
PLANS FOR 11 NOLAN STREET MORNINGTON DUNEDIN

PRIMARY & SECONDARY DWELLINGS

Andrew Sutherland

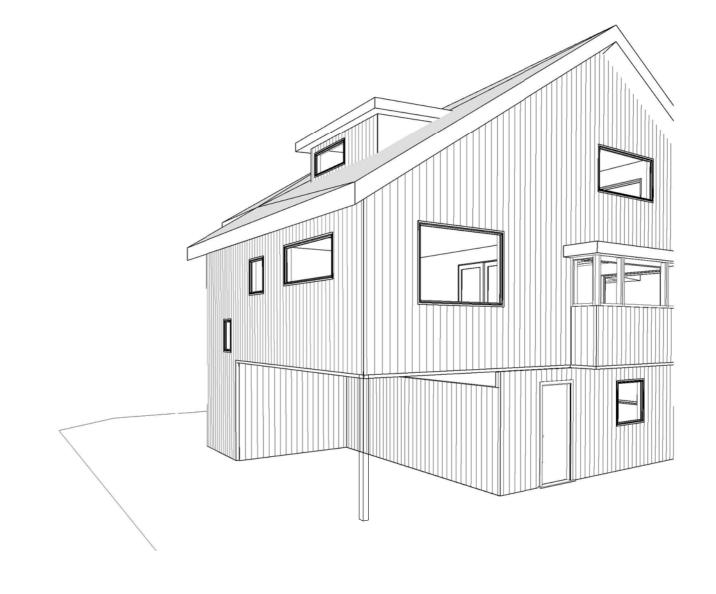



PRIMARY DWELLING


		LIZ	Drainage Plan
L01	Site Plan	L14	Site Elevations
L02	Foundation Plan	L15	Site Elevations
L03	Ground & First Floor Plans	A01	Foundations & PFC Details
L04	Second Floor Plan	A02	UB and Garage Portal Details
L05	Floor Framing Plans	A03	Lounge Bay Details
L06	Roof & Roof Framing Plans	A04	Framing Details
	<u> </u>	A05	Load Path Details
L07	North & South Elevations	A06	Ridge Beam Details
L08	East & West Elevations	A07	Cladding Details
L09	Section A-A	80A	Window Details
L10	Section B-B	A09	Meter Box Details
L11	Stair Plan & Section	S01	Bracing
		S02	Bracing
		S0§ ₀₃	Window & Donald Schedule Schedule

SECONDARY DWELLING

L02	Foundation Plan
L03	Floor Plans
L04	Floor Framing Plans
L05	Roof Plan
L06	Elevations
L07	Elevations
L08	Section A
L09	Section B
A01	Detials
A02	Details
S01	Bracing

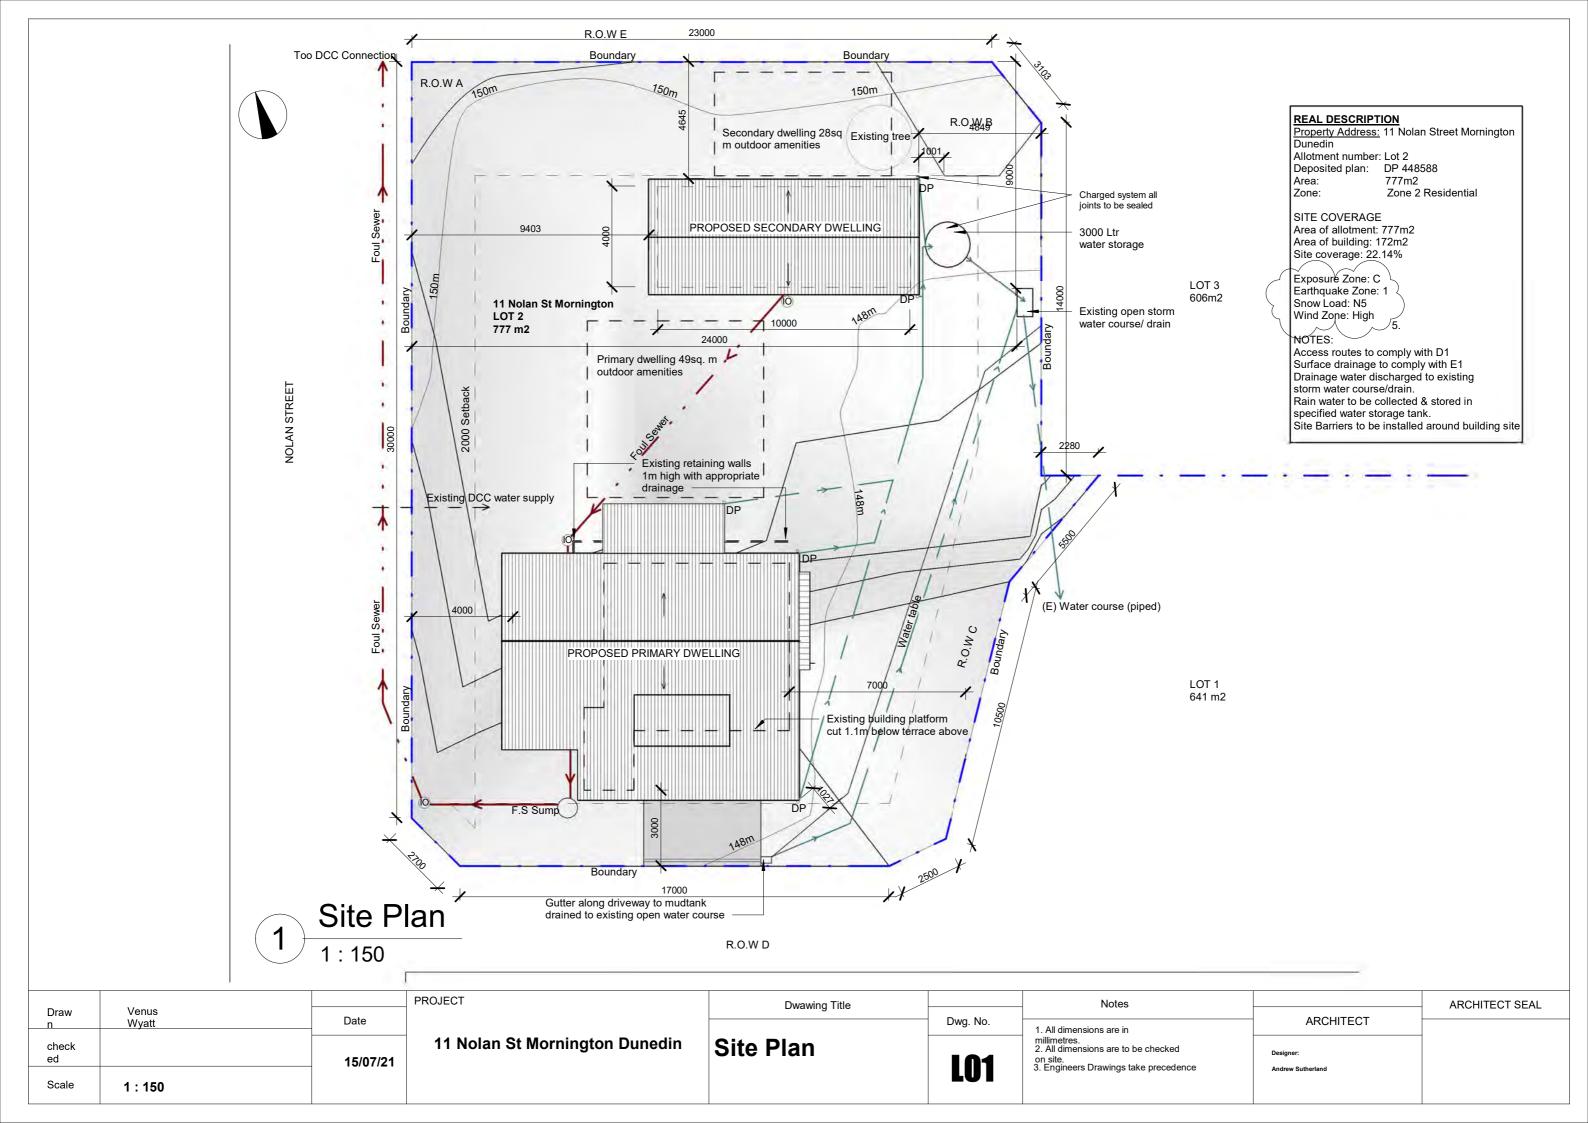

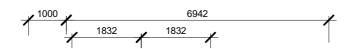


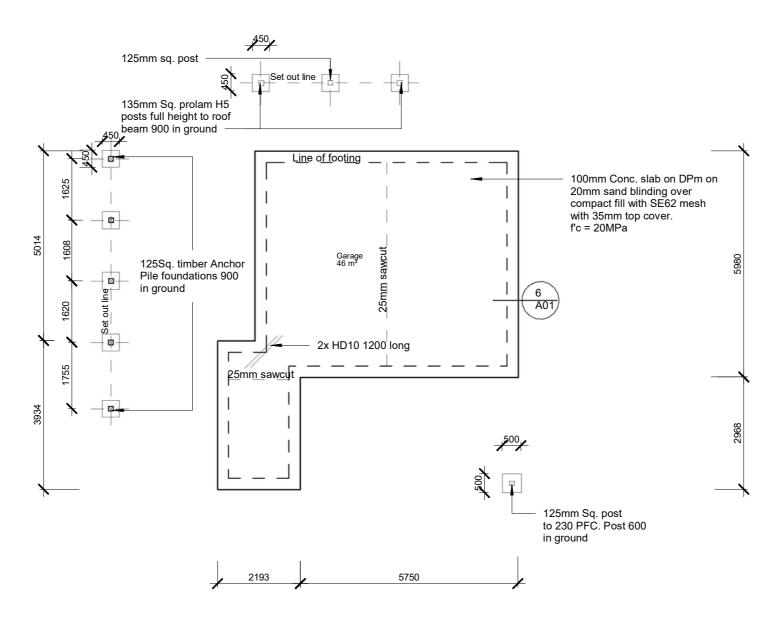

TImber foundations to comply with NZS 3604 section 6.
Concrete slab to comply with NZS 3604 7.5

1 Slab & Foundation Plan 1: 100

		PROJECT	Dwawing Title		Notes		ARCHITECT SEAL
Draw	Venus Wyatt	Date	2 naming rice	Dwg. No.		ARCHITECT	711101111201102112
- "	11,500				1. All dimensions are in		
check ed		11 Nolan St Mornington Dunedin	Foundation Plan	100	millimetres. 2. All dimensions are to be checked on site.	Designer:	
Scale	1:100	15/07/21		L02	Engineers Drawings take precedence	Andrew Sutherland	

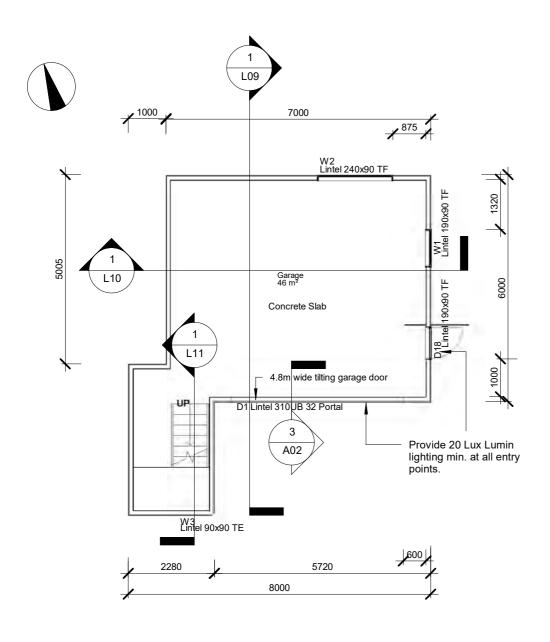



General: Smoke alarms:

S =Smoke Alarm- to comply with NZBC clause F7/AS1.3.1. Positioned in every sleeping area or within 3m of the door.

-0.4mm vertical Zincalume corrugate directly fixed over building paper to timber framing

-12mm Ecoply directly fixed over building paper to timber framing with stain less steel 50x2.8mm nails @ 150 crs both perimeter @ intermediate

Timber wall framing to comply with NZS 3604 section 8.
-90x45mm H1.2 SG8 Timber studs, 400crs lower level, 600 crs upper levels. max. stud height for ground & first floor 2.3m

All Glazing to have minimum sill height of 800mm. All above 1 story high to have stay restrictors. All bathroom & stairwell glazing to be safety glass.

- Linnings:
 -10mm Gib plaster board internal lining to walls & ceilings
- -10mm Gib Aqualine in all wet zones walls & ceilings

- Gib Braceline where specified

Concrete Slab

100mm cast in situ concrete slab on DPC on 20mm sand blinding over compact fill with SE62 mesh with 35mm top cover f'c= 20MPa

Aqualine hot water cylinder tray or similar approved Hot water cylinder **PROJECT**

11 Nolan St Mornington Dunedin

Kitchen to have mechanical extraction vented to the exterior as per G4, clause 1.2.5. 50L/s for cooktops.

Electrical

AS 3786 & NZS6401

All entry points to have Min. 20 Lux lumin lighting

Wet Areas

WHB to be sealed to wall with approved wet area silicone. Acrylic shower & liners to be used.

Bathrooms & laundry to have mechanical ventilation ducted to the exterior as per G4 clause 1.2.5 -25L/s for shower/bath.

Meter Box Switch Board Denotes Impervious flooring required (apply 2 acrylic paint to walls)

Range Hood

dw F Dish washer Pantry

Laundry Tub Washing Machine

Dwawing Title

Ground & First Floor Plans

LO3

Dwg. No.

1. All dimensions are in millimetres.
2. All dimensions are to be checked on site.
3. Engineers Drawings take precedence

Notes

6 L11

D3 Lintel 190x90 TF

L11

W3 Lintel 90x90TF

200 min 200 min

11000

Hall & Stairwell ®

2500

Living / Dining

HWC

W7 Lintel 140x90 TF

ARCHITECT SEAL **ARCHITECT** Andrew Sutherland

Coated & sand/grit impregnated Ext. stair 710mm high. At 37deg pitch with max riser

190mm & min tread 280mm

Provide 20 Lux Lumin lighting min. at all entry

W12 Lintel 240x90 TF

D4 Lintel 190x90 TE

Bedroom 1 14 m²

2000

Scale	1:100	
check ed		15/07/21
Draw n	Venus Wyatt	Date
Bottom & top	plate fixings to comply with NZS 3605 7.5.12	safe

Water closet Wash hand basin shw W01 Shower All electrical work to comply with NZBC F7/AS1, AS/NZ3000, AS/NZS3008, Window No D01 Door No. Smoke Alarm Hot water closet Bathrooms to be lined with Gib Aqualine & finished with Water resistant paint. Mechanical extraction vent

3

A07

L10

Provide 20 Lux Lumin

points.

lighting min. at all entry

tread 280mm

Coated & sand/grit impregnated Ext. stair 10mm high. At 37deg pitch

with max riser 190mm & min


Lintel 240x90 TF

Lintel 140x90 TE

W9 Lintel 240x90 TF

tub

First Floor 1:100 FLOOR PLAN LEGEND

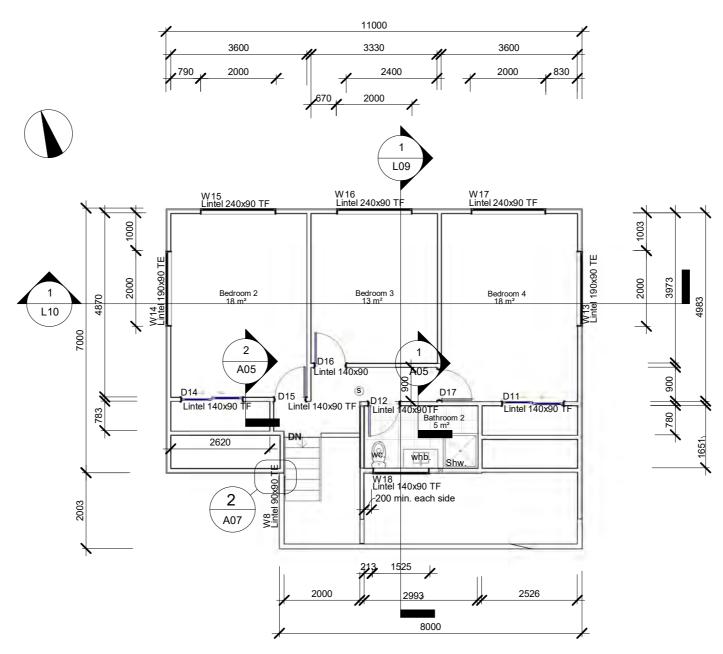

		G7/AS1 NATURAL L	JGHT	G4/AS1 VENTELA	G4/AS1 VENTELATION	
ROOM	ROOM AREA	MIN W AREA 10%	PROVID.	MIN OPEN 5%	PROVID.	
Kitch/liv	28m2	2.8m2	20m2	1.4m2	9.1m2	
lounge	19m2	1.9m2	5.6m2	0.95m2	2.8m2	
Bed 1	14m2	1.4m2	4.4m2	0.7m2	1.6m2	
Bed 2	18m2	1.8m2	4m2	0.9m2	2m2	
Bed 3	13m2	1.3m2	2m2	0.65m2	2m2	
Bed 4	18m2	1.8m2	4m2	0.9m2	2m2	

Second FI. 1:100

GENERAL: Smoke alarms:

S = Smoke Alarm- to comply with NZBC clause F7/AS1.3.1. Positioned in every sleeping area or within 3m of the door.

-0.4mm vertical Zincalume corrugate directly fixed over building paper to (filmber framing

-12mm Ecoply directly fixed over building paper to timber framing

Walls:
-90x45mm H1.2 SG8 Timber studs @ max. 600crs dwangs @ max.
1200 crs

Walls:
Timber wall framing to comply with NZS 3604 section 8.
-90x45mm H1.2 SG8 Timber studs @ max. 600crs.

stud height for second floor 3.2m Bottom $\ensuremath{\ensuremath{\widetilde{\&}}}$ top plate fixings to comply with NZS 3604 7.5.12

<u>Linnings:</u> -10mm Gib plaster board internal lining to walls & ceilings

-10mm Gib Aqualine in all wet zones walls & ceilings

-Gib Braceline where specified

All Glazing to have minimum sill height of 800mm. All above 1 story high to have stay restrictors. All bathroom & stairwell glazing to be safety glass.

Wet areas

Bathrooms to be lined with Gib Aqualine & finished with Water Resistant paint.
WHB to be sealed to wall with approved wet area silicone.

Acrylic shower & liners to be used.

Bathrooms to have mechanical ventilation ducted to exterior as per G4 clause 1.2.5 -25ls for shower/bath.

FLOOR PLAN LEGEND

WC Water closet Wash hand basin Shower Window No. shw W01 D01 Door No. Smoke Alarm Hot water closet

Mechanical extraction vent Denotes Impervious flooring required (apply 2 acrylic paint to walls)


			PROJECT
Draw n	Venus Wyatt	Date	
check ed		15/07/21	11 No
Scale	1:100		

11 Nolan St Mornington Dunedin

Dwawing Title	
<u> </u>	Dwg. No.
Second Floor Plan	L04


	Notes
No.	1. All dimensions are in
) 4	millimetres. 2. All dimensions are to be checked on site. 3. Engineers Drawings take precedence

Notes		ARCHITECT SEAL	
	ADOLUTEOT	71101111201 02712	
. All dimensions are in	ARCHITECT		
nillimetres. . All dimensions are to be checked	Designer		

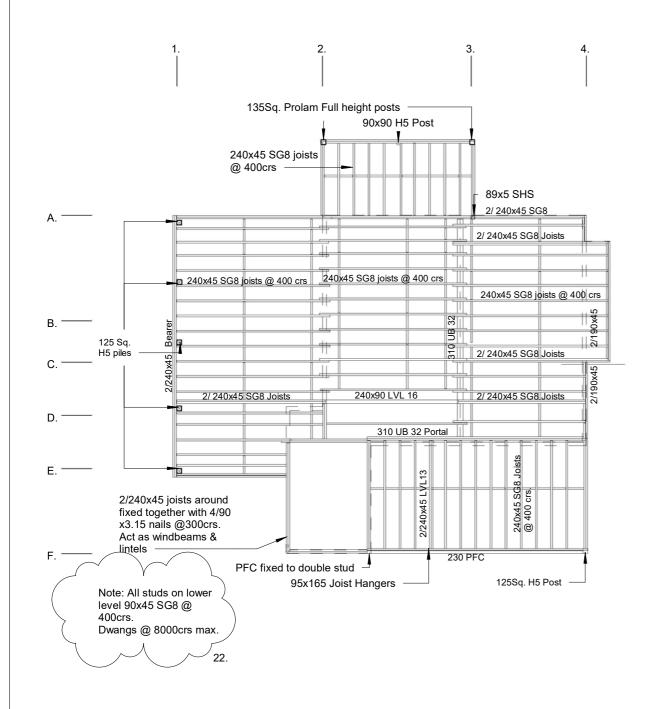

First Floor Framing Plan


1: 100

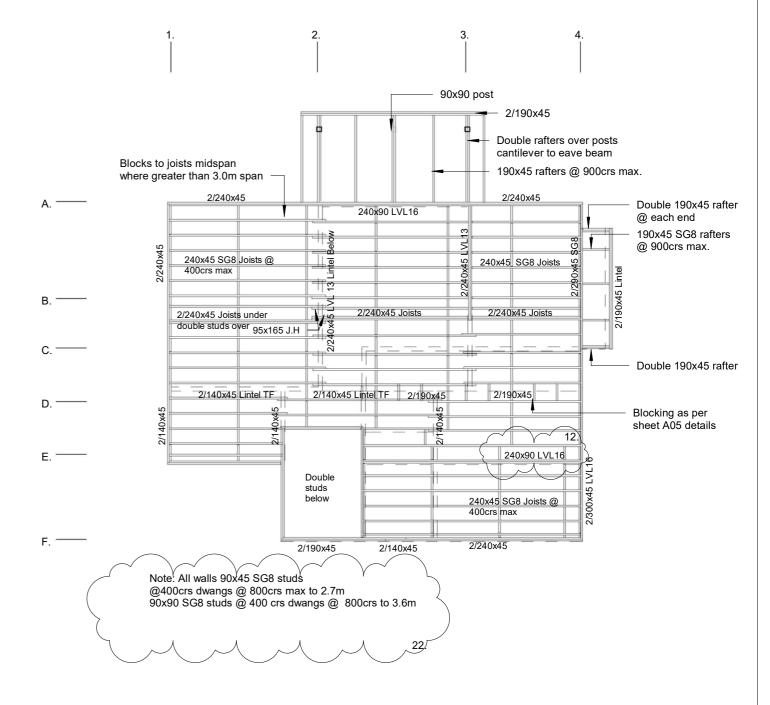


Second Floor Framing Plan 1: 100

Suspended timber floors to comply with NZS 3603 section 7. Fixings to comply with table 7.5

Draw Venus PROJECT		Dwawing Title		Notes		ARCHITECT SEAL			
n_		Wyatt	Date			Dwg. No.	1. All dimensions are in	ARCHITECT	
che ed	eck		15/07/21	11 Nolan St Mornington Dunedin	Floor Framing	L05	millimetres. 2. All dimensions are to be checked on site. 3. Engineers Drawings take precedence	Designer:	
Sca	ale	1:100			Plans	LUJ	5. Engineers Brawings take precedence	Andrew Suberiand	

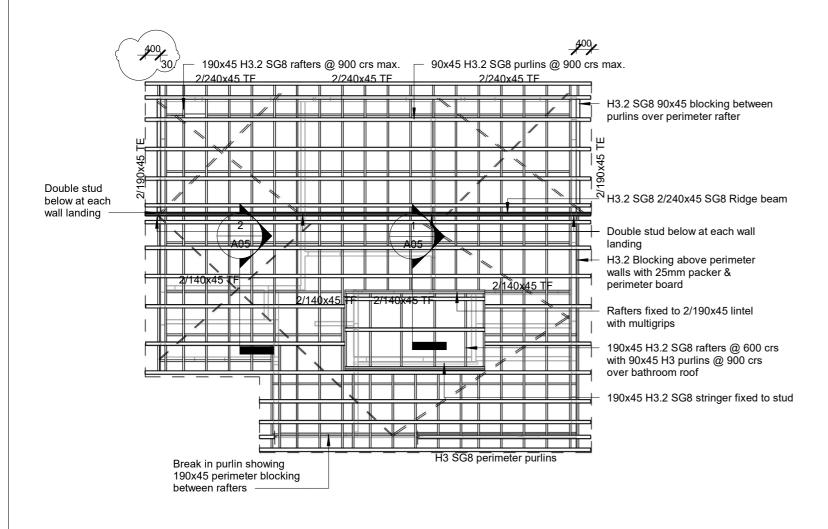

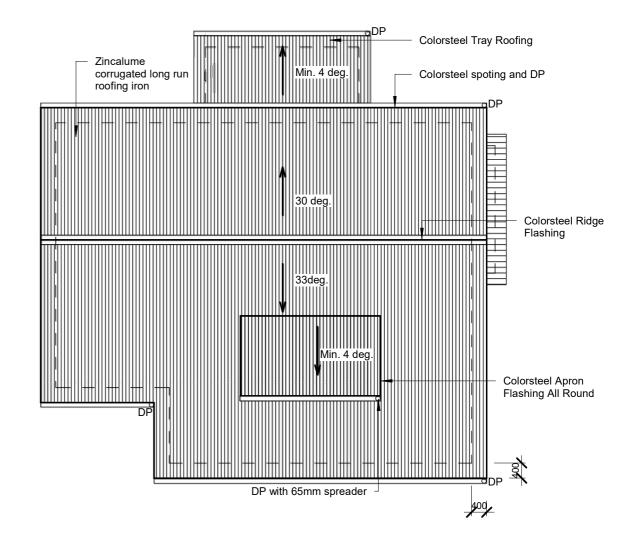

NOTE

EXTERNAL WALLS: Studs 90x45 SG8 @400 crs up to 2.7 high 90x90 SG8 @ 400 crs up to 3.6m high INTERNAL WALLS: 90x45 SG8 studs @ 400crs up to 3m high 90x45 SG8 studs @ 300 crs up to 3.6m high TF and TE mitec lintel fixings as per specified

2 Roof Framing Plan
1:100


1 Roof 1:100


Roof Area: 129m2 Allow for Flashings & sealing of roof penetrations to achieve weatherproof roofing cladding

Downpipe capacity- Refer to E1/AS1 clause 4.0 63mm int. diam. downpipe = 60m2 catchment


Roof- Refer to E1/AS1 Clause 4.0 129m2 roof area= 2.15 4 provided


Draw	Venus		PROJECT	Dwawing Title	5	. Notes	ADOUGTOT	ARCHITECT SEAL
n	Wyatt	Date			Dwg. No.	1. All dimensions are in	ARCHITECT	
check ed		15/07/21	11 Nolan St Mornington Dunedin	Roof Plan & Roof	106	millimetres. 2. All dimensions are to be checked on site. 3. Engineers Drawings take precedence	Designer:	
Scale	1 : 100			Framing	L06	3. Engineers Drawings take precedence	Andrew Sutherland	

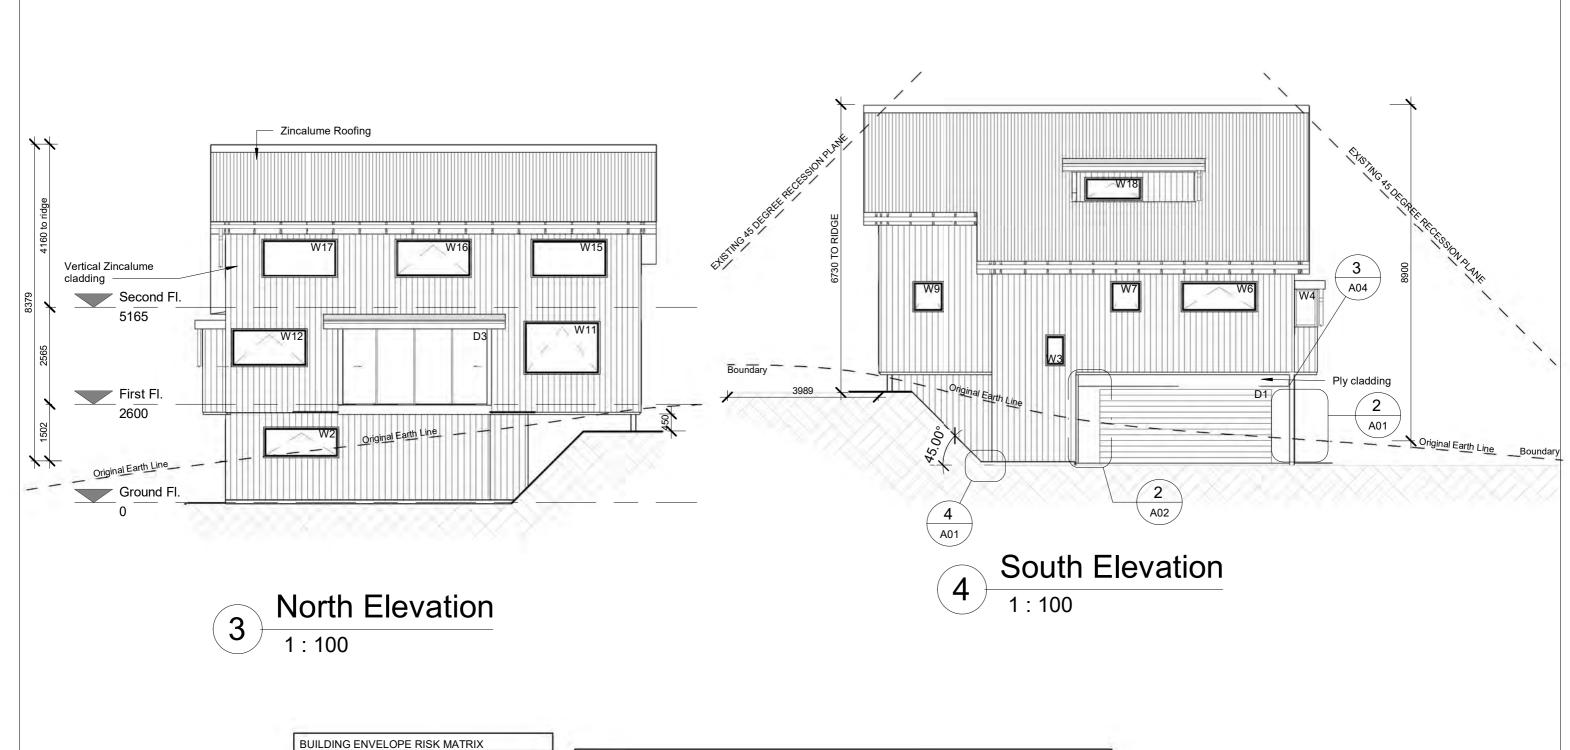

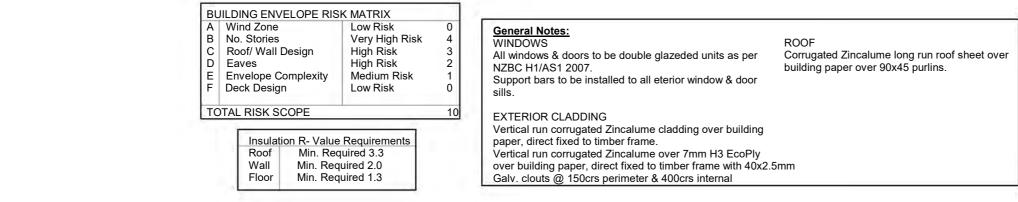

PROJECT Notes ARCHITECT SEAL **Dwawing Title** Draw Venus ARCHITECT Date Dwg. No. Wyatt 1. All dimensions are in 11 Nolan St Mornington Dunedin **North & South** millimetres.
2. All dimensions are to be checked check **L07** ed 15/07/21 on site.
3. Engineers Drawings take precedence **Elevations** Scale 1:100

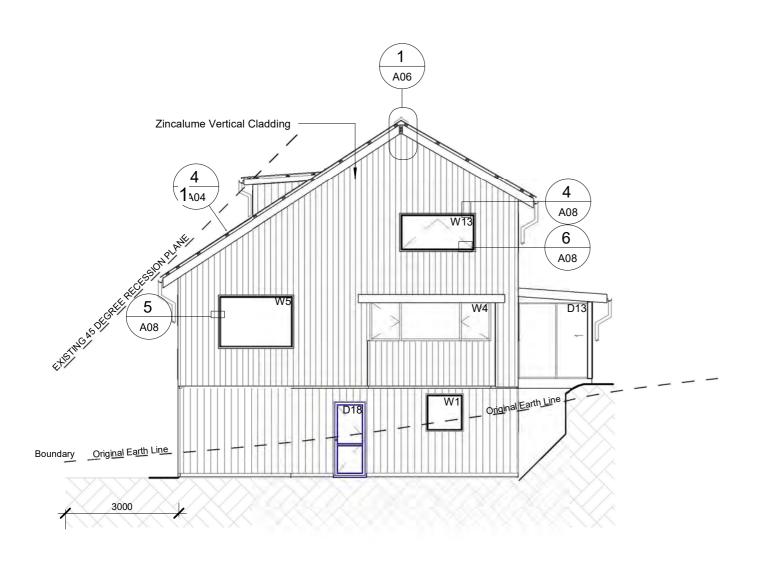

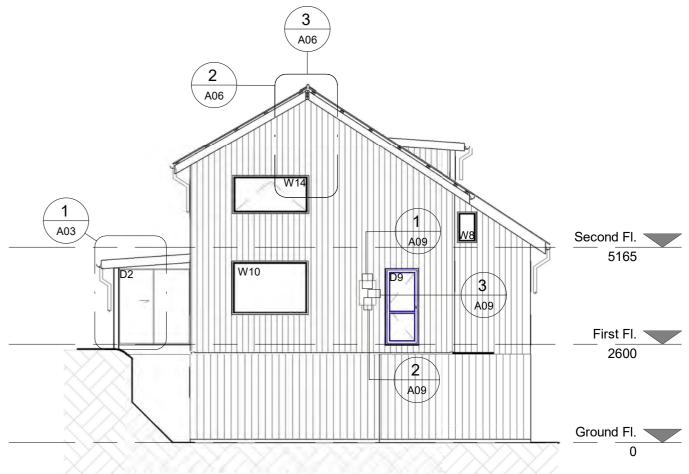

East Elevation 1:100

Insulation R- Value Requirements

Min. Required 3.3 Min. Required 2.0 Wall Floor Min. Required 1.3

General Notes:
WINDOWS
All windows & doors to be double glazeded units as per
NZBC H1/AS1 2007.

Support bars to be installed to all exterior window & door

EXTERIOR CLADDING

Vertical run corrugated Zincalume cladding over building paper, direct fixed to timber frame.

Vertical run cirrugated Zincalume cladding over


7mm EcoPly over building paper, direct fixed to timber


Corrugated Zincalume long run roof sheet over building paper over 90x45 purlins.


West Elevation 1:100


			PROJECT	Dwawing Title	
Draw n	Venus Wyatt	Date		Bwawing Title	Dwg. No.
check ed		15/07/21	11 Nolan St Mornington Dunedin	East & West	INO
Scale	1 : 100			Elevations	L08


Notes ARCHITECT SEAL ARCHITECT 1. All dimensions are in millimetres.
2. All dimensions are to be checked on site.
3. Engineers Drawings take precedence Andrew Sutherland

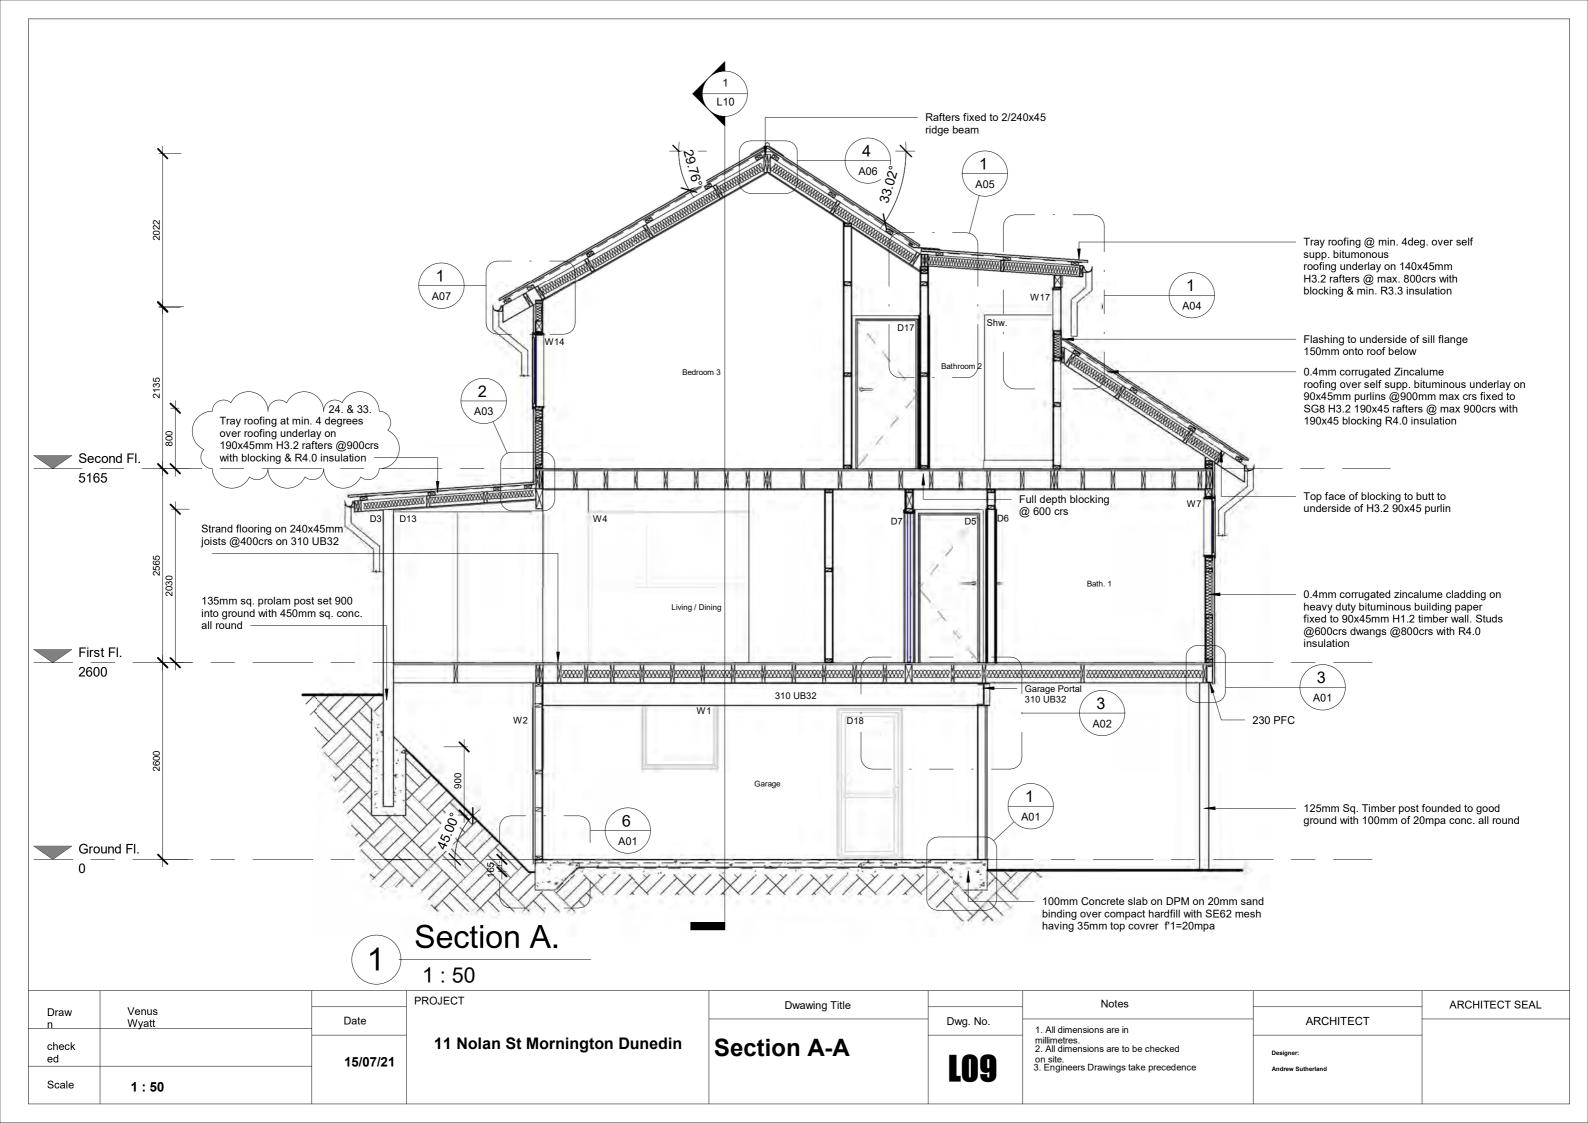

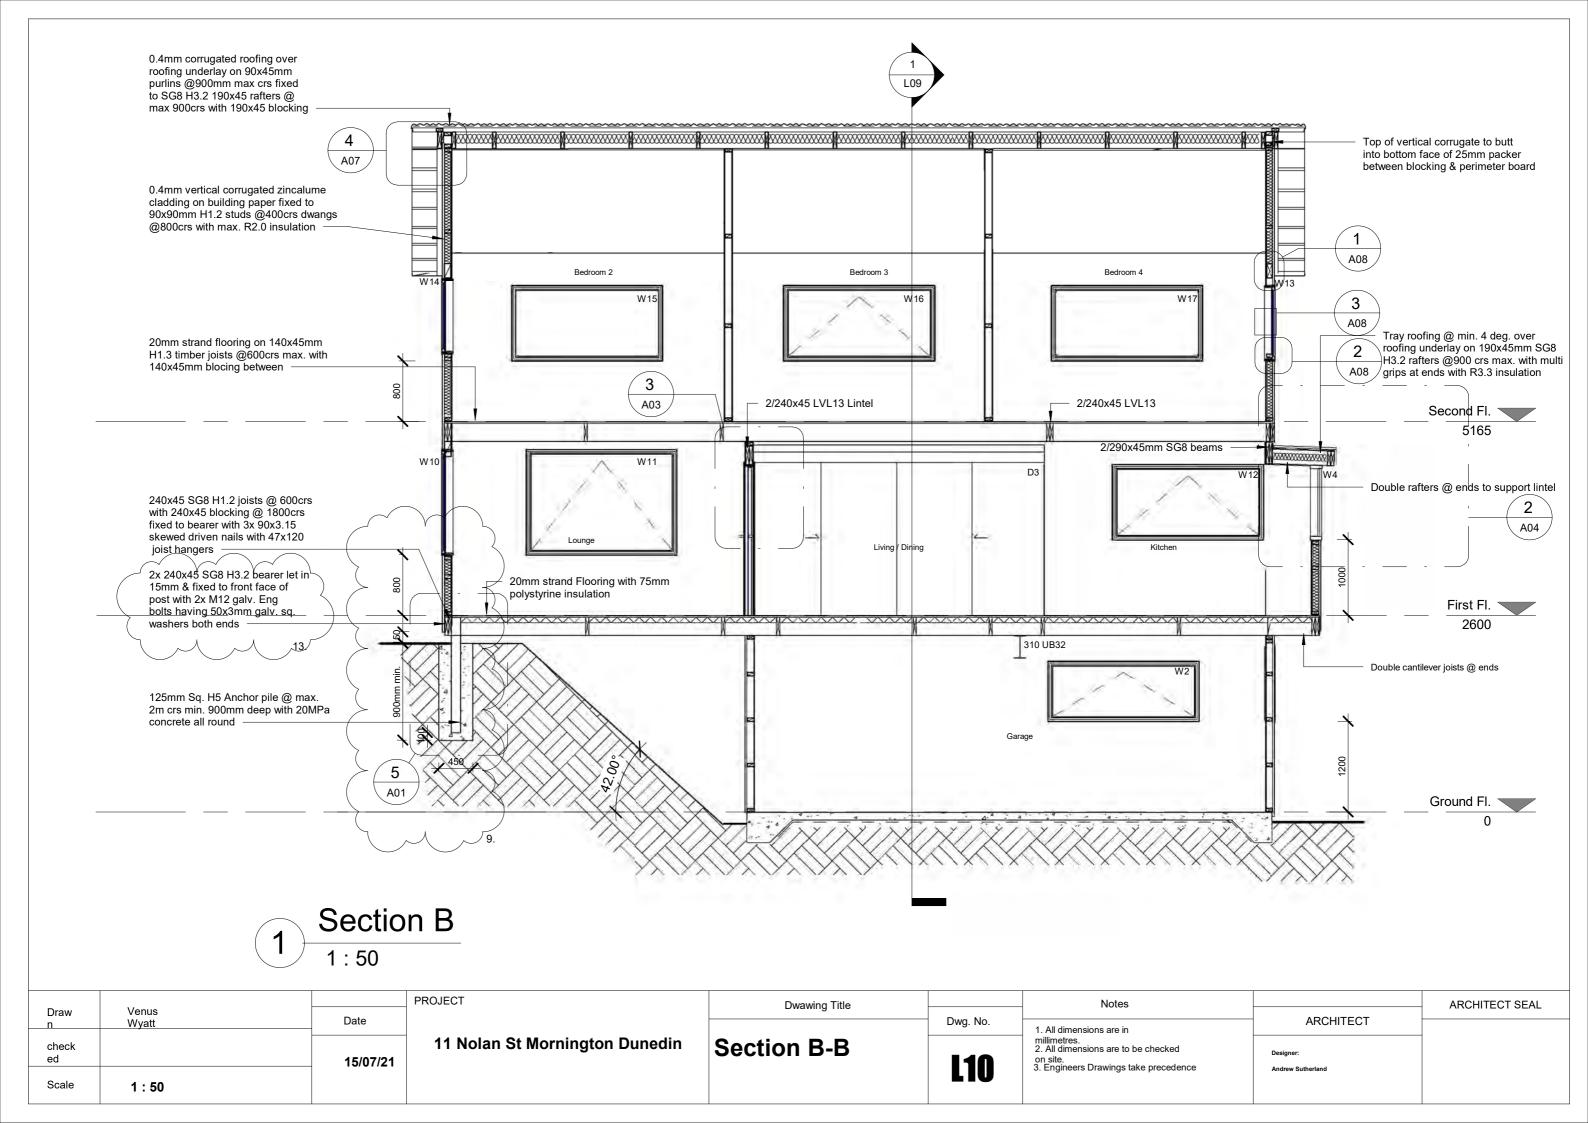

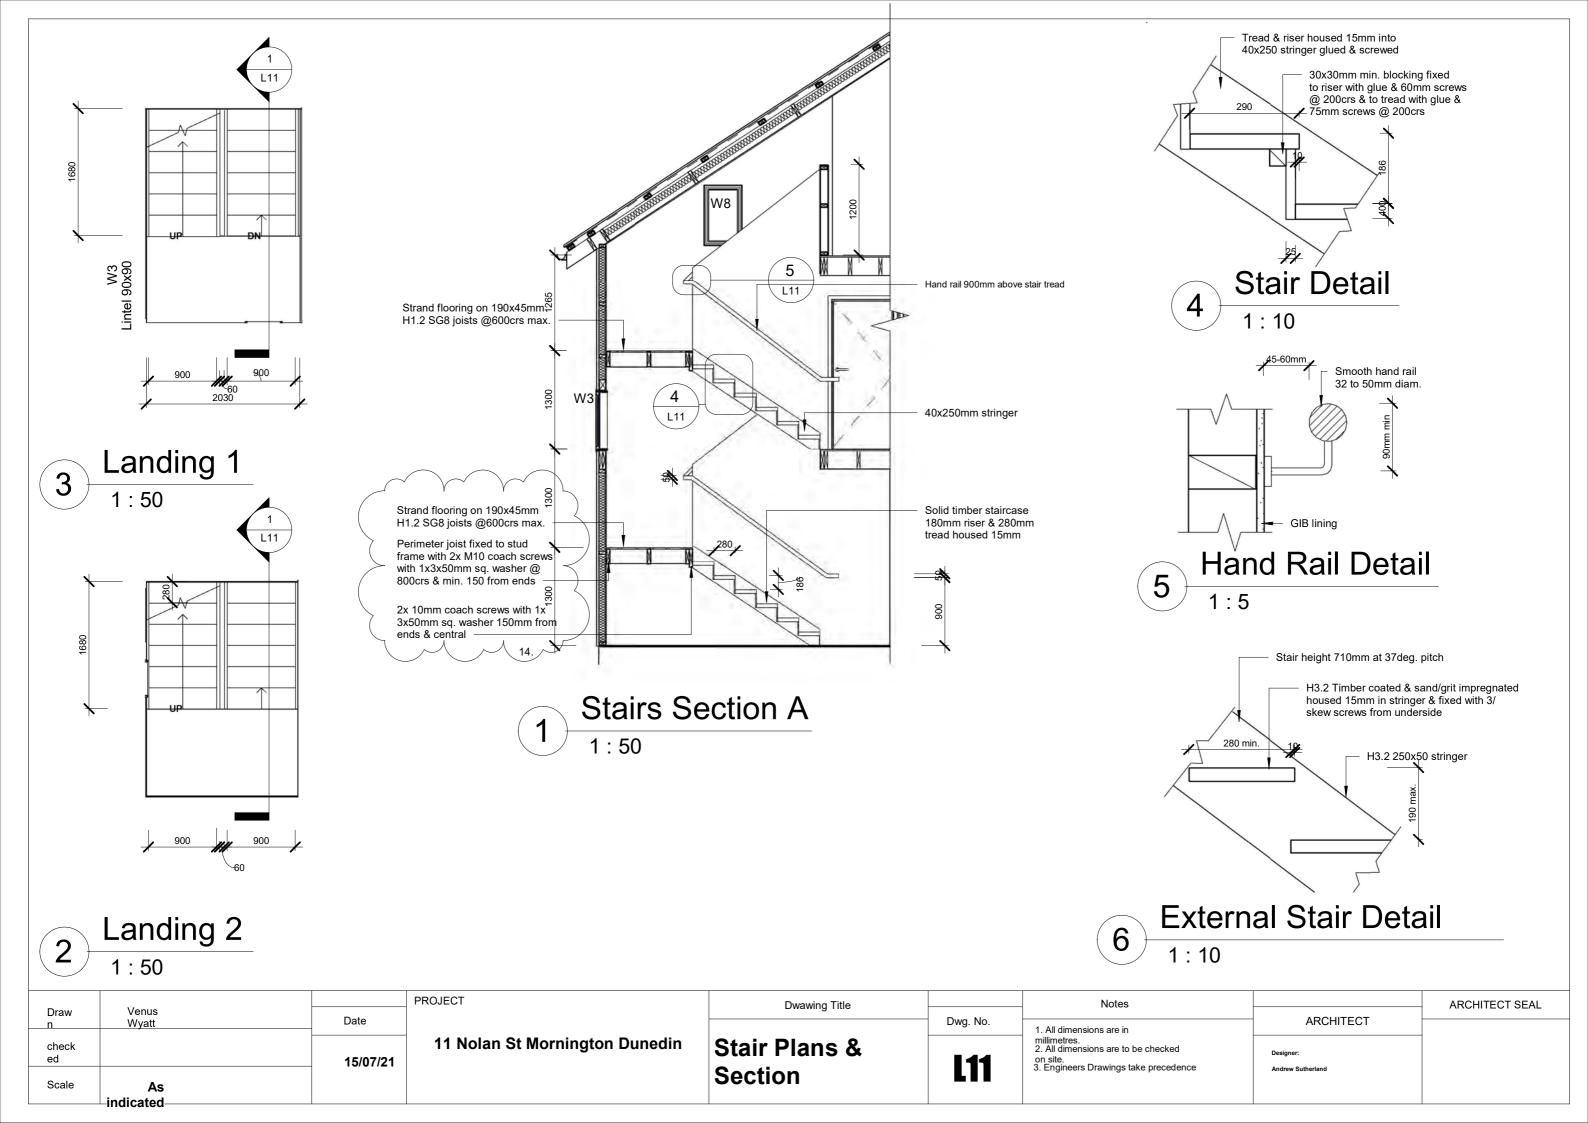

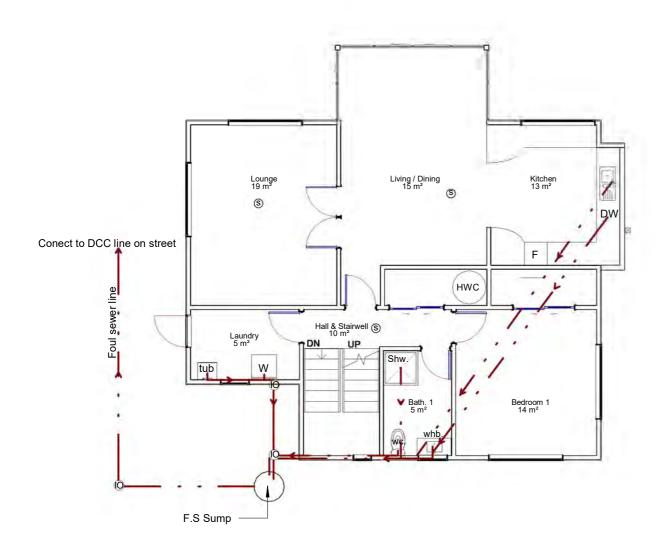

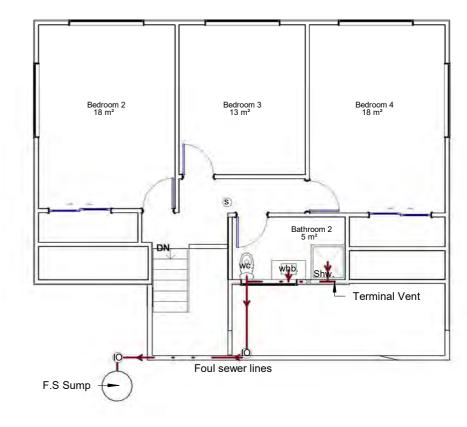



PLUMBING & DRAINAGE

Cylinder Tray

Aqualine hot water cylinder tray or similar approved Hot water cylinder safe tray with 40mm waste outlet

All drains to comply with AS/NZS3500.2

<u>Electical Hot water:</u> Hot water cylinder to comply with NZS 4305-1996. Valve train- High pressure Apex Combipack CP20, discharge to exterior wall. Cylinder vent located on roof. The delivered hot water temp. at any sanitary fixture used for personal hygiene shall not exceed 55 deg. HWC to be seismically restrained woth 50x0.6mm Galv. metal straps twisted & nailed to dwangs with 5/30x3.15mm nails.

Hot water supply insulation:
Closed cell foam polymer insulation or fibreglass insulation which is preformed to the shape of the pipe & not less than 13mm thick, is acceptable material for preventing pipes less than or equal to 40mm diam. from freezing, Any insulation materials that absorb moisture shall be protected in a waterproof membrane.

Second Floor

1:100

PLUMBING PLAN LEGEND

Water closet Wash hand basin whb shw Shower hwc Hot water closet Inspection Opening Foul Sewer Line

Waste / pipe size / material

Shower waste : DN40mm dia. PVC-U : DN40mm dia. PVC-U : DN100mm dia. PVC-U WC waste Sewer waste drain Wash. Mach. : DN40mm dia. PVC-U

Gradients: Up to DN80 PVC-U 1:40 Over DN80 PVC-U 1:60 Total fixture Load: 10

			PROJECT
Draw n	Venus Wyatt	Date	
check ed		15/07/21	11 No
Scale	1:100		

11 Nolan St Mornington Dunedin


Plumbing & **Drainage**


Dwawing Title

Dwg. No. **L12**

Notes	
	ADCI
1. All dimensions are in	ARCH
millimetres. 2. All dimensions are to be checked	
on site.	Designer:
Engineers Drawings take precedence	Andrew Sutherland

ARCHITECT SEAL HITECT

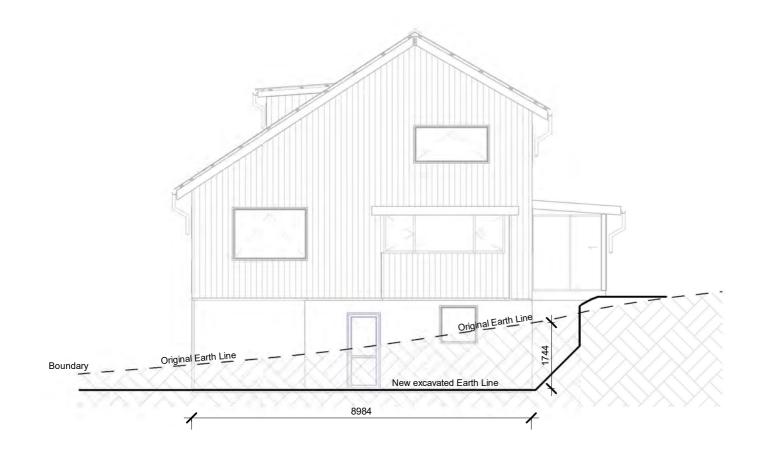

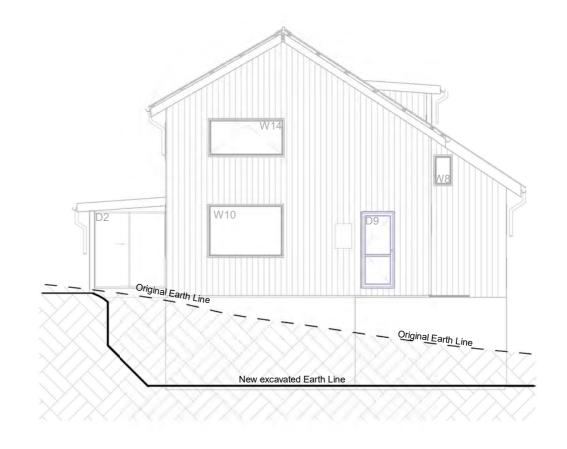


Site Excavation East

1:100

2 Site Excavation West

_		.,	F	PROJECT	Dwawing Title		Notes		ARCHITECT SEAL
Drav n	v	Venus Wyatt	Date			Dwg. No.	All dimensions are in	ARCHITECT	
ched ed	:k		15/07/21	11 Nolan St Mornington Dunedin	Site Elevations	14/	millimetres. 2. All dimensions are to be checked on site.	Designer:	
Scal	е	1:100			East & West	L14	Engineers Drawings take precedence	Andrew Sutherland	

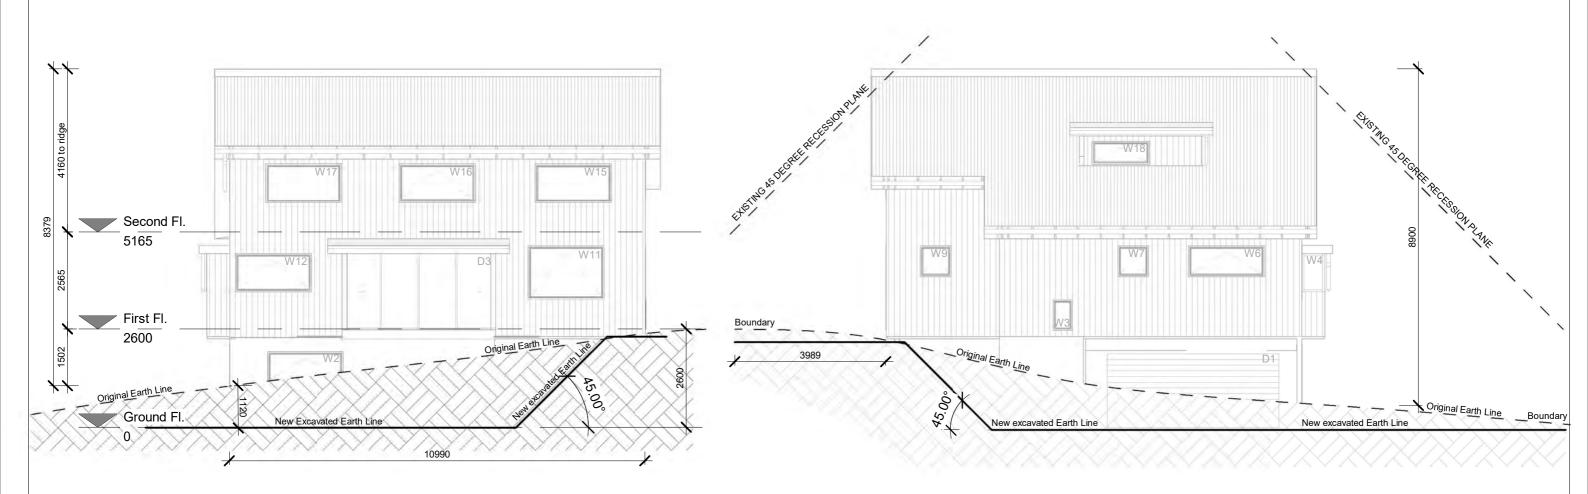



Site Excavation North


1: 100

2 Site Excavation South
1:100

	Vanue		PROJECT	Dwawing Title		Notes		ARCHITECT SEAL
Draw n	Venus Wyatt	Date			Dwg. No.	All dimensions are in	ARCHITECT	
check ed		15/07/21	11 Nolan St Mornington Dunedin	Site Elevations	L15	millimetres. 2. All dimensions are to be checked on site. 3. Engineers Drawings take precedence	Designer:	
Scale	1:100			North & South	LIJ	3. Engineers Drawings take precedence	Andrew Sutherland	

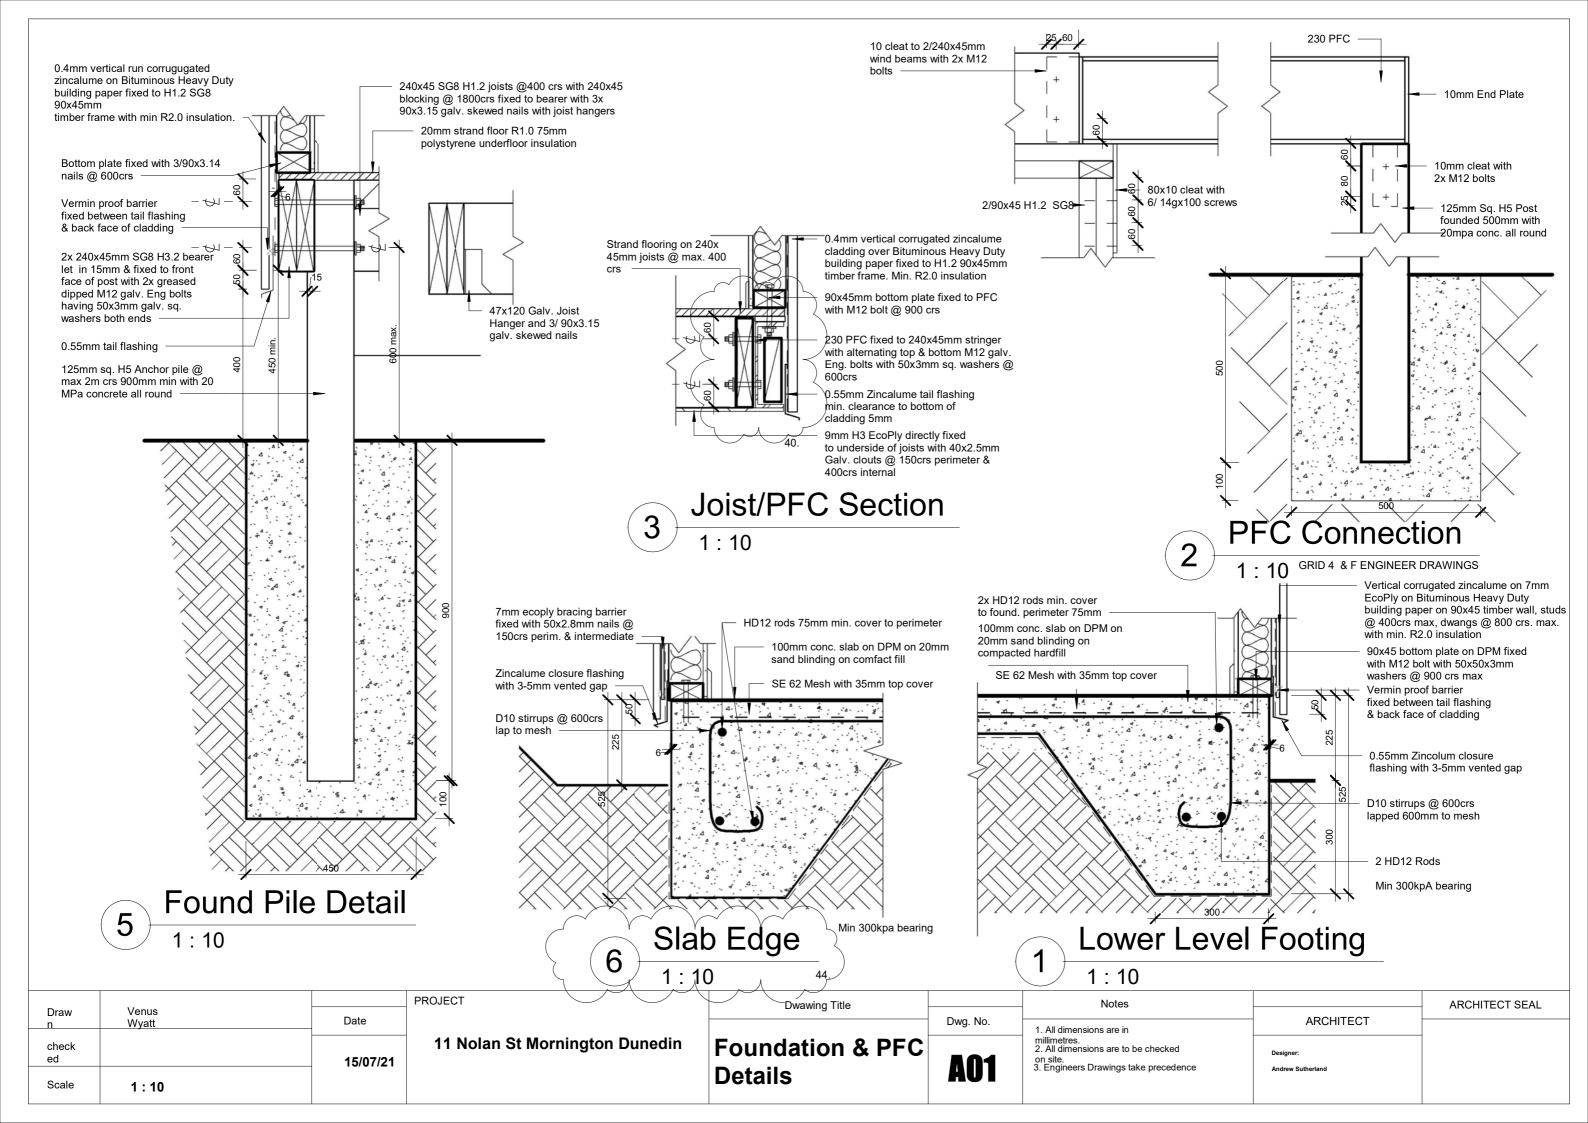

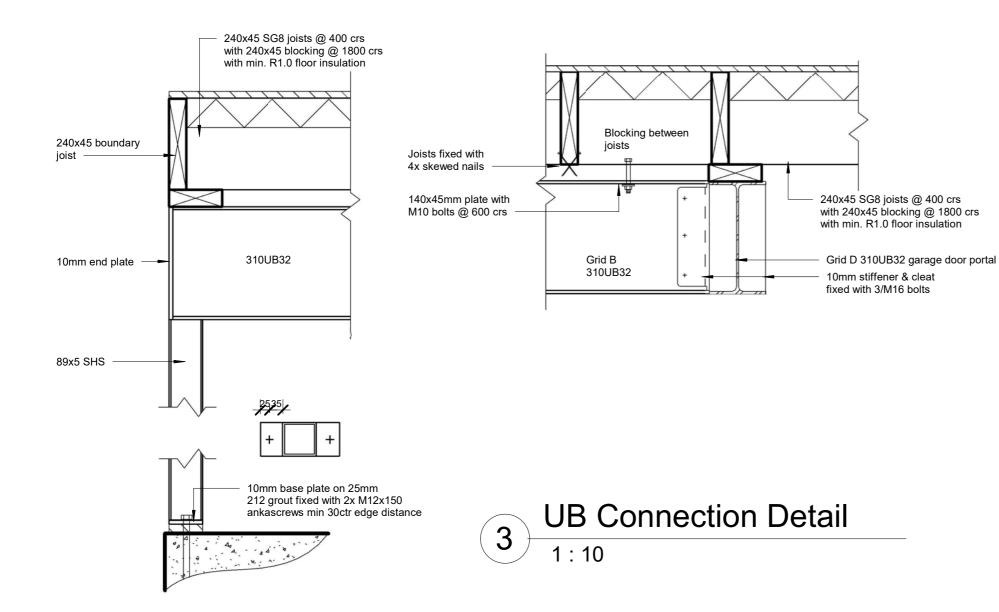

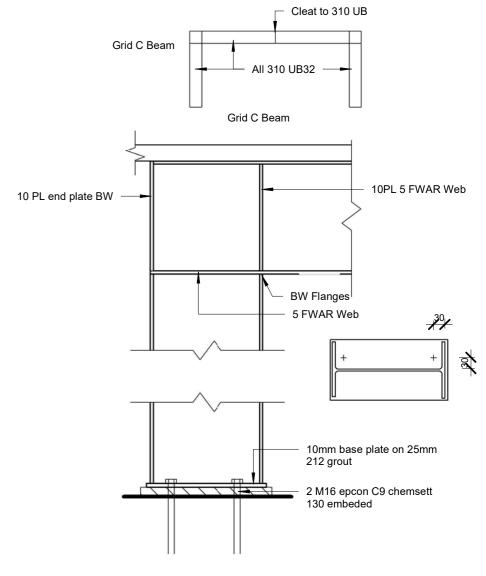

Garage door portal

Draw n	Venus Wyatt	Date
check ed		15/07/21
Scale	1:10	

11 Nolan St Mornington Dunedin

PROJECT

UB & Garage Portal Details

Dwawing Title

Dwg. No.


Notes


1. All dimensions are in millimetres.
2. All dimensions are to be checked on site.
3. Engineers Drawings take precedence Andrew Sutherlan

ARCHITECT SEAL


ARCHITECT

Designer:
Andrew Sutherland

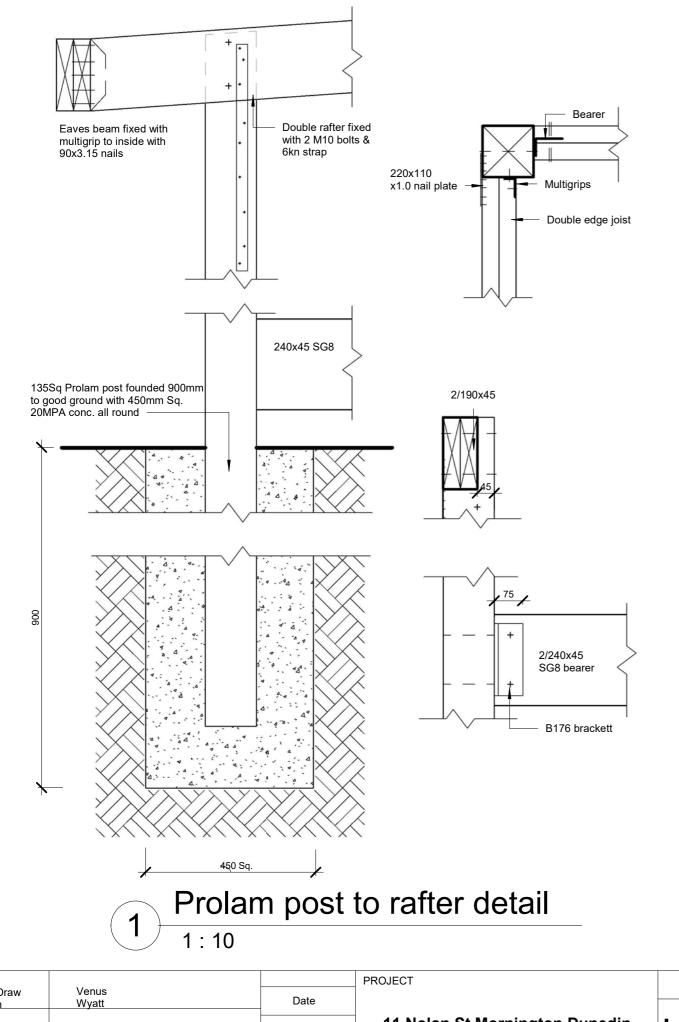

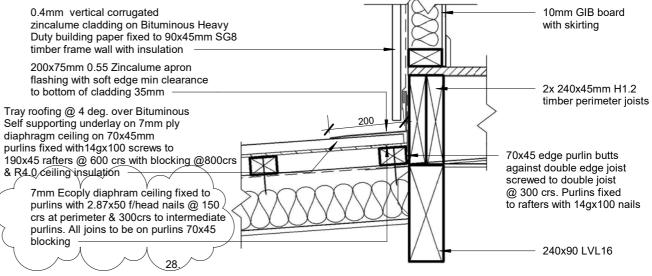



Joist to Lintel Detail

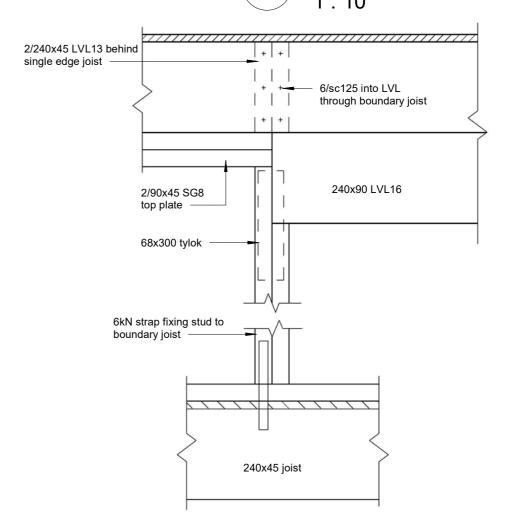


3 LVL Lintel Details 1:10

Draw	Venus	5.4	PROJECT	Dwawing Title		. Notes	ADOLUTEOT	- ARCHITECT SEAL
n	Wyatt	Date			Dwg. No.	1. All dimensions are in	ARCHITECT	
check ed		15/07/21	11 Nolan St Mornington Dunedin	Lounge Bay	VUS	millimetres. 2. All dimensions are to be checked on site. 3. Engineers Drawings take precedence	Designer: Andrew Sutherland	
Scale	1:10			Details	AUJ	3. Engineers Drawings take precedence	Andrew Sutheriand	

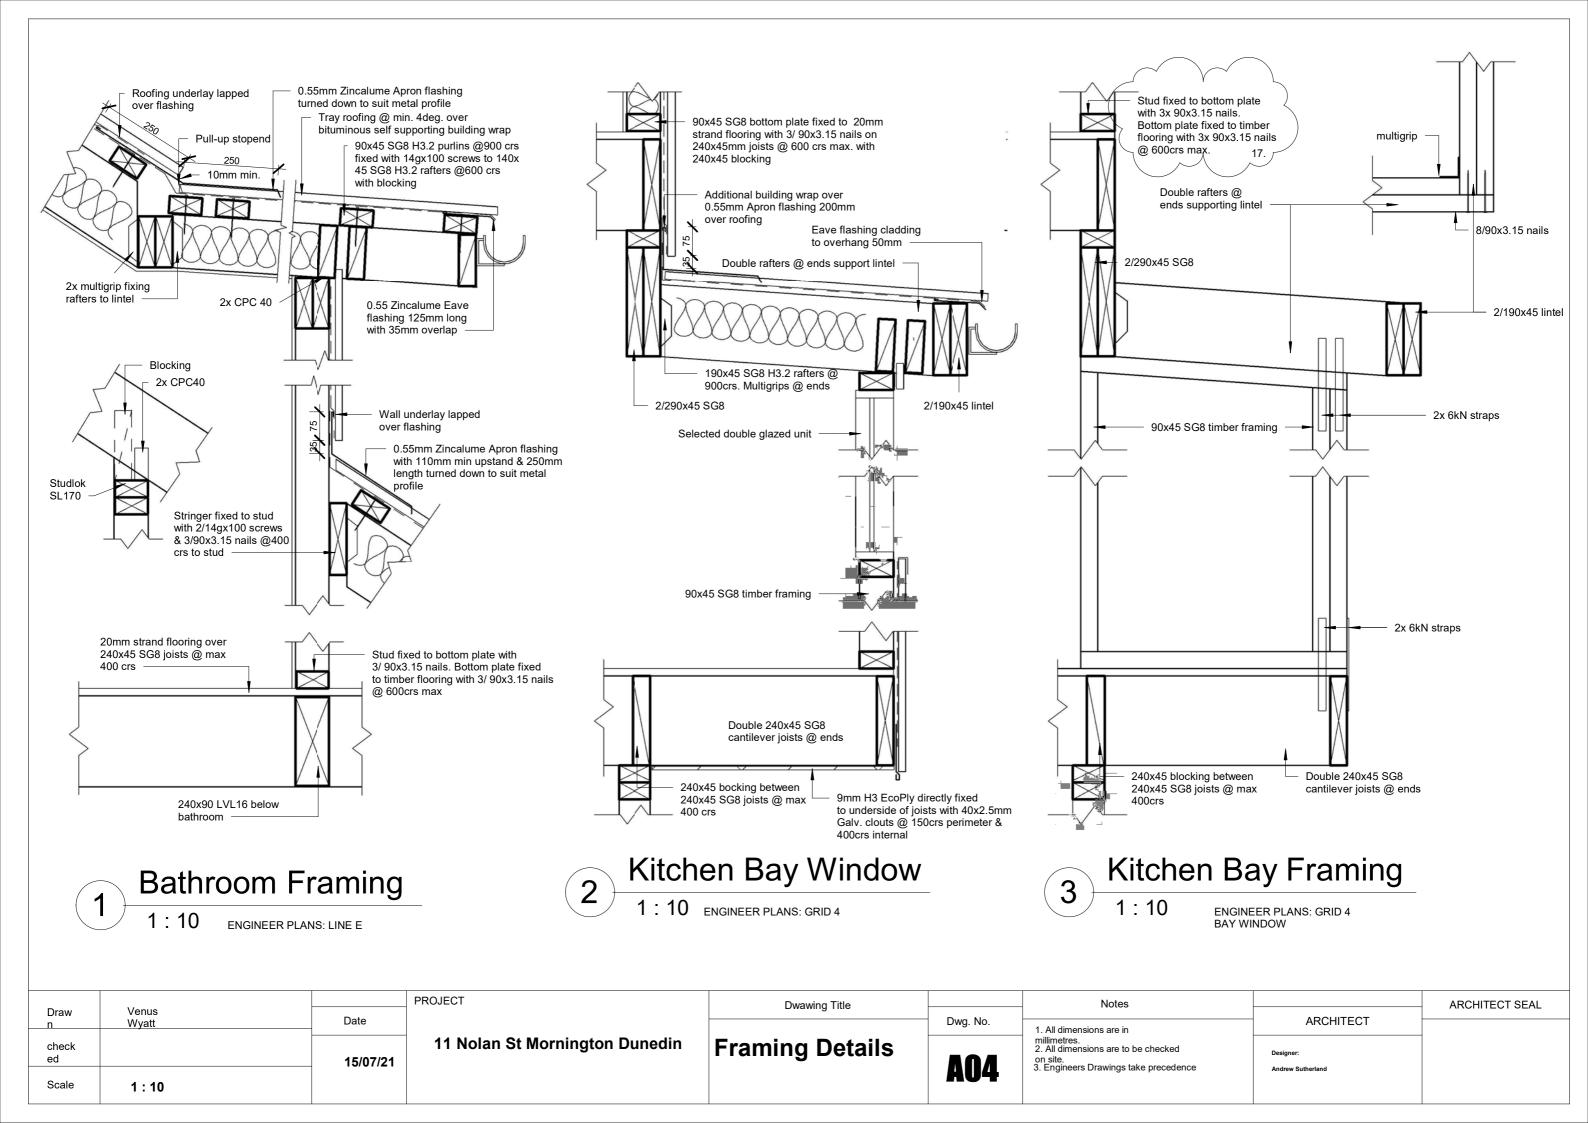

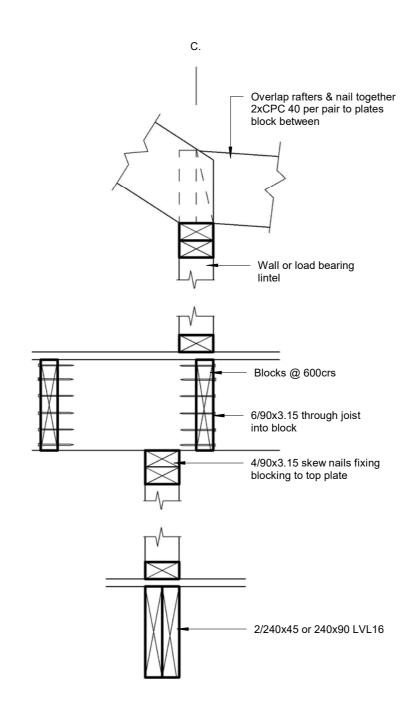





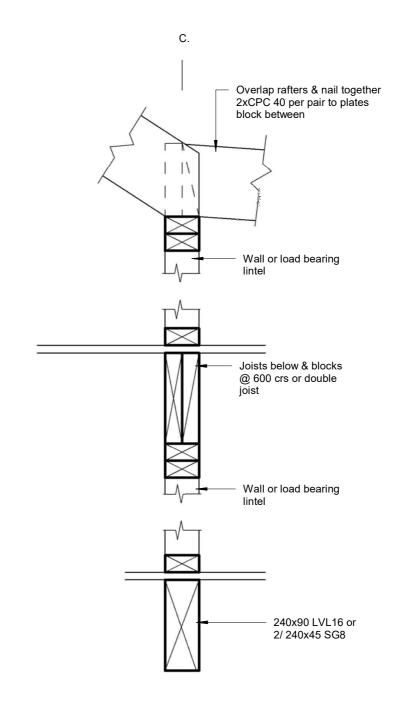

2 Load Path Framing 1: 10 GRID C


_	.,		PROJECT	Dwawing Title		Notes		ARCHITECT SEAL
Draw n	Venus Wyatt	Date			Dwg. No.	All dimensions are in	ARCHITECT	
check ed		15/07/21	11 Nolan St Mornington Dunedin	Load Path Details	A05	millimetres. 2. All dimensions are to be checked on site. 3. Engineers Drawings take precedence	Designer:	
Scale	1:10				AUJ	5. Engineers Drawings take precedence	Andrew Sutherland	

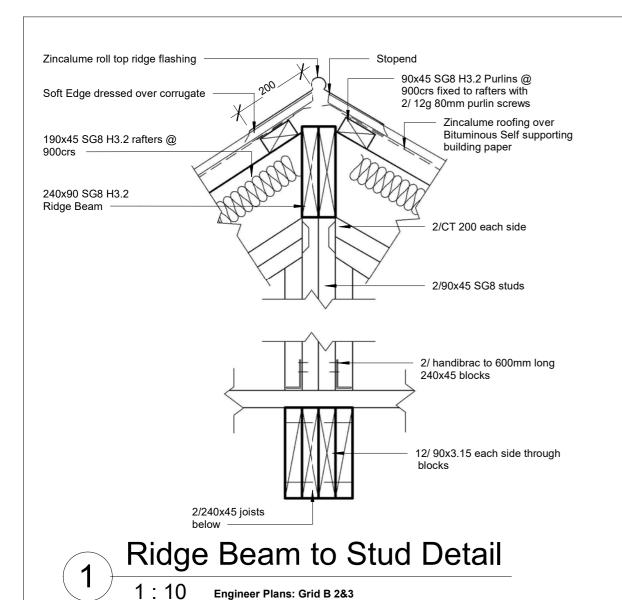

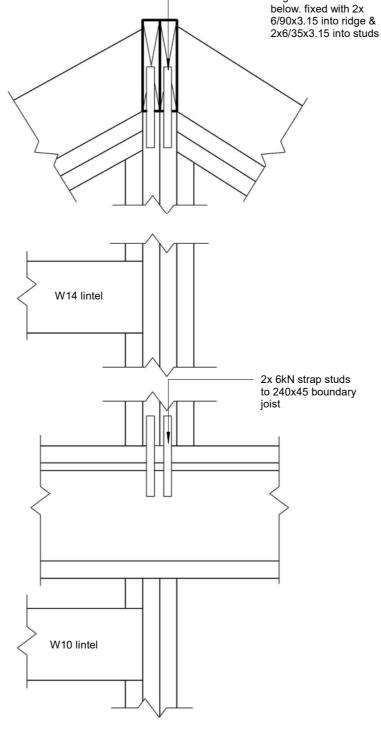

2x 6kN strap joining

ridge beam to studs

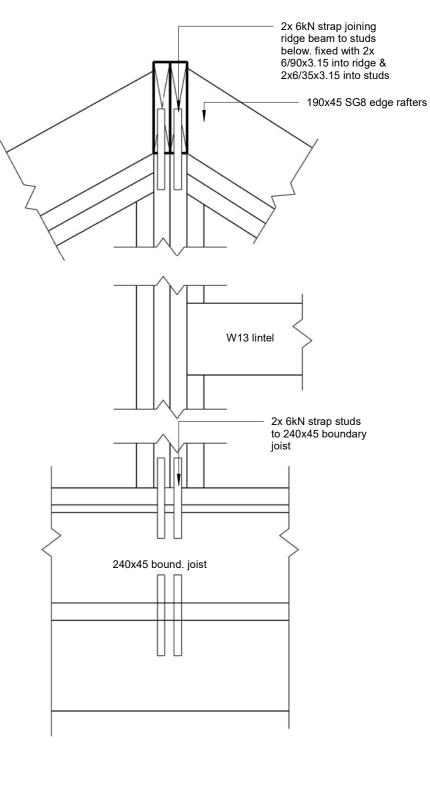

Rafter Ridge connection

1:10

on

2/240x45 SG8 Ridge beam

190x45 SG8 rafters @600 crs fixed with 2x multigrips to ridge

West Ridge Beam Detail

1:10


Engineer Plans: Grid I


East Ridge Beam Detail

1:10

Engineer Plans: Grid 4


_	.,		PROJECT	Dwawing Title		Notes		ARCHITECT SEAL
Draw n	Venus Wyatt	Date		<u> </u>	Dwg. No.	All dimensions are in	ARCHITECT	
check ed		15/07/21	11 Nolan St Mornington Dunedin	Ridge Beam	AOG	millimetres. 2. All dimensions are to be checked on site. 3. Engineers Drawings take precedence	Designer:	
Scale	1:10			Details	A06	5. Engineers Drawings take precedence	Andrew Sutherland	

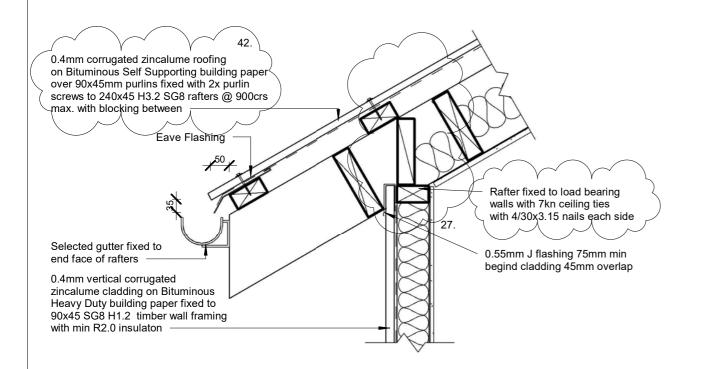


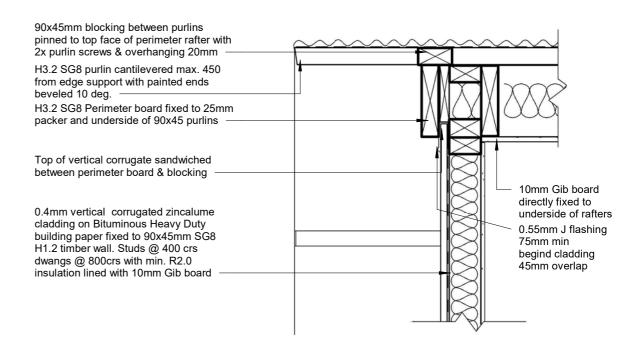

Eave Detail 1:10

Barge Roof Detail

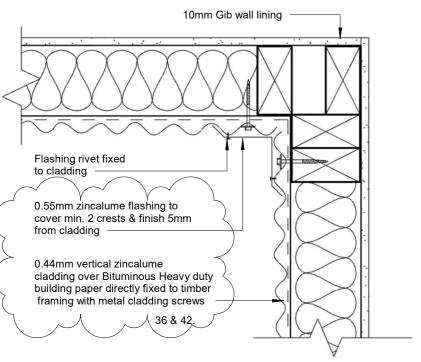

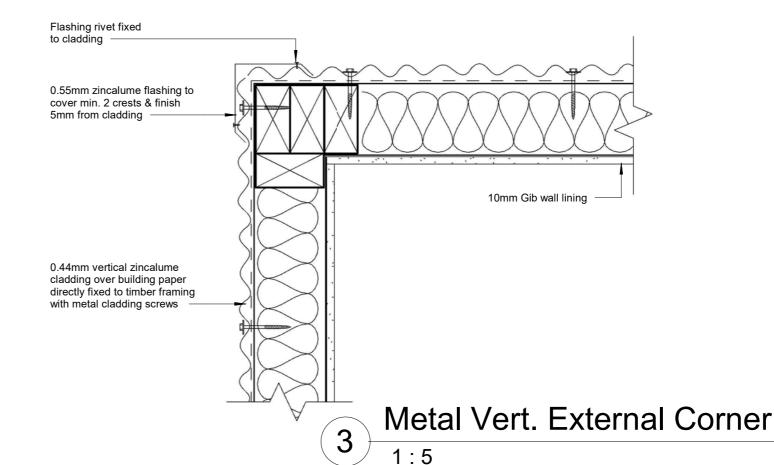

Metal Vert. Internal Corner

1:5

indicated

PROJECT Draw Venus Date Wyatt check 15/07/21 Scale As

11 Nolan St Mornington Dunedin

Roof Details


Dwawing Title

Dwg. No. **A07** on site.
3. Engineers Drawings take precedence


Notes 1. All dimensions are in millimetres.
2. All dimensions are to be checked

ARCHITECT Andrew Sutherland


ARCHITECT SEAL

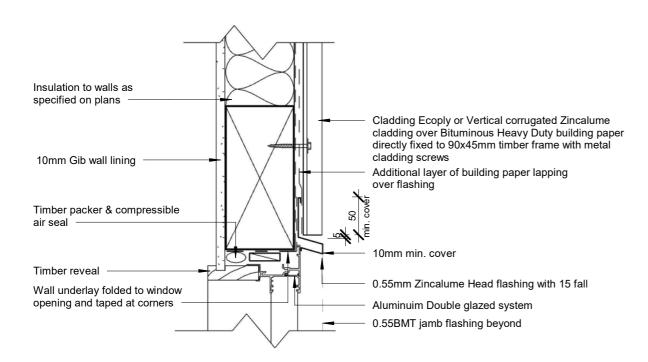



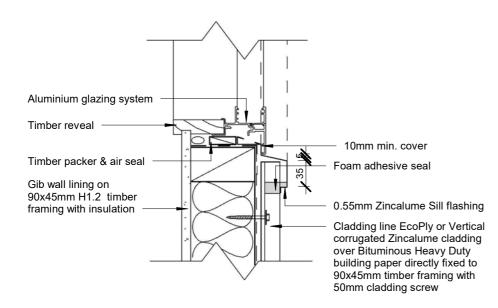



6 Vert. Metal Window Sill

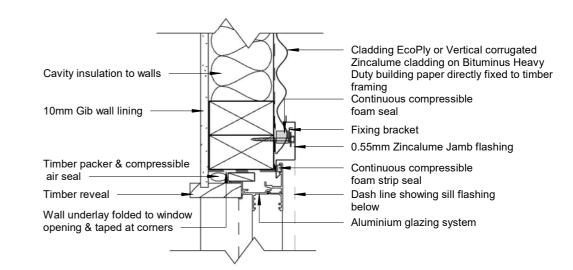

Vert. Metal Window Jamb

Draw	Venus		PROJECT	Dwawing Title		Notes		ARCHITECT SEAL
n	Wyatt	Date			Dwg. No.	1. All dimensions are in	ARCHITECT	
check ed		15/07/21	11 Nolan St Mornington Dunedin	Window Details	80A	millimetres. 2. All dimensions are to be checked on site. 3. Engineers Drawings take precedence	Designer: Andrew Sutherland	
Scale	As indicated				AUO	S. Engineers Brawings take precedence	Andrew Sudienand	

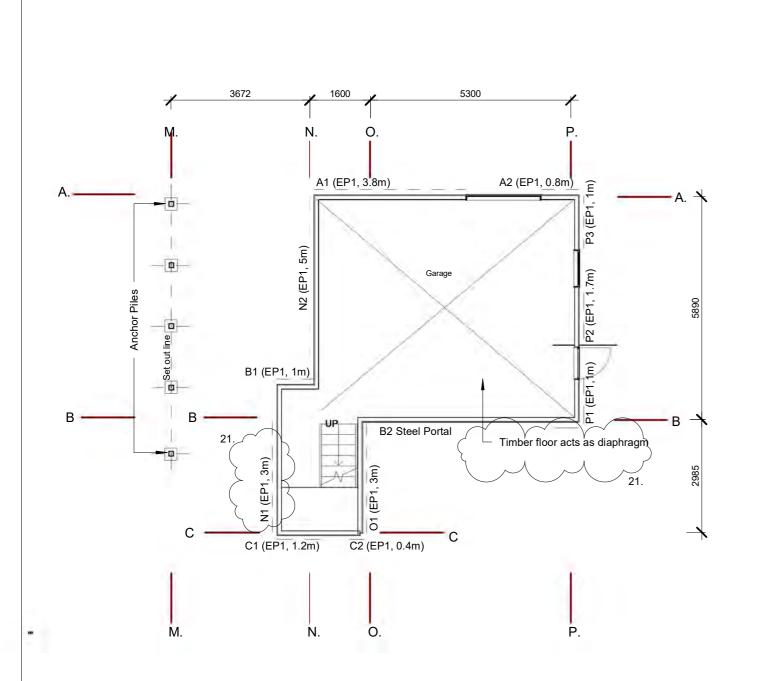

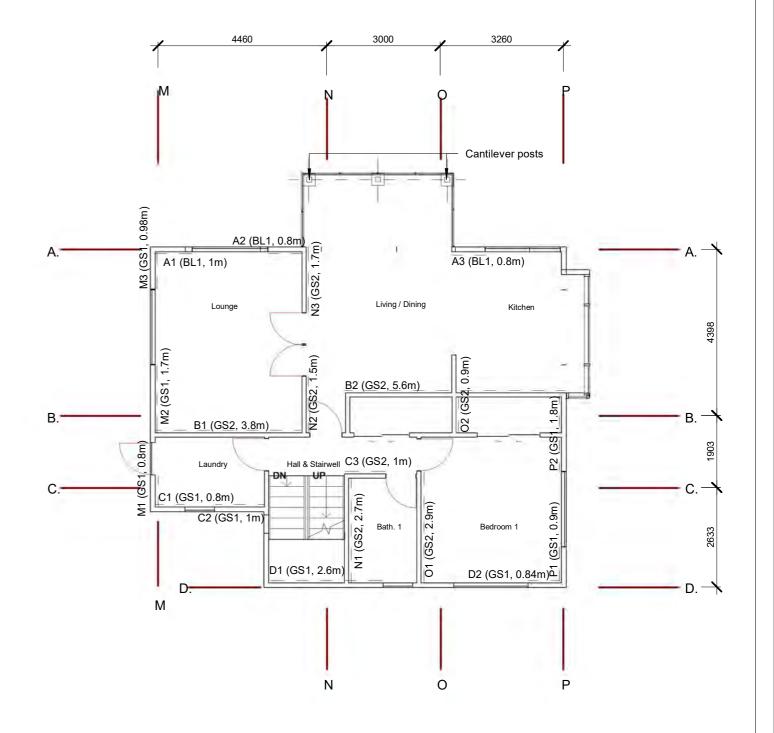

Ground Fl. Bracing

1: 100

Pirst Floor
1: 100

	Manua.		PROJECT	Dwawing Title		Notes		ARCHITECT SEAL
Draw n	Venus Wyatt	Date			Dwg. No.	All dimensions are in	ARCHITECT	
check ed		15/07/21	11 Nolan St Mornington Dunedin	Ground & First	CO1	millimetres. 2. All dimensions are to be checked on site. 3. Engineers Drawings take precedence	Designer:	
Scale	1:100			Floor Bracing	S01	Engineers Drawings take precedence	Andrew Sutherland	
				[⊥] Plans				