

Barrett Homes

Welcome to the *whānau*. CONTENTS:

- COVER SHEET
- 1 ELEVATIONS
- 2 ELEVATIONS
- 3 LOCATION PLAN
- 4 SITE PLAN
- 5 SITE LANDSCAPING
- 6 CONCEPT PLAN
- 7 KITCHEN & BATHROOM
- 8 CROSS SECTION
- 9 JOINERY SCHEDULE



ADDRESS:


LOT 47, 12 MISSION HILLS DRIVE STAGE 1A, MISSION HILLS, NAPIER








	Project No:	MH47	Designed:	NS	Wind: VERY HIGH	Drawing:	COVER SHEET	Date:	21/05/2025
	Plan:	OAK-11	Drawn:	CY	EQ: 3	Client Name:	CLAYBROOK HOLDINGS LTD	Rev:	
	Version:	1.0	Checked:	CY			LOT 47, 12 MISSION HILLS DRIVE	Sheet:	
s		design@	barretthomes.co.	nz	Council: Napier City		STAGE 1A, MISSION HILLS, NAPIER	Scale:	
s		design@	barretthomes.co.	nz	^{Council:} Napier City		STAGE 1A, MISSION HILLS, NAPIER	Scale:	

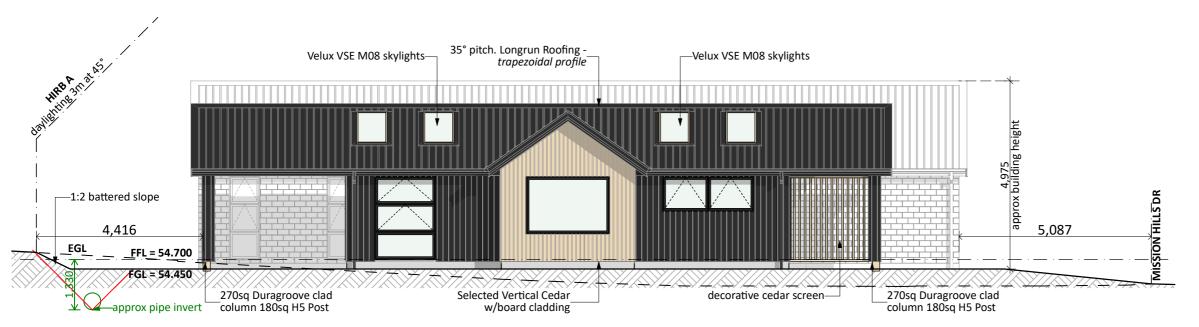

NORTH ELEVATION

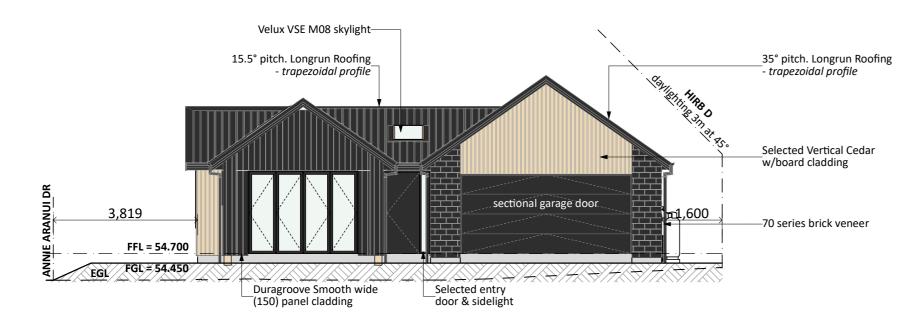

WEST ELEVATION



	Project
	Plan:
TM TM	Versio
Barrett Homes	

roject No	MH47	Designed: NS	Wind: VERY HIGH	Drawing: ELEVATIONS	Date:	21/05/2025
lan:	OAK-11	Drawn: CY	, ^{EQ:} 3	^{Client Name:} CLAYBROOK HOLDINGS LTD	Rev:	
ersion:	1.0	Checked: CY	, Exposure:	Site Address: LOT 47, 12 MISSION HILLS DRIVE	Sheet:	1
	design@	barretthomes.co.nz	Council Napier City	STAGE 1A, MISSION HILLS, NAPIER	Scale:	1:100

General Notes:

Any encroachments shown are to be confirmed by a registered surveyor prior to commencement of foundations. No liability shall be held by designer with this confirmation.

NZBC D1/AS1 Access

Minimum slip resistance to steps and landings in accordance with NZBC D1/AS1 Table 2. Concrete or H5 timber step to all access points, min. 150mm and max. 190mm below finished floor level.

CJ = Control joint

Foundation:

Ribraft floor to Firth specifications (see plan notes and details)

Wall Cladding:

70 series brick veneer - ensure cavity and weep holes are free from excess mortar
Duragroove Smooth wide (150) panel cladding

Selected Vertical Cedar w/board cladding

*All claddings to be installed over FPS Weathertight System. FPS Weathertight System to be installed over timber framing strictly as per manufacturers specification.

Roof Cladding:

35° & 15.5° pitch. NZS Colorsteel Endura - Trapezoidal

Fascia and Spouting:

COLORCOTE fascia & spouting with 80mm Ø Alipipes powder coated aluminium downpipes

Joinery:

Selected powder coated aluminium joinery with thermally improved Low E double glazing.

PRELIMINARY ONLY.

Elevations are subject to the following: - Site Levels


CONCEPT PLAN APPROVAL (confirmation to

consent drawings) <u>Signature</u>


<u>Date</u>

CONCEPT ONLY

MINOR VARIATIONS TO THE PLANS MAY BE NECESSARY DURING WORKING DRAWINGS DUE TO BRACING REQUIREMENTS, ENGINEERING AND UNFORSEEN SITE CONDITIONS

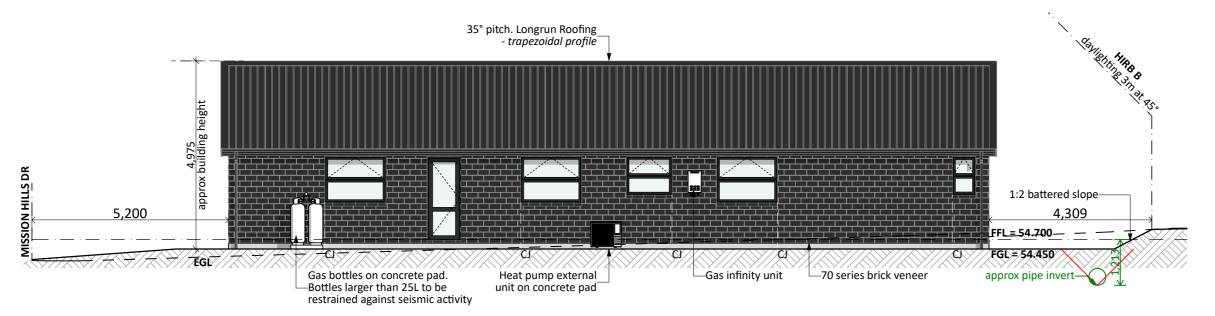

SOUTH ELEVATION

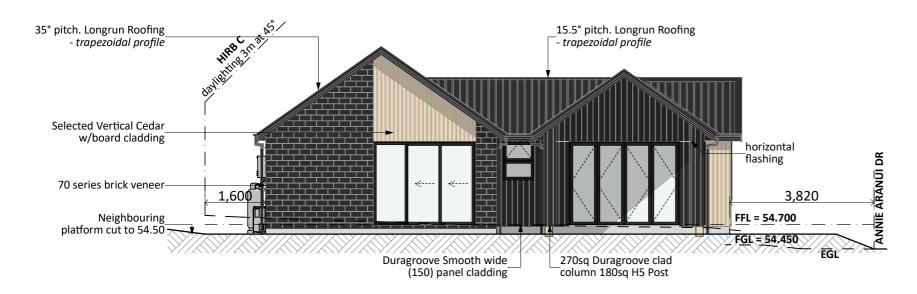

EAST ELEVATION





oject No:	MH47	Designed: NS	Wind: VERY HIGH	Drawing: ELEVATIONS	Date: 21/	05/202
an:	OAK-11	Drawn: CY	EQ:	Client Name: CLAYBROOK HOLDINGS LTD	Rev:	
rsion:	1.0	CY		LOT 47, 12 MISSION HILLS DRIVE	Sheet:	i
	design@	Dbarretthomes.co.nz	Council: Napier City	STAGE 1A, MISSION HILLS, NAPIER	Scale:	1:100

General Notes:

Any encroachments shown are to be confirmed by a registered surveyor prior to commencement of foundations. No liability shall be held by designer with this confirmation.

NZBC D1/AS1 Access

Minimum slip resistance to steps and landings in accordance with NZBC D1/AS1 Table 2. Concrete or H5 timber step to all access points, min. 150mm and max. 190mm below finished floor level.

CJ = Control joint

Foundation:

Ribraft floor to Firth specifications (see plan notes and details)

Wall Cladding:

70 series brick veneer - ensure cavity and weep holes are free from excess mortar
Duragroove Smooth wide (150) panel cladding

Selected Vertical Cedar w/board cladding *All claddings to be installed over FPS Weathertight System. FPS Weathertight System to be installed over timber framing strictly as per manufacturers

Roof Cladding:

specification.

35° & 15.5° pitch. NZS Colorsteel Endura - Trapezoidal

Fascia and Spouting:

COLORCOTE fascia & spouting with 80mm Ø Alipipes powder coated aluminium downpipes

Joinery:

Selected powder coated aluminium joinery with thermally improved Low E double glazing.

PRELIMINARY ONLY.

Elevations are subject to the following: - Site Levels


CONCEPT PLAN APPROVAL (confirmation to


consent drawings) <u>Signature</u>

<u>Date</u>

CONCEPT ONLY
MINOR VARIATIONS TO THE PLANS MAY BE NECESSARY
DURING WORKING DRAWINGS DUE TO BRACING REQUIREMENTS, ENGINEERING AND UNFORSEEN SITE CONDITIONS

Y:\#GM Proiects\#HAWKES BAY\#Mission Hills - Napier\#MH47 (SHOW HOME)\#Consent Plans\#MH47 Consent.pln

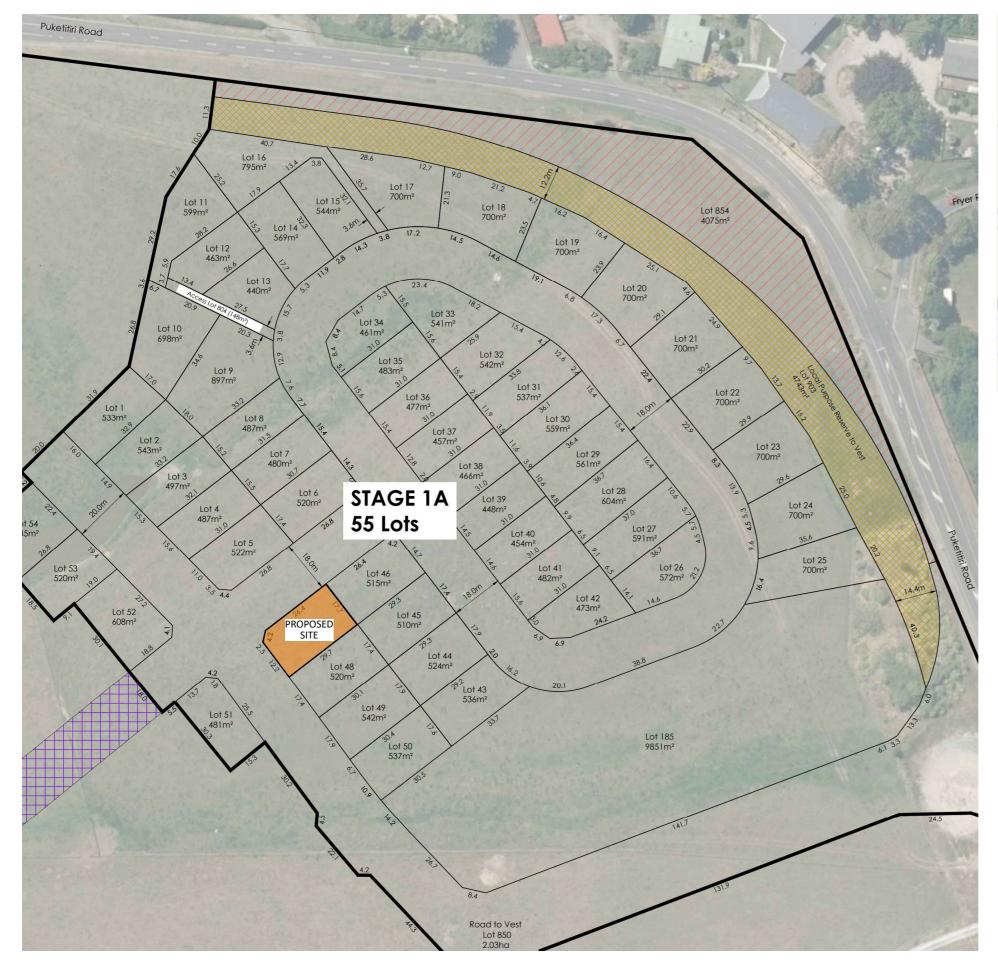


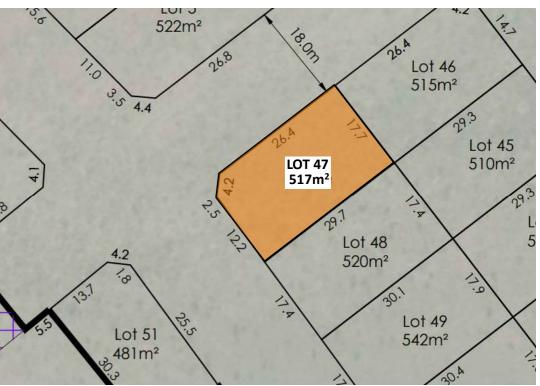




	MH47		Wind: VERY HIGH	H ^{Drawing:} LOCATION PLAN
	OAK-11	Drawn: CY	, EQ: 3	3 Client Name: CLAYBROOK HOLDINGS LTD
ion:	1.0	Checked: CY	Exposure:	C Site Address: LOT 47, 12 MISSION HILLS DRIVE
	design@	barretthomes.co.nz	Council:Napier City	ty STAGE 1A, MISSION HILLS, NAPIER

21/05/2025

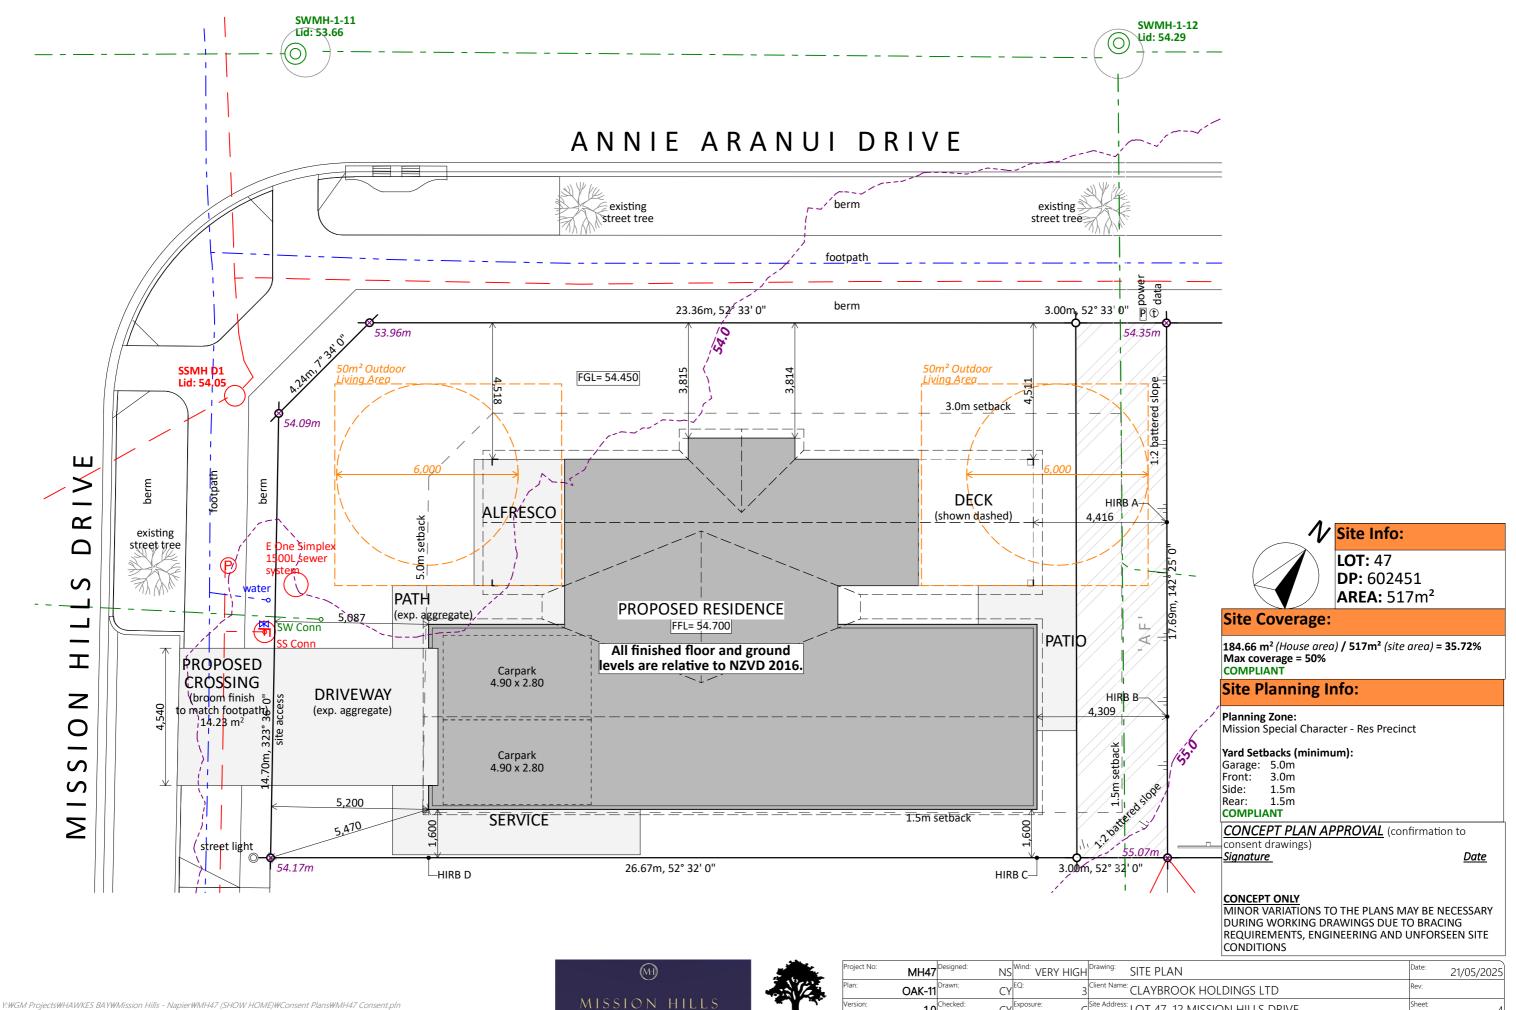



ANNIE ARANUI DRIVE

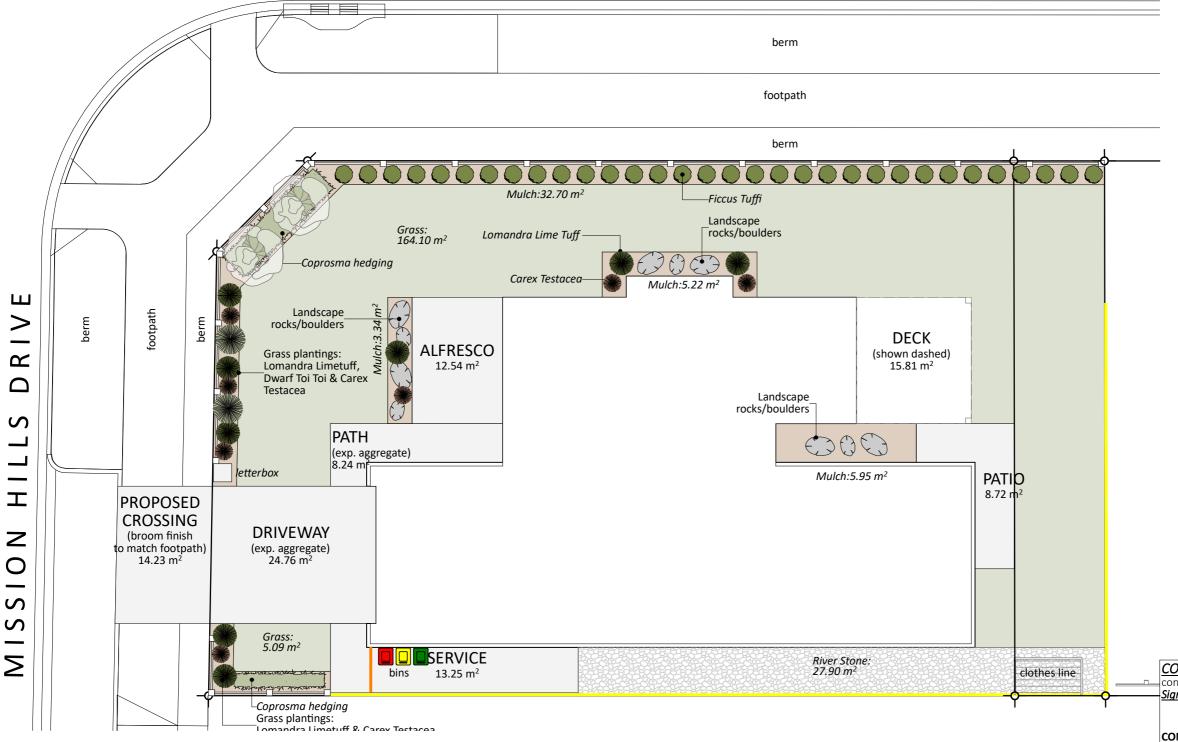

Landscape Key: HydroSeed Grass Riverstones Mulch 1.2m Post & Rail Fence 1.2m Fence 1.8m Timber Fence Fence & Gate **Selected Grass Plantings** Selected Hedgings Specimen Tree

CONCEPT PLAN APPROVAL (confirmation to consent drawings)


<u>Signature</u>

<u>Date</u>

CONCEPT ONLY
MINOR VARIATIONS TO THE PLANS MAY BE NECESSARY
DURING WORKING DRAWINGS DUE TO BRACING REQUIREMENTS, ENGINEERING AND UNFORSEEN SITE CONDITIONS



	Project No:	MH47	Designed: NS	Wind: VERY HIGH	Drawing: SITE LANDSCAPING	Date: 21/05/202	
		OAK-11		,EQ:	Client Name: CLAYBROOK HOLDINGS LTD	Rev:	
	Version:	1.0	Checked: CY	Exposure:	Site Address: LOT 47, 12 MISSION HILLS DRIVE	Sheet:	
es		design@	@barretthomes.co.nz	Council:Napier City	STAGE 1A, MISSION HILLS, NAPIER	Scale: 1:12	

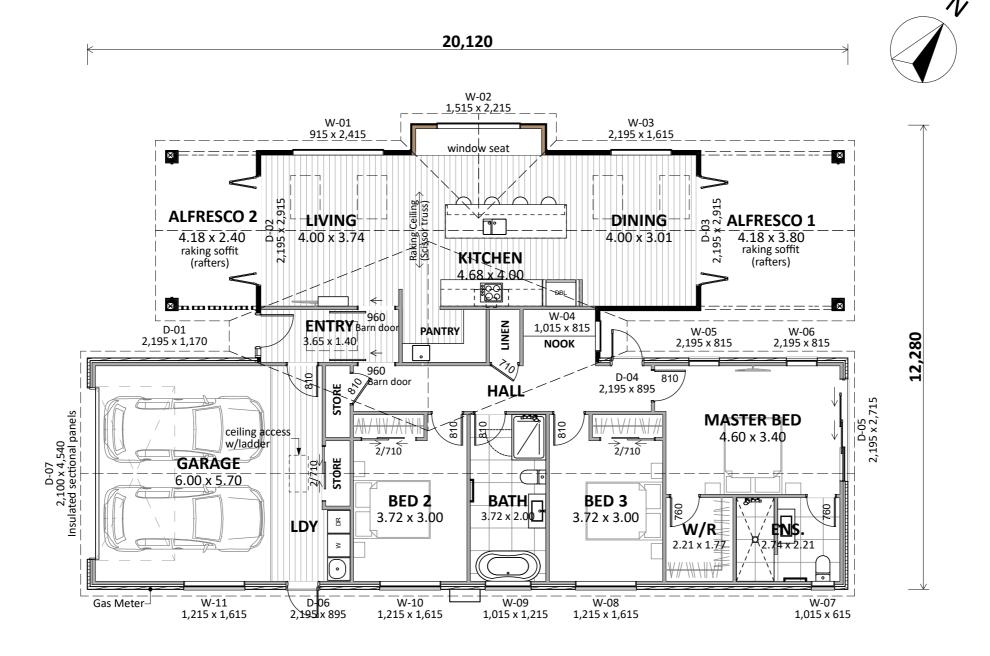

Plan Notes:
2.425 Stud height throughout
All full height joinery (2195)
Raking ceiling (scissor trusses) to Living/Kitchen/Dining
Rafters to both Alfrescos
Feature timber screen at entry - Cedar

Floor Area:

Area o/frame: 180.04 m² Area o/foundation: 184.66 m²

Cladding Key:

Duragroove
Brick Veneer

_____ Cedar

CONCEPT PLAN APPROVAL (confirmation to

consent drawings)
Signature

<u>Date</u>


CONCEPT ONLY


MINOR VARIATIONS TO THE PLANS MAY BE NECESSARY DURING WORKING DRAWINGS DUE TO BRACING REQUIREMENTS, ENGINEERING AND UNFORSEEN SITE CONDITIONS







						· · · · · · · · · · · · · · · · · · ·		
	Project No:	MH47	Designed: N	S ^{Wind:} VERY HIGH	Drawing:	CONCEPT PLAN	Date:	21/05/2025
	Plan:	OAK-11	Drawn:	Y ^{EQ:} 3	Client Name:	CLAYBROOK HOLDINGS LTD	Rev:	
	Version:	1.0	Checked:	Y Exposure:	Site Address:	LOT 47, 12 MISSION HILLS DRIVE	Sheet:	6
s		design@	barretthomes.co.nz	Council Napier City	/	STAGE 1A, MISSION HILLS, NAPIER	Scale:	1:100
								•

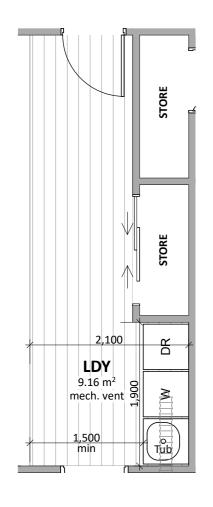

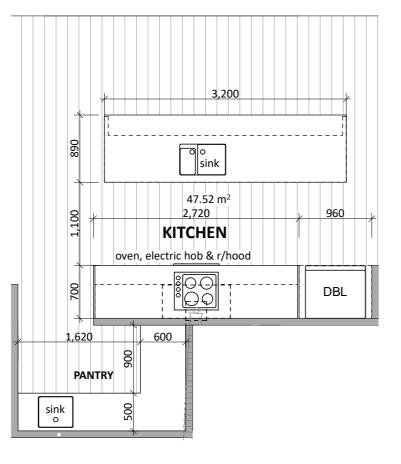

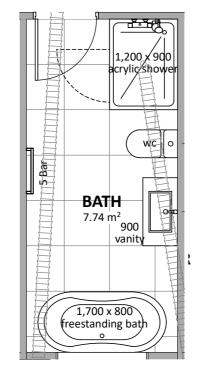

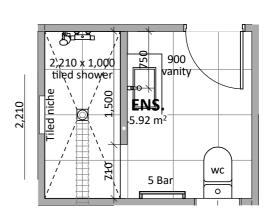




<u>Signature</u>

CONCEPT ONLY
MINOR VARIATIONS TO THE PLANS MAY BE NECESSARY
DURING WORKING DRAWINGS DUE TO BRACING
REQUIREMENTS, ENGINEERING AND UNFORSEEN SITE CONDITIONS






	Project No:	MH47	Designed: NS	Wind: VERY HIGH	Drawing: KITCHEN & BATHROOM	Date: 21/05/202
	Plan:	OAK-11	Drawn: CY	EQ:	Client Name: CLAYBROOK HOLDINGS LTD	Rev:
	Version:	1.0	Checked: CY	Exposure:	Site Address: LOT 47, 12 MISSION HILLS DRIVE	Sheet:
s		design@	barretthomes.co.nz	Council: Napier City	STAGE 1A, MISSION HILLS, NAPIER	Scale: 1:5

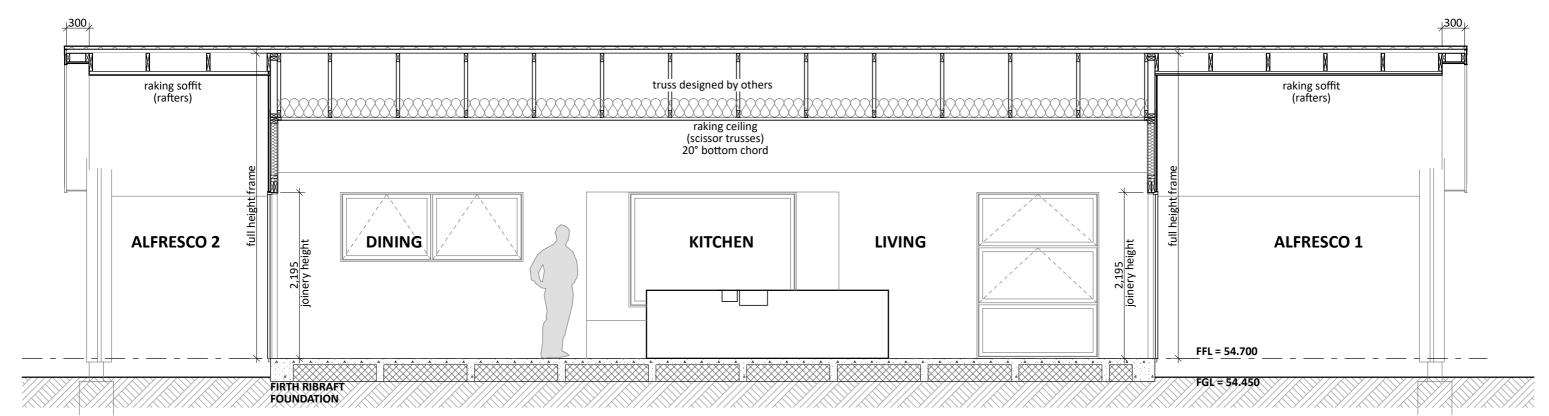

CROSS SECTION D SCALE1:50

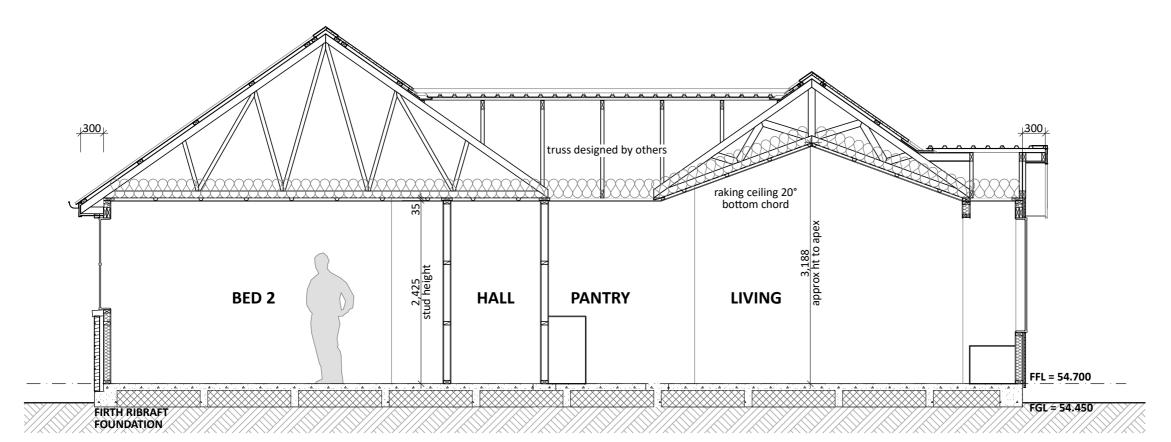

CONCEPT PLAN APPROVAL (confirmation to consent drawings)

<u>Signature</u>

<u>Date</u>


CONCEPT ONLY
MINOR VARIATIONS TO THE PLANS MAY BE NECESSARY
DURING WORKING DRAWINGS DUE TO BRACING
REQUIREMENTS, ENGINEERING AND UNFORSEEN SITE CONDITIONS

$\frac{\text{CROSS SECTION B}}{\text{SCALE1:50}}$





	Project No:	MH47	Designed: NS	Wind: VERY HIGH	Drawing: CROSS SECTION	Date:	21/05/2025
	Plan:	OAK-11	Drawn: CY	, EQ: 3	Client Name: CLAYBROOK HOLDINGS LTD	Rev:	
	Version:	1.0	Checked: CY	Exposure:	Site Address: LOT 47, 12 MISSION HILLS DRIVE	Sheet:	8
es		design@	barretthomes.co.nz	Council Napier City	STAGE 1A, MISSION HILLS, NAPIER	Scale:	1:50

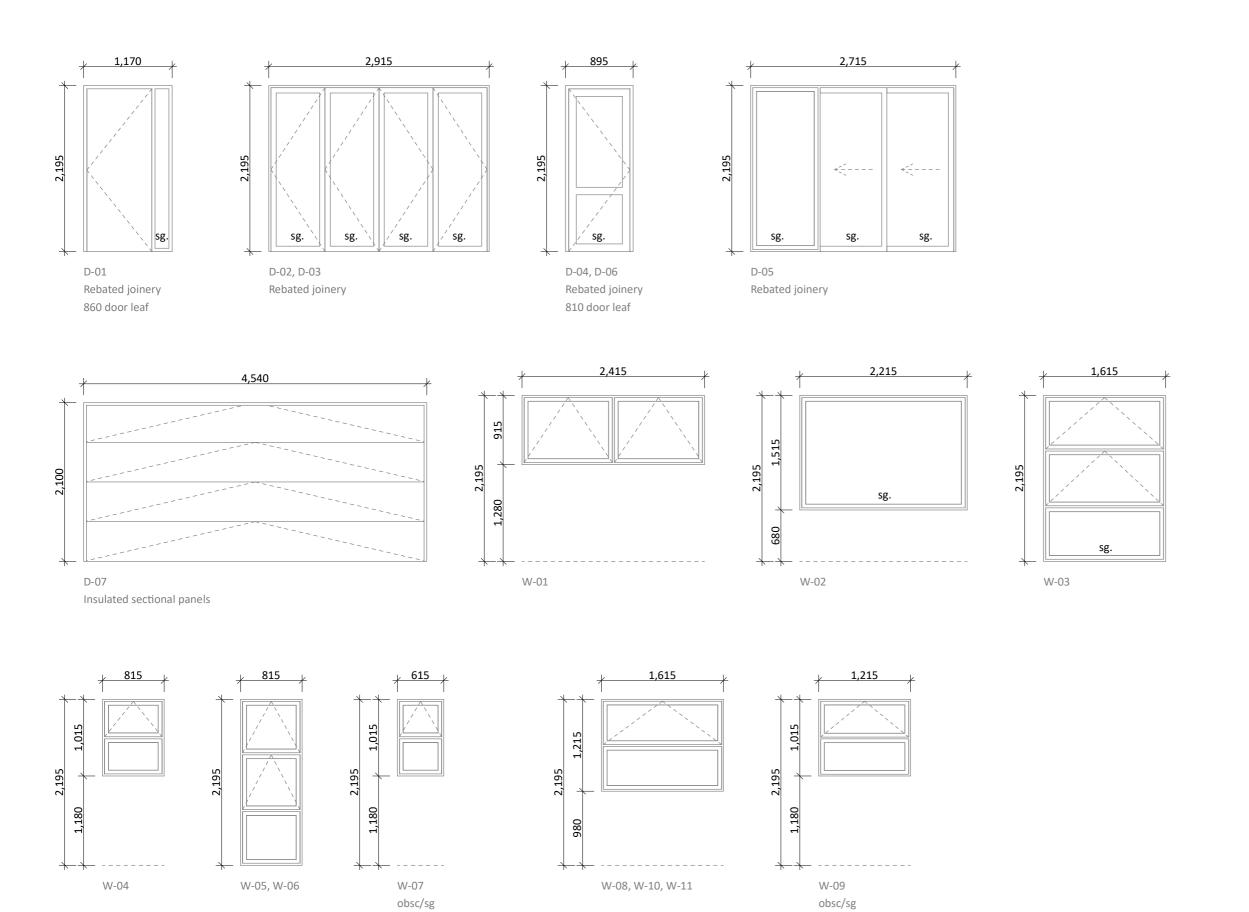

General notes:

Aluminium joinery head heights to be 2.195m (excludes rebated joinery units). Refer to floor plan for door & window sizes. Joinery schedule & sizes to be confirmed on site PRIOR to manufacture

Thermally improved double glazing to all window and door joinery including garage joinery.

Glazing in accordance with NZS 4223 & 2016 amendments.

All glazing clear float unless noted anywhere, (refer to joinery schedule)

- Low level glazing = Any glazing within 800mm from FFL, depending on size and proportions, safety glass or 5mm annealed will be required.

- Doors with glazing area > 0.75m² = safety glass
- Doors with glazing area < 0.75m² = 5mm annealed Side panels within 800mm of a door = safety glass, side panels not within 800mm of door considered a window.

sg = Safety glass as required by standards, joinery manufacturer to take precedence ss = Safety stays (in accordance with NZBC:F4 clause 2.0) obsc = Obscure glass

REBATED JOINERY

Rebated joinery sizes are to be confirmed with joinery

CONCEPT PLAN APPROVAL (confirmation to consent drawings)

<u>Signature</u>

<u>Date</u>

CONCEPT ONLY

MINOR VARIATIONS TO THE PLANS MAY BE NECESSARY DURING WORKING DRAWINGS DUE TO BRACING REQUIREMENTS, ENGINEERING AND UNFORSEEN SITE CONDITIONS





	Project No:	MH47	Designed: NS	Wind: VERY HIGH	Drawing: J	OINERY SCHEDULE	Date:	21/05/2025
	Plan:	OAK-11	Drawn: CY	EQ: 3	Client Name: (CLAYBROOK HOLDINGS LTD	Rev:	
	Version:	1.0	Checked: CY	Exposure:	Site Address: L	OT 47, 12 MISSION HILLS DRIVE	Sheet:	9
s		design@	barretthomes.co.nz	Council: Napier City	S	STAGE 1A, MISSION HILLS, NAPIER	Scale:	1:50