

Welcome to the whānau.

CONTENTS:

- COVER SHEET
- 1 ELEVATIONS
- 2 ELEVATIONS
- 3 SITE PLAN
- 4 LANDSCAPING PLAN
- 5 CONCEPT PLAN
- 6 KITCHEN & BATHROOM
- 7 CROSS SECTIONS
- 8 JOINERY SCHEDULE




NEW DWELLING FOR: BARRETT HOMES (NORTHLAND) LTD

ADDRESS:


LOT 10, 22 MOORING WAY ONE TREE POINT, WHANGAREI



	Project No:	MOOR10	Designed: DP	Wind: HIGH	Drawing: COVER SHEET	Date:	29/07/2025
	Plan:	Sea La Vie	Drawn:	EQ:	^{Client Name:} BARRETT HOMES (NORTHLAND) LTD	Rev:	
	Version:	2.0	Checked: KB	Exposure: D	Site Address: LOT 10, 22 MOORING WAY	Sheet:	
s		design@	Dbarretthomes.co.nz	Council: WDC	ONE TREE POINT, WHANGAREI	Scale:	

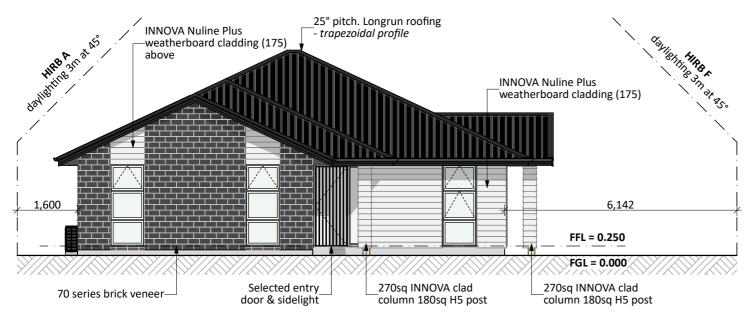

NORTH ELEVATION

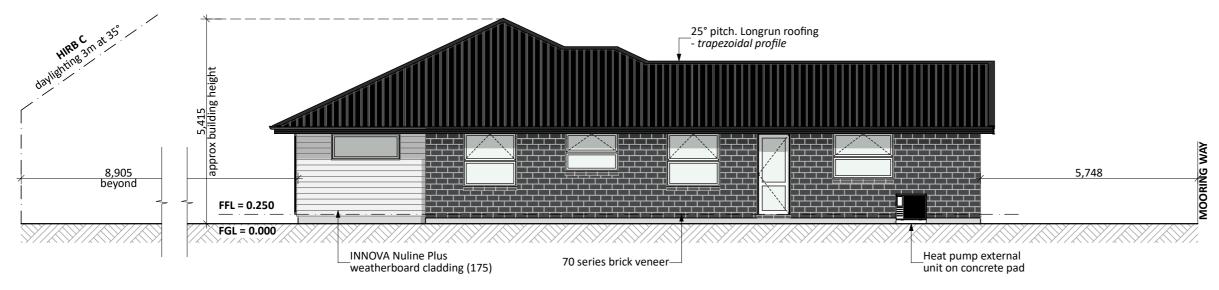

EAST ELEVATION

Barrett Home

	Project No:	MOOR10	Designed: DP	Wind: HIGH	Drawing: FLEVATIONS	Date:	29/07/2025
	Plan:	Sea La Vie	Drawn:		Client Name: BARRETT HOMES (NORTHLAND) LTD	Rev:	25/01/2025
	Version:					Sheet:	1
es		design@	barretthomes.co.nz	Council:		Scale:	1:100

General Notes:

Any encroachments shown are to be confirmed by a registered surveyor prior to commencement of foundations. No liability shall be held by designer with this confirmation.

NZBC D1/AS1 Access

Minimum slip resistance to steps and landings in accordance with NZBC D1/AS1 Table 2. Concrete or H5 timber step to all access points, min. 150mm and max. 190mm below finished floor level.

CJ = Control joint

Foundation:

Raft floor to engineers design (see plan notes and details)

Wall Cladding:

70 series brick veneer - ensure cavity and weep holes are free from excess mortar

INNOVA Nuline Plus 175 Smooth weatherboard cladding

Roof Cladding:

25° pitch. Longrun roofing - *Trapezoidal profile*

Fascia and Spouting:

COLORCOTE fascia, spouting & 80mm Ø MARLEY PVC downpipes

Joinery & Glazing:

Selected powder coated aluminium joinery with thermally improved Low E double glazing

PRELIMINARY ONLY.

Elevations are subject to the following:

CONCEPT PLAN APPROVAL (confirmation to


consent drawings)

<u>Signature</u>


<u>Date</u>

CONCEPT ONLY

MINOR VARIATIONS TO THE PLANS MAY BE NECESSARY DURING WORKING DRAWINGS DUE TO BRACING REQUIREMENTS, ENGINEERING AND UNFORSEEN SITE CONDITIONS

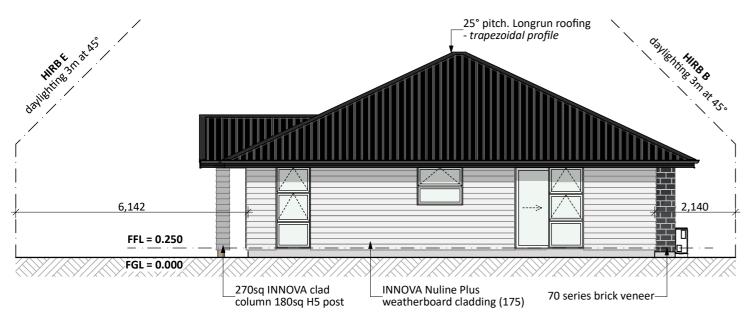

SOUTH ELEVATION

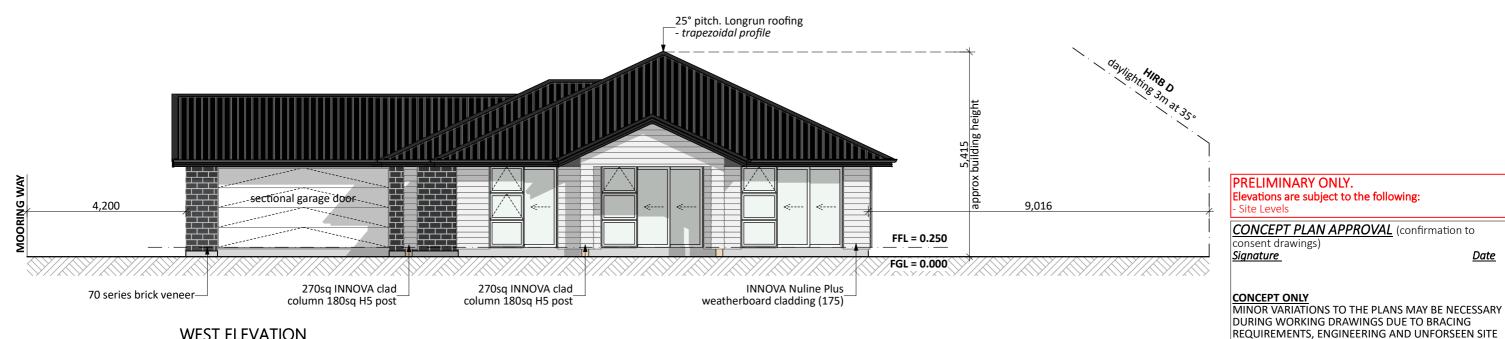

WEST ELEVATION

Barrett Homes

	Project No:	MOOR10	Designed: DP	Wind: HIGH	Drawing:	ELEVATIONS	Date:	29/07/2025
	Plan:	Sea La Vie	Drawn:	EQ:	Client Name	BARRETT HOMES (NORTHLAND) LTD	Rev:	
	Version:	2.0	Checked: KB	Exposure: D	Site Address:	LOT 10, 22 MOORING WAY	Sheet:	2
s		design@	Dbarretthomes.co.nz	Council: WDC		ONE TREE POINT, WHANGAREI	Scale:	1:100

CONDITIONS

General Notes:

Any encroachments shown are to be confirmed by a registered surveyor prior to commencement of foundations. No liability shall be held by designer with this confirmation.

NZBC D1/AS1 Access

Minimum slip resistance to steps and landings in accordance with NZBC D1/AS1 Table 2. Concrete or H5 timber step to all access points, min. 150mm and max. 190mm below finished floor level.

CJ = Control joint

Foundation:

Raft floor to engineers design (see plan notes and details)

Wall Cladding:

70 series brick veneer - ensure cavity and weep holes are free from excess mortar

INNOVA Nuline Plus 175 Smooth weatherboard cladding

Roof Cladding:

25° pitch. Longrun roofing - *Trapezoidal profile*


Fascia and Spouting:

COLORCOTE fascia, spouting & 80mm Ø MARLEY PVC downpipes


<u>Date</u>

Joinery & Glazing:

Selected powder coated aluminium joinery with thermally improved Low E double glazing

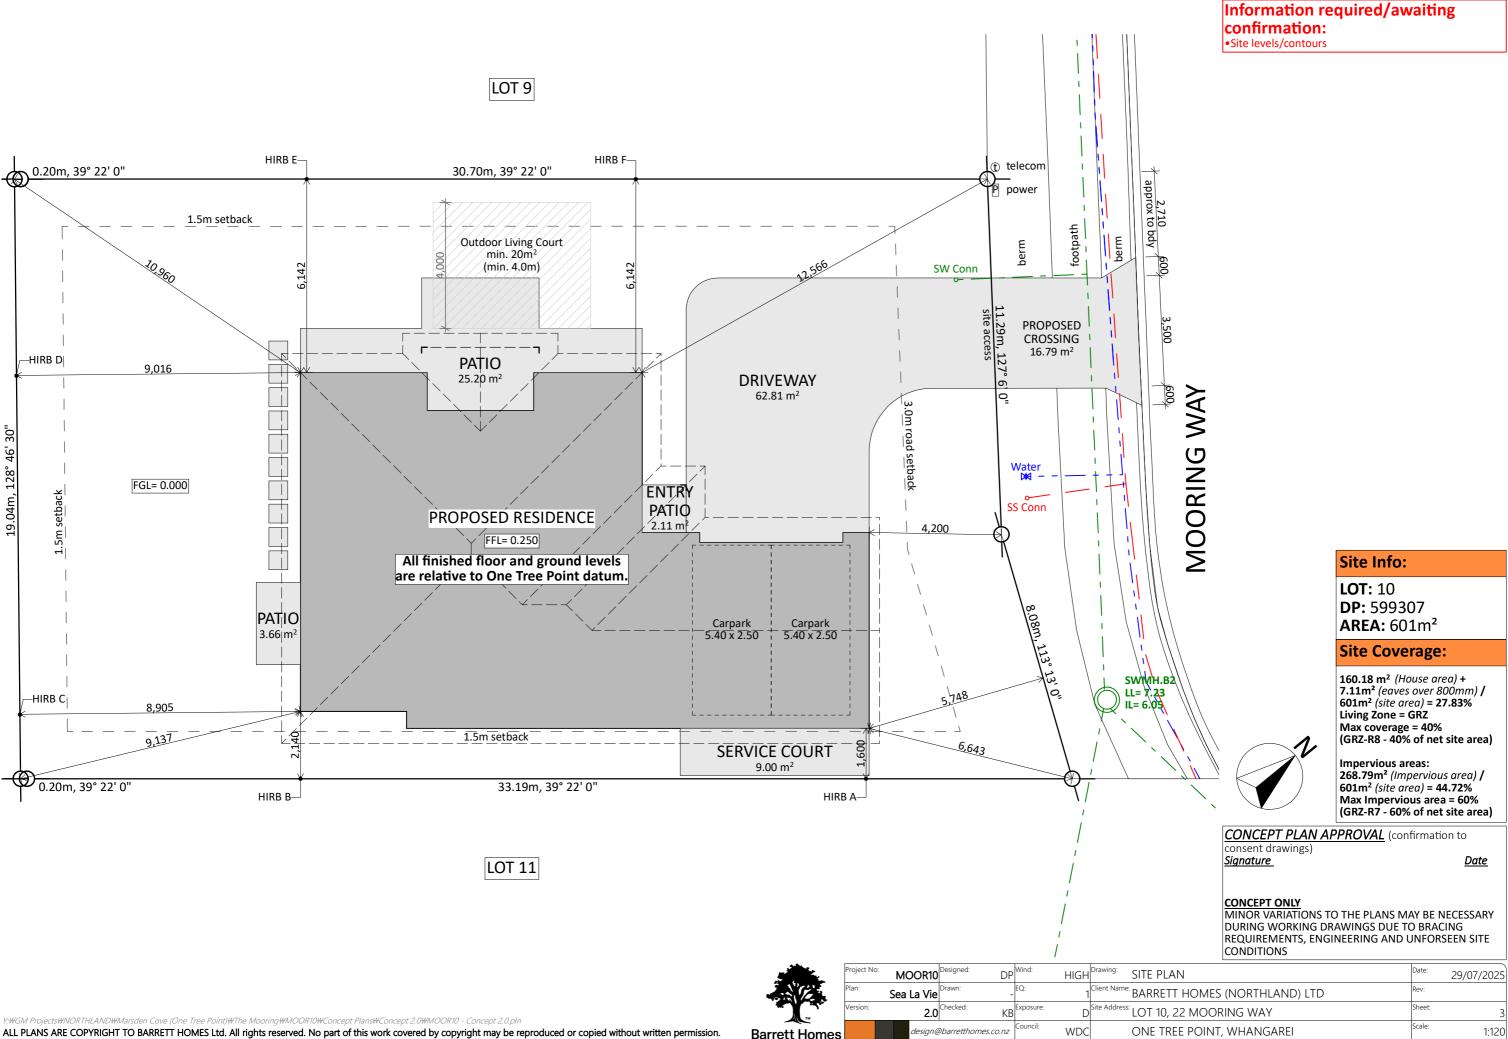

Barrett Homes

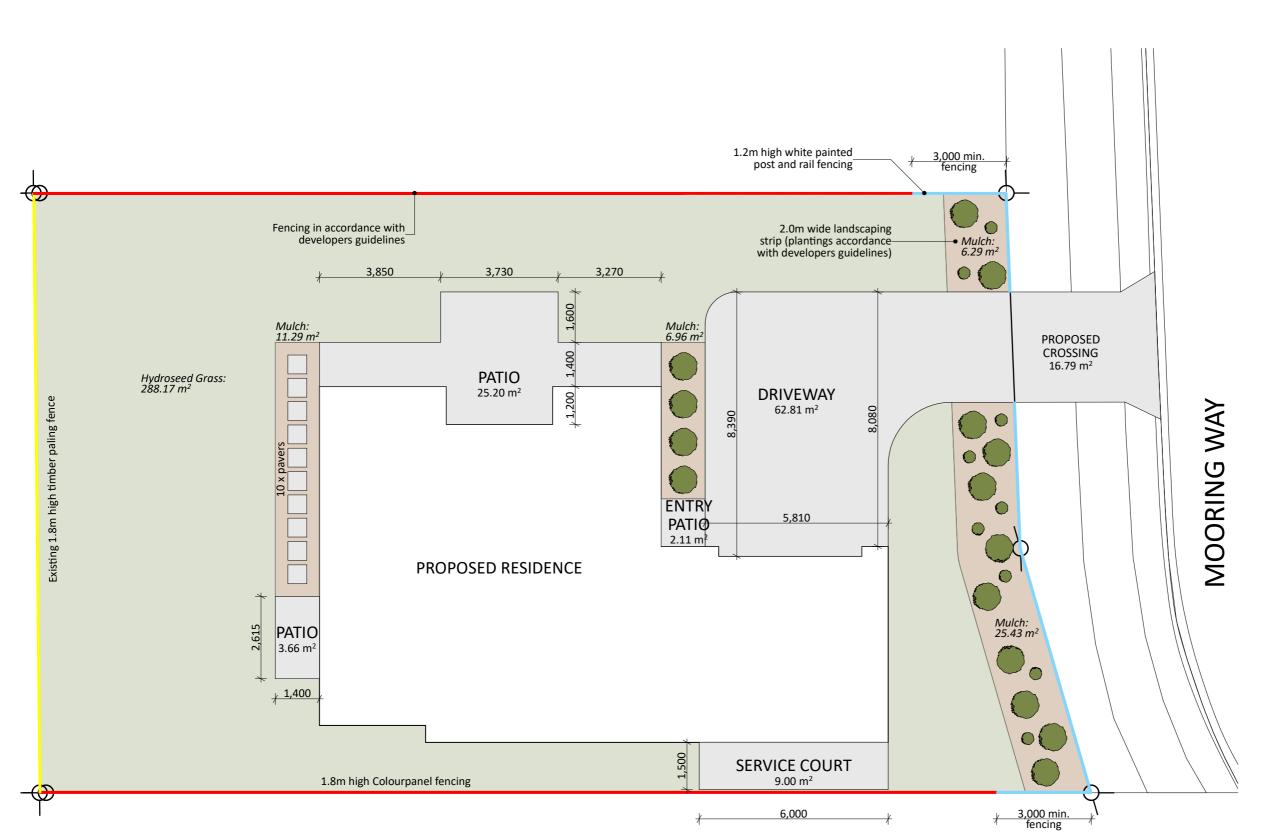

Landscape Key: HydroSeed Grass Mulch with Plantings 1.8m Colourpanel Fencing 1.2m White Painted Post & Rail Fencing 1.8m Existing Timber Paling Fencing **Selected Grass Plantings**

CONCEPT PLAN APPROVAL (confirmation to


consent drawings) <u>Signature</u>

<u>Date</u>

CONCEPT ONLY
MINOR VARIATIONS TO THE PLANS MAY BE NECESSARY
DURING WORKING DRAWINGS DUE TO BRACING
REQUIREMENTS, ENGINEERING AND UNFORSEEN SITE CONDITIONS



	Project No:	MOOR10	Designed: DP	Wind: HIGH	Drawing: LANDSCAPING PLAN	Date: 29/07/2025
	Plan:	Sea La Vie	Drawn:	EQ:	Client Name: BARRETT HOMES (NORTHLAND) LTD	Rev:
	Version:	2.0	Checked: KB	Exposure: D	Site Address: LOT 10, 22 MOORING WAY	Sheet: 2
s		design@	Dbarretthomes.co.nz	Council: WDC	ONE TREE POINT, WHANGAREI	Scale: 1:120

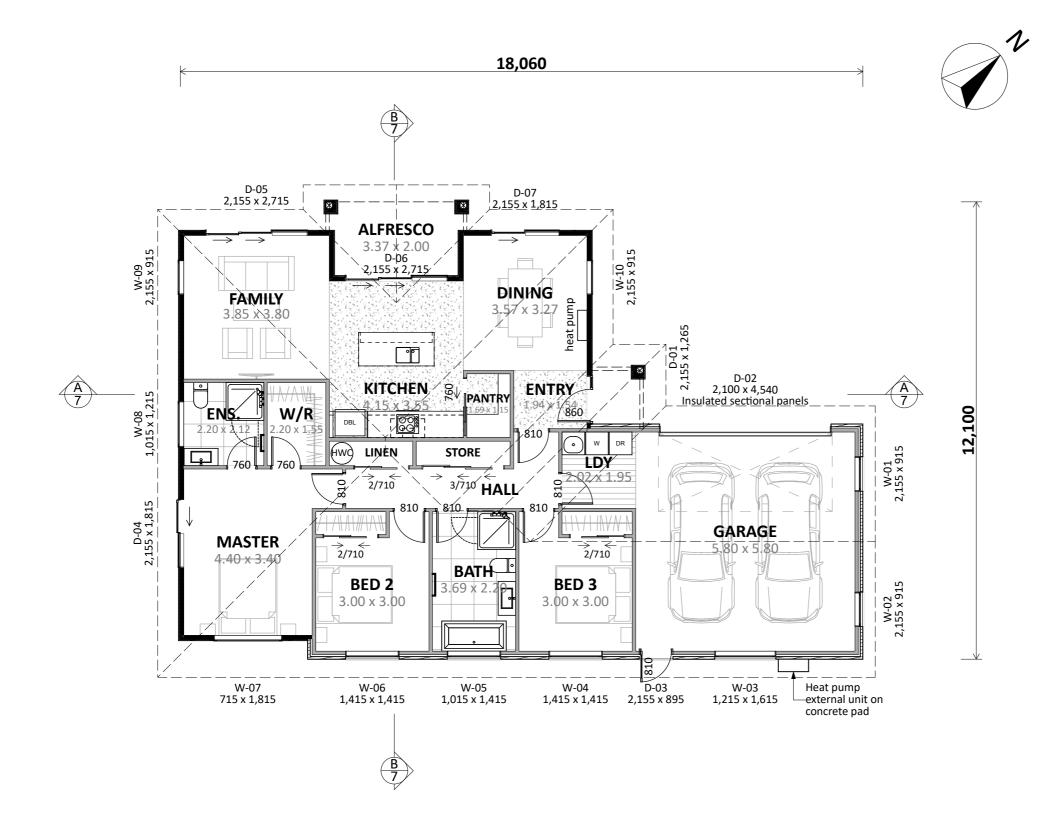

CHANGES TO PLAN:

- Increased Master Bedroom by 1.0m.
- Extended roofline to Master to avoid hip/velley junctions.
- Flipped orientation of plan

ENGINEERING REQUIRED: - Foundation

Plan Notes:

2.415 Stud height throughout All joinery 2155 head height Flat soffit to Alfresco (joinery height)

Flat soffit to Entry

Floor Area:

Area o/frame: 157.33 m² Area o/foundation: 160.18 m²

Cladding Key:

INNOVA Nuline Plus
Brick Veneer

CONCEPT PLAN APPROVAL (confirmation to

consent drawings)
Signature


<u>Date</u>


CONCEPT ONLY


MINOR VARIATIONS TO THE PLANS MAY BE NECESSARY DURING WORKING DRAWINGS DUE TO BRACING REQUIREMENTS, ENGINEERING AND UNFORSEEN SITE CONDITIONS





	Project No:	MOOR10	Designed: DP	Wind: HIGH	Drawing: CONCEPT PLAN	Date:	29/07/2025
	Plan:	Sea La Vie	Drawn:	EQ:	^{Client Name:} BARRETT HOMES (NORTHLAND) LTD	Rev:	
	Version:	2.0	Checked: KB	Exposure: D	Site Address: LOT 10, 22 MOORING WAY	Sheet:	5
s		design@	barretthomes.co.nz	Council: WDC	ONE TREE POINT, WHANGAREI	Scale:	1:100

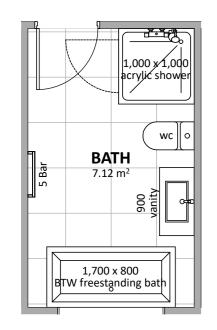

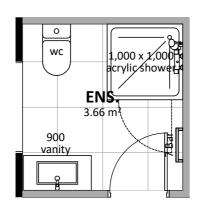

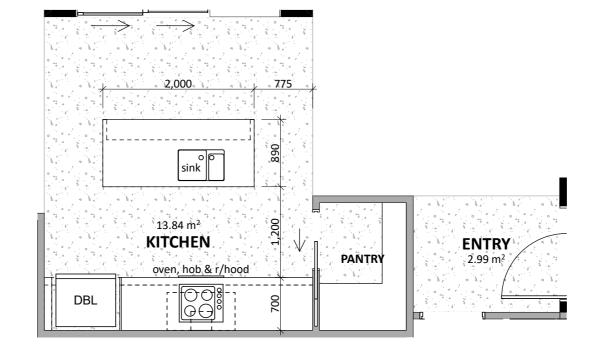

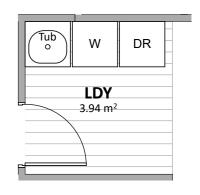


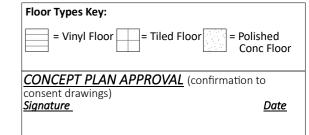


CONCEPT ONLY
MINOR VARIATIONS TO THE PLANS MAY BE NECESSARY
DURING WORKING DRAWINGS DUE TO BRACING
REQUIREMENTS, ENGINEERING AND UNFORSEEN SITE CONDITIONS



	Project No:	MOOR10	Designed: DP	Wind: HIGH	Drawing: KITCHEN & BATHROOM	Date:	29/07/2025
	Plan:	Sea La Vie	Drawn:	EQ:	^{Client Name:} BARRETT HOMES (NORTHLAND) LTD	Rev:	
	Version:	2.0	Checked: KB	Exposure: D	Site Address: LOT 10, 22 MOORING WAY	Sheet:	6
es		design@	Dbarretthomes.co.nz	Council: WDC	ONE TREE POINT, WHANGAREI	Scale:	1:50

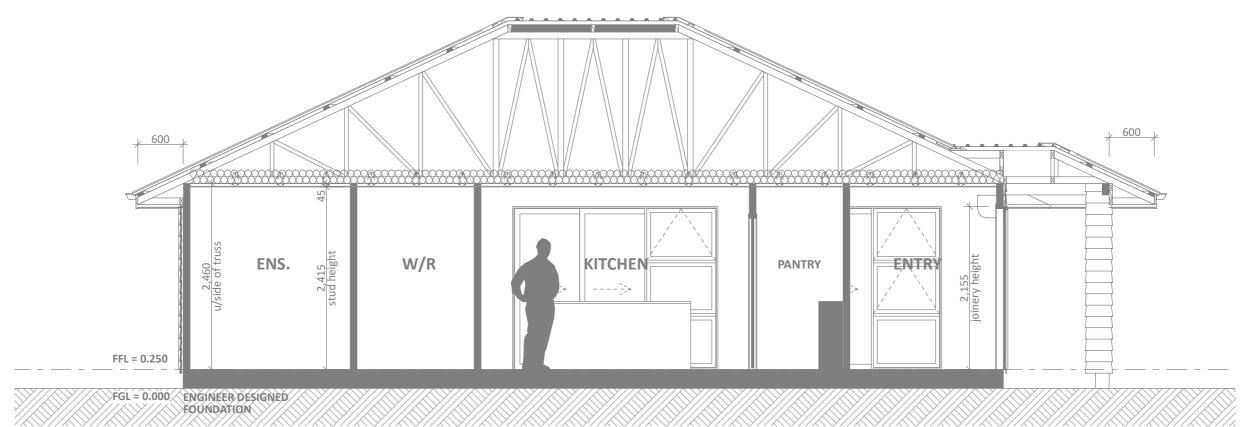

CROSS SECTION A SCALE 1:50

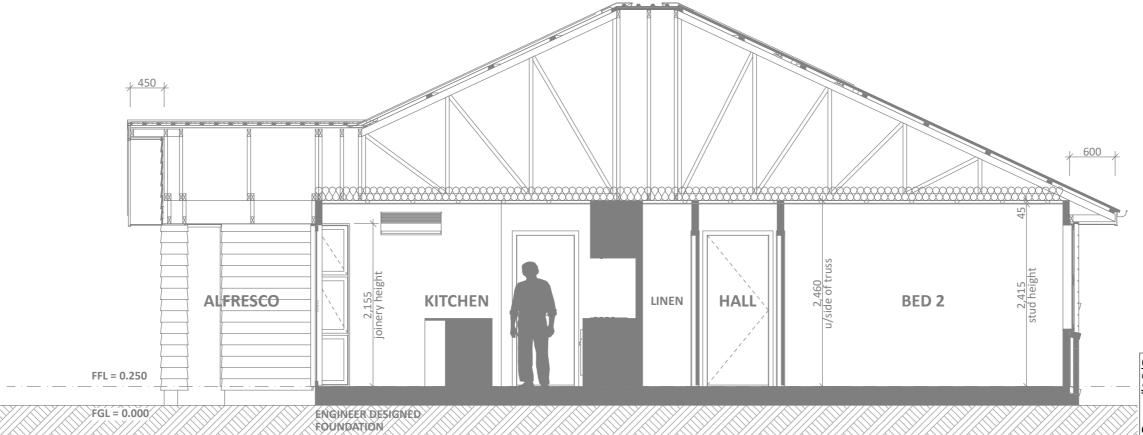

CROSS SECTION B
SCALE 1:50

CONCEPT PLAN APPROVAL (confirmation to consent drawings)


<u>Signature</u>

<u>Date</u>

CONCEPT ONLY
MINOR VARIATIONS TO THE PLANS MAY BE NECESSARY
DURING WORKING DRAWINGS DUE TO BRACING
REQUIREMENTS, ENGINEERING AND UNFORSEEN SITE CONDITIONS



	Project No:	MOOR10	Designed: DP	Wind: HIGH	Drawing: CROSS SECTIONS	Date: 29/07/2025
	Plan:	Sea La Vie	Drawn:	EQ:	Client Name: BARRETT HOMES (NORTHLAND) LTD	Rev:
	Version:	2.0	Checked: KB	Exposure: D	Site Address: LOT 10, 22 MOORING WAY	Sheet:
3		design@	Dbarretthomes.co.nz	Council: WDC	ONE TREE POINT, WHANGAREI	Scale: 1:50

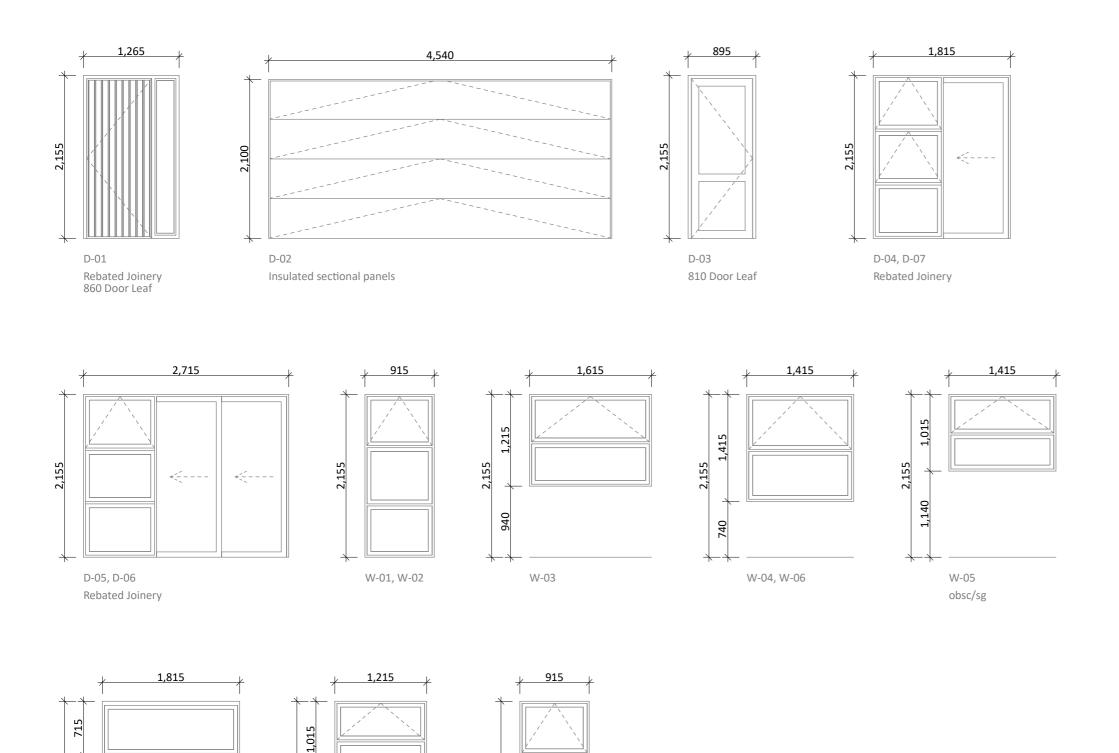

W-09, W-10

General notes:

Aluminium joinery head heights to be 2.155m (excludes rebated joinery units). Refer to floor plan for door & window sizes. Joinery schedule & sizes to be confirmed on site PRIOR to manufacture

Thermally improved double glazing to all window and door joinery including garage joinery.

Glazing in accordance with NZS 4223 &~2016amendments.

All glazing clear float unless noted anywhere, (refer to joinery schedule)

- Low level glazing = Any glazing within 800mm from FFL, depending on size and proportions, safety glass or 5mm annealed will be required.

- Doors with glazing area > 0.75m² = safety glass
- Doors with glazing area < 0.75m² = 5mm annealed Side panels within 800mm of a door = safety glass, side panels not within 800mm of door considered a window.

sg = Safety glass as required by standards, joinery manufacturer to take precedence ss = Safety stays (in accordance with NZBC:F4 clause 2.0) obsc = Obscure glass

REBATED JOINERY

Rebated joinery sizes are to be confirmed with joinery

CONCEPT PLAN APPROVAL (confirmation to consent drawings)

<u>Signature</u>

<u>Date</u>

CONCEPT ONLY

MINOR VARIATIONS TO THE PLANS MAY BE NECESSARY DURING WORKING DRAWINGS DUE TO BRACING REQUIREMENTS, ENGINEERING AND UNFORSEEN SITE CONDITIONS



	Project No:	MOOR10	Designed: DP	Wind: HIGH	Drawing: JOINERY SCHEDULE	Date:	29/07/2025
	Plan:	Sea La Vie	Drawn:	EQ:	^{Client Name:} BARRETT HOMES (NORTHLAND) LTD	Rev:	
	Version:	2.0	Checked: KB	Exposure: D	Site Address: LOT 10, 22 MOORING WAY	Sheet:	8
s		design@	Dbarretthomes.co.nz	Council: WDC	ONE TREE POINT, WHANGAREI	Scale:	1:50

W-07

W-08

obsc/sg