

Barrett Homes

Welcome to the whānau.

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COVER SHEET

MATERIALITY

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NEW DWELLING FOR:

BARRETT HOMES (CENTRAL PLATEAU) LTD

ADDRESS:

LOT 24, 39 ANNIE ARANUI DRIVE STAGE 1A, MISSION HILLS, NAPIER CONCEPT PLAN APPROVAL (confirmation to consent drawings)

<u>Signature</u>

<u>Date</u>

CONCEPT ONLY





	Project No:	MH24	Designed: C'	Y VERY HIGH	Drawing: COVER SHEET	8/08/202
Ī	OAKURA	1 (Alt)	Drawn:	EQ: 3	Client Name: BARRETT HOMES (CENTRAL PLATEAU) LTD	Rev:
	Version:	1.1	Checked: C'	Y Exposure:		Sheet:
s		design@	barretthomes.co.nz	Napier City	STAGE 1A, MISSION HILLS, NAPIER	Scale:



Metal Roofing

- Roofing Industries - trimrib profile



Brick cladding - Black



Vertical Shiplap Weathboard



Joinery



Panel cladding
- INNOVA Duragroove Smooth wide (150) panel cladding

MH

MISSION HILLS


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<u>Signature</u>

<u>Date</u>





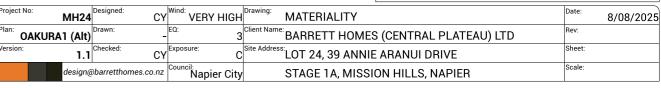

Velux FS M06 35° pitch. Longrun Roofing -INNOVA Duragroove Smooth CJ = Control joint Skylights Trapezoidal profile wide (150) panel cladding 5,281 ox building height HIRB C daylighting 3m at 45° sectional garage door 11,807 FFL = 57.250 EGL existing battered 70 series brick veneer INNOVA Duragroove Smooth 70 series brick veneer wide (150) panel cladding clad column **NORTH ELEVATION**

35° pitch. Longrun Roofing 15° pitch. Longrun Roofing -35° pitch. Longrun Roofing -Trapezoidal profile Trapezoidal profile Trapezoidal profile Velux FS M06 Skylights HIRB B daylighting HIRB E daylighting 3m at 45% Min 1.1m high barrier to FFL = 57.250 comply with NZBC: F4 FGL = 57.000 **Engineered TPRW** Selected vertical timber INNOVA Duragroove Smooth 70 series brick veneer Max. 1600mm high w/board cladding wide (150) panel cladding clad column **EAST ELEVATION**

Minimum slip resistance to steps and landings in accordance with NZBC D1/AS1 Table 2. Concrete or H5 timber step to all access points, min. 150mm and max. 190mm below finished floor level.

Any encroachments shown are to be confirmed by a registered surveyor prior to commencement of foundations. No liability shall be held by designer with

General Notes:

this confirmation.

NZBC D1/AS1 Access

Foundation:

Ribraft floor to Firth specifications (see plan notes and details)

Wall Cladding:

70 series brick veneer - ensure cavity and weep holes are free from excess mortar

INNOVA Duragroove Smooth wide (150) panel cladding Selected Vertical timber w/board cladding

*All claddings to be installed over FPS Weathertight System. FPS Weathertight System to be installed over timber framing strictly as per manufacturers specification.

Roof Cladding:

35° & 15° pitch. Endura Longrun roofing - *Trapezoidal profile*

Fascia and Spouting:

COLORCOTE fascia & spouting with 80mm Ø Alipipes - powder coated aluminium downpipes

Joinery & Glazing:

Selected powder coated aluminium joinery with thermally improved Low E double glazing.

CONCEPT PLAN APPROVAL (confirmation to

consent drawings)
Signature

<u>Date</u>

CONCEPT ONLY



	Project No
	Plan: O
7M	Version:
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	Project No: MH2	Designed: C\	VERY HIGH	Drawing: ELEVATIONS	Date:	8/08/2025
	OAKURA1 (A	t) Drawn:	-EQ: 3	Client Name: BARRETT HOMES (CENTRAL PLATEAU) LTD	Rev:	
	Version:	.1 Checked: C	/ ^{Exposure:} C	Site Address: LOT 24, 39 ANNIE ARANUI DRIVE	Sheet:	1
es	desig	n@barretthomes.co.nz	Council: Napier City	STAGE 1A, MISSION HILLS, NAPIER	Scale:	1:100


General Notes:

Any encroachments shown are to be confirmed by a registered surveyor prior to commencement of foundations. No liability shall be held by designer with this confirmation.

NZBC D1/AS1 Access

Minimum slip resistance to steps and landings in accordance with NZBC D1/AS1 Table 2. Concrete or H5 timber step to all access points, min. 150mm and max. 190mm below finished floor level.

CJ = Control joint

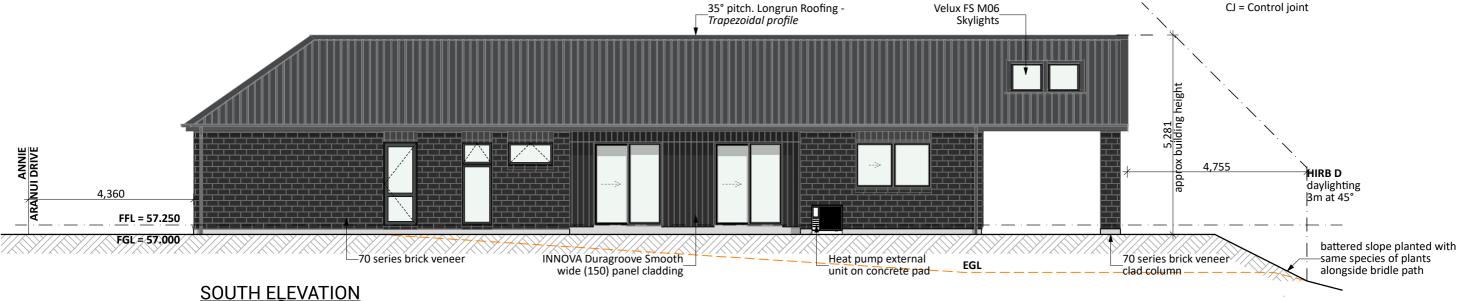

35° pitch. Longrun Roofing 35° pitch. Longrun Roofing -15° pitch. Longrun Roofing Sun tunnel-Trapezoidal profile - Trapezoidal profilé - Trapezoidal profile HIRB A HIRB F daylighting daylighting Bm at 45° 3m at 45° Horizontal flashing-FFL = 57.250 FGL = 57.000 EGL INNOVA Duragroove Smooth Selected vertical timber -70 series brick veneer w/board cladding wide (150) panel cladding WEST ELEVATION

Foundation:

Ribraft floor to Firth specifications (see plan notes and details)

Wall Cladding:

70 series brick veneer - ensure cavity and weep holes are free from excess mortar

INNOVA Duragroove Smooth wide (150) panel cladding Selected Vertical timber w/board cladding

*All claddings to be installed over FPS Weathertight System. FPS Weathertight System to be installed over timber framing strictly as per manufacturers specification.

Roof Cladding:

35° & 15° pitch. Endura Longrun roofing - Trapezoidal

Fascia and Spouting:

COLORCOTE fascia & spouting with 80mm Ø Alipipes - powder coated aluminium downpipes

Joinery & Glazing:

Selected powder coated aluminium joinery with thermally improved Low E double glazing.

CONCEPT PLAN APPROVAL (confirmation to

consent drawings) Signature


<u>Date</u>

CONCEPT ONLY



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Barrett Homes	

	Project No: MH	24	esigned: CY	Wind: VERY HIGH	Drawing: ELEVATIONS	Date:	8/08/2025
	OAKURA1 (A	(lt)	rawn:	EQ:	Client Name: BARRETT HOMES (CENTRAL PLATEAU) LTD	Rev:	
	Version:	1.1 CI	hecked: CY			Sheet:	2
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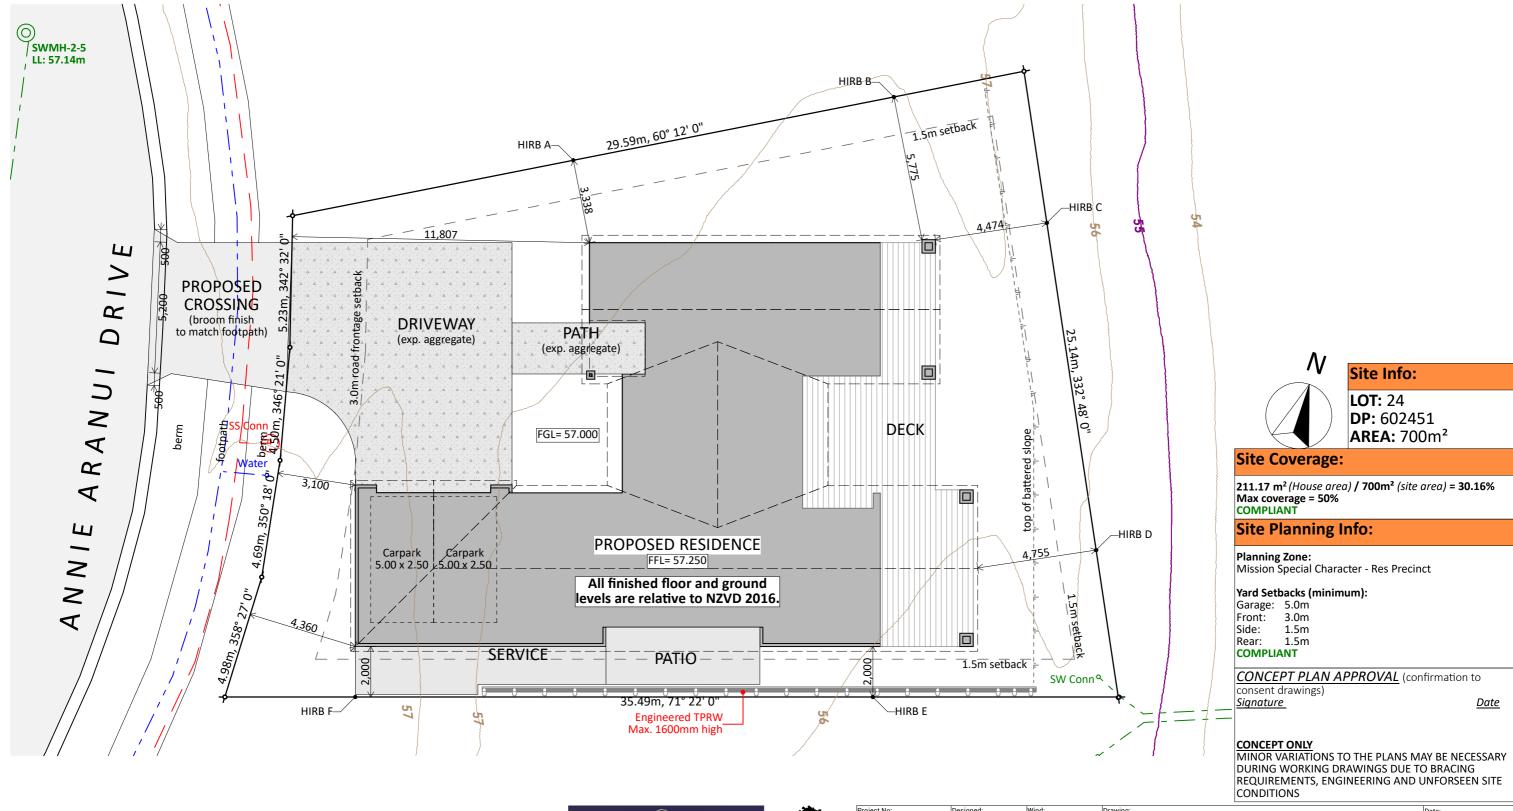
<u>Signature</u>
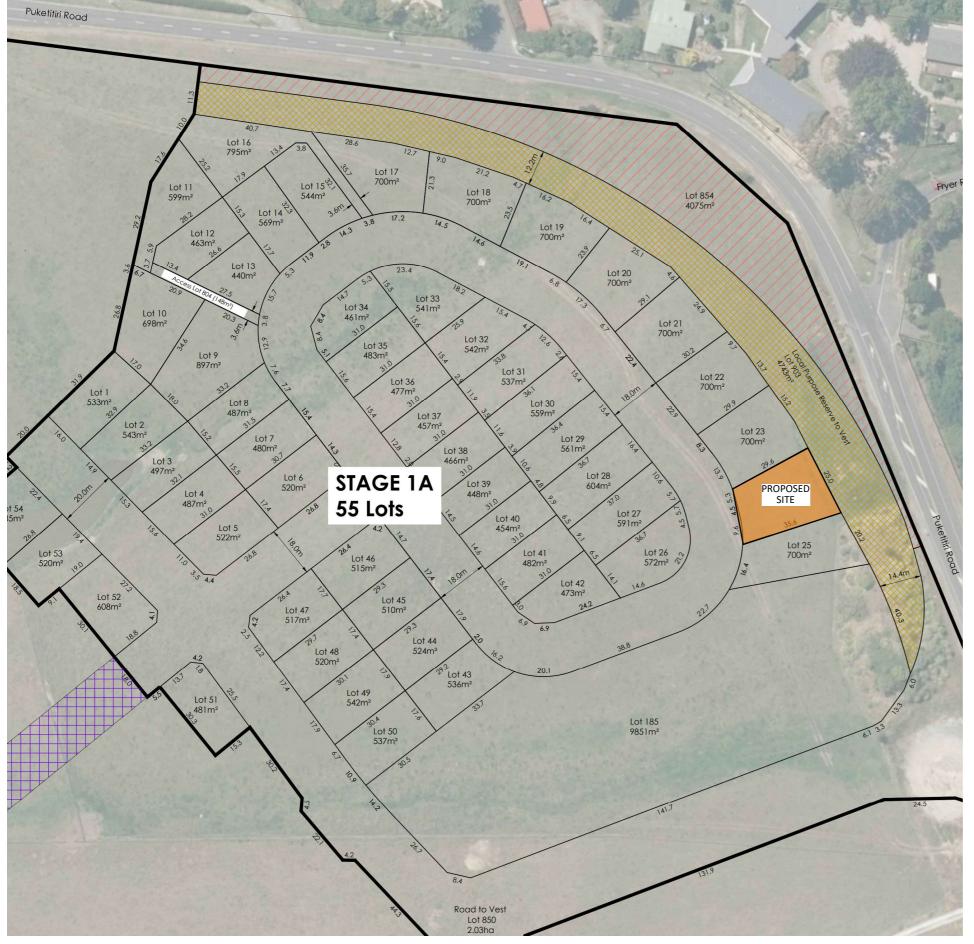
<u>Date</u>





	Project No:	MH24		Wind: VERY HIGH	Drawing: LOCATION PLAN	Date:	8/08/2025
	Plan: OAKURA	1 (Alt)	Drawn:	EQ:	^{Client Name:} BARRETT HOMES (CENTRAL PLATEAU) LTD	Rev:	
	Version:	1.1	Checked: CY		Site Address: LOT 24, 39 ANNIE ARANUI DRIVE	Sheet:	3
s		design@	barretthomes.co.nz	Council: Napier City	STAGE 1A, MISSION HILLS, NAPIER	Scale:	



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	Project No:	MH24	Designed: CY	Wind: VERY HIGH	rawing: SITE PLAN	Date:	8/08/2025
	Plan: OAKURA	1 (Alt)	Drawn:	EQ:	Slient Name: BARRETT HOMES (CENTRAL PLATEAU) LTD	Rev:	
	Version:	1.1	Checked: CY	Exposure:		Sheet:	4
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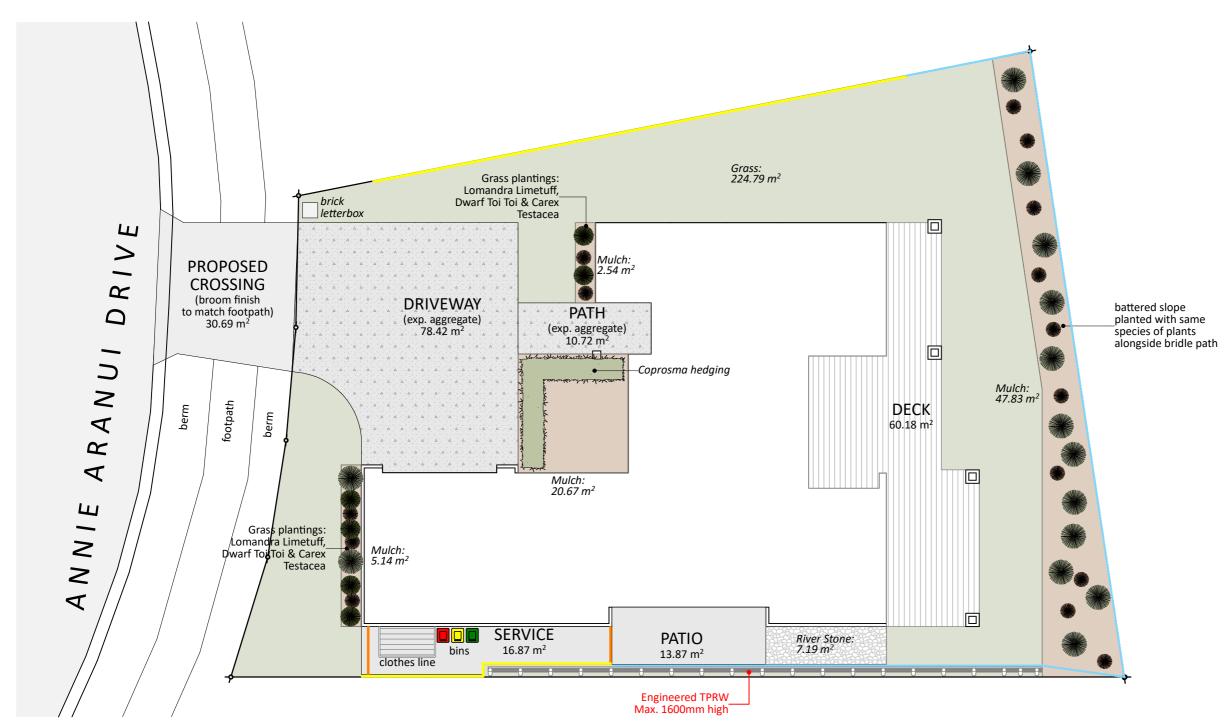








Testacea - Prairie Fire Riverstone - Goldrush



HydroSeed Grass
Riverstones
Mulch
1.2m permeable Fence
1.8m Timber Fence
Fence & Gate
Selected Grass Plantings
Selected Hedgings
Selected planting

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Signature

<u>Date</u>

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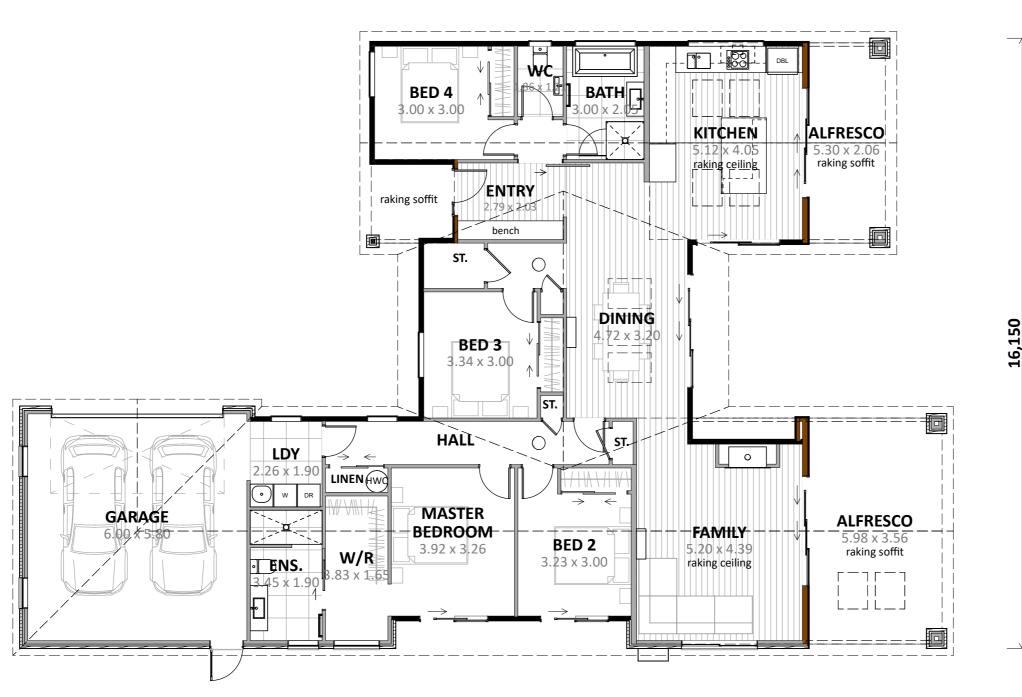




	Project No: MH2	4 Designed: CY	VERY HIGH	Drawing: LANDSCAPING PLAN	Date:	8/08/202
	OAKURA1 (Al	t) Drawn:	EQ:	Client Name: BARRETT HOMES (CENTRAL PLATEAU) LTD	Rev:	
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es	design	n@barretthomes.co.nz	Council: Napier City	STAGE 1A, MISSION HILLS, NAPIER	Scale:	1:15

24,525





CHANGES TO PLAN:

- Remove Eastern retaining wall and reinstate with battered slope
- Battered slope to be planted with similar species as council bridle path.

- ENGINEERING REQUIRED:
 Alfresco raking portals x 4
- Alfresco Footings
- Ridge Beams x 2 & supports Timber retaining wall

Plan Notes:
2.575 Stud height throughout
All full height joinery (2195)
Raking ceiling to Family & Kitchen as shown (rafters)
Raking soffit to alfresco as shown (rafters)

Floor Area:

Area o/frame: 208.28 m² Area o/foundation: 211.17 m²

Cladding Key:

INNOVA Duragroove Vertical Timber

Brick Veneer

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consent drawings) <u>Signature</u>


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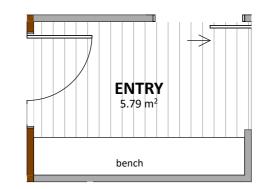
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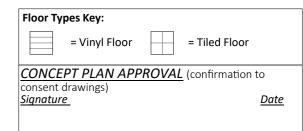


	Project No:	MH24	Designed: CY	Wind: VERY HIGH	Drawing: CONCEPT PLAN	8/08/202
	OAKURA	l (Alt)	Drawn:	EQ:	Client Name: BARRETT HOMES (CENTRAL PLATEAU) LTD	Rev:
	Version:	1.1	Checked: CY	Exposure:		Sheet:
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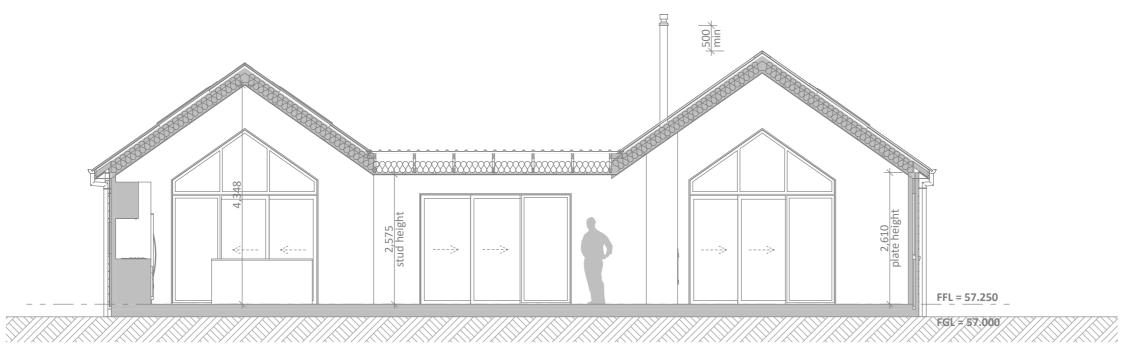







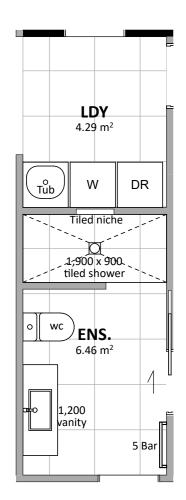

	Project No:	MH24	Designed: CY	Wind: VERY HIGH	Drawing: WET AREAS	B/08/202
	OAKURA	1 (Alt)	Drawn:	EQ:	Client Name: BARRETT HOMES (CENTRAL PLATEAU) LTD	Rev:
	Version:	1.1	Checked: CY	Exposure:		Sheet: .
s		design@	barretthomes.co.nz	Council: Napier City	STAGE 1A, MISSION HILLS, NAPIER	Scale: 1:5



CONCEPT SECTION A SCALE 1:75

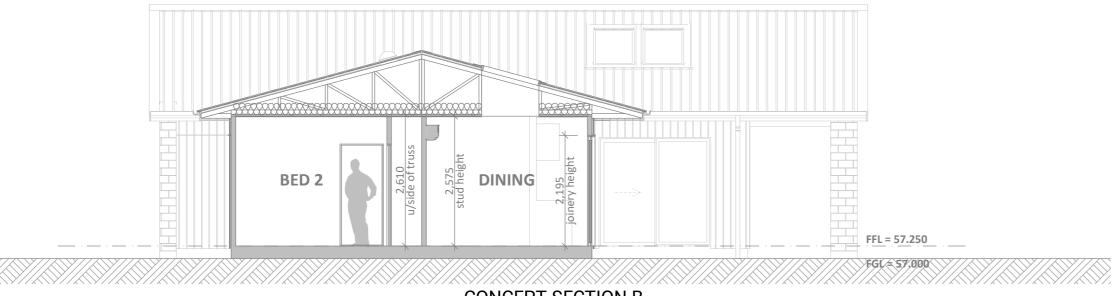

CONCEPT SECTION B
SCALE 1:75

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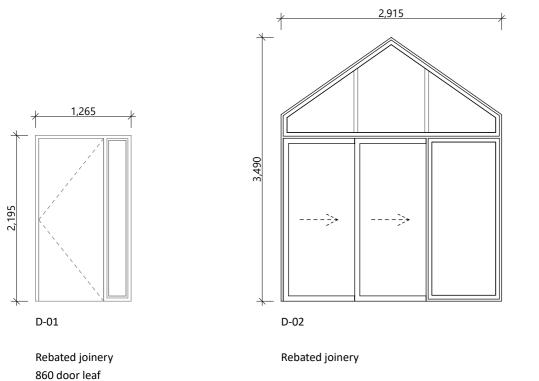
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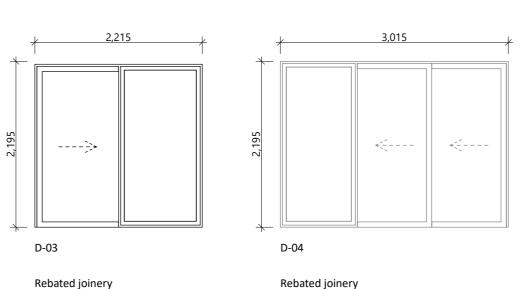
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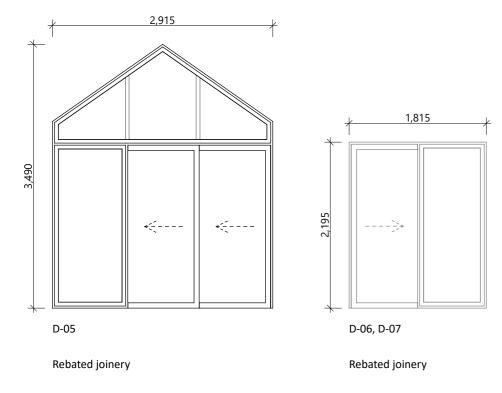





	Project No:	MH24	Designed: CY	Wind: VERY HIGH	Drawing: CROSS SECTIONS	Date:	8/08/202
	Plan: OAKURA	1 (Alt)	Drawn:	EQ:	^{Client Name:} BARRETT HOMES (CENTRAL PLATEAU) LTD	Rev:	
	Version:	1.1	Checked: CY		Site Address: LOT 24, 39 ANNIE ARANUI DRIVE	Sheet:	
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MH MISSION HILLS



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ect No	:	MH24	Designed:	CY	Wind: VERY HIGH	Drawing: JOINERY SCHEDU	JLE	Date:	8/08/2025
0/	KURA	1 (Alt)	Drawn:	-	EQ:	Client Name: BARRETT HOMES	G (CENTRAL PLATEAU) LTD	Rev:	
ion:		1.1	Checked:	CY	Exposure: C	LOT 24, 39 ANNIE	ARANUI DRIVE	Sheet:	9
		design@	barretthomes.	co.nz	Council:			Scale:	1:50

General notes:

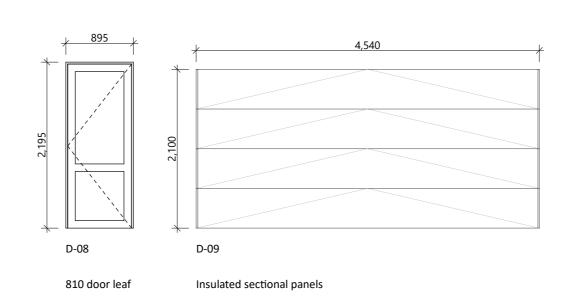Aluminium joinery head heights to be 2.195m (excludes rebated joinery units). Refer to floor plan for door & window sizes. Joinery schedule & sizes to be confirmed on site PRIOR to manufacture

Thermally improved double glazing to all window and door joinery including garage joinery.

Glazing in accordance with NZS 4223 &~2016amendments.

All glazing clear float unless noted anywhere, (refer to joinery schedule)

- Low level glazing = Any glazing within 800mm from FFL, depending on size and proportions, safety glass or 5mm annealed will be required.

 Doors with glazing area > 0.75m² = safety glass
 Doors with glazing area < 0.75m² = 5mm annealed
 Side panels within 800mm of a door = safety glass, side panels not within 800mm of door considered a window.

sg = Safety glass as required by standards, joinery manufacturer to take precedence ss = Safety stays (in accordance with NZBC:F4 clause 2.0) obsc = Obscure glass

REBATED JOINERY


Rebated joinery sizes are to be confirmed with joinery


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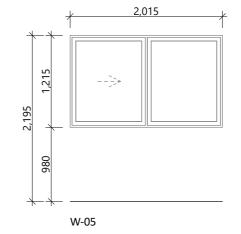
consent drawings) Signature

<u>Date</u>

CONCEPT ONLY



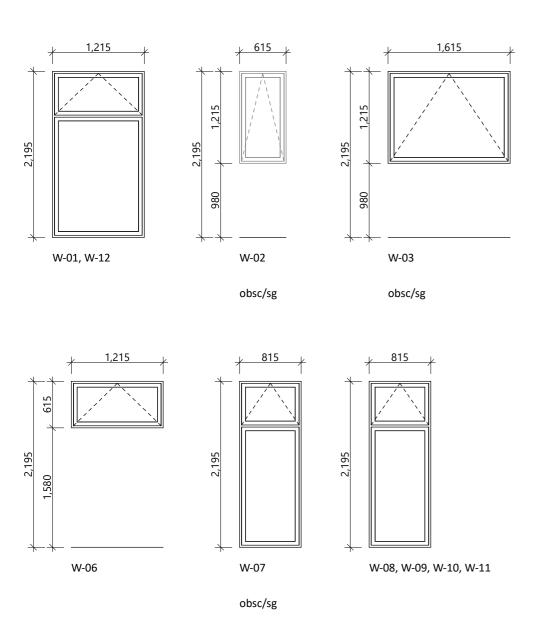

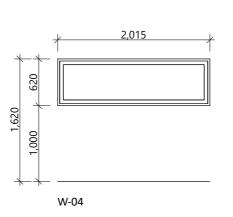

General notes:

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REBATED JOINERY

Rebated joinery sizes are to be confirmed with joinery

CONCEPT PLAN APPROVAL (confirmation to consent drawings)

Signature

<u>Date</u>

CONCEPT ONLY





Project No: MH24	Designed: CY	VERY HIGH	JOINERY SCHEDULE	Date:	8/08/2025
OAKURA1 (Alt)	Drawn:	EQ:	Client Name: BARRETT HOMES (CENTRAL PLATEAU) LTD	Rev:	
/ersion:	Checked: CY	Exposure:		Sheet:	10
design(@barretthomes.co.nz	Council: Napier City	STAGE 1A, MISSION HILLS, NAPIER	Scale:	1:50