

Barrett Homes

Welcome to the whānau.

CONTENTS:

COVER SHEET

MATERIALITY

- 1 ELEVATIONS
- 2 ELEVATIONS
- 3 LOCATION PLAN
- 4 SITE PLAN
- 5 LANDSCAPING PLAN
- 6 CONCEPT PLAN
- 7 WET AREAS
- 8 CROSS SECTIONS
- 9 JOINERY SCHEDULE
- 10 JOINERY SCHEDULE



NEW DWELLING FOR:

BARRETT HOMES (CENTRAL PLATEAU) LTD

ADDRESS:

LOT 24, 39 ANNIE ARANUI DRIVE STAGE 1A, MISSION HILLS, NAPIER CONCEPT PLAN APPROVAL (confirmation to consent drawings)

Date

<u>Signature</u>

CONCEPT ONLY





	Project No:	MH24	Designed: CY	Wind: VERY HIGH	Orawing: COVER SHEET	Date: 4/09/202
	Plan: OAKURA	1 (Alt)	Drawn:	EQ:	Slient Name: BARRETT HOMES (CENTRAL PLATEAU) LTD	Rev:
	Version:	1.1	Checked: CY			Sheet:
s		design@	barretthomes.co.nz	Council: Napier City	STAGE 1A, MISSION HILLS, NAPIER	Scale:



Metal Roofing

- Roofing Industries - trimrib profile



Brick cladding - Black



Vertical Shiplap Weathboard



Joinery



Panel cladding
- INNOVA Duragroove Smooth wide (150) panel cladding


CONCEPT PLAN APPROVAL (confirmation to consent drawings)

<u>Signature</u>


<u>Date</u>





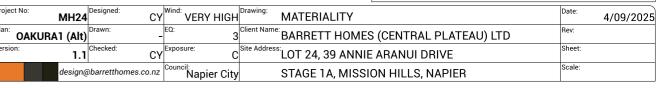

Velux FS M06 35° pitch. Longrun Roofing -INNOVA Duragroove Smooth CJ = Control joint Skylights Trapezoidal profile wide (150) panel cladding 5,281 ox building height HIRB C daylighting 3m at 45° sectional garage door 11,807 FFL = 57.250 EGL existing battered 70 series brick veneer INNOVA Duragroove Smooth 70 series brick veneer wide (150) panel cladding clad column **NORTH ELEVATION**

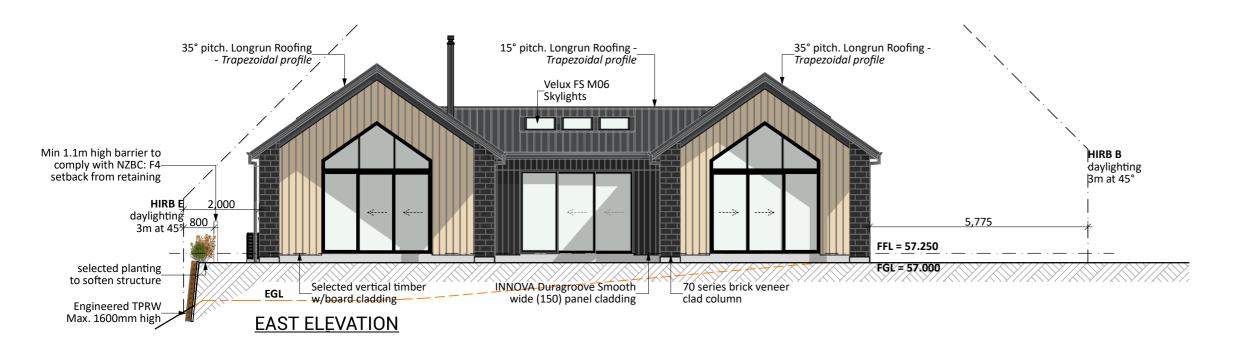

General Notes:

Any encroachments shown are to be confirmed by a registered surveyor prior to commencement of foundations. No liability shall be held by designer with this confirmation.

NZBC D1/AS1 Access

Minimum slip resistance to steps and landings in accordance with NZBC D1/AS1 Table 2. Concrete or H5 timber step to all access points, min. 150mm and max. 190mm below finished floor level.

Foundation:

Ribraft floor to Firth specifications (see plan notes and details)

Wall Cladding:

70 series brick veneer - ensure cavity and weep holes are free from excess mortar

INNOVA Duragroove Smooth wide (150) panel cladding Selected Vertical timber w/board cladding

*All claddings to be installed over FPS Weathertight System. FPS Weathertight System to be installed over timber framing strictly as per manufacturers specification.

Roof Cladding:

35° & 15° pitch. Endura Longrun roofing - *Trapezoidal*

Fascia and Spouting:

COLORCOTE fascia & spouting with 80mm Ø Alipipes - powder coated aluminium downpipes

Joinery & Glazing:

Selected powder coated aluminium joinery with thermally improved Low E double glazing.

CONCEPT PLAN APPROVAL (confirmation to

consent drawings) Signature

Date

4/09/2025

1:100

CONCEPT ONLY



J) LTD


General Notes:

Any encroachments shown are to be confirmed by a registered surveyor prior to commencement of foundations. No liability shall be held by designer with this confirmation.

NZBC D1/AS1 Access

Minimum slip resistance to steps and landings in accordance with NZBC D1/AS1 Table 2. Concrete or H5 timber step to all access points, min. 150mm and max. 190mm below finished floor level.

CJ = Control joint

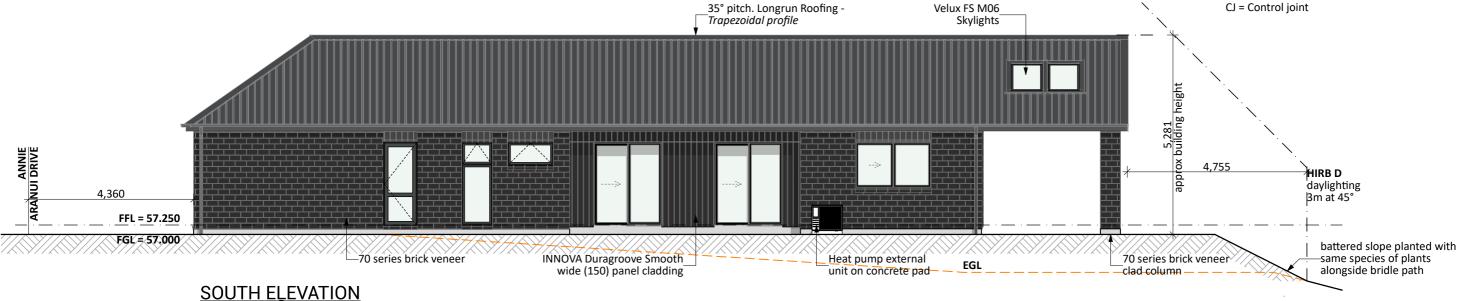

35° pitch. Longrun Roofing 35° pitch. Longrun Roofing -15° pitch. Longrun Roofing Sun tunnel-Trapezoidal profile - Trapezoidal profilé - Trapezoidal profile HIRB A HIRB F daylighting daylighting Bm at 45° 3m at 45° Horizontal flashing-FFL = 57.250 FGL = 57.000 EGL INNOVA Duragroove Smooth Selected vertical timber -70 series brick veneer w/board cladding wide (150) panel cladding WEST ELEVATION

Foundation:

Ribraft floor to Firth specifications (see plan notes and details)

Wall Cladding:

70 series brick veneer - ensure cavity and weep holes are free from excess mortar

INNOVA Duragroove Smooth wide (150) panel cladding Selected Vertical timber w/board cladding

*All claddings to be installed over FPS Weathertight System. FPS Weathertight System to be installed over timber framing strictly as per manufacturers specification.

Roof Cladding:

35° & 15° pitch. Endura Longrun roofing - Trapezoidal

Fascia and Spouting:

COLORCOTE fascia & spouting with 80mm Ø Alipipes - powder coated aluminium downpipes

Joinery & Glazing:

Selected powder coated aluminium joinery with thermally improved Low E double glazing.

CONCEPT PLAN APPROVAL (confirmation to

consent drawings) Signature


<u>Date</u>

CONCEPT ONLY





	Project No: MH24	Designed: CY	Wind: VERY HIGH	Drawing: ELEVATIONS	Date:	4/09/2025
	OAKURA1 (Alt)	Drawn:	EQ:	Client Name: BARRETT HOMES (CENTRAL PLATEAU) LTD	Rev:	
	Version:	Checked: CY	Exposure: C	Site Address: LOT 24, 39 ANNIE ARANUI DRIVE	Sheet:	2
s	design@	barretthomes.co.nz	Council: Napier City	STAGE 1A, MISSION HILLS, NAPIER	Scale:	1:100

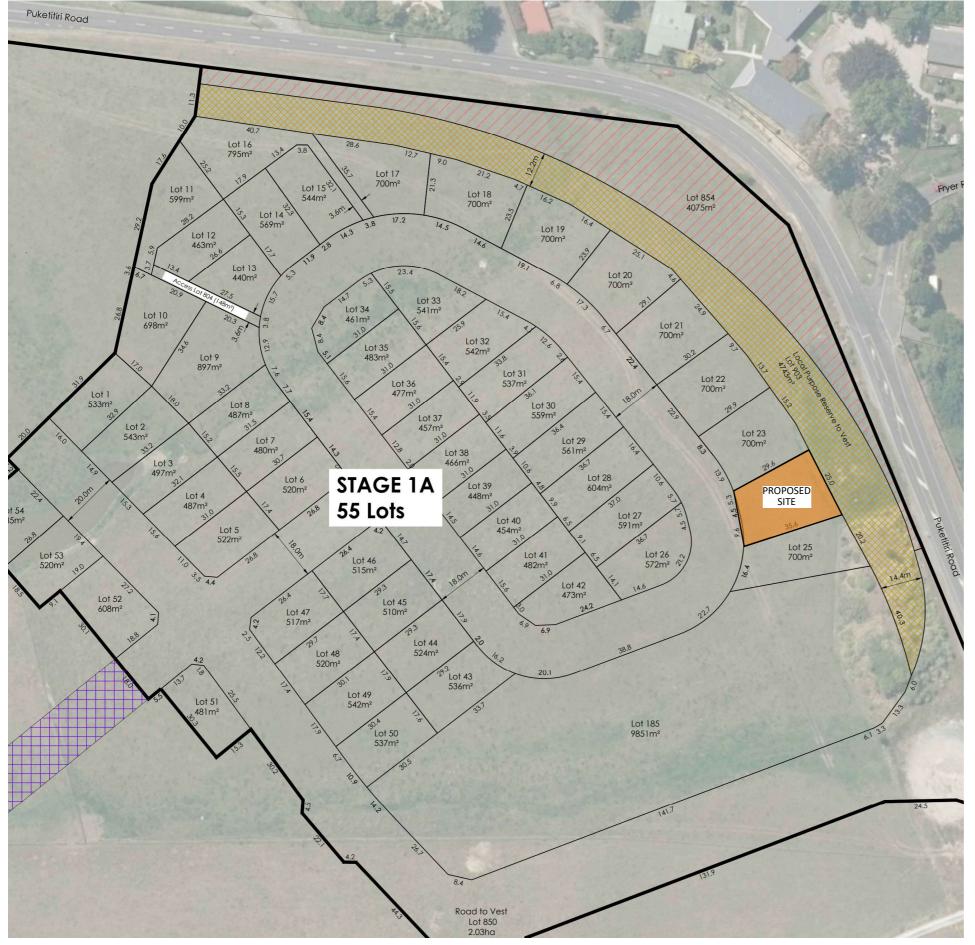

CONCEPT PLAN APPROVAL (confirmation to consent drawings)


<u>Signature</u>

<u>Date</u>





	Project No:	MH24		Wind: VERY HIGH	Drawing: LOCATION PLAN	Date:	4/09/2025
	Plan: OAKURA	1 (Alt)	Drawn:	EQ:	^{Client Name:} BARRETT HOMES (CENTRAL PLATEAU) LTD	Rev:	
	Version:	1.1	Checked: CY		Site Address: LOT 24, 39 ANNIE ARANUI DRIVE	Sheet:	3
s		design@	barretthomes.co.nz	Council: Napier City	STAGE 1A, MISSION HILLS, NAPIER	Scale:	

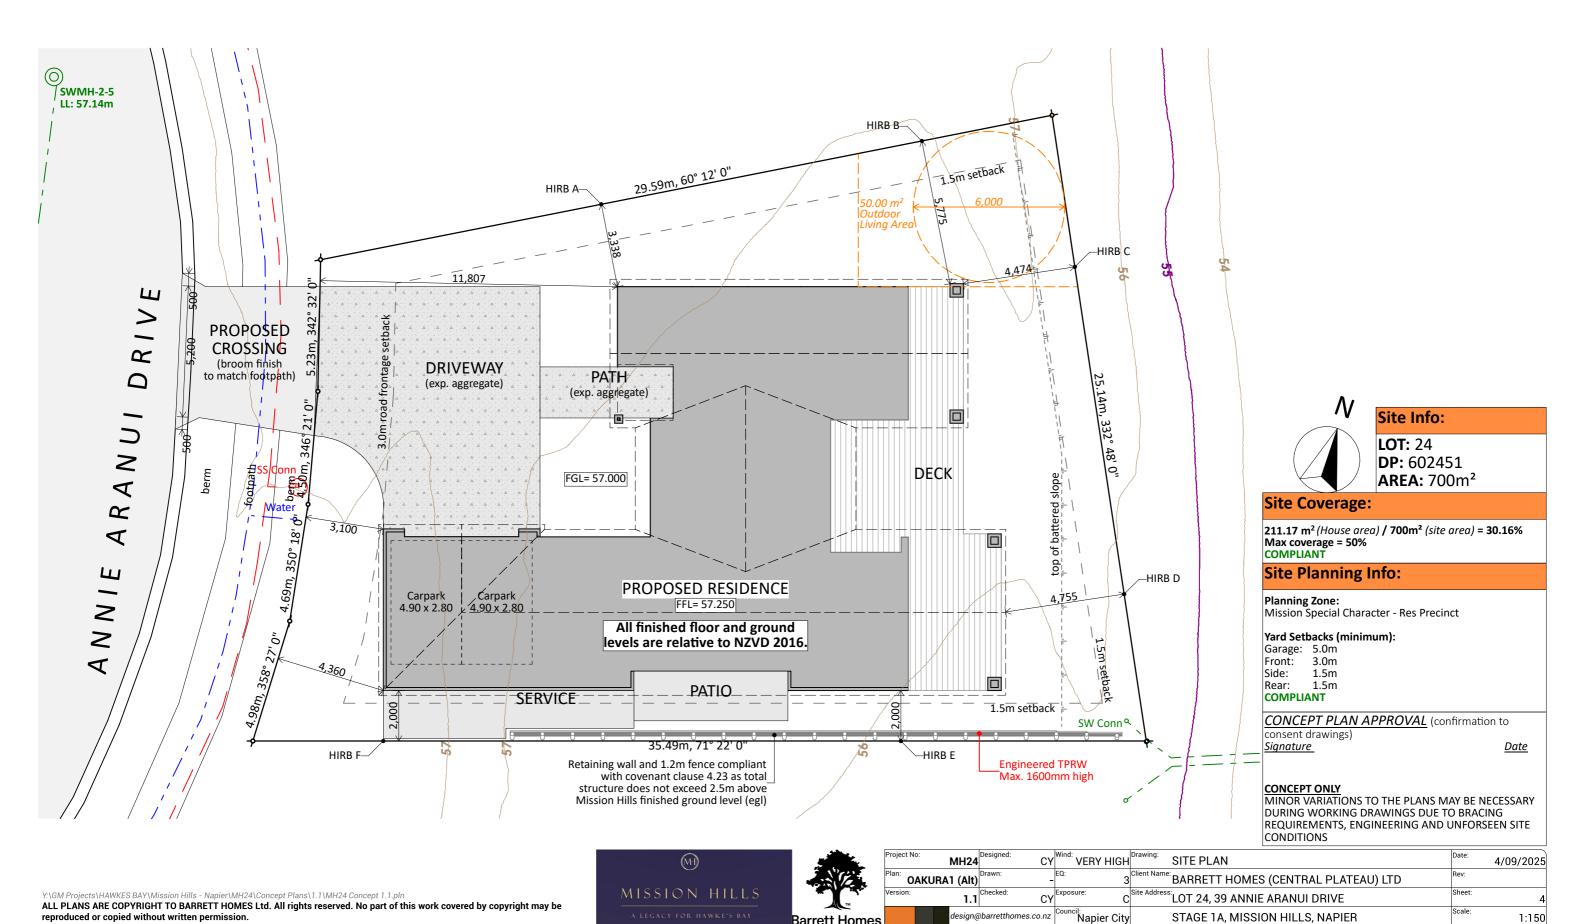

Barrett Homes

reproduced or copied without written permission.

STAGE 1A, MISSION HILLS, NAPIER

1:150












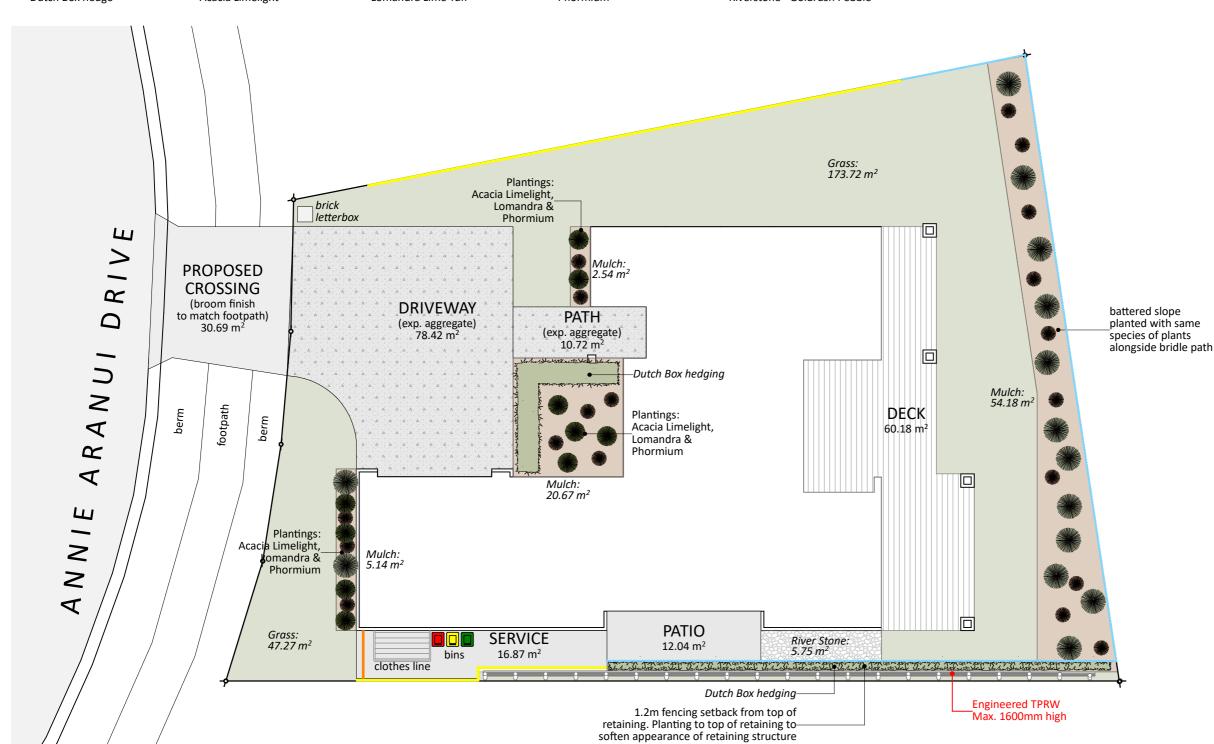

Landscape Key: HydroSeed Grass Riverstones Mulch 1.2m permeable Fence 1.8m Timber Fence Fence & Gate **Selected Grass Plantings** Selected Hedgings Selected planting

CONCEPT PLAN APPROVAL (confirmation to

consent drawings) Signature

<u>Date</u>

CONCEPT ONLY






	Project No:	MH24	Designed: CY	Wind: VERY HIGH	Drawing: LANDSCAPING PLAN	Date:	4/09/2025
	Plan: OAKURA	1 (Alt)	Drawn:	EQ:	Client Name: BARRETT HOMES (CENTRAL PLATEAU) LTD	Rev:	
	Version:	1.1	Checked: CY	Exposure: C	Site Address: LOT 24, 39 ANNIE ARANUI DRIVE	Sheet:	5
s		design@	barretthomes.co.nz	Council: Napier City	STAGE 1A, MISSION HILLS, NAPIER	Scale:	1:150

24,525



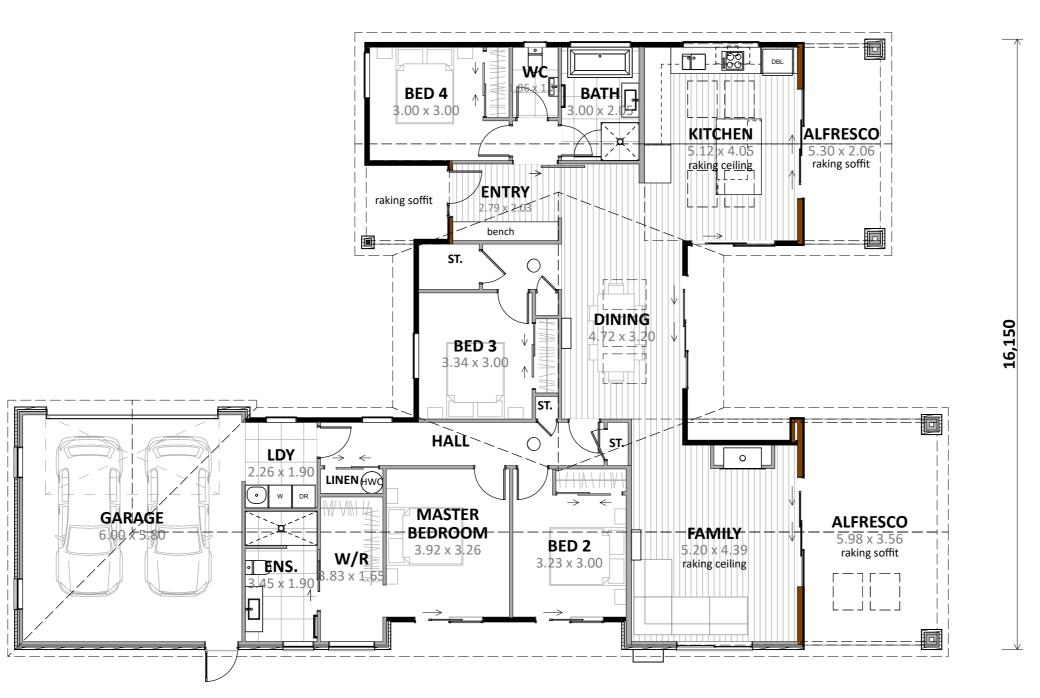

CHANGES TO PLAN: 04/09/25

- Revise landscaping plan

ENGINEERING REQUIRED:
- Alfresco raking portals x 4

Alfresco Footings

- Ridge Beams x 2 & supports - Timber retaining wall

Plan Notes:
2.575 Stud height throughout
All full height joinery (2195)
Raking ceiling to Family & Kitchen as shown (rafters)
Raking soffit to alfresco as shown (rafters)

Floor Area:

Area o/frame: 208.28 m² Area o/foundation: 211.17 m²

Cladding Key:

INNOVA Duragroove Vertical Timber

Brick Veneer

CONCEPT PLAN APPROVAL (confirmation to

consent drawings) <u>Signature</u>


<u>Date</u>


CONCEPT ONLY







	Project No:	MH24	Designed: CY	VERY HIGH	Orawing: CONCEPT PLAN	Oate: 4/09/2025
	OAKURA	1 (Alt)	Drawn:	EQ:	Dient Name: BARRETT HOMES (CENTRAL PLATEAU) LTD	Rev:
	Version:	1.1	Checked: CY	Exposure:		Sheet:
s		design@	barretthomes.co.nz	Council: Napier City	STAGE 1A, MISSION HILLS, NAPIER	Scale: 1:100

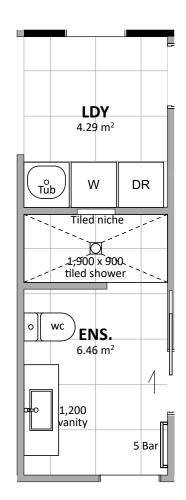

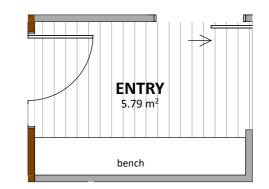

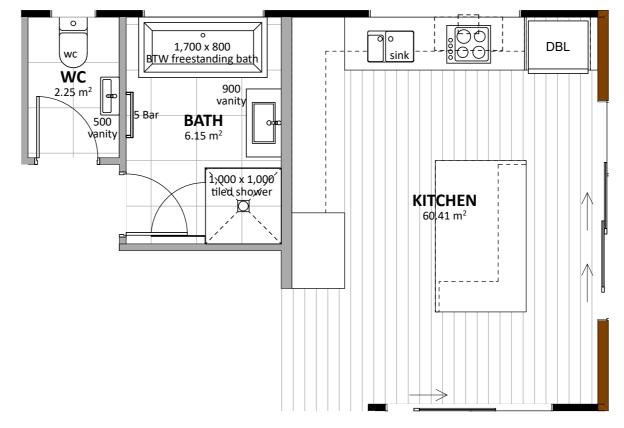


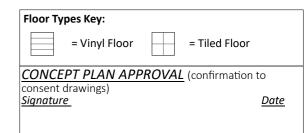






t No:	Docianod:	Wind:	Drawing	Date	
MH24	CY	VERY HIGH	WET AREAS	Date:	4/09/202
OAKURA1 (Alt)	Drawn:	EQ:	Client Name: BARRETT HOMES (CENTRAL PLATEAU) LTD	Rev:	
n: 1.1	Checked: CY			Sheet:	-
design@	abarretthomes.co.nz	Council: Napier City	STAGE 1A, MISSION HILLS, NAPIER	Scale:	1:50
	MH24 OAKURA1 (Alt)	MH24 CY OAKURA1 (Alt) Drawn: - 1.1 Checked: CY	MH24 CY VERY HIGH OAKURA1 (Alt) Drawn: - EQ: 3 1:1 Checked: CY Exposure: C Council: Council: C C	MH24 CY VERY HIGH WE LAREAS OAKURA1 (Alt) Drawn: - EQ: 3 Client Name: BARRETT HOMES (CENTRAL PLATEAU) LTD 1.1 Checked: CY Exposure: C Site Address: LOT 24, 39 ANNIE ARANUI DRIVE	MH24 CY VERY HIGH WE LAREAS OAKURA1 (Alt) Drawn: - EQ: 3 Client Name: BARRETT HOMES (CENTRAL PLATEAU) LTD T. 1.1 Checked: CY Exposure: C Site Address: LOT 24, 39 ANNIE ARANUI DRIVE Scale: Council Scale: CY Exposure:

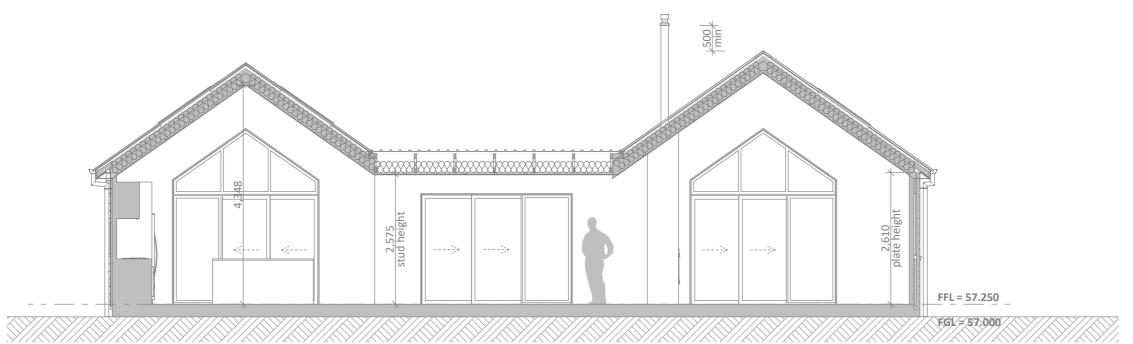

CONCEPT SECTION A SCALE 1:75

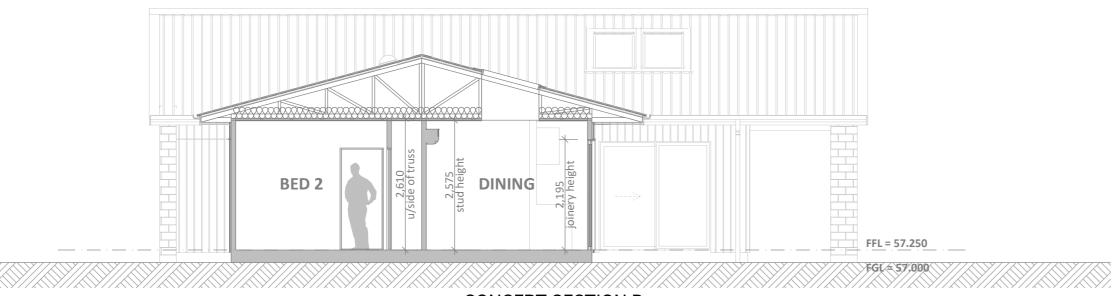

CONCEPT SECTION B SCALE 1:75

CONCEPT PLAN APPROVAL (confirmation to consent drawings)


<u>Signature</u>


<u>Date</u>








	Project No:	MH24	Designed: CY	VERY HIGH	Orawing: CROSS SECTIONS	Date:	4/09/202
	Plan: OAKURA	1 (Alt)	Drawn:	EQ: 3	Client Name: BARRETT HOMES (CENTRAL PLATEAU) LTD	Rev:	
	Version:	1.1	Checked: CY			Sheet:	
s		design@	barretthomes.co.nz	Council: Napier City	STAGE 1A, MISSION HILLS, NAPIER	Scale:	1:75
٠.							

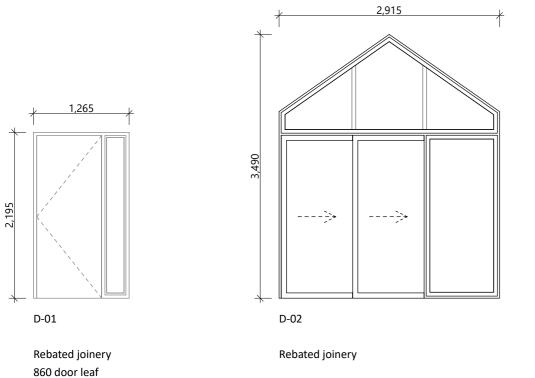

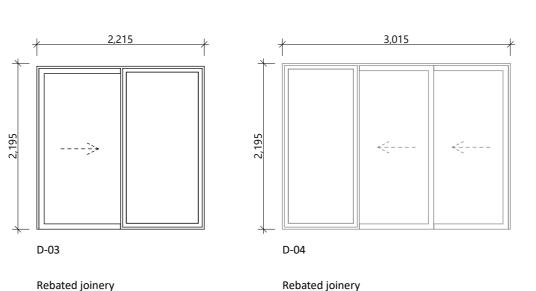

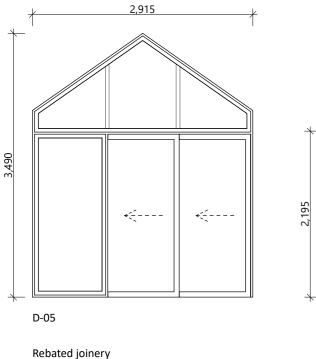

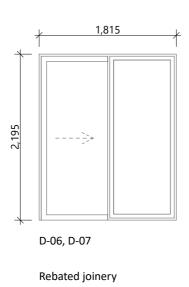

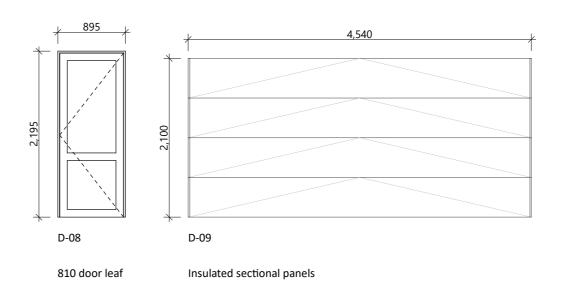

MH MISSION HILLS



oject No:	MH24	Designed: C'	Y VERY HIGH	Drawing: JOINERY SCHEDULE	Oate: 4/09/202
OAKURA	1 (Alt)	Drawn:	- EQ: 3	Client Name: BARRETT HOMES (CENTRAL PLATEAU) LTD	Rev:
rsion:	1.1	Checked: C'			Sheet:
	design@	barretthomes.co.na	Council: Napier City	STAGE 1A, MISSION HILLS, NAPIER	Scale: 1:5

General notes:

Aluminium joinery head heights to be 2.195m (excludes rebated joinery units). Refer to floor plan for door & window sizes. Joinery schedule & sizes to be confirmed on site PRIOR to manufacture

Thermally improved double glazing to all window and door joinery including garage joinery.

Glazing in accordance with NZS 4223 &~2016amendments.

All glazing clear float unless noted anywhere, (refer to joinery schedule)

- Low level glazing = Any glazing within 800mm from FFL, depending on size and proportions, safety glass or 5mm annealed will be required.

 Doors with glazing area > 0.75m² = safety glass
 Doors with glazing area < 0.75m² = 5mm annealed
 Side panels within 800mm of a door = safety glass, side panels not within 800mm of door considered a window.

sg = Safety glass as required by standards, joinery manufacturer to take precedence ss = Safety stays (in accordance with NZBC:F4 clause 2.0) obsc = Obscure glass

REBATED JOINERY


Rebated joinery sizes are to be confirmed with joinery


CONCEPT PLAN APPROVAL (confirmation to


consent drawings) Signature

<u>Date</u>

CONCEPT ONLY

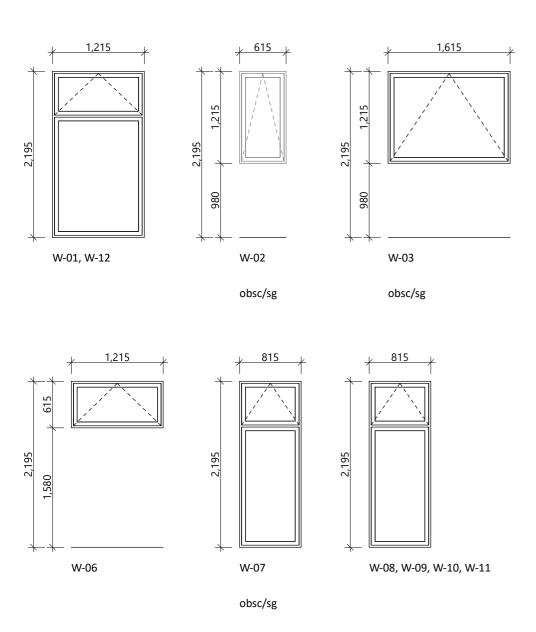

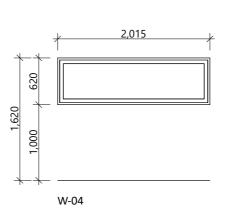

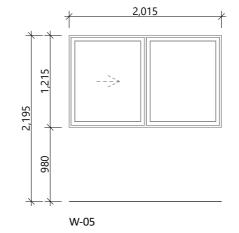

General notes:

Aluminium joinery head heights to be 2.195m (excludes rebated joinery units). Refer to floor plan for door & window sizes. Joinery schedule & sizes to be confirmed on site PRIOR to manufacture

Thermally improved double glazing to all window and door joinery including garage joinery.

Glazing in accordance with NZS 4223 &~2016amendments.

All glazing clear float unless noted anywhere, (refer to joinery schedule)

- Low level glazing = Any glazing within 800mm from FFL, depending on size and proportions, safety glass or 5mm annealed will be required.

- Doors with glazing area > 0.75m² = safety glass
 Doors with glazing area < 0.75m² = 5mm annealed
 Side panels within 800mm of a door = safety glass, side panels not within 800mm of door considered a window.

sg = Safety glass as required by standards, joinery manufacturer to take precedence ss = Safety stays (in accordance with NZBC:F4 clause 2.0) obsc = Obscure glass

REBATED JOINERY

Rebated joinery sizes are to be confirmed with joinery

CONCEPT PLAN APPROVAL (confirmation to consent drawings)

Signature

<u>Date</u>

CONCEPT ONLY





Project No: MH2	4 Designed: CY	Wind: VERY HIGH	Drawing: JOINERY SCHEDULE	Date:	4/09/2025
Plan: OAKURA1 (Al	Drawn:	EQ:	Client Name: BARRETT HOMES (CENTRAL PLATEAU) LTD	Rev:	
Version:	1 Checked: CY	Exposure:		Sheet:	10
desig	@barretthomes.co.nz	Council: Napier City	STAGE 1A, MISSION HILLS, NAPIER	Scale:	1:50