

Welcome to the whānau.

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NEW DWELLING FOR: BARRETT HOMES (NORTHLAND) LTD

ADDRESS:

LOT 8, 18 MOORING WAY, ONE TREE POINT, WHANGAREI











Project No:	MOOR8	Designed: DP	Wind: HIGH	Drawing: COVER SHEET	Date:	4/04/2025
Plan:	RUA7	Drawn:	EQ:	Client Name: BARRETT HOMES (NORTHLAND) LTD	Rev:	
Version:	1.1	Checked: KB	Exposure:	Site Address: LOT 8, 18 MOORING WAY,	Sheet:	
	design@	barretthomes.co.nz	Council: WD0	ONE TREE POINT, WHANGAREI	Scale:	

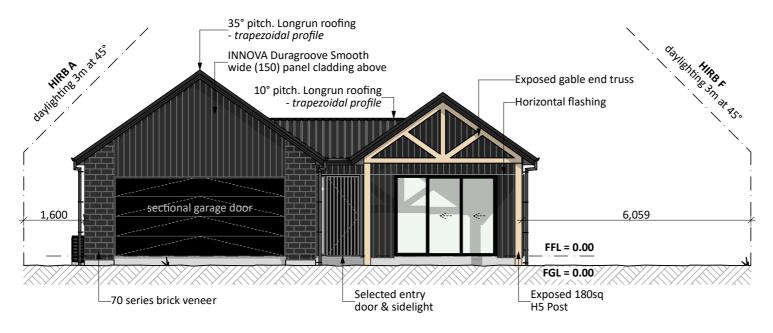

NORTH ELEVATION

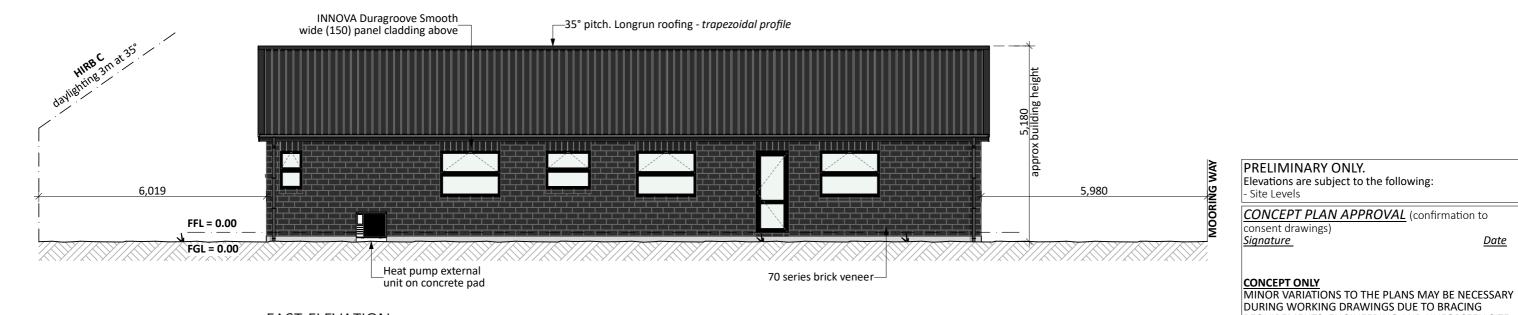

EAST ELEVATION

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Project No:	MOOR8	Designed: DP	Wind: HIGI	Drawing:	ELEVATIONS	Date:	4/04/2025
Plan:	RUA7	Drawn:	EQ:	Client Nam	^{e:} BARRETT HOMES (NORTHLAND) LTD	Rev:	
Version:	1.1	Checked: KB	Exposure:	Site Addres	SELOT 8, 18 MOORING WAY,	Sheet:	1
	design@	barretthomes.co.nz	Council: WD	2	ONE TREE POINT, WHANGAREI	Scale:	1:100

CONDITIONS

General Notes:

Any encroachments shown are to be confirmed by a registered surveyor prior to commencement of foundations. No liability shall be held by designer with this confirmation.

NZBC D1/AS1 Access

Minimum slip resistance to steps and landings in accordance with NZBC D1/AS1 Table 2. Concrete or H5 timber step to all access points, min. 150mm and max. 190mm below finished floor level.

CJ = Control joint

Foundation:

Raft floor to engineers design (see plan notes and details)

Wall Cladding:

70 series brick veneer - ensure cavity and weep holes are free from excess mortar

INNOVA Duragroove Smooth wide (150) panel cladding

Roof Cladding:

35° pitch. Longrun roofing - *Trapezoidal profile*


Fascia and Spouting:

COLORCOTE fascia, spouting & 80mm Ø MARLEY PVC downpipes


REQUIREMENTS, ENGINEERING AND UNFORSEEN SITE

Date

Joinery & Glazing: Selected powder coated aluminium joinery with thermally improved Low E double glazing

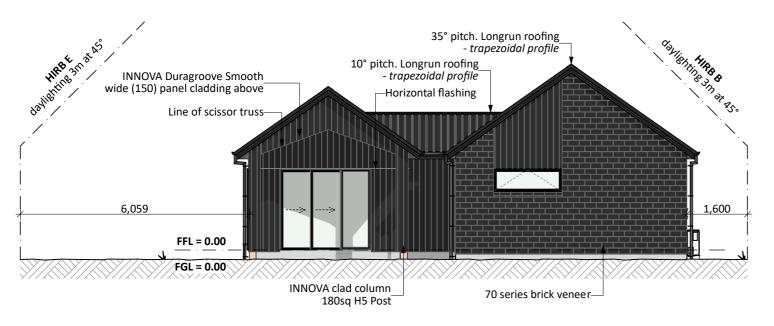

SOUTH ELEVATION

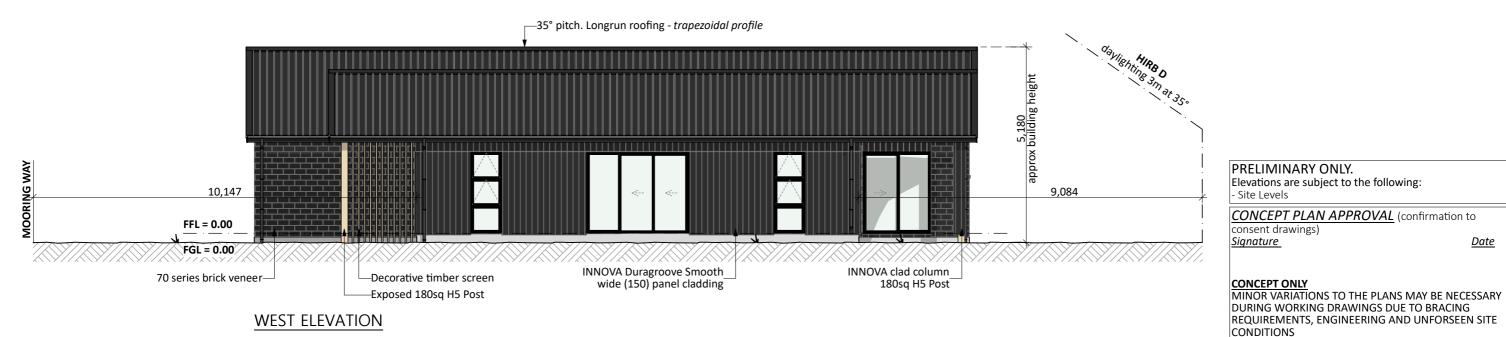

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	Project No:	MOOR8	Designed: D	P Wind:	HIGH	Drawing:	ELEVATIONS	Date:	4/04/2025
	Plan:	RUA7	Drawn:	EQ:	-	Client Name	BARRETT HOMES (NORTHLAND) LTD	Rev:	
	Version:	1.1	Checked: K	B Exposure:	-	Site Address	LOT 8, 18 MOORING WAY,	Sheet:	2
s		design@	Dbarretthomes.co.nz	Council:	WDC		ONE TREE POINT, WHANGAREI	Scale:	1:100

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CJ = Control joint

Foundation:

Raft floor to engineers design (see plan notes and details)

Wall Cladding:

70 series brick veneer - ensure cavity and weep holes are free from excess mortar

INNOVA Duragroove Smooth wide (150) panel cladding

Roof Cladding:


35° pitch. Longrun roofing - *Trapezoidal profile*

Fascia and Spouting:

COLORCOTE fascia, spouting & 80mm Ø MARLEY PVC downpipes


Date

Joinery & Glazing: Selected powder coated aluminium joinery with thermally improved Low E double glazing

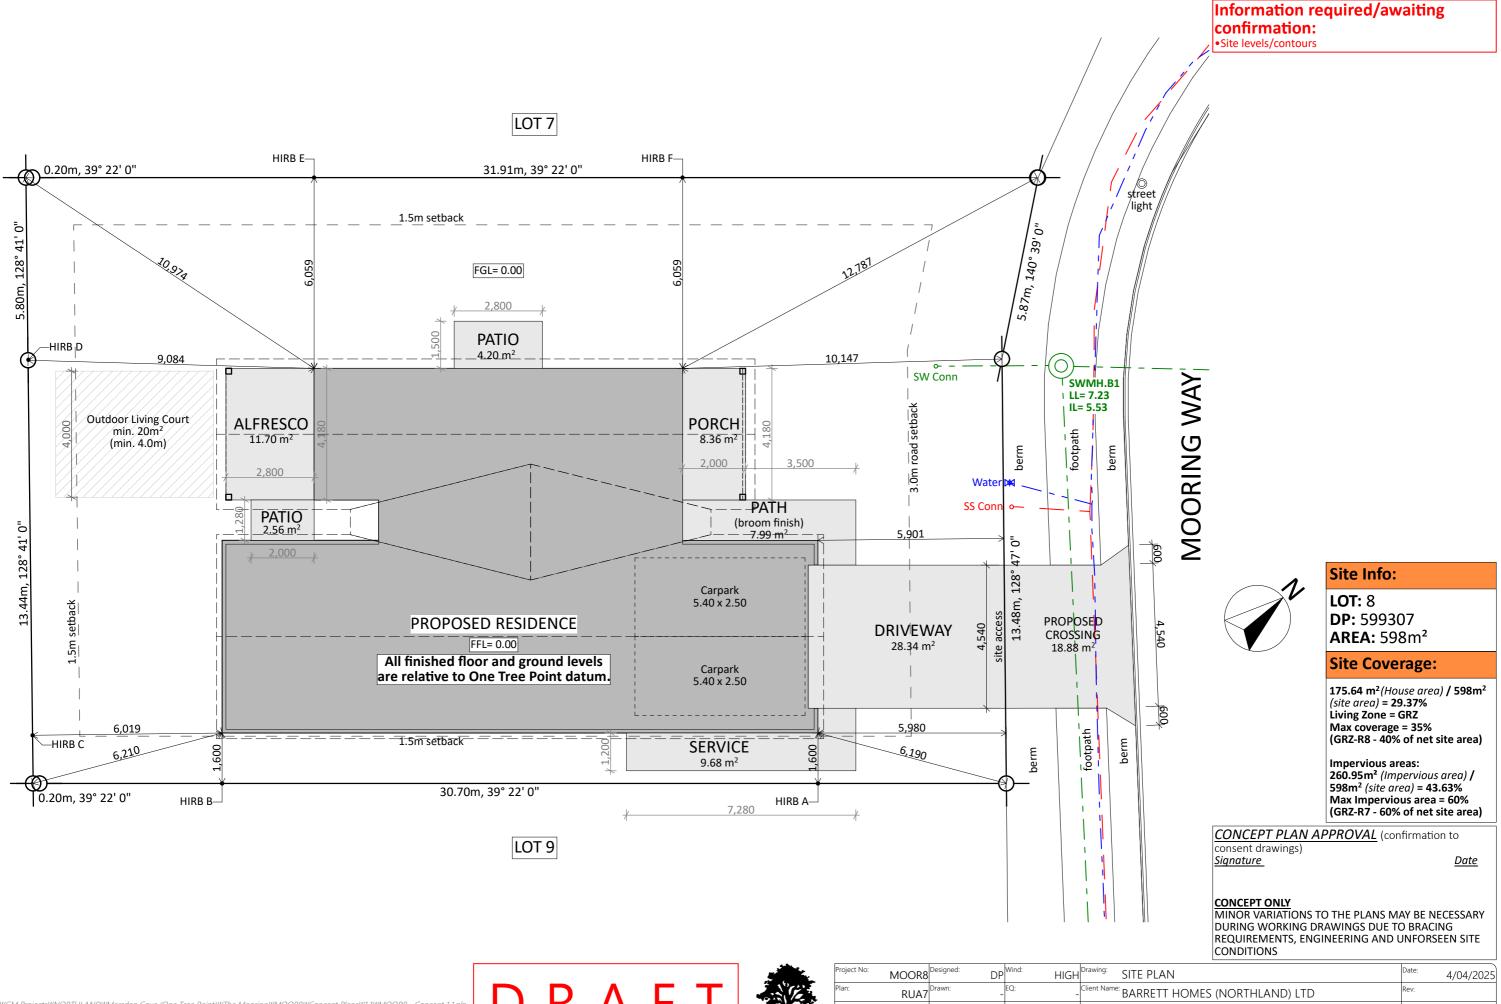



Project N	lo: MOOR8	Designed: DF	Wind:	HIGH	Drawing: SITE PLAN	Date:	4/04/2025
Plan:	RUA7	Drawn:	EQ:	-	^{Client Name:} BARRETT HOMES (NORTHLAND) LTD	Rev:	
Version:	1.1	Checked: KE	Exposure:	-	Site Address: LOT 8, 18 MOORING WAY,	Sheet:	3
3	design@	barretthomes.co.nz	Council:	WDC	ONE TREE POINT, WHANGAREI	Scale:	1:120

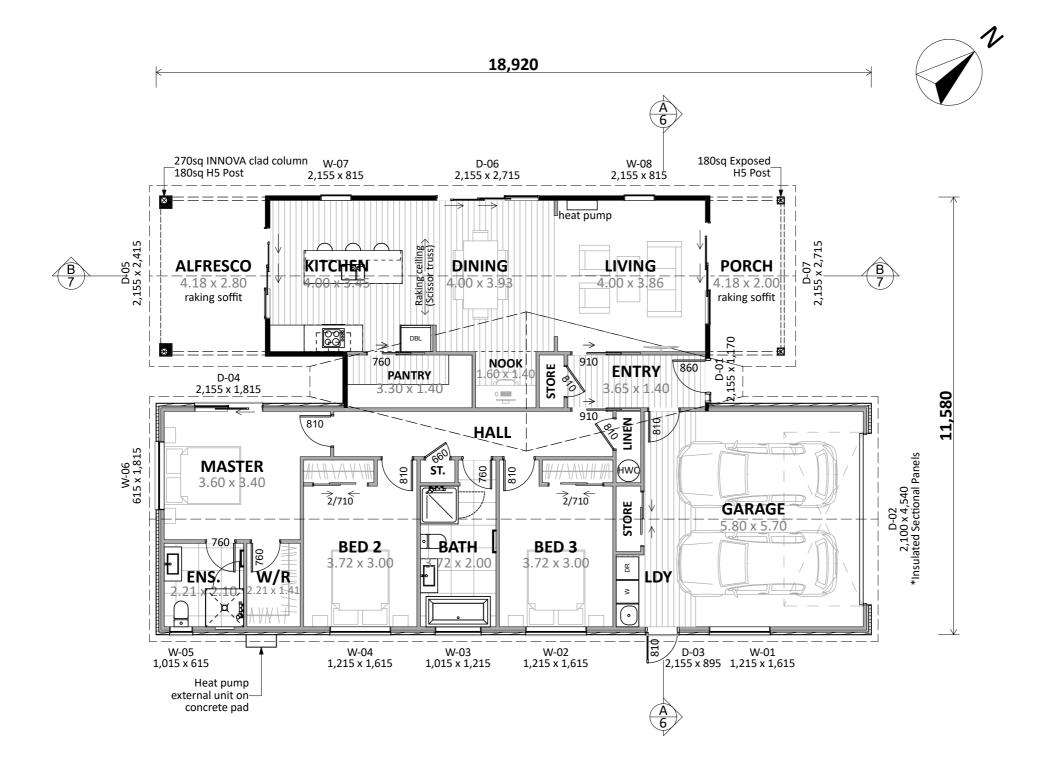

ENGINEERING REQUIRED:

- Foundation

Plan Notes:
2.415 Stud height throughout
All joinery 2155 head height
Raking ceiling to Living, Dining, Kitchen (scissor trusses)
Raking soffit to Alfresco (scissor trusses)

Raking soffit to Alfresco (scissor trusses)
Raking soffit to Porch (rafters)
Insulation to Garage walls, ceiling and door

Floor Area:

Area o/frame: 171.39 m² Area o/foundation: 175.64 m²

Cladding Key:

INNOVA Duragroove
Brick Veneer

CONCEPT PLAN APPROVAL (confirmation to

consent drawings)
Signature

<u>Date</u>


CONCEPT ONLY


MINOR VARIATIONS TO THE PLANS MAY BE NECESSARY DURING WORKING DRAWINGS DUE TO BRACING REQUIREMENTS, ENGINEERING AND UNFORSEEN SITE CONDITIONS







Project No:	MOOR8	Designed:	DP	Wind: HIGH	Drawing: CONCEPT PLAN	Date:	4/04/2025
Plan:	RUA7	Drawn:	-	EQ:	^{Client Name:} BARRETT HOMES (NORTHLAND) LTD	Rev:	
Version:	1.1	Checked:	KB	Exposure:	Site Address: LOT 8, 18 MOORING WAY,	Sheet:	4
6	design@	barretthomes.	co.nz	Council: WDC	ONE TREE POINT, WHANGAREI	Scale:	1:100

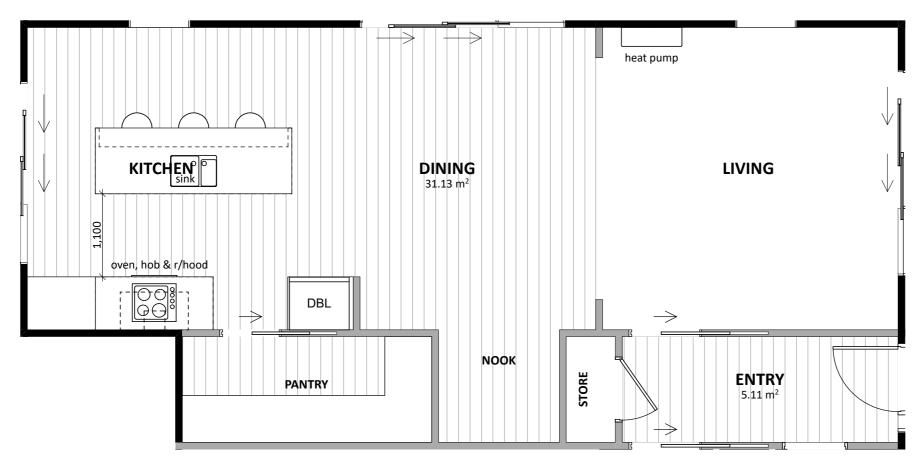

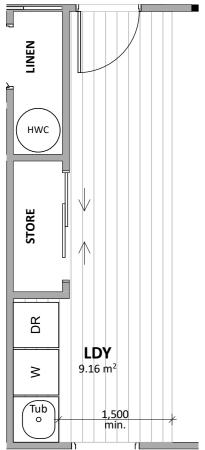

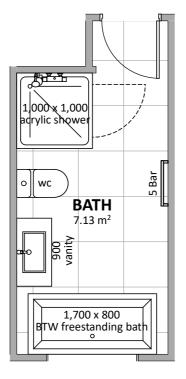

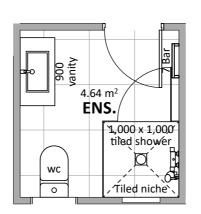


Floor Types Key: = Tiled Floor = Vinyl Floor CONCEPT PLAN APPROVAL (confirmation to consent drawings) <u>Signature</u> <u>Date</u>

CONCEPT ONLY
MINOR VARIATIONS TO THE PLANS MAY BE NECESSARY
DURING WORKING DRAWINGS DUE TO BRACING
REQUIREMENTS, ENGINEERING AND UNFORSEEN SITE CONDITIONS





	Project No:	MOOR8	Designed: DP	Wind: HIGH	Drawing: KITCHEN & BATHROOM	Date: 4/04/2025
	Plan:	RUA7	Drawn:	EQ:	^{Client Name:} BARRETT HOMES (NORTHLAND) LTD	Rev:
	Version:	1.1	Checked: KB	Exposure:	Site Address: LOT 8, 18 MOORING WAY,	Sheet: 5
s		design@	barretthomes.co.nz	Council: WDC	ONE TREE POINT, WHANGAREI	Scale: 1:50

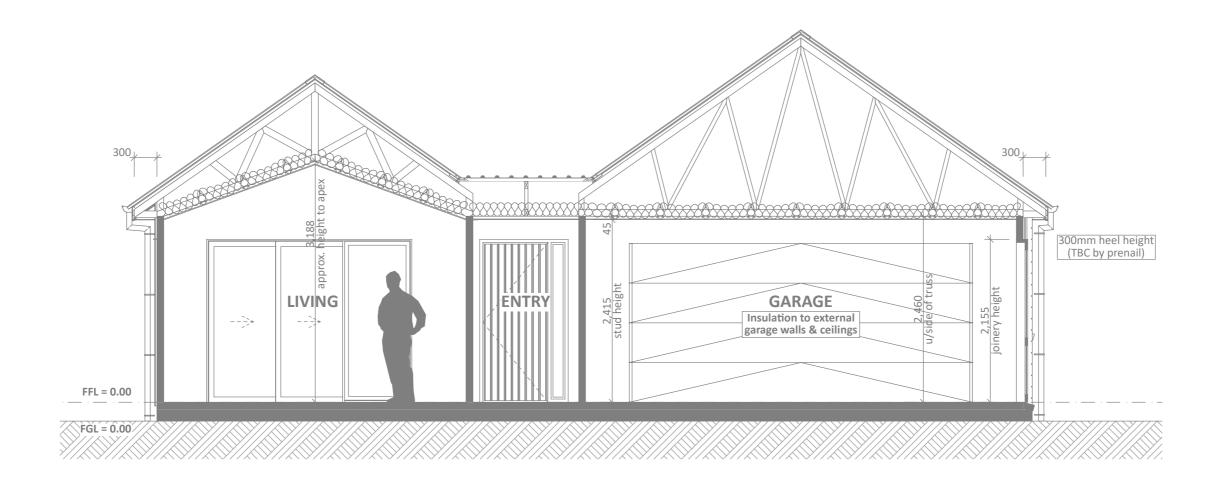

CONCEPT SECTION A SCALE 1:50

CONCEPT PLAN APPROVAL (confirmation to consent drawings)

<u>Signature</u>


<u>Date</u>

CONCEPT ONLY
MINOR VARIATIONS TO THE PLANS MAY BE NECESSARY
DURING WORKING DRAWINGS DUE TO BRACING
REQUIREMENTS, ENGINEERING AND UNFORSEEN SITE CONDITIONS





	Project No:	MOOR8	Designed: DP	Wind: HIGH	Drawing: CROSS SECTION A	Date:	4/04/2025
	Plan:	RUA7	Drawn:	EQ:	Client Name: BARRETT HOMES (NORTHLAND) LTD	Rev:	
	Version:	1.1	Checked: KB	Exposure:	Site Address: LOT 8, 18 MOORING WAY,	Sheet:	6
es		design@	barretthomes.co.nz	Council: WDC	ONE TREE POINT, WHANGAREI	Scale:	1:50

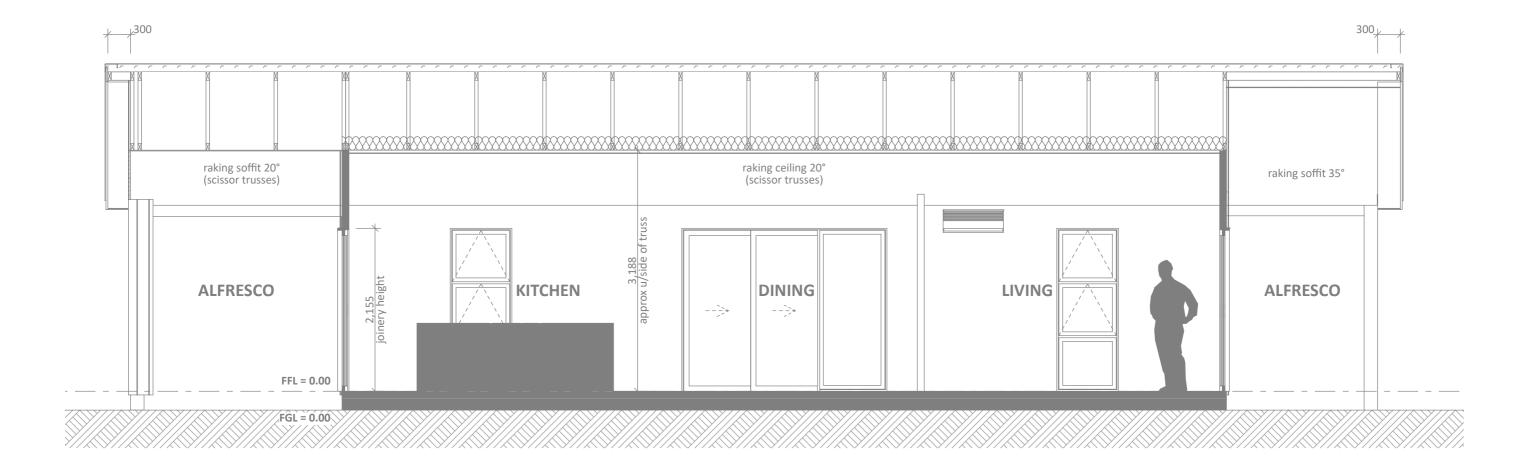

CONCEPT SECTION B SCALE 1:50

CONCEPT PLAN APPROVAL (confirmation to consent drawings)

<u>Signature</u>


<u>Date</u>

CONCEPT ONLY
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	Project No:	MOOR8	Designed: DI	Wind: HIGH	Drawing: CROSS SECTION B	Date:	4/04/2025
	Plan:	RUA7	Drawn:	EQ:	Client Name: BARRETT HOMES (NORTHLAND) LTD	Rev:	
	Version:	1.1	Checked: KE	Exposure:	Site Address: LOT 8, 18 MOORING WAY,	Sheet:	7
es		design@	barretthomes.co.nz	Council: WD0	ONE TREE POINT, WHANGAREI	Scale:	1:50



General notes:

Aluminium joinery head heights to be 2.155m (excludes rebated joinery units). Refer to floor plan for door & window sizes. Joinery schedule & sizes to be confirmed on site PRIOR to manufacture

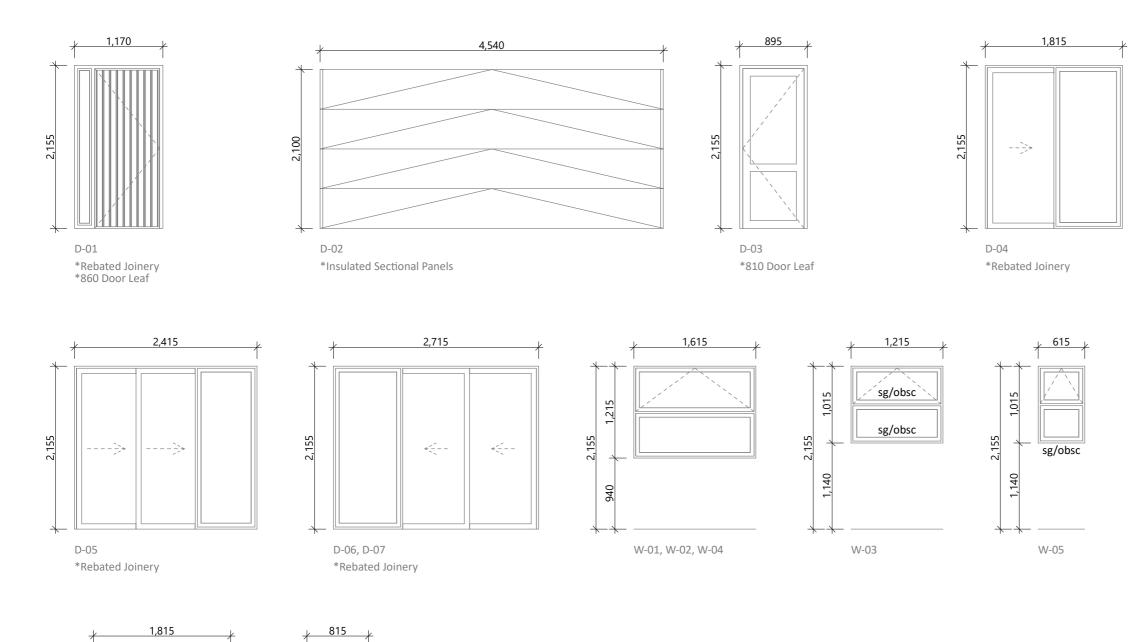Thermally improved double glazing to all window and door joinery including garage joinery.

Glazing in accordance with NZS 4223 &~2016amendments.

All glazing clear float unless noted anywhere, (refer to joinery schedule)

- Low level glazing = Any glazing within 800mm from FFL, depending on size and proportions, safety glass or 5mm annealed will be required.

- Doors with glazing area > 0.75m² = safety glass
- Doors with glazing area < 0.75m² = 5mm annealed Side panels within 800mm of a door = safety glass, side panels not within 800mm of door considered a window.

sg = Safety glass as required by standards, joinery manufacturer to take precedence ss = Safety stays (in accordance with NZBC:F4 clause 2.0) obsc = Obscure glass

REBATED JOINERY

Rebated joinery sizes are to be confirmed with joinery

CONCEPT PLAN APPROVAL (confirmation to consent drawings)

Signature

<u>Date</u>

CONCEPT ONLY

MINOR VARIATIONS TO THE PLANS MAY BE NECESSARY DURING WORKING DRAWINGS DUE TO BRACING REQUIREMENTS, ENGINEERING AND UNFORSEEN SITE CONDITIONS





	Project No:	MOOR8	Designed: D	P Wind:	HIGH	Drawing: JOINERY SCHEDULE	Date:	4/04/2025
L	Plan:	RUA7	Drawn:	EQ:	-	Client Name: BARRETT HOMES (NORTHLAND) LTD	Rev:	
	Version:	1.1	Checked: K	B Exposure:	-	ite Address: LOT 8, 18 MOORING WAY,	Sheet:	8
es		design@	barretthomes.co.nz	Council:	WDC	ONE TREE POINT, WHANGAREI	Scale:	1:50

W-07, W-08

W-06