

Welcome to the whānau. **CONTENTS:**

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ELEVATIONS

ELEVATIONS

LOCATION PLAN SITE PLAN

LANDSCAPING PLAN

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WET AREAS

CROSS SECTIONS

JOINERY SCHEDULE



ARTIST IMPRESSION ONLY

NEW DWELLING FOR: BARRETT HOMES (CENTRAL PLATEAU) LTD

ADDRESS:

LOT 18, 27 ANNIE ARANUI DRIVE STAGE 1A, MISSION HILLS, NAPIER CONCEPT PLAN APPROVAL (confirmation to

<u>Signature</u>

<u>Date</u>





Pr	oject No:	MH18	Designed: CY	Wind: EXTRA HIGH	Drawing: COVER SHEET	Date: 26/09/2025
Pla	an:	New Design	Drawn:	-EQ: 3	^{Client Name:} BARRETT HOMES (CENTRAL PLATEAU) LTD	Rev:
Ve	ersion:	1.0	Checked: CY	, Exposure:	ite Address: LOT 18, 27 ANNIE ARANUI DRIVE	Sheet:
s		design@	barretthomes.co.nz	Council: Napier City	STAGE 1A, MISSION HILLS, NAPIER	Scale:



Metal Roofing

- Roofing Industries - trimrib profile



Panel cladding - INNOVA Stratum (400) panel cladding



Vertical Shiplap Weatherboard



Joinery

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<u>Date</u>






General Notes:


Any encroachments shown are to be confirmed by a registered surveyor prior to commencement of foundations. No liability shall be held by designer with this confirmation.

NZBC D1/AS1 Access

Minimum slip resistance to steps and landings in accordance with NZBC D1/AS1 Table 2. Concrete or H5 timber step to all access points, min. 150mm and max. 190mm below finished floor level.

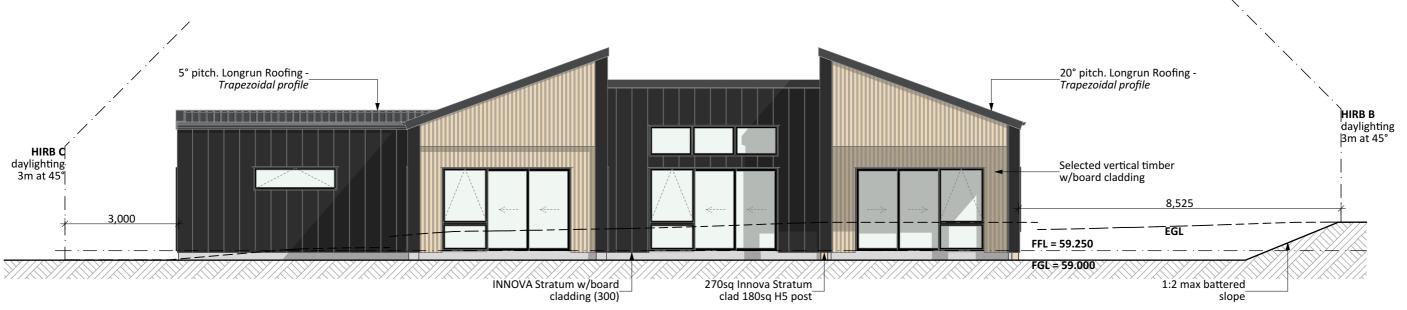

NORTH ELEVATION

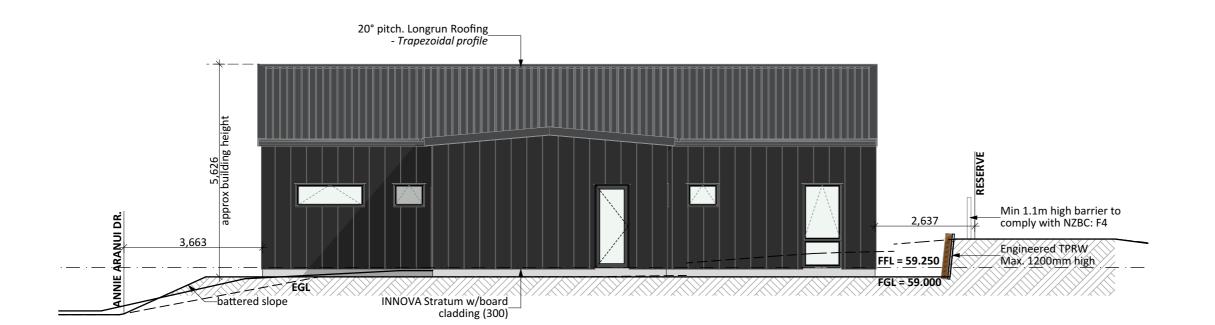

Foundation:

Ribraft floor to Firth specifications (see plan notes and details)

Wall Cladding:

INNOVA Stratum w/board cladding (300mm) Selected Vertical timber w/board cladding

*All claddings to be installed over FPS Weathertight System. FPS Weathertight System to be installed over timber framing strictly as per manufacturers specification.

Roof Cladding:

20° & 5° pitch. Maxam Longrun roofing - *Trapezoidal* profile

Fascia and Spouting:

COLORCOTE fascia & spouting with 80mm Ø Alipipes - powder coated aluminium downpipes

Joinery & Glazing:

Selected powder coated aluminium joinery with thermally improved Low E double glazing.

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Signature

<u>Date</u>

CONCEPT ONLY

MINOR VARIATIONS TO THE PLANS MAY BE NECESSARY DURING WORKING DRAWINGS DUE TO BRACING REQUIREMENTS, ENGINEERING AND UNFORSEEN SITE CONDITIONS







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	Plan:	New Des	ign	Drawn:	-	EQ:	Client Name:	BARRETT HOMES (CENTRAL PLATEAU) LTD	Rev:	
	Version:		1.0	Checked:	ΞY	Exposure:	Site Address:	LOT 18, 27 ANNIE ARANUI DRIVE	Sheet:	1
s		des	ign@	barretthomes.co.n	z	Council: Napier City		STAGE 1A, MISSION HILLS, NAPIER	Scale:	1:100

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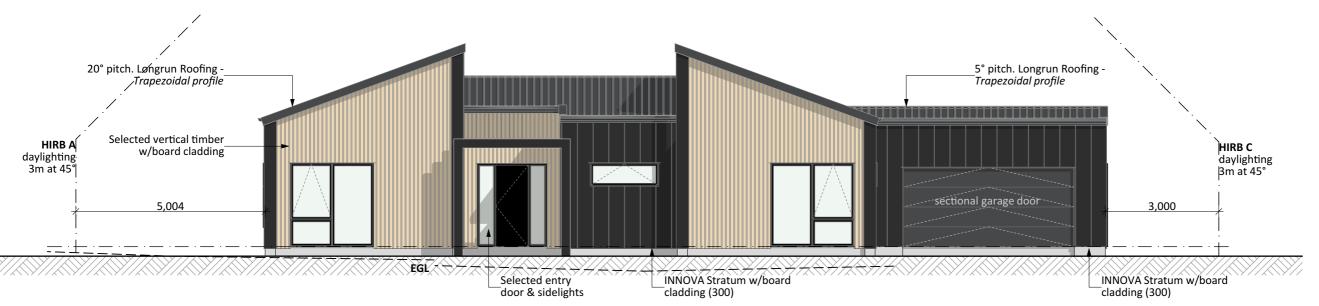
EAST ELEVATION

General Notes:

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NZBC D1/AS1 Access

Minimum slip resistance to steps and landings in accordance with NZBC D1/AS1 Table 2. Concrete or H5 timber step to all access points, min. 150mm and max. 190mm below finished floor level.



SOUTH ELEVATION

WEST ELEVATION

Min 1.1m high barrier to comply with NZBC: F4 Engineered TPRW Max. 1200mm high FGL = 59.000 INNOVA Stratum w/board cladding (300)

Foundation:

Ribraft floor to Firth specifications (see plan notes and details)

Wall Cladding:

INNOVA Stratum w/board cladding (300mm) Selected Vertical timber w/board cladding

*All claddings to be installed over FPS Weathertight System. FPS Weathertight System to be installed over timber framing strictly as per manufacturers specification.

Roof Cladding:

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CONCEPT ONLY





	Project No:		MH18	Designed:	CY	Wind: EXTRA HIGH	Drawing:	ELEVATIONS	Date:	26/09/2025
	Plan:	New	Design	Drawn:	-	EQ: 3	Client Name	E BARRETT HOMES (CENTRAL PLATEAU) LTD	Rev:	
	Version:		1.0	Checked:	CY	Exposure:	Site Addres	^{s:} Lot 18, 27 Annie Aranui Drive	Sheet:	2
es			design@	barretthom	es.co.nz	Council: Napier City		STAGE 1A, MISSION HILLS, NAPIER	Scale:	1:100



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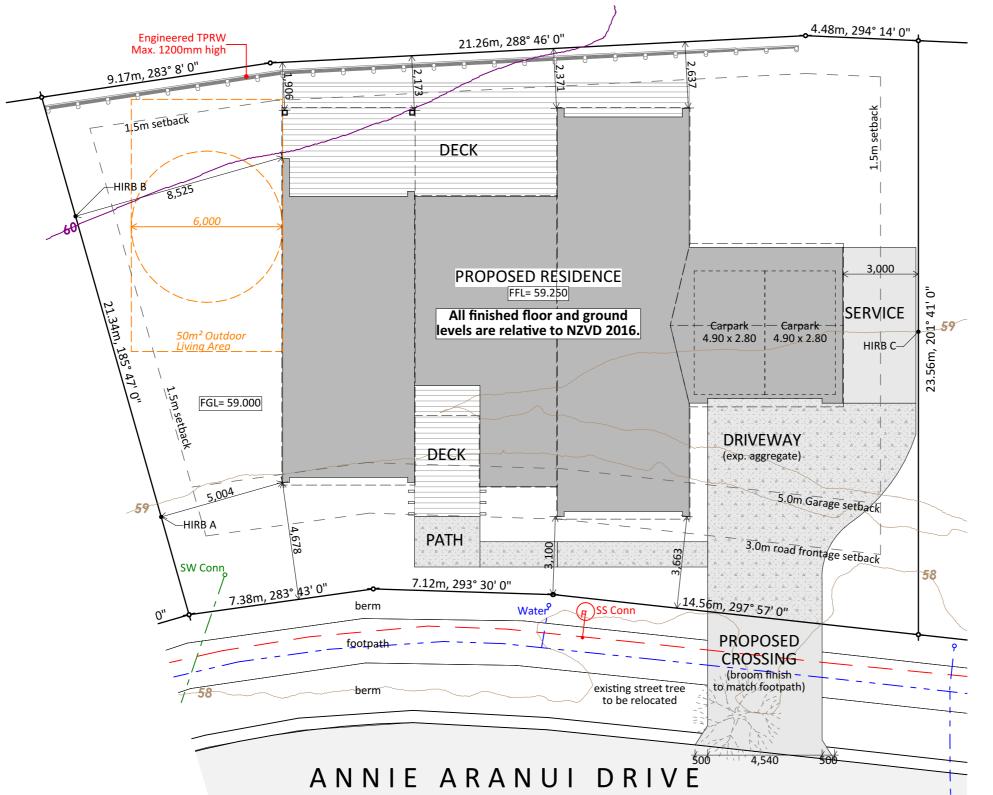
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	Project No:	MH18	Designed: CY	W ^{ind:} EXTRA HIGH	Drawing: LOCATION PLAN	Date:	26/09/2025
	Plan:	New Design	Drawn:	EQ: 3	^{Client Name:} BARRETT HOMES (CENTRAL PLATEAU) LTD	Rev:	
	Version:	1.0	CY		LOT 18, 27 ANNIE ARANUI DRIVE	Sheet:	3
s		design@	abarretthomes.co.nz	Council Napier City	STAGE 1A, MISSION HILLS, NAPIER	Scale:	





Site Info:

LOT: 18 **DP:** 602451 AREA: 700m²

Site Coverage:

232.61 m² (House area) / 700m² (site area) = 32.97% Max coverage = 50% COMPLIANT

Site Planning Info:

Planning Zone: Mission Special Character - Res Precinct

Yard Setbacks (minimum): Garage: 5.0m COMPLIANT COMPLIANT COMPLIANT 3.0m Front: Side: 1.5m Rear: 1.5m COMPLIANT

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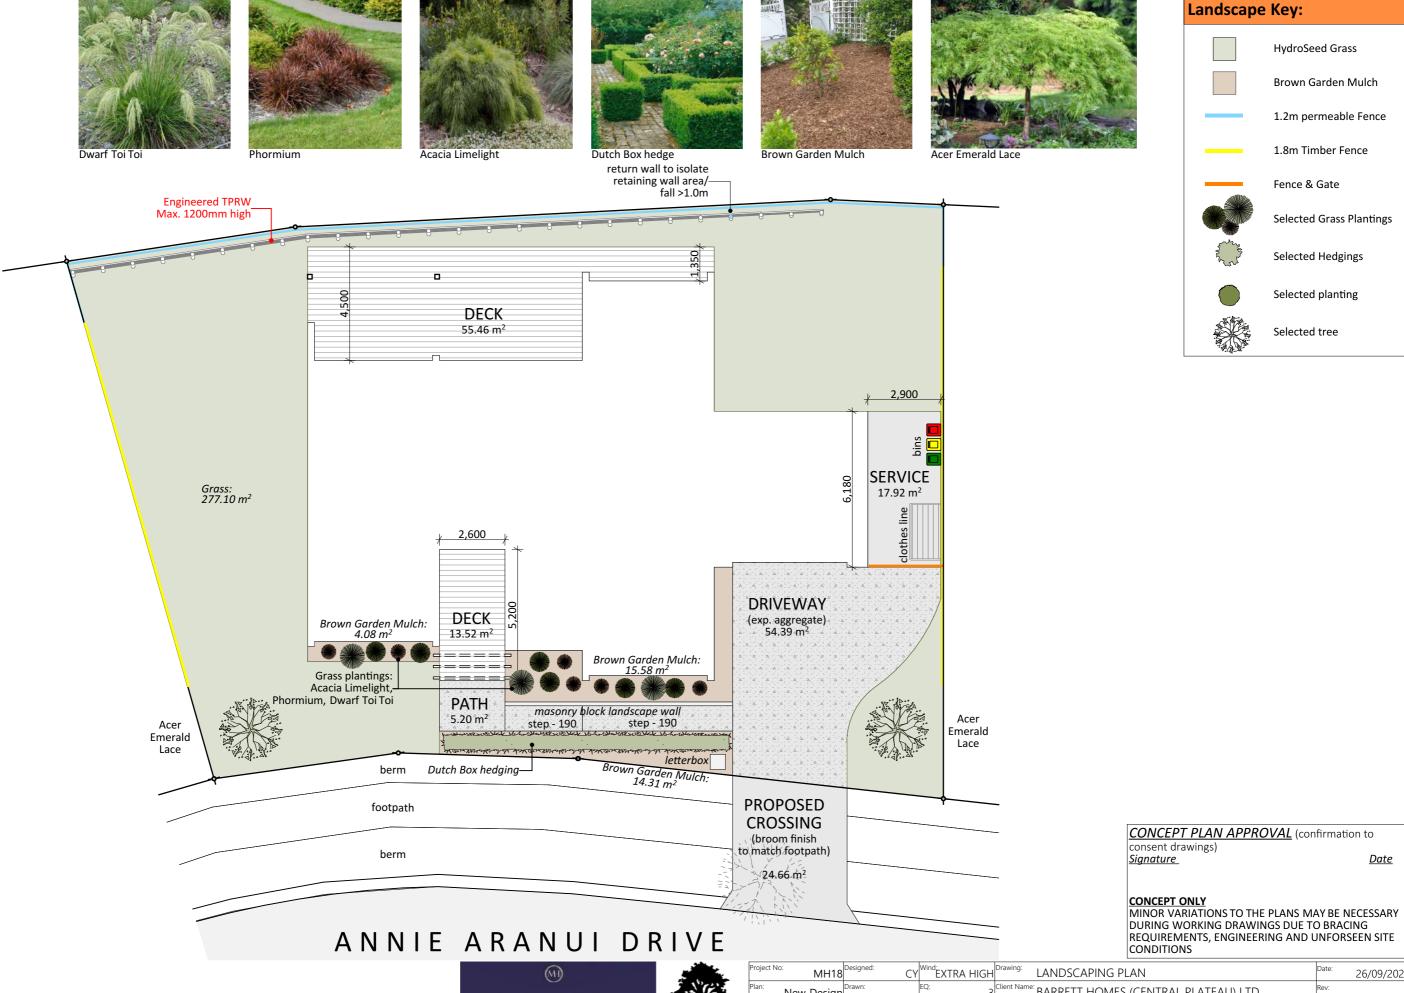
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MINOR VARIATIONS TO THE PLANS MAY BE NECESSARY
DURING WORKING DRAWINGS DUE TO BRACING
REQUIRED TO STREET ON THE PLANS MAY BE NECESSARY
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REQUIRED TO STREET ON THE PLANS MAY BE NECESSARY CONDITIONS





	Project No	· MH18	Designed: CY	EXTRA HIGH	Drawing: SITE PLAN	Date: 26/09/2025
	Plan:	New Design	Drawn:	EQ: 3	Client Name: BARRETT HOMES (CENTRAL PLATEAU) LTD	Rev:
	Version:	1.0	Checked: CY	Exposure:	Site Address: LOT 18, 27 ANNIE ARANUI DRIVE	Sheet: 2
s		design@	barretthomes.co.nz	Council: Napier City	STAGE 1A, MISSION HILLS, NAPIER	Scale: 1:15(
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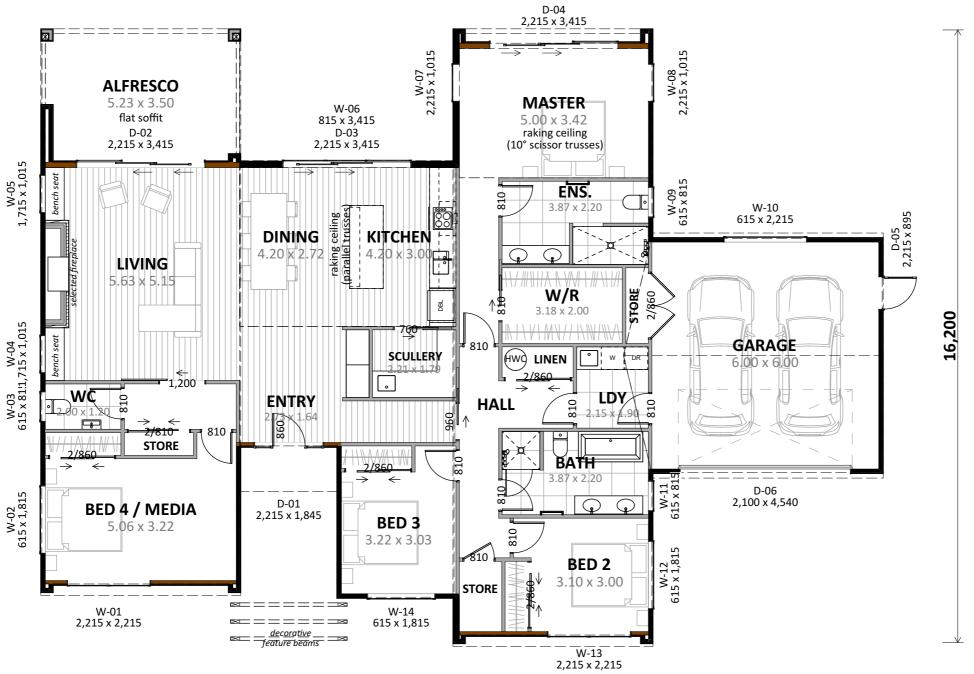




	Project No):	MH18	Designed:	CY	Wind: EXTRA HIGH	Drawing:	LANDSCAPING PLAN	Date:	26/09/
	Plan:	New	Design	Drawn:	-	EQ:	Client Name:	BARRETT HOMES (CENTRAL PLATEAU) LTD	Rev:	
	Version:		1.0	Checked:	CY	Exposure:	Site Address:	LOT 18, 27 ANNIE ARANUI DRIVE	Sheet:	
s			design@	barretthome:	s.co.nz	Council: Napier City		STAGE 1A, MISSION HILLS, NAPIER	Scale:	

<u>Date</u>

22,220



ENGINEERING REQUIRED:

Alfresco bracing

- Alfresco wing wall foundation - Timber pole retaining wall

Plan Notes:

2.725 Stud height throughout
All full height joinery (2215)
Raking ceiling to Dining & Kitchen (parallel trusses)
Raking ceiling to Master Bedroom (scissor trusses)
Flat soffit to Alfresco and Entry

Selected Fireplace

Floor Area:

Area o/frame: 232.61 m²

Cladding Key:

INNOVA Stratum Vertical Timber

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<u>Date</u>


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	Plan:	New De	esign	Drawn:	- EQ: 3	^{Client Name:} BARRETT HOMES (CENTRAL PLATEAU) LTD	Rev:	
	Version:		1.0	Checked: C	Y Exposure:	Site Address: LOT 18, 27 ANNIE ARANUI DRIVE	Sheet:	6
s		de	esign@	barretthomes.co.nz	Council Napier City	STAGE 1A, MISSION HILLS, NAPIER	Scale:	1:100









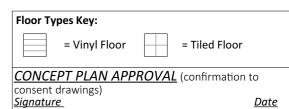

	Project No:	MH18	Designed: C\	Wind- EXTRA HIGH	Drawing: WET AREAS	Date:	26/09/2025
	Plan:	New Design	Drawn:	-EQ: 3	^{Client Name:} BARRETT HOMES (CENTRAL PLATEAU) LTD	Rev:	
	Version:	1.0	Checked: C\	Exposure:	Site Address: LOT 18, 27 ANNIE ARANUI DRIVE	Sheet:	7
s		design@	barretthomes.co.nz	Council: Napier City	STAGE 1A, MISSION HILLS, NAPIER	Scale:	1:50

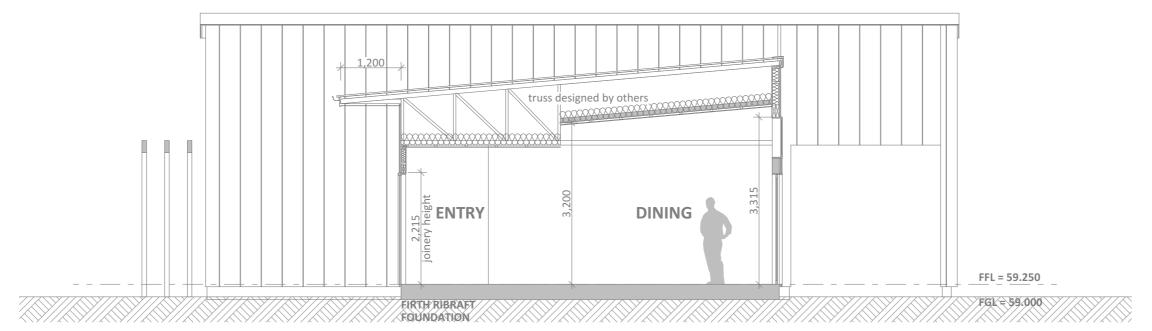

CONCEPT SECTION A

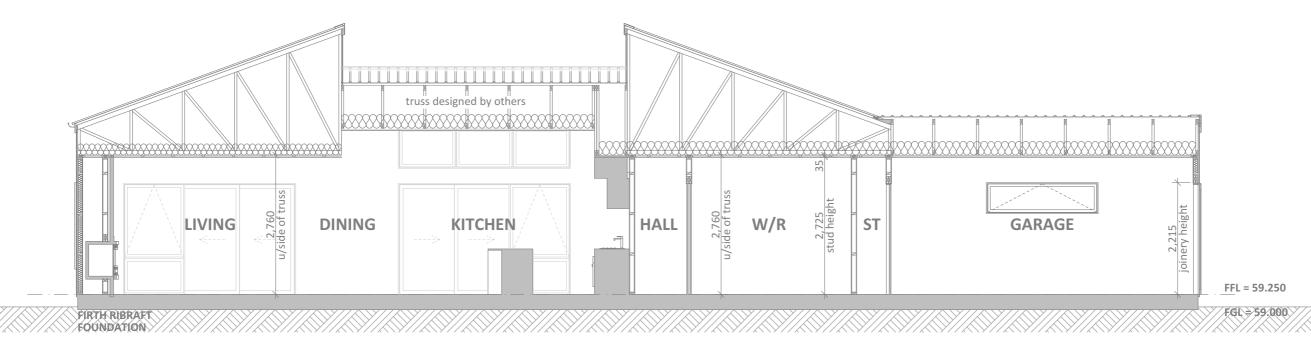

CONCEPT SECTION B SCALE 1:75

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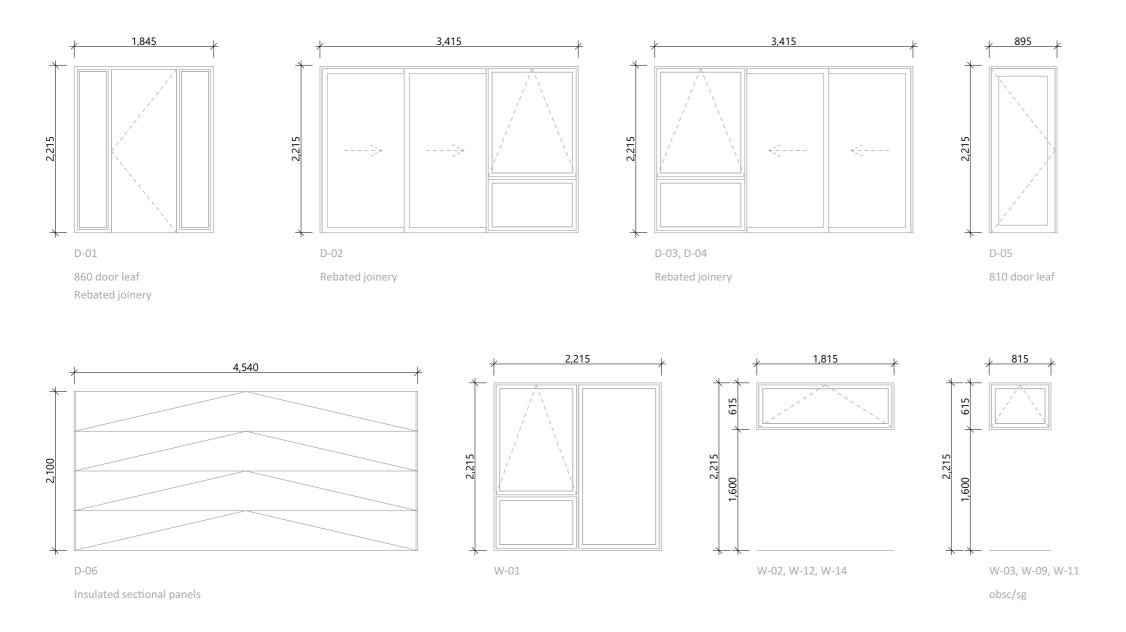
consent drawings) <u>Signature</u>

<u>Date</u>





Project N	No: MH18	Designed: CY	Wind: EXTRA HIGH	Orawing: CROSS SECTIONS	Date: 26/09/202
Plan:	New Design	Drawn:	EQ: 3	Client Name: BARRETT HOMES (CENTRAL PLATEAU) LTD	Rev:
Version:	1.0	Checked: CY	Exposure: C	iite Address: LOT 18, 27 ANNIE ARANUI DRIVE	Sheet:
	design@	barretthomes.co.nz	Council Napier City	STAGE 1A, MISSION HILLS, NAPIER	Scale: 1:7!



General notes:

Aluminium joinery head heights to be 2.215m (excludes rebated joinery units). Refer to floor plan for door & window sizes. Joinery schedule & sizes to be confirmed on site PRIOR to manufacture

Thermally improved double glazing to all window and door joinery including garage joinery.

Glazing in accordance with NZS 4223 & 2016 amendments.

All glazing clear float unless noted anywhere, (refer to joinery schedule)


- Low level glazing = Any glazing within 800mm from FFL, depending on size and proportions, safety glass or 5mm annealed will be required.

- Doors with glazing area > 0.75m² = safety glass Doors with glazing area < 0.75m² = 5mm annealed Side panels within 800mm of a door = safety glass, side panels not within 800mm of door considered a window.

sg = Safety glass as required by standards, joinery manufacturer to take precedence ss = Safety stays (in accordance with NZBC:F4 clause 2.0) obsc = Obscure glass

REBATED JOINERY

Rebated joinery sizes are to be confirmed with joinery

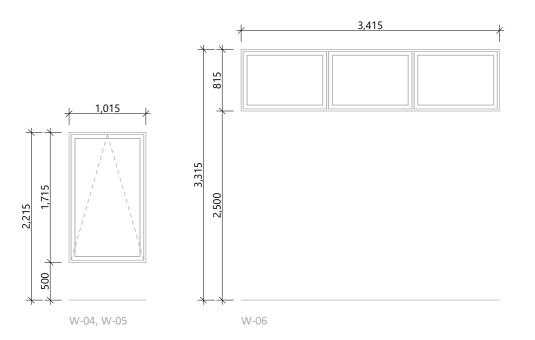

1,015 615 W-07, W-08 W-10 W-13

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