

Welcome to the whānau. **CONTENTS:** 

COVER SHEET MATERIALITY

**ELEVATIONS** 

**ELEVATIONS** LOCATION PLAN

SITE PLAN

LANDSCAPING PLAN CONCEPT PLAN

WET AREAS

**CROSS SECTIONS** 

JOINERY SCHEDULE

JOINERY SCHEDULE



ARTIST IMPRESSION ONLY

**NEW DWELLING FOR:** BARRETT HOMES (CENTRAL PLATEAU) LTD

**ADDRESS**:

LOT 17, 25 ANNIE ARANUI DRIVE STAGE 1A, MISSION HILLS, NAPIER CONCEPT PLAN APPROVAL (confirmation to

<u>Signature</u>

<u>Date</u>





E	M.		D. J d.	Mr. J.	Possessiana.	L
ľ	roject No:	MH17	Designed: C\	′ <sup>∣Wind:</sup> VERY HIGH	Drawing: COVER SHEET	Date: 26/09/2025
P	Plan:	New Design	Drawn:	-EQ: 3	<sup>Client Name:</sup> BARRETT HOMES (CENTRAL PLATEAU) LTD	Rev:
٧	/ersion:	2.0	Checked: C\	Exposure:	Site Address: LOT 17, 25 ANNIE ARANUI DRIVE	Sheet:
s		design@	barretthomes.co.nz	Council: Napier City	STAGE 1A, MISSION HILLS, NAPIER	Scale: 1:



**Metal Roofing** - Trapezoidal profile



**Brick cladding** - Black



Vertical Shiplap Weathboard



**Aluminium Joinery** 



Panel cladding - INNOVA Stratum w/baord cladding

(M)

CONCEPT PLAN APPROVAL (confirmation to


consent drawings)


<u>Signature</u>

<u>Date</u>






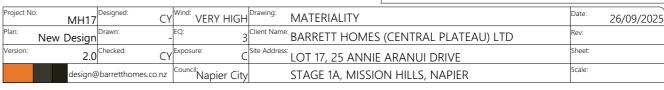


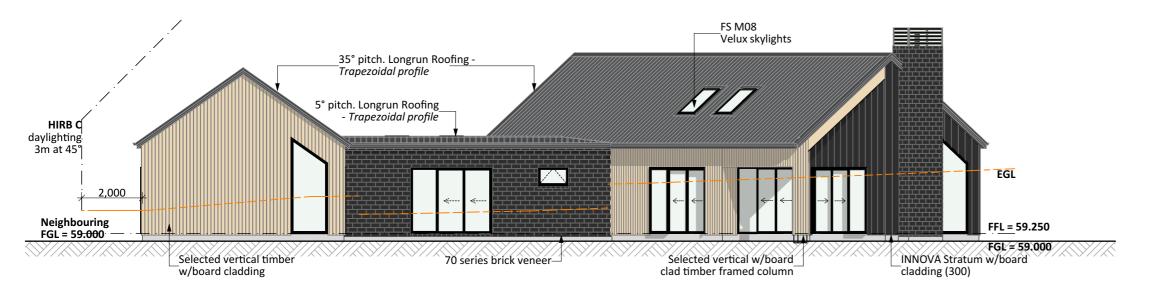

# NORTH ELEVATION

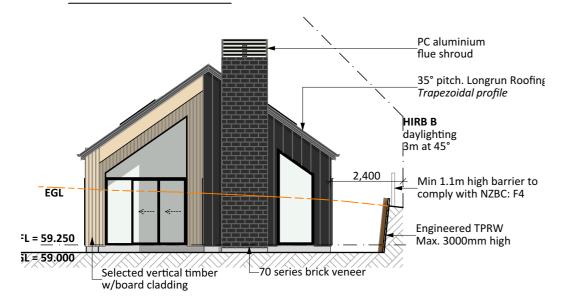

# NORTH WEST ELEVATION

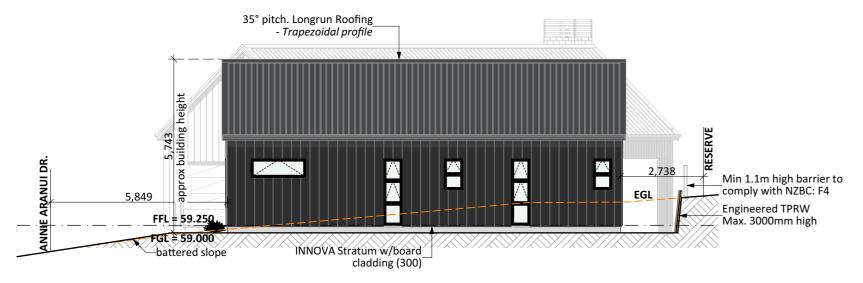

# **EAST ELEVATION**

MISSION HILLS

A LEGACY FOR HAWKE'S BAY



Pr	roject No	· N	/H17		Wind: VERY HIGH	Drawing:	ELEVATIONS	Date:	26/09/202
PI	an:	New De	esign	Drawn:	-EQ: 3	Client Name	BARRETT HOMES (CENTRAL PLATEAU) LTD	Rev:	
Ve	ersion:		2.0	Checked: CY	Exposure:	Site Address	LOT 17, 25 ANNIE ARANUI DRIVE	Sheet:	
		d	esign@	barretthomes.co.nz	Council:			Scale:	1:12

#### **General Notes**:

Any encroachments shown are to be confirmed by a registered surveyor prior to commencement of foundations. No liability shall be held by designer with this confirmation.

#### NZBC D1/AS1 Access

Minimum slip resistance to steps and landings in accordance with NZBC D1/AS1 Table 2. Concrete or H5 timber step to all access points, min. 150mm and max. 190mm below finished floor level.

CJ = Control joint

#### Foundation:

Ribraft floor to Firth specifications (see plan notes and details)

## Wall Cladding:

70 series brick veneer - ensure cavity and weep holes are free from excess mortar

INNOVA Duragroove Smooth wide (150) panel cladding Selected Vertical timber w/board cladding

\*All claddings to be installed over FPS Weathertight System. FPS Weathertight System to be installed over timber framing strictly as per manufacturers specification.

## **Roof Cladding:**

35° & 5° pitch. Maxam Longrun roofing - *Trapezoidal* profile

## Fascia and Spouting:

COLORCOTE fascia & spouting with 80mm Ø Alipipes - powder coated aluminium downpipes

## Joinery & Glazing:

Selected powder coated aluminium joinery with thermally improved Low E double glazing.

CONCEPT PLAN APPROVAL (confirmation to

consent drawings)

<u>Signature</u>


<u>Date</u>

# CONCEPT ONLY

MINOR VARIATIONS TO THE PLANS MAY BE NECESSARY DURING WORKING DRAWINGS DUE TO BRACING REQUIREMENTS, ENGINEERING AND UNFORSEEN SITE CONDITIONS


Y:\(\psi M \) Projects\(\psi H \) AWKES BAY\(\psi M \) Sion Hills - Napier\(\psi M \) HIT\(\psi C \) Coper Plans\(\psi 2.0 \) WMH17 Concept 2.0.pln

ALL PLANS ARE COPYRIGHT TO BARRETT HOMES Ltd. All rights reserved. No part of this work covered by copyright may be reproduced or copied without written permission.

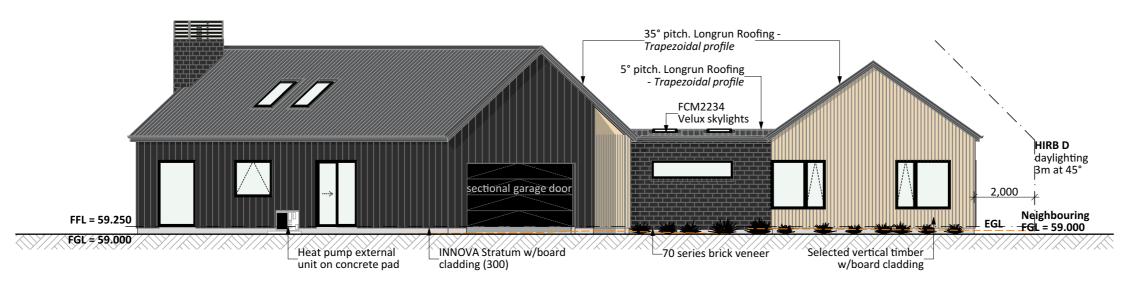

# SOUTH ELEVATION HIRB A daylighting 3m at 45° Min 1.1m high barrier to comply with NZBC: F4 sectional garage door 2,400 **Engineered TPRW** FFL = 59.250 Max. 3000mm high FGL=59.000 INNOVA Stratum w/board Selected entry cladding (300) door & sidelight

# SOUTH EAST ELEVATION

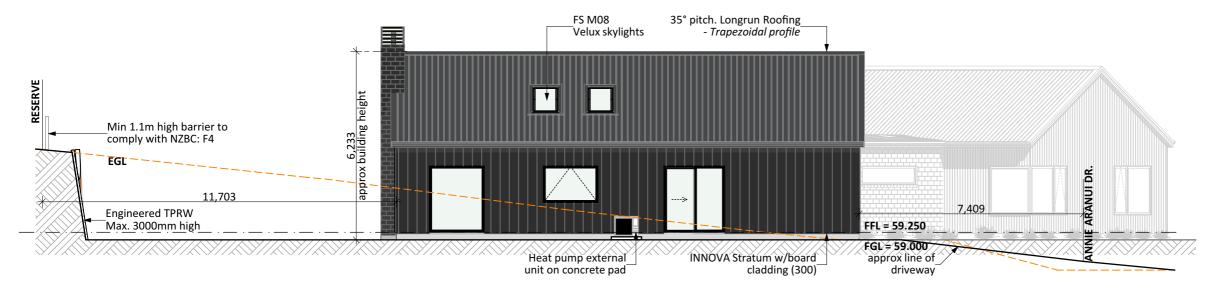

# **WEST ELEVATION**

# MISSION HILLS A LEGACY FOR HAWKE'S BAY Barrett Ho

	Project N
	Plan:
7M	Version:
tt Homes	

roject No	о: МН17	Designed: CY	Wind: VERY HIGH	Drawing:	ELEVATIONS	Date:	26/09/202
lan:	New Design	Drawn:	EQ: 3	Client Name	BARRETT HOMES (CENTRAL PLATEAU) LTD	Rev:	
ersion:	2.0	CY			LOT 17, 25 ANNIE ARANUI DRIVE	Sheet:	
	design@	barretthomes.co.nz	Council: Napier City		STAGE 1A, MISSION HILLS, NAPIER	Scale:	1:12

#### General Notes:

Any encroachments shown are to be confirmed by a registered surveyor prior to commencement of foundations. No liability shall be held by designer with this confirmation.

#### NZBC D1/AS1 Access

Minimum slip resistance to steps and landings in accordance with NZBC D1/AS1 Table 2.
Concrete or H5 timber step to all access points, min. 150mm and max. 190mm below finished floor level.

CJ = Control joint

#### Foundation:

Ribraft floor to Firth specifications (see plan notes and details)

## Wall Cladding:

70 series brick veneer - ensure cavity and weep holes are free from excess mortar

INNOVA Duragroove Smooth wide (150) panel cladding Selected Vertical timber w/board cladding

\*All claddings to be installed over FPS Weathertight System. FPS Weathertight System to be installed over timber framing strictly as per manufacturers specification.

## **Roof Cladding:**

35° & 5° pitch. Maxam Longrun roofing - *Trapezoidal* profile

# Fascia and Spouting:

COLORCOTE fascia & spouting with 80mm Ø Alipipes - powder coated aluminium downpipes

# Joinery & Glazing:

Selected powder coated aluminium joinery with thermally improved Low E double glazing.

CONCEPT PLAN APPROVAL (confirmation to

consent drawings)

<u>Signature</u>


<u>Date</u>

## CONCEPT ONLY

MINOR VARIATIONS TO THE PLANS MAY BE NECESSARY DURING WORKING DRAWINGS DUE TO BRACING REQUIREMENTS, ENGINEERING AND UNFORSEEN SITE CONDITIONS

Y:\GM Projects\HAWKES BAY\Mission Hills - Napier\MH17\Concept Plans\2.0\MH17 Concept 2.0.pln

ALL PLANS ARE COPYRIGHT TO BARRETT HOMES Ltd. All rights reserved. No part of this work covered by copyright may be reproduced or copied without written permission.

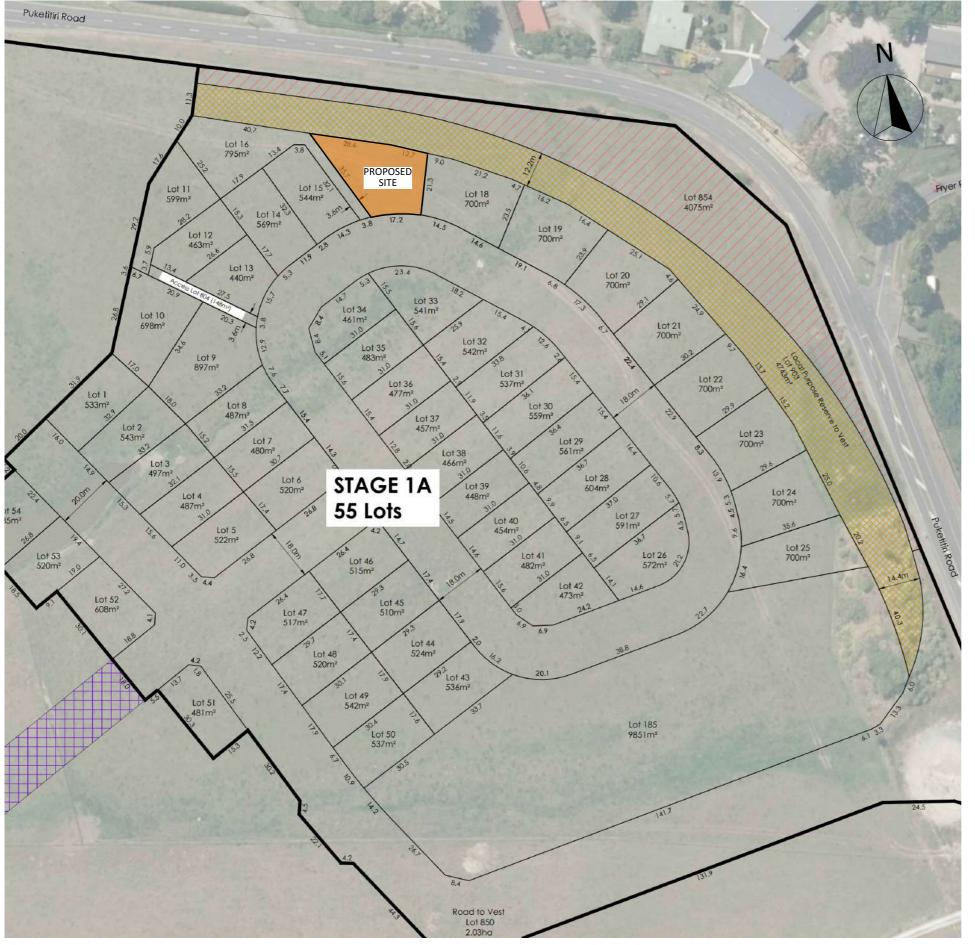

**CONCEPT PLAN APPROVAL** (confirmation to

consent drawings)


<u>Signature</u>

<u>Date</u>







	Project No:		MH17	Designed: (	СХ	Wind: VERY HIGH	Drawing: L	OCATION PLAN	Date:	26/09/2025
	Plan:	New	Design	Drawn:	-	EQ: 3	Client Name: E	BARRETT HOMES (CENTRAL PLATEAU) LTD	Rev:	
	Version:		2.0	Checked: (	СХ	Exposure:	Site Address:	OT 17, 25 ANNIE ARANUI DRIVE	Sheet:	3
es			design@	barretthomes.co.r	ız	Council: Napier City	9	STAGE 1A, MISSION HILLS, NAPIER	Scale:	

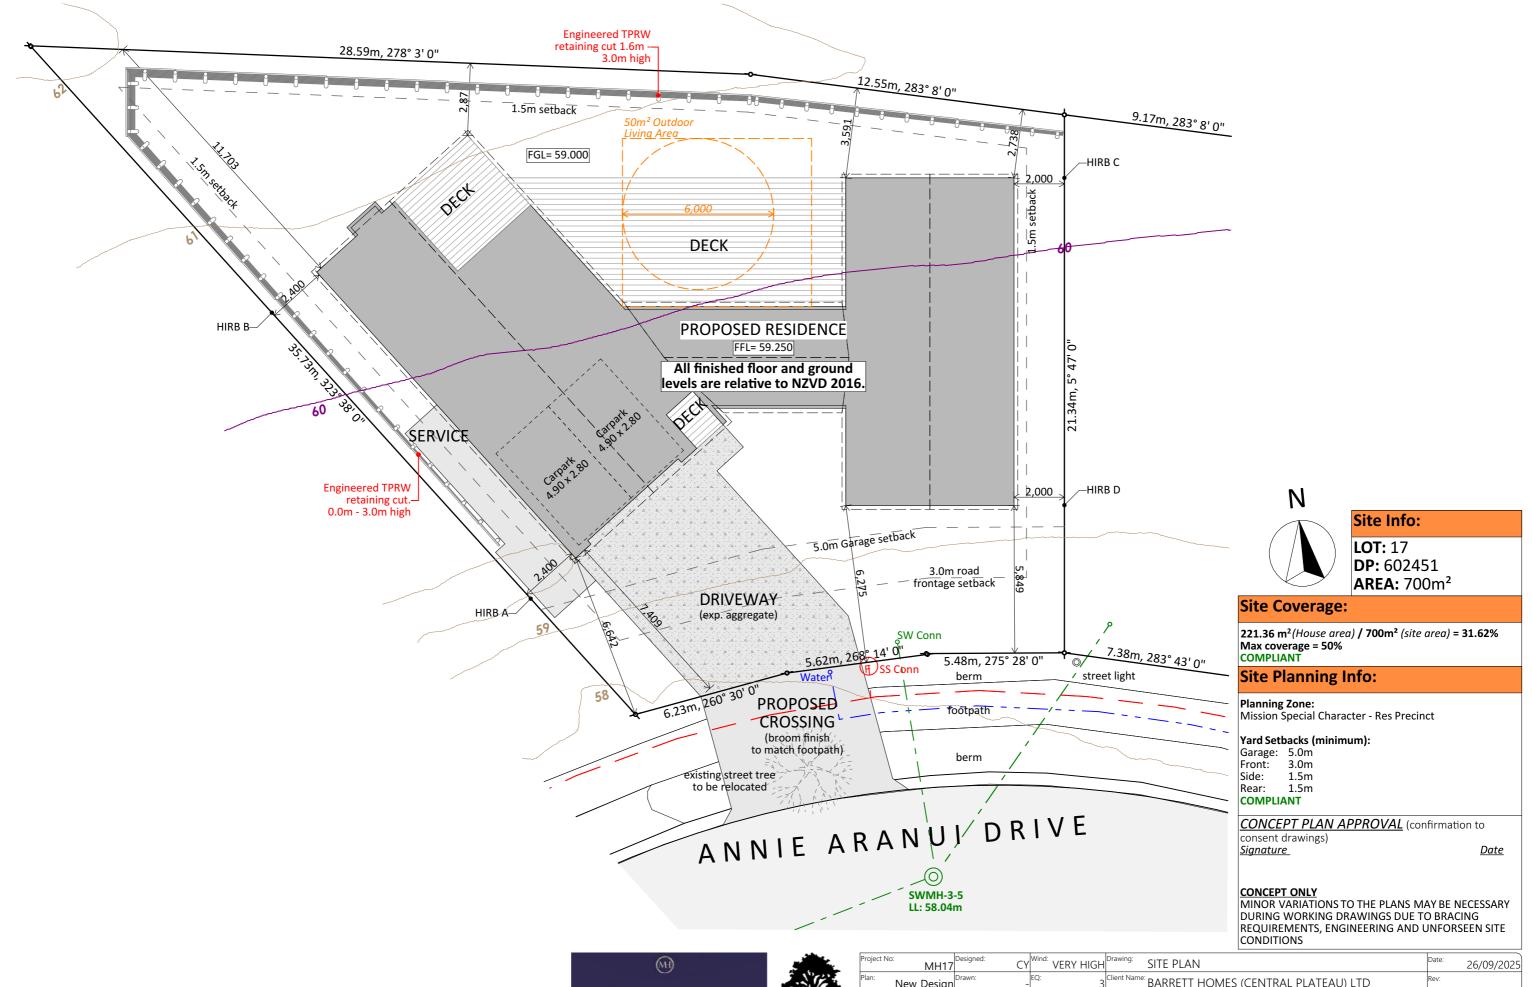

may be reproduced or copied without written permission.

	Project No		MH17	Designed: (	ΞY	Wind: VERY HIGH	Drawing:	SITE PLAN	Date:	26/09/2025
	Plan:	New	Design	Drawn:	-	EQ:	Client Name:	BARRETT HOMES (CENTRAL PLATEAU) LTD	Rev:	
	Version:		2.0	Checked:	- Y			LOT 17, 25 ANNIE ARANUI DRIVE	Sheet:	4
es			design@	barretthomes.co.n	z	Council: Napier City		STAGE 1A, MISSION HILLS, NAPIER	Scale:	1:150

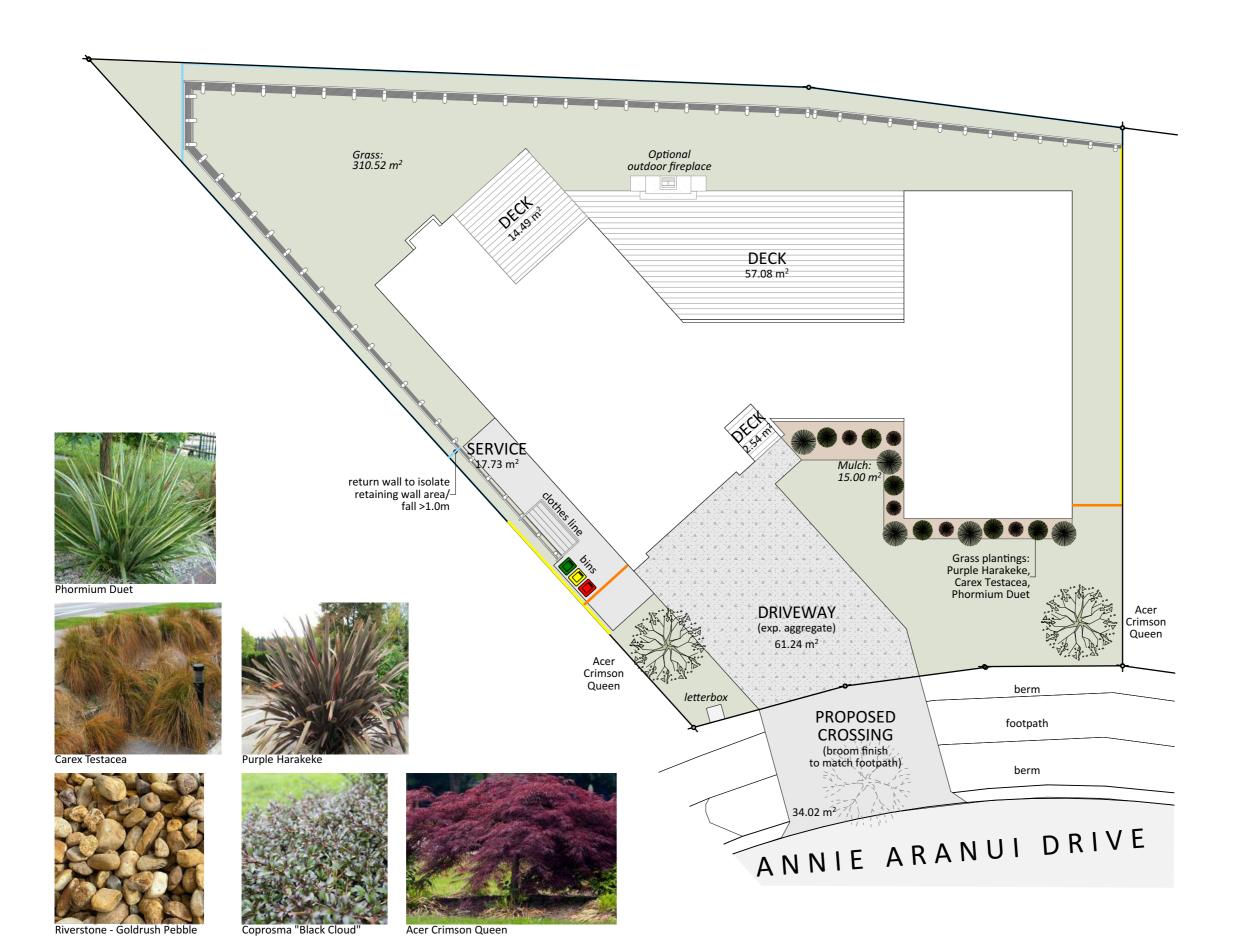

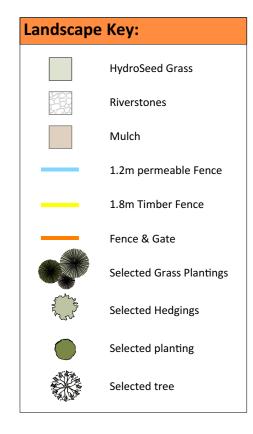

CONCEPT PLAN APPROVAL (confirmation to


consent drawings) <u>Signature</u>

<u>Date</u>

**CONCEPT ONLY** 






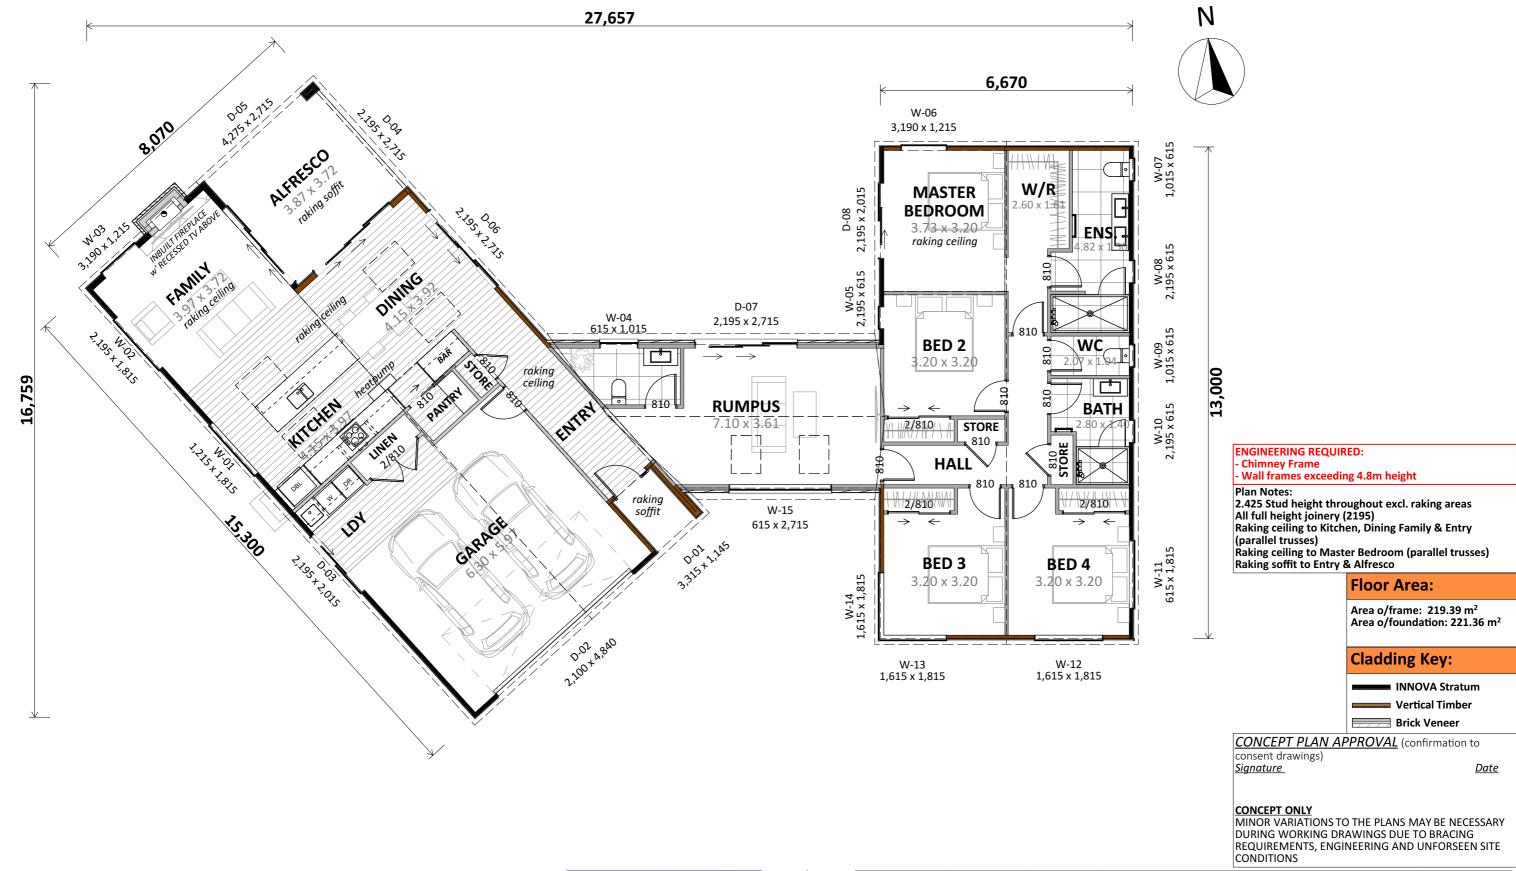




	Project No:	:	MH17	Designed: CY	Wind: VERY HIGH	Drawing: CONCEPT PLAN	Date:	26/09/2025
	Plan:	New I	Design	Drawn:	EQ:	Client Name: BARRETT HOMES (CENTRAL PLATEAU) LTD	Rev:	
	Version:		2.0	Checked: CY	Exposure:	Site Address: LOT 17, 25 ANNIE ARANUI DRIVE	Sheet:	6
s			design@	barretthomes.co.nz	Council: Napier City	STAGE 1A, MISSION HILLS, NAPIER	Scale:	1:100



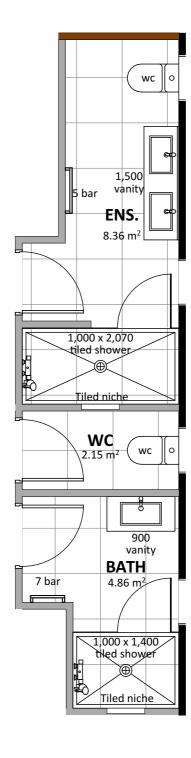

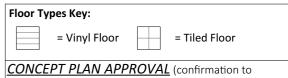


consent drawings) <u>Signature</u>

<u>Date</u>







F	Project No	: MH17	Designed: CY	Wind: VERY HIGH	Drawing: WET AREAS	Date: 26/09/202
F	Plan:	New Design	Drawn:	EQ:	Client Name: BARRETT HOMES (CENTRAL PLATEAU) LTD	Rev:
1	/ersion:	2.0	Checked: CY	Exposure:	Site Address: LOT 17, 25 ANNIE ARANUI DRIVE	Sheet:
s		design@	barretthomes.co.nz	Council: Napier City	STAGE 1A, MISSION HILLS, NAPIER	Scale: 1:50
_						

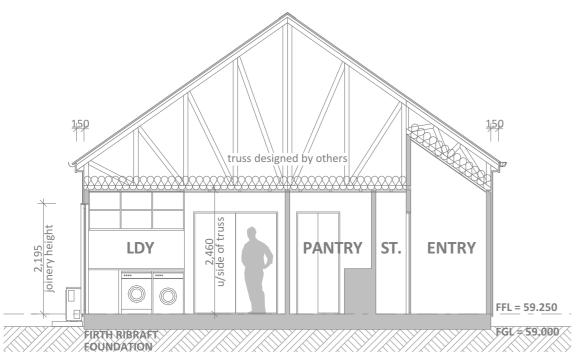


CONCEPT SECTION A SCALE 1:75

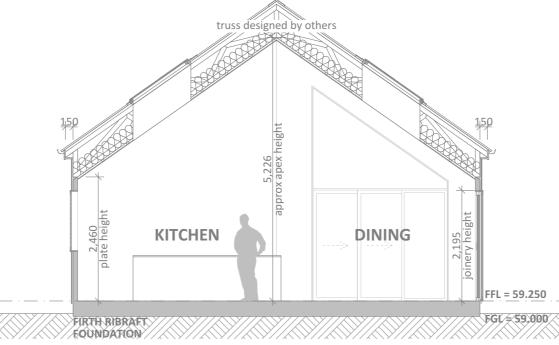

CONCEPT SECTION B SCALE 1:75

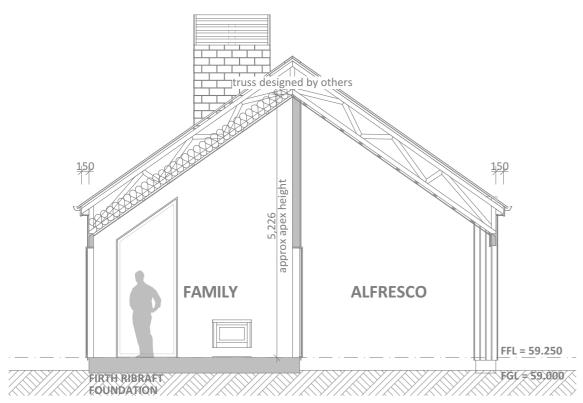

CONCEPT SECTION C SCALE 1:75

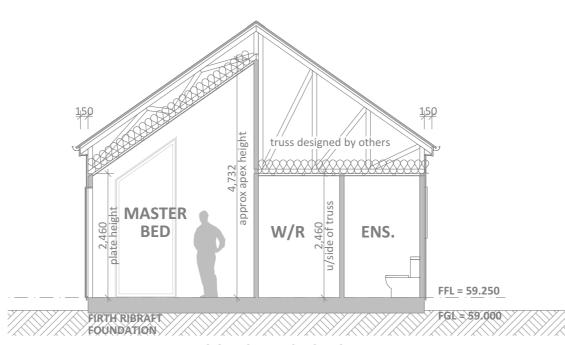

CONCEPT SECTION D SCALE 1:75

**CONCEPT PLAN APPROVAL** (confirmation to consent drawings)


<u>Signature</u>


<u>Date</u>








	Project No:	· MH17	Designed: CY	Wind: VERY HIGH	Drawing: CROSS SECTIONS	Date: 26/09/2025
	Plan:	New Design	Drawn:	EQ:	<sup>Client Name:</sup> BARRETT HOMES (CENTRAL PLATEAU) LTD	Rev:
	Version:	2.0	CY	, c	LOT 17, 25 ANNIE ARANUI DRIVE	Sheet: {
s		design@	barretthomes.co.nz	Council: Napier City	STAGE 1A, MISSION HILLS, NAPIER	Scale: 1:75

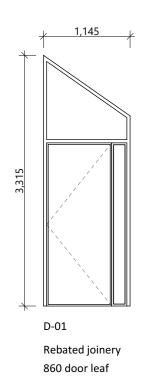


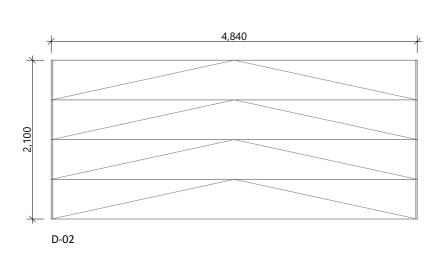


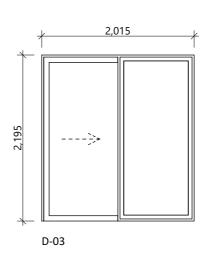


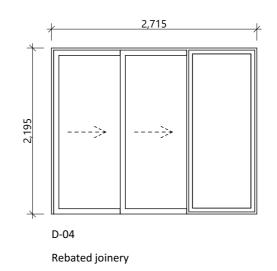

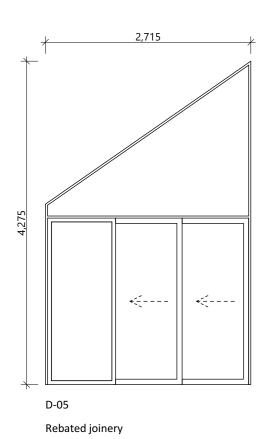

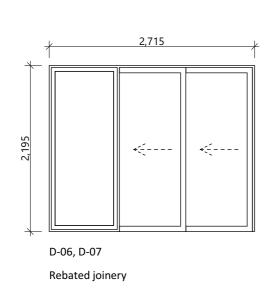

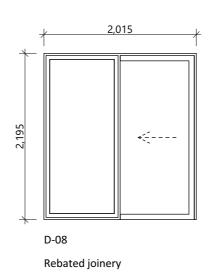

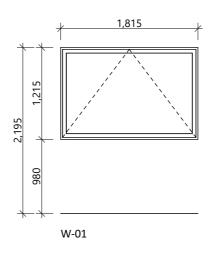

## General notes:

Aluminium joinery head heights to be 2.195m (excludes rebated joinery units). Refer to floor plan for door & window sizes. Joinery schedule & sizes to be confirmed on site PRIOR to manufacture

Thermally improved double glazing to all window and door joinery including garage joinery.

Glazing in accordance with NZS 4223 & 2016 amendments.

All glazing clear float unless noted anywhere, (refer to joinery schedule)

- Low level glazing = Any glazing within 800mm from FFL, depending on size and proportions, safety glass or 5mm annealed will be required.

- Doors with glazing area > 0.75m² = safety glass
   Doors with glazing area < 0.75m² = 5mm annealed</li>
   Side panels within 800mm of a door = safety glass, side panels not within 800mm of door considered a window.

sg = Safety glass as required by standards, joinery manufacturer to take precedence ss = Safety stays (in accordance with NZBC:F4 clause 2.0) obsc = Obscure glass

#### REBATED JOINERY

Rebated joinery sizes are to be confirmed with joinery

CONCEPT PLAN APPROVAL (confirmation to consent drawings)

<u>Signature</u>


<u>Date</u>

## **CONCEPT ONLY**





	Project No		MH17	Designed:	CY	Wind: VERY HIGH	Drawing: JOINERY SCHEDULE	Date:	26/09/202
	Plan:	New	Design	Drawn:	-	EQ:	Client Name: BARRETT HOMES (CENTRAL PLATEAU) LTD	Rev:	
	Version:		2.0	Checked:	CY	Exposure:	Site Address: LOT 17, 25 ANNIE ARANUI DRIVE	Sheet:	
es			design@	barretthome	es.co.nz	Council: Napier City	STAGE 1A, MISSION HILLS, NAPIER	Scale:	1:5

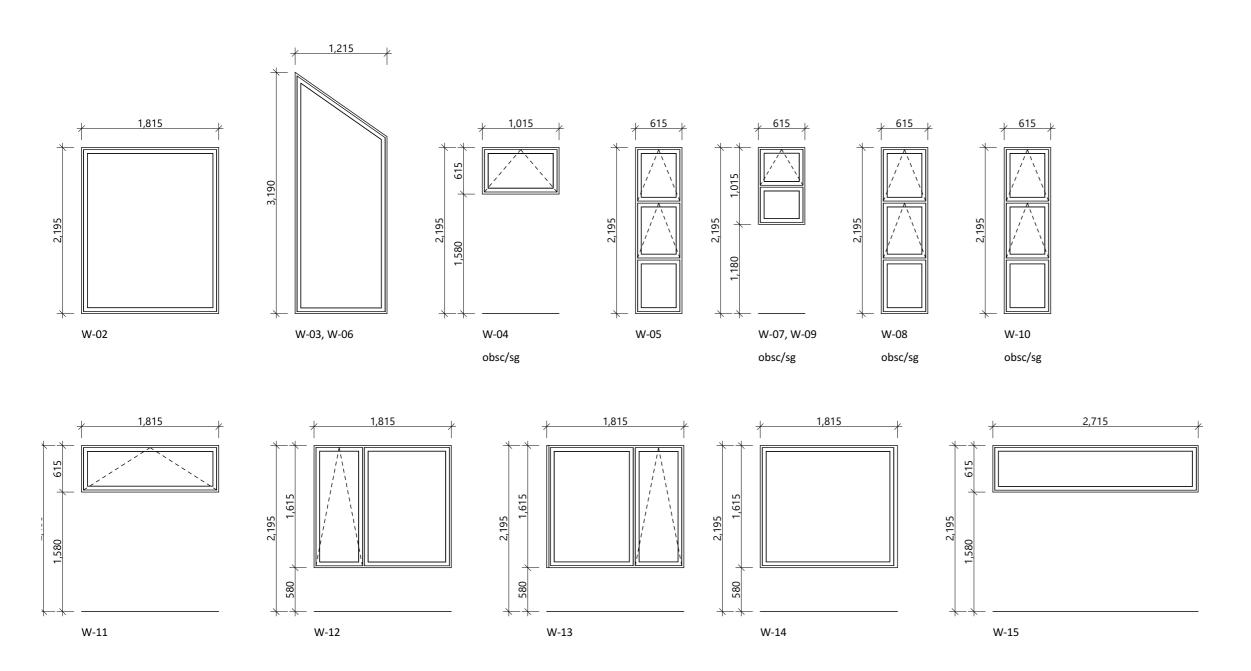

## General notes:

Aluminium joinery head heights to be 2.195m (excludes rebated joinery units). Refer to floor plan for door & window sizes. Joinery schedule & sizes to be confirmed on site PRIOR to manufacture

Thermally improved double glazing to all window and door joinery including garage joinery.

Glazing in accordance with NZS 4223 & 2016 amendments.

All glazing clear float unless noted anywhere, (refer to joinery schedule)

- Low level glazing = Any glazing within 800mm from FFL, depending on size and proportions, safety glass or 5mm annealed will be required.

- Doors with glazing area > 0.75m² = safety glass
   Doors with glazing area < 0.75m² = 5mm annealed</li>
   Side panels within 800mm of a door = safety glass, side panels not within 800mm of door considered a window.

sg = Safety glass as required by standards, joinery manufacturer to take precedence ss = Safety stays (in accordance with NZBC:F4 clause 2.0) obsc = Obscure glass

#### REBATED JOINERY

Rebated joinery sizes are to be confirmed with joinery

CONCEPT PLAN APPROVAL (confirmation to

consent drawings) <u>Signature</u>

<u>Date</u>





	Project No:	: MH17	Designed: CY	Wind: VERY HIGH	Drawing: JOINERY SCHEDULE	Date:	26/09/202
	Plan:	New Design	Drawn:	EQ:	<sup>Client Name:</sup> BARRETT HOMES (CENTRAL PLATEAU) LTD	Rev:	·
	Version:	2.0	Checked: CY	Exposure:	Site Address: LOT 17, 25 ANNIE ARANUI DRIVE	Sheet:	10
s		design@	barretthomes.co.nz	Council:	STAGE 1A, MISSION HILLS, NAPIER	Scale:	1:50