

Welcome to the whānau.

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- **ELEVATIONS**
- SITE PLAN
- LANDSCAPING PLAN
- CONCEPT PLAN

ELEVATIONS

- KITCHEN & BATHROOM
- **CROSS SECTIONS** JOINERY SCHEDULE



NEW DWELLING FOR: JASON COPELAND

ADDRESS:

LOT 437, BOOTH DRIVE WOOING TREE, STAGE 2C, CROMWELL



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Project	NO:	NT437	Designed: C	s	rind: HIGH	Drawing:	COVER SHEET	Date:	3/09/2025
Plan:	NEW D	ESIGN	Drawn:	- EC	Q: 2	Client Name:	JASON COPELAND	Rev:	
Version	i.	1.0	Checked: K	ВЕх	xposure:	Site Address	LOT 437, BOOTH DRIVE	Sheet:	
s		design@	barretthomes.co.n.	z Co	ouncil: CODC		WOOING TREE, STAGE 2C, CROMWELL	Scale:	



Architectural Feature - Boxed Chimney cowl



Architectural Feature - Decorative Cedar Louvre



Metal cladding
- PCC Zinacore vertical cladding - trapezoidal profile



Panel cladding
- JH Axon panel (400)
panel cladding




Natural cladding
- Vertical Knotted Cedar w/board cladding




Joinery



	Project	No: WT437	Designed: CS	Wind: HIG	H Drawing:	MATERIALITY	Date:	3/09/202
	Plan:	NEW DESIGN	Drawn:	EQ:	2 Client Name	JASON COPELAND	Rev:	
TM	Version:	1.0		Exposure:	C Site Addres	SELOT 437, BOOTH DRIVE	Sheet:	
Barrett Homes		design(@barretthomes.co.nz	Council: COD	С	WOOING TREE, STAGE 2C, CROMWELL	Scale:	

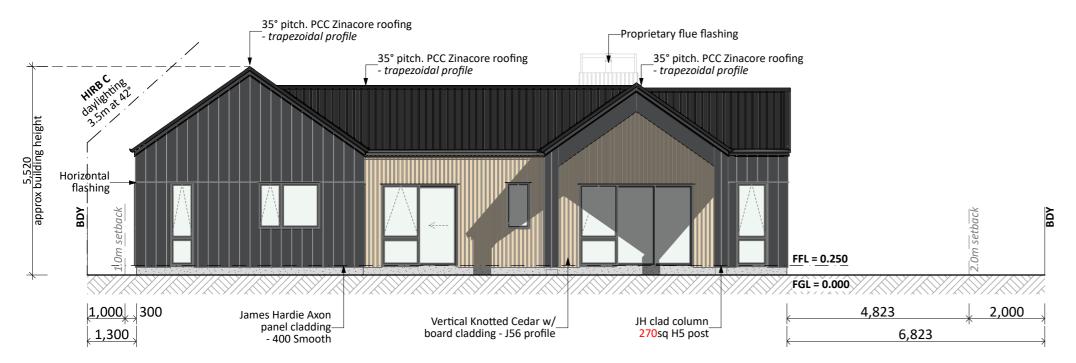

NORTH ELEVATION

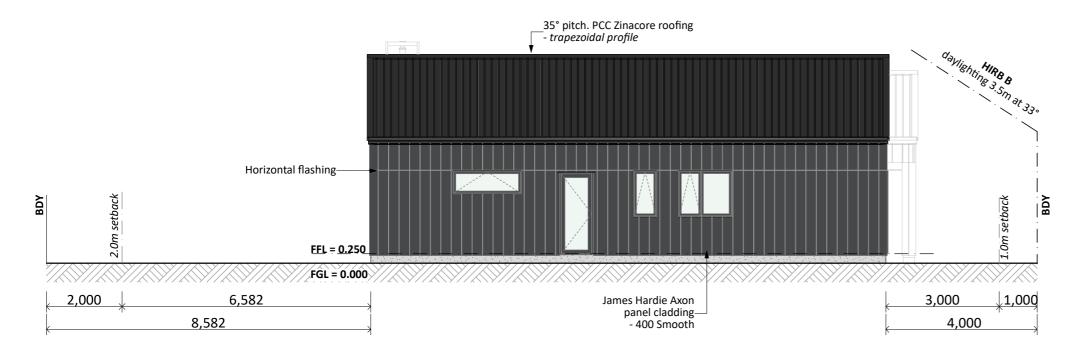

EAST ELEVATION

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Barrett Homes

Project No: WT437 Designed: CS Wind: HIGH Drawing: ELEVATIONS Date: 3/09/2025 Plan: NEW DESIGN Drawn: - ED: 2 Client Name: JASON COPELAND Version: 1.0 Checked: KB Exposure: C Site Address: LOT 437, BOOTH DRIVE Sheet: 1 design@barretthomes.co.nz Council: CODC WOOING TREE, STAGE 2C, CROMWELL Scale: 1:100

General Notes:

Any encroachments shown are to be confirmed by a registered surveyor prior to commencement of foundations. No liability shall be held by designer with this confirmation.

NZBC D1/AS1 Access

Minimum slip resistance to steps and landings Concrete or H5 timber step to all access points, min. 150mm below finished floor level

Foundation:

Engineered MaxRaft foundation (refer to notes and details)

Wall Cladding:

James Hardie Axon panel cladding - 400 Smooth Vertical Knotted Knotted Cedar w/board cladding

Roof Cladding:

35° & 20° pitch. Longrun roofing - Trapezoidal profile

Fascia and Spouting:

COLORCOTE fascia, spouting & 80mm Ø downpipes

Joinery

APL Residental series aluminium joinery with thermally improved double glazing

PRELIMINARY ONLY.


Elevations are subject to the following:
- Site Levels


CONCEPT PLAN APPROVAL (confirmation to consent drawings)

Signature

<u>Date</u>

CONCEPT ONLY

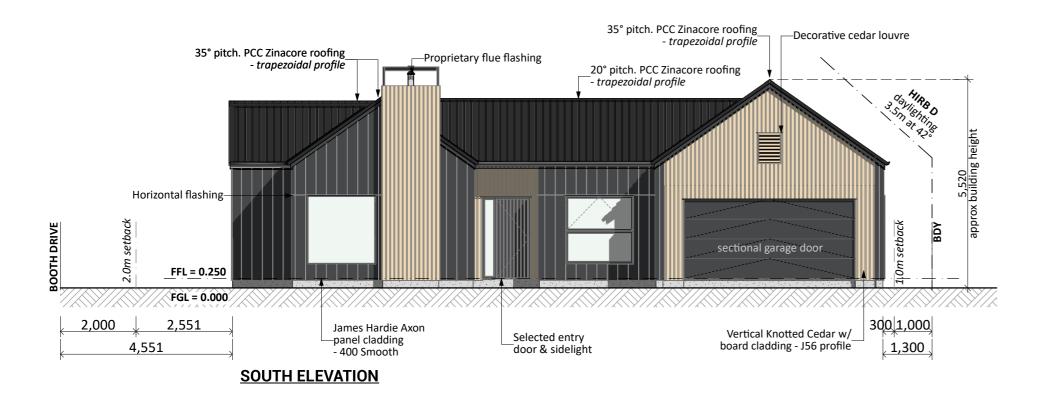

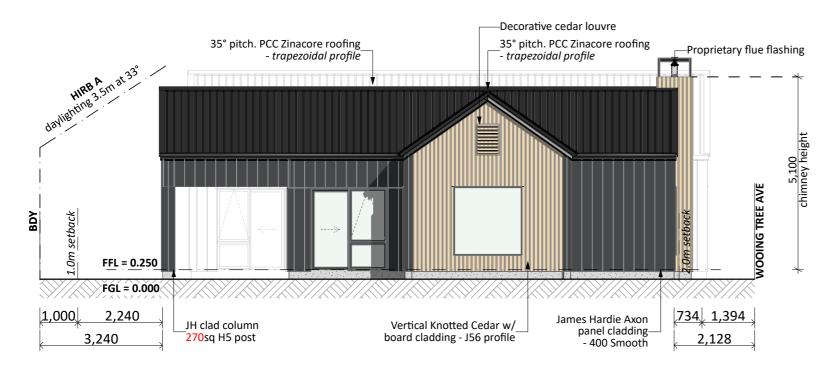

WEST ELEVATION

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Barrett Homes

K.	Project N	o: W	/T437	Designed: CS	Wind:	HIGH	Drawing:	ELEVATIONS	Date:	3/09/2025
2	Plan:	NEW DE	SIGN	Drawn:	EQ:	2	Client Name:	JASON COPELAND	Rev:	
Par.	Version:		1.0	Checked: KB	Exposure:	С	Site Address	LOT 437, BOOTH DRIVE	Sheet:	2
mes			design@	barretthomes.co.nz	Council:	CODC		WOOING TREE, STAGE 2C, CROMWELL	Scale:	1:100

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PRELIMINARY ONLY.


Elevations are subject to the following:
- Site Levels

CONCEPT PLAN APPROVAL (confirmation to consent drawings)

Signature

<u>Date</u>


CONCEPT ONLY

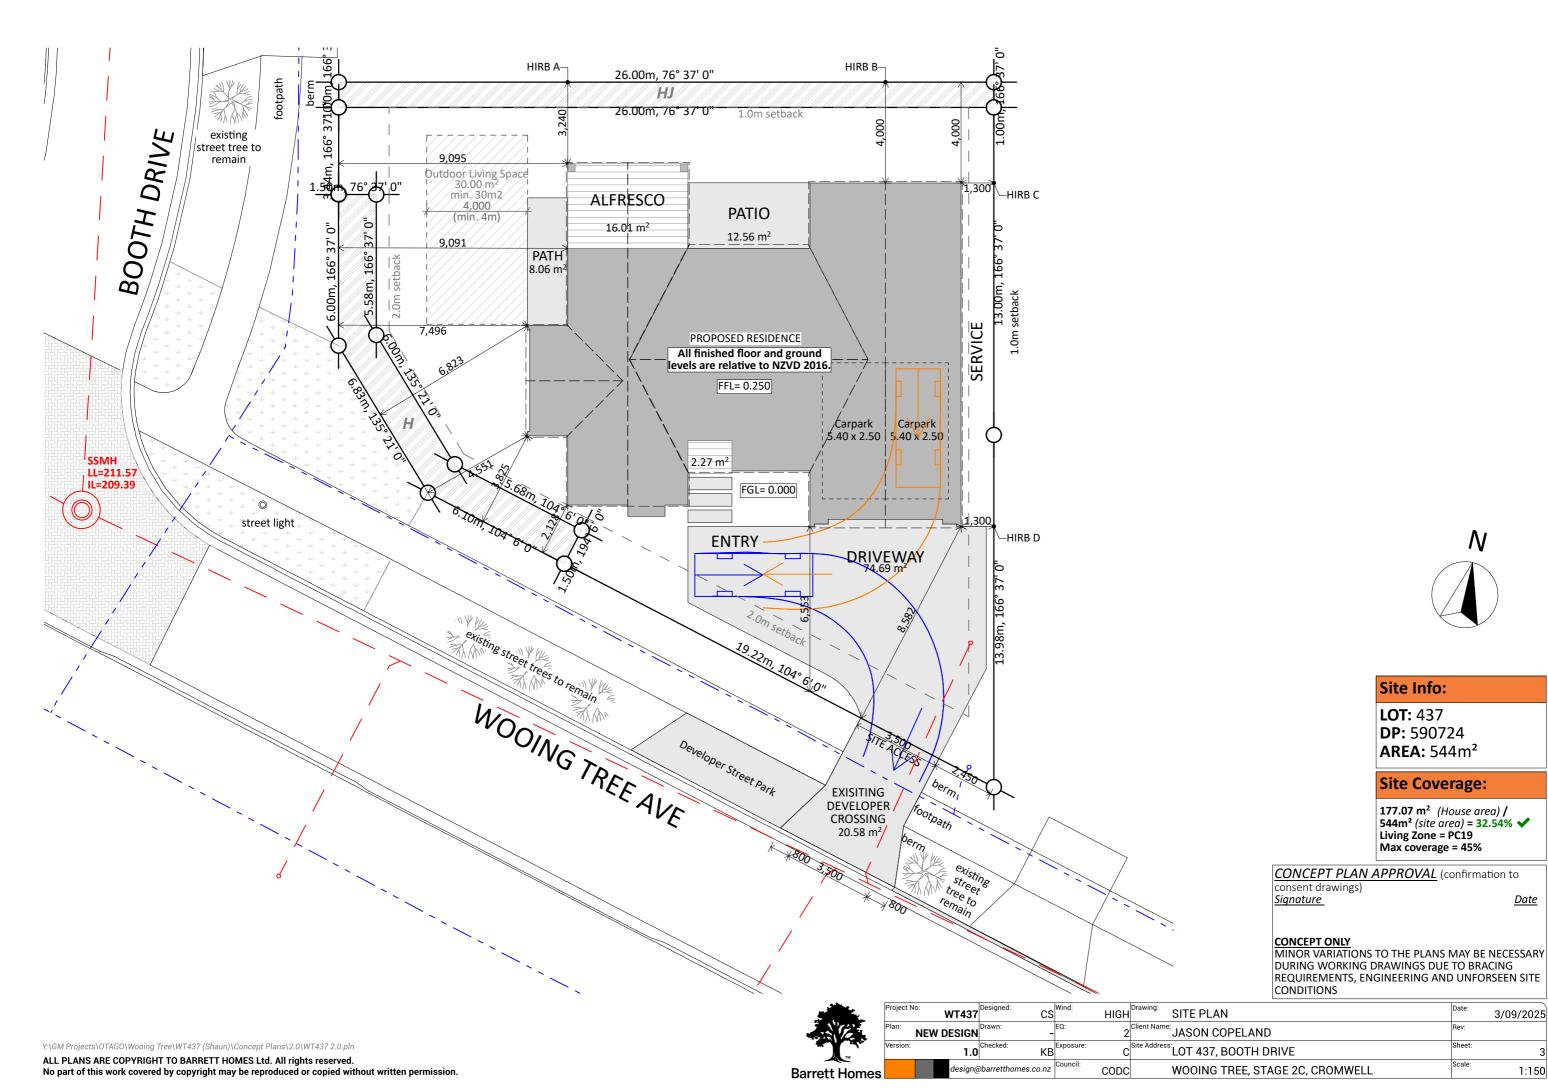

<u>Date</u>

3/09/2025

1:150

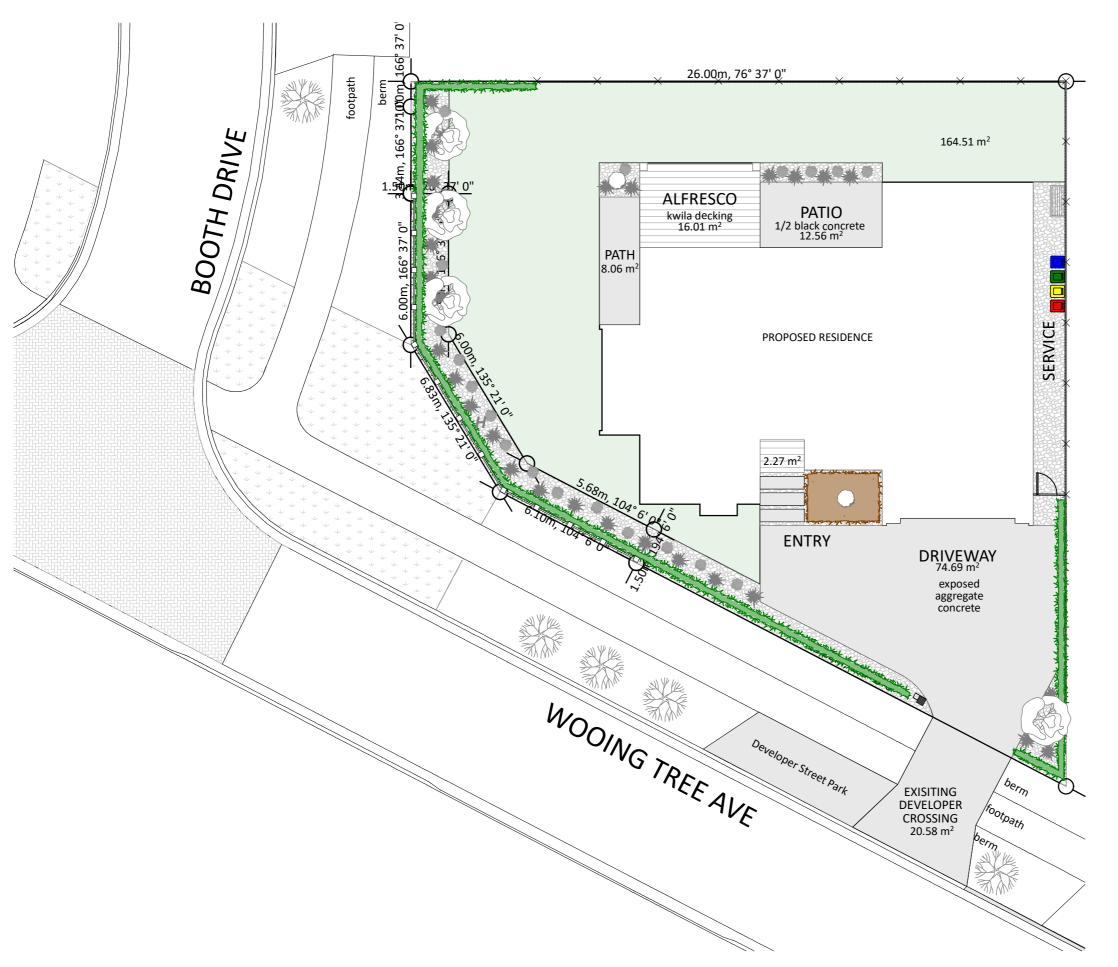



Landscape Key:

Developer macrocarpa post and rail fence - unstained

_ Se

Selected developer letter box



Smart wall wooden fence & gates -unstained



Schist gravel



800x500 exposed aggregate concrete pavers - 100mm spacing with schist gravel between



Hair Sedge & Hebes



Hedging - Pittosporum Kohuhu



Cherry tree



Japanese Maple



Muehlenbeckia



Washing line on posts

Permeable Areas:

HydroSeed Grass: 173.19m²



Schist: 78.59m²

Landscaping Coverage:

192.76m² (to tal planted areas) / 544m² (site area) = 35.43% ✓

Living Zone = MRZ-S8 Min coverage = 25%

CONCEPT PLAN APPROVAL (confirmation to

consent drawings)
Signature


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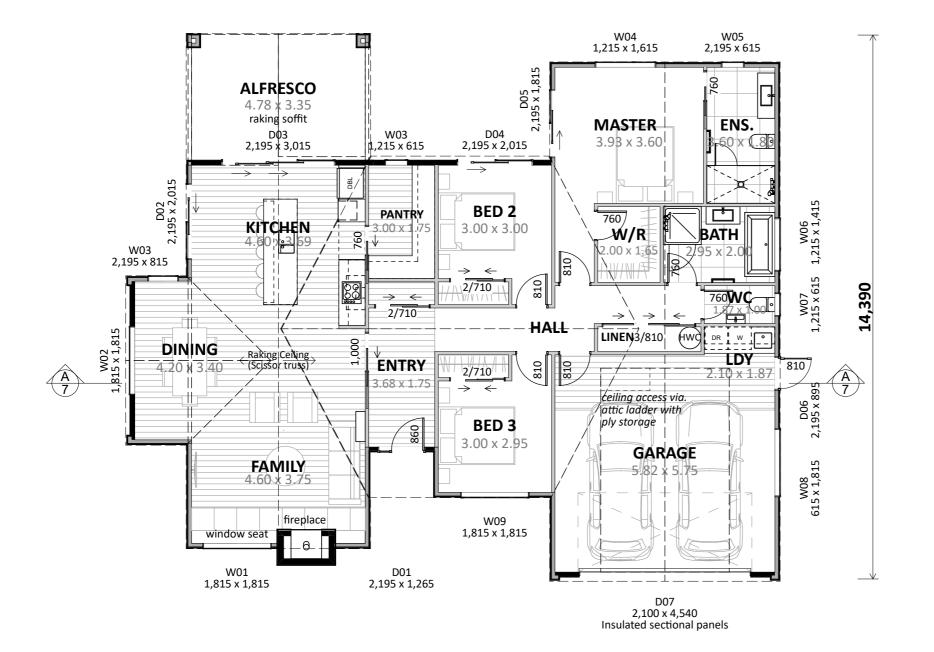
CONCEPT ONLY



	Project No	[∞] WT437	Designed: CS	Wind: HIGH	Drawing: LANDSCAPING PLAN	3/09/2025
	Plan:	NEW DESIGN	Drawn:	EQ: 2	Client Name: JASON COPELAND	Rev:
	Version:	1.0	Checked: KB	Exposure: C	Site Address: LOT 437, BOOTH DRIVE	Sheet: 4
s		design@	barretthomes.co.nz	Council: CODC	WOOING TREE, STAGE 2C, CROMWELL	Scale:

17,210



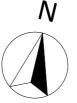

Floor Area:

Area o/foundation: 177.07 m²

Cladding Key:

JH Axon panel (400)

Vert. Knotted Cedar WB

CONCEPT PLAN APPROVAL (confirmation to

consent drawings)
Signature

ENGINEERING REQUIRED:
- Foundation (Maxraft)
- Alfresco Posts
- Chimney Structure

2.425 Stud height throughout All joinery 2195 head height Raking ceiling as shown (scissor)

Ducted Heating sytem
Attic truss storage to garage (x6 attic trusses)


Plan Notes:


<u>Date</u>

CONCEPT ONLY



	Project N	No: WT43	7 Designed:	CS Wind:	HIGH	CONCEPT PLAN	Date: 3/09/2025
i.	Plan:	NEW DESIG	N Drawn:	- EQ:	2 Clie	ent Name: JASON COPELAND	Rev:
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nes		desigr	@barretthom	es.co.nz	CODC	WOOING TREE, STAGE 2C, CROMWELL	Scale:

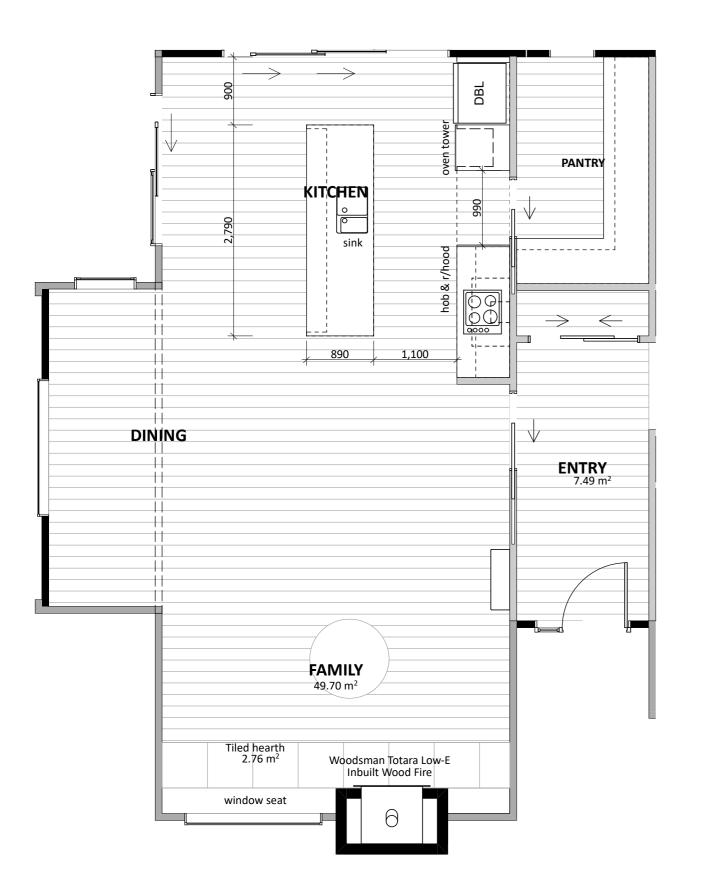

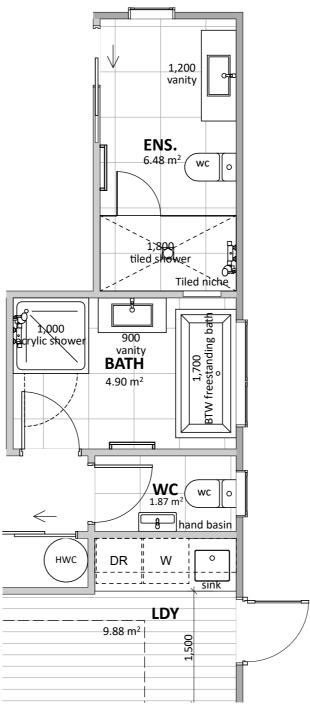

Floor Types Key:
= Tiled Floor
= Vinyl Floor


CONCEPT PLAN APPROVAL (confirmation to

consent drawings) Signature

<u>Date</u>




	Project N	o: WT437	Designed: CS	Wind: HIGH	Drawing: KITCHEN & BATHROOM	Date:	3/09/2025
	Plan:	NEW DESIGN	Drawn:	EQ: 2	Client Name: JASON COPELAND	Rev:	
	Version:	1.0	VD.	Exposure: C	Site Address: LOT 437, BOOTH DRIVE	Sheet:	6
s		design(abarretthomes.co.nz	Council: CODC	WOOING TREE, STAGE 2C, CROMWELL	Scale:	

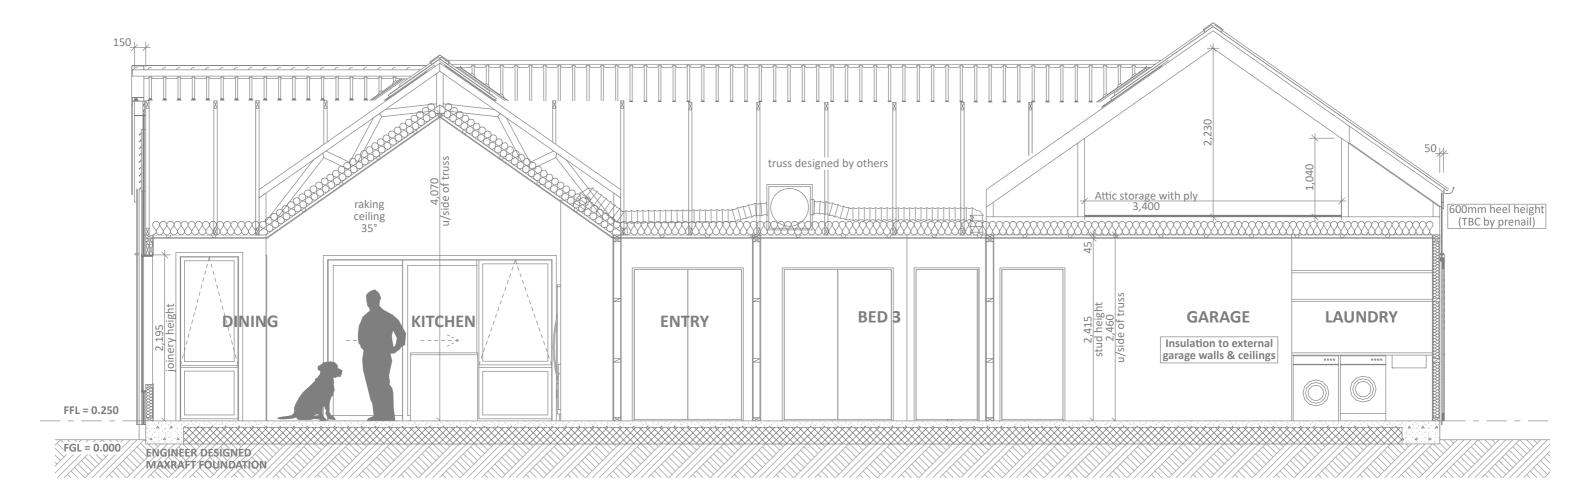

CONCEPT SECTION A SCALE 1:50



	Project N	No: WT437	Designed:	CS Wind:	HIGH	Drawing: CROSS SECTIONS	Date:	3/09/2025
	Plan:	NEW DESIGN	Drawn:	EQ:	2	Client Name: JASON COPELAND	Rev:	
•	Version:	1.0	Checked:	KB Exposure	· c	Site Address: LOT 437, BOOTH DRIVE	Sheet:	7
nes		design(@barretthomes.co	o.nz Council:	CODC	WOOING TREE, STAGE 2C, CROMWELL	Scale:	1:50

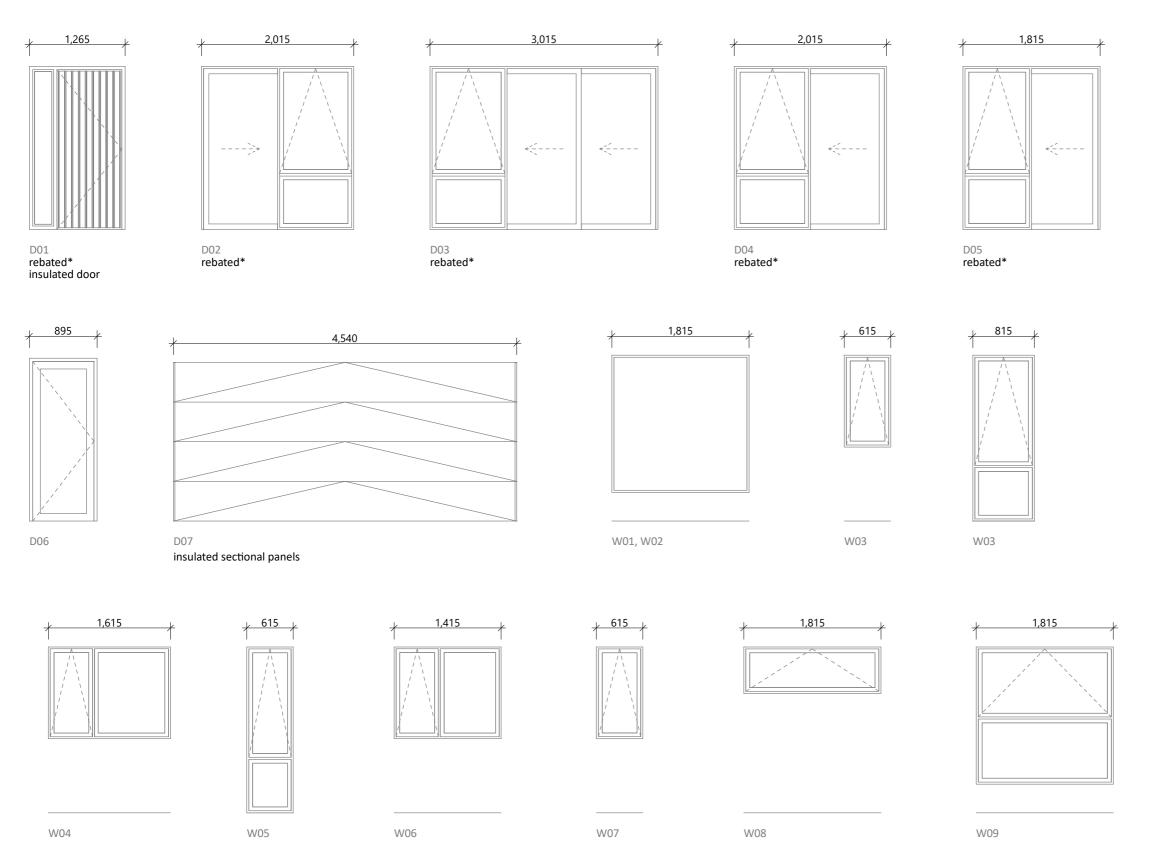

General notes:

Aluminium joinery head heights to be 2.195m (excludes rebated joinery units & include Garage door). Unless otherwise specified.

Refer to floor plan for door & window sizes. Joinery schedule & sizes to be confirmed on site PRIOR to manufacture

APL Residental series aluminium joinery with thermally improved double glazing to all window and door joinery including garage joinery.

Glazing in accordance with NZS 4223 & 2016 amendments.

All glazing clear float unless noted anywhere, (refer to joinery schedule)

- Low level glazing = Any glazing within 800mm from FFL, depending on size and proportions, safety glass or 5mm annealed will be required.

- Doors with glazing area > 0.75m² = safety glass
- Doors with glazing area < 0.75m² = 5mm annealed
- Side panels within 800mm of a door = safety glass, side panels not within 800mm of door considered a window.

sg = Safety glass as required by standards, joinery manufacturer to take precedence ss = Safety stays (in accordance with NZBC:F4 clause 2.0) obsc = Obscure glass

REBATED JOINERY

Rebated joinery sizes are to be confirmed with joinery manufacturer.

CONCEPT PLAN APPROVAL (confirmation to consent drawings) Signature

<u>Date</u>

CONCEPT ONLY



	Project N	No: WT437	Designed: CS	Wind: HIGH	Drawing: JOINERY SCHEDULE	Date: 3/09/2025
	Plan:	NEW DESIGN	Drawn:	EQ: 2	Client Name: JASON COPELAND	Rev:
•	Version:	1.0	Checked: KE	Exposure:	Site Address: LOT 437, BOOTH DRIVE	Sheet:
nes		design@	barretthomes.co.nz	Council: CODC	WOOING TREE, STAGE 2C, CROMWELL	Scale: 1:50