




YOKE


The Yoke is a charming Spanish-style 1 bedroom 1 bathroom home designed for efficient and comfortable living. Its exterior features a classic white stucco finish, a combination of clay tile and flat roof, and a charming pergola over the entrance, creating a warm and inviting atmosphere. The lean-to roofline adds a touch of architectural interest, while the simple design complements any surrounding landscape.

Inside, the open floor plan seamlessly integrates the living and kitchen areas. And a private sleeping quarter, maximizing space and sense of openness while maintaining privacy. This studio home offers a perfect blend of style and functionality for those seeking a compact and cozy living space.

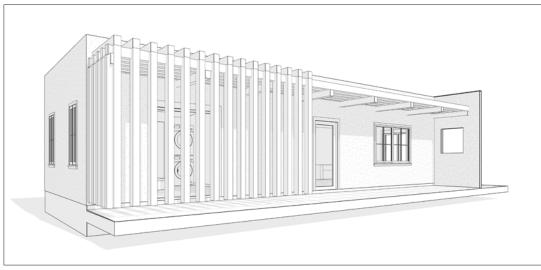

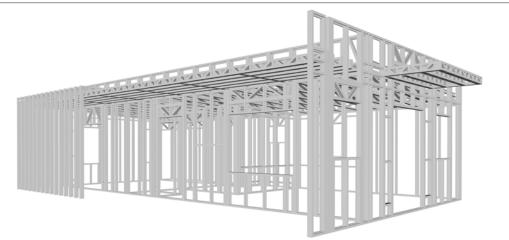

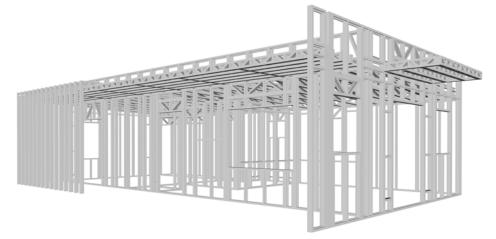

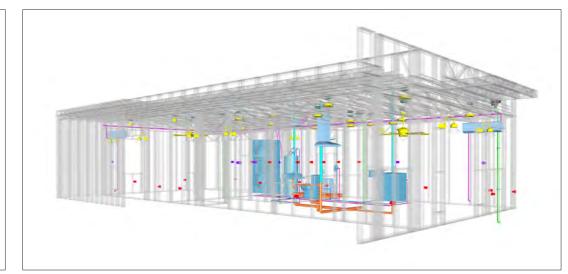

Materials Shopping List

Please print and take this Materials Shopping List to your favorite Home Depot and ask for assistance in selecting the materials, fixtures and fittings to complete your new home.

Record your selection and the price of the item. Then do the math to determine the cost for your selections and the total cost of finishing your home.

< CLICK HERE >

To Go To Materials Shopping List



22' - 10" PORCH#1 200 SF BEDROOM 181 SF KITCHEN 115 SF LIVING ROOM 151 SF PORCH#2 146 SF

FLOOR PLAN

680 SF

1 Bed Room



TABLE OF CONTENTS

RENDERINGS	ABOUT THE HOME -	— 01
1	RENDERINGS -	— 01
FLOOR PLAN	SCHEMATIC FLOOR PLAN	— 01
1	HOME SPECS -	— 01
	DISCLAIMER -	— 01
ABOUT	ABOUT FrameUpNow	— 01
1	ABOUT HouseDocs -	— 01
DESCRIPTIONS	BOM (Bill Of Materials)	02
2	STRUCTURAL -	— 02
	ARCHITECTURAL⊢	 02
	MECHANICAL -	 02
	ELECTRICAL	 02
	PLUMBING -	 02
MATERIALS LIST 2	MATERIALS LIST PREVIEW	— 02
HOW TO BUILD	CONSTRUCTION STEPS -	 02

ARCHITECTURAL **COVER SHEET** FLOOR PLAN + DIMENSION PLAN + FOUNDATION PLAN

STRUCTURAL FLOOR PLAN -WALL FRAME LAYOUT ROOF TRUSS LAYOUT ROOF PLAN + ARCHITECTURAL ELEVATIONS -ARCHITECTURAL ELEVATIONS -ARCHITECTURAL SECTIONS -ARCHITECTURAL DETAILS

ARCHITECTURAL CASEWORK

03

COVER SHEET STRUCTURAL GENERAL NOTES WALL FRAME LAYOUT WALL PANEL & LAYOUT PLAN 19 ROOF TRUSS LAYOUT

20 21 **STRUCTURAL SECTIONS** -WALL BRACING LAYOUT 22 HOLD-DOWN PLAN **STRUCTURAL DETAILS 1 STRUCTURAL DETAILS 2 STRUCTURAL DETAILS 3 27** TRUSS BLOCKING LAYOUT 28 SHEETROCK BACKING 1

ROOF BRACING LAYOUT 29 **MECHANICAL COVER SHEET** 30 HVAC PLAN 31

ELECTRICAL SCHEDULE 32 LIGHTING

POWER PLAN 34 DIMENSION FOR LIGHTING DIMENSION FOR FITTING

PLUMBING

NOTES AND SCHEDULES WATER SUPPLY & SEWAGE SYSTEM # 38

MATERIALS SHOPPING LIST MATERIALS SHOPPING LIST

DISCLAIMER

marketing content.

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not warranted to be complete or accurate. Unauthorized copying, distribution, or application of these proprietary materials, in any form or format, is strictly prohibited. FrameUpNow assumes no liability for any issues arising from improper use of this

ABOUT



FrameUpNow is a design and manufacturing company providing precision-engineered home framing solutions. We offer a catalog of Affordable Homes, Tiny Homes, Garages, Shops and Barndominiums. FrameUpNow manufactures cold-formed steel (CFS) also known as Light Gauge Steel (LGS) framing components that conform to our engineered metal house frame plans or can be purchased as DIY skeleton kits.

The CFS/LGS framing is lightweight, easily assembled, and does not require heavy equipment or specialized labor, enabling homeowners to erect the frame themselves in just a few days. Unlike wood, the steel framing is impervious termites and bores, warping, expansion, and fire.

Our home plans come complete with a structural engineered stamp for permit approvals. Customers receive a full BOM also known as a Materials Shopping List to purchase finish materials from a Building Materials retailer. FrameUpNow prides itself on the quality and efficiency of our precision-engineered home framing solutions for construction professionals and DIY homeowners.



KEY PLAN

NO.	DESCRIPTION	DATE

NOTE:

LEGEND:

PROJECT

34-Yoke-680-1Bd1Ba-**Contemporary-550**

DRAWING NAME

INTRODUCTION

С	CLIENT NAME:
Р	PROJECT NUMBER:
D	DATE:
D	DESIGNED BY:
D	DRAWN BY:
С	CHECKED BY:

1101

SCALE:

DESCRIPTIONS

MATERIALS LIST

The BOM (Bill Of Materials) package, known as the Materials Shopping List document, provides:

Comprehensive Inventory: Detailed lists of essential materials sourced from architectural, mechanical, HVAC, electrical, and plumbing design drawing sets.

Precise Curation: Each item meticulously selected and organized for accuracy and efficiency in project planning.

Customizable Options: Customers can modify listed items to their preferences and calculate costs accordingly, ensuring alignment with personal project needs and budget.

Dedicated Space for Details: Includes tables for customers to note Home Depot SKU numbers or product descriptions for selected items, facilitating seamless purchasing and coordination with suppliers.

Customer Convenience: Take the list to Home Depot or preferred suppliers for accurate pricing, helping align the total home budget with personal financial plans.

Simplify your construction journey with our Materials Shopping List document, where detailed preparation meets streamlined implementation for your dream home.

STRUCTURAL

The structural drawings package provides an exhaustive set of detailed plans essential for the precise assembly of your building. This comprehensive package includes:

Framing Plans: Detailed layouts for all framing components. Truss Layouts: Clear instructions for truss placement and

Panel Length Plans: Specifications for panel dimensions. Framing Elevations and Sections: Precise elevation and sectional views for accurate construction.

Truss and Wall Blocking Plans: Plans for truss and wall blocking to ensure structural integrity.

Hold-Down Plan: Detailed hold-down requirements for stability. Snap Sheet: Reference sheet for quick identification of components

Structural Details and Bracing Plans: Complete details and bracing plans for all structural elements.

Accompanying these plans is a comprehensive Bill of Materials (BOM) that lists every necessary building component, from cold formed steel (CFS) frames to fasteners.

ARCHITECTURAL

With the comprehensive architectural package, both builders and DIY homeowners can confidently execute the construction.

The architectural package includes:

Furnished Floor Plans: Complete with furniture layouts for a clear understanding of space utilization.

Detailed Dimension Plans: Ensures precise measurements, from the overall footprint down to the exact placement of windows and

Foundation Plan: Detailed plan to establish a solid foundation.

Wall Framing and Truss Layout: Comprehensive plans for wall framing and truss placement.

Architectural Elevations: Exterior views showcasing the design.

Strategic Building Sections: Critical cross-sectional details for a thorough understanding of the build.

Casework Drawings and Diagrams: Suggested designs for built-in caseworks, such as kitchen cabinets.

MECHANICAL ELECTRICAL

The mechanical package includes everything needed to guide HVAC

Detailed HVAC Floor Plan: Precisely maps out the placement of air handlers, ductwork, and vents throughout the home's layout.

HVAC Sections and Riser Diagrams: Technical drawings offering critical cross-sectional details and piping schematics, ensuring proper integration of the heating and cooling system into the home's structure.

Bill of Materials: A complete list of all necessary HVAC components.

The electrical package includes all the plans and documentation needed to guide the installation of your home's electrical system:

Detailed Power Plan: Precisely maps out the placement of outlets, switches, and other power components throughout the layout.

Comprehensive Lighting Plan: Shows the optimal locations for lighting fixtures, sconces, and other illumination sources to create a well-lit. functional interior.

Dimensioned Electrical Layout: Provides exact dimensions and measurements to ensure proper placement of all electrical elements.

Bill of Materials: A complete list of every component needed, from circuit breakers to wiring.

ARCHITECTURAL BOM

PLUMBING

The plumbing package includes everything needed to guide the

Detailed Water Supply System Plan: Precisely maps out the placement of pipes, valves, and plumbing fixtures throughout the

Comprehensive Sewage System Plan: Shows the optimal routing and sizing of drain lines to effectively remove waste and ensure proper drainage.

Detailed Riser Diagrams: Provide information needed to properly

Bill of Materials: A complete list of every component needed, from pipes to fixtures.



2 Sewage

Installation

4 Concrete Floor

3 Foundation

Layout and Marking

1 Staged Wall

Panels

2 Staged Truss

3 Concrete Floor

Metal Delivery and Staging

Wall Panel Installation

HOW TO BUILD

Tuscon,AZ, USA 888-864-0184 inquire@frameupnow.com www.frameupnow.com

KEY PLAN

DESCRIPTION DATE

NOTE:

LEGEND:

34-Yoke-680-1Bd1Ba-**Contemporary-550**

DRAWING NAME


INTRODUCTION

CLIENT NAME: DATE: **DESIGNED BY** DRAWN BY: CHECKED BY:

1102

SCALE:


BOM (Bill Of Materials) (Separately Attached)

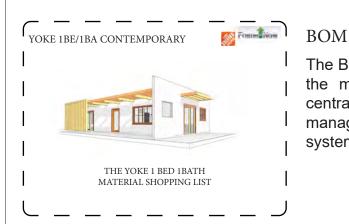


The Bill of Materials (BOM) is a crucial document that compiles the material requirements from different disciplines into a centralized inventory, enabling efficient procurement, inventory management, and cost estimation for a specified project or

ELECTRICAL BOM




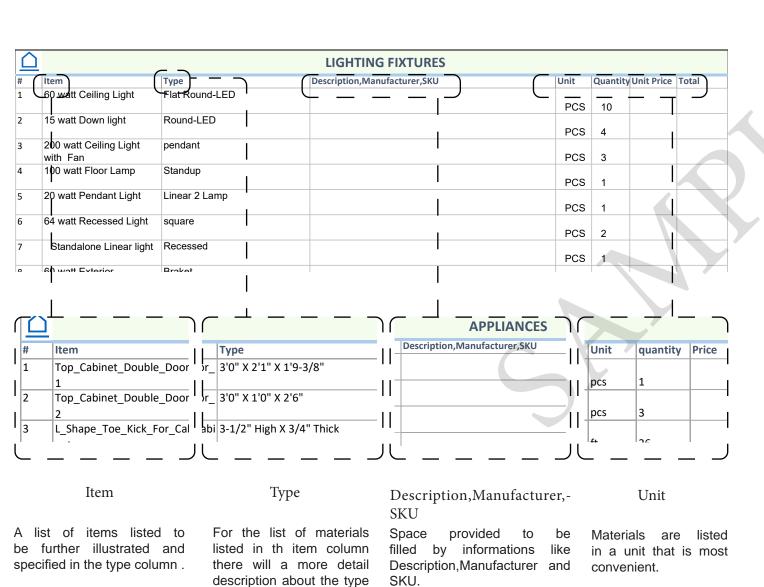

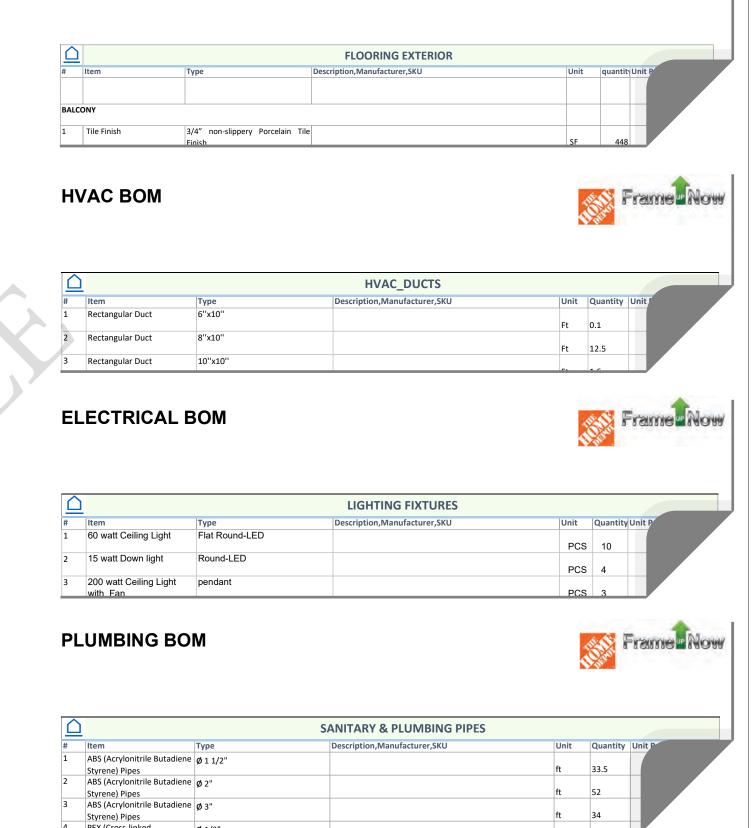

installation of your home's water supply and drainage systems: 2 Installed Trusses 2 Installed Trusses OSB Sheathing Roof Truss Installation **5** Exterior OSB Cladding install all vertical plumbing risers and vent stacks. Mechanical, Electrica (MEP) Integration Mechanical, Electrical & Plumbing Wall & Roof Insulation Frame Now 1 OSB Sheathing 1 Installed Walls 2 Insulation 2 Plumbing System 3 HVAC System 4 Electrical System 1 OSB Sheathing 1 Home Wrap 2 Floor 2 Roof Felt Paper 3 Dry Wall Board 4 Ceiling Dry Wall Exterior Wall & Roof Covering ndows,Doors & Rain Gutters Corrugated 1 Doors and iron sheet windows 2 Rain Gutters 2 Home Wrap 3 Roof Felt Paper 4 Coronado Stone 5 Corrugated iron sheet

of the Material.

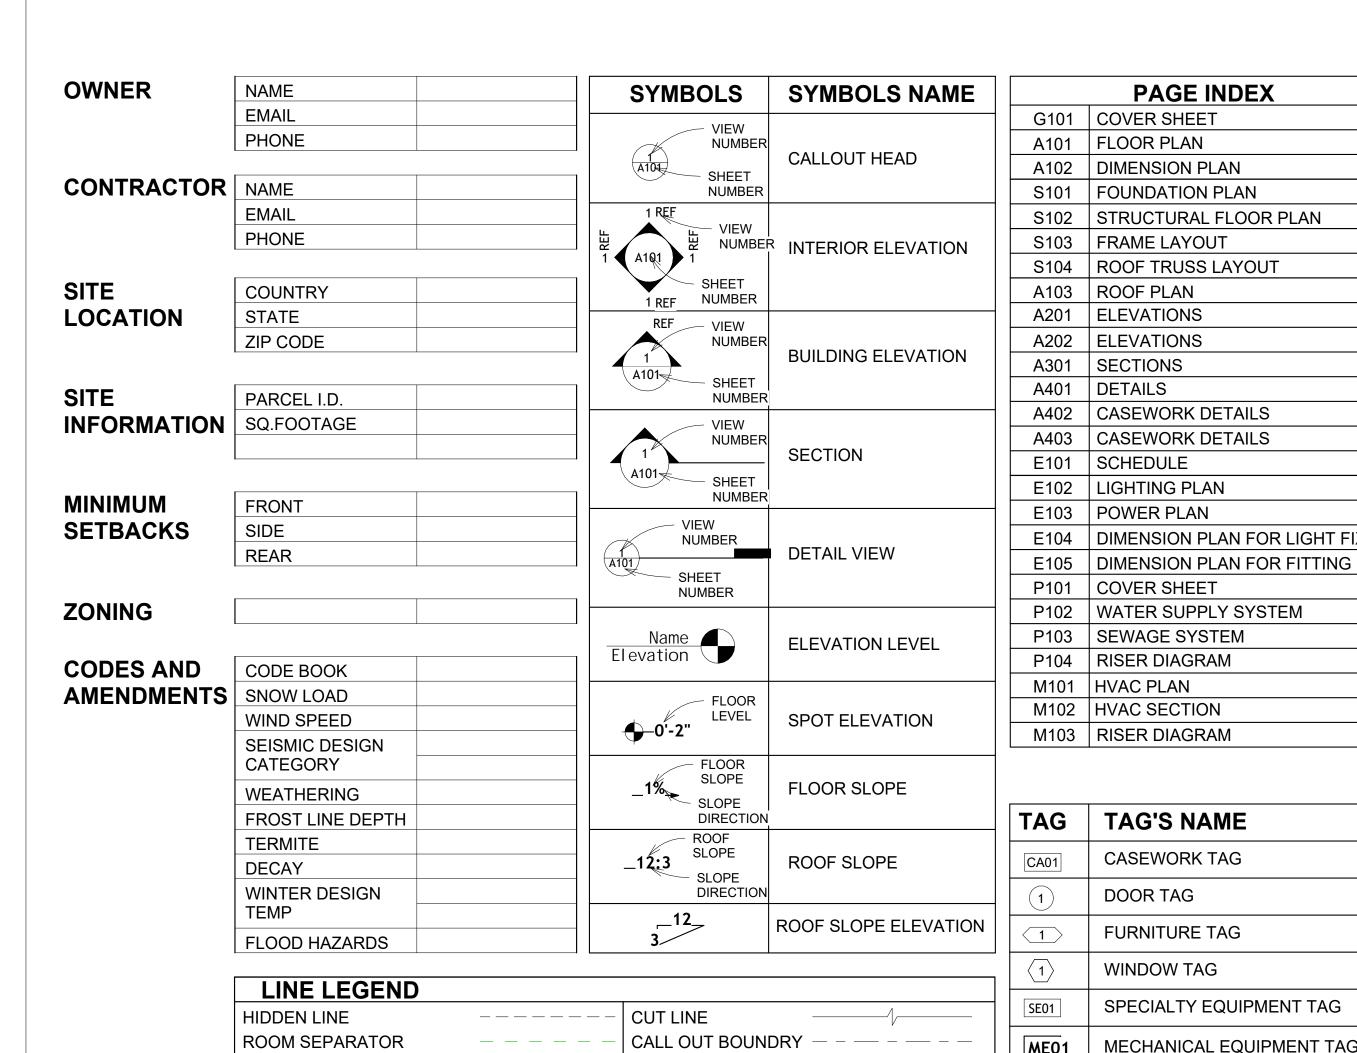

_	1		
	FOUNDATION PLAN	CA	CASEWORK
	STRUCTURAL FLOOR PLAN	EL	ELECTRICAL
	FRAME LAYOUT	F.F.E	FINISHED FLOOR ELEVATION
	ROOF TRUSS LAYOUT	F.F.L	FINISHED FLOOR LEVEL
	ROOF PLAN	FTG	FOOTINGS
	ELEVATIONS	HVAC	HEATING, VENTILATION & AIR
	ELEVATIONS		CONDITIONING
	SECTIONS	IRC	INTERNATIONAL RESIDENCE
	DETAILS		CODE
	CASEWORK DETAILS	IMC	INTERNATIONAL MECHANICAL
	CASEWORK DETAILS		CODE
	SCHEDULE	MAX.	MAXIMUM
	LIGHTING PLAN	ME	MECHANICAL
	POWER PLAN	MIN.	MINIMUM
	DIMENSION PLAN FOR LIGHT FIXTURE	NO.	NUMBER
	DIMENSION PLAN FOR FITTING	O.C	ON CENTER
	COVER SHEET	OSB	ORIENTED STRAND BOARD
	WATER SUPPLY SYSTEM	PL	PLUMBING
	SEWAGE SYSTEM	PSI	POUNDS PER SQUARE INCH
	RISER DIAGRAM	PVC	POLYVINYL CHLORIDE
	HVAC PLAN	REF	REFERENCE
	HVAC SECTION	RG	RIGHT GARAGE
	RISER DIAGRAM	SE	SPECIAL EQUIPMENT
	,	SF	SQUARE FEET
		SIMP. STHD8	
	TAG'S NAME	SIMP. STHU8	SIMPSON STRAP THE HOLDDOWN
		SIMP. ABE66	SIMPSON ANCHOR BOLT EDGE
	CASEWORK TAG	TV	TELEVISION
	DOOR TAG	UNO	UNLESS NOTED OTHERWISE
		W/	WITH
	FURNITURE TAG	W/D	WASHER/DRYER
	WINDOW TAG	AC	AIR CONDITIONING UNIT
	SPECIALTY EQUIPMENT TAG	ACC	AIR COOLED CONDENSER
	MECHANICAL EQUIPMENT TAG	ACCU	AIR COOLED CONDSENSING
	WEST / WIS/ C EQUI WEIT 1/ C	AHU	知 HANDLING UNIT
	PLUMBING EQUIPMENT TAG	CC	COOLING COIL
		CD	CEILING DIFFUSER
		CFm	Cubic Feet Per Minute
		CR	CEILING REGISTER
		CU	CONDENSING UNIT
		CW	COLD WATER
		E/A	EXHAUST AIR
		EF	EXHAUST FAN
		ET	EXPANSION TANK
		EX.	EXISTING
		FC	FLEXIBLE CONNECTION
1		FCU	FAN COIL UNIT
		FLR.	FLOOR
-		HC	HEATING COIL
		HE	AIR TO AIR HEAT EXCHANGER
		HV	HEATING AND VENTILATING UNI
1		IV	INLET VANES
100		MER	MECHANICAL ROOM
1		MAX.	MAXIMUM
1		MIN.	MINIMUM
o o		''''' '	
0		R/A	RETURN AIR
		-	

RETURN FAN SUPPLY AIR

STATIC PRESSURE

SMOKE CONTROL DAMPER

SCD SP

ABBREVIATION

AFS


ASTM D698

ACTION FLOOR SYSTEMS

AMERICAN SOCIETY FOR

TESTING AND MATERIAL

PAGE INDEX

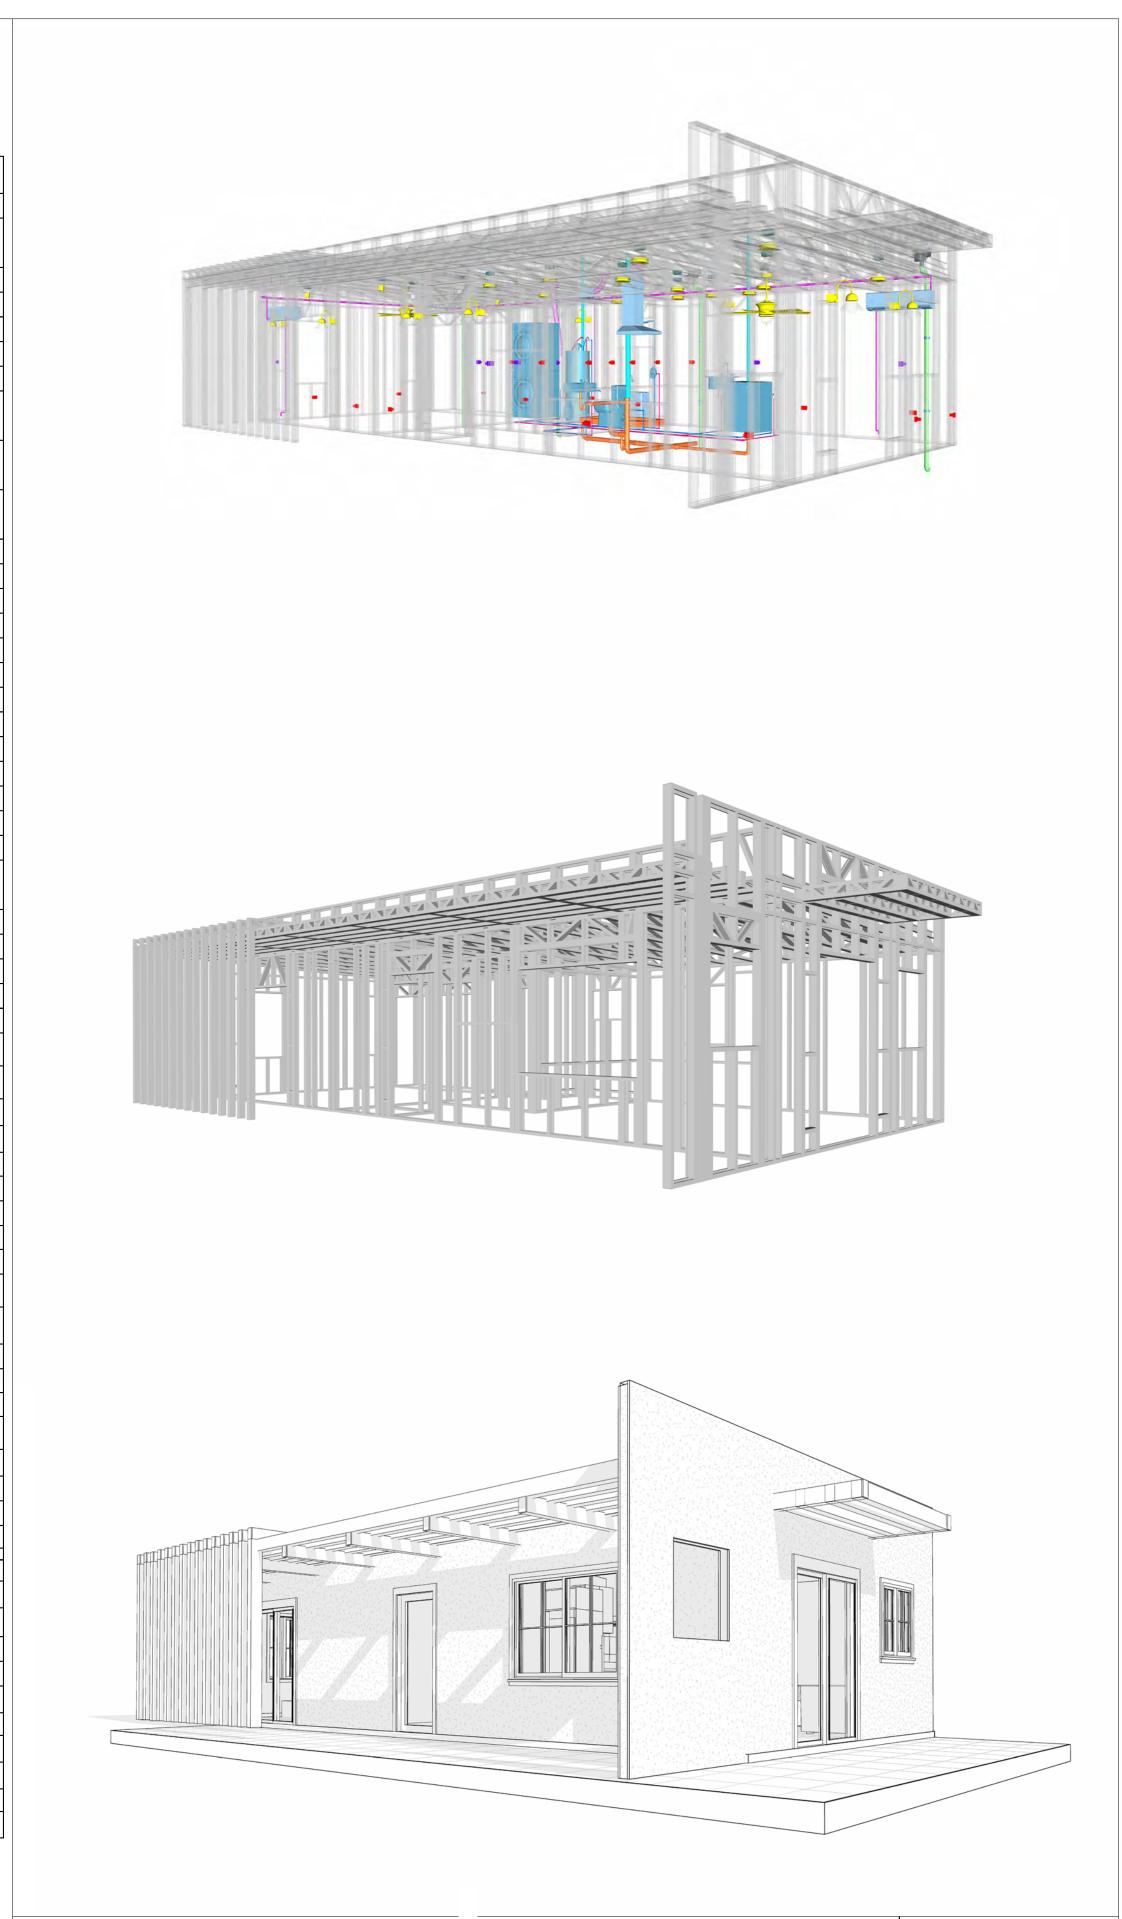

34 YOKE 680 1Bd/1Ba **CONTEMPORARY 550**

SQUARE FOOTAGE		
LIVIN G	625	
PORCH	479	
TOTAL	1102	



KEY PLAN

NO.	DESCRIPTION	DATE

LEGEND:

PROJECT

34 YOKE 680 1Bd/1Ba **CONTEMPORARY 550**

DRAWING NAME

COVER SHEET

ME:	Client Name
NUMBER:	0061_12
	2/10/2025 6:04:30 PM
BY:	Designer
' :	Author
BY:	Checker

G101

SCALE: As indicated

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OVER HEAD

GENERAL NOTES

- THIS DRAWING DEPICTS THE ARCHITECTURAL (SPACE LAYOUT, FURNISHING, FLOOR, WALLS, ROOFS, FOUNDATION, WINDOWS AND DOORS) SYSTEMS. IT PROVIDES A VISUAL REPRESENTATION OF THE ARCHITECTURAL LAYOUT AND COMPONENTS.
- THE ARCHITECTURAL DRAWINGS ARE PREPARED TO MEET THE SPECIFIC REQUIREMENTS OF THE BUILDING, AS PER THE PROJECT SPECIFICATIONS AND APPLICABLE CODES AND STANDARDS.
- THE CONSTRUCTION OF THIS HOME SHALL COMPLY WITH THE LATEST EDITION OF THE INTERNATIONAL RESIDENTIAL CODE (IRC), INTERNATIONAL MECHANICAL CODE (IMC), THE INTERNATIONAL PLUMBING STANDARD, THE NATIONAL ELECTRICAL STANDARD AND ALL OTHER APPLICABLE LOCAL, STATE, AND NATIONAL CODES AND REGULATIONS.
- COORDINATION WITH OTHER TRADES HAS BEEN DONE ON A DESIGN LEVEL. THIS DRAWING SHALL BE READ TOGETHER WITH THE ME, EL AND PL DESIGN DRAWINGS TO ENSURE PROPER CONSTRUCTION AND INTEGRATION OF THE BUILDING SYSTEMS.

ABOUT WALLS:

- SHOWER WALL COVERING
- BATHTUB AND SHOWER SPACES (WALLS AND FLOORS) WITH INSTALLED SHOWER HEADS AND IN SHOWER COMPARTMENTS SHALL BE FINISHED WITH A NON-ABSORBENT SURFACE.
- 2. WALL PAINT (INTERNAL)
 - THE TYPICAL THICKNESS OF LATEX WALL PAINT IS 1/32 OF AN INCH FOR A SINGLE COAT. AND
- DOUBLE COAT (1/16") SHALL BE APPLIED FOR DURABILITY.

3. ADHESIVES:

THE ADVISABLE TYPE OF ADHESIVE FOR THIS PROJECT IS **EPOXY ADHESIVES**BECAUSE THEY ARE KNOWN FOR THEIR HIGH STRENGTH, DURABILITY, AND RESISTANCE TO MOISTURE, CHEMICALS AND

REFER TO SHEETS A201 & A202 FOR GENERAL NOTES ON EXTERNAL FINISHING MATERIALS

ABOUT FLOORS:


- THE SPOT ELEVATION INDICATES THE FINISHED FLOOR ELEVATION.
- FINISHED FLOORS PER PLANS.
- FIELD VERIFY FOR DIMENSION DROP 4" FOR SHOWER AND BATHTUB USE.
- 1% SLOPE ON OUTDOOR BALCONIES FOR WATER RUN OFF.
- 2% SLOPE TOWARDS THE SHOWER DRAIN FOR SUFFICIENT DRAINAGE.
- 4" DROP AT THE DOOR LEADING TO EXTERIOR BALCONY FROM THE MAIN LIVING AREA.

CLOSED - 900 X 660MM 2

5% SLOPE FOR GARAGE IS USED, WHICH SHOULD BE CHECKED WITH THE LOCAL GARAGING ZONING LAWS.

FURNITURE SCHEDULE TYPE **TYPE MARK** COUNT KING SIZE BED FOUR SIT 85" X 85" ONE SEAT SOFA DINING CHAIR

	ROOM FINISH SCHEDULE						
ROOM NUMBE R	ROOM NAME	FLOOR FINISH	BASE FINISH	WALL FINISH	CEILING FINISH	CEILING HEIGHT	COM MEN TS
01	BEDROOM	HARDWOOD	CONCRETE	WALL PAINT	DRY WALL		
02	CL#1	HARDWOOD	CONCRETE	WALL PAINT	DRY WALL		
03	W/D	VINYL TILES	CONCRETE	CERAMIC TILE	DRY WALL		
04	WH	VINYL TILES	CONCRETE	CERAMIC TILE	DRY WALL		
05	BATH	VINYL TILES	CONCRETE	CERAMIC TILE	MRD		
06	CL#2	HARDWOOD	CONCRETE	WALL PAINT	DRY WALL		
07	KITCHEN	VINYL TILES	CONCRETE	WALL PAINT + CERAMIC	DRY WALL		
08	LIVING ROOM	HARDWOOD	CONCRETE	WALL PAINT	DRY WALL		
09	HALL	HARDWOOD	CONCRETE	WALL PAINT	DRY WALL		
10	PORCH#1	PROCELAIN TILE	CONCRETE	STUCCO FINISH	DRY WALL		
11	PORCH#2	PROCELAIN TILE	CONCRETE	STUCCO FINISH	DRY WALL		

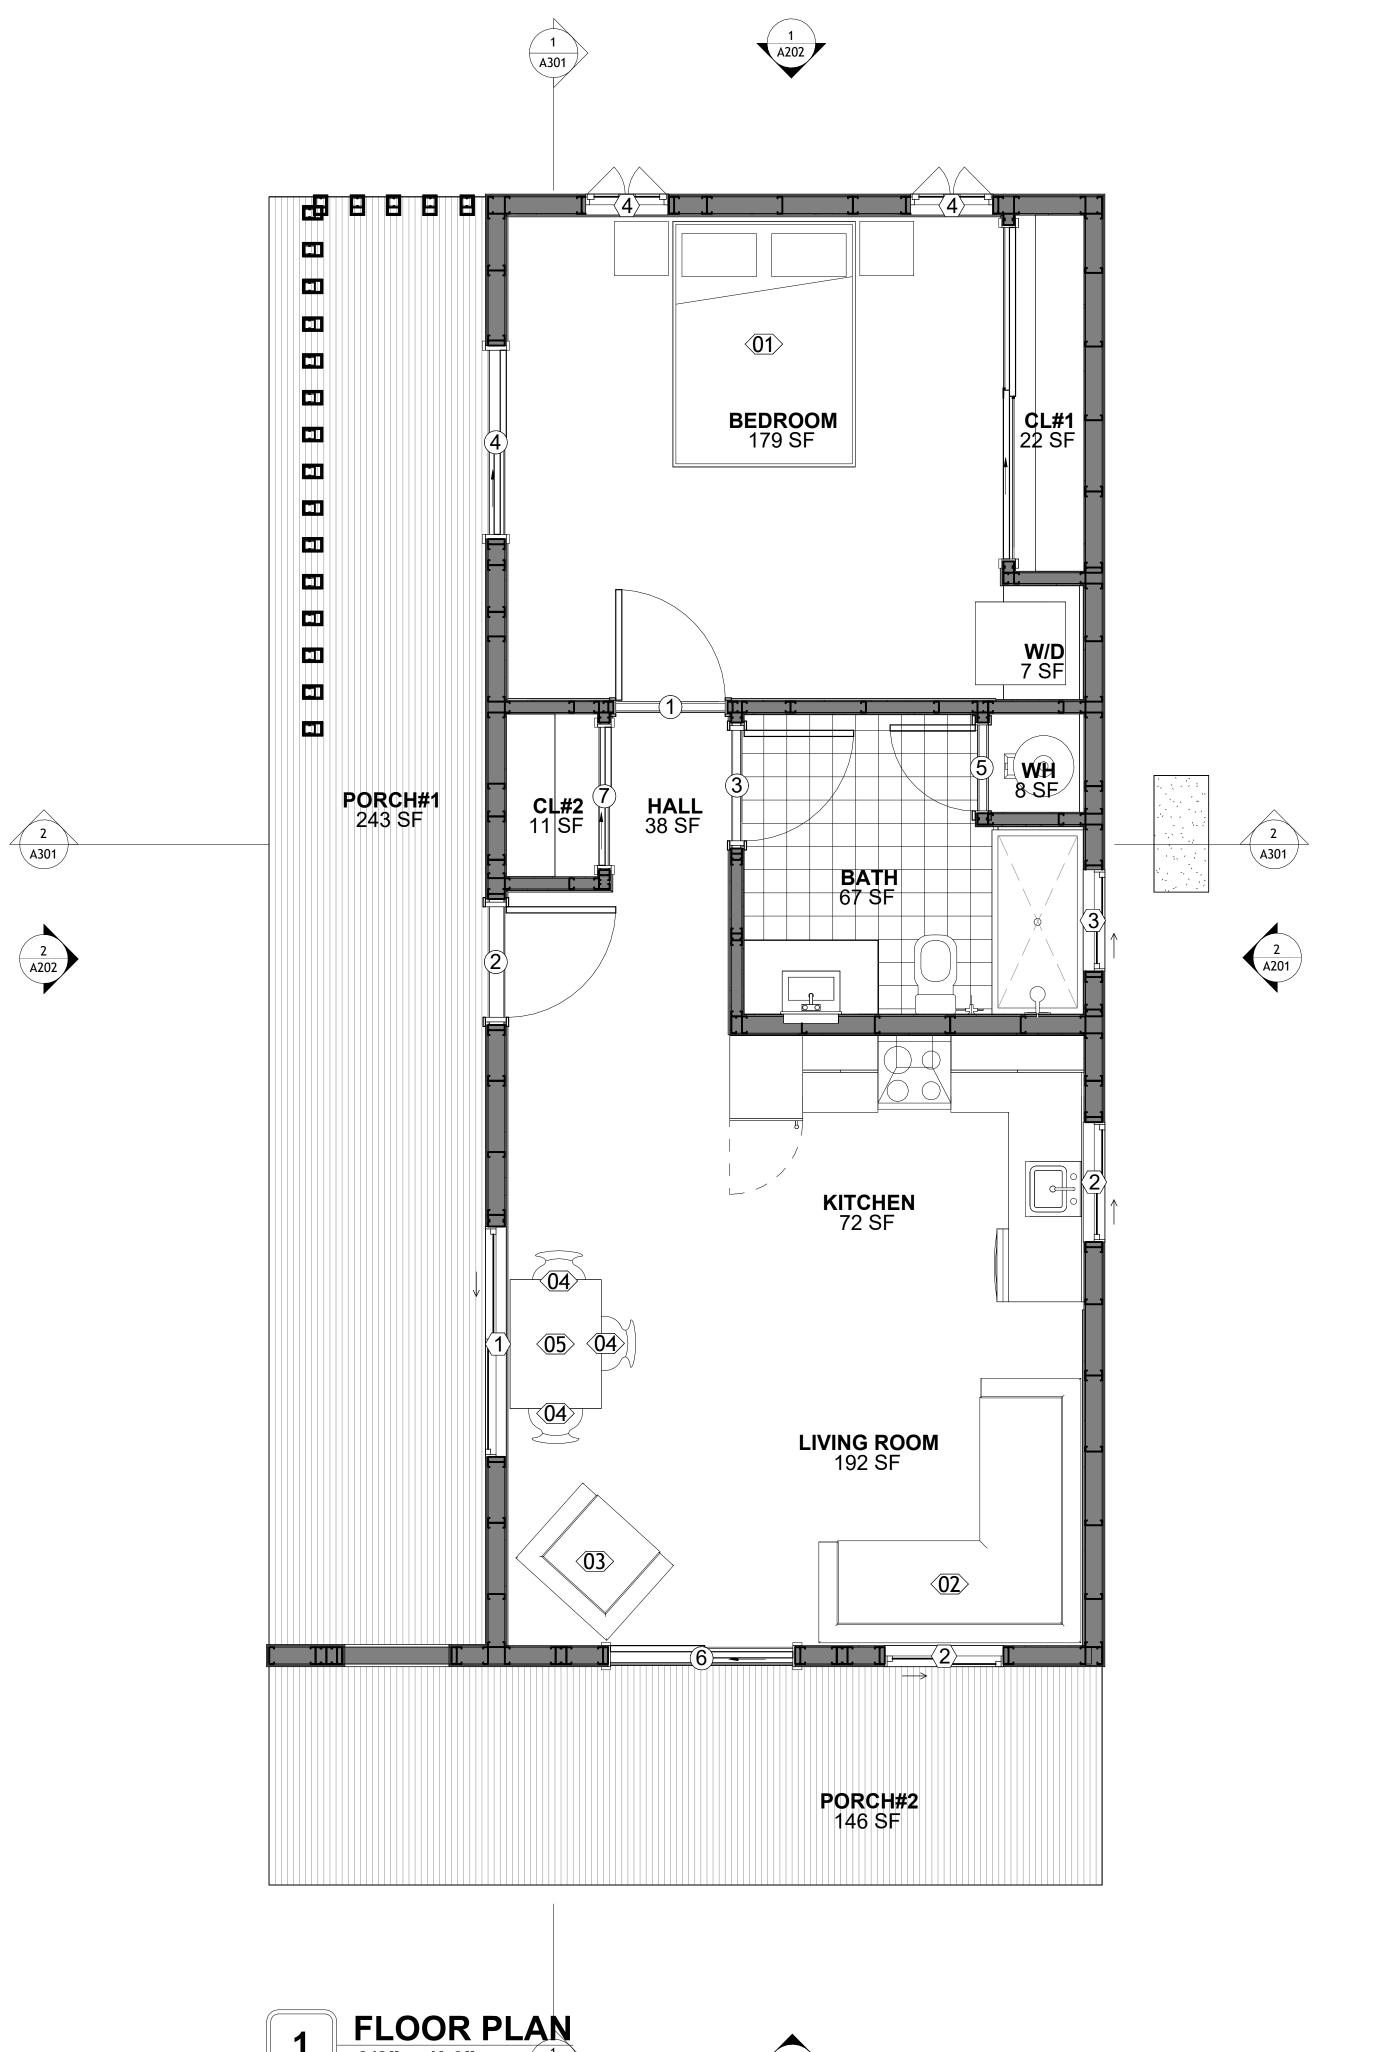



KEY PLAN

NO.	DESCRIPTION	DATE

NOTE:

LEGEND:

PROJECT

34 YOKE 680 1Bd/1Ba **CONTEMPORARY 550**

DRAWING NAME

FLOOR PLAN

Client Name	CLIENT NAME:
0061_12	PROJECT NUMBER:
2/10/2025 6:04:31 PM	DATE:
Designer	DESIGNED BY:
Author	DRAWN BY:
Checker	CHECKED BY:

A101

SCALE: As indicated

SQUARE FOOTAGE

PORCH


TOTAL

625

479

1102



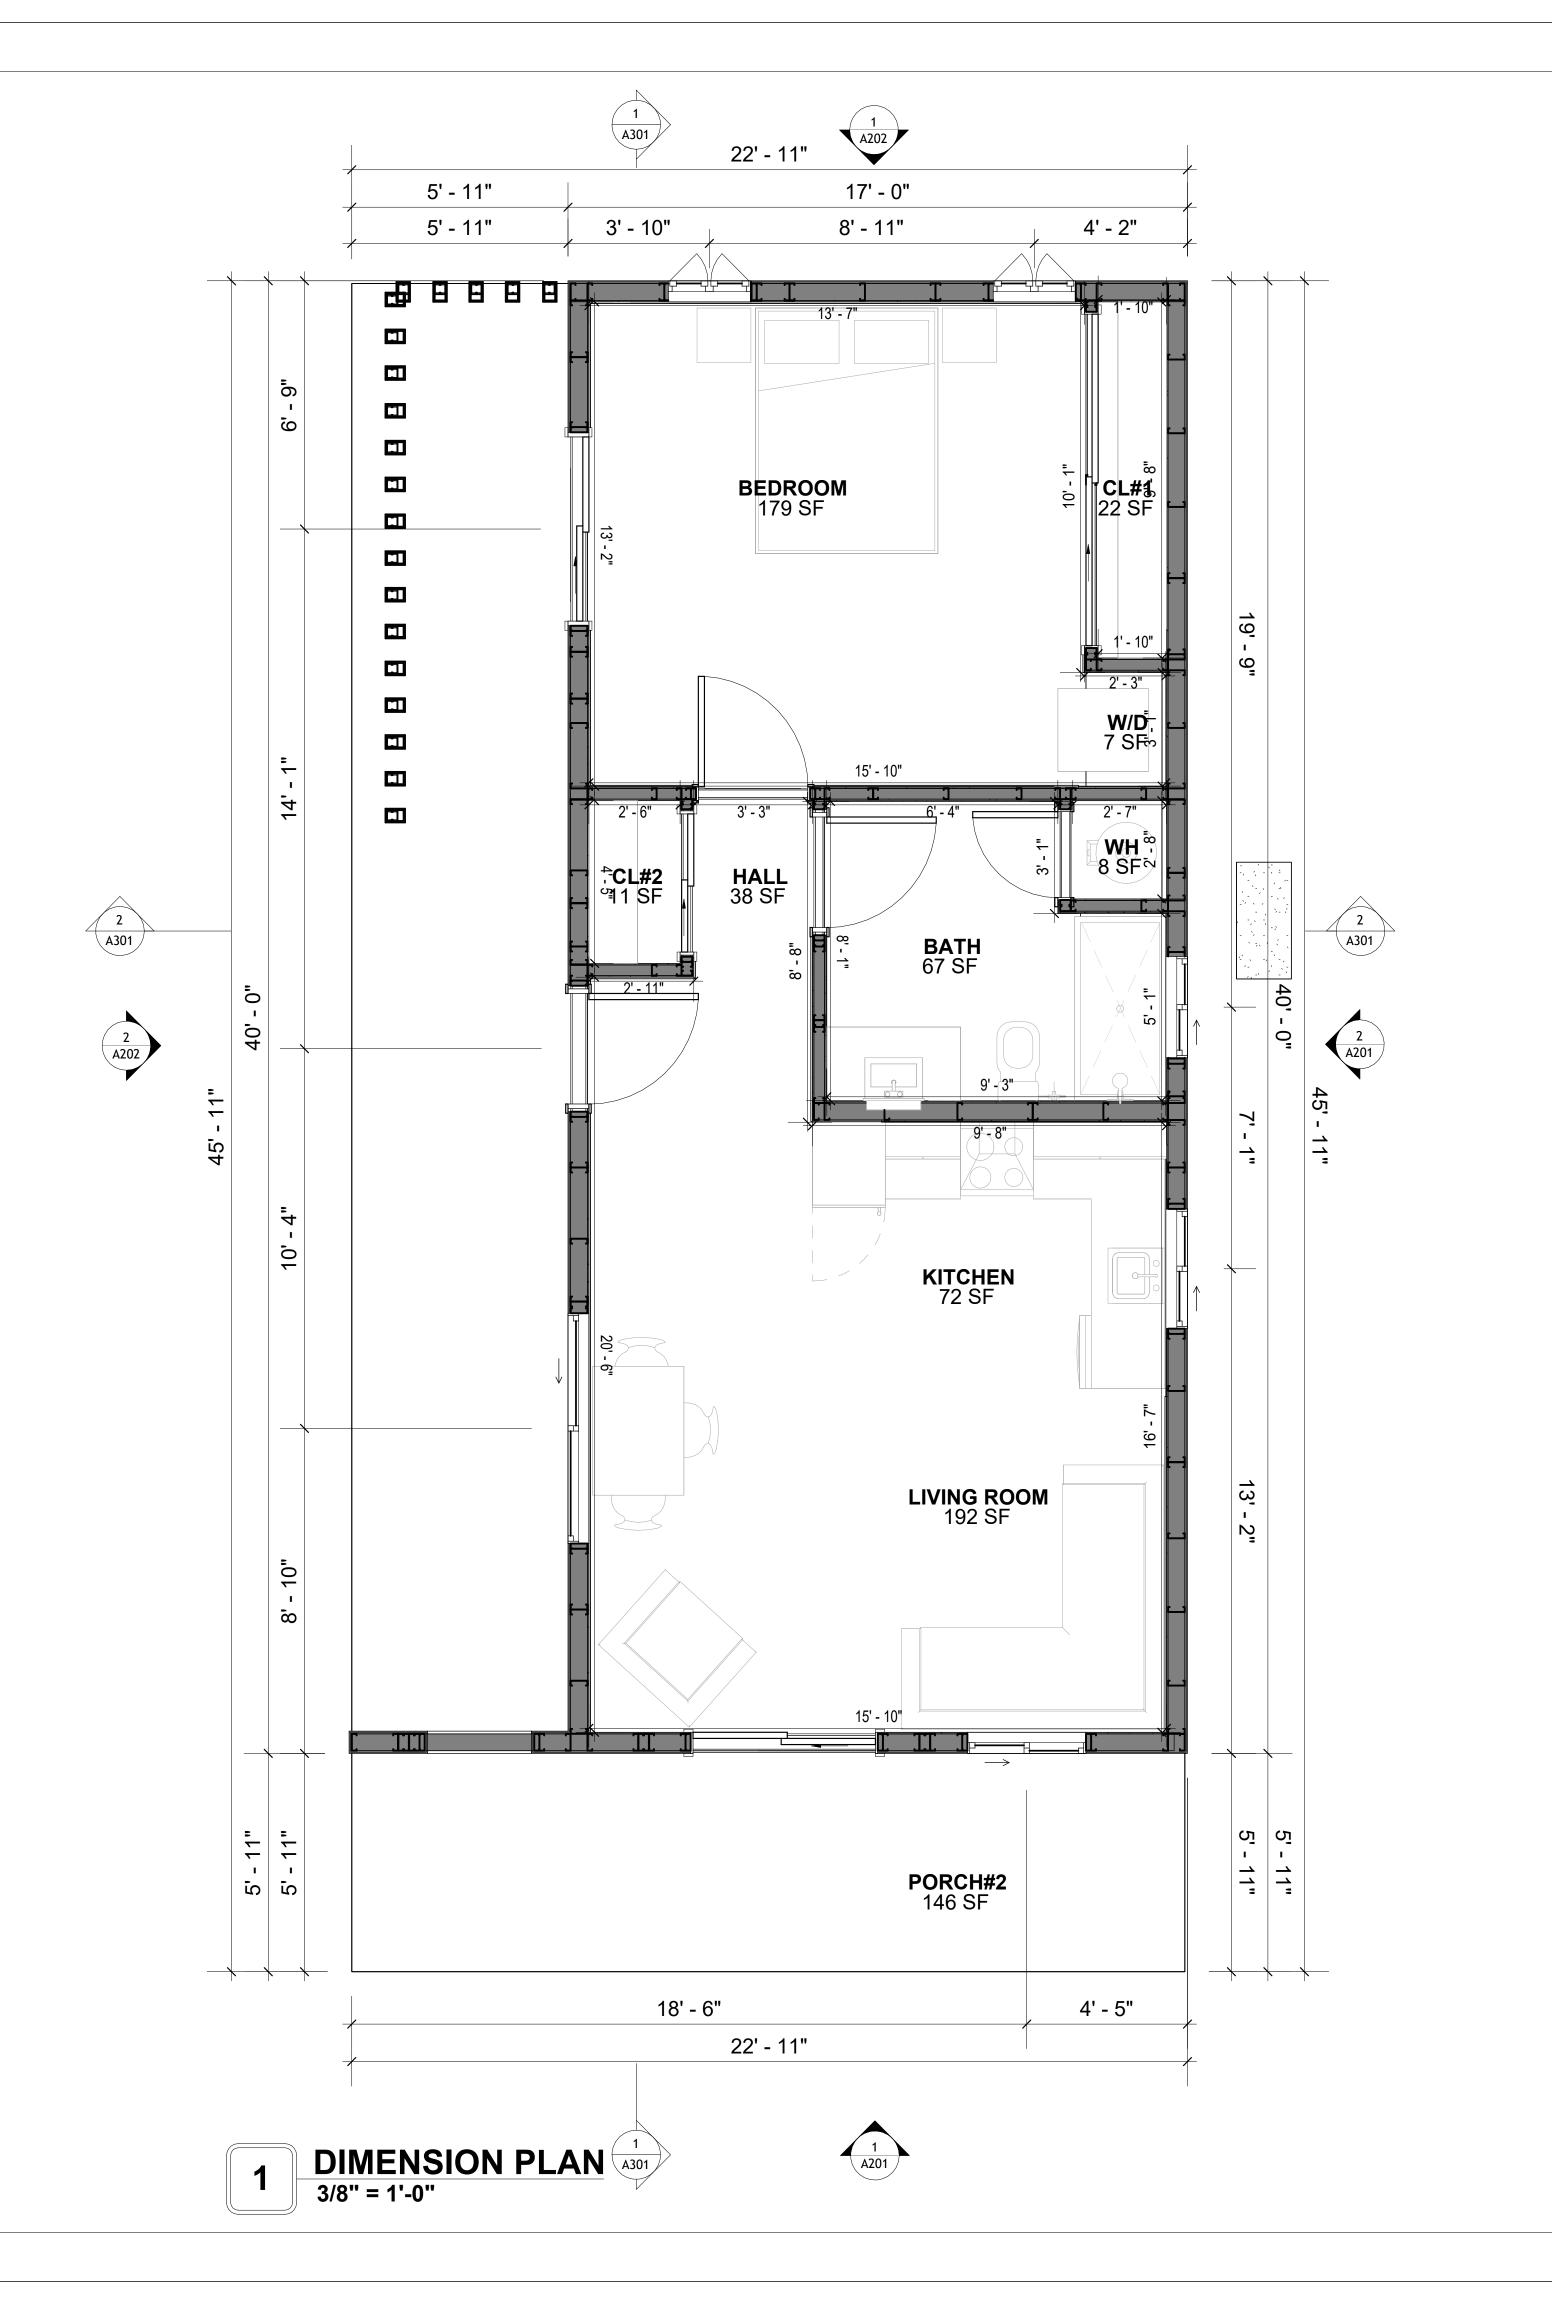



KEY PLAN

NO.	DESCRIPTION	DATE

NOTE:

LEGEND:

PROJECT

34 YOKE 680 1Bd/1Ba **CONTEMPORARY 550**

DRAWING NAME

DIMENSION PLAN

CLIENT NAME:	Client Name
PROJECT NUMBER:	0061_12
DATE:	2/10/2025 6:04:33 PM
DESIGNED BY:	Designer
DRAWN BY:	Author
CHECKED BY:	Checker

SQUARE FOOTAGE 625 PORCH 479 TOTAL

1102

A102

SCALE: 3/8" = 1'-0"

DIMENSIONS IN THE ARCHITECTURAL DRAWINGS CONSIDER FINISHING MATERIALS. FOR PRECISE MEASUREMENTS OF THE STRUCTUAL FRAMING, REFER TO THE ATTACHED STRUCTURAL PLAN SET.

FOUNDATION NOTES

TERMITES PRETREATMENT BY LICENSED CONTRACTOR UNDER SLAB AND AROUND FOOTINGS. ALL AREAS BELOW SLABS SHALL BE TREATED NO MORE THAN 24 HOURS PRIOR TO CONCRETE POUR. EVIDENCE OF TREATMENT MUST BE PROVIDED PRIOR TO PLACING OF CONCRETE.

. MATERIALS:

ALL INTERIOR CONCRETE SLABS SHALL BE A MIN. OF 4" THICK CONCRETE OVER 4" COMPACTED AGGREGATE BASE (ASTM D698), FINISH ELEVATIONS AS NOTED ON DRAWINGS, 6" ABOVE ADJACENT GRADE, LEVEL SLABS TO 1/8"-10' MAX., CONCRETE SLABS SHALL BE 2500# PSI AT 28 DAYS. A 4" ALLOWABLE SLUMP.

2. PAD PREPARATION:

EXCAVATION FOR FOOTING SHALL BE NEAT.

FOOTINGS SHALL BE POURED IMMEDIATELY AFTER EXCAVATION AND APPROPRIATE

ALL REINFORCING STEEL MARKED "CONTINUOUS" SHALL BE LAPPED 36 BAR DIAMETERS AT SPLICES AND AROUND CORNERS OR INTERSECTIONS WITH A STANDARD 90 DEGREE BEND ON CORNER BARS. LAP WIRE MESH ONE FULL MESH AT SIDE AND END LAPS. ALL HARDWARE TO BE SIMPSON OR EQUIVALENT.

EXTERIOR FRAME WALL TO BE SECURED WITH 1/2"X10" ANCHOR BOLTS 4'-0" O.C. FOR 1-STORY AND 2'-8" O.C. FOR 2-STORY. BOLTS SHALL BE LOCATED WITHIN 1'-0" OF EACH END PIECE AND SHALL HAVE A MIN. OF TWO BOLTS PER PIECE

-FOUNDATION ANCHOR STRAPS SHALL BE PERMITTED, ACCORDING TO RESIDENTIAL CODE

- ALL INTERIOR WALLS TO BE SECURED WITH POWER DRIVEN PINS PER MANUFACTURER SPECIFICATION USE PIN SPACING EQUIVALENT TO 1/2" ANCHOR BOLTS.

ALL CONSTRUCTION TO CONFORM TO THE 2012 IRC

R-10 RIGID INSULATION OUTSIDE OF EXTERIOR FOUNDATION WALLS UNDER LIVING AREA.

CONCRETE PAD FOR CONDENSER THICKNESS IS 4" MIN UNLESS OTHERWISE NOTED.

3. CONCRETE CONSTRUCTION:

THE SLAB SHALL BE UNDERLAIN BY A VAPOR BARRIER/RETARDER IN THE LIVING AREA (TYPICALLY POLYETHYLENE, UNLESS MORE STRINGENT PROTECTION REQUIRED BY THE ARCHITECT, ENGINEER, FLOOR COVERING MANUFACTURER, OR ACCEPTED PRACTICE). UNLESS OTHERWISE REQUIRED, BARRIER MAY BE OMITTED AT GARAGES, PORCHES AND PATIOS WITHOUT FLOOR COVERINGS. IT IS BEYOND THE SCOPE OF THESE PLANS TO DETERMINE THE APPLICABILITY OF THESE MORE STRINGENT REQUIREMENTS. BUILDER SHALL VERIFY PRIOR TO CONSTRUCTION.

4. REINFORCEMENT:

OWNER OF THE FOLLOWING:

- IF CONSTRUCTED ON ACTIVE SOILS, THE LONG TERM PERFORMANCE OF THE FOUNDATION IS DEPENDENT ON MAINTENANCE BY THE OWNER. THUS THE BUILDER SHALL ADVISE THE

. DRAINAGE MUST BE MAINTAINED. WATER SHALL NEVER BE ALLOWED TO POND NEAR THE FOUNDATION.

2. THE SOIL AROUND THE FOUNDATION SHALL BE MAINTAINED IN A RELATIVELY DAMP CONDITION, SUCH AS THAT REQUIRED TO KEEP A LAWN GREEN. IF IT DRIES OUT IT WILL

SHRINK. IF IT GETS WET, IT WILL HEAVE UPWARD. SLABS ON THE SHORTER SIDE USES MAIN BARS ARE USED IN THIS DIRECTION ONLY

WITH SMALLER DIAMETER DISTRIBUTION BARS ARE PLACED. FORMING A MAT OR GRID. 4. ALL REINFORCEMENT BARS SIZE 10MM OR LARGER IN ACCORDANCE TO ASTM

ANCHOR BOLTS AT ALL EXTERIOR WALLS SHALL BE MINIMUM 1/2 INCH DIAMETER WITH A MAXIMUM SPACING OF 6'-0" ON CENTER, UNLESS NOTED OTHERWISE.

ANCHOR BOLTS SHALL BE INSTALLED WITHIN 12 INCHES OF EACH END OF EACH SILL PLATE WITH AT LEAST TWO ANCHOR BOLTS FOR EACH BOLTS FOR EACH SILL PLATE LONGER THAN 12 INCHES.

5. SIMPSONS SILL ANCHORS MAYBE SUBSTITUTED FOR ANCHOR BOLTS AT THE SAME SPACING.

6. EXTERIOR CONCRETE SLABS WHICH ARE NOT PART OF THE MAIN SLAB SHALL BE MINIMUM 4 INCHES THICK WITH NO STEEL REINFORCING BARS REQUIRED. UNLESS NOTED OTHERWISE ON FOUNDATION PLAN.

VERIFY THE FOLLOWING PRIOR TO POURING:

ALL HOLDDOWNS, STRAP, AND POST LOCATIONS.

CONCRETE FINISHES. PANEL RISER LOCATION - WHERE APPLICABLE.

UNDERSLAB MECHANICAL REQUIREMENTS.

STEM WALL BLOCKOUTS.

5. UNDERSLAB ELECTRICAL REQUIREMENTS AND PANEL RISER LOCATION. WHERE APPLICABLE.


6. PROVIDE THE FOLLOWING:

- PVC SLEEVES THROUGH FTG IF REQUIRED

- 20' #4 COPPER GROUND BAR.

SLOPE FINISH GRADE AWAY FROM FOOTING.

NOTE: FIELD VERIFY ALL DIMENSIONS SEE DIMENSIONED ARCHITECTURAL DRAWINGS

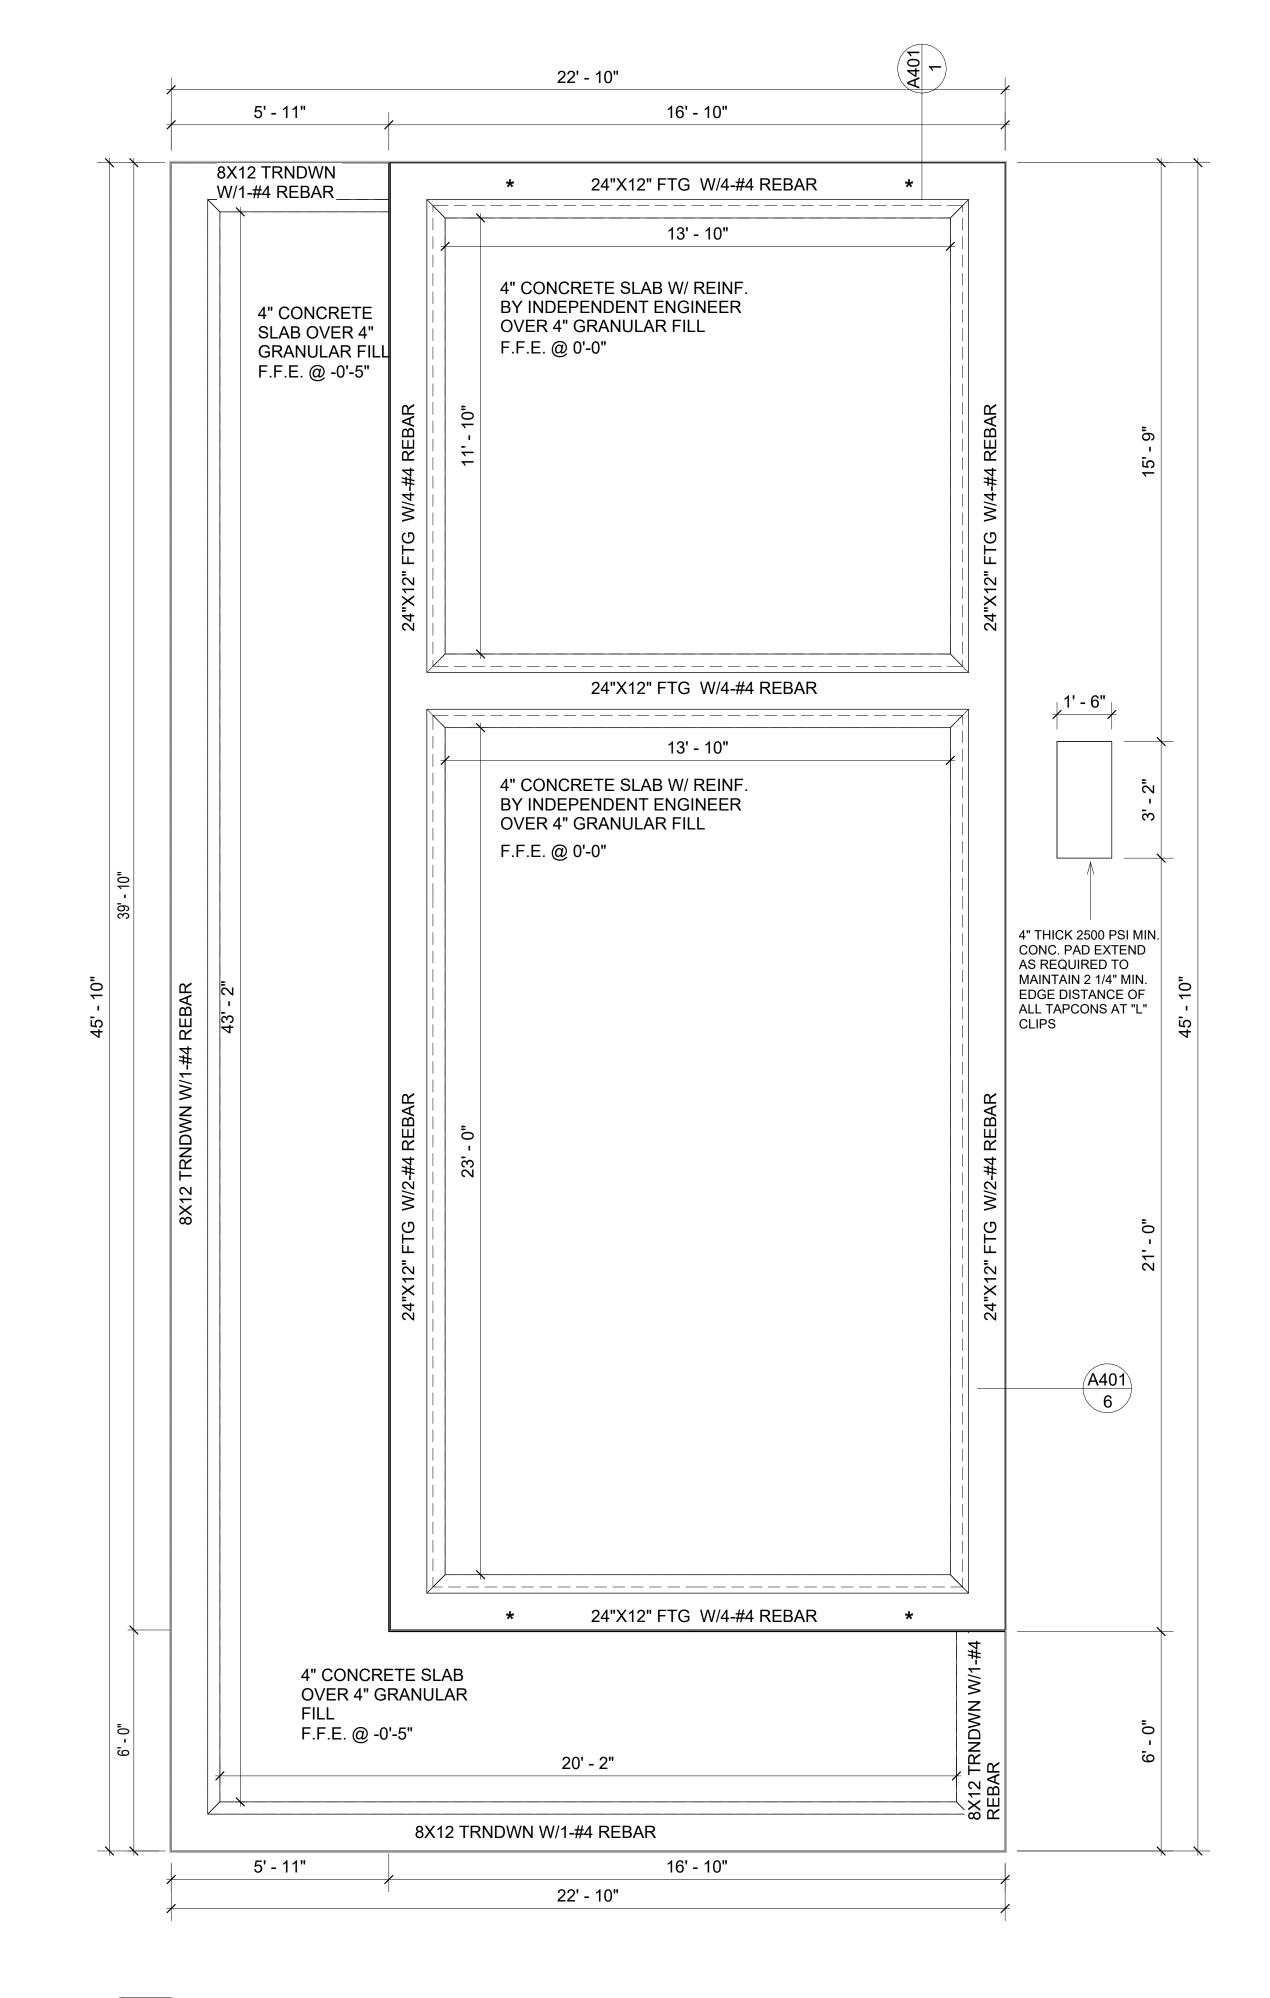

FOUNDATION PLAN 3/8" = 1'-0"

SQUARE FOOTAGE 625 LIVIN PORCH 479 TOTAL 1102



KEY PLAN

NO.	DESCRIPTION	DATE

NOTE:

LEGEND:

PROJECT

34 YOKE 680 1Bd/1Ba **CONTEMPORARY 550**

DRAWING NAME

FOUNDATION PLAN

CLIENT NAME:	Client Name
PROJECT NUMBER:	0061_12
DATE:	2/10/2025 6:04:33 PM
DESIGNED BY:	Designer
DRAWN BY:	Author
CHECKED BY:	Checker

S101

SCALE: 3/8" = 1'-0"

GENERAL NOTES

NOTES:

-ALL BEARING WALLS SHOULD HAVE A THICKENED SLAB PER SECTION PER DETAIL A401/5.

A) **FOUNDATION PLAN NOTES**:

- 1. CONCRETE SLAB SHALL BE 6" THICK WITH 1/2" DIAMETER TENDONS PER LAYOUT PLAN, CENTERED IN SLAB THICKNESS, OVER APPROVED SUBBASE PER GENERAL STRUCTURE NOTES.
- TERMITE PROTECTION SHALL BE PROVIDED PER IRC SECTION R318.1
 NONE TYPICAL ANCHOR BOLT SPACING AT SHEAR WALL AND HOLD DOWN
- SPECIFICATIONS PER APPROVED ARCHITECTURAL PLANS.

 4. INSTALL HOLDOWNS BEFORE CONCRETE SLAB POUR.
- 5. EXISTING FILL ON-SITE SHALL BE COMPACTED IN ACCORDANCE WITH THE REQUIREMENTS IN THE GEOTECHNICAL REPORT.
- 6. ALL FLOOR SLABS ARE REINFORCED ON CONCRETE SLABS.

SPECIAL INSPECTION IS REQUIRED FOR THICKENED FOUNDATION CONSTRUCTION

- 1. REINFORCEMENT
- 2. 2300 PSI CONCRETE POUR

B) REINFORCEMENT FOR CONCRETE:


 ALL REINFORCING SLABS BARS SIZE 10MM OR LARGER SHALL BE DEFORMED IN ACCORDANCE TO ASTM-A706, AND BARS SMALLER THAN 10 MM MAYBE PLAIN.
 UNLESS OTHERWISE NOTED IN PLANS, THE YIELD STRENGTH OF REINFORCING BARS SHALL BE:


> A) FOOTING = 40,000 PSI B) NON-LOAD BEARING WALLS AND PARAPETS= 40,000 PSI

- 3. SPLICES SHALL BE SECURELY WIRED TOGETHER AND SHALL LAP OR EXTEND
- 4. GRADE OF STEEL FOR RCC WORKS SHALL BE GRADE 4 10.
- . BAR NOTATIONS GIVES INFORMATION
- A) BAR SIZE
- B) SPACING(IF REQUIRED)
- LAP REINFORCEMENT ONLY AT LOCATION SHOWN IN THE DRAWINGS
 REINFORCEMENT SHALL NOT BE CUT, VENT OR HEATED ON SITE WITHOUT ENGINEERS' APPROVAL.
- C) CONCRETE SLAB NOTES
- 1. ALL SLAB REINFORCEMENT SHALL BE 20MM CLEAR MINIMUM FROM BOTTOM AND FROM TOP OF SLAB.
- 2. REINFORCEMENT IN CONTINUOUS ELEVATED SLAB SHALL BE CUT AS FOLLOWS.

NOTE

- THIS IS A SCHEMATIC PLAN FOR THE PURPOSE OF LOCATING AND IDENTIFYING FOUNDATION REINFORCING ELEMENTS ONLY. VERIFY ALL DIMENSIONS, DROPS, OFFSETS AND FEATURES WITH THE ARCHITECTURAL PLANS BEFORE FORMING THE FOUNDATION.

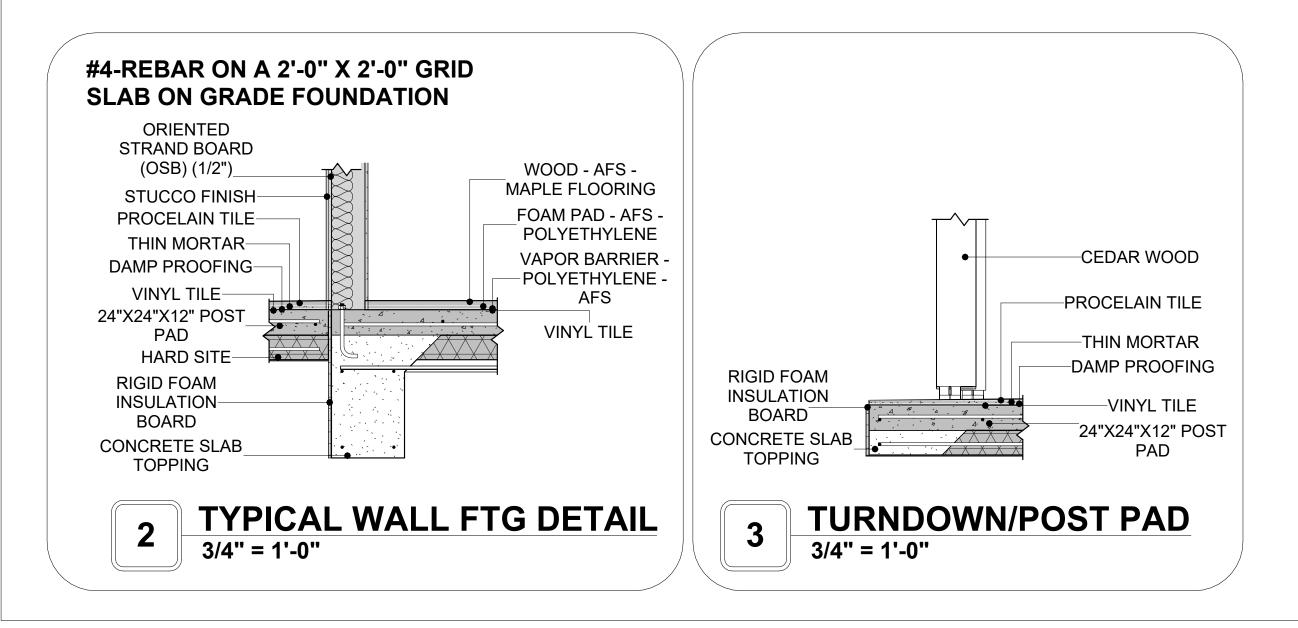

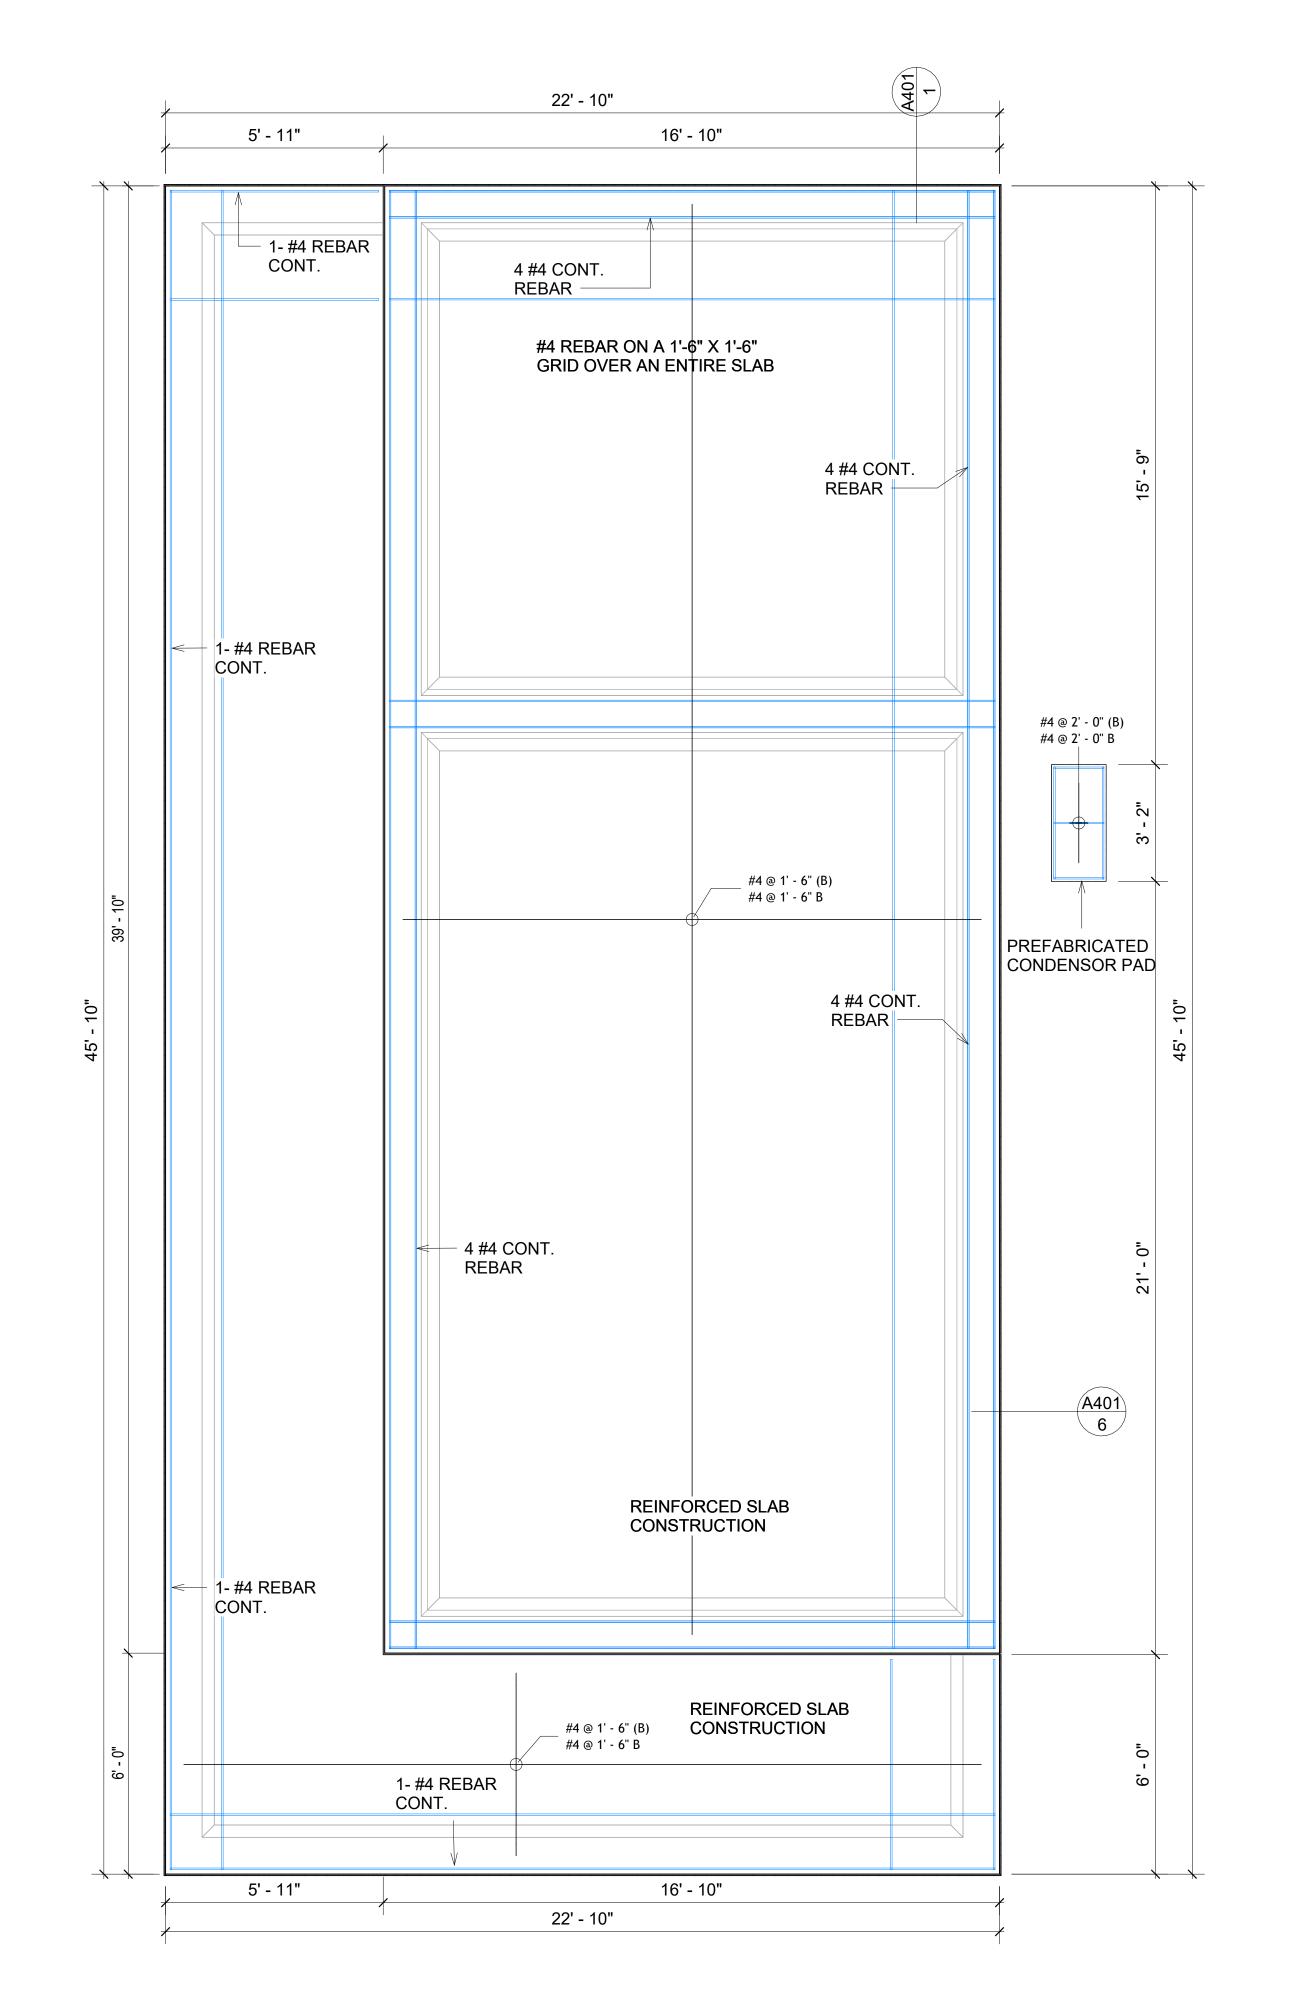

1 FOUNDATION REBAR PLAN
3/8" = 1'-0"



KEY PLAN

NO.	DESCRIPTION	DATE
	·	

NOTE:

LEGEND:

PROJECT

34 YOKE 680 1Bd/1Ba CONTEMPORARY 550

DRAWING NAME

STRUCTURAL FLOOR PLAN

CLIENT NAME:

PROJECT NUMBER:

0061_12

DATE:

2/10/2025 6:04:34 PM

DESIGNED BY:

DRAWN BY:


CHECKED BY:

Checker

S102

ROOF NOTES

- ROOFING COMPOSITION ROOFING PER OWNERS/BUILDERS SPECIFICATIONS INSTALL PER MANUFACTURE SPECIFICATIONS ON 1/2" ORIENTED STRAND BOARD ON PRE-ENGINEERED TRUSS @ 24" O.C. (UNO.) 2. 73" OVERHANG AT EAVES (UNO.)
- ENDS OF ALL TRUSSES AND JOISTS TO BE FULLY BLOCKED. PROVIDE SOLID
- BLOCKING AT ALL RIDGES AND VALLEYS 4. SHEATHING TO BE 1/2", 3/8" OSB SHEAR PANEL AND EQUIVALENT.
- UNDERSIDE OF PORCH TRUSSES TO BE FINISHED WITH MOISTURE RESISTANT DRYWALL, TAPED AND TEXTURED. 5. EXPOSED EAVES AND OTHER WEATHER EXPOSED AREAS TO BE SHEATHED
- WITH EXTERIOR GRADE PLYWOOD. 6. ALL MATERIALS THICKNESS AND SIZE ARE THE MINIMUM. Refer TO LOCAL
- STANDARDS FOR ACTUAL THICKNESS AND LAYERING OF MATERIALS. ENGINEERED TRUSS CALCULATIONS TO BE SUBMITTED TO BUILDING
- DEPARTMENT PRIOR TO FABRICATION AND INSTALLATION.
- TRUSS MANUFACTURER TO SPECIFY HANGER CONNECTORS FOR TRUSS COMPONENTS (TYPICAL)
- 9. DESIGNER ASSUMES THAT TRUSSES BEAR ON ALL EXTERIOR PERIMETER WALLS (TYPICAL) OR BEAMS.
- 10. PROVIDE GALVANIZED STEEL FLASHING WITH A LENGTH OF 10 FEET, WIDTH OF 12 INCHES, AND THICKNESS OF 24 GAUGE.

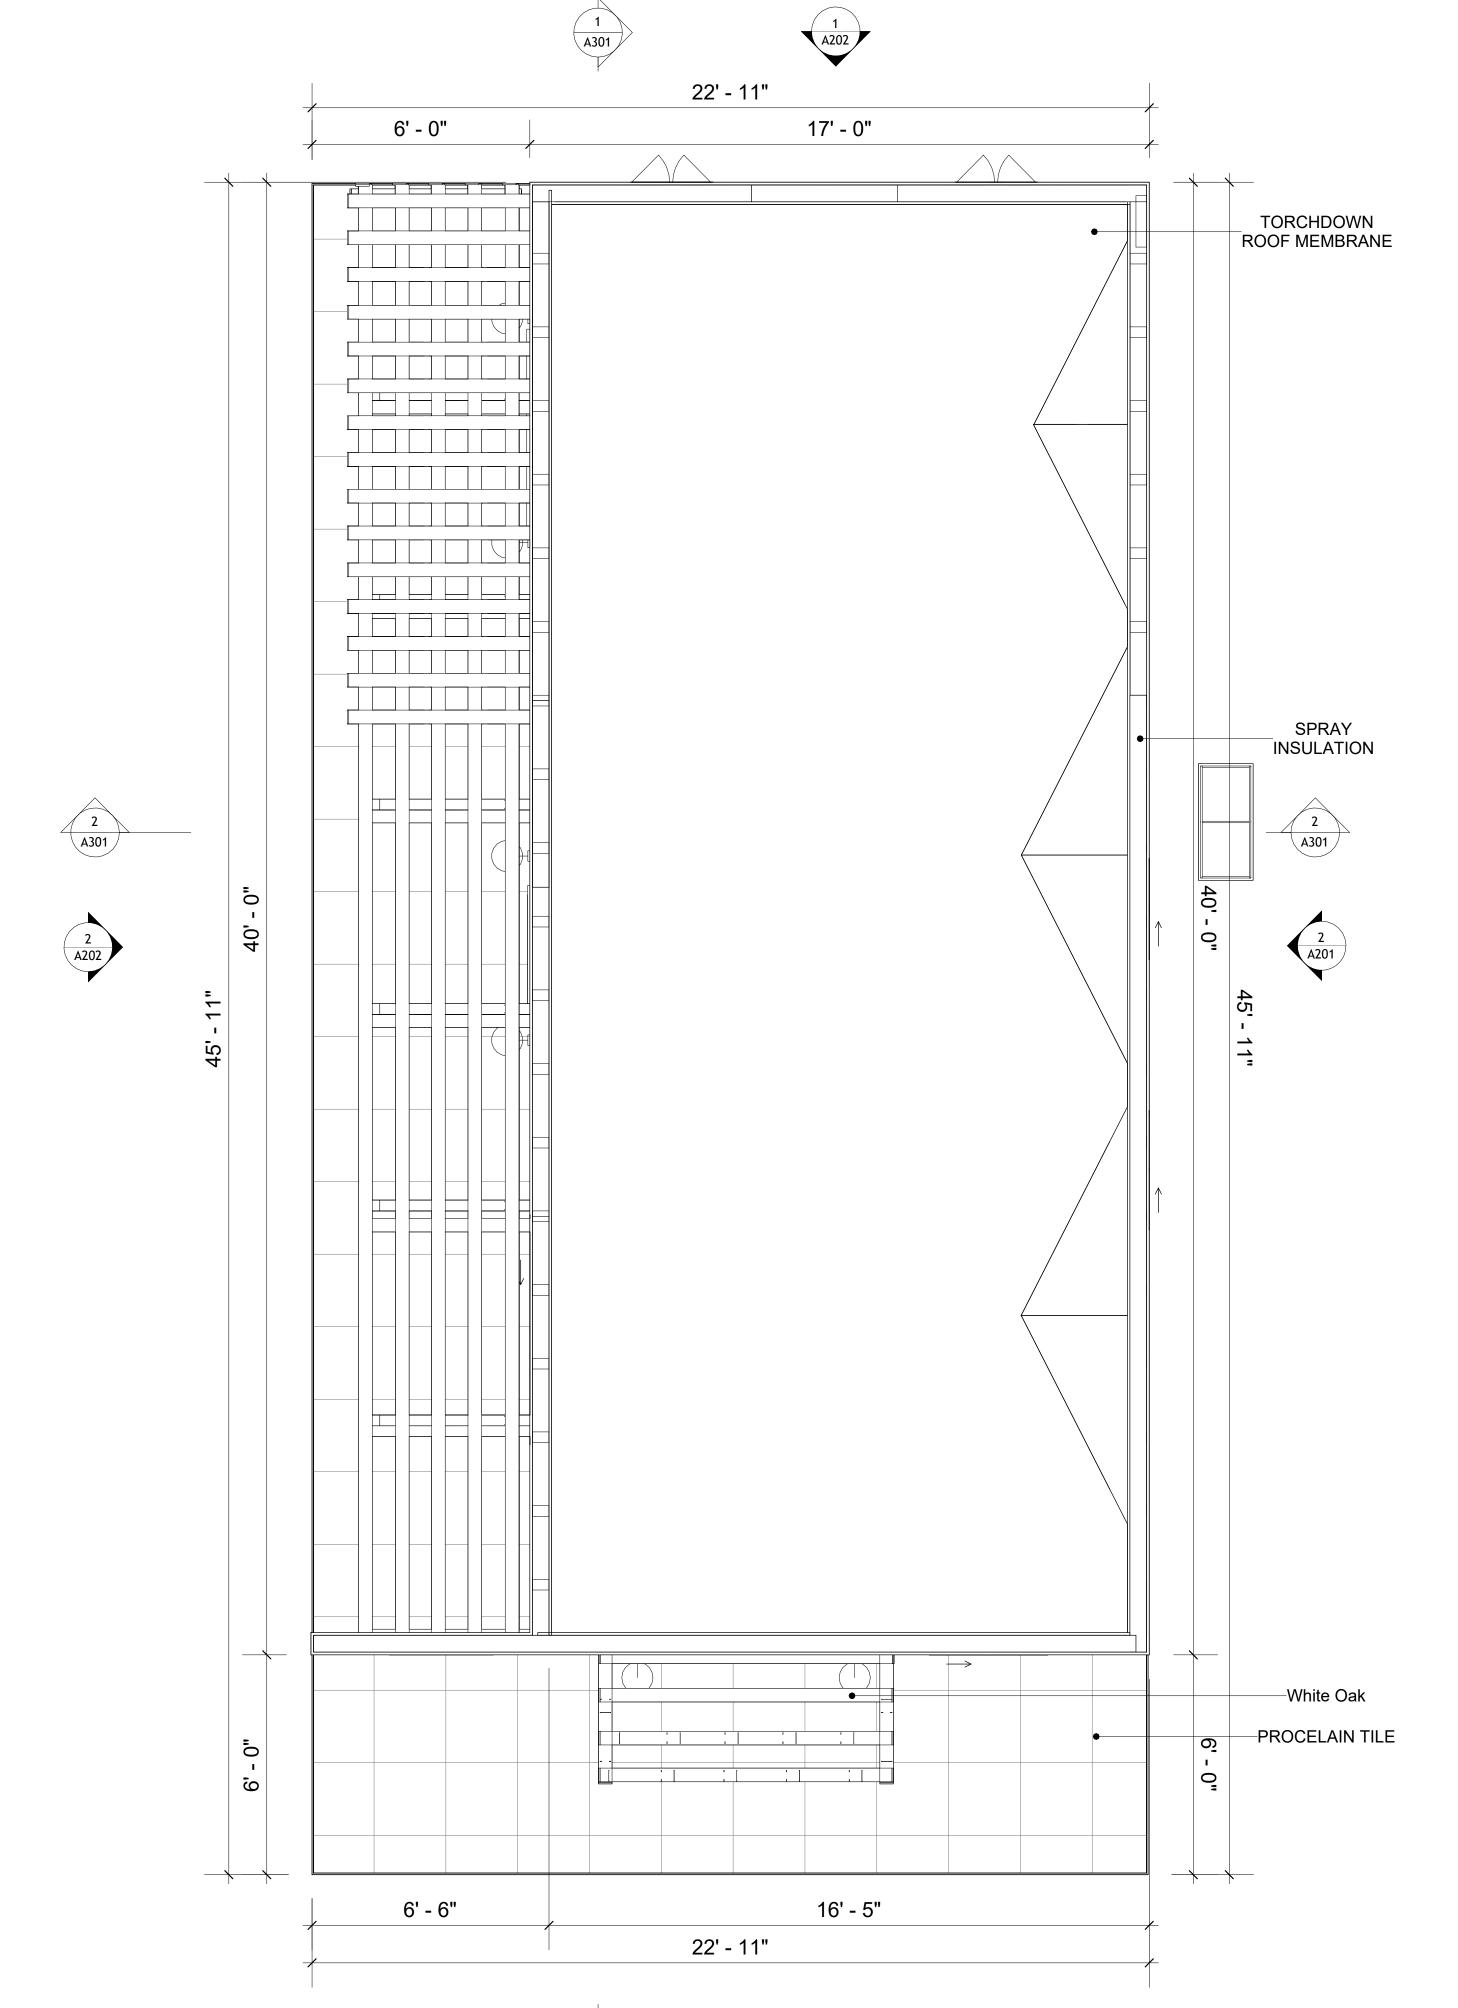



KEY PLAN

NO. DESCRIPTION DATE

NOTE:

LEGEND:

PROJECT

34 YOKE 680 1Bd/1Ba **CONTEMPORARY 550**

DRAWING NAME

ROOF PLAN

CLIENT NAME:	Client Name
PROJECT NUMBER:	0061_12
DATE:	2/10/2025 6:04:38 PM
DESIGNED BY:	Designer
DRAWN BY:	Author
CHECKED BY:	Checker

A103

SCALE: As indicated

SQUARE FOOTAGE

PORCH

TOTAL

625

479

1102

ROOF PLAN





ABOUT WALL FINISHING

STUCCO FINISH

STUCCO IS A CEMENT-BASED EXTERIOR WALL FINISH THAT OFFERS A DURABLE, WEATHER-RESISTANT, AND CUSTOMIZABLE CLADDING SOLUTION FOR BUILDINGS.

IN THIS SPECIFIC PROJECT, AMERICAN STUCCO SYSTEMS IS USED AS A FINISH MATERIAL BECAUSE IT IS GENERALLY CONSIDERED A WATER-RESISTANT EXTERIOR FINISH AND USES A THREE-COAT APPLICATION PROCESS.

3/8-INCH OF IT IS APPLIED AS AN EXTERNAL WALL FINISH AS IT IS THE MOST COMMON AND WIDELY ACCEPTED STANDARD THICKNESS FOR STUCCO EXTERIOR WALL FINISHES. THIS MULTI-LAYER APPROACH ALSO HELPS CREATE A STRONG, CRACK-RESISTANT STUCCO SURFACE.

THIS STANDARD STUCCO IS APPLIED OVER OSB SHEATHINGS (FOR COLD FORMED STRUCTURE CONSTRUCTION).

IT IS NOT DIRECTLY TROWELED OVER THE OSB BUT OVER A WATER-RESISTANT BARRIER (HOMEWRAP) AND METAL/PLASTIC LATH THAT ARE INSTALLED ON TOP SURFACE OF THE OSB TO PROVIDE AN ADDITIONAL LAYER OF PROTECTION AGAINST MOISTURE INTRUSION.

REGULAR INSPECTION AND PROMPT REPAIR OF ANY CRACKS, CHIPS, OR DAMAGE TO THE STUCCO FINISH IS IMPORTANT. THIS MAINTAINS THE STUCCO'S WATER-RESISTANT PROPERTIES OVER THE BUILDING'S LIFE SPAN. CEDAR WOOD

CEDAR WOOD REFERS TO THE WOOD FROM VARIOUS SPECIES OF CEDAR TREES, WHICH ARE CONIFEROUS EVERGREEN TREES KNOWN FOR THEIR DISTINCT AROMA AND NATURAL RESISTANCE TO DECAY AND INSECTS.

IN THIS SPECIFIC PROJECT, CEDAR WOOD IS USED AS A FURRING STRIP AND A FINISH MATERIAL ON BEAMS AND COLUMNS.

CEDAR WOOD AS A FURRING STRIPS PROVIDE THERMAL INSULATION AND MOISTURE MANAGEMENT. THE VERTICAL CEDAR WOOD FURRING STRIPS ARE ATTACHED TO HOME WRAP USING CORROSION-RESISTANT FASTENERS (HOT-DIP GALVANIZED SCREWS), ENSURING PROPER PENETRATION INTO THE WALL FRAMING.



1 FRONT ELEVATION
3/8" = 1'-0"




2 RIGHT SIDE ELEVATION
3/8" = 1'-0"

DOOR SCHEDULE						
TYPE				SIZE		
MAR K	SUPPLIER	DOOR TYPE	LOCATIO N	WIDTH	HEIGHT	COUNT
1	HOME DEPOT	INTERIOR SINGLE PANEL SWINGING	INTERIOR	3' - 0"	6' - 8"	1
2	HOME DEPOT	EXTERIOR SINGLE PANEL SWINGING	INTERIOR	3' - 0"	6' - 8"	1
3	HOME DEPOT	INTERIOR SINGLE PANEL SWINGING	INTERIOR	3' - 0"	6' - 8"	1
4	HOME DEPOT	PATIO_DOUBLE PANEL_SLIDING	EXTERIOR	5' - 0"	6' - 8"	1
5	HOME DEPOT	INTERIOR SINGLE PANEL SWINGING	INTERIOR	2' - 4"	6' - 8"	1
6	HOME DEPOT	PATIO_DOUBLE PANEL_SLIDING	EXTERIOR	5' - 0"	6' - 8"	1
7	HOME DEPOT	INTERIOR DOUBLE PANEL SLIDING	INTERIOR	3' - 9"	6' - 8"	1
8	HOME DEPOT	INTERIOR DOUBLE PANEL SLIDING	INTERIOR	9' - 0"	6' - 8"	1

WINDOW SCHEDULE					
			S		
TYPE MARK	SUPPLIER	WINDOW TYPE	WIDTH	HEIGHT	COUNT
1	HOME DEPOT	SLIDING	6' - 3"	4' - 3"	1
2	HOME DEPOT	SLIDING	3' - 3"	3' - 3"	2
3	HOME DEPOT	SLIDING	2' - 9"	1' - 9"	1
4	HOME DEPOT	CASEMENT	2' - 3"	4' - 3"	2



KEY PLAN

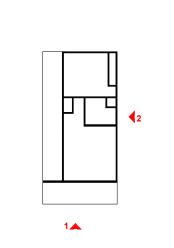

NO.	DESCRIPTION	DAT

NOTE:

LEGEND:

PROJECT

34 YOKE 680 1Bd/1Ba CONTEMPORARY 550

DRAWING NAME

ARCHITECTURAL ELEVATIONS

CLIENT NAME:	Client Name
PROJECT NUMBER:	0061_12
DATE:	2/10/2025 6:04:41 PM
DESIGNED BY:	Designer
DRAWN BY:	Author
CHECKED BY:	Checker

A201

ABOUT WALL FINISHING

STUCCO FINISH

STUCCO IS A CEMENT-BASED EXTERIOR WALL FINISH THAT OFFERS A DURABLE, WEATHER-RESISTANT, AND CUSTOMIZABLE CLADDING SOLUTION FOR BUILDINGS.

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3/8-INCH OF IT IS APPLIED AS AN EXTERNAL WALL FINISH AS IT IS THE MOST COMMON AND WIDELY ACCEPTED STANDARD THICKNESS FOR STUCCO EXTERIOR WALL FINISHES. THIS MULTI-LAYER APPROACH ALSO HELPS CREATE A STRONG, CRACK-RESISTANT STUCCO SURFACE.

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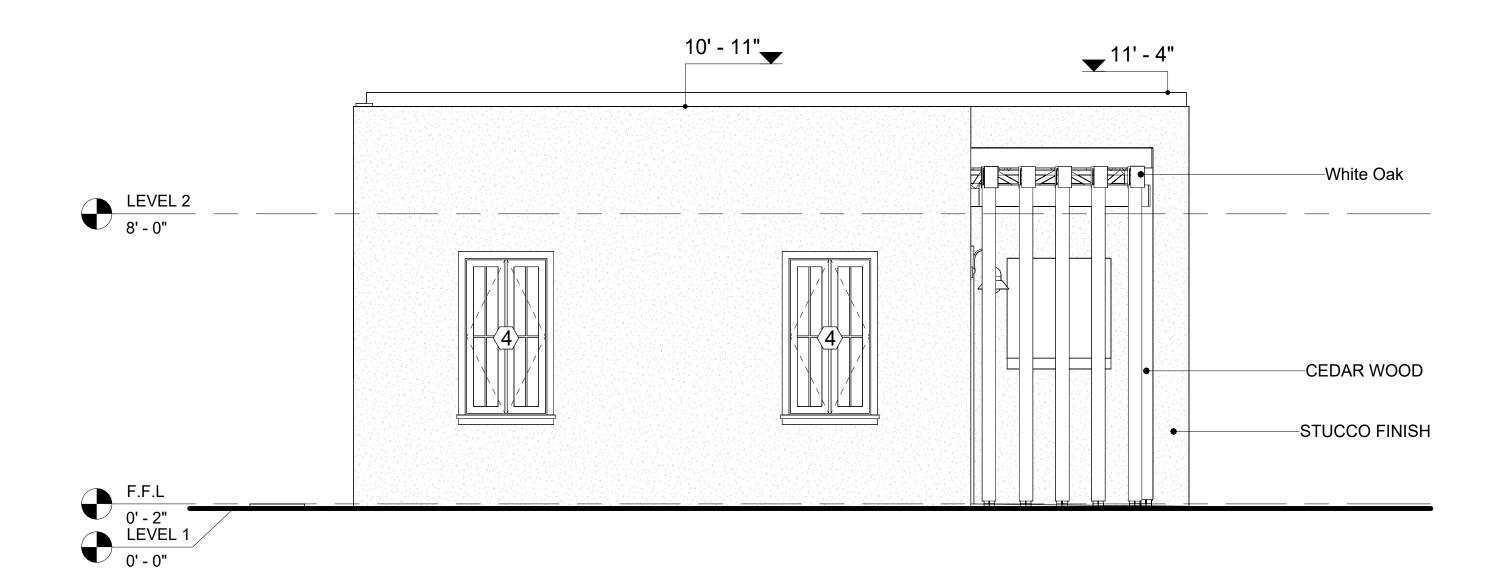
REGULAR INSPECTION AND PROMPT REPAIR OF ANY CRACKS, CHIPS, OR DAMAGE TO THE STUCCO FINISH IS IMPORTANT. THIS MAINTAINS THE STUCCO'S WATER-RESISTANT PROPERTIES OVER THE BUILDING'S LIFE SPAN.

CEDAR WOOD


CEDAR WOOD REFERS TO THE WOOD FROM VARIOUS SPECIES OF CEDAR TREES, WHICH ARE CONIFEROUS EVERGREEN TREES KNOWN FOR THEIR DISTINCT AROMA AND NATURAL RESISTANCE TO DECAY AND INSECTS.

IN THIS SPECIFIC PROJECT, CEDAR WOOD IS USED AS A FURRING STRIP AND A FINISH MATERIAL ON BEAMS AND COLUMNS.

CEDAR WOOD AS A FURRING STRIPS PROVIDE THERMAL INSULATION AND MOISTURE MANAGEMENT. THE VERTICAL CEDAR WOOD FURRING STRIPS ARE ATTACHED TO HOME WRAP USING CORROSION-RESISTANT FASTENERS (HOT-DIP GALVANIZED SCREWS), ENSURING PROPER PENETRATION INTO THE WALL FRAMING.



1 REAR ELEVATION
3/8" = 1'-0"

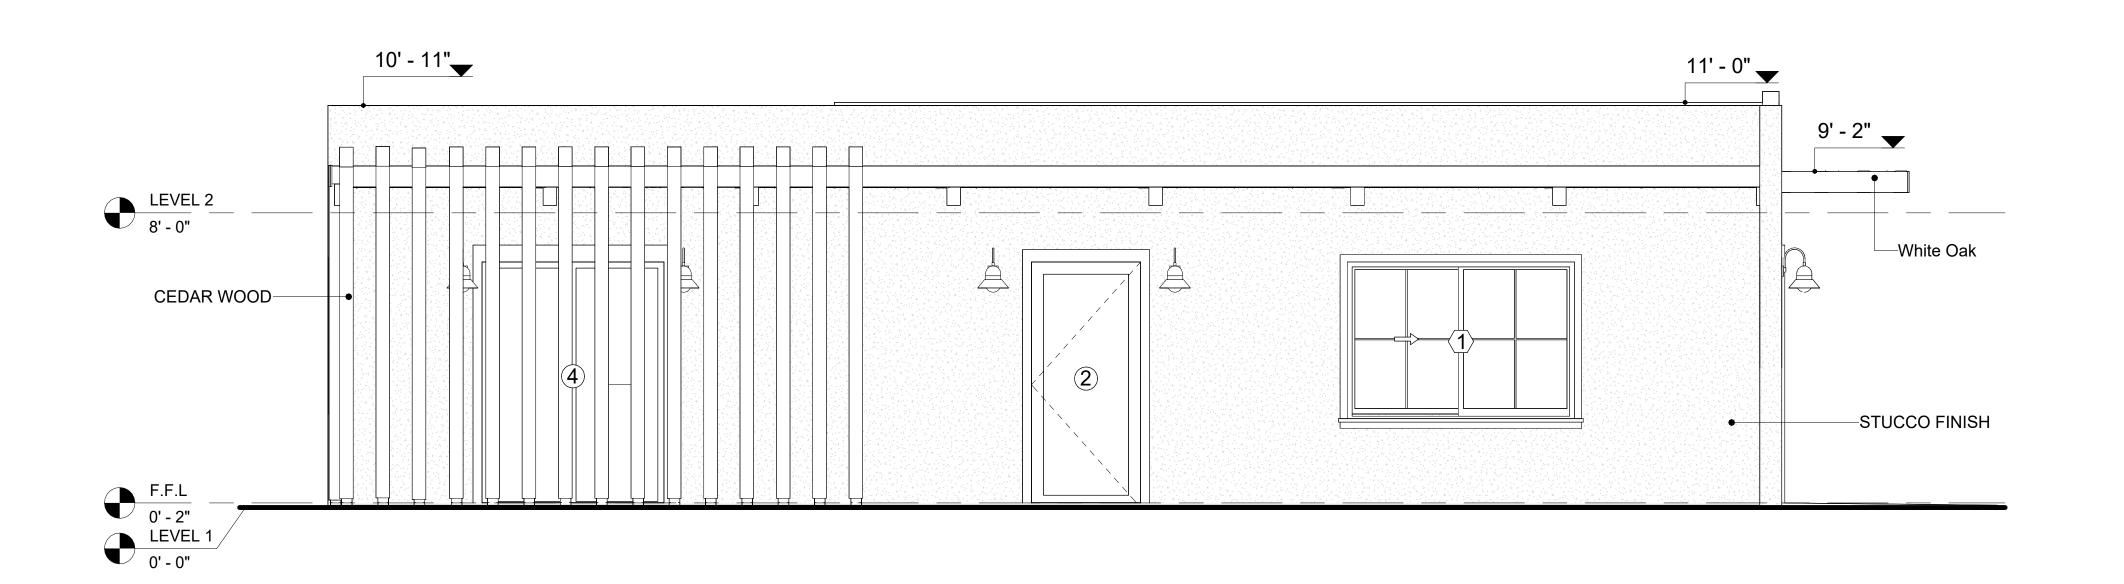

2 LEFT SIDE ELEVATION
3/8" = 1'-0"



KEY PLAN

1

2

NO.	DESCRIPTION	DATE

NOTE:

LEGEND:

PROJECT

34 YOKE 680 1Bd/1Ba CONTEMPORARY 550

DRAWING NAME

ARCHITECTURAL ELEVATIONS

CLIENT NAME:

PROJECT NUMBER:

DATE:

DATE:

DESIGNED BY:

DRAWN BY:

CHECKED BY:

Client Name

0061_12


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Designer


Author

Checker

A202



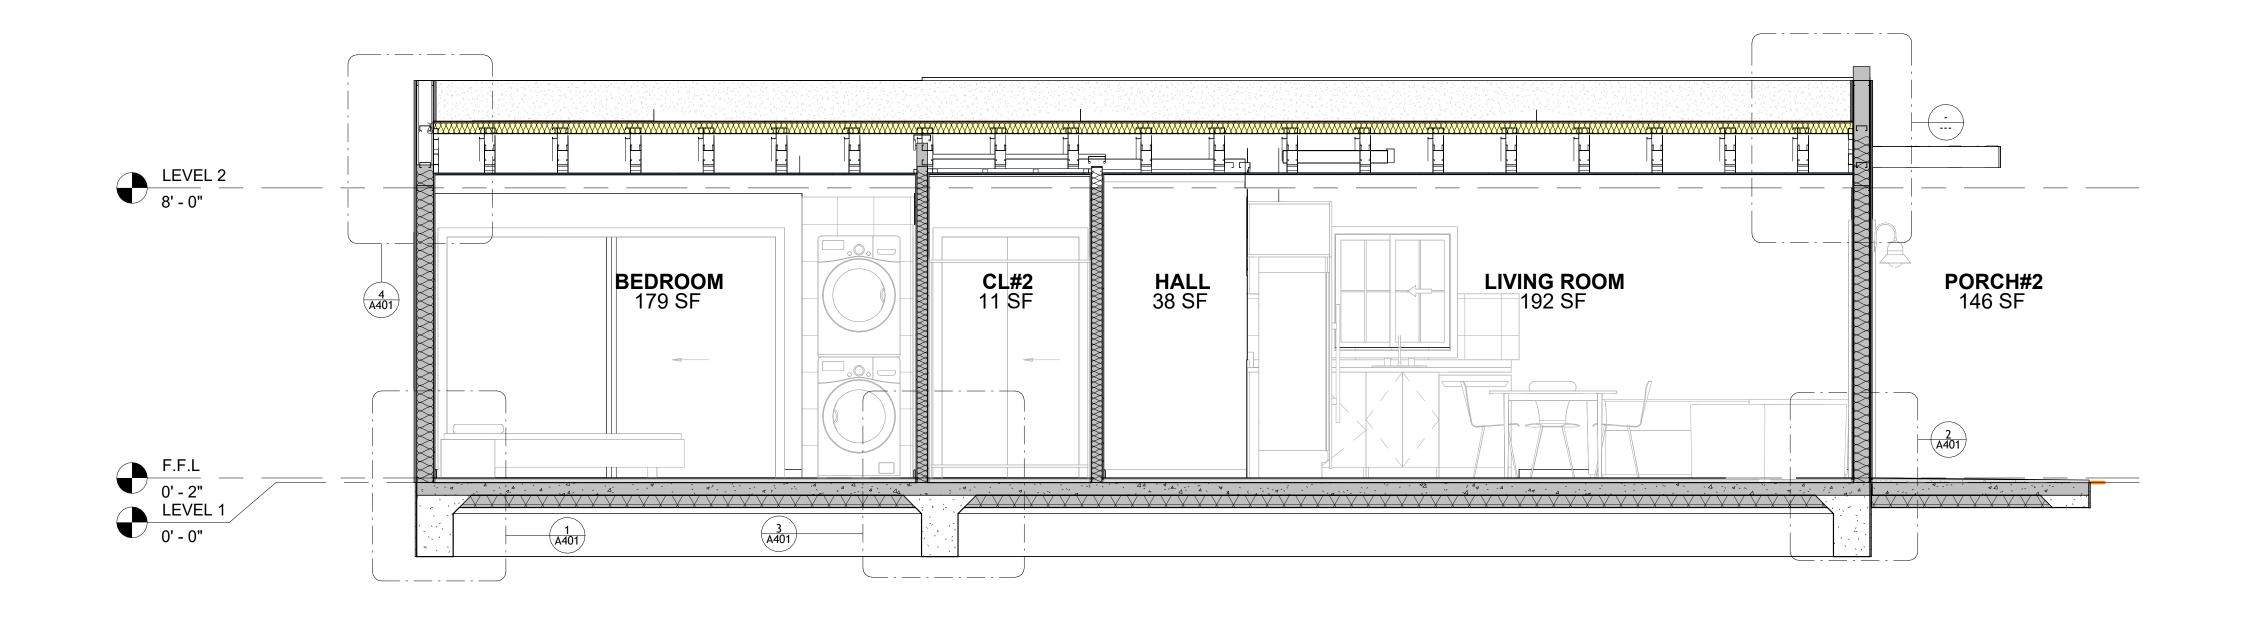


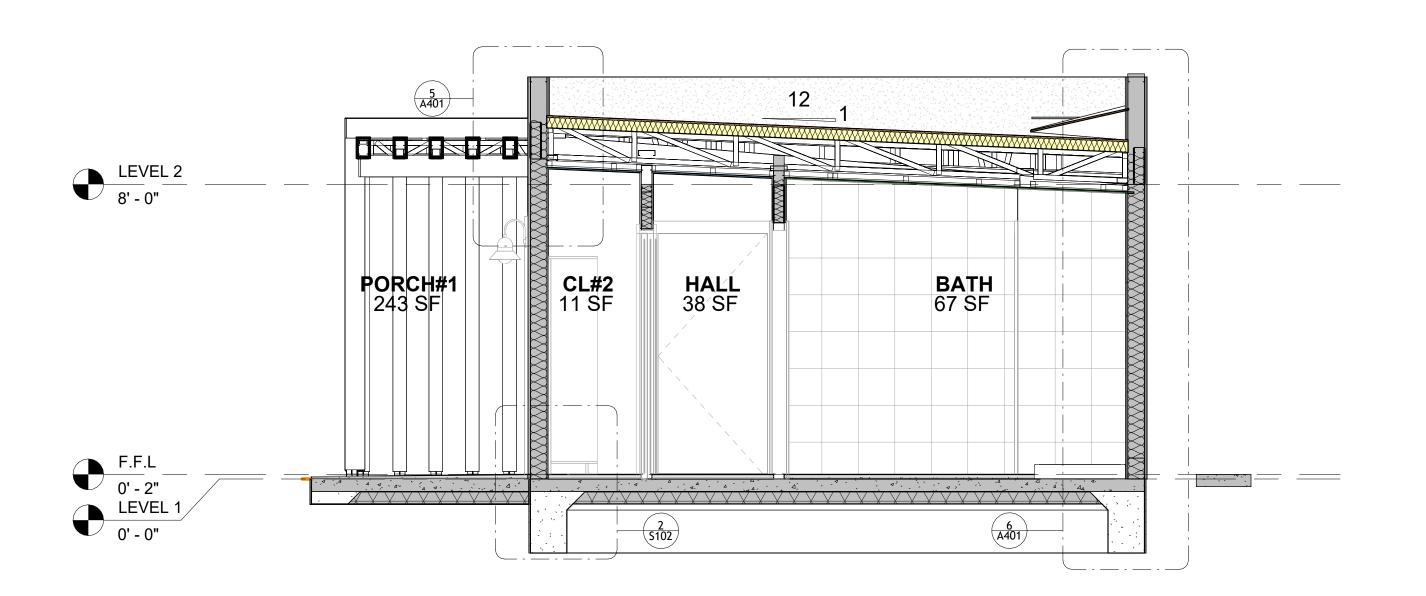

2 SECTION-2 3/8" = 1'-0"



KEY PLAN

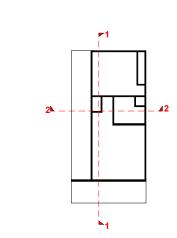

NO.	DESCRIPTION	DATE

NOTE:

LEGEND:

PROJECT


34 YOKE 680 1Bd/1Ba CONTEMPORARY 550


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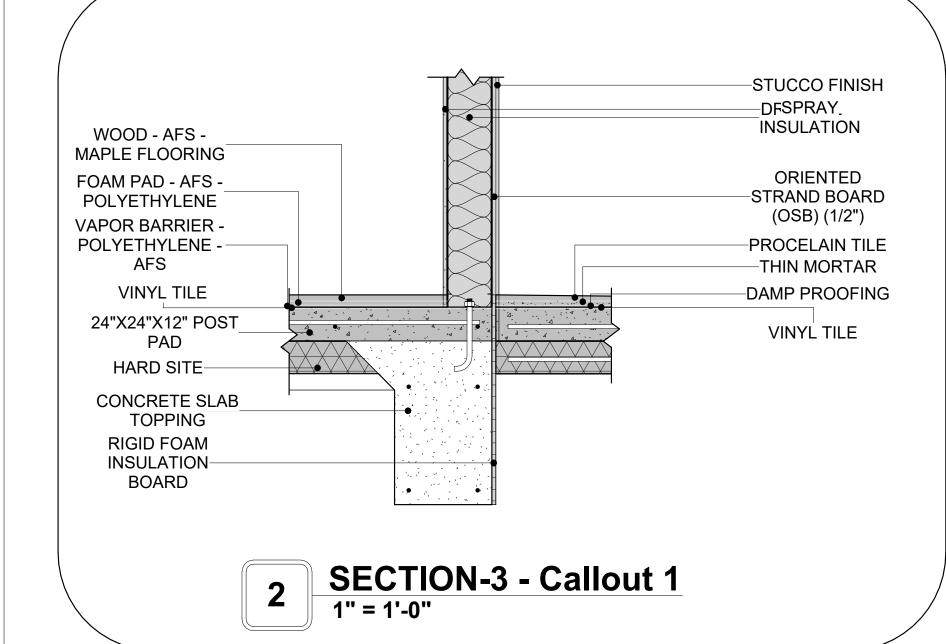
ARCHITECTURAL SECTIONS


Client Name	CLIENT NAME:	
0061_12	PROJECT NUMBER:	
2/10/2025 6:04:46 PM	DATE:	
Designer	DESIGNED BY:	
Author	DRAWN BY:	
Checker	CHECKED BY:	


A301



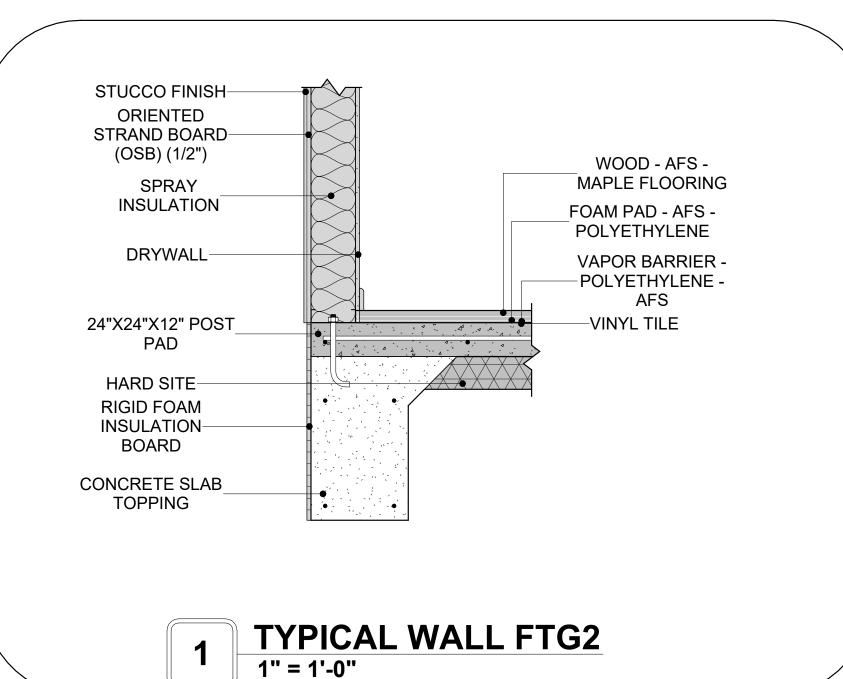


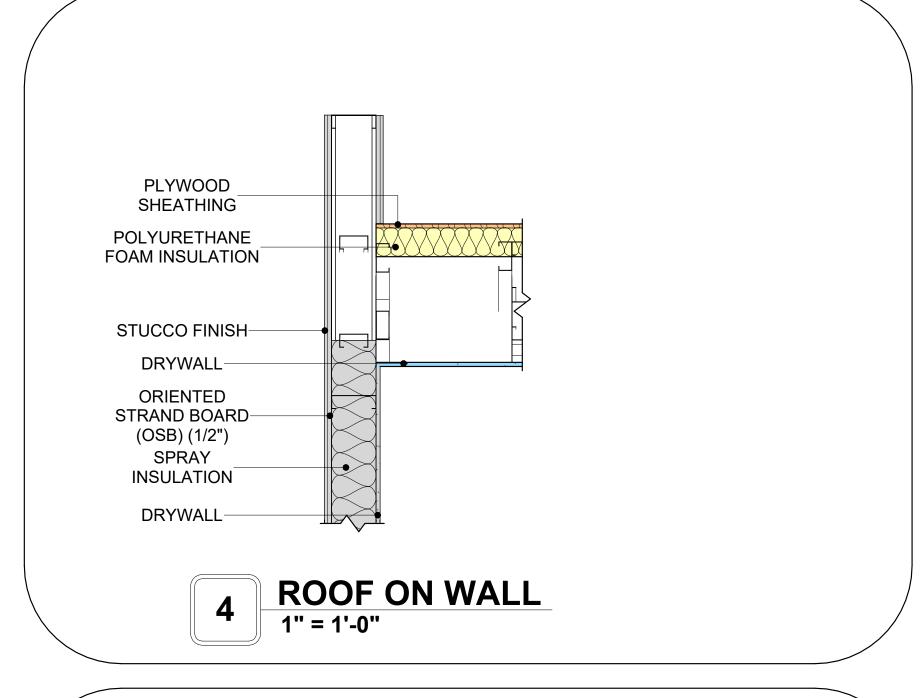

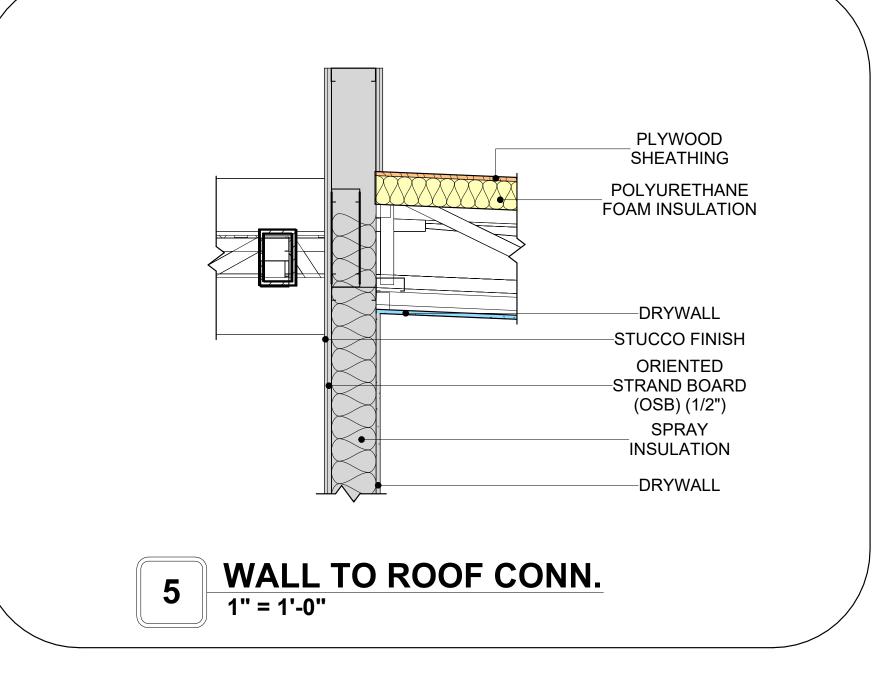

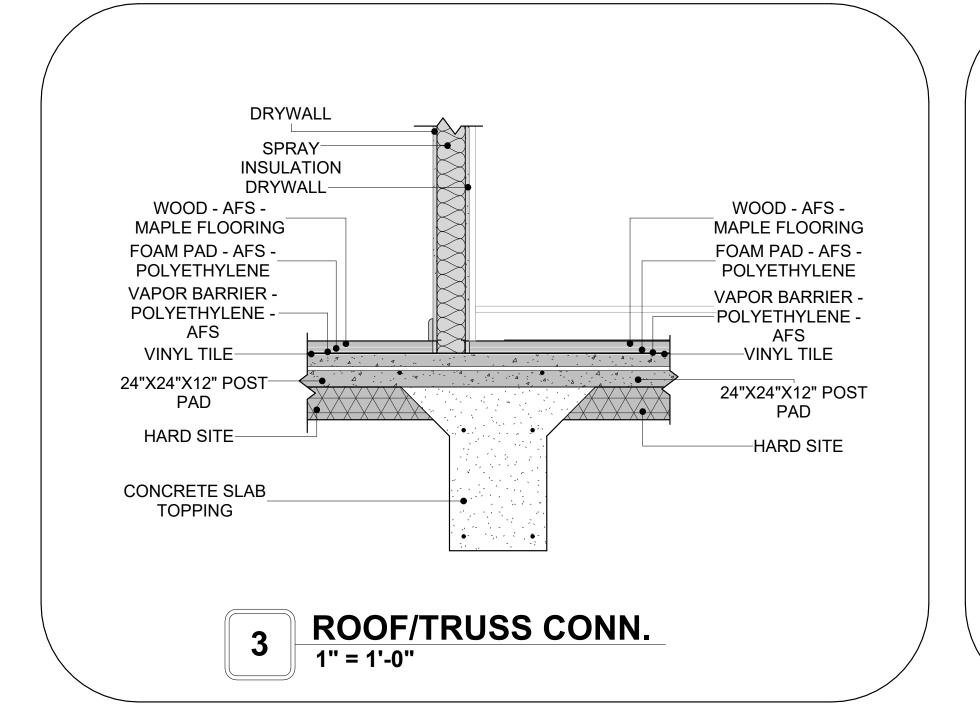



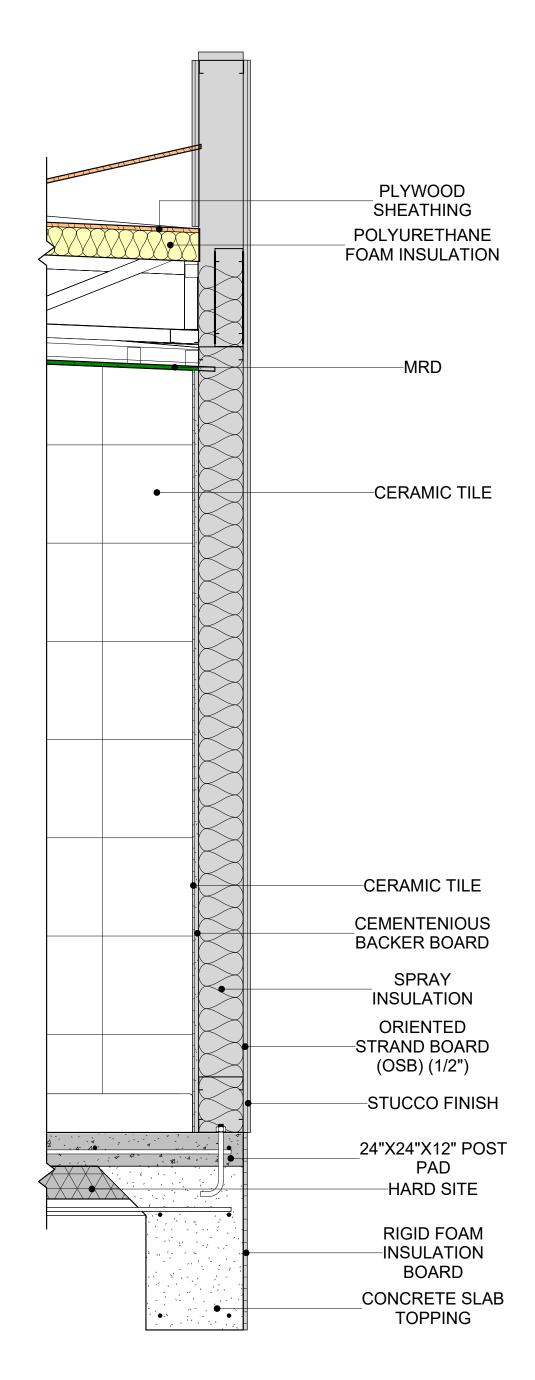

6 TYPICAL WALL FTG



KEY PLAN

NO.	DESCRIPTION	DATE

NOTE:

LEGEND:

PROJECT

34 YOKE 680 1Bd/1Ba CONTEMPORARY 550

DRAWING NAME

ARCHITECTURAL DETAILS

CLIENT NAME:	Client Name
PROJECT NUMBER:	0061_12
DATE:	2/10/2025 6:04:47 PM
DESIGNED BY:	Designer
DRAWN BY:	Author
CHECKED BY:	Checker

A401


SCALE: 1" = 1'-0"

CASEWORK GENERAL NOTES

- ALL CABINET HEIGHTS INCLUDE COUNTERTOPS. DIMENSIONS ARE TO THE NEAREST INCH. DIVISIONS IN CASEWORK ARE SHOWN FOR CLARITY AND DO NOT REPRESENT BREAKS IN THE COUNTERTOP.
- PROVIDE CONTINUOUS COUNTERTOP OVER ALL SIMILAR HEIGHT CASEWORK, UNLESS AND OTHERWISE NOTED.
- MANUFACTURER AND CATALOG NUMBERS ARE FOR REFERENCE AND ILLUSTRATION PURPOSES
- DOTTED LINES INDICATE WALL HUNG CABINETS, DIVISIONS OF BASE CABINETS BELOW THE COUNTERTOP, FURNITURE NOT IN THE CONTRACT OR PROJECTION SCREENS -SEE CASEWORK KEY AND SPECIFICATIONS.
- ALL CABINETS AND DRAWERS TO HAVE CAM LOCKS EXCEPT FOR SINK BASE CABINETS. ALL EXPOSED SURFACES (EXPOSED TO VIEW FROM ANY PERSPECTIVE) TO BE COVERED WITH LAMINATE.
- ALL CASEWORK WHICH MEETS A WALL AT ONE OR BOTH ENDS, TO BE PROVIDED WITH FILLER
- PANELS AND SCRIBED TO THE WALL(S) AS REQUIRED. 10. ALL CABINETS AND DRAWERS ARE PROVIDED WITH RECESSED HANDLES.
- 11. CONTRACTOR TO FIELD VERIFY ALL CLEAR OPENINGS PRIOR TO MILLWORK OR CASEWORK FABRICATION.
- 12. CASEWORK DRAWINGS ARE DIAGRAMMATIC IN NATURE TO SHOW DESIGN INTENT.


	CASEWORK SCHEDULE						
TYPE MAR K	TYPE	COUN T	HEIGHT	WIDTH	DEPTH	AREA	
01	L-SHAPE COUNTER TOP	1	0' - 4"	7' - 0"	7' - 0"	2 SF	
02	BASE CABINET DOUBLE DOOR 1	1	2' - 11"	2' - 0"	2' - 0"	6 SF	
03	BASE CABINET L-SHAPED	1	2' - 11"	3' - 3"	3' - 3"	9 SF	
04	WALL FILLER	1	2' - 11"	0' - 5"	2' - 0"	1 SF	
05	BASE CABINET DOUBLE DOOR 2	1	2' - 11"	2' - 1"	2' - 0"	6 SF	
06	LINEAR COUNTER TOP 2	1	0' - 4"	2' - 1"	2' - 1"	1 SF	
07	WALL CABINET DOUBLE DOOR 1	1	2' - 6"	3' - 8"	1' - 0"	9 SF	
08	WALL_CABINET_DOUBLE_DOOR 5	1	2' - 6"	2' - 1"	1' - 0"	5 SF	
09	LAUNDRY OPEN CABINET	1	1' - 6"	2' - 0"	2' - 4"	3 SF	
10	VANITY_CABINET_3	1	2' - 4"	3' - 8"	2' - 0"	9 SF	
11	RECESSED_MED_CABINET 2	1	2' - 0"	1' - 6"	0' - 3"	3 SF	
12	CLOSET 3	1	5' - 11"	4' - 5"	1' - 4"	26 SF	
13	CLOSET 4	1	5' - 11"	9' - 8"	1' - 4"	57 SF	
GRAND	TOTAL	13					

SPECIALTY EQUIPMENT SCHEDULE			
TYPE MARK	TYPE	COUNT	
01	WASHER-FRONT-LOAD	1	
02	REFRIGERATOR	1	
03	RANGE	1	
04	DRYER-FRONT-LOAD	1	
05	DISHWASHER	1	
GRAND TOTAL: 5		,	

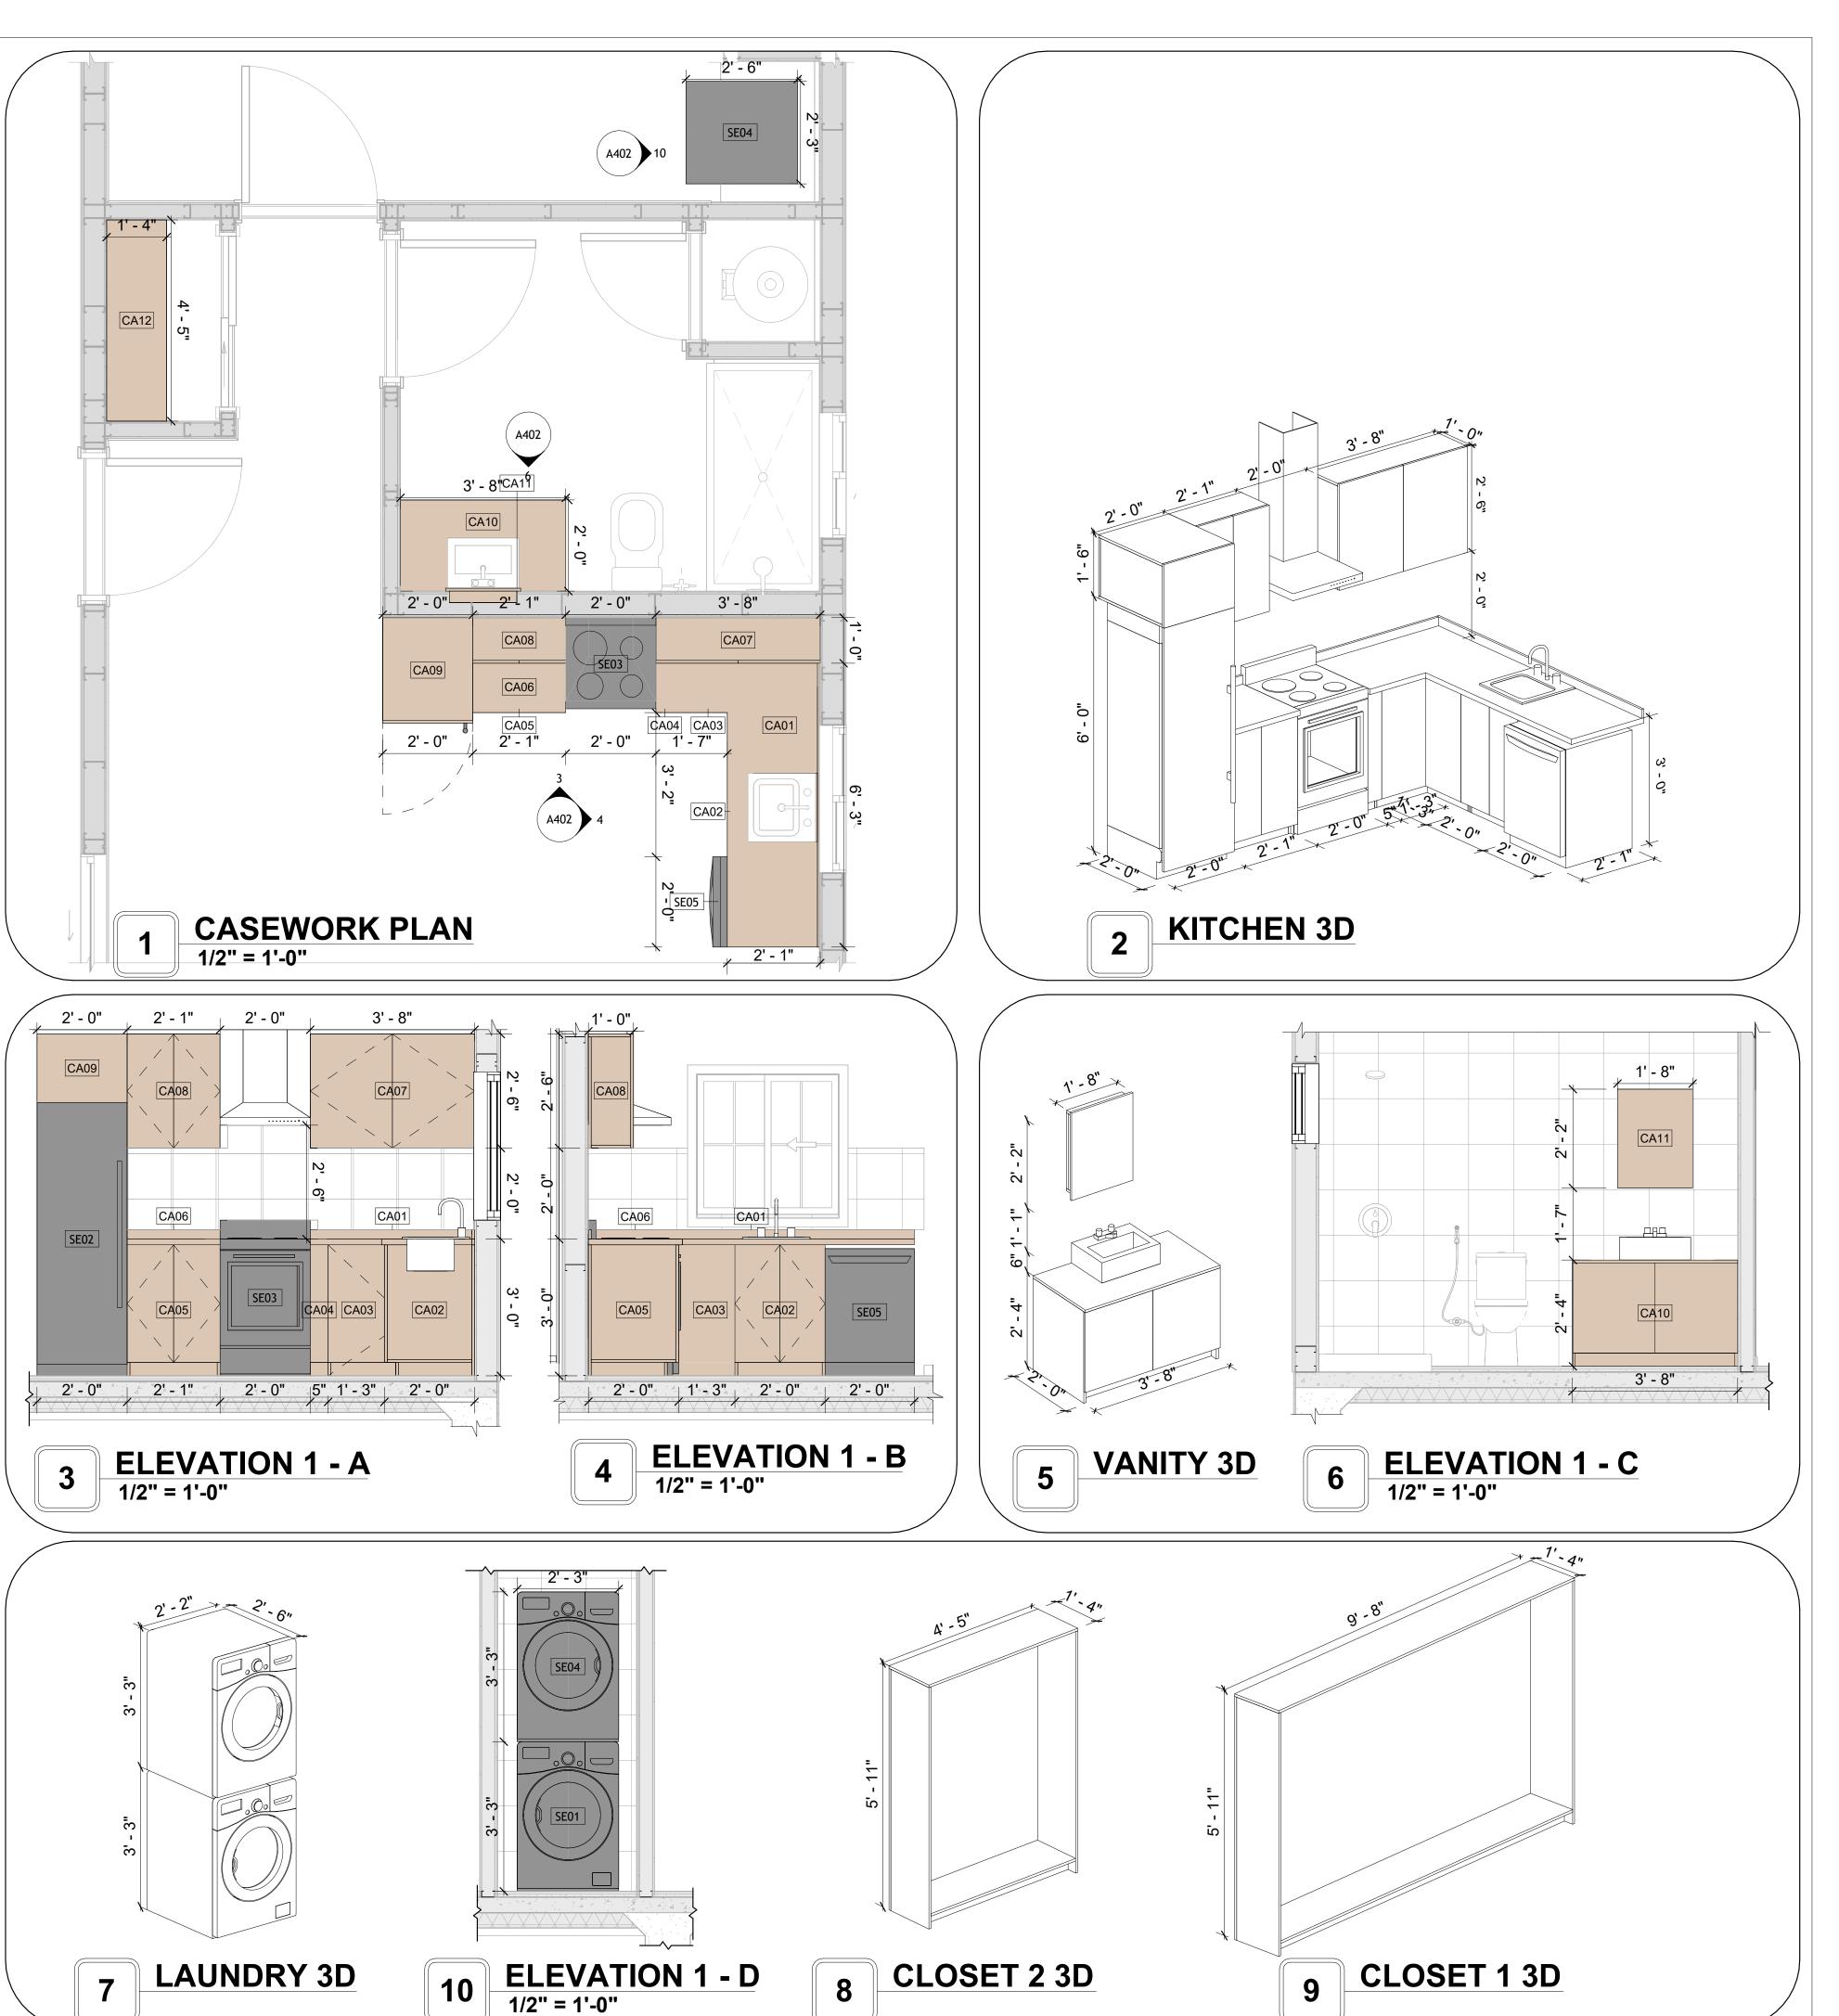



KEY PLAN

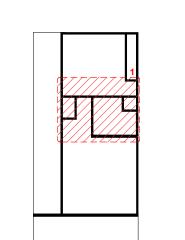

NO.	DESCRIPTION	DATE

NOTE:

LEGEND:

PROJECT

34 YOKE 680 1Bd/1Ba **CONTEMPORARY 550**

DRAWING NAME

ARCHITECTURAL CASEWORK

CLIENT NAME:	Client Name
PROJECT NUMBER:	0061_12
DATE:	2/10/2025 6:04:50 PM
DESIGNED BY:	Designer
DRAWN BY:	Author
CHECKED BY:	Checker

A402

GENERAL NOTES

1. THIS DRAWING DEPICTS THE HVAC (HEATING, VENTILATION, AND AIR CONDITIONING) SYSTEM FOR THE YOKE CONTEMPORARY 550_NG_CB. IT PROVIDES A VISUAL REPRESENTATION OF THE SYSTEM LAYOUT AND COMPONENTS.

2.THE HVAC SYSTEM IS DESIGNED TO MEET THE SPECIFIC REQUIREMENTS OF THE BUILDING, INCLUDING HEATING, COOLING, AND VENTILATION NEEDS, AS PER THE PROJECT SPECIFICATIONS AND APPLICABLE CODES AND STANDARDS.

3. THE HVAC SYSTEM INSTALLATION SHALL COMPLY WITH THE LATEST EDITION OF THE INTERNATIONAL MECHANICAL CODE (IMC), INTERNATIONAL RESIDENTIAL CODE (IRC), AND ALL OTHER APPLICABLE LOCAL, STATE, AND NATIONAL CODES AND REGULATIONS.

4. THE EQUIPMENT SHOWN ON THIS DRAWING INCLUDES BUT IS NOT LIMITED TO AIR HANDLING UNITS (AHUS), CHILLERS, BOILERS, COOLING TOWERS, PUMPS, DUCTWORK, DIFFUSERS, GRILLES, AND CONTROL DEVICES.

5. ALL EQUIPMENT, DUCTWORK, AND PIPING SHALL BE INSTALLED IN ACCORDANCE WITH MANUFACTURER'S SPECIFICATIONS, LOCAL CODES, AND INDUSTRY BEST PRACTICES.

6. ALL DUCTWORK SHALL BE SIZED, FABRICATED, AND INSTALLED IN ACCORDANCE WITH THE LATEST EDITION OF THE ACCA MANUAL D AND THE SMACNA HVAC DUCT CONSTRUCTION STANDARDS. DUCTWORK SHALL BE INSTALLED IN A NEAT AND WORKMANLIKE MANNER, PROPERLY SUPPORTED AND BRACED TO PREVENT SAGGING, AIR LEAKAGE, OR VIBRATION.

7. CONDENSATE DRAINAGE PIPING SHALL BE PROPERLY PITCHED TO ENSURE POSITIVE DRAINAGE TO AN APPROVED DISPOSAL LOCATION, SUCH AS A FLOOR DRAIN, SUMP PUMP, OR EXTERIOR GRADE. CONDENSATE LINES SHALL BE INSULATED TO PREVENT SWEATING.

8. THE LOCATION OF CONTROL PANELS AND SENSORS INDICATED ON THIS DRAWING CAN BEMODIFY WITH THE SPECIFIC LOCATIONS AND WIRING DETAILS WILL BE DETERMINED DURING THE CONTROL SYSTEM DESIGN AND INSTALLATION.

9. THE HVAC SYSTEM DESIGN CONSIDER ENERGY EFFICIENCY, INDOOR AIR QUALITY, OCCUPANT COMFORT, AND NOISE CONTROL, FOLLOWING APPLICABLE GUIDELINES AND REGULATIONS.

10. COORDINATION WITH OTHER TREADS HAS BEEN DONE ON A DESIGN LEVEL. THIS DRAWING SHALL BE READ TOGETHER WITH THE AR, EL AND SN DESIGN DRAWINGS TO ENSURE PROPER INSTALLATION AND INTEGRATION OF THE HVAC SYSTEMS.

11. THE HVAC CONTRACTOR IS RESPONSIBLE FOR OBTAINING ALL NECESSARY PERMITS AND LICENSES, AND FOR SCHEDULING AND COORDINATING WITH THE LOCAL BUILDING DEPARTMENT AND UTILITY PROVIDERS TO ENSURE A TIMELY AND COMPLIANT INSTALLATION.

12. ALL DUCTWORK PENETRATIONS THROUGH WALLS, FLOORS, OR CEILINGS SHALL BE PROPERLY SEALED AND FIRE-STOPPED USING APPROVED METHODS AND MATERIALS TO MAINTAIN THE INTEGRITY OF THE BUILDING'S FIRE-RESISTANCE RATINGS.

13. HVAC EQUIPMENT SHALL BE INSTALLED LEVEL AND PLUMB, AND IN STRICT ACCORDANCE WITH THE MANUFACTURER'S INSTALLATION INSTRUCTIONS AND RECOMMENDATIONS. PROVIDE ADEQUATE CLEARANCES AROUND EQUIPMENT FOR PROPER AIRFLOW, SERVICE ACCESS, AND CODE COMPLIANCE.


14. ALL HVAC EQUIPMENT AND COMPONENTS, INCLUDING THERMOSTATS, DAMPERS, AND ACCESS PANELS, SHALL BE LOCATED IN ACCESSIBLE AREAS FOR EASY SERVICING AND MAINTENANCE. PROVIDE ADEQUATE SPACE AROUND EQUIPMENT FOR PROPER AIRFLOW AND SERVICE ACCESS.

15. THE HVAC SYSTEM SHALL BE BALANCED AND ADJUSTED TO ENSURE PROPER AIRFLOW, TEMPERATURE DISTRIBUTION, AND SYSTEM PERFORMANCE THROUGHOUT THE RESIDENCE. PROVIDE A WRITTEN REPORT DOCUMENTING THE FINAL SYSTEM BALANCE.

16. ANY DEVIATIONS OR MODIFICATIONS TO THE HVAC SYSTEM DESIGN SHALL BE REVIEWED AND APPROVED BY THE RESPONSIBLE DESIGN PROFESSIONALS AND COMMUNICATED TO ALL RELEVANT PARTIES INVOLVED IN THE CONSTRUCTION PROCESS.


17. FOR ANY INQUIRIES OR CLARIFICATIONS REGARDING THE HVAC SYSTEM DESIGN, PLEASE CONSULT THE RESPONSIBLE DESIGN PROFESSIONALS OR THE PROJECT MANAGEMENT TEAM.

SYMBOLS

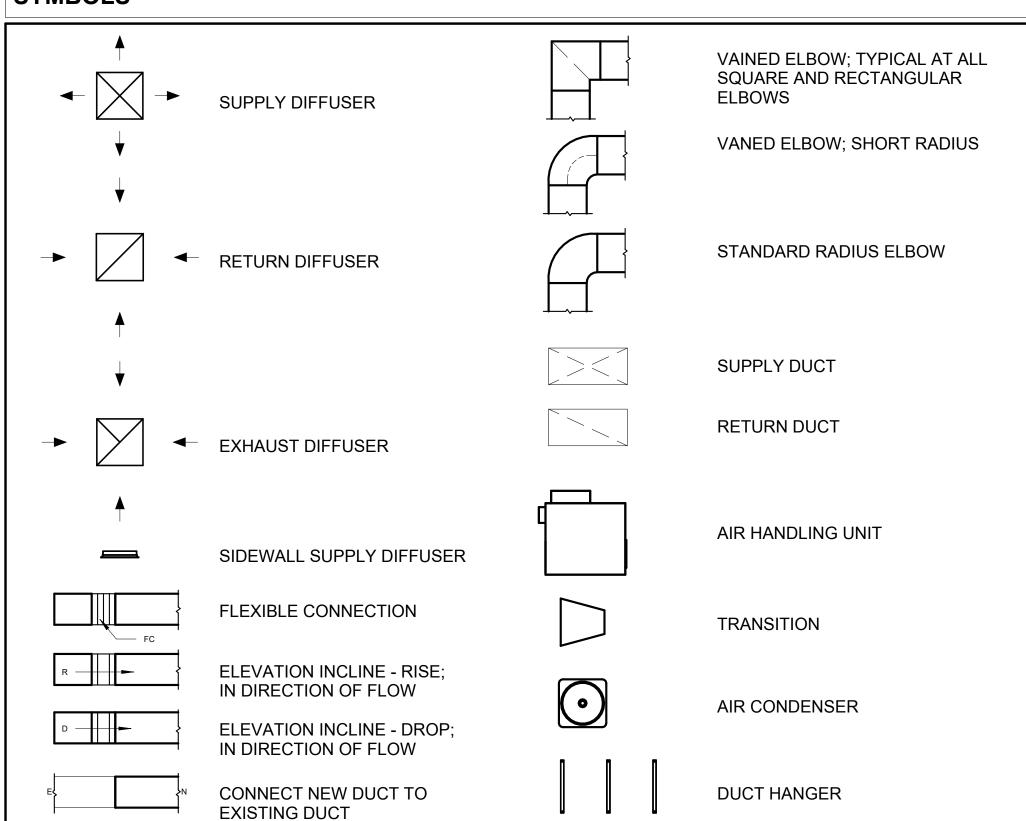



AIR CONDITIONING PIPE LINE

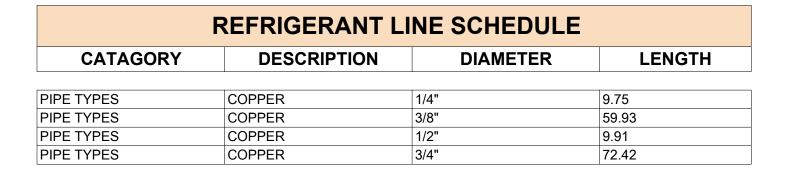

REFRIGERANT LINE FITTING SCHEDULE				
CATAGORY	DESCRIPTION	Size	Count	
ELBOW - GENERIC	ELBOW - GENERIC: STANDARD/HVAC	1/2"ø-1/2"ø	2	
ELBOW - GENERIC	ELBOW - GENERIC: STANDARD/HVAC	1/4"ø-1/4"ø	2	
ELBOW - GENERIC	ELBOW - GENERIC: STANDARD/HVAC	3/4"ø-3/4"ø	14	
ELBOW - GENERIC	ELBOW - GENERIC: STANDARD/HVAC	3/8"ø-3/8"ø	8	
TEE - GENERIC	TEE - GENERIC: STANDARD	3/4"ø-3/4"ø-3/ 4"ø	1	
TEE - GENERIC	TEE - GENERIC: STANDARD	3/8"ø-3/8"ø-3/ 8"ø	1	
TRANSITION - GENERIC	TRANSITION - GENERIC: STANDARD	3/4"ø-1/2"ø	4	
TRANSITION - GENERIC	TRANSITION - GENERIC: STANDARD	3/4"ø-5/8"ø	2	
TRANSITION - GENERIC	TRANSITION - GENERIC: STANDARD	3/8"ø-1/4"ø	1	

MECHANICAL EQUIPMENT SCHEDULE				
CATAGORY	DESCRIPTION	COUNT		
AIR HANDLING UNIT	AIR HANDLING UNIT: WALL MOUNTED	2		
CONDENSER	CONDENSER: OUT DOOR	1		
EXHAUST FAN	EXHAUST FAN: 75 CFM	1		
	HOOD-WALL: VENT	1		

D	UCT FITTI	NG SCHEDULE	
CATAGORY		DESCRIPTION	COUNT
ROUND TRANSITION - ANGLE	45 DEGREE		2

	DUCT ACCESSORY SCHEDULE	
CATAGORY	DESCRIPTION	COUNT
ROOF VENT	3" DIAMETER	3

FLEX DUCT SCHEDULE				
DESCRIPTION	DESCRIPTION	LENGTH	DIAMETER	COUNT
FLEX DUCT ROUND	FLEX-ROUND	9.08	4"	3
GRAND TOTAL: 3		9.08		

1 HVAC PLAN 3/8" = 1'-0"

AIR HANDLING UNIT

4' - 6 1/2"

4' - 2 1/2"

4' - 0"

EXHAUST FAN

HOOD-WALL

AIR HANDLING UNIT-

CONDENSER



KEY PLAN

NO.	DESCRIPTION	DATE

NOTE:

LEGEND:

PROJECT

34-Yoke-670-1Bd1Ba-Contemporary-550

DRAWING NAME

HVAC PLAN

CLIENT NAME:

PROJECT NUMBER:

15_0001

DATE:

2/10/2025 12:04:26 PM

DESIGNED BY:

DRAWN BY:

CHECKED BY:

Checker

M101

ELECTRICAL NOTES

- 1. THIS DRAWING DEPICTS THE ELECTRICAL SYSTEM FOR THE 35-Yoke-680-1Bd1Ba Farmouse-550 . IT PROVIDES A VISUAL REPRESENTATION OF THE ELECTRICAL LAYOUT AND COMPONENTS, INCLUDING POWER DISTRIBUTION, LIGHTING, AND CONTROL SYSTEMS.
- 2. THE ELECTRICAL SYSTEM IS DESIGNED TO MEET THE SPECIFIC REQUIREMENTS OF THE BUILDING, INCLUDING POWER DISTRIBUTION, LIGHTING, AND SPECIALIZED ELECTRICAL EQUIPMENT NEEDS, AS PER THE PROJECT SPECIFICATIONS AND APPLICABLE CODES AND STANDARDS.
- 3. THE ELECTRICAL SYSTEM INSTALLATION SHALL COMPLY WITH THE LATEST EDITION OF THE NATIONAL ELECTRICAL CODE (NEC), INTERNATIONAL BUILDING CODE (IBC), AND ALL OTHER APPLICABLE LOCAL, STATE, AND NATIONAL CODES AND REGULATIONS.
- 4. LOCATIONS AS NEEDED, DEVICES ARE SHOWN ON PLANS IN APPROXIMATE IDEAL LOCATIONS, UNLESS SPECIFICALLY DIMMENSIONED.
- OPEN WALLS AS NEEDED TO ALLOW FOR NEW ELECTRICAL INSTALLATIONS.
- 6. LABEL ALL CIRCUITS ON JUNCTION BOXES, RECEPTACLES, DATA, SMOKE DETECTOR, AND EQUIPMENT IN PANEL BOX.
- 7. INSTALL RACEWAY AS NEEDED FOR DDC, ACCESS CONTROL, LOW VOLTAGE WIRING & DATA.
- 8. RELABEL POWER, DATA & FIRE ALARM FOR ROOM #CHANGES.
- 9. VERIFY ALL CIRCUITS LABELED ON PRINT ARE CORRECT BEFORE WORKING ON THEM. 10. NOTE ON SITE PLAN – ALL CHANGES OR MISSING DETAIL TO BE INCORPORATED INTO THE MASTER PLAN.
- 11. DRAWINGS ARE DIAGRAMMATIC ONLY FOR THE PURPOSE OF SHOWING FIXTURE AND OUTLET LOCATIONS.
- 12. ELECTRICAL CONTRACTOR TO VERIFY SERVICE SIZE BY CALCULATION BASED UPON ACTUAL NAME
- PLATE RATINGS OF SELECTED EQUIPMENT. 13. VERIFY LOCATION OF SERVICE ENTRANCE WITH POWER COMPANY. PROVIDE UFER GROUND IN
- BUILDING FOUNDATION AT SERVICE ENTRANCE LOCATION.
- 14. PROVIDE A MIN. OF 20 FEET OF ONE *4 BARE COPPER UFER WIRE EMBEDDED IN CONCRETE FOOTING
- AT THE SERVICE ENTRANCE LOCATION WHERE APPROVED BY LOCAL SERVICE PROVIDER.
- 15. PROVIDE WATERPROOF FIXTURES IN ALL HIGH MOISTURE AREAS (EXTERIOR, SHOWER AND TUB CEILINGS ETC.)
- 16. PROVIDE DEDICATED CIRCUITS TO EACH BATH, DEN, FAMILY ROOM, BEDROOM, LOFT, KITCHEN
- REFRIGERATOR, KITCHEN FREEZER DISHWASHER, AND ANY AREA/ITEM SPECIFIED BY OWNER. 17. INCANDESCENT FIXTURES WITH OPEN OR PARTIALLY ENCLOSED LAMPS, PENDANT FIXTURES, AND
- LAMP HOLDERS ARE NOT PERMITTED IN CLOSETS. 18. ALL WORKMANSHIP AND MATERIALS TO CONFORM WITH THE 2015 IRC.
- 19. PROVIDE A MIN. OF 20 FEET OF ONE *4 BARE COPPER UFER WIRE EMBEDDED IN CONCRETE FOOTING AT THE SERVICE ENTRANCE LOCATION WHERE APPROVED BY LOCAL SERVICE PROVIDER.
- 20. PROVIDE A BONDING CONDUCTOR CONSISTING OF A MINIMUM OF ONE *4 BARE COPPER WIRE CONNECTING THE BUILDING'S METAL WATER PIPING SYSTEM TO THE SERVICE EQUIPMENT ENCLOSURE GROUNDING.

MAIN PANEL CALCS	CALCS	ANEL	MAIN	M
------------------	-------	------	------	---

(USE 200 AMP SERVICE)

ELECTRICAL CALCS	
LIGHT AND OUTLETS 680 @ 3W	2,040 W
3 APPLIANCE CIRCUITS	4,500 W
DRYER	2,000 W
WASHER	2,000 W
RANGE	5,000 W
WATER HEATER	5,000 W
REFRIG.	1,800 W
DISHWASHER & DISPOSAL	3000 W
TOTAL	25,340 W
FRIST 10,000 @ 100% REMAINDER @ 40% MINI. SPLIT UNITS	10,000 W 6,136W 10,000W
TOTAL	26,136 W
26,136 W DIVIDED BY 240V =	109 AMPS TOTAL

ELECTRICAL ABBREVIATIONS LIST

1P	1 POLE (2P, 3P, 4P, ETC.)	CTR	CENTER	нт	HEIGHT
A	AMPERE	CU	COPPER	HTG	HEATING
AC	ABOVE COUNTER OR AIR CONDITIONER	DCP	DOMESTIC WATER CIRCULATING PUMP	HTR	HEATER
ACLG	ABOVE COUNTER OR AIR CONDITIONER	DEPT	DEPARTMENT	HV	HIGH VOLTAGE
ADO	AUTOMATIC DOOR OPENER	DET	DETAIL	HVAC	HEATING, VENTILATING AND AIR
AF	AMP FRAME	DIA	DIAMETER	CONDITIONING	CONDITIONING
AFF	ABOVE FINISHED FLOOR	DISC	DISCONNECT	HWP	HYDRONIC WATER PUMP
AFG	ABOVE FINISHED GRADE	DIST	DISTRIBUTION	IC	INTERRUPTING CAPACITY
AFI	ARC FAULT CIRCUIT INTERRUPTER	DN	DOWN	IG	ISOLATED GROUND
AHU	AIR HANDLING UNIT	DPR	DAMPER	IMC	INTERMEDIATE METAL CONDUIT
AL	ALUMINUM	DS	SAFETY DISCONNECT SWITCH	INCAND	INCANDESCENT
ALT	ALTERNATE	DT	DOUBLE THROW	IR	INFRARED
AMP	AMPERE	DWG	DRAWING	I/W	INTERLOCK WITH
AMPL	AMPLIFIER	DDC	DIRECT DIGITAL CONTROL	J-BOX	JUNCTION BOX
ANNUN	ANNUNCIATOR APPROX APPROXIMATELY	EC	ELECTRICAL CONTRACTOR	KV	KILOVOLT
AQ-STAT	AQUASTAT	ELEC	ELECTRIC, ELECTRICAL	KVA	KILOVOLT-AMPERE
ARCH	ARCHITECT, ARCHITECTURAL	ELEV	ELEVATOR	KVAR	KILOVOLT-AMPERE REACTIVE
AS	AMP SWITCH	EM	EMERGENCY	KW	KILOWATT
AT	AMP TRIP	EMS	ENERGY MANAGEMENT SYSTEM	KWH	KILOWATT HOUR
ATS	AUTOMATIC TRANSFER SWITCH	EMT	ELECTRICAL METALLIC TUBING	LOC	LOCATE OR LOCATION
AUTO	AUTOMATIC	EP	ELECTRIC PNEUMATIC	LT	LIGHT
AUX	AUXILIARY	EQUIP	EQUIPMENT	LTG	LIGHTING
AV	AUDIO VISUAL	EWC	ELECTRIC WATER COOLER	LTNG	LIGHTNING
AWG	AMERICAN WIRE GAUGE	EXIST	EXISTING	LV	LOW VOLTAGE
BATT	BATTERY	EXH	EXHAUST	MAX	MAXIMUM
BD	BOARD	EXP	EXPLOSION PROOF	MAG.S	MAGNETIC STARTER
BLDG	BUILDING	FA	FIRE ALARM	M/C	MOMENTARY CONTACT
BMS	BUILDING MANAGEMENT SYSTEM	FABP	FIRE ALARM BOOSTER POWER	MC	MECHANICAL CONTRACTOR
C	CONDUIT	SUPPLY PANEL	SUPPLY PANEL	MCB	MAIN CIRCUIT BREAKER
CAB	CABINET	FACP	FIRE ALARM CONTROL PANEL	MCC	MOTOR CONTROL CENTER
CAT	CATALOG	FCU	FAN COIL UNIT	MDC	MAIN DISTRIBUTION CENTER
CATV	CATALOG CABLE TELEVISION	FIXT	FIXTURE	MDP	MAIN DISTRIBUTION PANEL
CB	CIRCUIT BREAKER	FLR	FLOOR	MFR	MANUFACTURERMAIN FUSED
CCTV	CLOSED CIRCUIT TELEVISION	FLUOR	FLUORESCENT	IVIFIX	DISCONNECT SWITCH
CKT			FUSE	MH	MANHOLE
	CIRCUIT	FU	FUSED SAFETY DISCONNECT SWITCH		
CLG	CEILING	FUDS		MIC	MICROPHONE
COMB	COMBINATION	GA	GAUGE	MIN	MINIMUM
CMPR	COMPRESSOR	GAL	GALLON	MISC	MISCELLANEOUS
CONN	CONNECTION	GALV	GALVANIZED	MLO	MAIN LUGS ONLY
CONST	CONSTRUCTION	GC	GENERAL CONTRACTOR	MMS	MANUAL MOTOR STARTER
CONT	CONTINUATION OR CONTINUOUS	GEN	GENERATOR	MOA	MULTIOUTLET ASSEMBLY
CONTR	CONTRACTOR	GFI	GROUND FAULT CIRCUIT INTERRUPTER	MSP	MOTOR STARTER PANELBOARD
CONV	CONVECTOR	GFP	GROUND FAULT PROTECTOR	MSBD	MAIN SWITCHBOARD
CP	CIRCULATING PUMP	GND	GROUND	MT	MOUNT
CRT	CATHODE-RAY TUBE	GRS	GALVANIZED RIGID STEEL (CONDUIT)	MT.C	EMPTY CONDUIT
СТ	CURRENT TRANSFORMER	GYP BD	GYPSUM BOARD	UL	UNDERWRITERS LABORATORIES

Branch Panel:

Location: LIVING ROOM 08 Supply From:

Mounting: Recessed

Enclosure: Type 1

Volts: 120/240 Single

Phases: 1

Wires: 3

A.I.C. Rating: Mains Type: Mains Rating: 200 A MCB Rating: 1 A

Circuit Numb er	Circuit Description	Number of Elements	Rating	Length	Wire Size	A			В	Wire Size	Length	Rating	Number of Elements	Circuit Description	Circui Numb er
	BED LIGHT	9	15 A	52' - 4 21/32"	1-#14, 1-#14, 1-#14	568 VA	600 VA			1-#14, 1-#14, 1-#14	58' - 8 23/32"	15 A	9	OUTDOOR LIGHT	2
3	BATH GFCI	7	20 A	36' - 11"	1-#12, 1-#12, 1-#12			576 VA	516 VA	1-#14, 1-#14, 1-#14	33' - 11 15/32"	15 A	12	KITCHEN & HALL LIGHT	4
5	LIV. LIGHT	7	15 A	23' - 6 11/16"	1-#14, 1-#14, 1-#14	336 VA	720 VA			1-#12, 1-#12, 1-#12	59' - 7 1/2"	20 A	4	BED RECEPTACLE	6
7	DRYER	1	30 A	33' - 4 1/4"	2-#10, 1-#10, 1-#10			750 VA	1200 VA	1-#12, 1-#12, 1-#12	35' - 3 3/8"	20 A	1	WASHING MASHEIN	8
9						750 VA	750 VA			2-#6, 1-#6, 1-#10	29' - 8 5/16"	60 A	1	CONDENSER	10
11	WATER HEATER	1	30 A	31' - 10 13/16"	2-#10, 1-#10, 1-#10			750 VA	750 VA						12
13						750 VA	360 VA			1-#12, 1-#12, 1-#12	48' - 0 5/8"	20 A	2	OUTDOOE GFCI	14
15	LIV. RECEPTACLE	5	20 A	33' - 5 23/32"	1-#12, 1-#12, 1-#12			900 VA	1500 VA	1-#12, 1-#12, 1-#12	30' - 5 1/8"	20 A	1	RIFRIGRATOR	16
17	KITCHEN GFCI	3	20 A	28' - 2 5/8"	1-#12, 1-#12, 1-#12	540 VA	750 VA			2-#8, 1-#8, 1-#10	26' - 5 11/16"	40 A	1	RANGE	18
19	Receptacle	1	20 A	22' - 2 7/16"	1-#12, 1-#12, 1-#12			180 VA	750 VA						20
21	Receptacle	1	20 A	17' - 9 1/4"	1-#12, 1-#12, 1-#12	1200 VA									22
23															24
25															26
						7296	VA	787	0 VA						1
						61	A	66	6 A						

Load Classification	Connected Load	Demand Factor	Estimated Demand	Panel	Totals
Lighting - Dwelling Unit	800 VA	100.00%	800 VA		
Other	1252 VA	100.00%	1252 VA	Total Conn. Load:	15165 VA
Receptacle	12960 VA	88.58%	11480 VA	Total Est. Demand:	13686 VA
Lighting	200 VA	100.00%	200 VA	Total Conn.:	63 A
				Total Est. Demand:	57 A
Notos	<u> </u>	1			



NO.	DESCRIPTION	DATE

NOTE:

LEGEND:

PROJECT

35-Yoke-680-1Bd1Ba Farmouse-550

DRAWING NAME

SCHEDULE

CLIENT NAME: Owner PROJECT NUMBER: 0150_12 2/11/2025 10:39:38 AM Designer DESIGNED BY: DRAWN BY: CHECKED BY: Checker

E101

SCALE: 1/4" = 1'-0"

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ELECTRICAL NOTE

- PROVIDE INTERCONNECTED SMOKE ALARMS IN EACH SLEEPING ROOMS, OUTSIDE EACH SLEEPING ROOM, ON EACH STORY, IN THE HALL OR ADJACENT ROOM LUHERE THE CEILING HEIGHT OF A ROOM OPEN TO THE HALL EXCEEDS THE HALL BY 24'. SMOKE ALARMS SHALL BE PERMANENTLY HARD WIRED WITH BATTERY BACKUP.
- B. RECEPTACLE OUTLETS FOR RANGES AND CLOTHES DRYERS SHALL BE A THREE POLE WITH GROUND TYPE. FOUR WIRE GROUNDING-TYPE FLEXIBLE CORDS WILL BE REQUIRED FOR CONNECTION OF RANGES AND CLOTHES DRYERS. THE BONDING JUMPER SHALL NOT BE CONNECTED BETWEEN NEUTRAL TERMINAL AND THE FRAME OF THE **APPLIANCE**
- C. TWO OR MORE 20 AMP SMALL APPLIANCE CIRCUITS SHALL BE PROVIDED TO SERVE THE KITCHEN, BREAKFAST NOOK, AND DINING ROOM. SUCH CIRCUITS SHALL HAVE NO OTHER OUTLETS.
- D. AT LEAST ONE 20 AMP BRANCH CIRCUIT SHALL BE PROVIDED TO SERVICE THE LAUNDRY ROOM. THIS CIRCUIT SHALL HAVE NO OTHER OUTLETS.
- E. ALL RECEPTACLES WITH IN 6' OF A WET BAR SINK OR KITCHEN SINK TO SERVE COUNTER TOP SURFACES MUST BE GFCI. ON KITCHEN COUNTERS 12' OR WIDER NO POINT ALONG THE WALL SHALL BE MORE THAN 2' FROM A RECEPTACLE. ALL RECEPTACLES WITH IN 6' OF KITCHEN SINK MUST BE GFCI. AT LEAST ONE GFCI RECEPTACLE SHALL BE INSTALLED IN THE BATHROOM ADJACENT TO EACH BASIN.
- FIXTURES INCLUDING CEILING FANS THAT ARE LOCATED IN DAMP LOCATIONS SHALL BE LISTED TO BE SUITABLE FOR
- SUCH LOCATIONS PER 2012 IRC
- G. PROVIDE ONE (1) SWITCHED OUTLET @ ALL BEDROOMS AND DEN
- H. CEILING FANS NOT EXCEEDING 35 LBS. (WITH OR WITHOUT ACCESSORIES MAY BE SUPPORTED BY OUTLET BOXES PROVIDED THE OUTLET BOXES ARE IDENTIFIED FOR SUCH USE PER 2012 IRC
- ELECTRICAL OUTLET BOXES ON OPPOSITE SIDES OF FIRE RATED WALLS SHALL BE SEPARATED BY A HORIZONTAL DISTANCE OF NOT LESS THAN 24".
- OUTLET BOXES IN THE WALLS BETWEEN THE GARAGE AND DWELLING SHALL BE METAL OR U.L. APPROVED FIRE RESISTIVE PLASTIC. BOXES IN GARAGE CEILING SHALL BE METAL.
- K. ALL BRANCH CIRCUITS THAT SUPPLY 120 VOLTS SINGLE PHASE 15 AND 20 AMPS RECEPTACLE OUTLETS INSTALLED IN THE DWELLING SHALL BE PROTECTED BY AN ARC FAULT CIRCUIT INTERRUPTER, EXCEPT GFCI RECEPTICLES.

NOTE:

RECEPTACLES MUST BE PROVIDED IN HALLWAYS 10'-0" OR MORE IN LENGTH. FOR A ONE FAMILY DWELLINGS AND EACH OF A TWO FAMILY DWELLING THAT IS AT GRADE LEVEL, AT LEAST ONE WP-GFCI RECEPTACLE OUTLET ACCESSIBLE AT GRADE LEVEL AND NOT MORE THAN 6'-6" ABOVE GRADE SHALL BE INSTALLED AT THE FRONT AND BACK OF THE DWELLING.

NOTE: APPLIANCE DISCONNECT

E4001.5 GROUNDING OF ENCLOSURES.

METAL ENCLOSURES FOR SWITCHES OR CIRCUIT BREAKERS SHALL BE CONNECTED TO AN

EQUIPMENT GROUNDING CONDUCTOR.

METAL ENCLOSURES FOR SWITCHES OR CIRCUIT BREAKERS USED AS SERVICE EQUIPMENT SHALL COMPLY WITH THE PROVISIONS OF SECTION E3609.4. WHERE


NONMETALLIC ENCLOSURES ARE USED WITH METAL RACEWAYS OR METAL-ARMORED


CABLES, PROVISIONS SHALL BE MADE FOR CONNECTING THE EQUIPMENT GROUNDING

CONDUCTOR.


NONMETALLIC BOXES FOR SWITCHES SHALL BE INSTALLED WITH A WIRING METHOD THAT


PROVIDES OR INCLUDES AN EQUIPMENT GROUNDING CONDUCTOR. (404.12)

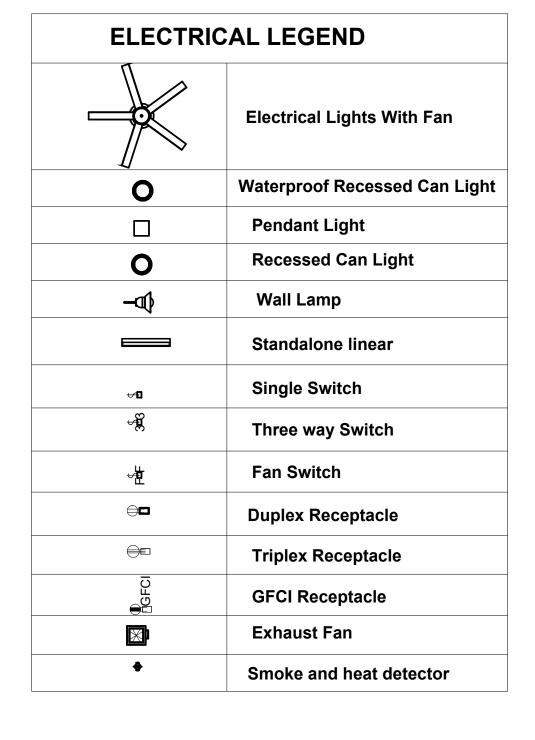

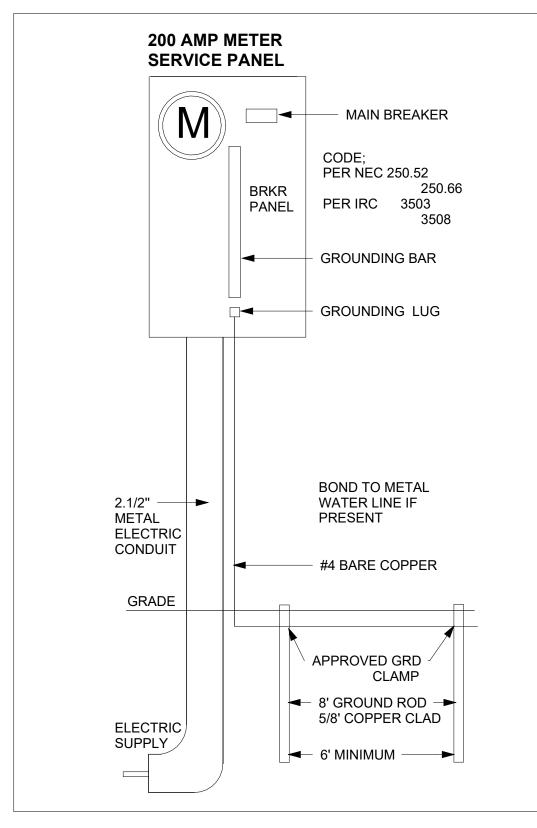



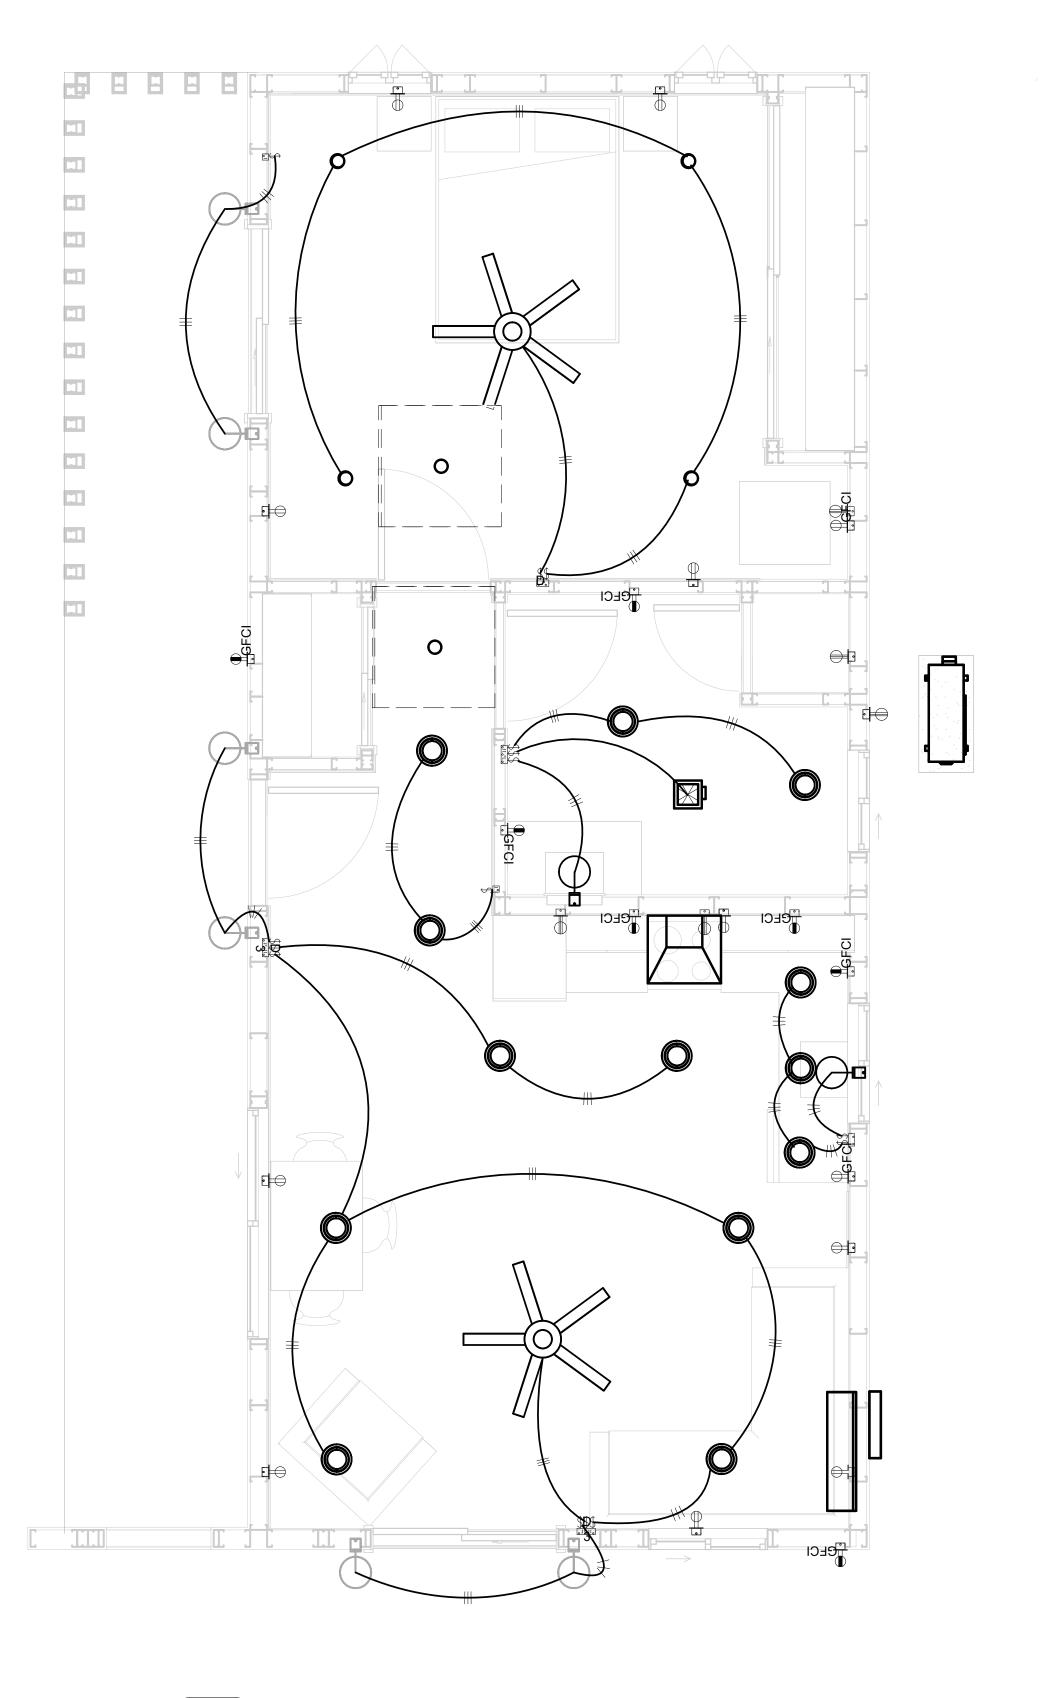

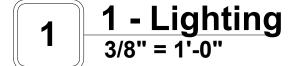



KEY PLAN

NO.	DESCRIPTION	DATE

NOTE:

LEGEND:

PROJECT

35-Yoke-680-1Bd1Ba Farmouse-550

DRAWING NAME


LIGHTING

CLIENT NAME:	Owner
PROJECT NUMBER:	0150_12
DATE:	2/11/2025 10:39:41 AM
DESIGNED BY:	Designer
DRAWN BY:	Author
CHECKED BY:	Checker


E102

NOTES: CONDUIT, CABLE AND WIRING


- Use Metalic Conduits (IMC) for cables running under concrete slabs.
 Use IMC for circuits with high voltage appliances (240 volts and above)
 For circuits with 120 volts consider using EMT or PVC conduits if needed.
 For Low voltage applications up to 50 volts consider using non metalic conduits.
 All conduits to be used in the project must conform to the latest National Electrical Code (NEC),
- 5. All conduits to be used in the project must comorn to the latest National Electrical Code (NEC), 2015.
 6. All wiring and cables to be used in the project must also conform to the latest National Electrical Code (NEC), 2015.
 7. All cables and wires used should be rated for their respective loading and should be gauged and conform to the NEC.

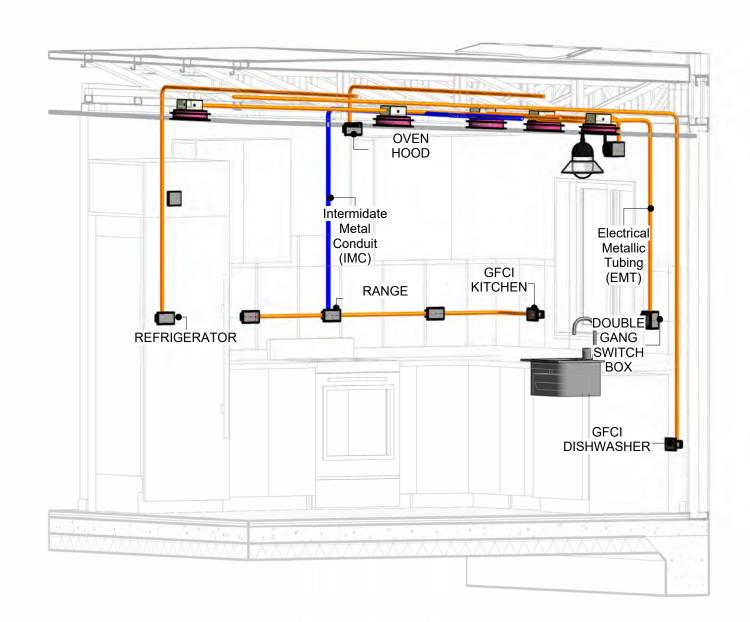


3D-KITCHEN

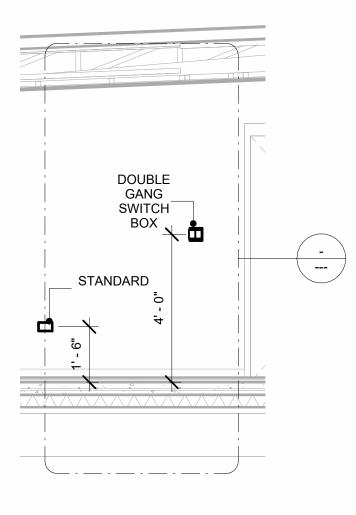


Section 1

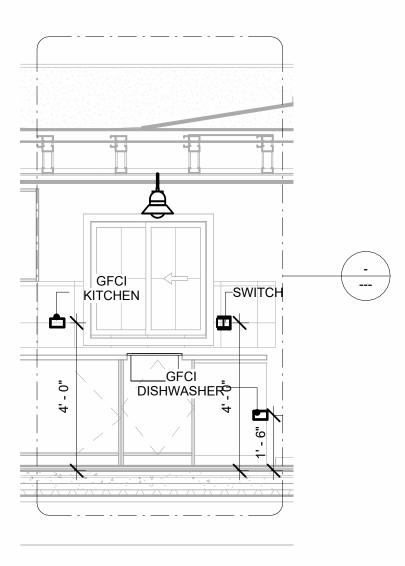


Section 3
3/8" = 1'-0"

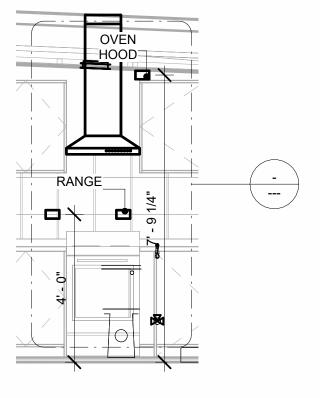

Section 2 3/8" = 1'-0"

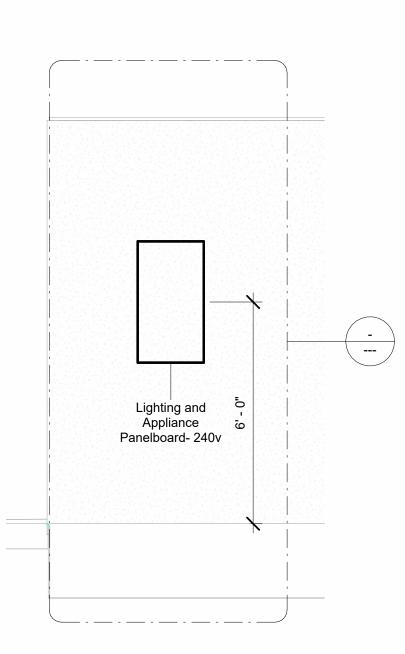



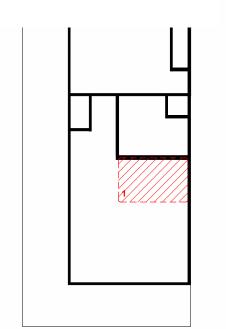

NO.	DESCRIPTION	DATE

NOTE:

LEGEND:

PROJECT

35-Yoke-680-1Bd1Ba Farmouse-550

DRAWING NAME

POWER

CLIENT NAME:	Owner
PROJECT NUMBER:	0150_12
DATE:	2/11/2025 10:40:05 AM
DESIGNED BY:	Designer
DRAWN BY:	Author
CHECKED BY:	Checker

E103

NOTES: LIGHT

- 1. LIGHT FIXTURES AND LUMINARIES SHALL CONFORM TO THE NEC, THE IRC AND LOCAL SAFETY & BUILDING CODE.
- 2. ALL LIGHTING FIXTURES SHOULD CONFORM TO THE DESIGN ELECTRICAL LOAD AND SHALL BE PROPERLY WIRED AND MOUNTED BY QUALIFIED ELECTRICIAN FOLLOWING MANUFACTURERS SPECIFICATIONS.
- 3. CEILING FANS AND FANS WITH LIGHT WITH WEIGHT EXCEEDING 35 LBS SHOULD BE PROVIDED WITH STRUCTURAL BACKING FOR SUPPORT AND SHALL BE FIXED AS PER MANUFACTURERS SPECIFICATIONS.
- 4. EXTERIOR LIGHTS SHALL CONFORM TO LOCAL BUILDING CODE AND GUIDELINES.

NOTES: SWITCH JUNCTION BOX


- 1. THE MINIMUM SIZE OF JUCTION BOX TO BE USED IS 2"X4"X(1.5" OR 3.5" DEEP) THIS ARE TO BE USED FOR SINGLE GANG SWITCH OR OUTLETS.
- 2. FOR DOUBLE GANG (2 GANG) OUTLETS AND SWITCHS THE MINIMUM SIZE OF THE
- JUCTION BOX TO BE PROVIDED SHALL NOT BE LESS THAN 4"X4"X(1.5" OR 3.5" DEEP)
- 3. FOR THREE GANG (3 GANG) OUTLETS AND SWITCHS THE MINIMUM SIZE OF THE JUĆTION BOX SHALL NOT BE LESS THAN 6"X4"X(1.5" OR 3.5" DEEP).

FITTING SCHEDULE(PULL BOX)							
FAMILY	COUNT	DESCRIPTION					
PULLBOX1	21	#1/4 PULLBOX					

ELECTRICAL FIXTURE SCHEDULE (SWITCH BOX)						
TYPE	COUNT					
DOUBLE GANG SWITCH BOX	2					
SINGLE GANG SWITCH BOX	2					
TRIPLE GANG SWITCH BOX	3					

LIGHTING DEVICE		
TYPE	COUNT	
DIMMER	1	
SINGLE POLE	12	
THREE WAY WITH DIMMER 2		

LIGHTING FIXTURE			
LIGHTING FIXTURE TYPE	VOLTAGE	ELECTRICAL LOAD	COUNT
ELECTRICAL_LIGHTS_FAN-LIGHT1	120 V/1-100 VA- 120 V/1-100 VA	200 A, 120 V/240 V, SINGLE PHASE, 3 WIRES	2
LIGHTING_OTHER_LUMENWE RX_SHELL-RECESSED-8	120 V/1-60 VA	200 A, 120 V/240 V, SINGLE PHASE, 3 WIRES	13
SASSO 100 ROUND WALLWASHER TRIM	120 V/1-28 VA	200 A, 120 V/240 V, SINGLE PHASE, 3 WIRES	4
WALL LAMP - BRACKET	120 V/1-100 VA	200 A, 120 V/240 V, SINGLE PHASE, 3 WIRES	8

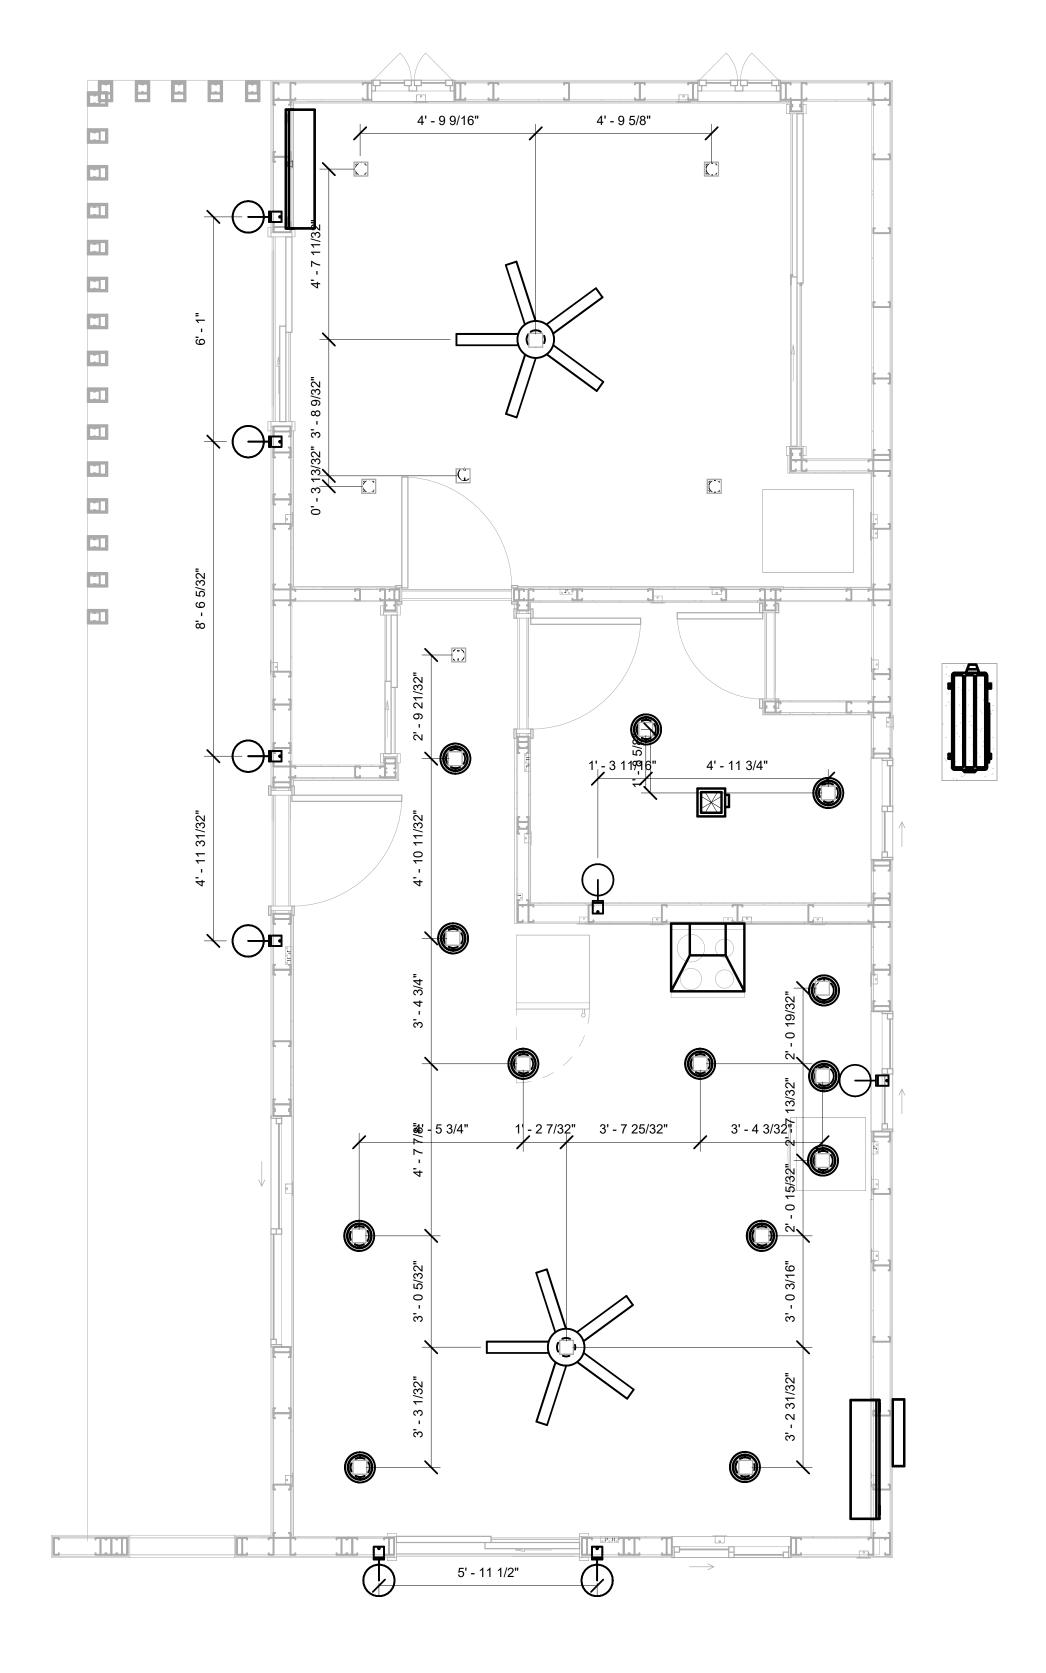

DIMENSION FOR LIGHT FIXTURES
3/8" = 1'-0"



NO.	DESCRIPTION	DATE

NOTE:

LEGEND:

PROJECT

35-Yoke-680-1Bd1Ba Farmouse-550

DRAWING NAME

DIMENSION PLAN FOR LIGHT FIXTURES

CLIENT NAME:	Owner
PROJECT NUM	IBER: 0150_12
DATE:	2/11/2025 10:40:07 AM
DESIGNED BY:	Designer
DRAWN BY:	Author
CHECKED BY:	Checker


E104

NOTES;

- 1. VERIFY EQUIPMENT PLUG CONFIGURATION BEFORE PURCHASING RECEPTACLES 2. FOR ALL EQUIPMENT.
- 3. COORDINATE EXACT LOCATION OF LIGHT FIXTURES, WALL SWITCHES, RECEPTACLES AND OTHER DEVICES WITH ARCHITECTURAL DRAWINGS.
- 4. USE METALLIC JUNCTION BOX WITH THE GFCI RECEPTACLES, WITH HIGHT VOLTAGE.

ELECTRICAL FIXTURE SCHEDULE (RECEPTACLE)				
TYPE COUNT				
CONDENSER	1			
DRYER	1			
GFCI BATH ROOM	2			
GFCI DISHWASHER	1			
GFCI KITCHEN	3			
GFCI OUT DOOR	2			
GFCI WASHER	1			
OVEN HOOD	1			
RANGE	1			
REFRIGERATOR	1			
STANDARD	9			
WATER HEATER	1			

ELECTRICAL OUTLET SCHEDULE			
TYPE CIRCUIT NUMBER ELECTRICAL DATA COUNT			
GFCI BATH ROOM	3	120 V/1-180 VA	2
STANDARD	6	120 V/1-180 VA	4
DRYER	7,9	240 V/2-1500 VA	1
GFCI WASHER	8	120 V/1-1200 VA	1
CONDENSER	10,12	240 V/2-1500 VA	1
WATER HEATER	11,13	240 V/2-1500 VA	1
GFCI OUT DOOR	14	120 V/1-180 VA	2
STANDARD	15	120 V/1-180 VA	5
REFRIGERATOR	16	120 V/1-1500 VA	1
GFCI KITCHEN	17	120 V/1-180 VA	3
RANGE	18,20	240 V/2-1500 VA	1
OVEN HOOD	19	120 V/1-180 VA	1
GFCI DISHWASHER	21	120 V/1-1200 VA	1

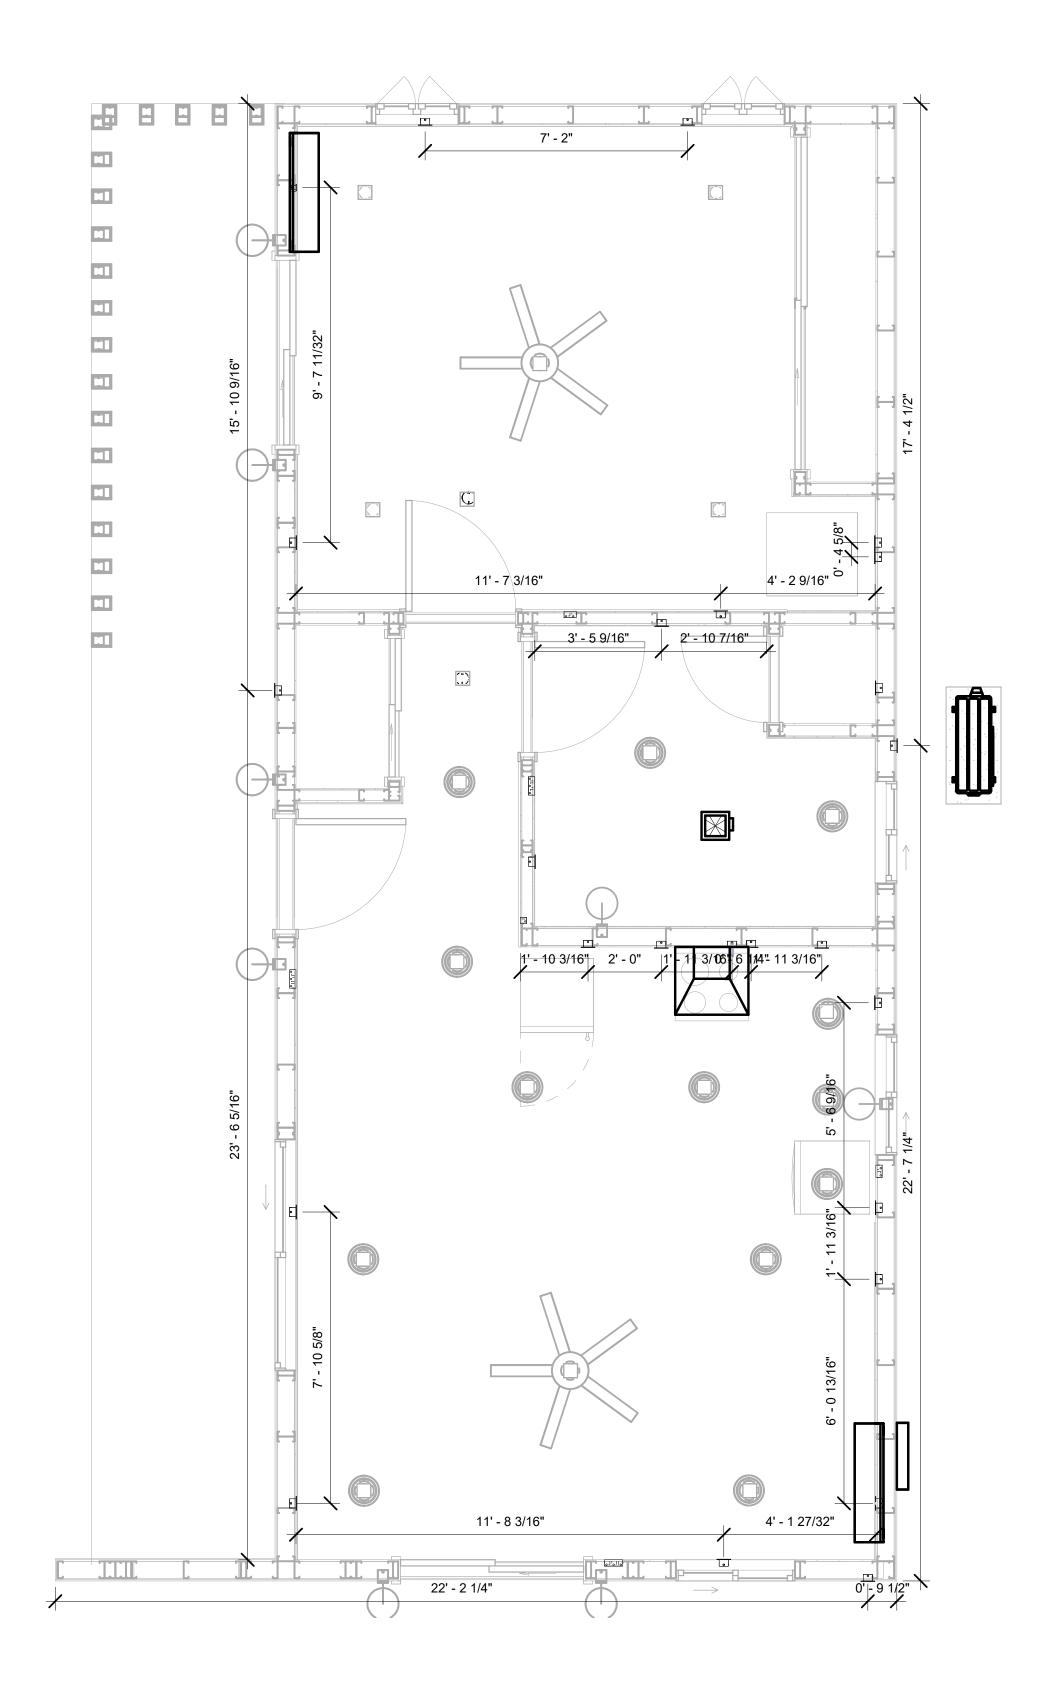

DIMENSION FOR FITTINGS



NO.	DESCRIPTION	DATE

NOTE:

LEGEND:

PROJECT

35-Yoke-680-1Bd1Ba Farmouse-550

DRAWING NAME

DIMENSION PLAN FOR FITTINGS

CLIENT NAME:	Owner
PROJECT NUMBER:	0150_12
DATE:	2/11/2025 10:40:08 AM
DESIGNED BY:	Designer
DRAWN BY:	Author
CHECKED BY:	Checker

E105

SHEET LIST

SHEET NUMBER SHEET NAME

P101 NOTE AND SCHEDULE WATER SUPPLY AND SEWAGE P102 SYSTEM

PIPE COLOR S	SCHEME
DO	OMESTIC COLD WATE OMESTIC HOT WATER ANITARY VENT
SA	ANITARY SEWER FORM DRAINAGE
	RAY WATER AS LINE

PLUMBING NOTES

- THE PLUMBING SYSTEM IS DESIGNED TO MEET THE BUILDING'S DOMESTIC WATER SUPPLY, SANITARY DRAINAGE, AND STORM DRAINAGE REQUIREMENTS, AS PER PROJECT SPECIFICATIONS AND APPLICABLE CODES.
- THE SYSTEM INSTALLATION SHALL COMPLY WITH THE LATEST INTERNATIONAL PLUMBING CODE (IPC), INTERNATIONAL RESIDENTIAL CODE (IRC), AND ALL OTHER RELEVANT LOCAL, STATE, AND NATIONAL REGULATIONS.
- ALL PLUMBING WORK SHALL COMPLY WITH THE LATEST EDITION OF THE INTERNATIONAL PLUMBING CODE (IPC) AND THE LOCAL PLUMBING CODE.
- PLUMBING SYSTEMS SHALL BE TESTED AND INSPECTED IN ACCORDANCE WITH THE LOCAL PLUMBING CODE REQUIREMENTS.
- 5. PLUMBING FIXTURES SHALL BE INSTALLED WITH THE APPROPRIATE TRIM, FITTINGS, AND ACCESSORIES, AS RECOMMENDED BY THE MANUFACTURER.
- 6. PIPING SHALL BE PROPERLY SUPPORTED AND SECURED TO PREVENT SAGGING, MOVEMENT, AND VIBRATION.
- SHUT-OFF VALVES SHALL BE PROVIDED AT ALL BRANCH CONNECTIONS AND AT THE INLET AND OUTLET OF EACH PIECE OF EQUIPMENT.
- BACKFLOW PREVENTION DEVICES SHALL BE INSTALLED AS REQUIRED BY THE LOCAL
- PLUMBING CODE TO PROTECT THE POTABLE WATER SYSTEM. PLUMBING FIXTURES AND EQUIPMENT SHALL BE ACCESSIBLE FOR MAINTENANCE AND
- 10. EXPOSED PLUMBING PIPING AND FIXTURES SHALL BE INSULATED TO PREVENT CONDENSATION AND ENERGY LOSS.
- 11. DEAD ENDS IN THE DRAINAGE SYSTEM MUST BE AVOIDED, EXCEPT WHERE NECESSARY TO INSTALL A CLEANOUT IN AN ACCESSIBLE LOCATION, AND MUST HAVE A VENTED CONNECTION TO THE OUTSIDE ATMOSPHERE.
- 12. THE VERTICAL DEFLECTION OF PVC PIPE MUST NOT EXCEED 5%, AND NO DEFLECTION IS PERMITTED FOR IRON PIPE.
- 13. WORK MUST BE PROPERLY COORDINATED WITH OTHER TRADES TO AVOID CONFLICTS, REFERRING TO THE ARCHITECTURAL AND STRUCTURAL DRAWINGS FOR INFORMATION REGARDING CEILING ELEVATIONS, SPACE CLEARANCES, WALL AND PARTITION LOCATIONS, ETC.
- 14. ALL FIXTURES SHALL HAVE ACCESSIBLE STOPS.
- 15. DOMESTIC WATER PIPING SHALL BE PEX, AND PVC PIPING IS NOT ACCEPTABLE FOR INTERIOR USE.
- 16. VENT TERMINATIONS SHALL BE LOCATED AT LEAST 10 FEET FROM OR 3 FEET ABOVE ANY OPERABLE WINDOW, DOOR OPENING, AIR INTAKE, OR VENT SHAFT, AND AT LEAST 3 FEET IN EVERY DIRECTION FROM ANY LOT LINE, ALLEY, OR STREET.
- 17. PIPE AND FITTINGS UTILIZED IN THE WATER SUPPLY SYSTEM SHALL HAVE A MAXIMUM OF 8 PERCENT LEAD.
- 18. ACRYLONITRILE BUTADIENE STYRENE (ABS) SHALL BE USED FOR THE SEWERAGE AND VENTILATION SYSTEM.
- 19. CROSS-LINKED POLYETHYLENE (PEX) SHALL BE USED FOR THE WATER SUPPLY SYSTEM.
- POLYVINYL CHLORIDE (PVC) SHALL BE USED FOR THE RAIN WATER SYSTEM.
- 21. THE MIMIMUM WATER SUPPLY DEPTH UNDER FLOOR FINISH SHOUD BE 1/2".
- 22. ANY PIPE INSTALLED UNDERGROUND MUST HAVE AT LEAST 12 INCHES OF CLEARANCE BETWEEN THE OUTSIDE OF THE PIPE AND ANY OTHER UNDERGROUND STRUCTURE.
- 23. THE MINIMUM CLEARANCE BETWEEN COLD AND HOT WATER LINES IN RESIDENTIAL
- HOMES MAINTAIN A MINIMUM DISTANCE OF 6 INCHES.
- HORIZONTAL SEPARATION BETWEEN WATER AND SEWER LINES: A MINIMUM OF 12 INCHES BETWEEN POTABLE WATER SUPPLY LINES (COLD AND HOT WATER) AND SANITARY SEWER LINES.

ABBREVIATIONS

Ø	DIAMETER
ABS	ACRYLONITRILE BUTADIENE STYRENE
ABV	ABOVE
AD	AREA DRAIN
AFF	ABOVE FINISHED FLOOR
ALT	ALTERNATE
BFF	BELOW FINISHED FLOOR
BLW	BELOW
CO	CLEAN OUT
CW	COLD WATER
D	DEGREE
DFU	DRANAGE FIXTURE UNIT
DIA	DIAMETER
DN	DOWN
FCO	FLOOR CLEAN OUT
FD	FLOOR DRAIN
FL	FLOOR
FS	FLOOR SINK
FT	FOOT/FEET
HB	HOSE BIB
HW	HOT WATER
IN	INCH
MIN	MINIMUM
NO	NUMBER
NTS	NOT TO SCALE
PEX	CROSS-LINKED POLYETHYLENE
PLBG	PLUMBING
PVC	POLYVINYL CHLORIDE
QTY	QUANTITY
RD	ROOF DRAIN
RED	REDUCER
RM	ROOM
RW	RAIN WATER
SF	SQUARE FOOT
VTD	VENT TUROUGH ROOF
VTR	VENT THROUGH ROOF
WCO	WASTE WALL CLEAN OUT
WSFU	WATER SUPPLY FIXTURE UNIT
WOLO	WATER SUPPLIFIATURE UNIT

PLUMBING LEGEND

D	CAP
	BEND 45 DEG
\Box	BEND 90 DEG
	TEE REDUCING
	TEE
	CLEAN TWO-WAY
	WYE 45 DEG
	WYE 45 DEG DOUBLE
	WYE COMBINATION
	P-TRAP

PIPE SCHEDULE			
MATERIAL	DIAMETER	LENGTH	
ACRYLONITRILE BUTADIENE STYRENE (ABS)	1 1/2"	7 FT	
ACRYLONITRILE BUTADIENE STYRENE (ABS)	2"	31 FT	
ACRYLONITRILE BUTADIENE STYRENE (ABS)	3"	23 FT	
CROSS-LINKED POLYETHYLENE (PEX)	1/2"	60 FT	
CROSS-LINKED POLYETHYLENE (PEX)	3/4"	65 FT	
CROSS-LINKED POLYETHYLENE (PEX)	2"	1 FT	
POLYVINYL CHLORIDE - RIGID	2"	38 FT	

FITTING SCHEDULE							
FITTING	SIZE	QTY					
DOMESTIC COLD WATER							
PEX 90 DEGREE ELBOW	1/2"ø-1/2"ø	11					
PEX 90 DEGREE ELBOW	3/4"ø-3/4"ø	3					
PEX CROSS ELBOW	3/4"ø-3/4"ø-3/4"ø	1					
PEX TEE ELBOW	3/4"ø-3/4"ø-3/4"ø	5					
PEX TRANSITION ELBOW	1"ø-3/4"ø	2					
PEX TRANSITION ELBOW	3/4"ø-1/2"ø	6					
DOMESTIC HOT WATER							
PEX 90 DEGREE ELBOW	1/2"ø-1/2"ø	11					
PEX 90 DEGREE ELBOW	3/4"ø-3/4"ø	5					
PEX CROSS ELBOW	3/4"ø-3/4"ø-3/4"ø	1					
PEX TEE ELBOW	3/4"ø-3/4"ø-3/4"ø	2					
PEX TRANSITION ELBOW	3/4"ø-1/2"ø	5					
RAIN WATER ABS 90 DEGREE BEND ELBOW PVC 90 DEG BEND ELBOW	2"ø-2"ø 2"ø-2"ø	8 4					
SEWAGE							
ABS 90 DEGREE BEND ELBOW	1 1/2"ø-1 1/2"ø	2					
ABS 90 DEGREE BEND ELBOW	2"ø-2"ø	2					
ABS 90 DEGREE BEND ELBOW	3"ø-3"ø	2					
ABS P-TRAP	1 1/2"ø-1 1/2"ø	3					
ABS P-TRAP	2"ø-2"ø	2					
ABS REDUCER ELBOW	2"ø-1 1/2"ø	1					
ABS REDUCER ELBOW	3"ø-2"ø	2					
ABS TEE ELBOW	2"ø-2"ø-2"ø	1					
ABS TEE ELBOW	3"ø-3"ø-3"ø	1					
ABS TEE REDUCER ELBOW	3"ø-3"ø-1 1/2"ø	2					
WASTE DOUBLE TEE	2"ø-2"ø-2"ø	1					
WASTE DOUBLE TEE	3"ø-3"ø-3"ø	1					
VENT							
ABS VENT CAP ELBOW	2"ø	2					
ABS VENT CAP ELBOW	3"ø	1					

	FIXTURE CONNECTION SCHEDULE											
AMILY	W	V	TRAP	CW	HW	QTY	DFU	TOT.	WFU	TOT.	NOTES	

DISHWASHER	2"	1-1/2"	1-1/2"	1/2"	1/2"	1	0		DRAIN TO SEWER SEE PLANS
DRYER	N/A	N/A	N/A	N/A	N/A	1	0		
HANGING PIPES CLAMP						8	0		
SHOWER TRAY	2"	1-1/2"	1-1/2"	1/2"	1/2"	1	0		
SHOWER TRIM	-	-	-	1/2"	1/2"	1	0		
SINK ISLAND SINGLE	2"	1-1/2"	1-1/2"	1/2"	1/2"	1	0		
VANITY SINK	2"	1-1/2"	1-1/2"	1/2"	1/2"	1	0		
WASHER	2"	1-1/2"	2"	1/2"	1/2"	1	0		DRAINS TO GRAY WATER OR SEWER SEE PLANS
WATER CLOSET	3"	2"	3"	1/2"	1/2"	1	0		
WATER HEATER	N/A	N/A	N/A	3/4"	3/4"	1	0		

FIXTURE SCHEDULE								
FIXTURE	QTY	DESCRIPTION						
DISHWASHER	1	DRAIN TO SEWER SEE PLANS						
DRYER	1							
HANGING PIPES CLAMP	8							
SHOWER TRAY	1							
SHOWER TRIM	1							
SINK ISLAND SINGLE	1							
VANITY SINK	1							
WASHER	1	DRAINS TO GRAY WATER OR SEWER SEE PLANS						
WATER CLOSET	1							
WATER HEATER	1							

ACCESSORIES & FITTINGS SCHEDULE								
FIXTURE QTY DESCRIPTIONS								
DISHWASHER CONNECTOR	1							
HOSE BIB	1							
LAUNDRY SWEAT CONNECTOR1	1							
ROOF DRAIN SCUPPER	4							
SHUTOFF VALVE	6							

PLUMBING SCHEDULE										
FIXTURE	TRAP	WASTE	VENT	C.W	H.W					
DISHWASHER	1-1/2"	2"	1-1/2"	1/2"	1/2"					
DRYER	N/A	N/A	N/A	N/A	N/A					
SHOWER TRAY	1-1/2"	2"	1-1/2"	1/2"	1/2"					
SHOWER TRIM	-	-	-	1/2"	1/2"					
SINK ISLAND SINGLE	1-1/2"	2"	1-1/2"	1/2"	1/2"					
VANITY SINK	1-1/2"	2"	1-1/2"	1/2"	1/2"					
WASHER	2"	2"	1-1/2"	1/2"	1/2"					
WATER CLOSET	3"	3"	2"	1/2"	1/2"					
WATER HEATER	N/A	N/A	N/A	3/4"	3/4"					

WATER FIXTURE UNIT SCHEDULE										
FAMILY QTY UNIT VALUE TOTAL										
DISHWASHER	1		0							
DRYER	1		0							
HANGING PIPES CLAMP	8		0							
SHOWER TRAY	1		0							
SHOWER TRIM	1		0							
SINK ISLAND SINGLE	1		0							
VANITY SINK	1		0							
WASHER	1		0							
WATER CLOSET	1		0							
WATER HEATER	1		0							

WASTE FIXTURE UNIT SCHEDULE									
FAMILY QTY DFU VALUES TOTAL									
DISHWASHER 1 0									
DRYER	1		0						
HANGING PIPES CLAMP	8		0						
SHOWER TRAY	1		0						
SHOWER TRIM	1		0						
SINK ISLAND SINGLE	1		0						
VANITY SINK	1		0						
WASHER	1		0						
WATER CLOSET	1		0						
WATER HEATER	1		0						



KEY PLAN

DESCRIPTION DATE

NOTE:

LEGEND:

PROJECT

34-Yoke-670-1Bd/1Ba **Contemporary-550**

DRAWING NAME


NOTE AND SCHEDULE

CLIENT NAME:


PROJECT NUMBER: 00150_12 DATE: 2/10/2025 6:33:29 PM Designer DESIGNED BY: DRAWN BY: Author CHECKED BY: Checker

P101

SCALE: 1/2" = 1'-0"

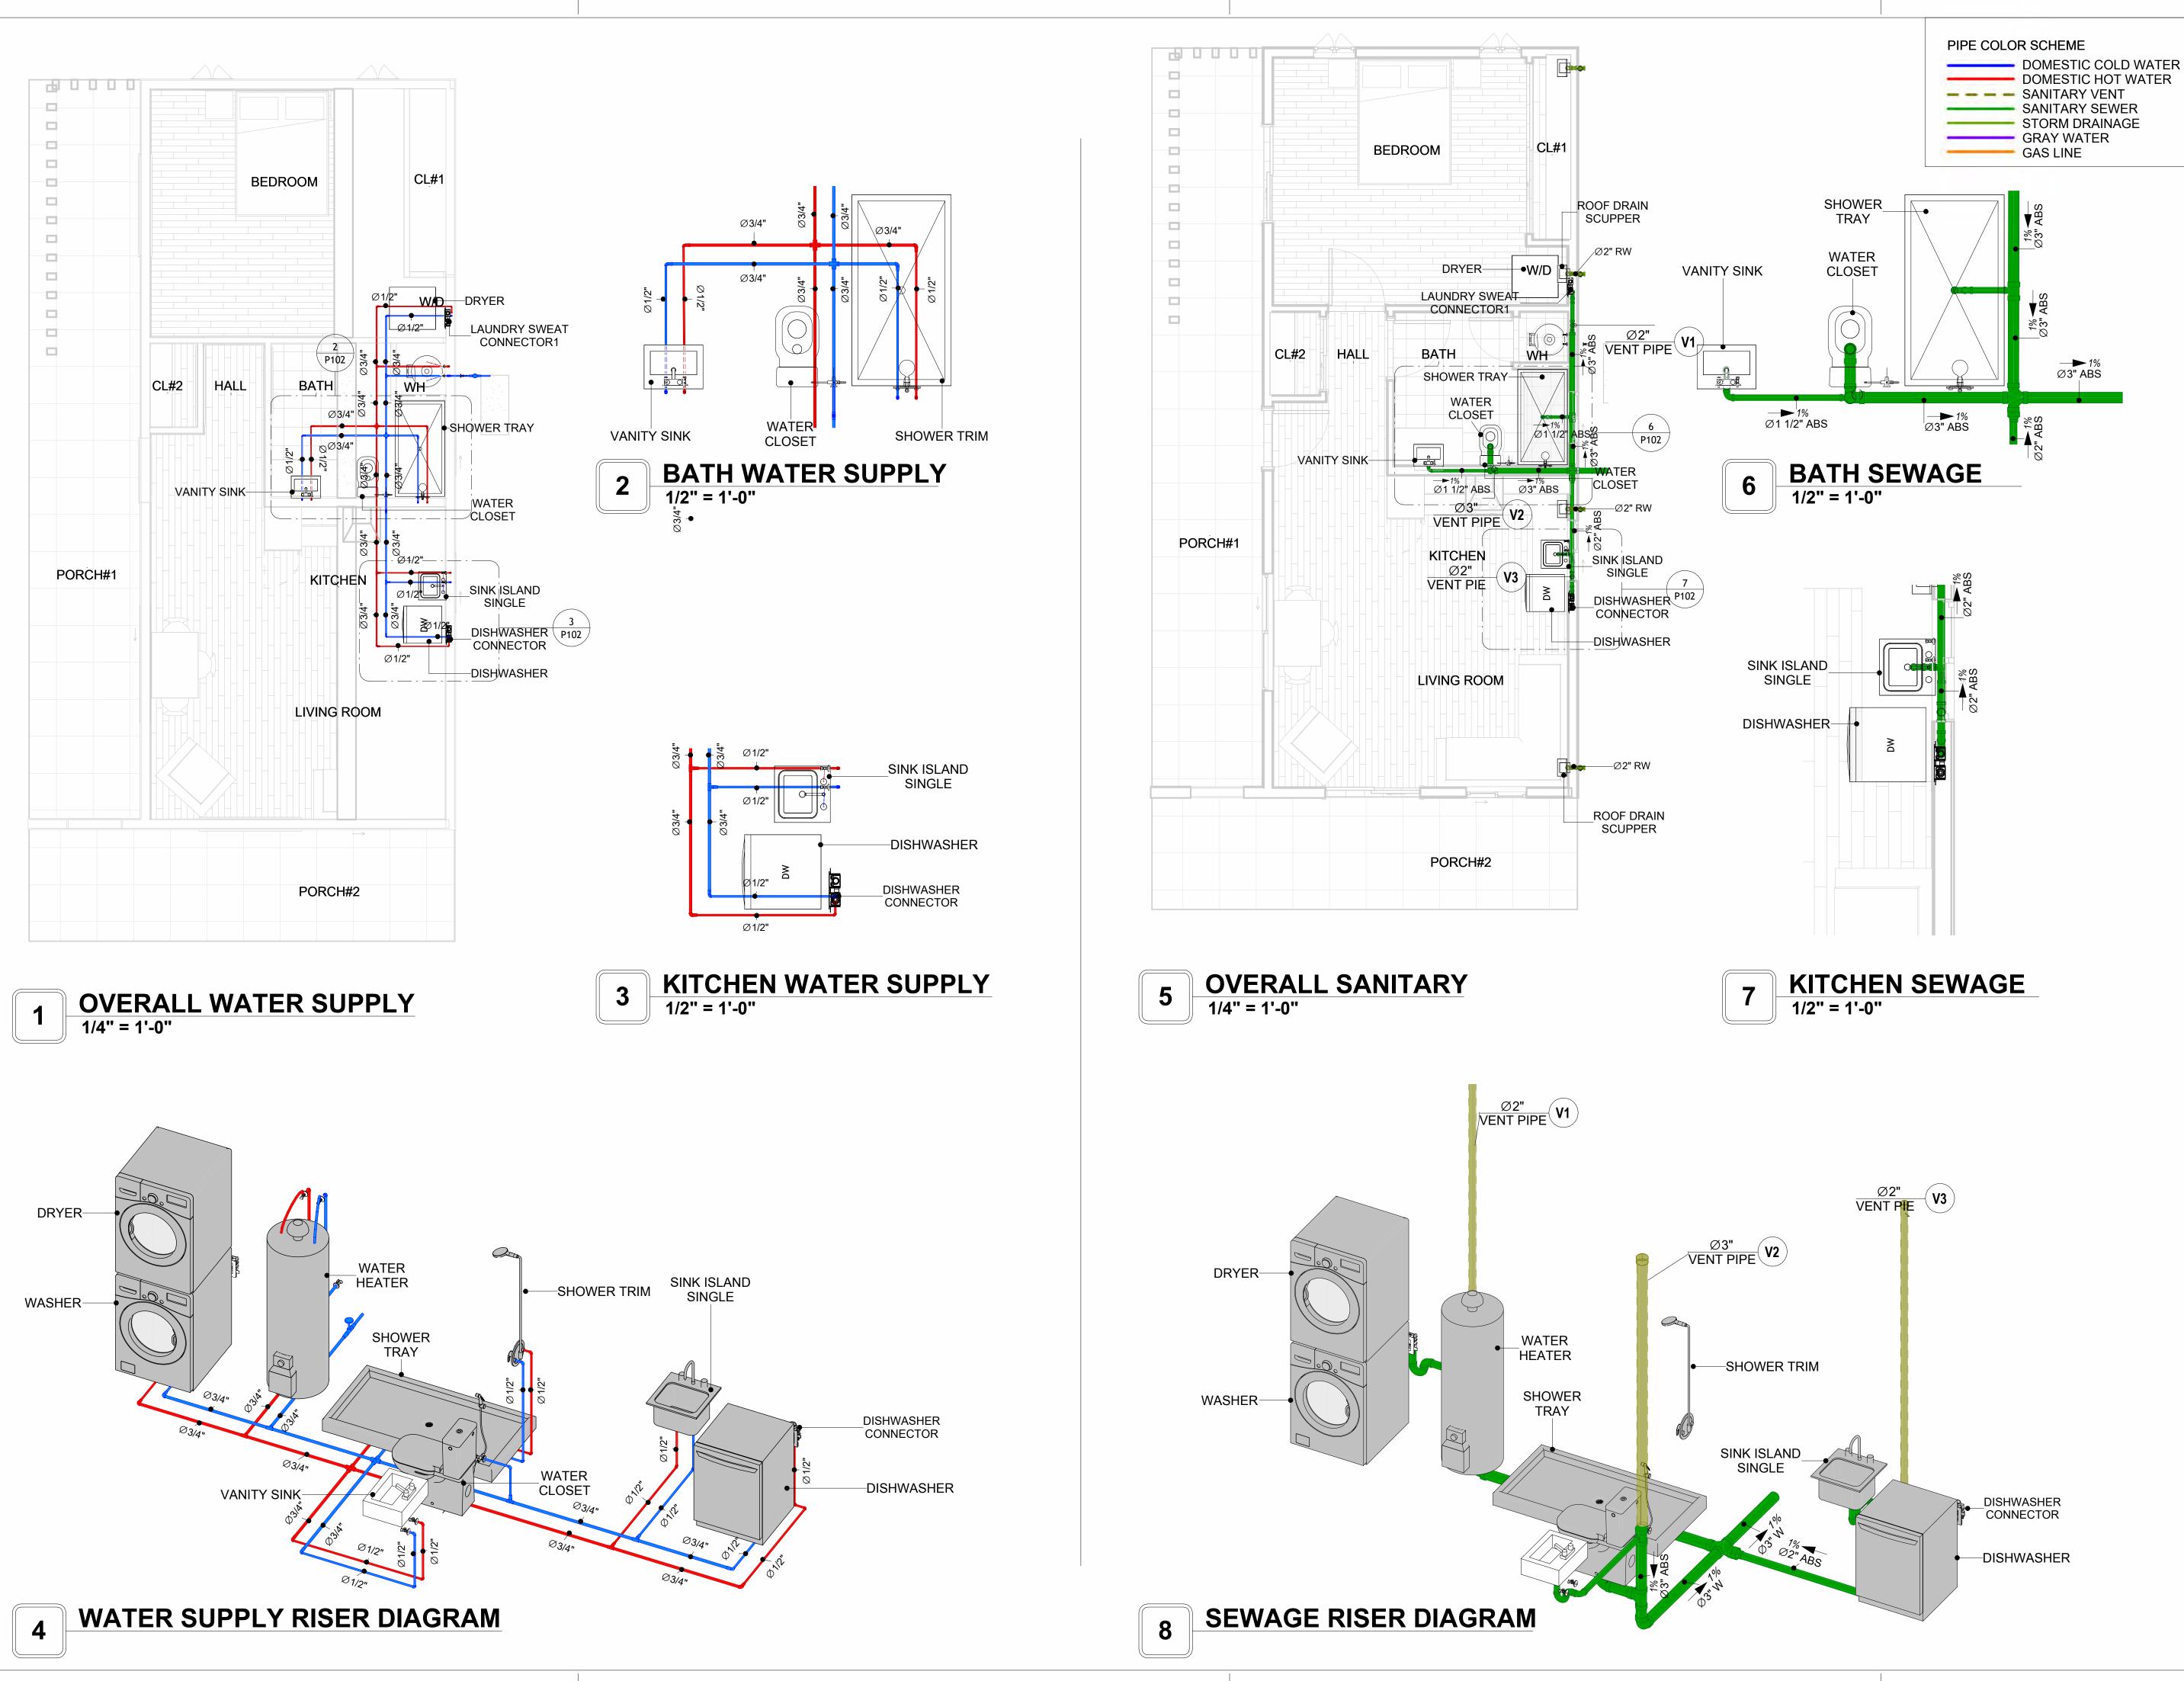



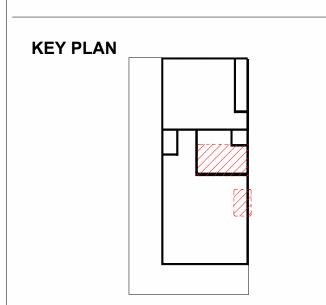

NO.	DESCRIPTION	DATE

LEGEND:

NOTE:

PROJECT

34-Yoke-670-1Bd/1Ba Contemporary-550

DRAWING NAME

WATER SUPPLY AND SEWAGE SYSTEM

CLIENT NAME:	
PROJECT NUMBER:	00150_12
DATE:	2/10/2025 6:34:14 PM
DESIGNED BY:	Designer
DRAWN BY:	Author
CHECKED BY:	Checker

P102

Materials Shopping List

Please print and take this Materials Shopping List to your favorite Home Depot and ask for assistance in selecting the materials, fixtures and fittings to complete your new home.

Record your selection and the price of the item. Then do the math to determine the cost for your selections and the total cost of finishing your home.

Have It Your Way!

The material types listed in this document were selected based on personal preferences. The Customer is encouraged to make changes to the material types in accordance with local customs, regulations, and personal preferences.

Have It Your Way!



20 good reasons to frame a home with metal and not wood



Why build your ADU with metal vs wood	Wood	Metal	Explanation
1 DIY Construction Benefit		~	The wall frames, trusses and beams can be erected in a just a few days
2 Minimal Construction Skills Required		~	Pre-assembled walls and trusses require no specialized skills to errect
Build as DIY, Hybrid or by a General Contractor		~	Do it yourself, Hybrid (involve special contractors) or hire a General Contractor
4 Build It As You Can Afford It		~	Impervious to Weather - build as you have the time and money
5 Up Front Cost of Framing Materials	~		As to only the framing material, wood is less expensive
6 Total Cost To Build		~	Savings in time, labor, and other areas make light gauge steel LESS expensive
7 Termites and wood boring insects		~	Termites, carpenter ants and wood boring insects eat wood, not metal
8 Mold resistant		~	Metal does not attract mold
9 Damage caused by exterior and interior flooding		~	Metal needs no reconditioning after a flood
10 Fire Resistant		~	Non-combustible
11 Lower insurance rates		~	Many insurance underwriters now provide lower rates for metal framed homes
12 Walls, trusses, and beams retain their original form		~	Perfectly straight walls - no shimming of drywall
13 Corners are 90 degrees		~	No need for templating of countertops to adjust for out of square corners
14 Strength and weight		~	Metal is stronger than wood and weighs less - no need for crane to lift ADU trusses
15 IBC Engineered Stamp		~	If an engineering stamp is necessary, months of waiting are saved
16 Complete BOM (Materials Shopping List)		~	Take the materials shopping list to Home Depot and start shopping/pricing
17 Flexible in Seismic Areas - Won't Fracture		~	Light gauge steel is flexible and won't fracture when the earth moves
18 No Waste At Job Site		~	Steel is the most recycled material in the world. A typical wood home has 20-30% waste
19 Environmentally Friendly		~	Trees don't have to be destroyed and the source of most metal is from recycling
20 How-To Videos Included		~	How-to videos provide simple assembly instructions
21 Relationship Counselor		~	Eliminate emotional uphevels - save time, money, and preserve the relationship

Universal Requirements - some or all may be required

- 1 Site plan
- 2 Electrical Supply Connection
- 3 Sewer Connection
- 4 Fresh Water Supply Connection
- 5 Set Backs
- 6 Soils Evaluation

- 7 Earthquake (fault) evaluation
- 8 Foundation Plan subject to soils
- 9 Compliance with local energy codes: insulation home wrap and flashing
- 10 Engineering for wind speed and snow load.
- 11 State and Local ordinances regarding ADUs
- 12 Local Architect and/or Engineer may be necessary

Yoke-1Bd1Ba-Contemporary





Yoke-1Bd1Ba-Contemporary MATERIAL SHOPPING LIST

Have It Your Way!

The material types listed in this document were selected based on personal preferences. The Customer is encouraged to make changes to the material types in accordance with local customs, regulations, and personal preferences. Have It Your Way!

TOC



Table Of Content # Name Link Page No 1 Cover Page Cover Page 2 TOC TOC 2 3 ELECTRICAL BOM **ELECTRICAL BOM** 3 5 HVAC BOM **HVAC BOM** 7 **4** PLUMBING BOM **PLUMBING BOM** 10 6 ARCHITECTURAL BOM ARCHITECTURAL BOM 15

Have It Your Way!

The material types listed in this document were selected based on personal preferences. The Customer is encouraged to make changes to the material types in accordance with local customs, regulations, and personal preferences. Have It Your Way!

GENERAL NOTES

- 1 This BOM (Bill of Materials) is prepared as a Materials Shopping List to help builders and DIYers gain a complete understanding of most if not all elements required for the complete construction of this structure, according to the original design documents provided by FrameUpNow.
- 2 All quantities and specifications are subject to change based on the final design, field measurements, availability of products and customer preferences. The customer should verify all information prior to purchasing materials.
- 3 All products and elements in the list shall conform to the International Residential Code (IRC), or any other local and international building codes, safety regulations, and standards that are applicable to the location of the structure.
- 4 If any changes are made by the customer to the list of materials specified in this document, the customer is responsible for assuring that the correct type and quantity of materials are utilized in accordance with local building codes.
- 5 FrameUpNow, will not be held responsible for any misuse of this document, the products listed, or for deviations from the content that are made due to changes in specifications, pricing, availability, or customer preferences.
- 6 The customer is advised to consult a qualified professional or technician prior to purchasing materials for specialized construction system items. Some items including but not limited to caseworks, doors and windows may require as built measurements prior to purchase to confirmation of final dimensions.
- 7 If there are additional trim elements or specific installation methods, the total amount of materials needed might vary. Consider any additional trim required for corners, intersections, or other architectural details that might cause this variations before procedding to purchase and construction.

ARCHITECTURAL BOM



	Yoke-1Bd1Ba-Contemporary									
		ARCHITECTURA	AL MATERIA							
No.	Item	Туре	Unit	Quantity	Unit Price	Total	Description			
	APPLIANCES									
	Refrigerator		PCS	1						
	Range		PCS	1						
3	Washer		PCS	1						
4	Dryer		PCS	1						
5 6	Dish Washer		PCS PCS	1 0						
	Oven Microwave		PCS	0						
	CASEWORKS		PCS							
	Kitchen Cabinet		FT	15						
	Laundry Cabinet		FT	0						
	Vanity Cabinet		FT	3.6						
	Medicine Cabinet		PCS	1						
	Kitchen countertop		SF	22.85						
	Laundry Countertop		PCS	0						
	Bathroom Countertop		SF	0						
8	Island		FT	0						
	Peninsula		FT	0						
	Closets		SF	85.38						
	CEILING	1	, ,,							
	Ceiling Board	Dry Wall	SF	548.99						
	Dry Wall Fastener	Screw	PCS	960.73						
	Vapor Retarder	Polyethylene film	SF	618.6						
	Vapor Retarder Fastener	Nails with washer heads	PCS	1855.8						
	Ceiling Board (MRD)	Moisture resistant drywall	SF	69.61						
	MRD Fastener		PCS	121.82						
	Ceiling Board	Marine Plywood	SF	0						
	Marine Plywood Fastener	Screw	PCS	0						
	Dry Wall Tape		FT	309.3						
	FLOORING		·			-				
1	Main Living Space		SF	327						
2	Bathroom		SF	72.3						
3	Bedrooms		SF	206.6						
	Porch		SF	373.3						
	STRUCTURE									
	Foundation		SF	1044.2						
	WALLS EXTERIOR									
	Exterior Wall Siding		SF	1055						
	Wall Paint		SF	1055						
	Wall Shteathing (OSB)	0.15.1333	SF	1055						
	Shteathing Fastener	Self-drilling screws(100/pkt)	PKT	10.55						
	Wall Insulation		SF	2283.4						
	Wall Homewrap	0. 1.15 1 (2221.12)	SF	1055						
	Home wrap Fastener	Stapled fastener (200/pkt)	PKT	4.009						
	Furring Strip	0.15.1311	PCS	131.9						
	Furring Strip Fastener	Self-drilling screws(100/pkt)	PKT	10.55						
	Stone Copping	Masonry stone	SF	9						
	Stone Veneer	Masonry stone	SF	88						
	WALLS INTERIOR Computitious Packer Paged		СГ	E 40						
	Cementitious Backer Board		SF SF	540						
	Kerdi membrane Fastener			540						
	Kerdi membrane Fastener Wall Ceramic Tile		SF SF	540 540						
	Drywall Board		SF	1707						
	Drywall Fastener	Self-drilling screws(100/pkt)	PKT	17.07						
	Wall Paint	Sell-utilling Screws(100/pkt)	SF	17.07						
	Drywall Tape		FT	320.6						
	Wall Skerting		FT	129						
7	I ANGUINA		FI	129						

ARCHITECTURAL BOM



	DOORS					
1	Interior Swinging	3' - 0" X 6'-8"	PCS	1		
2	Interior Swinging	2' - 8" X 6'-8"	PCS	2		
3	Interior Swinging	2' - 0" X 6'-8"	PCS	1		
4	Front Door With Sidelight	6' - 2" X 6'-8"	PCS	1		
5	Interior Sliding	7' - 3" X 6'-8"	PCS	2		
6	Interior Swinging	9' - 2" X 6'-8"	PCS	1		
7	Interior Sliding	5' - 0" X 6'-8"	PCS	1		
8	Patio Sliding	3' - 0" X 6'-8"	PCS	2		
9	Exterior Door Trim		FT	57.1		
10	Interior Door Trim		FT	339.1		
11	Entry Lock set		PCS	3		
12	Privacy Lock set		PCS	4		
13	Passage Lock set		PCS	4		
	WINDOWS					
1	Sliding	5' - 3" X 3'-3"	PCS	1		
2	Single Hung	3' - 3" X 3'-3"	PCS	1		
3	Sliding	3' - 3" X 3'-3"	PCS	2		
4	Sliding	2' - 3" X 3'-3"	PCS	1		
5	Sliding	3' - 3" X 4'-3"	PCS	1		
6	Sliding	2' - 3" X 3'-3"	PCS	2		
7	Exterior Window Trim		FT	105.6		
8	Interior Window Trim		FT	105.6		
	ROOF					
	Roof Covering		SF	676		
2	Roof Covering Fastener		PCS	338		
3	Roof Felt Paper		SF	676		
4	Roof Felt Paper Fastener		PCS	2028		
5	Roof Sheathing		SF	676		
6	Roof Sheathing Fastener		PCS	5408		
7	Batten		FT	0		
8	Batten Fastener		PCS	0		
9	Soffit		SF	0		
10	Soffit Fastener		PCS	0		
	Fascia		FT	0		
	Fascia board fastener		PCS	0		
13	Roof Insulation		SF	676		



		Yoke	-1Bd1Ba-Co	ontempora	ary		
		ELECTRICAL N	MATERIAL S	HOPPING	G LIST		
No.	Item	Туре	Unit	Quantity		Total	Description
Δ	LIGHTING FIXTURES	<u>'</u>	· ·				
1	Kitchen Ceiling Light		PCS	5			
2	Exterior Wall Mounted Light		PCS	6			
3	Livingroom Ceiling Light With Fan		PCS	1			
4	Bedroom Ceiling Light With Fan		PCS	1			
5	Dining Ceiling Light		PCS	1			
6	Bath Wall Mounted Light		PCS	1			
7	Bathroom Ceiling Light		PCS	2			
8	Livingroom Ceiling Light		PCS	3			
9	BedRoom Ceiling Light		PCS	4			
10	Hall & Entry Ceiling Light		PCS	2			
11	Smoke Detector		PCS	2			
Δ	ELECTRICAL FITTINGS	<u>'</u>	· · · · · · · · · · · · · · · · · · ·			'	
12	Standard Receptacle 120V	20 A	PCS	9			
13	GFCI Receptacle 120V	20 A	PCS	10			
14	GFCI Receptacle 240V	30 A	PCS	3			
15	GFCI Receptacle 240V	40 A	PCS	0			
16	GFCI Receptacle 240V	50 A	PCS	1			
17	GFCI Receptacle 240V	60 A	PCS	1			
18	Fan Switch		PCS	3			
19	Single Pole Switch		PCS	12			
20	Three Way Switch		PCS	2			
21	Dimmer Switch		PCS	1			
	ELECTRICAL CONDUITS & WIRING		1				
22	ROMEX 14 AWG	14/2 w/ground	FT	0			
23	ROMEX 12 AWG	12/2 w/ground	FT	441			
	ROMEX 12 AWG	12/3 w/ground	FT	0			
25	ROMEX 10 AWG	10/3 w/ground	FT	81			
26	ROMEX 8 AWG	8/3 w/ground	FT	27			
27	ROMEX 6 AWG	6/3 w/ground	FT	31			
	ELECTRICAL BOXES & CIRCUTES						
28	Panelboard -240V 1 Phase MLO	200 AMP	PCS	1			
29	Circuit breaker	15 A	PCS	0			
30	Circuit breaker	20 A	PCS	11			
31	Circuit breaker	30 A	PCS	3			
34	Circuit breaker	40 A	PCS	0			
32	Circuit breaker	50 A	PCS	1			
33	Circuit breaker	60 A	PCS	1			
34	Single Gang Switch Box	5571	PCS	2			
35	Double Gang Switch Box		PCS	3			
36	Triple Gang Switch Box		PCS	3			
37	Pull Box	#1/4	PCS	24			
	Receptacle Box	II T	PCS	24			

PLUMBING BOM



Yoke-1Bd1Ba-Contemporary

		Yoke-1Bd	1Ba-Co	ntempor	ary		
	PL	UMBING SYSTEM MA	ATERIA	L SHOPE	PING LIST	-	
No.	Item	Туре	Unit	Quantity	Unit Price	Total	Description
\triangle	PLUMBING FIXTURES & ACCESSORIES						
1	Bath Tub (Alcove Tub)		PCS	0			
2	Kitchen Sink		PCS	1			
3	Kitchen Faucets		PCS	1			
4	Vanity Sink		PCS	1			
5	Bath room Faucets		PCS	1			
6	Water Closet		PCS	1			
7	Shower Trim		PCS	1			
8	Shower Tray		PCS	1			
9	Water Heater		PCS	1			
10	Hose Bib		PCS	1			
11	Shutoff Valve		PCS	8			
	Hanging pipe clamp		PCS	19			
	Gate Valve		PCS	1			
	Dishwasher Supply Single Connector		PCS	1			
	Dishwasher Sewage Single Connector		PCS	1			
	Laundry Sweat Connector		PCS	1			
	SANITARY & PLUMBING PIPES		1 . 00				
	ABS (Acrylonitrile Butadiene Styrene) Pipes	ø 1"	FT	0			
	ABS (Acrylonitrile Butadiene Styrene) Pipes	ø 1 1/2"	FT	7			
	ABS (Acrylonitrile Butadiene Styrene) Pipes	ø 2"	FT	31			
	ABS (Acrylonitrile Butadiene Styrene) Pipes	ø 3"	FT	23			
5	PEX (Cross-linked polyethylene) Pipes	ø 1/2"	FT	60			
	PEX (Cross-linked polyethylene) Pipes	ø 3/4"	FT	65			
	PEX (Cross-linked polyethylene) Pipes	ø 1"	FT	1			
	PVC Pipes Sch.80 - Rigid	ø 1 1/2"	FT	0			
9	PVC Pipes Sch.80 - Rigid	Ø 2"	FT	38			
	PVC Pipes Sch.80 - Rigid	ø 3"	FT	0			
	Flex Pipe Round	ø 1/2"	PCS	6			
	PIPE FITTINGS	10 17Z	103	U			
	ABS 90 Degree Bend Elbow	1 1/2"ø-1 1/2"ø	PCS	2			
	ABS 90 Degree Bend Elbow	2"ø-2"ø	PCS	10			
	ABS 90 Degree Bend Elbow	3"ø-3"ø	PCS	2			
	ABS P-Trap	1 1/2"ø-1 1/2"ø	PCS	3			
	ABS P-Trap	2"ø-2"ø	PCS	2			
	ABS Reducer Elbow	2 'Ø-2 'Ø 2 'Ø-1 1/2 'Ø	PCS	1			
7	ABS Reducer Elbow ABS TEE Elbow	3"ø-2"ø 2"ø-2"ø-2"ø	PCS PCS	2			
9	ABS TEE Elbow	3"ø-3"ø-3"ø	PCS	1			
	ABS Tee Reducer Elbow	3"ø-3"ø-1 1/2"ø	PCS	2			
	ABS Vent Cap Elbow	2"ø	PCS	2			
	ABS Vent Cap Elbow	3"ø	PCS	1			
	PEX 90 Degree Elbow	1/2"ø-1/2"ø	PCS	22			
	PEX 90 Degree Elbow	3/4"ø-3/4"ø	PCS	8			
	PEX Cross Elbow	3/4"ø-3/4"ø-3/4"ø	PCS	2			
	PEX Tee Elbow	3/4"ø-3/4"ø-3/4"ø	PCS	7			
		1"ø-3/4"ø	PCS	2			
	PEX Transition Elbow	3/4"ø-1/2"ø	PCS	11			
	PVC 90 Deg Bend Elbow	2"ø-2"ø	PCS	4			
	WASTE DOUBLE TEE	2"ø-2"ø-2"ø	PCS	1			
21	WASTE DOUBLE TEE	3"ø-3"ø-3"ø-3"ø	PCS	1			



		Yoke-1B	d1Ba-C	ontempo	orary		
		HVAC SYSTEM MAT	ERIAL	SHOPPI	NG LIST		
No.	Item	Туре	Unit	Quantity	Unit Price	Total	Description
	HVAC_DUCTS						
1	PIPE (REFRIGERANT LINE)	1/4" Ø	FT	9.75			
2	PIPE (REFRIGERANT LINE)	3/8" Ø	FT	59.62			
3	PIPE (REFRIGERANT LINE)	1/2" Ø	FT	9.91			
4	PIPE (REFRIGERANT LINE)	3/4" Ø	FT	71.9			
5	DRAYER HOSE	5" Ø	FT	4			
6	FLEX DUCT ROUND	4"	FT	6.79			
	DUCT FITTINGS & ACCESSORIES						
7	ELBOW (REFRIGERANT LINE)	1/2" (Ø)-1/2" (Ø)	PCS	2			
8	ELBOW (REFRIGERANT LINE)	1/4" (Ø)-1/4" (Ø)	PCS	2			
9	ELBOW (REFRIGERANT LINE)	3/4" (Ø)-3/4" (Ø)	PCS	14			
10	ELBOW (REFRIGERANT LINE)	3/8" (Ø)-3/8" (Ø)	PCS	8			
11	TRANSITION (REFRIGERANT	3/4" (Ø)-1/2" (Ø)	PCS	4			
12	TRANSITION (REFRIGERANT	3/4" (Ø)-3/8" (Ø)	PCS	2			
13	TRANSITION (REFRIGERANT	3/8" (Ø)-1/4" (Ø)	PCS	1			
14	TEE (REFRIGERANT LINE)	3/4" (Ø)-3/4" (Ø)-3/4" (Ø)	PCS	1			
15	TEE (REFRIGERANT LINE)	3/8" (Ø)-3/8" (Ø)-3/8" (Ø)	PCS	1			
16	ROUND TRANSITION(ANGLE)	45 DEGREE	PCS	3			
	HVAC_EQUIPMENTS						
17	AIR HANDLING UNIT	WALL MOUNTED	PCS	2			
18	CONDENSER	OUTDOOR UNIT	PCS	1			
19	EXHAUST FAN	75 CFM	PCS	1			
20	EXHAUST HOOD	WALL MOUNTED	PCS	1			
21	HOOD-WALL: VENT	HOOD-WALL: VENT	PCS	1			
22	DRAYER: VENT	DRAYER: VENT	PCS	1			
23	ROOF VENT	3"(Ø)	PCS	1			



Table Of Content

#	Name	Link	Page No
1	Cover Page	<u>Cover Page</u>	1
2	TOC	TOC	2
3	ELECTRICAL BOM	ELECTRICAL BOM	3
5	HVAC BOM	HVAC BOM	7
4	PLUMBING BOM	PLUMBING BOM	10
6	ARCHITECTURAL BOM	ARCHITECTURAL BOM_	15

Have It Your Way!

The material types listed in this document were selected based on personal preferences. The Customer is encouraged to make changes to the material types in accordance with local customs, regulations, and personal preferences. Have It Your Way!

GENERAL NOTES

- This BOM (Bill of Materials) is prepared as a Materials Shopping List to help builders and DIYers gain a complete understanding of most if not all elements required for the complete construction of this structure, according to the original design documents provided by FrameUpNow.
- ² All quantities and specifications are subject to change based on the final design, field measurements, availability of products and customer preferences. The customer should verify all information prior to purchasing materials.
- 3 All products and elements in the list shall conform to the International Residential Code (IRC), or any other local and international building codes, safety regulations, and standards that are applicable to the location of the structure.
- 4 If any changes are made by the customer to the list of materials specified in this document, the customer is responsible for assuring that the correct type and quantity of materials are utilized in accordance with local building codes.
- FrameUpNow, will not be held responsible for any misuse of this document, the products listed, or for deviations from the content that are made due to changes in specifications, pricing, availability, or customer preferences.
- The customer is advised to consult a qualified professional or technician prior to purchasing materials for specialized construction system items. Some items including but not limited to caseworks, doors and windows may require as built measurements prior to purchase to confirmation of final dimensions.
- 7 If there are additional trim elements or specific installation methods, the total amount of materials needed might vary. Consider any additional trim required for corners, intersections, or other architectural details that might cause this variations before procedding to purchase and construction.



			LIGHTING FIXTURES				
#		Туре	Description, Manufacturer, SKU	Unit	Quantity	Unit Price	Total
1	Kitchen Ceiling Light			PCS	5		
2	Exterior Wall Mounted Light			PCS	6		
}	Livingroom Ceiling Light With Fan			PCS	1		
1	Bedroom Ceiling Light With Fan			PCS	1		
5	Dining Ceiling Light			PCS	1		
6	Bath Wall Mounted Light			PCS	1		
7	Bathroom Ceiling Light			PCS	2		
8	Livingroom Ceiling Light			PCS	3		
)	Bed Ceiling Light			PCS	4		
0	Hall & Entry Ceiling Light			PCS	2		
l1	Smoke Detector			PCS	2		
12							
13							
14							
15							



			ELECTRICAL FITTINGS				
#	Item	Туре	Description, Manufacturer, SKU	Unit	Quantity	Unit Price	Total
1	Standard Receptacle 120V	20 A		PCS	9		
2	GFCI Receptacle 120V	20 A		PCS	10		
3	GFCI Receptacle 240V	30 A		PCS	3		
4	GFCI Receptacle 240V	40 A		PCS	0		
5	GFCI Receptacle 240V	50 A		PCS	1		
6	GFCI Receptacle 240V	60 A		PCS	1		
7	Fan Switch			PCS	3		
8	Single Pole Switch			PCS	12		
9	Three Way Switch			PCS	2		
10	Dimmer Switch			PCS	1		
11							
12							
13							
14							
15							



			ELECTRICAL CONDUITS & WIRING				
#	Item	Туре	Description, Manufacturer, SKU	Unit	Quantity	Unit Price	Total
1	ROMEX 14 AWG	14/2 w/ground		FT	0		
2	ROMEX 12 AWG	12/2 w/ground		FT	441		
3	ROMEX 12 AWG	12/3 w/ground		FT	0		
1	ROMEX 10 AWG	10/3 w/ground		FT	81		
5	ROMEX 8 AWG	8/3 w/ground		FT	27		
5	ROMEX 6 AWG	6/3 w/ground		FT	31		
7	Bare Copper Ground Wire 6 AWG						
3							
)							
.0							
11							
L2							
13							
14							
L5							



			ELECTRICAL BOXES & CIRCUTES				
#	Item	Туре	Description, Manufacturer, SKU	Unit	Quantity	Unit Price	Total
1	Panelboard -240V 1 Phase MLO	200 AMP		PCS	1		
2	Circuit breaker	15 A		PCS	0		
3	Circuit breaker	20 A		PCS	11		
4	Circuit breaker	30 A		PCS	3		
5	Circuit breaker	40 A		PCS	0		
6	Circuit breaker	50 A		PCS	1		
7	Circuit breaker	60 A		PCS	1		
8	Single Gang Switch Box			PCS	2		
9	Double Gang Switch Box			PCS	3		
10	Triple Gang Switch Box			PCS	3		
11	Pull Box	#1/4		PCS	24		
12	Receptacle Box			PCS	24		
13							
14							
15							



			HVAC_DUCTS 01				
#	Item	Туре	Description, Manufacturer, SKU	Unit	Quantity	Unit Price	Total
1	PIPE (REFRIGERANT LINE)	1/4" (Ø)		FT	9.75		
2	PIPE (REFRIGERANT LINE)	3/8" (Ø)		FT	59.62		
3	PIPE (REFRIGERANT LINE)	1/2" (Ø)		FT	9.91		
4	PIPE (REFRIGERANT LINE)	3/4" (Ø)		FT	71.9		
5	DRAYER HOSE	4" (Ø)		FT	4		
6	FLEX DUCT ROUND	4" (Ø)		FT	6.79		
7							
8							
9							
10							
11							
12							
13							
14							
15							



		D	UCT FITTINGS & ACCESSORIES				
:	Item	Туре	Description, Manufacturer, SKU	Unit	Quantity	Unit Price	Total
1	ELBOW (REFRIGERANT LINE)	1/2" (Ø)-1/2" (Ø)		PCS	2		
2	ELBOW (REFRIGERANT LINE)	1/4" (Ø)-1/4" (Ø)		PCS	2		
1	ELBOW (REFRIGERANT LINE)	3/4" (Ø)-3/4" (Ø)		PCS	14		
1	ELBOW (REFRIGERANT LINE)	3/8" (Ø)-3/8" (Ø)		PCS	8		
5	TRANSITION (REFRIGERANT LINE)	3/4" (Ø)-1/2" (Ø)		PCS	4		
6	TRANSITION (REFRIGERANT LINE)	3/4" (Ø)-3/8" (Ø)		PCS	2		
7	TRANSITION (REFRIGERANT LINE)	3/8" (Ø)-1/4" (Ø)		PCS	1		
3	TEE (REFRIGERANT LINE)	3/4" (Ø)-3/4" (Ø)-3/4" (Ø)		PCS	1		
)	TEE (REFRIGERANT LINE)	3/8" (Ø)-3/8" (Ø)-3/8" (Ø)		PCS	1		
10	ROUND TRANSITION(ANGLE)	45 DEGREE		PCS	3		
11							
12							
L3							
L4							
15							



			HVAC_EQUIPMENTS				
#	Item	Туре	Description, Manufacturer, SKU	Unit	Quantity	Unit Price	Total
1	AIR HANDLING UNIT	WALL MOUNTED		PCS		2	
2	CONDENSER	OUTDOOR UNIT		PCS		1	
3	EXHAUST FAN	75 CFM		PCS		1	
4	EXHAUST HOOD	WALL MOUNTED		PCS		1	
5	HOOD-WALL: VENT	HOOD-WALL: VENT		PCS		1	
6	DRAYER: VENT	DRAYER: VENT		PCS		1	
7	ROOF VENT	3"(Ø)		PCS		1	
8							
9							
10							
11							
12							
13							
14							
15							



	PLUMBING FIXTURES & ACCESSORIES								
#	Item	Туре	Description, Manufacturer, SKU	Unit	Quantity	Unit Price	Total		
1	Bath Tub (Alcove Tub)			PCS	0				
)	Kitchen Sink			PCS	1				
3	Kitchen faucets			PCS	1				
1	Vanity Sink			PCS	1				
5	Bath room faucets			PCS	1				
6	Water Closet			PCS	1				
7	Shower Trim			PCS	1				
3	Shower Tray			PCS	1				
9	Water Heater			PCS	1				
10	Hose Bib			PCS	1				
11	Shutoff Valve			PCS	8				
12	Hanging pipe clamp			PCS	8				
13	Gate Valve			PCS	1				
14	Dishwasher Supply Single Connector			PCS	1				
15	Dishwasher Sewage Single Connector			PCS	1				
16	Laundry Sweat Connector			PCS	1				



\wedge		SAN	IITARY & PLUMBING PIPES				
#	ltem	Туре	Description, Manufacturer, SKU	Unit	Quantity	Unit Price	Total
1	ABS (Acrylonitrile Butadiene Styrene) Pipes	ø 1"		FT	0		
2	ABS (Acrylonitrile Butadiene Styrene) Pipes	ø 1 1/2"		FT	7		
3	ABS (Acrylonitrile Butadiene Styrene) Pipes	ø 2"		FT	31		
4	ABS (Acrylonitrile Butadiene Styrene) Pipes	ø 3"		FT	23		
5	PEX (Cross-linked polyethylene) Pipes	ø 1/2"		FT	60		
6	PEX (Cross-linked polyethylene) Pipes	ø 3/4"		FT	65		
7	PEX (Cross-linked polyethylene) Pipes	ø 1"		FT	1		
8	PVC Pipes Sch.80 - Rigid	ø 1 1/2"		FT	0		
9	PVC Pipes Sch.80 - Rigid	ø 2"		FT	38		
10	PVC Pipes Sch.80 - Rigid	ø 3"		FT	0		
11	Flex Pipe Round	ø 1/2"		PCS	6		
12							
13							
14							
15							



		PIPI	E FITTINGS 01				
#	Item	Туре	Description, Manufacturer, SKU	Unit	Quantity	Unit Price	Total
1	ABS 90 Degree Bend Elbow	1 1/2"ø-1 1/2"ø		PCS	2		
2	ABS 90 Degree Bend Elbow	2"ø-2"ø		PCS	10		
3	ABS 90 Degree Bend Elbow	3"Ø-3"Ø		PCS	2		
4	ABS P-Trap	1 1/2"ø-1 1/2"ø		PCS	3		
5	ABS P-Trap	2"Ø-2"Ø		PCS	2		
6	ABS Reducer Elbow	2"ø-1 1/2"ø		PCS	1		
7	ABS Reducer Elbow	3"Ø-2"Ø		PCS	2		
8	ABS TEE Elbow	2"ø-2"ø-2"ø		PCS	1		
9	ABS TEE Elbow	3"ø-3"ø-3"ø		PCS	1		
10	ABS Tee Reducer Elbow	3"ø-3"ø-1 1/2"ø		PCS	2		
11	ABS Vent Cap Elbow	2"Ø		PCS	2		
12	ABS Vent Cap Elbow	3"Ø		PCS	1		
13	PEX 90 Degree Elbow	1/2"ø-1/2"ø		PCS	22		
14	PEX 90 Degree Elbow	3/4"ø-3/4"ø		PCS	8		
15	PEX Cross Elbow	3/4"ø-3/4"ø-3/4"ø-3/4"ø		PCS	2		



\triangle		PI	PE FITTINGS 02				
#	Item	Туре	Description, Manufacturer, SKU	Unit	Quantity	Unit Price	Total
1	PEX Tee Elbow	3/4"ø-3/4"ø-3/4"ø		PCS	7		
2	PEX Transition Elbow	1"ø-3/4"ø		PCS	2		
3	PEX Transition Elbow	3/4"ø-1/2"ø		PCS	11		
4	PVC 90 Deg Bend Elbow	2"ø-2"ø		PCS	4		
5	WASTE DOUBLE TEE	2"Ø-2"Ø-2"Ø		PCS	1		
6	WASTE DOUBLE TEE	3"Ø-3"Ø-3"Ø-3"Ø		PCS	1		
7							
8							
9							
10							
11							
12							
13							
14							
15							



			APPLIANCES			
#	Item	Туре	Description, Manufacturer, SKU	Unit	Quantity Unit Price	Total
1	Refrigerator			PCS	1	
2	Range			PCS	1	
3	Washer Front Load	Stackable		PCS	1	
4	Dryer Front Load	Stackable		PCS	1	
5	Dish Washer			PCS	1	
6	Oven			PCS	0	
7	Microwave			PCS	0	
8						
9						
10						
11						
12						
13						
14						
15						



			CASEWORKS 01				
#	Item	Туре	Description, Manufacturer, SKU	Unit	Quantity	Unit Price	Total
1	Kitchen Cabinet			FT	15		
2	Laundry Cabinet			FT	0		
3	Vanity Cabinet			FT	3.6		
4	Medicine Cabinet			PCS	1		
5	Kitchen countertop			SF	22.85		
6	Laundry Countertop			PCS	0		
7	Bathroom Countertop			SF	0		
8	Island			FT	0		
9	Peninsula			FT	0		
10	Closets			SF	85.38		
11							
12							
13							
14							
15							



			CEILING 01				
#	Item	Туре	Description, Manufacturer, SKU	Unit	Quantity	Unit Price	Total
	LIVINGROOM + KITCHEN			SF	273.8		
1	Ceiling Board	Drywall		SF	274		
2	Drywall Fastener	Screw		PCS	479		
3	Vapor Retarder	Polyethylene film		SF	274		
4	Vapor Retarder Fastener	Nails with washer heads		PCS	821		
	BATHROOM			SF	69.6		
5	Ceiling Board	MRD (Moisture resistant drywall)		SF	70		
6	MRD Fastener	Screw		PCS	122		
	HALL			SF	41.0		
7	Ceiling Board	Drywall		SF	41		
8	Drywall Fastener	Screw		PCS	72		
9	Vapor Retarder	Polyethylene film		SF	41		
10	Vapor Retarder Fastener	Nails with washer heads		PCS	123		



			CEILING 02			
#	Item	Туре	Description, Manufacturer, SKU	Unit	Quantity Unit Price	Total
	CLOSET 1			SF	21.1	
13	Ceiling Board	Drywall		SF	21	
14	Drywall Fastener	Screw		PCS	37	
15	Vapor Retarder	Polyethylene film		SF	21	
16	Vapor Retarder Fastener	Nails with washer heads		PCS	63	
	CLOSET 2			SF	12.4	
17	Ceiling Board	Drywall		SF	12	
18	Drywall Fastener	Screw		PCS	22	
19	Vapor Retarder	Polyethylene film		SF	12	
20	Vapor Retarder Fastener	Nails with washer heads		PCS	37	
	WH			SF	7.8	
21	Ceiling Board	Drywall		SF	8	
22	Drywall Fastener	Screw		PCS	14	
23	Vapor Retarder	Polyethylene film		SF	8	
24	Vapor Retarder Fastener	Nails with washer heads		PCS	23	



			CEILING 03				
#	Item	Туре	Description, Manufacturer, SKU	Unit	Quantity	Unit Price	Total
	BEDROOM+W/D			SF	193.0		
25	Ceiling Board	Drywall		SF	193		
26	Drywall Fastener	Screw		PCS	338		
27	Vapor Retarder	Polyethylene film		SF	193		
28	Vapor Retarder Fastener	Nails with washer heads		PCS	579		



			FLOORING INTERIOR 01	I		
#	Item	Туре	Description, Manufacturer, SKU	Unit	quantity Unit Price	Total
	BEDROOM					
1	Bedroom Flooring			SF	185.6	
2	Wood underlay	Foam Pad Polyethylene		SF	185.6	
3	Vapor Retarder	Vapor Barrier Polyethylene		SF	185.6	
	CL #1					
7	Closet Flooring			SF	21	
8	Wood underlay	Foam Pad Polyethylene		SF	21	
9	Vapor Retarder	Vapor Barrier Polyethylene		SF	21	
	CL#2					
10	Closet Flooring			SF	12.4	
11	Wood underlay	Foam Pad Polyethylene		SF	12.4	
12	Vapor Retarder	Vapor Barrier Polyethylene		SF	12.4	
	LIVING ROOM AND KITCI	HEN				
4	Living Area Flooring			SF	314.6	
5	Wood underlay	Foam Pad Polyethylene		SF	314.6	
6	Vapor Retarder	Vapor Barrier Polyethylene		SF	314.6	



			FLOORING INTERIOR 02	2			
#	Item	Туре	Description, Manufacturer, SKU	Unit	quantity U	nit Price	Total
	BATHROOM						
7	Tile Finish			SF	56.3		
8	Adhesive	1/2" Thin set Mortar		SF	56.3		
9	Vapor Retarder	Vapor Barrier Polyethylene		SF	56.3		
	W/D						
10	Tile Finish			SF	7.2		
11	Adhesive	1/2" Thin set Mortar		SF	7.2		
12	Vapor Retarder	Vapor Barrier Polyethylene		SF	7.2		
	BOILER ROOM						
1	Tile Finish			SF	7.8		
2	Adhesive	1/2" Thin set Mortar		SF	7.8		
3	Vapor Retarder	Vapor Barrier Polyethylene		SF	7.8		



		FLOORING EXTERIOR			
Item	Туре	Description, Manufacturer, SKU	Unit	quantity Unit Price	Total
STRUCTURE			SF	1044.2	
Concrete Slab	4"concrete cast in situ		CF	358.4	
Insulation	Rigid insulation		SF	288	
Hard core	Compacted soil		CF	262.2	
Re-bar	#4 re-bar		Ton	0.97	
Concrete Pad	4"concrete cast in situ		CF	1.58	
Slab edge	Turndown		CF	253.17	
PORCH FRONT					
Tile Finish			SF	136	
Adhesive	1/2" Thin set Mortar		SF	136	
Vapor Retarder	Vapor Barrier Polyethylene		SF	136	
PORCH SIDE					
Tile Finish			SF	237.3	
Adhesive	1/2" Thin set Mortar		SF	237.3	
Vapor Retarder	Vapor Barrier Polyethylene		SF	237.3	



WALLS: EXTERIOR							
Item	Туре	Description, Manufacturer, SKU	Unit	quantity Ur	nit Price	Total	
Stocco Finish			SF	1347			
Wall Homewrap							
Homewrap Fastener	Stapled fastener (200/pkt)		SF	1347			
Wall Shteathing (OSB)			PKT	5.1186			
	(400/11)		SF	1347			
Shteathing Fastener	Self-drilling screws(100/pkt)		PKT	13.47			
Stone Copping			SF	162.0			
Mortar for Stone Veneer			SF	162.0			
Wall Paint							
Wall Insulation			SF	1347			
			SF	1906			



			WALLS: INTERIOR 01			
#	Item	Type Descri	otion, Manufacturer, SKU	Unit	quantity Unit Price	Total
	BATHROOM			SF	67	
1	Cementitious Backer Board			SF	236	
2	Kerdi membrane			SF	236	
3	Kerdi membrane Fastener			SF	236	
4	Wall Ceramic Tile			SF	236	
	BEDROOM			SF	185	
5	Drywall Board			SF	277	
6	Drywall Fastener	Self-drilling screws(100/pkt)		PKT	2.77	
7	Wall Paint			SF	277	
8	Drywall Tape			FT	51.9407463	
	HALL			SF	42	
9	Drywall Board			SF	67	
10	Drywall Fastener	Self-drilling screws(100/pkt)		PKT	0.67	
11	Wall Paint			SF	67	
12	Drywall Tape			FT	12.56328521	



	WALLS: INTERIOR 02							
ŧ	Item	Туре	Description, Manufacturer, SKU	Unit	quantity	Init Price	Total	
	LIVING ROOM			SF	199			
3	Drywall Board			SF	284			
4	Drywall Fastener	Self-drilling screws(100/pkt)		PKT	2.84			
5	Wall Paint			SF	284			
6	Drywall Tape			FT	53.2			
	KITCHEN			SF	73			
7	Cementitious Backer Board			SF	23			
8	Drywall Board			SF	129			
9	Drywall Fastener	Self-drilling screws(100/pkt)		PKT	1.29			
0	Kerdi membrane			SF	23			
1	Kerdi membrane Fastener			SF	23			
2	Wall Ceramic Tile			SF	23			
3	Wall Paint			SF	129			
4	Drywall Tape			FT	24.3			



WALLS: INTERIOR 03						
#	Item	Туре	Description, Manufacturer, SKU	Unit	Quantity Unit Price	Total
	CLOSET 1			SF	24	
25	Drywall Board			SF	124	
26	Drywall Fastener	Self-drilling screws(100/pkt)		PKT	1.24	
27	Wall Paint			SF	124	
28	Drywall Tape			FT	23.2	
	CLOSET 2			SF	12	
29	Drywall Board			SF	93	
30	Drywall Fastener	Self-drilling screws(100/pkt)		PKT	0.93	
31	Wall Paint			SF	93	
32	Drywall Tape			FT	17.4	



			WALLS: INTERIOR 04				
#	Item	Туре	Description, Manufacturer, SKU	Unit	Quantity	Unit Price	Total
	WD			SF			
37	Cementitious Backer Board			SF	61		
38	Kerdi membrane			SF	61		
39	Kerdi membrane Fastener			SF	61		
40	Wall Ceramic Tile			SF	61		
	WH			SF	8		
41	Drywall Board			SF	70		
42	Drywall Fastener	Self-drilling screws(100/pkt)		PKT	0.7		
43	Wall Paint			SF	70		
44	Drywall Tape			FT	13.20754717		
p	Wall Skirting	Ceramic		FT	82		



			DOORS				
:	Item	Туре	Description, Manufacturer, SKU	Unit	Quantity	Unit Price	Total
	Interior Swinging	3' - 0" X 6'-8"		PCS	2		
	Exterior Swinging	3' - 0" X 6'-8"		PCS	1		
	Patio Sliding	5' - 0" X 6'-8"		PCS	2		
	Interior Sliding	9' - 2" X 6'-8"		PCS	1		
	Interior Sliding	3' - 6" X 6'-8"		PCS	1		
	Interior Swinging	2' - 0" X 6'-8"		PCS	1		
	Exterior Door Trim			FT	53.7		
	Interior Door Trim			FT	227.62		
	Entry Lock set			PCS	3		
0	Privacy Lock set			PCS	2		
1	Passage Lock set			PCS	3		



			WINDOWS			
#	Item	Туре	Description, Manufacturer, SKU	Unit	Quantity Unit Price	ce Total
1	Sliding	3' - 3" X 3'-3"		PCS	2	
2	Casment	2' - 3" X 4'-3"		PCS	2	
3	Sliding	2' - 9" X 1'-9"		PCS	1	
4	Sliding	6' - 3" X 4'-3"		PCS	1	
5	Fixed	1' - 9" X 1'-9"		PCS	5	
6	Exterior Window Trim			FT	119.2	
7	Interior Window Trim			FT	119.2	



			ROOF 01			
#	Item	Туре	Description, Manufacturer, SKU	Unit	Quantity Unit Price	Total
1	Roof Covering			SF	676.0	
2	Roof Covering Fastener			PCS	338	
3	Roof Felt Paper			SF	676.0	
4	Roof Felt Paper Fastener			PCS	2028.0	
5	Roof Sheathing			SF	676.0	
5	Roof Sheathing Fastener			PCS	5408	
7	Batten			FT	0.0	
3	Batten Fastener			PCS	0.0	
9	Soffit			SF	0.0	
10	Soffit Fastener			PCS	0.0	
11	Fascia			FT	0.0	
12	Fascia board fastener			PCS	0	
13	Roof Insulation			SF	676.0	
14						
15						