

YOKE

The Yoke is a contemporary 3 bedroom 2 bathroom home with a sleek and minimalist aesthetic. The exterior features a flat roof with simple parapet walls, creating a clean and modern silhouette. The white stucco finish adds a touch of sophistication, while the wooden pergola and vertical grills provide visual interest and create a sense of warmth. Inside, a simple L-shape layout of the plan seamlessly integrates the living and kitchen areas. And a private sleeping quarters on both ends of the home, maximizing space and sense of openness while maintaining privacy. This home offers a perfect blend of style and functionality for those seeking a compact and cozy living space.

Materials Shopping List

Please print and take this Materials Shopping List to your favorite Home Depot and ask for assistance in selecting the materials, fixtures and fittings to complete your new home.

Record your selection and the price of the item. Then do the math to determine the cost for your selections and the total cost of finishing your home.

< CLICK HERE >

To Go To Materials Shopping List



29' - 7" BEDROOM 1 140 SF BEDROOM 2 137 SF PORCH 421 SF LIVING ROOM BEDROOM 3


FLOOR PLAN

999 SF

3 Bed Rooms



TABLE OF CONTENTS

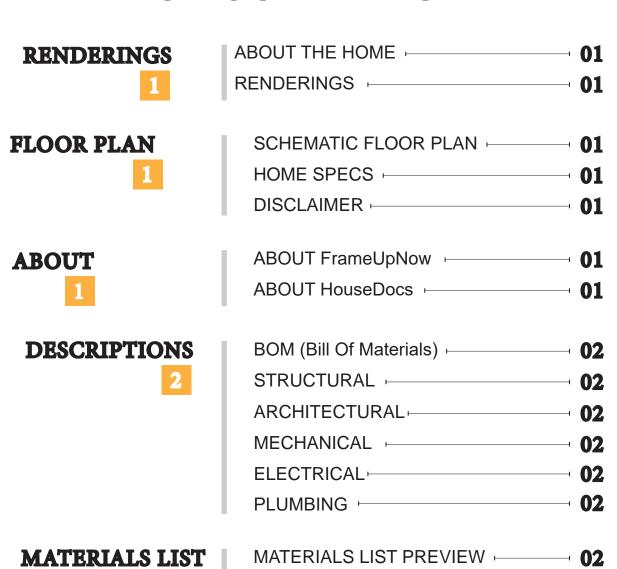

HOW TO BUILD

CONSTRUCTION STEPS

ARCHITECTURAL

COVER SHEET 03 FLOOR PLAN + DIMENSION PLAN + FOUNDATION PLAN STRUCTURAL FLOOR PLAN -WALL FRAME LAYOUT ROOF TRUSS LAYOUT ROOF PLAN + ARCHITECTURAL ELEVATIONS -ARCHITECTURAL ELEVATIONS -ARCHITECTURAL SECTIONS -ARCHITECTURAL DETAILS ARCHITECTURAL CASEWORK **COVER SHEET**

STRUCTURAL

MATERIALS

SHOPPING LIST

	WALL FRAME LAYOUT ⊢	− 1 8
	WALL PANEL & LAYOUT PLAN	⊣ 1 9
	ROOF TRUSS LAYOUT	⊣ 2 (
	STRUCTURAL SECTIONS	⊸ 2 1
	WALL BRACING LAYOUT	− 2 2
	HOLD-DOWN PLAN	⊸ 2 3
	STRUCTURAL DETAILS 1	⊸ 2 4
	STRUCTURAL DETAILS 2	⊣ 2 !
	STRUCTURAL DETAILS 3	⊣ 2 (
	TRUSS BLOCKING LAYOUT	→ 2 7
	SHEETROCK BACKING	⊣ 2 8
	ROOF BRACING LAYOUT	− 29
MECHANICAL	COVER SHEET -	⊣ 3 (
30	HVAC PLAN -	
ELECTRICAL	SCHEDULE -	⊣ 3 2
32	LIGHTING -	
	POWER PLAN -	
	DIMENSION FOR LIGHTING	_
	DIMENSION FOR FITTING -	
PLUMBING	NOTES AND SCHEDULES	⊸ 3 ′
27	WATER SUPPLY & SEWAGE SYSTEM	
37		

MATERIALS SHOPPING LIST

GENERAL NOTES

ABOUT



FrameUpNow is a design and manufacturing company providing precision-engineered home framing solutions. We offer a catalog of Affordable Homes, Tiny Homes, Garages, Shops and Barndominiums. FrameUpNow manufactures cold-formed steel (CFS) also known as Light Gauge Steel (LGS) framing components that conform to our engineered metal house frame plans or can be purchased as DIY skeleton kits.

The CFS/LGS framing is lightweight, easily assembled, and does not require heavy equipment or specialized labor, enabling homeowners to erect the frame themselves in just a few days. Unlike wood, the steel framing is impervious termites and bores, warping, expansion, and fire.

Our home plans come complete with a structural engineered stamp for permit approvals. Customers receive a full BOM also known as a Materials Shopping List to purchase finish materials from a Building Materials retailer. FrameUpNow prides itself on the quality and efficiency of our precision-engineered home framing solutions for construction professionals and DIY homeowners.



KEY PLAN

NO.	DESCRIPTION	DAIL

NOTE:

LEGEND:

PROJECT

40-Yoke-999-3Bd2Ba-**Contemporary-550**

DRAWING NAME

INTRODUCTION

CLIENT NAME:
PROJECT NUMBER:
DATE:
DESIGNED BY:
DRAWN BY:
CHECKED BY:

1101

SCALE:

© [2024] [FrameUpNow] . All rights reserved

DISCLAIMER: This documentation and all it's contents are the intellectual property of FrameUpNow. It is provided solely for marketing the services of FrameUpNow. The preliminary information is not approved for actual construction use and is not warranted to be complete or accurate. Unauthorized copying, distribution, or application of these proprietary materials, in any form or format, is strictly prohibited. FrameUpNow assumes no liability for any issues arising from improper use of this marketing content.

DISCLAIMER

DESCRIPTIONS

MATERIALS LIST

The BOM (Bill Of Materials) package, known as the Materials Shopping List document, provides:

Comprehensive Inventory: Detailed lists of essential materials sourced from architectural, mechanical, HVAC, electrical, and plumbing design drawing sets.

Precise Curation: Each item meticulously selected and organized for accuracy and efficiency in project planning.

Customizable Options: Customers can modify listed items to their preferences and calculate costs accordingly, ensuring alignment with personal project needs and budget.

Dedicated Space for Details: Includes tables for customers to note Home Depot SKU numbers or product descriptions for selected items,

facilitating seamless purchasing and coordination with suppliers.

Customer Convenience: Take the list to Home Depot or preferred suppliers for accurate pricing, helping align the total home budget with personal financial plans.

Simplify your construction journey with our Materials Shopping List document, where detailed preparation meets streamlined implementation for your dream home.

STRUCTURAL

The structural drawings package provides an exhaustive set of detailed plans essential for the precise assembly of your building. This comprehensive package includes:

Framing Plans: Detailed layouts for all framing components. Truss Layouts: Clear instructions for truss placement and

Panel Length Plans: Specifications for panel dimensions. Framing Elevations and Sections: Precise elevation and sectional views for accurate construction.

Truss and Wall Blocking Plans: Plans for truss and wall blocking to ensure structural integrity.

Hold-Down Plan: Detailed hold-down requirements for stability. Snap Sheet: Reference sheet for quick identification of components

Structural Details and Bracing Plans: Complete details and bracing plans for all structural elements.

Accompanying these plans is a comprehensive Bill of Materials (BOM) that lists every necessary building component, from cold formed steel (CFS) frames to fasteners.

ARCHITECTURAL

With the comprehensive architectural package, both builders and DIY homeowners can confidently execute the construction.

HOW TO BUILD

The architectural package includes:

Furnished Floor Plans: Complete with furniture layouts for a clear understanding of space utilization.

Detailed Dimension Plans: Ensures precise measurements, from the overall footprint down to the exact placement of windows and

Foundation Plan: Detailed plan to establish a solid foundation.

Wall Framing and Truss Layout: Comprehensive plans for wall framing and truss placement.

Architectural Elevations: Exterior views showcasing the design.

Strategic Building Sections: Critical cross-sectional details for a thorough understanding of the build.

Casework Drawings and Diagrams: Suggested designs for built-in caseworks, such as kitchen cabinets.

MECHANICAL ELECTRICAL

The mechanical package includes everything needed to guide HVAC

Detailed HVAC Floor Plan: Precisely maps out the placement of air handlers, ductwork, and vents throughout the home's layout.

HVAC Sections and Riser Diagrams: Technical drawings offering critical cross-sectional details and piping schematics, ensuring proper integration of the heating and cooling system into the home's structure.

Bill of Materials: A complete list of all necessary HVAC components.

The electrical package includes all the plans and documentation needed to guide the installation of your home's electrical system:

Detailed Power Plan: Precisely maps out the placement of outlets, switches, and other power components throughout the layout.

Comprehensive Lighting Plan: Shows the optimal locations for lighting fixtures, sconces, and other illumination sources to create a well-lit, functional interior.

Dimensioned Electrical Layout: Provides exact dimensions and measurements to ensure proper placement of all electrical elements.

Bill of Materials: A complete list of every component needed, from circuit breakers to wiring.

ARCHITECTURAL BOM

PLUMBING


The plumbing package includes everything needed to guide the installation of your home's water supply and drainage systems:

Detailed Water Supply System Plan: Precisely maps out the placement of pipes, valves, and plumbing fixtures throughout the

Comprehensive Sewage System Plan: Shows the optimal routing and sizing of drain lines to effectively remove waste and ensure proper drainage.


Detailed Riser Diagrams: Provide information needed to properly install all vertical plumbing risers and vent stacks.

Bill of Materials: A complete list of every component needed, from pipes to fixtures.

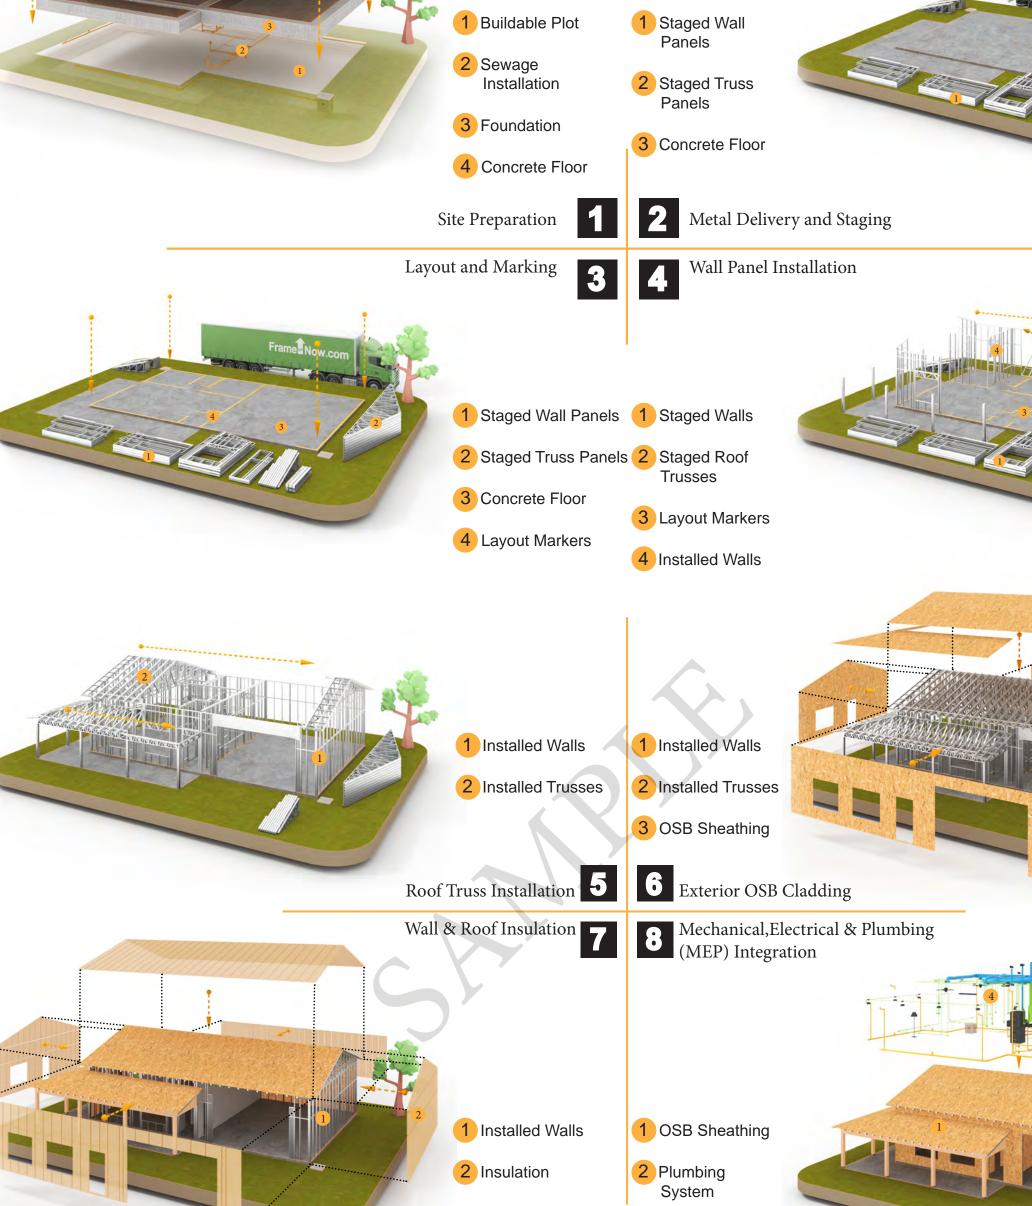





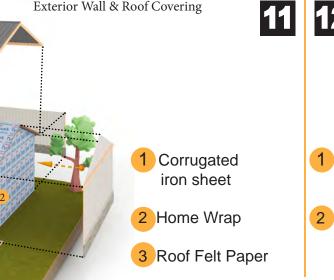

4 Coronado Stone


5 Corrugated

iron sheet



3 HVAC System

4 Electrical System

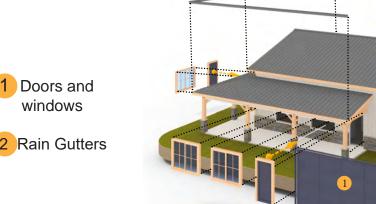

Tuscon,AZ, USA 888-864-0184 inquire@frameupnow.com www.frameupnow.com

KEY PLAN

DESCRIPTION DATE

NOTE:

LEGEND:

40-Yoke-999-3Bd2Ba-**Contemporary-550**

DRAWING NAME

INTRODUCTION

CLIENT NAME: PROJECT NUMBER: DATE: **DESIGNED BY** DRAWN BY: CHECKED BY:

1102

SCALE:


BOM (Bill Of Materials) (Separately Attached)




The Bill of Materials (BOM) is a crucial document that compiles the material requirements from different disciplines into a centralized inventory, enabling efficient procurement, inventory management, and cost estimation for a specified project or

ELECTRICAL BOM



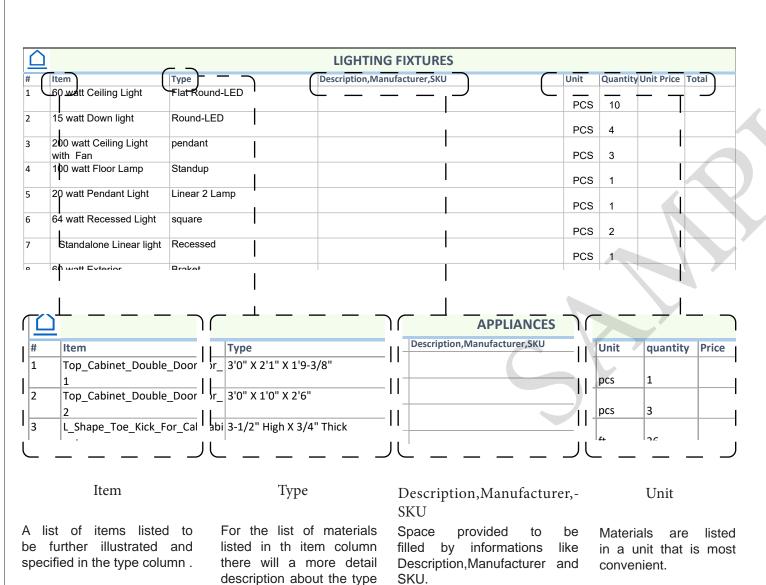


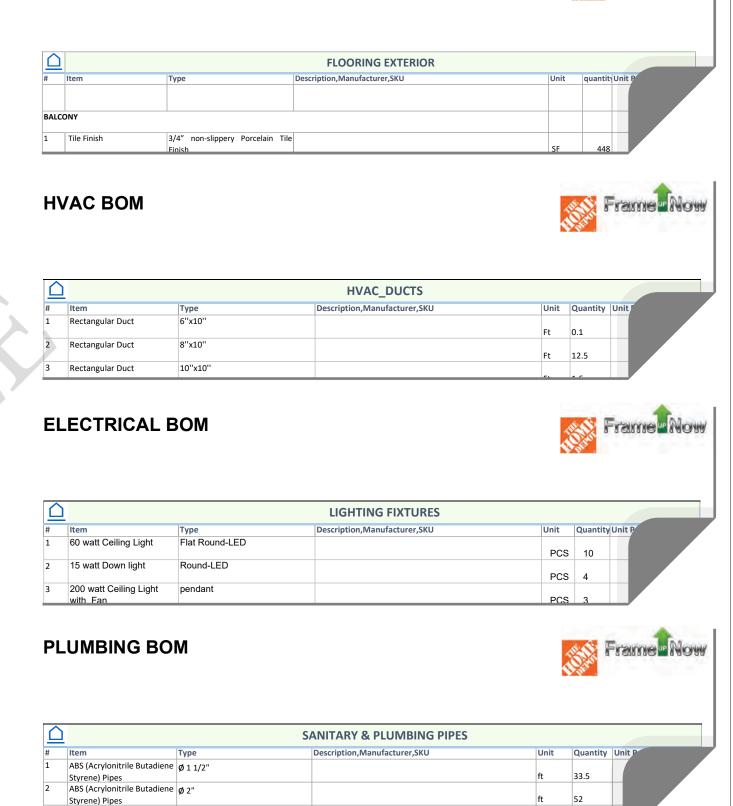


Frame Now


Styrene) Pipes ABS (Acrylonitrile Butadiene Ø 3" Styrene) Pipes

of the Material.

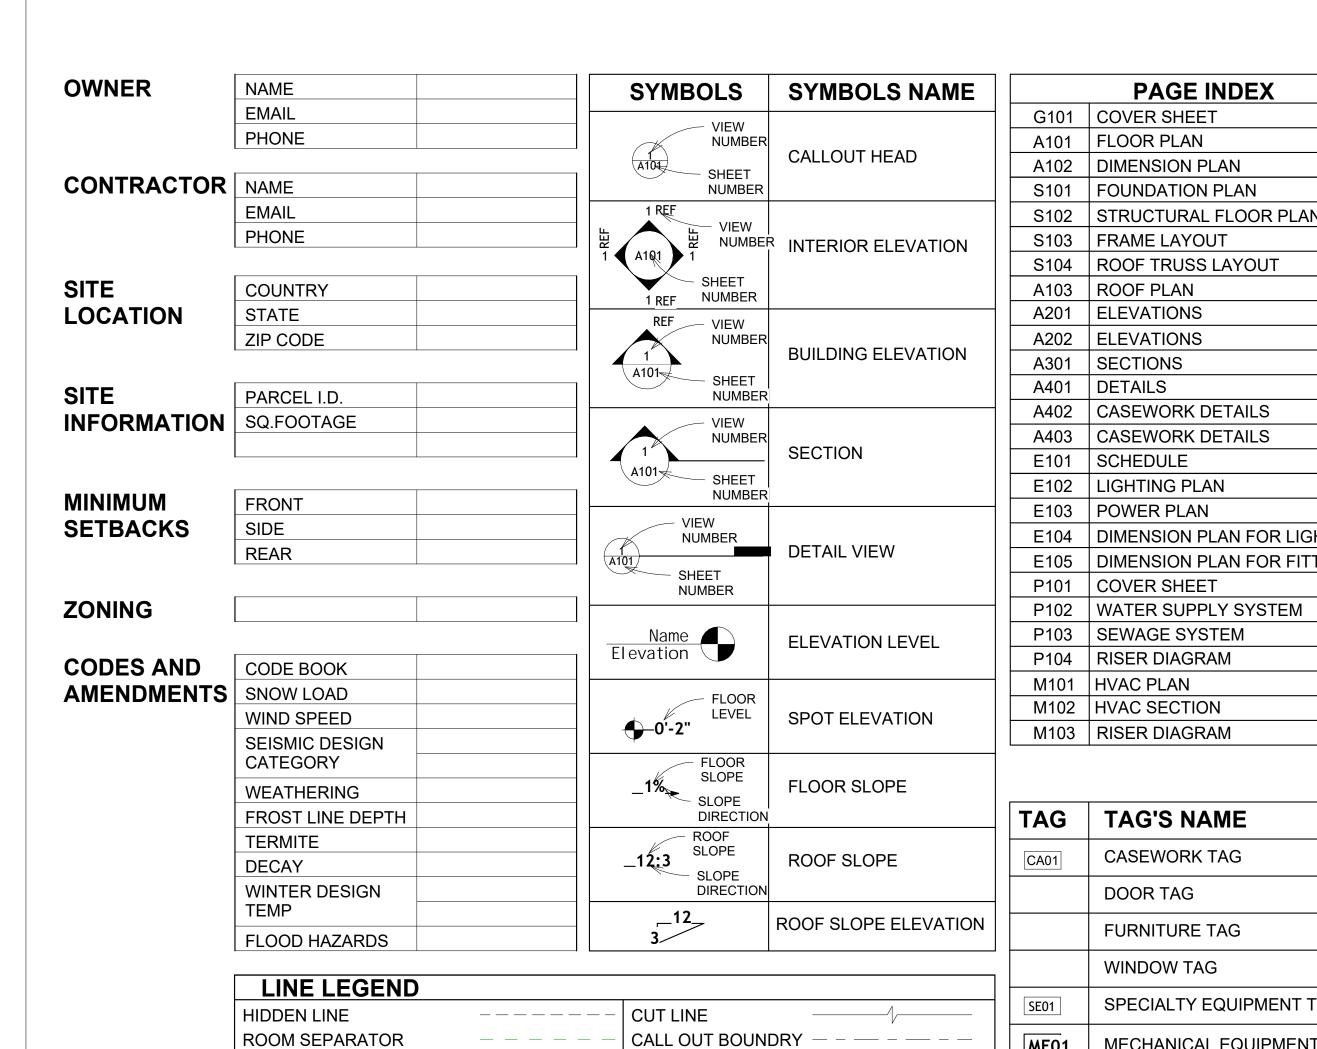

	PAGE INDEX	A	BBREVIATION
	COVER SHEET	AFS	ACTION FLOOR SY
	FLOOR PLAN	ASTM D698	AMERICAN SOCIET
	DIMENSION PLAN		TESTING AND MAT
	FOUNDATION PLAN	CA	CASEWORK
	STRUCTURAL FLOOR PLAN	EL	ELECTRICAL
	FRAME LAYOUT	F.F.E	FINISHED FLOOR E
	ROOF TRUSS LAYOUT	F.F.L	FINISHED FLOOR L
	ROOF PLAN	FTG	FOOTINGS
	ELEVATIONS	HVAC	HEATING, VENTILA
	ELEVATIONS		CONDITIONING
	SECTIONS	IRC	INTERNATIONAL R
	DETAILS		CODE
	CASEWORK DETAILS	IMC	INTERNATIONAL M
	CASEWORK DETAILS		CODE
	SCHEDULE	MAX.	MAXIMUM
	LIGHTING PLAN	ME	MECHANICAL
	POWER PLAN	MIN.	MINIMUM
	DIMENSION PLAN FOR LIGHT FIXTURE	NO.	NUMBER
	DIMENSION PLAN FOR FITTING	O.C	ON CENTER
	COVER SHEET	OSB	ORIENTED STRANI
	WATER SUPPLY SYSTEM	PL	PLUMBING
	SEWAGE SYSTEM	PSI	POUNDS PER SQU
	RISER DIAGRAM	PVC	POLYVINYL CHLOF
	HVAC PLAN	REF	REFERENCE
	HVAC SECTION	RG	RIGHT GARAGE
	RISER DIAGRAM	SE	SPECIAL EQUIPME
		SF	SQUARE FEET
		SIMP. STHD8	SIMPSON STRAP T
	TAG'S NAME		HOLDDOWN
		SIMP. ABE66	SIMPSON ANCHOR
	CASEWORK TAG	TV	TELEVISION
	DOOR TAG	UNO	UNLESS NOTED OT
	ELIDAUTURE TAG	W/	WITH
	FURNITURE TAG	W/D	WASHER/DRYER
	WINDOW TAG	AC	AIR CONDITIONING
	SPECIALTY EQUIPMENT TAG	ACC	AIR COOLED CONE
	MECHANICAL EQUIPMENT TAG	ACCU	AIR COOLED CONDSI
_		AHU	AIR HANDLING UNI
_	PLUMBING EQUIPMENT TAG	CC	COOLING COIL
		CD	CEILING DIFFUSER

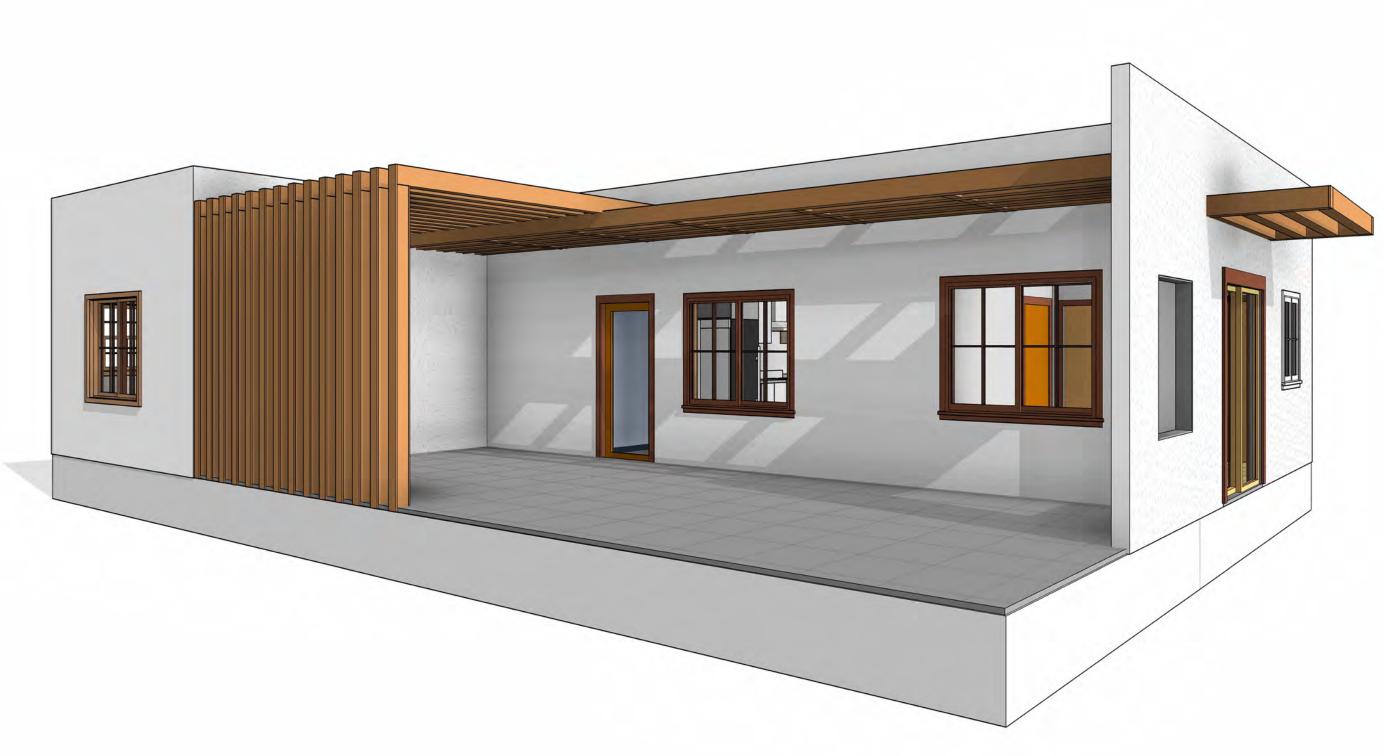


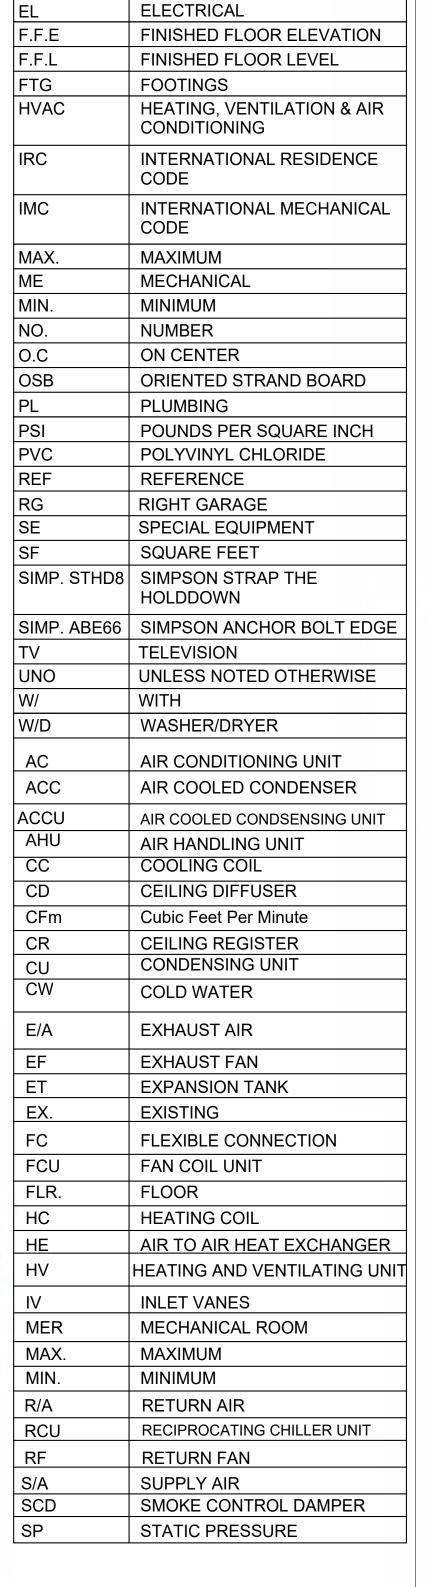

ACTION FLOOR SYSTEMS

AMERICAN SOCIETY FOR


TESTING AND MATERIAL

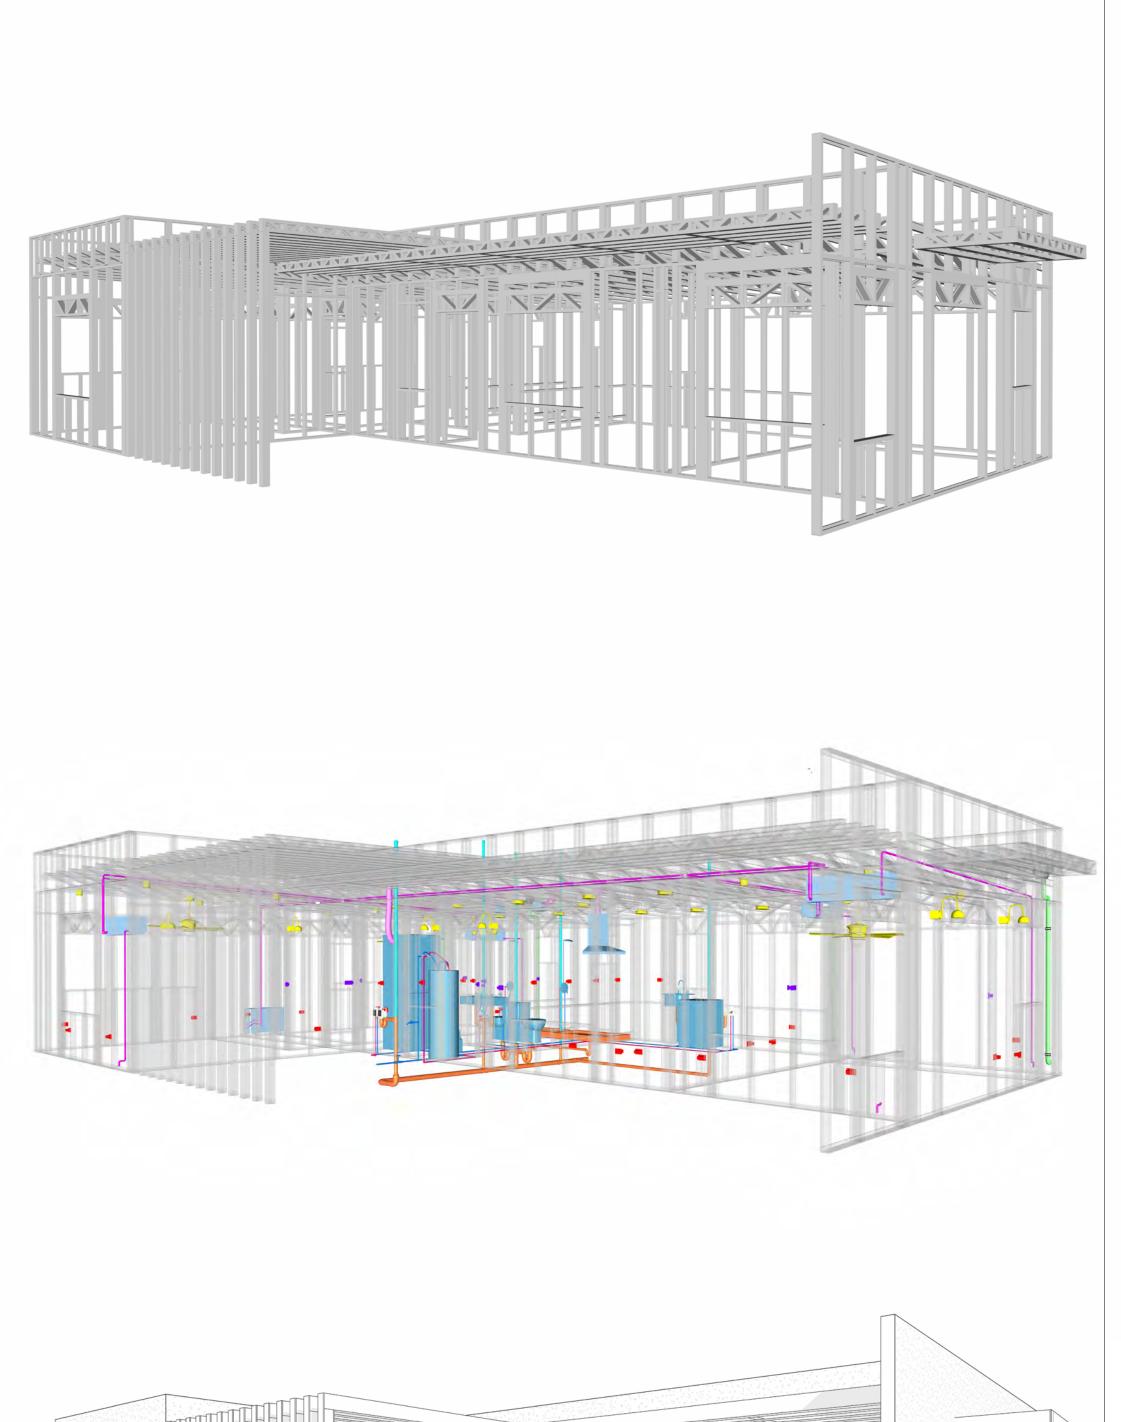

40-Yoke-999-3Bd/2Ba-Contemporary-550

SQUARE FOOTAGE		
LIVING	985	
PORCH	265	
TOTAL	1250	



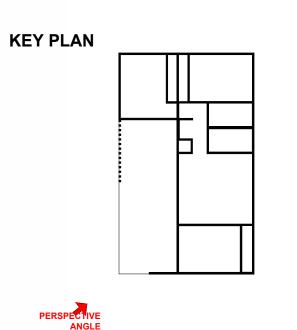

	Altone	
NO.	DESCRIPTION	DATE

LEGEND:

PROJECT

40 Yoke 999 3Bd/2Ba **Contemporary 550**

DRAWING NAME

COVER SHEET

Client Name
0061_12
2/11/2025 9:32:00 AM
Designer
Author
Checker

G101

SCALE: As indicated

OVER HEAD

GENERAL NOTES

- THIS DRAWING DEPICTS THE ARCHITECTURAL (SPACE LAYOUT, FURNISHING, FLOOR, WALLS, ROOFS, FOUNDATION, WINDOWS AND DOORS) SYSTEMS. IT PROVIDES A VISUAL REPRESENTATION OF THE ARCHITECTURAL LAYOUT AND COMPONENTS.
- THE ARCHITECTURAL DRAWINGS ARE PREPARED TO MEET THE SPECIFIC REQUIREMENTS OF THE BUILDING, AS PER THE PROJECT SPECIFICATIONS AND APPLICABLE CODES AND STANDARDS.
- 3. THE CONSTRUCTION OF THIS HOME SHALL COMPLY WITH THE LATEST EDITION OF THE INTERNATIONAL RESIDENTIAL CODE (IRC), INTERNATIONAL MECHANICAL CODE (IMC), THE INTERNATIONAL PLUMBING STANDARD, THE NATIONAL ELECTRICAL STANDARD AND ALL OTHER APPLICABLE LOCAL, STATE, AND NATIONAL CODES AND REGULATIONS.
- COORDINATION WITH OTHER TRADES HAS BEEN DONE ON A DESIGN LEVEL. THIS DRAWING SHALL BE READ TOGETHER WITH THE ME, EL AND PL DESIGN DRAWINGS TO ENSURE PROPER CONSTRUCTION AND INTEGRATION OF THE BUILDING SYSTEMS.

ABOUT WALLS:

SHOWER WALL COVERING

BATHTUB AND SHOWER SPACES (WALLS AND FLOORS) WITH INSTALLED SHOWER HEADS AND IN SHOWER COMPARTMENTS SHALL BE FINISHED WITH A NON-ABSORBENT SURFACE.

WALL PAINT (INTERNAL)

THE TYPICAL THICKNESS OF LATEX WALL PAINT IS 1/32 OF AN INCH FOR A SINGLE COAT. AND DOUBLE COAT (1/16") SHALL BE APPLIED FOR DURABILITY.

THE ADVISABLE TYPE OF ADHESIVE FOR THIS PROJECT IS **EPOXY ADHESIVES**BECAUSE THEY ARE KNOWN FOR THEIR HIGH STRENGTH, DURABILITY, AND RESISTANCE TO MOISTURE, CHEMICALS AND


REFER TO SHEETS A201 & A202 FOR GENERAL NOTES ON EXTERNAL FINISHING MATERIALS


ABOUT FLOORS:

- THE SPOT ELEVATION INDICATES THE FINISHED FLOOR ELEVATION.
- FINISHED FLOORS PER PLANS.
- FIELD VERIFY FOR DIMENSION DROP 4" FOR SHOWER AND BATHTUB USE.
- 1% SLOPE ON OUTDOOR BALCONIES FOR WATER RUN OFF.
- 2% SLOPE TOWARDS THE SHOWER DRAIN FOR SUFFICIENT DRAINAGE.
- 4" DROP AT THE DOOR LEADING TO EXTERIOR BALCONY FROM THE MAIN LIVING AREA.
- 5% SLOPE FOR GARAGE IS USED, WHICH SHOULD BE CHECKED WITH THE LOCAL GARAGING ZONING LAWS.


	FURNITURE SCHEDULE			
	TYPE MARK	TYPE	COUNT	
01		Queen 60" x 79"	3	
02		THREE SEAT SOFA	1	
03		DINING CHAIR	2	
04		Coffe Table	1	

	ROOM FINISH SCHEDULE						
ROOM NUMBE R	ROOM NAME	FLOOR FINISH	BASE FINISH	WALL FINISH	CEILING FINISH	CEILING HEIGHT	COM MEN TS
00	LIVING DOOM	LIABBWOOD	CONODETE	MALL DAINT	DDV/MALI	01 011	
00	LIVING ROOM	HARDWOOD	CONCRETE	WALL PAINT	DRY WALL	8' - 0"	
01	KITCHEN	HARDWOOD	CONCRETE	WALL PAINT + CERAMIC	DRY WALL	8' - 0"	
02	BEDROOM 1	HARDWOOD	CONCRETE	WALL PAINT	DRY WALL	8' - 0"	
03	CL 1	HARDWOOD	CONCRETE	WALL PAINT	DRY WALL	8' - 0"	
04	BEDROOM 2	HARDWOOD	CONCRETE	WALL PAINT	DRY WALL	8' - 0"	
05	CL 2	HARDWOOD	CONCRETE	WALL PAINT	DRY WALL	8' - 0"	
06	BEDROOM 3	HARDWOOD	CONCRETE	WALL PAINT	DRY WALL	8' - 0"	
07	CL 3	HARDWOOD	CONCRETE	WALL PAINT	DRY WALL	8' - 0"	
08	BATH 1	VINYL TILES	CONCRETE	CERAMIC TILE	MRD	8' - 0"	
09	BATH 2	VINYL TILES	CONCRETE	CERAMIC TILE	MRD	8' - 0"	
10	HALL	HARDWOOD	CONCRETE	WALL PAINT	DRY WALL	8' - 0"	
11	WD	HARDWOOD	CONCRETE	WALL PAINT	DRY WALL	8' - 0"	
13	WH	HARDWOOD	CONCRETE	WALL PAINT	DRY WALL	8' - 0"	
14	PORCH	PROCELAIN TILE	CONCRETE	EXTERIOR-GRADE PLYWOOD	PLYWOOD	8' - 0"	

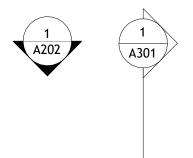

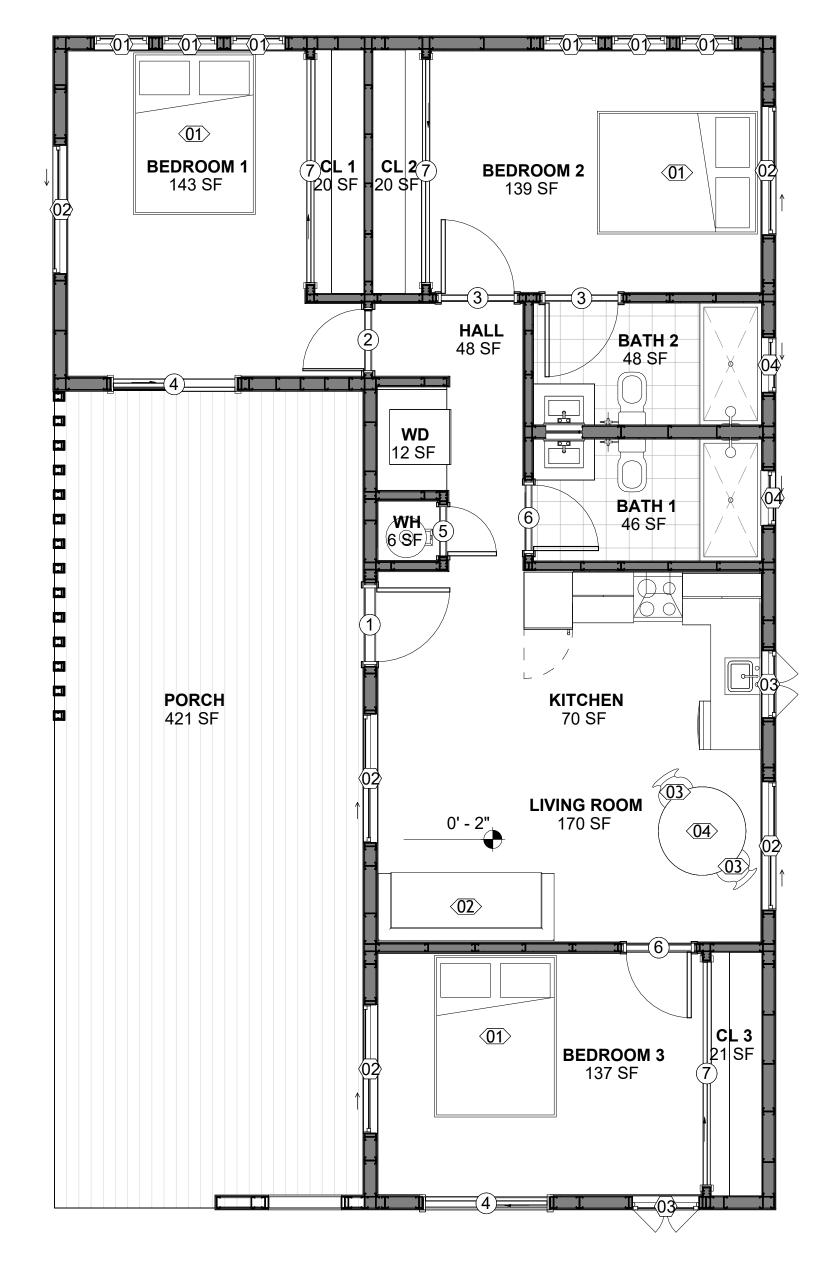



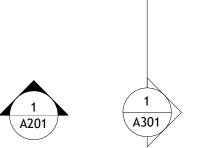



KEY PLAN

NO.	DESCRIPTION	DATE

NOTE:

√ A301

LEGEND:

PROJECT

40 Yoke 999 3Bd/2Ba **Contemporary 550**

DRAWING NAME

FLOOR PLAN

Client Name	CLIENT NAME:
0061_12	PROJECT NUMBER:
2/11/2025 9:32:01 AN	DATE:
Designer	DESIGNED BY:
Author	DRAWN BY:
Checker	CHECKED BY:

A101

SCALE: 1/4" = 1'-0"

SQUARE FOOTAGE

PORCH


TOTAL

985

265

1250

© [2024] [FrameUpNow] . All rights reserved

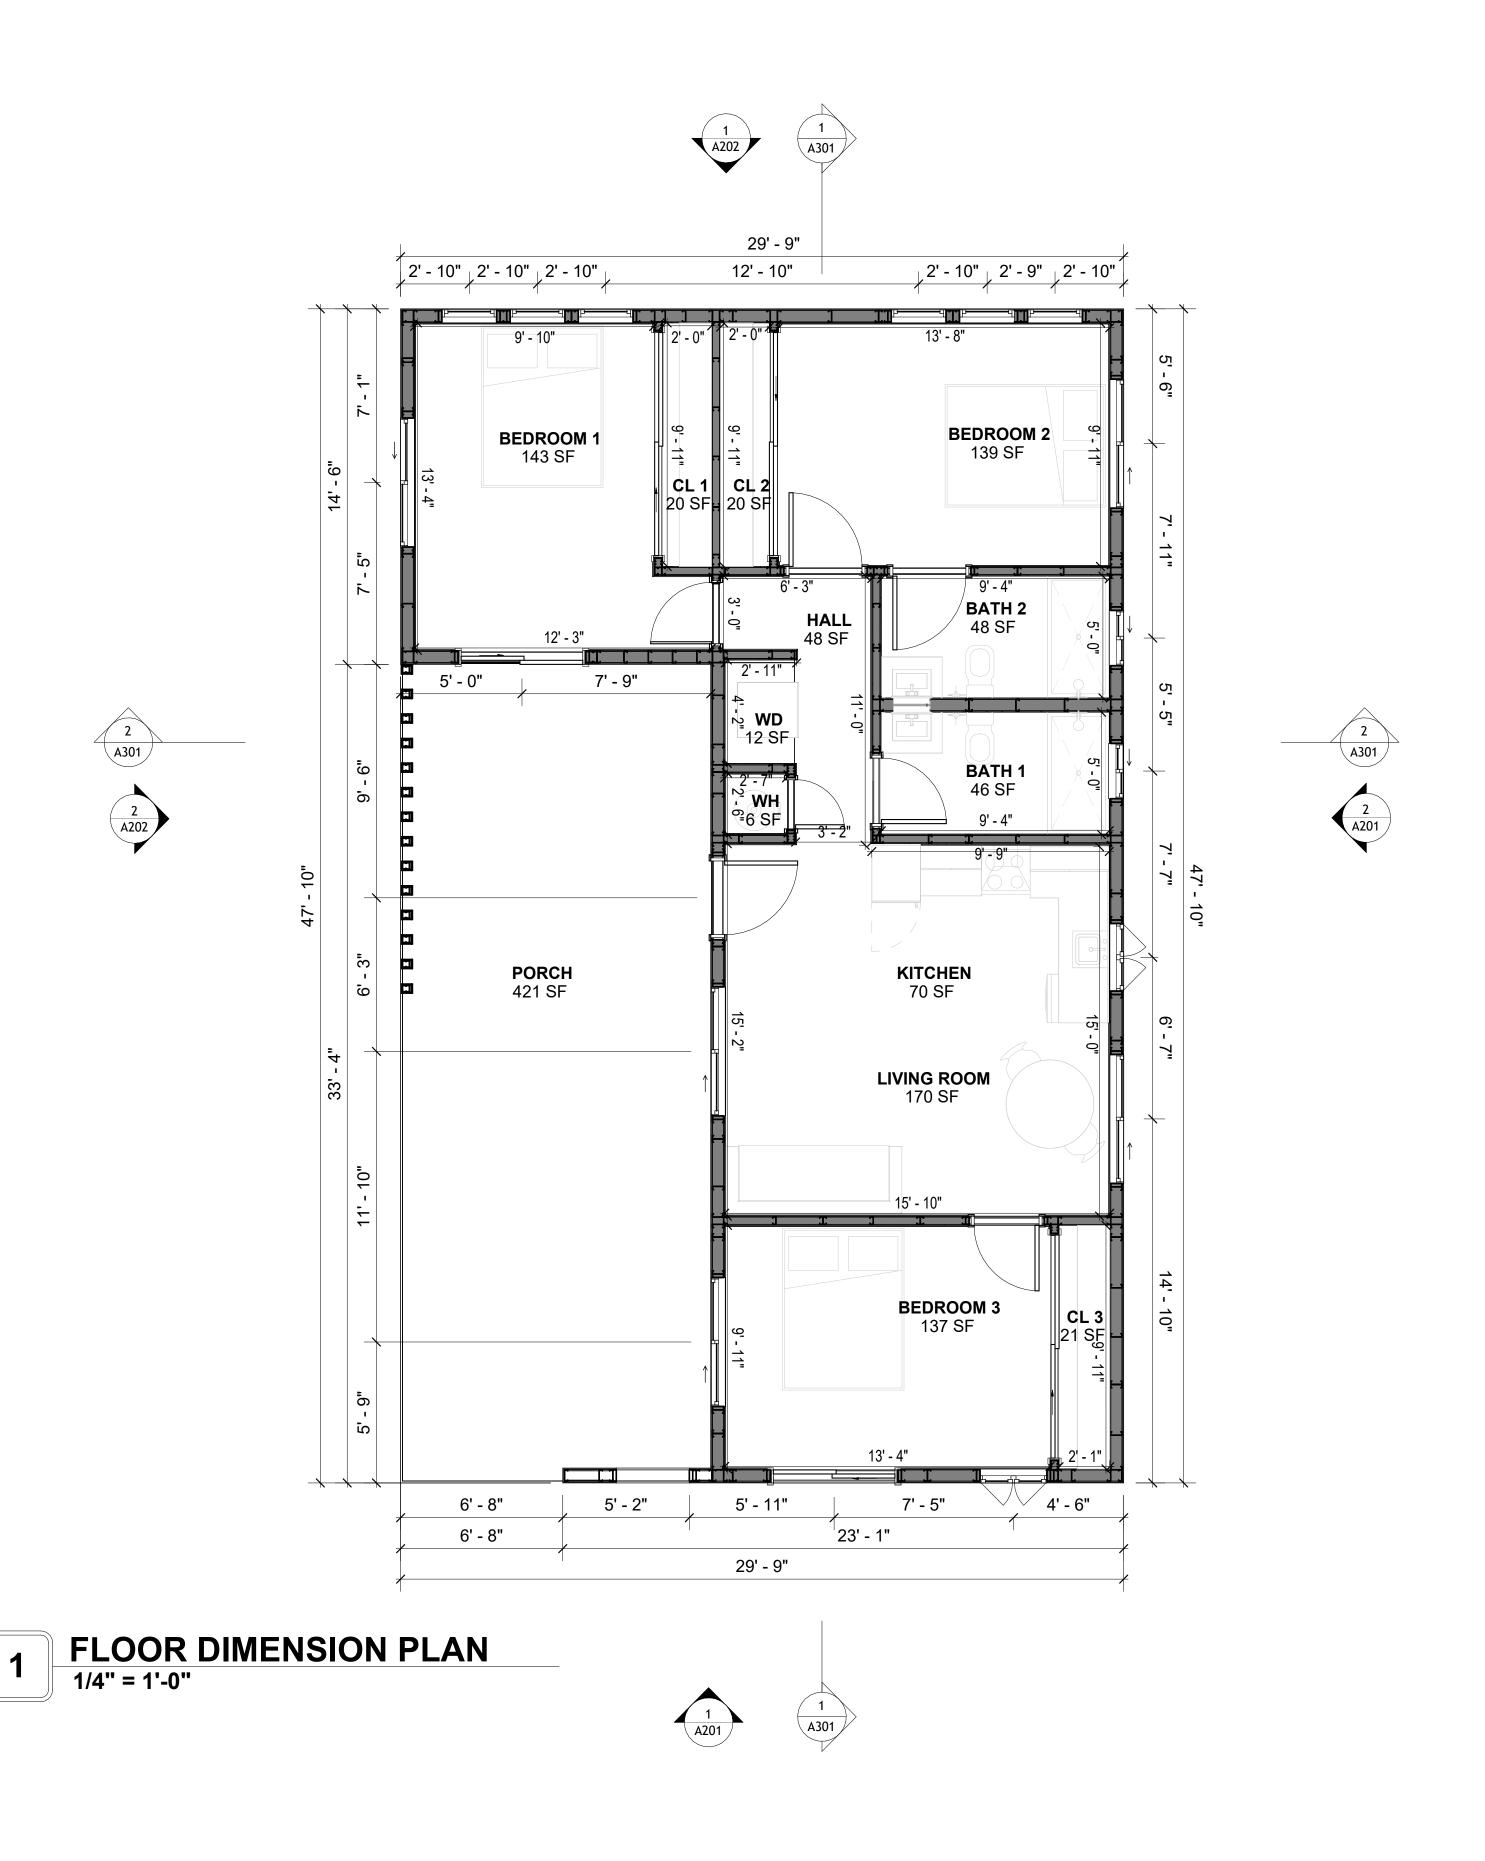



KEY PLAN

NO.	DESCRIPTION	DATE

NOTE:

LEGEND:

PROJECT

40 Yoke 999 3Bd/2Ba Contemporary 550

DRAWING NAME

DIMENSION PLAN

CLIENT NAME:	Client Name
PROJECT NUMBER:	0061_12
DATE:	2/11/2025 9:32:02 AM
DESIGNED BY:	Designer
DRAWN BY:	Author
CHECKED BY:	Checker

A102

SQUARE FOOTAGE

LIVING 985

PORCH 265

TOTAL 1250

DIMENSIONS IN THE ARCHITECTURAL DRAWINGS CONSIDER FINISHING MATERIALS. FOR PRECISE MEASUREMENTS OF THE STRUCTUAL FRAMING, REFER TO THE ATTACHED STRUCTURAL PLAN SET.

FOUNDATION NOTES

NOTES:

TERMITES PRETREATMENT BY LICENSED CONTRACTOR UNDER SLAB AND AROUND FOOTINGS. ALL AREAS BELOW SLABS SHALL BE TREATED NO MORE THAN 24 HOURS PRIOR TO CONCRETE POUR. EVIDENCE OF TREATMENT MUST BE PROVIDED PRIOR TO PLACING OF CONCRETE.

1. MATERIALS

ALL INTERIOR CONCRETE SLABS SHALL BE A MIN. OF 4" THICK CONCRETE OVER 4" COMPACTED AGGREGATE BASE (ASTM D698), FINISH ELEVATIONS AS NOTED ON DRAWINGS, 6" ABOVE ADJACENT GRADE, LEVEL SLABS TO 1/8"-10' MAX.. CONCRETE SLABS SHALL BE 2500# PSI AT 28 DAYS. A 4" ALLOWABLE SLUMP.

2. **PAD PREPARATION:**

EXCAVATION FOR FOOTING SHALL BE NEAT.

FOOTINGS SHALL BE POURED IMMEDIATELY AFTER EXCAVATION AND APPROPRIATE

INSPECTION.
- ALL REINFORCING STEEL MARKED "CONTINUOUS" SHALL BE LAPPED 36 BAR DIAMETERS AT SPLICES AND AROUND CORNERS OR INTERSECTIONS WITH A STANDARD 90 DEGREE BEND ON CORNER BARS. LAP WIRE MESH ONE FULL MESH AT SIDE AND END LAPS.

- ALL HARDWARE TO BE SIMPSON OR EQUIVALENT.

- EXTERIOR FRAME WALL TO BE SECURED WITH 1/2"X10" ANCHOR BOLTS 4'-0" O.C. FOR 1-STORY AND 2'-8" O.C. FOR 2-STORY. BOLTS SHALL BE LOCATED WITHIN 1'-0" OF EACH END PIECE AND SHALL HAVE A MIN. OF TWO BOLTS PER PIECE.

-FOUNDATION ANCHOR STRAPS SHALL BE PERMITTED, ACCORDING TO RESIDENTIAL CODE 2021

- ALL INTERIOR WALLS TO BE SECURED WITH POWER DRIVEN PINS PER MANUFACTURER SPECIFICATION USE PIN SPACING EQUIVALENT TO 1/2" ANCHOR BOLTS.

- ALL CONSTRUCTION TO CONFORM TO THE 2012 IRC

R-10 RIGID INSULATION OUTSIDE OF EXTERIOR FOUNDATION WALLS UNDER LIVING AREA.
 CONCRETE PAD FOR CONDENSER THICKNESS IS 4" MIN UNLESS OTHERWISE NOTED.

3. CONCRETE CONSTRUCTION:

- THE SLAB SHALL BE UNDERLAIN BY A VAPOR BARRIER/RETARDER IN THE LIVING AREA (TYPICALLY POLYETHYLENE, UNLESS MORE STRINGENT PROTECTION REQUIRED BY THE ARCHITECT, ENGINEER, FLOOR COVERING MANUFACTURER, OR ACCEPTED PRACTICE). UNLESS OTHERWISE REQUIRED, BARRIER MAY BE OMITTED AT GARAGES, PORCHES AND PATIOS WITHOUT FLOOR COVERINGS. IT IS BEYOND THE SCOPE OF THESE PLANS TO DETERMINE THE APPLICABILITY OF THESE MORE STRINGENT REQUIREMENTS. BUILDER SHALL VERIFY PRIOR TO CONSTRUCTION.

4. REINFORCEMENT:

- IF CONSTRUCTED ON ACTIVE SOILS, THE LONG TERM PERFORMANCE OF THE FOUNDATION IS DEPENDENT ON MAINTENANCE BY THE OWNER. THUS THE BUILDER SHALL ADVISE THE OWNER OF THE FOLLOWING:

- 1. DRAINAGE MUST BE MAINTAINED. WATER SHALL NEVER BE ALLOWED TO POND NEAR THE FOUNDATION.
- 2. THE SOIL AROUND THE FOUNDATION SHALL BE MAINTAINED IN A RELATIVELY DAMP CONDITION, SUCH AS THAT REQUIRED TO KEEP A LAWN GREEN. IF IT DRIES OUT IT WILL

SHRINK. IF IT GETS WET, IT WILL HEAVE UPWARD.

3. SLABS ON THE SHORTER SIDE USES MAIN BARS ARE USED IN THIS DIRECTION ONLY WITH SMALLER DIAMETER DISTRIBUTION BARS ARE PLACED, FORMING A MAT OR GRID.

4. ALL REINFORCEMENT BARS SIZE 10MM OR LARGER IN ACCORDANCE TO ASTM

3. ANCHOR BOLTS AT ALL EXTERIOR WALLS SHALL BE MINIMUM 1/2 INCH DIAMETER WITH A MAXIMUM SPACING OF 6'-0" ON CENTER, UNLESS NOTED OTHERWISE.

4. ANCHOR BOLTS SHALL BE INSTALLED WITHIN 12 INCHES OF EACH END OF EACH SILL PLATE WITH AT LEAST TWO ANCHOR BOLTS FOR EACH BOLTS FOR EACH SILL PLATE LONGER THAN 12 INCHES.

5. SIMPSONS SILL ANCHORS MAYBE SUBSTITUTED FOR ANCHOR BOLTS AT THE SAME SPACING.

6. EXTERIOR CONCRETE SLABS WHICH ARE NOT PART OF THE MAIN SLAB SHALL BE MINIMUM 4 INCHES THICK WITH NO STEEL REINFORCING BARS REQUIRED, UNLESS NOTED


OTHERWISE ON FOUNDATION PLAN.

VERIFY THE FOLLOWING PRIOR TO POURING:

- 1. ALL HOLDDOWNS , STRAP, AND POST LOCATIONS.
- 2. CONCRETE FINISHES. PANEL RISER LOCATION WHERE APPLICABLE.
- UNDERSLAB MECHANICAL REQUIREMENTS.
 STEM WALL BLOCKOUTS.
- 5. UNDERSLAB ELECTRICAL REQUIREMENTS AND PANEL RISER LOCATION. WHERE APPLICABLE.
- 6. PROVIDE THE FOLLOWING:
- PVC SLEEVES THROUGH FTG IF REQUIRED
- 20' #4 COPPER GROUND BAR.

7. SLOPE FINISH GRADE AWAY FROM FOOTING.

NOTE: FIELD VERIFY ALL DIMENSIONS SEE DIMENSIONED ARCHITECTURAL DRAWINGS

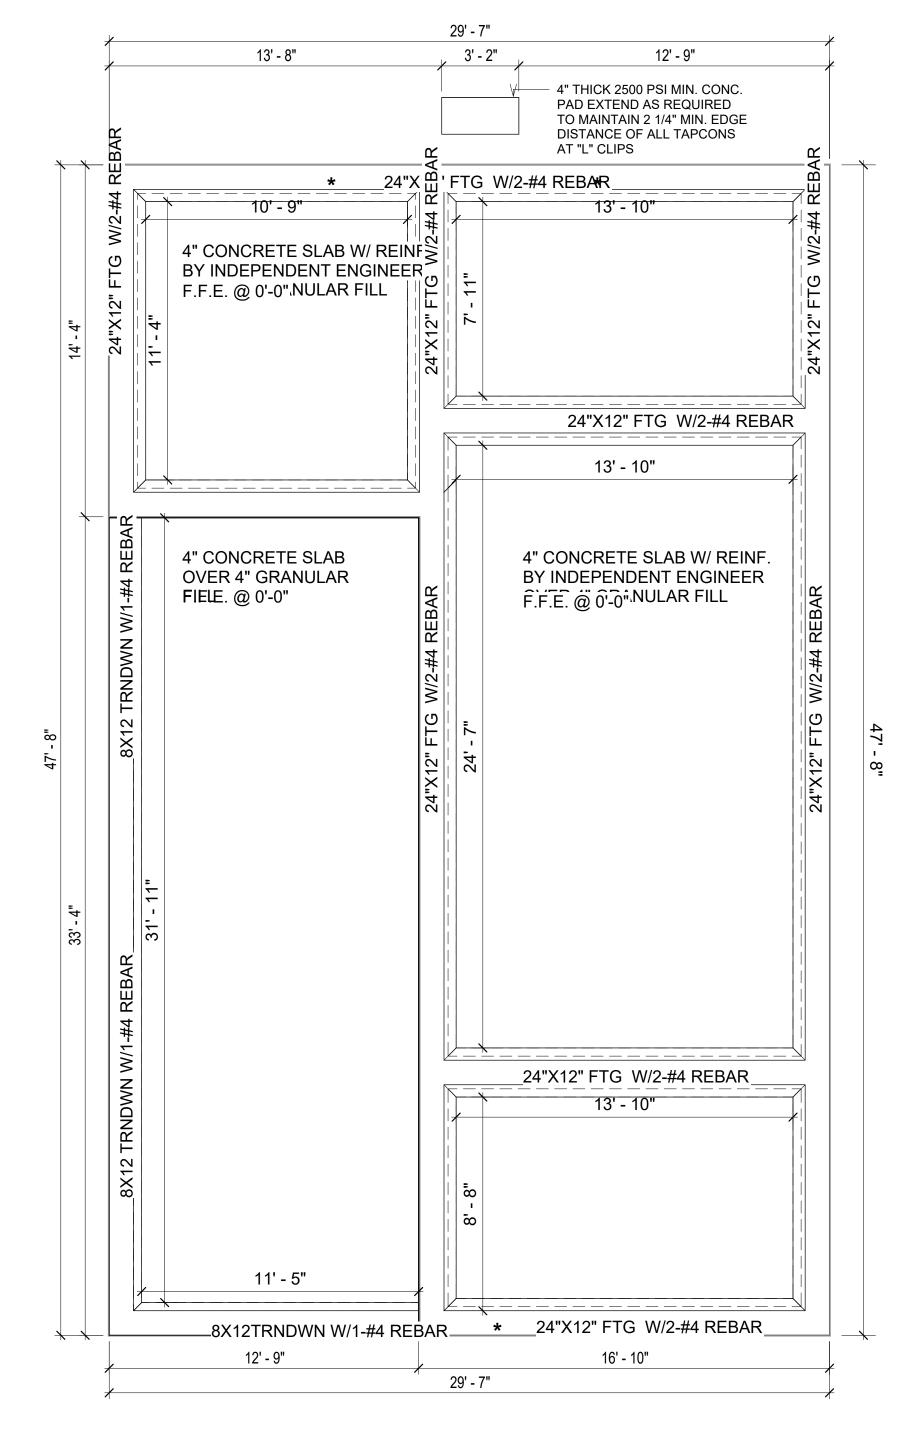

FOUNDATION PLAN
1/4" = 1'-0"

SQUARE FOOTAGE

LIVING 985

PORCH 265

TOTAL 1250



KEY PLAN

NO. DESCRIPTION DATE

NOTE:

LEGEND:

PROJECT

40 Yoke 999 3Bd/2Ba Contemporary 550

DRAWING NAME

FOUNDATION PLAN

CLIENT NAME:

PROJECT NUMBER:

DATE:

DATE:

DESIGNED BY:

DRAWN BY:

CHECKED BY:

Client Name

0061_12

D061_12

D761

S101

SCALE: 1/4" = 1'-0"

GENERAL NOTES

NOTES:

-ALL BEARING WALLS SHOULD HAVE A THICKENED SLAB PER SECTION PER DETAIL A401/5.

A) **FOUNDATION PLAN NOTES**:

- 1. CONCRETE SLAB SHALL BE 6" THICK WITH 1/2" DIAMETER TENDONS PER LAYOUT PLAN, CENTERED IN SLAB THICKNESS, OVER APPROVED SUBBASE PER GENERAL STRUCTURE NOTES.
- TERMITE PROTECTION SHALL BE PROVIDED PER IRC SECTION R318.1
 NONE TYPICAL ANCHOR BOLT SPACING AT SHEAR WALL AND HOLD DOWN
- SPECIFICATIONS PER APPROVED ARCHITECTURAL PLANS.
 4. INSTALL HOLDOWNS BEFORE CONCRETE SLAB POUR.
- 5. EXISTING FILL ON-SITE SHALL BE COMPACTED IN ACCORDANCE WITH THE REQUIREMENTS IN THE GEOTECHNICAL REPORT.
- 6. ALL FLOOR SLABS ARE REINFORCED ON CONCRETE SLABS.

SPECIAL INSPECTION IS REQUIRED FOR THICKENED FOUNDATION CONSTRUCTION

- 1. REINFORCEMENT
- 2. 2300 PSI CONCRETE POUR

B) REINFORCEMENT FOR CONCRETE:


 ALL REINFORCING SLABS BARS SIZE 10MM OR LARGER SHALL BE DEFORMED IN ACCORDANCE TO ASTM-A706, AND BARS SMALLER THAN 10 MM MAYBE PLAIN.
 UNLESS OTHERWISE NOTED IN PLANS, THE YIELD STRENGTH OF REINFORCING BARS SHALL BE:


> A) FOOTING = 40,000 PSI B) NON-LOAD BEARING WALLS AND PARAPETS= 40,000 PSI


- 3. SPLICES SHALL BE SECURELY WIRED TOGETHER AND SHALL LAP OR EXTEND
- 4. GRADE OF STEEL FOR RCC WORKS SHALL BE GRADE 4 10.
- 5. BAR NOTATIONS GIVES INFORMATION
- A) BAR SIZE
- B) SPACING(IF REQUIRED)
- LAP REINFORCEMENT ONLY AT LOCATION SHOWN IN THE DRAWINGS
 REINFORCEMENT SHALL NOT BE CUT, VENT OR HEATED ON SITE WITHOUT ENGINEERS' APPROVAL.
- C) CONCRETE SLAB NOTES
- 1. ALL SLAB REINFORCEMENT SHALL BE 20MM CLEAR MINIMUM FROM BOTTOM AND FROM TOP OF SLAB.
- 2. REINFORCEMENT IN CONTINUOUS ELEVATED SLAB SHALL BE CUT AS FOLLOWS.

NOTE:

- THIS IS A SCHEMATIC PLAN FOR THE PURPOSE OF LOCATING AND IDENTIFYING FOUNDATION REINFORCING ELEMENTS ONLY. VERIFY ALL DIMENSIONS, DROPS, OFFSETS AND FEATURES WITH THE ARCHITECTURAL PLANS BEFORE FORMING THE FOUNDATION.

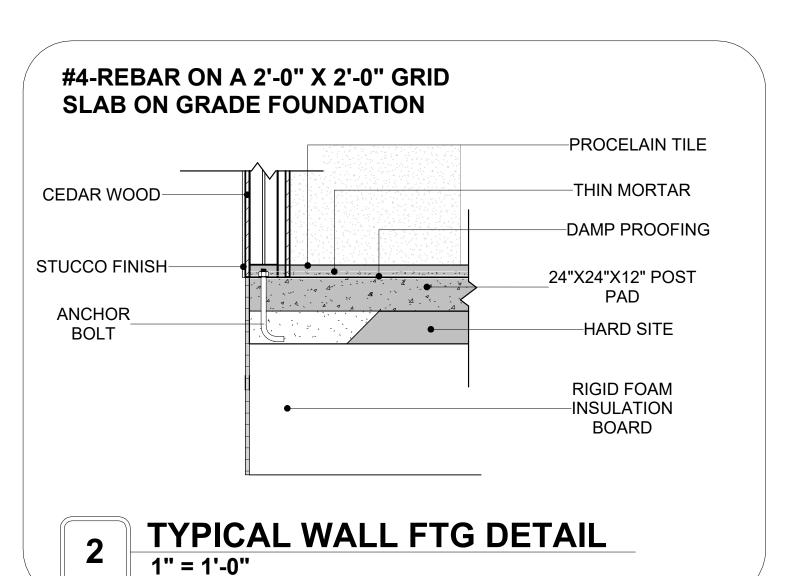

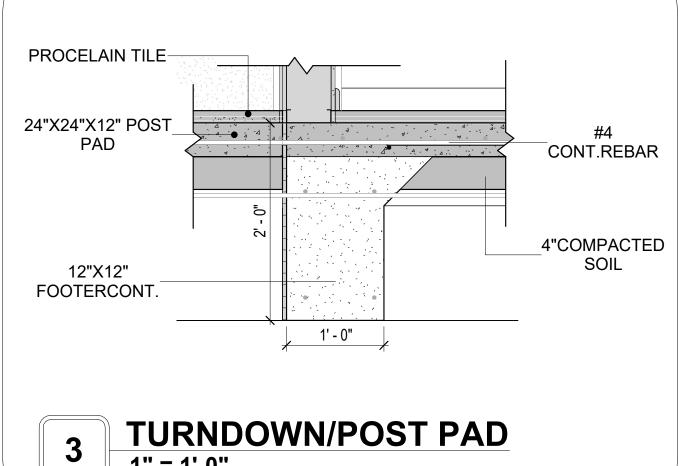

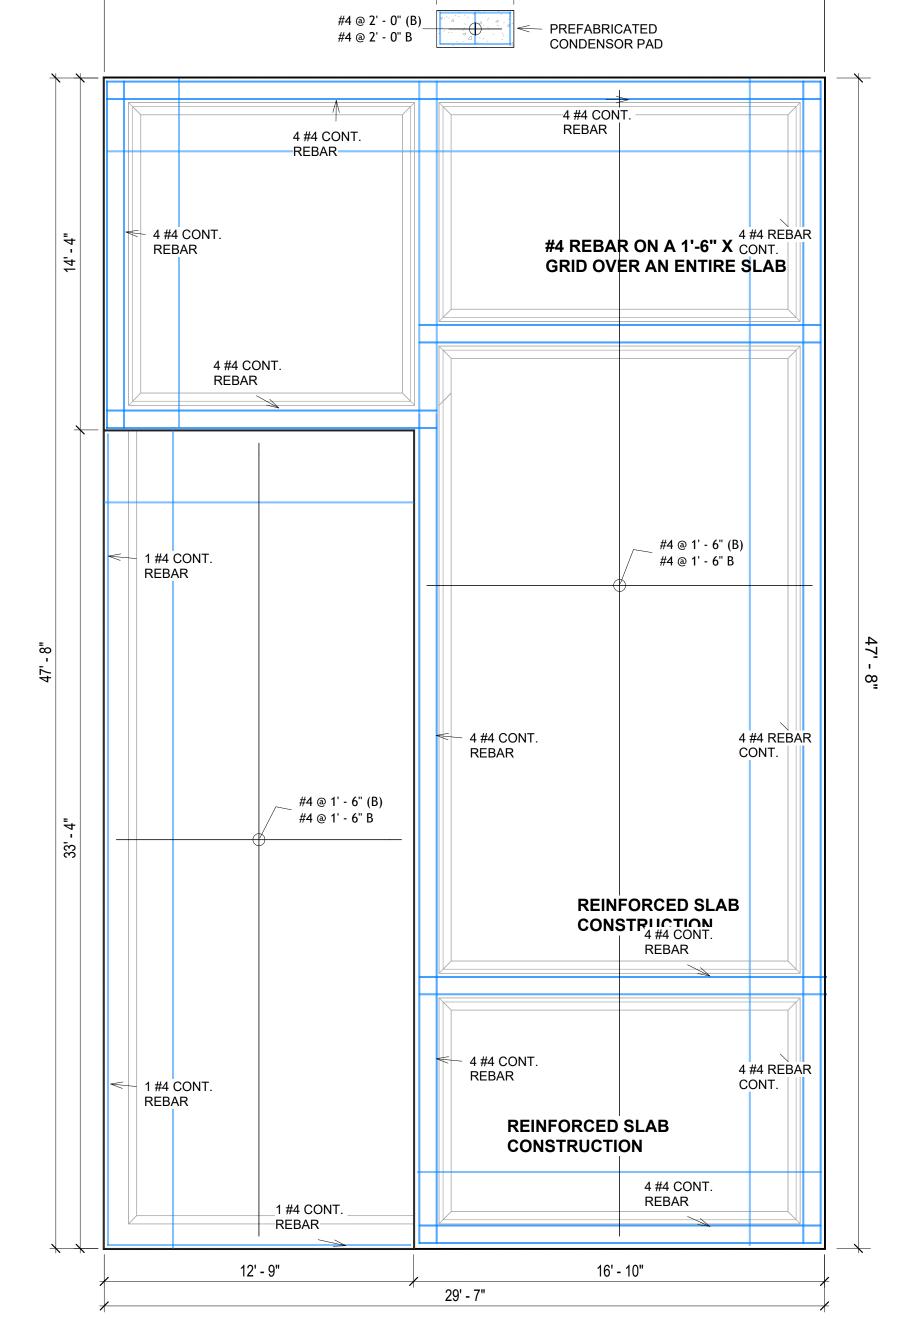

29' - 7"

3' - 2"

13' - 8"

12' - 9"

FOUNDATION REBAR PLAN
1/4" = 1'-0"



KEY PLAN

NO.	DESCRIPTION	DATE	

NOTE:

LEGEND:

PROJECT

40 Yoke 999 3Bd/2Ba Contemporary 550

DRAWING NAME

STRUCTURAL FLOOR PLAN

CLIENT NAME:

PROJECT NUMBER:

DATE:

2/11/2025 9:32:04 AM

DESIGNED BY:

DRAWN BY:

CHECKED BY:


Checker


S102


ROOF NOTES

- ROOFING COMPOSITION ROOFING PER OWNERS/BUILDERS SPECIFICATIONS INSTALL PER MANUFACTURE SPECIFICATIONS ON 1/2" ORIENTED STRAND BOARD ON PRE-ENGINEERED TRUSS @ 24" O.C. (UNO.)
- 2. 73" OVERHANG AT EAVES (UNO.) ENDS OF ALL TRUSSES AND JOISTS TO BE FULLY BLOCKED. PROVIDE SOLID
- BLOCKING AT ALL RIDGES AND VALLEYS 4. SHEATHING TO BE 1/2", 3/8" OSB SHEAR PANEL AND EQUIVALENT.
- UNDERSIDE OF PORCH TRUSSES TO BE FINISHED WITH MOISTURE RESISTANT DRYWALL, TAPED AND TEXTURED.
- 5. EXPOSED EAVES AND OTHER WEATHER EXPOSED AREAS TO BE SHEATHED WITH EXTERIOR GRADE PLYWOOD.
- 6. ALL MATERIALS THICKNESS AND SIZE ARE THE MINIMUM. Refer TO LOCAL STANDARDS FOR ACTUAL THICKNESS AND LAYERING OF MATERIALS.
- ENGINEERED TRUSS CALCULATIONS TO BE SUBMITTED TO BUILDING
- DEPARTMENT PRIOR TO FABRICATION AND INSTALLATION. TRUSS MANUFACTURER TO SPECIFY HANGER CONNECTORS FOR TRUSS
- COMPONENTS (TYPICAL) 9. DESIGNER ASSUMES THAT TRUSSES BEAR ON ALL EXTERIOR PERIMETER
- WALLS (TYPICAL) OR BEAMS.
- 10. PROVIDE GALVANIZED STEEL FLASHING WITH A LENGTH OF 10 FEET, WIDTH

OF 12 INCHES, AND THICKNESS OF 24 GAUGE.

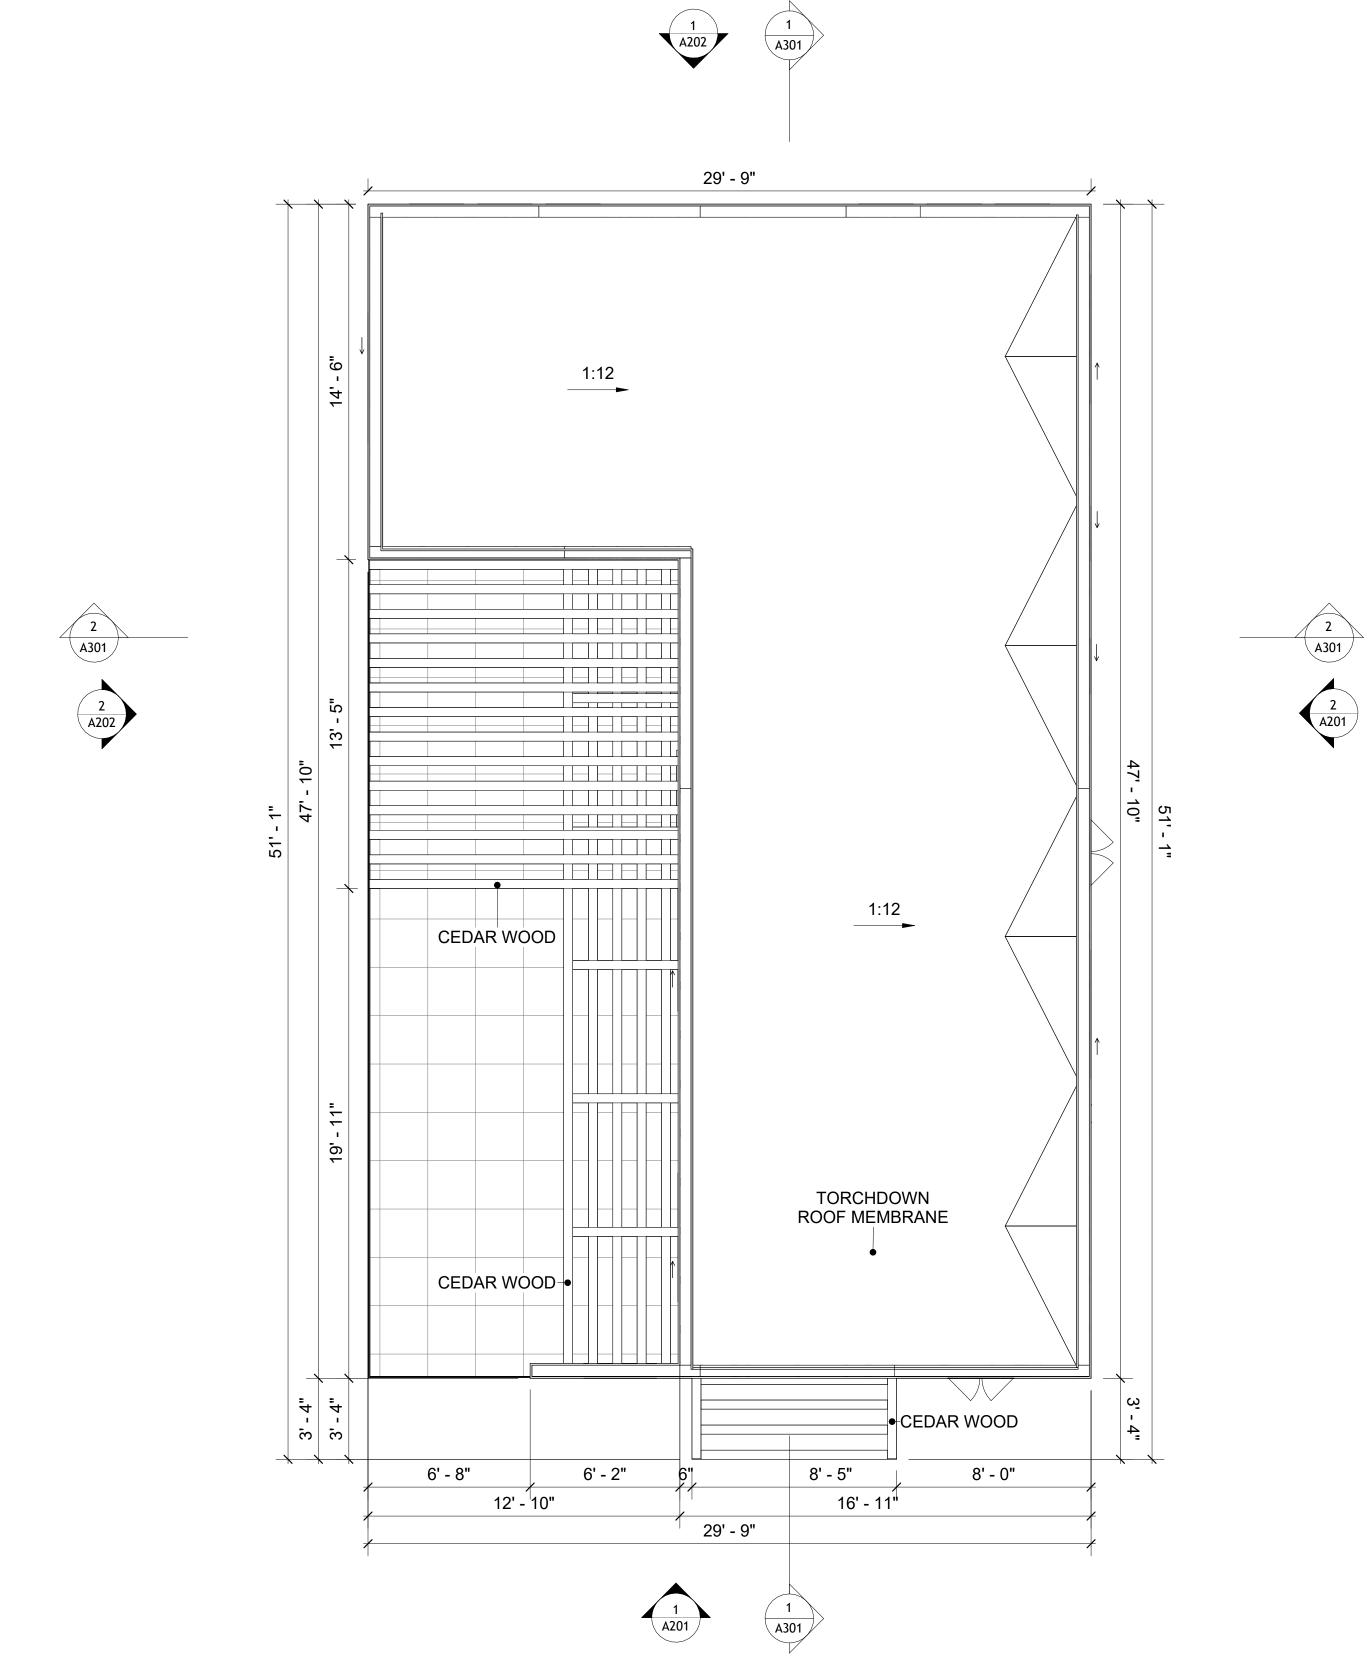

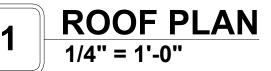

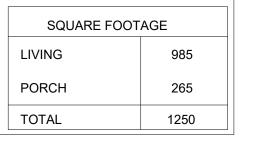



KEY PLAN

NO.	DESCRIPTION	DATE

NOTE:

LEGEND:

PROJECT

40 Yoke 999 3Bd/2Ba Contemporary 550

DRAWING NAME

ROOF PLAN

CLIENT NAME:	Client Name
PROJECT NUMBER:	0061_12
DATE:	2/11/2025 9:32:06 AM
DESIGNED BY:	Designer
DRAWN BY:	Author
CHECKED BY:	Checker

A103

SCALE: 1/4" = 1'-0"

ABOUT WALL FINISHING

STUCCO FINISH

STUCCO FINISH IS A CEMENT-BASED EXTERIOR WALL FINISH THAT OFFERS A DURABLE, WEATHER-RESISTANT, AND CUSTOMIZABLE CLADDING SOLUTION FOR BUILDINGS.

IN THIS SPECIFIC PROJECT, AMERICAN STUCCO SYSTEMS IS USED AS A FINISH MATERIAL BECAUSE IT IS GENERALLY CONSIDERED A WATER-RESISTANT EXTERIOR FINISH AND USES A THREE-COAT APPLICATION PROCESS. 3/8-INCH OF IT IS APPLIED AS AN EXTERNAL WALL FINISH AS IT IS THE MOST COMMON AND WIDELY ACCEPTED STANDARD THICKNESS FOR STUCCO EXTERIOR WALL FINISHES.


THIS MULTI-LAYER APPROACH ALSO HELPS CREATE A STRONG, CRACK-RESISTANT STUCCO SURFACE. THIS STANDARD STUCCO IS APPLIED OVER OSB SHEATHINGS (FOR COLD FORMED STRUCTURE CONSTRUCTION). IT IS NOT DIRECTLY TROWELLED OVER THE OSB BUT OVER A WATER-RESISTANT BARRIER (HOMEWRAP) AND METAL/PLASTIC LATH THAT ARE INSTALLED ON TOP SURFACE OF THE OSB TO PROVIDE AN ADDITIONAL LAYER OF PROTECTION AGAINST MOISTURE INTRUSION.


REGULAR INSPECTION AND PROMPT REPAIR OF ANY CRACKS, CHIPS, OR DAMAGE TO THE STUCCO FINISH IS IMPORTANT. THIS MAINTAINS THE STUCCO'S WATER-RESISTANT PROPERTIES OVER THE BUILDING'S LIFE SPAN.

CEDAR WOOD

CEDAR WOOD REFERS TO THE WOOD FROM VARIOUS SPECIES OF CEDAR TREES, WHICH ARE CONIFEROUS EVERGREEN TREES KNOWN FOR THEIR DISTINCT AROMA AND NATURAL RESISTANCE TO DECAY AND INSECTS.

IN THIS SPECIFIC PROJECT, CEDAR WOOD IS USED A FINISH MATERIAL ON BEAMS AND COLUMNS.

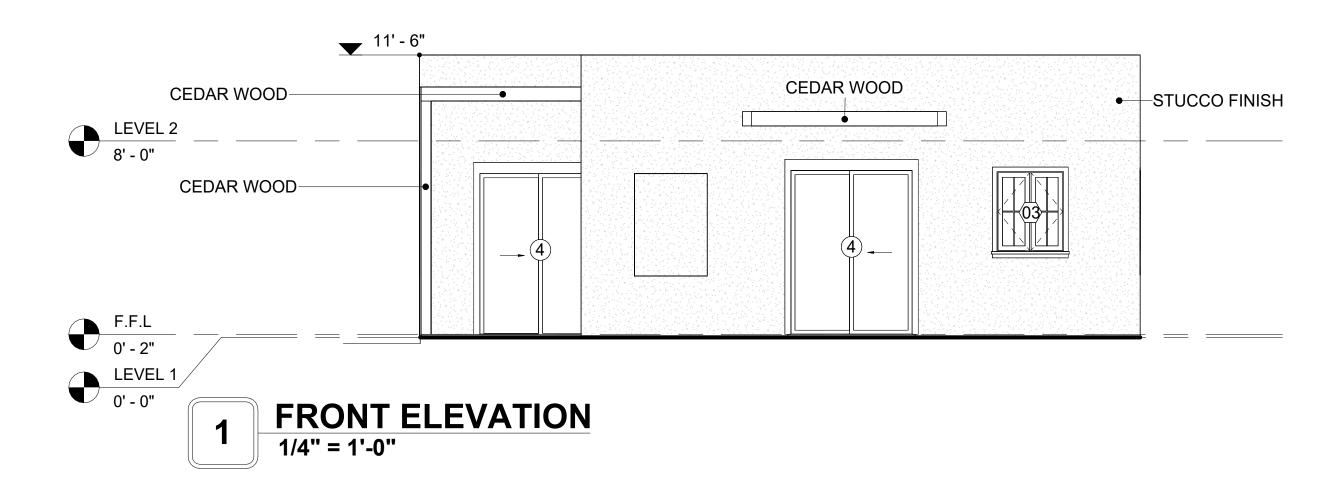

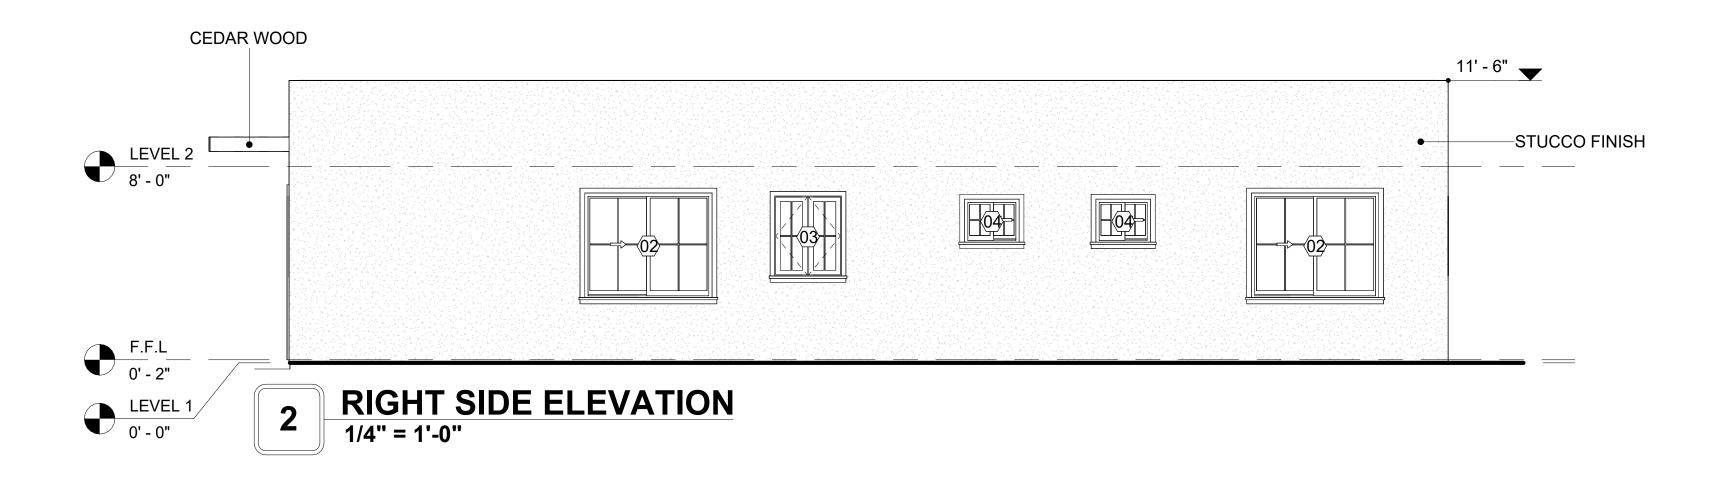


	DOOR SCHEDULE						
TYPE				SIZE		SIZE	
MAR K	SUPPLIER	DOOR TYPE	LOCATIO N	WIDTH	HEIGHT	COUNT	
1	HOME DEPOT	Exterior Single Panel Swinging	Interior	3' - 0"	6' - 8"	1	
2	HOME DEPOT	Interior Single Panel Swinging	Interior	2' - 6"	6' - 8"	1	
3	HOME DEPOT	Interior Single Panel Swinging	Interior	3' - 0"	6' - 8"	2	
4	HOME DEPOT	Patio_Double Panel_Sliding	Exterior	5' - 0"	6' - 8"	2	
5	HOME DEPOT	Interior Single Panel Swinging	Interior	2' - 0"	6' - 8"	1	
6	HOME DEPOT	Interior Single Panel Swinging	Interior	2' - 8"	6' - 8"	2	
7	HOME DEPOT	Interior Double Panel Sliding	Interior	9' - 1"	6' - 8"	3	

WINDOW SCHEDULE					
			SIZE		
TYPE MARK	SUPPLIER	WINDOW TYPE	WIDTH	HEIGHT	COUNT
01	Home Depot	Single Hung	2' - 3"	3' - 3"	6
02	Home Depot	Sliding	5' - 3"	4' - 3"	5
03	Home Depot		2' - 9"	3' - 3"	2
04	Home Depot	Sliding	2' - 3"	1' - 9"	2



KEY PLAN

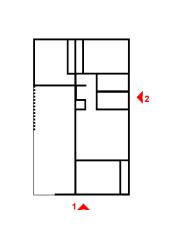

NO.	DESCRIPTION	DATE	

NOTE:

LEGEND:

PROJECT

40 Yoke 999 3Bd/2Ba Contemporary 550

DRAWING NAME

ARCHITECTURAL ELEVATIONS

CLIENT NAME:	Client Name
PROJECT NUMBER:	0061_12
DATE:	2/11/2025 9:32:10 AM
DESIGNED BY:	Designer
DRAWN BY:	Author
CHECKED BY:	Checker

A201

ABOUT WALL FINISHING

STUCCO FINISH

STUCCO FINISH IS A CEMENT-BASED EXTERIOR WALL FINISH THAT OFFERS A DURABLE, WEATHER-RESISTANT, AND CUSTOMIZABLE CLADDING SOLUTION FOR BUILDINGS.

IN THIS SPECIFIC PROJECT, AMERICAN STUCCO SYSTEMS IS USED AS A FINISH MATERIAL BECAUSE IT IS GENERALLY CONSIDERED A WATER-RESISTANT EXTERIOR FINISH AND USES A THREE-COAT APPLICATION PROCESS. 3/8-INCH OF IT IS APPLIED AS AN EXTERNAL WALL FINISH AS IT IS THE MOST COMMON AND WIDELY ACCEPTED STANDARD THICKNESS FOR STUCCO EXTERIOR WALL FINISHES.

THIS MULTI-LAYER APPROACH ALSO HELPS CREATE A STRONG, CRACK-RESISTANT STUCCO SURFACE. THIS STANDARD STUCCO IS APPLIED OVER OSB SHEATHINGS (FOR COLD FORMED STRUCTURE CONSTRUCTION). IT IS NOT DIRECTLY TROWELLED OVER THE OSB BUT OVER A WATER-RESISTANT BARRIER (HOMEWRAP) AND METAL/PLASTIC LATH THAT ARE INSTALLED ON TOP SURFACE OF THE OSB TO PROVIDE AN ADDITIONAL LAYER OF PROTECTION AGAINST MOISTURE INTRUSION.


REGULAR INSPECTION AND PROMPT REPAIR OF ANY CRACKS, CHIPS, OR DAMAGE TO THE STUCCO FINISH IS IMPORTANT. THIS MAINTAINS THE STUCCO'S WATER-RESISTANT PROPERTIES OVER THE BUILDING'S LIFE SPAN.

CEDAR WOOD

CEDAR WOOD REFERS TO THE WOOD FROM VARIOUS SPECIES OF CEDAR TREES, WHICH ARE CONIFEROUS EVERGREEN TREES KNOWN FOR THEIR DISTINCT AROMA AND NATURAL RESISTANCE TO DECAY AND INSECTS.


IN THIS SPECIFIC PROJECT, CEDAR WOOD IS USED A FINISH MATERIAL ON BEAMS AND COLUMNS.




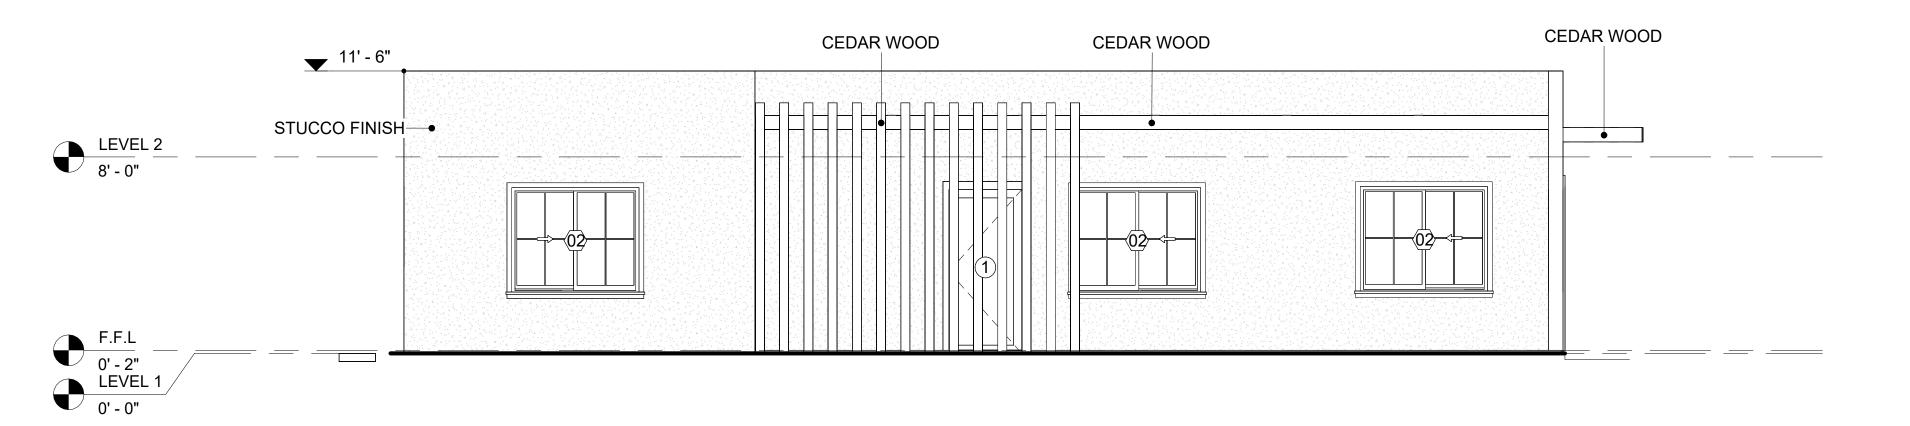





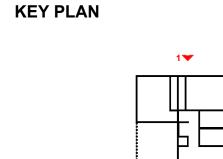

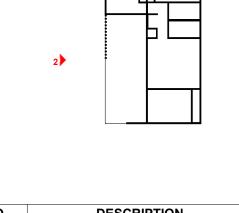

NO.	DESCRIPTION	DATE

NOTE:

LEGEND:

PROJECT


40 Yoke 999 3Bd/2Ba Contemporary 550


DRAWING NAME

ARCHITECTURAL ELEVATIONS

CLIENT NAME:	Client Name
PROJECT NUMBER:	0061_12
DATE:	2/11/2025 9:32:14 AM
DESIGNED BY:	Designer
DRAWN BY:	Author
CHECKED BY:	Checker

A202

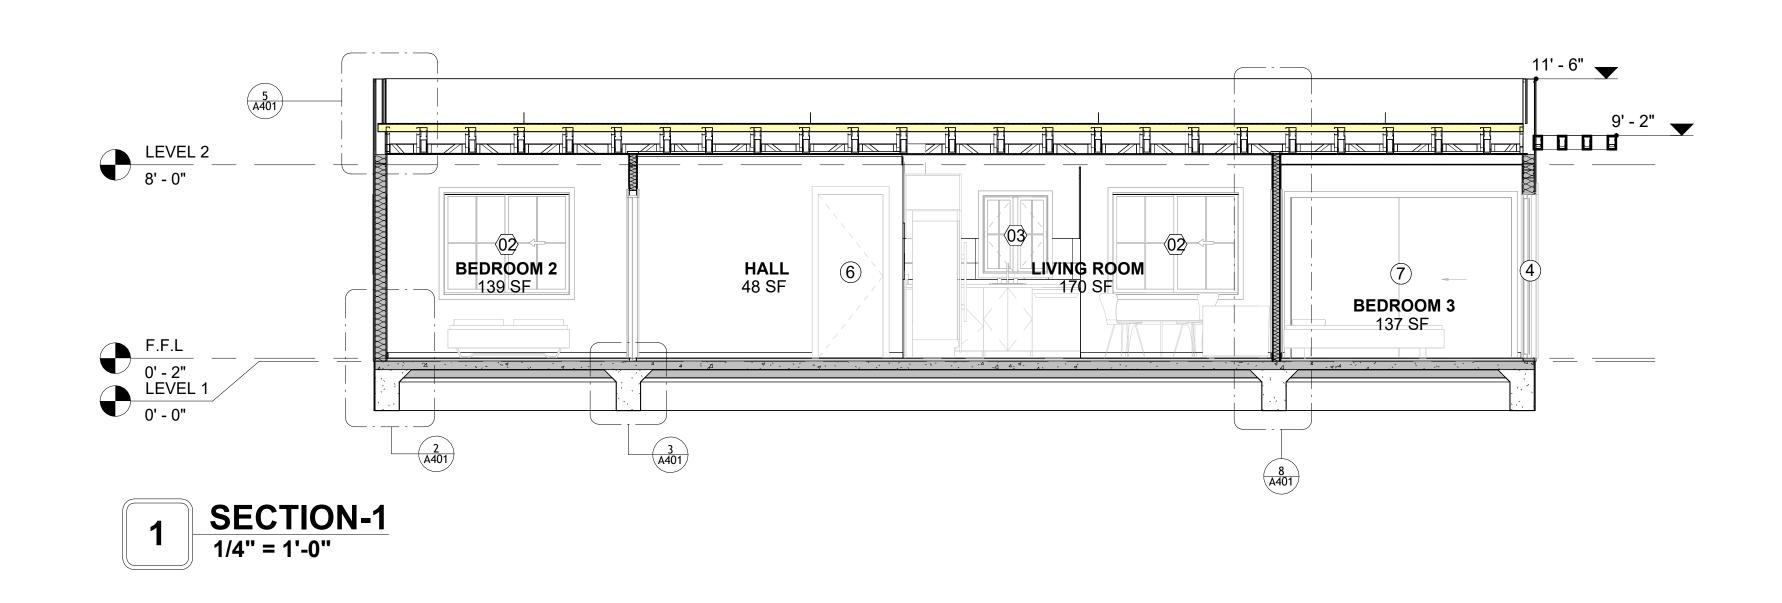


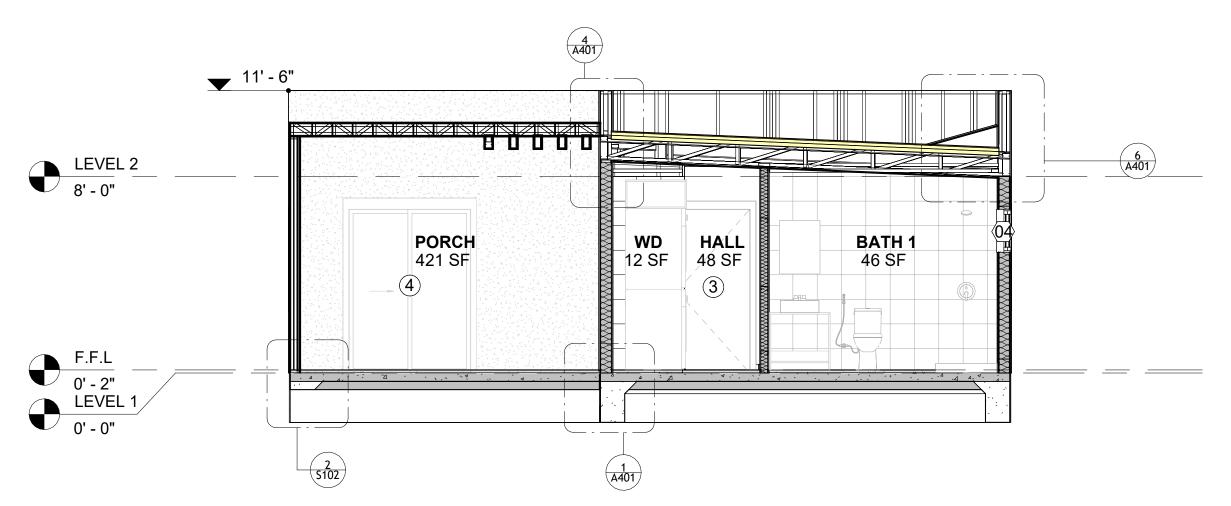





KEY PLAN

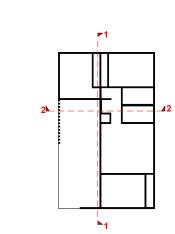

DESCRIPTION	DATE
	DESCRIPTION

NOTE:

LEGEND:

PROJECT


40 Yoke 999 3Bd/2Ba Contemporary 550


DRAWING NAME

ARCHITECTURAL SECTIONS

	Client Name
	0061_12
2	/11/2025 9:32:15 AM
	Designer
	Author
	Checker

A301

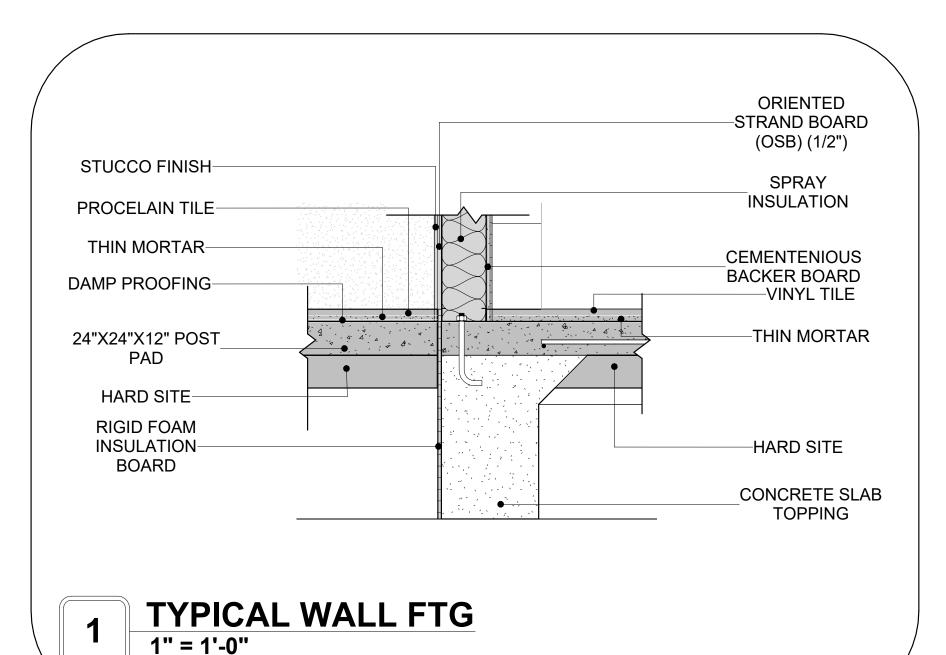

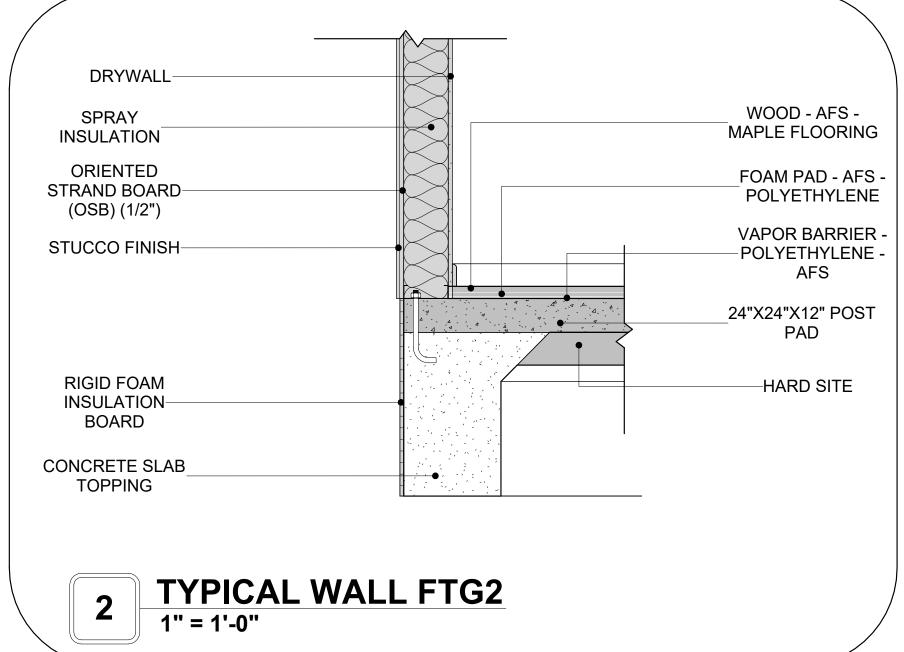

ORIENTED

-STRAND BOARD

(OSB) (1/2")

PLYWOOD

SHEATHING

POLYURETHANE

FOAM INSULATION

-DRYWALL

-CERAMIC TILE

CEMENTENIOUS BACKER BOARD

ORIENTED

STRAND BOARD

(OSB) (1/2")


STUCCO FINISH-


SPRAY INSULATION


ORIENTED STRAND BOARD-

(OSB) (1/2")


STUCCO FINISH-

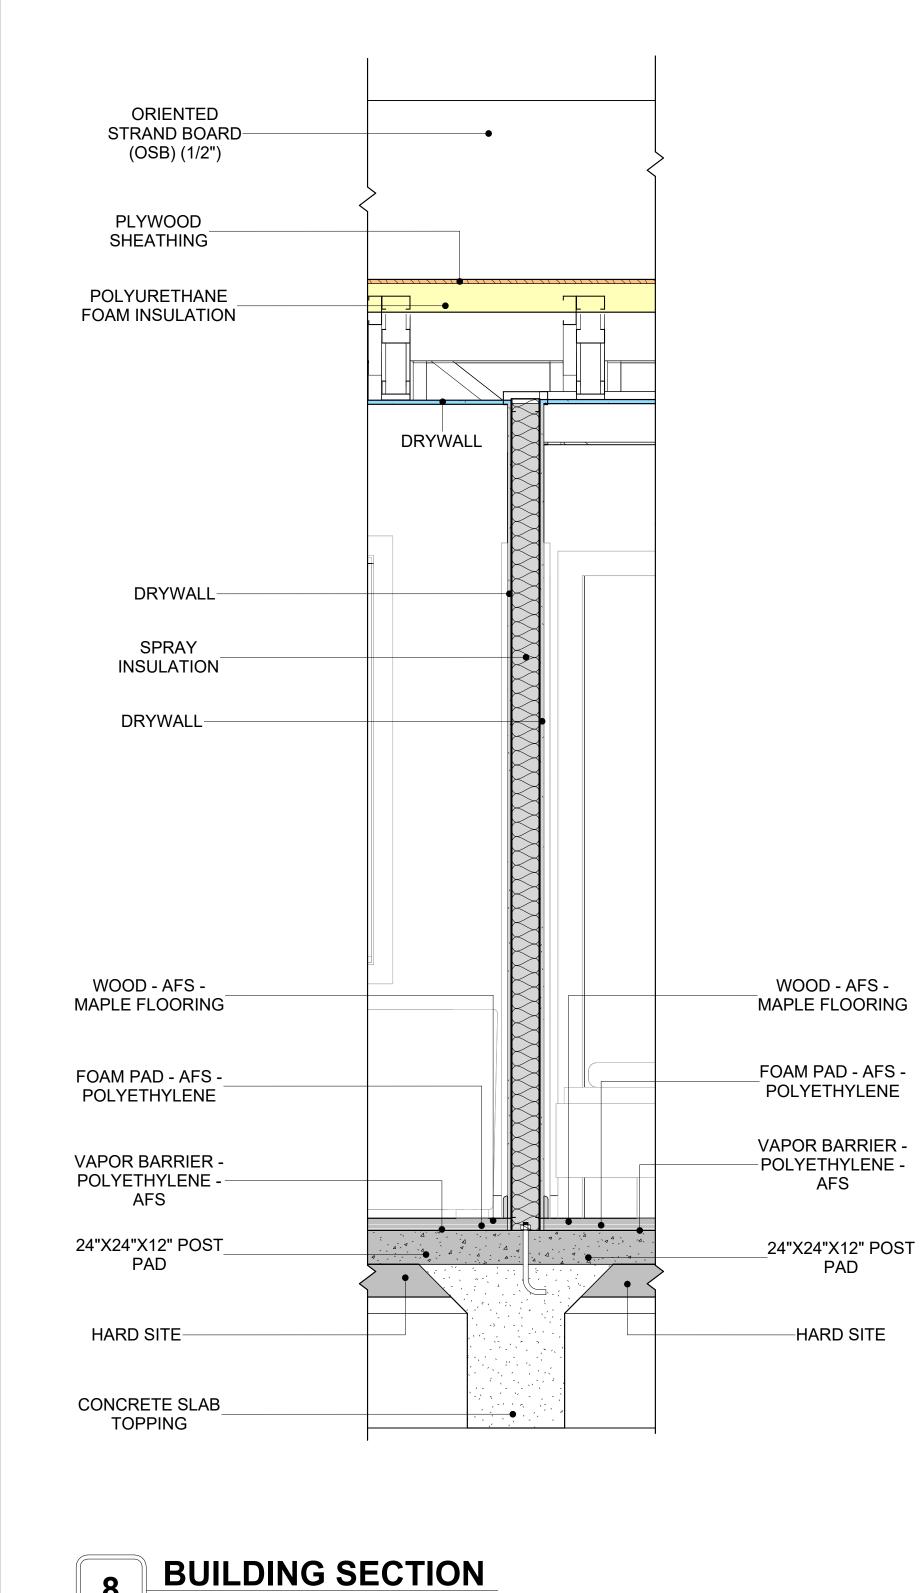

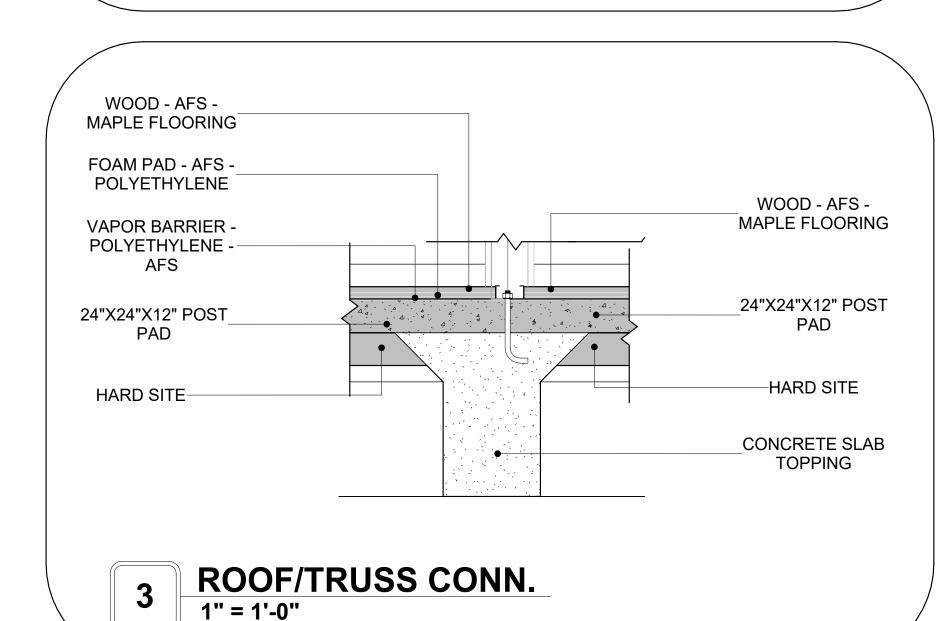

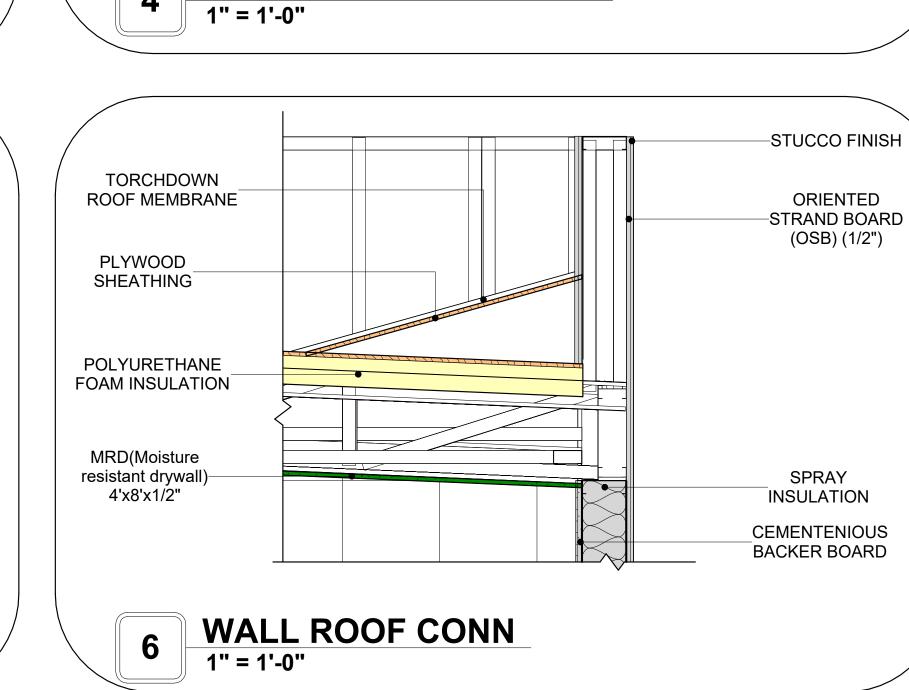

WALL TO ROOF CONN.

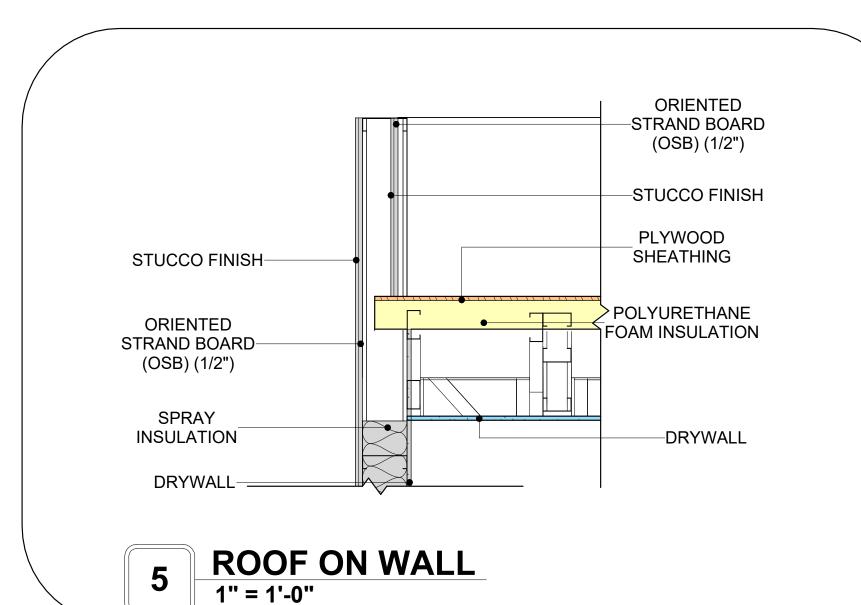



Tuscon,AZ, USA
888-864-0184
inquire@frameupnow.com
www.frameupnow.com

KEY PLAN

NO. DESCRIPTION DATE

NOTE:

LEGEND:

PROJECT

40 Yoke 999 3Bd/2Ba Contemporary 550

DRAWING NAME

ARCHITECTURAL DETAILS

CLIENT NAME:	Client Name
PROJECT NUMBER:	0061_12
DATE:	2/11/2025 9:32:17 AM
DESIGNED BY:	Designer
DRAWN BY:	Author
CHECKED BY:	Checker

A401


SCALE: 1" = 1'-0"


CASEWORK GENERAL NOTES

- ALL CABINET HEIGHTS INCLUDE COUNTERTOPS. DIMENSIONS ARE TO THE NEAREST INCH. DIVISIONS IN CASEWORK ARE SHOWN FOR CLARITY AND DO NOT REPRESENT BREAKS IN THE
- COUNTERTOP. PROVIDE CONTINUOUS COUNTERTOP OVER ALL SIMILAR HEIGHT CASEWORK, UNLESS AND
- OTHERWISE NOTED. MANUFACTURER AND CATALOG NUMBERS ARE FOR REFERENCE AND ILLUSTRATION PURPOSES
- DOTTED LINES INDICATE WALL HUNG CABINETS, DIVISIONS OF BASE CABINETS BELOW THE
- COUNTERTOP, FURNITURE NOT IN THE CONTRACT OR PROJECTION SCREENS -SEE CASEWORK KEY AND SPECIFICATIONS.
- ALL CABINETS AND DRAWERS TO HAVE CAM LOCKS EXCEPT FOR SINK BASE CABINETS.
 ALL EXPOSED SURFACES (EXPOSED TO VIEW FROM ANY PERSPECTIVE) TO BE COVERED WITH LAMINATE.
- ALL CASEWORK WHICH MEETS A WALL AT ONE OR BOTH ENDS, TO BE PROVIDED WITH FILLER
- PANELS AND SCRIBED TO THE WALL(S) AS REQUIRED.
- 10. ALL CABINETS AND DRAWERS ARE PROVIDED WITH RECESSED HANDLES. 11. CONTRACTOR TO FIELD VERIFY ALL CLEAR OPENINGS PRIOR TO MILLWORK OR CASEWORK FABRICATION.
- 12. CASEWORK DRAWINGS ARE DIAGRAMMATIC IN NATURE TO SHOW DESIGN INTENT

	CASEWORK SCHEDULE					
TYPE MAR K	TYPE	COUN	HEIGHT	WIDTH	DEPTH	AREA
00	Base Cabinet Double Door 1	2	2' - 11"	2' - 0"	2' - 0"	6 SF
01	VANITY	2	2' - 4"	2' - 6"	1' - 8"	6 SF
02	LAUNDRY OPEN CABINET 3 158	1	1' - 2"	2' - 3"	2' - 6"	3 SF
03	Wall Cabinet Double Door 3 158	1	2' - 6"	2' - 6"	1' - 0"	6 SF
04	Linear Counter Top 2 158	1	0' - 4"	2' - 6"	2' - 0"	1 SF
05	Base Filler 1 2 158	1	2' - 11"	0' - 6"	2' - 0"	1 SF
06	Wall Cabinet Double Door 2 158	1	2' - 6"	3' - 3"	1' - 0"	8 SF
07	L-SHAPE COUNTER TOP 158	1	0' - 4"	7' - 0"	7' - 0"	2 SF
08	Closet 3 158	3	6' - 0"	9' - 11"	1' - 4"	60 SF
09	Base_Cabinet_L-Shaped	1	2' - 11"	3' - 3"	3' - 3"	9 SF
10	LAUNDRY OPEN CABINET	1	1' - 6"	2' - 0"	2' - 4"	3 SF
11	RECESSED_MED_CABINET	2	2' - 0"	1' - 6"	0' - 3"	3 SF
Grand to	otal	17		•		

SPECIALTY EQUIPMENT SCHEDULE			
TYPE MARK	TYPE	COUNT	
01	WASHER-FRONT-LOAD	1	
02	REFRIGERATOR	1	
03	RANGE	1	
04	DRYER-FRONT-LOAD	1	
05	Dishwasher	1	
Grand total: 5			

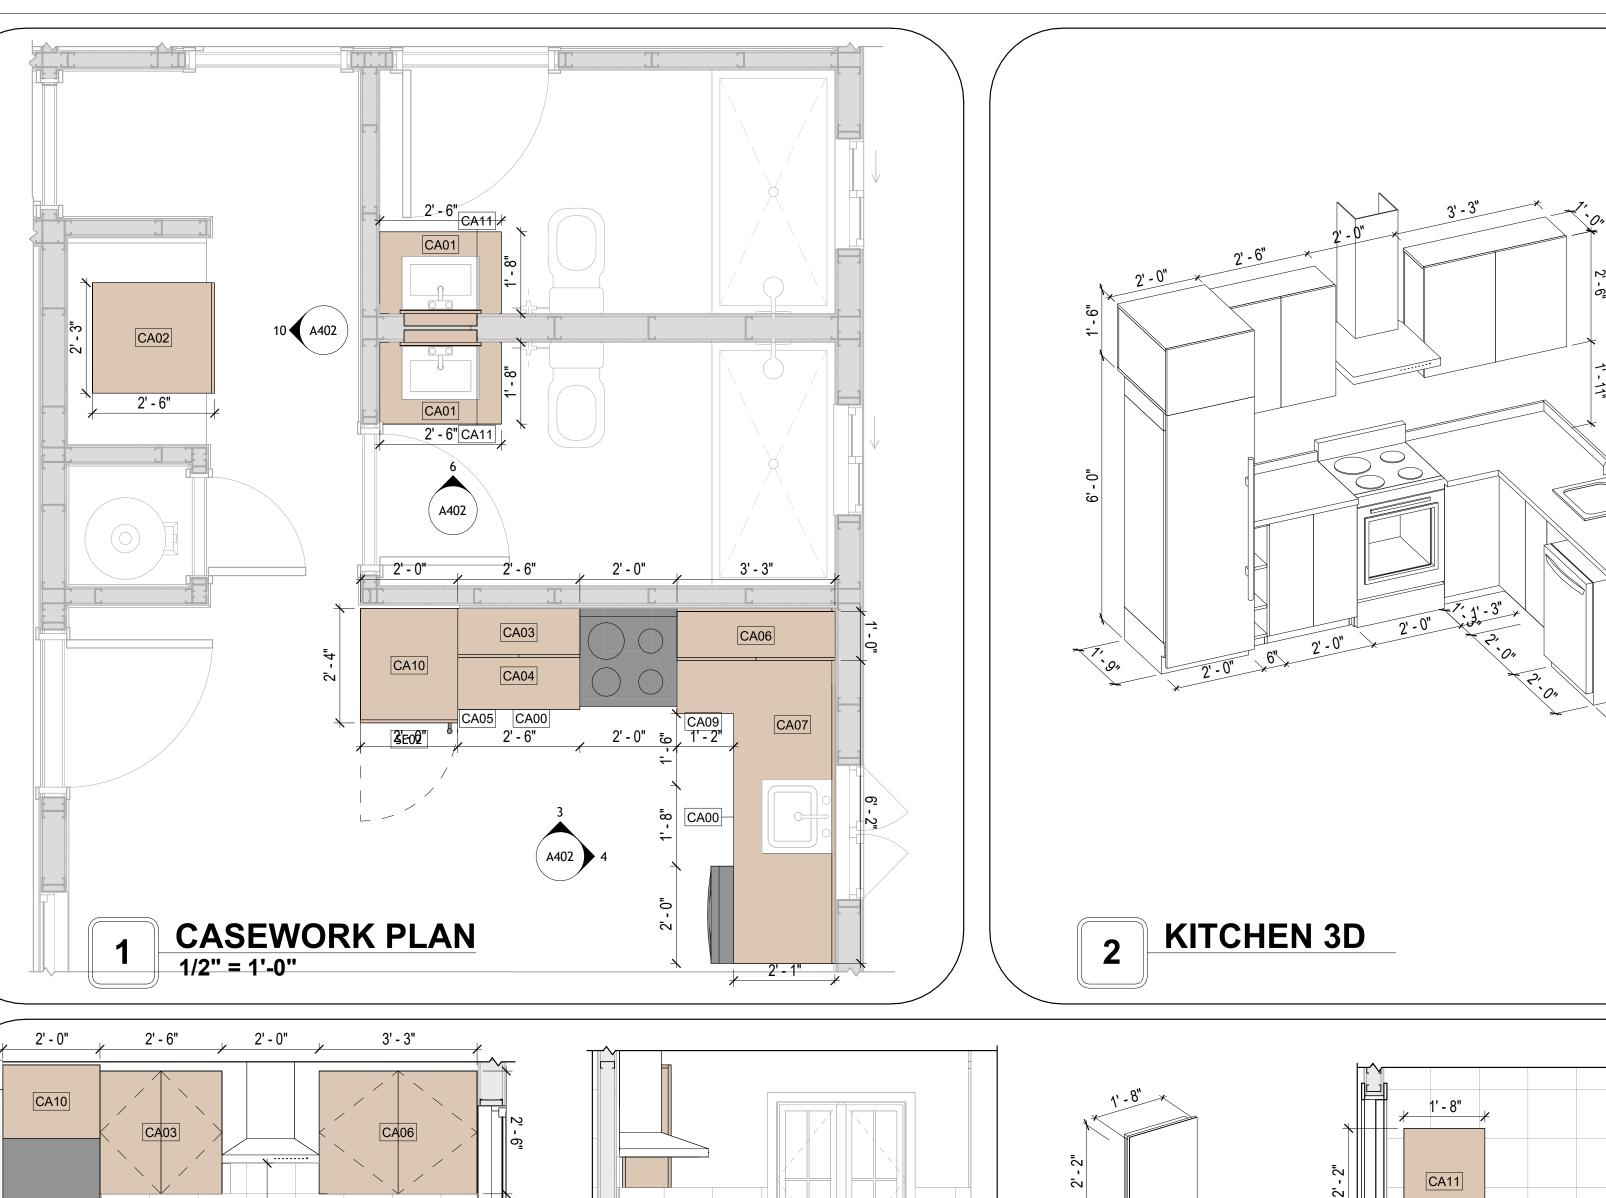

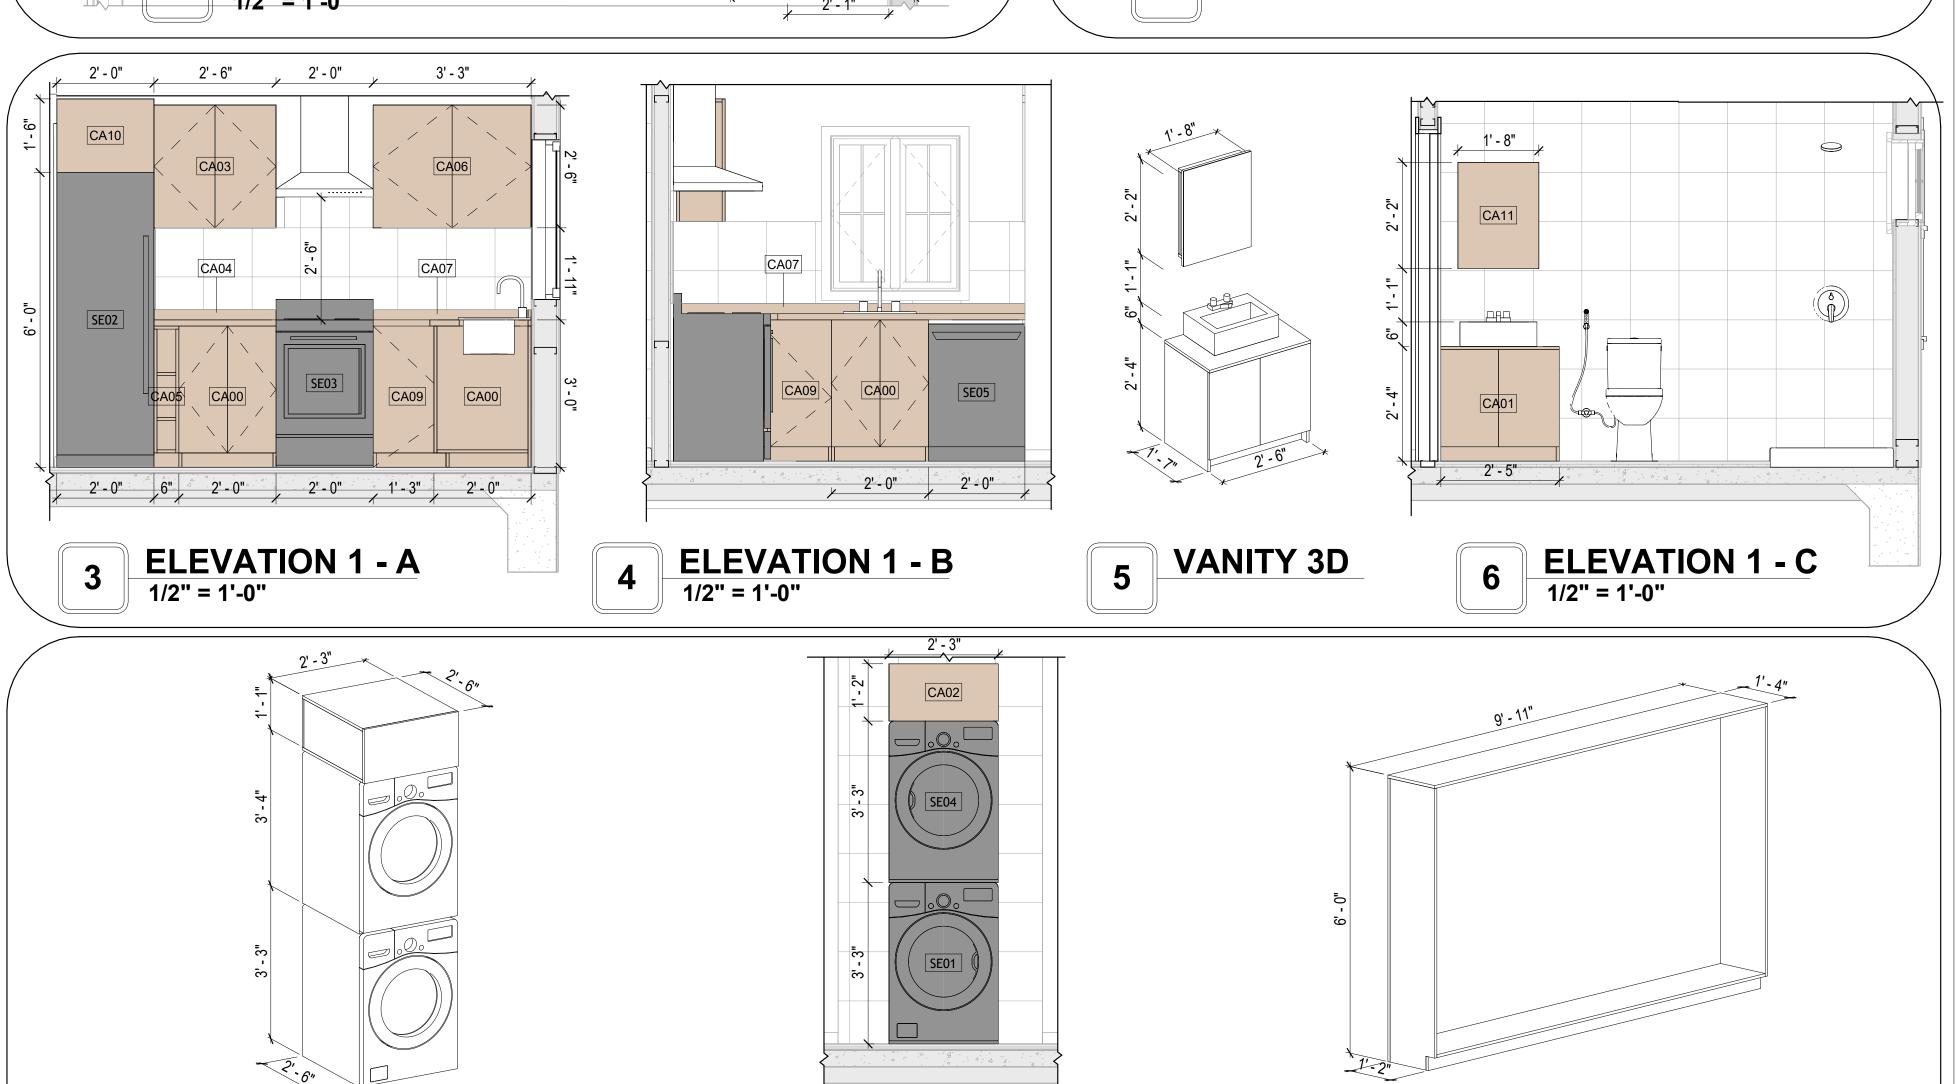


ELEVATION 1 - E 1/2" = 1'-0"

LAUNDRY 3D

CLOSET 3D 1



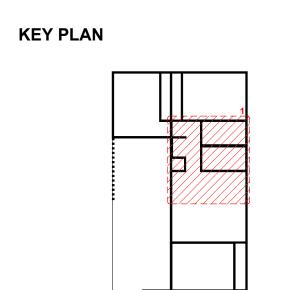

NO.	DESCRIPTION	DATE

NOTE:

LEGEND:

PROJECT

40 Yoke 999 3Bd/2Ba **Contemporary 550**

DRAWING NAME

ARCHITECTURAL CASEWORK

CLIENT NAME:	Client Name
PROJECT NUMBER:	0061_12
DATE:	2/11/2025 9:32:20 AM
DESIGNED BY:	Designer
DRAWN BY:	Author
CHECKED BY:	Checker

A402

GENERAL NOTES

APPLICABLE GUIDELINES AND REGULATIONS.

1. THIS DRAWING DEPICTS THE HVAC (HEATING, VENTILATION, AND AIR CONDITIONING) SYSTEM FOR THE ------ NG. IT PROVIDES A VISUAL REPRESENTATION OF THE SYSTEM LAYOUT AND COMPONENTS.

2.THE HVAC SYSTEM IS DESIGNED TO MEET THE SPECIFIC REQUIREMENTS OF THE BUILDING, INCLUDING HEATING, COOLING, AND VENTILATION NEEDS, AS PER THE PROJECT SPECIFICATIONS AND APPLICABLE CODES AND STANDARDS.

3. THE HVAC SYSTEM INSTALLATION SHALL COMPLY WITH THE LATEST EDITION OF THE INTERNATIONAL MECHANICAL CODE (IMC), INTERNATIONAL RESIDENTIAL CODE (IRC), AND ALL OTHER APPLICABLE LOCAL, STATE, AND NATIONAL CODES AND REGULATIONS.

4. THE EQUIPMENT SHOWN ON THIS DRAWING INCLUDES BUT IS NOT LIMITED TO AIR HANDLING UNITS (AHUS), CHILLERS, BOILERS, COOLING TOWERS, PUMPS, DUCTWORK, DIFFUSERS, GRILLES, AND CONTROL DEVICES.

5. ALL EQUIPMENT, DUCTWORK, AND PIPING SHALL BE INSTALLED IN ACCORDANCE WITH MANUFACTURER'S SPECIFICATIONS, LOCAL CODES, AND

6. ALL DUCTWORK SHALL BE SIZED, FABRICATED, AND INSTALLED IN ACCORDANCE WITH THE LATEST EDITION OF THE ACCA MANUAL D AND THE SMACNA HVAC DUCT CONSTRUCTION STANDARDS. DUCTWORK SHALL BE INSTALLED IN A NEAT AND WORKMANLIKE MANNER, PROPERLY SUPPORTED AND BRACED TO PREVENT SAGGING, AIR LEAKAGE, OR VIBRATION.

7. CONDENSATE DRAINAGE PIPING SHALL BE PROPERLY PITCHED TO ENSURE POSITIVE DRAINAGE TO AN APPROVED DISPOSAL LOCATION, SUCH AS A FLOOR DRAIN, SUMP PUMP, OR EXTERIOR GRADE. CONDENSATE LINES SHALL BE INSULATED TO PREVENT SWEATING.

8. THE LOCATION OF CONTROL PANELS AND SENSORS INDICATED ON THIS DRAWING CAN BEMODIFY WITH THE SPECIFIC LOCATIONS AND WIRING DETAILS WILL BE DETERMINED DURING THE CONTROL SYSTEM DESIGN AND INSTALLATION.

9. THE HVAC SYSTEM DESIGN CONSIDER ENERGY EFFICIENCY, INDOOR AIR QUALITY, OCCUPANT COMFORT, AND NOISE CONTROL, FOLLOWING

10. COORDINATION WITH OTHER TREADS HAS BEEN DONE ON A DESIGN LEVEL. THIS DRAWING SHALL BE READ TOGETHER WITH THE AR, EL AND SN

DESIGN DRAWINGS TO ENSURE PROPER INSTALLATION AND INTEGRATION OF THE HVAC SYSTEMS. 11. THE HVAC CONTRACTOR IS RESPONSIBLE FOR OBTAINING ALL NECESSARY PERMITS AND LICENSES, AND FOR SCHEDULING AND COORDINATING

WITH THE LOCAL BUILDING DEPARTMENT AND UTILITY PROVIDERS TO ENSURE A TIMELY AND COMPLIANT INSTALLATION. 12. ALL DUCTWORK PENETRATIONS THROUGH WALLS, FLOORS, OR CEILINGS SHALL BE PROPERLY SEALED AND FIRE-STOPPED USING APPROVED

METHODS AND MATERIALS TO MAINTAIN THE INTEGRITY OF THE BUILDING'S FIRE-RESISTANCE RATINGS. 13. HVAC EQUIPMENT SHALL BE INSTALLED LEVEL AND PLUMB, AND IN STRICT ACCORDANCE WITH THE MANUFACTURER'S INSTALLATION


INSTRUCTIONS AND RECOMMENDATIONS. PROVIDE ADEQUATE CLEARANCES AROUND EQUIPMENT FOR PROPER AIRFLOW, SERVICE ACCESS, AND CODE COMPLIANCE.


14. ALL HVAC EQUIPMENT AND COMPONENTS, INCLUDING THERMOSTATS, DAMPERS, AND ACCESS PANELS, SHALL BE LOCATED IN ACCESSIBLE AREAS FOR EASY SERVICING AND MAINTENANCE. PROVIDE ADEQUATE SPACE AROUND EQUIPMENT FOR PROPER AIRFLOW AND SERVICE ACCESS.


15. THE HVAC SYSTEM SHALL BE BALANCED AND ADJUSTED TO ENSURE PROPER AIRFLOW, TEMPERATURE DISTRIBUTION, AND SYSTEM PERFORMANCE THROUGHOUT THE RESIDENCE. PROVIDE A WRITTEN REPORT DOCUMENTING THE FINAL SYSTEM BALANCE.

16. ANY DEVIATIONS OR MODIFICATIONS TO THE HVAC SYSTEM DESIGN SHALL BE REVIEWED AND APPROVED BY THE RESPONSIBLE DESIGN PROFESSIONALS AND COMMUNICATED TO ALL RELEVANT PARTIES INVOLVED IN THE CONSTRUCTION PROCESS.

17. FOR ANY INQUIRIES OR CLARIFICATIONS REGARDING THE HVAC SYSTEM DESIGN, PLEASE CONSULT THE RESPONSIBLE DESIGN PROFESSIONALS OR THE PROJECT MANAGEMENT TEAM.

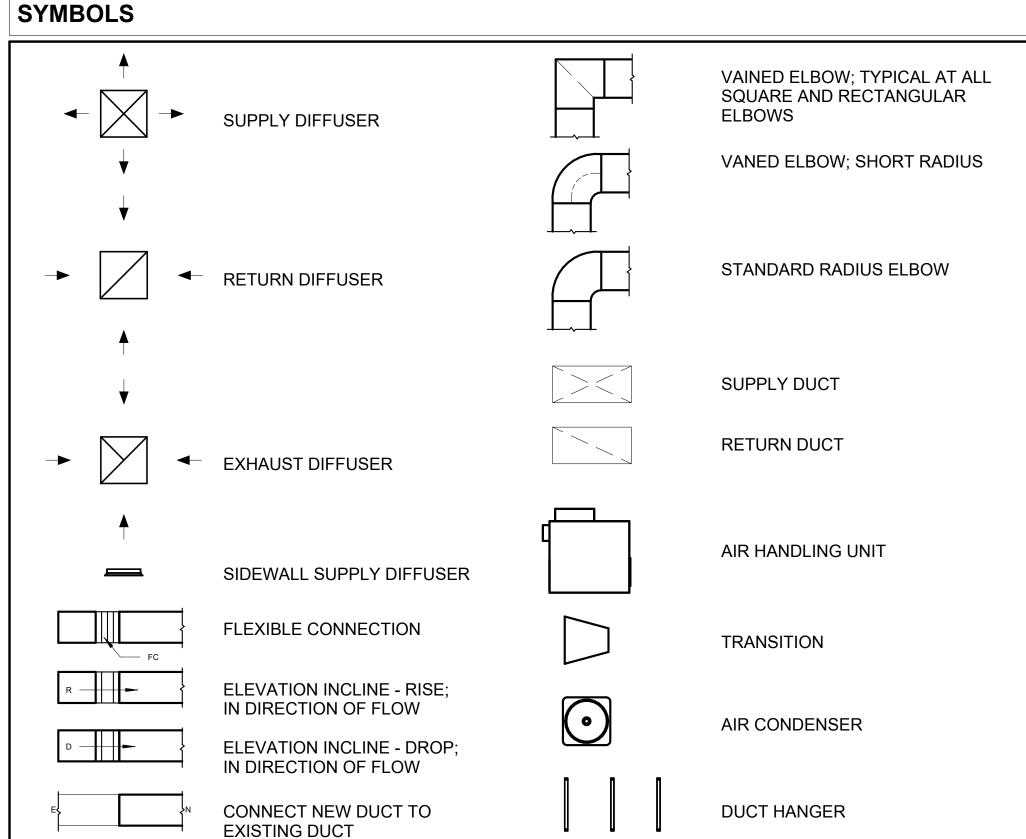

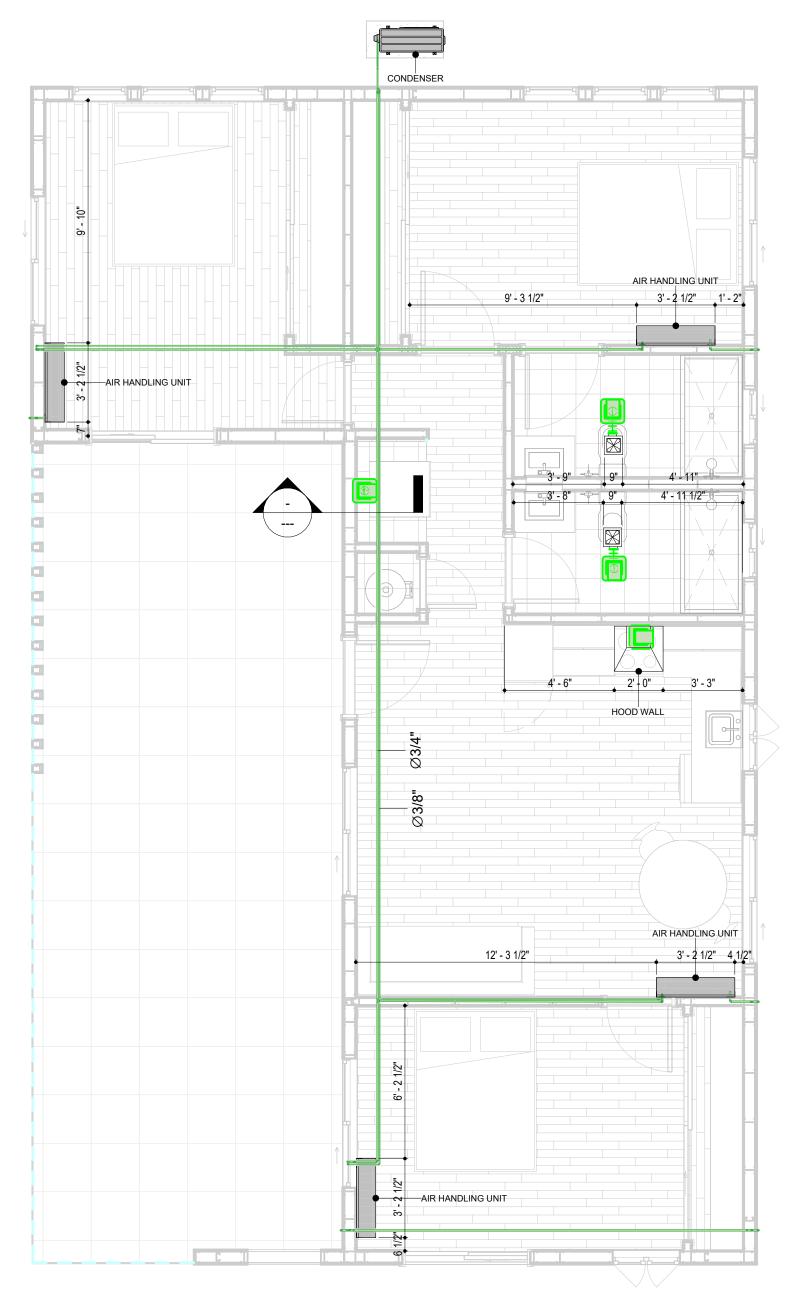

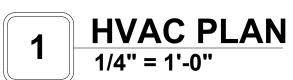

HVAC COLOR SCHEME

AIR CONDITIONING PIPE

REFRIGERANT LINE SCHEDULE				
CATAGORY	DESCRIPTION	DIAMETER	LENGTH	
PIPE TYPES	COPPER	1/4"	1.21	
PIPE TYPES	COPPER	3/8"	97.62	
PIPE TYPES	COPPER	1/2"	1.22	
PIPE TYPES	COPPER	3/4"	147.01	

CATAGORY	DESCRIPTION	Size	Count
		1	1
CROSS - GENERIC	CROSS - GENERIC: STANDARD	3/4"ø-3/4"ø-3/ 4"ø-3/4"ø	1
ELBOW - GENERIC	ELBOW - GENERIC: STANDARD/HVAC	1/2"ø-1/2"ø	1
ELBOW - GENERIC	ELBOW - GENERIC: STANDARD/HVAC	1/4"ø-1/4"ø	1
ELBOW - GENERIC	ELBOW - GENERIC: STANDARD/HVAC	3/4"ø-3/4"ø	37
ELBOW - GENERIC	ELBOW - GENERIC: STANDARD/HVAC	3/8"ø-3/8"ø	23
TEE - GENERIC	TEE - GENERIC: STANDARD	3/4"ø-3/4"ø-3/ 4"ø	1
TEE - GENERIC	TEE - GENERIC: STANDARD	3/8"ø-3/8"ø-3/ 8"ø	3
TRANSITION - GENERIC	TRANSITION - GENERIC: STANDARD	3/4"ø-1/2"ø	5
TRANSITION - GENERIC	TRANSITION - GENERIC: STANDARD	3/4"ø-5/8"ø	4
TRANSITION - GENERIC	TRANSITION - GENERIC: STANDARD	3/8"ø-1/4"ø	1

MECHANICAL EQUIPMENT SCHEDULE				
CATAGORY	DESCRIPTION	COUNT		
AIR HANDLING UNIT	AIR HANDLING UNIT: WALL MOUNTED	4		
CONDENSER	CONDENSER: OUT DOOR	1		
EXHAUST FAN	EXHAUST FAN: 75 CFM	2		
	HOOD WALL: VENT			

DUCT FITTING SCHEDULE			
CATAGORY	DESCRIPTION	COUNT	
ROUND TRANSITION - ANGLE	45 DEGREE	7	

	DUCT ACCESSORY SCHEDULE	
CATAGORY	DESCRIPTION	COUNT
ROOF VENT	3" DIAMETER	4

FLEX DUCT SCHEDULE				
DESCRIPTION	DESCRIPTION	LENGTH	DIAMETER	COUNT
FLEX DUCT ROUND	FLEX-ROUND	8.42	4"	4
GRAND TOTAL: 4		8.42		



KEY PLAN

NO.	DESCRIPTION	DATE

NOTE:

LEGEND:

PROJECT

40-Yoke-999-3Bd2Ba-Contemporary-350

DRAWING NAME

HVAC PLAN

CLIENT NAME: Owner PROJECT NUMBER: 15_0001 DATE: 2/10/2025 9:23:37 PM Designer DESIGNED BY: DRAWN BY: Author CHECKED BY: Checker

M101

© [2024] [FrameUpNow] . All rights reserved

ELECTRICAL NOTES

- 1. THIS DRAWING DEPICTS THE ELECTRICAL SYSTEM FOR THE 40-YOKE-999-3Bd2Ba-Contemporary-550. IT PROVIDES A VISUAL REPRESENTATION OF THE ELECTRICAL LAYOUT AND COMPONENTS, INCLUDING POWER DISTRIBUTION, LIGHTING, AND CONTROL SYSTEMS.
- 2. THE ELECTRICAL SYSTEM IS DESIGNED TO MEET THE SPECIFIC REQUIREMENTS OF THE BUILDING, INCLUDING POWER DISTRIBUTION, LIGHTING, AND SPECIALIZED ELECTRICAL EQUIPMENT NEEDS, AS PER THE PROJECT SPECIFICATIONS AND APPLICABLE CODES AND STANDARDS.
- 3. THE ELECTRICAL SYSTEM INSTALLATION SHALL COMPLY WITH THE LATEST EDITION OF THE NATIONAL ELECTRICAL CODE (NEC), INTERNATIONAL BUILDING CODE (IBC), AND ALL OTHER APPLICABLE LOCAL, STATE, AND NATIONAL CODES AND REGULATIONS.
- 4. LOCATIONS AS NEEDED, DEVICES ARE SHOWN ON PLANS IN APPROXIMATE IDEAL LOCATIONS, UNLESS SPECIFICALLY DIMMENSIONED.
- 5. OPEN WALLS AS NEEDED TO ALLOW FOR NEW ELECTRICAL INSTALLATIONS.
- 6. LABEL ALL CIRCUITS ON JUNCTION BOXES, RECEPTACLES, DATA, SMOKE DETECTOR, AND EQUIPMENT IN PANEL BOX.
- 7. INSTALL RACEWAY AS NEEDED FOR DDC, ACCESS CONTROL, LOW VOLTAGE WIRING & DATA.
- 8. RELABEL POWER, DATA & FIRE ALARM FOR ROOM #CHANGES.
- 9. VERIFY ALL CIRCUITS LABELED ON PRINT ARE CORRECT BEFORE WORKING ON THEM.
 10. NOTE ON SITE PLAN ALL CHANGES OR MISSING DETAIL TO BE INCORPORATED INTO THE MASTER PLAN.
- 11. DRAWINGS ARE DIAGRAMMATIC ONLY FOR THE PURPOSE OF SHOWING FIXTURE AND OUTLET LOCATIONS.
- 12. ELECTRICAL CONTRACTOR TO VERIFY SERVICE SIZE BY CALCULATION BASED UPON ACTUAL NAME
- PLATE RATINGS OF SELECTED EQUIPMENT.

 13. VERIEY LOCATION OF SERVICE ENTRANCE WITH POWER COMPANY PROVIDE LIFER GROUND IN
- 13. VERIFY LOCATION OF SERVICE ENTRANCE WITH POWER COMPANY. PROVIDE UFER GROUND IN BUILDING FOUNDATION AT SERVICE ENTRANCE LOCATION.
- 14. PROVIDE A MIN. OF 20 FEET OF ONE *4 BARE COPPER UFER WIRE EMBEDDED IN CONCRETE FOOTING AT THE SERVICE ENTRANCE LOCATION WHERE APPROVED BY LOCAL SERVICE PROVIDER.
- 15. PROVIDE WATERPROOF FIXTURES IN ALL HIGH MOISTURE AREAS (EXTERIOR, SHOWER AND TUB
- CEILINGS ETC.)
- 16. PROVIDE DEDICATED CIRCUITS TO EACH BATH, DEN, FAMILY ROOM, BEDROOM, LOFT, KITCHEN REFRIGERATOR, KITCHEN FREEZER DISHWASHER, AND ANY AREA/ITEM SPECIFIED BY OWNER.
- 17. INCANDESCENT FIXTURES WITH OPEN OR PARTIALLY ENCLOSED LAMPS, PENDANT FIXTURES, AND
- LAMP HOLDERS ARE NOT PERMITTED IN CLOSETS.

 18. ALL WORKMANSHIP AND MATERIALS TO CONFORM WITH THE 2015 IRC.
- 19. PROVIDE A MIN. OF 20 FEET OF ONE *4 BARE COPPER UFER WIRE EMBEDDED IN CONCRETE FOOTING AT THE SERVICE ENTRANCE LOCATION WHERE APPROVED BY LOCAL SERVICE PROVIDER.
- 20. PROVIDE A BONDING CONDUCTOR CONSISTING OF A MINIMUM OF ONE *4 BARE COPPER WIRE CONNECTING THE BUILDING'S METAL WATER PIPING SYSTEM TO THE SERVICE EQUIPMENT ENCLOSURE GROUNDING.

MAIN PANEL CALCS

ELECTRICAL CALCS	
LIGHT AND OUTLETS 999 @ 3W	2,997 W
3 APPLIANCE CIRCUITS	4,500 W
DRYER	2,000 W
WASHER	2,000 W
RANGE	5,000 W
WATER HEATER	5,000 W
REFRIG.	1,800 W
DISHWASHER & DISPOSAL	3000 W
TOTAL	26,297 W
FRIST 10,000 @ 100% REMAINDER @ 40% MINI. SPLIT UNITS	10,000 W 6,519W 2880 W
TOTAL	19,396 W

19,396 W DIVIDED BY 240V = 81 AMPS TOTAL

(USE 200 AMP SERVICE)

ELECTRICAL ABBREVIATIONS LIST

1P	1 POLE (2P, 3P, 4P, ETC.)	CTR	CENTER	HT	HEIGHT
A	AMPERE	CU	COPPER	HTG	HEATING
AC	ABOVE COUNTER OR AIR CONDITIONER	DCP	DOMESTIC WATER CIRCULATING PUMP	HTR	HEATER
			DEPARTMENT	HV	
ACLG	ABOVE CEILING	DEPT			HIGH VOLTAGE
ADO	AUTOMATIC DOOR OPENER	DET	DETAIL	HVAC	HEATING, VENTILATING AND AIR
AF	AMP FRAME	DIA	DIAMETER	CONDITIONING	CONDITIONING
AFF	ABOVE FINISHED FLOOR	DISC	DISCONNECT	HWP	HYDRONIC WATER PUMP
AFG	ABOVE FINISHED GRADE	DIST	DISTRIBUTION	IC	INTERRUPTING CAPACITY
AFI	ARC FAULT CIRCUIT INTERRUPTER	DN	DOWN	IG	ISOLATED GROUND
AHU	AIR HANDLING UNIT	DPR	DAMPER	IMC	INTERMEDIATE METAL CONDUIT
AL	ALUMINUM	DS	SAFETY DISCONNECT SWITCH	INCAND	INCANDESCENT
ALT	ALTERNATE	DT	DOUBLE THROW	IR	INFRARED
AMP	AMPERE	DWG	DRAWING	I/W	INTERLOCK WITH
AMPL	AMPLIFIER	DDC	DIRECT DIGITAL CONTROL	J-BOX	JUNCTION BOX
ANNUN	ANNUNCIATOR APPROX APPROXIMATELY	EC	ELECTRICAL CONTRACTOR	KV	KILOVOLT
AQ-STAT	AQUASTAT	ELEC	ELECTRIC, ELECTRICAL	KVA	KILOVOLT-AMPERE
ARCH	ARCHITECT, ARCHITECTURAL	ELEV	ELEVATOR	KVAR	KILOVOLT-AMPERE REACTIVE
AS	AMP SWITCH	EM	EMERGENCY	KW	KILOWATT
AT	AMP TRIP	EMS	ENERGY MANAGEMENT SYSTEM	KWH	KILOWATT HOUR
ATS	AUTOMATIC TRANSFER SWITCH	EMT	ELECTRICAL METALLIC TUBING	LOC	LOCATE OR LOCATION
AUTO	AUTOMATIC	EP	ELECTRIC PNEUMATIC	LT	LIGHT
AUX	AUXILIARY	EQUIP	EQUIPMENT	LTG	LIGHTING
AV	AUDIO VISUAL	EWC	ELECTRIC WATER COOLER	LTNG	LIGHTNING
AWG	AMERICAN WIRE GAUGE	EXIST	EXISTING	LV	LOW VOLTAGE
BATT	BATTERY	EXH	EXHAUST	MAX	MAXIMUM
BD	BOARD	EXP	EXPLOSION PROOF	MAG.S	MAGNETIC STARTER
BLDG	BUILDING	FA	FIRE ALARM	M/C	MOMENTARY CONTACT
BMS	BUILDING MANAGEMENT SYSTEM	FABP	FIRE ALARM BOOSTER POWER	MC	MECHANICAL CONTRACTOR
C	CONDUIT	SUPPLY PANEL	SUPPLY PANEL	MCB	MAIN CIRCUIT BREAKER
CAB	CABINET		FIRE ALARM CONTROL PANEL	MCC	MOTOR CONTROL CENTER
		FACP		_ I	MAIN DISTRIBUTION CENTER
CATY	CATALOG	FCU	FAN COIL UNIT	MDC	
CATV	CABLE TELEVISION	FIXT	FIXTURE	MDP	MAIN DISTRIBUTION PANEL
CB	CIRCUIT BREAKER	FLR	FLOOR	MFR	MANUFACTURERMAIN FUSED
CCTV	CLOSED CIRCUIT TELEVISION	FLUOR	FLUORESCENT	N.41.1	DISCONNECT SWITCH
CKT	CIRCUIT	FUDO	FUSE	MH	MANHOLE
CLG	CEILING	FUDS	FUSED SAFETY DISCONNECT SWITCH	MIC	MICROPHONE
COMB	COMBINATION	GA	GAUGE	MIN	MINIMUM
CMPR	COMPRESSOR	GAL	GALLON	MISC	MISCELLANEOUS
CONN	CONNECTION	GALV	GALVANIZED	MLO	MAIN LUGS ONLY
CONST	CONSTRUCTION	GC	GENERAL CONTRACTOR	MMS	MANUAL MOTOR STARTER
CONT	CONTINUATION OR CONTINUOUS	GEN	GENERATOR	MOA	MULTIOUTLET ASSEMBLY
CONTR	CONTRACTOR	GFI	GROUND FAULT CIRCUIT INTERRUPTER	MSP	MOTOR STARTER PANELBOARD
CONV	CONVECTOR	GFP	GROUND FAULT PROTECTOR	MSBD	MAIN SWITCHBOARD
CP	CIRCULATING PUMP	GND	GROUND	MT	MOUNT
CRT	CATHODE-RAY TUBE	GRS	GALVANIZED RIGID STEEL (CONDUIT)	MT.C	EMPTY CONDUIT
CT	CURRENT TRANSFORMER	GYP BD	GYPSUM BOARD	UL	UNDERWRITERS LABORATORIES

Branch Panel:

Location: KITCHEN 01
Supply From:
Mounting: Recessed

Enclosure: Type 1

Volts: 120/240 Single
Phases: 1
Wires: 3

A.I.C. Rating:
Mains Type:
Mains Rating: 200 A
MCB Rating: 1 A

Notes:

Circuit Numb er		Number of Elements	Rating	Length	Wire Size	A		E	3	Wire Size	Length	Rating	Number of Elements	Circuit Description	Circui Numb er
1	CONDENSER	1	60 A	50' - 8"	2-#6, 1-#6, 1-#10	750 VA	720 VA			1-#12, 1-#12, 1-#12	62' - 2 15/32"	20 A	4	BEDROOM 1 RECEPTACLES	2
3								750 VA	900 VA	1-#12, 1-#12, 1-#12	46' - 6 5/8"	20 A	5	BEDROOM 2 RECEPTACLES	4
	BED ROOM 1 AND 2 LIGHT POINTS	16	20 A	52' - 9 25/32"	1-#12, 1-#12, 1-#12	419 VA	540 VA			1-#12, 1-#12, 1-#12	35' - 5"	20 A	13	LIVINGROOM AND HALL LIGHT UNITS	6
	BEDROOM 3 LIGHT PONTS	8	20 A	38' - 8 1/16"	1-#12, 1-#12, 1-#12			209 VA	720 VA	1-#12, 1-#12, 1-#12	48' - 5 7/8"	20 A	4	BEDROOM 3 RECEPTACLES	8
9	LIVINGROOM RECEPTACLES	4	20 A	38' - 4 23/32"	1-#12, 1-#12, 1-#12	720 VA	360 VA			1-#12, 1-#12, 1-#12	16' - 11 7/32"	20 A	2	KITCHEN GFCI	10
11	REFRIGERATOR	1	20 A	20' - 2"	1-#12, 1-#12, 1-#12			1500 VA	1200 VA	1-#10, 1-#10, 1-#10	14' - 5"	30 A	1	DISH WASHER	12
13	RANGE	1	50 A	14' - 7 15/32"	2-#8, 1-#8, 1-#10	750 VA	336 VA			1-#12, 1-#12, 1-#12	27' - 3 15/32"	20 A	5	BATHROOM 1 UNITS	14
15								750 VA	336 VA	1-#12, 1-#12, 1-#12	25' - 4"	20 A	6	BATHROOM 2 UNITS	16
17	GFCI WASHER	1	20 A	33' - 5 5/32"	1-#12, 1-#12, 1-#12	1200 VA	750 VA			2-#10, 1-#10, 1-#10	32' - 3"	30 A	1	DRYER	18
19	WATER HEATER	1	30 A	30' - 8 5/32"	2-#10, 1-#10, 1-#10			750 VA	750 VA						20
21						750 VA	720 VA			1-#12, 1-#12, 1-#12	41' - 1 31/32"	20 A	4	OUTDOOR GFCI RECEPTACLES	22
	OUTDOOR LIGHT UNITS	9	20 A	45' - 3 21/32"	1-#12, 1-#12, 1-#12			600 VA	1080 VA	1-#14, 1-#14, 1-#14	33' - 2 25/32"	15 A	6	SMOKE DETECTORS	24
25															26
						8010	VA	9514	5 VA						

	Legend
--	--------

Load Classification	Connected Load	Demand Factor	Estimated Demand	Panel	Totals
Lighting - Dwelling Unit	800 VA	100.00%	800 VA		
Other	2076 VA	100.00%	2076 VA	Total Conn. Load:	17524 VA
Receptacle	14400 VA	84.72%	12200 VA	Total Est. Demand:	15325 VA
Lighting	300 VA	100.00%	300 VA	Total Conn.:	73 A
				Total Est. Demand:	64 A



KEY PLAN

NO.	DESCRIPTION	DATE

NOTE:

LEGEND:

PROJECT

40-YOKE-999-3Bd2Ba Contemporary-550

DRAWING NAME

SCHEDULE

	Owner
R:	0037_14
2/10/2	2025 7:36:24 AM
	Designer
	Author
	Checker

E101

SCALE: 1/4" = 1'-0"

© [2024] [FrameUpNow] . All rights reserved

ELECTRICAL NOTE

- A. PROVIDE INTERCONNECTED SMOKE ALARMS IN EACH SLEEPING ROOMS, OUTSIDE EACH SLEEPING ROOM, ON EACH STORY, IN THE HALL OR ADJACENT ROOM LUHERE THE CEILING HEIGHT OF A ROOM OPEN TO THE HALL EXCEEDS THE HALL BY 24'. SMOKE ALARMS SHALL BE PERMANENTLY HARD WIRED WITH BATTERY BACKUP.
- B. RECEPTACLE OUTLETS FOR RANGES AND CLOTHES DRYERS SHALL BE A THREE POLE WITH GROUND TYPE. FOUR WIRE GROUNDING-TYPE FLEXIBLE CORDS WILL BE REQUIRED FOR CONNECTION OF RANGES AND CLOTHES DRYERS. THE BONDING JUMPER SHALL NOT BE CONNECTED BETWEEN NEUTRAL TERMINAL AND THE FRAME OF THE APPLIANCE
- C. TWO OR MORE 20 AMP SMALL APPLIANCE CIRCUITS SHALL BE PROVIDED TO SERVE THE KITCHEN, BREAKFAST NOOK, AND DINING ROOM. SUCH CIRCUITS SHALL HAVE NO OTHER OUTLETS.
- D. AT LEAST ONE 20 AMP BRANCH CIRCUIT SHALL BE PROVIDED TO SERVICE THE LAUNDRY ROOM. THIS CIRCUIT SHALL HAVE NO OTHER OUTLETS.
- E. ALL RECEPTACLES WITH IN 6' OF A WET BAR SINK OR KITCHEN SINK TO SERVE COUNTER TOP SURFACES MUST BE GFCI. ON KITCHEN COUNTERS 12' OR WIDER NO POINT ALONG THE WALL SHALL BE MORE THAN 2' FROM A RECEPTACLE. ALL RECEPTACLES WITH IN 6' OF KITCHEN SINK MUST BE GFCI. AT LEAST ONE GFCI RECEPTACLE SHALL BE INSTALLED IN THE BATHROOM ADJACENT TO EACH BASIN.
- F. FIXTURES INCLUDING CEILING FANS THAT ARE LOCATED IN DAMP LOCATIONS SHALL BE LISTED TO BE SUITABLE FOR
- SUCH LOCATIONS PER 2012 IRC
- G. PROVIDE ONE (1) SWITCHED OUTLET @ ALL BEDROOMS AND DEN
- H. CEILING FANS NOT EXCEEDING 35 LBS. (WITH OR WITHOUT ACCESSORIES MAY BE SUPPORTED BY OUTLET BOXES PROVIDED THE OUTLET BOXES ARE IDENTIFIED FOR SUCH USE PER 2012 IRC
- I. ELECTRICAL OUTLET BOXES ON OPPOSITE SIDES OF FIRE RATED WALLS SHALL BE SEPARATED BY A HORIZONTAL DISTANCE OF NOT LESS THAN 24".
- J. OUTLET BOXES IN THE WALLS BETWEEN THE GARAGE AND DWELLING SHALL BE METAL OR U.L. APPROVED FIRE RESISTIVE PLASTIC. BOXES IN GARAGE CEILING SHALL BE METAL.
- K. ALL BRANCH CIRCUITS THAT SUPPLY 120 VOLTS SINGLE PHASE 15 AND 20 AMPS RECEPTACLE OUTLETS INSTALLED IN THE DWELLING SHALL BE PROTECTED BY AN ARC FAULT CIRCUIT INTERRUPTER, EXCEPT GFCI RECEPTICLES.

NOTE:

A. RECEPTACLES MUST BE PROVIDED IN HALLWAYS 10'-0" OR MORE IN LENGTH. FOR A ONE FAMILY DWELLINGS AND EACH OF A TWO FAMILY DWELLING THAT IS AT GRADE LEVEL, AT LEAST ONE WP-GFCI RECEPTACLE OUTLET ACCESSIBLE AT GRADE LEVEL AND NOT MORE THAN 6'-6" ABOVE GRADE SHALL BE INSTALLED AT THE FRONT AND BACK OF THE DWELLING.

NOTE: APPLIANCE DISCONNECT

E4001.5 GROUNDING OF ENCLOSURES.

METAL ENCLOSURES FOR SWITCHES OR CIRCUIT BREAKERS SHALL BE CONNECTED TO AN

EQUIPMENT GROUNDING CONDUCTOR.

METAL ENCLOSURES FOR SWITCHES OR CIRCUIT BREAKERS USED AS SERVICE


EQUIPMENT SHALL COMPLY WITH THE PROVISIONS OF SECTION E3609.4. WHERE NONMETALLIC ENCLOSURES ARE USED WITH METAL RACEWAYS OR METAL-ARMORED

CABLES, PROVISIONS SHALL BE MADE FOR CONNECTING THE EQUIPMENT GROUNDING


NONMETALLIC BOXES FOR SWITCHES SHALL BE INSTALLED WITH A WIRING METHOD THAT

PROVIDES OR INCLUDES AN EQUIPMENT GROUNDING CONDUCTOR. (404.12)

ELECTRI	CAL LEGEND
	Electrical Lights With Fan
0	Waterproof Recessed Can Light
	Pendant Light
0	Recessed Can Light
	Wall Lamp
	Standalone linear
√1	Single Switch
ზ	Three way Switch
, H	Fan Switch
	Duplex Receptacle
	Triplex Receptacle
⊕ ⊞GFCI	GFCI Receptacle
	Exhaust Fan
•	Smoke and heat detector

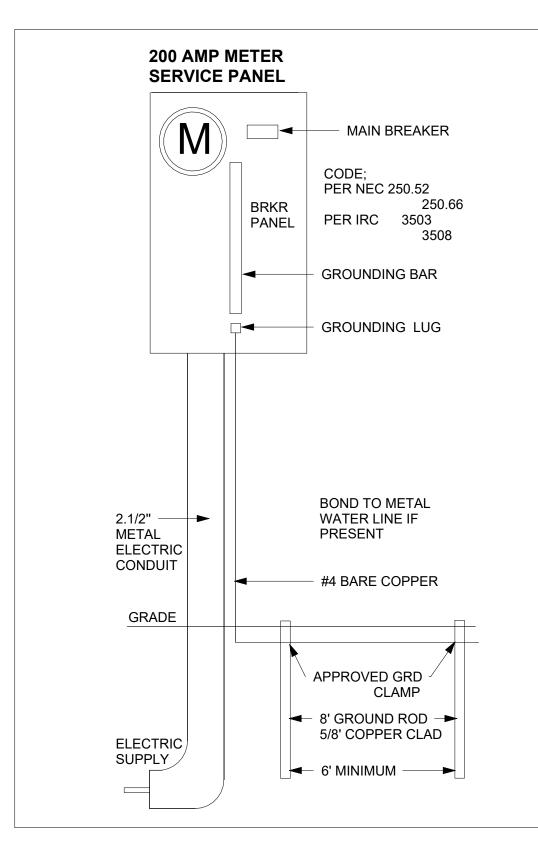



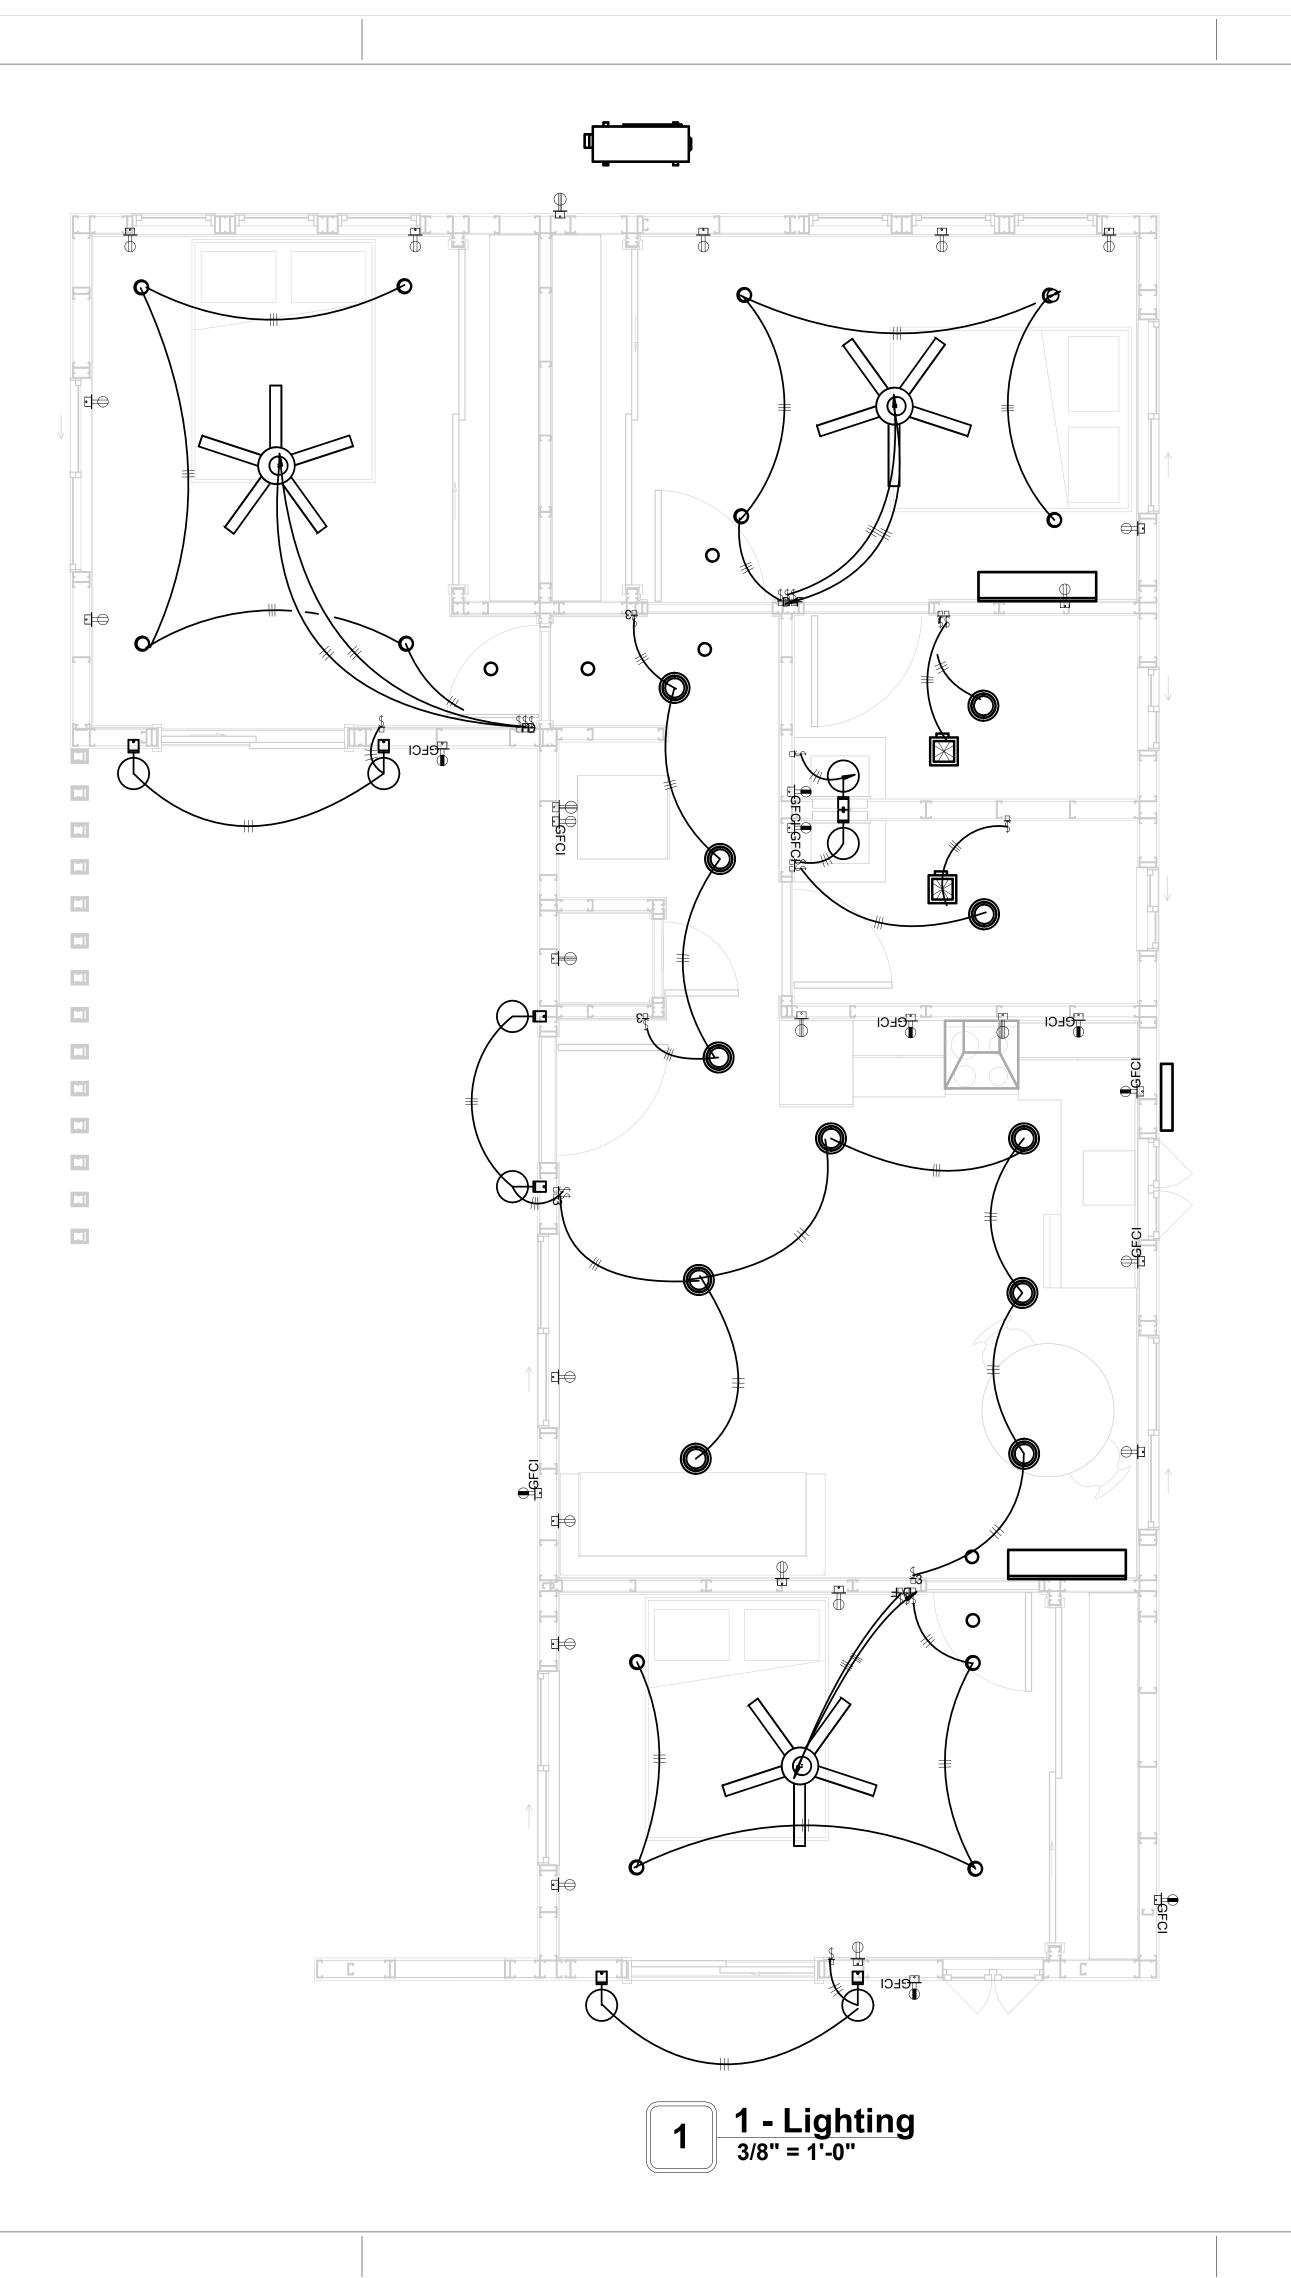



KEY PLAN

NO.	DESCRIPTION	DATE

NOTE:

LEGEND:

PROJECT

40-YOKE-999-3Bd2Ba Contemporary-550

DRAWING NAME


LIGHTING


CLIENT NAME:	Owner
PROJECT NUMBER:	0037_14
DATE:	2/10/2025 7:36:26 AM
DESIGNED BY:	Designer
DRAWN BY:	Author
CHECKED BY:	Checker


E102


NOTES: CONDUIT, CABLE AND WIRING


- Use Metalic Conduits (IMC) for cables running under concrete slabs.
 Use IMC for circuits with high voltage appliances (240 volts and above)
 For circuits with 120 volts consider using EMT or PVC conduits if needed.
 For Low voltage applications up to 50 volts consider using non metalic conduits.
 All conduits to be used in the project must conform to the latest National Electrical Code (NEC),
- 5. All conduits to be used in the project must comorn to the latest National Electrical Code (NEC), 2015.
 6. All wiring and cables to be used in the project must also conform to the latest National Electrical Code (NEC), 2015.
 7. All cables and wires used should be rated for their respective loading and should be gauged and conform to the NEC.

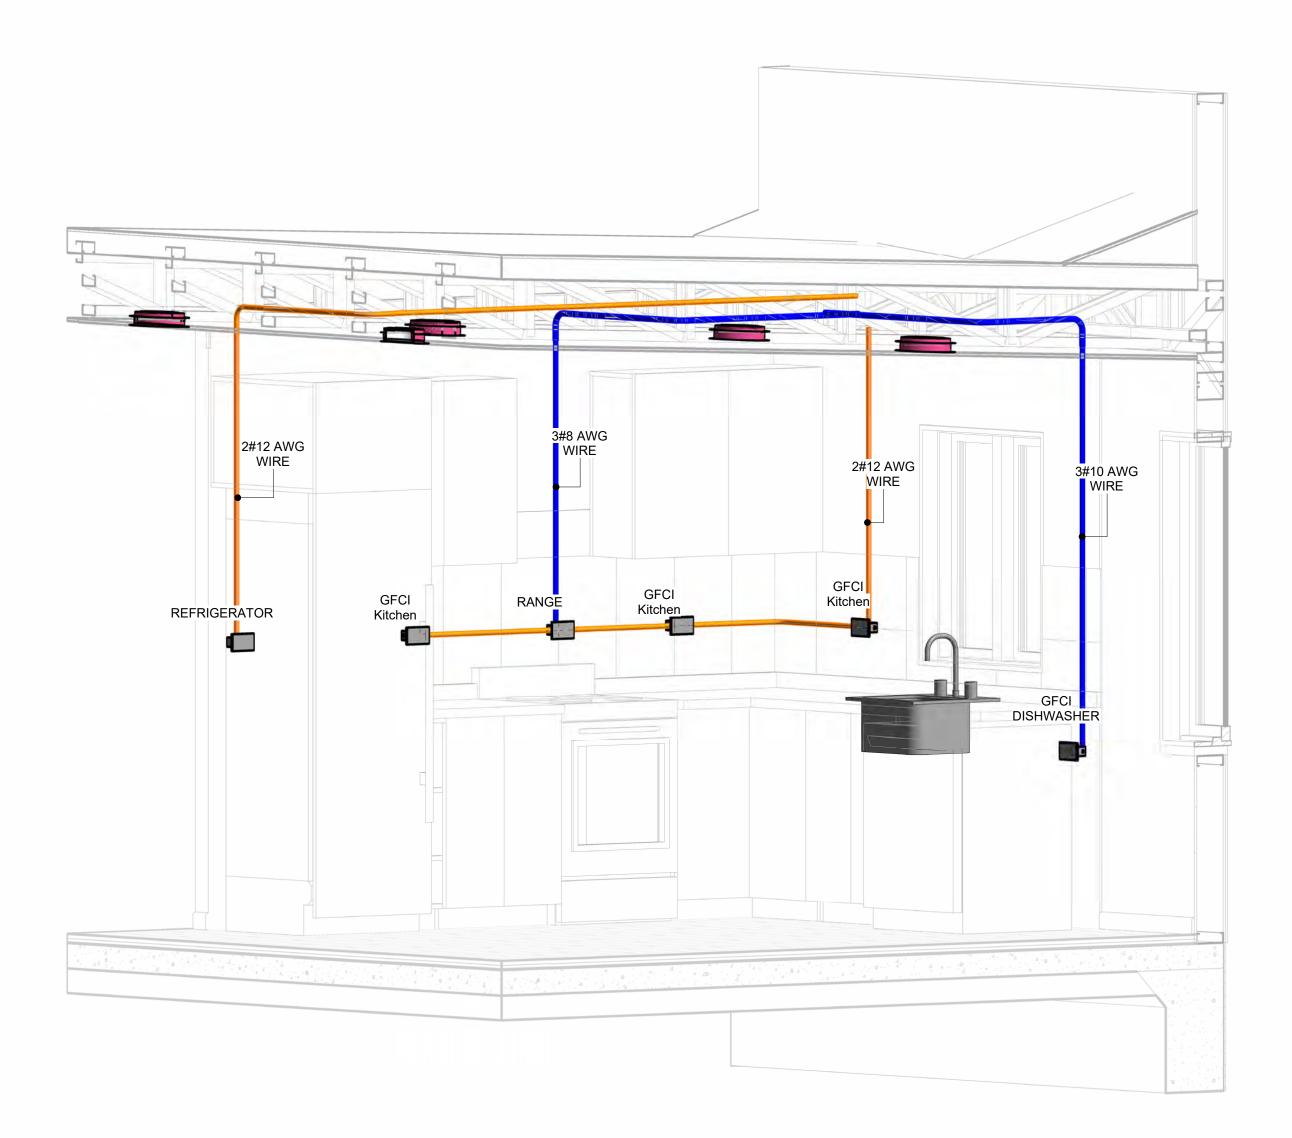


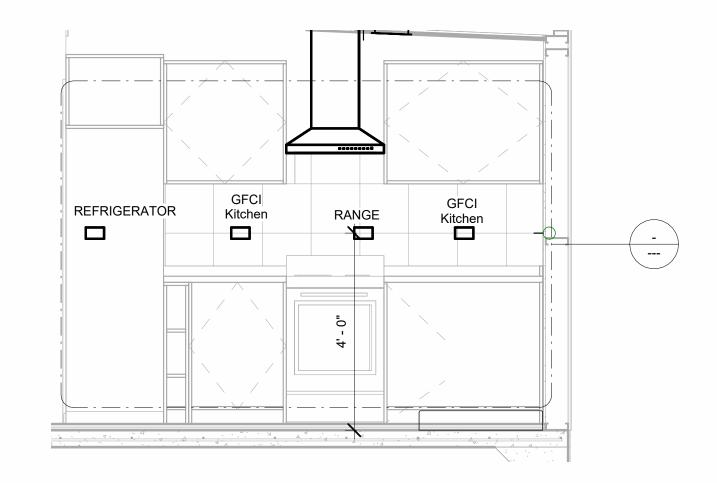


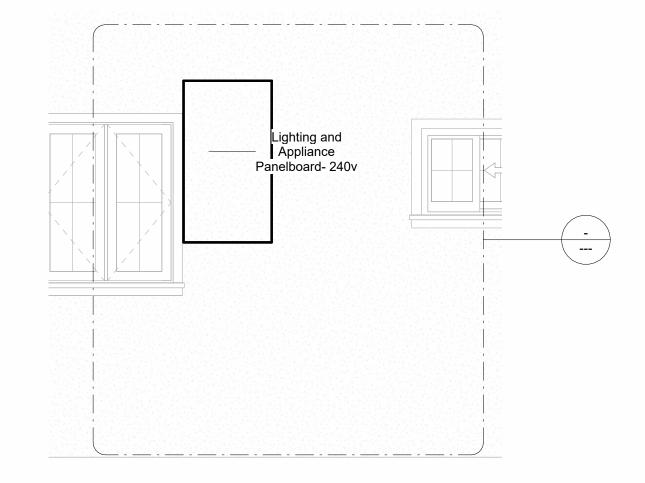


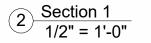

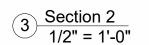

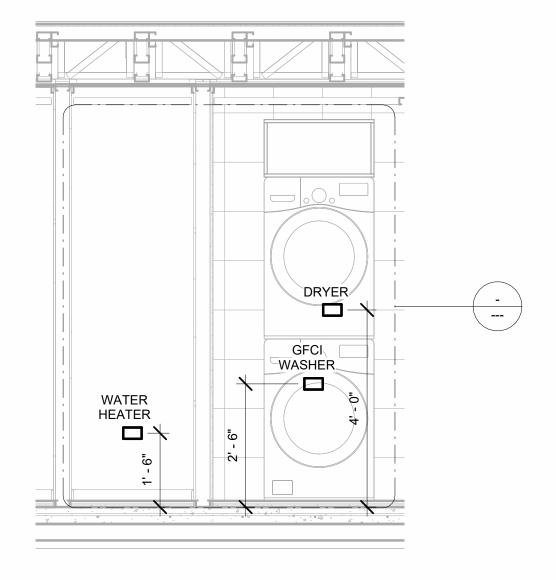

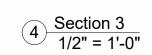

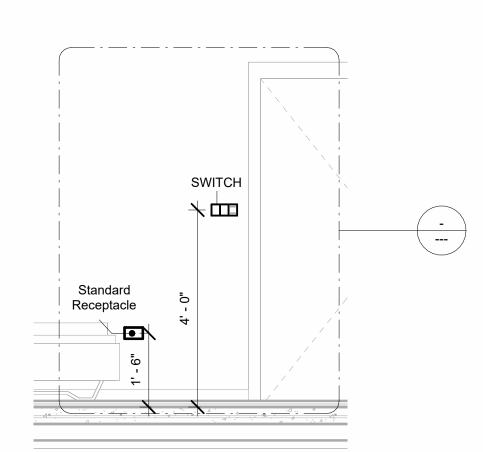


6 Section 4 1/2" = 1'-0"





KEY PLAN

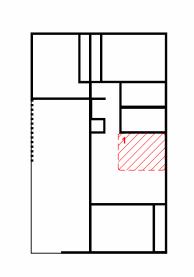

NO.	DESCRIPTION	DATE
		1

NOTE:

LEGEND:

PROJECT

40-YOKE-999-3Bd2Ba Contemporary-550

DRAWING NAME

POWER

CLIENT NAME:
PROJECT NUMBER:
DATE:
DESIGNED BY:
DRAWN BY:
CHECKED BY:
2/

E103



- 1. LIGHT FIXTURES AND LUMINARIES SHALL CONFORM TO THE NEC, THE IRC AND LOCAL SAFETY & BUILDING CODE.
- 2. ALL LIGHTING FIXTURES SHOULD CONFORM TO THE DESIGN ELECTRICAL LOAD AND SHALL BE PROPERLY WIRED AND MOUNTED BY QUALIFIED ELECTRICIAN FOLLOWING MANUFACTURERS SPECIFICATIONS.
- 3. CEILING FANS AND FANS WITH LIGHT WITH WEIGHT EXCEEDING 35 LBS SHOULD BE PROVIDED WITH STRUCTURAL BACKING FOR SUPPORT AND SHALL BE FIXED AS PER MANUFACTURERS SPECIFICATIONS.
- 4. EXTERIOR LIGHTS SHALL CONFORM TO LOCAL BUILDING CODE AND GUIDELINES.

NOTES: SWITCH JUNCTION BOX


- 1. THE MINIMUM SIZE OF JUCTION BOX TO BE USED IS 2"X4"X(1.5" OR 3.5" DEEP) THIS ARE TO BE USED FOR SINGLE GANG SWITCH OR OUTLETS.
- 2. FOR DOUBLE GANG (2 GANG) OUTLETS AND SWITCHS THE MINIMUM SIZE OF THE
- JUCTION BOX TO BE PROVIDED SHALL NOT BE LESS THAN 4"X4"X(1.5" OR 3.5" DEEP)
- 3. FOR THREE GANG (3 GANG) OUTLETS AND SWITCHS THE MINIMUM SIZE OF THE JUĆTION BOX SHALL NOT BE LESS THAN 6"X4"X(1.5" OR 3.5" DEEP).

Conduit Fitting Schedule(junction box)				
Family Count Description				

Electrical Fixture Schedule (SWITCH BOX)	
Type	Count

Lighting Device		
Туре	Count	
Dimmer	3	
Fan switch	3	
Single Pole	13	
Three Way	4	

Lighting Fixture			
Lighting Fixture Type Voltage Electrical Load		Electrical Load	Count
Electrical_Lights_Fan-Light1	120 V/1-100 VA- 120 V/1-100 VA	200 A, 120 V/240 V, Single Phase, 3 Wires	3
Lighting_Other_LumenWerx_Sh ell-Recessed-8	120 V/1-60 VA	200 A, 120 V/240 V, Single Phase, 3 Wires	11
SASSO 100 round wallwasher trim	120 V/1-28 VA	200 A, 120 V/240 V, Single Phase, 3 Wires	12
Wall Lamp - Bracket	120 V/1-100 VA	200 A, 120 V/240 V, Single Phase, 3 Wires	8

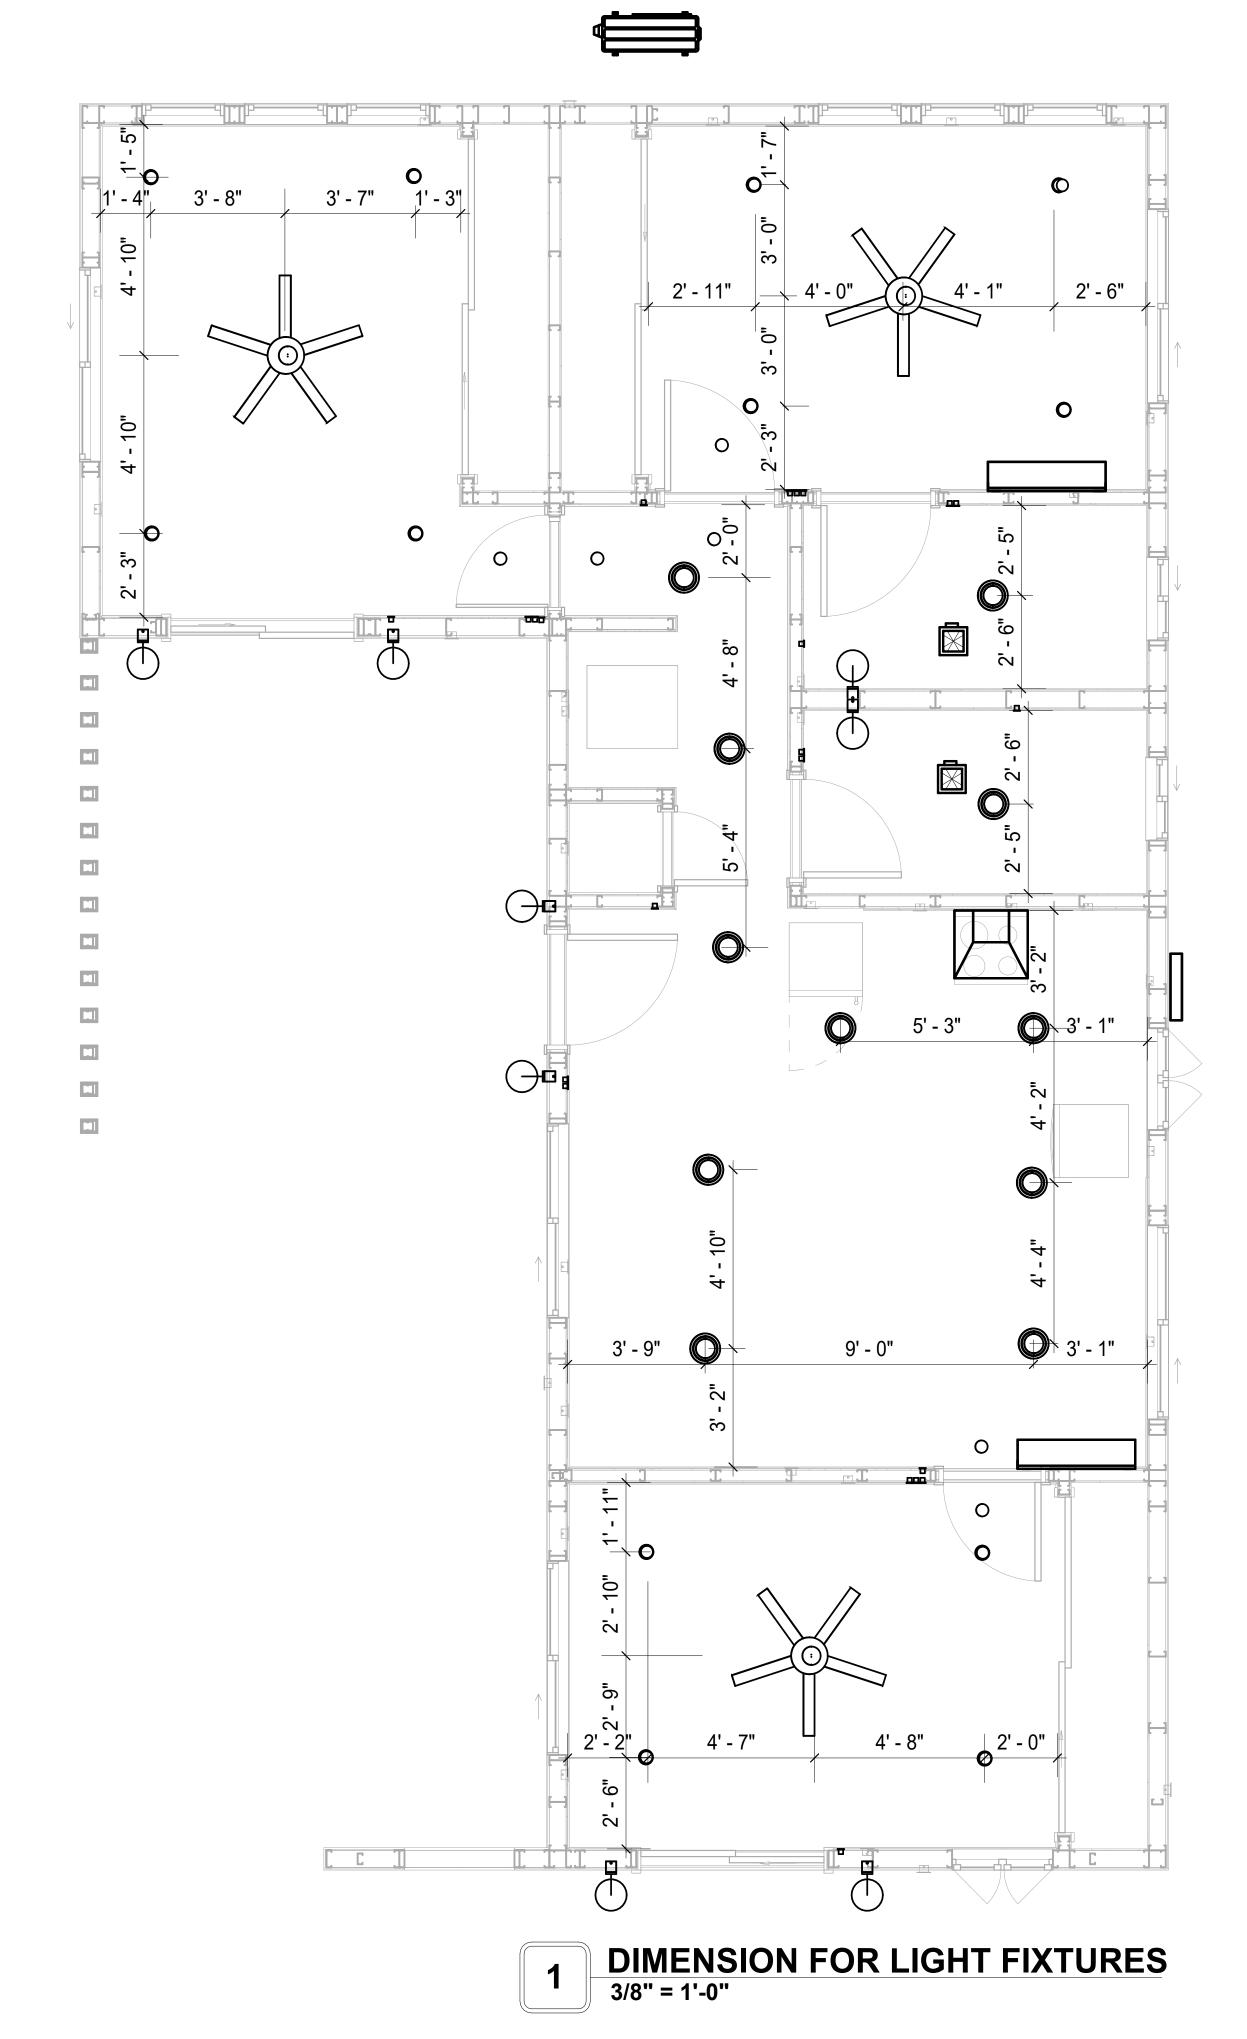



KEY PLAN

DESCRIPTION DATE

NOTE:

LEGEND:

PROJECT

40-YOKE-999-3Bd2Ba Contemporary-550

DRAWING NAME

DIMENSION PLAN FOR LIGHT FIXTURES

CLIENT NAME:	Owner
PROJECT NUMBER:	0037_14
DATE:	2/10/2025 7:36:53 AM
DESIGNED BY:	Designer
DRAWN BY:	Author
CHECKED BY:	Checker

E104

SCALE: 3/8" = 1'-0"






- VERIFY EQUIPMENT PLUG CONFIGURATION BEFORE PURCHASING RECEPTACLES
 FOR ALL EQUIPMENT.
- 3. COORDINATE EXACT LOCATION OF LIGHT FIXTURES, WALL SWITCHES, RECEPTACLES AND OTHER DEVICES WITH ARCHITECTURAL DRAWINGS.
- 4. USE METALLIC JUNCTION BOX WITH THE GFCI RECEPTACLES, WITH HIGHT VOLTAGE.

Electrical Fixture Schedule (Receptacle)			
Type Count			
CONDENSER	1		
DRYER	1		
GFCI BATH ROOM	2		
GFCI DISHWASHER	1		
GFCI Kitchen	3		
GFCI OUT DOOR	4		
GFCI WASHER	1		
RANGE	1		
REFRIGERATOR	1		
Standard Receptacle	17		
WATER HEATER	1		

Electrical Outlet Schedule				
Туре	Circuit Number	Electrical Data	Cou	ınt
GFCI Kitchen		120 V/1-180 VA	1	
CONDENSER	1,3	240 V/2-1500 VA	1	
Standard Receptacle	2	120 V/1-180 VA	4	
Standard Receptacle	4	120 V/1-180 VA	5	
Standard Receptacle	8	120 V/1-180 VA	4	
Standard Receptacle	9	120 V/1-180 VA	4	
GFCI Kitchen	10	120 V/1-180 VA	2	
REFRIGERATOR	11	120 V/1-1500 VA	1	
GFCI DISHWASHER	12	120 V/1-1200 VA	1	
RANGE	13,15	240 V/2-1500 VA	1	
GFCI BATH ROOM	14	120 V/1-180 VA	1	
GFCI BATH ROOM	16	120 V/1-180 VA	1	
GFCI WASHER	17	120 V/1-1200 VA	1	
DRYER	18,20	240 V/2-1500 VA	1	
WATER HEATER	19,21	240 V/2-1500 VA	1	
GFCI OUT DOOR	22	120 V/1-180 VA	4	

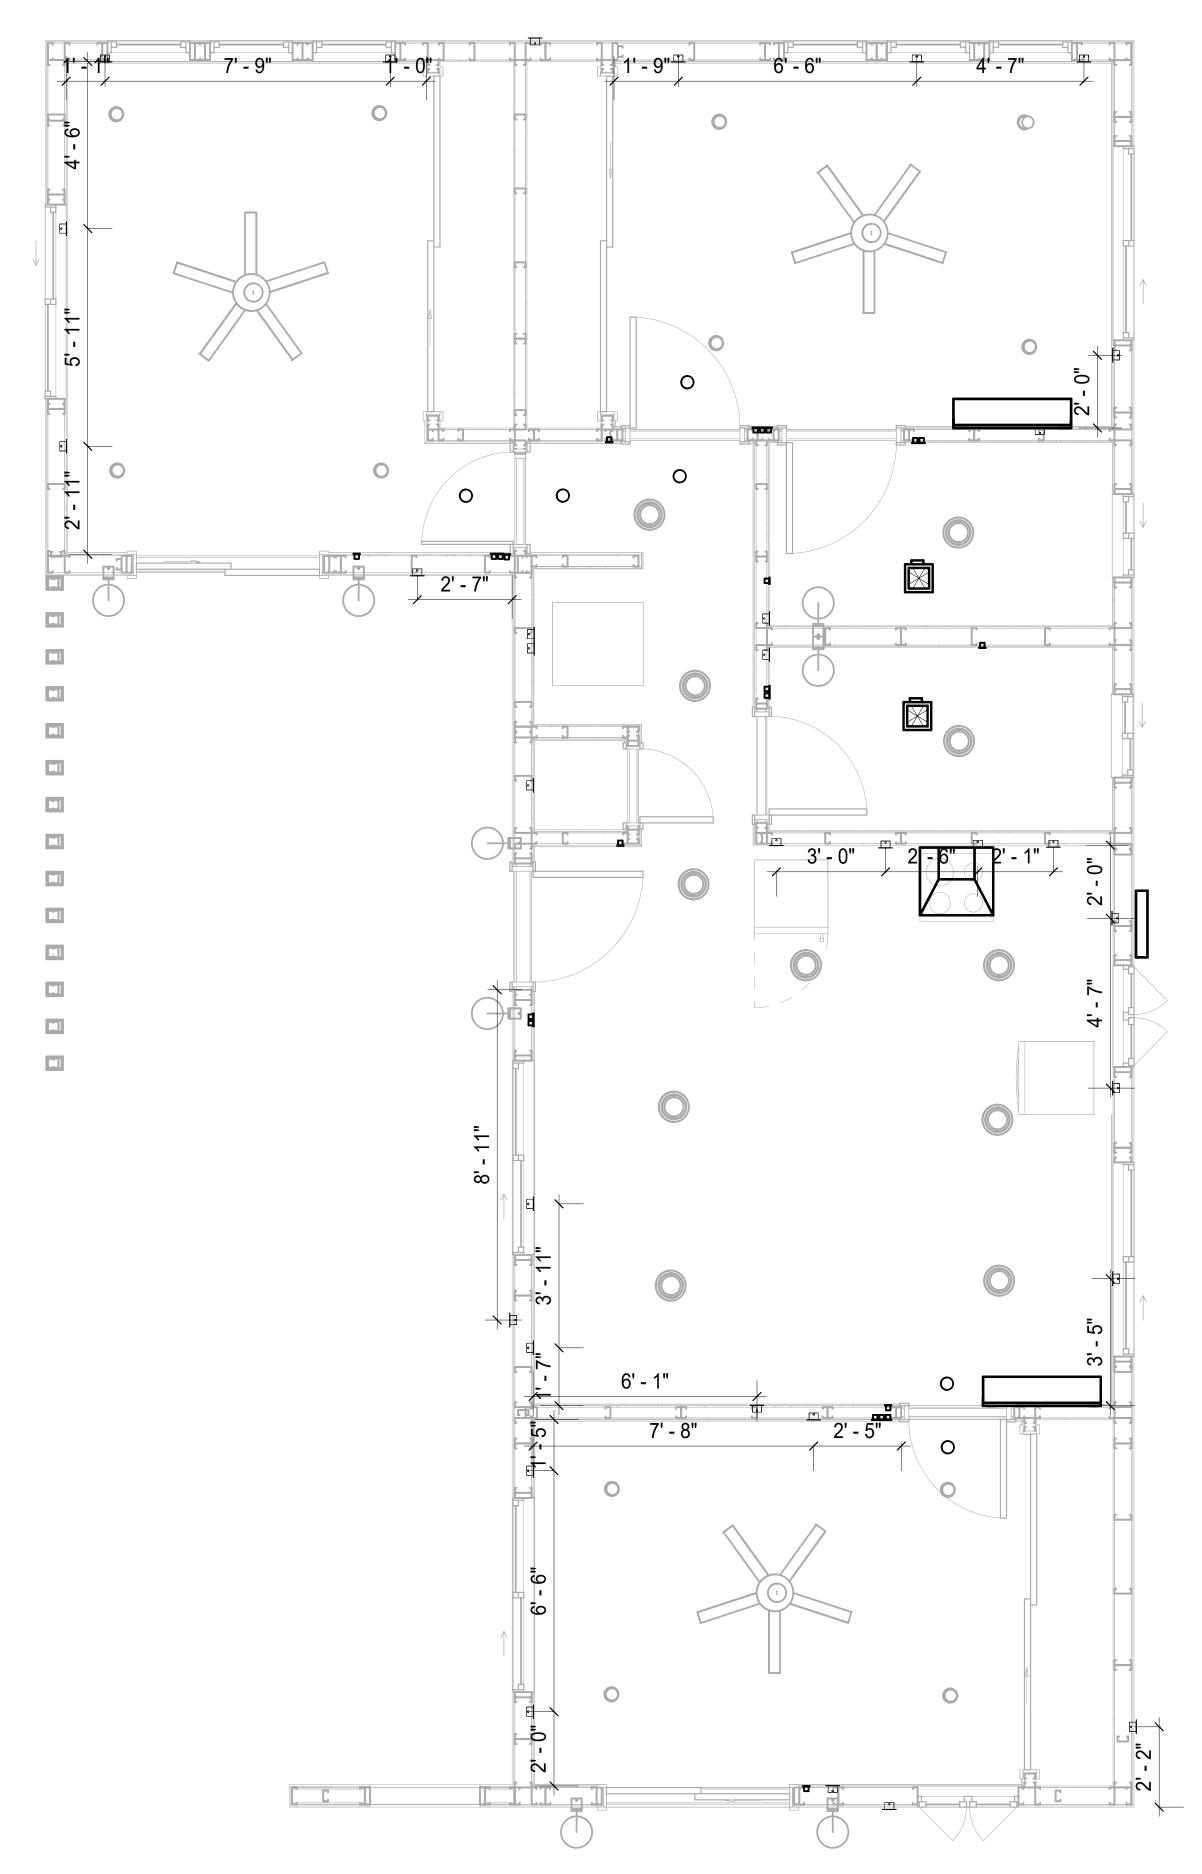

DIMENSION FOR FITTINGS
3/8" = 1'-0"

KEY PLAN

NO. DESCRIPTION DATE

NOTE:

LEGEND:

PROJECT

40-YOKE-999-3Bd2Ba Contemporary-550

DRAWING NAME

DIMENSION PLAN FOR FITTINGS

CLIENT NAME:	Owner
PROJECT NUMBER:	0037_14
DATE:	2/10/2025 7:36:54 AM
DESIGNED BY:	Designer
DRAWN BY:	Author
CHECKED BY:	Checker

E105

SCALE: 3/8" = 1'-0"

SHEET LIST

SHEET NUMBER SHEET NAME

P101 NOTE AND SCHEDULE
P102 WATER SUPPLY AND SEWAGE
SYSTEM

PIPE COLOR SCHEME
DOMESTIC COLD WATER
— — — SANITARY VENT
SANITARY SEWER
STORM DRAINAGE
GRAY WATER
GAS LINE

PLUMBING NOTES

- THE PLUMBING SYSTEM IS DESIGNED TO MEET THE BUILDING'S DOMESTIC WATER SUPPLY, SANITARY DRAINAGE, AND STORM DRAINAGE REQUIREMENTS, AS PER PROJECT SPECIFICATIONS AND APPLICABLE CODES.
- 2. THE SYSTEM INSTALLATION SHALL COMPLY WITH THE LATEST INTERNATIONAL PLUMBING CODE (IPC), INTERNATIONAL RESIDENTIAL CODE (IRC), AND ALL OTHER RELEVANT LOCAL, STATE, AND NATIONAL REGULATIONS.
- ALL PLUMBING WORK SHALL COMPLY WITH THE LATEST EDITION OF THE INTERNATIONAL PLUMBING CODE (IPC) AND THE LOCAL PLUMBING CODE.
- 4. PLUMBING SYSTEMS SHALL BE TESTED AND INSPECTED IN ACCORDANCE WITH THE LOCAL PLUMBING CODE REQUIREMENTS.
- 5. PLUMBING FIXTURES SHALL BE INSTALLED WITH THE APPROPRIATE TRIM, FITTINGS, AND
- ACCESSORIES, AS RECOMMENDED BY THE MANUFACTURER.

 6. PIPING SHALL BE PROPERLY SUPPORTED AND SECURED TO PREVENT SAGGING,
- MOVEMENT, AND VIBRATION.
 7. SHUT-OFF VALVES SHALL BE PROVIDED AT ALL BRANCH CONNECTIONS AND AT THE
- INLET AND OUTLET OF EACH PIECE OF EQUIPMENT.
- 8. BACKFLOW PREVENTION DEVICES SHALL BE INSTALLED AS REQUIRED BY THE LOCAL PLUMBING CODE TO PROTECT THE POTABLE WATER SYSTEM.
- PLUMBING FIXTURES AND EQUIPMENT SHALL BE ACCESSIBLE FOR MAINTENANCE AND SERVICING.
- 10. EXPOSED PLUMBING PIPING AND FIXTURES SHALL BE INSULATED TO PREVENT CONDENSATION AND ENERGY LOSS.
- 11. DEAD ENDS IN THE DRAINAGE SYSTEM MUST BE AVOIDED, EXCEPT WHERE NECESSARY TO INSTALL A CLEANOUT IN AN ACCESSIBLE LOCATION, AND MUST HAVE A VENTED CONNECTION TO THE OUTSIDE ATMOSPHERE.
- 12. THE VERTICAL DEFLECTION OF PVC PIPE MUST NOT EXCEED 5%, AND NO DEFLECTION IS PERMITTED FOR IRON PIPE.
- 13. WORK MUST BE PROPERLY COORDINATED WITH OTHER TRADES TO AVOID CONFLICTS, REFERRING TO THE ARCHITECTURAL AND STRUCTURAL DRAWINGS FOR INFORMATION REGARDING CEILING ELEVATIONS, SPACE CLEARANCES, WALL AND PARTITION LOCATIONS, ETC.
- 14. ALL FIXTURES SHALL HAVE ACCESSIBLE STOPS.
- 15. DOMESTIC WATER PIPING SHALL BE PEX, AND PVC PIPING IS NOT ACCEPTABLE FOR INTERIOR USE.
- 16. VENT TERMINATIONS SHALL BE LOCATED AT LEAST 10 FEET FROM OR 3 FEET ABOVE ANY OPERABLE WINDOW, DOOR OPENING, AIR INTAKE, OR VENT SHAFT, AND AT LEAST 3 FEET IN EVERY DIRECTION FROM ANY LOT LINE, ALLEY, OR STREET.
- 17. PIPE AND FITTINGS UTILIZED IN THE WATER SUPPLY SYSTEM SHALL HAVE A MAXIMUM OF 8 PERCENT LEAD.
- 18. ACRYLONITRILE BUTADIENE STYRENE (ABS) SHALL BE USED FOR THE SEWERAGE AND VENTILATION SYSTEM.
- 19. CROSS-LINKED POLYETHYLENE (PEX) SHALL BE USED FOR THE WATER SUPPLY SYSTEM.
- 20. POLYVINYL CHLORIDE (PVC) SHALL BE USED FOR THE RAIN WATER SYSTEM.
- 21. THE MIMIMUM WATER SUPPLY DEPTH UNDER FLOOR FINISH SHOUD BE 1/2".
- 22. ANY PIPE INSTALLED UNDERGROUND MUST HAVE AT LEAST 12 INCHES OF CLEARANCE BETWEEN THE OUTSIDE OF THE PIPE AND ANY OTHER UNDERGROUND STRUCTURE.
- 23. THE MINIMUM CLEARANCE BETWEEN COLD AND HOT WATER LINES IN RESIDENTIAL
- HOMES MAINTAIN A MINIMUM DISTANCE OF 6 INCHES.

 24. HORIZONTAL SEPARATION BETWEEN WATER AND SEWER LINES: A MINIMUM OF 12
- 24. HORIZONTAL SEPARATION BETWEEN WATER AND SEWER LINES: A MINIMUM OF 12 INCHES BETWEEN POTABLE WATER SUPPLY LINES (COLD AND HOT WATER) AND SANITARY SEWER LINES.

ABBREVIATIONS

Ø	DIAMETER
ABS	ACRYLONITRILE BUTADIENE STYRENE
ABV	ABOVE
AD	AREA DRAIN
AFF	ABOVE FINISHED FLOOR
ALT	ALTERNATE
BFF	BELOW FINISHED FLOOR
BLW	BELOW
CO	CLEAN OUT
CW	COLD WATER
D	DEGREE
DFU	DRANAGE FIXTURE UNIT
DIA	DIAMETER
DN	DOWN
FCO	FLOOR CLEAN OUT
FD	FLOOR DRAIN
FL	FLOOR
FS	FLOOR SINK
FT	FOOT/FEET
HB	HOSE BIB
HW	HOT WATER
IN	INCH
MIN	MINIMUM
NO	NUMBER
NTS	NOT TO SCALE
PEX	CROSS-LINKED POLYETHYLENE
PLBG	PLUMBING
PVC	POLYVINYL CHLORIDE
QTY	QUANTITY
RD	ROOF DRAIN
RED	REDUCER
RM	ROOM
RW	RAIN WATER
SF	SQUARE FOOT
V	VENT
VTR	VENT THROUGH ROOF
W	WASTE
WCO	WALL CLEAN OUT
WSFU	WATER SUPPLY FIXTURE UNIT

PLUMBING LEGEND

D	CAP
	BEND 45 DEG
U	BEND 90 DEG
	TEE REDUCING
	TEE
	CLEAN TWO-WAY
	WYE 45 DEG
	WYE 45 DEG DOUBLE
	WYE COMBINATION
	P-TRAP

PIPE SCHEDULE					
MATERIAL DIAMETER LENGTH					
ACRYLONITRILE BUTADIENE STYRENE (ABS) 1 1/2" 49 FT					
ACRYLONITRILE BUTADIENE STYRENE (ABS)	2"	66 FT			
ACRYLONITRILE BUTADIENE STYRENE (ABS) 3" 18 FT					
CROSS-LINKED POLYETHYLENE (PEX) 1/2" 84 FT					
CROSS-LINKED POLYETHYLENE (PEX)	3/4"	54 FT			

FITTING SCHEDULE					
FITTING	SIZE	QTY			
DOMESTIC COLD WATER					
DOMESTIC COLD WATER PEX 90 DEGREE ELBOW	1/2"ø-1/2"ø	12			
PEX 90 DEGREE ELBOW	3/4"ø-3/4"ø	4			
PEX TEE ELBOW	1/2"ø-1/2"ø	4			
PEX TEE ELBOW	3/4"ø-3/4"ø-3/4"ø	6			
PEX TRANSITION ELBOW	1"ø-3/4"ø	2			
PEX TRANSITION ELBOW	3/4"ø-1/2"ø	5			
LX HANOIHON LEBOW	014 W-112 W	<u> </u>			
DOMESTIC HOT WATER					
PEX 90 DEGREE ELBOW	1/2"ø-1/2"ø	10			
PEX 90 DEGREE ELBOW	3/4"ø-3/4"ø	4			
PEX TEE ELBOW	1/2"ø-1/2"ø	3			
PEX TEE ELBOW	3/4"ø-3/4"ø	3			
PEX TRANSITION ELBOW	3/4"ø-1/2"ø	4			
RAIN WATER					
ABS 90 DEGREE BEND ELBOW	2"ø-2"ø	3			
PVC 90 DEG BEND ELBOW	2"ø-2"ø	3			
SEWAGE ABS 90 DEGREE BEND ELBOW ABS 90 DEGREE BEND ELBOW	1 1/2"ø-1 1/2"ø 2"ø-2"ø	1			
ABS 90 DEGREE BEND ELBOW	3"ø-3"ø	2			
ABS P-TRAP	1 1/2"ø-1 1/2"ø	5			
ABS P-TRAP	2"ø-2"ø	1			
ABS P-TRAP	3"ø-3"ø	2			
ABS REDUCER ELBOW	2"ø-1 1/2"ø	1			
ABS REDUCER ELBOW	3"ø-1 1/2"ø	1			
ABS REDUCER ELBOW	3"ø-2"ø	1			
ABS TEE ELBOW	2"ø-2"ø	1			
ABS TEE ELBOW	3"ø-3"ø-3"ø	1			
ABS TEE REDUCER ELBOW	3"ø-3"ø-1 1/2"ø	2			
ABS TEE REDUCER ELBOW ABS TEE REDUCER ELBOW	3"ø-3"ø-2"ø				
ABS TRAP P	2"ø-2"ø	1 1			
ABS WASTE DOUBLE TEE	1 1/2"ø-1 1/2"ø-1 1/2"ø	1			
ABS WASTE DOUBLE TEE	3"ø-3"ø-3"ø-3"ø	1			
WASTE DOUBLE TEE	1 1/2"ø-1 1/2"ø-1 1/2"ø	1			
WASTE DOUBLE TEE WASTE DOUBLE TEE	2"ø-2"ø-2"ø	1			
WAS IE DOUBLE TEE	2 6-2 6-2 6				
VENT					
ABS VENT CAP ELBOW	1 1/2"ø	3			
ABS VENT CAP ELBOW	2"ø	2			

FIXTURE CONNECTION SCHEDULE

W V TRAP CW HW QTY DFU TOT. WFU TOT.

NOTES

FAMILY

DISHWASHER	2"	1-1/2"	1-1/2"	1/2"	1/2"	1		0			DRAIN TO SEWER SEE PLANS
DRYER	N/A	N/A	N/A	N/A	N/A	1		0			
SHOWER TRAY	2"	1-1/2"	1-1/2"	1/2"	1/2"	2		0			
SHOWER TRIM	-	-	-	1/2"	1/2"	2		0			
SINK ISLAND SINGLE	2"	1-1/2"	1-1/2"	1/2"	1/2"	1		0			
VANITY SINK	2"	1-1/2"	1-1/2"	1/2"	1/2"	2		0			
WASHER	2"	1-1/2"	2"	1/2"	1/2"	1	2	2	1.4	1.4	DRAINS TO GRAY WATER OR SEWER SEE PLANS
WATER CLOSET	3"	2"	3"	1/2"	1/2"	2	3	6	2.2	2.2	
WATER HEATER	N/A	N/A	N/A	3/4"	3/4"	1		0			

FIXTURE SCHEDULE							
FIXTURE	QTY	DESCRIPTION					
DISHWASHER	1	DRAIN TO SEWER SEE PLANS					
DRYER	1	DIV IIIV 10 DEVIET DELT ETHO					
SHOWER TRAY	2						
SHOWER TRIM	2						
SINK ISLAND SINGLE	1						
VANITY SINK	2						
WASHER	1	DRAINS TO GRAY WATER OR SEWER SEE PLANS					
WATER CLOSET	2						
WATER HEATER	1						

WATER FIXTURE UNIT SCHEDULE							
FAMILY	QTY	UNIT VALUE	TOTAL				
DISHWASHER	1		0				
DRYER	1		0				
SHOWER TRAY	2		0				
SHOWER TRIM	2		0				
SINK ISLAND SINGLE	1		0				
VANITY SINK	2		0				
WASHER	1	1.4	1.4				
WATER CLOSET	2	2.2	4.4				
WATER HEATER	1		0				

PLUMBING SCHEDULE								
FIXTURE	TRAP	WASTE	VENT	C.W	H.W			
DISHWASHER	1-1/2"	2"	1-1/2"	1/2"	1/2"			
DRYER	N/A	N/A	N/A	N/A	N/A			
SHOWER TRAY	1-1/2"	2"	1-1/2"	1/2"	1/2"			
SHOWER TRIM	-	-	-	1/2"	1/2"			
SINK ISLAND SINGLE	1-1/2"	2"	1-1/2"	1/2"	1/2"			
VANITY SINK	1-1/2"	2"	1-1/2"	1/2"	1/2"			
WASHER	2"	2"	1-1/2"	1/2"	1/2"			
WATER CLOSET	3"	3"	2"	1/2"	1/2"			
WATER HEATER	N/A	N/A	N/A	3/4"	3/4"			

ACCESSORIES & FITTINGS SCHEDULE							
FIXTURE QTY DESCRIPTIONS							
DISHWASHER CONNECTOR	1						
HANGING PIPES CLAMP	6						
HOSE BIB	1						
LAUNDRY SWEAT CONNECTOR	1						
ROOF DRAIN SCUPPER	3						
SHUTOFF VALVE	8						

WASTE FIXTURE UNIT SCHEDULE							
FAMILY	QTY	DFU VALUES	TOTAL				
DISHWASHER	1		0				
DRYER	1		0				
SHOWER TRAY	2		0				
SHOWER TRIM	2		0				
SINK ISLAND SINGLE	1		0				
VANITY SINK	2		0				
WASHER	1	2	2				
WATER CLOSET	2	3	6				
WATER HEATER	1		0				



KEY PLAN

NO.	DESCRIPTION	DATE

NOTE:

LEGEND:

PROJECT

42-Yoke-999-3Bd2Ba Spanish-550

DRAWING NAME

NOTE AND SCHEDULE

 CLIENT NAME:

 PROJECT NUMBER:
 0162_15

 DATE:
 2/10/2025 10:44:46 AM


 DESIGNED BY:
 Designer

 DRAWN BY:
 Author

 CHECKED BY:
 Checker


P101

SCALE: 1/2" = 1'-0"

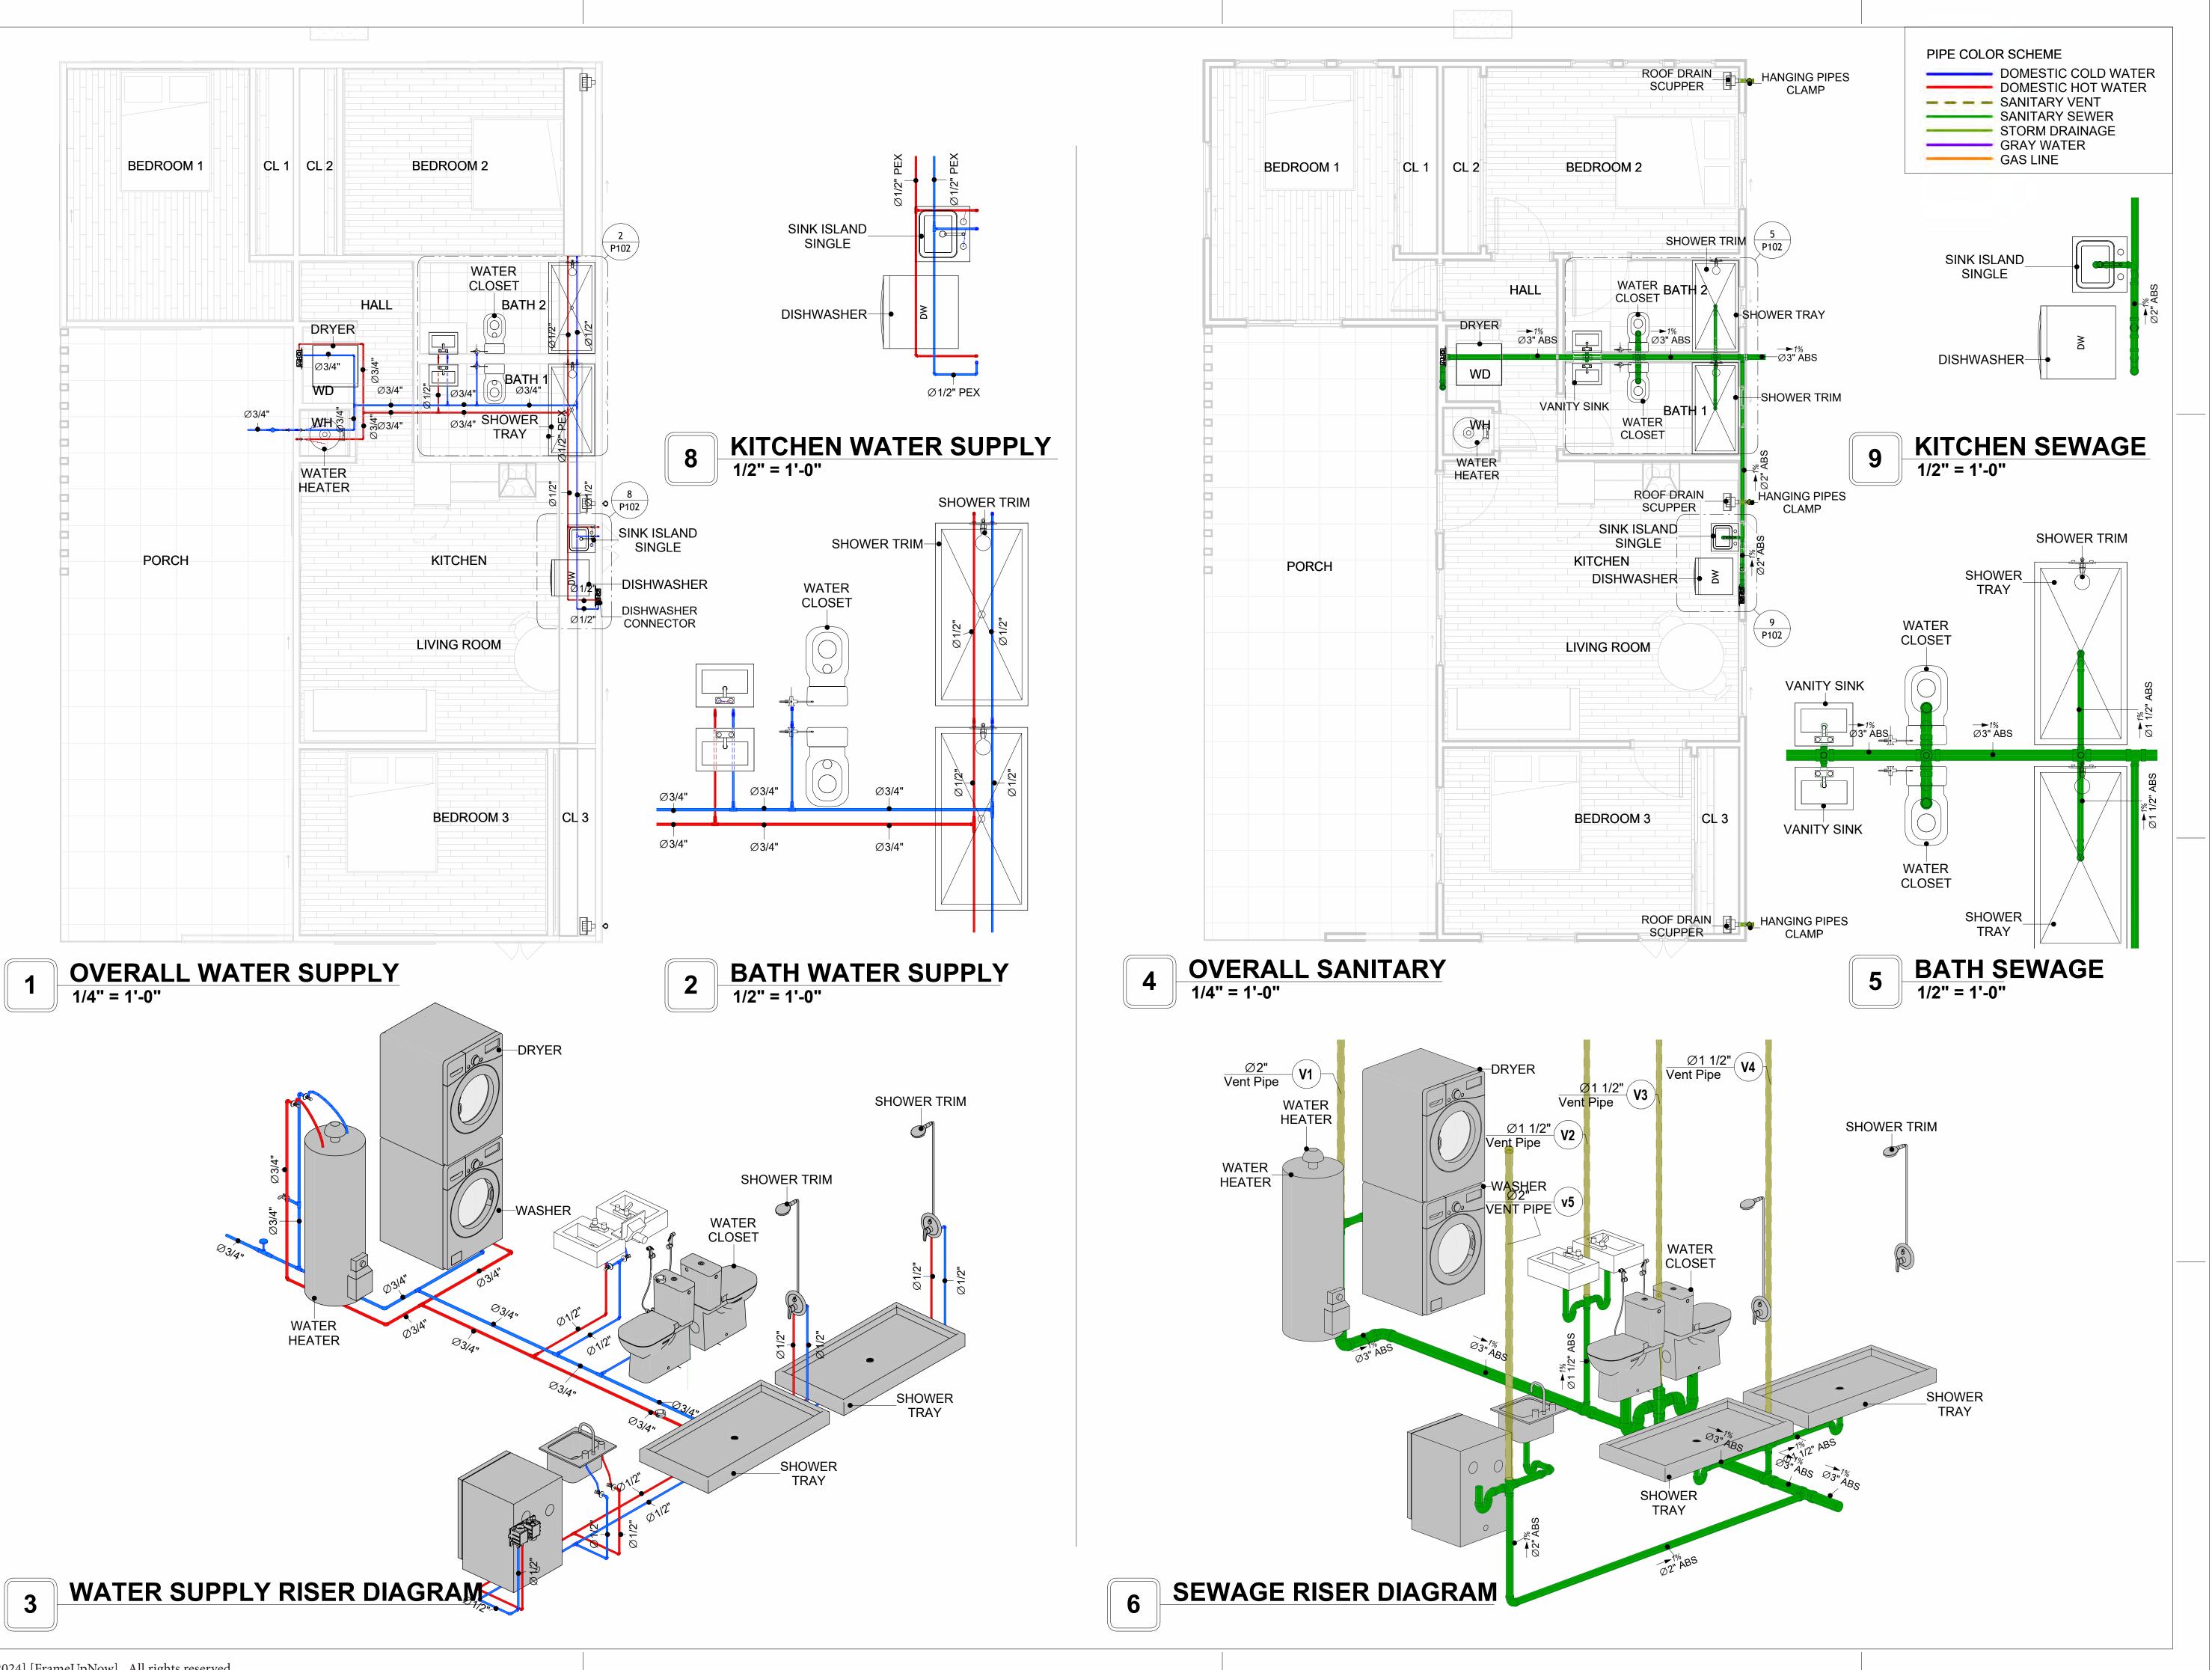



KEY PLAN

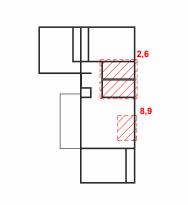

NO.	DESCRIPTION	DATE

LEGEND:

NOTE:

PROJECT

42-Yoke-999-3Bd2Ba Spanish-550

DRAWING NAME

WATER SUPPLY AND **SEWAGE SYSTEM**

CLIENT NAME:	
PROJECT NUMBER:	0162_15
DATE:	2/10/2025 10:45:17 AN
DESIGNED BY:	Designer
DRAWN BY:	Author
CHECKED BY:	Checker

P102

Materials Shopping List

Please print and take this Materials Shopping List to your favorite Home Depot and ask for assistance in selecting the materials, fixtures and fittings to complete your new home.

Record your selection and the price of the item. Then do the math to determine the cost for your selections and the total cost of finishing your home.

Have It Your Way!

The material types listed in this document were selected based on personal preferences. The Customer is encouraged to make changes to the material types in accordance with local customs, regulations, and personal preferences.

Have It Your Way!



20 good reasons to frame a home with metal and not wood



Why build your ADU with metal vs wood	Wood	Metal	Explanation
1 DIY Construction Benefit		~	The wall frames, trusses and beams can be erected in a just a few days
2 Minimal Construction Skills Required		~	Pre-assembled walls and trusses require no specialized skills to errect
3 Build as DIY, Hybrid or by a General Contractor		✓	Do it yourself, Hybrid (involve special contractors) or hire a General Contractor
4 Build It As You Can Afford It		✓	Impervious to Weather - build as you have the time and money
5 Up Front Cost of Framing Materials	~		As to only the framing material, wood is less expensive
6 Total Cost To Build		~	Savings in time, labor, and other areas make light gauge steel LESS expensive
7 Termites and wood boring insects		Y	Termites, carpenter ants and wood boring insects eat wood, not metal
8 Mold resistant		~	Metal does not attract mold
9 Damage caused by exterior and interior flooding		~	Metal needs no reconditioning after a flood
10 Fire Resistant		~	Non-combustible
11 Lower insurance rates		~	Many insurance underwriters now provide lower rates for metal framed homes
12 Walls, trusses, and beams retain their original form		Y	Perfectly straight walls - no shimming of drywall
13 Corners are 90 degrees		✓	No need for templating of countertops to adjust for out of square corners
14 Strength and weight		✓	Metal is stronger than wood and weighs less - no need for crane to lift ADU trusses
15 IBC Engineered Stamp		✓	If an engineering stamp is necessary, months of waiting are saved
16 Complete BOM (Materials Shopping List)		~	Take the materials shopping list to Home Depot and start shopping/pricing
17 Flexible in Seismic Areas - Won't Fracture		~	Light gauge steel is flexible and won't fracture when the earth moves
18 No Waste At Job Site		~	Steel is the most recycled material in the world. A typical wood home has 20-30% waste
19 Environmentally Friendly		~	Trees don't have to be destroyed and the source of most metal is from recycling
20 How-To Videos Included		~	How-to videos provide simple assembly instructions
21 Relationship Counselor		~	Eliminate emotional uphevels - save time, money, and preserve the relationship

Universal Requirements - some or all may be required

- 1 Site plan
- 2 Electrical Supply Connection
- 3 Sewer Connection
- 4 Fresh Water Supply Connection
- 5 Set Backs
- 6 Soils Evaluation

- 7 Earthquake (fault) evaluation
- 8 Foundation Plan subject to soils
- 9 Compliance with local energy codes: insulation home wrap and flashing
- 10 Engineering for wind speed and snow load.
- 11 State and Local ordinances regarding ADUs
- 12 Local Architect and/or Engineer may be necessary

Yoke-3Bd2Ba-Contemporary





Yoke-3Bd2Ba-Contemporary MATERIAL SHOPPING LIST

Have It Your Way!

The material types listed in this document were selected based on personal preferences. The Customer is encouraged to make changes to the material types in accordance with local customs, regulations, and personal preferences. Have It Your Way!

TOC



Table Of Content # Name Link Page No 1 Cover Page Cover Page 2 TOC TOC 2 3 ELECTRICAL BOM **ELECTRICAL BOM** 3 5 HVAC BOM **HVAC BOM** 7 PLUMBING BOM 4 PLUMBING BOM 10 6 ARCHITECTURAL BOM ARCHITECTURAL BOM 15

Have It Your Way!

The material types listed in this document were selected based on personal preferences. The Customer is encouraged to make changes to the material types in accordance with local customs, regulations, and personal preferences. Have It Your Way!

GENERAL NOTES

- 1 This BOM (Bill of Materials) is prepared as a Materials Shopping List to help builders and DIYers gain a complete understanding of most if not all elements required for the complete construction of this structure, according to the original design documents provided by FrameUpNow.
- 2 All quantities and specifications are subject to change based on the final design, field measurements, availability of products and customer preferences. The customer should verify all information prior to purchasing materials.
- 3 All products and elements in the list shall conform to the International Residential Code (IRC), or any other local and international building codes, safety regulations, and standards that are applicable to the location of the structure.
- 4 If any changes are made by the customer to the list of materials specified in this document, the customer is responsible for assuring that the correct type and quantity of materials are utilized in accordance with local building codes.
- 5 FrameUpNow, will not be held responsible for any misuse of this document, the products listed, or for deviations from the content that are made due to changes in specifications, pricing, availability, or customer preferences.
- 6 The customer is advised to consult a qualified professional or technician prior to purchasing materials for specialized construction system items. Some items including but not limited to caseworks, doors and windows may require as built measurements prior to purchase to confirmation of final dimensions.
- 7 If there are additional trim elements or specific installation methods, the total amount of materials needed might vary. Consider any additional trim required for corners, intersections, or other architectural details that might cause this variations before proceeding to purchase and construction.

ARCHITECTURAL BOM



		Yoke-3Bd2Ba- ARCHITECTURAL MAT			
No.	Item	Type	Unit	Quantity	Description
	APPLIANCES				•
1	Refrigerator		PCS	1	
2	Range		PCS	1	
3	Washer		PCS	1	
4	Dryer		PCS	1	
5	Dish Washer		PCS	1	
6	Oven		PCS	0	
7	Microwave		PCS	0	
Δ	CASEWORKS				
1	Kitchen Cabinet		FT	15	
2	Laundry Cabinet		FT	2.25	
3	Vanity Cabinet		FT	2.5	
4	Medicine Cabinet		PCS	2	
5	Kitchen countertop		SF	22.82	
6	Laundry Countertop		PCS	0	
7	Bathroom Countertop		SF	0	
8	Island		FT	0	
9	Peninsula		FT	0	
10	Closets		SF	180.5	
Δ	CEILING	I		I	
1	Ceiling Board	Dry Wall	SF	805	
2	Dry Wall Fastener	Screw	PCS	1408.75	
3	Vapor Retarder	Polyethylene film	SF	903	
4	Vapor Retarder Fastener	Nails with washer heads	PCS	2709	
5	Ceiling Board (MRD)	Moisture resistant drywall	SF	98	
6	MRD Fastener		PCS	171.50	
7	Ceiling Board	Marine Plywood	SF	0	
8	Marine Plywood Fastener	Screw	PCS	0.00	
9	Dry Wall Tape		FT	451.50	
Δ	FLOORING				
1	Main Living Space		SF	339	
2	Bathroom		SF	103	
3	Bedrooms		SF	386	
4	Porch		SF	482	
Δ	STRUCTURE				
1	Foundation		SF	1408.12	

ARCHITECTURAL BOM



	WALLS EXTERIOR				
1	Exterior Wall Stucco finish		SF	1896	
2	Wall Paint		SF	1896	
3	Wall Shteathing (OSB)		SF	1896	
4	Shteathing Fastener	Self-drilling screws(100/pkt)	PKT	18.96	
5	Wall Insulation		SF	2162	
6	Wall Homewrap		SF	1896	
7	Home wrap Fastener	Stapled fastener (200/pkt)	PKT	7.2048	
8	Furring Strip		PCS	0	
9	Furring Strip Fastener	Self-drilling screws(100/pkt)	PKT	0	
10	Stone Copping	Masonry stone	SF	0	
11	Stone Veneer	Masonry stone	SF	0	
Δ	WALLS INTERIOR				
1	Cementitious Backer Board		SF	485	
2	Kerdi membrane		SF	485	
3	Kerdi membrane Fastener		SF	485	
4	Wall Ceramic Tile		SF	485	
5	Drywall Board		SF	1849	
6	Drywall Fastener	Self-drilling screws(100/pkt)	PKT	18.49	
7	Wall Paint		SF	1849	
	Drywall Tape		FT	321.65	
8	Wall Skerting		FT	228	
	DOORS				
1	Exterior Swinging	3' - 0" X 6'-8"	PCS	1	
2	Interior Swinging	2' - 4" X 6'-8"	PCS	1	
3	Interior Swinging	2' - 6" X 6'-8"	PCS	1	
4	Interior Swinging	2' - 8" X 6'-8"	PCS	2	
5	Interior Swinging	3' - 0" X 6'-8"	PCS	2	
6	Interior Sliding	9' - 6" X 6'-8"	PCS	3	
7	Patio Sliding	5' - 0" X 6'-8"	PCS	2	
8	Exterior Door Trim		FT	53.02	
9	Interior Door Trim		FT	248.08	
10	Entry Lock set		PCS	3	
11	Privacy Lock set		PCS	5	
12	Passage Lock set		PCS	4	

ARCHITECTURAL BOM



	WINDOWS				
1	Casement	2' - 9" X 3'-3"	PCS	2	
'			F 0.3	2	
2	Single Hung	2' - 3" X 3'-3"	PCS	6	
3	Sliding	2' - 3" X 1'-9"	PCS	2	
4	Sliding	5' - 3" X 4'-3"	PCS	5	
5	Exterior Window Trim		FT	186	
6	Interior Window Trim		FT	186	
<u></u>	ROOF				
1	Roof Covering		SF	1000	
2	Roof Covering Fastener		PCS	500	
3	Roof Felt Paper		SF	1000	
4	Roof Felt Paper Fastener		PCS	3000	
5	Roof Sheathing		SF	1000	
6	Roof Sheathing Fastener		PCS	8000	
7	Batten		FT	0	
8	Batten Fastener		PCS	0	
9	Soffit		SF	0	
10	Soffit Fastener		PCS	0	
11	Fascia		FT	0	
12	Fascia board fastener		PCS	0	
13	Roof Insulation		SF	1000	



Yoke-3Bd2Ba-Contemporary **ELECTRICAL MATERIAL SHOPPING LIST** No. Item Type Unit Quantity Description LIGHTING FIXTURES Kitchen Ceiling Light PCS 3 **Exterior Wall Mounted Light PCS** 6 Livingroom Ceiling Light With Fan PCS 0 Bedroom Ceiling Light With Fan PCS 3 Dining Ceiling Light PCS 0 Bath Wall Mounted Light **PCS** 2 Bathroom Ceiling Light 2 7 PCS Livingroom Ceiling Light PCS 3 Bed Ceiling Light PCS 12 10 Hall & Entry Ceiling Light 3 PCS 11 Smoke Detector PCS 6 **ELECTRICAL FITTINGS** 12 Standard Receptacle 120V 20 A PCS 17 13 GFCI Receptacle 120V 20 A PCS 11 30 A 14 GFCI Receptacle 240V 3 PCS 15 GFCI Receptacle 240V 40 A PCS 0 16 GFCI Receptacle 240V 50 A 1 PCS 17 GFCI Receptacle 240V 60 A **PCS** 1 3 18 Fan Switch PCS 19 Single Pole Switch **PCS** 13 20 Three Way Switch PCS 4 3 21 Dimmer Switch PCS **ELECTRICAL CONDUITS & WIRING** 14/2 w/ground 22 ROMEX 14 AWG FT 23 ROMEX 12 AWG 12/2 w/ground FT 613.5 24 ROMEX 12 AWG 12/3 w/ground FT 0 25 ROMEX 10 AWG 10/3 w/ground 75 FT 8/3 w/ground 15 26 ROMEX 8 AWG FT 27 ROMEX 6 AWG 6/3 w/ground FT 51 28 ROMEX 6 AWG 6/3 w/ground FT 29.3 29 Bare Copper Ground Wire 6 AWG **ELECTRICAL BOXES & CIRCUTES** Panelboard -240V 1 Phase MLO 200 AMP PCS Circuit breaker 15 A PCS 1 20 A 32 Circuit breaker PCS 14 30 A 3 33 Circuit breaker PCS 40 A 34 Circuit breaker **PCS** 0 35 Circuit breaker 50 A **PCS** 1 36 Circuit breaker 60 A PCS 1 Single Gang Switch Box PCS 7 38 Double Gang Switch Box PCS 3 39 Triple Gang Switch Box PCS 3

PLUMBING BOM



		Yoke-3Bd2	Ba-Contem	porary			
	F	LUMBING SYSTEM	MATERIAL	SHOPPI	NG LIST		
No.	Item	Туре	Unit	Quantity	Unit Price	Total	Description
Δ	PLUMBING FIXTURES & ACCESSORIES						
1	Bath Tub (Alcove Tub)		PCS	0			
2	Kitchen Sink		PCS	1			
3	Kitchen Faucets		PCS	1			
4	Vanity Sink		PCS	2			
5	Bath room Faucets		PCS	2			
6	Water Closet		PCS	2			
7	Shower Trim		PCS	2			
8	Shower Tray		PCS	2			
9	Water Heater		PCS	1			
10	Hose Bib		PCS	1			
11	Shutoff Valve		PCS	8			
12	Hanging pipe clamp		PCS	19			
13	Gate Valve		PCS	1			
14	Dishwasher Supply Single Connector		PCS	1			
15	Dishwasher Sewage Single Connector		PCS	1			
16	Laundry Sweat Connector		PCS	1			
Δ	SANITARY & PLUMBING PIPES						
1	ABS (Acrylonitrile Butadiene Styrene) Pipes	ø 1"	FT	0			
2	ABS (Acrylonitrile Butadiene Styrene) Pipes	ø 1 1/2"	FT	13			
3	ABS (Acrylonitrile Butadiene Styrene) Pipes	ø 2"	FT	183			
4	ABS (Acrylonitrile Butadiene Styrene) Pipes	ø 3"	FT	9			
5	PEX (Cross-linked polyethylene) Pipes	ø 1/2"	FT	84			
6	PEX (Cross-linked polyethylene) Pipes	ø 3/4"	FT	63			
7	PEX (Cross-linked polyethylene) Pipes	ø 1"	FT	0			
8	PVC Pipes Sch.80 - Rigid	ø 1 1/2"	FT	0			
9	PVC Pipes Sch.80 - Rigid	ø 2"	FT	0			
10	PVC Pipes Sch.80 - Rigid	ø 3"	FT	0			
11	Flex Pipe Round	ø 1/2"	PCS	8			

PLUMBING BOM



Δ	PIPE FITTINGS				
1	ABS 90 Degree Bend Elbow	1 1/2"ø-1 1/2"ø	PCS	3	
2	ABS 90 Degree Bend Elbow	2"ø-2"ø	PCS	4	
3	ABS 90 Degree Bend Elbow	3"ø-3"ø	PCS	2	
4	ABS Bend Long Sweep Elbow	2"ø-2"ø	PCS	1	
5	ABS P-Trap	1 1/2"ø-1 1/2"ø	PCS	4	
6	ABS P-Trap	2"ø-2"ø	PCS	1	
7	ABS Reducer Elbow	2"ø-1 1/2"ø	PCS	3	
8	ABS Reducer Elbow	3"ø-2"ø	PCS	3	
9	ABS TEE Elbow	2"ø-2"ø-2"ø	PCS	4	
10	ABS TEE Elbow	3"ø-3"ø-3"ø	PCS	1	
11	ABS Trap P	2"ø-2"ø	PCS	1	
12	ABS Vent Cap Elbow	2"ø	PCS	3	
13	ABS WASTE DOUBLE TEE	1 1/2"ø-1 1/2"ø-1 1/2"ø-1	PCS	1	
14	ABS WASTE DOUBLE TEE	2"ø-2"ø-2"ø	PCS	1	
15	ABS WASTE DOUBLE TEE	3"ø-3"ø-3"ø-3"ø	PCS	1	
16	ABS Wye Combination with 8th Bend Elbow	2"ø-2"ø-1 1/2"ø	PCS	1	
17	ABS Wye Combination with 8th Bend Elbow	3"ø-3"ø-1 1/2"ø	PCS	1	
18	ABS Wye Combination with 8th Bend Elbow	3"ø-3"ø-2"ø	PCS	1	
19	ABS Wye Combination with 8th Bend Elbow	3"ø-3"ø-3"ø	PCS	1	
20	Bend Rain Water System	2"ø-2"ø	PCS	20	
21	Bend Sewerage System	2"ø-2"ø	PCS	8	
22	PEX 90 Degree Elbow	1/2"ø-1/2"ø	PCS	21	
	PEX 90 Degree Elbow	3/4"ø-3/4"ø	PCS	7	
24	PEX Tee Elbow	1/2"ø-1/2"ø-1/2"ø	PCS	10	
25	PEX Tee Elbow	3/4"ø-3/4"ø-3/4"ø	PCS	8	
26	PEX Transition Elbow	1"ø-3/4"ø	PCS	2	
27	PEX Transition Elbow	3/4"ø-1/2"ø	PCS	11	

HVAC BOM



		Yoke-3Bd2E	Ba-Con	temporai	γ		
		HVAC SYSTEM MA	TERIAL	. SHOPPI	NG LIST		
No.	Item	Туре	Unit	Quantity	Unit Price	Total	Description
<u></u>	HVAC_DUCTS						
1	PIPE (REFRIGERANT LINE)	1/4" Ø	FT	0.88			
2	PIPE (REFRIGERANT LINE)	3/4" Ø	FT	41.51			
3	PIPE (REFRIGERANT LINE)	1/2" Ø	FT	0.87			
4	PIPE (REFRIGERANT LINE)	3/4" Ø	FT	47.71			
5	DRAYER HOSE	5" Ø	FT	6.9			
6	FLEX DUCT ROUND	4"	FT	5			
<u></u>	DUCT FITTINGS & ACCESSORIES						
7	ELBOW (REFRIGERANT LINE)	1/2" (Ø)-1/2" (Ø)	PCS	1			
8	ELBOW (REFRIGERANT LINE)	1/4" (Ø)-1/4" (Ø)	PCS	1			
9	ELBOW (REFRIGERANT LINE)	3/4" (Ø)-3/4" (Ø)	PCS	11			
10	ELBOW (REFRIGERANT LINE)	3/8" (Ø)-3/8" (Ø)	PCS	8			
11	TRANSITION (REFRIGERANT	3/4" (Ø)-1/2" (Ø)	PCS	5			
12	TRANSITION (REFRIGERANT	3/4" (Ø)-3/8" (Ø)	PCS	4			
13	TRANSITION (REFRIGERANT	3/8" (Ø)-1/4" (Ø)	PCS	1			
14	ROUND TRANSITION(ANGLE)	45 DEGREE	PCS	5			
<u></u>	HVAC_EQUIPMENTS						
15	AIR HANDLING UNIT	WALL MOUNTED	PCS	4			
16	CONDENSER	OUTDOOR UNIT	PCS	1			
17	EXHAUST FAN	75 CFM	PCS	2			
18	EXHAUST HOOD	WALL MOUNTED	PCS	#REF!			
19	HOOD-WALL: VENT	HOOD-WALL: VENT	PCS	1			
20	DRAYER: VENT	DRAYER: VENT	PCS	1			
21	ROOF VENT	3"(Ø)	PCS	3			



Table Of Content

#	Name	Link	Page No
1	Cover Page	<u>Cover Page</u>	1
2	TOC	TOC	2
3	ELECTRICAL BOM	ELECTRICAL BOM	3
5	HVAC BOM	HVAC BOM	7
4	PLUMBING BOM	PLUMBING BOM	10
6	ARCHITECTURAL BOM	ARCHITECTURAL BOM	15

Have It Your Way!

The material types listed in this document were selected based on personal preferences. The Customer is encouraged to make changes to the material types in accordance with local customs, regulations, and personal preferences. Have It Your Way!

GENERAL NOTES

- This BOM (Bill of Materials) is prepared as a Materials Shopping List to help builders and DIYers gain a complete understanding of most if not all elements required for the complete construction of this structure, according to the original design documents provided by FrameUpNow.
- 2 All quantities and specifications are subject to change based on the final design, field measurements, availability of products and customer preferences. The customer should verify all information prior to purchasing materials.
- 3 All products and elements in the list shall conform to the International Residential Code (IRC), or any other local and international building codes, safety regulations, and standards that are applicable to the location of the structure.
- 4 If any changes are made by the customer to the list of materials specified in this document, the customer is responsible for assuring that the correct type and quantity of materials are utilized in accordance with local building codes.
- 5 FrameUpNow, will not be held responsible for any misuse of this document, the products listed, or for deviations from the content that are made due to changes in specifications, pricing, availability, or customer preferences.
- The customer is advised to consult a qualified professional or technician prior to purchasing materials for specialized construction system items. Some items including but not limited to caseworks, doors and windows may require as built measurements prior to purchase to confirmation of final dimensions.
- 7 If there are additional trim elements or specific installation methods, the total amount of materials needed might vary. Consider any additional trim required for corners, intersections, or other architectural details that might cause this variations before procedding to purchase and construction.



			LIGHTING FIXTURES				
#	Lighting	Туре	Description, Manufacturer, SKU	Unit	Quantity	Unit Price	Total
1	Kitchen Ceiling Light			PCS	3		
2	Exterior Wall Mounted Light			PCS	6		
3	Livingroom Ceiling Light With Fan			PCS	0		
4	Bedroom Ceiling Light With Fan			PCS	3		
5	Dining Ceiling Light			PCS	0		
6	Bath Wall Mounted Light			PCS	2		
7	Bathroom Ceiling Light			PCS	2		
8	Livingroom Ceiling Light			PCS	3		
9	Bed Ceiling Light			PCS	12		
10	Hall & Entry Ceiling Light			PCS	3		
11	Smoke Detector			PCS	6		



			ELECTRICAL FITTINGS				
# Iter	m	Туре	Description, Manufacturer, SKU	Unit	Quantity	Unit Price	Total
L Sta	andard Receptacle 120V	20 A		PCS	17		
GF	FCI Receptacle 120V	20 A		PCS	11		
GF	CI Receptacle 240V	30 A		PCS	3		
GF	FCI Receptacle 240V	40 A		PCS	0		
GF	FCI Receptacle 240V	50 A		PCS	1		
GF	FCI Receptacle 240V	60 A		PCS	1		
Far	n Switch			PCS	1		
Sin	ngle Pole Switch				3		
Thr	ree Way Switch			PCS PCS	13		
0 Din	mmer Switch				4		
				PCS	3		



		E	LECTRICAL CONDUITS & WIRING				
#	Item	Туре	Description, Manufacturer, SKU	Unit	Quantity	Unit Price	Total
1	ROMEX 14 AWG	14/2 w/ground		FT	0		
2	ROMEX 12 AWG	12/2 w/ground		FT	614		
3	ROMEX 12 AWG	12/3 w/ground		FT	0		
4	ROMEX 10 AWG	10/3 w/ground		FT	75		
5		8/3 w/ground		FT	15		
6	ROMEX 6 AWG	6/3 w/ground		FT	51		
7	Bare Copper Ground Wire 6 AWG						



			ELECTRICAL BOXES & CIRCUTE	S			
#	Item	Туре	Description,Manufacturer,SKU	Unit	Quantity	Unit Price	Total
1	Panelboard -240V 1 Phase MLO	200 AMP		PCS	1		
2	Circuit breaker	15 A		PCS	1		
3	Circuit breaker	20 A		PCS	14		
4	Circuit breaker	30 A		PCS	3		
5	Circuit breaker	40 A		PCS	0		
6	Circuit breaker	50 A		PCS	1		
7	Circuit breaker	60 A		PCS	1		
8	Single Gang Switch Box			PCS	7		
9	Double Gang Switch Box			PCS	3		
10	Triple Gang Switch Box			PCS	3		
11	Pull Box	#1/4		PCS	24		
12	Receptacle Box			PCS	33		

HVAC BOM



			HVAC_DUCTS 01				
#	Item	Туре	Description, Manufacturer, SKU	Unit	Quantity	Unit Price	Total
1	PIPE (REFRIGERANT LINE)	1/4" (Ø)		FT	1.21		
2	PIPE (REFRIGERANT LINE)	3/8" (Ø)		FT	97.62		
3	PIPE (REFRIGERANT LINE)	1/2" (Ø)		FT	1.22		
4	PIPE (REFRIGERANT LINE)	3/4"' (Ø)		FT	147.01		
5	DRAYER HOSE	4" (Ø)		FT	3.7		
6	FLEX DUCT ROUND	4" (Ø)		FT	5.72		

HVAC BOM



		D	UCT FITTINGS & ACCESSORIES				
#	Item	Туре	Description, Manufacturer, SKU	Unit	Quantity	Unit Price	Total
1	CROSS (REFRIGERANT LINE)	3/4" (Ø)-3/4" (Ø)-3/4" (Ø)		PCS	1		
2	ELBOW (REFRIGERANT LINE)	1/2" (Ø)-1/2" (Ø)		PCS	1		
3	ELBOW (REFRIGERANT LINE)	1/4" (Ø)-1/4" (Ø)		PCS	1		
4	ELBOW (REFRIGERANT LINE)	3/4" (Ø)-3/4" (Ø)		PCS	37		
5	ELBOW (REFRIGERANT LINE)	3/8" (Ø)-3/8" (Ø)		PCS	23		
6	TEE (REFRIGERANT LINE)	3/4" (Ø)-3/4" (Ø)-3/4"		PCS	1		
7	TEE (REFRIGERANT LINE)	3/8" (Ø)-3/8" (Ø)-3/8"		PCS	3		
8	TRANSITION (REFRIGERANT LINE)	3/4" (Ø)-1/2" (Ø)		PCS	5		
9	TRANSITION (REFRIGERANT LINE)	3/4" (Ø)-5/8" (Ø)		PCS	4		
10	TRANSITION (REFRIGERANT LINE)	3/8" (Ø)-1/4" (Ø)		PCS	1		
11	ROUND TRANSITION(ANGLE)	45 DEGREE		PCS	7		

HVAC BOM



			HVAC_EQUIPMENTS				
#	Item	Туре	Description, Manufacturer, SKU	Unit	Quantity	Unit Price	Total
1	AIR HANDLING UNIT	WALL MOUNTED		PCS	4		
2	CONDENSER	OUTDOOR UNIT		PCS	1		
3	EXHAUST FAN	75 CFM		PCS	2		
4	HOOD-WALL: VENT	HOOD-WALL: VENT		PCS	1		
5	DRAYER: VENT	DRAYER: VENT		PCS	1		
6	ROOF VENT	3"(Ø)		PCS	3		



		PLUMBIN	NG FIXTURES & ACCESSORIES				
#	Item	Туре	Description, Manufacturer, SKU	Unit	Quantity	Unit Price	Total
1	Bath Tub (Alcove Tub)			PCS	0		
2	Kitchen Sink			PCS	1		
3	Kitchen faucets			PCS	1		
4	Vanity Sink			PCS	2		
5	Bath room faucets			PCS	2		
6	Water Closet			PCS	2		
7	Shower Trim			PCS	2		
8	Shower Tray			PCS	2		
9	Water Heater			PCS	1		
10	Hose Bib			PCS	1		
11	Shutoff Valve			PCS	8		
12	Hanging pipe clamp			PCS	8		
13	Globe Valve			PCS	1		
14	Dishwasher Supply Single Connector			PCS	1		
15	Dishwasher Sewage Single Connector			PCS	1		
16	Laundry Sweat Connector			PCS	1		



		SANI	TARY & PLUMBING PIPES				
#	Item	Туре	Description, Manufacturer, SKU	Unit	Quantity	Unit Price	Total
1	ABS (Acrylonitrile Butadiene Styrene) Pipes	ø 1"		FT	C		
2	ABS (Acrylonitrile Butadiene Styrene) Pipes	ø 1 1/2"		FT	49		
3	ABS (Acrylonitrile Butadiene Styrene) Pipes	Ø 2"		FT	70		
4	ABS (Acrylonitrile Butadiene Styrene) Pipes	ø 3"		FT	18		
5	PEX (Cross-linked polyethylene) Pipes	ø 1/2"		FT	84		
6	PEX (Cross-linked polyethylene) Pipes	ø 3/4"		FT	54		
7	PEX (Cross-linked polyethylene) Pipes	ø 1"		FT	C		
8	PVC Pipes Sch.80 - Rigid	ø 1 1/2"		FT	C		
9	PVC Pipes Sch.80 - Rigid	ø 2"		FT	C		
10	PVC Pipes Sch.80 - Rigid	ø 3"		FT	C		
11	Flex Pipe Round	ø 1/2"		FT	8		
12	Flex Pipe Round	ø 3/4"		FT	C		
13	Flex Pipe Round	ø 1"		FT	C		



		Р	IPE FITTINGS 01				
#	Item	Туре	Description, Manufacturer, SKU	Unit	Quantity	Unit Price	Total
1	ABS 90 Deg Bend Elbow	2"ø-2"ø		PCS	4		
2	ABS 90 Degree Bend Elbow	1 1/2"ø-1 1/2"ø		PCS	1		
3	ABS 90 Degree Bend Elbow	2"Ø-2"Ø		PCS	5		
4	ABS 90 Degree Bend Elbow	3"ø-3"ø		PCS	2		
5	ABS P-Trap	1 1/2"ø-1 1/2"ø		PCS	5		
6	ABS P-Trap	2"ø-2"ø		PCS	1		
7	ABS P-Trap	3"ø-3"ø		PCS	2)	
8	ABS Reducer Elbow	2"ø-1 1/2"ø		PCS	1		
9	ABS Reducer Elbow	3"ø-1 1/2"ø		PCS	1		
10	ABS Reducer Elbow	3"ø-2"ø		PCS	1		
11	ABS TEE Elbow	2"Ø-2"Ø-2"Ø		PCS	1		
12	ABS TEE Elbow	3"ø-3"ø-3"ø		PCS	1		
13	ABS Tee Reducer Elbow	3"ø-3"ø-1 1/2"ø		PCS	2		
14	ABS Tee Reducer Elbow	3"ø-3"ø-2"ø		PCS	1		
15	ABS Trap P	2"ø-2"ø		PCS	1		



		PIPE FI	TTINGS 02				
#	Item	Туре	Description, Manufacturer, SKU	Unit	Quantity	Unit Price	Total
1	ABS Vent Cap Elbow	1 1/2"ø		PCS	3	3	
2	ABS Vent Cap Elbow	2"ø		PCS	2	2	
3	ABS WASTE DOUBLE TEE	1 1/2"ø-1 1/2"ø-1 1/2"ø		PCS	1		
4	ABS WASTE DOUBLE TEE	3"ø-3"ø-3"ø		PCS	1		
5	PEX 90 Degree Elbow	1/2"ø-1/2"ø		PCS	22		
6	PEX 90 Degree Elbow	3/4"ø-3/4"ø		PCS	8	}	
7	PEX Tee Elbow	1/2"ø-1/2"ø-1/2"ø		PCS	7	,	
8	PEX Tee Elbow	3/4"ø-3/4"ø-3/4"ø		PCS	9		
9	PEX Transition Elbow	1"ø-3/4"ø		PCS	2		
10	PEX Transition Elbow	3/4"ø-1/2"ø		PCS	9		
11	PVC 90 Deg Bend Elbow	2"Ø-2"Ø		PCS	4		
12	WASTE DOUBLE TEE	1 1/2"ø-1 1/2"ø-1 1/2"ø		PCS	1		
13	WASTE DOUBLE TEE	2"Ø-2"Ø-2"Ø		PCS	1		



	1		APPLIANCES				
#	Item	Туре	Description, Manufacturer, SKU	Unit	Quantity	Unit Price	Total
1	Refrigerator			PCS	1		
2	Range			PCS	1		
3	Washer Front Load	Stackable		PCS	1		
1	Dryer Front Load	Stackable		PCS	1		
5	Dish Washer			PCS	1		
6	Oven			PCS	0		
7	Microwave			PCS	0		



			CASEWORKS 01				
#	Item	Туре	Description, Manufacturer, SKU	Unit	Quantity	Unit Price	Total
1	Kitchen Cabinet			FT	15		
2	Laundry Cabinet			FT	2.25		
3	Vanity Cabinet			FT	2.5		
4	Medicine Cabinet			PCS	2		
5	Kitchen countertop			SF	22.82		
6	Laundry Countertop			PCS	0		
7	Bathroom Countertop			SF	0		
8	Island			FT	0		
9	Peninsula			FT	0		
10	Closets			SF	180.5		



			CEILING 01				
#	item	Туре	Description, Manufacturer, SKU	Unit	Quantity	Jnit Price	Total
	LIVING ROOM + KITCHEN +	DINING		SF	248.0		
1	Ceiling Board	Drywall		SF	248		
2	Drywall Fastener	Screw		PCS	434		
3	Vapor Retarder	Polyethylene film		SF	248		
	Vapor Retarder Fastener	Nails with washer heads		PCS	744		
4	BATHROOM 1			SF	49.0		
5	Ceiling Board	MRD (Moisture resistant drywall)		SF	49		
6	MRD Fastener	Screw		PCS	86		
	BATHROOM 2			SF	49.0		
7	Ceiling Board	MRD (Moisture resistant drywall)		SF	49		
8	MRD Fastener	Screw		PCS	86		



			CEILING 02				
#	Item	Туре	Description, Manufacturer, SKU	Unit	Quantity	Unit Price	Total
	BED ROOM 1			SF	141.0		
1	Ceiling Board	Drywall		SF	141		
2	Drywall Fastener	Screw		PCS	247		
3	Vapor Retarder	Polyethylene film		SF	141		
4	Vapor Retarder Fastener	Nails with washer heads		PCS	423		
	BED ROOM 2			SF	147.0		
5	Ceiling Board	Drywall		SF	147		
6	Drywall Fastener	Screw		PCS	257		
7	Vapor Retarder	Polyethylene film		SF	147		
8	Vapor Retarder Fastener	Nails with washer heads		PCS	441		
	BED ROOM 3			SF	139.0		
9	Ceiling Board	Drywall		SF	139		
10	Drywall Fastener	Screw		PCS	243		
11	Vapor Retarder	Polyethylene film		SF	139		
12	Vapor Retarder Fastener	Nails with washer heads		PCS	417		



			CEILING 03				
#	Item	Туре	Description, Manufacturer, SKU	Unit	Quantity	Unit Price	Total
	CL 1			SF	21.0		
21	Ceiling Board	Drywall		SF	21		
22	Drywall Fastener	Screw		PCS	37		
23	Vapor Retarder	Polyethylene film		SF	21.0		
24	Vapor Retarder Fastener	Nails with washer heads		PCS	63.0		
	CL 2			SF	21.0		
25	Ceiling Board	Drywall		SF	21		
26	Drywall Fastener	Screw		PCS	37		
27	Vapor Retarder	Polyethylene film		SF	21.0		
28	Vapor Retarder Fastener	Nails with washer heads		PCS	63.0		
	CL 3			SF	24.0		
21	Ceiling Board	Drywall		SF	24		
22	Drywall Fastener	Screw		PCS	42		
23	Vapor Retarder	Polyethylene film		SF	24.0		
24	Vapor Retarder Fastener	Nails with washer heads		PCS	72.0		



	<u>)</u>		CEILING 03				
#	Item	Туре	Description, Manufacturer, SKU	Unit	Quantity	Unit Price	Total
	HALL			SF	57.0		
	Ceiling Board	Drywall		SF	57		
	Drywall Fastener	Screw		PCS	100		
	Vapor Retarder	Polyethylene film		SF	57		
	Vapor Retarder Fastener	Nails with washer heads		PCS	171		
	W/H			SF	7.0		
	Ceiling Board	Drywall		SF	7		
	Drywall Fastener	Screw		PCS	12		
	Vapor Retarder	Polyethylene film		SF	7		
	Vapor Retarder Fastener	Nails with washer heads		PCS	21		



	1		FLOORING INTERIOR 02				
#	Item	Туре	Description, Manufacturer, SKU	Unit	Quantity	Unit Price	Total
	CL #2						
16	Closet Flooring			SF	21		
17	Wood underlay	Foam Pad Polyethylene		SF	21		
18	Vapor Retarder	Vapor Barrier Polyethylene		SF	21.2		
	CL#3						
19	Closet Flooring			SF	24		
20	Wood underlay	Foam Pad Polyethylene		SF	24		
21	Vapor Retarder	Vapor Barrier Polyethylene		SF	23.7		
	LIVING ROOM AND KITCHEN						
22	Living Area Flooring			SF	293		
23	Wood underlay	Foam Pad Polyethylene		SF	293		
24	Vapor Retarder	Vapor Barrier Polyethylene		SF	293.0		
	BATHROOM #1						
25	Tile Finish			SF	36		
26	Adhesive	1/2" Thin set Mortar		SF	36		
27	Vapor Retarder	Vapor Barrier Polyethylene		SF	35.9		



			FLOORING INTERIOR 03				
#	Item	Туре	Description, Manufacturer, SKU	Unit	Quantity	Unit Price	Total
	BATHROOM #2						
28	Tile Finish			SF	36		
29	Adhesive	1/2" Thin set Mortar		SF	36		
30	Vapor Retarder	Vapor Barrier Polyethylene		SF	35.9		
	W/D						
31	Tile Finish			SF	12		
32	Adhesive	1/2" Thin set Mortar		SF	12.2		
33	Vapor Retarder	Vapor Barrier Polyethylene		SF	12		
	BOILER ROOM						
34	Tile Finish			SF	7.2		
35	Adhesive	1/2" Thin set Mortar		SF	7		
36	Vapor Retarder	Vapor Barrier Polyethylene		SF	7		



			FLOORING EXTERIOR			
#	Item	Туре	Description, Manufacturer, SKU	Unit	Quantity	Unit Price
	STRUCTURE			SF	1408.12	
1	Concrete Slab	4"concrete cast in situ		CF	484	
2	Insulation	Rigid insulation		SF	403	
3	Hard core	Compacted soil		CF	363.5	
4	Re-bar	#4 re-bar		Ton	1.29	
5	Concrete Pad	4"concrete cast in situ		CF	1.58	
6	Slab edge	Turndown		CF	344.55	
	PORCH					
1	Tile Finish			SF	423.07	
2	Adhesive	1/2" Thin set Mortar		SF	423.07	
3	Vapor Retarder	Vapor Barrier Polyethylene		SF	423.07	



			WALLS: EXTERIOR				
	Item	Туре	Description, Manufacturer, SKU	Unit	Quantity	Unit Price	Total
1	Exterior-Stucco finish			SF	1896		
2	Exterior-Grade Plywood Fastener 8/panel	Self-drilling screws(100/pkt)		PKT	0		
3	Wall Shteathing (OSB)			SF	1896		
4	Shteathing Fastener	Self-drilling screws(100/pkt)		PKT	18.96		
5	Wall Homewrap			SF	1896		
6	Homewrap Fastener	Stapled fastener (200/pkt)		PKT	7.20		
7	Furring Strip			PCS	0.00		
8	Furring Strip Fastener	Self-drilling screws(100/pkt)		PKT	0		
9	Wall Paint			SF	1896		
10	Stone Copping	Masonry stone		SF	0		
11	Stone Veneer	Masonry stone		SF	0		
12	Mortar for Stone Veneer			SF	0		
13	Wall Insulation			SF	2162		



			WALLS: INTERIOR 01				
#	Item	Туре	Description, Manufacturer, SKU	Unit	Quantity	Unit Price	Total
	BATHROOM 1			SF	49		
1	Cementitious Backer Board			SF	207		
2	Kerdi membrane			SF	207		
3	Kerdi membrane Fastener			SF	207		
4	Wall Ceramic Tile			SF	207		
	BATHROOM 2			SF	48		
5	Cementitious Backer Board			SF	210		
6	Kerdi membrane			SF	210		
7	Kerdi membrane Fastener			SF	210		
8	Wall Ceramic Tile			SF	210		
	BEDROOM 1			SF	150		
9	Drywall Board			SF	303		
10	Drywall Fastener	Self-drilling screws(100/pkt)		PKT	3.03		
11	Wall Paint			SF	303		
12	Drywall Tape			FT	56.8		



			WALLS: INTERIOR 02			
#	ıtem	Туре	Description, Manufacturer, SKU	Unit	Quantity Unit Price	Total
	BEDROOM 2			SF	143	
13	Drywall Board			SF	252	
14	Drywall Fastener	Self-drilling screws(100/pkt)		PKT	2.52	
15	Wall Paint			SF	252	
16	Drywall Tape			FT	47.3	
	KITCHEN			SF	72	
17	Cementitious Backer Board			SF	8	
18	Drywall Board			SF	136	
19	Drywall Fastener	Self-drilling screws(100/pkt)		PKT	1.36	
20	Kerdi membrane			SF	8	
21	Kerdi membrane Fastener			SF	8	
22	Wall Ceramic Tile			SF	8	
23	Wall Paint			SF	136	
24	Drywall Tape			FT	25.7	



			WALLS: INTERIOR 03				
#	Item	Туре	Description, Manufacturer, SKU	Unit	Quantity	Unit Price	Total
	BEDROOM 3			SF	142		
37	Drywall Board			SF	243		
38	Drywall Fastener	Self-drilling screws(100/pkt)		PKT	2.43		
39	Wall Paint			SF	243		
40	Drywall Tape			FT	45.6		
	LIVING ROOM			SF	174		
41	Drywall Board			SF	264		
42	Drywall Fastener	Self-drilling screws(100/pkt)		PKT	2.64		
43	Wall Paint			SF	264		
44	Drywall Tape			FT	49.5		
	CLOSET 1			SF	20		
45	Drywall Board			SF	148		
46	Drywall Fastener	Self-drilling screws(100/pkt)		PKT	1.48		
47	Wall Paint			SF	148		
48	Drywall Tape			FT	27.8		



			WALLS: INTERIOR 04				
#	Item	Туре	Description, Manufacturer, SKU	Unit	Quantity	Unit Price	Total
	CLOSET 2			SF	20		
19	Drywall Board			SF	145		
50	Drywall Fastener	Self-drilling screws(100/pkt)		PKT	1.45		
51	Wall Paint			SF	145		
52	Drywall Tape			FT	27.2		
	CLOSET 3			SF	23		
3	Drywall Board			SF	136		
54	Drywall Fastener	Self-drilling screws(100/pkt)		PKT	1.36		
55	Wall Paint			SF	136		
6	Drywall Tape			FT	26		
	HALL	'		SF	48		
7	Drywall Board			SF	149		
8	Drywall Fastener	Self-drilling screws(100/pkt)		PKT	1.49		
9	Wall Paint			SF	149		
50	Drywall Tape			FT	28.11320755		



			WALLS: INTERIOR 05				
#	Item	Туре	Description, Manufacturer, SKU	Unit	Quantity	Unit Price	Total
	WH			SF	7		
61	Drywall Board			SF	73		
62	Drywall Fastener	Self-drilling screws(100/pkt)		PKT	0.73		
63	Wall Paint			SF	73		
64	Drywall Tape			FT	14		
	WD			SF	12		
65	Cementitious Backer Board			SF	60		
66	Kerdi membrane			SF	60		
67	Kerdi membrane Fastener			SF	60		
68	Wall Ceramic Tile			SF	60		
69	Wall Skirting	Ceramic		FT	228		



			DOORS			
#	Item	Туре	Description, Manufacturer, SKU	Unit	Quantity Unit Price	Total
1	Exterior Swinging	3' - 0" X 6'-8"		PCS	1	
2	Interior Swinging	2' - 4" X 6'-8"		PCS	1	
3	Interior Swinging	2' - 6" X 6'-8"		PCS	1	
4	Interior Swinging	2' - 8" X 6'-8"		PCS	2	
5	Interior Swinging	3' - 0" X 6'-8"		PCS	2	
6	Interior Sliding	9' - 6" X 6'-8"		PCS	3	
7	Patio Sliding	5' - 0" X 6'-8"		PCS	2	
8	Exterior Door Trim			FT	53.02	
9	Interior Door Trim			FT	248.08	
10	Entry Lock set			PCS	3	
11	Privacy Lock set			PCS	5	
12	Passage Lock set			PCS	4	



			WINDOWS				
#	Item	Туре	Description, Manufacturer, SKU	Unit	Quantity	Unit Price	Total
1	Casement	2' - 9" X 3'-3"		PCS	2		
2	Single Hung	2' - 3" X 3'-3"		PCS	6		
3	Sliding	2' - 3" X 1'-9"		PCS	2		
4	Sliding	5' - 3" X 4'-3"		PCS	5		
5	Exterior Window Trim			FT	186		
6	Interior Window Trim			FT	186		



			ROOF 01				
#	Item	Туре	Description, Manufacturer, SKU	Unit	Quantity	Jnit Price	Total
1	Roof Covering			SF	1000.0		
2	Roof Covering Fastener			PCS	500		
3	Roof Felt Paper			SF	1000.0		
4	Roof Felt Paper Fastener			PCS	3000.0		
5	Roof Sheathing			SF	1000.0		
6	Roof Sheathing Fastener			PCS	8000		
7	Batten			FT	0.0		
8	Batten Fastener			PCS	0.0		
9	Soffit			SF	0.0		
10	Soffit Fastener			PCS	0.0		
11	Fascia			FT	0.0		
12	Fascia board fastener			PCS	0		
13	Roof Insulation			SF	1000.0		