

HAMILTON

The Hamilton is a charming one-bedroom, onebathroom Spanish-style home designed for efficient and comfortable living. Its exterior features a classic white stucco finish and a simple gable roof adorned with Spanish clay tiles, creating a timeless and visually appealing facade. The addition of small, decorative wooden awnings over the entrances adds a touch of rustic charm and provides some shade.

Inside, the Hamilton embraces an open floor plan layout. The living and kitchen areas are combined into a single, spacious room, promoting a sense of openness and flow. On the opposite side, the bedroom offers a private and comfortable retreat. The bathroom and laundry areas are thoughtfully integrated into the design, maximizing space efficiency.




Please print and take this Materials Shopping List to your favorite Home Depot and ask for assistance in selecting the materials, fixtures and fittings to complete your new home.

Record your selection and the price of the item. Then do the math to determine the cost for your selections and the total cost of finishing your home.



To Go To Materials Shopping List



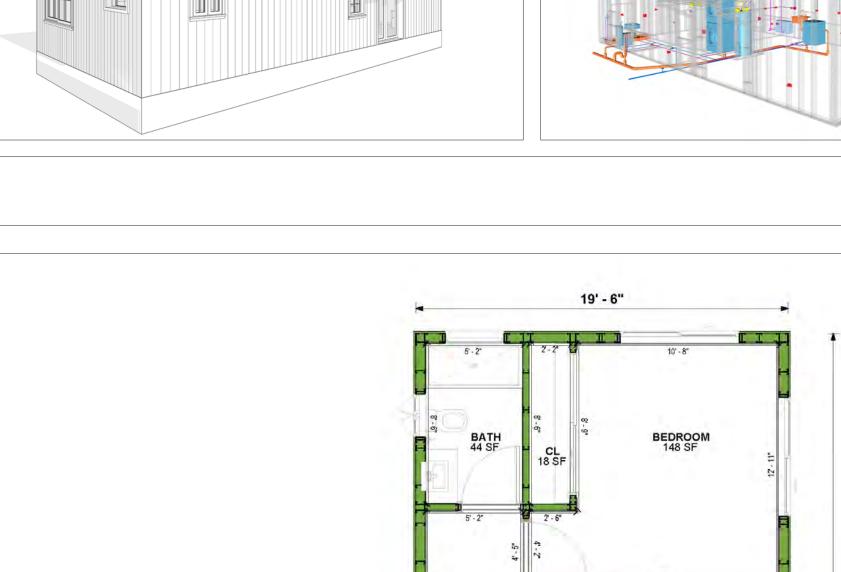


FLOOR PLAN



746 SF


1 Bed Room

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MATERIALS SHOPPING LIST

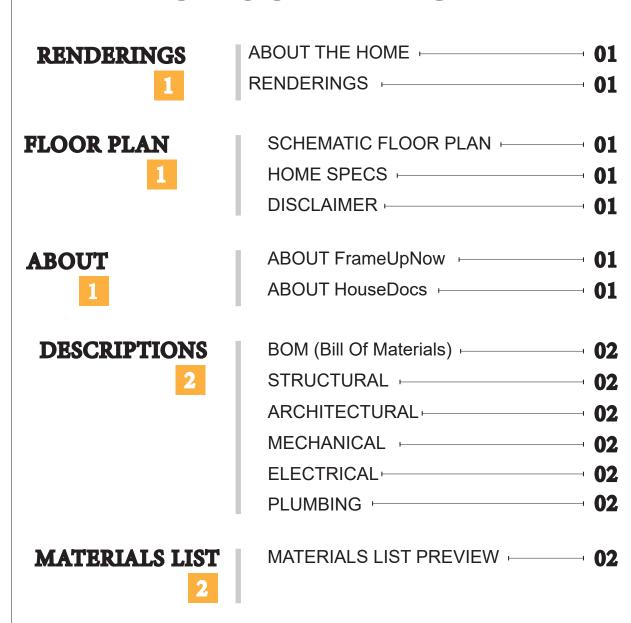



FrameUpNow is a design and manufacturing company providing precision-engineered home framing solutions. We offer a catalog of Affordable Homes, Tiny Homes, Garages, Shops and Barndominiums. FrameUpNow manufactures cold-formed steel (CFS) also known as Light Gauge Steel (LGS) framing components that conform to our engineered metal house frame plans or can be purchased as DIY skeleton kits.

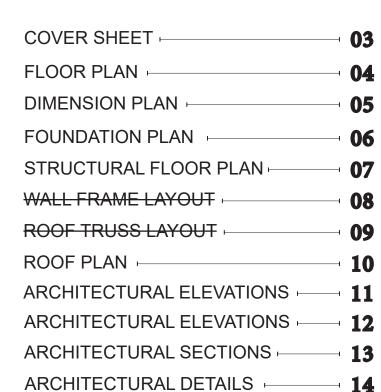The CFS/LGS framing is lightweight, easily assembled, and does not require heavy equipment or specialized labor, enabling homeowners to erect the frame themselves in just a few days. Unlike wood, the steel framing is impervious termites and bores, warping, expansion, and fire.

Our home plans come complete with a structural engineered stamp for permit approvals. Customers receive a full BOM also known as a Materials Shopping List to purchase finish materials from a Building Materials retailer. FrameUpNow prides itself on the quality and efficiency of our precision-engineered home framing solutions for construction professionals and DIY homeowners.



KEY PLAN

NO.	DESCRIPTION	DATE

NOTE:

LEGEND:

PROJECT

56-Hamilton-746-1Bd-1Ba-Spanish-550

DRAWING NAME

INTRODUCTION

CLIENT NAME:	
PROJECT NUMBER:	
DATE:	
DESIGNED BY:	
DRAWN BY:	
CHECKED BY:	

1101

SCALE:

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DESCRIPTIONS

MATERIALS LIST

The BOM (Bill Of Materials) package, known as the Materials Shopping List document, provides:

Comprehensive Inventory: Detailed lists of essential materials sourced from architectural, mechanical, HVAC, electrical, and plumbing design drawing sets.

Precise Curation: Each item meticulously selected and organized for accuracy and efficiency in project planning.

Customizable Options: Customers can modify listed items to their preferences and calculate costs accordingly, ensuring alignment with personal project needs and budget.

Dedicated Space for Details: Includes tables for customers to note Home Depot SKU numbers or product descriptions for selected items, facilitating seamless purchasing and coordination with suppliers.

Customer Convenience: Take the list to Home Depot or preferred suppliers for accurate pricing, helping align the total home budget with personal financial plans.

Simplify your construction journey with our Materials Shopping List document, where detailed preparation meets streamlined implementation for your dream home.

STRUCTURAL

The structural drawings package provides an exhaustive set of detailed plans essential for the precise assembly of your building. This comprehensive package includes:

Framing Plans: Detailed layouts for all framing components. Truss Layouts: Clear instructions for truss placement and

Panel Length Plans: Specifications for panel dimensions. Framing Elevations and Sections: Precise elevation and sectional views for accurate construction.

Truss and Wall Blocking Plans: Plans for truss and wall blocking to ensure structural integrity.

Hold-Down Plan: Detailed hold-down requirements for stability. Snap Sheet: Reference sheet for quick identification of components

Structural Details and Bracing Plans: Complete details and bracing plans for all structural elements.

Accompanying these plans is a comprehensive Bill of Materials (BOM) that lists every necessary building component, from cold formed steel (CFS) frames to fasteners.

ARCHITECTURAL

With the comprehensive architectural package, both builders and DIY homeowners can confidently execute the construction.

The architectural package includes:

Furnished Floor Plans: Complete with furniture layouts for a clear understanding of space utilization.

Detailed Dimension Plans: Ensures precise measurements, from the overall footprint down to the exact placement of windows and

Foundation Plan: Detailed plan to establish a solid foundation.

Wall Framing and Truss Layout: Comprehensive plans for wall framing and truss placement.

Architectural Elevations: Exterior views showcasing the design.

Strategic Building Sections: Critical cross-sectional details for a thorough understanding of the build.

Casework Drawings and Diagrams: Suggested designs for built-in caseworks, such as kitchen cabinets.

MECHANICAL ELECTRICAL

The mechanical package includes everything needed to guide HVAC

Detailed HVAC Floor Plan: Precisely maps out the placement of air handlers, ductwork, and vents throughout the home's layout.

HVAC Sections and Riser Diagrams: Technical drawings offering critical cross-sectional details and piping schematics, ensuring proper integration of the heating and cooling system into the home's structure.

Bill of Materials: A complete list of all necessary HVAC components.

The electrical package includes all the plans and documentation needed to guide the installation of your home's electrical system:

Detailed Power Plan: Precisely maps out the placement of outlets, switches, and other power components throughout the layout.

Comprehensive Lighting Plan: Shows the optimal locations for lighting fixtures, sconces, and other illumination sources to create a well-lit, functional interior.

Dimensioned Electrical Layout: Provides exact dimensions and measurements to ensure proper placement of all electrical elements.

Bill of Materials: A complete list of every component needed, from circuit breakers to wiring.

PLUMBING

The plumbing package includes everything needed to guide the installation of your home's water supply and drainage systems:

Detailed Water Supply System Plan: Precisely maps out the placement of pipes, valves, and plumbing fixtures throughout the

Comprehensive Sewage System Plan: Shows the optimal routing and sizing of drain lines to effectively remove waste and ensure

Detailed Riser Diagrams: Provide information needed to properly

Bill of Materials: A complete list of every component needed, from

proper drainage.

install all vertical plumbing risers and vent stacks.

pipes to fixtures.


BOM (Bill Of Materials) (Separately Attached)





The Bill of Materials (BOM) is a crucial document that compiles the material requirements from different disciplines into a centralized inventory, enabling efficient procurement, inventory management, and cost estimation for a specified project or

ELECTRICAL BOM



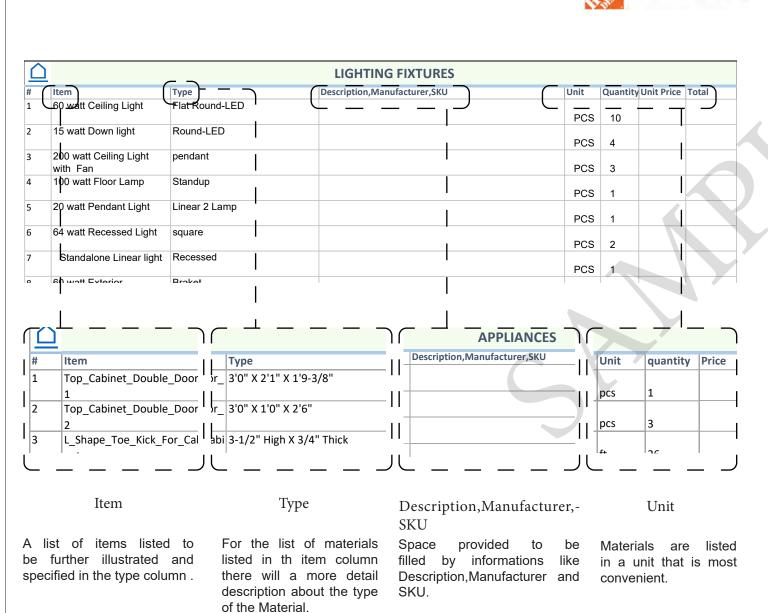

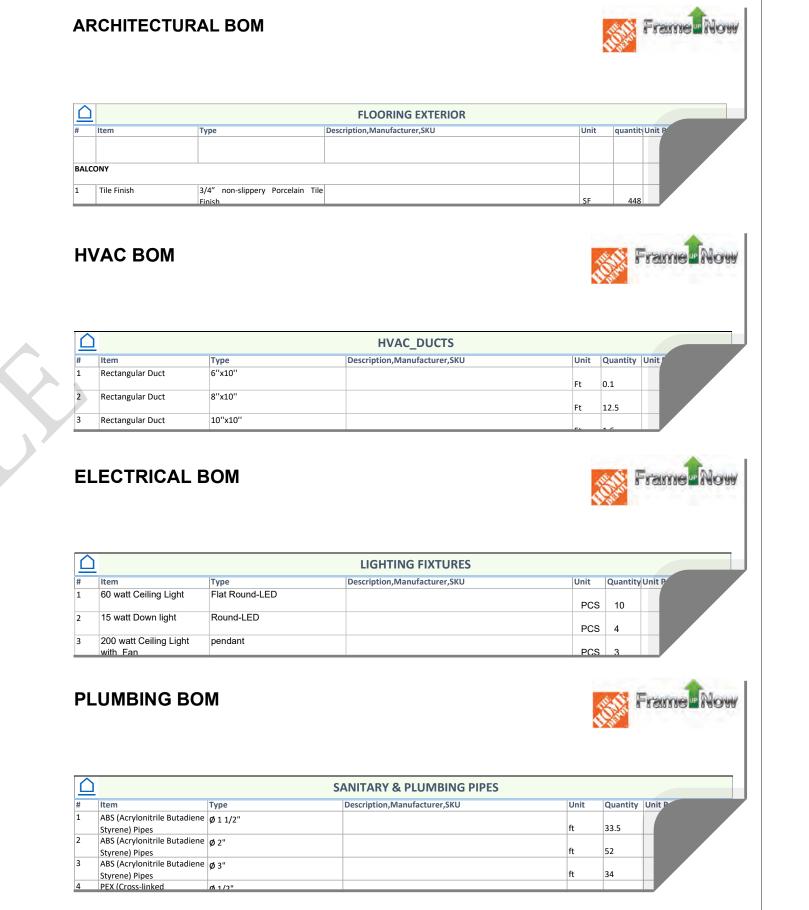

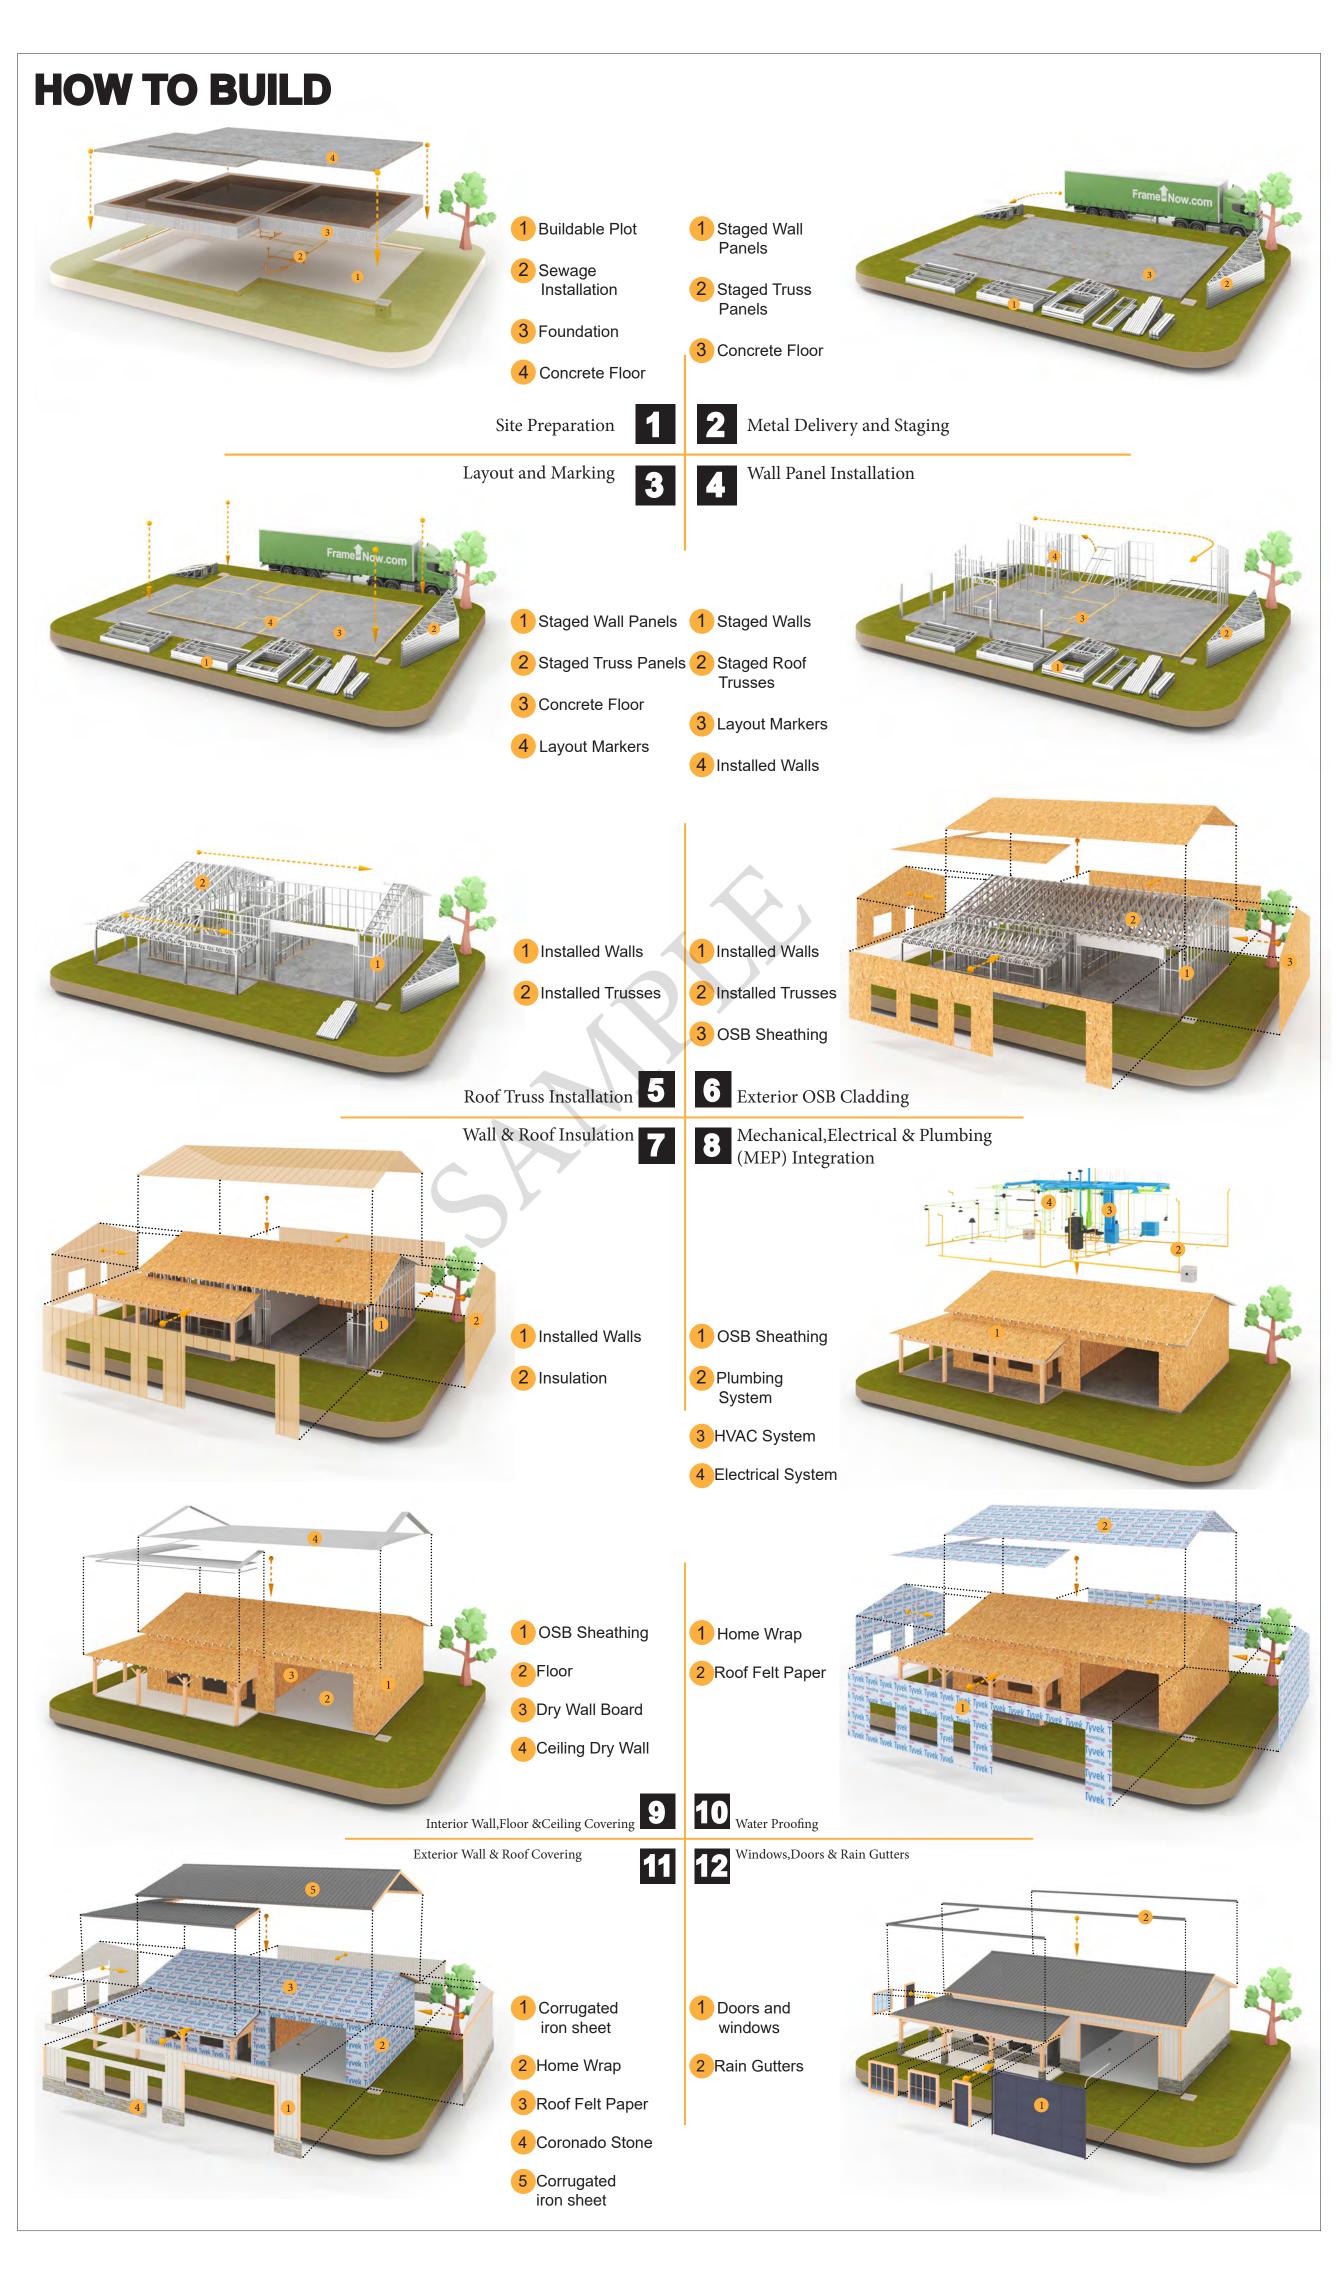



KEY PLAN

DESCRIPTION DATE

NOTE:

LEGEND:

PROJECT

56-Hamilton-746-1Bd-1Ba-Spanish-550


DRAWING NAME

INTRODUCTION

CLIENT NAME: PROJECT NUMBER: DATE: **DESIGNED BY** DRAWN BY: CHECKED BY:

1102

SCALE:

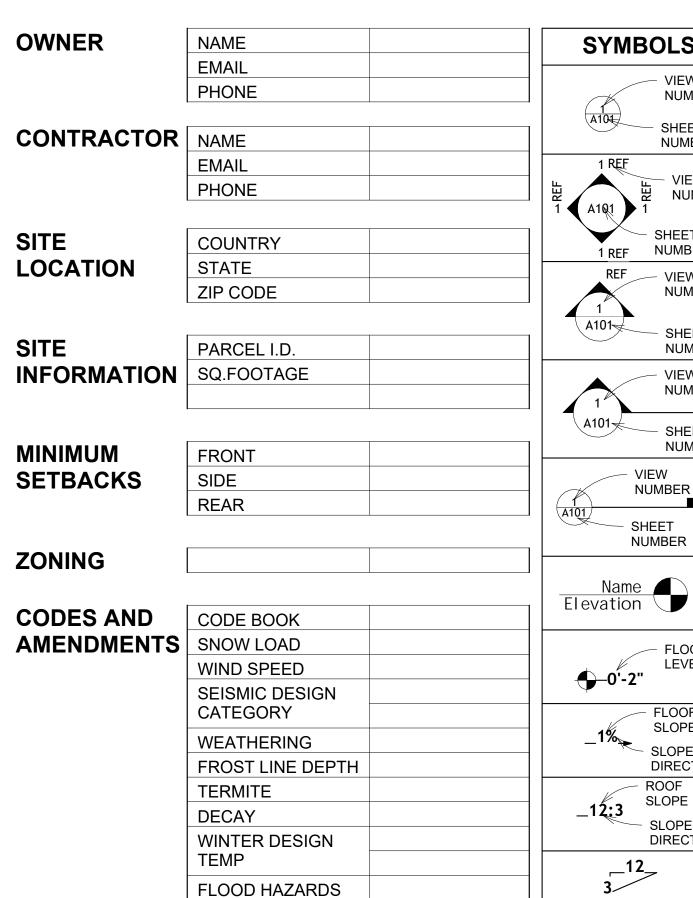

LINE LEGEND

DOOR OPENING DIRECTION

ROOM SEPARATOR

HIDDEN LINE

OVER HEAD

SYMBOLS	SYMBOLS NAME
VIEW NUMBER A101 SHEET NUMBER	CALLOUT HEAD
1 REF VIEW NUMBER 1 REF NUMBER	R INTERIOR ELEVATION
REF VIEW NUMBER 1 A101 SHEET NUMBER	BUILDING ELEVATION
VIEW NUMBER A101 SHEET NUMBER	SECTION
VIEW NUMBER SHEET NUMBER	DETAIL VIEW

CALL OUT BOUNDRY — - — - — - —

- FLOOR SLOPE

SLOPE

ROOF SLOPE

SLOPE

CUT LINE

GROUND CUT

DIRECTION

		7102	DIVILIVOION I LAIN
≀		S101	FOUNDATION PLAN
		S102	STRUCTURAL FLOOR PLAN
I ER	INTERIOR ELEVATION	S103	FRAME LAYOUT
		S104	ROOF TRUSS LAYOUT
		A103	ROOF PLAN
t		A201	ELEVATIONS
R		A202	ELEVATIONS
	BUILDING ELEVATION	A301	SECTIONS
 R		A401	DETAILS
+		A402	CASEWORK DETAILS
R		A403	CASEWORK DETAILS
-	SECTION	E101	SCHEDULE
 R		E102	LIGHTING PLAN
+		E103	POWER PLAN
		E104	DIMENSION PLAN FOR LIGHT FIXTURE
1	DETAIL VIEW	E105	DIMENSION PLAN FOR FITTING
		P101	COVER SHEET
t		P102	WATER SUPPLY SYSTEM
	ELEVATION LEVEL	P103	SEWAGE SYSTEM
		P104	RISER DIAGRAM
t		M101	HVAC PLAN
	SPOT ELEVATION	M102	HVAC SECTION
	or or elevation	M103	RISER DIAGRAM
t			
	FLOOR SLOPE		
 N		TAG	TAG'S NAME
Ť		IAG	TAG 5 NAME
	ROOF SLOPE	CA01	CASEWORK TAG
N			DOOR TAG
	ROOF SLOPE ELEVATION		FURNITURE TAG

PAGE INDEX

G101 | COVER SHEET

A102 DIMENSION PLAN

A101 FLOOR PLAN

14400	LIVA C OF OTION	1 1	THE ENCINOE
M102	HVAC SECTION	RG	RIGHT GARAGE
M103	RISER DIAGRAM	SE	SPECIAL EQUIPMENT
		SF	SQUARE FEET
		SIMP. STHD8	SIMPSON STRAP THE
TAG	TAG'S NAME		HOLDDOWN
		SIMP. ABE66	SIMPSON ANCHOR BOLT EDGE
CA01	CASEWORK TAG	TV	TELEVISION
	DOOR TAG	UNO	UNLESS NOTED OTHERWISE
		W/	WITH
	FURNITURE TAG	W/D	WASHER/DRYER
	WINDOW TAG	AC	AIR CONDITIONING UNIT
SE01	SPECIALTY EQUIPMENT TAG	ACC	AIR COOLED CONDENSER
14504	MECHANICAL FOLUDAENT TAC	ACCU	AIR COOLED CONDSENSING UNIT
LME01	MECHANICAL EQUIPMENT TAG	AHU	AIR HANDLING UNIT
PE01	PLUMBING EQUIPMENT TAG	CC	COOLING COIL
		CD	CEILING DIFFUSER
		CFm	Cubic Feet Per Minute

AFS

F.F.E

F.F.L

FTG

MAX.

NO.

OSB

PSI

PVC

REF

CR

CU

PLUMBING

REFERENCE

POUNDS PER SQUARE INCH

Cubic Feet Per Minute

CEILING REGISTER CONDENSING UNIT

COLD WATER

EXHAUST AIR

EXHAUST FAN

FAN COIL UNIT

HEATING COIL

INLET VANES

RETURN AIR

RETURN FAN

STATIC PRESSURE

SUPPLY AIR

MAXIMUM

MINIMUM

MECHANICAL ROOM

EXISTING

FLOOR

EXPANSION TANK

FLEXIBLE CONNECTION

AIR TO AIR HEAT EXCHANGER

HEATING AND VENTILATING UNI


RECIPROCATING CHILLER UNIT


SMOKE CONTROL DAMPER


POLYVINYL CHLORIDE

HVAC



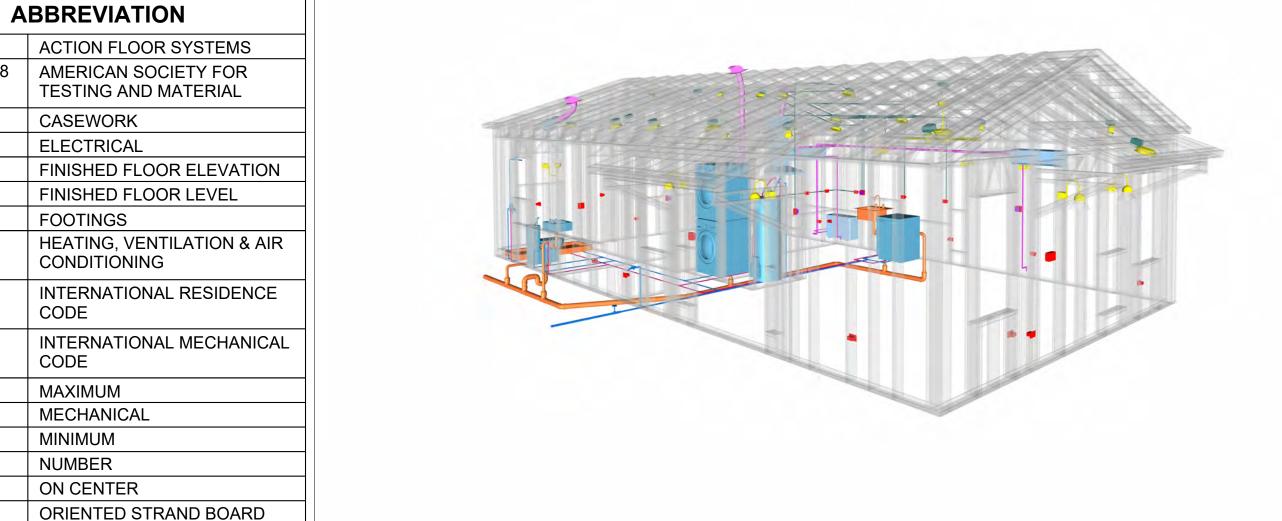

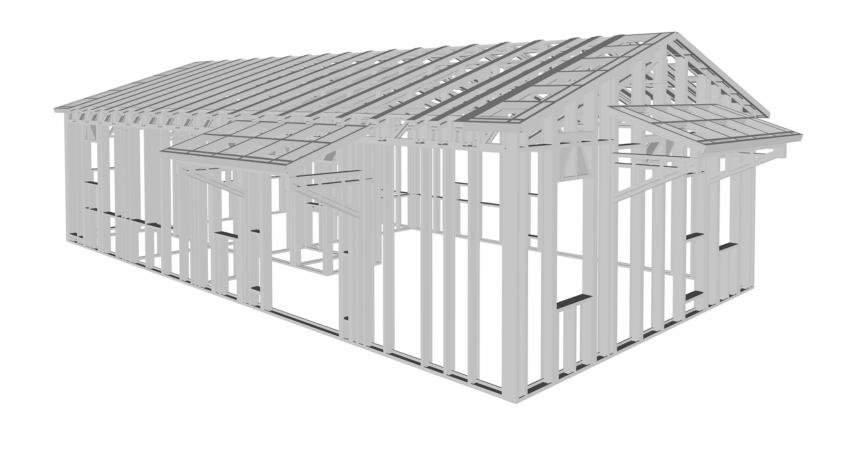


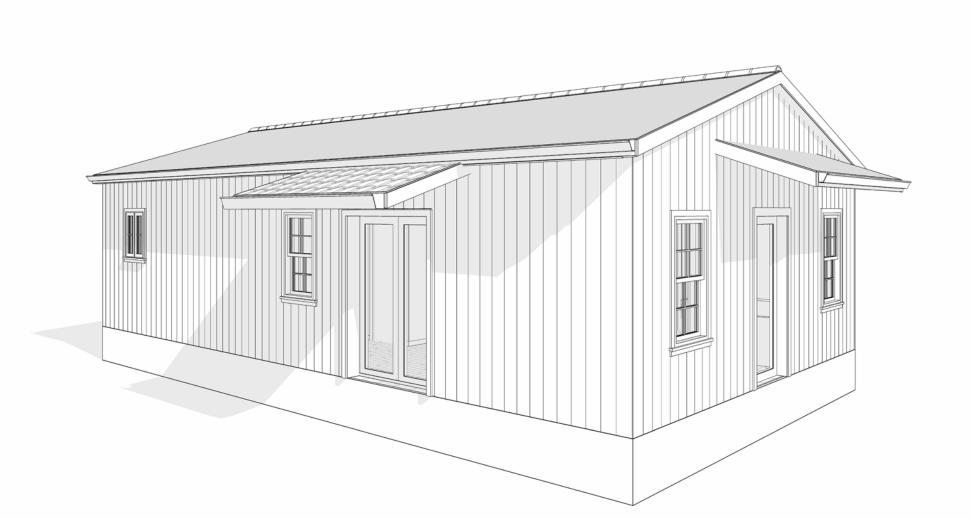

56 HAMILTON 746 1Bd/1Ba SPANISH 550

SQUARE FOOTAGE		
LIVING	746	
PORCH	56	
TOTAL	802	



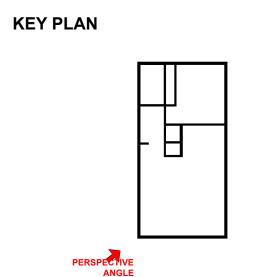

NO.	DESCRIPTION	DATE

NOTE:

LEGEND:

PROJECT

56 HAMILTON 746 1Bd/1Ba **SPANISH 550**

DRAWING NAME

COVER SHEET

CLIENT NAME:	Client Name
PROJECT NUMBER:	0061_12
DATE:	2/17/2025 12:15:42 PM
DESIGNED BY:	Designer
DRAWN BY:	Author
CHECKED BY:	Checker

G101

GENERAL NOTES

- 1. THIS DRAWING DEPICTS THE ARCHITECTURAL (SPACE LAYOUT, FURNISHING, FLOOR, WALLS, ROOFS, FOUNDATION, WINDOWS AND DOORS) SYSTEMS. IT PROVIDES A VISUAL REPRESENTATION OF THE ARCHITECTURAL LAYOUT AND COMPONENTS.
- THE ARCHITECTURAL DRAWINGS ARE PREPARED TO MEET THE SPECIFIC REQUIREMENTS OF THE BUILDING, AS PER THE PROJECT SPECIFICATIONS AND APPLICABLE CODES AND STANDARDS.
- THE CONSTRUCTION OF THIS HOME SHALL COMPLY WITH THE LATEST EDITION OF THE INTERNATIONAL RESIDENTIAL CODE (IRC), INTERNATIONAL MECHANICAL CODE (IMC), THE INTERNATIONAL PLUMBING STANDARD, THE NATIONAL ELECTRICAL STANDARD AND ALL OTHER APPLICABLE LOCAL, STATE, AND NATIONAL CODES AND REGULATIONS.
- 4. COORDINATION WITH OTHER TRADES HAS BEEN DONE ON A DESIGN LEVEL. THIS DRAWING SHALL BE READ TOGETHER WITH THE ME, EL AND PL DESIGN DRAWINGS TO ENSURE PROPER CONSTRUCTION AND INTEGRATION OF THE BUILDING SYSTEMS.

ABOUT WALLS:

1. SHOWER WALL COVERING

BATHTUB AND SHOWER SPACES (WALLS AND FLOORS) WITH INSTALLED SHOWER HEADS AND IN SHOWER COMPARTMENTS SHALL BE FINISHED WITH A NON-ABSORBENT SURFACE.

2. WALL PAINT (INTERNAL

THE TYPICAL THICKNESS OF LATEX WALL PAINT IS 1/32 OF AN INCH FOR A SINGLE COAT. AND DOUBLE COAT (1/16") SHALL BE APPLIED FOR DURABILITY.

3. ADHESIVES:

THE ADVISABLE TYPE OF ADHESIVE FOR THIS PROJECT IS **EPOXY ADHESIVES**BECAUSE THEY ARE KNOWN FOR THEIR HIGH STRENGTH, DURABILITY, AND RESISTANCE TO MOISTURE, CHEMICALS AND HEAT


REFER TO SHEETS A201 & A202 FOR GENERAL NOTES ON EXTERNAL FINISHING MATERIALS

ABOUT FLOORS:

- . THE SPOT ELEVATION INDICATES THE FINISHED FLOOR ELEVATION.
- 2. FINISHED FLOORS PER PLANS.
- 3. FIELD VERIFY FOR DIMENSION DROP 4" FOR SHOWER AND BATHTUB USE.
- 4. 1% SLOPE ON OUTDOOR BALCONIES FOR WATER RUN OFF.
- 5. 2% SLOPE TOWARDS THE SHOWER DRAIN FOR SUFFICIENT DRAINAGE.
- 6. 4" DROP AT THE DOOR LEADING TO EXTERIOR BALCONY FROM THE MAIN LIVING AREA.
- 7. 5% SLOPE FOR GARAGE IS USED, WHICH SHOULD BE CHECKED WITH THE LOCAL GARAGING ZONING LAWS.

	FURNITURE SCHEDULE				
TYPE MARK	TYPE	COUNT			
01	60" X 80" - Queen	1			
02	Four Sit 85" X 85"	1			
03	ONE SEAT SOFA	1			
04	Coffe Table	1			
05	DINING CHAIR	4			

	ROOM FINISH SCHEDULE						
ROOM NUMBE R	ROOM NAME	FLOOR FINISH	BASE FINISH	WALL FINISH	CEILING FINISH	CEILING HEIGHT	COM MEN TS
1	BEDROOM	HARDWOOD	CONCRETE	WALL PAINT	DRY WALL	8' - 0"	
2	CL	HARDWOOD	CONCRETE	WALL PAINT	DRY WALL	8' - 0"	
3	BATH	HARDWOOD	CONCRETE	CERAMIC TILE	MRD	8' - 0"	
4	KITCHEN	HARDWOOD	CONCRETE	WALL PAINT	DRY WALL	8' - 0"	
5	W/D	HARDWOOD	CONCRETE	CERAMIC TILE	DRY WALL	8' - 0"	
6	WH	HARDWOOD	CONCRETE	WALL PAINT	DRY WALL	8' - 0"	
8	LIVING ROOM	HARDWOOD	CONCRETE	WALL PAINT	DRY WALL	8' - 0"	
9	HALL	HARDWOOD	CONCRETE	WALL PAINT	DRY WALL	8' - 0"	

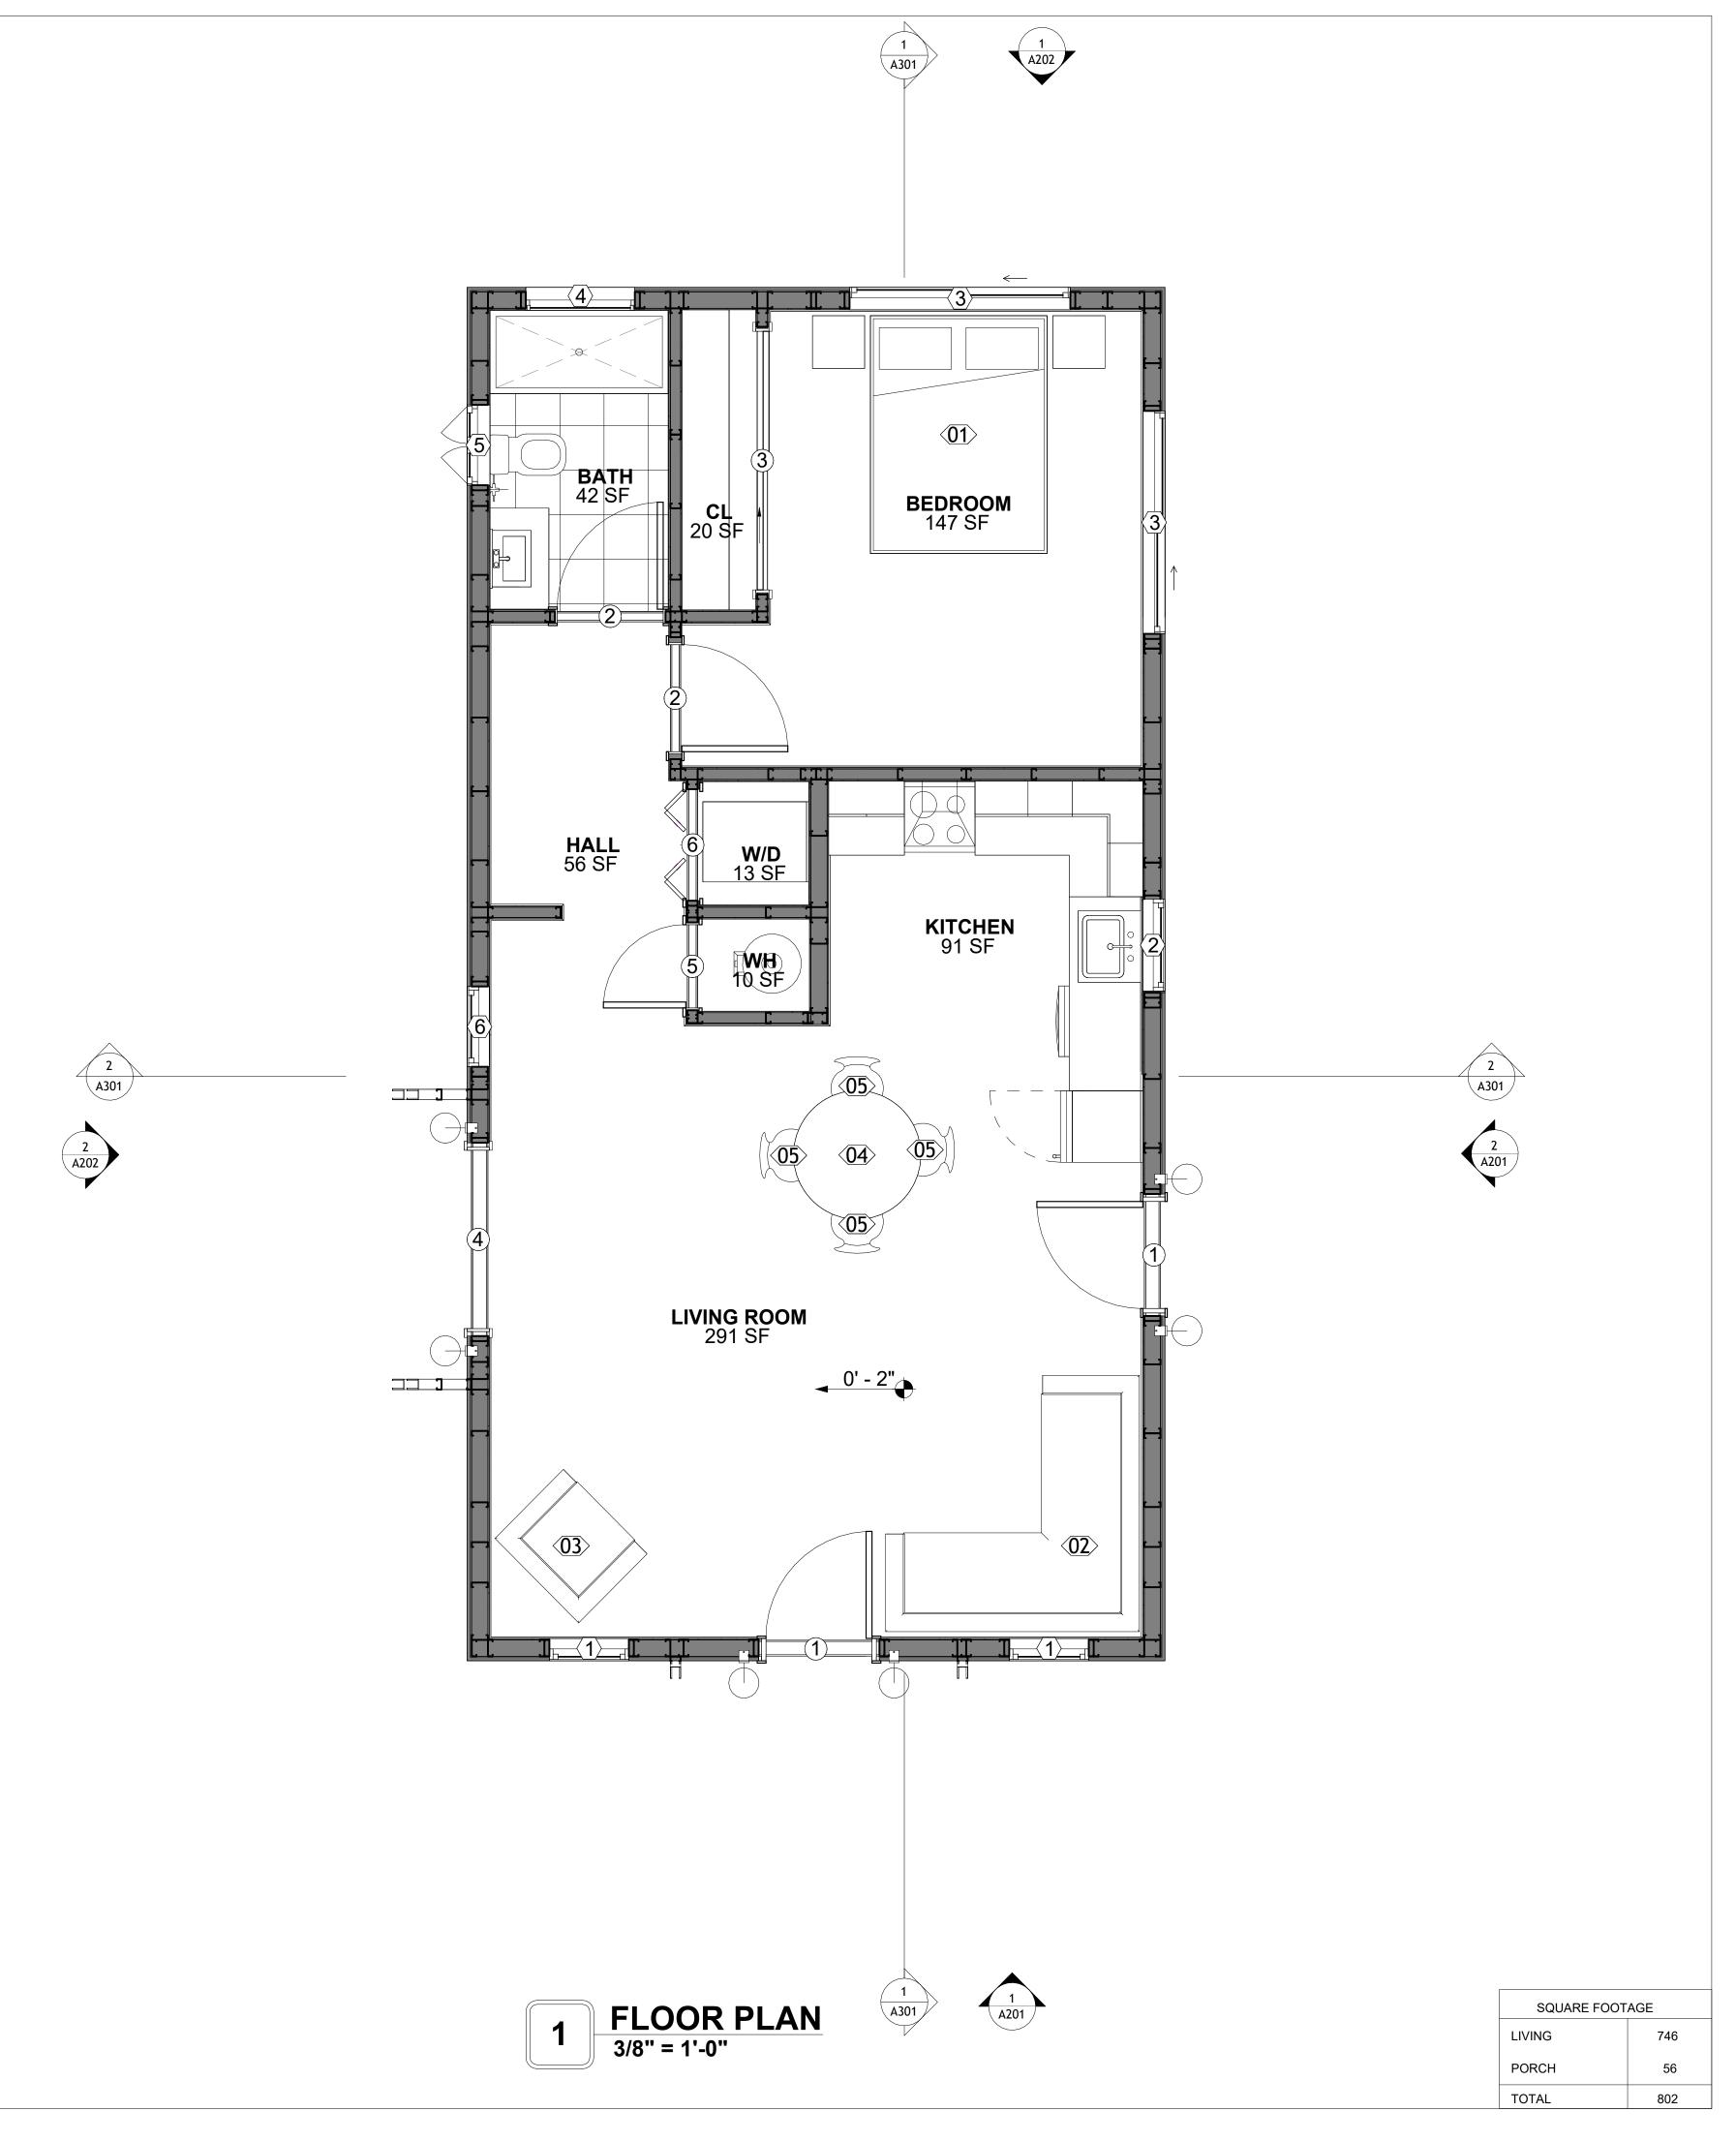



KEY PLAN

NO.	DESCRIPTION	DATE

NOTE:

LEGEND:

PROJECT


56 HAMILTON 746 1Bd/1Ba SPANISH 550

DRAWING NAME

FLOOR PLAN

CLIENT NAME:	Client Name
PROJECT NUMBER:	0061_12
DATE:	2/17/2025 12:15:43 PM
DESIGNED BY:	Designer
DRAWN BY:	Author
CHECKED BY:	Checker

A101

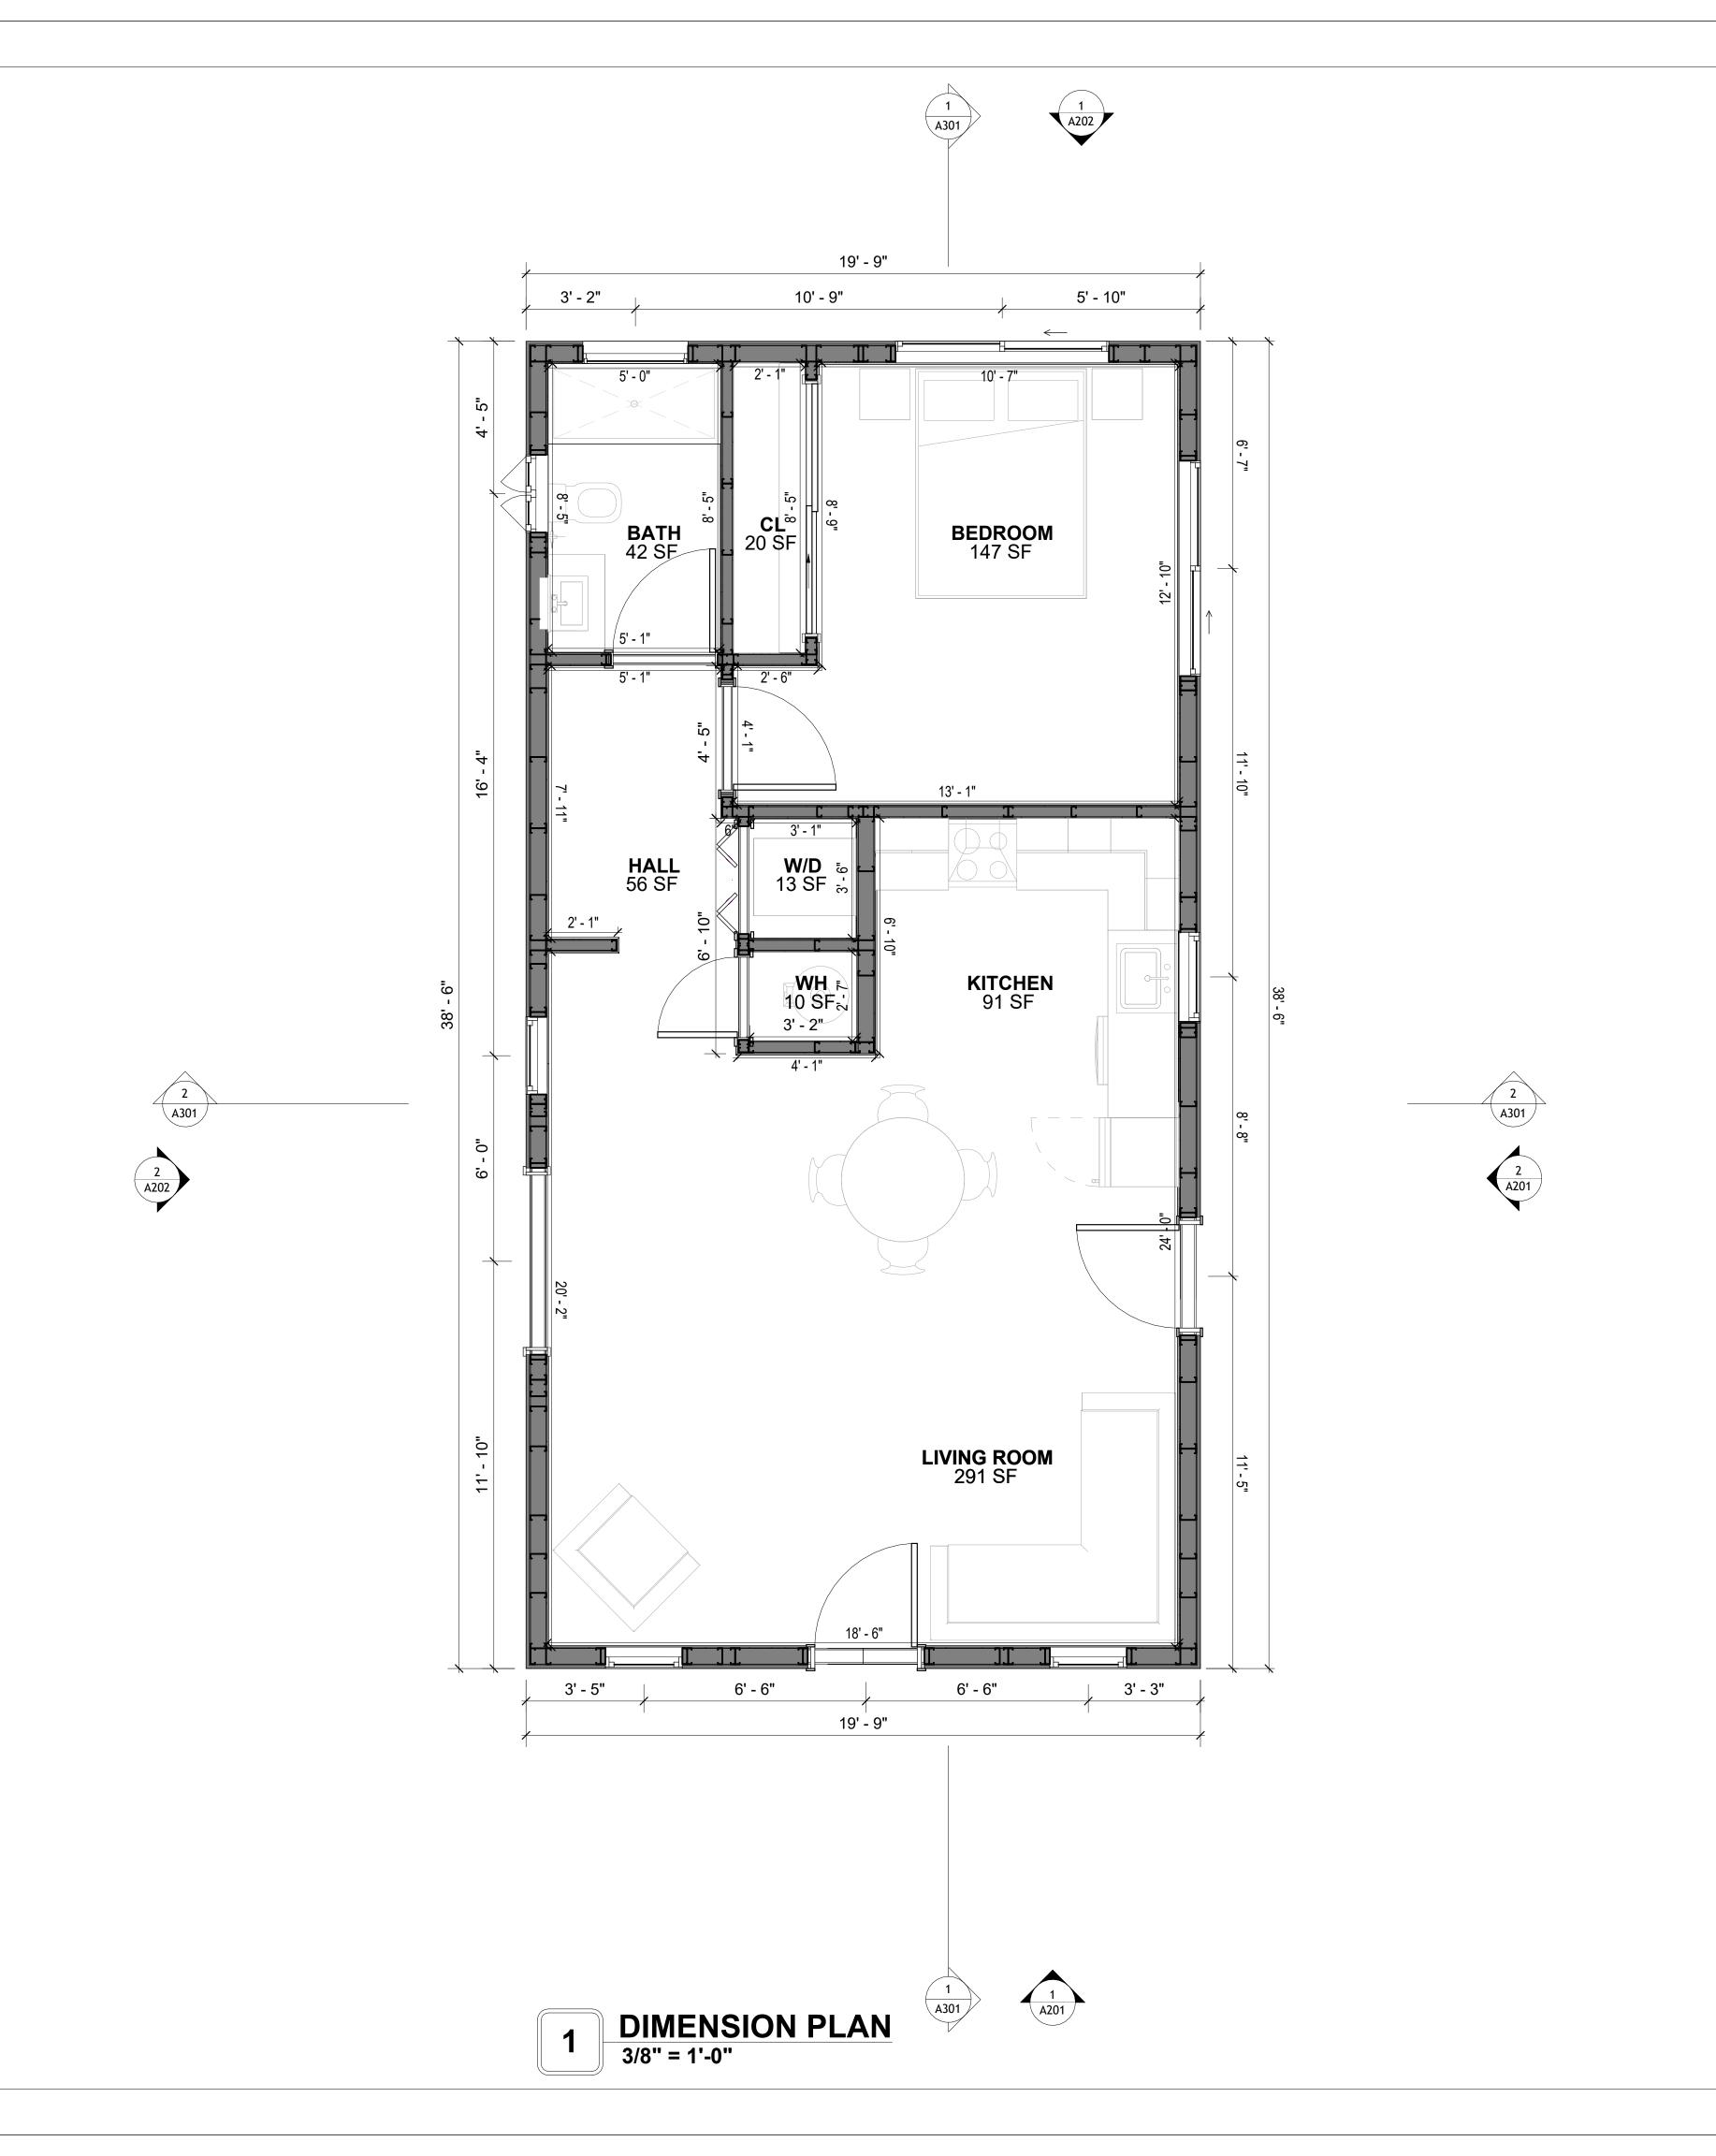



KEY PLAN

NO.	DESCRIPTION	DATE

NOTE:

LEGEND:

PROJECT

56 HAMILTON 746 1Bd/1Ba SPANISH 550

DRAWING NAME

DIMENSION PLAN

CLIENT NAME:	Client Name
PROJECT NUMBER:	0061_12
DATE:	2/17/2025 12:15:44 PM
DESIGNED BY:	Designer
DRAWN BY:	Author
CHECKED BY:	Checker

A102

SCALE: 3/8" = 1'-0"

SQUARE FOOTAGE

802

PORCH

TOTAL

DIMENSIONS IN THE ARCHITECTURAL DRAWINGS CONSIDER FINISHING MATERIALS. FOR PRECISE MEASUREMENTS OF THE STRUCTUAL FRAMING, REFER TO THE ATTACHED STRUCTURAL PLAN SET.

FOUNDATION NOTES

NOTES:

TERMITES PRETREATMENT BY LICENSED CONTRACTOR UNDER SLAB AND AROUND FOOTINGS. ALL AREAS BELOW SLABS SHALL BE TREATED NO MORE THAN 24 HOURS PRIOR TO CONCRETE POUR. EVIDENCE OF TREATMENT MUST BE PROVIDED PRIOR TO PLACING OF CONCRETE.

MATERIALS:

ALL INTERIOR CONCRETE SLABS SHALL BE A MIN. OF 4" THICK CONCRETE OVER 4" COMPACTED AGGREGATE BASE (ASTM D698), FINISH ELEVATIONS AS NOTED ON DRAWINGS, 6" ABOVE ADJACENT GRADE, LEVEL SLABS TO 1/8"-10' MAX.. CONCRETE SLABS SHALL BE 2500# PSI AT 28 DAYS. A 4" ALLOWABLE SLUMP.

2. PAD PREPARATION:

EXCAVATION FOR FOOTING SHALL BE NEAT.

FOOTINGS SHALL BE POURED IMMEDIATELY AFTER EXCAVATION AND APPROPRIATE INSPECTION.

ALL REINFORCING STEEL MARKED "CONTINUOUS" SHALL BE LAPPED 36 BAR DIAMETERS AT SPLICES AND AROUND CORNERS OR INTERSECTIONS WITH A STANDARD 90 DEGREE BEND ON CORNER BARS. LAP WIRE MESH ONE FULL MESH AT SIDE AND END LAPS.

ALL HARDWARE TO BE SIMPSON OR EQUIVALENT. EXTERIOR FRAME WALL TO BE SECURED WITH 1/2"X10" ANCHOR BOLTS 4'-0" O.C. FOR 1-STORY AND 2'-8" O.C. FOR 2-STORY. BOLTS SHALL BE LOCATED WITHIN 1'-0" OF EACH END PIECE AND SHALL HAVE A MIN. OF TWO BOLTS PER PIECE.

-FOUNDATION ANCHOR STRAPS SHALL BE PERMITTED, ACCORDING TO RESIDENTIAL CODE

- ALL INTERIOR WALLS TO BE SECURED WITH POWER DRIVEN PINS PER MANUFACTURER SPECIFICATION USE PIN SPACING EQUIVALENT TO 1/2" ANCHOR BOLTS.

ALL CONSTRUCTION TO CONFORM TO THE 2012 IRC · R-10 RIGID INSULATION OUTSIDE OF EXTERIOR FOUNDATION WALLS UNDER LIVING AREA.

CONCRETE PAD FOR CONDENSER THICKNESS IS 4" MIN UNLESS OTHERWISE NOTED.

3. CONCRETE CONSTRUCTION:

- THE SLAB SHALL BE UNDERLAIN BY A VAPOR BARRIER/RETARDER IN THE LIVING AREA (TYPICALLY POLYETHYLENE, UNLESS MORE STRINGENT PROTECTION REQUIRED BY THE ARCHITECT, ENGINEER, FLOOR COVERING MANUFACTURER, OR ACCEPTED PRACTICE). UNLESS OTHERWISE REQUIRED, BARRIER MAY BE OMITTED AT GARAGES, PORCHES AND PATIOS WITHOUT FLOOR COVERINGS. IT IS BEYOND THE SCOPE OF THESE PLANS TO DETERMINE THE APPLICABILITY OF THESE MORE STRINGENT REQUIREMENTS. BUILDER SHALL VERIFY PRIOR TO CONSTRUCTION.

4. REINFORCEMENT:

- IF CONSTRUCTED ON ACTIVE SOILS, THE LONG TERM PERFORMANCE OF THE FOUNDATION IS DEPENDENT ON MAINTENANCE BY THE OWNER. THUS THE BUILDER SHALL ADVISE THE OWNER OF THE FOLLOWING:

DRAINAGE MUST BE MAINTAINED. WATER SHALL NEVER BE ALLOWED TO POND NEAR THE FOUNDATION.

2. THE SOIL AROUND THE FOUNDATION SHALL BE MAINTAINED IN A RELATIVELY DAMP CONDITION, SUCH AS THAT REQUIRED TO KEEP A LAWN GREEN. IF IT DRIES OUT IT WILL

SHRINK. IF IT GETS WET, IT WILL HEAVE UPWARD. 3. SLABS ON THE SHORTER SIDE USES MAIN BARS ARE USED IN THIS DIRECTION ONLY WITH SMALLER DIAMETER DISTRIBUTION BARS ARE PLACED, FORMING A MAT OR GRID.

4. ALL REINFORCEMENT BARS SIZE 10MM OR LARGER IN ACCORDANCE TO ASTM 3. ANCHOR BOLTS AT ALL EXTERIOR WALLS SHALL BE MINIMUM 1/2 INCH DIAMETER WITH A

MAXIMUM SPACING OF 6'-0" ON CENTER, UNLESS NOTED OTHERWISE. 4. ANCHOR BOLTS SHALL BE INSTALLED WITHIN 12 INCHES OF EACH END OF EACH SILL PLATE WITH AT LEAST TWO ANCHOR BOLTS FOR EACH BOLTS FOR EACH SILL PLATE LONGER


THAN 12 INCHES. 5. SIMPSONS SILL ANCHORS MAYBE SUBSTITUTED FOR ANCHOR BOLTS AT THE SAME SPACING.

6. EXTERIOR CONCRETE SLABS WHICH ARE NOT PART OF THE MAIN SLAB SHALL BE MINIMUM 4 INCHES THICK WITH NO STEEL REINFORCING BARS REQUIRED, UNLESS NOTED OTHERWISE ON FOUNDATION PLAN.

VERIFY THE FOLLOWING PRIOR TO POURING:

- ALL HOLDDOWNS, STRAP, AND POST LOCATIONS.
- 2. CONCRETE FINISHES. PANEL RISER LOCATION WHERE APPLICABLE.
- B. UNDERSLAB MECHANICAL REQUIREMENTS.
- STEM WALL BLOCKOUTS.
- 5. UNDERSLAB ELECTRICAL REQUIREMENTS AND PANEL RISER LOCATION. WHERE
- APPLICABLE. PROVIDE THE FOLLOWING:
- PVC SLEEVES THROUGH FTG IF REQUIRED
- 20' #4 COPPER GROUND BAR.
- SLOPE FINISH GRADE AWAY FROM FOOTING.

NOTE: FIELD VERIFY ALL DIMENSIONS SEE DIMENSIONED ARCHITECTURAL DRAWINGS

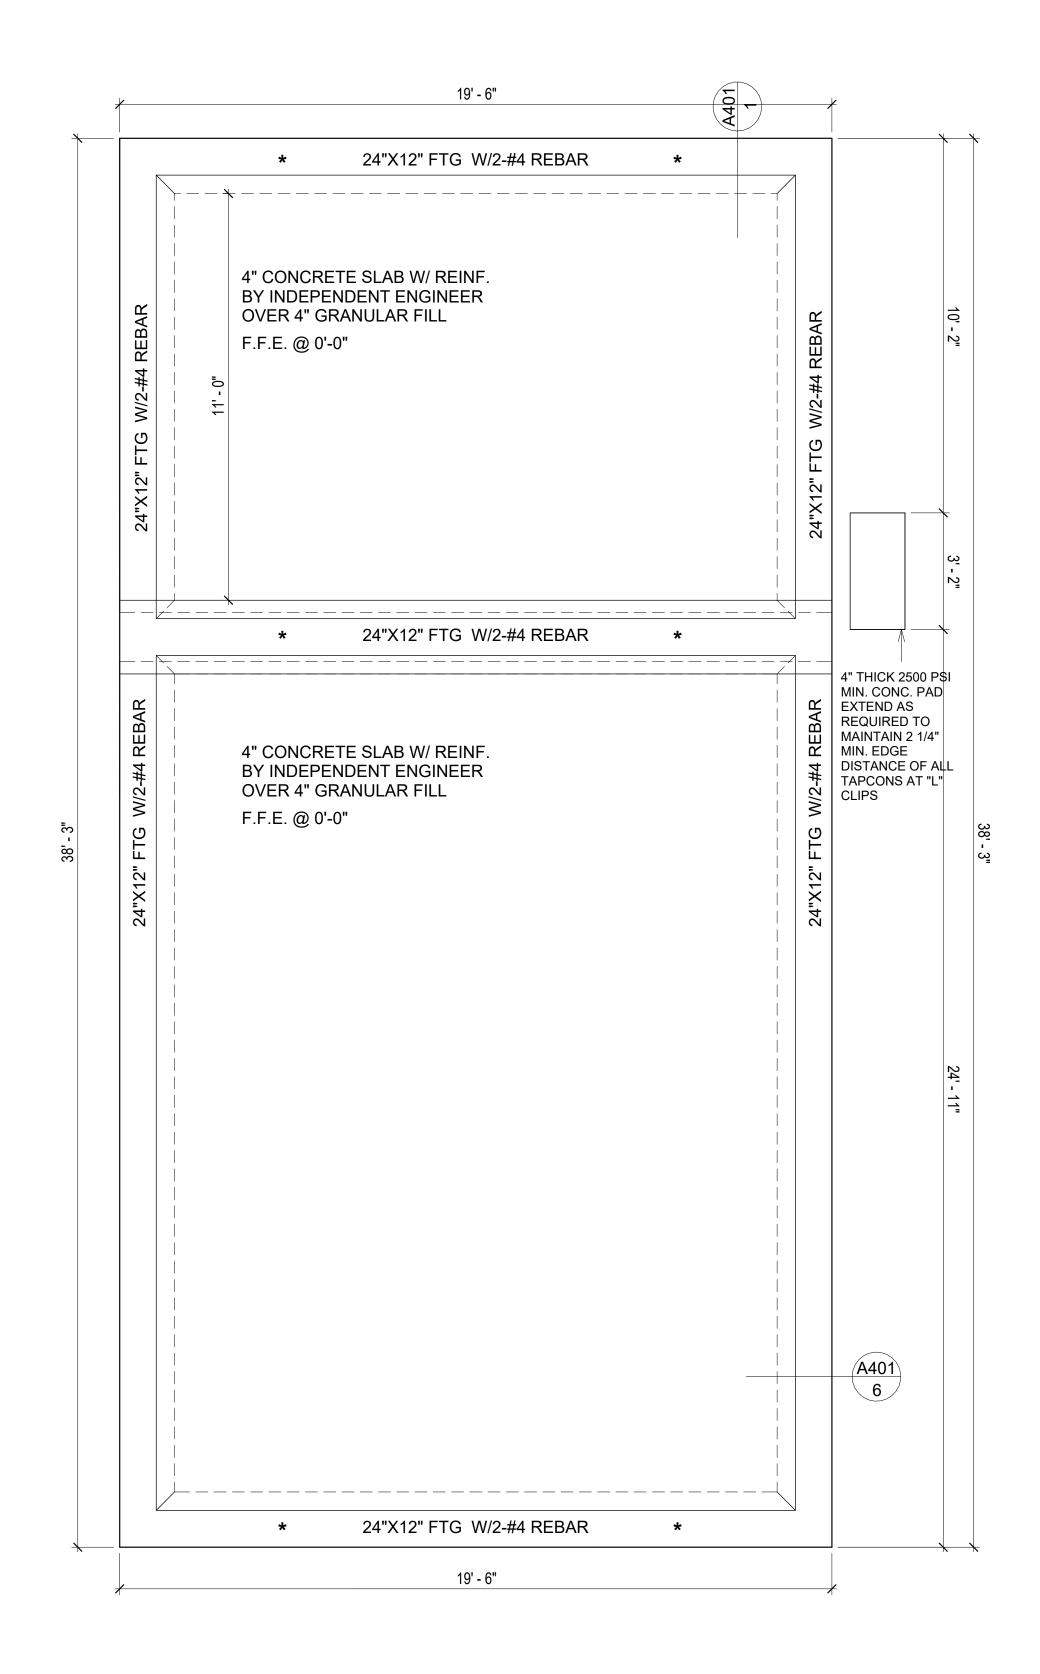





KEY PLAN

NO.	DESCRIPTION	DATE

NOTE:

LEGEND:

PROJECT

56 HAMILTON 746 1Bd/1Ba SPANISH 550

DRAWING NAME

FOUNDATION PLAN

CLIENT NAME:	Client Name
PROJECT NUMBER:	0061_12
DATE:	2/17/2025 12:15:44 PM
DESIGNED BY:	Designer
DRAWN BY:	Author
CHECKED BY:	Checker

S101

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SCALE: 3/8" = 1'-0"

SQUARE FOOTAGE

802

LIVING

PORCH

TOTAL

GENERAL NOTES

NOTES:

-ALL BEARING WALLS SHOULD HAVE A THICKENED SLAB PER SECTION PER DETAIL A401/5.

A) **FOUNDATION PLAN NOTES**:

- CONCRETE SLAB SHALL BE 6" THICK WITH 1/2" DIAMETER TENDONS PER LAYOUT PLAN, CENTERED IN SLAB THICKNESS, OVER APPROVED SUBBASE PER GENERAL STRUCTURE NOTES.
- 2. TERMITE PROTECTION SHALL BE PROVIDED PER IRC SECTION R318.1 NONE TYPICAL ANCHOR BOLT SPACING AT SHEAR WALL AND HOLD DOWN
- SPECIFICATIONS PER APPROVED ARCHITECTURAL PLANS. 4. INSTALL HOLDOWNS BEFORE CONCRETE SLAB POUR.
- 5. EXISTING FILL ON-SITE SHALL BE COMPACTED IN ACCORDANCE WITH THE
- REQUIREMENTS IN THE GEOTECHNICAL REPORT.
- 6. ALL FLOOR SLABS ARE REINFORCED ON CONCRETE SLABS.

SPECIAL INSPECTION IS REQUIRED FOR THICKENED FOUNDATION CONSTRUCTION

- 1. REINFORCEMENT
- 2. 2300 PSI CONCRETE POUR


B) **REINFORCEMENT FOR CONCRETE**:


1. ALL REINFORCING SLABS BARS SIZE 10MM OR LARGER SHALL BE DEFORMED IN ACCORDANCE TO ASTM-A706, AND BARS SMALLER THAN 10 MM MAYBE PLAIN. 2. UNLESS OTHERWISE NOTED IN PLANS, THE YIELD STRENGTH OF REINFORCING BARS SHALL BE:

> A) FOOTING = 40,000 PSI B) NON-LOAD BEARING WALLS AND PARAPETS= 40,000 PSI

- 3. SPLICES SHALL BE SECURELY WIRED TOGETHER AND SHALL LAP OR EXTEND
- 4. GRADE OF STEEL FOR RCC WORKS SHALL BE GRADE 4 10.
- BAR NOTATIONS GIVES INFORMATION
- A) BAR SIZE
- B) SPACING(IF REQUIRED)
- 6. LAP REINFORCEMENT ONLY AT LOCATION SHOWN IN THE DRAWINGS
- REINFORCEMENT SHALL NOT BE CUT, VENT OR HEATED ON SITE WITHOUT ENGINEERS' APPROVAL.
- C) **CONCRETE SLAB NOTES**
- 1. ALL SLAB REINFORCEMENT SHALL BE 20MM CLEAR MINIMUM FROM BOTTOM AND FROM TOP OF SLAB.
- 2. REINFORCEMENT IN CONTINUOUS ELEVATED SLAB SHALL BE CUT AS FOLLOWS.

- THIS IS A SCHEMATIC PLAN FOR THE PURPOSE OF LOCATING AND IDENTIFYING FOUNDATION REINFORCING ELEMENTS ONLY. VERIFY ALL DIMENSIONS, DROPS, OFFSETS AND FEATURES WITH THE ARCHITECTURAL PLANS BEFORE FORMING THE FOUNDATION.

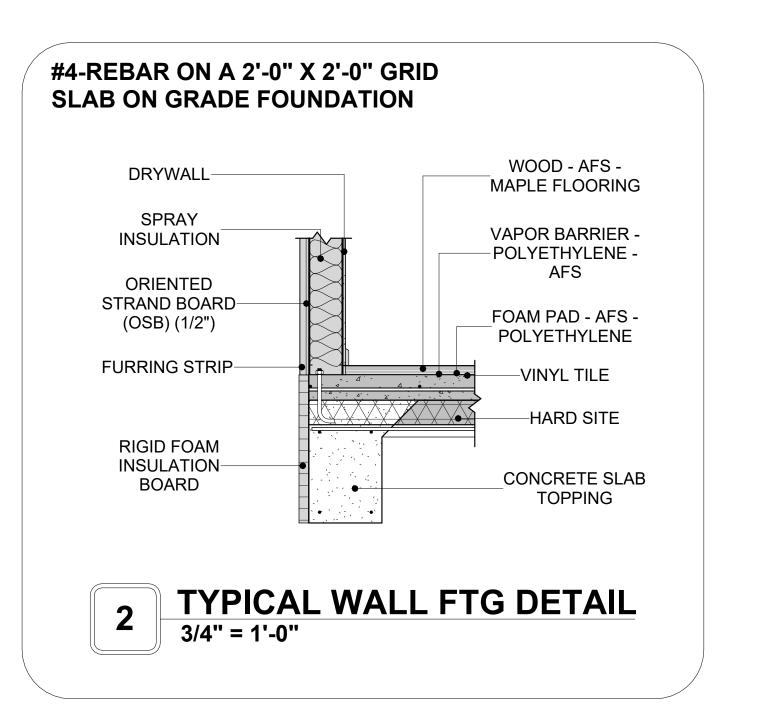

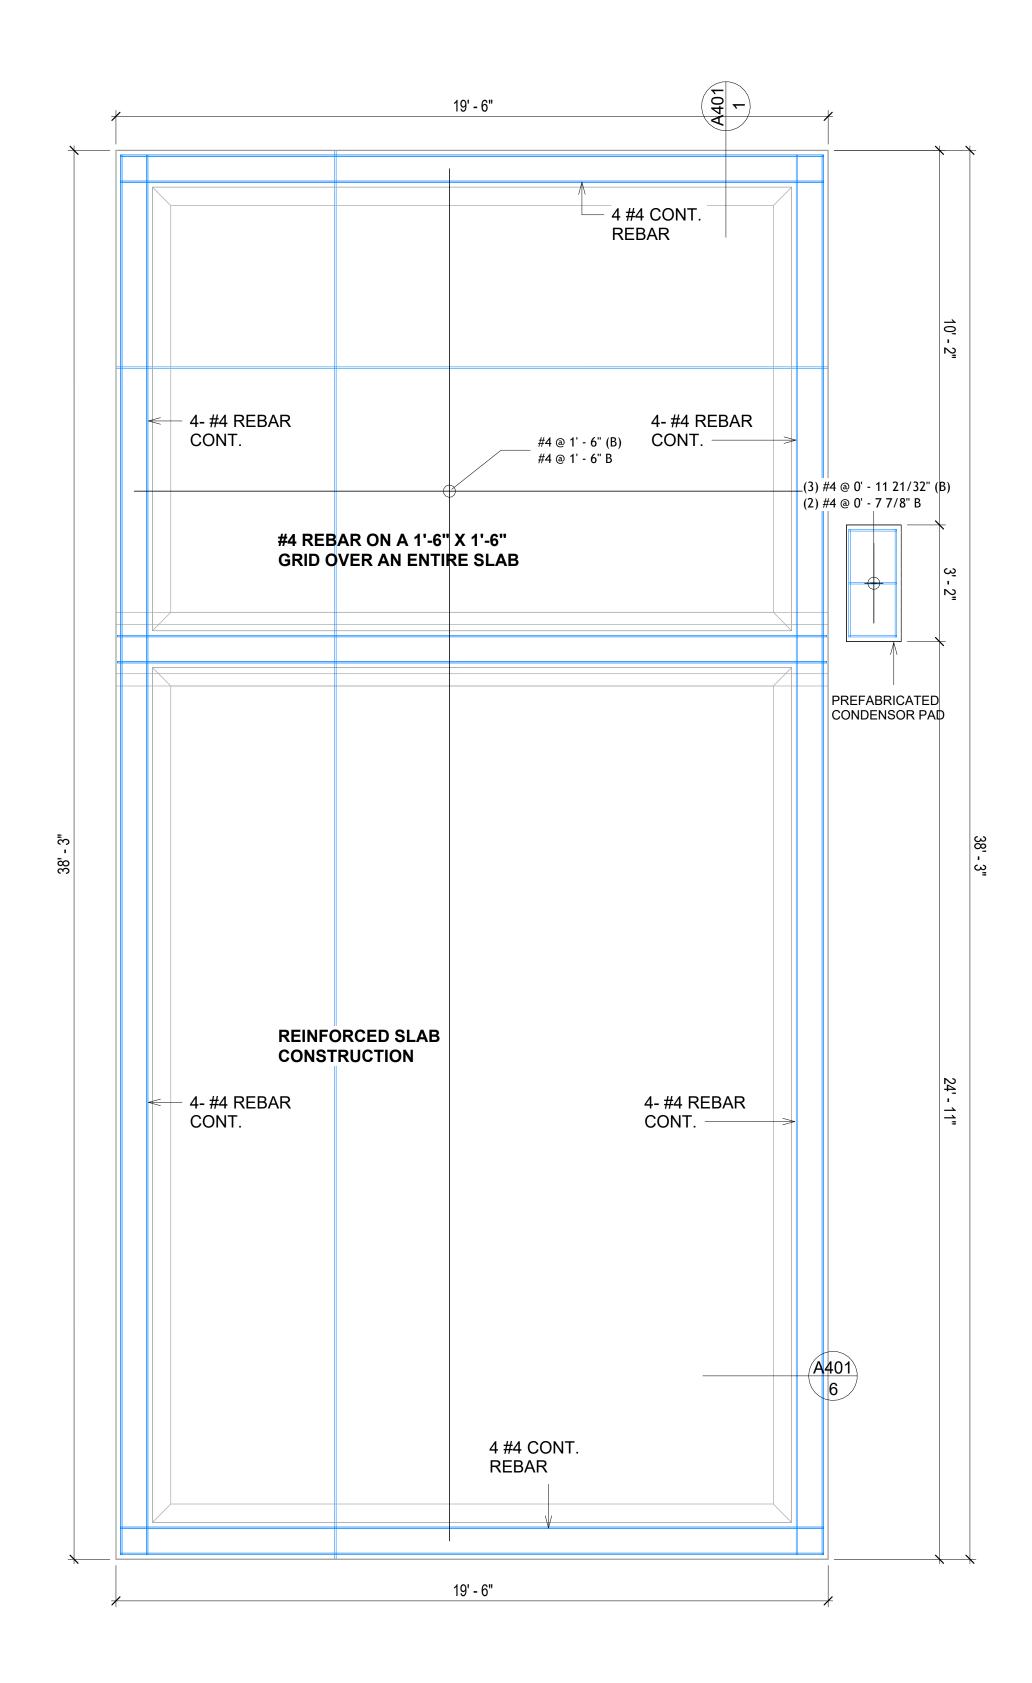

FOUNDATION REBAR PLAN



KEY PLAN

DESCRIPTION DATE

NOTE:

LEGEND:

PROJECT

56 HAMILTON 746 1Bd/1Ba SPANISH 550

DRAWING NAME

STRUCTURAL FLOOR PLAN


CLIENT NAME: **Client Name** PROJECT NUMBER: 0061_12 2/17/2025 12:15:45 PM Designer DESIGNED BY: DRAWN BY: **Author** CHECKED BY: Checker

S102


ROOF NOTES

- ROOFING COMPOSITION ROOFING PER OWNERS/BUILDERS
 SPECIFICATIONS INSTALL PER MANUFACTURE SPECIFICATIONS ON 1/2"
 ORIENTED STRAND BOARD ON PRE-ENGINEERED TRUSS @ 24" O.C. (UNO.)
 73" OVERHANG AT EAVES (UNO.)
- 3. ENDS OF ALL TRUSSES AND JOISTS TO BE FULLY BLOCKED. PROVIDE SOLID
- BLOCKING AT ALL RIDGES AND VALLEYS

 SHEATHING TO BE 1/2", 3/8" OSB SHEAR PANEL AND EQUIVALENT.
- UNDERSIDE OF PORCH TRUSSES TO BE FINISHED WITH MOISTURE RESISTANT DRYWALL, TAPED AND TEXTURED.
- 5. EXPOSED EAVES AND OTHER WEATHER EXPOSED AREAS TO BE SHEATHED WITH EXTERIOR GRADE PLYWOOD.
- 6. ALL MATERIALS THICKNESS AND SIZE ARE THE MINIMUM. Refer TO LOCAL STANDARDS FOR ACTUAL THICKNESS AND LAYERING OF MATERIALS.
- 7. ENGINEERED TRUSS CALCULATIONS TO BE SUBMITTED TO BUILDING DEPARTMENT PRIOR TO FABRICATION AND INSTALLATION.
- 8. TRUSS MANUFACTURER TO SPECIFY HANGER CONNECTORS FOR TRUSS COMPONENTS (TYPICAL)
- 9. DESIGNER ASSUMES THAT TRUSSES BEAR ON ALL EXTERIOR PERIMETER WALLS (TYPICAL) OR BEAMS.
- 10. PROVIDE GALVANIZED STEEL FLASHING WITH A LENGTH OF 10 FEET, WIDTH OF 12 INCHES, AND THICKNESS OF 24 GAUGE.

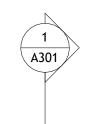



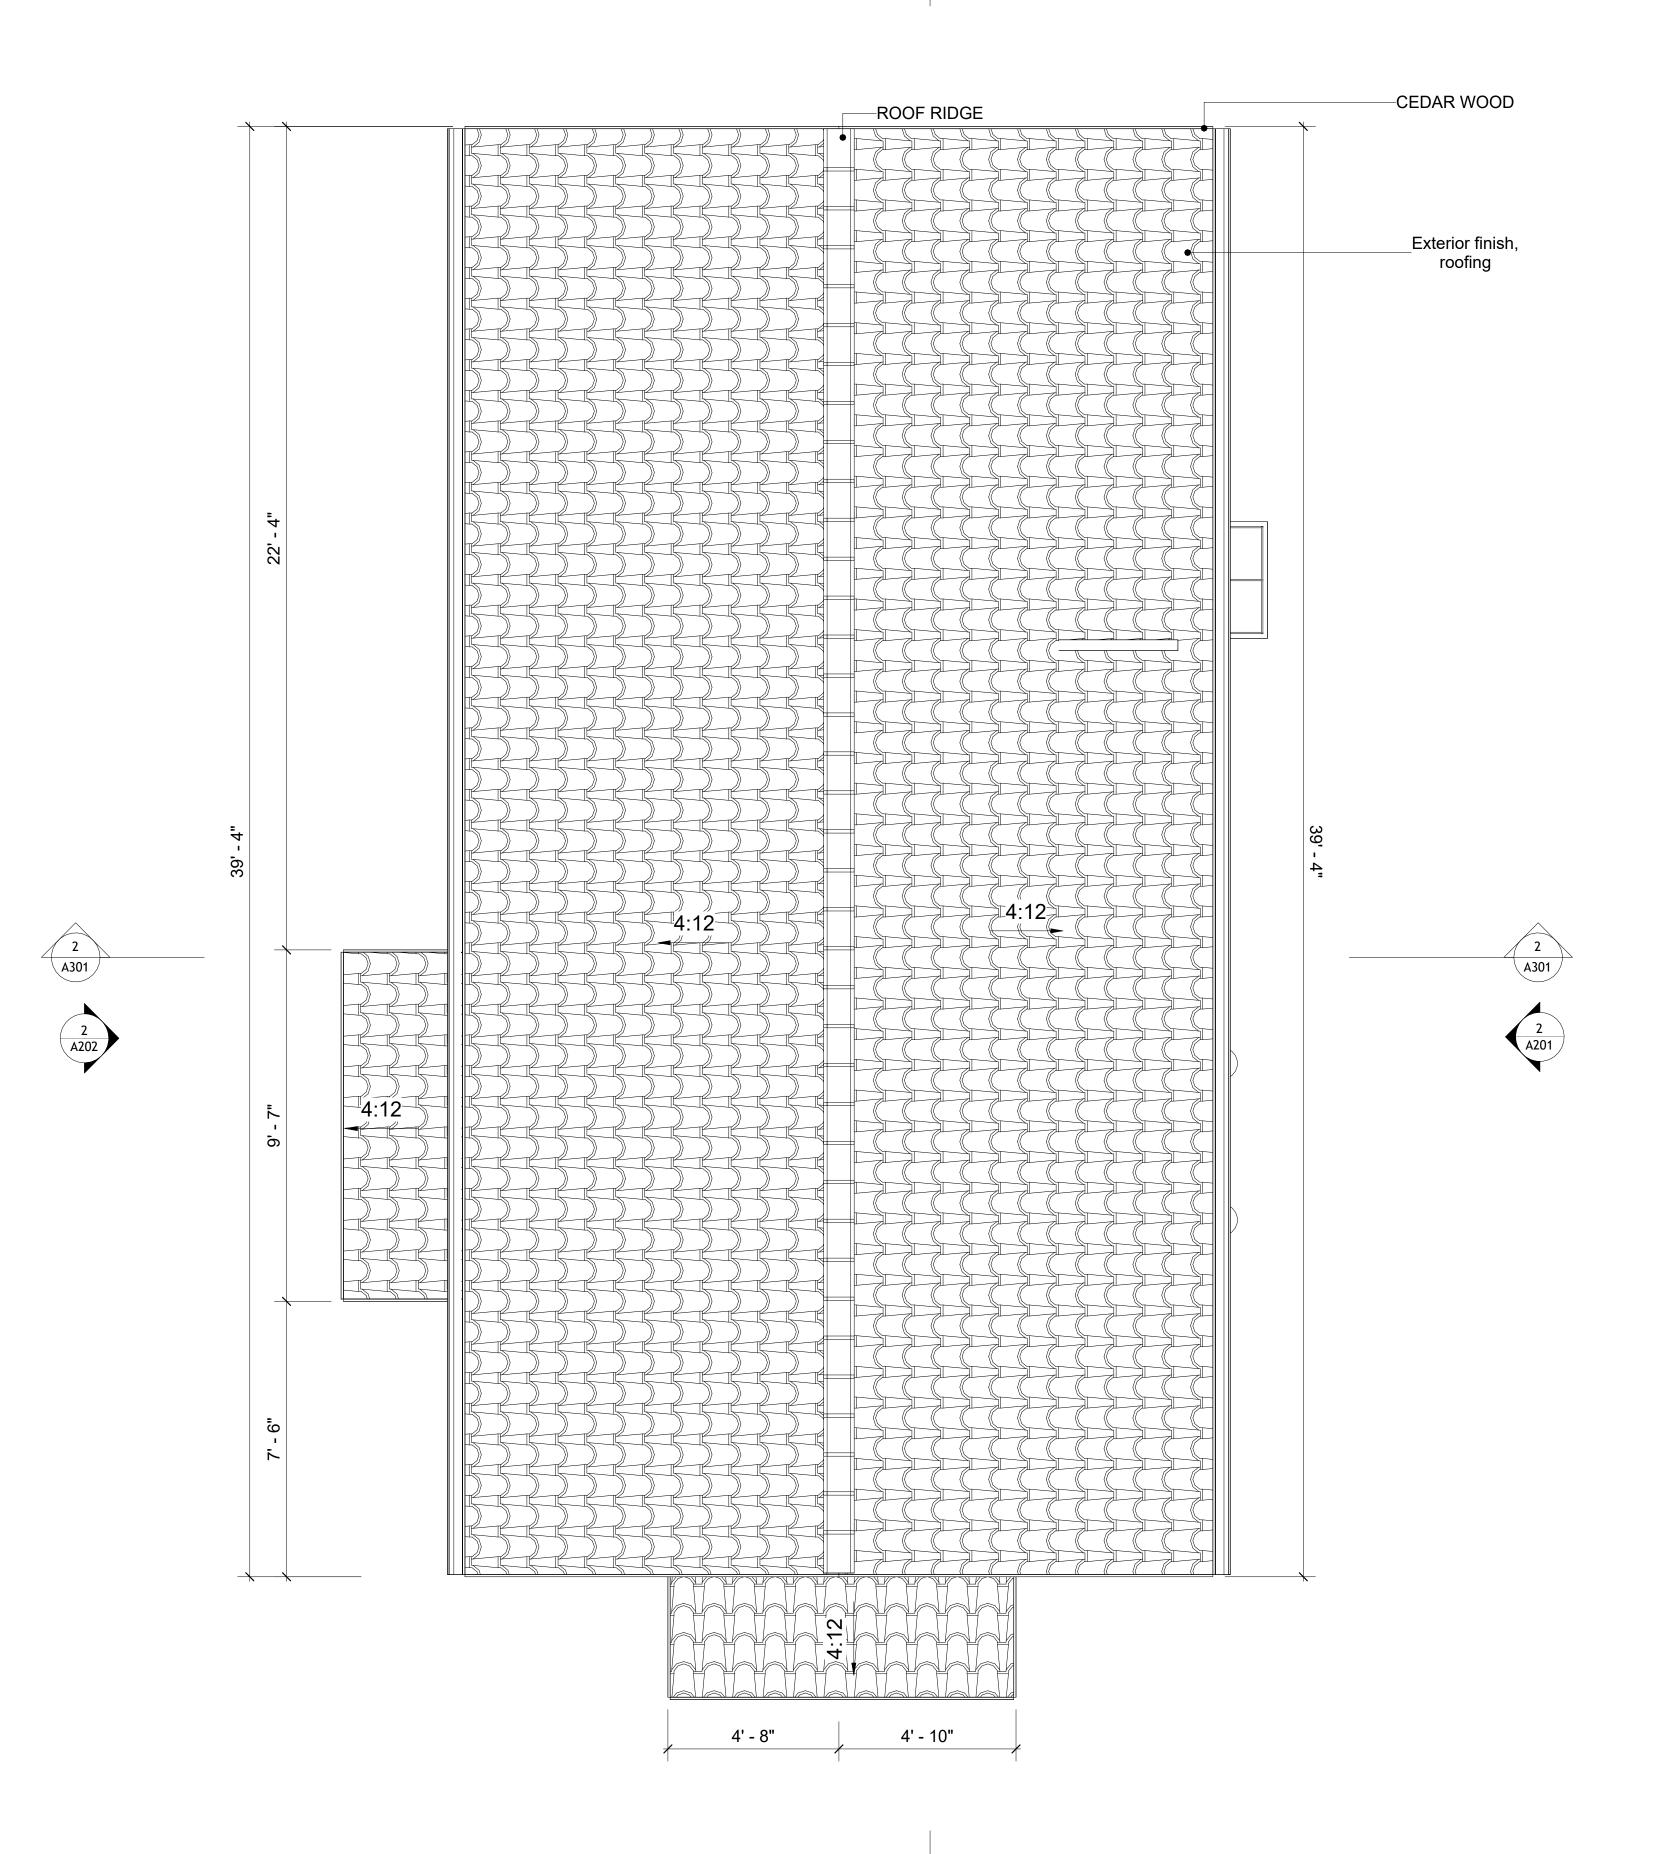



ROOF PLAN 3/8" = 1'-0"





KEY PLAN

NO.	DESCRIPTION	DATE

NOTE:

LEGEND:

PROJECT

56 HAMILTON 746 1Bd/1Ba SPANISH 550

DRAWING NAME

ROOF PLAN

CLIENT NAME:	Client Name
PROJECT NUMBER:	0061_12
DATE:	2/17/2025 12:15:47 PM
DESIGNED BY:	Designer
DRAWN BY:	Author
CHECKED BY:	Checker

A103

SCALE: As indicated

SQUARE FOOTAGE

802

PORCH

TOTAL

ABOUT WALL FINISHING

CORRUGATED IRON SHEET

CORRUGATED IRON IS A FINISHING MATERIAL MADE FROM STEEL THAT HAS BEEN GALVANIZED (COATED WITH A THIN LAYER OF ZINC) TO PROTECT IT FROM CORROSION AND RUST.


IN THIS SPECIFIC PROJECT, THE CORRUGATED IRON SHEETS ARE INSTALLED HORIZONTALLY ON VERTICAL FURRING STRIPS THAT ARE DIRECTLY ATTACHED ONTO THE PROPERLY INSTALLED AND SEALED HOME WRAP, USING SELF-DRILLING SCREWS THAT ARE DRIVEN THROUGH THE RIDGES OR VALLEYS OF THE CORRUGATIONS.

CEDAR WOOD


CEDAR WOOD REFERS TO THE WOOD FROM VARIOUS SPECIES OF CEDAR TREES, WHICH ARE CONIFEROUS EVERGREEN TREES KNOWN FOR THEIR DISTINCT AROMA AND NATURAL RESISTANCE TO DECAY AND INSECTS. IN THIS SPECIFIC PROJECT, CEDAR WOOD IS USED AS A FURRING STRIP AND A FINISH MATERIAL ON BEAMS AND COLUMNS.

CEDAR WOOD AS A FURRING STRIPS PROVIDE THERMAL INSULATION, MOISTURE MANAGEMENT, AND AN AESTHETICALLY PLEASING, VERSATILE FRAMING SOLUTION WHEN INTEGRATED WITH CORONADO STONE AND CORRUGATED IRON SHEET CLADDING.

THE VERTICAL CEDAR WOOD FURRING STRIPS ARE ATTACHED TO HOME RAP USING CORROSION-RESISTANT FASTENERS (HOT DIP GALVANIZED SCREWS), ENSURING PROPER PENETRATION INTO THE WALL FRAMING.

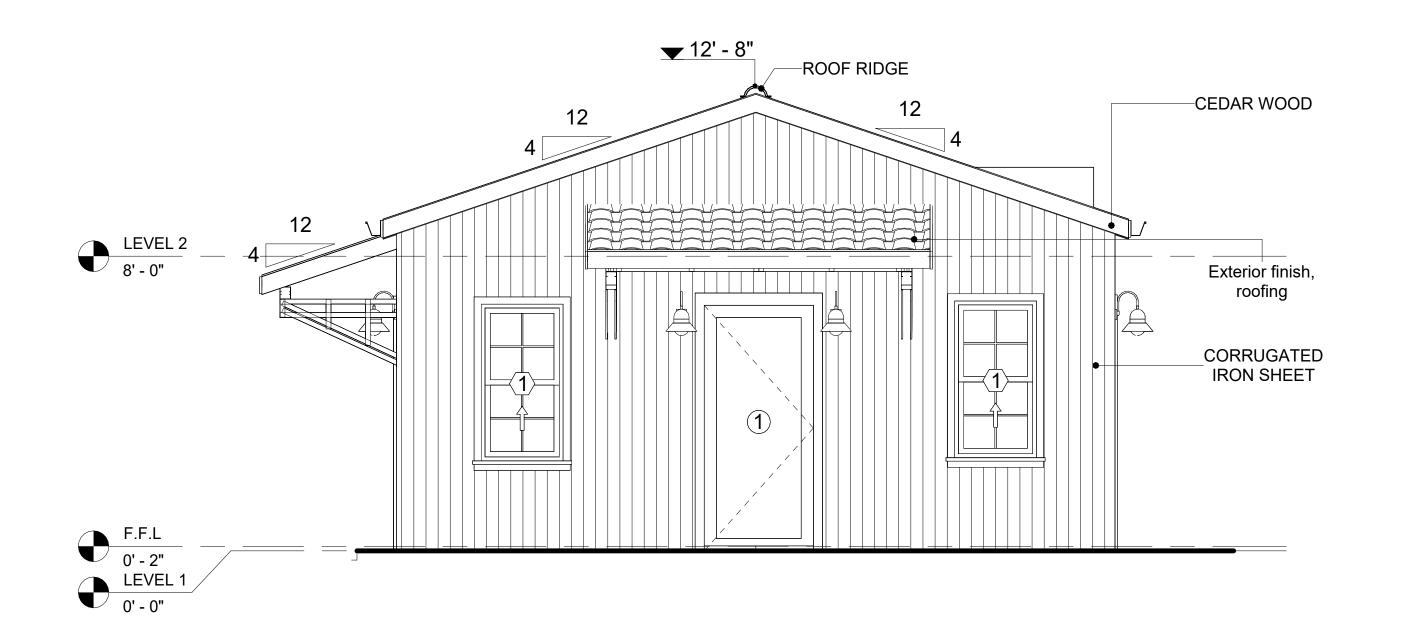

1 FRONT ELEVATION
3/8" = 1'-0"

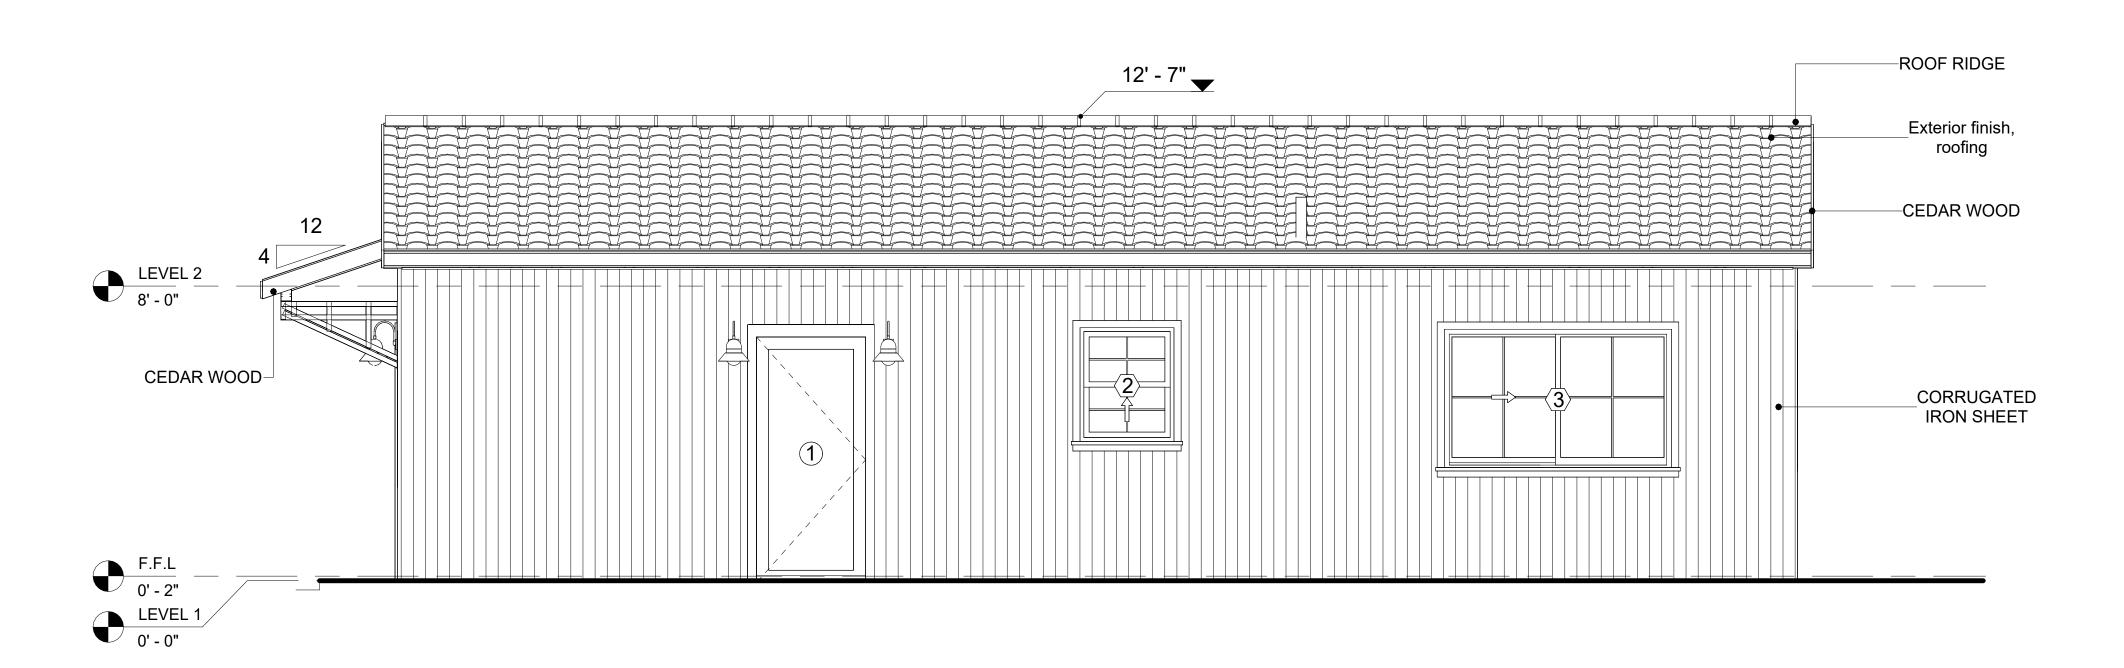


2 RIGHT SIDE ELEVATION
3/8" = 1'-0"

DOOR SCHEDULE						
TYPE				S	SIZE	
MAR K	SUPPLIER	DOOR TYPE	LOCATIO N	WIDTH	HEIGHT	COUNT
1	Homo Donot	Exterior Single Danel Swinging	Interior	3' - 0"	6' - 8"	2
2	Home Depot HOME DEPOT	Exterior Single Panel Swinging Interior Single Panel Swinging	Interior	3' - 0"	6' - 8"	2
3	HOME DEPOT	Interior Double Panel Sliding	Interior	7' - 3"	6' - 8"	1
4	HOME DEPOT	Exterior Double Panel Swinging	Interior	5' - 0"	6' - 8"	1
5	HOME DEPOT	Interior Single Panel Swinging	Interior	2' - 4"	6' - 8"	1
6	Typhoon	Door-Bifold_9052	Interior	3' - 0"	6' - 8"	1

WINDOW SCHEDULE					
TYPE MARK	SUPPLIER	WINDOW TYPE	WIDTH	HEIGHT	COUNT
1	Home Depot	Single Hung	2' - 3"	4' - 3"	2
2	Home Depot	Single Hung	2' - 7"	3' - 1"	1
3	Home Depot	Sliding	6' - 3"	3' - 9"	2
4	Home Depot	FIXED	3' - 1"	2' - 1"	1
5	Home Depot	Casement	2' - 3"	2' - 7"	1
6	Home Depot	Single Hung	2' - 3"	3' - 9"	1



KEY PLAN

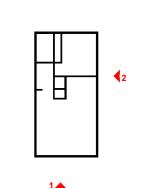

NO.	DESCRIPTION	DATE

NOTE:

LEGEND:

PROJECT

56 HAMILTON 746 1Bd/1Ba SPANISH 550

DRAWING NAME

ARCHITECTURAL ELEVATIONS

Client Name	CLIENT NAME:
0061_12	PROJECT NUMBER:
2/17/2025 12:15:49 PN	DATE:
Designer	DESIGNED BY:
Author	DRAWN BY:
Checker	CHECKED BY:

A201

ABOUT WALL FINISHING

CORRUGATED IRON SHEET

CORRUGATED IRON IS A FINISHING MATERIAL MADE FROM STEEL THAT HAS BEEN GALVANIZED (COATED WITH A THIN LAYER OF ZINC) TO PROTECT IT FROM CORROSION AND RUST.


IN THIS SPECIFIC PROJECT, THE CORRUGATED IRON SHEETS ARE INSTALLED HORIZONTALLY ON VERTICAL FURRING STRIPS THAT ARE DIRECTLY ATTACHED ONTO THE PROPERLY INSTALLED AND SEALED HOME WRAP, USING SELF-DRILLING SCREWS THAT ARE DRIVEN THROUGH THE RIDGES OR VALLEYS OF THE CORRUGATIONS.

CEDAR WOOD


CEDAR WOOD REFERS TO THE WOOD FROM VARIOUS SPECIES OF CEDAR TREES, WHICH ARE CONIFEROUS EVERGREEN TREES KNOWN FOR THEIR DISTINCT AROMA AND NATURAL RESISTANCE TO DECAY AND INSECTS. IN THIS SPECIFIC PROJECT, CEDAR WOOD IS USED AS A FURRING STRIP AND A FINISH MATERIAL ON BEAMS AND COLUMNS.

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THE VERTICAL CEDAR WOOD FURRING STRIPS ARE ATTACHED TO HOME RAP USING CORROSION-RESISTANT FASTENERS (HOT DIP GALVANIZED SCREWS), ENSURING PROPER PENETRATION INTO THE WALL FRAMING.

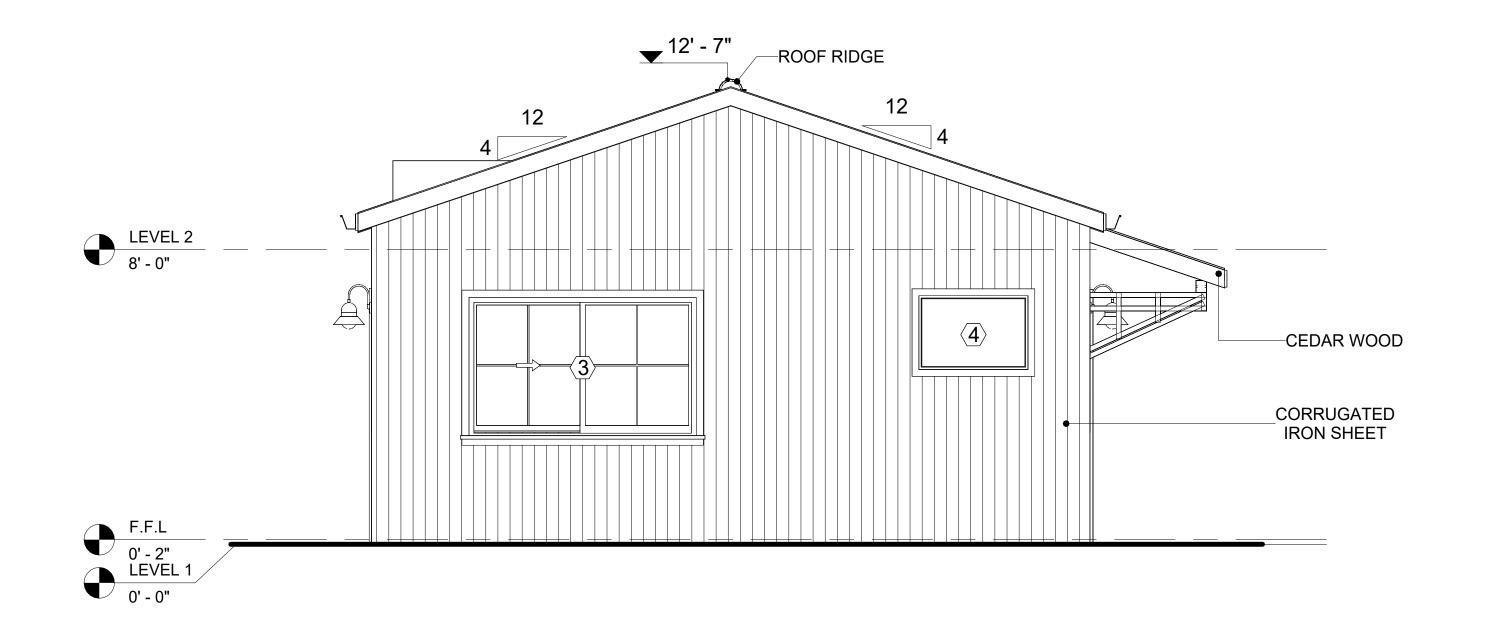


1 REAR ELEVATION 3/8" = 1'-0"

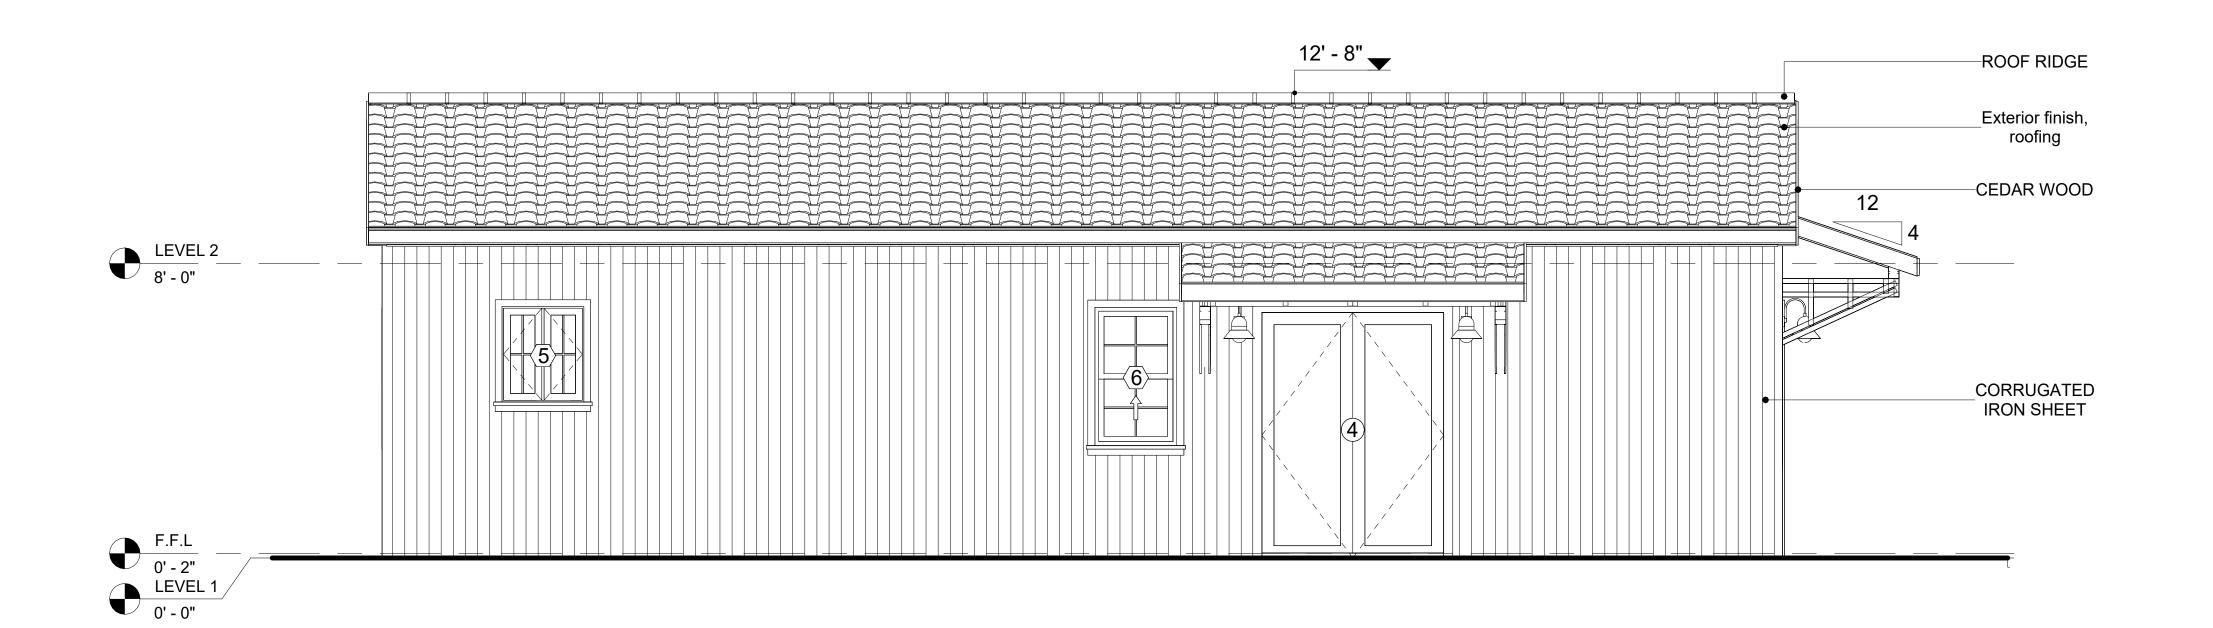

2 LEFT SIDE ELEVATION
3/8" = 1'-0"



KEY PLAN

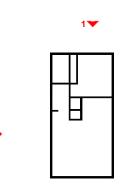

NO.	DESCRIPTION	DATE

NOTE:

LEGEND:

PROJECT

56 HAMILTON 746 1Bd/1Ba SPANISH 550

DRAWING NAME

ARCHITECTURAL ELEVATIONS

CLIENT NAME:

PROJECT NUMBER:

0061_12

DATE:

2/17/2025 12:15:52 PM


DESIGNED BY:

DRAWN BY:


CHECKED BY:

Checker

A202

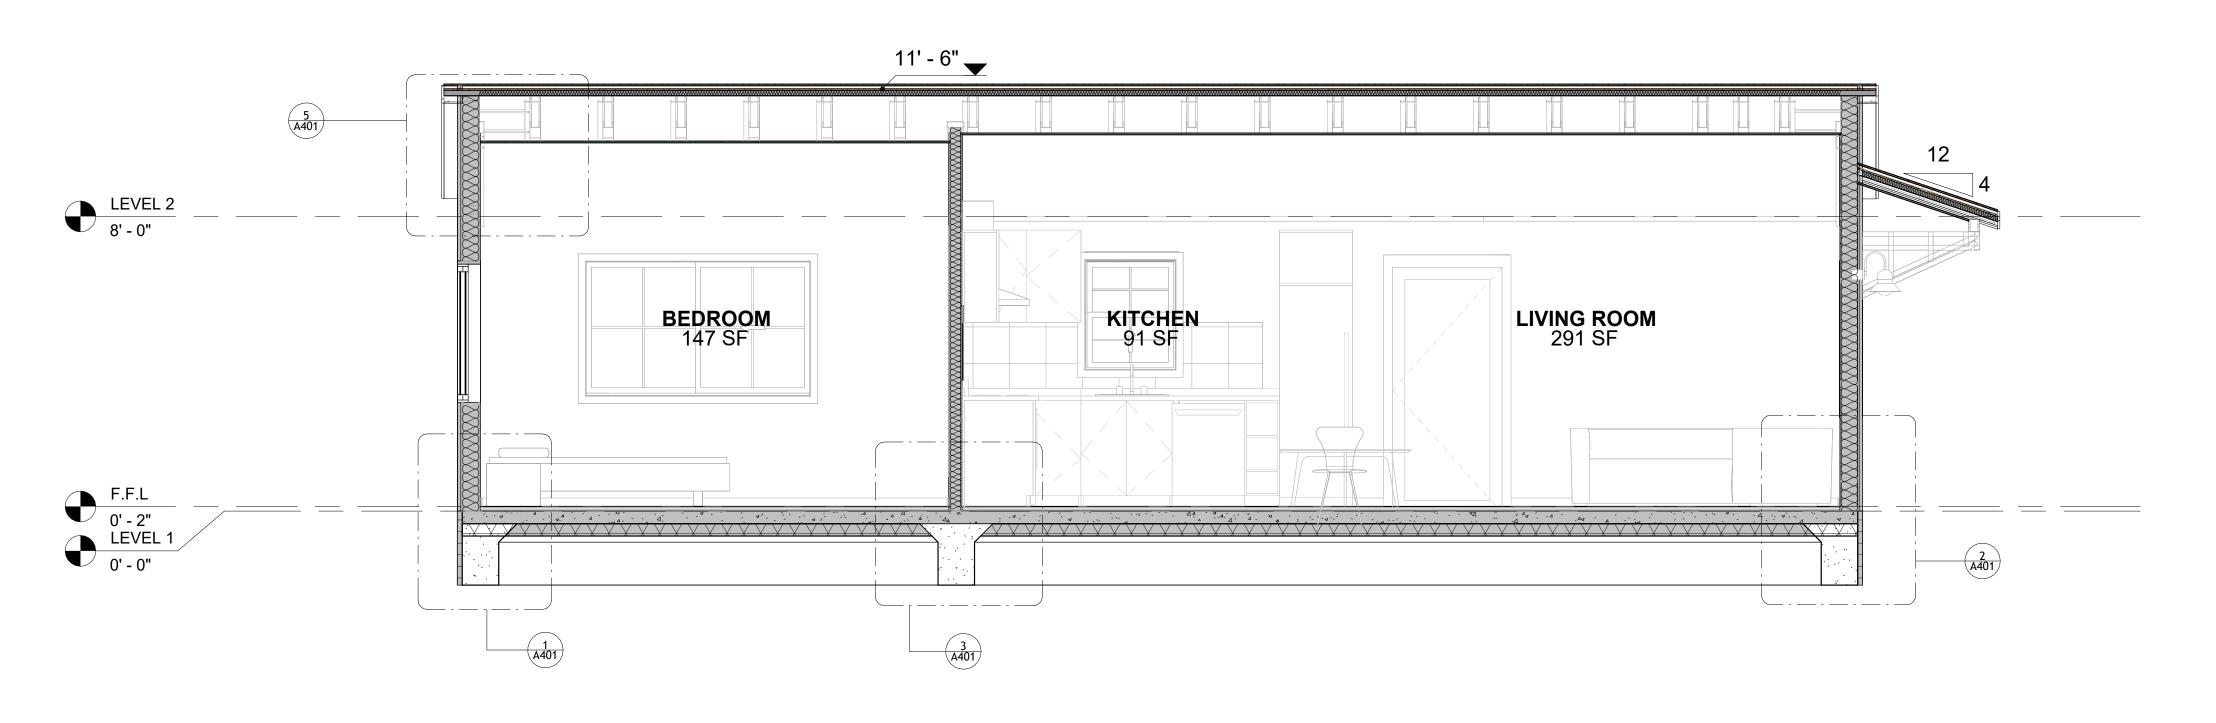




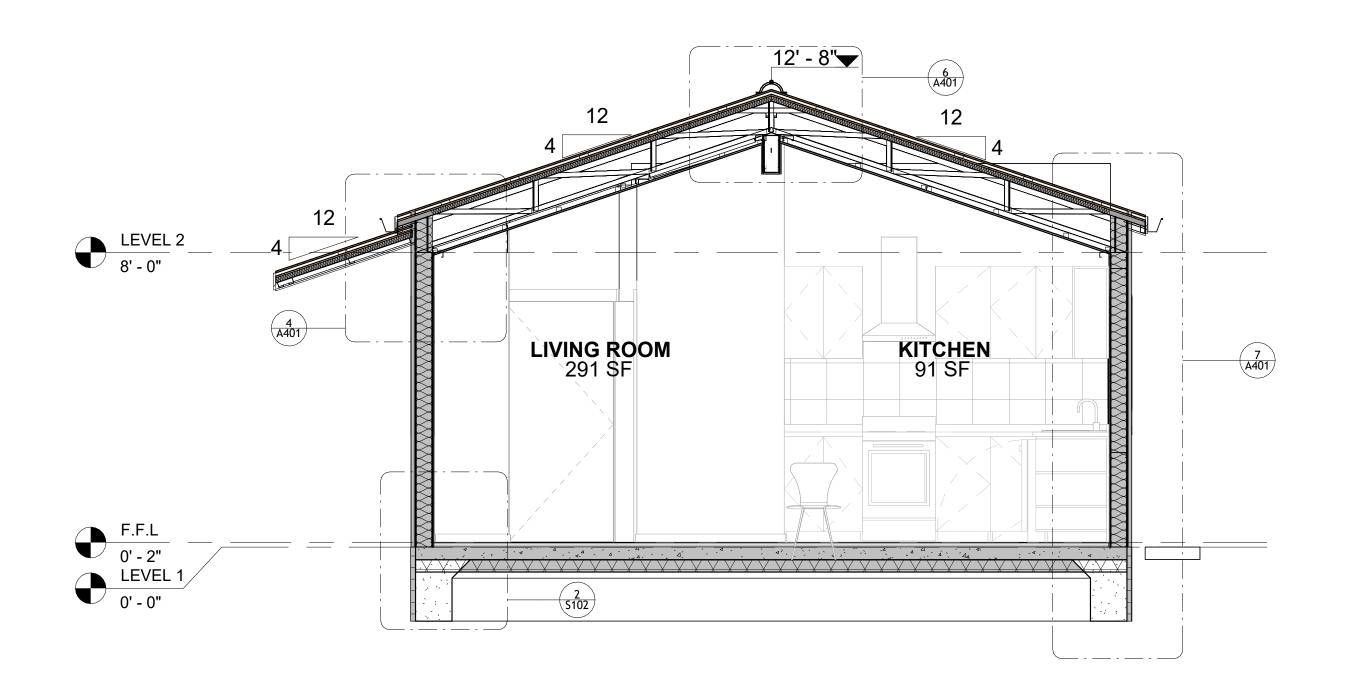

2 SECTION-2 3/8" = 1'-0"



KEY PLAN

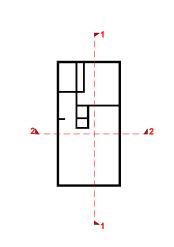

NO.	DESCRIPTION	DATE

NOTE:

LEGEND:

PROJECT


56 HAMILTON 746 1Bd/1Ba SPANISH 550


DRAWING NAME


ARCHITECTURAL SECTIONS

Client Name	CLIENT NAME:
0061_12	PROJECT NUMBER:
2/17/2025 12:15:53 PM	DATE:
Designer	DESIGNED BY:
Author	DRAWN BY:
Checker	CHECKED BY:


A301

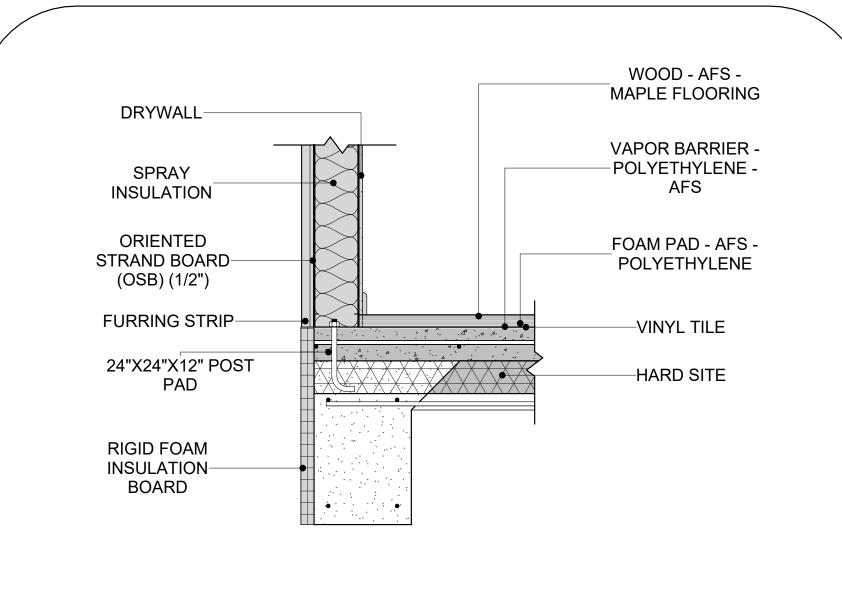


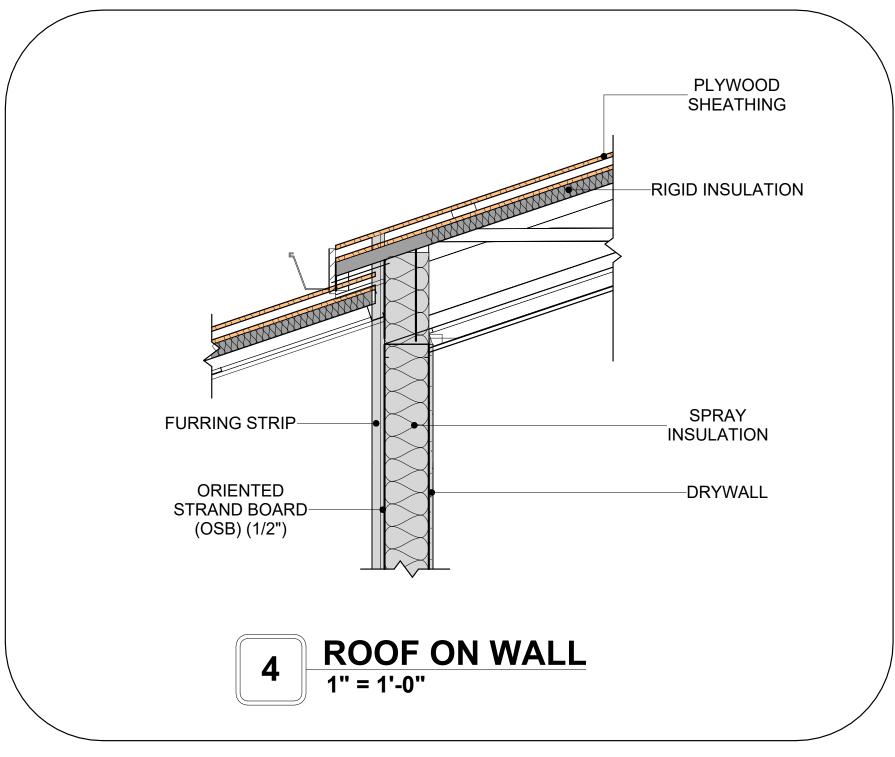


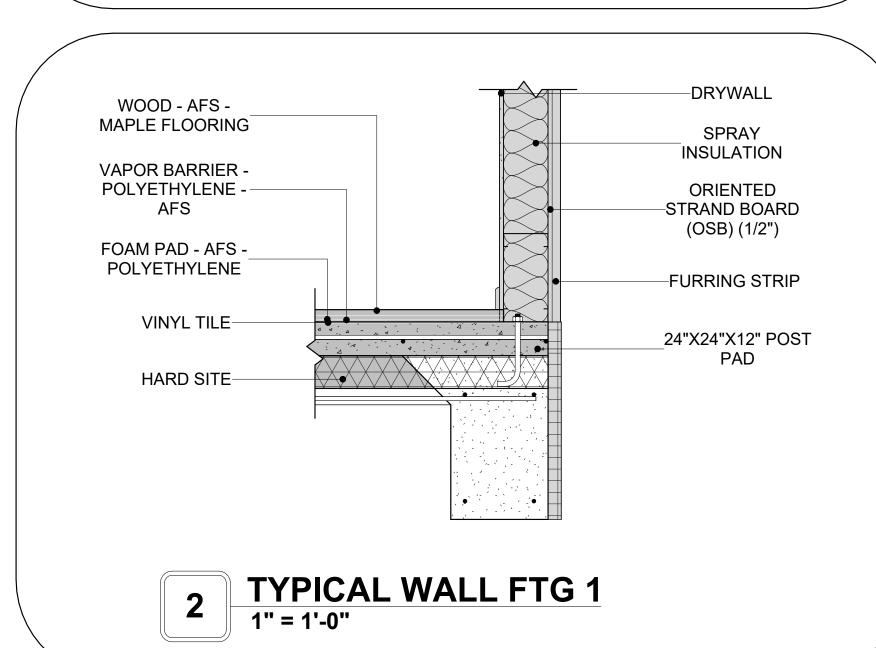


TYPICAL WALL FTG

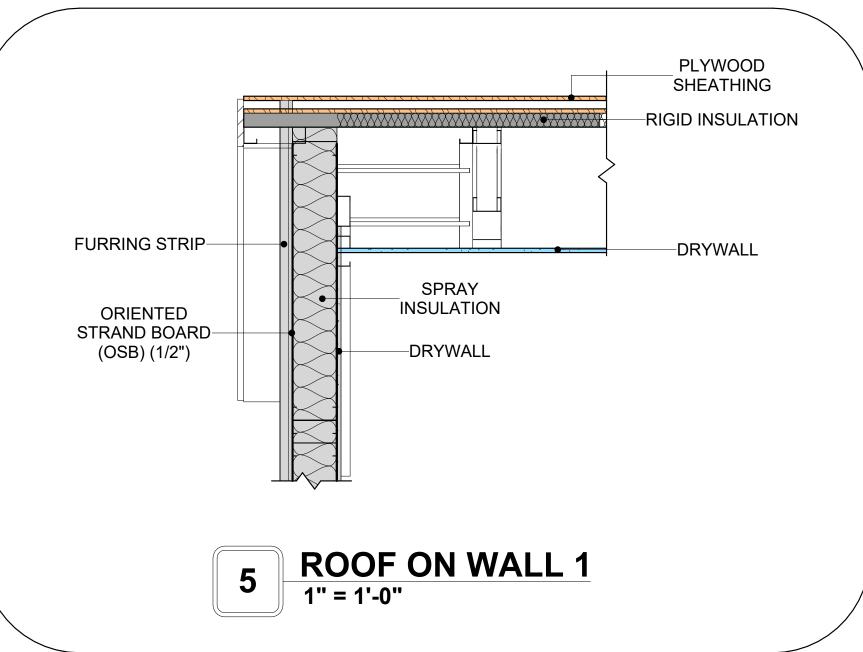

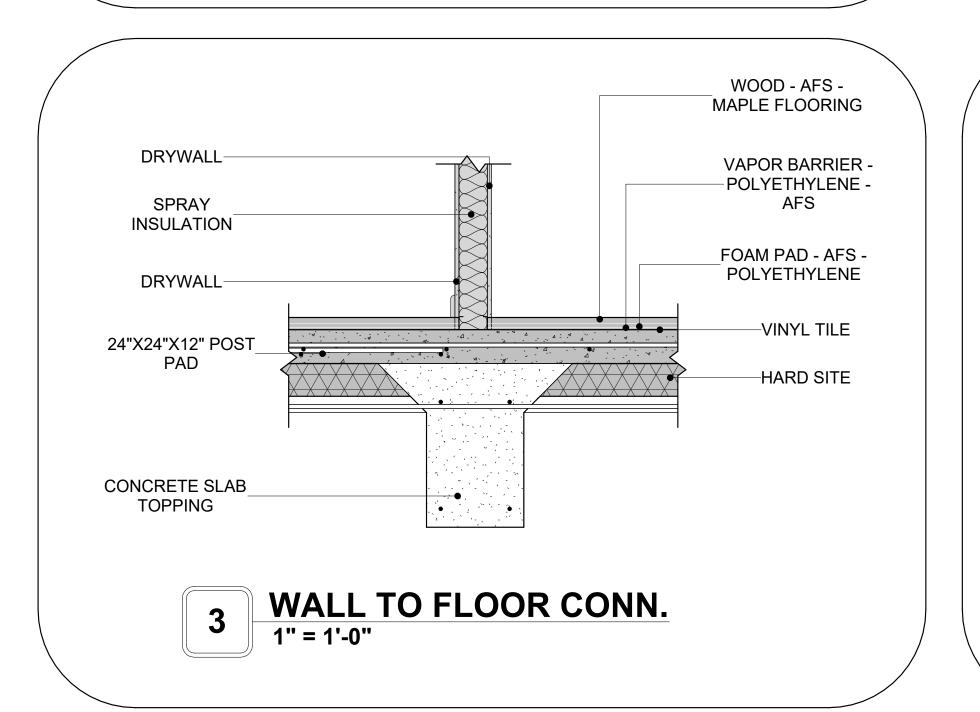

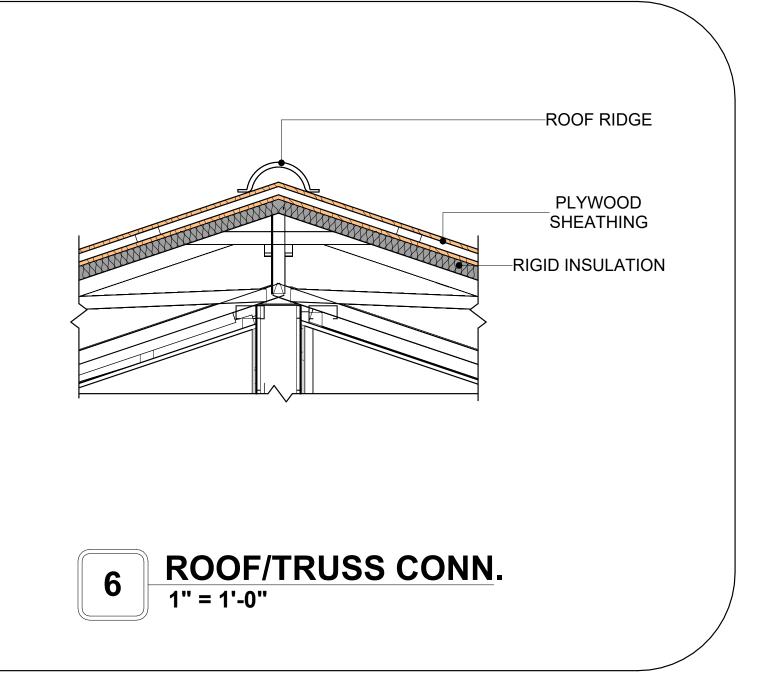

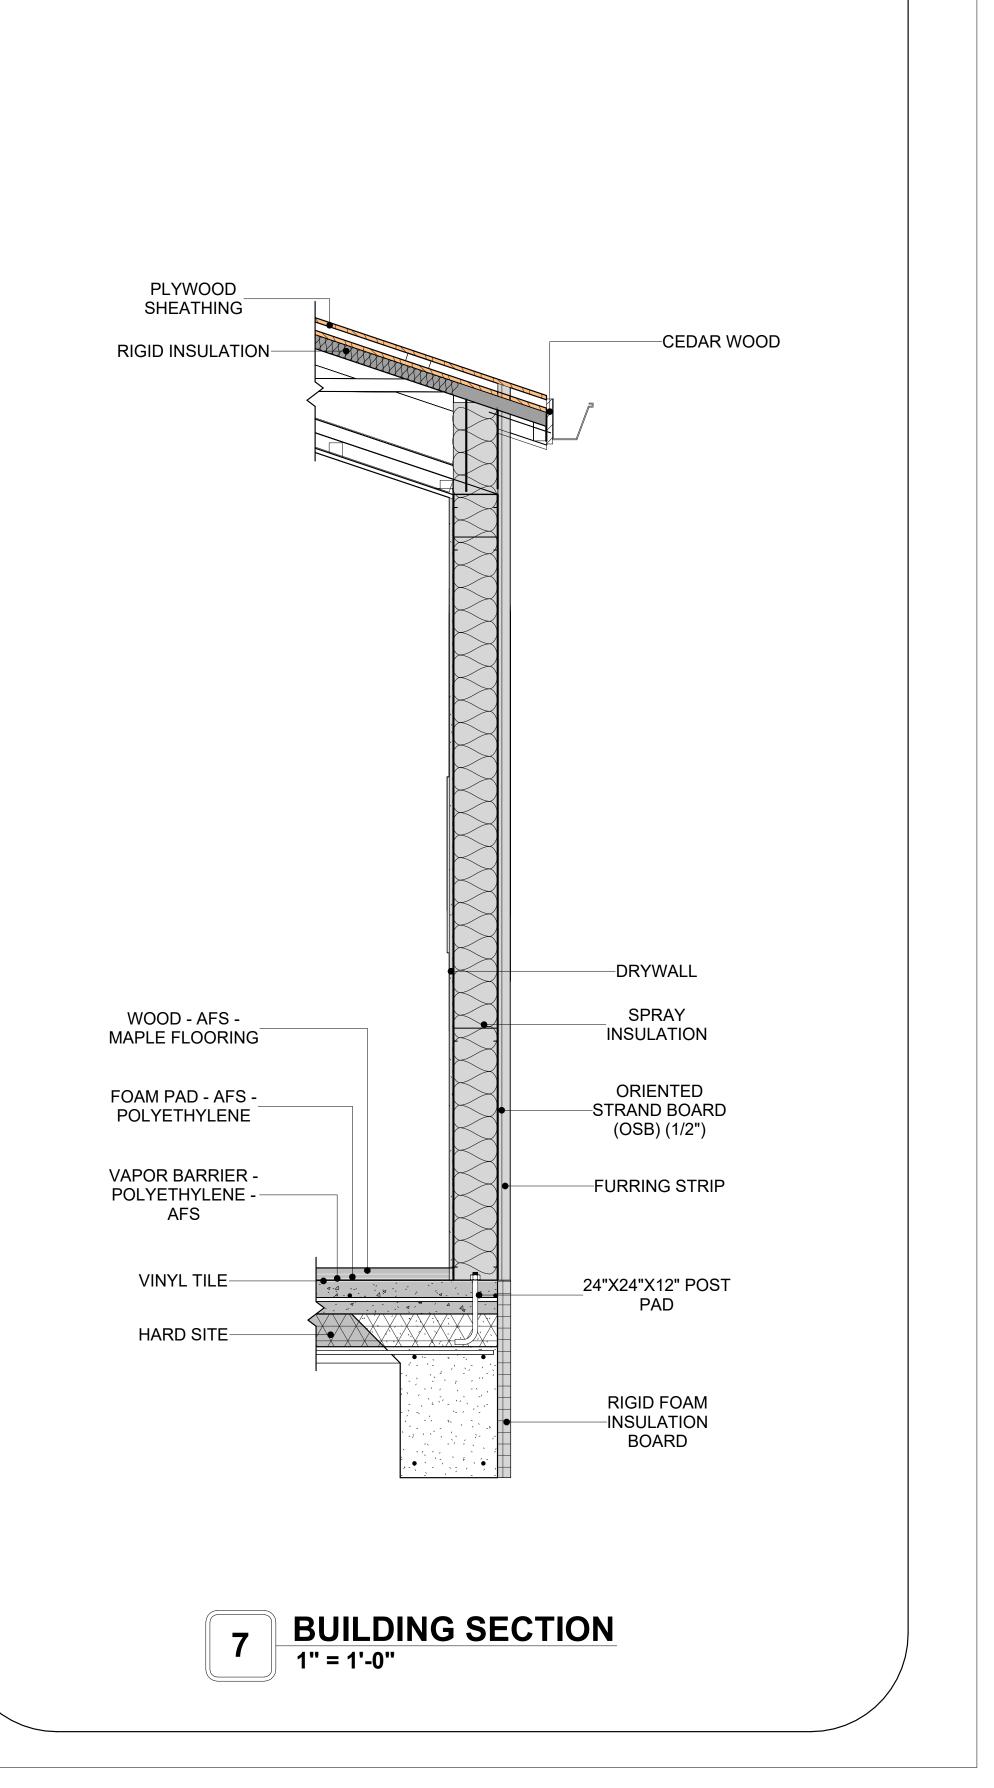



KEY PLAN

NO.	DESCRIPTION	DATE

NOTE:

LEGEND:

PROJECT

56 HAMILTON 746 1Bd/1Ba SPANISH 550

DRAWING NAME

ARCHITECTURAL DETAILS

CLIENT NAME:	Client Name
PROJECT NUMBER:	0061_12
DATE:	2/17/2025 12:15:54 PM
DESIGNED BY:	Designer
DRAWN BY:	Author
CHECKED BY:	Checker

A401


SCALE: 1" = 1'-0"

CASEWORK GENERAL NOTES

- ALL CABINET HEIGHTS INCLUDE COUNTERTOPS. DIMENSIONS ARE TO THE NEAREST INCH. DIVISIONS IN CASEWORK ARE SHOWN FOR CLARITY AND DO NOT REPRESENT BREAKS IN THE COUNTERTOP.
- PROVIDE CONTINUOUS COUNTERTOP OVER ALL SIMILAR HEIGHT CASEWORK, UNLESS AND OTHERWISE NOTED.
- MANUFACTURER AND CATALOG NUMBERS ARE FOR REFERENCE AND ILLUSTRATION PURPOSES
- DOTTED LINES INDICATE WALL HUNG CABINETS, DIVISIONS OF BASE CABINETS BELOW THE
- COUNTERTOP, FURNITURE NOT IN THE CONTRACT OR PROJECTION SCREENS -SEE CASEWORK KEY AND SPECIFICATIONS.
- ALL CABINETS AND DRAWERS TO HAVE CAM LOCKS EXCEPT FOR SINK BASE CABINETS. ALL EXPOSED SURFACES (EXPOSED TO VIEW FROM ANY PERSPECTIVE) TO BE COVERED WITH
- LAMINATE.
- ALL CASEWORK WHICH MEETS A WALL AT ONE OR BOTH ENDS, TO BE PROVIDED WITH FILLER PANELS AND SCRIBED TO THE WALL(S) AS REQUIRED.
- 10. ALL CABINETS AND DRAWERS ARE PROVIDED WITH RECESSED HANDLES.
- 11. CONTRACTOR TO FIELD VERIFY ALL CLEAR OPENINGS PRIOR TO MILLWORK OR CASEWORK FABRICATION.
- 12. CASEWORK DRAWINGS ARE DIAGRAMMATIC IN NATURE TO SHOW DESIGN INTENT.


	CA	SEWOR	K SCHEDU	JLE		
TYPE MAR K	TYPE	COUN	HEIGHT	WIDTH	DEPTH	AREA
01	Wall Cabinet Double Door 4	1	2' - 6"	2' - 2"	1' - 0"	5 SF
02	HD Linear Counter Top 2	1	0' - 4"	2' - 2"	2' - 1"	1 SF
03	Base Cabinet Double Door 4	1	2' - 11"	2' - 2"	2' - 0"	6 SF
04	Wall Cabinet Single Door	1	2' - 6"	1' - 6"	1' - 0"	4 SF
05	Wall Cabinet Single Door	1	2' - 6"	1' - 3"	1' - 0"	3 SF
06	Wall_Cabinet_L-Shape 4	1	2' - 6"	1' - 9"	2' - 0"	4 SF
07	Base_Cabinet_Single_Door	1	2' - 7"	1' - 6"	2' - 0"	4 SF
08	Base_Cabinet_L-Shaped	1	2' - 11"	3' - 3"	3' - 3"	9 SF
09	HD_L-Shape_Counter_Top	1	0' - 4"	4' - 4"	6' - 3"	1 SF
10	Wall_Cabinet_Single_Door 2	1	2' - 6"	1' - 6"	1' - 0"	4 SF
11	Base_Cabinet_Double_Door 2	1	2' - 11"	2' - 6"	2' - 0"	7 SF
12	HD_Linear_Counter_Top 4	1	0' - 4"	7' - 7"	2' - 1"	3 SF
13	Base_Filler_1	1	2' - 11"	1' - 0"	2' - 0"	3 SF
14	HD_LAUNDRY_OPEN_CABINET	1	1' - 6"	2' - 0"	2' - 0"	3 SF
15	RECESSED_MED_CABINET 2	1	2' - 0"	1' - 6"	0' - 3"	3 SF
16	<varies></varies>	2	<varies></varies>	<varies></varies>	<varies></varies>	<varies></varies>
20	Linen 7'	1	6' - 0"	8' - 5"	1' - 4"	51 SF
Grand t	otal	18				

SPECIALTY EQUIPMENT SCHEDULE			
TYPE MARK	TYPE	COUNT	
01	WASHER-FRONT-LOAD	1	
02	REFRIGERATOR	1	
03	RANGE	1	
04	DRYER-FRONT-LOAD	1	
05	Dishwasher	1	
05 Grand total: 5	Dishwasher	1	

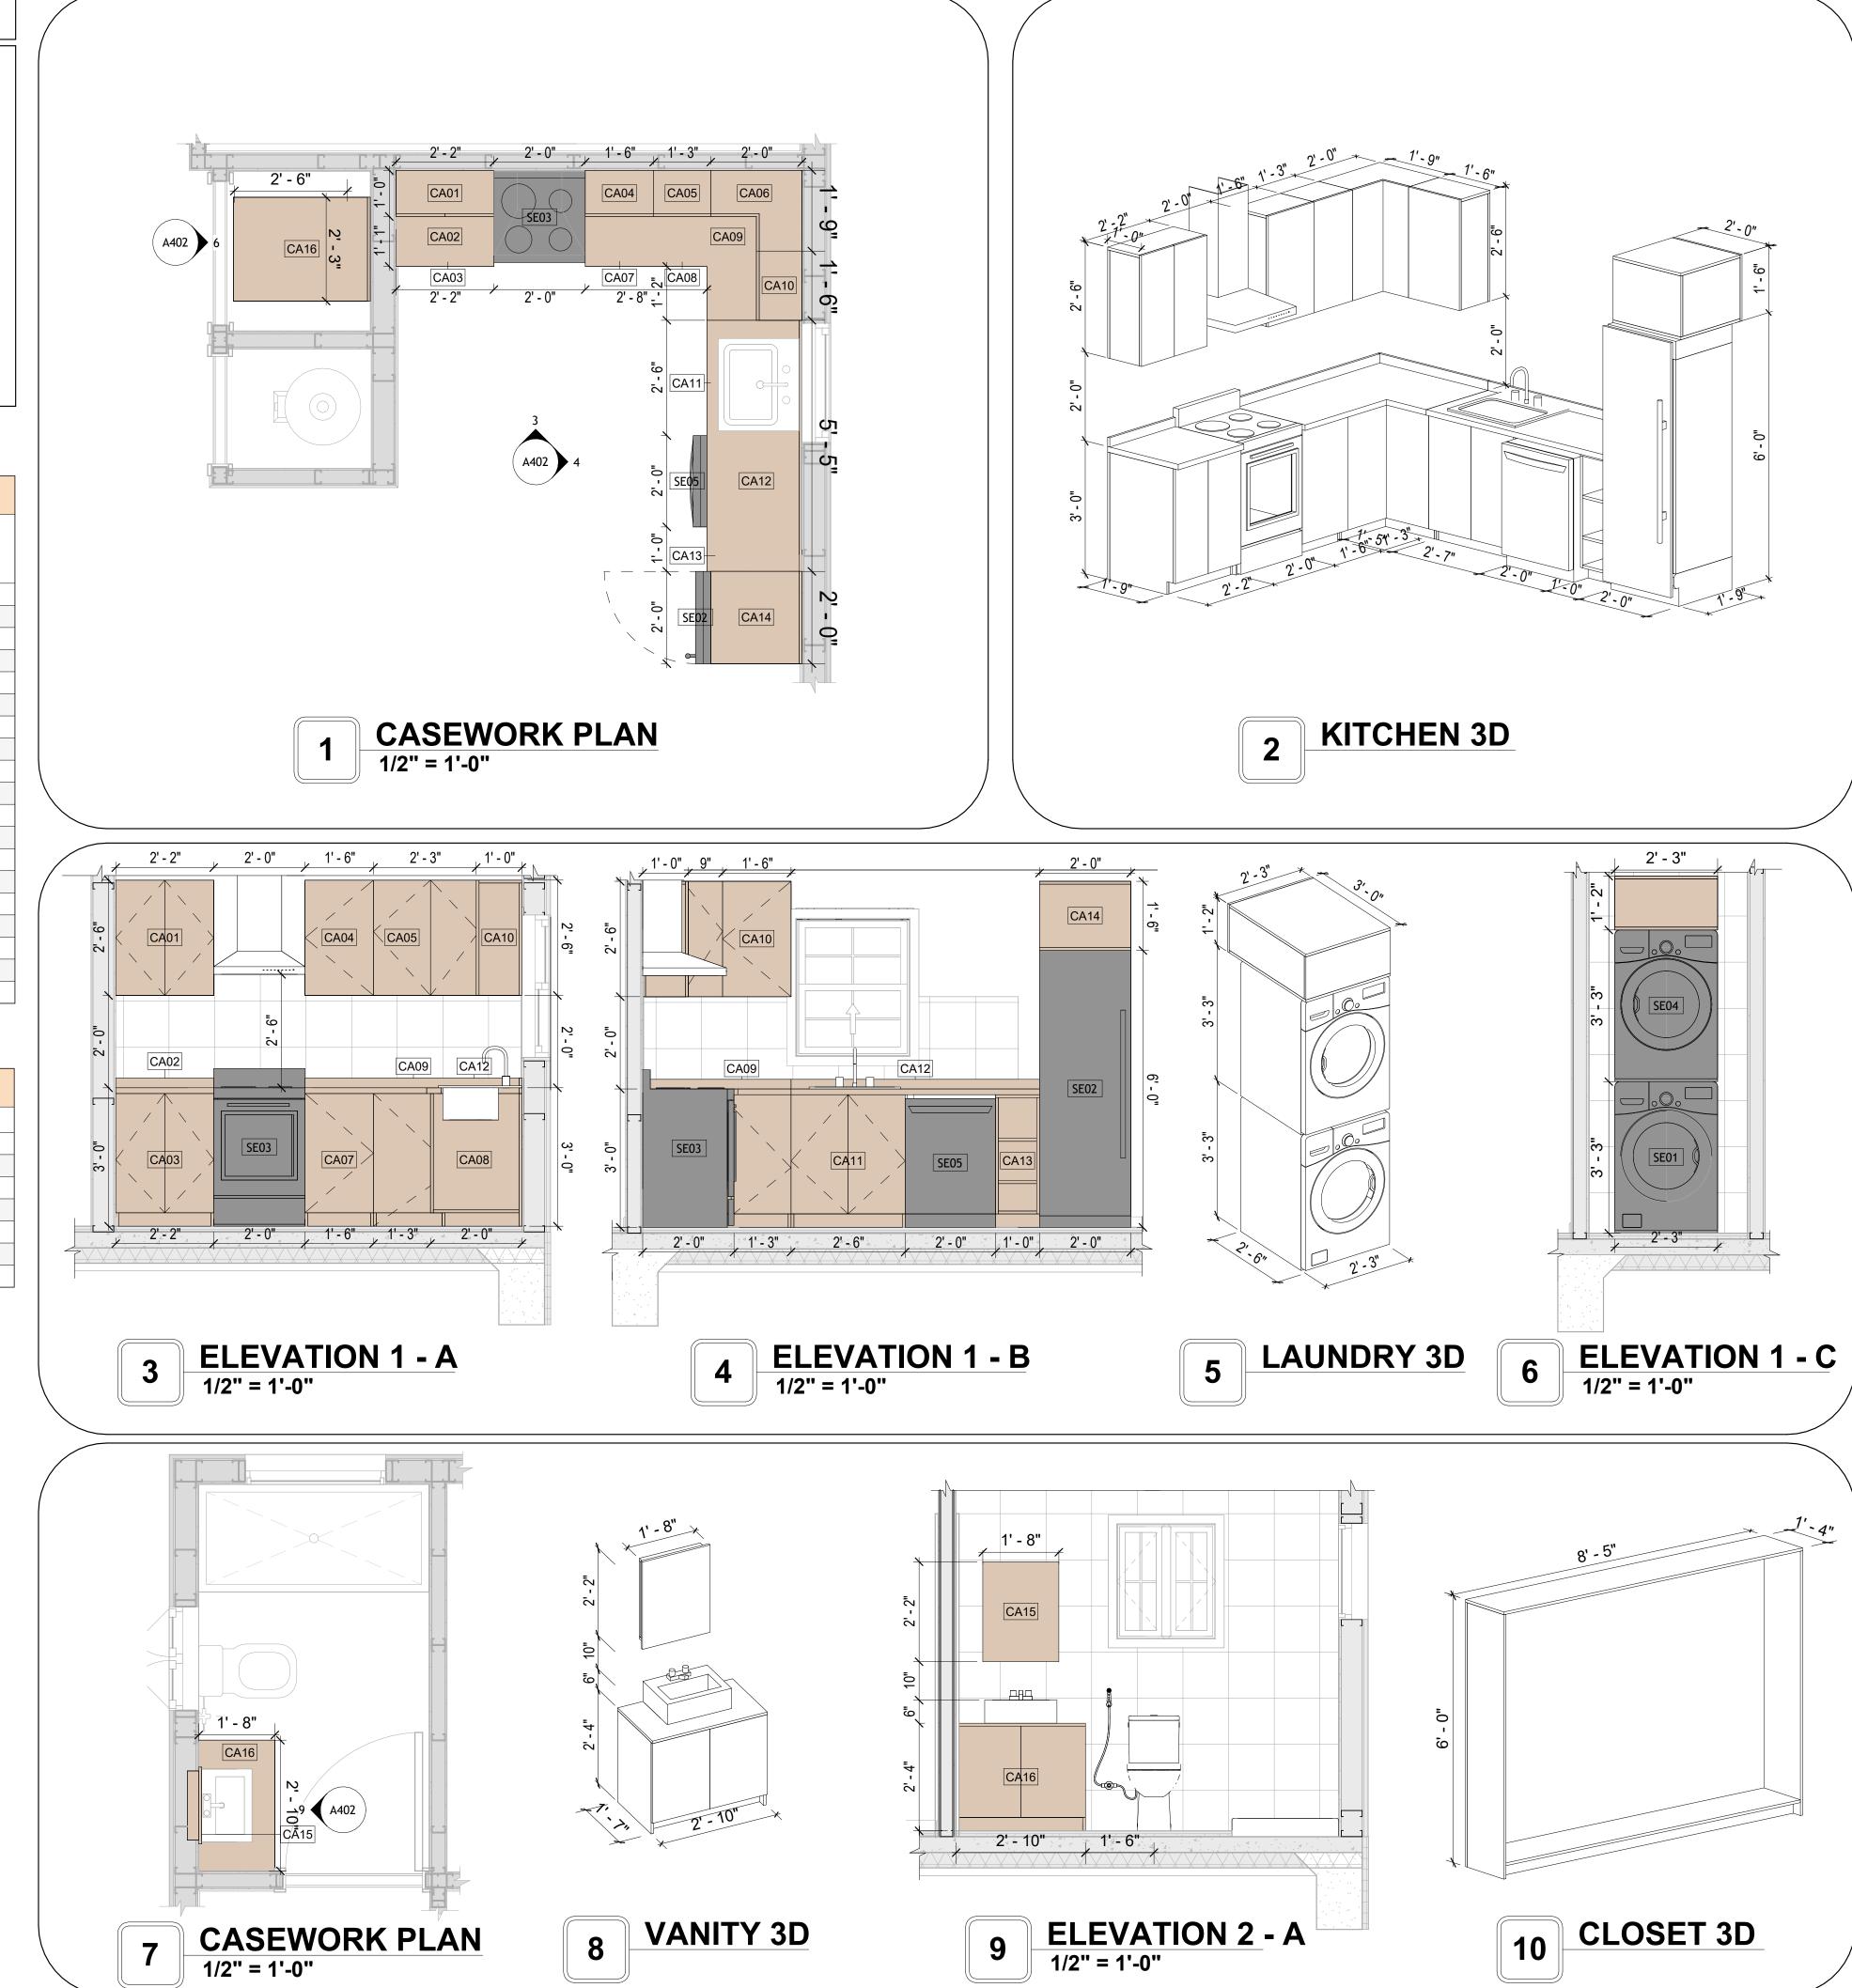



KEY PLAN

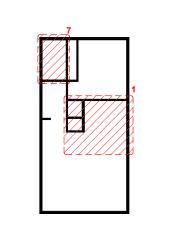

NO.	DESCRIPTION	DATE

NOTE:

LEGEND:

PROJECT

56 HAMILTON 746 1Bd/1Ba SPANISH 550

DRAWING NAME

ARCHITECTURAL CASEWORK

CLIENT NAME:	Client Name
PROJECT NUMBER:	0061_12
DATE:	2/17/2025 12:15:56 PM
DESIGNED BY:	Designer
DRAWN BY:	Author
CHECKED BY:	Checker

A402

GENERAL NOTES

1. THIS DRAWING DEPICTS THE HVAC (HEATING, VENTILATION, AND AIR CONDITIONING) SYSTEM FOR THE HAMILTON 1BD 1BA SPANISH. IT PROVIDES A VISUAL REPRESENTATION OF THE SYSTEM LAYOUT AND COMPONENTS.

2.THE HVAC SYSTEM IS DESIGNED TO MEET THE SPECIFIC REQUIREMENTS OF THE BUILDING, INCLUDING HEATING, COOLING, AND VENTILATION NEEDS, AS PER THE PROJECT SPECIFICATIONS AND APPLICABLE CODES AND STANDARDS.

3. THE HVAC SYSTEM INSTALLATION SHALL COMPLY WITH THE LATEST EDITION OF THE INTERNATIONAL MECHANICAL CODE (IMC), INTERNATIONAL RESIDENTIAL CODE (IRC), AND ALL OTHER APPLICABLE LOCAL, STATE, AND NATIONAL CODES AND REGULATIONS.

4. THE EQUIPMENT SHOWN ON THIS DRAWING INCLUDES BUT IS NOT LIMITED TO AIR HANDLING UNITS (AHUS), CHILLERS, BOILERS, COOLING TOWERS, PUMPS, DUCTWORK, DIFFUSERS, GRILLES, AND CONTROL DEVICES.

5. ALL EQUIPMENT, DUCTWORK, AND PIPING SHALL BE INSTALLED IN ACCORDANCE WITH MANUFACTURER'S SPECIFICATIONS, LOCAL CODES, AND

6. ALL DUCTWORK SHALL BE SIZED, FABRICATED, AND INSTALLED IN ACCORDANCE WITH THE LATEST EDITION OF THE ACCA MANUAL D AND THE SMACNA HVAC DUCT CONSTRUCTION STANDARDS. DUCTWORK SHALL BE INSTALLED IN A NEAT AND WORKMANLIKE MANNER, PROPERLY SUPPORTED AND BRACED TO PREVENT SAGGING, AIR LEAKAGE, OR VIBRATION.

7. CONDENSATE DRAINAGE PIPING SHALL BE PROPERLY PITCHED TO ENSURE POSITIVE DRAINAGE TO AN APPROVED DISPOSAL LOCATION, SUCH AS A FLOOR DRAIN, SUMP PUMP, OR EXTERIOR GRADE. CONDENSATE LINES SHALL BE INSULATED TO PREVENT SWEATING.

8. THE LOCATION OF CONTROL PANELS AND SENSORS INDICATED ON THIS DRAWING CAN BEMODIFY WITH THE SPECIFIC LOCATIONS AND WIRING DETAILS WILL BE DETERMINED DURING THE CONTROL SYSTEM DESIGN AND INSTALLATION.

9. THE HVAC SYSTEM DESIGN CONSIDER ENERGY EFFICIENCY, INDOOR AIR QUALITY, OCCUPANT COMFORT, AND NOISE CONTROL, FOLLOWING APPLICABLE GUIDELINES AND REGULATIONS.

10. COORDINATION WITH OTHER TREADS HAS BEEN DONE ON A DESIGN LEVEL. THIS DRAWING SHALL BE READ TOGETHER WITH THE AR, EL AND SN

DESIGN DRAWINGS TO ENSURE PROPER INSTALLATION AND INTEGRATION OF THE HVAC SYSTEMS. 11. THE HVAC CONTRACTOR IS RESPONSIBLE FOR OBTAINING ALL NECESSARY PERMITS AND LICENSES, AND FOR SCHEDULING AND COORDINATING

12. ALL DUCTWORK PENETRATIONS THROUGH WALLS, FLOORS, OR CEILINGS SHALL BE PROPERLY SEALED AND FIRE-STOPPED USING APPROVED METHODS AND MATERIALS TO MAINTAIN THE INTEGRITY OF THE BUILDING'S FIRE-RESISTANCE RATINGS.

13. HVAC EQUIPMENT SHALL BE INSTALLED LEVEL AND PLUMB, AND IN STRICT ACCORDANCE WITH THE MANUFACTURER'S INSTALLATION INSTRUCTIONS AND RECOMMENDATIONS. PROVIDE ADEQUATÉ CLEARANCES AROUND EQUIPMENT FOR PROPER AIRFLOW, SERVICE ACCESS, AND

CODE COMPLIANCE.

14. ALL HVAC EQUIPMENT AND COMPONENTS, INCLUDING THERMOSTATS, DAMPERS, AND ACCESS PANELS, SHALL BE LOCATED IN ACCESSIBLE AREAS


FOR EASY SERVICING AND MAINTENANCE. PROVIDE ADEQUATE SPACE AROUND EQUIPMENT FOR PROPER AIRFLOW AND SERVICE ACCESS. 15. THE HVAC SYSTEM SHALL BE BALANCED AND ADJUSTED TO ENSURE PROPER AIRFLOW, TEMPERATURE DISTRIBUTION, AND SYSTEM


PERFORMANCE THROUGHOUT THE RESIDENCE. PROVIDE A WRITTEN REPORT DOCUMENTING THE FINAL SYSTEM BALANCE.

16. ANY DEVIATIONS OR MODIFICATIONS TO THE HVAC SYSTEM DESIGN SHALL BE REVIEWED AND APPROVED BY THE RESPONSIBLE DESIGN PROFESSIONALS AND COMMUNICATED TO ALL RELEVANT PARTIES INVOLVED IN THE CONSTRUCTION PROCESS.

WITH THE LOCAL BUILDING DEPARTMENT AND UTILITY PROVIDERS TO ENSURE A TIMELY AND COMPLIANT INSTALLATION.

17. FOR ANY INQUIRIES OR CLARIFICATIONS REGARDING THE HVAC SYSTEM DESIGN, PLEASE CONSULT THE RESPONSIBLE DESIGN PROFESSIONALS OR THE PROJECT MANAGEMENT TEAM.

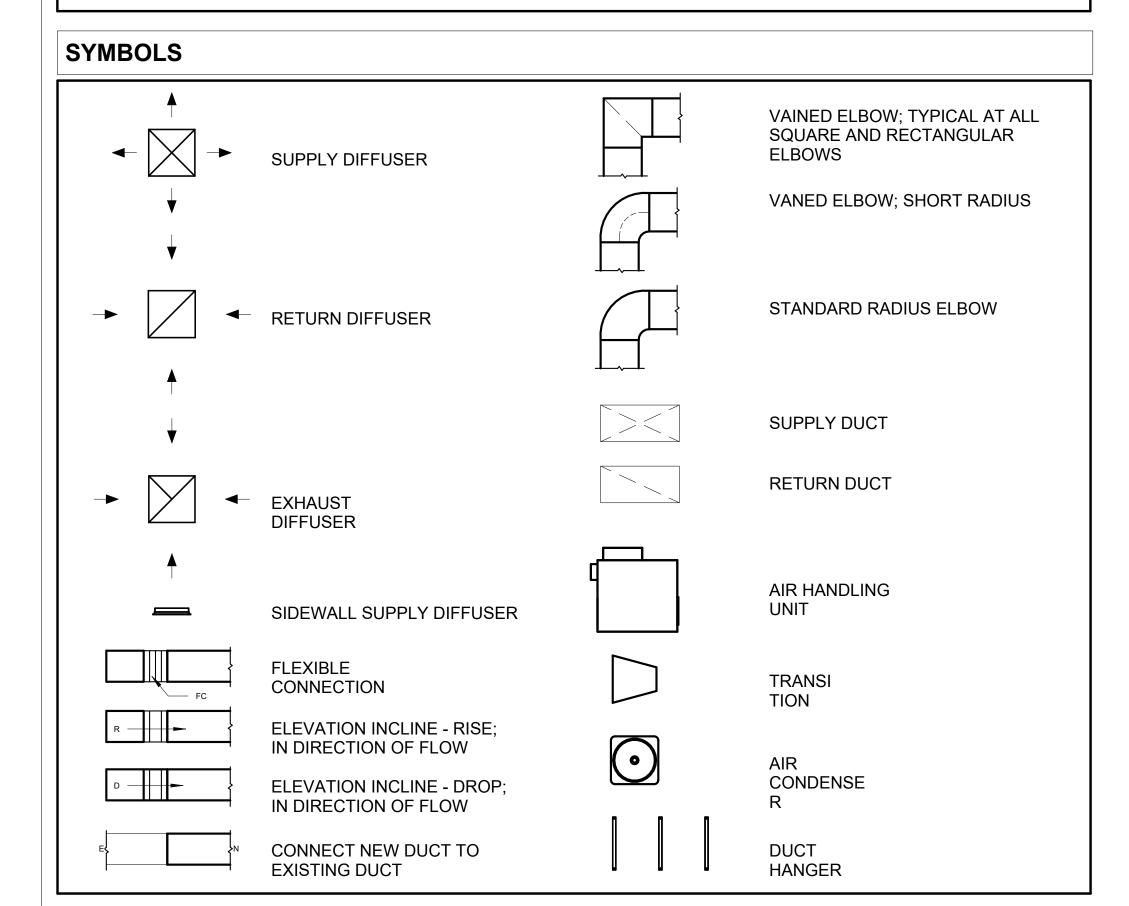

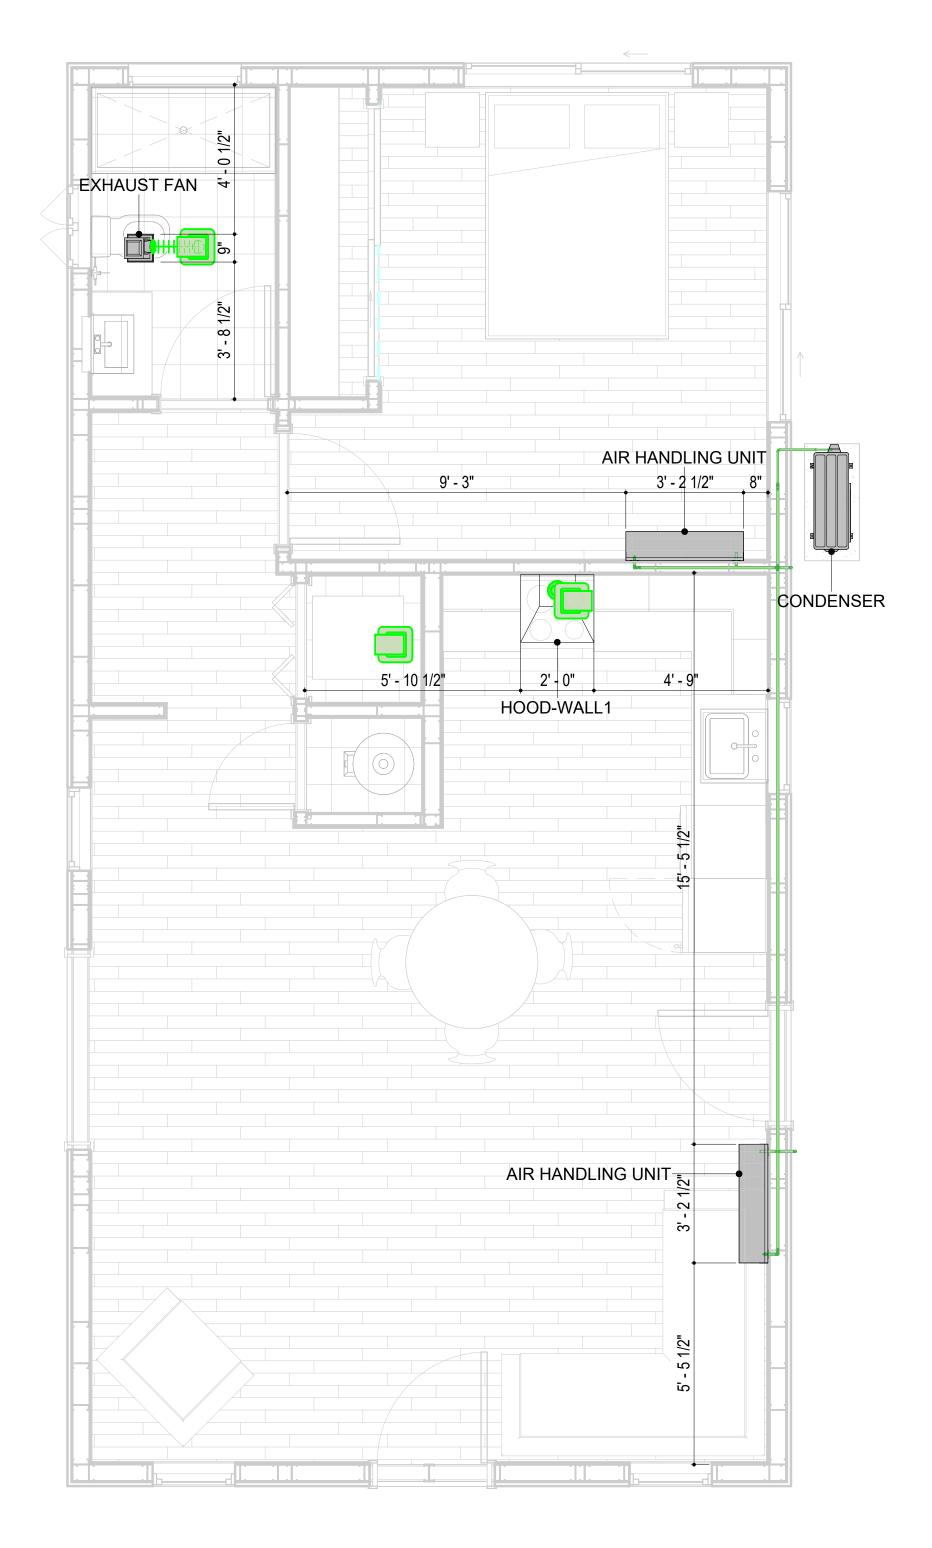

HVAC PLAN 3/8" = 1'-0"

HVAC COLOR SCHEME

AIR CONDITIONING PIPE

REFRIGERANT LINE SCHEDULE				
CATAGORY	DESCRIPTION	DIAMETER	LENGTH	
PIPE TYPES	COPPER	1/4"	0.45	
PIPE TYPES	COPPER	3/8"	34.68	
PIPE TYPES	COPPER	1/2"	0.42	
PIPE TYPES	COPPER	3/4"	49.23	

REFRIGERANT LINE FITTING SCHEDULE				
CATAGORY	DESCRIPTION	Size	Count	
ELBOW - GENERIC	ELBOW - GENERIC: STANDARD/HVAC	1/4"ø-1/4"ø	1	
ELBOW - GENERIC	ELBOW - GENERIC: STANDARD/HVAC	3/4"ø-3/4"ø	16	
ELBOW - GENERIC	ELBOW - GENERIC: STANDARD/HVAC	3/8"ø-3/8"ø	10	
TEE - GENERIC	TEE - GENERIC: STANDARD	3/4"ø-3/4"ø-3/ 4"ø	1	
TEE - GENERIC	TEE - GENERIC: STANDARD	3/8"ø-3/8"ø-3/ 8"ø	1	
TRANSITION - GENERIC	TRANSITION - GENERIC: STANDARD	3/4"ø-1/2"ø	3	
TRANSITION - GENERIC	TRANSITION - GENERIC: STANDARD	3/4"ø-5/8"ø	2	
TRANSITION - GENERIC	TRANSITION - GENERIC: STANDARD	3/8"ø-1/4"ø	1	

MECHANICAL EQUIPMENT SCHEDULE			
CATAGORY	DESCRIPTION	COUNT	
		'	
AIR HANDLING UNIT	AIR HANDLING UNIT: WALL MOUNTED	2	
AIIT HANDLING ONLI			
CONDENSER	CONDENSER: OUT DOOR	1	
,	CONDENSER: OUT DOOR EXHAUST FAN: 75 CFM	1	

DUCT FITTING SCHEDULE			
CATAGORY	DESCRIPTION	COUNT	
ROUND TRANSITION - ANGLE	45 DEGREE	5	

DUCT ACCESSORY SCHEDULE					
CATAGORY	DESCRIPTION	COUNT			
		1-			
ROOF VENT	3" DIAMETER	3			

FLEX DUCT SCHEDULE							
DESCRIPTION	DESCRIPTION	LENGTH	DIAMETER	COUNT			
FLEX DUCT ROUND	FLEX-ROUND	12.40	4"	3			
GRAND TOTAL: 3		12.40					



KEY PLAN

NO.	DESCRIPTION	DATE

NOTE:

LEGEND:

PROJECT

56-Hamilton-746-1Bd-1Ba Spanish-550

DRAWING NAME

HVAC PLAN

CLIENT NAME:	Owner
PROJECT NUMBER:	15_0001
DATE:	2/14/2025 5:31:16 AM
DESIGNED BY:	Designer
DRAWN BY:	Author
CHECKED BY:	Checker

M101

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ELECTRICAL NOTES

- 1. THIS DRAWING DEPICTS THE ELECTRICAL SYSTEM FOR THE 56-Hamilton-746-1Bd-1Ba Spanish-550. IT PROVIDES A VISUAL REPRESENTATION OF THE ELECTRICAL LAYOUT AND COMPONENTS, INCLUDING POWER DISTRIBUTION, LIGHTING, AND CONTROL SYSTEMS.
- 2. THE ELECTRICAL SYSTEM IS DESIGNED TO MEET THE SPECIFIC REQUIREMENTS OF THE BUILDING, INCLUDING POWER DISTRIBUTION, LIGHTING, AND SPECIALIZED ELECTRICAL EQUIPMENT NEEDS, AS PER THE PROJECT SPECIFICATIONS AND APPLICABLE CODES AND STANDARDS.
- 3. THE ELECTRICAL SYSTEM INSTALLATION SHALL COMPLY WITH THE LATEST EDITION OF THE NATIONAL ELECTRICAL CODE (NEC), INTERNATIONAL BUILDING CODE (IBC), AND ALL OTHER APPLICABLE LOCAL, STATE, AND NATIONAL CODES AND REGULATIONS.
- 4. LOCATIONS AS NEEDED, DEVICES ARE SHOWN ON PLANS IN APPROXIMATE IDEAL LOCATIONS, UNLESS SPECIFICALLY DIMMENSIONED.
- 5. OPEN WALLS AS NEEDED TO ALLOW FOR NEW ELECTRICAL INSTALLATIONS.
- 6. LABEL ALL CIRCUITS ON JUNCTION BOXES, RECEPTACLES, DATA, SMOKE DETECTOR, AND EQUIPMENT IN PANEL BOX.
- 7. INSTALL RACEWAY AS NEEDED FOR DDC, ACCESS CONTROL, LOW VOLTAGE WIRING & DATA.
- 8. RELABEL POWER, DATA & FIRE ALARM FOR ROOM #CHANGES.
- 9. VERIFY ALL CIRCUITS LABELED ON PRINT ARE CORRECT BEFORE WORKING ON THEM.
 10. NOTE ON SITE PLAN ALL CHANGES OR MISSING DETAIL TO BE INCORPORATED INTO THE MASTER PLAN.
- 11. DRAWINGS ARE DIAGRAMMATIC ONLY FOR THE PURPOSE OF SHOWING FIXTURE AND OUTLET LOCATIONS.
- 12. ELECTRICAL CONTRACTOR TO VERIFY SERVICE SIZE BY CALCULATION BASED UPON ACTUAL NAME PLATE RATINGS OF SELECTED EQUIPMENT.
- PLATE RATINGS OF SELECTED EQUIPMENT.

 13. VERIFY LOCATION OF SERVICE ENTRANCE WITH POWER COMPANY. PROVIDE UFER GROUND IN
- 13. VERIFY LOCATION OF SERVICE ENTRANCE WITH POWER COMPANY. PROVIDE UFER GROUND IN BUILDING FOUNDATION AT SERVICE ENTRANCE LOCATION.
- 14. PROVIDE A MIN. OF 20 FEET OF ONE *4 BARE COPPER UFER WIRE EMBEDDED IN CONCRETE FOOTING AT THE SERVICE ENTRANCE LOCATION WHERE APPROVED BY LOCAL SERVICE PROVIDER.
- 15. PROVIDE WATERPROOF FIXTURES IN ALL HIGH MOISTURE AREAS (EXTERIOR, SHOWER AND TUB
- CEILINGS ETC.)
 16. PROVIDE DEDICATED CIRCUITS TO EACH BATH, DEN, FAMILY ROOM, BEDROOM, LOFT, KITCHEN
- REFRIGERATOR, KITCHEN FREEZER DISHWASHER, AND ANY AREA/ITEM SPECIFIED BY OWNER.

 17. INCANDESCENT FIXTURES WITH OPEN OR PARTIALLY ENCLOSED LAMPS, PENDANT FIXTURES, AND
- LAMP HOLDERS ARE NOT PERMITTED IN CLOSETS.

 18. ALL WORKMANSHIP AND MATERIALS TO CONFORM WITH THE 2015 IRC.
- 19. PROVIDE A MIN. OF 20 FEET OF ONE *4 BARE COPPER UFER WIRE EMBEDDED IN CONCRETE FOOTING AT THE SERVICE ENTRANCE LOCATION WHERE APPROVED BY LOCAL SERVICE PROVIDER.
- 20. PROVIDE A BONDING CONDUCTOR CONSISTING OF A MINIMUM OF ONE *4 BARE COPPER WIRE CONNECTING THE BUILDING'S METAL WATER PIPING SYSTEM TO THE SERVICE EQUIPMENT ENCLOSURE GROUNDING.

ΜΔΙΝ	PANFI	_ CALCS

(USE 200 AMP SERVICE)

ELECTRICAL CALCS			
LIGHT AND OUTLETS 746 @ 3W	2,238 W		
3 APPLIANCE CIRCUITS	4,500 W		
DRYER	2,000 W		
WASHER	2,000 W		
RANGE	5,000 W		
WATER HEATER	5,000 W		
REFRIG.	1,800 W		
DISHWASHER & DISPOSAL	3000 W		
TOTAL	25,538 W		
FRIST 10,000 @ 100% REMAINDER @ 40% MINI. SPLIT UNITS	10,000 W 6,215W 10,000 W		
TOTAL	26,215 W		
26,215 W DIVIDED BY 240V =	109 AMPS TOTAL		

ELECTRICAL ABBREVIATIONS LIST

1P	1 POLE (2P, 3P, 4P, ETC.)	CTR	CENTER	HT	HEIGHT
A	AMPERE	CU	COPPER	HTG	HEATING
AC	ABOVE COUNTER OR AIR CONDITIONER	DCP	DOMESTIC WATER CIRCULATING PUMP	HTR	HEATER
ACLG	ABOVE CEILING	DEPT	DEPARTMENT	HV	HIGH VOLTAGE
ADO	AUTOMATIC DOOR OPENER	DET	DETAIL	HVAC	HEATING, VENTILATING AND AIR
AF	AMP FRAME	DIA	DIAMETER	CONDITIONING	CONDITIONING
AFF	ABOVE FINISHED FLOOR	DISC	DISCONNECT	HWP	HYDRONIC WATER PUMP
AFG	ABOVE FINISHED GRADE	DIST	DISTRIBUTION	IC	INTERRUPTING CAPACITY
AFI	ARC FAULT CIRCUIT INTERRUPTER	DN	DOWN	IG	ISOLATED GROUND
AHU	AIR HANDLING UNIT	DPR	DAMPER	IMC	INTERMEDIATE METAL CONDUIT
AL	ALUMINUM	DS	SAFETY DISCONNECT SWITCH	INCAND	INCANDESCENT
ALT	ALTERNATE	DT	DOUBLE THROW	IR	INFRARED
AMP	AMPERE	DWG	DRAWING	I/W	INTERLOCK WITH
AMPL	AMPLIFIER	DDC	DIRECT DIGITAL CONTROL	J-BOX	JUNCTION BOX
ANNUN	ANNUNCIATOR APPROX APPROXIMATELY	EC	ELECTRICAL CONTRACTOR	KV	KILOVOLT
AQ-STAT	AQUASTAT	ELEC	ELECTRIC, ELECTRICAL	KVA	KILOVOLT-AMPERE
ARCH	ARCHITECT, ARCHITECTURAL	ELEV	ELEVATOR	KVAR	KILOVOLT-AMPERE REACTIVE
AS	AMP SWITCH	EM	EMERGENCY	KW	KILOWATT
AT	AMP TRIP	EMS	ENERGY MANAGEMENT SYSTEM	KWH	KILOWATT HOUR
ATS	AUTOMATIC TRANSFER SWITCH	EMT	ELECTRICAL METALLIC TUBING	LOC	LOCATE OR LOCATION
AUTO	AUTOMATIC	EP	ELECTRIC PNEUMATIC	LT	LIGHT
AUX	AUXILIARY	EQUIP	EQUIPMENT	LTG	LIGHTING
				I .	
AV	AUDIO VISUAL	EWC	ELECTRIC WATER COOLER	LTNG	LIGHTNING
AWG	AMERICAN WIRE GAUGE	EXIST	EXISTING	LV	LOW VOLTAGE
BATT	BATTERY	EXH	EXHAUST	MAX	MAXIMUM
BD	BOARD	EXP	EXPLOSION PROOF	MAG.S	MAGNETIC STARTER
BLDG	BUILDING	FA	FIRE ALARM	M/C	MOMENTARY CONTACT
BMS	BUILDING MANAGEMENT SYSTEM	FABP	FIRE ALARM BOOSTER POWER	MC	MECHANICAL CONTRACTOR
C	CONDUIT	SUPPLY PANEL	SUPPLY PANEL	MCB	MAIN CIRCUIT BREAKER
CAB	CABINET	FACP	FIRE ALARM CONTROL PANEL	MCC	MOTOR CONTROL CENTER
CAT	CATALOG	FCU	FAN COIL UNIT	MDC	MAIN DISTRIBUTION CENTER
CATV	CABLE TELEVISION	FIXT	FIXTURE	MDP	MAIN DISTRIBUTION PANEL
СВ	CIRCUIT BREAKER	FLR	FLOOR	MFR	MANUFACTURERMAIN FUSED
CCTV	CLOSED CIRCUIT TELEVISION	FLUOR	FLUORESCENT		DISCONNECT SWITCH
CKT	CIRCUIT	FU	FUSE	MH	MANHOLE
CLG	CEILING	FUDS	FUSED SAFETY DISCONNECT SWITCH	MIC	MICROPHONE
COMB	COMBINATION	GA	GAUGE	MIN	MINIMUM
CMPR	COMPRESSOR	GAL	GALLON	MISC	MISCELLANEOUS
CONN	CONNECTION	GALV	GALVANIZED	MLO	MAIN LUGS ONLY
CONST	CONSTRUCTION	GC	GENERAL CONTRACTOR	MMS	MANUAL MOTOR STARTER
CONT	CONTINUATION OR CONTINUOUS	GEN	GENERATOR	MOA	MULTIOUTLET ASSEMBLY
CONTR	CONTRACTOR	GFI	GROUND FAULT CIRCUIT INTERRUPTER	MSP	MOTOR STARTER PANELBOARD
CONV	CONVECTOR	GFP	GROUND FAULT PROTECTOR	MSBD	MAIN SWITCHBOARD
CP	CIRCULATING PUMP	GND	GROUND	MT	MOUNT
CRT	CATHODE-RAY TUBE	GRS	GALVANIZED RIGID STEEL (CONDUIT)	MT.C	EMPTY CONDUIT
CT	CURRENT TRANSFORMER	GYP BD	GYPSUM BOARD `	UL	UNDERWRITERS LABORATORIES

Branch Panel:

Location: LIVING ROOM 8
Supply From:
Mounting: Recessed
Enclosure: Type 1

Volts: 120/240 Single
Phases: 1
Wires: 3

A.I.C. Rating:
Mains Type:
Mains Rating: 200 A
MCB Rating: 1 A

Notes:

Circuit Numb er	Circuit Description	Number of Elements	Rating	Length	Wire Size	A		i i	3	Wire Size	Length	Rating	Number of Elements	Circuit Description	Circu Num er
1	BATH GFCI	8	20 A	50' - 8 11/16"	1-#12, 1-#12, 1-#12	576 VA	180 VA			1-#14, 1-#14, 1-#14	41' - 7 7/16"	15 A	4	HALL LIGHT	2
3	KITCHEN LIGHT	8	15 A	45' - 11 21/32"	1-#14, 1-#14, 1-#14			336 VA	657 VA	1-#14, 1-#14, 1-#14	36' - 8"	15 A	10	OUTDOOR LIGHT	4
5	LIV. LIGHT	7	15 A	25' - 8 25/32"	1-#14, 1-#14, 1-#14	209 VA	900 VA			1-#12, 1-#12, 1-#12	52' - 7 7/16"	20 A	5	BED RECEPTACLE	6
7	LIV. RECEPTACLE	5	20 A	48' - 11 3/32"	1-#12, 1-#12, 1-#12			900 VA	2500 VA	2-#8, 1-#8, 1-#10	33' - 2 3/8"	50 A	1	RANGE	8
9	OVENHOOD	1	20 A	27' - 5 13/16"	1-#12, 1-#12, 1-#12	180 VA	2500 VA								10
11	DISHWASHER	1	20 A	23' - 11 25/32"	1-#12, 1-#12, 1-#12			1200 VA	1800 VA	1-#12, 1-#12, 1-#12	17' - 8 31/32"	20 A	1	REFRIGERATOR	1:
13	KITCHEN GFCI	4	20 A	35' - 0 3/4"	1-#12, 1-#12, 1-#12	720 VA	2500 VA			2-#10, 1-#10, 1-#10	35' - 9 27/32"	30 A	1	DRYER	14
15	WATER HEATER	1	30 A	35' - 3 9/32"	2-#10, 1-#10, 1-#10			2250 VA	2500 VA	I					10
17	-					2250 VA	540 VA			1-#12, 1-#12, 1-#12	44' - 11 13/16"	20 A	3	OUTDOOR GFCI	1
19	WASHING MASHEIN	1	20 A	38' - 6 7/32"	1-#12, 1-#12, 1-#12			1200 VA	2500 VA	2-#6, 1-#6, 1-#10	31' - 2 3/8"	60 A	1	CONDENSER	2
21	BED LIGHT	9	15 A	61' - 1 29/32"	1-#14, 1-#14, 1-#14	568 VA	2500 VA			ŀ					2
23															24
25															20
						13619	VA	1581	7 VA						1

Legend:

Load Classification	Connected Load	Demand Factor	Estimated Demand	Panel Totals
LIGHTING - DWELLING UNIT	800 VA	100.00%	800 VA	
OTHER	1184 VA	100.00%	1184 VA	Total Conn. Load: 29436 VA
RECEPTACLE	6000 VA	100.00%	6000 VA	Total Est. Demand: 28436 VA
LIGHTING	200 VA	100.00%	200 VA	Total Conn.: 123 A
CONDENSER	5000 VA	100.00%	5000 VA	Total Est. Demand: 118 A
WATER HEATER	4500 VA	100.00%	4500 VA	
RANGE	5000 VA	80.00%	4000 VA	
DRYER	5000 VA	100.00%	5000 VA	
REFRIGERATOR	1800 VA	100.00%	1800 VA	



KEY PLAN

NO.	DESCRIPTION	DATE

NOTE:

LEGEND:

PROJECT

56-Hamilton-746-1Bd-1Ba Spanish-550

DRAWING NAME

SCHEDULE

CLIENT NAME:	Owner
PROJECT NUMBER:	0173_12
DATE:	2/15/2025 11:55:31 AM
DESIGNED BY:	Designer
DRAWN BY:	Author
CHECKED BY:	Checker

E101

SCALE: 1/4" = 1'-0"

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ELECTRICAL NOTE

- PROVIDE INTERCONNECTED SMOKE ALARMS IN EACH SLEEPING ROOMS, OUTSIDE EACH SLEEPING ROOM, ON EACH STORY, IN THE HALL OR ADJACENT ROOM LUHERE THE CEILING HEIGHT OF A ROOM OPEN TO THE HALL EXCEEDS THE HALL BY 24'. SMOKE ALARMS SHALL BE PERMANENTLY HARD WIRED WITH BATTERY BACKUP.
- B. RECEPTACLE OUTLETS FOR RANGES AND CLOTHES DRYERS SHALL BE A THREE POLE WITH GROUND TYPE. FOUR WIRE GROUNDING-TYPE FLEXIBLE CORDS WILL BE REQUIRED FOR CONNECTION OF RANGES AND CLOTHES DRYERS. THE BONDING JUMPER SHALL NOT BE CONNECTED BETWEEN NEUTRAL TERMINAL AND THE FRAME OF THE **APPLIANCE**
- C. TWO OR MORE 20 AMP SMALL APPLIANCE CIRCUITS SHALL BE PROVIDED TO SERVE THE KITCHEN, BREAKFAST NOOK, AND DINING ROOM. SUCH CIRCUITS SHALL HAVE NO OTHER OUTLETS.
- D. AT LEAST ONE 20 AMP BRANCH CIRCUIT SHALL BE PROVIDED TO SERVICE THE LAUNDRY ROOM. THIS CIRCUIT SHALL HAVE NO OTHER OUTLETS.
- E. ALL RECEPTACLES WITH IN 6' OF A WET BAR SINK OR KITCHEN SINK TO SERVE COUNTER TOP SURFACES MUST BE GFCI. ON KITCHEN COUNTERS 12' OR WIDER NO POINT ALONG THE WALL SHALL BE MORE THAN 2' FROM A RECEPTACLE. ALL RECEPTACLES WITH IN 6' OF KITCHEN SINK MUST BE GFCI. AT LEAST ONE GFCI RECEPTACLE SHALL BE INSTALLED IN THE BATHROOM ADJACENT TO EACH BASIN.
- FIXTURES INCLUDING CEILING FANS THAT ARE LOCATED IN DAMP LOCATIONS SHALL BE LISTED TO BE SUITABLE FOR
- SUCH LOCATIONS PER 2012 IRC
- G. PROVIDE ONE (1) SWITCHED OUTLET @ ALL BEDROOMS AND DEN
- H. CEILING FANS NOT EXCEEDING 35 LBS. (WITH OR WITHOUT ACCESSORIES MAY BE SUPPORTED BY OUTLET BOXES PROVIDED THE OUTLET BOXES ARE IDENTIFIED FOR SUCH USE PER 2012 IRC
- ELECTRICAL OUTLET BOXES ON OPPOSITE SIDES OF FIRE RATED WALLS SHALL BE SEPARATED BY A HORIZONTAL DISTANCE OF NOT LESS THAN 24".
- OUTLET BOXES IN THE WALLS BETWEEN THE GARAGE AND DWELLING SHALL BE METAL OR U.L. APPROVED FIRE RESISTIVE PLASTIC. BOXES IN GARAGE CEILING SHALL BE METAL.
- K. ALL BRANCH CIRCUITS THAT SUPPLY 120 VOLTS SINGLE PHASE 15 AND 20 AMPS RECEPTACLE OUTLETS INSTALLED IN THE DWELLING SHALL BE PROTECTED BY AN ARC FAULT CIRCUIT INTERRUPTER. EXCEPT GFCI RECEPTICLES.

NOTE:

RECEPTACLES MUST BE PROVIDED IN HALLWAYS 10'-0" OR MORE IN LENGTH. FOR A ONE FAMILY DWELLINGS AND EACH OF A TWO FAMILY DWELLING THAT IS AT GRADE LEVEL, AT LEAST ONE WP-GFCI RECEPTACLE OUTLET ACCESSIBLE AT GRADE LEVEL AND NOT MORE THAN 6'-6" ABOVE GRADE SHALL BE INSTALLED AT THE FRONT AND BACK OF THE DWELLING.

NOTE: APPLIANCE DISCONNECT

E4001.5 GROUNDING OF ENCLOSURES.

METAL ENCLOSURES FOR SWITCHES OR CIRCUIT BREAKERS SHALL BE CONNECTED TO AN

EQUIPMENT GROUNDING CONDUCTOR.

METAL ENCLOSURES FOR SWITCHES OR CIRCUIT BREAKERS USED AS SERVICE EQUIPMENT SHALL COMPLY WITH THE PROVISIONS OF SECTION E3609.4. WHERE

NONMETALLIC ENCLOSURES ARE USED WITH METAL RACEWAYS OR METAL-ARMORED


CABLES, PROVISIONS SHALL BE MADE FOR CONNECTING THE EQUIPMENT GROUNDING


CONDUCTOR.

NONMETALLIC BOXES FOR SWITCHES SHALL BE INSTALLED WITH A WIRING METHOD THAT


PROVIDES OR INCLUDES AN EQUIPMENT GROUNDING CONDUCTOR. (404.12)

ELECTRICAL LEGEND Electrical Lights With Fan Recessed Spot Light 0 **Recessed Can Light −**Ø Wall Mounted Light Smoke and heat detector Single Switch ₩ ₩ **Three way Switch** ₩. Fan Switch **Three way with Dimmer Switch** \ominus **Duplex Receptacle Triplex Receptacle GFCI Receptacle** Exhaust Fan

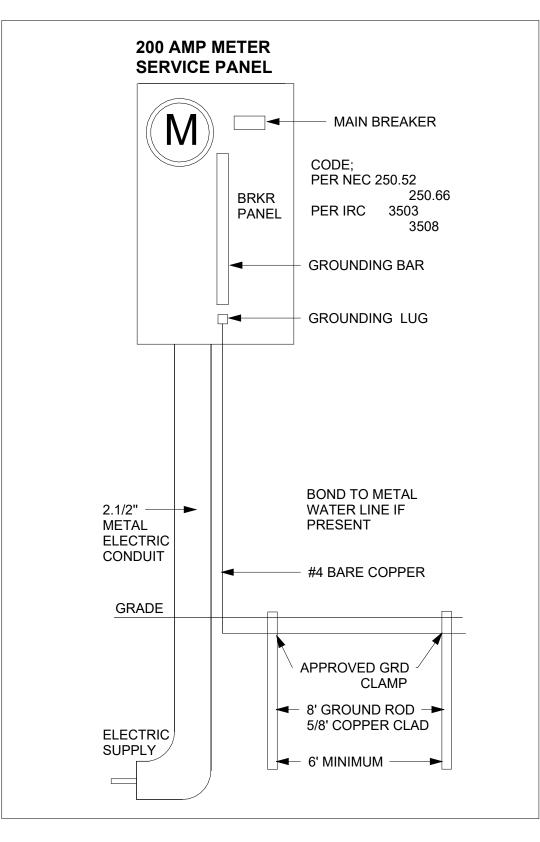

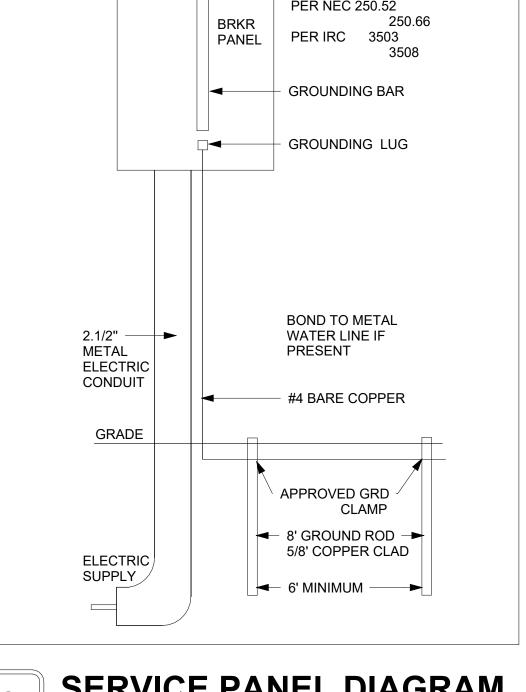



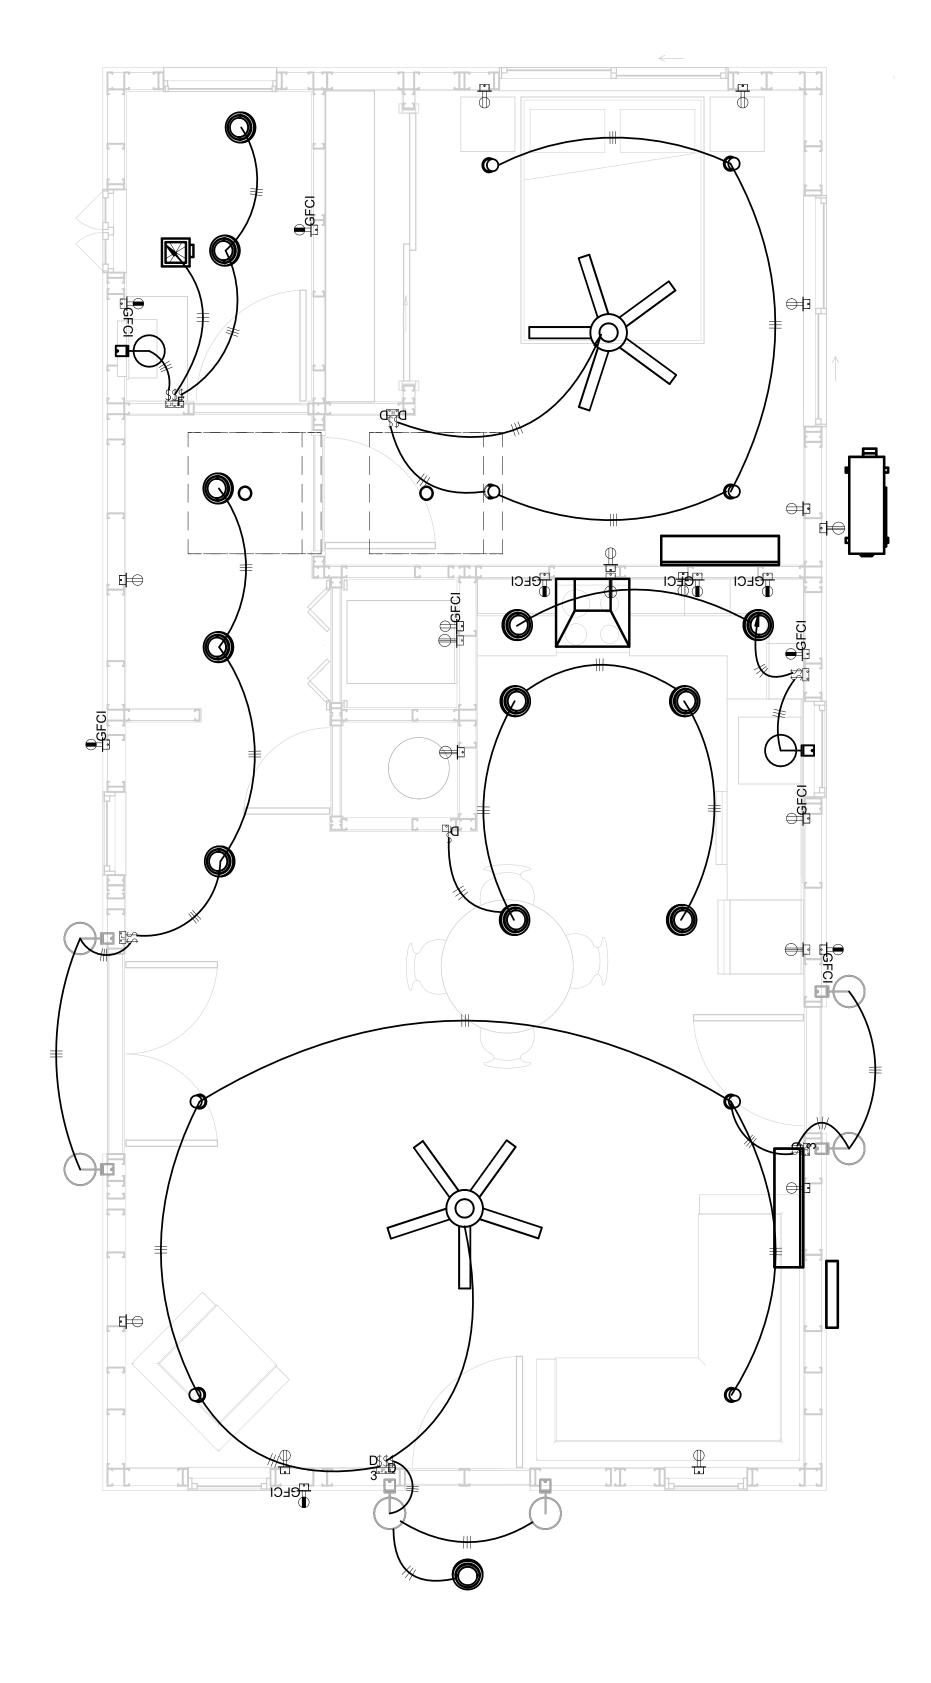



KEY PLAN

NO.	DESCRIPTION	DATE

NOTE:

LEGEND:

PROJECT

56-Hamilton-746-1Bd-1Ba Spanish-550

DRAWING NAME


LIGHTING

Owner	CLIENT NAME:
0173_12	PROJECT NUMBER:
2/15/2025 11:55:33 AM	DATE:
Designer	DESIGNED BY:
Author	DRAWN BY:
Checker	CHECKED BY:


E102

NOTES: CONDUIT, CABLE AND WIRING


- Use Metalic Conduits (IMC) for cables running under concrete slabs.
 Use IMC for circuits with high voltage appliances (240 volts and above)
 For circuits with 120 volts consider using EMT or PVC conduits if needed.
 For Low voltage applications up to 50 volts consider using non metalic conduits.
 All conduits to be used in the project must conform to the latest National Electrical Code (NEC),
- 6. All wiring and cables to be used in the project must also conform to the latest National Electrical Code (NEC), 2015.
 7. All cables and wires used should be rated for their respective loading and should be gauged and
- conform to the NEC.

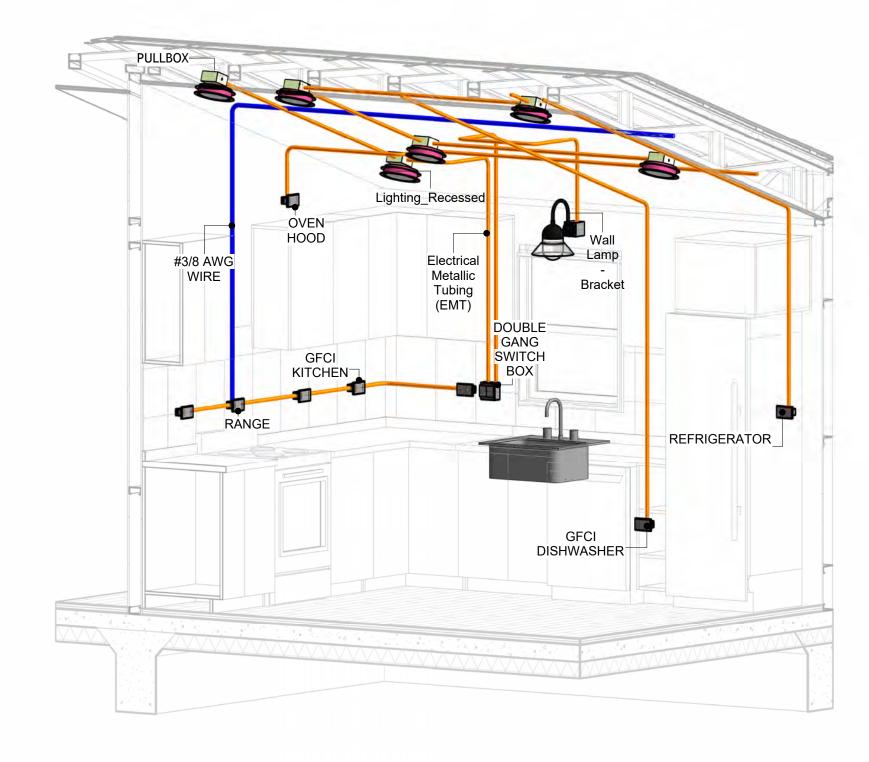


3D-KITCHEN

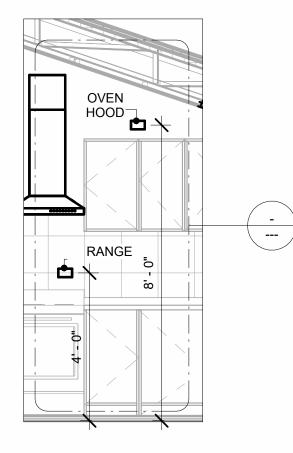


Section 1 3/8" = 1'-0"

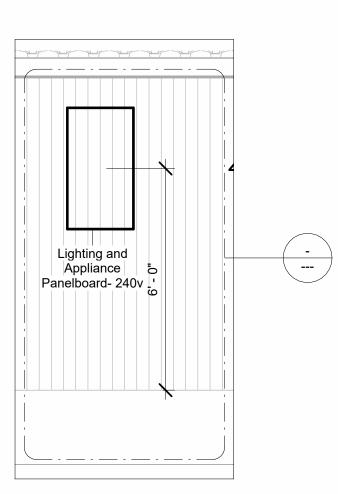

Section 3 3/8" = 1'-0"

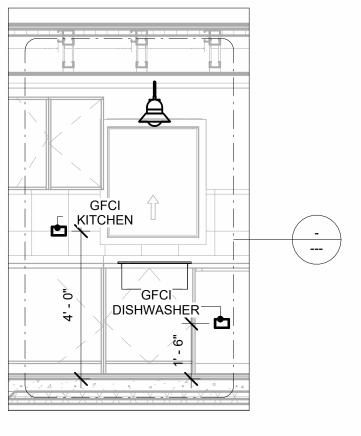


Section 2 3/8" = 1'-0"

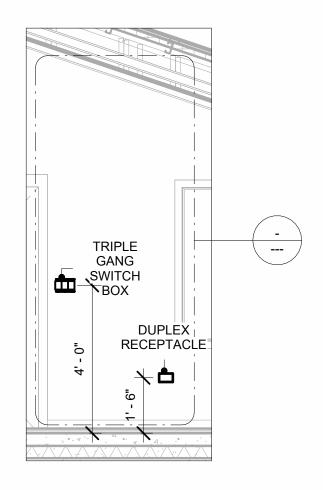

Section 4 3/8" = 1'-0"



KEY PLAN

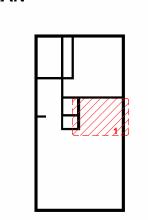

NO.	DESCRIPTION	DATE

NOTE:

LEGEND:

PROJECT

56-Hamilton-746-1Bd-1Ba Spanish-550

DRAWING NAME

POWER

CLIENT NAME:	Owner
PROJECT NUMBER:	0173_12
DATE:	2/15/2025 11:55:57 AM
DESIGNED BY:	Designer
DRAWN BY:	Author
CHECKED BY:	Checker

E103

NOTES: LIGHT

- 1. LIGHT FIXTURES AND LUMINARIES SHALL CONFORM TO THE NEC, THE IRC AND LOCAL SAFETY & BUILDING CODE.
- 2. ALL LIGHTING FIXTURES SHOULD CONFORM TO THE DESIGN ELECTRICAL LOAD AND SHALL BE PROPERLY WIRED AND MOUNTED BY QUALIFIED ELECTRICIAN FOLLOWING MANUFACTURERS SPECIFICATIONS.
- 3. CEILING FANS AND FANS WITH LIGHT WITH WEIGHT EXCEEDING 35 LBS SHOULD BE PROVIDED WITH STRUCTURAL BACKING FOR SUPPORT AND SHALL BE FIXED AS PER MANUFACTURERS SPECIFICATIONS.
- 4. EXTERIOR LIGHTS SHALL CONFORM TO LOCAL BUILDING CODE AND GUIDELINES.

NOTES: SWITCH JUNCTION BOX


- 1. THE MINIMUM SIZE OF JUCTION BOX TO BE USED IS 2"X4"X(1.5" OR 3.5" DEEP) THIS ARE TO BE USED FOR SINGLE GANG SWITCH OR OUTLETS.
- 2. FOR DOUBLE GANG (2 GANG) OUTLETS AND SWITCHS THE MINIMUM SIZE OF THE
- JUCTION BOX TO BE PROVIDED SHALL NOT BE LESS THAN 4"X4"X(1.5" OR 3.5" DEEP)
- 3. FOR THREE GANG (3 GANG) OUTLETS AND SWITCHS THE MINIMUM SIZE OF THE JUĆTION BOX SHALL NOT BE LESS THAN 6"X4"X(1.5" OR 3.5" DEEP).

FITTING SCHEDULE(PULL BOX)			
FAMILY COUNT		DESCRIPTION	
PULLBOX1	24	#1/4 PULLBOX	

ELECTRICAL FIXTURE SCHEDULE (SWITCH BOX)		
TYPE	COUNT	
DOUBLE GANG SWITCH BOX	4	
SINGLE GANG SWITCH BOX	1	
TRIPLE GANG SWITCH BOX	2	

LIGHTING DEVICE		
TYPE	COUNT	
DIMMER	4	
FAN SWITCH	1	
SINGLE POLE	8	
THREE WAY WITH DIMMER	2	

LIGHTING FIXTURE				
LIGHTING FIXTURE TYPE	VOLTAGE	ELECTRICAL LOAD	COUNT	
ELECTRICAL_LIGHTS_FAN-LIGHT1	120 V/1-100 VA- 120 V/1-100 VA	200 A, 120 V/240 V, SINGLE PHASE, 3 WIRES	2	
LIGHTING_RECESSED	120 V/1-60 VA	<varies></varies>	12	
SASSO 100 ROUND WALLWASHER TRIM	120 V/1-28 VA	200 A, 120 V/240 V, SINGLE PHASE, 3 WIRES	8	
WALL LAMP - BRACKET	120 V/1-100 VA	200 A, 120 V/240 V, SINGLE PHASE, 3 WIRES	8	

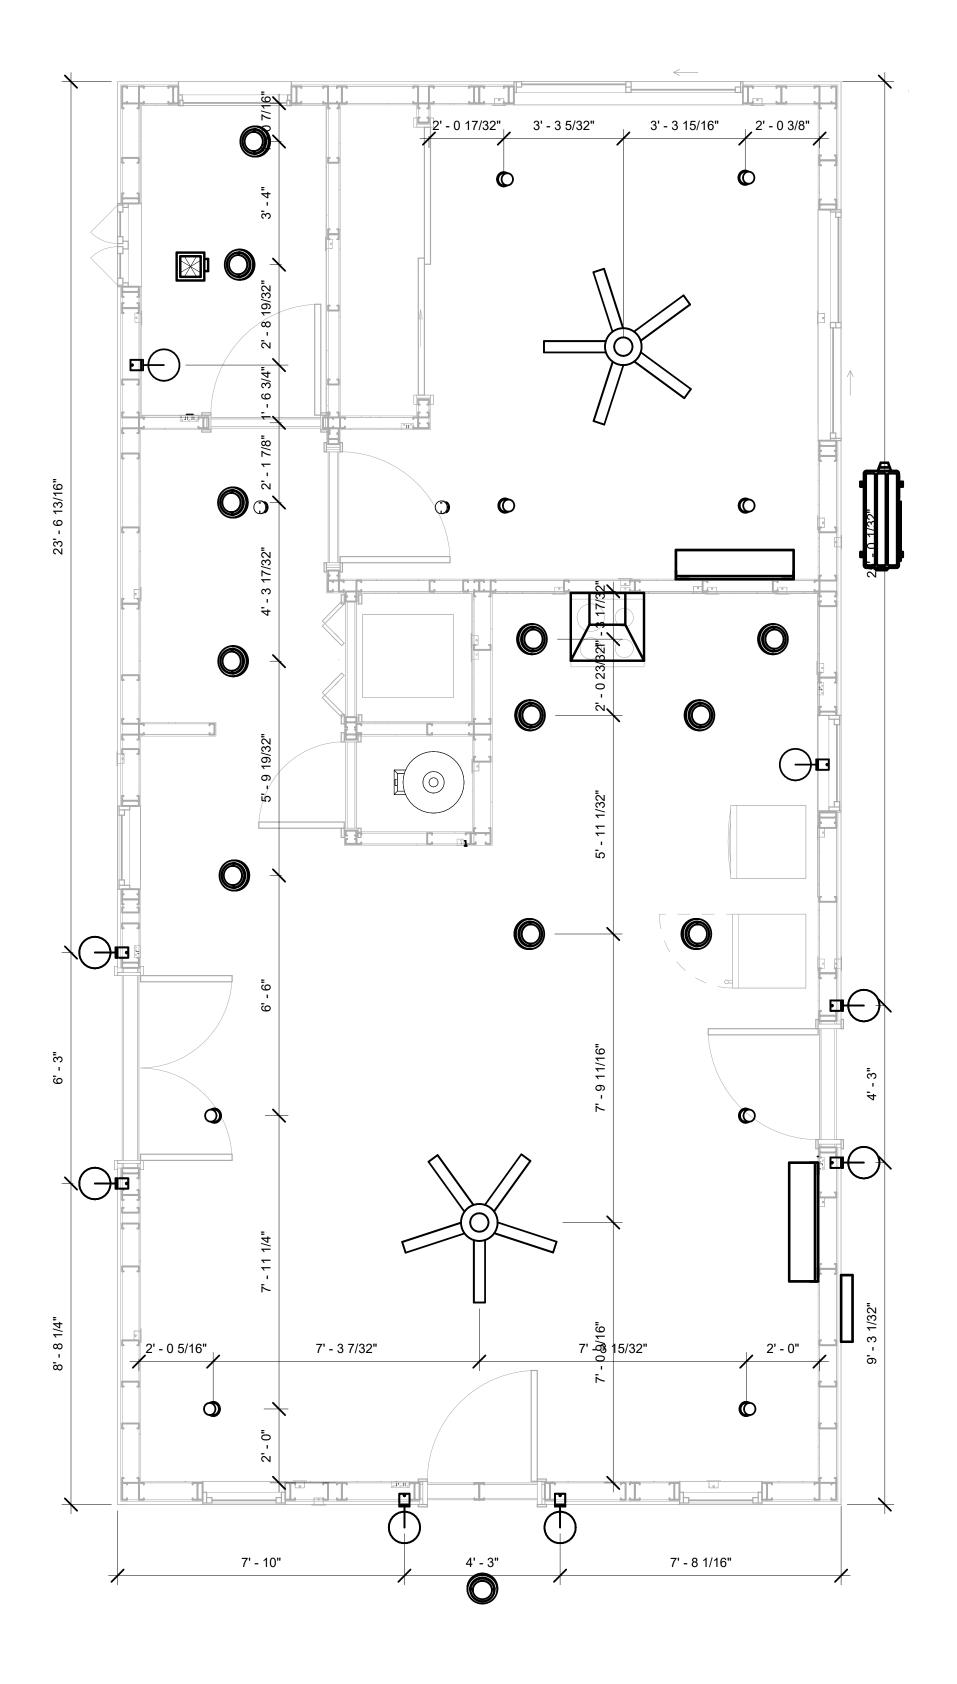

DIMENSION FOR LIGHT FIXTURES



KEY PLAN

NO.	DESCRIPTION	DATE

NOTE:

LEGEND:

PROJECT

56-Hamilton-746-1Bd-1Ba Spanish-550

DRAWING NAME

DIMENSION PLAN FOR LIGHT FIXTURES

CLIENT NAME:	Owner
PROJECT NUMBER:	0173_12
DATE:	2/15/2025 11:55:59 AM
DESIGNED BY:	Designer
DRAWN BY:	Author
CHECKED BY:	Checker

E104


NOTES;

REFRIGERATOR WATER HEATER

- 1. VERIFY EQUIPMENT PLUG CONFIGURATION BEFORE PURCHASING RECEPTACLES 2. FOR ALL EQUIPMENT.
- 3. COORDINATE EXACT LOCATION OF LIGHT FIXTURES, WALL SWITCHES, RECEPTACLES AND OTHER DEVICES WITH ARCHITECTURAL DRAWINGS. 4. USE METALLIC JUNCTION BOX WITH THE GFCI RECEPTACLES, WITH HIGHT VOLTAGE.

ELECTRICAL FIXTURE SCHEDULE (RECEPTACLE)			
TYPE	COUNT		
CONDENSER	1		
DRYER	1		
DUPLEX RECEPTACLE	10		
GFCI BATH ROOM	2		
GFCI DISHWASHER	1		
GFCI KITCHEN	4		
GFCI OUT DOOR	3		
GFCI WASHER	1		
OVEN HOOD	1		
RANGE	1		

ELECTRICAL OUTLET SCHEDULE				
TYPE	CIRCUIT NUMBER	ELECTRICAL DATA	COUNT	
GFCI BATH ROOM	1	120 V/1-180 VA	2	
DUPLEX RECEPTACLE	6	120 V/1-180 VA	5	
DUPLEX RECEPTACLE	7	120 V/1-180 VA	5	
RANGE	8,10	240 V/2-5000 VA	1	
OVEN HOOD	9	120 V/1-180 VA	1	
GFCI DISHWASHER	11	120 V/1-1200 VA	1	
REFRIGERATOR	12	120 V/1-1800 VA	1	
GFCI KITCHEN	13	120 V/1-180 VA	4	
DRYER	14,16	240 V/2-5000 VA	1	
WATER HEATER	15,17	240 V/2-4500 VA	1	
GFCI OUT DOOR	18	120 V/1-180 VA	3	
GFCI WASHER	19	120 V/1-1200 VA	1	
CONDENSER	20,22	240 V/2-5000 VA	1	

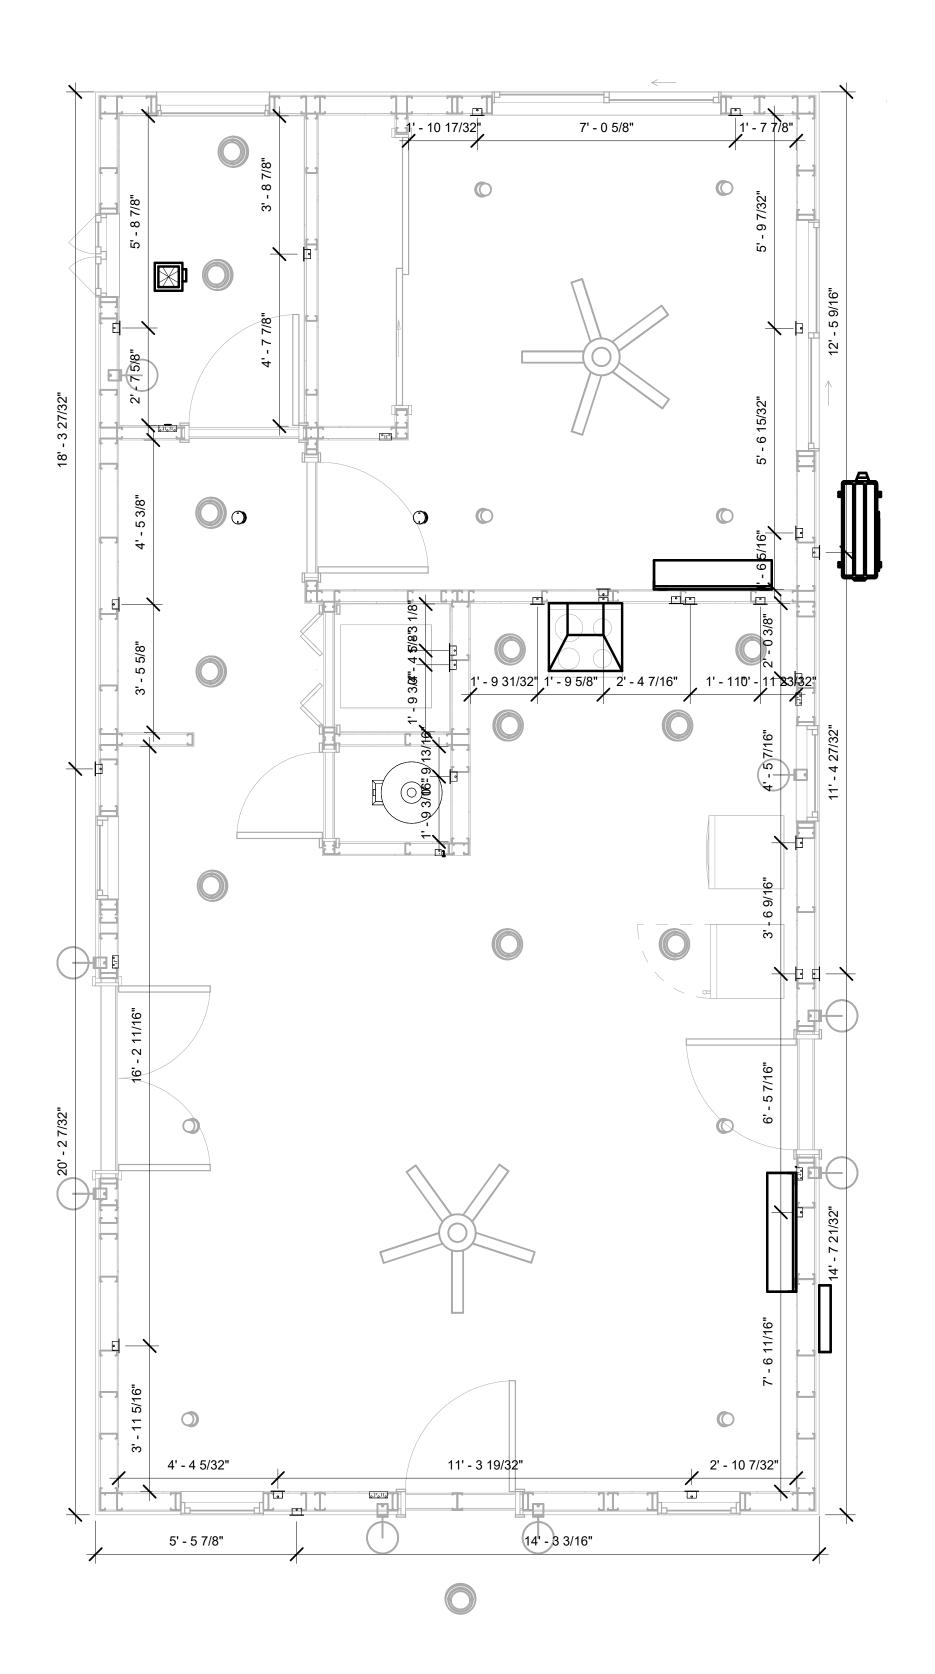

DIMENSION FOR FITTINGS 3/8" = 1'-0"



KEY PLAN

NO.	DESCRIPTION	DATE

NOTE:

LEGEND:

PROJECT

56-Hamilton-746-1Bd-1Ba Spanish-550

DRAWING NAME

DIMENSION PLAN FOR FITTINGS

Owner	CLIENT NAME:
0173_12	PROJECT NUMBER:
2/15/2025 11:56:00 AN	DATE:
Designer	DESIGNED BY:
Author	DRAWN BY:
Checker	CHECKED BY:

E105

SHEET LIST

SHEET NUMBER SHEET NAME

P101 NOTE AND SCHEDULE
P102 WATER SUPPLY AND SEWAGE
SYSTEM

PIPE COLO	R SCHEME
	DOMESTIC COLD WATER DOMESTIC HOT WATER
	SANITARY VENT
	SANITARY SEWER
	STORM DRAINAGE
	GRAY WATER
	GAS LINE

PLUMBING NOTES

- . THE PLUMBING SYSTEM IS DESIGNED TO MEET THE BUILDING'S DOMESTIC WATER SUPPLY, SANITARY DRAINAGE, AND STORM DRAINAGE REQUIREMENTS, AS PER PROJECT SPECIFICATIONS AND APPLICABLE CODES.
- THE SYSTEM INSTALLATION SHALL COMPLY WITH THE LATEST INTERNATIONAL PLUMBING CODE (IPC), INTERNATIONAL RESIDENTIAL CODE (IRC), AND ALL OTHER RELEVANT LOCAL, STATE, AND NATIONAL REGULATIONS.
- ALL PLUMBING WORK SHALL COMPLY WITH THE LATEST EDITION OF THE INTERNATIONAL PLUMBING CODE (IPC) AND THE LOCAL PLUMBING CODE.
- 4. PLUMBING SYSTEMS SHALL BE TESTED AND INSPECTED IN ACCORDANCE WITH THE LOCAL PLUMBING CODE REQUIREMENTS.
- 5. PLUMBING FIXTURES SHALL BE INSTALLED WITH THE APPROPRIATE TRIM, FITTINGS, AND ACCESSORIES, AS RECOMMENDED BY THE MANUFACTURER.
- 6. PIPING SHALL BE PROPERLY SUPPORTED AND SECURED TO PREVENT SAGGING, MOVEMENT, AND VIBRATION.
- 7. SHUT-OFF VALVES SHALL BE PROVIDED AT ALL BRANCH CONNECTIONS AND AT THE
- INLET AND OUTLET OF EACH PIECE OF EQUIPMENT.
 8. BACKFLOW PREVENTION DEVICES SHALL BE INSTALLED AS REQUIRED BY THE LOCAL PLUMBING CODE TO PROTECT THE POTABLE WATER SYSTEM.
- 9. PLUMBING FIXTURES AND EQUIPMENT SHALL BE ACCESSIBLE FOR MAINTENANCE AND SERVICING
- 10. EXPOSED PLUMBING PIPING AND FIXTURES SHALL BE INSULATED TO PREVENT CONDENSATION AND ENERGY LOSS.
- 11. DEAD ENDS IN THE DRAINAGE SYSTEM MUST BE AVOIDED, EXCEPT WHERE NECESSARY TO INSTALL A CLEANOUT IN AN ACCESSIBLE LOCATION, AND MUST HAVE A VENTED CONNECTION TO THE OUTSIDE ATMOSPHERE.
- 12. THE VERTICAL DEFLECTION OF PVC PIPE MUST NOT EXCEED 5%, AND NO DEFLECTION IS PERMITTED FOR IRON PIPE.
- 13. WORK MUST BE PROPERLY COORDINATED WITH OTHER TRADES TO AVOID CONFLICTS, REFERRING TO THE ARCHITECTURAL AND STRUCTURAL DRAWINGS FOR INFORMATION REGARDING CEILING ELEVATIONS, SPACE CLEARANCES, WALL AND PARTITION LOCATIONS, ETC.
- 14. ALL FIXTURES SHALL HAVE ACCESSIBLE STOPS.
- 15. DOMESTIC WATER PIPING SHALL BE PEX, AND PVC PIPING IS NOT ACCEPTABLE FOR INTERIOR USE.
- 16. VENT TERMINATIONS SHALL BE LOCATED AT LEAST 10 FEET FROM OR 3 FEET ABOVE ANY OPERABLE WINDOW, DOOR OPENING, AIR INTAKE, OR VENT SHAFT, AND AT LEAST 3 FEET IN EVERY DIRECTION FROM ANY LOT LINE, ALLEY, OR STREET.
- 17. PIPE AND FITTINGS UTILIZED IN THE WATER SUPPLY SYSTEM SHALL HAVE A MAXIMUM OF 8 PERCENT LEAD.
- 18. ACRYLONITRILE BUTADIENE STYRENE (ABS) SHALL BE USED FOR THE SEWERAGE AND
- VENTILATION SYSTEM.

 19. CROSS-LINKED POLYETHYLENE (PEX) SHALL BE USED FOR THE WATER SUPPLY SYSTEM.
- 20. POLYVINYL CHLORIDE (PVC) SHÀLL BÉ USED FOR THE RAIN WATER SYSTEM.
- 21. THE MIMIMUM WATER SUPPLY DEPTH UNDER FLOOR FINISH SHOUD BE 1/2".
- 22. ANY PIPE INSTALLED UNDERGROUND MUST HAVE AT LEAST 12 INCHES OF CLEARANCE BETWEEN THE OUTSIDE OF THE PIPE AND ANY OTHER UNDERGROUND STRUCTURE.
- 23. THE MINIMUM CLEARANCE BETWEEN COLD AND HOT WATER LINES IN RESIDENTIAL HOMES MAINTAIN A MINIMUM DISTANCE OF 6 INCHES.
- 24. HORIZONTAL SEPARATION BETWEEN WATER AND SEWER LINES: A MINIMUM OF 12 INCHES BETWEEN POTABLE WATER SUPPLY LINES (COLD AND HOT WATER) AND SANITARY SEWER LINES.

ABBREVIATIONS

Ø	DIAMETER
ABS	ACRYLONITRILE BUTADIENE STYRENE
ABV	ABOVE
AD	AREA DRAIN
AFF	ABOVE FINISHED FLOOR
ALT	ALTERNATE
BFF	BELOW FINISHED FLOOR
BLW	BELOW
CO	CLEAN OUT
CW	COLD WATER
D	DEGREE
DFU	DRANAGE FIXTURE UNIT
DIA	DIAMETER
DN	DOWN
FCO	FLOOR CLEAN OUT
FD	FLOOR DRAIN
FL	FLOOR
FS	FLOOR SINK
FT	FOOT/FEET
HB	HOSE BIB
HW	HOT WATER
IN	INCH
MIN	MINIMUM
NO	NUMBER
NTS	NOT TO SCALE
PEX	CROSS-LINKED POLYETHYLENE
PLBG	PLUMBING
PVC	POLYVINYL CHLORIDE
QTY	QUANTITY
RD	ROOF DRAIN
RED	REDUCER
RM	ROOM
RW	RAIN WATER
SF	SQUARE FOOT
V	VENT
VTR	VENT THROUGH ROOF
W	WASTE
WCO	WALL CLEAN OUT
WSFU	WATER SUPPLY FIXTURE UNIT

PLUMBING LEGEND

D	CAP
	BEND 45 DEG
B	BEND 90 DEG
	TEE REDUCING
	TEE
	CLEAN TWO-WAY
	WYE 45 DEG
	WYE 45 DEG DOUBLE
	WYE COMBINATION
	P-TRAP

PIPE SCHEDULE					
MATERIAL	DIAMETER	LENGTH			
ACRYLONITRILE BUTADIENE STYRENE (ABS)	1 1/2"	52 FT			
ACRYLONITRILE BUTADIENE STYRENE (ABS)	2"	17 FT			
ACRYLONITRILE BUTADIENE STYRENE (ABS)	3"	37 FT			
CROSS-LINKED POLYETHYLENE (PEX)	1/2"	99 FT			
CROSS-LINKED POLYETHYLENE (PEX)	3/4"	42 FT			
CROSS-LINKED POLYETHYLENE (PEX)	1"	3 FT			
POLYVINYL CHLORIDE - RIGID	2"	60 FT			

F	FITTING SCHEDULE				
FITTING	SIZE	QTY			
DOMESTIC COLD WATER	T				
PEX 90 DEGREE ELBOW	1/2"ø-1/2"ø	12			
PEX 90 DEGREE ELBOW	3/4"ø-3/4"ø	3			
PEX TEE ELBOW	1/2"ø-1/2"ø-1/2"ø	3			
PEX TEE ELBOW	3/4"ø-3/4"ø-3/4"ø	4			
PEX TRANSITION ELBOW	1"ø-3/4"ø	1			
PEX TRANSITION ELBOW	3/4"ø-1/2"ø	5			
DOMESTIC HOT WATER					
PEX 90 DEGREE ELBOW	1/2"ø-1/2"ø	13			
PEX 90 DEGREE ELBOW	3/4"ø-3/4"ø	2			
PEX TEE ELBOW	1/2"ø-1/2"ø	2			
PEX TEE ELBOW	3/4"ø-3/4"ø-3/4"ø	2			
PEX TRANSITION ELBOW	3/4"ø-1/2"ø	3			
RAIN WATER PVC 90 DEG BEND ELBOW	2"ø-2"ø	24			
SEWAGE					
ABS 90 DEGREE BEND ELBOW	3"ø-3"ø	4			
ABS P-TRAP	1 1/2"ø-1 1/2"ø	3			
ABS P-TRAP	2"ø-2"ø	2			
ABS P-TRAP	3"ø-3"ø	1			
ABS REDUCER ELBOW	2"ø-1 1/2"ø	1			
ABS REDUCER ELBOW	3"ø-1 1/2"ø	4			
ABS REDUCER ELBOW	3"ø-2"ø	2			
ABS TEE ELBOW	1 1/2"ø-1 1/2"ø-1 1/2"ø	3			
ABS TEE ELBOW	2"ø-2"ø-2"ø	2			
ABS TEE ELBOW	3"ø-3"ø	6			
\/_NIT					
VENT	1 1/2"~	F			
ABS VENT CAP ELBOW	1 1/2"ø	5			
ABS VENT CAP ELBOW	2"ø	1			

FIXTURE CONNECTION SCHEDULE

NOTES

W V TRAP CW HW QTY DFU TOT. WFU TOT.

FAMILY

						-					
DISHWASHER	2"	1-1/2"	1-1/2"	1/2"	1/2"	1		0			DRAIN TO SEWER SEE PLANS
DRYER	N/A	N/A	N/A	N/A	N/A	1		0			
SHOWER TRAY2						1		0			
SHOWER TRIM	-	-	-	1/2"	1/2"	1		0			
SINK ISLAND SINGLE1						1		0			
VANITY SINK2	2"	1-1/2"	1-1/2"	1/2"	1/2"	1		0			
WASHER	2"	1-1/2"	2"	1/2"	1/2"	1	2	2	1.4	1.4	DRAINS TO GRAY WATER OR SEWER SEE PLANS
WATER CLOSET2						1		0			
WATER HEATER	N/A	N/A	N/A	3/4"	3/4"	1		0			

FIXTURE SCHEDULE					
FIXTURE QTY DESCRIPTION					
DISHWASHER	1	DRAIN TO SEWER SEE PLANS			
DRYER	1				
SHOWER TRAY2	1				
SHOWER TRIM	1				
SINK ISLAND SINGLE1	1				
VANITY SINK2	1				
WASHER	1	DRAINS TO GRAY WATER OR SEWER SEE PLANS			
WATER CLOSET2	1				
WATER HEATER	1				

ACCESSORIES & FITTINGS SCHEDULE						
FIXTURE	QTY	DESCRIPTIONS				
DISHWASHER SUPPLY SINGLE CONNECTOR	1					
DISHWASHER CONNECTOR	1					
DISHWASHER CONNECTOR SINGLE	1					
HANGING PIPES CLAMP	16					
HOSE BIB	1					
SHUTOFF VALVE	6					

PLUMBING SCHEDULE							
	' -	OWIDII 10 C	OHEDOLL				
FIXTURE	TRAP	WASTE	VENT	C.W	H.W		
DISHWASHER	1-1/2"	2"	1-1/2"	1/2"	1/2"		
DRYER	N/A	N/A	N/A	N/A	N/A		
HANGING PIPES CLAMP							
SHOWER TRAY2							
SHOWER TRIM	-	-	-	1/2"	1/2"		
SINK ISLAND SINGLE1							
VANITY SINK2	1-1/2"	2"	1-1/2"	1/2"	1/2"		
WASHER	2"	2"	1-1/2"	1/2"	1/2"		
WATER CLOSET2							
WATER HEATER	N/A	N/A	N/A	3/4"	3/4"		

WATER FIXTURE UNIT SCHEDULE					
FAMILY	QTY	UNIT VALUE	TOTAL		
DISHWASHER	1		0		
DRYER	1		0		
SHOWER TRAY2	1		0		
SHOWER TRIM	1		0		
SINK ISLAND SINGLE1	1		0		
VANITY SINK2	1		0		
WASHER	1	1.4	1.4		
WATER CLOSET2	1		0		
WATER HEATER	1		0		

WASTE FIXTURE UNIT SCHEDULE						
FAMILY	QTY	DFU VALUES	TOTAL			
DISHWASHER	1		0			
DRYER	1		0			
SHOWER TRAY2	1		0			
SHOWER TRIM	1		0			
SINK ISLAND SINGLE1	1		0			
VANITY SINK2	1		0			
WASHER	1	2	2			
WATER CLOSET2	1		0			
WATER HEATER	1		0			



KEY PLAN

NO. DESCRIPTION DATE

NOTE:

LEGEND:

PROJECT

56-Hamilton-746 1Bd-1Ba-Spanish-550

DRAWING NAME

NOTE AND SCHEDULE

 CLIENT NAME:

 PROJECT NUMBER:
 0173_12


 DATE:
 2/15/2025 12:29:02 PM

 DESIGNED BY:
 Designer

 DRAWN BY:
 Author


 CHECKED BY:
 Checker

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KEY PLAN

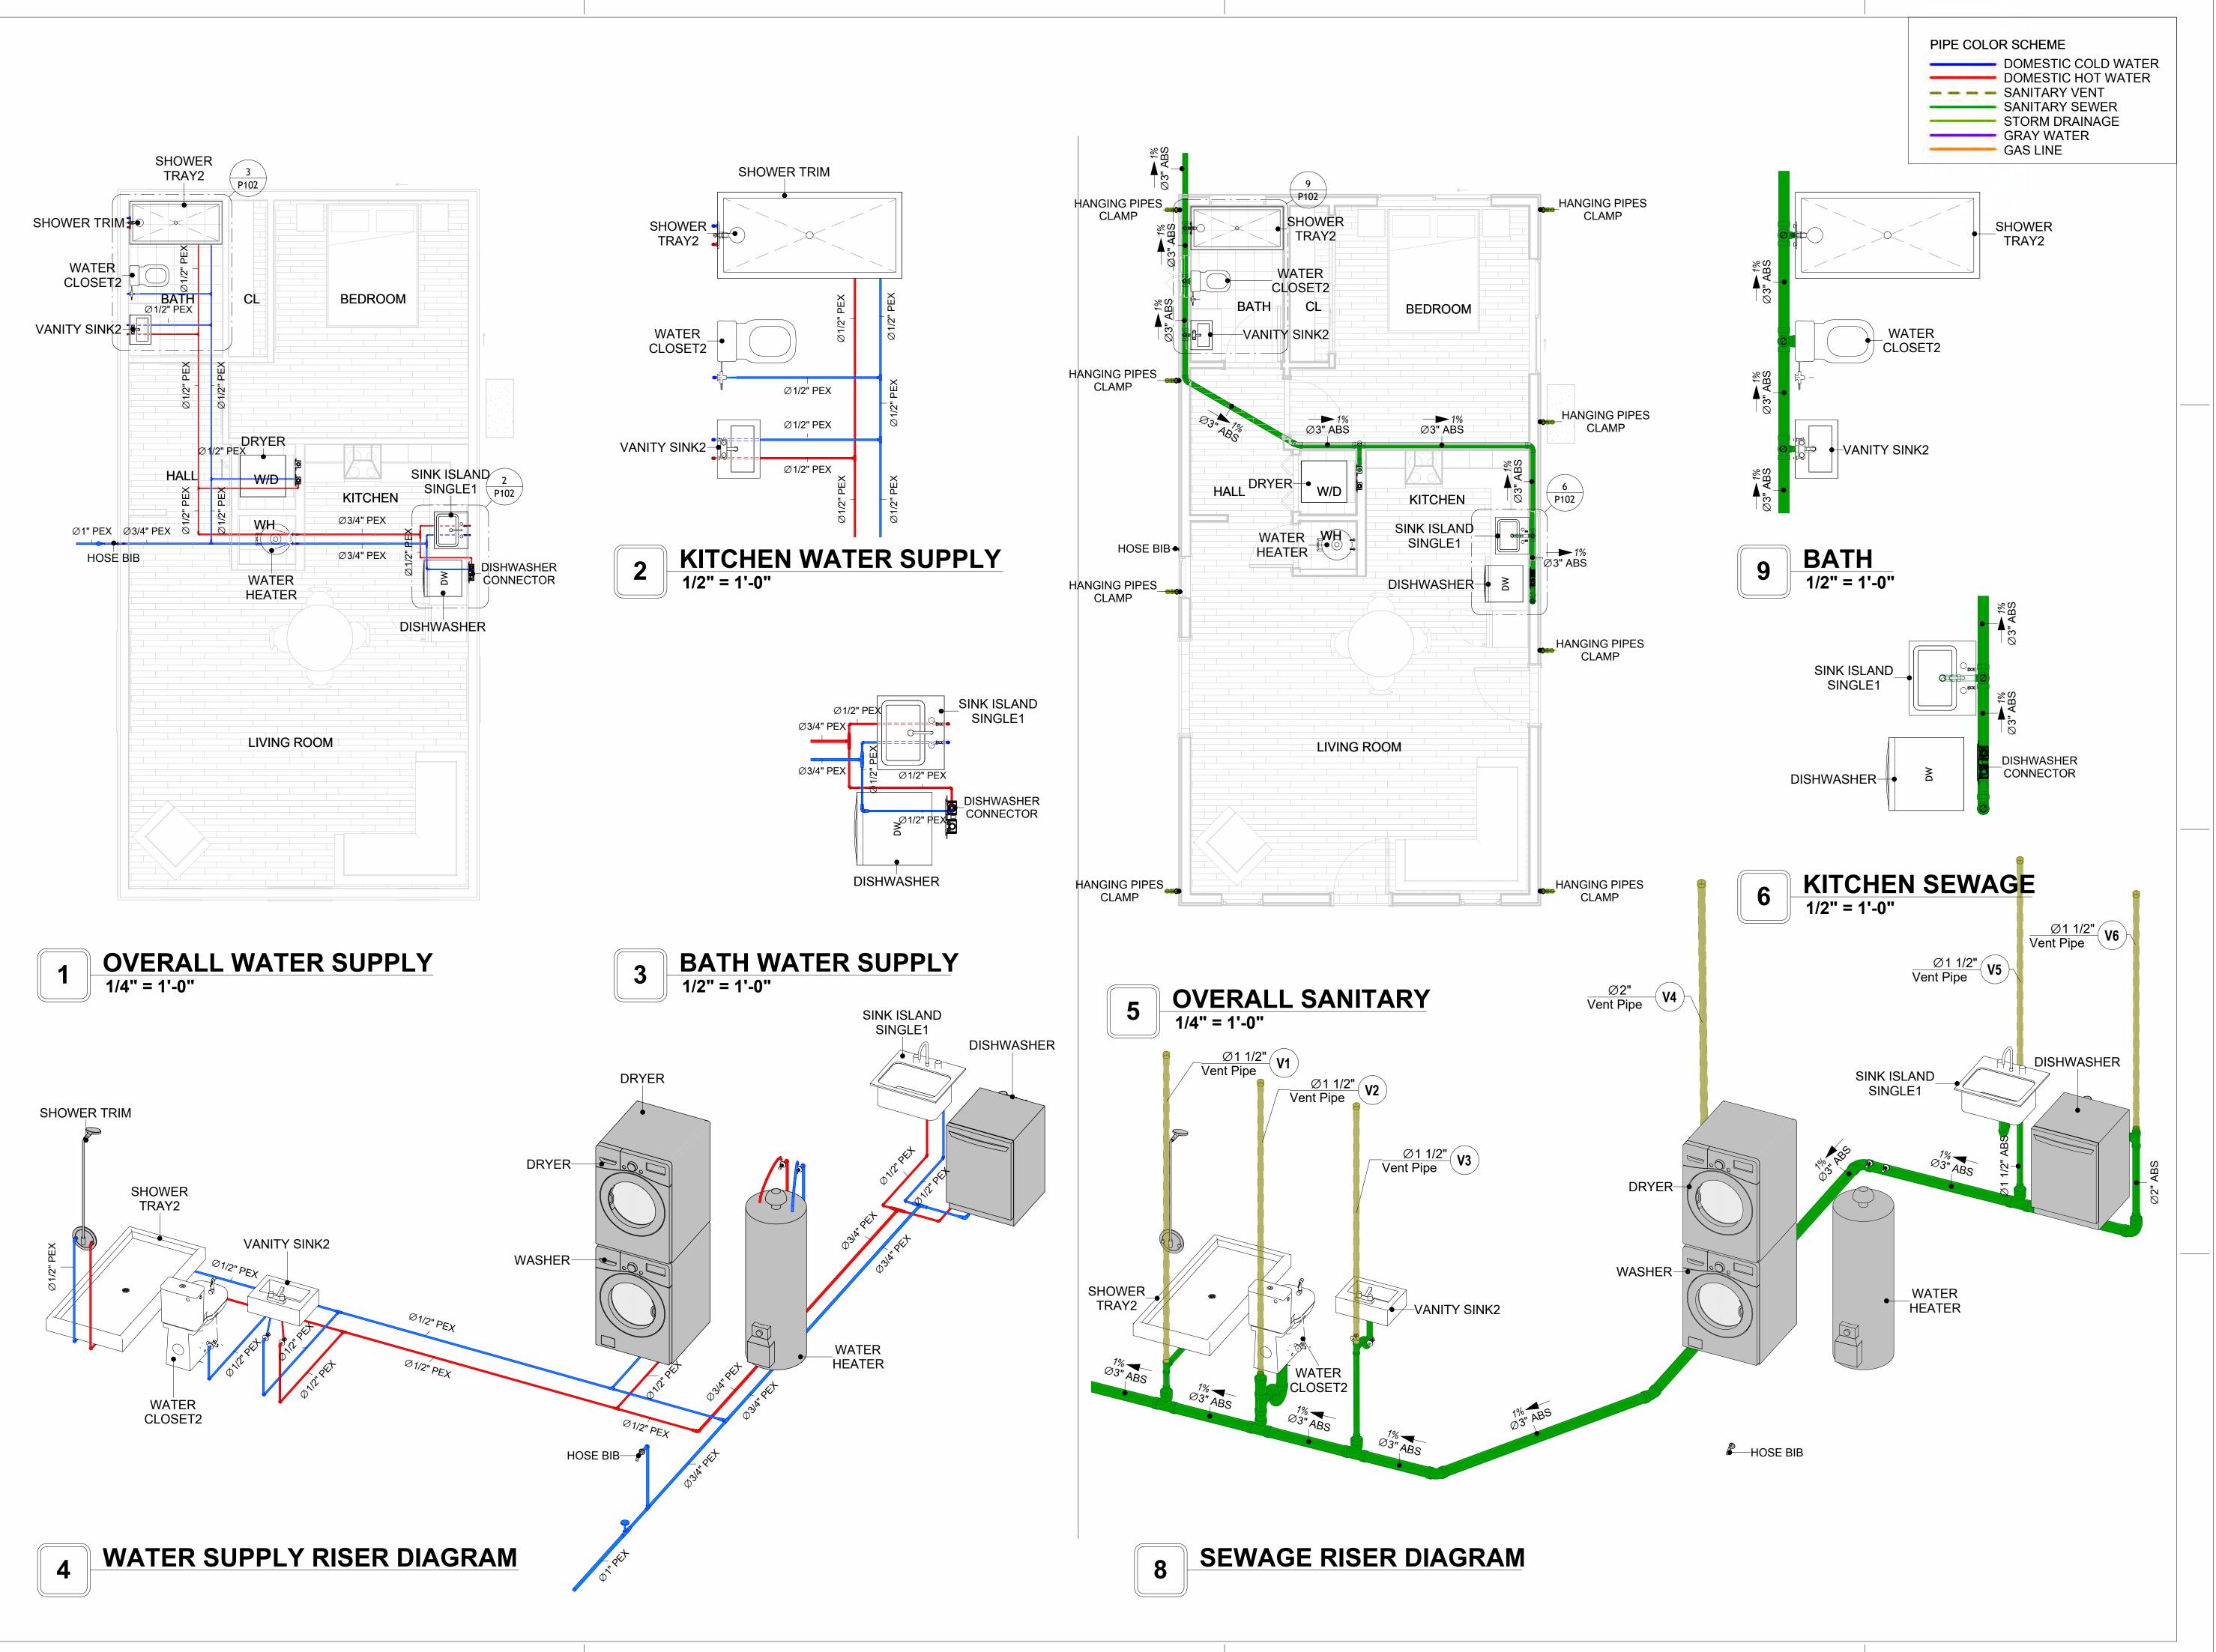

NO.	DESCRIPTION	DATE

NOTE:

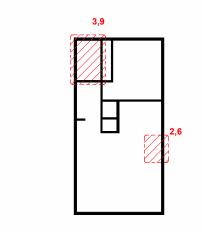LEGEND:

PROJECT

56-Hamilton-746 1Bd-1Ba-Spanish-550

DRAWING NAME

WATER SUPPLY AND SEWAGE SYSTEM

CLIENT NAME:	
PROJECT NUMBER:	0173_12
DATE:	2/15/2025 12:29:32 PM
DESIGNED BY:	Designer
DRAWN BY:	Author
CHECKED BY:	Checker

P102

Materials Shopping List

Please print and take this Materials Shopping List to your favorite Home Depot and ask for assistance in selecting the materials, fixtures and fittings to complete your new home.

Record your selection and the price of the item. Then do the math to determine the cost for your selections and the total cost of finishing your home.

Have It Your Way!

The material types listed in this document were selected based on personal preferences. The Customer is encouraged to make changes to the material types in accordance with local customs, regulations, and personal preferences.

Have It Your Way!



20 good reasons to frame a home with metal and not wood



Why build your ADU with metal vs wood	Wood	Metal	Explanation
1 DIY Construction Benefit		~	The wall frames, trusses and beams can be erected in a just a few days
2 Minimal Construction Skills Required		~	Pre-assembled walls and trusses require no specialized skills to errect
3 Build as DIY, Hybrid or by a General Contractor		~	Do it yourself, Hybrid (involve special contractors) or hire a General Contractor
4 Build It As You Can Afford It		~	Impervious to Weather - build as you have the time and money
5 Up Front Cost of Framing Materials	~		As to only the framing material, wood is less expensive
6 Total Cost To Build		~	Savings in time, labor, and other areas make light gauge steel LESS expensive
7 Termites and wood boring insects		~	Termites, carpenter ants and wood boring insects eat wood, not metal
8 Mold resistant		~	Metal does not attract mold
9 Damage caused by exterior and interior flooding		~	Metal needs no reconditioning after a flood
10 Fire Resistant		~	Non-combustible
11 Lower insurance rates		~	Many insurance underwriters now provide lower rates for metal framed homes
12 Walls, trusses, and beams retain their original form		~	Perfectly straight walls - no shimming of drywall
13 Corners are 90 degrees		~	No need for templating of countertops to adjust for out of square corners
14 Strength and weight		~	Metal is stronger than wood and weighs less - no need for crane to lift ADU trusses
15 IBC Engineered Stamp		~	If an engineering stamp is necessary, months of waiting are saved
16 Complete BOM (Materials Shopping List)		~	Take the materials shopping list to Home Depot and start shopping/pricing
17 Flexible in Seismic Areas - Won't Fracture		~	Light gauge steel is flexible and won't fracture when the earth moves
18 No Waste At Job Site		~	Steel is the most recycled material in the world. A typical wood home has 20-30% waste
19 Environmentally Friendly		~	Trees don't have to be destroyed and the source of most metal is from recycling
20 How-To Videos Included		~	How-to videos provide simple assembly instructions
21 Relationship Counselor		~	Eliminate emotional uphevels - save time, money, and preserve the relationship

Universal Requirements - some or all may be required

- 1 Site plan
- 2 Electrical Supply Connection
- 3 Sewer Connection
- 4 Fresh Water Supply Connection
- 5 Set Backs
- 6 Soils Evaluation

- 7 Earthquake (fault) evaluation
- 8 Foundation Plan subject to soils
- 9 Compliance with local energy codes: insulation home wrap and flashing
- 10 Engineering for wind speed and snow load.
- 11 State and Local ordinances regarding ADUs
- 12 Local Architect and/or Engineer may be necessary

Hamilton-1Bd1Ba-Spanish





Hamilton-1Bd1Ba-Spanish MATERIAL SHOPPING LIST

Have It Your Way!

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TOC



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PLUMBING BOM

Table Of Content

Have It Your Way!

ARCHITECTURAL BOM

The material types listed in this document were selected based on personal preferences. The Customer is encouraged to make changes to the material types in accordance with local customs, regulations, and personal preferences. Have It Your Way!

GENERAL NOTES

4 PLUMBING BOM

6 ARCHITECTURAL BOM

- 1 This BOM (Bill of Materials) is prepared as a Materials Shopping List to help builders and DIYers gain a complete understanding of most if not all elements required for the complete construction of this structure, according to the original design documents provided by FrameUpNow.
- 2 All quantities and specifications are subject to change based on the final design, field measurements, availability of products and customer preferences. The customer should verify all information prior to purchasing materials.
- 3 All products and elements in the list shall conform to the International Residential Code (IRC), or any other local and international building codes, safety regulations, and standards that are applicable to the location of the structure.
- 4 If any changes are made by the customer to the list of materials specified in this document, the customer is responsible for assuring that the correct type and quantity of materials are utilized in accordance with local building codes.
- 5 FrameUpNow, will not be held responsible for any misuse of this document, the products listed, or for deviations from the content that are made due to changes in specifications, pricing, availability, or customer preferences.
- 6 The customer is advised to consult a qualified professional or technician prior to purchasing materials for specialized construction system items. Some items including but not limited to caseworks, doors and windows may require as built measurements prior to purchase to confirmation of final dimensions.
- 7 If there are additional trim elements or specific installation methods, the total amount of materials needed might vary. Consider any additional trim required for corners, intersections, or other architectural details that might cause this variations before procedding to purchase and construction.

ARCHITECTURAL BOM



		Har	milton-1Bd	1Ba-Spanis	h		
		ARCHITECTI					
No.	Item	Type	Unit	Quantity	Unit Price	Total	Description
Δ	APPLIANCES	, ,,,,,,,,,,,,,,,,,,,,,,,,,,,,,,,,,,,,,	<u> </u>				·
1	Refrigerator		PCS	1			
2	Range		PCS	1			
3	Washer		PCS	1			
4	Dryer		PCS	1			
5	Dish Washer		PCS	1			
6	Oven		PCS	0			
7	Microwave		PCS	0			
	CASEWORKS						
1	Kitchen Cabinet		FT	17.58			
2	Laundry Cabinet		FT	2.25			
3	Vanity Cabinet		FT	2.83			
4	Medicine Cabinet		PCS	1			
5	Kitchen countertop		SF	28.31			
6	Laundry Countertop		PCS	0			
7	Bathroom Countertop		SF	0			
8	Island		FT	0			
9	Peninsula		FT	0			
	Closets		SF	50.46			
	CEILING						
1	Ceiling Board	Dry Wall	SF	663			
2	Dry Wall Fastener	Screw	PCS	1160.25			
3	Vapor Retarder	Polyethylene film	SF	762			
4	Vapor Retarder Fastener	Nails with washer heads	PCS	2286			
5	Ceiling Board (MRD)	Moisture resistant drywall	SF	46			
6	MRD Fastener		PCS	80.5			
7	Ceiling Board	Marine Plywood	SF	53			
	Marine Plywood Fastener	Screw	PCS	92.75			
	Dry Wall Tape		FT	381			
Δ	FLOORING						
	Main Living Space		SF	443.48			
	Bathroom		SF	51.53			
3	Bedrooms		SF	166.32			
<u></u>	STRUCTURE		1				
1	Foundation		SF	745.87			
	WALLS EXTERIOR			1			
	Exterior Wall Siding		SF	943			
	Wall Paint		SF	943			
3	Wall Shteathing (OSB)	0.15.1389	SF	943			
4	Shteathing Fastener	Self-drilling screws(100/pkt)	PKT	9.43			
5	Wall Insulation		SF	2695			
6	Wall Homewrap	0, 1, 15, 1, (0001.13)	SF	943			
7	Home wrap Fastener	Stapled fastener (200/pkt)	PKT	3.5834			
<u></u>	WALLS INTERIOR		CF	240		-	
1	Cementitious Backer Board		SF	348			
2	Kerdi membrane		SF	348			
3	Kerdi membrane Fastener		SF	348			
4	Wall Ceramic Tile		SF	348			
5	Drywall Board	0 15 1 1111 (4004 1 1)	SF	1411			
6	Drywall Fastener	Self-drilling screws(100/pkt)	PKT	14.11			
7	Wall Paint		SF	1411			
8	Drywall Tape		FT	265.0066681			

ARCHITECTURAL BOM



	DOORS					
<u> </u>		01.01.1/. (1.01.	lnoc.	10		
<u> </u>	Exterior Swinging	3' - 0" X 6'-8"	PCS	2		
2	Interior Swinging	3' - 0" X 6'-8"	PCS	2		
3	Interior Sliding	7' - 3" X 6'-8"	PCS	1		
4	Exterior Swinging	5' - 0" X 6'-8"	PCS	1		
5	Interior Swinging	2' - 4" X 6'-8"	PCS	1		
6	Bifold Door	3' - 0" X 6'-8"	PCS	1		
7	Exterior Door Trim			51.02		
8	Interior Door Trim			221.6		
9	Entry Lock set			3		
10	Privacy Lock set			2		
	Passage Lock set			3		
Δ	WINDOWS	·	·			
1	Hung	2' - 3" X 4'-3"	PCS	2		
2	Hung	2' - 7" X 3'-1"	PCS	1		
3	Sliding	6' - 3" X 3'-9"	PCS	2		
4	Fixed	3' - 1" X 2'-1"	PCS	1		
5	Casment	2' - 3" X 2'-7"	PCS	1		
6	Hung	2' - 3" X 3'-9"	PCS	1		
7	Exterior Window Trim			109.4		
8	Interior Window Trim			109.4		
	ROOF					
1	Roof Covering		SF	1846		
2	Roof Covering Fastener		PCS	923		
3	Roof Felt Paper		SF	923		
4	Roof Felt Paper Fastener		PCS	5538		
5	Roof Sheathing		SF	923		$\overline{}$
6	Roof Sheathing Fastener		PCS	7384		
7	Batten		FT	411		
8	Batten Fastener		PCS	309.02		$\overline{}$
9	Soffit		SF	79		$\overline{}$
10	Soffit Fastener		PCS	39.5		
	Fascia		FT	157		
	Fascia board fastener		PCS	78.5		
	Roof Insulation		SF	1846		
_ 13	TOOL ITSUIGNOT		Ji Ji	11040		



		Hamil	ton-1Bd1B	a-Spanis	h		
		ELECTRICAL	MATERIA	_ SHOPP	ING LIST		
No.	Item	Туре	Unit	Quantity	Unit Price	Total	Description
	LIGHTING FIXTURES		·				
1	Kitchen Ceiling Light		PCS	6		3	
2	Kitchen Wall Mounted Light		PCS	1		6	
3	Exterior Wall Mounted Light		PCS	6		0	
4	Exterior Ceiling Light		PCS	1		3	
5	Livingroom Ceiling Light With Fan		PCS	1		0	
6	Bedroom Ceiling Light With Fan		PCS	1		2	
7	Bathroom Wall Mounted Light		PCS	1		2	
8	Bathroom Ceiling Light		PCS	2		3	
9	Livingroom Ceiling Light		PCS	4		12	
10	Bed Ceiling Light		PCS	4		3	
11	Hall & Entry Ceiling Light		PCS	3			
12	Smoke Detector		PCS	2		6	
Δ	ELECTRICAL FITTINGS						
13	Standard Receptacle 120V	20A	PCS	10		17	
14	GFCI Receptacle 120V	20 A	PCS	13		11	
15	GFCI Receptacle 240V	30 A	PCS	2		3	
16	GFCI Receptacle 240V	50 A	PCS	1		0	
17	GFCI Receptacle 240V	60 A	PCS	1		1	
18	Fan Switch		PCS	1		1	
19	Single Pole Switch		PCS	8		3	
20	Three Way With Dimmer Switch		PCS	2		13	
21	Dimmer Switch		PCS	4		4	
Δ	ELECTRICAL CONDUITS & WIRING						
22	ROMEX 14 AWG	14/2/W/ground	FT	211.2		0	
23	ROMEX 12 AWG	12/2/W/ground	FT	340		613.5	
24	ROMEX 10 AWG	10/3/W/ground	FT	71.1		0	
25	Romex 8 AWG	8/3/W/ground	FT	33.2		75	
26	ROMEX 6 AWG	6/3/W/ground	FT	31.2		15	
27	Bare Copper Ground Wire 6 AWG	_	FT			51	
Δ	ELECTRICAL BOXES & CIRCUTES						
27	Panelboard -240V 1 Phase MLO	200 AMP	PCS	1		1	
28	Circuit breaker	15 A	PCS	5		1	
29	Circuit breaker	20 A	PCS	9		14	
30	Circuit breaker	30 A	PCS	2		3	
31	Circuit breaker	50 A	PCS	1		0	
32	Circuit breaker	60 A	PCS	1		1	
33	Single Gang Switch Box		PCS	1		1	
34	Double Gang Switch Box		PCS	4		7	
35	Triple Gang Switch Box		PCS	2		3	
36	Pull Box	#1/4	PCS	24		3	
37	Receptacle Box		PCS	24		24	

PLUMBING BOM

11 Flex Pipe Round



Hamilton-1Bd1Ba-Spanish PLUMBING SYSTEM MATERIAL SHOPPING LIST Quantity Unit Price Total Description Item Unit □ PLUMBING FIXTURES & ACCESSORIES 1 Bath Tub (Alcove Tub) PCS 2 Kitchen Sink 3 Kitchen Faucets PCS 1 PCS 4 Vanity Sink PCS 5 Bath room Faucets PCS 6 Water Closet PCS 7 Shower Trim PCS 8 Shower Tray PCS 9 Water Heater PCS 10 Hose Bib PCS 11 Shutoff Valve PCS 12 Hanging pipe clamp PCS 16 13 Gate Valve PCS 14 Dishwasher Supply Single Connector PCS 1 15 Dishwasher Sewage Single Connector PCS 16 Laundry Sweat Connector PCS 1 SANITARY & PLUMBING PIPES ABS (Acrylonitrile Butadiene Styrene) Pipes ABS (Acrylonitrile Butadiene Styrene) Pipes ø 1" FT 0 ø 1 1/2" FT 52 3 ABS (Acrylonitrile Butadiene Styrene) Pipes ø 2" FT 17 4 ABS (Acrylonitrile Butadiene Styrene) Pipes ø 3" FT 37 5 PEX (Cross-linked polyethylene) Pipes ø 1/2" FT 99 6 PEX (Cross-linked polyethylene) Pipes 42 ø 3/4" FT 7 PEX (Cross-linked polyethylene) Pipes ø 1" FT 3 8 PVC Pipes Sch.80 - Rigid ø 1 1/2" FT 0 9 PVC Pipes Sch.80 - Rigid 60 ø 2" FT 10 PVC Pipes Sch.80 - Rigid ø 3" FT 0

PCS

6

ø 1/2"

PLUMBING BOM



	PIPE FITTINGS				
1	PEX 90 Degree Elbow	1/2"ø-1/2"ø	PCS	12	
2	PEX 90 Degree Elbow	3/4"ø-3/4"ø	PCS	3	
3	PEX Tee Elbow	1/2"ø-1/2"ø-1/2"ø	PCS	3	
4	PEX Tee Elbow	3/4"ø-3/4"ø-3/4"ø	PCS	4	
5	PEX Transition Elbow	1"ø-3/4"ø	PCS	1	
6	PEX Transition Elbow	3/4"ø-1/2"ø	PCS	5	
7	PEX 90 Degree Elbow	1/2"ø-1/2"ø	PCS	13	
8	PEX 90 Degree Elbow	3/4"ø-3/4"ø	PCS	2	
9	PEX Tee Elbow	1/2"ø-1/2"ø-1/2"ø	PCS	2	
10	PEX Tee Elbow	3/4"ø-3/4"ø-3/4"ø	PCS	2	
11	PEX Transition Elbow	3/4"ø-1/2"ø	PCS	3	
12	PVC 90 Deg Bend Elbow	2"ø-2"ø	PCS	24	
13	ABS 90 Degree Bend Elbow	3"ø-3"ø	PCS	4	
14	ABS P-Trap	1 1/2"ø-1 1/2"ø	PCS	3	
15	ABS P-Trap	2"ø-2"ø	PCS	2	
16	ABS P-Trap	3"ø-3"ø	PCS	1	
17	ABS Reducer Elbow	2"ø-1 1/2"ø	PCS	1	
18	ABS Reducer Elbow	3"ø-1 1/2"ø	PCS	4	
19	ABS Reducer Elbow	3"ø-2"ø	PCS	2	
20	ABS TEE Elbow	1 1/2"ø-1 1/2"ø-1 1/2"ø	PCS	3	
21	ABS TEE Elbow	2"ø-2"ø-2"ø	PCS	2	
22	ABS TEE Elbow	3"ø-3"ø-3"ø	PCS	6	
23	ABS Vent Cap Elbow	1 1/2"ø	PCS	5	
24	ABS Vent Cap Elbow	2"ø	PCS	1	

HVAC BOM



		Hamilton-1	Bd1Ba	-Spanish	1					
	HVAC SYSTEM MATERIAL SHOPPING LIST									
No.	No. Item Type Unit Quantity Unit Price Total Description									
Δ	HVAC_DUCTS									
1	PIPE (REFRIGERANT LINE)	3/8" (Ø)		FT	34.95					
2	PIPE (REFRIGERANT LINE)	3/4" (Ø)		FT	49.55					
3	DRAYER HOSE	4" (Ø)		FT	6.2					
4	FLEX DUCT ROUND	4" (Ø)		FT	6.2					
\triangle	DUCT FITTINGS & ACCESSORIES									
5	ELBOW (REFRIGERANT LINE)	3/4" (Ø)-3/4" (Ø)		PCS	17					
6	ELBOW (REFRIGERANT LINE)	3/8" (Ø)-3/8" (Ø)		PCS	13					
7	TEE (REFRIGERANT LINE)	3/4" (Ø)-3/4" (Ø))-3/4" (Ø)		PCS	1					
8	TEE (REFRIGERANT LINE)	3/8" (Ø)-3/8" (Ø))-3/8" (Ø)		PCS	1					
9	TRANSITION (REFRIGERANT	3/4" (Ø)-1/2" (Ø)		PCS	3					
10	TRANSITION (REFRIGERANT	3/4" (Ø)-5/8" (Ø)		PCS	2					
11	TRANSITION (REFRIGERANT	3/8" (Ø)-1/4" (Ø)		PCS	1					
\triangle	HVAC_EQUIPMENTS									
12	AIR HANDLING UNIT	WALL MOUNTED		PCS	2					
13	CONDENSER	OUTDOOR UNIT		PCS	1					
14	EXHAUST FAN	75 CFM		PCS	1					
15	EXHAUST HOOD	WALL MOUNTED		PCS	1					
16	HOOD-WALL: VENT	HOOD-WALL: VENT		PCS	1					
17	DRAYER: VENT	DRAYER: VENT		PCS	1					
18	ROOF VENT	3"(Ø)		PCS	1					



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Have It Your Way!

The material types listed in this document were selected based on personal preferences. The Customer is encouraged to make changes to the material types in accordance with local customs, regulations, and personal preferences. Have It Your Way!

GENERAL NOTES

- 1 This BOM (Bill of Materials) is prepared as a Materials Shopping List to help builders and DIYers gain a complete understanding of most if not all elements required for the complete construction of this structure, according to the original design documents provided by FrameUpNow.
- 2 All quantities and specifications are subject to change based on the final design, field measurements, availability of products and customer preferences. The customer should verify all information prior to purchasing materials.
- 3 All products and elements in the list shall conform to the International Residential Code (IRC), or any other local and international building codes, safety regulations, and standards that are applicable to the location of the structure.
- 4 If any changes are made by the customer to the list of materials specified in this document, the customer is responsible for assuring that the correct type and quantity of materials are utilized in accordance with local building codes.
- FrameUpNow, will not be held responsible for any misuse of this document, the products listed, or for deviations from the content that are made due to changes in specifications, pricing, availability, or customer preferences.
- The customer is advised to consult a qualified professional or technician prior to purchasing materials for specialized construction system items. Some items including but not limited to caseworks, doors and windows may require as built measurements prior to purchase to confirmation of final dimensions.
- 7 If there are additional trim elements or specific installation methods, the total amount of materials needed might vary. Consider any additional trim required for corners, intersections, or other architectural details that might cause this variations before procedding to purchase and construction.



			LIGHTING FIXTURES				
#	Lighting	Туре	Description, Manufacturer, SKU	Unit	Quantity	Unit Price	Total
1	Kitchen Ceiling Light			PCS	6		
2	Kitchen Wall Mounted Light			PCS	1		
3	Exterior Wall Mounted Light			PCS	6		
4	Exterior Ceiling Light			PCS	1		
5	Livingroom Ceiling Light With Fan			PCS	1		
6	Bedroom Ceiling Light With Fan			PCS	1		
7	Bathroom Wall Mounted Light			PCS	1		
8	Bathroom Ceiling Light			PCS	2		
9	Livingroom Ceiling Light			PCS	4		
10	Bed Ceiling Light			PCS	4		
11	Hall & Entry Ceiling Light			PCS	3		
12	Smoke Detector			PCS	2		
13							
14							
15							



			ELECTRICAL FITTINGS				
#	Item	Туре	Description, Manufacturer, SKU	Unit	Quantity	Unit Price	Total
1	Standard Receptacle 120V	20A		PCS	10		
2	GFCI Receptacle 120V	20 A		PCS	13		
3	GFCI Receptacle 240V	30 A		PCS	2		
4	GFCI Receptacle 240V	50 A		PCS	1		
5	GFCI Receptacle 240V	60 A		PCS	1		
6	Fan Switch			PCS	1		
7	Single Pole Switch			PCS	8		
8	Three Way With Dimmer Switch			PCS	2		
9	Dimmer Switch			PCS	4		
10							
11							
12							
13							
14							
15							



		E	LECTRICAL CONDUITS & WIRING				
#	Item	Туре	Description, Manufacturer, SKU	Unit	Quantity	Unit Price	Total
1	ROMEX 14 AWG	14/2/W/ground		FT	211.2		
2	ROMEX 12 AWG	12/2/W/ground		FT	340		
3	ROMEX 10 AWG	10/3/W/ground		FT	71.1		
4	Romex 8 AWG	8/3/W/ground		FT	33.2		
5	ROMEX 6 AWG	6/3/W/ground		FT	31.2		
6	Bare Copper Ground Wire 6 AWG			FT			
7							
8							
9							
10							
11							
12							
13							
14							
15							



			ELECTRICAL BOXES & CIRCUTE	S			
#	Item	Туре	Description,Manufacturer,SKU	Unit	Quantity	Unit Price	Total
1	Panelboard -240V 1 Phase MLO	200 AMP		PCS	1		
2	Circuit breaker	15 A		PCS	5		
3	Circuit breaker	20 A		PCS	9		
1	Circuit breaker	30 A		PCS	2		
5	Circuit breaker	50 A		PCS	1		
5	Circuit breaker	60 A		PCS	1		
7	Single Gang Switch Box			PCS	1		
3	Double Gang Switch Box			PCS	4		
)	Triple Gang Switch Box			PCS	2		
10	Pull Box	#1/4		PCS	24		
11	Receptacle Box			PCS	24		
12							
13							
14							
15							

HVAC BOM



			HVAC_DUCTS 01				
#	Item	Туре	Description, Manufacturer, SKU	Unit	Quantity	Unit Price	Total
1	PIPE (REFRIGERANT LINE)			FT	34.95		
2	PIPE (REFRIGERANT LINE)	3/4" (Ø)		FT	49.55		
3	DRAYER HOSE	4" (Ø)		FT	6.2		
4	FLEX DUCT ROUND	4" (Ø)		FT	6.2		

HVAC BOM



t Item	Туре	Description, Manufacturer, SKU	Unit	Quantity	Unit Price	Total
ELBOW (REFRIGERANT LINE)	3/4" (Ø)-3/4" (Ø)		PCS	17		
ELBOW (REFRIGERANT LINE)	3/8" (Ø)-3/8" (Ø)		PCS	13		
TEE (REFRIGERANT LINE)	3/4" (Ø)-3/4" (Ø))-3/4" (Ø)		PCS	1		
TEE (REFRIGERANT LINE)	3/8" (Ø)-3/8" (Ø))-3/8" (Ø)		PCS	1		
TRANSITION (REFRIGERANT LINE)	3/4" (Ø)-1/2" (Ø)		PCS	3		
TRANSITION (REFRIGERANT LINE)	3/4" (Ø)-5/8" (Ø)		PCS	2		
TRANSITION (REFRIGERANT LINE)	3/8" (Ø)-1/4" (Ø)		PCS	1		

HVAC BOM



			HVAC_EQUIPMENTS				
#	Item	Туре	Description, Manufacturer, SKU	Unit	Quantity	Unit Price	Total
1	AIR HANDLING UNIT	WALL MOUNTED		PCS	2		
2	CONDENSER	OUTDOOR UNIT		PCS	1		
3	EXHAUST FAN	75 CFM		PCS	1		
4	EXHAUST HOOD	WALL MOUNTED		PCS	1		
5	HOOD-WALL: VENT	HOOD-WALL: VENT		PCS	1		
6	DRAYER: VENT	DRAYER: VENT		PCS	1		
7	ROOF VENT	3"(Ø)		PCS	1		



PLUMBING FIXTURES & ACCESSORIES								
#	Item	Туре	Description, Manufacturer, SKU	Unit	Quantity	Unit Price	Total	
1	Bath Tub (Alcove Tub)			PCS	0			
2	Kitchen Sink			PCS	1			
3	Kitchen faucets			PCS	1			
4	Vanity Sink			PCS	1			
5	Bath room faucets			PCS	1			
6	Water Closet			PCS	1			
7	Shower Trim			PCS	1			
8	Shower Tray			PCS	1			
9	Water Heater			PCS	1			
10	Hose Bib			PCS	1			
11	Shutoff Valve			PCS	6			
12	Hanging pipe clamp			PCS	16			
13	Gate Valve			PCS	1			
14	Dishwasher Supply Single Connector			PCS	1			
15	Dishwasher Sewage Single Connector			PCS	1			
16	Laundry Sweat Connector			PCS	1			



		SANITARY & PLUMBING PIPES									
#	Item	Туре	Description, Manufacturer, SKU	Unit	Quantity	Unit Price	Total				
1	ABS (Acrylonitrile Butadiene Styrene) Pipes	ø 1"		FT	0						
2	ABS (Acrylonitrile Butadiene Styrene) Pipes	ø 1 1/2"		FT	52						
3	ABS (Acrylonitrile Butadiene Styrene) Pipes	ø 2"		FT	17						
4	ABS (Acrylonitrile Butadiene Styrene) Pipes	ø 3"		FT	37						
5	PEX (Cross-linked polyethylene) Pipes	ø 1/2"		FT	99						
6	PEX (Cross-linked polyethylene) Pipes	ø 3/4"		FT	42						
7	PEX (Cross-linked polyethylene) Pipes	ø 1"		FT	3						
8	PVC Pipes Sch.80 - Rigid	ø 1 1/2"		FT	0						
9	PVC Pipes Sch.80 - Rigid	ø 2"		FT	60						
10	PVC Pipes Sch.80 - Rigid	ø 3"		FT	0						
11	Flex Pipe Round	ø 1/2"		PCS	6						
12											
13											
14											
15											



		PI	PE FITTINGS 01				
#	Item	Туре	Description, Manufacturer, SKU	Unit	Quantity	Unit Price	Total
1	PEX 90 Degree Elbow	1/2"ø-1/2"ø		PCS	12		
2	PEX 90 Degree Elbow	3/4"ø-3/4"ø		PCS	3		
3	PEX Tee Elbow	1/2"ø-1/2"ø-1/2"ø		PCS	3		
4	PEX Tee Elbow	3/4"ø-3/4"ø-3/4"ø		PCS	4		
5	PEX Transition Elbow	1"ø-3/4"ø		PCS	1		
6	PEX Transition Elbow	3/4"ø-1/2"ø		PCS	5		
7	PEX 90 Degree Elbow	1/2"ø-1/2"ø		PCS	13		
8	PEX 90 Degree Elbow	3/4"ø-3/4"ø		PCS	2		
9	PEX Tee Elbow	1/2"ø-1/2"ø-1/2"ø		PCS	2		
10	PEX Tee Elbow	3/4"ø-3/4"ø-3/4"ø		PCS	2		
11	PEX Transition Elbow	3/4"ø-1/2"ø		PCS	3		
12	PVC 90 Deg Bend Elbow	2"ø-2"ø		PCS	24		
13	ABS 90 Degree Bend Elbow	3"ø-3"ø		PCS	4		
14	ABS P-Trap	1 1/2"ø-1 1/2"ø		PCS	3		
15	ABS P-Trap	2"ø-2"ø		PCS	2		



		PIPE	FITTINGS 02				
#	Item	Туре	Description, Manufacturer, SKU	Unit	Quantity	Unit Price	Total
	ABS P-Trap	3"ø-3"ø		PCS	1		
	ABS Reducer Elbow	2"ø-1 1/2"ø		PCS	1		
	ABS Reducer Elbow	3"ø-1 1/2"ø		PCS	4		
	ABS Reducer Elbow	3"ø-2"ø		PCS	2)	
	ABS TEE Elbow	1 1/2"ø-1 1/2"ø-1 1/2"ø		PCS	3	3	
١	ABS TEE Elbow	2"ø-2"ø-2"ø		PCS	2		
	ABS TEE Elbow	3"ø-3"ø-3"ø		PCS	6		
	ABS Vent Cap Elbow	1 1/2"ø		PCS	5		
	ABS Vent Cap Elbow	2"ø		PCS	1		
0							
1							
2							
3							
4							
5							



			APPLIANCES				
#	Item	Туре	Description, Manufacturer, SKU	Unit	Quantity	Unit Price	Total
1	Refrigerator			PCS	1		
2	Range			PCS	1		
3	Washer Front Load	Stackable		PCS	1		
4	Dryer Front Load	Stackable		PCS	1		
5	Dish Washer			PCS	1		
6	Oven			PCS	(
7	Microwave			PCS	(
8							
9							
10							
11							
12							
13							
14							
15							
16							



			CASEWORKS 01				
#	Item	Туре	Description, Manufacturer, SKU	Unit	Quantity	Unit Price	Total
1	Kitchen Cabinet			FT	17.58		
2	Laundry Cabinet			FT	2.25		
3	Vanity Cabinet			FT	2.83		
4	Medicine Cabinet			PCS	1		
5	Kitchen countertop			SF	28.31		
6	Laundry Countertop			PCS	0		
7	Bathroom Countertop			SF	0		
8	Island			FT	0		
9	Peninsula			FT	0		
10	Closets			SF	50.46		
11							
12							
13							
14							
15							



	1		CEILING 01			
#	item	Туре	Description, Manufacturer, SKU	Unit	Quantity Unit	Price Total
	LIVING ROOM + KITCHEN +	DINING		SF	403.0	
1	Ceiling Board	Drywall		SF	403	
2	Drywall Fastener	Screw		PCS	705	
3	Vapor Retarder	Polyethylene film		SF	403	
4	Vapor Retarder Fastener	Nails with washer heads		PCS	1209	
	BATH ROOM			SF	46.0	
5	Ceiling Board	MRD (Moisture resistant drywall)		SF	46	
6	MRD Fastener	Screw		PCS	81	
	PORCH 1			SF	27.0	
7	Ceiling Board	Marine Plywood		SF	27	
3	Exterior Grade Plywood	Screw		PCS	47	
	PORCH 2			SF	26.0	
9	Ceiling Board	Marine Plywood		SF	26	
10	Exterior Grade Plywood	Screw		PCS	46	



			CEILING 02				
#	Item	Туре	Description, Manufacturer, SKU	Unit	Quantity	Unit Price	Total
	BED ROOM			SF	156.0		
1	Ceiling Board	Drywall		SF	156		
2	Drywall Fastener	Screw		PCS	273		
3	Vapor Retarder	Polyethylene film		SF	156		
4	Vapor Retarder Fastener	Nails with washer heads		PCS	468		
	CLOSET			SF	19.0		
5	Ceiling Board	Drywall		SF	19		
6	Drywall Fastener	Screw		PCS	33		
7	Vapor Retarder	Polyethylene film		SF	19		
8	Vapor Retarder Fastener	Nails with washer heads		PCS	57		
	HALL			SF	64.0		
9	Ceiling Board	Drywall		SF	64		
10	Drywall Fastener	Screw		PCS	112		
11	Vapor Retarder	Polyethylene film		SF	64		
12	Vapor Retarder Fastener	Nails with washer heads		PCS	192.0		



			CEILING 03			
#	Item	Туре	Description, Manufacturer, SKU	Unit	Quantity Unit Price	Total
	W/D			SF	12.0	
13	Ceiling Board	Drywall		SF	12	
14	Drywall Fastener	Screw		PCS	21	
15	Vapor Retarder	Polyethylene film		SF	12	
16	Vapor Retarder Fastener	Nails with washer heads		PCS	36	
	WH			SF	9.0	
17	Ceiling Board	Drywall		SF	9	
18	Drywall Fastener	Screw		PCS	16	
19	Vapor Retarder	Polyethylene film		SF	9	
20	Vapor Retarder Fastener	Nails with washer heads		PCS	27	



			FLOORING INTERIOR 01			
#	Item	Туре	Description, Manufacturer, SKU	Unit	Quantity Unit	Price Total
	BEDROOM					
1	Bedroom Flooring			SF	148	
2	Wood underlay	Foam Pad Polyethylene		SF	148	
3	Vapor Retarder	Vapor Barrier Polyethylene		SF	147.9	
	CL #1					
4	Closet Flooring			SF	18	
5	Wood underlay	Foam Pad Polyethylene		SF	18	
6	Vapor Retarder	Vapor Barrier Polyethylene		SF	18.4	
	LIVING ROOM AND KITCH	EN				
7	Living Area Flooring			SF	443	
8	Wood underlay	Foam Pad Polyethylene		SF	443	
9	Vapor Retarder	Vapor Barrier Polyethylene		SF	443.5	
	BATHROOM					
10	Tile Finish			SF	32	
11	Adhesive	1/2" Thin set Mortar		SF	32	
12	Vapor Retarder	Vapor Barrier Polyethylene		SF	31.5	



			FLOORING INTERIOR 02			
#	Item	Туре	Description, Manufacturer, SKU	Unit	Quantity Unit Price	e Total
	W/D					
13	Tile Finish			SF	11	
14	Adhesive	1/2" Thin set Mortar		SF	11	
15	Vapor Retarder	Vapor Barrier Polyethylene		SF	11.5	
	BOILER ROOM					
16	Tile Finish			SF	9	
17	Adhesive	1/2" Thin set Mortar		SF	9	
18	Vapor Retarder	Vapor Barrier Polyethylene		SF	8.5	



		FLOORING EXTERIOR							
#	item	Туре	Description, Manufacturer, SKU	Unit	Quantity Unit Price				
	STRUCTURE			SF	745.9				
1	Concrete Slab	4"concrete cast in situ		CF	256.39				
2	Insulation	Rigid insulation		SF	233.66				
3	Hard core	Compacted soil		CF	190.38				
4	Re-bar	#4 re-bar		Ton	0.73				
5	Concrete Pad	4"concrete cast in situ		CF	1.58				
6	Slab edge	Turndown		CF	232.22				
	PORCH FRONT								
1	Tile Finish			SF	83.2				
2	Adhesive	1/2" Thin set Mortar		SF	83.2				
3	Vapor Retarder	Vapor Barrier Polyethylene		SF	83.2				



			WALLS: EXTERIOR				
	Item	Туре	Description, Manufacturer, SKU	Unit	Quantity	Unit Price	Total
1	Stocco Finish			SF	943		
2	Wall Homewrap			SF	943		
3	Homewrap Fastener	Stapled fastener (200/pkt)		PKT	3.5834		
4	Wall Shteathing (OSB)			SF	943		
5	Shteathing Fastener	Self-drilling screws(100/pkt)		PKT	9.43		
6	Stone Copping			SF	0.00		
7	Mortar for Stone Veneer			SF	0.00		
8	Wall Paint			SF	943		
9	Wall Insulation			SF	2695		
10							
11							
12							
13							
14							
15							



			WALLS: INTERIOR 01				
#	item	Туре	Description, Manufacturer, SKU	Unit	Quantity	Unit Price	Total
	BATHROOM			SF	42.0		
1	Cementitious Backer Board			SF	200		
2	Kerdi membrane			SF	200		
3	Kerdi membrane Fastener			SF	200		
4	Wall Ceramic Tile			SF	200		
	BEDROOM			SF	147.0		
5	Drywall Board			SF	363		
6	Drywall Fastener	Self-drilling screws(100/pkt)		PKT	3.63		
7	Wall Paint			SF	363		
8	Drywall Tape			FT	68.06675417		
	HALL			SF	58.0		
9	Drywall Board			SF	197		
10	Drywall Fastener	Self-drilling screws(100/pkt)		PKT	1.97		
11	Wall Paint			SF	197		
12	Drywall Tape			FT	36.9		



			WALLS: INTERIOR 02				
#	item	Туре	Description, Manufacturer, SKU	Unit	Quantity	Unit Price	Total
	LIVING ROOM			SF	291.0		
13	Drywall Board			SF	357		
14	Drywall Fastener	Self-drilling screws(100/pkt)		PKT	3.57		
15	Wall Paint			SF	357		
16	Drywall Tape			FT	66.9793621		
	KITCHEN			SF	91.0		
17	Cementitious Backer Board			SF	28		
18	Drywall Board			SF	230		
19	Drywall Fastener	Self-drilling screws(100/pkt)		PKT	2.3		
20	Kerdi membrane			SF	28		
21	Kerdi membrane Fastener			SF	28		
22	Wall Ceramic Tile			SF	28		
23	Wall Paint			SF	230		
24	Drywall Tape			FT	43.4		



		WALLS: INTERIOR 03							
#	ıtem	Туре	Description, Manufacturer, SKU	Unit	Quantity	Unit Price	Total		
	CLOSET			SF	20.0				
25	Drywall Board			SF	160				
26	Drywall Fastener	Self-drilling screws(100/pkt)		PKT	1.6				
27	Wall Paint			SF	160				
28	Drywall Tape			FT	30.00187512				



			WALLS: INTERIOR 04				
#	item	Туре	Description, Manufacturer, SKU	Unit	Quantity	Unit Price	Total
	WD			SF	13.0		
37	Cementitious Backer Board			SF	120		
38	Kerdi membrane			SF	120		
39	Kerdi membrane Fastener			SF	120		
40	Wall Ceramic Tile			SF	120		
	WH			SF	10.0		
41	Drywall Board			SF	104		
42	Drywall Fastener	Self-drilling screws(100/pkt)		PKT	1.04		
43	Wall Paint			SF	104		
44	Drywall Tape			FT	19.62264151		
1	Wall Skirting	Ceramic		FT	118		



			DOORS			
#	Item	Туре	Description, Manufacturer, SKU	Unit	Quantity Unit Price	Total
1	Exterior Swinging	3' - 0" X 6'-8"		PCS	2	
2	Interior Swinging	3' - 0" X 6'-8"		PCS	2	
3	Interior Sliding	7' - 3" X 6'-8"		PCS	1	
4	Exterior Swinging	5' - 0" X 6'-8"		PCS	1	
5	Interior Swinging	2' - 4" X 6'-8"		PCS	1	
6	Bifold Door	3' - 0" X 6'-8"		PCS	1	
7	Exterior Door Trim			FT	51.02	
8	Interior Door Trim			FT	221.6	
9	Entry Lock set			PCS	3	
10	Privacy Lock set			PCS	2	
11	Passage Lock set			PCS	3	
12						
13						
14						
15						



			WINDOWS			
#	Item	Туре	Description, Manufacturer, SKU	Unit	Quantity Unit Price	Total
1	Hung	2' - 3" X 4'-3"		PCS	2	
2	Hung	2' - 7" X 3'-1"		PCS	1	
3	Sliding	6' - 3" X 3'-9"		PCS	2	
4	Fixed	3' - 1" X 2'-1"		PCS	1	
5	Casment	2' - 3" X 2'-7"		PCS	1	
6	Hung	2' - 3" X 3'-9"		PCS	1	
7	Exterior Window Trim			FT	109.4	
8	Interior Window Trim			FT	109.4	
9						
10						
11						
12						
13						
14						
15						



			ROOF 01				
#	Item	Туре	Description, Manufacturer, SKU	Unit	Quantity	Unit Price	Total
1	Roof Covering			SF	923.0		
2	Roof Covering Fastener			PCS	462		
3	Roof Felt Paper			SF	923.0		
4	Roof Felt Paper Fastener			PCS	2769.0		
5	Roof Sheathing			SF	923.0		
6	Roof Sheathing Fastener			PCS	7384		
7	Batten			FT	411.0		
8	Batten Fastener			PCS	309.0		
9	Soffit			SF	79.0		
10	Soffit Fastener			PCS	39.5		
11	Fascia			FT	157.0		
12	Fascia board fastener			PCS	79		
13	Roof Insulation			SF	923.0		
14							
15							



			ROOF 02			
#	Item	Туре	Description, Manufacturer, SKU	Unit	Quantity Unit	Price Total
1	Roof Covering			SF	923.0	
2	Roof Covering Fastener			PCS	461.5	
3	Roof Felt Paper			SF	923.0	
4	Roof Felt Paper Fastener			PCS	2769.0	
5	Roof Sheathing			SF	923.0	
6	Roof Sheathing Fastener			PCS	7384.0	
7	Batten			FT	0.0	
8	Batten Fastener			PCS	0.0	
9	Soffit			SF	0.0	
10	Soffit Fastener			PCS	0.0	
11	Fascia			FT	0.0	
12	Fascia board fastener			PCS	0.0	
13	Roof Insulation			SF	923.0	
14					7.20.0	
15						