

# **HAMILTON**

The Hamilton is a charming two-bedroom, twobathroom Craftsman-style home designed for comfortable living. Its exterior features a combination of wood shingles and gray siding, creating a classic and inviting aesthetic. The prominent porch with stone pillars and decorative trim adds a touch of rustic charm. A pergola with latticework provides shade and enhances the outdoor living space. The roof is covered with dark shingles, complementing the overall aesthetic. Inside, the Hamilton embraces an L-shaped floor plan. The living and kitchen areas are combined into a spacious and inviting open-concept space. The bedrooms are thoughtfully positioned on one side of the home, creating a private and secluded wing for rest and relaxation.

#### Materials Shopping List

Please print and take this Materials Shopping List to your favorite Home Depot and ask for assistance in selecting the materials, fixtures and fittings to complete your new home.

Record your selection and the price of the item. Then do the math to determine the cost for your selections and the total cost of finishing your home.

#### < CLICK HERE >

To Go To Materials Shopping List



# 37' - 1" BEDROOM 2 139 SF PORCH 186 SF


# **FLOOR PLAN**

1000 SF

2 Bed Rooms



# **TABLE OF CONTENTS**

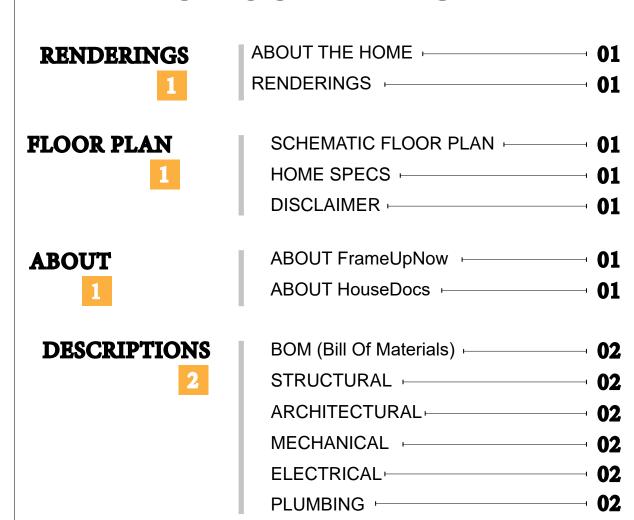


**MATERIALS LIST** MATERIALS LIST PREVIEW -

**HOW TO BUILD** 

CONSTRUCTION STEPS

**ARCHITECTURAL** 

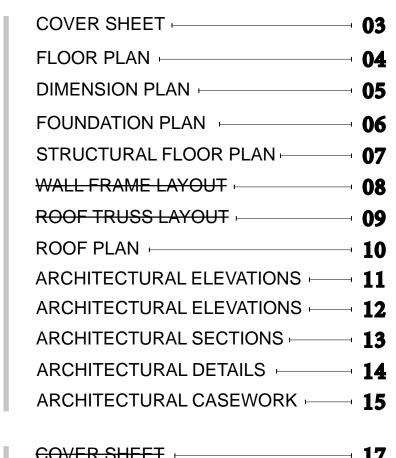

STRUCTURAL.

**MATERIALS** 

SHOPPING LIST

STRUCTURAL	COVER SHEET	<b>17</b>
16	GENERAL NOTES	18
	WALL FRAME LAYOUT	19
	WALL PANEL & LAYOUT PLAN	<b>20</b>
	ROOF TRUSS LAYOUT	<b>21</b>
	STRUCTURAL SECTIONS	<b>22</b>
	WALL BRACING LAYOUT	<b>23</b>
	HOLD-DOWN PLAN	<b>24</b>
	STRUCTURAL DETAILS 1	<b>25</b>
	STRUCTURAL DETAILS 2	<b>26</b>
	STRUCTURAL DETAILS 3	<b>27</b>
	TRUSS BLOCKING LAYOUT	<b>28</b>
	SHEETROCK BACKING	<b>□ 29</b>
	ROOF BRACING LAYOUT	<b>30</b>
MECHANICAL	COVER SHEET -	· 31
30	HVAC PLAN -	32
ELECTRICAL	SCHEDULE -	<b>₃ 33</b>
<b>32</b>	LIGHTING -	34
	POWER PLAN -	<b>35</b>
	DIMENSION FOR LIGHTING -	36
	DIMENSION FOR FITTING	<b>37</b>
PLUMBING	NOTES AND SCHEDULES	<b>∃ 38</b>
37	WATER SUPPLY & SEWAGE SYSTEM	39

MATERIALS SHOPPING LIST -

# **ABOUT**



FrameUpNow is a design and manufacturing company providing precision-engineered home framing solutions. We offer a catalog of Affordable Homes, Tiny Homes, Garages, Shops and Barndominiums. FrameUpNow manufactures cold-formed steel (CFS) also known as Light Gauge Steel (LGS) framing components that conform to our engineered metal house frame plans or can be purchased as DIY skeleton kits.

The CFS/LGS framing is lightweight, easily assembled, and does not require heavy equipment or specialized labor, enabling homeowners to erect the frame themselves in just a few days. Unlike wood, the steel framing is impervious termites and bores, warping, expansion, and fire.

Our home plans come complete with a structural engineered stamp for permit approvals. Customers receive a full BOM also known as a Materials Shopping List to purchase finish materials from a Building Materials retailer. FrameUpNow prides itself on the quality and efficiency of our precision-engineered home framing solutions for construction professionals and DIY homeowners.



**KEY PLAN** 

NO.	DESCRIPTION	DATE
	I.	

NOTE:

LEGEND:

PROJECT

**57-Hamilton-1000-**2Bd-2Ba-Craftsman-550

DRAWING NAME

# INTRODUCTION

CLIENT NAME:
PROJECT NUMBER:
DATE:
DESIGNED BY:
DRAWN BY:
CHECKED BY:

**I101** 

SCALE:

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**DISCLAIMER** 

# **DESCRIPTIONS**

# MATERIALS LIST

The BOM (Bill Of Materials) package, known as the Materials Shopping List document, provides:

Comprehensive Inventory: Detailed lists of essential materials sourced from architectural, mechanical, HVAC, electrical, and plumbing design drawing sets.

Precise Curation: Each item meticulously selected and organized for accuracy and efficiency in project planning.

Customizable Options: Customers can modify listed items to their preferences and calculate costs accordingly, ensuring alignment with personal project needs and budget.

Dedicated Space for Details: Includes tables for customers to note Home Depot SKU numbers or product descriptions for selected items, facilitating seamless purchasing and coordination with suppliers.

Customer Convenience: Take the list to Home Depot or preferred suppliers for accurate pricing, helping align the total home budget with personal financial plans.

Simplify your construction journey with our Materials Shopping List document, where detailed preparation meets streamlined implementation for your dream home.

# STRUCTURAL

The structural drawings package provides an exhaustive set of detailed plans essential for the precise assembly of your building. This comprehensive package includes:

Framing Plans: Detailed layouts for all framing components. Truss Layouts: Clear instructions for truss placement and

Panel Length Plans: Specifications for panel dimensions. Framing Elevations and Sections: Precise elevation and sectional views for accurate construction.

Truss and Wall Blocking Plans: Plans for truss and wall blocking to ensure structural integrity.

Hold-Down Plan: Detailed hold-down requirements for stability. Snap Sheet: Reference sheet for quick identification of components

Structural Details and Bracing Plans: Complete details and bracing plans for all structural elements.

Accompanying these plans is a comprehensive Bill of Materials (BOM) that lists every necessary building component, from cold formed steel (CFS) frames to fasteners.

# ARCHITECTURAL

With the comprehensive architectural package, both builders and DIY homeowners can confidently execute the construction.

The architectural package includes:

Furnished Floor Plans: Complete with furniture layouts for a clear understanding of space utilization.

Detailed Dimension Plans: Ensures precise measurements, from the overall footprint down to the exact placement of windows and

Foundation Plan: Detailed plan to establish a solid foundation.

Wall Framing and Truss Layout: Comprehensive plans for wall framing and truss placement.

Architectural Elevations: Exterior views showcasing the design.

Strategic Building Sections: Critical cross-sectional details for a thorough understanding of the build.

Casework Drawings and Diagrams: Suggested designs for built-in caseworks, such as kitchen cabinets.

#### **MECHANICAL ELECTRICAL**

The mechanical package includes everything needed to guide HVAC

Detailed HVAC Floor Plan: Precisely maps out the placement of air handlers, ductwork, and vents throughout the home's layout.

HVAC Sections and Riser Diagrams: Technical drawings offering critical cross-sectional details and piping schematics, ensuring proper integration of the heating and cooling system into the home's structure.

Bill of Materials: A complete list of all necessary HVAC components.

The electrical package includes all the plans and documentation needed to guide the installation of your home's electrical system:

Detailed Power Plan: Precisely maps out the placement of outlets, switches, and other power components throughout the layout.

Comprehensive Lighting Plan: Shows the optimal locations for lighting fixtures, sconces, and other illumination sources to create a well-lit, functional interior.

Dimensioned Electrical Layout: Provides exact dimensions and measurements to ensure proper placement of all electrical elements.

Bill of Materials: A complete list of every component needed, from circuit breakers to wiring.

The plumbing package includes everything needed to guide the

Detailed Water Supply System Plan: Precisely maps out the placement of pipes, valves, and plumbing fixtures throughout the

Comprehensive Sewage System Plan: Shows the optimal routing and sizing of drain lines to effectively remove waste and ensure

Detailed Riser Diagrams: Provide information needed to properly

Bill of Materials: A complete list of every component needed, from

# **PLUMBING**


installation of your home's water supply and drainage systems:

proper drainage.

install all vertical plumbing risers and vent stacks.

pipes to fixtures.


# BOM (Bill Of Materials) (Separately Attached)

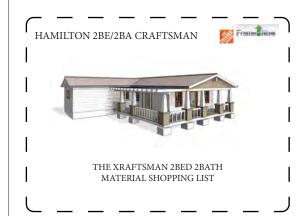



The Bill of Materials (BOM) is a crucial document that compiles the material requirements from different disciplines into a centralized inventory, enabling efficient procurement, inventory management, and cost estimation for a specified project or

**ELECTRICAL BOM** 



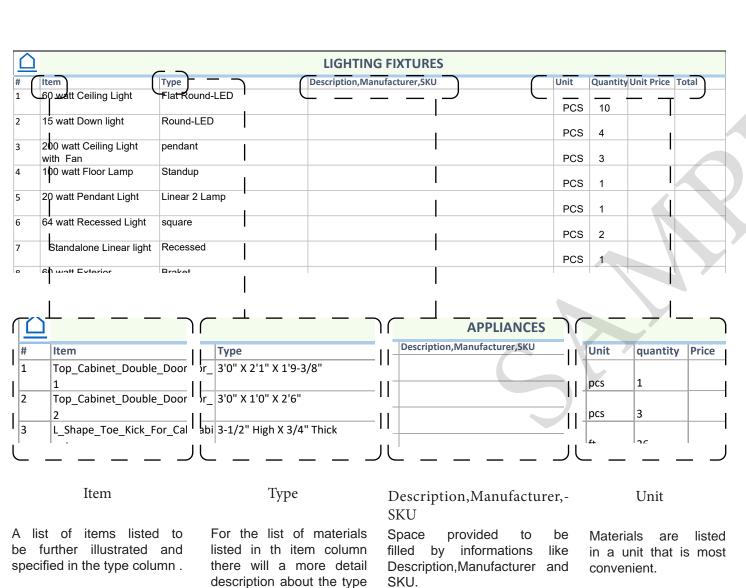

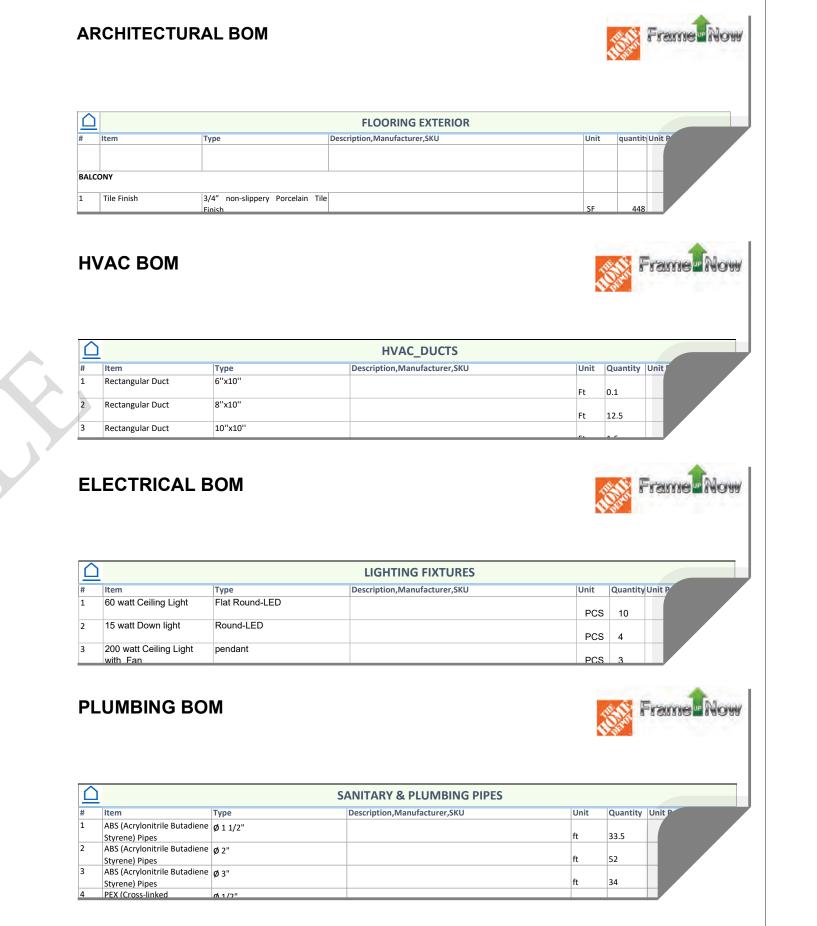

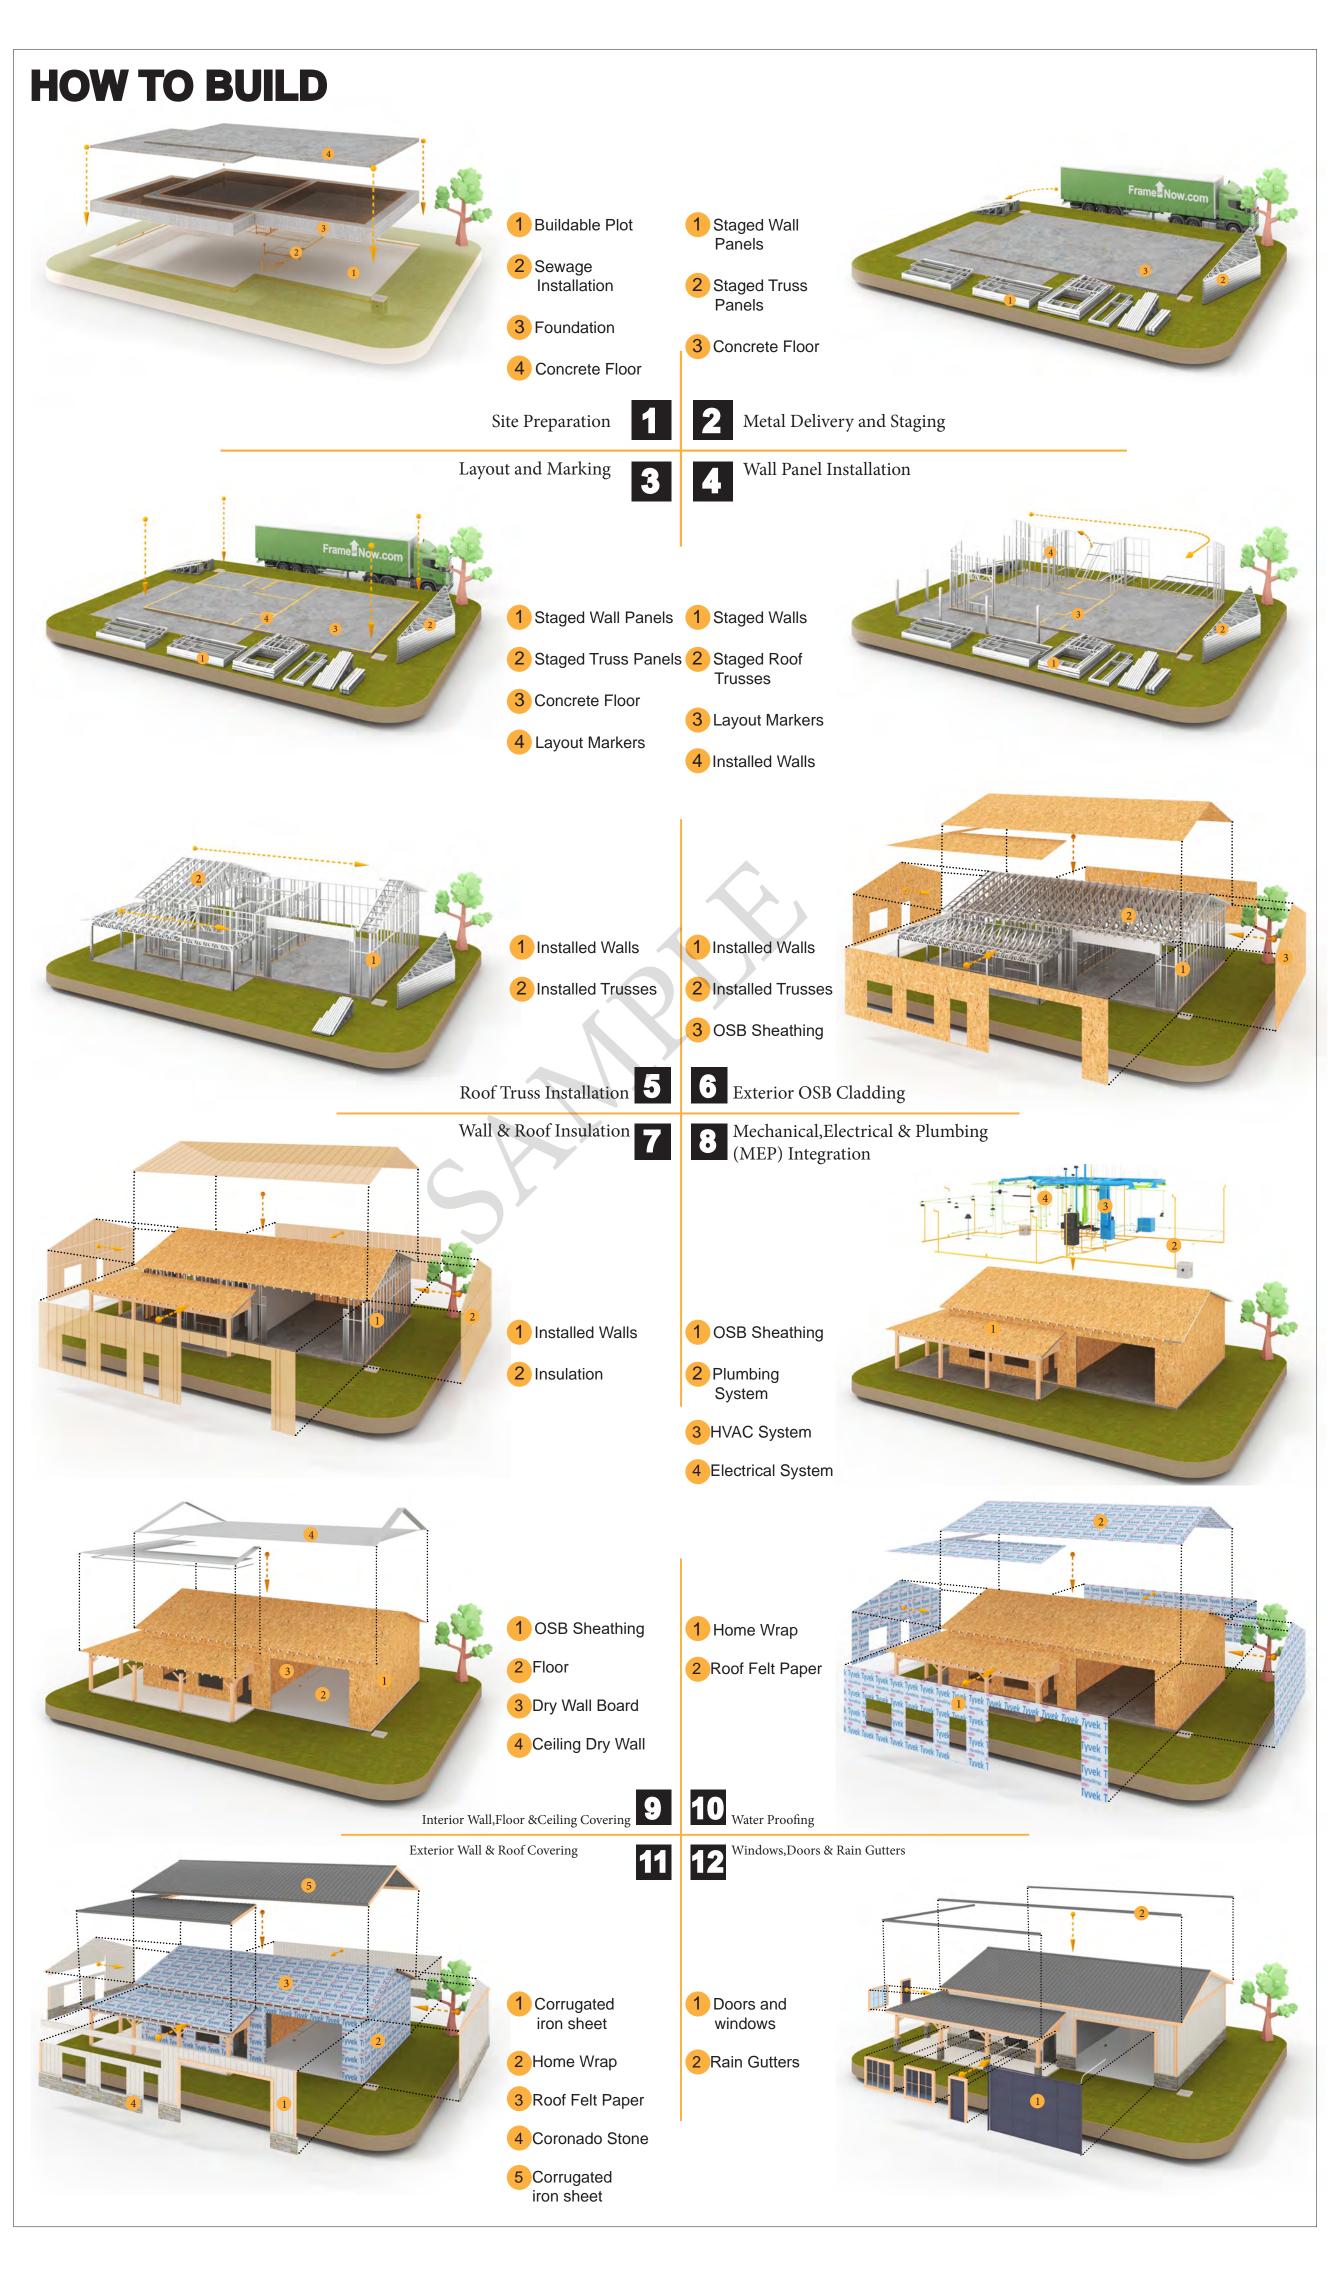



**KEY PLAN** 

NO.	DESCRIPTION	DATE

NOTE:

LEGEND:

PROJECT

57-Hamilton-1000-2Bd-2Ba-Craftsman-550

DRAWING NAME


# INTRODUCTION

CLIENT NAME: PROJECT NUMBER: DATE: **DESIGNED BY** DRAWN BY: CHECKED BY:


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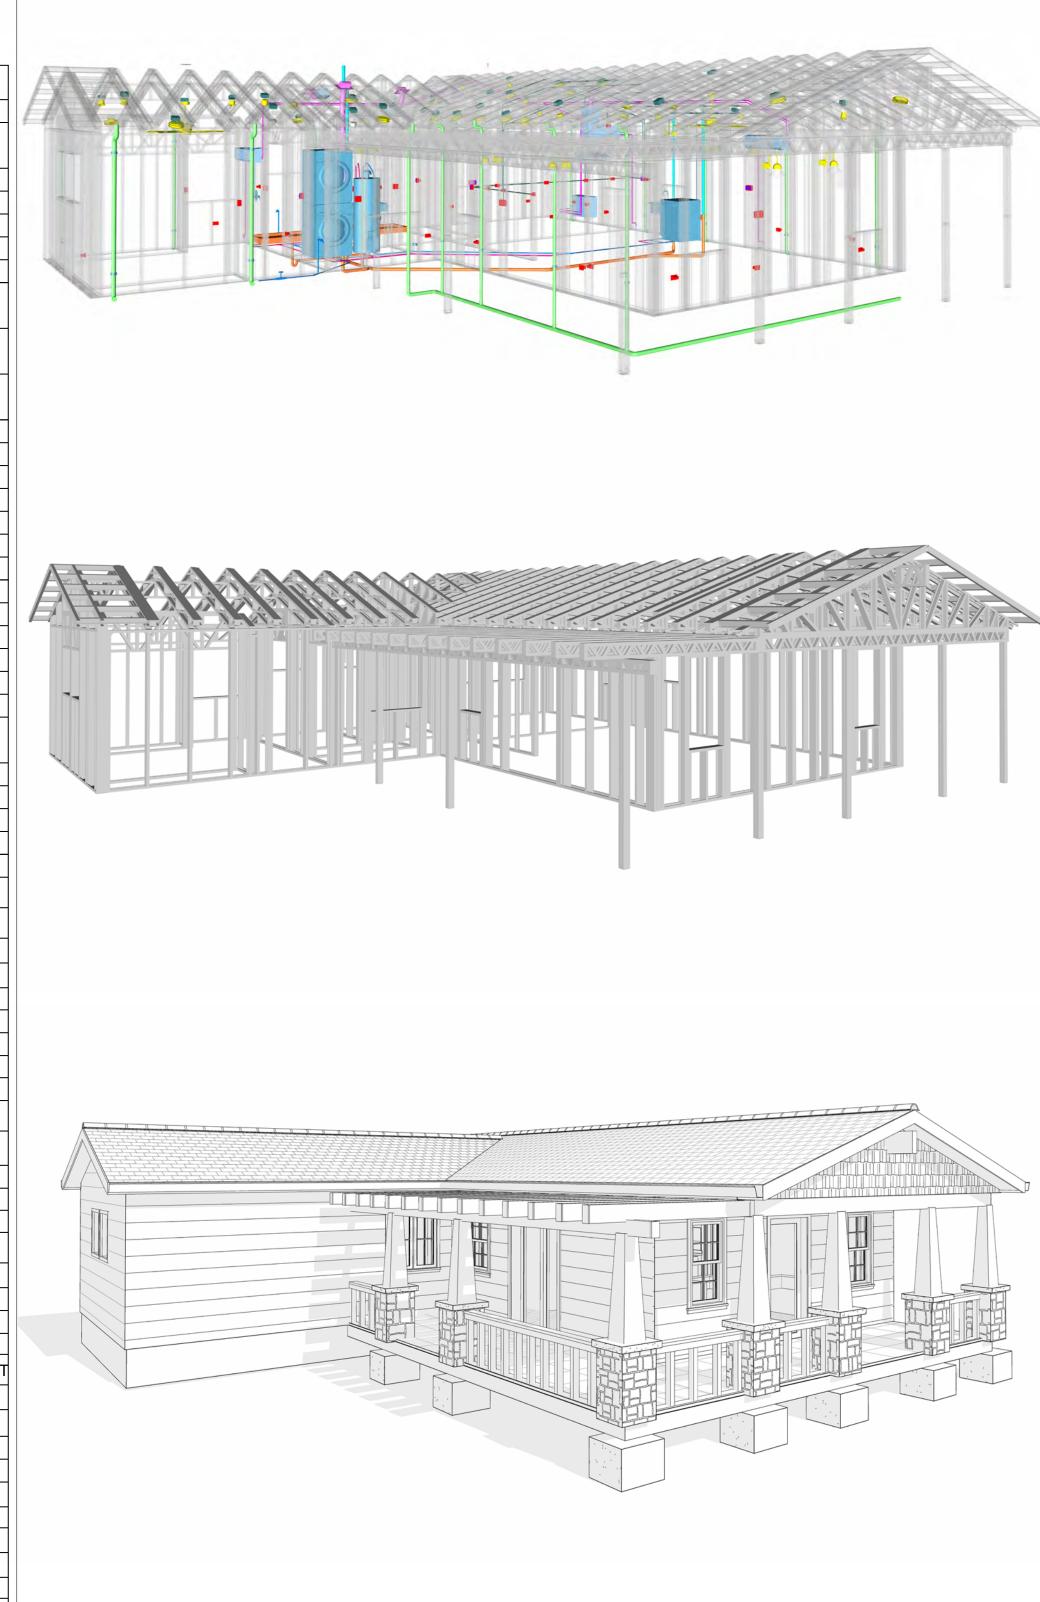
of the Material.



PAGE INDEX	
COVER SHEET	AFS
FLOOR PLAN	ASTM
DIMENSION PLAN	
FOUNDATION PLAN	CA
STRUCTURAL FLOOR PLAN	EL
FRAME LAYOUT	F.F.E
ROOF TRUSS LAYOUT	F.F.L
ROOF PLAN	FTG
ELEVATIONS	HVAC
ELEVATIONS	
SECTIONS	IRC
DETAILS	
CASEWORK DETAILS	IMC
CASEWORK DETAILS	
SCHEDULE	MAX.
LIGHTING PLAN	ME
POWER PLAN	MIN.
DIMENSION PLAN FOR LIGHT FIXTURE	NO.
DIMENSION PLAN FOR FITTING	O.C
COVER SHEET	OSB
WATER SUPPLY SYSTEM	PL
SEWAGE SYSTEM	PSI
RISER DIAGRAM	PVC
HVAC PLAN HVAC SECTION	REF
RISER DIAGRAM	RG
NISER DIAGRAIVI	SE
	SF
	SIMP.
TAG'S NAME	
CASEWORK TAG	SIMP.
	TV
DOOR TAG	UNO
FURNITURE TAG	W/
NAMES OF TARGET	W/D
WINDOW TAG	AC
SPECIALTY EQUIPMENT TAG	ACC
MECHANICAL EQUIPMENT TAG	ACCU
PLUMBING EQUIPMENT TAG	CC
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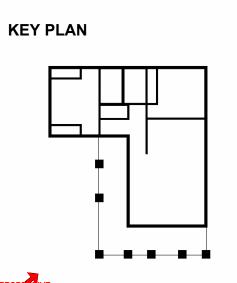
STATIC PRESSURE

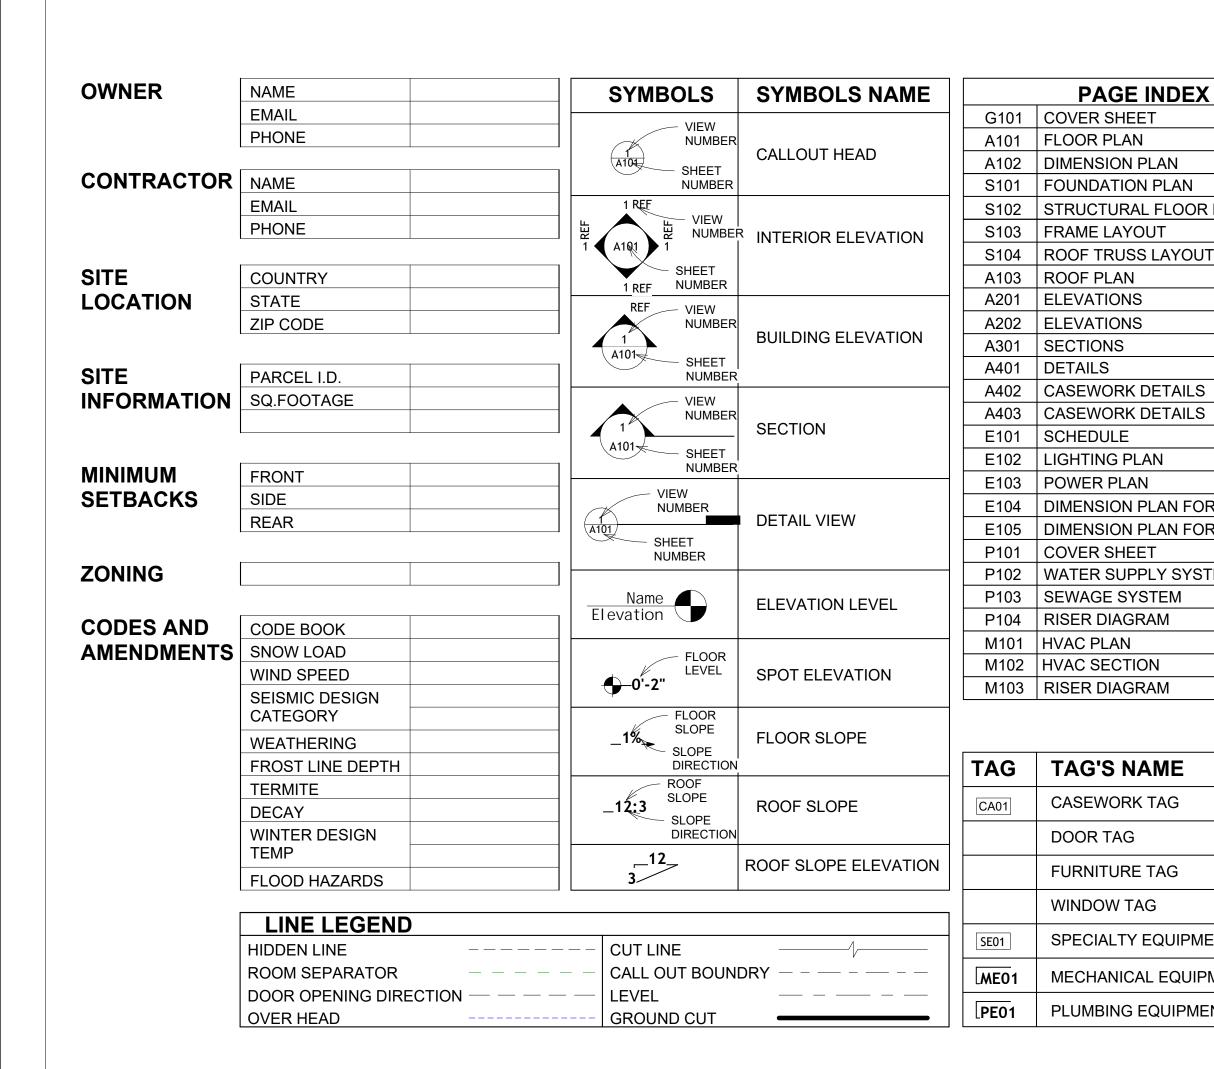

57-Hamilton-1000-2Bd/2Ba Craftsma 550

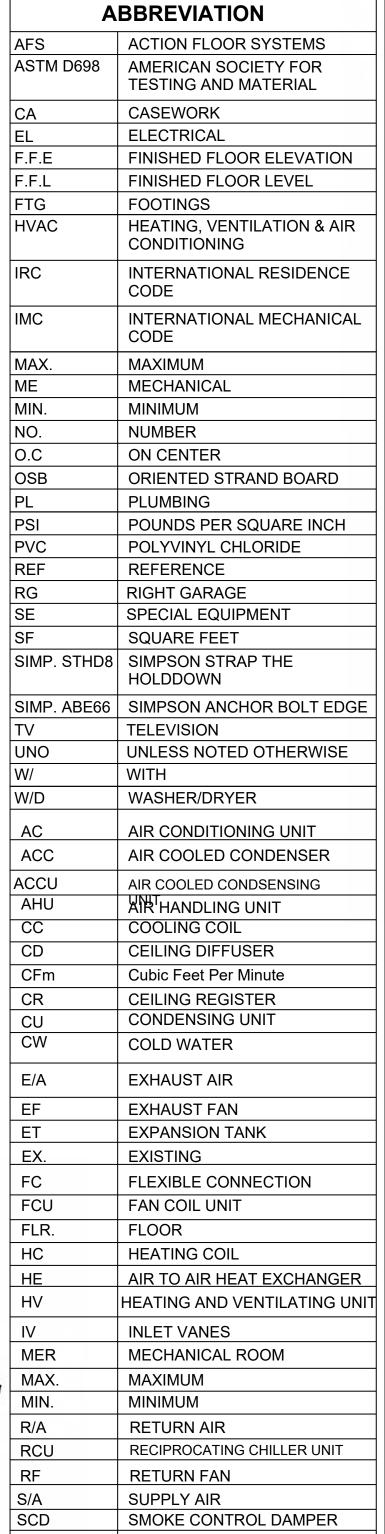d		
	SQUARE FOOT	AGE
	LIVING	998
	PORCH	308
	TOTAL	1306







NOTE:

LEGEND:

PROJECT


57-Hamilton-1000-2Bd/2Ba Craftsma 550

DRAWING NAME

**COVER SHEET** 

CLIENT NAME:	Client Name
PROJECT NUMBER:	0061_12
DATE:	2/17/2025 2:50:57 PM
DESIGNED BY:	Designer
DRAWN BY:	Author
CHECKED BY:	Checker

G101

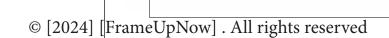

#### **GENERAL NOTES**

- THIS DRAWING DEPICTS THE ARCHITECTURAL (SPACE LAYOUT, FURNISHING, FLOOR, WALLS, ROOFS, FOUNDATION, WINDOWS AND DOORS) SYSTEMS. IT PROVIDES A VISUAL REPRESENTATION OF THE ARCHITECTURAL LAYOUT AND COMPONENTS.
- THE ARCHITECTURAL DRAWINGS ARE PREPARED TO MEET THE SPECIFIC REQUIREMENTS OF THE BUILDING, AS PER THE PROJECT SPECIFICATIONS AND APPLICABLE CODES AND STANDARDS.
- THE CONSTRUCTION OF THIS HOME SHALL COMPLY WITH THE LATEST EDITION OF THE INTERNATIONAL RESIDENTIAL CODE (IRC), INTERNATIONAL MECHANICAL CODE (IMC), THE INTERNATIONAL PLUMBING STANDARD, THE NATIONAL ELECTRICAL STANDARD AND ALL OTHER APPLICABLE LOCAL, STATE, AND NATIONAL CODES AND REGULATIONS.
- COORDINATION WITH OTHER TRADES HAS BEEN DONE ON A DESIGN LEVEL. THIS DRAWING SHALL BE READ TOGETHER WITH THE ME, EL AND PL DESIGN DRAWINGS TO ENSURE PROPER CONSTRUCTION AND INTEGRATION OF THE BUILDING SYSTEMS.

#### ABOUT WALLS:


- SHOWER WALL COVERING
- BATHTUB AND SHOWER SPACES (WALLS AND FLOORS) WITH INSTALLED SHOWER HEADS AND IN SHOWER COMPARTMENTS SHALL BE FINISHED WITH A NON-ABSORBENT SURFACE.
- 2. WALL PAINT (INTERNAL)
  - THE TYPICAL THICKNESS OF LATEX WALL PAINT IS 1/32 OF AN INCH FOR A SINGLE COAT. AND DOUBLE COAT (1/16") SHALL BE APPLIED FOR DURABILITY.

THE ADVISABLE TYPE OF ADHESIVE FOR THIS PROJECT IS **EPOXY ADHESIVES**BECAUSE THEY ARE KNOWN FOR THEIR HIGH STRENGTH, DURABILITY, AND RESISTANCE TO MOISTURE, CHEMICALS AND

REFER TO SHEETS A201 & A202 FOR GENERAL NOTES ON EXTERNAL FINISHING MATERIALS

#### ABOUT FLOORS:


- THE SPOT ELEVATION INDICATES THE FINISHED FLOOR ELEVATION.
- FINISHED FLOORS PER PLANS.
- FIELD VERIFY FOR DIMENSION DROP 4" FOR SHOWER AND BATHTUB USE.
- 1% SLOPE ON OUTDOOR BALCONIES FOR WATER RUN OFF.
- 2% SLOPE TOWARDS THE SHOWER DRAIN FOR SUFFICIENT DRAINAGE.
- 4" DROP AT THE DOOR LEADING TO EXTERIOR BALCONY FROM THE MAIN LIVING AREA.
- 5% SLOPE FOR GARAGE IS USED, WHICH SHOULD BE CHECKED WITH THE LOCAL GARAGING ZONING LAWS.

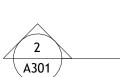



FURNITURE SCHEDULE				
TYPE MARK	TYPE	COUNT		
1	QUEEN 60" X 79"	2		
2	THREE SEAT SOFA 2	1		
3	THREE SEAT SOFA	1		
4	<varies></varies>	5		
5	COFFE TABLE	1		

ROOM FINISH SCHEDULE							
ROOM NUMBE R	ROOM NAME	FLOOR FINISH	BASE FINISH	WALL FINISH	CEILING FINISH	CEILING HEIGHT	COM MEN TS
	1						
01	LIVING ROOM	HARDWOOD	CONCRETE	WALL PAINT	DRY WALL	8' - 0"	
02	KITCHEN	HARDWOOD	CONCRETE	WALL PAINT + CERAMIC	DRY WALL	8' - 0"	
03	BEDROOM 1	HARDWOOD	CONCRETE	WALL PAINT	DRY WALL	8' - 0"	
04	CL 1	HARDWOOD	CONCRETE	WALL PAINT	DRY WALL	8' - 0"	
05	BEDROOM 2	HARDWOOD	CONCRETE	WALL PAINT	DRY WALL	8' - 0"	
06	CL 2	HARDWOOD	CONCRETE	WALL PAINT	DRY WALL	8' - 0"	
07	CL 3	HARDWOOD	CONCRETE	WALL PAINT	DRY WALL	8' - 0"	
08	BATH 1	VINYL TILES	CONCRETE	CERAMIC TILE	MRD	8' - 0"	
09	BATH 2	VINYL TILES	CONCRETE	CERAMIC TILE	MRD	8' - 0"	
10	WD	HARDWOOD	CONCRETE	WALL PAINT	DRY WALL	8' - 0"	
11	HALL	HARDWOOD	CONCRETE	WALL PAINT	DRY WALL	8' - 0"	
12	WH	HARDWOOD	CONCRETE	WALL PAINT	DRY WALL	8' - 0"	
13	PORCH	PROCELAIN TILE	CONCRETE	EXTERIOR-GRADE PLYWOOD	PLYWOOD	8' - 0"	

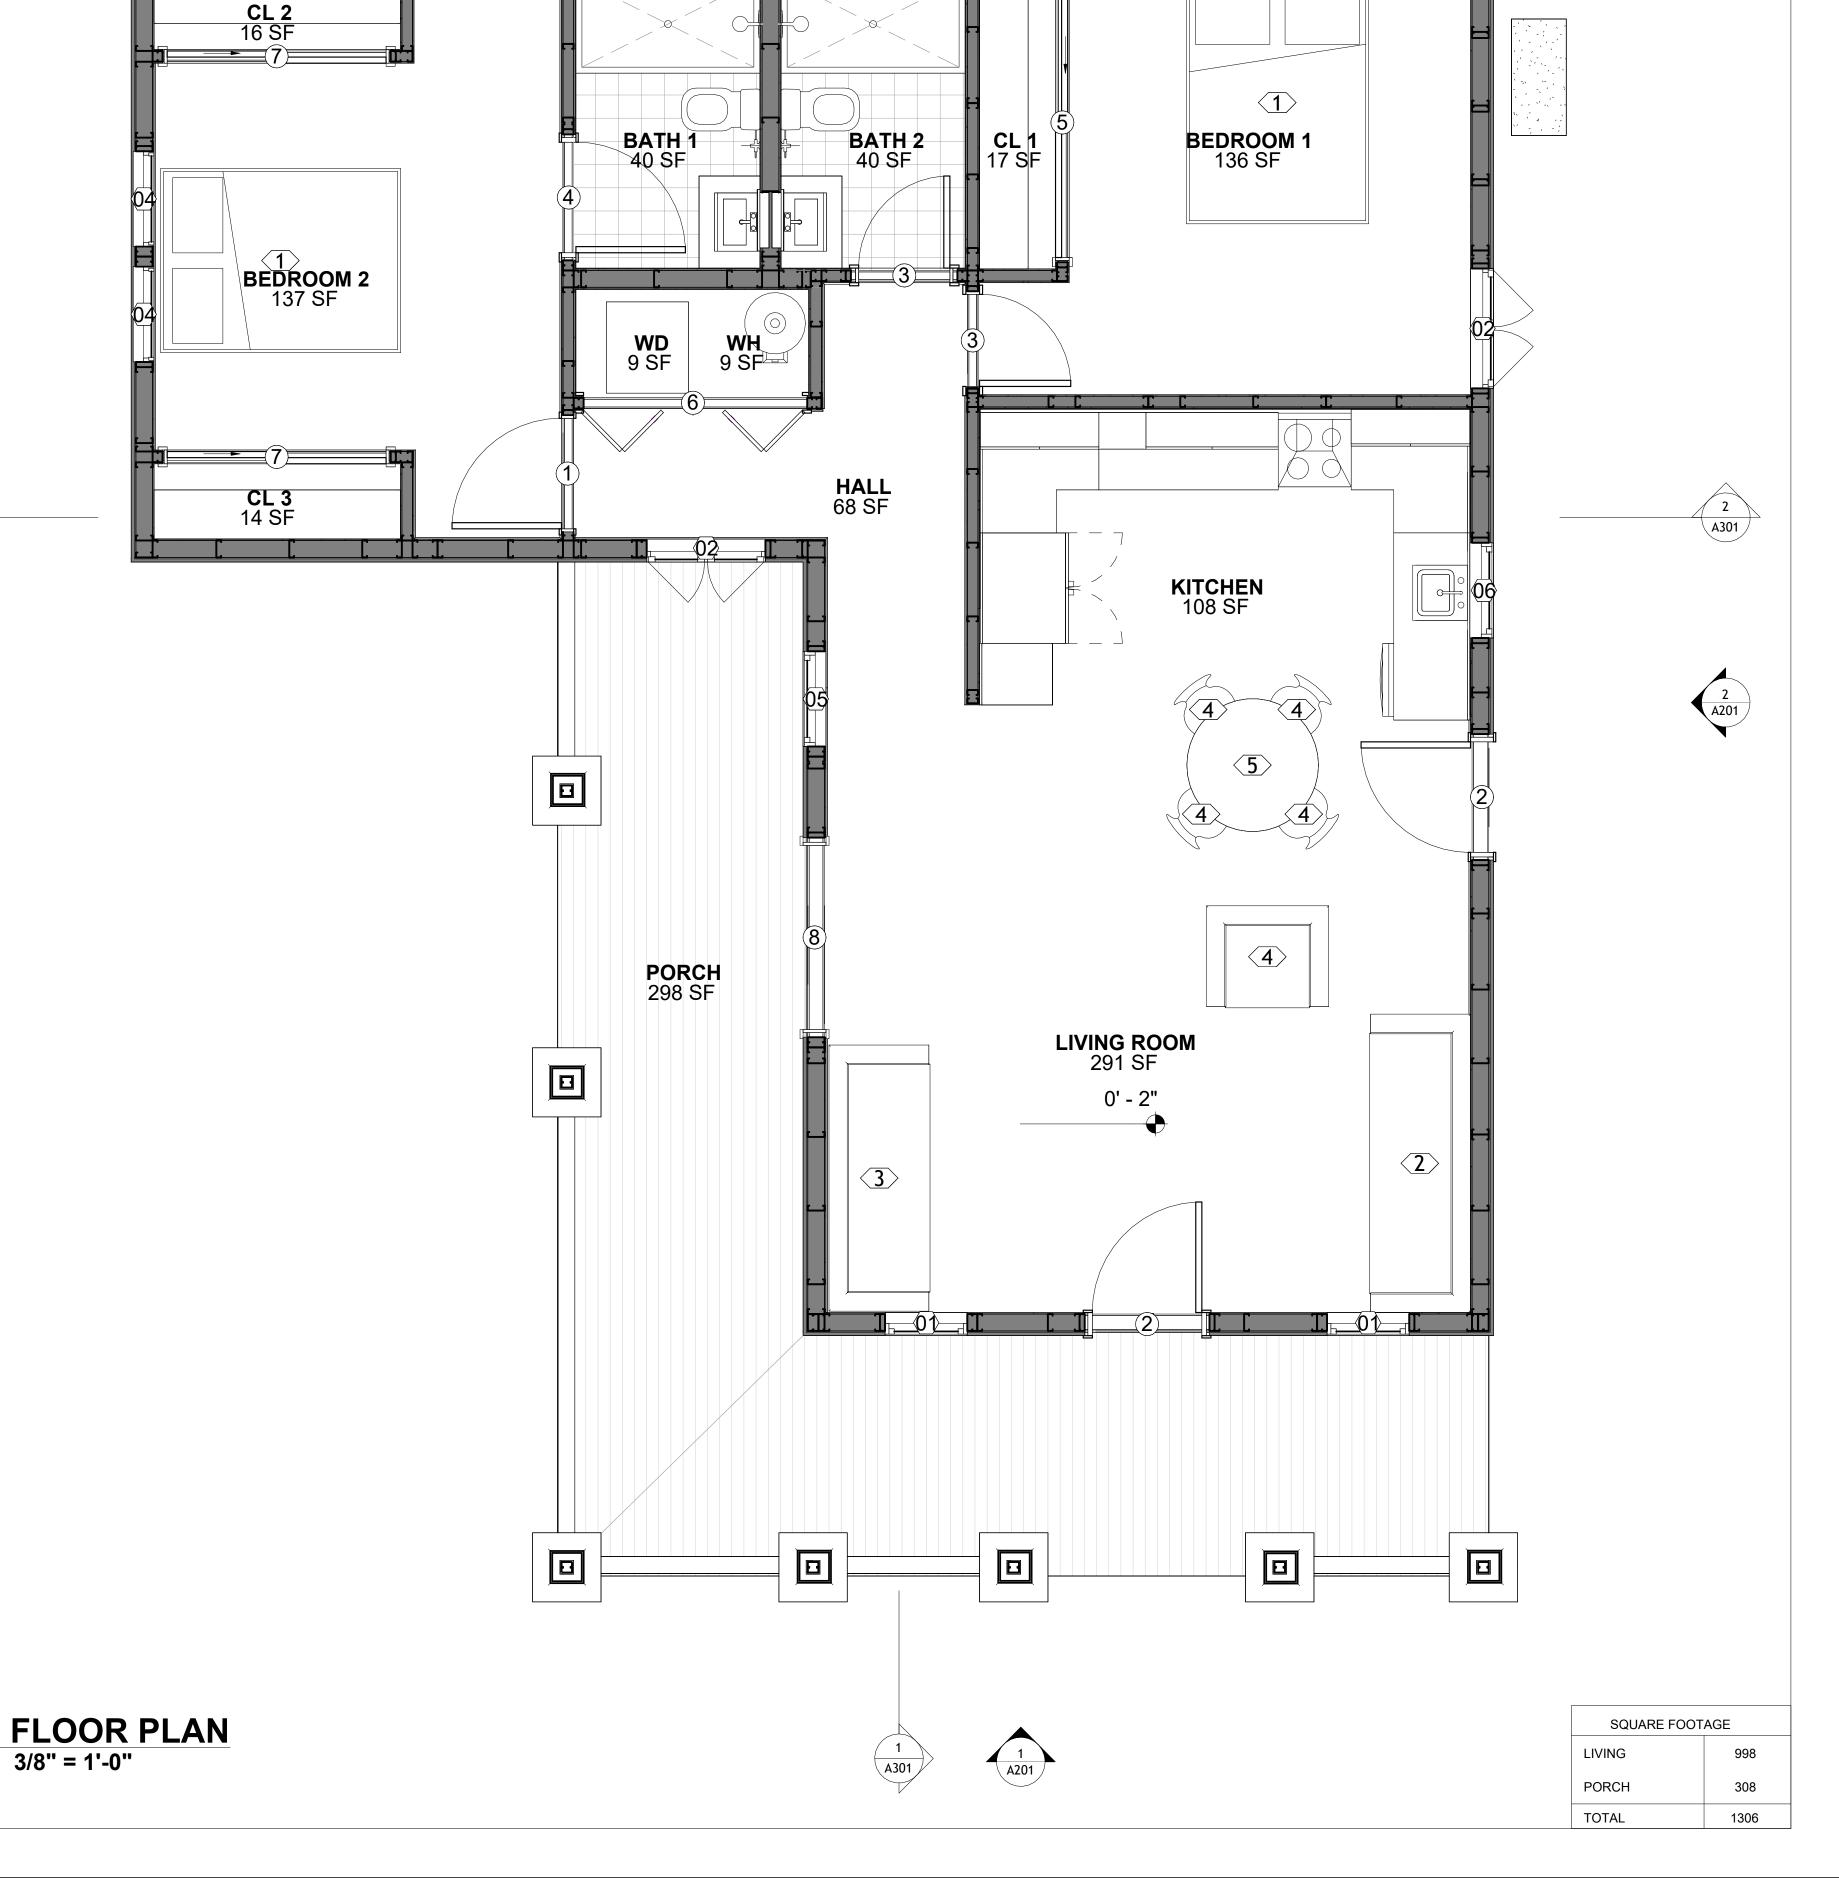



**KEY PLAN** 

NO.	DESCRIPTION	DATE

NOTE:

LEGEND:

PROJECT

57-Hamilton-1000-2Bd/2Ba Craftsma 550

DRAWING NAME


**FLOOR PLAN** 

Client Name
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2/17/2025 2:50:59 PM
Designer
Author
Checker


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SCALE: As indicated

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**KEY PLAN** 

NO.	NO. DESCRIPTION	

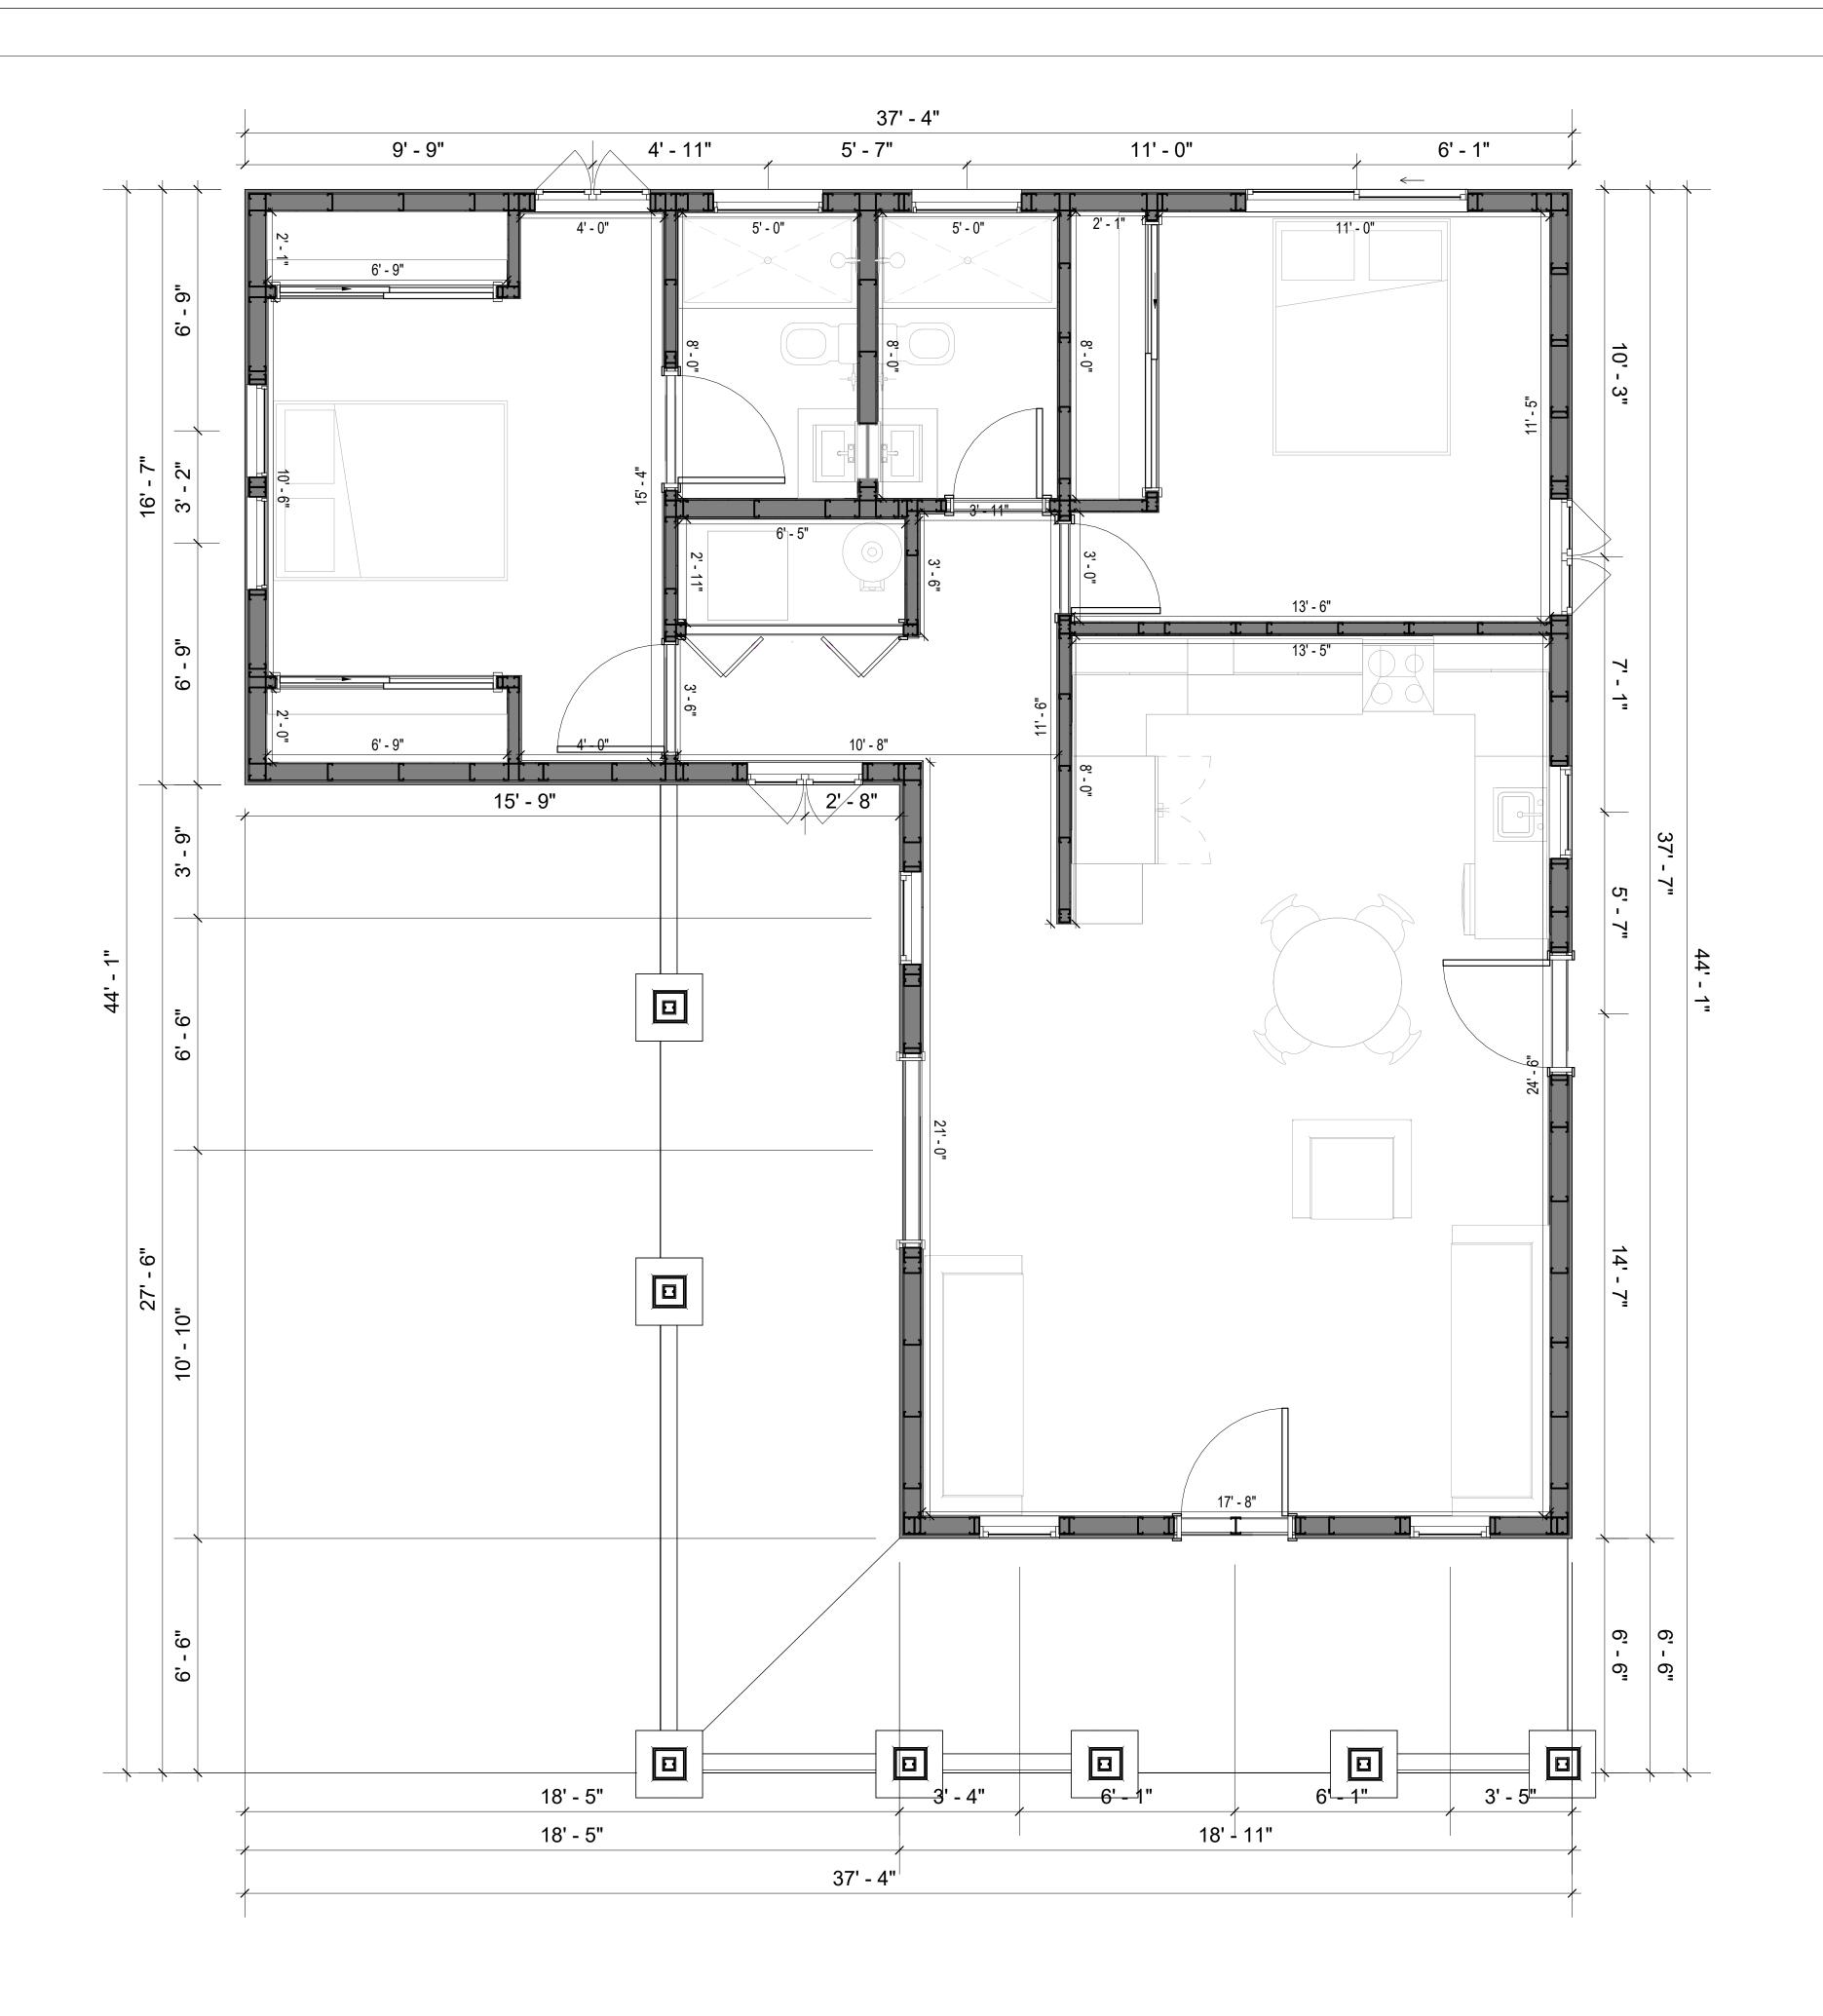NOTE:

LEGEND:

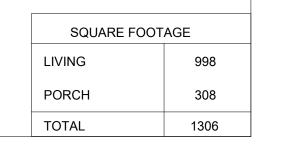PROJECT

57-Hamilton-1000-2Bd/2Ba Craftsma 550

DRAWING NAME

DIMENSION PLAN

CLIENT NAME:	Client Name
PROJECT NUMBER:	0061_12
DATE:	2/17/2025 2:51:00 PM
DESIGNED BY:	Designer
DRAWN BY:	Author
CHECKED BY:	Checker

A102

SCALE: 3/8" = 1'-0"

#### **FOUNDATION NOTES**

#### NOTES:

TERMITES PRETREATMENT BY LICENSED CONTRACTOR UNDER SLAB AND AROUND FOOTINGS. ALL AREAS BELOW SLABS SHALL BE TREATED NO MORE THAN 24 HOURS PRIOR TO CONCRETE POUR. EVIDENCE OF TREATMENT MUST BE PROVIDED PRIOR TO PLACING OF CONCRETE.

#### 1. MATERIALS:

ALL INTERIOR CONCRETE SLABS SHALL BE A MIN. OF 4" THICK CONCRETE OVER 4" COMPACTED AGGREGATE BASE (ASTM D698), FINISH ELEVATIONS AS NOTED ON DRAWINGS, 6" ABOVE ADJACENT GRADE, LEVEL SLABS TO 1/8"-10' MAX.. CONCRETE SLABS SHALL BE 2500# PSI AT 28 DAYS. A 4" ALLOWABLE SLUMP.

#### 2. **PAD PREPARATION:**

EXCAVATION FOR FOOTING SHALL BE NEAT.

- FOOTINGS SHALL BE POURED IMMEDIATELY AFTER EXCAVATION AND APPROPRIATE INSPECTION.

- ALL REINFORCING STEEL MARKED "CONTINUOUS" SHALL BE LAPPED 36 BAR DIAMETERS AT SPLICES AND AROUND CORNERS OR INTERSECTIONS WITH A STANDARD 90 DEGREE BEND ON CORNER BARS. LAP WIRE MESH ONE FULL MESH AT SIDE AND END LAPS.

- ALL HARDWARE TO BE SIMPSON OR EQUIVALENT.
- EXTERIOR FRAME WALL TO BE SECURED WITH 1/2"X10" ANCHOR BOLTS 4'-0" O.C. FOR 1-STORY AND 2'-8" O.C. FOR 2-STORY. BOLTS SHALL BE LOCATED WITHIN 1'-0" OF EACH END

PIECE AND SHALL HAVE A MIN. OF TWO BOLTS PER PIECE.
-FOUNDATION ANCHOR STRAPS SHALL BE PERMITTED, ACCORDING TO RESIDENTIAL CODE

- ALL INTERIOR WALLS TO BE SECURED WITH POWER DRIVEN PINS PER MANUFACTURER SPECIFICATION USE PIN SPACING EQUIVALENT TO 1/2" ANCHOR BOLTS.

ALL CONSTRUCTION TO CONFORM TO THE 2012 IRC
 R-10 RIGID INSULATION OUTSIDE OF EXTERIOR FOUNDATION WALLS UNDER LIVING AREA.
 CONCRETE PAD FOR CONDENSER THICKNESS IS 4" MIN UNLESS OTHERWISE NOTED.

#### 3. CONCRETE CONSTRUCTION:

- THE SLAB SHALL BE UNDERLAIN BY A VAPOR BARRIER/RETARDER IN THE LIVING AREA (TYPICALLY POLYETHYLENE, UNLESS MORE STRINGENT PROTECTION REQUIRED BY THE ARCHITECT, ENGINEER, FLOOR COVERING MANUFACTURER, OR ACCEPTED PRACTICE). UNLESS OTHERWISE REQUIRED, BARRIER MAY BE OMITTED AT GARAGES, PORCHES AND PATIOS WITHOUT FLOOR COVERINGS. IT IS BEYOND THE SCOPE OF THESE PLANS TO DETERMINE THE APPLICABILITY OF THESE MORE STRINGENT REQUIREMENTS. BUILDER SHALL VERIFY PRIOR TO CONSTRUCTION.

#### 4. REINFORCEMENT:

- IF CONSTRUCTED ON ACTIVE SOILS, THE LONG TERM PERFORMANCE OF THE FOUNDATION IS DEPENDENT ON MAINTENANCE BY THE OWNER. THUS THE BUILDER SHALL ADVISE THE OWNER OF THE FOLLOWING:

1. DRAINAGE MUST BE MAINTAINED. WATER SHALL NEVER BE ALLOWED TO POND NEAR THE FOUNDATION.

2. THE SOIL AROUND THE FOUNDATION SHALL BE MAINTAINED IN A RELATIVELY DAMP CONDITION, SUCH AS THAT REQUIRED TO KEEP A LAWN GREEN. IF IT DRIES OUT IT WILL

SHRINK. IF IT GETS WET, IT WILL HEAVE UPWARD.

3. SLABS ON THE SHORTER SIDE USES MAIN BARS ARE USED IN THIS DIRECTION ONLY WITH SMALLER DIAMETER DISTRIBUTION BARS ARE PLACED, FORMING A MAT OR GRID.

4. ALL REINFORCEMENT BARS SIZE 10MM OR LARGER IN ACCORDANCE TO ASTM

3. ANCHOR BOLTS AT ALL EXTERIOR WALLS SHALL BE MINIMUM 1/2 INCH DIAMETER WITH A

MAXIMUM SPACING OF 6'-0" ON CENTER, UNLESS NOTED OTHERWISE.

4. ANCHOR BOLTS SHALL BE INSTALLED WITHIN 12 INCHES OF EACH END OF EACH SILL PLATE WITH AT LEAST TWO ANCHOR BOLTS FOR EACH BOLTS FOR EACH SILL PLATE LONGER

THAN 12 INCHES.


5. SIMPSONS SILL ANCHORS MAYBE SUBSTITUTED FOR ANCHOR BOLTS AT THE SAME SPACING.

6. EXTERIOR CONCRETE SLABS WHICH ARE NOT PART OF THE MAIN SLAB SHALL BE MINIMUM 4 INCHES THICK WITH NO STEEL REINFORCING BARS REQUIRED, UNLESS NOTED OTHERWISE ON FOUNDATION PLAN.

#### **VERIFY THE FOLLOWING PRIOR TO POURING:**

- . ALL HOLDDOWNS , STRAP, AND POST LOCATIONS.
- 2. CONCRETE FINISHES. PANEL RISER LOCATION WHERE APPLICABLE.
- 3. UNDERSLAB MECHANICAL REQUIREMENTS.
- 4. STEM WALL BLOCKOUTS.
- 5. UNDERSLAB ELECTRICAL REQUIREMENTS AND PANEL RISER LOCATION. WHERE APPLICABLE.
- 6. PROVIDE THE FOLLOWING:
- PVC SLEEVES THROUGH FTG IF REQUIRED
- 20' #4 COPPER GROUND BAR.
- 7. SLOPE FINISH GRADE AWAY FROM FOOTING.

**NOTE**: FIELD VERIFY ALL DIMENSIONS SEE DIMENSIONED ARCHITECTURAL DRAWINGS

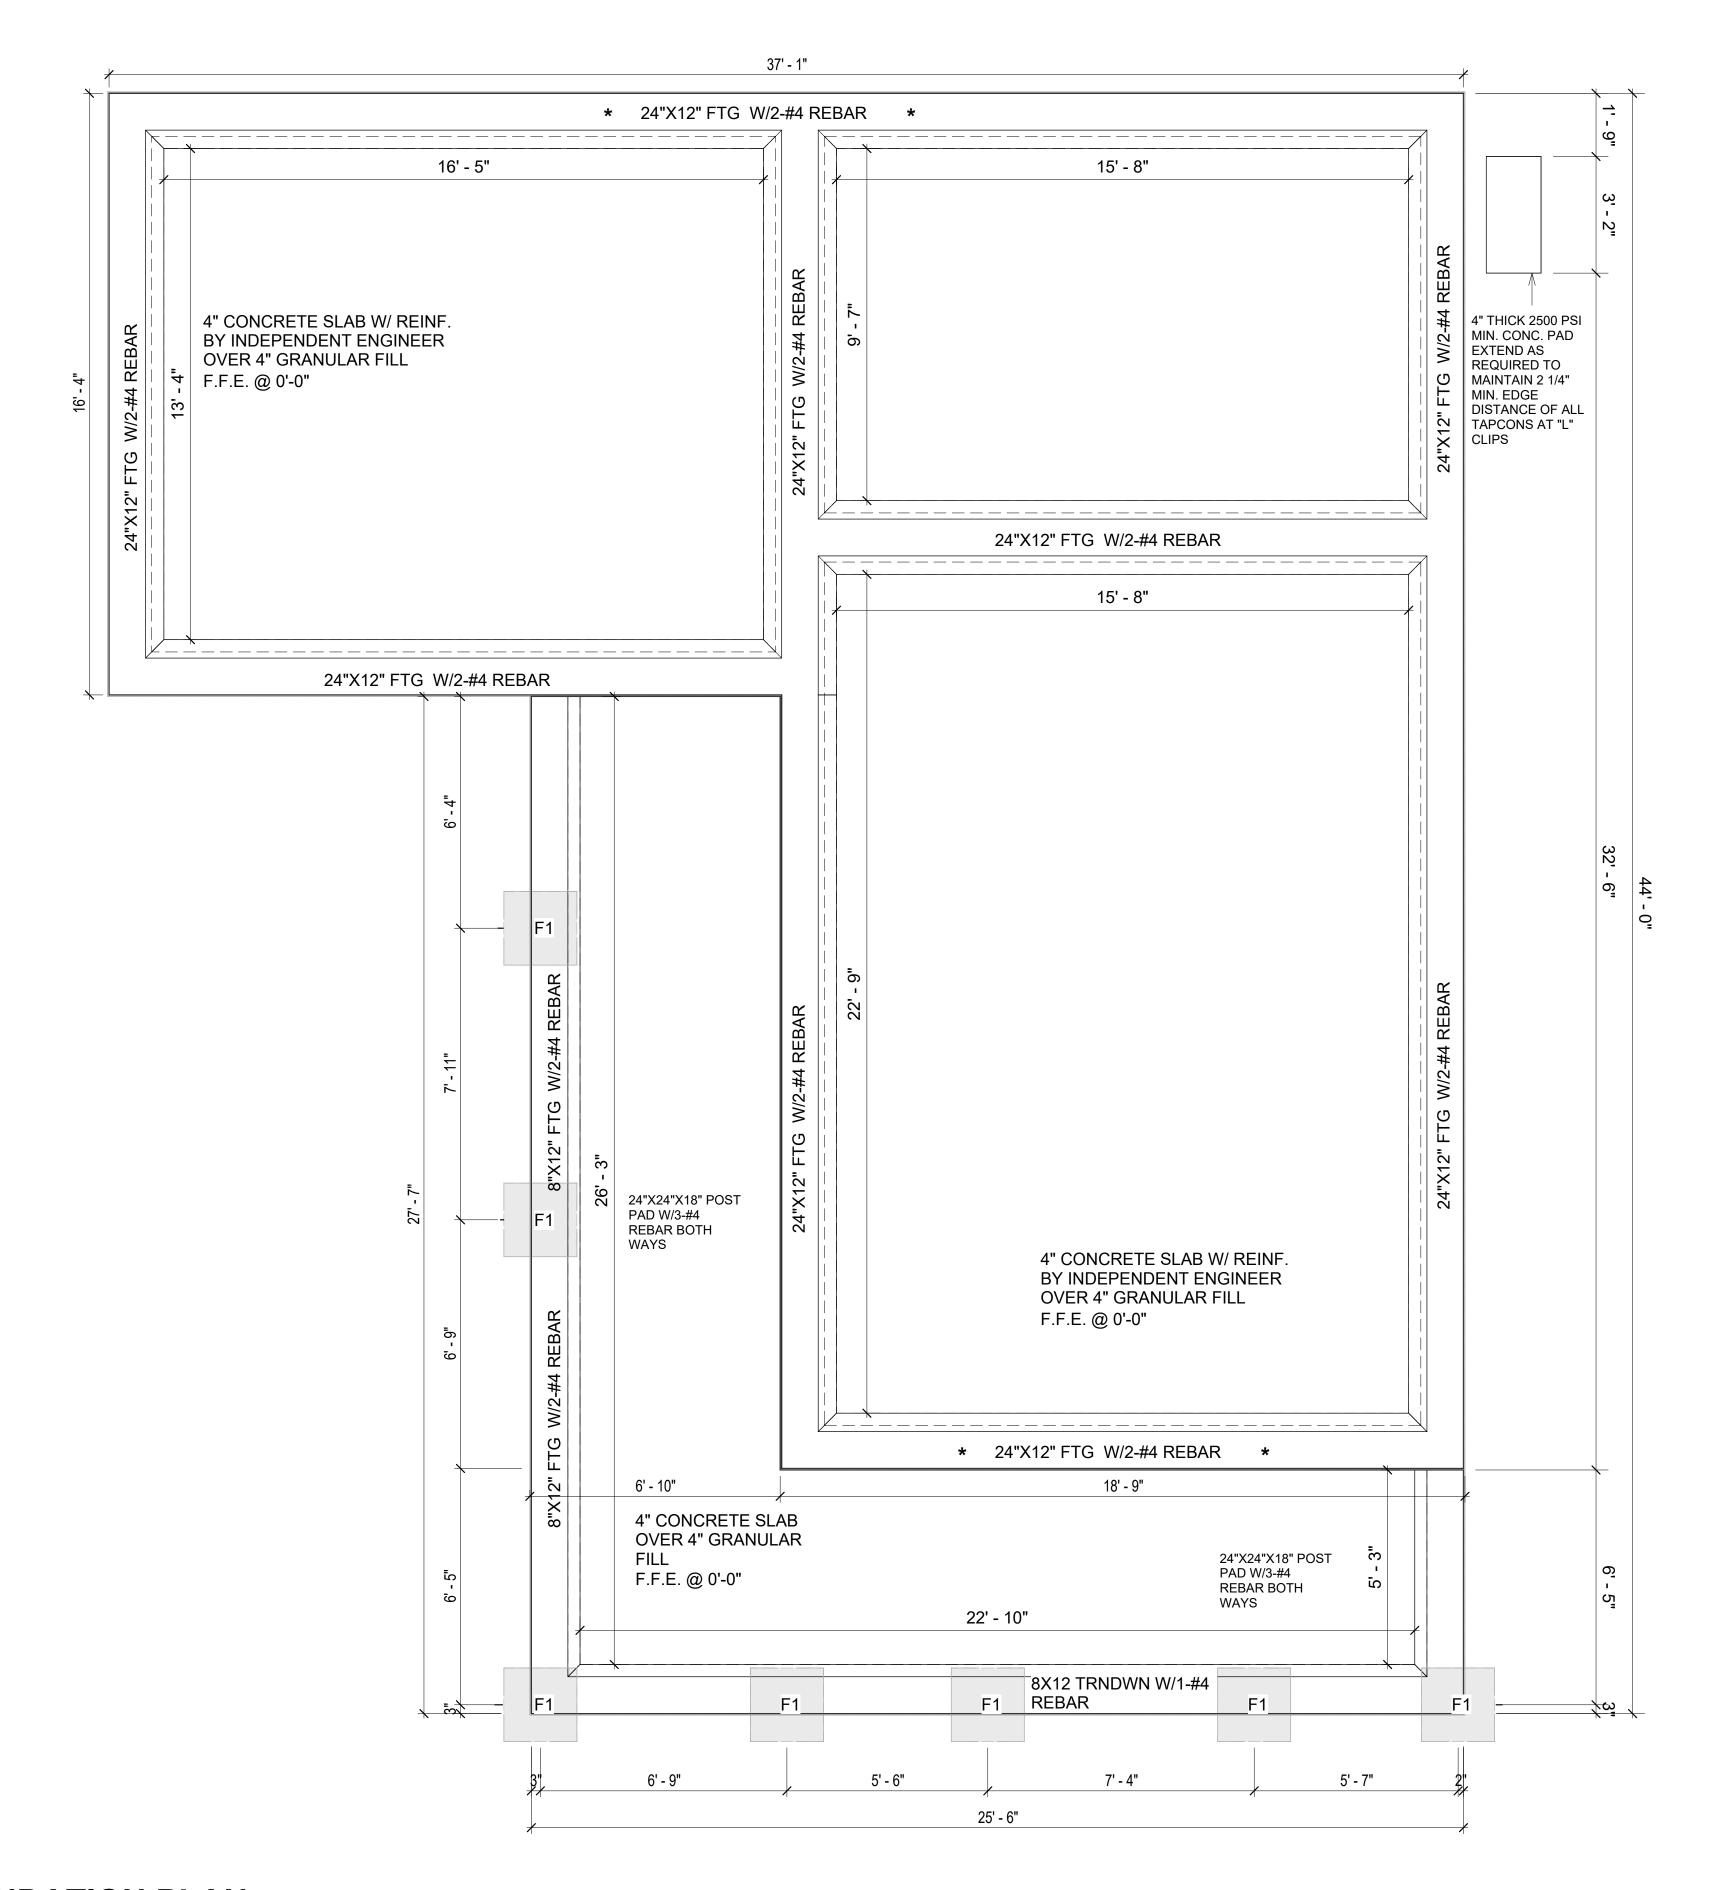

FOUNDATION PLAN
3/8" = 1'-0"

SQUARE FOOTAGE

LIVING 998

PORCH 308

TOTAL 1306



**KEY PLAN** 

NO.	DESCRIPTION	DATE

NOTE:

LEGEND:

PROJECT

57-Hamilton-1000-2Bd/2Ba Craftsma 550

DRAWING NAME

FOUNDATION PLAN

CLIENT NAME:	Client Name
PROJECT NUMBER:	0061_12
DATE:	2/17/2025 2:51:00 PM
DESIGNED BY:	Designer
DRAWN BY:	Author
CHECKED BY:	Checker
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**S101** 

SCALE: 3/8" = 1'-0"

#### **GENERAL NOTES**

NOTES:

-ALL BEARING WALLS SHOULD HAVE A THICKENED SLAB PER SECTION PER DETAIL A401/5.

#### A) **FOUNDATION PLAN NOTES**:

- CONCRETE SLAB SHALL BE 6" THICK WITH 1/2" DIAMETER TENDONS PER LAYOUT PLAN, CENTERED IN SLAB THICKNESS, OVER APPROVED SUBBASE PER GENERAL STRUCTURE NOTES.
- 2. TERMITE PROTECTION SHALL BE PROVIDED PER IRC SECTION R318.1 NONE TYPICAL ANCHOR BOLT SPACING AT SHEAR WALL AND HOLD DOWN
- SPECIFICATIONS PER APPROVED ARCHITECTURAL PLANS. 4. INSTALL HOLDOWNS BEFORE CONCRETE SLAB POUR.
- EXISTING FILL ON-SITE SHALL BE COMPACTED IN ACCORDANCE WITH THE
- REQUIREMENTS IN THE GEOTECHNICAL REPORT.
- 6. ALL FLOOR SLABS ARE REINFORCED ON CONCRETE SLABS.

#### SPECIAL INSPECTION IS REQUIRED FOR THICKENED FOUNDATION CONSTRUCTION

- 1. REINFORCEMENT
- 2. 2300 PSI CONCRETE POUR


#### B) **REINFORCEMENT FOR CONCRETE**:


1. ALL REINFORCING SLABS BARS SIZE 10MM OR LARGER SHALL BE DEFORMED IN ACCORDANCE TO ASTM-A706, AND BARS SMALLER THAN 10 MM MAYBE PLAIN. 2. UNLESS OTHERWISE NOTED IN PLANS, THE YIELD STRENGTH OF REINFORCING BARS SHALL BE:

> A) FOOTING = 40,000 PSI B) NON-LOAD BEARING WALLS AND PARAPETS= 40,000 PSI

- 3. SPLICES SHALL BE SECURELY WIRED TOGETHER AND SHALL LAP OR EXTEND
- 4. GRADE OF STEEL FOR RCC WORKS SHALL BE GRADE 4 10.
- BAR NOTATIONS GIVES INFORMATION
- A) BAR SIZE
- B) SPACING(IF REQUIRED)
- 6. LAP REINFORCEMENT ONLY AT LOCATION SHOWN IN THE DRAWINGS REINFORCEMENT SHALL NOT BE CUT, VENT OR HEATED ON SITE WITHOUT ENGINEERS' APPROVAL.
- C) **CONCRETE SLAB NOTES**
- 1. ALL SLAB REINFORCEMENT SHALL BE 20MM CLEAR MINIMUM FROM BOTTOM AND FROM TOP OF SLAB.
- 2. REINFORCEMENT IN CONTINUOUS ELEVATED SLAB SHALL BE CUT AS FOLLOWS.

- THIS IS A SCHEMATIC PLAN FOR THE PURPOSE OF LOCATING AND IDENTIFYING FOUNDATION REINFORCING ELEMENTS ONLY. VERIFY ALL DIMENSIONS, DROPS, OFFSETS AND FEATURES WITH THE ARCHITECTURAL PLANS BEFORE FORMING THE FOUNDATION.

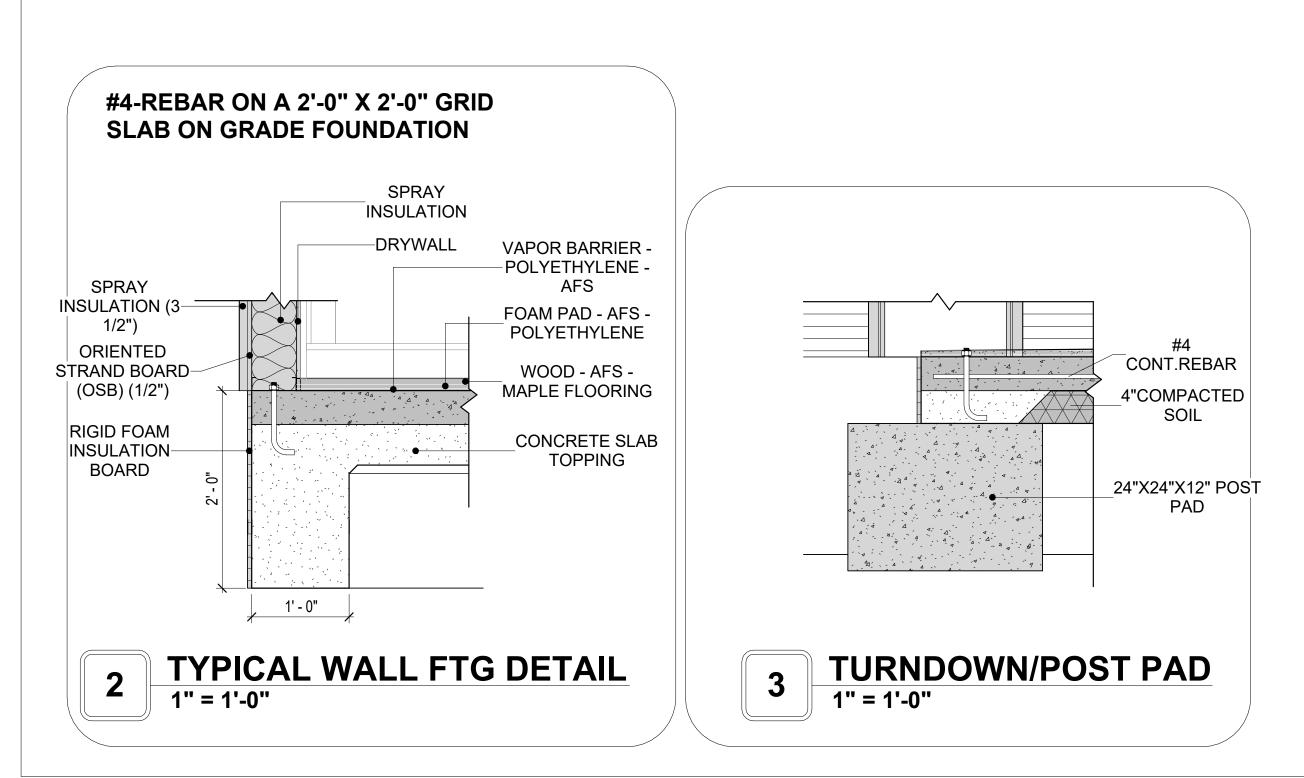

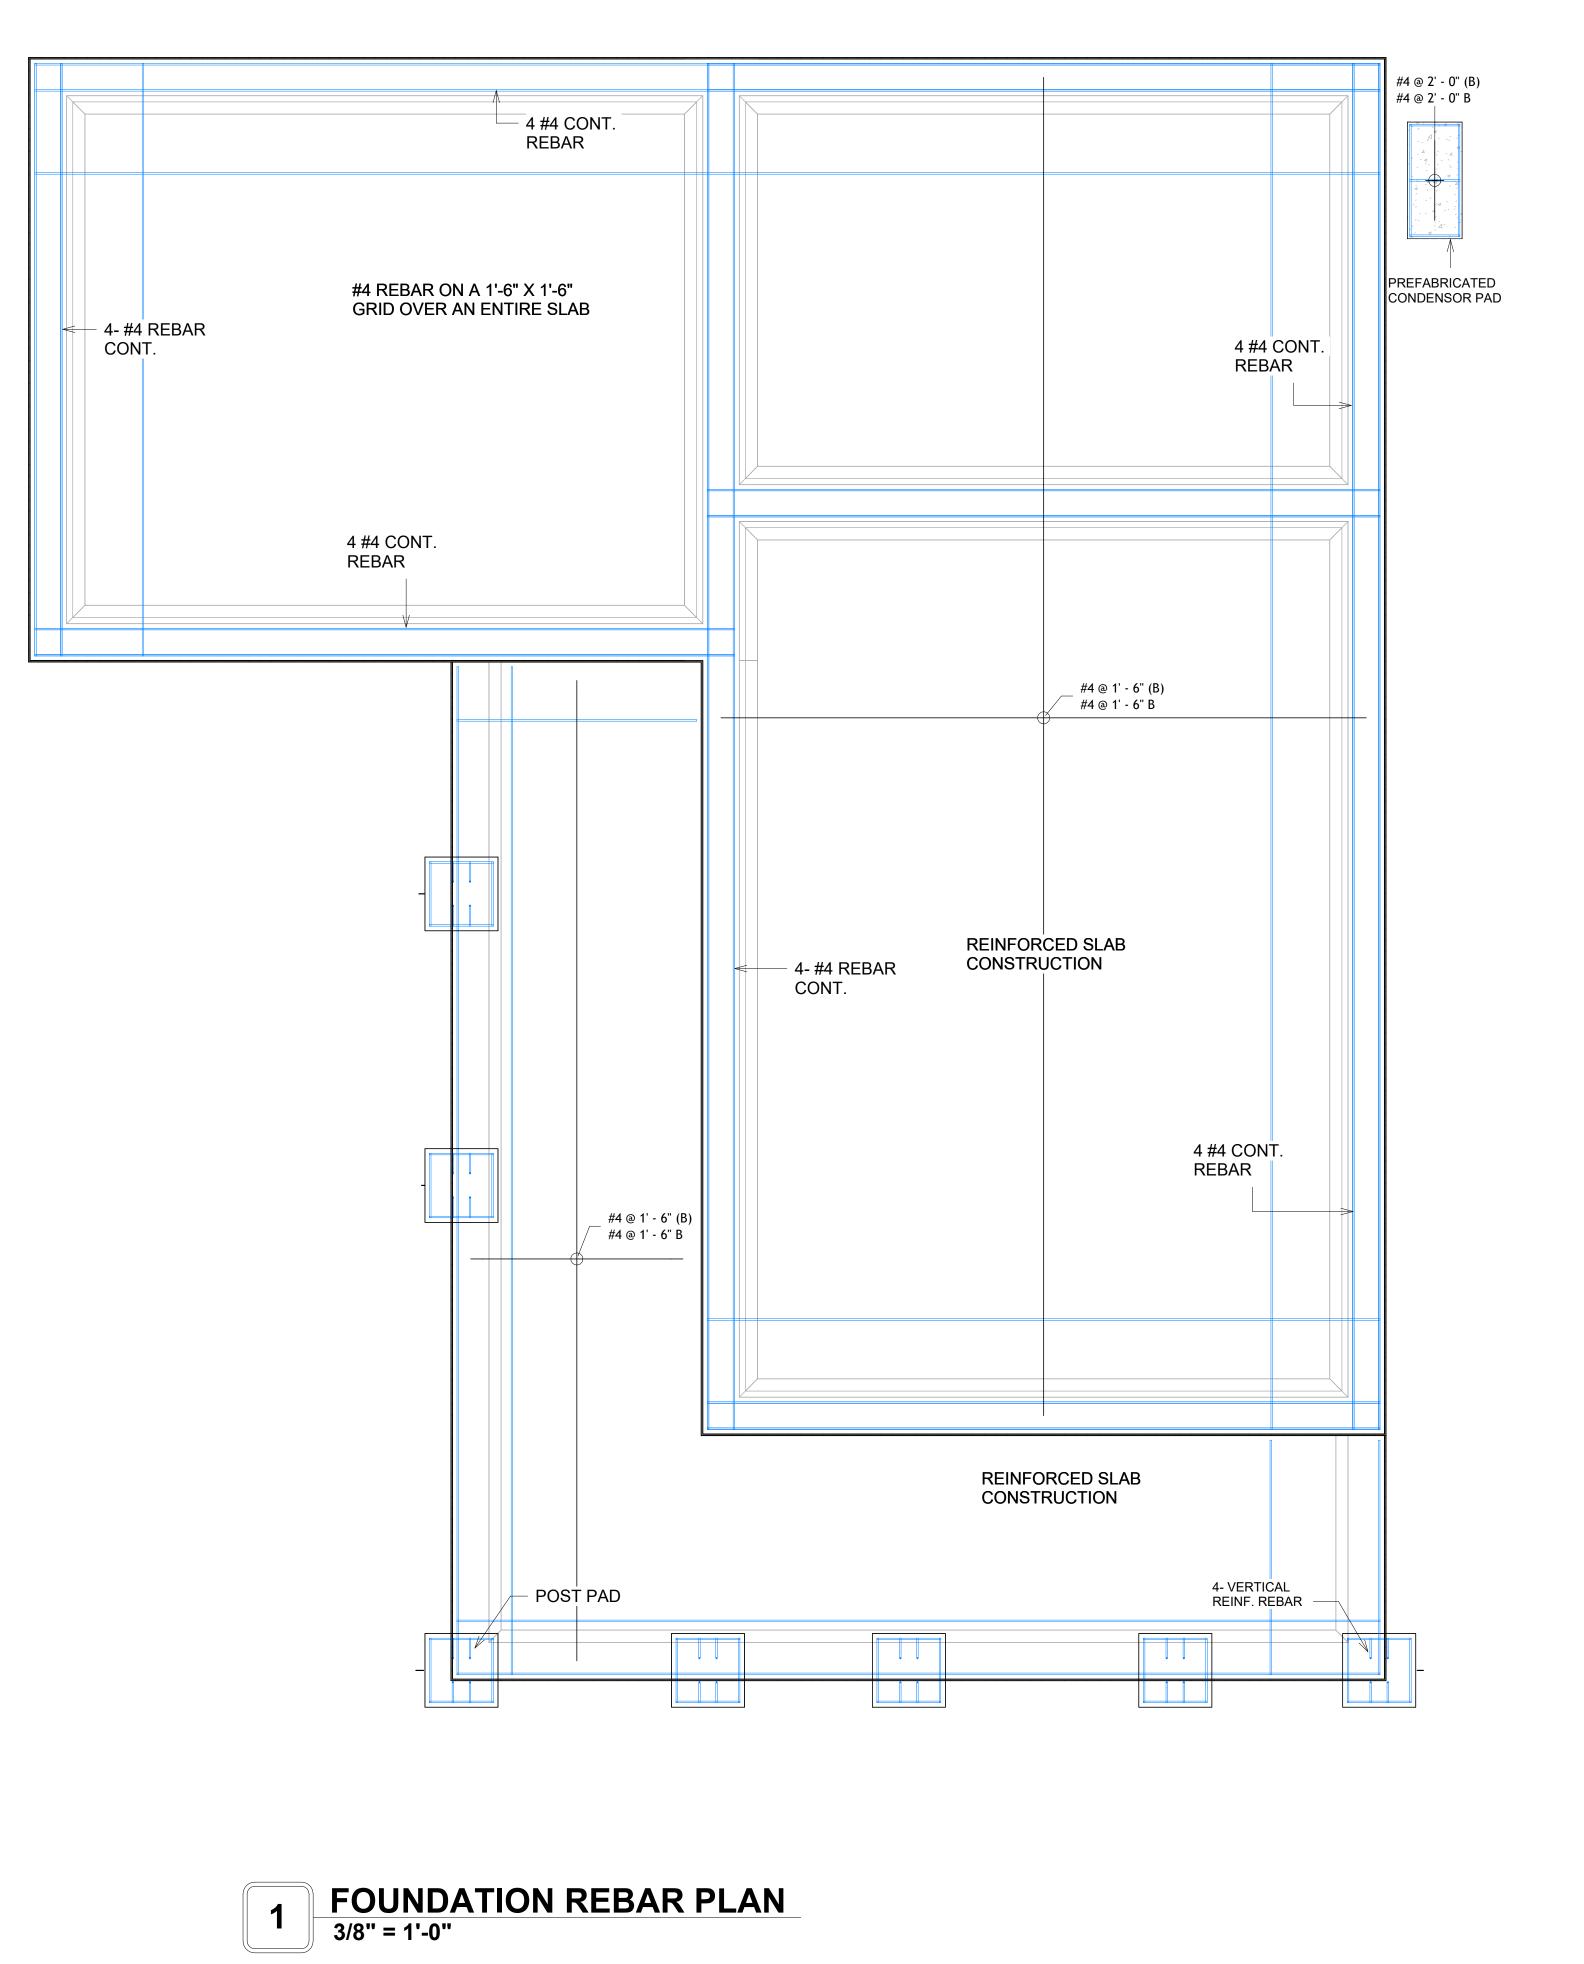



**KEY PLAN** 

NO.	DESCRIPTION	DATE

NOTE:

LEGEND:

PROJECT

57-Hamilton-1000-2Bd/2Ba Craftsma 550

DRAWING NAME

STRUCTURAL FLOOR PLAN

CLIENT NAME: **Client Name** PROJECT NUMBER: 0061\_12 2/17/2025 2:51:01 PM Designer **DESIGNED BY:** DRAWN BY: **Author** CHECKED BY: Checker

**S102** 


# ROOF NOTES

- ROOFING COMPOSITION ROOFING PER OWNERS/BUILDERS
   SPECIFICATIONS INSTALL PER MANUFACTURE SPECIFICATIONS ON 1/2"
   ORIENTED STRAND BOARD ON PRE-ENGINEERED TRUSS @ 24" O.C. (UNO.)
   73" OVERHANG AT EAVES (UNO.)
- 3. ENDS OF ALL TRUSSES AND JOISTS TO BE FULLY BLOCKED. PROVIDE SOLID BLOCKING AT ALL RIDGES AND VALLEYS

RESISTANT DRYWALL, TAPED AND TEXTURED.

- 1. SHEATHING TO BE 1/2", 3/8" OSB SHEAR PANEL AND EQUIVALENT.

  UNDERSIDE OF PORCH TRUSSES TO BE FINISHED WITH MOISTURE
- 5. EXPOSED EAVES AND OTHER WEATHER EXPOSED AREAS TO BE SHEATHED WITH EXTERIOR GRADE PLYWOOD.
- 6. ALL MATERIALS THICKNESS AND SIZE ARE THE MINIMUM. Refer TO LOCAL STANDARDS FOR ACTUAL THICKNESS AND LAYERING OF MATERIALS.
- 7. ENGINEERED TRUSS CALCULATIONS TO BE SUBMITTED TO BUILDING
- DEPARTMENT PRIOR TO FABRICATION AND INSTALLATION.
  8. TRUSS MANUFACTURER TO SPECIFY HANGER CONNECTORS FOR TRUSS
- 9. DESIGNER ASSUMES THAT TRUSSES BEAR ON ALL EXTERIOR PERIMETER
- WALLS (TYPICAL) OR BEAMS.
- 10. PROVIDE GALVANIZED STEEL FLASHING WITH A LENGTH OF 10 FEET, WIDTH OF 12 INCHES, AND THICKNESS OF 24 GAUGE.

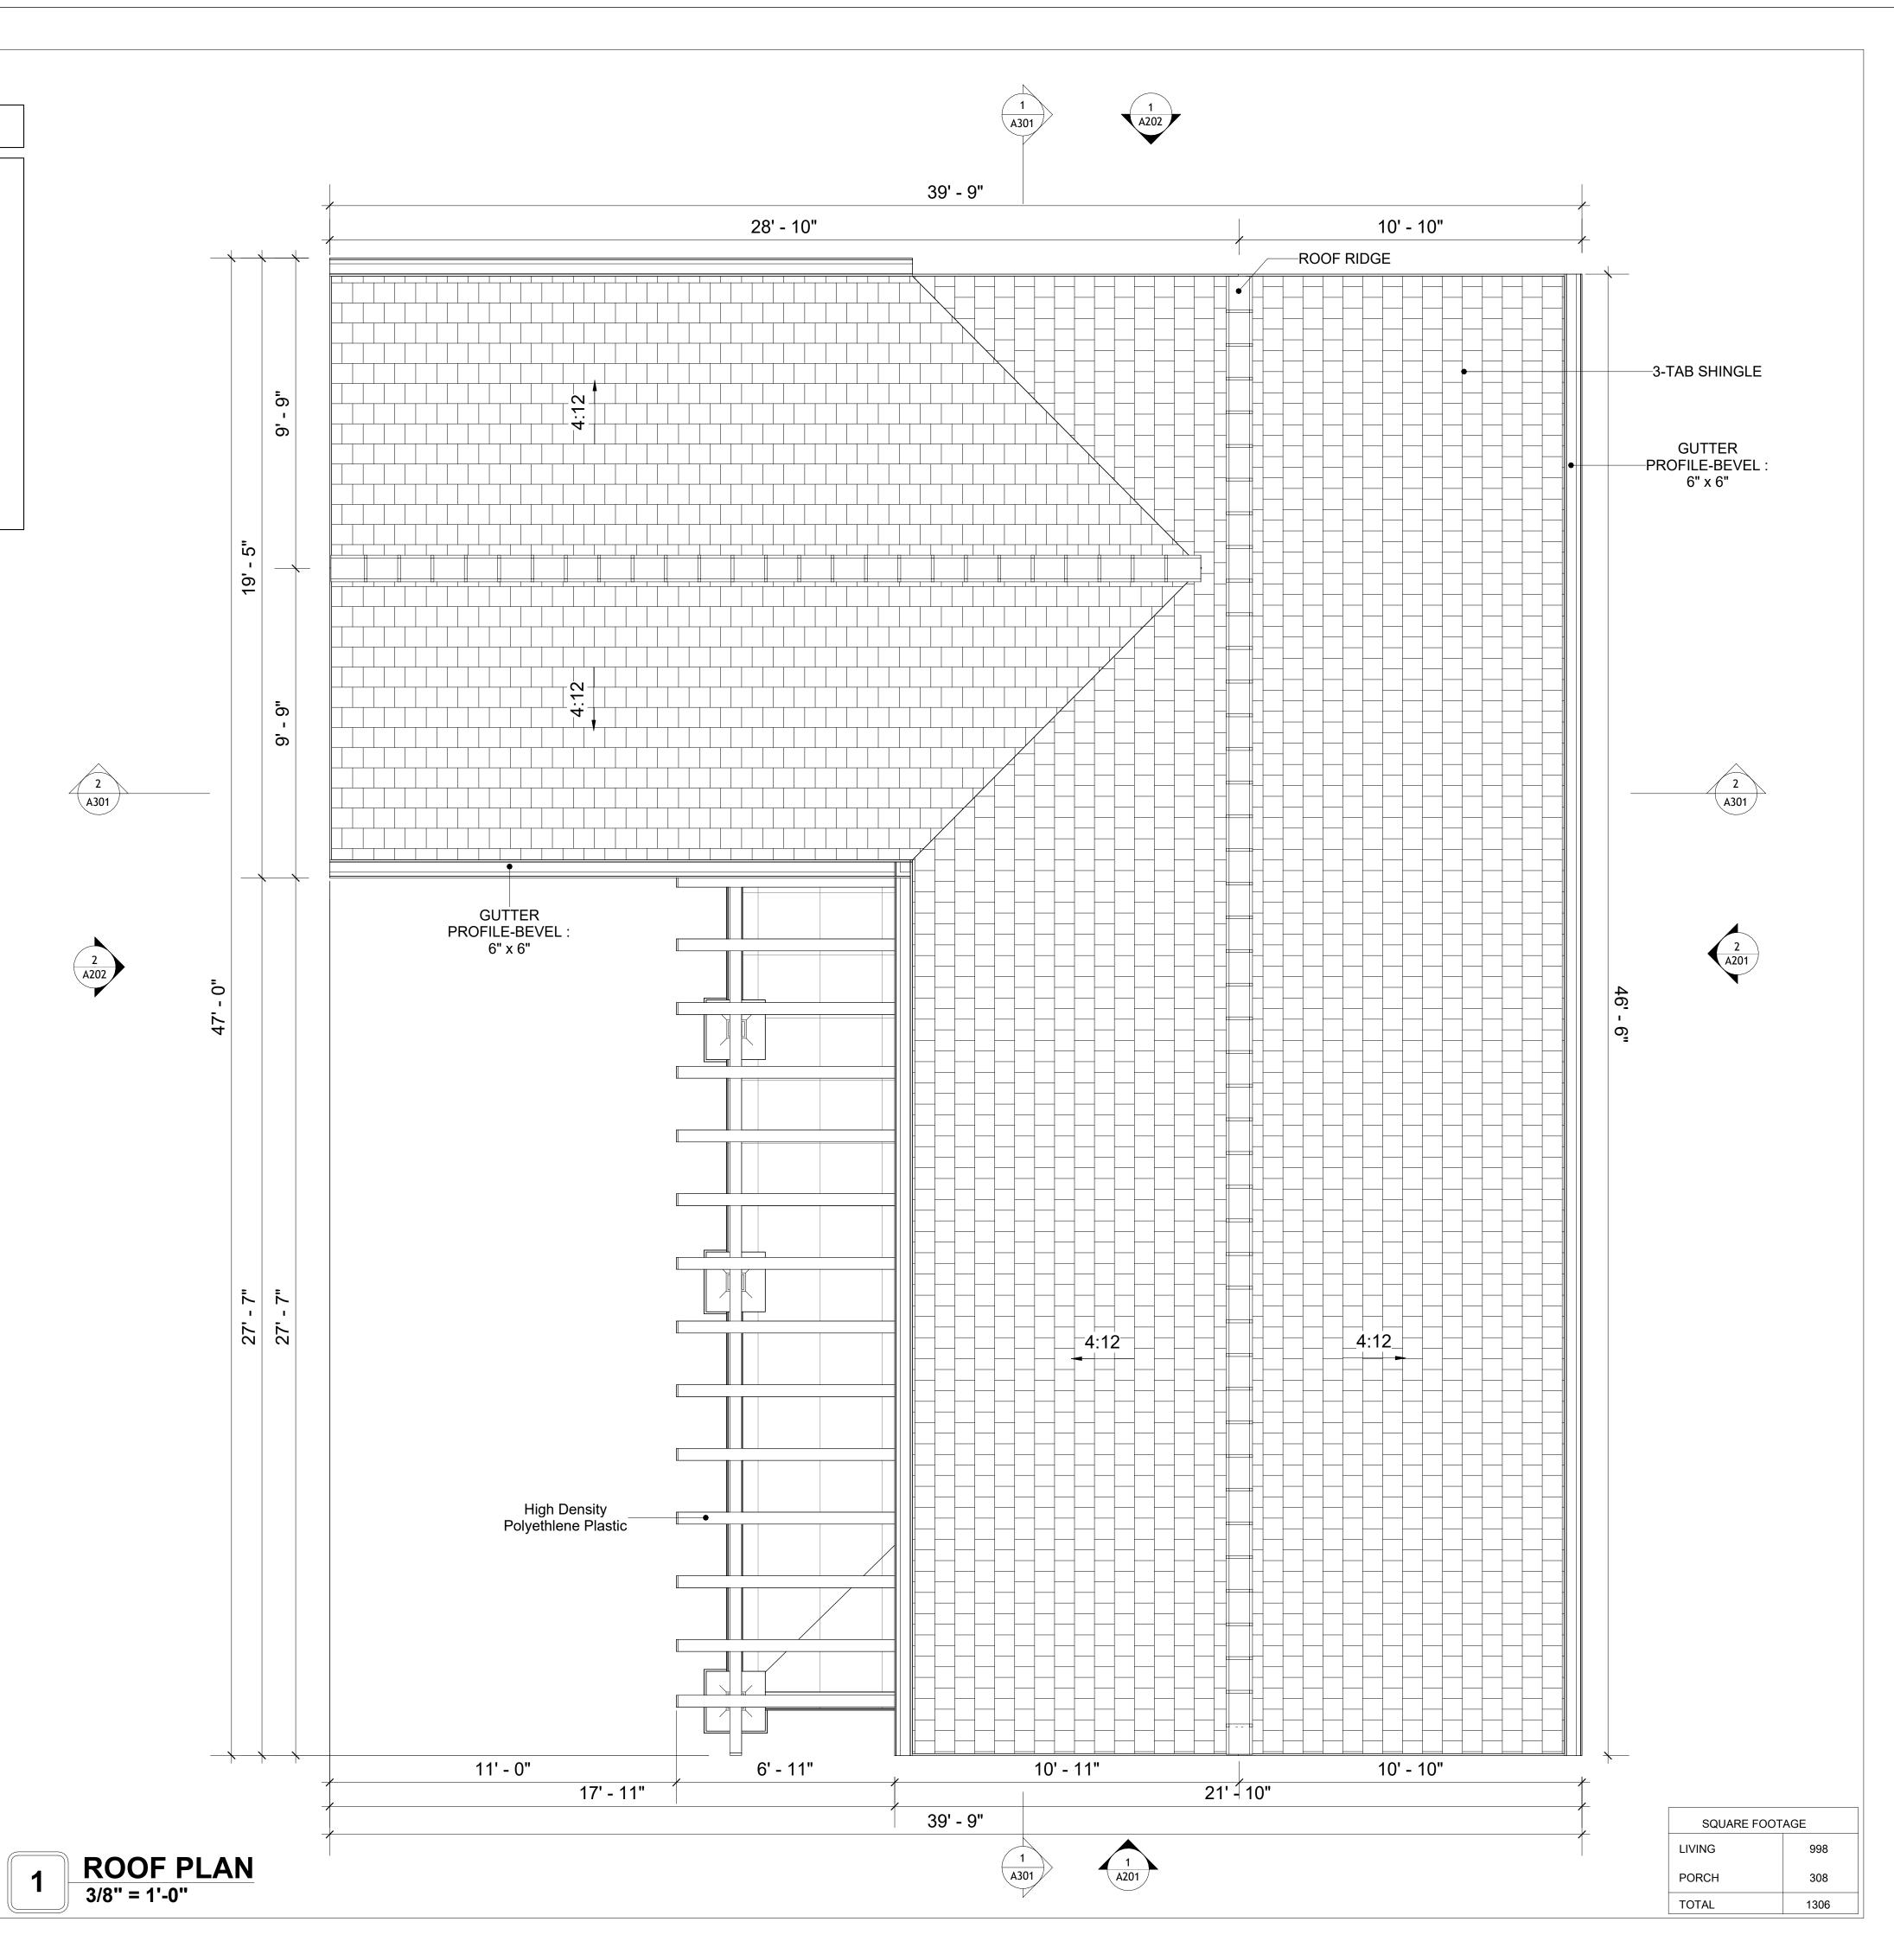



**KEY PLAN** 

NO. DESCRIPTION DATE

NOTE:

LEGEND:

PROJECT

57-Hamilton-1000-2Bd/2Ba Craftsma 550

DRAWING NAME

**ROOF PLAN** 

CLIENT NAME:

PROJECT NUMBER:

0061\_12

DATE:

2/17/2025 2:51:05 PM

DESIGNED BY:

DRAWN BY:

CHECKED BY:

Checker

A103

#### **ABOUT WALL FINISHING**

#### **EXTERNAL STONE**

THESE STONE PRODUCTS ARE MADE FROM A BLEND OF NATURAL AGGREGATES, CEMENT, AND OTHER PROPRIETARY MATERIALS.

THE STONE FINISH IS DIRECTLY ATTACHED TO COLD-FORMED STEEL (CS) FRAMING. (FOR COLUMN FINISH) EXTERNAL STONE CAN BE AN EXCELLENT EXTERIOR CLADDING OPTION FOR CS-FRAMED BUILDINGS. IN THIS SCENARIO, THE EXTERNAL STONE WOULD BE ADHERED TO THE CS FRAME USING A SCRATCH COAT AND MORTAR-BASED ADHESIVE.

#### CAST MANUFACTURED STONE


MANUFACTURED STONE, ALSO KNOWN AS CULTURED OR ARTIFICIAL STONE, IS A SYNTHETIC BUILDING MATERIAL MADE FROM A BLEND OF CEMENT, AGGREGATES, AND PIGMENTS TO MIMIC THE APPEARANCE OF NATURAL STONE. IT IS LIGHTWEIGHT, DURABLE, AND CUSTOMIZABLE IN COLOR AND TEXTURE.

IN THIS PROJECT, MANUFACTURED STONE IS USED AS THE COPING MATERIAL, PROVIDING A DURABLE AND AESTHETIC FINISH THAT MIMICS THE APPEARANCE OF NATURAL STONE.

#### **CORRUGATED IRON SHEET**

CORRUGATED IRON IS A FINISHING MATERIAL MADE FROM STEEL THAT HAS BEEN GALVANIZED (COATED WITH A THIN LAYER OF ZINC) TO PROTECT IT FROM CORROSION AND RUST.

IN THIS SPECIFIC PROJECT, THE CORRUGATED IRON SHEETS ARE INSTALLED HORIZONTALLY ON VERTICAL FURRING STRIPS THAT ARE DIRECTLY ATTACHED ONTO THE PROPERLY INSTALLED AND SEALED HOME WRAP, USING SELF-DRILLING SCREWS THAT ARE DRIVEN THROUGH THE RIDGES OR VALLEYS OF THE CORRUGATIONS.

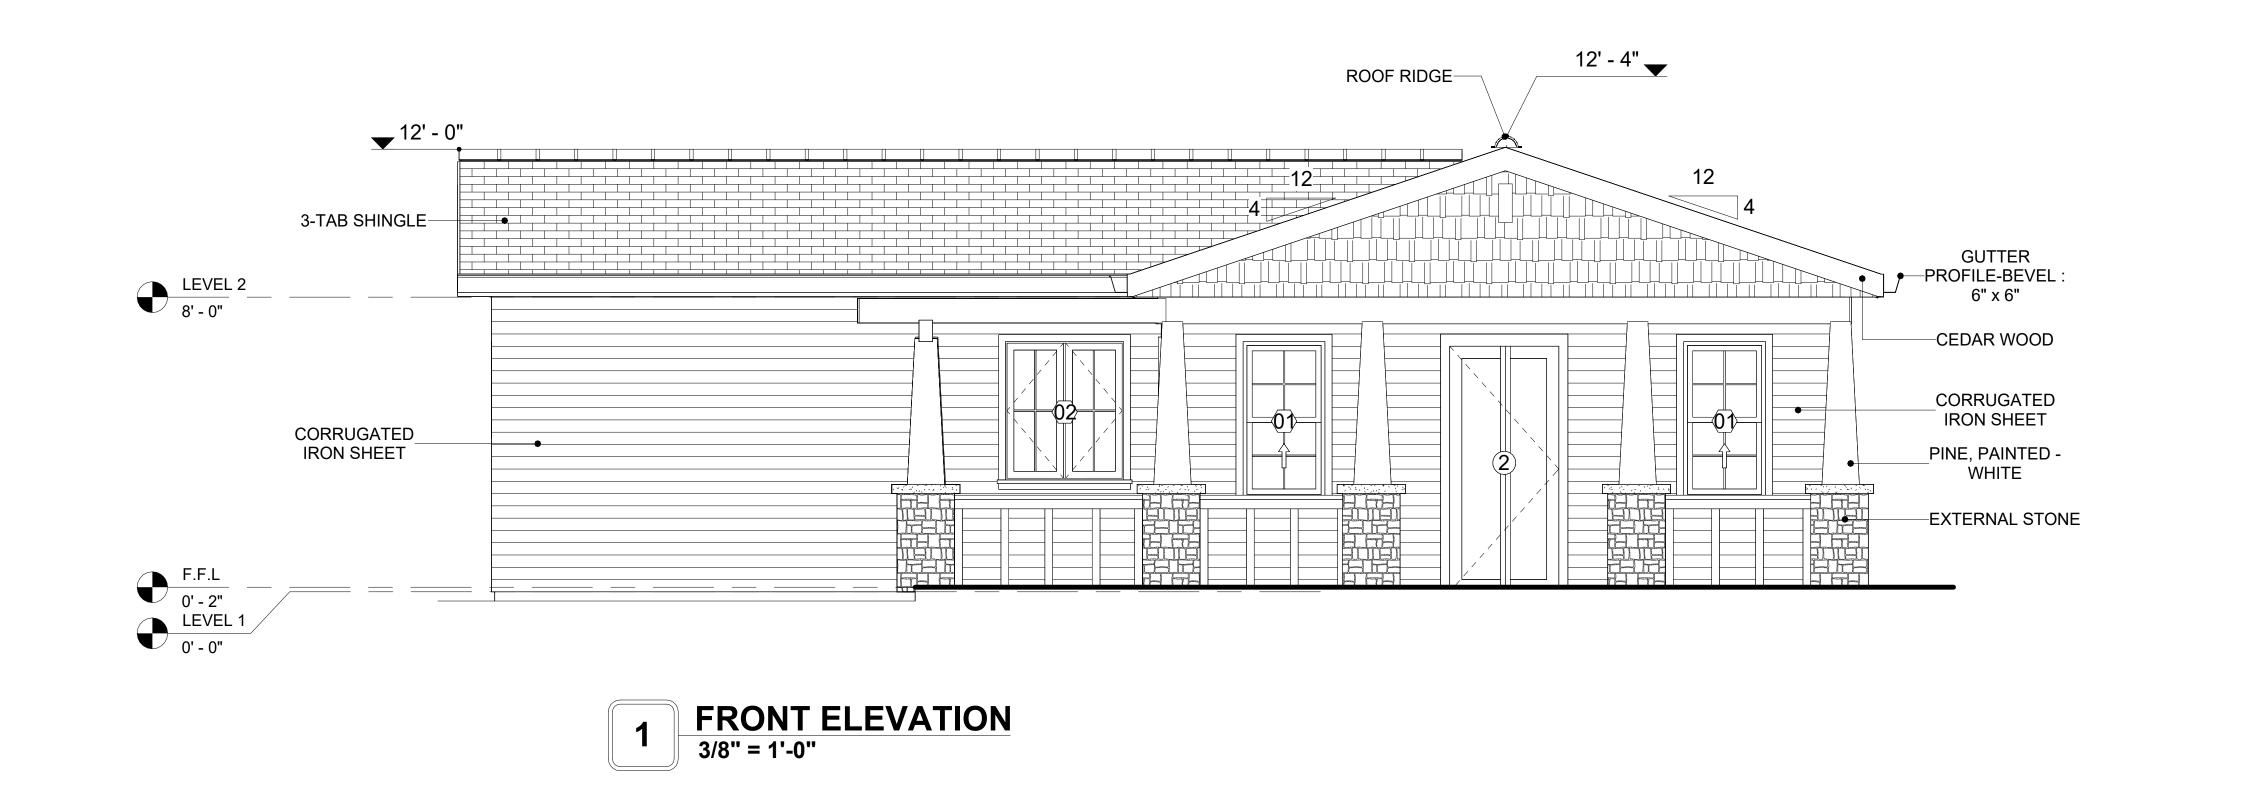




DOOR SCHEDULE						
TYPE			S		SIZE	
MAR K	SUPPLIER	DOOR TYPE	LOCATIO N	WIDTH	HEIGHT	COUNT
1	HOME DEPOT	INTERIOR SINGLE PANEL SWINGING	INTERIOR	3' - 0"	6' - 8"	1
2	HOME DEPOT	EXTERIOR SINGLE PANEL SWINGING	INTERIOR	3' - 0"	6' - 8"	2
3	HOME DEPOT	INTERIOR SINGLE PANEL SWINGING	INTERIOR	2' - 6"	6' - 8"	2
4	HOME DEPOT	INTERIOR SINGLE PANEL SWINGING	INTERIOR	3' - 0"	6' - 8"	1
5	HOME DEPOT	INTERIOR DOUBLE PANEL SLIDING	INTERIOR	7' - 4"	6' - 8"	1
6	HOME DEPOT	DOOR-BIFOLD_9052	INTERIOR	6' - 0"	6' - 8"	1
7	HOME DEPOT	INTERIOR DOUBLE PANEL SLIDING	INTERIOR	6' - 0"	6' - 8"	2
8	HOME DEPOT	EXTERIOR DOUBLE PANEL SWINGING	INTERIOR	5' - 0"	6' - 8"	1

WINDOW SCHEDULE					
			SIZE		
TYPE MARK	SUPPLIER	WINDOW TYPE	WIDTH	HEIGHT	COUNT
01	HOME DEPOT	SINGLE HUNG	2' - 3"	4' - 3"	2
02	HOME DEPOT		3' - 3"	3' - 9"	3
03	HOME DEPOT	FIXED	3' - 1"	2' - 1"	2
04	HOME DEPOT	FIXED	2' - 7"	2' - 7"	2
05	HOME DEPOT	SINGLE HUNG	2' - 7"	3' - 9"	1
06	HOME DEPOT	SINGLE HUNG	2' - 7"	3' - 1"	1
07	HOME DEPOT	SLIDING	6' - 3"	3' - 9"	1



**KEY PLAN** 

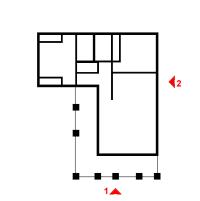

NO.	DESCRIPTION	DATE

NOTE:

LEGEND:

PROJECT

57-Hamilton-1000-2Bd/2Ba Craftsma 550

DRAWING NAME

ARCHITECTURAL ELEVATIONS

CLIENT NAME:	Client Name
PROJECT NUMBER:	0061_12
DATE:	2/17/2025 2:51:08 PM
DESIGNED BY:	Designer
DRAWN BY:	Author
CHECKED BY:	Checker

A201

#### **ABOUT WALL FINISHING**

#### **EXTERNAL STONE**

THESE STONE PRODUCTS ARE MADE FROM A BLEND OF NATURAL AGGREGATES, CEMENT, AND OTHER PROPRIETARY MATERIALS.

THE STONE FINISH IS DIRECTLY ATTACHED TO COLD-FORMED STEEL (CS) FRAMING. (FOR COLUMN FINISH) EXTERNAL STONE CAN BE AN EXCELLENT EXTERIOR CLADDING OPTION FOR CSFRAMED BUILDINGS. IN THIS SCENARIO, THE EXTERNAL STONE WOULD BE ADHERED TO THE CS FRAME USING A SCRATCH COAT AND MORTAR-BASED ADHESIVE.

#### CAST MANUFACTURED STONE


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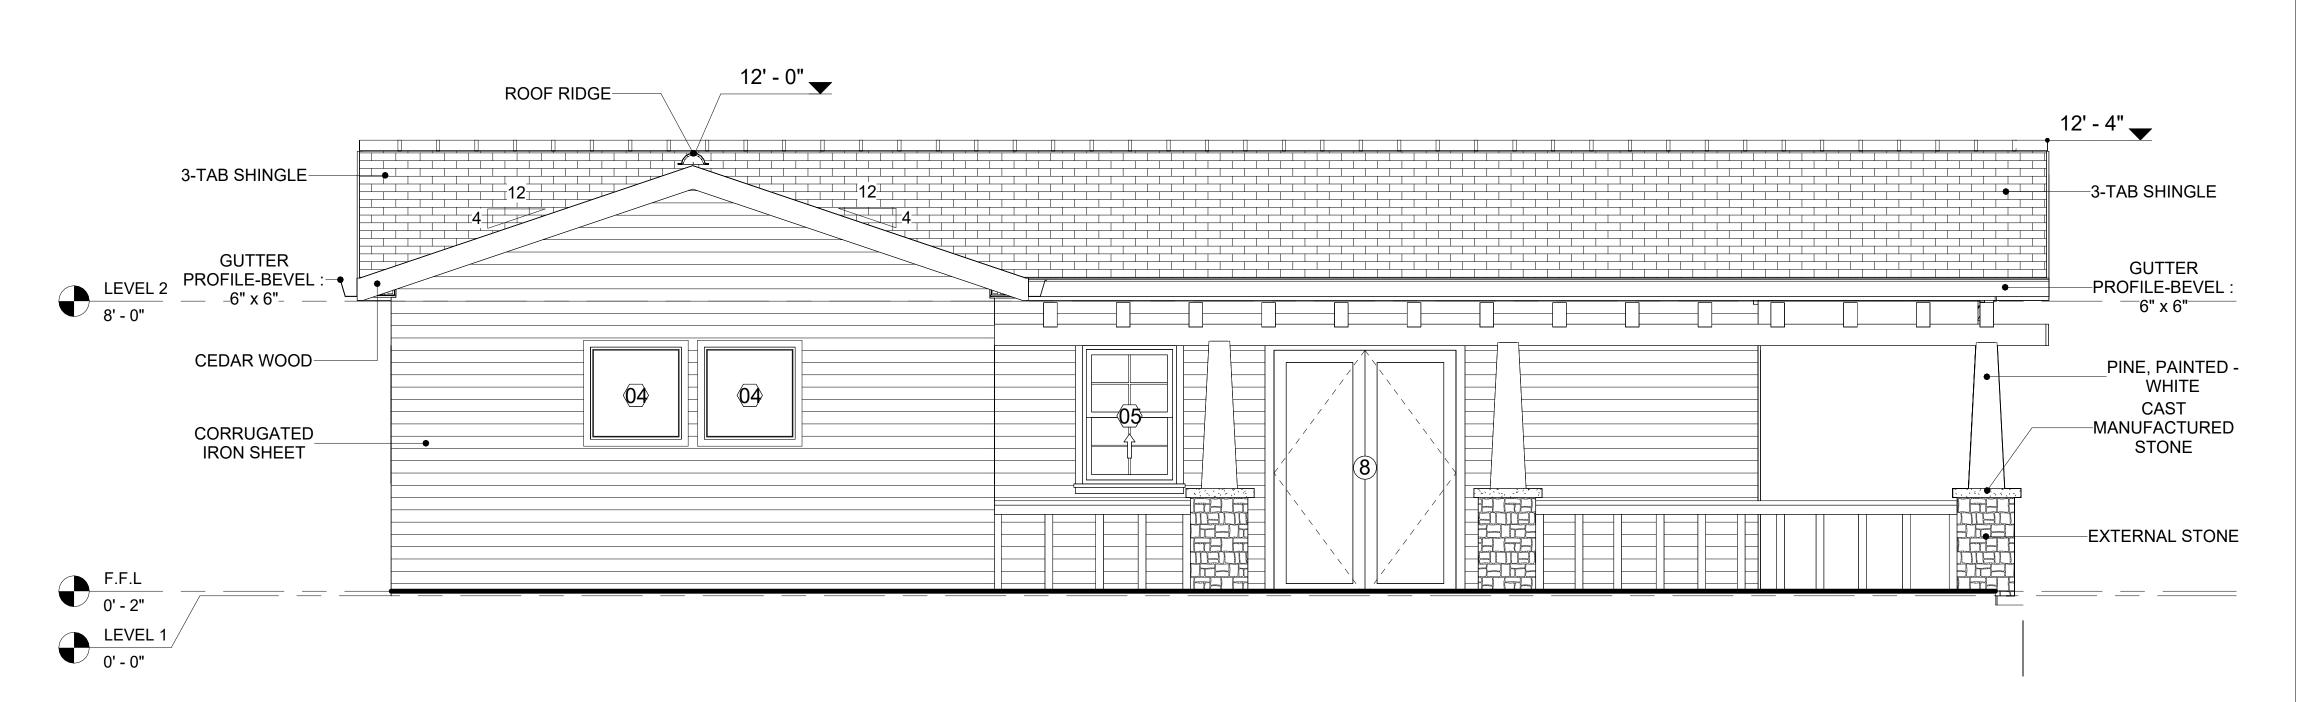
#### **CORRUGATED IRON SHEET**

CORRUGATED IRON IS A FINISHING MATERIAL MADE FROM STEEL THAT HAS BEEN GALVANIZED (COATED WITH A THIN LAYER OF ZINC) TO PROTECT IT FROM CORROSION AND RUST.

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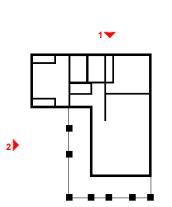
1 REAR ELEVATION 3/8" = 1'-0"



2 LEFT SIDE ELEVATION
3/8" = 1'-0"

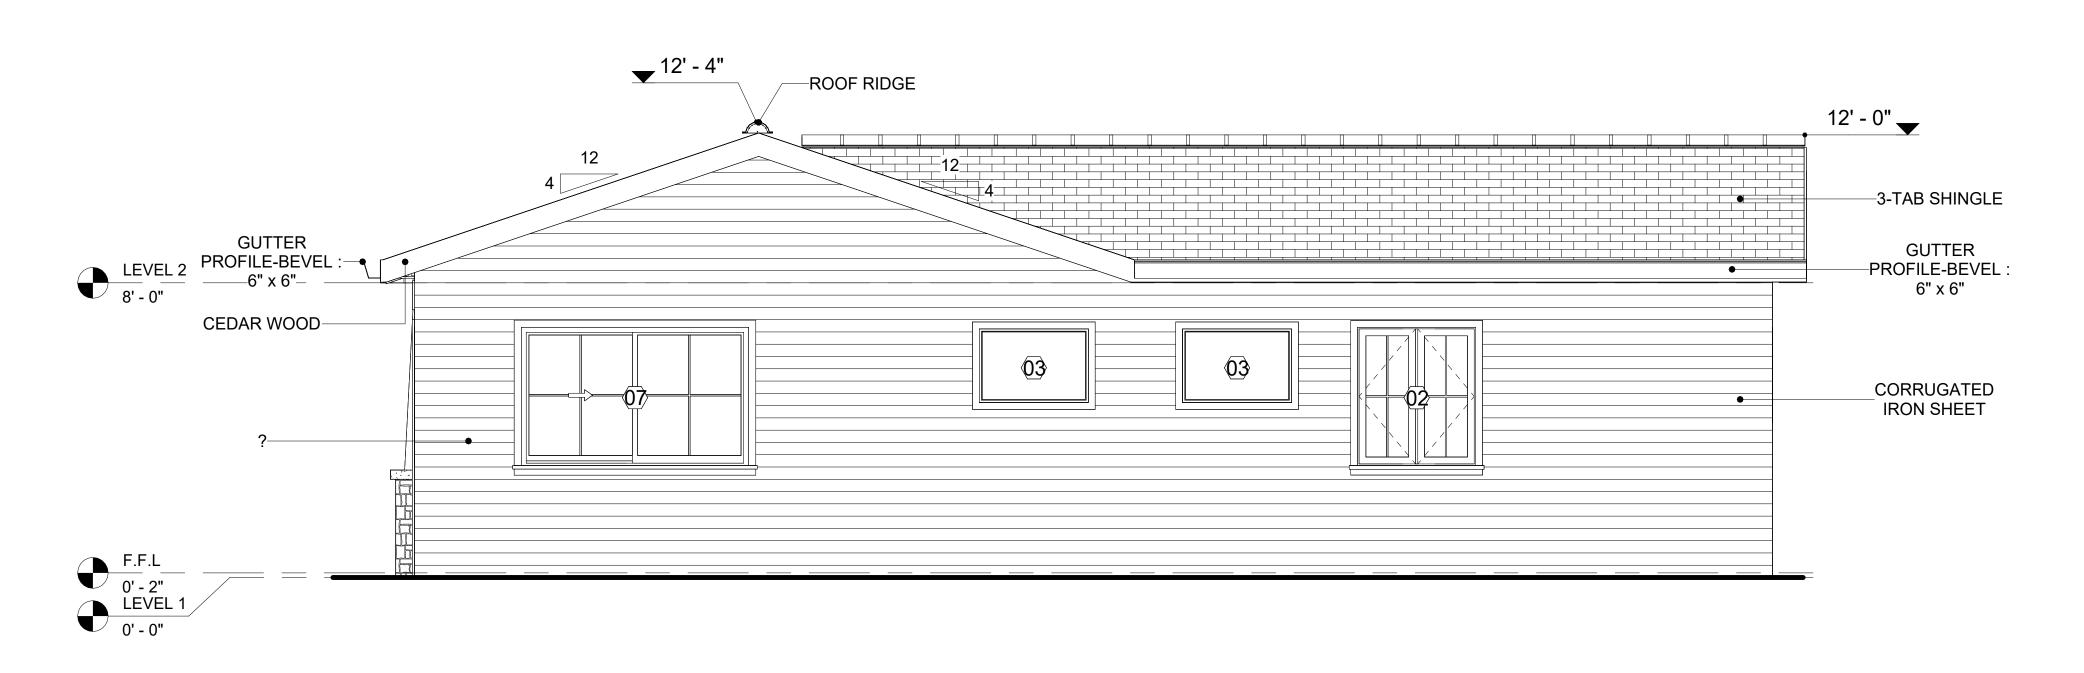

KEY PLAN



NO.	DESCRIPTION	DATE

NOTE:

LEGEND:

PROJECT

57-Hamilton-1000-2Bd/2Ba Craftsma 550

DRAWING NAME

ARCHITECTURAL ELEVATIONS

CLIENT NAME:

PROJECT NUMBER:

0061\_12

DATE:

2/17/2025 2:51:13 PM


DESIGNED BY:


DRAWN BY:

CHECKED BY:

Checker

A202

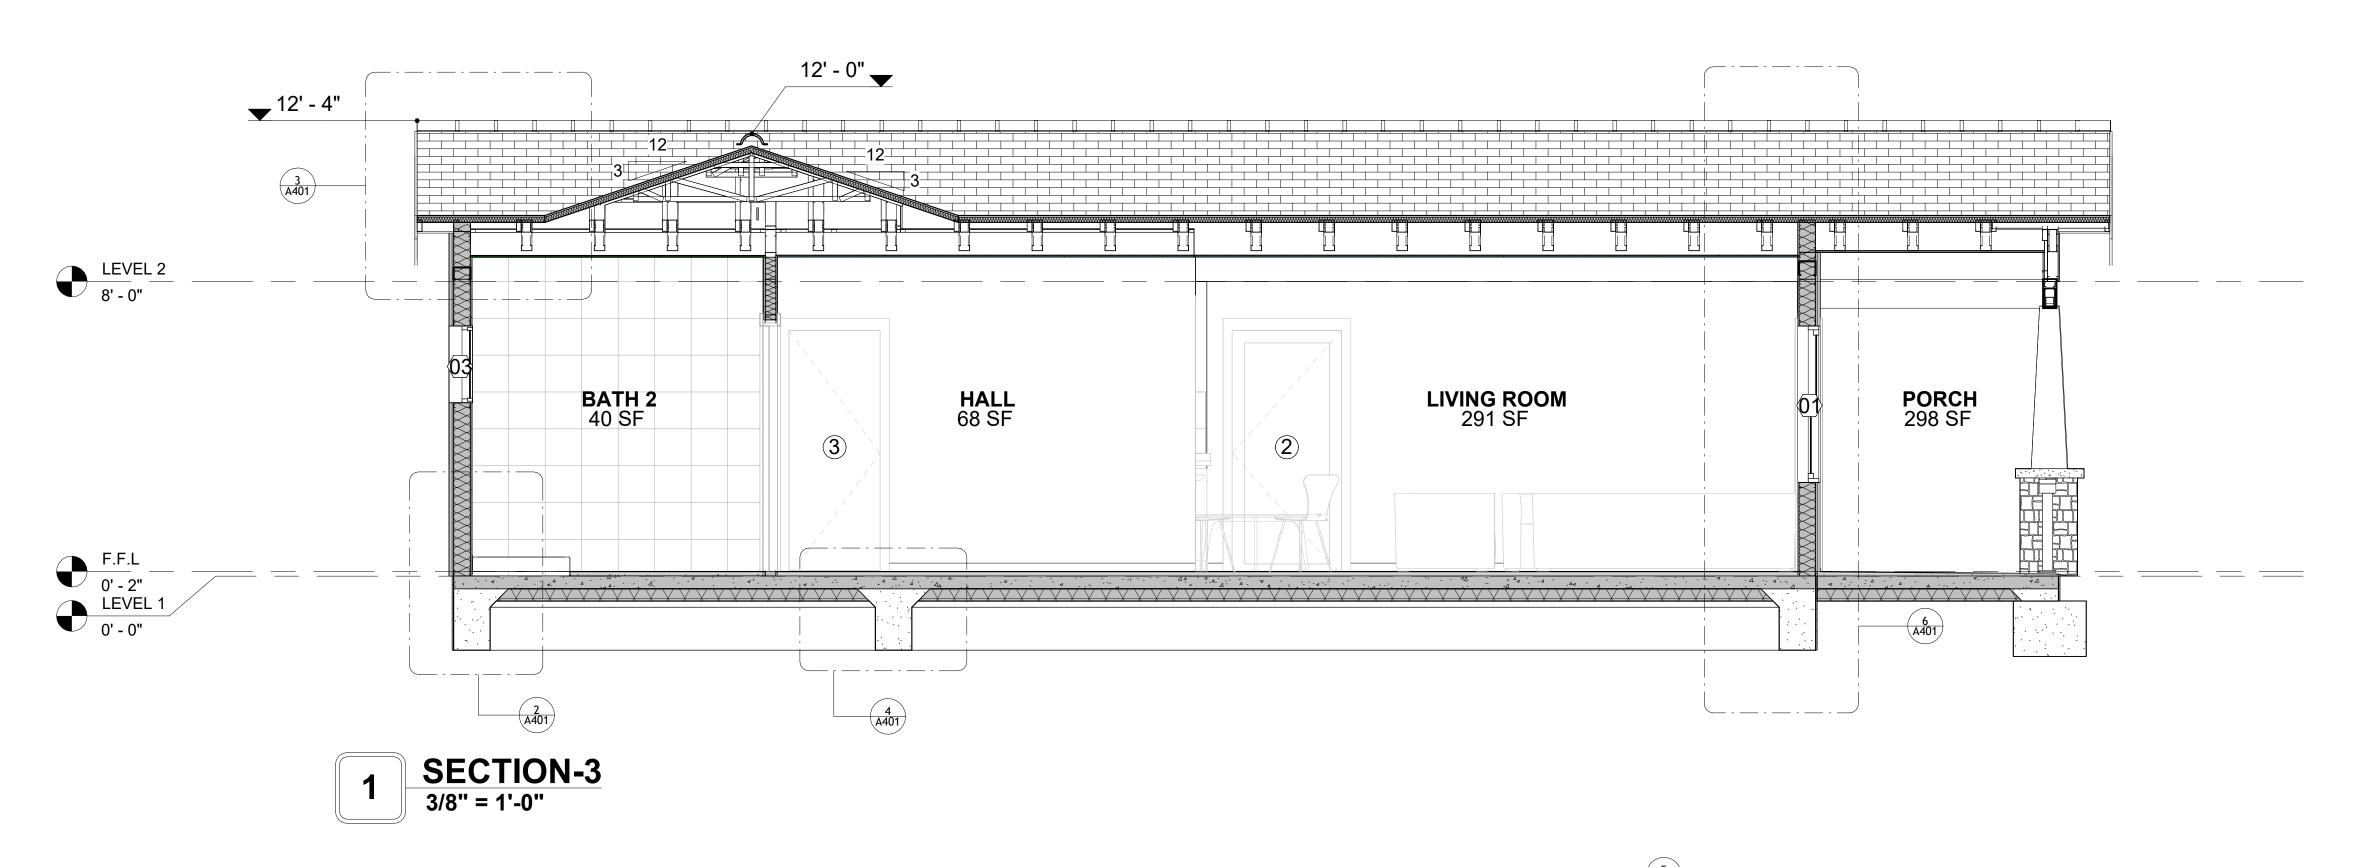


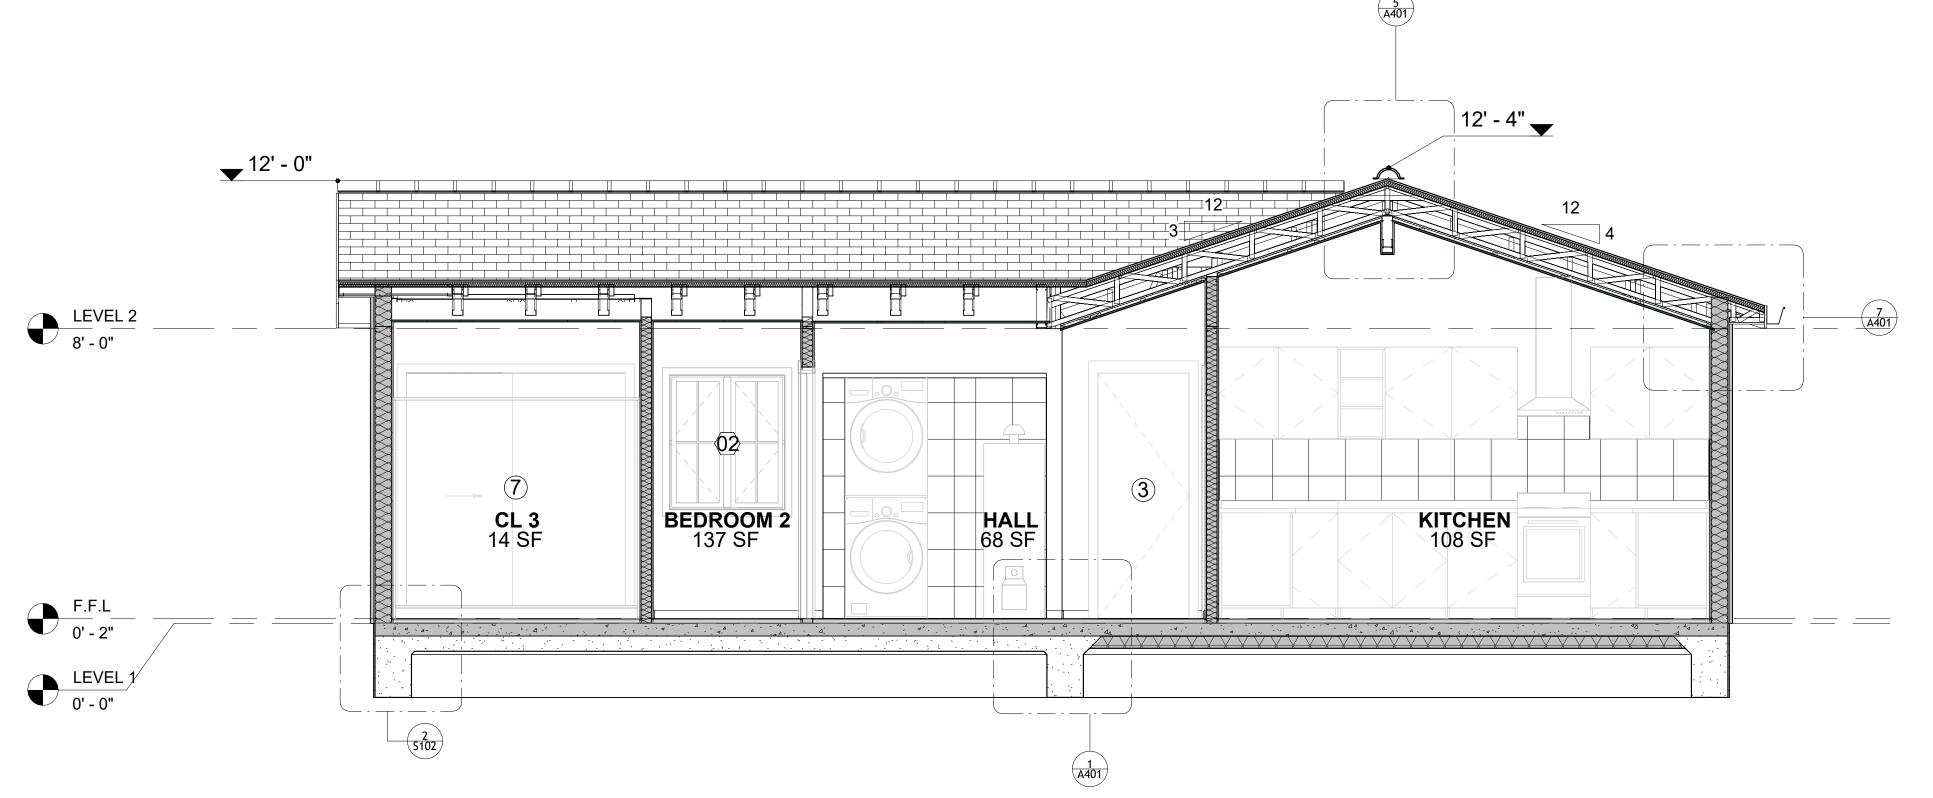

2 SECTION-2 3/8" = 1'-0"



**KEY PLAN** 

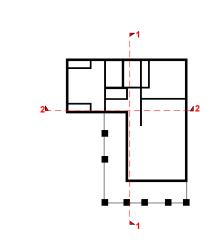

NO.	DESCRIPTION	DATE

NOTE:

LEGEND:

PROJECT


57-Hamilton-1000-2Bd/2Ba Craftsma 550

DRAWING NAME


ARCHITECTURAL SECTIONS


Client Name
0061_12
2/17/2025 2:51:15 PM
Designer
Author
Checker


A301

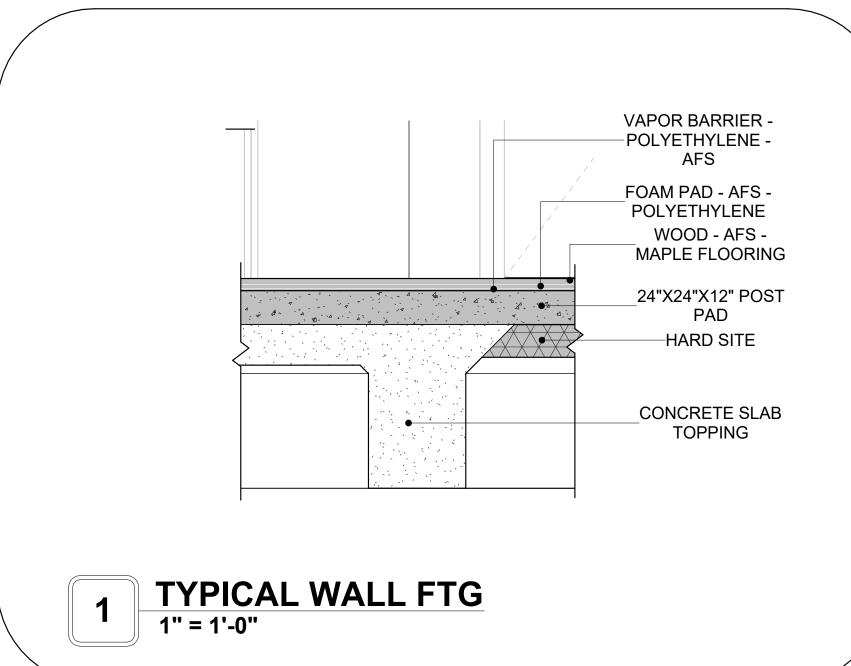



ROOF/TRUSS CONN.

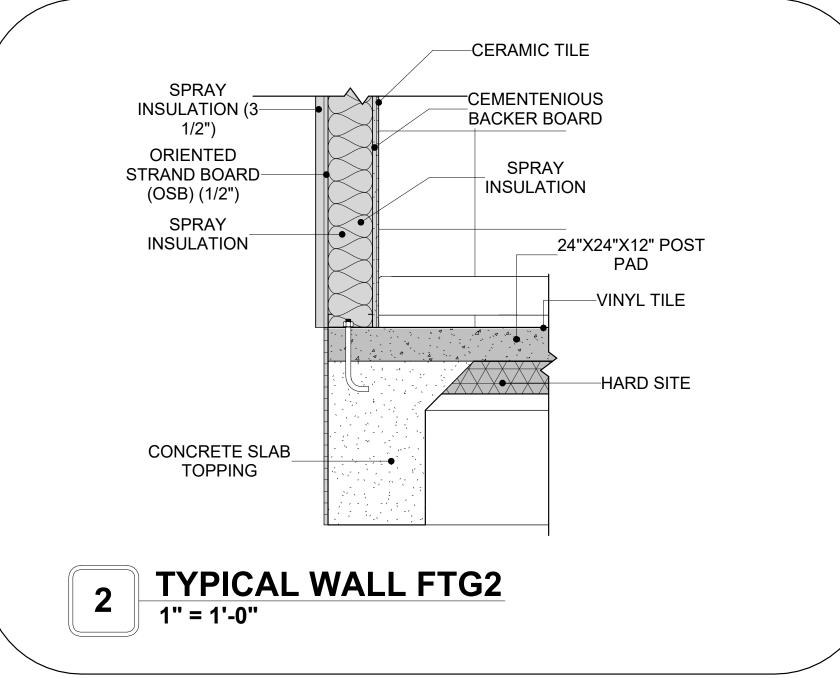


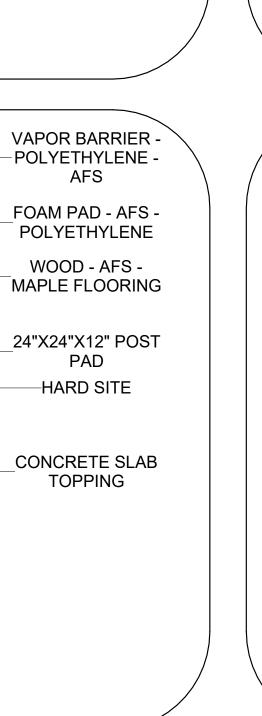

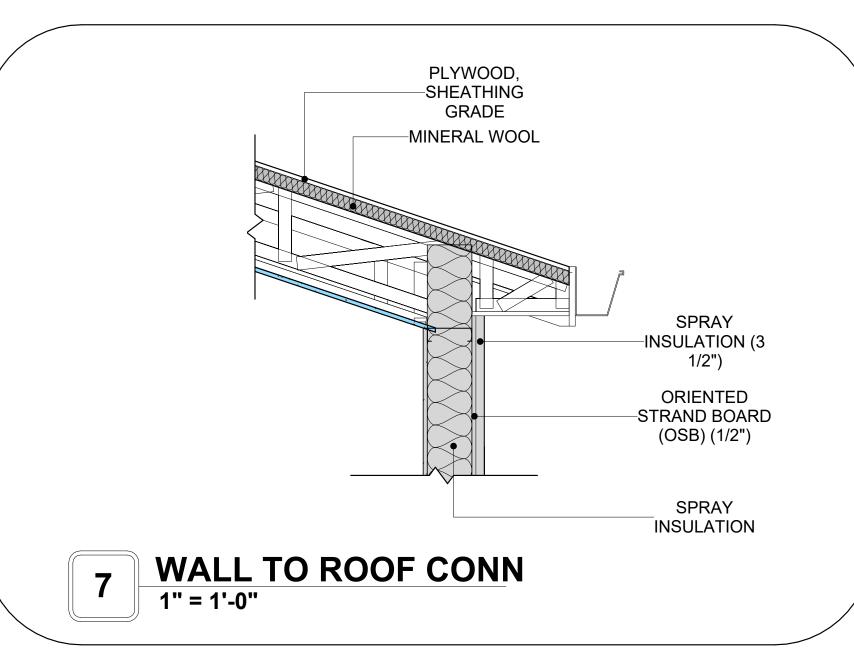

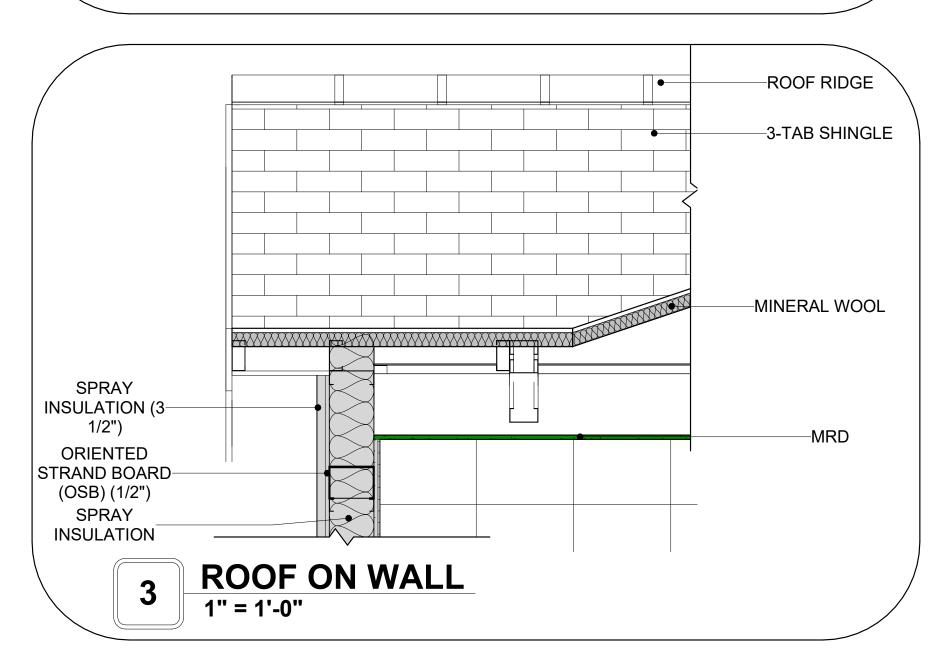

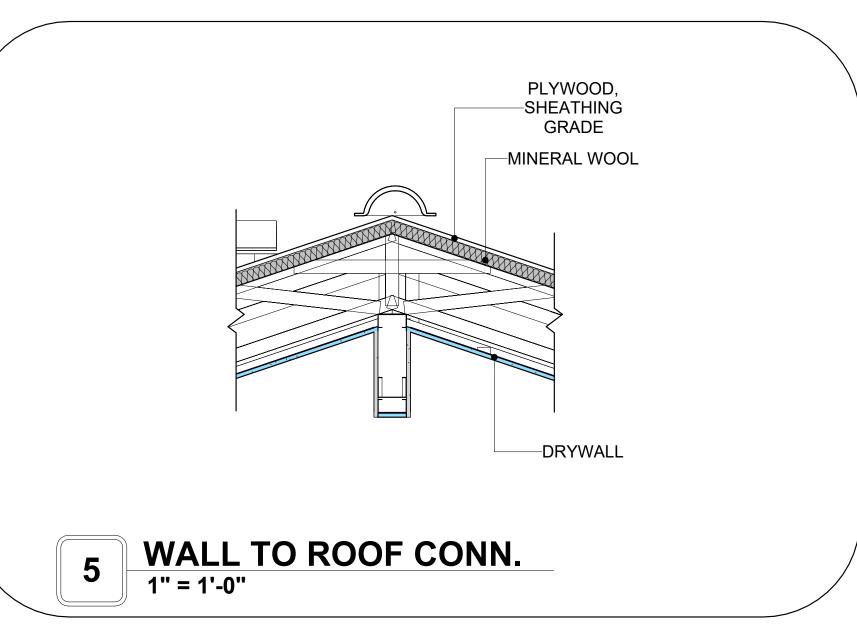

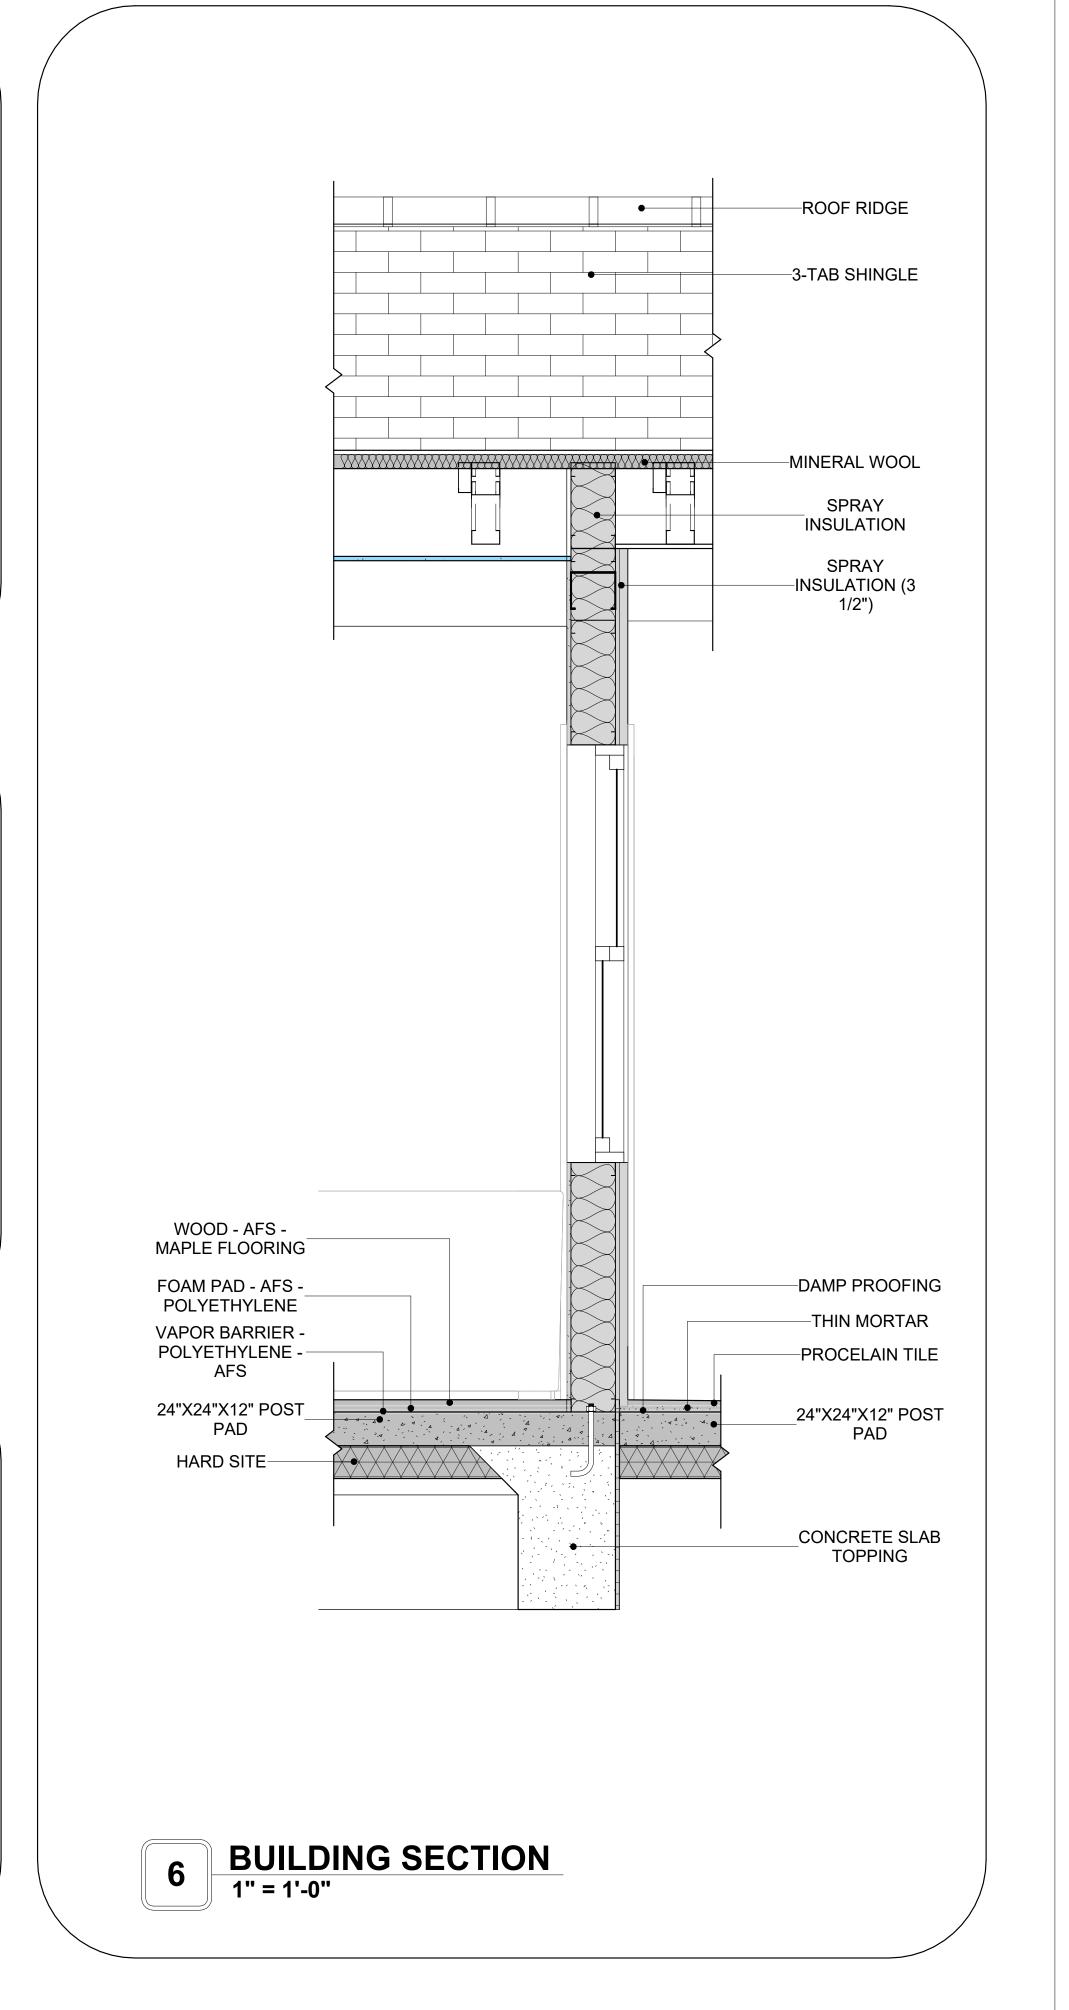



**KEY PLAN** 

NO.	DESCRIPTION	DATE

NOTE:

LEGEND:

PROJECT

57-Hamilton-1000-2Bd/2Ba Craftsma 550

DRAWING NAME

ARCHITECTURAL DETAILS

CLIENT NAME:	Client Name
PROJECT NUMBER:	0061_12
DATE:	2/17/2025 2:51:17 PM
DESIGNED BY:	Designer
DRAWN BY:	Author
CHECKED BY:	Checker

A401

SCALE: 1" = 1'-0"


#### **CASEWORK GENERAL NOTES**

- ALL CABINET HEIGHTS INCLUDE COUNTERTOPS. DIMENSIONS ARE TO THE NEAREST INCH. DIVISIONS IN CASEWORK ARE SHOWN FOR CLARITY AND DO NOT REPRESENT BREAKS IN THE COUNTERTOP.
- PROVIDE CONTINUOUS COUNTERTOP OVER ALL SIMILAR HEIGHT CASEWORK, UNLESS AND OTHERWISE NOTED.
- MANUFACTURER AND CATALOG NUMBERS ARE FOR REFERENCE AND ILLUSTRATION PURPOSES
- DOTTED LINES INDICATE WALL HUNG CABINETS, DIVISIONS OF BASE CABINETS BELOW THE
- COUNTERTOP, FURNITURE NOT IN THE CONTRACT OR PROJECTION SCREENS -SEE CASEWORK KEY AND SPECIFICATIONS.
- ALL CABINETS AND DRAWERS TO HAVE CAM LOCKS EXCEPT FOR SINK BASE CABINETS.
  ALL EXPOSED SURFACES (EXPOSED TO VIEW FROM ANY PERSPECTIVE) TO BE COVERED WITH LAMINATE.
- ALL CASEWORK WHICH MEETS A WALL AT ONE OR BOTH ENDS, TO BE PROVIDED WITH FILLER PANELS AND SCRIBED TO THE WALL(S) AS REQUIRED.
- 10. ALL CABINETS AND DRAWERS ARE PROVIDED WITH RECESSED HANDLES.
- 11. CONTRACTOR TO FIELD VERIFY ALL CLEAR OPENINGS PRIOR TO MILLWORK OR CASEWORK FABRICATION.
- 12. CASEWORK DRAWINGS ARE DIAGRAMMATIC IN NATURE TO SHOW DESIGN INTENT.


	CASEWORK SCHEDULE					
TYPE MAR K	TYPE	COUN T	HEIGHT	WIDTH	DEPTH	AREA
00	CLOSET 3 180	1	6' - 0"	8' - 0"	1' - 4"	48 SF
01		1	2' - 6"	1' - 3"	1' - 0"	3 SF
02	HD_WALL_FILLER_18 2 153 VANITY	2	2' - 4"	2' - 6"	1' - 8"	6 SF
03	WALL CABINET DOUBLE DOOR 2 158		2' - 6"	3' - 3"	1' - 0"	8 SF
04	RECESSED_MED_CABINET	2	2' - 0"	1' - 6"	0' - 3"	3 SF
05	LINEAR_COUNTER_TOP 2	1	0' - 4"	2' - 0"	2' - 1"	1 SF
06	CLOSET 3 153	2	6' - 0"	6' - 9"	1' - 4"	41 SF
07	BASE_CABINET_L-SHAPED	2	2' - 11"	3' - 3"	3' - 3"	9 SF
08	BASE_CABINET_SINGLE_DOOR 2	1	2' - 7"	1' - 11"	2' - 0"	5 SF
10	LAUNDRY OPEN CABINET 3	1	1' - 8"	3' - 0"	2' - 4"	5 SF
11	HD L-SHAPE COUNTER TOP11	2	0' - 4"	9' - 7"	4' - 0"	3 SF
12	HD LINEAR COUNTER TOP 3	1	0' - 4"	4' - 11"	2' - 1"	2 SF
13	WALL CABINET DOUBLE DOOR 2 59	1	2' - 6"	3' - 8"	1' - 0"	9 SF
14	BASE CABINET DOUBLE DOOR 2	2	2' - 11"	3' - 0"	2' - 0"	9 SF
15	HD TALL CABINET 24 2 3 181	1	7' - 6"	1' - 8"	2' - 0"	13 SF
GRAND	TOTAL	22				,


SPECIALTY EQUIPMENT SCHEDULE			
TYPE MARK	TYPE	COUNT	
01	<varies></varies>	2	
03	RANGE	1	
04	DRYER-FRONT-LOAD	1	
05	DISHWASHER	1	




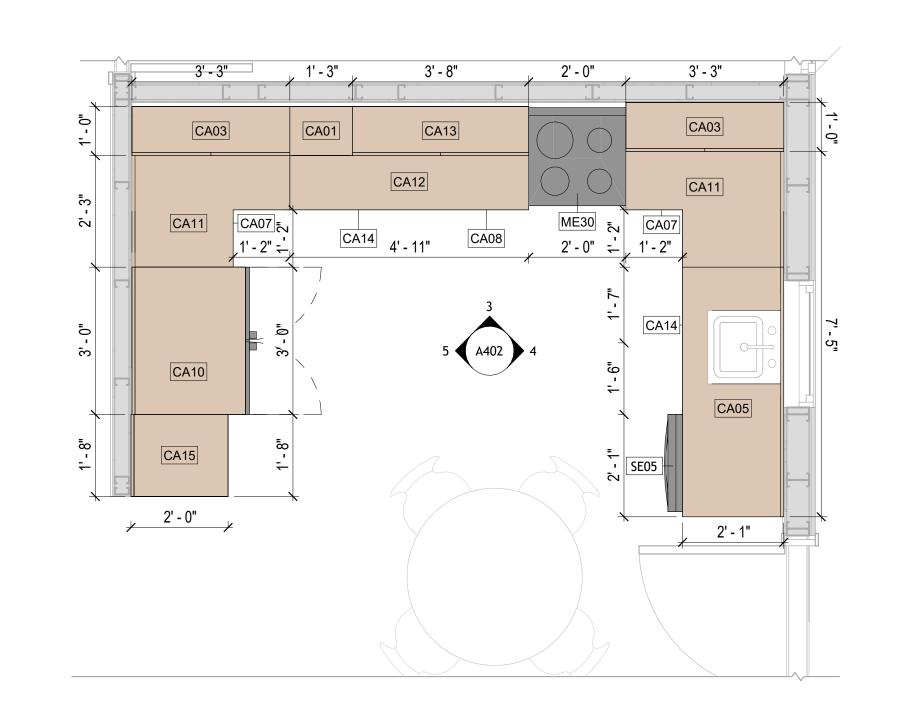




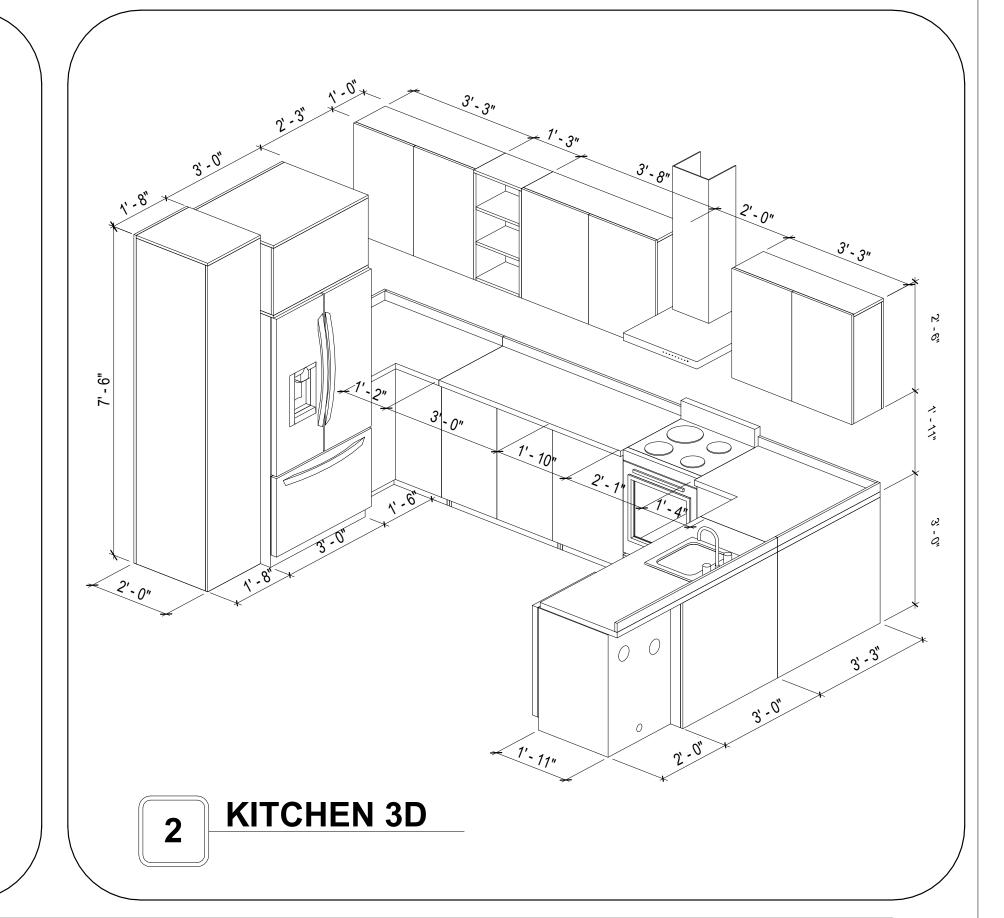

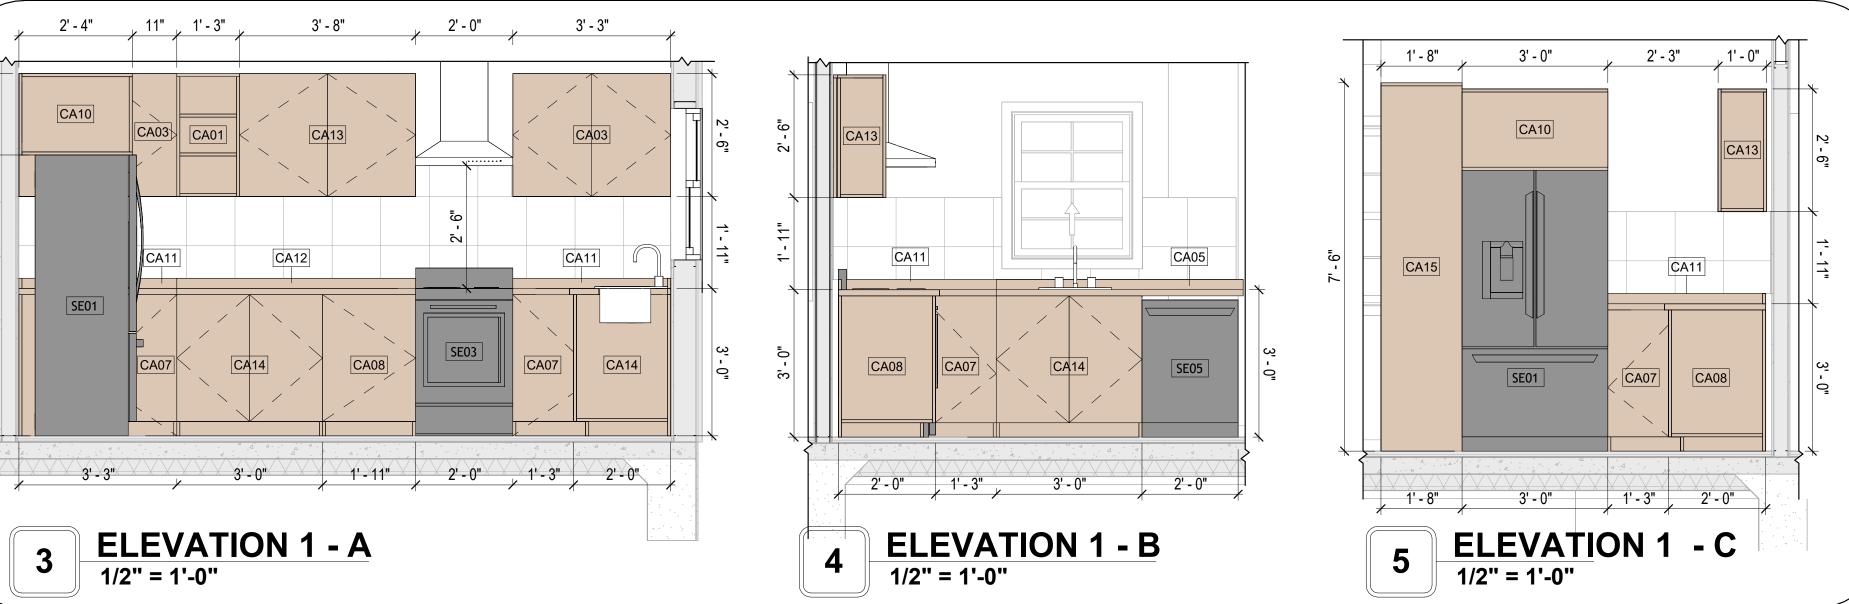

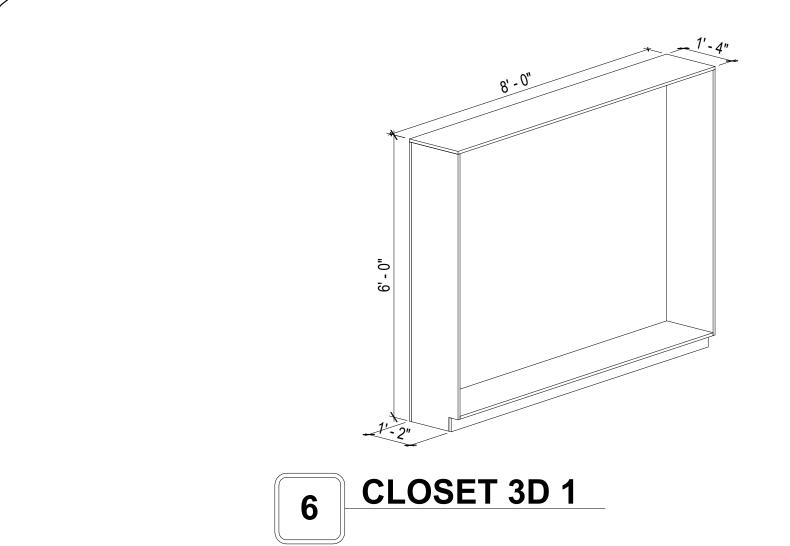


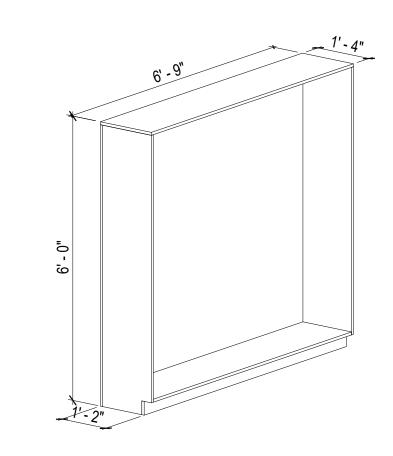


CLOSET 3D 2



**KEY PLAN** 

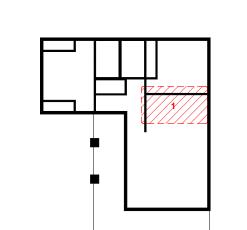

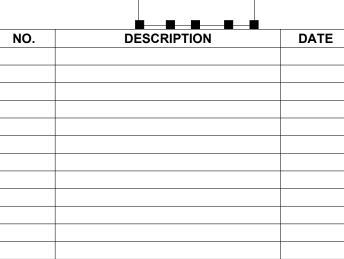

NOTE:

LEGEND:

PROJECT


57-Hamilton-1000-2Bd/2Ba Craftsma 550


DRAWING NAME

ARCHITECTURAL CASEWORK

Client Name
0061_12
2/17/2025 2:51:19 PM
Designer
Author
Checker

A402

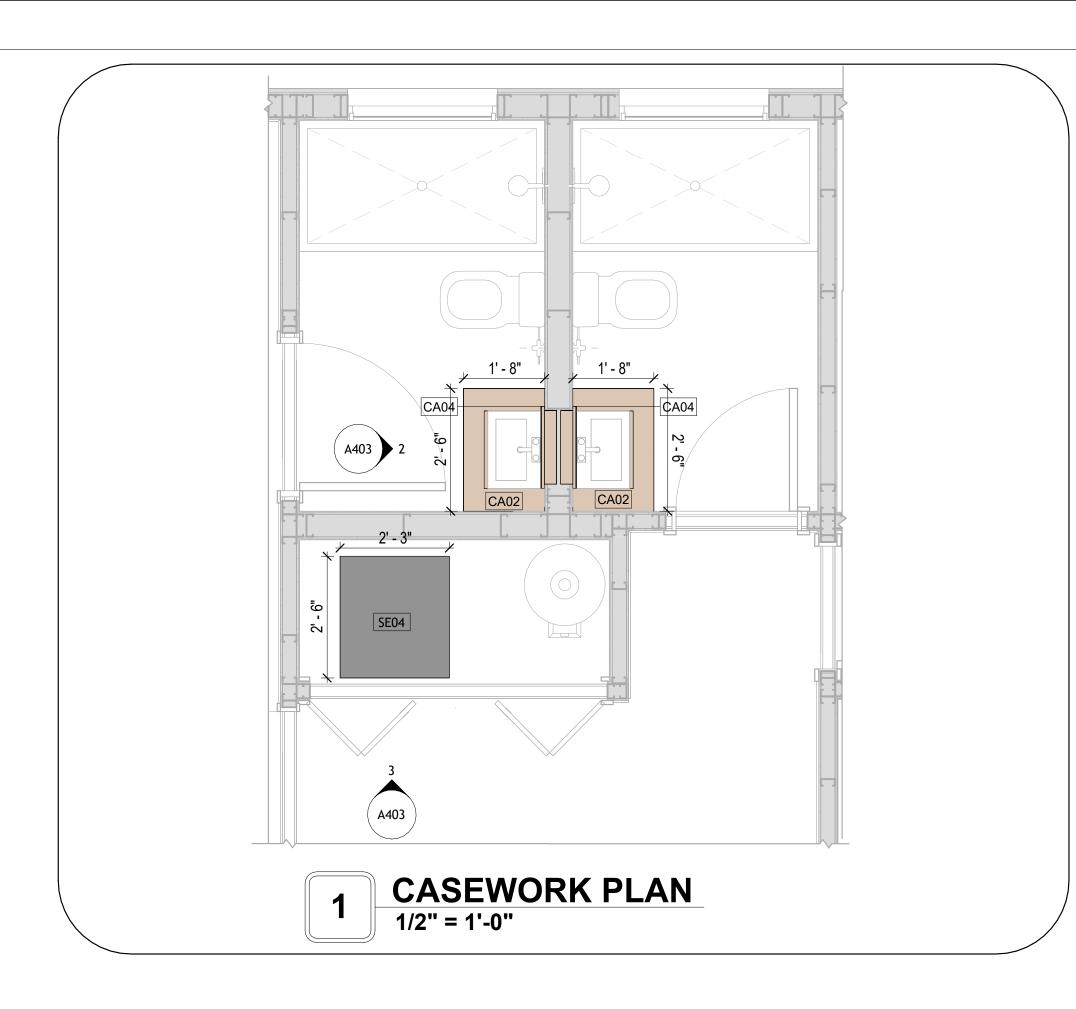

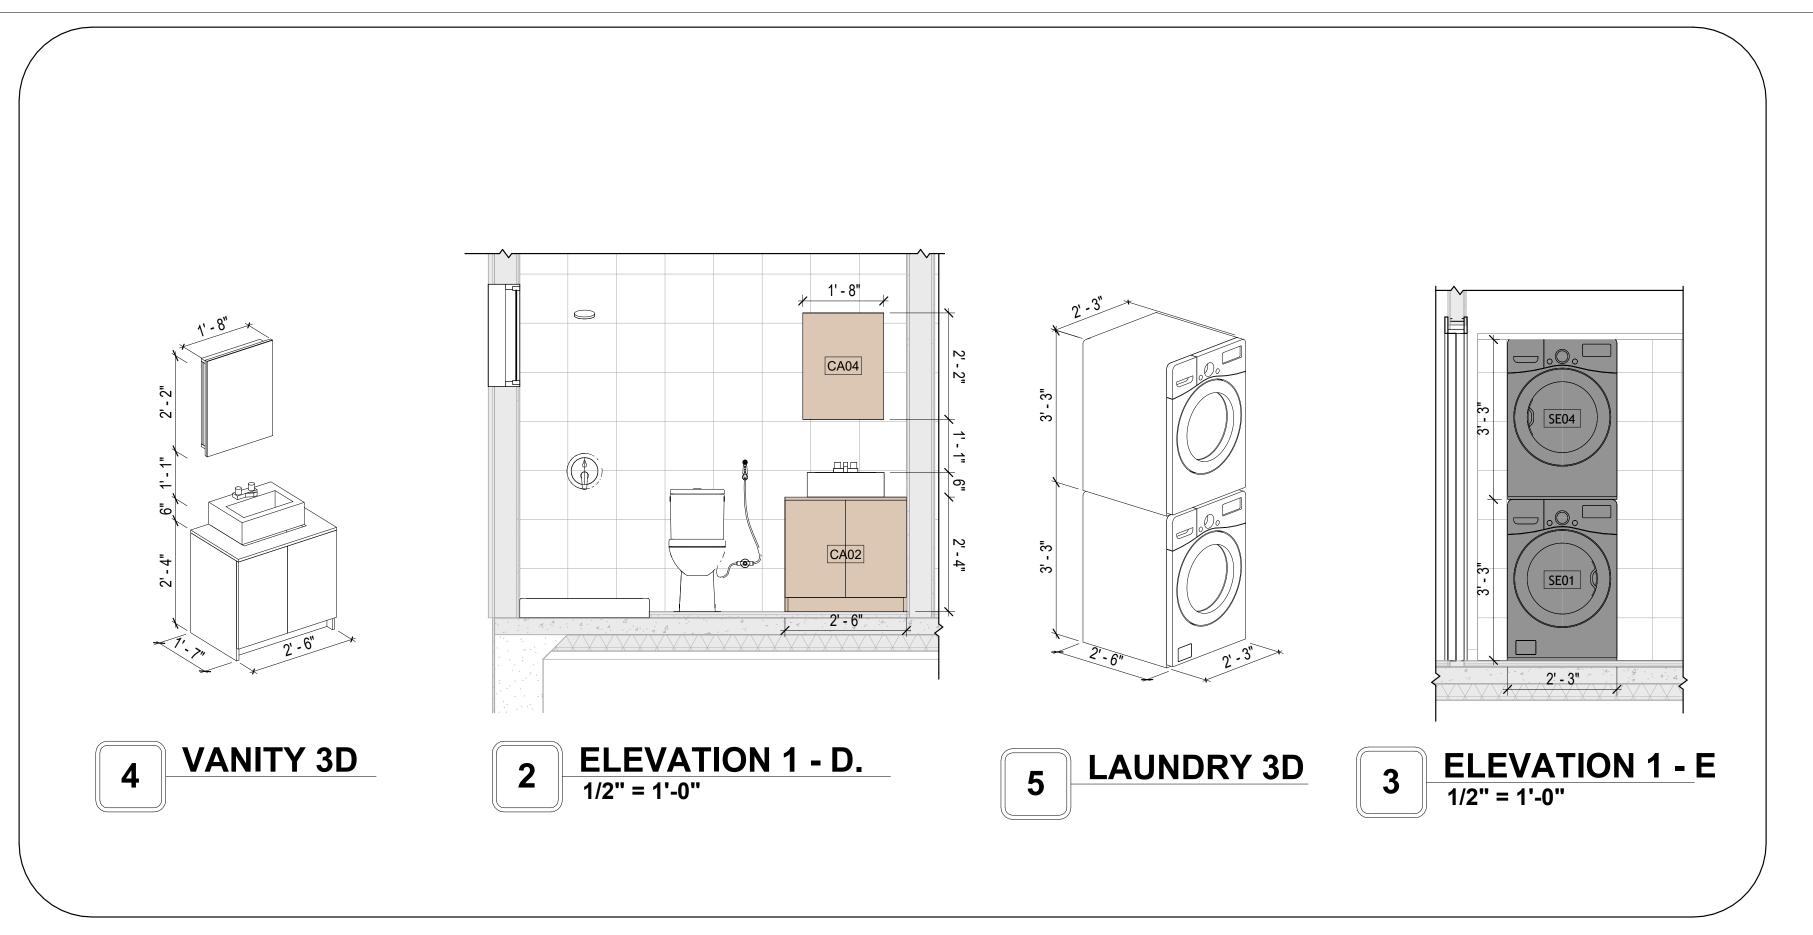



**KEY PLAN** 

NO.	DESCRIPTION	DATE

NOTE:

LEGEND:

PROJECT

57-Hamilton-1000-2Bd/2Ba Craftsma 550

DRAWING NAME

#### ARCHITECTURAL CASEWORK 2

Client Name
0061_12
2/17/2025 2:51:21 PM
Designer
Author
Checker

A403

SCALE: 1/2" = 1'-0"

#### **GENERAL NOTES**

AND BRACED TO PREVENT SAGGING, AIR LEAKAGE, OR VIBRATION.

1. THIS DRAWING DEPICTS THE HVAC (HEATING, VENTILATION, AND AIR CONDITIONING) SYSTEM FOR THE HAMILTON 2BD 2BA CRAFTSMAN. IT PROVIDES A VISUAL REPRESENTATION OF THE SYSTEM LAYOUT AND COMPONENTS.

2.THE HVAC SYSTEM IS DESIGNED TO MEET THE SPECIFIC REQUIREMENTS OF THE BUILDING, INCLUDING HEATING, COOLING, AND VENTILATION NEEDS, AS PER THE PROJECT SPECIFICATIONS AND APPLICABLE CODES AND STANDARDS.

3. THE HVAC SYSTEM INSTALLATION SHALL COMPLY WITH THE LATEST EDITION OF THE INTERNATIONAL MECHANICAL CODE (IMC), INTERNATIONAL RESIDENTIAL CODE (IRC), AND ALL OTHER APPLICABLE LOCAL, STATE, AND NATIONAL CODES AND REGULATIONS.

4. THE EQUIPMENT SHOWN ON THIS DRAWING INCLUDES BUT IS NOT LIMITED TO AIR HANDLING UNITS (AHUS), CHILLERS, BOILERS, COOLING TOWERS, PUMPS, DUCTWORK, DIFFUSERS, GRILLES, AND CONTROL DEVICES.

5. ALL EQUIPMENT, DUCTWORK, AND PIPING SHALL BE INSTALLED IN ACCORDANCE WITH MANUFACTURER'S SPECIFICATIONS, LOCAL CODES, AND INDUSTRY REST PRACTICES

6. ALL DUCTWORK SHALL BE SIZED, FABRICATED, AND INSTALLED IN ACCORDANCE WITH THE LATEST EDITION OF THE ACCA MANUAL D AND THE SMACNA HVAC DUCT CONSTRUCTION STANDARDS. DUCTWORK SHALL BE INSTALLED IN A NEAT AND WORKMANLIKE MANNER, PROPERLY SUPPORTED

7. CONDENSATE DRAINAGE PIPING SHALL BE PROPERLY PITCHED TO ENSURE POSITIVE DRAINAGE TO AN APPROVED DISPOSAL LOCATION, SUCH AS A FLOOR DRAIN, SUMP PUMP, OR EXTERIOR GRADE. CONDENSATE LINES SHALL BE INSULATED TO PREVENT SWEATING.

8. THE LOCATION OF CONTROL PANELS AND SENSORS INDICATED ON THIS DRAWING CAN BEMODIFY WITH THE SPECIFIC LOCATIONS AND WIRING DETAILS WILL BE DETERMINED DURING THE CONTROL SYSTEM DESIGN AND INSTALLATION.

9. THE HVAC SYSTEM DESIGN CONSIDER ENERGY EFFICIENCY, INDOOR AIR QUALITY, OCCUPANT COMFORT, AND NOISE CONTROL, FOLLOWING

APPLICABLE GUIDELINES AND REGULATIONS.

10. COORDINATION WITH OTHER TREADS HAS BEEN DONE ON A DESIGN LEVEL. THIS DRAWING SHALL BE READ TOGETHER WITH THE AR, EL AND SN

DESIGN DRAWINGS TO ENSURE PROPER INSTALLATION AND INTEGRATION OF THE HVAC SYSTEMS.

11. THE HVAC CONTRACTOR IS RESPONSIBLE FOR OBTAINING ALL NECESSARY PERMITS AND LICENSES, AND FOR SCHEDULING AND COORDINATING WITH THE LOCAL BUILDING DEPARTMENT AND UTILITY PROVIDERS TO ENSURE A TIMELY AND COMPLIANT INSTALLATION.

12. ALL DUCTWORK PENETRATIONS THROUGH WALLS, FLOORS, OR CEILINGS SHALL BE PROPERLY SEALED AND FIRE-STOPPED USING APPROVED METHODS AND MATERIALS TO MAINTAIN THE INTEGRITY OF THE BUILDING'S FIRE-RESISTANCE RATINGS.

13. HVAC EQUIPMENT SHALL BE INSTALLED LEVEL AND PLUMB, AND IN STRICT ACCORDANCE WITH THE MANUFACTURER'S INSTALLATION INSTRUCTIONS AND RECOMMENDATIONS. PROVIDE ADEQUATE CLEARANCES AROUND EQUIPMENT FOR PROPER AIRFLOW, SERVICE ACCESS, AND CODE COMPLIANCE.


14. ALL HVAC EQUIPMENT AND COMPONENTS, INCLUDING THERMOSTATS, DAMPERS, AND ACCESS PANELS, SHALL BE LOCATED IN ACCESSIBLE AREAS FOR EASY SERVICING AND MAINTENANCE. PROVIDE ADEQUATE SPACE AROUND EQUIPMENT FOR PROPER AIRFLOW AND SERVICE ACCESS.

15. THE HVAC SYSTEM SHALL BE BALANCED AND ADJUSTED TO ENSURE PROPER AIRFLOW, TEMPERATURE DISTRIBUTION, AND SYSTEM PERFORMANCE THROUGHOUT THE RESIDENCE. PROVIDE A WRITTEN REPORT DOCUMENTING THE FINAL SYSTEM BALANCE.

16. ANY DEVIATIONS OR MODIFICATIONS TO THE HVAC SYSTEM DESIGN SHALL BE REVIEWED AND APPROVED BY THE RESPONSIBLE DESIGN PROFESSIONALS AND COMMUNICATED TO ALL RELEVANT PARTIES INVOLVED IN THE CONSTRUCTION PROCESS.


17. FOR ANY INQUIRIES OR CLARIFICATIONS REGARDING THE HVAC SYSTEM DESIGN, PLEASE CONSULT THE RESPONSIBLE DESIGN PROFESSIONALS OR THE PROJECT MANAGEMENT TEAM.

#### SYMBOLS

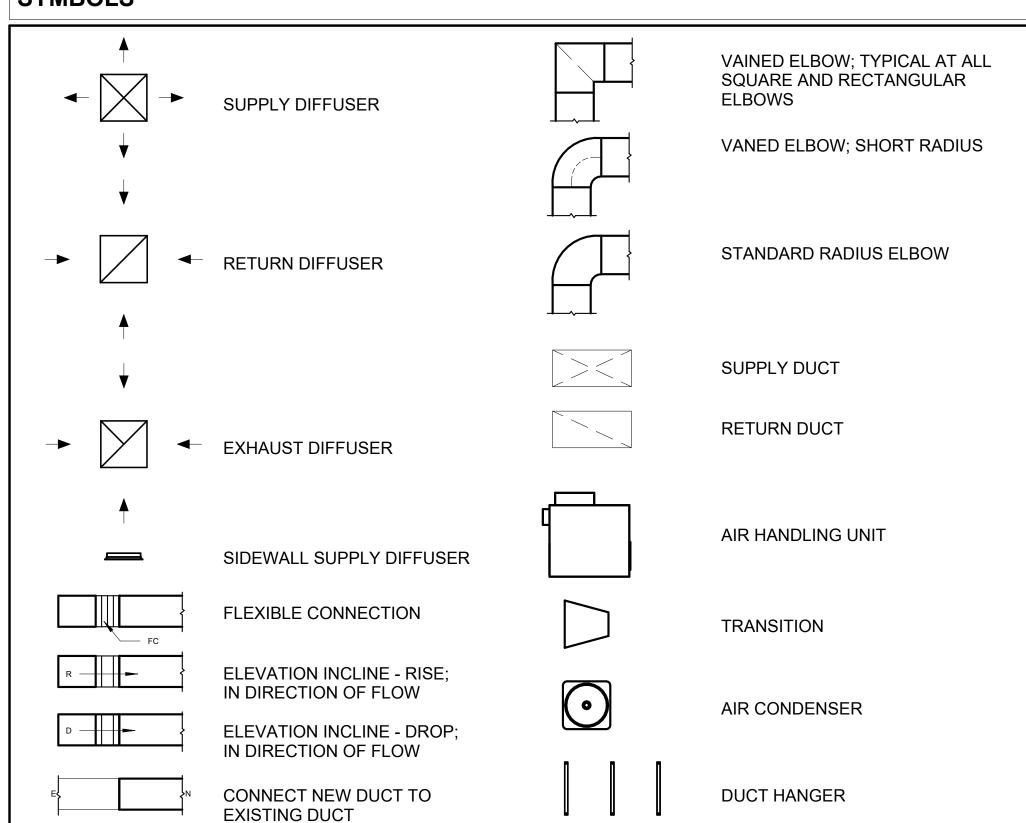



AIR CONDITIONING PIPE LINE

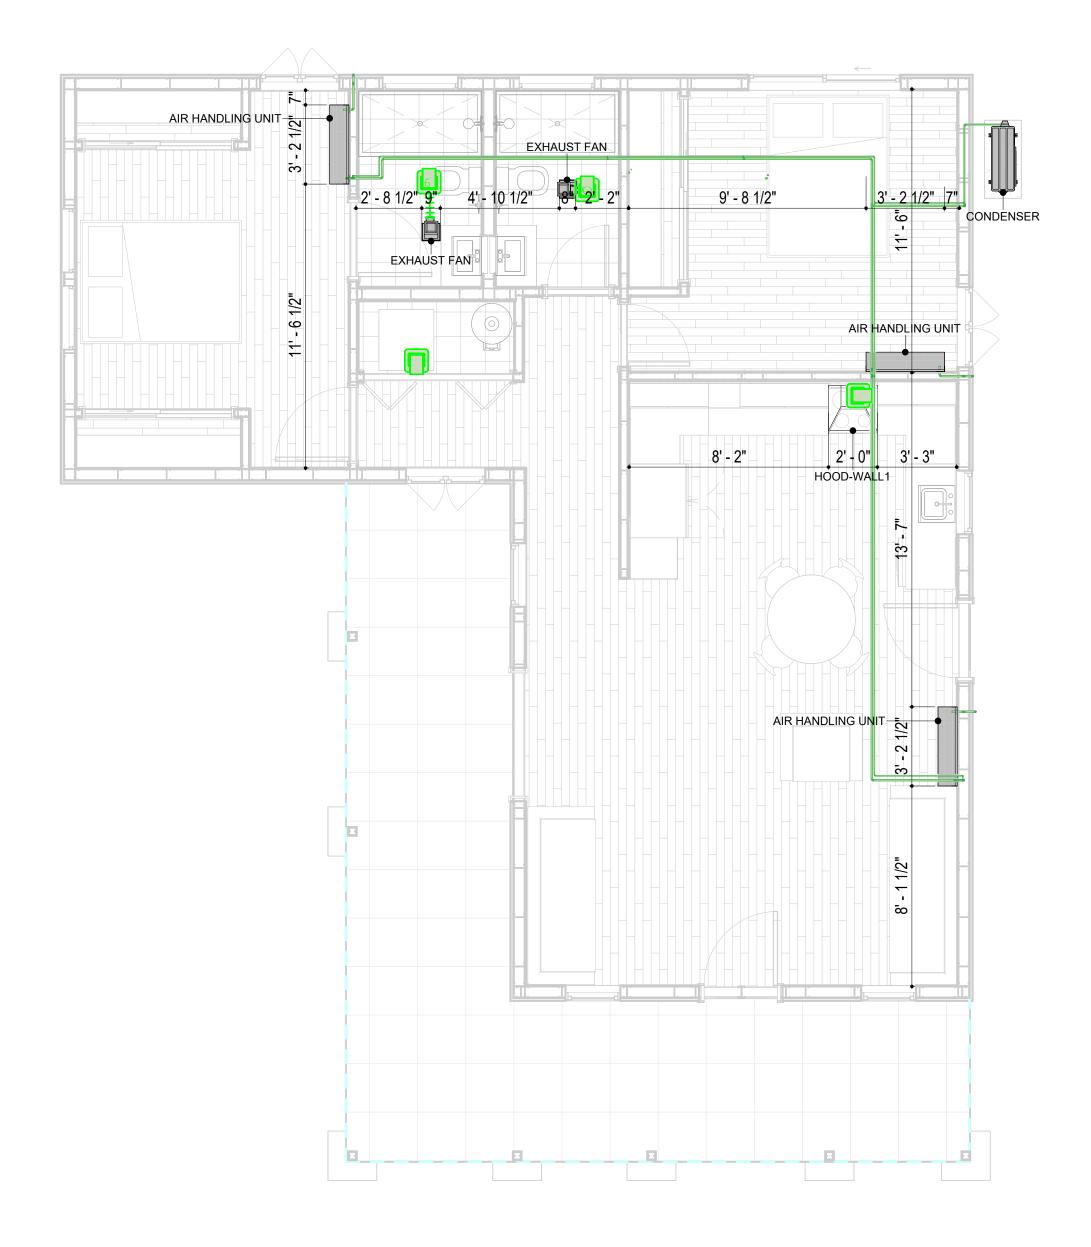



FLEX DUCT SCHEDULE				
DESCRIPTION	DESCRIPTION	LENGTH	DIAMETER	COUNT
FLEX DUCT ROUND	FLEX-ROUND	12.32	4"	4
GRAND TOTAL: 4	•	12.32		

	DUCT ACCESSORY SCHEDULE	
CATAGORY	DESCRIPTION	COUNT
ROOF VENT	3" DIAMETER	4

REFRIGERANT LINE FITTING SCHEDULE				
CATAGORY	DESCRIPTION	Size	Count	
ELBOW - GENERIC	ELBOW - GENERIC: STANDARD/HVAC	3/4"ø-3/4"ø	31	
ELBOW - GENERIC	ELBOW - GENERIC: STANDARD/HVAC	3/8"ø-3/8"ø	23	
TEE - GENERIC	TEE - GENERIC: STANDARD	3/4"ø-3/4"ø-3/ 4"ø	2	
TEE - GENERIC	TEE - GENERIC: STANDARD	3/8"ø-3/8"ø-3/ 8"ø	2	
TRANSITION - GENERIC	TRANSITION - GENERIC: STANDARD	3/4"ø-1/2"ø	4	
TRANSITION - GENERIC	TRANSITION - GENERIC: STANDARD	3/4"ø-5/8"ø	3	
TRANSITION - GENERIC	TRANSITION - GENERIC: STANDARD	3/8"ø-1/4"ø	1	

DUCT FITTING SCHEDULE		
CATAGORY	DESCRIPTION	COUNT
ROUND TRANSITION - ANGLE	45 DEGREE	7

REFRIGERANT LINE SCHEDULE			
CATAGORY	DESCRIPTION	DIAMETER	LENGTH
PIPE TYPES	COPPER	3/8"	75.97
PIPE TYPES	COPPER	3/4"	98.00

MECHANICAL EQUIPMENT SCHEDULE		
CATAGORY	DESCRIPTION	COUNT
AIR HANDLING UNIT	AIR HANDLING UNIT: WALL MOUNTED	3
CONDENSER	CONDENSER: OUT DOOR	1
EXHAUST FAN	EXHAUST FAN: 75 CFM	2
	HOOD-WALL1: VENT 2	1



**KEY PLAN** 

NO.	DESCRIPTION	DATE			

NOTE:

LEGEND:

PROJECT

57-Hamilton-1000-2Bd-2Ba Craftsman-550

DRAWING NAME

**HVAC PLAN** 

CLIENT NAME:

PROJECT NUMBER:

15\_0001

DATE:

2/14/2025 12:47:43 AM

DESIGNED BY:

DRAWN BY:

CHECKED BY:

Checker

M101

#### **ELECTRICAL NOTES**

- 1. THIS DRAWING DEPICTS THE ELECTRICAL SYSTEM FOR THE 57-Hamilton-1000-2Bd-2Ba Craftsman-550. IT PROVIDES A VISUAL REPRESENTATION OF THE ELECTRICAL LAYOUT AND COMPONENTS, INCLUDING POWER DISTRIBUTION, LIGHTING, AND CONTROL SYSTEMS.
- 2. THE ELECTRICAL SYSTEM IS DESIGNED TO MEET THE SPECIFIC REQUIREMENTS OF THE BUILDING, INCLUDING POWER DISTRIBUTION, LIGHTING, AND SPECIALIZED ELECTRICAL EQUIPMENT NEEDS, AS PER THE PROJECT SPECIFICATIONS AND APPLICABLE CODES AND STANDARDS.
- 3. THE ELECTRICAL SYSTEM INSTALLATION SHALL COMPLY WITH THE LATEST EDITION OF THE NATIONAL ELECTRICAL CODE (NEC), INTERNATIONAL BUILDING CODE (IBC), AND ALL OTHER APPLICABLE LOCAL, STATE, AND NATIONAL CODES AND REGULATIONS.
- 4. LOCATIONS AS NEEDED, DEVICES ARE SHOWN ON PLANS IN APPROXIMATE IDEAL LOCATIONS, UNLESS SPECIFICALLY DIMMENSIONED.
- 5. OPEN WALLS AS NEEDED TO ALLOW FOR NEW ELECTRICAL INSTALLATIONS.
- 6. LABEL ALL CIRCUITS ON JUNCTION BOXES, RECEPTACLES, DATA, SMOKE DETECTOR, AND EQUIPMENT IN PANEL BOX.
- 7. INSTALL RACEWAY AS NEEDED FOR DDC, ACCESS CONTROL, LOW VOLTAGE WIRING & DATA.
- 8. RELABEL POWER, DATA & FIRE ALARM FOR ROOM #CHANGES.
- 9. VERIFY ALL CIRCUITS LABELED ON PRINT ARE CORRECT BEFORE WORKING ON THEM.
   10. NOTE ON SITE PLAN ALL CHANGES OR MISSING DETAIL TO BE INCORPORATED INTO THE MASTER PLAN.
- 11. DRAWINGS ARE DIAGRAMMATIC ONLY FOR THE PURPOSE OF SHOWING FIXTURE AND OUTLET LOCATIONS.
- 12. ELECTRICAL CONTRACTOR TO VERIFY SERVICE SIZE BY CALCULATION BASED UPON ACTUAL NAME PLATE RATINGS OF SELECTED FOLIPMENT
- PLATE RATINGS OF SELECTED EQUIPMENT.

  13. VERIEY LOCATION OF SERVICE ENTRANCE WITH POWER COMPANY PROVIDE LIFER GROUND IN
- 13. VERIFY LOCATION OF SERVICE ENTRANCE WITH POWER COMPANY. PROVIDE UFER GROUND IN BUILDING FOUNDATION AT SERVICE ENTRANCE LOCATION.
- 14. PROVIDE A MIN. OF 20 FEET OF ONE \*4 BARE COPPER UFER WIRE EMBEDDED IN CONCRETE FOOTING AT THE SERVICE ENTRANCE LOCATION WHERE APPROVED BY LOCAL SERVICE PROVIDER.
- 15. PROVIDE WATERPROOF FIXTURES IN ALL HIGH MOISTURE AREAS (EXTERIOR, SHOWER AND TUB CEILINGS ETC.)
- 16. PROVIDE DEDICATED CIRCUITS TO EACH BATH, DEN, FAMILY ROOM, BEDROOM, LOFT, KITCHEN
- REFRIGERATOR, KITCHEN FREEZER DISHWASHER, AND ANY AREA/ITEM SPECIFIED BY OWNER.

  17. INCANDESCENT FIXTURES WITH OPEN OR PARTIALLY ENCLOSED LAMPS, PENDANT FIXTURES, AND
- LAMP HOLDERS ARE NOT PERMITTED IN CLOSETS.

  18. ALL WORKMANSHIP AND MATERIALS TO CONFORM WITH THE 2015 IRC.
- 19. PROVIDE A MIN. OF 20 FEET OF ONE \*4 BARE COPPER UFER WIRE EMBEDDED IN CONCRETE FOOTING AT THE SERVICE ENTRANCE LOCATION WHERE APPROVED BY LOCAL SERVICE PROVIDER.
- 20. PROVIDE A BONDING CONDUCTOR CONSISTING OF A MINIMUM OF ONE \*4 BARE COPPER WIRE CONNECTING THE BUILDING'S METAL WATER PIPING SYSTEM TO THE SERVICE EQUIPMENT ENCLOSURE GROUNDING.

#### MAIN PANEL CALCS

(USE 200 AMP SERVICE)

ELECTRICAL CALCS	
LIGHT AND OUTLETS 1000 @ 3W	3000W
3 APPLIANCE CIRCUITS	4,500 W
DRYER	2,000 W
WASHER	2,000 W
RANGE	5,000 W
WATER HEATER	5,000 W
REFRIG.	1,800 W
DISHWASHER & DISPOSAL	3000 W
TOTAL	26,300 W
FRIST 10,000 @ 100% REMAINDER @ 40% MINI. SPLIT UNITS	10,000 W 6,520W 10,000 W
TOTAL	26,520 W
26,520 W DIVIDED BY 240V = 11	1 AMPS TOTAL

#### **ELECTRICAL ABBREVIATIONS LIST**

1P	1 POLE (2P, 3P, 4P, ETC.)	CTR	CENTER	HT	HEIGHT
A	AMPERE	CU	COPPER	HTG	HEATING
AC	ABOVE COUNTER OR AIR CONDITIONER	DCP	DOMESTIC WATER CIRCULATING PUMP	HTR	HEATER
			DEPARTMENT	HV	
ACLG	ABOVE CEILING	DEPT			HIGH VOLTAGE
ADO	AUTOMATIC DOOR OPENER	DET	DETAIL	HVAC	HEATING, VENTILATING AND AIR
AF	AMP FRAME	DIA	DIAMETER	CONDITIONING	CONDITIONING
AFF	ABOVE FINISHED FLOOR	DISC	DISCONNECT	HWP	HYDRONIC WATER PUMP
AFG	ABOVE FINISHED GRADE	DIST	DISTRIBUTION	IC	INTERRUPTING CAPACITY
AFI	ARC FAULT CIRCUIT INTERRUPTER	DN	DOWN	IG	ISOLATED GROUND
AHU	AIR HANDLING UNIT	DPR	DAMPER	IMC	INTERMEDIATE METAL CONDUIT
AL	ALUMINUM	DS	SAFETY DISCONNECT SWITCH	INCAND	INCANDESCENT
ALT	ALTERNATE	DT	DOUBLE THROW	IR	INFRARED
AMP	AMPERE	DWG	DRAWING	I/W	INTERLOCK WITH
AMPL	AMPLIFIER	DDC	DIRECT DIGITAL CONTROL	J-BOX	JUNCTION BOX
ANNUN	ANNUNCIATOR APPROX APPROXIMATELY	EC	ELECTRICAL CONTRACTOR	KV	KILOVOLT
AQ-STAT	AQUASTAT	ELEC	ELECTRIC, ELECTRICAL	KVA	KILOVOLT-AMPERE
ARCH	ARCHITECT, ARCHITECTURAL	ELEV	ELEVATOR	KVAR	KILOVOLT-AMPERE REACTIVE
AS	AMP SWITCH	EM	EMERGENCY	KW	KILOWATT
AT	AMP TRIP	EMS	ENERGY MANAGEMENT SYSTEM	KWH	KILOWATT HOUR
ATS	AUTOMATIC TRANSFER SWITCH	EMT	ELECTRICAL METALLIC TUBING	LOC	LOCATE OR LOCATION
AUTO	AUTOMATIC	EP	ELECTRIC PNEUMATIC	LT	LIGHT
AUX	AUXILIARY	EQUIP	EQUIPMENT	LTG	LIGHTING
AV	AUDIO VISUAL	EWC	ELECTRIC WATER COOLER	LTNG	LIGHTNING
AWG	AMERICAN WIRE GAUGE	EXIST	EXISTING	LV	LOW VOLTAGE
BATT	BATTERY	EXH	EXHAUST	MAX	MAXIMUM
BD	BOARD	EXP	EXPLOSION PROOF	MAG.S	MAGNETIC STARTER
BLDG	BUILDING	FA	FIRE ALARM	M/C	MOMENTARY CONTACT
BMS	BUILDING MANAGEMENT SYSTEM	FABP	FIRE ALARM BOOSTER POWER	MC	MECHANICAL CONTRACTOR
C	CONDUIT	SUPPLY PANEL	SUPPLY PANEL	MCB	MAIN CIRCUIT BREAKER
CAB	CABINET		FIRE ALARM CONTROL PANEL	MCC	MOTOR CONTROL CENTER
		FACP		_ I	MAIN DISTRIBUTION CENTER
CATY	CATALOG	FCU	FAN COIL UNIT	MDC	
CATV	CABLE TELEVISION	FIXT	FIXTURE	MDP	MAIN DISTRIBUTION PANEL
CB	CIRCUIT BREAKER	FLR	FLOOR	MFR	MANUFACTURERMAIN FUSED
CCTV	CLOSED CIRCUIT TELEVISION	FLUOR	FLUORESCENT	N.41.1	DISCONNECT SWITCH
CKT	CIRCUIT	FUDO	FUSE	MH	MANHOLE
CLG	CEILING	FUDS	FUSED SAFETY DISCONNECT SWITCH	MIC	MICROPHONE
COMB	COMBINATION	GA	GAUGE	MIN	MINIMUM
CMPR	COMPRESSOR	GAL	GALLON	MISC	MISCELLANEOUS
CONN	CONNECTION	GALV	GALVANIZED	MLO	MAIN LUGS ONLY
CONST	CONSTRUCTION	GC	GENERAL CONTRACTOR	MMS	MANUAL MOTOR STARTER
CONT	CONTINUATION OR CONTINUOUS	GEN	GENERATOR	MOA	MULTIOUTLET ASSEMBLY
CONTR	CONTRACTOR	GFI	GROUND FAULT CIRCUIT INTERRUPTER	MSP	MOTOR STARTER PANELBOARD
CONV	CONVECTOR	GFP	GROUND FAULT PROTECTOR	MSBD	MAIN SWITCHBOARD
CP	CIRCULATING PUMP	GND	GROUND	MT	MOUNT
CRT	CATHODE-RAY TUBE	GRS	GALVANIZED RIGID STEEL (CONDUIT)	MT.C	EMPTY CONDUIT
CT	CURRENT TRANSFORMER	GYP BD	GYPSUM BOARD	UL	UNDERWRITERS LABORATORIES

#### **Branch Panel:**

Location: LIVING ROOM 01
Supply From:
Mounting: Recessed

Enclosure: Type 1

Volts: 120/240 Single
Phases: 1
Wires: 3

A.I.C. Rating: Mains Type: Mains Rating: 200 A MCB Rating: 1 A

#### lotes:

Circuit Numb er	Circuit Description	Number of Elements	Rating	Length	Wire Size	A			В	Wire Size	Length	Rating	Number of Elements	Circuit Description	Circuit Numb er
1	BED1 LIGHT	13	15 A	68' - 11 9/16"	1-#12, 1-#12, 1-#12	688 VA	300 VA			1-#14, 1-#14, 1-#14	43' - 8 11/32"	15 A	7	HALL LIGHT	2
3	BED2 LIGHT	11	15 A	45' - 4 1/2"	1-#14, 1-#14, 1-#14			628 VA	715 VA	1-#12, 1-#12, 1-#12	35' - 0 7/16"	20 A	10	OUTDOOR LIGHT	4
5	BED1&2 RECEPTACLE	9	20 A	75' - 5 11/16"	1-#8, 1-#8, 1-#8	1620 VA	1260 VA			1-#12, 1-#12, 1-#12	46' - 7 21/32"	20 A	7	LIV. & HALL RECEPTACLE	6
7	KITCHEN GFCI	6	20 A	41' - 0 5/16"	1-#12, 1-#12, 1-#12			1080 VA	1200 VA	1-#12, 1-#12, 1-#12	24' - 2 19/32"	20 A	1	DISHWASHER	8
9	OVENHOOD	1	20 A	27' - 8 5/32"	1-#12, 1-#12, 1-#12	180 VA	2500 VA			2-#8, 1-#8, 1-#10	33' - 8 23/32"	50 A	1	RANGE	10
11	REFRIGERATOR	1	20 A	39' - 0 25/32"	2-#12, 1-#12, 1-#12			900 VA	2500 VA						12
13						900 VA	516 VA			1-#14, 1-#14, 1-#14	53' - 4"	15 A	12	KITCHEN LIGHT	14
15	LIV. LIGHT	7	15 A	26' - 5 1/2"	1-#14, 1-#14, 1-#14			209 VA	720 VA	1-#12, 1-#12, 1-#12	37' - 9 1/32"	20 A	4	OUTDOOR GFCI	16
17	CONDENSER	1	60 A	39' - 8 9/32"	2-#6, 1-#6, 1-#10	2500 VA	2250 VA			2-#10, 1-#10, 1-#10	55' - 4 17/32"	30 A	1	WATERHEATER	18
19								2500 VA	2250 VA						20
21	WASHEING MASHEIN	1	20 A	57' - 6 29/32"	1-#12, 1-#12, 1-#12	1200 VA	2500 VA			2-#10, 1-#10, 1-#10	54' - 10 17/32"	30 A	1	DRYER	22
23	BATH GFCI	10	30 A	63' - 6 1/32"	1-#10, 1-#10, 1-#10			1152 VA	2500 VA						24
25															26
						16412	2 VA	1632	27 VA						
						137	A	13	6 A						

#### Legend:

Load Classification	Connected Load	Demand Factor	Estimated Demand	Panel 1	Totals
LIGHTING - DWELLING UNIT	900 VA	100.00%	900 VA		
OTHER	2316 VA	100.00%	2316 VA	Total Conn. Load:	32738 VA
RECEPTACLE	7980 VA	100.00%	7980 VA	Total Est. Demand:	31738 VA
LIGHTING	300 VA	100.00%	300 VA	Total Conn.:	136 A
CONDENSER	5000 VA	100.00%	5000 VA	Total Est. Demand:	132 A
WATER HEATER	4500 VA	100.00%	4500 VA		
RANGE	5000 VA	80.00%	4000 VA		
DRYER	5000 VA	100.00%	5000 VA		
REFRIGERATOR	1800 VA	100.00%	1800 VA		
	•				



**KEY PLAN** 

NO. DESCRIPTION DATE

NOTE:

LEGEND:

PROJECT

57-Hamilton-1000-2Bd-2Ba Craftsman-550

DRAWING NAME

# **SCHEDULE**

CLIENT NAME:

PROJECT NUMBER:

0181\_14

DATE:

2/15/2025 4:30:17 PM

DESIGNED BY:

DRAWN BY:

CHECKED BY:

Checker

E101

SCALE: 1/4" = 1'-0"

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#### **ELECTRICAL NOTE**

- PROVIDE INTERCONNECTED SMOKE ALARMS IN EACH SLEEPING ROOMS, OUTSIDE EACH SLEEPING ROOM, ON EACH STORY, IN THE HALL OR ADJACENT ROOM LUHERE THE CEILING HEIGHT OF A ROOM OPEN TO THE HALL EXCEEDS THE HALL BY 24'. SMOKE ALARMS SHALL BE PERMANENTLY HARD WIRED WITH BATTERY BACKUP.
- B. RECEPTACLE OUTLETS FOR RANGES AND CLOTHES DRYERS SHALL BE A THREE POLE WITH GROUND TYPE. FOUR WIRE GROUNDING-TYPE FLEXIBLE CORDS WILL BE REQUIRED FOR CONNECTION OF RANGES AND CLOTHES DRYERS. THE BONDING JUMPER SHALL NOT BE CONNECTED BETWEEN NEUTRAL TERMINAL AND THE FRAME OF THE **APPLIANCE**
- C. TWO OR MORE 20 AMP SMALL APPLIANCE CIRCUITS SHALL BE PROVIDED TO SERVE THE KITCHEN, BREAKFAST NOOK, AND DINING ROOM. SUCH CIRCUITS SHALL HAVE NO OTHER OUTLETS.
- D. AT LEAST ONE 20 AMP BRANCH CIRCUIT SHALL BE PROVIDED TO SERVICE THE LAUNDRY ROOM. THIS CIRCUIT SHALL HAVE NO OTHER OUTLETS.
- E. ALL RECEPTACLES WITH IN 6' OF A WET BAR SINK OR KITCHEN SINK TO SERVE COUNTER TOP SURFACES MUST BE GFCI. ON KITCHEN COUNTERS 12' OR WIDER NO POINT ALONG THE WALL SHALL BE MORE THAN 2' FROM A RECEPTACLE. ALL RECEPTACLES WITH IN 6' OF KITCHEN SINK MUST BE GFCI. AT LEAST ONE GFCI RECEPTACLE SHALL BE INSTALLED IN THE BATHROOM ADJACENT TO EACH BASIN.
- FIXTURES INCLUDING CEILING FANS THAT ARE LOCATED IN DAMP LOCATIONS SHALL BE LISTED TO BE SUITABLE FOR SUCH LOCATIONS PER 2012 IRC
- G. PROVIDE ONE (1) SWITCHED OUTLET @ ALL BEDROOMS AND DEN
- H. CEILING FANS NOT EXCEEDING 35 LBS. (WITH OR WITHOUT ACCESSORIES MAY BE SUPPORTED BY OUTLET BOXES PROVIDED THE OUTLET BOXES ARE IDENTIFIED FOR SUCH USE PER 2012 IRC
- ELECTRICAL OUTLET BOXES ON OPPOSITE SIDES OF FIRE RATED WALLS SHALL BE SEPARATED BY A HORIZONTAL DISTANCE OF NOT LESS THAN 24".
- OUTLET BOXES IN THE WALLS BETWEEN THE GARAGE AND DWELLING SHALL BE METAL OR U.L. APPROVED FIRE RESISTIVE PLASTIC. BOXES IN GARAGE CEILING SHALL BE METAL.
- K. ALL BRANCH CIRCUITS THAT SUPPLY 120 VOLTS SINGLE PHASE 15 AND 20 AMPS RECEPTACLE OUTLETS INSTALLED IN THE DWELLING SHALL BE PROTECTED BY AN ARC FAULT CIRCUIT INTERRUPTER, EXCEPT GFCI RECEPTICLES.

#### NOTE:

RECEPTACLES MUST BE PROVIDED IN HALLWAYS 10'-0" OR MORE IN LENGTH. FOR A ONE FAMILY DWELLINGS AND EACH OF A TWO FAMILY DWELLING THAT IS AT GRADE LEVEL, AT LEAST ONE WP-GFCI RECEPTACLE OUTLET ACCESSIBLE AT GRADE LEVEL AND NOT MORE THAN 6'-6" ABOVE GRADE SHALL BE INSTALLED AT THE FRONT AND BACK OF THE DWELLING.

#### NOTE: APPLIANCE DISCONNECT

#### **E4001.5 GROUNDING OF ENCLOSURES.**

METAL ENCLOSURES FOR SWITCHES OR CIRCUIT BREAKERS SHALL BE CONNECTED TO AN

EQUIPMENT GROUNDING CONDUCTOR.

METAL ENCLOSURES FOR SWITCHES OR CIRCUIT BREAKERS USED AS SERVICE

EQUIPMENT SHALL COMPLY WITH THE PROVISIONS OF SECTION E3609.4. WHERE


NONMETALLIC ENCLOSURES ARE USED WITH METAL RACEWAYS OR METAL-ARMORED CABLES. PROVISIONS SHALL BE MADE FOR CONNECTING THE EQUIPMENT GROUNDING

CONDUCTOR.


NONMETALLIC BOXES FOR SWITCHES SHALL BE INSTALLED WITH A WIRING METHOD THAT

PROVIDES OR INCLUDES AN EQUIPMENT GROUNDING CONDUCTOR. (404.12)

#### **ELECTRICAL LEGEND Electrical Lights With Fan Recessed Spot Light Recessed Can Light** 0 **−**Ø Wall Lamp Smoke and heat detector Single Switch ₩Ð ₩ **Three way Switch** 343 DD **Three way with Dimmer Switch** Fan Switch 塘 **Duplex Receptacle** Triplex Receptacle **GFCI Receptacle** Exhaust Fan

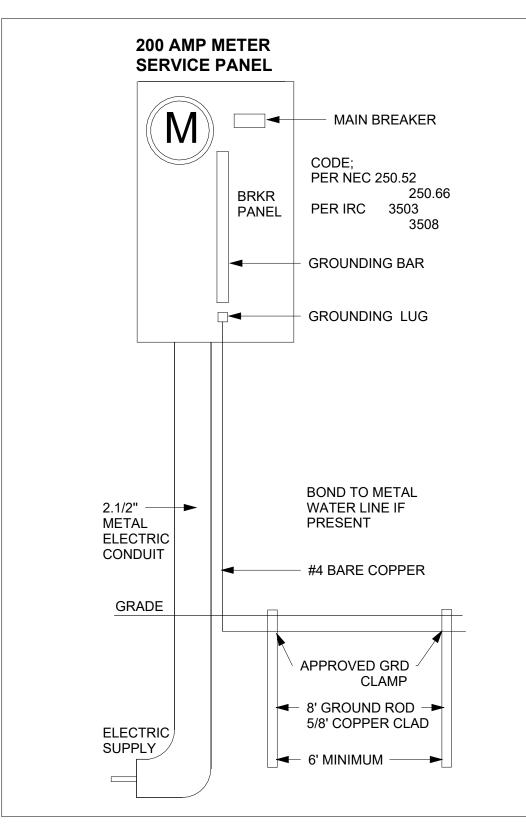



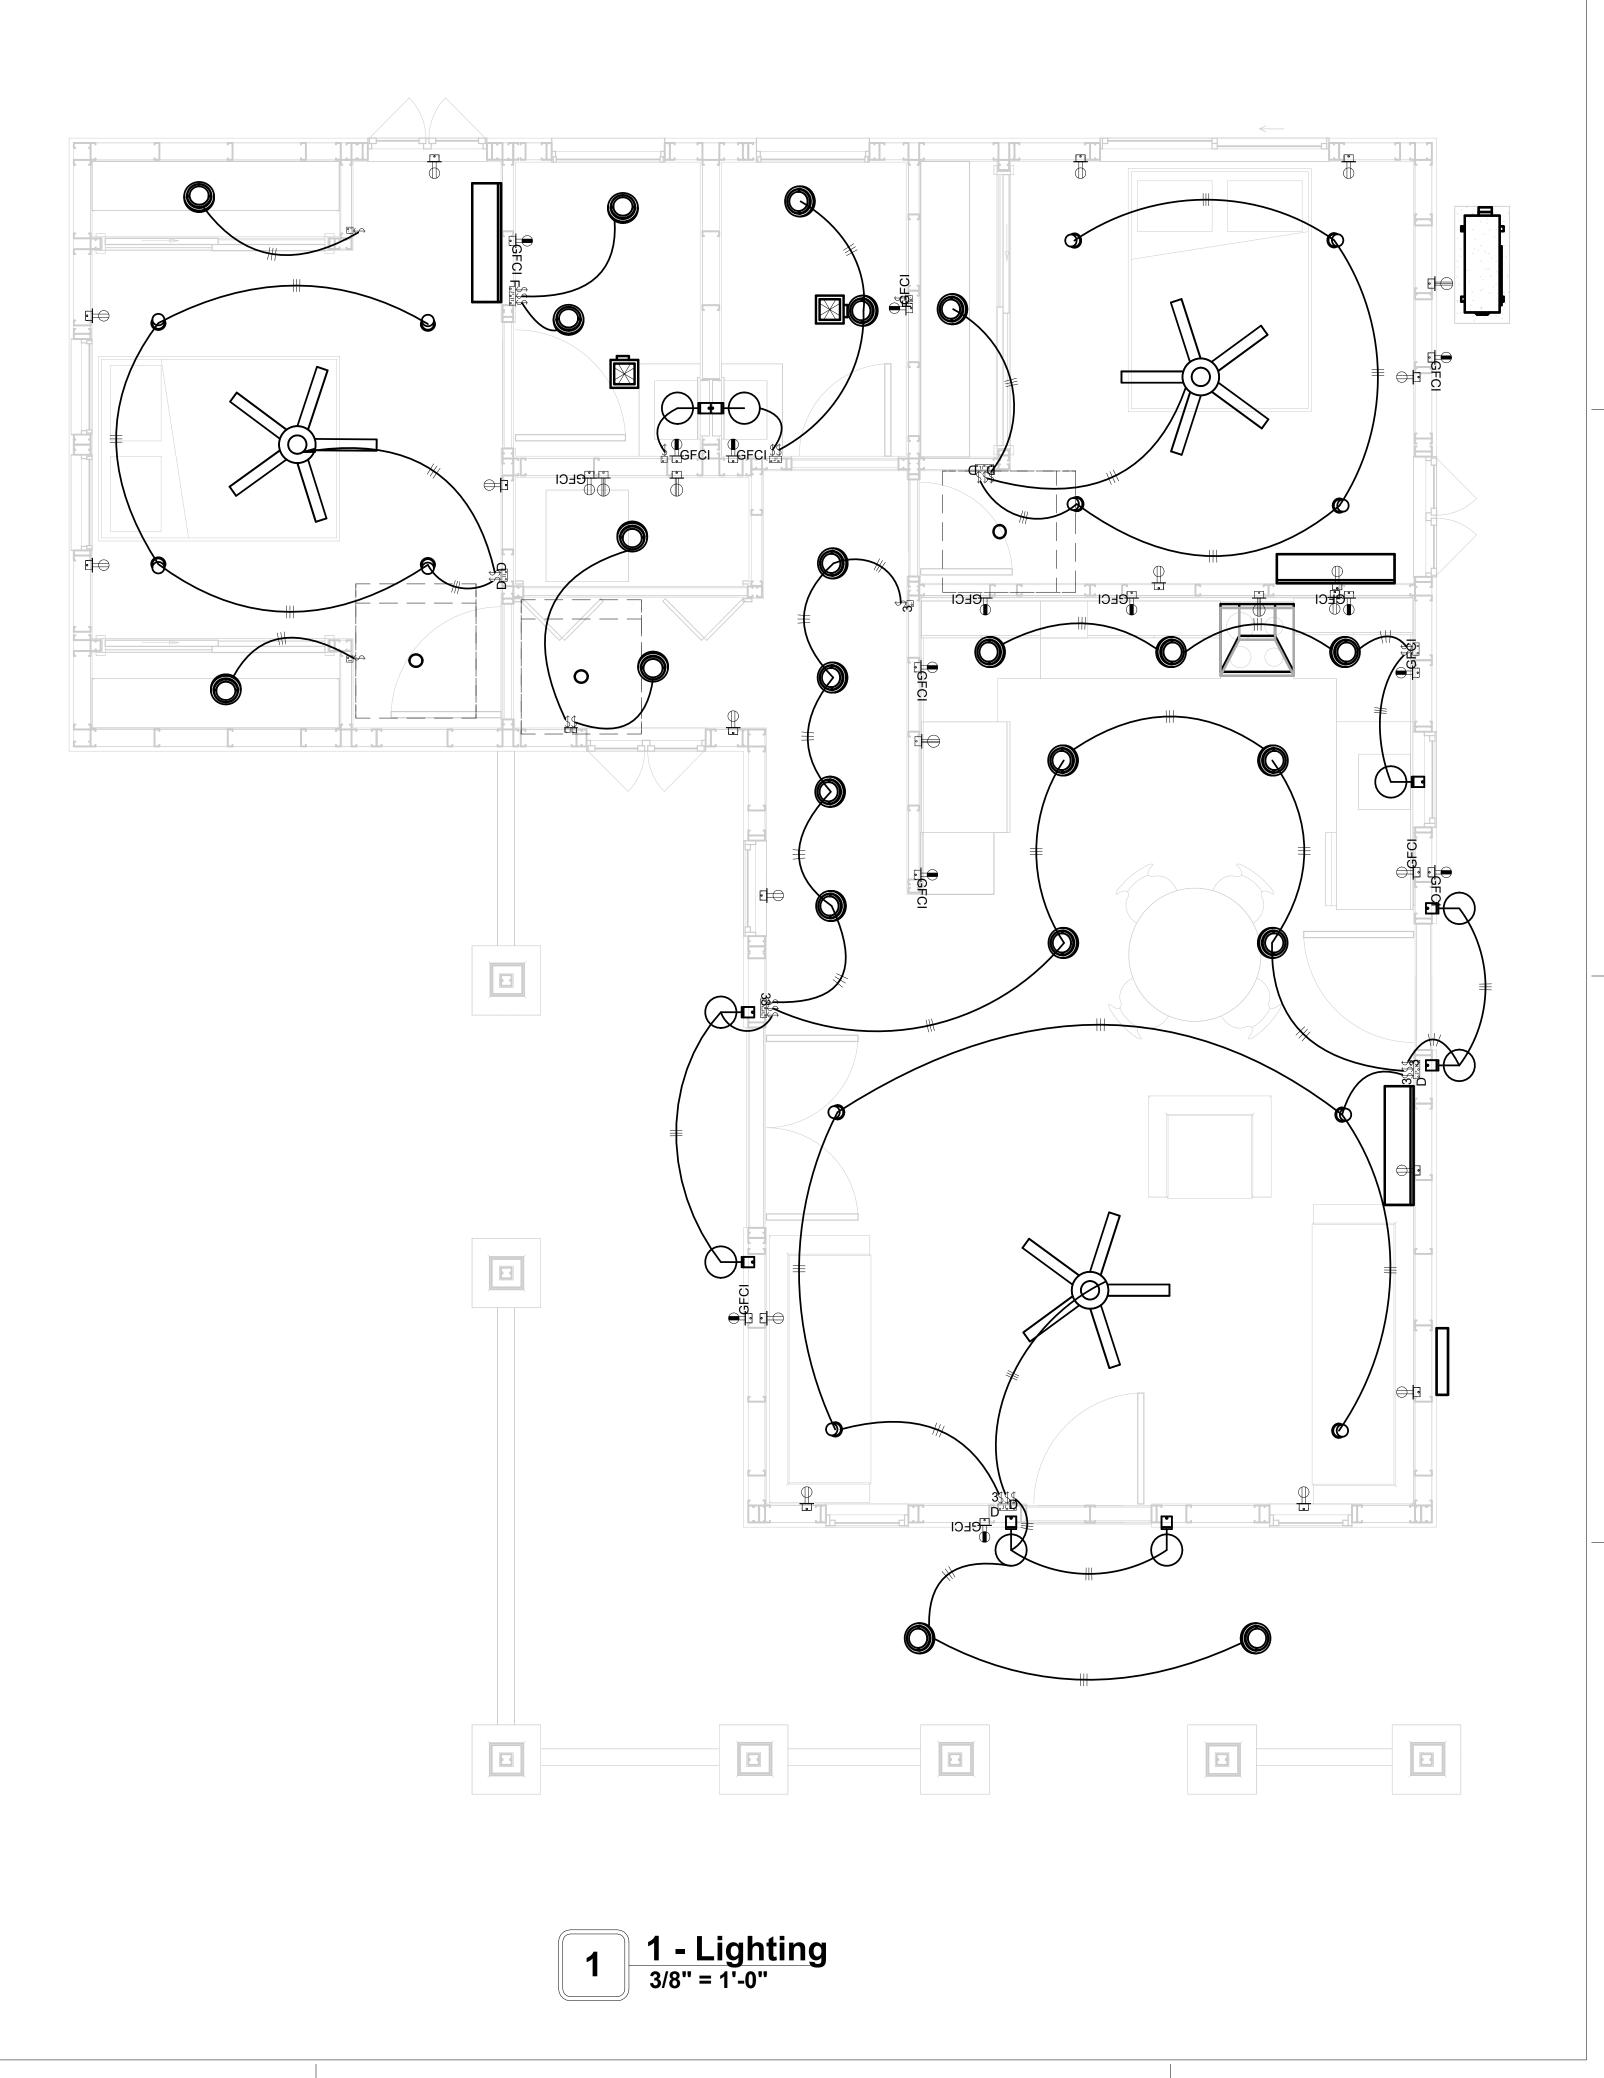



**KEY PLAN** 

DESCRIPTION DATE

NOTE:

LEGEND:

PROJECT

57-Hamilton-1000-2Bd-2Ba Craftsman-550

DRAWING NAME


LIGHTING


Owner CLIENT NAME: PROJECT NUMBER: 0181\_14 DATE: 2/15/2025 4:30:20 PM DESIGNED BY: Designer DRAWN BY: **Author** CHECKED BY: Checker


E102


#### **NOTES: CONDUIT, CABLE AND WIRING**

- Use Metalic Conduits (IMC) for cables running under concrete slabs.
   Use IMC for circuits with high voltage appliances (240 volts and above)
   For circuits with 120 volts consider using EMT or PVC conduits if needed.
   For Low voltage applications up to 50 volts consider using non metalic conduits.
   All conduits to be used in the project must conform to the latest National Electrical Code (NEC),
- All wiring and cables to be used in the project must also conform to the latest National Electrical Code (NEC), 2015.
- 7. All cables and wires used should be rated for their respective loading and should be gauged and conform to the NEC.

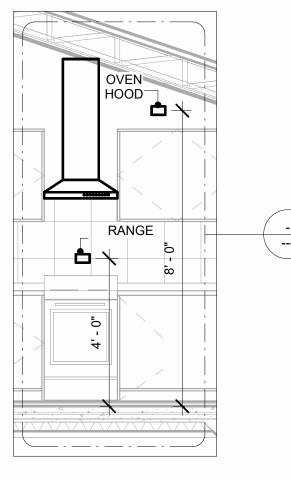

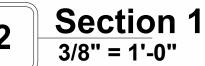


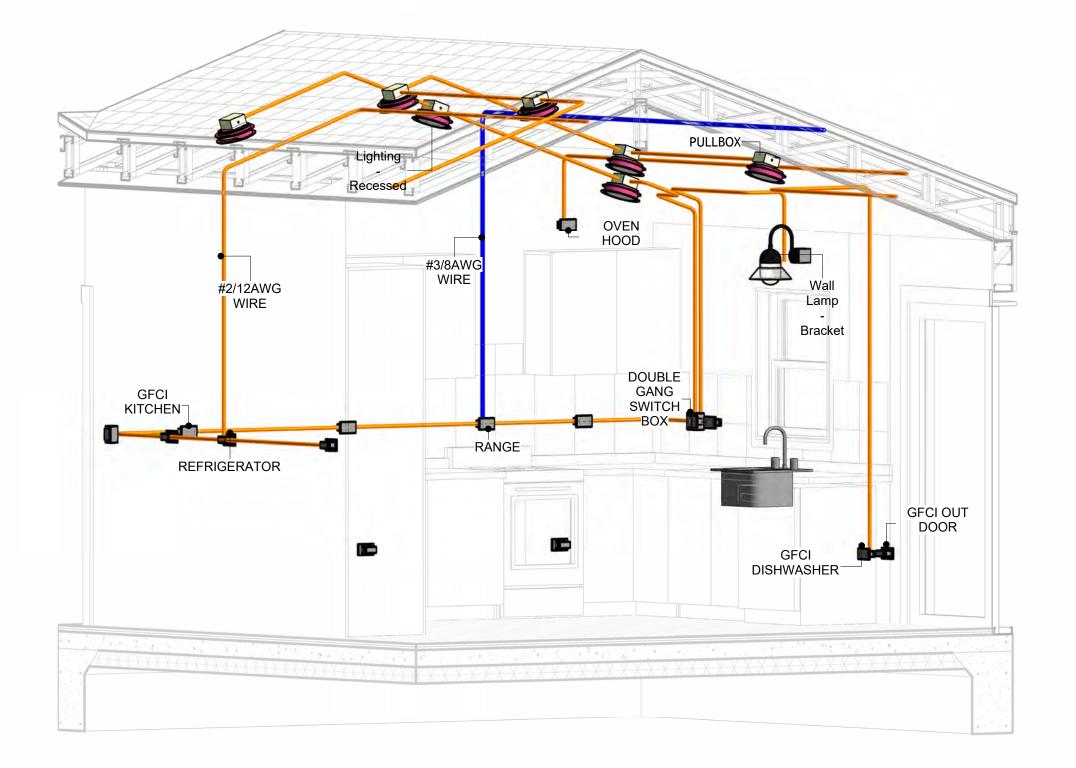


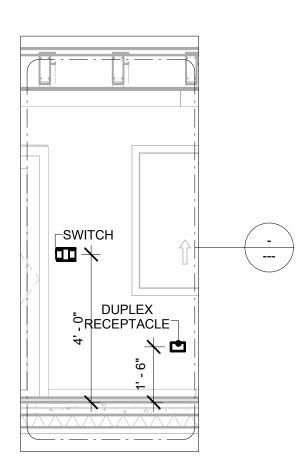


Section 3 3/8" = 1'-0"



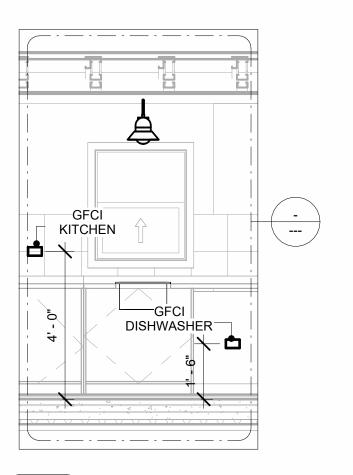

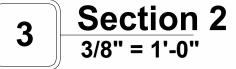


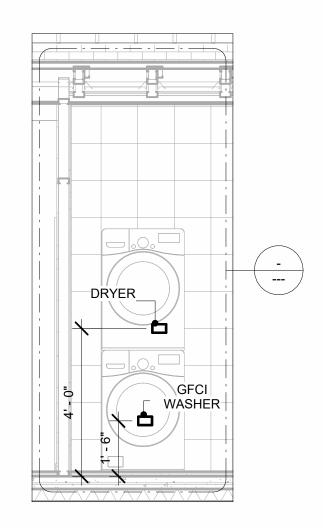

Section 4
3/8" = 1'-0"



**KEY PLAN** 

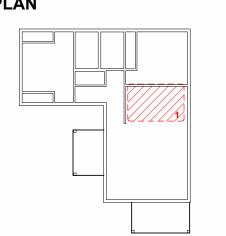

NO.	DESCRIPTION	DATE

NOTE:

LEGEND:

PROJECT

57-Hamilton-1000-2Bd-2Ba Craftsman-550

DRAWING NAME

**POWER** 

CLIENT NAME:	Owner
PROJECT NUMBER:	0181_14
DATE:	2/15/2025 4:30:45 PM
DESIGNED BY:	Designer
DRAWN BY:	Author
CHECKED BY:	Checker

E103

#### **NOTES: LIGHT**

- 1. LIGHT FIXTURES AND LUMINARIES SHALL CONFORM TO THE NEC, THE IRC AND LOCAL SAFETY & BUILDING CODE.
- 2. ALL LIGHTING FIXTURES SHOULD CONFORM TO THE DESIGN ELECTRICAL LOAD AND SHALL BE PROPERLY WIRED AND MOUNTED BY QUALIFIED ELECTRICIAN FOLLOWING MANUFACTURERS SPECIFICATIONS.
- 3. CEILING FANS AND FANS WITH LIGHT WITH WEIGHT EXCEEDING 35 LBS SHOULD BE PROVIDED WITH STRUCTURAL BACKING FOR SUPPORT AND SHALL BE FIXED AS PER MANUFACTURERS SPECIFICATIONS.
- 4. EXTERIOR LIGHTS SHALL CONFORM TO LOCAL BUILDING CODE AND GUIDELINES.

#### **NOTES: SWITCH JUNCTION BOX**

- 1. THE MINIMUM SIZE OF JUCTION BOX TO BE USED IS 2"X4"X(1.5" OR 3.5" DEEP) THIS ARE TO BE USED FOR SINGLE GANG SWITCH OR OUTLETS.
- 2. FOR DOUBLE GANG (2 GANG) OUTLETS AND SWITCHS THE MINIMUM SIZE OF THE
- JUCTION BOX TO BE PROVIDED SHALL NOT BE LESS THAN 4"X4"X(1.5" OR 3.5" DEEP)
- 3. FOR THREE GANG (3 GANG) OUTLETS AND SWITCHS THE MINIMUM SIZE OF THE JUĆTION BOX SHALL NOT BE LESS THAN 6"X4"X(1.5" OR 3.5" DEEP).

FITTING SCHEDULE(PULL BOX)								
FAMILY COUNT DESCRIPTION								
PULLBOX1	40	#1/4 PULLBOX						


ELECTRICAL FIXTURE SCHEDULE (SWITCH BOX)							
TYPE COUNT							
DOUBLE GANG SWITCH BOX	4						
SINGLE GANG SWITCH BOX	5						
TRIPLE GANG SWITCH BOX	5						

LIGHTING DEVICE							
TYPE	COUNT						
DIMMER	5						
FAN SWITCH	2						
SINGLE POLE	15						
THREE WAY	4						
THREE WAY WITH DIMMER	2						

LIGHTING FIXTURE							
LIGHTING FIXTURE TYPE	VOLTAGE	ELECTRICAL LOAD	COUNT				
ELECTRICAL_LIGHTS_FAN-LIGHT1	120 V/1-100 VA- 120 V/1-100 VA	200 A, 120 V/240 V, SINGLE PHASE, 3 WIRES	3				
LIGHTING - RECESSED	120 V/1-60 VA	<varies></varies>	21				
LIGHTING_RECESSED	120 V/1-60 VA	200 A, 120 V/240 V, SINGLE PHASE, 3 WIRES	1				
SASSO 100 ROUND WALLWASHER TRIM	120 V/1-28 VA	200 A, 120 V/240 V, SINGLE PHASE, 3 WIRES	12				

120 V/1-100 VA

200 A, 120 V/240 V, SINGLE PHASE, 3 WIRES

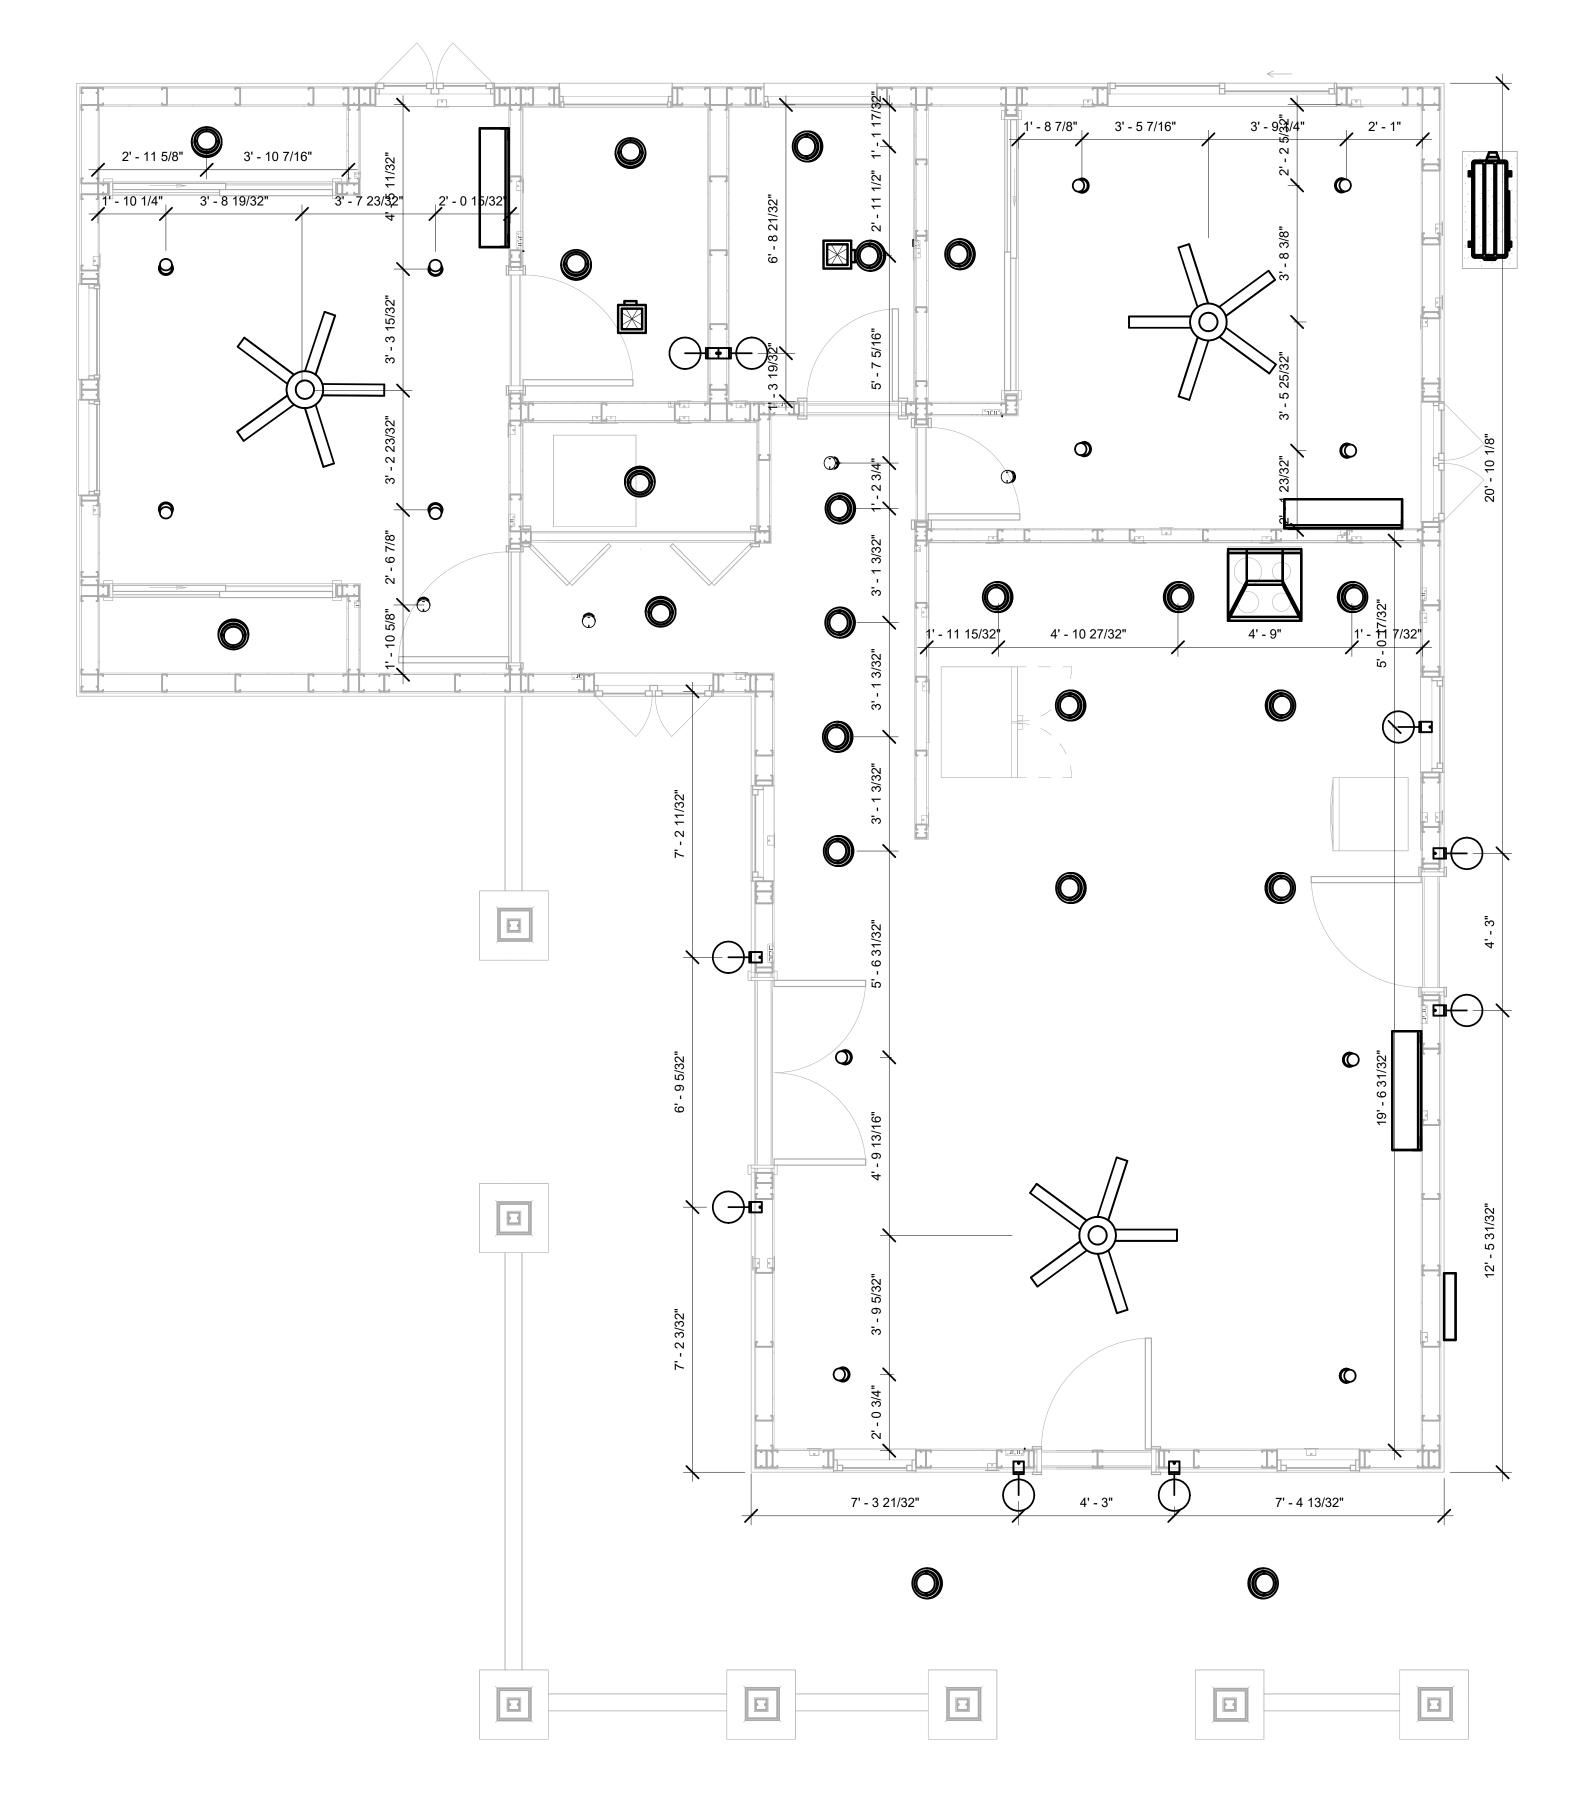

1 DIMENSION FOR LIGHT FIXTURES
3/8" = 1'-0"



**KEY PLAN** 

DESCRIPTION	DATE
	DESCRIPTION

NOTE:

LEGEND:

PROJECT

57-Hamilton-1000-2Bd-2Ba Craftsman-550

DRAWING NAME

# DIMENSION PLAN FOR LIGHT FIXTURES

Owner
0181_14
2/15/2025 4:30:47 PM
Designer
Author
Checker

E104

SCALE: As indicated


WALL LAMP - BRACKET

#### NOTES;

- 1. VERIFY EQUIPMENT PLUG CONFIGURATION BEFORE PURCHASING RECEPTACLES
- 2. FOR ALL EQUIPMENT.
- 3. COORDINATE EXACT LOCATION OF LIGHT FIXTURES, WALL SWITCHES, RECEPTACLES AND OTHER DEVICES WITH ARCHITECTURAL DRAWINGS.
- 4. USE METALLIC JUNCTION BOX WITH THE GFCI RECEPTACLES, WITH HIGHT VOLTAGE.

ELECTRICAL FIXTUR	RE SCHEDULE (RECEPTACLE)
TYPE	COUNT
CONDENSER	1
DRYER	1
DUPLEX RECEPTACLE	16
GFCI BATH ROOM	4
GFCI DISHWASHER	1
GFCI KITCHEN	6
GFCI OUT DOOR	4
GFCI WASHER	1
OVEN HOOD	1
RANGE	1
REFRIGERATOR	1
WATER HEATER	1

	ELECTRICAL O	UTLET SCHEDULE	≣
TYPE	CIRCUIT NUMBER	ELECTRICAL DATA	COUNT
DUPLEX RECEPTACLE	5	120 V/1-180 VA	9
DUPLEX RECEPTACLE	6	120 V/1-180 VA	7
GFCI KITCHEN	7	120 V/1-180 VA	6
GFCI DISHWASHER	8	120 V/1-1200 VA	1
OVEN HOOD	9	120 V/1-180 VA	1
RANGE	10,12	240 V/2-5000 VA	1
REFRIGERATOR	11,13	240 V/2-1800 VA	1
GFCI OUT DOOR	16	120 V/1-180 VA	4
CONDENSER	17,19	240 V/2-5000 VA	1
WATER HEATER	18,20	240 V/2-4500 VA	1
GFCI WASHER	21	120 V/1-1200 VA	1
DRYER	22,24	240 V/2-5000 VA	1
GFCI BATH ROOM	23	120 V/1-180 VA	4

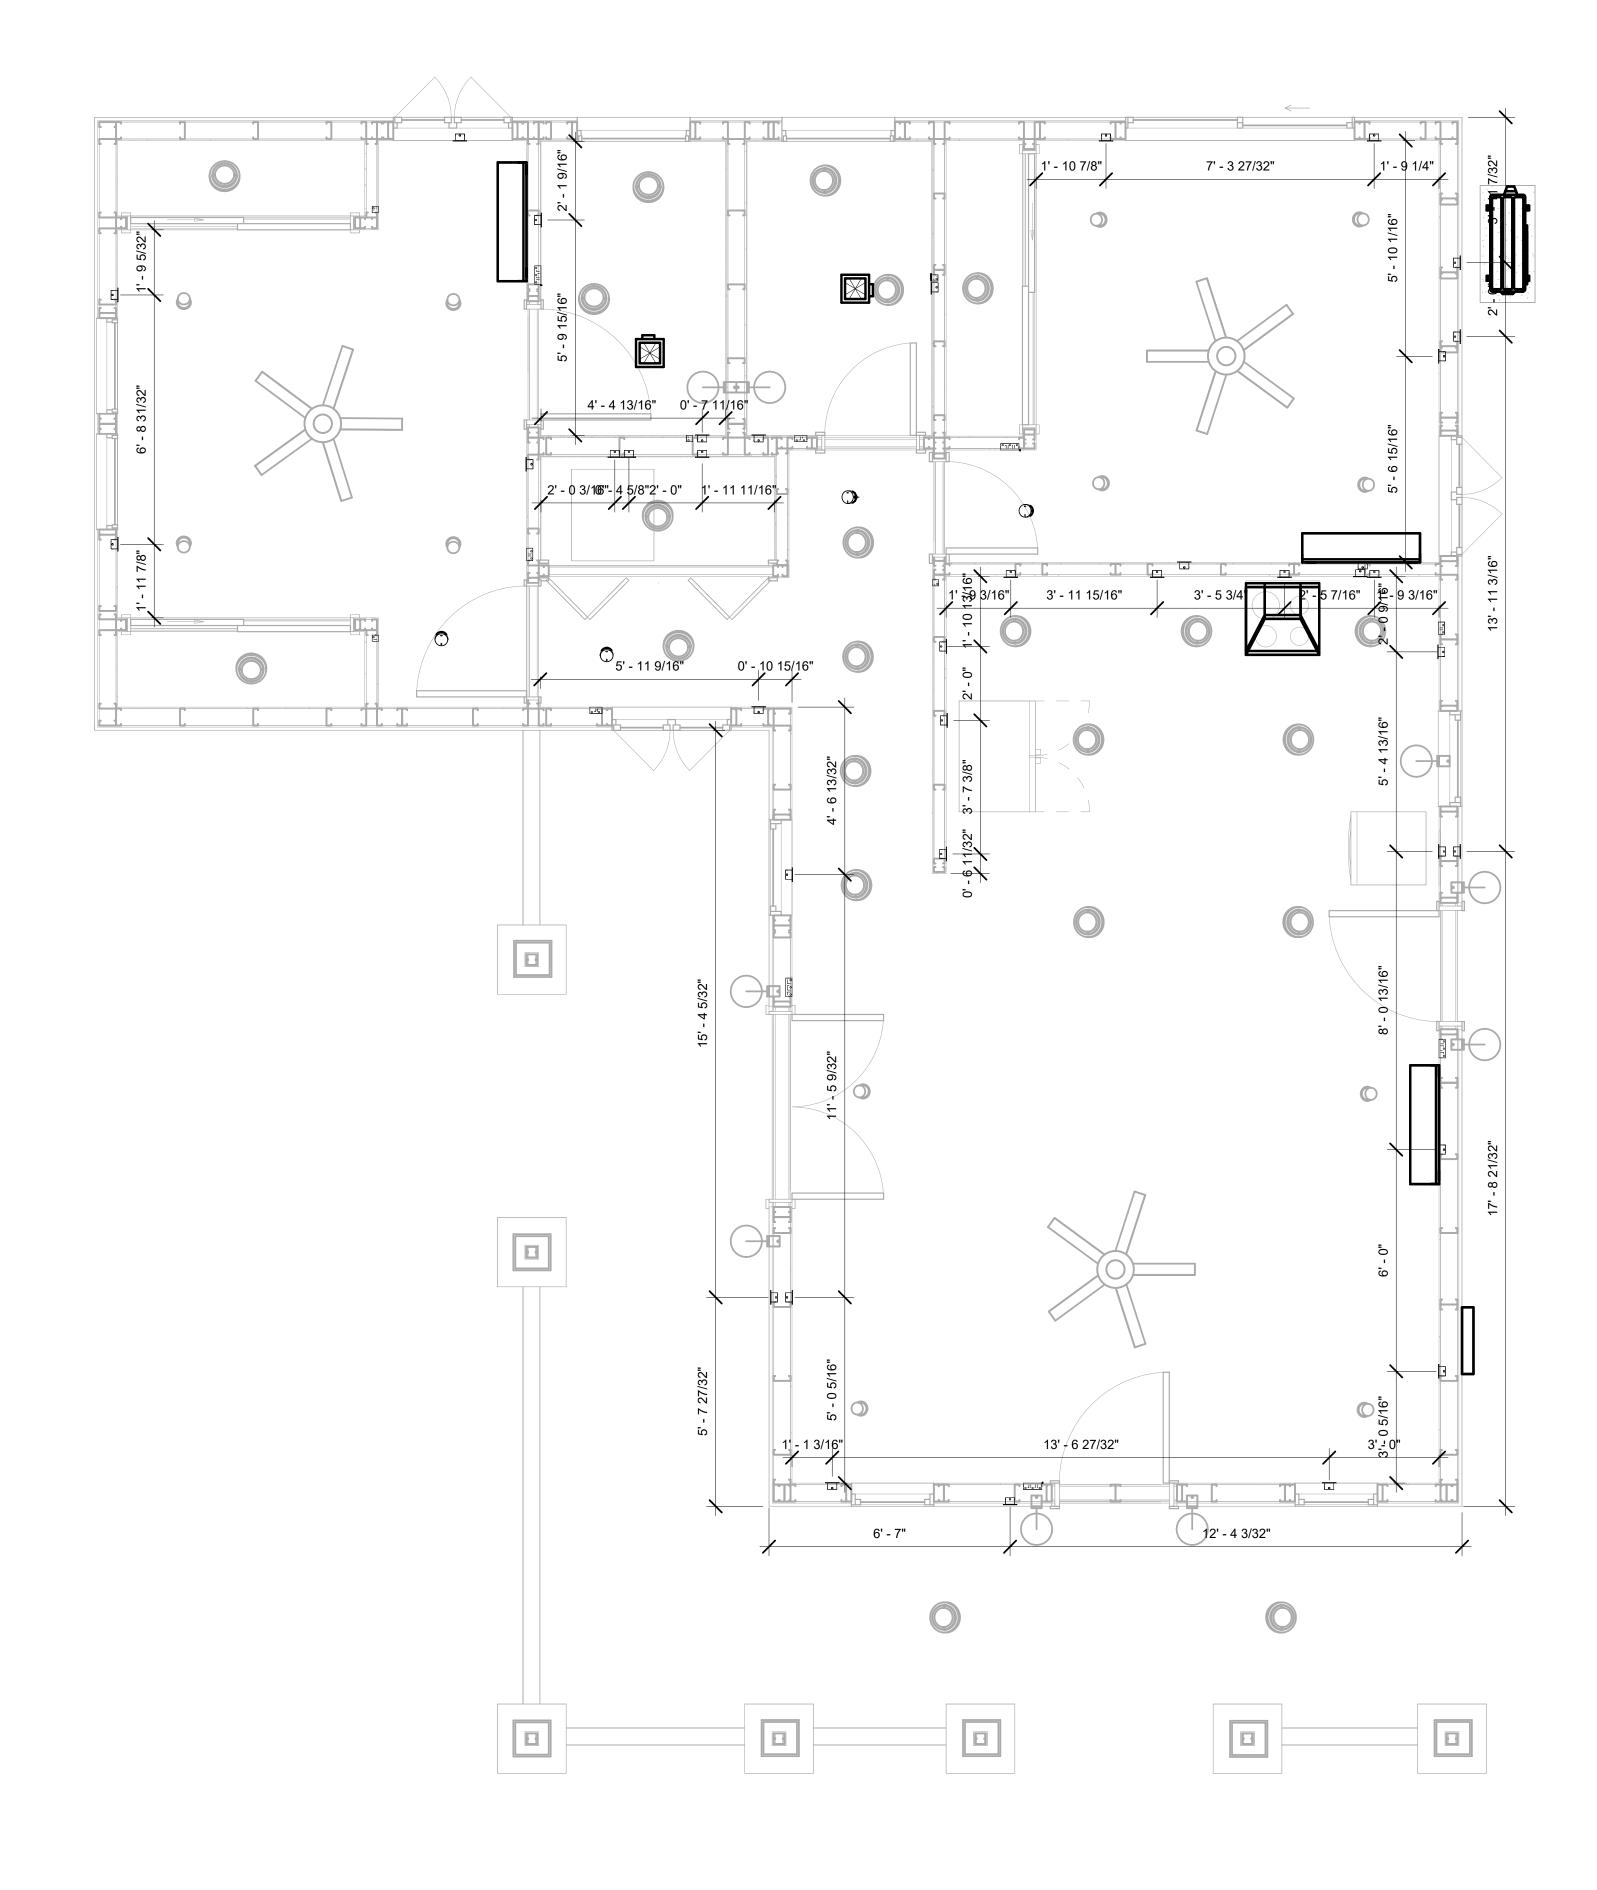

1 DIMENSION FOR FITTINGS
3/8" = 1'-0"



**KEY PLAN** 

NO. DESCRIPTION DATE

NOTE:

LEGEND:

PROJECT

57-Hamilton-1000-2Bd-2Ba Craftsman-550

DRAWING NAME

# DIMENSION PLAN FOR FITTINGS

CLIENT NAME:

PROJECT NUMBER:

0181\_14

DATE:

2/15/2025 4:30:48 PM

DESIGNED BY:

DRAWN BY:

CHECKED BY:

Checker

E105

#### SHEET LIST

SHEET NUMBER SHEET NAME

P101 NOTE AND SCHEDULE
P102 WATER SUPPLY AND SEWAGE
SYSTEM

# PIPE COLOR SCHEME DOMESTIC COLD WATER DOMESTIC HOT WATER SANITARY VENT SANITARY SEWER STORM DRAINAGE GRAY WATER GAS LINE

#### PLUMBING NOTES

- THE PLUMBING SYSTEM IS DESIGNED TO MEET THE BUILDING'S DOMESTIC WATER SUPPLY, SANITARY DRAINAGE, AND STORM DRAINAGE REQUIREMENTS, AS PER PROJECT SPECIFICATIONS AND APPLICABLE CODES.
- THE SYSTEM INSTALLATION SHALL COMPLY WITH THE LATEST INTERNATIONAL PLUMBING CODE (IPC), INTERNATIONAL RESIDENTIAL CODE (IRC), AND ALL OTHER RELEVANT LOCAL, STATE, AND NATIONAL REGULATIONS.
- ALL PLUMBING WORK SHALL COMPLY WITH THE LATEST EDITION OF THE INTERNATIONAL PLUMBING CODE (IPC) AND THE LOCAL PLUMBING CODE.
- 4. PLUMBING SYSTEMS SHALL BE TESTED AND INSPECTED IN ACCORDANCE WITH THE LOCAL PLUMBING CODE REQUIREMENTS.
- 5. PLUMBING FIXTURES SHALL BE INSTALLED WITH THE APPROPRIATE TRIM, FITTINGS, AND ACCESSORIES, AS RECOMMENDED BY THE MANUFACTURER.
- 6. PIPING SHALL BE PROPERLY SUPPORTED AND SECURED TO PREVENT SAGGING, MOVEMENT, AND VIBRATION.
- 7. SHUT-OFF VALVES SHALL BE PROVIDED AT ALL BRANCH CONNECTIONS AND AT THE INLET AND OUTLET OF EACH PIECE OF EQUIPMENT.
- 8. BACKFLOW PREVENTION DEVICES SHALL BE INSTALLED AS REQUIRED BY THE LOCAL PLUMBING CODE TO PROTECT THE POTABLE WATER SYSTEM.
- 9. PLUMBING FIXTURES AND EQUIPMENT SHALL BE ACCESSIBLE FOR MAINTENANCE AND SERVICING
- 10. EXPOSED PLUMBING PIPING AND FIXTURES SHALL BE INSULATED TO PREVENT CONDENSATION AND ENERGY LOSS.
- 11. DEAD ENDS IN THE DRAINAGE SYSTEM MUST BE AVOIDED, EXCEPT WHERE NECESSARY TO INSTALL A CLEANOUT IN AN ACCESSIBLE LOCATION, AND MUST HAVE A VENTED CONNECTION TO THE OUTSIDE ATMOSPHERE.
- 12. THE VERTICAL DEFLECTION OF PVC PIPE MUST NOT EXCEED 5%, AND NO DEFLECTION IS PERMITTED FOR IRON PIPE.
- 13. WORK MUST BE PROPERLY COORDINATED WITH OTHER TRADES TO AVOID CONFLICTS, REFERRING TO THE ARCHITECTURAL AND STRUCTURAL DRAWINGS FOR INFORMATION REGARDING CEILING ELEVATIONS, SPACE CLEARANCES, WALL AND PARTITION LOCATIONS, ETC.
- 14. ALL FIXTURES SHALL HAVE ACCESSIBLE STOPS.
- 15. DOMESTIC WATER PIPING SHALL BE PEX, AND PVC PIPING IS NOT ACCEPTABLE FOR INTERIOR USE.
- 16. VENT TERMINATIONS SHALL BE LOCATED AT LEAST 10 FEET FROM OR 3 FEET ABOVE ANY OPERABLE WINDOW, DOOR OPENING, AIR INTAKE, OR VENT SHAFT, AND AT LEAST 3 FEET IN EVERY DIRECTION FROM ANY LOT LINE, ALLEY, OR STREET.
- 17. PIPE AND FITTINGS UTILIZED IN THE WATER SUPPLY SYSTEM SHALL HAVE A MAXIMUM OF 8 PERCENT LEAD.
- 18. ACRYLONITRILE BUTADIENE STYRENE (ABS) SHALL BE USED FOR THE SEWERAGE AND
- VENTILATION SYSTEM.

  19. CROSS-LINKED POLYETHYLENE (PEX) SHALL BE USED FOR THE WATER SUPPLY SYSTEM.
- 20. POLYVINYL CHLORIDE (PVC) SHALL BÉ USED FOR THE RAIN WATER SYSTEM.
- 21. THE MIMIMUM WATER SUPPLY DEPTH UNDER FLOOR FINISH SHOUD BE 1/2".
- 22. ANY PIPE INSTALLED UNDERGROUND MUST HAVE AT LEAST 12 INCHES OF CLEARANCE BETWEEN THE OUTSIDE OF THE PIPE AND ANY OTHER UNDERGROUND STRUCTURE.
- 23. THE MINIMUM CLEARANCE BETWEEN COLD AND HOT WATER LINES IN RESIDENTIAL
- HOMES MAINTAIN A MINIMUM DISTANCE OF 6 INCHES.

  24. HORIZONTAL SEPARATION BETWEEN WATER AND SEWER LINES: A MINIMUM OF 12 INCHES BETWEEN POTABLE WATER SUPPLY LINES (COLD AND HOT WATER) AND

#### **ABBREVIATIONS**

SANITARY SEWER LINES.

Ø	DIAMETER
ABS	ACRYLONITRILE BUTADIENE STYRENE
ABV	ABOVE
AD	AREA DRAIN
AFF	ABOVE FINISHED FLOOR
ALT	ALTERNATE
BFF	BELOW FINISHED FLOOR
BLW	BELOW
CO	CLEAN OUT
CW	COLD WATER
D	DEGREE
DFU	DRANAGE FIXTURE UNIT
DIA	DIAMETER
DN	DOWN
FCO	FLOOR CLEAN OUT
FD	FLOOR DRAIN
FL	FLOOR
FS	FLOOR SINK
FT	FOOT/FEET
HB	HOSE BIB
HW	HOT WATER
IN	INCH
MIN	MINIMUM
NO	NUMBER
NTS	NOT TO SCALE
PEX	CROSS-LINKED POLYETHYLENE
PLBG	PLUMBING
PVC	POLYVINYL CHLORIDE
QTY	QUANTITY
RD	ROOF DRAIN
RED	REDUCER
RM	ROOM
RW	RAIN WATER
SF	SQUARE FOOT
V	VENT
VTR	VENT THROUGH ROOF
W	WASTE
WCO	WALL CLEAN OUT
WSFU	WATER SUPPLY FIXTURE UNIT

### PLUMBING LEGEND

D	CAP
	BEND 45 DEG
$\Box$	BEND 90 DEG
	TEE REDUCING
	TEE
	CLEAN TWO-WAY
	WYE 45 DEG
	WYE 45 DEG DOUBLE
	WYE COMBINATION
	P-TRAP

PIPE SCHEI	DULE	
MATERIAL	DIAMETER	LENGTH
ACRYLONITRILE BUTADIENE STYRENE (ABS)	1 1/2"	62 FT
ACRYLONITRILE BUTADIENE STYRENE (ABS)	2"	191 FT
ACRYLONITRILE BUTADIENE STYRENE (ABS)	3"	8 FT
CROSS-LINKED POLYETHYLENE (PEX)	1/2"	90 FT
CROSS-LINKED POLYETHYLENE (PEX)	3/4"	73 FT

FITTING	SCHEDULE	
FITTING	SIZE	QTY
DOMESTIC COLD WATER		
DOMESTIC COLD WATER PEX 90 DEGREE ELBOW	1/2"ø-1/2"ø	14
PEX 90 DEGREE ELBOW PEX 90 DEGREE ELBOW	3/4"ø-3/4"ø	7
PEX CROSS ELBOW	3/4"ø-3/4"ø-3/4"ø-3/4"ø	1
PEX TEE ELBOW	1/2"ø-1/2"ø-1/2"ø	6
PEX TEE ELBOW	3/4"ø-3/4"ø	4
PEX TRANSITION ELBOW	1"ø-1/2"ø	2
PEX TRANSITION ELBOW	3/4"ø-1/2"ø	9
FEX TRANSITION ELBOW	3/4 Ø-1/2 Ø	9
DOMESTIC HOT WATER		
PEX 90 DEGREE ELBOW	1/2"ø-1/2"ø	13
PEX 90 DEGREE ELBOW	3/4"ø-3/4"ø	3
PEX TEE ELBOW	1/2"ø-1/2"ø-1/2"ø	3
PEX TEE ELBOW	3/4"ø-3/4"ø	3
PEX TRANSITION ELBOW	3/4"ø-1/2"ø	6
RAIN WATER	011 011	22
ABS 90 DEG BEND ELBOW	2"ø-2"ø	33
ABS REDUCER ELBOW	1 1/2"ø-1 1/2"ø	1
ABS TEE REDUCER ELBOW	2"ø-2"ø-1 1/2"ø	4
PVC 90 DEGREE BEND ELBOW	1 1/2"ø-1 1/2"ø	8
PVC 90 DEGREE BEND ELBOW	2"ø-2"ø	2
SEWAGE		
ABS 90 DEGREE BEND ELBOW	2"ø-2"ø	6
ABS 90 DEGREE BEND ELBOW	3"ø-3"ø	2
ABS P-TRAP	1 1/2"ø-1 1/2"ø	5
ABS P-TRAP	2"ø-2"ø	2
ABS REDUCER ELBOW	2"ø-1 1/2"ø	2
ABS REDUCER ELBOW	3"ø-2"ø	1
ABS TEE REDUCER ELBOW	1 1/2"ø-1 1/2"ø-1 1/2"ø	1
ABS TEE REDUCER ELBOW	2"ø-2"ø-2"ø	4
ABS TEE REDUCER ELBOW	3"ø-2"ø-3"ø	1
ABS WYE COMBINATION WITH 8TH BEND DOUBLE ELBOW	3"ø-3"ø-1 1/2"ø-1 1/2"ø	1
ABS WYE COMBINATION WITH 8TH BEND ELBOW	2"ø-2"ø-2"ø	1
WASTE DOUBLE TEE	1 1/2"ø-1 1/2"ø-1 1/2"ø	1
WASTE DOUBLE TEE	3"ø-3"ø-3"ø	1
A/FAIT		
VENT ABS 90 DEGREE BEND ELBOW	1 1/2"ø-1 1/2"ø	1
ABS TEE REDUCER ELBOW	2"ø-2"ø-1 1/2"ø	1
	1 1/2"ø	1
ABS VENT CAP ELBOW		

FAMILY	W	V	TRAP	CW	HW	QTY	DFU	TOT.	WFU	TOT.	NOTES
DISHWASHER	2"	1-1/2"	1-1/2"	1/2"	1/2"	1		0			DRAIN TO SEWER SEE PLANS
DRYER	N/A	N/A	N/A	N/A	N/A	1		0			
HANGING PIPES CLAMP						30		0			
SHOWER TRAY						2		0			
SHOWER TRIM	-	-	-	1/2"	1/2"	2		0			
SINK ISLAND SINGLE	2"	1-1/2"	1-1/2"	1/2"	1/2"	1		0			
VANITY SINK	2"	1-1/2"	1-1/2"	1/2"	1/2"	2		0			
WASHER	2"	1-1/2"	2"	1/2"	1/2"	1		0			DRAINS TO GRAY WATI OR SEWER SEE PLANS
WATER CLOSET	3"	2"	3"	1/2"	1/2"	2		0			
WATER HEATER	N/A	N/A	N/A	3/4"	3/4"	1		0			

	FIX	TURE SCHEDULE			
FIXTURE	FIXTURE QTY DESCRIPTION				
DISHWASHER	1	DRAIN TO SEWER SEE PLANS			
DRYER	1				
HANGING PIPES CLAMP	30				
SHOWER TRAY	2				
SHOWER TRIM	2				
SINK ISLAND SINGLE	1				
VANITY SINK	2				
WASHER	1	DRAINS TO GRAY WATER OR SEWER SEE PLANS			
WATER CLOSET	2				
WATER HEATER	1				

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ACC	ESSURIE	S & FITTINGS SCHEDULE
FIXTURE	QTY	DESCRIPTIONS
DISHWASHER CONNECTOR	1	
HOSE BIB	3	
LAUNDRY SWEAT CONNECTOR	1	
SHUTOFF VALVE	8	

	PL	UMBING S	CHEDULE		
FIXTURE	TRAP	WASTE	VENT	C.W	H.W
DISHWASHER	1-1/2"	2"	1-1/2"	1/2"	1/2"
DRYER	N/A	N/A	N/A	N/A	N/A
SHOWER TRAY					
SHOWER TRIM	-	-	-	1/2"	1/2"
SINK ISLAND SINGLE	1-1/2"	2"	1-1/2"	1/2"	1/2"
VANITY SINK	1-1/2"	2"	1-1/2"	1/2"	1/2"
WASHER	2"	2"	1-1/2"	1/2"	1/2"
WATER CLOSET	3"	3"	2"	1/2"	1/2"
WATER HEATER	N/A	N/A	N/A	3/4"	3/4"

WATER FIXTURE UNIT SCHEDULE						
FAMILY	QTY	UNIT VALUE	TOTAL			
DISHWASHER	1		0			
DRYER	1		0			
HANGING PIPES CLAMP	30		0			
SHOWER TRAY	2		0			
SHOWER TRIM	2		0			
SINK ISLAND SINGLE	1		0			
VANITY SINK	2		0			
WASHER	1		0			
WATER CLOSET	2		0			
WATER HEATER	1		0			

WASTE FIXTURE UNIT SCHEDULE							
	WICH INTOINE O	TATE COLLEGE					
FAMILY	QTY	DFU VALUES	TOTAL				
DISHWASHER	1		0				
DRYER	1		0				
HANGING PIPES CLAMP	30		0				
SHOWER TRAY	2		0				
SHOWER TRIM	2		0				
SINK ISLAND SINGLE	1		0				
VANITY SINK	2		0				
WASHER	1		0				
WATER CLOSET	2		0				
WATER HEATER	1		0				



Tuscon,AZ, USA 888-864-0184

**KEY PLAN** 

NO.	DESCRIPTION	DATE

NOTE:

LEGEND:

PROJECT

57-Hamilton-1000-2Bd/2Ba Craftsman-550 Work Order

DRAWING NAME

NOTE AND SCHEDULE

CLIENT NAME:

 PROJECT NUMBER:
 0181\_14

 DATE:
 2/17/2025 12:14:52 PM


 DESIGNED BY:
 Designer

 DRAWN BY:
 Author

 CHECKED BY:
 Checker

P101


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**KEY PLAN** 

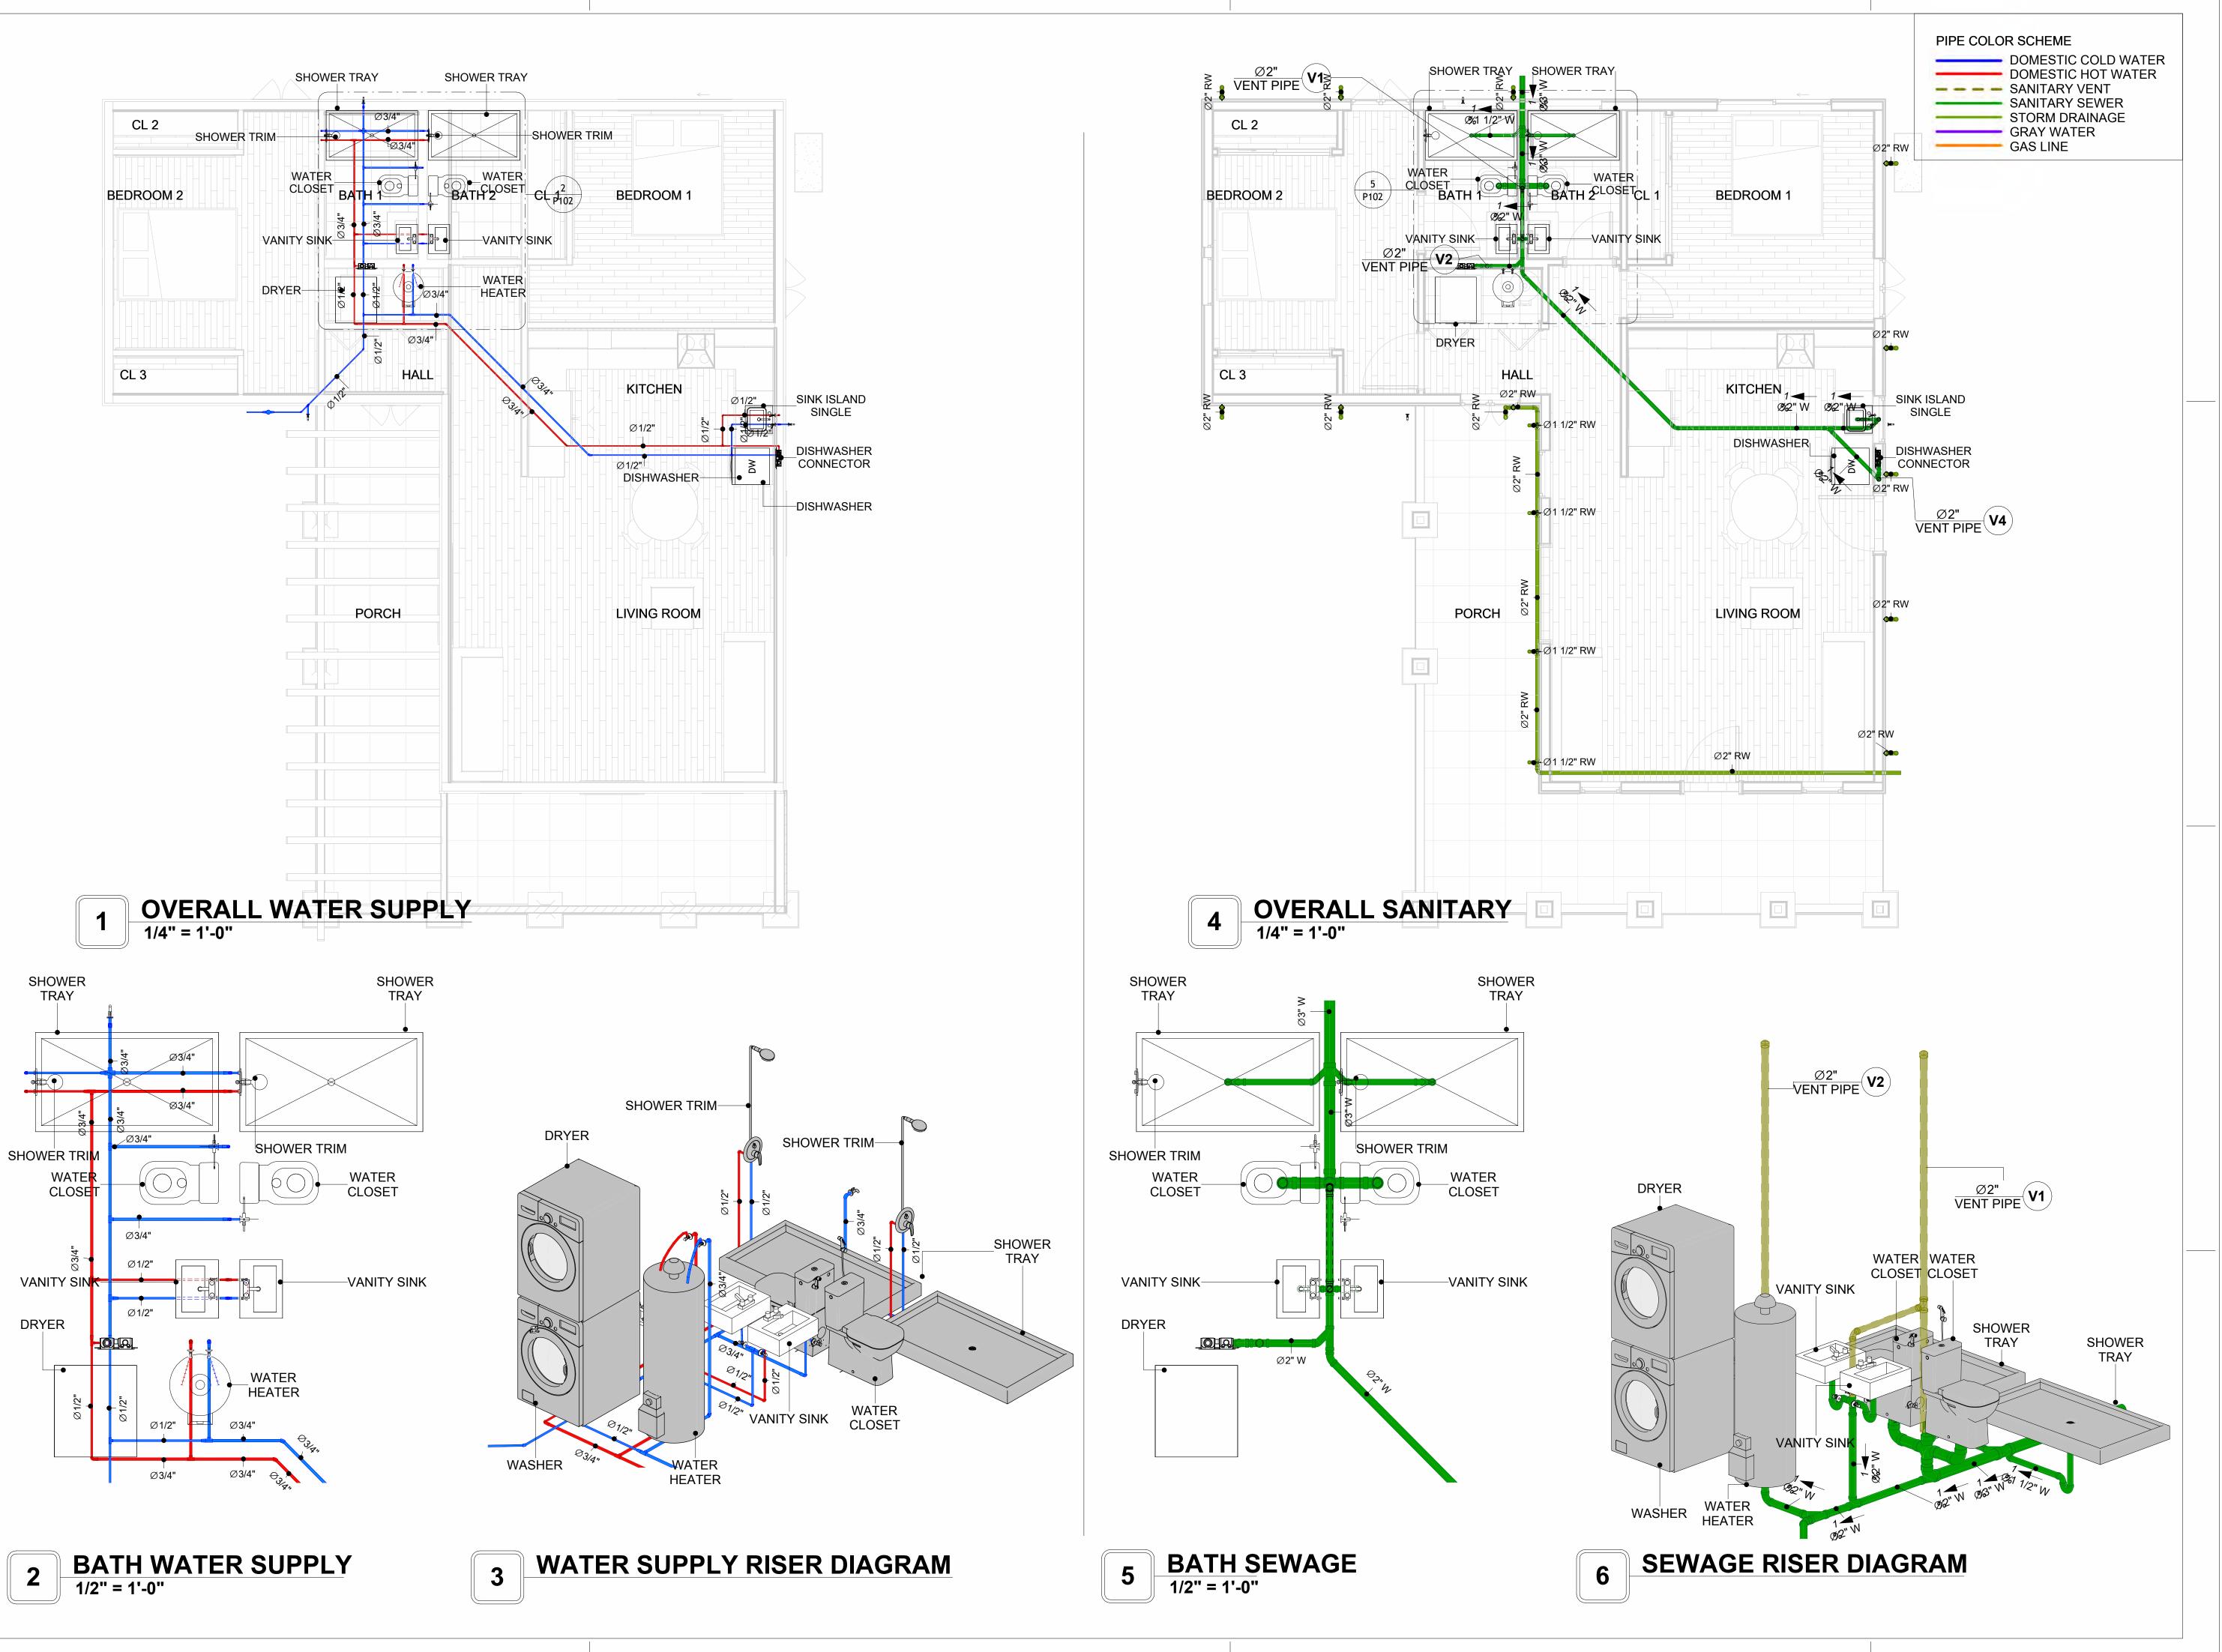Tuscon,AZ, USA 888-864-0184



DATE

DESCRIPTION

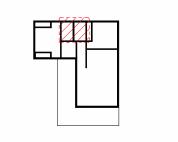NOTE:

LEGEND:

PROJECT

57-Hamilton-1000-2Bd/2Ba Craftsman-550 Work Order

DRAWING NAME

# WATER SUPPLY AND SEWAGE SYSTEM

CLIENT NAME:	
PROJECT NUMBER:	0181_14
DATE:	2/17/2025 12:15:24 PM
DESIGNED BY:	Designer
DRAWN BY:	Author
CHECKED BY:	Checker

P102

# Materials Shopping List

Please print and take this Materials Shopping List to your favorite Home Depot and ask for assistance in selecting the materials, fixtures and fittings to complete your new home.

Record your selection and the price of the item. Then do the math to determine the cost for your selections and the total cost of finishing your home.

#### **Have It Your Way!**

The material types listed in this document were selected based on personal preferences. The Customer is encouraged to make changes to the material types in accordance with local customs, regulations, and personal preferences.

Have It Your Way!



# 20 good reasons to frame a home with metal and not wood



Why build your ADU with metal vs wood	Wood	Metal	Explanation
1 DIY Construction Benefit		~	The wall frames, trusses and beams can be erected in a just a few days
2 Minimal Construction Skills Required		~	Pre-assembled walls and trusses require no specialized skills to errect
Build as DIY, Hybrid or by a General Contractor		<b>~</b>	Do it yourself, Hybrid (involve special contractors) or hire a General Contractor
4 Build It As You Can Afford It		<b>~</b>	Impervious to Weather - build as you have the time and money
5 Up Front Cost of Framing Materials	<b>~</b>		As to only the framing material, wood is less expensive
6 Total Cost To Build		~	Savings in time, labor, and other areas make light gauge steel LESS expensive
7 Termites and wood boring insects		<b>~</b>	Termites, carpenter ants and wood boring insects eat wood, not metal
8 Mold resistant		<b>~</b>	Metal does not attract mold
9 Damage caused by exterior and interior flooding		<b>~</b>	Metal needs no reconditioning after a flood
10 Fire Resistant		~	Non-combustible
11 Lower insurance rates		<b>~</b>	Many insurance underwriters now provide lower rates for metal framed homes
12 Walls, trusses, and beams retain their original form		<b>~</b>	Perfectly straight walls - no shimming of drywall
13 Corners are 90 degrees		<b>~</b>	No need for templating of countertops to adjust for out of square corners
14 Strength and weight		<b>~</b>	Metal is stronger than wood and weighs less - no need for crane to lift ADU trusses
15 IBC Engineered Stamp		<b>~</b>	If an engineering stamp is necessary, months of waiting are saved
16 Complete BOM (Materials Shopping List)		~	Take the materials shopping list to Home Depot and start shopping/pricing
17 Flexible in Seismic Areas - Won't Fracture		~	Light gauge steel is flexible and won't fracture when the earth moves
18 No Waste At Job Site		~	Steel is the most recycled material in the world. A typical wood home has 20-30% waste
19 Environmentally Friendly		<b>~</b>	Trees don't have to be destroyed and the source of most metal is from recycling
20 How-To Videos Included		<b>~</b>	How-to videos provide simple assembly instructions
21 Relationship Counselor		<b>~</b>	Eliminate emotional uphevels - save time, money, and preserve the relationship

#### Universal Requirements - some or all may be required

- 1 Site plan
- 2 Electrical Supply Connection
- 3 Sewer Connection
- 4 Fresh Water Supply Connection
- 5 Set Backs
- 6 Soils Evaluation

- 7 Earthquake (fault) evaluation
- 8 Foundation Plan subject to soils
- 9 Compliance with local energy codes: insulation home wrap and flashing
- 10 Engineering for wind speed and snow load.
- 11 State and Local ordinances regarding ADUs
- 12 Local Architect and/or Engineer may be necessary

#### Hamilton-1Bd1Ba-Craftsman





# Hamilton-1Bd1Ba-Craftsman MATERIAL SHOPPING LIST

#### **Have It Your Way!**

The material types listed in this document were selected based on personal preferences. The Customer is encouraged to make changes to the material types in accordance with local customs, regulations, and personal preferences. Have It Your Way!

#### TOC



#### **Table Of Content**

#	Name	Link	Page No
1	Cover Page	Cover Page	1
2	TOC	TOC	2
3	ELECTRICAL BOM	ELECTRICAL BOM	3
5	HVAC BOM	HVAC BOM	7
4	PLUMBING BOM	PLUMBING BOM	10
6	ARCHITECTURAL BOM	ARCHITECTURAL BOM	15

#### **Have It Your Way!**

The material types listed in this document were selected based on personal preferences. The Customer is encouraged to make changes to the material types in accordance with local customs, regulations, and personal preferences. Have It Your Way!

#### **GENERAL NOTES**

- 1 This BOM (Bill of Materials) is prepared as a Materials Shopping List to help builders and DIYers gain a complete understanding of most if not all elements required for the complete construction of this structure, according to the original design documents provided by FrameUpNow.
- 2 All quantities and specifications are subject to change based on the final design, field measurements, availability of products and customer preferences. The customer should verify all information prior to purchasing materials.
- 3 All products and elements in the list shall conform to the International Residential Code (IRC), or any other local and international building codes, safety regulations, and standards that are applicable to the location of the structure.
- 4 If any changes are made by the customer to the list of materials specified in this document, the customer is responsible for assuring that the correct type and quantity of materials are utilized in accordance with local building codes.
- 5 FrameUpNow, will not be held responsible for any misuse of this document, the products listed, or for deviations from the content that are made due to changes in specifications, pricing, availability, or customer preferences.
- 6 The customer is advised to consult a qualified professional or technician prior to purchasing materials for specialized construction system items. Some items including but not limited to caseworks, doors and windows may require as built measurements prior to purchase to confirmation of final dimensions.
- 7 If there are additional trim elements or specific installation methods, the total amount of materials needed might vary. Consider any additional trim required for corners, intersections, or other architectural details that might cause this variations before proceeding to purchase and construction.

#### **ARCHITECTURAL BOM**



				Ba-Craftsm					
NI.	ARCHITECTURAL MATERIAL SHOPPING LIST								
No.	Item	Туре	Unit	Quantity	Unit Price	Total	Description		
<u></u>	APPLIANCES	I	200	1 4					
1	Refrigerator		PCS	1					
2	Range		PCS	1					
3	Washer		PCS	1					
4	Dryer		PCS	1					
5	Dish Washer		PCS	1					
6	Oven		PCS	0					
7	Microwave		PCS	0					
Δ	CASEWORKS								
1	Kitchen Cabinet		FT	25.02					
2	Laundry Cabinet		FT	0					
3	Vanity Cabinet		FT	2.5					
4	Medicine Cabinet		PCS	2					
5	Kitchen countertop		SF	38.23					
6	Laundry Countertop		PCS	0					
7	Bathroom Countertop		SF	0					
	Island		FT	0					
9	Peninsula								
			FT	0					
10	Closets		SF	129					
<u> </u>	CEILING	5 W "	1	'		1			
1	Ceiling Board	Dry Wall	SF	859.42					
2	Dry Wall Fastener	Screw	PCS	1503.985					
3	Vapor Retarder	Polyethylene film	SF	1064.88					
4	Vapor Retarder Fastener	Nails with washer heads	PCS	3194.64					
5	Ceiling Board (MRD)	Moisture resistant drywall	SF	86					
6	MRD Fastener		PCS	150.5					
7	Ceiling Board	Marine Plywood	SF	119.46					
8	Marine Plywood Fastener	Screw	PCS	209.055					
9	Dry Wall Tape		FT	532.44					
	FLOORING			002.11					
1	Main Living Space		SF	473					
2	Bathroom		SF	75.5					
3	Bedrooms		SF	320.7					
			SF	311.9					
4	Porch		SF	311.9					
<u></u>	STRUCTURE	I	lor.	4000 54					
1	Foundation		SF	1309.54					
	WALLS EXTERIOR	1							
1	Exterior-Grade Plywood								
	Horizontal Siding		SF	1089					
2		Self-drilling screws(100/pkt)							
	8/panel		PKT	10.89					
3	Wall Shteathing (OSB)		SF	1201					
4	Shteathing Fastener	Self-drilling screws(100/pkt)	PKT	12.01					
5	Wall Homewrap		SF	1201					
6	Homewrap Fastener	Stapled fastener (200/pkt)	PKT	4.5638					
7	Furring Strip		PCS	150.125					
	Furring Strip Fastener	Self-drilling screws(100/pkt)	PKT	12.01					
	Wall Paint	J 2 2 2 2 2 2 2 2 2 2 2 2 2 2 2 2 2 2 2	SF	1089					
	Stone Copping	Masonry stone	SF	8					
	Stone Veneer	Masonry stone	SF	109					
12	Mortar for Stone Veneer	Mason y stone	SF	109					
	Wall Insulation		SF	3641					
	WALLS INTERIOR		SF	3041					
1		I	CF	252					
	Cementitious Backer Board		SF	353					
2	Kerdi membrane		SF	353					
3	Kerdi membrane Fastener		SF	353					
4	Wall Ceramic Tile		SF	353					
5	Drywall Board		SF	1895					
6	Drywall Fastener	Self-drilling screws(100/pkt)	PKT	18.95					
7	Wall Paint		SF	1895					
8	Drywall Tape		FT	355.9876925					
	Wall Skerting		FT	145					

#### **ARCHITECTURAL BOM**



	DOORS					
	Exterior Swinging	3' - 0" X 6'-8"	PCS	2		
	Interior Swinging	2' - 6" X 6'-8"	PCS	2		
3	Interior Swinging	3' - 0" X 6'-8"	PCS	2		
4	Interior Sliding	7' - 4" X 6'-8"	PCS	1		
5	Bifold Door	6' - 0" X 6'-8"	PCS	1		
6	Interior Sliding	6' - 0" X 6'-8"	PCS	2		
_						
7	Exterior Swinging	5' - 0" X 6'-8"	PCS	1		
8	Exterior Door Trim		FT	51.02		
9	Interior Door Trim		FT	337		
	Entry Lock set		PCS	3		
	Privacy Lock set		PCS	4		
_	Passage Lock set		PCS	4		
	WINDOWS					
1	Hung	2' - 3" X 4'-3"	PCS	2		
2	Casment	3' - 3" X 3'-9"	PCS	3		
3	Fixed	3' - 1" X 2'-1"	PCS	2		
4	Fixed	2' - 7" X 2'-7"	PCS	2		
5	Hung	2' - 7" X 3'-9"	PCS	1		
6	Hung	2' - 7" X 3'-1"	PCS	1		
7	Sliding	6' - 3" X 3'-9"	PCS	1		
8	Exterior Window Trim		FT	153		
9	Interior Window Trim		FT	153		
10	Interior Window Trim		FT	222		
	ROOF				<u> </u>	
1	Roof Covering		SF	1367		
2	Roof Covering Fastener		PCS	683.5		
3	Roof Felt Paper		SF	1367		
4	Roof Felt Paper Fastener		PCS	4101		
5	Roof Sheathing		SF	1367		
6	Roof Sheathing Fastener		PCS	10936		
7	Batten		FT	0		
8	Batten Fastener		PCS	0		
9	Soffit		SF	178		
10	Soffit Fastener		PCS	89		
	Fascia		FT	174		
12	Fascia board fastener		PCS	87		
	Roof Insulation		SF	1367		
13	LUON INSUIGNON		SF	130/		



Hamilton-1Bd1Ba-Craftsman  ELECTRICAL MATERIAL SHOPPING LIST								
$\triangle$	LIGHTING FIXTURES							
1	Kitchen Ceiling Light		PCS	7				
2	Exterior Wall Mounted Light		PCS	4				
3	Livingroom Ceiling Light With Fan		PCS	1				
4	Bedroom Ceiling Light With Fan		PCS	2				
5	Dining Ceiling Light		PCS	0				
6	Bath Wall Mounted Light		PCS	2				
7	Bathroom Ceiling Light		PCS	4				
8	Livingroom Ceiling Light		PCS	4				
9	Bedroom Ceiling Light		PCS	8				
10	Hall & Entry Ceiling Light		PCS	5				
11	Closet Ceiling Light		PCS	3				
12	Smoke Detector		PCS	4				
$\triangle$	ELECTRICAL FITTINGS							
13	Standard Receptacle 120V	20A	PCS	16				
14	GFCI Receptacle 120V	20 A	PCS	16				
15	GFCI Receptacle 240V	30 A	PCS	2				
16	GFCI Receptacle 240V	50 A	PCS	1				
17	GFCI Receptacle 240V	60 A	PCS	1				
18	Fan Switch		PCS	2				
19	Single Pole Switch		PCS	15				
20	Three Way Switch		PCS	6				
21	Dimmer Switch		PCS	5				
Δ	<b>ELECTRICAL CONDUITS &amp; WIRING</b>							
22	ROMEX 14 AWG	14/2/W/ground	FT	169				
23	ROMEX 12 AWG	12/3/W/ground	FT	340				
24	ROMEX 12 AWG	12/2/W/ground	FT	39				
25	ROMEX 10 AWG	10/3/W/ground	FT	63				
26	ROMEX 10 AWG	10/2/W/ground	FT	111				
27	Romex 8 AWG	8/3/W/ground	FT	75				
	Romex 8 AWG	8/2/W/ground	FT	34				
	ROMEX 6 AWG	6/3/W/ground	FT	40				
30	Bare Copper Ground Wire 6 AWG		FT	0				
$\triangle$	ELECTRICAL BOXES & CIRCUTES							
	Panelboard -240V 1 Phase MLO	200 AMP	PCS	1				
32	Circuit breaker	15 A	PCS	5				
33	Circuit breaker	20 A	PCS	9				
34	Circuit breaker	30 A	PCS	3				
35	Circuit breaker	40 A	PCS	0				
36	Circuit breaker	50 A	PCS	1				
37	Circuit breaker	60 A	PCS	1				
39	Single Gang Switch Box		PCS	5				
	Double Gang Switch Box		PCS	4				
	Triple Gang Switch Box		PCS	5				
	Pull Box	#1/4	PCS	41				
43	Receptacle Box		PCS	38				

#### **PLUMBING BOM**



	Hamilton-1Bd1Ba-Craftsman									
	PLUMBING SYSTEM MATERIAL SHOPPING LIST									
No.	Item	Туре	Unit	Quantity	Unit Price	Total	Description			
	PLUMBING FIXTURES & ACCESSORIES									
1	Bath Tub (Alcove Tub)		PCS	0						
2	Kitchen Sink		PCS	1						
3	Kitchen Faucets		PCS	1						
4	Vanity Sink		PCS	2						
5	Bath room Faucets		PCS	2						
6	Water Closet		PCS	2						
7	Shower Trim		PCS	2						
8	Shower Tray		PCS	2						
9	Water Heater		PCS	1						
10	Hose Bib		PCS	2						
11	Shutoff Valve		PCS	8						
12	Hanging pipe clamp		PCS	30						
13	Gate Valve		PCS	1						
14	Dishwasher Supply Single Connector		PCS	1						
15	Dishwasher Sewage Single Connector		PCS	1						
16	Laundry Sweat Connector		PCS	1						
Δ	SANITARY & PLUMBING PIPES									
1	ABS (Acrylonitrile Butadiene Styrene) Pipes	ø 1"	FT	0						
2	ABS (Acrylonitrile Butadiene Styrene) Pipes	ø 1 1/2"	FT	62						
3	ABS (Acrylonitrile Butadiene Styrene) Pipes	ø 2"	FT	191						
4	ABS (Acrylonitrile Butadiene Styrene) Pipes	ø 3"	FT	8						
5	PEX (Cross-linked polyethylene) Pipes	ø 1/2"	FT	90						
6	PEX (Cross-linked polyethylene) Pipes	ø 3/4"	FT	73						
7	PEX (Cross-linked polyethylene) Pipes	ø 1"	FT	0						
8	PVC Pipes Sch.80 - Rigid	ø 1 1/2"	FT	0						
9	PVC Pipes Sch.80 - Rigid	ø 2"	FT	0						
10	PVC Pipes Sch.80 - Rigid	ø 3"	FT	0						
11	Flex Pipe Round	ø 1/2"	PCS	8						

#### **PLUMBING BOM**



	PIPE FITTINGS				
1	ABS 90 Deg Bend Elbow	2"ø-2"ø	PCS	33	
2	ABS 90 Degree Bend Elbow	1 1/2"ø-1 1/2"ø	PCS	1	
3	ABS 90 Degree Bend Elbow	2"ø-2"ø	PCS	6	
4	ABS 90 Degree Bend Elbow	3"ø-3"ø	PCS	2	
5	ABS P-Trap	1 1/2"ø-1 1/2"ø	PCS	5	
6	ABS P-Trap	2"ø-2"ø	PCS	2	
7	ABS Reducer Elbow	1 1/2"ø-1 1/2"ø	PCS	1	
8	ABS Reducer Elbow	2"ø-1 1/2"ø	PCS	2	
9	ABS Reducer Elbow	3"ø-2"ø	PCS	1	
10	ABS Tee Reducer Elbow	1 1/2"ø-1 1/2"ø-1 1/2"ø	PCS	1	
11	ABS Tee Reducer Elbow	2"ø-2"ø-1 1/2"ø	PCS	5	
12	ABS Tee Reducer Elbow	2"ø-2"ø-2"ø	PCS	4	
13	ABS Tee Reducer Elbow	3"ø-2"ø-3"ø	PCS	1	
14	ABS Vent Cap Elbow	1 1/2"ø	PCS	1	
15	ABS Vent Cap Elbow	2"ø	PCS	3	
16	ABS Wye Combination with 8th Bend Double	3"ø-3"ø-1 1/2"ø-1 1/2"ø	PCS	1	
17	ABS Wye Combination with 8th Bend Elbow	2"ø-2"ø-2"ø	PCS	1	
18	PEX 90 Degree Elbow	1/2"ø-1/2"ø	PCS	27	
19	PEX 90 Degree Elbow	3/4"ø-3/4"ø	PCS	10	
20	PEX Cross Elbow	3/4"ø-3/4"ø-3/4"ø	PCS	1	
21	PEX Tee Elbow	1/2"ø-1/2"ø-1/2"ø	PCS	9	
22	PEX Tee Elbow	3/4"ø-3/4"ø-3/4"ø	PCS	7	
23	PEX Transition Elbow	1"ø-1/2"ø	PCS	2	
24	PEX Transition Elbow	3/4"ø-1/2"ø	PCS	15	
25	PVC 90 Degree Bend Elbow	1 1/2"ø-1 1/2"ø	PCS	8	
26	PVC 90 Degree Bend Elbow	2"ø-2"ø	PCS	2	
27	WASTE DOUBLE TEE	1 1/2"ø-1 1/2"ø-1 1/2"ø-1	PCS	1	
28	WASTE DOUBLE TEE	3"ø-3"ø-3"ø	PCS	1	

#### **HVAC BOM**



	Hamilton-1Bd1Ba-Craftsman								
	HVAC SYSTEM MATERIAL SHOPPING LIST								
No.	Item	Туре	Unit	Quantity	Unit Price	Total	Description		
	HVAC_DUCTS								
1	PIPE (REFRIGERANT LINE)	3/8" (Ø)	FT	75.97					
2	PIPE (REFRIGERANT LINE)	3/4''' (Ø)	FT	98					
3	DRAYER HOSE	4" (Ø)	FT	5.8					
4	FLEX DUCT ROUND	4" (Ø)	FT	6.52					
	DUCT FITTINGS & ACCESSORIES								
5	ELBOW (REFRIGERANT LINE)	3/4" (Ø)-3/4" (Ø)	PCS	31					
6	ELBOW (REFRIGERANT LINE)	3/8" (Ø)-3/8" (Ø)	PCS	23					
7	TEE (REFRIGERANT LINE)	3/4" (Ø)-3/4" (Ø)-3/4"	PCS	2					
8	TEE (REFRIGERANT LINE)	3/8" (Ø)-3/8" (Ø)-3/8"	PCS	2					
9	TRANSITION (REFRIGERANT	3/4" (Ø)-1/2" (Ø)	PCS	4					
10	TRANSITION (REFRIGERANT	3/4" (Ø)-5/8" (Ø)	PCS	3					
11	TRANSITION (REFRIGERANT	3/8" (Ø)-1/4" (Ø)	PCS	1					
12	ROUND TRANSITION(ANGLE)	45 DEGREE	PCS	7					
	HVAC_EQUIPMENTS								
13	AIR HANDLING UNIT	WALL MOUNTED	PCS	3					
14	CONDENSER	OUTDOOR UNIT	PCS	1					
15	EXHAUST FAN	75 CFM	PCS	2					
16	HOOD-WALL: VENT	HOOD-WALL: VENT	PCS	1					
17	DRAYER: VENT	DRAYER: VENT	PCS	1					
18	ROOF VENT	3"(Ø)	PCS	3					



#### **Table Of Content**

#	Name	Link	Page No
1	Cover Page	<u>Cover Page</u>	1
2	TOC	TOC	2
3	ELECTRICAL BOM	ELECTRICAL BOM	3
5	HVAC BOM	HVAC BOM	7
4	PLUMBING BOM	PLUMBING BOM	10
6	ARCHITECTURAL BOM	ARCHITECTURAL BOM_	15

#### **Have It Your Way!**

The material types listed in this document were selected based on personal preferences. The Customer is encouraged to make changes to the material types in accordance with local customs, regulations, and personal preferences. Have It Your Way!

#### **GENERAL NOTES**

- This BOM (Bill of Materials) is prepared as a Materials Shopping List to help builders and DIYers gain a complete understanding of most if not all elements required for the complete construction of this structure, according to the original design documents provided by FrameUpNow.
- 2 All quantities and specifications are subject to change based on the final design, field measurements, availability of products and customer preferences. The customer should verify all information prior to purchasing materials.
- 3 All products and elements in the list shall conform to the International Residential Code (IRC), or any other local and international building codes, safety regulations, and standards that are applicable to the location of the structure.
- 4 If any changes are made by the customer to the list of materials specified in this document, the customer is responsible for assuring that the correct type and quantity of materials are utilized in accordance with local building codes.
- 5 FrameUpNow, will not be held responsible for any misuse of this document, the products listed, or for deviations from the content that are made due to changes in specifications, pricing, availability, or customer preferences.
- The customer is advised to consult a qualified professional or technician prior to purchasing materials for specialized construction system items. Some items including but not limited to caseworks, doors and windows may require as built measurements prior to purchase to confirmation of final dimensions.
- 7 If there are additional trim elements or specific installation methods, the total amount of materials needed might vary. Consider any additional trim required for corners, intersections, or other architectural details that might cause this variations before procedding to purchase and construction.



			LIGHTING FIXTURES				
#	Lighting	Туре	Description, Manufacturer, SKU	Unit	Quantity	Unit Price	Total
1	Kitchen Ceiling Light			PCS	-	,	
2	Exterior Wall Mounted Light			PCS	4	l.	
3	Livingroom Ceiling Light With Fan			PCS	1		
4	Bedroom Ceiling Light With Fan			PCS	2		
5	Dining Ceiling Light			PCS	(	)	
6	Bath Wall Mounted Light			PCS	2	2	
7	Bathroom Ceiling Light			PCS	4		
8	Livingroom Ceiling Light			PCS			
9	Bedroom Ceiling Light			PCS	}	}	
10	Hall & Entry Ceiling Light			PCS	Ę		
11	Closet Ceiling Light			PCS	3		
12	Smoke Detector			PCS			
13							
14							
15							



			ELECTRICAL FITTINGS				
#	Item	Туре	Description, Manufacturer, SKU	Unit	Quantity	Unit Price	Total
1	Standard Receptacle 120V	20A		PCS	16		
2	GFCI Receptacle 120V	20 A		PCS	16	)	
3	GFCI Receptacle 240V	30 A		PCS	2	)	
4	GFCI Receptacle 240V	50 A		PCS	1		
5	GFCI Receptacle 240V	60 A		PCS	1		
6	Fan Switch			PCS	2	)	
7	Single Pole Switch			PCS	15		
8	Three Way Switch			PCS	6		
9	Dimmer Switch			PCS	5		
10							
11							
12							
13							
14							
15							



			ELECTRICAL CONDUITS & WIRIN	G			
#	Item	Туре	Description, Manufacturer, SKU	Unit	Quantity	Unit Price	Total
1	ROMEX 14 AWG	14/2/W/ground		FT	169		
2	ROMEX 12 AWG	12/3/W/ground		FT	340		
	ROMEX 12 AWG	12/2/W/ground		FT	39		
1	ROMEX 10 AWG	10/3/W/ground		FT	63		
•	ROMEX 10 AWG	10/2/W/ground		FT	111		
5	Romex 8 AWG	8/3/W/ground		FT	75		
,	Romex 8 AWG	8/2/W/ground		FT	34		
3	ROMEX 6 AWG	6/3/W/ground		FT	40		
)	Bare Copper Ground Wire 6 AWG			FT			
.0							
.1							
.2							
L3							
4							
.5							



			ELECTRICAL BOXES & CIRCUTE	S			
#	Item	Туре	Description, Manufacturer, SKU	Unit	Quantity	Unit Price	Total
1	Panelboard -240V 1 Phase MLO	200 AMP		PCS	1		
2	Circuit breaker	15 A		PCS	5		
3	Circuit breaker	20 A		PCS	9		
4	Circuit breaker	30 A		PCS	3		
5	Circuit breaker	50 A		PCS	1		
6	Circuit breaker	60 A		PCS	1		
7	Single Gang Switch Box			PCS	5		
8	Double Gang Switch Box			PCS	4		
9	Triple Gang Switch Box			PCS	5		
10	Pull Box	#1/4		PCS	41		
11	Receptacle Box			PCS	38		
12							
13							
14							
15							

# **HVAC BOM**



	HVAC_DUCTS 01							
#	Item	Туре	Description, Manufacturer, SKU	Unit	Quantity	Unit Price	Total	
	PIPE (REFRIGERANT LINE)	3/8" (Ø)		FT	75.97			
	PIPE (REFRIGERANT LINE)			FT	98			
		4" (Ø)		FT	5.8			
4	FLEX DUCT ROUND	4" (Ø)		FT	6.52			

# **HVAC BOM**



		1	DUCT FITTINGS & ACCESSORIES				
#	Item	Туре	Description, Manufacturer, SKU	Unit	Quantity	Unit Price	Total
1	ELBOW (REFRIGERANT LINE)	3/4" (Ø)-3/4" (Ø)		PCS	31		
2	ELBOW (REFRIGERANT LINE)	3/8" (Ø)-3/8" (Ø)		PCS	23		
3	TEE (REFRIGERANT LINE)	3/4" (Ø)-3/4" (Ø)-3/4"		PCS	2		
4	TEE (REFRIGERANT LINE)	3/8" (Ø)-3/8" (Ø)-3/8"		PCS	2		
5	TRANSITION (REFRIGERANT LINE)	3/4" (Ø)-1/2" (Ø)		PCS	4		
6	TRANSITION (REFRIGERANT LINE)	3/4" (Ø)-5/8" (Ø)		PCS	3		
7	TRANSITION (REFRIGERANT LINE)	3/8" (Ø)-1/4" (Ø)		PCS	1		
8	ROUND TRANSITION(ANGLE)	45 DEGREE		PCS	7		
9							
10							
11							
12							

# **HVAC BOM**



			HVAC_EQUIPMENTS				
#	Item	Туре	Description, Manufacturer, SKU	Unit	Quantity	Unit Price	Total
1	AIR HANDLING UNIT	WALL MOUNTED		PCS	3		
2	CONDENSER	OUTDOOR UNIT		PCS	1		
3	EXHAUST FAN	75 CFM		PCS	2		
4	HOOD-WALL: VENT	HOOD-WALL: VENT		PCS	1		
5	DRAYER: VENT	DRAYER: VENT		PCS	1		
6	ROOF VENT	3"(Ø)		PCS	3		



		PLUMBII	NG FIXTURES & ACCESSORIES				
#	Item	Туре	Description, Manufacturer, SKU	Unit	Quantity	Unit Price	Total
1	Bath Tub (Alcove Tub)			PCS	C		
2	Kitchen Sink			PCS	1		
3	Kitchen faucets			PCS	1		
4	Vanity Sink			PCS	2		
5	Bath room faucets			PCS	2		
6	Water Closet			PCS	2		
7	Shower Trim			PCS	2		
8	Shower Tray			PCS	2		
9	Water Heater			PCS	1		
10	Hose Bib			PCS	2		
11	Shutoff Valve			PCS	8		
12	Hanging pipe clamp			PCS	30		
13	Gate Valve			PCS	1		
14	Dishwasher Supply Single Connector			PCS	1		
15	Dishwasher Sewage Single Connector			PCS	1		
16	Laundry Sweat Connector			PCS	1		



		SANI	ITARY & PLUMBING PIPES				
#	Item	Туре	Description, Manufacturer, SKU	Unit	Quantity	Unit Price	Total
1	ABS (Acrylonitrile Butadiene Styrene) Pipes	ø 1"		FT	0		
2	ABS (Acrylonitrile Butadiene Styrene) Pipes	ø 1 1/2"		FT	62		
3	ABS (Acrylonitrile Butadiene Styrene) Pipes	ø 2"		FT	191		
4	ABS (Acrylonitrile Butadiene Styrene) Pipes	ø 3"		FT	8		
5	PEX (Cross-linked polyethylene) Pipes	ø 1/2"		FT	90		
6	PEX (Cross-linked polyethylene) Pipes	ø 3/4"		FT	73		
7	PEX (Cross-linked polyethylene) Pipes	ø 1"		FT	0		
8	PVC Pipes Sch.80 - Rigid	ø 1 1/2"		FT	0		
9	PVC Pipes Sch.80 - Rigid	ø 2"		FT	0		
10	PVC Pipes Sch.80 - Rigid	ø 3"		FT	0		
11	Flex Pipe Round	ø 1/2"		PCS	8		
12							
13							
14							
15							



		PIPE	FITTINGS 01				
#	Item	Туре	Description, Manufacturer, SKU	Unit	Quantity	Unit Price	Total
1	ABS 90 Deg Bend Elbow	2"ø-2"ø		PCS	33		
2	ABS 90 Degree Bend Elbow	1 1/2"ø-1 1/2"ø		PCS	1		
3	ABS 90 Degree Bend Elbow	2"ø-2"ø		PCS	6		
4	ABS 90 Degree Bend Elbow	3"ø-3"ø		PCS	2		
5	ABS P-Trap	1 1/2"ø-1 1/2"ø		PCS	5		
6	ABS P-Trap	2"Ø-2"Ø		PCS	2		
7	ABS Reducer Elbow	1 1/2"ø-1 1/2"ø		PCS	1		
8	ABS Reducer Elbow	2"ø-1 1/2"ø		PCS	2		
9	ABS Reducer Elbow	3"Ø-2"Ø		PCS	1		
10	ABS Tee Reducer Elbow	1 1/2"ø-1 1/2"ø-1 1/2"ø		PCS	1		
11	ABS Tee Reducer Elbow	2"ø-2"ø-1 1/2"ø		PCS	5		
12	ABS Tee Reducer Elbow	2"Ø-2"Ø-2"Ø		PCS	4		
13	ABS Tee Reducer Elbow	3"Ø-2"Ø-3"Ø		PCS	1		
14	ABS Vent Cap Elbow	1 1/2"ø		PCS	1		
15	ABS Vent Cap Elbow	2"Ø		PCS	3		



		PIPE F	ITTINGS 02				
#	Item	Туре	Description, Manufacturer, SKU	Unit	Quantity	Unit Price	Total
1	ABS Wye Combination with 8th Bend Double Elbow	3"ø-3"ø-1 1/2"ø-1 1/2"ø		PCS	1		
2	ABS Wye Combination with 8th Bend Elbow	2"Ø-2"Ø-2"Ø		PCS	1		
3	PEX 90 Degree Elbow	1/2"ø-1/2"ø		PCS	27	,	
4	PEX 90 Degree Elbow	3/4"ø-3/4"ø		PCS	10		
5	PEX Cross Elbow	3/4"ø-3/4"ø-3/4"ø		PCS	1		
6	PEX Tee Elbow	1/2"ø-1/2"ø-1/2"ø		PCS	9		
7	PEX Tee Elbow	3/4"ø-3/4"ø		PCS	7	,	
8	PEX Transition Elbow	1"ø-1/2"ø		PCS	2		
9	PEX Transition Elbow	3/4"ø-1/2"ø		PCS	15		
10	PVC 90 Degree Bend Elbow	1 1/2"ø-1 1/2"ø		PCS	8	3	
11	PVC 90 Degree Bend Elbow	2"Ø-2"Ø		PCS	2	2	
12	WASTE DOUBLE TEE	1 1/2"ø-1 1/2"ø-1 1/2"ø		PCS	1		
13	WASTE DOUBLE TEE	3"Ø-3"Ø-3"Ø-3"Ø		PCS	1		
14							
15							



			APPLIANCES				
#	Item	Туре	Description, Manufacturer, SKU	Unit	Quantity	Unit Price	Total
1	Refrigerator			PCS			
2	Range			PCS			
3	Washer Front Load	Stackable		PCS			
4	Dryer Front Load	Stackable		PCS			
5	Dish Washer			PCS			
6	Oven			PCS	(		
7	Microwave			PCS	(		
8							
9							
10							
11							
12							
13							
14							
15							
16							



			CASEWORKS 01				
#	Item	Туре	Description, Manufacturer, SKU	Unit	Quantity	Unit Price	Total
1	Kitchen Cabinet			FT	25.02		
2	Laundry Cabinet			FT	0		
3	Vanity Cabinet			FT	2.5		
4	Medicine Cabinet			PCS	2		
5	Kitchen countertop			SF	38.23		
6	Laundry Countertop			PCS	0		
7	Bathroom Countertop			SF	0		
8	Island			FT	0		
9	Peninsula			FT	0		
10	Closets			SF	129		
11							
12							
13							
14							
15							



			CEILING 01				
#	Item	Туре	Description, Manufacturer, SKU	Unit	Quantity	Unit Price	Total
	LIVING ROOM + KITCHEN			SF	428.3		
1	Ceiling Board	Drywall		SF	428		
2	Drywall Fastener	Screw		PCS	749		
3	Vapor Retarder	Polyethylene film		SF	428		
4	Vapor Retarder Fastener	Nails with washer heads		PCS	1285		
	BATH ROOM 1			SF	42.0		
5	Ceiling Board	MRD (Moisture resistant drywall)		SF	42		
6	MRD Fastener	Screw		PCS	73		
	BATH ROOM 2			SF	44		
7	Ceiling Board	MRD (Moisture resistant drywall)		SF	44		
8	MRD Fastener	Screw		PCS	77		
	WH + WD			SF	20.6		
9	Ceiling Board	Drywall		SF	21		
10	Drywall Fastener	Screw		PCS	36		
11	Vapor Retarder	Polyethylene film		SF	21		
12	Vapor Retarder Fastener	Nails with washer heads		PCS	62		



			CEILING 02				
#	Item	Туре	Description, Manufacturer, SKU	Unit	Quantity	Unit Price	Total
	BED ROOM 1			SF	146.3		
13	Ceiling Board	Drywall		SF	146		
14	Drywall Fastener	Screw		PCS	256		
15	Vapor Retarder	Polyethylene film		SF	146		
16	Vapor Retarder Fastener	Nails with washer heads		PCS	439		
	BED ROOM 2			SF	142.3		
17	Ceiling Board	Drywall		SF	142		
18	Drywall Fastener	Screw		PCS	249		
19	Vapor Retarder	Polyethylene film		SF	142		
20	Vapor Retarder Fastener	Nails with washer heads		PCS	427		
	CL 1			SF	15.3		
21	Ceiling Board	Drywall		SF	15		
22	Drywall Fastener	Screw		PCS	27		
23	Vapor Retarder	Polyethylene film		SF	15		
24	Vapor Retarder Fastener	Nails with washer heads		PCS	45.9		



			CEILING 03				
#	Item	Туре	Description, Manufacturer, SKU	Unit	Quantity	Unit Price	Total
	CL 2			SF	18.5		
25	Ceiling Board	Drywall		SF	18		
26	Drywall Fastener	Screw		PCS	32		
27	Vapor Retarder	Polyethylene film		SF	18		
28	Vapor Retarder Fastener	Nails with washer heads		PCS	55		
	CL 3			SF	15.3		
29	Ceiling Board	Drywall		SF	15		
30	Drywall Fastener	Screw		PCS	27		
31	Vapor Retarder	Polyethylene film		SF	15		
32	Vapor Retarder Fastener	Nails with washer heads		PCS	46		
	HALL			SF	72.9		
33	Ceiling Board	Drywall		SF	73		
34	Drywall Fastener	Screw		PCS	128		
35	Vapor Retarder	Polyethylene film		SF	73		
36	Vapor Retarder Fastener	Nails with washer heads		PCS	219		
	FRONT PORCH			SF	119		
37	Ceiling Board	Marine Plywood		SF	119		
38	Exterior Grade Plywood	Screw		PCS	209		



			FLOORING INTERIOR 01				
#	Item	Туре	Description, Manufacturer, SKU	Unit	Quantity	Unit Price	Total
	BEDROOM #1						
1	Bedroom Flooring			SF	139		
2	Wood underlay	Foam Pad Polyethylene		SF	139		
3	Vapor Retarder	Vapor Barrier Polyethylene		SF	139.0		
	BEDROOM#2						
4	Bedroom Flooring			SF	135		
5	Wood underlay	Foam Pad Polyethylene		SF	135		
6	Vapor Retarder	Vapor Barrier Polyethylene		SF	135.2		
	CL#1						
7	Closet Flooring			SF	15		
8	Wood underlay	Foam Pad Polyethylene		SF	15		
9	Vapor Retarder	Vapor Barrier Polyethylene		SF	14.5		
	CL#2						
10	Closet Flooring			SF	15		
11	Wood underlay	Foam Pad Polyethylene		SF	15		
12	Vapor Retarder	Vapor Barrier Polyethylene		SF	14.5		



			FLOORING INTERIOR 02				
#	Item	Туре	Description, Manufacturer, SKU	Unit	Quantity	Unit Price	Total
	CL#3						
13	Closet Flooring			SF	18		
14	Wood underlay	Foam Pad Polyethylene		SF	18		
15	Vapor Retarder	Vapor Barrier Polyethylene		SF	17.5		
	LIVING ROOM AND KITCH	EN					
16	Living Area Flooring			SF	474		
17	Wood underlay	Foam Pad Polyethylene		SF	474		
18	Vapor Retarder	Vapor Barrier Polyethylene		SF	474.0		
	BATHROOM#1						
19	Tile Finish			SF	28		
20	Adhesive	1/2" Thin set Mortar		SF	28		
21	Vapor Retarder	Vapor Barrier Polyethylene		SF	28.0		
	BATHROOM#2						
22	Tile Finish			SF	28		
23	Adhesive	1/2" Thin set Mortar		SF	28		
24	Vapor Retarder	Vapor Barrier Polyethylene		SF	28.0		



			FLOORING INTERIOR 03				
#	Item	Туре	Description, Manufacturer, SKU	Unit	Quantity	Unit Price	Total
	W/D						
1	Tile Finish			SF	20		
2	Adhesive	1/2" Thin set Mortar		SF	20		
3	Vapor Retarder	Vapor Barrier Polyethylene		SF	19.5		



			FLOORING EXTERIOR			
#	Item	Туре	Description, Manufacturer, SKU	Unit	Quantity	Unit Price
	STRUCTURE			SF	1309.5	
1	Concrete Slab	4"concrete cast in situ		CF	394.8	
2	Insulation	Rigid insulation		SF	347	
3	Hard core	Compacted soil		CF	333.97	
4	Re-bar	#4 re-bar		Ton	1.21	
5	Concrete Pad	4"concrete cast in situ		CF	1.58	
6	Slab edge	Turndown		CF	339.73	
7	Footing	Cast-in-place concrete		CF	21	
	PORCH					
1	Tile Finish			SF		
2	Adhesive	1/2" Thin set Mortar		SF	311.9	
3	Vapor Retarder	Vapor Barrier Polyethylene		SF	311.9	



			WALLS: EXTERIOR				
#	Item	Туре	Description, Manufacturer, SKU	Unit	Quantity	Unit Price	Total
1	Exterior-Grade Plywood Horizontal Siding			SF	1089		
2	Exterior-Grade Plywood Fastener 8/panel	Self-drilling screws(100/pkt)		PKT	10.89		
3	Wall Shteathing (OSB)			SF	1201		
4	Shteathing Fastener	Self-drilling screws(100/pkt)		PKT	12.01		
5	Wall Homewrap			SF	1201		
6	Homewrap Fastener	Stapled fastener (200/pkt)		PKT	4.56		
7	Furring Strip			PCS	150.13		
8	Furring Strip Fastener	Self-drilling screws(100/pkt)		PKT	12.01		
9	Wall Paint			SF	1089		
10	Stone Copping	Masonry stone		SF	8		
11	Stone Veneer	Masonry stone		SF	109		
12	Mortar for Stone Veneer			SF	109		
13	Wall Insulation			SF	3641		
14							
15							



			WALLS: INTERIOR 01				
#	Item	Туре	Description, Manufacturer, SKU	Unit	Quantity	Unit Price	Total
	BATHROOM 1			SF	40.0		
1	Cementitious Backer Board			SF	209		
2	Kerdi membrane			SF	209		
3	Kerdi membrane Fastener			SF	209		
4	Wall Ceramic Tile			SF	209		
	BATHROOM 2			SF	40.0		
5	Cementitious Backer Board			SF	192		
6	Kerdi membrane			SF	192		
7	Kerdi membrane Fastener			SF	192		
8	Wall Ceramic Tile			SF	192		
	BEDROOM 1			SF	136.0		
9	Drywall Board			SF	363		
10	Drywall Fastener	Self-drilling screws(100/pkt)		PKT	3.63		
11	Wall Paint			SF	363		
12	Drywall Tape			FT	68.1		



			WALLS: INTERIOR 02				
#	Item	Туре	Description, Manufacturer, SKU	Unit	Quantity	Unit Price	Total
	BEDROOM 2			SF	137.0		
13	Drywall Board			SF	319		
14	Drywall Fastener	Self-drilling screws(100/pkt)		PKT	3.19		
15	Wall Paint			SF	319		
16	Drywall Tape			FT	59.81623851		
	KITCHEN			SF	110.0		
17	Cementitious Backer Board			SF	42		
18	Drywall Board			SF	266		
19	Drywall Fastener	Self-drilling screws(100/pkt)		PKT	2.66		
20	Kerdi membrane			SF	42		
21	Kerdi membrane Fastener			SF	42		
22	Wall Ceramic Tile			SF	42		
23	Wall Paint			SF	266		
24	Drywall Tape			FT	50.2		



			WALLS: INTERIOR 03				
#	Item	Туре	Description, Manufacturer, SKU	Unit	Quantity	Unit Price	Total
	LIVING ROOM			SF	289.0		
25	Drywall Board			SF	324		
26	Drywall Fastener	Self-drilling screws(100/pkt)		PKT	3.24		
27	Wall Paint			SF	324		
28	Drywall Tape			FT	60.7879925		
	CLOSET 1			SF	17.0		
29	Drywall Board			SF	147	,	
30	Drywall Fastener	Self-drilling screws(100/pkt)		PKT	1.47	,	
31	Wall Paint			SF	147	,	
32	Drywall Tape			FT	27.56422276		
	CLOSET 2			SF	16.0		
33	Drywall Board			SF	106		
34	Drywall Fastener	Self-drilling screws(100/pkt)		PKT	1.06		
35	Wall Paint			SF	106		
36	Drywall Tape			FT	19.9		



			WALLS: INTERIOR 04				
#	Item	Туре	Description, Manufacturer, SKU	Unit	Quantity	Unit Price	Total
	CLOSET 3			SF	14.0		
37	Drywall Board			SF	106		
38	Drywall Fastener	Self-drilling screws(100/pkt)		PKT	1.06		
39	Wall Paint			SF	106		
40	Drywall Tape			FT	19.87624227		
	HALL			SF	69.0		
41	Drywall Board			SF	202		
42	Drywall Fastener	Self-drilling screws(100/pkt)		PKT	2.02		
43	Wall Paint			SF	202		
44	Drywall Tape			FT	38.11320755		
	WD			SF	9.0		
45	Cementitious Backer Board			SF	79		
46	Kerdi membrane			SF	79		
47	Kerdi membrane Fastener			SF	79		
48	Wall Ceramic Tile			SF	79		



			WALLS: INTERIOR 05				
#	Item	Туре	Description, Manufacturer, SKU	Unit	Quantity	Unit Price	Total
	WH			SF	9.0		
49	Drywall Board			SF	62		
50	Drywall Fastener	Self-drilling screws(100/pkt)		PKT	0.62		
51	Wall Paint			SF	62		
52	Drywall Tape			FT	11.69		
53	Wall Skirting	Ceramic		FT	145		



			DOORS			
#	Item	Туре	Description, Manufacturer, SKU	Unit	Quantity Unit Price	Total
1	Exterior Swinging	3' - 0" X 6'-8"		PCS	2	
2	Interior Swinging	2' - 6" X 6'-8"		PCS	2	
3	Interior Swinging	3' - 0" X 6'-8"		PCS	2	
4	Interior Sliding	7' - 4" X 6'-8"		PCS	1	
5	Bifold Door	6' - 0" X 6'-8"		PCS	1	
6	Interior Sliding	6' - 0" X 6'-8"		PCS	2	
7	Exterior Swinging	5' - 0" X 6'-8"		PCS	1	
8	Exterior Door Trim			FT	51.02	
9	Interior Door Trim			FT	337	
10	Entry Lock set			PCS	3	
11	Privacy Lock set			PCS	4	
12	Passage Lock set			PCS	4	
13						
14						
15						



			WINDOWS			
#	Item	Туре	Description, Manufacturer, SKU	Unit	Quantity Unit Price	Total
1	Hung	2' - 3" X 4'-3"		PCS	2	
2	Casment	3' - 3" X 3'-9"		PCS	3	
3	Fixed	3' - 1" X 2'-1"		PCS	2	
4	Fixed	2' - 7" X 2'-7"		PCS	2	
5	Hung	2' - 7" X 3'-9"		PCS	1	
6	Hung	2' - 7" X 3'-1"		PCS	1	
7	Sliding	6' - 3" X 3'-9"		PCS	1	
8	Exterior Window Trim			FT	153	
9	Interior Window Trim			FT	153	
10						
11						
12						
13						
14						
15						



		ROOF 01				
Item	Туре	Description, Manufacturer, SKU	Unit	Quantity	Unit Price	Total
Roof Covering			SF	1367.0		
Roof Covering Fastener			PCS	684		
Roof Felt Paper			SF	1367.0		
Roof Felt Paper Fastener			PCS			
Roof Sheathing			SF			
Roof Sheathing Fastener			PCS			
Batten						
Batten Fastener						
Soffit						
Soffit Fastener						
Fascia						
Fascia board fastener						
Roof Insulation						
			01	1007.0		
	Roof Covering Roof Covering Fastener Roof Felt Paper Roof Felt Paper Fastener Roof Sheathing Roof Sheathing Fastener Batten Batten Batten Fastener Soffit Soffit Fastener Fascia Fascia board fastener	Roof Covering Roof Covering Fastener Roof Felt Paper Roof Felt Paper Fastener Roof Sheathing Roof Sheathing Fastener Batten Batten Batten Fastener Soffit Soffit Fastener Fascia Fascia board fastener	Item Type Description, Manufacturer, SKU  Roof Covering  Roof Covering Fastener  Roof Felt Paper  Roof Felt Paper Fastener  Roof Sheathing  Roof Sheathing Fastener  Batten  Batten Fastener  Soffit  Soffit Fastener  Fascia  Fascia board fastener	Item     Type     Description, Manufacturer, SKU     Unit       Roof Covering     SF       Roof Covering Fastener     PCS       Roof Felt Paper     SF       Roof Felt Paper Fastener     PCS       Roof Sheathing     SF       Roof Sheathing Fastener     PCS       Batten     FT       Batten Fastener     PCS       Soffit     SF       Soffit Fastener     PCS       Fascia     FT       Fascia board fastener     PCS	Item     Type     Description, Manufacturer, SKU     Unit     Quantity       Roof Covering     SF     1367.0       Roof Covering Fastener     PCS     684       Roof Felt Paper     SF     1367.0       Roof Felt Paper Fastener     PCS     4101.0       Roof Sheathing     SF     1367.0       Roof Sheathing Fastener     PCS     10936       Batten     FT     0.0       Soffit     SF     178.0       Soffit Fastener     PCS     89.0       Fascia     FT     174.0       Fascia board fastener     PCS     87       Roof Insulation     Ro	Item         Type         Description, Manufacturer, SKU         Unit         Quantity Unit Price           Roof Covering         SF         1367.0           Roof Covering Fastener         PCS         684           Roof Felt Paper         SF         1367.0           Roof Felt Paper Fastener         PCS         4101.0           Roof Sheathing         SF         1367.0           Roof Sheathing Fastener         PCS         10936           Batten         FT         0.0           Soffit         SF         178.0           Soffit Fastener         PCS         89.0           Fascia         FT         174.0           Fascia board fastener         PCS         87           Roof Insulation         Ro         87