

HAMILTON

The Hamilton is a charming two-bedroom, two-bathroom Ranch-style home designed for comfortable living. Its exterior features a combination of white vertical siding and stucco finish separated by a gray band running along the base of the house. The roof is covered with a classic gray asphalt shingles. The front porch is a highlight, featuring wooden posts, a contrasting wooden beam at the ceiling, and a decorative metal bracket supporting the overhang.

Inside, the Hamilton embraces an L-shaped floor plan. The living and kitchen areas are combined into a spacious and inviting open-concept space. The bedrooms are thoughtfully positioned on one side of the home, creating a private and secluded wing for rest and relaxation.

Materials Shopping List

Please print and take this Materials Shopping List to your favorite Home Depot and ask for assistance in selecting the materials, fixtures and fittings to complete your new home.

Record your selection and the price of the item. Then do the math to determine the cost for your selections and the total cost of finishing your home.

< CLICK HERE >

To Go To Materials Shopping List



37' - 1" BEDROOM 2 139 SF WD WH 10 SF10 SF KITCHEN 110 SF PORCH 1 65 SF LIVING ROOM 294 SF

FLOOR PLAN

1000 SF

2 Bed Rooms



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DISCLAIMER

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ABOUT



FrameUpNow is a design and manufacturing company providing precision-engineered home framing solutions. We offer a catalog of Affordable Homes, Tiny Homes, Garages, Shops and Barndominiums. FrameUpNow manufactures cold-formed steel (CFS) also known as Light Gauge Steel (LGS) framing components that conform to our engineered metal house frame plans or can be purchased as DIY skeleton kits.

The CFS/LGS framing is lightweight, easily assembled, and does not require heavy equipment or specialized labor, enabling homeowners to erect the frame themselves in just a few days. Unlike wood, the steel framing is impervious termites and bores, warping, expansion, and fire.

Our home plans come complete with a structural engineered stamp for permit approvals. Customers receive a full BOM also known as a Materials Shopping List to purchase finish materials from a Building Materials retailer. FrameUpNow prides itself on the quality and efficiency of our precision-engineered home framing solutions for construction professionals and DIY homeowners.



KEY PLAN

NO.	DESCRIPTION	DATE

NOTE:

LEGEND:

PROJECT

58-Hamilton-1000-2Bd-2Ba-Ranch-550

DRAWING NAME

INTRODUCTION

CLIENT NAME:
PROJECT NUMBER:
DATE:
DESIGNED BY:
DRAWN BY:
CHECKED BY:

I101

SCALE:

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DESCRIPTIONS

MATERIALS LIST

The BOM (Bill Of Materials) package, known as the Materials Shopping List document, provides:

Comprehensive Inventory: Detailed lists of essential materials sourced from architectural, mechanical, HVAC, electrical, and plumbing design drawing sets.

Precise Curation: Each item meticulously selected and organized for accuracy and efficiency in project planning.

Customizable Options: Customers can modify listed items to their preferences and calculate costs accordingly, ensuring alignment with personal project needs and budget.

Dedicated Space for Details: Includes tables for customers to note Home Depot SKU numbers or product descriptions for selected items, facilitating seamless purchasing and coordination with suppliers.

Customer Convenience: Take the list to Home Depot or preferred suppliers for accurate pricing, helping align the total home budget with personal financial plans.

Simplify your construction journey with our Materials Shopping List document, where detailed preparation meets streamlined implementation for your dream home.

STRUCTURAL

The structural drawings package provides an exhaustive set of detailed plans essential for the precise assembly of your building. This comprehensive package includes:

Framing Plans: Detailed layouts for all framing components. Truss Layouts: Clear instructions for truss placement and

Panel Length Plans: Specifications for panel dimensions. Framing Elevations and Sections: Precise elevation and sectional views for accurate construction.

Truss and Wall Blocking Plans: Plans for truss and wall blocking to ensure structural integrity.

Hold-Down Plan: Detailed hold-down requirements for stability. Snap Sheet: Reference sheet for quick identification of components

Structural Details and Bracing Plans: Complete details and bracing plans for all structural elements.

Accompanying these plans is a comprehensive Bill of Materials (BOM) that lists every necessary building component, from cold formed steel (CFS) frames to fasteners.

ARCHITECTURAL

With the comprehensive architectural package, both builders and DIY homeowners can confidently execute the construction.

The architectural package includes:

Furnished Floor Plans: Complete with furniture layouts for a clear understanding of space utilization.

Detailed Dimension Plans: Ensures precise measurements, from the overall footprint down to the exact placement of windows and

Foundation Plan: Detailed plan to establish a solid foundation.

Wall Framing and Truss Layout: Comprehensive plans for wall framing and truss placement.

Architectural Elevations: Exterior views showcasing the design.

Strategic Building Sections: Critical cross-sectional details for a thorough understanding of the build.

Casework Drawings and Diagrams: Suggested designs for built-in caseworks, such as kitchen cabinets.

MECHANICAL

The mechanical package includes everything needed to guide HVAC

Detailed HVAC Floor Plan: Precisely maps out the placement of air handlers, ductwork, and vents throughout the home's layout.

HVAC Sections and Riser Diagrams: Technical drawings offering critical cross-sectional details and piping schematics, ensuring proper integration of the heating and cooling system into the home's structure.

Bill of Materials: A complete list of all necessary HVAC components.

ELECTRICAL

The electrical package includes all the plans and documentation needed to guide the installation of your home's electrical system:

Detailed Power Plan: Precisely maps out the placement of outlets, switches, and other power components throughout the layout.

Comprehensive Lighting Plan: Shows the optimal locations for lighting fixtures, sconces, and other illumination sources to create a well-lit, functional interior.

Dimensioned Electrical Layout: Provides exact dimensions and measurements to ensure proper placement of all electrical elements.

Bill of Materials: A complete list of every component needed, from circuit breakers to wiring.

PLUMBING

The plumbing package includes everything needed to guide the

Detailed Water Supply System Plan: Precisely maps out the placement of pipes, valves, and plumbing fixtures throughout the

Comprehensive Sewage System Plan: Shows the optimal routing and sizing of drain lines to effectively remove waste and ensure

Detailed Riser Diagrams: Provide information needed to properly

pipes to fixtures.

installation of your home's water supply and drainage systems:

proper drainage.

install all vertical plumbing risers and vent stacks.

Bill of Materials: A complete list of every component needed, from


BOM (Bill Of Materials) (Separately Attached)





The Bill of Materials (BOM) is a crucial document that compiles the material requirements from different disciplines into a centralized inventory, enabling efficient procurement, inventory management, and cost estimation for a specified project or

ELECTRICAL BOM



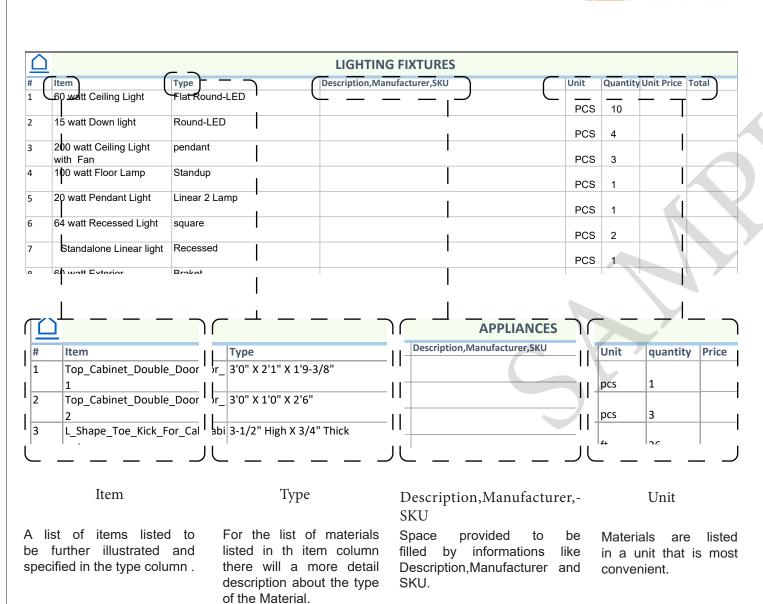

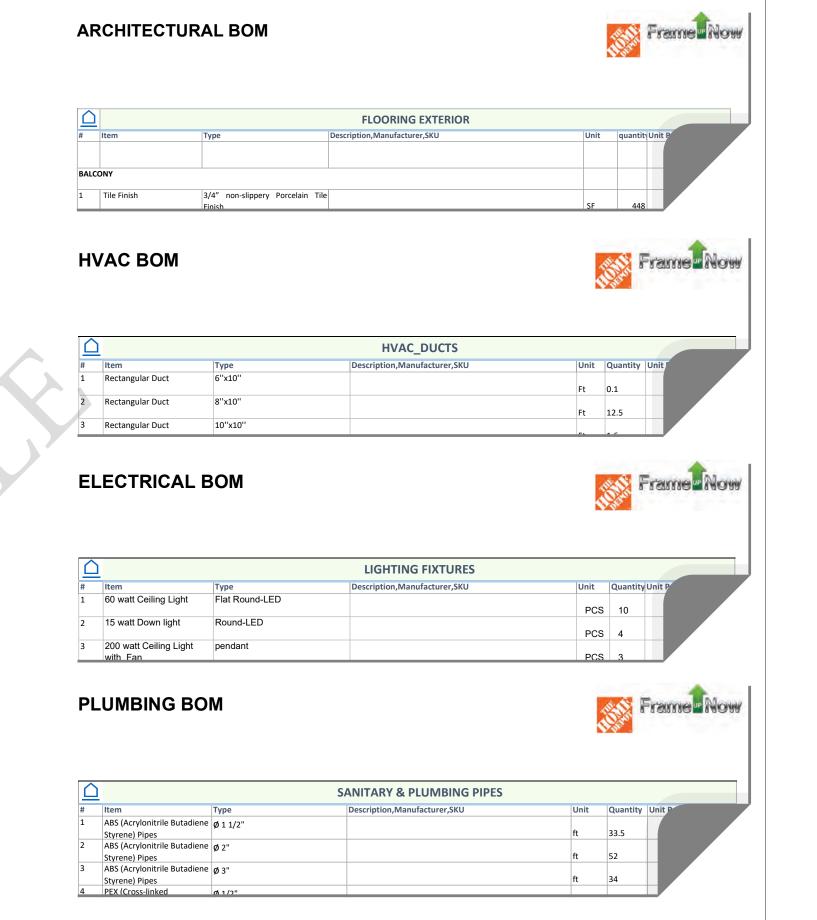

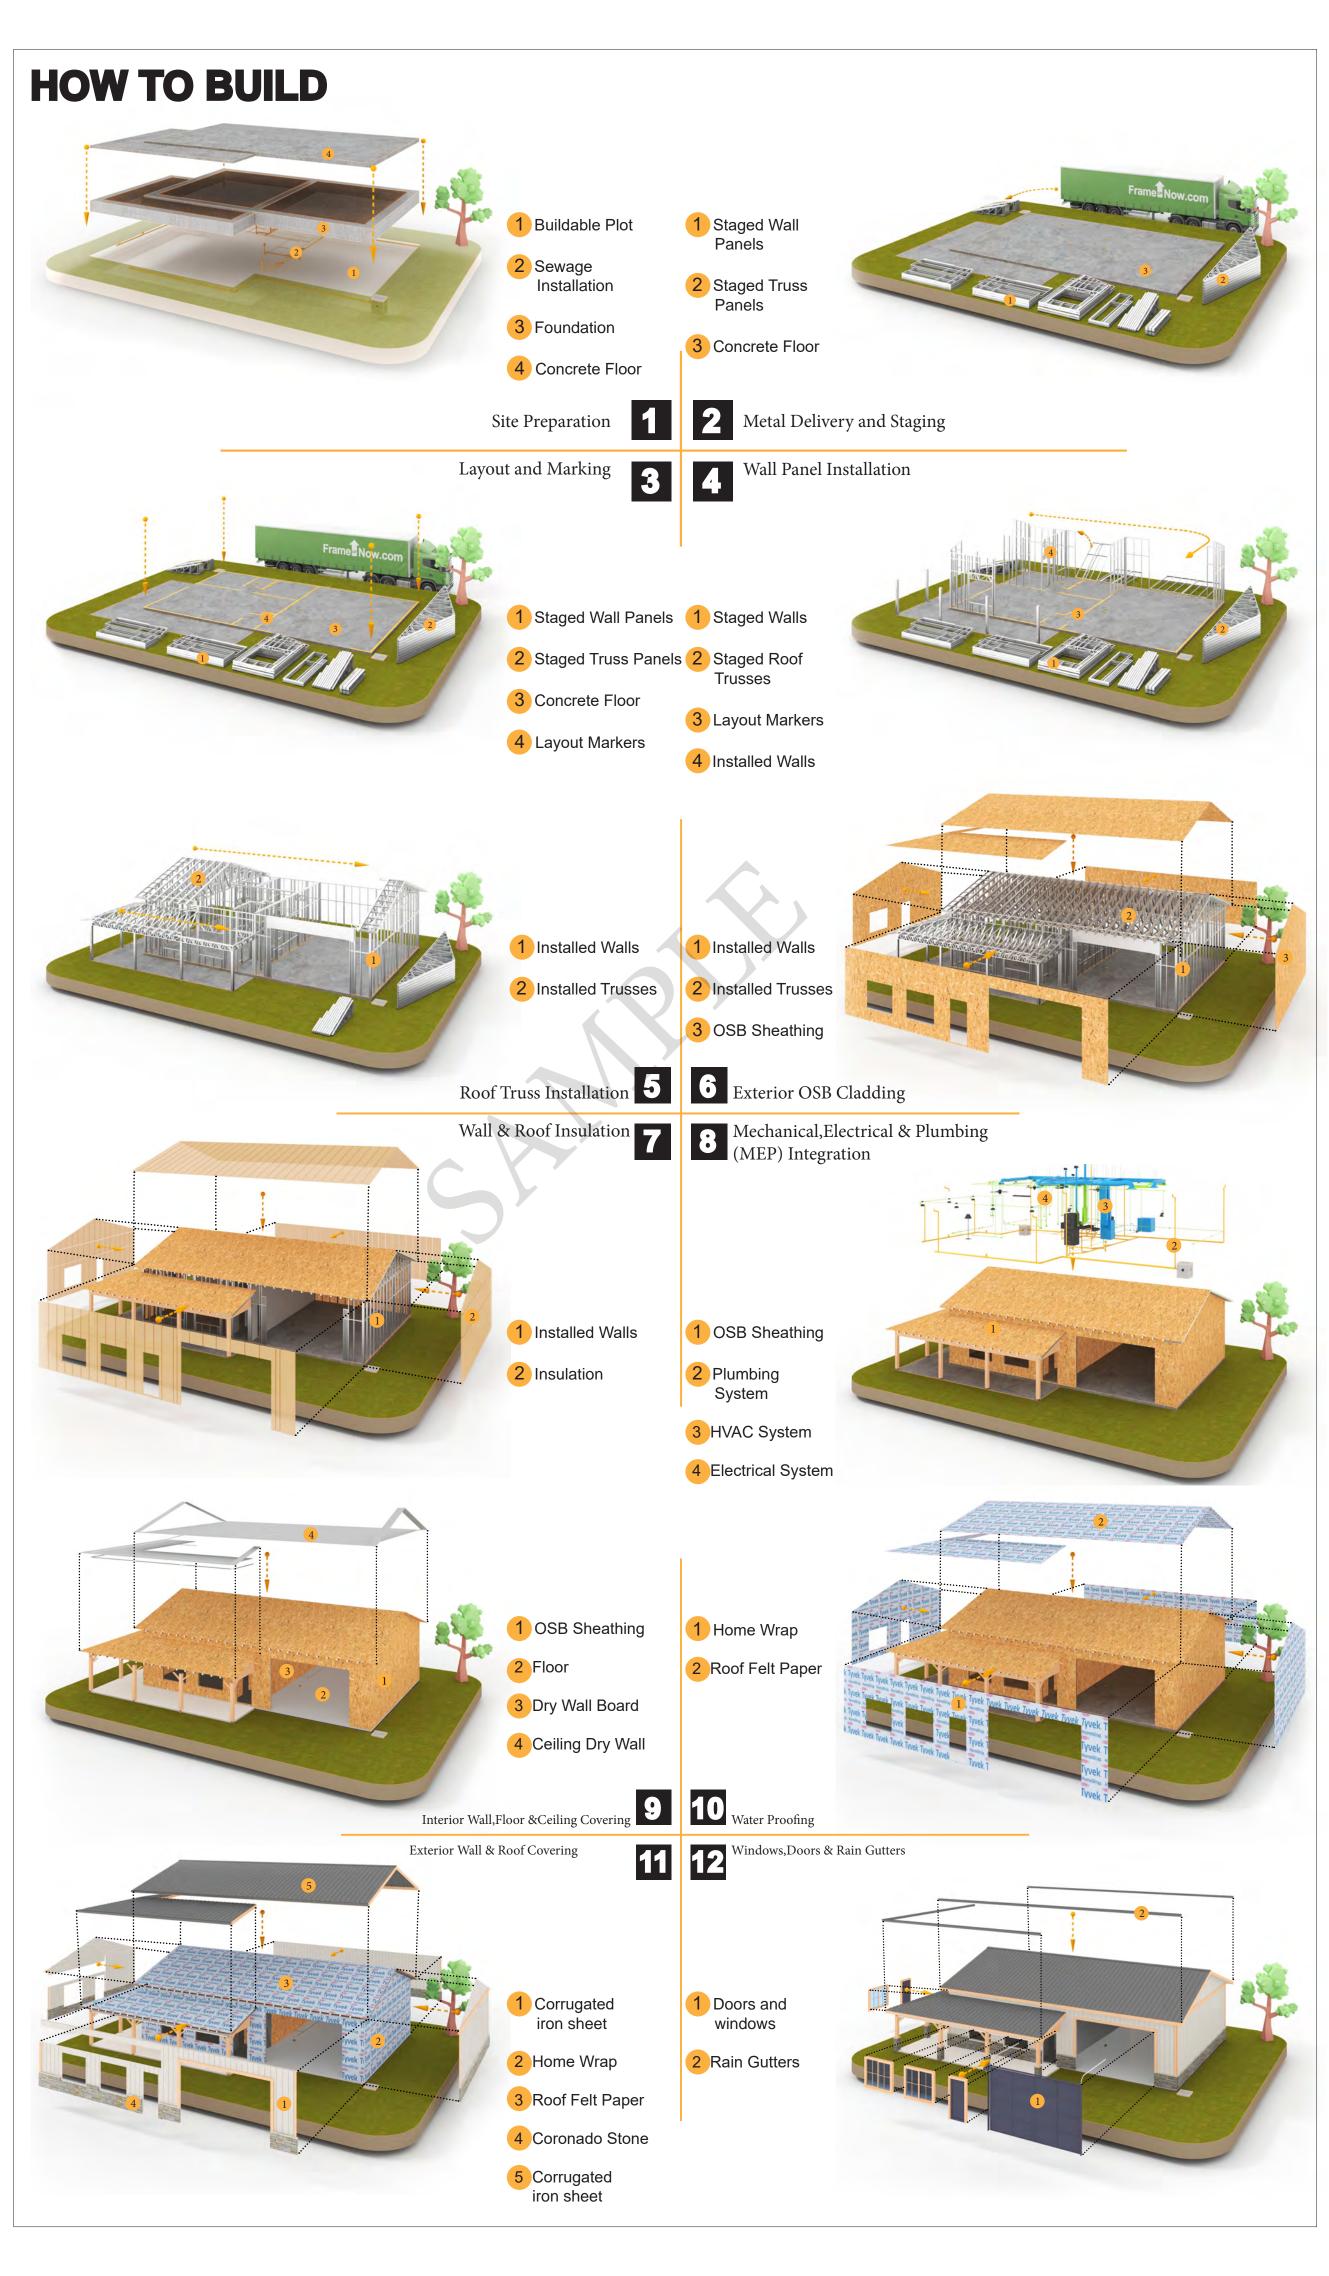



KEY PLAN

NO.	DESCRIPTION	DATE

NOTE:

LEGEND:

PROJECT

58-Hamilton-1000-2Bd-2Ba-Ranch-550


DRAWING NAME

INTRODUCTION

CLIENT NAME: PROJECT NUMBER: DATE: **DESIGNED BY** DRAWN BY: CHECKED BY:

1102

SCALE:

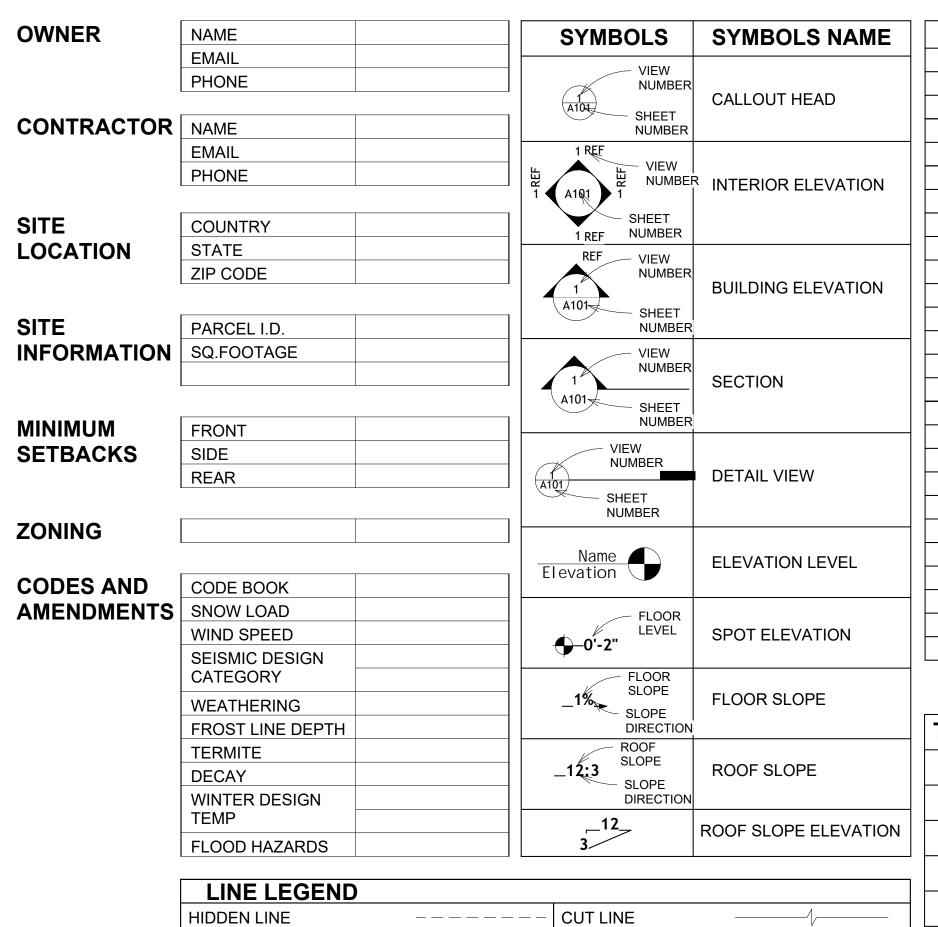

CALL OUT BOUNDRY — — — — — —

ROOM SEPARATOR

DOOR OPENING DIRECTION -

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		SIMP. S
TAG	TAG'S NAME	
	CASEWORK TAG	SIMP. A
CA01	CASEWORK TAG	TV
	DOOR TAG	UNO
	FURNITURE TAG	W/
		W/D
	WINDOW TAG	AC
SE01	SPECIALTY EQUIPMENT TAG	ACC
MEO1	MECHANICAL EQUIPMENT TAG	ACCU

PLUMBING EQUIPMENT TAG



ABBREVIATION

CASEWORK ELECTRICAL

FOOTINGS

CODE

CONDITIONING

ACTION FLOOR SYSTEMS

AMERICAN SOCIETY FOR

TESTING AND MATERIAL


FINISHED FLOOR LEVEL


FINISHED FLOOR ELEVATION


HEATING, VENTILATION & AIR

INTERNATIONAL RESIDENCE

INTERNATIONAL MECHANICAL

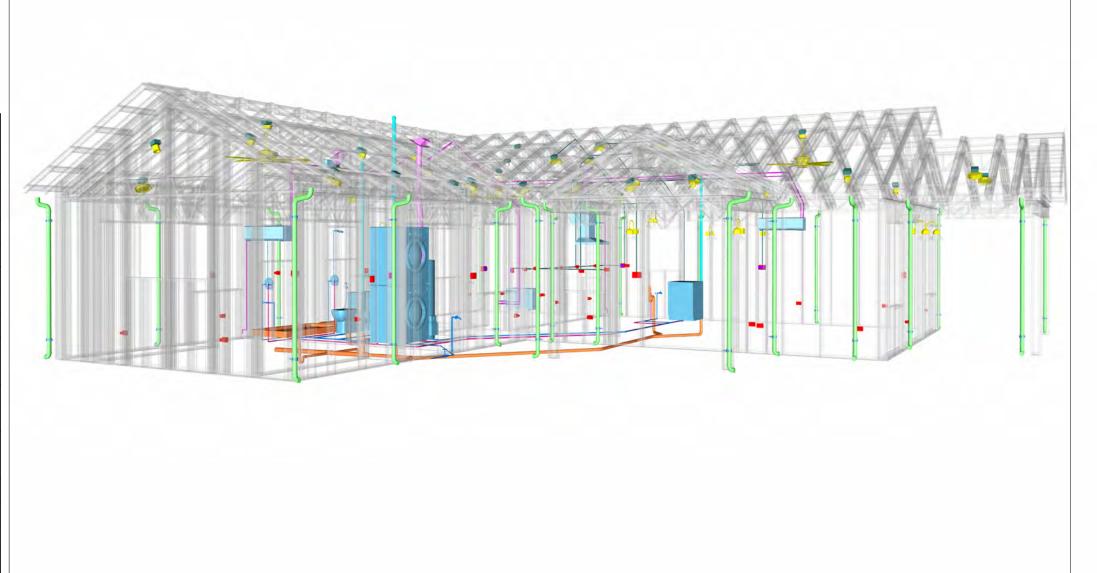

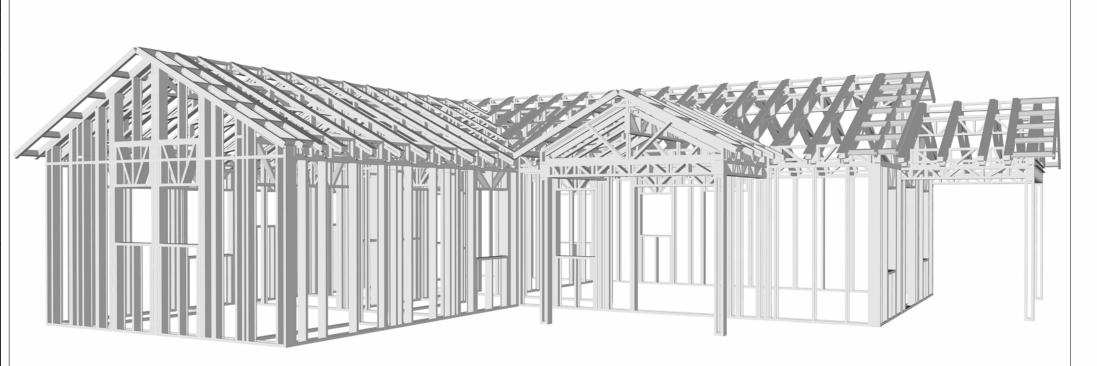

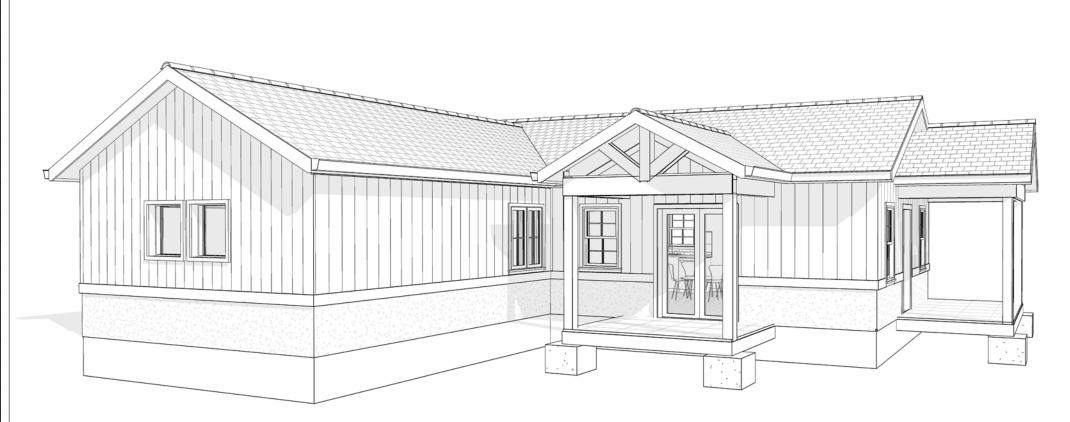


58-Hamilton-1000-2Bd/2Ba-Ranch 550

SQUARE FOOTAGE		
LIVING	998	
PORCH	149	
TOTAL	1147	





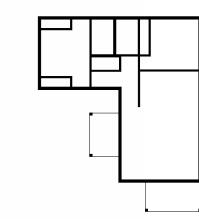

7		
NO.	DESCRIPTION	DATE

NOTE:

LEGEND:

PROJECT

58-Hamilton-1000-2Bd/2Ba Ranch 550

DRAWING NAME

COVER SHEET

CLIENT NAME:	Client Name
PROJECT NUMBER:	0061_12
DATE:	2/17/2025 12:29:28 PM
DESIGNED BY:	Designer
DRAWN BY:	Author
CHECKED BY:	Checker

G101

GENERAL NOTES

- THIS DRAWING DEPICTS THE ARCHITECTURAL (SPACE LAYOUT, FURNISHING, FLOOR, WALLS, ROOFS, FOUNDATION, WINDOWS AND DOORS) SYSTEMS. IT PROVIDES A VISUAL REPRESENTATION
- OF THE ARCHITECTURAL LAYOUT AND COMPONENTS.
 THE ARCHITECTURAL DRAWINGS ARE PREPARED TO MEET THE SPECIFIC REQUIREMENTS OF THE BUILDING, AS PER THE PROJECT SPECIFICATIONS AND APPLICABLE CODES AND STANDARDS.
- THE CONSTRUCTION OF THIS HOME SHALL COMPLY WITH THE LATEST EDITION OF THE INTERNATIONAL RESIDENTIAL CODE (IRC), INTERNATIONAL MECHANICAL CODE (IMC), THE INTERNATIONAL PLUMBING STANDARD, THE NATIONAL ELECTRICAL STANDARD AND ALL OTHER APPLICABLE LOCAL, STATE, AND NATIONAL CODES AND REGULATIONS.
- COORDINATION WITH OTHER TRADES HAS BEEN DONE ON A DESIGN LEVEL. THIS DRAWING SHALL BE READ TOGETHER WITH THE ME, EL AND PL DESIGN DRAWINGS TO ENSURE PROPER CONSTRUCTION AND INTEGRATION OF THE BUILDING SYSTEMS.

ABOUT WALLS:

- SHOWER WALL COVERING
- BATHTUB AND SHOWER SPACES (WALLS AND FLOORS) WITH INSTALLED SHOWER HEADS AND IN SHOWER COMPARTMENTS SHALL BE FINISHED WITH A NON-ABSORBENT SURFACE.
- 2. WALL PAINT (INTERNAL)
 - THE TYPICAL THICKNESS OF LATEX WALL PAINT IS 1/32 OF AN INCH FOR A SINGLE COAT. AND DOUBLE COAT (1/16") SHALL BE APPLIED FOR DURABILITY.

THE ADVISABLE TYPE OF ADHESIVE FOR THIS PROJECT IS **EPOXY ADHESIVES**BECAUSE THEY ARE KNOWN FOR THEIR HIGH STRENGTH, DURABILITY, AND RESISTANCE TO MOISTURE, CHEMICALS AND

REFER TO SHEETS A201 & A202 FOR GENERAL NOTES ON EXTERNAL FINISHING MATERIALS

ABOUT FLOORS:


- THE SPOT ELEVATION INDICATES THE FINISHED FLOOR ELEVATION.
- FINISHED FLOORS PER PLANS.
- FIELD VERIFY FOR DIMENSION DROP 4" FOR SHOWER AND BATHTUB USE.
- 1% SLOPE ON OUTDOOR BALCONIES FOR WATER RUN OFF.
- 2% SLOPE TOWARDS THE SHOWER DRAIN FOR SUFFICIENT DRAINAGE.
- 4" DROP AT THE DOOR LEADING TO EXTERIOR BALCONY FROM THE MAIN LIVING AREA.
- 5% SLOPE FOR GARAGE IS USED, WHICH SHOULD BE CHECKED WITH THE LOCAL GARAGING
- ZONING LAWS.





	FURNITURE SCHEDULE			
	TYPE MARK	TYPE		COUNT
1		QUEEN 60" X 79"	1	
2		THREE SEAT SOFA 2	1	
3		THREE SEAT SOFA	1	
4		DINING CHAIR	4	
5		COFFE TABLE	1	
6		ONE SEAT SOFA	1	

		RO	OM FINISH	SCHEDULE			
ROOM NUMBE R	ROOM NAME	FLOOR FINISH	BASE FINISH	WALL FINISH	CEILING FINISH	CEILING HEIGHT	COM MEN TS
1	BEDROOM 2	HARDWOOD	CONCRETE	WALL PAINT	DRY WALL	8' - 0"	
2	CL 2	HARDWOOD	CONCRETE	WALL PAINT	DRY WALL	8' - 0"	
3	CL 3	HARDWOOD	CONCRETE	WALL PAINT	DRY WALL	8' - 0"	
4	BATH 1	VINYL TILES	CONCRETE	CERAMIC TILE	MRD	8' - 0"	
5	BATH 2	VINYL TILES	CONCRETE	CERAMIC TILE	MRD	8' - 0"	
6	BEDROOM 1	HARDWOOD	CONCRETE	WALL PAINT	DRY WALL	8' - 0"	
7	CL 1	HARDWOOD	CONCRETE	WALL PAINT	DRY WALL	8' - 0"	
8	WD	HARDWOOD	CONCRETE	WALL PAINT	DRY WALL	8' - 0"	
9	PORCH 1	HARDWOOD	CONCRETE	WALL PAINT	DRY WALL	8' - 0"	
10	HALL	HARDWOOD	CONCRETE	WALL PAINT	DRY WALL	8' - 0"	
11	KITCHEN	HARDWOOD	CONCRETE	WALL PAINT + CERAMIC	DRY WALL	8' - 0"	
12	PORCH 2	HARDWOOD	CONCRETE	WALL PAINT	DRY WALL	8' - 0"	
13	LIVING ROOM	HARDWOOD	CONCRETE	WALL PAINT	DRY WALL	8' - 0"	
14	WH	HARDWOOD	CONCRETE	WALL PAINT	DRY WALL	8' - 0"	

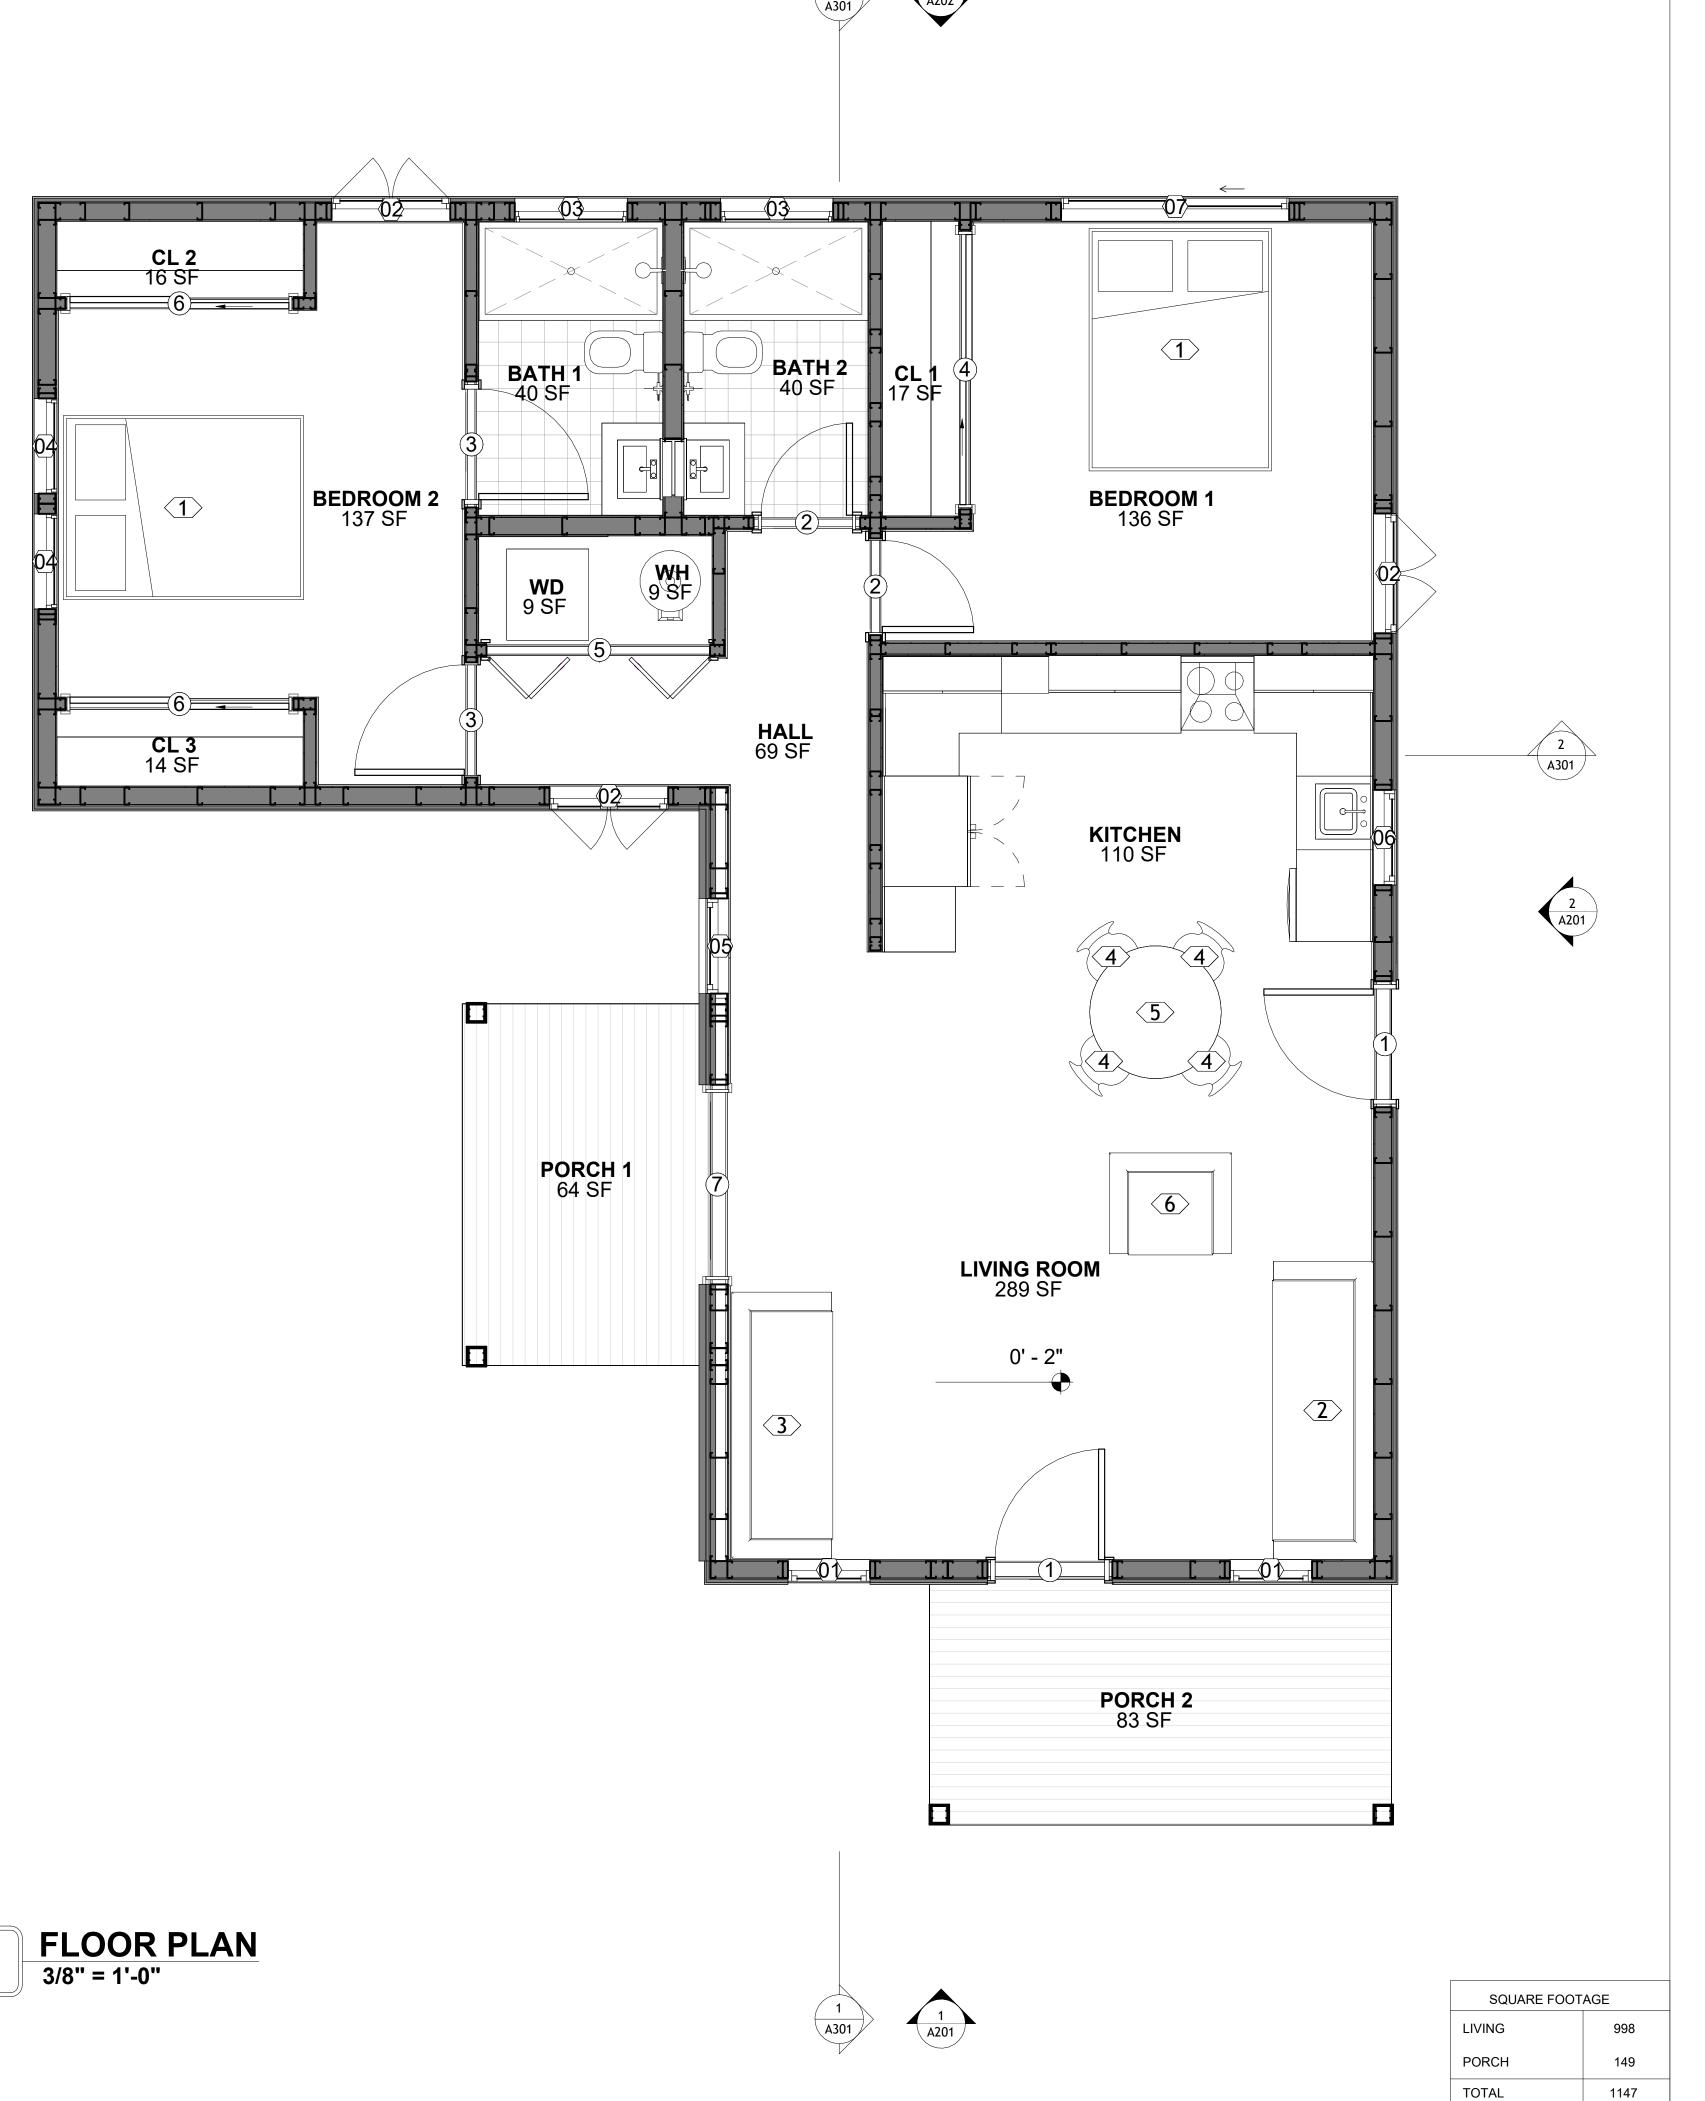



KEY PLAN

NO.	DESCRIPTION	DATE

NOTE:

LEGEND:

PROJECT


58-Hamilton-1000-2Bd/2Ba Ranch 550

DRAWING NAME

FLOOR PLAN


Client Name
0061_12
2/17/2025 12:29:30 PM
Designer
Author
Checker

A101

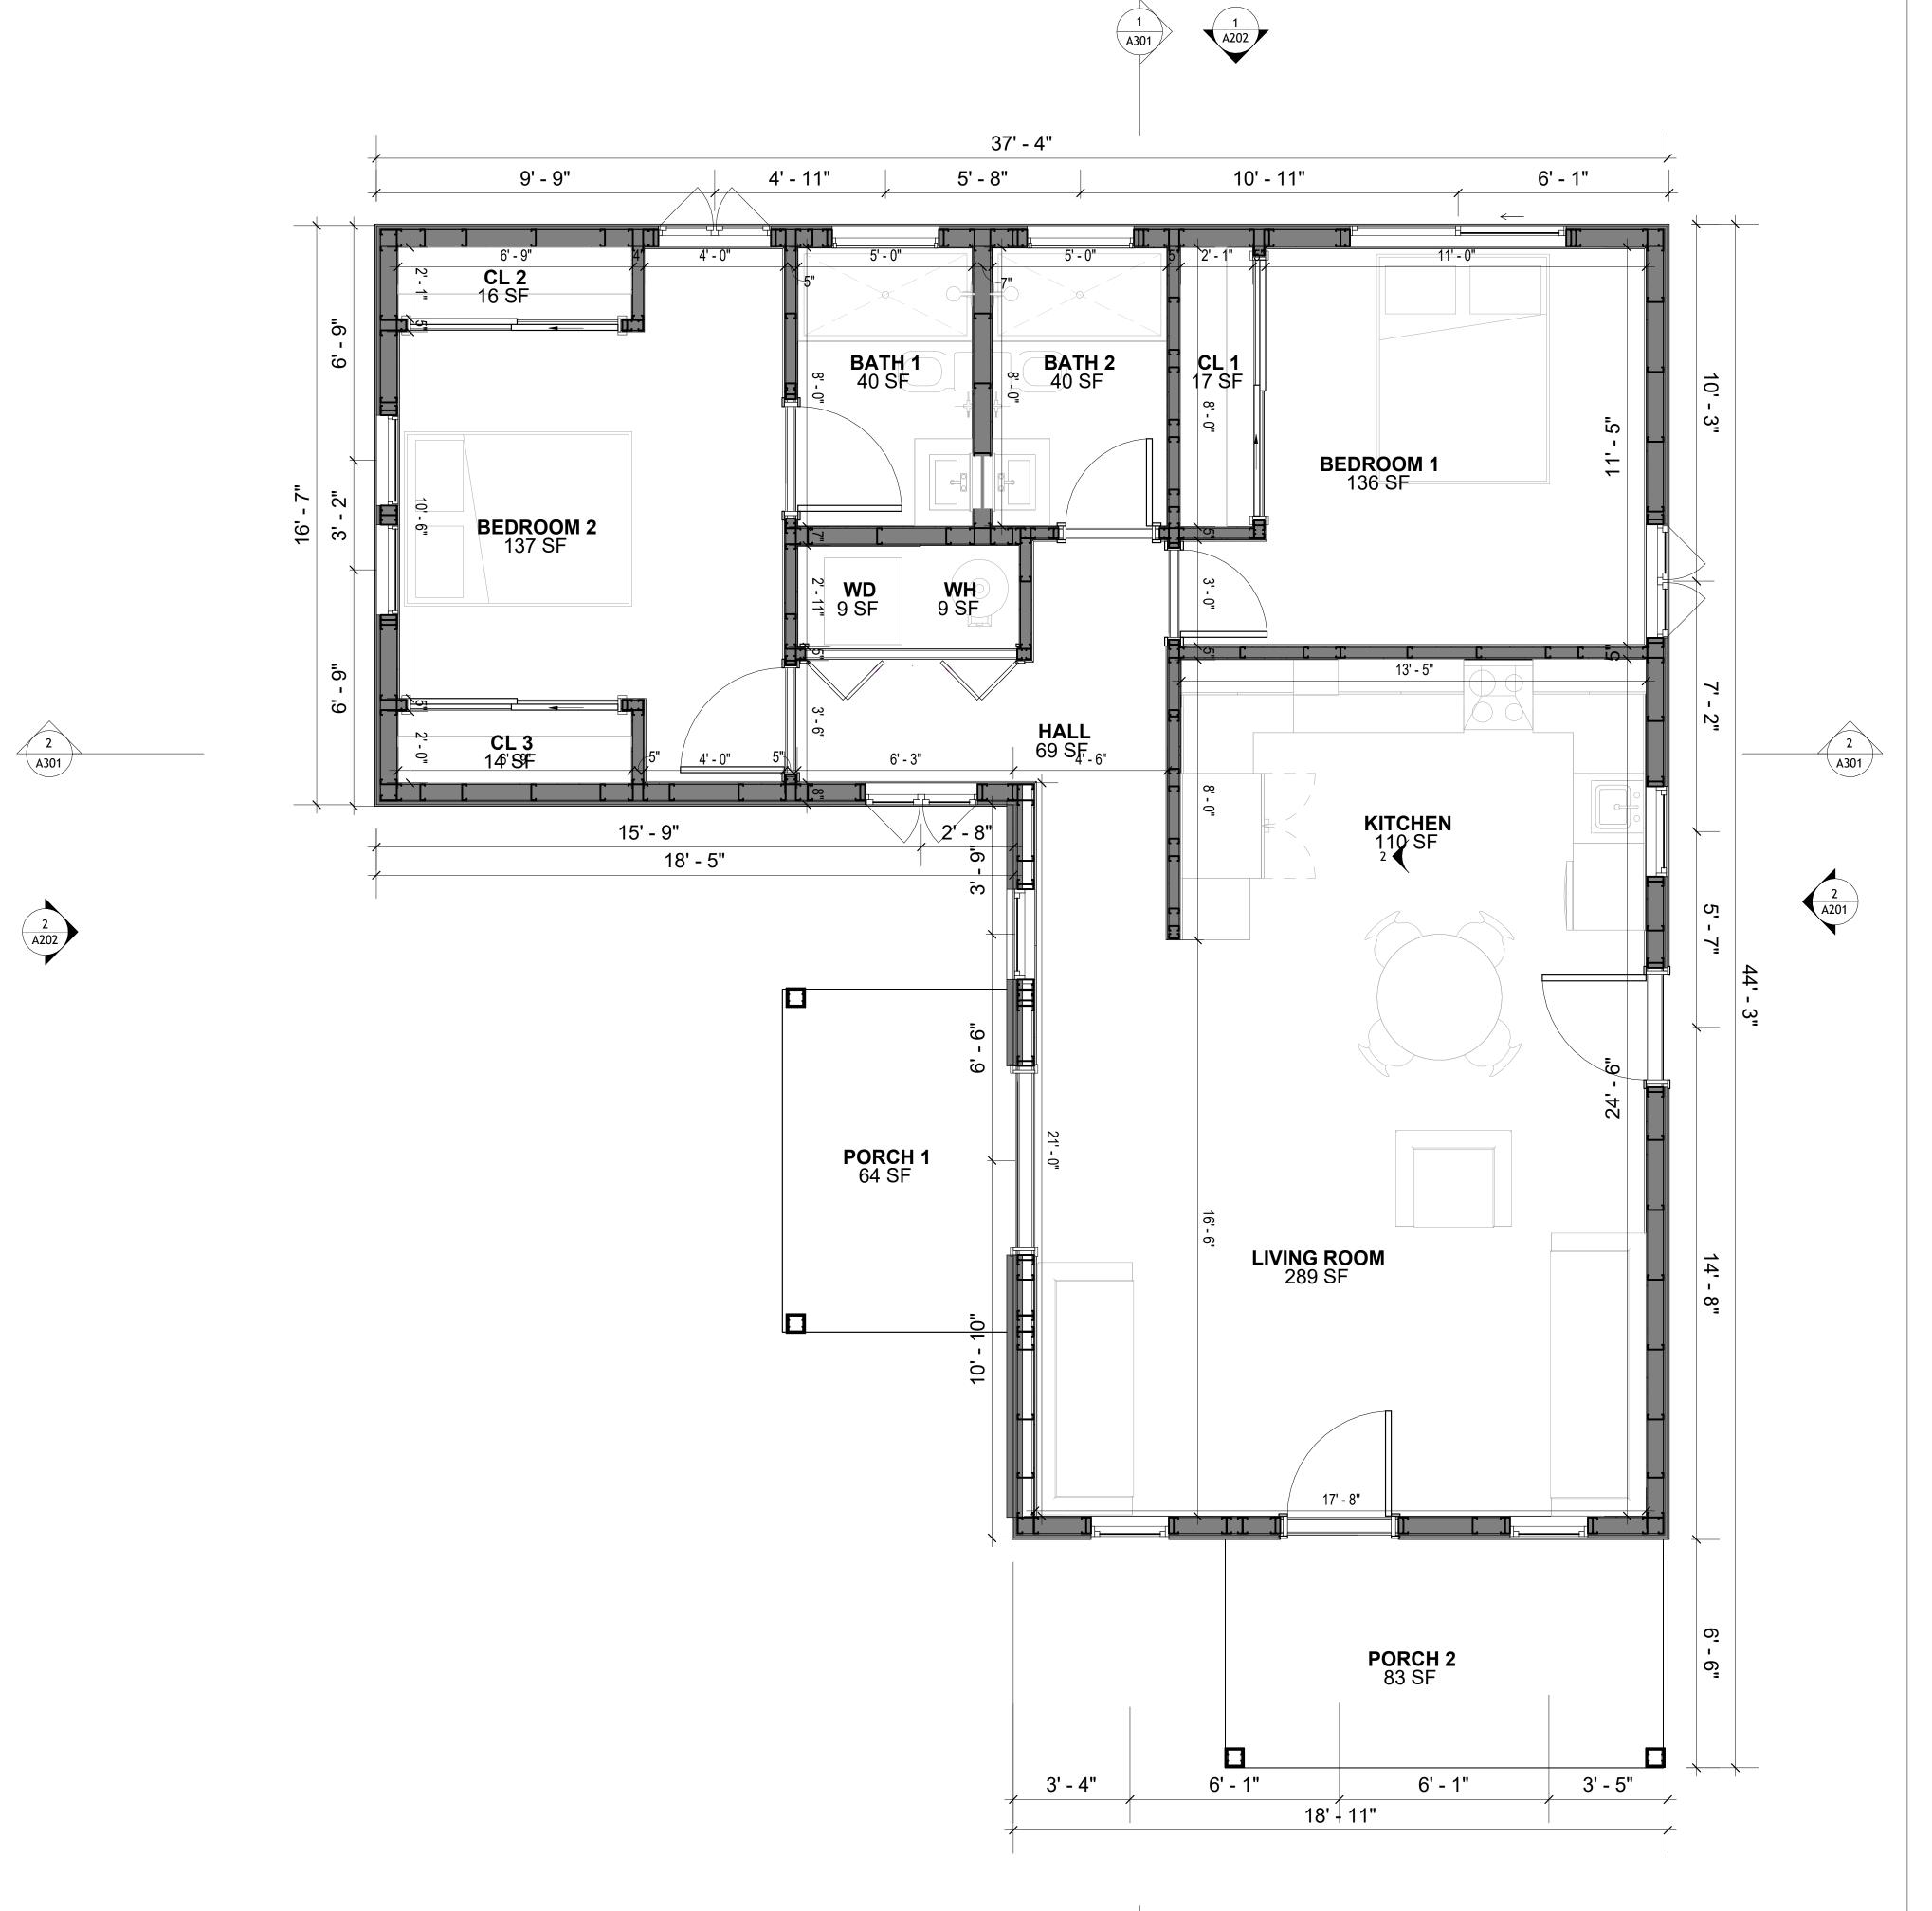

DIMENSIONS IN THE ARCHITECTURAL DRAWINGS CONSIDER FINISHING MATERIALS. FOR PRECISE MEASUREMENTS OF THE STRUCTUAL FRAMING, REFER TO THE ATTACHED STRUCTURAL PLAN SET.

1ST FLOOR DIMENSION PLAN
3/8" = 1'-0"

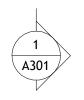







KEY PLAN

NO.	DESCRIPTION	DATE

NOTE:

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PROJECT

58-Hamilton-1000-2Bd/2Ba Ranch 550

DRAWING NAME

DIMENSION PLAN

CLIENT NAME:	Client Name
PROJECT NUMBER:	0061_12
DATE:	2/17/2025 12:29:32 PM
DESIGNED BY:	Designer
DRAWN BY:	Author
CHECKED BY:	Checker

A102

SCALE: 3/8" = 1'-0"

998

149

1147

FOUNDATION NOTES

NOTES:

TERMITES PRETREATMENT BY LICENSED CONTRACTOR UNDER SLAB AND AROUND FOOTINGS. ALL AREAS BELOW SLABS SHALL BE TREATED NO MORE THAN 24 HOURS PRIOR TO CONCRETE POUR. EVIDENCE OF TREATMENT MUST BE PROVIDED PRIOR TO PLACING OF CONCRETE.

1. MATERIALS

ALL INTERIOR CONCRETE SLABS SHALL BE A MIN. OF 4" THICK CONCRETE OVER 4" COMPACTED AGGREGATE BASE (ASTM D698), FINISH ELEVATIONS AS NOTED ON DRAWINGS, 6" ABOVE ADJACENT GRADE, LEVEL SLABS TO 1/8"-10' MAX.. CONCRETE SLABS SHALL BE 2500# PSI AT 28 DAYS. A 4" ALLOWABLE SLUMP.

2. **PAD PREPARATION:**

EXCAVATION FOR FOOTING SHALL BE NEAT.

- FOOTINGS SHALL BE POURED IMMEDIATELY AFTER EXCAVATION AND APPROPRIATE INSPECTION.

- ALL REINFORCING STEEL MARKED "CONTINUOUS" SHALL BE LAPPED 36 BAR DIAMETERS AT SPLICES AND AROUND CORNERS OR INTERSECTIONS WITH A STANDARD 90 DEGREE BEND ON CORNER BARS. LAP WIRE MESH ONE FULL MESH AT SIDE AND END LAPS.

- ALL HARDWARE TO BE SIMPSON OR EQUIVALENT.
- EXTERIOR FRAME WALL TO BE SECURED WITH 1/2"X10" ANCHOR BOLTS 4'-0" O.C. FOR 1-STORY AND 2'-8" O.C. FOR 2-STORY. BOLTS SHALL BE LOCATED WITHIN 1'-0" OF EACH END PIECE AND SHALL HAVE A MIN. OF TWO BOLTS PER PIECE.

-FOUNDATION ANCHOR STRAPS SHALL BE PERMITTED, ACCORDING TO RESIDENTIAL CODE 2021
- ALL INTERIOR WALLS TO BE SECURED WITH POWER DRIVEN PINS PER MANUFACTURER

SPECIFICATION USE PIN SPACING EQUIVALENT TO 1/2" ANCHOR BOLTS.
- ALL CONSTRUCTION TO CONFORM TO THE 2012 IRC

R-10 RIGID INSULATION OUTSIDE OF EXTERIOR FOUNDATION WALLS UNDER LIVING AREA.
 CONCRETE PAD FOR CONDENSER THICKNESS IS 4" MIN UNLESS OTHERWISE NOTED.

3. CONCRETE CONSTRUCTION:

- THE SLAB SHALL BE UNDERLAIN BY A VAPOR BARRIER/RETARDER IN THE LIVING AREA (TYPICALLY POLYETHYLENE, UNLESS MORE STRINGENT PROTECTION REQUIRED BY THE ARCHITECT, ENGINEER, FLOOR COVERING MANUFACTURER, OR ACCEPTED PRACTICE). UNLESS OTHERWISE REQUIRED, BARRIER MAY BE OMITTED AT GARAGES, PORCHES AND PATIOS WITHOUT FLOOR COVERINGS. IT IS BEYOND THE SCOPE OF THESE PLANS TO DETERMINE THE APPLICABILITY OF THESE MORE STRINGENT REQUIREMENTS. BUILDER SHALL VERIFY PRIOR TO CONSTRUCTION.

4. REINFORCEMENT:

- IF CONSTRUCTED ON ACTIVE SOILS, THE LONG TERM PERFORMANCE OF THE FOUNDATION IS DEPENDENT ON MAINTENANCE BY THE OWNER. THUS THE BUILDER SHALL ADVISE THE OWNER OF THE FOLLOWING:

1. DRAINAGE MUST BE MAINTAINED. WATER SHALL NEVER BE ALLOWED TO POND NEAR THE FOUNDATION.

2. THE SOIL AROUND THE FOUNDATION SHALL BE MAINTAINED IN A RELATIVELY DAMP CONDITION, SUCH AS THAT REQUIRED TO KEEP A LAWN GREEN. IF IT DRIES OUT IT WILL

SHRINK. IF IT GETS WET, IT WILL HEAVE UPWARD.

3. SLABS ON THE SHORTER SIDE USES MAIN BARS ARE USED IN THIS DIRECTION ONLY WITH SMALLER DIAMETER DISTRIBUTION BARS ARE PLACED, FORMING A MAT OR GRID.

4. ALL REINFORCEMENT BARS SIZE 10MM OR LARGER IN ACCORDANCE TO ASTM
3. ANCHOR BOLTS AT ALL EXTERIOR WALLS SHALL BE MINIMUM 1/2 INCH DIAMETER WITH A

MAXIMUM SPACING OF 6'-0" ON CENTER, UNLESS NOTED OTHERWISE.

4. ANCHOR BOLTS SHALL BE INSTALLED WITHIN 12 INCHES OF EACH END OF EACH SILL PLATE WITH AT LEAST TWO ANCHOR BOLTS FOR EACH BOLTS FOR EACH SILL PLATE LONGER

THAN 12 INCHES.


5. SIMPSONS SILL ANCHORS MAYBE SUBSTITUTED FOR ANCHOR BOLTS AT THE SAME SPACING.

6. EXTERIOR CONCRETE SLABS WHICH ARE NOT PART OF THE MAIN SLAB SHALL BE MINIMUM 4 INCHES THICK WITH NO STEEL REINFORCING BARS REQUIRED, UNLESS NOTED OTHERWISE ON FOUNDATION PLAN.

VERIFY THE FOLLOWING PRIOR TO POURING:

- 1. ALL HOLDDOWNS , STRAP, AND POST LOCATIONS.
- 2. CONCRETE FINISHES. PANEL RISER LOCATION WHERE APPLICABLE.
- 3. UNDERSLAB MECHANICAL REQUIREMENTS.
- 4. STEM WALL BLOCKOUTS.
- 5. UNDERSLAB ELECTRICAL REQUIREMENTS AND PANEL RISER LOCATION. WHERE APPLICABLE.
- 6. PROVIDE THE FOLLOWING:
- PVC SLEEVES THROUGH FTG IF REQUIRED
 20' #4 COPPER GROUND BAR.
- 7. SLOPE FINISH GRADE AWAY FROM FOOTING.

NOTE: FIELD VERIFY ALL DIMENSIONS SEE DIMENSIONED ARCHITECTURAL DRAWINGS

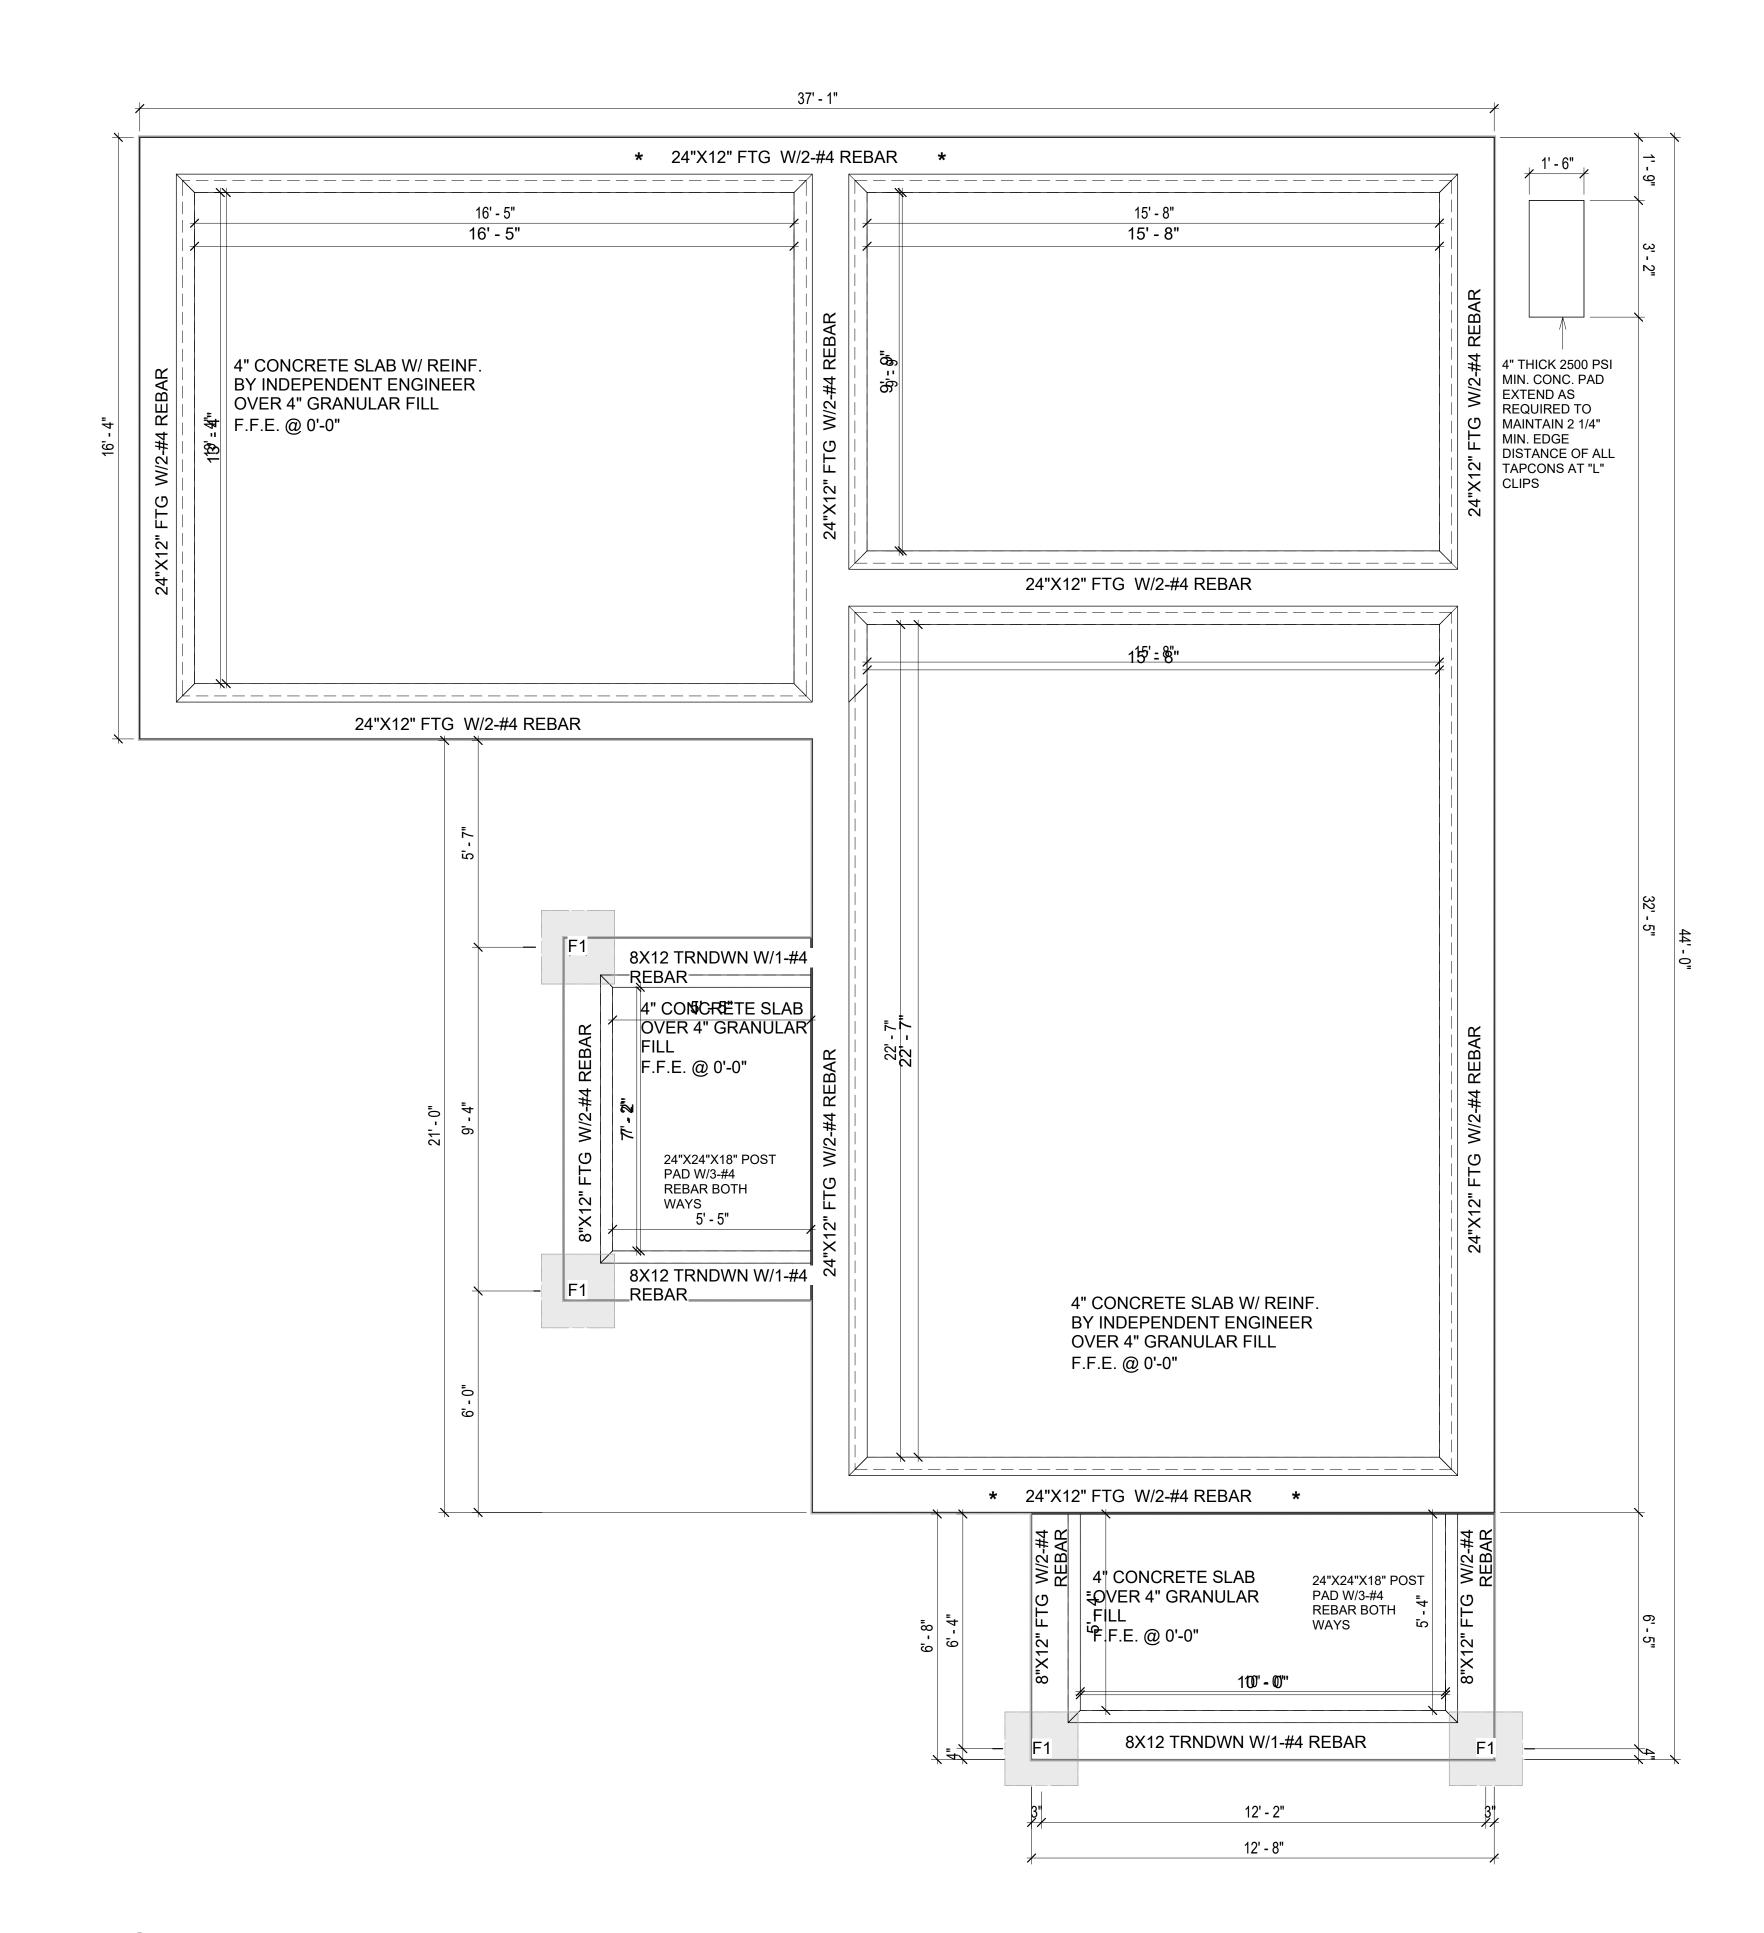

1 **FOUNDATION PLAN**3/8" = 1'-0"

SQUARE FOOTAGE

LIVING 998

PORCH 149

TOTAL 1147



KEY PLAN

NO.	DESCRIPTION	DATE

NOTE:

LEGEND:

PROJECT

58-Hamilton-1000-2Bd/2Ba Ranch 550

DRAWING NAME

FOUNDATION PLAN

CLIENT NAME: Client Name

PROJECT NUMBER: 0061_12

DATE: 2/17/2025 12:29:32 PM

DESIGNED BY: Designer

DRAWN BY: Author

CHECKED BY: Checker

S101

SCALE: 3/8" = 1'-0"

GENERAL NOTES

NOTES:

-ALL BEARING WALLS SHOULD HAVE A THICKENED SLAB PER SECTION PER DETAIL A401/5.

A) **FOUNDATION PLAN NOTES**:

- CONCRETE SLAB SHALL BE 6" THICK WITH 1/2" DIAMETER TENDONS PER LAYOUT PLAN, CENTERED IN SLAB THICKNESS, OVER APPROVED SUBBASE PER GENERAL STRUCTURE
- 2. TERMITE PROTECTION SHALL BE PROVIDED PER IRC SECTION R318.1 NONE TYPICAL ANCHOR BOLT SPACING AT SHEAR WALL AND HOLD DOWN
- SPECIFICATIONS PER APPROVED ARCHITECTURAL PLANS. 4. INSTALL HOLDOWNS BEFORE CONCRETE SLAB POUR.
- EXISTING FILL ON-SITE SHALL BE COMPACTED IN ACCORDANCE WITH THE REQUIREMENTS IN THE GEOTECHNICAL REPORT.
- 6. ALL FLOOR SLABS ARE REINFORCED ON CONCRETE SLABS.

SPECIAL INSPECTION IS REQUIRED FOR THICKENED FOUNDATION CONSTRUCTION

- 1. REINFORCEMENT
- 2. 2300 PSI CONCRETE POUR

B) **REINFORCEMENT FOR CONCRETE**:

1. ALL REINFORCING SLABS BARS SIZE 10MM OR LARGER SHALL BE DEFORMED IN ACCORDANCE TO ASTM-A706, AND BARS SMALLER THAN 10 MM MAYBE PLAIN. 2. UNLESS OTHERWISE NOTED IN PLANS, THE YIELD STRENGTH OF REINFORCING BARS SHALL BE:

> A) FOOTING = 40,000 PSI B) NON-LOAD BEARING WALLS AND PARAPETS= 40,000 PSI

- 3. SPLICES SHALL BE SECURELY WIRED TOGETHER AND SHALL LAP OR EXTEND
- 4. GRADE OF STEEL FOR RCC WORKS SHALL BE GRADE 4 10.

#4-REBAR ON A 2'-0" X 2'-0" GRID

SLAB ON GRADE FOUNDATION

- BAR NOTATIONS GIVES INFORMATION
- A) BAR SIZE
- B) SPACING(IF REQUIRED) 6. LAP REINFORCEMENT ONLY AT LOCATION SHOWN IN THE DRAWINGS
- REINFORCEMENT SHALL NOT BE CUT, VENT OR HEATED ON SITE WITHOUT ENGINEERS' APPROVAL.
- C) **CONCRETE SLAB NOTES**
- 1. ALL SLAB REINFORCEMENT SHALL BE 20MM CLEAR MINIMUM FROM BOTTOM AND FROM TOP OF SLAB.

-DRYWALL

SPRAY

INSULATION

TYPICAL WALL FTG DETAIL

FOAM PAD - AFS -

POLYETHYLENE

WOOD - AFS -

MAPLE FLOORING

_24"X24"X12" POST

_CONCRETE SLAB


TOPPING

CONT.REBAR

3/4" = 1'-0"

2. REINFORCEMENT IN CONTINUOUS ELEVATED SLAB SHALL BE CUT AS FOLLOWS.

- THIS IS A SCHEMATIC PLAN FOR THE PURPOSE OF LOCATING AND IDENTIFYING FOUNDATION REINFORCING ELEMENTS ONLY. VERIFY ALL DIMENSIONS, DROPS, OFFSETS AND FEATURES WITH THE ARCHITECTURAL PLANS BEFORE FORMING THE FOUNDATION.

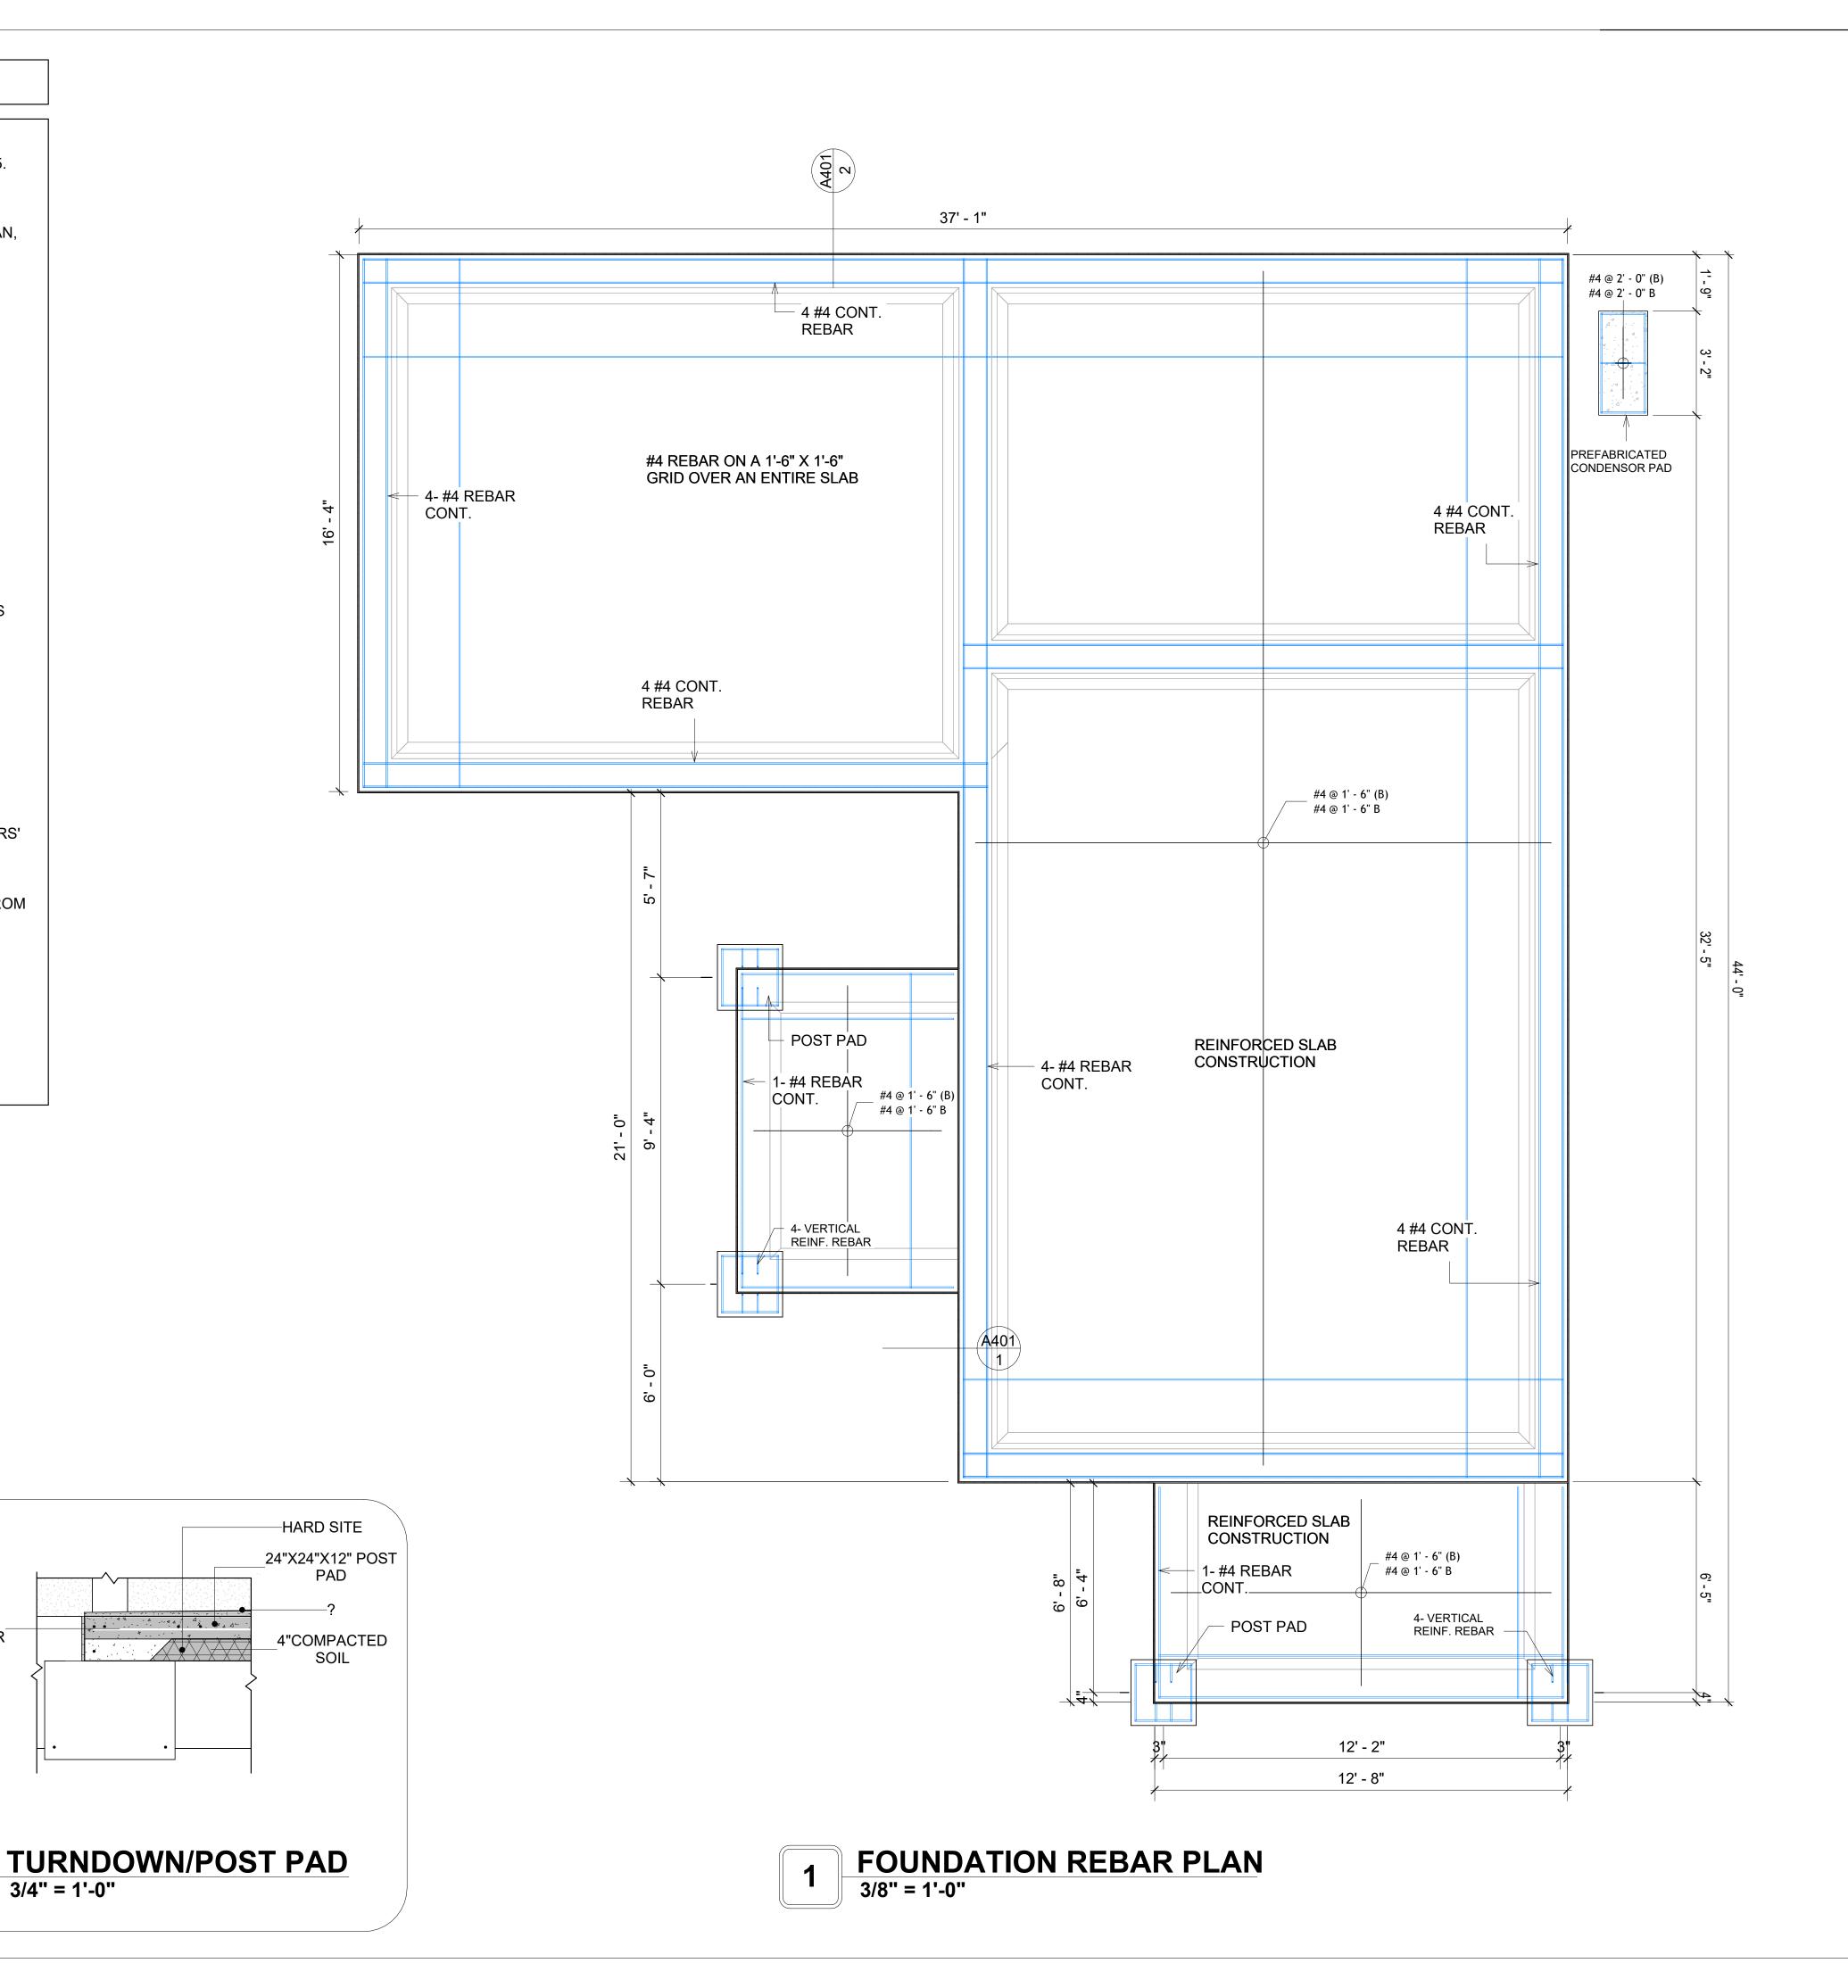



KEY PLAN

NO.	DESCRIPTION	DATE

NOTE:

LEGEND:

PROJECT

58-Hamilton-1000-2Bd/2Ba Ranch 550

DRAWING NAME

STRUCTURAL FLOOR PLAN

CLIENT NAME: **Client Name** PROJECT NUMBER: 0061_12 2/17/2025 12:29:33 PM Designer **DESIGNED BY:** DRAWN BY: **Author** CHECKED BY: Checker

S102

SCALE: As indicated

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STUCCO FINISH-ORIENTED

STRAND BOARD-


(OSB) (1/2")

CONCRETE SLAB

TOPPING

ROOF NOTES

- ROOFING COMPOSITION ROOFING PER OWNERS/BUILDERS SPECIFICATIONS INSTALL PER MANUFACTURE SPECIFICATIONS ON 1/2" ORIENTED STRAND BOARD ON PRE-ENGINEERED TRUSS @ 24" O.C. (UNO.) 2. 73" OVERHANG AT EAVES (UNO.)
- ENDS OF ALL TRUSSES AND JOISTS TO BE FULLY BLOCKED. PROVIDE SOLID
- BLOCKING AT ALL RIDGES AND VALLEYS SHEATHING TO BE 1/2", 3/8" OSB SHEAR PANEL AND EQUIVALENT.
- UNDERSIDE OF PORCH TRUSSES TO BE FINISHED WITH MOISTURE RESISTANT DRYWALL, TAPED AND TEXTURED. 5. EXPOSED EAVES AND OTHER WEATHER EXPOSED AREAS TO BE SHEATHED
- WITH EXTERIOR GRADE PLYWOOD. 6. ALL MATERIALS THICKNESS AND SIZE ARE THE MINIMUM. Refer TO LOCAL
- STANDARDS FOR ACTUAL THICKNESS AND LAYERING OF MATERIALS. ENGINEERED TRUSS CALCULATIONS TO BE SUBMITTED TO BUILDING
- DEPARTMENT PRIOR TO FABRICATION AND INSTALLATION.
- TRUSS MANUFACTURER TO SPECIFY HANGER CONNECTORS FOR TRUSS COMPONENTS (TYPICAL)
- 9. DESIGNER ASSUMES THAT TRUSSES BEAR ON ALL EXTERIOR PERIMETER WALLS (TYPICAL) OR BEAMS.
- 10. PROVIDE GALVANIZED STEEL FLASHING WITH A LENGTH OF 10 FEET, WIDTH OF 12 INCHES, AND THICKNESS OF 24 GAUGE.

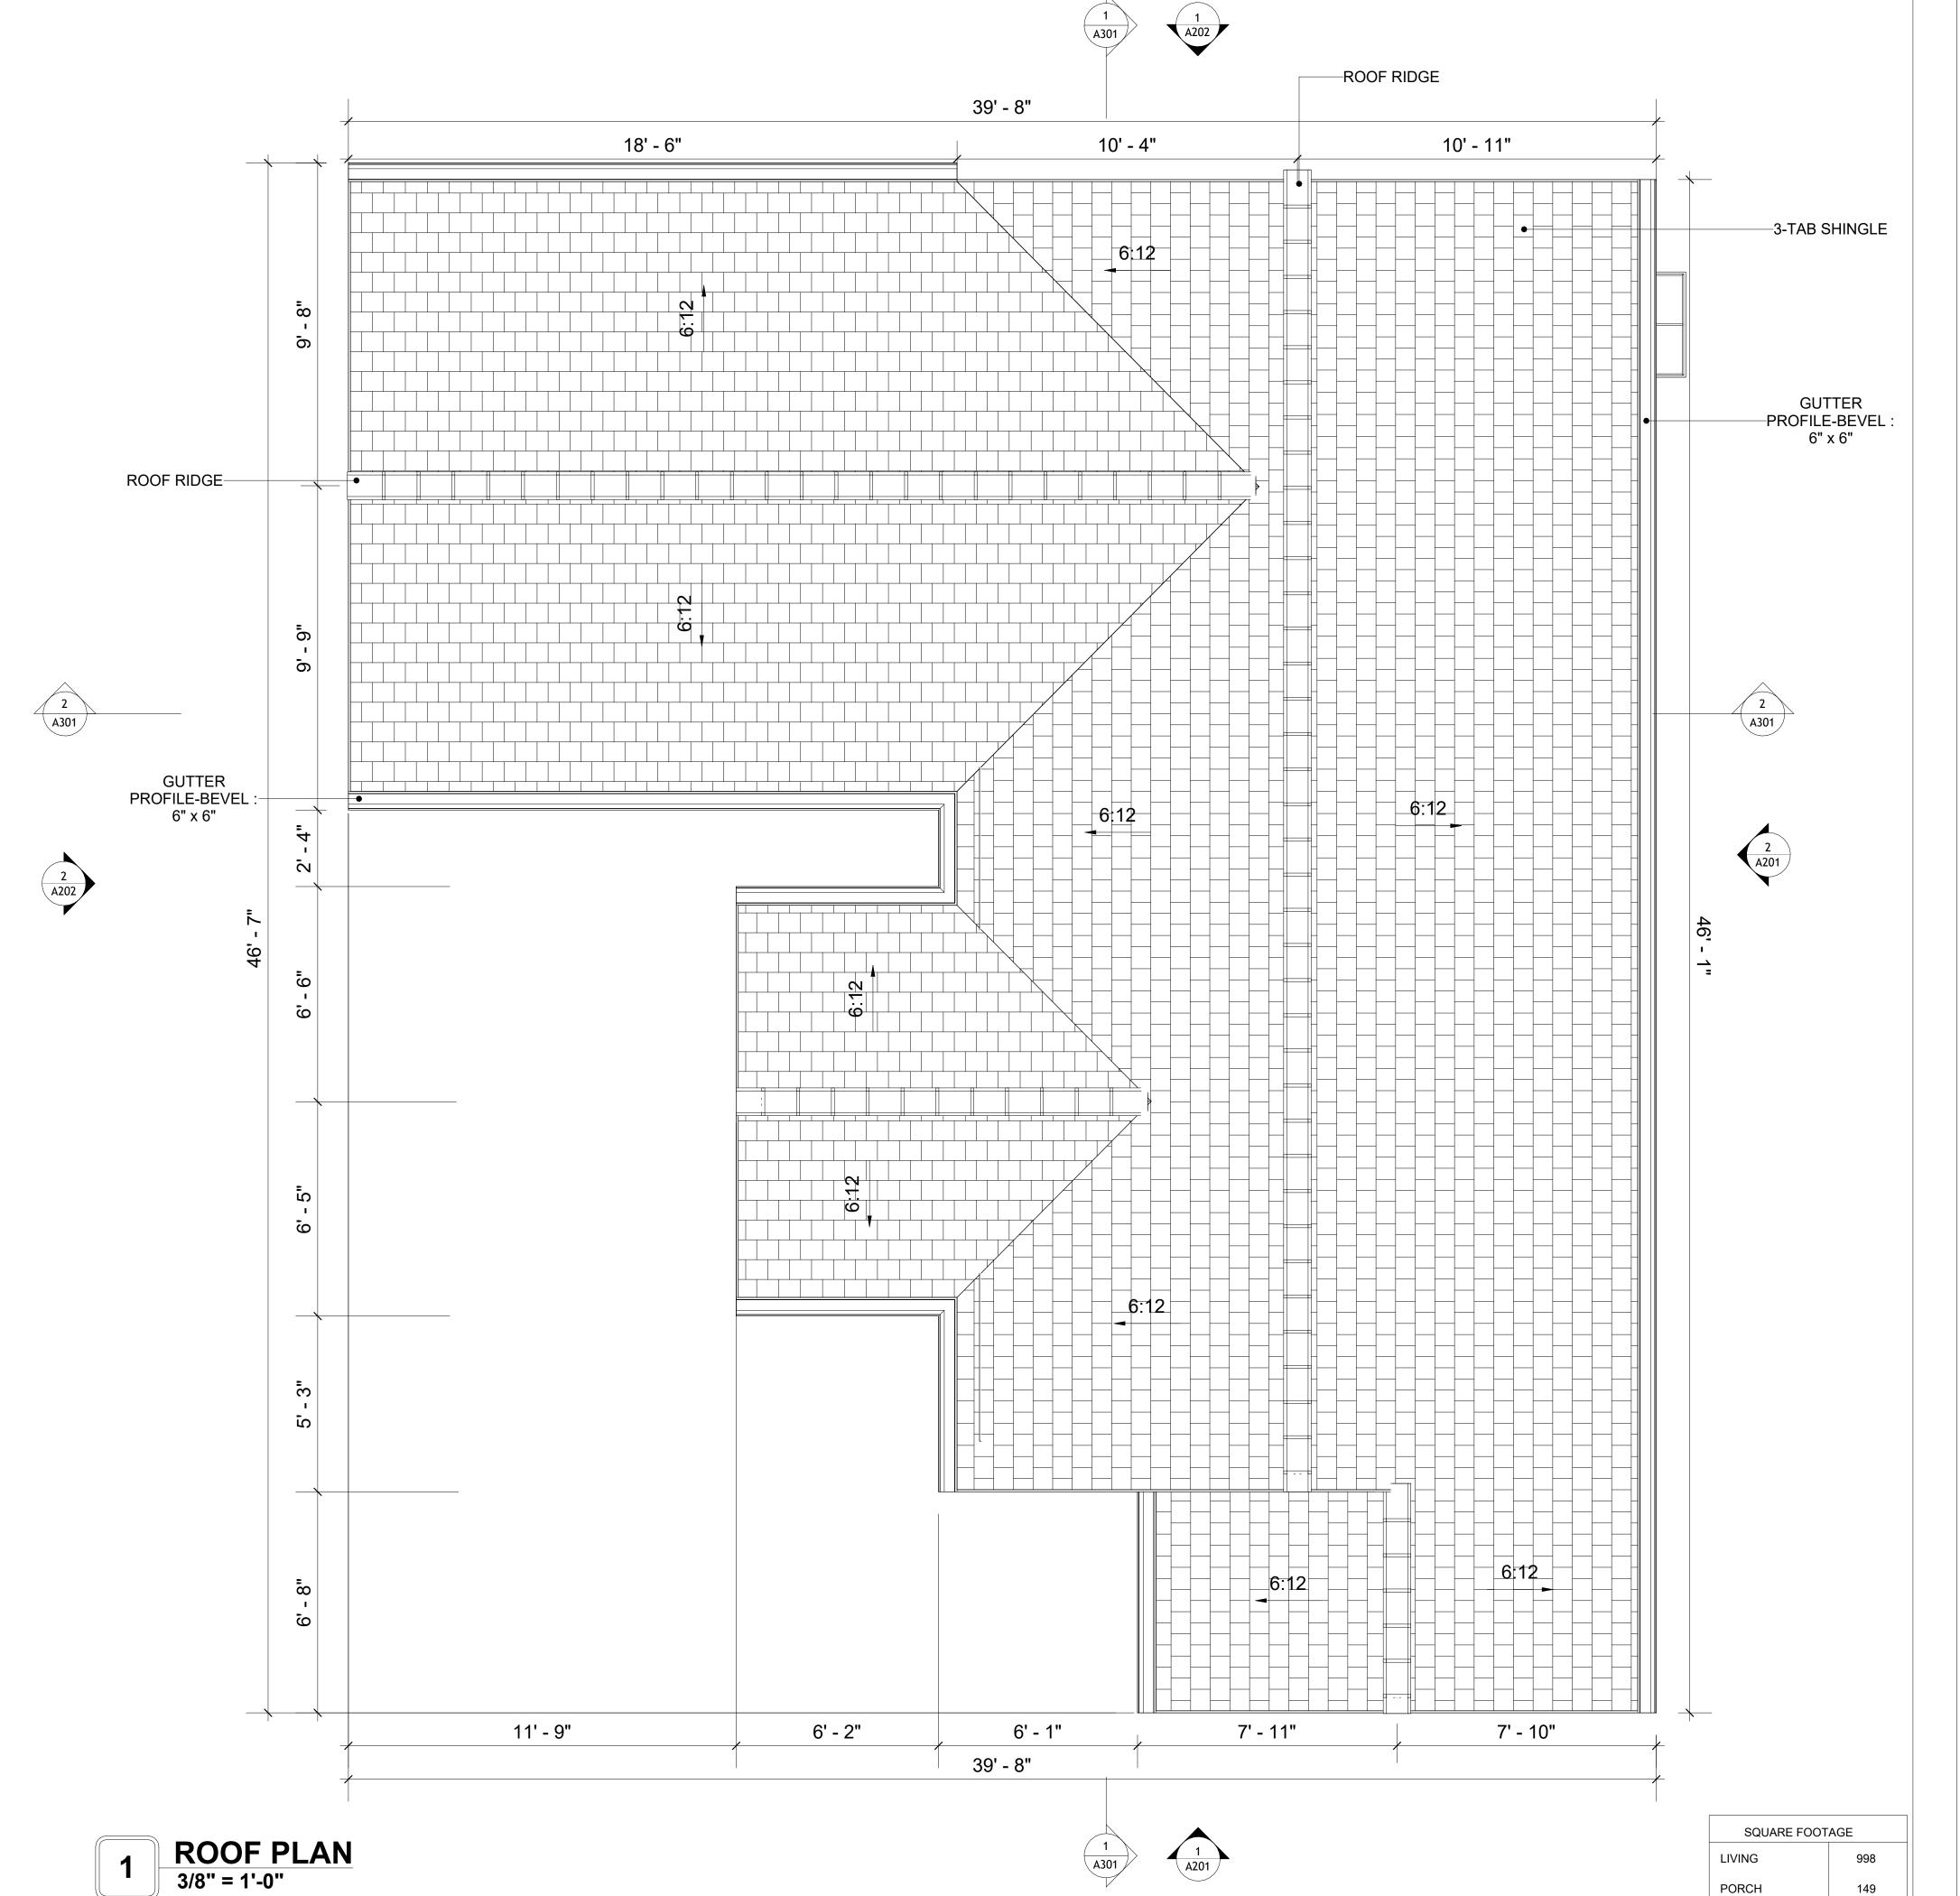



KEY PLAN

NO.	DESCRIPTION	DATE

NOTE:

LEGEND:

PROJECT

58-Hamilton-1000-2Bd/2Ba Ranch 550

DRAWING NAME

ROOF PLAN

Client Name CLIENT NAME: 0061_12 PROJECT NUMBER: 2/17/2025 12:29:36 PM DESIGNED BY: Designer DRAWN BY: **Author** Checker CHECKED BY:

A103

SCALE: As indicated

TOTAL

1147

ABOUT WALL FINISHING

CORRUGATED IRON SHEET

CORRUGATED IRON IS A FINISHING MATERIAL MADE FROM STEEL THAT HAS BEEN GALVANIZED (COATED WITH A THIN LAYER OF ZINC) TO PROTECT IT FROM CORROSION AND RUST.

IN THIS SPECIFIC PROJECT, THE CORRUGATED IRON SHEETS ARE INSTALLED HORIZONTALLY ON VERTICAL FURRING STRIPS THAT ARE DIRECTLY ATTACHED ONTO THE PROPERLY INSTALLED AND SEALED HOME WRAP, USING SELF-DRILLING SCREWS THAT ARE DRIVEN THROUGH THE RIDGES OR VALLEYS OF THE CORRUGATIONS.

STUCCO FINISH

STUCCO IS A CEMENT-BASED EXTERIOR WALL FINISH THAT OFFERS A DURABLE, WEATHER-RESISTANT, AND CUSTOMIZABLE CLADDING SOLUTION FOR BUILDINGS.

IN THIS SPECIFIC PROJECT, AMERICAN STUCCO SYSTEMS IS USED AS A FINISH MATERIAL BECAUSE IT IS GENERALLY CONSIDERED A WATER-RESISTANT EXTERIOR FINISH AND USES A THREE-COAT APPLICATION PROCESS.

3/8-INCH OF IT IS APPLIED AS AN EXTERNAL WALL FINISH AS IT IS THE MOST COMMON AND WIDELY ACCEPTED STANDARD THICKNESS FOR STUCCO EXTERIOR WALL FINISHES. THIS MULTI-LAYER APPROACH ALSO HELPS CREATE A STRONG, CRACK-RESISTANT STUCCO SURFACE.

THIS STANDARD STUCCO IS APPLIED OVER OSB SHEATHINGS (FOR COLD FORMED STRUCTURE CONSTRUCTION).


IT IS NOT DIRECTLY TROWELED OVER THE OSB BUT OVER A WATER-RESISTANT BARRIER (HOMEWRAP) AND METAL/PLASTIC LATH THAT ARE INSTALLED ON TOP SURFACE OF THE OSB TO PROVIDE AN ADDITIONAL LAYER OF PROTECTION AGAINST MOISTURE INTRUSION.

REGULAR INSPECTION AND PROMPT REPAIR OF ANY CRACKS, CHIPS, OR DAMAGE TO THE STUCCO FINISH IS IMPORTANT. THIS MAINTAINS THE STUCCO'S WATER-RESISTANT PROPERTIES OVER THE BUILDING'S LIFE SPAN.


CEDAR WOOD

CEDAR WOOD REFERS TO THE WOOD FROM VARIOUS SPECIES OF CEDAR TREES, WHICH ARE CONIFEROUS EVERGREEN TREES KNOWN FOR THEIR DISTINCT AROMA AND NATURAL RESISTANCE TO DECAY AND INSECTS.

IN THIS SPECIFIC PROJECT, CEDAR WOOD IS USED A FINISH MATERIAL ON BEAMS AND COLUMNS.

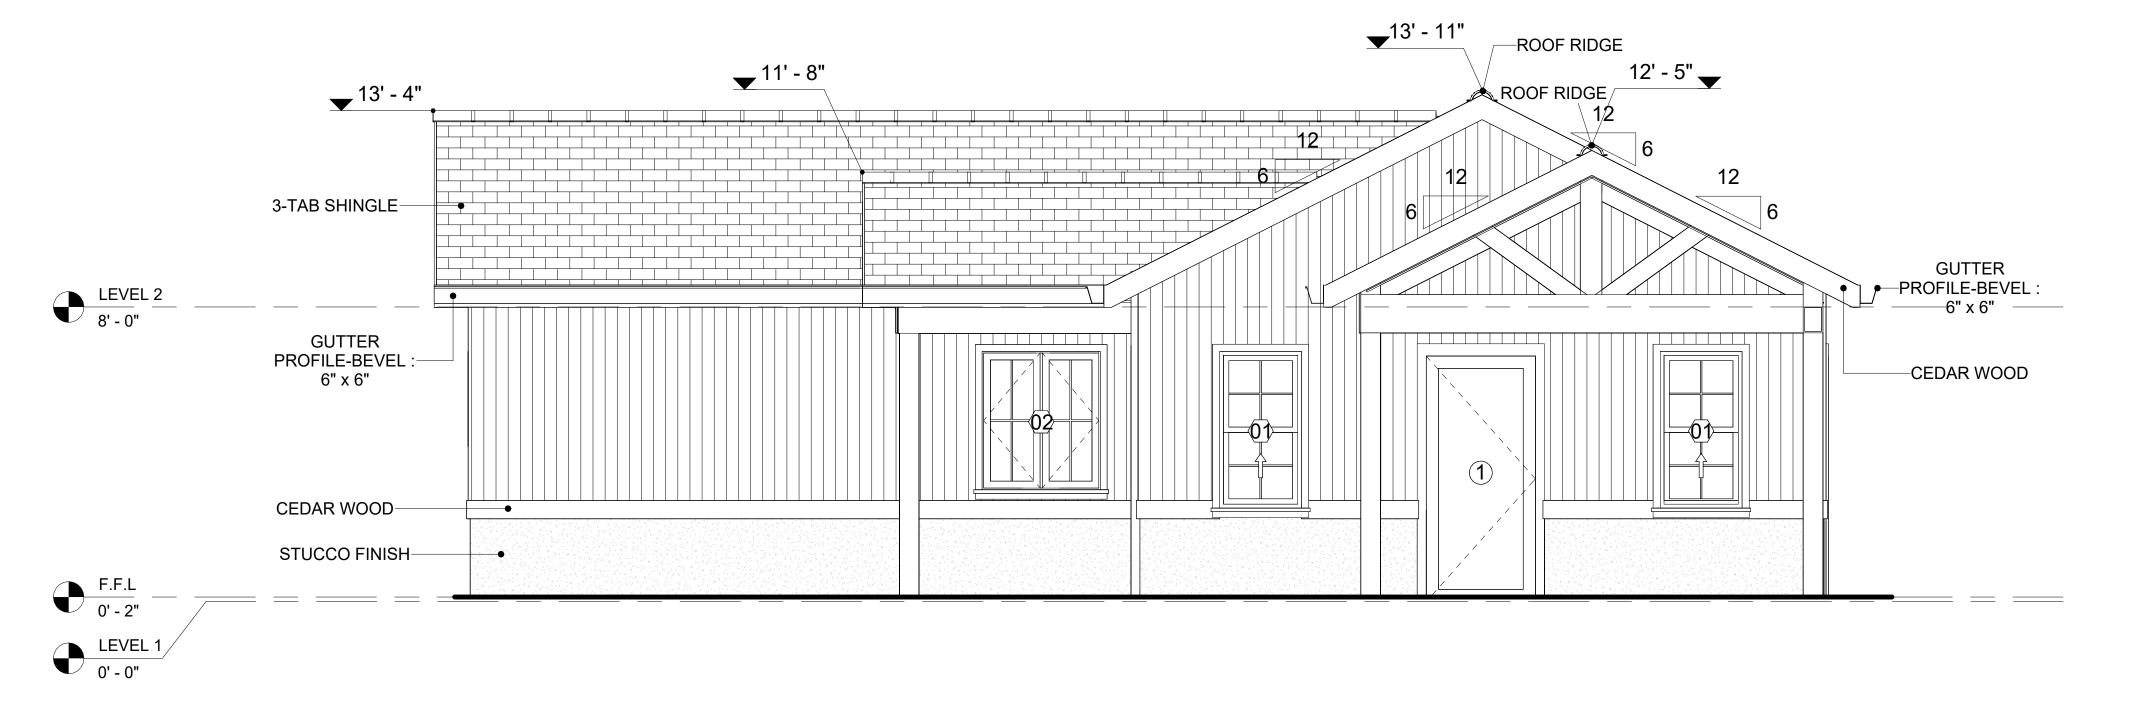

1 FRONT ELEVATION
3/8" = 1'-0"

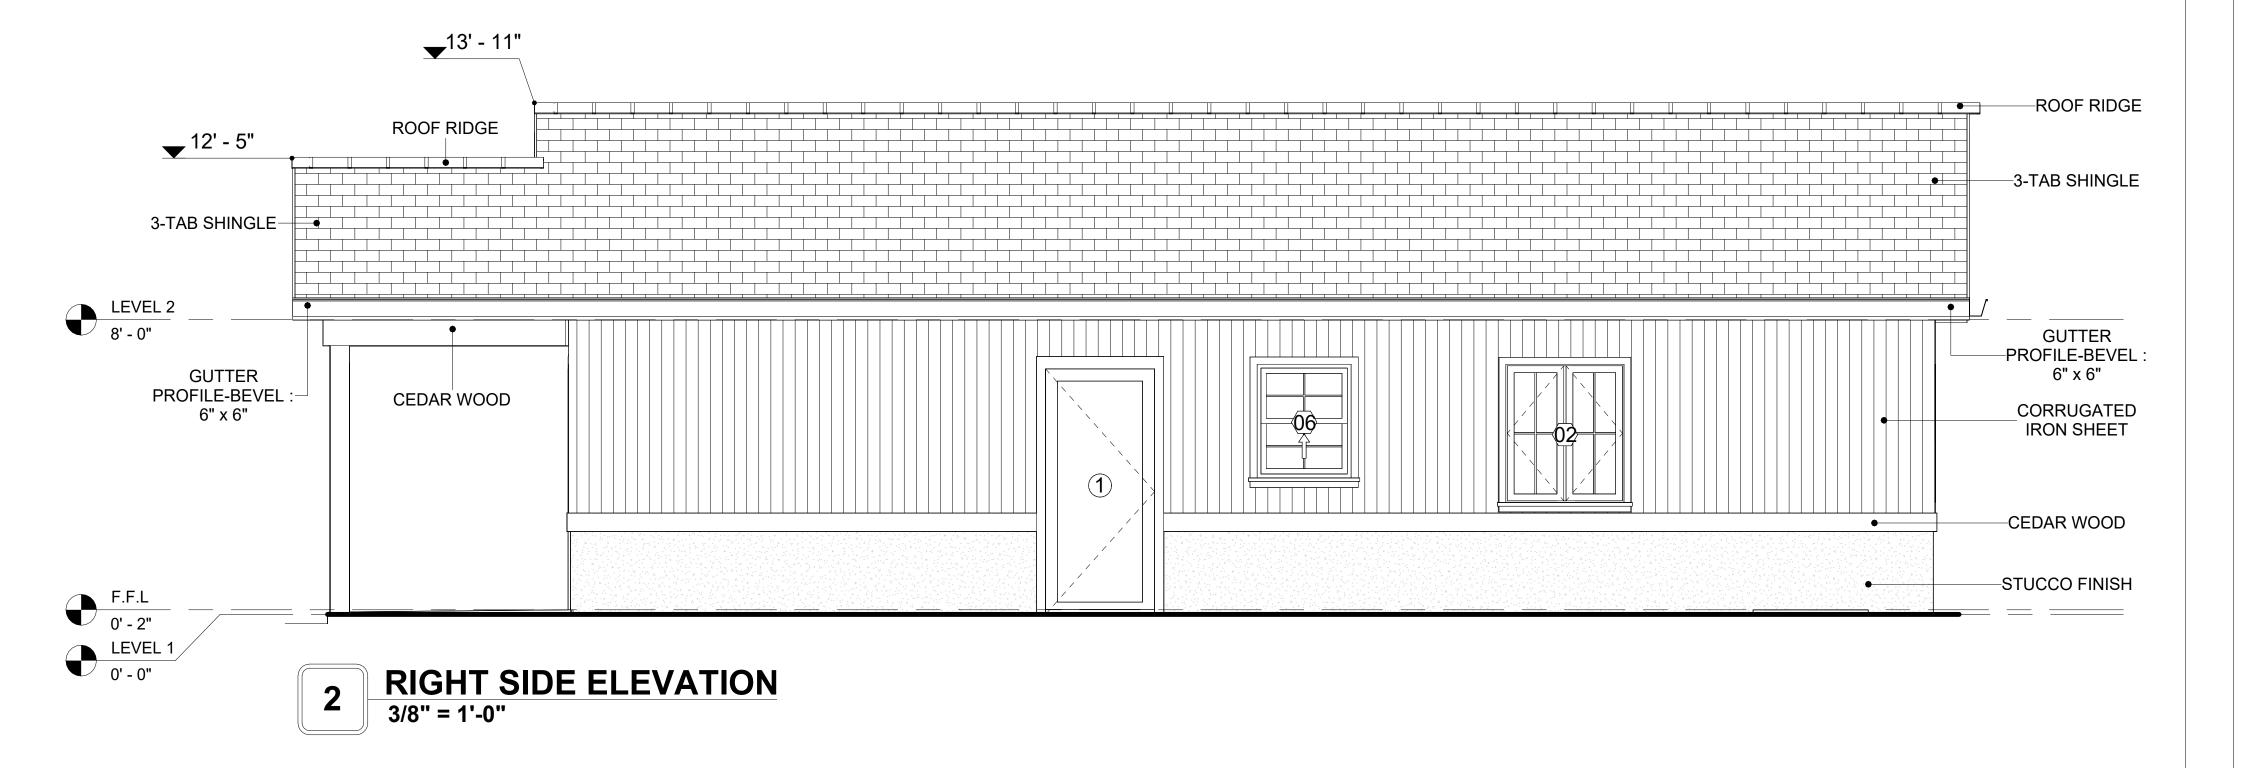


		DOOR SCH	DULE			
TYPE				S	SIZE	
MAR K	SUPPLIER	DOOR TYPE	LOCATIO N	WIDTH	HEIGHT	COUNT
1	HOME DEPOT	EXTERIOR SINGLE PANEL SWINGING	INTERIOR	3' - 0"	6' - 8"	2
2	HOME DEPOT	INTERIOR SINGLE PANEL SWINGING	INTERIOR	2' - 6"	6' - 8"	2
 3	HOME DEPOT	INTERIOR SINGLE PANEL SWINGING	INTERIOR	3' - 0"	6' - 8"	2
4	HOME DEPOT	INTERIOR DOUBLE PANEL SLIDING	INTERIOR	7' - 4"	6' - 8"	1
5	HOME DEPOT	DOOR-BIFOLD_9052	INTERIOR	6' - 0"	6' - 8"	1
6	HOME DEPOT	INTERIOR DOUBLE PANEL SLIDING	INTERIOR	6' - 0"	6' - 8"	2
7	HOME DEPOT	EXTERIOR DOUBLE PANEL SWINGING	INTERIOR	5' - 0"	6' - 8"	1

		WINDOV	SCHEDULE		
				SIZE	
TYPE MARK	SUPPLIER	WINDOW TYPE	WIDTH	HEIGHT	COUNT
01	HOME DEPOT	SINGLE HUNG	2' - 3"	4' - 3"	2
02	HOME DEPOT	FIXED	3' - 3"	3' - 9"	3
03	HOME DEPOT	FIXED	3' - 1"	2' - 1"	2
04	HOME DEPOT	FIXED	2' - 7"	2' - 7"	2
05	HOME DEPOT	SINGLE HUNG	2' - 7"	3' - 9"	1
06	HOME DEPOT	SINGLE HUNG	2' - 7"	3' - 1"	1
07	HOME DEPOT	SLIDING	6' - 3"	3' - 9"	1



KEY PLAN

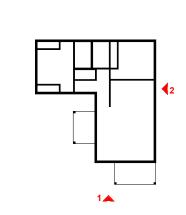

NO.	DESCRIPTION	DATE

NOTE:

LEGEND:

PROJECT

58-Hamilton-1000-2Bd/2Ba Ranch 550

DRAWING NAME

ARCHITECTURAL ELEVATIONS

CLIENT NAME:	Client Name
PROJECT NUMBER:	0061_12
DATE:	2/17/2025 12:29:40 PM
DESIGNED BY:	Designer
DRAWN BY:	Author
CHECKED BY:	Checker

A201

ABOUT WALL FINISHING

CORRUGATED IRON SHEET

CORRUGATED IRON IS A FINISHING MATERIAL MADE FROM STEEL THAT HAS BEEN GALVANIZED (COATED WITH A THIN LAYER OF ZINC) TO PROTECT IT FROM CORROSION AND RUST.

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THIS STANDARD STUCCO IS APPLIED OVER OSB SHEATHINGS (FOR COLD FORMED STRUCTURE CONSTRUCTION).


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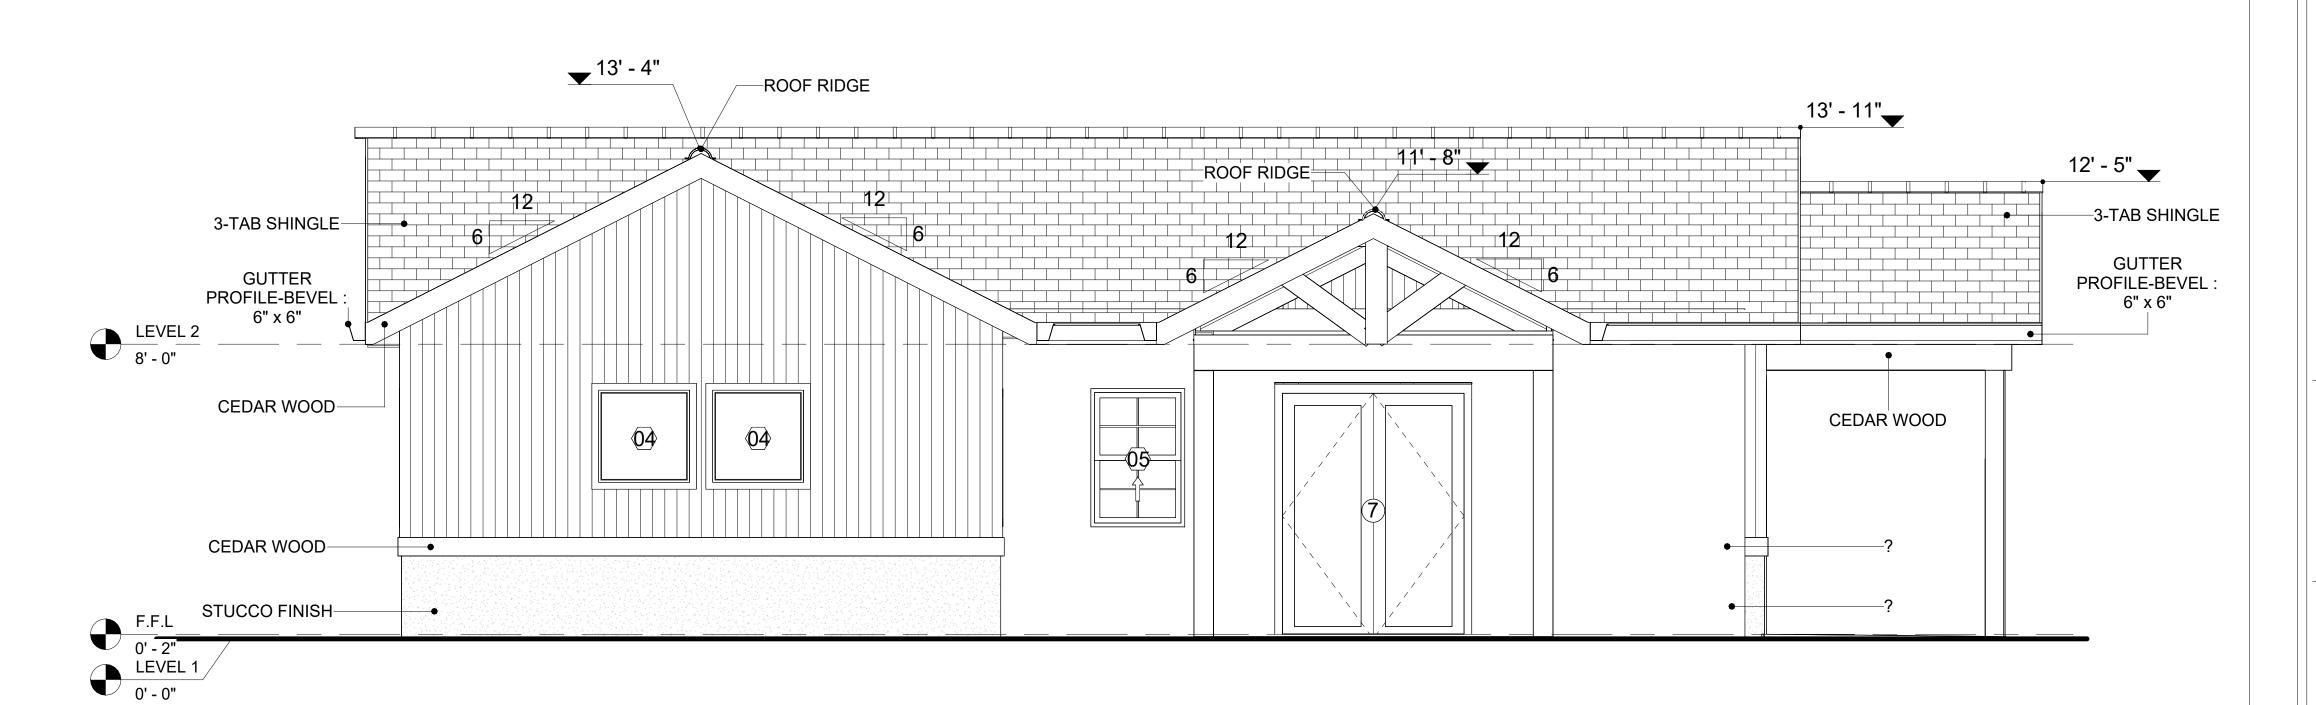
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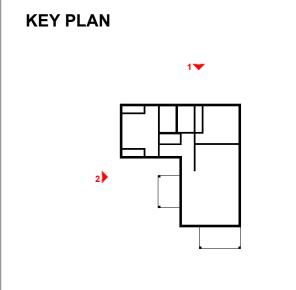
IN THIS SPECIFIC PROJECT, CEDAR WOOD IS USED A FINISH MATERIAL ON BEAMS AND COLUMNS.





2 LEFT SIDE ELEVATION
3/8" = 1'-0"



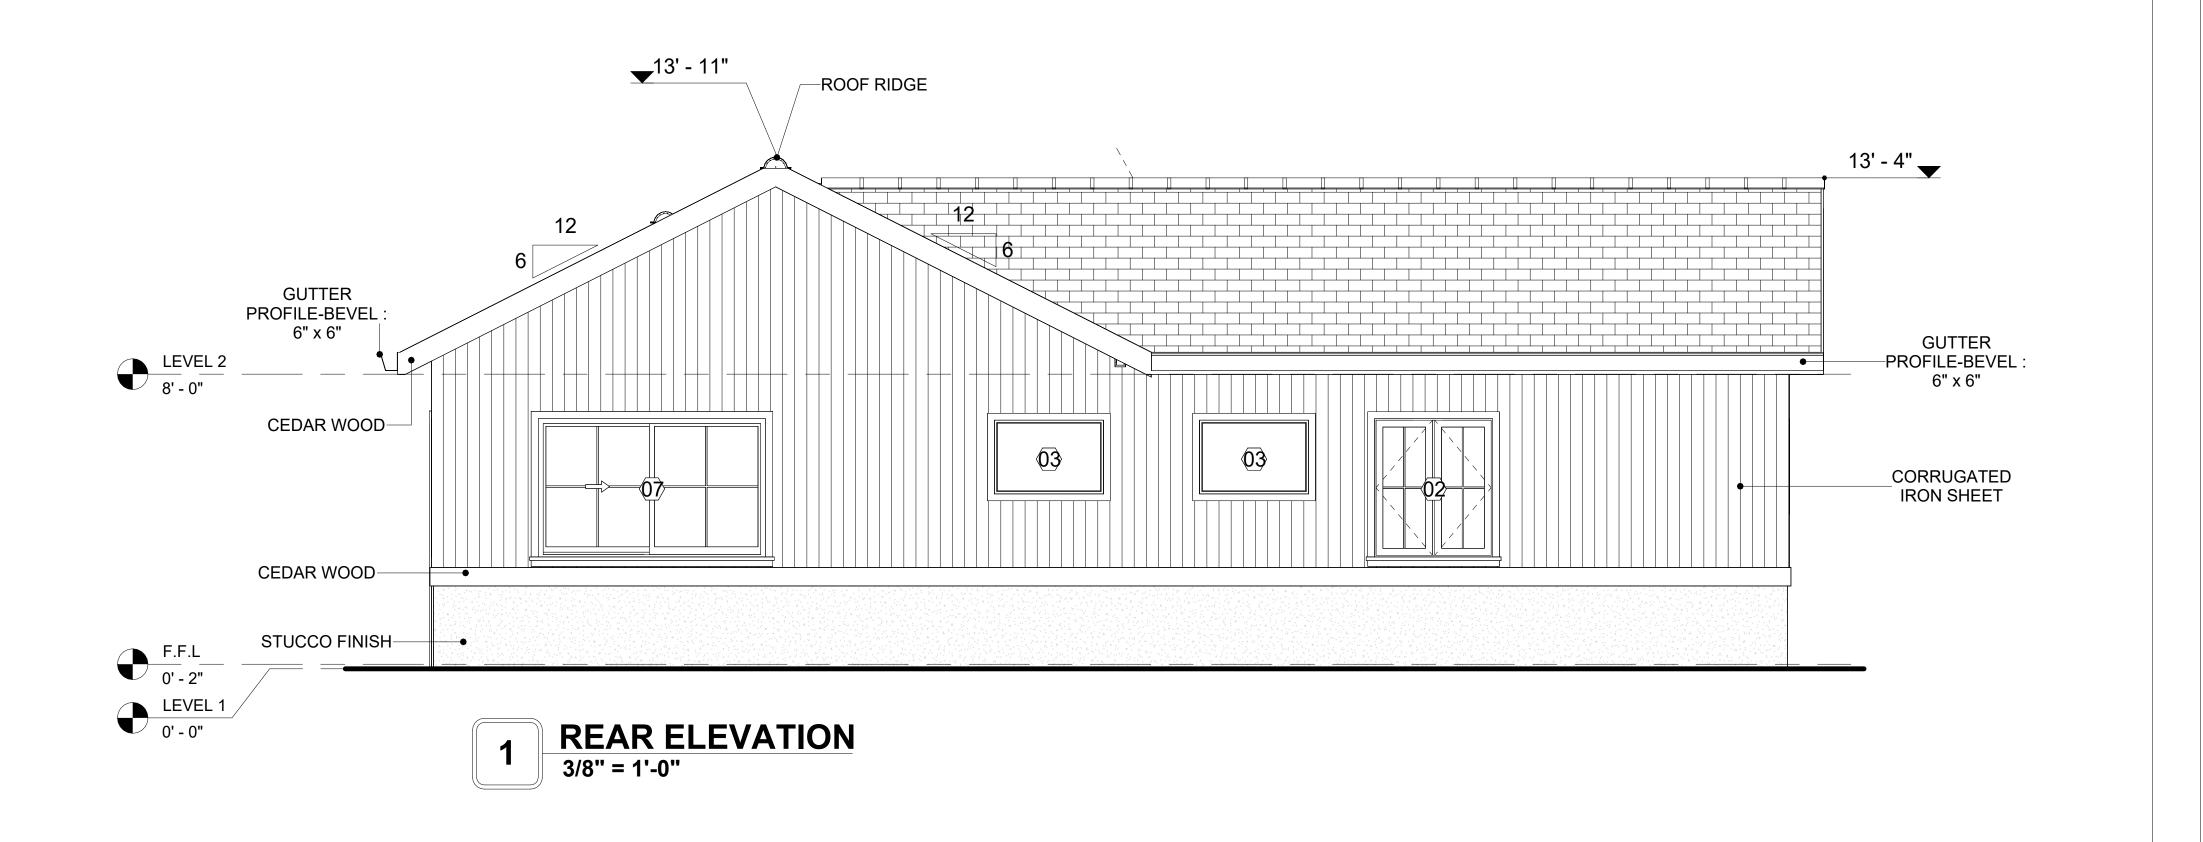

NO.	DESCRIPTION	DATE

NOTE:

LEGEND:

PROJECT

58-Hamilton-1000-2Bd/2Ba Ranch 550

DRAWING NAME

ARCHITECTURAL ELEVATIONS

CLIENT NAME: Client Name
PROJECT NUMBER: 0061_12


DATE: 2/17/2025 12:29:44 PM

DESIGNED BY: Designer

DRAWN BY: Author


CHECKED BY: Checker

A202

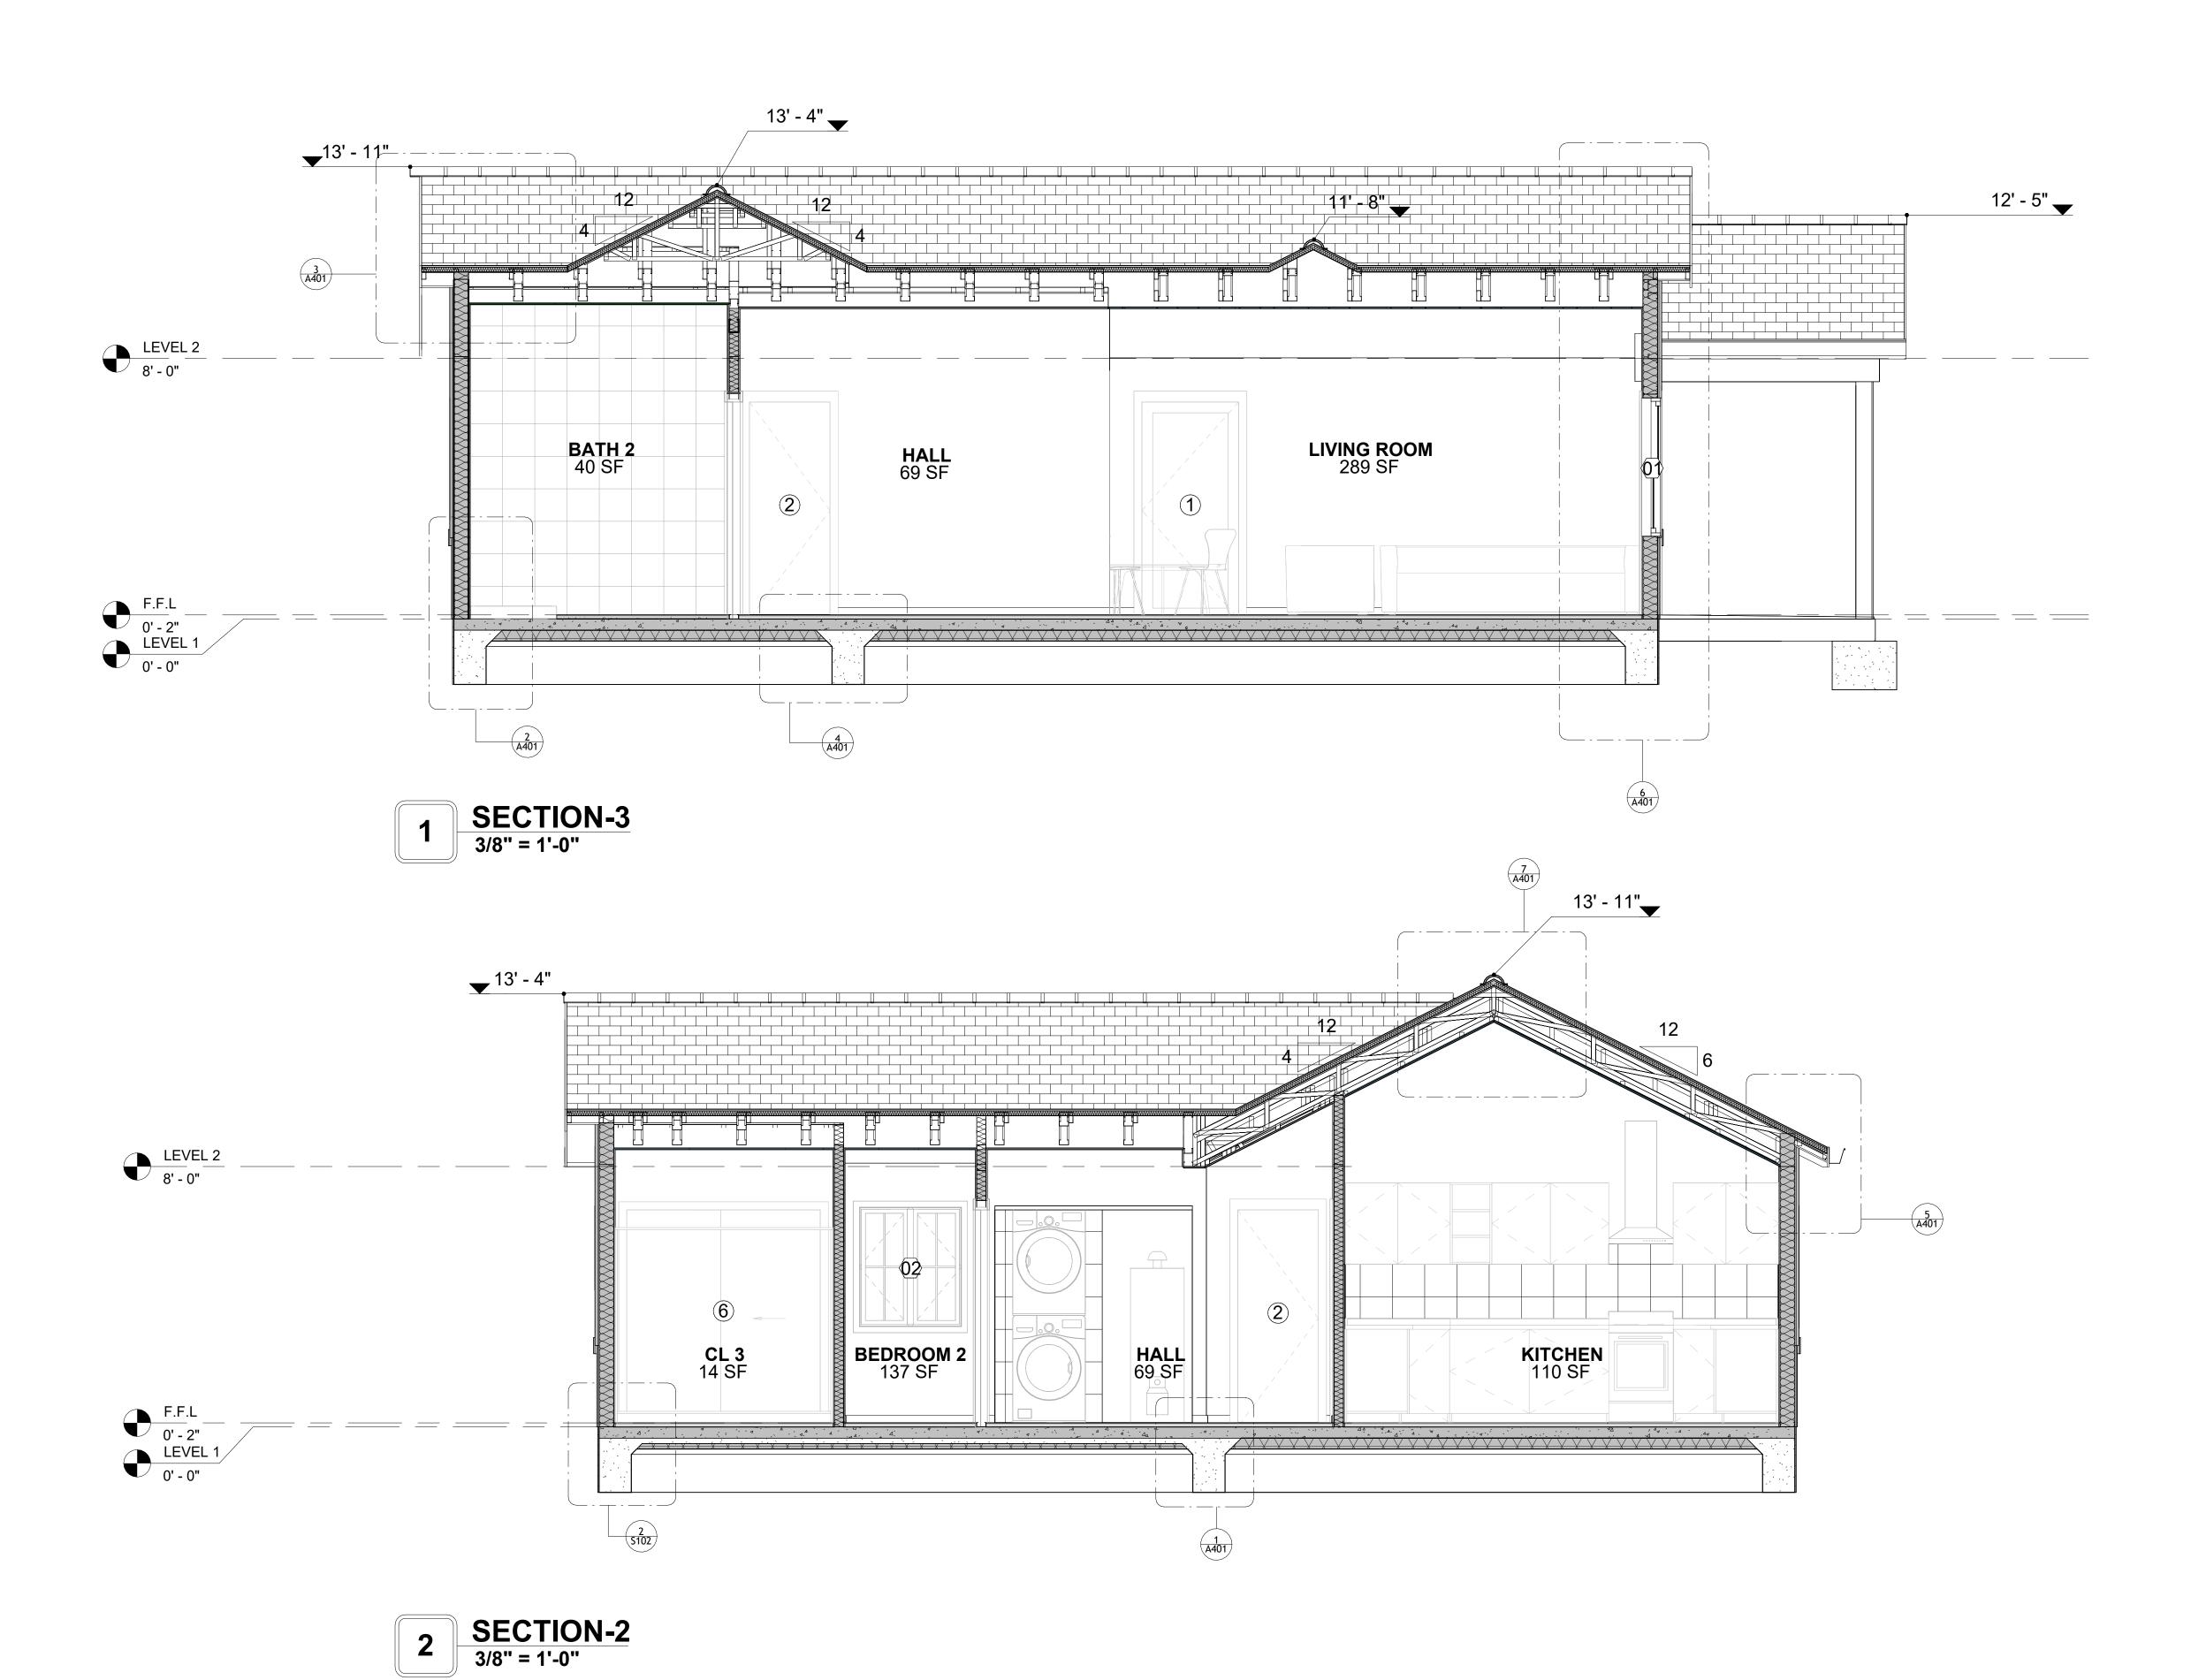



KEY PLAN

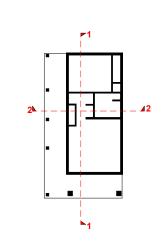

NO.	DESCRIPTION	DATE

NOTE:

LEGEND:

PROJECT


58-Hamilton-1000-2Bd/2Ba Ranch 550


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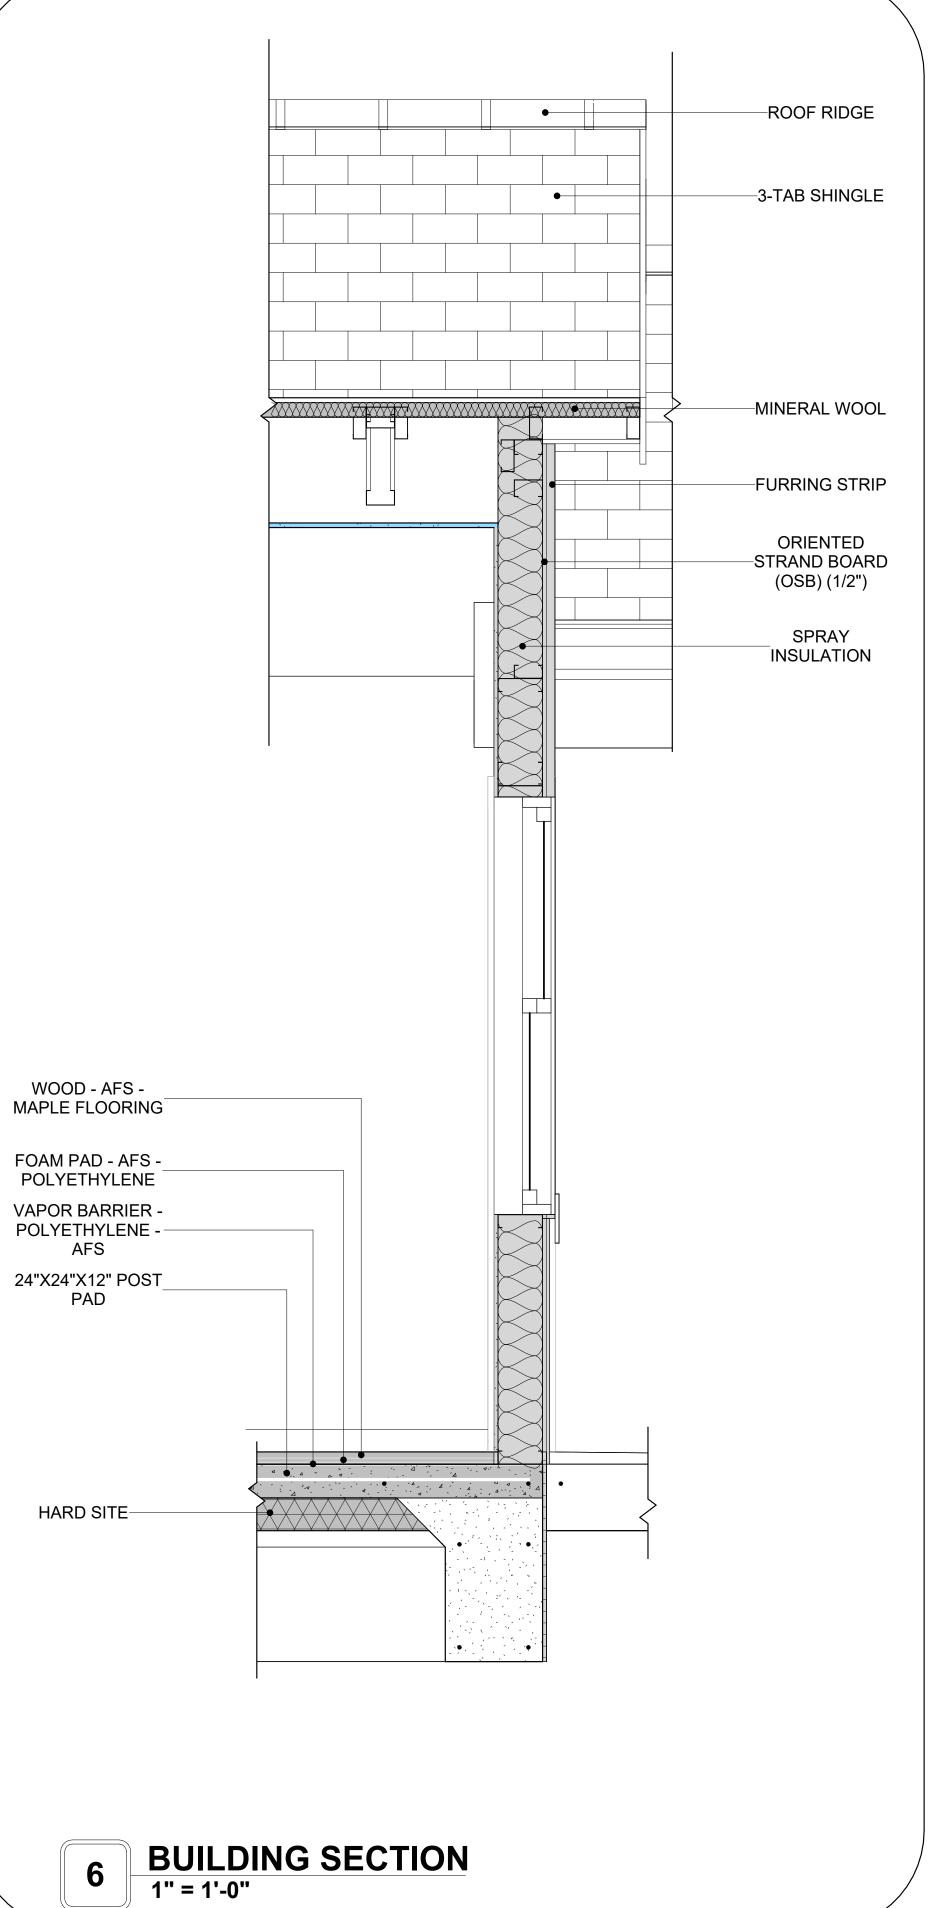
ARCHITECTURAL SECTIONS


Client Name	CLIENT NAME:
0061_12	PROJECT NUMBER:
2/17/2025 12:29:46 PM	DATE:
Designer	DESIGNED BY:
Author	DRAWN BY:
Checker	CHECKED BY:

A301




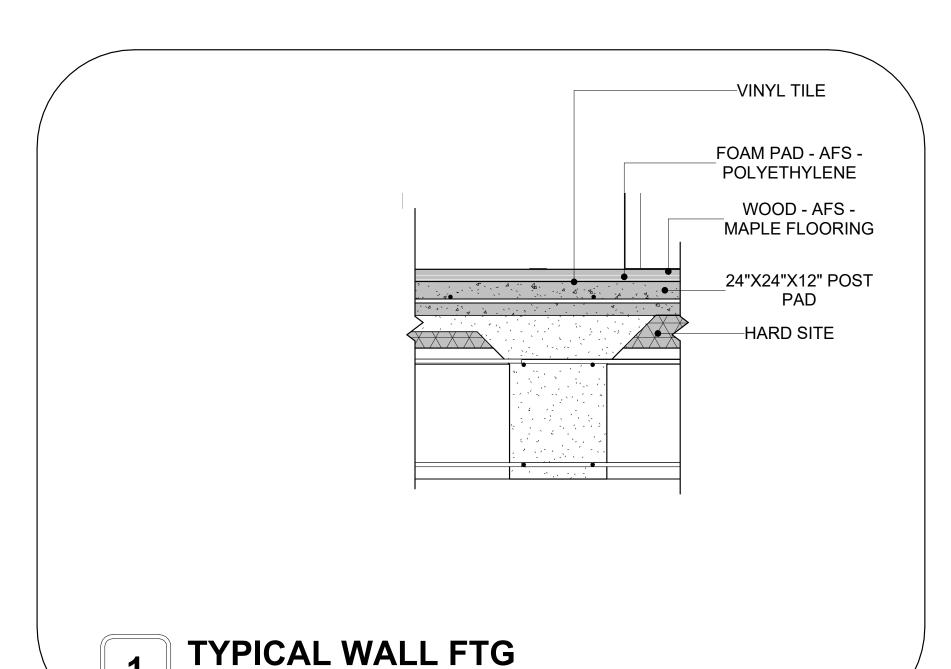


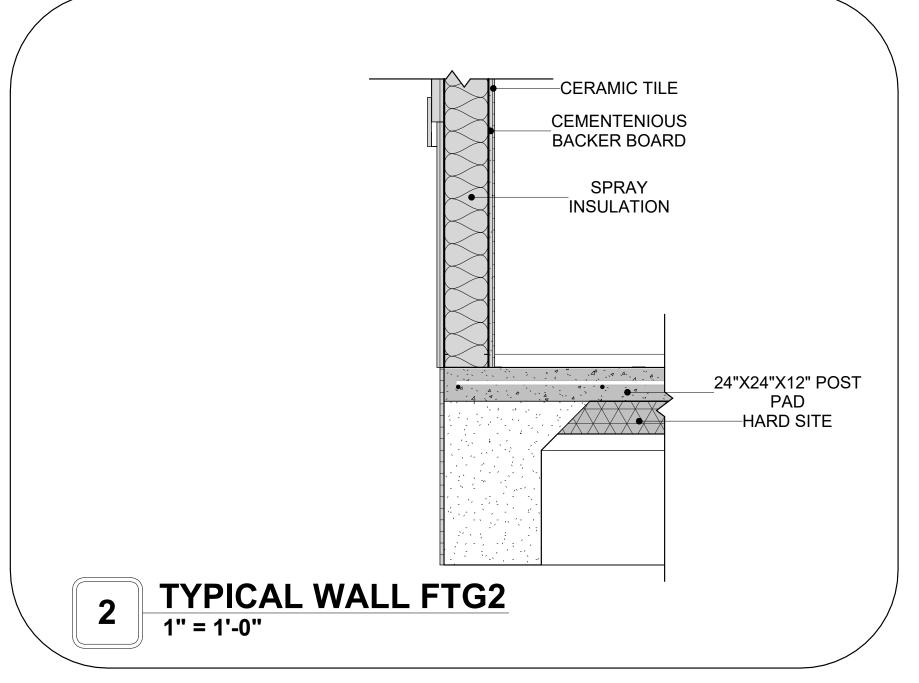


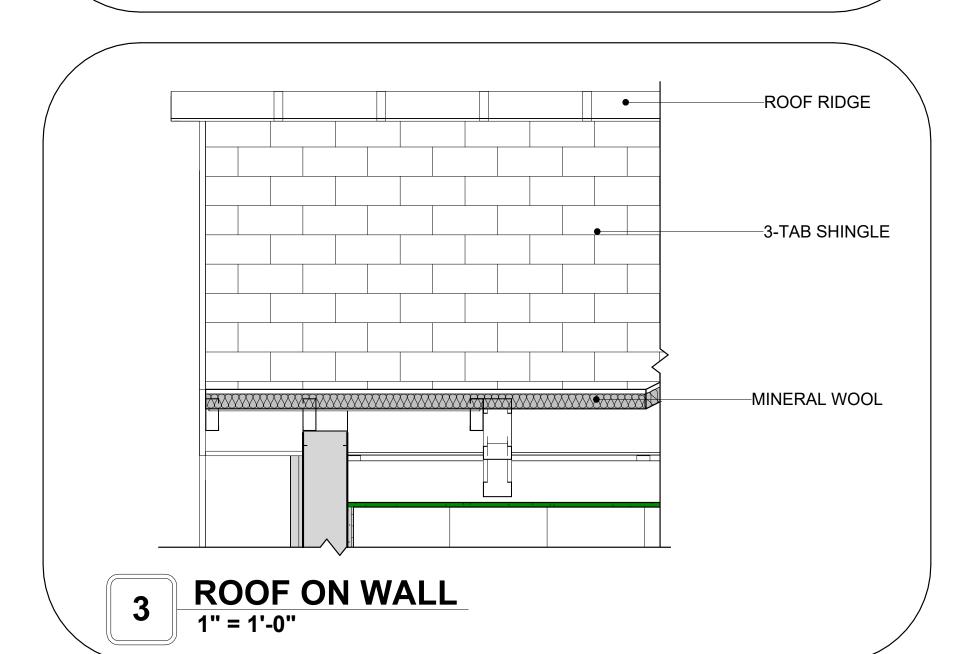


1" = 1'-0"

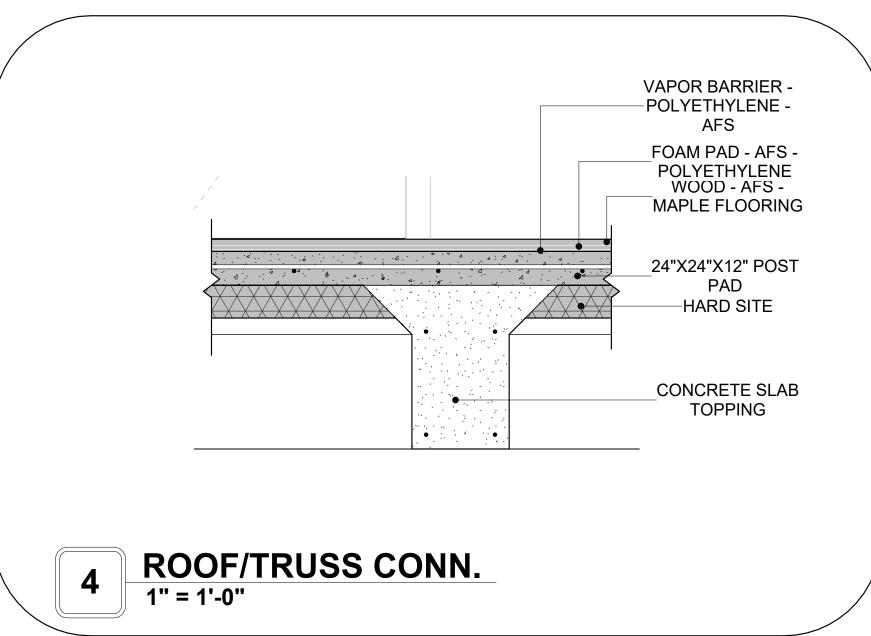

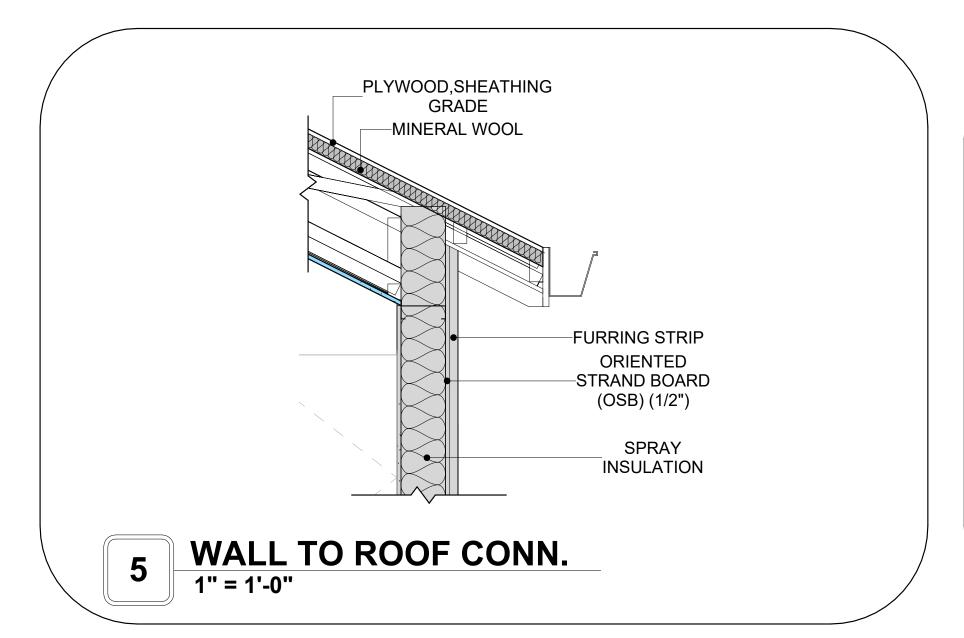

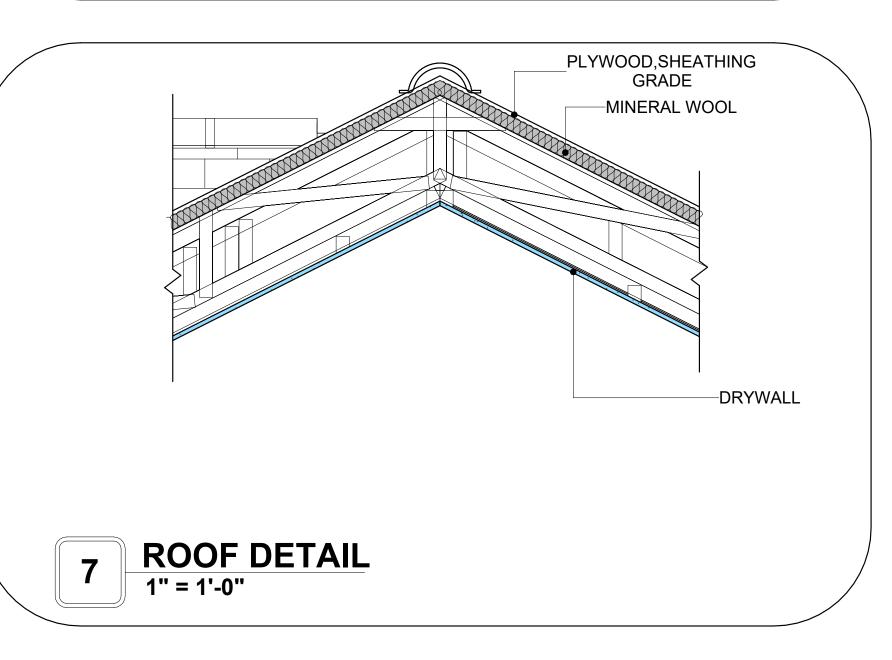

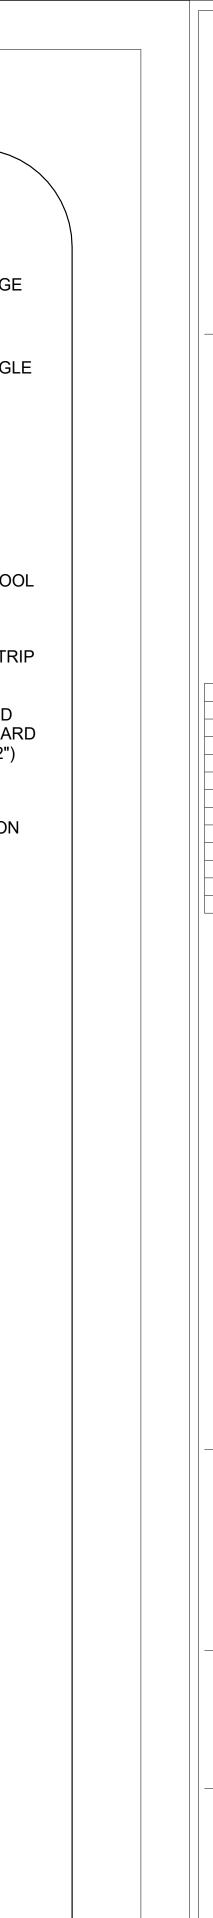

Tuscon,AZ, USA
888-864-0184
inquire@frameupnow.com
www.frameupnow.com

KEY PLAN

NO.	DESCRIPTION	

NOTE:

LEGEND:

PROJECT

58-Hamilton-1000-2Bd/2Ba Ranch 550

DRAWING NAME

ARCHITECTURAL DETAILS

CLIENT NAME:	Client Name
PROJECT NUMBER:	0061_12
DATE:	2/17/2025 12:29:46 PM
DESIGNED BY:	Designer
DRAWN BY:	Author
CHECKED BY:	Checker

A401


SCALE: 1" = 1'-0"

CASEWORK GENERAL NOTES


- ALL CABINET HEIGHTS INCLUDE COUNTERTOPS. DIMENSIONS ARE TO THE NEAREST INCH. DIVISIONS IN CASEWORK ARE SHOWN FOR CLARITY AND DO NOT REPRESENT BREAKS IN THE COUNTERTOP.
- PROVIDE CONTINUOUS COUNTERTOP OVER ALL SIMILAR HEIGHT CASEWORK, UNLESS AND OTHERWISE NOTED.
- MANUFACTURER AND CATALOG NUMBERS ARE FOR REFERENCE AND ILLUSTRATION PURPOSES
- DOTTED LINES INDICATE WALL HUNG CABINETS, DIVISIONS OF BASE CABINETS BELOW THE
- COUNTERTOP, FURNITURE NOT IN THE CONTRACT OR PROJECTION SCREENS -SEE CASEWORK KEY AND SPECIFICATIONS.
- ALL CABINETS AND DRAWERS TO HAVE CAM LOCKS EXCEPT FOR SINK BASE CABINETS. ALL EXPOSED SURFACES (EXPOSED TO VIEW FROM ANY PERSPECTIVE) TO BE COVERED WITH
- LAMINATE. ALL CASEWORK WHICH MEETS A WALL AT ONE OR BOTH ENDS, TO BE PROVIDED WITH FILLER
- PANELS AND SCRIBED TO THE WALL(S) AS REQUIRED. 10. ALL CABINETS AND DRAWERS ARE PROVIDED WITH RECESSED HANDLES.
- 11. CONTRACTOR TO FIELD VERIFY ALL CLEAR OPENINGS PRIOR TO MILLWORK OR CASEWORK FABRICATION.
- 12. CASEWORK DRAWINGS ARE DIAGRAMMATIC IN NATURE TO SHOW DESIGN INTENT.


	CASEWORK SCHEDULE						
TYPE MAR K	TYPE	COUN T	HEIGHT	WIDTH	DEPTH	AREA	
0.4	01 0057 0 454			01 011	41 41	10.05	
01	CLOSET 3 154	1	6' - 0"	8' - 0"	1' - 4"	48 SF	
02	HD_WALL_FILLER_18 2 153	1	2' - 6"	1' - 3"	1' - 0"	3 SF	
03	VANITY	2	2' - 4"	2' - 6"	1' - 8"	6 SF	
04	LINEAR COUNTER TOP	1	0' - 4"	3' - 0"	2' - 1"	1 SF	
05	CLOSET 3 153	2	6' - 0"	6' - 9"	1' - 4"	41 SF	
06	WALL CABINET DOUBLE DOOR 2 158	1	2' - 6"	3' - 3"	1' - 0"	8 SF	
07	RECESSED_MED_CABINET	2	2' - 0"	1' - 6"	0' - 3"	3 SF	
08	LINEAR COUNTER TOP 2	1	0' - 4"	2' - 0"	2' - 1"	1 SF	
09	BASE CABINET L-SHAPED	2	2' - 11"	3' - 3"	3' - 3"	9 SF	
10	BASE CABINET DOUBLE DOOR 5	1	2' - 11"	2' - 6"	2' - 0"	7 SF	
11	HD_TALL_CABINET_24 3	1	7' - 6"	1' - 9"	2' - 0"	13 SF	
12	HD_L-SHAPE_COUNTER_TOP11	2	0' - 4"	9' - 7"	4' - 0"	3 SF	
13	HD_LINEAR_COUNTER_TOP 4	1	0' - 4"	4' - 11"	2' - 1"	2 SF	
14	WALL CABINET DOUBLE DOOR 2 59	1	2' - 6"	3' - 8"	1' - 0"	9 SF	
15	BASE CABINET DOUBLE DOOR 6	1	2' - 11"	4' - 11"	2' - 0"	14 SF	
16	LAUNDRY OPEN CABINET 5	1	1' - 9"	3' - 0"	2' - 4"	5 SF	
17	WALL CABINET DOUBLE DOOR 2 159	1	2' - 6"	3' - 3"	1' - 0"	8 SF	
GRAND	TOTAL	22		•	•	•	


SPECIALTY EQUIPMENT SCHEDULE					
TYPE MARK TYPE COUNT					
01	WASHER-FRONT-LOAD	1			
02	RANGE	1			
03	REFRIGERATOR	1			
04	DRYER-FRONT-LOAD	1			
05	DISHWASHER	1			
GRAND TOTAL: 5					

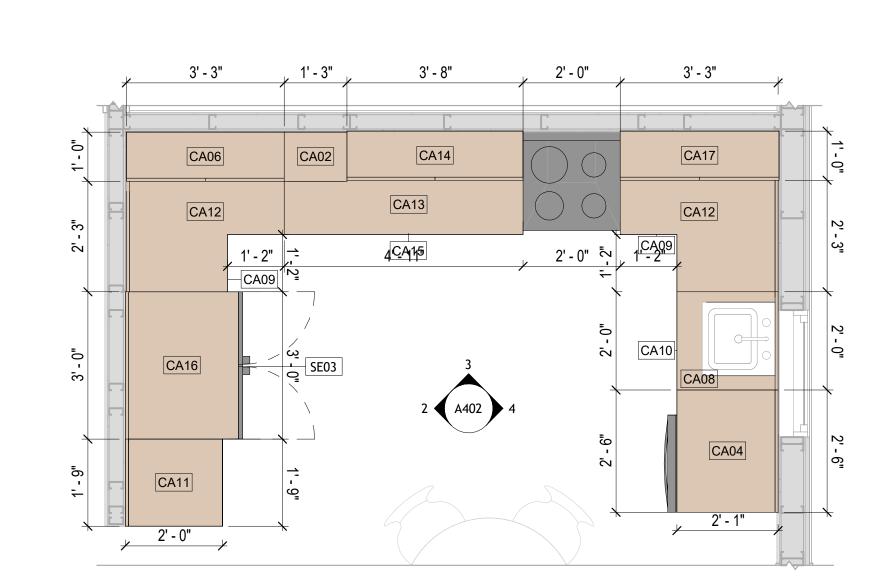


CASEWORK PLAN 1/2" = 1'-0"

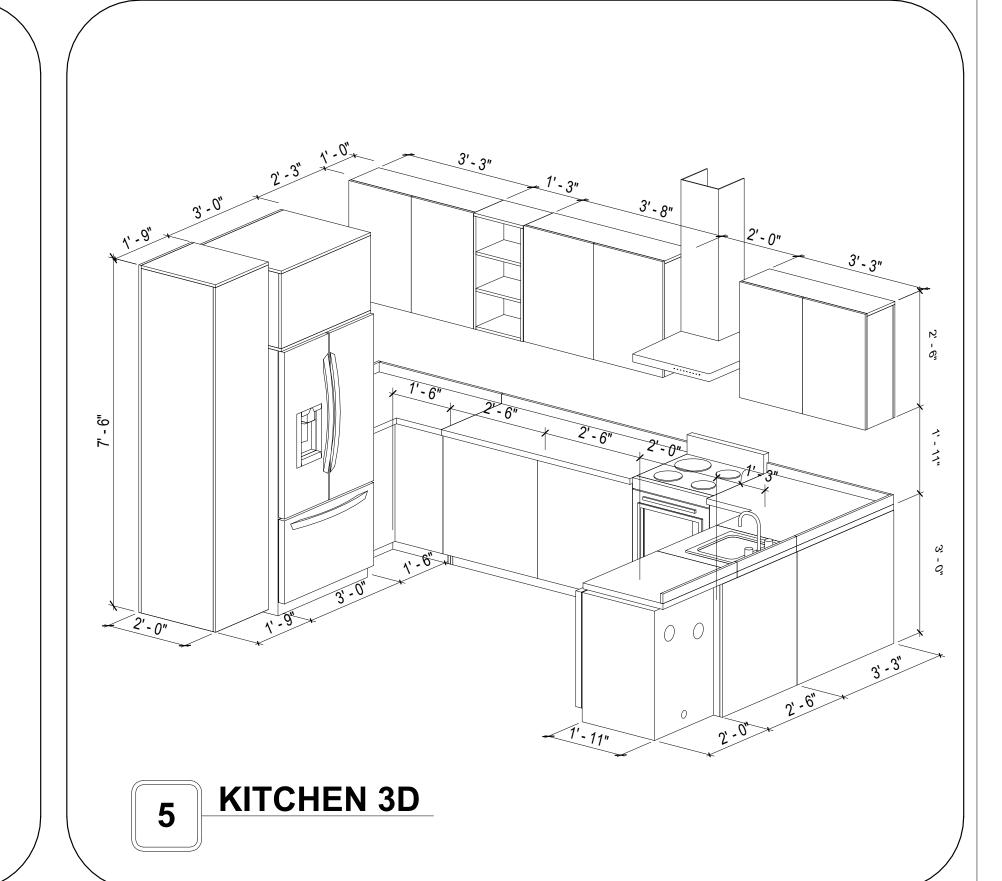


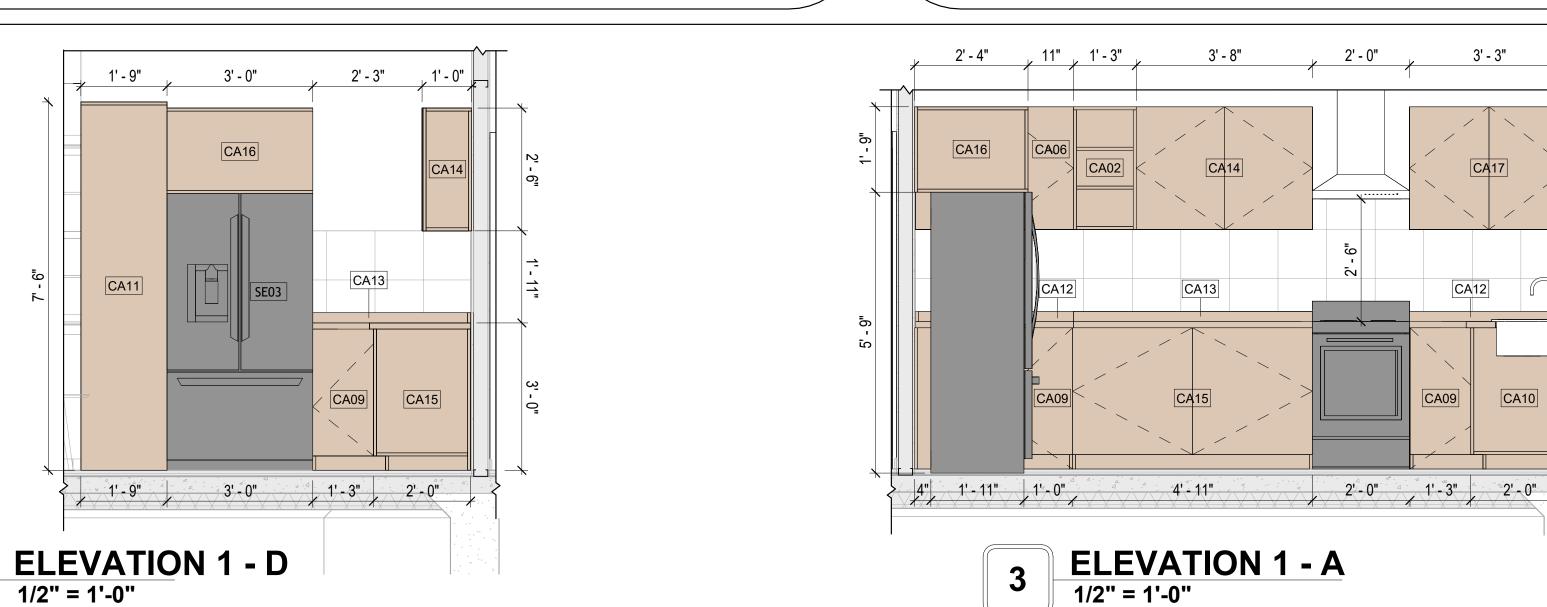

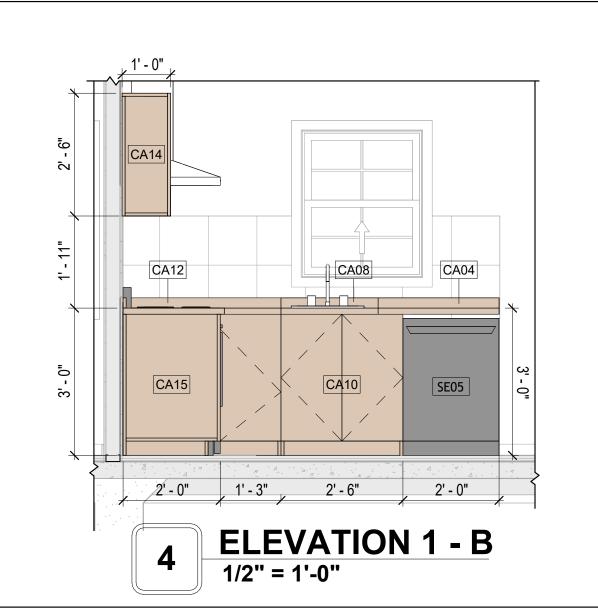

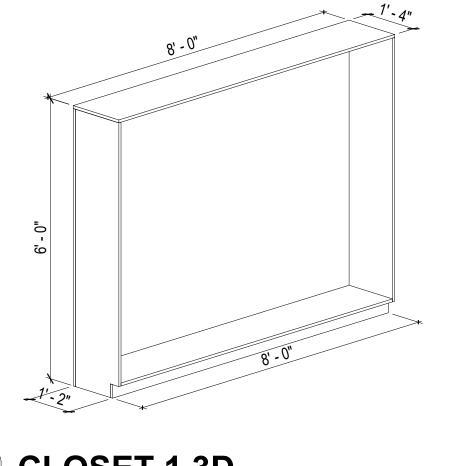

CLOSET 13D

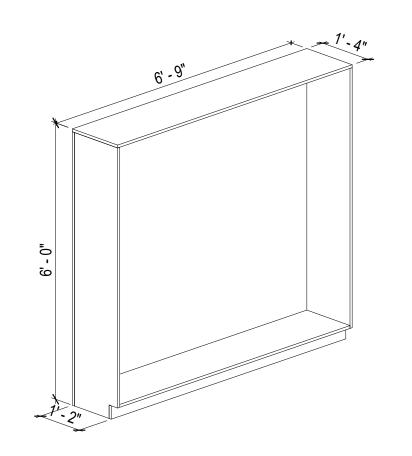

CA12


CA10

CA09

CLOSET 2 3D

Tuscon,AZ, USA 888-864-0184 inquire@frameupnow.com www.frameupnow.com

KEY PLAN

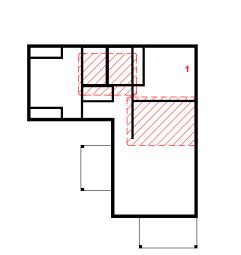

NO.	DESCRIPTION	DATE

NOTE:

LEGEND:

PROJECT


58-Hamilton-1000-2Bd/2Ba Ranch 550


DRAWING NAME

ARCHITECTURAL CASEWORK

Client Name CLIENT NAME: 0061_12 PROJECT NUMBER: 2/17/2025 12:29:49 PM DATE: Designer DESIGNED BY: **Author** DRAWN BY: CHECKED BY: Checker


A402

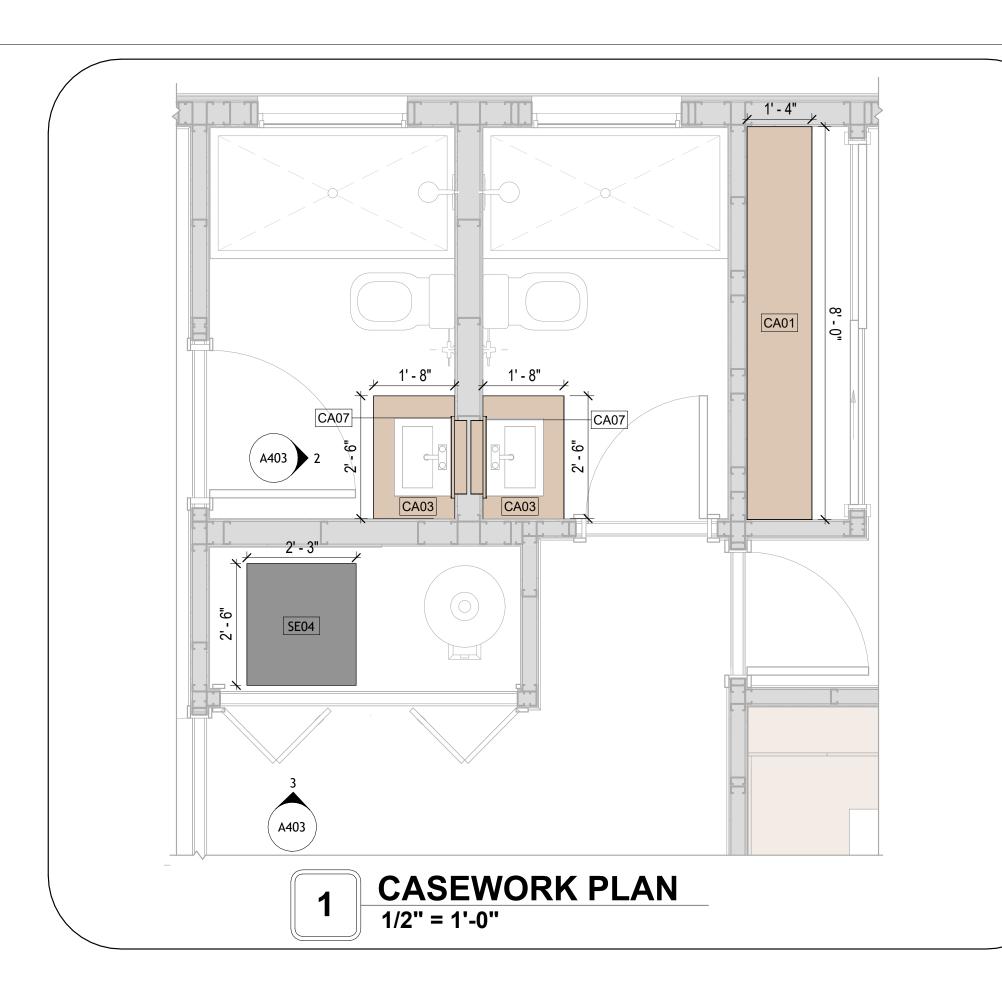

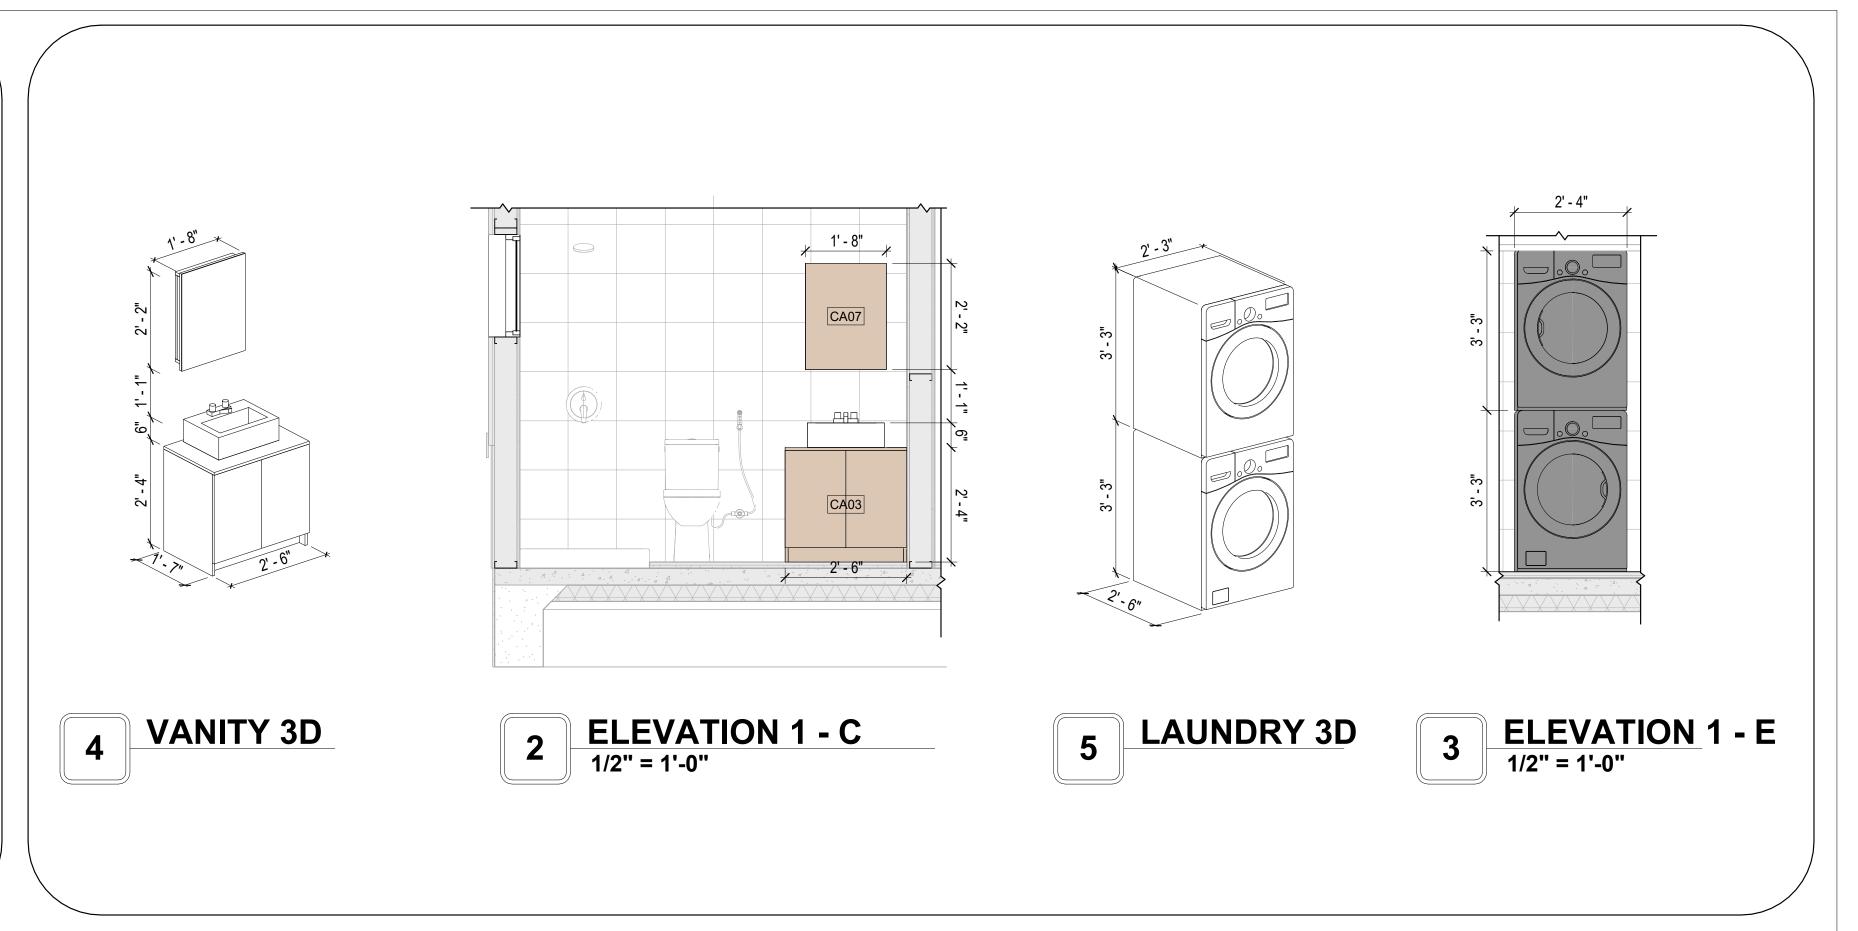



KEY PLAN

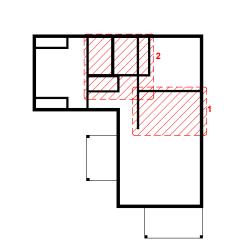

NO.	DESCRIPTION	DATE	

NOTE:

LEGEND:

PROJECT

58-Hamilton-1000-2Bd/2Ba Ranch 550

DRAWING NAME

ARCHITECTURAL CASEWORK 2

Client Name
0061_12
2/17/2025 12:29:50 PM
Designer
Author
Checker

A403

GENERAL NOTES

1. THIS DRAWING DEPICTS THE HVAC (HEATING, VENTILATION, AND AIR CONDITIONING) SYSTEM FOR THE HAMILTON 2BD 2BA RANCH. IT PROVIDES A VISUAL REPRESENTATION OF THE SYSTEM LAYOUT AND COMPONENTS.

2.THE HVAC SYSTEM IS DESIGNED TO MEET THE SPECIFIC REQUIREMENTS OF THE BUILDING, INCLUDING HEATING, COOLING, AND VENTILATION NEEDS, AS PER THE PROJECT SPECIFICATIONS AND APPLICABLE CODES AND STANDARDS.

3. THE HVAC SYSTEM INSTALLATION SHALL COMPLY WITH THE LATEST EDITION OF THE INTERNATIONAL MECHANICAL CODE (IMC), INTERNATIONAL RESIDENTIAL CODE (IRC), AND ALL OTHER APPLICABLE LOCAL, STATE, AND NATIONAL CODES AND REGULATIONS.

4. THE EQUIPMENT SHOWN ON THIS DRAWING INCLUDES BUT IS NOT LIMITED TO AIR HANDLING UNITS (AHUS), CHILLERS, BOILERS, COOLING TOWERS, PUMPS, DUCTWORK, DIFFUSERS, GRILLES, AND CONTROL DEVICES.

5. ALL EQUIPMENT, DUCTWORK, AND PIPING SHALL BE INSTALLED IN ACCORDANCE WITH MANUFACTURER'S SPECIFICATIONS, LOCAL CODES, AND INDUSTRY REST PRACTICES

6. ALL DUCTWORK SHALL BE SIZED, FABRICATED, AND INSTALLED IN ACCORDANCE WITH THE LATEST EDITION OF THE ACCA MANUAL D AND THE SMACNA HVAC DUCT CONSTRUCTION STANDARDS. DUCTWORK SHALL BE INSTALLED IN A NEAT AND WORKMANLIKE MANNER, PROPERLY SUPPORTED AND BRACED TO PREVENT SAGGING, AIR LEAKAGE, OR VIBRATION.

7. CONDENSATE DRAINAGE PIPING SHALL BE PROPERLY PITCHED TO ENSURE POSITIVE DRAINAGE TO AN APPROVED DISPOSAL LOCATION, SUCH AS A FLOOR DRAIN, SUMP PUMP, OR EXTERIOR GRADE. CONDENSATE LINES SHALL BE INSULATED TO PREVENT SWEATING.

8. THE LOCATION OF CONTROL PANELS AND SENSORS INDICATED ON THIS DRAWING CAN BEMODIFY WITH THE SPECIFIC LOCATIONS AND WIRING DETAILS WILL BE DETERMINED DURING THE CONTROL SYSTEM DESIGN AND INSTALLATION.

9. THE HVAC SYSTEM DESIGN CONSIDER ENERGY EFFICIENCY, INDOOR AIR QUALITY, OCCUPANT COMFORT, AND NOISE CONTROL, FOLLOWING APPLICABLE GUIDELINES AND REGULATIONS.

WITH THE LOCAL BUILDING DEPARTMENT AND UTILITY PROVIDERS TO ENSURE A TIMELY AND COMPLIANT INSTALLATION.

10. COORDINATION WITH OTHER TREADS HAS BEEN DONE ON A DESIGN LEVEL. THIS DRAWING SHALL BE READ TOGETHER WITH THE AR, EL AND SN

DESIGN DRAWINGS TO ENSURE PROPER INSTALLATION AND INTEGRATION OF THE HVAC SYSTEMS.

11. THE HVAC CONTRACTOR IS RESPONSIBLE FOR OBTAINING ALL NECESSARY PERMITS AND LICENSES, AND FOR SCHEDULING AND COORDINATING

12. ALL DUCTWORK PENETRATIONS THROUGH WALLS, FLOORS, OR CEILINGS SHALL BE PROPERLY SEALED AND FIRE-STOPPED USING APPROVED METHODS AND MATERIALS TO MAINTAIN THE INTEGRITY OF THE BUILDING'S FIRE-RESISTANCE RATINGS.

13. HVAC EQUIPMENT SHALL BE INSTALLED LEVEL AND PLUMB, AND IN STRICT ACCORDANCE WITH THE MANUFACTURER'S INSTALLATION INSTRUCTIONS AND RECOMMENDATIONS. PROVIDE ADEQUATE CLEARANCES AROUND EQUIPMENT FOR PROPER AIRFLOW, SERVICE ACCESS, AND

CODE COMPLIANCE.

14. ALL HVAC EQUIPMENT AND COMPONENTS, INCLUDING THERMOSTATS, DAMPERS, AND ACCESS PANELS, SHALL BE LOCATED IN ACCESSIBLE AREAS

15. THE HVAC SYSTEM SHALL BE BALANCED AND ADJUSTED TO ENSURE PROPER AIRFLOW, TEMPERATURE DISTRIBUTION, AND SYSTEM

PERFORMANCE THROUGHOUT THE RESIDENCE. PROVIDE A WRITTEN REPORT DOCUMENTING THE FINAL SYSTEM BALANCE.


FOR EASY SERVICING AND MAINTENANCE. PROVIDE ADEQUATE SPACE AROUND EQUIPMENT FOR PROPER AIRFLOW AND SERVICE ACCESS.

16. ANY DEVIATIONS OR MODIFICATIONS TO THE HVAC SYSTEM DESIGN SHALL BE REVIEWED AND APPROVED BY THE RESPONSIBLE DESIGN PROFESSIONALS AND COMMUNICATED TO ALL RELEVANT PARTIES INVOLVED IN THE CONSTRUCTION PROCESS.

17. FOR ANY INQUIRIES OR CLARIFICATIONS REGARDING THE HVAC SYSTEM DESIGN, PLEASE CONSULT THE RESPONSIBLE DESIGN PROFESSIONALS


SYMBOLS

OR THE PROJECT MANAGEMENT TEAM.

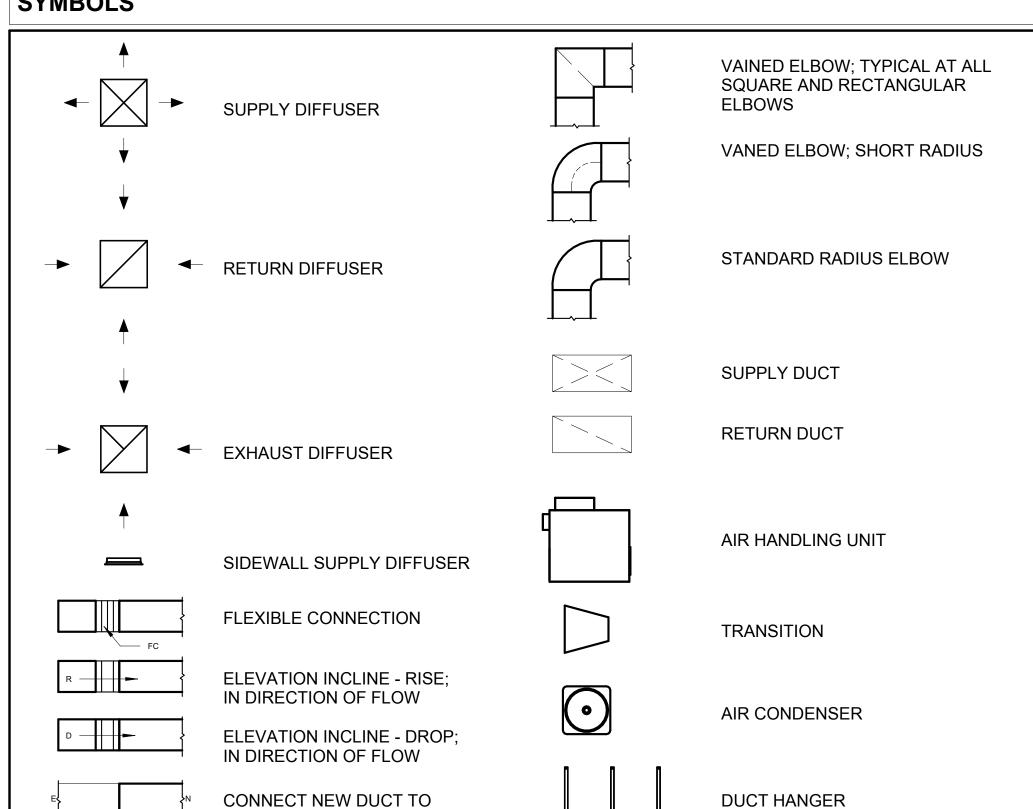



AIR CONDITIONING PIPE LINE

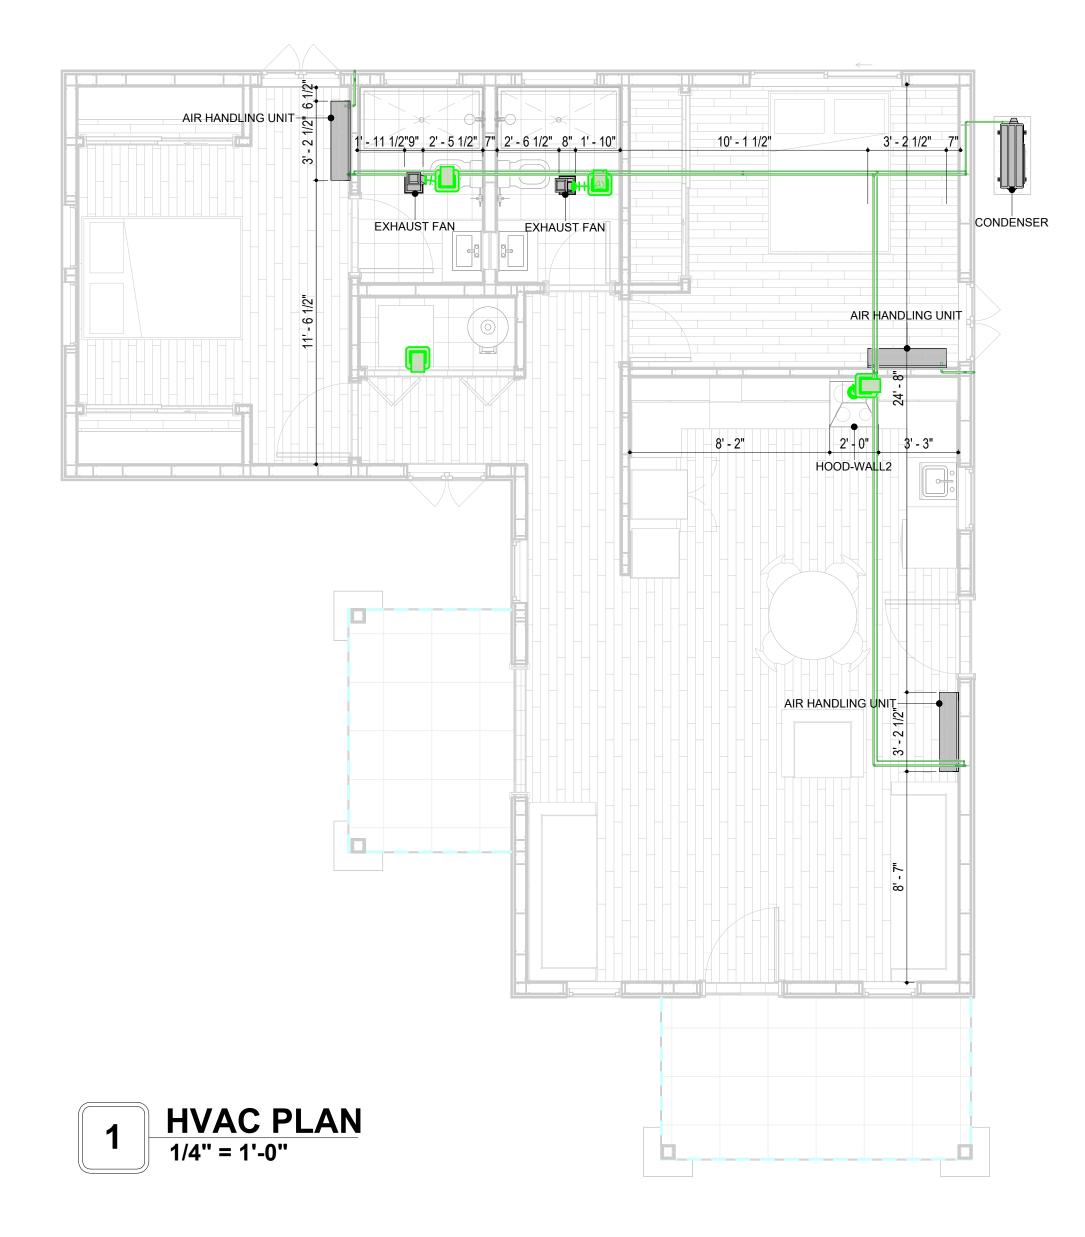

FLEX DUCT SCHEDULE					
DESCRIPTION DESCRIPTION LENGTH DIAMETER COUNT					
FLEX DUCT ROUND	FLEX-ROUND	14.54	4"	4	
GRAND TOTAL: 4 14.54					

DUCT FITTING SCHEDULE					
CATAGORY DESCRIPTION COUNT					
ROUND TRANSITION - ANGLE 45 DEGREE 7					

REFRIGERANT LINE FITTING SCHEDULE					
CATAGORY	DESCRIPTION	Size	Count		
ELBOW - GENERIC	ELBOW - GENERIC: STANDARD/HVAC	3/4"ø-3/4"ø	23		
ELBOW - GENERIC	ELBOW - GENERIC: STANDARD/HVAC	3/8"ø-3/8"ø	18		
TEE - GENERIC	TEE - GENERIC: STANDARD	3/4"ø-3/4"ø-3/ 4"ø	2		
TEE - GENERIC	TEE - GENERIC: STANDARD	3/8"ø-3/8"ø-3/ 8"ø	2		
TRANSITION - GENERIC	TRANSITION - GENERIC: STANDARD	3/4"ø-1/2"ø	3		
TRANSITION - GENERIC	TRANSITION - GENERIC: STANDARD	3/4"ø-5/8"ø	3		
TRANSITION - GENERIC	TRANSITION - GENERIC: STANDARD	3/8"ø-1/4"ø	1		

DUCT ACCESSORY SCHEDULE					
CATAGORY DESCRIPTION COUNT					
ROOF VENT 3" DIAMETER 4					

REFRIGERANT LINE SCHEDULE						
CATAGORY DESCRIPTION DIAMETER LENGTH						
PIPE TYPES COPPER 3/8" 76.20						
PIPE TYPES	91.65					

MECHANICAL EQUIPMENT SCHEDULE					
CATAGORY DESCRIPTION COUNT					
AIR HANDLING UNIT					
CONDENSER	CONDENSER: OUT DOOR 1				
EXHAUST FAN	EXHAUST FAN: 75 CFM 2				
HOOD-WALL2: VENT 2 1					



KEY PLAN

NO.	DESCRIPTION	DATE
·		
·	·	

NOTE:

LEGEND:

PROJECT

58-Hamilton-1000-2Bd-2Ba Ranch-550

DRAWING NAME

HVAC PLAN

CLIENT NAME:

PROJECT NUMBER:

15_0001

DATE:

2/14/2025 12:45:10 AM

DESIGNED BY:

DRAWN BY:

CHECKED BY:

Checker

M101

SCALE: As indicated

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EXISTING DUCT

ELECTRICAL NOTES

- 1. THIS DRAWING DEPICTS THE ELECTRICAL SYSTEM FOR THE 58-Hamilton-1000-2Bd-2Ba Ranch-550. IT PROVIDES A VISUAL REPRESENTATION OF THE ELECTRICAL LAYOUT AND COMPONENTS, INCLUDING POWER DISTRIBUTION, LIGHTING, AND CONTROL SYSTEMS.
- 2. THE ELECTRICAL SYSTEM IS DESIGNED TO MEET THE SPECIFIC REQUIREMENTS OF THE BUILDING, INCLUDING POWER DISTRIBUTION, LIGHTING, AND SPECIALIZED ELECTRICAL EQUIPMENT NEEDS, AS PER THE PROJECT SPECIFICATIONS AND APPLICABLE CODES AND STANDARDS.
- 3. THE ELECTRICAL SYSTEM INSTALLATION SHALL COMPLY WITH THE LATEST EDITION OF THE NATIONAL ELECTRICAL CODE (NEC), INTERNATIONAL BUILDING CODE (IBC), AND ALL OTHER APPLICABLE LOCAL, STATE, AND NATIONAL CODES AND REGULATIONS.
- 4. LOCATIONS AS NEEDED, DEVICES ARE SHOWN ON PLANS IN APPROXIMATE IDEAL LOCATIONS, UNLESS SPECIFICALLY DIMMENSIONED.
- 5. OPEN WALLS AS NEEDED TO ALLOW FOR NEW ELECTRICAL INSTALLATIONS.
- 6. LABEL ALL CIRCUITS ON JUNCTION BOXES, RECEPTACLES, DATA, SMOKE DETECTOR, AND EQUIPMENT IN PANEL BOX.
- 7. INSTALL RACEWAY AS NEEDED FOR DDC, ACCESS CONTROL, LOW VOLTAGE WIRING & DATA.
- 8. RELABEL POWER, DATA & FIRE ALARM FOR ROOM #CHANGES.
- 9. VERIFY ALL CIRCUITS LABELED ON PRINT ARE CORRECT BEFORE WORKING ON THEM.
 10. NOTE ON SITE PLAN ALL CHANGES OR MISSING DETAIL TO BE INCORPORATED INTO THE MASTER PLAN.
- 11. DRAWINGS ARE DIAGRAMMATIC ONLY FOR THE PURPOSE OF SHOWING FIXTURE AND OUTLET LOCATIONS.
- 12. ELECTRICAL CONTRACTOR TO VERIFY SERVICE SIZE BY CALCULATION BASED UPON ACTUAL NAME PLATE RATINGS OF SELECTED FOLIPMENT
- PLATE RATINGS OF SELECTED EQUIPMENT.

 13. VERIFY LOCATION OF SERVICE ENTRANCE WITH POWER COMPANY. PROVIDE UFER GROUND IN
- BUILDING FOUNDATION AT SERVICE ENTRANCE WITH POWER COMPANY. PROVIDE UPER GROUND IN
- 14. PROVIDE A MIN. OF 20 FEET OF ONE *4 BARE COPPER UFER WIRE EMBEDDED IN CONCRETE FOOTING AT THE SERVICE ENTRANCE LOCATION WHERE APPROVED BY LOCAL SERVICE PROVIDER.
- 15. PROVIDE WATERPROOF FIXTURES IN ALL HIGH MOISTURE AREAS (EXTERIOR, SHOWER AND TUB
- CEILINGS ETC.)

 16. PROVIDE DEDICATED CIRCUITS TO EACH BATH, DEN, FAMILY ROOM, BEDROOM, LOFT, KITCHEN
- REFRIGERATOR, KITCHEN FREEZER DISHWASHER, AND ANY AREA/ITEM SPECIFIED BY OWNER.

 17. INCANDESCENT FIXTURES WITH OPEN OR PARTIALLY ENCLOSED LAMPS, PENDANT FIXTURES, AND
- LAMP HOLDERS ARE NOT PERMITTED IN CLOSETS.

 18. ALL WORKMANSHIP AND MATERIALS TO CONFORM WITH THE 2015 IRC.
- 19. PROVIDE A MIN. OF 20 FEET OF ONE *4 BARE COPPER UFER WIRE EMBEDDED IN CONCRETE FOOTING AT THE SERVICE ENTRANCE LOCATION WHERE APPROVED BY LOCAL SERVICE PROVIDER.
- 20. PROVIDE A BONDING CONDUCTOR CONSISTING OF A MINIMUM OF ONE *4 BARE COPPER WIRE CONNECTING THE BUILDING'S METAL WATER PIPING SYSTEM TO THE SERVICE EQUIPMENT ENCLOSURE GROUNDING.

MAIN PANEL CALCS

ELECTRICAL CALCS	
LIGHT AND OUTLETS 1000 @ 3W	3000W
3 APPLIANCE CIRCUITS	4,500 W
DRYER	2,000 W
WASHER	2,000 W
RANGE	5,000 W
WATER HEATER	5,000 W
REFRIG.	1,800 W
DISHWASHER & DISPOSAL	3000 W
TOTAL	26,300 W
FRIST 10,000 @ 100% REMAINDER @ 40% MINI. SPLIT UNITS	10,000 W 6,520W 10,000 W

TOTAL 26,520 W

26,520 W DIVIDED BY 240V = 111 AMPS TOTAL

(USE 200 AMP SERVICE)

ELECTRICAL ABBREVIATIONS LIST

1P	1 POLE (2P, 3P, 4P, ETC.)	CTR	CENTER	HT	HEIGHT
A	AMPERE	CU	COPPER	HTG	HEATING
AC	ABOVE COUNTER OR AIR CONDITIONER	DCP	DOMESTIC WATER CIRCULATING PUMP	HTR	HEATER
ACLG	ABOVE CEILING	DEPT	DEPARTMENT	HV	HIGH VOLTAGE
ADO	AUTOMATIC DOOR OPENER	DET	DETAIL	HVAC	HEATING, VENTILATING AND AIR
AF	AMP FRAME	DIA	DIAMETER	CONDITIONING	CONDITIONING
AFF	ABOVE FINISHED FLOOR	DISC	DISCONNECT	HWP	HYDRONIC WATER PUMP
AFG	ABOVE FINISHED FLOOR ABOVE FINISHED GRADE	DIST	DISTRIBUTION		INTERRUPTING CAPACITY
I .		DN		IC IG	
AFI	ARC FAULT CIRCUIT INTERRUPTER		DOWN DAMPER	IMC	ISOLATED GROUND
AHU	AIR HANDLING UNIT	DPR			INTERMEDIATE METAL CONDUIT
AL	ALUMINUM	DS DT	SAFETY DISCONNECT SWITCH	INCAND	INCANDESCENT
ALT	ALTERNATE		DOUBLE THROW	IR	INFRARED
AMP	AMPERE	DWG	DRAWING	I/W	INTERLOCK WITH
AMPL	AMPLIFIER	DDC	DIRECT DIGITAL CONTROL	J-BOX	JUNCTION BOX
ANNUN	ANNUNCIATOR APPROX APPROXIMATELY	EC	ELECTRICAL CONTRACTOR	KV	KILOVOLT
AQ-STAT	AQUASTAT	ELEC	ELECTRIC, ELECTRICAL	KVA	KILOVOLT-AMPERE
ARCH	ARCHITECT, ARCHITECTURAL	ELEV	ELEVATOR	KVAR	KILOVOLT-AMPERE REACTIVE
AS	AMP SWITCH	EM	EMERGENCY	KW	KILOWATT
AT	AMP TRIP	EMS	ENERGY MANAGEMENT SYSTEM	KWH	KILOWATT HOUR
ATS	AUTOMATIC TRANSFER SWITCH	EMT	ELECTRICAL METALLIC TUBING	LOC	LOCATE OR LOCATION
AUTO	AUTOMATIC	EP	ELECTRIC PNEUMATIC	LT	LIGHT
AUX	AUXILIARY	EQUIP	EQUIPMENT	LTG	LIGHTING
AV	AUDIO VISUAL	EWC	ELECTRIC WATER COOLER	LTNG	LIGHTNING
AWG	AMERICAN WIRE GAUGE	EXIST	EXISTING	LV	LOW VOLTAGE
BATT	BATTERY	EXH	EXHAUST	MAX	MAXIMUM
BD	BOARD	EXP	EXPLOSION PROOF	MAG.S	MAGNETIC STARTER
BLDG	BUILDING	FA	FIRE ALARM	M/C	MOMENTARY CONTACT
BMS	BUILDING MANAGEMENT SYSTEM	FABP	FIRE ALARM BOOSTER POWER	MC	MECHANICAL CONTRACTOR
С	CONDUIT	SUPPLY PANEL	SUPPLY PANEL	MCB	MAIN CIRCUIT BREAKER
CAB	CABINET	FACP	FIRE ALARM CONTROL PANEL	MCC	MOTOR CONTROL CENTER
CAT	CATALOG	FCU	FAN COIL UNIT	MDC	MAIN DISTRIBUTION CENTER
CATV	CABLE TELEVISION	FIXT	FIXTURE	MDP	MAIN DISTRIBUTION PANEL
CB	CIRCUIT BREAKER	FLR	FLOOR	MFR	MANUFACTURERMAIN FUSED
CCTV	CLOSED CIRCUIT TELEVISION	FLUOR	FLUORESCENT		DISCONNECT SWITCH
CKT	CIRCUIT	FU	FUSE	MH	MANHOLE
CLG	CEILING	FUDS	FUSED SAFETY DISCONNECT SWITCH	MIC	MICROPHONE
COMB	COMBINATION	GA	GAUGE	MIN	MINIMUM
CMPR	COMPRESSOR	GAL	GALLON	MISC	MISCELLANEOUS
CONN	CONNECTION	GALV	GALVANIZED	MLO	MAIN LUGS ONLY
CONST	CONSTRUCTION	GC	GENERAL CONTRACTOR	MMS	MANUAL MOTOR STARTER
CONT	CONTINUATION OR CONTINUOUS	GEN	GENERATOR	MOA	MULTIOUTLET ASSEMBLY
CONTR	CONTRACTOR	GFI	GROUND FAULT CIRCUIT INTERRUPTER	MSP	MOTOR STARTER PANELBOARD
CONV	CONVECTOR	GFP	GROUND FAULT PROTECTOR	MSBD	MAIN SWITCHBOARD
CP	CIRCULATING PUMP	GND	GROUND	MT	MOUNT
CRT	CATHODE-RAY TUBE	GRS	GALVANIZED RIGID STEEL (CONDUIT)	MT.C	EMPTY CONDUIT
CT	CURRENT TRANSFORMER	GYP BD	GYPSUM BOARD `	UL	UNDERWRITERS LABORATORIES

Branch Panel:

Location: LIVING ROOM 73
Supply From:
Mounting: Recessed

Enclosure: Type 1

Volts: 120/240 Single
Phases: 1
Wires: 3

A.I.C. Rating: Mains Type: Mains Rating: 200 A MCB Rating: 1 A

lotes:

Circuit Numb er	Circuit Description	Number of Elements	Rating	Length	Wire Size	A			В	Wire Size	Length	Rating	Number of Elements	Circuit Description	Circuit Numb er
1	BED1 LIGHT	13	15 A	84' - 10 1/2"	1-#12, 1-#12, 1-#12	688 VA	300 VA			1-#14, 1-#14, 1-#14	43' - 4 5/32"	15 A	7	HALL LIGHT	2
3	BED2 LIGHT	11	15 A	59' - 7 5/32"	1-#14, 1-#14, 1-#14			628 VA	715 VA	1-#12, 1-#12, 1-#12	35' - 0 15/16"	20 A	10	OUTDOOR LIGHT	4
5	BED1&2 RECEPTACLE	9	20 A	75' - 6 3/16"	1-#8, 1-#8, 1-#8	1620 VA	1260 VA			1-#12, 1-#12, 1-#12	46' - 8 5/32"	20 A	7	LIV. & HALL RECEPTACLE	6
7	KITCHEN GFCI	6	20 A	41' - 2 29/32"	1-#12, 1-#12, 1-#12			1080 VA	1200 VA	1-#12, 1-#12, 1-#12	25' - 0 15/16"	20 A	1	DISHWASHER	8
9	OVENHOOD	1	20 A	28' - 7 9/16"	1-#12, 1-#12, 1-#12	180 VA	2500 VA			2-#8, 1-#8, 1-#10	34' - 2 9/32"	50 A	1	RANGE	10
11	REFRIGERATOR	1	20 A	38' - 0 5/32"	2-#12, 1-#12, 1-#12			900 VA	2500 VA						12
13						900 VA	516 VA			1-#14, 1-#14, 1-#14	51' - 6 9/16"	15 A	12	KITCHEN LIGHT	14
15	LIV. LIGHT	7	15 A	26' - 4 11/32"	1-#14, 1-#14, 1-#14			209 VA	720 VA	1-#12, 1-#12, 1-#12	37' - 4 29/32"	20 A	4	OUTDOOR GFCI	16
17	CONDENSER	1	60 A	41' - 4 5/32"	2-#6, 1-#6, 1-#10	2500 VA	2250 VA			2-#10, 1-#10, 1-#10	55' - 3 17/32"	30 A	1	WATERHEATER	18
19								2500 VA	2250 VA			-			20
21	WASHEING MASHEIN	1	20 A	57' - 5 29/32"	1-#12, 1-#12, 1-#12	1200 VA	2500 VA			2-#10, 1-#10, 1-#10	54' - 9 17/32"	30 A	1	DRYER	22
23	BATH GFCI	10	30 A	63' - 6 17/32"	1-#10, 1-#10, 1-#10			1152 VA	2500 VA						24
25															26
	1					16412	VA	163	27 VA						1
						137	Α	13	86 A					1	

_egend

Load Classification	Connected Load	Demand Factor	Estimated Demand	Panel	Totals
LIGHTING - DWELLING UNIT	900 VA	100.00%	900 VA		
OTHER	2316 VA	100.00%	2316 VA	Total Conn. Load:	32738 VA
RECEPTACLE	7980 VA	100.00%	7980 VA	Total Est. Demand:	31738 VA
LIGHTING	300 VA	100.00%	300 VA	Total Conn.:	136 A
CONDENSER	5000 VA	100.00%	5000 VA	Total Est. Demand:	132 A
WATER HEATER	4500 VA	100.00%	4500 VA		
RANGE	5000 VA	80.00%	4000 VA		
DRYER	5000 VA	100.00%	5000 VA		
REFRIGERATOR	1800 VA	100.00%	1800 VA		



KEY PLAN

NO. DESCRIPTION DATE

NOTE:

LEGEND:

PROJECT

58-Hamilton-1000-2Bd-2Ba Ranch-550

DRAWING NAME

SCHEDULE

CLIENT NAME:

PROJECT NUMBER:

0180_14

DATE:

2/15/2025 3:59:20 PM

DESIGNED BY:

DRAWN BY:

CHECKED BY:

Checker

E101

SCALE: 1/4" = 1'-0"

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ELECTRICAL NOTE

- A. PROVIDE INTERCONNECTED SMOKE ALARMS IN EACH SLEEPING ROOMS, OUTSIDE EACH SLEEPING ROOM, ON EACH STORY, IN THE HALL OR ADJACENT ROOM LUHERE THE CEILING HEIGHT OF A ROOM OPEN TO THE HALL EXCEEDS THE HALL BY 24'. SMOKE ALARMS SHALL BE PERMANENTLY HARD WIRED WITH BATTERY BACKUP.
- B. RECEPTACLE OUTLETS FOR RANGES AND CLOTHES DRYERS SHALL BE A THREE POLE WITH GROUND TYPE. FOUR WIRE GROUNDING-TYPE FLEXIBLE CORDS WILL BE REQUIRED FOR CONNECTION OF RANGES AND CLOTHES DRYERS. THE BONDING JUMPER SHALL NOT BE CONNECTED BETWEEN NEUTRAL TERMINAL AND THE FRAME OF THE APPLIANCE.
- C. TWO OR MORE 20 AMP SMALL APPLIANCE CIRCUITS SHALL BE PROVIDED TO SERVE THE KITCHEN, BREAKFAST NOOK, AND DINING ROOM. SUCH CIRCUITS SHALL HAVE NO OTHER OUTLETS.
- D. AT LEAST ONE 20 AMP BRANCH CIRCUIT SHALL BE PROVIDED TO SERVICE THE LAUNDRY ROOM. THIS CIRCUIT SHALL HAVE NO OTHER OUTLETS.
- E. ALL RECEPTACLES WITH IN 6' OF A WET BAR SINK OR KITCHEN SINK TO SERVE COUNTER TOP SURFACES MUST BE GFCI. ON KITCHEN COUNTERS 12' OR WIDER NO POINT ALONG THE WALL SHALL BE MORE THAN 2' FROM A RECEPTACLE. ALL RECEPTACLES WITH IN 6' OF KITCHEN SINK MUST BE GFCI. AT LEAST ONE GFCI RECEPTACLE SHALL BE INSTALLED IN THE BATHROOM ADJACENT TO EACH BASIN.
- F. FIXTURES INCLUDING CEILING FANS THAT ARE LOCATED IN DAMP LOCATIONS SHALL BE LISTED TO BE SUITABLE FOR
- SUCH LOCATIONS PER 2012 IRC
 G. PROVIDE ONE (1) SWITCHED OUTLET @ ALL BEDROOMS AND DEN
- H. CEILING FANS NOT EXCEEDING 35 LBS. (WITH OR WITHOUT ACCESSORIES MAY BE SUPPORTED BY OUTLET BOXES PROVIDED THE OUTLET BOXES ARE IDENTIFIED FOR SUCH USE PER 2012 IRC
- I. ELECTRICAL OUTLET BOXES ON OPPOSITE SIDES OF FIRE RATED WALLS SHALL BE SEPARATED BY A HORIZONTAL DISTANCE OF NOT LESS THAN 24".
- J. OUTLET BOXES IN THE WALLS BETWEEN THE GARAGE AND DWELLING SHALL BE METAL OR U.L. APPROVED FIRE RESISTIVE PLASTIC. BOXES IN GARAGE CEILING SHALL BE METAL.
- K. ALL BRANCH CIRCUITS THAT SUPPLY 120 VOLTS SINGLE PHASE 15 AND 20 AMPS RECEPTACLE OUTLETS INSTALLED IN THE DWELLING SHALL BE PROTECTED BY AN ARC FAULT CIRCUIT INTERRUPTER, EXCEPT GFCI RECEPTICLES.

NOTE:

A. RECEPTACLES MUST BE PROVIDED IN HALLWAYS 10'-0" OR MORE IN LENGTH. FOR A ONE FAMILY DWELLINGS AND EACH OF A TWO FAMILY DWELLING THAT IS AT GRADE LEVEL, AT LEAST ONE WP-GFCI RECEPTACLE OUTLET ACCESSIBLE AT GRADE LEVEL AND NOT MORE THAN 6'-6" ABOVE GRADE SHALL BE INSTALLED AT THE FRONT AND BACK OF THE DWELLING.

NOTE: APPLIANCE DISCONNECT

E4001.5 GROUNDING OF ENCLOSURES.

METAL ENCLOSURES FOR SWITCHES OR CIRCUIT BREAKERS SHALL BE CONNECTED TO AN

EQUIPMENT GROUNDING CONDUCTOR.

METAL ENCLOSURES FOR SWITCHES OR CIRCUIT BREAKERS USED AS SERVICE

EQUIPMENT SHALL COMPLY WITH THE PROVISIONS OF SECTION E3609.4. WHERE


NONMETALLIC ENCLOSURES ARE USED WITH METAL RACEWAYS OR METAL-ARMORED

CABLES, PROVISIONS SHALL BE MADE FOR CONNECTING THE EQUIPMENT GROUNDING CONDUCTOR.


NONMETALLIC BOXES FOR SWITCHES SHALL BE INSTALLED WITH A WIRING METHOD THAT

PROVIDES OR INCLUDES AN EQUIPMENT GROUNDING CONDUCTOR. (404.12)

ELECTRICAL LEGEND			
	Electrical Lights With Fan		
9	Recessed Spot Light		
0	Recessed Can Light		
-4	Wall Lamp		
⊬1	Single Switch		
₩	Three way Switch		
	Three way with Dimmer Switch		
₩	Fan Switch		
	Duplex Receptacle		
	Triplex Receptacle		
⊕ ⊟GFCI	GFCI Receptacle		
	Exhaust Fan		
•	Smoke and heat detector		

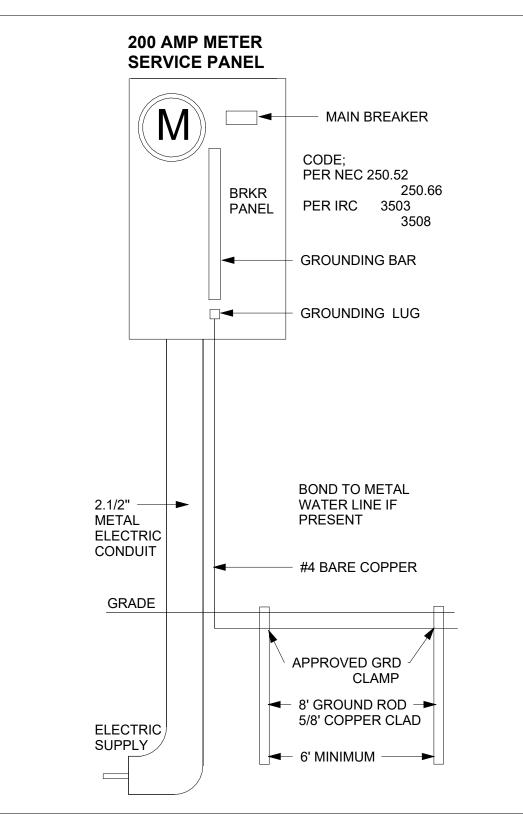



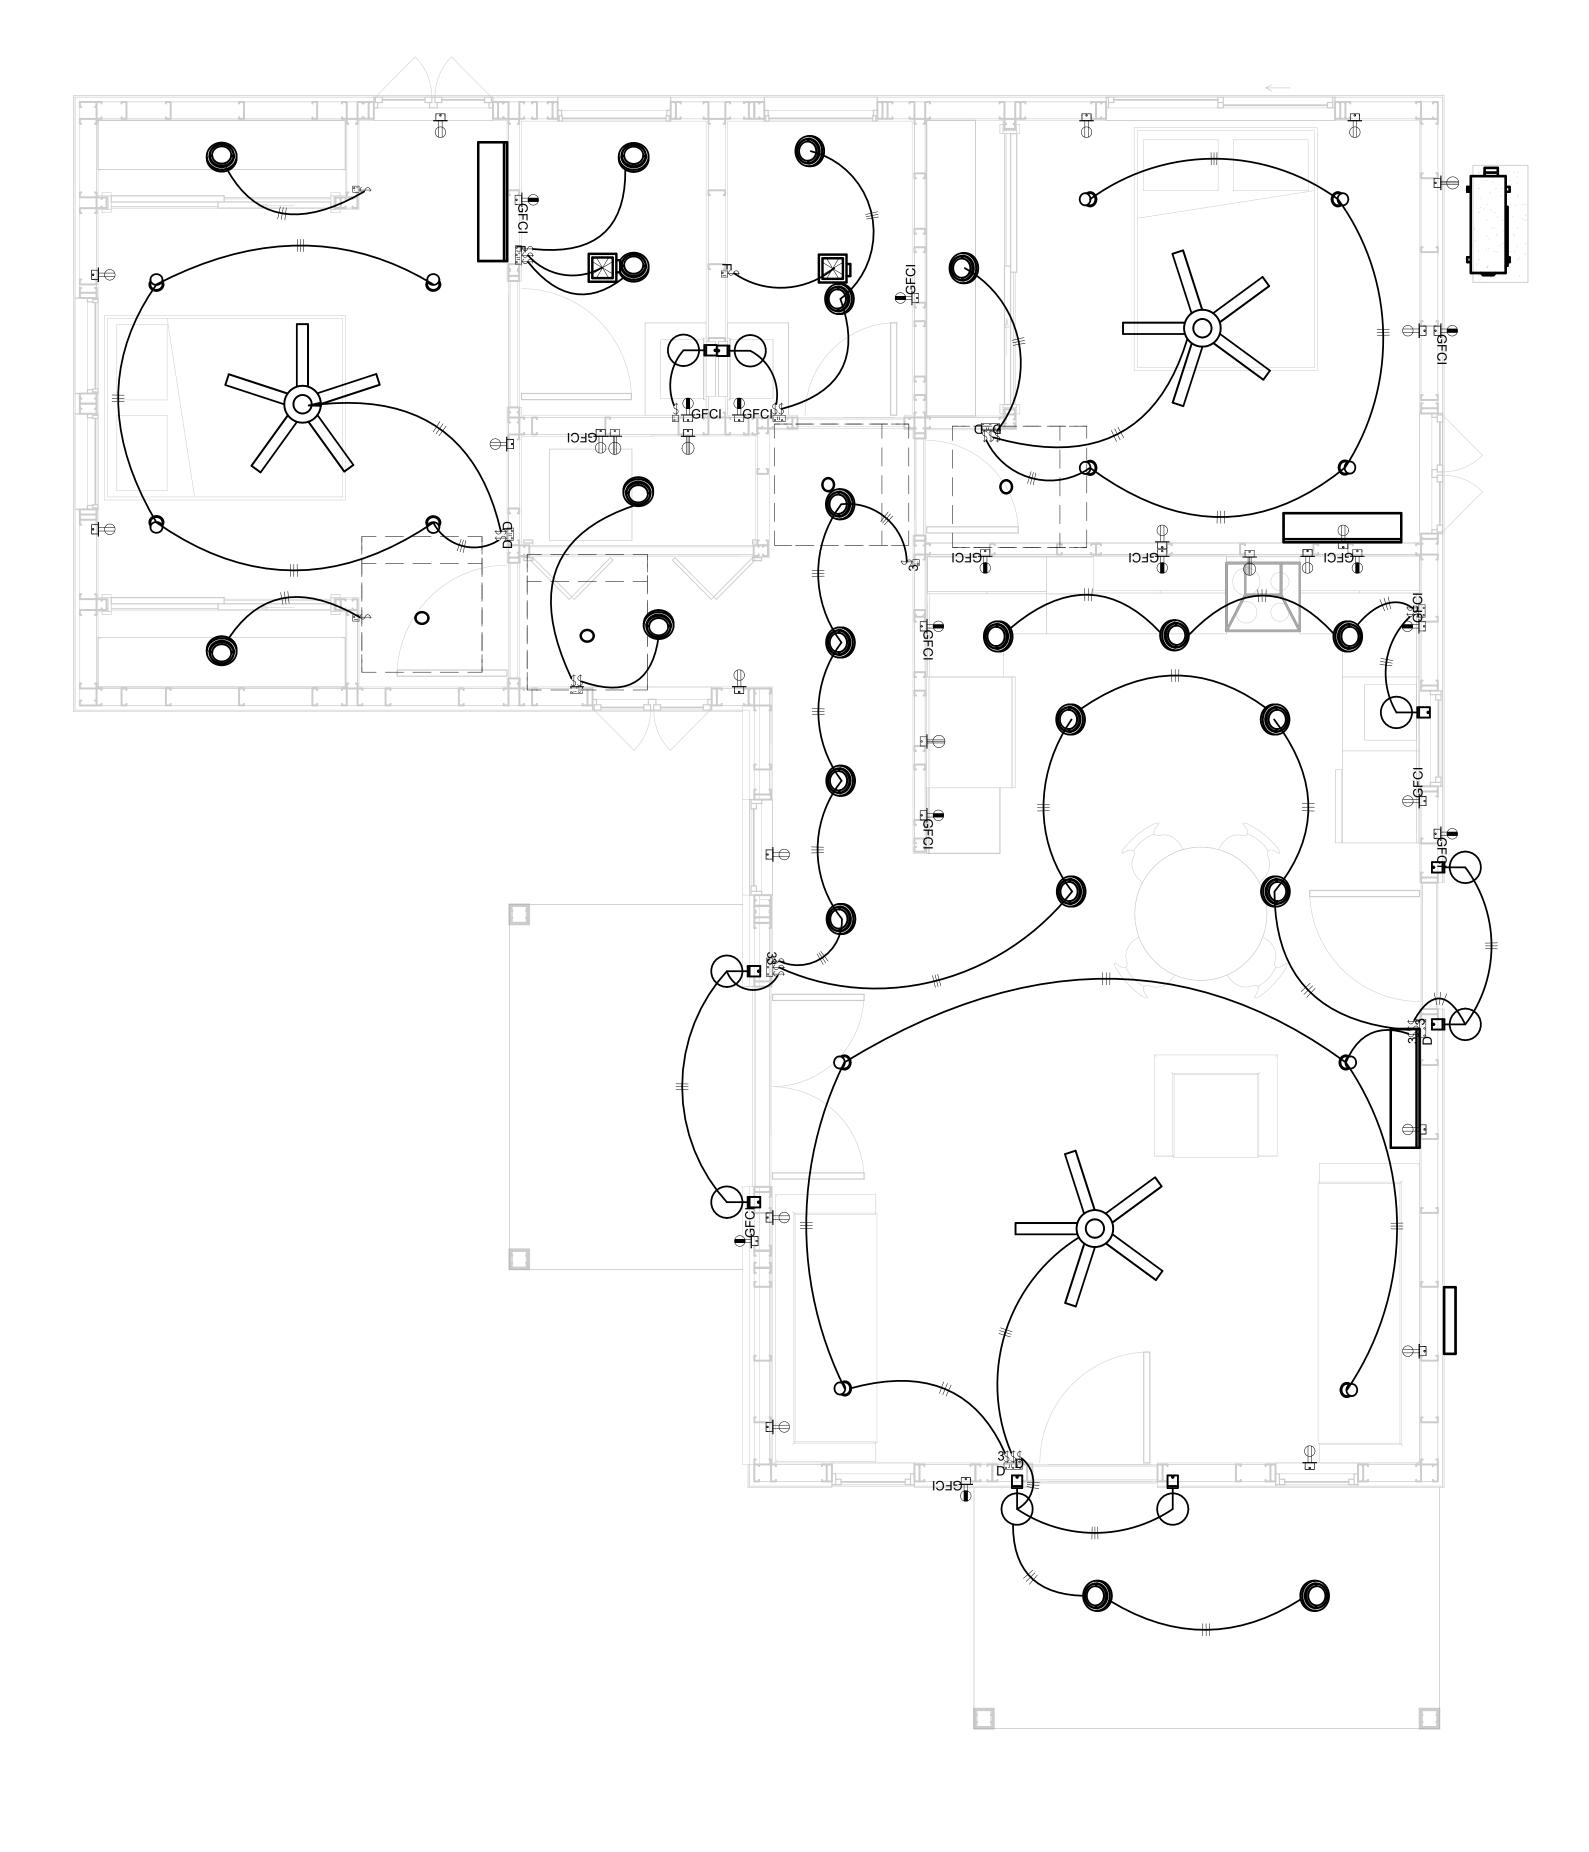

1 - Lighting 3/8" = 1'-0"



KEY PLAN

NO. DESCRIPTION DATE

NOTE:

LEGEND:

PROJECT

58-Hamilton-1000-2Bd-2Ba Ranch-550

DRAWING NAME


LIGHTING

CLIENT NAME:	Owner
PROJECT NUMBER:	0180_14
DATE:	2/15/2025 3:59:23 PM
DESIGNED BY:	Designer
DRAWN BY:	Author
CHECKED BY:	Checker


E102

NOTES: CONDUIT, CABLE AND WIRING


- Use Metalic Conduits (IMC) for cables running under concrete slabs.
 Use IMC for circuits with high voltage appliances (240 volts and above)
 For circuits with 120 volts consider using EMT or PVC conduits if needed.
 For Low voltage applications up to 50 volts consider using non metalic conduits.
 All conduits to be used in the project must conform to the latest National Electrical Code (NEC),
- All wiring and cables to be used in the project must also conform to the latest National Electrical Code (NEC), 2015.
- 7. All cables and wires used should be rated for their respective loading and should be gauged and conform to the NEC.

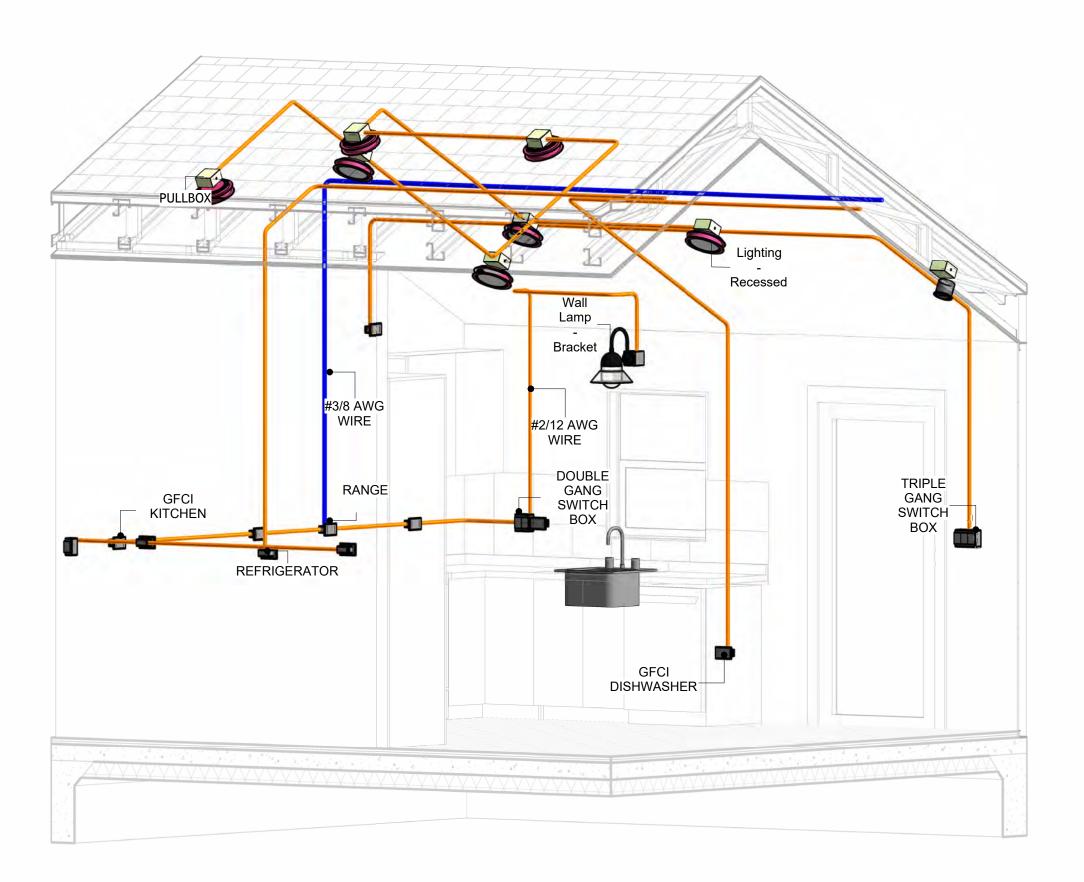




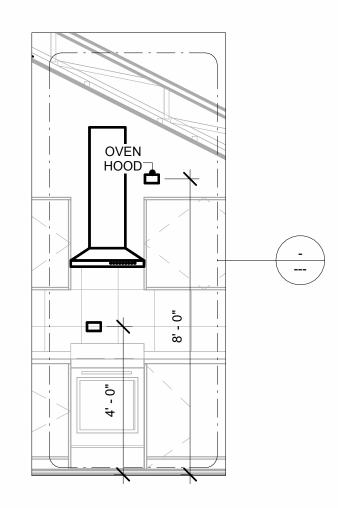


Section 1 3/8" = 1'-0"

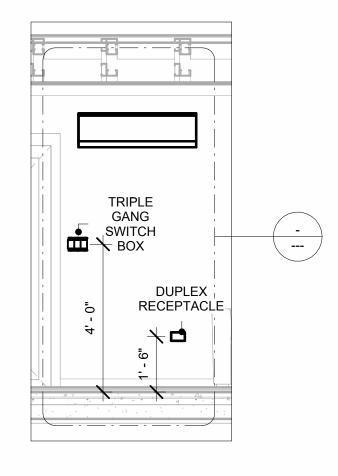

Section 3 3/8" = 1'-0"

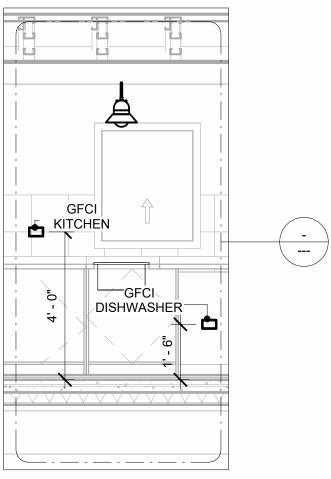


Section 2 3/8" = 1'-0"

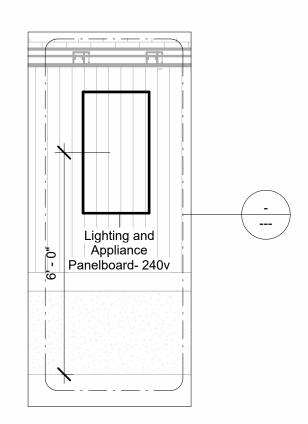

Section 4 3/8" = 1'-0"



KEY PLAN

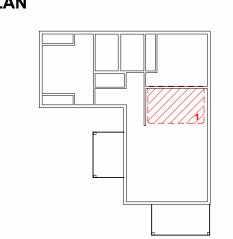

NO.	DESCRIPTION	DATE

NOTE:

LEGEND:

PROJECT

58-Hamilton-1000-2Bd-2Ba Ranch-550

DRAWING NAME

POWER

CLIENT NAME:	Owner
PROJECT NUMBER:	0180_14
DATE:	2/15/2025 3:59:48 PM
DESIGNED BY:	Designer
DRAWN BY:	Author
CHECKED BY:	Checker

E103

SCALE: As indicated

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NOTES: LIGHT

- 1. LIGHT FIXTURES AND LUMINARIES SHALL CONFORM TO THE NEC, THE IRC AND LOCAL SAFETY & BUILDING CODE.
- 2. ALL LIGHTING FIXTURES SHOULD CONFORM TO THE DESIGN ELECTRICAL LOAD AND SHALL BE PROPERLY WIRED AND MOUNTED BY QUALIFIED ELECTRICIAN FOLLOWING MANUFACTURERS SPECIFICATIONS.
- CEILING FANS AND FANS WITH LIGHT WITH WEIGHT EXCEEDING 35 LBS SHOULD BE PROVIDED WITH STRUCTURAL BACKING FOR SUPPORT AND SHALL BE FIXED AS PER MANUFACTURERS SPECIFICATIONS.
- 4. EXTERIOR LIGHTS SHALL CONFORM TO LOCAL BUILDING CODE AND GUIDELINES.

NOTES: SWITCH JUNCTION BOX

- THE MINIMUM SIZE OF JUCTION BOX TO BE USED IS 2"X4"X(1.5" OR 3.5" DEEP) THIS ARE TO BE USED FOR SINGLE GANG SWITCH OR OUTLETS.
- 2. FOR DOUBLE GANG (2 GANG) OUTLETS AND SWITCHS THE MINIMUM SIZE OF THE
- JUCTION BOX TO BE PROVIDED SHALL NOT BE LESS THAN 4"X4"X(1.5" OR 3.5" DEEP)
- 3. FOR THREE GANG (3 GANG) OUTLETS AND SWITCHS THE MINIMUM SIZE OF THE JUĆTION BOX SHALL NOT BE LESS THAN 6"X4"X(1.5" OR 3.5" DEEP).

FITTING SCHEDULE(PULL BOX)						
FAMILY COUNT DESCRIPTION						
PULLBOX1 41 #1/4 PULLBOX						


ELECTRICAL FIXTURE SCHEDULE (SWITCH BOX)					
TYPE	COUNT				
DOUBLE GANG SWITCH BOX	4				
SINGLE GANG SWITCH BOX	5				
TRIPLE GANG SWITCH BOX	5				

LIGHTING DEVICE			
TYPE	COUNT		
DIMMER	5		
FAN SWITCH	2		
SINGLE POLE	15		
THREE WAY	4		
THREE WAY WITH DIMMER	2		

LIGHTING FIXTURE				
LIGHTING FIXTURE TYPE	VOLTAGE	ELECTRICAL LOAD	COUNT	
ELECTRICAL_LIGHTS_FAN-LIGHT1	120 V/1-100 VA- 120 V/1-100 VA	200 A, 120 V/240 V, SINGLE PHASE, 3 WIRES	3	
LIGHTING - RECESSED	120 V/1-60 VA	<varies></varies>	21	
LIGHTING_RECESSED	120 V/1-60 VA	200 A, 120 V/240 V, SINGLE PHASE, 3 WIRES	1	
SASSO 100 ROUND WALLWASHER TRIM	120 V/1-28 VA	200 A, 120 V/240 V, SINGLE PHASE, 3 WIRES	12	

120 V/1-100 VA

200 A, 120 V/240 V, SINGLE PHASE, 3 WIRES

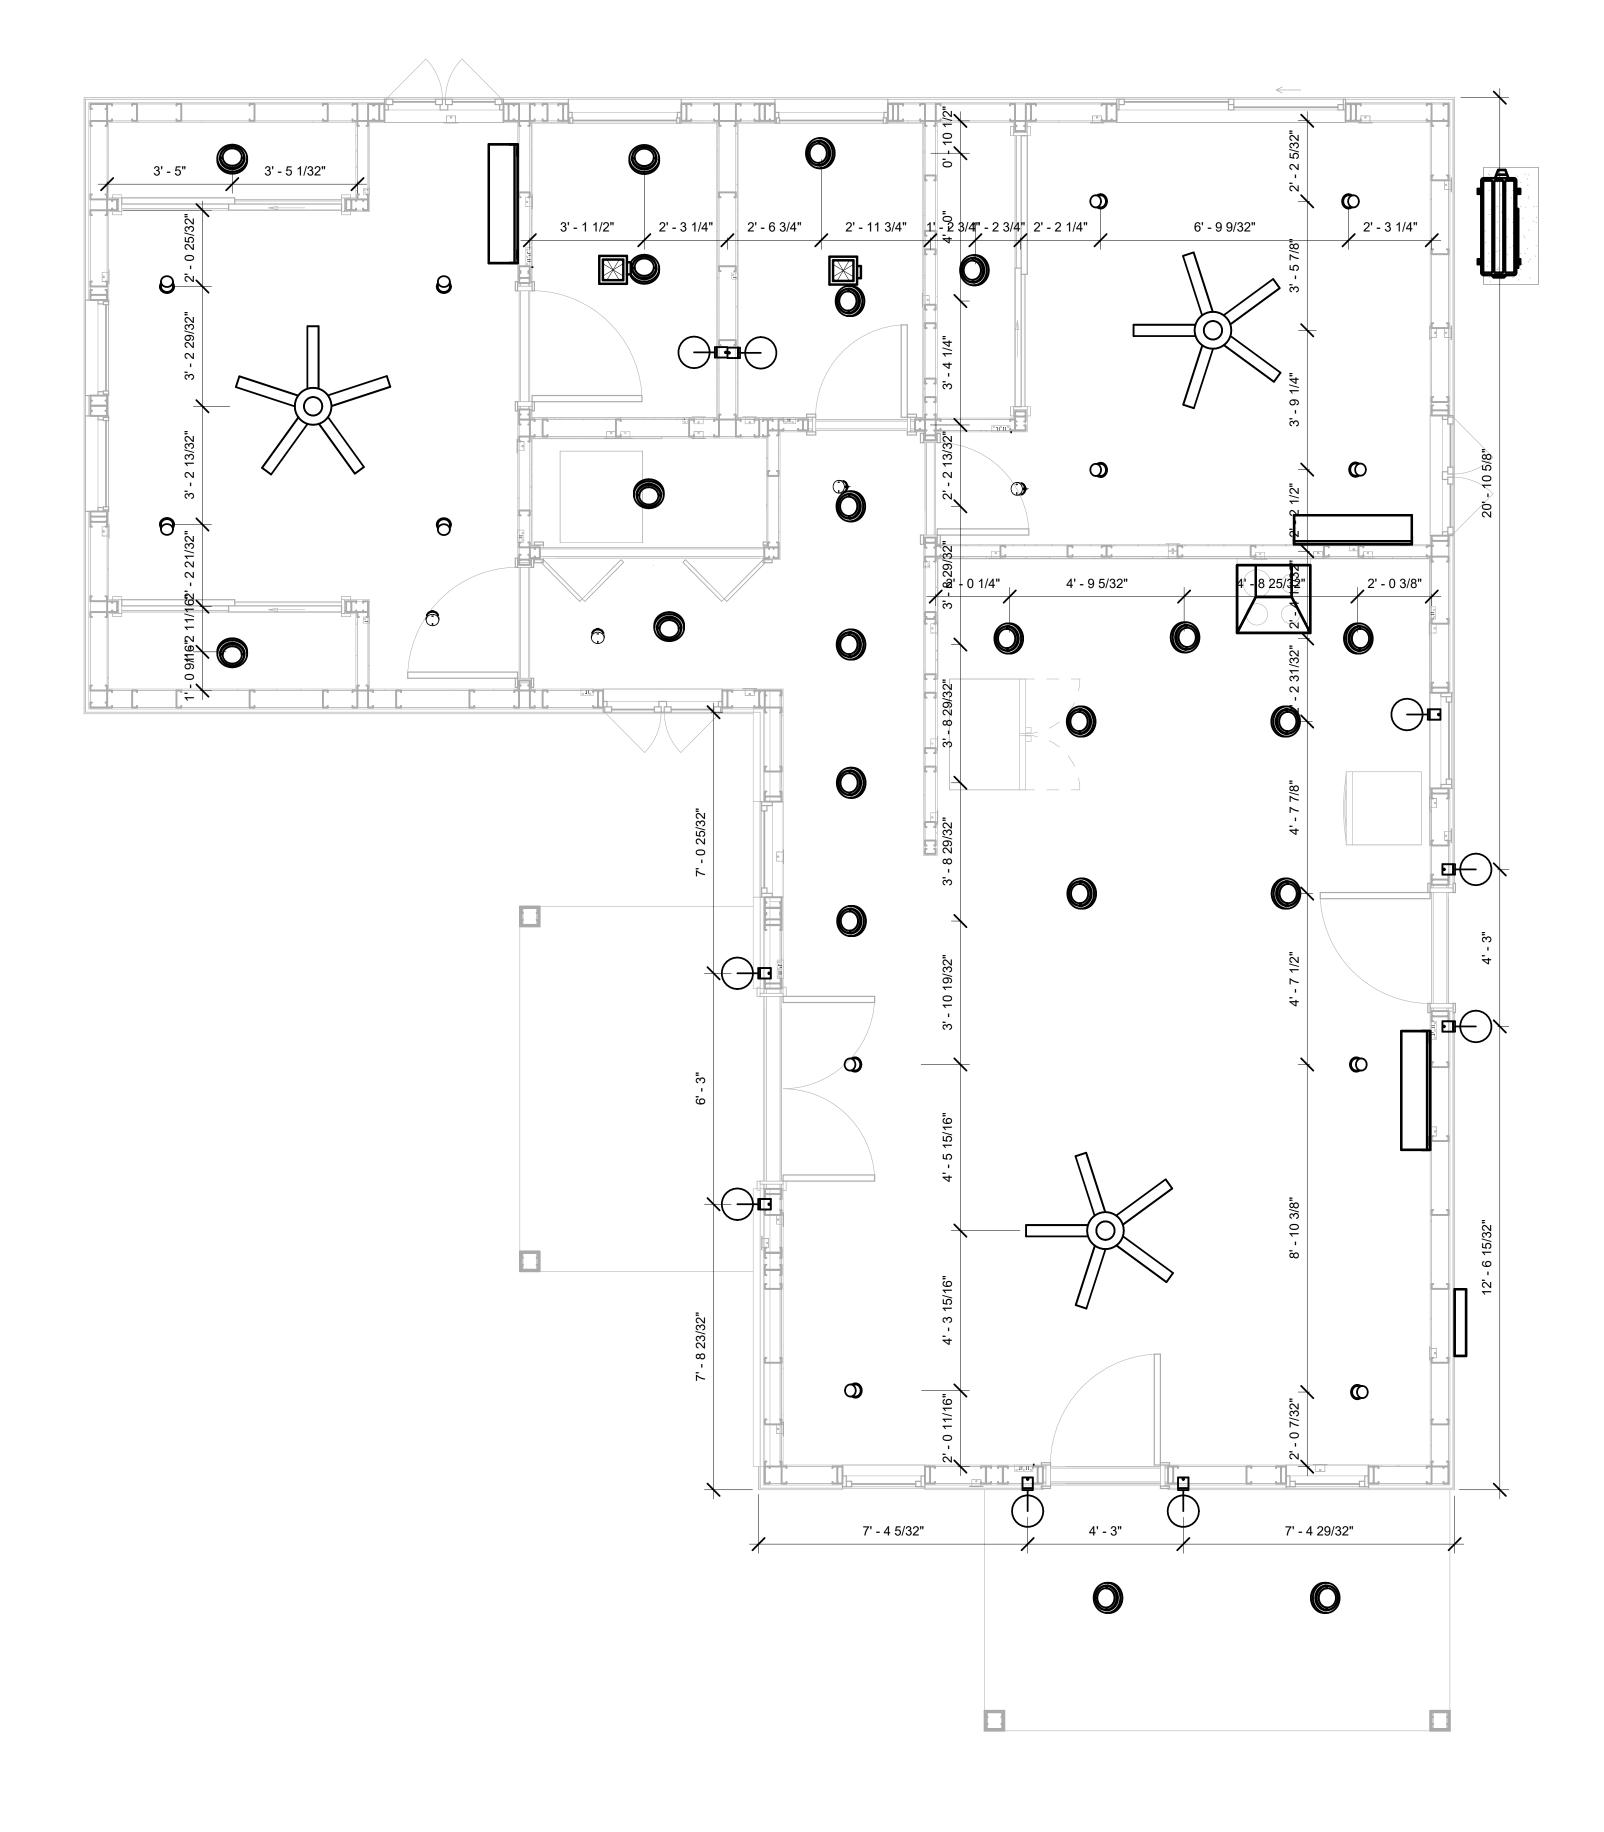

1 DIMENSION FOR LIGHT FIXTURES
3/8" = 1'-0"



KEY PLAN

NO.	NO. DESCRIPTION			

NOTE:

LEGEND:

PROJECT

58-Hamilton-1000-2Bd-2Ba Ranch-550

DRAWING NAME

DIMENSION PLAN FOR LIGHT FIXTURES

CLIENT NAME:	Owner
PROJECT NUMBER:	0180_14
DATE:	2/15/2025 3:59:50 PM
DESIGNED BY:	Designer
DRAWN BY:	Author
CHECKED BY:	Checker

E104

SCALE: As indicated


WALL LAMP - BRACKET

NOTES;

- 1. VERIFY EQUIPMENT PLUG CONFIGURATION BEFORE PURCHASING RECEPTACLES
- 2. FOR ALL EQUIPMENT.
- 3. COORDINATE EXACT LOCATION OF LIGHT FIXTURES, WALL SWITCHES, RECEPTACLES AND OTHER DEVICES WITH ARCHITECTURAL DRAWINGS.
- 4. USE METALLIC JUNCTION BOX WITH THE GFCI RECEPTACLES, WITH HIGHT VOLTAGE.

ELECTRICAL FIXTURE SCHEDULE (RECEPTACLE)			
TYPE	COUNT		
CONDENSER	1		
DRYER	1		
DUPLEX RECEPTACLE	16		
GFCI BATH ROOM	4		
GFCI DISHWASHER	1		
GFCI KITCHEN	6		
GFCI OUT DOOR	4		
GFCI WASHER	1		
OVEN HOOD	1		
RANGE	1		
REFRIGERATOR	1		
WATER HEATER	1		

ELECTRICAL OUTLET SCHEDULE				
TYPE	CIRCUIT NUMBER	ELECTRICAL DATA	COUNT	
DUPLEX RECEPTACLE	5	120 V/1-180 VA	9	
DUPLEX RECEPTACLE	6	120 V/1-180 VA	7	
GFCI KITCHEN	7	120 V/1-180 VA	6	
GFCI DISHWASHER	8	120 V/1-1200 VA	1	
OVEN HOOD	9	120 V/1-180 VA	1	
RANGE	10,12	240 V/2-5000 VA	1	
REFRIGERATOR	11,13	240 V/2-1800 VA	1	
GFCI OUT DOOR	16	120 V/1-180 VA	4	
CONDENSER	17,19	240 V/2-5000 VA	1	
WATER HEATER	18,20	240 V/2-4500 VA	1	
GFCI WASHER	21	120 V/1-1200 VA	1	
DRYER	22,24	240 V/2-5000 VA	1	
GFCI BATH ROOM	23	120 V/1-180 VA	4	

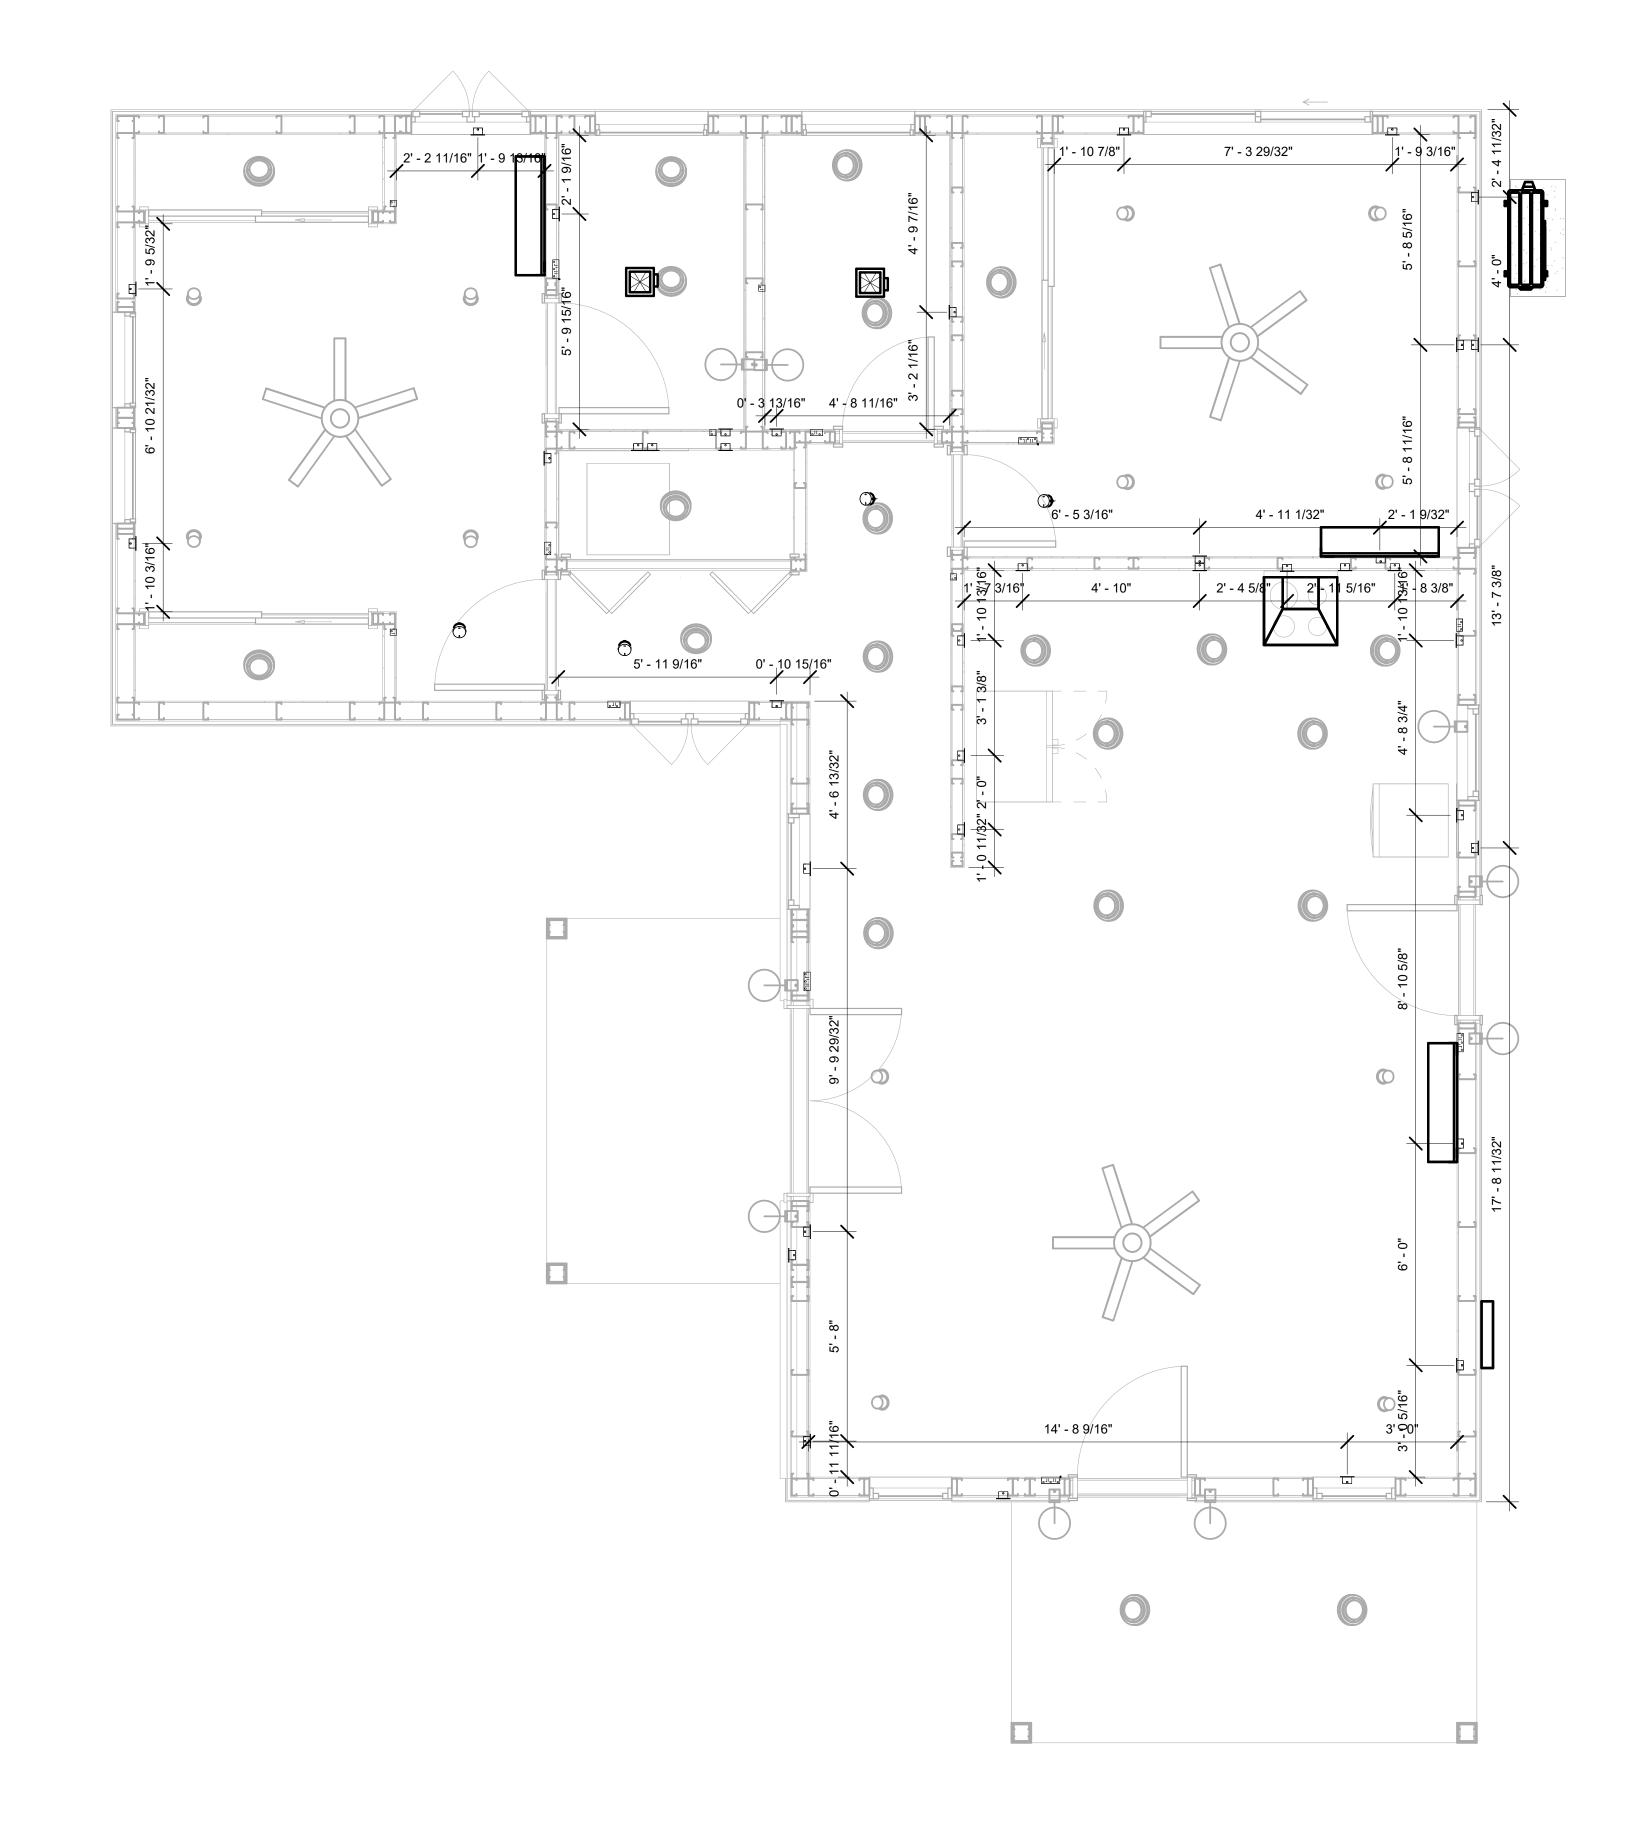

1 DIMENSION FOR FITTINGS 3/8" = 1'-0"



KEY PLAN

NO. DESCRIPTION DATE

NOTE:

LEGEND:

PROJECT

58-Hamilton-1000-2Bd-2Ba Ranch-550

DRAWING NAME

DIMENSION PLAN FOR FITTINGS

CLIENT NAME:

PROJECT NUMBER:

0180_14

DATE:

2/15/2025 3:59:51 PM

DESIGNED BY:

DRAWN BY:

CHECKED BY:

Checker

E105

SHEET LIST

SHEET NUMBER SHEET NAME

P101 NOTE AND SCHEDULE P102 WATER SUPPLY AND SEWAGE SYSTEM

PIPE COLC	R SCHEME
	DOMESTIC COLD WATE
	DOMESTIC HOT WATER
	SANITARY VENT
	SANITARY SEWER
	STORM DRAINAGE
	GRAY WATER
	GAS LINE

PLUMBING NOTES

- THE PLUMBING SYSTEM IS DESIGNED TO MEET THE BUILDING'S DOMESTIC WATER SUPPLY, SANITARY DRAINAGE, AND STORM DRAINAGE REQUIREMENTS, AS PER PROJECT SPECIFICATIONS AND APPLICABLE CODES.
- THE SYSTEM INSTALLATION SHALL COMPLY WITH THE LATEST INTERNATIONAL PLUMBING CODE (IPC), INTERNATIONAL RESIDENTIAL CODE (IRC), AND ALL OTHER RELEVANT LOCAL, STATE, AND NATIONAL REGULATIONS.
- ALL PLUMBING WORK SHALL COMPLY WITH THE LATEST EDITION OF THE INTERNATIONAL PLUMBING CODE (IPC) AND THE LOCAL PLUMBING CODE.
- PLUMBING SYSTEMS SHALL BE TESTED AND INSPECTED IN ACCORDANCE WITH THE LOCAL PLUMBING CODE REQUIREMENTS.
- 5. PLUMBING FIXTURES SHALL BE INSTALLED WITH THE APPROPRIATE TRIM, FITTINGS, AND
- ACCESSORIES, AS RECOMMENDED BY THE MANUFACTURER. 6. PIPING SHALL BE PROPERLY SUPPORTED AND SECURED TO PREVENT SAGGING, MOVEMENT, AND VIBRATION.
- SHUT-OFF VALVES SHALL BE PROVIDED AT ALL BRANCH CONNECTIONS AND AT THE INLET AND OUTLET OF EACH PIECE OF EQUIPMENT.
- BACKFLOW PREVENTION DEVICES SHALL BE INSTALLED AS REQUIRED BY THE LOCAL
- PLUMBING CODE TO PROTECT THE POTABLE WATER SYSTEM. PLUMBING FIXTURES AND EQUIPMENT SHALL BE ACCESSIBLE FOR MAINTENANCE AND
- 10. EXPOSED PLUMBING PIPING AND FIXTURES SHALL BE INSULATED TO PREVENT CONDENSATION AND ENERGY LOSS.
- 11. DEAD ENDS IN THE DRAINAGE SYSTEM MUST BE AVOIDED, EXCEPT WHERE NECESSARY TO INSTALL A CLEANOUT IN AN ACCESSIBLE LOCATION, AND MUST HAVE A VENTED CONNECTION TO THE OUTSIDE ATMOSPHERE.
- 12. THE VERTICAL DEFLECTION OF PVC PIPE MUST NOT EXCEED 5%, AND NO DEFLECTION IS PERMITTED FOR IRON PIPE.
- 13. WORK MUST BE PROPERLY COORDINATED WITH OTHER TRADES TO AVOID CONFLICTS, REFERRING TO THE ARCHITECTURAL AND STRUCTURAL DRAWINGS FOR INFORMATION REGARDING CEILING ELEVATIONS, SPACE CLEARANCES, WALL AND PARTITION LOCATIONS, ETC.
- 14. ALL FIXTURES SHALL HAVE ACCESSIBLE STOPS.
- 15. DOMESTIC WATER PIPING SHALL BE PEX, AND PVC PIPING IS NOT ACCEPTABLE FOR INTERIOR USE.
- 16. VENT TERMINATIONS SHALL BE LOCATED AT LEAST 10 FEET FROM OR 3 FEET ABOVE ANY OPERABLE WINDOW, DOOR OPENING, AIR INTAKE, OR VENT SHAFT, AND AT LEAST 3 FEET IN EVERY DIRECTION FROM ANY LOT LINE, ALLEY, OR STREET.
- 17. PIPE AND FITTINGS UTILIZED IN THE WATER SUPPLY SYSTEM SHALL HAVE A MAXIMUM OF 8 PERCENT LEAD.
- 18. ACRYLONITRILE BUTADIENE STYRENE (ABS) SHALL BE USED FOR THE SEWERAGE AND
- VENTILATION SYSTEM. 19. CROSS-LINKED POLYETHYLENE (PEX) SHALL BE USED FOR THE WATER SUPPLY SYSTEM.
- POLYVINYL CHLORIDE (PVC) SHALL BE USED FOR THE RAIN WATER SYSTEM.
- 21. THE MIMIMUM WATER SUPPLY DEPTH UNDER FLOOR FINISH SHOUD BE 1/2".
- 22. ANY PIPE INSTALLED UNDERGROUND MUST HAVE AT LEAST 12 INCHES OF CLEARANCE BETWEEN THE OUTSIDE OF THE PIPE AND ANY OTHER UNDERGROUND STRUCTURE.
- 23. THE MINIMUM CLEARANCE BETWEEN COLD AND HOT WATER LINES IN RESIDENTIAL HOMES MAINTAIN A MINIMUM DISTANCE OF 6 INCHES.
- 24. HORIZONTAL SEPARATION BETWEEN WATER AND SEWER LINES: A MINIMUM OF 12 INCHES BETWEEN POTABLE WATER SUPPLY LINES (COLD AND HOT WATER) AND SANITARY SEWER LINES.

ABBREVIATIONS

Ø	DIAMETER
ABS	ACRYLONITRILE BUTADIENE STYRENE
ABV	ABOVE
AD	AREA DRAIN
AFF	ABOVE FINISHED FLOOR
ALT	ALTERNATE
BFF	BELOW FINISHED FLOOR
BLW	BELOW
CO	CLEAN OUT
CW	COLD WATER
D	DEGREE
DFU	DRANAGE FIXTURE UNIT
DIA	DIAMETER
DN	DOWN
FCO	FLOOR CLEAN OUT
FD	FLOOR DRAIN
FL	FLOOR
FS	FLOOR SINK
FT	FOOT/FEET
НВ	HOSE BIB
HW	HOT WATER
IN	INCH
MIN	MINIMUM
NO	NUMBER
NTS	NOT TO SCALE
PEX	CROSS-LINKED POLYETHYLENE
PLBG	PLUMBING
PVC	POLYVINYL CHLORIDE
QTY	QUANTITY
RD	ROOF DRAIN
RED	REDUCER
RM	ROOM
RW	RAIN WATER
SF	SQUARE FOOT
V	VENT
VTR	VENT THROUGH ROOF
W	WASTE
WCO	WALL CLEAN OUT
WSFU	WATER SUPPLY FIXTURE UNIT

PLUMBING LEGEND

D	CAP
	BEND 45 DEG
B	BEND 90 DEG
	TEE REDUCING
	TEE
	CLEAN TWO-WAY
	WYE 45 DEG
	WYE 45 DEG DOUBLE
	WYE COMBINATION
	P-TRAP

PIPE SCHEDULE			
MATERIAL	DIAMETER	LENGTH	
ACRYLONITRILE BUTADIENE STYRENE (ABS)	1 1/2"	14 FT	
ACRYLONITRILE BUTADIENE STYRENE (ABS)	2"	73 FT	
ACRYLONITRILE BUTADIENE STYRENE (ABS)	3"	8 FT	
CROSS-LINKED POLYETHYLENE (PEX)	1/2"	90 FT	
CROSS-LINKED POLYETHYLENE (PEX)	3/4"	74 FT	
POLYVINYL CHLORIDE - RIGID	2"	157 FT	

FITTING SCHEDULE			
FITTING	SIZE	QTY	
DOMESTIC COLD WATER			
PEX 90 DEGREE ELBOW	1/2"ø-1/2"ø	14	
PEX 90 DEGREE ELBOW	3/4"ø-3/4"ø	7	
PEX CROSS ELBOW	3/4"ø-3/4"ø-3/4"ø	1	
PEX TEE ELBOW	1/2"ø-1/2"ø	6	
PEX TEE ELBOW	3/4"ø-3/4"ø	4	
PEX TRANSITION ELBOW	1"ø-1/2"ø	2	
PEX TRANSITION ELBOW	3/4"ø-1/2"ø	9	
DOMESTIC HOT WATER			
PEX 90 DEGREE ELBOW	1/2"ø-1/2"ø	13	
PEX 90 DEGREE ELBOW	3/4"ø-3/4"ø	3	
PEX TEE ELBOW	1/2"ø-1/2"ø-1/2"ø	3	
PEX TEE ELBOW	3/4"ø-3/4"ø	3	
PEX TRANSITION ELBOW	3/4"ø-1/2"ø	6	
PVC 90 DEG BEND ELBOW SEWAGE	2"ø-2"ø	63	
ABS 90 DEGREE BEND ELBOW	1 1/2"ø-1 1/2"ø	1	
ABS 90 DEGREE BEND ELBOW	2"ø-2"ø	6	
ABS 90 DEGREE BEND ELBOW	3"ø-3"ø	2	
ABS P-TRAP	1 1/2"ø-1 1/2"ø	5	
ABS P-TRAP	2"ø-2"ø	2	
ABS REDUCER ELBOW	2"ø-1 1/2"ø	2	
ABS REDUCER ELBOW	3"ø-2"ø	2	
ABS TEE ELBOW	2"ø-2"ø-2"ø	4	
ABS TEE ELBOW	3"ø-3"ø-3"ø	1	
ABS WYE COMBINATION WITH 8TH BEND DOUBLE ELBOW	3"ø-3"ø-1 1/2"ø-1 1/2"ø	1	
ABS WYE COMBINATION WITH 8TH BEND ELBOW	2"ø-2"ø-2"ø	1	
WASTE DOUBLE TEE	1 1/2"ø-1 1/2"ø-1 1/2"ø-1 1/2"ø	1	
WASTE DOUBLE TEE	3"ø-3"ø-3"ø	1	
VENT			
VENT ABS 90 DEGREE BEND ELBOW	1 1/2"ø-1 1/2"ø	1	
	1 1/2"ø-1 1/2"ø 2"ø-2"ø-1 1/2"ø	1 1	

FIXTURE CONNECTION SCHEDULE					
FAMILY	WV	TRAP CW	W HW QTY D	FU TOT. WFU TOT.	NOTES

DISHWASHER	2"	1-1/2"	1-1/2"	1/2"	1/2"	1	0	DRAIN TO SEWER SEE PLANS
DRYER	N/A	N/A	N/A	N/A	N/A	1	0	
HANGING PIPES CLAMP						42	0	
SHOWER TRAY						2	0	
SHOWER TRIM	-	-	-	1/2"	1/2"	2	0	
VANITY SINK	2"	1-1/2"	1-1/2"	1/2"	1/2"	2	0	
WASHER	2"	1-1/2"	2"	1/2"	1/2"	1	0	DRAINS TO GRAY WATER OR SEWER SEE PLANS
WATER CLOSET	3"	2"	3"	1/2"	1/2"	2	0	
WATER HEATER	N/A	N/A	N/A	3/4"	3/4"	1	0	

FIXTURE SCHEDULE							
FIXTURE	QTY	DESCRIPTION					
DISHWASHER	1	DRAIN TO SEWER SEE PLANS					
DRYER	1						
HANGING PIPES CLAMP	42						
SHOWER TRAY	2						
SHOWER TRIM	2						
VANITY SINK	2						
WASHER	1	DRAINS TO GRAY WATER OR SEWER SEE PLANS					
WATER CLOSET	2						
WATER HEATER	1						

ACCESSORIES & FITTINGS SCHEDULE							
FIXTURE QTY DESCRIPTIONS							
DISHWASHER CONNECTOR	1						
HOSE BIB	3						
LAUNDRY SWEAT CONNECTOR	1						
SHUTOFF VALVE	8						

PLUMBING SCHEDULE									
FIXTURE	TRAP	WASTE	VENT	C.W	H.W				
DISHWASHER	1-1/2"	2"	1-1/2"	1/2"	1/2"				
DRYER	N/A	N/A	N/A	N/A	N/A				
SHOWER TRAY									
SHOWER TRIM	-	-	-	1/2"	1/2"				
VANITY SINK	1-1/2"	2"	1-1/2"	1/2"	1/2"				
WASHER	2"	2"	1-1/2"	1/2"	1/2"				
WATER CLOSET	3"	3"	2"	1/2"	1/2"				
WATER HEATER	N/A	N/A	N/A	3/4"	3/4"				

WATER FIXTURE UNIT SCHEDULE							
FAMILY	QTY	UNIT VALUE	TOTAL				
DISHWASHER	1		0				
DRYER	1		0				
HANGING PIPES CLAMP	42		0				
SHOWER TRAY	2		0				
SHOWER TRIM	2		0				
VANITY SINK	2		0				
WASHER	1		0				
WATER CLOSET	2		0				
WATER HEATER	1		0				

WASTE FIXTURE UNIT SCHEDULE								
FAMILY	QTY	DFU VALUES	TOTAL					
DISHWASHER	1		0					
DRYER	1		0					
HANGING PIPES CLAMP	42		0					
SHOWER TRAY	2		0					
SHOWER TRIM	2		0					
VANITY SINK	2		0					
WASHER	1		0					
WATER CLOSET	2		0					
WATER HEATER	1		0					



Tuscon, AZ, USA 888-864-0184

KEY PLAN

DESCRIPTION DATE

NOTE:

LEGEND:

PROJECT

58-Hamilton-1000-2Bd/2Ba Ranch-550 Work Order

DRAWING NAME


NOTE AND SCHEDULE

CLIENT NAME:

PROJECT NUMBER: 0180_14 2/13/2025 5:38:19 PM DATE: Designer DESIGNED BY: DRAWN BY: Author CHECKED BY: Checker

P101


SCALE: 1/2" = 1'-0"

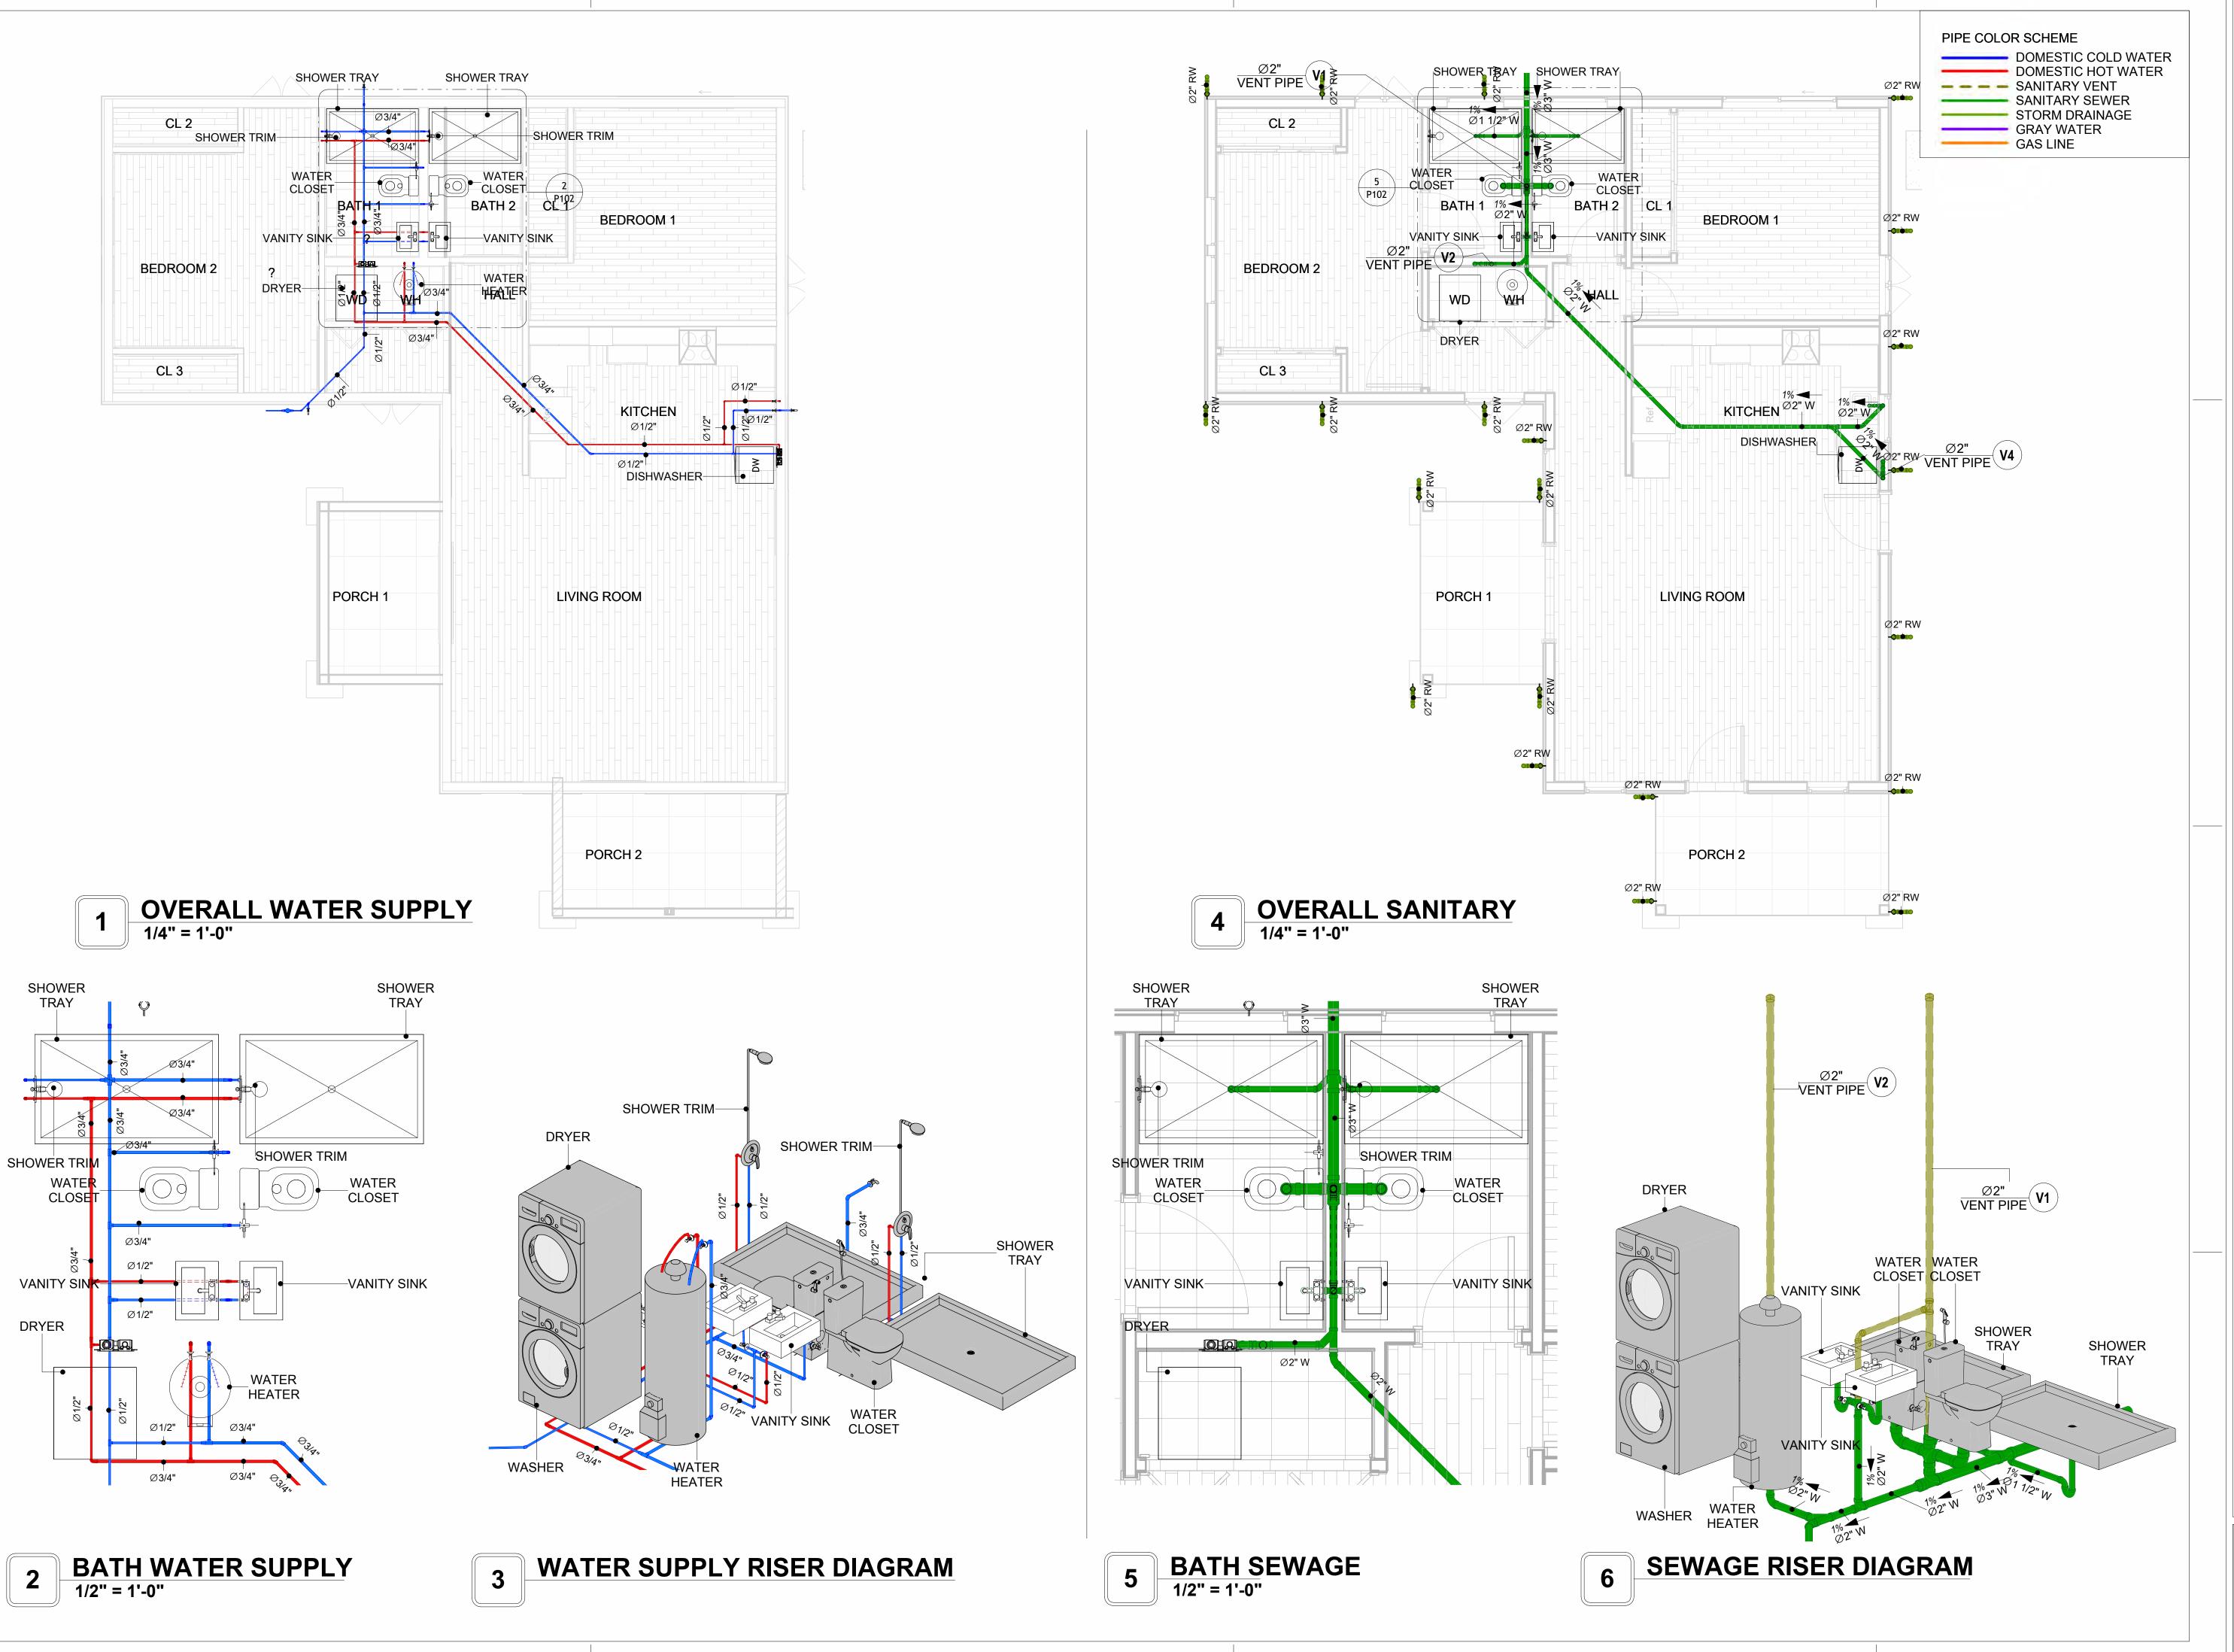



KEY PLAN

Tuscon,AZ, USA 888-864-0184

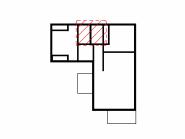

DESCRIPTION

DATE

NOTE:

NO.

LEGEND:

PROJECT

58-Hamilton-1000-2Bd/2Ba Ranch-550 Work Order

DRAWING NAME

WATER SUPPLY AND SEWAGE SYSTEM

CLIENT NAME:	
PROJECT NUMBER:	0180_14
DATE:	2/13/2025 5:38:53 PM
DESIGNED BY:	Designer
DRAWN BY:	Author
CHECKED BY:	Checker

P102

Materials Shopping List

Please print and take this Materials Shopping List to your favorite Home Depot and ask for assistance in selecting the materials, fixtures and fittings to complete your new home.

Record your selection and the price of the item. Then do the math to determine the cost for your selections and the total cost of finishing your home.

Have It Your Way!

The material types listed in this document were selected based on personal preferences. The Customer is encouraged to make changes to the material types in accordance with local customs, regulations, and personal preferences.

Have It Your Way!



20 good reasons to frame a home with metal and not wood



Why build your ADU with metal vs wood	Wood	Metal	Explanation
1 DIY Construction Benefit		~	The wall frames, trusses and beams can be erected in a just a few days
2 Minimal Construction Skills Required		~	Pre-assembled walls and trusses require no specialized skills to errect
3 Build as DIY, Hybrid or by a General Contractor		✓	Do it yourself, Hybrid (involve special contractors) or hire a General Contractor
4 Build It As You Can Afford It		✓	Impervious to Weather - build as you have the time and money
5 Up Front Cost of Framing Materials	~		As to only the framing material, wood is less expensive
6 Total Cost To Build		~	Savings in time, labor, and other areas make light gauge steel LESS expensive
7 Termites and wood boring insects		Y	Termites, carpenter ants and wood boring insects eat wood, not metal
8 Mold resistant		~	Metal does not attract mold
9 Damage caused by exterior and interior flooding		~	Metal needs no reconditioning after a flood
10 Fire Resistant		~	Non-combustible
11 Lower insurance rates		Y	Many insurance underwriters now provide lower rates for metal framed homes
12 Walls, trusses, and beams retain their original form		~	Perfectly straight walls - no shimming of drywall
13 Corners are 90 degrees		✓	No need for templating of countertops to adjust for out of square corners
14 Strength and weight		✓	Metal is stronger than wood and weighs less - no need for crane to lift ADU trusses
15 IBC Engineered Stamp		✓	If an engineering stamp is necessary, months of waiting are saved
16 Complete BOM (Materials Shopping List)		~	Take the materials shopping list to Home Depot and start shopping/pricing
17 Flexible in Seismic Areas - Won't Fracture		~	Light gauge steel is flexible and won't fracture when the earth moves
18 No Waste At Job Site		~	Steel is the most recycled material in the world. A typical wood home has 20-30% waste
19 Environmentally Friendly		~	Trees don't have to be destroyed and the source of most metal is from recycling
20 How-To Videos Included		~	How-to videos provide simple assembly instructions
21 Relationship Counselor		~	Eliminate emotional uphevels - save time, money, and preserve the relationship

Universal Requirements - some or all may be required

- 1 Site plan
- 2 Electrical Supply Connection
- 3 Sewer Connection
- 4 Fresh Water Supply Connection
- 5 Set Backs
- 6 Soils Evaluation

- 7 Earthquake (fault) evaluation
- 8 Foundation Plan subject to soils
- 9 Compliance with local energy codes: insulation home wrap and flashing
- 10 Engineering for wind speed and snow load.
- 11 State and Local ordinances regarding ADUs
- 12 Local Architect and/or Engineer may be necessary

Hamilton-2Bd2Ba-Ranch





Hamilton-2Bd2Ba-Ranch MATERIAL SHOPPING LIST

Have It Your Way!

The material types listed in this document were selected based on personal preferences. The Customer is encouraged to make changes to the material types in accordance with local customs, regulations, and personal preferences. Have It Your Way!

TOC



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Have It Your Way!

The material types listed in this document were selected based on personal preferences. The Customer is encouraged to make changes to the material types in accordance with local customs, regulations, and personal preferences. Have It Your Way!

GENERAL NOTES

- 1 This BOM (Bill of Materials) is prepared as a Materials Shopping List to help builders and DIYers gain a complete understanding of most if not all elements required for the complete construction of this structure, according to the original design documents provided by FrameUpNow.
- 2 All quantities and specifications are subject to change based on the final design, field measurements, availability of products and customer preferences. The customer should verify all information prior to purchasing materials.
- 3 All products and elements in the list shall conform to the International Residential Code (IRC), or any other local and international building codes, safety regulations, and standards that are applicable to the location of the structure.
- 4 If any changes are made by the customer to the list of materials specified in this document, the customer is responsible for assuring that the correct type and quantity of materials are utilized in accordance with local building codes.
- FrameUpNow, will not be held responsible for any misuse of this document, the products listed, or for deviations from the content that are made due to changes in specifications, pricing, availability, or customer preferences.
- 6 The customer is advised to consult a qualified professional or technician prior to purchasing materials for specialized construction system items. Some items including but not limited to caseworks, doors and windows may require as built measurements prior to purchase to confirmation of final dimensions.
- 7 If there are additional trim elements or specific installation methods, the total amount of materials needed might vary. Consider any additional trim required for corners, intersections, or other architectural details that might cause this variations before procedding to purchase and construction.

ARCHITECTURAL BOM



				l2Ba-Ranch			
Nc	Itom	ARCHITECTI			PING LIST Unit Price	Total	Doccrintion
Vo. ☐	APPLIANCES	Туре	Unit	Quantity	Unit Price	Total	Description
1	Refrigerator	I	PCS	1			
2	Range		PCS	1			
3	Washer		PCS	1			
			PCS	1			
4	Dryer Dish Washer		PCS				
5	Dish Washer			1			
6	Oven		PCS	0			
7	Microwave		PCS	0			
<u> </u>	CASEWORKS	I	le-r	05.00			
1	Kitchen Cabinet		FT	25.02			
2	Laundry Cabinet		FT	0			
3	Vanity Cabinet		FT	2.5			
	Medicine Cabinet		PCS	2			
5	Kitchen countertop		SF	38.23			
6	Laundry Countertop		PCS	0			
7	Bathroom Countertop		SF	0			
8	Island		FT	0			
9	Peninsula		FT	0			
10	Closets		SF	129			
Δ	CEILING						
1	Ceiling Board	Dry Wall	SF	909.15			
2	Dry Wall Fastener	Screw	PCS	1591.0125			
3	Vapor Retarder	Polyethylene film	SF	1142.09			
4	Vapor Retarder Fastener	Nails with washer heads	PCS	3426.27			
5	Ceiling Board (MRD)	Moisture resistant drywall	SF	93.44			
6	MRD Fastener		PCS	163.52			
7	Ceiling Board	Marine Plywood	SF	139.5			
	Marine Plywood Fastener	Screw	PCS	244.125			
	Dry Wall Tape	0.0.0.0	FT	571.045			
Δ	FLOORING			071.010			
	Main Living Space		SF	473			
2	Bathroom		SF	75.5			
3	Bedrooms		SF	320.7			
4	Porch		SF	150.8			
<u>4</u>	STRUCTURE	l .	31	150.6			
	Foundation		SF	1148.5			
	WALLS EXTERIOR		31	1140.5			
1	Stocco Finish	I	SF	342			
	Exterior-Grade Plywood		SF	860			
		C-16 d-:!!:(100/-14)					
3		Self-drilling screws(100/pkt)	PKT	8.6			
4	Wall Shteathing (OSB)	C 15 1 1111 (400/ 11)	SF	1202			
5	Shteathing Fastener	Self-drilling screws(100/pkt)	PKT	12.02			
6	Wall Homewrap	0. 1.15 1. (000/11)	SF	1202			
7	Homewrap Fastener	Stapled fastener (200/pkt)	PKT	4.5676			
8	Furring Strip		PCS	107.5			
9	Furring Strip Fastener	Self-drilling screws(100/pkt)	PKT	8.6			
	Wall Paint		SF	1202			
	Stone Copping	Masonry stone	SF	0			
	Stone Veneer	Masonry stone	SF	0			
	Mortar for Stone Veneer		SF	0			
	Wall Insulation		SF	3837			
	WALLS INTERIOR						
1	Cementitious Backer Board		SF	355			
2	Kerdi membrane		SF	355			
	Kerdi membrane Fastener		SF	355			
	Wall Ceramic Tile		SF	355			
	Drywall Board		SF	2048			
5	Drywall Fastener	Self-drilling screws(100/pkt)	PKT	20.48			
				L-0.10			
6				2048			
	Wall Paint Drywall Tape	l l l l l l l l l l l l l l l l l l l	SF FT	2048 384.7388644			

ARCHITECTURAL BOM



	DOORS				
		21 011 1/ (1 011	DCC	12	
	Exterior Swinging	3' - 0" X 6'-8"	PCS PCS	2	
	Interior Swinging	2' - 6" X 6'-8"		2	
	Interior Swinging	3' - 0" X 6'-8"	PCS	2	
	Interior Sliding	7' - 4" X 6'-8"	PCS	1	
	Bifold Door	6' - 0" X 6'-8"	PCS	1	
	Interior Sliding	6' - 0" X 6'-8"	PCS	2	
	Exterior Swinging	5' - 0" X 6'-8"	PCS	1	
	Exterior Door Trim		FT	51.02	
9	Interior Door Trim		FT	337	
10	Entry Lock set		PCS	3	
11	Privacy Lock set		PCS	4	
12	Passage Lock set		PCS	4	
Δ	WINDOWS				
1	Hung	2' - 3" X 4'-3"	PCS	2	
2	Casment	3' - 3" X 3'-9"	PCS	3	
3	Fixed	3' - 1" X 2'-1"	PCS	2	
4	Fixed	2' - 7" X 2'-7"	PCS	2	
5	Hung	2' - 7" X 3'-9"	PCS	1	
6	Hung	2' - 7" X 3'-1"	PCS	1	
7	Sliding	6' - 3" X 3'-9"	PCS	1	
8	Exterior Window Trim		FT	153	
	Interior Window Trim		FT	153	
	ROOF	-			-
	Roof Covering		SF	1490	
	Roof Covering Fastener		PCS	745	
	Roof Felt Paper		SF	1490	
	Roof Felt Paper Fastener		PCS	4470	
	Roof Sheathing		SF	1490	
	Roof Sheathing Fastener		PCS	11920	
7	Batten		FT	0	
8	Batten Fastener		PCS	0	
9	Soffit		SF	208	
10	Soffit Fastener		PCS	104	
	Fascia		FT	201	
	Fascia board fastener		PCS	100.5	
	Roof Insulation		SF	1490	
13	KOOI IIISUIAIIOII		SF	1490	



		Ham	ilton-2Bd2l	Ba-Ranch	1		
		ELECTRICAL	MATERIA	L SHOPP	ING LIST		
No.	Item	Туре	Unit	Quantity	Unit Price	Total	Description
Δ	LIGHTING FIXTURES						
1	Kitchen Ceiling Light		PCS	7			
2	Exterior Wall Mounted Light		PCS	4			
3	Livingroom Ceiling Light With Fan		PCS	1			
4	Bedroom Ceiling Light With Fan		PCS	2			
5	Dining Ceiling Light		PCS	0			
6	Bath Wall Mounted Light		PCS	2			
7	Bathroom Ceiling Light		PCS	4			
8	Livingroom Ceiling Light		PCS	4			
9	Bedroom Ceiling Light		PCS	8			
	Hall & Entry Ceiling Light		PCS	5			
11	Closet Ceiling Light		PCS	3			
12	Smoke Detector		PCS	4			
Δ	ELECTRICAL FITTINGS						
13	Standard Receptacle 120V	20A	PCS	16			
14	GFCI Receptacle 120V	20 A	PCS	16			
15	GFCI Receptacle 240V	30 A	PCS	2			
16	GFCI Receptacle 240V	50 A	PCS	1			
17	GFCI Receptacle 240V	60 A	PCS	1			
	Fan Switch		PCS	2			
19	Single Pole Switch		PCS	15			
20	Three Way Switch		PCS	6			
	Dimmer Switch		PCS	5			
	ELECTRICAL CONDUITS & WIRING		1. 55	0			
	ROMEX 14 AWG	14/2/W/ground	FT	169			
23	ROMEX 12 AWG	12/3/W/ground	FT	340			
	ROMEX 12 AWG	12/2/W/ground	FT	39			
	ROMEX 10 AWG	10/3/W/ground	FT	63			
	ROMEX 10 AWG	10/2/W/ground	FT	111			
27	Romex 8 AWG	8/3/W/ground	FT	75			
	Romex 8 AWG	8/2/W/ground	FT	34			
	ROMEX 6 AWG	6/3/W/ground	FT	40			
	Bare Copper Ground Wire 6 AWG	5757 VV/gi Outiu	FT	0			
<u></u>	ELECTRICAL BOXES & CIRCUTES		11	3			
	Panelboard -240V 1 Phase MLO	200 AMP	PCS	1			
32	Circuit breaker	15 A	PCS	5			
	Circuit breaker	20 A	PCS	9			
	Circuit breaker	30 A	PCS	3			
35	Circuit breaker	40 A	PCS	0			
	Circuit breaker	50 A	PCS	1			
	Circuit breaker	60 A	PCS	1			
	Single Gang Switch Box	00 A	PCS	5			
	Double Gang Switch Box		PCS	4			
	Triple Gang Switch Box		PCS	5			
41	Pull Box	#1/4	PCS	41			
		# 1/4					
43	Receptacle Box		PCS	38			

PLUMBING BOM



	Hamilton-2Bd2Ba-Ranch							
	Р	LUMBING SYSTEM	/I MATERIAL	. SHOPPIN	NG LIST			
No.	Item	Туре	Unit	Quantity	Unit Price	Total	Description	
	PLUMBING FIXTURES & ACCESSORIES							
1	Bath Tub (Alcove Tub)		PCS	0				
2	Kitchen Sink		PCS	1				
3	Kitchen Faucets		PCS	1				
4	Vanity Sink		PCS	2				
5	Bath room Faucets		PCS	2				
6	Water Closet		PCS	2				
7	Shower Trim		PCS	2				
8	Shower Tray		PCS	2				
9	Water Heater		PCS	1				
10	Hose Bib		PCS	2				
11	Shutoff Valve		PCS	8				
12	Hanging pipe clamp		PCS	30				
13	Gate Valve		PCS	1				
14	Dishwasher Supply Single Connector		PCS	1				
15	Dishwasher Sewage Single Connector		PCS	1				
16	Laundry Sweat Connector		PCS	1				
	SANITARY & PLUMBING PIPES							
1	ABS (Acrylonitrile Butadiene Styrene) Pipes	ø 1"	FT	0				
2	ABS (Acrylonitrile Butadiene Styrene) Pipes	ø 1 1/2"	FT	62				
3	ABS (Acrylonitrile Butadiene Styrene) Pipes	ø 2"	FT	191				
4	ABS (Acrylonitrile Butadiene Styrene) Pipes	ø 3"	FT	8				
5	PEX (Cross-linked polyethylene) Pipes	ø 1/2"	FT	90				
6	PEX (Cross-linked polyethylene) Pipes	ø 3/4"	FT	73				
7	PEX (Cross-linked polyethylene) Pipes	ø 1"	FT	0				
8	PVC Pipes Sch.80 - Rigid	ø 1 1/2"	FT	0				
9	PVC Pipes Sch.80 - Rigid	ø 2"	FT	157				
10	PVC Pipes Sch.80 - Rigid	ø 3"	FT	0				
11	Flex Pipe Round	ø 1/2"	PCS	8				

PLUMBING BOM



Δ	PIPE FITTINGS				
1	ABS 90 Degree Bend Elbow	1 1/2"ø-1 1/2"ø	PCS	2	
2	ABS 90 Degree Bend Elbow	2"ø-2"ø	PCS	6	
3	ABS 90 Degree Bend Elbow	3"ø-3"ø	PCS	2	
4	ABS P-Trap	1 1/2"ø-1 1/2"ø	PCS	5	
5	ABS P-Trap	2"ø-2"ø	PCS	2	
6	ABS Reducer Elbow	2"ø-1 1/2"ø	PCS	2	
7	ABS Reducer Elbow	3"ø-2"ø	PCS	2	
8	ABS TEE Elbow	2"ø-2"ø-2"ø	PCS	4	
9	ABS TEE Elbow	3"ø-3"ø-3"ø	PCS	1	
10	ABS Tee Reducer Elbow	2"ø-2"ø-1 1/2"ø	PCS	1	
11	ABS Vent Cap Elbow	2"ø	PCS	3	
12	ABS Wye Combination with 8th Bend Double	3"ø-3"ø-1 1/2"ø-1 1/2"ø	PCS	1	
13	ABS Wye Combination with 8th Bend Elbow	2"ø-2"ø-2"ø	PCS	1	
14	PEX 90 Degree Elbow	1/2"ø-1/2"ø	PCS	27	
15	PEX 90 Degree Elbow	3/4"ø-3/4"ø	PCS	10	
16	PEX Cross Elbow	3/4"ø-3/4"ø-3/4"ø	PCS	1	
17	PEX Tee Elbow	1/2"ø-1/2"ø-1/2"ø	PCS	9	
18	PEX Tee Elbow	3/4"ø-3/4"ø-3/4"ø	PCS	7	
19	PEX Transition Elbow	1"ø-1/2"ø	PCS	2	
20	PEX Transition Elbow	3/4"ø-1/2"ø	PCS	15	
21	PVC 90 Deg Bend Elbow	2"ø-2"ø	PCS	63	
22	WASTE DOUBLE TEE	1 1/2"ø-1 1/2"ø-1 1/2"ø-1	PCS	1	
23	WASTE DOUBLE TEE	3"ø-3"ø-3"ø	PCS	1	

HVAC BOM



		Hamilton-	2Bd2Ba	a-Ranch			
		HVAC SYSTEM MA	TERIAL	SHOPP	ING LIST		
No.	Item	Туре	Unit	Quantity	Unit Price	Total	Description
	HVAC_DUCTS						
1	PIPE (REFRIGERANT LINE)	3/8" (Ø)	FT	75.97			
2	PIPE (REFRIGERANT LINE)	3/4''' (Ø)	FT	91.42			
3	DRAYER HOSE	4" (Ø)	FT	6.7			
4	FLEX DUCT ROUND	4" (Ø)	FT	7.84			
	DUCT FITTINGS & ACCESSORIES						
5	ELBOW (REFRIGERANT LINE)	3/4" (Ø)-3/4" (Ø)	PCS	23			
6	ELBOW (REFRIGERANT LINE)	3/8" (Ø)-3/8" (Ø)	PCS	18			
7	TEE (REFRIGERANT LINE)	3/4" (Ø)-3/4" (Ø)-3/4"	PCS	2			
8	TEE (REFRIGERANT LINE)	3/8" (Ø)-3/8" (Ø)-3/8"	PCS	2			
9	TRANSITION (REFRIGERANT	3/4" (Ø)-1/2" (Ø)	PCS	3			
10	TRANSITION (REFRIGERANT	3/4" (Ø)-5/8" (Ø)	PCS	3			
11	TRANSITION (REFRIGERANT	3/8" (Ø)-1/4" (Ø)	PCS	1			
12	ROUND TRANSITION(ANGLE)	45 DEGREE	PCS	7			
	HVAC_EQUIPMENTS						
13	AIR HANDLING UNIT	WALL MOUNTED	PCS	3			
14	CONDENSER	OUTDOOR UNIT	PCS	1			
15	EXHAUST FAN	75 CFM	PCS	2			
16	HOOD-WALL: VENT	HOOD-WALL: VENT	PCS	1			
17	DRAYER: VENT	DRAYER: VENT	PCS	1			
18	ROOF VENT	3"(Ø)	PCS	3			



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Have It Your Way!

The material types listed in this document were selected based on personal preferences. The Customer is encouraged to make changes to the material types in accordance with local customs, regulations, and personal preferences. Have It Your Way!

GENERAL NOTES

- This BOM (Bill of Materials) is prepared as a Materials Shopping List to help builders and DIYers gain a complete understanding of most if not all elements required for the complete construction of this structure, according to the original design documents provided by FrameUpNow.
- 2 All quantities and specifications are subject to change based on the final design, field measurements, availability of products and customer preferences. The customer should verify all information prior to purchasing materials.
- 3 All products and elements in the list shall conform to the International Residential Code (IRC), or any other local and international building codes, safety regulations, and standards that are applicable to the location of the structure.
- 4 If any changes are made by the customer to the list of materials specified in this document, the customer is responsible for assuring that the correct type and quantity of materials are utilized in accordance with local building codes.
- 5 FrameUpNow, will not be held responsible for any misuse of this document, the products listed, or for deviations from the content that are made due to changes in specifications, pricing, availability, or customer preferences.
- The customer is advised to consult a qualified professional or technician prior to purchasing materials for specialized construction system items. Some items including but not limited to caseworks, doors and windows may require as built measurements prior to purchase to confirmation of final dimensions.
- 7 If there are additional trim elements or specific installation methods, the total amount of materials needed might vary. Consider any additional trim required for corners, intersections, or other architectural details that might cause this variations before procedding to purchase and construction.



			LIGHTING FIXTURES				
Ħ	Lighting	Туре	Description, Manufacturer, SKU	Unit	Quantity	Unit Price	Total
1	Kitchen Ceiling Light			PCS	7		
<u> </u>	Exterior Wall Mounted Light			PCS	4		
3	Livingroom Ceiling Light With Fan			PCS	1		
ļ	Bedroom Ceiling Light With Fan			PCS	2		
5	Dining Ceiling Light			PCS	C		
5	Bath Wall Mounted Light			PCS	2		
7	Bathroom Ceiling Light			PCS	4		
3	Livingroom Ceiling Light			PCS	4		
)	Bedroom Ceiling Light			PCS	8		
.0	Hall & Entry Ceiling Light			PCS	5		
.1	Closet Ceiling Light			PCS	3		
.2	Smoke Detector			PCS	4		
L3							
L4							
.5							



			ELECTRICAL FITTINGS				
#	Item	Туре	Description, Manufacturer, SKU	Unit	Quantity	Unit Price	Total
1	Standard Receptacle 120V	20A		PCS	16		
2	GFCI Receptacle 120V	20 A		PCS	16)	
3	GFCI Receptacle 240V	30 A		PCS	2)	
4	GFCI Receptacle 240V	50 A		PCS	1		
5	GFCI Receptacle 240V	60 A		PCS	1		
6	Fan Switch			PCS	2)	
7	Single Pole Switch			PCS	15		
8	Three Way Switch			PCS	6		
9	Dimmer Switch			PCS	5		
10							
11							
12							
13							
14							
15							



			ELECTRICAL CONDUITS & WIRIN	IG			
#	Item	Туре	Description, Manufacturer, SKU	Unit	Quantity	Unit Price	Total
1	ROMEX 14 AWG	14/2/W/ground		FT	169		
2	ROMEX 12 AWG	12/3/W/ground		FT	340		
	ROMEX 12 AWG	12/2/W/ground		FT	39		
1	ROMEX 10 AWG	10/3/W/ground		FT	63		
•	ROMEX 10 AWG	10/2/W/ground		FT	111		
5	Romex 8 AWG	8/3/W/ground		FT	75		
,	Romex 8 AWG	8/2/W/ground		FT	34		
3	ROMEX 6 AWG	6/3/W/ground		FT	40		
)	Bare Copper Ground Wire 6 AWG			FT			
.0							
.1							
.2							
.3							
4							
.5							



			ELECTRICAL BOXES & CIRCUTE	S			
#	Item	Туре	Description, Manufacturer, SKU	Unit	Quantity	Unit Price	Total
1	Panelboard -240V 1 Phase MLO	200 AMP		PCS	1		
2	Circuit breaker	15 A		PCS	5		
3	Circuit breaker	20 A		PCS	9		
4	Circuit breaker	30 A		PCS	3		
5	Circuit breaker	50 A		PCS	1		
6	Circuit breaker	60 A		PCS	1		
7	Single Gang Switch Box			PCS	5		
8	Double Gang Switch Box			PCS	4		
9	Triple Gang Switch Box			PCS	5		
10	Pull Box	#1/4		PCS	41		
11	Receptacle Box			PCS	38		
12							
13							
14							
15							

HVAC BOM



			HVAC_DUCTS 01				
#	Item	Туре	Description, Manufacturer, SKU	Unit	Quantity	Unit Price	Total
1	PIPE (REFRIGERANT LINE)	3/8" (Ø)		FT	75.97		
2	PIPE (REFRIGERANT LINE)	3/4"' (Ø)		FT	91.42		
3	DRAYER HOSE	4" (Ø)		FT	6.7		
4	FLEX DUCT ROUND	4" (Ø)		FT	7.84		

HVAC BOM



			DUCT FITTINGS & ACCESSORIES				
#	Item	Туре	Description, Manufacturer, SKU	Unit	Quantity	Unit Price	Total
1	ELBOW (REFRIGERANT LINE)	3/4" (Ø)-3/4" (Ø)		PCS	23		
2	ELBOW (REFRIGERANT LINE)	3/8" (Ø)-3/8" (Ø)		PCS	18		
3	TEE (REFRIGERANT LINE)	3/4" (Ø)-3/4" (Ø)-3/4"		PCS	2		
4	TEE (REFRIGERANT LINE)	3/8" (Ø)-3/8" (Ø)-3/8"		PCS	2		
5	TRANSITION (REFRIGERANT LINE)	3/4" (Ø)-1/2" (Ø)		PCS	3		
6	TRANSITION (REFRIGERANT LINE)	3/4" (Ø)-5/8" (Ø)		PCS	3		
7	TRANSITION (REFRIGERANT LINE)	3/8" (Ø)-1/4" (Ø)		PCS	1		
8	ROUND TRANSITION(ANGLE)	45 DEGREE		PCS	7		

HVAC BOM



			HVAC_EQUIPMENTS				
#	Item	Туре	Description, Manufacturer, SKU	Unit	Quantity	Unit Price	Total
1	AIR HANDLING UNIT	WALL MOUNTED		PCS	3		
2	CONDENSER	OUTDOOR UNIT		PCS	1		
3	EXHAUST FAN	75 CFM		PCS	2		
4	HOOD-WALL: VENT	HOOD-WALL: VENT		PCS	1		
5	DRAYER: VENT	DRAYER: VENT		PCS	1		
6	ROOF VENT	3"(Ø)		PCS	3		



	PLUMBING FIXTURES & ACCESSORIES								
#	Item	Туре	Description, Manufacturer, SKU	Unit	Quantity	Unit Price	Total		
1	Bath Tub (Alcove Tub)			PCS	0				
2	Kitchen Sink			PCS	1				
3	Kitchen faucets			PCS	1				
4	Vanity Sink			PCS	2				
5	Bath room faucets			PCS	2				
6	Water Closet			PCS	2				
7	Shower Trim			PCS	2				
8	Shower Tray			PCS	2				
9	Water Heater			PCS	1				
10	Hose Bib			PCS	2				
11	Shutoff Valve			PCS	8				
12	Hanging pipe clamp			PCS	42				
13	Gate Valve			PCS	1				
14	Dishwasher Supply Single Connector			PCS	1				
15	Dishwasher Sewage Single Connector			PCS	1				
16	Laundry Sweat Connector			PCS	1				



		SANI	TARY & PLUMBING PIPES				
#	Item	Туре	Description, Manufacturer, SKU	Unit	Quantity	Unit Price	Total
1	ABS (Acrylonitrile Butadiene Styrene) Pipes	ø 1"		FT	0		
2	ABS (Acrylonitrile Butadiene Styrene) Pipes	ø 1 1/2"		FT	14		
3	ABS (Acrylonitrile Butadiene Styrene) Pipes	ø 2"		FT	73		
4	ABS (Acrylonitrile Butadiene Styrene) Pipes	ø 3"		FT	8		
5	PEX (Cross-linked polyethylene) Pipes	ø 1/2"		FT	90		
6	PEX (Cross-linked polyethylene) Pipes	ø 3/4"		FT	74		
7	PEX (Cross-linked polyethylene) Pipes	ø 1"		FT	0		
8	PVC Pipes Sch.80 - Rigid	ø 1 1/2"		FT	0		
9	PVC Pipes Sch.80 - Rigid	ø 2"		FT	157		
10	PVC Pipes Sch.80 - Rigid	ø 3"		FT	0		
11	Flex Pipe Round	ø 1/2"		PCS	8		
12							
13							
14							
15							



		PIPE	FITTINGS 01				
#	Item	Туре	Description, Manufacturer, SKU	Unit	Quantity	Unit Price	Total
1	ABS 90 Degree Bend Elbow	1 1/2"ø-1 1/2"ø		PCS	2		
2	ABS 90 Degree Bend Elbow	2"Ø-2"Ø		PCS	6		
3	ABS 90 Degree Bend Elbow	3"ø-3"ø		PCS	2		
4	ABS P-Trap	1 1/2"ø-1 1/2"ø		PCS	5		
5	ABS P-Trap	2"Ø-2"Ø		PCS	2		
6	ABS Reducer Elbow	2"ø-1 1/2"ø		PCS	2		
7	ABS Reducer Elbow	3"ø-2"ø		PCS	2		
8	ABS TEE Elbow	2"ø-2"ø-2"ø		PCS	4		
9	ABS TEE Elbow	3"ø-3"ø-3"ø		PCS	1		
10	ABS Tee Reducer Elbow	2"ø-2"ø-1 1/2"ø		PCS	1		
11	ABS Vent Cap Elbow	2"ø		PCS	3		
12	ABS Wye Combination with 8th Bend Double Elbow	3"ø-3"ø-1 1/2"ø-1 1/2"ø		PCS	1		
13	ABS Wye Combination with 8th Bend Elbow	2"ø-2"ø-2"ø		PCS	1		
14	PEX 90 Degree Elbow	1/2"ø-1/2"ø		PCS	27		
15	PEX 90 Degree Elbow	3/4"ø-3/4"ø		PCS	10		



		PIPE FI	TTINGS 02				
#	Item	Туре	Description, Manufacturer, SKU	Unit	Quantity	Unit Price	Total
	PEX Cross Elbow	3/4"ø-3/4"ø-3/4"ø-3/4"ø		PCS	1		
	PEX Tee Elbow	1/2"ø-1/2"ø-1/2"ø		PCS	9		
	PEX Tee Elbow	3/4"ø-3/4"ø-3/4"ø		PCS	7	,	
	PEX Transition Elbow	1"ø-1/2"ø		PCS	2		
	PEX Transition Elbow	3/4"ø-1/2"ø		PCS	15		
	PVC 90 Deg Bend Elbow	2"ø-2"ø		PCS	63		
	WASTE DOUBLE TEE	1 1/2"ø-1 1/2"ø-1 1/2"ø-1 1/2"ø		PCS	1		
	WASTE DOUBLE TEE	3"ø-3"ø-3"ø		PCS	1		
0							
1							
2							
3							
4							
5							



			APPLIANCES				
#	Item	Туре	Description, Manufacturer, SKU	Unit	Quantity	Unit Price	Total
1	Refrigerator			PCS			
2	Range			PCS			
3	Washer Front Load	Stackable		PCS			
4	Dryer Front Load	Stackable		PCS			
5	Dish Washer			PCS			
6	Oven			PCS	(
7	Microwave			PCS	(
8							
9							
10							
11							
12							
13							
14							
15							
16							



			CASEWORKS 01				
#	Item	Туре	Description, Manufacturer, SKU	Unit	Quantity	Unit Price	Total
1	Kitchen Cabinet			FT	25.02		
2	Laundry Cabinet			FT	0		
3	Vanity Cabinet			FT	2.5		
4	Medicine Cabinet			PCS	2		
5	Kitchen countertop			SF	38.23		
6	Laundry Countertop			PCS	0		
7	Bathroom Countertop			SF	0		
8	Island			FT	0		
9	Peninsula			FT	0		
10	Closets			SF	129		
11							
12							
13							
14							
15							



			CEILING 01				
#	item	Туре	Description, Manufacturer, SKU	Unit	Quantity	Unit Price	Total
	LIVING ROOM + KITCHEN			SF	451.0		
1	Ceiling Board	Drywall		SF	451		
2	Drywall Fastener	Screw		PCS	789		
3	Vapor Retarder	Polyethylene film		SF	451.0		
4	Vapor Retarder Fastener	Nails with washer heads		PCS	1352.9		
	BATH ROOM 1			SF	46.7		
5	Ceiling Board	MRD (Moisture resistant drywall)		SF	47		
6	MRD Fastener	Screw		PCS	82		
	BATH ROOM 2			SF	46.7		
7	Ceiling Board	MRD (Moisture resistant drywall)		SF	47		
8	MRD Fastener	Screw		PCS	82		
9	WH + WD			SF	21.7		
10	Ceiling Board	Drywall		SF	22		
	Drywall Fastener	Screw		PCS	38		
11	Vapor Retarder	Polyethylene film		SF	21.7		
12	Vapor Retarder Fastener	Nails with washer heads		PCS	65.0		



			CEILING 02				
#	Item	Туре	Description, Manufacturer, SKU	Unit	Quantity	Unit Price	Total
	BED ROOM 1			SF	155.5		
13	Ceiling Board	Drywall		SF	155		
14	Drywall Fastener	Screw		PCS	272		
15	Vapor Retarder	Polyethylene film		SF	155.5		
16	Vapor Retarder Fastener	Nails with washer heads		PCS	466.4		
	BED ROOM 2			SF	151.2		
17	Ceiling Board	Drywall		SF	151		
18	Drywall Fastener	Screw		PCS	265		
19	Vapor Retarder	Polyethylene film		SF	151.2		
20	Vapor Retarder Fastener	Nails with washer heads		PCS	453.5		
	CL 1			SF	16.3		
21	Ceiling Board	Drywall		SF	16		
22	Drywall Fastener	Screw		PCS	28		
23	Vapor Retarder	Polyethylene film		SF	16.3		
24	Vapor Retarder Fastener	Nails with washer heads		PCS	48.8		



			CEILING 03				
#	Item	Туре	Description, Manufacturer, SKU	Unit	Quantity	Unit Price	Total
	CL 2			SF	19.6		
25	Ceiling Board	Drywall		SF	20		
26	Drywall Fastener	Screw		PCS	34		
27	Vapor Retarder	Polyethylene film		SF	19.6		
28	Vapor Retarder Fastener	Nails with washer heads		PCS	58.7		
	CL 3			SF	16.3		
29	Ceiling Board	Drywall		SF	16		
30	Drywall Fastener	Screw		PCS	28		
31	Vapor Retarder	Polyethylene film		SF	16.3		
32	Vapor Retarder Fastener	Nails with washer heads		PCS	48.8		
	HALL			SF	77.8		
33	Ceiling Board	Drywall		SF	78		
34	Drywall Fastener	Screw		PCS	136		
35	Vapor Retarder	Polyethylene film		SF	77.8		
36	Vapor Retarder Fastener	Nails with washer heads		PCS	233.4		



			CEILING 04				
#	Item	Туре	Description, Manufacturer, SKU	Unit	Quantity	Unit Price	Total
	FRONT PORCH			SF	81.0		
37	Ceiling Board	Marine Plywood		SF	81		
38	Exterior Grade Plywood	Screw		PCS	142		
	SIDE PORCH			SF	58.5		
39	Ceiling Board	Marine Plywood		SF	59		
40	Exterior Grade Plywood	Screw		PCS	102		



			FLOORING INTERIOR 01			
#	Item	Туре	Description, Manufacturer, SKU	Unit	Quantity Unit P	rice Total
	BEDROOM #1					
1	Bedroom Flooring			SF	139	
2	Wood underlay	Foam Pad Polyethylene		SF	139	
3	Vapor Retarder	Vapor Barrier Polyethylene		SF	139.0	
	BEDROOM#2					
7	Bedroom Flooring			SF	135	
8	Wood underlay	Foam Pad Polyethylene		SF	135	
9	Vapor Retarder	Vapor Barrier Polyethylene		SF	135.2	
	CL#1					
10	Closet Flooring			SF	15	
11	Wood underlay	Foam Pad Polyethylene		SF	15	
12	Vapor Retarder	Vapor Barrier Polyethylene		SF	14.5	
	CL#2	,				
13	Closet Flooring			SF	15	
14	Wood underlay	Foam Pad Polyethylene		SF	15	
15	Vapor Retarder	Vapor Barrier Polyethylene		SF	14.5	



			FLOORING INTERIOR 02				
#	Item	Туре	Description, Manufacturer, SKU	Unit	Quantity	Unit Price	Total
	CL#3						
16	Closet Flooring			SF	18		
17	Wood underlay	Foam Pad Polyethylene		SF	18		
18	Vapor Retarder	Vapor Barrier Polyethylene		SF	17.5		
	LIVING ROOM AND KITCH	EN					
19	Living Area Flooring			SF	473		
20	Wood underlay	Foam Pad Polyethylene		SF	473		
21	Vapor Retarder	Vapor Barrier Polyethylene		SF	473.0		
	BATHROOM#1						
22	Tile Finish			SF	28		
23	Adhesive	1/2" Thin set Mortar		SF	28		
24	Vapor Retarder	Vapor Barrier Polyethylene		SF	28.0		
	BATHROOM#2						
25	Tile Finish			SF	28		
26	Adhesive	1/2" Thin set Mortar		SF	28		
27	Vapor Retarder	Vapor Barrier Polyethylene		SF	28.0		



			FLOORING INTERIOR 03				
#	Item	Туре	Description, Manufacturer, SKU	Unit	Quantity	Unit Price	Total
	W/D						
1	Tile Finish			SF	20		
2	Adhesive	1/2" Thin set Mortar		SF	20		
3	Vapor Retarder	Vapor Barrier Polyethylene		SF	19.5		



	1		FLOORING EXTERIOR			
#	item	Туре	Description, Manufacturer, SKU	Unit	Quantity Unit Price	
	STRUCTURE			SF	1148.5	
1	Concrete Slab	4"concrete cast in situ		CF	394.8	
2	Insulation	Rigid insulation		SF	338	
3	Hard core	Compacted soil		CF	285.3	
4	Re-bar	#4 re-bar		Ton	1.12	
5	Concrete Pad	4"concrete cast in situ		CF	1.58	
6	Slab edge	Turndown		CF	334.8	
7	Footing	Cast-in-place concrete		CF	12	
	PORCH FRONT					
8	Tile Finish			SF	84.4	
9	Adhesive	1/2" Thin set Mortar		SF	84.4	
10	Vapor Retarder	Vapor Barrier Polyethylene		SF	84.4	
	PORCH SIDE					
11	Tile Finish			SF	66.4	
12	Adhesive	1/2" Thin set Mortar		SF	66.4	
13	Vapor Retarder	Vapor Barrier Polyethylene		SF	66.4	



			WALLS: EXTERIOR				
	Item	Туре	Description, Manufacturer, SKU	Unit	Quantity	Unit Price	Total
1	Stocco Finish			SF	342		
2	Exterior-Grade Plywood Horizontal Siding			SF	860		
3	8/panel	Self-drilling screws(100/pkt)		PKT	8.6		
4	Wall Shteathing (OSB)			SF	1202		
5	Shteathing Fastener	Self-drilling screws(100/pkt)		PKT	12.02		
6	Wall Homewrap			SF	1202.00		
7	Homewrap Fastener	Stapled fastener (200/pkt)		PKT	4.57		
8	Furring Strip			PCS	107.5		
9	Furring Strip Fastener	Self-drilling screws(100/pkt)		PKT	8.6		
10	Wall Paint			SF	1202		
11	Stone Copping	Masonry stone		SF	0		
12	Stone Veneer	Masonry stone		SF	0		
13	Mortar for Stone Veneer			SF	0		
14	Wall Insulation			SF	3837		
15							



			WALLS: INTERIOR 01				
#	item	Туре	Description, Manufacturer, SKU	Unit	Quantity	Unit Price	Total
	BATHROOM 1			SF	40.0		
1	Cementitious Backer Board			SF	230		
2	Kerdi membrane			SF	230		
3	Kerdi membrane Fastener			SF	230		
4	Wall Ceramic Tile			SF	230		
	BATHROOM 2			SF	40.0		
5	Cementitious Backer Board			SF	201		
6	Kerdi membrane			SF	201		
7	Kerdi membrane Fastener			SF	201		
8	Wall Ceramic Tile			SF	201		
	BEDROOM 1			SF	136.0		
9	Drywall Board			SF	402		
10	Drywall Fastener	Self-drilling screws(100/pkt)		PKT	4.02		
11	Wall Paint			SF	402		
12	Drywall Tape			FT	75.4		



			WALLS: INTERIOR 02				
#	item	Туре	Description, Manufacturer, SKU	Unit	Quantity	Unit Price	Total
	BEDROOM 2			SF	137.0		
13	Drywall Board			SF	351		
14	Drywall Fastener	Self-drilling screws(100/pkt)		PKT	3.51		
15	Wall Paint			SF	351		
16	Drywall Tape			FT	65.81661354		
	KITCHEN			SF	110.0		
17	Cementitious Backer Board			SF	35		
18	Drywall Board			SF	280		
19	Drywall Fastener	Self-drilling screws(100/pkt)		PKT	2.8		
20	Kerdi membrane			SF	35		
21	Kerdi membrane Fastener			SF	35		
22	Wall Ceramic Tile			SF	35		
23	Wall Paint			SF	280		
24	Drywall Tape			FT	52.8		



			WALLS: INTERIOR 03				
#	Item	Туре	Description, Manufacturer, SKU	Unit	Quantity	Unit Price	Total
	LIVING ROOM			SF	289.0		
25	Drywall Board			SF	324		
26	Drywall Fastener	Self-drilling screws(100/pkt)		PKT	3.24		
27	Wall Paint			SF	324		
28	Drywall Tape			FT	60.7879925		
	CLOSET 1			SF	17.0		
29	Drywall Board			SF	166		
30	Drywall Fastener	Self-drilling screws(100/pkt)		PKT	1.66		
31	Wall Paint			SF	166		
32	Drywall Tape			FT	31.12694543		
	CLOSET 2			SF	16.0		
33	Drywall Board			SF	111		
34	Drywall Fastener	Self-drilling screws(100/pkt)		PKT	1.11		
35	Wall Paint			SF	111		
36	Drywall Tape			FT	20.8		



			WALLS: INTERIOR 04				
#	Item	Туре	Description, Manufacturer, SKU	Unit	Quantity	Unit Price	Total
	CLOSET 3			SF	14.0		
37	Drywall Board			SF	111		
38	Drywall Fastener	Self-drilling screws(100/pkt)		PKT	1.11		
39	Wall Paint			SF	111		
40	Drywall Tape			FT	20.81380086		
	HALL			SF	69.0		
41	Drywall Board			SF	248		
42	Drywall Fastener	Self-drilling screws(100/pkt)		PKT	2.48		
43	Wall Paint			SF	248		
44	Drywall Tape			FT	46.79245283		
	WD			SF	9.0		
45	Cementitious Backer Board			SF	79		
46	Kerdi membrane			SF	79		
47	Kerdi membrane Fastener			SF	79		
48	Wall Ceramic Tile			SF	79		



			WALLS: INTERIOR 05				
#	Item	Туре	Description, Manufacturer, SKU	Unit	Quantity	Unit Price	Total
	WH			SF	9.0		
49	Drywall Board			SF	55		
50	Drywall Fastener	Self-drilling screws(100/pkt)		PKT	0.55		
51	Wall Paint			SF	55		
52	Drywall Tape			FT	10.37735849		
	Wall Skirting	Ceramic		FT	145		



			DOORS			
#	Item	Туре	Description, Manufacturer, SKU	Unit	Quantity Unit Price	Total
1	Exterior Swinging	3' - 0" X 6'-8"		PCS	2	
2	Interior Swinging	2' - 6" X 6'-8"		PCS	2	
3	Interior Swinging	3' - 0" X 6'-8"		PCS	2	
4	Interior Sliding	7' - 4" X 6'-8"		PCS	1	
5	Bifold Door	6' - 0" X 6'-8"		PCS	1	
6	Interior Sliding	6' - 0" X 6'-8"		PCS	2	
7	Exterior Swinging	5' - 0" X 6'-8"		PCS	1	
8	Exterior Door Trim			FT	51.02	
9	Interior Door Trim			FT	337	
10	Entry Lock set			PCS	3	
11	Privacy Lock set			PCS	4	
12	Passage Lock set			PCS	4	
13						
14						
15						



			WINDOWS			
#	Item	Туре	Description, Manufacturer, SKU	Unit	Quantity Unit Price	Total
1	Hung	2' - 3" X 4'-3"		PCS	2	
2	Casment	3' - 3" X 3'-9"		PCS	3	
3	Fixed	3' - 1" X 2'-1"		PCS	2	
4	Fixed	2' - 7" X 2'-7"		PCS	2	
5	Hung	2' - 7" X 3'-9"		PCS	1	
6	Hung	2' - 7" X 3'-1"		PCS	1	
7	Sliding	6' - 3" X 3'-9"		PCS	1	
8	Exterior Window Trim			FT	153	
9	Interior Window Trim			FT	153	
10						
11						
12						
13						
14						
15						



			ROOF 01				
#	Item	Туре	Description, Manufacturer, SKU	Unit	Quantity	Unit Price	Total
1	Roof Covering			SF	1490.0		
2	Roof Covering Fastener			PCS	745		
3	Roof Felt Paper			SF	1490.0		
4	Roof Felt Paper Fastener			PCS	4470.0		
5	Roof Sheathing			SF	1490.0		
6	Roof Sheathing Fastener			PCS	11920		
7	Batten			FT	0.0		
8	Batten Fastener			PCS	0.0		
9	Soffit			SF	208.0		
10	Soffit Fastener			PCS	104.0		
11	Fascia			FT	201.0		
12	Fascia board fastener			PCS	101		
13	Roof Insulation			SF	1490.0		
14							
15							