

# **HAMILTON**

The Hamilton is a charming two-bedroom, twobathroom Spanish-style home designed for comfortable living. Its exterior features a classic white stucco finish, complemented by a warmtoned clay tile roof. The prominent pergola over the entrance adds a touch of rustic charm and creates a shaded outdoor seating area. The carefully placed windows, with their traditional grid patterns, allow for ample natural light while maintaining privacy. Inside, the Hamilton embraces an L-shaped floor plan. The living and kitchen areas are combined into a spacious and inviting open-concept space. The bedrooms are thoughtfully positioned on one side of the home, creating a private and secluded wing for rest and relaxation.

## Materials Shopping List

Please print and take this Materials Shopping List to your favorite Home Depot and ask for assistance in selecting the materials, fixtures and fittings to complete your new home.

Record your selection and the price of the item. Then do the math to determine the cost for your selections and the total cost of finishing your home.

## < CLICK HERE >

To Go To Materials Shopping List



# 37' - 1" BEDROOM 2 139 SF


# **FLOOR PLAN**

1000 SF

2 Bed Rooms



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MATERIALS SHOPPING LIST
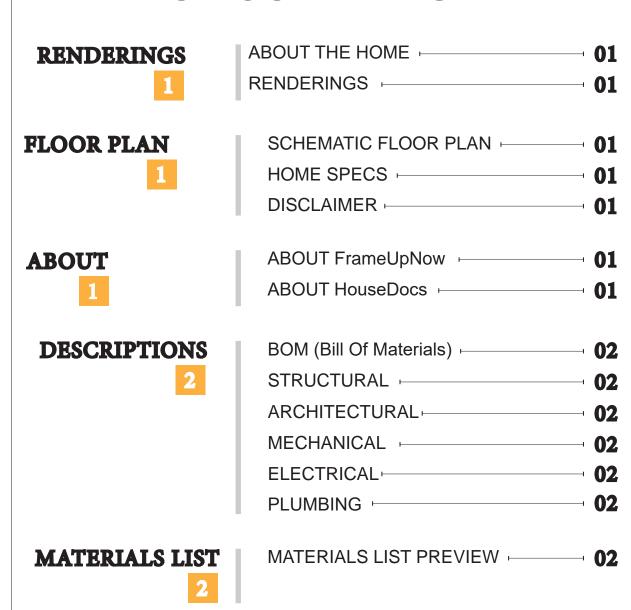
# **ABOUT**



FrameUpNow is a design and manufacturing company providing precision-engineered home framing solutions. We offer a catalog of Affordable Homes, Tiny Homes, Garages, Shops and Barndominiums. FrameUpNow manufactures cold-formed steel (CFS) also known as Light Gauge Steel (LGS) framing components that conform to our engineered metal house frame plans or can be purchased as DIY skeleton kits.

The CFS/LGS framing is lightweight, easily assembled, and does not require heavy equipment or specialized labor, enabling homeowners to erect the frame themselves in just a few days. Unlike wood, the steel framing is impervious termites and bores, warping, expansion, and fire.

Our home plans come complete with a structural engineered stamp for permit approvals. Customers receive a full BOM also known as a Materials Shopping List to purchase finish materials from a Building Materials retailer. FrameUpNow prides itself on the quality and efficiency of our precision-engineered home framing solutions for construction professionals and DIY homeowners.



**KEY PLAN** 

NO.	DESCRIPTION	DATE

NOTE:

LEGEND:

PROJECT

59-Hamilton-1000-2Bd-2Ba-Spanish-550

DRAWING NAME

# INTRODUCTION

CLIE	ENT NAME:	
PRO	DJECT NUMBER:	
DATI	E:	
DES	SIGNED BY:	
DRA	AWN BY:	
CHE	ECKED BY:	

1101

SCALE:

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# **DESCRIPTIONS**

## MATERIALS LIST

The BOM (Bill Of Materials) package, known as the Materials Shopping List document, provides:

Comprehensive Inventory: Detailed lists of essential materials sourced from architectural, mechanical, HVAC, electrical, and plumbing design drawing sets.

Precise Curation: Each item meticulously selected and organized for accuracy and efficiency in project planning.

Customizable Options: Customers can modify listed items to their preferences and calculate costs accordingly, ensuring alignment with personal project needs and budget.

Dedicated Space for Details: Includes tables for customers to note Home Depot SKU numbers or product descriptions for selected items, facilitating seamless purchasing and coordination with suppliers.

Customer Convenience: Take the list to Home Depot or preferred suppliers for accurate pricing, helping align the total home budget with personal financial plans.

Simplify your construction journey with our Materials Shopping List document, where detailed preparation meets streamlined implementation for your dream home.

HVAC Sections and Riser Diagrams: Technical drawings offering

critical cross-sectional details and piping schematics, ensuring

proper integration of the heating and cooling system into the home's

Bill of Materials: A complete list of all necessary HVAC components.

**MECHANICAL** 

## STRUCTURAL

The structural drawings package provides an exhaustive set of detailed plans essential for the precise assembly of your building. This comprehensive package includes:

Framing Plans: Detailed layouts for all framing components. Truss Layouts: Clear instructions for truss placement and

Panel Length Plans: Specifications for panel dimensions. Framing Elevations and Sections: Precise elevation and sectional views for accurate construction.

Truss and Wall Blocking Plans: Plans for truss and wall blocking to ensure structural integrity.

Hold-Down Plan: Detailed hold-down requirements for stability. Snap Sheet: Reference sheet for quick identification of components

Structural Details and Bracing Plans: Complete details and bracing plans for all structural elements.

Accompanying these plans is a comprehensive Bill of Materials (BOM) that lists every necessary building component, from cold formed steel (CFS) frames to fasteners.

## ARCHITECTURAL

With the comprehensive architectural package, both builders and DIY homeowners can confidently execute the construction.

The architectural package includes:

Furnished Floor Plans: Complete with furniture layouts for a clear understanding of space utilization.

Detailed Dimension Plans: Ensures precise measurements, from the overall footprint down to the exact placement of windows and

Foundation Plan: Detailed plan to establish a solid foundation.

Wall Framing and Truss Layout: Comprehensive plans for wall framing and truss placement.

Architectural Elevations: Exterior views showcasing the design.

Strategic Building Sections: Critical cross-sectional details for a thorough understanding of the build.

Casework Drawings and Diagrams: Suggested designs for built-in caseworks, such as kitchen cabinets.

# **ELECTRICAL**

The mechanical package includes everything needed to guide HVAC The electrical package includes all the plans and documentation needed to guide the installation of your home's electrical system:

Detailed HVAC Floor Plan: Precisely maps out the placement of air Detailed Power Plan: Precisely maps out the placement of outlets, handlers, ductwork, and vents throughout the home's layout. switches, and other power components throughout the layout.

> Comprehensive Lighting Plan: Shows the optimal locations for lighting fixtures, sconces, and other illumination sources to create a well-lit, functional interior.

Dimensioned Electrical Layout: Provides exact dimensions and measurements to ensure proper placement of all electrical elements.

Bill of Materials: A complete list of every component needed, from circuit breakers to wiring.

## **PLUMBING**

The plumbing package includes everything needed to guide the

Detailed Water Supply System Plan: Precisely maps out the placement of pipes, valves, and plumbing fixtures throughout the

Comprehensive Sewage System Plan: Shows the optimal routing and sizing of drain lines to effectively remove waste and ensure

Detailed Riser Diagrams: Provide information needed to properly


installation of your home's water supply and drainage systems:

proper drainage.

install all vertical plumbing risers and vent stacks.

Bill of Materials: A complete list of every component needed, from pipes to fixtures.

# BOM (Bill Of Materials) (Separately Attached)

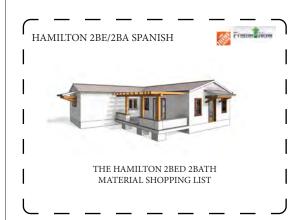



structure.


The Bill of Materials (BOM) is a crucial document that compiles the material requirements from different disciplines into a centralized inventory, enabling efficient procurement, inventory management, and cost estimation for a specified project or

## **ELECTRICAL BOM**



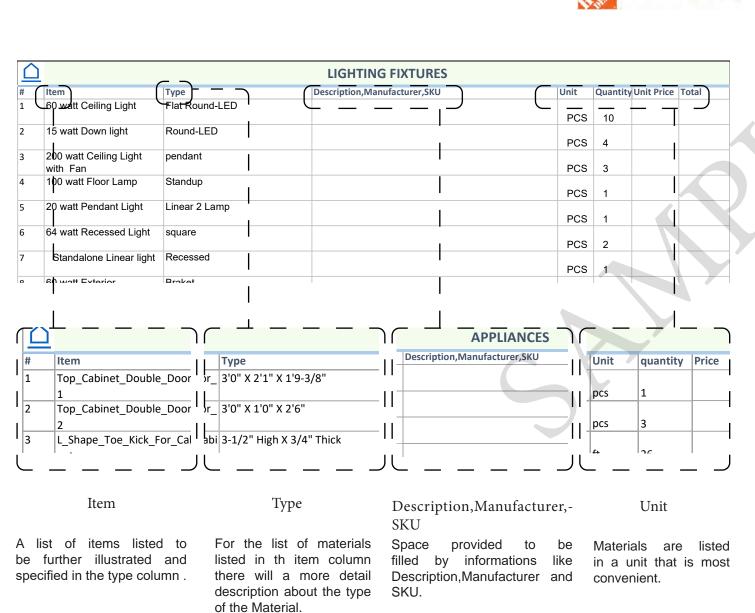

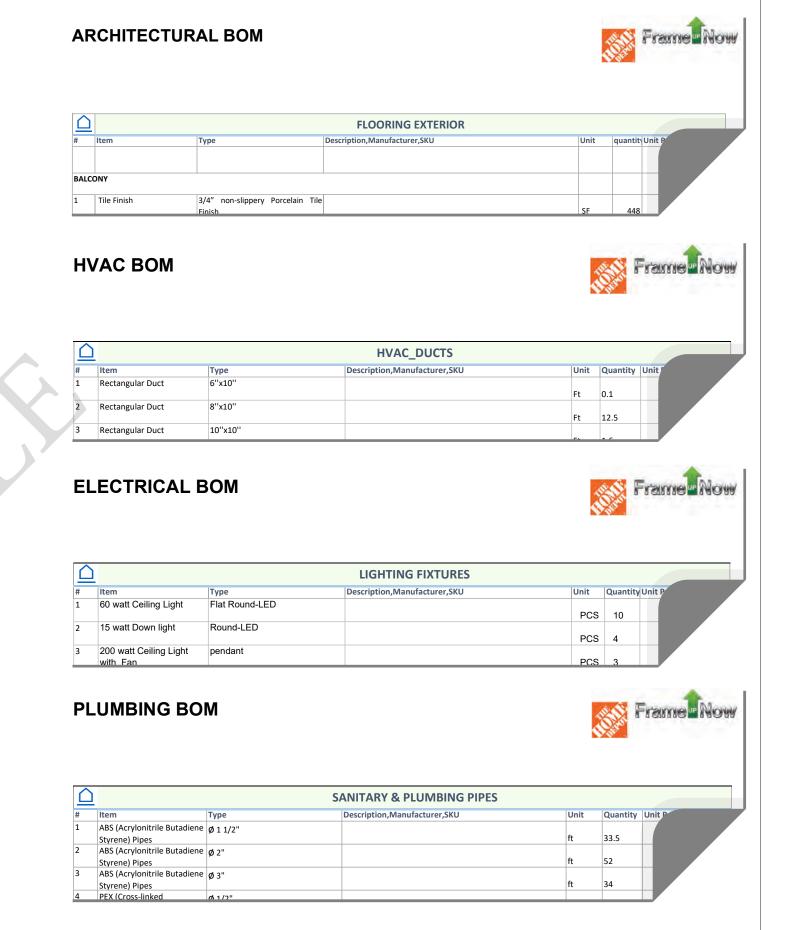

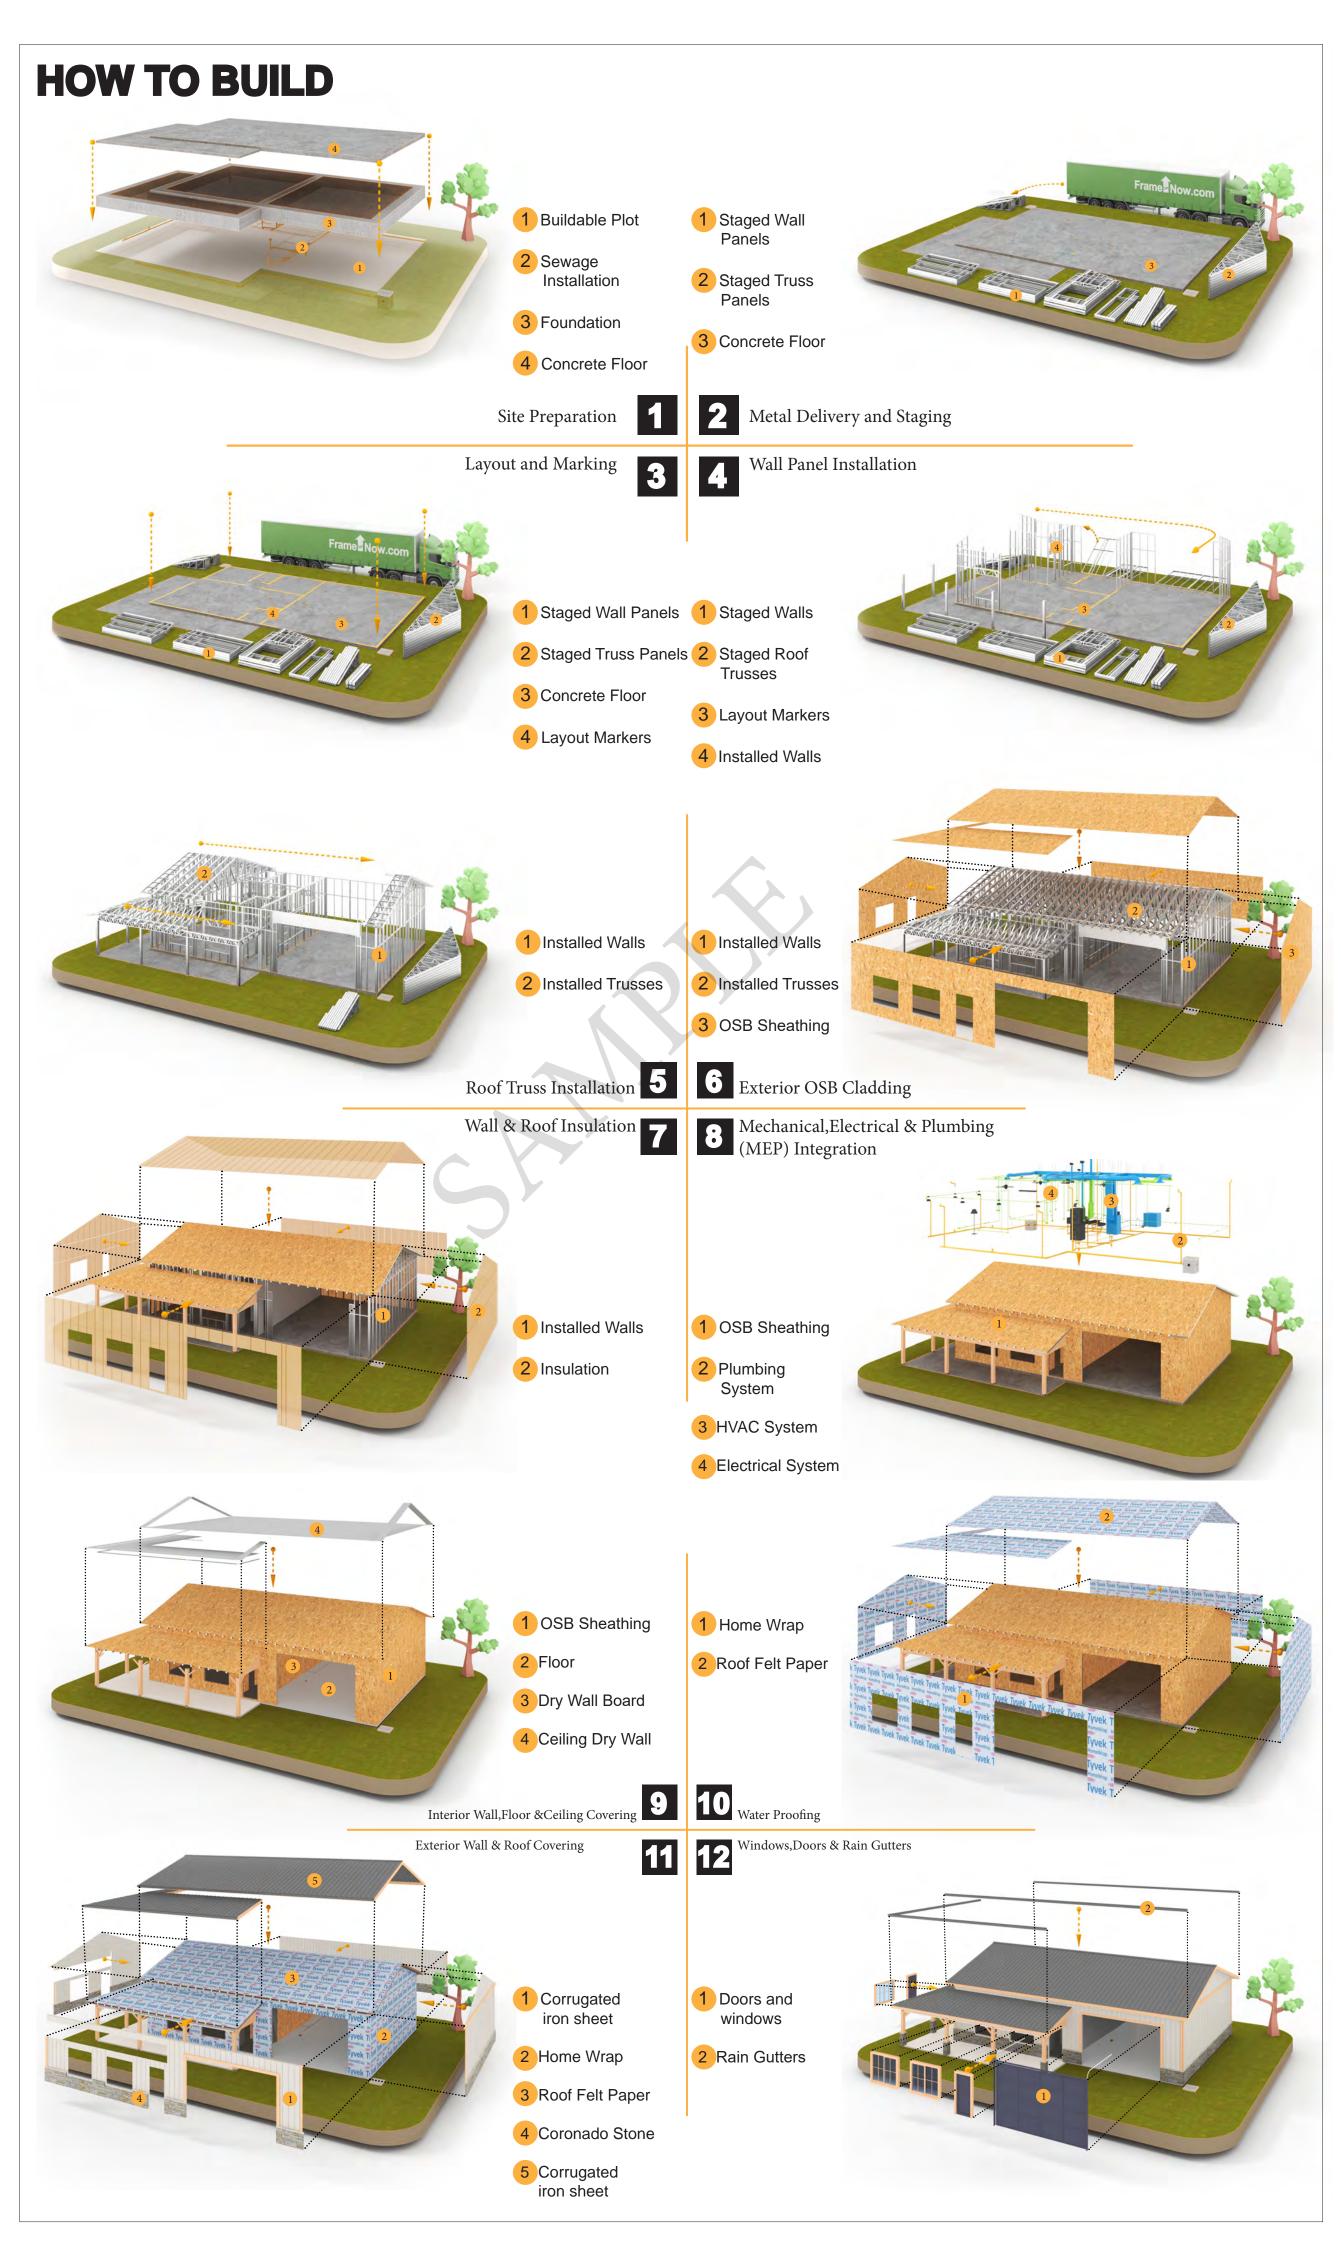



**KEY PLAN** 

NO.	DESCRIPTION	DATE

NOTE:

LEGEND:

PROJECT

59-Hamilton-1000-2Bd-2Ba-Spanish-550


DRAWING NAME

# INTRODUCTION

CLIENT NAME: PROJECT NUMBER: DATE: **DESIGNED BY** DRAWN BY: CHECKED BY:

1102


SCALE:

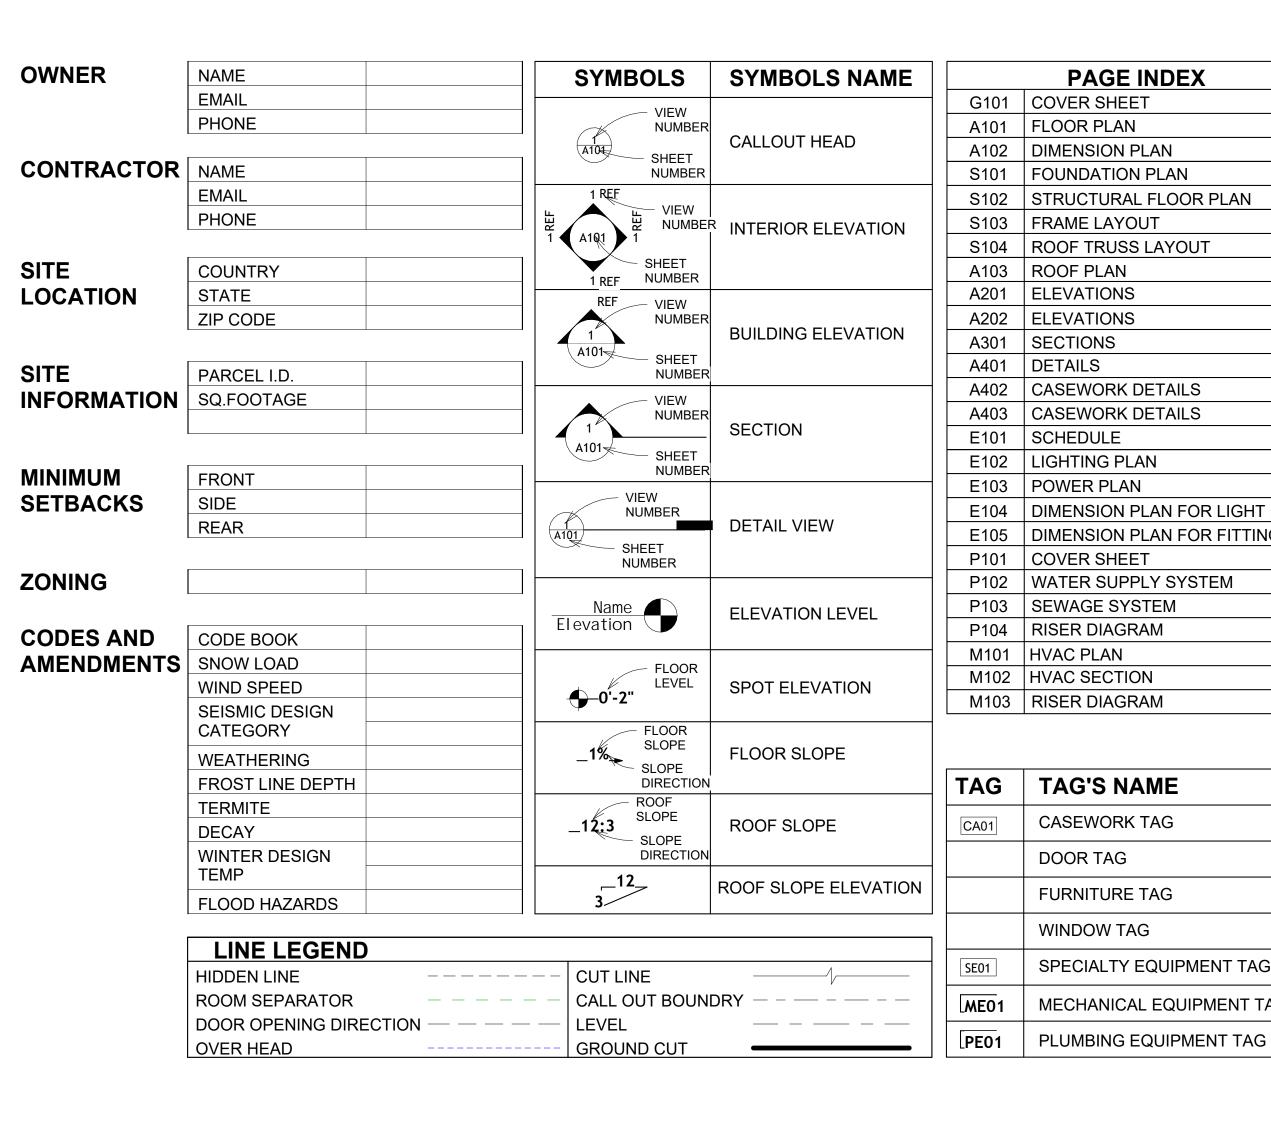

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TAG	TAG'S NAME	
		SIMP. A
CA01	CASEWORK TAG	TV
	DOOR TAG	UNO
	FUDNITUDE TAC	W/
	FURNITURE TAG	W/D
	WINDOW TAG	AC

SPECIALTY EQUIPMENT TAG

MECHANICAL EQUIPMENT TAG

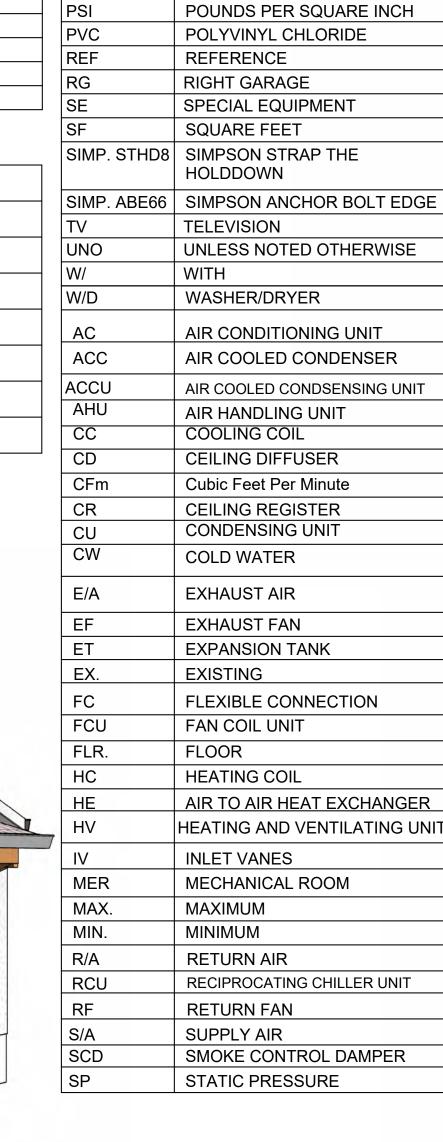

**ABBREVIATION** 

CASEWORK **ELECTRICAL** 

FOOTINGS

MAXIMUM

MINIMUM

NUMBER

ON CENTER

PLUMBING

**MECHANICAL** 

CONDITIONING

ACTION FLOOR SYSTEMS

AMERICAN SOCIETY FOR

**TESTING AND MATERIAL** 

FINISHED FLOOR LEVEL


FINISHED FLOOR ELEVATION

HEATING, VENTILATION & AIR

INTERNATIONAL RESIDENCE

INTERNATIONAL MECHANICAL


ORIENTED STRAND BOARD

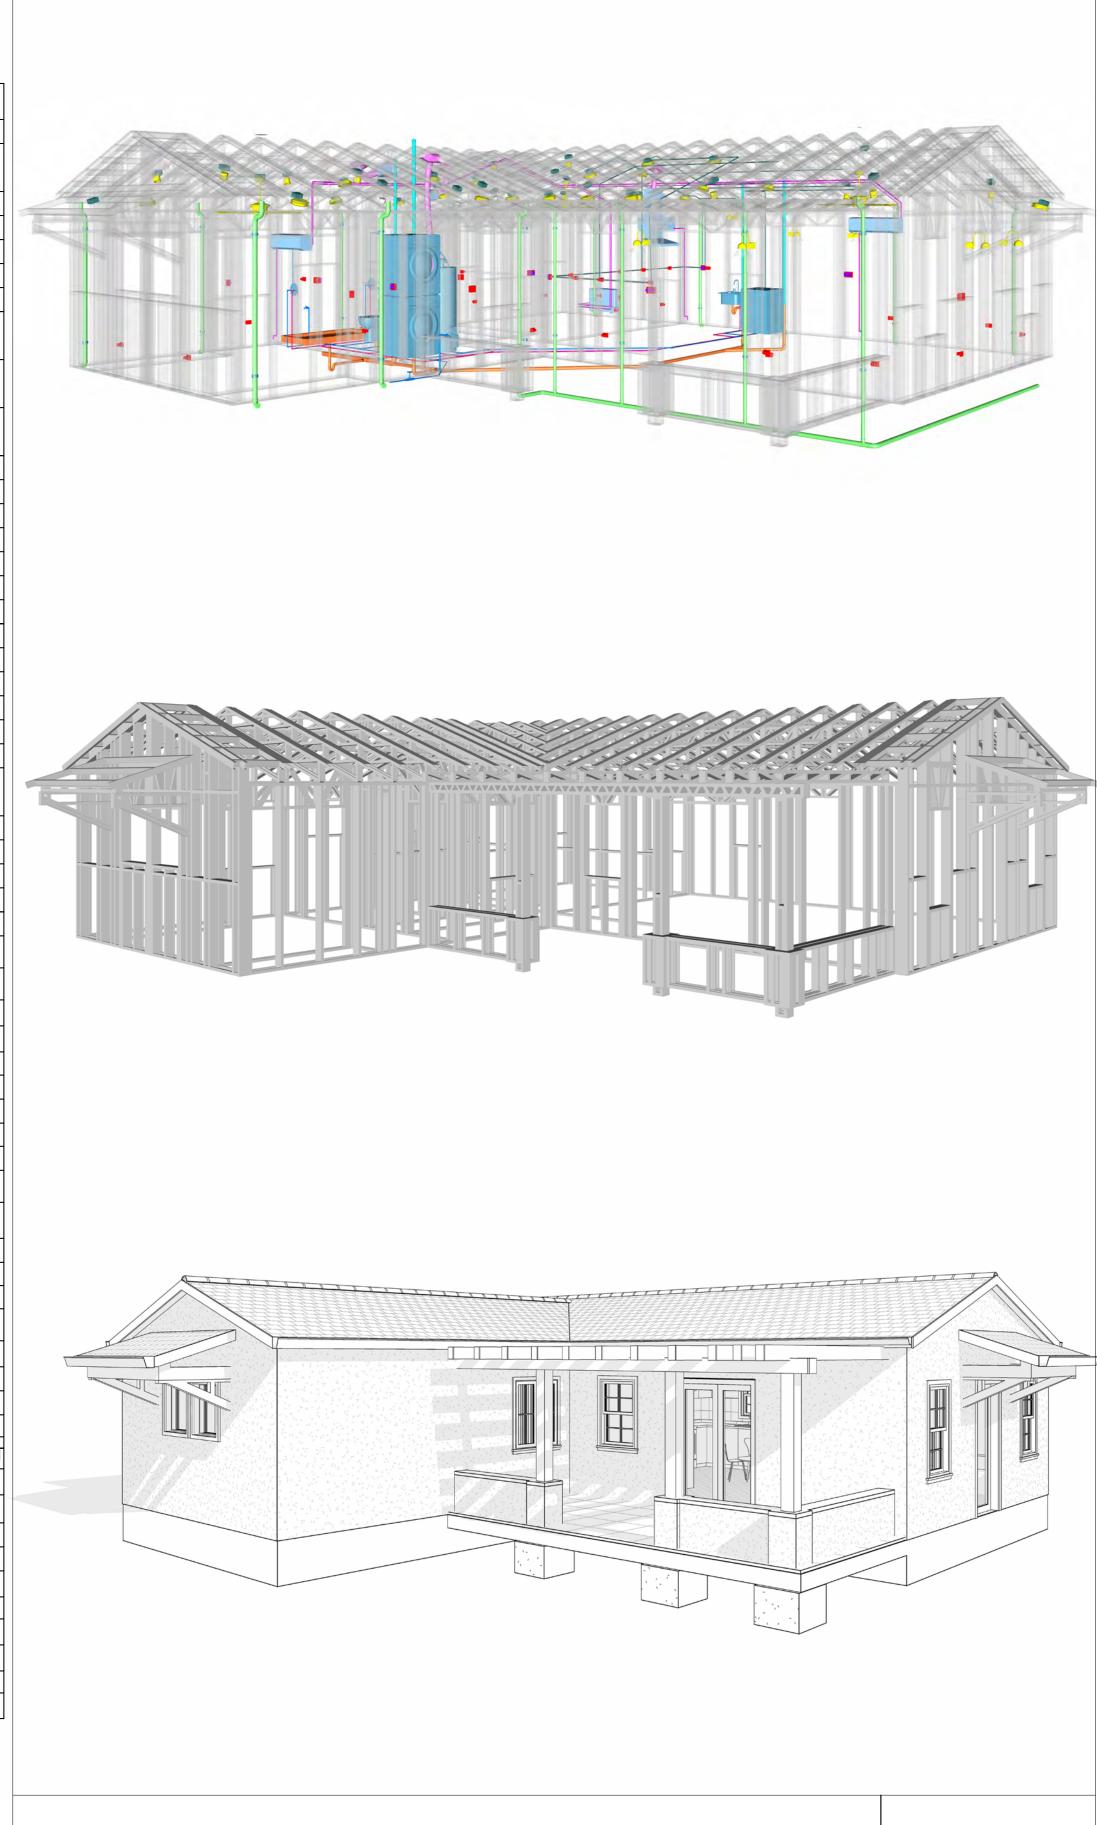

59-Hamilton-1000-2Bd/2Ba-Spanish-550

SQUARE FOOT	AGE
LIVING	998
PORCH	174
TOTAL	1172



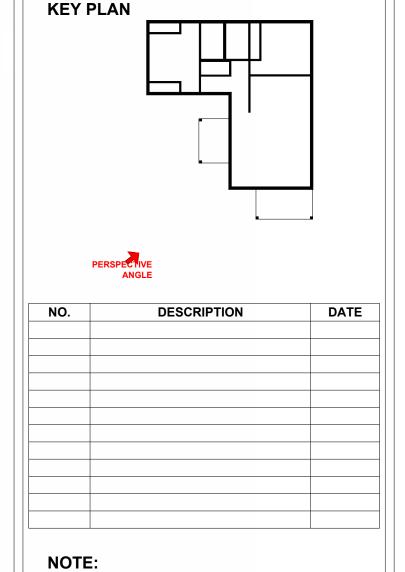

LEGEND:

**PROJECT** 

59-Hamilton-1000-2Bd/2Ba Spanish 550

DRAWING NAME

**COVER SHEET** 

Client Name	CLIENT NAME:
0061_12	PROJECT NUMBER:
2/17/2025 4:20:34 PM	DATE:
Designer	DESIGNED BY:
Author	DRAWN BY:
Checker	CHECKED BY:

G101

#### **GENERAL NOTES**

- THIS DRAWING DEPICTS THE ARCHITECTURAL (SPACE LAYOUT, FURNISHING, FLOOR, WALLS, ROOFS, FOUNDATION, WINDOWS AND DOORS) SYSTEMS. IT PROVIDES A VISUAL REPRESENTATION OF THE ARCHITECTURAL LAYOUT AND COMPONENTS.
- THE ARCHITECTURAL DRAWINGS ARE PREPARED TO MEET THE SPECIFIC REQUIREMENTS OF THE BUILDING, AS PER THE PROJECT SPECIFICATIONS AND APPLICABLE CODES AND STANDARDS.
- THE CONSTRUCTION OF THIS HOME SHALL COMPLY WITH THE LATEST EDITION OF THE INTERNATIONAL RESIDENTIAL CODE (IRC), INTERNATIONAL MECHANICAL CODE (IMC), THE INTERNATIONAL PLUMBING STANDARD, THE NATIONAL ELECTRICAL STANDARD AND ALL OTHER APPLICABLE LOCAL, STATE, AND NATIONAL CODES AND REGULATIONS.
- COORDINATION WITH OTHER TRADES HAS BEEN DONE ON A DESIGN LEVEL. THIS DRAWING SHALL BE READ TOGETHER WITH THE ME, EL AND PL DESIGN DRAWINGS TO ENSURE PROPER CONSTRUCTION AND INTEGRATION OF THE BUILDING SYSTEMS.

#### ABOUT WALLS:

#### SHOWER WALL COVERING

BATHTUB AND SHOWER SPACES (WALLS AND FLOORS) WITH INSTALLED SHOWER HEADS AND IN SHOWER COMPARTMENTS SHALL BE FINISHED WITH A NON-ABSORBENT SURFACE.

#### WALL PAINT (INTERNAL)

THE TYPICAL THICKNESS OF LATEX WALL PAINT IS 1/32 OF AN INCH FOR A SINGLE COAT. AND DOUBLE COAT (1/16") SHALL BE APPLIED FOR DURABILITY.

THE ADVISABLE TYPE OF ADHESIVE FOR THIS PROJECT IS **EPOXY ADHESIVES**BECAUSE THEY ARE KNOWN FOR THEIR HIGH STRENGTH, DURABILITY, AND RESISTANCE TO MOISTURE, CHEMICALS AND HEAT.

REFER TO SHEETS A201 & A202 FOR GENERAL NOTES ON EXTERNAL FINISHING MATERIALS

#### ABOUT FLOORS:

- THE SPOT ELEVATION INDICATES THE FINISHED FLOOR ELEVATION.
- FINISHED FLOORS PER PLANS.
- FIELD VERIFY FOR DIMENSION DROP 4" FOR SHOWER AND BATHTUB USE.
- 1% SLOPE ON OUTDOOR BALCONIES FOR WATER RUN OFF.
- 2% SLOPE TOWARDS THE SHOWER DRAIN FOR SUFFICIENT DRAINAGE. 4" DROP AT THE DOOR LEADING TO EXTERIOR BALCONY FROM THE MAIN LIVING AREA.
- 5% SLOPE FOR GARAGE IS USED, WHICH SHOULD BE CHECKED WITH THE LOCAL GARAGING








	FURNITURE SCHEDULE	
TYPE MARK	TYPE	COUNT

ROOM FINISH SCHEDULE							
ROOM NUMBE R	ROOM NAME	FLOOR FINISH	BASE FINISH	WALL FINISH	CEILING FINISH	CEILING HEIGHT	COM MEN TS
61	BEDROOM 2	HARDWOOD	CONCRETE	WALL PAINT	DRY WALL	8' - 0"	
62	CL 2	HARDWOOD	CONCRETE	WALL PAINT	DRY WALL	8' - 0"	
63	CL 3	HARDWOOD	CONCRETE	WALL PAINT	DRY WALL	8' - 0"	
64	BATH 1	VINYL TILES	CONCRETE	CERAMIC TILE	MRD	8' - 0"	
65	BATH 2	VINYL TILES	CONCRETE	CERAMIC TILE	MRD	8' - 0"	
66	BEDROOM 1	HARDWOOD	CONCRETE	WALL PAINT	DRY WALL	8' - 0"	
67	CL 1	HARDWOOD	CONCRETE	WALL PAINT	DRY WALL	8' - 0"	
68	WD	HARDWOOD	CONCRETE	WALL PAINT	DRY WALL	8' - 0"	
70	HALL	HARDWOOD	CONCRETE	WALL PAINT	DRY WALL	8' - 0"	
71	KITCHEN	HARDWOOD	CONCRETE	WALL PAINT + CERAMIC	DRY WALL	8' - 0"	
73	LIVING ROOM	HARDWOOD	CONCRETE	WALL PAINT	DRY WALL	8' - 0"	
74	WH	HARDWOOD	CONCRETE	WALL PAINT	DRY WALL	8' - 0"	
75	PORCH	BALCONY TILE	CONCRETE	STUCCO FINISH	PLYWOOD	8' - 0"	

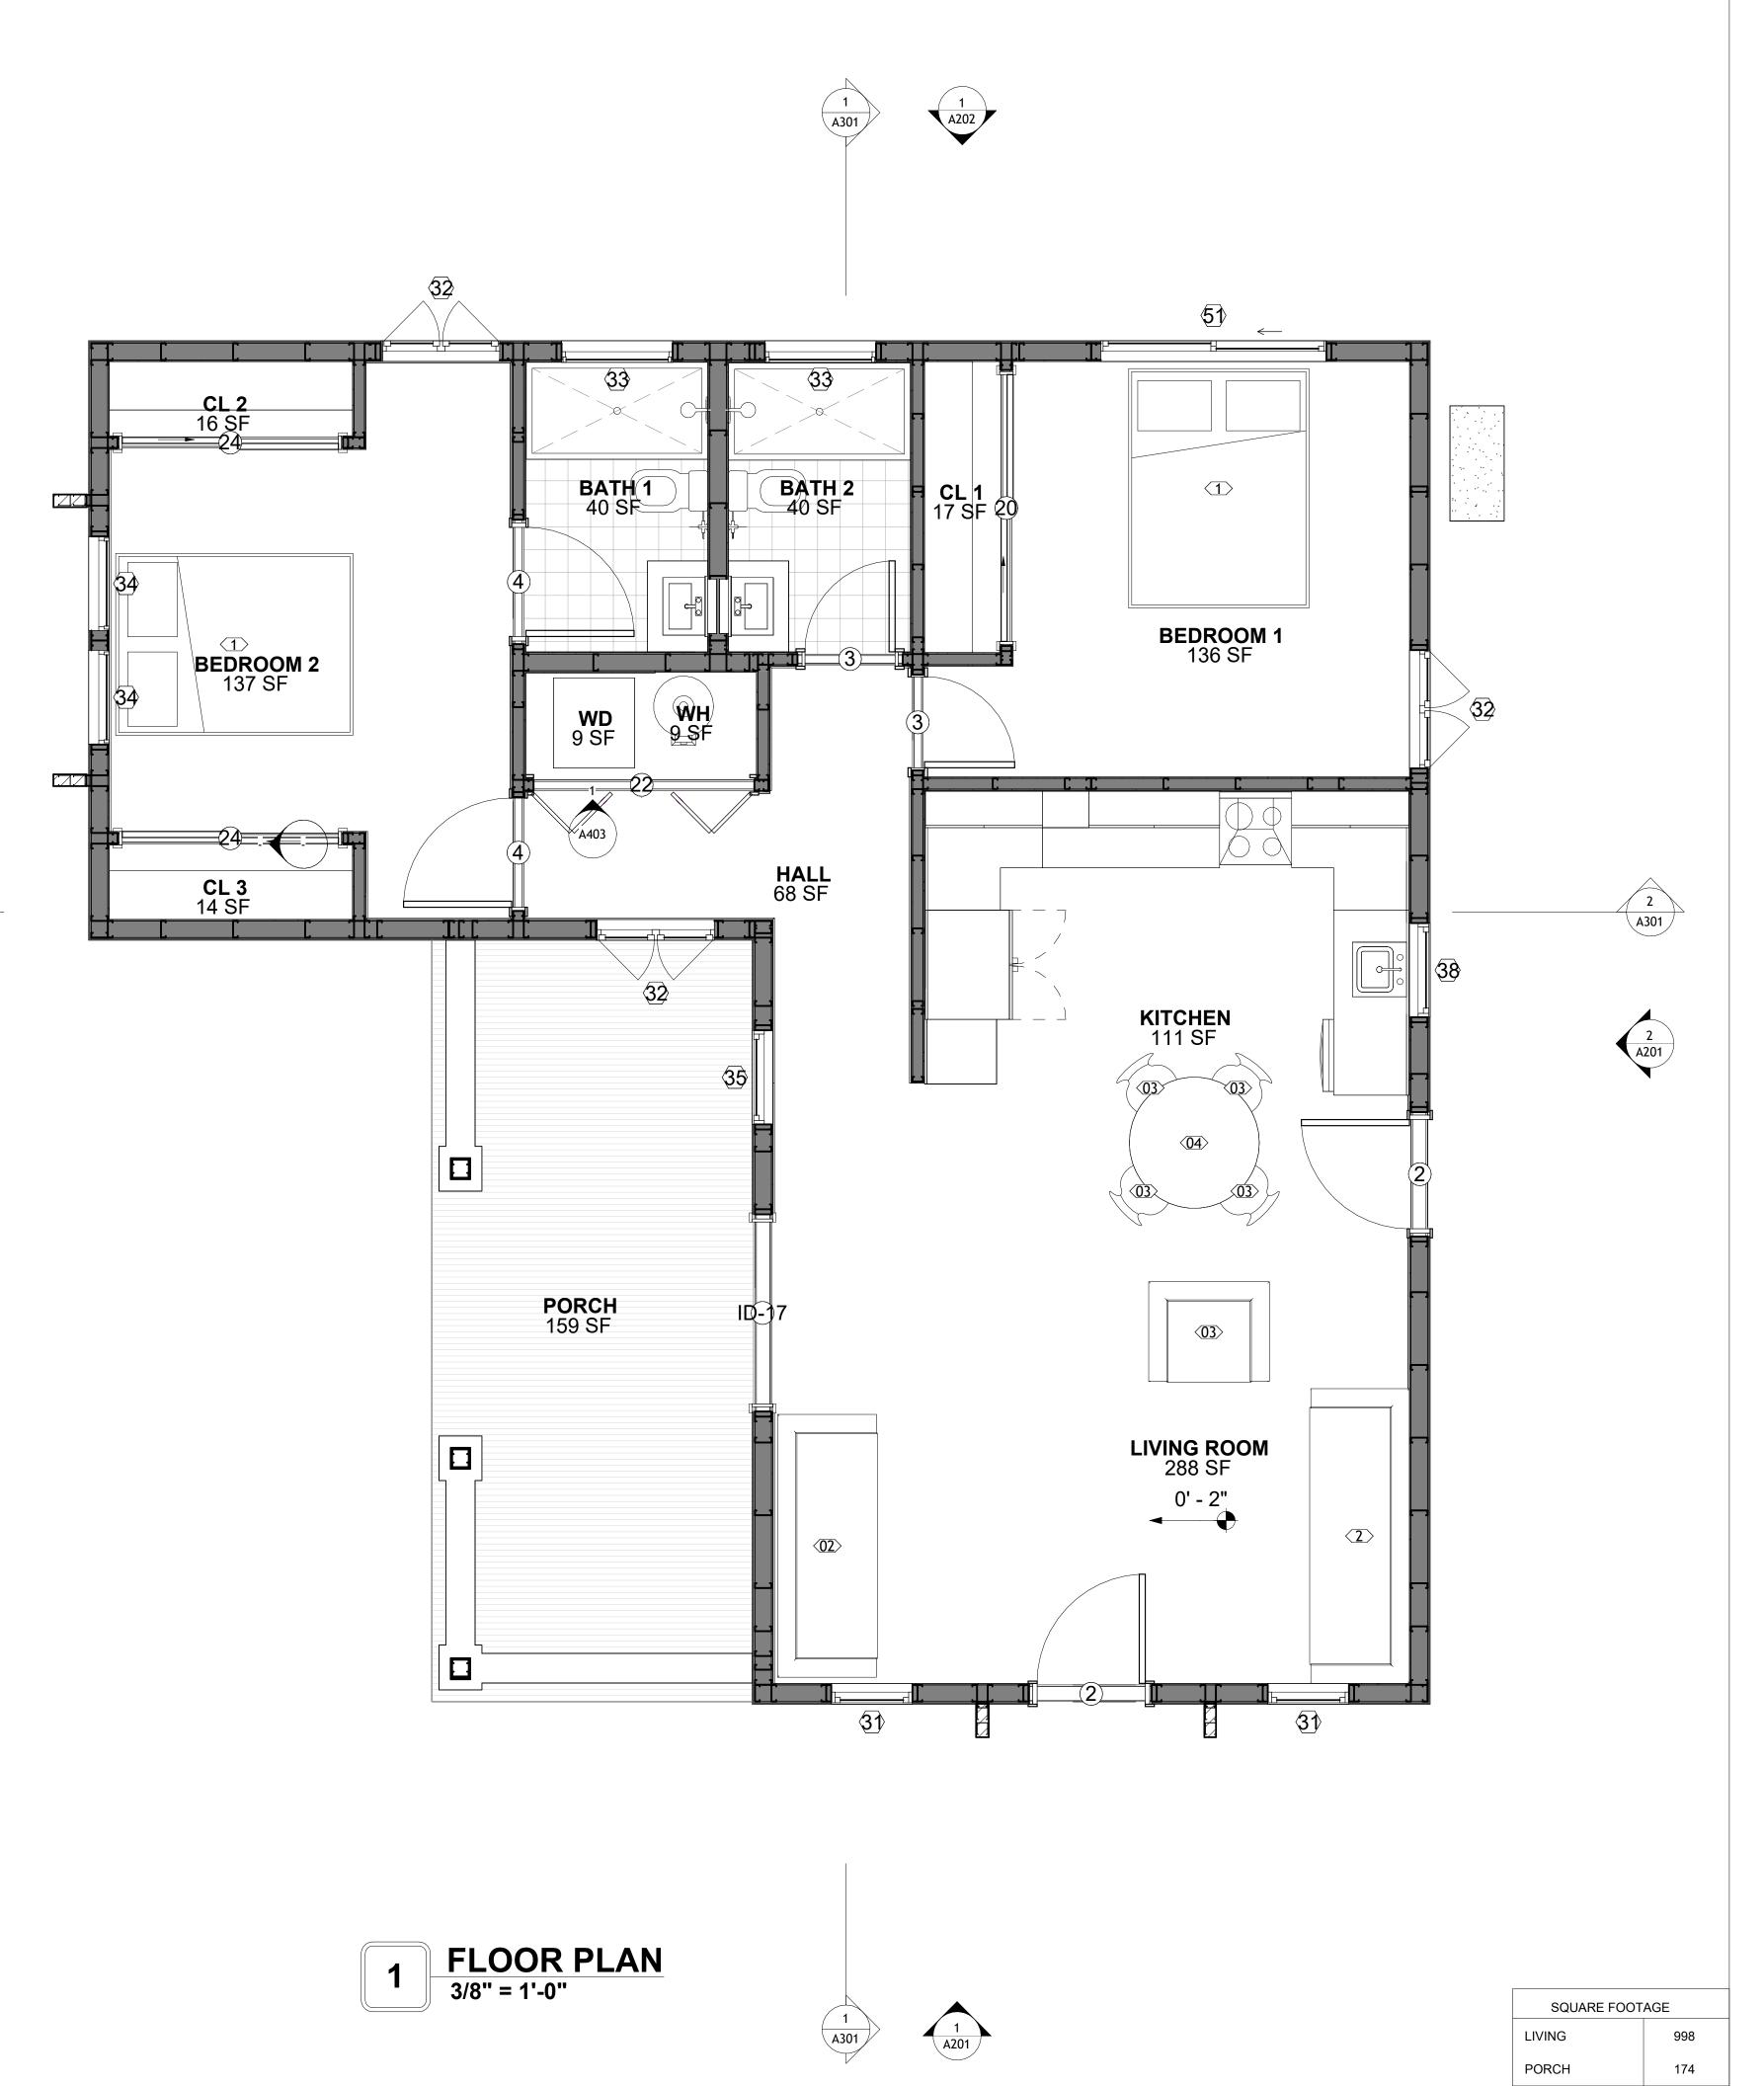



**KEY PLAN** 

NO. DESCRIPTION DATE

NOTE:

LEGEND:

PROJECT

59-Hamilton-1000-2Bd/2Ba Spanish 550

DRAWING NAME

**FLOOR PLAN** 


CLIENT NAME: **Client Name** PROJECT NUMBER: 0061\_12 2/17/2025 4:20:37 PM DATE: Designer DESIGNED BY: DRAWN BY: Author CHECKED BY: Checker


A101

SCALE: As indicated

TOTAL

1172

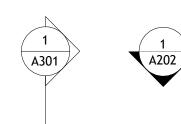

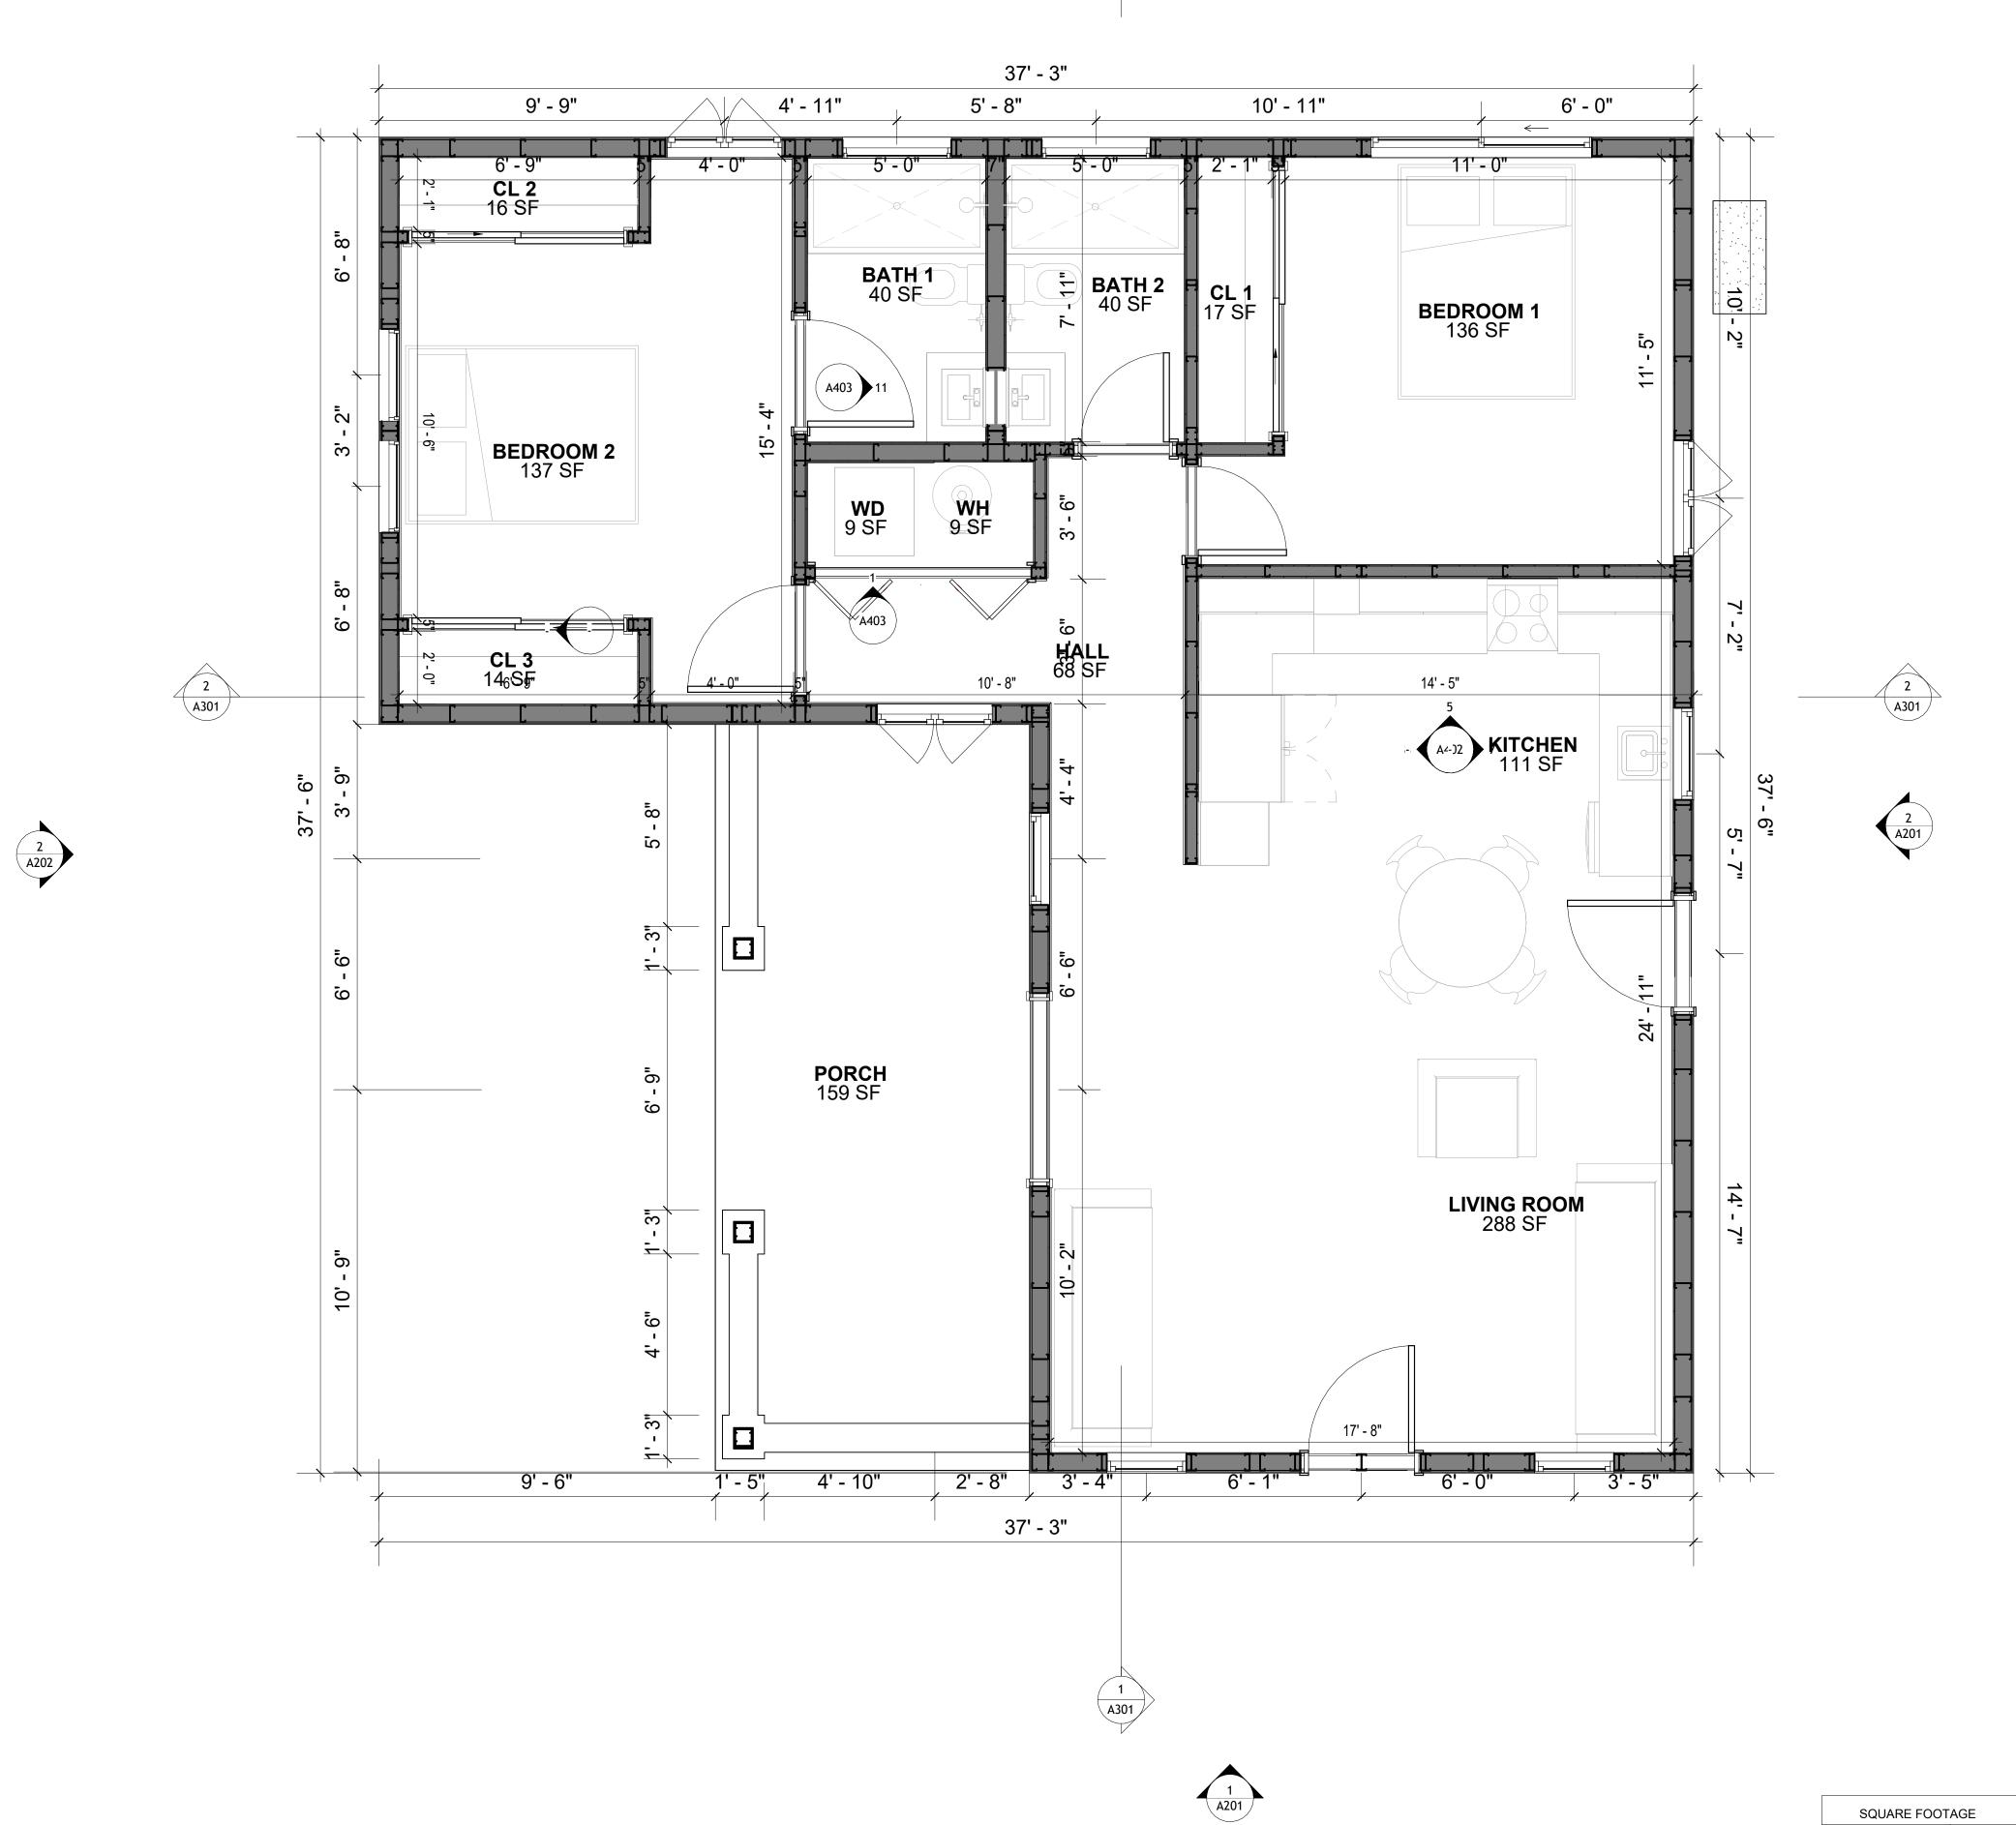

DIMENSIONS IN THE ARCHITECTURAL DRAWINGS CONSIDER FINISHING MATERIALS. FOR PRECISE MEASUREMENTS OF THE STRUCTUAL FRAMING, REFER TO THE ATTACHED STRUCTURAL PLAN SET.

1 FLOOR DIMENSION PLAN
3/8" = 1'-0"

Tuscon,AZ, USA
888-864-0184
inquire@frameupnow.com
www.frameupnow.com

**KEY PLAN** 

NO.	DESCRIPTION	DATE

NOTE:

LEGEND:

PROJECT

59-Hamilton-1000-2Bd/2Ba Spanish 550

DRAWING NAME

# DIMENSION PLAN

CLIENT NAME:	Client Name
PROJECT NUMBER:	0061_12
DATE:	2/17/2025 4:20:39 PM
DESIGNED BY:	Designer
DRAWN BY:	Author
CHECKED BY:	Checker

A102

SCALE: 3/8" = 1'-0"

PORCH

TOTAL

174

1172

#### **FOUNDATION NOTES**

#### NOTES:

TERMITES PRETREATMENT BY LICENSED CONTRACTOR UNDER SLAB AND AROUND FOOTINGS. ALL AREAS BELOW SLABS SHALL BE TREATED NO MORE THAN 24 HOURS PRIOR TO CONCRETE POUR. EVIDENCE OF TREATMENT MUST BE PROVIDED PRIOR TO PLACING OF CONCRETE.

#### 1. MATERIALS:

ALL INTERIOR CONCRETE SLABS SHALL BE A MIN. OF 4" THICK CONCRETE OVER 4" COMPACTED AGGREGATE BASE (ASTM D698), FINISH ELEVATIONS AS NOTED ON DRAWINGS, 6" ABOVE ADJACENT GRADE, LEVEL SLABS TO 1/8"-10' MAX.. CONCRETE SLABS SHALL BE 2500# PSI AT 28 DAYS. A 4" ALLOWABLE SLUMP.

#### 2. **PAD PREPARATION:**

- EXCAVATION FOR FOOTING SHALL BE NEAT.

- FOOTINGS SHALL BE POURED IMMEDIATELY AFTER EXCAVATION AND APPROPRIATE INSPECTION.

- ALL REINFORCING STEEL MARKED "CONTINUOUS" SHALL BE LAPPED 36 BAR DIAMETERS AT SPLICES AND AROUND CORNERS OR INTERSECTIONS WITH A STANDARD 90 DEGREE BEND ON CORNER BARS. LAP WIRE MESH ONE FULL MESH AT SIDE AND END LAPS.
- ALL HARDWARE TO BE SIMPSON OR EQUIVALENT.

- ALL HARDWARE TO BE SIMPSON OR EQUIVALENT.
- EXTERIOR FRAME WALL TO BE SECURED WITH 1/2"X10" ANCHOR BOLTS 4'-0" O.C. FOR 1-STORY AND 2'-8" O.C. FOR 2-STORY. BOLTS SHALL BE LOCATED WITHIN 1'-0" OF EACH END PIECE AND SHALL HAVE A MIN. OF TWO BOLTS PER PIECE.

-FOUNDATION ANCHOR STRAPS SHALL BE PERMITTED, ACCORDING TO RESIDENTIAL CODE 2021

- ALL INTERIOR WALLS TO BE SECURED WITH POWER DRIVEN PINS PER MANUFACTURER SPECIFICATION USE PIN SPACING EQUIVALENT TO 1/2" ANCHOR BOLTS.

ALL CONSTRUCTION TO CONFORM TO THE 2012 IRC
 R-10 RIGID INSULATION OUTSIDE OF EXTERIOR FOUNDATION WALLS UNDER LIVING AREA.
 CONCRETE PAD FOR CONDENSER THICKNESS IS 4" MIN UNLESS OTHERWISE NOTED.

#### 3. CONCRETE CONSTRUCTION:

- THE SLAB SHALL BE UNDERLAIN BY A VAPOR BARRIER/RETARDER IN THE LIVING AREA (TYPICALLY POLYETHYLENE, UNLESS MORE STRINGENT PROTECTION REQUIRED BY THE ARCHITECT, ENGINEER, FLOOR COVERING MANUFACTURER, OR ACCEPTED PRACTICE). UNLESS OTHERWISE REQUIRED, BARRIER MAY BE OMITTED AT GARAGES, PORCHES AND PATIOS WITHOUT FLOOR COVERINGS. IT IS BEYOND THE SCOPE OF THESE PLANS TO DETERMINE THE APPLICABILITY OF THESE MORE STRINGENT REQUIREMENTS. BUILDER SHALL VERIFY PRIOR TO CONSTRUCTION.

#### 4. REINFORCEMENT:

- IF CONSTRUCTED ON ACTIVE SOILS, THE LONG TERM PERFORMANCE OF THE FOUNDATION IS DEPENDENT ON MAINTENANCE BY THE OWNER. THUS THE BUILDER SHALL ADVISE THE OWNER OF THE FOLLOWING:

1. DRAINAGE MUST BE MAINTAINED. WATER SHALL NEVER BE ALLOWED TO POND NEAR THE FOUNDATION.

2. THE SOIL AROUND THE FOUNDATION SHALL BE MAINTAINED IN A RELATIVELY DAMP CONDITION, SUCH AS THAT REQUIRED TO KEEP A LAWN GREEN. IF IT DRIES OUT IT WILL

SHRINK. IF IT GETS WET, IT WILL HEAVE UPWARD.

3. SLABS ON THE SHORTER SIDE USES MAIN BARS ARE USED IN THIS DIRECTION ONLY WITH SMALLER DIAMETER DISTRIBUTION BARS ARE PLACED, FORMING A MAT OR GRID.

4. ALL REINFORCEMENT BARS SIZE 10MM OR LARGER IN ACCORDANCE TO ASTM

4. ALL REINFORCEMENT BARS SIZE 10MM OR LARGER IN ACCORDANCE TO ASTM

3. ANCHOR BOLTS AT ALL EXTERIOR WALLS SHALL BE MINIMUM 1/2 INCH DIAMETER WITH A MAXIMUM SPACING OF 6'-0" ON CENTER, UNLESS NOTED OTHERWISE.

4. ANCHOR BOLTS SHALL BE INSTALLED WITHIN 12 INCHES OF EACH END OF EACH SILL PLATE WITH AT LEAST TWO ANCHOR BOLTS FOR EACH BOLTS FOR EACH SILL PLATE LONGER THAN 12 INCHES.


5. SIMPSONS SILL ANCHORS MAYBE SUBSTITUTED FOR ANCHOR BOLTS AT THE SAME SPACING.

6. EXTERIOR CONCRETE SLABS WHICH ARE NOT PART OF THE MAIN SLAB SHALL BE MINIMUM 4 INCHES THICK WITH NO STEEL REINFORCING BARS REQUIRED, UNLESS NOTED OTHERWISE ON FOUNDATION PLAN.

#### **VERIFY THE FOLLOWING PRIOR TO POURING:**

- 1. ALL HOLDDOWNS , STRAP, AND POST LOCATIONS.
- 2. CONCRETE FINISHES. PANEL RISER LOCATION WHERE APPLICABLE.
- 3. UNDERSLAB MECHANICAL REQUIREMENTS.
- STEM WALL BLOCKOUTS.
   UNDERSLAB ELECTRICAL REQUIREMENTS AND PANEL RISER LOCATION. WHERE
- APPLICABLE.
- 6. PROVIDE THE FOLLOWING:- PVC SLEEVES THROUGH FTG IF REQUIRED
- 20' #4 COPPER GROUND BAR.7. SLOPE FINISH GRADE AWAY FROM FOOTING.

NOTE: FIELD VERIFY ALL DIMENSIONS SEE DIMENSIONED ARCHITECTURAL DRAWINGS

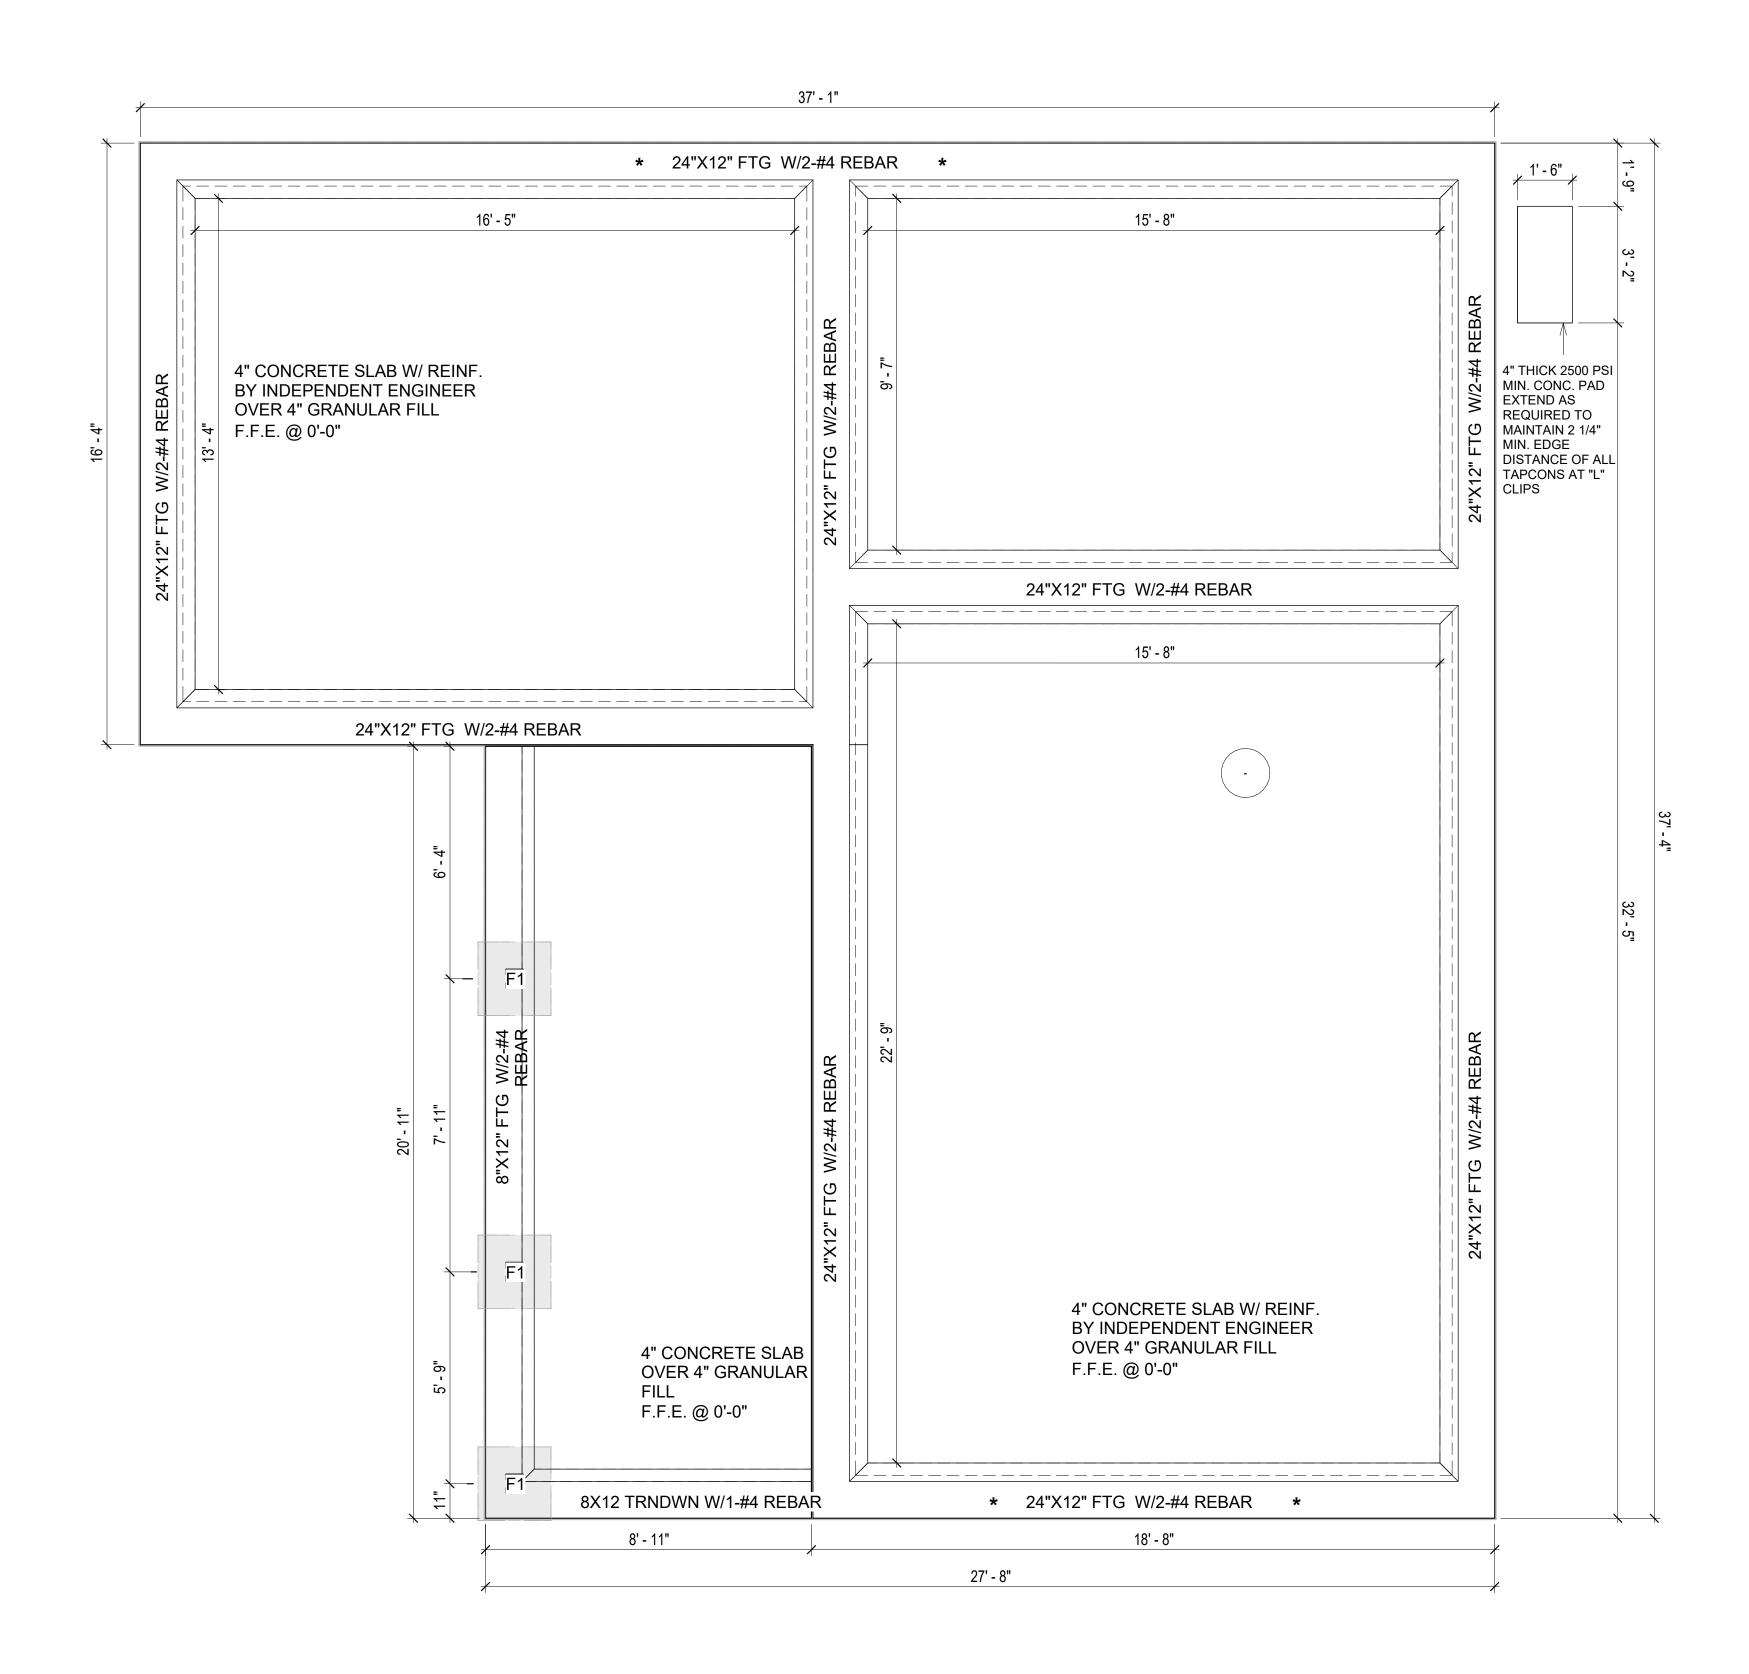



SQUARE FOOTAGE		
LIVING	998	
PORCH	174	
TOTAL	1172	



**KEY PLAN** 

NO.	DESCRIPTION	DATE

NOTE:

LEGEND:

PROJECT

59-Hamilton-1000-2Bd/2Ba Spanish 550

DRAWING NAME

FOUNDATION PLAN

CLIENT NAME:	Client Name
PROJECT NUMBER:	0061_12
DATE:	2/17/2025 4:20:39 PM
DESIGNED BY:	Designer
DRAWN BY:	Author
CHECKED BY:	Checker

**S101** 

SCALE: 3/8" = 1'-0"

#### **GENERAL NOTES**

#### NOTES:

-ALL BEARING WALLS SHOULD HAVE A THICKENED SLAB PER SECTION PER DETAIL A401/5.

#### A) **FOUNDATION PLAN NOTES**:

- CONCRETE SLAB SHALL BE 6" THICK WITH 1/2" DIAMETER TENDONS PER LAYOUT PLAN, CENTERED IN SLAB THICKNESS, OVER APPROVED SUBBASE PER GENERAL STRUCTURE NOTES.
- 2. TERMITE PROTECTION SHALL BE PROVIDED PER IRC SECTION R318.1 NONE TYPICAL ANCHOR BOLT SPACING AT SHEAR WALL AND HOLD DOWN
- SPECIFICATIONS PER APPROVED ARCHITECTURAL PLANS. 4. INSTALL HOLDOWNS BEFORE CONCRETE SLAB POUR.
- EXISTING FILL ON-SITE SHALL BE COMPACTED IN ACCORDANCE WITH THE
- REQUIREMENTS IN THE GEOTECHNICAL REPORT.
- 6. ALL FLOOR SLABS ARE REINFORCED ON CONCRETE SLABS.

#### SPECIAL INSPECTION IS REQUIRED FOR THICKENED FOUNDATION CONSTRUCTION

- 1. REINFORCEMENT
- 2. 2300 PSI CONCRETE POUR

#### B) **REINFORCEMENT FOR CONCRETE**:


1. ALL REINFORCING SLABS BARS SIZE 10MM OR LARGER SHALL BE DEFORMED IN ACCORDANCE TO ASTM-A706, AND BARS SMALLER THAN 10 MM MAYBE PLAIN. 2. UNLESS OTHERWISE NOTED IN PLANS, THE YIELD STRENGTH OF REINFORCING BARS SHALL BE:

> A) FOOTING = 40,000 PSI B) NON-LOAD BEARING WALLS AND PARAPETS= 40,000 PSI

- 3. SPLICES SHALL BE SECURELY WIRED TOGETHER AND SHALL LAP OR EXTEND
- 4. GRADE OF STEEL FOR RCC WORKS SHALL BE GRADE 4 10.
- BAR NOTATIONS GIVES INFORMATION
- A) BAR SIZE
- B) SPACING(IF REQUIRED)
- 6. LAP REINFORCEMENT ONLY AT LOCATION SHOWN IN THE DRAWINGS REINFORCEMENT SHALL NOT BE CUT, VENT OR HEATED ON SITE WITHOUT ENGINEERS'
- C) **CONCRETE SLAB NOTES**
- 1. ALL SLAB REINFORCEMENT SHALL BE 20MM CLEAR MINIMUM FROM BOTTOM AND FROM TOP OF SLAB.
- 2. REINFORCEMENT IN CONTINUOUS ELEVATED SLAB SHALL BE CUT AS FOLLOWS.


APPROVAL.

- THIS IS A SCHEMATIC PLAN FOR THE PURPOSE OF LOCATING AND IDENTIFYING FOUNDATION REINFORCING ELEMENTS ONLY. VERIFY ALL DIMENSIONS, DROPS, OFFSETS AND FEATURES WITH THE ARCHITECTURAL PLANS BEFORE FORMING THE FOUNDATION.

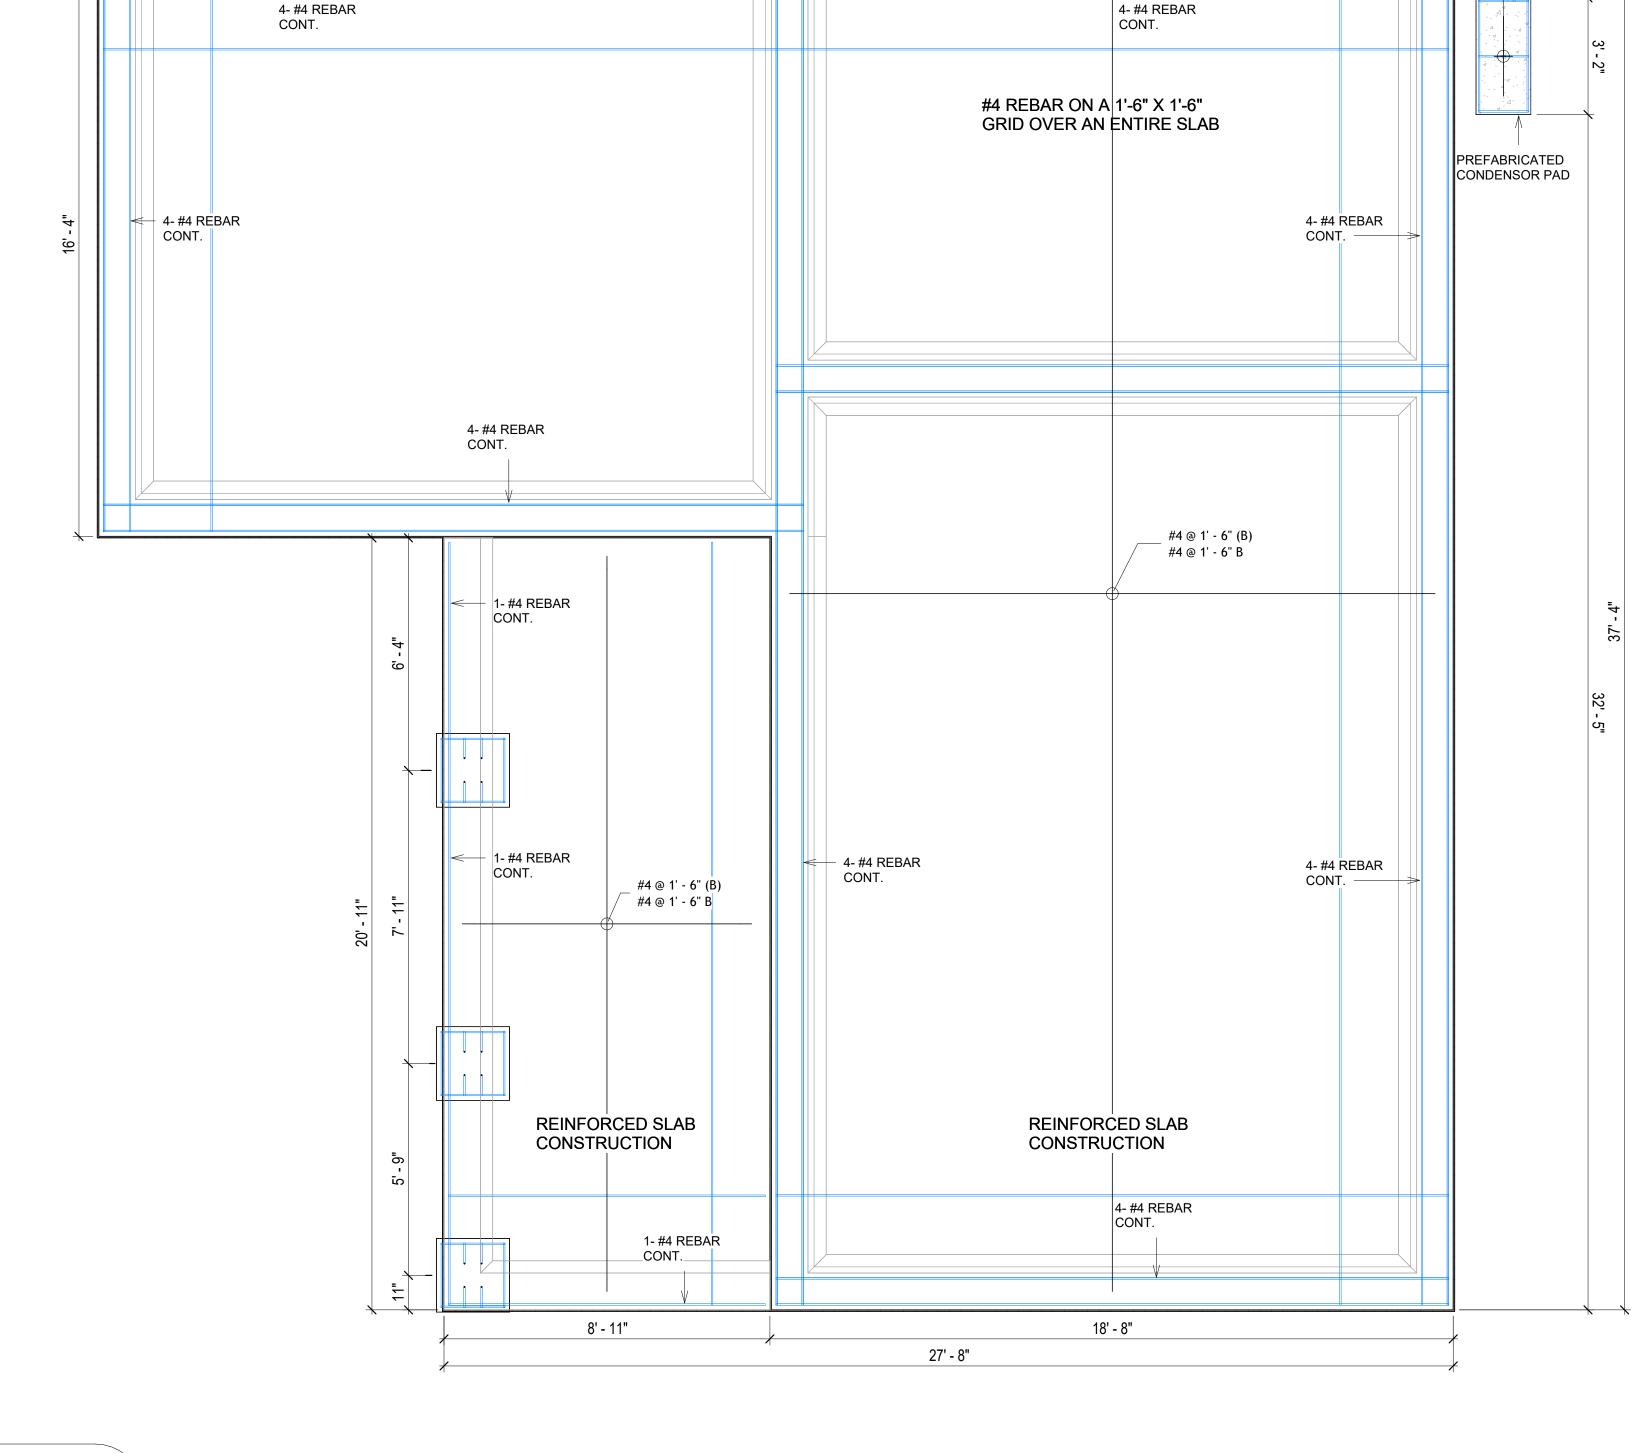

37' - 1"

## #4-REBAR ON A 2'-0" X 2'-0" GRID **SLAB ON GRADE FOUNDATION**

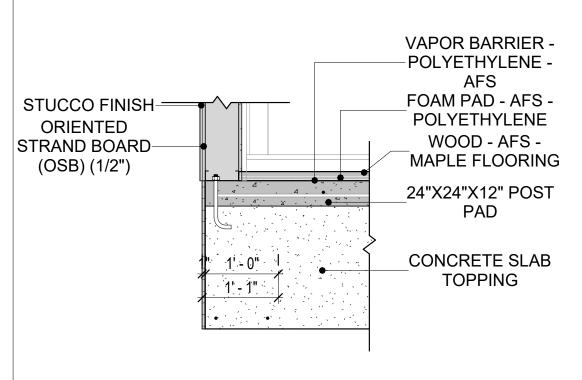

TYPICAL WALL FTG DETAIL

ORIENTED STRAND BOARD (OSB) (1/2") -STUCCO FINISH CONT.REBAR 4"COMPACTED SOIL −F02 TURNDOWN/POST PAD 3/4" = 1'-0"

FOUNDATION REBAR PLAN 3/8" = 1'-0"



**KEY PLAN** 

#4 @ 2' - 0" (B)

#4 @ 2' - 0" B

**DESCRIPTION** DATE

NOTE:

LEGEND:

PROJECT

59-Hamilton-1000-2Bd/2Ba Spanish 550

DRAWING NAME

STRUCTURAL FLOOR PLAN

CLIENT NAME: **Client Name** PROJECT NUMBER: 0061\_12 2/17/2025 4:20:41 PM Designer **DESIGNED BY:** DRAWN BY: **Author** CHECKED BY: Checker


**S102** 

SCALE: As indicated

3/4" = 1'-0"

## **ROOF NOTES**

- ROOFING COMPOSITION ROOFING PER OWNERS/BUILDERS SPECIFICATIONS INSTALL PER MANUFACTURE SPECIFICATIONS ON 1/2" ORIENTED STRAND BOARD ON PRE-ENGINEERED TRUSS @ 24" O.C. (UNO.) 2. 73" OVERHANG AT EAVES (UNO.)
- ENDS OF ALL TRUSSES AND JOISTS TO BE FULLY BLOCKED. PROVIDE SOLID
- BLOCKING AT ALL RIDGES AND VALLEYS SHEATHING TO BE 1/2", 3/8" OSB SHEAR PANEL AND EQUIVALENT.
- UNDERSIDE OF PORCH TRUSSES TO BE FINISHED WITH MOISTURE RESISTANT DRYWALL, TAPED AND TEXTURED.
- 5. EXPOSED EAVES AND OTHER WEATHER EXPOSED AREAS TO BE SHEATHED WITH EXTERIOR GRADE PLYWOOD.
- 6. ALL MATERIALS THICKNESS AND SIZE ARE THE MINIMUM. Refer TO LOCAL STANDARDS FOR ACTUAL THICKNESS AND LAYERING OF MATERIALS.
- ENGINEERED TRUSS CALCULATIONS TO BE SUBMITTED TO BUILDING DEPARTMENT PRIOR TO FABRICATION AND INSTALLATION.
- TRUSS MANUFACTURER TO SPECIFY HANGER CONNECTORS FOR TRUSS COMPONENTS (TYPICAL)
- 9. DESIGNER ASSUMES THAT TRUSSES BEAR ON ALL EXTERIOR PERIMETER WALLS (TYPICAL) OR BEAMS.
- 10. PROVIDE GALVANIZED STEEL FLASHING WITH A LENGTH OF 10 FEET, WIDTH
- OF 12 INCHES, AND THICKNESS OF 24 GAUGE.

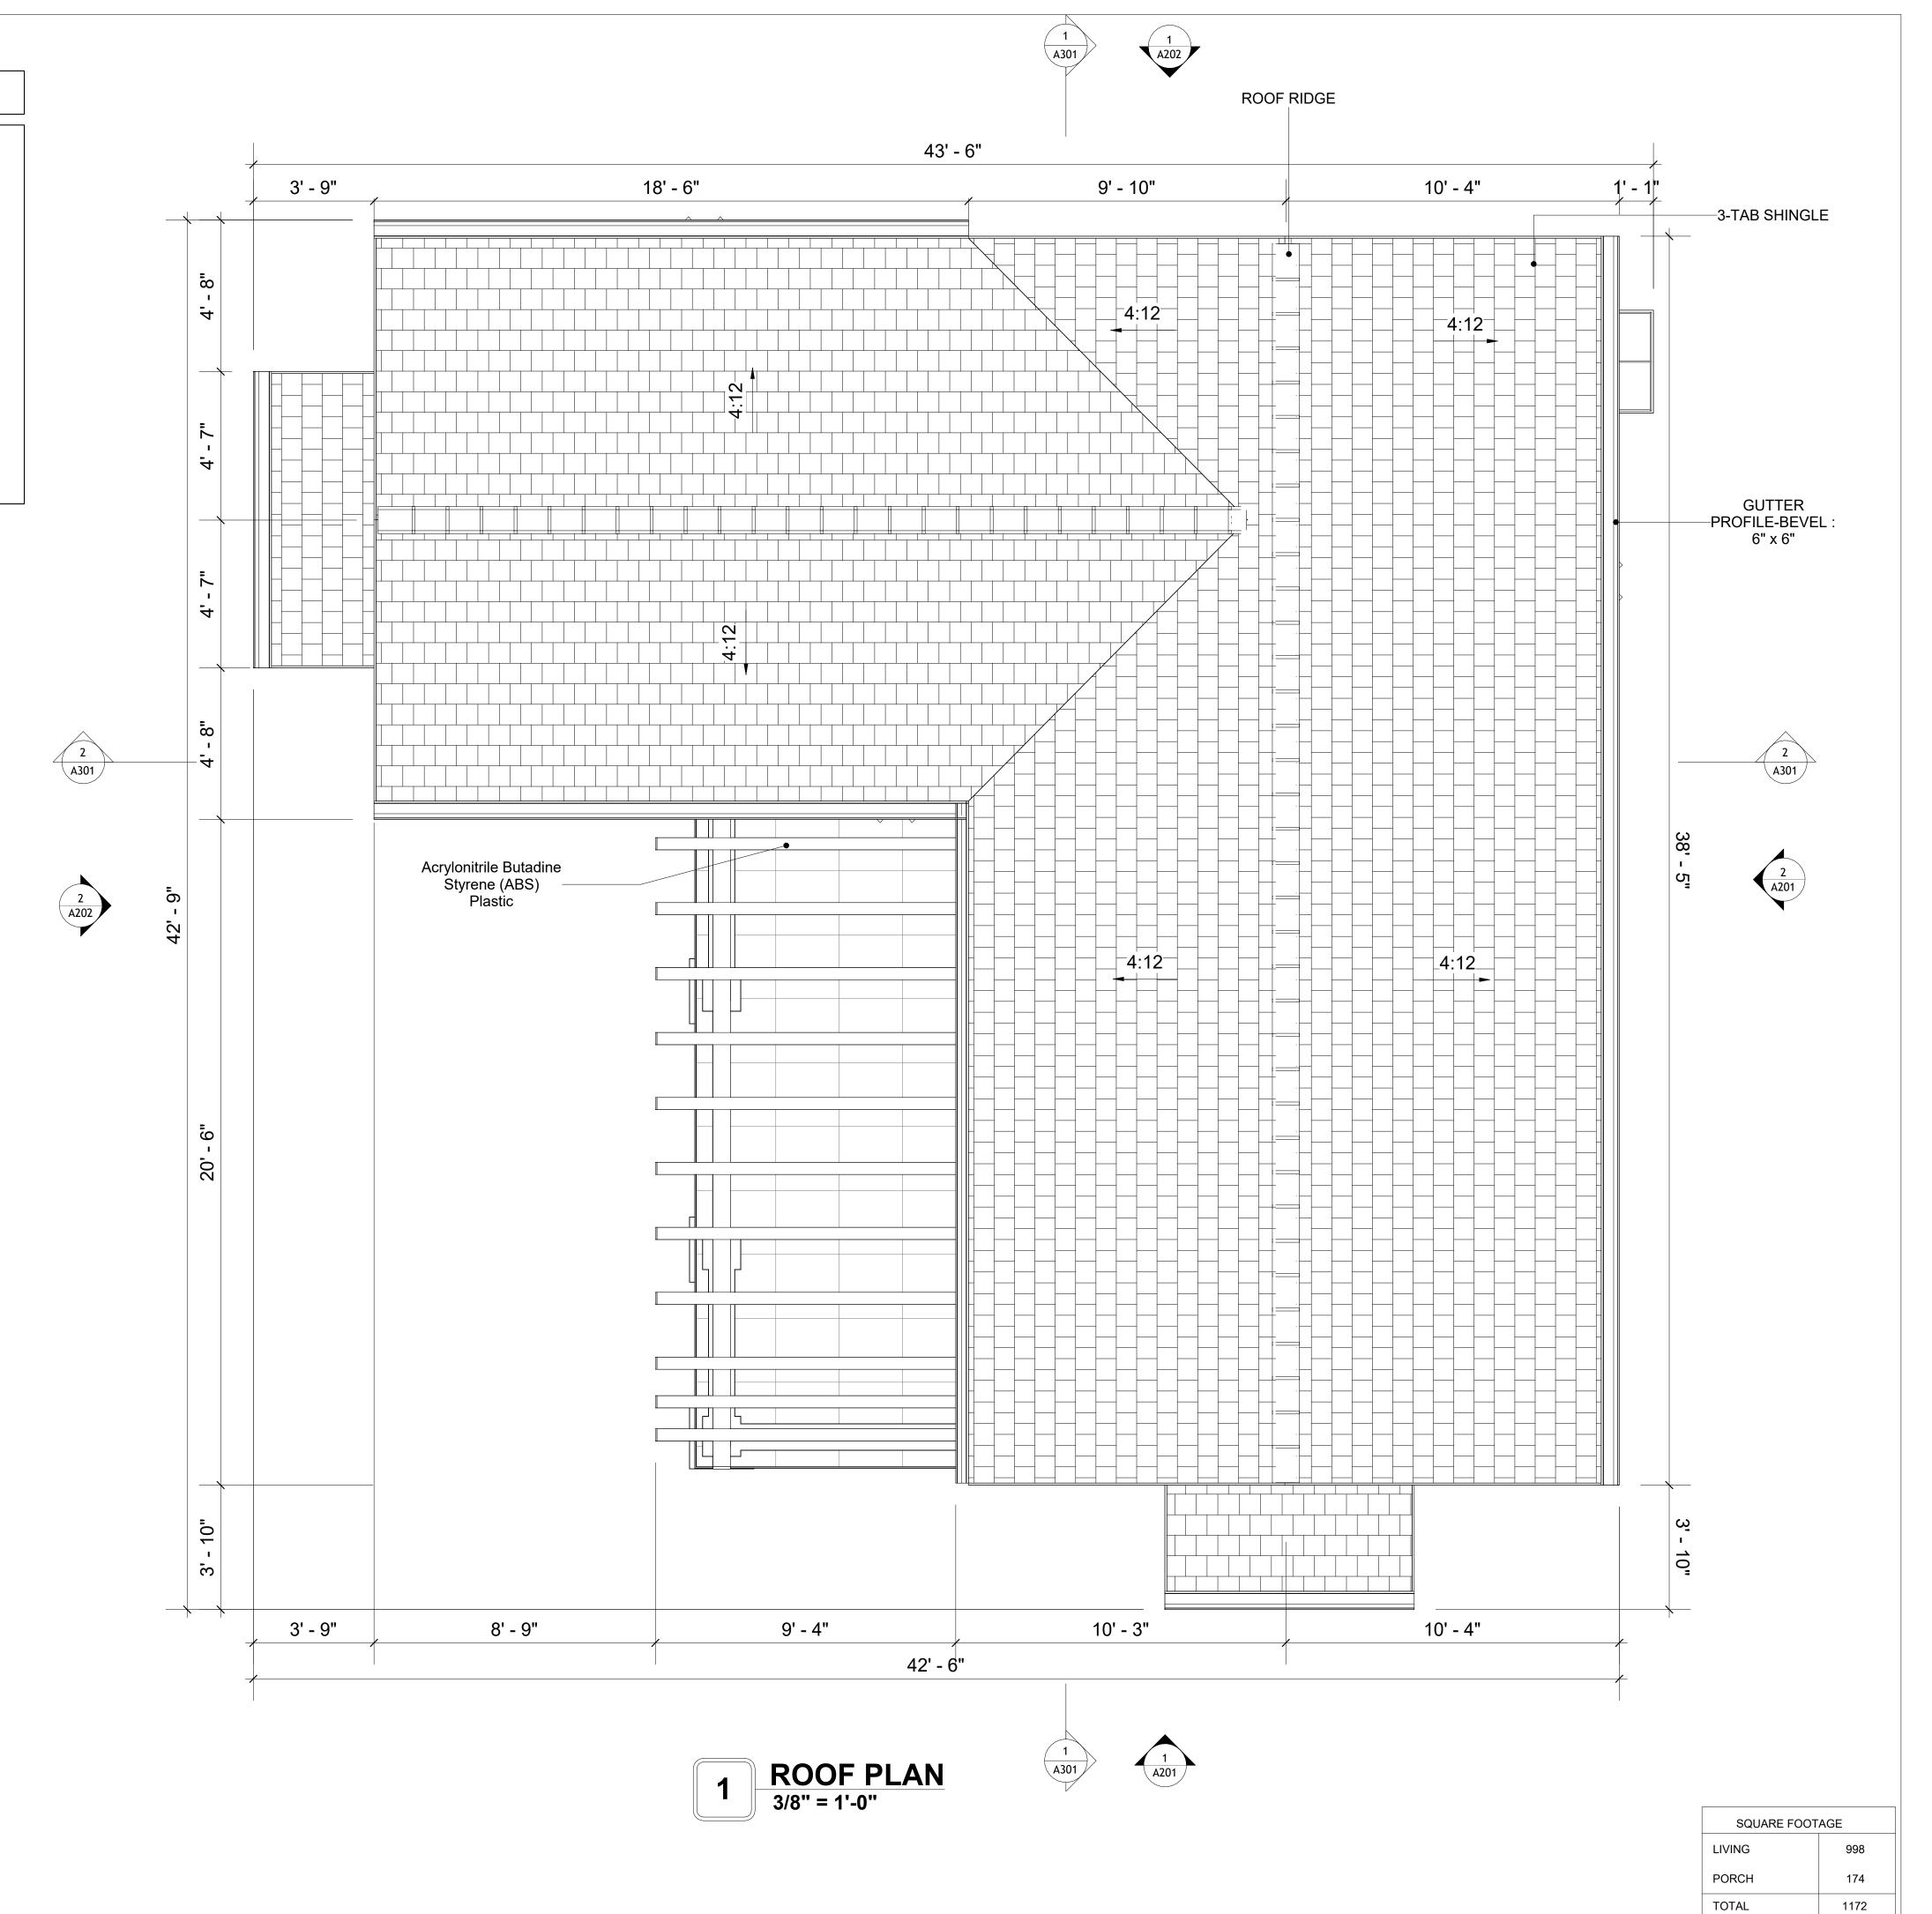



**KEY PLAN** 

NO.	DESCRIPTION	DATE

NOTE:

LEGEND:

PROJECT

59-Hamilton-1000-2Bd/2Ba Spanish 550

DRAWING NAME

**ROOF PLAN** 

CLIENT NAME:	Client Name
PROJECT NUMBER:	0061_12
DATE:	2/17/2025 4:20:44 PM
DESIGNED BY:	Designer
DRAWN BY:	Author
CHECKED BY:	Checker

A103

SCALE: As indicated

1172

#### **ABOUT WALL FINISHING**

#### PLYWOOD WALL SIDING

WALL SIDING IS AN EXTERIOR CLADDING MATERIAL USED TO COVER AND PROTECT THE WALLS OF A BUILDING, PROVIDING BOTH FUNCTIONAL AND AESTHETIC BENEFITS.

IN THIS SPECIFIC PROJECT, PLYWOOD WALL PANELS ARE USED AS A FINISH SIDING BECAUSE THIS TYPE OF SIDING PROVIDES A DURABLE, COST-EFFECTIVE, AND VERSATILE EXTERIOR CLADDING THAT CAN BE EASILY INSTALLED, FINISHED, AND MAINTAINED TO ENHANCE THE AESTHETIC AND PROTECTIVE QUALITIES OF A BUILDING'S EXTERIOR.

STANDARD SIZES OF 1' X 8' EXTERIOR-GRADE PLYWOOD PANELS ARE INSTALLED ON THE FURRING STRIPS USING GALVANIZED STEEL SELF-DRILLING SCREWS.

#### STUCCO FINISH

STUCCO IS A CEMENT-BASED EXTERIOR WALL FINISH THAT OFFERS A DURABLE, WEATHER-RESISTANT, AND CUSTOMIZABLE CLADDING SOLUTION FOR BUILDINGS.

IN THIS SPECIFIC PROJECT, AMERICAN STUCCO SYSTEMS IS USED AS A FINISH MATERIAL BECAUSE IT IS GENERALLY CONSIDERED A WATER-RESISTANT EXTERIOR FINISH AND USES A THREE-COAT APPLICATION PROCESS.

3/8-INCH OF IT IS APPLIED AS AN EXTERNAL WALL FINISH AS IT IS THE MOST COMMON AND WIDELY ACCEPTED STANDARD THICKNESS FOR STUCCO EXTERIOR WALL FINISHES. THIS MULTI-LAYER APPROACH ALSO HELPS CREATE A STRONG, CRACK-RESISTANT STUCCO SURFACE.

THIS STANDARD STUCCO IS APPLIED OVER OSB SHEATHINGS (FOR COLD FORMED STRUCTURE CONSTRUCTION).

IT IS NOT DIRECTLY TROWELED OVER THE OSB BUT OVER A WATER-RESISTANT BARRIER (HOMEWRAP) AND METAL/PLASTIC LATH THAT ARE INSTALLED ON TOP SURFACE OF THE OSB TO PROVIDE AN ADDITIONAL LAYER OF PROTECTION AGAINST MOISTURE INTRUSION.

REGULAR INSPECTION AND PROMPT REPAIR OF ANY CRACKS, CHIPS, OR DAMAGE TO THE STUCCO FINISH IS IMPORTANT. THIS MAINTAINS THE STUCCO'S WATER-RESISTANT PROPERTIES OVER THE BUILDING'S LIFE SPAN.

#### CAST MANUFACTURED STONE


MANUFACTURED STONE, ALSO KNOWN AS CULTURED OR ARTIFICIAL STONE, IS A SYNTHETIC BUILDING MATERIAL MADE FROM A BLEND OF CEMENT, AGGREGATES, AND PIGMENTS TO MIMIC THE APPEARANCE OF NATURAL STONE. IT IS LIGHTWEIGHT, DURABLE, AND CUSTOMIZABLE IN COLOR AND TEXTURE.


IN THIS PROJECT, MANUFACTURED STONE IS USED AS THE COPING MATERIAL, PROVIDING A DURABLE AND AESTHETIC FINISH THAT MIMICS THE APPEARANCE OF NATURAL STONE.

#### CEDAR WOOD

CEDAR WOOD REFERS TO THE WOOD FROM VARIOUS SPECIES OF CEDAR TREES, WHICH ARE CONIFEROUS EVERGREEN TREES KNOWN FOR THEIR DISTINCT AROMA AND NATURAL RESISTANCE TO DECAY AND INSECTS.

IN THIS SPECIFIC PROJECT, CEDAR WOOD IS USED A FINISH MATERIAL ON BEAMS AND COLUMNS.

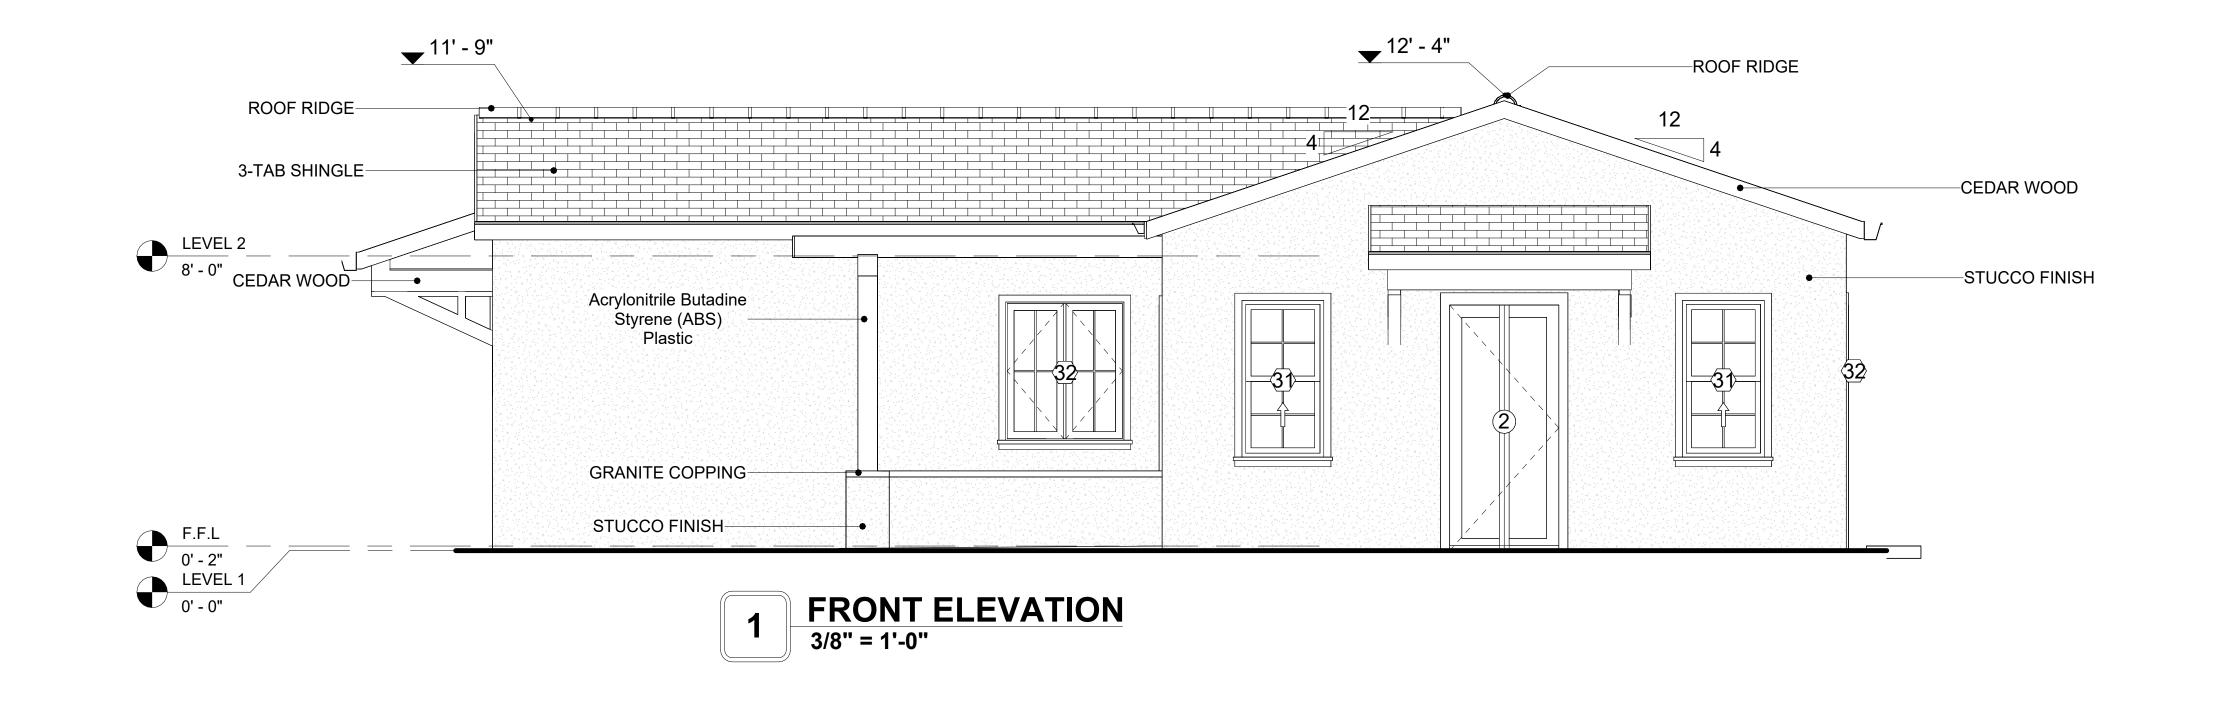

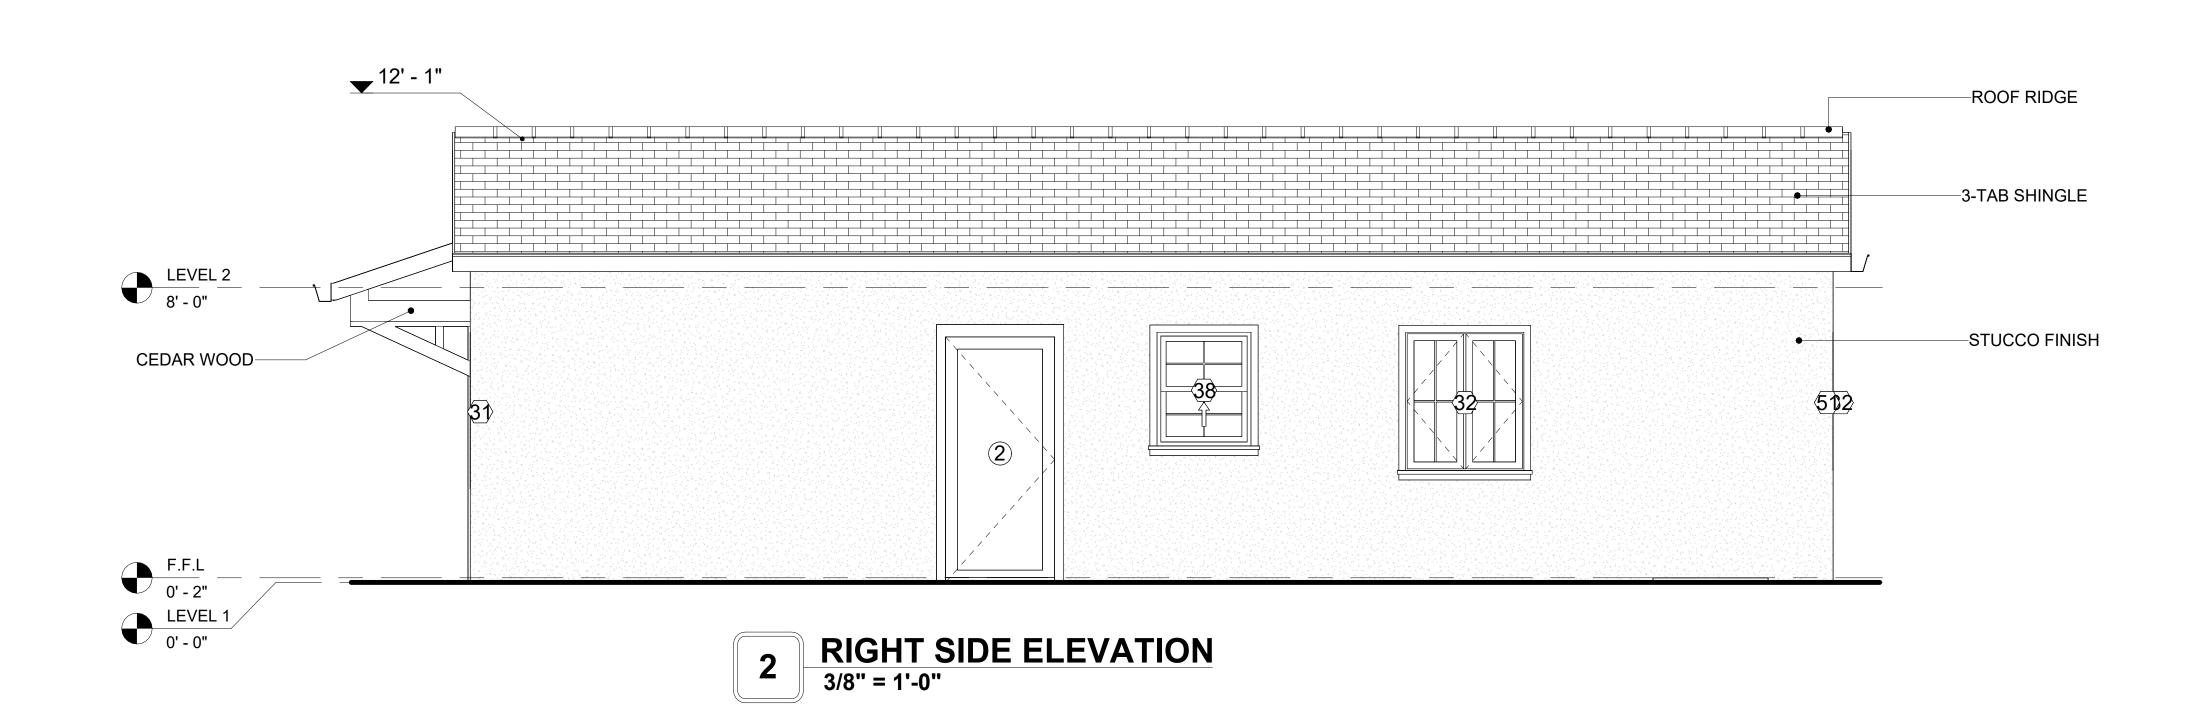


DOOR SCHEDULE						
TYPE				SIZE		
MAR K	SUPPLIER	DOOR TYPE	LOCATIO	WIDTH	HEIGHT	COUNT
2	HOME DEPOT	EXTERIOR SINGLE PANEL SWINGING	INTERIOR	3' - 0"	6' - 8"	2
3	HOME DEPOT	INTERIOR SINGLE PANEL SWINGING	INTERIOR	2' - 6"	6' - 8"	2
4	HOME DEPOT	INTERIOR SINGLE PANEL SWINGING	INTERIOR	3' - 0"	6' - 8"	2
20	HOME DEPOT	INTERIOR DOUBLE PANEL SLIDING	INTERIOR	7' - 4"	6' - 8"	1
22	HOME DEPOT	DOOR-BIFOLD_9052	INTERIOR	6' - 0"	6' - 8"	1
24	HOME DEPOT	INTERIOR DOUBLE PANEL SLIDING	INTERIOR	6' - 0"	6' - 8"	2
ID-17	HOME DEPOT	EXTERIOR DOUBLE PANEL SWINGING	INTERIOR	5' - 0"	6' - 8"	1

WINDOW SCHEDULE					
			SIZE		
TYPE MARK	SUPPLIER	WINDOW TYPE	WIDTH	HEIGHT	COUNT
31	HOME DEPOT	SINGLE HUNG	2' - 3"	4' - 3"	2
32	HOME DEPOT	DOUBLE HUNG	3' - 3"	3' - 9"	3
33	HOME DEPOT	FIXED	3' - 1"	2' - 1"	2
34	HOME DEPOT	FIXED	2' - 7"	2' - 7"	2
35	HOME DEPOT	SINGLE HUNG	2' - 7"	3' - 9"	1
38	HOME DEPOT	SINGLE HUNG	2' - 7"	3' - 1"	1
51	HOME DEPOT	SLIDING	6' - 3"	3' - 9"	1



**KEY PLAN** 

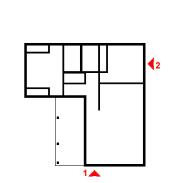

NO.	DESCRIPTION	DATE	

NOTE:

LEGEND:

PROJECT

59-Hamilton-1000-2Bd/2Ba Spanish 550

DRAWING NAME

ARCHITECTURAL ELEVATIONS

CLIENT NAME:	Client Name
PROJECT NUMBER:	0061_12
DATE:	2/17/2025 4:20:47 PM
DESIGNED BY:	Designer
DRAWN BY:	Author
CHECKED BY:	Checker

A201

#### **ABOUT WALL FINISHING**

#### PLYWOOD WALL SIDING

WALL SIDING IS AN EXTERIOR CLADDING MATERIAL USED TO COVER AND PROTECT THE WALLS OF A BUILDING, PROVIDING BOTH FUNCTIONAL AND AESTHETIC BENEFITS.

IN THIS SPECIFIC PROJECT, PLYWOOD WALL PANELS ARE USED AS A FINISH SIDING BECAUSE THIS TYPE OF SIDING PROVIDES A DURABLE, COST-EFFECTIVE, AND VERSATILE EXTERIOR CLADDING THAT CAN BE EASILY INSTALLED, FINISHED, AND MAINTAINED TO ENHANCE THE AESTHETIC AND PROTECTIVE QUALITIES OF A BUILDING'S EXTERIOR.

STANDARD SIZES OF 1' X 8' EXTERIOR-GRADE PLYWOOD PANELS ARE INSTALLED ON THE FURRING STRIPS USING GALVANIZED STEEL SELF-DRILLING SCREWS.

#### **EXTERNAL STONE**

THESE STONE PRODUCTS ARE MADE FROM A BLEND OF NATURAL AGGREGATES, CEMENT, AND OTHER PROPRIETARY MATERIALS.

THE STONE FINISH IS DIRECTLY ATTACHED TO COLD-FORMED STEEL (CS) FRAMING. (FOR COLUMN FINISH) EXTERNAL STONE CAN BE AN EXCELLENT EXTERIOR CLADDING OPTION FOR CSFRAMED BUILDINGS. IN THIS SCENARIO, THE EXTERNAL STONE WOULD BE ADHERED TO THE CS FRAME USING A SCRATCH COAT AND MORTAR-BASED ADHESIVE.

#### CAST MANUFACTURED STONE

MANUFACTURED STONE, ALSO KNOWN AS CULTURED OR ARTIFICIAL STONE, IS A SYNTHETIC BUILDING MATERIAL MADE FROM A BLEND OF CEMENT, AGGREGATES, AND PIGMENTS TO MIMIC THE APPEARANCE OF NATURAL STONE. IT IS LIGHTWEIGHT, DURABLE, AND CUSTOMIZABLE IN COLOR AND TEXTURE.

IN THIS PROJECT, MANUFACTURED STONE IS USED AS THE COPING MATERIAL, PROVIDING A DURABLE AND AESTHETIC FINISH THAT MIMICS THE APPEARANCE OF NATURAL STONE.

#### **CEDAR WOOD**


CEDAR WOOD REFERS TO THE WOOD FROM VARIOUS SPECIES OF CEDAR TREES, WHICH ARE CONIFEROUS EVERGREEN TREES KNOWN FOR THEIR DISTINCT AROMA AND NATURAL RESISTANCE TO DECAY AND INSECTS.

IN THIS SPECIFIC PROJECT, CEDAR WOOD IS USED A FINISH MATERIAL ON BEAMS AND COLUMNS.


#### WOOD SHAKES

WOOD SHAKES ARE ROUGH-SAWN PIECES OF WOOD, TYPICALLY MADE FROM CEDAR OR REDWOOD, USED FOR ROOFING OR WALL CLADDING. THEY OFFER A RUSTIC, TEXTURED LOOK BUT REQUIRE REGULAR MAINTENANCE FOR DURABILITY AND PROTECTION AGAINST THE ELEMENTS.

IN THIS SPECIFIC PROJECT, WOOD SHAKES ARE APPLIED AT THE TOP OF THE EXTERNAL WALL, CREATING AN EYE-CATCHING DETAIL THAT COMPLEMENTS THE OVERALL ARCHITECTURE AND ENSURES A STURDY, WEATHER-RESISTANT FINISH.

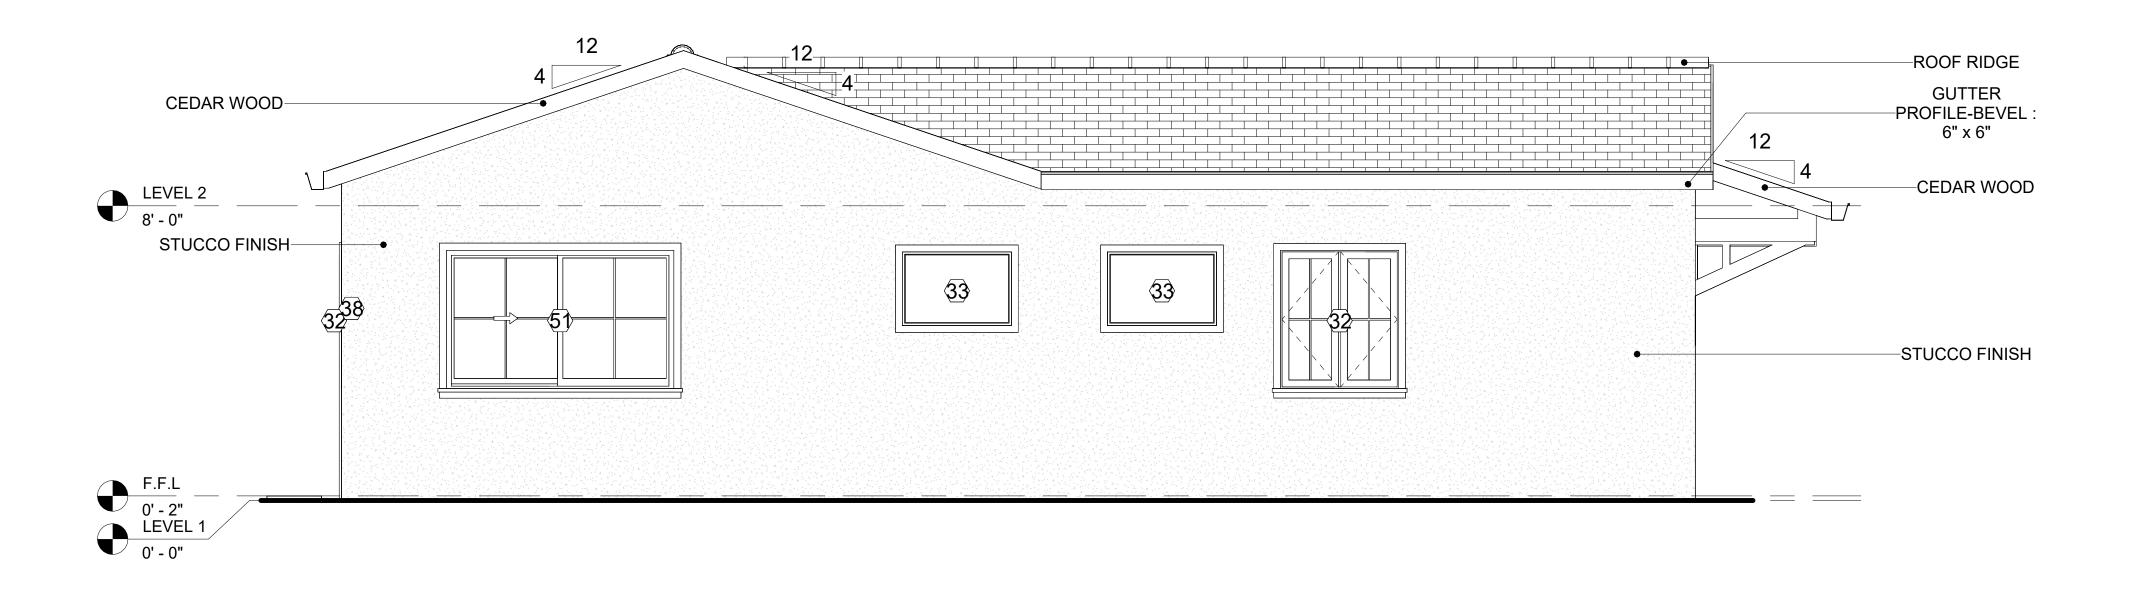

1 REAR ELEVATION
3/8" = 1'-0"

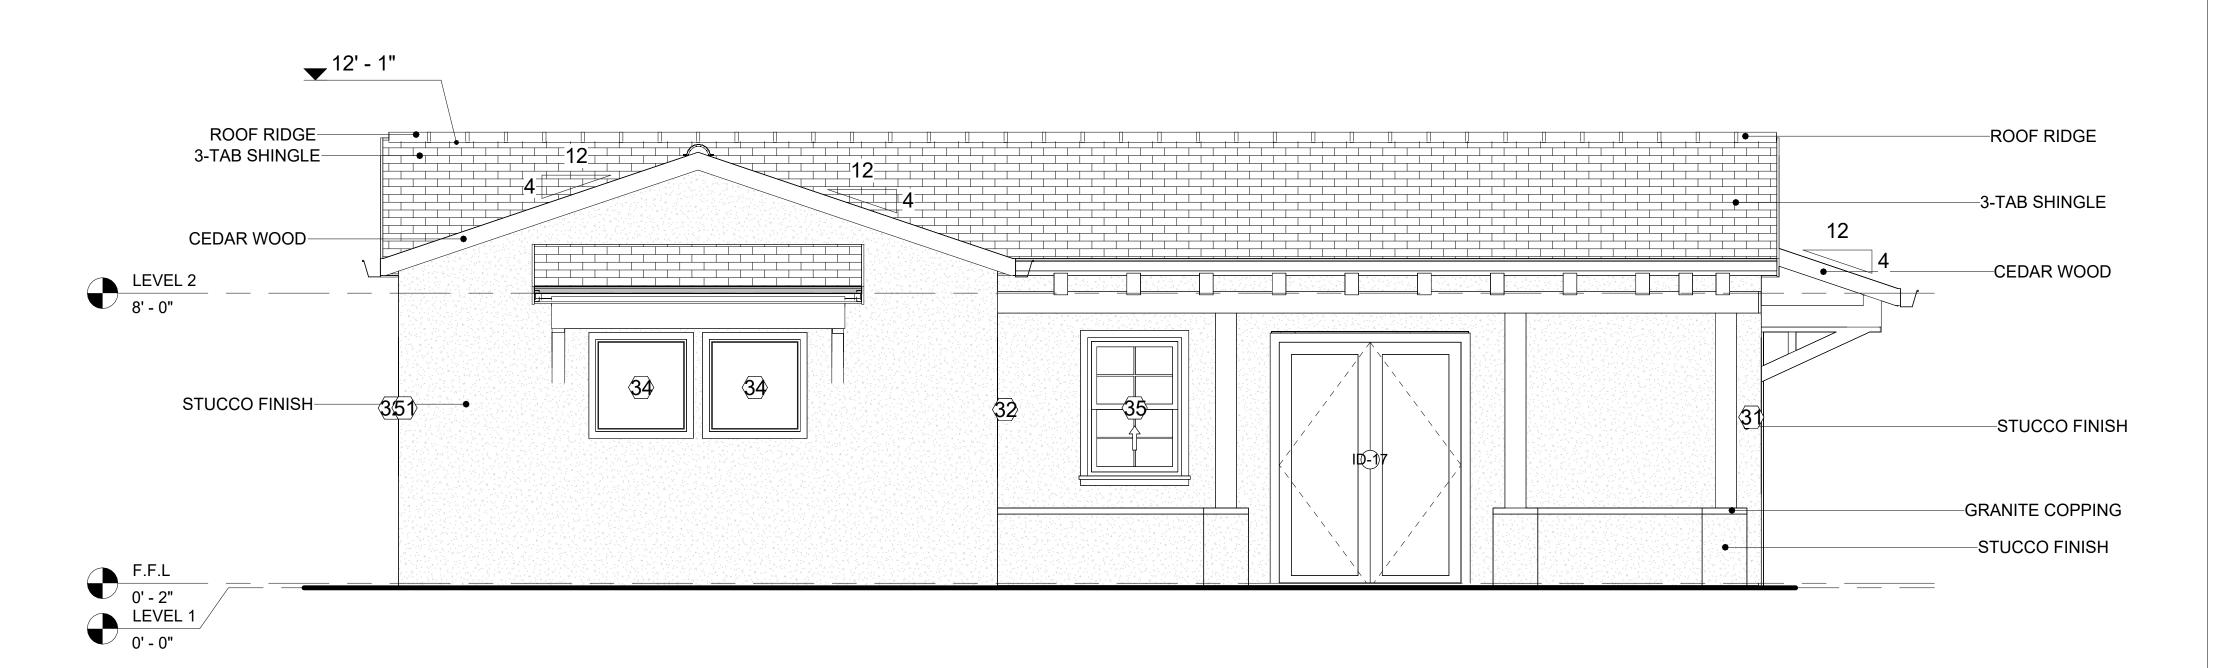

LEFT SIDE ELEVATION
3/8" = 1'-0"



**KEY PLAN** 



DESCRIPTION	DATE
	DESCRIPTION

NOTE:

LEGEND:

PROJECT

59-Hamilton-1000-2Bd/2Ba Spanish 550

DRAWING NAME

ARCHITECTURAL ELEVATIONS

CLIENT NAME:

PROJECT NUMBER:

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DATE:

2/17/2025 4:20:51 PM


DESIGNED BY:

DRAWN BY:


CHECKED BY:

Checker

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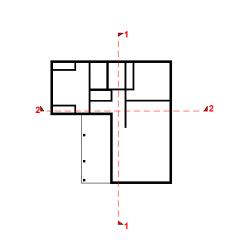
**SECTION-3** 3/8" = 1'-0"

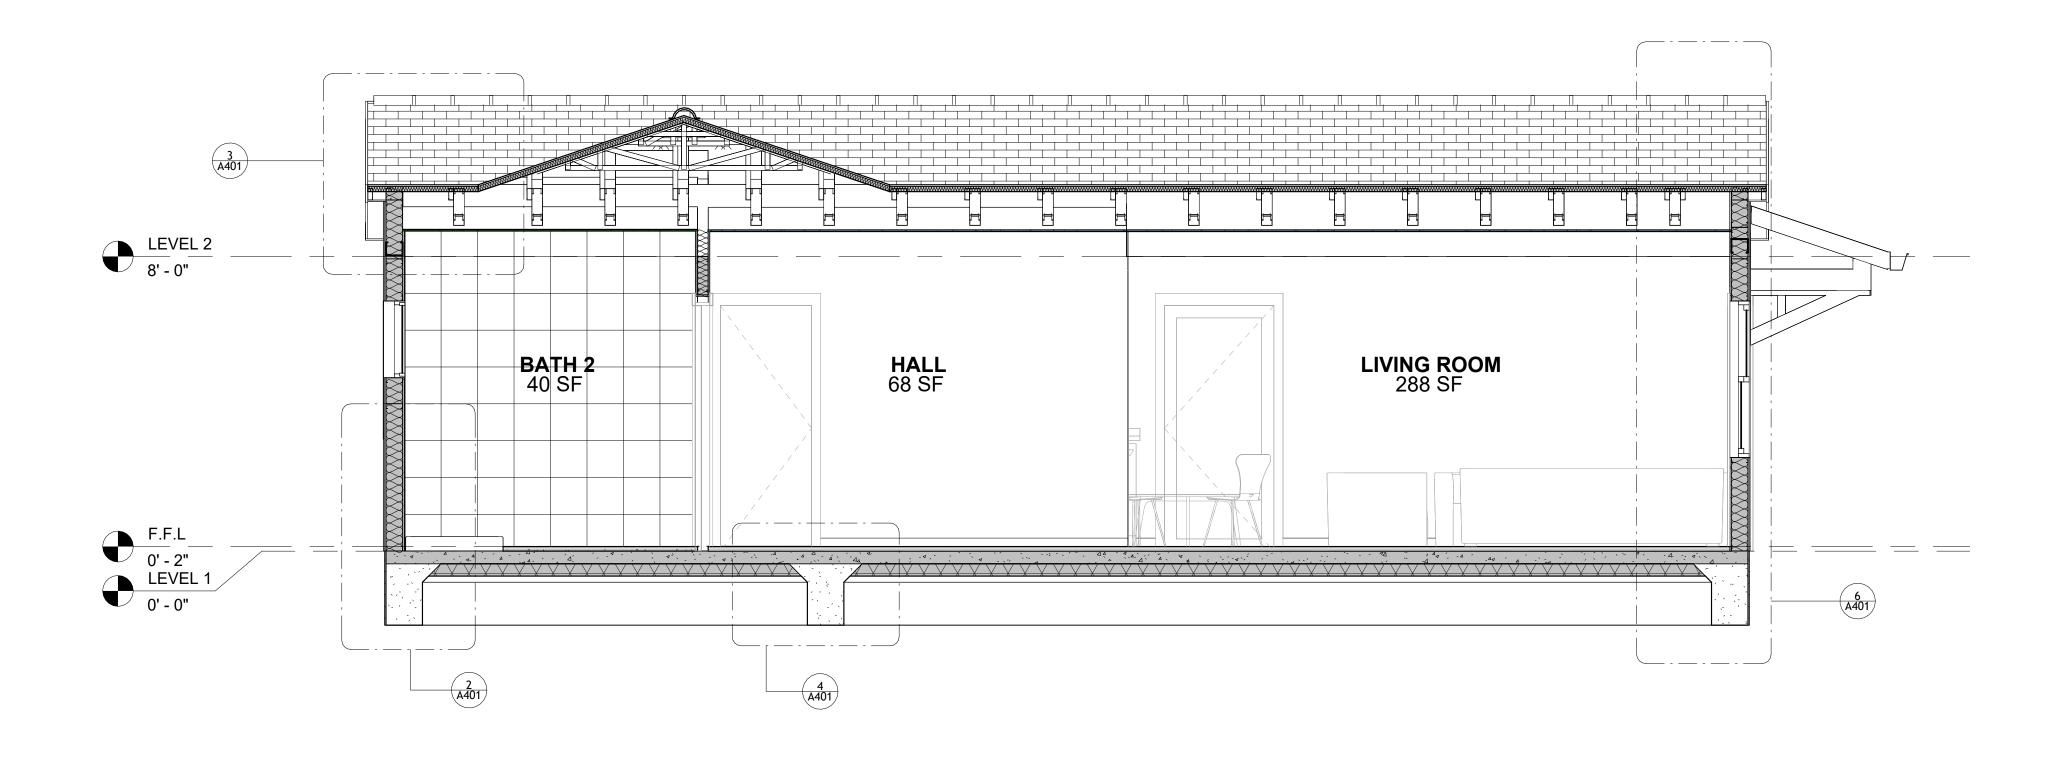

2 SECTION-2 3/8" = 1'-0"

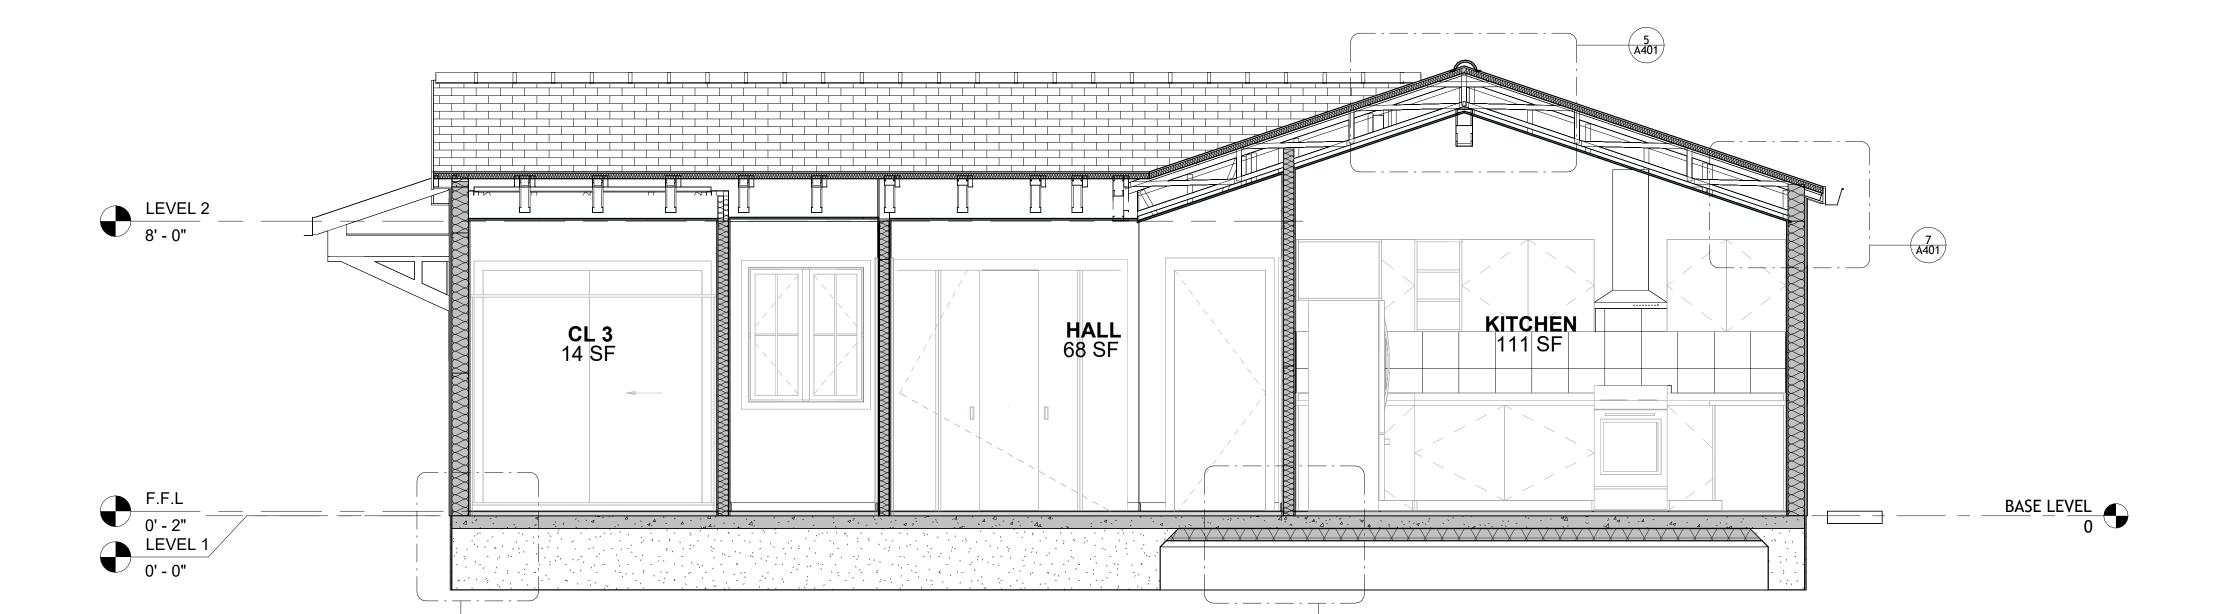

**KEY PLAN** 



NO.	DESCRIPTION	DATE

NOTE:

LEGEND:

PROJECT


59-Hamilton-1000-2Bd/2Ba Spanish 550


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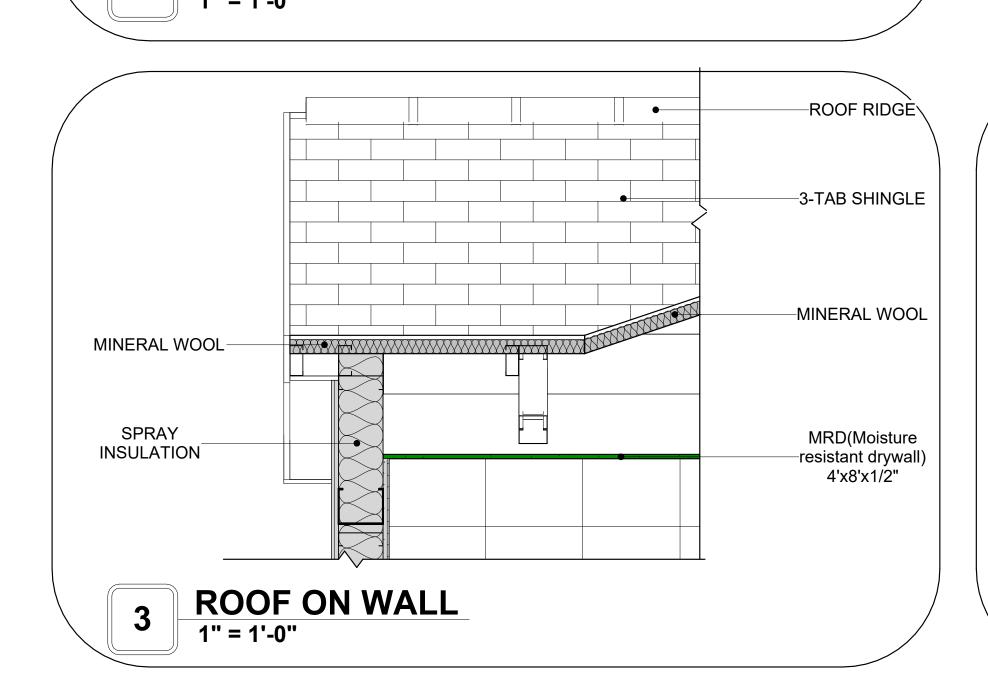
ARCHITECTURAL SECTIONS


Client Name	CLIENT NAME:
0061_12	PROJECT NUMBER:
2/17/2025 4:20:53 PM	DATE:
Designer	DESIGNED BY:
Author	DRAWN BY:
Checker	CHECKED BY:


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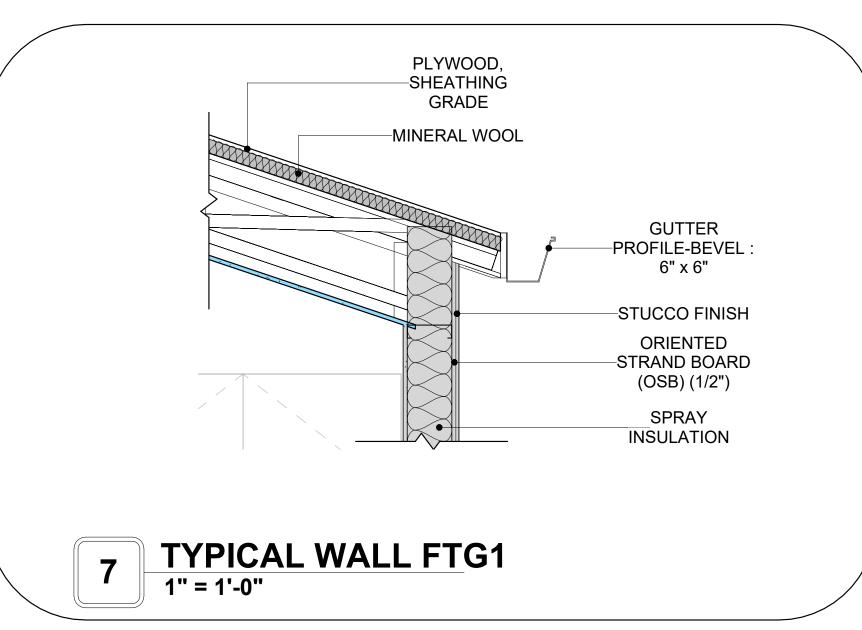





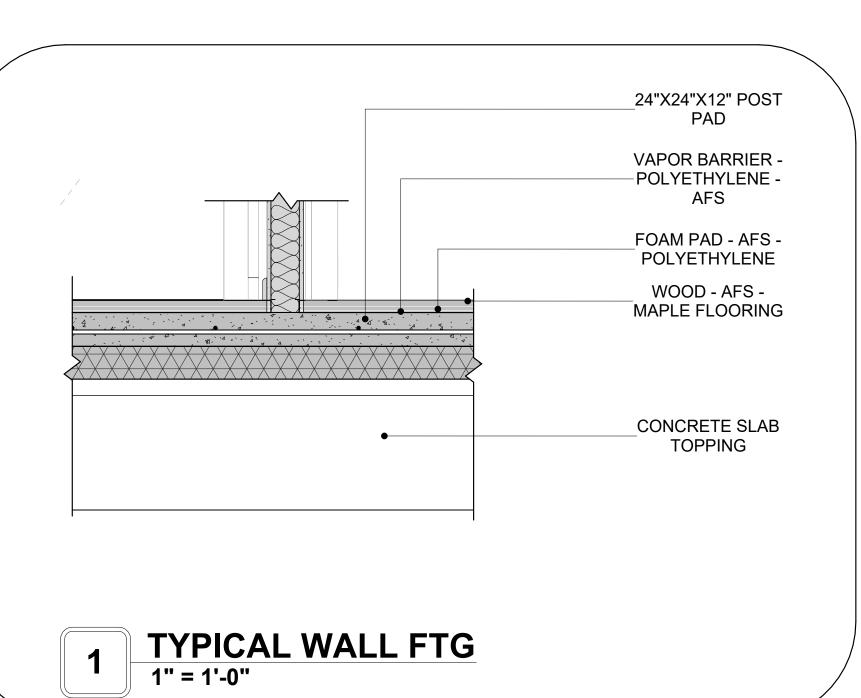

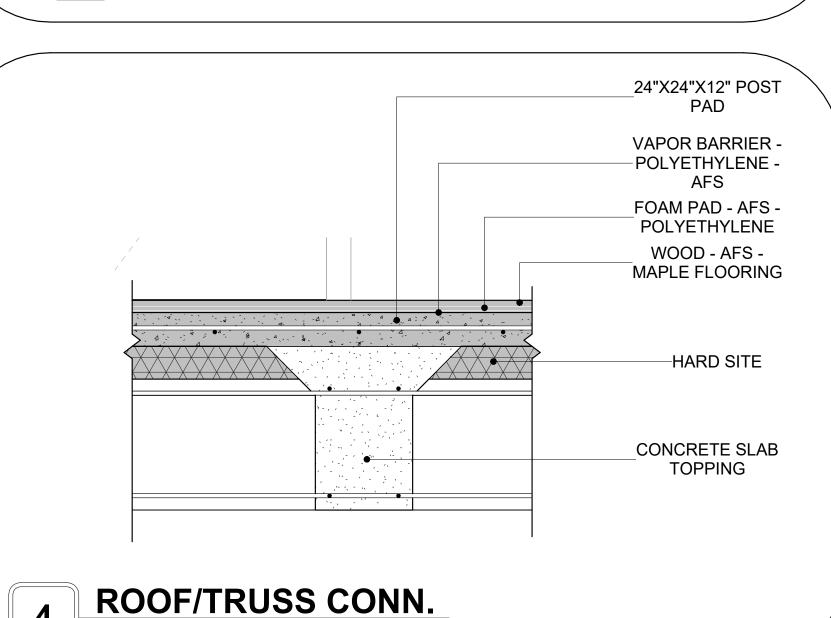

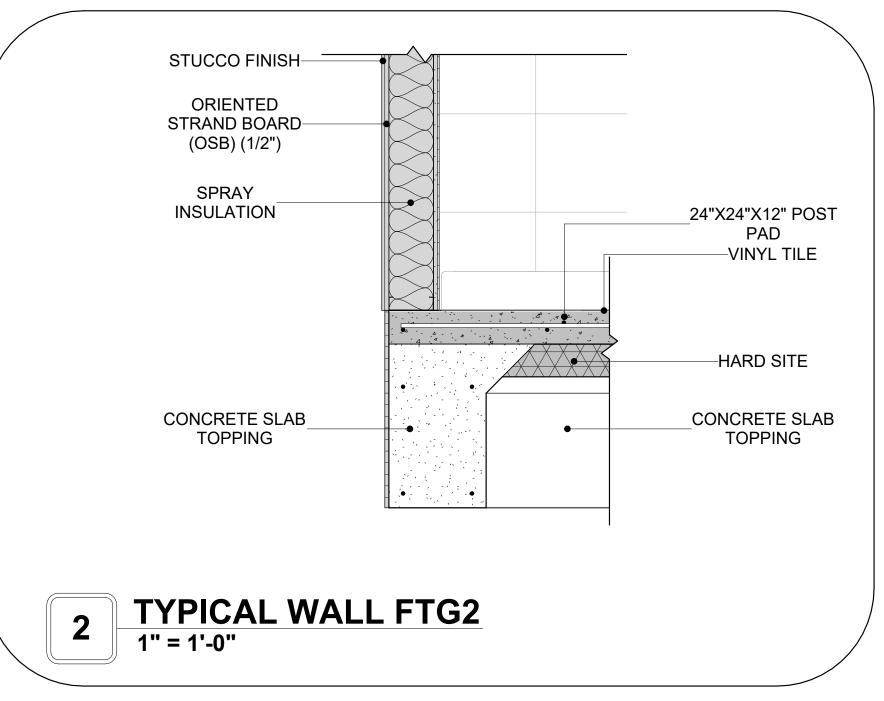

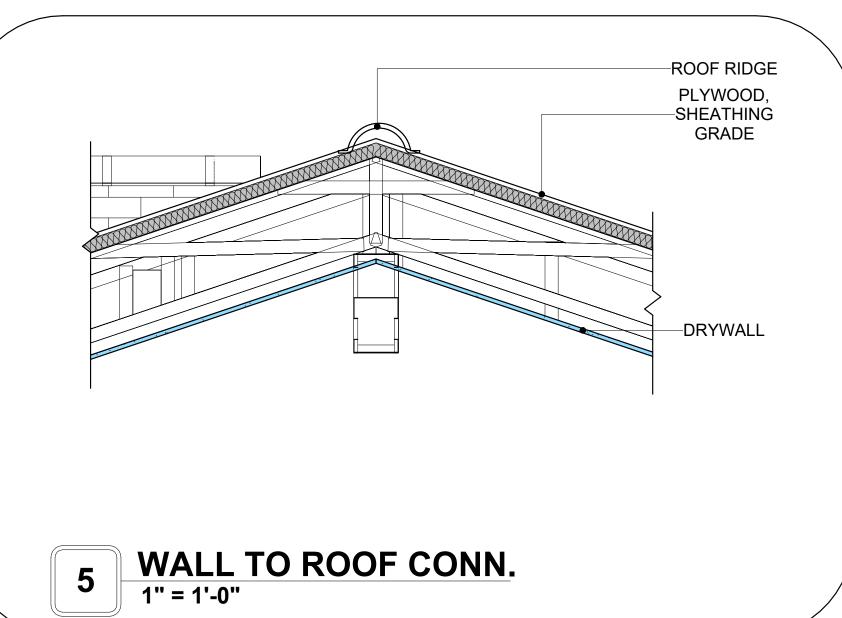

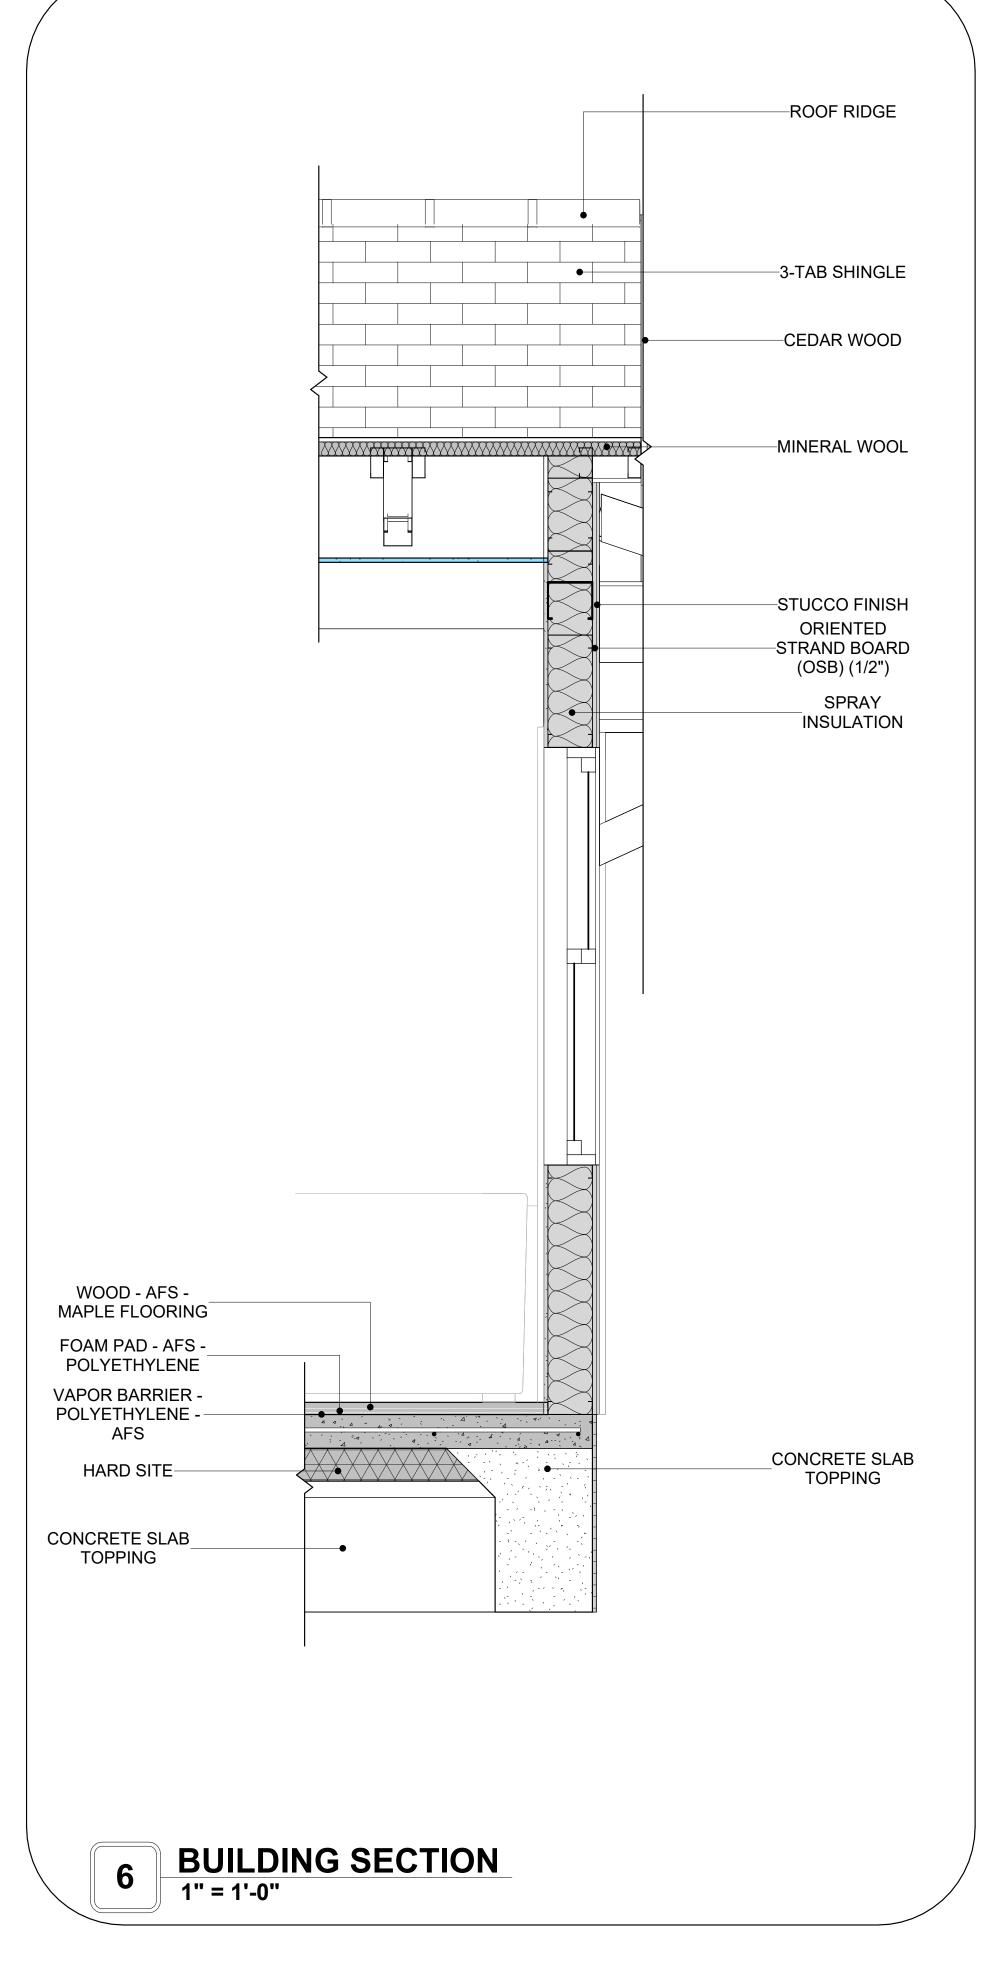



**KEY PLAN** 

NO.	DESCRIPTION	DATE

NOTE:

LEGEND:

PROJECT

59-Hamilton-1000-2Bd/2Ba Spanish 550

DRAWING NAME

ARCHITECTURAL DETAILS

Client Name
0061_12
2/17/2025 4:20:54 PM
Designer
Author
Checker

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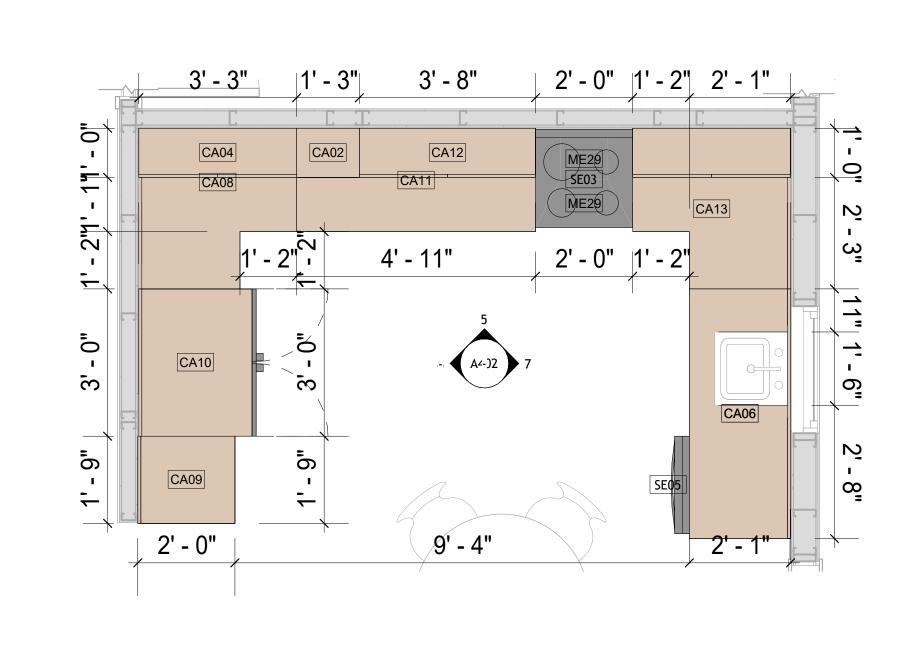
SCALE: 1" = 1'-0"

#### **CASEWORK GENERAL NOTES**


- ALL CABINET HEIGHTS INCLUDE COUNTERTOPS. DIMENSIONS ARE TO THE NEAREST INCH. DIVISIONS IN CASEWORK ARE SHOWN FOR CLARITY AND DO NOT REPRESENT BREAKS IN THE COUNTERTOP.
- PROVIDE CONTINUOUS COUNTERTOP OVER ALL SIMILAR HEIGHT CASEWORK, UNLESS AND OTHERWISE NOTED.
- MANUFACTURER AND CATALOG NUMBERS ARE FOR REFERENCE AND ILLUSTRATION PURPOSES
- DOTTED LINES INDICATE WALL HUNG CABINETS, DIVISIONS OF BASE CABINETS BELOW THE
- COUNTERTOP, FURNITURE NOT IN THE CONTRACT OR PROJECTION SCREENS -SEE CASEWORK KEY AND SPECIFICATIONS.
- ALL CABINETS AND DRAWERS TO HAVE CAM LOCKS EXCEPT FOR SINK BASE CABINETS. ALL EXPOSED SURFACES (EXPOSED TO VIEW FROM ANY PERSPECTIVE) TO BE COVERED WITH LAMINATE.
- ALL CASEWORK WHICH MEETS A WALL AT ONE OR BOTH ENDS, TO BE PROVIDED WITH FILLER
- PANELS AND SCRIBED TO THE WALL(S) AS REQUIRED.
- 10. ALL CABINETS AND DRAWERS ARE PROVIDED WITH RECESSED HANDLES. 11. CONTRACTOR TO FIELD VERIFY ALL CLEAR OPENINGS PRIOR TO MILLWORK OR CASEWORK
- FABRICATION. 12. CASEWORK DRAWINGS ARE DIAGRAMMATIC IN NATURE TO SHOW DESIGN INTENT.


	CASEWORK SCHEDULE					
TYPE MAR K	TYPE	COUN T	HEIGHT	WIDTH	DEPTH	AREA
01	CLOSET 3 180	1	6' - 0"	8' - 0"	1' - 4"	48 SF
02	HD WALL FILLER 18 2 153	1	2' - 6"	1' - 3"	1' - 0"	3 SF
03	VANITY	2	2' - 4"	2' - 6"	1' - 8"	6 SF
04		2	2' - 6"	3' - 3"	1' - 0"	8 SF
05	RECESSED MED CABINET	2	2' - 0"	1' - 6"	0' - 3"	3 SF
06	LINEAR COUNTER TOP 2	1	0' - 4"	2' - 0"	2' - 1"	1 SF
07	CLOSET 3 153	2	6' - 0"	6' - 9"	1' - 4"	41 SF
08	BASE_CABINET_L-SHAPED	2	2' - 11"	3' - 3"	3' - 3"	9 SF
09	HD TALL CABINET 24 2	1	7' - 6"	1' - 9"	2' - 0"	13 SF
10	LAUNDRY OPEN CABINET 3	1	1' - 8"	3' - 0"	2' - 4"	5 SF
11	HD LINEAR COUNTER TOP 3	1	0' - 4"	4' - 11"	2' - 1"	2 SF
12	WALL CABINET DOUBLE DOOR 2 59	1	2' - 6"	3' - 8"	1' - 0"	9 SF
13	HD_L-SHAPE_COUNTER_TOP11	2	0' - 4"	9' - 7"	4' - 0"	3 SF
14	BASE CABINET DOUBLE DOOR 3	1	2' - 11"	3' - 0"	2' - 0"	9 SF
15	BASE CABINET DOUBLE DOOR 2	1	2' - 11"	4' - 11"	2' - 0"	14 SF
GRAND	TOTAL	21			•	•


SPECIALTY EQUIPMENT SCHEDULE			
TYPE MARK	TYPE	COUNT	
01	WASHER-FRONT-LOAD	1	
03	RANGE	1	
04	DRYER-FRONT-LOAD	1	
05	DISHWASHER	1	
16	REFRIGERATOR	1	
GRAND TOTAL: 5		·	







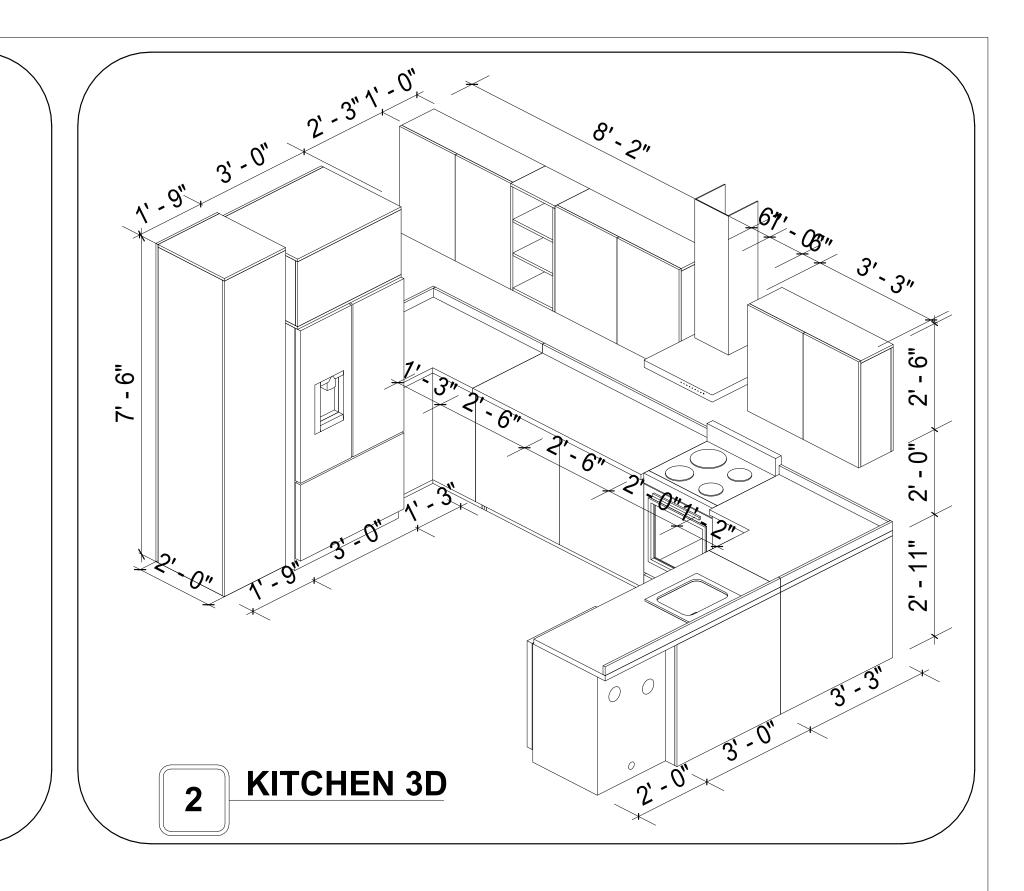

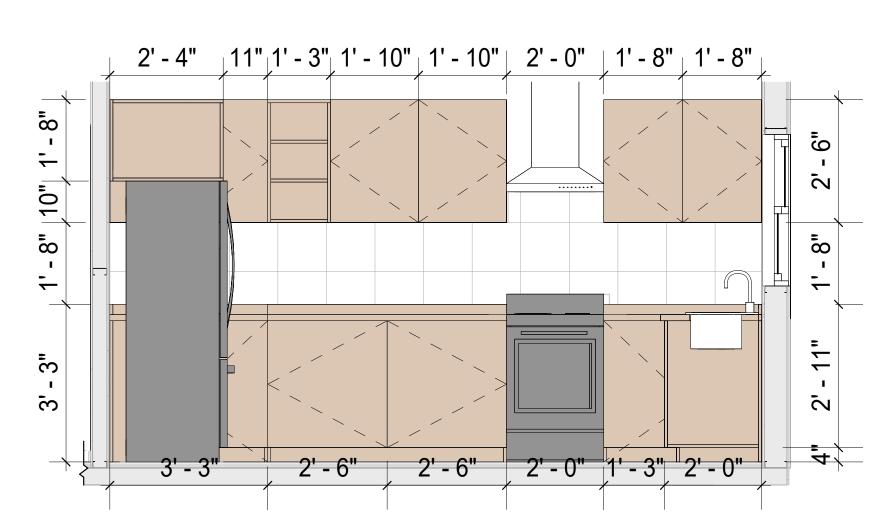

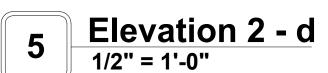


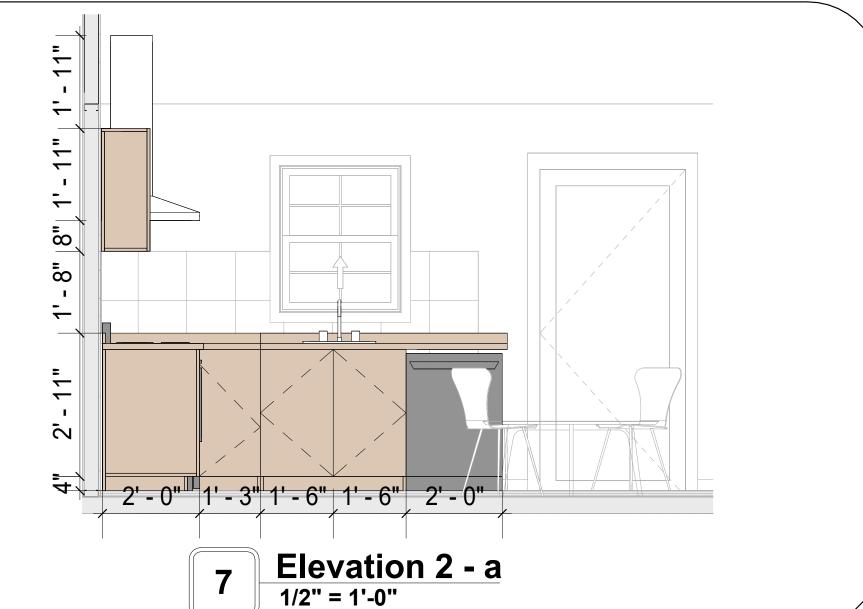

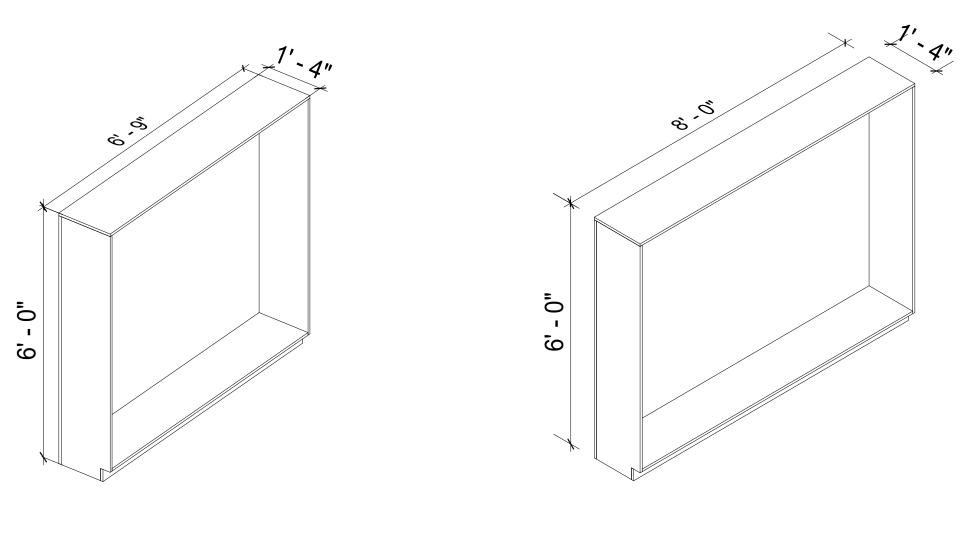

CLOSET 3D 1


**CLOSET 3D** 

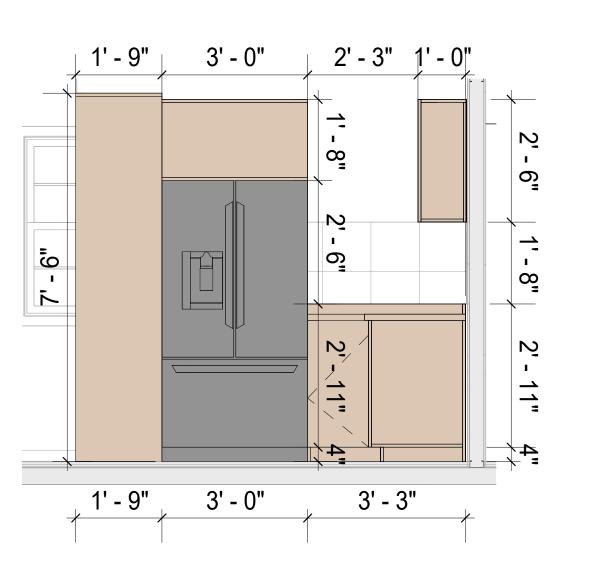

Elevation 2 - c 1/2" = 1'-0"



**KEY PLAN** 

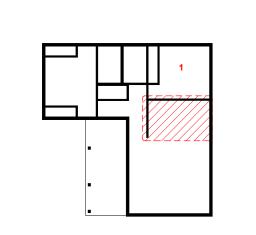

NO.	DESCRIPTION	DATE

NOTE:

LEGEND:

PROJECT


59-Hamilton-1000-2Bd/2Ba Spanish 550


DRAWING NAME

ARCHITECTURAL CASEWORK

**Client Name** CLIENT NAME: PROJECT NUMBER: 0061\_12 DATE: 2/17/2025 4:20:56 PM DESIGNED BY: Designer DRAWN BY: **Author** CHECKED BY: Checker


A402

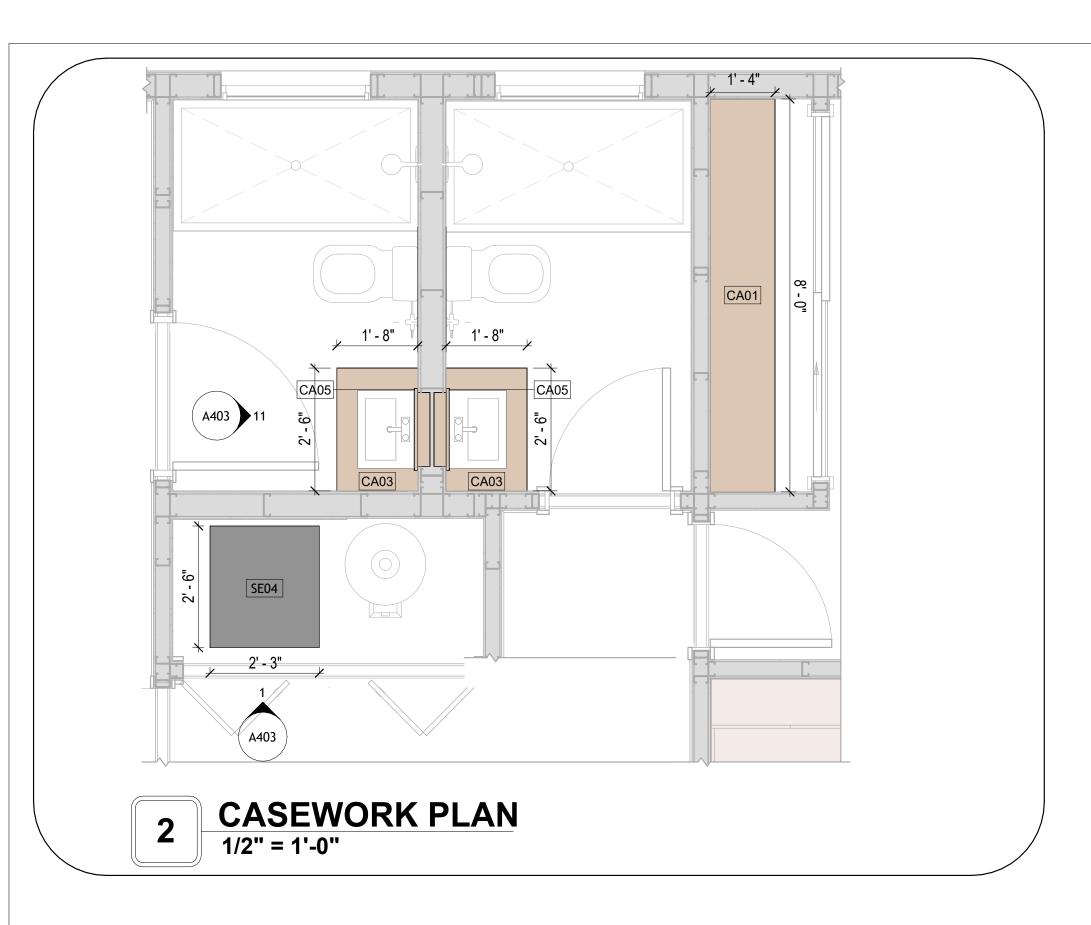

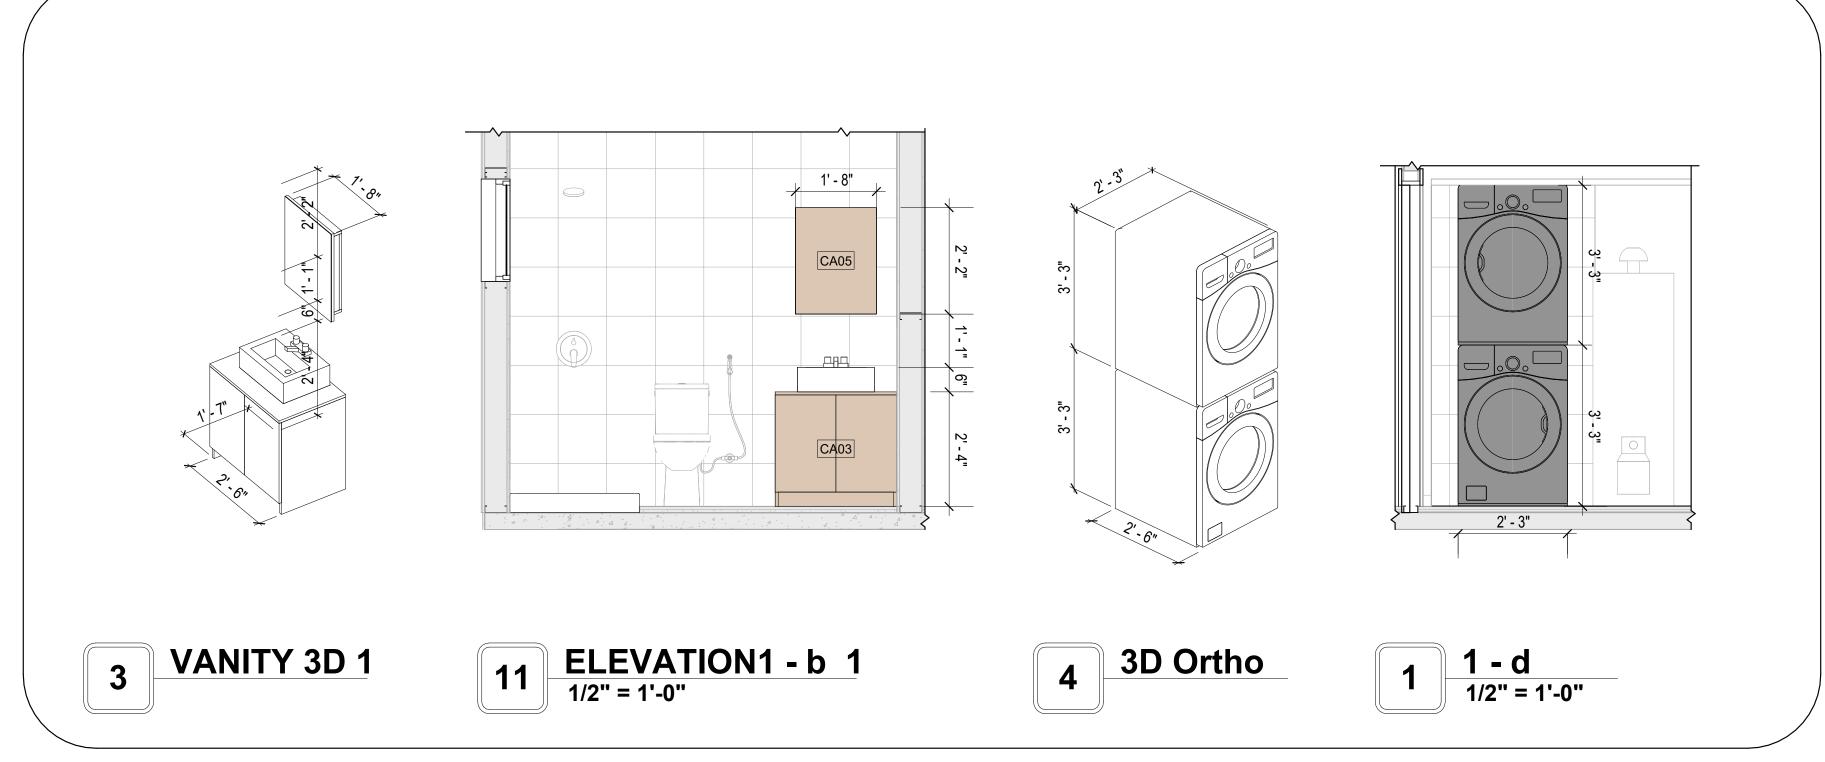



**KEY PLAN** 

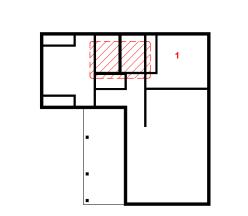

NO.	DESCRIPTION	DATE

NOTE:

LEGEND:

PROJECT

59-Hamilton-1000-2Bd/2Ba Spanish 550

DRAWING NAME

ARCHITECTURAL CASEWORK
Copy 1

CLIENT NAME:	Client Name
PROJECT NUMBER:	0061_12
DATE:	2/17/2025 4:20:58 PM
DESIGNED BY:	Designer
DRAWN BY:	Author
CHECKED BY:	Checker

A403

#### **GENERAL NOTES**

AND BRACED TO PREVENT SAGGING, AIR LEAKAGE, OR VIBRATION.

1. THIS DRAWING DEPICTS THE HVAC (HEATING, VENTILATION, AND AIR CONDITIONING) SYSTEM FOR THE HAMILTON 2BD 2BA SPANISH. IT PROVIDES A VISUAL REPRESENTATION OF THE SYSTEM LAYOUT AND COMPONENTS.

2.THE HVAC SYSTEM IS DESIGNED TO MEET THE SPECIFIC REQUIREMENTS OF THE BUILDING, INCLUDING HEATING, COOLING, AND VENTILATION NEEDS, AS PER THE PROJECT SPECIFICATIONS AND APPLICABLE CODES AND STANDARDS.

3. THE HVAC SYSTEM INSTALLATION SHALL COMPLY WITH THE LATEST EDITION OF THE INTERNATIONAL MECHANICAL CODE (IMC), INTERNATIONAL RESIDENTIAL CODE (IRC), AND ALL OTHER APPLICABLE LOCAL, STATE, AND NATIONAL CODES AND REGULATIONS.

4. THE EQUIPMENT SHOWN ON THIS DRAWING INCLUDES BUT IS NOT LIMITED TO AIR HANDLING UNITS (AHUS), CHILLERS, BOILERS, COOLING TOWERS, PUMPS, DUCTWORK, DIFFUSERS, GRILLES, AND CONTROL DEVICES.

5. ALL EQUIPMENT, DUCTWORK, AND PIPING SHALL BE INSTALLED IN ACCORDANCE WITH MANUFACTURER'S SPECIFICATIONS, LOCAL CODES, AND

6. ALL DUCTWORK SHALL BE SIZED, FABRICATED, AND INSTALLED IN ACCORDANCE WITH THE LATEST EDITION OF THE ACCA MANUAL D AND THE SMACNA HVAC DUCT CONSTRUCTION STANDARDS. DUCTWORK SHALL BE INSTALLED IN A NEAT AND WORKMANLIKE MANNER, PROPERLY SUPPORTED

7. CONDENSATE DRAINAGE PIPING SHALL BE PROPERLY PITCHED TO ENSURE POSITIVE DRAINAGE TO AN APPROVED DISPOSAL LOCATION, SUCH AS A FLOOR DRAIN, SUMP PUMP, OR EXTERIOR GRADE. CONDENSATE LINES SHALL BE INSULATED TO PREVENT SWEATING.

8. THE LOCATION OF CONTROL PANELS AND SENSORS INDICATED ON THIS DRAWING CAN BEMODIFY WITH THE SPECIFIC LOCATIONS AND WIRING

DETAILS WILL BE DETERMINED DURING THE CONTROL SYSTEM DESIGN AND INSTALLATION.

9. THE HVAC SYSTEM DESIGN CONSIDER ENERGY EFFICIENCY, INDOOR AIR QUALITY, OCCUPANT COMFORT, AND NOISE CONTROL, FOLLOWING APPLICABLE GUIDELINES AND REGULATIONS.

10. COORDINATION WITH OTHER TREADS HAS BEEN DONE ON A DESIGN LEVEL. THIS DRAWING SHALL BE READ TOGETHER WITH THE AR, EL AND SN DESIGN DRAWINGS TO ENSURE PROPER INSTALLATION AND INTEGRATION OF THE HVAC SYSTEMS.

11. THE HVAC CONTRACTOR IS RESPONSIBLE FOR OBTAINING ALL NECESSARY PERMITS AND LICENSES, AND FOR SCHEDULING AND COORDINATING WITH THE LOCAL BUILDING DEPARTMENT AND UTILITY PROVIDERS TO ENSURE A TIMELY AND COMPLIANT INSTALLATION.

12. ALL DUCTWORK PENETRATIONS THROUGH WALLS, FLOORS, OR CEILINGS SHALL BE PROPERLY SEALED AND FIRE-STOPPED USING APPROVED METHODS AND MATERIALS TO MAINTAIN THE INTEGRITY OF THE BUILDING'S FIRE-RESISTANCE RATINGS.

13. HVAC EQUIPMENT SHALL BE INSTALLED LEVEL AND PLUMB, AND IN STRICT ACCORDANCE WITH THE MANUFACTURER'S INSTALLATION INSTRUCTIONS AND RECOMMENDATIONS. PROVIDE ADEQUATE CLEARANCES AROUND EQUIPMENT FOR PROPER AIRFLOW, SERVICE ACCESS, AND

CODE COMPLIANCE. 14. ALL HVAC EQUIPMENT AND COMPONENTS, INCLUDING THERMOSTATS, DAMPERS, AND ACCESS PANELS, SHALL BE LOCATED IN ACCESSIBLE AREAS


15. THE HVAC SYSTEM SHALL BE BALANCED AND ADJUSTED TO ENSURE PROPER AIRFLOW, TEMPERATURE DISTRIBUTION, AND SYSTEM PERFORMANCE THROUGHOUT THE RESIDENCE. PROVIDE A WRITTEN REPORT DOCUMENTING THE FINAL SYSTEM BALANCE.

FOR EASY SERVICING AND MAINTENANCE. PROVIDE ADEQUATE SPACE AROUND EQUIPMENT FOR PROPER AIRFLOW AND SERVICE ACCESS.

16. ANY DEVIATIONS OR MODIFICATIONS TO THE HVAC SYSTEM DESIGN SHALL BE REVIEWED AND APPROVED BY THE RESPONSIBLE DESIGN PROFESSIONALS AND COMMUNICATED TO ALL RELEVANT PARTIES INVOLVED IN THE CONSTRUCTION PROCESS.


17. FOR ANY INQUIRIES OR CLARIFICATIONS REGARDING THE HVAC SYSTEM DESIGN, PLEASE CONSULT THE RESPONSIBLE DESIGN PROFESSIONALS OR THE PROJECT MANAGEMENT TEAM.

#### SYMBOLS

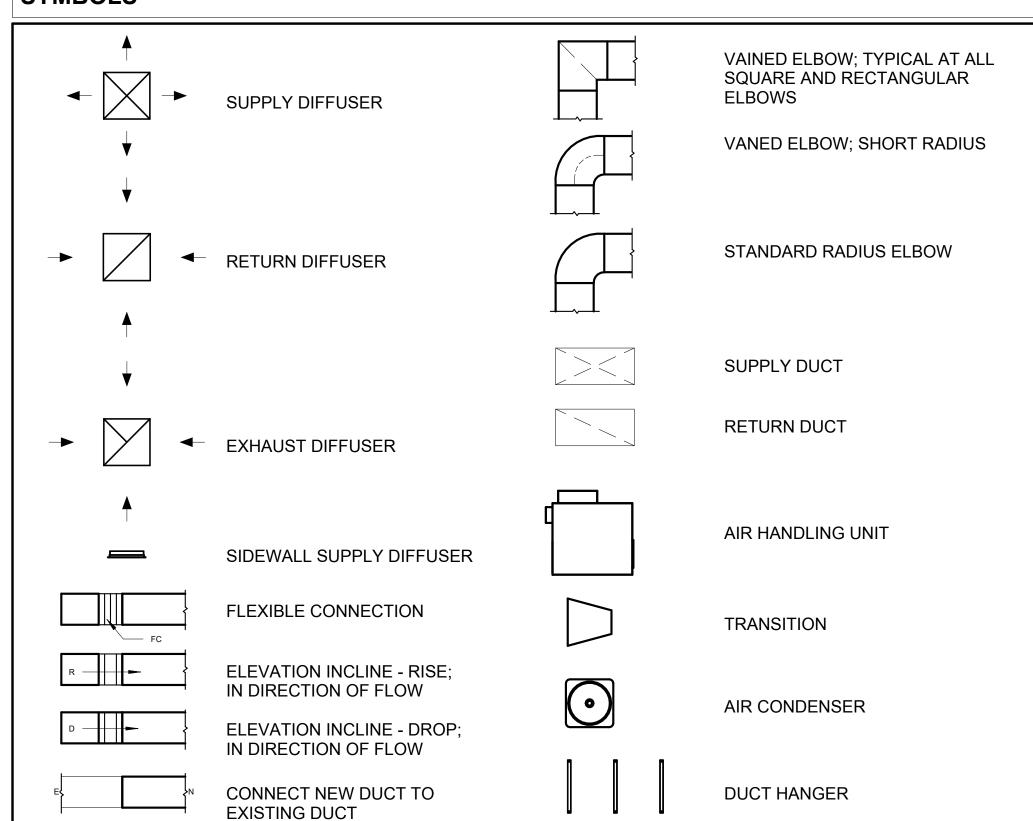

HVAC COLOR SCHEME

AIR CONDITIONING PIPE LINE

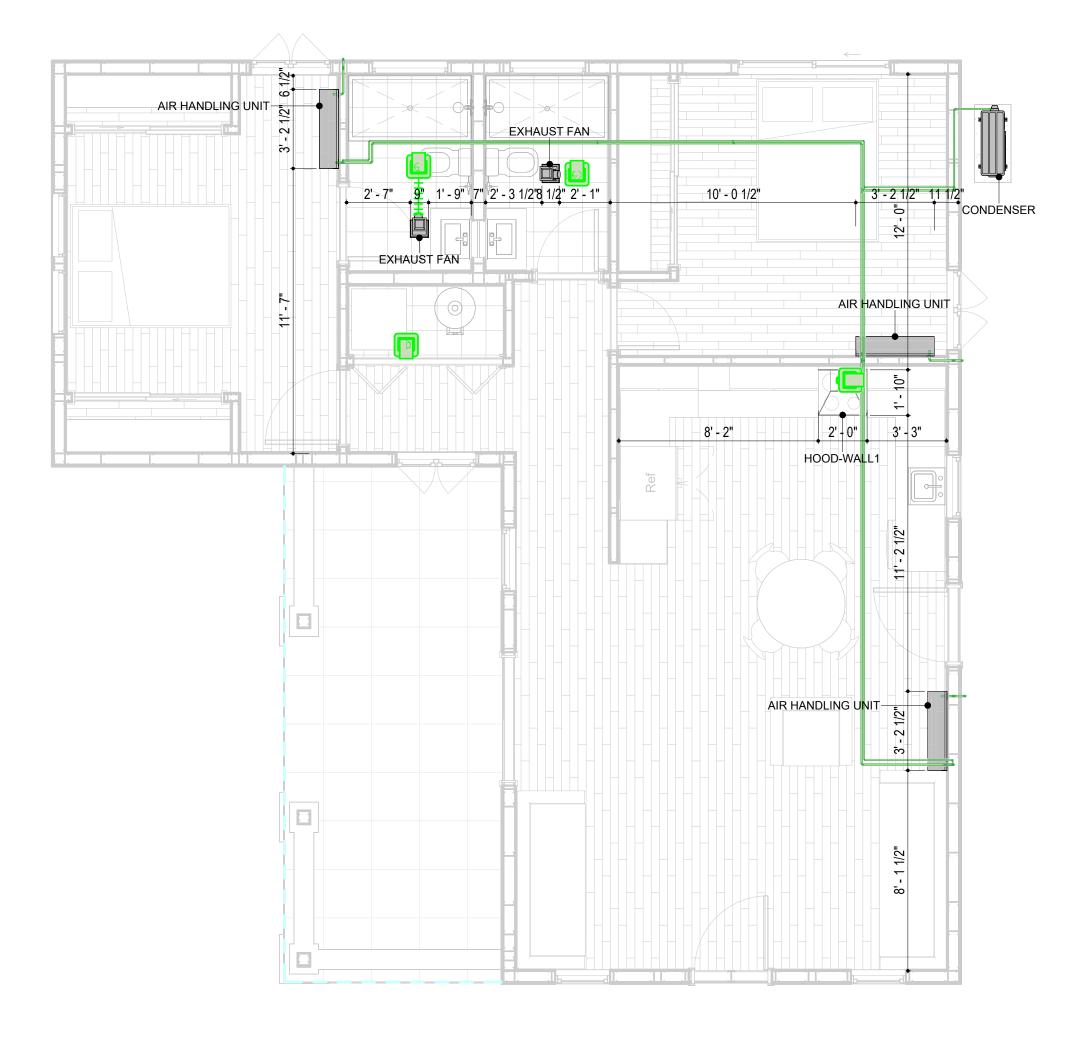



FLEX DUCT SCHEDULE					
DESCRIPTION	DESCRIPTION	LENGTH	DIAMETER	COUNT	
FLEX DUCT ROUND	FLEX-ROUND	13.29	4"	1	
GRAND TOTAL: 4	FLEX-ROUND	13.29	4	4	

DUCT ACCESSORY SCHEDULE			
CATAGORY	DESCRIPTION	COUNT	
ROOF VENT	3" DIAMETER	4	

REFRIGERANT LINE FITTING SCHEDULE					
CATAGORY	DESCRIPTION	Size	Count		
ELBOW - GENERIC	ELBOW - GENERIC: STANDARD/HVAC	3/4"ø-3/4"ø	29		
ELBOW - GENERIC	ELBOW - GENERIC: STANDARD/HVAC	3/8"ø-3/8"ø	21		
TEE - GENERIC	TEE - GENERIC: STANDARD	3/4"ø-3/4"ø-3/ 4"ø	2		
TEE - GENERIC	TEE - GENERIC: STANDARD	3/8"ø-3/8"ø-3/ 8"ø	2		
TRANSITION - GENERIC	TRANSITION - GENERIC: STANDARD	3/4"ø-1/2"ø	4		
TRANSITION - GENERIC	TRANSITION - GENERIC: STANDARD	3/4"ø-5/8"ø	4		
TRANSITION - GENERIC	TRANSITION - GENERIC: STANDARD	3/8"ø-1/4"ø	1		

DUCT FITTING SCHEDULE			
CATAGORY	DESCRIPTION	COUNT	
ROUND TRANSITION - ANGLE	45 DEGREE	7	

REFRIGERANT LINE SCHEDULE			
CATAGORY	DESCRIPTION	DIAMETER	LENGTH
		2 (2)	
PIPE TYPES	COPPER	3/8"	76.39
PIPE TYPES	COPPER	3/4"	97.96

MECHANICAL EQUIPMENT SCHEDULE				
CATAGORY	DESCRIPTION	COUNT		
AID HANDLING LINIT	AID HANDI ING LINIT, WALL MOUNTED	2		
AIR HANDLING UNIT CONDENSER	AIR HANDLING UNIT: WALL MOUNTED 3  CONDENSER: OUT DOOR 1			
EXHAUST FAN	EXHAUST FAN: 75 CFM 2			
	HOOD-WALL1: VENT 2	1		



**KEY PLAN** 

NO.	DESCRIPTION	DATE

NOTE:

LEGEND:

PROJECT

59-Hamilton-1000-2Bd-2Ba Spanish-550

DRAWING NAME

**HVAC PLAN** 

CLIENT NAME: Owner PROJECT NUMBER: 15\_0001 DATE: 2/14/2025 12:44:14 AM Designer DESIGNED BY: DRAWN BY: Author CHECKED BY: Checker

M101

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#### **ELECTRICAL NOTES**

- 1. THIS DRAWING DEPICTS THE ELECTRICAL SYSTEM FOR THE 59-Hamilton-1000-2Bd-2Ba Spanish-550. IT PROVIDES A VISUAL REPRESENTATION OF THE ELECTRICAL LAYOUT AND COMPONENTS, INCLUDING POWER DISTRIBUTION, LIGHTING, AND CONTROL SYSTEMS.
- 2. THE ELECTRICAL SYSTEM IS DESIGNED TO MEET THE SPECIFIC REQUIREMENTS OF THE BUILDING, INCLUDING POWER DISTRIBUTION, LIGHTING, AND SPECIALIZED ELECTRICAL EQUIPMENT NEEDS, AS PER THE PROJECT SPECIFICATIONS AND APPLICABLE CODES AND STANDARDS.
- 3. THE ELECTRICAL SYSTEM INSTALLATION SHALL COMPLY WITH THE LATEST EDITION OF THE NATIONAL ELECTRICAL CODE (NEC), INTERNATIONAL BUILDING CODE (IBC), AND ALL OTHER APPLICABLE LOCAL, STATE, AND NATIONAL CODES AND REGULATIONS.
- 4. LOCATIONS AS NEEDED, DEVICES ARE SHOWN ON PLANS IN APPROXIMATE IDEAL LOCATIONS, UNLESS SPECIFICALLY DIMMENSIONED.
- OPEN WALLS AS NEEDED TO ALLOW FOR NEW ELECTRICAL INSTALLATIONS.
- 6. LABEL ALL CIRCUITS ON JUNCTION BOXES, RECEPTACLES, DATA, SMOKE DETECTOR, AND EQUIPMENT IN PANEL BOX.
- 7. INSTALL RACEWAY AS NEEDED FOR DDC, ACCESS CONTROL, LOW VOLTAGE WIRING & DATA.
- 8. RELABEL POWER, DATA & FIRE ALARM FOR ROOM #CHANGES. 9. VERIFY ALL CIRCUITS LABELED ON PRINT ARE CORRECT BEFORE WORKING ON THEM.
- 10. NOTE ON SITE PLAN ALL CHANGES OR MISSING DETAIL TO BE INCORPORATED INTO THE MASTER PLAN.
- 11. DRAWINGS ARE DIAGRAMMATIC ONLY FOR THE PURPOSE OF SHOWING FIXTURE AND OUTLET LOCATIONS.
- 12. ELECTRICAL CONTRACTOR TO VERIFY SERVICE SIZE BY CALCULATION BASED UPON ACTUAL NAME
- PLATE RATINGS OF SELECTED EQUIPMENT.
- 13. VERIFY LOCATION OF SERVICE ENTRANCE WITH POWER COMPANY. PROVIDE UFER GROUND IN BUILDING FOUNDATION AT SERVICE ENTRANCE LOCATION.
- 14. PROVIDE A MIN. OF 20 FEET OF ONE \*4 BARE COPPER UFER WIRE EMBEDDED IN CONCRETE FOOTING AT THE SERVICE ENTRANCE LOCATION WHERE APPROVED BY LOCAL SERVICE PROVIDER.
- 15. PROVIDE WATERPROOF FIXTURES IN ALL HIGH MOISTURE AREAS (EXTERIOR, SHOWER AND TUB
- CEILINGS ETC.) 16. PROVIDE DEDICATED CIRCUITS TO EACH BATH, DEN, FAMILY ROOM, BEDROOM, LOFT, KITCHEN
- REFRIGERATOR, KITCHEN FREEZER DISHWASHER, AND ANY AREA/ITEM SPECIFIED BY OWNER.
- 17. INCANDESCENT FIXTURES WITH OPEN OR PARTIALLY ENCLOSED LAMPS, PENDANT FIXTURES, AND LAMP HOLDERS ARE NOT PERMITTED IN CLOSETS.
- 18. ALL WORKMANSHIP AND MATERIALS TO CONFORM WITH THE 2015 IRC.
- 19. PROVIDE A MIN. OF 20 FEET OF ONE \*4 BARE COPPER UFER WIRE EMBEDDED IN CONCRETE FOOTING AT THE SERVICE ENTRANCE LOCATION WHERE APPROVED BY LOCAL SERVICE PROVIDER.
- 20. PROVIDE A BONDING CONDUCTOR CONSISTING OF A MINIMUM OF ONE \*4 BARE COPPER WIRE CONNECTING THE BUILDING'S METAL WATER PIPING SYSTEM TO THE SERVICE EQUIPMENT ENCLOSURE GROUNDING.

#### MAIN PANEL CALCS

(USE 200 AMP SERVICE)

ELECTRICAL CALCS				
LIGHT AND OUTLETS 1000 @ 3W	3000W			
3 APPLIANCE CIRCUITS	4,500 W			
DRYER	2,000 W			
WASHER	2,000 W			
RANGE	5,000 W			
WATER HEATER	5,000 W			
REFRIG.	1,800 W			
DISHWASHER & DISPOSAL	3000 W			
TOTAL	26,300 W			
FRIST 10,000 @ 100% REMAINDER @ 40% MINI. SPLIT UNITS	10,000 W 6,520W 10,000 W			
TOTAL	26,520 W			
26,520 W DIVIDED BY 240V = 111 AMPS TOTAL				

## **ELECTRICAL ABBREVIATIONS LIST**

1P	1 POLE (2P, 3P, 4P, ETC.)	CTR	CENTER	HT	HEIGHT
A	AMPERE	CU	COPPER	HTG	HEATING
AC	ABOVE COUNTER OR AIR CONDITIONER	DCP	DOMESTIC WATER CIRCULATING PUMP	HTR	HEATER
			DEPARTMENT	HV	
ACLG	ABOVE CEILING	DEPT			HIGH VOLTAGE
ADO	AUTOMATIC DOOR OPENER	DET	DETAIL	HVAC	HEATING, VENTILATING AND AIR
AF	AMP FRAME	DIA	DIAMETER	CONDITIONING	CONDITIONING
AFF	ABOVE FINISHED FLOOR	DISC	DISCONNECT	HWP	HYDRONIC WATER PUMP
AFG	ABOVE FINISHED GRADE	DIST	DISTRIBUTION	IC	INTERRUPTING CAPACITY
AFI	ARC FAULT CIRCUIT INTERRUPTER	DN	DOWN	IG	ISOLATED GROUND
AHU	AIR HANDLING UNIT	DPR	DAMPER	IMC	INTERMEDIATE METAL CONDUIT
AL	ALUMINUM	DS	SAFETY DISCONNECT SWITCH	INCAND	INCANDESCENT
ALT	ALTERNATE	DT	DOUBLE THROW	IR	INFRARED
AMP	AMPERE	DWG	DRAWING	I/W	INTERLOCK WITH
AMPL	AMPLIFIER	DDC	DIRECT DIGITAL CONTROL	J-BOX	JUNCTION BOX
ANNUN	ANNUNCIATOR APPROX APPROXIMATELY	EC	ELECTRICAL CONTRACTOR	KV	KILOVOLT
AQ-STAT	AQUASTAT	ELEC	ELECTRIC, ELECTRICAL	KVA	KILOVOLT-AMPERE
ARCH	ARCHITECT, ARCHITECTURAL	ELEV	ELEVATOR	KVAR	KILOVOLT-AMPERE REACTIVE
AS	AMP SWITCH	EM	EMERGENCY	KW	KILOWATT
AT	AMP TRIP	EMS	ENERGY MANAGEMENT SYSTEM	KWH	KILOWATT HOUR
ATS	AUTOMATIC TRANSFER SWITCH	EMT	ELECTRICAL METALLIC TUBING	LOC	LOCATE OR LOCATION
AUTO	AUTOMATIC	EP	ELECTRIC PNEUMATIC	LT	LIGHT
AUX	AUXILIARY	EQUIP	EQUIPMENT	LTG	LIGHTING
AV	AUDIO VISUAL	EWC	ELECTRIC WATER COOLER	LTNG	LIGHTNING
AWG	AMERICAN WIRE GAUGE	EXIST	EXISTING	LV	LOW VOLTAGE
BATT	BATTERY	EXH	EXHAUST	MAX	MAXIMUM
BD	BOARD	EXP	EXPLOSION PROOF	MAG.S	MAGNETIC STARTER
BLDG	BUILDING	FA	FIRE ALARM	M/C	MOMENTARY CONTACT
BMS	BUILDING MANAGEMENT SYSTEM	FABP	FIRE ALARM BOOSTER POWER	MC	MECHANICAL CONTRACTOR
C	CONDUIT	SUPPLY PANEL	SUPPLY PANEL	MCB	MAIN CIRCUIT BREAKER
CAB	CABINET		FIRE ALARM CONTROL PANEL	MCC	MOTOR CONTROL CENTER
		FACP		_ I	MAIN DISTRIBUTION CENTER
CATY	CATALOG	FCU	FAN COIL UNIT	MDC	
CATV	CABLE TELEVISION	FIXT	FIXTURE	MDP	MAIN DISTRIBUTION PANEL
CB	CIRCUIT BREAKER	FLR	FLOOR	MFR	MANUFACTURERMAIN FUSED
CCTV	CLOSED CIRCUIT TELEVISION	FLUOR	FLUORESCENT	N.41.1	DISCONNECT SWITCH
CKT	CIRCUIT	FUDO	FUSE	MH	MANHOLE
CLG	CEILING	FUDS	FUSED SAFETY DISCONNECT SWITCH	MIC	MICROPHONE
COMB	COMBINATION	GA	GAUGE	MIN	MINIMUM
CMPR	COMPRESSOR	GAL	GALLON	MISC	MISCELLANEOUS
CONN	CONNECTION	GALV	GALVANIZED	MLO	MAIN LUGS ONLY
CONST	CONSTRUCTION	GC	GENERAL CONTRACTOR	MMS	MANUAL MOTOR STARTER
CONT	CONTINUATION OR CONTINUOUS	GEN	GENERATOR	MOA	MULTIOUTLET ASSEMBLY
CONTR	CONTRACTOR	GFI	GROUND FAULT CIRCUIT INTERRUPTER	MSP	MOTOR STARTER PANELBOARD
CONV	CONVECTOR	GFP	GROUND FAULT PROTECTOR	MSBD	MAIN SWITCHBOARD
CP	CIRCULATING PUMP	GND	GROUND	MT	MOUNT
CRT	CATHODE-RAY TUBE	GRS	GALVANIZED RIGID STEEL (CONDUIT)	MT.C	EMPTY CONDUIT
CT	CURRENT TRANSFORMER	GYP BD	GYPSUM BOARD	UL	UNDERWRITERS LABORATORIES

#### **Branch Panel:**

Location: LIVING ROOM 73 Supply From: Mounting: Recessed

Enclosure: Type 1

Volts: 120/240 Single Phases: Wires: 3

A.I.C. Rating: Mains Type: Mains Rating: 200 A MCB Rating: 1 A

Circuit Numb er	Circuit Description	Number of Elements	Rating	Length	Wire Size	A			В	Wire Size	Length	Rating	Number of Elements	Circuit Description	Circui Numb er
1	BED1 LIGHT	13	15 A	68' - 10 29/32"	1-#12, 1-#12, 1-#12	688 VA	300 VA			1-#14, 1-#14, 1-#14	43' - 7 11/16"	15 A	7	HALL LIGHT	2
3	BED2 LIGHT	11	15 A	45' - 3 27/32"	1-#14, 1-#14, 1-#14			628 VA	657 VA	1-#12, 1-#12, 1-#12	34' - 11 3/32"	20 A	9	OUTDOOR LIGHT	4
	BED1&2 RECEPTACLE	9	20 A	75' - 2 9/32"	1-#8, 1-#8, 1-#8	1620 VA	1260 VA			1-#12, 1-#12, 1-#12	46' - 7"	20 A	7	LIV. & HALL RECEPTACLE	6
7	KITCHEN GFCI	6	20 A	40' - 11 1/2"	1-#12, 1-#12, 1-#12			1080 VA	1200 VA	1-#12, 1-#12, 1-#12	24' - 11 3/4"	20 A	1	DISHWASHER	8
9	OVENHOOD	1	20 A	28' - 5 5/32"	1-#12, 1-#12, 1-#12	180 VA	2500 VA			2-#8, 1-#8, 1-#10	34' - 0 9/32"	50 A	1	RANGE	10
11	REFRIGERATOR	1	20 A	38' - 10 3/8"	2-#12, 1-#12, 1-#12			900 VA	2500 VA						12
13						900 VA	516 VA			1-#14, 1-#14, 1-#14	53' - 3 5/16"	15 A	12	KITCHEN LIGHT	14
15	LIV. LIGHT	7	15 A	26' - 7 19/32"	1-#14, 1-#14, 1-#14			209 VA	720 VA	1-#12, 1-#12, 1-#12	37' - 6 5/8"	20 A	4	OUTDOOR GFCI	16
17	CONDENSER	1	60 A	39' - 7 5/8"	2-#6, 1-#6, 1-#10	2500 VA	2250 VA			2-#10, 1-#10, 1-#10	55' - 7 1/8"	30 A	1	WATERHEATER	18
19								2500 VA	2250 VA						20
	WASHEING MASHEIN	1	20 A	57' - 9 1/2"	1-#12, 1-#12, 1-#12	1200 VA	2500 VA			2-#10, 1-#10, 1-#10	55' - 1 1/8"	30 A	1	DRYER	22
23	BATH GFCI	10	30 A	63' - 3 3/16"	1-#10, 1-#10, 1-#10			1152 VA	2500 VA						24
25	_														26
						16412	2 VA	1626	57 VA						
						137	' A	13	6 A					1	

	Lege	n

oad Classification	Connected Load	Demand Factor	Estimated Demand	Panel	Totals
IGHTING - DWELLING UNIT	900 VA	100.00%	900 VA		
OTHER	2256 VA	100.00%	2256 VA	Total Conn. Load:	32678 VA
RECEPTACLE	7980 VA	100.00%	7980 VA	Total Est. Demand:	31678 VA
IGHTING	300 VA	100.00%	300 VA	Total Conn.:	136 A
CONDENSER	5000 VA	100.00%	5000 VA	Total Est. Demand:	132 A
VATER HEATER	4500 VA	100.00%	4500 VA		
RANGE	5000 VA	80.00%	4000 VA		
RYER	5000 VA	100.00%	5000 VA		
REFRIGERATOR	1800 VA	100.00%	1800 VA		
1.4	· · · · · · · · · · · · · · · · · · ·		•		



**KEY PLAN** 

DESCRIPTION DATE

NOTE:

LEGEND:

PROJECT

59-Hamilton-1000-2Bd-2Ba Spanish-550

DRAWING NAME

# **SCHEDULE**

CLIENT NAME: Owner PROJECT NUMBER: 0179\_14 2/15/2025 3:27:01 PM Designer DESIGNED BY: DRAWN BY: CHECKED BY: Checker

E101

SCALE: 1/4" = 1'-0"

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#### **ELECTRICAL NOTE**

- PROVIDE INTERCONNECTED SMOKE ALARMS IN EACH SLEEPING ROOMS, OUTSIDE EACH SLEEPING ROOM, ON EACH STORY, IN THE HALL OR ADJACENT ROOM LUHERE THE CEILING HEIGHT OF A ROOM OPEN TO THE HALL EXCEEDS THE HALL BY 24'. SMOKE ALARMS SHALL BE PERMANENTLY HARD WIRED WITH BATTERY BACKUP.
- B. RECEPTACLE OUTLETS FOR RANGES AND CLOTHES DRYERS SHALL BE A THREE POLE WITH GROUND TYPE. FOUR WIRE GROUNDING-TYPE FLEXIBLE CORDS WILL BE REQUIRED FOR CONNECTION OF RANGES AND CLOTHES DRYERS. THE BONDING JUMPER SHALL NOT BE CONNECTED BETWEEN NEUTRAL TERMINAL AND THE FRAME OF THE **APPLIANCE**
- C. TWO OR MORE 20 AMP SMALL APPLIANCE CIRCUITS SHALL BE PROVIDED TO SERVE THE KITCHEN, BREAKFAST NOOK, AND DINING ROOM. SUCH CIRCUITS SHALL HAVE NO OTHER OUTLETS.
- D. AT LEAST ONE 20 AMP BRANCH CIRCUIT SHALL BE PROVIDED TO SERVICE THE LAUNDRY ROOM. THIS CIRCUIT SHALL HAVE NO OTHER OUTLETS.
- E. ALL RECEPTACLES WITH IN 6' OF A WET BAR SINK OR KITCHEN SINK TO SERVE COUNTER TOP SURFACES MUST BE GFCI. ON KITCHEN COUNTERS 12' OR WIDER NO POINT ALONG THE WALL SHALL BE MORE THAN 2' FROM A RECEPTACLE. ALL RECEPTACLES WITH IN 6' OF KITCHEN SINK MUST BE GFCI. AT LEAST ONE GFCI RECEPTACLE SHALL BE INSTALLED IN THE BATHROOM ADJACENT TO EACH BASIN.
- FIXTURES INCLUDING CEILING FANS THAT ARE LOCATED IN DAMP LOCATIONS SHALL BE LISTED TO BE SUITABLE FOR SUCH LOCATIONS PER 2012 IRC
- G. PROVIDE ONE (1) SWITCHED OUTLET @ ALL BEDROOMS AND DEN H. CEILING FANS NOT EXCEEDING 35 LBS. (WITH OR WITHOUT ACCESSORIES MAY BE SUPPORTED BY OUTLET BOXES
- PROVIDED THE OUTLET BOXES ARE IDENTIFIED FOR SUCH USE PER 2012 IRC ELECTRICAL OUTLET BOXES ON OPPOSITE SIDES OF FIRE RATED WALLS SHALL BE SEPARATED BY A HORIZONTAL
- DISTANCE OF NOT LESS THAN 24". J. OUTLET BOXES IN THE WALLS BETWEEN THE GARAGE AND DWELLING SHALL BE METAL OR U.L. APPROVED FIRE RESISTIVE PLASTIC. BOXES IN GARAGE CEILING SHALL BE METAL.
- K. ALL BRANCH CIRCUITS THAT SUPPLY 120 VOLTS SINGLE PHASE 15 AND 20 AMPS RECEPTACLE OUTLETS INSTALLED IN THE DWELLING SHALL BE PROTECTED BY AN ARC FAULT CIRCUIT INTERRUPTER, EXCEPT GFCI RECEPTICLES.

#### NOTE:

RECEPTACLES MUST BE PROVIDED IN HALLWAYS 10'-0" OR MORE IN LENGTH. FOR A ONE FAMILY DWELLINGS AND EACH OF A TWO FAMILY DWELLING THAT IS AT GRADE LEVEL, AT LEAST ONE WP-GFCI RECEPTACLE OUTLET ACCESSIBLE AT GRADE LEVEL AND NOT MORE THAN 6'-6" ABOVE GRADE SHALL BE INSTALLED AT THE FRONT AND BACK OF THE DWELLING.

#### NOTE: APPLIANCE DISCONNECT

#### **E4001.5 GROUNDING OF ENCLOSURES.**

METAL ENCLOSURES FOR SWITCHES OR CIRCUIT BREAKERS SHALL BE CONNECTED TO AN

**EQUIPMENT GROUNDING CONDUCTOR.** 

METAL ENCLOSURES FOR SWITCHES OR CIRCUIT BREAKERS USED AS SERVICE

EQUIPMENT SHALL COMPLY WITH THE PROVISIONS OF SECTION E3609.4. WHERE


NONMETALLIC ENCLOSURES ARE USED WITH METAL RACEWAYS OR METAL-ARMORED CABLES, PROVISIONS SHALL BE MADE FOR CONNECTING THE EQUIPMENT GROUNDING

CONDUCTOR.


NONMETALLIC BOXES FOR SWITCHES SHALL BE INSTALLED WITH A WIRING METHOD THAT

PROVIDES OR INCLUDES AN EQUIPMENT GROUNDING CONDUCTOR. (404.12)

ELECTRICAL LEGEND				
	Electrical Lights With Fan			
•	Recessed Spot Light			
0	Recessed Can Light			
<b>-</b> Φ	Wall Lamp			
•	Smoke and heat detector			
<b>⊬1</b> 3	Single Switch			
₩,	Three way Switch			
85 G	Three way with Dimmer Switch			
<b>₩</b>	Fan Switch			
	Duplex Receptacle			
	Triplex Receptacle			
⊕ □GFCI	GFCI Receptacle			
	Exhaust Fan			

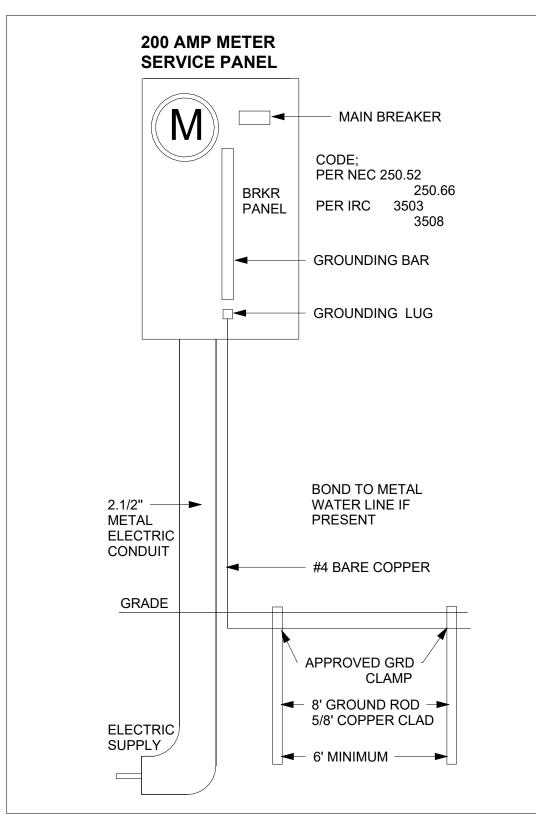



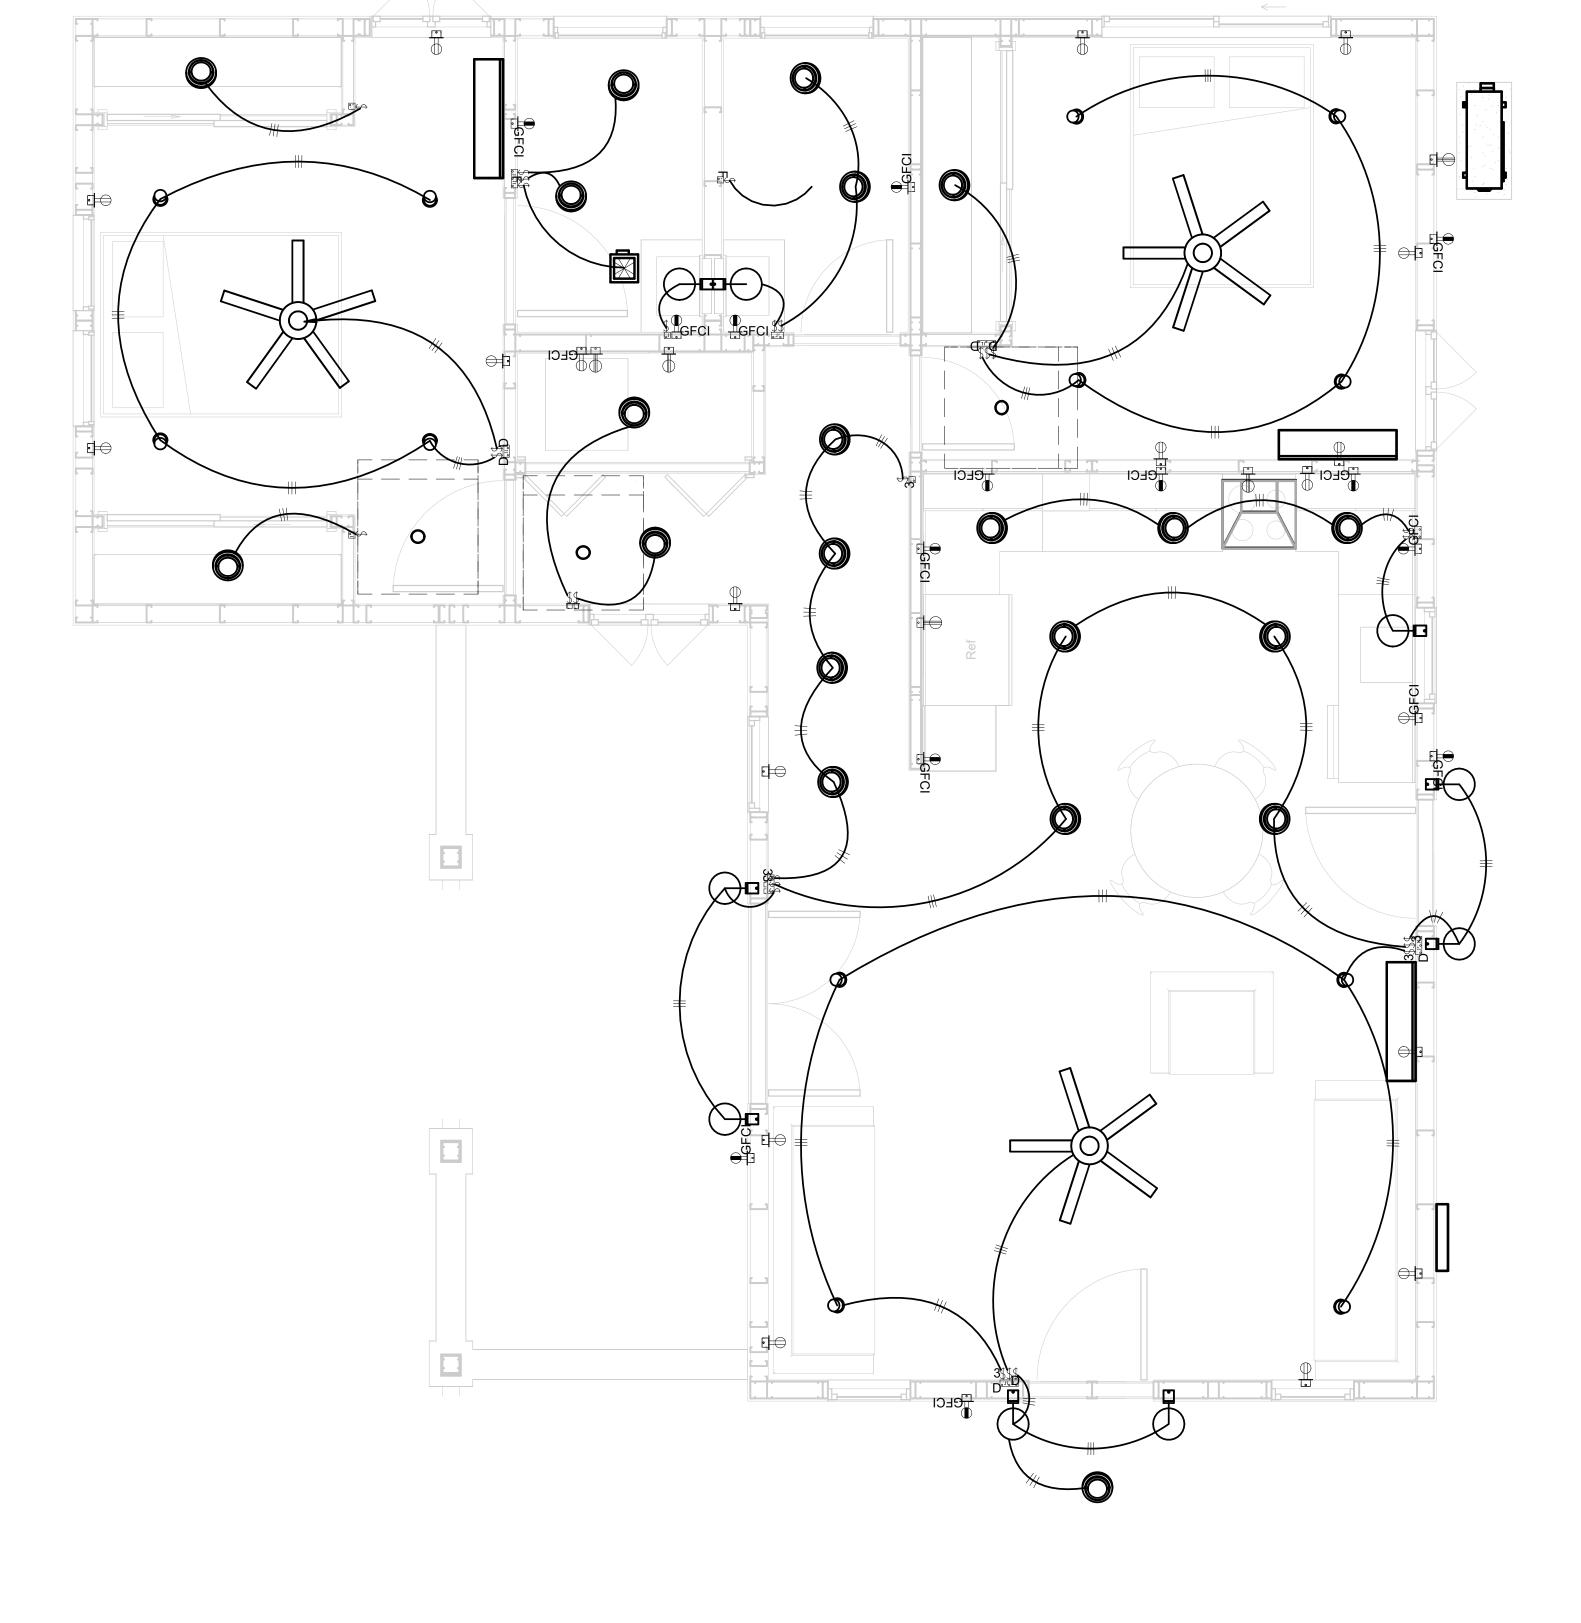



**KEY PLAN** 

DESCRIPTION DATE

NOTE:

LEGEND:

PROJECT

59-Hamilton-1000-2Bd-2Ba Spanish-550

DRAWING NAME


# LIGHTING

CLIENT NAME:	Owner
PROJECT NUME	BER: 0179_14
DATE:	2/15/2025 3:27:03 PM
DESIGNED BY:	Designer
DRAWN BY:	Author
CHECKED BY:	Checker


E102


## **NOTES: CONDUIT, CABLE AND WIRING**

- Use Metalic Conduits (IMC) for cables running under concrete slabs.
   Use IMC for circuits with high voltage appliances (240 volts and above)
   For circuits with 120 volts consider using EMT or PVC conduits if needed.
   For Low voltage applications up to 50 volts consider using non metalic conduits.
   All conduits to be used in the project must conform to the latest National Electrical Code (NEC),
- 5. All conduits to be used in the project must also conform to the latest National Electrical Code (NEC), 2015.
  6. All wiring and cables to be used in the project must also conform to the latest National Electrical Code (NEC), 2015.
  7. All cables and wires used should be rated for their respective loading and should be gauged and

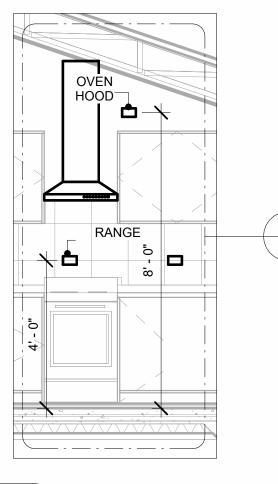




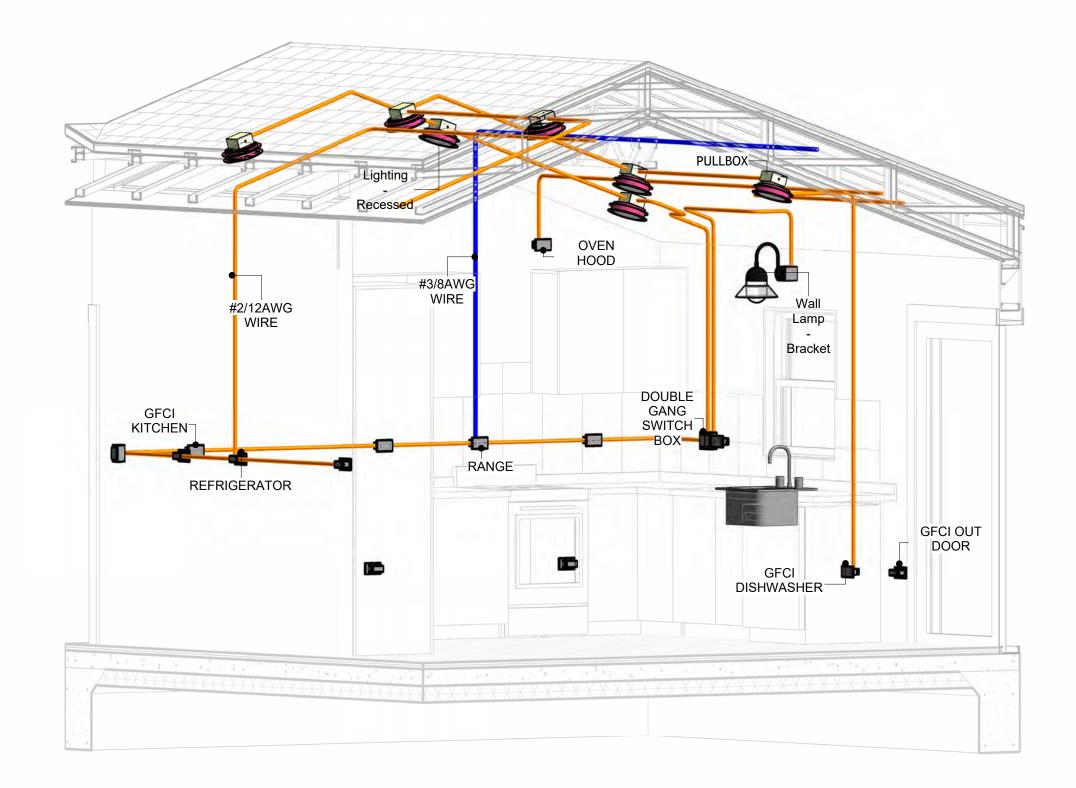

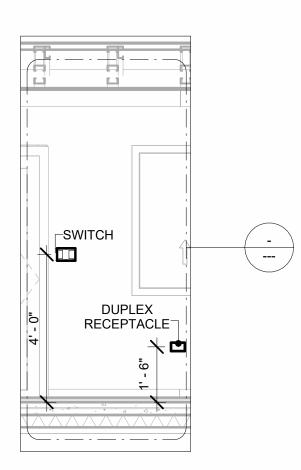


Section 3 3/8" = 1'-0"



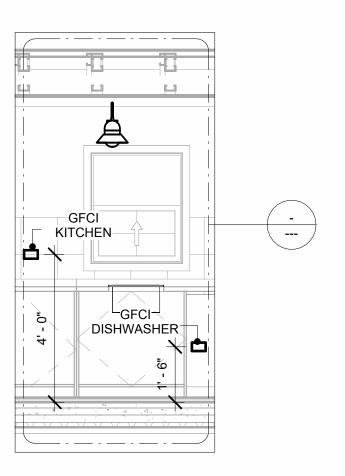




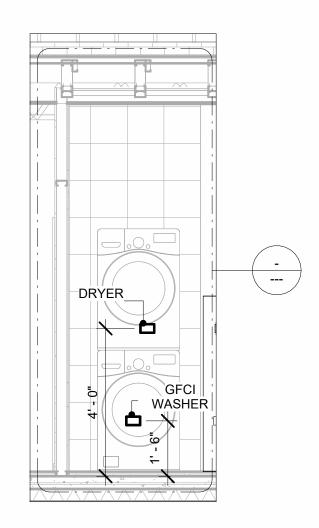

Section 4
3/8" = 1'-0"



**KEY PLAN** 

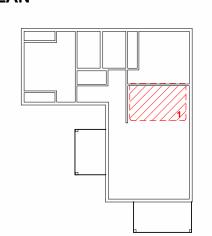

NO.	DESCRIPTION	DATE

NOTE:

LEGEND:

PROJECT

59-Hamilton-1000-2Bd-2Ba Spanish-550

DRAWING NAME

**POWER** 

CLIENT NAME:	Owner
PROJECT NUMBER:	0179_14
DATE:	2/15/2025 3:27:28 PM
DESIGNED BY:	Designer
DRAWN BY:	Author
CHECKED BY:	Checker

E103

#### **NOTES: LIGHT**

- 1. LIGHT FIXTURES AND LUMINARIES SHALL CONFORM TO THE NEC, THE IRC AND LOCAL SAFETY & BUILDING CODE.
- 2. ALL LIGHTING FIXTURES SHOULD CONFORM TO THE DESIGN ELECTRICAL LOAD AND SHALL BE PROPERLY WIRED AND MOUNTED BY QUALIFIED ELECTRICIAN FOLLOWING MANUFACTURERS SPECIFICATIONS.
- 3. CEILING FANS AND FANS WITH LIGHT WITH WEIGHT EXCEEDING 35 LBS SHOULD BE PROVIDED WITH STRUCTURAL BACKING FOR SUPPORT AND SHALL BE FIXED AS PER MANUFACTURERS SPECIFICATIONS.
- 4. EXTERIOR LIGHTS SHALL CONFORM TO LOCAL BUILDING CODE AND GUIDELINES.

#### **NOTES: SWITCH JUNCTION BOX**


- 1. THE MINIMUM SIZE OF JUCTION BOX TO BE USED IS 2"X4"X(1.5" OR 3.5" DEEP) THIS ARE TO BE USED FOR SINGLE GANG SWITCH OR OUTLETS.
- 2. FOR DOUBLE GANG (2 GANG) OUTLETS AND SWITCHS THE MINIMUM SIZE OF THE
- JUCTION BOX TO BE PROVIDED SHALL NOT BE LESS THAN 4"X4"X(1.5" OR 3.5" DEEP)
- 3. FOR THREE GANG (3 GANG) OUTLETS AND SWITCHS THE MINIMUM SIZE OF THE JUĆTION BOX SHALL NOT BE LESS THAN 6"X4"X(1.5" OR 3.5" DEEP).

FITTING SCHEDULE(PULL BOX)						
FAMILY	COUNT	DESCRIPTION				
LLBOX1 41 #1/4 PULLBOX						

ELECTRICAL FIXTURE SCHEDULE (SWITCH BOX)					
TYPE	COUNT				
DOUBLE GANG SWITCH BOX	4				
SINGLE GANG SWITCH BOX	5				
TRIPLE GANG SWITCH BOX	5				

LIGHTING DEVICE	
TYPE	COUNT
DIMMER	5
FAN SWITCH	2
SINGLE POLE	15
THREE WAY	4
THREE WAY WITH DIMMER	2

LIGHTING FIXTURE			
LIGHTING FIXTURE TYPE	VOLTAGE	ELECTRICAL LOAD	COUNT
ELECTRICAL_LIGHTS_FAN-LIGHT1	120 V/1-100 VA- 120 V/1-100 VA	200 A, 120 V/240 V, SINGLE PHASE, 3 WIRES	3
LIGHTING - RECESSED	120 V/1-60 VA	<varies></varies>	20
LIGHTING_RECESSED	120 V/1-60 VA	200 A, 120 V/240 V, SINGLE PHASE, 3 WIRES	1
SASSO 100 ROUND WALLWASHER TRIM	120 V/1-28 VA	200 A, 120 V/240 V, SINGLE PHASE, 3 WIRES	12
WALL LAMP - BRACKET	120 V/1-100 VA	200 A, 120 V/240 V, SINGLE PHASE, 3 WIRES	9

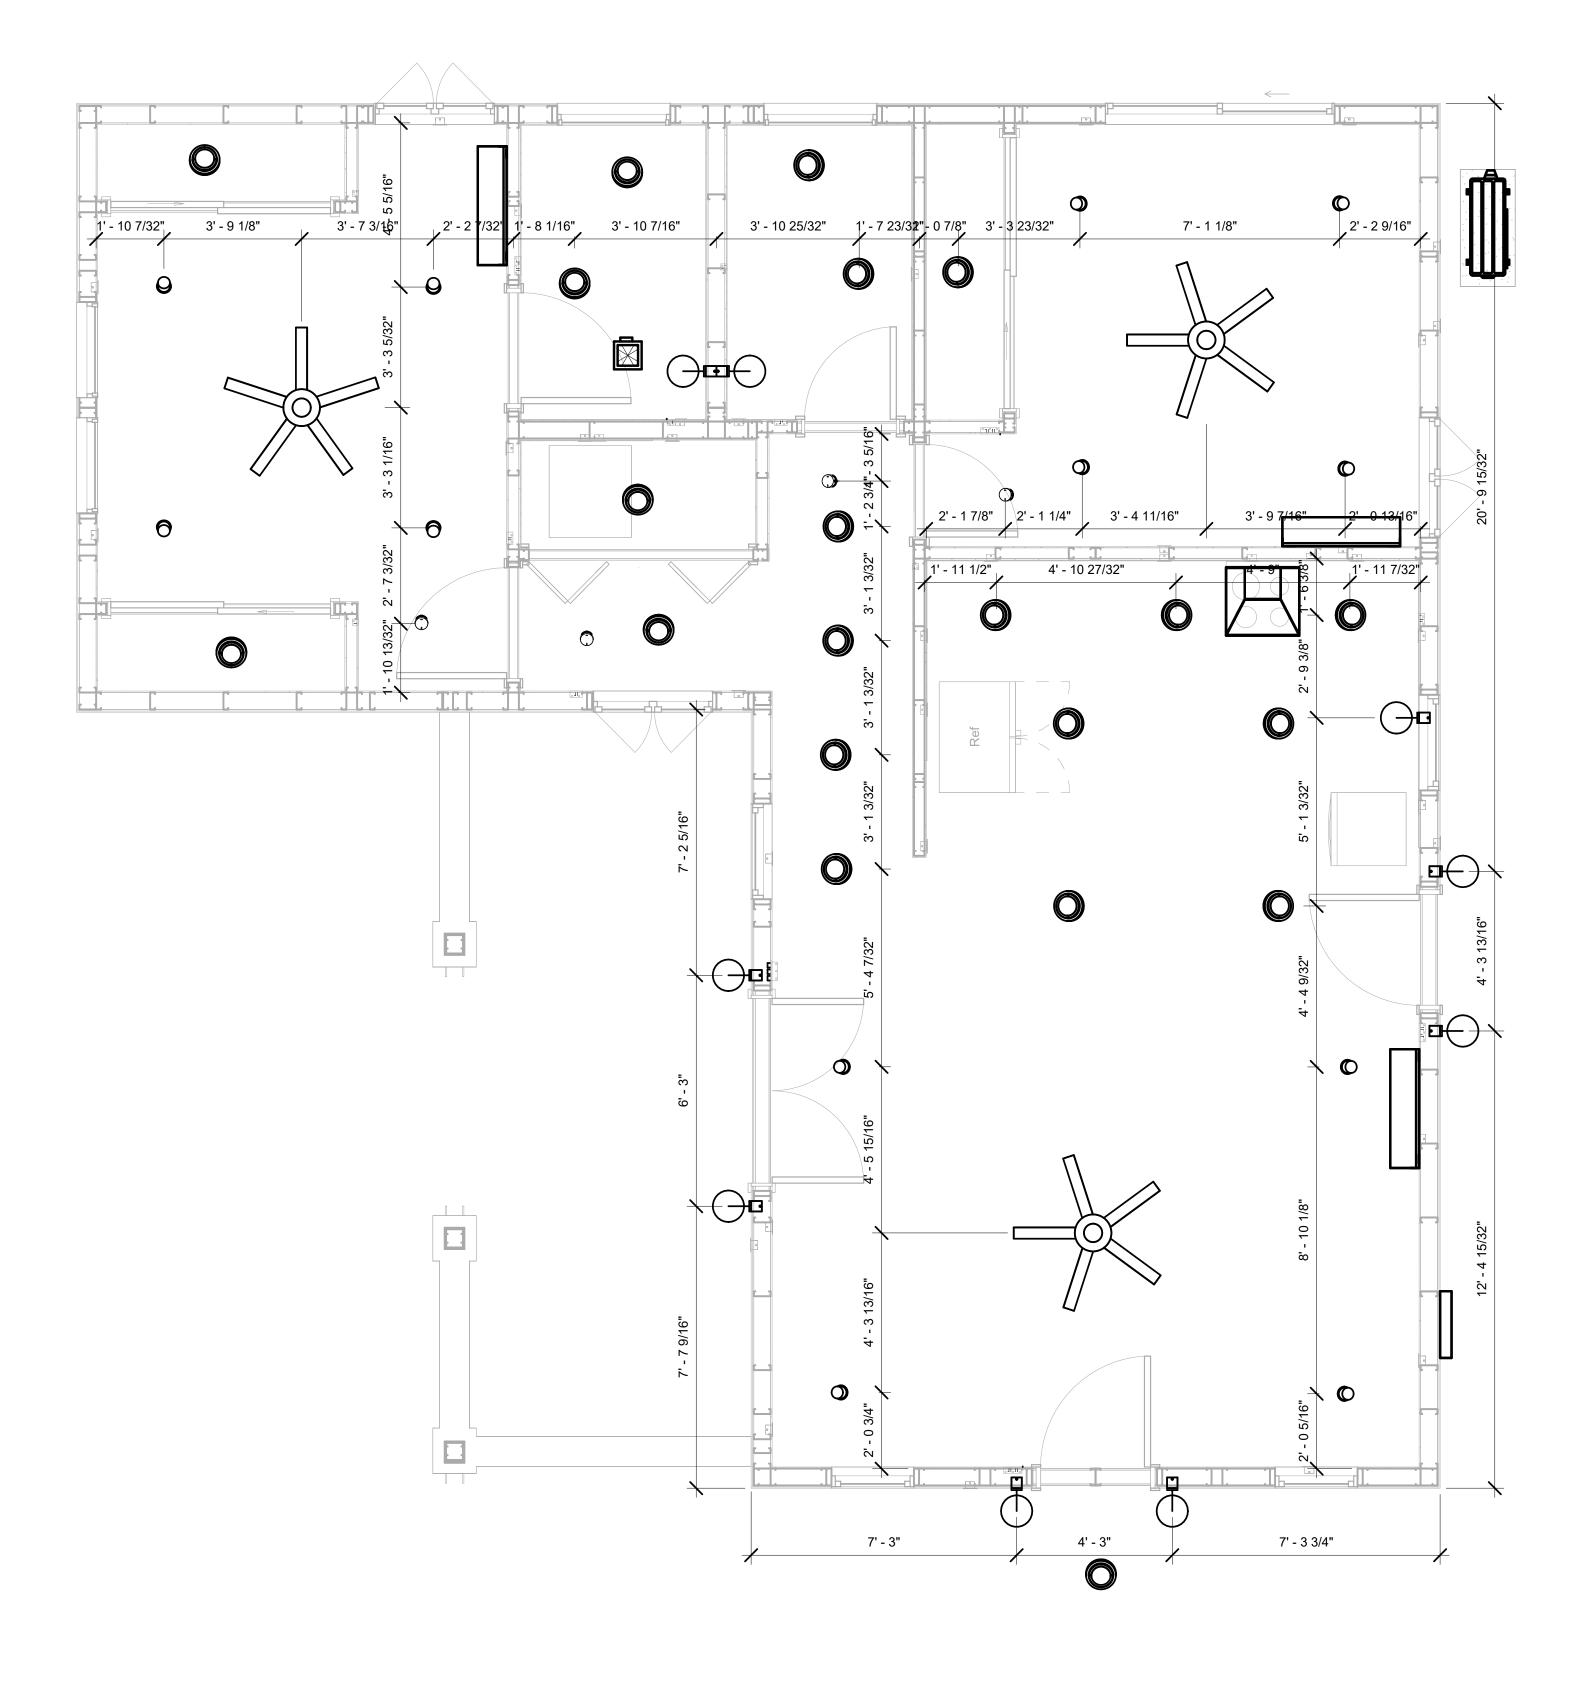

**DIMENSION FOR LIGHT FIXTURES** 



**KEY PLAN** 

NO.	DESCRIPTION	DATE

NOTE:

LEGEND:

PROJECT

59-Hamilton-1000-2Bd-2Ba Spanish-550

DRAWING NAME

# **DIMENSION PLAN** FOR LIGHT FIXTURES

CLIENT NAME:	Owner
PROJECT NUMBER:	0179_14
DATE:	2/15/2025 3:27:30 PM
DESIGNED BY:	Designer
DRAWN BY:	Author
CHECKED BY:	Checker


E104

## NOTES;

- 1. VERIFY EQUIPMENT PLUG CONFIGURATION BEFORE PURCHASING RECEPTACLES
- 2. FOR ALL EQUIPMENT.
- 3. COORDINATE EXACT LOCATION OF LIGHT FIXTURES, WALL SWITCHES, RECEPTACLES AND OTHER DEVICES WITH ARCHITECTURAL DRAWINGS.
- 4. USE METALLIC JUNCTION BOX WITH THE GFCI RECEPTACLES, WITH HIGHT VOLTAGE.

ELECTRICAL FIXTURE SCHEDULE (RECEPTACLE)			
TYPE COUNT			
CONDENSER	1		
DRYER	1		
DUPLEX RECEPTACLE	16		
GFCI BATH ROOM	4		
GFCI DISHWASHER	1		
GFCI KITCHEN	6		
GFCI OUT DOOR	4		
GFCI WASHER	1		
OVEN HOOD	1		
RANGE	1		
REFRIGERATOR	1		
WATER HEATER	1		

ELECTRICAL OUTLET SCHEDULE			
TYPE	CIRCUIT NUMBER	ELECTRICAL DATA	COUNT
DUPLEX RECEPTACLE	5	120 V/1-180 VA	9
DUPLEX RECEPTACLE	6	120 V/1-180 VA	7
GFCI KITCHEN	7	120 V/1-180 VA	6
GFCI DISHWASHER	8	120 V/1-1200 VA	1
OVEN HOOD	9	120 V/1-180 VA	1
RANGE	10,12	240 V/2-5000 VA	1
REFRIGERATOR	11,13	240 V/2-1800 VA	1
GFCI OUT DOOR	16	120 V/1-180 VA	4
CONDENSER	17,19	240 V/2-5000 VA	1
WATER HEATER	18,20	240 V/2-4500 VA	1
GFCI WASHER	21	120 V/1-1200 VA	1
DRYER	22,24	240 V/2-5000 VA	1
GFCI BATH ROOM	23	120 V/1-180 VA	4

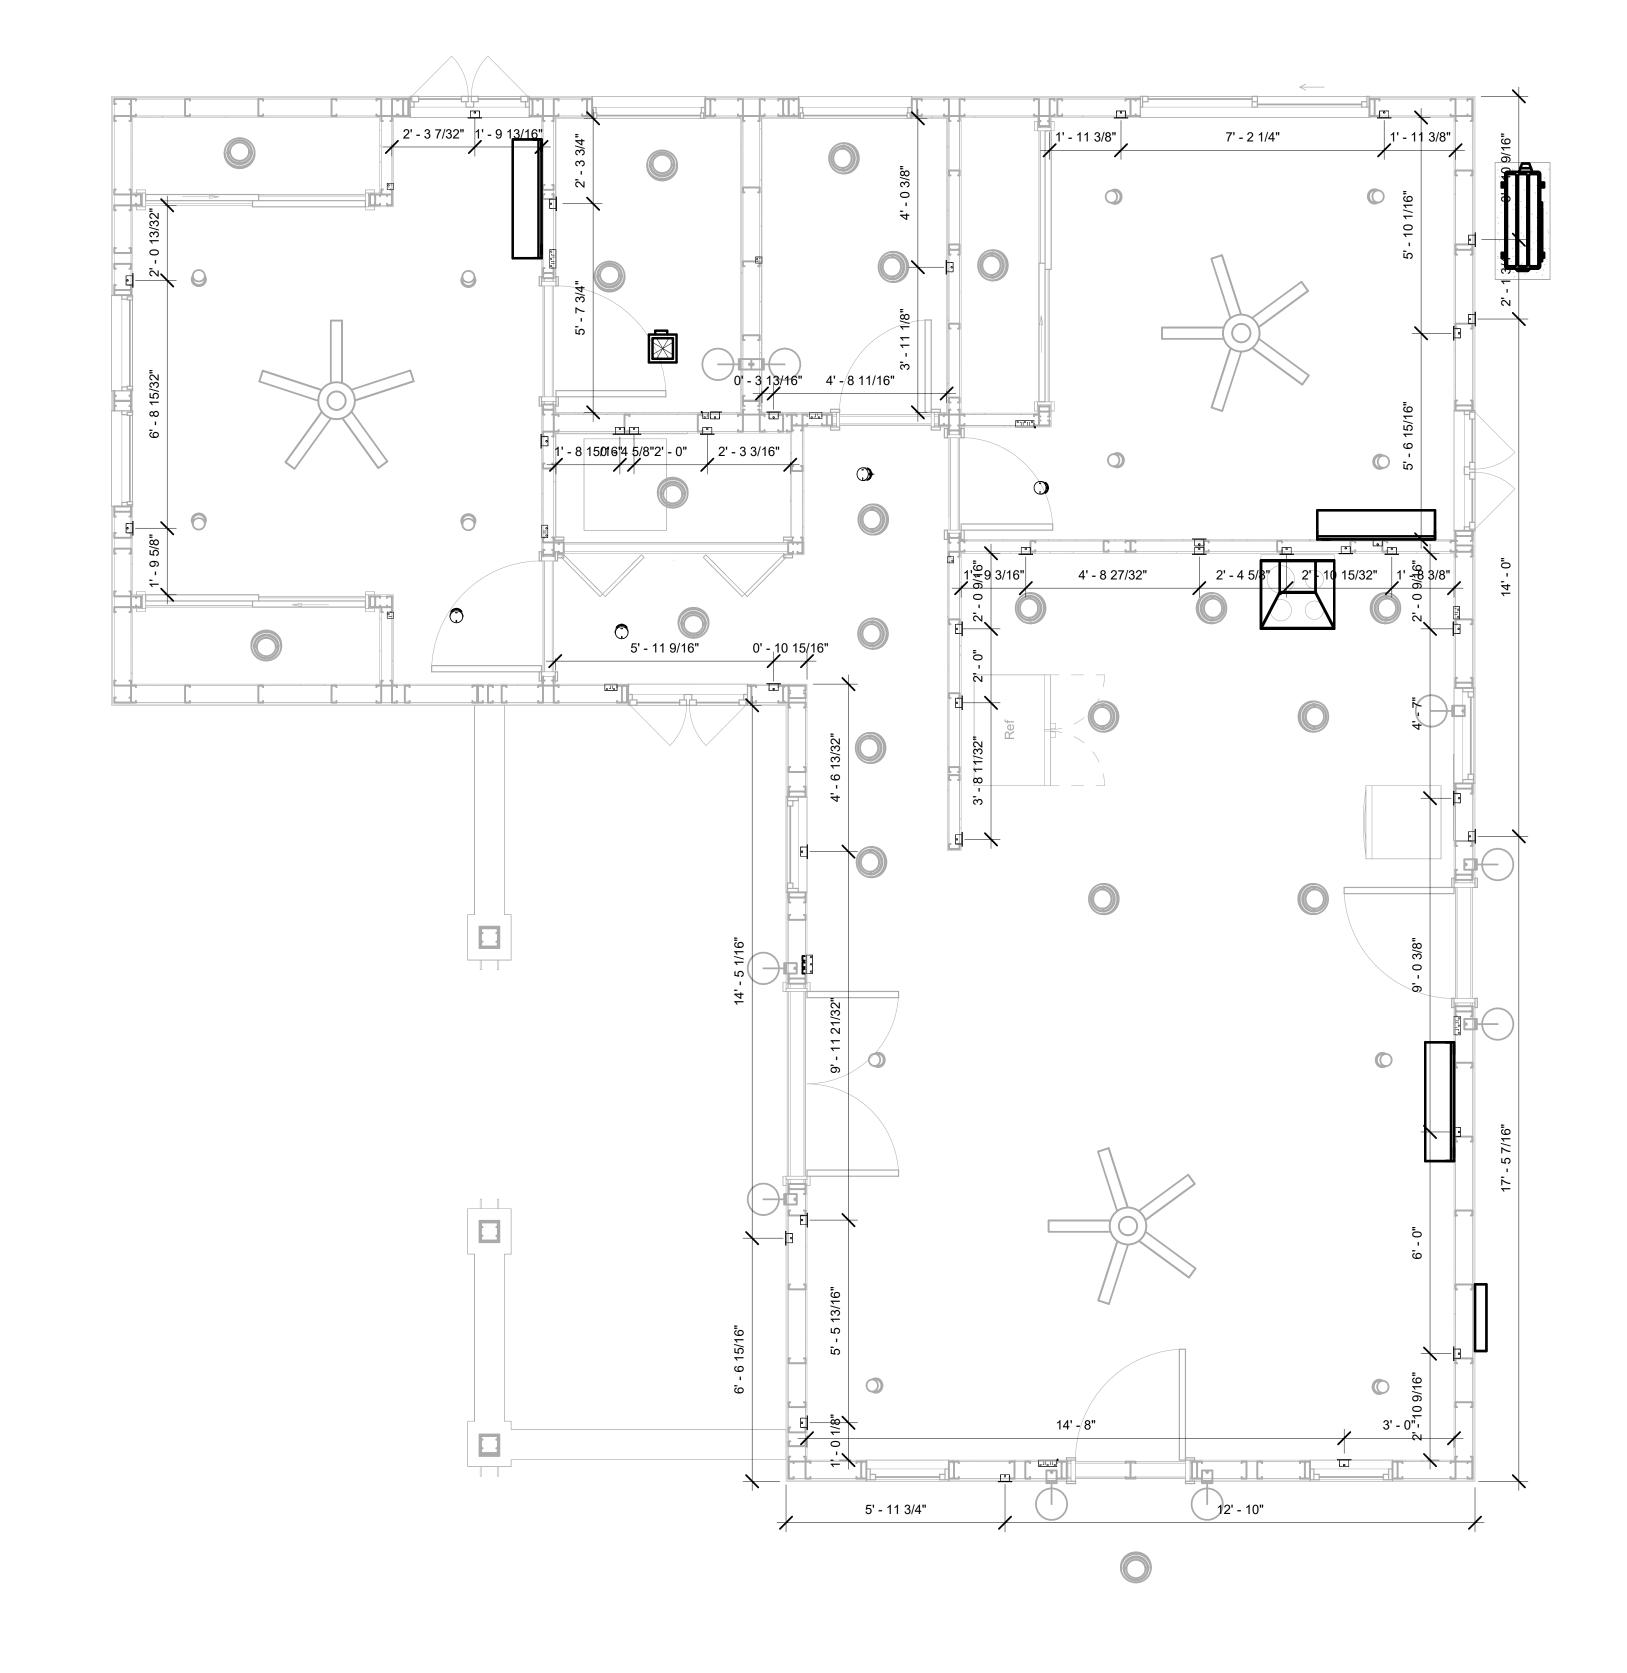

1 DIMENSION FOR FITTINGS 3/8" = 1'-0"



**KEY PLAN** 

NO. DESCRIPTION DATE

NOTE:

LEGEND:

PROJECT

59-Hamilton-1000-2Bd-2Ba Spanish-550

DRAWING NAME

# DIMENSION PLAN FOR FITTINGS

CLIENT NAME:	Owner
PROJECT NUMBER:	0179_14
DATE:	2/15/2025 3:27:32 PM
DESIGNED BY:	Designer
DRAWN BY:	Author
CHECKED BY:	Checker

E105

#### SHEET LIST

SHEET NUMBER SHEET NAME

P101 NOTE AND SCHEDULE
P102 WATER SUPPLY AND SEWAGE
SYSTEM

PIPE COLOR	RSCHEME
	DOMESTIC COLD WATE DOMESTIC HOT WATER
	SANITARY VENT
	SANITARY SEWER
	STORM DRAINAGE
	GRAY WATER
	GAS LINE

#### PLUMBING NOTES

- THE PLUMBING SYSTEM IS DESIGNED TO MEET THE BUILDING'S DOMESTIC WATER SUPPLY, SANITARY DRAINAGE, AND STORM DRAINAGE REQUIREMENTS, AS PER PROJECT SPECIFICATIONS AND APPLICABLE CODES.
- THE SYSTEM INSTALLATION SHALL COMPLY WITH THE LATEST INTERNATIONAL PLUMBING CODE (IPC), INTERNATIONAL RESIDENTIAL CODE (IRC), AND ALL OTHER RELEVANT LOCAL, STATE, AND NATIONAL REGULATIONS.
- 3. ALL PLUMBING WORK SHALL COMPLY WITH THE LATEST EDITION OF THE INTERNATIONAL PLUMBING CODE (IPC) AND THE LOCAL PLUMBING CODE.
- 4. PLUMBING SYSTEMS SHALL BE TESTED AND INSPECTED IN ACCORDANCE WITH THE LOCAL PLUMBING CODE REQUIREMENTS.
- 5. PLUMBING FIXTURES SHALL BE INSTALLED WITH THE APPROPRIATE TRIM, FITTINGS, AND ACCESSORIES, AS RECOMMENDED BY THE MANUFACTURER.
- 6. PIPING SHALL BE PROPERLY SUPPORTED AND SECURED TO PREVENT SAGGING, MOVEMENT, AND VIBRATION.
- 7. SHUT-OFF VALVES SHALL BE PROVIDED AT ALL BRANCH CONNECTIONS AND AT THE INLET AND OUTLET OF EACH PIECE OF EQUIPMENT.
- 8. BACKFLOW PREVENTION DEVICES SHALL BE INSTALLED AS REQUIRED BY THE LOCAL
- PLUMBING CODE TO PROTECT THE POTABLE WATER SYSTEM.

  9. PLUMBING FIXTURES AND EQUIPMENT SHALL BE ACCESSIBLE FOR MAINTENANCE AND
- 10. EXPOSED PLUMBING PIPING AND FIXTURES SHALL BE INSULATED TO PREVENT CONDENSATION AND ENERGY LOSS.
- 11. DEAD ENDS IN THE DRAINAGE SYSTEM MUST BE AVOIDED, EXCEPT WHERE NECESSARY TO INSTALL A CLEANOUT IN AN ACCESSIBLE LOCATION, AND MUST HAVE A VENTED CONNECTION TO THE OUTSIDE ATMOSPHERE.
- 12. THE VERTICAL DEFLECTION OF PVC PIPE MUST NOT EXCEED 5%, AND NO DEFLECTION IS PERMITTED FOR IRON PIPE.
- 13. WORK MUST BE PROPERLY COORDINATED WITH OTHER TRADES TO AVOID CONFLICTS, REFERRING TO THE ARCHITECTURAL AND STRUCTURAL DRAWINGS FOR INFORMATION REGARDING CEILING ELEVATIONS, SPACE CLEARANCES, WALL AND PARTITION LOCATIONS, ETC.
- 14. ALL FIXTURES SHALL HAVE ACCESSIBLE STOPS.
- 15. DOMESTIC WATER PIPING SHALL BE PEX, AND PVC PIPING IS NOT ACCEPTABLE FOR INTERIOR USE.
- 16. VENT TERMINATIONS SHALL BE LOCATED AT LEAST 10 FEET FROM OR 3 FEET ABOVE ANY OPERABLE WINDOW, DOOR OPENING, AIR INTAKE, OR VENT SHAFT, AND AT LEAST 3 FEET IN EVERY DIRECTION FROM ANY LOT LINE, ALLEY, OR STREET.
- 17. PIPE AND FITTINGS UTILIZED IN THE WATER SUPPLY SYSTEM SHALL HAVE A MAXIMUM OF 8 PERCENT LEAD.
- 18. ACRYLONITRILE BUTADIENE STYRENE (ABS) SHALL BE USED FOR THE SEWERAGE AND
- VENTILATION SYSTEM.

  19. CROSS-LINKED POLYETHYLENE (PEX) SHALL BE USED FOR THE WATER SUPPLY SYSTEM.
- 20. POLYVINYL CHLORIDE (PVC) SHÀLL BÉ USED FOR THE RAIN WATER SYSTEM.
- 21. THE MIMIMUM WATER SUPPLY DEPTH UNDER FLOOR FINISH SHOUD BE 1/2".
- 22. ANY PIPE INSTALLED UNDERGROUND MUST HAVE AT LEAST 12 INCHES OF CLEARANCE BETWEEN THE OUTSIDE OF THE PIPE AND ANY OTHER UNDERGROUND STRUCTURE.
- 23. THE MINIMUM CLEARANCE BETWEEN COLD AND HOT WATER LINES IN RESIDENTIAL HOMES MAINTAIN A MINIMUM DISTANCE OF 6 INCHES.
- 24. HORIZONTAL SEPARATION BETWEEN WATER AND SEWER LINES: A MINIMUM OF 12 INCHES BETWEEN POTABLE WATER SUPPLY LINES (COLD AND HOT WATER) AND SANITARY SEWER LINES.

## **ABBREVIATIONS**

Ø	DIAMETER
ABS	ACRYLONITRILE BUTADIENE STYRENE
ABV	ABOVE
AD	AREA DRAIN
AFF	ABOVE FINISHED FLOOR
ALT	ALTERNATE
BFF	BELOW FINISHED FLOOR
BLW	BELOW
CO	CLEAN OUT
CW	COLD WATER
D	DEGREE
DFU	DRANAGE FIXTURE UNIT
DIA	DIAMETER
DN	DOWN
FCO	FLOOR CLEAN OUT
FD	FLOOR DRAIN
FL	FLOOR
FS	FLOOR SINK
FT	FOOT/FEET
HB	HOSE BIB
HW	HOT WATER
IN	INCH
MIN	MINIMUM
NO	NUMBER
NTS	NOT TO SCALE
PEX	CROSS-LINKED POLYETHYLENE
PLBG	PLUMBING
PVC	POLYVINYL CHLORIDE
QTY	QUANTITY
RD	ROOF DRAIN
RED	REDUCER
RM	ROOM
RW	RAIN WATER
SF	SQUARE FOOT
VTD	VENT TUROUGH ROOF
VTR	VENT THROUGH ROOF
WCO	WASTE WALL CLEAN OUT
WSFU	WATER SUPPLY FIXTURE UNIT
WOLO	WATER SUPPLIFIATURE UNIT

## PLUMBING LEGEND

I LOMBINO LLOCIND		
CAP		
BEND 45 DEG		
BEND 90 DEG		
TEE REDUCING		
TEE		
CLEAN TWO-WAY		
WYE 45 DEG		
WYE 45 DEG DOUBLE		
WYE COMBINATION		
P-TRAP		

PIPE SCHEDULE			
MATERIAL DIAMETER LENGTH			
ACRYLONITRILE BUTADIENE STYRENE (ABS)	1 1/2"	62 FT	
ACRYLONITRILE BUTADIENE STYRENE (ABS) 2" 191 FT			
ACRYLONITRILE BUTADIENE STYRENE (ABS) 3" 8 FT			
CROSS-LINKED POLYETHYLENE (PEX)	1/2"	90 FT	
CROSS-LINKED POLYETHYLENE (PEX)	3/4"	73 FT	

FITTING SCHEDULE		
FITTING	SIZE	QTY
DOMESTIC COLD WATER		
PEX 90 DEGREE ELBOW	1/2"ø-1/2"ø	14
PEX 90 DEGREE ELBOW	3/4"ø-3/4"ø	7
PEX CROSS ELBOW	3/4"ø-3/4"ø-3/4"ø-3/4"ø	1
PEX TEE ELBOW	1/2"ø-1/2"ø-1/2"ø	6
PEX TEE ELBOW	3/4"ø-3/4"ø-3/4"ø	4
PEX TRANSITION ELBOW	1"ø-1/2"ø	2
	3/4"ø-1/2"ø	
PEX TRANSITION ELBOW	3/4 Ø-1/2 Ø	9
DOMESTIC HOT WATER		
PEX 90 DEGREE ELBOW	1/2"ø-1/2"ø	13
PEX 90 DEGREE ELBOW	3/4"ø-3/4"ø	3
PEX TEE ELBOW	1/2"ø-1/2"ø-1/2"ø	3
PEX TEE ELBOW	3/4"ø-3/4"ø-3/4"ø	3
PEX TRANSITION ELBOW	3/4"ø-1/2"ø	6
RAIN WATER		
ABS 90 DEG BEND ELBOW	2"ø-2"ø	33
ABS REDUCER ELBOW	1 1/2"ø-1 1/2"ø	1
ABS TEE REDUCER ELBOW	2"ø-2"ø-1 1/2"ø	4
PVC 90 DEGREE BEND ELBOW	1 1/2"ø-1 1/2"ø	8
PVC 90 DEGREE BEND ELBOW	2"ø-2"ø	2
	,	1
SEWAGE		
ABS 90 DEGREE BEND ELBOW	2"ø-2"ø	6
ABS 90 DEGREE BEND ELBOW	3"ø-3"ø	2
ABS P-TRAP	1 1/2"ø-1 1/2"ø	5
ABS P-TRAP	2"ø-2"ø	2
ABS REDUCER ELBOW	2"ø-1 1/2"ø	2
ABS REDUCER ELBOW	3"ø-2"ø	1
ABS TEE REDUCER ELBOW	1 1/2"ø-1 1/2"ø-1 1/2"ø	1
ABS TEE REDUCER ELBOW	2"ø-2"ø-2"ø	4
ABS TEE REDUCER ELBOW	3"ø-2"ø-3"ø	1
ABS WYE COMBINATION WITH 8TH BEND DOUBLE ELBOW	3"ø-3"ø-1 1/2"ø-1 1/2"ø	1
ABS WYE COMBINATION WITH 8TH BEND ELBOW	2"ø-2"ø-2"ø	1
WASTE DOUBLE TEE	1 1/2"ø-1 1/2"ø-1 1/2"ø	1
WASTE DOUBLE TEE	3"ø-3"ø-3"ø-3"ø	1
VENT		
ABS 90 DEGREE BEND ELBOW	1 1/2"ø-1 1/2"ø	1
ABS TEE REDUCER ELBOW	2"ø-2"ø-1 1/2"ø	1
ABS VENT CAP ELBOW	1 1/2"ø	1
ABS VENT CAP ELBOW	2"ø	3

		FIX	TURE	CON	NECT	ΓΙΟΝ	SCH	HEDL	JLE	
LY	W	V	TRAP	CW HV	V QTY	DFU	TOT.	WFU <sup>-</sup>	TOT.	NOTES

DISHWASHER	2"	1-1/2"	1-1/2"	1/2"	1/2"	1	0		DRAIN TO SEWER SEE PLANS	
DRYER	N/A	N/A	N/A	N/A	N/A	1	0			
HANGING PIPES CLAMP						30	0			
SHOWER TRAY						2	0			
SHOWER TRIM	-	-	-	1/2"	1/2"	2	0			
SINK ISLAND SINGLE	2"	1-1/2"	1-1/2"	1/2"	1/2"	1	0			
VANITY SINK	2"	1-1/2"	1-1/2"	1/2"	1/2"	2	0			
WASHER	2"	1-1/2"	2"	1/2"	1/2"	1	0		DRAINS TO GRAY WATER OR SEWER SEE PLANS	
WATER CLOSET	3"	2"	3"	1/2"	1/2"	2	0			
WATER HEATER	N/A	N/A	N/A	3/4"	3/4"	1	0			
	FIXTURE SCHEDULE									

	TIXTORE SOFIEDOLE						
FIXTURE	QTY	DESCRIPTION					
DISHWASHER	1	DRAIN TO SEWER SEE PLANS					
DRYER	1						
HANGING PIPES CLAMP	30						
SHOWER TRAY	2						
SHOWER TRIM	2						
SINK ISLAND SINGLE	1						
VANITY SINK	2						
WASHER	1	DRAINS TO GRAY WATER OR SEWER SEE PLANS					
WATER CLOSET	2						
WATER HEATER	1						

ACCESSORIES & FITTINGS SCHEDULE						
FIXTURE	QTY	DESCRIPTIONS				
DISHWASHER CONNECTOR	1					
HOSE BIB	3					
LAUNDRY SWEAT CONNECTOR	1					
SHUTOFF VALVE	8					

PLUMBING SCHEDULE									
FIXTURE	TRAP	WASTE	VENT	C.W	H.W				
DISHWASHER	1-1/2"	2"	1-1/2"	1/2"	1/2"				
DRYER	N/A	N/A	N/A	N/A	N/A				
SHOWER TRAY									
SHOWER TRIM	-	-	-	1/2"	1/2"				
SINK ISLAND SINGLE	1-1/2"	2"	1-1/2"	1/2"	1/2"				
VANITY SINK	1-1/2"	2"	1-1/2"	1/2"	1/2"				
WASHER	2"	2"	1-1/2"	1/2"	1/2"				
WATER CLOSET	3"	3"	2"	1/2"	1/2"				
WATER HEATER	N/A	N/A	N/A	3/4"	3/4"				

WATER FIXTURE UNIT SCHEDULE								
FAMILY	QTY	UNIT VALUE	TOTAL					
DIOLUMA OLUED								
DISHWASHER	1		0					
DRYER	1		0					
HANGING PIPES CLAMP	30		0					
SHOWER TRAY	2		0					
SHOWER TRIM	2		0					
SINK ISLAND SINGLE	1		0					
VANITY SINK	2		0					
WASHER	1		0					
WATER CLOSET	2		0					
WATER HEATER	1		0					

WASTE FIXTURE UNIT SCHEDULE								
FAMILY	QTY	DFU VALUES	TOTAL					
DISHWASHER	1	0						
DRYER	1	0						
HANGING PIPES CLAMP	30	0						
SHOWER TRAY	2	0						
SHOWER TRIM	2	0						
SINK ISLAND SINGLE	1	0						
VANITY SINK	2	0						
WASHER	1	0						
WATER CLOSET	2	0						
WATER HEATER	1	0						



Tuscon,AZ, USA 888-864-0184

**KEY PLAN** 

NO. DESCRIPTION DATE

NOTE:

LEGEND:

PROJECT

59-Hamilton-1000-2Bd/2Ba Spanish-550

DRAWING NAME

NOTE AND SCHEDULE

CLIENT NAME:

 PROJECT NUMBER:
 0179\_14

 DATE:
 2/14/2025 11:18:41 AM


 DESIGNED BY:
 Designer

 DRAWN BY:
 Author


 CHECKED BY:
 Checker


P101

SCALE: 1/2" = 1'-0"

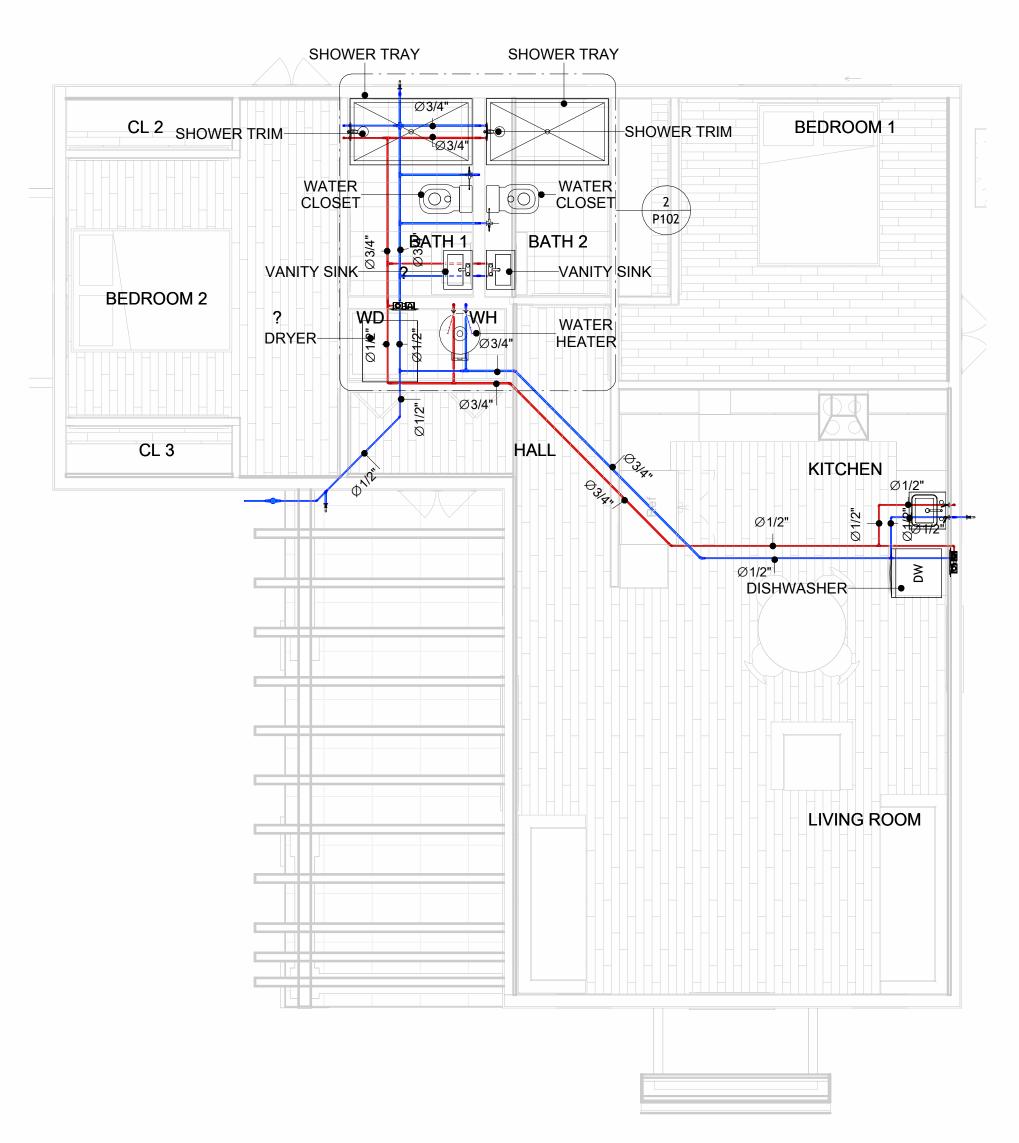




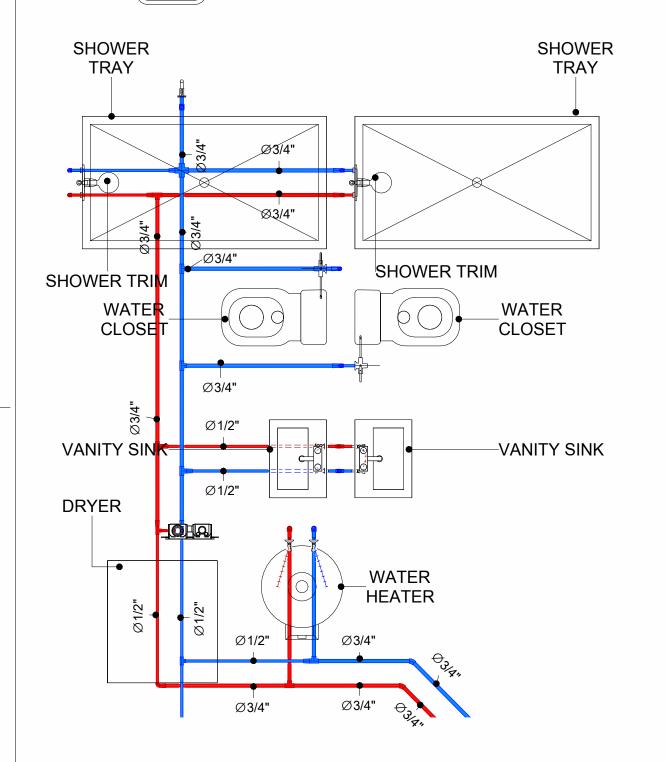

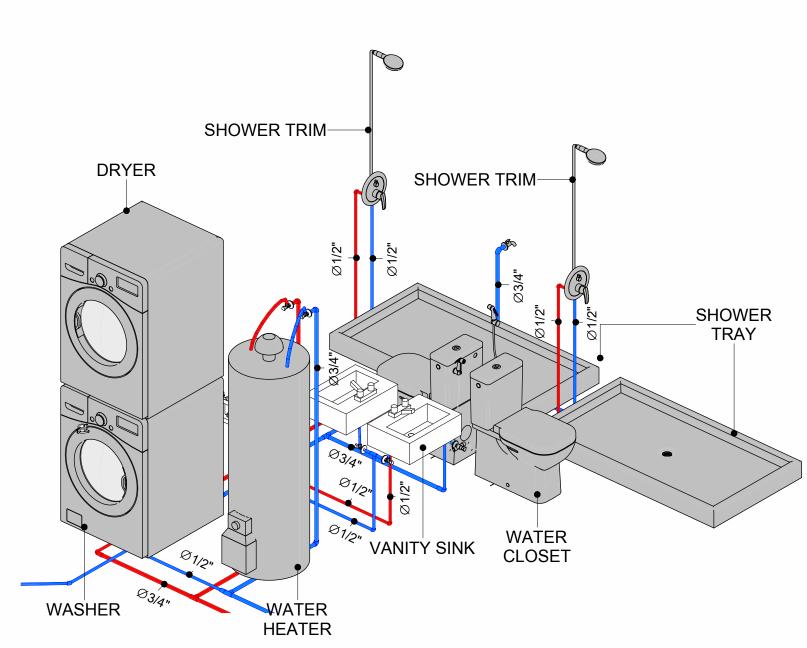


**BATH WATER SUPPLY** 1/2" = 1'-0"


WATER SUPPLY RISER DIAGRAM

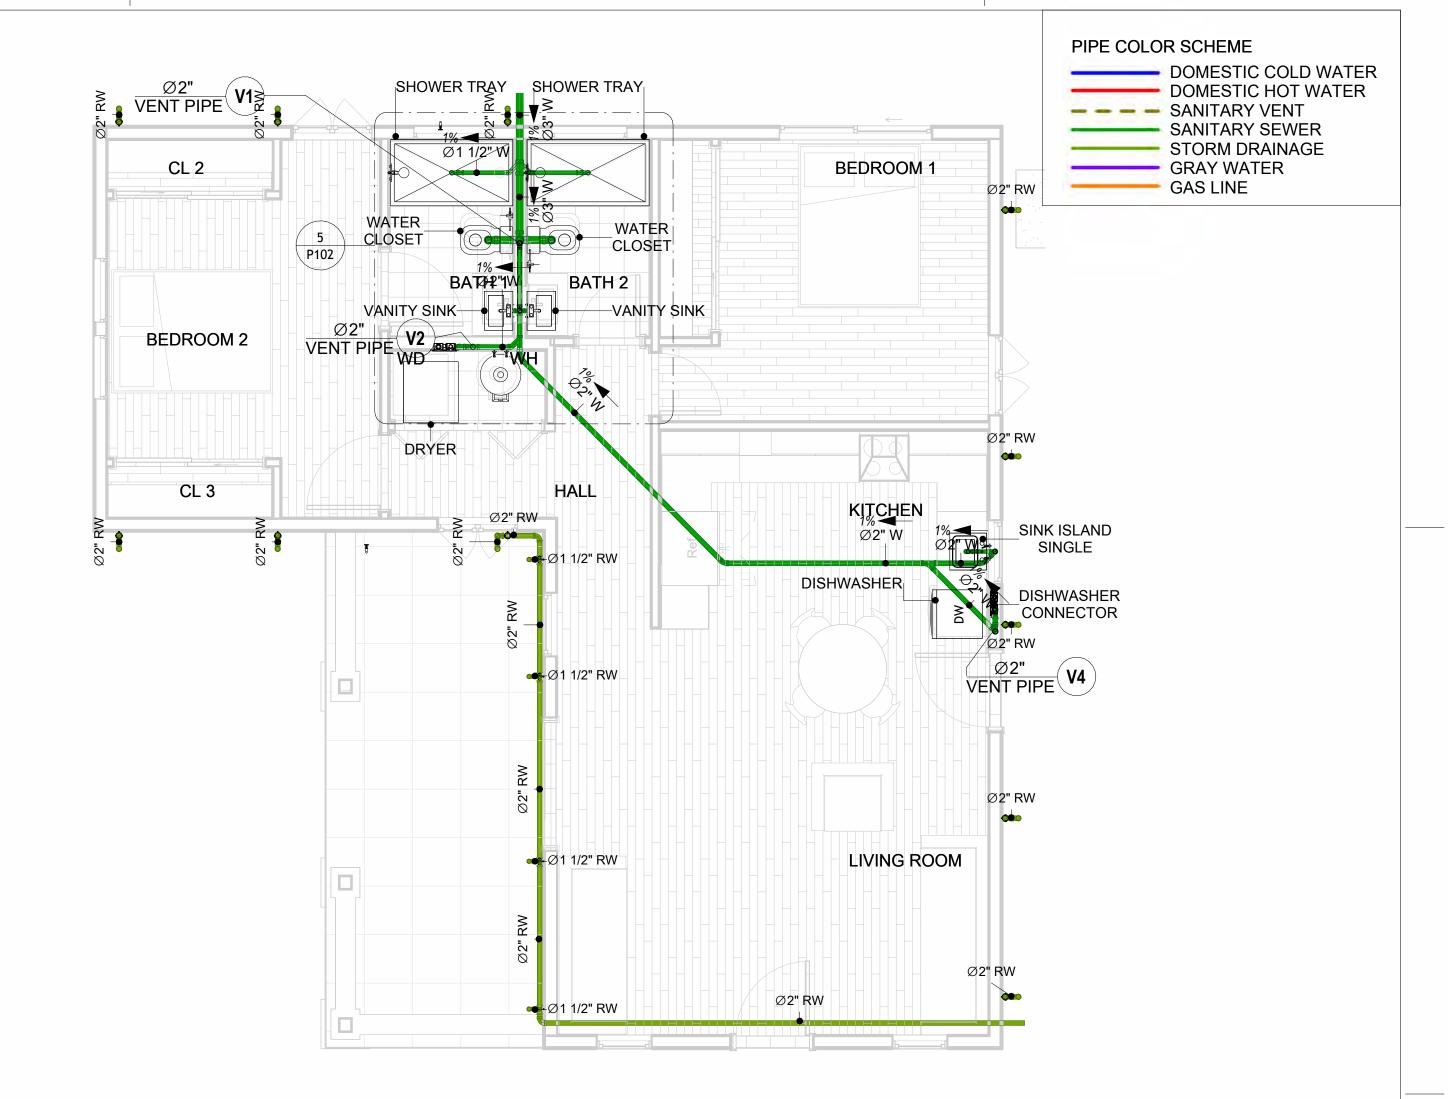



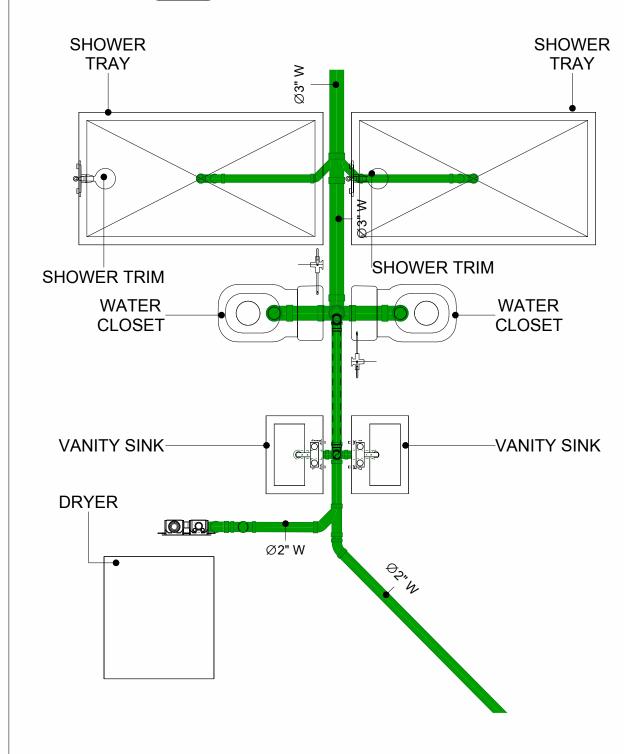


**BATH SEWAGE** 1/2" = 1'-0"

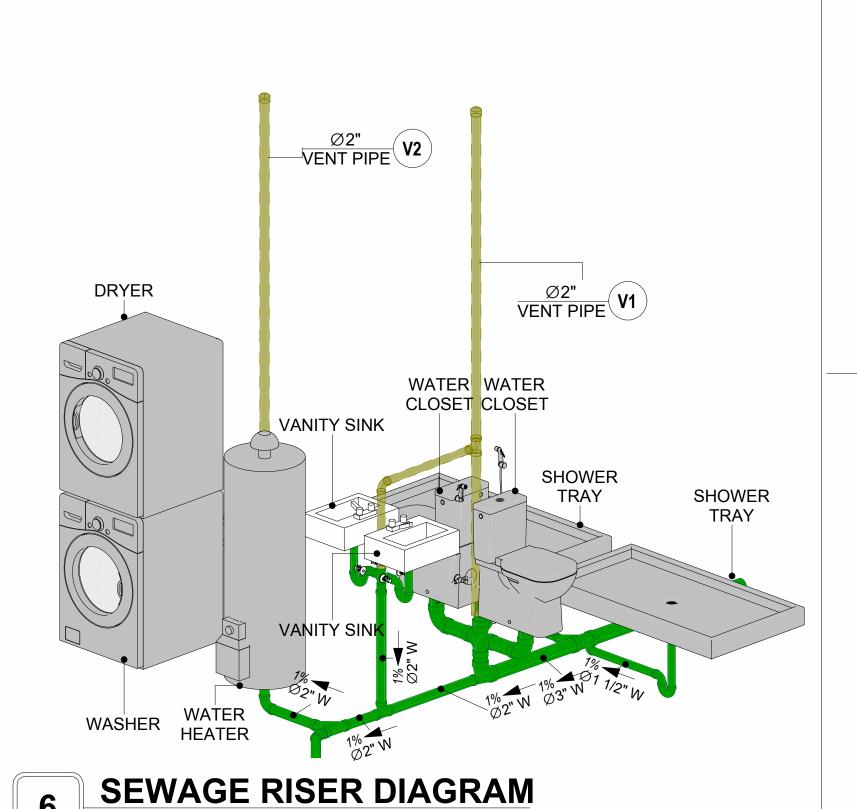

Tuscon,AZ, USA 888-864-0184

**KEY PLAN** 

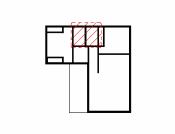

NO.	DESCRIPTION	DATE		

NOTE:

LEGEND:

PROJECT

59-Hamilton-1000-2Bd/2Ba Spanish-550

DRAWING NAME

## WATER SUPPLY AND SEWAGE SYSTEM

CLIENT NAME:	
PROJECT NUMBER:	0179_14
DATE:	2/14/2025 11:19:15 AM
DESIGNED BY:	Designer
DRAWN BY:	Author
CHECKED BY:	Checker

P102

SCALE: As indicated

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# Materials Shopping List

Please print and take this Materials Shopping List to your favorite Home Depot and ask for assistance in selecting the materials, fixtures and fittings to complete your new home.

Record your selection and the price of the item. Then do the math to determine the cost for your selections and the total cost of finishing your home.

#### **Have It Your Way!**

The material types listed in this document were selected based on personal preferences. The Customer is encouraged to make changes to the material types in accordance with local customs, regulations, and personal preferences.

Have It Your Way!



# 20 good reasons to frame a home with metal and not wood



Why build your ADU with metal vs wood	Wood	Metal	Explanation
1 DIY Construction Benefit		<b>~</b>	The wall frames, trusses and beams can be erected in a just a few days
2 Minimal Construction Skills Required		<b>~</b>	Pre-assembled walls and trusses require no specialized skills to errect
3 Build as DIY, Hybrid or by a General Contractor		<b>✓</b>	Do it yourself, Hybrid (involve special contractors) or hire a General Contractor
4 Build It As You Can Afford It		<b>✓</b>	Impervious to Weather - build as you have the time and money
5 Up Front Cost of Framing Materials	<b>~</b>		As to only the framing material, wood is less expensive
6 Total Cost To Build		<b>~</b>	Savings in time, labor, and other areas make light gauge steel LESS expensive
7 Termites and wood boring insects		<b>Y</b>	Termites, carpenter ants and wood boring insects eat wood, not metal
8 Mold resistant		<b>~</b>	Metal does not attract mold
9 Damage caused by exterior and interior flooding		<b>~</b>	Metal needs no reconditioning after a flood
10 Fire Resistant		<b>~</b>	Non-combustible
11 Lower insurance rates		<b>Y</b>	Many insurance underwriters now provide lower rates for metal framed homes
12 Walls, trusses, and beams retain their original form		<b>~</b>	Perfectly straight walls - no shimming of drywall
13 Corners are 90 degrees		<b>✓</b>	No need for templating of countertops to adjust for out of square corners
14 Strength and weight		<b>✓</b>	Metal is stronger than wood and weighs less - no need for crane to lift ADU trusses
15 IBC Engineered Stamp		<b>✓</b>	If an engineering stamp is necessary, months of waiting are saved
16 Complete BOM (Materials Shopping List)		<b>~</b>	Take the materials shopping list to Home Depot and start shopping/pricing
17 Flexible in Seismic Areas - Won't Fracture		<b>~</b>	Light gauge steel is flexible and won't fracture when the earth moves
18 No Waste At Job Site		~	Steel is the most recycled material in the world. A typical wood home has 20-30% waste
19 Environmentally Friendly		<b>~</b>	Trees don't have to be destroyed and the source of most metal is from recycling
20 How-To Videos Included		<b>~</b>	How-to videos provide simple assembly instructions
21 Relationship Counselor		<b>~</b>	Eliminate emotional uphevels - save time, money, and preserve the relationship

#### Universal Requirements - some or all may be required

- 1 Site plan
- 2 Electrical Supply Connection
- 3 Sewer Connection
- 4 Fresh Water Supply Connection
- 5 Set Backs
- 6 Soils Evaluation

- 7 Earthquake (fault) evaluation
- 8 Foundation Plan subject to soils
- 9 Compliance with local energy codes: insulation home wrap and flashing
- 10 Engineering for wind speed and snow load.
- 11 State and Local ordinances regarding ADUs
- 12 Local Architect and/or Engineer may be necessary

#### Hamilton-2Bd2Ba-Spanish





# Hamilton-2Bd2Ba-Spanish MATERIAL SHOPPING LIST

#### **Have It Your Way!**

The material types listed in this document were selected based on personal preferences. The Customer is encouraged to make changes to the material types in accordance with local customs, regulations, and personal preferences. Have It Your Way!

#### TOC



#### **Table Of Content**

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4	PLUMBING BOM	PLUMBING BOM	10
6	ARCHITECTURAL BOM	ARCHITECTURAL BOM	15

#### **Have It Your Way!**

The material types listed in this document were selected based on personal preferences. The Customer is encouraged to make changes to the material types in accordance with local customs, regulations, and personal preferences. Have It Your Way!

#### **GENERAL NOTES**

- 1 This BOM (Bill of Materials) is prepared as a Materials Shopping List to help builders and DIYers gain a complete understanding of most if not all elements required for the complete construction of this structure, according to the original design documents provided by FrameUpNow.
- 2 All quantities and specifications are subject to change based on the final design, field measurements, availability of products and customer preferences. The customer should verify all information prior to purchasing materials.
- 3 All products and elements in the list shall conform to the International Residential Code (IRC), or any other local and international building codes, safety regulations, and standards that are applicable to the location of the structure.
- 4 If any changes are made by the customer to the list of materials specified in this document, the customer is responsible for assuring that the correct type and quantity of materials are utilized in accordance with local building codes
- FrameUpNow, will not be held responsible for any misuse of this document, the products listed, or for deviations from the content that are made due to changes in specifications, pricing, availability, or customer preferences.
- 6 The customer is advised to consult a qualified professional or technician prior to purchasing materials for specialized construction system items. Some items including but not limited to caseworks, doors and windows may require as built measurements prior to purchase to confirmation of final dimensions.
- 7 If there are additional trim elements or specific installation methods, the total amount of materials needed might vary. Consider any additional trim required for corners, intersections, or other architectural details that might cause this variations before procedding to purchase and construction.

#### **ARCHITECTURAL BOM**



Hamilton-2Bd2Ba-Spanish									
		ARCHITECTI							
No.	Item	Туре	Unit	Quantity	Unit Price	Total	Description		
	APPLIANCES								
1	Refrigerator		PCS	1					
2	Range		PCS	1					
3	Washer		PCS	1					
4	Dryer		PCS	1					
5	Dish Washer		PCS	1					
6	Oven		PCS	0					
7	Microwave		PCS	0					
Δ	CASEWORKS	·							
1	Kitchen Cabinet		FT	25.02					
2	Laundry Cabinet		FT	0					
3	Vanity Cabinet		FT	2.5					
4	Medicine Cabinet		PCS	2					
5	Kitchen countertop		SF	38.23					
6	Laundry Countertop		PCS	0					
7	Bathroom Countertop		SF	0					
8	Island		FT	0					
9	Peninsula		FT	0					
10	Closets		SF	129					
	CEILING		JJI	127					
1	Ceiling Board	Dry Wall	SF	861.2					
2	Dry Wall Fastener	Screw	PCS	1507.1					
	Vapor Retarder		SF	999.79					
3		Polyethylene film							
4	Vapor Retarder Fastener	Nails with washer heads	PCS	2999.37					
5	Ceiling Board (MRD)	Moisture resistant drywall	SF	86					
6	MRD Fastener		PCS	150.5					
7	Ceiling Board	Marine Plywood	SF	52.59					
8	Marine Plywood Fastener	Screw	PCS	92.0325					
9	Dry Wall Tape		FT	499.895					
	FLOORING								
1	Main Living Space		SF	473					
2	Bathroom		SF	75.5					
3	Bedrooms		SF	320.7					
4	Porch		SF	171.6					
$\triangle$	STRUCTURE								
1	Foundation		SF	1185					
	WALLS EXTERIOR								
1	Exterior Wall Siding		SF	1253					
2	Wall Paint		SF	1253					
3	Wall Shteathing (OSB)		SF	1253					
4	Shteathing Fastener	Self-drilling screws(100/pkt)	PKT	12.53					
5	Wall Insulation		SF	3682					
6	Wall Homewrap		SF	1253					
7	Home wrap Fastener	Stapled fastener (200/pkt)	PKT	4.7614					
8	Stone Copping	1	SF	45					
Δ	WALLS INTERIOR		1.						
	Cementitious Backer Board		SF	359					
	Kerdi membrane		SF	359					
	Kerdi membrane Fastener		SF	359					
4	Wall Ceramic Tile		SF	359					
5	Drywall Board		SF	1844					
6	Drywall Fastener	Self-drilling screws(100/pkt)	PKT	18.44					
7	Wall Paint	Sell-utiling Sciews(100/pkt)	SF	1844					
				346.367386					
	Drywall Tape Wall Skerting		FT FT	145					

#### **ARCHITECTURAL BOM**



	DOORS				
1	Exterior Swinging	3' - 0" X 6'-8"	PCS	2	
2	Interior Swinging	2' - 6" X 6'-8"	PCS	2	
3	Interior Swinging	3' - 0" X 6'-8"	PCS	2	
4	Interior Sliding	7' - 4" X 6'-8"	PCS	1	
5	Bifold Door	6' - 0" X 6'-8"	PCS	1	
6	Interior Sliding	6' - 0" X 6'-8"	PCS	2	
7	Exterior Swinging	5' - 0" X 6'-8"	PCS	1	
8	Exterior Door Trim		FT	51.02	
9	Interior Door Trim		FT	337	
10	Entry Lock set		PCS	3	
	Privacy Lock set		PCS	4	
	Passage Lock set		PCS	4	
	WINDOWS				'
1	Hung	2' - 3" X 4'-3"	PCS	2	
2	Casment	3' - 3" X 3'-9"	PCS	3	
3	Fixed	3' - 1" X 2'-1"	PCS	2	
4	Fixed	2' - 7" X 2'-7"	PCS	2	
5	Hung	2' - 7" X 3'-9"	PCS	1	
6	Hung	2' - 7" X 3'-1"	PCS	1	
7	Sliding	6' - 3" X 3'-9"	PCS	1	
8	Exterior Window Trim		FT	153	
9	Interior Window Trim		FT	153	
	ROOF	-			
1	Roof Covering		SF	1196	
2	Roof Covering Fastener		PCS	598	
	Roof Felt Paper		SF	1196	
4	Roof Felt Paper Fastener		PCS	3588	
5	Roof Sheathing		SF	1196	
6	Roof Sheathing Fastener		PCS	9568	
7	Batten		FT	0	
8	Batten Fastener		PCS	0	
9	Soffit		SF	94	
10	Soffit Fastener		PCS	47	
11	Fascia		FT	188	
12	Fascia board fastener		PCS	94	
	Roof Insulation		SF	1196	
_ 15	1.001 modiation	1	51	11170	1



		Hami	lton-2Bd2B	a-Spanis	h		
		ELECTRICAL	MATERIA	L SHOPP	ING LIST		
No.	Item	Туре	Unit	Quantity	Unit Price	Total	Description
Δ	LIGHTING FIXTURES						
1	Kitchen Ceiling Light		PCS	7			
2	Exterior Wall Mounted Light		PCS	4			
3	Livingroom Ceiling Light With Fan		PCS	1			
4	Bedroom Ceiling Light With Fan		PCS	2			
5	Dining Ceiling Light		PCS	0			
6	Bath Wall Mounted Light		PCS	2			
7	Bathroom Ceiling Light		PCS	4			
8	Livingroom Ceiling Light		PCS	4			
9	Bedroom Ceiling Light		PCS	8			
10	Hall & Entry Ceiling Light		PCS	5			
11	Closet Ceiling Light		PCS	3			
12	Smoke Detector		PCS	4			
	ELECTRICAL FITTINGS						
13	Standard Receptacle 120V	20A	PCS	16			
14	GFCI Receptacle 120V	20 A	PCS	16			
15	GFCI Receptacle 240V	30 A	PCS	2			
16	GFCI Receptacle 240V	50 A	PCS	1			
17	GFCI Receptacle 240V	60 A	PCS	1			
18	Fan Switch		PCS	2			
19	Single Pole Switch		PCS	15			
20	Three Way Switch		PCS	6			
21	Dimmer Switch		PCS	5			
Δ	<b>ELECTRICAL CONDUITS &amp; WIRING</b>		<u> </u>				
22	ROMEX 14 AWG	14/2/W/ground	FT	169			
23	ROMEX 12 AWG	12/3/W/ground	FT	340			
24	ROMEX 12 AWG	12/2/W/ground	FT	39			
	ROMEX 10 AWG	10/3/W/ground	FT	63			
26	ROMEX 10 AWG	10/2/W/ground	FT	111			
27	Romex 8 AWG	8/3/W/ground	FT	75			
	Romex 8 AWG	8/2/W/ground	FT	34			
	ROMEX 6 AWG	6/3/W/ground	FT	40			
	Bare Copper Ground Wire 6 AWG	<b>J</b>	FT	0			
Δ	ELECTRICAL BOXES & CIRCUTES						
	Panelboard -240V 1 Phase MLO	200 AMP	PCS	1			
32	Circuit breaker	15 A	PCS	5			
33	Circuit breaker	20 A	PCS	9			
	Circuit breaker	30 A	PCS	3			
35	Circuit breaker	40 A	PCS	0			
	Circuit breaker	50 A	PCS	1			
	Circuit breaker	60 A	PCS	1			
	Single Gang Switch Box		PCS	5			
	Double Gang Switch Box		PCS	4			
41	Triple Gang Switch Box		PCS	5			
	Pull Box	#1/4	PCS	41			
	Receptacle Box		PCS	38			
	1	1	1. 00	1 33			

#### **PLUMBING BOM**

11 Flex Pipe Round



#### Hamilton-2Bd2Ba-Spanish PLUMBING SYSTEM MATERIAL SHOPPING LIST Quantity Unit Price Total Description Item Unit □ PLUMBING FIXTURES & ACCESSORIES 1 Bath Tub (Alcove Tub) PCS 2 Kitchen Sink 3 Kitchen Faucets PCS 1 PCS 4 Vanity Sink PCS 2 5 Bath room Faucets PCS 2 6 Water Closet PCS 7 Shower Trim PCS 8 Shower Tray PCS 2 9 Water Heater PCS 10 Hose Bib PCS 2 11 Shutoff Valve PCS 8 12 Hanging pipe clamp PCS 30 13 Gate Valve PCS 14 Dishwasher Supply Single Connector PCS 1 15 Dishwasher Sewage Single Connector PCS 16 Laundry Sweat Connector PCS 1 SANITARY & PLUMBING PIPES ABS (Acrylonitrile Butadiene Styrene) Pipes ABS (Acrylonitrile Butadiene Styrene) Pipes ø 1" FT 0 ø 1 1/2" FT 62 3 ABS (Acrylonitrile Butadiene Styrene) Pipes ø 2" FT 191 4 ABS (Acrylonitrile Butadiene Styrene) Pipes ø 3" FT 8 5 PEX (Cross-linked polyethylene) Pipes ø 1/2" FT 90 6 PEX (Cross-linked polyethylene) Pipes 73 ø 3/4" FT 7 PEX (Cross-linked polyethylene) Pipes ø 1" FT 0 8 PVC Pipes Sch.80 - Rigid ø 1 1/2" FT 0 9 PVC Pipes Sch.80 - Rigid ø 2" FT 0 10 PVC Pipes Sch.80 - Rigid ø 3" FT 0

PCS

8

ø 1/2"

#### **PLUMBING BOM**



Δ	PIPE FITTINGS				
1	ABS 90 Deg Bend Elbow	2"ø-2"ø	PCS	33	
2	ABS 90 Degree Bend Elbow	1 1/2"ø-1 1/2"ø	PCS	1	
3	ABS 90 Degree Bend Elbow	2"ø-2"ø	PCS	6	
4	ABS 90 Degree Bend Elbow	3"ø-3"ø	PCS	2	
5	ABS P-Trap	1 1/2"ø-1 1/2"ø	PCS	5	
6	ABS P-Trap	2"ø-2"ø	PCS	2	
7	ABS Reducer Elbow	1 1/2"ø-1 1/2"ø	PCS	1	
8	ABS Reducer Elbow	2"ø-1 1/2"ø	PCS	2	
9	ABS Reducer Elbow	3"ø-2"ø	PCS	1	
10	ABS Tee Reducer Elbow	1 1/2"ø-1 1/2"ø-1 1/2"ø	PCS	1	
11	ABS Tee Reducer Elbow	2"ø-2"ø-1 1/2"ø	PCS	5	
12	ABS Tee Reducer Elbow	2"ø-2"ø-2"ø	PCS	4	
13	ABS Tee Reducer Elbow	3"ø-2"ø-3"ø	PCS	1	
14	ABS Vent Cap Elbow	1 1/2"ø	PCS	1	
15	ABS Vent Cap Elbow	2"ø	PCS	3	
16	ABS Wye Combination with 8th Bend Double	3"ø-3"ø-1 1/2"ø-1 1/2"ø	PCS	1	
17	ABS Wye Combination with 8th Bend Elbow	2"ø-2"ø-2"ø	PCS	1	
18	PEX 90 Degree Elbow	1/2"ø-1/2"ø	PCS	27	
19	PEX 90 Degree Elbow	3/4"ø-3/4"ø	PCS	10	
20	PEX Cross Elbow	3/4"ø-3/4"ø-3/4"ø	PCS	1	
21	PEX Tee Elbow	1/2"ø-1/2"ø-1/2"ø	PCS	9	
22	PEX Tee Elbow	3/4"ø-3/4"ø-3/4"ø	PCS	7	
23	PEX Transition Elbow	1"ø-1/2"ø	PCS	2	
24	PEX Transition Elbow	3/4"ø-1/2"ø	PCS	15	
25	PVC 90 Degree Bend Elbow	1 1/2"ø-1 1/2"ø	PCS	8	
26	PVC 90 Degree Bend Elbow	2"ø-2"ø	PCS	2	
27	WASTE DOUBLE TEE	1 1/2"ø-1 1/2"ø-1 1/2"ø-1	PCS	1	
28	WASTE DOUBLE TEE	3"ø-3"ø-3"ø	PCS	1	

#### **HVAC BOM**



	Hamilton-2Bd2Ba-Spanish										
		HVAC SYSTEM MA	TERIAL	SHOPP	ING LIST						
No.	Item	Туре	Unit	Quantity	Unit Price	Total	Description				
	HVAC_DUCTS										
1	PIPE (REFRIGERANT LINE)	3/8" (Ø)	FT	76.39							
2	PIPE (REFRIGERANT LINE)	3/4''' (Ø)	FT	97.96							
3	DRAYER HOSE	4" (Ø)	FT	6							
4	FLEX DUCT ROUND	4" (Ø)	FT	6.75							
	<b>DUCT FITTINGS &amp; ACCESSORIES</b>										
5	ELBOW (REFRIGERANT LINE)	3/4" (Ø)-3/4" (Ø)	PCS	29							
6	ELBOW (REFRIGERANT LINE)	3/8" (Ø)-3/8" (Ø)	PCS	21							
7	TEE (REFRIGERANT LINE)	3/4" (Ø)-3/4" (Ø)-3/4"	PCS	2							
8	TEE (REFRIGERANT LINE)	3/8" (Ø)-3/8" (Ø)-3/8"	PCS	2							
9	TRANSITION (REFRIGERANT	3/4" (Ø)-1/2" (Ø)	PCS	4							
10	TRANSITION (REFRIGERANT	3/4" (Ø)-5/8" (Ø)	PCS	4							
11	TRANSITION (REFRIGERANT	3/8" (Ø)-1/4" (Ø)	PCS	1							
12	ROUND TRANSITION(ANGLE)	45 DEGREE	PCS	7							
	HVAC_EQUIPMENTS										
13	AIR HANDLING UNIT	WALL MOUNTED	PCS	3							
14	CONDENSER	OUTDOOR UNIT	PCS	1							
15	EXHAUST FAN	75 CFM	PCS	2							
16	HOOD-WALL: VENT	HOOD-WALL: VENT	PCS	1							
17	DRAYER: VENT	DRAYER: VENT	PCS	1							
18	ROOF VENT	3"(Ø)	PCS	3							



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#### **Have It Your Way!**

The material types listed in this document were selected based on personal preferences. The Customer is encouraged to make changes to the material types in accordance with local customs, regulations, and personal preferences. Have It Your Way!

#### **GENERAL NOTES**

- This BOM (Bill of Materials) is prepared as a Materials Shopping List to help builders and DIYers gain a complete understanding of most if not all elements required for the complete construction of this structure, according to the original design documents provided by FrameUpNow.
- 2 All quantities and specifications are subject to change based on the final design, field measurements, availability of products and customer preferences. The customer should verify all information prior to purchasing materials.
- 3 All products and elements in the list shall conform to the International Residential Code (IRC), or any other local and international building codes, safety regulations, and standards that are applicable to the location of the structure.
- 4 If any changes are made by the customer to the list of materials specified in this document, the customer is responsible for assuring that the correct type and quantity of materials are utilized in accordance with local building codes.
- 5 FrameUpNow, will not be held responsible for any misuse of this document, the products listed, or for deviations from the content that are made due to changes in specifications, pricing, availability, or customer preferences.
- The customer is advised to consult a qualified professional or technician prior to purchasing materials for specialized construction system items. Some items including but not limited to caseworks, doors and windows may require as built measurements prior to purchase to confirmation of final dimensions.
- 7 If there are additional trim elements or specific installation methods, the total amount of materials needed might vary. Consider any additional trim required for corners, intersections, or other architectural details that might cause this variations before procedding to purchase and construction.



			LIGHTING FIXTURES				
Ħ	Lighting	Туре	Description, Manufacturer, SKU	Unit	Quantity	Unit Price	Total
1	Kitchen Ceiling Light			PCS	7		
<u> </u>	Exterior Wall Mounted Light			PCS	4		
3	Livingroom Ceiling Light With Fan			PCS	1		
ļ	Bedroom Ceiling Light With Fan			PCS	2		
5	Dining Ceiling Light			PCS	C		
5	Bath Wall Mounted Light			PCS	2		
7	Bathroom Ceiling Light			PCS	4		
3	Livingroom Ceiling Light			PCS	4		
)	Bedroom Ceiling Light			PCS	8		
.0	Hall & Entry Ceiling Light			PCS	5		
.1	Closet Ceiling Light			PCS	3		
.2	Smoke Detector			PCS	4		
L3							
L4							
.5							



			ELECTRICAL FITTINGS				
#	Item	Туре	Description, Manufacturer, SKU	Unit	Quantity	Unit Price	Total
1	Standard Receptacle 120V	20A		PCS	16		
2	GFCI Receptacle 120V	20 A		PCS	16	)	
3	GFCI Receptacle 240V	30 A		PCS	2	)	
4	GFCI Receptacle 240V	50 A		PCS	1		
5	GFCI Receptacle 240V	60 A		PCS	1		
6	Fan Switch			PCS	2	)	
7	Single Pole Switch			PCS	15		
8	Three Way Switch			PCS	6		
9	Dimmer Switch			PCS	5		
10							
11							
12							
13							
14							
15							



			ELECTRICAL CONDUITS & WIRIN	IG			
#	Item	Туре	Description, Manufacturer, SKU	Unit	Quantity	Unit Price	Total
1	ROMEX 14 AWG	14/2/W/ground		FT	169		
2	ROMEX 12 AWG	12/3/W/ground		FT	340		
	ROMEX 12 AWG	12/2/W/ground		FT	39		
1	ROMEX 10 AWG	10/3/W/ground		FT	63		
•	ROMEX 10 AWG	10/2/W/ground		FT	111		
5	Romex 8 AWG	8/3/W/ground		FT	75		
,	Romex 8 AWG	8/2/W/ground		FT	34		
3	ROMEX 6 AWG	6/3/W/ground		FT	40		
)	Bare Copper Ground Wire 6 AWG			FT			
.0							
.1							
.2							
.3							
4							
.5							



			ELECTRICAL BOXES & CIRCUTE	S			
#	Item	Туре	Description, Manufacturer, SKU	Unit	Quantity	Unit Price	Total
1	Panelboard -240V 1 Phase MLO	200 AMP		PCS	1		
2	Circuit breaker	15 A		PCS	5		
3	Circuit breaker	20 A		PCS	9		
4	Circuit breaker	30 A		PCS	3		
5	Circuit breaker	50 A		PCS	1		
6	Circuit breaker	60 A		PCS	1		
7	Single Gang Switch Box			PCS	5		
8	Double Gang Switch Box			PCS	4		
9	Triple Gang Switch Box			PCS	5		
10	Pull Box	#1/4		PCS	41		
11	Receptacle Box			PCS	38		
12							
13							
14							
15							

## **HVAC BOM**



			HVAC_DUCTS 01				
#	Item	Туре	Description, Manufacturer, SKU	Unit	Quantity	Unit Price	Total
1	PIPE (REFRIGERANT LINE			FT	76.39		
2	PIPE (REFRIGERANT LINE	E) 3/4''' (Ø)		FT	97.96		
3	DRAYER HOSE	4" (Ø)		FT	6		
4	FLEX DUCT ROUND	4" (Ø)		FT	6.75		
5							
6							

# **HVAC BOM**



			<b>DUCT FITTINGS &amp; ACCESSORIES</b>				
#	Item	Туре	Description, Manufacturer, SKU	Unit	Quantity	Unit Price	Total
1	ELBOW (REFRIGERANT LINE)	3/4" (Ø)-3/4" (Ø)		PCS	29		
2	ELBOW (REFRIGERANT LINE)	3/8" (Ø)-3/8" (Ø)		PCS	21		
3	TEE (REFRIGERANT LINE)	3/4" (Ø)-3/4" (Ø)-3/4"		PCS	2		
4	TEE (REFRIGERANT LINE)	3/8" (Ø)-3/8" (Ø)-3/8"		PCS	2		
5	TRANSITION (REFRIGERANT LINE)	3/4" (Ø)-1/2" (Ø)		PCS	4		
6	TRANSITION (REFRIGERANT LINE)	3/4" (Ø)-5/8" (Ø)		PCS	4		
7	TRANSITION (REFRIGERANT LINE)	3/8" (Ø)-1/4" (Ø)		PCS	1		
8	ROUND TRANSITION(ANGLE)	45 DEGREE		PCS	7		
9							
10							
11							
12							

# **HVAC BOM**



			HVAC_EQUIPMENTS				
#	Item	Туре	Description, Manufacturer, SKU	Unit	Quantity	Unit Price	Total
1	AIR HANDLING UNIT	WALL MOUNTED		PCS	3		
2	CONDENSER	OUTDOOR UNIT		PCS	1		
3	EXHAUST FAN	75 CFM		PCS	2		
4	HOOD-WALL: VENT	HOOD-WALL: VENT		PCS	1		
5	DRAYER: VENT	DRAYER: VENT		PCS	1		
6	ROOF VENT	3"(Ø)		PCS	3		



		PLUMBII	NG FIXTURES & ACCESSORIES				
#	Item	Туре	Description, Manufacturer, SKU	Unit	Quantity	Unit Price	Total
1	Bath Tub (Alcove Tub)			PCS	C		
2	Kitchen Sink			PCS	1		
3	Kitchen faucets			PCS	1		
4	Vanity Sink			PCS	2		
5	Bath room faucets			PCS	2		
6	Water Closet			PCS	2		
7	Shower Trim			PCS	2		
8	Shower Tray			PCS	2		
9	Water Heater			PCS	1		
10	Hose Bib			PCS	2		
11	Shutoff Valve			PCS	8		
12	Hanging pipe clamp			PCS	30		
13	Gate Valve			PCS	1		
14	Dishwasher Supply Single Connector			PCS	1		
15	Dishwasher Sewage Single Connector			PCS	1		
16	Laundry Sweat Connector			PCS	1		



		SANI	TARY & PLUMBING PIPES				
#	Item	Туре	Description, Manufacturer, SKU	Unit	Quantity	Unit Price	Total
1	ABS (Acrylonitrile Butadiene Styrene) Pipes	ø 1"		FT	0		
2	ABS (Acrylonitrile Butadiene Styrene) Pipes	ø 1 1/2"		FT	62		
3	ABS (Acrylonitrile Butadiene Styrene) Pipes	ø 2"		FT	191		
4	ABS (Acrylonitrile Butadiene Styrene) Pipes	ø 3"		FT	8		
5	PEX (Cross-linked polyethylene) Pipes	ø 1/2"		FT	90		
6	PEX (Cross-linked polyethylene) Pipes	ø 3/4"		FT	73		
7	PEX (Cross-linked polyethylene) Pipes	ø 1"		FT	0		
8	PVC Pipes Sch.80 - Rigid	ø 1 1/2"		FT	0		
9	PVC Pipes Sch.80 - Rigid	ø 2"		FT	0		
10	PVC Pipes Sch.80 - Rigid	ø 3"		FT	0		
11	Flex Pipe Round	ø 1/2"		PCS	8		
12							
13							
14							
15							



		PIPE	FITTINGS 01				
#	Item	Туре	Description, Manufacturer, SKU	Unit	Quantity	Unit Price	Total
1	ABS 90 Deg Bend Elbow	2"ø-2"ø		PCS	33		
<u>)</u>	ABS 90 Degree Bend Elbow	1 1/2"ø-1 1/2"ø		PCS	1		
}	ABS 90 Degree Bend Elbow	2"ø-2"ø		PCS	6		
1	ABS 90 Degree Bend Elbow	3"ø-3"ø		PCS	2		
5	ABS P-Trap	1 1/2"ø-1 1/2"ø		PCS	5		
5	ABS P-Trap	2"ø-2"ø		PCS	2		
7	ABS Reducer Elbow	1 1/2"ø-1 1/2"ø		PCS	1		
3	ABS Reducer Elbow	2"ø-1 1/2"ø		PCS	2		
9	ABS Reducer Elbow	3"Ø-2"Ø		PCS	1		
10	ABS Tee Reducer Elbow	1 1/2"ø-1 1/2"ø-1 1/2"ø		PCS	1		
11	ABS Tee Reducer Elbow	2"ø-2"ø-1 1/2"ø		PCS	5		
12	ABS Tee Reducer Elbow	2"Ø-2"Ø-2"Ø		PCS	4		
13	ABS Tee Reducer Elbow	3"Ø-2"Ø-3"Ø		PCS	1		
14	ABS Vent Cap Elbow	1 1/2"ø		PCS	1		
15	ABS Vent Cap Elbow	2"ø		PCS	3		



		PIPE FI	TTINGS 02				
#	Item	Туре	Description, Manufacturer, SKU	Unit	Quantity	Unit Price	Total
1	ABS Wye Combination with 8th Bend Double Elbow	3"ø-3"ø-1 1/2"ø-1 1/2"ø		PCS	1		
2	ABS Wye Combination with 8th Bend Elbow	2"ø-2"ø-2"ø		PCS	1		
3	PEX 90 Degree Elbow	1/2"ø-1/2"ø		PCS	27		
4	PEX 90 Degree Elbow	3/4"ø-3/4"ø		PCS	10		
5	PEX Cross Elbow	3/4"ø-3/4"ø-3/4"ø		PCS	1		
6	PEX Tee Elbow	1/2"ø-1/2"ø-1/2"ø		PCS	9		
7	PEX Tee Elbow	3/4"ø-3/4"ø-3/4"ø		PCS	7		
8	PEX Transition Elbow	1"ø-1/2"ø		PCS	2		
9	PEX Transition Elbow	3/4"ø-1/2"ø		PCS	15		
10	PVC 90 Degree Bend Elbow	1 1/2"ø-1 1/2"ø		PCS	8		
11	PVC 90 Degree Bend Elbow	2"Ø-2"Ø		PCS	2		
12	WASTE DOUBLE TEE	1 1/2"ø-1 1/2"ø-1 1/2"ø		PCS	1		
13	WASTE DOUBLE TEE	3"ø-3"ø-3"ø-3"ø		PCS	1		
14							
15							



			APPLIANCES			
#	Item	Туре	Description, Manufacturer, SKU	Unit	Quantity Unit Price	Total
1	Refrigerator			PCS	1	
2	Range			PCS	1	
3	Washer Front Load	Stackable		PCS	1	
4	Dryer Front Load	Stackable		PCS	1	
5	Dish Washer			PCS	1	
6	Oven			PCS	0	
7	Microwave			PCS	0	
8						
9						
10						
11						
12						
13						
14						
15						
16						



			CASEWORKS 01				
#	Item	Туре	Description, Manufacturer, SKU	Unit	Quantity	Unit Price	Total
1	Kitchen Cabinet			FT	25.02		
2	Laundry Cabinet			FT	0		
3	Vanity Cabinet			FT	2.5		
4	Medicine Cabinet			PCS	2		
5	Kitchen countertop			SF	38.23		
6	Laundry Countertop			PCS	0		
7	Bathroom Countertop			SF	0		
8	Island			FT	0		
9	Peninsula			FT	0		
10	Closets			SF	129		
11							
12							
13							
14							
15							



			CEILING 01				
#	Item	Туре	Description, Manufacturer, SKU	Unit	Quantity U	Jnit Price	Total
	LIVING ROOM + KITCHEN			SF	428.7		
1	Ceiling Board	Drywall		SF	429		
2	Drywall Fastener	Screw		PCS	750		
3	Vapor Retarder	Polyethylene film		SF	429		
4	Vapor Retarder Fastener	Nails with washer heads		PCS	1286		
	BATH ROOM 1			SF	42.0		
5	Ceiling Board	MRD (Moisture resistant drywall)		SF	42		
6	MRD Fastener	Screw		PCS	73		
	BATH ROOM 2			SF	44		
7	Ceiling Board	MRD (Moisture resistant drywall)		SF	44		
8	MRD Fastener	Screw		PCS	77		
9	WH + WD			SF	20.6		
10	Ceiling Board	Drywall		SF	21		
	Drywall Fastener	Screw		PCS	36		
11	Vapor Retarder	Polyethylene film		SF	21		
12	Vapor Retarder Fastener	Nails with washer heads		PCS	62		



			CEILING 02				
#	Item	Туре	Description, Manufacturer, SKU	Unit	Quantity	Unit Price	Total
	BED ROOM 1			SF	146.5		
13	Ceiling Board	Drywall		SF	147		
14	Drywall Fastener	Screw		PCS	256		
15	Vapor Retarder	Polyethylene film		SF	147		
16	Vapor Retarder Fastener	Nails with washer heads		PCS	440		
	BED ROOM 2			SF	142.4		
17	Ceiling Board	Drywall		SF	142		
18	Drywall Fastener	Screw		PCS	249		
19	Vapor Retarder	Polyethylene film		SF	142		
20	Vapor Retarder Fastener	Nails with washer heads		PCS	427		
	CL 1			SF	15.3		
21	Ceiling Board	Drywall		SF	15		
22	Drywall Fastener	Screw		PCS	27		
23	Vapor Retarder	Polyethylene film		SF	15		
24	Vapor Retarder Fastener	Nails with washer heads		PCS	45.9		



			CEILING 03				
#	Item	Туре	Description, Manufacturer, SKU	Unit	Quantity	Unit Price	Total
	CL 2			SF	18.5		
25	Ceiling Board	Drywall		SF	18		
26	Drywall Fastener	Screw		PCS	32		
27	Vapor Retarder	Polyethylene film		SF	18		
28	Vapor Retarder Fastener	Nails with washer heads		PCS	55		
	CL 3			SF	15.3		
29	Ceiling Board	Drywall		SF	15		
30	Drywall Fastener	Screw		PCS	27		
31	Vapor Retarder	Polyethylene film		SF	15		
32	Vapor Retarder Fastener	Nails with washer heads		PCS	46		
	HALL			SF	73.9		
33	Ceiling Board	Drywall		SF	74		
34	Drywall Fastener	Screw		PCS	129		
35	Vapor Retarder	Polyethylene film		SF	74		
36	Vapor Retarder Fastener	Nails with washer heads		PCS	222		



			CEILING 04				
#	Item	Туре	Description, Manufacturer, SKU	Unit	Quantity	Unit Price	Total
	FRONT PORCH			SF	24.5		
37	Ceiling Board	Marine Plywood		SF	24		
38	Exterior Grade Plywood	Screw		PCS	43		
	SIDE PORCH			SF	28.1		
39	Ceiling Board	Marine Plywood		SF	28		
40	Exterior Grade Plywood	Screw		PCS	49		



			FLOORING INTERIOR 01			
#	Item	Туре	Description, Manufacturer, SKU	Unit	Quantity Unit P	rice Total
	BEDROOM #1					
1	Bedroom Flooring			SF	139	
2	Wood underlay	Foam Pad Polyethylene		SF	139	
3	Vapor Retarder	Vapor Barrier Polyethylene		SF	139.0	
	BEDROOM#2					
7	Bedroom Flooring			SF	135	
8	Wood underlay	Foam Pad Polyethylene		SF	135	
9	Vapor Retarder	Vapor Barrier Polyethylene		SF	135.2	
	CL#1					
10	Closet Flooring			SF	15	
11	Wood underlay	Foam Pad Polyethylene		SF	15	
12	Vapor Retarder	Vapor Barrier Polyethylene		SF	14.5	
	CL#2	'				
4	Closet Flooring			SF	15	
5	Wood underlay	Foam Pad Polyethylene		SF	15	
6	Vapor Retarder	Vapor Barrier Polyethylene		SF	14.5	



			FLOORING INTERIOR 02				
#	Item	Туре	Description, Manufacturer, SKU	Unit	Quantity	Unit Price	Total
	CL#3						
7	Closet Flooring			SF	18		
8	Wood underlay	Foam Pad Polyethylene		SF	18		
9	Vapor Retarder	Vapor Barrier Polyethylene		SF	17.5		
	LIVING ROOM AND KITCH	EN					
10	Living Area Flooring			SF	473		
11	Wood underlay	Foam Pad Polyethylene		SF	473		
12	Vapor Retarder	Vapor Barrier Polyethylene		SF	473.0		
	BATHROOM#1						
1	Tile Finish			SF	28		
2	Adhesive	1/2" Thin set Mortar		SF	28		
3	Vapor Retarder	Vapor Barrier Polyethylene		SF	28.0		
	BATHROOM#2	,					
1	Tile Finish			SF	28		
2	Adhesive	1/2" Thin set Mortar		SF	28		
3	Vapor Retarder	Vapor Barrier Polyethylene		SF	28.0		



			FLOORING INTERIOR 03				
#	Item	Туре	Description, Manufacturer, SKU	Unit	Quantity	Unit Price	Total
	W/D						
1	Tile Finish			SF	20		
2	Adhesive	1/2" Thin set Mortar		SF	20		
3	Vapor Retarder	Vapor Barrier Polyethylene		SF	19.5		



	1		FLOORING EXTERIOR			
#	item	Туре	Description, Manufacturer, SKU	Unit	Quantity Unit Price	
	STRUCTURE			SF	1185.0	
1	Concrete Slab	4"concrete cast in situ		CF	408	
2	Insulation	Rigid insulation		SF	322	
3	Hard core	Compacted soil		CF	303.5	
4	Re-bar	#4 re-bar		Ton	1.2	
5	Concrete Pad	4"concrete cast in situ		CF	1.58	
6	Slab edge	Turndown		CF	328.6	
7	Footing	Cast-in-place concrete		CF	9	
	PORCH					
8	Tile Finish			SF	171.6	
9	Adhesive	1/2" Thin set Mortar		SF	171.6	
10	Vapor Retarder	Vapor Barrier Polyethylene		SF	171.6	



			WALLS: EXTERIOR				
	Item	Туре	Description, Manufacturer, SKU	Unit	Quantity	Unit Price	Total
1	Stocco Finish			SF	1253		
2	Wall Homewrap			SF	1253		
3	Homewrap Fastener	Stapled fastener (200/pkt)		PKT	4.8		
4	Wall Shteathing (OSB)			SF	1253		
5	Shteathing Fastener	Self-drilling screws(100/pkt)		PKT	12.53		
6	Stone Copping			SF	45		
7	Wall Paint			SF	1253		
8	Wall Insulation			SF	3682		
9							
10							
11							
12							
13							
14							
15							



			WALLS: INTERIOR 01				
#	Item	Туре	Description, Manufacturer, SKU	Unit	Quantity	Unit Price	Total
	BATHROOM 1			SF	40.0		
1	Cementitious Backer Board			SF	213		
2	Kerdi membrane			SF	213		
3	Kerdi membrane Fastener			SF	213		
4	Wall Ceramic Tile			SF	213		
	BATHROOM 2			SF	40.0		
5	Cementitious Backer Board			SF	195		
6	Kerdi membrane			SF	195		
7	Kerdi membrane Fastener			SF	195		
8	Wall Ceramic Tile			SF	195		
	BEDROOM 1			SF	136.0		
9	Drywall Board			SF	363		
10	Drywall Fastener	Self-drilling screws(100/pkt)		PKT	3.63		
11	Wall Paint			SF	363		
12	Drywall Tape			FT	68.1		



			WALLS: INTERIOR 02				
#	Item	Туре	Description, Manufacturer, SKU	Unit	Quantity	Unit Price	Total
	BEDROOM 2			SF	137.0		
13	Drywall Board			SF	319		
14	Drywall Fastener	Self-drilling screws(100/pkt)		PKT	3.19		
15	Wall Paint			SF	319		
16	Drywall Tape			FT	59.8		
	KITCHEN			SF	111.0		
17	Cementitious Backer Board			SF	44		
18	Drywall Board			SF	187		
19	Drywall Fastener	Self-drilling screws(100/pkt)		PKT	1.87		
20	Kerdi membrane			SF	44		
21	Kerdi membrane Fastener			SF	44		
22	Wall Ceramic Tile			SF	44		
23	Wall Paint			SF	187		
24	Drywall Tape			FT	35.3		



			WALLS: INTERIOR 03				
#	Item	Туре	Description, Manufacturer, SKU	Unit	Quantity	Unit Price	Total
	LIVING ROOM			SF	288.0		
25	Drywall Board			SF	324		
26	Drywall Fastener	Self-drilling screws(100/pkt)		PKT	3.24		
27	Wall Paint			SF	324		
28	Drywall Tape			FT	60.8		
	CLOSET 1			SF	17.0		
29	Drywall Board			SF	147		
30	Drywall Fastener	Self-drilling screws(100/pkt)		PKT	1.47		
31	Wall Paint			SF	147		
32	Drywall Tape			FT	27.6		
	CLOSET 2			SF	16.0		
33	Drywall Board			SF	106		
34	Drywall Fastener	Self-drilling screws(100/pkt)		PKT	1.06		
35	Wall Paint			SF	106		
36	Drywall Tape			FT	19.9		



			WALLS: INTERIOR 04				
#	Item	Туре	Description, Manufacturer, SKU	Unit	Quantity	Unit Price	Total
	CLOSET 3			SF	14.0		
37	Drywall Board			SF	104		
38	Drywall Fastener	Self-drilling screws(100/pkt)		PKT	1.04		
39	Wall Paint			SF	104		
40	Drywall Tape			FT	19.50121883		
	HALL			SF	68.0	)	
41	Drywall Board			SF	232		
42	Drywall Fastener	Self-drilling screws(100/pkt)		PKT	2.32		
43	Wall Paint			SF	232		
44	Drywall Tape			FT	43.77358491		
	WD			SF	9.0		
45	Cementitious Backer Board			SF	80		
46	Kerdi membrane			SF	80		
47	Kerdi membrane Fastener			SF	80		
48	Wall Ceramic Tile			SF	80		



			WALLS: INTERIOR 04				
#	Item	Туре	Description, Manufacturer, SKU	Unit	Quantity	Unit Price	Total
	WH			SF	9.0		
49	Drywall Board			SF	62		
50	Drywall Fastener	Self-drilling screws(100/pkt)		PKT	0.62		
51	Wall Paint			SF	62		
52	Drywall Tape			FT	12		
53	Wall Skirting	Ceramic		FT	145		



			DOORS			
#	Item	Туре	Description, Manufacturer, SKU	Unit	Quantity Unit Price	Total
1	Exterior Swinging	3' - 0" X 6'-8"		PCS	2	
2	Interior Swinging	2' - 6" X 6'-8"		PCS	2	
3	Interior Swinging	3' - 0" X 6'-8"		PCS	2	
4	Interior Sliding	7' - 4" X 6'-8"		PCS	1	
5	Bifold Door	6' - 0" X 6'-8"		PCS	1	
6	Interior Sliding	6' - 0" X 6'-8"		PCS	2	
7	Exterior Swinging	5' - 0" X 6'-8"		PCS	1	
8	Exterior Door Trim			FT	51.02	
9	Interior Door Trim			FT	337	
10	Entry Lock set			PCS	3	
11	Privacy Lock set			PCS	4	
12	Passage Lock set			PCS	4	
13						
14						
15						



			WINDOWS			
#	Item	Туре	Description, Manufacturer, SKU	Unit	Quantity Unit Price	Total
1	Hung	2' - 3" X 4'-3"		PCS	2	
2	Casment	3' - 3" X 3'-9"		PCS	3	
3	Fixed	3' - 1" X 2'-1"		PCS	2	
4	Fixed	2' - 7" X 2'-7"		PCS	2	
5	Hung	2' - 7" X 3'-9"		PCS	1	
6	Hung	2' - 7" X 3'-1"		PCS	1	
7	Sliding	6' - 3" X 3'-9"		PCS	1	
8	Exterior Window Trim			FT	153	
9	Interior Window Trim			FT	153	
10						
11						
12						
13						
14						
15						



			ROOF 01				
#	Item	Туре	Description, Manufacturer, SKU	Unit	Quantity	Unit Price	Total
1	Roof Covering			SF	1196.0		
2	Roof Covering Fastener			PCS	598		
3	Roof Felt Paper			SF	1196.0		
4	Roof Felt Paper Fastener			PCS	3588.0		
5	Roof Sheathing			SF	1196.0		
6	Roof Sheathing Fastener			PCS	9568		
7	Batten			FT	0.0		
8	Batten Fastener			PCS	0.0		
9	Soffit			SF	94.0		
10	Soffit Fastener			PCS	47.0		
11	Fascia			FT	188.0		
12	Fascia board fastener			PCS	94		
13	Roof Insulation			SF	1196.0		
14							
15							