

HUNTER

The Hunter is a sleek and modern studio home with a compact footprint of 350 square feet. Its exterior features clean lines and a contemporary aesthetic. The white horizontal siding provides a crisp backdrop, while the angled roofline adds visual interest. A covered porch supported by wooden columns creates a welcoming entryway. Inside, the Hunter boasts an open-concept layout, combining the living, kitchen, and sleeping areas into a single, integrated space. This maximizes the use of available space and creates a sense of openness and flow. The bathroom, laundry and other functional areas are thoughtfully positioned for convenience and efficiency.

Materials Shopping List

Please print and take this Materials Shopping List to your favorite Home Depot and ask for assistance in selecting the materials, fixtures and fittings to complete your new home.

Record your selection and the price of the item. Then do the math to determine the cost for your selections and the total cost of finishing your home.

< CLICK HERE >

To Go To Materials Shopping List



FLOOR PLAN





27' - 7" MASTER BED 1 118 SF 10' - 8" CL 2 23 SF 12' - 3" BEDROOM 2 108 SF LIVING 94 SF

TABLE OF CONTENTS

RENDERINGS 1	ABOUT THE HOME	-
FLOOR PLAN 1	SCHEMATIC FLOOR PLAN	─ 01
ABOUT 1	ABOUT FrameUpNow ABOUT HouseDocs	
DESCRIPTIONS 2	BOM (Bill Of Materials)	 02 02 03 04 05 06
MATERIALS LIST	MATERIALS LIST PREVIEW	 0 2

ARCHITECTURAL

HOW TO BUILD

03	COVER SHEET
04	FLOOR PLAN
05	DIMENSION PLAN
06	FOUNDATION PLAN
07	STRUCTURAL FLOOR PLAN
08	WALL FRAME LAYOUT
09	ROOF TRUSS LAYOUT
10	ROOF PLAN -
11	ARCHITECTURAL ELEVATIONS
12	ARCHITECTURAL ELEVATIONS
13	ARCHITECTURAL SECTIONS
14	ARCHITECTURAL DETAILS
15	ARCHITECTURAL CASEWORK

CONSTRUCTION STEPS

COVER SHEET

STRUCTURAL

MECHANICAL

ELECTRICAL

PLUMBING

MATERIALS

SHOPPING LIST

GENERAL NOTES	17
WALL FRAME LAYOUT	18
WALL PANEL & LAYOUT PLAN	19
ROOF TRUSS LAYOUT	20
STRUCTURAL SECTIONS	21
WALL BRACING LAYOUT	22
HOLD-DOWN PLAN	23
STRUCTURAL DETAILS 1	24
STRUCTURAL DETAILS 2	25
STRUCTURAL DETAILS 3	26
TRUSS BLOCKING LAYOUT	27
SHEETROCK BACKING	28
ROOF BRACING LAYOUT	29
COVER SHEET -	30
HVAC PLAN -	31
SCHEDULE -	32
LIGHTING -	33
POWER PLAN	34
DIMENSION FOR LIGHTING -	35
DIMENSION FOR FITTING -	36
NOTES AND SCHEDULES -	37

WATER SUPPLY & SEWAGE SYSTEM # 38

MATERIALS SHOPPING LIST -

ABOUT



FrameUpNow is a design and manufacturing company providing precision-engineered home framing solutions. We offer a catalog of Affordable Homes, Tiny Homes, Garages, Shops and Barndominiums. FrameUpNow manufactures cold-formed steel (CFS) also known as Light Gauge Steel (LGS) framing components that conform to our engineered metal house frame plans or can be purchased as DIY skeleton kits.

The CFS/LGS framing is lightweight, easily assembled, and does not require heavy equipment or specialized labor, enabling homeowners to erect the frame themselves in just a few days. Unlike wood, the steel framing is impervious termites and bores, warping, expansion, and fire.

Our home plans come complete with a structural engineered stamp for permit approvals. Customers receive a full BOM also known as a Materials Shopping List to purchase finish materials from a Building Materials retailer. FrameUpNow prides itself on the quality and efficiency of our precision-engineered home framing solutions for construction professionals and DIY homeowners.



KEY PLAN

NO.	DESCRIPTION	DATE

NOTE:

LEGEND:

PROJECT

79-Hunter-745-2Bd2Ba-**Stone Veneer-550**

DRAWING NAME

INTRODUCTION

CLIENT NAME:
PROJECT NUMBER:
DATE:
DESIGNED BY:
DRAWN BY:
CHECKED BY:

1101

SCALE:

© [2024] [FrameUpNow] . All rights reserved

DISCLAIMER

marketing content.

DISCLAIMER: This documentation and all it's contents are the intellectual property of FrameUpNow. It is provided solely for marketing the services of FrameUpNow. The preliminary information is not approved for actual construction use and is not warranted to be complete or accurate. Unauthorized copying, distribution, or application of these proprietary materials, in any form or format, is strictly prohibited. FrameUpNow assumes no liability for any issues arising from improper use of this

DESCRIPTIONS

MATERIALS LIST

The BOM (Bill Of Materials) package, known as the Materials Shopping List document, provides:

Comprehensive Inventory: Detailed lists of essential materials sourced from architectural, mechanical, HVAC, electrical, and plumbing design drawing sets.

Precise Curation: Each item meticulously selected and organized for accuracy and efficiency in project planning.

Customizable Options: Customers can modify listed items to their preferences and calculate costs accordingly, ensuring alignment with personal project needs and budget.

Dedicated Space for Details: Includes tables for customers to note Home Depot SKU numbers or product descriptions for selected items, facilitating seamless purchasing and coordination with suppliers.

Customer Convenience: Take the list to Home Depot or preferred suppliers for accurate pricing, helping align the total home budget with personal financial plans.

Simplify your construction journey with our Materials Shopping List document, where detailed preparation meets streamlined implementation for your dream home.

Detailed HVAC Floor Plan: Precisely maps out the placement of air

HVAC Sections and Riser Diagrams: Technical drawings offering

critical cross-sectional details and piping schematics, ensuring

proper integration of the heating and cooling system into the home's

Bill of Materials: A complete list of all necessary HVAC components.

handlers, ductwork, and vents throughout the home's layout.

MECHANICAL

structure.

STRUCTURAL

The structural drawings package provides an exhaustive set of detailed plans essential for the precise assembly of your building. This comprehensive package includes:

Framing Plans: Detailed layouts for all framing components. Truss Layouts: Clear instructions for truss placement and

Panel Length Plans: Specifications for panel dimensions. Framing Elevations and Sections: Precise elevation and sectional views for accurate construction.

Truss and Wall Blocking Plans: Plans for truss and wall blocking to ensure structural integrity.

Hold-Down Plan: Detailed hold-down requirements for stability. Snap Sheet: Reference sheet for quick identification of components

Structural Details and Bracing Plans: Complete details and bracing plans for all structural elements.

Accompanying these plans is a comprehensive Bill of Materials (BOM) that lists every necessary building component, from cold formed steel (CFS) frames to fasteners.

ARCHITECTURAL

With the comprehensive architectural package, both builders and DIY homeowners can confidently execute the construction.

The architectural package includes:

Furnished Floor Plans: Complete with furniture layouts for a clear understanding of space utilization.

Detailed Dimension Plans: Ensures precise measurements, from the overall footprint down to the exact placement of windows and

Foundation Plan: Detailed plan to establish a solid foundation.

Wall Framing and Truss Layout: Comprehensive plans for wall framing and truss placement.

Architectural Elevations: Exterior views showcasing the design.

Strategic Building Sections: Critical cross-sectional details for a thorough understanding of the build.

Casework Drawings and Diagrams: Suggested designs for built-in caseworks, such as kitchen cabinets.

ELECTRICAL

The mechanical package includes everything needed to guide HVAC The electrical package includes all the plans and documentation needed to guide the installation of your home's electrical system:

> Detailed Power Plan: Precisely maps out the placement of outlets, switches, and other power components throughout the layout.

Comprehensive Lighting Plan: Shows the optimal locations for lighting fixtures, sconces, and other illumination sources to create a well-lit, functional interior.

Dimensioned Electrical Layout: Provides exact dimensions and measurements to ensure proper placement of all electrical elements.

Bill of Materials: A complete list of every component needed, from circuit breakers to wiring.

The plumbing package includes everything needed to guide the installation of your home's water supply and drainage systems:

Detailed Water Supply System Plan: Precisely maps out the placement of pipes, valves, and plumbing fixtures throughout the

Comprehensive Sewage System Plan: Shows the optimal routing and sizing of drain lines to effectively remove waste and ensure

Detailed Riser Diagrams: Provide information needed to properly

pipes to fixtures.

PLUMBING

proper drainage.

install all vertical plumbing risers and vent stacks.

Bill of Materials: A complete list of every component needed, from


BOM (Bill Of Materials) (Separately Attached)





The Bill of Materials (BOM) is a crucial document that compiles the material requirements from different disciplines into a centralized inventory, enabling efficient procurement, inventory management, and cost estimation for a specified project or

ELECTRICAL BOM



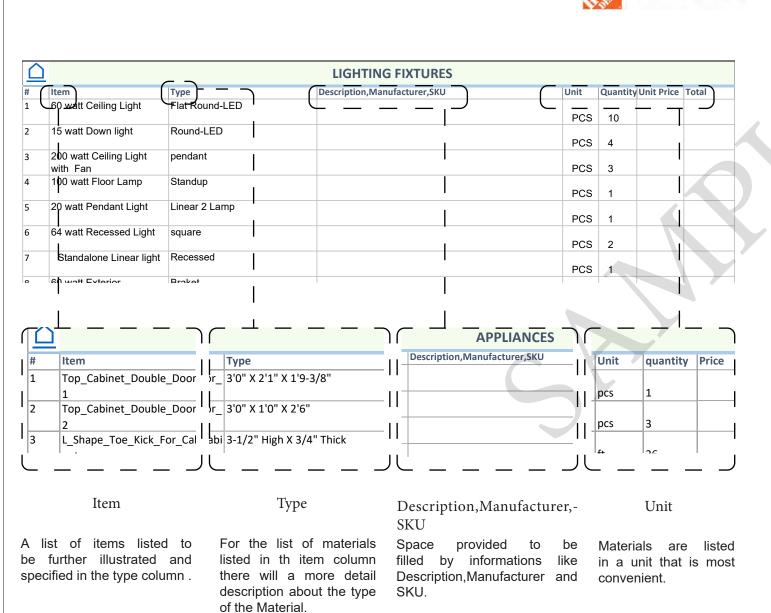

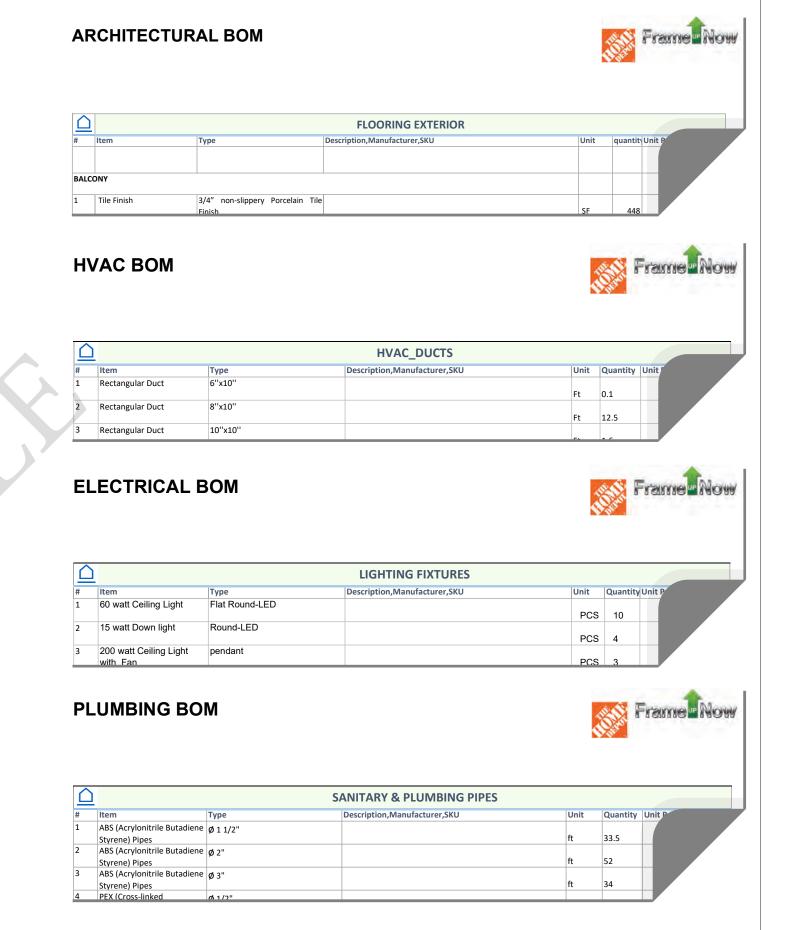

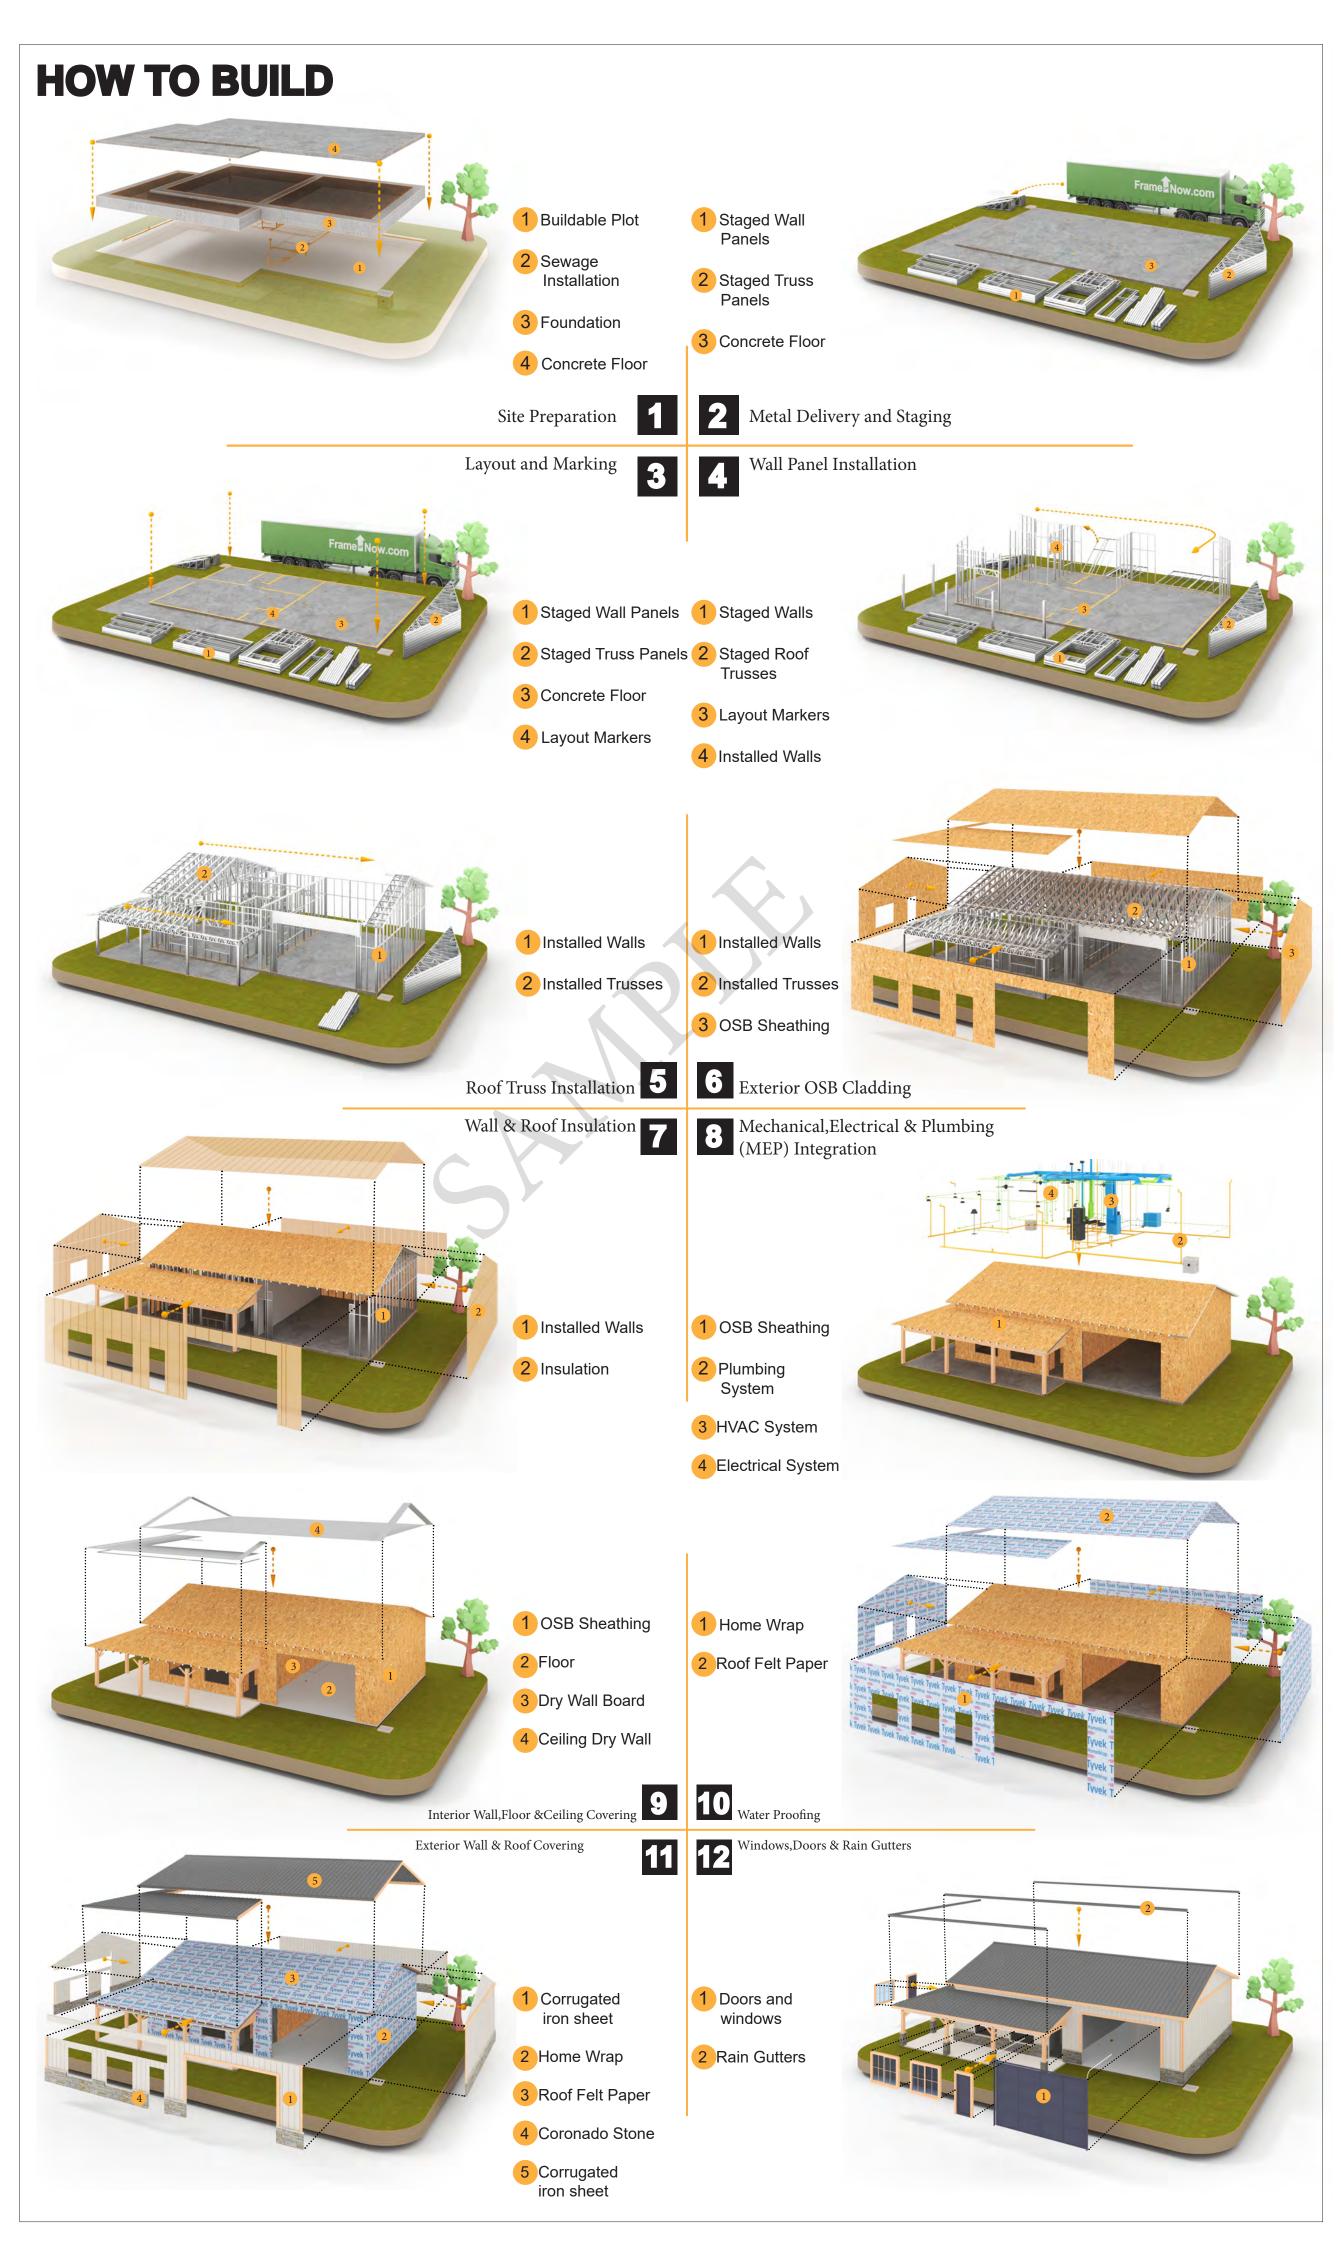



KEY PLAN

NO.	DESCRIPTION	DATE

NOTE:

LEGEND:

PROJECT

79-Hunter-745-2Bd2Ba-**Stone Veneer-550**


DRAWING NAME

INTRODUCTION

CLIENT NAME: PROJECT NUMBER: DATE: **DESIGNED BY** DRAWN BY: CHECKED BY:

1102

SCALE:

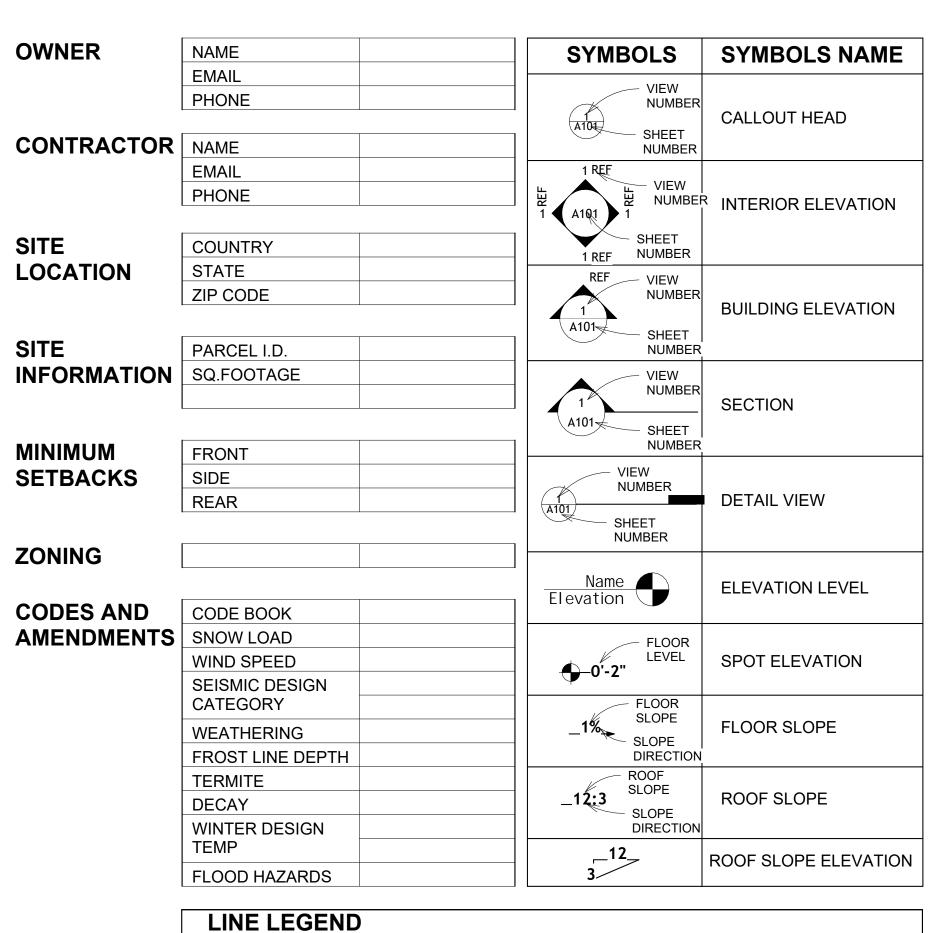

ROOM SEPARATOR

DOOR OPENING DIRECTION -

PAGE INDEX		
G101	COVER SHEET	
A101	FLOOR PLAN	
A102	DIMENSION PLAN	
S101	FOUNDATION PLAN	
S102	STRUCTURAL FLOOR PLAN	
S103	FRAME LAYOUT	
S104	ROOF TRUSS LAYOUT	
A103	ROOF PLAN	
A201	ELEVATIONS	
A202	ELEVATIONS	
A301	SECTIONS	
A401	DETAILS	
A402	CASEWORK DETAILS	
A403	CASEWORK DETAILS	
E101	SCHEDULE	
E102	LIGHTING PLAN	
E103	POWER PLAN	
E104	DIMENSION PLAN FOR LIGHT FIXTURE	
E105	DIMENSION PLAN FOR FITTING	
P101	COVER SHEET	
P102	WATER SUPPLY SYSTEM	
P103	SEWAGE SYSTEM	
P104	RISER DIAGRAM	
M101	HVAC PLAN	
M102	HVAC SECTION	
M103	RISER DIAGRAM	

ABBREVIATION

ASTM D698 | AMERICAN SOCIETY FOR

CASEWORK ELECTRICAL

FOOTINGS

MAXIMUM MECHANICAL

MINIMUM

NUMBER

ON CENTER

PLUMBING

REFERENCE

RIGHT GARAGE

SQUARE FEET

HOLDDOWN

TELEVISION

WASHER/DRYER

AIR HANDLING UNIT

CEILING DIFFUSER

Cubic Feet Per Minute CEILING REGISTER CONDENSING UNIT

COOLING COIL

COLD WATER

EXHAUST AIR

EXHAUST FAN

FAN COIL UNIT

HEATING COIL

INLET VANES

RETURN AIR

RETURN FAN SUPPLY AIR

STATIC PRESSURE

MAXIMUM

MECHANICAL ROOM

FLOOR

EXPANSION TANK

FLEXIBLE CONNECTION

AIR CONDITIONING UNIT

AIR COOLED CONDENSER

SIMP. STHD8 SIMPSON STRAP THE

POLYVINYL CHLORIDE

SPECIAL EQUIPMENT

CONDITIONING

F.F.L

FTG

IRC

IMC

MAX.

MIN.

NO.

O.C

OSB

PVC

UNO

W/D

RCU

HVAC

ACTION FLOOR SYSTEMS

TESTING AND MATERIAL


FINISHED FLOOR LEVEL

TAG	TAG'S NAME
CA01	CASEWORK TAG
1	DOOR TAG
1	FURNITURE TAG
1	WINDOW TAG
SE01	SPECIALTY EQUIPMENT TAG
ME01	MECHANICAL EQUIPMENT TAG
PE01	PLUMBING EQUIPMENT TAG



CUT LINE

CALL OUT BOUNDRY — - — - — - —

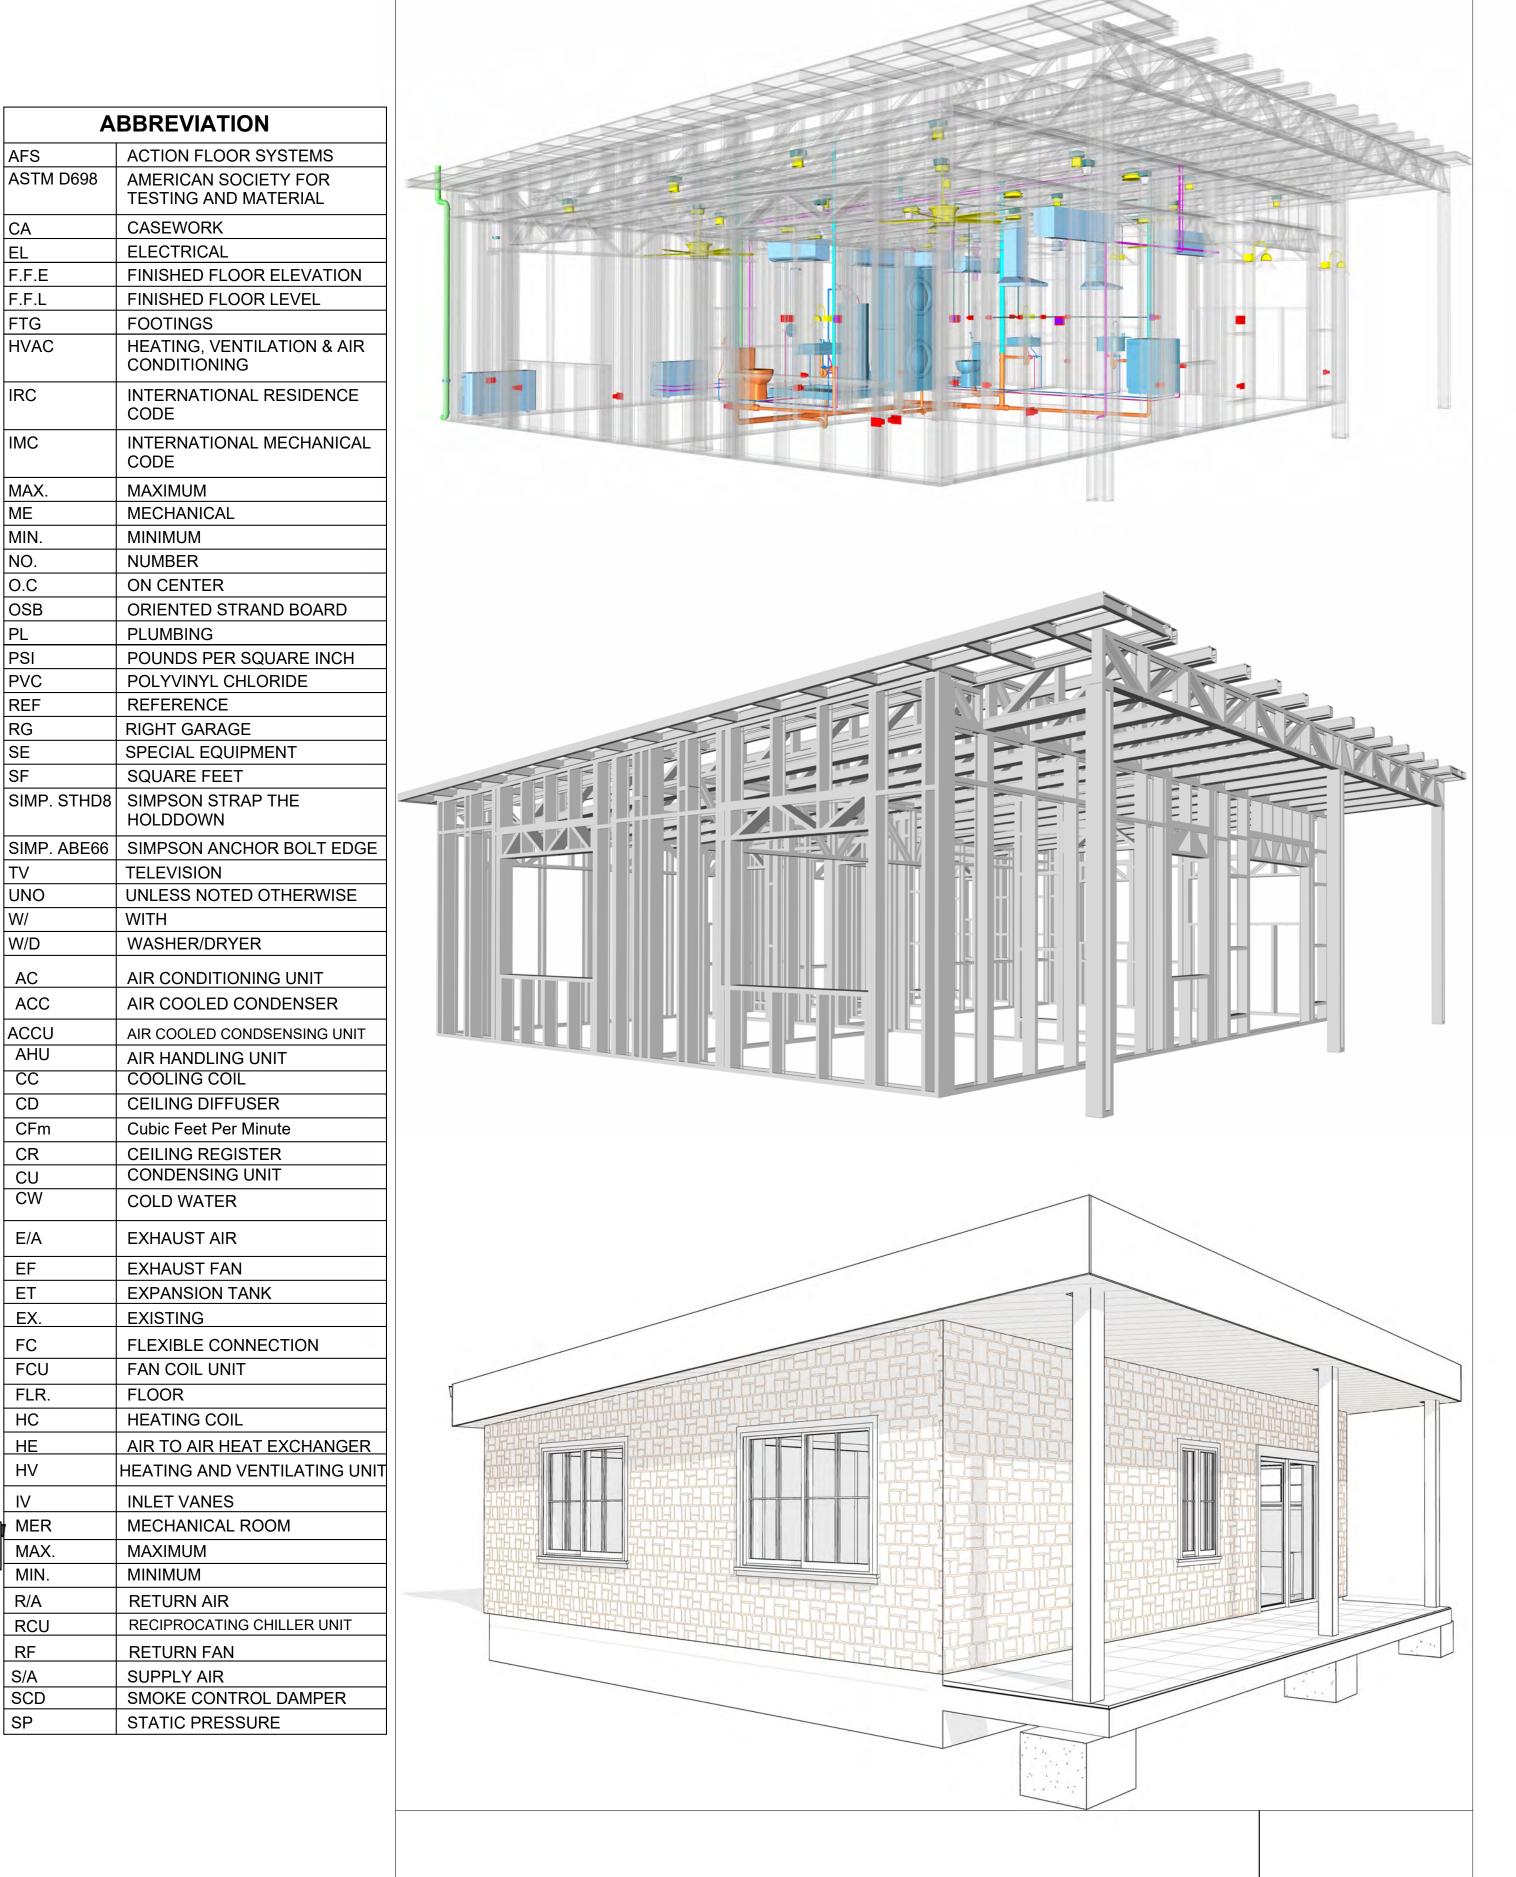


79-HUNTER-745-2BD-2BA-**STONE VENEER-550**

SQUARE FOOTAGE	
LIVING	745
PORCH	136
TOTAL	881



KEY PLAN

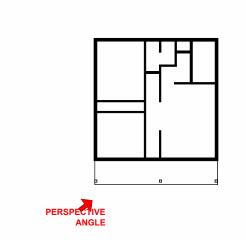

NO.	DESCRIPTION	DATE

NOTE:

PROJECT

79-HUNTER-745-2BD-2BA STONE **VENEER 550**

DRAWING NAME

COVER SHEET

CLIENT NAME:	Client Name
PROJECT NUMBER:	0061_12
DATE:	2/28/2025 1:59:47 PM
DESIGNED BY:	Designer
DRAWN BY:	Author
CHECKED BY:	Checker

G101

GENERAL NOTES

- 1. THIS DRAWING DEPICTS THE ARCHITECTURAL (SPACE LAYOUT, FURNISHING, FLOOR, WALLS, ROOFS, FOUNDATION, WINDOWS AND DOORS) SYSTEMS. IT PROVIDES A VISUAL REPRESENTATION OF THE ARCHITECTURAL LAYOUT AND COMPONENTS.
- THE ARCHITECTURAL DATA AND COMPONENTS.

 THE ARCHITECTURAL DRAWINGS ARE PREPARED TO MEET THE SPECIFIC REQUIREMENTS OF THE BUILDING, AS PER THE PROJECT SPECIFICATIONS AND APPLICABLE CODES AND STANDARDS.
- 3. THE CONSTRUCTION OF THIS HOME SHALL COMPLY WITH THE LATEST EDITION OF THE INTERNATIONAL RESIDENTIAL CODE (IRC), INTERNATIONAL MECHANICAL CODE (IMC), THE INTERNATIONAL PLUMBING STANDARD, THE NATIONAL ELECTRICAL STANDARD AND ALL OTHER APPLICABLE LOCAL, STATE, AND NATIONAL CODES AND REGULATIONS.
- 4. COORDINATION WITH OTHER TRADES HAS BEEN DONE ON A DESIGN LEVEL. THIS DRAWING SHALL BE READ TOGETHER WITH THE ME, EL AND PL DESIGN DRAWINGS TO ENSURE PROPER CONSTRUCTION AND INTEGRATION OF THE BUILDING SYSTEMS.

ABOUT WALLS:

1. SHOWER WALL COVERING

BATHTUB AND SHOWER SPACES (WALLS AND FLOORS) WITH INSTALLED SHOWER HEADS AND IN SHOWER COMPARTMENTS SHALL BE FINISHED WITH A NON-ABSORBENT SURFACE.

2. WALL PAINT (INTERNAL)

THE TYPICAL THICKNESS OF LATEX WALL PAINT IS 1/32 OF AN INCH FOR A SINGLE COAT. AND DOUBLE COAT (1/16") SHALL BE APPLIED FOR DURABILITY.

ADHESIVES:

THE ADVISABLE TYPE OF ADHESIVE FOR THIS PROJECT IS EPOXY ADHESIVES BECAUSE THEY ARE KNOWN FOR THEIR HIGH STRENGTH, DURABILITY, AND RESISTANCE TO MOISTURE, CHEMICALS AND HEAT.


REFER TO SHEETS A201 & A202 FOR GENERAL NOTES ON EXTERNAL FINISHING MATERIALS

ABOUT FLOORS:

- 1. THE SPOT ELEVATION INDICATES THE FINISHED FLOOR ELEVATION.
- 2. FINISHED FLOORS PER PLANS.
- 3. FIELD VERIFY FOR DIMENSION DROP 4" FOR SHOWER AND BATHTUB USE.
- 4. 1% SLOPE ON OUTDOOR BALCONIES FOR WATER RUN OFF.
- 5. 2% SLOPE TOWARDS THE SHOWER DRAIN FOR SUFFICIENT DRAINAGE.
- 6. 4" DROP AT THE DOOR LEADING TO EXTERIOR BALCONY FROM THE MAIN LIVING AREA.
- 5% SLOPE FOR GARAGE IS USED, WHICH SHOULD BE CHECKED WITH THE LOCAL GARAGING ZONING LAWS.

	FURNITURE SCHEDULE		
TYPE MARK TYPE COUNT		COUNT	
1		KING SIZE BED	1
2		THREE SEAT SOFA	1
3		QUEEN 60" X 79"	1

	ROOM FINISH SCHEDULE						
ROOM NUMBE R	ROOM NAME	FLOOR FINISH	BASE FINISH	WALL FINISH	CEILING FINISH	CEILING HEIGHT	COM MEN TS
1	MASTER BED 1	HARDWOOD	CONCRETE	WALL PAINT	DRY WALL	8' - 0"	
2	CL 1	HARDWOOD	CONCRETE	WALL PAINT	DRY WALL	8' - 0"	
3	MASTER BATH	VINYL TILES	CONCRETE	CERAMIC TILE	MRD	8' - 0"	
4	BEDROOM 2	HARDWOOD	CONCRETE	WALL PAINT	DRY WALL	8' - 0"	
5	CL 2	HARDWOOD	CONCRETE	WALL PAINT	DRY WALL	8' - 0"	
6	BATH 2	VINYL TILES	CONCRETE	CERAMIC TILE	MRD	8' - 0"	
7	LIVING	HARDWOOD	CONCRETE	WALL PAINT	DRY WALL	8' - 0"	
8	LAUNDRY	HARDWOOD	CONCRETE	WALL PAINT	DRY WALL	8' - 0"	
9	WH	HARDWOOD	CONCRETE	WALL PAINT	DRY WALL	8' - 0"	
10	KITCHEN	HARDWOOD	CONCRETE	WALL PAINT + CERAMIC	DRY WALL	8' - 0"	
11	PORCH	BALCONY TILE	CONCRETE	EXTERIOR-GRADE PLYWOOD	PLYWOOD	8' - 0"	
12	CL 3	HARDWOOD	CONCRETE	WALL PAINT	DRY WALL	8' - 0"	
13	HALL	HARDWOOD	CONCRETE	WALL PAINT	DRY WALL	8' - 0"	

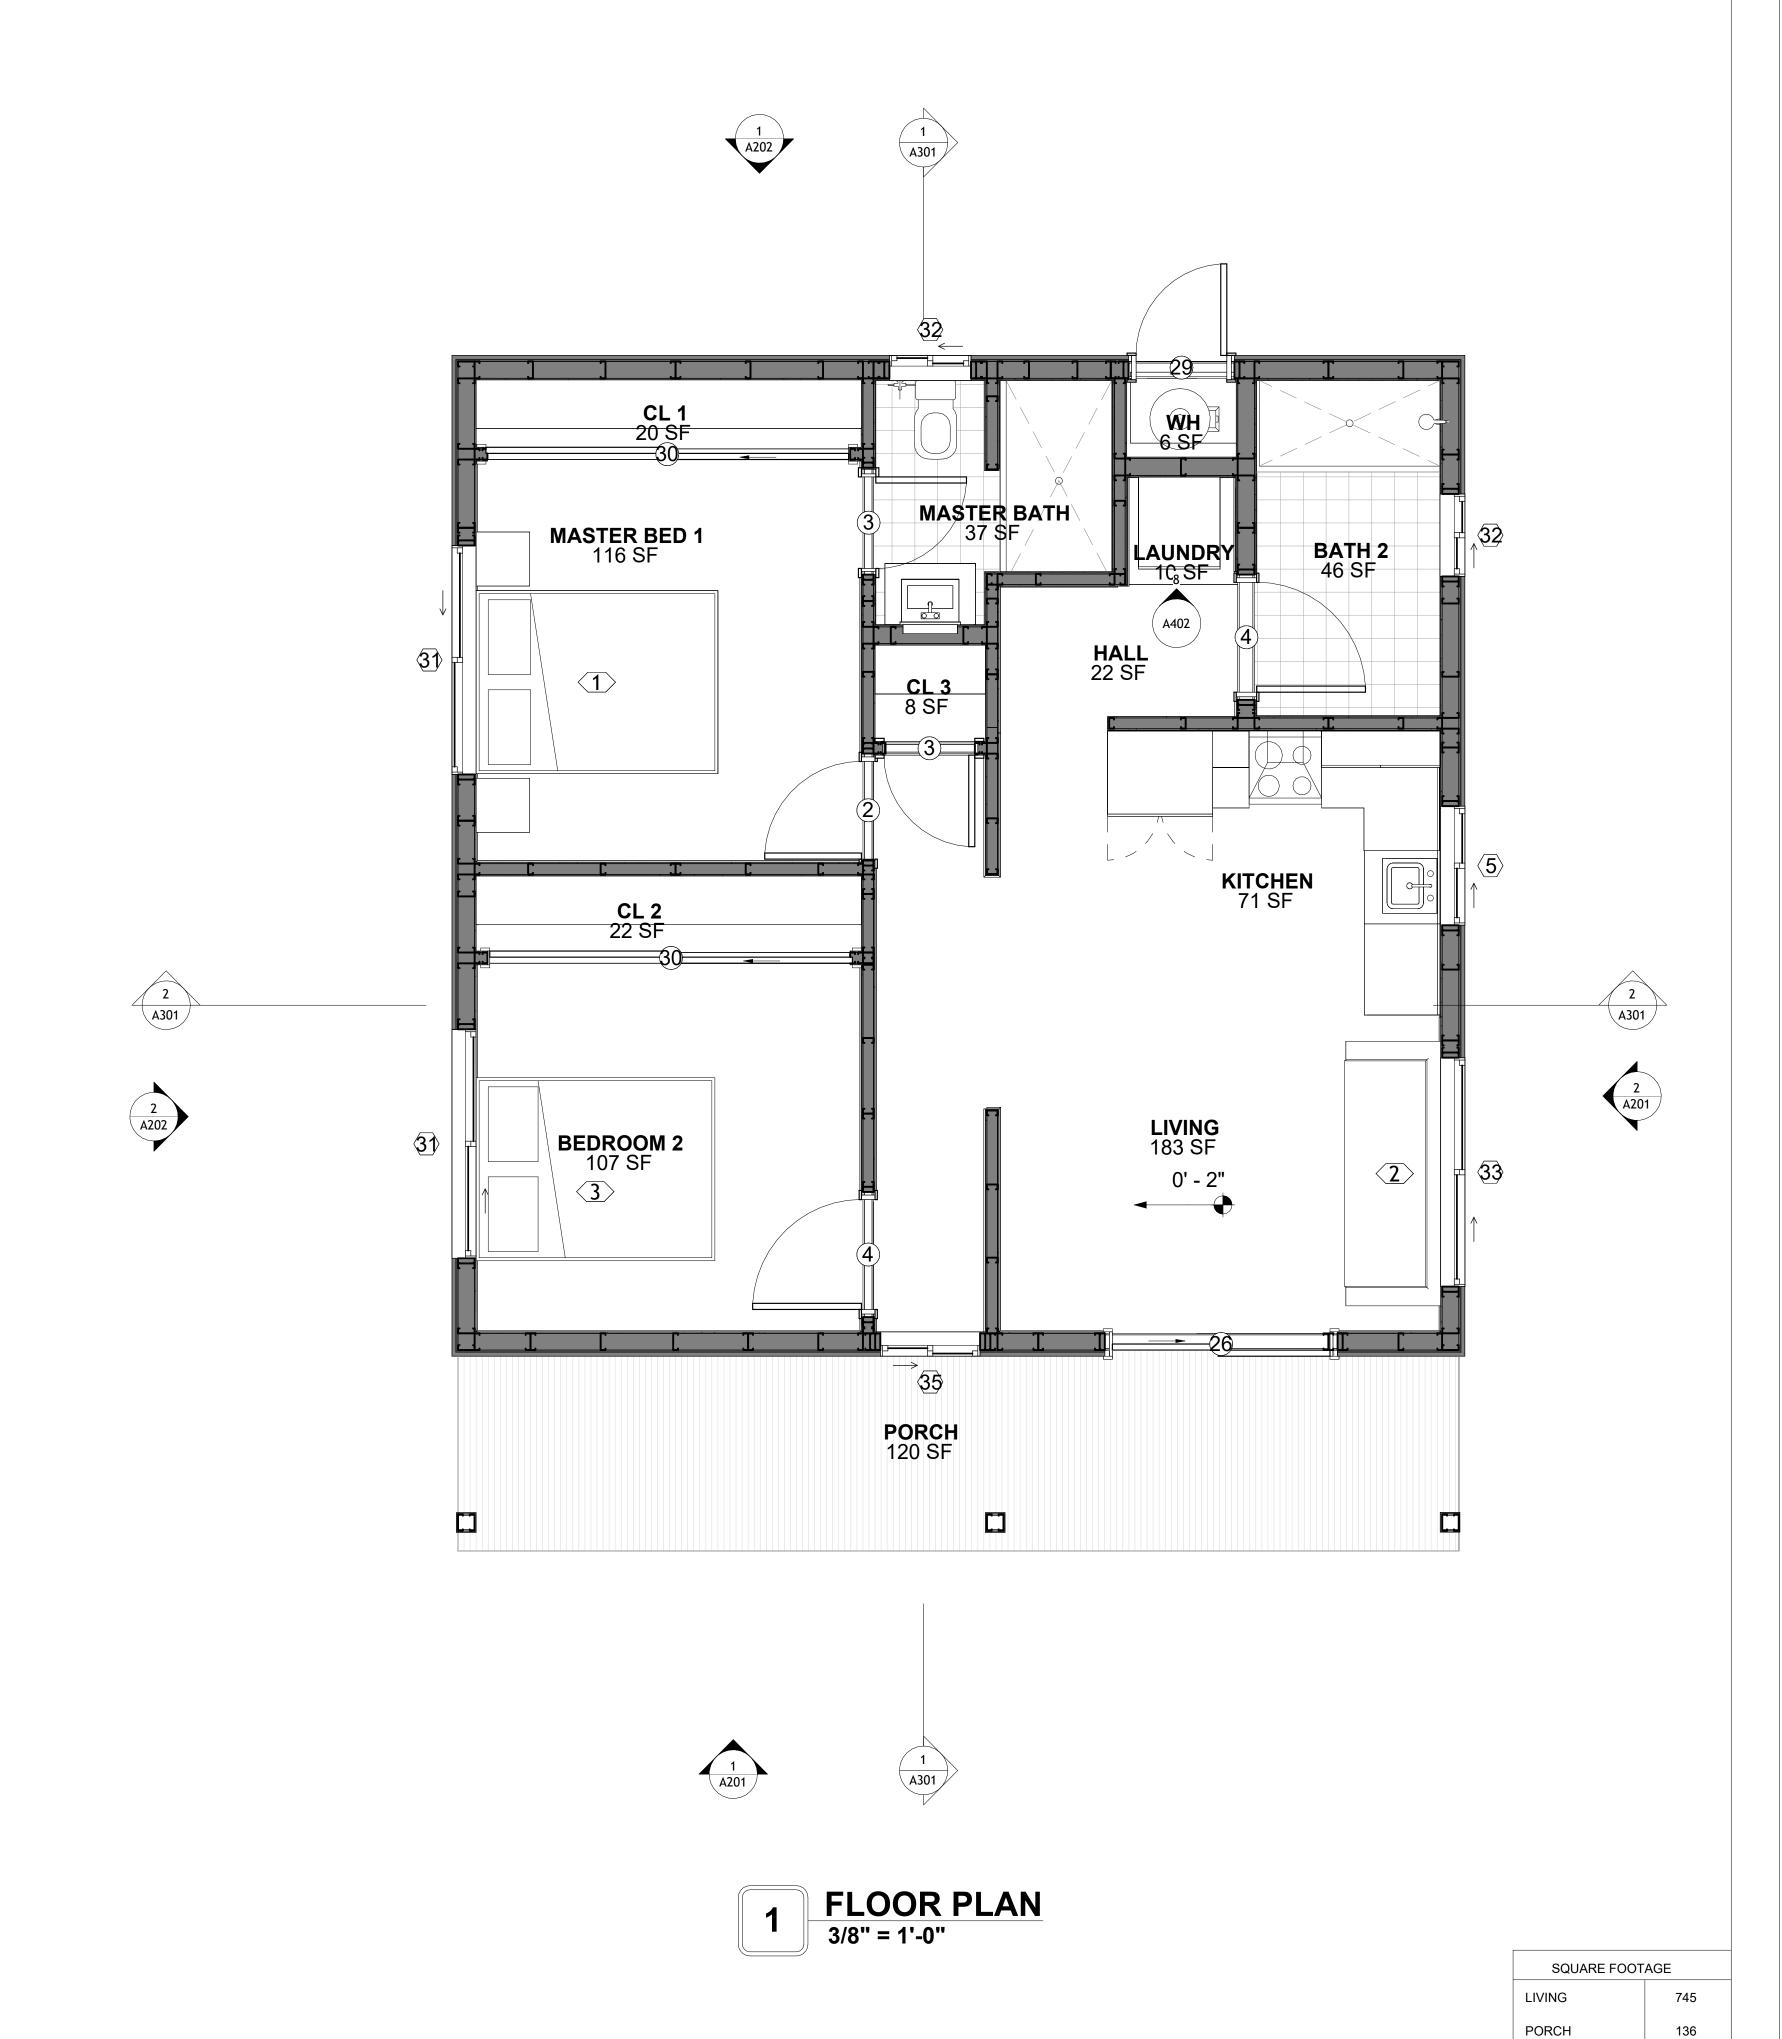



KEY PLAN

NO. DESCRIPTION DATE

NOTE:

LEGEND:

PROJECT

79-HUNTER-745-2BD-2BA STONE VENEER 550

DRAWING NAME

FLOOR PLAN

CLIENT NAME:

Client Name

PROJECT NUMBER:

DATE:

DATE:

DESIGNED BY:

DRAWN BY:

CHECKED BY:


Checker

A101

SCALE: As indicated

TOTAL

881

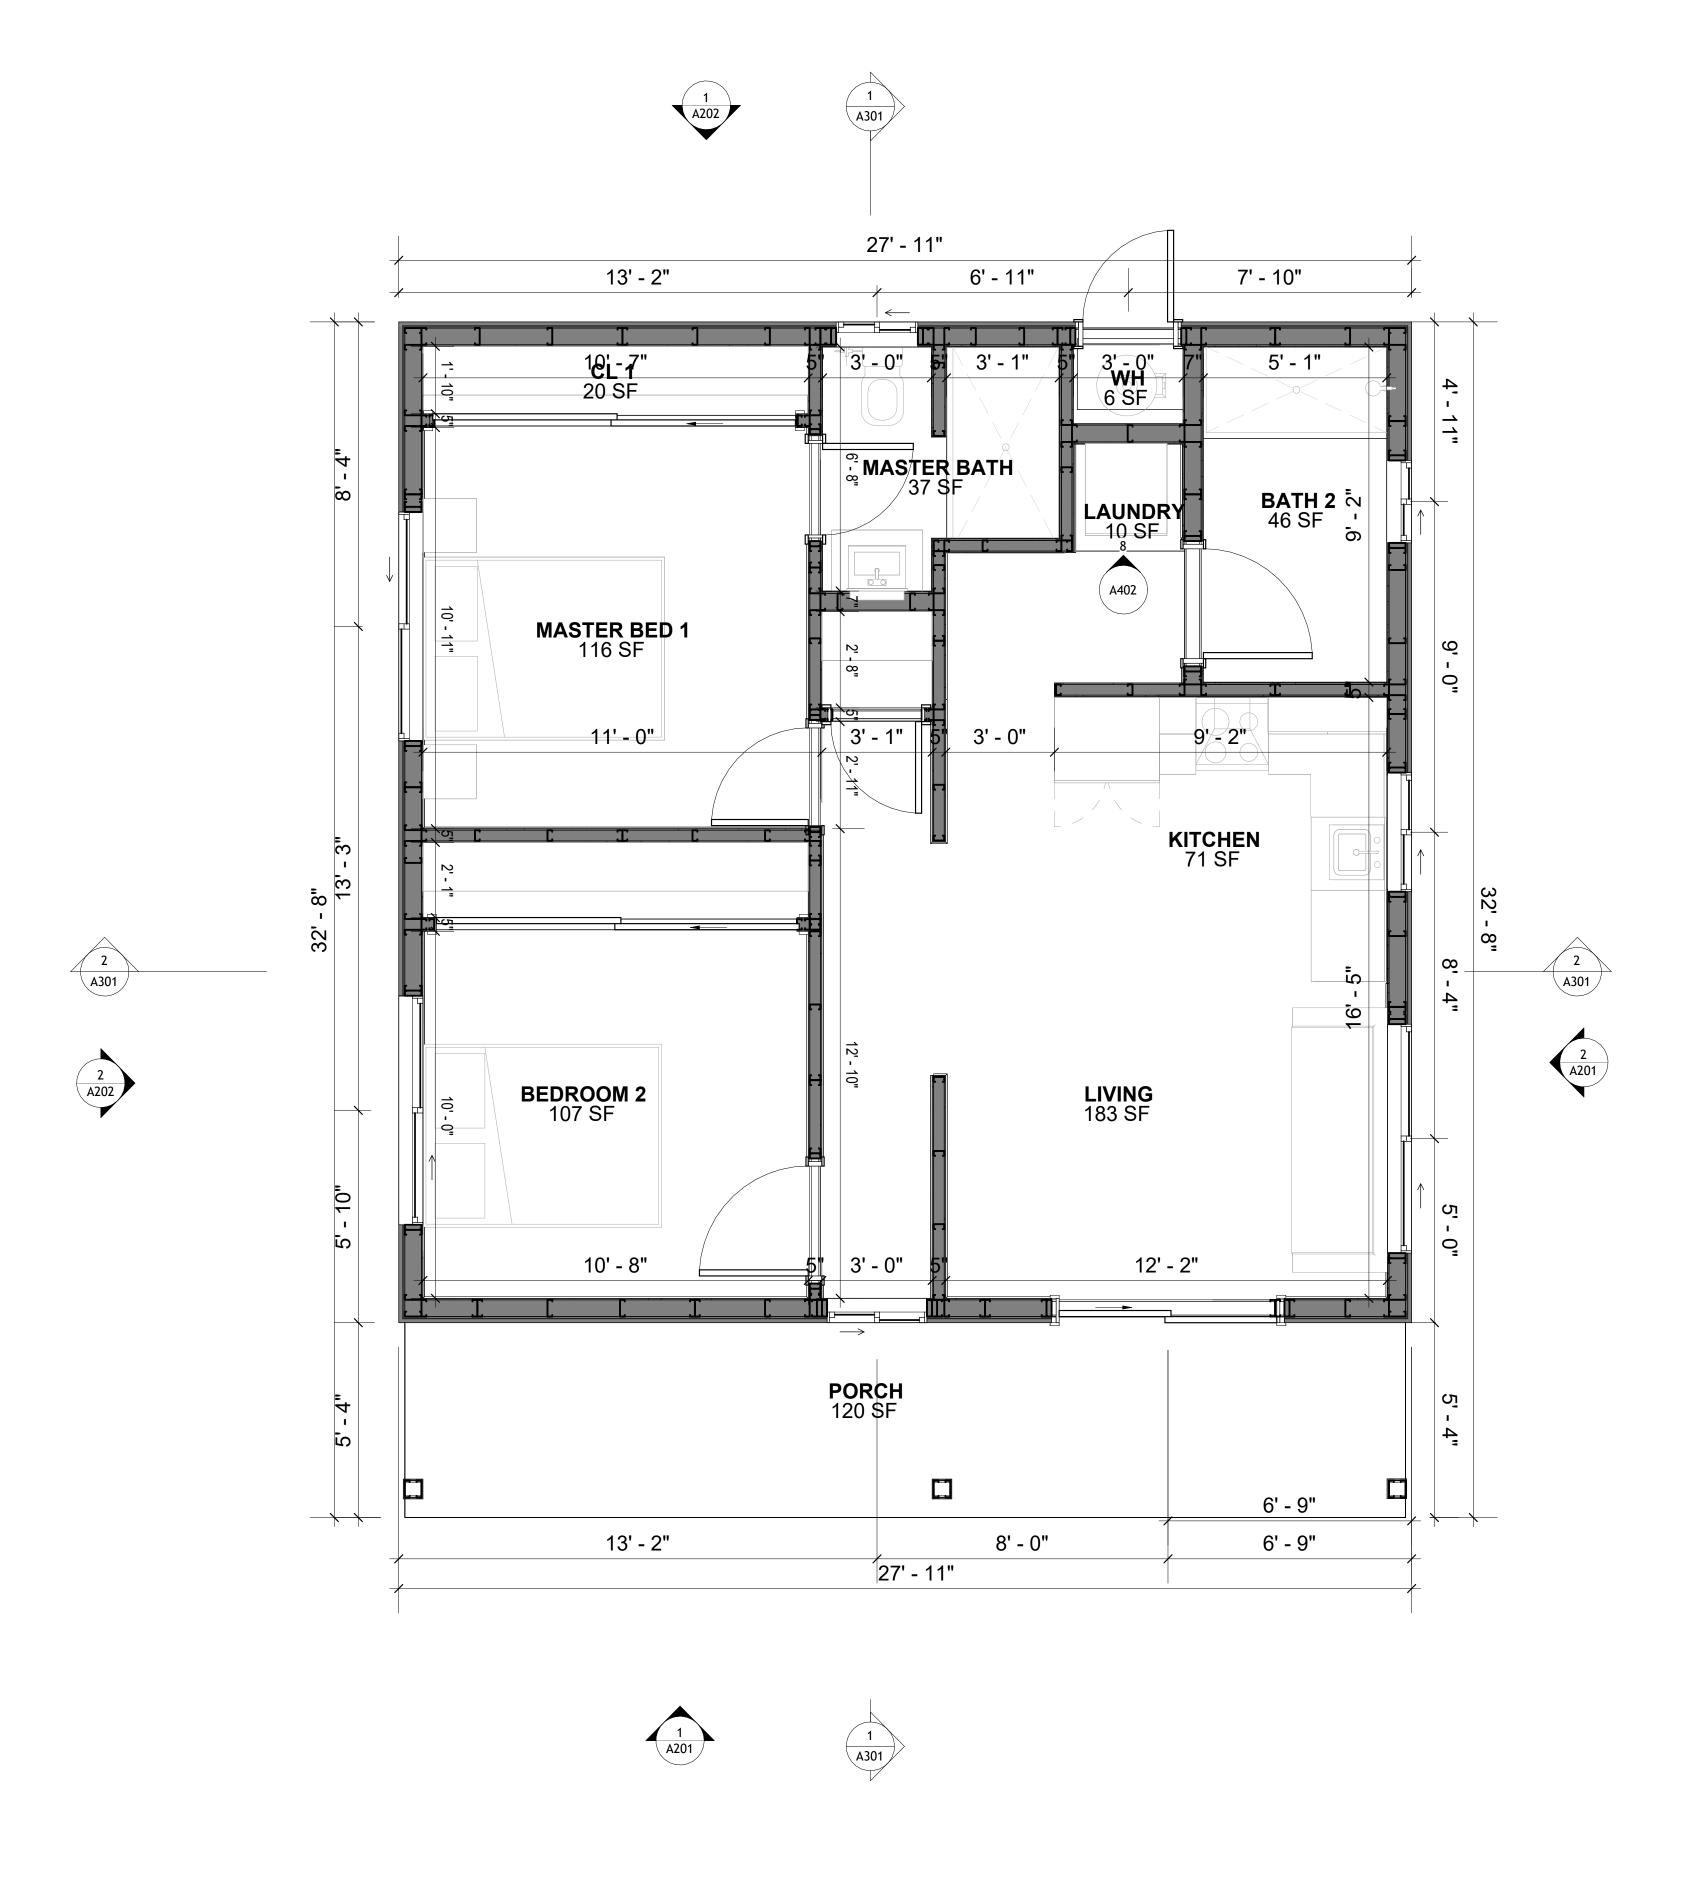

1 FLOOR DIMENSION PLAN
3/8" = 1'-0"

SQUARE FOOTAGE

LIVING 745

PORCH 136

TOTAL 881



KEY PLAN

NO.	DESCRIPTION	DATE

NOTE:

LEGEND:

PROJECT

79-HUNTER-745-2BD-2BA STONE VENEER 550

DRAWING NAME

DIMENSION PLAN

CLIENT NAME:	Client Name
PROJECT NUMBER:	0061_12
DATE:	2/28/2025 1:59:49 PI
DESIGNED BY:	Designer
DRAWN BY:	Author
CHECKED BY:	Checkei

A102

SCALE: 3/8" = 1'-0"

DIMENSIONS IN THE ARCHITECTURAL DRAWINGS CONSIDER FINISHING MATERIALS. FOR PRECISE MEASUREMENTS OF THE STRUCTUAL FRAMING, REFER TO THE ATTACHED STRUCTURAL PLAN SET.

FOUNDATION NOTES

NOTES:

TERMITES PRETREATMENT BY LICENSED CONTRACTOR UNDER SLAB AND AROUND FOOTINGS. ALL AREAS BELOW SLABS SHALL BE TREATED NO MORE THAN 24 HOURS PRIOR TO CONCRETE POUR. EVIDENCE OF TREATMENT MUST BE PROVIDED PRIOR TO PLACING OF CONCRETE.

1. **MATERIALS**:

ALL INTERIOR CONCRETE SLABS SHALL BE A MIN. OF 4" THICK CONCRETE OVER 4" COMPACTED AGGREGATE BASE (ASTM D698), FINISH ELEVATIONS AS NOTED ON DRAWINGS, 6" ABOVE ADJACENT GRADE, LEVEL SLABS TO 1/8"-10' MAX.. CONCRETE SLABS SHALL BE 2500# PSI AT 28 DAYS. A 4" ALLOWABLE SLUMP.

2. **PAD PREPARATION:**

- EXCAVATION FOR FOOTING SHALL BE NEAT.
- FOOTINGS SHALL BE POURED IMMEDIATELY AFTER EXCAVATION AND APPROPRIATE INSPECTION.
- ALL REINFORCING STEEL MARKED "CONTINUOUS" SHALL BE LAPPED 36 BAR DIAMETERS AT SPLICES AND AROUND CORNERS OR INTERSECTIONS WITH A STANDARD 90 DEGREE BEND ON CORNER BARS. LAP WIRE MESH ONE FULL MESH AT SIDE AND END LAPS.
- ALL HARDWARE TO BE SIMPSON OR EQUIVALENT.
 EXTERIOR FRAME WALL TO BE SECURED WITH 1/2"X10" ANCHOR BOLTS 4'-0" O.C. FOR 1-STORY AND 2'-8" O.C. FOR 2-STORY. BOLTS SHALL BE LOCATED WITHIN 1'-0" OF EACH END PIECE AND SHALL HAVE A MIN. OF TWO BOLTS PER PIECE.
- -FOUNDATION ANCHOR STRAPS SHALL BE PERMITTED, ACCORDING TO RESIDENTIAL CODE
- ALL INTERIOR WALLS TO BE SECURED WITH POWER DRIVEN PINS PER MANUFACTURER
- SPECIFICATION USE PIN SPACING EQUIVALENT TO 1/2" ANCHOR BOLTS.
 ALL CONSTRUCTION TO CONFORM TO THE 2012 IRC
- R-10 RIGID INSULATION OUTSIDE OF EXTERIOR FOUNDATION WALLS UNDER LIVING AREA.
 CONCRETE PAD FOR CONDENSER THICKNESS IS 4" MIN UNLESS OTHERWISE NOTED.

3. CONCRETE CONSTRUCTION:

- THE SLAB SHALL BE UNDERLAIN BY A VAPOR BARRIER/RETARDER IN THE LIVING AREA (TYPICALLY POLYETHYLENE, UNLESS MORE STRINGENT PROTECTION REQUIRED BY THE ARCHITECT, ENGINEER, FLOOR COVERING MANUFACTURER, OR ACCEPTED PRACTICE). UNLESS OTHERWISE REQUIRED, BARRIER MAY BE OMITTED AT GARAGES, PORCHES AND PATIOS WITHOUT FLOOR COVERINGS. IT IS BEYOND THE SCOPE OF THESE PLANS TO DETERMINE THE APPLICABILITY OF THESE MORE STRINGENT REQUIREMENTS. BUILDER SHALL VERIFY PRIOR TO CONSTRUCTION.

4. REINFORCEMENT:


- IF CONSTRUCTED ON ACTIVE SOILS, THE LONG TERM PERFORMANCE OF THE FOUNDATION IS DEPENDENT ON MAINTENANCE BY THE OWNER. THUS THE BUILDER SHALL ADVISE THE OWNER OF THE FOLLOWING:
- 1. DRAINAGE MUST BE MAINTAINED. WATER SHALL NEVER BE ALLOWED TO POND NEAR THE FOUNDATION.
- 2. THE SOIL AROUND THE FOUNDATION SHALL BE MAINTAINED IN A RELATIVELY DAMP CONDITION, SUCH AS THAT REQUIRED TO KEEP A LAWN GREEN. IF IT DRIES OUT IT WILL SHRINK. IF IT GETS WET, IT WILL HEAVE UPWARD.
- 3. SLABS ON THE SHORTER SIDE USES MAIN BARS ARE USED IN THIS DIRECTION ONLY WITH SMALLER DIAMETER DISTRIBUTION BARS ARE PLACED, FORMING A MAT OR GRID.
- ALL REINFORCEMENT BARS SIZE 10MM OR LARGER IN ACCORDANCE TO ASTM
 ANCHOR BOLTS AT ALL EXTERIOR WALLS SHALL BE MINIMUM 1/2 INCH DIAMETER WITH A
- MAXIMUM SPACING OF 6'-0" ON CENTER, UNLESS NOTED OTHERWISE.

 4. ANCHOR BOLTS SHALL BE INSTALLED WITHIN 12 INCHES OF EACH END OF EACH SILL
 PLATE WITH AT LEAST TWO ANCHOR BOLTS FOR EACH BOLTS FOR EACH SILL PLATE LONGER
 THAN 12 INCHES.
- 5. SIMPSONS SILL ANCHORS MAYBE SUBSTITUTED FOR ANCHOR BOLTS AT THE SAME SPACING.
- 6. EXTERIOR CONCRETE SLABS WHICH ARE NOT PART OF THE MAIN SLAB SHALL BE MINIMUM 4 INCHES THICK WITH NO STEEL REINFORCING BARS REQUIRED, UNLESS NOTED OTHERWISE ON FOUNDATION PLAN.

VERIFY THE FOLLOWING PRIOR TO POURING:

- 1. ALL HOLDDOWNS , STRAP, AND POST LOCATIONS.
- 2. CONCRETE FINISHES. PANEL RISER LOCATION WHERE APPLICABLE.
- 3. UNDERSLAB MECHANICAL REQUIREMENTS.4. STEM WALL BLOCKOUTS.
- 5. UNDERSLAB ELECTRICAL REQUIREMENTS AND PANEL RISER LOCATION. WHERE
- APPLICABLE.
- 6. PROVIDE THE FOLLOWING:
- PVC SLEEVES THROUGH FTG IF REQUIRED
- 20' #4 COPPER GROUND BAR.. SLOPE FINISH GRADE AWAY FROM FOOTING.

NOTE: FIELD VERIFY ALL DIMENSIONS SEE DIMENSIONED ARCHITECTURAL DRAWINGS

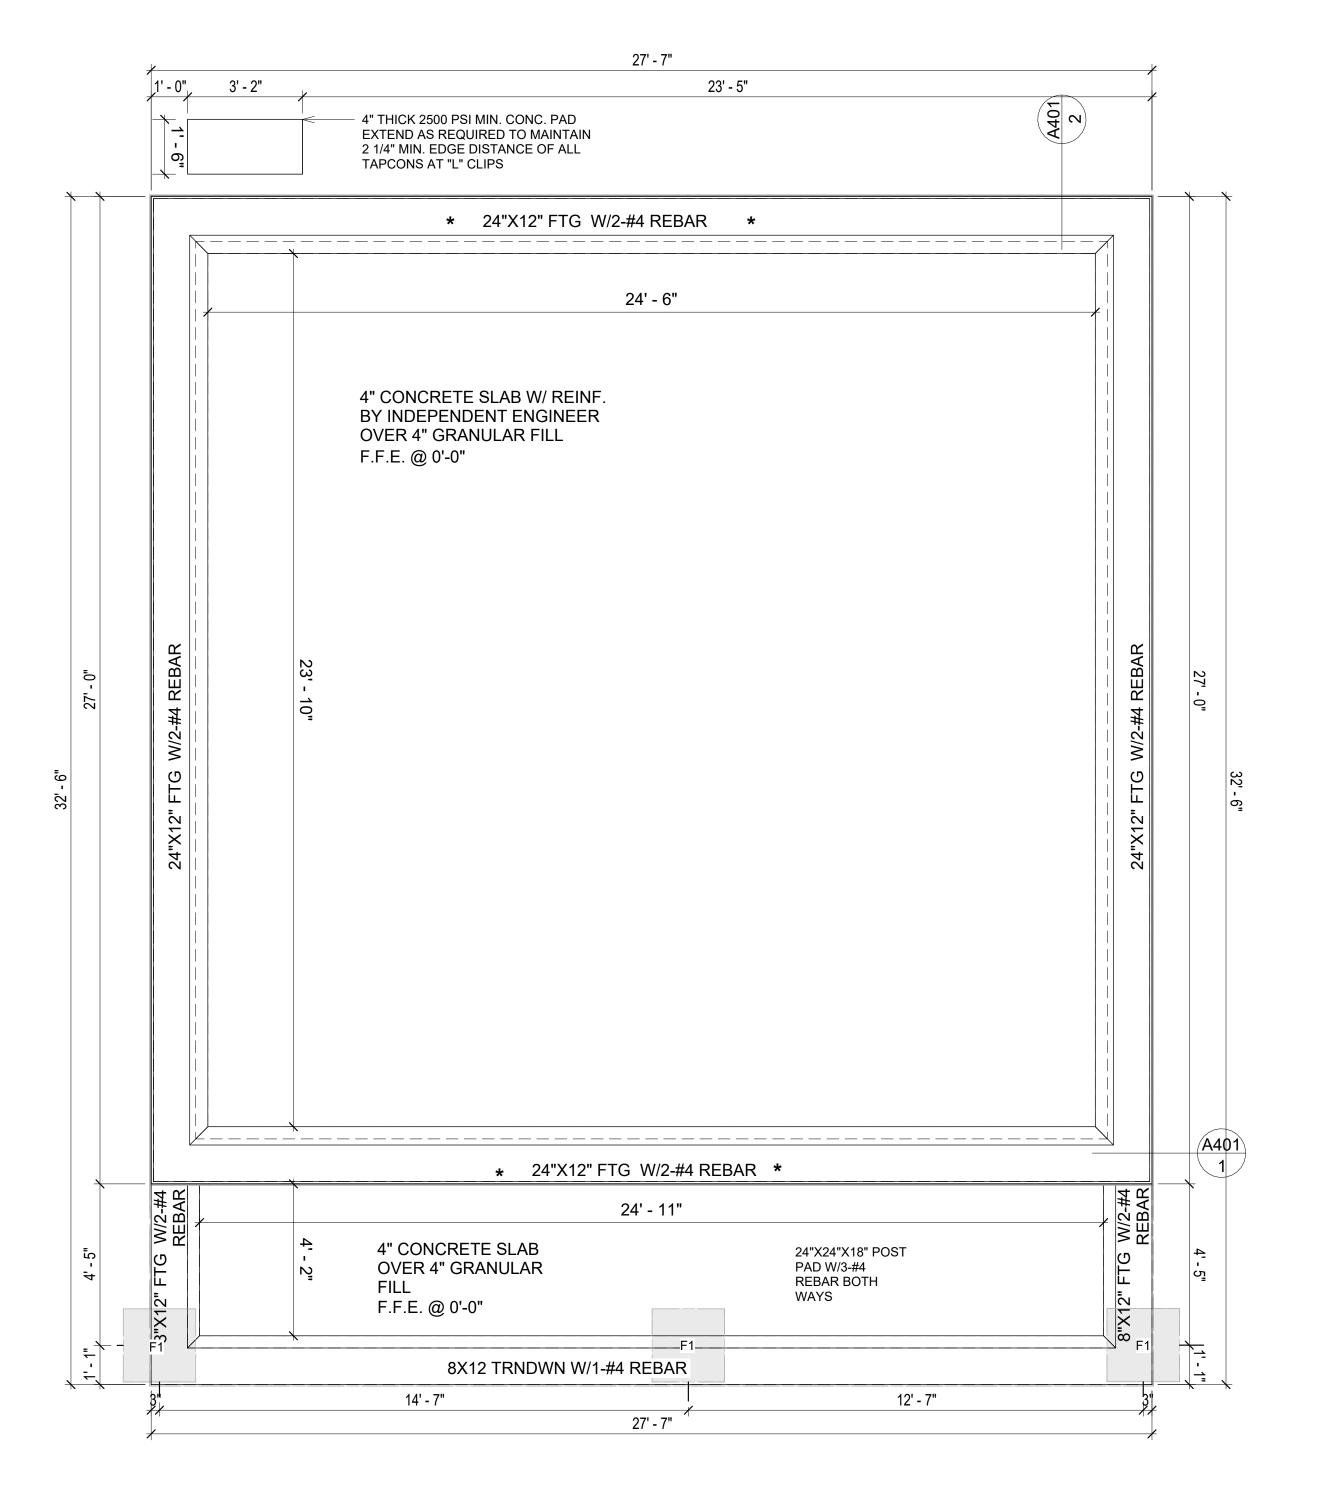

1 FOUNDATION PLAN
3/8" = 1'-0"



KEY PLAN

NO.	DESCRIPTION	DATE

NOTE:

LEGEND:

PROJECT

79-HUNTER-745-2BD-2BA STONE VENEER 550

DRAWING NAME

FOUNDATION PLAN

CLIENT NAME:	Client Name
PROJECT NUMBER:	0061_12
DATE:	2/28/2025 1:59:50 PM
DESIGNED BY:	Designer
DRAWN BY:	Author
CHECKED BY:	Checker

S101

SCALE: 3/8" = 1'-0"

SQUARE FOOTAGE

LIVING 745

PORCH 136

TOTAL 881

GENERAL NOTES

-ALL BEARING WALLS SHOULD HAVE A THICKENED SLAB PER SECTION PER DETAIL A401/5.

A) **FOUNDATION PLAN NOTES**:

- 1. CONCRETE SLAB SHALL BE 6" THICK WITH 1/2" DIAMETER TENDONS PER LAYOUT PLAN, CENTERED IN SLAB THICKNESS, OVER APPROVED SUBBASE PER GENERAL STRUCTURE
- 2. TERMITE PROTECTION SHALL BE PROVIDED PER IRC SECTION R318.1
- NONE TYPICAL ANCHOR BOLT SPACING AT SHEAR WALL AND HOLD DOWN
- SPECIFICATIONS PER APPROVED ARCHITECTURAL PLANS.
- 4. INSTALL HOLDOWNS BEFORE CONCRETE SLAB POUR. 5. EXISTING FILL ON-SITE SHALL BE COMPACTED IN ACCORDANCE WITH THE
- REQUIREMENTS IN THE GEOTECHNICAL REPORT.
- 6. ALL FLOOR SLABS ARE REINFORCED ON CONCRETE SLABS.


SPECIAL INSPECTION IS REQUIRED FOR THICKENED FOUNDATION CONSTRUCTION


- 1. REINFORCEMENT
- 2. 2300 PSI CONCRETE POUR

B) REINFORCEMENT FOR CONCRETE:

- 1. ALL REINFORCING SLABS BARS SIZE 10MM OR LARGER SHALL BE DEFORMED IN ACCORDANCE TO ASTM-A706, AND BARS SMALLER THAN 10 MM MAYBE PLAIN.
- 2. UNLESS OTHERWISE NOTED IN PLANS, THE YIELD STRENGTH OF REINFORCING BARS SHALL BE:
 - A) FOOTING = 40,000 PSI
 - B) NON-LOAD BEARING WALLS AND PARAPETS= 40,000 PSI
- 3. SPLICES SHALL BE SECURELY WIRED TOGETHER AND SHALL LAP OR EXTEND
- GRADE OF STEEL FOR RCC WORKS SHALL BE GRADE 4 10.
- 5. BAR NOTATIONS GIVES INFORMATION
- A) BAR SIZE
- B) SPACING(IF REQUIRED)
- 6. LAP REINFORCEMENT ONLY AT LOCATION SHOWN IN THE DRAWINGS
- REINFORCEMENT SHALL NOT BE CUT, VENT OR HEATED ON SITE WITHOUT ENGINEERS' APPROVAL.
- C) CONCRETE SLAB NOTES
- 1. ALL SLAB REINFORCEMENT SHALL BE 20MM CLEAR MINIMUM FROM BOTTOM AND FROM TOP OF SLAB.
- 2. REINFORCEMENT IN CONTINUOUS ELEVATED SLAB SHALL BE CUT AS FOLLOWS.

- THIS IS A SCHEMATIC PLAN FOR THE PURPOSE OF LOCATING AND IDENTIFYING FOUNDATION REINFORCING ELEMENTS ONLY. VERIFY ALL DIMENSIONS, DROPS, OFFSETS AND FEATURES WITH THE ARCHITECTURAL PLANS BEFORE FORMING THE FOUNDATION.

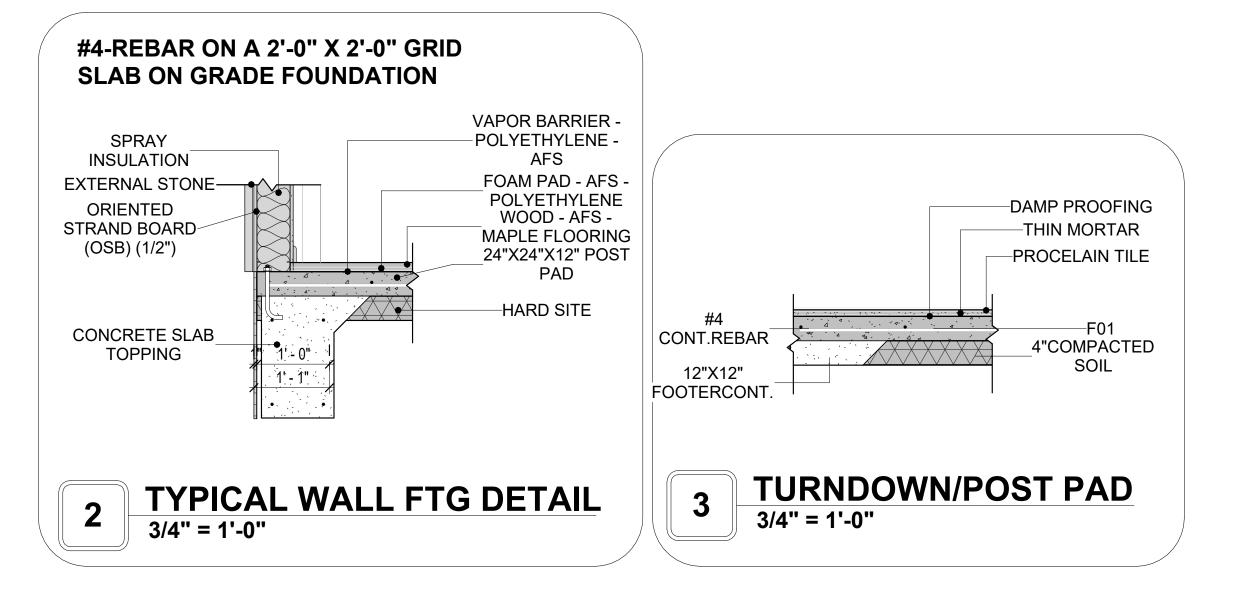

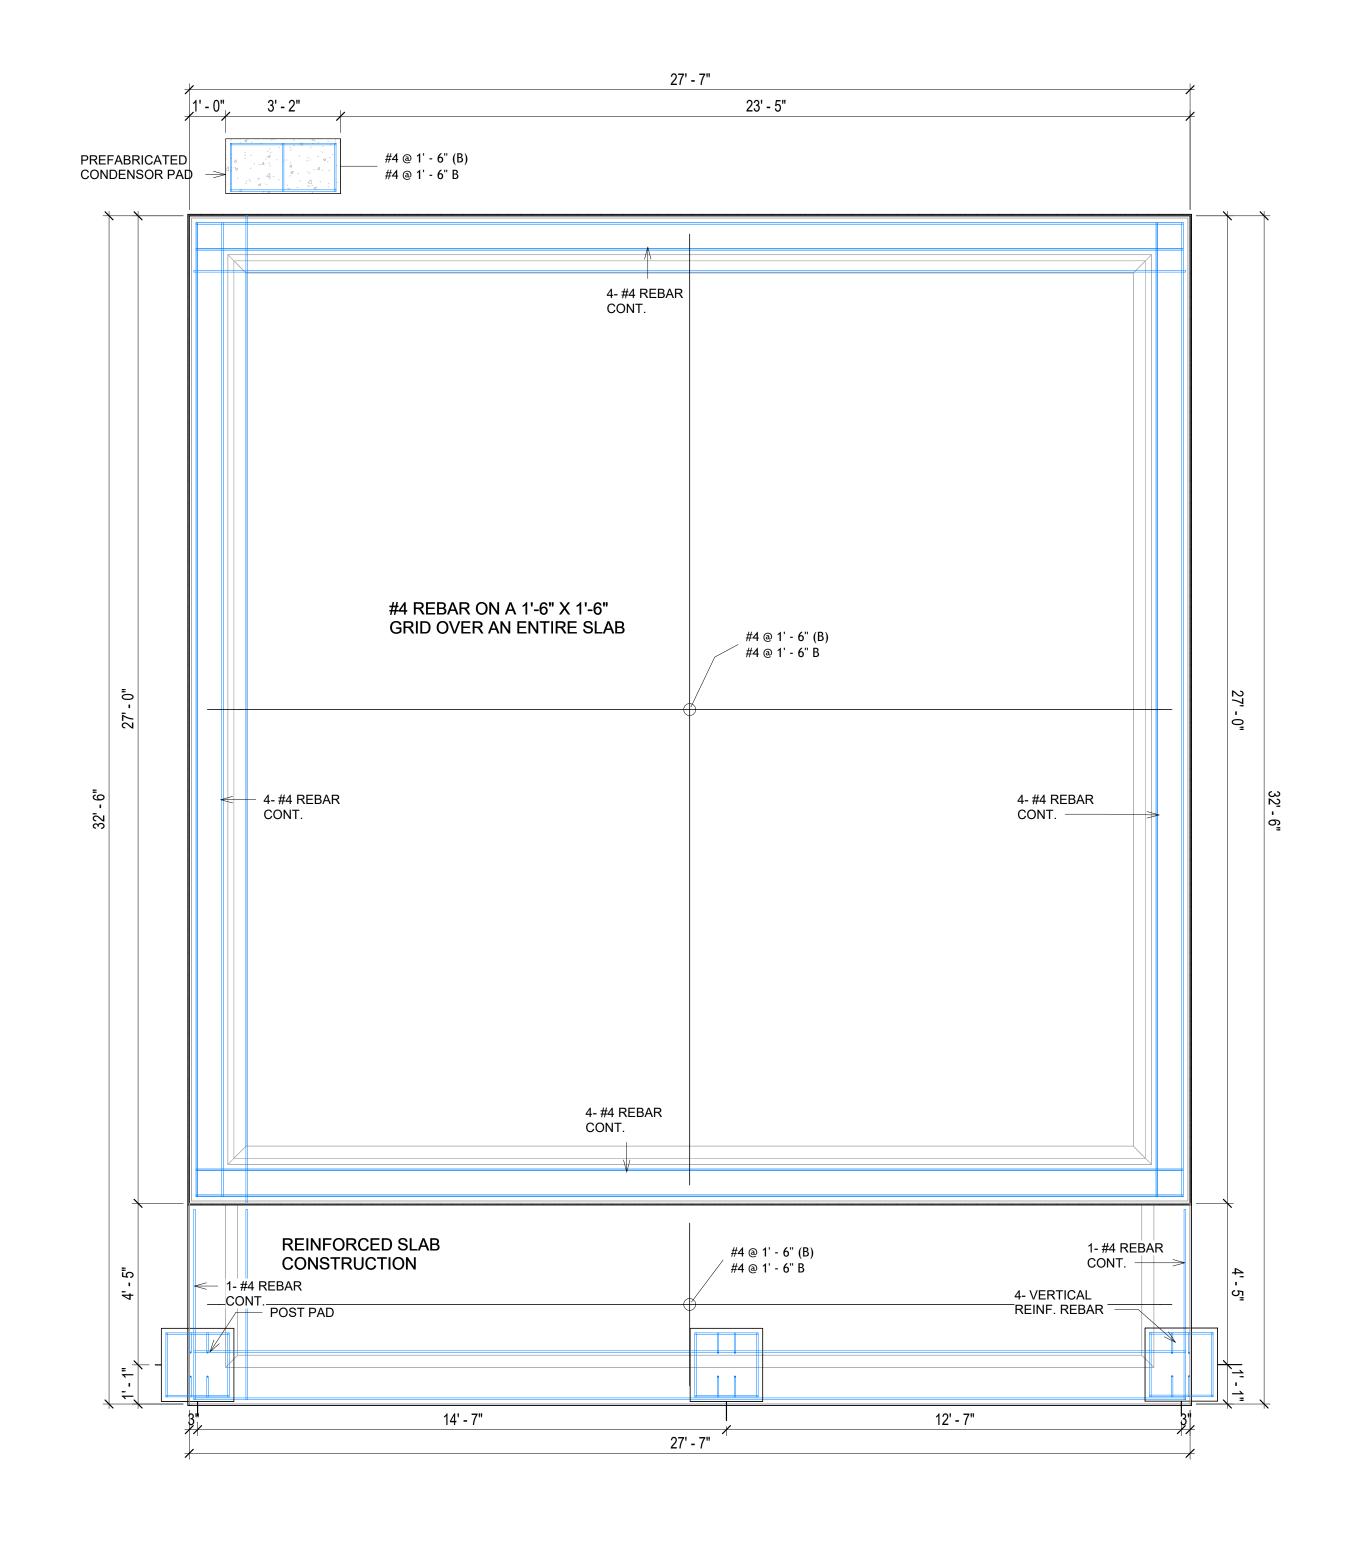

FOUNDATION REBAR PLAN 3/8" = 1'-0"



KEY PLAN

DESCRIPTION DATE NOTE:

LEGEND:

PROJECT

79-HUNTER-745-2BD-2BA STONE **VENEER 550**

DRAWING NAME

STRUCTURAL FLOOR PLAN

CLIENT NAME: Client Name PROJECT NUMBER: 0061_12 DATE: 2/28/2025 1:59:51 PM Designer DESIGNED BY: **Author** DRAWN BY: CHECKED BY: Checker


S102

ROOF NOTES

- 1. ROOFING COMPOSITION ROOFING PER OWNERS/BUILDERS SPECIFICATIONS INSTALL PER MANUFACTURE SPECIFICATIONS ON 1/2" ORIENTED STRAND BOARD ON PRE-ENGINEERED TRUSS @ 24" O.C. (UNO.)
- 73" OVERHANG AT EAVES (UNO.)
 ENDS OF ALL TRUSSES AND JOISTS TO BE FULLY BLOCKED. PROVIDE SOLID
- BLOCKING AT ALL RIDGES AND VALLEYS
- 4. SHEATHING TO BE 1/2", 3/8" OSB SHEAR PANEL AND EQUIVALENT. UNDERSIDE OF PORCH TRUSSES TO BE FINISHED WITH MOISTURE RESISTANT DRYWALL, TAPED AND TEXTURED.
- 5. EXPOSED EAVES AND OTHER WEATHER EXPOSED AREAS TO BE SHEATHED WITH EXTERIOR GRADE PLYWOOD.
- 6. ALL MATERIALS THICKNESS AND SIZE ARE THE MINIMUM. Refer TO LOCAL
- STANDARDS FOR ACTUAL THICKNESS AND LAYERING OF MATERIALS.
 7. ENGINEERED TRUSS CALCULATIONS TO BE SUBMITTED TO BUILDING
- DEPARTMENT PRIOR TO FABRICATION AND INSTALLATION.

 8. TRUSS MANUFACTURER TO SPECIFY HANGER CONNECTORS FOR TRUSS
- COMPONENTS (TYPICAL)

 9. DESIGNER ASSUMES THAT TRUSSES BEAR ON ALL EXTERIOR PERIMETER
- WALLS (TYPICAL) OR BEAMS.
- 10. PROVIDE GALVANIZED STEEL FLASHING WITH A LENGTH OF 10 FEET, WIDTH OF 12 INCHES, AND THICKNESS OF 24 GAUGE.

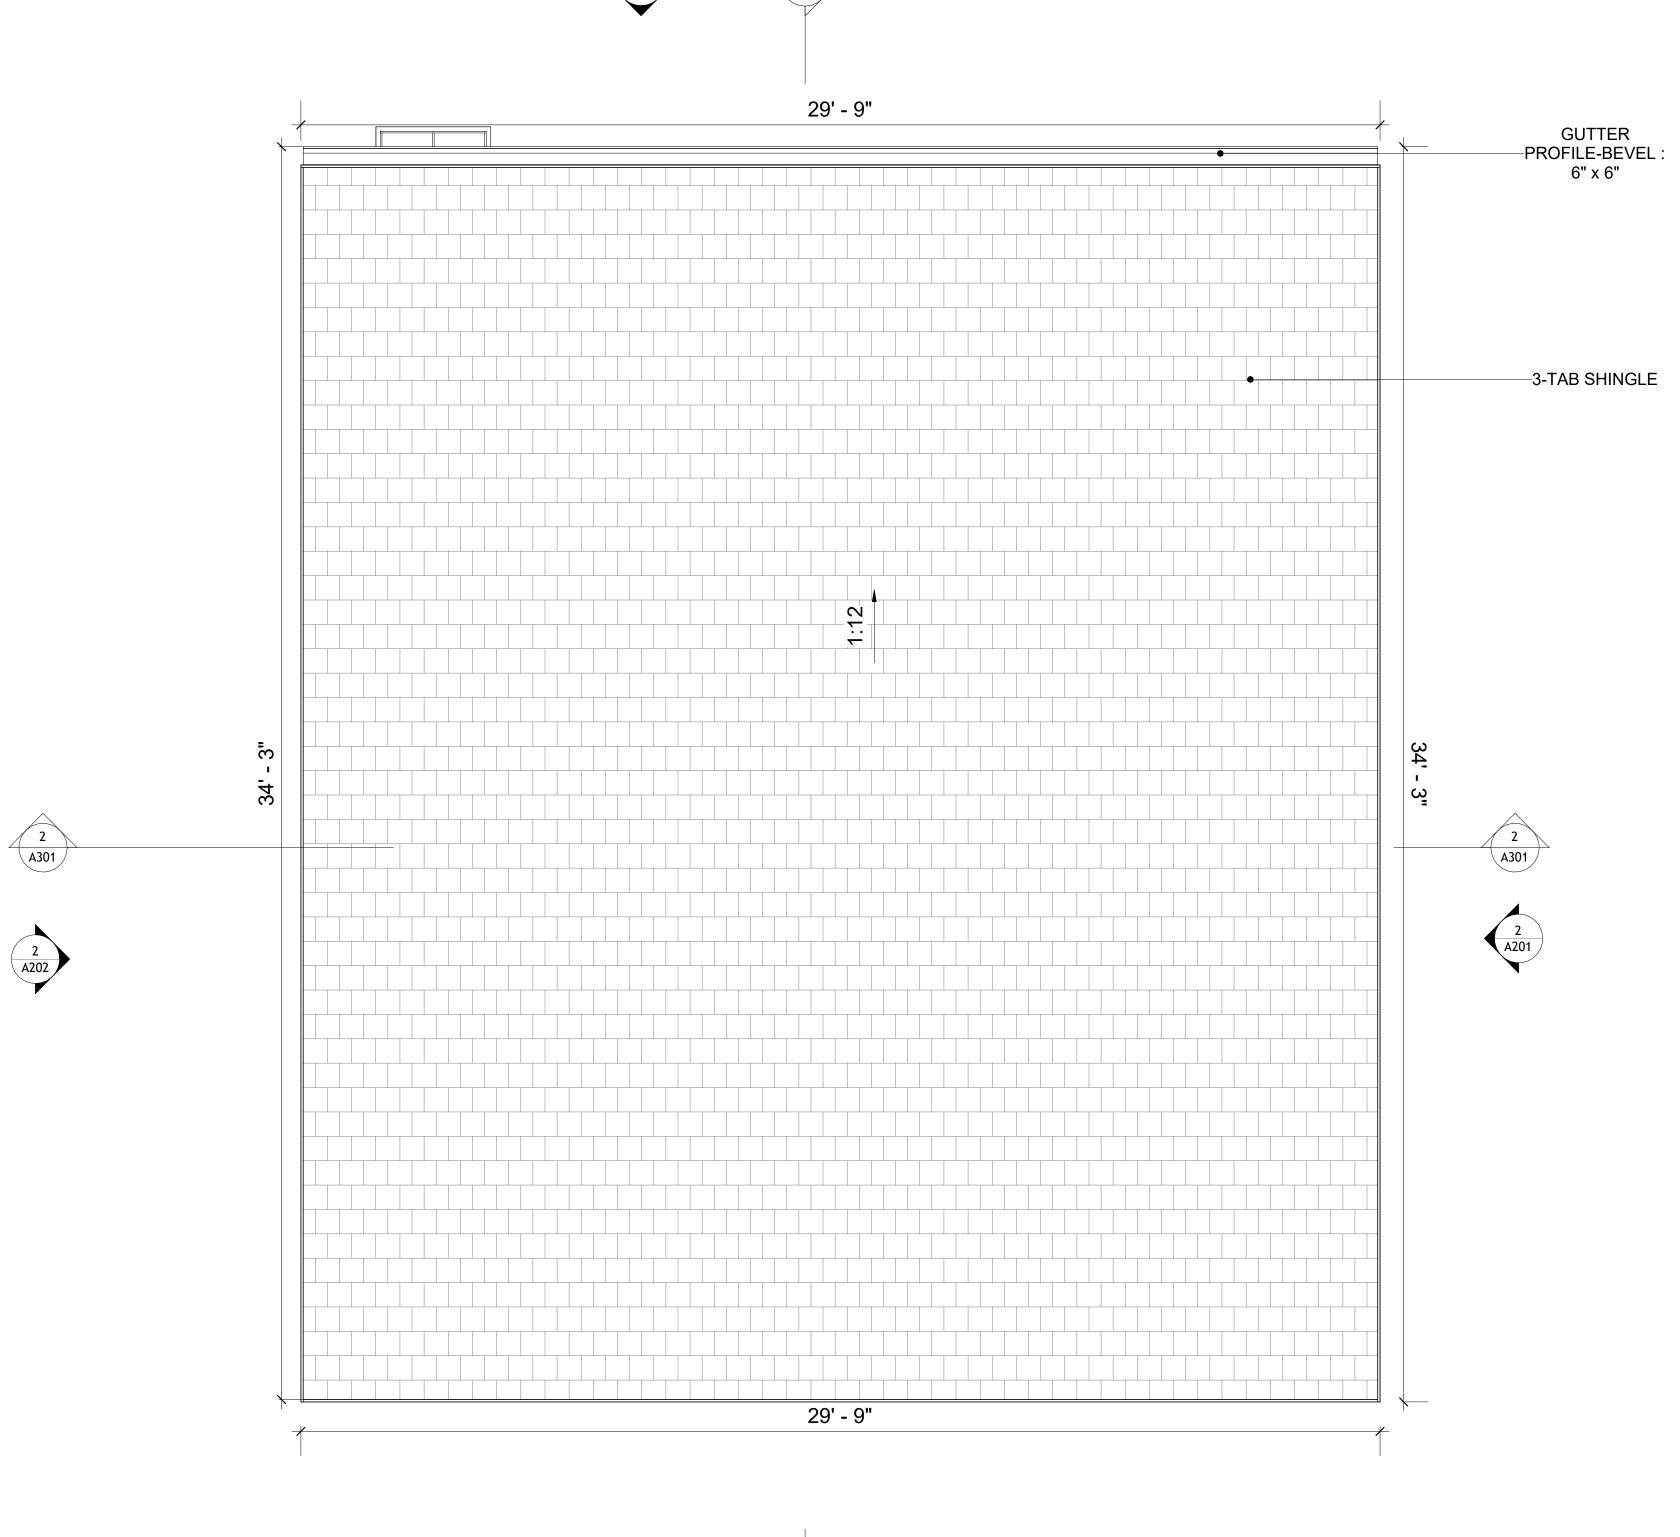





SQUARE FC	SQUARE FOOTAGE		
LIVING	745		
PORCH	136		
TOTAL	881		



KEY PLAN

NO.	DESCRIPTION	DATE

NOTE:

LEGEND:

PROJECT

79-HUNTER-745-2BD-2BA STONE VENEER 550

DRAWING NAME

ROOF PLAN

CLIENT NAME:

PROJECT NUMBER:

0061_12

DATE:

2/28/2025 1:59:53 PM

DESIGNED BY:

DRAWN BY:

CHECKED BY:

Checker

A103

ABOUT WALL FINISHING

EXTERNAL STONE

THESE STONE PRODUCTS ARE MADE FROM A BLEND OF NATURAL AGGREGATES, CEMENT, AND OTHER PROPRIETARY MATERIALS.

THE STONE FINISH IS DIRECTLY ATTACHED TO COLD-FORMED STEEL (CS) FRAMING. (FOR COLUMN FINISH) EXTERNAL STONE CAN BE AN EXCELLENT EXTERIOR CLADDING OPTION FOR CS-FRAMED BUILDINGS. IN THIS SCENARIO, THE EXTERNAL STONE WOULD BE ADHERED TO THE CS FRAME USING A SCRATCH COAT AND MORTAR-BASED ADHESIVE.

CEDAR WOOD


CEDAR WOOD REFERS TO THE WOOD FROM VARIOUS SPECIES OF CEDAR TREES, WHICH ARE CONIFEROUS EVERGREEN TREES KNOWN FOR THEIR DISTINCT AROMA AND NATURAL RESISTANCE TO DECAY AND INSECTS.

IN THIS SPECIFIC PROJECT, CEDAR WOOD IS USED A FINISH MATERIAL ON BEAMS AND COLUMNS.


WOOD SHAKES

WOOD SHAKES ARE ROUGH-SAWN PIECES OF WOOD, TYPICALLY MADE FROM CEDAR OR REDWOOD, USED FOR ROOFING OR WALL CLADDING. THEY OFFER A RUSTIC, TEXTURED LOOK BUT REQUIRE REGULAR MAINTENANCE FOR DURABILITY AND PROTECTION AGAINST THE ELEMENTS.

IN THIS SPECIFIC PROJECT, WOOD SHAKES ARE APPLIED AT THE TOP OF THE EXTERNAL WALL, CREATING AN EYE-CATCHING DETAIL THAT COMPLEMENTS THE OVERALL ARCHITECTURE AND ENSURES A STURDY, WEATHER-RESISTANT FINISH.

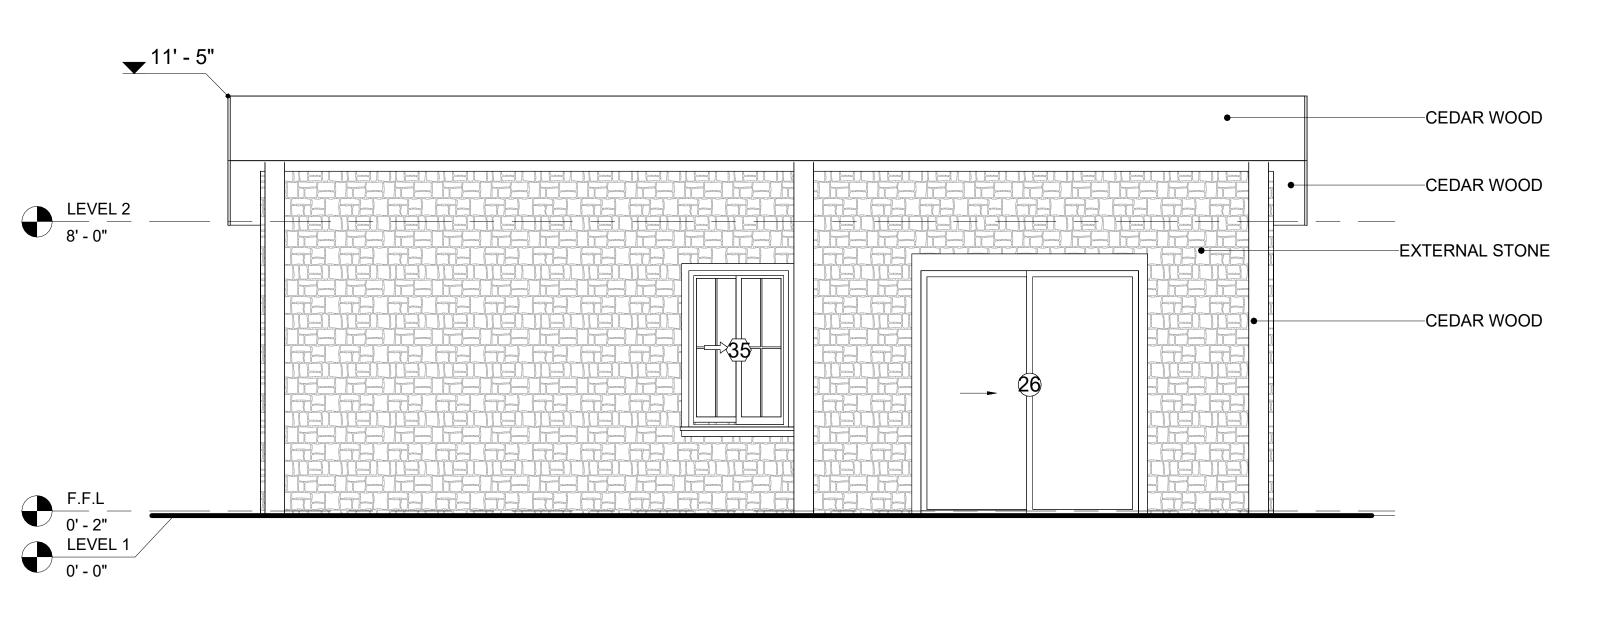

1 FRONT ELEVATION
3/8" = 1'-0"

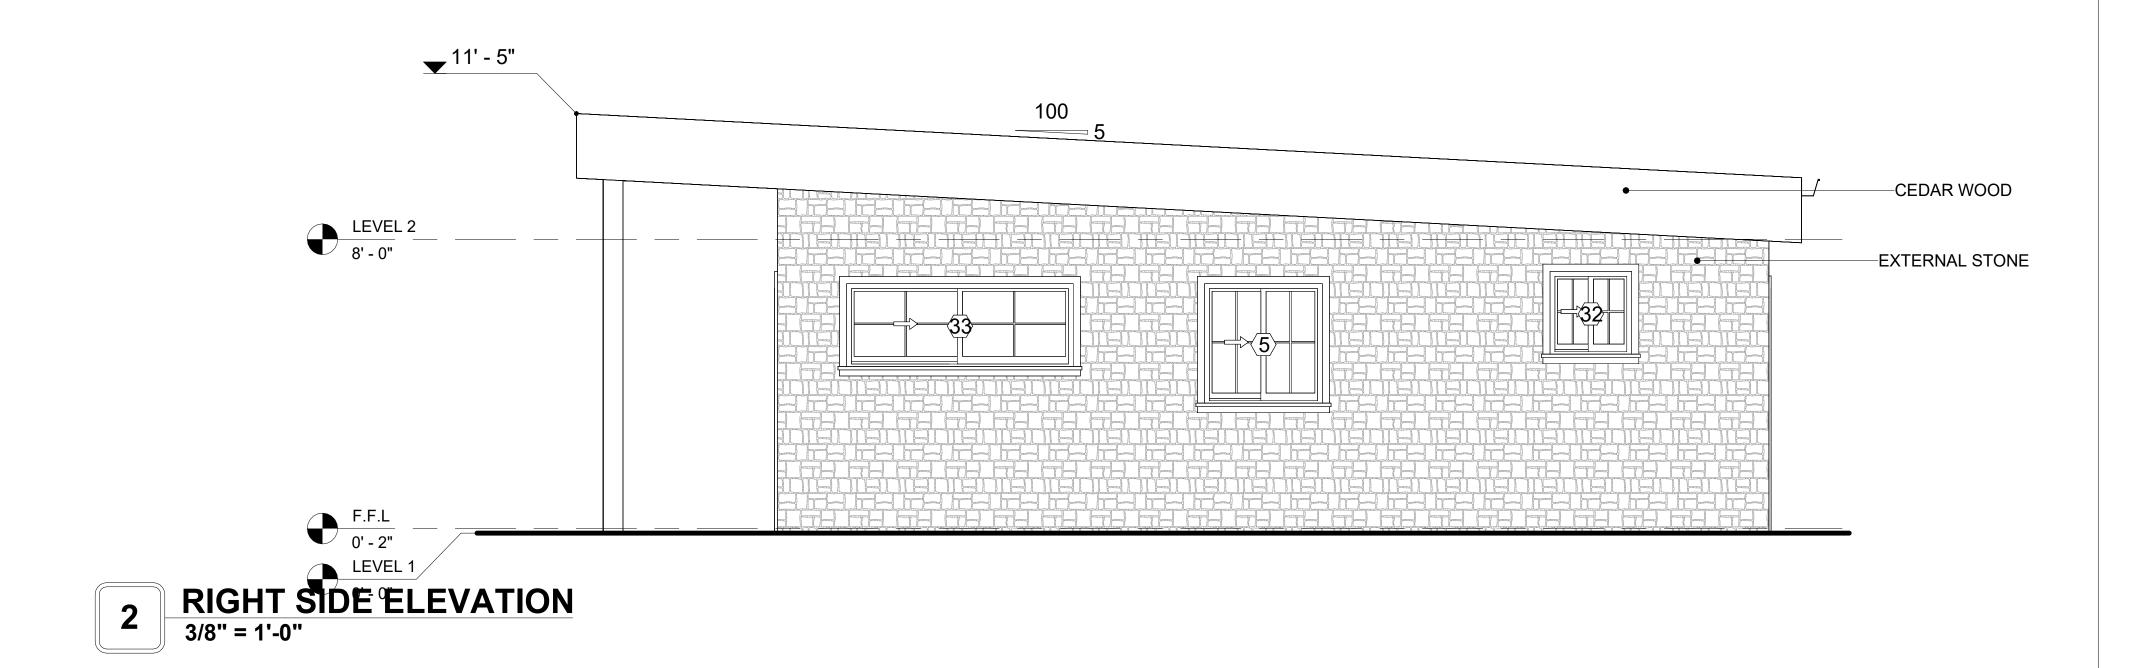


DOOR SCHEDULE							
TYPE				SIZE			
MAR K	SUPPLIER	DOOR TYPE	LOCATIO N	WIDTH	HEIGHT	COUNT	
2	HOME DEPOT	INTERIOR SINGLE PANEL SWINGING	INTERIOR	2' - 8"	6' - 8"	1	
3	HOME DEPOT	INTERIOR SINGLE PANEL SWINGING	INTERIOR	2' - 6"	6' - 8"	2	
4	HOME DEPOT	INTERIOR SINGLE PANEL SWINGING	INTERIOR	3' - 0"	6' - 8"	2	
26	HOME DEPOT	PATIO_DOUBLE PANEL_SLIDING	INTERIOR	6' - 0"	6' - 8"	1	
29	HOME DEPOT	EXTERIOR SINGLE PANEL SWINGING	INTERIOR	2' - 6"	6' - 8"	1	
30	HOME DEPOT	INTERIOR DOUBLE PANEL SLIDING	INTERIOR	10' - 0"	6' - 8"	2	

WINDOW SCHEDULE						
				SIZE		
TYPE MARK	SUPPLIER	WINDOW TYPE	WIDTH	HEIGHT	COUNT	
5	HOME DEPOT	SLIDING	3' - 3"	3' - 3"	1	
31	HOME DEPOT	SLIDING	6' - 3"	4' - 3"	2	
32	HOME DEPOT	SLIDING	2' - 3"	2' - 3"	2	
33	HOME DEPOT	SLIDING	6' - 3"	2' - 3"	1	
35	HOME DEPOT	SLIDING	2' - 9"	4' - 3"	1	



KEY PLAN

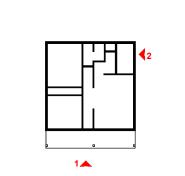

NO.	DESCRIPTION	DATE	

NOTE:

LEGEND:

PROJECT

79-HUNTER-745-2BD-2BA STONE VENEER 550

DRAWING NAME

ARCHITECTURAL ELEVATIONS

CLIENT NAME: Client Name
PROJECT NUMBER: 0061_12

DATE: 2/28/2025 1:59:56 PM

DESIGNED BY: Designer

DRAWN BY: Author

CHECKED BY: Checker

A201

ABOUT WALL FINISHING

EXTERNAL STONE

THESE STONE PRODUCTS ARE MADE FROM A BLEND OF NATURAL AGGREGATES, CEMENT, AND OTHER PROPRIETARY MATERIALS.

THE STONE FINISH IS DIRECTLY ATTACHED TO COLD-FORMED STEEL (CS) FRAMING. (FOR COLUMN FINISH) EXTERNAL STONE CAN BE AN EXCELLENT EXTERIOR CLADDING OPTION FOR CS-FRAMED BUILDINGS. IN THIS SCENARIO, THE EXTERNAL STONE WOULD BE ADHERED TO THE CS FRAME USING A SCRATCH COAT AND MORTAR-BASED ADHESIVE.

CEDAR WOOD


CEDAR WOOD REFERS TO THE WOOD FROM VARIOUS SPECIES OF CEDAR TREES, WHICH ARE CONIFEROUS EVERGREEN TREES KNOWN FOR THEIR DISTINCT AROMA AND NATURAL RESISTANCE TO DECAY AND INSECTS.

IN THIS SPECIFIC PROJECT, CEDAR WOOD IS USED A FINISH MATERIAL ON BEAMS AND COLUMNS.


WOOD SHAKES

WOOD SHAKES ARE ROUGH-SAWN PIECES OF WOOD, TYPICALLY MADE FROM CEDAR OR REDWOOD, USED FOR ROOFING OR WALL CLADDING. THEY OFFER A RUSTIC, TEXTURED LOOK BUT REQUIRE REGULAR MAINTENANCE FOR DURABILITY AND PROTECTION AGAINST THE ELEMENTS.

IN THIS SPECIFIC PROJECT, WOOD SHAKES ARE APPLIED AT THE TOP OF THE EXTERNAL WALL, CREATING AN EYE-CATCHING DETAIL THAT COMPLEMENTS THE OVERALL ARCHITECTURE AND ENSURES A STURDY, WEATHER-RESISTANT FINISH.

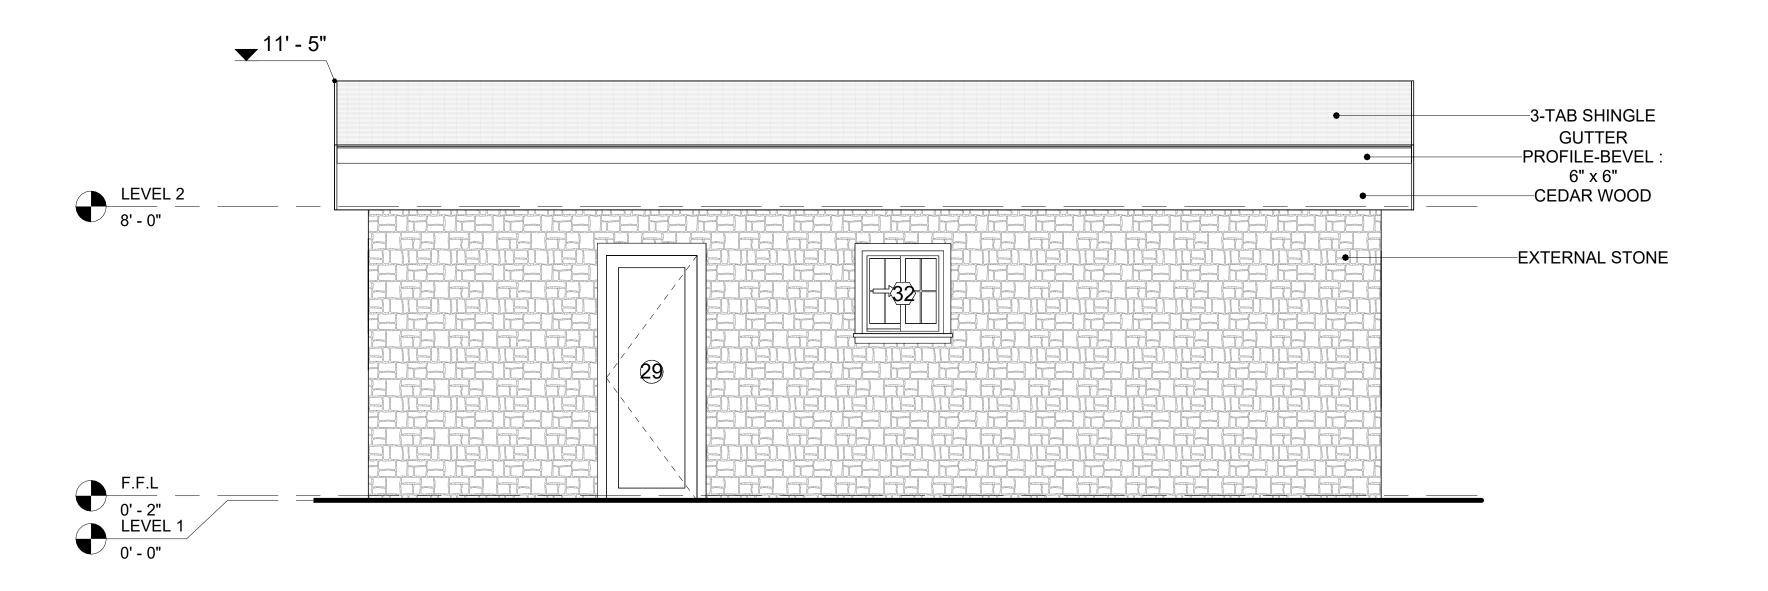


1 REAR ELEVATION 3/8" = 1'-0"

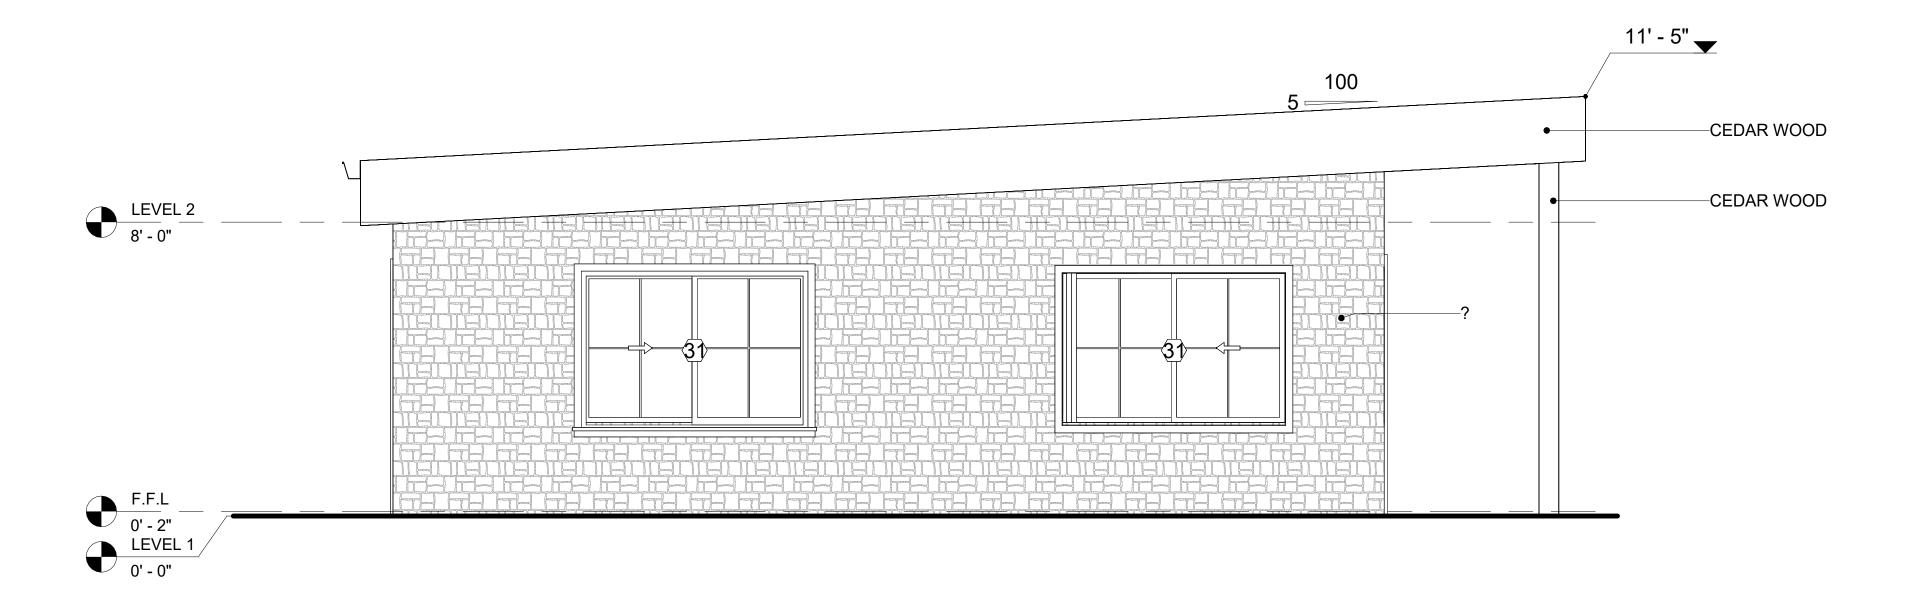

2 LEFT SIDE ELEVATION
3/8" = 1'-0"



KEY PLAN

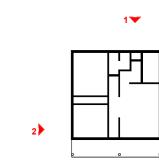

NO.	DESCRIPTION	DATE	

NOTE:

LEGEND:

PROJECT

79-HUNTER-745-2BD-2BA STONE VENEER 550

DRAWING NAME

ARCHITECTURAL ELEVATIONS

CLIENT NAME:

PROJECT NUMBER:

DATE:

DATE:

DESIGNED BY:

DRAWN BY:

CHECKED BY:

CHECKED BY:

Client Name

0061_12


2/28/2025 1:59:59 PM

Designer


Author

Checker

A202

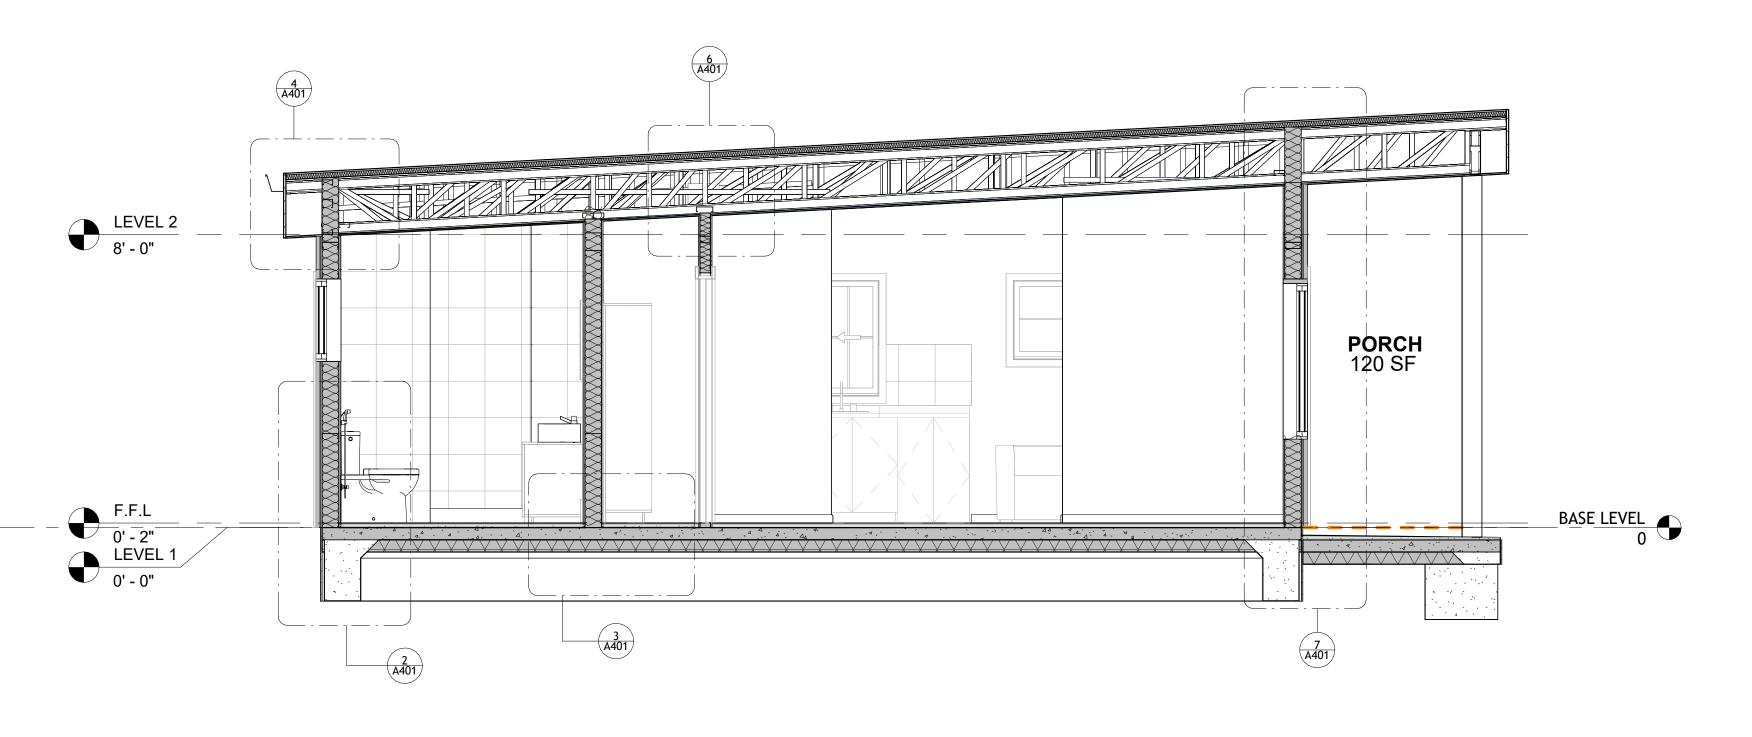


1 SECTION-3 3/8" = 1'-0"

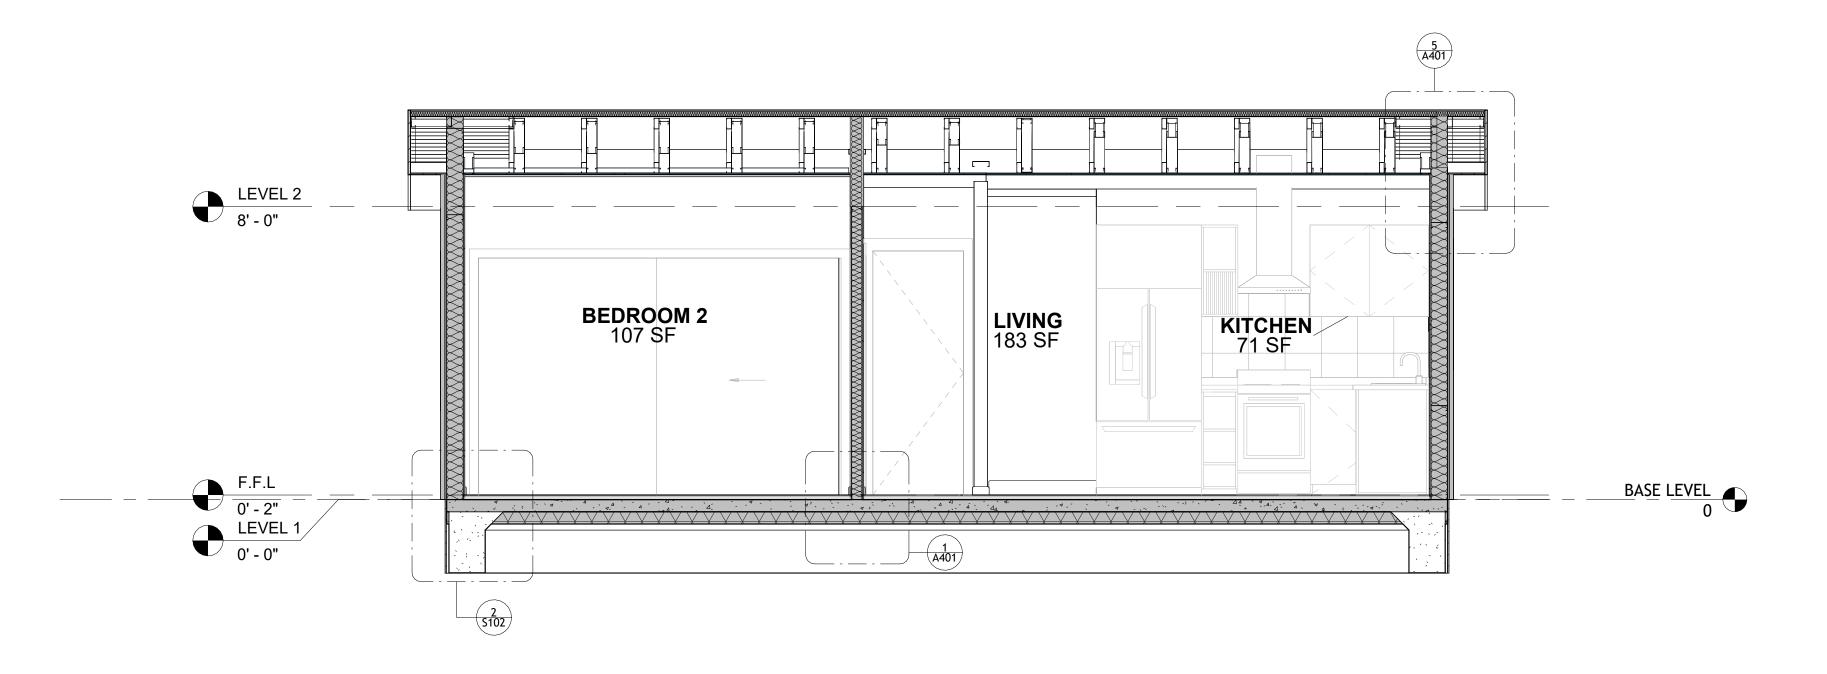

2 SECTION-2 3/8" = 1'-0"



KEY PLAN

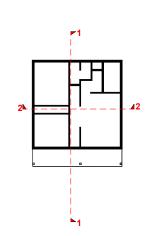

NO.	DESCRIPTION	DATE

NOTE:

LEGEND:

PROJECT

79-HUNTER-745-2BD-2BA STONE VENEER 550

DRAWING NAME

ARCHITECTURAL SECTIONS

CLIENT NAME:

PROJECT NUMBER:

DATE:

DESIGNED BY:

DRAWN BY:

CHECKED BY:

Client Name

0061_12


2/28/2025 2:00:01 PM

Designer


Author

Checker


A301

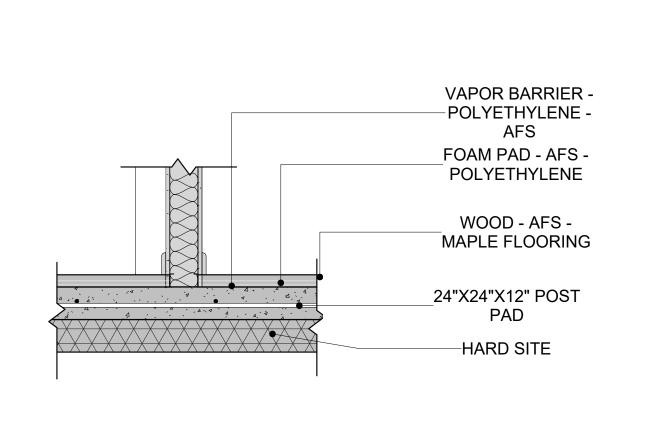



1 TYPICAL WALL FTG

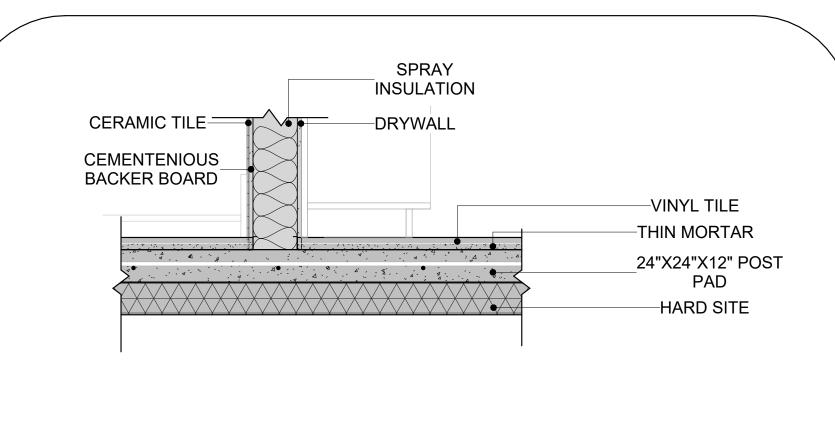



3 WALL ON FLOOR

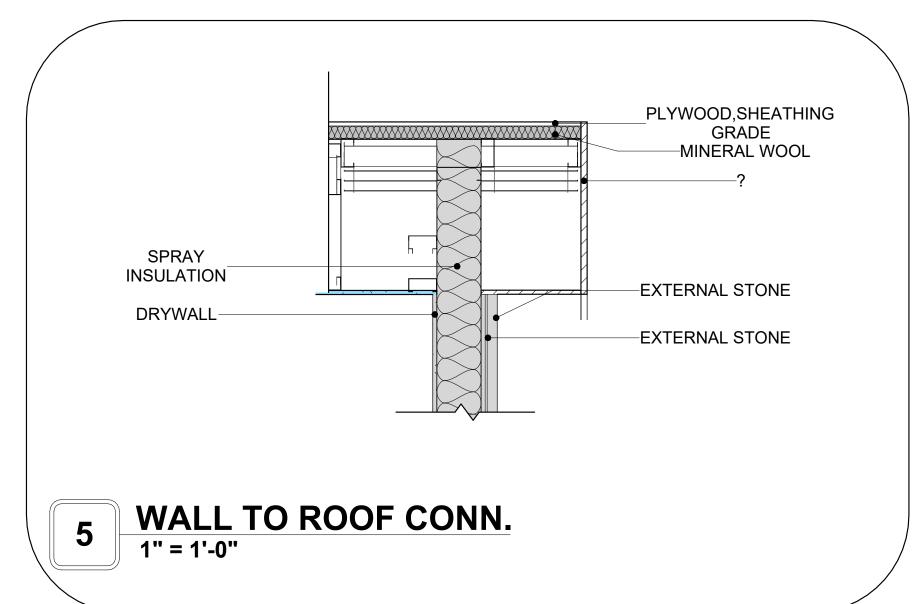

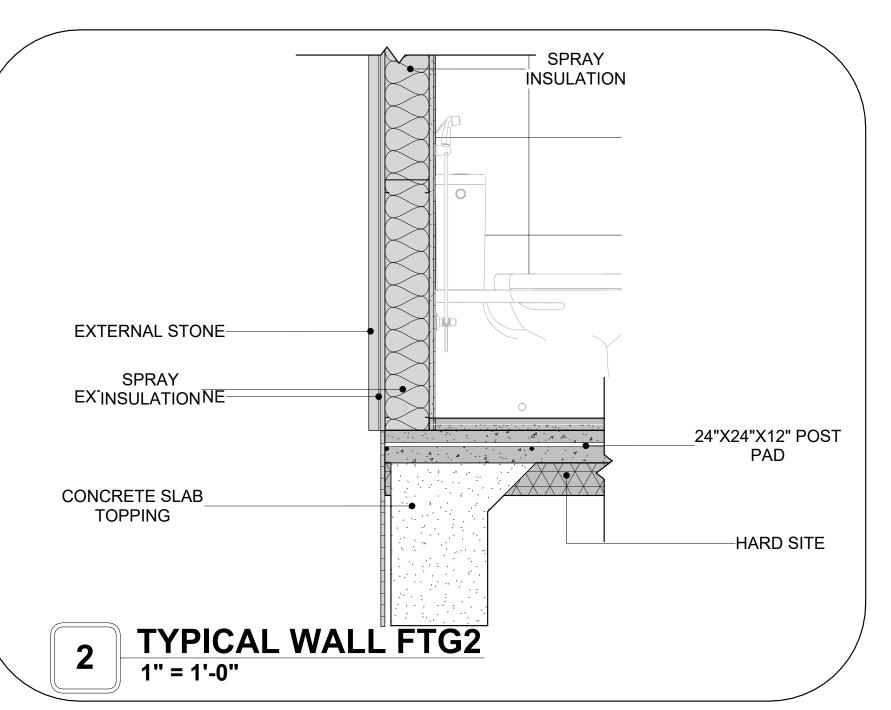

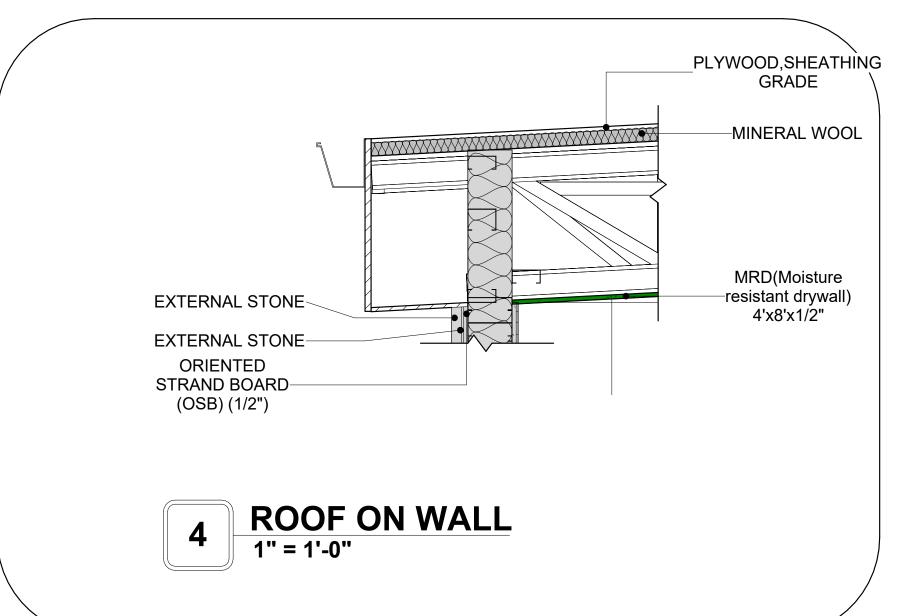

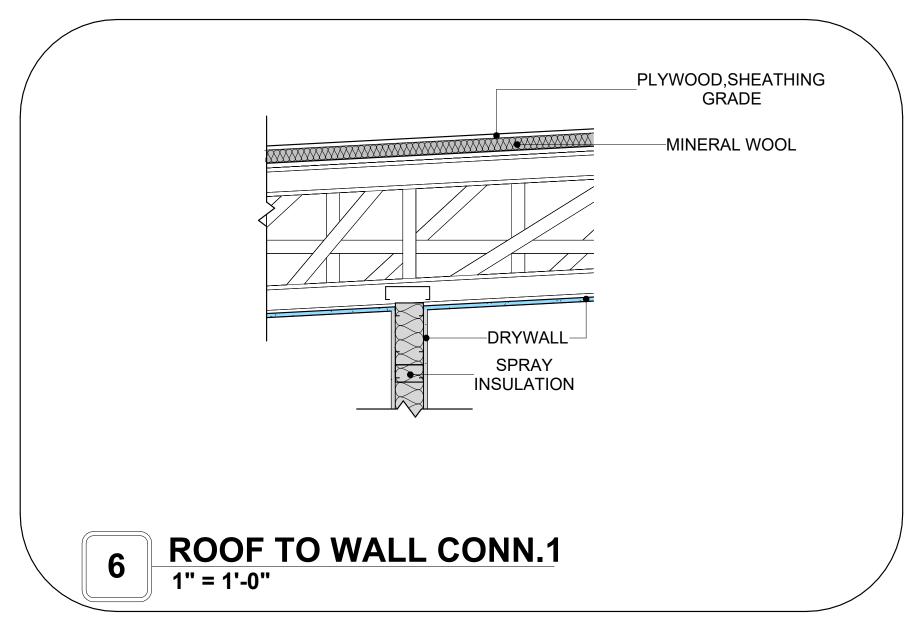

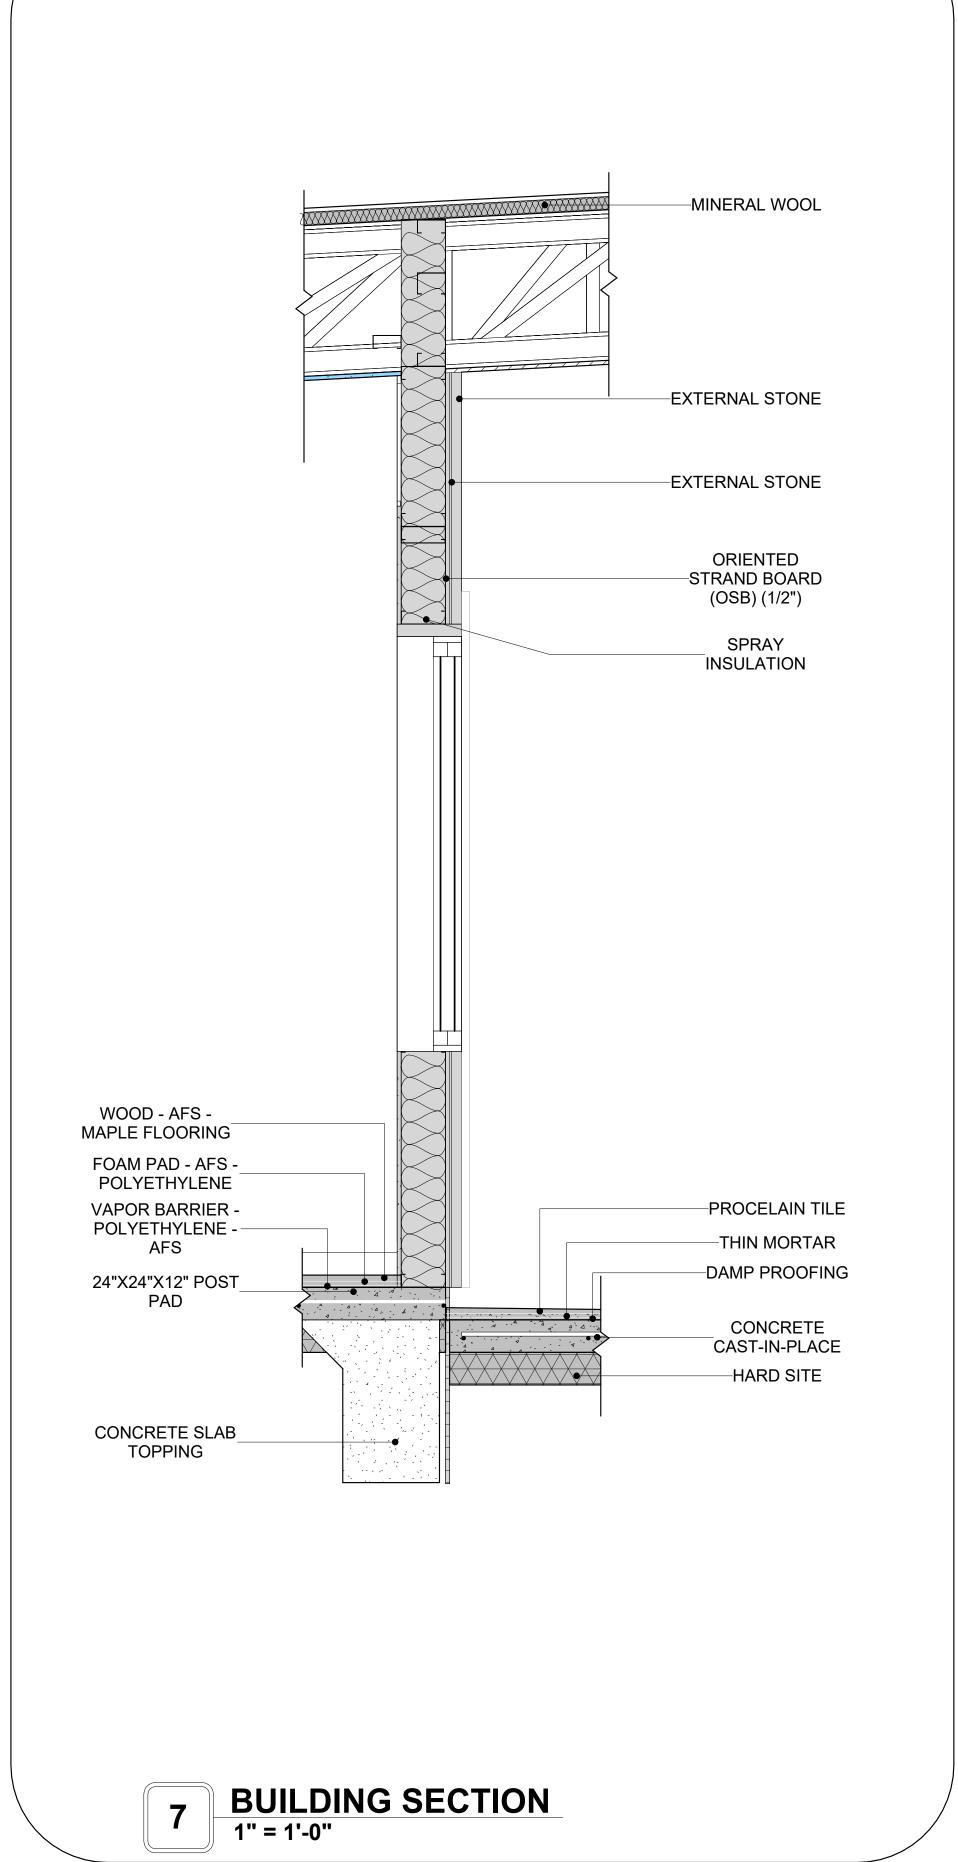

Tuscon,AZ, USA
888-864-0184
inquire@frameupnow.com
www.frameupnow.com

KEY PLAN

NO. DESCRIPTION DATE

NOTE:

LEGEND:

PROJECT

79-HUNTER-745-2BD-2BA STONE VENEER 550

DRAWING NAME

ARCHITECTURAL DETAILS

CLIENT NAME: Client Name
PROJECT NUMBER: 0061_12

DATE: 2/28/2025 2:00:03 PM

DESIGNED BY: Designer

DRAWN BY: Author

CHECKED BY: Checker

A401

SCALE: 1" = 1'-0"

CASEWORK GENERAL NOTES


- 1. ALL CABINET HEIGHTS INCLUDE COUNTERTOPS. DIMENSIONS ARE TO THE NEAREST INCH.
- 2. DIVISIONS IN CASEWORK ARE SHOWN FOR CLARITY AND DO NOT REPRESENT BREAKS IN THE COUNTERTOP.
- 3. PROVIDE CONTINUOUS COUNTERTOP OVER ALL SIMILAR HEIGHT CASEWORK, UNLESS AND
- OTHERWISE NOTED.


 4. MANUFACTURER AND CATALOG NUMBERS ARE FOR REFERENCE AND ILLUSTRATION PURPOSES
- ONLY.
 5. DOTTED LINES INDICATE WALL HUNG CABINETS, DIVISIONS OF BASE CABINETS BELOW THE
- 6. COUNTERTOP, FURNITURE NOT IN THE CONTRACT OR PROJECTION SCREENS -SEE CASEWORK KEY AND SPECIFICATIONS.
- 7. ALL CABINETS AND DRAWERS TO HAVE CAM LOCKS EXCEPT FOR SINK BASE CABINETS.
 8. ALL EXPOSED SURFACES (EXPOSED TO VIEW FROM ANY PERSPECTIVE) TO BE COVERED WITH
- LAMINATE.
- 9. ALL CASEWORK WHICH MEETS A WALL AT ONE OR BOTH ENDS, TO BE PROVIDED WITH FILLER
- PANELS AND SCRIBED TO THE WALL(S) AS REQUIRED.


 10. ALL CABINETS AND DRAWERS ARE PROVIDED WITH RECESSED HANDLES.
- 11. CONTRACTOR TO FIELD VERIFY ALL CLEAR OPENINGS PRIOR TO MILLWORK OR CASEWORK
- FABRICATION.
- 12. CASEWORK DRAWINGS ARE DIAGRAMMATIC IN NATURE TO SHOW DESIGN INTENT.


	CASEWORK SCHEDULE					
TYPE MAR K	TYPE	COUN	HEIGHT	WIDTH	DEPTH	AREA
1	VANITY	1	2' - 4"	2' - 6"	1' - 8"	6 SF
2	LINEAR COUNTER TOP 2	1	0' - 4"	3' - 0"	2' - 1"	1 SF
3	TOP_FILLER_2	1	2' - 6"	1' - 0"	1' - 0"	3 SF
4	BASE CABINET DOUBLE DOOR 5	1	2' - 11"	2' - 6"	2' - 0"	7 SF
5	LAUNDRY OPEN CABINET 3 158	1	1' - 2"	2' - 3"	2' - 6"	3 SF
6	RECESSED_MED_CABINET	1	2' - 0"	1' - 6"	0' - 3"	3 SF
7	HD_LINEAR_COUNTER_TOP 4	1	0' - 4"	1' - 0"	2' - 1"	0 SF
8	BASE_CABINET_L-SHAPED	1	2' - 11"	3' - 3"	3' - 3"	9 SF
9	WALL CABINET DOUBLE DOOR 2 159	1	2' - 6"	3' - 3"	1' - 0"	8 SF
10	BASE_FILLER_2	1	3' - 0"	1' - 0"	2' - 0"	3 SF
11	REFRIGERATOR TOP	1	1' - 9"	2' - 11"	2' - 4"	5 SF
12	BASE_CABINET_DOUBLE_DOOR_1	1	2' - 11"	2' - 0"	2' - 0"	6 SF
13	LINEAR_COUNTER_TOP 2	1	0' - 4"	2' - 0"	2' - 1"	1 SF
14	HD_L-SHAPE_COUNTER_TOP11	1	0' - 4"	9' - 7"	4' - 0"	3 SF
15	CLOSET 3 154	2	6' - 0"	10' - 7"	1' - 4"	64 SF
899	CLOSET 3 155	1	6' - 0"	3' - 1"	1' - 4"	18 SF
GRAND	GRAND TOTAL 17					


SPECIALTY EQUIPMENT SCHEDULE			
TYPE MARK TYPE COUNT			
01	WASHER-FRONT-LOAD	1	
02	REFRIGERATOR 2	1	
03	RANGE	1	
04	DRYER-FRONT-LOAD	1	
GRAND TOTAL: 4			

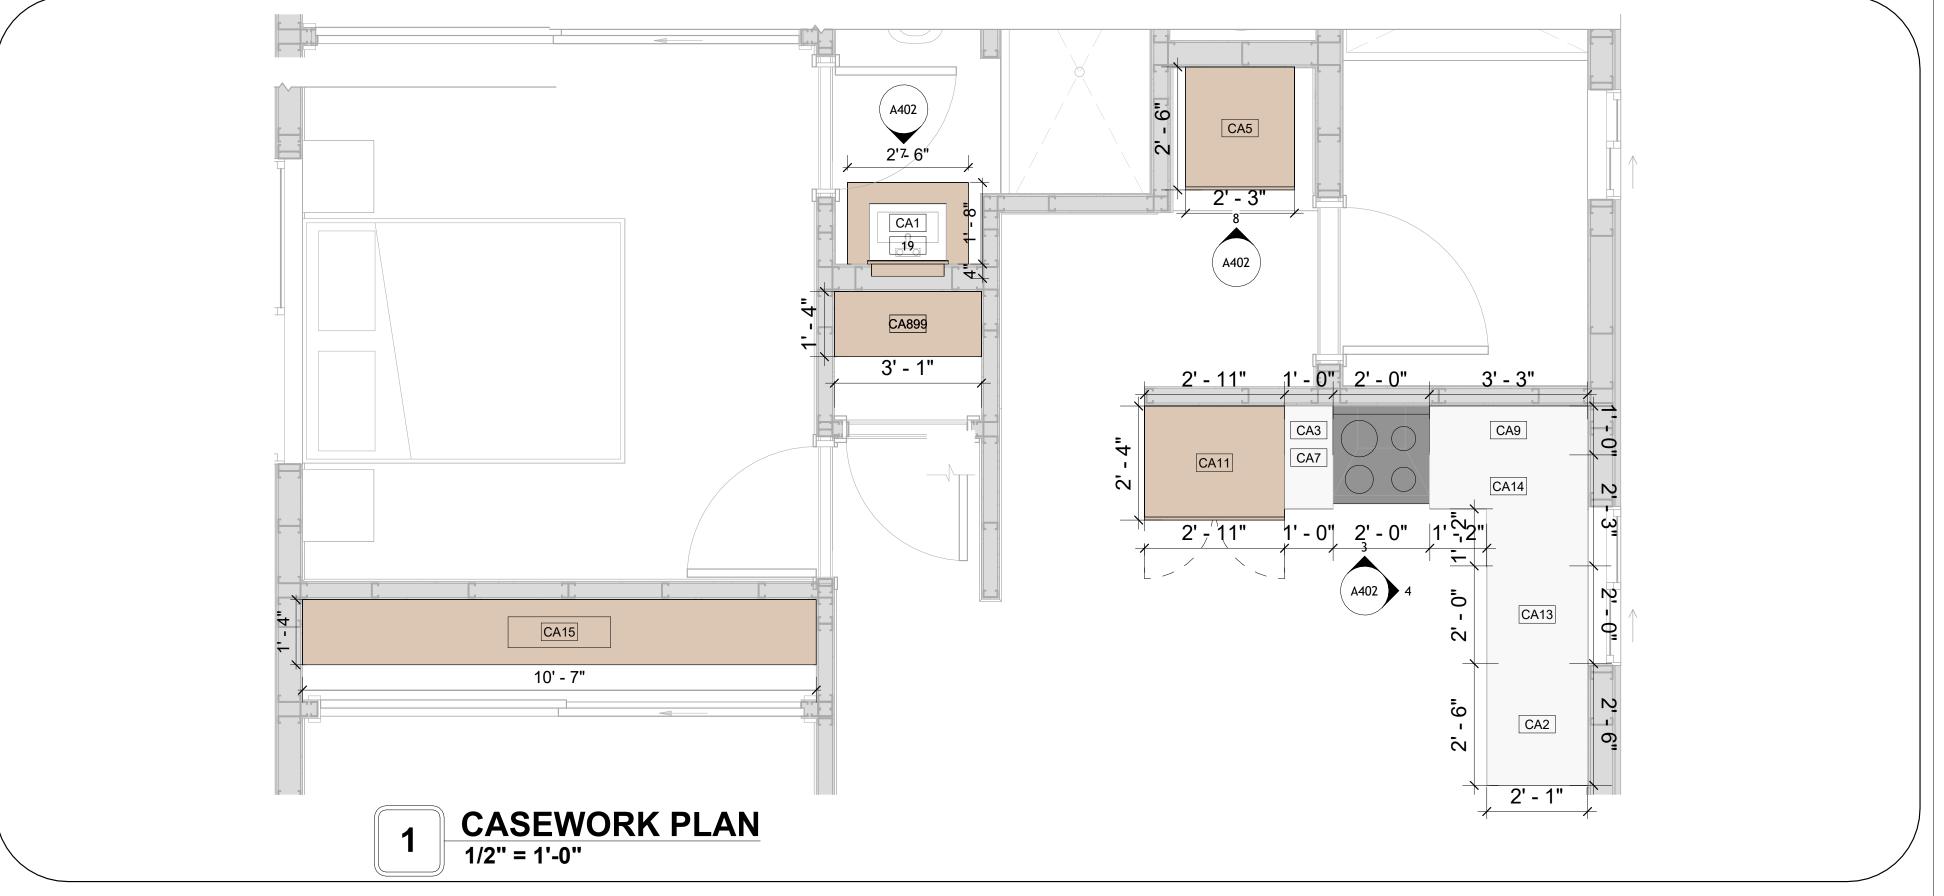

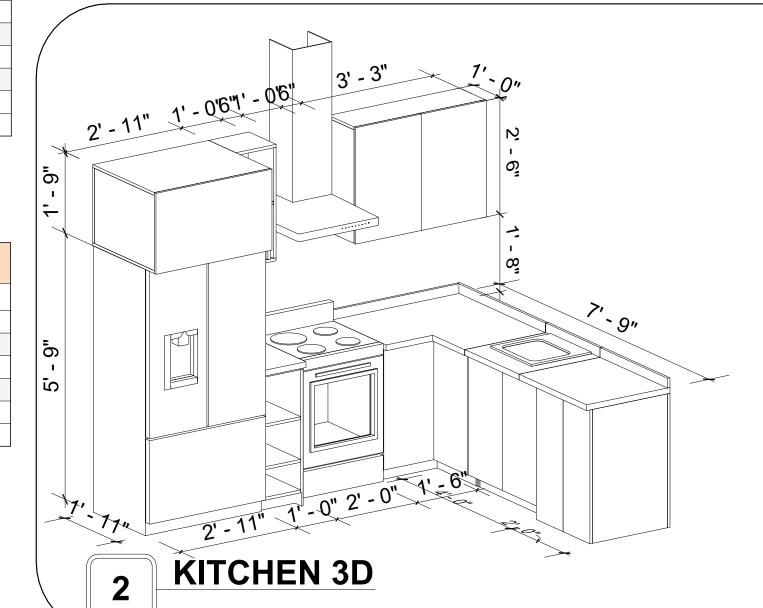


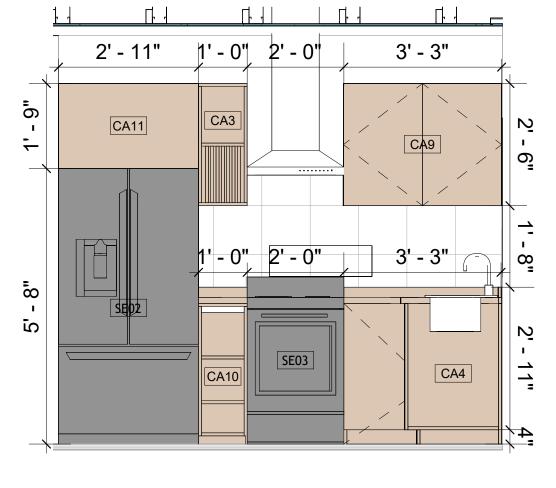


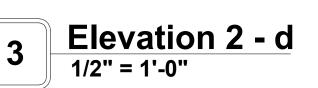


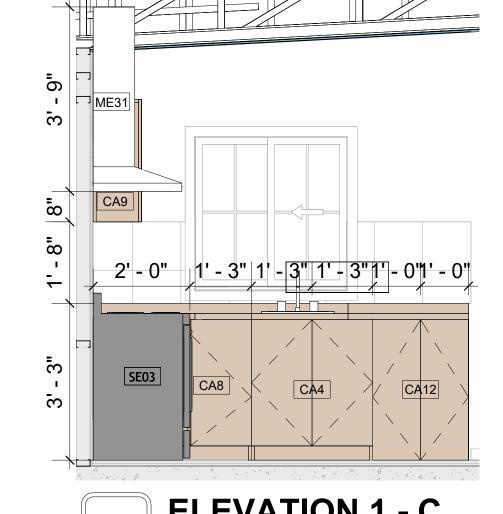


4 ELEVATION 1 - C 1/2" = 1'-0"

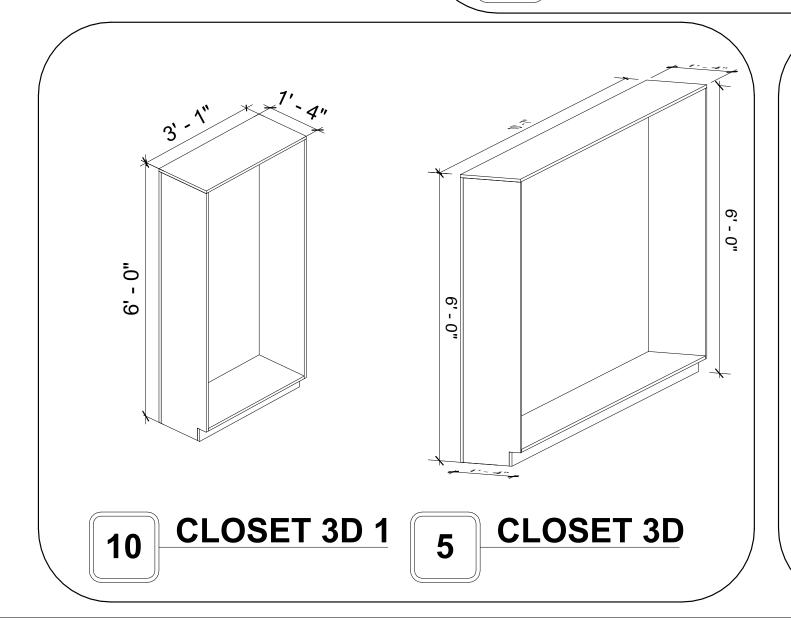

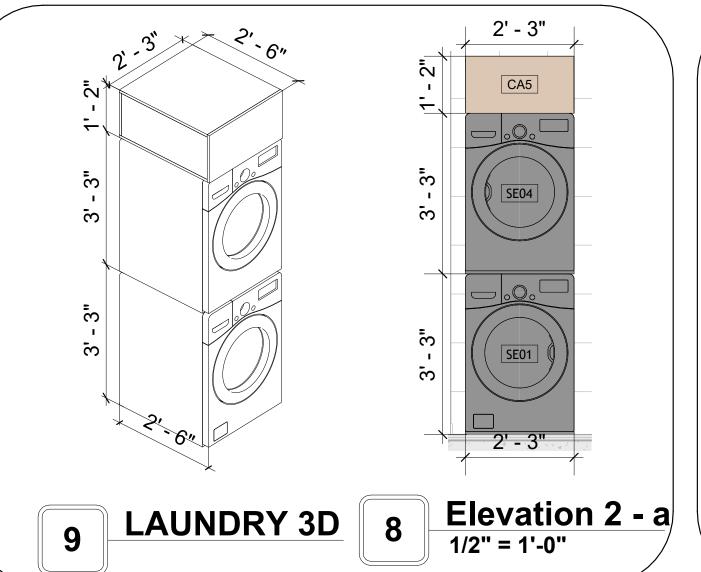

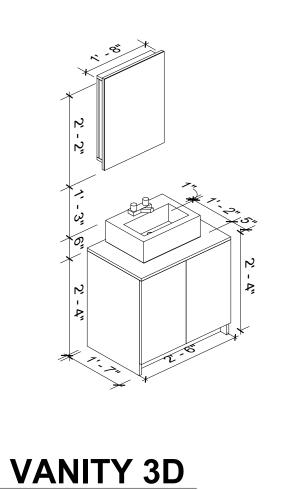


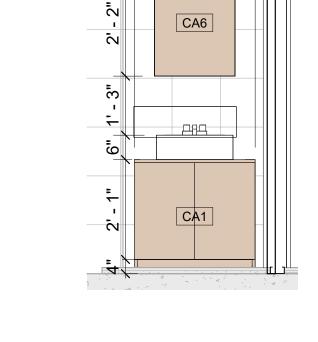

7 ELEVATION 1 - D

Tuscon,AZ, USA
888-864-0184
inquire@frameupnow.com
www.frameupnow.com

KEY PLAN

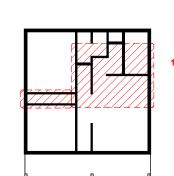

NO.	DESCRIPTION	DATE

NOTE:

LEGEND:

PROJECT

79-HUNTER-745-2BD-2BA STONE VENEER 550

DRAWING NAME

ARCHITECTURAL CASEWORK

CLIENT NAME:

PROJECT NUMBER:

0061_12

DATE:

2/28/2025 2:00:05 PM

DESIGNED BY:

DRAWN BY:

CHECKED BY:

Checker

A402

GENERAL NOTES

T1. THIS DRAWING DEPICTS THE HVAC (HEATING, VENTILATION, AND AIR CONDITIONING) SYSTEM FOR THE HUNTER 2BD 2BA STONE VENEER. IT PROVIDES A VISUAL REPRESENTATION OF THE SYSTEM LAYOUT AND COMPONENTS.

2.THE HVAC SYSTEM IS DESIGNED TO MEET THE SPECIFIC REQUIREMENTS OF THE BUILDING, INCLUDING HEATING, COOLING, AND VENTILATION NEEDS AS PER THE PROJECT SPECIFICATIONS AND APPLICABLE CODES AND STANDARDS.

3. THE HVAC SYSTEM INSTALLATION SHALL COMPLY WITH THE LATEST EDITION OF THE INTERNATIONAL MECHANICAL CODE (IMC), INTERNATIONAL RESIDENTIAL CODE (IRC), AND ALL OTHER APPLICABLE LOCAL, STATE, AND NATIONAL CODES AND REGULATIONS.

4. THE EQUIPMENT SHOWN ON THIS DRAWING INCLUDES BUT IS NOT LIMITED TO AIR HANDLING UNITS (AHUS), CHILLERS, BOILERS, COOLING TOWERS, PUMPS, DUCTWORK, DIFFUSERS, GRILLES, AND CONTROL DEVICES.

5. ALL EQUIPMENT, DUCTWORK, AND PIPING SHALL BE INSTALLED IN ACCORDANCE WITH MANUFACTURER'S SPECIFICATIONS, LOCAL CODES, AND INDUSTRY BEST PRACTICES.

6. ALL DUCTWORK SHALL BE SIZED, FABRICATED, AND INSTALLED IN ACCORDANCE WITH THE LATEST EDITION OF THE ACCA MANUAL D AND THE SMACNA HVAC DUCT CONSTRUCTION STANDARDS. DUCTWORK SHALL BE INSTALLED IN A NEAT AND WORKMANLIKE MANNER, PROPERLY SUPPORTED AND BRACED TO PREVENT SAGGING, AIR LEAKAGE, OR VIBRATION.

7. CONDENSATE DRAINAGE PIPING SHALL BE PROPERLY PITCHED TO ENSURE POSITIVE DRAINAGE TO AN APPROVED DISPOSAL LOCATION, SUCH AS A FLOOR DRAIN, SUMP PUMP, OR EXTERIOR GRADE. CONDENSATE LINES SHALL BE INSULATED TO PREVENT SWEATING.

8. THE LOCATION OF CONTROL PANELS AND SENSORS INDICATED ON THIS DRAWING CAN BEMODIFY with THE SPECIFIC LOCATIONS AND WIRING DETAILS WILL BE DETERMINED DURING THE CONTROL SYSTEM DESIGN AND INSTALLATION.

9. THE HVAC SYSTEM DESIGN CONSIDER ENERGY EFFICIENCY, INDOOR AIR QUALITY, OCCUPANT COMFORT, AND NOISE CONTROL, FOLLOWING APPLICABLE GUIDELINES AND REGULATIONS.

10. COORDINATION WITH OTHER TREADS HAS BEEN DONE ON A DESIGN LEVEL. THIS DRAWING SHALL BE READ TOGETHER WITH THE AR, EL AND SN DESIGN DRAWINGS TO ENSURE PROPER INSTALLATION AND INTEGRATION OF THE HVAC SYSTEMS.

11. THE HVAC CONTRACTOR IS RESPONSIBLE FOR OBTAINING ALL NECESSARY PERMITS AND LICENSES, AND FOR SCHEDULING AND COORDINATING

12. ALL DUCTWORK PENETRATIONS THROUGH WALLS, FLOORS, OR CEILINGS SHALL BE PROPERLY SEALED AND FIRE-STOPPED USING APPROVED METHODS AND MATERIALS TO MAINTAIN THE INTEGRITY OF THE BUILDING'S FIRE-RESISTANCE RATINGS.

WITH THE LOCAL BUILDING DEPARTMENT AND UTILITY PROVIDERS TO ENSURE A TIMELY AND COMPLIANT INSTALLATION.

13. HVAC EQUIPMENT SHALL BE INSTALLED LEVEL AND PLUMB, AND IN STRICT ACCORDANCE WITH THE MANUFACTURER'S INSTALLATION INSTRUCTIONS AND RECOMMENDATIONS. PROVIDE ADEQUATE CLEARANCES AROUND EQUIPMENT FOR PROPER AIRFLOW, SERVICE ACCESS, AND

CODE COMPLIANCE.

14. ALL HVAC EQUIPMENT AND COMPONENTS, INCLUDING THERMOSTATS, DAMPERS, AND ACCESS PANELS, SHALL BE LOCATED IN ACCESSIBLE AREAS

FOR EASY SERVICING AND MAINTENANCE. PROVIDE ADEQUATE SPACE AROUND EQUIPMENT FOR PROPER AIRFLOW AND SERVICE ACCESS.

15. THE HVAC SYSTEM SHALL BE BALANCED AND ADJUSTED TO ENSURE PROPER AIRFLOW, TEMPERATURE DISTRIBUTION, AND SYSTEM PERFORMANC


THROUGHOUT THE RESIDENCE. PROVIDE A WRITTEN REPORT DOCUMENTING THE FINAL SYSTEM BALANCE.


16. ANY DEVIATIONS OF MODIFICATIONS TO THE HYAC SYSTEM DESIGN SHALL BE REVIEWED AND APPROVED BY THE RESPONSIBLE DESIGN.

16. ANY DEVIATIONS OR MODIFICATIONS TO THE HVAC SYSTEM DESIGN SHALL BE REVIEWED AND APPROVED BY THE RESPONSIBLE DESIGN PROFESSIONALS AND COMMUNICATED TO ALL RELEVANT PARTIES INVOLVED IN THE CONSTRUCTION PROCESS.

17. FOR ANY INQUIRIES OR CLARIFICATIONS REGARDING THE HVAC SYSTEM DESIGN, PLEASE CONSULT THE RESPONSIBLE DESIGN PROFESSIONALS OR THE PROJECT MANAGEMENT TEAM.

SYMBOLS

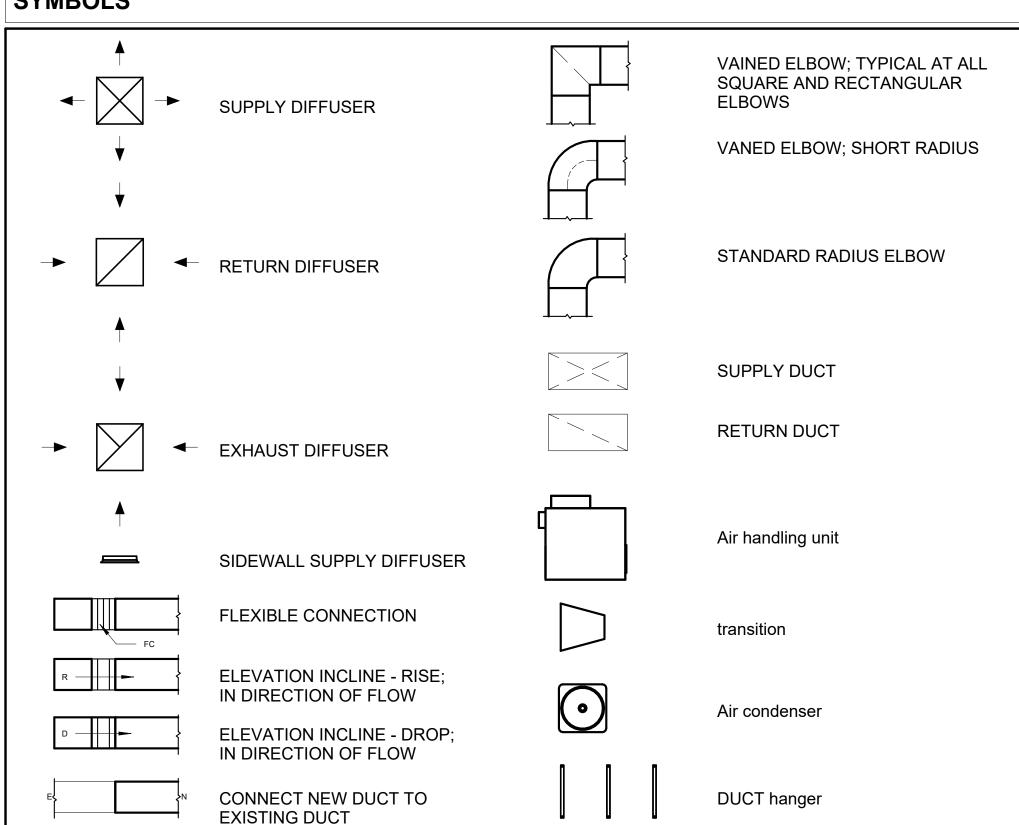

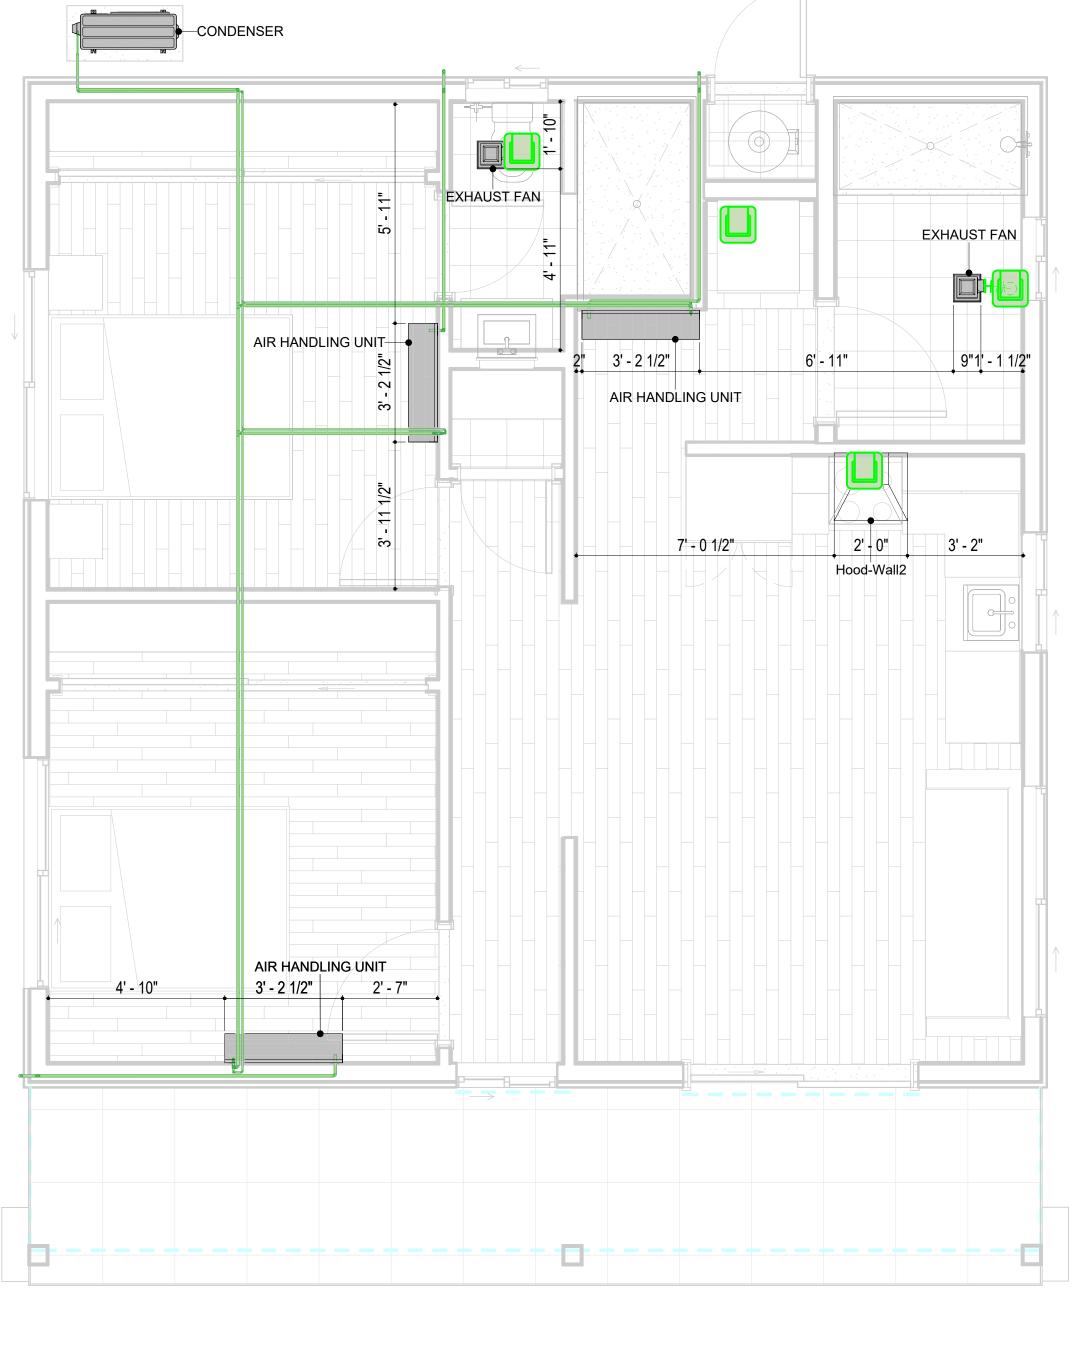

1	HVAC PLAN
	3/8" = 1'-0"

	REFRIGERANT L	INE SCHEDULE	
CATAGORY	DESCRIPTION	DIAMETER	LENGTH
	•		
Pipe Types	Copper	1/4"	0.59

1/2"

Copper

Copper

Pipe Types

Pipe Types

Pipe Types

Hvac Color scheme

air conditioning pipe line

67.43

0.62

109.53

REFRIGERANT LINE FITTING SCHEDULE				
CATAGORY	DESCRIPTION	Size	Count	
	I			
Elbow - Generic	Elbow - Generic: Standard/HVAC	1/2"ø-1/2"ø	1	
Elbow - Generic	Elbow - Generic: Standard/HVAC	3/4"ø-3/4"ø	27	
Elbow - Generic	Elbow - Generic: Standard/HVAC	3/8"ø-3/8"ø	14	
Tee - Generic	Tee - Generic: Standard	3/4"ø-3/4"ø-3/ 4"ø	2	
Tee - Generic	Tee - Generic: Standard	3/8"ø-3/8"ø-3/ 8"ø	2	
Transition - Generic	Transition - Generic: Standard	3/4"ø-1/2"ø	4	
Transition - Generic	Transition - Generic: Standard	3/4"ø-5/8"ø	3	
Transition - Generic	Transition - Generic: Standard	3/8"ø-1/4"ø	1	

MECHANICAL EQUIPMENT SCHEDULE				
CATAGORY	DESCRIPTION COU			
AIR HANDLING UNIT	AIR HANDLING UNIT: WALL MOUNTED	3		
CONDENSER	CONDENSER: OUT DOOR 1			
Exhaust Fan	EXHAUST FAN: 75 CFM 2			
	Hood-Wall2: VENT 2 1			

DUCT FITTING SCHEDULE				
CATAGORY	DESCRIPTION	COUNT		
Round Transition - Angle 45 Degree 7				

	DUCT ACCESSORY SCHEDULE	
CATAGORY	DESCRIPTION	COUNT
ROOF VENT	3" DIAMETER	4

	FLEX DUCT SCHEDULE			
DESCRIPTION	DESCRIPTION	LENGTH	DIAMETER	COUNT
Flex Duct Round	FLEX-ROUND	10.12	4"	4
Grand total: 4		10.12		



KEY PLAN

NO.	DESCRIPTION	DATE

NOTE:

LEGEND:

PROJECT

79-Hunter-745-2Bd-2Ba Stone-veneer-550

DRAWING NAME

HVAC PLAN

 CLIENT NAME:
 Owner

 PROJECT NUMBER:
 15_0001

 DATE:
 2/24/2025 1:23:27 AM

 DESIGNED BY:
 Designer

 DRAWN BY:
 Author

 CHECKED BY:
 Checker

M101

ELECTRICAL NOTES

- 1. THIS DRAWING DEPICTS THE ELECTRICAL SYSTEM FOR THE 79-Hunter-745-2Bd-2Ba Stone Veneer-550. IT PROVIDES A VISUAL REPRESENTATION OF THE ELECTRICAL LAYOUT AND COMPONENTS, INCLUDING POWER DISTRIBUTION, LIGHTING, AND CONTROL SYSTEMS.
- 2. THE ELECTRICAL SYSTEM IS DESIGNED TO MEET THE SPECIFIC REQUIREMENTS OF THE BUILDING, INCLUDING POWER DISTRIBUTION, LIGHTING, AND SPECIALIZED ELECTRICAL EQUIPMENT NEEDS, AS PER THE PROJECT SPECIFICATIONS AND APPLICABLE CODES AND STANDARDS.
- 3. THE ELECTRICAL SYSTEM INSTALLATION SHALL COMPLY WITH THE LATEST EDITION OF THE NATIONAL ELECTRICAL CODE (NEC), INTERNATIONAL BUILDING CODE (IBC), AND ALL OTHER APPLICABLE LOCAL, STATE, AND NATIONAL CODES AND REGULATIONS.
- 4. LOCATIONS AS NEEDED, DEVICES ARE SHOWN ON PLANS IN APPROXIMATE IDEAL LOCATIONS, UNLESS SPECIFICALLY DIMMENSIONED.
- 5. OPEN WALLS AS NEEDED TO ALLOW FOR NEW ELECTRICAL INSTALLATIONS.
- 6. LABEL ALL CIRCUITS ON JUNCTION BOXES, RECEPTACLES, DATA, SMOKE DETECTOR, AND EQUIPMENT IN PANEL BOX.
- 7. INSTALL RACEWAY AS NEEDED FOR DDC, ACCESS CONTROL, LOW VOLTAGE WIRING & DATA.
- 8. RELABEL POWER, DATA & FIRE ALARM FOR ROOM #CHANGES.
 9. VERIFY ALL CIRCUITS LABELED ON PRINT ARE CORRECT BEFORE WORKING ON THEM.
- 10. NOTE ON SITE PLAN ALL CHANGES OR MISSING DETAIL TO BE INCORPORATED INTO THE MASTER PLAN.
- 11. DRAWINGS ARE DIAGRAMMATIC ONLY FOR THE PURPOSE OF SHOWING FIXTURE AND OUTLET LOCATIONS.
- 12. ELECTRICAL CONTRACTOR TO VERIFY SERVICE SIZE BY CALCULATION BASED UPON ACTUAL NAME PLATE RATINGS OF SELECTED EQUIPMENT.
- PLATE RATINGS OF SELECTED EQUIPMENT.

 13. VERIFY LOCATION OF SERVICE ENTRANCE WITH POWER COMPANY. PROVIDE UFER GROUND IN
- BUILDING FOUNDATION AT SERVICE ENTRANCE WITH POWER COMPANY. PROVIDE UPER GROUND IN
- 14. PROVIDE A MIN. OF 20 FEET OF ONE *4 BARE COPPER UFER WIRE EMBEDDED IN CONCRETE FOOTING
- AT THE SERVICE ENTRANCE LOCATION WHERE APPROVED BY LOCAL SERVICE PROVIDER.

 15. PROVIDE WATERPROOF FIXTURES IN ALL HIGH MOISTURE AREAS (EXTERIOR, SHOWER AND TUB
- 15. PROVIDE WATERPROOF FIXTURES IN ALL HIGH MOISTURE AREAS (EXTERIOR, SHOWER AND TUB CEILINGS ETC.)
- 16. PROVIDE DEDICATED CIRCUITS TO EACH BATH, DEN, FAMILY ROOM, BEDROOM, LOFT, KITCHEN
- REFRIGERATOR, KITCHEN FREEZER DISHWASHER, AND ANY AREA/ITEM SPECIFIED BY OWNER.

 17. INCANDESCENT FIXTURES WITH OPEN OR PARTIALLY ENCLOSED LAMPS, PENDANT FIXTURES, AND
- LAMP HOLDERS ARE NOT PERMITTED IN CLOSETS.

 18. ALL WORKMANSHIP AND MATERIALS TO CONFORM WITH THE 2015 IRC.
- 19. PROVIDE A MIN. OF 20 FEET OF ONE *4 BARE COPPER UFER WIRE EMBEDDED IN CONCRETE FOOTING AT THE SERVICE ENTRANCE LOCATION WHERE APPROVED BY LOCAL SERVICE PROVIDER.
- 20. PROVIDE A BONDING CONDUCTOR CONSISTING OF A MINIMUM OF ONE *4 BARE COPPER WIRE CONNECTING THE BUILDING'S METAL WATER PIPING SYSTEM TO THE SERVICE EQUIPMENT ENCLOSURE GROUNDING.

MAIN PANEL CALCS

ELECTRICAL CALCS	
LIGHT AND OUTLETS 745 @ 3W	2,235 W
3 APPLIANCE CIRCUITS	4,500 W
DRYER	2,000 W
WASHER	2,000 W
RANGE	5,000 W
WATER HEATER	5,000 W
REFRIG.	1,800 W
DISHWASHER & DISPOSAL	3000 W
TOTAL	25,535 W
FRIST 10,000 @ 100% REMAINDER @ 40% MINI. SPLIT UNITS	10,000 W 6,214W 10,000 W
TOTAL	26,214 W

26,214 W DIVIDED BY 240V = 108 AMPS TOTAL

(USE 200 AMP SERVICE)

ELECTRICAL ABBREVIATIONS LIST

1P A AC ACLG ADO AF AFF AFG AFI AHU ALT AMP AMPL ANNUN AQ-STAT ARCH AS AT ATS AUTO AUX AWG BATT BD	1 POLE (2P, 3P, 4P, ETC.) AMPERE ABOVE COUNTER OR AIR CONDITIONER ABOVE CEILING AUTOMATIC DOOR OPENER AMP FRAME ABOVE FINISHED FLOOR ABOVE FINISHED GRADE ARC FAULT CIRCUIT INTERRUPTER AIR HANDLING UNIT ALUMINUM ALTERNATE AMPERE AMPLIFIER ANNUNCIATOR APPROX APPROXIMATELY AQUASTAT ARCHITECT, ARCHITECTURAL AMP SWITCH AMP TRIP AUTOMATIC TRANSFER SWITCH AUTOMATIC AUXILIARY AUDIO VISUAL AMERICAN WIRE GAUGE BATTERY BOARD	CTR CU DCP DEPT DET DIA DISC DIST DN DPR DS DT DWG DDC ELEC ELEV EM EMS EMT EP EQUIP EWC EXIST EXH EXP	CENTER COPPER DOMESTIC WATER CIRCULATING PUMP DEPARTMENT DETAIL DIAMETER DISCONNECT DISTRIBUTION DOWN DAMPER SAFETY DISCONNECT SWITCH DOUBLE THROW DRAWING DIRECT DIGITAL CONTROL ELECTRICAL CONTRACTOR ELECTRIC, ELECTRICAL ELEVATOR EMERGENCY ENERGY MANAGEMENT SYSTEM ELECTRICAL METALLIC TUBING ELECTRIC PNEUMATIC EQUIPMENT ELECTRIC WATER COOLER EXISTING EXHAUST EXPLOSION PROOF	HT HTG HTR HV HVAC CONDITIONING HWP IC IG IMC INCAND IR I/W J-BOX KV KVA KVAR KW KWH LOC LT LTG LTNG LV MAX MAG.S	HEIGHT HEATING HEATER HIGH VOLTAGE HEATING, VENTILATING AND AIR CONDITIONING HYDRONIC WATER PUMP INTERRUPTING CAPACITY ISOLATED GROUND INTERMEDIATE METAL CONDUIT INCANDESCENT INFRARED INTERLOCK WITH JUNCTION BOX KILOVOLT KILOVOLT-AMPERE KILOVOLT-AMPERE REACTIVE KILOWATT KILOWATT KILOWATT HOUR LOCATE OR LOCATION LIGHT LIGHTING LIGHTNING LOW VOLTAGE MAXIMUM MAGNETIC STARTER
C CAB	CONDUIT CABINET	SUPPLY PANEL FACP	SUPPLY PANEL FIRE ALARM CONTROL PANEL	MCB MCC	MAIN CIRCUIT BREAKER MOTOR CONTROL CENTER
CAT	CATALOG	FCU	FAN COIL UNIT	MDC	MAIN DISTRIBUTION CENTER
CATV	CABLE TELEVISION	FIXT	FIXTURE	MDP	MAIN DISTRIBUTION PANEL
СВ	CIRCUIT BREAKER	FLR	FLOOR	MFR	MANUFACTURERMAIN FUSED
CCTV	CLOSED CIRCUIT TELEVISION	FLUOR	FLUORESCENT	NAL I	DISCONNECT SWITCH
CKT CLG	CIRCUIT CEILING	FU FUDS	FUSE FUSED SAFETY DISCONNECT SWITCH	MH MIC	MANHOLE MICROPHONE
COMB	COMBINATION	GA	GAUGE	MIN	MINIMUM
CMPR	COMPRESSOR	GAL	GALLON	MISC	MISCELLANEOUS
CONN	CONNECTION	GALV	GALVANIZED	MLO	MAIN LUGS ONLY
CONST	CONSTRUCTION	GC	GENERAL CONTRACTOR	MMS	MANUAL MOTOR STARTER
CONT	CONTINUATION OR CONTINUOUS	GEN	GENERATOR	MOA	MULTIOUTLET ASSEMBLY
CONTR	CONTRACTOR CONVECTOR	GFI GFP	GROUND FAULT BROTECTOR	MSP MSBD	MOTOR STARTER PANELBOARD
CONV CP	CIRCULATING PUMP	GND	GROUND FAULT PROTECTOR GROUND	MT	MAIN SWITCHBOARD MOUNT
CRT	CATHODE-RAY TUBE	GRS	GALVANIZED RIGID STEEL (CONDUIT)	MT.C	EMPTY CONDUIT
CT	CURRENT TRANSFORMER	GYP BD	GYPSUM BOARD	UL	UNDERWRITERS LABORATORIES

Branch Panel:

Location: KITCHEN 10 Supply From:

Enclosure: Type 1

Mounting: Recessed

Volts: 120/240 Single
Phases: 1
Wires: 3

A.I.C. Rating:

Mains Type:

Mains Rating: 200 A

MCB Rating: 1 A

Note

Legend:

Circui Numb er		Number of Elements	Rating	Length	Wire Size	A		ı	В	Wire Size	Length	Rating	Number of Elements	Circuit Description	Circuit Numb er
1	BED1 & 2 LIGHT	18	15 A	41' - 10 9/16"	1-#12, 1-#12, 1-#12	1136 VA	1440 VA			1-#10, 1-#10, 1-#10	50' - 0 9/16"	20 A	8	BED1 & 2 RECEPTACLE	2
3	HALL LIGHT	6	15 A	24' - 9 1/4"	1-#14, 1-#14, 1-#14			300 VA	456 VA	1-#14, 1-#14, 1-#14	16' - 0 13/16"	15 A	9	KITCHEN LIGHT	4
5	LIV. LIGHT	6	15 A	27' - 5 7/16"	1-#14, 1-#14, 1-#14	209 VA	396 VA			1-#12, 1-#12, 1-#12	31' - 7 1/4"	20 A	7	BATH 1 GFCI	6
7	BATH2 GFCI	8	20 A	22' - 3 21/32"	1-#12, 1-#12, 1-#12			576 VA	720 VA	1-#12, 1-#12, 1-#12	24' - 8 3/32"	20 A	5	KITCHEN GFCI	8
9	OVEN HOOD	1	20 A	15' - 1 7/16"	1-#12, 1-#12, 1-#12	180 VA	2500 VA			2-#8, 1-#8, 1-#10	19' - 7 7/16"	50 A	1	RANGE	10
11	RIFRIGRATOR	1	20 A	23' - 6 5/8"	1-#12, 1-#12, 1-#12			1500 VA	2500 VA						12
13	OUTDOOR GFCI	3	20 A	45' - 8 11/32"	1-#12, 1-#12, 1-#12	540 VA	900 VA			1-#12, 1-#12, 1-#12	30' - 7 1/2"	20 A	5	LIV. RECEPTACLE	14
15	WASHEING MASHEIN	1	20 A	32' - 5"	1-#12, 1-#12, 1-#12			1200 VA	2500 VA	2-#10, 1-#10, 1-#10	30' - 5 7/8"	30 A	1	DRYER	16
17	WATER HEATER	1	30 A	32' - 8 5/8"	2-#10, 1-#10, 1-#10	2250 VA	2500 VA								18
19			-					2250 VA	200 VA	1-#14, 1-#14, 1-#14	27' - 3 11/32"	15 A	3	OUTDOOR LIGHT	20
21	CONDENSER	1	60 A	53' - 10 9/16"	2-#6, 1-#6, 1-#10	2500 VA									22
23			-					2500 VA							24
25															26
	'					14547			1 VA						1
						121	Α	12	2 A						

Load Classification	Connected Load	Demand Factor	Estimated Demand	Panel	Totals
LIGHTING - DWELLING UNIT	500 VA	100.00%	500 VA		
OTHER	1956 VA	100.00%	1956 VA	Total Conn. Load:	29237 VA
RECEPTACLE	5520 VA	100.00%	5520 VA	Total Est. Demand:	28237 VA
LIGHTING	300 VA	100.00%	300 VA	Total Conn.:	122 A
CONDENSER	5000 VA	100.00%	5000 VA	Total Est. Demand:	118 A
WATER HEATER	4500 VA	100.00%	4500 VA		
RANGE	5000 VA	80.00%	4000 VA		
DRYER	5000 VA	100.00%	5000 VA		
REFRIGERATOR	1500 VA	100.00%	1500 VA		

Tuscon,AZ, USA 888-864-0184 inquire@frameupnow.com

www.frameupnow.com

KEY PLAN

NO. DESCRIPTION DATE

NOTE:

LEGEND:

PROJECT

79-Hunter-745-2Bd-2Ba Stone Veneer-550

DRAWING NAME

SCHEDULE

CLIENT NAME:

PROJECT NUMBER:

0338_14

DATE:

2/25/2025 11:57:36 AM

DESIGNED BY:

DRAWN BY:

CHECKED BY:

Checker

E101

SCALE: 1/4" = 1'-0"

© [2024] [FrameUpNow] . All rights reserved

ELECTRICAL NOTE

- A. PROVIDE INTERCONNECTED SMOKE ALARMS IN EACH SLEEPING ROOMS, OUTSIDE EACH SLEEPING ROOM, ON EACH STORY, IN THE HALL OR ADJACENT ROOM LUHERE THE CEILING HEIGHT OF A ROOM OPEN TO THE HALL EXCEEDS THE HALL BY 24'. SMOKE ALARMS SHALL BE PERMANENTLY HARD WIRED WITH BATTERY BACKUP.
- B. RECEPTACLE OUTLETS FOR RANGES AND CLOTHES DRYERS SHALL BE A THREE POLE WITH GROUND TYPE. FOUR WIRE GROUNDING-TYPE FLEXIBLE CORDS WILL BE REQUIRED FOR CONNECTION OF RANGES AND CLOTHES DRYERS. THE BONDING JUMPER SHALL NOT BE CONNECTED BETWEEN NEUTRAL TERMINAL AND THE FRAME OF THE APPLIANCE.
- C. TWO OR MORE 20 AMP SMALL APPLIANCE CIRCUITS SHALL BE PROVIDED TO SERVE THE KITCHEN, BREAKFAST NOOK, AND DINING ROOM. SUCH CIRCUITS SHALL HAVE NO OTHER OUTLETS.
- D. AT LEAST ONE 20 AMP BRANCH CIRCUIT SHALL BE PROVIDED TO SERVICE THE LAUNDRY ROOM. THIS CIRCUIT SHALL HAVE NO OTHER OUTLETS.
- E. ALL RECEPTACLES WITH IN 6' OF A WET BAR SINK OR KITCHEN SINK TO SERVE COUNTER TOP SURFACES MUST BE GFCI. ON KITCHEN COUNTERS 12' OR WIDER NO POINT ALONG THE WALL SHALL BE MORE THAN 2' FROM A RECEPTACLE. ALL RECEPTACLES WITH IN 6' OF KITCHEN SINK MUST BE GFCI. AT LEAST ONE GFCI RECEPTACLE SHALL
- BE INSTALLED IN THE BATHROOM ADJACENT TO EACH BASIN.

 F. FIXTURES INCLUDING CEILING FANS THAT ARE LOCATED IN DAMP LOCATIONS SHALL BE LISTED TO BE SUITABLE FOR
- SUCH LOCATIONS PER 2012 IRC
 G. PROVIDE ONE (1) SWITCHED OUTLET @ ALL BEDROOMS AND DEN
- H. CEILING FANS NOT EXCEEDING 35 LBS. (WITH OR WITHOUT ACCESSORIES MAY BE SUPPORTED BY OUTLET BOXES PROVIDED THE OUTLET BOXES ARE IDENTIFIED FOR SUCH USE PER 2012 IRC
- I. ELECTRICAL OUTLET BOXES ON OPPOSITE SIDES OF FIRE RATED WALLS SHALL BE SEPARATED BY A HORIZONTAL DISTANCE OF NOT LESS THAN 24".
- J. OUTLET BOXES IN THE WALLS BETWEEN THE GARAGE AND DWELLING SHALL BE METAL OR U.L. APPROVED FIRE RESISTIVE PLASTIC. BOXES IN GARAGE CEILING SHALL BE METAL.
- K. ALL BRANCH CIRCUITS THAT SUPPLY 120 VOLTS SINGLE PHASE 15 AND 20 AMPS RECEPTACLE OUTLETS INSTALLED IN THE DWELLING SHALL BE PROTECTED BY AN ARC FAULT CIRCUIT INTERRUPTER, EXCEPT GFCI RECEPTICLES.

NOTE:

A. RECEPTACLES MUST BE PROVIDED IN HALLWAYS 10'-0" OR MORE IN LENGTH. FOR A ONE FAMILY DWELLINGS AND EACH OF A TWO FAMILY DWELLING THAT IS AT GRADE LEVEL, AT LEAST ONE WP-GFCI RECEPTACLE OUTLET ACCESSIBLE AT GRADE LEVEL AND NOT MORE THAN 6'-6" ABOVE GRADE SHALL BE INSTALLED AT THE FRONT AND BACK OF THE DWELLING.

NOTE: APPLIANCE DISCONNECT

E4001.5 GROUNDING OF ENCLOSURES.

METAL ENCLOSURES FOR SWITCHES OR CIRCUIT BREAKERS SHALL BE CONNECTED TO AN

EQUIPMENT GROUNDING CONDUCTOR.

METAL ENCLOSURES FOR SWITCHES OR CIRCUIT BREAKERS USED AS SERVICE


EQUIPMENT SHALL COMPLY WITH THE PROVISIONS OF SECTION E3609.4. WHERE NONMETALLIC ENCLOSURES ARE USED WITH METAL RACEWAYS OR METAL-ARMORED

CABLES. PROVISIONS SHALL BE MADE FOR CONNECTING THE EQUIPMENT GROUNDING


CONDUCTOR.
NONMETALLIC BOXES FOR SWITCHES SHALL BE INSTALLED WITH A WIRING METHOD THAT

PROVIDES OR INCLUDES AN EQUIPMENT GROUNDING CONDUCTOR. (404.12)

ELECTRICAL LEGEND				
	Electrical Lights With Fan			
0	Waterproof Recessed Can Light			
	Pendant Light			
0	Recessed Can Light			
-Ф	Wall Lamp			
	Standalone linear			
⊎ Ð	Single Switch			
₩.	Three way Switch			
₩	Fan Switch			
	Duplex Receptacle			
	Triplex Receptacle			
⊕ □GFCI	GFCI Receptacle			
	Exhaust Fan			
•	Smoke and heat detector			

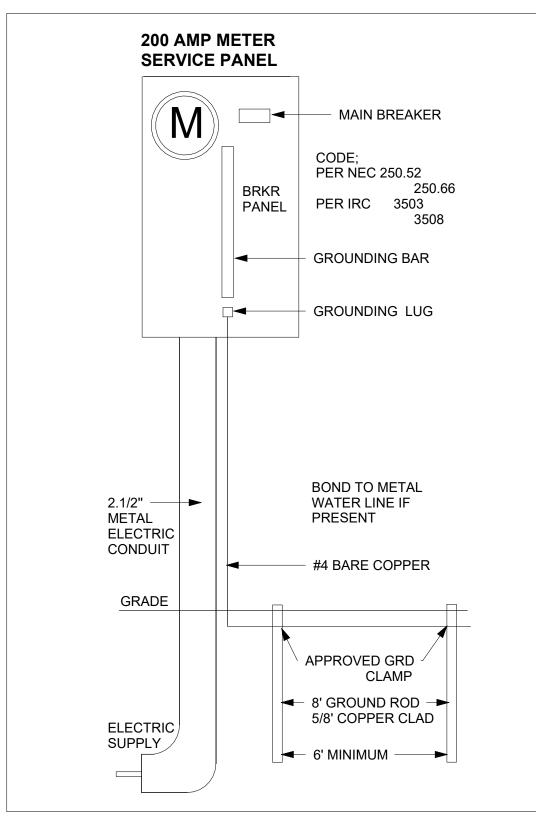



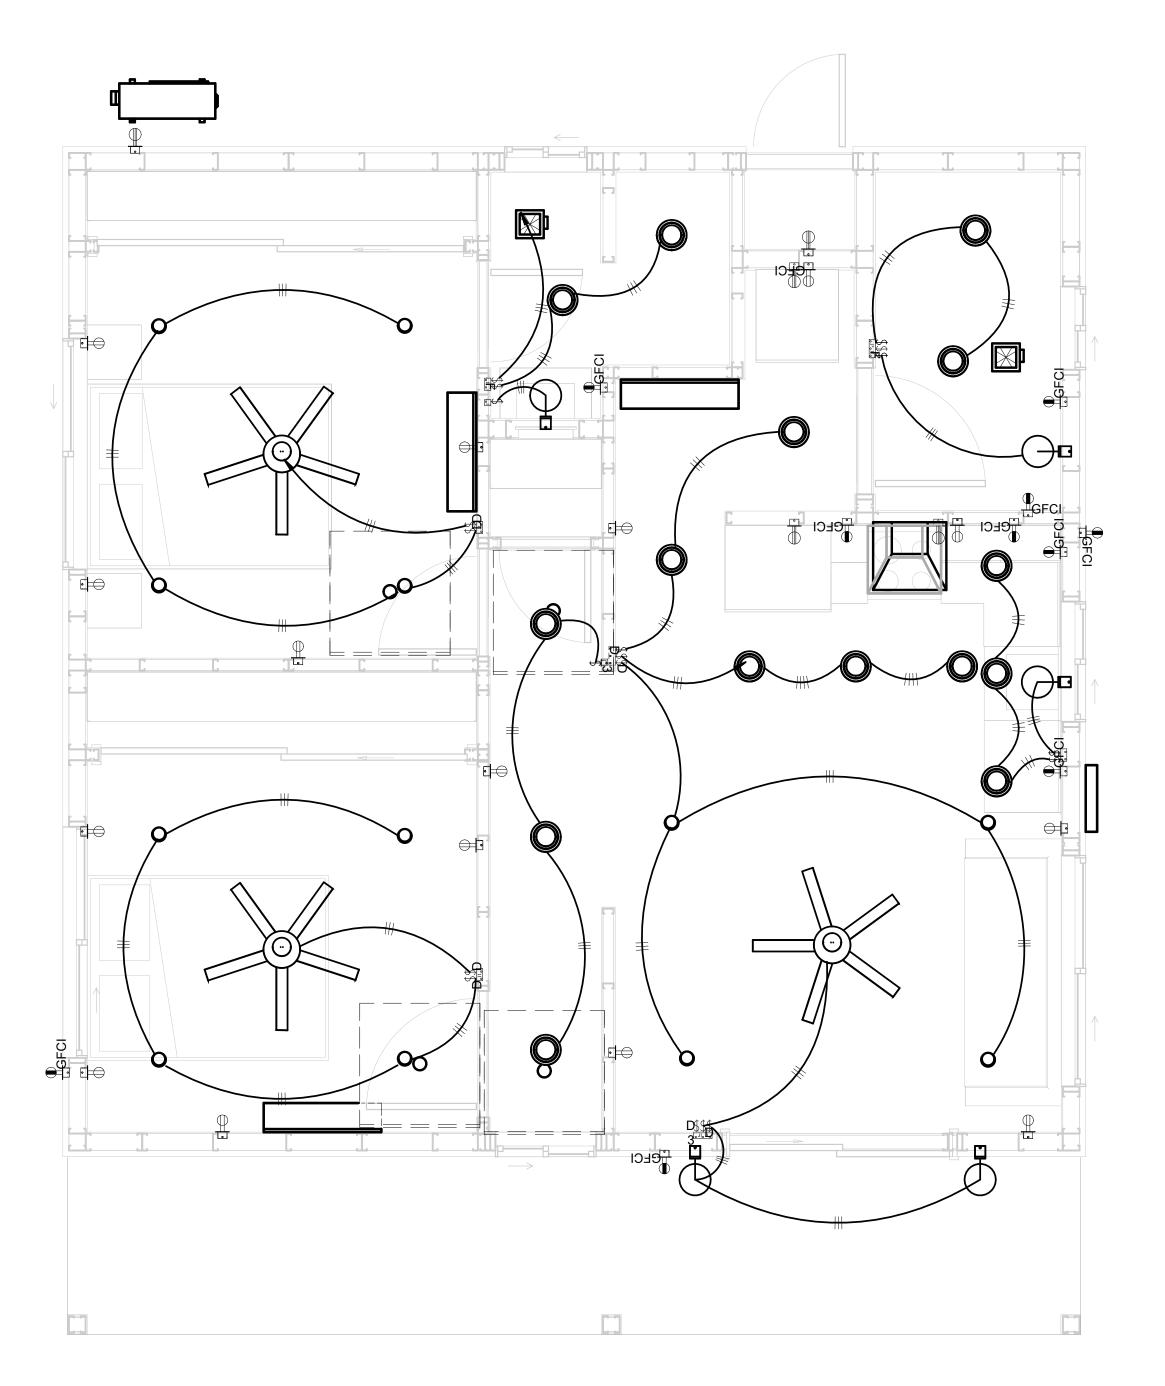

1 - Lighting 3/8" = 1'-0"



KEY PLAN

NO. DESCRIPTION DATE

NOTE:

LEGEND:

PROJECT

79-Hunter-745-2Bd-2Ba Stone Veneer-550

DRAWING NAME

LIGHTING

CLIENT NAME:

PROJECT NUMBER:

DATE:

2/25/2025 11:57:39 AM

DESIGNED BY:

DRAWN BY:


CHECKED BY:

Checker


E102

NOTES: CONDUIT, CABLE AND WIRING


- Use Metalic Conduits (IMC) for cables running under concrete slabs.
 Use IMC for circuits with high voltage appliances (240 volts and above)
 For circuits with 120 volts consider using EMT or PVC conduits if needed.
 For Low voltage applications up to 50 volts consider using non metalic conduits.
 All conduits to be used in the project must conform to the latest National Electrical Code (NEC),
- 6. All wiring and cables to be used in the project must also conform to the latest National Electrical
- 7. All cables and wires used should be rated for their respective loading and should be gauged and conform to the NEC.

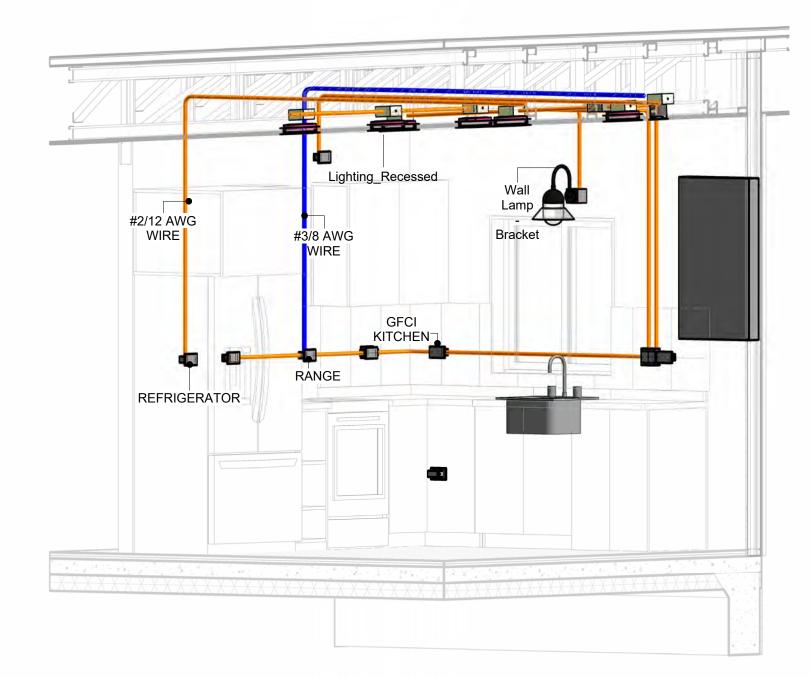


3D-KITCHEN

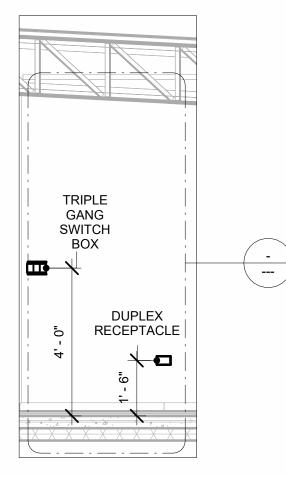


Section 1
3/8" = 1'-0"

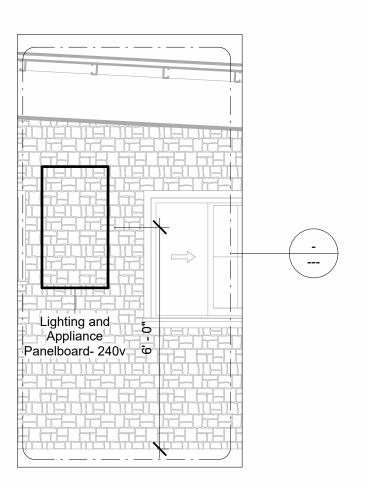

Section 3 3/8" = 1'-0"

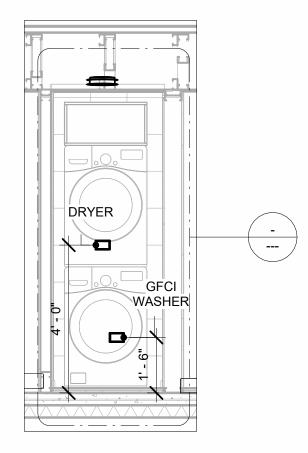

Section 2 3/8" = 1'-0"

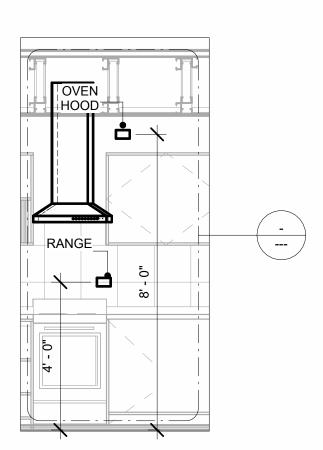

Section 4 3/8" = 1'-0"



KEY PLAN



NO.	DESCRIPTION	DATE

NOTE:

LEGEND:

PROJECT

79-Hunter-745-2Bd-2Ba Stone Veneer-550

DRAWING NAME

POWER

CLIENT NAME:	Owner
PROJECT NUMBER:	0338_14
DATE:	2/25/2025 11:58:03 AM
DESIGNED BY:	Designer
DRAWN BY:	Author
CHECKED BY:	Checker

E103

© [2024] [FrameUpNow] . All rights reserved

NOTES: LIGHT

- 1. LIGHT FIXTURES AND LUMINARIES SHALL CONFORM TO THE NEC, THE IRC AND LOCAL SAFETY & BUILDING CODE.
- 2. ALL LIGHTING FIXTURES SHOULD CONFORM TO THE DESIGN ELECTRICAL LOAD AND SHALL BE PROPERLY WIRED AND MOUNTED BY QUALIFIED ELECTRICIAN FOLLOWING MANUFACTURERS SPECIFICATIONS.
- 3. CEILING FANS AND FANS WITH LIGHT WITH WEIGHT EXCEEDING 35 LBS SHOULD BE PROVIDED WITH STRUCTURAL BACKING FOR SUPPORT AND SHALL BE FIXED AS PER MANUFACTURERS SPECIFICATIONS.
- 4. EXTERIOR LIGHTS SHALL CONFORM TO LOCAL BUILDING CODE AND GUIDELINES.

NOTES: SWITCH JUNCTION BOX

- 1. THE MINIMUM SIZE OF JUCTION BOX TO BE USED IS 2"X4"X(1.5" OR 3.5" DEEP) THIS ARE TO BE USED FOR SINGLE GANG SWITCH OR OUTLETS.
- 2. FOR DOUBLE GANG (2 GANG) OUTLETS AND SWITCHS THE MINIMUM SIZE OF THE
- JUCTION BOX TO BE PROVIDED SHALL NOT BE LESS THAN 4"X4"X(1.5" OR 3.5" DEEP)
- 3. FOR THREE GANG (3 GANG) OUTLETS AND SWITCHS THE MINIMUM SIZE OF THE JUĆTION BOX SHALL NOT BE LESS THAN 6"X4"X(1.5" OR 3.5" DEEP).


FITTING SCHEDULE(PULL BOX)						
FAMILY	COUNT	DESCRIPTION				
CONDUIT JUNCTION BOX - TEE - ALUMINUM	1					
PULLBOX1	34	#1/4 PULLBOX				

ELECTRICAL FIXTURE SCHEDULE (SWITCH BOX)					
TYPE COUNT					
DOUBLE GANG SWITCH BOX	4				
SINGLE GANG SWITCH BOX	2				
TRIPLE GANG SWITCH BOX	3				

LIGHTING DEVICE							
TYPE	COUNT						
DIMMER	6						
FAN SWITCH	2						
SINGLE POLE	9						
THREE WAY WITH DIMMER	2						

VOLTAGE	ELECTRICAL LOAD	COUNT
		·
120 V/1-100 VA- 120 V/1-100 VA	200 A, 120 V/240 V, SINGLE PHASE, 3 WIRES	3
120 V/1-60 VA	200 A, 120 V/240 V, SINGLE PHASE, 3 WIRES	15
120 V/1-28 VA	200 A, 120 V/240 V, SINGLE PHASE, 3 WIRES	12
120 V/1-100 VA	200 A, 120 V/240 V, SINGLE PHASE, 3 WIRES	5
	120 V/1-100 VA- 120 V/1-100 VA 120 V/1-60 VA 120 V/1-28 VA	120 V/1-100 VA- 120 V/1-100 VA PHASE, 3 WIRES 120 V/1-60 VA 200 A, 120 V/240 V, SINGLE PHASE, 3 WIRES 120 V/1-28 VA 200 A, 120 V/240 V, SINGLE PHASE, 3 WIRES 120 V/1-100 VA 200 A, 120 V/240 V, SINGLE PHASE, 3 WIRES

LIGHTING FIXTURE

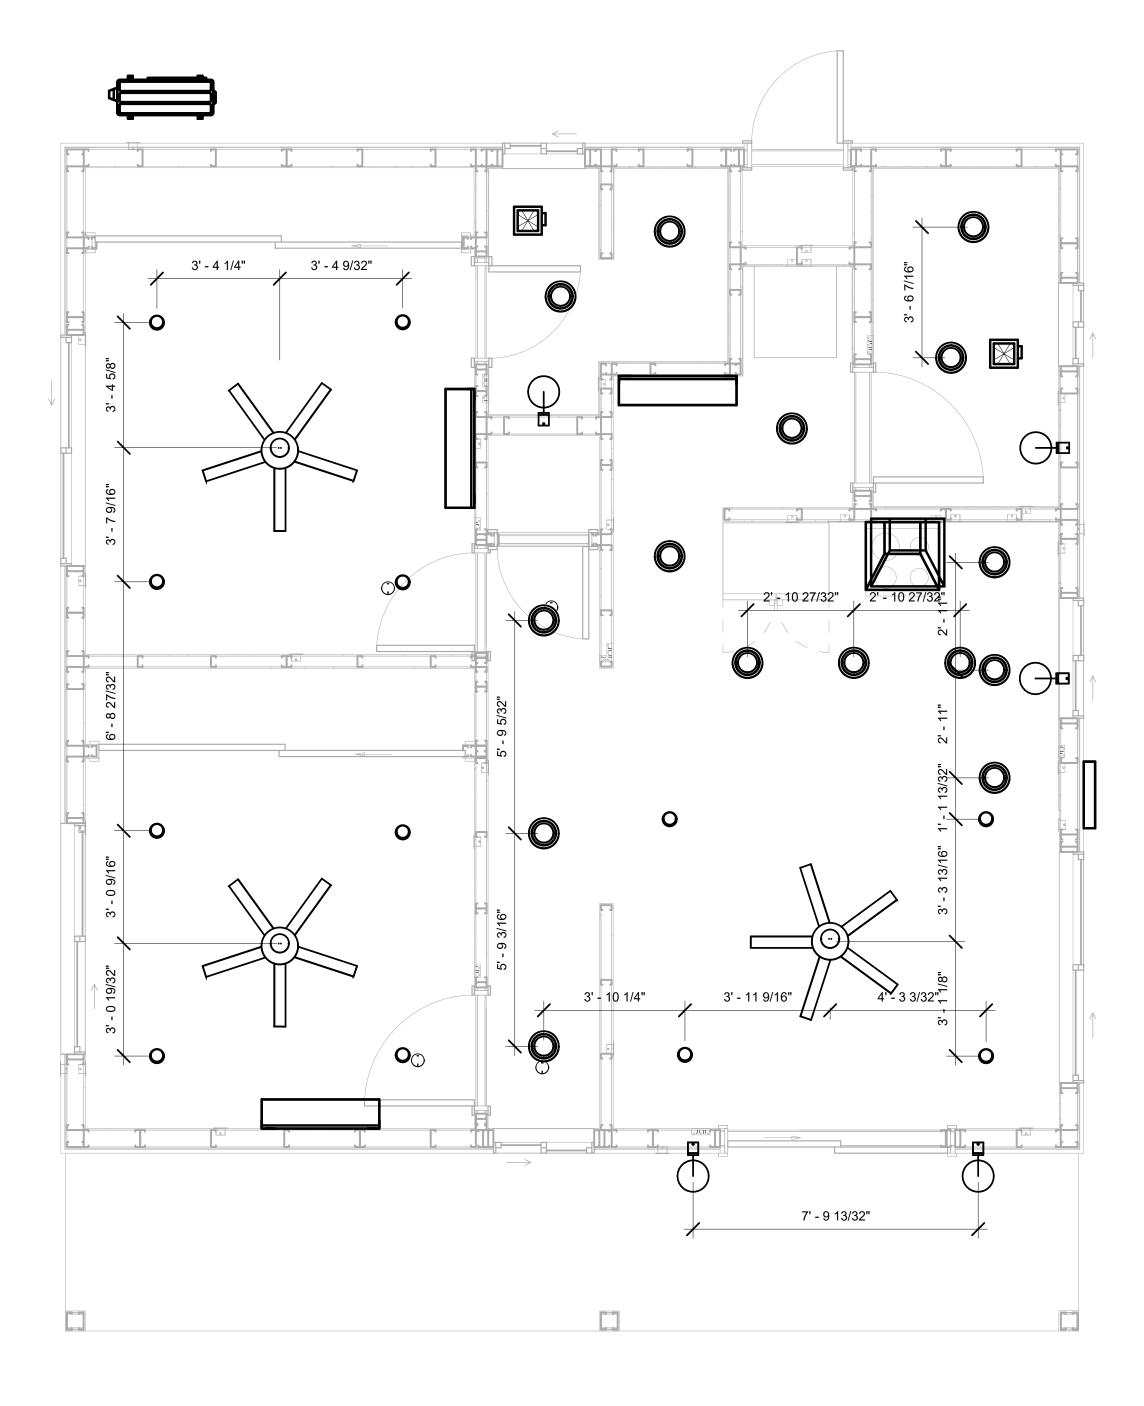

DIMENSION FOR LIGHT FIXTURES 3/8" = 1'-0"



KEY PLAN

NO.	DESCRIPTION	DATE			

NOTE:

LEGEND:

PROJECT

79-Hunter-745-2Bd-2Ba Stone Veneer-550

DRAWING NAME

DIMENSION PLAN FOR LIGHT FIXTURES

CLIENT NAME:	Owner
PROJECT NUMBER:	0338_14
DATE:	2/25/2025 11:58:05 AM
DESIGNED BY:	Designer
DRAWN BY:	Author
CHECKED BY:	Checker


E104

NOTES;

- 1. VERIFY EQUIPMENT PLUG CONFIGURATION BEFORE PURCHASING RECEPTACLES
- 2. FOR ALL EQUIPMENT.
- 3. COORDINATE EXACT LOCATION OF LIGHT FIXTURES, WALL SWITCHES, RECEPTACLES AND OTHER DEVICES WITH ARCHITECTURAL DRAWINGS.
- 4. USE METALLIC JUNCTION BOX WITH THE GFCI RECEPTACLES, WITH HIGHT VOLTAGE.

ELECTRICAL FIXTURE SCHEDULE (RECEPTACLE)					
TYPE	COUNT				
CONDENSER	1				
DRYER	1				
DUPLEX RECEPTACLE	13				
GFCI BATH ROOM	3				
GFCI KITCHEN	4				
GFCI OUT DOOR	3				
GFCI WASHER	1				
OVEN HOOD	1				
RANGE	1				
REFRIGERATOR	1				
WATER HEATER	1				

ELECTRICAL OUTLET SCHEDULE							
TYPE	CIRCUIT NUMBER	ELECTRICAL DATA	COUNT				
			-				
DUPLEX RECEPTACLE	2	120 V/1-180 VA	8				
GFCI BATH ROOM	6	120 V/1-180 VA	1				
GFCI BATH ROOM	7	120 V/1-180 VA	2				
GFCI KITCHEN	8	120 V/1-180 VA	4				
OVEN HOOD	9	120 V/1-180 VA	1				
RANGE	10,12	240 V/2-5000 VA	1				
REFRIGERATOR	11	120 V/1-1500 VA	1				
GFCI OUT DOOR	13	120 V/1-180 VA	3				
DUPLEX RECEPTACLE	14	120 V/1-180 VA	5				
GFCI WASHER	15	120 V/1-1200 VA	1				
DRYER	16,18	240 V/2-5000 VA	1				
WATER HEATER	17,19	240 V/2-4500 VA	1				
CONDENSER	21,23	240 V/2-5000 VA	1				

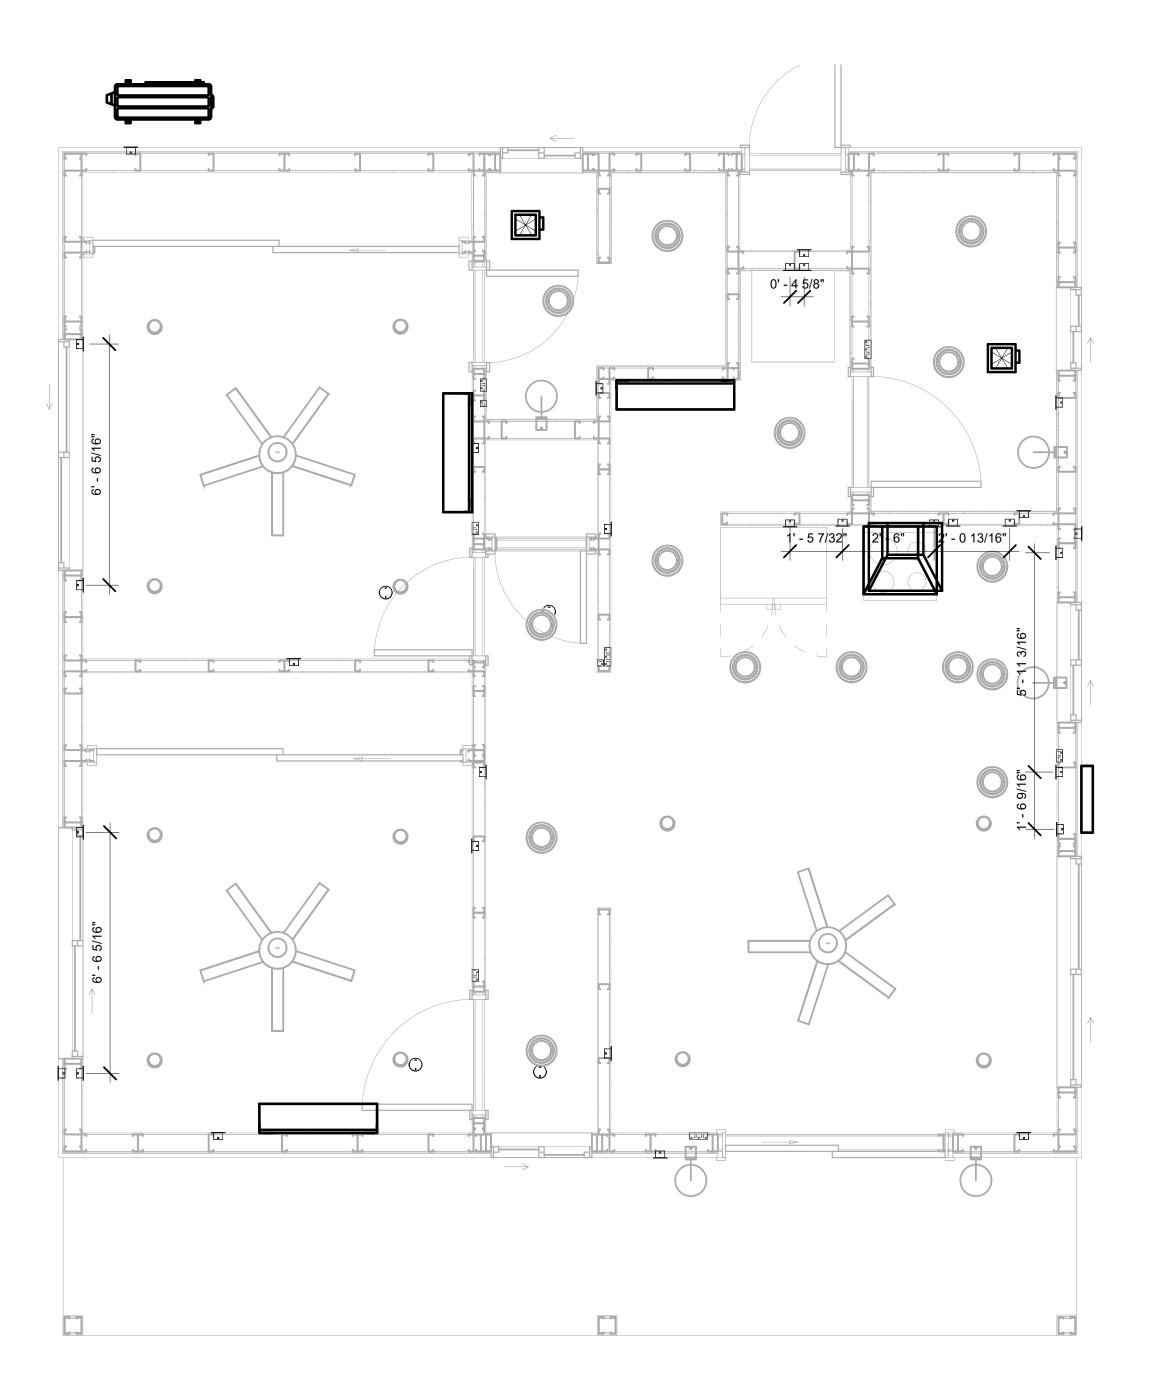

DIMENSION FOR FITTINGS
3/8" = 1'-0"



KEY PLAN

NO.	DESCRIPTION	DATE

NOTE:

LEGEND:

PROJECT

79-Hunter-745-2Bd-2Ba Stone Veneer-550

DRAWING NAME

DIMENSION PLAN FOR FITTINGS

CLIENT NAME:	Owner
PROJECT NUMBER:	0338_14
DATE:	2/25/2025 11:58:07 AM
DESIGNED BY:	Designer
DRAWN BY:	Author
CHECKED BY:	Checker

E105

SHEET LIST

SHEET NUMBER SHEET NAME

P101 NOTE AND SCHEDULE WATER SUPPLY AND SEWAGE P102 SYSTEM

PIPE COLOR SCHE	ME
DOMES SANITA	RY SEWER I DRAINAGE
GAS LII	·· ·· —· ·

PLUMBING NOTES

- THE PLUMBING SYSTEM IS DESIGNED TO MEET THE BUILDING'S DOMESTIC WATER SUPPLY, SANITARY DRAINAGE, AND STORM DRAINAGE REQUIREMENTS, AS PER PROJECT SPECIFICATIONS AND APPLICABLE CODES.
- THE SYSTEM INSTALLATION SHALL COMPLY WITH THE LATEST INTERNATIONAL PLUMBING CODE (IPC), INTERNATIONAL RESIDENTIAL CODE (IRC), AND ALL OTHER RELEVANT LOCAL, STATE, AND NATIONAL REGULATIONS.
- ALL PLUMBING WORK SHALL COMPLY WITH THE LATEST EDITION OF THE INTERNATIONAL PLUMBING CODE (IPC) AND THE LOCAL PLUMBING CODE.
- PLUMBING SYSTEMS SHALL BE TESTED AND INSPECTED IN ACCORDANCE WITH THE LOCAL PLUMBING CODE REQUIREMENTS.
- 5. PLUMBING FIXTURES SHALL BE INSTALLED WITH THE APPROPRIATE TRIM, FITTINGS, AND
- ACCESSORIES, AS RECOMMENDED BY THE MANUFACTURER. 6. PIPING SHALL BE PROPERLY SUPPORTED AND SECURED TO PREVENT SAGGING, MOVEMENT, AND VIBRATION.
- SHUT-OFF VALVES SHALL BE PROVIDED AT ALL BRANCH CONNECTIONS AND AT THE INLET AND OUTLET OF EACH PIECE OF EQUIPMENT.
- BACKFLOW PREVENTION DEVICES SHALL BE INSTALLED AS REQUIRED BY THE LOCAL
- PLUMBING CODE TO PROTECT THE POTABLE WATER SYSTEM. PLUMBING FIXTURES AND EQUIPMENT SHALL BE ACCESSIBLE FOR MAINTENANCE AND
- 10. EXPOSED PLUMBING PIPING AND FIXTURES SHALL BE INSULATED TO PREVENT CONDENSATION AND ENERGY LOSS.
- 11. DEAD ENDS IN THE DRAINAGE SYSTEM MUST BE AVOIDED, EXCEPT WHERE NECESSARY TO INSTALL A CLEANOUT IN AN ACCESSIBLE LOCATION, AND MUST HAVE A VENTED CONNECTION TO THE OUTSIDE ATMOSPHERE.
- 12. THE VERTICAL DEFLECTION OF PVC PIPE MUST NOT EXCEED 5%, AND NO DEFLECTION IS PERMITTED FOR IRON PIPE.
- 13. WORK MUST BE PROPERLY COORDINATED WITH OTHER TRADES TO AVOID CONFLICTS, REFERRING TO THE ARCHITECTURAL AND STRUCTURAL DRAWINGS FOR INFORMATION REGARDING CEILING ELEVATIONS, SPACE CLEARANCES, WALL AND PARTITION LOCATIONS, ETC.
- 14. ALL FIXTURES SHALL HAVE ACCESSIBLE STOPS.
- 15. DOMESTIC WATER PIPING SHALL BE PEX, AND PVC PIPING IS NOT ACCEPTABLE FOR INTERIOR USE.
- 16. VENT TERMINATIONS SHALL BE LOCATED AT LEAST 10 FEET FROM OR 3 FEET ABOVE ANY OPERABLE WINDOW, DOOR OPENING, AIR INTAKE, OR VENT SHAFT, AND AT LEAST 3 FEET IN EVERY DIRECTION FROM ANY LOT LINE, ALLEY, OR STREET.
- 17. PIPE AND FITTINGS UTILIZED IN THE WATER SUPPLY SYSTEM SHALL HAVE A MAXIMUM OF 8 PERCENT LEAD.
- 18. ACRYLONITRILE BUTADIENE STYRENE (ABS) SHALL BE USED FOR THE SEWERAGE AND **VENTILATION SYSTEM.**
- 19. CROSS-LINKED POLYETHYLENE (PEX) SHALL BE USED FOR THE WATER SUPPLY SYSTEM.
- POLYVINYL CHLORIDE (PVC) SHALL BE USED FOR THE RAIN WATER SYSTEM.
- 21. THE MIMIMUM WATER SUPPLY DEPTH UNDER FLOOR FINISH SHOUD BE 1/2". 22. ANY PIPE INSTALLED UNDERGROUND MUST HAVE AT LEAST 12 INCHES OF CLEARANCE
- BETWEEN THE OUTSIDE OF THE PIPE AND ANY OTHER UNDERGROUND STRUCTURE.
- 23. THE MINIMUM CLEARANCE BETWEEN COLD AND HOT WATER LINES IN RESIDENTIAL
- HOMES MAINTAIN A MINIMUM DISTANCE OF 6 INCHES. 24. HORIZONTAL SEPARATION BETWEEN WATER AND SEWER LINES: A MINIMUM OF 12 INCHES BETWEEN POTABLE WATER SUPPLY LINES (COLD AND HOT WATER) AND

ABBREVIATIONS

SANITARY SEWER LINES.

Ø DIAMETER ABS ACRYLONITRILE BUTADIENE STYRENE ABV ABOVE AD AREA DRAIN AFF ABOVE FINISHED FLOOR ALT ALTERNATE BFF BELOW FINISHED FLOOR BLW BELOW CO CLEAN OUT CW COLD WATER D DEGREE DFU DRANAGE FIXTURE UNIT DIA DIAMETER DN DOWN FCO FLOOR CLEAN OUT FD FLOOR DRAIN FL FLOOR FS FLOOR SINK FT FOOT/FEET HB HOSE BIB HW HOT WATER IN INCH MIN MINIMUM NO NUMBER NTS NOT TO SCALE PEX CROSS-LINKED POLYETHYLENE PLBG PLUMBING PVC POLYVINYL CHLORIDE QTY QUANTITY RD ROOF DRAIN RED REDUCER
ABV ABOVE AD AREA DRAIN AFF ABOVE FINISHED FLOOR ALT ALTERNATE BFF BELOW FINISHED FLOOR BLW BELOW CO CLEAN OUT CW COLD WATER D DEGREE DFU DRANAGE FIXTURE UNIT DIA DIAMETER DN DOWN FCO FLOOR CLEAN OUT FD FLOOR DRAIN FL FLOOR FS FLOOR SINK FT FOOT/FEET HB HOSE BIB HW HOT WATER IN INCH MIN MINIMUM NO NUMBER NTS NOT TO SCALE PEX CROSS-LINKED POLYETHYLENE PLBG PLUMBING PVC POLYVINYL CHLORIDE QTY QUANTITY RD ROOF DRAIN
AD AREA DRAIN AFF ABOVE FINISHED FLOOR ALT ALTERNATE BFF BELOW FINISHED FLOOR BLW BELOW CO CLEAN OUT CW COLD WATER D DEGREE DFU DRANAGE FIXTURE UNIT DIA DIAMETER DN DOWN FCO FLOOR CLEAN OUT FD FLOOR DRAIN FL FLOOR FS FLOOR SINK FT FOOT/FEET HB HOSE BIB HW HOT WATER IN INCH MIN MINIMUM NO NUMBER NTS NOT TO SCALE PEX CROSS-LINKED POLYETHYLENE PLBG PLUMBING PVC POLYVINYL CHLORIDE QTY QUANTITY RD ROOF DRAIN
AFF ABOVE FINISHED FLOOR ALT ALTERNATE BFF BELOW FINISHED FLOOR BLW BELOW CO CLEAN OUT CW COLD WATER D DEGREE DFU DRANAGE FIXTURE UNIT DIA DIAMETER DN DOWN FCO FLOOR CLEAN OUT FD FLOOR DRAIN FL FLOOR FS FLOOR SINK FT FOOT/FEET HB HOSE BIB HW HOT WATER IN INCH MIN MINIMUM NO NUMBER NTS NOT TO SCALE PEX CROSS-LINKED POLYETHYLENE PLBG PLUMBING PVC POLYVINYL CHLORIDE QTY QUANTITY RD ROOF DRAIN
ALT ALTERNATE BFF BELOW FINISHED FLOOR BLW BELOW CO CLEAN OUT CW COLD WATER D DEGREE DFU DRANAGE FIXTURE UNIT DIA DIAMETER DN DOWN FCO FLOOR CLEAN OUT FD FLOOR DRAIN FL FLOOR FS FLOOR SINK FT FOOT/FEET HB HOSE BIB HW HOT WATER IN INCH MIN MINIMUM NO NUMBER NTS NOT TO SCALE PEX CROSS-LINKED POLYETHYLENE PLBG PLUMBING PVC POLYVINYL CHLORIDE QTY QUANTITY RD ROOF DRAIN
BFF BELOW FINISHED FLOOR BLW BELOW CO CLEAN OUT CW COLD WATER D DEGREE DFU DRANAGE FIXTURE UNIT DIA DIAMETER DN DOWN FCO FLOOR CLEAN OUT FD FLOOR DRAIN FL FLOOR FS FLOOR SINK FT FOOT/FEET HB HOSE BIB HW HOT WATER IN INCH MIN MINIMUM NO NUMBER NTS NOT TO SCALE PEX CROSS-LINKED POLYETHYLENE PLBG PLUMBING PVC POLYVINYL CHLORIDE QTY QUANTITY RD ROOF DRAIN
BLW BELOW CO CLEAN OUT CW COLD WATER D DEGREE DFU DRANAGE FIXTURE UNIT DIA DIAMETER DN DOWN FCO FLOOR CLEAN OUT FD FLOOR DRAIN FL FLOOR FS FLOOR SINK FT FOOT/FEET HB HOSE BIB HW HOT WATER IN INCH MIN MINIMUM NO NUMBER NTS NOT TO SCALE PEX CROSS-LINKED POLYETHYLENE PLBG PLUMBING PVC POLYVINYL CHLORIDE QTY QUANTITY RD ROOF DRAIN
CO CLEAN OUT CW COLD WATER D DEGREE DFU DRANAGE FIXTURE UNIT DIA DIAMETER DN DOWN FCO FLOOR CLEAN OUT FD FLOOR DRAIN FL FLOOR FS FLOOR SINK FT FOOT/FEET HB HOSE BIB HW HOT WATER IN INCH MIN MINIMUM NO NUMBER NTS NOT TO SCALE PEX CROSS-LINKED POLYETHYLENE PLBG PLUMBING PVC POLYVINYL CHLORIDE QTY QUANTITY RD ROOF DRAIN
CW COLD WATER D DEGREE DFU DRANAGE FIXTURE UNIT DIA DIAMETER DN DOWN FCO FLOOR CLEAN OUT FD FLOOR DRAIN FL FLOOR FS FLOOR SINK FT FOOT/FEET HB HOSE BIB HW HOT WATER IN INCH MIN MINIMUM NO NUMBER NTS NOT TO SCALE PEX CROSS-LINKED POLYETHYLENE PLBG PLUMBING PVC POLYVINYL CHLORIDE QTY QUANTITY RD ROOF DRAIN
D DEGREE DFU DRANAGE FIXTURE UNIT DIA DIAMETER DN DOWN FCO FLOOR CLEAN OUT FD FLOOR DRAIN FL FLOOR FS FLOOR SINK FT FOOT/FEET HB HOSE BIB HW HOT WATER IN INCH MIN MINIMUM NO NUMBER NTS NOT TO SCALE PEX CROSS-LINKED POLYETHYLENE PLBG PLUMBING PVC POLYVINYL CHLORIDE QTY QUANTITY RD ROOF DRAIN
DFU DRANAGE FIXTURE UNIT DIA DIAMETER DN DOWN FCO FLOOR CLEAN OUT FD FLOOR DRAIN FL FLOOR FS FLOOR SINK FT FOOT/FEET HB HOSE BIB HW HOT WATER IN INCH MIN MINIMUM NO NUMBER NTS NOT TO SCALE PEX CROSS-LINKED POLYETHYLENE PLBG PLUMBING PVC POLYVINYL CHLORIDE QTY QUANTITY RD ROOF DRAIN
DIA DIAMETER DN DOWN FCO FLOOR CLEAN OUT FD FLOOR DRAIN FL FLOOR FS FLOOR SINK FT FOOT/FEET HB HOSE BIB HW HOT WATER IN INCH MIN MINIMUM NO NUMBER NTS NOT TO SCALE PEX CROSS-LINKED POLYETHYLENE PLBG PLUMBING PVC POLYVINYL CHLORIDE QTY QUANTITY RD ROOF DRAIN
DN DOWN FCO FLOOR CLEAN OUT FD FLOOR DRAIN FL FLOOR FS FLOOR SINK FT FOOT/FEET HB HOSE BIB HW HOT WATER IN INCH MIN MINIMUM NO NUMBER NTS NOT TO SCALE PEX CROSS-LINKED POLYETHYLENE PLBG PLUMBING PVC POLYVINYL CHLORIDE QTY QUANTITY RD ROOF DRAIN
FCO FLOOR CLEAN OUT FD FLOOR DRAIN FL FLOOR FS FLOOR SINK FT FOOT/FEET HB HOSE BIB HW HOT WATER IN INCH MIN MINIMUM NO NUMBER NTS NOT TO SCALE PEX CROSS-LINKED POLYETHYLENE PLBG PLUMBING PVC POLYVINYL CHLORIDE QTY QUANTITY RD ROOF DRAIN
FD FLOOR DRAIN FL FLOOR FS FLOOR SINK FT FOOT/FEET HB HOSE BIB HW HOT WATER IN INCH MIN MINIMUM NO NUMBER NTS NOT TO SCALE PEX CROSS-LINKED POLYETHYLENE PLBG PLUMBING PVC POLYVINYL CHLORIDE QTY QUANTITY RD ROOF DRAIN
FL FLOOR FS FLOOR SINK FT FOOT/FEET HB HOSE BIB HW HOT WATER IN INCH MIN MINIMUM NO NUMBER NTS NOT TO SCALE PEX CROSS-LINKED POLYETHYLENE PLBG PLUMBING PVC POLYVINYL CHLORIDE QTY QUANTITY RD ROOF DRAIN
FS FLOOR SINK FT FOOT/FEET HB HOSE BIB HW HOT WATER IN INCH MIN MINIMUM NO NUMBER NTS NOT TO SCALE PEX CROSS-LINKED POLYETHYLENE PLBG PLUMBING PVC POLYVINYL CHLORIDE QTY QUANTITY RD ROOF DRAIN
FT FOOT/FEET HB HOSE BIB HW HOT WATER IN INCH MIN MINIMUM NO NUMBER NTS NOT TO SCALE PEX CROSS-LINKED POLYETHYLENE PLBG PLUMBING PVC POLYVINYL CHLORIDE QTY QUANTITY RD ROOF DRAIN
HB HOSE BIB HW HOT WATER IN INCH MIN MINIMUM NO NUMBER NTS NOT TO SCALE PEX CROSS-LINKED POLYETHYLENE PLBG PLUMBING PVC POLYVINYL CHLORIDE QTY QUANTITY RD ROOF DRAIN
HW HOT WATER IN INCH MIN MINIMUM NO NUMBER NTS NOT TO SCALE PEX CROSS-LINKED POLYETHYLENE PLBG PLUMBING PVC POLYVINYL CHLORIDE QTY QUANTITY RD ROOF DRAIN
IN INCH MIN MINIMUM NO NUMBER NTS NOT TO SCALE PEX CROSS-LINKED POLYETHYLENE PLBG PLUMBING PVC POLYVINYL CHLORIDE QTY QUANTITY RD ROOF DRAIN
MIN MINIMUM NO NUMBER NTS NOT TO SCALE PEX CROSS-LINKED POLYETHYLENE PLBG PLUMBING PVC POLYVINYL CHLORIDE QTY QUANTITY RD ROOF DRAIN
NO NUMBER NTS NOT TO SCALE PEX CROSS-LINKED POLYETHYLENE PLBG PLUMBING PVC POLYVINYL CHLORIDE QTY QUANTITY RD ROOF DRAIN
NTS NOT TO SCALE PEX CROSS-LINKED POLYETHYLENE PLBG PLUMBING PVC POLYVINYL CHLORIDE QTY QUANTITY RD ROOF DRAIN
PEX CROSS-LINKED POLYETHYLENE PLBG PLUMBING PVC POLYVINYL CHLORIDE QTY QUANTITY RD ROOF DRAIN
PLBG PLUMBING PVC POLYVINYL CHLORIDE QTY QUANTITY RD ROOF DRAIN
PVC POLYVINYL CHLORIDE QTY QUANTITY RD ROOF DRAIN
QTY QUANTITY RD ROOF DRAIN
RD ROOF DRAIN
RED REDUCER
RM ROOM
RW RAIN WATER
SF SQUARE FOOT
V VENT
VTR VENT THROUGH ROOF
W WASTE
WCO WALL CLEAN OUT
WSFU WATER SUPPLY FIXTURE UNIT

PLUMBING LEGEND

D	CAP
	BEND 45 DEG
\Box	BEND 90 DEG
	TEE REDUCING
	TEE
	CLEAN TWO-WAY
	WYE 45 DEG
	WYE 45 DEG DOUBLE
	WYE COMBINATION
	P-TRAP

PIPE SCHEDULE								
MATERIAL	DIAMETER	LENGTH						
ACRYLONITRILE BUTADIENE STYRENE (ABS)	1 1/2"	30 FT						
ACRYLONITRILE BUTADIENE STYRENE (ABS)	2"	41 FT						
ACRYLONITRILE BUTADIENE STYRENE (ABS)	3"	45 FT						
CROSS-LINKED POLYETHYLENE (PEX)	1/2"	108 FT						
CROSS-LINKED POLYETHYLENE (PEX)	3/4"	34 FT						
POLYVINYL CHLORIDE - RIGID	2"	28 FT						

FITTING SCHEDULE					
FITTING	SIZE	QTY			
ABS 90 DEG BEND ELBOW	3"ø-3"ø	1			
ABS 90 DEGREE BEND ELBOW	1 1/2"ø-1 1/2"ø	3			
ABS 90 DEGREE BEND ELBOW	2"ø-2"ø	2			
ABS 90 DEGREE BEND ELBOW	3"ø-3"ø	1			
ABS P-TRAP	1 1/2"ø-1 1/2"ø	5			
ABS P-TRAP	2"ø-2"ø	2			
ABS REDUCER ELBOW	2"ø-1 1/2"ø	1			
ABS REDUCER ELBOW	3"ø-1 1/2"ø	1			
ABS REDUCER ELBOW	3"ø-2"ø	1			
ABS TEE ELBOW	1 1/2"ø-1 1/2"ø-1 1/2"ø	1			
ABS TEE ELBOW	2"ø-2"ø-2"ø	1			
ABS TEE ELBOW	3"ø-3"ø	4			
ABS TEE REDUCER ELBOW	3"ø-3"ø-1 1/2"ø	3			
ABS TEE REDUCER ELBOW	3"ø-3"ø-2"ø	1			
ABS TEE REDUCER ELBOW	3"ø-3"ø-3"ø	1			
ABS VENT CAP ELBOW	1 1/2"ø	1			
ABS VENT CAP ELBOW	2"ø	2			
ABS VENT CAP ELBOW	3"ø	2			
PEX 90 DEGREE ELBOW	1/2"ø-1/2"ø	35			
PEX 90 DEGREE ELBOW	3/4"ø-3/4"ø	5			
PEX TEE ELBOW	1/2"ø-1/2"ø	7			
PEX TEE ELBOW	3/4"ø-3/4"ø	9			
PEX TRANSITION ELBOW	1"ø-3/4"ø	2			
PEX TRANSITION ELBOW	3/4"ø-1/2"ø	9			
PVC 90 DEG BEND ELBOW	2"ø-2"ø	9			
WASTE DOUBLE TEE	2"ø-2"ø-2"ø	1			

		FIX	TURE	CONN	IECTI	ION	SCH	HEDULE	
FAMILY	W	V	TRAP	CW HW	QTY [DFU	TOT.	WFU TOT.	NOTES

DISHWASHER	2"	1-1/2"	1-1/2"	1/2"	1/2"	1	0		DRAIN TO SEWER SEE PLANS
DRYER	N/A	N/A	N/A	N/A	N/A	1	0		
HANGING PIPES CLAMP						6	0		
SHOWER TRAY	2"	1-1/2"	1-1/2"	1/2"	1/2"	2	0		
SHOWER TRIM	-	-	-	1/2"	1/2"	2	0		
SINK ISLAND SINGLE	2"	1-1/2"	1-1/2"	1/2"	1/2"	1	0		
VANITY SINK	2"	1-1/2"	1-1/2"	1/2"	1/2"	2	0		
WASHER	2"	1-1/2"	2"	1/2"	1/2"	1	0		DRAINS TO GRAY WATER OR SEWER SEE PLANS
WATER CLOSET						2	0		
WATER HEATER	N/A	N/A	N/A	3/4"	3/4"	1	0		

FIXTURE SCHEDULE							
FIXTURE	QTY	DESCRIPTION					
1 3 1 3 1 2							
DISHWASHER	1	DRAIN TO SEWER SEE PLANS					
DRYER	1						
HANGING PIPES CLAMP	6						
SHOWER TRAY	2						
SHOWER TRIM	2						
SINK ISLAND SINGLE	1						
VANITY SINK	2						
WASHER	1	DRAINS TO GRAY WATER OR SEWER SEE PLANS					
WATER CLOSET	2						
WATER HEATER	1						

ACC	ESSORIES	S & FITTINGS SCHEDULE
FIXTURE	QTY	DESCRIPTIONS
HOSE BIB	1	
LAUNDRY SWEAT CONNECTOR	1	
LAUNDRY SWEAT CONNECTOR1	1	
SHUTOFF VALVE	8	

	PL	UMBING S	CHEDULE		
FIXTURE	TRAP	WASTE	VENT	C.W	H.W
DISHWASHER	1-1/2"	2"	1-1/2"	1/2"	1/2"
DRYER	N/A	N/A	N/A	N/A	N/A
SHOWER TRAY	1-1/2"	2"	1-1/2"	1/2"	1/2"
SHOWER TRIM	-	-	-	1/2"	1/2"
SINK ISLAND SINGLE	1-1/2"	2"	1-1/2"	1/2"	1/2"
VANITY SINK	1-1/2"	2"	1-1/2"	1/2"	1/2"
WASHER	2"	2"	1-1/2"	1/2"	1/2"
WATER CLOSET					
WATER HEATER	N/A	N/A	N/A	3/4"	3/4"

1	WATER FIXTURE	UNIT SCHEDULE	
FAMILY	QTY	UNIT VALUE	TOTAL
DISHWASHER	1		0
DRYER	1		0
HANGING PIPES CLAMP	6		0
SHOWER TRAY	2		0
SHOWER TRIM	2		0
SINK ISLAND SINGLE	1		0
VANITY SINK	2		0
WASHER	1		0
WATER CLOSET	2		0
WATER HEATER	1		0

	WASTE FIXTURE L	INIT SCHEDULE	
FAMILY	QTY	DFU VALUES	TOTAL
DISHWASHER	1		0
DRYER	1		0
HANGING PIPES CLAMP	6		0
SHOWER TRAY	2		0
SHOWER TRIM	2		0
SINK ISLAND SINGLE	1		0
VANITY SINK	2		0
WASHER	1		0
WATER CLOSET	2		0
WATER HEATER	1		0



KEY PLAN

NO.	DESCRIPTION	DATE

NOTE:

LEGEND:

PROJECT


79-Hunter-745-2Bd-2Ba Stone Veneer-500

DRAWING NAME

NOTE AND SCHEDULE

CLIENT NAME: PROJECT NUMBER: 0338_14 DATE: 2/21/2025 2:55:42 PM Designer DESIGNED BY: DRAWN BY: Author CHECKED BY: Checker

P101

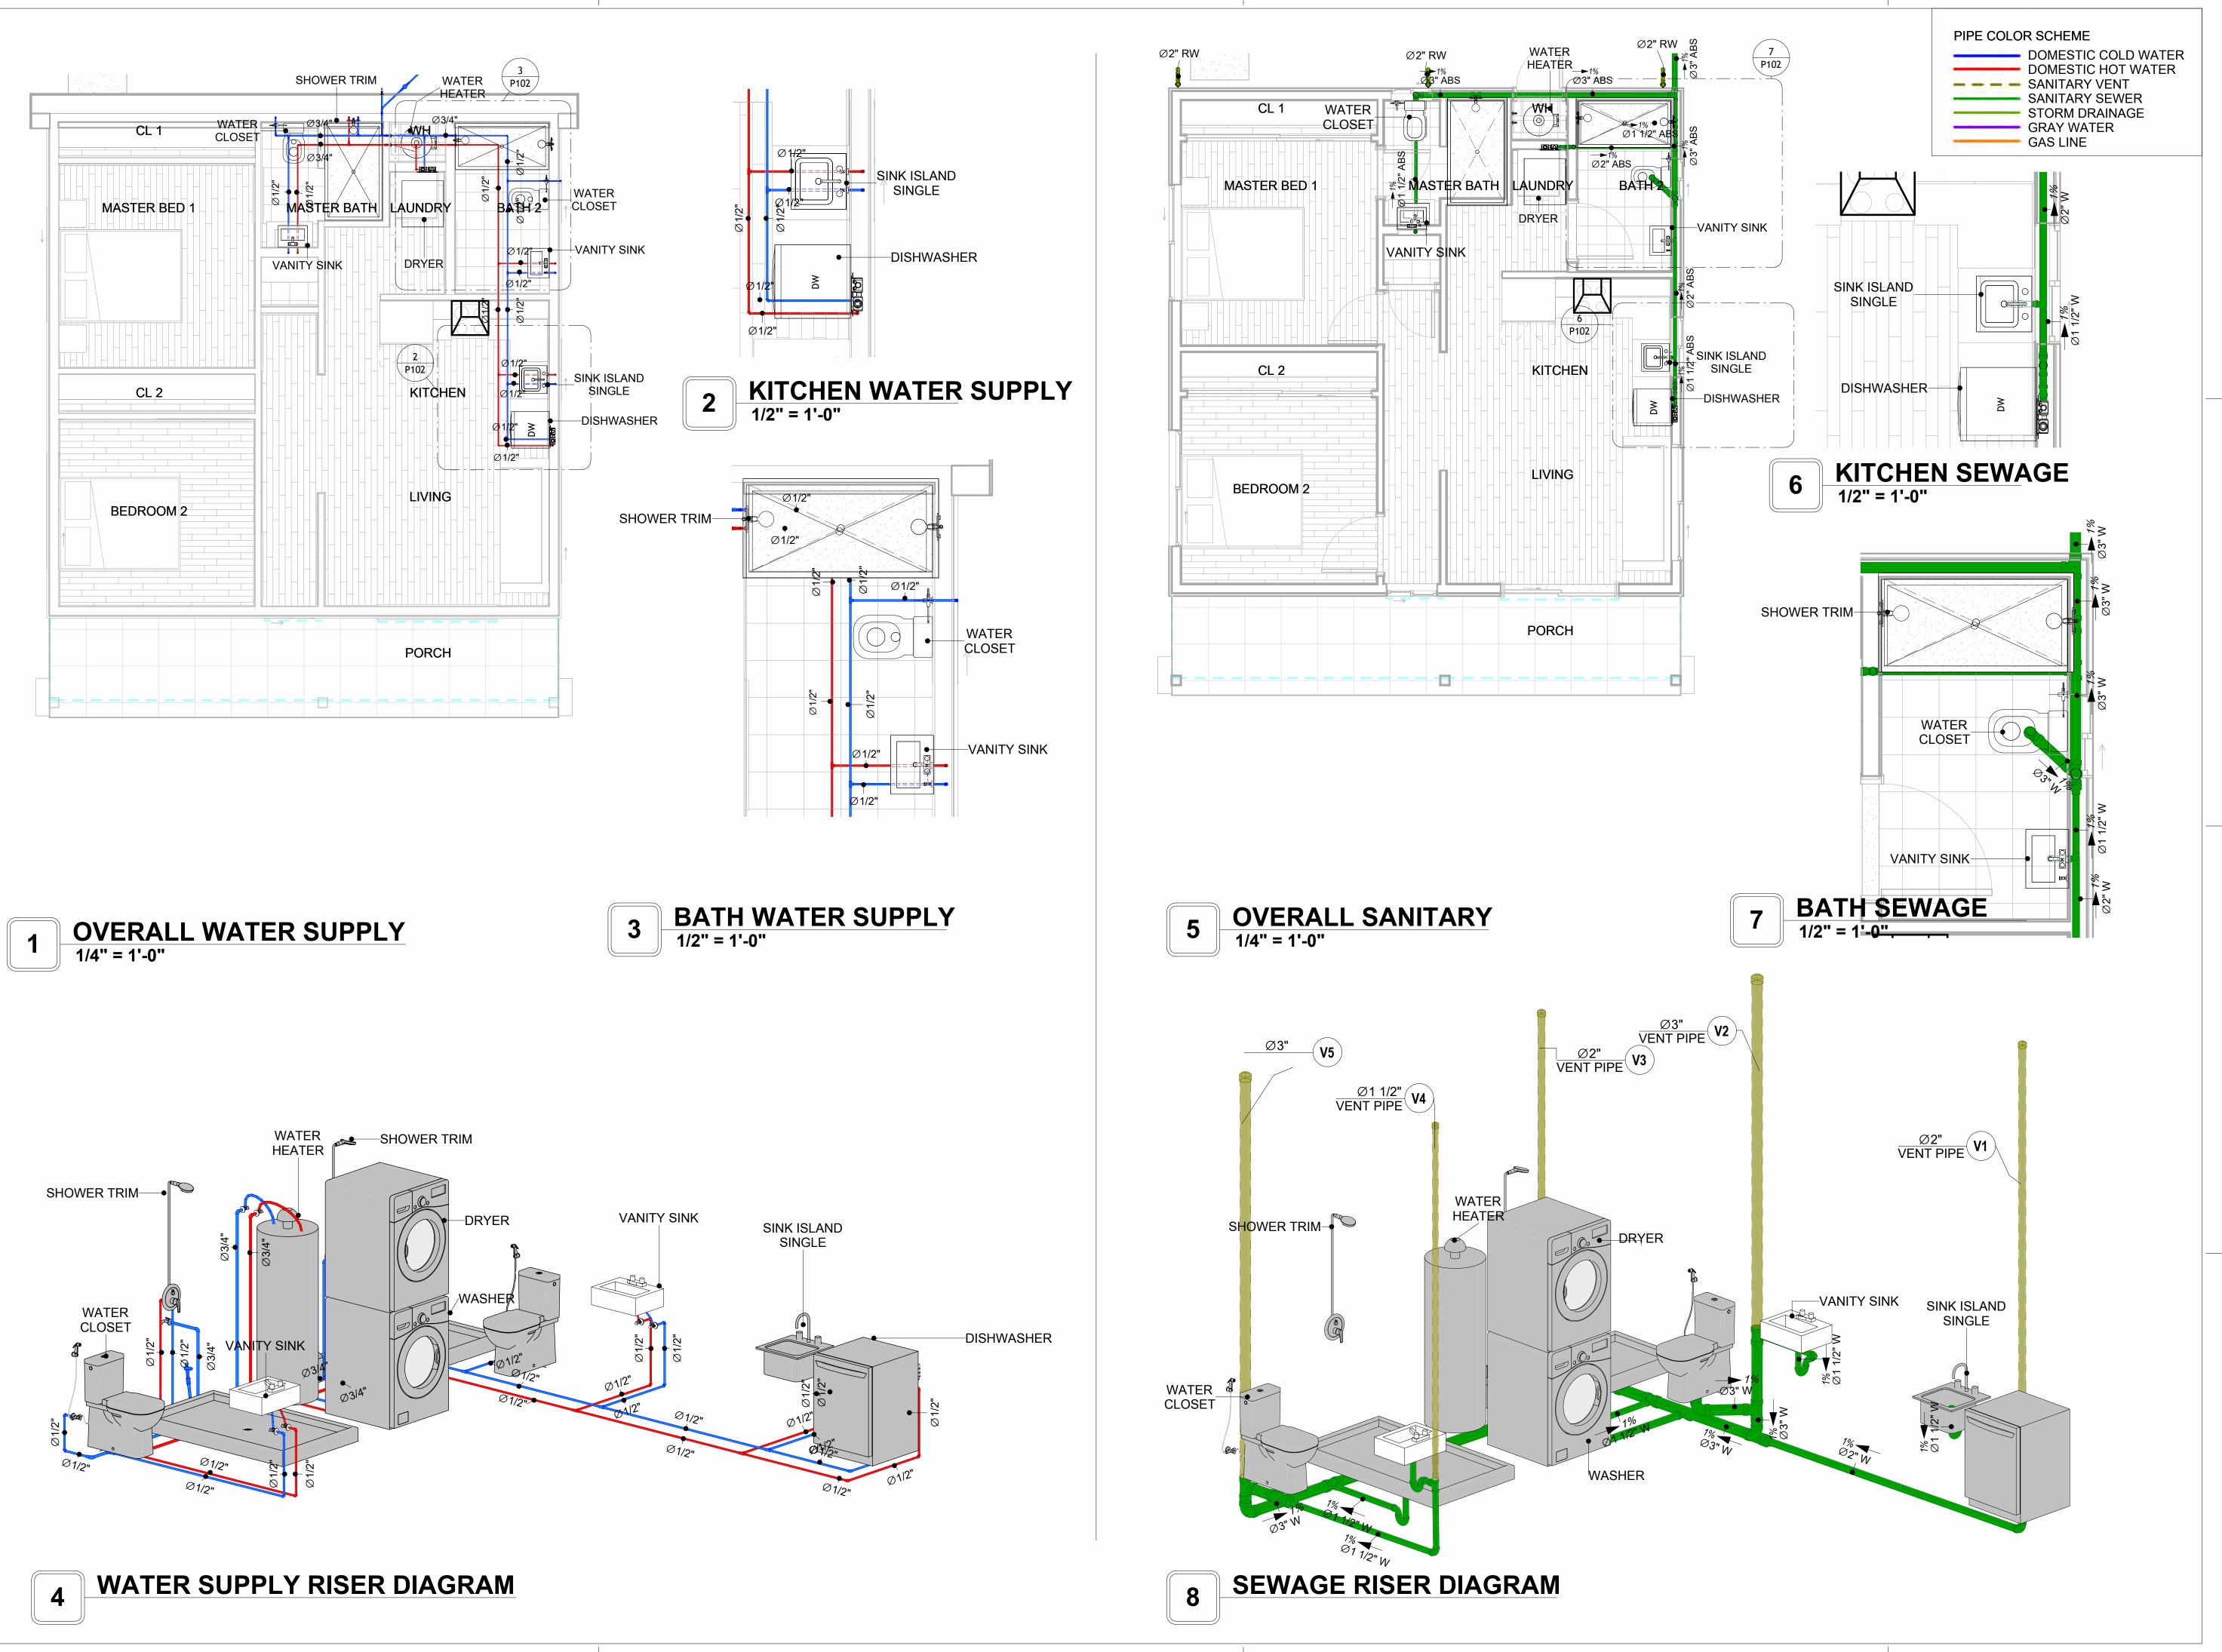



KEY PLAN



DATE

ı		1

DESCRIPTION

NOTE:

LEGEND:

PROJECT

79-Hunter-745-2Bd-2Ba Stone Veneer-500

DRAWING NAME

WATER SUPPLY AND SEWAGE SYSTEM

CLIENT NAME:

PROJECT NUMBER:

0338_14

DATE:

2/21/2025 2:56:20 PM

DESIGNED BY:

DRAWN BY:

CHECKED BY:

Checker

P102

Materials Shopping List

Please print and take this Materials Shopping List to your favorite Home Depot and ask for assistance in selecting the materials, fixtures and fittings to complete your new home.

Record your selection and the price of the item. Then do the math to determine the cost for your selections and the total cost of finishing your home.

Have It Your Way!

The material types listed in this document were selected based on personal preferences. The Customer is encouraged to make changes to the material types in accordance with local customs, regulations, and personal preferences.

Have It Your Way!



20 good reasons to frame a home with metal and not wood



Why build your ADU with metal vs wood	Wood	Metal	Explanation
1 DIY Construction Benefit		~	The wall frames, trusses and beams can be erected in a just a few days
2 Minimal Construction Skills Required		~	Pre-assembled walls and trusses require no specialized skills to errect
Build as DIY, Hybrid or by a General Contractor		~	Do it yourself, Hybrid (involve special contractors) or hire a General Contractor
4 Build It As You Can Afford It		~	Impervious to Weather - build as you have the time and money
5 Up Front Cost of Framing Materials	~		As to only the framing material, wood is less expensive
6 Total Cost To Build		~	Savings in time, labor, and other areas make light gauge steel LESS expensive
7 Termites and wood boring insects		~	Termites, carpenter ants and wood boring insects eat wood, not metal
8 Mold resistant		~	Metal does not attract mold
9 Damage caused by exterior and interior flooding		~	Metal needs no reconditioning after a flood
10 Fire Resistant		~	Non-combustible
11 Lower insurance rates		~	Many insurance underwriters now provide lower rates for metal framed homes
12 Walls, trusses, and beams retain their original form		~	Perfectly straight walls - no shimming of drywall
13 Corners are 90 degrees		~	No need for templating of countertops to adjust for out of square corners
14 Strength and weight		~	Metal is stronger than wood and weighs less - no need for crane to lift ADU trusses
15 IBC Engineered Stamp		~	If an engineering stamp is necessary, months of waiting are saved
16 Complete BOM (Materials Shopping List)		~	Take the materials shopping list to Home Depot and start shopping/pricing
17 Flexible in Seismic Areas - Won't Fracture		~	Light gauge steel is flexible and won't fracture when the earth moves
18 No Waste At Job Site		~	Steel is the most recycled material in the world. A typical wood home has 20-30% waste
19 Environmentally Friendly		~	Trees don't have to be destroyed and the source of most metal is from recycling
20 How-To Videos Included		~	How-to videos provide simple assembly instructions
21 Relationship Counselor		~	Eliminate emotional uphevels - save time, money, and preserve the relationship

Universal Requirements - some or all may be required

- 1 Site plan
- 2 Electrical Supply Connection
- 3 Sewer Connection
- 4 Fresh Water Supply Connection
- 5 Set Backs
- 6 Soils Evaluation

- 7 Earthquake (fault) evaluation
- 8 Foundation Plan subject to soils
- 9 Compliance with local energy codes: insulation home wrap and flashing
- 10 Engineering for wind speed and snow load.
- 11 State and Local ordinances regarding ADUs
- 12 Local Architect and/or Engineer may be necessary

Hunter-2Bd 2Ba-Stone Veneer





Hunter-2Bd 2Ba-Stone Veneer MATERIAL SHOPPING LIST

Have It Your Way!

The material types listed in this document were selected based on personal preferences. The Customer is encouraged to make changes to the material types in accordance with local customs, regulations, and personal preferences. Have It Your Way!

TOC



10

15

Name | Link | Page No | 1 | Cover Page | Cover Page | 1 | 2 | TOC | TOC | 2 | 3 | ELECTRICAL BOM | ELECTRICAL BOM | 3 | 5 | HVAC BOM | HVAC BOM | 7

PLUMBING BOM

Table Of Content

Have It Your Way!

ARCHITECTURAL BOM

The material types listed in this document were selected based on personal preferences. The Customer is encouraged to make changes to the material types in accordance with local customs, regulations, and personal preferences. Have It Your Way!

GENERAL NOTES

4 PLUMBING BOM

6 ARCHITECTURAL BOM

- 1 This BOM (Bill of Materials) is prepared as a Materials Shopping List to help builders and DIYers gain a complete understanding of most if not all elements required for the complete construction of this structure, according to the original design documents provided by FrameUpNow.
- 2 All quantities and specifications are subject to change based on the final design, field measurements, availability of products and customer preferences. The customer should verify all information prior to purchasing materials.
- 3 All products and elements in the list shall conform to the International Residential Code (IRC), or any other local and international building codes, safety regulations, and standards that are applicable to the location of the structure.
- 4 If any changes are made by the customer to the list of materials specified in this document, the customer is responsible for assuring that the correct type and quantity of materials are utilized in accordance with local building codes.
- FrameUpNow, will not be held responsible for any misuse of this document, the products listed, or for deviations from the content that are made due to changes in specifications, pricing, availability, or customer preferences.
- 6 The customer is advised to consult a qualified professional or technician prior to purchasing materials for specialized construction system items. Some items including but not limited to caseworks, doors and windows may require as built measurements prior to purchase to confirmation of final dimensions.
- 7 If there are additional trim elements or specific installation methods, the total amount of materials needed might vary. Consider any additional trim required for corners, intersections, or other architectural details that might cause this variations before proceeding to purchase and construction.

ARCHITECTURAL BOM



Hunter-2Bd 2Ba-Stone Veneer									
ARCHITECTURAL MATERIAL SHOPPING LIST									
lo.		Туре	Unit	Quantity	Unit Price	Total	Description		
	APPLIANCES								
1	Refrigerator		PCS	1					
2	Range		PCS	1					
3	Washer		PCS	1					
4	Dryer		PCS	1					
5	Dish Washer		PCS	0					
6	Oven		PCS	0					
7	Microwave		PCS	0					
Δ	CASEWORKS								
1	Kitchen Cabinet		FT	14.82					
2	Laundry Cabinet		FT	2.25					
3	Vanity Cabinet		FT	2.5					
4	Medicine Cabinet		PCS	1					
5	Kitchen countertop		SF	20.8					
6	Laundry Countertop		PCS	1					
7	Bathroom Countertop		SF	0					
8	Island		FT	0					
9	Peninsula		FT	0					
10	Closets		SF	145.75					
Δ	CEILING	·							
1	Ceiling Board	Dry Wall	SF	522.72					
2	Dry Wall Fastener	Screw	PCS	914.76					
3	Vapor Retarder	Polyethylene film	SF	861.93					
4	Vapor Retarder Fastener	Nails with washer heads	PCS	2585.79					
5	Ceiling Board (MRD)	Moisture resistant drywall	SF	87.46					
6	MRD Fastener	inicistare resistant dryman	PCS	153.055					
7	Ceiling Board	Marine Plywood	SF	251.75					
8	Marine Plywood Fastener	Screw	PCS	440.5625					
9	Dry Wall Tape	Julian	FT	430.965					
<u>^</u>	FLOORING			100.700					
1	Main Living Space		SF	278.91					
2	Bathroom		SF	73.06					
3	Bedrooms		SF	269.93					
Δ	STRUCTURE	I	51	207.73	1				
	Foundation		SF	895.37	1				
•	WALLS EXTERIOR		51	075.57					
1	Exterior Wall Siding		SF	787					
	Wall Paint		SF	787					
3	Wall Shteathing (OSB)		SF	787					
4	Shteathing Fastener	Self-drilling screws(100/pkt)	PKT	7.87					
5	Wall Insulation	Jen-drilling sciews(100/pkt)	SF	3121					
6	Wall Homewrap		SF	787					
7	Home wrap Fastener	Stapled fastener (200/pkt)	PKT	2.9906					
<u>/</u>	WALLS INTERIOR	Stapieu lasterier (200/pkt)	PNI	2.7900					
<u></u> 1	Cementitious Backer Board		SF	332	Т	1			
2	Kerdi membrane		SF	332					
3	Kerdi membrane Kerdi membrane Fastener		SF SF	332					
4	Wall Ceramic Tile		SF	332					
5	Drywall Board	Call dalling and (4007.11)	SF	1573					
6	Drywall Fastener	Self-drilling screws(100/pkt)	PKT	15.73					
7	Wall Paint		SF	1573					
8	Drywall Tape		FT	295.5538932					
9	Wall Skerting		FT	119					

ARCHITECTURAL BOM



	DOORS					
1	Interior Swinging	2' - 8" X 6'-8"	PCS	1		
1			PCS			
2	Interior Swinging	2' - 6" X 6'-8"		2		
3	Interior Swinging	3' - 0" X 6'-8"	PCS	2		
4	Patio Sliding	6' - 0" X 6'-8"	PCS	1		
5	Exterior Swinging	2' - 6" X 6'-8"	PCS	1		
6	Interior Sliding	10' - 0" X 6'-8"	PCS	2		
7	Exterior Door Trim		FT	35.2		
8	Interior Door Trim		FT	242.6		
9	Entry Lock set		PCS	2		
	Privacy Lock set		PCS	4		
11	Passage Lock set		PCS	3		
	WINDOWS					
1	Sliding	3' - 3" X 3'-3"	PCS	1		
2	Sliding	6' - 3" X 4'-3"	PCS	2		
3	Sliding	2' - 3" X 2'-3"	PCS	2		
4	Sliding	6' - 3" X 2'-3"	PCS	1		
5	Sliding	2' - 9" X 4'-3"	PCS	1		
6	Exterior Window Trim		FT	105.4		
7	Interior Window Trim		FT	105.4		
Δ	ROOF	·				
1	Roof Covering		SF	998		
2	Roof Covering Fastener		PCS	499		
3	Roof Felt Paper		SF	998		
4	Roof Felt Paper Fastener		PCS	2994		
5	Roof Sheathing		SF	998		
6	Roof Sheathing Fastener		PCS	7984		
7	Batten		FT	0		
8	Batten Fastener		PCS	0		
9	Soffit		SF	0		
10	Soffit Fastener		PCS	0		
_	Fascia		FT	465		
	Fascia board fastener		PCS	232.5		
_	Roof Insulation		SF	998		
13	TXOOT ITISUIGUOTI	1	JJI	1770		



	Hunt	er-2Bd 2Ba-Stone	Veneer		
	FI FCTRIC	AL MATERIAL SHO	DENIG LIST	=	
No.	Item	Type		Quantity	Description
	LIGHTING FIXTURES		, 51.11		
	Kitchen Ceiling Light		PCS	6	
	Exterior Wall Mounted Light		PCS	2	
	Livingroom Ceiling Light With Fan		PCS	1	
4	Bedroom Ceiling Light With Fan		PCS	2	
_	Dining Ceiling Light		PCS	0	
	Bath Wall Mounted Light		PCS	2	
7	Bathroom Ceiling Light		PCS	4	
	Livingroom Ceiling Light		PCS	4	
	Bedroom Ceiling Light		PCS	8	
	Hall & Entry Ceiling Light		PCS	5	
	Closet Ceiling Light		PCS	0	
	Smoke Detector		PCS	4	
	ELECTRICAL FITTINGS				
	Standard Receptacle 120V	20A	PCS	13	
	GFCI Receptacle 120V	20 A	PCS	12	
15	·	30 A	PCS	2	
16	·	50 A	PCS	1	
17	GFCI Receptacle 240V	60 A	PCS	1	
	Fan Switch		PCS	2	
	Single Pole Switch		PCS	9	
	Three Way Switch		PCS	2	
	Dimmer Switch		PCS	6	
	ELECTRICAL CONDUITS & WIRING		į. C		
	ROMEX 14 AWG	14/2/W/ground	FT	95.6	
	ROMEX 12 AWG	12/3/W/ground	FT	268	
	ROMEX 12 AWG	12/2/W/ground	FT	0	
	ROMEX 10 AWG	10/3/W/ground	FT	50.3	
	ROMEX 10 AWG	10/2/W/ground	FT	63.3	
	Romex 8 AWG	8/3/W/ground	FT	0	
	Romex 8 AWG	8/2/W/ground	FT	20	
	ROMEX 6 AWG	6/3/W/ground	FT	54	
	Bare Copper Ground Wire 6 AWG		FT	0	
	ELECTRICAL BOXES & CIRCUTES				
_	Panelboard -240V 1 Phase MLO	200 AMP	PCS	1	
	Circuit breaker	15 A	PCS	5	
	Circuit breaker	20 A	PCS	9	
	Circuit breaker	30 A	PCS	2	
	Circuit breaker	40 A	PCS	0	
	Circuit breaker	50 A	PCS	1	
	Circuit breaker	60 A	PCS	1	
	Single Gang Switch Box		PCS	2	
	Double Gang Switch Box		PCS	4	
	Triple Gang Switch Box		PCS	3	
	Pull Box	#1/4	PCS	34	
	Receptacle Box	n 11 1	PCS	30	

PLUMBING BOM

Hunter-2Bd 2Ba-Stone Veneer	
IC CACLEW WYLEDIVI CHUDDIN	i

No.	Item	Туре	Unit	Quantity	Unit Price	Total	Description
	PLUMBING FIXTURES & ACCESSORIES		<u> </u>			<u> </u>	
1 E	Bath Tub (Alcove Tub)		PCS	0			
2 k	Citchen Sink		PCS	1			
3 k	Citchen Faucets		PCS	1			
	/anity Sink		PCS	2			
5 E	Bath room Faucets		PCS	2			
6 \	Vater Closet		PCS	2			
7 5	Shower Trim		PCS	2			
8 5	Shower Tray		PCS	2			
9 \	Vater Heater		PCS	1			
10 F	łose Bib		PCS	2			
11 5	Shutoff Valve		PCS	8			
12 H	langing pipe clamp		PCS	6			
13 (Gate Valve		PCS	1			
14 [Dishwasher Supply Single Connector		PCS	1			
15 [Dishwasher Sewage Single Connector		PCS	1			
16 L	aundry Sweat Connector		PCS	1			
	SANITARY & PLUMBING PIPES	·					
1 /	ABS (Acrylonitrile Butadiene Styrene) Pipes	ø 1"	FT	0			
2 /	ABS (Acrylonitrile Butadiene Styrene) Pipes	ø 1 1/2"	FT	62			
	ABS (Acrylonitrile Butadiene Styrene) Pipes	ø 2"	FT	191			
	ABS (Acrylonitrile Butadiene Styrene) Pipes	ø 3"	FT	8			
	PEX (Cross-linked polyethylene) Pipes	ø 1/2"	FT	90			
	PEX (Cross-linked polyethylene) Pipes	ø 3/4"	FT	73			
	PEX (Cross-linked polyethylene) Pipes	ø 1"	FT	0			
	PVC Pipes Sch.80 - Rigid	ø 1 1/2"	FT	0			
	PVC Pipes Sch.80 - Rigid	ø 2"	FT	157			
	PVC Pipes Sch.80 - Rigid	ø 3"	FT	0			
11 F	Tex Pipe Round	ø 1/2"	PCS	8			

PLUMBING BOM

	PIPE FITTINGS				
1	ABS 90 Deg Bend Elbow	3"ø-3"ø	PCS	1	
2	ABS 90 Degree Bend Elbow	1 1/2"ø-1 1/2"ø	PCS	3	
3	ABS 90 Degree Bend Elbow	2"ø-2"ø	PCS	2	
4	ABS 90 Degree Bend Elbow	3"ø-3"ø	PCS	1	
5	ABS P-Trap	1 1/2"ø-1 1/2"ø	PCS	5	
6	ABS P-Trap	2"ø-2"ø	PCS	2	
7	ABS Reducer Elbow	2"ø-1 1/2"ø	PCS	1	
8	ABS Reducer Elbow	3"ø-1 1/2"ø	PCS	1	
9	ABS Reducer Elbow	3"ø-2"ø	PCS	1	
10	ABS TEE Elbow	1 1/2"ø-1 1/2"ø-1 1/2"ø	PCS	1	
11	ABS TEE Elbow	2"ø-2"ø-2"ø	PCS	1	
12	ABS TEE Elbow	3"ø-3"ø-3"ø	PCS	4	
13	ABS Tee Reducer Elbow	3"ø-3"ø-1 1/2"ø	PCS	3	
14	ABS Tee Reducer Elbow	3"ø-3"ø-2"ø	PCS	1	
15	ABS Tee Reducer Elbow	3"ø-3"ø-3"ø	PCS	1	
16	ABS Vent Cap Elbow	1 1/2"ø	PCS	1	
17	ABS Vent Cap Elbow	2"ø	PCS	2	
18	ABS Vent Cap Elbow	3"ø	PCS	2	
	PEX 90 Degree Elbow	1/2"ø-1/2"ø	PCS	35	
20	PEX 90 Degree Elbow	3/4"ø-3/4"ø	PCS	5	
21	PEX Tee Elbow	1/2"ø-1/2"ø-1/2"ø	PCS	7	
22	PEX Tee Elbow	3/4"ø-3/4"ø-3/4"ø	PCS	9	
23	PEX Transition Elbow	1"ø-3/4"ø	PCS	2	
	PEX Transition Elbow	3/4"ø-1/2"ø	PCS	9	
25	PVC 90 Deg Bend Elbow	2"ø-2"ø	PCS	9	
26	WASTE DOUBLE TEE	2"ø-2"ø-2"ø	PCS	1	

HVAC BOM



		Hunter-2Bd	2Ba-Sto	one Vene	er		
		HVAC SYSTEM MA	TERIAL	SHOPP	ING LIST		
No.	Item	Туре	Unit	Quantity	Unit Price	Total	Description
\triangle	HVAC_DUCTS						
1	PIPE (REFRIGERANT LINE)	3/8" (Ø)	FT	75.97			
2	PIPE (REFRIGERANT LINE)	3/4''' (Ø)	FT	98			
3	DRAYER HOSE	4" (Ø)	FT	5.8			
4	FLEX DUCT ROUND	4" (Ø)	FT	6.52			
\triangle	DUCT FITTINGS & ACCESSORIES						
5	ELBOW (REFRIGERANT LINE)	3/4" (Ø)-3/4" (Ø)	PCS	31			
6	ELBOW (REFRIGERANT LINE)	3/8" (Ø)-3/8" (Ø)	PCS	23			
7	TEE (REFRIGERANT LINE)	3/4" (Ø)-3/4" (Ø)-3/4"	PCS	2			
8	TEE (REFRIGERANT LINE)	3/8" (Ø)-3/8" (Ø)-3/8"	PCS	2			
9	TRANSITION (REFRIGERANT	3/4" (Ø)-1/2" (Ø)	PCS	4			
10	TRANSITION (REFRIGERANT	3/4" (Ø)-5/8" (Ø)	PCS	3			
11	TRANSITION (REFRIGERANT	3/8" (Ø)-1/4" (Ø)	PCS	1			
12	ROUND TRANSITION(ANGLE)	45 DEGREE	PCS	7			
	HVAC_EQUIPMENTS						
13	AIR HANDLING UNIT	WALL MOUNTED	PCS	3			
14	CONDENSER	OUTDOOR UNIT	PCS	1			
15	EXHAUST FAN	75 CFM	PCS	2			
16	HOOD-WALL: VENT	HOOD-WALL: VENT	PCS	1			
17	DRAYER: VENT	DRAYER: VENT	PCS	1			
18	ROOF VENT	3"(Ø)	PCS	3			



Table Of Content

#	Name	Link	Page No
1	Cover Page	<u>Cover Page</u>	1
2	TOC	TOC	2
3	ELECTRICAL BOM	ELECTRICAL BOM	3
5	HVAC BOM	HVAC BOM	7
4	PLUMBING BOM	PLUMBING BOM	10
6	ARCHITECTURAL BOM	ARCHITECTURAL BOM	15

Have It Your Way!

The material types listed in this document were selected based on personal preferences. The Customer is encouraged to make changes to the material types in accordance with local customs, regulations, and personal preferences. Have It Your Way!

GENERAL NOTES

- This BOM (Bill of Materials) is prepared as a Materials Shopping List to help builders and DIYers gain a complete understanding of most if not all elements required for the complete construction of this structure, according to the original design documents provided by FrameUpNow.
- 2 All quantities and specifications are subject to change based on the final design, field measurements, availability of products and customer preferences. The customer should verify all information prior to purchasing materials.
- 3 All products and elements in the list shall conform to the International Residential Code (IRC), or any other local and international building codes, safety regulations, and standards that are applicable to the location of the structure.
- 4 If any changes are made by the customer to the list of materials specified in this document, the customer is responsible for assuring that the correct type and quantity of materials are utilized in accordance with local building codes.
- 5 FrameUpNow, will not be held responsible for any misuse of this document, the products listed, or for deviations from the content that are made due to changes in specifications, pricing, availability, or customer preferences.
- The customer is advised to consult a qualified professional or technician prior to purchasing materials for specialized construction system items. Some items including but not limited to caseworks, doors and windows may require as built measurements prior to purchase to confirmation of final dimensions.
- 7 If there are additional trim elements or specific installation methods, the total amount of materials needed might vary. Consider any additional trim required for corners, intersections, or other architectural details that might cause this variations before procedding to purchase and construction.



			LIGHTING FIXTURES				
#	Item	Туре	Description, Manufacturer, SKU	Unit	Quantity	Unit Price	Total
1	Kitchen Ceiling Light			PCS	6		
3	Exterior Wall Mounted Light			PCS	2		
4	Livingroom Ceiling Light With Fan			PCS	1		
5	Bedroom Ceiling Light With Fan			PCS	2		
6	Dining Ceiling Light			PCS	0		
7	Bath Wall Mounted Light			PCS	2		
8	Bathroom Ceiling Light			PCS	4		
9	Livingroom Ceiling Light			PCS	4		
10	Bedroom Ceiling Light			PCS	8		
11	Hall & Entry Ceiling Light			PCS	5		
12	Closet Ceiling Light			PCS	0		
12	Smoke Detector			PCS	4		
13							
14							
15							



			ELECTRICAL FITTINGS				
#	Item	Туре	Description, Manufacturer, SKU	Unit	Quantity	Unit Price	Total
1	Standard Receptacle 120V	20A		PCS	13		
2	GFCI Receptacle 120V	20 A		PCS	12		
3	GFCI Receptacle 240V	30 A		PCS	2		
4	GFCI Receptacle 240V	50 A		PCS	1		
5	GFCI Receptacle 240V	60 A		PCS	1		
6	Fan Switch			PCS	2		
7	Single Pole Switch			PCS	9		
8	Three Way Switch			PCS	2		
9	Dimmer Switch			PCS	6		
10							
11							
12							
13							
14							
15							



	ELECTRI	ICAL CONDUITS & WIRING				
Item	Туре	Description, Manufacturer, SKU	Unit	Quantity	Unit Price	Total
ROMEX 14 AWG	14/2/W/ground		FT	95.6		
ROMEX 12 AWG	12/3/W/ground					
ROMEX 12 AWG	12/2/W/ground					
ROMEX 10 AWG	10/3/W/ground					
ROMEX 10 AWG	10/2/W/ground					
Romex 8 AWG	8/3/W/ground					
Romex 8 AWG	8/2/W/ground					
ROMEX 6 AWG	6/3/W/ground					
Bare Copper Ground Wire 6 AWG						
	ROMEX 14 AWG ROMEX 12 AWG ROMEX 12 AWG ROMEX 10 AWG ROMEX 10 AWG ROMEX 8 AWG ROMEX 8 AWG	Item Type ROMEX 14 AWG 14/2/W/ground ROMEX 12 AWG 12/3/W/ground ROMEX 12 AWG 12/2/W/ground ROMEX 10 AWG 10/3/W/ground ROMEX 10 AWG 10/2/W/ground Romex 8 AWG 8/3/W/ground ROMEX 6 AWG 6/3/W/ground	ROMEX 14 AWG 14/2/W/ground ROMEX 12 AWG 12/3/W/ground ROMEX 12 AWG 12/2/W/ground ROMEX 10 AWG 10/3/W/ground ROMEX 10 AWG 10/2/W/ground Romex 8 AWG 8/3/W/ground Romex 8 AWG 8/2/W/ground ROMEX 6 AWG 6/3/W/ground	Item Type Description,Manufacturer,SKU Unit ROMEX 14 AWG 14/2/W/ground FT ROMEX 12 AWG 12/3/W/ground FT ROMEX 12 AWG 12/2/W/ground FT ROMEX 10 AWG 10/3/W/ground FT ROMEX 10 AWG 10/2/W/ground FT Romex 8 AWG 8/3/W/ground FT Romex 8 AWG 8/2/W/ground FT ROMEX 6 AWG 6/3/W/ground FT	Item	Item



		ELEC	CTRICAL BOXES & CIRCUTES				
#	Item	Туре	Description, Manufacturer, SKU	Unit	Quantity	Unit Price	Total
1	Panelboard -240V 1 Phase MLO	200 AMP		PCS	1		
2	Circuit breaker	15 A		PCS	5		
3	Circuit breaker	20 A		PCS	9		
4	Circuit breaker	30 A		PCS	2		
5	Circuit breaker	50 A		PCS	1		
6	Circuit breaker	60 A		PCS	1		
7	Single Gang Switch Box			PCS	2		
8	Double Gang Switch Box			PCS	4		
9	Triple Gang Switch Box			PCS	3		
10	Pull Box	#1/4		PCS	34		
11	Receptacle Box			PCS	30		
12							
13							
14							
15							

HVAC BOM



		HVAC_DUCTS 01								
:		Туре	Description, Manufacturer, SKU	Unit		Unit Price Total				
	PIPE (REFRIGERANT LINE)	1/4" (Ø)		FT	0.59					
	PIPE (REFRIGERANT LINE)	3/8" (Ø)		FT	67.43					
	PIPE (REFRIGERANT LINE)	1/2" (Ø)		FT	0.62					
	PIPE (REFRIGERANT LINE)	3/4''' (Ø)		FT	109.53					
	DRAYER HOSE	4" (Ø)		FT	3.4					
j	FLEX DUCT ROUND	4" (Ø)		FT	6.72					
,										
)										
.0										
.1										
.2										
.3										
.4										
15										
16										

HVAC BOM



			DUCT FITTINGS & ACCESSORIES				
‡	Item	Туре	Description, Manufacturer, SKU	Unit	Quantity	Unit Price	Total
1	ELBOW (REFRIGERANT LINE)	1/2" (Ø)-1/2" (Ø)		PCS	1		
2	ELBOW (REFRIGERANT LINE)	3/4" (Ø)-3/4" (Ø)		PCS	27		
3	ELBOW (REFRIGERANT LINE)	3/8" (Ø)-3/8" (Ø)		PCS	14		
ļ		3/4" (Ø)-3/4" (Ø)-3/4"		PCS	2		
<u> </u>	TEE (REFRIGERANT LINE)	3/8" (Ø)-3/8" (Ø)-3/8"		PCS	2		
6	TRANSITION (REFRIGERANT LINE)	3/4" (Ø)-1/2" (Ø)		PCS	4		
7	TRANSITION (REFRIGERANT LINE)	3/4" (Ø)-5/8" (Ø)		PCS	3		
3	TRANSITION (REFRIGERANT LINE)	3/8" (Ø)-1/4" (Ø)		PCS	1		
)	ROUND TRANSITION(ANGLE)	45 DEGREE		PCS	7		
LO	TIVANSITION(ANGLE)						
1							
.2							
.3							
L4							
15							
L6							

HVAC BOM



			HVAC_EQUIPMENTS				
#	Item	Туре	Description, Manufacturer, SKU	Unit	Quantity	Unit Price	Total
1	AIR HANDLING UNIT	WALL MOUNTED		PCS	3		
2	CONDENSER	OUTDOOR UNIT		PCS	1		
3	EXHAUST FAN	75 CFM		PCS	2		
4	EXHAUST HOOD	WALL MOUNTED		PCS	1		
5	HOOD-WALL: VENT	HOOD-WALL: VENT		PCS	1		
6	DRAYER: VENT	DRAYER: VENT		PCS	1		
7	ROOF VENT	3"(Ø)		PCS	2		
8							
9							
10							
11							
12							
13							
14							



		PLUMBING FIXTURES & ACCESSORIES								
#	Item	Туре	Description, Manufacturer, SKU	Unit	Quantity	Unit Price	Total			
1	Bath Tub (Alcove Tub)			PCS	0					
2	Kitchen Sink			PCS	1					
3	Kitchen faucets			PCS	1					
4	Vanity Sink			PCS	2					
5	Bath room faucets			PCS	2					
6	Water Closet			PCS	2					
7	Shower Trim			PCS	2					
8	Shower Tray			PCS	2					
9	Water Heater			PCS	1					
10	Hose Bib			PCS	2					
11	Shutoff Valve			PCS	8					
12	Hanging pipe clamp			PCS	6					
13	Gate Valve			PCS	1					
14	Dishwasher Supply Single Connector			PCS	1					
15	Dishwasher Sewage Single Connector			PCS	1					
16	Laundry Sweat Connector			PCS	1					



		S	SANITARY & PLUMBING PIPES				
#	Item	Туре	Description, Manufacturer, SKU	Unit	Quantity	Unit Price	Total
1	ABS (Acrylonitrile Butadiene	ø 1"					
	Styrene) Pipes			FT	0		
2	ABS (Acrylonitrile Butadiene	ø 1 1/2"					
	Stvrene) Pipes			FT	14		
3	ABS (Acrylonitrile Butadiene	ø 2"					
	Stvrene) Pipes			FT	73		
4	ABS (Acrylonitrile Butadiene	ø 3"			_		
	Stvrene) Pipes			FT	8		
5	PEX (Cross-linked	ø 1/2"					
	polvethylene) Pipes			FT	90		
6	PEX (Cross-linked	ø 3/4"			,		
	polvethylene) Pipes			FT	74		
7	PEX (Cross-linked	ø 1"			_		
	polvethylene) Pipes	4.4/00		FT	0		
8	PVC Pipes Sch.80 - Rigid	ø 1 1/2"		FT	0		
9	PVC Pipes Sch.80 - Rigid	Ø 2"		FT	157		
10	PVC Pipes Sch.80 - Rigid	Ø 3''		FT	0		
11	Flex Pipe Round	ø 1/2"		PCS	8		
12							
13							
14							
15							



		PIPE FITTINGS 01									
#	Item	Туре	Description, Manufacturer, SKU	Unit	Quantity	Unit Price	Total				
1	ABS 90 Deg Bend Elbow	3"ø-3"ø		PCS	1						
2	ABS 90 Degree Bend Elbow	1 1/2"ø-1 1/2"ø		PCS	3						
3	ABS 90 Degree Bend Elbow	2"ø-2"ø		PCS	2						
4	ABS 90 Degree Bend Elbow	3"ø-3"ø		PCS	1						
5	ABS P-Trap	1 1/2"ø-1 1/2"ø		PCS	5						
6	ABS P-Trap	2"ø-2"ø		PCS	2						
7	ABS Reducer Elbow	2"ø-1 1/2"ø		PCS	1						
8	ABS Reducer Elbow	3"ø-1 1/2"ø		PCS	1						
9	ABS Reducer Elbow	3"ø-2"ø		PCS	1						
10	ABS TEE Elbow	1 1/2"ø-1 1/2"ø-1 1/2"ø		PCS	1						
11	ABS TEE Elbow	2"Ø-2"Ø-2"Ø		PCS	1						
12	ABS TEE Elbow	3"ø-3"ø-3"ø		PCS	4						
13	ABS Tee Reducer Elbow	3"ø-3"ø-1 1/2"ø		PCS	3						
14	ABS Tee Reducer Elbow	3"ø-3"ø-2"ø		PCS	1						
15	ABS Tee Reducer Elbow	3"Ø-3"Ø-3"Ø		PCS	1						



	PIPE FITTINGS 02									
#	Item	Туре	Description, Manufacturer, SKU	Unit	Quantity	Unit Price	Total			
1	ABS Vent Cap Elbow	1 1/2"ø		PCS	1					
2	ABS Vent Cap Elbow	2"ø		PCS	2					
3	ABS Vent Cap Elbow	3"ø		PCS	2					
4	PEX 90 Degree Elbow	1/2"ø-1/2"ø		PCS	35					
5	PEX 90 Degree Elbow	3/4"ø-3/4"ø		PCS	5					
6	PEX Tee Elbow	1/2"ø-1/2"ø-1/2"ø		PCS	7					
7	PEX Tee Elbow	3/4"ø-3/4"ø-3/4"ø		PCS	9					
8	PEX Transition Elbow	1"ø-3/4"ø		PCS	2					
9	PEX Transition Elbow	3/4"ø-1/2"ø		PCS	9					
10	PVC 90 Deg Bend Elbow	2"ø-2"ø		PCS	9					
11	WASTE DOUBLE TEE	2"Ø-2"Ø-2"Ø		PCS	1					
12										
13										
14										
15										



			APPLIANCES				
#	Item	Туре	Description, Manufacturer, SKU	Unit	Quantity	Unit Price	Total
1	Refrigerator			PCS	1		
2	Range			PCS	1		
3	Washer Front Load	Stackable		PCS	1		
4	Dryer Front Load	Stackable		PCS	1		
5	Dish Washer			PCS	()	
6	Oven			PCS	()	
7	Microwave			PCS	(
8							
9							
10							
11							
12							
13							
14							
15							
16							



			CASEWORKS 01				
#	Item	Туре	Description, Manufacturer, SKU	Unit	Quantity	Unit Price	Total
1	Kitchen Cabinet			FT	14.82		
2	Laundry Cabinet			FT	2.25		
3	Vanity Cabinet			FT	2.5		
4	Medicine Cabinet			PCS	1		
5	Kitchen countertop			SF	20.8		
6	Laundry Countertop			PCS	1		
7	Bathroom Countertop			SF	0		
8	Island			FT	0		
9	Peninsula			FT	0		
10	Closets			SF	145.75		
11							
12							
13							
14							
15							



			CEILING 01				
#	Item	Туре	Description, Manufacturer, SKU	Unit	Quantity	Unit Price	Total
	LIVING ROOM + KITCHEN			SF	202.8	1	
1	Ceiling Board	Drywall		SF	203		
2	Drywall Fastener	Screw		PCS	355		
3	Vapor Retarder	Polyethylene film		SF	203		
4	Vapor Retarder Fastener	Nails with washer heads		PCS	608		
	BATH ROOM 1			SF	39.4		
5	Ceiling Board	MRD (Moisture resistant drywall)		SF	39		
6	MRD Fastener	Screw		PCS	69		
	BATH ROOM 2			SF	48.1		
7	Ceiling Board	MRD (Moisture resistant drywall)		SF	48		
8	MRD Fastener	Screw		PCS	84		
	HALL + WD			SF	34.3		
9	Ceiling Board	Drywall		SF	34		
10	Drywall Fastener	Screw		PCS	60		
11	Vapor Retarder	Polyethylene film		SF	34		
12	Vapor Retarder Fastener	Nails with washer heads		PCS	103.0		



			CEILING 02				
#	Item	Туре	Description, Manufacturer, SKU	Unit	Quantity	Unit Price	Total
	BED ROOM 1			SF	118.4		
13	Ceiling Board	Drywall		SF	118		
14	Drywall Fastener	Screw		PCS	207		
15	Vapor Retarder	Polyethylene film		SF	118		
16	Vapor Retarder Fastener	Nails with washer heads		PCS	355		
	BED ROOM 2			SF	108.4		
17	Ceiling Board	Drywall		SF	108		
18	Drywall Fastener	Screw		PCS	190		
19	Vapor Retarder	Polyethylene film		SF	108		
20	Vapor Retarder Fastener	Nails with washer heads		PCS	325		
	CL 1			SF	20.7		
21	Ceiling Board	Drywall		SF	21		
22	Drywall Fastener	Screw		PCS	36		
23	Vapor Retarder	Polyethylene film		SF	21		
24	Vapor Retarder Fastener	Nails with washer heads		PCS	62.0		



			CEILING 03				
#	Item	Туре	Description, Manufacturer, SKU	Unit	Quantity	Unit Price	Total
	CL 2			SF	22.9		
25	Ceiling Board	Drywall		SF	23		
26	Drywall Fastener	Screw		PCS	40		
27	Vapor Retarder	Polyethylene film		SF	23		
28	Vapor Retarder Fastener	Nails with washer heads		PCS	69		
	CL 3			SF	8.5		
29	Ceiling Board	Drywall		SF	8		
30	Drywall Fastener	Screw		PCS	15		
31	Vapor Retarder	Polyethylene film		SF	8		
32	Vapor Retarder Fastener	Nails with washer heads		PCS	25		
	WH			SF	6.8		
33	Ceiling Board	Drywall		SF	7		
34	Drywall Fastener	Screw		PCS	12		
35	Vapor Retarder	Polyethylene film		SF	7		
36	Vapor Retarder Fastener	Nails with washer heads		PCS	20		



			CEILING 04				
#	Item	Туре	Description, Manufacturer, SKU	Unit	Quantity	Unit Price	Total
	PORCH			SF	251.8		
37	Ceiling Board	Marine Plywood		SF	252		
38	Exterior Grade Plywood	Screw		PCS	441		
	HALL			SF	51.4		
39	Ceiling Board	Drywall		SF	51		
40	Drywall Fastener	Screw		PCS	90		
41	Vapor Retarder	Polyethylene film		SF	51		
42	Vapor Retarder Fastener	Nails with washer heads		PCS	154		



			FLOORING INTERIOR 01				
#	Item	Туре	Description, Manufacturer, SKU	Unit	Quantity	Unit Price	Total
	BEDROOM 1						
1	Bedroom Flooring			SF	118		
2	Wood underlay	Foam Pad Polyethylene		SF	118		
3	Vapor Retarder	Vapor Barrier Polyethylene		SF	118		
	BEDROOM 2	'					
4	Bedroom Flooring			SF	108		
5	Wood underlay	Foam Pad Polyethylene		SF	108		
6	Vapor Retarder	Vapor Barrier Polyethylene		SF	108		
	CL #1						
7	Closet Flooring			SF	21		
8	Wood underlay	Foam Pad Polyethylene		SF	21		
9	Vapor Retarder	Vapor Barrier Polyethylene		SF	21		
	CL #2	·					
10	Closet Flooring			SF	23		
11	Wood underlay	Foam Pad Polyethylene		SF	23		
12	Vapor Retarder	Vapor Barrier Polyethylene		SF	23		



	1		FLOORING INTERIOR 02				
#	Item	Туре	Description, Manufacturer, SKU	Unit	Quantity	Unit Price	Total
	LIVING ROOM AND KITCH	EN					
13	Living Area Flooring			SF	279		
14	Wood underlay	Foam Pad Polyethylene		SF	279		
15	Vapor Retarder	Vapor Barrier Polyethylene		SF	278.9		
	BATHROOM 1						
11	Tile Finish			SF	22		
12	Adhesive	1/2" Thin set Mortar		SF	22		
13	Vapor Retarder	Vapor Barrier Polyethylene		SF	22.2		
	BATHROOM 2						
11	Tile Finish			SF	35		
12	Adhesive	1/2" Thin set Mortar		SF	35		
13	Vapor Retarder	Vapor Barrier Polyethylene		SF	34.8	3	
	W/D						
14	Tile Finish			SF	9		
15	Adhesive	1/2" Thin set Mortar		SF	9		
16	Vapor Retarder	Vapor Barrier Polyethylene		SF	9.3	3	



			FLOORING INTERIOR 03				
#	Item	Туре	Description, Manufacturer, SKU	Unit	Quantity	Unit Price	Total
	BOILER ROOM						
17	Tile Finish			SF	7		
18	Adhesive	1/2" Thin set Mortar		SF	7		
19	Vapor Retarder	Vapor Barrier Polyethylene		SF	7		



			FLOORING EXTERIOR			
#	Item	Туре	Description, Manufacturer, SKU	Unit	Quantity	Unit Price
	STRUCTURE			SF	895.37	
1	Concrete Slab	4"concrete cast in situ		CF	298.46	
2	Insulation	Rigid insulation		SF	241.91	
3	Hard core	Compacted soil		CF	238.25	
4	Re-bar	#4 re-bar		Ton	0.83	
5	Concrete Pad	4"concrete cast in situ		CF	1.58	
6	Slab edge	Turndown		CF	201.85	
7	Footing	Cast-in-place concrete		CF	18	
	PORCH FRONT					
1	Tile Finish			SF	151.23	
2	Adhesive	1/2" Thin set Mortar		SF	151.23	
3	Vapor Retarder	Vapor Barrier Polyethylene		SF	151.23	



			WALLS: EXTERIOR				
#	Item	Туре	Description, Manufacturer, SKU	Unit	Quantity	Unit Price	Total
1	External Stone			SF	787		
2	Wall Homewrap			SF	787		
3	Homewrap Fastener	Stapled fastener (200/pkt)		PKT	2.9906		
4	Wall Shteathing (OSB)			SF	787		
5	Shteathing Fastener	Self-drilling screws(100/pkt)		PKT	7.87		
6	Stone Copping			SF	163.00		
7	Mortar for Stone Veneer			SF	163.00		
8	Wall Paint			SF	787		
9	Wall Insulation			SF	3121		



			WALLS: INTERIOR 01				
#	Item	Туре	Description, Manufacturer, SKU	Unit	Quantity	Unit Price	Total
	MASTER BATH			SF	37.0		
1	Cementitious Backer Board			SF	230		
2	Kerdi membrane			SF	230		
3	Kerdi membrane Fastener			SF	230		
4	Wall Ceramic Tile			SF	230		
	BATHROOM 2			SF	46.0		
5	Cementitious Backer Board			SF	205		
6	Kerdi membrane			SF	205		
7	Kerdi membrane Fastener			SF	205		
8	Wall Ceramic Tile			SF	205		
	MASTER BEDROOM			SF	116.0		
9	Drywall Board			SF	230		
10	Drywall Fastener	Self-drilling screws(100/pkt)		PKT	2.3		
11	Wall Paint			SF	230		
12	Drywall Tape			FT	43.12769548		



			WALLS: INTERIOR 02				
#	Item	Туре	Description, Manufacturer, SKU	Unit	Quantity	Unit Price	Total
	BEDROOM 2			SF	107.0		
13	Drywall Board			SF	259		
14	Drywall Fastener	Self-drilling screws(100/pkt)		PKT	2.59		
15	Wall Paint			SF	259		
16	Drywall Tape			FT	48.56553535		
	KITCHEN			SF	71.0		
17	Cementitious Backer Board			SF	20		
18	Drywall Board			SF	136		
19	Drywall Fastener	Self-drilling screws(100/pkt)		PKT	1.36		
20	Kerdi membrane			SF	20		
21	Kerdi membrane Fastener			SF	20		
22	Wall Ceramic Tile			SF	20		
23	Wall Paint			SF	136		
24	Drywall Tape			FT	25.66037736		



			WALLS: INTERIOR 03				
#	Item	Туре	Description, Manufacturer, SKU	Unit	Quantity	Unit Price	Total
	LIVING ROOM			SF	191.0		
25	Drywall Board			SF	223		
26	Drywall Fastener	Self-drilling screws(100/pkt)		PKT	2.23		
27	Wall Paint			SF	223		
28	Drywall Tape			FT	41.83864916		
	CLOSET 1			SF	20.0		
29	Drywall Board			SF	135		
30	Drywall Fastener	Self-drilling screws(100/pkt)		PKT	1.35		
31	Wall Paint			SF	135		
32	Drywall Tape			FT	25.31408213		
	CLOSET 2			SF	22.0		
33	Drywall Board			SF	156		
34	Drywall Fastener	Self-drilling screws(100/pkt)		PKT	1.56		
35	Wall Paint			SF	156		
36	Drywall Tape			FT	29.3		



			WALLS: INTERIOR 03				
#	Item	Туре	Description, Manufacturer, SKU	Unit	Quantity	Unit Price	Total
	CLOSET 3			SF	10.0		
37	Drywall Board			SF	78.0		
38	Drywall Fastener	Self-drilling screws(100/pkt)		PKT	0.8		
39	Wall Paint			SF	78.0		
40	Drywall Tape			FT	14.6		
	HALL			SF	69.0	l	
41	Drywall Board			SF	292.0		
42	Drywall Fastener	Self-drilling screws(100/pkt)		PKT	2.9		
43	Wall Paint			SF	292.0		
44	Drywall Tape			FT	55.1		
	LAUNDRAY			SF	10.0		
45	Cementitious Backer Board			SF	70.0		
46	Kerdi membrane			SF	70.0		
47	Kerdi membrane Fastener			SF	70.0		
48	Wall Ceramic Tile			SF	70.0		



			WALLS: INTERIOR 03				
#	Item	Туре	Description, Manufacturer, SKU	Unit	Quantity	Unit Price	Total
	WH			SF	6.0		
49	Drywall Board			SF	64.0		
50	Drywall Fastener	Self-drilling screws(100/pkt)		PKT	0.6		
51	Wall Paint			SF	64.0		
52	Drywall Tape			FT	12.1		
1	Wall Skirting	Ceramic		FT	119.0		



			DOORS				
#	Item	Туре	Description, Manufacturer, SKU	Unit	Quantity	Unit Price	Total
1	Interior Swinging	2' - 8" X 6'-8"		PCS	1		
2	Interior Swinging	2' - 6" X 6'-8"		PCS	2		
3	Interior Swinging	3' - 0" X 6'-8"		PCS	2		
4	Patio Sliding	6' - 0" X 6'-8"		PCS	1		
5	Exterior Swinging	2' - 6" X 6'-8"		PCS	1		
6	Interior Sliding	10' - 0" X 6'-8"		PCS	2		
7	Exterior Door Trim			FT	35.2		
8	Interior Door Trim			FT	242.6		
9	Entry Lock set			PCS	2		
10	Privacy Lock set			PCS	4		
11	Passage Lock set			PCS	3		
12							
13							
14							
15							



			WINDOWS				
#	Item	Туре	Description, Manufacturer, SKU	Unit	Quantity	Unit Price	Total
1	Sliding	3' - 3" X 3'-3"		PCS	1		
2	Sliding	6' - 3" X 4'-3"		PCS	2		
3	Sliding	2' - 3" X 2'-3"		PCS	2		
4	Sliding	6' - 3" X 2'-3"		PCS	1		
5	Sliding	2' - 9" X 4'-3"		PCS	1		
6	Exterior Window Trim			FT	105.4		
7	Interior Window Trim			FT	105.4		
8							
9							
10							
11							
12							
13							
14							
15							



			ROOF 01				
#	Item	Туре	Description, Manufacturer, SKU	Unit	Quantity	Unit Price	Total
1	Roof Covering			SF	998.0		
2	Roof Covering Fastener			PCS	499		
3	Roof Felt Paper			SF	998.0		
4	Roof Felt Paper Fastener			PCS	2994.0		
5	Roof Sheathing			SF	998.0		
6	Roof Sheathing Fastener			PCS	7984		
7	Batten			FT	0.0		
8	Batten Fastener			PCS	0.0		
9	Soffit			SF	0.0		
10	Soffit Fastener			PCS	0.0		
11	Fascia			FT	465.0		
12	Fascia board fastener			PCS	233		
13	Roof Insulation			SF	998.0		
14							
15							