

HUNTER

The Hunter is a modern three-bedroom, twobathroom home with a footprint of 935 square feet. Its exterior features clean lines and a contemporary aesthetic. The white siding provides a crisp backdrop, while the angled roofline adds visual interest. A covered porch supported by wooden columns creates a welcoming entryway.

Inside, the Hunter embraces an L-shaped floor plan. The living and kitchen areas are combined into a spacious and inviting open-concept space. The three bedrooms are thoughtfully positioned on one side of the home, creating a private and secluded wing for rest and relaxation. The functional spaces, such as the bathroom, are arranged in a corner, maximizing space efficiency and creating a clear separation between living and service areas.




Please print and take this Materials Shopping List to your favorite Home Depot and ask for assistance in selecting the materials, fixtures and fittings to complete your new home.


Record your selection and the price of the item. Then do the math to determine the cost for your selections and the total cost of finishing your home.



To Go To Materials Shopping List



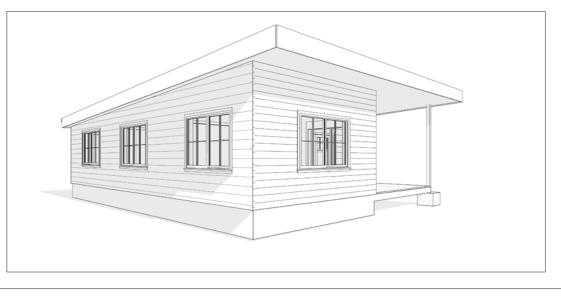

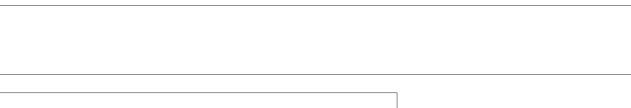



935 SF


3 Bed Rooms

FLOOR PLAN



27' - 7" BEDROOM 1 119 SF KITCHEN 82 SF CLOSET 2 22 SF BEDROOM 2 113 SF LIVING ROOM

TABLE OF CONTENTS

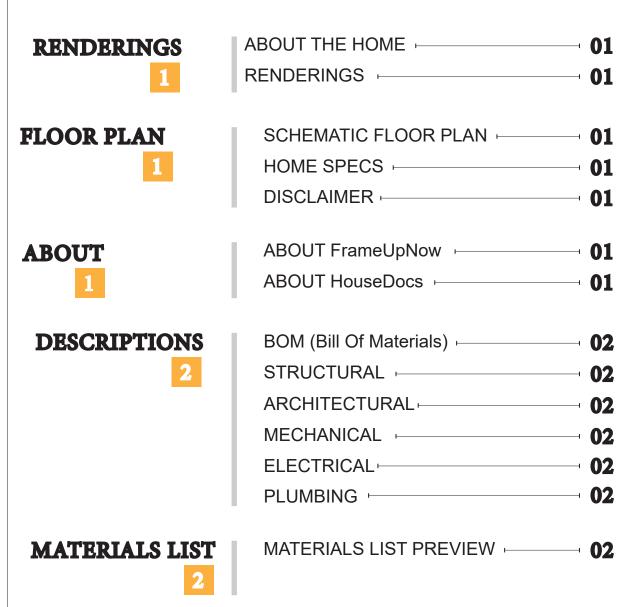

ARCHITECTURAL

HOW TO BUILD

ĺ	COVER SHEET - 0
l	FLOOR PLAN - 0
l	DIMENSION PLAN
l	FOUNDATION PLAN
l	STRUCTURAL FLOOR PLAN - 0
l	WALL FRAME LAYOUT - 0
l	ROOF TRUSS LAYOUT - 0
l	ROOF PLAN - 1
l	ARCHITECTURAL ELEVATIONS - 1
l	ARCHITECTURAL ELEVATIONS - 1
l	ARCHITECTURAL SECTIONS — 1
l	ARCHITECTURAL DETAILS - 1
	ARCHITECTURAL CASEWORK - 1

CONSTRUCTION STEPS

STRUCTURAL

MATERIALS

SHOPPING LIST

16	GENERAL NOTES	17
_	WALL FRAME LAYOUT	18
	WALL PANEL & LAYOUT PLAN	19
	ROOF TRUSS LAYOUT	20
	STRUCTURAL SECTIONS	21
	WALL BRACING LAYOUT	22
	HOLD-DOWN PLAN	23
	STRUCTURAL DETAILS 1	24
	STRUCTURAL DETAILS 2	25
	STRUCTURAL DETAILS 3	
	TRUSS BLOCKING LAYOUT	27
	SHEETROCK BACKING	28
	ROOF BRACING LAYOUT	29
MECHANICAL	COVER SHEET -	30
30	HVAC PLAN	
LECTRICAL	SCHEDULE -	32
32	LIGHTING -	
	POWER PLAN	
	DIMENSION FOR LIGHTING	_
	DIMENSION FOR FITTING	
PLUMBING	NOTES AND SCHEDULES	37
37	WATER SUPPLY & SEWAGE SYSTEM H	
	•	

MATERIALS SHOPPING LIST

COVER SHEET

CENERAL NOTES





FrameUpNow is a design and manufacturing company providing precision-engineered home framing solutions. We offer a catalog of Affordable Homes, Tiny Homes, Garages, Shops and Barndominiums. FrameUpNow manufactures cold-formed steel (CFS) also known as Light Gauge Steel (LGS) framing components that conform to our engineered metal house frame plans or can be purchased as DIY skeleton kits.

The CFS/LGS framing is lightweight, easily assembled, and does not require heavy equipment or specialized labor, enabling homeowners to erect the frame themselves in just a few days. Unlike wood, the steel framing is impervious termites and bores, warping, expansion, and fire.

Our home plans come complete with a structural engineered stamp for permit approvals. Customers receive a full BOM also known as a Materials Shopping List to purchase finish materials from a Building Materials retailer. FrameUpNow prides itself on the quality and efficiency of our precision-engineered home framing solutions for construction professionals and DIY homeowners.



KEY PLAN

NO.	DESCRIPTION	DAIE

NOTE:

LEGEND:

PROJECT

80-Hunter-935-3Bd2Ba-Siding-550

DRAWING NAME

INTRODUCTION

CLIENT NAME:	
PROJECT NUMBER:	
DATE:	
DESIGNED BY:	
DRAWN BY:	
CHECKED BY:	

I101

SCALE:

DISCLAIMER

DISCLAIMER: This documentation and all it's contents are the intellectual property of FrameUpNow. It is provided solely for marketing the services of FrameUpNow. The preliminary information is not approved for actual construction use and is not warranted to be complete or accurate. Unauthorized copying, distribution, or application of these proprietary materials, in any form or format, is strictly prohibited. FrameUpNow assumes no liability for any issues arising from improper use of this marketing content.

DESCRIPTIONS

MATERIALS LIST

The BOM (Bill Of Materials) package, known as the Materials Shopping List document, provides:

Comprehensive Inventory: Detailed lists of essential materials sourced from architectural, mechanical, HVAC, electrical, and plumbing design drawing sets.

Precise Curation: Each item meticulously selected and organized for accuracy and efficiency in project planning.

Customizable Options: Customers can modify listed items to their preferences and calculate costs accordingly, ensuring alignment with personal project needs and budget.

Dedicated Space for Details: Includes tables for customers to note Home Depot SKU numbers or product descriptions for selected items, facilitating seamless purchasing and coordination with suppliers.

Customer Convenience: Take the list to Home Depot or preferred suppliers for accurate pricing, helping align the total home budget with personal financial plans.

Simplify your construction journey with our Materials Shopping List document, where detailed preparation meets streamlined implementation for your dream home.

STRUCTURAL

The structural drawings package provides an exhaustive set of detailed plans essential for the precise assembly of your building. This comprehensive package includes:

Framing Plans: Detailed layouts for all framing components. Truss Layouts: Clear instructions for truss placement and

Panel Length Plans: Specifications for panel dimensions. Framing Elevations and Sections: Precise elevation and sectional views for accurate construction.

Truss and Wall Blocking Plans: Plans for truss and wall blocking to ensure structural integrity.

Hold-Down Plan: Detailed hold-down requirements for stability. Snap Sheet: Reference sheet for quick identification of components

Structural Details and Bracing Plans: Complete details and bracing plans for all structural elements.

Accompanying these plans is a comprehensive Bill of Materials (BOM) that lists every necessary building component, from cold formed steel (CFS) frames to fasteners.

ARCHITECTURAL

With the comprehensive architectural package, both builders and DIY homeowners can confidently execute the construction.

The architectural package includes:

Furnished Floor Plans: Complete with furniture layouts for a clear understanding of space utilization.

Detailed Dimension Plans: Ensures precise measurements, from the overall footprint down to the exact placement of windows and

Foundation Plan: Detailed plan to establish a solid foundation.

Wall Framing and Truss Layout: Comprehensive plans for wall framing and truss placement.

Architectural Elevations: Exterior views showcasing the design.

Strategic Building Sections: Critical cross-sectional details for a thorough understanding of the build.

Casework Drawings and Diagrams: Suggested designs for built-in caseworks, such as kitchen cabinets.

MECHANICAL

The mechanical package includes everything needed to guide HVAC

Detailed HVAC Floor Plan: Precisely maps out the placement of air handlers, ductwork, and vents throughout the home's layout.

HVAC Sections and Riser Diagrams: Technical drawings offering critical cross-sectional details and piping schematics, ensuring proper integration of the heating and cooling system into the home's structure.

Bill of Materials: A complete list of all necessary HVAC components.

ELECTRICAL

The electrical package includes all the plans and documentation needed to guide the installation of your home's electrical system:

Detailed Power Plan: Precisely maps out the placement of outlets, switches, and other power components throughout the layout.

Comprehensive Lighting Plan: Shows the optimal locations for lighting fixtures, sconces, and other illumination sources to create a well-lit, functional interior.

Dimensioned Electrical Layout: Provides exact dimensions and measurements to ensure proper placement of all electrical elements.

ARCHITECTURAL BOM

Bill of Materials: A complete list of every component needed, from circuit breakers to wiring.

PLUMBING

The plumbing package includes everything needed to guide the installation of your home's water supply and drainage systems:

Detailed Water Supply System Plan: Precisely maps out the placement of pipes, valves, and plumbing fixtures throughout the

Comprehensive Sewage System Plan: Shows the optimal routing and sizing of drain lines to effectively remove waste and ensure proper drainage.

Detailed Riser Diagrams: Provide information needed to properly install all vertical plumbing risers and vent stacks.

Bill of Materials: A complete list of every component needed, from pipes to fixtures.

1 Staged Wall Panels 1 Staged Walls 2 Staged Truss Panels 2 Staged Roof 3 Concrete Floor 3 Layout Markers 4 Layout Markers 4 Installed Walls Installed Walls 1 Installed Walls

HOW TO BUILD

Roof Truss Installation **5** Exterior OSB Cladding Wall & Roof Insulation

2 Installed Trusses

1 Staged Wall

Panels

2 Staged Truss

3 Concrete Floor

Metal Delivery and Staging

Wall Panel Installation


2 Sewage

Installation

4 Concrete Floor

3 Foundation

Layout and Marking

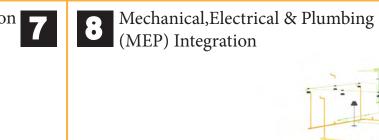

2 Installed Trusses

OSB Sheathing

1 OSB Sheathing 2 Plumbing

System 3 HVAC System

4 Electrical System



Corrugated

iron sheet

4 Coronado Stone

5 Corrugated

iron sheet


1 Installed Walls

2 Insulation

Exterior Wall & Roof Covering



ndows,Doors & Rain Gutters

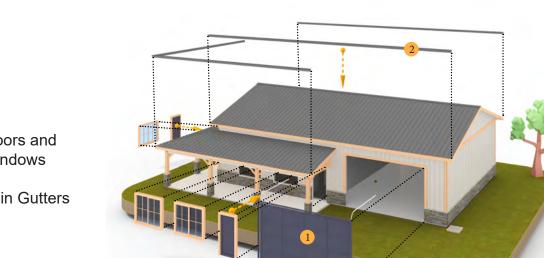

Tuscon,AZ, USA 888-864-0184 inquire@frameupnow.com www.frameupnow.com

KEY PLAN

DESCRIPTION DATE

NOTE:

LEGEND:

PROJECT

80-Hunter-935-3Bd2Ba-Siding-550

DRAWING NAME

INTRODUCTION

CLIENT NAME: PROJECT NUMBER: DATE: **DESIGNED BY** DRAWN BY: CHECKED BY:

1102


BOM (Bill Of Materials) (Separately Attached)




The Bill of Materials (BOM) is a crucial document that compiles the material requirements from different disciplines into a centralized inventory, enabling efficient procurement, inventory management, and cost estimation for a specified project or


ELECTRICAL BOM




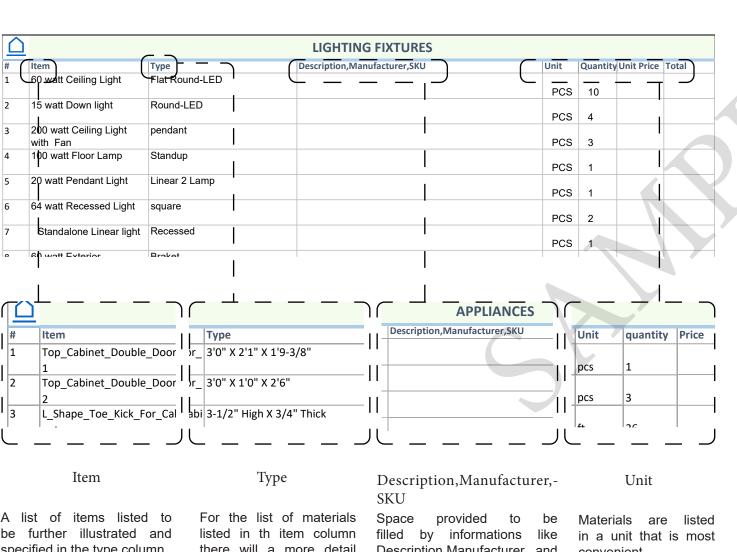

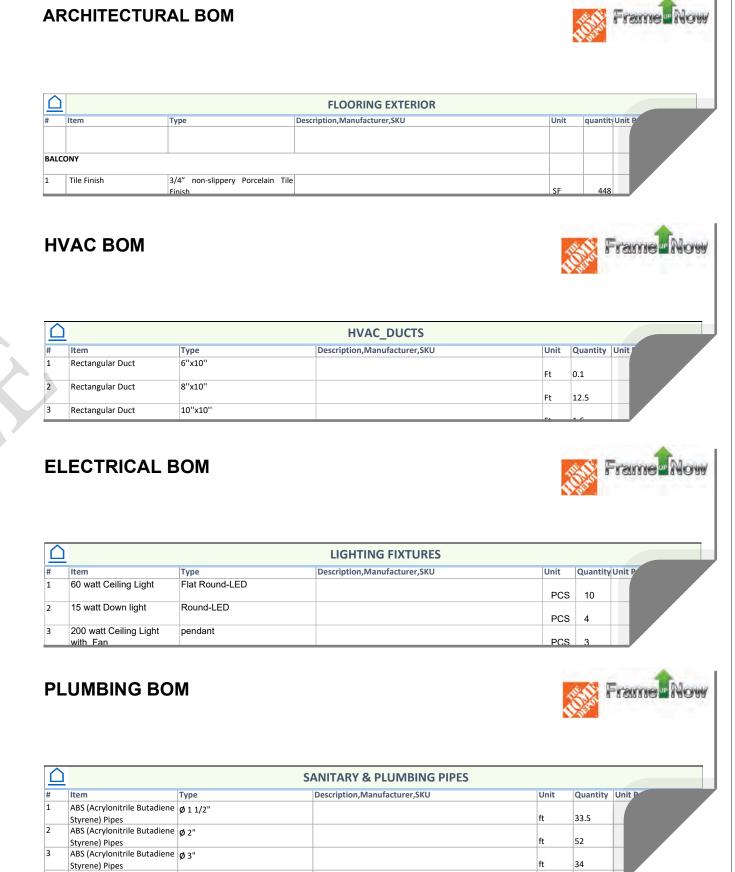

specified in the type column. there will a more detail Description, Manufacturer and convenient. description about the type SKU. of the Material. © [2024] [FrameUpNow] . All rights reserved

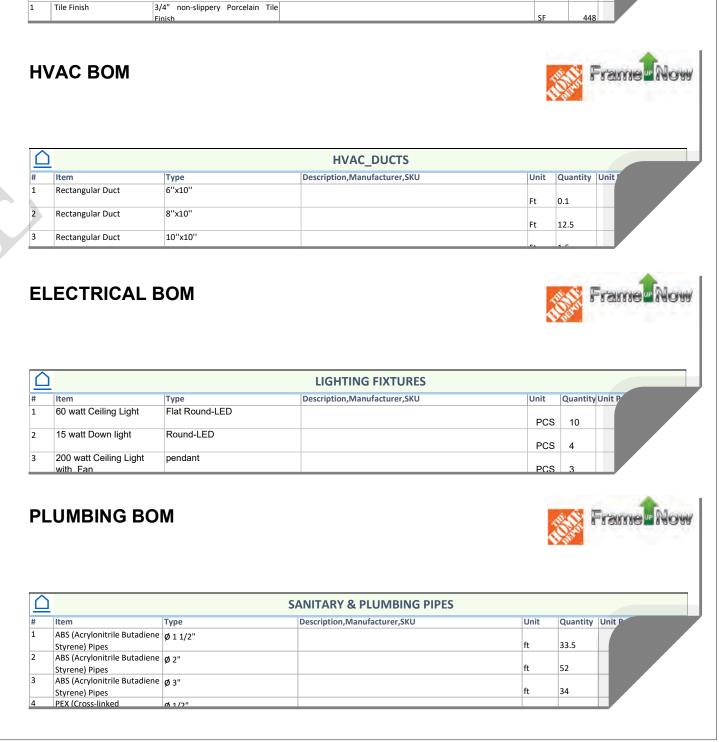

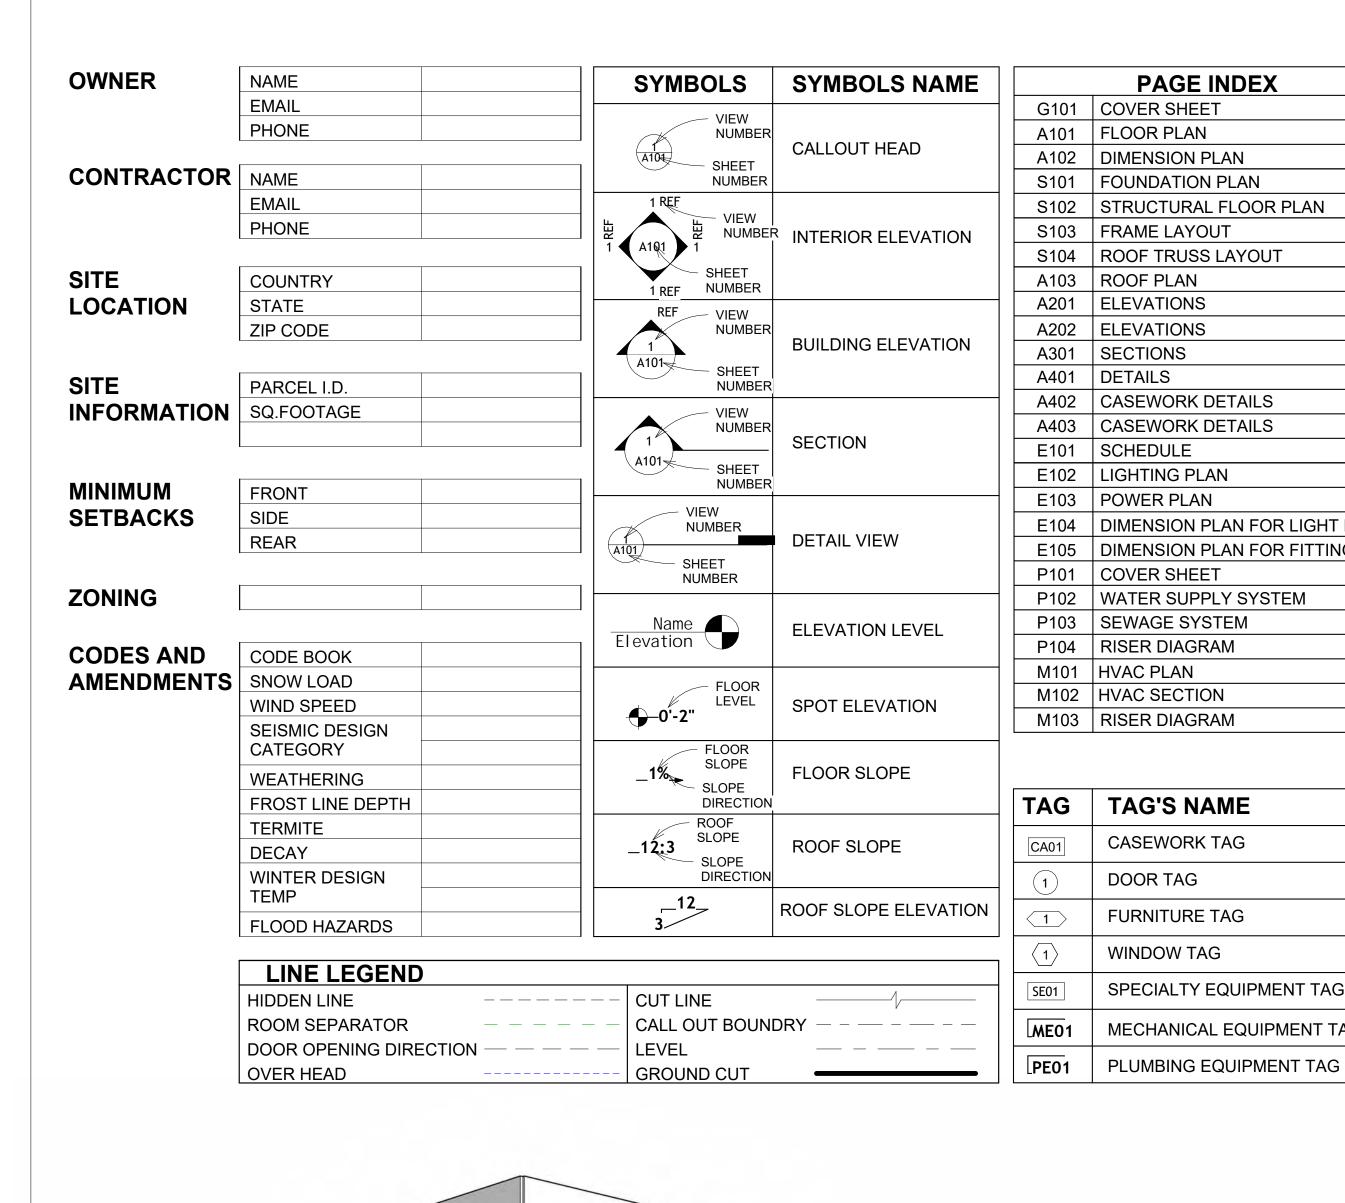

PAGE INDEX	Δ	BBREVIATION
OVER SHEET		_
OOR PLAN	AFS	ACTION FLOOR SYSTE
MENSION PLAN	ASTM D698	AMERICAN SOCIETY FO TESTING AND MATERIA
DUNDATION PLAN		
RUCTURAL FLOOR PLAN	CA	CASEWORK
AME LAYOUT	EL	ELECTRICAL
OOF TRUSS LAYOUT	F.F.E	FINISHED FLOOR ELEV
OOF PLAN	F.F.L	FINISHED FLOOR LEVE
EVATIONS	FTG	FOOTINGS
EVATIONS	HVAC	HEATING, VENTILATION CONDITIONING
CTIONS	IRC	INTERNATIONAL RESID
TAILS		CODE
SEWORK DETAILS	IMC	INTERNATIONAL MECH
SEWORK DETAILS		CODE
HEDULE	MAX.	MAXIMUM
GHTING PLAN	ME	MECHANICAL
OWER PLAN	MIN.	MINIMUM
MENSION PLAN FOR LIGHT FIXTURE	NO.	NUMBER
MENSION PLAN FOR FITTING	O.C	ON CENTER
OVER SHEET	OSB	ORIENTED STRAND BO
ATER SUPPLY SYSTEM	PL	PLUMBING
WAGE SYSTEM	PSI	POUNDS PER SQUARE
SER DIAGRAM	PVC	POLYVINYL CHLORIDE
AC PLAN	REF	REFERENCE
AC SECTION	RG	RIGHT GARAGE
SER DIAGRAM	SE	SPECIAL EQUIPMENT
	SF	SQUARE FEET
ACIC NAME	SIMP. STHD8	SIMPSON STRAP THE HOLDDOWN
AG'S NAME	SIMP. ABE66	SIMPSON ANCHOR BOL
ASEWORK TAG	TV	TELEVISION
OOR TAG	UNO	UNLESS NOTED OTHER
URNITURE TAG	W/	WITH
UNNITURE TAG	W/D	WASHER/DRYER
/INDOW TAG	AC	AIR CONDITIONING UNI

ELEVATIONS

ELEVATIONS

CASEWORK DETAIL

CASEWORK DETAIL

DIMENSION PLAN F

DIMENSION PLAN F

WATER SUPPLY SYS

SEWAGE SYSTEM

TAG'S NAME

CASEWORK TAG

FURNITURE TAG

SPECIALTY EQUIPMENT TAG

WINDOW TAG

DOOR TAG

RISER DIAGRAM

HVAC PLAN

LIGHTING PLAN


POWER PLAN

COVER SHEET

SECTIONS

SCHEDULE

DETAILS

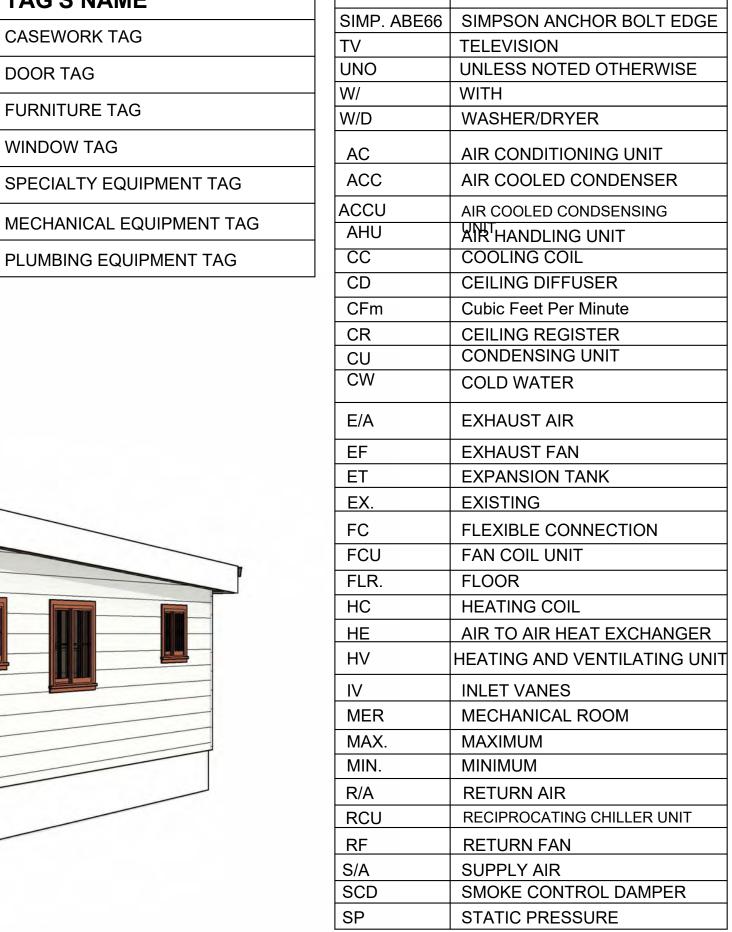

ACTION FLOOR SYSTEMS

AMERICAN SOCIETY FOR

TESTING AND MATERIAL

FINISHED FLOOR LEVEL

FINISHED FLOOR ELEVATION


HEATING, VENTILATION & AIR

INTERNATIONAL RESIDENCE

INTERNATIONAL MECHANICAL

ORIENTED STRAND BOARD

POUNDS PER SQUARE INCH

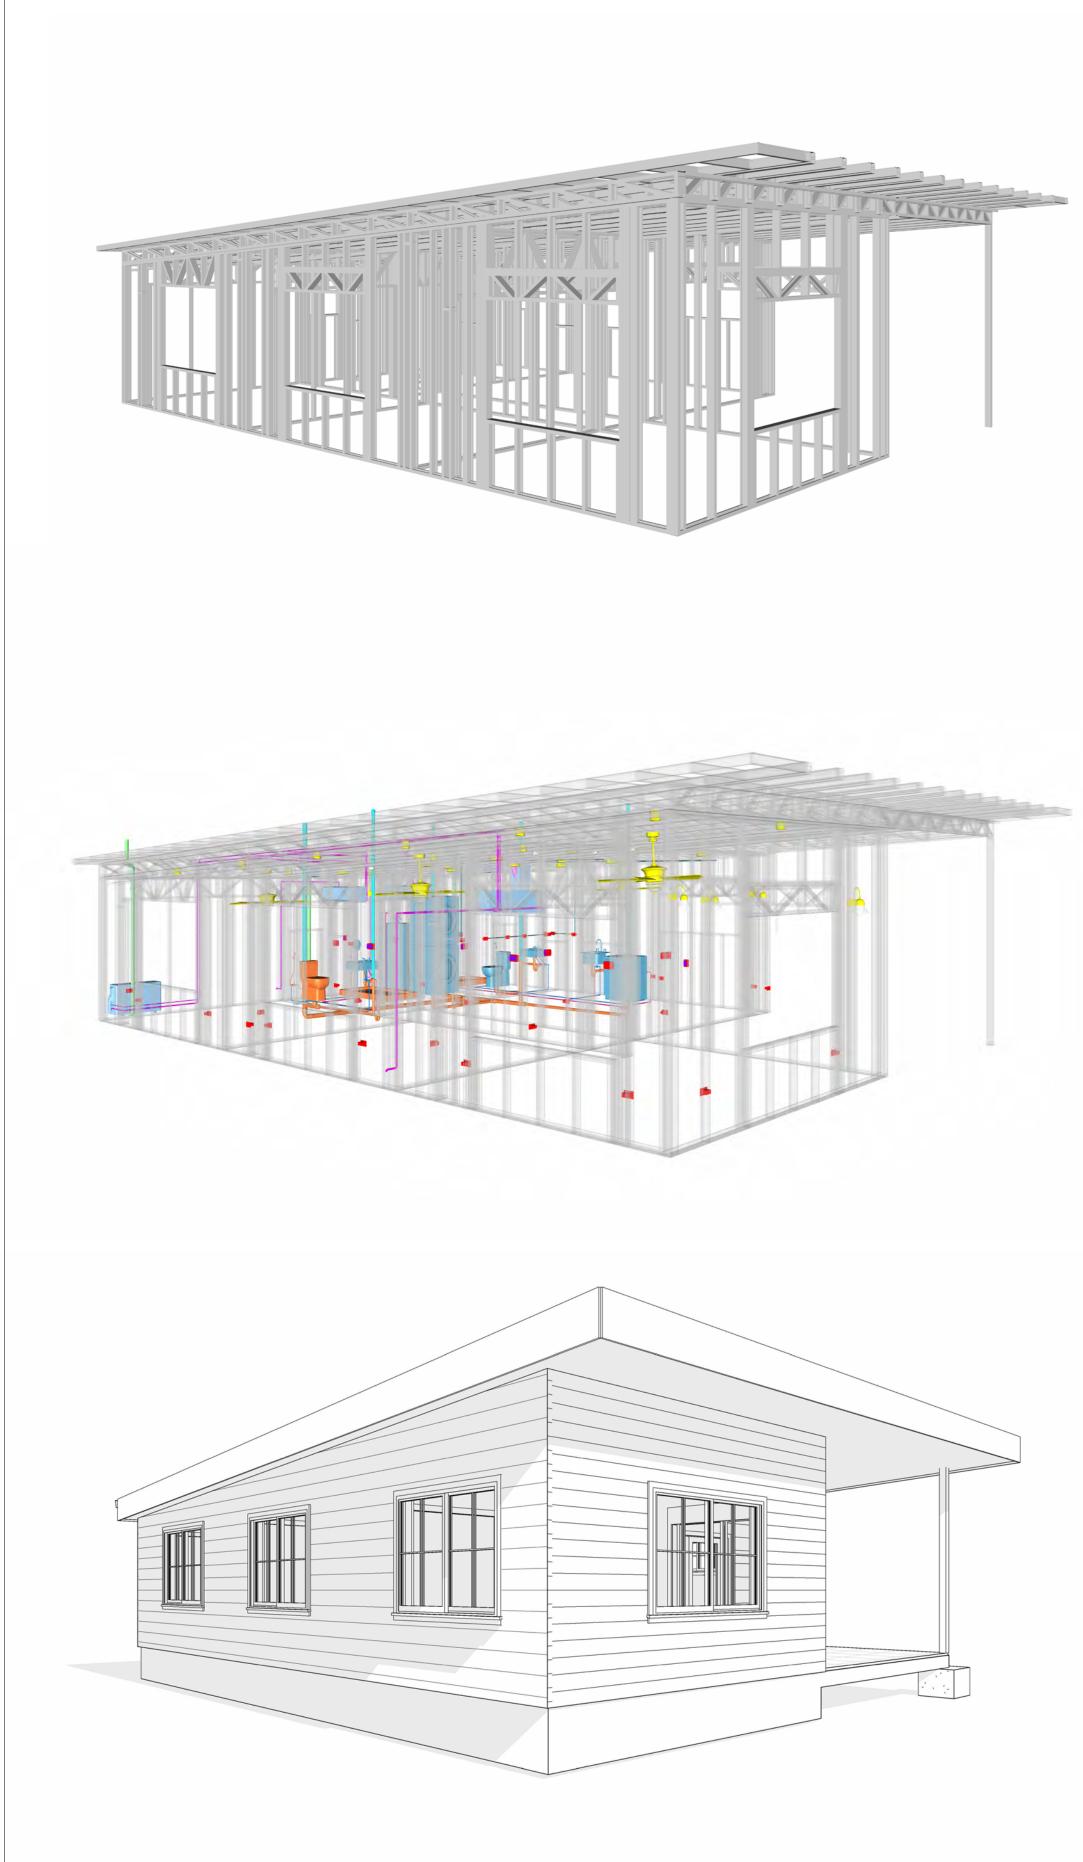

80 HUNTER 935 3Bd 2Ba SIDING 350

SQUARE FOOTAGE				
LIVIN G	939			
PORCH	165			
TOTAL	1104			



KEY PLAN

NO.	DESCRIPTION	DATE

NOTE:

LEGEND:

PROJECT

80 HUNTER 935 3Bd 2Ba SIDING

DRAWING NAME

COVER SHEET

CLIENT NAME:	Client Name
PROJECT NUMBER:	0061_12
DATE:	2/25/2025 5:26:31 PM
DESIGNED BY:	Designer
DRAWN BY:	Author
CHECKED BY:	Checker

G101

GENERAL NOTES

- THIS DRAWING DEPICTS THE ARCHITECTURAL (SPACE LAYOUT, FURNISHING, FLOOR, WALLS, ROOFS, FOUNDATION, WINDOWS AND DOORS) SYSTEMS. IT PROVIDES A VISUAL REPRESENTATION OF THE ARCHITECTURAL LAYOUT AND COMPONENTS.
- THE ARCHITECTURAL DRAWINGS ARE PREPARED TO MEET THE SPECIFIC REQUIREMENTS OF THE BUILDING, AS PER THE PROJECT SPECIFICATIONS AND APPLICABLE CODES AND STANDARDS. THE CONSTRUCTION OF THIS HOME SHALL COMPLY WITH THE LATEST EDITION OF THE
- INTERNATIONAL RESIDENTIAL CODE (IRC), INTERNATIONAL MECHANICAL CODE (IMC), THE INTERNATIONAL PLUMBING STANDARD, THE NATIONAL ELECTRICAL STANDARD AND ALL OTHER APPLICABLE LOCAL, STATE, AND NATIONAL CODES AND REGULATIONS.
- COORDINATION WITH OTHER TRADES HAS BEEN DONE ON A DESIGN LEVEL. THIS DRAWING SHALL BE READ TOGETHER WITH THE ME, EL AND PL DESIGN DRAWINGS TO ENSURE PROPER CONSTRUCTION AND INTEGRATION OF THE BUILDING SYSTEMS.

ABOUT WALLS:

- SHOWER WALL COVERING
- BATHTUB AND SHOWER SPACES (WALLS AND FLOORS) WITH INSTALLED SHOWER HEADS AND IN SHOWER COMPARTMENTS SHALL BE FINISHED WITH A NON-ABSORBENT SURFACE.
- WALL PAINT (INTERNAL)
 - THE TYPICAL THICKNESS OF LATEX WALL PAINT IS 1/32 OF AN INCH FOR A SINGLE COAT. AND DOUBLE COAT (1/16") SHALL BE APPLIED FOR DURABILITY.

THE ADVISABLE TYPE OF ADHESIVE FOR THIS PROJECT IS **EPOXY ADHESIVES**BECAUSE THEY ARE KNOWN FOR THEIR HIGH STRENGTH, DURABILITY, AND RESISTANCE TO MOISTURE, CHEMICALS AND


REFER TO SHEETS A201 & A202 FOR GENERAL NOTES ON EXTERNAL FINISHING MATERIALS

ABOUT FLOORS:

- THE SPOT ELEVATION INDICATES THE FINISHED FLOOR ELEVATION.
- FINISHED FLOORS PER PLANS.
- FIELD VERIFY FOR DIMENSION DROP 4" FOR SHOWER AND BATHTUB USE.
- 1% SLOPE ON OUTDOOR BALCONIES FOR WATER RUN OFF.
- 2% SLOPE TOWARDS THE SHOWER DRAIN FOR SUFFICIENT DRAINAGE.
- 4" DROP AT THE DOOR LEADING TO EXTERIOR BALCONY FROM THE MAIN LIVING AREA.
- 5% SLOPE FOR GARAGE IS USED, WHICH SHOULD BE CHECKED WITH THE LOCAL GARAGING ZONING LAWS.

FURNITURE SCHEDULE				
TYPE MARI	K TYPE	COUNT		
01	KING SIZE BED	3		
02	THREE SEAT SOFA	1		
03	DINING CHAIR	4		
04	SAMPLE PARAMETRIC TABLE 3	1		

	ROOM FINISH SCHEDULE						
ROOM NUMBE R	ROOM NAME	FLOOR FINISH	BASE FINISH	WALL FINISH	CEILING FINISH	CEILING HEIGHT	COM MEN TS
01	BEDROOM 1	HARDWOOD	CONCRETE	WALL PAINT	DRY WALL	8' - 0"	
02	CLOSET 1	HARDWOOD	CONCRETE	WALL PAINT	DRY WALL	8' - 0"	
03	BATH 1	VINYL TILES	CONCRETE	CERAMIC TILE	MRD	8' - 0"	
04	W/D	VINYL TILES	CONCRETE	CERAMIC TILE	DRY WALL	8' - 0"	
05	BATH 2	VINYL TILES	CONCRETE	CERAMIC TILE	MRD	8' - 0"	
06	CLOSET 4	HARDWOOD	CONCRETE	WALL PAINT	DRY WALL	8' - 0"	
07	CLOSET 2	HARDWOOD	CONCRETE	WALL PAINT	DRY WALL	8' - 0"	
08	BEDROOM 2	HARDWOOD	CONCRETE	WALL PAINT	DRY WALL	8' - 0"	
09	CLOSET 3	HARDWOOD	CONCRETE	WALL PAINT	DRY WALL	8' - 0"	
10	BEDROOM 3	HARDWOOD	CONCRETE	WALL PAINT	DRY WALL	8' - 0"	
11	WH	VINYL TILES	CONCRETE	CERAMIC TILE	DRY WALL	8' - 0"	
12	KITCHEN	HARDWOOD	CONCRETE	WALL PAINT + CERAMIC	DRY WALL	8' - 0"	
13	LIVING ROOM	HARDWOOD	CONCRETE	WALL PAINT	DRY WALL	8' - 0"	
14	HALL 2	HARDWOOD	CONCRETE	WALL PAINT	DRY WALL	8' - 0"	
15	PATIO	PROCELAIN TILE	CONCRETE	EXTERIOR-GRADE PLYWOOD	PLYWOOD	8' - 0"	
16	HALL 1	HARDWOOD	CONCRETE	WALL PAINT	DRY WALL	8' - 0"	

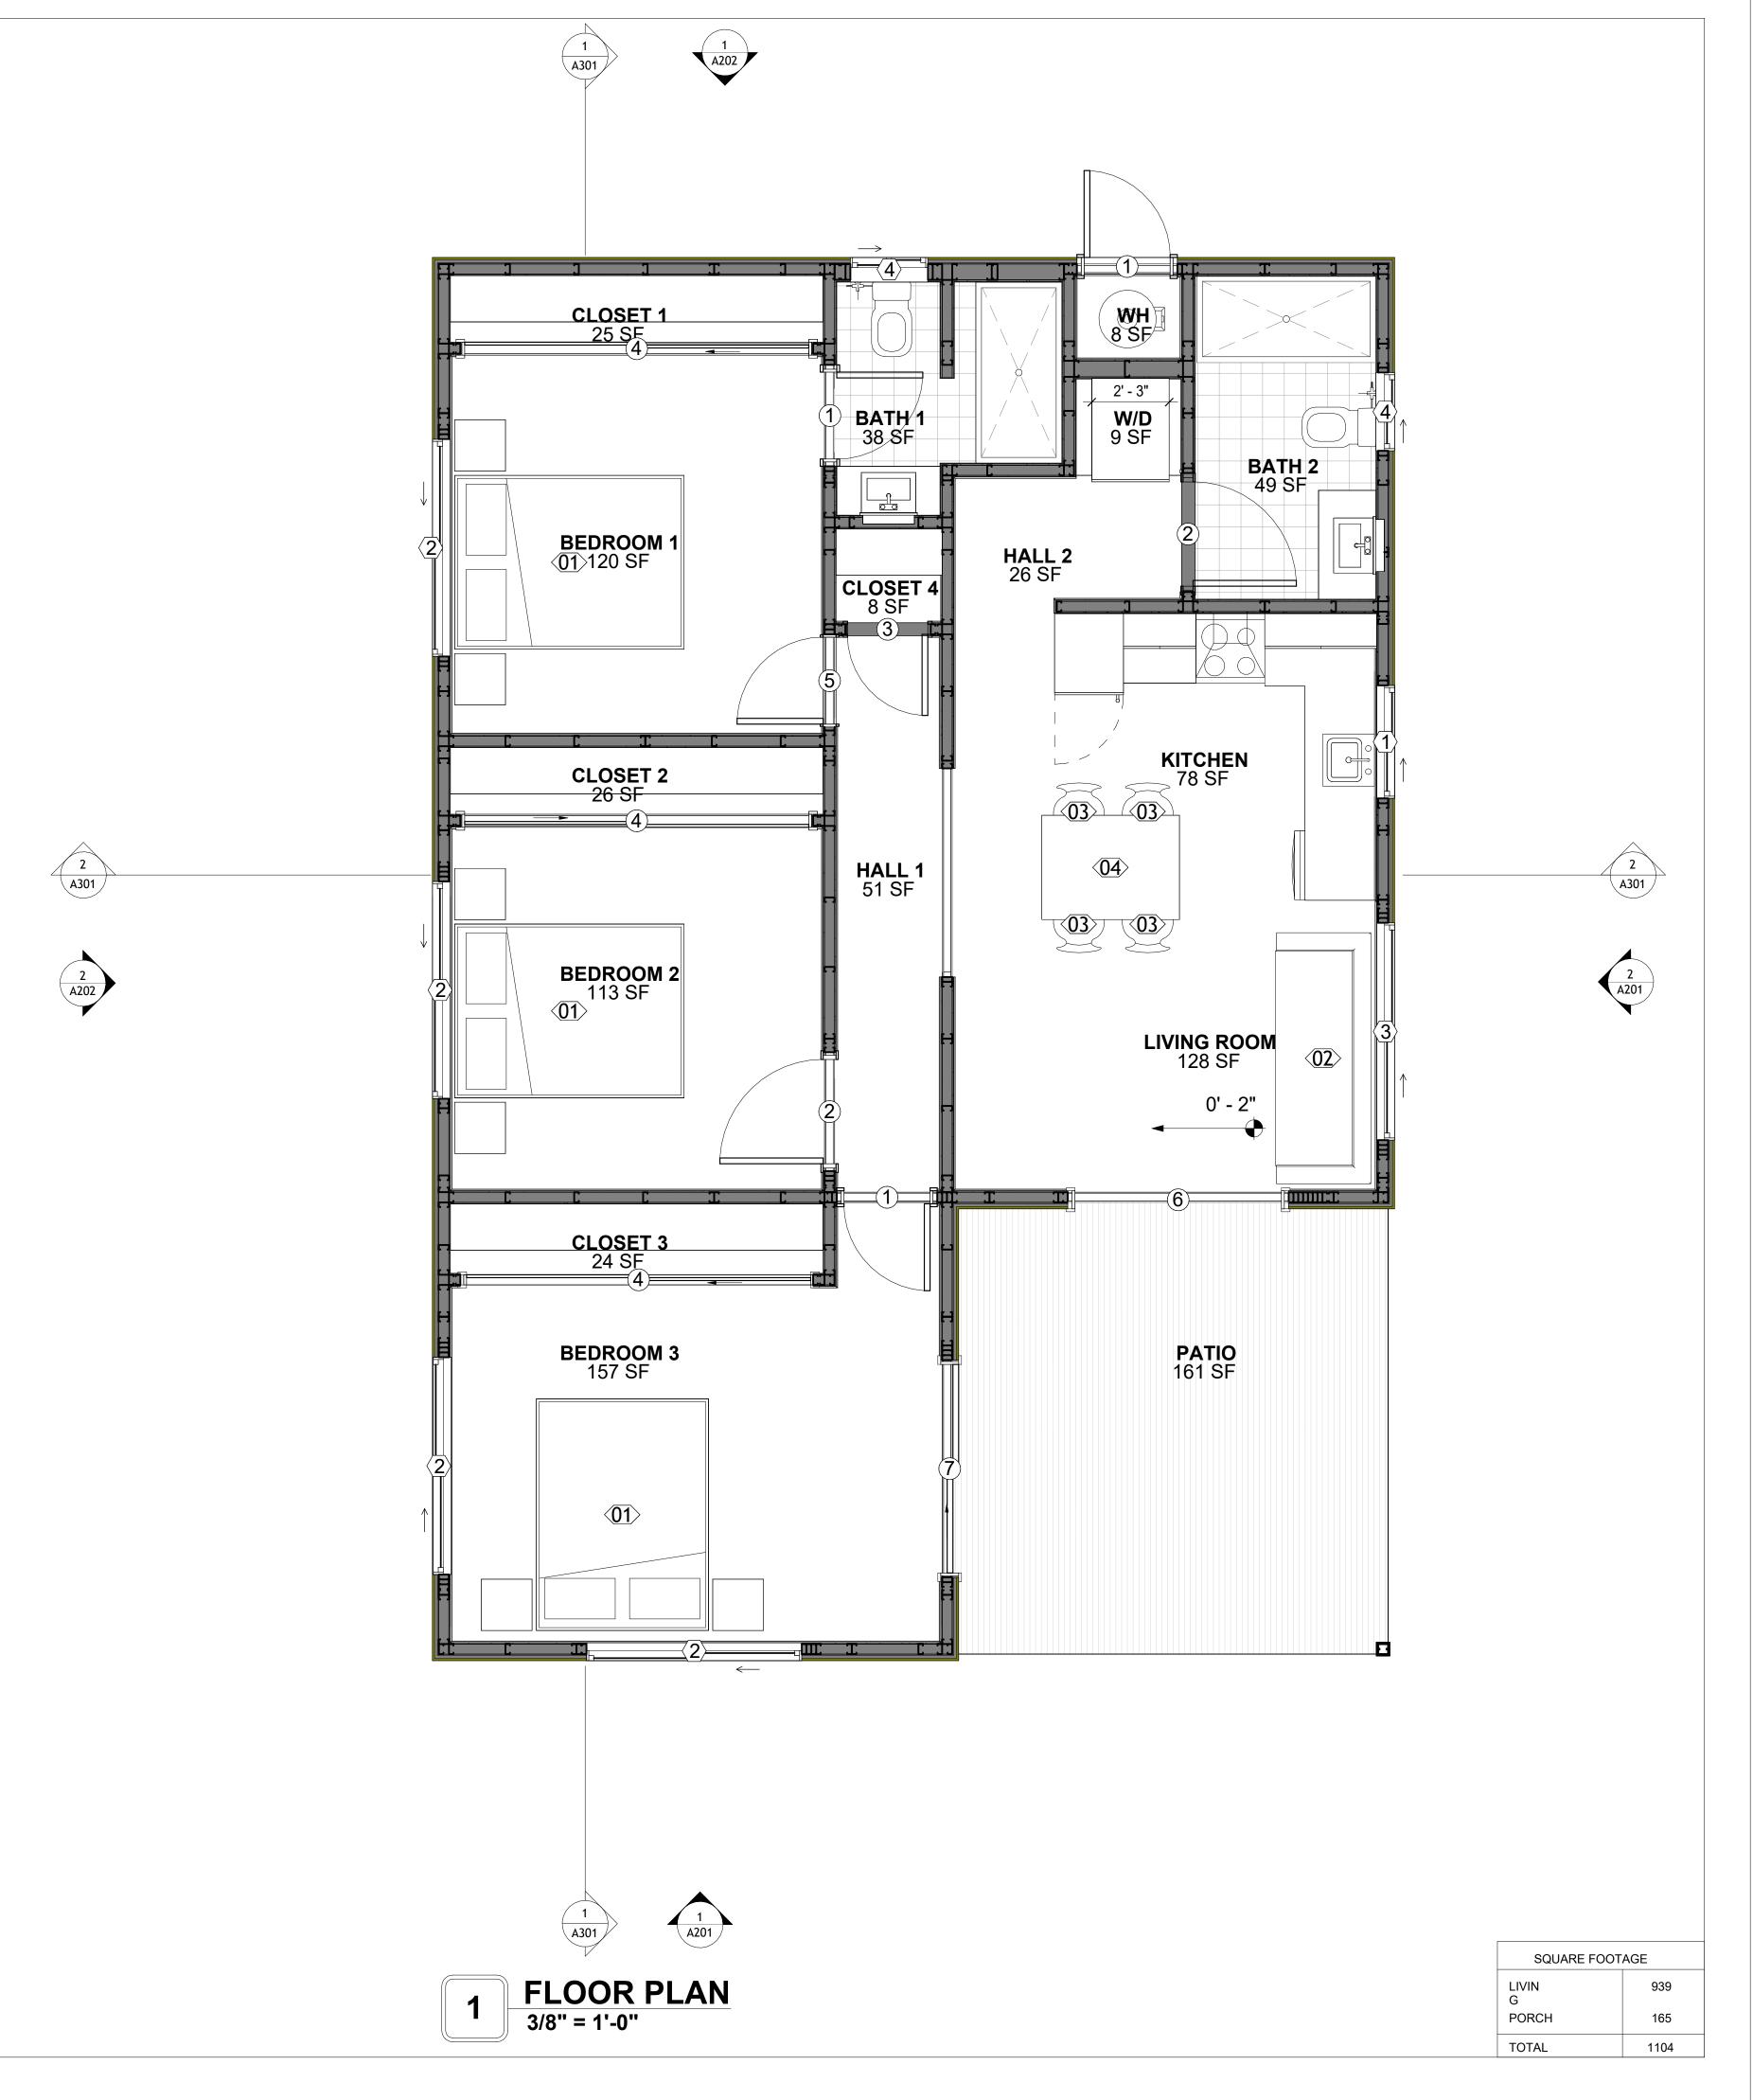



KEY PLAN

NO. DESCRIPTION DATE

NOTE:

LEGEND:

PROJECT


80 HUNTER 935 3Bd 2Ba SIDING

DRAWING NAME

FLOOR PLAN

Client Name CLIENT NAME: PROJECT NUMBER: 0061_12 2/25/2025 5:26:32 PM DATE: Designer DESIGNED BY: DRAWN BY: Author Checker CHECKED BY:

A101

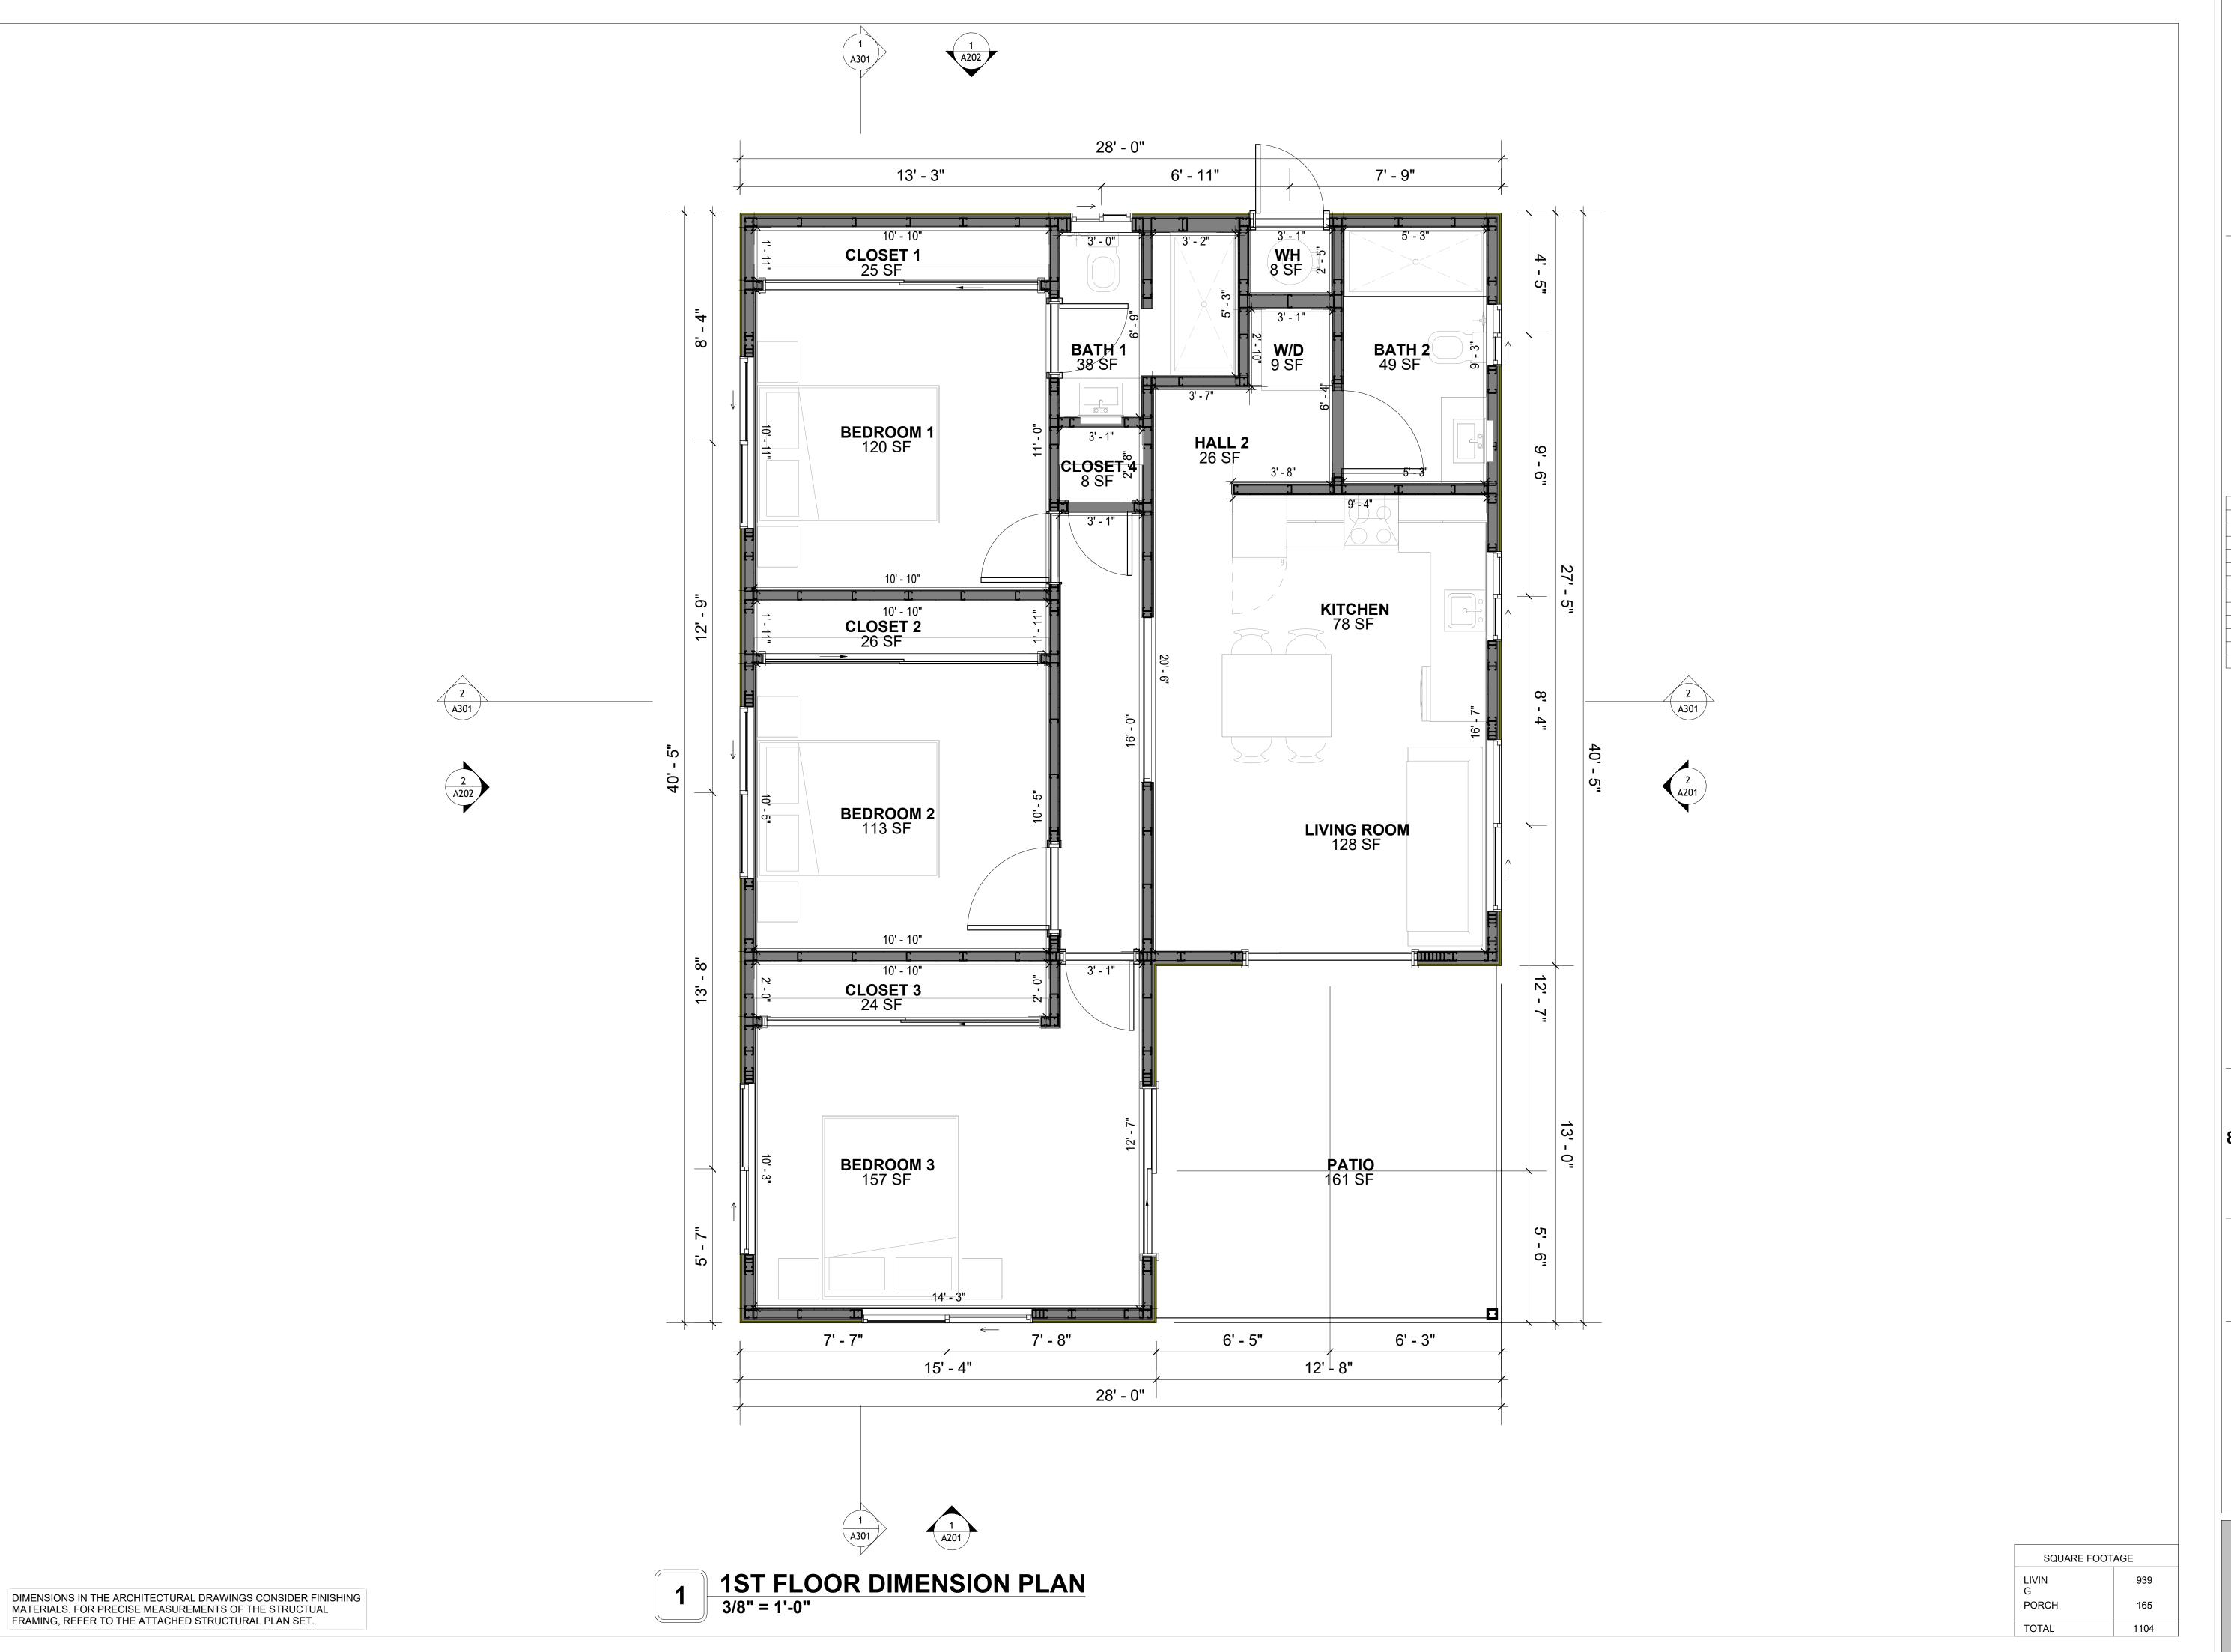



KEY PLAN

NO.	DESCRIPTION	DATE

NOTE:

LEGEND:

PROJECT

80 HUNTER 935 3Bd 2Ba SIDING 350

DRAWING NAME

DIMENSION PLAN

CLIENT NAME:	Client Name
PROJECT NUMBER:	0061_12
DATE:	2/25/2025 5:26:33 PM
DESIGNED BY:	Designer
DRAWN BY:	Author
CHECKED BY:	Checker

A102

SCALE: 3/8" = 1'-0"

FOUNDATION NOTES

NOTES:

TERMITES PRETREATMENT BY LICENSED CONTRACTOR UNDER SLAB AND AROUND FOOTINGS. ALL AREAS BELOW SLABS SHALL BE TREATED NO MORE THAN 24 HOURS PRIOR TO CONCRETE POUR. EVIDENCE OF TREATMENT MUST BE PROVIDED PRIOR TO PLACING OF CONCRETE.

1. MATERIALS:

ALL INTERIOR CONCRETE SLABS SHALL BE A MIN. OF 4" THICK CONCRETE OVER 4" COMPACTED AGGREGATE BASE (ASTM D698), FINISH ELEVATIONS AS NOTED ON DRAWINGS, 6" ABOVE ADJACENT GRADE, LEVEL SLABS TO 1/8"-10' MAX.. CONCRETE SLABS SHALL BE 2500# PSI AT 28 DAYS. A 4" ALLOWABLE SLUMP.

2. PAD PREPARATION:

- EXCAVATION FOR FOOTING SHALL BE NEAT.

- FOOTINGS SHALL BE POURED IMMEDIATELY AFTER EXCAVATION AND APPROPRIATE INSPECTION.

- ALL REINFORCING STEEL MARKED "CONTINUOUS" SHALL BE LAPPED 36 BAR DIAMETERS AT SPLICES AND AROUND CORNERS OR INTERSECTIONS WITH A STANDARD 90 DEGREE BEND ON CORNER BARS. LAP WIRE MESH ONE FULL MESH AT SIDE AND END LAPS.

- ALL HARDWARE TO BE SIMPSON OR EQUIVALENT.
- EXTERIOR FRAME WALL TO BE SECURED WITH 1/2"X10" ANCHOR BOLTS 4'-0" O.C. FOR 1-STORY AND 2'-8" O.C. FOR 2-STORY. BOLTS SHALL BE LOCATED WITHIN 1'-0" OF EACH END PIECE AND SHALL HAVE A MIN. OF TWO BOLTS PER PIECE.

-FOUNDATION ANCHOR STRAPS SHALL BE PERMITTED, ACCORDING TO RESIDENTIAL CODE 2021

- ALL INTERIOR WALLS TO BE SECURED WITH POWER DRIVEN PINS PER MANUFACTURER SPECIFICATION USE PIN SPACING EQUIVALENT TO 1/2" ANCHOR BOLTS.

- ALL CONSTRUCTION TO CONFORM TO THE 2012 IRC

R-10 RIGID INSULATION OUTSIDE OF EXTERIOR FOUNDATION WALLS UNDER LIVING AREA.
 CONCRETE PAD FOR CONDENSER THICKNESS IS 4" MIN UNLESS OTHERWISE NOTED.

3. CONCRETE CONSTRUCTION:

- THE SLAB SHALL BE UNDERLAIN BY A VAPOR BARRIER/RETARDER IN THE LIVING AREA (TYPICALLY POLYETHYLENE, UNLESS MORE STRINGENT PROTECTION REQUIRED BY THE ARCHITECT, ENGINEER, FLOOR COVERING MANUFACTURER, OR ACCEPTED PRACTICE). UNLESS OTHERWISE REQUIRED, BARRIER MAY BE OMITTED AT GARAGES, PORCHES AND PATIOS WITHOUT FLOOR COVERINGS. IT IS BEYOND THE SCOPE OF THESE PLANS TO DETERMINE THE APPLICABILITY OF THESE MORE STRINGENT REQUIREMENTS. BUILDER SHALL VERIFY PRIOR TO CONSTRUCTION.

4. REINFORCEMENT:

- IF CONSTRUCTED ON ACTIVE SOILS, THE LONG TERM PERFORMANCE OF THE FOUNDATION IS DEPENDENT ON MAINTENANCE BY THE OWNER. THUS THE BUILDER SHALL ADVISE THE OWNER OF THE FOLLOWING:

1. DRAINAGE MUST BE MAINTAINED. WATER SHALL NEVER BE ALLOWED TO POND NEAR THE FOUNDATION.

2. THE SOIL AROUND THE FOUNDATION SHALL BE MAINTAINED IN A RELATIVELY DAMP CONDITION, SUCH AS THAT REQUIRED TO KEEP A LAWN GREEN. IF IT DRIES OUT IT WILL SHRINK. IF IT GETS WET, IT WILL HEAVE UPWARD.

3. SLABS ON THE SHORTER SIDE USES MAIN BARS ARE USED IN THIS DIRECTION ONLY WITH SMALLER DIAMETER DISTRIBUTION BARS ARE PLACED, FORMING A MAT OR GRID.

4. ALL REINFORCEMENT BARS SIZE 10MM OR LARGER IN ACCORDANCE TO ASTM

3. ANCHOR BOLTS AT ALL EXTERIOR WALLS SHALL BE MINIMUM 1/2 INCH DIAMETER WITH A MAXIMUM SPACING OF 6'-0" ON CENTER, UNLESS NOTED OTHERWISE.
4. ANCHOR BOLTS SHALL BE INSTALLED WITHIN 12 INCHES OF EACH END OF EACH SILL

4. ANCHOR BOLTS SHALL BE INSTALLED WITHIN 12 INCHES OF EACH END OF EACH SILL PLATE WITH AT LEAST TWO ANCHOR BOLTS FOR EACH BOLTS FOR EACH SILL PLATE LONGER THAN 12 INCHES.


5. SIMPSONS SILL ANCHORS MAYBE SUBSTITUTED FOR ANCHOR BOLTS AT THE SAME SPACING.

6. EXTERIOR CONCRETE SLABS WHICH ARE NOT PART OF THE MAIN SLAB SHALL BE MINIMUM 4 INCHES THICK WITH NO STEEL REINFORCING BARS REQUIRED, UNLESS NOTED OTHERWISE ON FOUNDATION PLAN.

VERIFY THE FOLLOWING PRIOR TO POURING:

- 1. ALL HOLDDOWNS , STRAP, AND POST LOCATIONS.
- 2. CONCRETE FINISHES. PANEL RISER LOCATION WHERE APPLICABLE.
- UNDERSLAB MECHANICAL REQUIREMENTS.
 STEM WALL BLOCKOUTS.
- 5. UNDERSLAB ELECTRICAL REQUIREMENTS AND PANEL RISER LOCATION. WHERE APPLICABLE.
- 6. PROVIDE THE FOLLOWING:
- PVC SLEEVES THROUGH FTG IF REQUIRED 20' #4 COPPER GROUND BAR.
- 7. SLOPE FINISH GRADE AWAY FROM FOOTING.

NOTE: FIELD VERIFY ALL DIMENSIONS SEE DIMENSIONED ARCHITECTURAL DRAWINGS

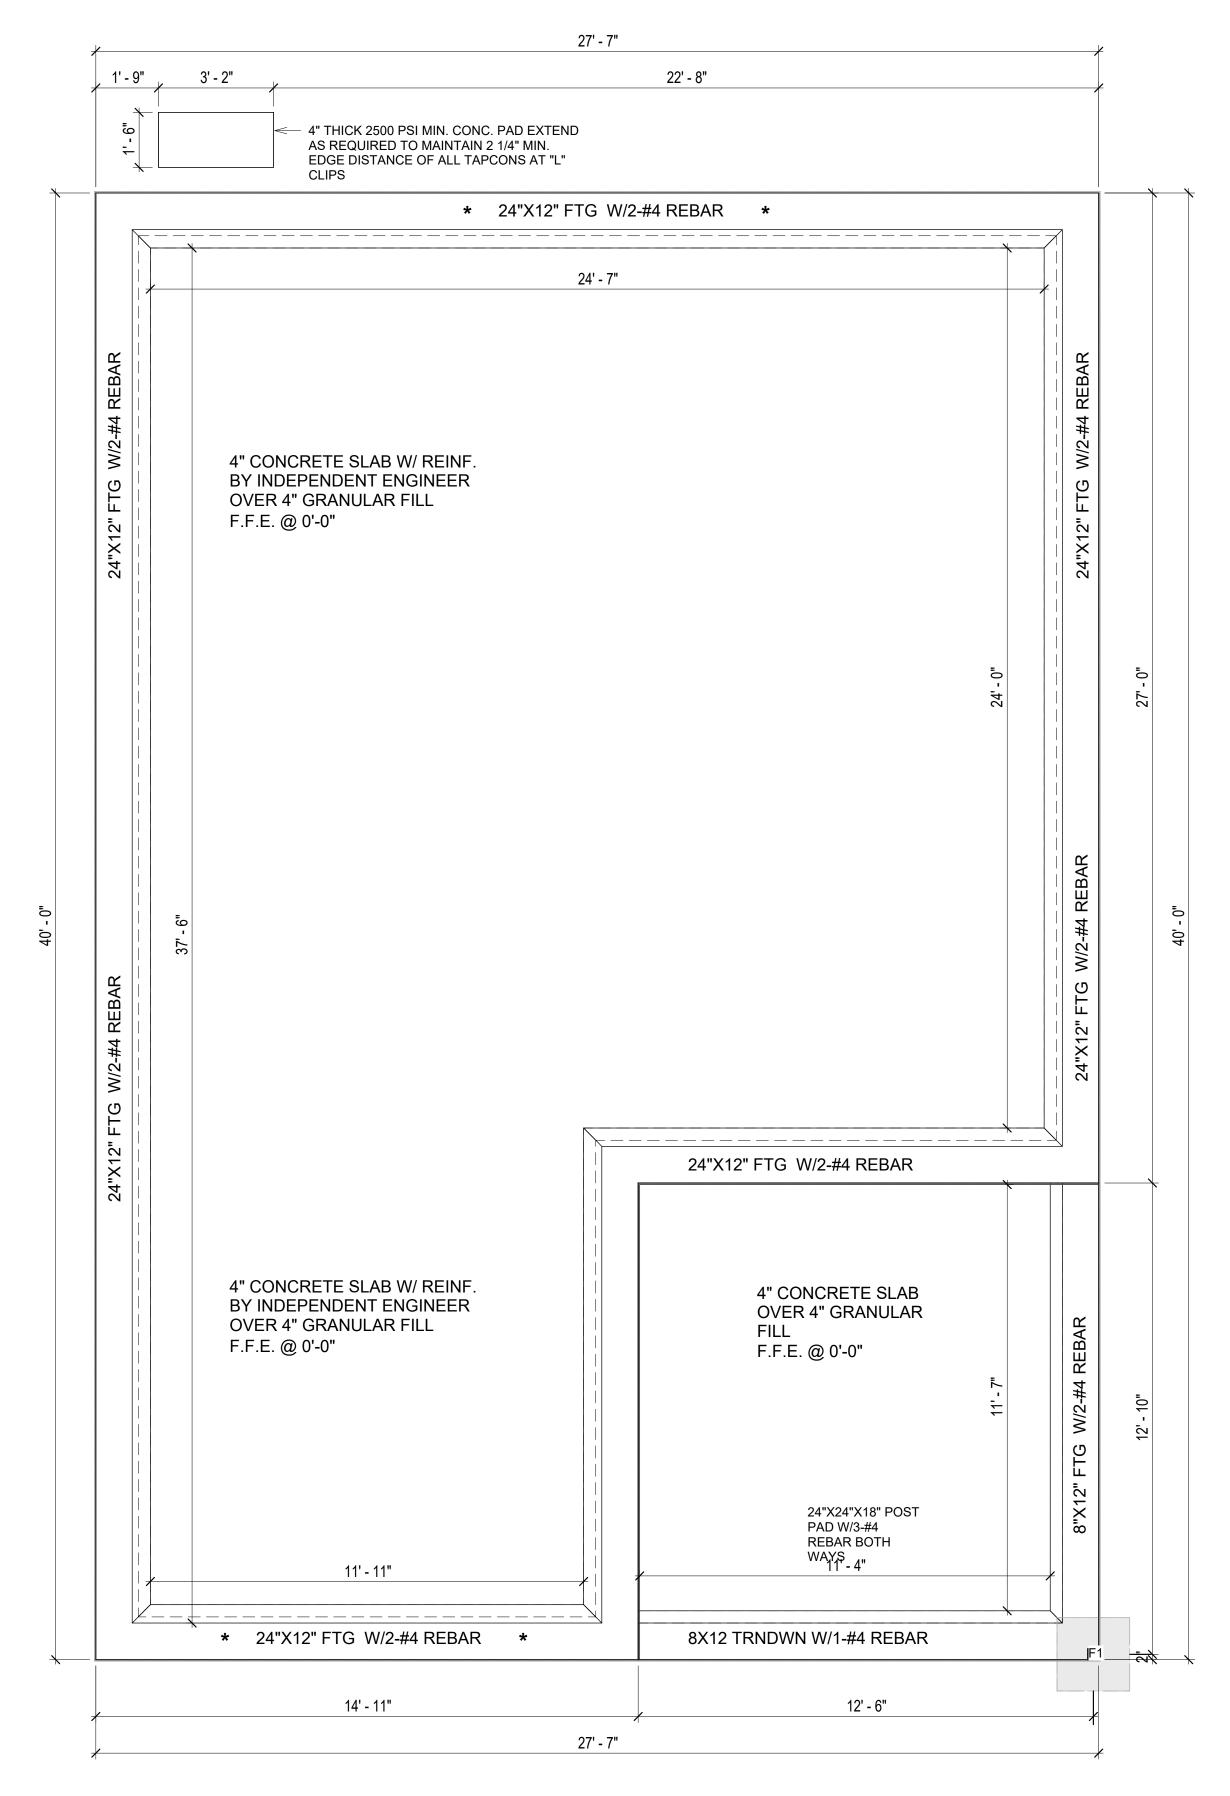



SQUARE FOO	OTAGE
LIVIN G	939
PORCH	165
TOTAL	1104



KEY PLAN

NO.	DESCRIPTION	DATE
NOTE	:	

LEGEND:

80 HUNTER 935 3Bd 2Ba SIDING 350

DRAWING NAME

FOUNDATION PLAN

CLIENT NAME:	Client Name
PROJECT NUMBER:	0061_12
DATE:	2/25/2025 5:26:34 PM
DESIGNED BY:	Designer
DRAWN BY:	Author
CHECKED BY:	Checker

S101

SCALE: 3/8" = 1'-0"

GENERAL NOTES

NOTES:

-ALL BEARING WALLS SHOULD HAVE A THICKENED SLAB PER SECTION PER DETAIL A401/5.

A) **FOUNDATION PLAN NOTES**:

- 1. CONCRETE SLAB SHALL BE 6" THICK WITH 1/2" DIAMETER TENDONS PER LAYOUT PLAN, CENTERED IN SLAB THICKNESS, OVER APPROVED SUBBASE PER GENERAL STRUCTURE NOTES.
- 2. TERMITE PROTECTION SHALL BE PROVIDED PER IRC SECTION R318.1
 3. NONE TYPICAL ANCHOR BOLT SPACING AT SHEAR WALL AND HOLD DOWN SPECIFICATIONS PER APPROVED ARCHITECTURAL PLANS.
- INSTALL HOLDOWNS BEFORE CONCRETE SLAB POUR.
 EXISTING FILL ON-SITE SHALL BE COMPACTED IN ACCORDANCE WITH THE
- 5. EXISTING FILL ON-SITE SHALL BE COMPACTED IN ACCORDANCE WITH 1 REQUIREMENTS IN THE GEOTECHNICAL REPORT.
- 6. ALL FLOOR SLABS ARE REINFORCED ON CONCRETE SLABS.

SPECIAL INSPECTION IS REQUIRED FOR THICKENED FOUNDATION CONSTRUCTION

1. REINFORCEMENT

2. 2300 PSI CONCRETE POUR

B) REINFORCEMENT FOR CONCRETE:


 ALL REINFORCING SLABS BARS SIZE 10MM OR LARGER SHALL BE DEFORMED IN ACCORDANCE TO ASTM-A706, AND BARS SMALLER THAN 10 MM MAYBE PLAIN.
 UNLESS OTHERWISE NOTED IN PLANS, THE YIELD STRENGTH OF REINFORCING BARS SHALL BE:


> A) FOOTING = 40,000 PSI B) NON-LOAD BEARING WALLS AND PARAPETS= 40,000 PSI

- 3. SPLICES SHALL BE SECURELY WIRED TOGETHER AND SHALL LAP OR EXTEND
- 4. GRADE OF STEEL FOR RCC WORKS SHALL BE GRADE 4 10.
- 5. BAR NOTATIONS GIVES INFORMATION
 - A) BAR SIZE
- B) SPACING(IF REQUIRED)6. LAP REINFORCEMENT ONLY AT LOCATION SHOWN IN THE DRAWINGS
- 7. REINFORCEMENT SHALL NOT BE CUT, VENT OR HEATED ON SITE WITHOUT ENGINEERS' APPROVAL.
- C) CONCRETE SLAB NOTES
- 1. ALL SLAB REINFORCEMENT SHALL BE 20MM CLEAR MINIMUM FROM BOTTOM AND FROM TOP OF SLAB.
- 2. REINFORCEMENT IN CONTINUOUS ELEVATED SLAB SHALL BE CUT AS FOLLOWS.

NOTE:

- THIS IS A SCHEMATIC PLAN FOR THE PURPOSE OF LOCATING AND IDENTIFYING FOUNDATION REINFORCING ELEMENTS ONLY. VERIFY ALL DIMENSIONS, DROPS, OFFSETS AND FEATURES WITH THE ARCHITECTURAL PLANS BEFORE FORMING THE FOUNDATION.

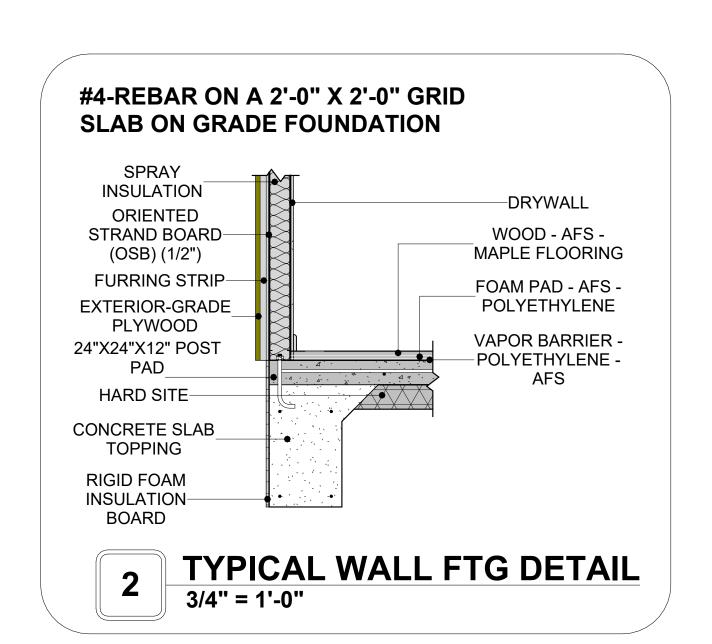

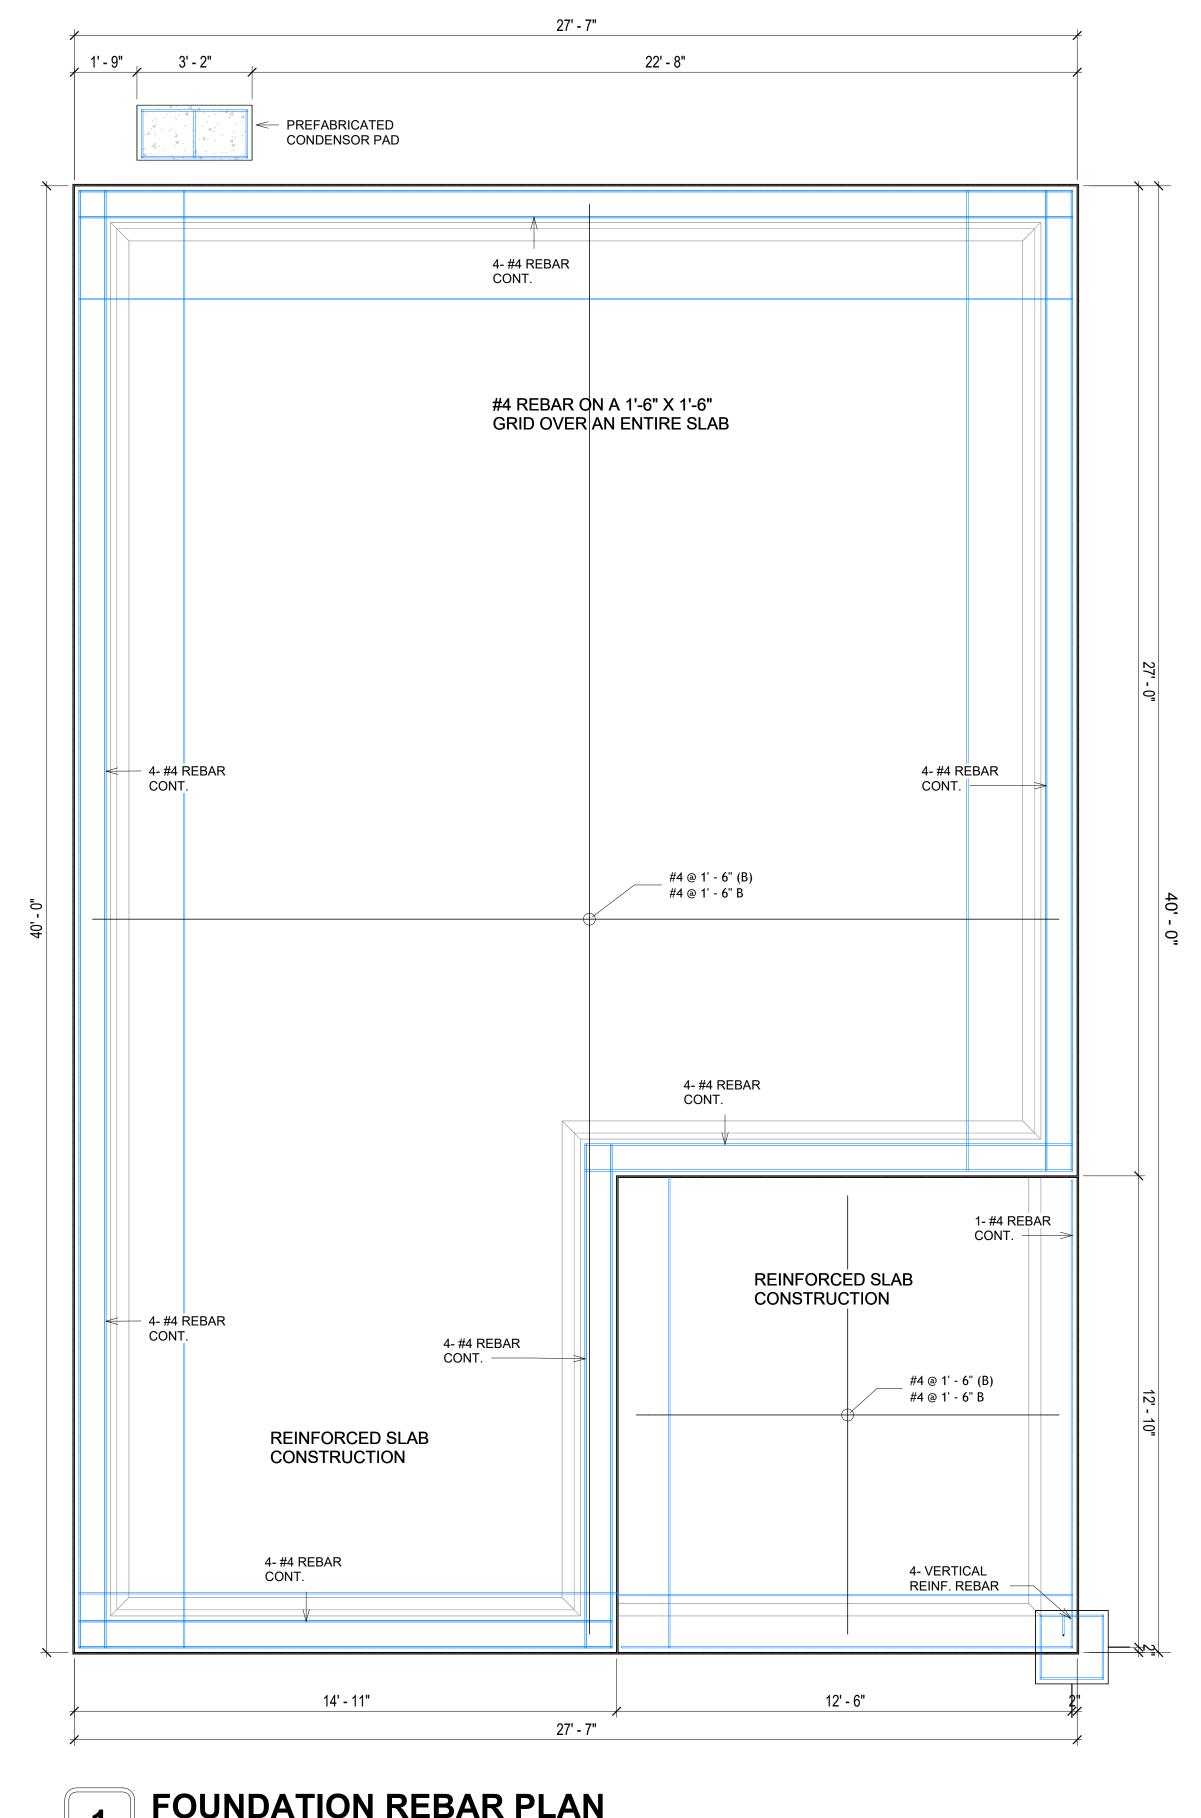

1 FOUNDATION REBAR PLAN
3/8" = 1'-0"



KEY PLAN

NO. DESCRIPTION DATE

NOTE:

LEGEND:

PROJECT

80 HUNTER 935 3Bd 2Ba SIDING 350

DRAWING NAME

STRUCTURAL FLOOR PLAN

CLIENT NAME:

PROJECT NUMBER:

0061_12

DATE:

2/25/2025 5:26:35 PM


DESIGNED BY:

DRAWN BY:

CHECKED BY:

Checker

S102

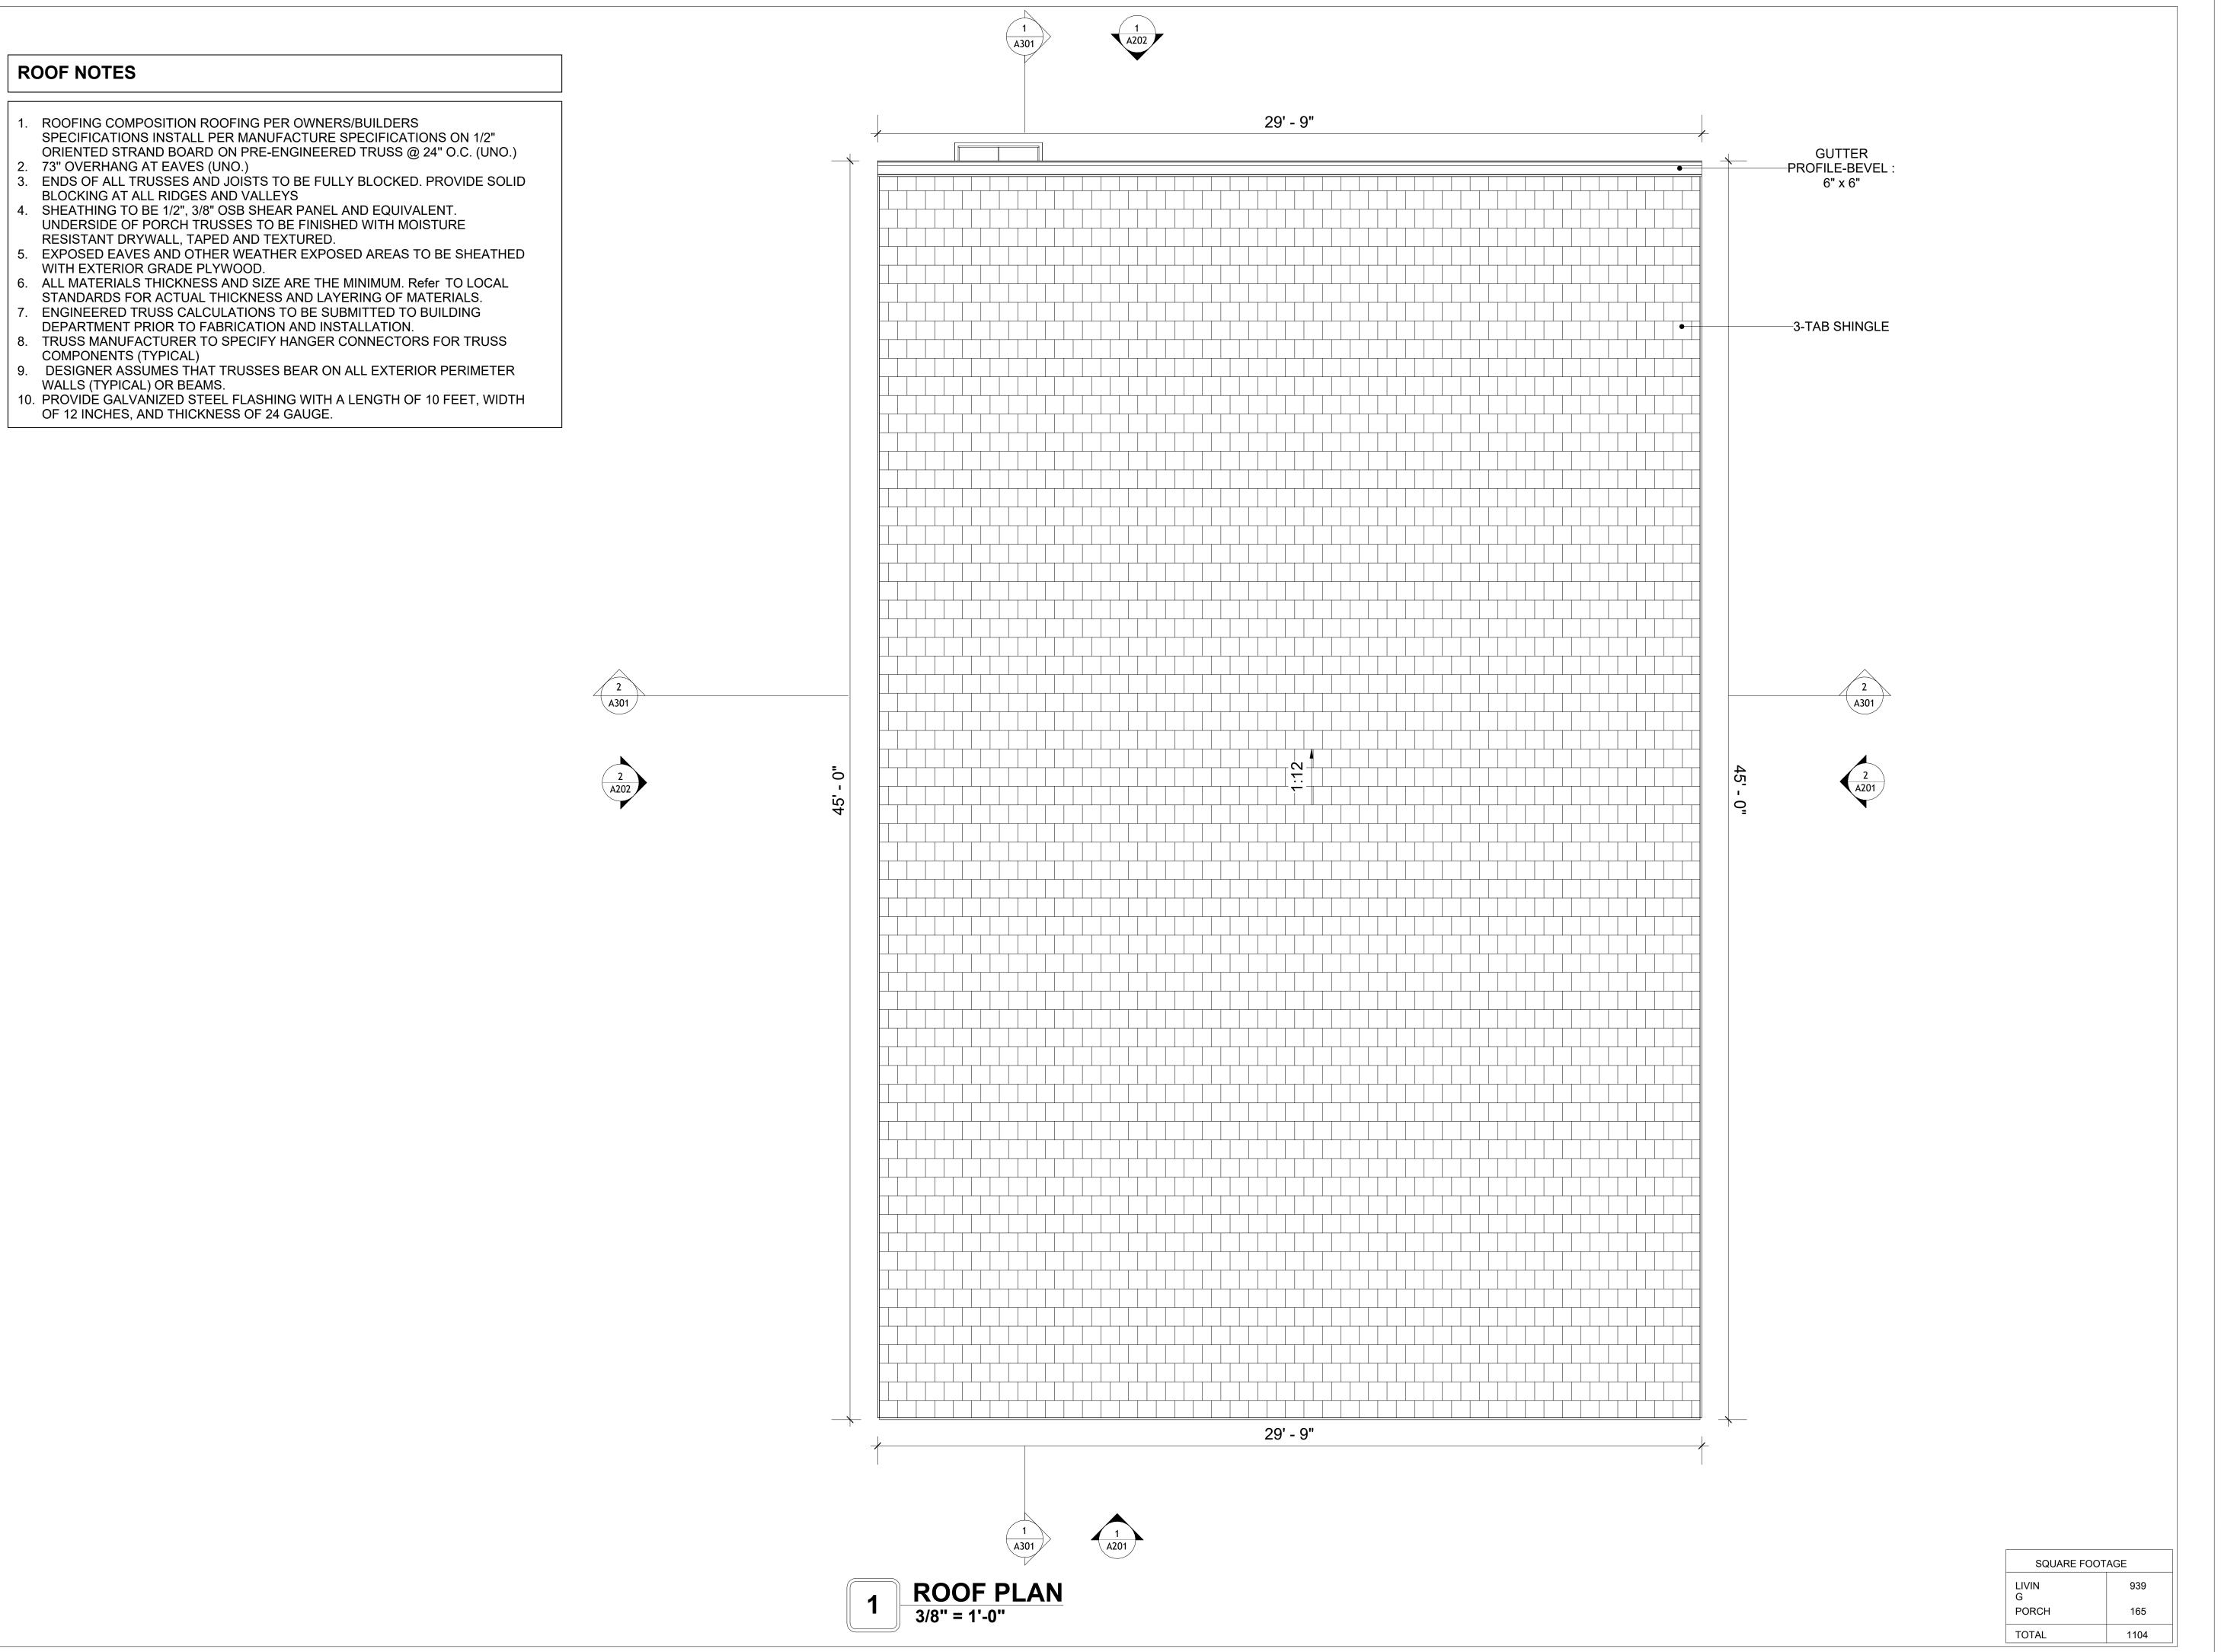



KEY PLAN

NO. DESCRIPTION DATE

NOTE:

LEGEND:

PROJECT

80 HUNTER 935 3Bd 2Ba SIDING 350

DRAWING NAME

ROOF PLAN

CLIENT NAME:

PROJECT NUMBER:

0061_12

DATE:

2/25/2025 5:26:37 PM

DESIGNED BY:

DRAWN BY:

CHECKED BY:

Checker

A103

ABOUT WALL FINISHING

PLYWOOD WALL SIDING

WALL SIDING IS AN EXTERIOR CLADDING MATERIAL USED TO COVER AND PROTECT THE WALLS OF A BUILDING, PROVIDING BOTH FUNCTIONAL AND AESTHETIC BENEFITS.

IN THIS SPECIFIC PROJECT, PLYWOOD WALL PANELS ARE USED AS A FINISH SIDING BECAUSE THIS TYPE OF SIDING PROVIDES A DURABLE, COST-EFFECTIVE, AND VERSATILE EXTERIOR CLADDING THAT CAN BE EASILY INSTALLED, FINISHED, AND MAINTAINED TO ENHANCE THE AESTHETIC AND PROTECTIVE QUALITIES OF A BUILDING'S EXTERIOR.


STANDARD SIZES OF 1' X 8' EXTERIOR-GRADE PLYWOOD PANELS ARE INSTALLED ON THE FURRING STRIPS USING GALVANIZED STEEL SELF-DRILLING SCREWS.

CEDAR WOOD


CEDAR WOOD REFERS TO THE WOOD FROM VARIOUS SPECIES OF CEDAR TREES, WHICH ARE CONIFEROUS EVERGREEN TREES KNOWN FOR THEIR DISTINCT AROMA AND NATURAL RESISTANCE TO DECAY AND INSECTS.

IN THIS SPECIFIC PROJECT, CEDAR WOOD IS USED AS A FURRING STRIP AND A FINISH MATERIAL ON BEAMS AND COLUMNS.

CEDAR WOOD AS A FURRING STRIPS PROVIDE THERMAL INSULATION AND MOISTURE MANAGEMENT. THE VERTICAL CEDAR WOOD FURRING STRIPS ARE ATTACHED TO HOME WRAP USING CORROSION-RESISTANT FASTENERS (HOT-DIP GALVANIZED SCREWS), ENSURING PROPER PENETRATION INTO THE WALL FRAMING.

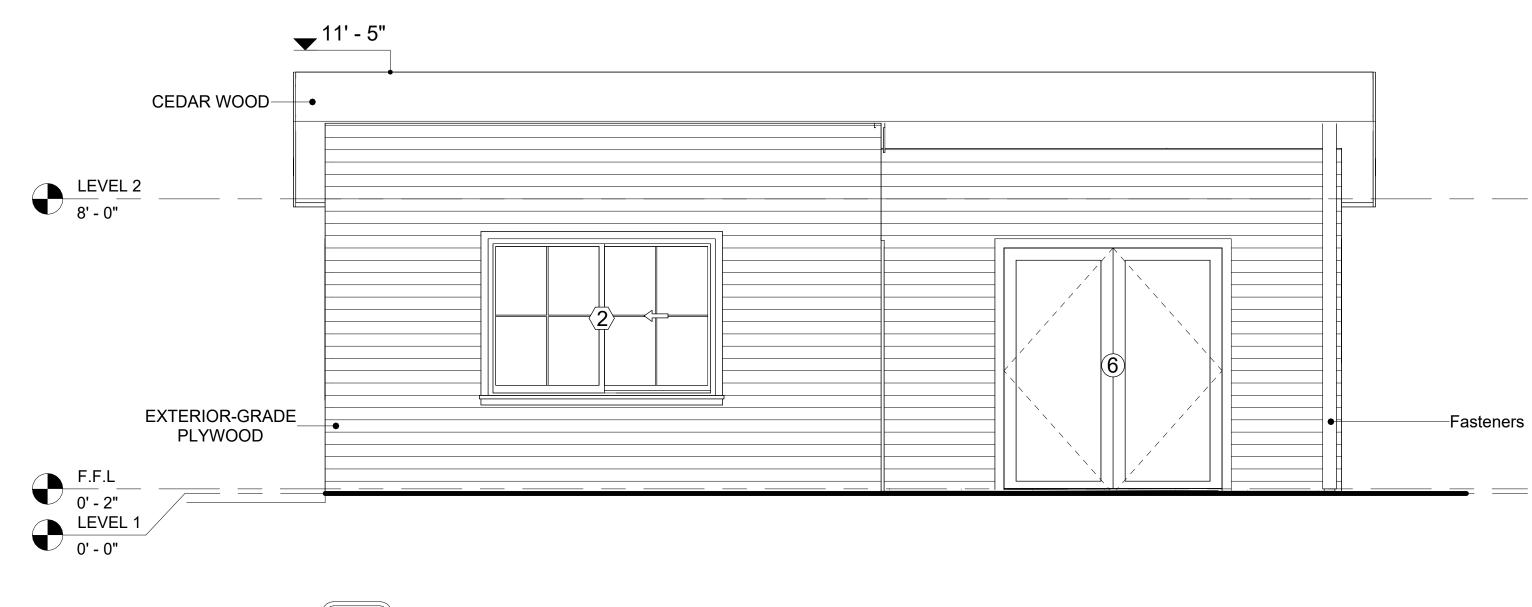




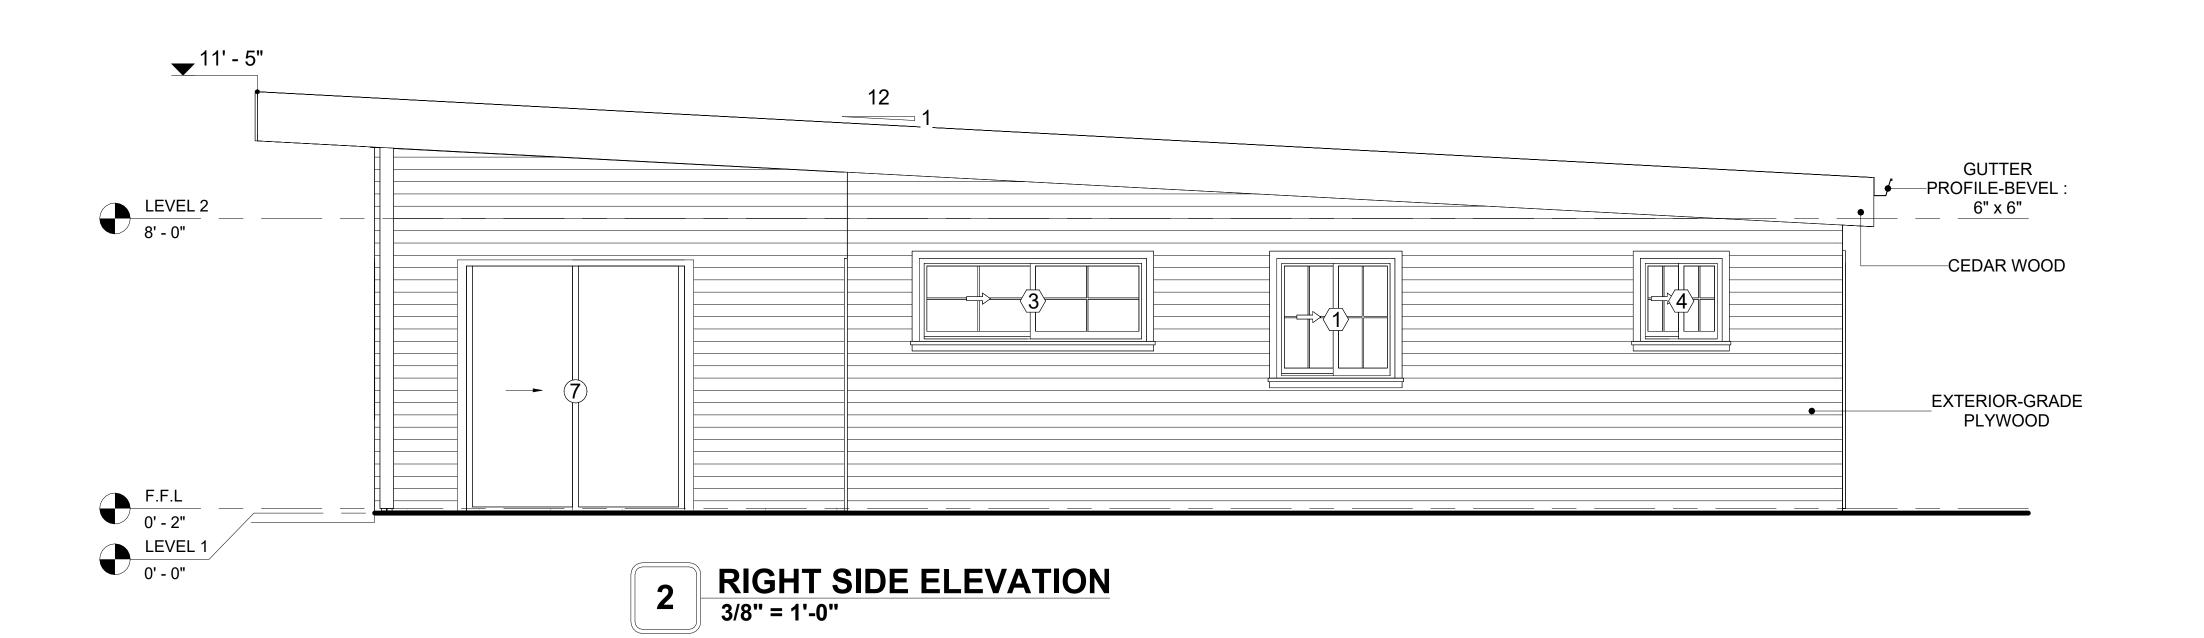

DOOR SCHEDULE						
TYPE	TYPE SIZE					
MAR K	SUPPLIER	DOOR TYPE	LOCATIO N	WIDTH	HEIGHT	COUNT
1	HOME DEPOT	INTERIOR SINGLE PANEL SWINGING	INTERIOR	2' - 6"	6' - 8"	3
2	HOME DEPOT	INTERIOR SINGLE PANEL SWINGING	INTERIOR	3' - 0"	6' - 8"	2
3	HOME DEPOT	INTERIOR SINGLE PANEL SWINGING	INTERIOR	2' - 4"	6' - 8"	1
4	HOME DEPOT	INTERIOR DOUBLE PANEL SLIDING	INTERIOR	10' - 0"	6' - 8"	3
5	HOME DEPOT	INTERIOR SINGLE PANEL SWINGING	INTERIOR	2' - 6"	6' - 8"	1
6	HOME DEPOT	EXTERIOR DOUBLE PANEL SWINGING	INTERIOR	6' - 0"	6' - 8"	1
7	HOME DEPOT	PATIO_DOUBLE PANEL_SLIDING	INTERIOR	6' - 0"	6' - 8"	1

	WINDOW SCHEDULE						
SIZE							
TYPE MARK	SUPPLIER	WINDOW TYPE	WIDTH	HEIGHT	COUNT		
1	HOME DEPOT	SLIDING	3' - 3"	3' - 3"	1		
2	HOME DEPOT	SLIDING	6' - 3"	4' - 3"	4		
3	HOME DEPOT	SLIDING	6' - 3"	2' - 3"	1		
4	HOME DEPOT	SLIDING	2' - 3"	2' - 3"	2		

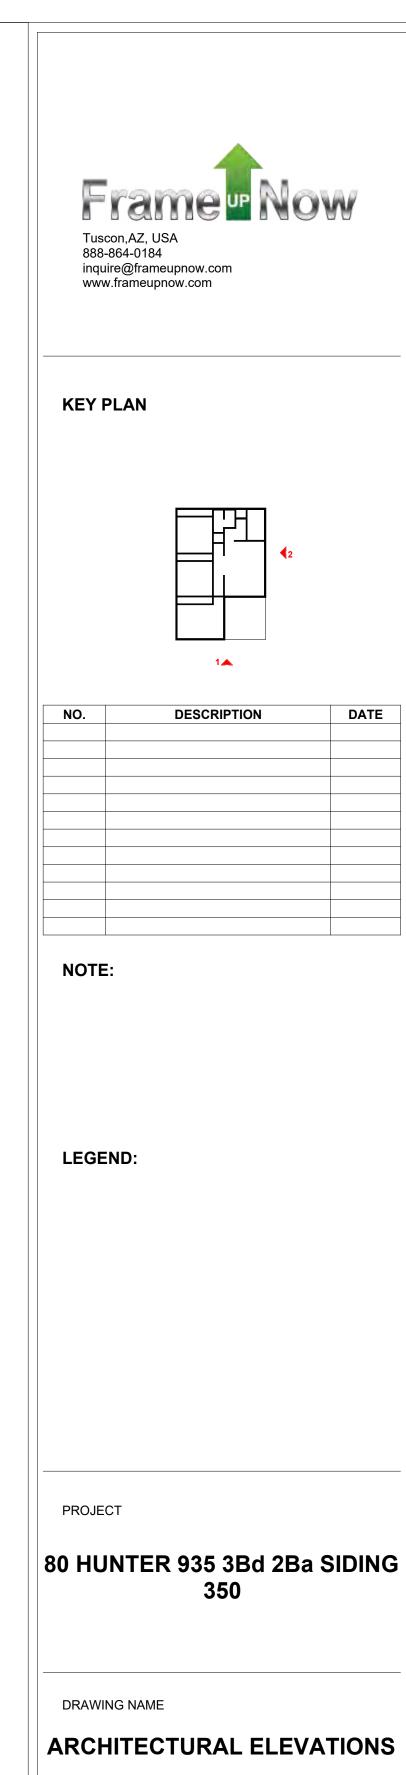

CLIENT NAME:	Client Name
PROJECT NUMBER:	0061_12
DATE:	2/25/2025 5:26:40 PM
DESIGNED BY:	Designer
DRAWN BY:	Author
CHECKED BY:	Checker

A201

ABOUT WALL FINISHING

PLYWOOD WALL SIDING

WALL SIDING IS AN EXTERIOR CLADDING MATERIAL USED TO COVER AND PROTECT THE WALLS OF A BUILDING, PROVIDING BOTH FUNCTIONAL AND AESTHETIC BENEFITS.

IN THIS SPECIFIC PROJECT, PLYWOOD WALL PANELS ARE USED AS A FINISH SIDING BECAUSE THIS TYPE OF SIDING PROVIDES A DURABLE, COST-EFFECTIVE, AND VERSATILE EXTERIOR CLADDING THAT CAN BE EASILY INSTALLED, FINISHED, AND MAINTAINED TO ENHANCE THE AESTHETIC AND PROTECTIVE QUALITIES OF A BUILDING'S EXTERIOR.

STANDARD SIZES OF 1' X 8' EXTERIOR-GRADE PLYWOOD PANELS ARE INSTALLED ON THE FURRING STRIPS USING GALVANIZED STEEL SELF-DRILLING SCREWS.

CEDAR WOOD


CEDAR WOOD REFERS TO THE WOOD FROM VARIOUS SPECIES OF CEDAR TREES, WHICH ARE CONIFEROUS EVERGREEN TREES KNOWN FOR THEIR DISTINCT AROMA AND NATURAL RESISTANCE TO DECAY AND INSECTS.

IN THIS SPECIFIC PROJECT, CEDAR WOOD IS USED AS A FURRING STRIP AND A FINISH MATERIAL ON BEAMS AND COLUMNS.

CEDAR WOOD AS A FURRING STRIPS PROVIDE THERMAL INSULATION AND MOISTURE MANAGEMENT. THE VERTICAL CEDAR WOOD FURRING STRIPS ARE ATTACHED TO HOME WRAP USING CORROSION-RESISTANT FASTENERS (HOT-DIP GALVANIZED SCREWS), ENSURING PROPER PENETRATION INTO THE WALL FRAMING.




1 REAR ELEVATION 3/8" = 1'-0"

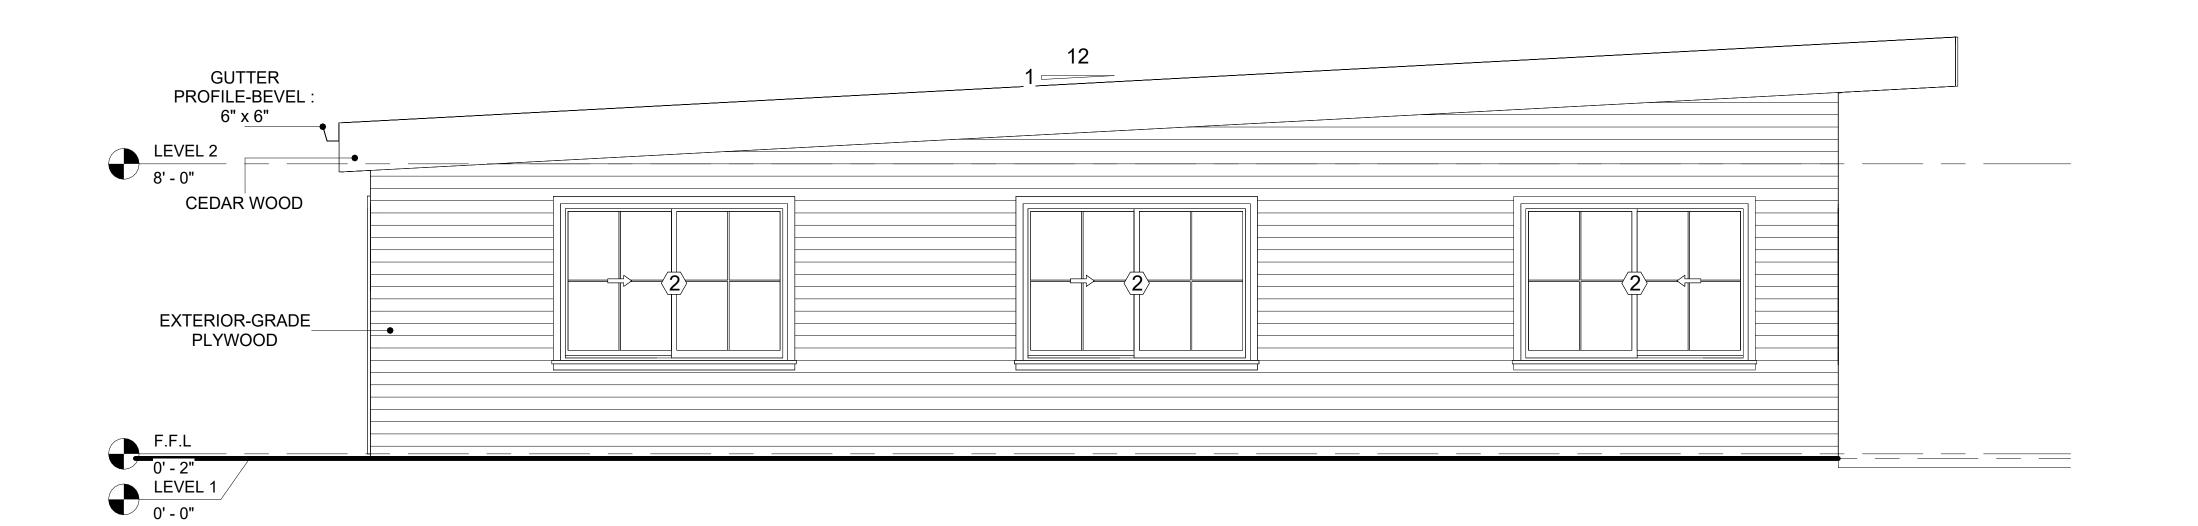

2 LEFT SIDE ELEVATION
3/8" = 1'-0"



KEY PLAN

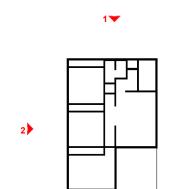

DESCRIPTION	DATE
	DESCRIPTION

NOTE:

LEGEND:

PROJECT

80 HUNTER 935 3Bd 2Ba SIDING 350

DRAWING NAME

ARCHITECTURAL ELEVATIONS

CLIENT NAME:

PROJECT NUMBER:

0061_12

DATE:

2/25/2025 5:26:43 PM


DESIGNED BY:

DRAWN BY:


CHECKED BY:

Checker

A202

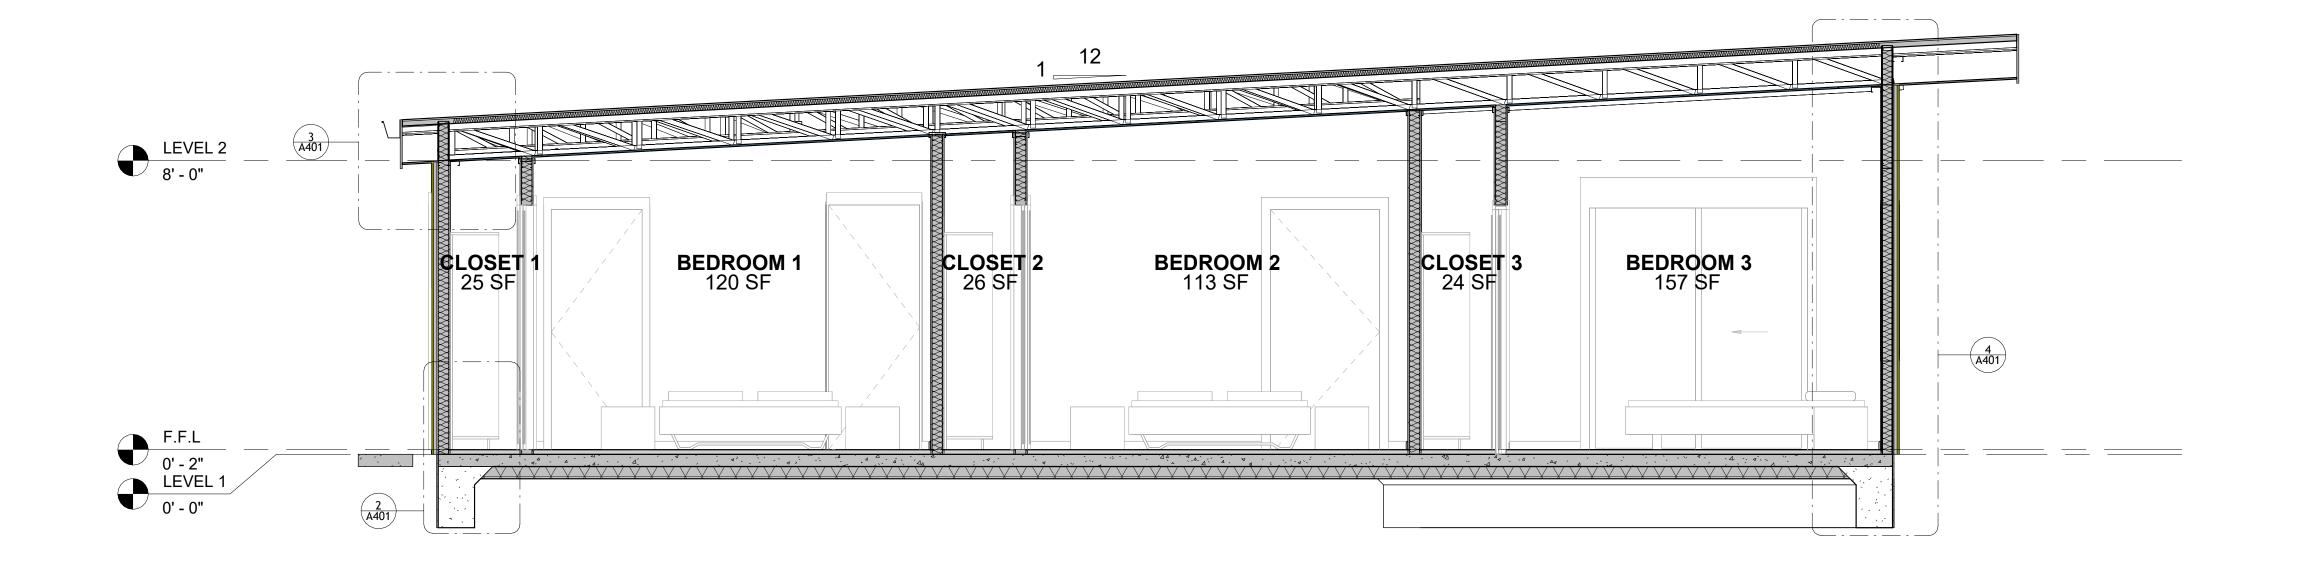




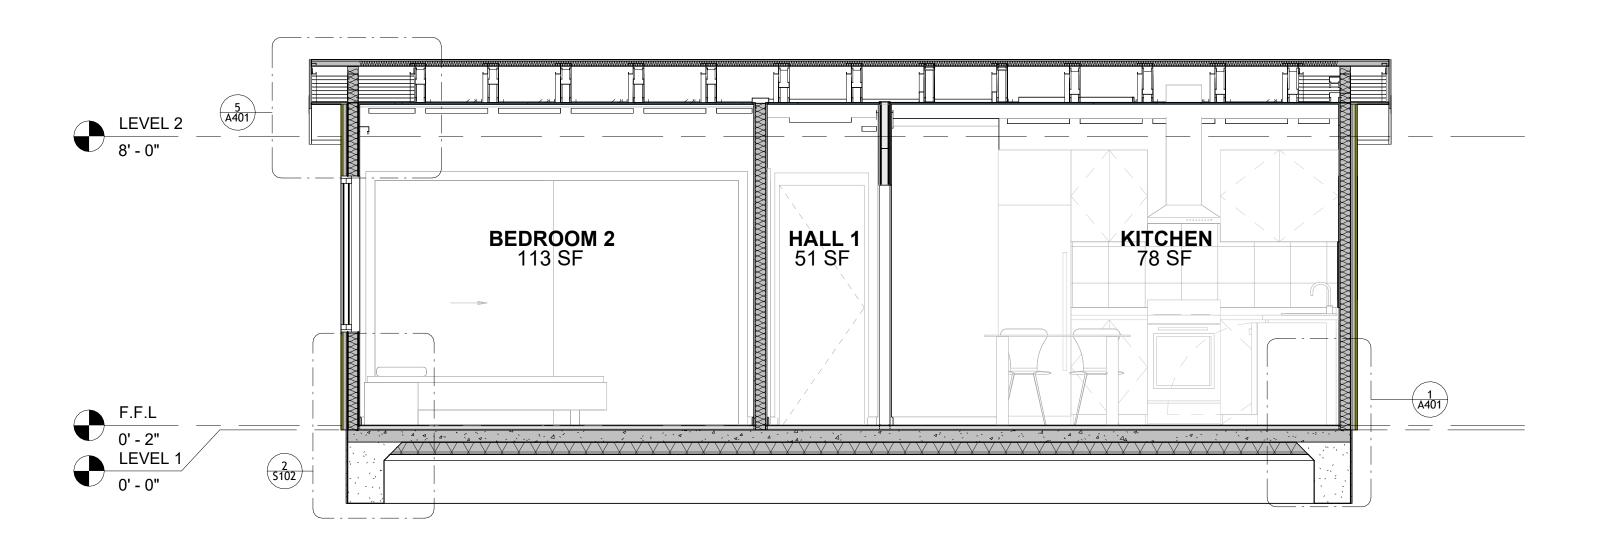

2 SECTION-2 3/8" = 1'-0"



KEY PLAN

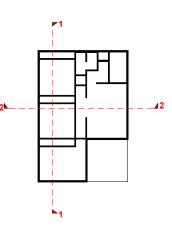

NO.	DESCRIPTION	DATE

NOTE:

LEGEND:

PROJECT


80 HUNTER 935 3Bd 2Ba SIDING 350


DRAWING NAME


ARCHITECTURAL SECTIONS


CLIENT NAME:	Client Name
PROJECT NUMBER:	0061_12
DATE:	2/25/2025 5:26:45 PM
DESIGNED BY:	Designer
DRAWN BY:	Author
CHECKED BY:	Checker


A301

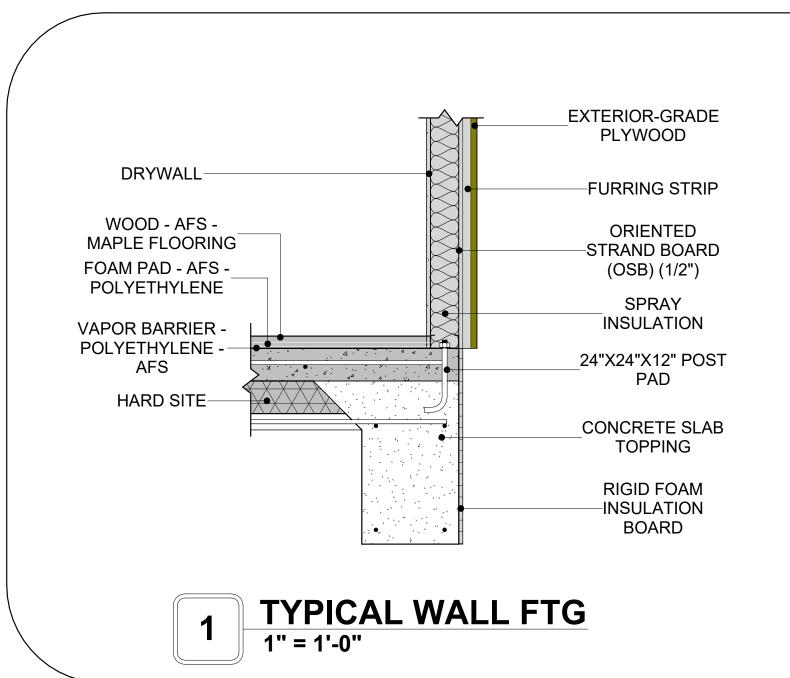


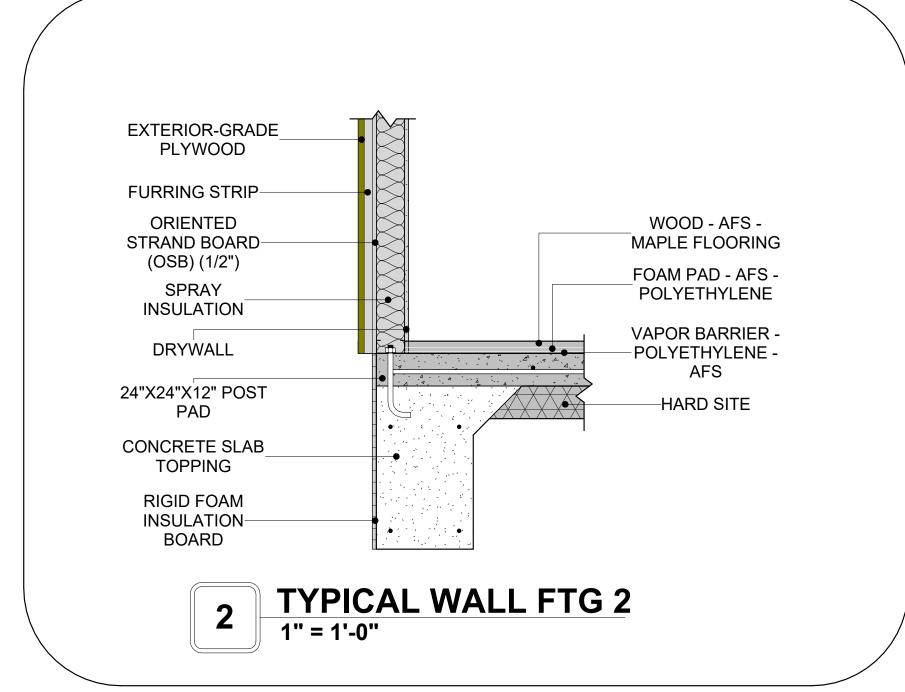

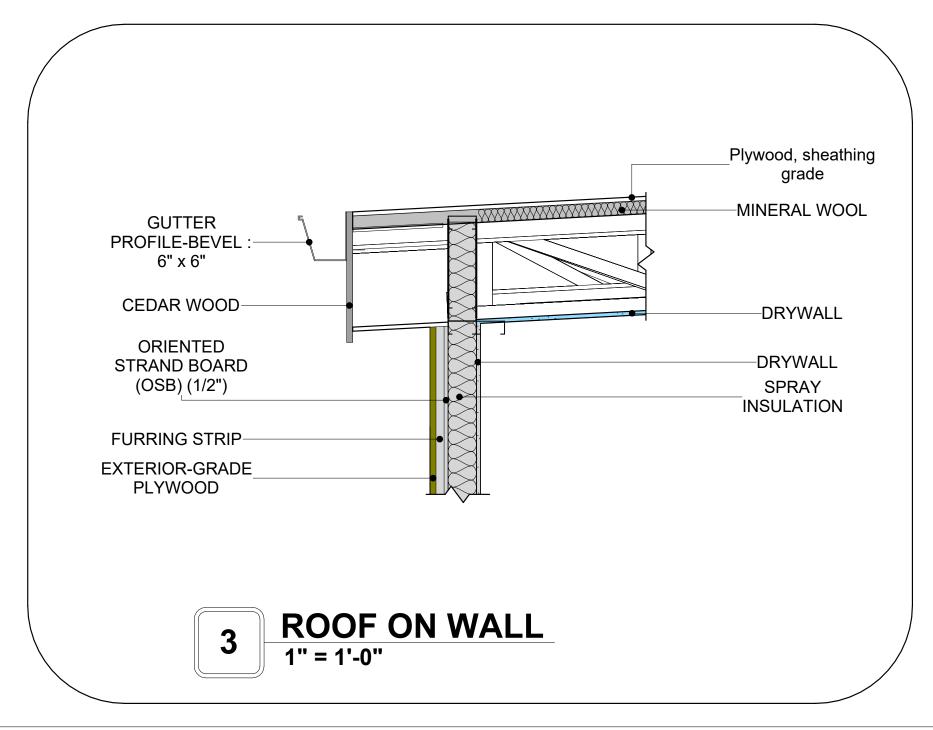

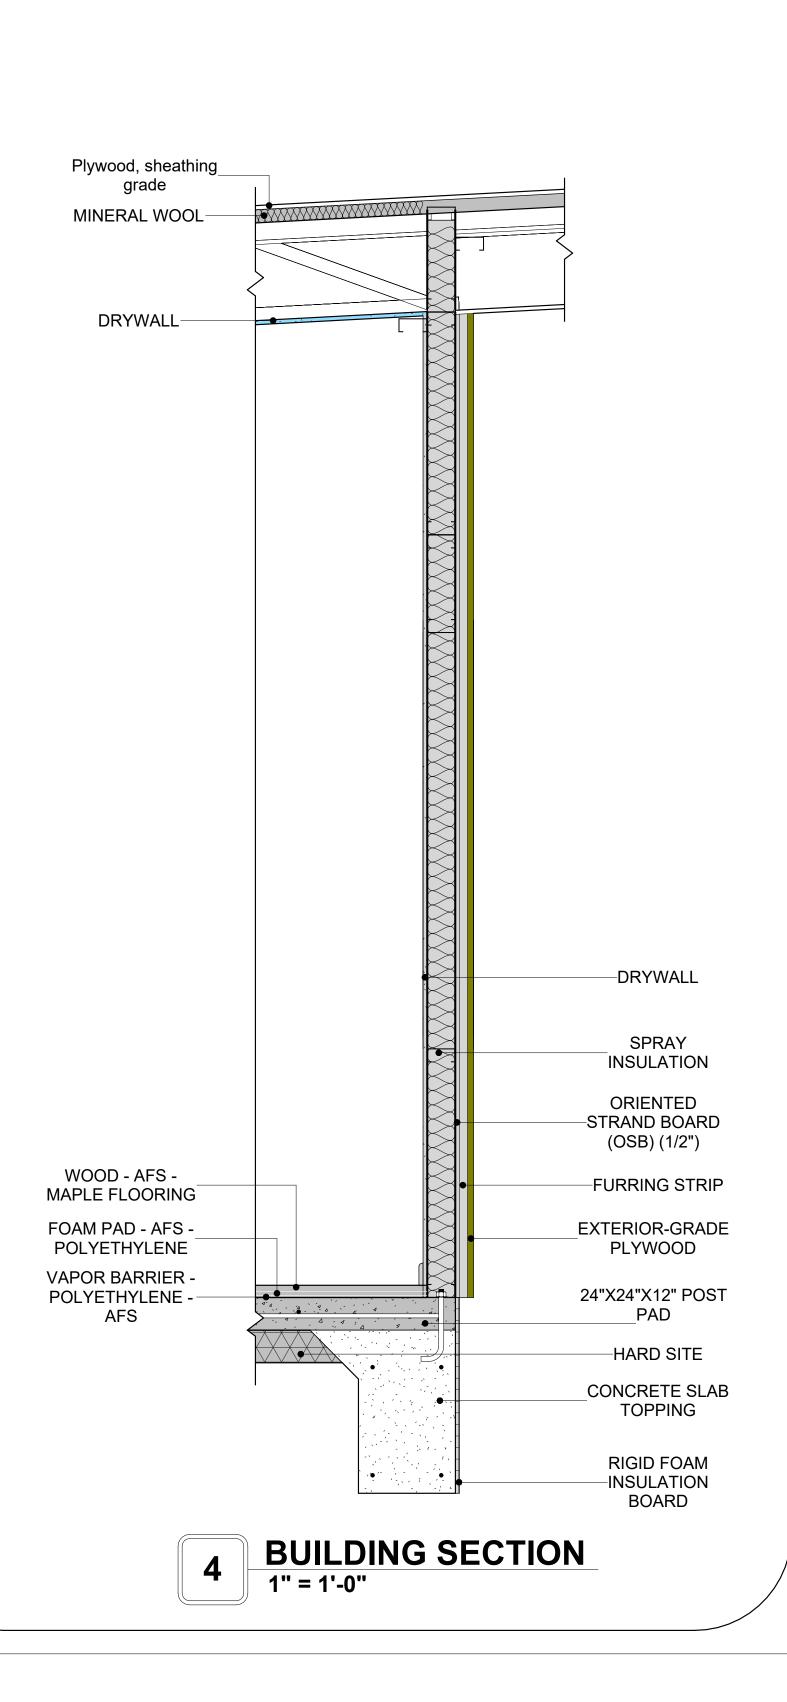

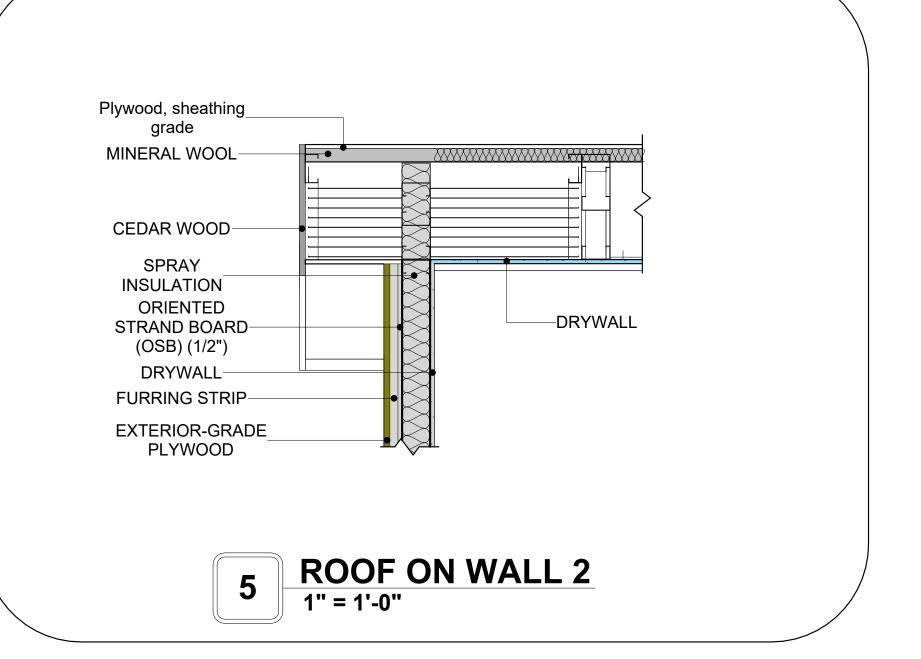

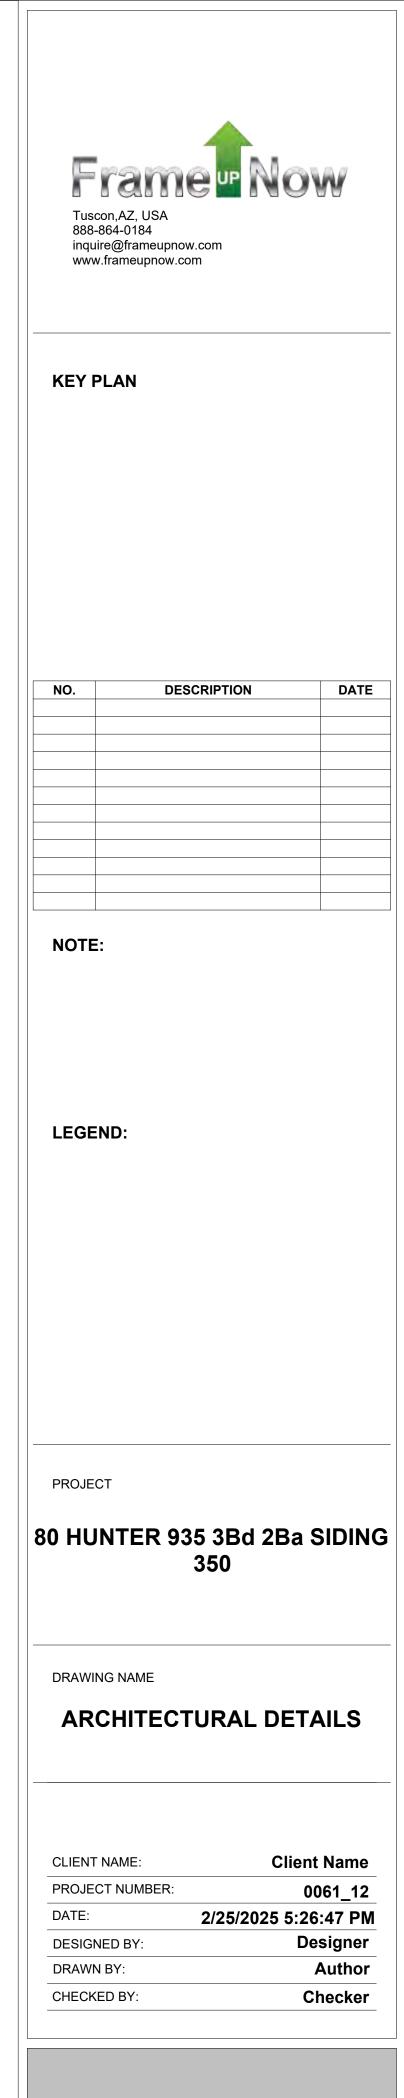

A401


SCALE: 1" = 1'-0"


CASEWORK GENERAL NOTES


- ALL CABINET HEIGHTS INCLUDE COUNTERTOPS. DIMENSIONS ARE TO THE NEAREST INCH. DIVISIONS IN CASEWORK ARE SHOWN FOR CLARITY AND DO NOT REPRESENT BREAKS IN THE COUNTERTOP.
- PROVIDE CONTINUOUS COUNTERTOP OVER ALL SIMILAR HEIGHT CASEWORK, UNLESS AND
- OTHERWISE NOTED. MANUFACTURER AND CATALOG NUMBERS ARE FOR REFERENCE AND ILLUSTRATION PURPOSES
- DOTTED LINES INDICATE WALL HUNG CABINETS, DIVISIONS OF BASE CABINETS BELOW THE
- COUNTERTOP, FURNITURE NOT IN THE CONTRACT OR PROJECTION SCREENS -SEE CASEWORK KEY AND SPECIFICATIONS.
- ALL CABINETS AND DRAWERS TO HAVE CAM LOCKS EXCEPT FOR SINK BASE CABINETS. ALL EXPOSED SURFACES (EXPOSED TO VIEW FROM ANY PERSPECTIVE) TO BE COVERED WITH
- LAMINATE.
- ALL CASEWORK WHICH MEETS A WALL AT ONE OR BOTH ENDS, TO BE PROVIDED WITH FILLER PANELS AND SCRIBED TO THE WALL(S) AS REQUIRED.
- 10. ALL CABINETS AND DRAWERS ARE PRÓVIDED WITH RECESSED HANDLES.
- 11. CONTRACTOR TO FIELD VERIFY ALL CLEAR OPENINGS PRIOR TO MILLWORK OR CASEWORK FABRICATION.
- 12. CASEWORK DRAWINGS ARE DIAGRAMMATIC IN NATURE TO SHOW DESIGN INTENT.


	CAS	EWOR	K SCHEDU	JLE		
TYPE MAR K	TYPE	COUN T	HEIGHT	WIDTH	DEPTH	AREA
01	L-SHAPE COUNTER TOP 158	1	0' - 4"	7' - 0"	7' - 0"	2 SF
02	BASE CABINET DOUBLE DOOR 2	1	2' - 11"	3' - 0"	2' - 0"	9 SF
03	BASE CABINET L-SHAPED	1	2' - 11"	3' - 3"	3' - 3"	9 SF
04	WALL CABINET DOUBLE DOOR 2 158	1	2' - 6"	3' - 3"	1' - 0"	8 SF
05	WALL CABINET DOUBLE DOOR 3 159.186 2	1	2' - 6"	2' - 1"	1' - 0"	5 SF
06	LINEAR COUNTER TOP 2 159.186 2	1	0' - 4"	2' - 1"	2' - 0"	1 SF
07	BASE CABINET DOUBLE DOOR 2 187	1	2' - 11"	2' - 1"	2' - 0"	6 SF
08	LAUNDRY OPEN CABINET	1	1' - 6"	2' - 0"	2' - 4"	3 SF
09	VANITY 3	1	2' - 4"	3' - 2"	1' - 8"	7 SF
10	RECESSED_MED_CABINET	2	2' - 0"	1' - 6"	0' - 3"	3 SF
11	LAUNDRY OPEN CABINET 3 159.186	1	1' - 1"	2' - 3"	3' - 0"	2 SF
12	VANITY 4	1	2' - 4"	3' - 0"	1' - 5"	7 SF
13	CLOSET_3	3	5' - 11"	10' - 10"	1' - 4"	64 SF
14	CLOSET 1	1	6' - 0"	3' - 1"	1' - 4"	19 SF
GRAND	TOTAL	17	•	,		

SPECIALTY EQUIPMENT SCHEDULE					
TYPE MARK	TYPE	COUNT			
01	WASHER-FRONT-LOAD	1			
02	REFRIGERATOR	1			
03	RANGE	1			
04	DRYER-FRONT-LOAD	1			
05	DISHWASHER	1			
GRAND TOTAL: 5					

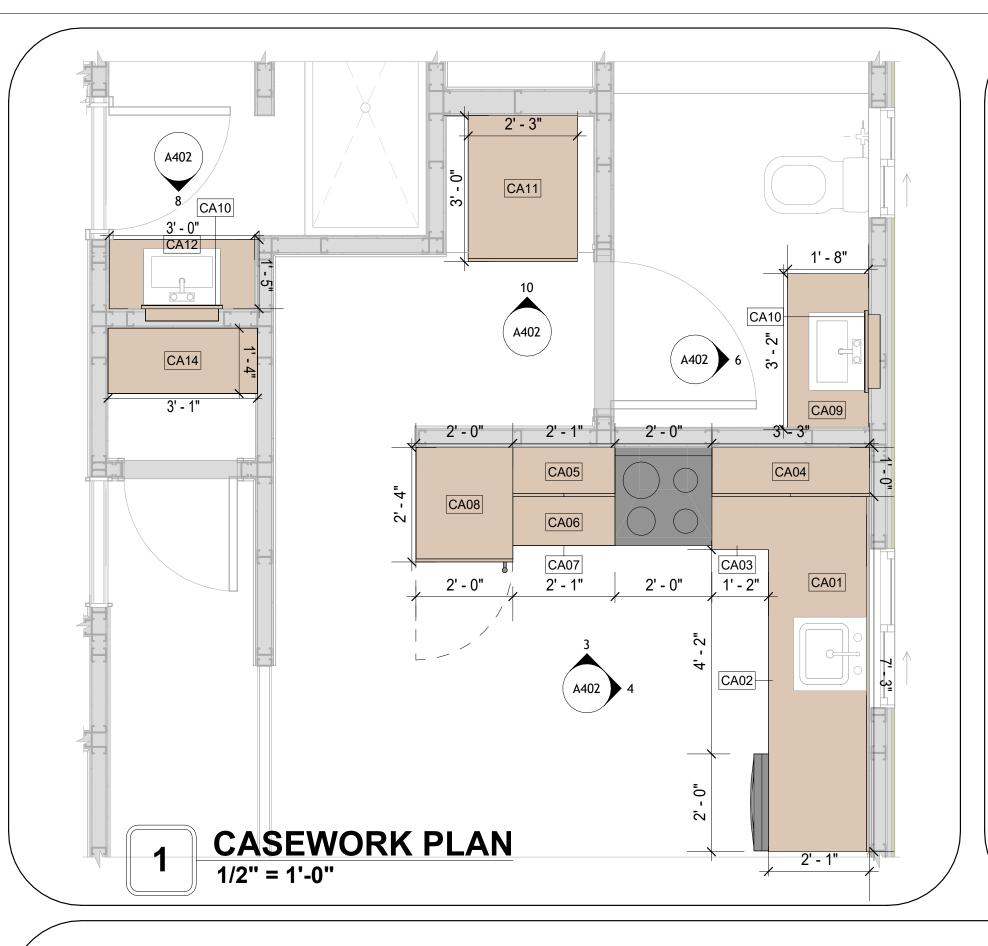


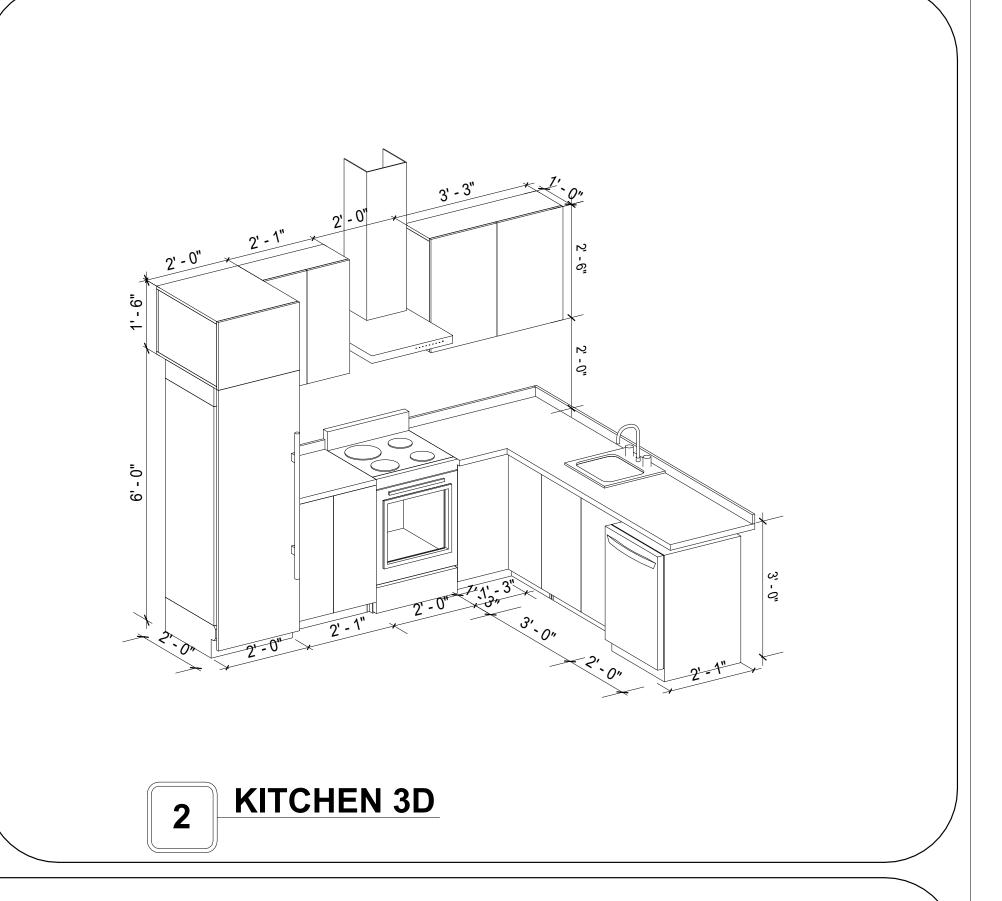


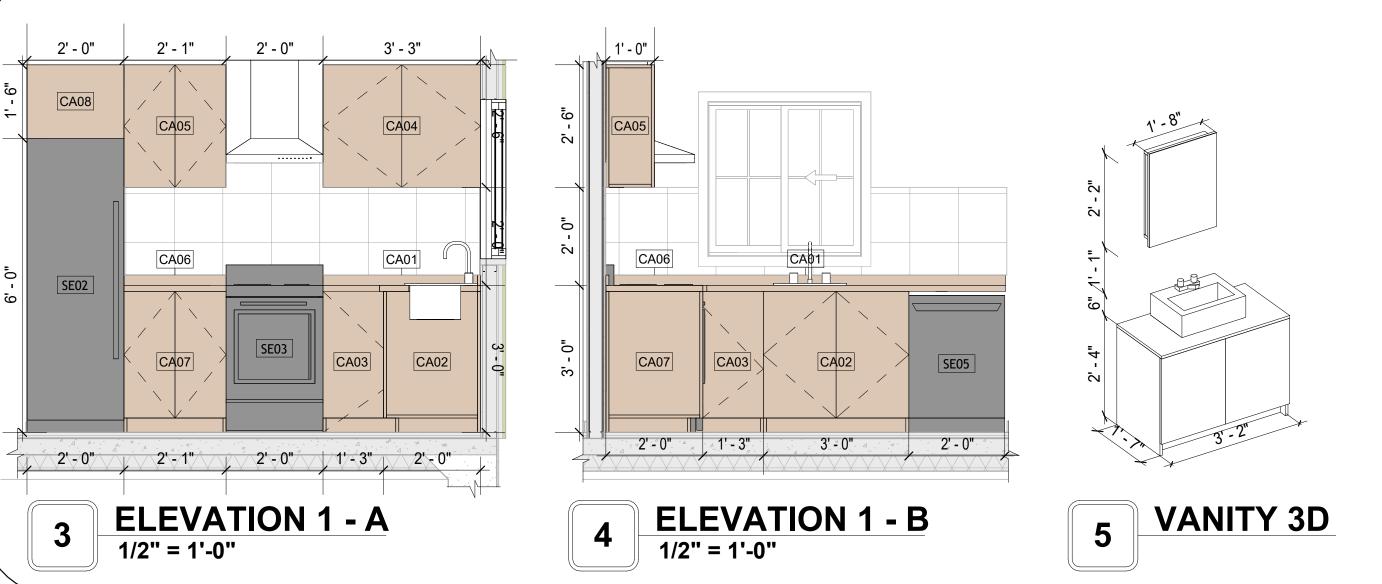


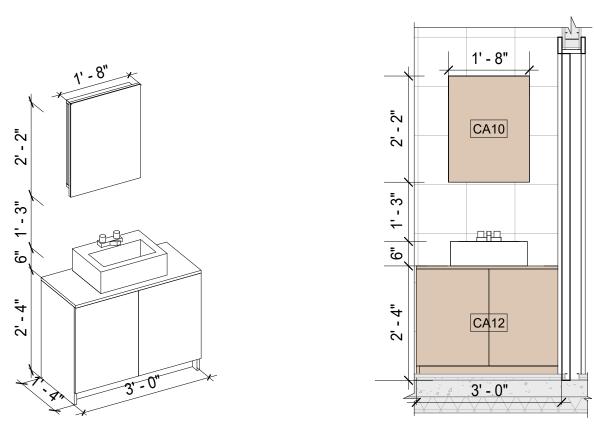



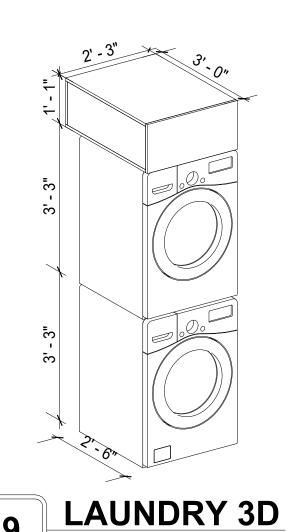

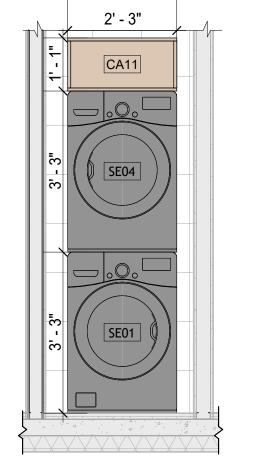

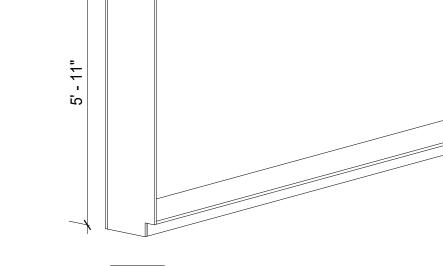

ELEVATION 1 - C

1/2" = 1'-0"


ELEVATION 1 - E 1/2" = 1'-0"

3' - 2"

11 CLOSET 3D



KEY PLAN

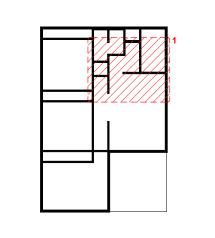

NO.	DESCRIPTION	DATE

NOTE:

LEGEND:

80 HUNTER 935 3Bd 2Ba SIDING

DRAWING NAME

PROJECT

ARCHITECTURAL CASEWORK

Client Name CLIENT NAME: PROJECT NUMBER: 0061_12 2/25/2025 5:26:50 PM Designer DESIGNED BY: DRAWN BY: **Author** CHECKED BY: Checker

A402

GENERAL NOTES

1. THIS DRAWING DEPICTS THE HVAC (HEATING, VENTILATION, AND AIR CONDITIONING) SYSTEM FOR THE HUNTER 3BD-2BA SIDING. IT PROVIDES A VISUAL REPRESENTATION OF THE SYSTEM LAYOUT AND COMPONENTS.

2.THE HVAC SYSTEM IS DESIGNED TO MEET THE SPECIFIC REQUIREMENTS OF THE BUILDING, INCLUDING HEATING, COOLING, AND VENTILATION NEEDS, AS PER THE PROJECT SPECIFICATIONS AND APPLICABLE CODES AND STANDARDS.

3. THE HVAC SYSTEM INSTALLATION SHALL COMPLY WITH THE LATEST EDITION OF THE INTERNATIONAL MECHANICAL CODE (IMC), INTERNATIONAL RESIDENTIAL CODE (IRC), AND ALL OTHER APPLICABLE LOCAL, STATE, AND NATIONAL CODES AND REGULATIONS.

4. THE EQUIPMENT SHOWN ON THIS DRAWING INCLUDES BUT IS NOT LIMITED TO AIR HANDLING UNITS (AHUS), CHILLERS, BOILERS, COOLING TOWERS, PUMPS, DUCTWORK, DIFFUSERS, GRILLES, AND CONTROL DEVICES.

5. ALL EQUIPMENT, DUCTWORK, AND PIPING SHALL BE INSTALLED IN ACCORDANCE WITH MANUFACTURER'S SPECIFICATIONS, LOCAL CODES, AND INDUSTRY BEST PRACTICES

6. ALL DUCTWORK SHALL BE SIZED, FABRICATED, AND INSTALLED IN ACCORDANCE WITH THE LATEST EDITION OF THE ACCA MANUAL D AND THE SMACNA HVAC DUCT CONSTRUCTION STANDARDS. DUCTWORK SHALL BE INSTALLED IN A NEAT AND WORKMANLIKE MANNER, PROPERLY SUPPORTED AND BRACED TO PREVENT SAGGING, AIR LEAKAGE, OR VIBRATION.

7. CONDENSATE DRAINAGE PIPING SHALL BE PROPERLY PITCHED TO ENSURE POSITIVE DRAINAGE TO AN APPROVED DISPOSAL LOCATION, SUCH AS A FLOOR DRAIN, SUMP PUMP, OR EXTERIOR GRADE. CONDENSATE LINES SHALL BE INSULATED TO PREVENT SWEATING.

8. THE LOCATION OF CONTROL PANELS AND SENSORS INDICATED ON THIS DRAWING CAN BEMODIFY WITH THE SPECIFIC LOCATIONS AND WIRING DETAILS WILL BE DETERMINED DURING THE CONTROL SYSTEM DESIGN AND INSTALLATION.

9. THE HVAC SYSTEM DESIGN CONSIDER ENERGY EFFICIENCY, INDOOR AIR QUALITY, OCCUPANT COMFORT, AND NOISE CONTROL, FOLLOWING APPLICABLE GUIDELINES AND REGULATIONS.

10. COORDINATION WITH OTHER TREADS HAS BEEN DONE ON A DESIGN LEVEL. THIS DRAWING SHALL BE READ TOGETHER WITH THE AR, EL AND SN DESIGN DRAWINGS TO ENSURE PROPER INSTALLATION AND INTEGRATION OF THE HVAC SYSTEMS.

11. THE HVAC CONTRACTOR IS RESPONSIBLE FOR OBTAINING ALL NECESSARY PERMITS AND LICENSES, AND FOR SCHEDULING AND COORDINATING WITH THE LOCAL BUILDING DEPARTMENT AND UTILITY PROVIDERS TO ENSURE A TIMELY AND COMPLIANT INSTALLATION.

12. ALL DUCTWORK PENETRATIONS THROUGH WALLS, FLOORS, OR CEILINGS SHALL BE PROPERLY SEALED AND FIRE-STOPPED USING APPROVED METHODS AND MATERIALS TO MAINTAIN THE INTEGRITY OF THE BUILDING'S FIRE-RESISTANCE RATINGS.

13. HVAC EQUIPMENT SHALL BE INSTALLED LEVEL AND PLUMB, AND IN STRICT ACCORDANCE WITH THE MANUFACTURER'S INSTALLATION

INSTRUCTIONS AND RECOMMENDATIONS. PROVIDE ADEQUATE CLEARANCES AROUND EQUIPMENT FOR PROPER AIRFLOW, SERVICE ACCESS, AND CODE COMPLIANCE.

14. ALL HVAC EQUIPMENT AND COMPONENTS, INCLUDING THERMOSTATS, DAMPERS, AND ACCESS PANELS, SHALL BE LOCATED IN ACCESSIBLE AREAS

FOR EASY SERVICING AND MAINTENANCE. PROVIDE ADEQUATE SPACE AROUND EQUIPMENT FOR PROPER AIRFLOW AND SERVICE ACCESS.


15. THE HVAC SYSTEM SHALL BE BALANCED AND ADJUSTED TO ENSURE PROPER AIRFLOW, TEMPERATURE DISTRIBUTION, AND SYSTEM

16. ANY DEVIATIONS OR MODIFICATIONS TO THE HVAC SYSTEM DESIGN SHALL BE REVIEWED AND APPROVED BY THE RESPONSIBLE DESIGN PROFESSIONALS AND COMMUNICATED TO ALL RELEVANT PARTIES INVOLVED IN THE CONSTRUCTION PROCESS.

PERFORMANCE THROUGHOUT THE RESIDENCE. PROVIDE A WRITTEN REPORT DOCUMENTING THE FINAL SYSTEM BALANCE.


17. FOR ANY INQUIRIES OR CLARIFICATIONS REGARDING THE HVAC SYSTEM DESIGN, PLEASE CONSULT THE RESPONSIBLE DESIGN PROFESSIONALS OR THE PROJECT MANAGEMENT TEAM.

SYMBOLS

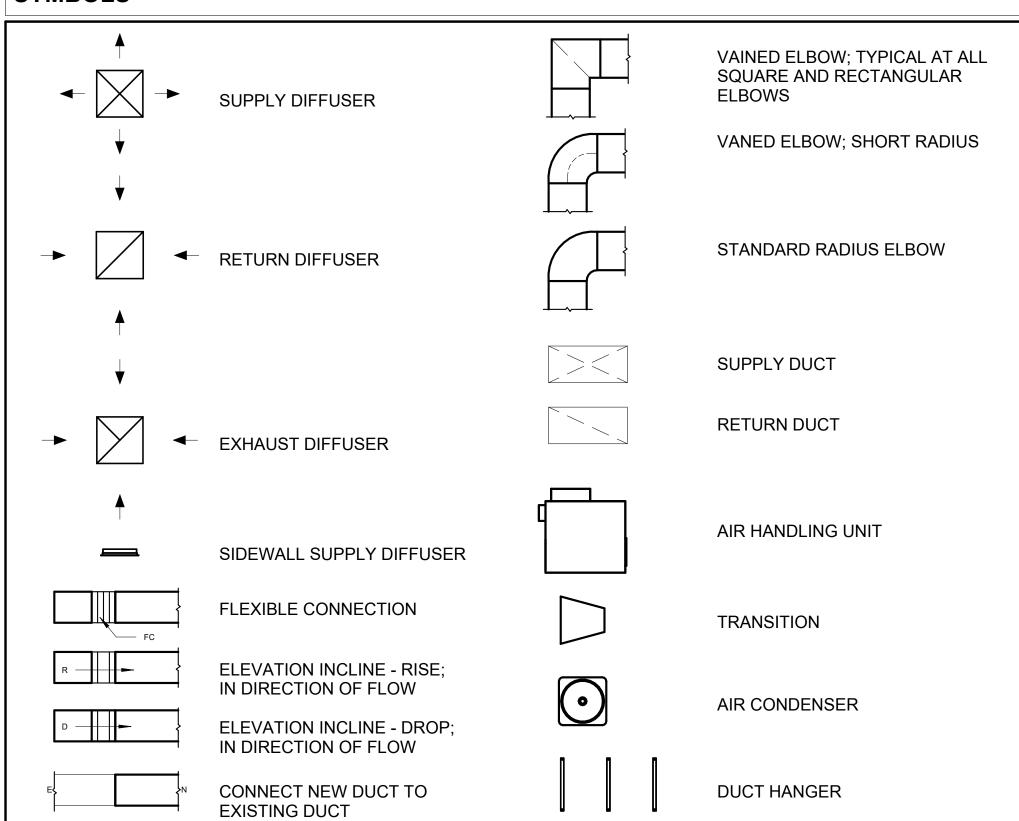



AIR CONDITIONING PIPE LINE

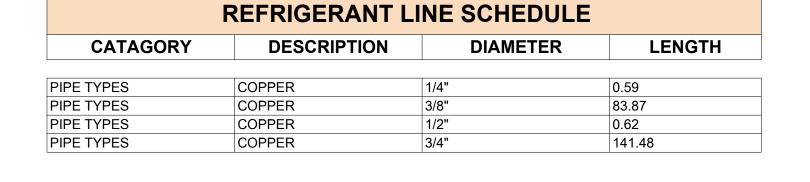

REFRIGERANT LINE FITTING SCHEDULE						
CATAGORY	DESCRIPTION	Size	Count			
ELBOW - GENERIC	ELBOW - GENERIC: STANDARD/HVAC	1/2"ø-1/2"ø	1			
ELBOW - GENERIC	ELBOW - GENERIC: STANDARD/HVAC	3/4"ø-3/4"ø	35			
ELBOW - GENERIC	ELBOW - GENERIC: STANDARD/HVAC	3/8"ø-3/8"ø	17			
TEE - GENERIC	TEE - GENERIC: STANDARD	3/4"ø-3/4"ø-3/ 4"ø	2			
TEE - GENERIC	TEE - GENERIC: STANDARD	3/8"ø-3/8"ø-3/ 8"ø	3			
TRANSITION - GENERIC	TRANSITION - GENERIC: STANDARD	3/4"ø-1/2"ø	5			
TRANSITION - GENERIC	TRANSITION - GENERIC: STANDARD	3/4"ø-5/8"ø	4			
TRANSITION - GENERIC	TRANSITION - GENERIC: STANDARD	3/8"ø-1/4"ø	1			

MECHANICAL EQUIPMENT SCHEDULE					
CATAGORY	DESCRIPTION	COUNT			
AIR HANDLING UNIT	AIR HANDLING UNIT: WALL MOUNTED	4			
CONDENSER	CONDENSER: OUT DOOR	1			
EXHAUST FAN	EXHAUST FAN: 75 CFM	2			
	HOOD-WALL: VENT	1			

DUCT FITTING SCHEDULE							
CATAGORY	DESCRIPTION	COUNT					
ROUND TRANSITION - ANGLE	45 DEGREE	7					

DUCT ACCESSORY SCHEDULE					
CATAGORY	DESCRIPTION	COUNT			
ROOF VENT	3" DIAMETER	4			

FLEX DUCT SCHEDULE						
DESCRIPTION	DESCRIPTION	LENGTH	DIAMETER	COUNT		
Г	1					
FLEX DUCT ROUND	FLEX-ROUND	8.86	4"	4		
GRAND TOTAL: 4		8.86				

1 HVAC PLAN
3/8" = 1'-0"

4' - 10"

EXHAUST FAN

AIR HANDLING UNIT

AIR HANDLING UNIT

AIR HANDLING UNIT

3' - 2 1/2"

5' - 10 1/2"

4' - 10"

3' - 2 1/2" 2' - 7 1/2"

3' - 2 1/2" 2 1/2'

AIR HANDLING UNIT

EXHAUST FAN

9 1/21 - 1 1/2'

6' - 8"

HOOD-WALL

Tuscon,AZ, USA 888-864-0184 inquire@frameupnow.com www.frameupnow.com

KEY PLAN

NO.	DESCRIPTION	DATE

NOTE:

LEGEND:

PROJECT

80-Hunter-935-3Bd-2Ba Siding-550

DRAWING NAME

HVAC PLAN

CLIENT NAME:	Owner
PROJECT NUMBER:	15_0001
DATE:	2/27/2025 8:41:26 AM
DESIGNED BY:	Designer
DRAWN BY:	Author
CHECKED BY:	Checker

M101

ELECTRICAL NOTES

- 1. THIS DRAWING DEPICTS THE ELECTRICAL SYSTEM FOR THE 80_HUNTER_935_3Bd2Ba_SIDING_350. IT PROVIDES A VISUAL REPRESENTATION OF THE ELECTRICAL LAYOUT AND COMPONENTS, INCLUDING POWER DISTRIBUTION, LIGHTING, AND CONTROL SYSTEMS.
- 2. THE ELECTRICAL SYSTEM IS DESIGNED TO MEET THE SPECIFIC REQUIREMENTS OF THE BUILDING, INCLUDING POWER DISTRIBUTION, LIGHTING, AND SPECIALIZED ELECTRICAL EQUIPMENT NEEDS, AS PER THE PROJECT SPECIFICATIONS AND APPLICABLE CODES AND STANDARDS.
- 3. THE ELECTRICAL SYSTEM INSTALLATION SHALL COMPLY WITH THE LATEST EDITION OF THE NATIONAL ELECTRICAL CODE (NEC), INTERNATIONAL BUILDING CODE (IBC), AND ALL OTHER APPLICABLE LOCAL, STATE, AND NATIONAL CODES AND REGULATIONS.
- 4. LOCATIONS AS NEEDED. DEVICES ARE SHOWN ON PLANS IN APPROXIMATE IDEAL LOCATIONS. UNLESS SPECIFICALLY DIMMENSIONED.
- OPEN WALLS AS NEEDED TO ALLOW FOR NEW ELECTRICAL INSTALLATIONS.
- 6. LABEL ALL CIRCUITS ON JUNCTION BOXES, RECEPTACLES, DATA, SMOKE DETECTOR, AND EQUIPMENT IN PANEL BOX.
- 7. INSTALL RACEWAY AS NEEDED FOR DDC, ACCESS CONTROL, LOW VOLTAGE WIRING & DATA.
- 8. RELABEL POWER, DATA & FIRE ALARM FOR ROOM #CHANGES. 9. VERIFY ALL CIRCUITS LABELED ON PRINT ARE CORRECT BEFORE WORKING ON THEM.
- 10. NOTE ON SITE PLAN ALL CHANGES OR MISSING DETAIL TO BE INCORPORATED INTO THE MASTER PLAN.
- 11. DRAWINGS ARE DIAGRAMMATIC ONLY FOR THE PURPOSE OF SHOWING FIXTURE AND OUTLET LOCATIONS.
- 12. ELECTRICAL CONTRACTOR TO VERIFY SERVICE SIZE BY CALCULATION BASED UPON ACTUAL NAME PLATE RATINGS OF SELECTED EQUIPMENT.
- 13. VERIFY LOCATION OF SERVICE ENTRANCE WITH POWER COMPANY. PROVIDE UFER GROUND IN
- BUILDING FOUNDATION AT SERVICE ENTRANCE LOCATION.
- 14. PROVIDE A MIN. OF 20 FEET OF ONE *4 BARE COPPER UFER WIRE EMBEDDED IN CONCRETE FOOTING AT THE SERVICE ENTRANCE LOCATION WHERE APPROVED BY LOCAL SERVICE PROVIDER.
- 15. PROVIDE WATERPROOF FIXTURES IN ALL HIGH MOISTURE AREAS (EXTERIOR, SHOWER AND TUB
- CEILINGS ETC.) 16. PROVIDE DEDICATED CIRCUITS TO EACH BATH, DEN, FAMILY ROOM, BEDROOM, LOFT, KITCHEN
- REFRIGERATOR, KITCHEN FREEZER DISHWASHER, AND ANY AREA/ITEM SPECIFIED BY OWNER.
- 17. INCANDESCENT FIXTURES WITH OPEN OR PARTIALLY ENCLOSED LAMPS, PENDANT FIXTURES, AND LAMP HOLDERS ARE NOT PERMITTED IN CLOSETS.
- 18. ALL WORKMANSHIP AND MATERIALS TO CONFORM WITH THE 2015 IRC.
- 19. PROVIDE A MIN. OF 20 FEET OF ONE *4 BARE COPPER UFER WIRE EMBEDDED IN CONCRETE FOOTING AT THE SERVICE ENTRANCE LOCATION WHERE APPROVED BY LOCAL SERVICE PROVIDER.
- 20. PROVIDE A BONDING CONDUCTOR CONSISTING OF A MINIMUM OF ONE *4 BARE COPPER WIRE CONNECTING THE BUILDING'S METAL WATER PIPING SYSTEM TO THE SERVICE EQUIPMENT ENCLOSURE GROUNDING.

MAIN PANEL CALCS

ELECTRICAL CALCS	
LIGHT AND OUTLETS 935 @ 3W	2,805 W
3 APPLIANCE CIRCUITS	4,500 W
DRYER	2,000 W
WASHER	2,000 W
RANGE	5,000 W
WATER HEATER	5,000 W
REFRIG.	1,800 W
DISHWASHER & DISPOSAL	3000 W
TOTAL	26,105 W
FRIST 10,000 @ 100% REMAINDER @ 40% MINI. SPLIT UNITS	10,000 W 6,442 W 2880 W
TOTAL	19,322 W
19,322 W DIVIDED BY 240V =	81 AMPS TOTAL

(USE 200 AMP SERVICE)

ELECTRICAL ABBREVIATIONS LIST

1P	1 POLE (2P, 3P, 4P, ETC.)	CTR	CENTER	HT	HEIGHT
A	AMPERÈ	CU	COPPER	HTG	HEATING
AC	ABOVE COUNTER OR AIR CONDITIONER	DCP	DOMESTIC WATER CIRCULATING PUMP	HTR	HEATER
ACLG	ABOVE CEILING	DEPT	DEPARTMENT	HV	HIGH VOLTAGE
ADO	AUTOMATIC DOOR OPENER	DET	DETAIL	HVAC	HEATING, VENTILATING AND AIR
AF	AMP FRAME	DIA	DIAMETER	CONDITIONING	CONDITIONING
AFF	ABOVE FINISHED FLOOR	DISC	DISCONNECT	HWP	HYDRONIC WATER PUMP
AFG	ABOVE FINISHED GRADE	DIST	DISTRIBUTION	IC	INTERRUPTING CAPACITY
AFI	ARC FAULT CIRCUIT INTERRUPTER	DN	DOWN	IG	ISOLATED GROUND
AHU	AIR HANDLING UNIT	DPR	DAMPER	IMC	INTERMEDIATE METAL CONDUIT
AL	ALUMINUM	DS	SAFETY DISCONNECT SWITCH	INCAND	INCANDESCENT
ALT	ALTERNATE	DT	DOUBLE THROW	IR	INFRARED
AMP	AMPERE	DWG	DRAWING	I/W	INTERLOCK WITH
AMPL	AMPLIFIER	DDC	DIRECT DIGITAL CONTROL	J-BOX	JUNCTION BOX
ANNUN	ANNUNCIATOR APPROX APPROXIMATELY		ELECTRICAL CONTRACTOR	KV	KILOVOLT
AQ-STAT	AQUASTAT	ELEC	ELECTRICAL CONTRACTOR ELECTRIC, ELECTRICAL	KVA	KILOVOLT-AMPERE
ARCH	ARCHITECT, ARCHITECTURAL	ELEV	ELEVATOR	KVAR	KILOVOLT-AMPERE REACTIVE
ARCH	AMP SWITCH	EM	EMERGENCY	KW	KILOWATT
AT	AMP TRIP	EMS	ENERGY MANAGEMENT SYSTEM	KWH	KILOWATT HOUR
ATS	AUTOMATIC TRANSFER SWITCH	EMT	ELECTRICAL METALLIC TUBING	LOC	LOCATE OR LOCATION
AUTO	AUTOMATIC TRANSPER SWITCH	EP	ELECTRIC PNEUMATIC	LOC	LIGHT
AUX	AUXILIARY	EQUIP	EQUIPMENT	LTG	LIGHTING
AV	AUDIO VISUAL	EWC	ELECTRIC WATER COOLER	LTNG	LIGHTNING
AWG	AMERICAN WIRE GAUGE	EXIST	EXISTING	LV	LOW VOLTAGE
BATT	BATTERY	EXH	EXHAUST	MAX	MAXIMUM
BD	BOARD	EXP	EXPLOSION PROOF	MAG.S	MAGNETIC STARTER
BLDG	BUILDING	FA	FIRE ALARM	M/C	MOMENTARY CONTACT
BMS	BUILDING MANAGEMENT SYSTEM	FABP	FIRE ALARM BOOSTER POWER	MC	MECHANICAL CONTRACTOR
C	CONDUIT	SUPPLY PANEL	SUPPLY PANEL	MCB	MAIN CIRCUIT BREAKER
CAB	CABINET	FACP	FIRE ALARM CONTROL PANEL	MCC	MOTOR CONTROL CENTER
CAD	CATALOG	FCU	FAN COIL UNIT	MDC	MAIN DISTRIBUTION CENTER
CATV	CABLE TELEVISION	FIXT	FIXTURE	MDP	MAIN DISTRIBUTION CENTER MAIN DISTRIBUTION PANEL
CATV	CIRCUIT BREAKER	FLR	FLOOR	MFR	MANUFACTURERMAIN FUSED
CCTV	CLOSED CIRCUIT TELEVISION	FLUOR	FLUORESCENT	IVII IX	DISCONNECT SWITCH
CKT	CIRCUIT	FU	FUSE	MH	MANHOLE
CLG	CEILING	FUDS	FUSED SAFETY DISCONNECT SWITCH	MIC	MICROPHONE
COMB	COMBINATION	GA	GAUGE	MIN	MINIMUM
CMPR	COMPRESSOR	GAL	GALLON	MISC	MISCELLANEOUS
CONN	CONNECTION	GALV	GALVANIZED	MLO	MAIN LUGS ONLY
CONST	CONSTRUCTION	GC	GENERAL CONTRACTOR	MMS	MANUAL MOTOR STARTER
CONT	CONTINUATION OR CONTINUOUS		GENERATOR	MOA	MULTIOUTLET ASSEMBLY
CONTR	CONTINUATION OR CONTINUOUS	GEN GFI	GROUND FAULT CIRCUIT INTERRUPTER	MSP	MOTOR STARTER PANELBOARD
CONTR	CONVECTOR	GFP	GROUND FAULT CIRCUIT INTERROPTER GROUND FAULT PROTECTOR	MSBD	MAIN SWITCHBOARD
CP	CIRCULATING PUMP	GND	GROUND	MT	MOUNT
CRT	CATHODE-RAY TUBE	GRS	GALVANIZED RIGID STEEL (CONDUIT)	MT.C	EMPTY CONDUIT
CKT	CURRENT TRANSFORMER	GYP BD	GYPSUM BOARD	UL	UNDERWRITERS LABORATORIES
	CONTRACT TRACTOR CONTRACT	011 00	OTT COM BOTTLE		ON THE CONTROL OF THE STATE OF

Branch Panel:

Location: LIVING ROOM 13 **Supply From:** Mounting: Recessed Enclosure: Type 1

Volts: 120/240 Single Phases: 1 Wires: 3

A.I.C. Rating: Mains Type: Mains Rating: 200 A MCB Rating: 1 A

DROOM 1-HALL GHT POINTS & 10KE	1 15	Rating 60 A 20 A	62' - 8 11/16"	2-#6, 1-#6, 1-#10	750 VA	900 VA			1-#12,		Rating		Circuit Description	
SHT POINTS & 10KE									1-#12, 1-#12	59' - 8 7/32"	20 A		BEDROOM 1 RECEPTACLES	2
SHT POINTS & 10KE	15	20 A					750 VA	750 VA	2-#10, 1-#10, 1-#10	38' - 10 13/16"	30 A	1	WATER HEATER	4
TH 1 UNITS			50' - 10 7/8"	1-#12, 1-#12, 1-#12	748 VA	750 VA								6
	7	20 A	40' - 3 1/2"	1-#12, 1-#12, 1-#12			576 VA	750 VA	2-#10, 1-#10, 1-#10	39' - 1 27/32"	30 A	1	DRYER	8
CI WASHER	1	20 A	41' - 0 31/32"	1-#12, 1-#12, 1-#12	1200 VA	750 VA								10
TH 2 UNITS	6	20 A	35' - 6 5/8"	1-#12, 1-#12, 1-#12			516 VA	576 VA	1-#12, 1-#12, 1-#12	30' - 5 3/32"	20 A	15	LIVING ROOM AND HALL LIGHT POINTS	12
DROOM 2 LIGHT DINTS	9	20 A	36' - 7 13/32"	1-#12, 1-#12, 1-#12	388 VA	568 VA			1-#12, 1-#12, 1-#12	40' - 8 29/32"	20 A		BEDROOM 3 LIGHT POINTS	14
D ROOM 3 CEPTACLES	4	20 A	50' - 0 9/32"	1-#12, 1-#12, 1-#12			720 VA	900 VA	1-#12, 1-#12, 1-#12	46' - 8 5/32"	20 A		BEDROOM 2 RECEPTACLES	16
/ING ROOM CEPTACLES	5	20 A	39' - 5 15/32"	1-#12, 1-#12, 1-#12	900 VA	1200 VA			1-#10, 1-#10, 1-#10	19' - 8 1/4"	30 A		GFCI DISH WASHER	18
CI KITCHEN	3	20 A	31' - 9 15/16"	1-#12, 1-#12, 1-#12			540 VA	1500 VA	1-#12, 1-#12, 1-#12	33' - 11 29/32"	20 A	1	REFRIGERATOR	20
NGE	1	50 A	28' - 2 5/8"	2-#8, 1-#8, 1-#10	750 VA	720 VA			1-#12, 1-#12, 1-#12	47' - 11 5/32"	20 A		OUTDOOR GFCI RECEPTACLES	22
							750 VA	400 VA	1-#12, 1-#12, 1-#12	29' - 7"	20 A		OUT-DOOR LIGHT POINTS	24
														26
					9621	1						1 '		
	ROOM 3 EPTACLES NG ROOM EPTACLES	ROOM 3 EPTACLES NG ROOM EPTACLES I KITCHEN 3 GE 1	ROOM 3 EPTACLES 4 20 A NG ROOM EPTACLES 5 20 A I KITCHEN 3 20 A GE 1 50 A	ROOM 3 EPTACLES 4 20 A 50' - 0 9/32" NG ROOM EPTACLES 5 20 A 39' - 5 15/32" I KITCHEN 3 20 A 31' - 9 15/16" GE 1 50 A 28' - 2 5/8"	ROOM 2 LIGHT 9 20 A 36' - 7 13/32" 1-#12, 1-#12 ROOM 3	ROOM 2 LIGHT 9 20 A 36' - 7 13/32" 1-#12,	ROOM 2 LIGHT 9 20 A 36' - 7 13/32" 1-#12, 1-#12 388 VA 568 VA ROOM 3 4 20 A 50' - 0 9/32" 1-#12, 1-#12, 1-#12 NG ROOM EPTACLES 5 20 A 39' - 5 15/32" 1-#12, 1-#12, 1-#12, 1-#12, 1-#12 I KITCHEN 3 20 A 31' - 9 15/16" 1-#12, 1-#12, 1-#12 GE 1 50 A 28' - 2 5/8" 2-#8, 1-#8, 750 VA 720 VA	ROOM 2 LIGHT 9 20 A 36' - 7 13/32" 1-#12, 1-#12 388 VA 568 VA FOR VA THE PROOM 3 EPTACLES 4 20 A 50' - 0 9/32" 1-#12, 1-#12 720 VA THE PROOM 5 20 A 39' - 5 15/32" 1-#12, 1-#12, 1-#12 900 VA THE PROOM 5 20 A 31' - 9 15/16" 1-#12, 1-#12 540 VA THE PROOM 5 20 A 31' - 9 15/16" 1-#12, 1-#12 540 VA THE PROOM 5 3 20 A 28' - 2 5/8" 2-#8, 1-#8, 1-#10 750 VA 720 VA	ROOM 2 LIGHT 9 20 A 36' - 7 13/32" 1-#12,	ROOM 2 LIGHT 9 20 A 36' - 7 13/32" 1.#12,	ROOM 2 LIGHT 9	ROOM 2 LIGH1 9 20 A 36' - 7 13/32" 1-#12, 1-#10, 1-#10, 1-#10, 1-#10, 1-#10, 1-#10, 1-#10, 1-#10, 1-#10, 1-#10, 1-#10, 1-#12	ROOM 3 1-#12	ROOM 3 1-1-12

Legend:

ighting - Dwelling Unit	600 VA				
	000 VA	100.00%	600 VA		
Other	2076 VA	100.00%	2076 VA	Total Conn. Load:	18329 VA
Receptacle	15300 VA	82.68%	12650 VA	Total Est. Demand:	15679 VA
_ighting	400 VA	100.00%	400 VA	Total Conn.:	76 A
				Total Est. Demand:	65 A



KEY PLAN

NO.	DESCRIPTION	DATE

NOTE:

LEGEND:

PROJECT

80-HUNTER-935-3Bd-2Ba SIDING-350

DRAWING NAME

SCHEDULE

CLIENT NAME: Owner PROJECT NUMBER: 0037_14 2/23/2025 11:23:42 PM Designer DESIGNED BY: DRAWN BY: CHECKED BY: Checker

E101

SCALE: 1/4" = 1'-0"

© [2024] [FrameUpNow] . All rights reserved

ELECTRICAL NOTE

- PROVIDE INTERCONNECTED SMOKE ALARMS IN EACH SLEEPING ROOMS, OUTSIDE EACH SLEEPING ROOM, ON EACH STORY, IN THE HALL OR ADJACENT ROOM LUHERE THE CEILING HEIGHT OF A ROOM OPEN TO THE HALL EXCEEDS THE HALL BY 24'. SMOKE ALARMS SHALL BE PERMANENTLY HARD WIRED WITH BATTERY BACKUP.
- B. RECEPTACLE OUTLETS FOR RANGES AND CLOTHES DRYERS SHALL BE A THREE POLE WITH GROUND TYPE. FOUR WIRE GROUNDING-TYPE FLEXIBLE CORDS WILL BE REQUIRED FOR CONNECTION OF RANGES AND CLOTHES DRYERS. THE BONDING JUMPER SHALL NOT BE CONNECTED BETWEEN NEUTRAL TERMINAL AND THE FRAME OF THE **APPLIANCE**
- C. TWO OR MORE 20 AMP SMALL APPLIANCE CIRCUITS SHALL BE PROVIDED TO SERVE THE KITCHEN, BREAKFAST NOOK, AND DINING ROOM. SUCH CIRCUITS SHALL HAVE NO OTHER OUTLETS.
- D. AT LEAST ONE 20 AMP BRANCH CIRCUIT SHALL BE PROVIDED TO SERVICE THE LAUNDRY ROOM. THIS CIRCUIT SHALL HAVE NO OTHER OUTLETS.
- E. ALL RECEPTACLES WITH IN 6' OF A WET BAR SINK OR KITCHEN SINK TO SERVE COUNTER TOP SURFACES MUST BE GFCI. ON KITCHEN COUNTERS 12' OR WIDER NO POINT ALONG THE WALL SHALL BE MORE THAN 2' FROM A RECEPTACLE. ALL RECEPTACLES WITH IN 6' OF KITCHEN SINK MUST BE GFCI. AT LEAST ONE GFCI RECEPTACLE SHALL BE INSTALLED IN THE BATHROOM ADJACENT TO EACH BASIN.
- FIXTURES INCLUDING CEILING FANS THAT ARE LOCATED IN DAMP LOCATIONS SHALL BE LISTED TO BE SUITABLE FOR
- SUCH LOCATIONS PER 2012 IRC
- G. PROVIDE ONE (1) SWITCHED OUTLET @ ALL BEDROOMS AND DEN
- H. CEILING FANS NOT EXCEEDING 35 LBS. (WITH OR WITHOUT ACCESSORIES MAY BE SUPPORTED BY OUTLET BOXES PROVIDED THE OUTLET BOXES ARE IDENTIFIED FOR SUCH USE PER 2012 IRC
- ELECTRICAL OUTLET BOXES ON OPPOSITE SIDES OF FIRE RATED WALLS SHALL BE SEPARATED BY A HORIZONTAL DISTANCE OF NOT LESS THAN 24".
- OUTLET BOXES IN THE WALLS BETWEEN THE GARAGE AND DWELLING SHALL BE METAL OR U.L. APPROVED FIRE RESISTIVE PLASTIC. BOXES IN GARAGE CEILING SHALL BE METAL.
- K. ALL BRANCH CIRCUITS THAT SUPPLY 120 VOLTS SINGLE PHASE 15 AND 20 AMPS RECEPTACLE OUTLETS INSTALLED IN THE DWELLING SHALL BE PROTECTED BY AN ARC FAULT CIRCUIT INTERRUPTER, EXCEPT GFCI RECEPTICLES.

NOTE:

RECEPTACLES MUST BE PROVIDED IN HALLWAYS 10'-0" OR MORE IN LENGTH. FOR A ONE FAMILY DWELLINGS AND EACH OF A TWO FAMILY DWELLING THAT IS AT GRADE LEVEL, AT LEAST ONE WP-GFCI RECEPTACLE OUTLET ACCESSIBLE AT GRADE LEVEL AND NOT MORE THAN 6'-6" ABOVE GRADE SHALL BE INSTALLED AT THE FRONT AND BACK OF THE DWELLING.

NOTE: APPLIANCE DISCONNECT

E4001.5 GROUNDING OF ENCLOSURES.

METAL ENCLOSURES FOR SWITCHES OR CIRCUIT BREAKERS SHALL BE CONNECTED TO AN

EQUIPMENT GROUNDING CONDUCTOR.

METAL ENCLOSURES FOR SWITCHES OR CIRCUIT BREAKERS USED AS SERVICE


EQUIPMENT SHALL COMPLY WITH THE PROVISIONS OF SECTION E3609.4. WHERE NONMETALLIC ENCLOSURES ARE USED WITH METAL RACEWAYS OR METAL-ARMORED

CABLES, PROVISIONS SHALL BE MADE FOR CONNECTING THE EQUIPMENT GROUNDING


CONDUCTOR. NONMETALLIC BOXES FOR SWITCHES SHALL BE INSTALLED WITH A WIRING METHOD THAT

PROVIDES OR INCLUDES AN EQUIPMENT GROUNDING CONDUCTOR. (404.12)

ELECTRICAL LEGEND		
	Electrical Lights With Fan	
0	Waterproof Recessed Can Light	
	Pendant Light	
0	Recessed Can Light	
– ₫)	Wall Lamp	
	Standalone linear	
↔1	Single Switch	
÷₩	Three way Switch	
, 	Fan Switch	
	Duplex Receptacle	
	Triplex Receptacle	
⊕ □GFCI	GFCI Receptacle	
	Exhaust Fan	
•	Smoke and heat detector	

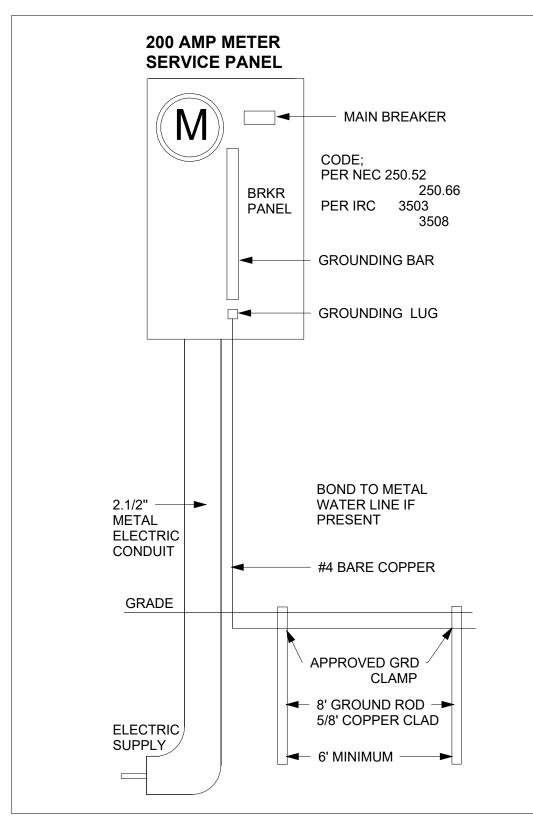



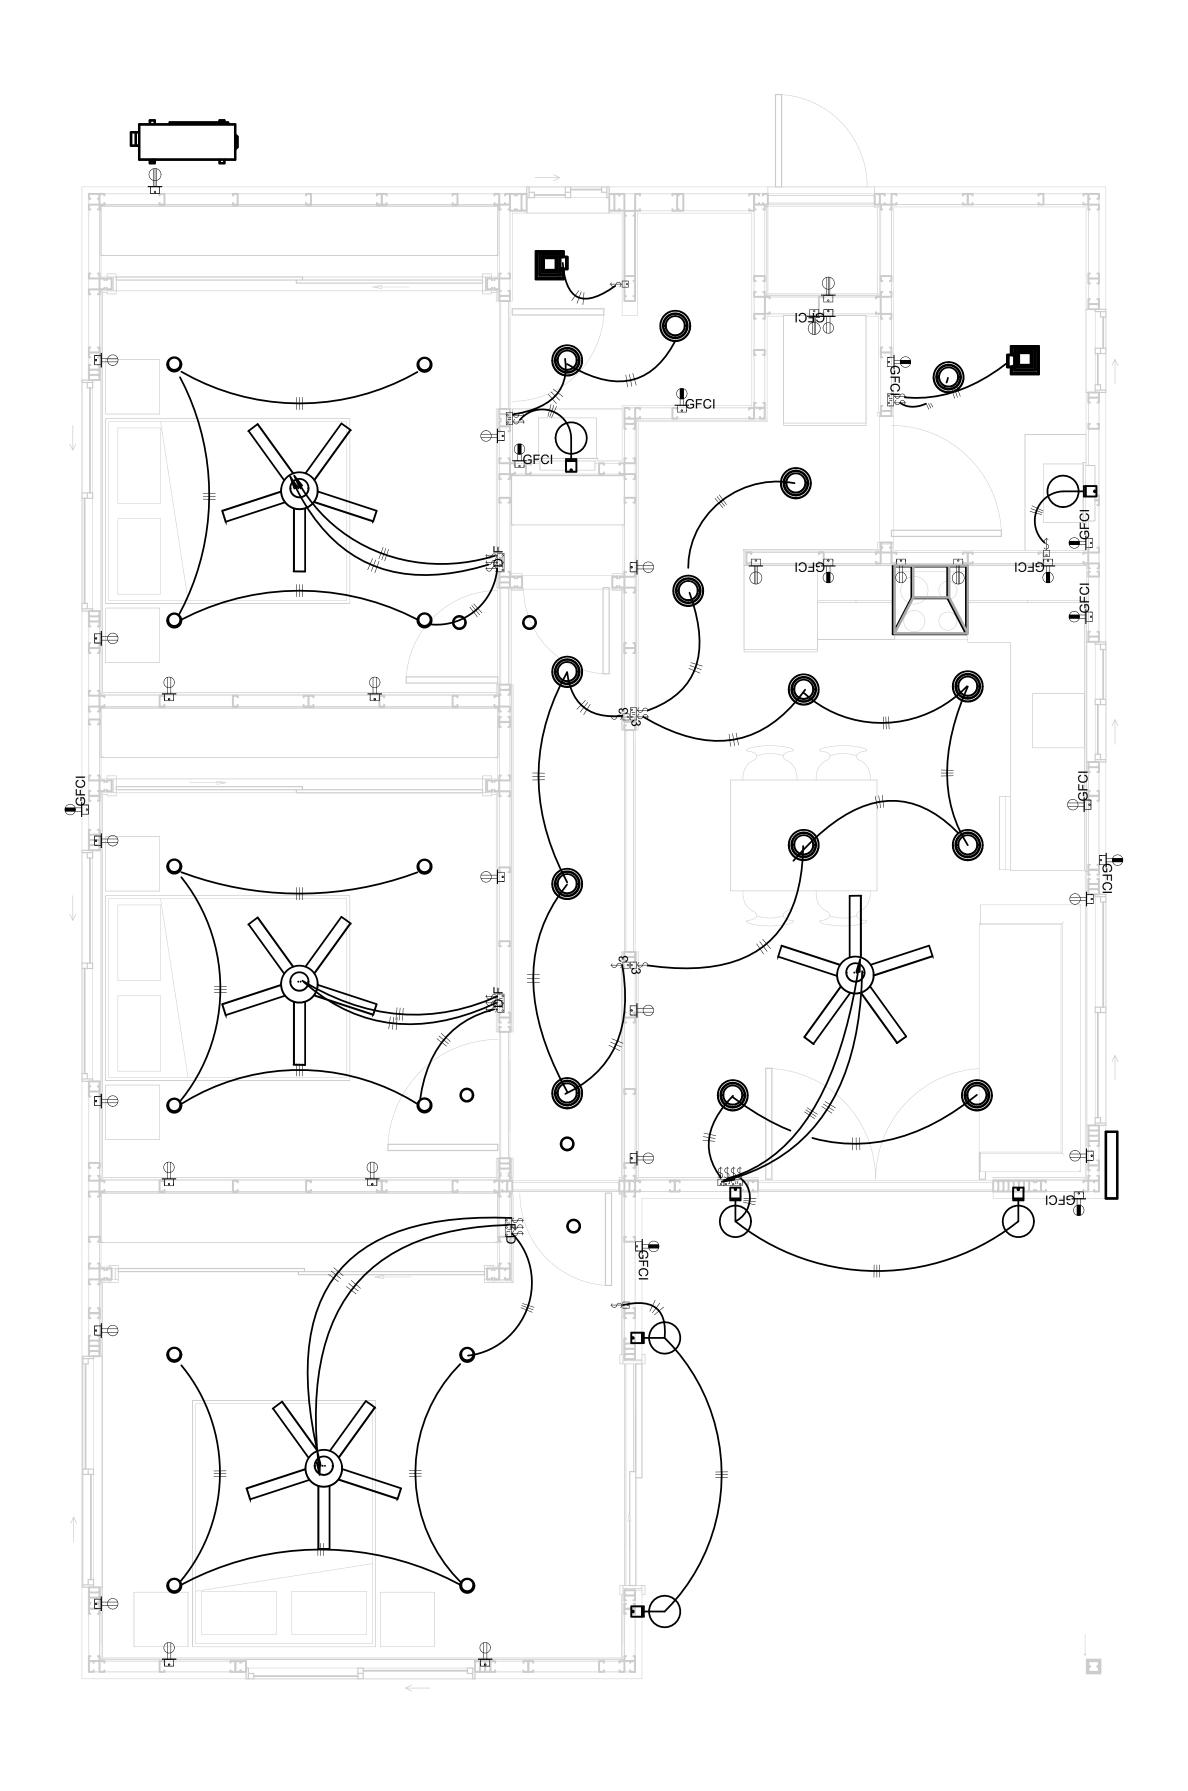

1 - Lighting



KEY PLAN

NO.	DESCRIPTION	DATE

NOTE:

LEGEND:

PROJECT

80-HUNTER-935-3Bd-2Ba SIDING-350

DRAWING NAME

LIGHTING


CLIENT NAME:	Owner
PROJECT NUMBER:	0037_14
DATE:	2/23/2025 11:23:44 PM
DESIGNED BY:	Designer
DRAWN BY:	Author
CHECKED BY:	Checker

E102


NOTES: CONDUIT, CABLE AND WIRING


- Use Metalic Conduits (IMC) for cables running under concrete slabs.
 Use IMC for circuits with high voltage appliances (240 volts and above)
 For circuits with 120 volts consider using EMT or PVC conduits if needed.
 For Low voltage applications up to 50 volts consider using non metalic conduits.
 All conduits to be used in the project must conform to the latest National Electrical Code (NEC),
- 6. All wiring and cables to be used in the project must also conform to the latest National Electrical Code (NEC), 2015.
 7. All cables and wires used should be rated for their respective loading and should be gauged and conform to the NEC.


	Conduit Schedule			
Туре	Length	Size		
2#12 AWG WIRE	9.25 ft	1/2"ø		
3#8 AWG WIRE	4.56 ft	1/2"ø		
3#10 AWG WIRE	6.06 ft	1/2"ø		
Electrical Metallic Tubing (EMT)	32.46 ft	1/2"ø		
Intermidate Metal Conduit (IMC)	21.92 ft	1/2"ø		

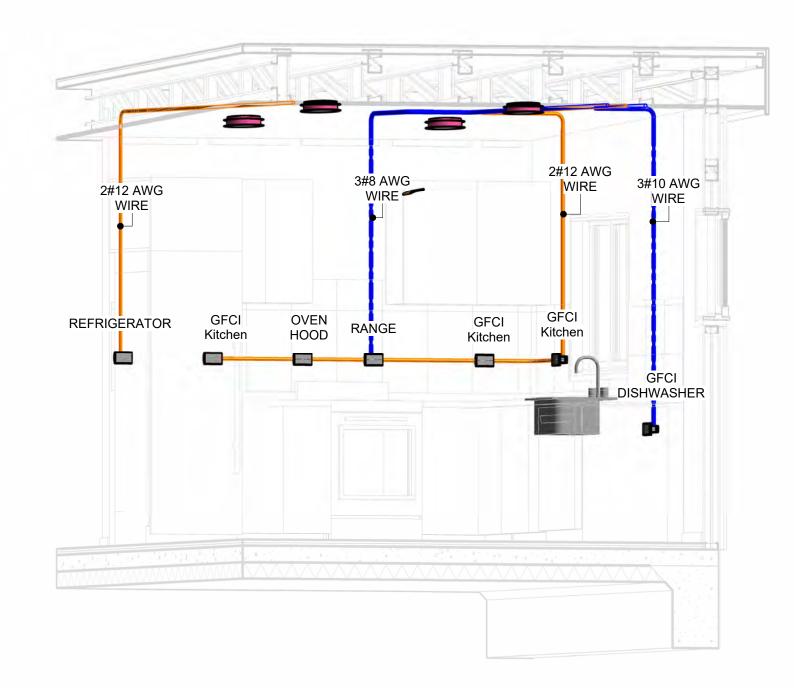




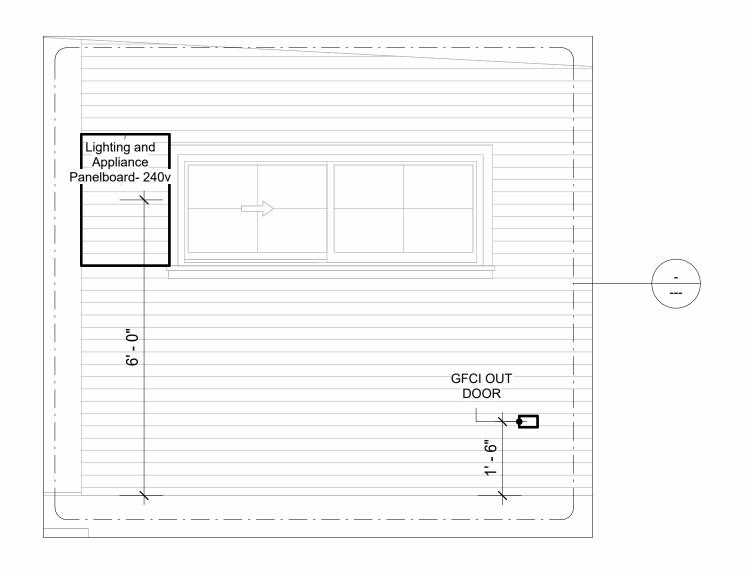

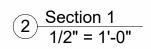


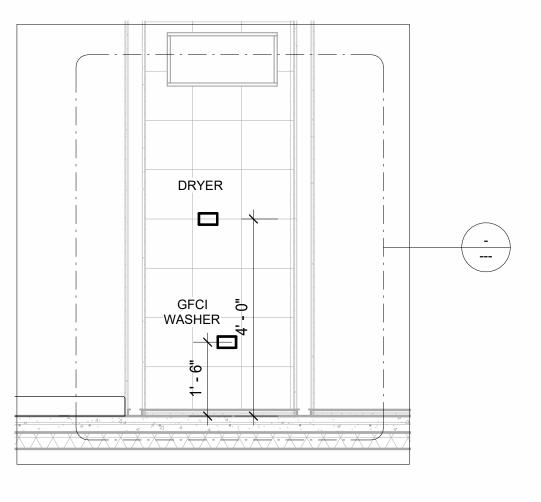

Section 3 1/2" = 1'-0"

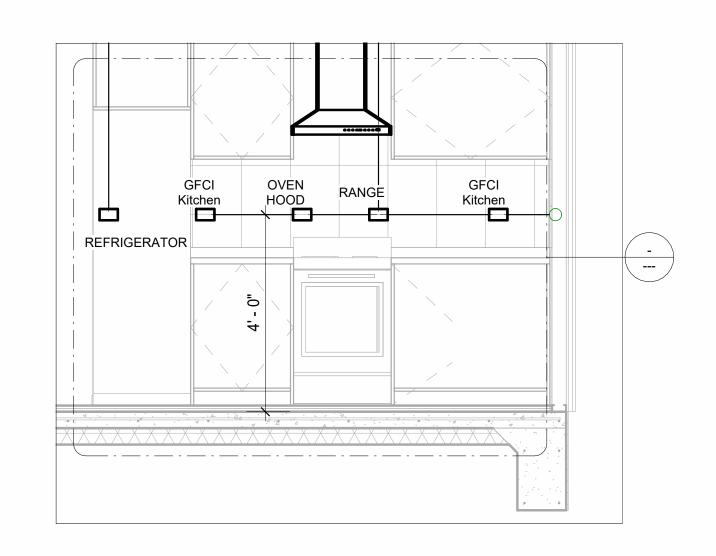

3 Section 2 1/2" = 1'-0"

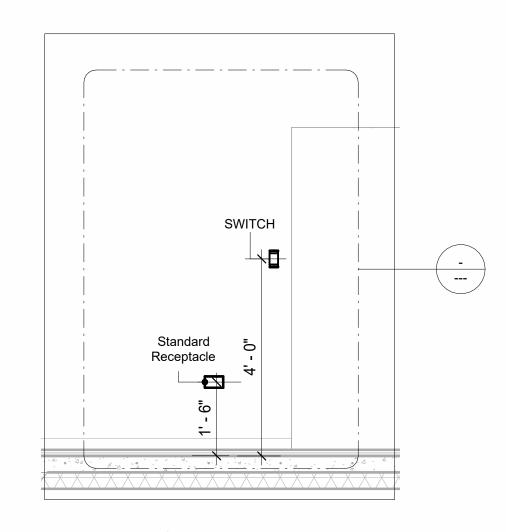


6 Section 4 1/2" = 1'-0"





KEY PLAN

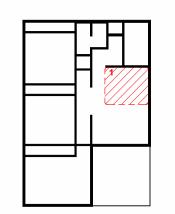

DESCRIPTION	DATE
	DESCRIPTION

NOTE:

LEGEND:

PROJECT

80-HUNTER-935-3Bd-2Ba SIDING-350

DRAWING NAME

POWER

CLIENT NAME:	Owner
PROJECT NUMBER:	0037_14
DATE:	2/23/2025 11:24:08 PM
DESIGNED BY:	Designer
DRAWN BY:	Author
CHECKED BY:	Checker

E103

NOTES: LIGHT

- 1. LIGHT FIXTURES AND LUMINARIES SHALL CONFORM TO THE NEC, THE IRC AND LOCAL SAFETY & BUILDING CODE.
- 2. ALL LIGHTING FIXTURES SHOULD CONFORM TO THE DESIGN ELECTRICAL LOAD AND SHALL BE PROPERLY WIRED AND MOUNTED BY QUALIFIED ELECTRICIAN FOLLOWING MANUFACTURERS SPECIFICATIONS.
- 3. CEILING FANS AND FANS WITH LIGHT WITH WEIGHT EXCEEDING 35 LBS SHOULD BE PROVIDED WITH STRUCTURAL BACKING FOR SUPPORT AND SHALL BE FIXED AS PER MANUFACTURERS SPECIFICATIONS.
- 4. EXTERIOR LIGHTS SHALL CONFORM TO LOCAL BUILDING CODE AND GUIDELINES.

NOTES: SWITCH JUNCTION BOX


- THE MINIMUM SIZE OF JUCTION BOX TO BE USED IS 2"X4"X(1.5" OR 3.5" DEEP) THIS ARE TO BE USED FOR SINGLE GANG SWITCH OR OUTLETS.
- 2. FOR DOUBLE GANG (2 GANG) OUTLETS AND SWITCHS THE MINIMUM SIZE OF THE
- JUCTION BOX TO BE PROVIDED SHALL NOT BE LESS THAN 4"X4"X(1.5" OR 3.5" DEEP)

 3. FOR THREE GANG (3 GANG) OUTLETS AND SWITCHS THE MINIMUM SIZE OF THE JUCTION
- 3. FOR THREE GANG (3 GANG) OUTLETS AND SWITCHS THE MINIMUM SIZE OF THE JUCTION BOX SHALL NOT BE LESS THAN 6"X4"X(1.5" OR 3.5" DEEP).

Electrical Fixture Schedule (SWITCH BOX)		
Type Count		
Double Gang Switch Box	3	
Single Gang Switch Box	7	
Triple Gang Switch Box	4	

Lighting Device		
Туре	Count	
Dimmer	3	
Fan switch	3	
Single Pole	15	
Three Way	4	

Lighting Fixture			
Lighting Fixture Type Voltage Electrical Load			
Electrical_Lights_Fan-Light1	120 V/1-100 VA- 120 V/1-100 VA	200 A, 120 V/240 V, Single Phase, 3 Wires	4
Lighting - Recessed	120 V/1-60 VA	200 A, 120 V/240 V, Single Phase, 3 Wires	14
SASSO 100 round wallwasher trim	120 V/1-28 VA	200 A, 120 V/240 V, Single Phase, 3 Wires	12
Wall Lamp - Bracket	120 V/1-100 VA	200 A, 120 V/240 V, Single Phase, 3 Wires	6

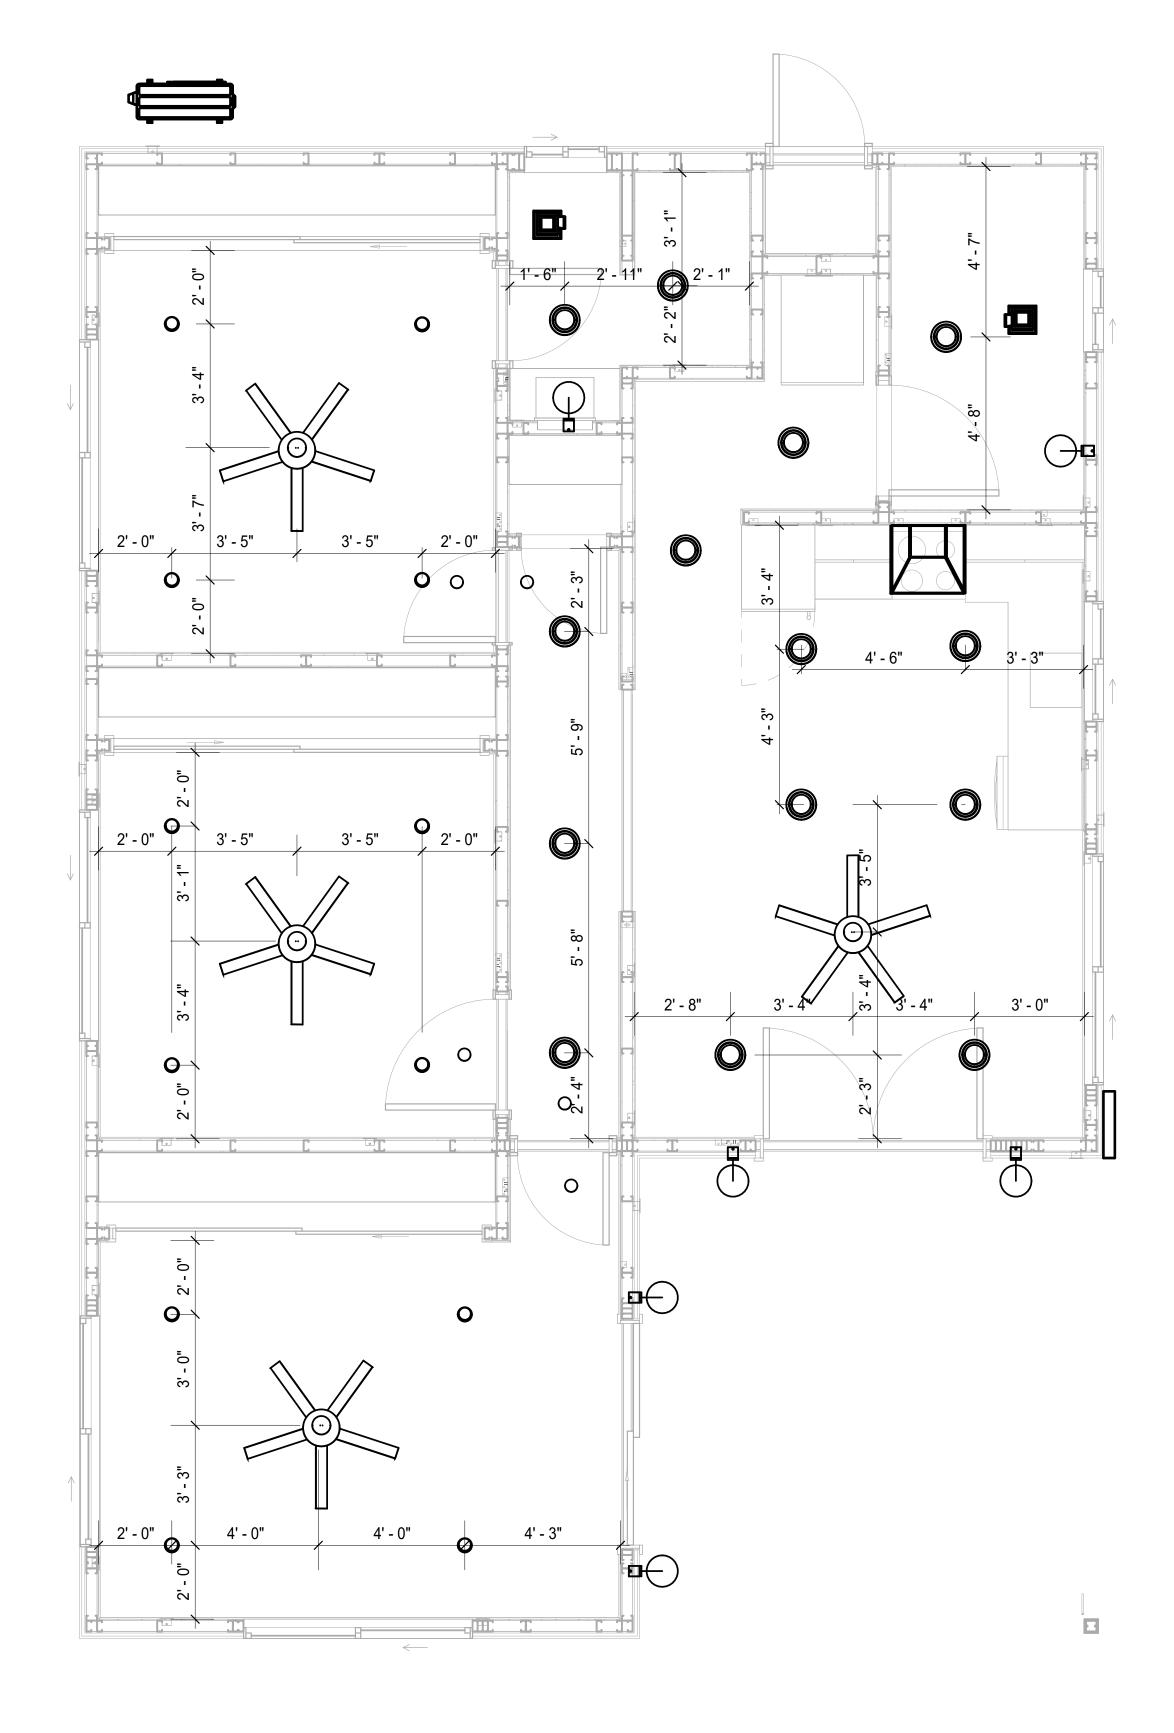

1 DIMENSION FOR LIGHT FIXTURES
3/8" = 1'-0"



KEY PLAN

NO. DESCRIPTION DATE

NOTE:

LEGEND:

PROJECT

80-HUNTER-935-3Bd-2Ba SIDING-350

DRAWING NAME

DIMENSION PLAN FOR LIGHT FIXTURES

CLIENT NAME:	Owner
PROJECT NUMBER:	0037_14
DATE:	2/23/2025 11:24:09 PM
DESIGNED BY:	Designer
DRAWN BY:	Author
CHECKED BY:	Checker

E104


SCALE: 3/8" = 1'-0"

NOTES;

- 1. VERIFY EQUIPMENT PLUG CONFIGURATION BEFORE PURCHASING RECEPTACLES
- 2. FOR ALL EQUIPMENT.
- 3. COORDINATE EXACT LOCATION OF LIGHT FIXTURES, WALL SWITCHES, RECEPTACLES AND OTHER DEVICES WITH ARCHITECTURAL DRAWINGS.
- 4. USE METALLIC JUNCTION BOX WITH THE GFCI RECEPTACLES, WITH HIGHT VOLTAGE.

Electrical Fixture Schedule (Receptacle)		
Туре	Count	
CONDENSER	1	
DRYER	1	
GFCI BATH ROOM	4	
GFCI DISHWASHER	1	
GFCI Kitchen	3	
GFCI OUT DOOR	4	
GFCI WASHER	1	
OVEN HOOD	1	
RANGE	1	
REFRIGERATOR	1	
Standard Receptacle	19	
water heater	1	

Electrical Outlet Schedule			
Туре	Circuit Number	Electrical Data	Count
OVEN HOOD		120 V/1-180 VA	1
CONDENSER	1,3	240 V/2-1500 VA	1
Standard Receptacle	2	120 V/1-180 VA	5
water heater	4,6	240 V/2-1500 VA	1
GFCI BATH ROOM	7	120 V/1-180 VA	2
DRYER	8,10	240 V/2-1500 VA	1
GFCI WASHER	9	120 V/1-1200 VA	1
GFCI BATH ROOM	11	120 V/1-180 VA	2
Standard Receptacle	15	120 V/1-180 VA	4
Standard Receptacle	16	120 V/1-180 VA	5
Standard Receptacle	17	120 V/1-180 VA	5
GFCI DISHWASHER	18	120 V/1-1200 VA	1
GFCI Kitchen	19	120 V/1-180 VA	3
REFRIGERATOR	20	120 V/1-1500 VA	1
RANGE	21,23	240 V/2-1500 VA	1
GFCI OUT DOOR	22	120 V/1-180 VA	4

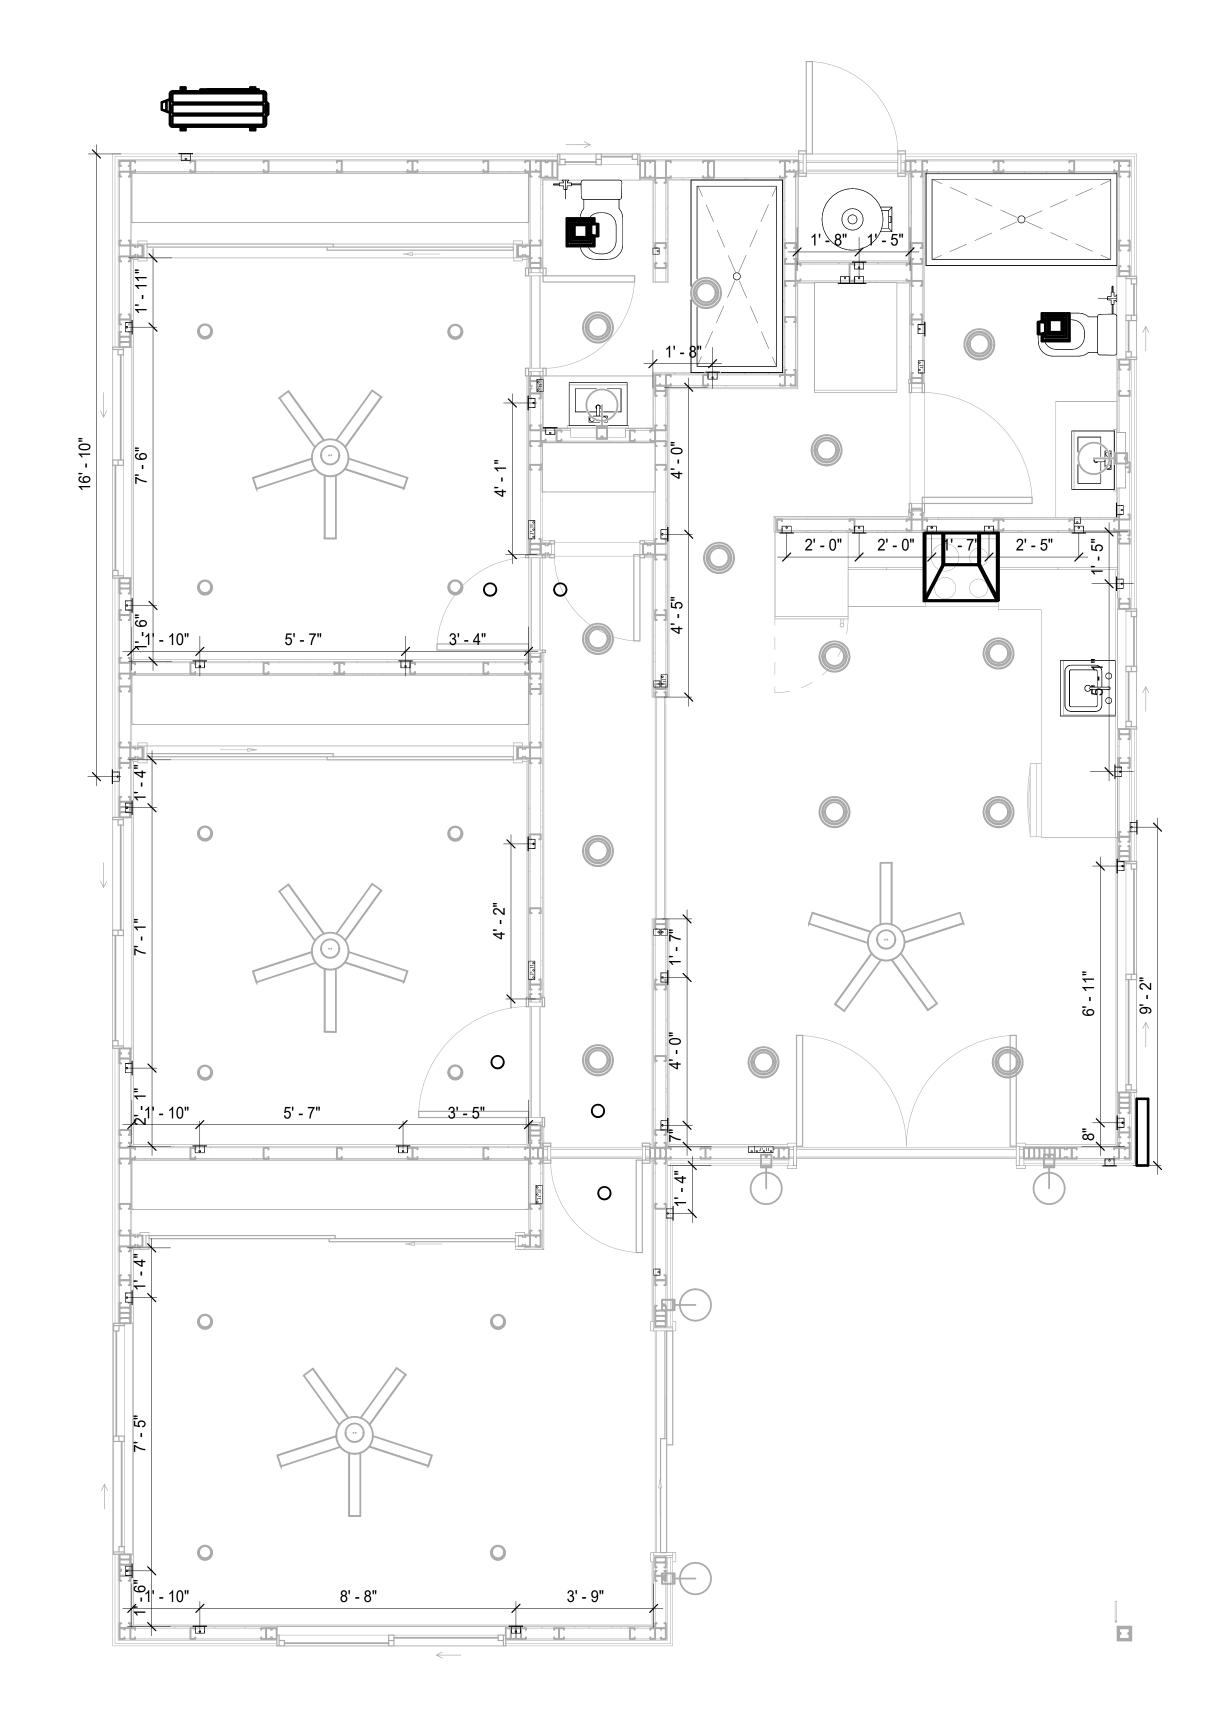

1 DIMENSION FOR FITTINGS
3/8" = 1'-0"

KEY PLAN

NO. DESCRIPTION DATE

NOTE:

LEGEND:

PROJECT

80-HUNTER-935-3Bd-2Ba SIDING-350

DRAWING NAME

DIMENSION PLAN FOR FITTINGS

CLIENT NAME:	Owner
PROJECT NUMBER:	0037_14
DATE:	2/23/2025 11:24:11 PM
DESIGNED BY:	Designer
DRAWN BY:	Author
CHECKED BY:	Checker

E105

SCALE: 3/8" = 1'-0"

SHEET LIST

SHEET NUMBER SHEET NAME

P101 NOTE AND SCHEDULE
P102 WATER SUPPLY AND SEWAGE
SYSTEM

PIPE COLOR SCHE	ME
DOMES SANITA	RY SEWER I DRAINAGE
GAS LII	·· ·· —· ·

PLUMBING NOTES

- THE PLUMBING SYSTEM IS DESIGNED TO MEET THE BUILDING'S DOMESTIC WATER SUPPLY, SANITARY DRAINAGE, AND STORM DRAINAGE REQUIREMENTS, AS PER PROJECT SPECIFICATIONS AND APPLICABLE CODES.
- THE SYSTEM INSTALLATION SHALL COMPLY WITH THE LATEST INTERNATIONAL PLUMBING CODE (IPC), INTERNATIONAL RESIDENTIAL CODE (IRC), AND ALL OTHER RELEVANT LOCAL, STATE, AND NATIONAL REGULATIONS.
- ALL PLUMBING WORK SHALL COMPLY WITH THE LATEST EDITION OF THE INTERNATIONAL PLUMBING CODE (IPC) AND THE LOCAL PLUMBING CODE.
- 4. PLUMBING SYSTEMS SHALL BE TESTED AND INSPECTED IN ACCORDANCE WITH THE LOCAL PLUMBING CODE REQUIREMENTS.
- 5. PLUMBING FIXTURES SHALL BE INSTALLED WITH THE APPROPRIATE TRIM, FITTINGS, AND ACCESSORIES, AS RECOMMENDED BY THE MANUFACTURER.
- 6. PIPING SHALL BE PROPERLY SUPPORTED AND SECURED TO PREVENT SAGGING, MOVEMENT, AND VIBRATION.
- 7. SHUT-OFF VALVES SHALL BE PROVIDED AT ALL BRANCH CONNECTIONS AND AT THE INLET AND OUTLET OF EACH PIECE OF EQUIPMENT.
- 8. BACKFLOW PREVENTION DEVICES SHALL BE INSTALLED AS REQUIRED BY THE LOCAL
- PLUMBING CODE TO PROTECT THE POTABLE WATER SYSTEM.

 9. PLUMBING FIXTURES AND EQUIPMENT SHALL BE ACCESSIBLE FOR MAINTENANCE AND
- 10. EXPOSED PLUMBING PIPING AND FIXTURES SHALL BE INSULATED TO PREVENT CONDENSATION AND ENERGY LOSS.
- 11. DEAD ENDS IN THE DRAINAGE SYSTEM MUST BE AVOIDED, EXCEPT WHERE NECESSARY TO INSTALL A CLEANOUT IN AN ACCESSIBLE LOCATION, AND MUST HAVE A VENTED CONNECTION TO THE OUTSIDE ATMOSPHERE.
- 12. THE VERTICAL DEFLECTION OF PVC PIPE MUST NOT EXCEED 5%, AND NO DEFLECTION IS PERMITTED FOR IRON PIPE.
- 13. WORK MUST BE PROPERLY COORDINATED WITH OTHER TRADES TO AVOID CONFLICTS, REFERRING TO THE ARCHITECTURAL AND STRUCTURAL DRAWINGS FOR INFORMATION REGARDING CEILING ELEVATIONS, SPACE CLEARANCES, WALL AND PARTITION LOCATIONS, ETC.
- 14. ALL FIXTURES SHALL HAVE ACCESSIBLE STOPS.
- 15. DOMESTIC WATER PIPING SHALL BE PEX, AND PVC PIPING IS NOT ACCEPTABLE FOR INTERIOR USE.
- 16. VENT TERMINATIONS SHALL BE LOCATED AT LEAST 10 FEET FROM OR 3 FEET ABOVE ANY OPERABLE WINDOW, DOOR OPENING, AIR INTAKE, OR VENT SHAFT, AND AT LEAST 3 FEET IN EVERY DIRECTION FROM ANY LOT LINE, ALLEY, OR STREET.
- 17. PIPE AND FITTINGS UTILIZED IN THE WATER SUPPLY SYSTEM SHALL HAVE A MAXIMUM OF 8 PERCENT LEAD.
- 18. ACRYLONITRILE BUTADIENE STYRENE (ABS) SHALL BE USED FOR THE SEWERAGE AND
- VENTILATION SYSTEM.

 19. CROSS-LINKED POLYETHYLENE (PEX) SHALL BE USED FOR THE WATER SUPPLY SYSTEM.
- 20. POLYVINYL CHLORIDE (PVC) SHÀLL BÉ USED FOR THE RAIN WATER SYSTEM.
- 21. THE MIMIMUM WATER SUPPLY DEPTH UNDER FLOOR FINISH SHOUD BE 1/2".
- 22. ANY PIPE INSTALLED UNDERGROUND MUST HAVE AT LEAST 12 INCHES OF CLEARANCE BETWEEN THE OUTSIDE OF THE PIPE AND ANY OTHER UNDERGROUND STRUCTURE.
- 23. THE MINIMUM CLEARANCE BETWEEN COLD AND HOT WATER LINES IN RESIDENTIAL HOMES MAINTAIN A MINIMUM DISTANCE OF 6 INCHES.
- 24. HORIZONTAL SEPARATION BETWEEN WATER AND SEWER LINES: A MINIMUM OF 12 INCHES BETWEEN POTABLE WATER SUPPLY LINES (COLD AND HOT WATER) AND SANITARY SEWER LINES.

ABBREVIATIONS

- A	DIAMETED
Ø ADS	DIAMETER
ABS ABV	ACRYLONITRILE BUTADIENE STYRENE ABOVE
	AREA DRAIN
AD AFF	
	ABOVE FINISHED FLOOR
ALT	ALTERNATE
BFF	BELOW FINISHED FLOOR BELOW
BLW	CLEAN OUT
CM	COLD WATER
D	DEGREE
DFU	
	DRANAGE FIXTURE UNIT
DIA	DIAMETER
	DOWN FLOOR CLEAN OLIT
FCO	FLOOR CLEAN OUT FLOOR DRAIN
FD FL	FLOOR DRAIN FLOOR
FS FT	FLOOR SINK FOOT/FEET
HB HW	HOSE BIB HOT WATER
IN	INCH
MIN	MINIMUM
NO	NUMBER
NTS	NOT TO SCALE
PEX	CROSS-LINKED POLYETHYLENE
PLBG	PLUMBING
PVC	POLYVINYL CHLORIDE
QTY	QUANTITY
RD	ROOF DRAIN
RED	REDUCER
RM	ROOM
RW	RAIN WATER
SF	SQUARE FOOT
V	VENT
VTR	VENT THROUGH ROOF
W	WASTE
WCO	WALL CLEAN OUT
WSFU	WATER SUPPLY FIXTURE UNIT
VVOI 0	WATER COLLET I MICHAEL CIVIT

PLUMBING LEGEND

CAP
BEND 45 DEG
BEND 90 DEG
TEE REDUCING
TEE
CLEAN TWO-WAY
WYE 45 DEG
WYE 45 DEG DOUBLE
WYE COMBINATION
P-TRAP

PIPE SCHEDULE							
MATERIAL	DIAMETER	LENGTH					
ACRYLONITRILE BUTADIENE STYRENE (ABS)	1 1/2"	21 FT					
ACRYLONITRILE BUTADIENE STYRENE (ABS)	2"	51 FT					
ACRYLONITRILE BUTADIENE STYRENE (ABS)	3"	45 FT					
CROSS-LINKED POLYETHYLENE (PEX)	1/2"	108 FT					
CROSS-LINKED POLYETHYLENE (PEX)	3/4"	35 FT					
POLYVINYL CHLORIDE - RIGID	2"	28 FT					

F	TITTING SCHEDULE	
FITTING	SIZE	QTY
DOMESTIC COLD WATER		
PEX 90 DEGREE ELBOW	1/2"ø-1/2"ø	17
PEX 90 DEGREE ELBOW	3/4"ø-3/4"ø	4
PEX TEE ELBOW	1/2"ø-1/2"ø	4
PEX TEE ELBOW	3/4"ø-3/4"ø	6
PEX TRANSITION ELBOW	1"ø-3/4"ø	2
PEX TRANSITION ELBOW	3/4"ø-1/2"ø	5
DOMESTIC HOT WATER		
PEX 90 DEGREE ELBOW	1/2"ø-1/2"ø	18
PEX 90 DEGREE ELBOW	3/4"ø-3/4"ø	1
PEX TEE ELBOW	1/2"ø-1/2"ø-1/2"ø	3
PEX TEE ELBOW	3/4"ø-3/4"ø-3/4"ø	3
PEX TRANSITION ELBOW	3/4"ø-1/2"ø	4
RAIN WATER PVC 90 DEG BEND ELBOW	2"ø-2"ø	9
SEWAGE		
ABS 90 DEG BEND ELBOW	3"ø-3"ø	1
ABS 90 DEGREE BEND ELBOW	1 1/2"ø-1 1/2"ø	3
ABS 90 DEGREE BEND ELBOW	2"ø-2"ø	2
ABS 90 DEGREE BEND ELBOW	3"ø-3"ø	1
ABS P-TRAP	1 1/2"ø-1 1/2"ø	5
ABS P-TRAP	2"ø-2"ø	2
ABS REDUCER ELBOW	2"ø-1 1/2"ø	1
ABS REDUCER ELBOW	3"ø-1 1/2"ø	1
ABS REDUCER ELBOW	3"ø-2"ø	1
ABS TEE ELBOW	1 1/2"ø-1 1/2"ø-1 1/2"ø	1
ABS TEE ELBOW	2"ø-2"ø	1
ABS TEE ELBOW	3"ø-3"ø-3"ø	4
ABS TEE REDUCER ELBOW	3"ø-3"ø-1 1/2"ø	3
ABS TEE REDUCER ELBOW	3"ø-3"ø-2"ø	1
ABS TEE REDUCER ELBOW	3"ø-3"ø	1
WASTE DOUBLE TEE	2"ø-2"ø-2"ø	1
VENT		
ABS VENT CAP ELBOW	2"ø	3
ABS VENT CAP ELBOW	3"ø	2

	I	FIX	TURE	CONN	ECT	ION	SCI	HED	ULE	
FAMILY	W	V	TRAP	CW HW	QTY	DFU	TOT.	WFU	TOT.	NOTES

DISHWASHER	2"	1-1/2"	1-1/2"	1/2"	1/2"	1	0	DRAIN TO SEWER SEE PLANS
DRYER	N/A	N/A	N/A	N/A	N/A	1	0	
HANGING PIPES CLAMP						6	0	
SHOWER TRAY	2"	1-1/2"	1-1/2"	1/2"	1/2"	2	0	
SHOWER TRIM	-	-	-	1/2"	1/2"	2	0	
SINK ISLAND SINGLE	2"	1-1/2"	1-1/2"	1/2"	1/2"	1	0	
VANITY SINK	2"	1-1/2"	1-1/2"	1/2"	1/2"	2	0	
WASHER	2"	1-1/2"	2"	1/2"	1/2"	1	0	DRAINS TO GRAY WATER OR SEWER SEE PLANS
WATER CLOSET						2	0	
WATER HEATER	N/A	N/A	N/A	3/4"	3/4"	1	0	

FIXTURE SCHEDULE									
TIXTORE COLLEGE									
FIXTURE	QTY	DESCRIPTION							
DISHWASHER	1	DRAIN TO SEWER SEE PLANS							
DRYER	1								
HANGING PIPES CLAMP	6								
SHOWER TRAY	2								
SHOWER TRIM	2								
SINK ISLAND SINGLE	1								
VANITY SINK	2								
WASHER	1	DRAINS TO GRAY WATER OR SEWER SEE PLANS							
WATER CLOSET	2								
WATER HEATER	1								

ACC	ACCESSORIES & FITTINGS SCHEDULE								
FIXTURE	QTY	DESCRIPTIONS							
DISHWASHER CONNECTOR	1								
HOSE BIB	1								
LAUNDRY SWEAT CONNECTOR	1								
SHUTOFF VALVE	8								

PLUMBING SCHEDULE									
FIXTURE	TRAP	WASTE	VENT	C.W	H.W				
DISHWASHER	1-1/2"	2"	1-1/2"	1/2"	1/2"				
DRYER	N/A	N/A	N/A	N/A	N/A				
SHOWER TRAY	1-1/2"	2"	1-1/2"	1/2"	1/2"				
SHOWER TRIM	-	-	-	1/2"	1/2"				
SINK ISLAND SINGLE	1-1/2"	2"	1-1/2"	1/2"	1/2"				
VANITY SINK	1-1/2"	2"	1-1/2"	1/2"	1/2"				
WASHER	2"	2"	1-1/2"	1/2"	1/2"				
WATER CLOSET									
WATER HEATER	N/A	N/A	N/A	3/4"	3/4"				

WATER FIXTURE UNIT SCHEDULE								
FAMILY	QTY	UNIT VALUE	TOTAL					
DIOLIMA OLIED								
DISHWASHER	1		0					
DRYER	1		0					
HANGING PIPES CLAMP	6		0					
SHOWER TRAY	2		0					
SHOWER TRIM	2		0					
SINK ISLAND SINGLE	1		0					
VANITY SINK	2		0					
WASHER	1		0					
WATER CLOSET	2		0					
WATER HEATER	1		0					

WASTE FIXTURE UNIT SCHEDULE									
FAMILY	QTY	DFU VALUES	TOTAL						
DISHWASHER	1		0						
DRYER	1		0						
HANGING PIPES CLAMP	6		0						
SHOWER TRAY	2		0						
SHOWER TRIM	2		0						
SINK ISLAND SINGLE	1		0						
VANITY SINK	2		0						
WASHER	1		0						
WATER CLOSET	2		0						
WATER HEATER	1		0						



KEY PLAN

NO.	DESCRIPTION	DATE

NOTE:

LEGEND:

PROJECT

80-Hunter-350-3Bd/2Ba Siding-350

DRAWING NAME

NOTE AND SCHEDULE

 CLIENT NAME:

 PROJECT NUMBER:
 0185_15

 DATE:
 2/18/2025 4:12:40 PM


 DESIGNED BY:
 Designer

 DRAWN BY:
 Author

 CHECKED BY:
 Checker


P101

SCALE: 1/2" = 1'-0"

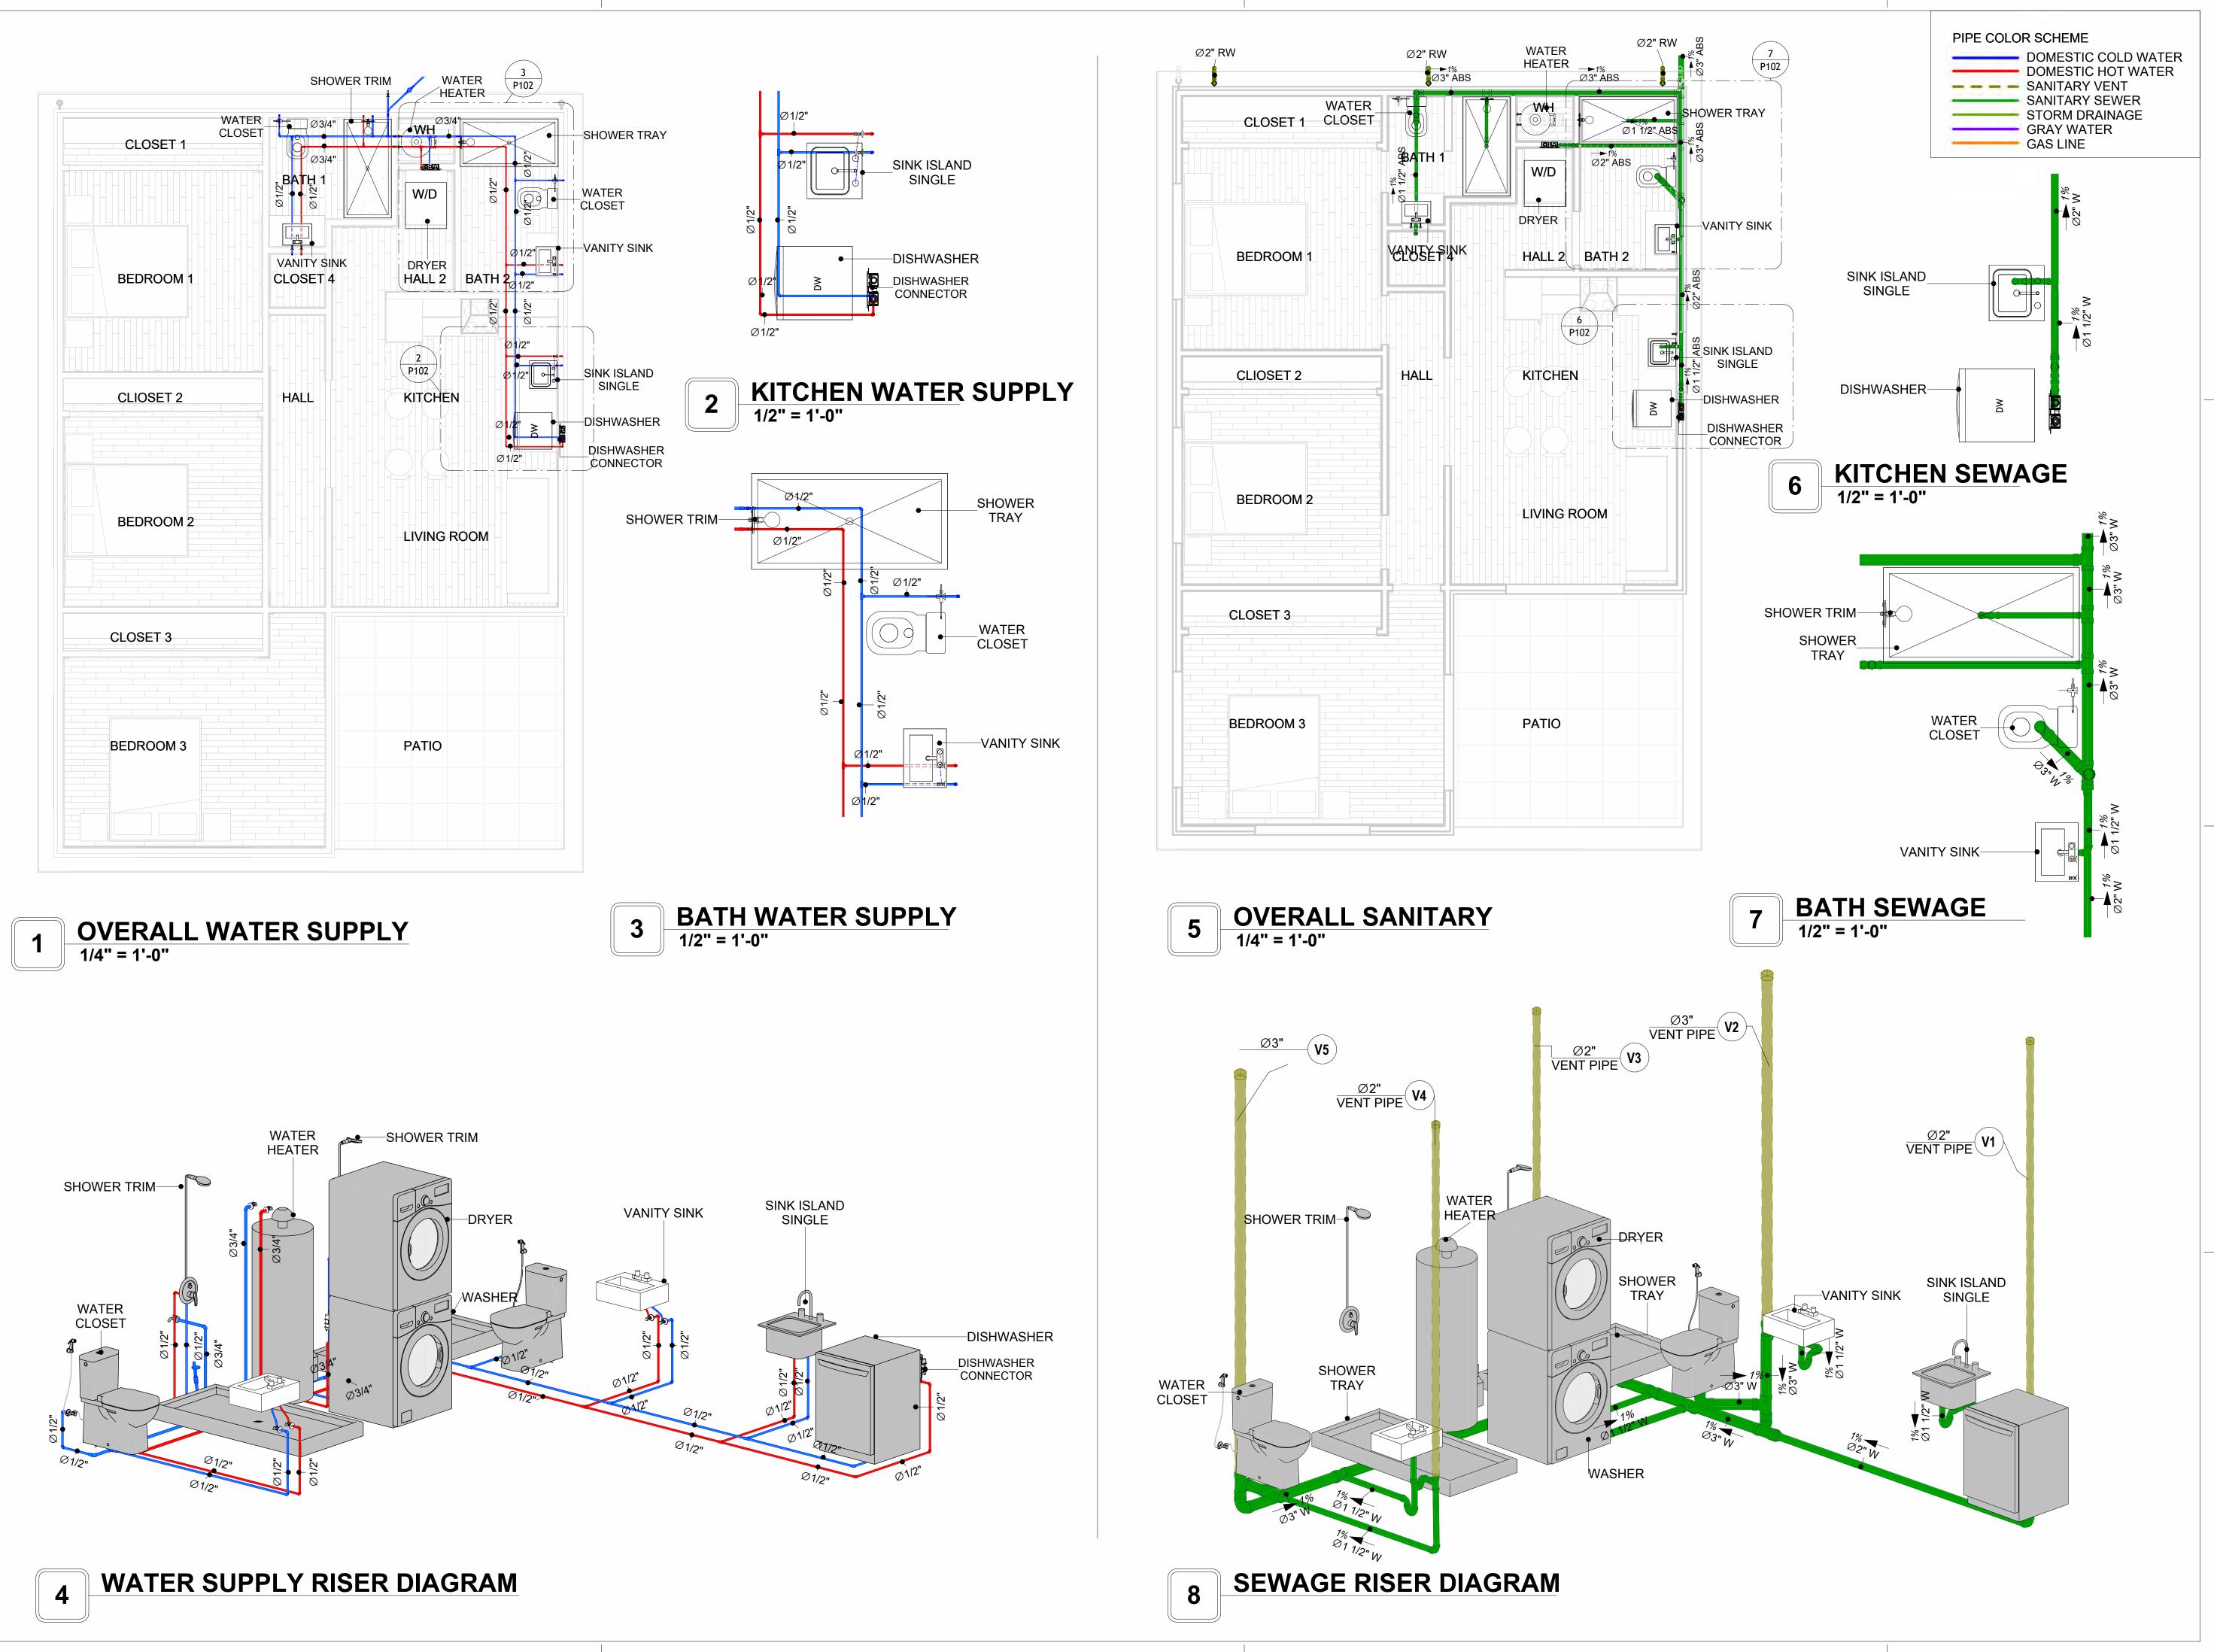



KEY PLAN

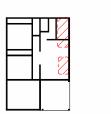

NO. DESCRIPTION DATE

NOTE:

LEGEND:

PROJECT

80-Hunter-350-3Bd/2Ba Siding-350

DRAWING NAME

WATER SUPPLY AND SEWAGE SYSTEM

CLIENT NAME:	
PROJECT NUMBER:	0185_15
DATE:	2/18/2025 4:13:11 PM
DESIGNED BY:	Designer
DRAWN BY:	Author
CHECKED BY:	Checker

P102

Materials Shopping List

Please print and take this Materials Shopping List to your favorite Home Depot and ask for assistance in selecting the materials, fixtures and fittings to complete your new home.

Record your selection and the price of the item. Then do the math to determine the cost for your selections and the total cost of finishing your home.

Have It Your Way!

The material types listed in this document were selected based on personal preferences. The Customer is encouraged to make changes to the material types in accordance with local customs, regulations, and personal preferences.

Have It Your Way!



20 good reasons to frame a home with metal and not wood



Why build your ADU with metal vs wood	Wood	Metal	Explanation
1 DIY Construction Benefit		~	The wall frames, trusses and beams can be erected in a just a few days
2 Minimal Construction Skills Required		~	Pre-assembled walls and trusses require no specialized skills to errect
Build as DIY, Hybrid or by a General Contractor		~	Do it yourself, Hybrid (involve special contractors) or hire a General Contractor
4 Build It As You Can Afford It		~	Impervious to Weather - build as you have the time and money
5 Up Front Cost of Framing Materials	~		As to only the framing material, wood is less expensive
6 Total Cost To Build		~	Savings in time, labor, and other areas make light gauge steel LESS expensive
7 Termites and wood boring insects		~	Termites, carpenter ants and wood boring insects eat wood, not metal
8 Mold resistant		~	Metal does not attract mold
9 Damage caused by exterior and interior flooding		~	Metal needs no reconditioning after a flood
10 Fire Resistant		~	Non-combustible
11 Lower insurance rates		~	Many insurance underwriters now provide lower rates for metal framed homes
12 Walls, trusses, and beams retain their original form		~	Perfectly straight walls - no shimming of drywall
13 Corners are 90 degrees		~	No need for templating of countertops to adjust for out of square corners
14 Strength and weight		~	Metal is stronger than wood and weighs less - no need for crane to lift ADU trusses
15 IBC Engineered Stamp		~	If an engineering stamp is necessary, months of waiting are saved
16 Complete BOM (Materials Shopping List)		~	Take the materials shopping list to Home Depot and start shopping/pricing
17 Flexible in Seismic Areas - Won't Fracture		~	Light gauge steel is flexible and won't fracture when the earth moves
18 No Waste At Job Site		~	Steel is the most recycled material in the world. A typical wood home has 20-30% waste
19 Environmentally Friendly		~	Trees don't have to be destroyed and the source of most metal is from recycling
20 How-To Videos Included		~	How-to videos provide simple assembly instructions
21 Relationship Counselor		~	Eliminate emotional uphevels - save time, money, and preserve the relationship

Universal Requirements - some or all may be required

- 1 Site plan
- 2 Electrical Supply Connection
- 3 Sewer Connection
- 4 Fresh Water Supply Connection
- 5 Set Backs
- 6 Soils Evaluation

- 7 Earthquake (fault) evaluation
- 8 Foundation Plan subject to soils
- 9 Compliance with local energy codes: insulation home wrap and flashing
- 10 Engineering for wind speed and snow load.
- 11 State and Local ordinances regarding ADUs
- 12 Local Architect and/or Engineer may be necessary

Hunter-3Bd 2Ba-Siding





Hunter-3Bd 2Ba-Siding MATERIAL SHOPPING LIST

Have It Your Way!

The material types listed in this document were selected based on personal preferences. The Customer is encouraged to make changes to the material types in accordance with local customs, regulations, and personal preferences. Have It Your Way!

TOC



Name Link Page No Cover Page TOC 2 **ELECTRICAL BOM** 3

1 Cover Page 2 TOC 3 ELECTRICAL BOM 5 HVAC BOM **HVAC BOM** 7 PLUMBING BOM 4 PLUMBING BOM 10 6 ARCHITECTURAL BOM ARCHITECTURAL BOM 15

Table Of Content

Have It Your Way!

The material types listed in this document were selected based on personal preferences. The Customer is encouraged to make changes to the material types in accordance with local customs, regulations, and personal preferences. Have It Your Way!

GENERAL NOTES

- 1 This BOM (Bill of Materials) is prepared as a Materials Shopping List to help builders and DIYers gain a complete understanding of most if not all elements required for the complete construction of this structure, according to the original design documents provided by FrameUpNow.
- 2 All quantities and specifications are subject to change based on the final design, field measurements, availability of products and customer preferences. The customer should verify all information prior to purchasing materials.
- 3 All products and elements in the list shall conform to the International Residential Code (IRC), or any other local and international building codes, safety regulations, and standards that are applicable to the location of the structure.
- 4 If any changes are made by the customer to the list of materials specified in this document, the customer is responsible for assuring that the correct type and quantity of materials are utilized in accordance with local building
- 5 FrameUpNow, will not be held responsible for any misuse of this document, the products listed, or for deviations from the content that are made due to changes in specifications, pricing, availability, or customer preferences.
- 6 The customer is advised to consult a qualified professional or technician prior to purchasing materials for specialized construction system items. Some items including but not limited to caseworks, doors and windows may require as built measurements prior to purchase to confirmation of final dimensions.
- If there are additional trim elements or specific installation methods, the total amount of materials needed might vary. Consider any additional trim required for corners, intersections, or other architectural details that might cause this variations before procedding to purchase and construction.

ARCHITECTURAL BOM



		Н	unter-3Bd	2Ba-Siding		
		ARCHITECT	URAL MAT	ERIAL SHOPPII	NG LIST	
No.	Item	Туре	Unit		Jnit Price Total	Description
Δ	APPLIANCES					
1	Refrigerator		PCS	1		
2	Range		PCS	1		
3	Washer		PCS	1		
4	Dryer		PCS	1		
5	Dish Washer		PCS	1		
6	Oven		PCS	0		
7	Microwave		PCS	0		
Δ	CASEWORKS	'				
1	Kitchen Cabinet		FT	15.5		
2	Laundry Cabinet		FT	2.25		
3	Vanity Cabinet		FT	6.16		
4	Medicine Cabinet		PCS	2		
5	Kitchen countertop		SF	23.68		
6	Laundry Countertop		PCS	0		
7	Bathroom Countertop		SF	0		
8	Island		FT	0		
9	Peninsula		FT	0		
10	Closets	+	SF	210.5		
	CEILING		31	210.3		
1	Ceiling Board	Dr. Well	CF	757		
		Dry Wall	SF PCS	757		
2	Dry Wall Fastener	Screw		1325		
3	Vapor Retarder	Polyethylene film	SF	1233		
4	Vapor Retarder Fastener	Nails with washer heads	PCS	3700		
5	Ceiling Board (MRD)	Moisture resistant drywall	SF	99		
6	MRD Fastener		PCS	173		
7	Ceiling Board	Marine Plywood	SF	377		
8	Marine Plywood Fastener	Screw	PCS	661		
9	Dry Wall Tape		FT	617		
	FLOORING					
1	Main Living Space		SF	292.56		
2	Bathroom		SF	80.39		
3	Bedrooms		SF	417.07		
\triangle	STRUCTURE					
1	Foundation		SF	1,103.36		
	WALLS EXTERIOR					
1	Horizontal Siding		SF	967		
2	Horizontal Siding Fastener	Self-drilling screws(100/pkt)	SF	9.67		
3	Mortar Stone Veneer		SF	0		
4	Wall Homewrap		SF	967		
5	Homewrap Fastener	Stapled fastener (200/pkt)	PKT	3.6746		
6	Furring Strip	` ` ` ` ` `	PCS	120.875		
7	Furring Strip Fastner	Self-drilling screws(100/pkt)	PKT	9.67		
8	Wall Shteathing (OSB)	J 2 3 3 2 2 2 2 2 2 2 2 2 2 2 2 2 2 2 2	SF	967		
9	Shteathing Fastener	Self-drilling screws(100/pkt)	PKT	9.67		
10	Wall Paint		SF	967		
	Wall Insulation		FT	1986		
	WALLS INTERIOR	1		1.700		
	Cementitious Backer Board		SF	548		
	Kerdi membrane		SF	548		
3	Kerdi membrane Fastener		SF	548		
	Wall Ceramic Tile			548		
4			SF			
5	Drywall Board	Colf drilling opening (400/-1-1)	SF	2496		
6	Drywall Fastener	Self-drilling screws(100/pkt)	PKT	24.96		
7	Wall Paint		SF	2496		
_	Drywall Tape		FT	470.9433962		
8	Wall Sweep		FT	246		

ARCHITECTURAL BOM



	DOORS					
1	Exterior Sliding	6' - 0" X 6'-8"	PCS	1		
2	Exterior Swinging	6' - 0" X 6'-8'	PCS	1		
3	Exterior Swinging	2' - 6" X 6'-8'	PCS	1		
4	Interior Sliding	10' - 0" X 6'-8'	PCS	3		
5	Interior Swinging	3' - 0" X 6'-8'	PCS	2		
6	Interior Swinging	2' - 6" X 6'-8'	PCS	3		
7	Interior Swinging	2' - 4" X 6'-8'	PCS	1		
8	Exterior Door Trim		FT	54.52		
9	Interior Door Trim		FT	386.3		
10	Entry Lock Set		PCS	3		
11	Privacy Lock Set		PCS	5		
12	Passage Lock Set		PCS	4		
Δ	WINDOWS					
1	Sliding	6' - 3" X 4'-9"	PCS	4		
2	Sliding	6' - 3" X 2'-3"	PCS	1		
3	Sliding	2' - 3" X 2'-3"	PCS	2		
4	Sliding	3' - 3" X 3'-3"	PCS	1		
5	Exterior Window Trim		FT	124		
6	Interior Window Trim		FT	124		
	ROOF					
1	Roof Covering		SF	1317.0		
2	Roof Covering Fastener		PCS	659		
3	Roof Felt Paper		SF	1317.0		
4	Roof Felt Paper Fastener		PCS	3951.0		
5	Roof Sheathing		SF	1317		
6	Roof Sheathing Fastener		PCS	10536		
7	Batten		FT	0.0		
8	Batten Fastener		PCS	0.0		
9	Soffit		SF	0.0		
10	Soffit Fastener		PCS	0.0		
	Fascia		FT	148.0		
_	Fascia board fastener		PCS	74		
13	Roof Insulation		SF	1317.0		



	Н	unter-3Bd 2Ba-Sid	ling		
	FI FCTRIC	AL MATERIAL SHO	OPPING LIS	Т	
No.	Item	Type	Unit	Quantity	Description
	LIGHTING FIXTURES	1,500	Ome	Quantity	Bosonphon
1	Kitchen Ceiling Light		PCS	4	
2	Exterior Wall Mounted Light		PCS	4	
3	Livingroom Ceiling Light With Fan		PCS	1	
4	Bedroom Ceiling Light With Fan		PCS	3	
5	Dining Ceiling Light		PCS	1	
6	Bath Wall Mounted Light		PCS	2	
7	Bathroom Ceiling Light		PCS	3	
8	Livingroom Ceiling Light		PCS	2	
9	Bedroom Ceiling Light		PCS	12	
10	Hall & Entry Ceiling Light		PCS	5	
11	Closet Ceiling Light		PCS	0	
	Smoke Detector		PCS	5	
	ELECTRICAL FITTINGS		. 55	0	
	Standard Receptacle 120V	20A	PCS	19	
	GFCI Receptacle 120V	20 A	PCS	14	
15	GFCI Receptacle 240V	30 A	PCS	3	
16	GFCI Receptacle 240V	50 A	PCS	1	
17	GFCI Receptacle 240V	60 A	PCS	1	
	Fan Switch	00 A	PCS	3	
	Single Pole Switch		PCS	15	
-	Three Way Switch		PCS	4	
-	Dimmer Switch		PCS	3	
21	ELECTRICAL CONDUITS & WIRING		PCS	3	
	ROMEX 14 AWG	14/2/W/ground	FT	0	
	ROMEX 14 AWG	12/3/W/ground	FT	0	
	ROMEX 12 AWG	12/2/W/ground	FT	615	
	ROMEX 12 AWG	10/3/W/ground	FT	98	
	ROMEX 10 AWG	10/2/W/ground	FT	0	
27	Romex 8 AWG	8/3/W/ground	FT	28	
	Romex 8 AWG	8/2/W/ground	FT		
			FT	62	
	ROMEX 6 AWG Bare Copper Ground Wire 6 AWG	6/3/W/ground	FT	0	
-	ELECTRICAL BOXES & CIRCUTES		11	U	
21		200 AMD	PCS	1	
	Panelboard -240V 1 Phase MLO	200 AMP	PCS	0	
	Circuit breaker	15 A	PCS		
	Circuit breaker	20 A	PCS	15	
	Circuit breaker	30 A	PCS	3	
	Circuit breaker	40 A	PCS	0	
	Circuit breaker	50 A	PCS	1	
	Circuit breaker	60 A		1	
	Single Gang Switch Box		PCS	7	
	Double Gang Switch Box		PCS	3	
	Triple Gang Switch Box	#4.1A	PCS	4	
	Pull Box	#1/4	PCS	30	
43	Receptacle Box		PCS	38	

PLUMBING BOM



		Hunter-	3Bd 2Ba-Si	ding			
	P	LUMBING SYSTEM	MATERIAL	SHOPPIN	IG LIST		
No.	Item	Туре	Unit	Quantity	Unit Price	Total	Description
	PLUMBING FIXTURES & ACCESSORIES						
1	Bath Tub (Alcove Tub)		PCS	0			
2	Kitchen Sink		PCS	1			
3	Kitchen Faucets		PCS	1			
4	Vanity Sink		PCS	2			
5	Bath room Faucets		PCS	2			
6	Water Closet		PCS	2			
7	Shower Trim		PCS	2			
8	Shower Tray		PCS	2			
9	Water Heater		PCS	1			
10	Hose Bib		PCS	2			
11	Shutoff Valve		PCS	8			
12	Hanging pipe clamp		PCS	19			
13	Gate Valve		PCS	1			
14	Dishwasher Supply Single Connector		PCS	1			
15	Dishwasher Sewage Single Connector		PCS	1			
16	Laundry Sweat Connector		PCS	1			
Δ	SANITARY & PLUMBING PIPES						
1	ABS (Acrylonitrile Butadiene Styrene) Pipes	ø 1"	FT	0			
2	ABS (Acrylonitrile Butadiene Styrene) Pipes	ø 1 1/2"	FT	21			
3	ABS (Acrylonitrile Butadiene Styrene) Pipes	ø 2"	FT	51			
4	ABS (Acrylonitrile Butadiene Styrene) Pipes	ø 3"	FT	45			
5	PEX (Cross-linked polyethylene) Pipes	ø 1/2"	FT	108			
6	PEX (Cross-linked polyethylene) Pipes	ø 3/4"	FT	35			
7	PEX (Cross-linked polyethylene) Pipes	ø 1"	FT	0			
8	PVC Pipes Sch.80 - Rigid	ø 1 1/2"	FT	0			
9	PVC Pipes Sch.80 - Rigid	ø 2"	FT	28			
10	PVC Pipes Sch.80 - Rigid	ø 3"	FT	0			
	Flex Pipe Round	ø 1/2"	PCS	8			



Table Of Content

#	Name	Link	Page No
1	Cover Page	<u>Cover Page</u>	1
2	TOC	TOC	2
3	ELECTRICAL BOM	ELECTRICAL BOM	3
5	HVAC BOM	HVAC BOM	7
4	PLUMBING BOM	PLUMBING BOM	10
6	ARCHITECTURAL BOM	ARCHITECTURAL BOM	15

Have It Your Way!

The material types listed in this document were selected based on personal preferences. The Customer is encouraged to make changes to the material types in accordance with local customs, regulations, and personal preferences. Have It Your Way!

GENERAL NOTES

- This BOM (Bill of Materials) is prepared as a Materials Shopping List to help builders and DIYers gain a complete understanding of most if not all elements required for the complete construction of this structure, according to the original design documents provided by FrameUpNow.
- 2 All quantities and specifications are subject to change based on the final design, field measurements, availability of products and customer preferences. The customer should verify all information prior to purchasing materials.
- 3 All products and elements in the list shall conform to the International Residential Code (IRC), or any other local and international building codes, safety regulations, and standards that are applicable to the location of the structure.
- 4 If any changes are made by the customer to the list of materials specified in this document, the customer is responsible for assuring that the correct type and quantity of materials are utilized in accordance with local building codes.
- FrameUpNow, will not be held responsible for any misuse of this document, the products listed, or for deviations from the content that are made due to changes in specifications, pricing, availability, or customer preferences.
- The customer is advised to consult a qualified professional or technician prior to purchasing materials for specialized construction system items. Some items including but not limited to caseworks, doors and windows may require as built measurements prior to purchase to confirmation of final dimensions.
- 7 If there are additional trim elements or specific installation methods, the total amount of materials needed might vary. Consider any additional trim required for corners, intersections, or other architectural details that might cause this variations before procedding to purchase and construction.



			LIGHTING FIXTURES				
#	Item	Туре	Description, Manufacturer, SKU	Unit	Quantity	Unit Price	Total
1	Kitchen Ceiling Light			PCS	4		
3	Exterior Wall Mounted Light			PCS	4		
4	Livingroom Ceiling Light With Fan			PCS	1		
5	Bedroom Ceiling Light With Fan			PCS	3		
6	Dining Ceiling Light			PCS	1		
7	Bath Wall Mounted Light			PCS	2		
8	Bathroom Ceiling Light			PCS	3		
9	Livingroom Ceiling Light			PCS	2		
10	Bedroom Ceiling Light			PCS	12		
11	Hall & Entry Ceiling Light			PCS	5		
12	Closet Ceiling Light			PCS	0		
12	Smoke Detector			PCS	5		
13							
14							
15							



			ELECTRICAL FITTINGS				
‡	Item	Туре	Description, Manufacturer, SKU	Unit	Quantity	Unit Price	Total
L	Standard Receptacle 120V	20A		PCS	19		
2	GFCI Receptacle 120V	20 A		PCS	14		
}	GFCI Receptacle 240V	30 A		PCS	3		
l	GFCI Receptacle 240V	50 A		PCS	1		
5	GFCI Receptacle 240V	60 A		PCS	1		
5	Fan Switch			PCS	3		
,	Single Pole Switch			PCS	15		
3	Three Way Switch			PCS	4		
)	Dimmer Switch			PCS	3		
LO			·				
.1							
.2							
L3							
L4							
L5							



		ELECTR	ICAL CONDUITS & WIRING				
#	Item	Туре	Description, Manufacturer, SKU	Unit	Quantity	Unit Price	Total
1	ROMEX 14 AWG	14/2/W/ground		FT	0		
2	ROMEX 12 AWG	12/3/W/ground		FT	0		
3	ROMEX 12 AWG	12/2/W/ground		FT	615		
4	ROMEX 10 AWG	10/3/W/ground		FT	98		
5	ROMEX 10 AWG	10/2/W/ground		FT	0		
6	Romex 8 AWG	8/3/W/ground		FT	28		
7	Romex 8 AWG	8/2/W/ground		FT	0		
8	ROMEX 6 AWG	6/3/W/ground		FT	62		
9	Bare Copper Ground Wire 6 AWG			FT			
10							
11							
12							
13							
14							
15							
16							



		ELEC	CTRICAL BOXES & CIRCUTES				
#	Item	Туре	Description, Manufacturer, SKU	Unit	Quantity	Unit Price	Total
1	Panelboard -240V 1 Phase MLO	200 AMP		PCS	1		
2	Circuit breaker	15 A		PCS	0		
3	Circuit breaker	20 A		PCS	15		
4	Circuit breaker	30 A		PCS	3		
5	Circuit breaker	50 A		PCS	1		
6	Circuit breaker	60 A		PCS	1		
7	Single Gang Switch Box			PCS	7		
8	Double Gang Switch Box			PCS	3		
9	Triple Gang Switch Box			PCS	4		
10	Pull Box	#1/4		PCS	30		
11	Receptacle Box			PCS	38		
12							
13							
14							
15							

HVAC BOM



			HVAC_DUCTS 01				
#	Item	Туре	Description, Manufacturer, SKU	Unit	Quantity	Unit Price	Total
1	PIPE (REFRIGERANT LINE)	1/4" (Ø)		FT	0.59		
2	PIPE (REFRIGERANT LINE)	3/8" (Ø)		FT	67.43		
3	PIPE (REFRIGERANT LINE)	1/2" (Ø)		FT	0.62		
4	PIPE (REFRIGERANT LINE)	3/4"' (Ø)		FT	109.53		
5	DRAYER HOSE	4" (Ø)		FT	3.4		
6	FLEX DUCT ROUND	4" (Ø)		FT	6.72		

HVAC BOM



			DUCT FITTINGS & ACCESSORIES				
#	Item	Туре	Description, Manufacturer, SKU	Unit	Quantity	Unit Price	Total
1	ELBOW (REFRIGERANT LINE)	1/2" (Ø)-1/2" (Ø)		PCS	1		
2	ELBOW (REFRIGERANT LINE)	3/4" (Ø)-3/4" (Ø)		PCS	27		
3	ELBOW (REFRIGERANT LINE)	3/8" (Ø)-3/8" (Ø)		PCS	14		
4	TEE (REFRIGERANT LINE)	3/4" (Ø)-3/4" (Ø)-3/4"		PCS	2		
5	TEE (REFRIGERANT LINE)	3/8" (Ø)-3/8" (Ø)-3/8"		PCS	2		
6	TRANSITION (REFRIGERANT LINE)	3/4" (Ø)-1/2" (Ø)		PCS	4		
7	TRANSITION (REFRIGERANT LINE)	3/4" (Ø)-5/8" (Ø)		PCS	3		
8	TRANSITION (REFRIGERANT LINE)	3/8" (Ø)-1/4" (Ø)		PCS	1		
9	ROUND TRANSITION(ANGLE)	45 DEGREE		PCS	7		
10							
11							
12							

HVAC BOM



			HVAC_EQUIPMENTS				
#	Item	Туре	Description, Manufacturer, SKU	Unit	Quantity	Unit Price	Total
1	AIR HANDLING UNIT	WALL MOUNTED		PCS	3		
2	CONDENSER	OUTDOOR UNIT		PCS	1		
3	EXHAUST FAN	75 CFM		PCS	2		
1	EXHAUST HOOD	WALL MOUNTED		PCS	1		
5	HOOD-WALL: VENT	HOOD-WALL: VENT		PCS	1		
5	DRAYER: VENT	DRAYER: VENT		PCS	1		
7	ROOF VENT	3"(Ø)		PCS	2		

PLUMBING BOM



		PLUMBII	NG FIXTURES & ACCESSORIES				
#	Item	Туре	Description, Manufacturer, SKU	Unit	Quantity	Unit Price	Total
1	Bath Tub (Alcove Tub)			PCS	C		
2	Kitchen Sink			PCS	1		
3	Kitchen faucets			PCS	1		
4	Vanity Sink			PCS	2		
5	Bath room faucets			PCS	2		
6	Water Closet			PCS	2		
7	Shower Trim			PCS	2		
8	Shower Tray			PCS	2		
9	Water Heater			PCS	1		
10	Hose Bib			PCS	2		
11	Shutoff Valve			PCS	8		
12	Hanging pipe clamp			PCS	6		
13	Gate Valve			PCS	1		
14	Dishwasher Supply Single Connector			PCS	1		
15	Dishwasher Sewage Single Connector			PCS	1		
16	Laundry Sweat Connector			PCS	1		



		SANI	TARY & PLUMBING PIPES				
#	Item	Туре	Description, Manufacturer, SKU	Unit	Quantity	Unit Price	Total
1	ABS (Acrylonitrile Butadiene Styrene) Pipes	ø 1"		FT	0		
2	ABS (Acrylonitrile Butadiene Styrene) Pipes	ø 1 1/2"		FT	21		
3	ABS (Acrylonitrile Butadiene Styrene) Pipes	ø 2"		FT	51		
4	ABS (Acrylonitrile Butadiene Styrene) Pipes	ø 3"		FT	45		
5	PEX (Cross-linked polyethylene) Pipes	ø 1/2"		FT	108		
6	PEX (Cross-linked polyethylene) Pipes	ø 3/4"		FT	35		
7	PEX (Cross-linked polyethylene) Pipes	ø 1"		FT	0		
8	PVC Pipes Sch.80 - Rigid	ø 1 1/2"		FT	0		
9	PVC Pipes Sch.80 - Rigid	ø 2"		FT	28		
10	PVC Pipes Sch.80 - Rigid	ø 3"		FT	0		
11	Flex Pipe Round	ø 1/2"		PCS	8		
12							
13							
14							
15							



		PIPE	FITTINGS 01				
#	Item	Туре	Description, Manufacturer, SKU	Unit	Quantity	Unit Price	Total
	ABS 90 Deg Bend Elbow	3"ø-3"ø		PCS	1		
	ABS 90 Degree Bend Elbow	1 1/2"ø-1 1/2"ø		PCS	3	3	
	ABS 90 Degree Bend Elbow	2"ø-2"ø		PCS	2	2	
	ABS 90 Degree Bend Elbow	3"ø-3"ø		PCS	1		
	ABS P-Trap	1 1/2"ø-1 1/2"ø		PCS	5		
ı	ABS P-Trap	2"ø-2"ø		PCS	2		
	ABS Reducer Elbow	2"ø-1 1/2"ø		PCS	1		
	ABS Reducer Elbow	3"ø-1 1/2"ø		PCS	1		
	ABS Reducer Elbow	3"Ø-2"Ø		PCS	1		
0	ABS TEE Elbow	1 1/2"ø-1 1/2"ø-1 1/2"ø		PCS	1		
1	ABS TEE Elbow	2"Ø-2"Ø-2"Ø		PCS	1		
2	ABS TEE Elbow	3"Ø-3"Ø-3"Ø		PCS	4		
3	ABS Tee Reducer Elbow	3"ø-3"ø-1 1/2"ø		PCS	3	3	
4	ABS Tee Reducer Elbow	3"ø-3"ø-2"ø		PCS	1		
5	ABS Tee Reducer Elbow	3"ø-3"ø-3"ø		PCS	1		



		PI	PE FITTINGS 02				
#	Item	Туре	Description, Manufacturer, SKU	Unit	Quantity	Unit Price	Total
	ABS Vent Cap Elbow	2"ø		PCS	3		
	ABS Vent Cap Elbow	3"ø		PCS	2		
	PEX 90 Degree Elbow	1/2"ø-1/2"ø		PCS	35		
	PEX 90 Degree Elbow	3/4"ø-3/4"ø		PCS	5		
	PEX Tee Elbow	1/2"ø-1/2"ø-1/2"ø		PCS	7		
ı	PEX Tee Elbow	3/4"ø-3/4"ø-3/4"ø		PCS	9		
	PEX Transition Elbow	1"ø-3/4"ø		PCS	2		
	PEX Transition Elbow	3/4"ø-1/2"ø		PCS	9		
	PVC 90 Deg Bend Elbow	2"ø-2"ø		PCS	9		
0	WASTE DOUBLE TEE	2"ø-2"ø-2"ø		PCS	1		
1							
2							
3							
4							
5							



			APPLIANCES				
#	Item	Туре	Description, Manufacturer, SKU	Unit	Quantity	Unit Price	Total
1	Refrigerator			PCS			
2	Range			PCS			
3	Washer Front Load	Stackable		PCS			
4	Dryer Front Load	Stackable		PCS			
5	Dish Washer			PCS			
6	Oven			PCS	(
7	Microwave			PCS	(
8							
9							
10							
11							
12							
13							
14							
15							
16							



			CASEWORKS 01				
#	Item	Туре	Description, Manufacturer, SKU	Unit	Quantity	Unit Price	Total
1	Kitchen Cabinet			FT	15.5		
2	Laundry Cabinet			FT	2.25		
3	Vanity Cabinet			FT	6.16		
4	Medicine Cabinet			PCS	2		
5	Kitchen countertop			SF	23.68		
6	Laundry Countertop			PCS	0		
7	Bathroom Countertop			SF	0		
8	Island			FT	0		
9	Peninsula			FT	0		
10	Closets			SF	210.5		
11							
12							
13							
14							
15							



	1		CEILING 01				
#	Item	Туре	Description, Manufacturer, SKU	Unit	Quantity	Unit Price	Total
	LIVING ROOM + KITCHEN			SF	207.0		
1	Ceiling Board	Drywall		SF	207		
2	Drywall Fastener	Screw		PCS	362		
3	Vapor Retarder	Polyethylene film		SF	207		
4	Vapor Retarder Fastener	Nails with washer heads		PCS	621		
	BATH 1			SF	48.2		
5	Ceiling Board	MRD (Moisture resistant drywall)		SF	48		
5	MRD Fastener	Screw		PCS	84		
	BATH 2			SF	50.7		
7	Ceiling Board	MRD (Moisture resistant drywall)		SF	51		
3	MRD Fastener	Screw		PCS	89		
	HALL +WD			SF	84.5		
)	Ceiling Board	Drywall		SF	84		
10	Drywall Fastener	Screw		PCS	148		
11	Vapor Retarder	Polyethylene film		SF	84		
12	Vapor Retarder Fastener	Nails with washer heads		PCS	253.4		



			CEILING 02				
#	Item	Туре	Description, Manufacturer, SKU	Unit	Quantity	Unit Price	Total
	BED ROOM 1			SF	120.2		
1	Ceiling Board	Drywall		SF	120		
2	Drywall Fastener	Screw		PCS	210		
3	Vapor Retarder	Polyethylene film		SF	120		
4	Vapor Retarder Fastener	Nails with washer heads		PCS	361		
	BED ROOM 2			SF	115.2		
5	Ceiling Board	Drywall		SF	115		
6	Drywall Fastener	Screw		PCS	202		
7	Vapor Retarder	Polyethylene film		SF	115		
8	Vapor Retarder Fastener	Nails with washer heads		PCS	346		
	BED ROOM 3			SF	155.7		
9	Ceiling Board	Drywall		SF	156		
10	Drywall Fastener	Screw		PCS	273		
11	Vapor Retarder	Polyethylene film		SF	156		
12	Vapor Retarder Fastener	Nails with washer heads		PCS	467		



			CEILING 03				
#	Item	Туре	Description, Manufacturer, SKU	Unit	Quantity	Unit Price	Total
	CLOSET 1			SF	21.9		
13	Ceiling Board	Drywall		SF	22		
14	Drywall Fastener	Screw		PCS	38		
15	Vapor Retarder	Polyethylene film		SF	22		
16	Vapor Retarder Fastener	Nails with washer heads		PCS	66		
	CLOSET 2			SF	21.9		
17	Ceiling Board	Drywall		SF	22		
18	Drywall Fastener	Screw		PCS	38		
19	Vapor Retarder	Polyethylene film		SF	22		
20	Vapor Retarder Fastener	Nails with washer heads		PCS	66		
	CLOSET 3			SF	22.8		
21	Ceiling Board	Drywall		SF	23		
22	Drywall Fastener	Screw		PCS	40		
23	Vapor Retarder	Polyethylene film		SF	23		
24	Vapor Retarder Fastener	Nails with washer heads		PCS	68		



			CEILING 04				
#	Item	Туре	Description, Manufacturer, SKU	Unit	Quantity	Unit Price	Total
	WH			SF	7.9		
13	Ceiling Board	Drywall		SF	8		
14	Drywall Fastener	Screw		PCS	14		
15	Vapor Retarder	Polyethylene film		SF	8		
16	Vapor Retarder Fastener	Nails with washer heads		PCS	24		
	PATIO			SF	377.5		
17	Ceiling Board	Marine Plywood		SF	377		
18	Exterior Grade Plywood	Screw		PCS	661		



	<u>)</u>		FLOORING INTERIOR 01				
#	Item	Туре	Description, Manufacturer, SKU	Unit	Quantity	Unit Price	Total
	BEDROOM 1						
1	Bedroom Flooring			SF	120.08		
2	Wood underlay	Foam Pad Polyethylene		SF	120.08		
3	Vapor Retarder	Vapor Barrier Polyethylene		SF	120.08		
	BEDROOM 2						
4	Bedroom Flooring			SF	115.07		
5	Wood underlay	Foam Pad Polyethylene		SF	115.07		
6	Vapor Retarder	Vapor Barrier Polyethylene		SF	115.07		
	BEDROOM 3						
4	Bedroom Flooring			SF	115.52		
5	Wood underlay	Foam Pad Polyethylene		SF	115.52		
6	Vapor Retarder	Vapor Barrier Polyethylene		SF	115.52		
	CL #1						
7	Closet Flooring			SF	21.83		
8	Wood underlay	Foam Pad Polyethylene		SF	21.83		
9	Vapor Retarder	Vapor Barrier Polyethylene		SF	21.83		



			FLOORING INTERIOR 01				
#	Item	Туре	Description, Manufacturer, SKU	Unit	Quantity	Unit Price	Total
	CL #2						
10	Closet Flooring			SF	21.83	3	
11	Wood underlay	Foam Pad Polyethylene		SF	21.83	3	
12	Vapor Retarder	Vapor Barrier Polyethylene		SF	21.83	}	
	CL #3						
10	Closet Flooring			SF	22.74	1	
11	Wood underlay	Foam Pad Polyethylene		SF	22.74	1	
12	Vapor Retarder	Vapor Barrier Polyethylene		SF	22.74	1	
	CL #4						
10	Closet Flooring		1	SF	8.69)	
11	Wood underlay	Foam Pad Polyethylene		SF	8.69)	
12	Vapor Retarder	Vapor Barrier Polyethylene		SF	8.69)	
	LIVING ROOM AND KITCHEN						
13	Living Area Flooring		,	SF	283.8	1	'
14	Wood underlay	Foam Pad Polyethylene		SF	283.8	1	
15	Vapor Retarder	Vapor Barrier Polyethylene		SF	283.8	1	



			FLOORING INTERIOR 02				
#	Item	Туре	Description, Manufacturer, SKU	Unit	Quantity	Unit Price	Total
	BATHROOM 1						
11	Tile Finish			SF	26.55		
12	Adhesive	1/2" Thin set Mortar		SF	26.55		
13	Vapor Retarder	Vapor Barrier Polyethylene		SF	26.55		
	BATHROOM 2						
11	Tile Finish			SF	36.95		
12	Adhesive	1/2" Thin set Mortar		SF	36.95		
13	Vapor Retarder	Vapor Barrier Polyethylene		SF	36.95		
	W/D						
14	Tile Finish			SF	8.98		
15	Adhesive	1/2" Thin set Mortar		SF	9		
16	Vapor Retarder	Vapor Barrier Polyethylene		SF	9.0		
	BOILER ROOM						
17	Tile Finish			SF	8		
18	Adhesive	1/2" Thin set Mortar		SF	8		
19	Vapor Retarder	Vapor Barrier Polyethylene		SF	7.9		



			FLOORING EXTERIOR			
#	Item	Туре	Description, Manufacturer, SKU	Unit	Quantity	Unit Price
	STRUCTURE			SF	1,103.36	
1	Concrete Slab	4"concrete cast in situ		CF	367.79	
2	Insulation	Rigid insulation		SF	287.74	
3	Hard core	Compacted soil		CF	300.24	
4	Re-bar	#4 re-bar		Ton	0.99	
5	Concrete Pad	4"concrete cast in situ		CF	1.58	
6	Slab edge	Turndown		CF	243.86	
7	Footing	Cast-in-place concrete		CF	6	
	PORCH FRONT					
1	Tile Finish			SF	164.67	
2	Adhesive	1/2" Thin set Mortar		SF	164.67	
3	Vapor Retarder	Vapor Barrier Polyethylene		SF	164.67	



			WALLS: EXTERIOR				
#	Item	Туре	Description, Manufacturer, SKU	Unit	Quantity	Unit Price	Total
1	Horizontal Siding			SF	967		
2	Horizontal Siding Fastener	Self-drilling screws(100/pkt)		SF	9.67		
3	Mortar Stone Veneer			SF	0		
4	Wall Homewrap			SF	967		
5	Homewrap Fastener	Stapled fastener (200/pkt)		PKT	3.6746		
6	Furring Strip			PCS	120.88		
7	Furring Strip Fastner	Self-drilling screws(100/pkt)		PKT	9.67		
8	Wall Shteathing (OSB)			SF	967		
9	Shteathing Fastener	Self-drilling screws(100/pkt)		PKT	9.67		
10	Wall Paint			SF	967		
11	Wall Insulation			FT	1986		
12							
13							
14							
15							



			WALLS: INTERIOR 01				
#	Item	Туре	Description, Manufacturer, SKU	Unit	Quantity	Unit Price	Total
	BATH 1			SF	38.0		
1	Cementitious Backer Board			SF	238	}	
2	Kerdi membrane			SF	238		
3	Kerdi membrane Fastener			SF	238		
4	Wall Ceramic Tile			SF	238	3	
	BATH 2			SF	49.0		
5	Cementitious Backer Board			SF	213		
6	Kerdi membrane			SF	213		
7	Kerdi membrane Fastener			SF	213		
8	Wall Ceramic Tile			SF	213	}	
	BEDROOM 1			SF	120.0		
9	Drywall Board			SF	232		
10	Drywall Fastener	Self-drilling screws(100/pkt)		PKT	2.32		
11	Wall Paint			SF	232		
12	Drywall Tape			FT	43.50271892		



			WALLS: INTERIOR 02				
#	Item	Туре	Description, Manufacturer, SKU	Unit	Quantity	Unit Price	Total
	BEDROOM 2			SF	113.0		
13	Drywall Board			SF	269		
14	Drywall Fastener	Self-drilling screws(100/pkt)		PKT	2.69		
15	Wall Paint			SF	269		
16	Drywall Tape			FT	50.46904315		
	BEDROOM 3			SF	157.0		
17	Drywall Board			SF	339		
18	Drywall Fastener	Self-drilling screws(100/pkt)		PKT	3.39		
19	Wall Paint			SF	339		
20	Drywall Tape			FT	63.96226415		
21	LIVING ROOM			SF	128.0		
22	Drywall Board			SF	244		
23	Drywall Fastener	Self-drilling screws(100/pkt)		PKT	2.44		
24	Wall Paint			SF	244		
25	Drywall Tape			FT	46.03773585		



			WALLS: INTERIOR 03				
#	Item	Туре	Description, Manufacturer, SKU	Unit	Quantity	Unit Price	Total
	KITCHEN			SF	78.0		
26	Cementitious Backer Board			SF	27		
27	Drywall Board			SF	141		
28	Drywall Fastener	Self-drilling screws(100/pkt)		PKT	1.41		
29	Kerdi membrane			SF	27		
30	Kerdi membrane Fastener			SF	27		
31	Wall Ceramic Tile			SF	27		
32	Wall Paint			SF	141		
33	Drywall Tape			FT	26.60377358		
	CLOSET 1			SF	25.0		
34	Drywall Board			SF	136		
35	Drywall Fastener	Self-drilling screws(100/pkt)		PKT	1.36		
36	Wall Paint			SF	136		



			WALLS: INTERIOR 04				
#	Item	Туре	Description, Manufacturer, SKU	Unit	Quantity	Unit Price	Total
	CLOSET 2			SF	26.0		
37	Drywall Board			SF	154		
38	Drywall Fastener	Self-drilling screws(100/pkt)		PKT	1.54		
39	Wall Paint			SF	154		
40	Drywall Tape			FT	29.05660377		
	CLOSET 3			SF	24.0)	
41	Drywall Board			SF	174		
42	Drywall Fastener	Self-drilling screws(100/pkt)		PKT	1.74		
43	Wall Paint			SF	174		
44	Drywall Tape			FT	32.83018868	8	
	CLOSET 4			SF	8.0		
45	Drywall Board			SF	72		
46	Drywall Fastener	Self-drilling screws(100/pkt)		PKT	0.72		
47	Wall Paint			SF	72		
48	Drywall Tape			FT	13.58490566		



			WALLS: INTERIOR 05				
#	Item	Туре	Description, Manufacturer, SKU	Unit	Quantity	Unit Price	Total
	HALL 1			SF	51.0		
49	Drywall Board			SF	223		
50	Drywall Fastener	Self-drilling screws(100/pkt)		PKT	2.23		
51	Wall Paint			SF	223		
52	Drywall Tape			FT	42.0754717		
	HALL 2			SF	28.0		
53	Drywall Board			SF	101		
54	Drywall Fastener	Self-drilling screws(100/pkt)		PKT	1.01		
55	Wall Paint			SF	101		
56	Drywall Tape			FT	19.05660377		
	WD			SF	9.0		
57	Cementitious Backer Board			SF	70		
58	Kerdi membrane			SF	70		
59	Kerdi membrane Fastener			SF	70		
60	Wall Ceramic Tile			SF	70		



			WALLS: INTERIOR 06				
#	Item	Туре	Description, Manufacturer, SKU	Unit	Quantity	Unit Price	Total
	WH			SF	8.0		
61	Drywall Board			SF	72		
62	Drywall Fastener	Self-drilling screws(100/pkt)		PKT	0.72		
	Wall Paint			SF	72		
64	Drywall Tape			FT	13.58490566		
2	Wall Skirting			FT	04/		
				FT	246		



			DOORS				
#	Item	Туре	Description, Manufacturer, SKU	Unit	Quantity	Unit Price	Total
1	Exterior Sliding	6' - 0" X 6'-8"		PCS	1		
2	Exterior Swinging	6' - 0" X 6'-8'		PCS	1		
3	Exterior Swinging	2' - 6" X 6'-8'		PCS	1		
4	Interior Sliding	10' - 0" X 6'-8'		PCS	3		
5	Interior Swinging	3' - 0" X 6'-8'		PCS	2		
6	Interior Swinging	2' - 6" X 6'-8'		PCS	3		
7	Interior Swinging	2' - 4" X 6'-8'		PCS	1		
8	Exterior Door Trim			FT	54.52		
9	Interior Door Trim			FT	386.3		
10	Entry Lock Set			PCS	3		
11	Privacy Lock Set			PCS	5		
12	Passage Lock Set			PCS	4		
13				. 55			
14							
15							



			WINDOWS				
#	Item	Туре	Description, Manufacturer, SKU	Unit	Quantity	Unit Price	Total
1	Sliding	6' - 3" X 4'-9"		PCS	4		
2	Sliding	6' - 3" X 2'-3"		PCS	1		
3	Sliding	2' - 3" X 2'-3"		PCS	2		
4	Sliding	3' - 3" X 3'-3"		PCS	1		
5	Exterior Window Trim			FT	124		
6	Interior Window Trim			FT	124		
7							
8							
9							
10							
11							
12							
13							
14							
15							



			ROOF 01				
#	Item	Туре	Description, Manufacturer, SKU	Unit	Quantity	Unit Price	Total
1	Roof Covering			SF	1317.0		
2	Roof Covering Fastener			PCS	659		
3	Roof Felt Paper			SF	1317.0		
4	Roof Felt Paper Fastener			PCS	3951.0		
5	Roof Sheathing			SF	1317.0		
6	Roof Sheathing Fastener			PCS	10536		
7	Batten			FT	0.0		
8	Batten Fastener			PCS	0.0		
9	Soffit			SF	0.0		
10	Soffit Fastener			PCS	0.0		
11	Fascia			FT	148.0		
12	Fascia board fastener			PCS	74		
13	Roof Insulation			SF	1317.0		
14					131770		
15							



Δ	PIPE FITTINGS				
1	ABS 90 Deg Bend Elbow	3"ø-3"ø	PCS	1	
2	ABS 90 Degree Bend Elbow	1 1/2"ø-1 1/2"ø	PCS	3	
3	ABS 90 Degree Bend Elbow	2"ø-2"ø	PCS	2	
4	ABS 90 Degree Bend Elbow	3"ø-3"ø	PCS	1	
5	ABS P-Trap	1 1/2"ø-1 1/2"ø	PCS	5	
6	ABS P-Trap	2"ø-2"ø	PCS	2	
7	ABS Reducer Elbow	2"ø-1 1/2"ø	PCS	1	
8	ABS Reducer Elbow	3"ø-1 1/2"ø	PCS	1	
9	ABS Reducer Elbow	3"ø-2"ø	PCS	1	
10	ABS TEE Elbow	1 1/2"ø-1 1/2"ø-1 1/2"ø	PCS	1	
11	ABS TEE Elbow	2"ø-2"ø-2"ø	PCS	1	
12	ABS TEE Elbow	3"ø-3"ø-3"ø	PCS	4	
13	ABS Tee Reducer Elbow	3"ø-3"ø-1 1/2"ø	PCS	3	
14	ABS Tee Reducer Elbow	3"ø-3"ø-2"ø	PCS	1	
15	ABS Tee Reducer Elbow	3"ø-3"ø-3"ø	PCS	1	
16	ABS Vent Cap Elbow	2"ø	PCS	3	
17	ABS Vent Cap Elbow	3"ø	PCS	2	
18	PEX 90 Degree Elbow	1/2"ø-1/2"ø	PCS	35	
19	PEX 90 Degree Elbow	3/4"ø-3/4"ø	PCS	5	
20	PEX Tee Elbow	1/2"ø-1/2"ø-1/2"ø	PCS	7	
21	PEX Tee Elbow	3/4"ø-3/4"ø-3/4"ø	PCS	9	
22	PEX Transition Elbow	1"ø-3/4"ø	PCS	2	
23	PEX Transition Elbow	3/4"ø-1/2"ø	PCS	9	
24	PVC 90 Deg Bend Elbow	2"ø-2"ø	PCS	9	
25	WASTE DOUBLE TEE	2"ø-2"ø-2"ø	PCS	1	

HVAC BOM



Hunter-3Bd 2Ba-Siding HVAC SYSTEM MATERIAL SHOPPING LIST							
\triangle	HVAC_DUCTS						
1	PIPE (REFRIGERANT LINE)	1/4" (Ø)	FT	0.59			
	PIPE (REFRIGERANT LINE)	3/8" (Ø)	FT	67.43			
3	PIPE (REFRIGERANT LINE)	1/2" (Ø)	FT	0.62			
4	PIPE (REFRIGERANT LINE)	3/4''' (Ø)	FT	109.53			
5	DRAYER HOSE	4" (Ø)	FT	3.4			
6	FLEX DUCT ROUND	4" (Ø)	FT	6.72			
\triangle	DUCT FITTINGS & ACCESSORIES						
7	ELBOW (REFRIGERANT LINE)	1/2" (Ø)-1/2" (Ø)	PCS	1			
8	ELBOW (REFRIGERANT LINE)	3/4" (Ø)-3/4" (Ø)	PCS	27			
9	ELBOW (REFRIGERANT LINE)	3/8" (Ø)-3/8" (Ø)	PCS	14			
10	TEE (REFRIGERANT LINE)	3/4" (Ø)-3/4" (Ø)-3/4"	PCS	2			
11	TEE (REFRIGERANT LINE)	3/8" (Ø)-3/8" (Ø)-3/8"	PCS	2			
12	TRANSITION (REFRIGERANT	3/4" (Ø)-1/2" (Ø)	PCS	4			
13	TRANSITION (REFRIGERANT	3/4" (Ø)-5/8" (Ø)	PCS	3			
14	TRANSITION (REFRIGERANT	3/8" (Ø)-1/4" (Ø)	PCS	1			
15	ROUND TRANSITION(ANGLE)	45 DEGREE	PCS	7			
	HVAC_EQUIPMENTS						
14	AIR HANDLING UNIT	WALL MOUNTED	PCS	3			
15	CONDENSER	OUTDOOR UNIT	PCS	1			
16	EXHAUST FAN	75 CFM	PCS	2			
17	EXHAUST HOOD	WALL MOUNTED	PCS	1			
18	HOOD-WALL: VENT	HOOD-WALL: VENT	PCS	1			
19	DRAYER: VENT	DRAYER: VENT	PCS	1			
20	ROOF VENT	3"(Ø)	PCS	2			