



BENNETT

The Bennett is a charming and efficient onebedroom, one-bathroom Spanish-style home. Its exterior exudes a warm and inviting Mediterranean aesthetic. The walls are finished with a textured stucco in a warm, earthy tone, creating a classic and timeless appearance. A simple gable roof with terracotta tiles provides shelter and complements the overall Spanish design. A notable feature is the arched entryway leading to a covered porch, adding a touch of architectural elegance and creating a welcoming outdoor space.

Inside, the Bennett features a simple rectangular layout with the front of the house dedicated to the living, dining, and kitchen areas, which are seamlessly merged into a single large open room. The bedroom is thoughtfully located at the back of the house, offering a private and secluded retreat. Functional spaces such as the bathroom, laundry, and closets are strategically placed between the living areas and the bedroom, creating a clear separation and enhancing the overall functionality of the home.

Materials Shopping List

Please print and take this Materials Shopping List to your favorite Home Depot and ask for assistance in selecting the materials, fixtures and fittings to complete your new home.

Record your selection and the price of the item. Then do the math to determine the cost for your selections and the total cost of finishing your home.

< CLICK HERE >

To Go To Materials Shopping List



16' - 5"


FLOOR PLAN

499 SF

1 Bed Room



TABLE OF CONTENTS

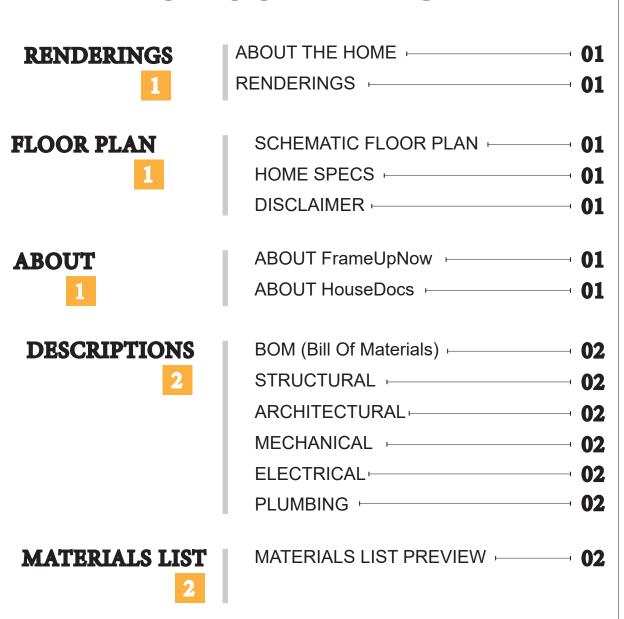

HOW TO BUILD

ARCHITECTURAL

COVER SHEET 03 FLOOR PLAN + DIMENSION PLAN + FOUNDATION PLAN STRUCTURAL FLOOR PLAN -WALL FRAME LAYOUT ROOF TRUSS LAYOUT ROOF PLAN + 10 ARCHITECTURAL ELEVATIONS **12** ARCHITECTURAL ELEVATIONS -ARCHITECTURAL SECTIONS -ARCHITECTURAL DETAILS ARCHITECTURAL CASEWORK

CONSTRUCTION STEPS

STRUCTURAL

MATERIALS

SHOPPING LIST

16	GENERAL NOTES	17
	WALL FRAME LAYOUT	18
	WALL PANEL & LAYOUT PLAN	19
	ROOF TRUSS LAYOUT	20
	STRUCTURAL SECTIONS	21
	WALL BRACING LAYOUT	22
	HOLD-DOWN PLAN	23
	STRUCTURAL DETAILS 1	24
	STRUCTURAL DETAILS 2	25
	STRUCTURAL DETAILS 3	26
	TRUSS BLOCKING LAYOUT	27
	SHEETROCK BACKING	28
	ROOF BRACING LAYOUT	29
MECHANICAL	COVER SHEET -	30
30	HVAC PLAN -	31
ELECTRICAL	SCHEDULE -	32
32	LIGHTING -	33
	POWER PLAN	34
	DIMENSION FOR LIGHTING -	35
	DIMENSION FOR FITTING -	36
PLUMBING	NOTES AND SCHEDULES -	37
37	WATER SUPPLY & SEWAGE SYSTEM +	38

MATERIALS SHOPPING LIST

COVER SHEET

ABOUT



FrameUpNow is a design and manufacturing company providing precision-engineered home framing solutions. We offer a catalog of Affordable Homes, Tiny Homes, Garages, Shops and Barndominiums. FrameUpNow manufactures cold-formed steel (CFS) also known as Light Gauge Steel (LGS) framing components that conform to our engineered metal house frame plans or can be purchased as DIY skeleton kits.

The CFS/LGS framing is lightweight, easily assembled, and does not require heavy equipment or specialized labor, enabling homeowners to erect the frame themselves in just a few days. Unlike wood, the steel framing is impervious termites and bores, warping, expansion, and fire.

Our home plans come complete with a structural engineered stamp for permit approvals. Customers receive a full BOM also known as a Materials Shopping List to purchase finish materials from a Building Materials retailer. FrameUpNow prides itself on the quality and efficiency of our precision-engineered home framing solutions for construction professionals and DIY homeowners.



KEY PLAN

NO.	DESCRIPTION	DATE

NOTE:

LEGEND:

PROJECT

106-Bennett-499-1Bd1Ba-Spanish-550

DRAWING NAME

INTRODUCTION

CLIENT NAME:
PROJECT NUMBER:
DATE:
DESIGNED BY:
DRAWN BY:
CHECKED BY:

I101

SCALE:

© [2024] [FrameUpNow] . All rights reserved

DISCLAIMER: This documentation and all it's contents are the intellectual property of FrameUpNow. It is provided solely for marketing the services of FrameUpNow. The preliminary information is not approved for actual construction use and is not warranted to be complete or accurate. Unauthorized copying, distribution, or application of these proprietary materials, in any form or format, is strictly prohibited.

DISCLAIMER

FrameUpNow assumes no liability for any issues arising from improper use of this marketing content.

DESCRIPTIONS

MATERIALS LIST

The BOM (Bill Of Materials) package, known as the Materials Shopping List document, provides:

Comprehensive Inventory: Detailed lists of essential materials sourced from architectural, mechanical, HVAC, electrical, and plumbing design drawing sets.

Precise Curation: Each item meticulously selected and organized for accuracy and efficiency in project planning.

Customizable Options: Customers can modify listed items to their preferences and calculate costs accordingly, ensuring alignment with personal project needs and budget.

Dedicated Space for Details: Includes tables for customers to note Home Depot SKU numbers or product descriptions for selected items, facilitating seamless purchasing and coordination with suppliers.

Customer Convenience: Take the list to Home Depot or preferred suppliers for accurate pricing, helping align the total home budget with personal financial plans.

Simplify your construction journey with our Materials Shopping List document, where detailed preparation meets streamlined implementation for your dream home.

STRUCTURAL

The structural drawings package provides an exhaustive set of detailed plans essential for the precise assembly of your building. This comprehensive package includes:

Framing Plans: Detailed layouts for all framing components. Truss Layouts: Clear instructions for truss placement and

Panel Length Plans: Specifications for panel dimensions. Framing Elevations and Sections: Precise elevation and sectional views for accurate construction.

Truss and Wall Blocking Plans: Plans for truss and wall blocking to ensure structural integrity.

Hold-Down Plan: Detailed hold-down requirements for stability. Snap Sheet: Reference sheet for quick identification of components

Structural Details and Bracing Plans: Complete details and bracing plans for all structural elements.

Accompanying these plans is a comprehensive Bill of Materials (BOM) that lists every necessary building component, from cold formed steel (CFS) frames to fasteners.

ARCHITECTURAL

With the comprehensive architectural package, both builders and DIY homeowners can confidently execute the construction.

The architectural package includes:

Furnished Floor Plans: Complete with furniture layouts for a clear understanding of space utilization.

Detailed Dimension Plans: Ensures precise measurements, from the overall footprint down to the exact placement of windows and

Foundation Plan: Detailed plan to establish a solid foundation.

Wall Framing and Truss Layout: Comprehensive plans for wall framing and truss placement.

Architectural Elevations: Exterior views showcasing the design.

Strategic Building Sections: Critical cross-sectional details for a thorough understanding of the build.

Casework Drawings and Diagrams: Suggested designs for built-in caseworks, such as kitchen cabinets.

MECHANICAL

The mechanical package includes everything needed to guide HVAC

Detailed HVAC Floor Plan: Precisely maps out the placement of air handlers, ductwork, and vents throughout the home's layout.

HVAC Sections and Riser Diagrams: Technical drawings offering critical cross-sectional details and piping schematics, ensuring proper integration of the heating and cooling system into the home's structure.

Bill of Materials: A complete list of all necessary HVAC components.

ELECTRICAL

The electrical package includes all the plans and documentation needed to guide the installation of your home's electrical system:

Detailed Power Plan: Precisely maps out the placement of outlets, switches, and other power components throughout the layout.

Comprehensive Lighting Plan: Shows the optimal locations for lighting fixtures, sconces, and other illumination sources to create a well-lit, functional interior.

Dimensioned Electrical Layout: Provides exact dimensions and measurements to ensure proper placement of all electrical elements.

Bill of Materials: A complete list of every component needed, from circuit breakers to wiring.

The plumbing package includes everything needed to guide the installation of your home's water supply and drainage systems:

Detailed Water Supply System Plan: Precisely maps out the placement of pipes, valves, and plumbing fixtures throughout the

Comprehensive Sewage System Plan: Shows the optimal routing and sizing of drain lines to effectively remove waste and ensure

Detailed Riser Diagrams: Provide information needed to properly

pipes to fixtures.

PLUMBING

proper drainage.

install all vertical plumbing risers and vent stacks.

Bill of Materials: A complete list of every component needed, from


BOM (Bill Of Materials) (Separately Attached)





The Bill of Materials (BOM) is a crucial document that compiles the material requirements from different disciplines into a centralized inventory, enabling efficient procurement, inventory management, and cost estimation for a specified project or

ELECTRICAL BOM



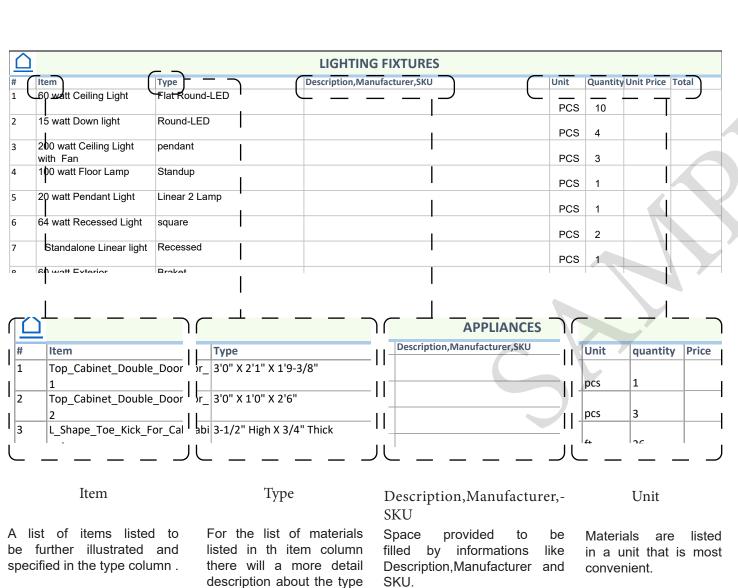

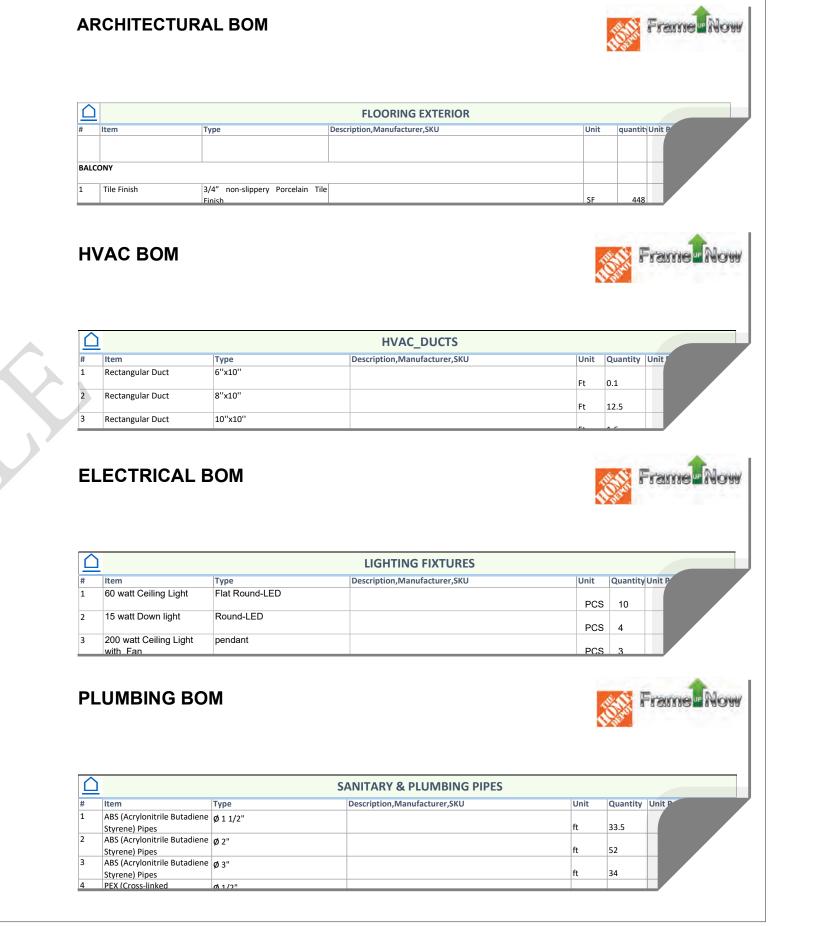

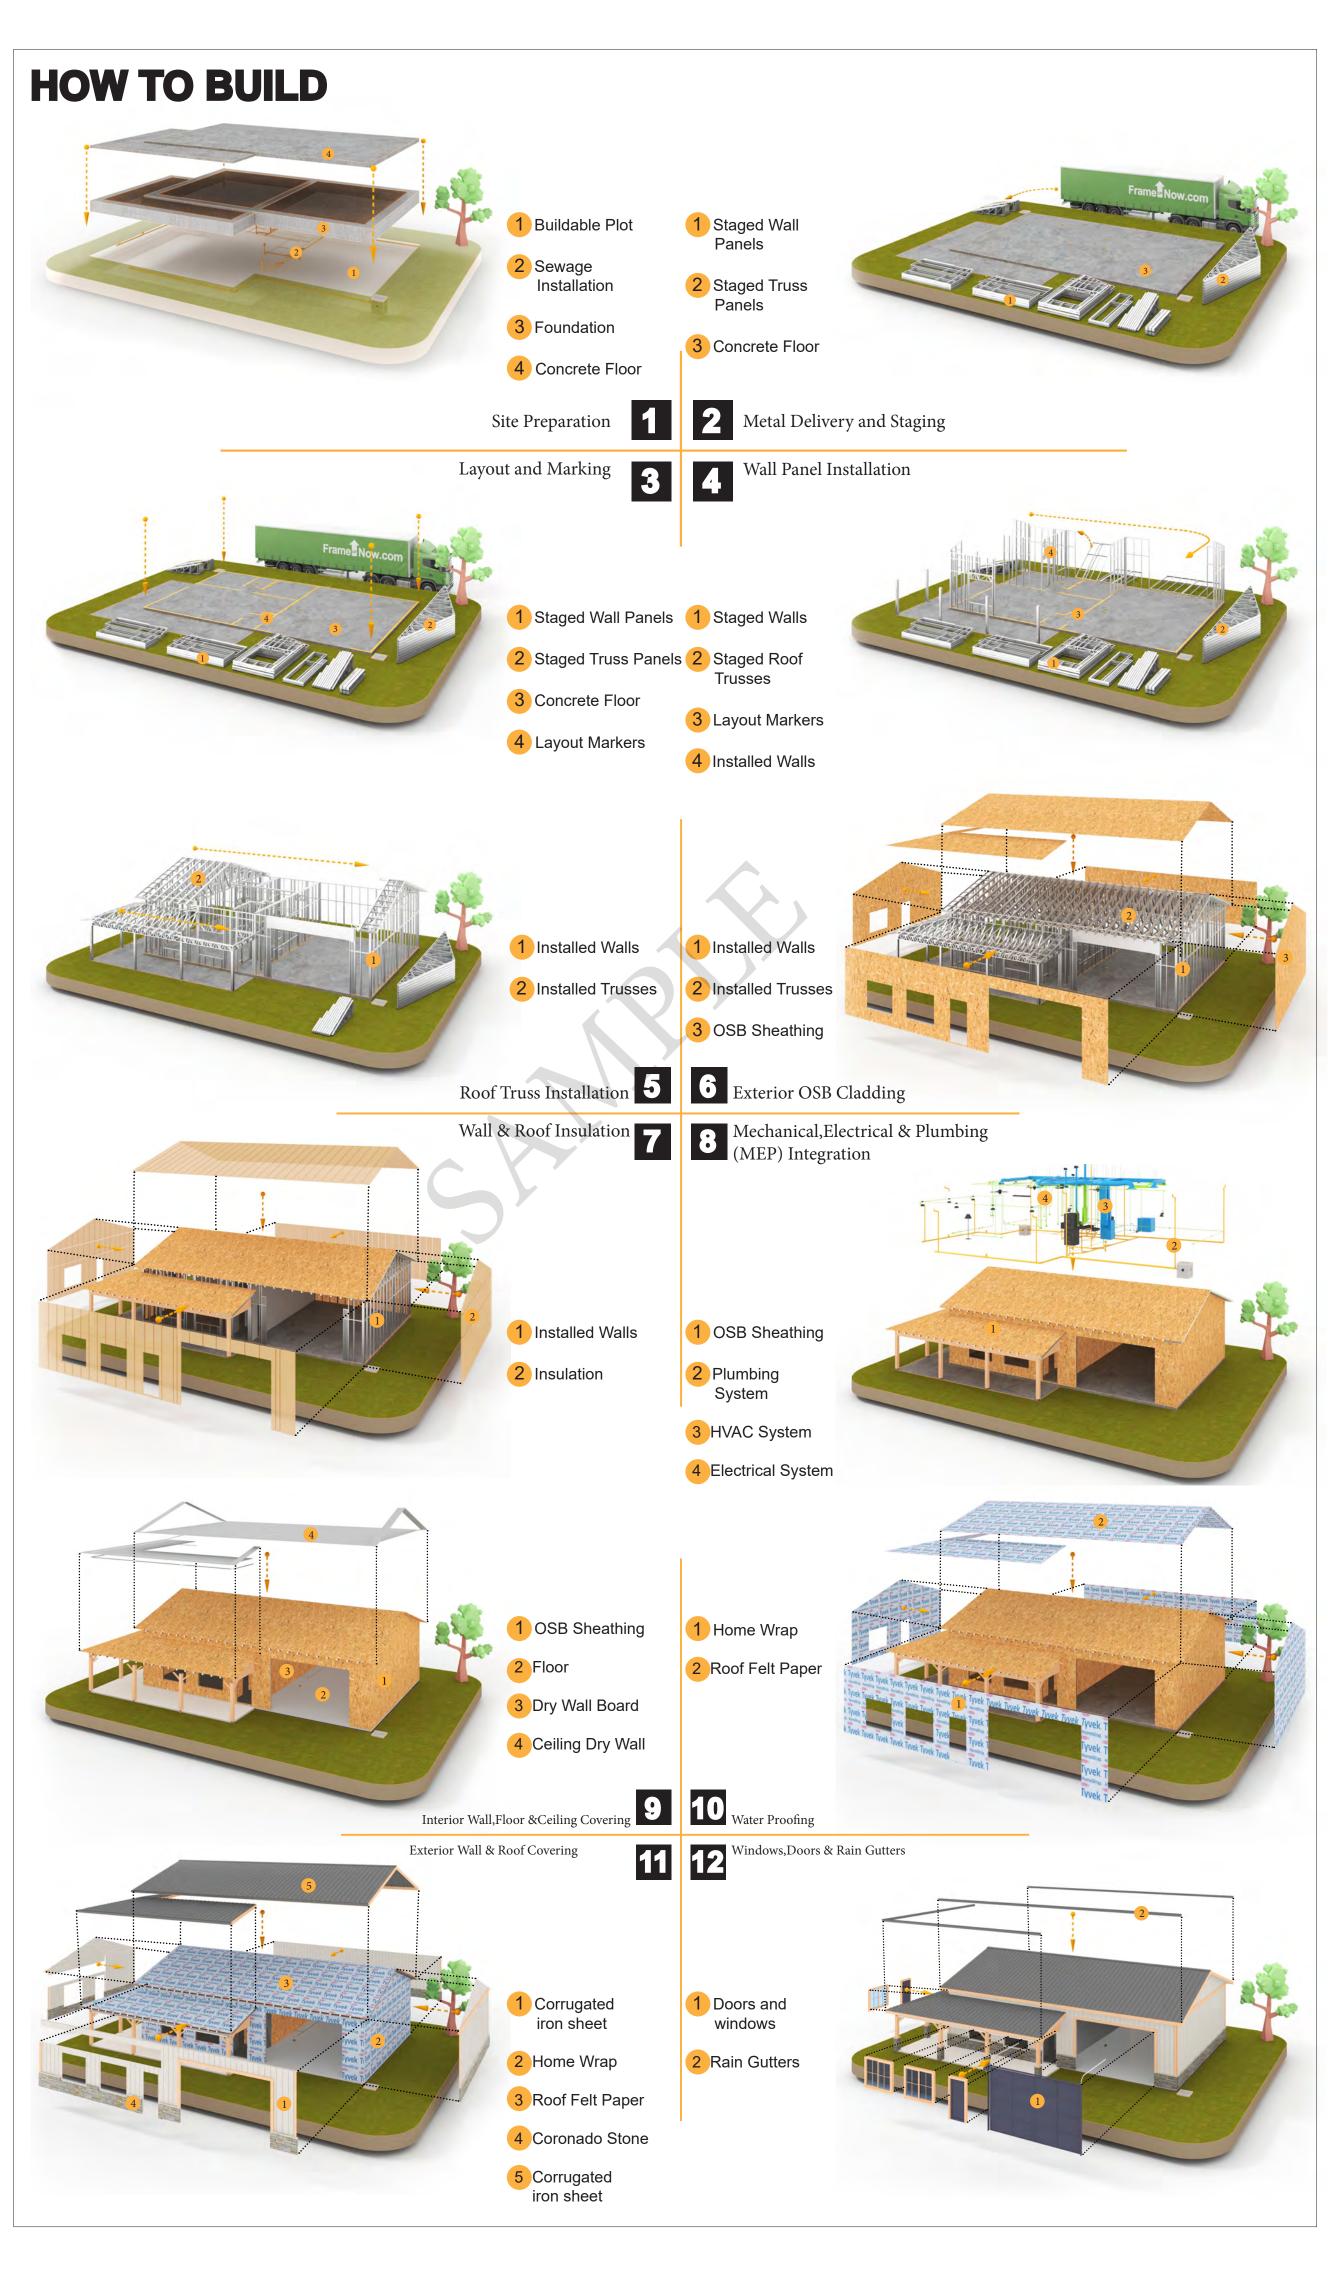



KEY PLAN

NO.	DESCRIPTION	DATE

NOTE:

LEGEND:

PROJECT

106-Bennett-499-1Bd1Ba-Spanish-550

DRAWING NAME


INTRODUCTION

CLIENT NAME: PROJECT NUMBER: DATE: **DESIGNED BY** DRAWN BY: CHECKED BY:

1102

SCALE:

of the Material.

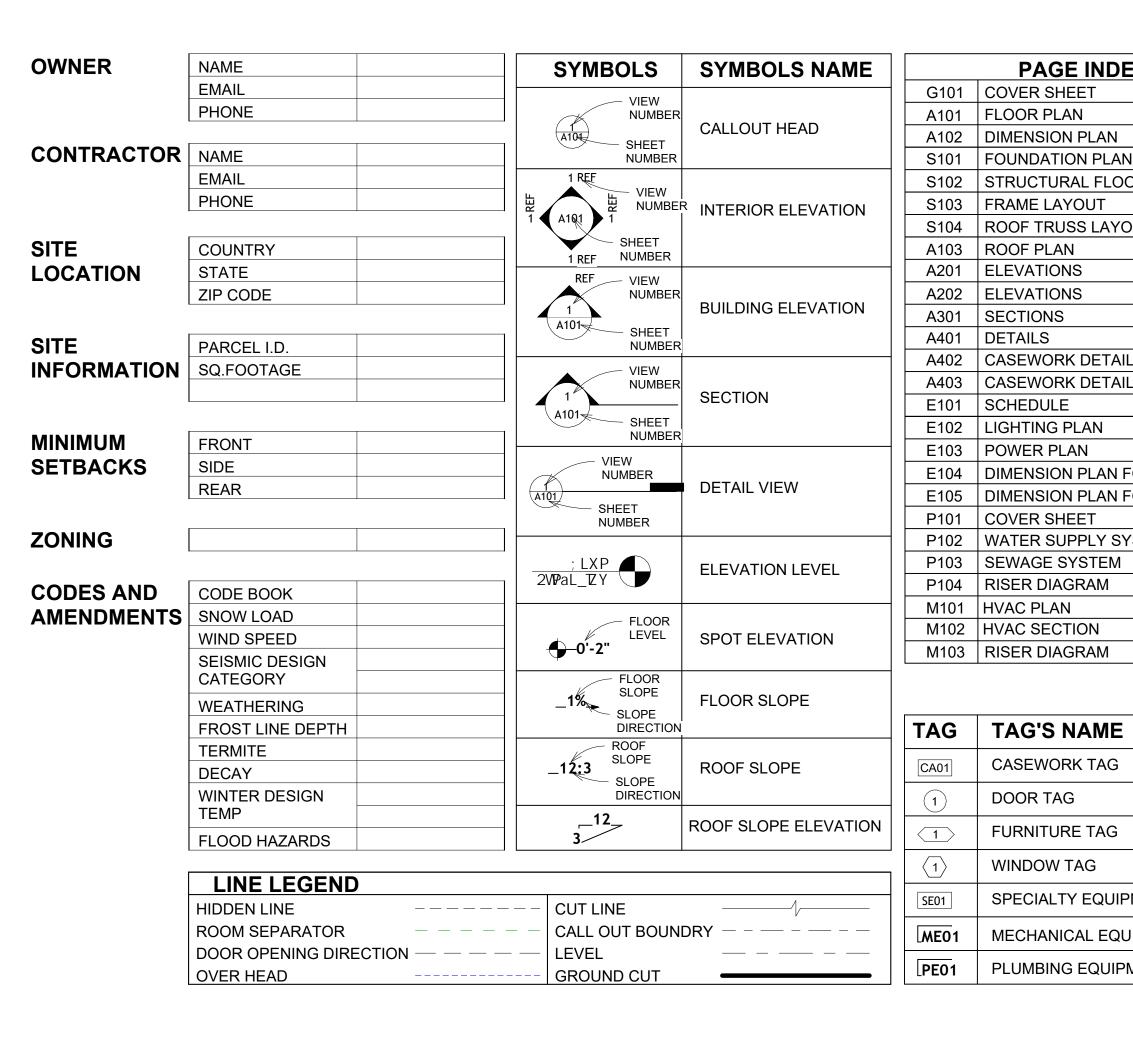

	PAGE INDEX
G101	COVER SHEET
A101	FLOOR PLAN
A102	DIMENSION PLAN
S101	FOUNDATION PLAN
S102	STRUCTURAL FLOOR PLAN
S103	FRAME LAYOUT
S104	ROOF TRUSS LAYOUT
A103	ROOF PLAN
A201	ELEVATIONS
A202	ELEVATIONS
A301	SECTIONS
A401	DETAILS
A402	CASEWORK DETAILS
A403	CASEWORK DETAILS
E101	SCHEDULE
E102	LIGHTING PLAN
E103	POWER PLAN
E104	DIMENSION PLAN FOR LIGHT FIXTURE
E105	DIMENSION PLAN FOR FITTING
P101	COVER SHEET
P102	WATER SUPPLY SYSTEM
P103	SEWAGE SYSTEM
P104	RISER DIAGRAM
M101	HVAC PLAN
M102	HVAC SECTION
M103	RISER DIAGRAM

CASEWORK TAG


FURNITURE TAG

SPECIALTY EQUIPMENT TAG

MECHANICAL EQUIPMENT TAG

WINDOW TAG

DOOR TAG

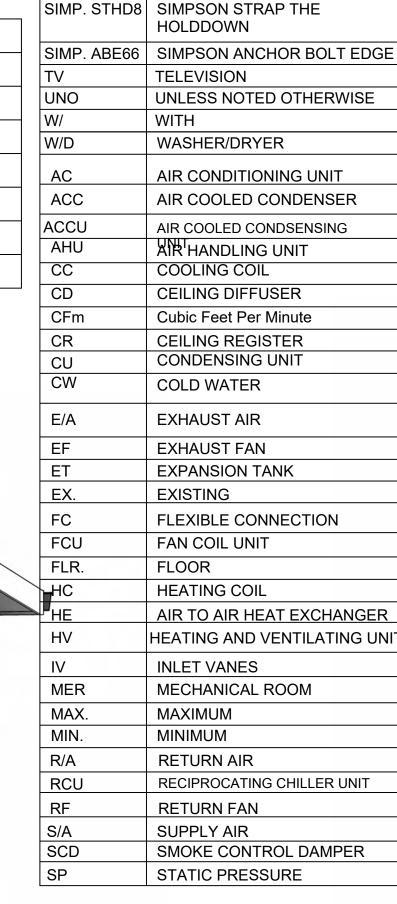

ABBREVIATION

ASTM D698 AMERICAN SOCIETY FOR

CASEWORK ELECTRICAL

FOOTINGS

CODE

MAXIMUM

MINIMUM

NUMBER

ON CENTER

PLUMBING

REFERENCE

RIGHT GARAGE

SQUARE FEET

MECHANICAL

CONDITIONING

ACTION FLOOR SYSTEMS

TESTING AND MATERIAL

FINISHED FLOOR LEVEL

FINISHED FLOOR ELEVATION

HEATING, VENTILATION & AIR

INTERNATIONAL RESIDENCE


INTERNATIONAL MECHANICAL


ORIENTED STRAND BOARD

POUNDS PER SQUARE INCH

POLYVINYL CHLORIDE

SPECIAL EQUIPMENT

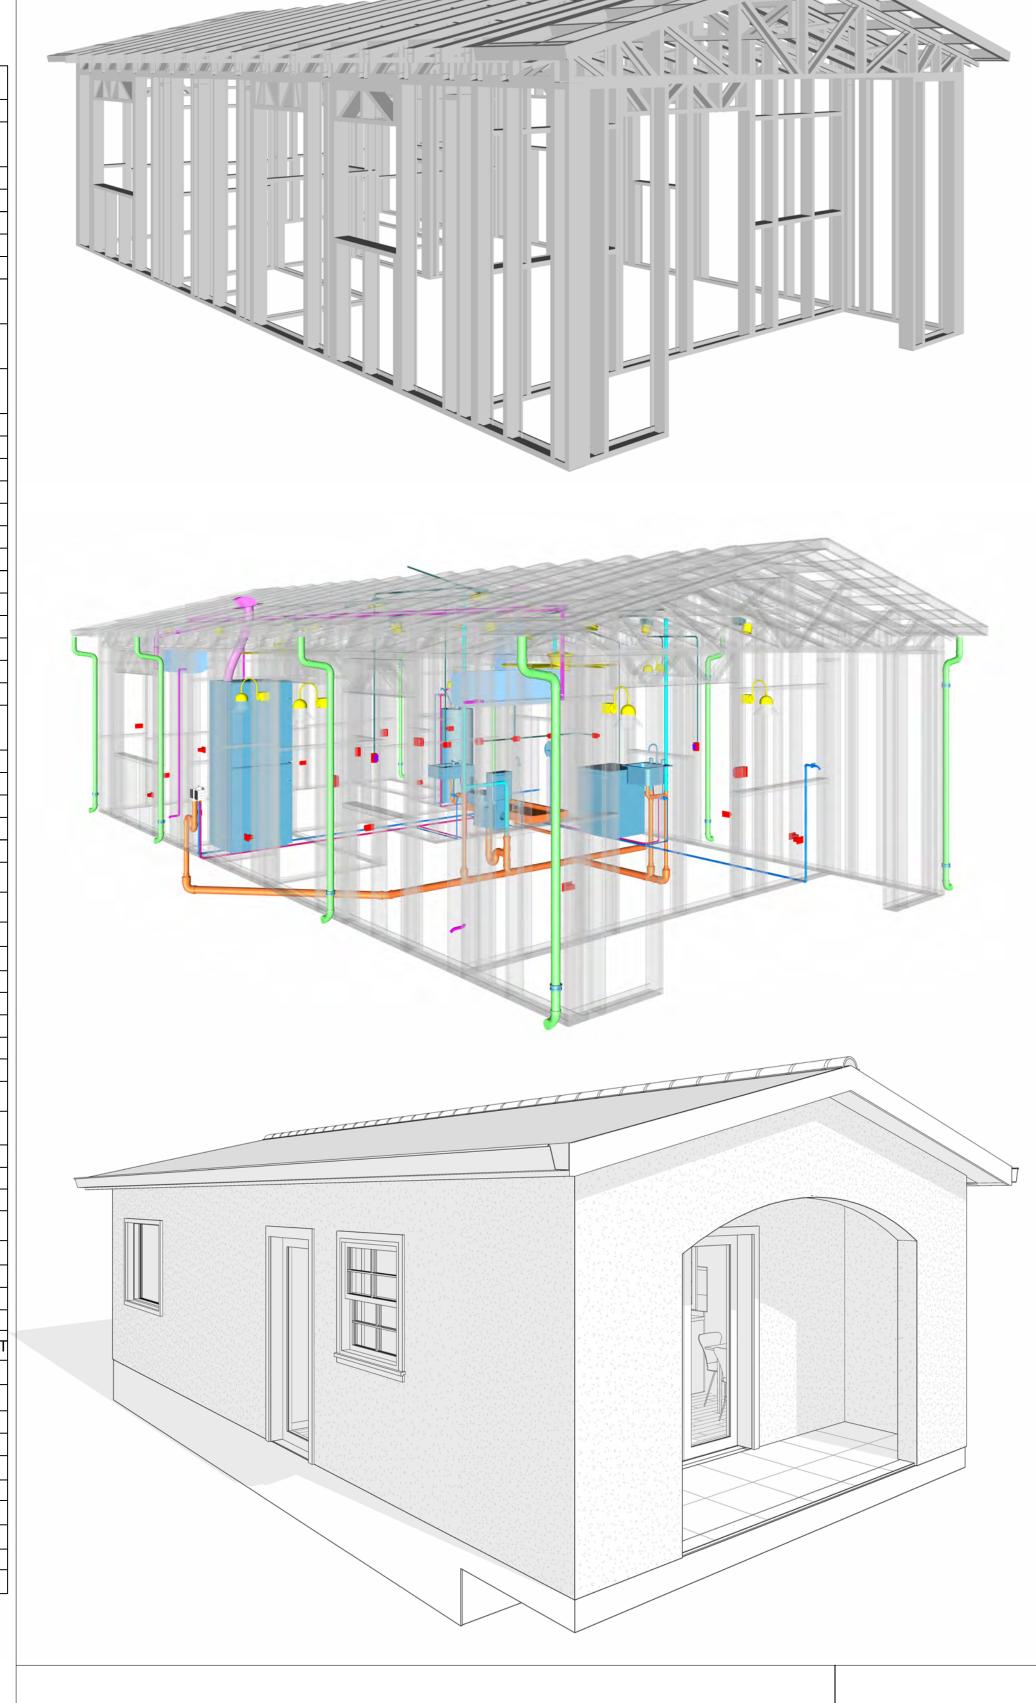

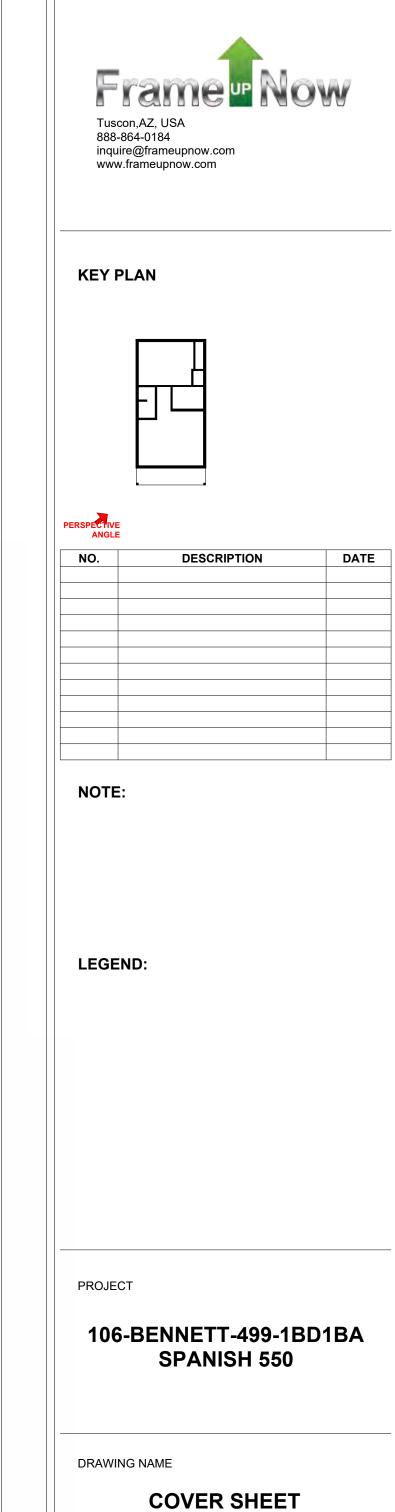



106-BENNETT-499-1BD1BA SPANISH 550

SQUARE FOOTAGE		
LIVIN G	499	
PORCH	65	
TOTAL	564	

CLIENT NAME:

DESIGNED BY:

DRAWN BY: CHECKED BY:

PROJECT NUMBER:

Client Name

3/10/2025 12:07:34 PM

0061_12

Designer

Checker

GENERAL NOTES

- THIS DRAWING DEPICTS THE ARCHITECTURAL (SPACE LAYOUT, FURNISHING, FLOOR, WALLS, ROOFS, FOUNDATION, WINDOWS AND DOORS) SYSTEMS. IT PROVIDES A VISUAL REPRESENTATION OF THE ARCHITECTURAL LAYOUT AND COMPONENTS.
- THE ARCHITECTURAL DRAWINGS ARE PREPARED TO MEET THE SPECIFIC REQUIREMENTS OF THE BUILDING, AS PER THE PROJECT SPECIFICATIONS AND APPLICABLE CODES AND STANDARDS.
- THE CONSTRUCTION OF THIS HOME SHALL COMPLY WITH THE LATEST EDITION OF THE INTERNATIONAL RESIDENTIAL CODE (IRC), INTERNATIONAL MECHANICAL CODE (IMC), THE INTERNATIONAL PLUMBING STANDARD, THE NATIONAL ELECTRICAL STANDARD AND ALL OTHER APPLICABLE LOCAL, STATE, AND NATIONAL CODES AND REGULATIONS.
- COORDINATION WITH OTHER TRADES HAS BEEN DONE ON A DESIGN LEVEL. THIS DRAWING SHALL BE READ TOGETHER WITH THE ME, EL AND PL DESIGN DRAWINGS TO ENSURE PROPER CONSTRUCTION AND INTEGRATION OF THE BUILDING SYSTEMS.

ABOUT WALLS:

- SHOWER WALL COVERING
- BATHTUB AND SHOWER SPACES (WALLS AND FLOORS) WITH INSTALLED SHOWER HEADS AND IN SHOWER COMPARTMENTS SHALL BE FINISHED WITH A NON-ABSORBENT SURFACE.
- 2. WALL PAINT (INTERNAL)
 - THE TYPICAL THICKNESS OF LATEX WALL PAINT IS 1/32 OF AN INCH FOR A SINGLE COAT. AND DOUBLE COAT (1/16") SHALL BE APPLIED FOR DURABILITY.

3. ADHESIVES: THE ADVISABLE TYPE OF ADHESIVE FOR THIS PROJECT IS **EPOXY ADHESIVES**BECAUSE THEY ARE KNOWN FOR THEIR HIGH STRENGTH, DURABILITY, AND RESISTANCE TO MOISTURE, CHEMICALS AND


REFER TO SHEETS A201 & A202 FOR GENERAL NOTES ON EXTERNAL FINISHING MATERIALS

ABOUT FLOORS:

- THE SPOT ELEVATION INDICATES THE FINISHED FLOOR ELEVATION.
- FINISHED FLOORS PER PLANS.
- FIELD VERIFY FOR DIMENSION DROP 4" FOR SHOWER AND BATHTUB USE.
- 1% SLOPE ON OUTDOOR BALCONIES FOR WATER RUN OFF.
- 2% SLOPE TOWARDS THE SHOWER DRAIN FOR SUFFICIENT DRAINAGE.
- 4" DROP AT THE DOOR LEADING TO EXTERIOR BALCONY FROM THE MAIN LIVING AREA.
- 5% SLOPE FOR GARAGE IS USED, WHICH SHOULD BE CHECKED WITH THE LOCAL GARAGING ZONING LAWS.

FURNITURE SCHEDULE TYPE COUNT **TYPE MARK** FOUR SIT 85" X 85" CLOSED - 900 X 660MM 2 DINING CHAIR QUEEN 60" X 79"

ROOM FINISH SCHEDULE							
ROOM NUMBE R	ROOM NAME	FLOOR FINISH	BASE FINISH	WALL FINISH	CEILING FINISH	CEILING HEIGHT	COM MEN TS
01	LIVING ROOM	HARDWOOD	CONCRETE	WALL PAINT	DRY WALL	8' - 0"	
02	KITCHEN	HARDWOOD	CONCRETE	WALL PAINTT + CERAMIC	DRY WALL	8' - 0"	
03	BED ROOM	HARDWOOD	CONCRETE	WALL PAINT	DRY WALL	8' - 0"	
04	CL	HARDWOOD	CONCRETE	WALL PAINT	DRY WALL	8' - 0"	
05	BATH	VINYL TILES	CONCRETE	CERAMIC TILE	MRD	8' - 0"	
06	WH	HARDWOOD	CONCRETE	WALL PAINT	DRY WALL	8' - 0"	
07	WD	HARDWOOD	CONCRETE	WALL PAINT	DRY WALL	8' - 0"	
08	HALL	HARDWOOD	CONCRETE	WALL PAINT	DRY WALL	8' - 0"	
09	PORCH	PROCELAIN TILE	CONCRETE	EXTERIOR-GRADE PLYWOOD	PLYWOOD	8' - 0"	

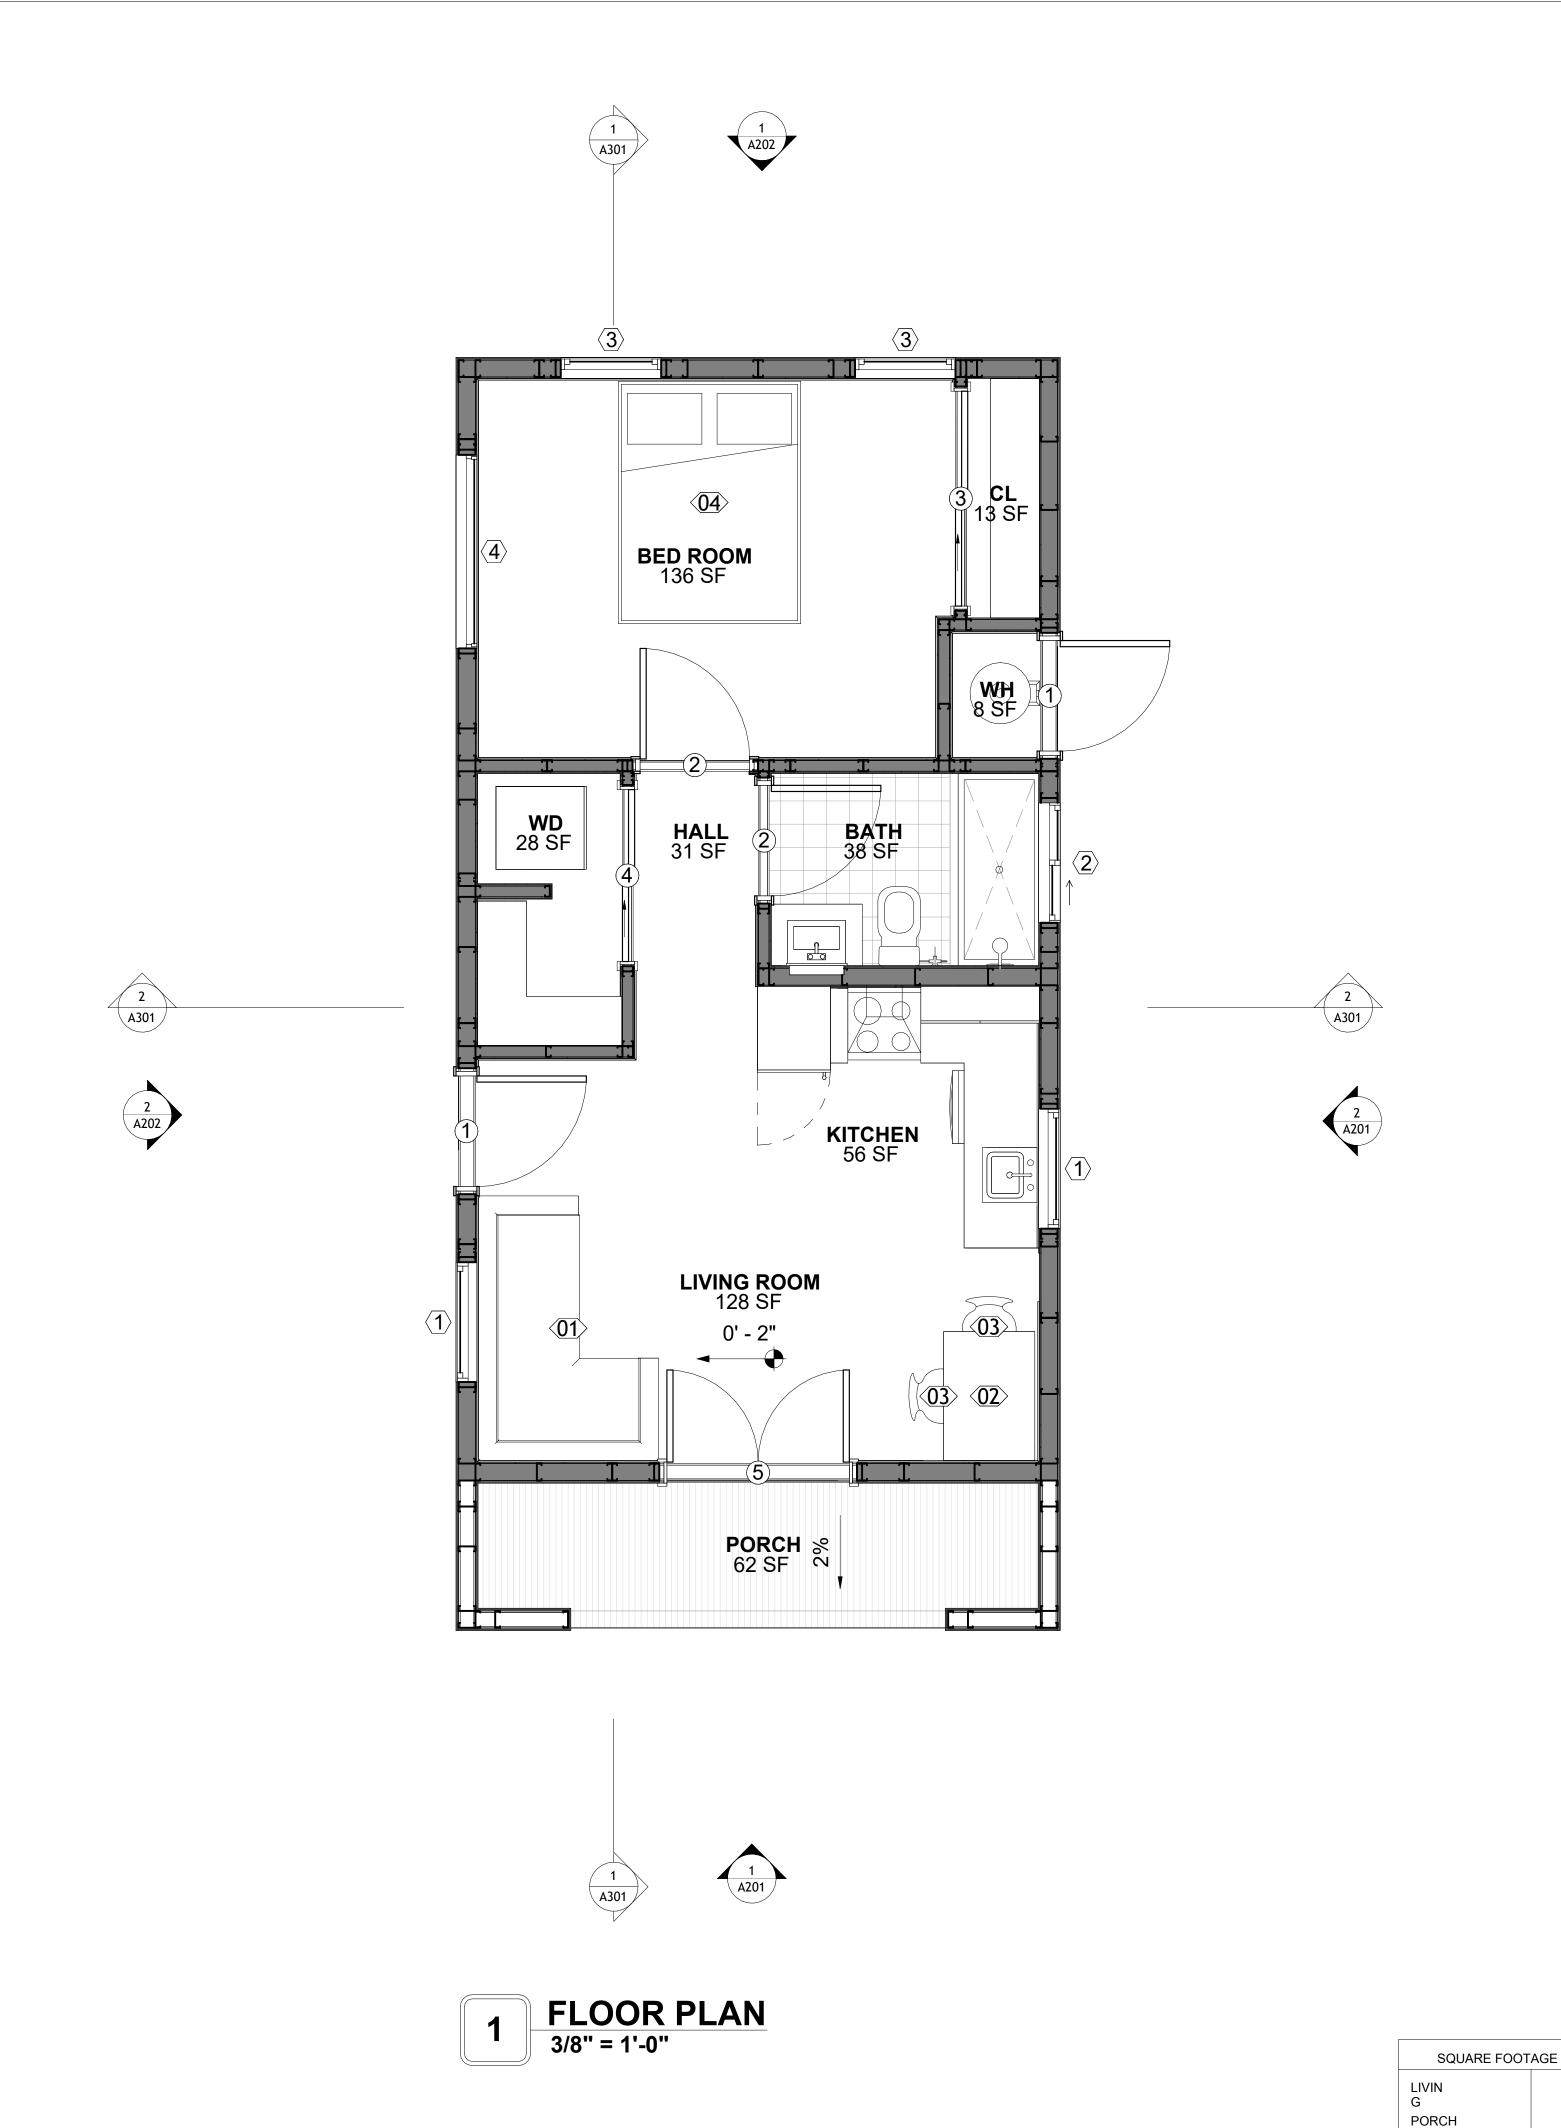



KEY PLAN

NO.	DESCRIPTION	DATE

NOTE:

LEGEND:

PROJECT

106-BENNETT-499-1BD1BA **SPANISH 550**

DRAWING NAME

FLOOR PLAN

CLIENT NAME:	Client Name
PROJECT NUMBER:	0061_12
DATE:	3/8/2025 3:34:20 PM
DESIGNED BY:	Designer
DRAWN BY:	Author
CHECKED BY:	Checker

A101

SCALE: As indicated


499

65

564

TOTAL

© [2024] [FrameUpNow] . All rights reserved

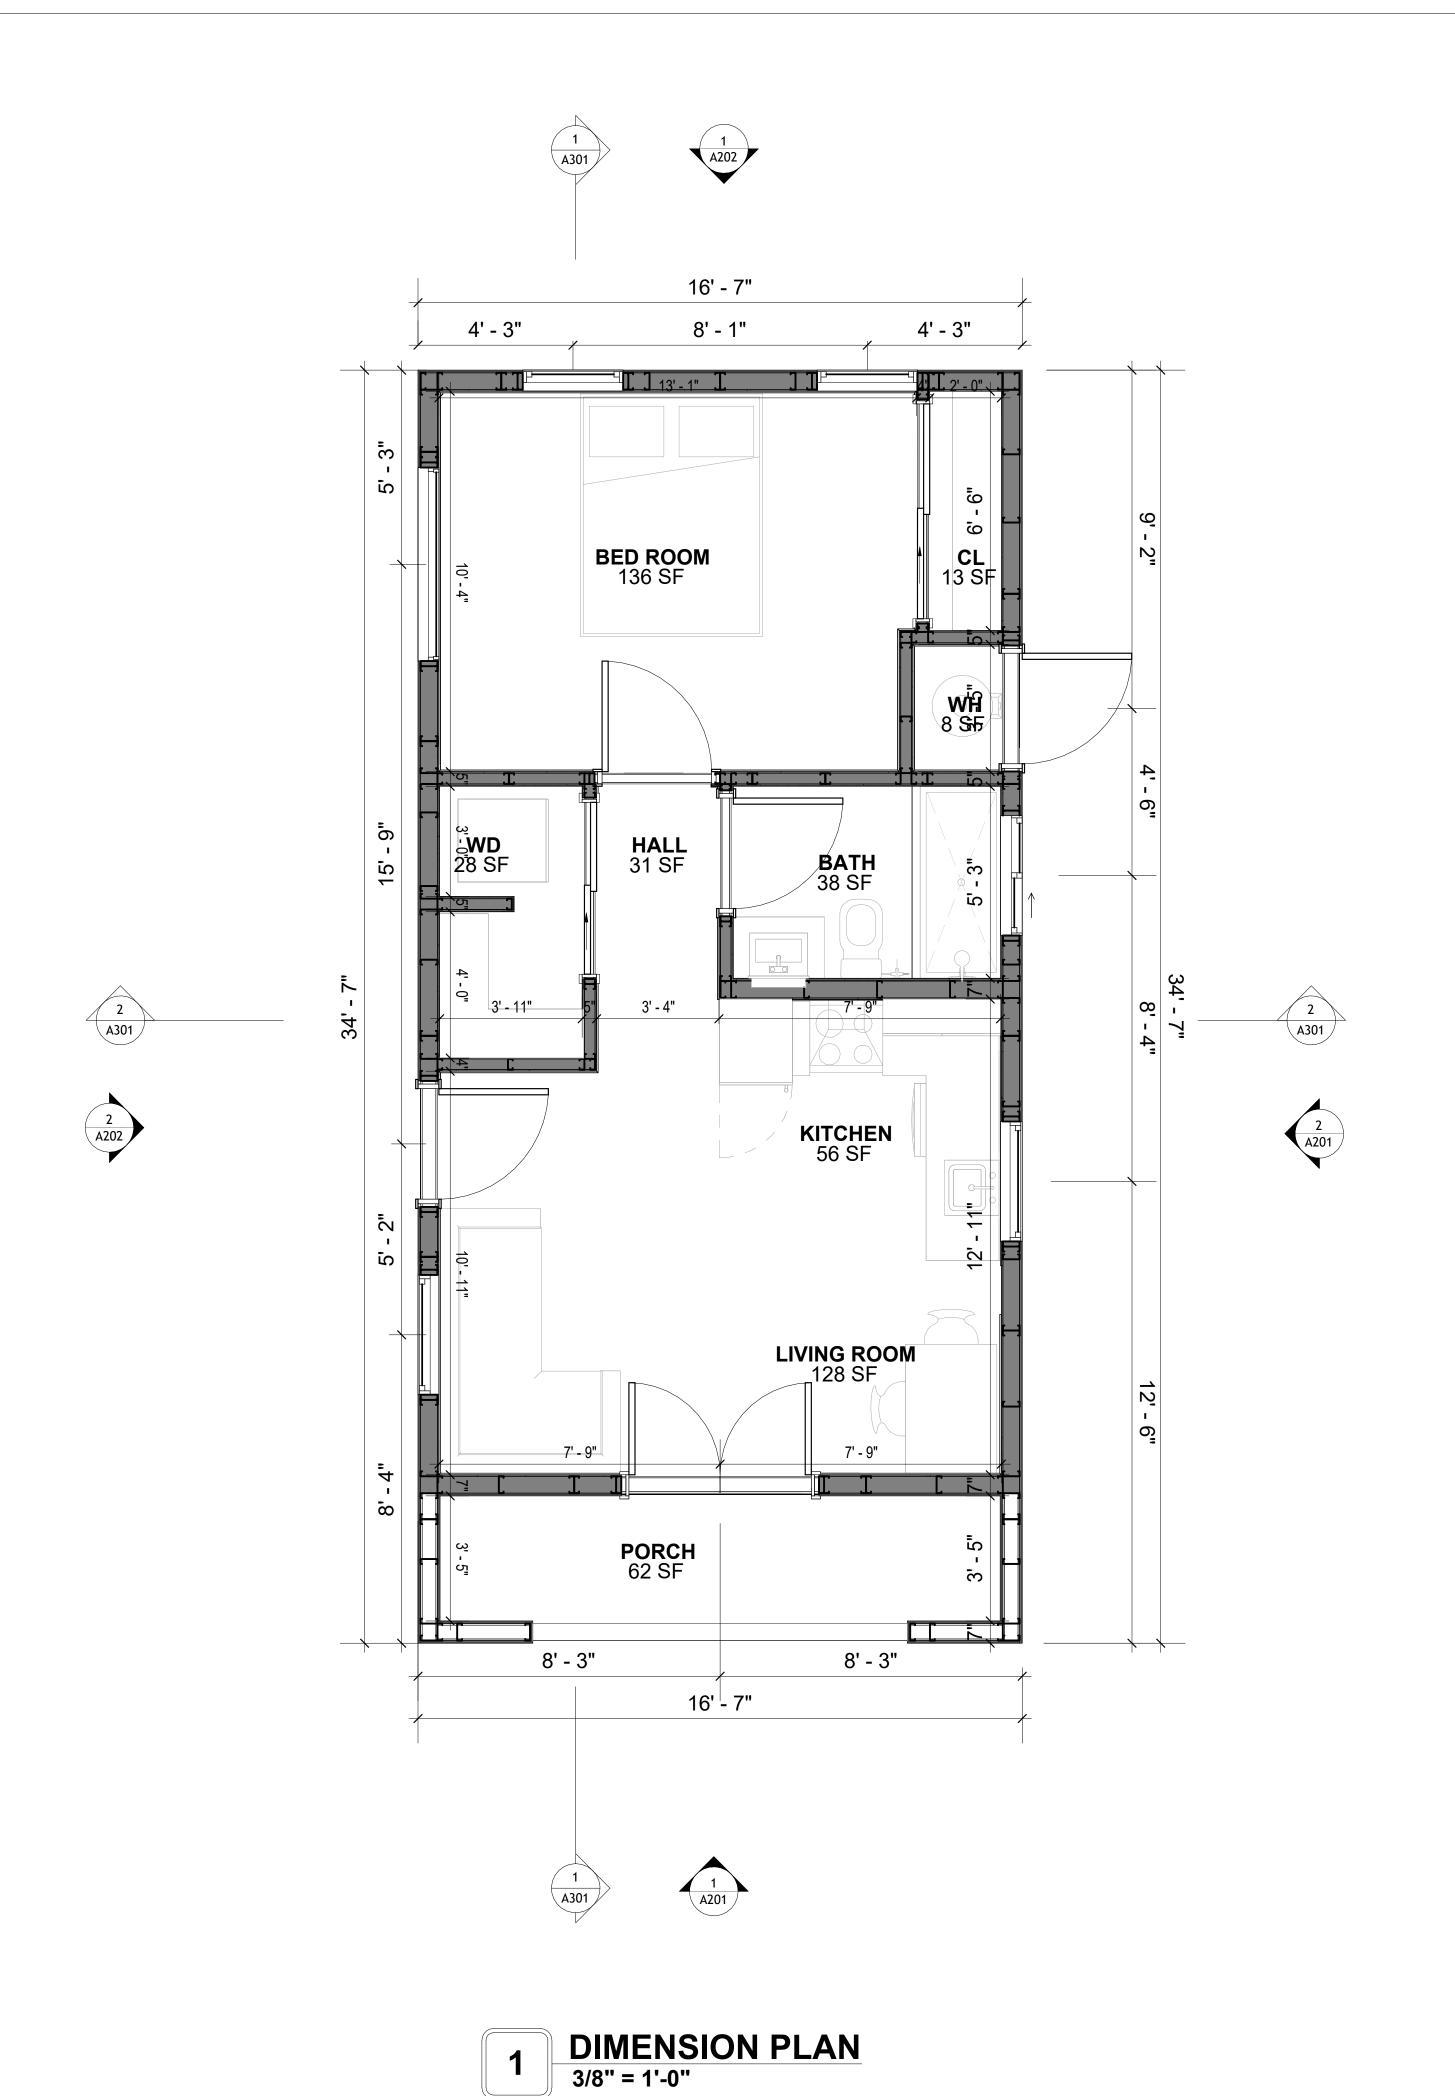

SQUARE FOOTAGE

LIVIN 499
G
PORCH 65

TOTAL 564



KEY PLAN

NO.	DESCRIPTION	DATE

NOTE:

LEGEND:

PROJECT

106-BENNETT-499-1BD1BA SPANISH 550

DRAWING NAME

DIMENSION PLAN

CLIENT NAME:	Client Name
PROJECT NUMBER:	0061_12
DATE:	3/8/2025 3:34:22 PM
DESIGNED BY:	Designer
DRAWN BY:	Author
CHECKED BY:	Checker

A102

SCALE: 3/8" = 1'-0"

DIMENSIONS IN THE ARCHITECTURAL DRAWINGS CONSIDER FINISHING MATERIALS. FOR PRECISE MEASUREMENTS OF THE STRUCTUAL FRAMING, REFER TO THE ATTACHED STRUCTURAL PLAN SET.

FOUNDATION NOTES

NOTES:

TERMITES PRETREATMENT BY LICENSED CONTRACTOR UNDER SLAB AND AROUND FOOTINGS. ALL AREAS BELOW SLABS SHALL BE TREATED NO MORE THAN 24 HOURS PRIOR TO CONCRETE POUR. EVIDENCE OF TREATMENT MUST BE PROVIDED PRIOR TO PLACING OF CONCRETE.

1. MATERIALS:

ALL INTERIOR CONCRETE SLABS SHALL BE A MIN. OF 4" THICK CONCRETE OVER 4" COMPACTED AGGREGATE BASE (ASTM D698), FINISH ELEVATIONS AS NOTED ON DRAWINGS, 6" ABOVE ADJACENT GRADE, LEVEL SLABS TO 1/8"-10' MAX.. CONCRETE SLABS SHALL BE 2500# PSI AT 28 DAYS. A 4" ALLOWABLE SLUMP.

2. PAD PREPARATION:

EXCAVATION FOR FOOTING SHALL BE NEAT.

- FOOTINGS SHALL BE POURED IMMEDIATELY AFTER EXCAVATION AND APPROPRIATE INSPECTION.

- ALL REINFORCING STEEL MARKED "CONTINUOUS" SHALL BE LAPPED 36 BAR DIAMETERS AT SPLICES AND AROUND CORNERS OR INTERSECTIONS WITH A STANDARD 90 DEGREE BEND ON CORNER BARS. LAP WIRE MESH ONE FULL MESH AT SIDE AND END LAPS.

- ALL HARDWARE TO BE SIMPSON OR EQUIVALENT.
- EXTERIOR FRAME WALL TO BE SECURED WITH 1/2"X10" ANCHOR BOLTS 4'-0" O.C. FOR 1-STORY AND 2'-8" O.C. FOR 2-STORY. BOLTS SHALL BE LOCATED WITHIN 1'-0" OF EACH END PIECE AND SHALL HAVE A MIN. OF TWO BOLTS PER PIECE.

-FOUNDATION ANCHOR STRAPS SHALL BE PERMITTED, ACCORDING TO RESIDENTIAL CODE 2021

- ALL INTERIOR WALLS TO BE SECURED WITH POWER DRIVEN PINS PER MANUFACTURER SPECIFICATION USE PIN SPACING EQUIVALENT TO 1/2" ANCHOR BOLTS.

- ALL CONSTRUCTION TO CONFORM TO THE 2012 IRC
 - R-10 RIGID INSULATION OUTSIDE OF EXTERIOR FOUNDATION WALLS UNDER LIVING AREA.
 - CONCRETE PAD FOR CONDENSER THICKNESS IS 4" MIN UNLESS OTHERWISE NOTED.

3. CONCRETE CONSTRUCTION:

- THE SLAB SHALL BE UNDERLAIN BY A VAPOR BARRIER/RETARDER IN THE LIVING AREA (TYPICALLY POLYETHYLENE, UNLESS MORE STRINGENT PROTECTION REQUIRED BY THE ARCHITECT, ENGINEER, FLOOR COVERING MANUFACTURER, OR ACCEPTED PRACTICE). UNLESS OTHERWISE REQUIRED, BARRIER MAY BE OMITTED AT GARAGES, PORCHES AND PATIOS WITHOUT FLOOR COVERINGS. IT IS BEYOND THE SCOPE OF THESE PLANS TO DETERMINE THE APPLICABILITY OF THESE MORE STRINGENT REQUIREMENTS. BUILDER SHALL VERIFY PRIOR TO CONSTRUCTION.

4. REINFORCEMENT:

- IF CONSTRUCTED ON ACTIVE SOILS, THE LONG TERM PERFORMANCE OF THE FOUNDATION IS DEPENDENT ON MAINTENANCE BY THE OWNER. THUS THE BUILDER SHALL ADVISE THE OWNER OF THE FOLLOWING:

- 1. DRAINAGE MUST BE MAINTAINED. WATER SHALL NEVER BE ALLOWED TO POND NEAR THE FOUNDATION.
- 2. THE SOIL AROUND THE FOUNDATION SHALL BE MAINTAINED IN A RELATIVELY DAMP CONDITION, SUCH AS THAT REQUIRED TO KEEP A LAWN GREEN. IF IT DRIES OUT IT WILL SHRINK. IF IT GETS WET, IT WILL HEAVE UPWARD.

3. SLABS ON THE SHORTER SIDE USES MAIN BARS ARE USED IN THIS DIRECTION ONLY WITH SMALLER DIAMETER DISTRIBUTION BARS ARE PLACED, FORMING A MAT OR GRID.

- 4. ALL REINFORCEMENT BARS SIZE 10MM OR LARGER IN ACCORDANCE TO ASTM
 3. ANCHOR BOLTS AT ALL EXTERIOR WALLS SHALL BE MINIMUM 1/2 INCH DIAMETER WITH A MAXIMUM SPACING OF 6'-0" ON CENTER, UNLESS NOTED OTHERWISE.
- 4. ANCHOR BOLTS SHALL BE INSTALLED WITHIN 12 INCHES OF EACH END OF EACH SILL PLATE WITH AT LEAST TWO ANCHOR BOLTS FOR EACH BOLTS FOR EACH SILL PLATE LONGER THAN 12 INCHES.

5. SIMPSONS SILL ANCHORS MAYBE SUBSTITUTED FOR ANCHOR BOLTS AT THE SAME SPACING.


6. EXTERIOR CONCRETE SLABS WHICH ARE NOT PART OF THE MAIN SLAB SHALL BE MINIMUM 4 INCHES THICK WITH NO STEEL REINFORCING BARS REQUIRED, UNLESS NOTED OTHERWISE ON FOUNDATION PLAN.

VERIFY THE FOLLOWING PRIOR TO POURING:

- 1. ALL HOLDDOWNS , STRAP, AND POST LOCATIONS.
- 2. CONCRETE FINISHES. PANEL RISER LOCATION WHERE APPLICABLE.
- 3. UNDERSLAB MECHANICAL REQUIREMENTS.
- 4. STEM WALL BLOCKOUTS.

 5. LINDERSLAR ELECTRICAL DECLUDEMENTS.
- 5. UNDERSLAB ELECTRICAL REQUIREMENTS AND PANEL RISER LOCATION. WHERE APPLICABLE.
- 6. PROVIDE THE FOLLOWING:
- PVC SLEEVES THROUGH FTG IF REQUIRED 20' #4 COPPER GROUND BAR.
- 7. SLOPE FINISH GRADE AWAY FROM FOOTING.

NOTE: FIELD VERIFY ALL DIMENSIONS SEE DIMENSIONED ARCHITECTURAL DRAWINGS

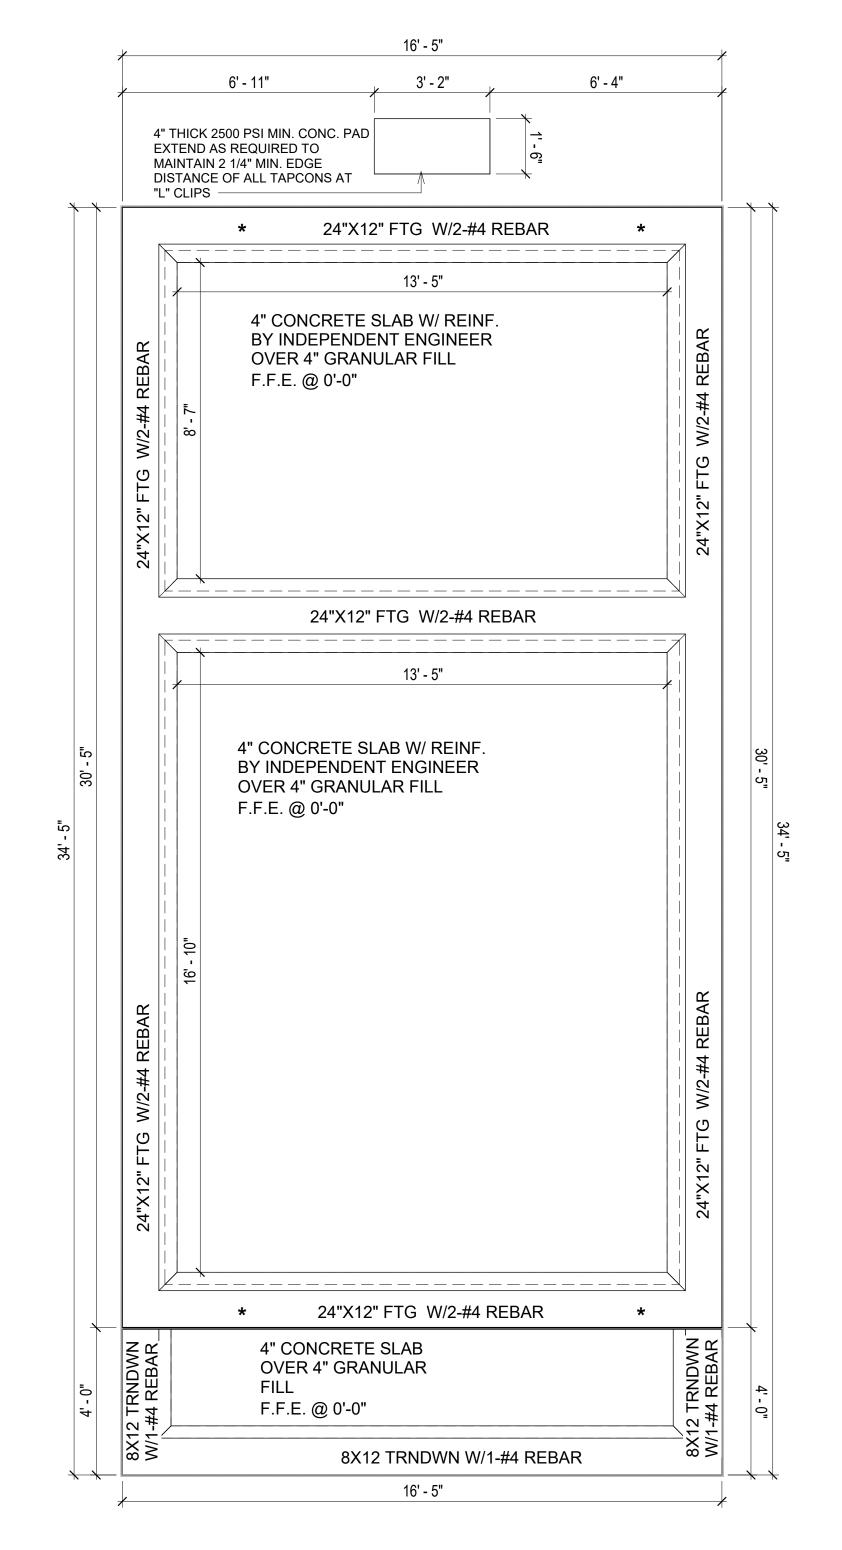



Tuscon,AZ, USA 888-864-0184 inquire@frameupnow.com www.frameupnow.com

KEY PLAN

NO. DESCRIPTION DATE

NOTE:

LEGEND:

PROJECT

106-BENNETT-499-1BD1BA SPANISH 550

DRAWING NAME

FOUNDATION PLAN

Client Name	CLIENT NAME:	
0061_12	PROJECT NUMBER:	
3/8/2025 3:34:22 PM	DATE:	
Designer	DESIGNED BY:	
Author	DRAWN BY:	
Checker	CHECKED BY:	

S101

SCALE: 3/8" = 1'-0"

SQUARE FOOTAGE

499

65

564

LIVIN

PORCH

TOTAL

© [2024] [FrameUpNow] . All rights reserved

GENERAL NOTES

NOTES:

-ALL BEARING WALLS SHOULD HAVE A THICKENED SLAB PER SECTION PER DETAIL A401/5.

A) **FOUNDATION PLAN NOTES**:

- CONCRETE SLAB SHALL BE 6" THICK WITH 1/2" DIAMETER TENDONS PER LAYOUT PLAN, CENTERED IN SLAB THICKNESS, OVER APPROVED SUBBASE PER GENERAL STRUCTURE
- 2. TERMITE PROTECTION SHALL BE PROVIDED PER IRC SECTION R318.1 NONE TYPICAL ANCHOR BOLT SPACING AT SHEAR WALL AND HOLD DOWN
- SPECIFICATIONS PER APPROVED ARCHITECTURAL PLANS. 4. INSTALL HOLDOWNS BEFORE CONCRETE SLAB POUR.
- EXISTING FILL ON-SITE SHALL BE COMPACTED IN ACCORDANCE WITH THE
- REQUIREMENTS IN THE GEOTECHNICAL REPORT.
- 6. ALL FLOOR SLABS ARE REINFORCED ON CONCRETE SLABS.

SPECIAL INSPECTION IS REQUIRED FOR THICKENED FOUNDATION CONSTRUCTION

- 1. REINFORCEMENT
- 2. 2300 PSI CONCRETE POUR


B) **REINFORCEMENT FOR CONCRETE**:


1. ALL REINFORCING SLABS BARS SIZE 10MM OR LARGER SHALL BE DEFORMED IN ACCORDANCE TO ASTM-A706, AND BARS SMALLER THAN 10 MM MAYBE PLAIN. 2. UNLESS OTHERWISE NOTED IN PLANS, THE YIELD STRENGTH OF REINFORCING BARS SHALL BE:

> A) FOOTING = 40,000 PSI B) NON-LOAD BEARING WALLS AND PARAPETS= 40,000 PSI

- 3. SPLICES SHALL BE SECURELY WIRED TOGETHER AND SHALL LAP OR EXTEND
- 4. GRADE OF STEEL FOR RCC WORKS SHALL BE GRADE 4 10.
- BAR NOTATIONS GIVES INFORMATION
- A) BAR SIZE
- B) SPACING(IF REQUIRED)
- 6. LAP REINFORCEMENT ONLY AT LOCATION SHOWN IN THE DRAWINGS REINFORCEMENT SHALL NOT BE CUT, VENT OR HEATED ON SITE WITHOUT ENGINEERS'
- APPROVAL.
- C) **CONCRETE SLAB NOTES**
- 1. ALL SLAB REINFORCEMENT SHALL BE 20MM CLEAR MINIMUM FROM BOTTOM AND FROM TOP OF SLAB.
- 2. REINFORCEMENT IN CONTINUOUS ELEVATED SLAB SHALL BE CUT AS FOLLOWS.

- THIS IS A SCHEMATIC PLAN FOR THE PURPOSE OF LOCATING AND IDENTIFYING FOUNDATION REINFORCING ELEMENTS ONLY. VERIFY ALL DIMENSIONS, DROPS, OFFSETS AND FEATURES WITH THE ARCHITECTURAL PLANS BEFORE FORMING THE FOUNDATION.

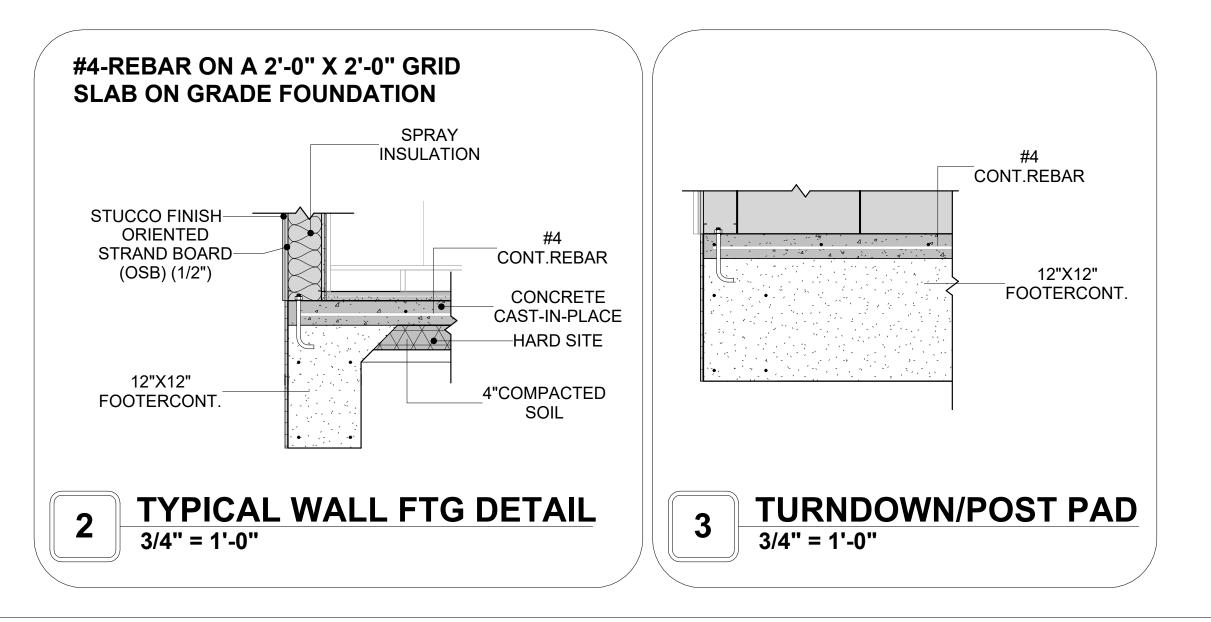

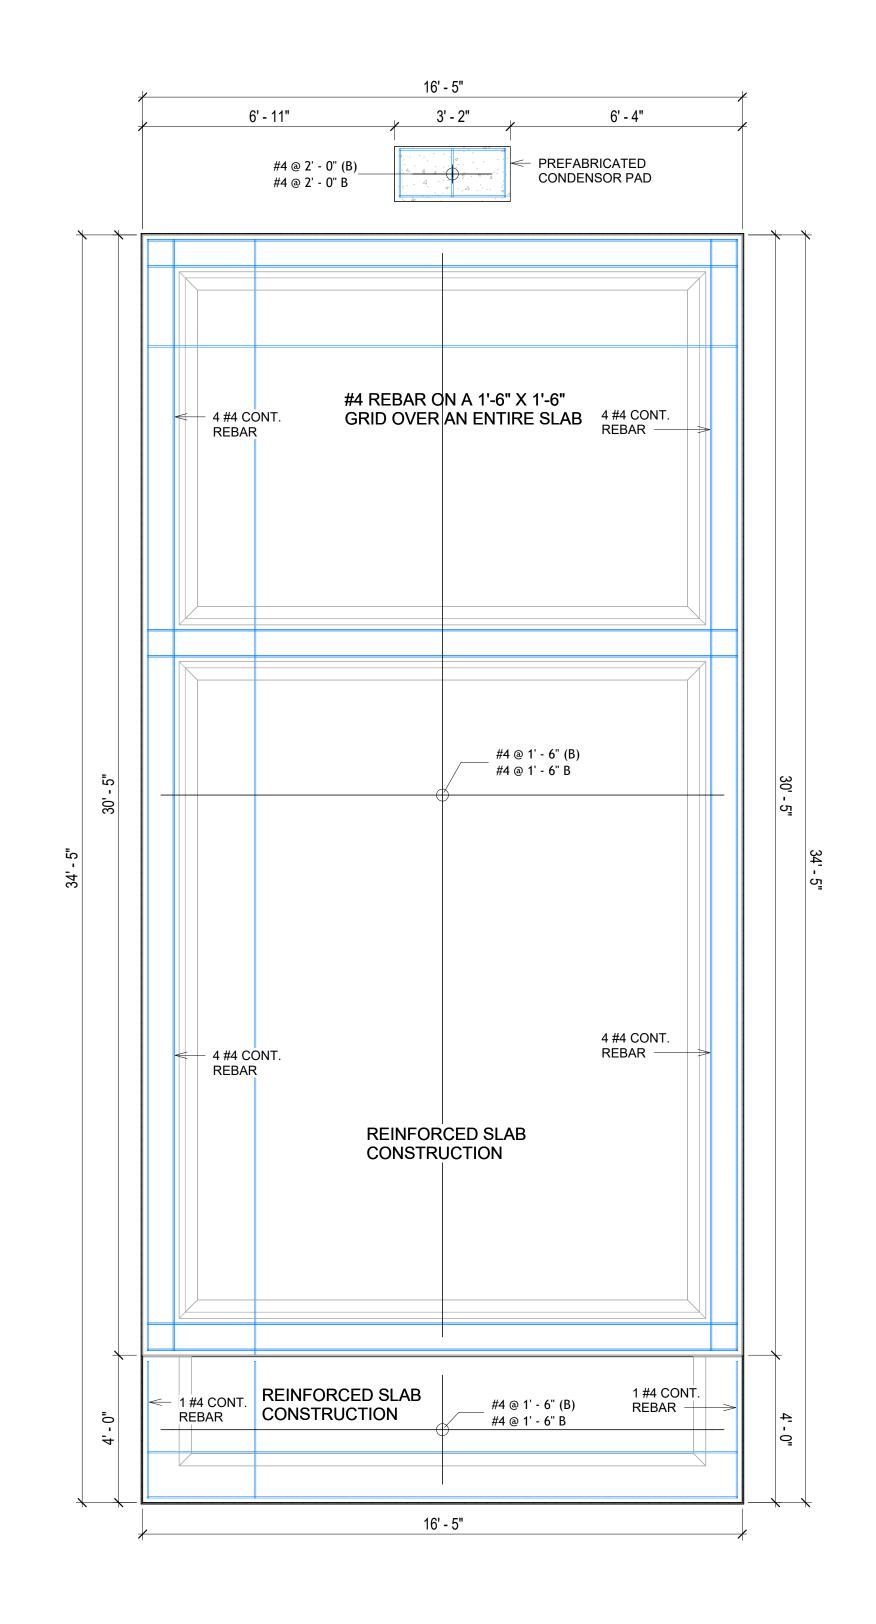

FOUNDATION REBAR PLAN 3/8" = 1'-0"



KEY PLAN

NO.	DESCRIPTION	DATE

NOTE:

LEGEND:

PROJECT

106-BENNETT-499-1BD1BA **SPANISH 550**

DRAWING NAME

STRUCTURAL FLOOR PLAN

CLIENT NAME: **Client Name** PROJECT NUMBER: 0061_12 3/8/2025 3:34:24 PM Designer DESIGNED BY: DRAWN BY: **Author** CHECKED BY: Checker

S102


ROOF NOTES


- 1. ROOFING COMPOSITION ROOFING PER OWNERS/BUILDERS SPECIFICATIONS INSTALL PER MANUFACTURE SPECIFICATIONS ON 1/2" ORIENTED STRAND BOARD ON PRE-ENGINEERED TRUSS @ 24" O.C. (UNO.)
- 73" OVERHANG AT EAVES (UNO.)
 ENDS OF ALL TRUSSES AND JOISTS TO BE FULLY BLOCKED. PROVIDE SOLID
- BLOCKING AT ALL RIDGES AND VALLEYS


 . SHEATHING TO BE 1/2", 3/8" OSB SHEAR PANEL AND EQUIVALENT.

 LINDERSIDE OF DORCH TRUSSES TO BE FINISHED WITH MOISTURE
- UNDERSIDE OF PORCH TRUSSES TO BE FINISHED WITH MOISTURE RESISTANT DRYWALL, TAPED AND TEXTURED.
- 5. EXPOSED EAVES AND OTHER WEATHER EXPOSED AREAS TO BE SHEATHED WITH EXTERIOR GRADE PLYWOOD.
- 6. ALL MATERIALS THICKNESS AND SIZE ARE THE MINIMUM. Refer TO LOCAL STANDARDS FOR ACTUAL THICKNESS AND LAYERING OF MATERIALS.
- 7. ENGINEERED TRUSS CALCULATIONS TO BE SUBMITTED TO BUILDING
- DEPARTMENT PRIOR TO FABRICATION AND INSTALLATION.

 8. TRUSS MANUFACTURER TO SPECIFY HANGER CONNECTORS FOR TRUSS COMPONENTS (TYPICAL)
- 9. DESIGNER ASSUMES THAT TRUSSES BEAR ON ALL EXTERIOR PERIMETER
- WALLS (TYPICAL) OR BEAMS.
- 10. PROVIDE GALVANIZED STEEL FLASHING WITH A LENGTH OF 10 FEET, WIDTH OF 12 INCHES, AND THICKNESS OF 24 GAUGE.

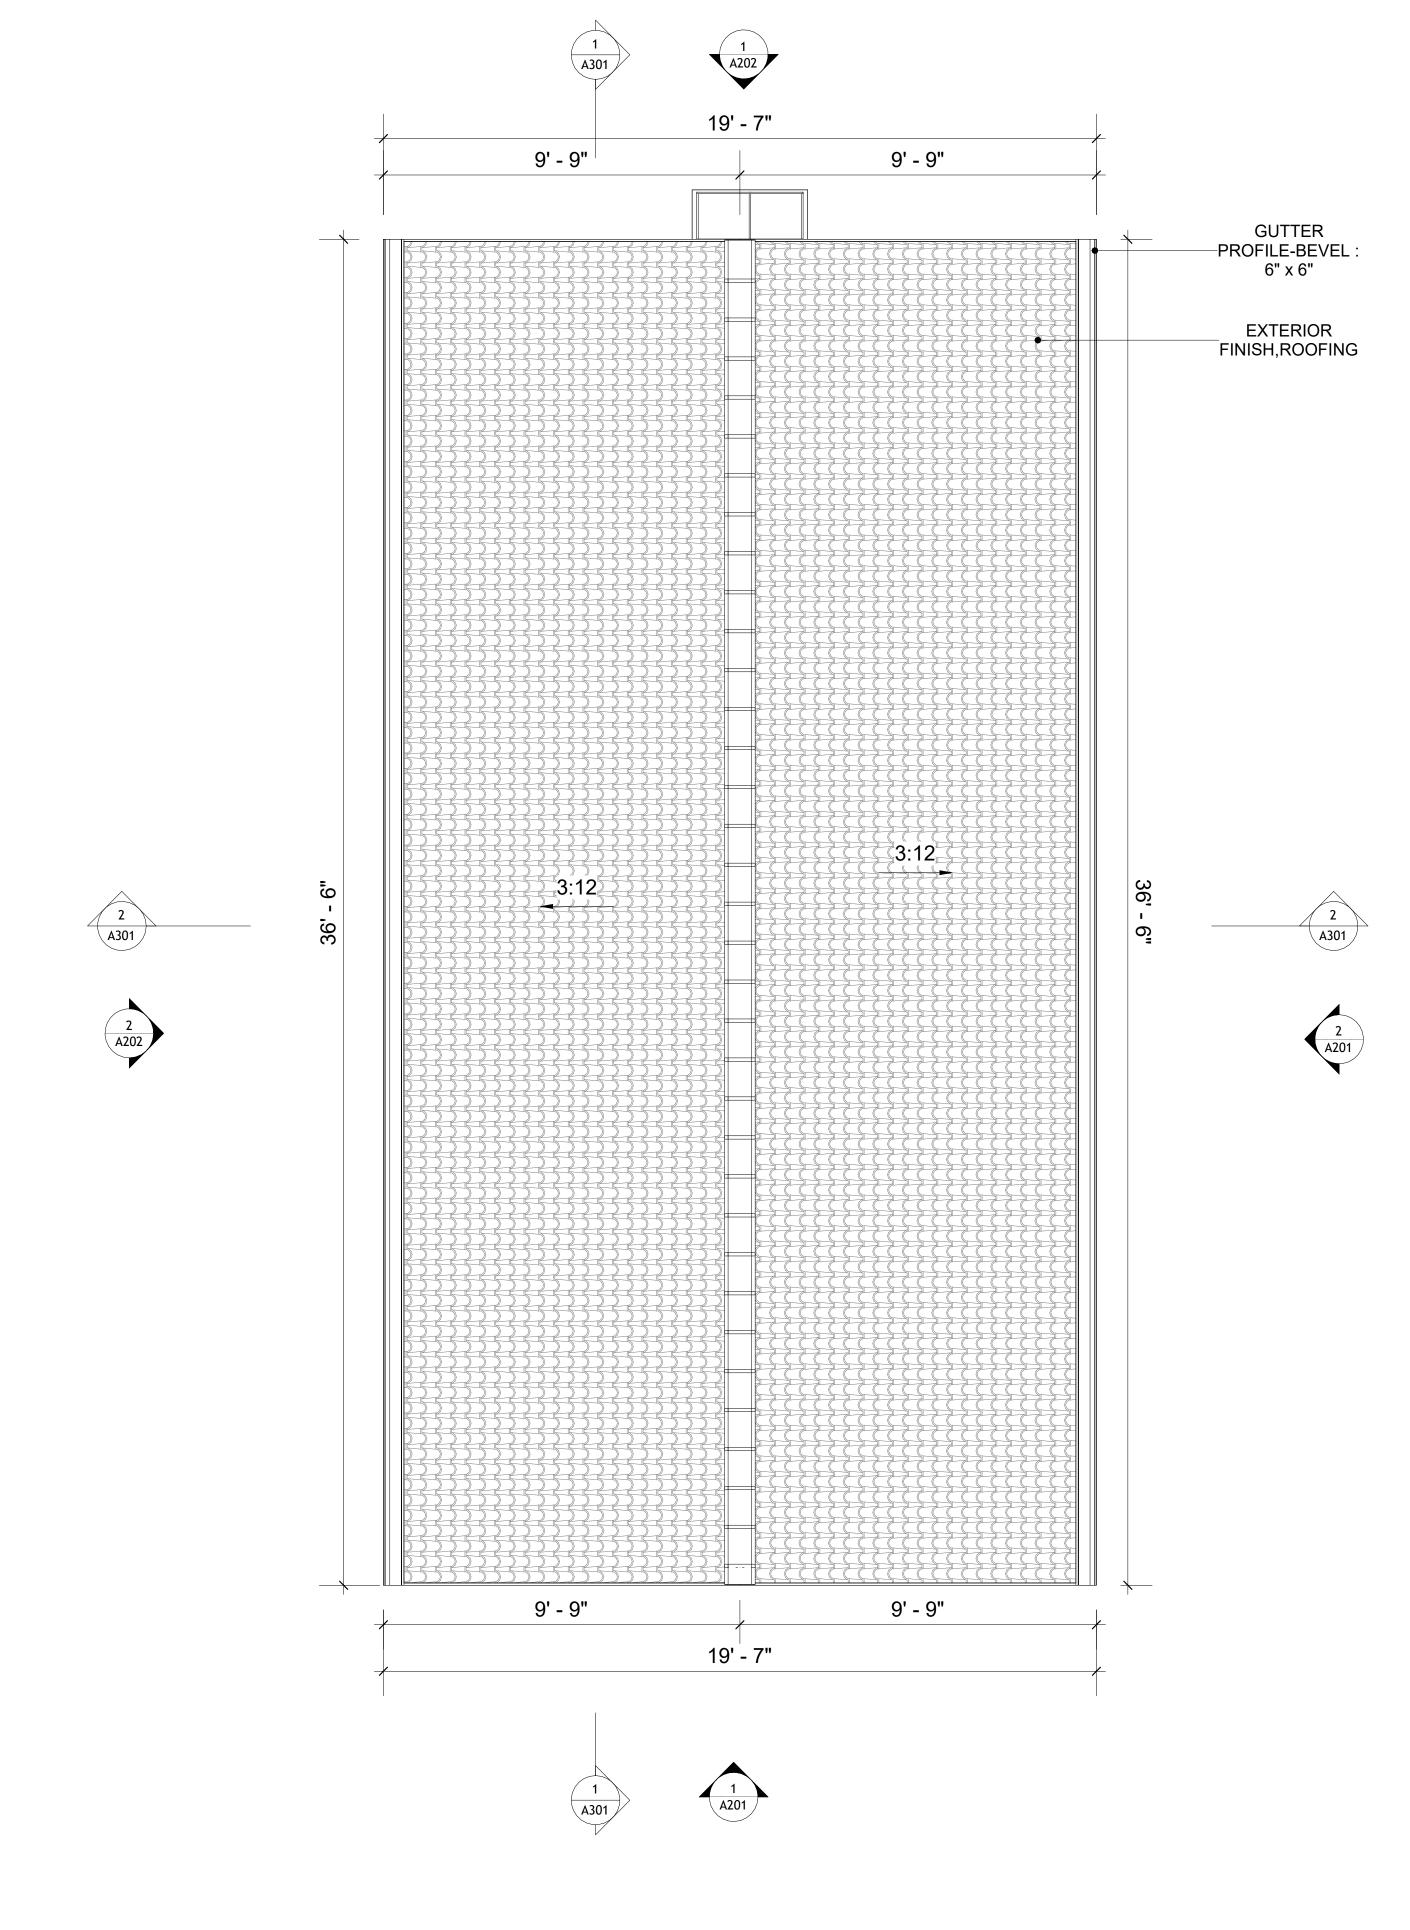

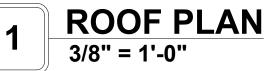

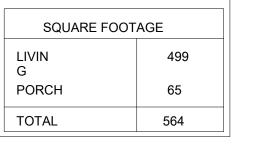



KEY PLAN

NO.	DESCRIPTION	DATE

NOTE:

LEGEND:

PROJECT

106-BENNETT-499-1BD1BA SPANISH 550

DRAWING NAME

ROOF PLAN

CLIENT NAME:	Client Name
PROJECT NUMBER:	0061_12
DATE:	3/8/2025 3:34:29 PM
DESIGNED BY:	Designer
DRAWN BY:	Author
CHECKED BY:	Checker

A103

ABOUT WALL FINISHING

STUCCO FINISH

STUCCO IS A CEMENT-BASED EXTERIOR WALL FINISH THAT OFFERS A DURABLE, WEATHER-RESISTANT, AND CUSTOMIZABLE CLADDING SOLUTION FOR BUILDINGS.

IN THIS SPECIFIC PROJECT, AMERICAN STUCCO SYSTEMS IS USED AS A FINISH MATERIAL BECAUSE IT IS GENERALLY CONSIDERED A WATER-RESISTANT EXTERIOR FINISH AND USES A THREE-COAT APPLICATION PROCESS.

3/8-INCH OF IT IS APPLIED AS AN EXTERNAL WALL FINISH AS IT IS THE MOST COMMON AND WIDELY ACCEPTED STANDARD THICKNESS FOR STUCCO EXTERIOR WALL FINISHES. THIS MULTI-LAYER APPROACH ALSO HELPS CREATE A STRONG, CRACK-RESISTANT STUCCO SURFACE.

THIS STANDARD STUCCO IS APPLIED OVER OSB SHEATHINGS (FOR COLD FORMED STRUCTURE CONSTRUCTION).


IT IS NOT DIRECTLY TROWELED OVER THE OSB BUT OVER A WATER-RESISTANT BARRIER (HOMEWRAP) AND METAL/PLASTIC LATH THAT ARE INSTALLED ON TOP SURFACE OF THE OSB TO PROVIDE AN ADDITIONAL LAYER OF PROTECTION AGAINST MOISTURE INTRUSION.


REGULAR INSPECTION AND PROMPT REPAIR OF ANY CRACKS, CHIPS, OR DAMAGE TO THE STUCCO FINISH IS IMPORTANT. THIS MAINTAINS THE STUCCO'S WATER-RESISTANT PROPERTIES OVER THE BUILDING'S LIFE SPAN.

CEDAR WOOD

CEDAR WOOD REFERS TO THE WOOD FROM VARIOUS SPECIES OF CEDAR TREES, WHICH ARE CONIFEROUS EVERGREEN TREES KNOWN FOR THEIR DISTINCT AROMA AND NATURAL RESISTANCE TO DECAY AND INSECTS.

IN THIS SPECIFIC PROJECT, CEDAR WOOD IS USED A FINISH MATERIAL ON BEAMS AND COLUMNS.

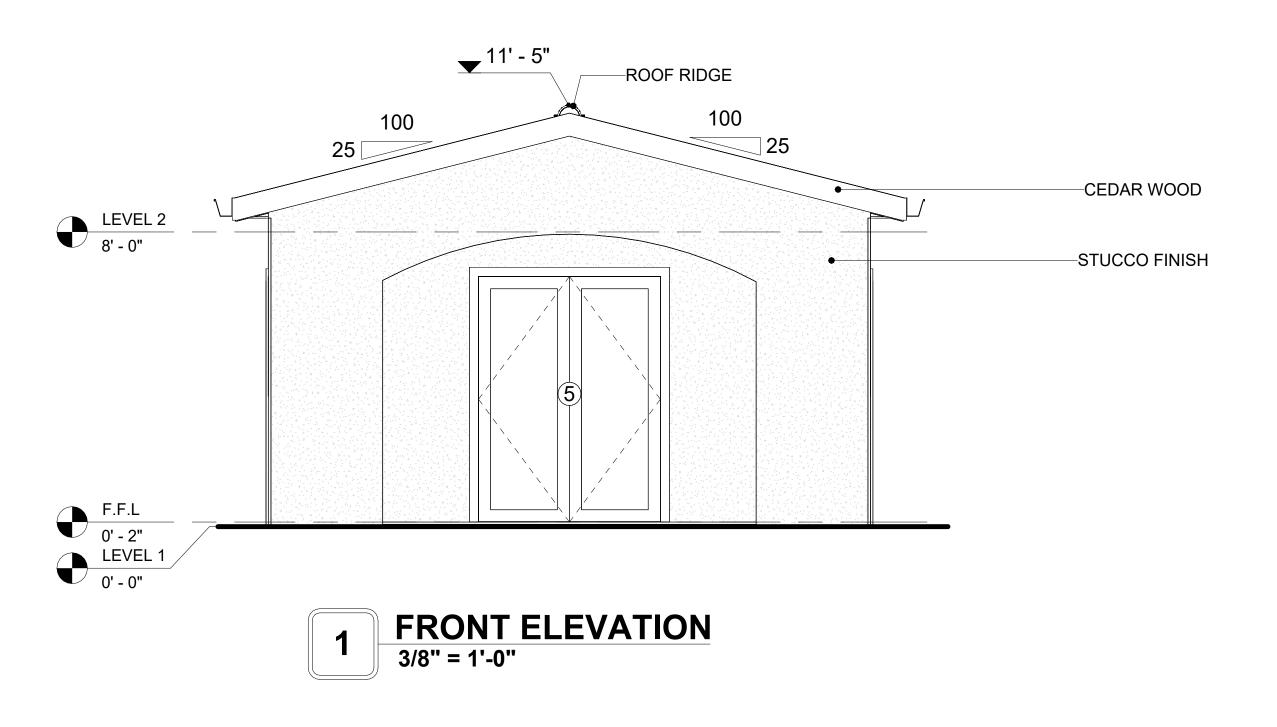

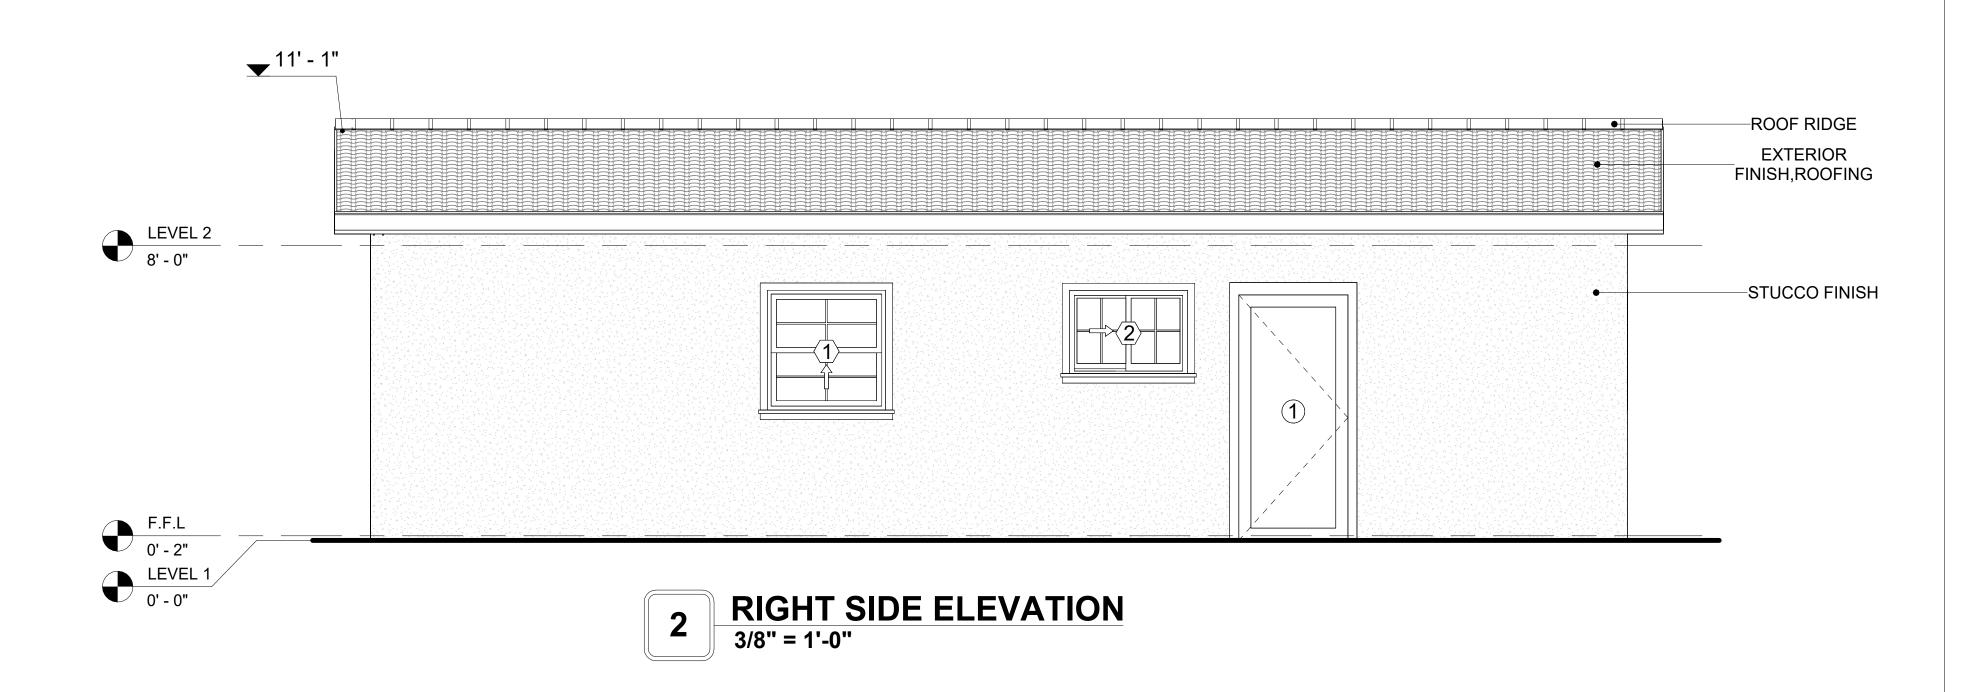


DOOR SCHEDULE						
TYPE				SIZE		
MAR K	SUPPLIER	DOOR TYPE	LOCATIO N	WIDTH	HEIGHT	COUNT
1	HOME DEPOT	EXTERIOR SINGLE PANEL SWINGING	INTERIOR	3' - 0"	6' - 8"	2
2	HOME DEPOT	INTERIOR SINGLE PANEL SWINGING	INTERIOR	3' - 0"	6' - 8"	2
3	HOME DEPOT	INTERIOR DOUBLE PANEL SLIDING	INTERIOR	5' - 10"	6' - 8"	1
4	HOME DEPOT	INTERIOR DOUBLE PANEL SLIDING	INTERIOR	4' - 8"	6' - 8"	1
5	HOME DEPOT	EXTERIOR DOUBLE PANEL SWINGING	INTERIOR	5' - 0"	6' - 8"	1

WINDOW SCHEDULE					
				SIZE	
TYPE MARK	SUPPLIER	WINDOW TYPE	WIDTH	HEIGHT	COUNT
1	HOME DEPOT	SINGLE HUNG	3' - 3"	3' - 3"	2
2	HOME DEPOT	SLIDING	3' - 3"	2' - 3"	1
3	HOME DEPOT	SINGLE HUNG	2' - 9"	3' - 3"	2
4	HOME DEPOT	FIXED	5' - 3"	3' - 9"	1



KEY PLAN

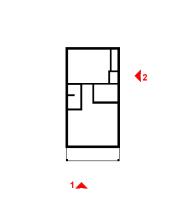

NO.	DESCRIPTION	DATE

NOTE:

LEGEND:

PROJECT

106-BENNETT-499-1BD1BA SPANISH 550

DRAWING NAME

ARCHITECTURAL ELEVATIONS

CLIENT NAME:	Client Name
PROJECT NUMBER:	0061_12
DATE:	3/8/2025 3:34:35 PM
DESIGNED BY:	Designer
DRAWN BY:	Author
CHECKED BY:	Checker

A201

ABOUT WALL FINISHING

STUCCO FINISH

STUCCO IS A CEMENT-BASED EXTERIOR WALL FINISH THAT OFFERS A DURABLE, WEATHER-RESISTANT, AND CUSTOMIZABLE CLADDING SOLUTION FOR BUILDINGS.

IN THIS SPECIFIC PROJECT, AMERICAN STUCCO SYSTEMS IS USED AS A FINISH MATERIAL BECAUSE IT IS GENERALLY CONSIDERED A WATER-RESISTANT EXTERIOR FINISH AND USES A THREE-COAT APPLICATION PROCESS.

3/8-INCH OF IT IS APPLIED AS AN EXTERNAL WALL FINISH AS IT IS THE MOST COMMON AND WIDELY ACCEPTED STANDARD THICKNESS FOR STUCCO EXTERIOR WALL FINISHES. THIS MULTI-LAYER APPROACH ALSO HELPS CREATE A STRONG, CRACK-RESISTANT STUCCO SURFACE.

THIS STANDARD STUCCO IS APPLIED OVER OSB SHEATHINGS (FOR COLD FORMED STRUCTURE CONSTRUCTION).


IT IS NOT DIRECTLY TROWELED OVER THE OSB BUT OVER A WATER-RESISTANT BARRIER (HOMEWRAP) AND METAL/PLASTIC LATH THAT ARE INSTALLED ON TOP SURFACE OF THE OSB TO PROVIDE AN ADDITIONAL LAYER OF PROTECTION AGAINST MOISTURE INTRUSION.

REGULAR INSPECTION AND PROMPT REPAIR OF ANY CRACKS, CHIPS, OR DAMAGE TO THE STUCCO FINISH IS IMPORTANT. THIS MAINTAINS THE STUCCO'S WATER-RESISTANT PROPERTIES OVER THE BUILDING'S LIFE SPAN.


CEDAR WOOD

CEDAR WOOD REFERS TO THE WOOD FROM VARIOUS SPECIES OF CEDAR TREES, WHICH ARE CONIFEROUS EVERGREEN TREES KNOWN FOR THEIR DISTINCT AROMA AND NATURAL RESISTANCE TO DECAY AND INSECTS.

IN THIS SPECIFIC PROJECT, CEDAR WOOD IS USED A FINISH MATERIAL ON BEAMS AND COLUMNS.

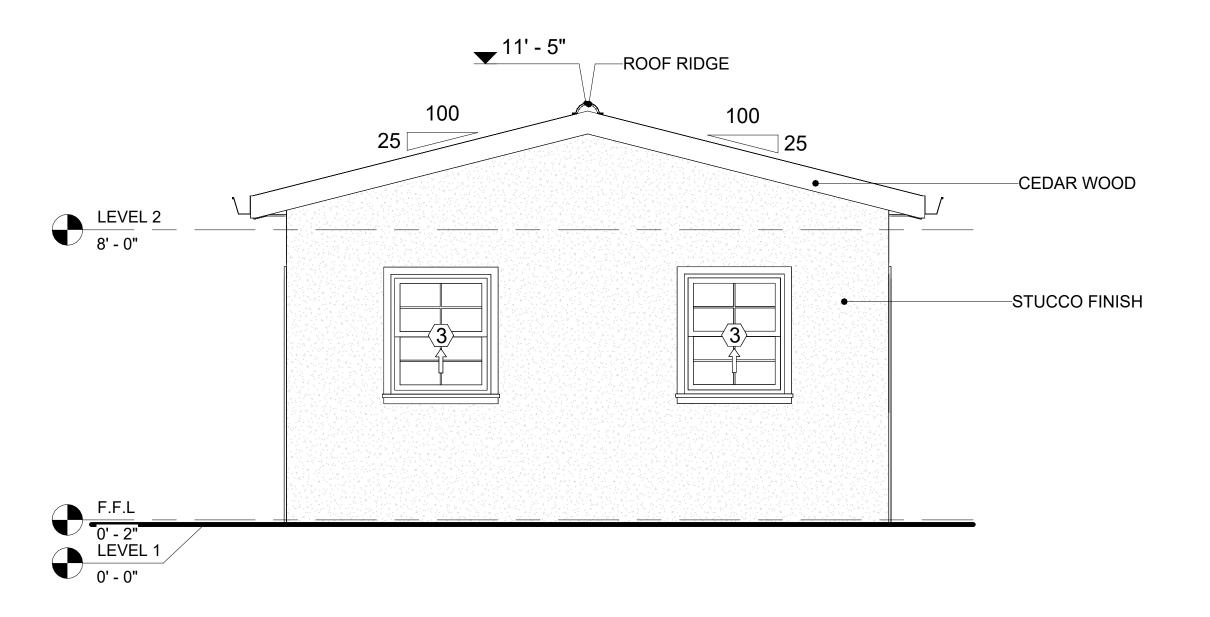


1 REAR ELEVATION
3/8" = 1'-0"

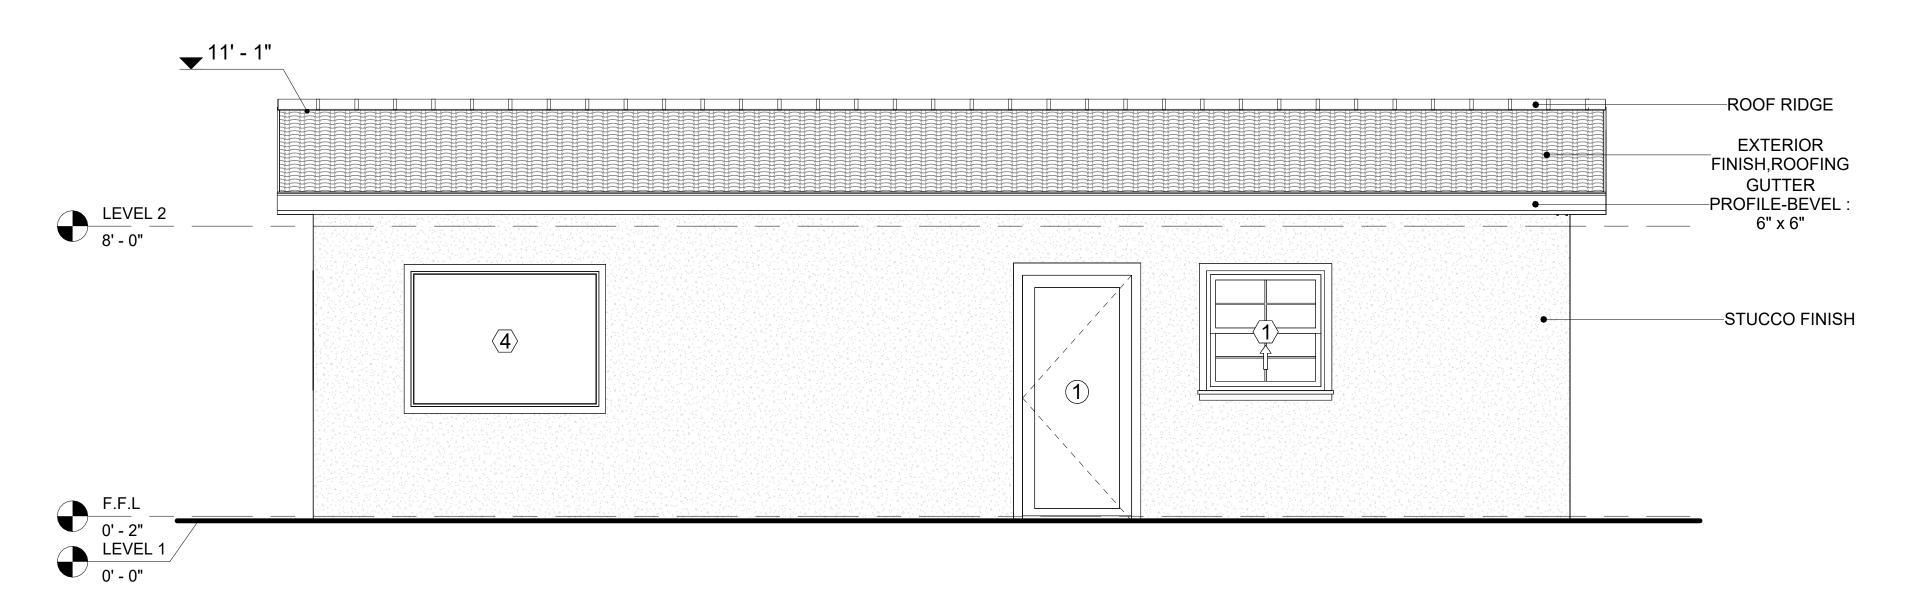

2 LEFT SIDE ELEVATION
3/8" = 1'-0"



KEY PLAN

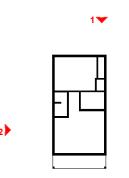

NOTE:

LEGEND:

PROJECT

106-BENNETT-499-1BD1BA SPANISH 550

DRAWING NAME

ARCHITECTURAL ELEVATIONS

CLIENT NAME:

PROJECT NUMBER:

0061_12

DATE:

3/8/2025 3:34:38 PM


DESIGNED BY:

DRAWN BY:


CHECKED BY:

Checker

A202

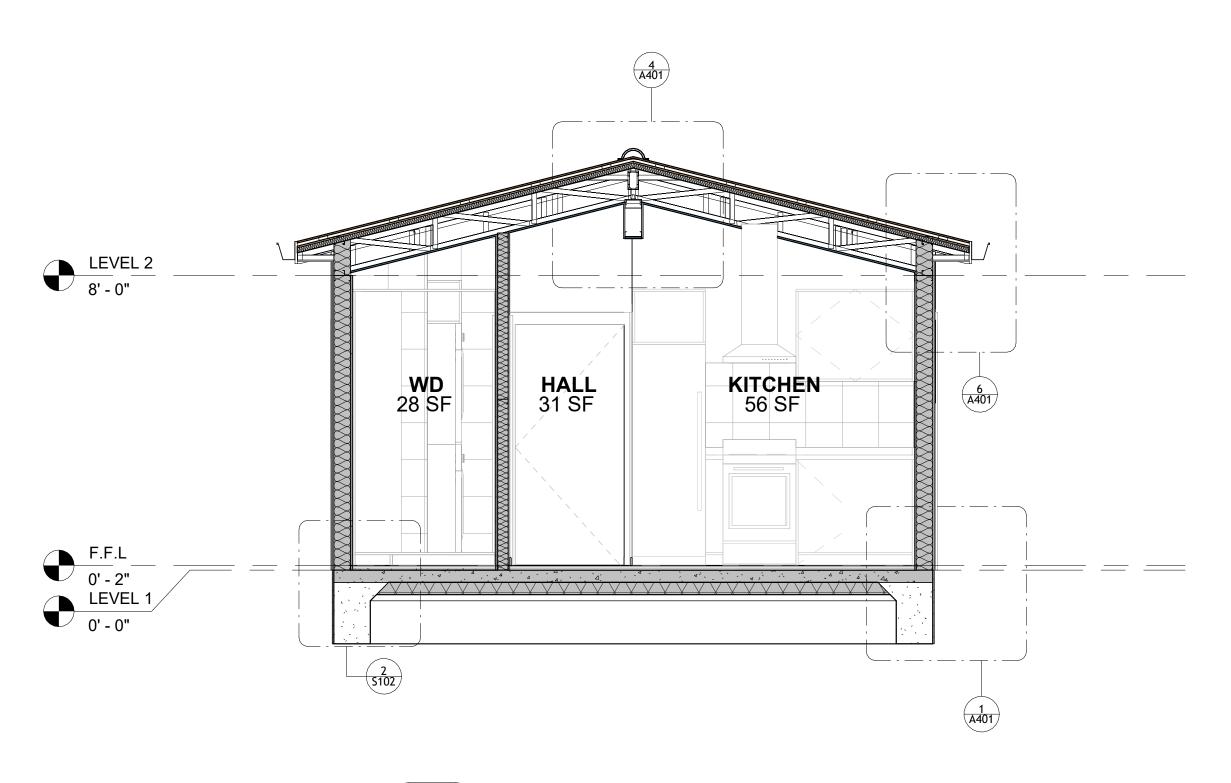


2 SECTION-2 3/8" = 1'-0"

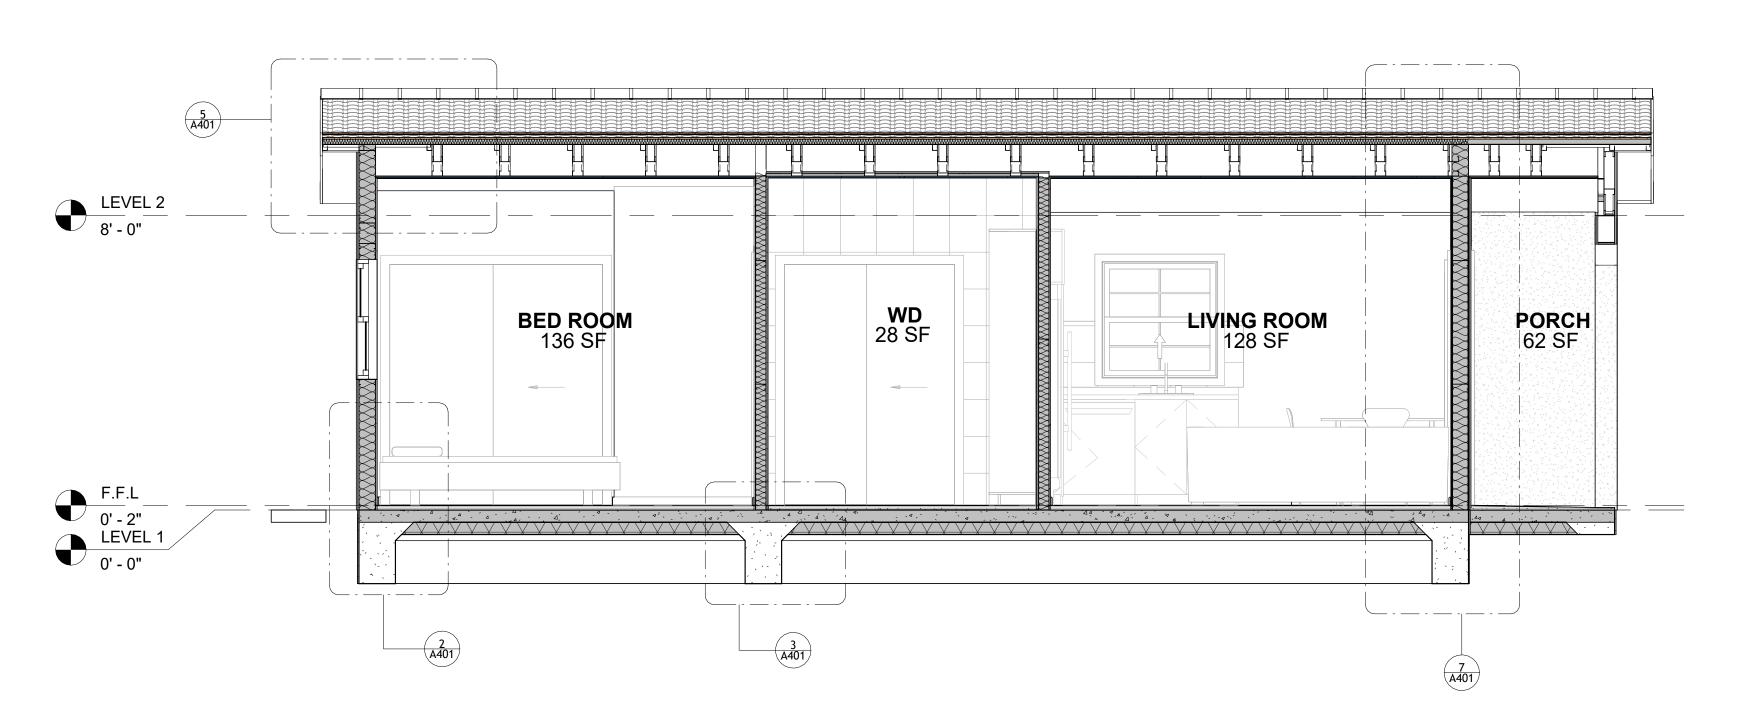

1 SECTION-3 3/8" = 1'-0"



KEY PLAN

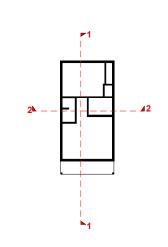

NO.	DESCRIPTION	DATE

NOTI

LEGEND:

PROJECT


106-BENNETT-499-1BD1BA SPANISH 550

DRAWING NAME


ARCHITECTURAL SECTIONS


Client Name
0061_12
3/8/2025 3:34:41 PM
Designer
Author
Checker

A301

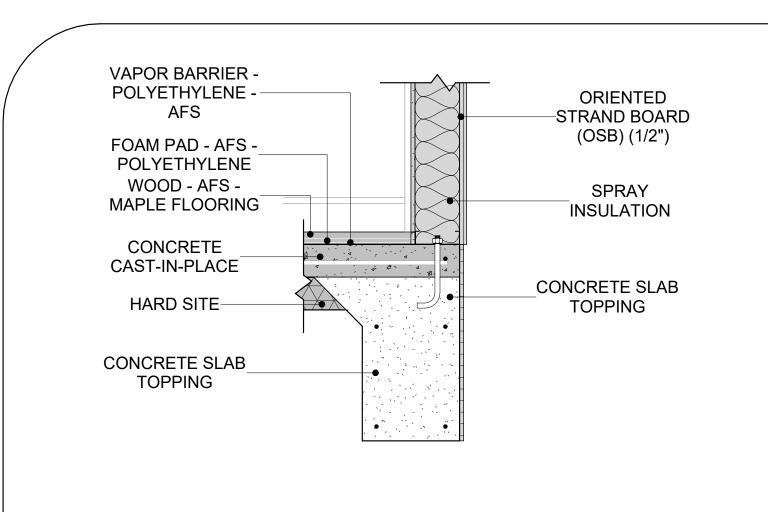



1 TYPICAL WALL FTG

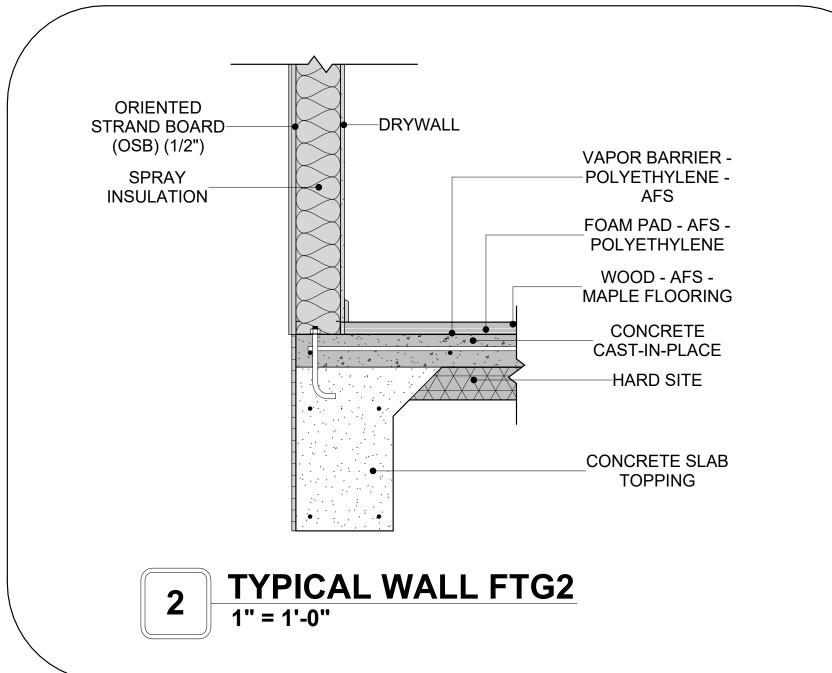


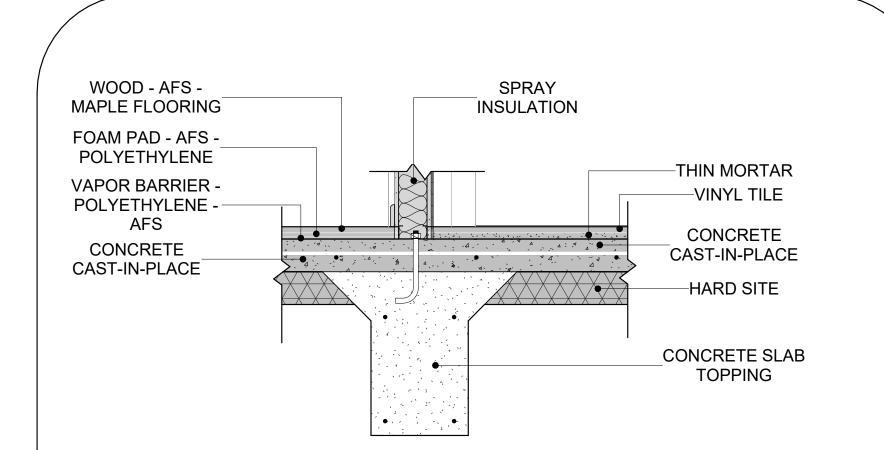


3 WALL ON FLOOR CONN.
1" = 1'-0"

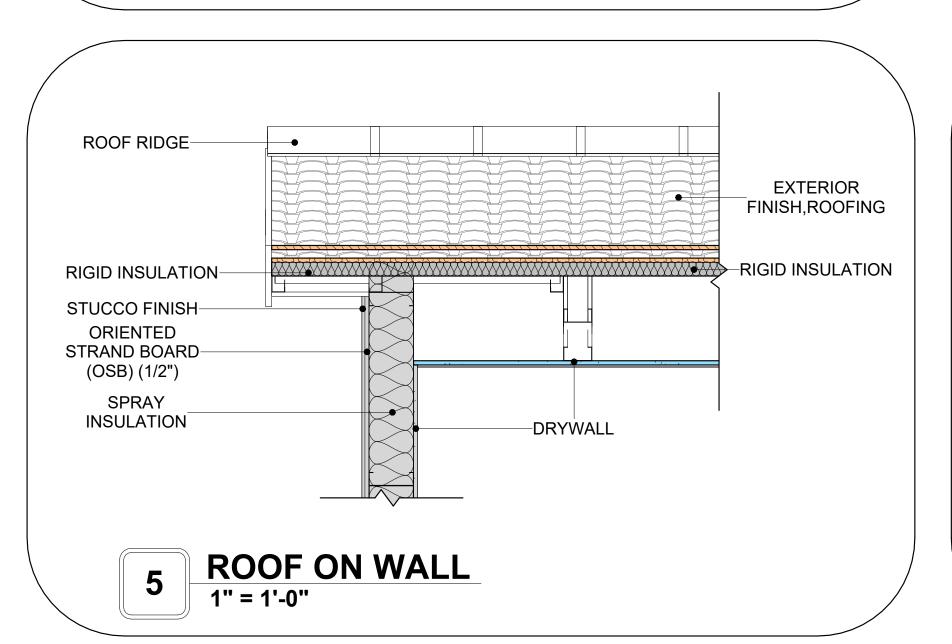

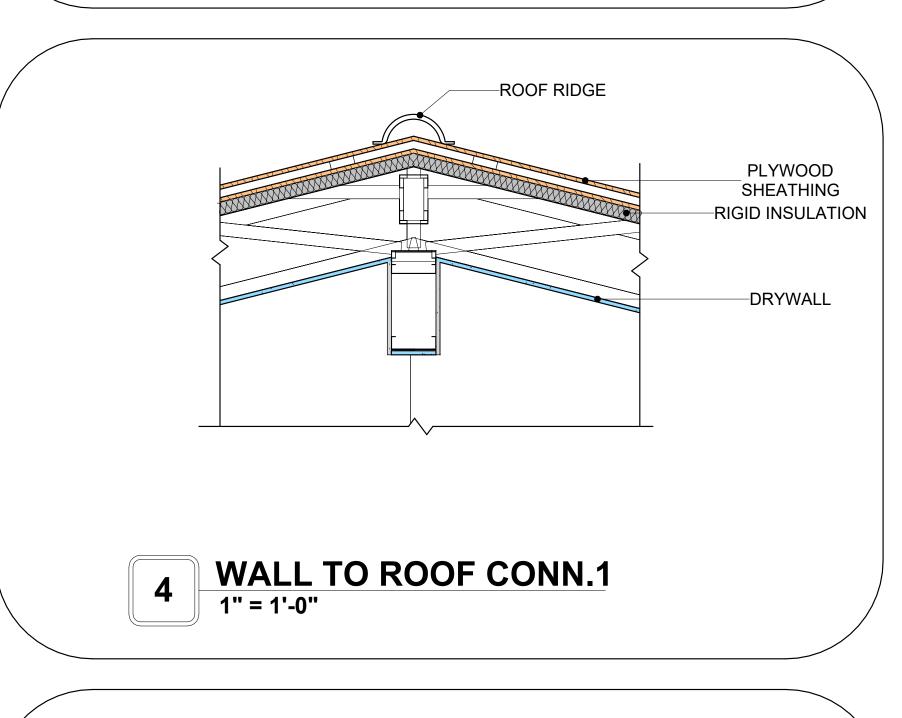

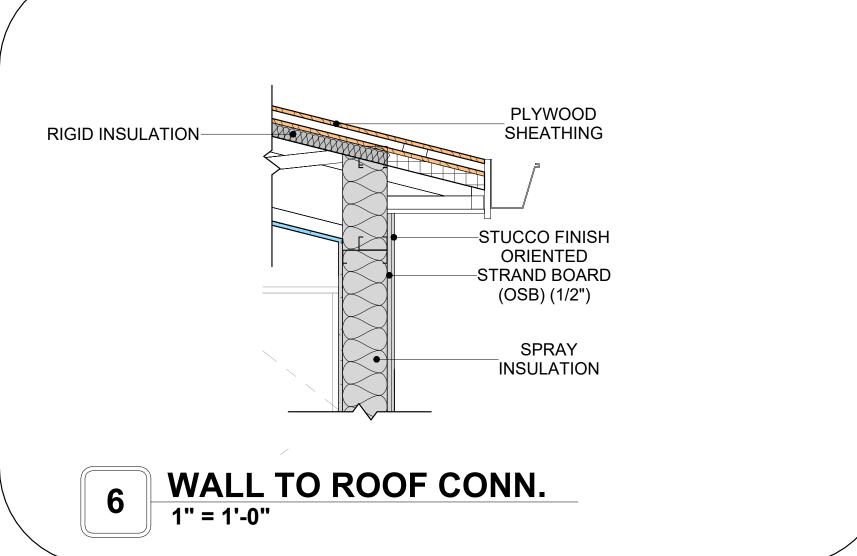

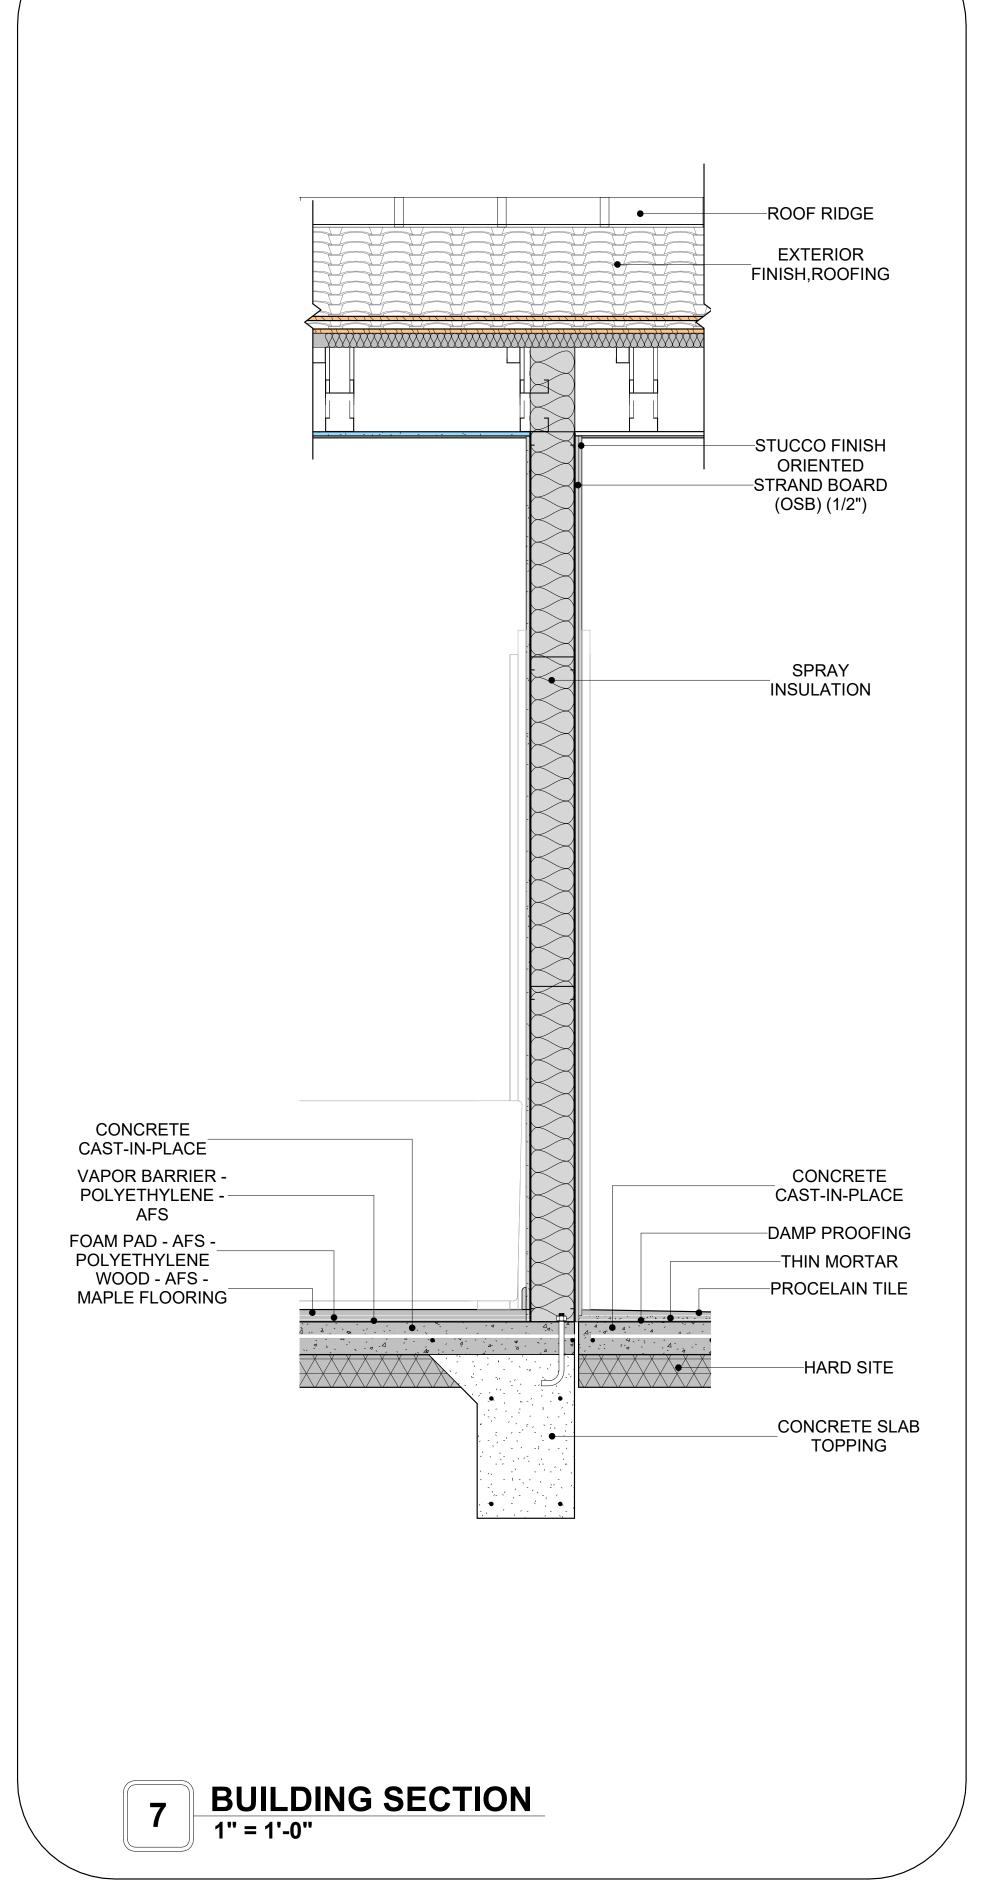



KEY PLAN

NO.	DESCRIPTION	DATE

NOTE:

LEGEND:

PROJECT

106-BENNETT-499-1BD1BA SPANISH 550

DRAWING NAME

ARCHITECTURAL DETAILS

CLIENT NAME:	Client Name
PROJECT NUMBER:	0061_12
DATE:	3/8/2025 3:34:43 PM
DESIGNED BY:	Designer
DRAWN BY:	Author
CHECKED BY:	Checker

A401


SCALE: 1" = 1'-0"


CASEWORK GENERAL NOTES

- ALL CABINET HEIGHTS INCLUDE COUNTERTOPS. DIMENSIONS ARE TO THE NEAREST INCH. DIVISIONS IN CASEWORK ARE SHOWN FOR CLARITY AND DO NOT REPRESENT BREAKS IN THE COUNTERTOP.
- PROVIDE CONTINUOUS COUNTERTOP OVER ALL SIMILAR HEIGHT CASEWORK, UNLESS AND OTHERWISE NOTED.
- MANUFACTURER AND CATALOG NUMBERS ARE FOR REFERENCE AND ILLUSTRATION PURPOSES
- DOTTED LINES INDICATE WALL HUNG CABINETS, DIVISIONS OF BASE CABINETS BELOW THE
- COUNTERTOP, FURNITURE NOT IN THE CONTRACT OR PROJECTION SCREENS -SEE CASEWORK KEY AND SPECIFICATIONS.
- ALL CABINETS AND DRAWERS TO HAVE CAM LOCKS EXCEPT FOR SINK BASE CABINETS.
 ALL EXPOSED SURFACES (EXPOSED TO VIEW FROM ANY PERSPECTIVE) TO BE COVERED WITH
- LAMINATE.
- ALL CASEWORK WHICH MEETS A WALL AT ONE OR BOTH ENDS, TO BE PROVIDED WITH FILLER PANELS AND SCRIBED TO THE WALL(S) AS REQUIRED.
- 10. ALL CABINETS AND DRAWERS ARE PROVIDED WITH RECESSED HANDLES.
- 11. CONTRACTOR TO FIELD VERIFY ALL CLEAR OPENINGS PRIOR TO MILLWORK OR CASEWORK FABRICATION.
- 12. CASEWORK DRAWINGS ARE DIAGRAMMATIC IN NATURE TO SHOW DESIGN INTENT.

	CAS	SEWOR	K SCHEDU	JLE		
TYPE MAR K	TYPE	COUN	HEIGHT	WIDTH	DEPTH	AREA
•			0. 411	- 1 011		0.05
01	L-SHAPE COUNTER TOP	1	0' - 4"	7' - 0"	7' - 0"	2 SF
02	RECESSED_MED_CABINET 2	1	2' - 0"	1' - 6"	0' - 3"	3 SF
03	BASE CABINET L-SHAPED	1	2' - 11"	3' - 3"	3' - 3"	9 SF
04	WALL FILLER	1	2' - 11"	0' - 6"	2' - 0"	1 SF
05	CLOSET_L_SHAPE 2	1	7' - 6"	4' - 9"	5' - 10"	36 SF
06	REFRIGERATOR TOP	1	1' - 6"	2' - 0"	2' - 4"	3 SF
07	VANITY	1	2' - 4"	2' - 6"	1' - 8"	6 SF
09	BASE CABINET DOUBLE DOOR 3	1	2' - 11"	2' - 10"	2' - 0"	8 SF
10	LINEAR COUNTER TOP 2	1	0' - 4"	0' - 6"	2' - 1"	0 SF
11	WALL CABINET DOUBLE DOOR 2	1	2' - 6"	3' - 3"	1' - 0"	8 SF
12	CLOSET_4	1	5' - 11"	6' - 6"	1' - 4"	38 SF
13	LAUNDRY OPEN CABINET 3	1	1' - 2"	2' - 3"	2' - 6"	3 SF
GRAND	TOTAL	12				


SPECIALTY EQUIPMENT SCHEDULE									
TYPE MARK TYPE COUNT									
01	WASHER-FRONT-LOAD	1							
02	REFRIGERATOR	1							
03	RANGE	1							
04	DRYER-FRONT-LOAD	1							
05	DISHWASHER	1							
GRAND TOTAL: 5	1	1							

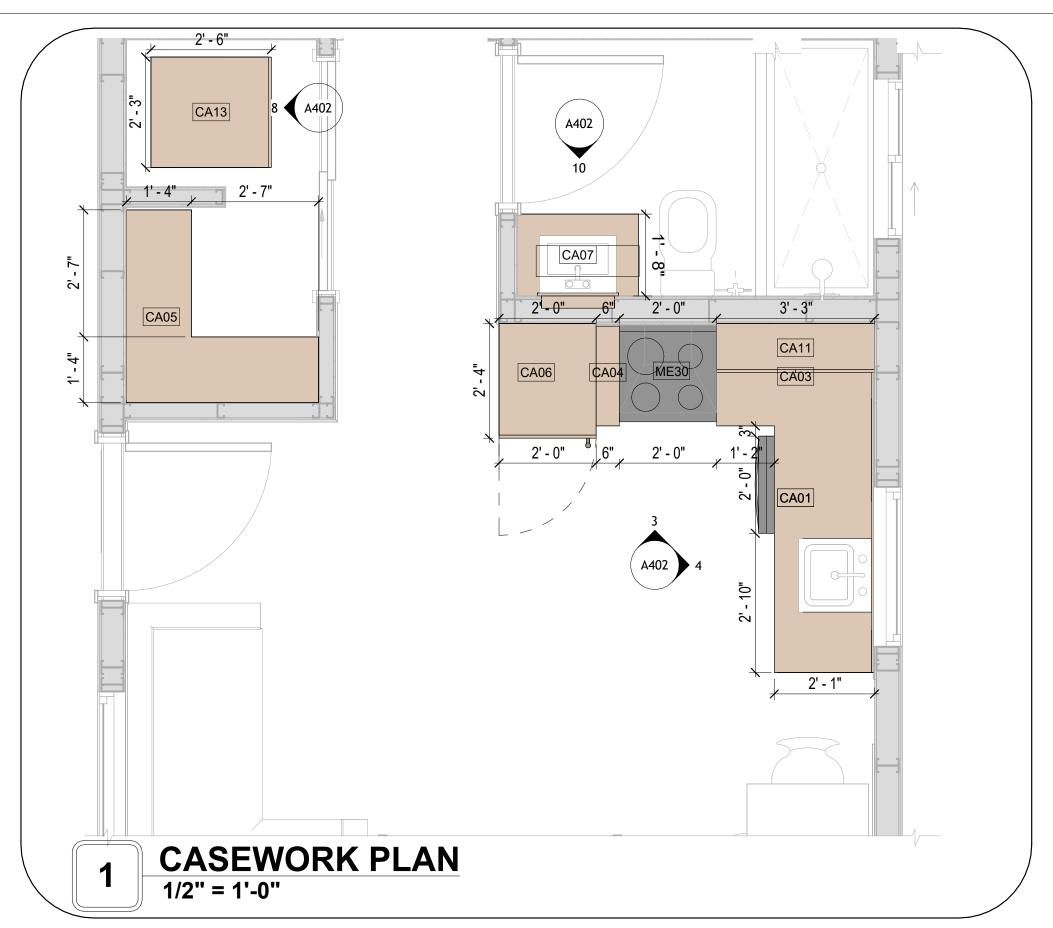

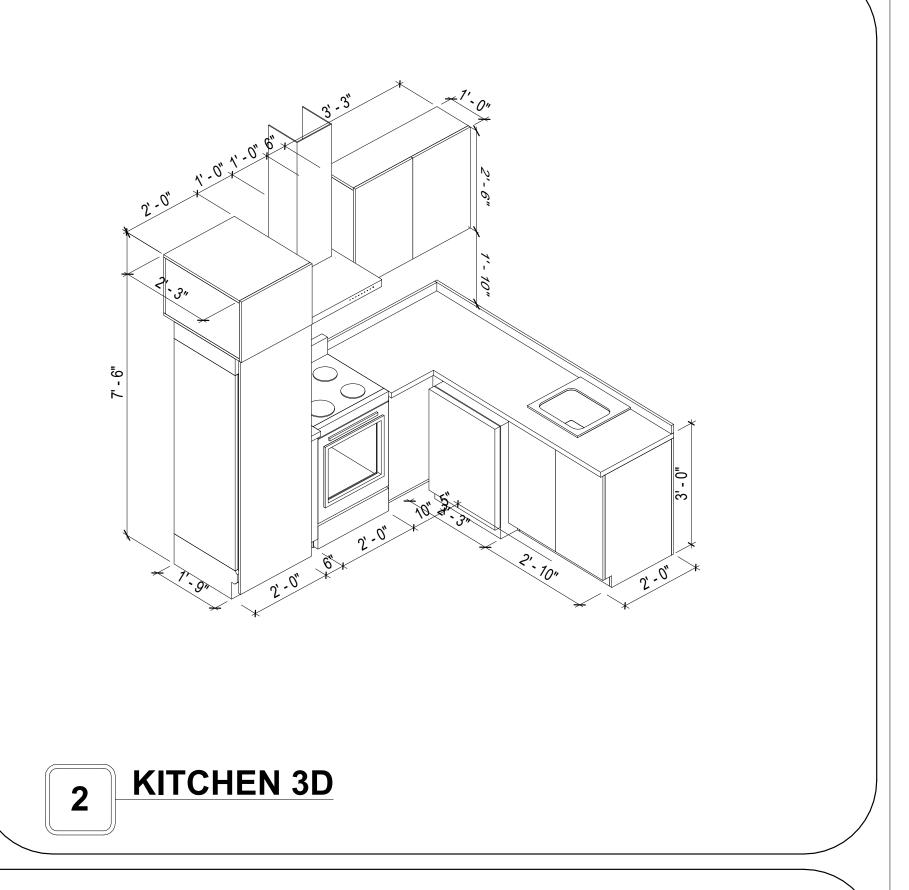




ELEVATION 1 - A 1/2" = 1'-0"

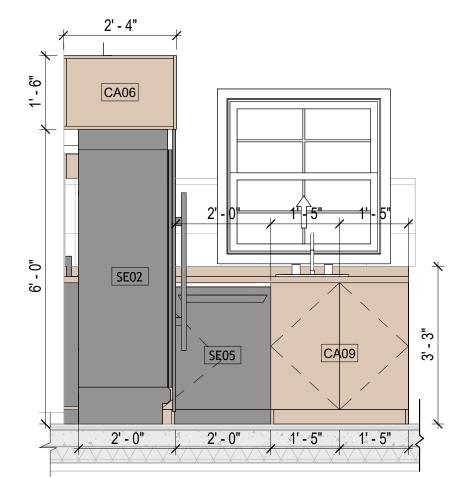



ELEVATION 1 - B 1/2" = 1'-0"

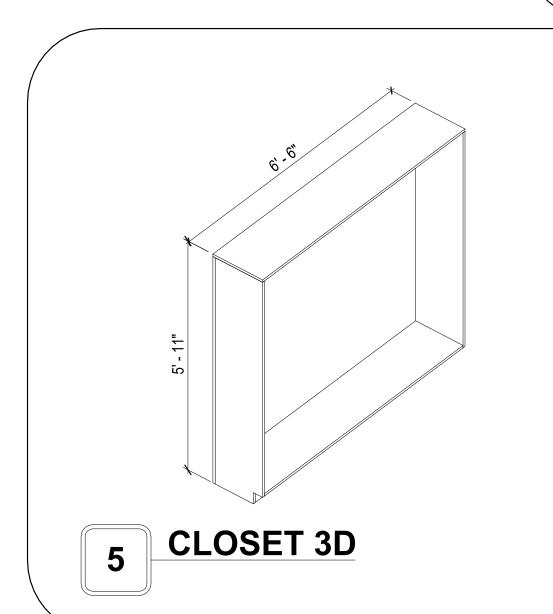


1'-4"

CLOSET 3D 1

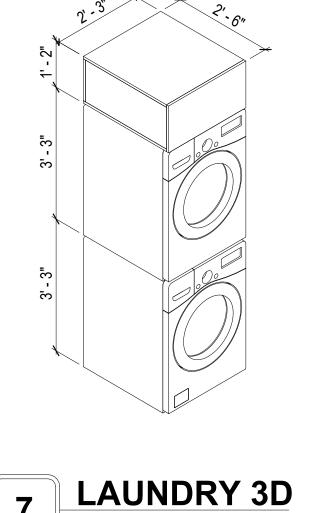


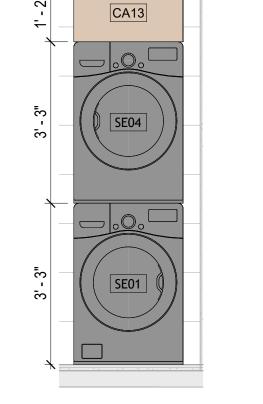

ELEVATION 1 - C 1/2" = 1'-0"

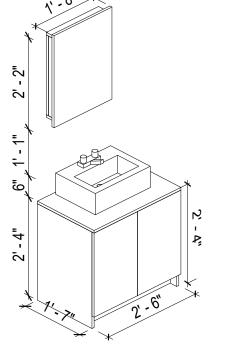

VANITY 3D

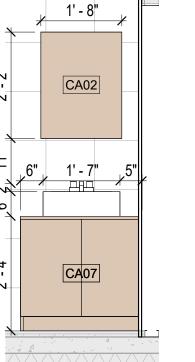

ELEVATION 1 - D

1/2" = 1'-0"

A402

106-BENNETT-499-1BD1BA

SPANISH 550

ARCHITECTURAL CASEWORK

Client Name

3/8/2025 3:34:46 PM

0061_12

Designer

Checker

Author

Tuscon,AZ, USA 888-864-0184

KEY PLAN

NO.

NOTE:

LEGEND:

PROJECT

DRAWING NAME

CLIENT NAME:

DESIGNED BY: DRAWN BY:

CHECKED BY:

DATE:

PROJECT NUMBER:

DESCRIPTION

DATE

inquire@frameupnow.com www.frameupnow.com

SCALE: As indicated © [2024] [FrameUpNow] . All rights reserved

GENERAL NOTES

1. THIS DRAWING DEPICTS THE HVAC (HEATING, VENTILATION, AND AIR CONDITIONING) SYSTEM FOR THE BENNETT 1BD 1BA SPANISH. IT PROVIDES A VISUAL REPRESENTATION OF THE SYSTEM LAYOUT AND COMPONENTS.

2.THE HVAC SYSTEM IS DESIGNED TO MEET THE SPECIFIC REQUIREMENTS OF THE BUILDING, INCLUDING HEATING, COOLING, AND VENTILATION NEEDS, AS PER THE PROJECT SPECIFICATIONS AND APPLICABLE CODES AND STANDARDS.

3. THE HVAC SYSTEM INSTALLATION SHALL COMPLY WITH THE LATEST EDITION OF THE INTERNATIONAL MECHANICAL CODE (IMC), INTERNATIONAL RESIDENTIAL CODE (IRC), AND ALL OTHER APPLICABLE LOCAL, STATE, AND NATIONAL CODES AND REGULATIONS.

4. THE EQUIPMENT SHOWN ON THIS DRAWING INCLUDES BUT IS NOT LIMITED TO AIR HANDLING UNITS (AHUS), CHILLERS, BOILERS, COOLING TOWERS, PUMPS, DUCTWORK, DIFFUSERS, GRILLES, AND CONTROL DEVICES.

5. ALL EQUIPMENT, DUCTWORK, AND PIPING SHALL BE INSTALLED IN ACCORDANCE WITH MANUFACTURER'S SPECIFICATIONS, LOCAL CODES, AND INDUSTRY BEST DRACTICES

6. ALL DUCTWORK SHALL BE SIZED, FABRICATED, AND INSTALLED IN ACCORDANCE WITH THE LATEST EDITION OF THE ACCA MANUAL D AND THE SMACNA HVAC DUCT CONSTRUCTION STANDARDS. DUCTWORK SHALL BE INSTALLED IN A NEAT AND WORKMANLIKE MANNER, PROPERLY SUPPORTED AND BRACED TO PREVENT SAGGING, AIR LEAKAGE, OR VIBRATION.

7. CONDENSATE DRAINAGE PIPING SHALL BE PROPERLY PITCHED TO ENSURE POSITIVE DRAINAGE TO AN APPROVED DISPOSAL LOCATION, SUCH AS A FLOOR DRAIN, SUMP PUMP, OR EXTERIOR GRADE. CONDENSATE LINES SHALL BE INSULATED TO PREVENT SWEATING.

8. THE LOCATION OF CONTROL PANELS AND SENSORS INDICATED ON THIS DRAWING CAN BEMODIFY WITH THE SPECIFIC LOCATIONS AND WIRING

DETAILS WILL BE DETERMINED DURING THE CONTROL SYSTEM DESIGN AND INSTALLATION.

9. THE HVAC SYSTEM DESIGN CONSIDER ENERGY EFFICIENCY, INDOOR AIR QUALITY, OCCUPANT COMFORT, AND NOISE CONTROL, FOLLOWING

APPLICABLE GUIDELINES AND REGULATIONS.

10. COORDINATION WITH OTHER TREADS HAS BEEN DONE ON A DESIGN LEVEL. THIS DRAWING SHALL BE READ TOGETHER WITH THE AR, EL AND SN DESIGN DRAWINGS TO ENSURE PROPER INSTALLATION AND INTEGRATION OF THE HVAC SYSTEMS.

11. THE HVAC CONTRACTOR IS RESPONSIBLE FOR OBTAINING ALL NECESSARY PERMITS AND LICENSES, AND FOR SCHEDULING AND COORDINATING WITH THE LOCAL BUILDING DEPARTMENT AND UTILITY PROVIDERS TO ENSURE A TIMELY AND COMPLIANT INSTALLATION.

12. ALL DUCTWORK PENETRATIONS THROUGH WALLS, FLOORS, OR CEILINGS SHALL BE PROPERLY SEALED AND FIRE-STOPPED USING APPROVED METHODS AND MATERIALS TO MAINTAIN THE INTEGRITY OF THE BUILDING'S FIRE-RESISTANCE RATINGS.

13. HVAC EQUIPMENT SHALL BE INSTALLED LEVEL AND PLUMB, AND IN STRICT ACCORDANCE WITH THE MANUFACTURER'S INSTALLATION INSTRUCTIONS AND RECOMMENDATIONS. PROVIDE ADEQUATE CLEARANCES AROUND EQUIPMENT FOR PROPER AIRFLOW, SERVICE ACCESS, AND CODE COMPLIANCE.


14. ALL HVAC EQUIPMENT AND COMPONENTS, INCLUDING THERMOSTATS, DAMPERS, AND ACCESS PANELS, SHALL BE LOCATED IN ACCESSIBLE AREAS FOR EASY SERVICING AND MAINTENANCE. PROVIDE ADEQUATE SPACE AROUND EQUIPMENT FOR PROPER AIRFLOW AND SERVICE ACCESS.


15. THE HVAC SYSTEM SHALL BE BALANCED AND ADJUSTED TO ENSURE PROPER AIRFLOW, TEMPERATURE DISTRIBUTION, AND SYSTEM PERFORMANCE THROUGHOUT THE RESIDENCE. PROVIDE A WRITTEN REPORT DOCUMENTING THE FINAL SYSTEM BALANCE.


16. ANY DEVIATIONS OR MODIFICATIONS TO THE HVAC SYSTEM DESIGN SHALL BE REVIEWED AND APPROVED BY THE RESPONSIBLE DESIGN PROFESSIONALS AND COMMUNICATED TO ALL RELEVANT PARTIES INVOLVED IN THE CONSTRUCTION PROCESS.

17. FOR ANY INQUIRIES OR CLARIFICATIONS REGARDING THE HVAC SYSTEM DESIGN, PLEASE CONSULT THE RESPONSIBLE DESIGN PROFESSIONALS OR THE PROJECT MANAGEMENT TEAM.

SYMBOLS

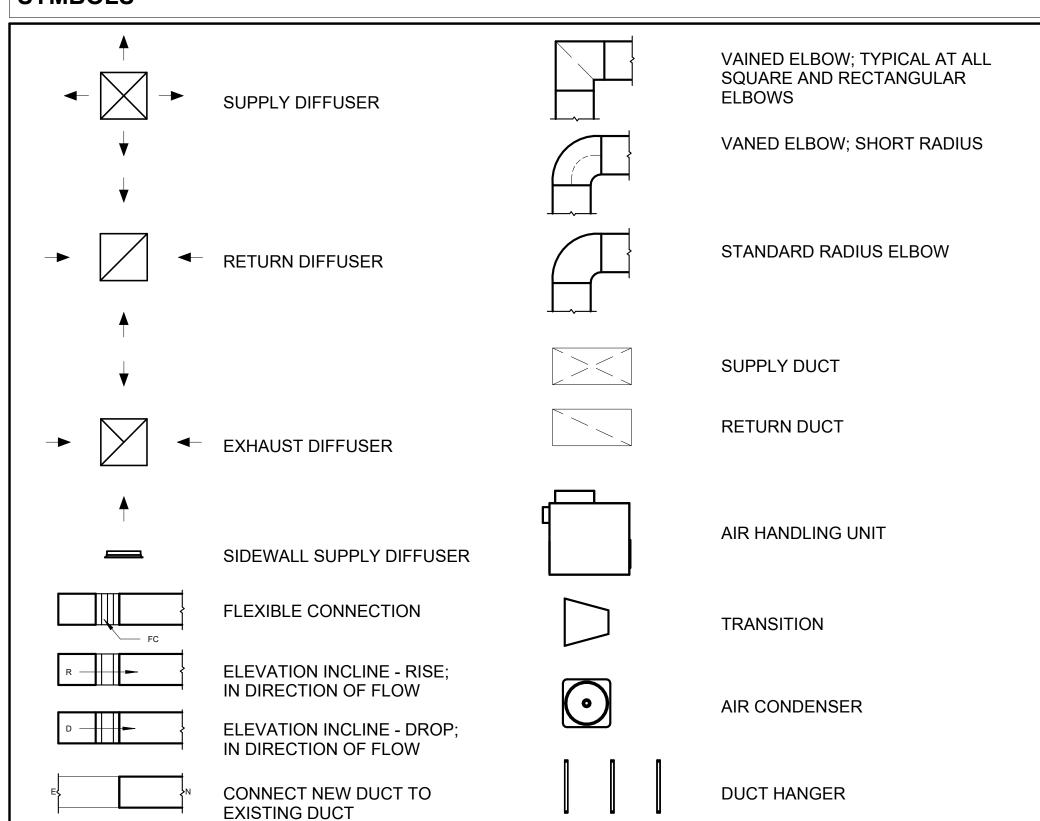

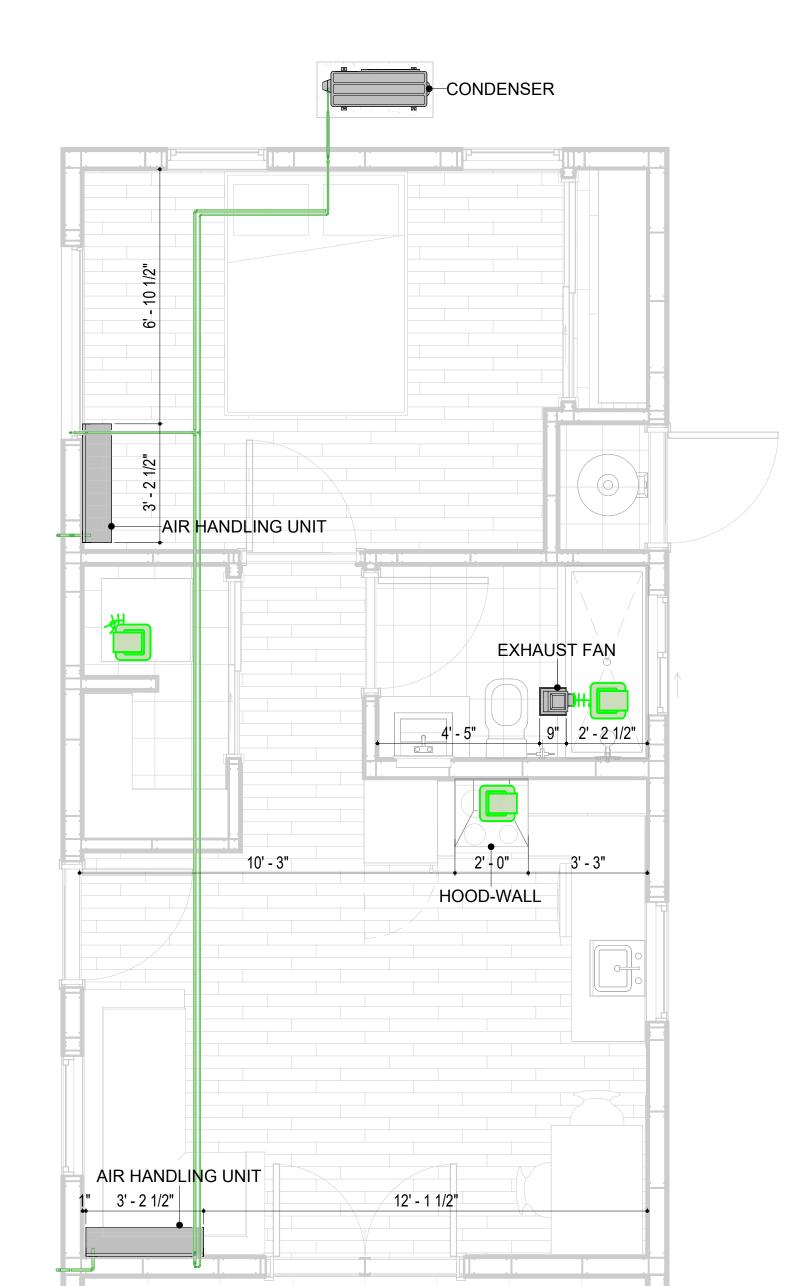

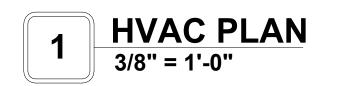

HVAC COLOR SCHEME

 AIR CONDITIONING PIPE LINE

ı	REFRIGERANT L	INE SCHEDULE							
CATAGORY DESCRIPTION DIAMETER LENGTH									
PIPE TYPES	COPPER	1/4"	0.65						
PIPE TYPES	COPPER	3/8"	52.57						
PIPE TYPES	COPPER	1/2"	0.62						
PIPE TYPES	COPPER	3/4"	59.46						

CATAGORY DESCRIPTION Size Count									
CATAGORT	DESCRIPTION	Size	Count						
ELBOW - GENERIC	ELBOW - GENERIC: STANDARD/HVAC	1/2"ø-1/2"ø	1						
ELBOW - GENERIC	ELBOW - GENERIC: STANDARD/HVAC	1/4"ø-1/4"ø	1						
ELBOW - GENERIC	ELBOW - GENERIC: STANDARD/HVAC	3/4"ø-3/4"ø	14						
ELBOW - GENERIC	ELBOW - GENERIC: STANDARD/HVAC	3/8"ø-3/8"ø	10						
TEE - GENERIC	TEE - GENERIC: STANDARD	3/4"ø-3/4"ø-3/ 4"ø	1						
TEE - GENERIC	TEE - GENERIC: STANDARD	3/8"ø-3/8"ø-3/ 8"ø	1						
TRANSITION - GENERIC	TRANSITION - GENERIC: STANDARD	3/4"ø-1/2"ø	3						
TRANSITION - GENERIC	TRANSITION - GENERIC: STANDARD	3/4"ø-5/8"ø	2						
TRANSITION - GENERIC	TRANSITION - GENERIC: STANDARD	3/8"ø-1/4"ø	1						

MECHANICAL EQUIPMENT SCHEDULE							
CATAGORY	DESCRIPTION	COUNT					
AIR HANDLING UNIT	AIR HANDLING UNIT: WALL MOUNTED	2					
CONDENSER	CONDENSER: OUT DOOR	1					
EXHAUST FAN	EXHAUST FAN: 75 CFM	1					
	HOOD-WALL: VENT	1					

DUCT FITTING SCHEDULE							
CATAGORY	DESCRIPTION	COUNT					
ROUND TRANSITION - ANGLE	45 DEGREE	5					

DUCT ACCESSORY SCHEDULE							
CATAGORY	DESCRIPTION	COUNT					
ROOF VENT	3" DIAMETER	3					

FLEX DUCT SCHEDULE									
DESCRIPTION DESCRIPTION LENGTH DIAMETER COU									
		-							
FLEX DUCT ROUND	FLEX-ROUND	8.24	4"	3					
GRAND TOTAL: 3		8.24							



KEY PLAN

NO.	DESCRIPTION	DATE

NOTE:

LEGEND:

PROJECT

106-Bennett-499-1Bd1Ba Spanish-550

DRAWING NAME

HVAC PLAN

 CLIENT NAME:
 Owner

 PROJECT NUMBER:
 15_0001

 DATE:
 3/3/2025 11:56:25 PM

 DESIGNED BY:
 Designer

 DRAWN BY:
 Author

 CHECKED BY:
 Checker

M101

SCALE: As indicated

© [2024] [FrameUpNow] . All rights reserved

ELECTRICAL NOTES

- 1. THIS DRAWING DEPICTS THE ELECTRICAL SYSTEM FOR THE 106-Bennett-499-1Bd1Ba Spanish-550. IT PROVIDES A VISUAL REPRESENTATION OF THE ELECTRICAL LAYOUT AND COMPONENTS, INCLUDING POWER DISTRIBUTION, LIGHTING, AND CONTROL SYSTEMS.
- 2. THE ELECTRICAL SYSTEM IS DESIGNED TO MEET THE SPECIFIC REQUIREMENTS OF THE BUILDING, INCLUDING POWER DISTRIBUTION, LIGHTING, AND SPECIALIZED ELECTRICAL EQUIPMENT NEEDS, AS PER THE PROJECT SPECIFICATIONS AND APPLICABLE CODES AND STANDARDS.
- 3. THE ELECTRICAL SYSTEM INSTALLATION SHALL COMPLY WITH THE LATEST EDITION OF THE NATIONAL ELECTRICAL CODE (NEC), INTERNATIONAL BUILDING CODE (IBC), AND ALL OTHER APPLICABLE LOCAL, STATE, AND NATIONAL CODES AND REGULATIONS.
- 4. LOCATIONS AS NEEDED, DEVICES ARE SHOWN ON PLANS IN APPROXIMATE IDEAL LOCATIONS, UNLESS SPECIFICALLY DIMMENSIONED.
- 5. OPEN WALLS AS NEEDED TO ALLOW FOR NEW ELECTRICAL INSTALLATIONS.
- 6. LABEL ALL CIRCUITS ON JUNCTION BOXES, RECEPTACLES, DATA, SMOKE DETECTOR, AND EQUIPMENT IN PANEL BOX.
- 7. INSTALL RACEWAY AS NEEDED FOR DDC, ACCESS CONTROL, LOW VOLTAGE WIRING & DATA.
- 8. RELABEL POWER, DATA & FIRE ALARM FOR ROOM #CHANGES.
- 9. VERIFY ALL CIRCUITS LABELED ON PRINT ARE CORRECT BEFORE WORKING ON THEM.
 10. NOTE ON SITE PLAN ALL CHANGES OR MISSING DETAIL TO BE INCORPORATED INTO THE MASTER PLAN.
- 11. DRAWINGS ARE DIAGRAMMATIC ONLY FOR THE PURPOSE OF SHOWING FIXTURE AND OUTLET LOCATIONS.
- 12. ELECTRICAL CONTRACTOR TO VERIFY SERVICE SIZE BY CALCULATION BASED UPON ACTUAL NAME PLATE RATINGS OF SELECTED FOLIPMENT
- PLATE RATINGS OF SELECTED EQUIPMENT.

 13. VERIFY LOCATION OF SERVICE ENTRANCE WITH POWER COMPANY. PROVIDE UFER GROUND IN
- 13. VERIFY LOCATION OF SERVICE ENTRANCE WITH POWER COMPANY. PROVIDE UFER GROUND IN BUILDING FOUNDATION AT SERVICE ENTRANCE LOCATION.
- BUILDING FOUNDATION AT SERVICE ENTRANCE LOCATION.

 14. PROVIDE A MIN. OF 20 FEET OF ONE *4 BARE COPPER UFER WIRE EMBEDDED IN CONCRETE FOOTING
- AT THE SERVICE ENTRANCE LOCATION WHERE APPROVED BY LOCAL SERVICE PROVIDER.

 15. PROVIDE WATERPROOF FIXTURES IN ALL HIGH MOISTURE AREAS (EXTERIOR, SHOWER AND TUB
- CEILINGS ETC.)
- 16. PROVIDE DEDICATED CIRCUITS TO EACH BATH, DEN, FAMILY ROOM, BEDROOM, LOFT, KITCHEN REFRIGERATOR, KITCHEN FREEZER DISHWASHER, AND ANY AREA/ITEM SPECIFIED BY OWNER.
- 17. INCANDESCENT FIXTURES WITH OPEN OR PARTIALLY ENCLOSED LAMPS, PENDANT FIXTURES, AND LAMP HOLDERS ARE NOT PERMITTED IN CLOSETS.
- 18. ALL WORKMANSHIP AND MATERIALS TO CONFORM WITH THE 2015 IRC.
- 19. PROVIDE A MIN. OF 20 FEET OF ONE *4 BARE COPPER UFER WIRE EMBEDDED IN CONCRETE FOOTING AT THE SERVICE ENTRANCE LOCATION WHERE APPROVED BY LOCAL SERVICE PROVIDER.
- 20. PROVIDE A BONDING CONDUCTOR CONSISTING OF A MINIMUM OF ONE *4 BARE COPPER WIRE CONNECTING THE BUILDING'S METAL WATER PIPING SYSTEM TO THE SERVICE EQUIPMENT ENCLOSURE GROUNDING.

MAIN PANEL CALCS

ELECTRICAL CALCS	
LIGHT AND OUTLETS 499 @ 3W	1,497 W
3 APPLIANCE CIRCUITS	4,500 W
DRYER	2,000 W
WASHER	2,000 W
RANGE	5,000 W
WATER HEATER	5,000 W
REFRIG.	1,800 W
DISHWASHER & DISPOSAL	3000 W
TOTAL	24,797 W
FRIST 10,000 @ 100% REMAINDER @ 40% MINI. SPLIT UNITS	10,000 W 5,919W 10,000 W
TOTAL	25,919 W

25,919 W DIVIDED BY 240V = 104 AMPS TOTAL

(USE 200 AMP SERVICE)

ELECTRICAL ABBREVIATIONS LIST

1P	1 POLE (2P, 3P, 4P, ETC.)	CTR	CENTER	HT	HEIGHT
A	AMPERE	CU	COPPER	HTG	HEATING
AC		DCP	DOMESTIC WATER CIRCULATING PUMP	_ I	HEATER
1	ABOVE COUNTER OR AIR CONDITIONER			HTR	
ACLG	ABOVE CEILING	DEPT	DEPARTMENT	HV	HIGH VOLTAGE
ADO	AUTOMATIC DOOR OPENER	DET	DETAIL	HVAC	HEATING, VENTILATING AND AIR
AF	AMP FRAME	DIA	DIAMETER	CONDITIONING	CONDITIONING
AFF	ABOVE FINISHED FLOOR	DISC	DISCONNECT	HWP	HYDRONIC WATER PUMP
AFG	ABOVE FINISHED GRADE	DIST	DISTRIBUTION	IC	INTERRUPTING CAPACITY
AFI	ARC FAULT CIRCUIT INTERRUPTER	DN	DOWN	lG	ISOLATED GROUND
AHU	AIR HANDLING UNIT	DPR	DAMPER	IMC	INTERMEDIATE METAL CONDUIT
AL	ALUMINUM	DS	SAFETY DISCONNECT SWITCH	INCAND	INCANDESCENT
ALT	ALTERNATE	DT	DOUBLE THROW	IR	INFRARED
AMP	AMPERE	DWG	DRAWING	I/W	INTERLOCK WITH
AMPL	AMPLIFIER	DDC	DIRECT DIGITAL CONTROL	J-BOX	JUNCTION BOX
ANNUN	ANNUNCIATOR APPROX APPROXIMATELY		ELECTRICAL CONTRACTOR	KV	KILOVOLT
AQ-STAT	AQUASTAT	ELEC	ELECTRIC, ELECTRICAL	KVA	KILOVOLT-AMPERE
ARCH	ARCHITECT, ARCHITECTURAL	ELEV	ELEVATOR	KVAR	KILOVOLT-AMPERE REACTIVE
ARCH	·			_ I	
	AMP SWITCH	EM	EMERGENCY EMERGY MANAGEMENT CYCLEM	KW	KILOWATT
AT	AMP TRIP	EMS	ENERGY MANAGEMENT SYSTEM	KWH	KILOWATT HOUR
ATS	AUTOMATIC TRANSFER SWITCH	EMT	ELECTRICAL METALLIC TUBING	LOC	LOCATE OR LOCATION
AUTO	AUTOMATIC	EP	ELECTRIC PNEUMATIC	LT	LIGHT
AUX	AUXILIARY	EQUIP	EQUIPMENT	LTG	LIGHTING
AV	AUDIO VISUAL	EWC	ELECTRIC WATER COOLER	LTNG	LIGHTNING
AWG	AMERICAN WIRE GAUGE	EXIST	EXISTING	LV	LOW VOLTAGE
BATT	BATTERY	EXH	EXHAUST	MAX	MAXIMUM
BD	BOARD	EXP	EXPLOSION PROOF	MAG.S	MAGNETIC STARTER
BLDG	BUILDING	FA	FIRE ALARM	M/C	MOMENTARY CONTACT
BMS	BUILDING MANAGEMENT SYSTEM	FABP	FIRE ALARM BOOSTER POWER	MC	MECHANICAL CONTRACTOR
C	CONDUIT	SUPPLY PANEL	SUPPLY PANEL	MCB	MAIN CIRCUIT BREAKER
CAB	CABINET	FACP	FIRE ALARM CONTROL PANEL	MCC	MOTOR CONTROL CENTER
CAT	CATALOG	FCU	FAN COIL UNIT	MDC	MAIN DISTRIBUTION CENTER
CATV	CABLE TELEVISION	FIXT	FIXTURE	MDP	MAIN DISTRIBUTION PANEL
CB	CIRCUIT BREAKER	FLR	FLOOR	MFR	MANUFACTURERMAIN FUSED
CCTV	CLOSED CIRCUIT TELEVISION	FLUOR	FLUORESCENT	N 41 1	DISCONNECT SWITCH
CKT	CIRCUIT	FU	FUSE	MH	MANHOLE
CLG	CEILING	FUDS	FUSED SAFETY DISCONNECT SWITCH	MIC	MICROPHONE
COMB	COMBINATION	GA	GAUGE	MIN	MINIMUM
CMPR	COMPRESSOR	GAL	GALLON	MISC	MISCELLANEOUS
CONN	CONNECTION	GALV	GALVANIZED	MLO	MAIN LUGS ONLY
CONST	CONSTRUCTION	GC	GENERAL CONTRACTOR	MMS	MANUAL MOTOR STARTER
CONT	CONTINUATION OR CONTINUOUS	GEN	GENERATOR	MOA	MULTIOUTLET ASSEMBLY
CONTR	CONTRACTOR	GFI	GROUND FAULT CIRCUIT INTERRUPTER	MSP	MOTOR STARTER PANELBOARD
CONV	CONVECTOR	GFP	GROUND FAULT PROTECTOR	MSBD	MAIN SWITCHBOARD
CP	CIRCULATING PUMP	GND	GROUND	MT	MOUNT
CRT	CATHODE-RAY TUBE	GRS	GALVANIZED RIGID STEEL (CONDUIT)	MT.C	EMPTY CONDUIT
CT	CURRENT TRANSFORMER	GYP BD	GYPSUM BOARD	UL	UNDERWRITERS LABORATORIES
	OCITICATION ON ON ONE				

Branch Panel:

Location:
Supply From:
Mounting: Recessed
Enclosure: Type 1

Volts: 120/240 Single
Phases: 1
Wires: 3

A.I.C. Rating:
Mains Type:
Mains Rating: 200 A
MCB Rating: 1 A

Notes:

Circuit Numb er	Circuit Description	Number of Elements	Rating	Length	Wire Size	A		E	3	Wire Size	Length	Rating	Number of Elements	Circuit Description	Circuit Numb er
1	BED LIGHT& SMOKE DETECTOR	14	20 A	32' - 11 29/32"	1-#12, 1-#12, 1-#12	748 VA	720 VA			1-#12, 1-#12, 1-#12	41' - 9 29/32"	20 A	4	BED RECEPTACLE	2
3	BATH GFCI & LIGHT	7	20 A	18' - 11 29/32"	1-#12, 1-#12, 1-#12			576 VA	277 VA	1-#14, 1-#14, 1-#14	15' - 9 27/32"	15 A	6	KITCHEN LIGHT	4
5	LIVING LIGHT	8	15 A	27' - 9 25/32"	1-#14, 1-#14, 1-#14	209 VA	400 VA			1-#14, 1-#14, 1-#14	30' - 9 13/32"	15 A	6	OUTDOOR LIGHT	6
7	WATER HEATER	1	30 A	22' - 5 1/4"	2-#10, 1-#10, 1-#10			2250 VA	2500 VA	2-#10, 1-#10, 1-#10	29' - 11 1/32"	30 A	1	DRYER	8
9						2250 VA	2500 VA								10
11	REFRIGERATOR	1	20 A	17' - 1 3/8"	1-#12, 1-#12, 1-#12			1800 VA	2500 VA	2-#8, 1-#8, 1-#10	13' - 2 23/32"	50 A	1	RANGE	12
13	OVEN HOOD	1	20 A	9' - 1 3/8"	1-#12, 1-#12, 1-#12	180 VA	2500 VA								14
15	KITCHEN GFCI	3	20 A	15' - 3 15/32"	1-#12, 1-#12, 1-#12			540 VA	1200 VA	1-#12, 1-#12, 1-#12	12' - 10 17/32"	20 A	1	DISHWASHER	16
17	LIVING RECEPTACLE	4	20 A	35' - 1 5/32"	1-#12, 1-#12, 1-#12	720 VA	540 VA			1-#12, 1-#12, 1-#12	40' - 7 23/32"	20 A	3	OUTDOOR GFCI	18
	WASHING MASHEIN	1	20 A	32' - 10 13/32"	1-#12, 1-#12, 1-#12			1200 VA							20
21															22
23															24
25															26
						10746 90			0 VA 7 A						•

Legen

Load Classification	Connected Load	Demand Factor	Estimated Demand	Panel	Totals
Lighting - Dwelling Unit	600 VA	100.00%	600 VA		
Other	1064 VA	100.00%	1064 VA	Total Conn. Load:	23585 VA
Receptacle	1440 VA	100.00%	1440 VA	Total Est. Demand:	22585 VA
Lighting	200 VA	100.00%	200 VA	Total Conn.:	98 A
WATER HEATER	4500 VA	100.00%	4500 VA	Total Est. Demand:	94 A
RANGE	5000 VA	80.00%	4000 VA		
DRYER	5000 VA	100.00%	5000 VA		
REFRIGERATOR	1800 VA	100.00%	1800 VA		
OVEN HOOD	1620 VA	100.00%	1620 VA		
WASHING MASHEIN	2400 VA	100.00%	2400 VA		



KEY PLAN

NO. DESCRIPTION DATE

NOTE:

LEGEND:

PROJECT

106-Bennett-499-1Bd1Ba Spanish-550

DRAWING NAME

SCHEDULE

CLIENT NAME:

PROJECT NUMBER:

DATE:

3/5/2025 11:21:23 AM

DESIGNED BY:

DRAWN BY:

CHECKED BY:

Checker

E101

SCALE: 1/4" = 1'-0"

© [2024] [FrameUpNow] . All rights reserved

ELECTRICAL NOTE

- A. PROVIDE INTERCONNECTED SMOKE ALARMS IN EACH SLEEPING ROOMS, OUTSIDE EACH SLEEPING ROOM, ON EACH STORY, IN THE HALL OR ADJACENT ROOM LUHERE THE CEILING HEIGHT OF A ROOM OPEN TO THE HALL EXCEEDS THE HALL BY 24'. SMOKE ALARMS SHALL BE PERMANENTLY HARD WIRED WITH BATTERY BACKUP.
- B. RECEPTACLE OUTLETS FOR RANGES AND CLOTHES DRYERS SHALL BE A THREE POLE WITH GROUND TYPE. FOUR WIRE GROUNDING-TYPE FLEXIBLE CORDS WILL BE REQUIRED FOR CONNECTION OF RANGES AND CLOTHES DRYERS. THE BONDING JUMPER SHALL NOT BE CONNECTED BETWEEN NEUTRAL TERMINAL AND THE FRAME OF THE APPLIANCE.
- C. TWO OR MORE 20 AMP SMALL APPLIANCE CIRCUITS SHALL BE PROVIDED TO SERVE THE KITCHEN, BREAKFAST NOOK, AND DINING ROOM. SUCH CIRCUITS SHALL HAVE NO OTHER OUTLETS.
- D. AT LEAST ONE 20 AMP BRANCH CIRCUIT SHALL BE PROVIDED TO SERVICE THE LAUNDRY ROOM. THIS CIRCUIT SHALL HAVE NO OTHER OUTLETS.
- E. ALL RECEPTACLES WITH IN 6' OF A WET BAR SINK OR KITCHEN SINK TO SERVE COUNTER TOP SURFACES MUST BE GFCI. ON KITCHEN COUNTERS 12' OR WIDER NO POINT ALONG THE WALL SHALL BE MORE THAN 2' FROM A RECEPTACLE. ALL RECEPTACLES WITH IN 6' OF KITCHEN SINK MUST BE GFCI. AT LEAST ONE GFCI RECEPTACLE SHALL
- BE INSTALLED IN THE BATHROOM ADJACENT TO EACH BASIN.

 F. FIXTURES INCLUDING CEILING FANS THAT ARE LOCATED IN DAMP LOCATIONS SHALL BE LISTED TO BE SUITABLE FOR
- SUCH LOCATIONS PER 2012 IRC
 G. PROVIDE ONE (1) SWITCHED OUTLET @ ALL BEDROOMS AND DEN
- H. CEILING FANS NOT EXCEEDING 35 LBS. (WITH OR WITHOUT ACCESSORIES MAY BE SUPPORTED BY OUTLET BOXES PROVIDED THE OUTLET BOXES ARE IDENTIFIED FOR SUCH USE PER 2012 IRC
- I. ELECTRICAL OUTLET BOXES ON OPPOSITE SIDES OF FIRE RATED WALLS SHALL BE SEPARATED BY A HORIZONTAL DISTANCE OF NOT LESS THAN 24".
- J. OUTLET BOXES IN THE WALLS BETWEEN THE GARAGE AND DWELLING SHALL BE METAL OR U.L. APPROVED FIRE RESISTIVE PLASTIC. BOXES IN GARAGE CEILING SHALL BE METAL.
- K. ALL BRANCH CIRCUITS THAT SUPPLY 120 VOLTS SINGLE PHASE 15 AND 20 AMPS RECEPTACLE OUTLETS INSTALLED IN THE DWELLING SHALL BE PROTECTED BY AN ARC FAULT CIRCUIT INTERRUPTER, EXCEPT GFCI RECEPTICLES.

NOTE:

A. RECEPTACLES MUST BE PROVIDED IN HALLWAYS 10'-0" OR MORE IN LENGTH. FOR A ONE FAMILY DWELLINGS AND EACH OF A TWO FAMILY DWELLING THAT IS AT GRADE LEVEL, AT LEAST ONE WP-GFCI RECEPTACLE OUTLET ACCESSIBLE AT GRADE LEVEL AND NOT MORE THAN 6'-6" ABOVE GRADE SHALL BE INSTALLED AT THE FRONT AND BACK OF THE DWELLING.

NOTE: APPLIANCE DISCONNECT

E4001.5 GROUNDING OF ENCLOSURES.

METAL ENCLOSURES FOR SWITCHES OR CIRCUIT BREAKERS SHALL BE CONNECTED TO AN

EQUIPMENT GROUNDING CONDUCTOR.

METAL ENCLOSURES FOR SWITCHES OR CIRCUIT BREAKERS USED AS SERVICE


EQUIPMENT SHALL COMPLY WITH THE PROVISIONS OF SECTION E3609.4. WHERE NONMETALLIC ENCLOSURES ARE USED WITH METAL RACEWAYS OR METAL-ARMORED

CABLES, PROVISIONS SHALL BE MADE FOR CONNECTING THE EQUIPMENT GROUNDING


CONDUCTOR.
NONMETALLIC BOXES FOR SWITCHES SHALL BE INSTALLED WITH A WIRING METHOD THAT

PROVIDES OR INCLUDES AN EQUIPMENT GROUNDING CONDUCTOR. (404.12)

Electrical Lights With Fan Waterproof Recessed Can Light Pendant Light Recessed Can Light Wall Lamp Standalone linear Single Switch Three way Switch Fan Switch Duplex Receptacle Triplex Receptacle GFCI Receptacle Exhaust Fan	ELECTRICAL LEGEND		
Pendant Light Recessed Can Light Wall Lamp Standalone linear Single Switch Three way Switch Fan Switch Duplex Receptacle Triplex Receptacle GFCI Receptacle		Electrical Lights With Fan	
Recessed Can Light Wall Lamp Standalone linear Single Switch Three way Switch Fan Switch Duplex Receptacle Triplex Receptacle GFCI Receptacle	0	Waterproof Recessed Can Light	
Wall Lamp Standalone linear Single Switch Three way Switch Fan Switch Duplex Receptacle Triplex Receptacle GFCI Receptacle		Pendant Light	
Standalone linear Single Switch Three way Switch Fan Switch Duplex Receptacle Triplex Receptacle GFCI Receptacle	0	Recessed Can Light	
Single Switch Three way Switch Fan Switch Duplex Receptacle Triplex Receptacle GFCI Receptacle	– ₫)	Wall Lamp	
Three way Switch Fan Switch Duplex Receptacle Triplex Receptacle GFCI Receptacle		Standalone linear	
Fan Switch Duplex Receptacle Triplex Receptacle GFCI Receptacle	⊬1 3	Single Switch	
Duplex Receptacle Triplex Receptacle GFCI Receptacle	₩	Three way Switch	
Triplex Receptacle GFCI Receptacle	≠	Fan Switch	
GFCI Receptacle		Duplex Receptacle	
		Triplex Receptacle	
Exhaust Fan	⊕ GFCI	GFCI Receptacle	
_		Exhaust Fan	
Smoke and heat detector			

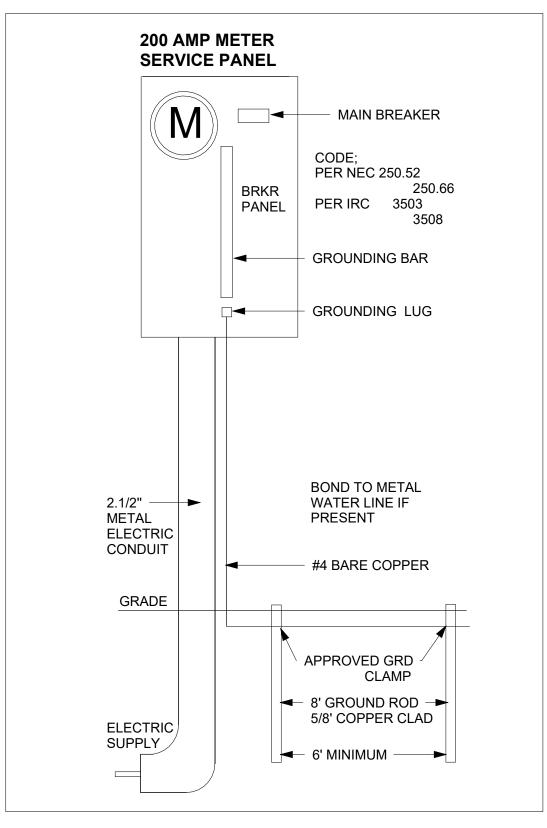



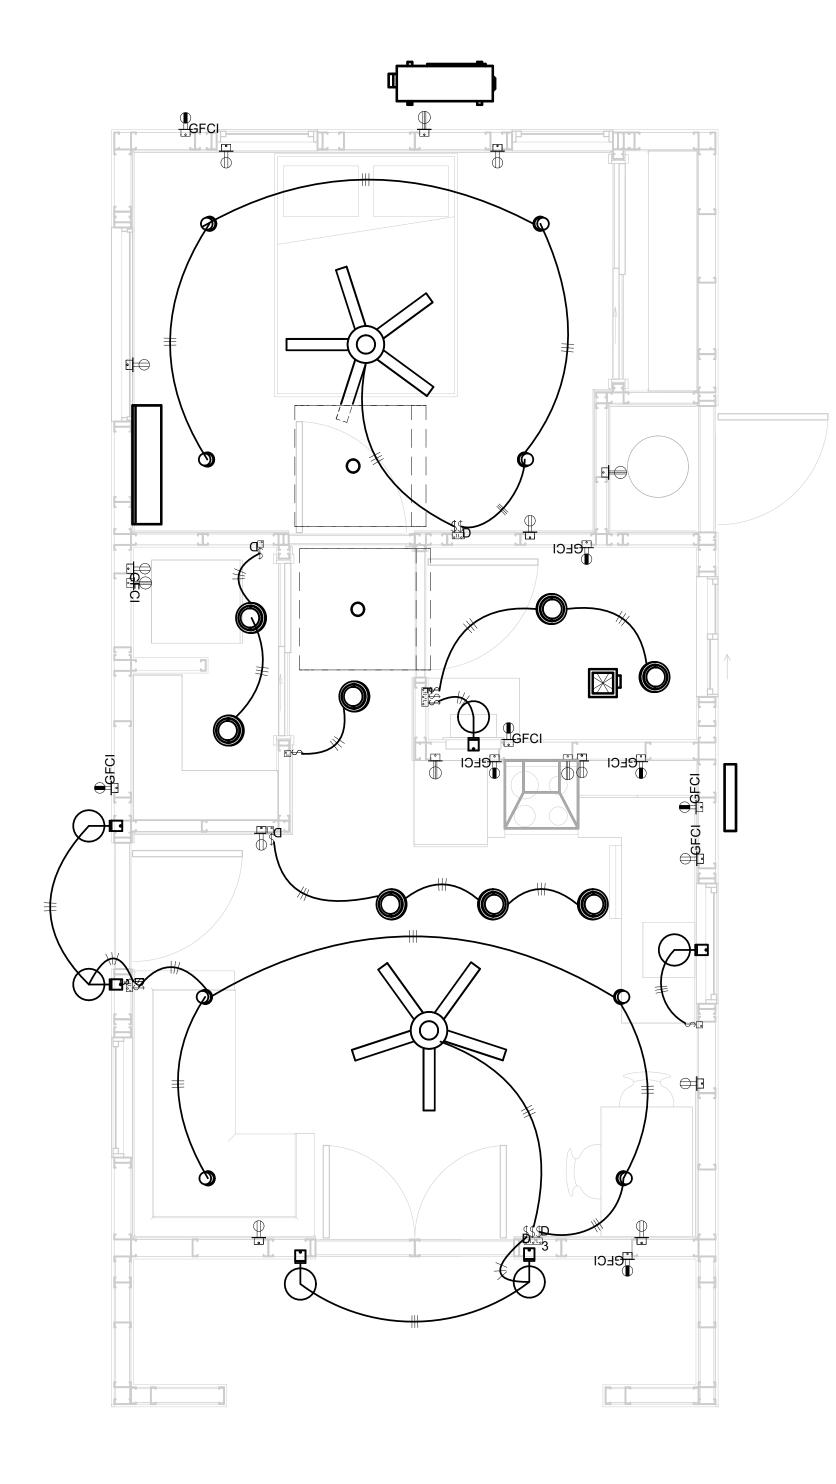

1 1 - Lighting 3/8" = 1'-0"



KEY PLAN

DESCRIPTION	DATE
	DESCRIPTION

NOTE:

LEGEND:

PROJECT

106-Bennett-499-1Bd1Ba Spanish-550

DRAWING NAME


LIGHTING

CLIENT NAME:	Owner
PROJECT NUMBER:	0201_12
DATE:	3/5/2025 11:21:24 AM
DESIGNED BY:	Designer
DRAWN BY:	Author
CHECKED BY:	Checker


E102

NOTES: CONDUIT, CABLE AND WIRING


- Use Metalic Conduits (IMC) for cables running under concrete slabs.
 Use IMC for circuits with high voltage appliances (240 volts and above)
 For circuits with 120 volts consider using EMT or PVC conduits if needed.
 For Low voltage applications up to 50 volts consider using non metalic conduits.
 All conduits to be used in the project must conform to the latest National Electrical Code (NEC),
- 6. All wiring and cables to be used in the project must also conform to the latest National Electrical
- 7. All cables and wires used should be rated for their respective loading and should be gauged and conform to the NEC.

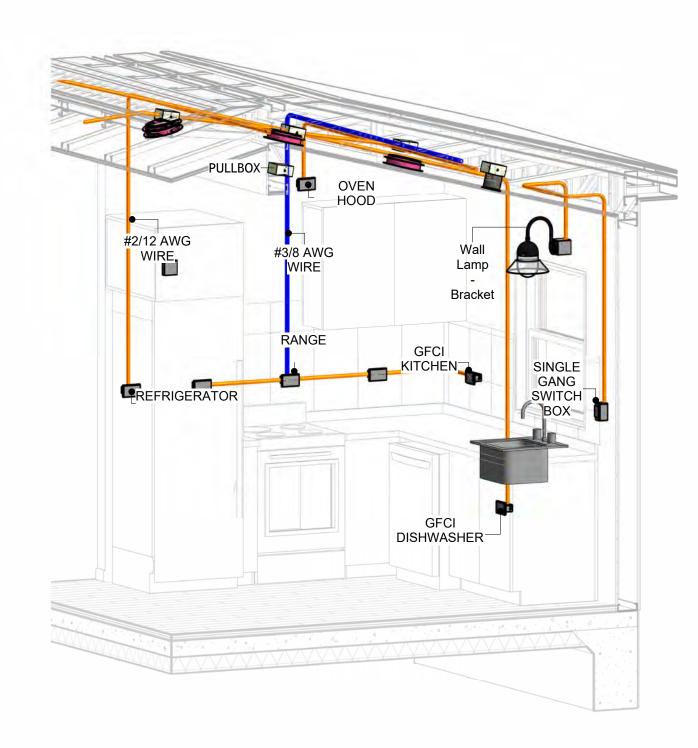

3D-KITCHEN

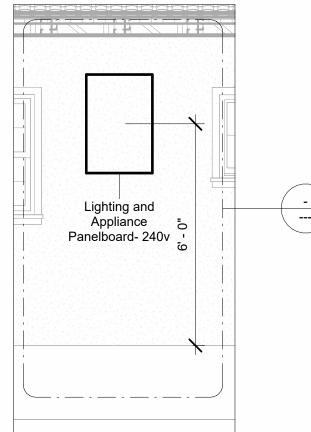


Section 1 3/8" = 1'-0"

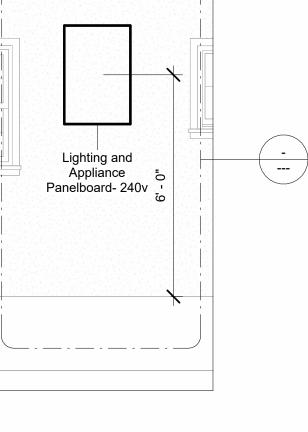


TRIPLE
GANG
SWITCH
BOX DUPLEX RECEPTCALE

Section 3 3/8" = 1'-0"

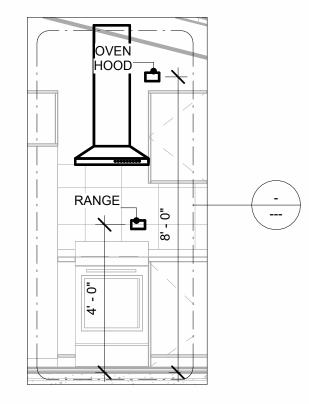

Section 2 3/8" = 1'-0"

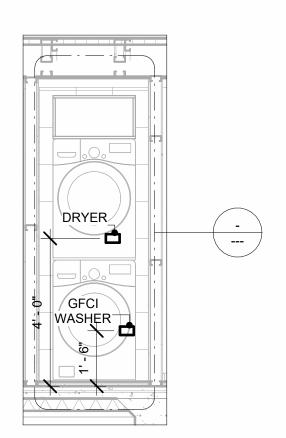

Section 4 3/8" = 1'-0"



KEY PLAN

DESCRIPTION DATE

NOTE:

LEGEND:

PROJECT

106-Bennett-499-1Bd1Ba Spanish-550

DRAWING NAME

POWER

Owner CLIENT NAME: 0201_12 PROJECT NUMBER: 3/5/2025 11:21:49 AM DATE: Designer DESIGNED BY: DRAWN BY: CHECKED BY: Checker

E103

SCALE: 3/8" = 1'-0"

NOTES: LIGHT

- 1. LIGHT FIXTURES AND LUMINARIES SHALL CONFORM TO THE NEC, THE IRC AND LOCAL SAFETY & BUILDING CODE.
- 2. ALL LIGHTING FIXTURES SHOULD CONFORM TO THE DESIGN ELECTRICAL LOAD AND SHALL BE PROPERLY WIRED AND MOUNTED BY QUALIFIED ELECTRICIAN FOLLOWING MANUFACTURERS SPECIFICATIONS.
- 3. CEILING FANS AND FANS WITH LIGHT WITH WEIGHT EXCEEDING 35 LBS SHOULD BE PROVIDED WITH STRUCTURAL BACKING FOR SUPPORT AND SHALL BE FIXED AS PER MANUFACTURERS SPECIFICATIONS.
- 4. EXTERIOR LIGHTS SHALL CONFORM TO LOCAL BUILDING CODE AND GUIDELINES.

NOTES: SWITCH JUNCTION BOX


- 1. THE MINIMUM SIZE OF JUCTION BOX TO BE USED IS 2"X4"X(1.5" OR 3.5" DEEP) THIS ARE TO BE USED FOR SINGLE GANG SWITCH OR OUTLETS.
- 2. FOR DOUBLE GANG (2 GANG) OUTLETS AND SWITCHS THE MINIMUM SIZE OF THE
- JUCTION BOX TO BE PROVIDED SHALL NOT BE LESS THAN 4"X4"X(1.5" OR 3.5" DEEP)
- 3. FOR THREE GANG (3 GANG) OUTLETS AND SWITCHS THE MINIMUM SIZE OF THE JUĆTION BOX SHALL NOT BE LESS THAN 6"X4"X(1.5" OR 3.5" DEEP).

FITTING SCHEDULE(PULL BOX)			
FAMILY COUNT DES			
PULLBOX1	20	#1/4 PULLBOX	

ELECTRICAL FIXTURE SCHEDULE (SWITCH BOX)			
TYPE	COUNT		
DOUBLE GANG SWITCH BOX	2		
SINGLE GANG SWITCH BOX	4		
TRIPLE GANG SWITCH BOX	2		

LIGHTING DEVICE			
TYPE	COUNT		
DIMMER	4		
FAN SWITCH	1		
SINGLE POLE	7		
THREE WAY WITH DIMMER	2		

LIGHTING FIXTURE				
LIGHTING FIXTURE TYPE	VOLTAGE	ELECTRICAL LOAD	COUNT	
ELECTRICAL_LIGHTS_FAN-LIGHT1	120 V/1-100 VA- 120 V/1-100 VA	200 A, 120 V/240 V, SINGLE PHASE, 3 WIRES	2	
LIGHTING_OTHER_LUMENWE RX_SHELL-RECESSED-8	120 V/1-60 VA	200 A, 120 V/240 V, SINGLE PHASE, 3 WIRES	8	
SASSO 100 ROUND WALLWASHER TRIM	120 V/1-28 VA	200 A, 120 V/240 V, SINGLE PHASE, 3 WIRES	8	
WALL LAMP - BRACKET	120 V/1-100 VA	200 A, 120 V/240 V, SINGLE PHASE, 3 WIRES	6	

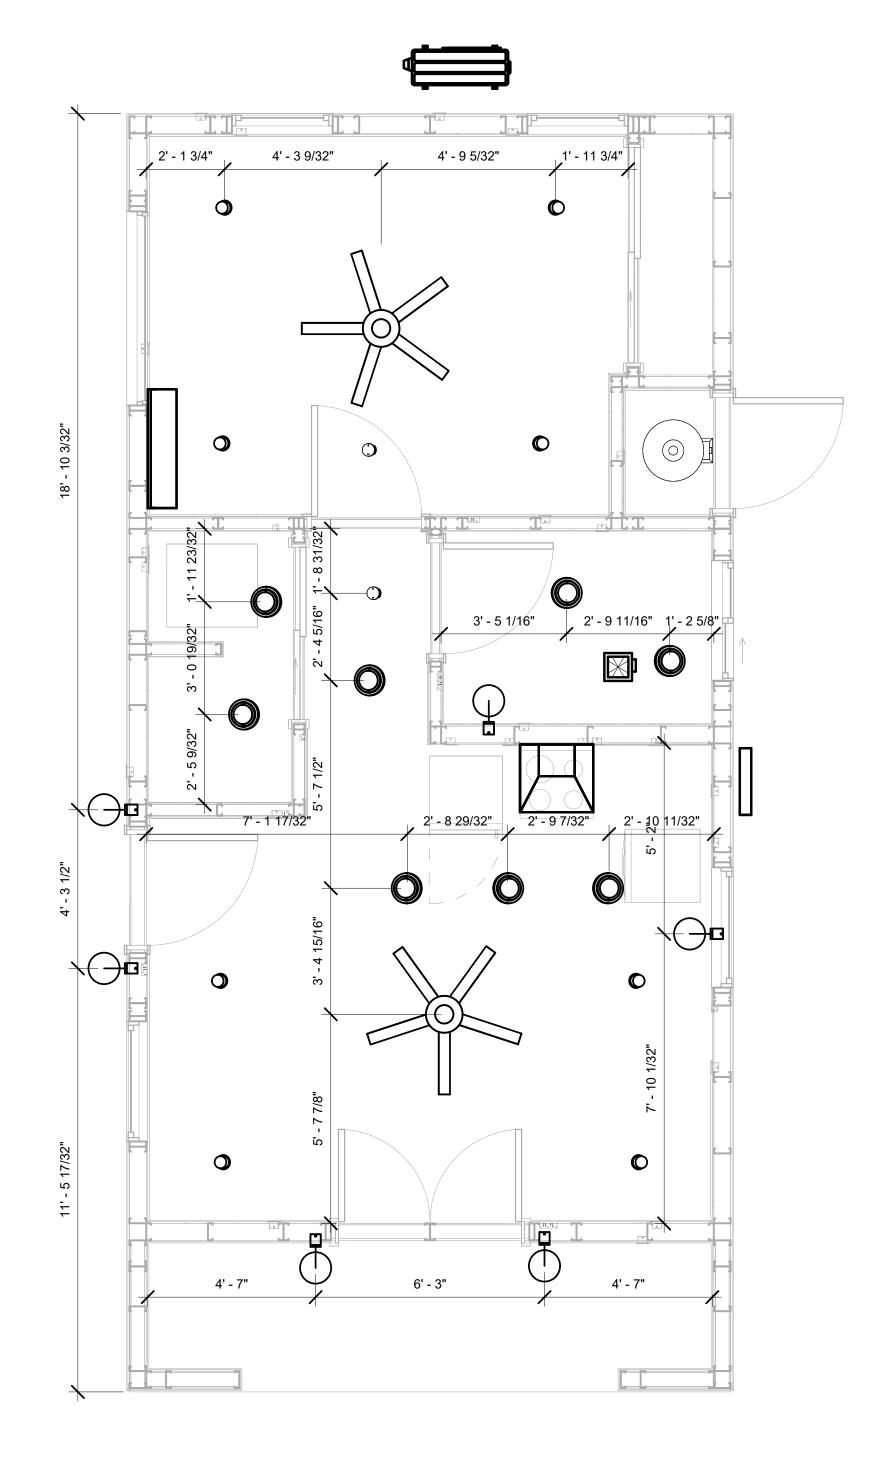

DIMENSION FOR LIGHT FIXTURES 3/8" = 1'-0"



KEY PLAN

NO.	DESCRIPTION	DATE

NOTE:

LEGEND:

PROJECT

106-Bennett-499-1Bd1Ba Spanish-550

DRAWING NAME

DIMENSION PLAN FOR LIGHT FIXTURES

CLIENT NAME:	Owner
PROJECT NUMBER:	0201_12
DATE:	3/5/2025 11:21:50 AM
DESIGNED BY:	Designer
DRAWN BY:	Author
CHECKED BY:	Checker


E104

NOTES;

- 1. VERIFY EQUIPMENT PLUG CONFIGURATION BEFORE PURCHASING RECEPTACLES
- 2. FOR ALL EQUIPMENT.
- 3. COORDINATE EXACT LOCATION OF LIGHT FIXTURES, WALL SWITCHES, RECEPTACLES AND OTHER DEVICES WITH ARCHITECTURAL DRAWINGS.
- 4. USE METALLIC JUNCTION BOX WITH THE GFCI RECEPTACLES, WITH HIGHT VOLTAGE.

ELECTRICAL FIXTURE SCHEDULE (RECEPTACLE)			
COUNT			
1			
1			
8			
2			
1			
3			
3			
1			
1			
1			
1			
1			

ELECTRICAL OUTLET SCHEDULE			
TYPE	CIRCUIT NUMBER	ELECTRICAL DATA	COUNT
CONDENSER		120 V/1-5000 VA	1
DUPLEX RECEPTCALE	2	120 V/1-180 VA	4
GFCI BATH ROOM	3	120 V/1-180 VA	2
WATER HEATER	7,9	240 V/2-4500 VA	1
DRYER	8,10	240 V/2-5000 VA	1
REFRIGERATOR	11	120 V/1-1800 VA	1
RANGE	12,14	240 V/2-5000 VA	1
OVEN HOOD	13	120 V/1-180 VA	1
GFCI KITCHEN	15	120 V/1-180 VA	3
GFCI DISHWASHER	16	120 V/1-1200 VA	1
DUPLEX RECEPTCALE	17	120 V/1-180 VA	4
GFCI OUT DOOR	18	120 V/1-180 VA	3
GFCI WASHER	19	120 V/1-1200 VA	1

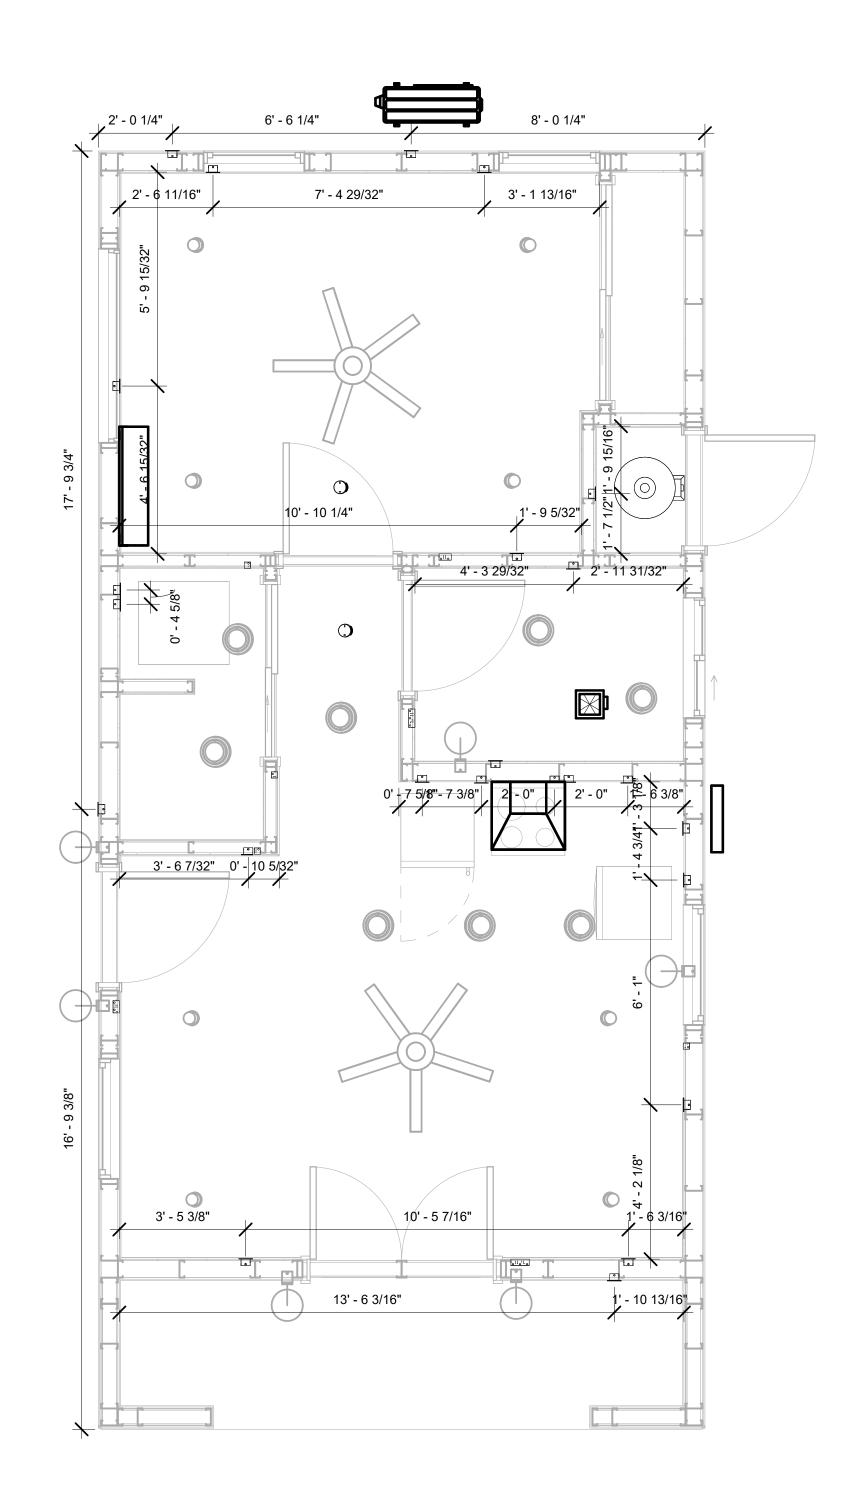

1 DIMENSION FOR FITTINGS
3/8" = 1'-0"



KEY PLAN

NO.	DESCRIPTION	DATE

NOTE:

LEGEND:

PROJECT

106-Bennett-499-1Bd1Ba Spanish-550

DRAWING NAME

DIMENSION PLAN FOR FITTINGS

CLIENT NAME:	Owner
PROJECT NUMBER:	0201_12
DATE:	3/5/2025 11:21:51 AM
DESIGNED BY:	Designer
DRAWN BY:	Author
CHECKED BY:	Checker

E105

SHEET LIST					
	Sheet Number	Sheet Name			
F	P101	NOTE AND SCHEDULE			
F	P102	WATER SUPPLY AND SEWAGE			

PIPe Color	SCHEME
	DOMESTIC COLD WATER DOMESTIC HOT WATER SANITARY VENT SANITARY SEWER
=	STORM DRAINAGE Gray Water GAS LINE

PLUMBING

SYSTEM

-NOTES

- 1. The plumbing system is designed to meet the building's domestic water supply, sanitary drainage, and storm drainage requirements, as per project specifications and applicable codes.
- The system installation shall comply with the latest International Plumbing Code (IPC), International
- Residential Code (IRC), and all other relevant local, state, and national regulations.

 3. ALL PLUMBING WORK SHALL COMPLY WITH THE LATEST EDITION OF THE INTERNATIONAL
- PLUMBING CODE (IPC) AND THE LOCAL PLUMBING CODE.

 4. PLUMBING SYSTEMS SHALL BE TESTED AND INSPECTED IN ACCORDANCE WITH THE
- LOCAL PLUMBING CODE REQUIREMENTS.
- 5. PLUMBING FIXTURES SHALL BE INSTALLED WITH THE APPROPRIATE TRIM, FITTINGS, AND
- ACCESSORIES, AS RECOMMENDED BY THE MANUFACTURER.

 6. PIPING SHALL BE PROPERLY SUPPORTED AND SECURED TO PREVENT SAGGING,
- MOVEMENT, AND VIBRATION.
- 7. SHUT-OFF VALVES SHALL BE PROVIDED AT ALL BRANCH CONNECTIONS AND AT THE
- INLET AND OUTLET OF EACH PIECE OF EQUIPMENT.

 8. BACKFLOW PREVENTION DEVICES SHALL BE INSTALLED AS REQUIRED BY THE LOCAL
- PLUMBING CODE TO PROTECT THE POTABLE WATER SYSTEM.

 9. PLUMBING FIXTURES AND EQUIPMENT SHALL BE ACCESSIBLE FOR MAINTENANCE AND
- SERVICING.

 10. EXPOSED PLUMBING PIPING AND FIXTURES SHALL BE INSULATED TO PREVENT
- 10. EXPOSED PLUMBING PIPING AND FIXTURES SHALL BE INSULATED TO PREVEN CONDENSATION AND ENERGY LOSS.
- 11. DEAD ENDS IN THE DRAINAGE SYSTEM MUST BE AVOIDED, EXCEPT WHERE NECESSARY TO INSTALL A CLEANOUT IN AN ACCESSIBLE LOCATION, AND MUST HAVE A VENTED CONNECTION TO THE OUTSIDE ATMOSPHERE.
- 12. THE VERTICAL DEFLECTION OF PVC PIPE MUST NOT EXCEED 5%, AND NO DEFLECTION IS PERMITTED FOR IRON PIPE.
- 13. WORK MUST BE PROPERLY COORDINATED WITH OTHER TRADES TO AVOID CONFLICTS, REFERRING TO THE ARCHITECTURAL AND STRUCTURAL DRAWINGS FOR INFORMATION REGARDING CEILING ELEVATIONS, SPACE CLEARANCES, WALL AND PARTITION LOCATIONS, ETC.
- 14. ALL FIXTURES SHALL HAVE ACCESSIBLE STOPS.
- 15. DOMESTIC WATER PIPING SHALL BE PEX, AND PVC PIPING IS NOT ACCEPTABLE FOR INTERIOR USE.
- 16. VENT TERMINATIONS SHALL BE LOCATED AT LEAST 10 FEET FROM OR 3 FEET ABOVE ANY OPERABLE WINDOW, DOOR OPENING, AIR INTAKE, OR VENT SHAFT, AND AT LEAST 3 FEET IN EVERY DIRECTION FROM ANY LOT LINE, ALLEY, OR STREET.
- 17. PIPE AND FITTINGS UTILIZED IN THE WATER SUPPLY SYSTEM SHALL HAVE A MAXIMUM OF 8 PERCENT LEAD.
- 18. ACRYLONITRILE BUTADIENE STYRENE (ABS) SHALL BE USED FOR THE SEWERAGE AND VENTILATION SYSTEM.
- 19. CROSS-LINKED POLYETHYLENE (PEX) SHALL BE USED FOR THE WATER SUPPLY SYSTEM.
- 20. POLYVINYL CHLORIDE (PVC) SHALL BE USED FOR THE RAIN WATER SYSTEM.
- 21. THE MIMIMUM WATER SUPPLY DEPTH UNDER FLOOR FINISH SHOUD BE 1/2".
- 22. ANY PIPE INSTALLED UNDERGROUND MUST HAVE AT LEAST 12 INCHES OF CLEARANCE BETWEEN THE OUTSIDE OF THE PIPE AND ANY OTHER UNDERGROUND STRUCTURE.
- 23. THE MINIMUM CLEARANCE BETWEEN COLD AND HOT WATER LINES IN RESIDENTIAL HOMES MAINTAIN A MINIMUM DISTANCE OF 6 INCHES.
- 24. HORIZONTAL SEPARATION BETWEEN WATER AND SEWER LINES: A MINIMUM OF 12 INCHES BETWEEN POTABLE WATER SUPPLY LINES (COLD AND HOT WATER) AND SANITARY SEWER LINES.

ABS ACRYLONITRILE BUTADIENE STYRENE ABV ABOVE AD AREA DRAIN AFF ABOVE FINISHED FLOOR ALT ALTERNATE BFF BELOW FINISHED FLOOR BLW BELOW CO CLEAN OUT CW COLD WATER D DEGREE DFU Dranage FIXTURE UNIT DIA DIAMETER DN DOWN FCO FLOOR CLEAN OUT FD FLOOR DRAIN FL FLOOR FS FLOOR SINK FT FOOT/FEET HB HOSE BIB HW HOT WATER IN INCH MIN MINIMUM NO NUMBER NTS NOT TO SCALE PEX CROSS-LINKED POLYETHYLENE PLBG PLUMBING PVC POLYVINYL CHLORIDE QTY Quantity RD ROOM RW RAIN WATER		BBREVIATION
ABS ACRYLONITRILE BUTADIENE STYRENE ABV ABOVE AD AREA DRAIN AFF ABOVE FINISHED FLOOR ALT ALTERNATE BFF BELOW FINISHED FLOOR BLW BELOW CO CLEAN OUT CW COLD WATER D DEGREE DFU Dranage FIXTURE UNIT DIA DIAMETER DN DOWN FCO FLOOR CLEAN OUT FD FLOOR DRAIN FL FLOOR FS FLOOR SINK FT FOOT/FEET HB HOSE BIB HW HOT WATER IN INCH MIN MINIMUM NO NUMBER NTS NOT TO SCALE PEX CROSS-LINKED POLYETHYLENE PLBG PLUMBING PVC POLYVINYL CHLORIDE QTY Quantity RD ROOM RW RAIN WATER	S	5 .
ABV ABOVE AD AREA DRAIN AFF ABOVE FINISHED FLOOR ALT ALTERNATE BFF BELOW FINISHED FLOOR BLW BELOW CO CLEAN OUT CW COLD WATER D DEGREE DFU Dranage FIXTURE UNIT DIA DIAMETER DN DOWN FCO FLOOR CLEAN OUT FD FLOOR DRAIN FL FLOOR FS FLOOR SINK FT FOOT/FEET HB HOSE BIB HW HOT WATER IN INCH MIN MINIMUM NO NUMBER NTS NOT TO SCALE PEX CROSS-LINKED POLYETHYLENE PLBG PLUMBING PVC POLYVINYL CHLORIDE QTY Quantity RD ROOM RW RAIN WATER		
AD AREA DRAIN AFF ABOVE FINISHED FLOOR ALT ALTERNATE BFF BELOW FINISHED FLOOR BLW BELOW CO CLEAN OUT CW COLD WATER D DEGREE DFU Dranage FIXTURE UNIT DIA DIAMETER DN DOWN FCO FLOOR CLEAN OUT FD FLOOR DRAIN FL FLOOR FS FLOOR SINK FT FOOT/FEET HB HOSE BIB HW HOT WATER IN INCH MIN MINIMUM NO NUMBER NTS NOT TO SCALE PEX CROSS-LINKED POLYETHYLENE PLBG PLUMBING PVC POLYVINYL CHLORIDE QTY Quantity RD ROOF DRAIN RED REDUCER RM ROOM RW RAIN WATER		
AFF ABOVE FINISHED FLOOR ALT ALTERNATE BFF BELOW FINISHED FLOOR BLW BELOW CO CLEAN OUT CW COLD WATER D DEGREE DFU Dranage FIXTURE UNIT DIA DIAMETER DN DOWN FCO FLOOR CLEAN OUT FD FLOOR DRAIN FL FLOOR FS FLOOR SINK FT FOOT/FEET HB HOSE BIB HW HOT WATER IN INCH MIN MINIMUM NO NUMBER NTS NOT TO SCALE PEX CROSS-LINKED POLYETHYLENE PLBG PLUMBING PVC POLYVINYL CHLORIDE QTY Quantity RD ROOF DRAIN RED REDUCER RM ROOM RW RAIN WATER		
ALT ALTERNATE BFF BELOW FINISHED FLOOR BLW BELOW CO CLEAN OUT CW COLD WATER D DEGREE DFU Dranage FIXTURE UNIT DIA DIAMETER DN DOWN FCO FLOOR CLEAN OUT FD FLOOR DRAIN FL FLOOR FS FLOOR SINK FT FOOT/FEET HB HOSE BIB HW HOT WATER IN INCH MIN MINIMUM NO NUMBER NTS NOT TO SCALE PEX CROSS-LINKED POLYETHYLENE PLBG PLUMBING PVC POLYVINYL CHLORIDE QTY Quantity RD ROOF DRAIN RED REDUCER RM ROOM RW RAIN WATER		
BFF BELOW FINISHED FLOOR BLW BELOW CO CLEAN OUT CW COLD WATER D DEGREE DFU Dranage FIXTURE UNIT DIA DIAMETER DN DOWN FCO FLOOR CLEAN OUT FD FLOOR DRAIN FL FLOOR FS FLOOR SINK FT FOOT/FEET HB HOSE BIB HW HOT WATER IN INCH MIN MINIMUM NO NUMBER NTS NOT TO SCALE PEX CROSS-LINKED POLYETHYLENE PLBG PLUMBING PVC POLYVINYL CHLORIDE QTY Quantity RD ROOF DRAIN RED REDUCER RM ROOM RW RAIN WATER		
BLW BELOW CO CLEAN OUT CW COLD WATER D DEGREE DFU Dranage FIXTURE UNIT DIA DIAMETER DN DOWN FCO FLOOR CLEAN OUT FD FLOOR DRAIN FL FLOOR FS FLOOR SINK FT FOOT/FEET HB HOSE BIB HW HOT WATER IN INCH MIN MINIMUM NO NUMBER NTS NOT TO SCALE PEX CROSS-LINKED POLYETHYLENE PLBG PLUMBING PVC POLYVINYL CHLORIDE QTY Quantity RD ROOF DRAIN RED REDUCER RM ROOM RW RAIN WATER		
CO CLEAN OUT CW COLD WATER D DEGREE DFU Dranage FIXTURE UNIT DIA DIAMETER DN DOWN FCO FLOOR CLEAN OUT FD FLOOR DRAIN FL FLOOR FS FLOOR SINK FT FOOT/FEET HB HOSE BIB HW HOT WATER IN INCH MIN MINIMUM NO NUMBER NTS NOT TO SCALE PEX CROSS-LINKED POLYETHYLENE PLBG PLUMBING PVC POLYVINYL CHLORIDE QTY Quantity RD ROOF DRAIN RED REDUCER RM ROOM RW RAIN WATER		
CW COLD WATER D DEGREE DFU Dranage FIXTURE UNIT DIA DIAMETER DN DOWN FCO FLOOR CLEAN OUT FD FLOOR DRAIN FL FLOOR FS FLOOR SINK FT FOOT/FEET HB HOSE BIB HW HOT WATER IN INCH MIN MINIMUM NO NUMBER NTS NOT TO SCALE PEX CROSS-LINKED POLYETHYLENE PLBG PLUMBING PVC POLYVINYL CHLORIDE QTY Quantity RD ROOF DRAIN RED REDUCER RM ROOM RW RAIN WATER		
D DEGREE DFU Dranage FIXTURE UNIT DIA DIAMETER DN DOWN FCO FLOOR CLEAN OUT FD FLOOR DRAIN FL FLOOR FS FLOOR SINK FT FOOT/FEET HB HOSE BIB HW HOT WATER IN INCH MIN MINIMUM NO NUMBER NTS NOT TO SCALE PEX CROSS-LINKED POLYETHYLENE PLBG PLUMBING PVC POLYVINYL CHLORIDE QTY Quantity RD ROOF DRAIN RED REDUCER RM ROOM RW RAIN WATER		
DFU Dranage FIXTURE UNIT DIA DIAMETER DN DOWN FCO FLOOR CLEAN OUT FD FLOOR DRAIN FL FLOOR FS FLOOR SINK FT FOOT/FEET HB HOSE BIB HW HOT WATER IN INCH MIN MINIMUM NO NUMBER NTS NOT TO SCALE PEX CROSS-LINKED POLYETHYLENE PLBG PLUMBING PVC POLYVINYL CHLORIDE QTY Quantity RD ROOF DRAIN RED REDUCER RM ROOM RW RAIN WATER		
DIA DIAMETER DN DOWN FCO FLOOR CLEAN OUT FD FLOOR DRAIN FL FLOOR FS FLOOR SINK FT FOOT/FEET HB HOSE BIB HW HOT WATER IN INCH MIN MINIMUM NO NUMBER NTS NOT TO SCALE PEX CROSS-LINKED POLYETHYLENE PLBG PLUMBING PVC POLYVINYL CHLORIDE QTY Quantity RD ROOF DRAIN RED REDUCER RM ROOM RW RAIN WATER	_	
DN DOWN FCO FLOOR CLEAN OUT FD FLOOR DRAIN FL FLOOR FS FLOOR SINK FT FOOT/FEET HB HOSE BIB HW HOT WATER IN INCH MIN MINIMUM NO NUMBER NTS NOT TO SCALE PEX CROSS-LINKED POLYETHYLENE PLBG PLUMBING PVC POLYVINYL CHLORIDE QTY Quantity RD ROOF DRAIN RED REDUCER RM ROOM RW RAIN WATER	_	
FCO FLOOR CLEAN OUT FD FLOOR DRAIN FL FLOOR FS FLOOR SINK FT FOOT/FEET HB HOSE BIB HW HOT WATER IN INCH MIN MINIMUM NO NUMBER NTS NOT TO SCALE PEX CROSS-LINKED POLYETHYLENE PLBG PLUMBING PVC POLYVINYL CHLORIDE QTY Quantity RD ROOF DRAIN RED REDUCER RM ROOM RW RAIN WATER		
FD FLOOR DRAIN FL FLOOR FS FLOOR SINK FT FOOT/FEET HB HOSE BIB HW HOT WATER IN INCH MIN MINIMUM NO NUMBER NTS NOT TO SCALE PEX CROSS-LINKED POLYETHYLENE PLBG PLUMBING PVC POLYVINYL CHLORIDE QTY Quantity RD ROOF DRAIN RED REDUCER RM ROOM RW RAIN WATER		
FL FLOOR FS FLOOR SINK FT FOOT/FEET HB HOSE BIB HW HOT WATER IN INCH MIN MINIMUM NO NUMBER NTS NOT TO SCALE PEX CROSS-LINKED POLYETHYLENE PLBG PLUMBING PVC POLYVINYL CHLORIDE QTY Quantity RD ROOF DRAIN RED REDUCER RM ROOM RW RAIN WATER		
FS FLOOR SINK FT FOOT/FEET HB HOSE BIB HW HOT WATER IN INCH MIN MINIMUM NO NUMBER NTS NOT TO SCALE PEX CROSS-LINKED POLYETHYLENE PLBG PLUMBING PVC POLYVINYL CHLORIDE QTY Quantity RD ROOF DRAIN RED REDUCER RM ROOM RW RAIN WATER		
FT FOOT/FEET HB HOSE BIB HW HOT WATER IN INCH MIN MINIMUM NO NUMBER NTS NOT TO SCALE PEX CROSS-LINKED POLYETHYLENE PLBG PLUMBING PVC POLYVINYL CHLORIDE QTY Quantity RD ROOF DRAIN RED REDUCER RM ROOM RW RAIN WATER		
HB HOSE BIB HW HOT WATER IN INCH MIN MINIMUM NO NUMBER NTS NOT TO SCALE PEX CROSS-LINKED POLYETHYLENE PLBG PLUMBING PVC POLYVINYL CHLORIDE QTY Quantity RD ROOF DRAIN RED REDUCER RM ROOM RW RAIN WATER		
HW HOT WATER IN INCH MIN MINIMUM NO NUMBER NTS NOT TO SCALE PEX CROSS-LINKED POLYETHYLENE PLBG PLUMBING PVC POLYVINYL CHLORIDE QTY Quantity RD ROOF DRAIN RED REDUCER RM ROOM RW RAIN WATER		
IN INCH MIN MINIMUM NO NUMBER NTS NOT TO SCALE PEX CROSS-LINKED POLYETHYLENE PLBG PLUMBING PVC POLYVINYL CHLORIDE QTY Quantity RD ROOF DRAIN RED REDUCER RM ROOM RW RAIN WATER		_
MIN MINIMUM NO NUMBER NTS NOT TO SCALE PEX CROSS-LINKED POLYETHYLENE PLBG PLUMBING PVC POLYVINYL CHLORIDE QTY Quantity RD ROOF DRAIN RED REDUCER RM ROOM RW RAIN WATER		
NO NUMBER NTS NOT TO SCALE PEX CROSS-LINKED POLYETHYLENE PLBG PLUMBING PVC POLYVINYL CHLORIDE QTY Quantity RD ROOF DRAIN RED REDUCER RM ROOM RW RAIN WATER		_
NTS NOT TO SCALE PEX CROSS-LINKED POLYETHYLENE PLBG PLUMBING PVC POLYVINYL CHLORIDE QTY Quantity RD ROOF DRAIN RED REDUCER RM ROOM RW RAIN WATER		
PEX CROSS-LINKED POLYETHYLENE PLBG PLUMBING PVC POLYVINYL CHLORIDE QTY Quantity RD ROOF DRAIN RED REDUCER RM ROOM RW RAIN WATER	NO	NUMBER
PLBG PLUMBING PVC POLYVINYL CHLORIDE QTY Quantity RD ROOF DRAIN RED REDUCER RM ROOM RW RAIN WATER		
PVC POLYVINYL CHLORIDE QTY Quantity RD ROOF DRAIN RED REDUCER RM ROOM RW RAIN WATER		CROSS-LINKED POLYETHYLENE
QTY Quantity RD ROOF DRAIN RED REDUCER RM ROOM RW RAIN WATER		PLUMBING
RD ROOF DRAIN RED REDUCER RM ROOM RW RAIN WATER	PVC	POLYVINYL CHLORIDE
RED REDUCER RM ROOM RW RAIN WATER	QTY	
RM ROOM RW RAIN WATER	RD	ROOF DRAIN
RW RAIN WATER	RED	
	RM	ROOM
	RW	RAIN WATER
SF SQUARE FOOT	SF	SQUARE FOOT
V VENT	V	VENT
VTR VENT THROUGH ROOF	VTR	VENT THROUGH ROOF
W WASTE		
WCO WALL CLEAN OUT	WCO	
WSFU WATER SUPPLY FIXTURE UNIT	WSFU	WATER SUPPLY FIXTURE UNIT

PLUMBI	PLUMBING LEGEND					
D	Сар					
△	Bend 45 Deg					
B	Bend 90 Deg					
	Tee Reducing					
	Tee					
	Clean Two-Way					
	Wye 45 Deg					
	Wye 45 Deg Double					
	Wye Combination					
	P-Trap					

Diameter	Length
·	
1 1/2"	37 ft
2"	8 ft
3"	25 ft
1/2"	34 ft
3/4"	86 ft
1"	3 ft
2"	62 ft
	1 1/2" 2" 3" 1/2" 3/4" 1"

FI	TTING SCHEDULE	
FITTING	Size	QTY
Domestic Cold Water		
	1/2"ø-1/2"ø	8
_		
PEX Tee Elbow		
PEX Transition Elbow		
PEX Transition Elbow	3/4"ø-1/2"ø	5
Domestic Hot Water		
PEX 90 Degree Elbow	1/2"ø-1/2"ø	7
PEX 90 Degree Elbow	3/4"ø-3/4"ø	6
PEX Tee Elbow	3/4"ø-3/4"ø-3/4"ø	4
PEX Transition Elbow	3/4"ø-1/2"ø	4
Sewage	2 0-2 0	24
<u> </u>	4.4/01/~ 4.4/01/~	0
-		
•		
·		
· · · · · · · · · · · · · · · · · · ·		
		· ·
Vent		
ABS 90 Degree Bend Elbow	1 1/2"ø-1 1/2"ø	2
EX Transition Elbow		
ABS TEE Elbow	1 1/2"ø-1 1/2"ø-1 1/2"ø	2
ABS Vent Cap Elbow	1 1/2"ø	3

FIXTURE CONNECTION SCHEDULE											
Family	w	V	Trap	cw	HW	QT Y	DFU	тот.	WF U	TOT	NOTES
Dishwasher	2"	1-1/2"	1-1/2"	1/2"	1/2"	1		0			Drain to sewer see plans
Dryer	N/A	N/A	N/A	N/A	N/A	1		0			
Hanging pipes clamp						12		0			
Shower Tray						1		0			
Shower Trim	-	-	-	1/2"	1/2"	1		0			
Sink Island Single	2"	1-1/2"	1-1/2"	1/2"	1/2"	1		0			
VANITY SINK						1		0			
Washer	2"	1-1/2"	2"	1/2"	1/2"	1		0			DRAINS TO GRAY WATER OR SEWER SEE PLANS
Water Closet	3"	2"	3"	1/2"	1/2"	1		0			
Water Heater	N/A	N/A	N/A	3/4"	3/4"	1		0			

	FIX	TURE SCHEDULE
fixture	QTY	Description
Dishwasher	1	Drain to sewer see plans
Dryer	1	·
Hanging pipes clamp	12	
Shower Tray	1	
Shower Trim	1	
Sink Island Single	1	
VANITY SINK	1	
Washer	1	DRAINS TO GRAY WATER OR SEWER SEE PLANS
Water Closet	1	
Water Heater	1	

ACC	ESSORIE	S & FITTINGS SCHEDULE
fixture	QTY	Descriptions
DISHWASHER CONNECTOR	1	
Hose Bib	1	
LAUNDRY SWEAT CONNECTOR	1	
Shutoff Valve	6	

PLUMBING SCHEDULE								
FIXTURE	Trap	Waste	Vent	C.W	H.W			
Dishwasher	1-1/2"	2"	1-1/2"	1/2"	1/2"			
Dryer	N/A	N/A	N/A	N/A	N/A			
Shower Tray								
Shower Trim	-	-	-	1/2"	1/2"			
Sink Island Single	1-1/2"	2"	1-1/2"	1/2"	1/2"			
VANITY SINK								
Washer	2"	2"	1-1/2"	1/2"	1/2"			
Water Closet	3"	3"	2"	1/2"	1/2"			
Water Heater	N/A	N/A	N/A	3/4"	3/4"			

WATER FIXTURE UNIT SCHEDULE							
Family QTY UNIT VALUE TOTAL							
Dishwasher	1		0				
Dryer	1		0				
Shower Tray	1		0				
Shower Trim	1		0				
Sink Island Single	1		0				
VANITY SINK	1		0				
Washer	1		0				
Water Closet	1		0				
Water Heater	1		0				

WASTE FIXTURE UNIT SCHEDULE							
Family	QTY	DFU Values	TOTAL				
D. I.							
Dishwasher	1	0					
Dryer	1	0					
Hanging pipes clamp	12	0)				
Shower Tray	1	0)				
Shower Trim	1	0)				
Sink Island Single	1	0					
VANITY SINK	1	0)				
Washer	1	0)				
Water Closet	1	0)				
Water Heater	1	0					



KEY PLAN

www.frameupnow.com

NO.	O. DESCRIPTION			

NOTE:

LEGEND:

PROJECT

106-Bennett-499-1Bd1Ba Spanish-550

DRAWING NAME

NOTE AND SCHEDULE

 CLIENT NAME:

 PROJECT NUMBER:
 0201_12

 DATE:
 3/10/2025 2:29:20 AM


 DESIGNED BY:
 Designer


 DRAWN BY:
 Author


 CHECKED BY:
 Checker

P101

SCALE: 1/2" = 1'-0"

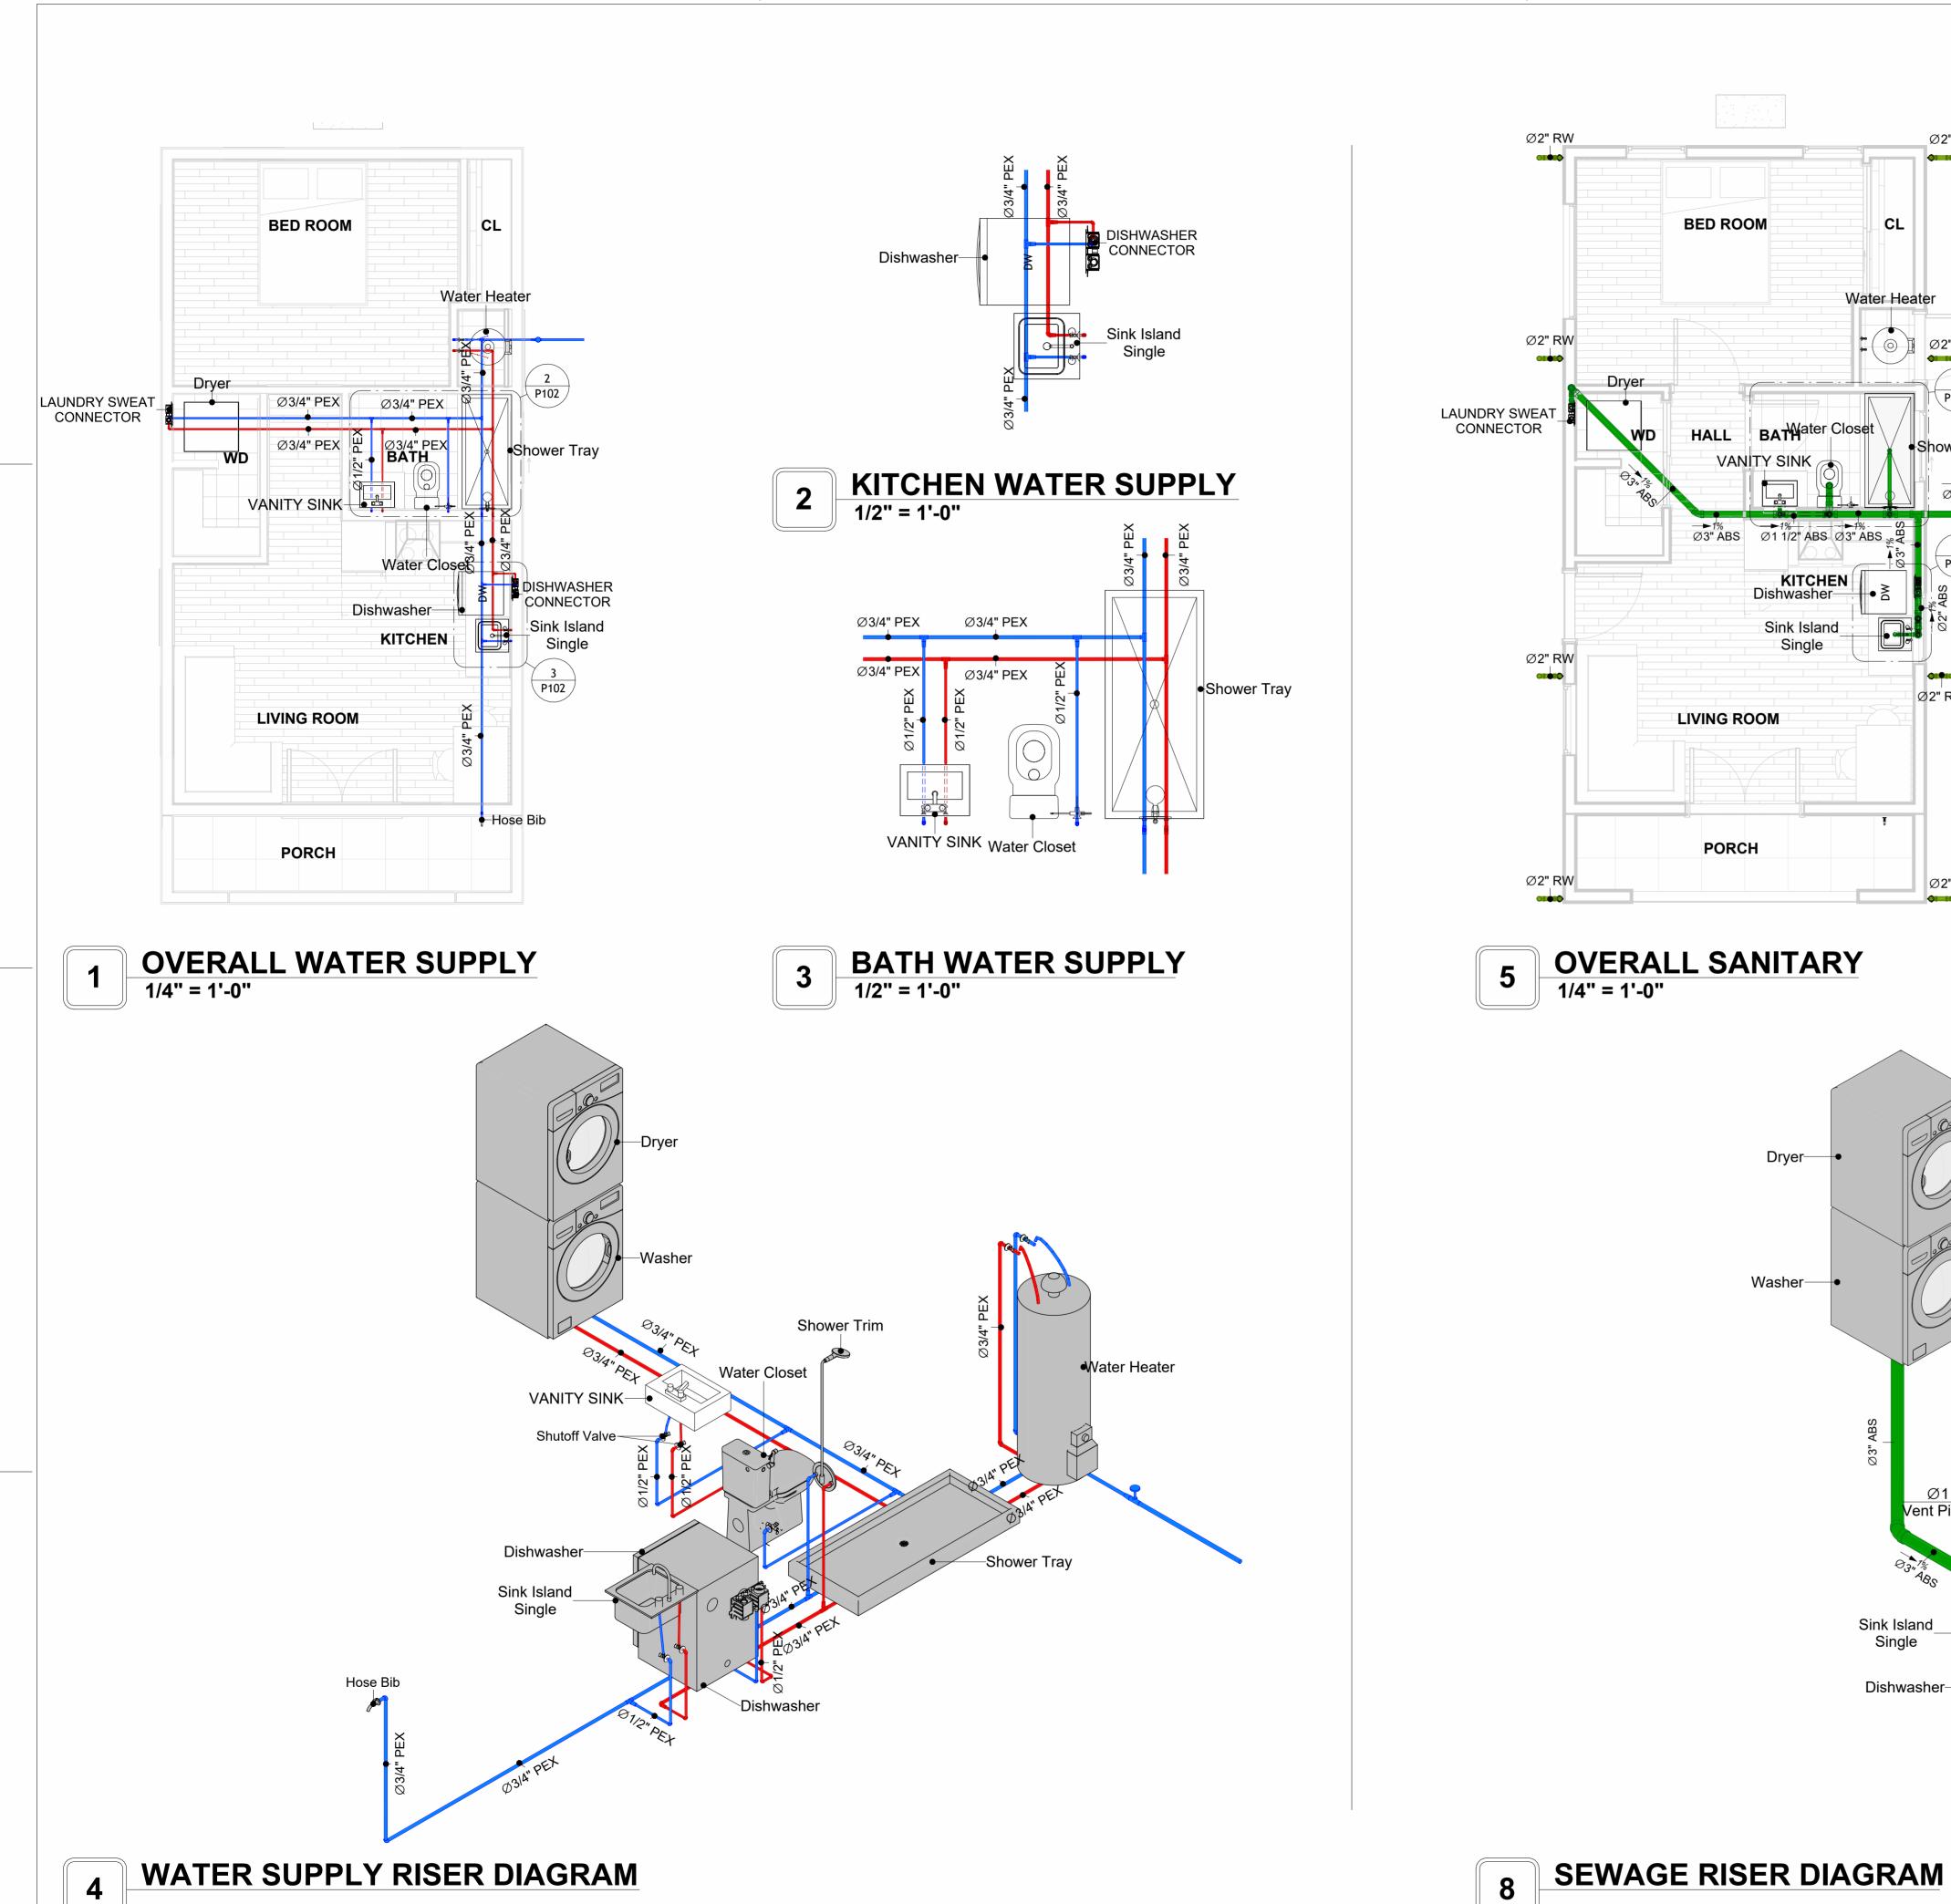

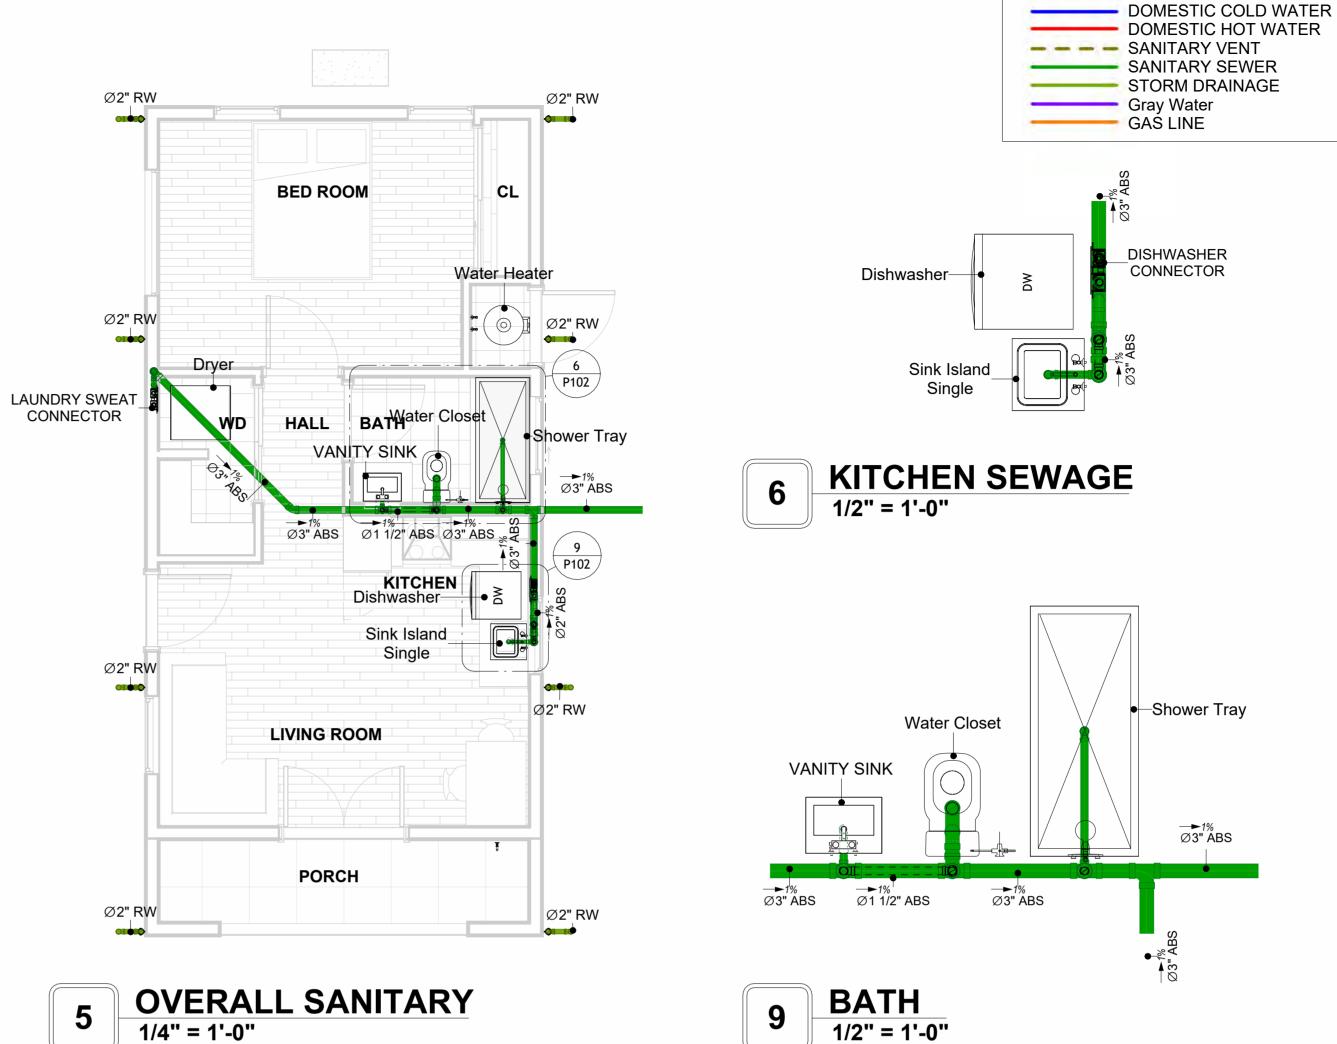

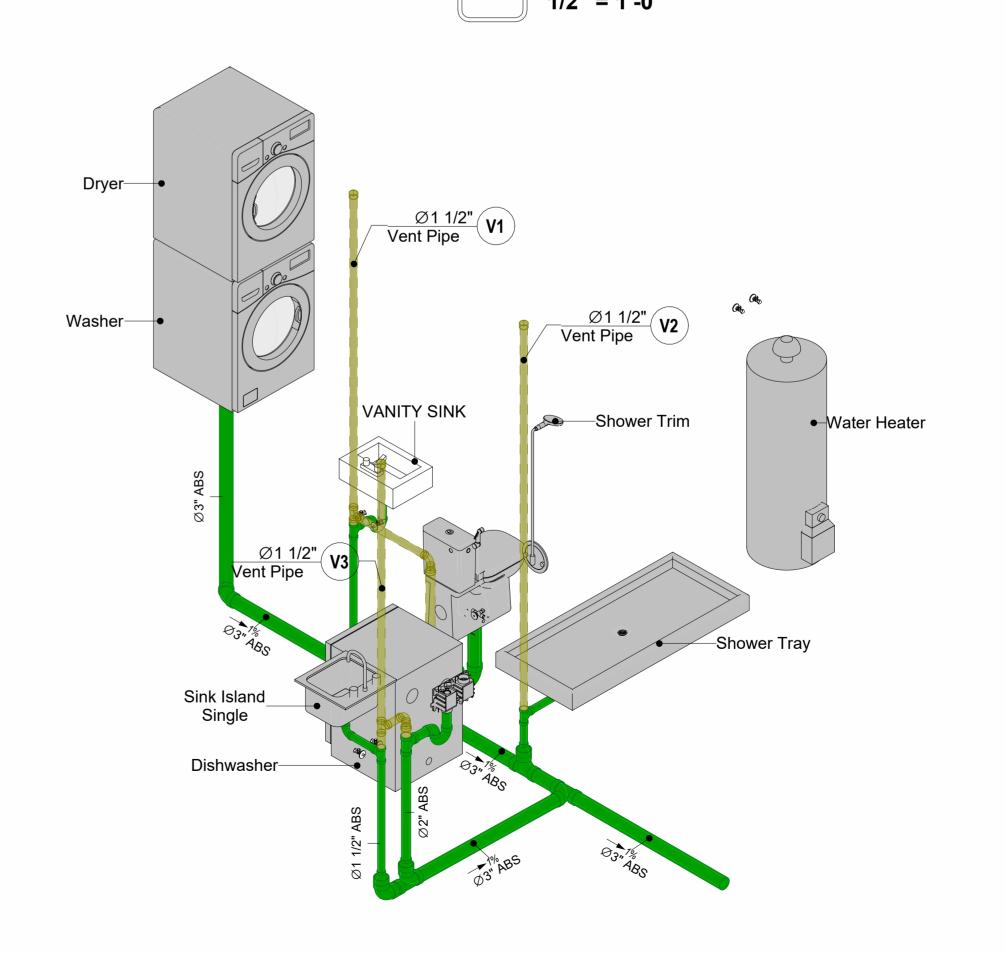

Tuscon,AZ, USA
888-864-0184
inquire@frameupnow.com
www.frameupnow.com

PIPe Color SCHEME

KEY PLAN

	T	
NO.	DESCRIPTION	DATE

NOTE:

LEGEND:

PROJECT

106-Bennett-499-1Bd1Ba Spanish-550

DRAWING NAME

WATER SUPPLY AND SEWAGE SYSTEM

CLIENT NAME:

PROJECT NUMBER:

DATE:

3/10/2025 2:29:48 AM

DESIGNED BY:

DRAWN BY:

CHECKED BY:

CHECKED BY:

Checker

P102

SCALE: As indicated

© [2024] [FrameUpNow] . All rights reserved

Materials Shopping List

Please print and take this Materials Shopping List to your favorite Home Depot and ask for assistance in selecting the materials, fixtures and fittings to complete your new home.

Record your selection and the price of the item. Then do the math to determine the cost for your selections and the total cost of finishing your home.

Have It Your Way!

The material types listed in this document were selected based on personal preferences. The Customer is encouraged to make changes to the material types in accordance with local customs, regulations, and personal preferences.

Have It Your Way!



20 good reasons to frame a home with metal and not wood



Why build your ADU with metal vs wood	Wood	Metal	Explanation
1 DIY Construction Benefit		~	The wall frames, trusses and beams can be erected in a just a few days
2 Minimal Construction Skills Required		~	Pre-assembled walls and trusses require no specialized skills to errect
3 Build as DIY, Hybrid or by a General Contractor		~	Do it yourself, Hybrid (involve special contractors) or hire a General Contractor
4 Build It As You Can Afford It		~	Impervious to Weather - build as you have the time and money
5 Up Front Cost of Framing Materials	~		As to only the framing material, wood is less expensive
6 Total Cost To Build		~	Savings in time, labor, and other areas make light gauge steel LESS expensive
7 Termites and wood boring insects		~	Termites, carpenter ants and wood boring insects eat wood, not metal
8 Mold resistant		~	Metal does not attract mold
9 Damage caused by exterior and interior flooding		~	Metal needs no reconditioning after a flood
10 Fire Resistant		✓	Non-combustible
11 Lower insurance rates		~	Many insurance underwriters now provide lower rates for metal framed homes
12 Walls, trusses, and beams retain their original form		~	Perfectly straight walls - no shimming of drywall
13 Corners are 90 degrees		~	No need for templating of countertops to adjust for out of square corners
14 Strength and weight		~	Metal is stronger than wood and weighs less - no need for crane to lift ADU trusses
15 IBC Engineered Stamp		✓	If an engineering stamp is necessary, months of waiting are saved
16 Complete BOM (Materials Shopping List)		~	Take the materials shopping list to Home Depot and start shopping/pricing
17 Flexible in Seismic Areas - Won't Fracture		~	Light gauge steel is flexible and won't fracture when the earth moves
18 No Waste At Job Site		~	Steel is the most recycled material in the world. A typical wood home has 20-30% waste
19 Environmentally Friendly		✓	Trees don't have to be destroyed and the source of most metal is from recycling
20 How-To Videos Included		~	How-to videos provide simple assembly instructions
21 Relationship Counselor		~	Eliminate emotional uphevels - save time, money, and preserve the relationship

Universal Requirements - some or all may be required

- 1 Site plan
- 2 Electrical Supply Connection
- 3 Sewer Connection
- 4 Fresh Water Supply Connection
- 5 Set Backs
- 6 Soils Evaluation

- 7 Earthquake (fault) evaluation
- 8 Foundation Plan subject to soils
- 9 Compliance with local energy codes: insulation home wrap and flashing
- 10 Engineering for wind speed and snow load.
- 11 State and Local ordinances regarding ADUs
- 12 Local Architect and/or Engineer may be necessary

Bennett-1Bd 1Ba-Spanish





Bennett-1Bd 1Ba-Spanish MATERIAL SHOPPING LIST

Have It Your Way!

The material types listed in this document were selected based on personal preferences. The Customer is encouraged to make changes to the material types in accordance with local customs, regulations, and personal preferences. Have It Your Way!

TOC



10

15

Name Link Page No 1 Cover Page Cover Page 1 2 TOC TOC 2 3 ELECTRICAL BOM ELECTRICAL BOM 3 5 HVAC BOM HVAC BOM 7

Table Of Content

Have It Your Way!

ARCHITECTURAL BOM

PLUMBING BOM

The material types listed in this document were selected based on personal preferences. The Customer is encouraged to make changes to the material types in accordance with local customs, regulations, and personal preferences. Have It Your Way!

GENERAL NOTES

4 PLUMBING BOM

6 ARCHITECTURAL BOM

- 1 This BOM (Bill of Materials) is prepared as a Materials Shopping List to help builders and DIYers gain a complete understanding of most if not all elements required for the complete construction of this structure, according to the original design documents provided by FrameUpNow.
- 2 All quantities and specifications are subject to change based on the final design, field measurements, availability of products and customer preferences. The customer should verify all information prior to purchasing materials.
- 3 All products and elements in the list shall conform to the International Residential Code (IRC), or any other local and international building codes, safety regulations, and standards that are applicable to the location of the structure.
- 4 If any changes are made by the customer to the list of materials specified in this document, the customer is responsible for assuring that the correct type and quantity of materials are utilized in accordance with local building codes.
- FrameUpNow, will not be held responsible for any misuse of this document, the products listed, or for deviations from the content that are made due to changes in specifications, pricing, availability, or customer preferences.
- 6 The customer is advised to consult a qualified professional or technician prior to purchasing materials for specialized construction system items. Some items including but not limited to caseworks, doors and windows may require as built measurements prior to purchase to confirmation of final dimensions.
- 7 If there are additional trim elements or specific installation methods, the total amount of materials needed might vary. Consider any additional trim required for corners, intersections, or other architectural details that might cause this variations before proceeding to purchase and construction.

ARCHITECTURAL BOM



	Bennett-1Bd 1Ba-Spanish							
		ARCHITECTU	JRAL MAT	ERIAL SHOP	PING LIST			
No.	Item	Туре	Unit	Quantity	Unit Price	Total	Description	
Δ	APPLIANCES		<u> </u>				·	
1	Refrigerator		PCS	1				
2	Range		PCS	1				
3	Washer		PCS	1				
4	Dryer		PCS	1				
5	Dish Washer		PCS	1				
6	Oven		PCS	0				
7	Microwave		PCS	0				
\triangle	CASEWORKS							
1	Kitchen Cabinet		FT	17.66				
2	Laundry Cabinet		FT	2.25				
3	Vanity Cabinet		FT	3.83				
4	Medicine Cabinet		PCS	1				
5	Kitchen countertop		SF	24.25				
6	Laundry Countertop		PCS	0				
7	Bathroom Countertop		SF	0				
8	Island		FT	0				
9	Peninsula		FT	0				
10	Closets		SF	149.23				
△	CEILING							
1	Ceiling Board	Dry Wall	SF	397				
2	Dry Wall Fastener	Screw	PCS	694.75				
3	Vapor Retarder	Polyethylene film	SF	530				
4	Vapor Retarder Fastener	Nails with washer heads	PCS	1590				
5	Ceiling Board (MRD)	Moisture resistant drywall	SF	41				
6	MRD Fastener		PCS	71.75				
7	Ceiling Board	Marine Plywood	SF	92				
	Marine Plywood Fastener	Screw	PCS	161				
	Dry Wall Tape		FT	265				
	FLOORING							
	Main Living Space		SF	213.02				
2	Bathroom		SF	64.9				
3	Bedroom		SF	148.7				
4	Porch		SF	59.1				
	STRUCTURE							
1	Foundation		SF	564.32				
	WALLS EXTERIOR		1.					
	Stucco Finish		SF	919				
2	Wall Shteathing (OSB)		SF	919				
3	Shteathing Fastener	Self-drilling screws(100/pkt)	PKT	9.19				
4	Wall Homewrap		SF	919				
5	Homewrap Fastener	Stapled fastener (200/pkt)	PKT	3.4922				
6	Wall Paint		SF	919				
7	Wall Insulation		SF	2142				

ARCHITECTURAL BOM



	WALLS INTERIOR					
			CF	105		
1	Cementitious Backer Board		SF	405		
2	Kerdi membrane		SF	405		
_	Kerdi membrane Fastener		SF	405		
4	Wall Ceramic Tile		SF	405		
5	Drywall Board		SF	920		
6	Drywall Fastener	Self-drilling screws(100/pkt)	PKT	9.2		
	Wall Paint		SF	920		
8	Drywall Tape		FT	173		
9	Wall Sweep		FT	111		
	DOORS					
1	Exterior Swinging	3' - 0" X 6'-8"	PCS	2		
2	Interior Swinging	3' - 0" X 6'-8"	PCS	2		
3	Interior Sliding	5' - 10" X 6'-8"	PCS	1		
4	Interior Sliding	4' - 8" X 6'-8"	PCS	1		
5	Exterior Swinging	5' - 0" X 6'-8"	PCS	1		
6	Exterior Door Trim		FT	51		
7	Interior Door Trim		FT	191		
8	Entry Lock set			3		
	Privacy Lock set			2		
	Passage Lock set			2		
	WINDOWS			2		
	Hung	3' - 3" X 3'-3"	PCS	2		
2	Sliding	3' - 3" X 2'-3"	PCS	1		
3	Hung	2' - 9" X 3'-3"	PCS	2		
4	Awning	5' - 3" X 3'-9"	PCS	1		
_	Exterior Window Trim	3 3 7 3 7	FT	80		
6	Interior Window Trim		FT	80		
	ROOF			00		
	Roof Covering		SF	1382.0		
	Roof Covering Fastener		PCS	691		
3	Roof Felt Paper		SF	691.0		
4			PCS	4146.0		
<u> </u>	Roof Felt Paper Fastener		SF	691		
5	Roof Sheathing					
6	Roof Sheathing Fastener		PCS	5528		
7	Batten		FT	364.0		
8	Batten Fastener		PCS	273.7		
9	Soffit		SF	107.0		
10	Soffit Fastener		PCS	53.5		
11	Fascia		FT	111.0		
	Fascia board fastener		PCS	56		
_ 13	Roof Insulation		SF	1382.0		



Bennett-1Bd 1Ba-Spanish									
ELECTRICAL MATERIAL SHOPPING LIST									
No.									
	LIGHTING FIXTURES	-,,							
1	Kitchen Ceiling Light		PCS	3					
2	Kitchen Wall Mounted Light		PCS	1					
	Exterior Wall Mounted Light		PCS	4					
4	Livingroom Ceiling Light With Fan		PCS	1					
5	Bedroom Ceiling Light With Fan		PCS	1					
6	Dining Ceiling Light		PCS	0					
7	Bath Wall Mounted Light		PCS	1					
8	Bathroom Ceiling Light		PCS	2					
9	Livingroom Ceiling Light		PCS	4					
	Bedroom Ceiling Light		PCS	4					
	Hall & Entry Ceiling Light		PCS	1					
	Closet Ceiling Light		PCS	2					
	Smoke Detector		PCS	2					
			1 03						
	ELECTRICAL FITTINGS Standard Basentagle 120V	20A	DCC	0					
	Standard Receptacle 120V GFCI Receptacle 120V	20 A	PCS	8					
	·	30 A	PCS	11					
16	·		PCS	2					
17	GFCI Receptacle 240V	50 A	PCS	1					
18	GFCI Receptacle 240V	60 A	PCS	1					
	Fan Switch		PCS	1					
	Single Pole Switch		PCS	7					
	Three Way Switch		PCS	2					
	Dimmer Switch		PCS	4					
	ELECTRICAL CONDUITS & WIRING								
	ROMEX 14 AWG	14/2/W/ground	FT	92					
	ROMEX 12 AWG	12/3/W/ground	FT	266					
	ROMEX 12 AWG	12/2/W/ground	FT	0					
	ROMEX 10 AWG	10/3/W/ground	FT	0					
	ROMEX 10 AWG	10/2/W/ground	FT	53					
28	Romex 8 AWG	8/3/W/ground	FT	0					
29	Romex 8 AWG	8/2/W/ground	FT	13					
30	ROMEX 6 AWG	6/3/W/ground	FT	0					
31	Bare Copper Ground Wire 6 AWG		FT	38					
\triangle	ELECTRICAL BOXES & CIRCUTES								
32	Panelboard -240V 1 Phase MLO	200 AMP	PCS	1					
33	Circuit breaker	15 A	PCS	3					
	Circuit breaker	20 A	PCS	10					
	Circuit breaker	30 A	PCS	2					
	Circuit breaker	50 A	PCS	1					
	Circuit breaker	60 A	PCS	1					
	Single Gang Switch Box	1.5	PCS	4					
	Double Gang Switch Box		PCS	2					
	Triple Gang Switch Box		PCS	2					
	Pull Box	#1/4	PCS	20					
	Receptacle Box	H 11 T	PCS	24					

PLUMBING BOM

Bennett-1Bd 1Ba-Spanish

	Bennett-1Ba 1Ba-Spanisn								
	PLUMBING SYSTEM MATERIAL SHOPPING LIST								
No.	Item	Туре	Unit	Quantity	Unit Price	Total	Description		
1	Bath Tub (Alcove Tub)		PCS	0					
2	Kitchen Sink		PCS	1					
3	Kitchen Faucets		PCS	1					
4	Vanity Sink		PCS	1					
5	Bath room Faucets		PCS	1					
6	Water Closet		PCS	1					
7	Shower Trim		PCS	1					
8	Shower Tray		PCS	1					
9	Water Heater		PCS	1					
10	Hose Bib		PCS	1					
11	Shutoff Valve		PCS	6					
12	Hanging pipe clamp		PCS	12					
13	Gate Valve		PCS	1					
14	Dishwasher Supply Single Connector		PCS	1					
15	Dishwasher Sewage Single Connector		PCS	1					
16	Laundry Sweat Connector		PCS	1					
	SANITARY & PLUMBING PIPES								
1	ABS (Acrylonitrile Butadiene Styrene) Pipes	ø 1"	FT	0					
2	ABS (Acrylonitrile Butadiene Styrene) Pipes	ø 1 1/2"	FT	37					
3	ABS (Acrylonitrile Butadiene Styrene) Pipes	ø 2"	FT	8					
4	ABS (Acrylonitrile Butadiene Styrene) Pipes	ø 3"	FT	25					
5	PEX (Cross-linked polyethylene) Pipes	ø 1/2"	FT	34					
6	PEX (Cross-linked polyethylene) Pipes	ø 3/4"	FT	85					
7	PEX (Cross-linked polyethylene) Pipes	ø 1"	FT	3					
8	PVC Pipes Sch.80 - Rigid	ø 1 1/2"	FT	0					
9	PVC Pipes Sch.80 - Rigid	ø 2"	FT	34					
10	PVC Pipes Sch.80 - Rigid	ø 3"	FT	0					
11	Flex Pipe Round	ø 1/2"	PCS	6					
12	Flex Pipe Round	ø 3/4"	PCS	6					
13	Flex Pipe Round	ø 1"	PCS	0					

PLUMBING BOM

	PIPE FITTINGS					
	PEX 90 Degree Elbow	1/2"ø-1/2"ø	PCS	8		
	PEX 90 Degree Elbow	3/4"ø-3/4"ø	PCS	5		
	PEX Tee Elbow	3/4"ø-3/4"ø-3/4"ø	PCS	7		
	PEX Transition Elbow	1"ø-3/4"ø	PCS	1		
	PEX Transition Elbow	3/4"ø-1/2"ø	PCS	5		
	PEX 90 Degree Elbow	1/2"ø-1/2"ø	PCS	7		
	PEX 90 Degree Elbow	3/4"ø-3/4"ø	PCS	6		
	PEX Tee Elbow	3/4"ø-3/4"ø-3/4"ø	PCS	4		
	PEX Transition Elbow	3/4"ø-1/2"ø	PCS	4		
	PVC 90 Deg Bend Elbow	2"ø-2"ø	PCS	12		
	ABS 90 Degree Bend Elbow	1 1/2"ø-1 1/2"ø	PCS	2		
	ABS 90 Degree Bend Elbow	2"ø-2"ø	PCS	1		
	ABS 90 Degree Bend Elbow	3"ø-3"ø	PCS	3		
	ABS P-Trap	1 1/2"ø-1 1/2"ø	PCS	1		
	ABS P-Trap	2"ø-2"ø	PCS	2		
	ABS P-Trap	3"ø-3"ø	PCS	1		
	ABS Reducer Elbow	3"ø-1 1/2"ø	PCS	3		
	ABS Reducer Elbow	3"ø-2"ø	PCS	3		
	ABS TEE Elbow	1 1/2"ø-1 1/2"ø-1 1/2"ø	PCS	3		
	ABS TEE Elbow	2"ø-2"ø-2"ø	PCS	1		
	ABS TEE Elbow	3"ø-3"ø-3"ø	PCS	6		
	ABS 90 Degree Bend Elbow	1 1/2"ø-1 1/2"ø	PCS	2		
	ABS Reducer Elbow	2"ø-1 1/2"ø	PCS	2		
47	ABS TEE Elbow	1 1/2"ø-1 1/2"ø-1 1/2"ø	PCS	2		
	ABS Vent Cap Elbow	1 1/2"ø	PCS	3		
	ribo vein sup Liberi		1.00			
					+	

HVAC BOM

	Bennett-1Bd 1Ba-Spanish							
	HVAC SYSTEM MATERIAL SHOPPING LIST							
No.	Item	Туре	Unit	Quantity	Unit Price	Total	Description	
	HVAC_DUCTS							
1	PIPE (REFRIGERANT LINE)	1/4" Ø	FT	0.65				
2	PIPE (REFRIGERANT LINE)	3/4" Ø	FT	52.33				
3	PIPE (REFRIGERANT LINE)	1/2" Ø	FT	0.62				
4	PIPE (REFRIGERANT LINE)	3/4" Ø	FT	59.27				
5	DRAYER HOSE	5" Ø	FT	4				
6	FLEX DUCT ROUND	4"	FT	4.24				
	DUCT FITTINGS & ACCESSORIES							
7	ELBOW (REFRIGERANT LINE)	1/2" (Ø)-1/2" (Ø)	PCS	1				
8	ELBOW (REFRIGERANT LINE)	1/4" (Ø)-1/4" (Ø)	PCS	1				
9	ELBOW (REFRIGERANT LINE)	3/4" (Ø)-3/4" (Ø)	PCS	11				
10	ELBOW (REFRIGERANT LINE)	3/8" (Ø)-3/8" (Ø)	PCS	8				
11	TRANSITION (REFRIGERANT	3/4" (Ø)-1/2" (Ø)	PCS	3				
12	TRANSITION (REFRIGERANT	3/4" (Ø)-3/8" (Ø)	PCS	2				
13	TRANSITION (REFRIGERANT	3/8" (Ø)-1/4" (Ø)	PCS	1				
14	TEE (REFRIGERANT LINE)	3/4" (Ø)-3/4" (Ø)-3/4" (Ø)	PCS	1				
15	TEE (REFRIGERANT LINE)	3/8" (Ø)-3/8" (Ø)-3/8" (Ø)	PCS	1				
16	ROUND TRANSITION(ANGLE)	3/4" (Ø)-3/4" (Ø)-3/4" (Ø)	PCS	5				
	HVAC_EQUIPMENTS							
17	AIR HANDLING UNIT	WALL MOUNTED	PCS	2				
18	CONDENSER	OUTDOOR UNIT	PCS	1				
19	EXHAUST FAN	75 CFM	PCS	1				
20	EXHAUST HOOD	WALL MOUNTED	PCS	1				
21	HOOD-WALL: VENT	HOOD-WALL: VENT	PCS	1				
22	DRAYER: VENT	DRAYER: VENT	PCS	1				
23	ROOF VENT	3"(Ø)	PCS	1				



Table Of Content

#	Name	Link	Page No
1	Cover Page	<u>Cover Page</u>	1
2	TOC	TOC	2
3	ELECTRICAL BOM	ELECTRICAL BOM	3
5	HVAC BOM	HVAC BOM	7
4	PLUMBING BOM	PLUMBING BOM	10
6	ARCHITECTURAL BOM	ARCHITECTURAL BOM	15

Have It Your Way!

The material types listed in this document were selected based on personal preferences. The Customer is encouraged to make changes to the material types in accordance with local customs, regulations, and personal preferences. Have It Your Way!

GENERAL NOTES

- This BOM (Bill of Materials) is prepared as a Materials Shopping List to help builders and DIYers gain a complete understanding of most if not all elements required for the complete construction of this structure, according to the original design documents provided by FrameUpNow.
- 2 All quantities and specifications are subject to change based on the final design, field measurements, availability of products and customer preferences. The customer should verify all information prior to purchasing materials.
- 3 All products and elements in the list shall conform to the International Residential Code (IRC), or any other local and international building codes, safety regulations, and standards that are applicable to the location of the structure.
- 4 If any changes are made by the customer to the list of materials specified in this document, the customer is responsible for assuring that the correct type and quantity of materials are utilized in accordance with local building codes.
- 5 FrameUpNow, will not be held responsible for any misuse of this document, the products listed, or for deviations from the content that are made due to changes in specifications, pricing, availability, or customer preferences.
- The customer is advised to consult a qualified professional or technician prior to purchasing materials for specialized construction system items. Some items including but not limited to caseworks, doors and windows may require as built measurements prior to purchase to confirmation of final dimensions.
- 7 If there are additional trim elements or specific installation methods, the total amount of materials needed might vary. Consider any additional trim required for corners, intersections, or other architectural details that might cause this variations before procedding to purchase and construction.



	LIGHTING FIXTURES								
#	Item	Туре	Description, Manufacturer, SKU	Unit	Quantity	Unit Price	Total		
1	Kitchen Ceiling Light			PCS	3				
2	Kitchen Wall Mounted Light			PCS	1				
3	Exterior Wall Mounted Light			PCS	4				
4	Livingroom Ceiling Light With Fan			PCS	1				
5	Bedroom Ceiling Light With Fan			PCS	1				
6	Dining Ceiling Light			PCS	0				
7	Bathroom Wall Mounted Light			PCS	1				
8	Bathroom Ceiling Light			PCS	2				
9	Livingroom Ceiling Light			PCS	4				
10	Bedroom Ceiling Light			PCS	4				
11	Hall & Entry Ceiling Light			PCS	1				
12	Closet Ceiling Light			PCS	2				
12	Smoke Detector			PCS	2				
13									
14									
15									



			ELECTRICAL FITTINGS				
#	Item	Туре	Description, Manufacturer, SKU	Unit	Quantity	Unit Price	Total
1	Standard Receptacle 120V	20A		PCS	8		
2	GFCI Receptacle 120V	20 A		PCS	11		
3	GFCI Receptacle 240V	30 A		PCS	2		
4	GFCI Receptacle 240V	50 A		PCS	1		
5	GFCI Receptacle 240V	60 A		PCS	1		
6	Fan Switch			PCS	1		
7	Single Pole Switch			PCS	7		
3	Three Way Switch			PCS	2		
)	Dimmer Switch			PCS	4		
10		'	·	'			
11							
12							
13							
14							
15							



		ELECTRI	CAL CONDUITS & WIRING				
#	Item	Туре	Description, Manufacturer, SKU	Unit	Quantity	Unit Price	Total
1	ROMEX 14 AWG	14/2/W/ground		FT	92		
2	ROMEX 12 AWG	12/3/W/ground		FT	266		
3	ROMEX 12 AWG	12/2/W/ground		FT	0		
4	ROMEX 10 AWG	10/3/W/ground		FT	0		
5	ROMEX 10 AWG	10/2/W/ground		FT	53		
6	Romex 8 AWG	8/3/W/ground		FT	0		
7	Romex 8 AWG	8/2/W/ground		FT	13		
8	ROMEX 6 AWG	6/2/W/ground		FT	0		
9	Bare Copper Ground Wire 6 AWG			FT	38		
10		+					
11							
12							
13							
14							
15							
16							



		ELEC	CTRICAL BOXES & CIRCUTES				
#	Item	Туре	Description, Manufacturer, SKU	Unit	Quantity	Unit Price	Total
1	Panelboard -240V 1 Phase MLO	200 AMP		PCS	1		
2	Circuit breaker	15 A		PCS	3		
3	Circuit breaker	20 A		PCS	10		
4	Circuit breaker	30 A		PCS	2		
5	Circuit breaker	50 A		PCS	1		
6	Circuit breaker	60 A		PCS	1		
7	Single Gang Switch Box			PCS	4		
8	Double Gang Switch Box			PCS	2		
9	Triple Gang Switch Box			PCS	2		
10	Pull Box	#1/4		PCS	20		
11	Receptacle Box			PCS	24		
12							
13							
14							
15							

HVAC BOM

			HVAC_DUCTS 01				
#	Item	Туре	Description, Manufacturer, SKU	Unit		Unit Price	Total
1	PIPE (REFRIGERANT LINF)	1/4" (Ø)		FT	0.65		
	PIPE (REFRIGERANT LINE)	3/8" (Ø)		FT	52.33		
	PIPE (REFRIGERANT LINE)	1/2" (Ø)		FT	0.62		
2	PIPE (REFRIGERANT LINE)	3/4''' (Ø)		FT	59.27		
3	DRAYER HOSE	4" (Ø)		FT	4		
4	FLEX DUCT ROUND	4" (Ø)		FT	4.24		
5							
6							
7							
8							
9							
10							
11							
12							
13							
14							
15							
16							

HVAC BOM

			DUCT FITTINGS & ACCESSORIES			
#	Item	Туре	Description, Manufacturer, SKU	Unit	Quantity	Unit Price Total
L	ELBOW (REFRIGERANT LINE)	1/2" (Ø)-1/2" (Ø)		PCS	1	
2	ELBOW (REFRIGERANT LINE)	1/4" (Ø)-1/4" (Ø)		PCS	1	
	ELBOW (REFRIGERANT LINE)	3/4" (Ø)-3/4" (Ø)		PCS	16	
	ELBOW (REFRIGERANT LINE)	3/8" (Ø)-3/8" (Ø)		PCS	11	
5	TRANSITION (REFRIGERANT LINE)	3/4" (Ø)-1/2" (Ø)		PCS	3	
5	TRANSITION (REFRIGERANT LINE)	3/4" (Ø)-5/8" (Ø)		PCS	2	
7	TRANSITION (REFRIGERANT LINE)	3/8" (Ø)-1/4" (Ø)		PCS	1	
3	TEE (REFRIGERANT LINE)	3/4" (Ø)-3/4" (Ø)-3/4" (Ø)		PCS	1	
)	TEE (REFRIGERANT LINE)	3/8" (Ø)-3/8" (Ø)-3/8" (Ø)		PCS	1	
11	ROUND TRANSITION(ANGLE)	45 DEGREE		PCS	5	
12	THE STATE OF THE S					
13						
.2						
.3						
.4						
L 5						
L6						

HVAC BOM

			HVAC_EQUIPMENTS				
#	Item	Туре	Description, Manufacturer, SKU	Unit	Quantity	Unit Price	Total
1	AIR HANDLING UNIT	WALL MOUNTED		PCS	2		
2	CONDENSER	OUTDOOR UNIT		PCS	1		
3	EXHAUST FAN	75 CFM		PCS	1		
4	EXHAUST HOOD	WALL MOUNTED		PCS	1		
5	HOOD-WALL: VENT	HOOD-WALL: VENT		PCS	1		
6	DRAYER: VENT	DRAYER: VENT		PCS	1		
7	ROOF VENT	3"(Ø)		PCS	1		
8						ı	
9							
10							
11							
12							
13							
14							

	PLUMBING FIXTURES & ACCESSORIES							
#		Туре	Description, Manufacturer, SKU	Unit	Quantity	Unit Price Total		
1	Bath Tub (Alcove Tub)			PCS	0			
2	Kitchen Sink			PCS	1			
3	Kitchen faucets			PCS	1			
4	Vanity Sink			PCS	1			
5	Bath room faucets			PCS	1			
6	Water Closet			PCS	1			
7	Shower Trim			PCS	1			
8	Shower Tray			PCS	1			
9	Water Heater			PCS	1			
10	Hose Bib			PCS	1			
11	Shutoff Valve			PCS	6			
12	Hanging pipe clamp			PCS	12			
13	Globe Valve			PCS	1			
14	Dishwasher Supply Single Connector			PCS	1			
15	Dishwasher Sewage Single Connector			PCS	1			
16	Laundry Sweat Connector			PCS	1			

	SANITARY & PLUMBING PIPES									
#	Item	Туре	Description, Manufacturer, SKU	Unit	Quantity	Unit Price	Total			
1	ABS (Acrylonitrile Butadiene	ø 1"								
	Stvrene) Pipes			FT	0					
2	ABS (Acrylonitrile Butadiene	ø 1 1/2"								
	Stvrene) Pipes			FT	37					
3	ABS (Acrylonitrile Butadiene	ø 2"								
	Stvrene) Pipes			FT	8					
4	ABS (Acrylonitrile Butadiene	ø 3"			0.5					
	Styrene) Pipes			FT	25					
5	PEX (Cross-linked	ø 1/2"		 ET	24					
	polvethylene) Pipes	0.44		FT	34					
6	PEX (Cross-linked	ø 3/4"		FT	0.5					
_	polvethylene) Pipes	4.11		FT	85					
7	PEX (Cross-linked	ø 1"		FT	3					
	polvethylene) Pipes	1 1/0		ГІ	3					
8	PVC Pipes Sch.80 - Rigid	ø 1 1/2"		FT	0					
9	PVC Pipes Sch.80 - Rigid	ø 2"		FT	62					
10	PVC Pipes Sch.80 - Rigid	ø 3"		1 1	02					
10	PVC Pipes Scii.ou - Rigiu	0 3		FT	0					
11	Flex Pipe Round	ø 1/2"		ГТ	,					
		2.110		FT	6					
12	Flex Pipe Round	ø 3/4"		FT	6					
13	Flex Pipe Round	ø 1"								
				FT	0					
14										
15										

	PIPE FITTINGS 01									
#	Item	Туре	Description, Manufacturer, SKU	Unit	Quantity	Unit Price	Total			
1	PEX 90 Degree Elbow	1/2"ø-1/2"ø		PCS	8					
2	PEX 90 Degree Elbow	3/4"ø-3/4"ø		PCS	5					
3	PEX Tee Elbow	3/4"ø-3/4"ø		PCS	7					
1	PEX Transition Elbow	1"ø-3/4"ø		PCS	1					
5	PEX Transition Elbow	3/4"ø-1/2"ø		PCS	5					
6	PEX 90 Degree Elbow	1/2"ø-1/2"ø		PCS	7					
7	PEX 90 Degree Elbow	3/4"ø-3/4"ø		PCS	6					
3	PEX Tee Elbow	3/4"ø-3/4"ø-3/4"ø		PCS	4					
)	PEX Transition Elbow	3/4"ø-1/2"ø		PCS	4					
10	PVC 90 Deg Bend Elbow	2"ø-2"ø		PCS	12					
l1	ABS 90 Degree Bend Elbow	1 1/2"ø-1 1/2"ø		PCS	2					
12	ABS 90 Degree Bend Elbow	2"Ø-2"Ø		PCS	1					
13	ABS 90 Degree Bend Elbow	3"Ø-3"Ø		PCS	3					
14	ABS P-Trap	1 1/2"ø-1 1/2"ø		PCS	1					
15	ABS P-Trap	2"ø-2"ø		PCS	2					

			PIPE FITTINGS 02				
#	Item	Туре	Description, Manufacturer, SKU	Unit	Quantity	Unit Price	Total
1	ABS P-Trap	3"Ø-3"Ø		PCS	1		
2	ABS Reducer Elbow	3"ø-1 1/2"ø		PCS	3		
3	ABS Reducer Elbow	3"Ø-2"Ø		PCS	3		
4	ABS TEE Elbow	1 1/2"ø-1 1/2"ø-1 1/2"ø		PCS	3		
5	ABS TEE Elbow	2"ø-2"ø-2"ø		PCS	1		
6	ABS TEE Elbow	3"ø-3"ø-3"ø		PCS	6		
7	ABS 90 Degree Bend Elbow	1 1/2"ø-1 1/2"ø		PCS	2		
8	ABS Reducer Elbow	2"ø-1 1/2"ø		PCS	2		
9	ABS TEE Elbow	1 1/2"ø-1 1/2"ø-1 1/2"ø		PCS	2		
10	ABS Vent Cap Elbow	1 1/2"ø		PCS	3		



			APPLIANCES				
#	Item	Туре	Description, Manufacturer, SKU	Unit	Quantity	Unit Price	Total
1	Refrigerator			PCS			
2	Range			PCS			
3	Washer Front Load	Stackable		PCS			
4	Dryer Front Load	Stackable		PCS			
5	Dish Washer			PCS			
6	Oven			PCS	(
7	Microwave			PCS	(
8							
9							
10							
11							
12							
13							
14							
15							
16							



			CASEWORKS 01				
#	Item	Туре	Description, Manufacturer, SKU	Unit	Quantity	Unit Price	Total
1	Kitchen Cabinet			FT	12.89		
2	Laundry Cabinet			FT	2.25		
3	Vanity Cabinet			FT	2.5		
4	Medicine Cabinet			PCS	1		
5	Kitchen countertop			SF	18.22		
6	Laundry Countertop			PCS	0		
7	Bathroom Countertop			SF	0		
8	Island			FT	0		
9	Peninsula			FT	0		
10	Closets			SF	74.9		
11							
12							
13							
14							
15							



			CEILING 01				
#	Item	Туре	Description, Manufacturer, SKU	Unit	Quantity	Unit Price	Total
	LIVING ROOM AND KITCHEN	I		SF	219.0		
1	Ceiling Board	Drywall		SF	219		
2	Drywall Fastener	Screw		PCS	383		
3	Vapor Retarder	Polyethylene film		SF	219		
4	Vapor Retarder Fastener	Nails with washer heads		PCS	657		
	BATHROOM			SF	41.0		
5	Ceiling Board	MRD (Moisture resistant drywall)		SF	41		
5	MRD Fastener	Screw		PCS	72		
	W/H			SF	9.0		
7	Ceiling Board	Drywall		SF	9		
3	Drywall Fastener	Screw		PCS	16		
)	Vapor Retarder	Polyethylene film		SF	9		
10	Vapor Retarder Fastener	Nails with washer heads		PCS	27		
	PORCH			SF	92.0		
11	Ceiling Board	Marine Plywood		SF	92		
12	Exterior Grade Plywood	Screw		PCS	161		



			CEILING 02				
#	Item	Туре	Description, Manufacturer, SKU	Unit	Quantity	Unit Price	Total
	W/D			SF	30.0		
13	Ceiling Board	Drywall		SF	30		
14	Drywall Fastener	Screw		PCS	53		
15	Vapor Retarder	Polyethylene film		SF	30		
16	Vapor Retarder Fastener	Nails with washer heads		PCS	90		
	BED ROOM			SF	139.0		
17	Ceiling Board	Drywall		SF	139		
18	Drywall Fastener	Screw		PCS	243		
20	Vapor Retarder	Polyethylene film		SF	139		
21	Vapor Retarder Fastener	Nails with washer heads		PCS	417		



			FLOORING INTERIOR 01				
#	Item	Туре	Description, Manufacturer, SKU	Unit	Quantity	Unit Price	Total
	BEDROOM						
1	Bedroom Flooring			SF	135		
2	Wood underlay	Foam Pad Polyethylene		SF	135		
3	Vapor Retarder	Vapor Barrier Polyethylene		SF	135		
	CLOSET	·					
4	Closet Flooring			SF	13		
5	Wood underlay	Foam Pad Polyethylene		SF	13		
6	Vapor Retarder	Vapor Barrier Polyethylene		SF	13	}	
	LIVING ROOM AND KITCH	EN					
7	Living Area Flooring			SF	213		
8	Wood underlay	Foam Pad Polyethylene		SF	213		
9	Vapor Retarder	Vapor Barrier Polyethylene		SF	213		
	BATHROOM						
10	Tile Finish			SF	27	,	
11	Adhesive	1/2" Thin set Mortar		SF	27	,	
12	Vapor Retarder	Vapor Barrier Polyethylene		SF	27	,	



			FLOORING INTERIOR 02				
#	Item	Туре	Description, Manufacturer, SKU	Unit	Quantity	Unit Price	Total
	W/D						
13	Tile Finish			SF	30		
14	Adhesive	1/2" Thin set Mortar		SF	30		
15	Vapor Retarder	Vapor Barrier Polyethylene		SF	30		
	BOILER ROOM						
16	Tile Finish			SF	9		
17	Adhesive	1/2" Thin set Mortar		SF	9		
18	Vapor Retarder	Vapor Barrier Polyethylene		SF	9		



			FLOORING EXTERIOR			
#	Item	Туре	Description, Manufacturer, SKU	Unit	Quantity	Unit Price
	STRUCTURE			SF	564.3	
1	Concrete Slab	4"concrete cast in situ		CF	188	
2	Insulation	Rigid insulation		SF	206	
3	Hard core	Compacted soil		CF	132.7	
4	Re-bar	#4 re-bar		Ton	0.59	
5	Concrete Pad	4"concrete cast in situ		CF	2	
6	Slab edge	Turndown		CF	195.7	
	PORCH					
7	Tile Finish			SF	59	
8	Adhesive	1/2" Thin set Mortar		SF	59	
9	Vapor Retarder	Vapor Barrier Polyethylene		SF	59	



	WALLS: EXTERIOR								
#	Item	Туре	Description, Manufacturer, SKU	Unit	Quantity	Unit Price	Total		
1	Stucco Finish			SF	919				
2	Wall Shteathing (OSB)			SF	919				
3	Shteathing Fastener	Self-drilling screws(100/pkt)		PKT	9.19				
4	Wall Homewrap			SF	919.0				
5	Homewrap Fastener	Stapled fastener (200/pkt)		PKT	3.5				
6	Wall Paint			SF	919				
7	Wall Insulation			SF	2142				



			WALLS: INTERIOR 01				
#	Item	Туре	Description, Manufacturer, SKU	Unit	Quantity	Unit Price	Total
	BATHROOM			SF	47.0		
1	Cementitious Backer Board			SF	190		
2	Kerdi membrane			SF	190		
3	Kerdi membrane Fastener			SF	190		
4	Wall Ceramic Tile			SF	190		
	BEDROOM			SF	160.0		
5	Drywall Board			SF	311		
6	Drywall Fastener	Self-drilling screws(100/pkt)		PKT	3.11		
7	Wall Paint			SF	311		
8	Drywall Tape			FT	58.3		
	HALL			SF	37.0		
9	Drywall Board			SF	76		
10	Drywall Fastener	Self-drilling screws(100/pkt)		PKT	0.76		
11	Wall Paint			SF	76		
12	Drywall Tape			FT	14		



			WALLS: INTERIOR 02				
#	Item	Туре	Description, Manufacturer, SKU	Unit	Quantity	Unit Price	Total
	LIVING ROOM			SF	116.0		
13	Drywall Board			SF	240		
14	Drywall Fastener	Self-drilling screws(100/pkt)		PKT	2.4		
15	Wall Paint			SF	240		
16	Drywall Tape			FT	45.0		
	KITCHEN			SF	78.0		
17	Cementitious Backer Board			SF	19		
18	Drywall Board			SF	118		
19	Drywall Fastener	Self-drilling screws(100/pkt)		PKT	1.18		
20	Kerdi membrane			SF	19		
21	Kerdi membrane Fastener			SF	19		
22	Wall Ceramic Tile			SF	19		
23	Wall Paint			SF	118		
24	Drywall Tape			FT	22.3		



			WALLS: INTERIOR 03				
#	Item	Туре	Description, Manufacturer, SKU	Unit	Quantity	Unit Price	Total
	CLOSET			SF	33.0		
25	Drywall Board			SF	101		
26	Drywall Fastener	Self-drilling screws(100/pkt)		PKT	1.01		
27	Wall Paint			SF	101		
28	Drywall Tape			FT	18.9		
	WD			SF	8.0		
29	Cementitious Backer Board			SF	196		
30	Kerdi membrane			SF	196		
31	Kerdi membrane Fastener			SF	196		
32	Wall Ceramic Tile			SF	196		
	WH	'		SF	7.0		
33	Drywall Board			SF	74		
34	Drywall Fastener	Self-drilling screws(100/pkt)		PKT	0.74		
35	Wall Paint			SF	74		
36	Drywall Tape			FT	14		
1	Wall Skirting	Ceramic		FT	111		



			DOORS				
#	Item	Туре	Description, Manufacturer, SKU	Unit	Quantity	Unit Price	Total
1	Exterior Swinging	3' - 0" X 6'-8"		PCS	2		
2	Interior Swinging	3' - 0" X 6'-8"		PCS	2		
3	Interior Sliding	5' - 10" X 6'-8"		PCS	1		
4	Interior Sliding	4' - 8" X 6'-8"		PCS	1		
5	Exterior Swinging	5' - 0" X 6'-8"		PCS	1		
6	Exterior Door Trim			FT	51		
7	Interior Door Trim			FT	191		
8	Entry Lock set			PCS	3		
9	Privacy Lock set			PCS	2		
10	Passage Lock set			PCS	2		
11							
12							
13							
14							
15							



			WINDOWS				
#	Item	Туре	Description, Manufacturer, SKU	Unit	Quantity	Unit Price	Total
1	Hung	3' - 3" X 3'-3"		PCS	2		
2	Sliding	3' - 3" X 2'-3"		PCS	1		
3	Hung	2' - 9" X 3'-3"		PCS	2		
4	Awning	5' - 3" X 3'-9"		PCS	1		
5	Exterior Window Trim			FT	80		
6	Interior Window Trim			FT	80		
7							
8							
9							
10							
11							
12							
13							
14							
15							



			ROOF 01				
#	Item	Туре	Description, Manufacturer, SKU	Unit	Quantity	Unit Price	Total
1	Roof Covering			SF	691.0		
2	Roof Covering Fastener			PCS	345.5		
3	Roof Felt Paper			SF	691.0		
4	Roof Felt Paper Fastener			PCS	2073.0		
5	Roof Sheathing			SF	691.0		
6	Roof Sheathing Fastener			PCS	5528.0		
7	Batten			FT	364.0		
8	Batten Fastener			PCS	273.7		
9	Soffit			SF	107.0		
10	Soffit Fastener			PCS	53.5		
11	Fascia			FT	111.0		
12	Fascia board fastener			PCS	55.5		
13	Roof Insulation			SF	691.0		



			ROOF 02				
#	Item	Туре	Description, Manufacturer, SKU	Unit	Quantity	Unit Price	Total
1	Roof Covering			SF	691.0		
2	Roof Covering Fastener			PCS	346		
3	Roof Felt Paper			SF	691.0		
4	Roof Felt Paper Fastener			PCS	2073.0		
5	Roof Sheathing			SF	691.0		
6	Roof Sheathing Fastener			PCS	5528		
7	Batten			FT	0.0		
8	Batten Fastener			PCS	0.0		
9	Soffit			SF	0.0		
10	Soffit Fastener			PCS	0.0		
11	Fascia			FT	0.0		
12	Fascia board fastener			PCS	0		
13	Roof Insulation			SF	691.0		
14							
15							