



# BENNETT

The Bennett is a stylish and efficient two-bedroom, two-bathroom modern home. Its exterior is characterized by clean lines and a minimalist aesthetic. The light-colored vertical siding creates a sense of height and a contemporary look. The slightly angled roofline, with its clean edge, adds a touch of architectural interest and reinforces the modern design. A simple covered porch, supported by slender wooden posts, provides a welcoming entrance and a small outdoor space.

Inside, the Bennett features a simple rectangular layout designed for comfortable living. The living and kitchen areas are centrally located and seamlessly merged into a single open room, creating a spacious and versatile living space. Two bedrooms are thoughtfully positioned on opposite ends of the house, offering privacy and quiet retreats for each resident. One of the bedrooms includes an en-suite bathroom, providing added convenience and luxury.

# Materials Shopping List

Please print and take this Materials Shopping List to your favorite Home Depot and ask for assistance in selecting the materials, fixtures and fittings to complete your new home.

Record your selection and the price of the item. Then do the math to determine the cost for your selections and the total cost of finishing your home.

# < CLICK HERE >

To Go To Materials Shopping List






# **FLOOR PLAN**

796 SF

2 Bed Rooms

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# **ABOUT**

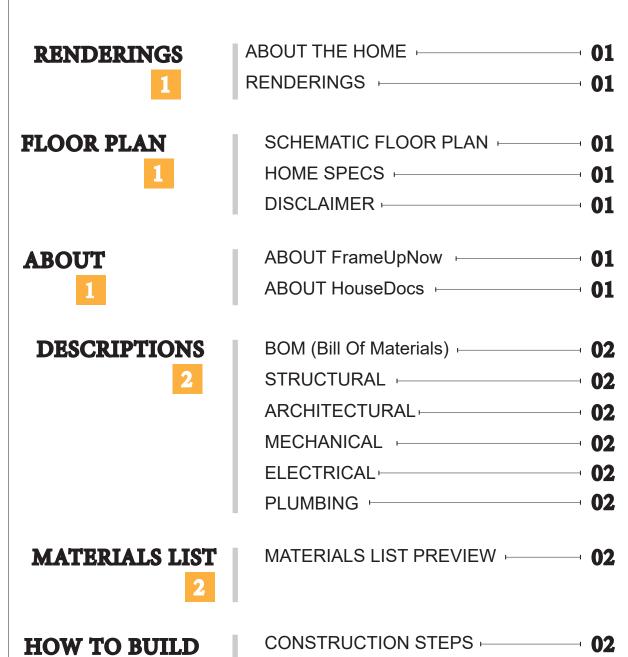

FrameUpNow is a design and manufacturing company providing precision-engineered home framing solutions. We offer a catalog of Affordable Homes, Tiny Homes, Garages, Shops and Barndominiums. FrameUpNow manufactures cold-formed steel (CFS) also known as Light Gauge Steel (LGS) framing components that conform to our engineered metal house frame plans or can be purchased as DIY skeleton kits.

The CFS/LGS framing is lightweight, easily assembled, and does not require heavy equipment or specialized labor, enabling homeowners to erect the frame themselves in just a few days. Unlike wood, the steel framing is impervious termites and bores, warping, expansion, and fire.

Our home plans come complete with a structural engineered stamp for permit approvals. Customers receive a full BOM also known as a Materials Shopping List to purchase finish materials from a Building Materials retailer. FrameUpNow prides itself on the quality and efficiency of our precision-engineered home framing solutions for construction professionals and DIY homeowners.



**KEY PLAN** 

NO.	DESCRIPTION	DATE
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NOTE:

LEGEND:

PROJECT

107-Bennett-796-2Bd2Ba-Modern-550

DRAWING NAME

# INTRODUCTION

CLIENT NAME:
PROJECT NUMBER:
DATE:
DESIGNED BY:
DRAWN BY:
CHECKED BY:

**I101** 

SCALE:

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# **DESCRIPTIONS**

# MATERIALS LIST

The BOM (Bill Of Materials) package, known as the Materials Shopping List document, provides:

Comprehensive Inventory: Detailed lists of essential materials sourced from architectural, mechanical, HVAC, electrical, and plumbing design drawing sets.

Precise Curation: Each item meticulously selected and organized for accuracy and efficiency in project planning.

Customizable Options: Customers can modify listed items to their preferences and calculate costs accordingly, ensuring alignment with personal project needs and budget.

Dedicated Space for Details: Includes tables for customers to note Home Depot SKU numbers or product descriptions for selected items, facilitating seamless purchasing and coordination with suppliers.

Customer Convenience: Take the list to Home Depot or preferred suppliers for accurate pricing, helping align the total home budget with personal financial plans.

Simplify your construction journey with our Materials Shopping List document, where detailed preparation meets streamlined implementation for your dream home.

**MECHANICAL** 

# STRUCTURAL

The structural drawings package provides an exhaustive set of detailed plans essential for the precise assembly of your building. This comprehensive package includes:

Framing Plans: Detailed layouts for all framing components. Truss Layouts: Clear instructions for truss placement and

Panel Length Plans: Specifications for panel dimensions. Framing Elevations and Sections: Precise elevation and sectional views for accurate construction.

Truss and Wall Blocking Plans: Plans for truss and wall blocking to ensure structural integrity.

Hold-Down Plan: Detailed hold-down requirements for stability. Snap Sheet: Reference sheet for quick identification of components

Structural Details and Bracing Plans: Complete details and bracing plans for all structural elements.

Accompanying these plans is a comprehensive Bill of Materials (BOM) that lists every necessary building component, from cold formed steel (CFS) frames to fasteners.

# ARCHITECTURAL

With the comprehensive architectural package, both builders and DIY homeowners can confidently execute the construction.

The architectural package includes:

Furnished Floor Plans: Complete with furniture layouts for a clear understanding of space utilization.

Detailed Dimension Plans: Ensures precise measurements, from the overall footprint down to the exact placement of windows and

Foundation Plan: Detailed plan to establish a solid foundation.

Wall Framing and Truss Layout: Comprehensive plans for wall framing and truss placement.

Architectural Elevations: Exterior views showcasing the design.

Strategic Building Sections: Critical cross-sectional details for a thorough understanding of the build.

Casework Drawings and Diagrams: Suggested designs for built-in caseworks, such as kitchen cabinets.

# **ELECTRICAL**

The mechanical package includes everything needed to guide HVAC

Detailed HVAC Floor Plan: Precisely maps out the placement of air handlers, ductwork, and vents throughout the home's layout.

HVAC Sections and Riser Diagrams: Technical drawings offering critical cross-sectional details and piping schematics, ensuring proper integration of the heating and cooling system into the home's structure.

Bill of Materials: A complete list of all necessary HVAC components.

The electrical package includes all the plans and documentation needed to guide the installation of your home's electrical system:

Detailed Power Plan: Precisely maps out the placement of outlets, switches, and other power components throughout the layout.

Comprehensive Lighting Plan: Shows the optimal locations for lighting fixtures, sconces, and other illumination sources to create a well-lit, functional interior.

Dimensioned Electrical Layout: Provides exact dimensions and measurements to ensure proper placement of all electrical elements.

Bill of Materials: A complete list of every component needed, from circuit breakers to wiring.

# **PLUMBING**

The plumbing package includes everything needed to guide the installation of your home's water supply and drainage systems:

Detailed Water Supply System Plan: Precisely maps out the placement of pipes, valves, and plumbing fixtures throughout the

Comprehensive Sewage System Plan: Shows the optimal routing and sizing of drain lines to effectively remove waste and ensure

Detailed Riser Diagrams: Provide information needed to properly install all vertical plumbing risers and vent stacks.

pipes to fixtures.

proper drainage.

Bill of Materials: A complete list of every component needed, from


# BOM (Bill Of Materials) (Separately Attached)





The Bill of Materials (BOM) is a crucial document that compiles the material requirements from different disciplines into a centralized inventory, enabling efficient procurement, inventory management, and cost estimation for a specified project or

## **ELECTRICAL BOM**



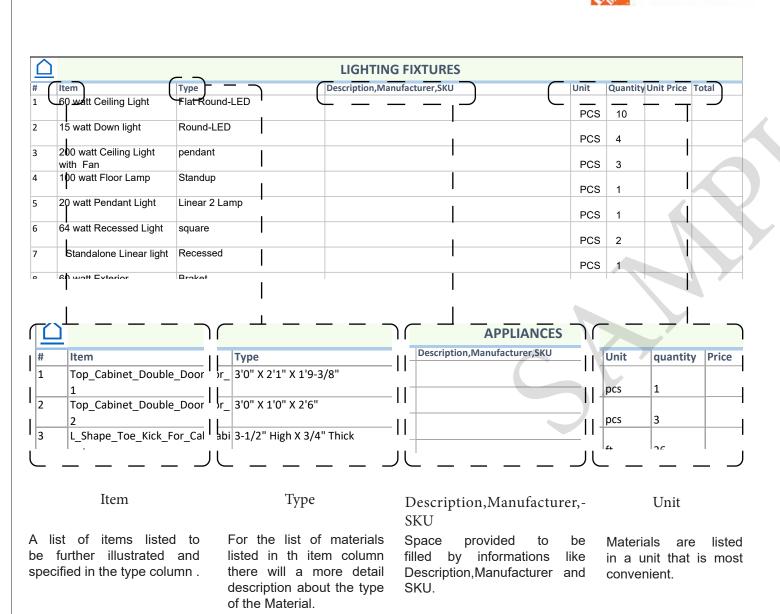

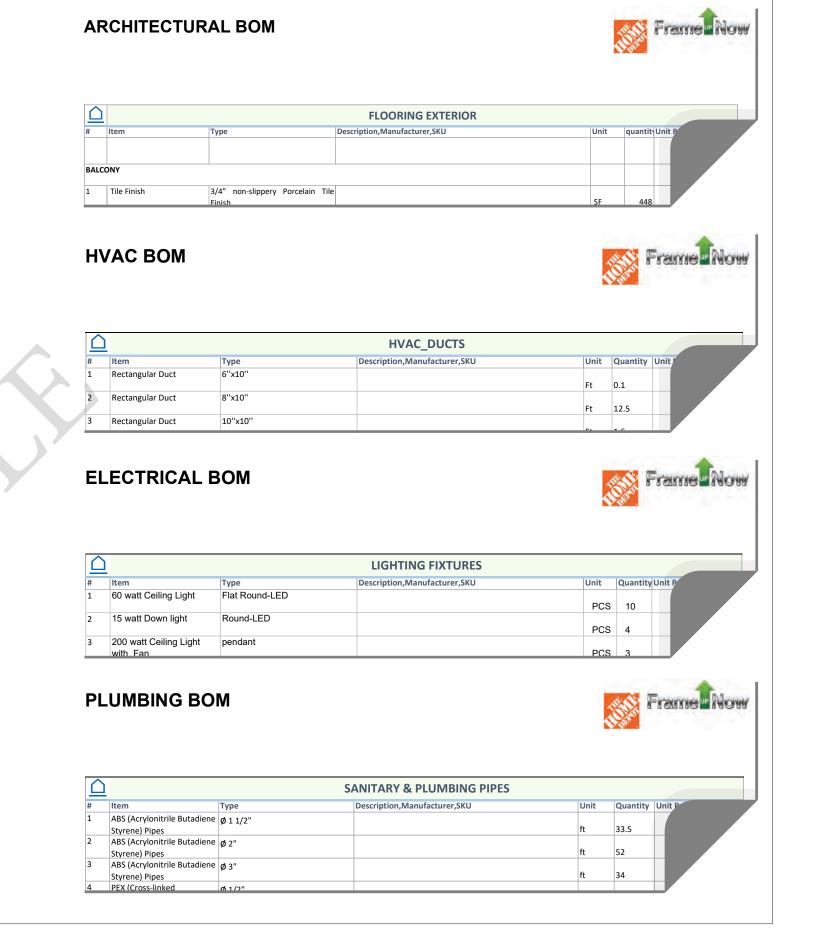

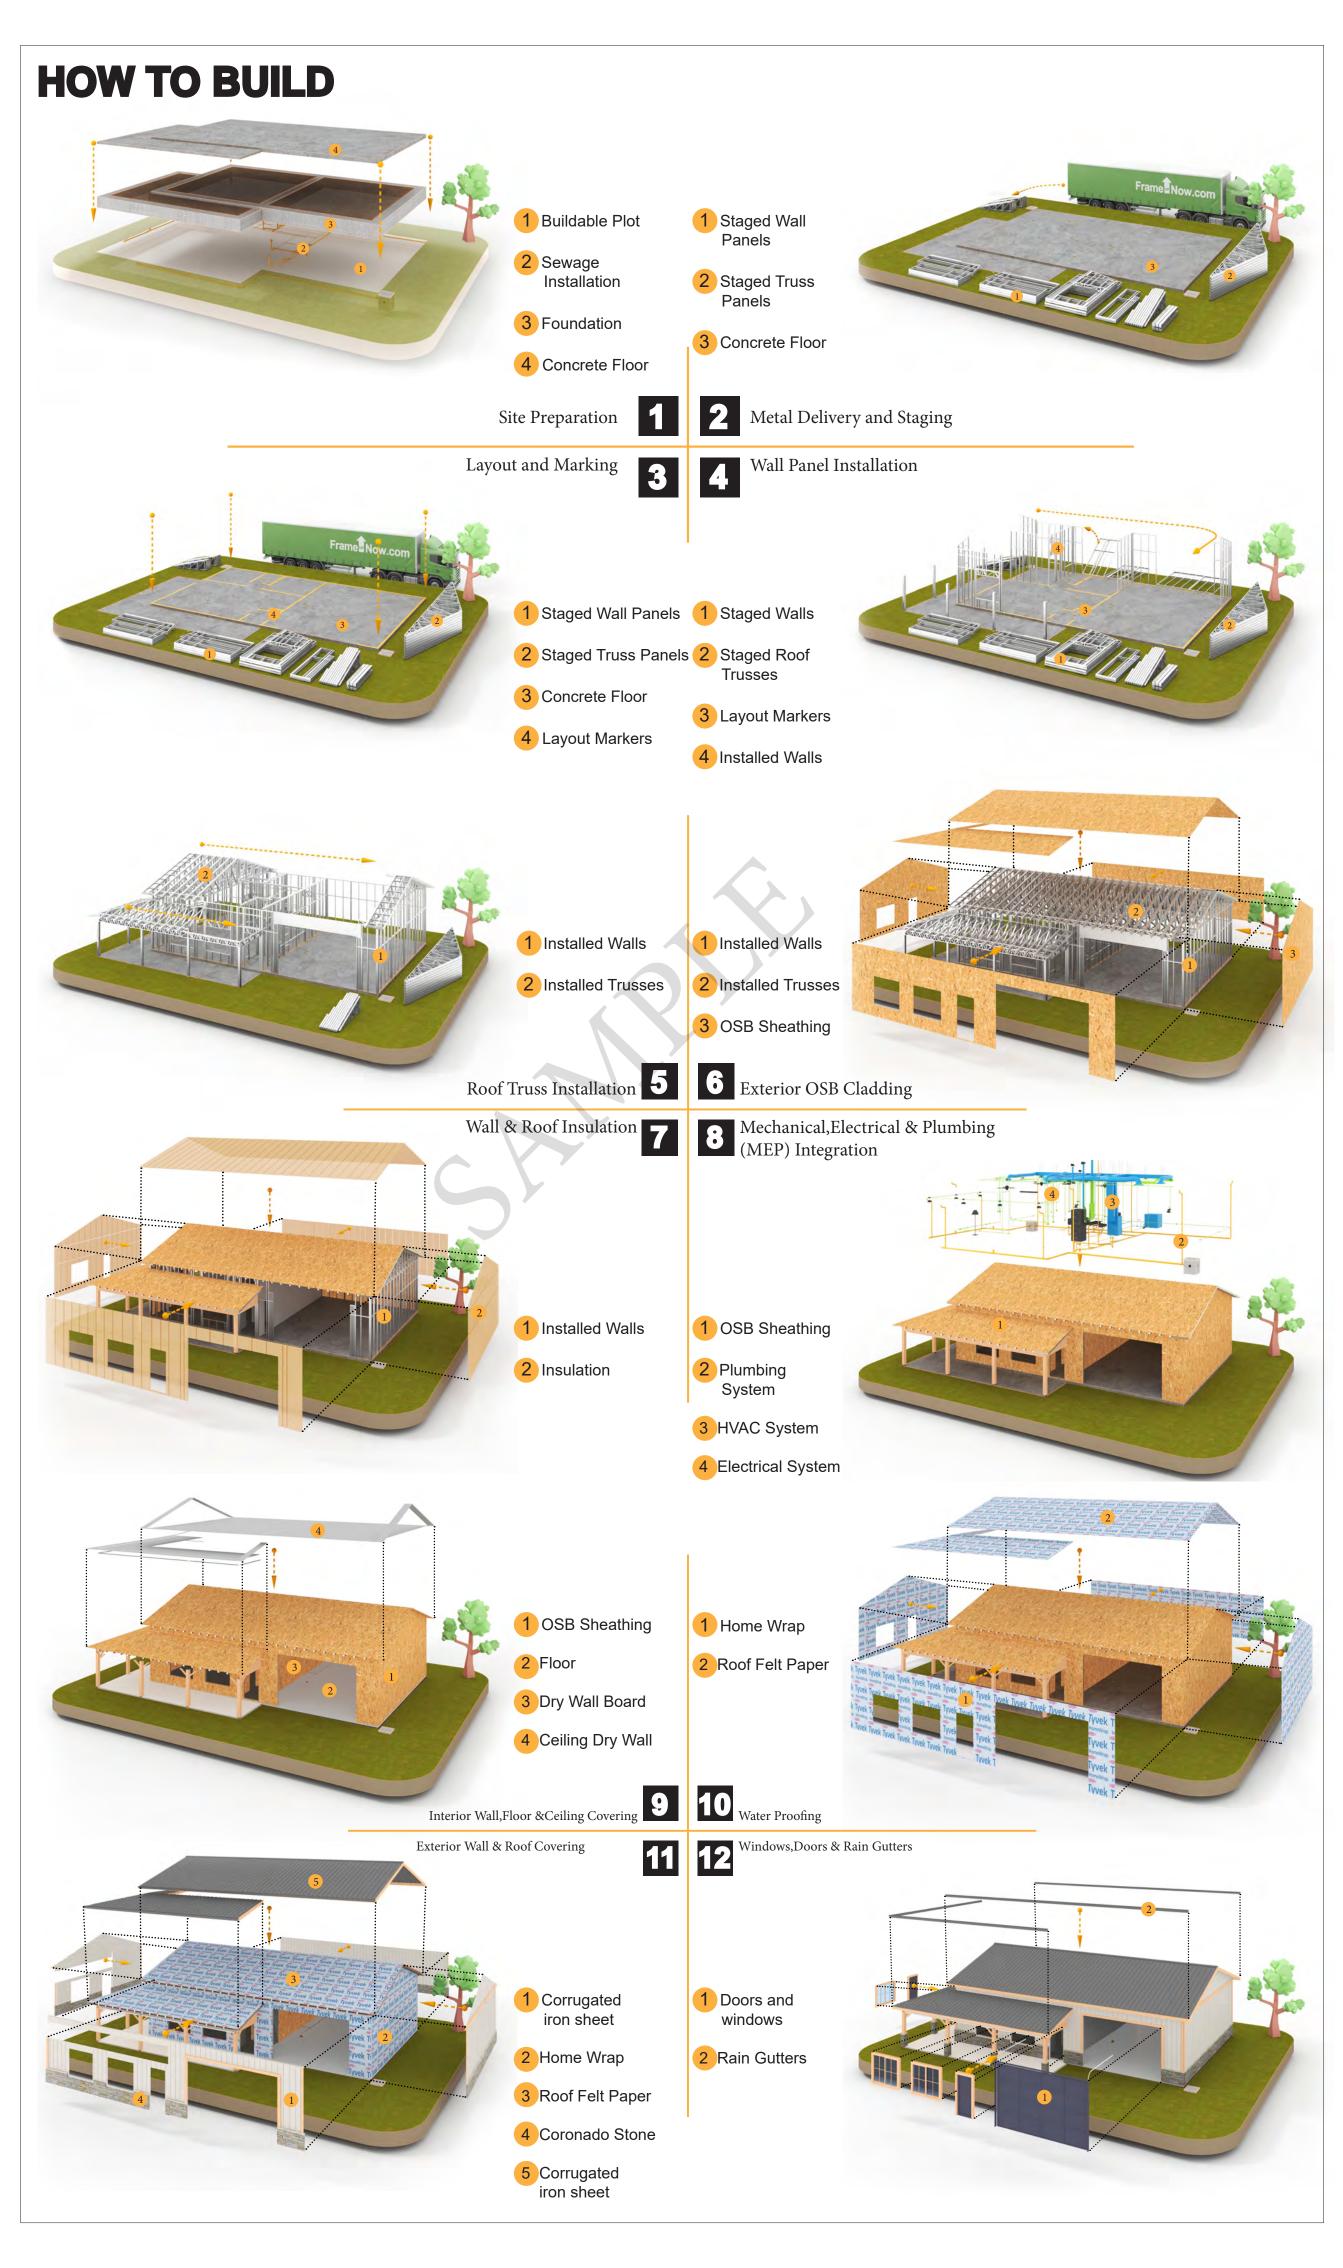



**KEY PLAN** 

NO.	DESCRIPTION	DATE

NOTE:

LEGEND:

PROJECT

107-Bennett-796-2Bd2Ba-Modern-550


DRAWING NAME

# INTRODUCTION

CLIENT NAME: PROJECT NUMBER: DATE: **DESIGNED BY** DRAWN BY: CHECKED BY:

1102

SCALE:

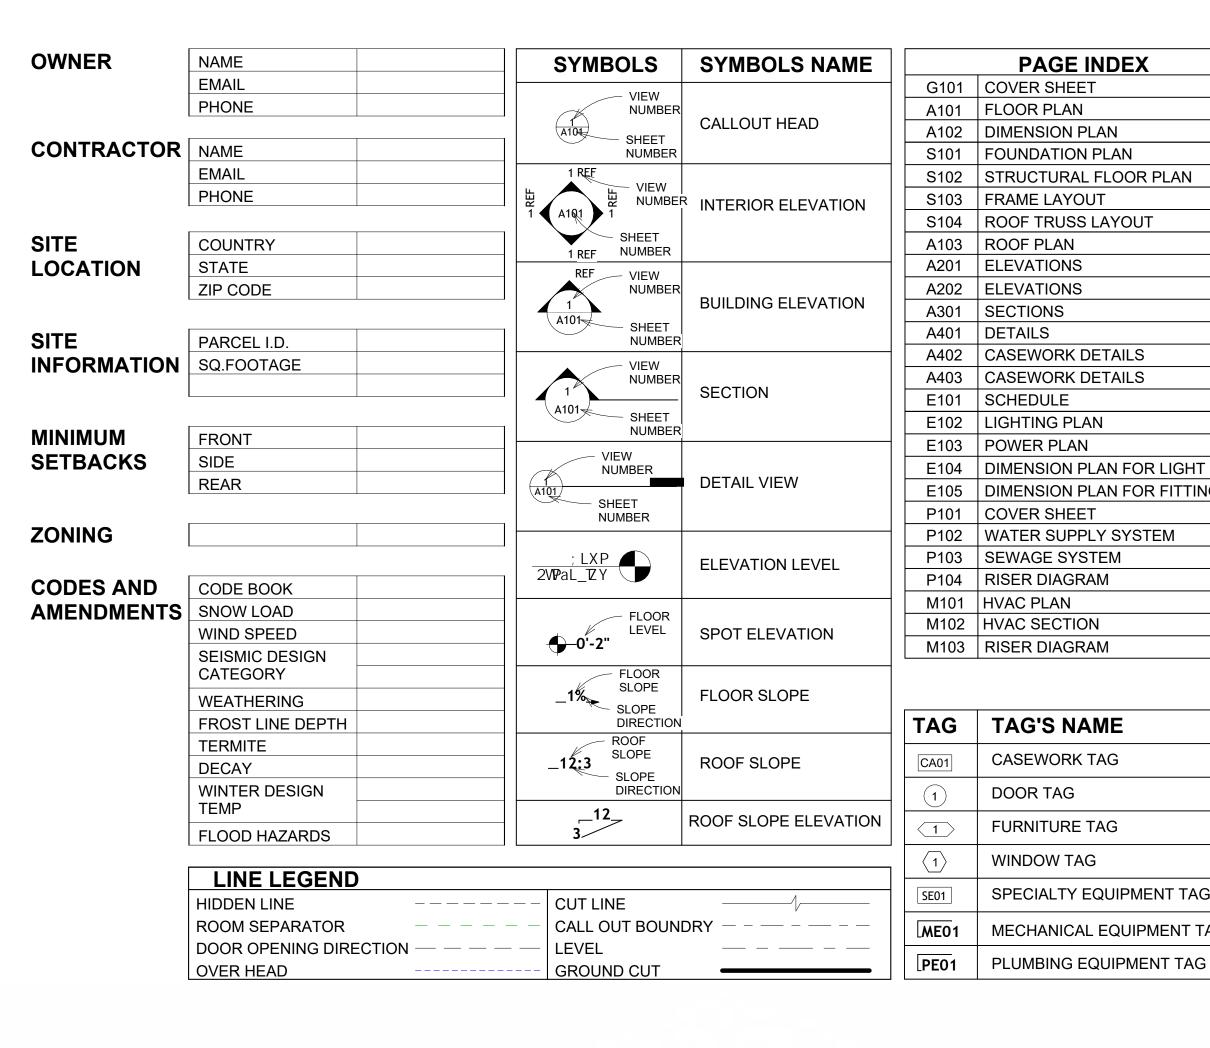

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CASEWORK TAG

**FURNITURE TAG** 

SPECIALTY EQUIPMENT TAG

WINDOW TAG

DOOR TAG



**ABBREVIATION** 

ASTM D698 AMERICAN SOCIETY FOR

CASEWORK

ELECTRICAL

FOOTINGS

CODE

MAXIMUM

MINIMUM

NUMBER

ON CENTER

PLUMBING

REFERENCE

RIGHT GARAGE

SQUARE FEET

HOLDDOWN

SIMP. ABE66 | SIMPSON ANCHOR BOLT EDGE

SIMP. STHD8 | SIMPSON STRAP THE

MECHANICAL

CONDITIONING

HVAC

MAX.

ACTION FLOOR SYSTEMS

TESTING AND MATERIAL

FINISHED FLOOR LEVEL

FINISHED FLOOR ELEVATION

HEATING, VENTILATION & AIR

INTERNATIONAL RESIDENCE


INTERNATIONAL MECHANICAL

ORIENTED STRAND BOARD

POUNDS PER SQUARE INCH


POLYVINYL CHLORIDE

SPECIAL EQUIPMENT

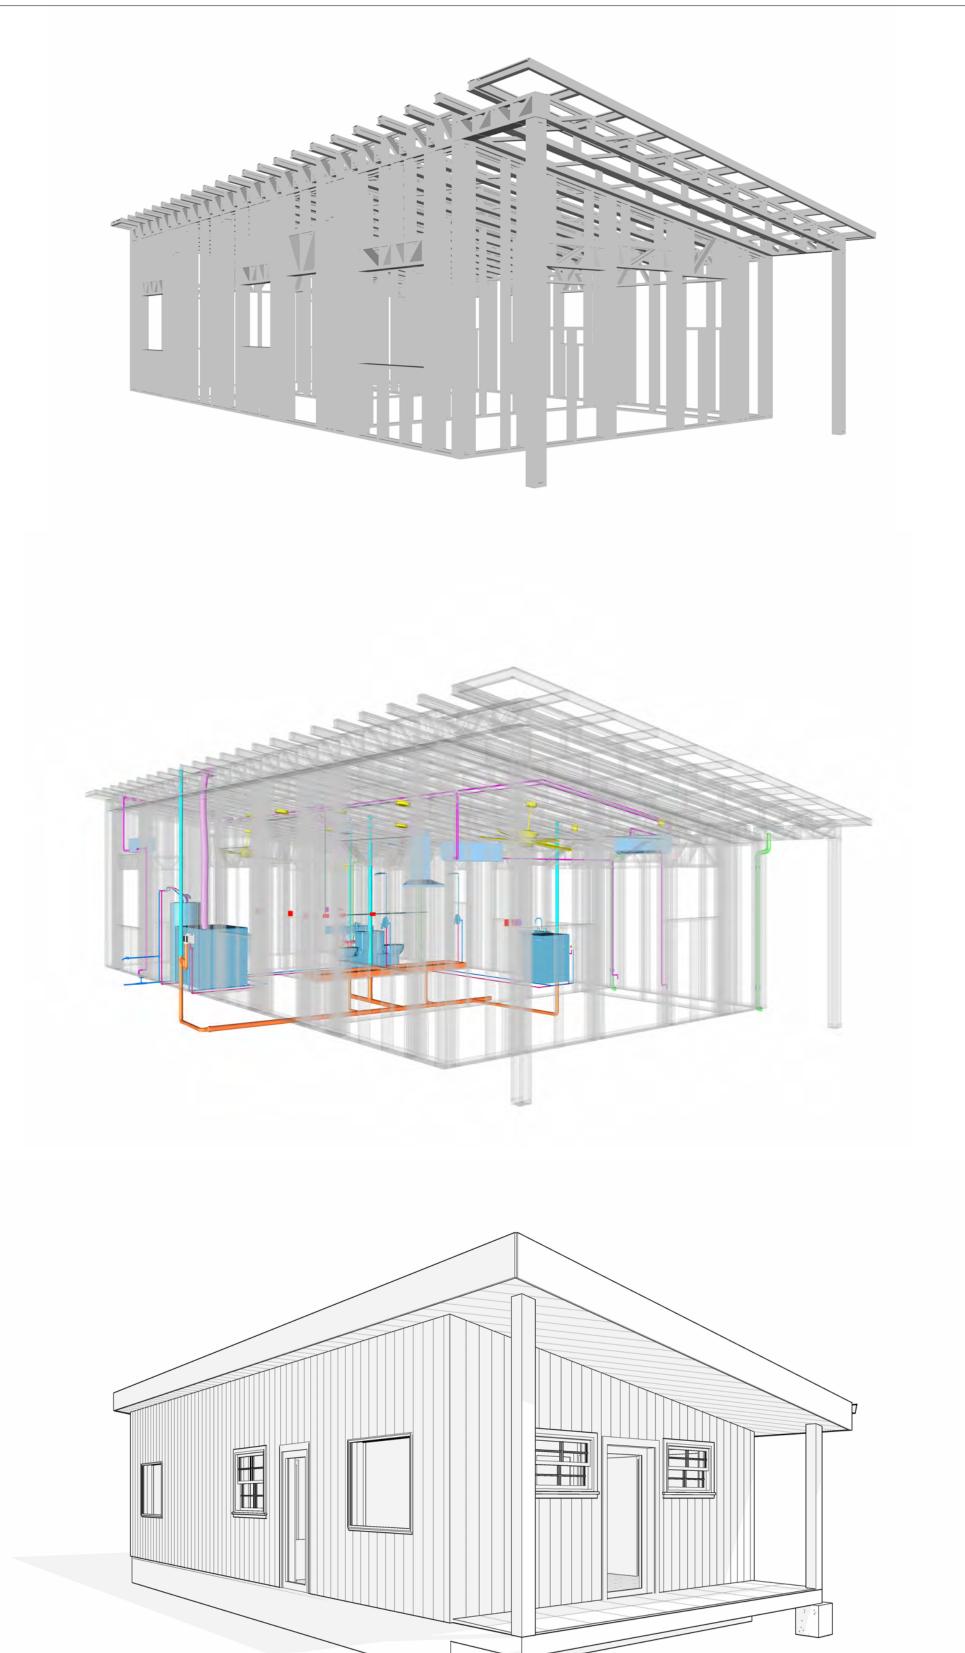

**107 BENNETT 796 2Bd2Ba** MODERN 550

SQUARE FOOT	AGE
LIVING	789
PORCH	74
TOTAL	863
•	

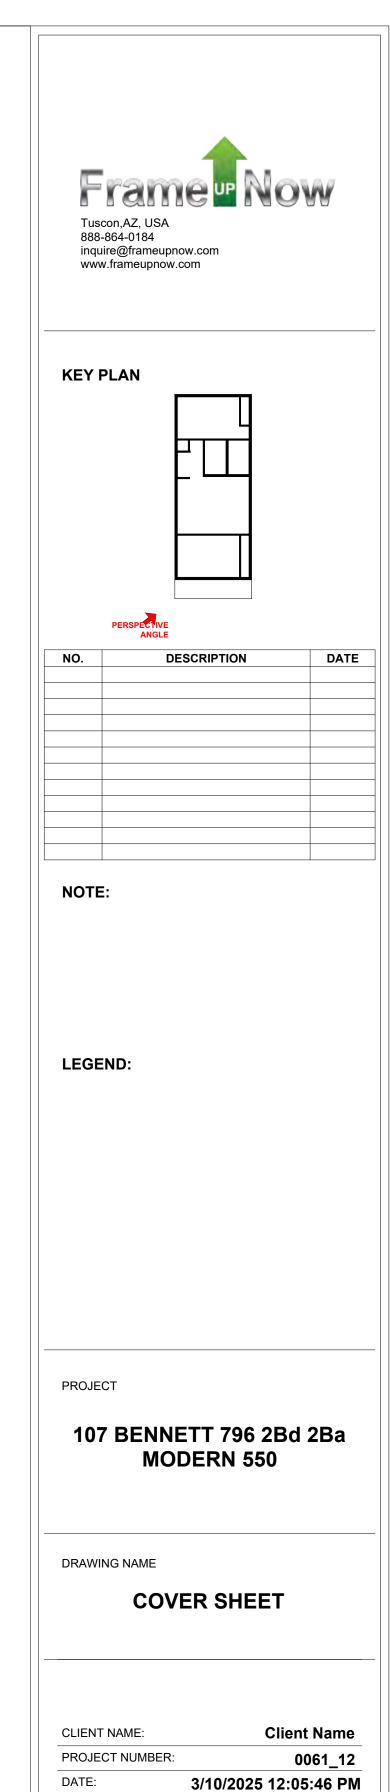

CHECKED BY: Checker G101

SCALE: As indicated

Designer

Author

DESIGNED BY:

DRAWN BY:

### GENERAL NOTES

- 1. THIS DRAWING DEPICTS THE ARCHITECTURAL (SPACE LAYOUT, FURNISHING, FLOOR, WALLS, ROOFS, FOUNDATION, WINDOWS AND DOORS) SYSTEMS. IT PROVIDES A VISUAL REPRESENTATION OF THE ARCHITECTURAL LAYOUT AND COMPONENTS.
- THE ARCHITECTURAL DRAWINGS ARE PREPARED TO MEET THE SPECIFIC REQUIREMENTS OF THE BUILDING, AS PER THE PROJECT SPECIFICATIONS AND APPLICABLE CODES AND STANDARDS. THE CONSTRUCTION OF THIS HOME SHALL COMPLY WITH THE LATEST EDITION OF THE
- INTERNATIONAL RESIDENTIAL CODE (IRC), INTERNATIONAL MECHANICAL CODE (IMC), THE INTERNATIONAL PLUMBING STANDARD, THE NATIONAL ELECTRICAL STANDARD AND ALL OTHER APPLICABLE LOCAL, STATE, AND NATIONAL CODES AND REGULATIONS.
- COORDINATION WITH OTHER TRADES HAS BEEN DONE ON A DESIGN LEVEL. THIS DRAWING SHALL BE READ TOGETHER WITH THE ME, EL AND PL DESIGN DRAWINGS TO ENSURE PROPER CONSTRUCTION AND INTEGRATION OF THE BUILDING SYSTEMS.

#### ABOUT WALLS:

SHOWER WALL COVERING

BATHTUB AND SHOWER SPACES (WALLS AND FLOORS) WITH INSTALLED SHOWER HEADS AND IN SHOWER COMPARTMENTS SHALL BE FINISHED WITH A NON-ABSORBENT SURFACE.

WALL PAINT (INTERNAL)

THE TYPICAL THICKNESS OF LATEX WALL PAINT IS 1/32 OF AN INCH FOR A SINGLE COAT. AND DOUBLE COAT (1/16") SHALL BE APPLIED FOR DURABILITY.

ADHESIVES:

THE ADVISABLE TYPE OF ADHESIVE FOR THIS PROJECT IS **EPOXY ADHESIVES**BECAUSE THEY ARE KNOWN FOR THEIR HIGH STRENGTH, DURABILITY, AND RESISTANCE TO MOISTURE, CHEMICALS AND


REFER TO SHEETS A201 & A202 FOR GENERAL NOTES ON EXTERNAL FINISHING MATERIALS

#### ABOUT FLOORS:

- 1. THE SPOT ELEVATION INDICATES THE FINISHED FLOOR ELEVATION.
- FINISHED FLOORS PER PLANS.
- FIELD VERIFY FOR DIMENSION DROP 4" FOR SHOWER AND BATHTUB USE.
- 1% SLOPE ON OUTDOOR BALCONIES FOR WATER RUN OFF. 2% SLOPE TOWARDS THE SHOWER DRAIN FOR SUFFICIENT DRAINAGE.
- 4" DROP AT THE DOOR LEADING TO EXTERIOR BALCONY FROM THE MAIN LIVING AREA.
- 5% SLOPE FOR GARAGE IS USED, WHICH SHOULD BE CHECKED WITH THE LOCAL GARAGING ZONING LAWS.

FURNITURE SCHEDULE					
TYPE MARK	TYPE		COUNT		
01	KING SIZE BED	2			
02	THREE SEAT SOFA	1			
03	ONE SEAT SOFA	1			
04	COFFE TABLE	1			
05	DINING CHAIR	2			

	ROOM FINISH SCHEDULE						
ROOM NUMBE R	ROOM NAME	FLOOR FINISH	BASE FINISH	WALL FINISH	CEILING FINISH	CEILING HEIGHT	COM MEN TS
01	BEDROOM 2	HARDWOOD	CONCRETE	WALL PAINT	DRY WALL	8' - 0"	
02	CL 2	HARDWOOD	CONCRETE	WALL PAINT	DRY WALL	8' - 0"	
03	BEDROOM 1	HARDWOOD	CONCRETE	WALL PAINT	DRY WALL	8' - 0"	
04	CL 1	HARDWOOD	CONCRETE	WALL PAINT	DRY WALL	8' - 0"	
05	BATH 1	VINYL TILES	CONCRETE	CERAMIC TILE	MRD	8' - 0"	
06	BATH 2	VINYL TILES	CONCRETE	CERAMIC TILE	MRD	8' - 0"	
07	W/D	VINYL TILES	CONCRETE	CERAMIC TILE	DRY WALL	8' - 0"	
08	KITCHEN	HARDWOOD	CONCRETE	WALL PAINT + CERAMIC	DRY WALL	8' - 0"	
09	LIVING	HARDWOOD	CONCRETE	WALL PAINT	DRY WALL	8' - 0"	
10	HALL	HARDWOOD	CONCRETE	WALL PAINT	DRY WALL	8' - 0"	
11	WH	VINYL TILES	CONCRETE	CERAMIC TILE	DRY WALL	8' - 0"	
12	PORCH	PROCELAIN TILE	CONCRETE	EXTERIOR-GRADE PLYWOOD	PLYWOOD	8' - 0"	

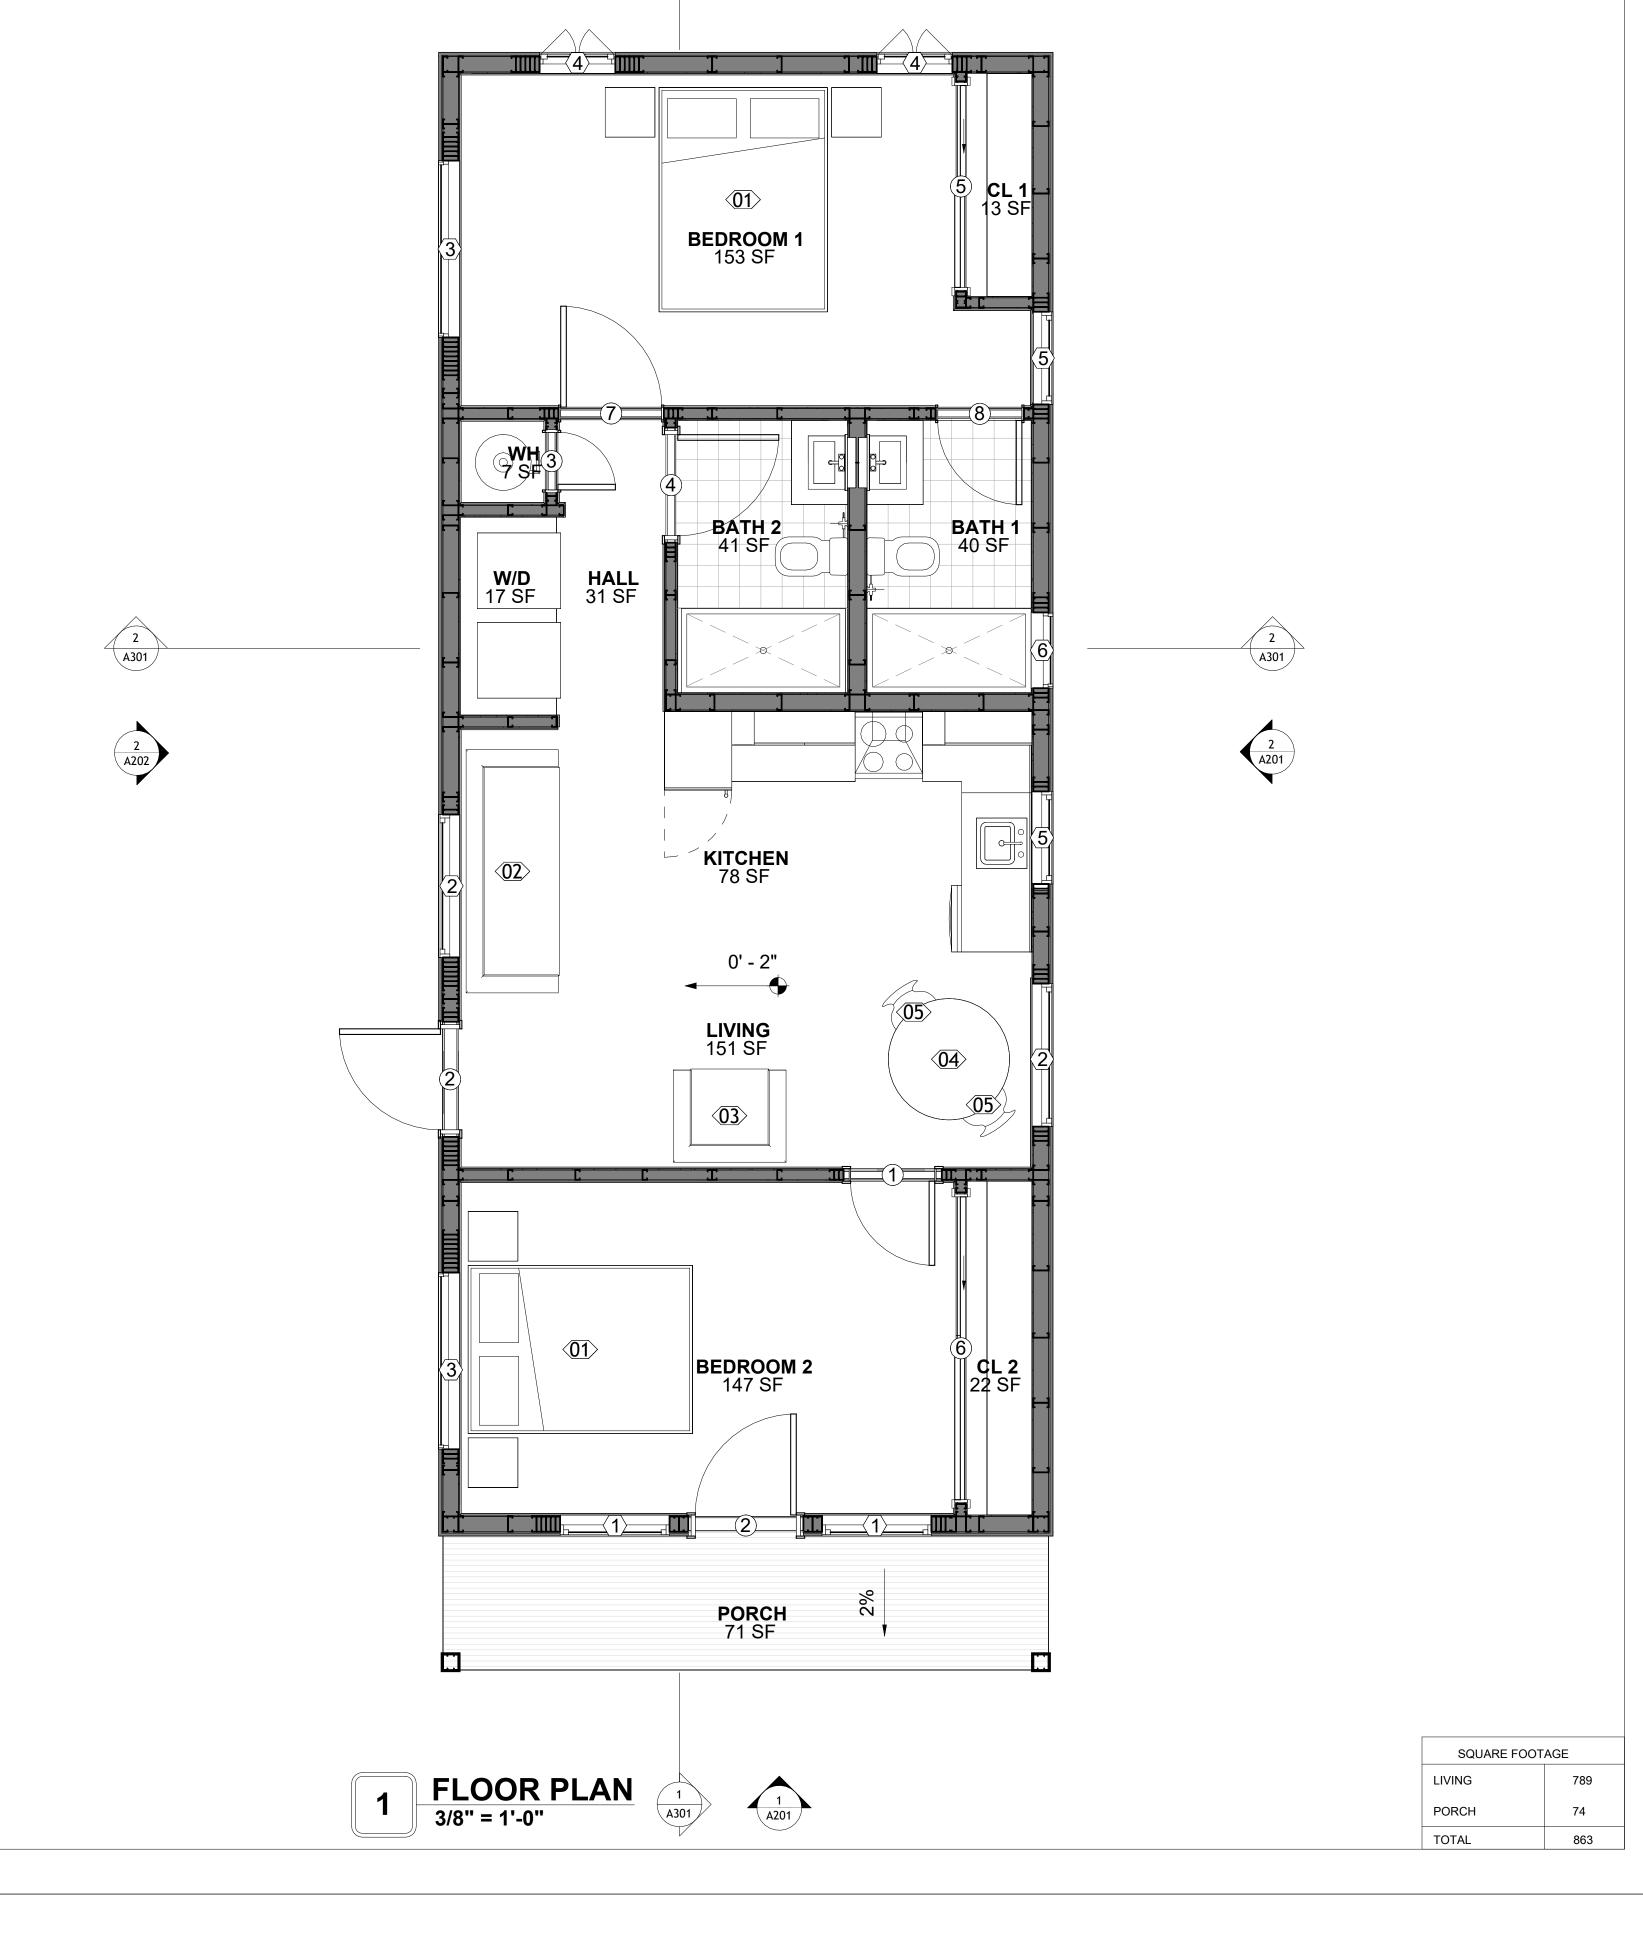



**KEY PLAN** 

NO.	DESCRIPTION	DATE

NOTE:

LEGEND:

PROJECT


107 BENNETT 796 2Bd 2Ba MODERN 550

DRAWING NAME

**FLOOR PLAN** 

CLIENT NAME:	Client Name
PROJECT NUMBER:	0061_12
DATE:	3/10/2025 12:05:47 PM
DESIGNED BY:	Designer
DRAWN BY:	Author
CHECKED BY:	Checker

A101

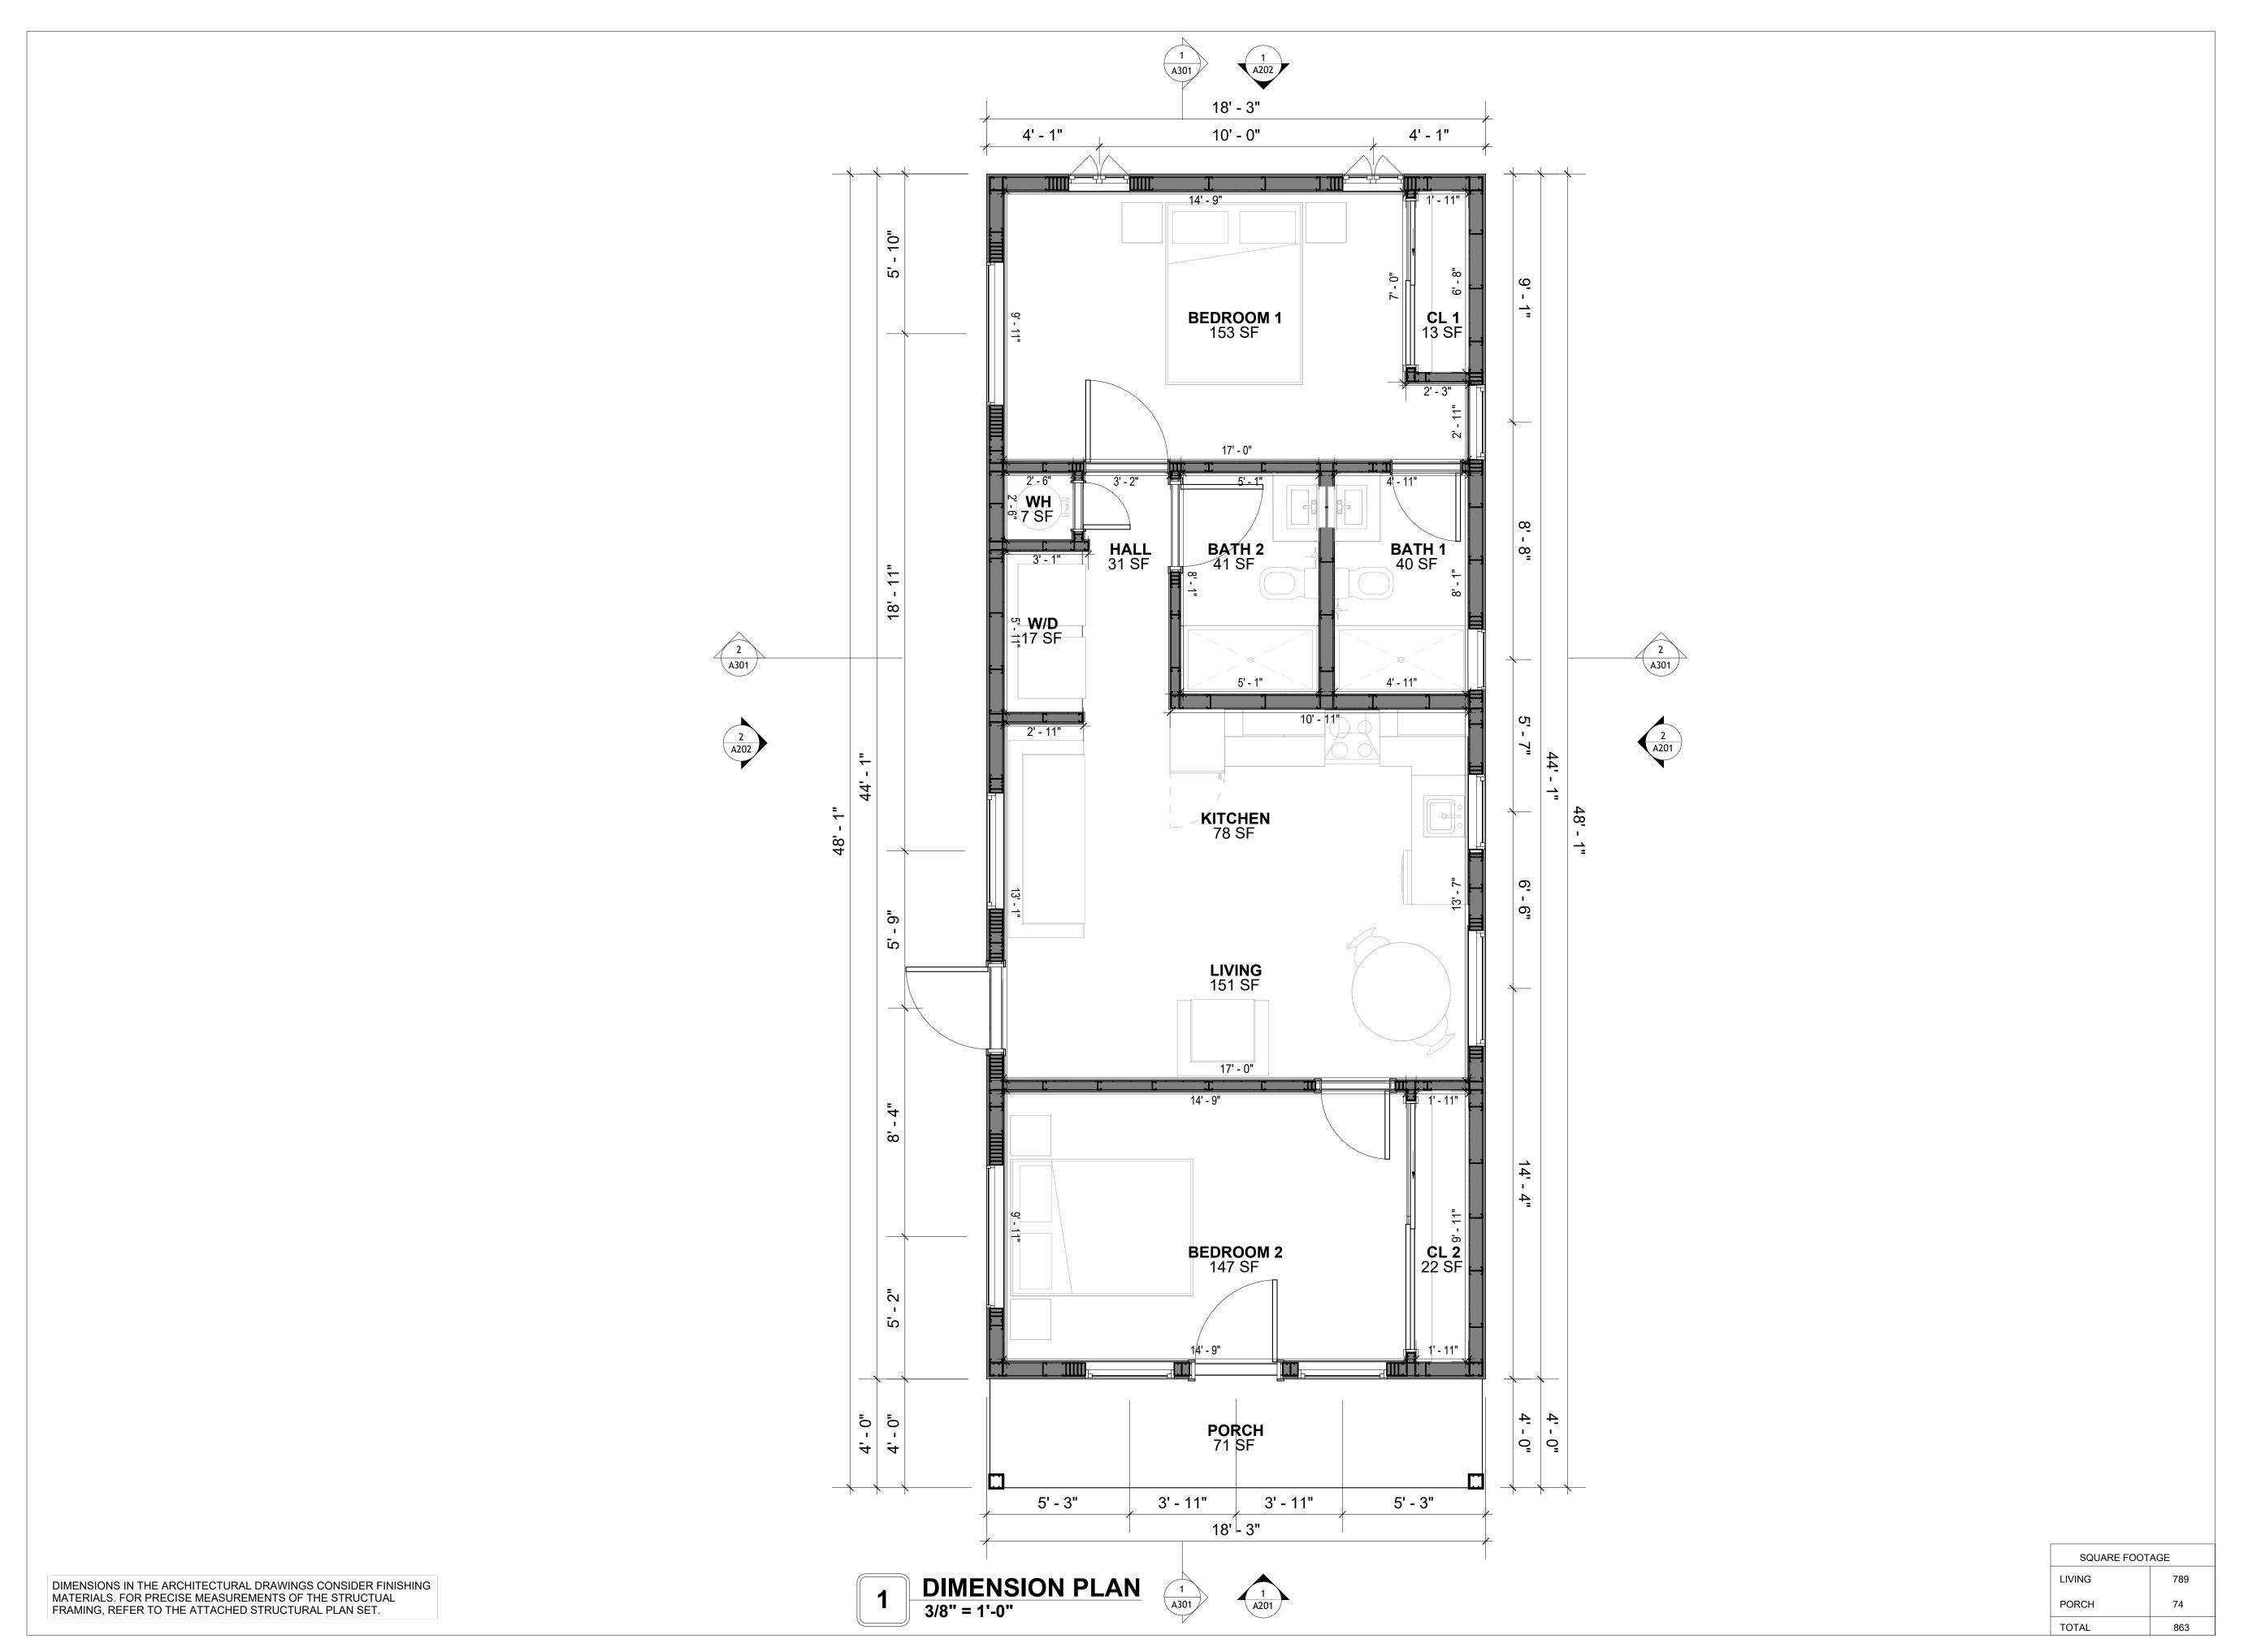



**KEY PLAN** 

NO.	DESCRIPTION	DATE
	NO.	NO. DESCRIPTION

NOTE:

LEGEND:

PROJECT

107 BENNETT 796 2Bd 2Ba MODERN 550

DRAWING NAME

DIMENSION PLAN

Client Name	CLIENT NAME:	
0061_12	PROJECT NUMBER:	
3/10/2025 12:05:49 PM	DATE:	
Designer	DESIGNED BY:	
Author	DRAWN BY:	
Checker	CHECKED BY:	

A102

SCALE: 3/8" = 1'-0"

### **FOUNDATION NOTES**

#### NOTES

TERMITES PRETREATMENT BY LICENSED CONTRACTOR UNDER SLAB AND AROUND FOOTINGS. ALL AREAS BELOW SLABS SHALL BE TREATED NO MORE THAN 24 HOURS PRIOR TO CONCRETE POUR. EVIDENCE OF TREATMENT MUST BE PROVIDED PRIOR TO PLACING OF CONCRETE.

#### . MATERIALS:

ALL INTERIOR CONCRETE SLABS SHALL BE A MIN. OF 4" THICK CONCRETE OVER 4" COMPACTED AGGREGATE BASE (ASTM D698), FINISH ELEVATIONS AS NOTED ON DRAWINGS, 6" ABOVE ADJACENT GRADE, LEVEL SLABS TO 1/8"-10' MAX.. CONCRETE SLABS SHALL BE 2500# PSI AT 28 DAYS. A 4" ALLOWABLE SLUMP.

### 2. PAD PREPARATION:

- EXCAVATION FOR FOOTING SHALL BE NEAT.

- FOOTINGS SHALL BE POURED IMMEDIATELY AFTER EXCAVATION AND APPROPRIATE INSPECTION.

- ALL REINFORCING STEEL MARKED "CONTINUOUS" SHALL BE LAPPED 36 BAR DIAMETERS AT SPLICES AND AROUND CORNERS OR INTERSECTIONS WITH A STANDARD 90 DEGREE BEND ON CORNER BARS. LAP WIRE MESH ONE FULL MESH AT SIDE AND END LAPS.
- ALL HARDWARE TO BE SIMPSON OR EQUIVALENT.

- EXTERIOR FRAME WALL TO BE SECURED WITH 1/2"X10" ANCHOR BOLTS 4'-0" O.C. FOR 1-STORY AND 2'-8" O.C. FOR 2-STORY. BOLTS SHALL BE LOCATED WITHIN 1'-0" OF EACH END PIECE AND SHALL HAVE A MIN. OF TWO BOLTS PER PIECE.

-FOUNDATION ANCHOR STRAPS SHALL BE PERMITTED, ACCORDING TO RESIDENTIAL CODE 2021

- ALL INTERIOR WALLS TO BE SECURED WITH POWER DRIVEN PINS PER MANUFACTURER SPECIFICATION USE PIN SPACING EQUIVALENT TO 1/2" ANCHOR BOLTS.
- ALL CONSTRUCTION TO CONFORM TO THE 2012 IRC

R-10 RIGID INSULATION OUTSIDE OF EXTERIOR FOUNDATION WALLS UNDER LIVING AREA.
 CONCRETE PAD FOR CONDENSER THICKNESS IS 4" MIN UNLESS OTHERWISE NOTED.

#### 3. CONCRETE CONSTRUCTION:

- THE SLAB SHALL BE UNDERLAIN BY A VAPOR BARRIER/RETARDER IN THE LIVING AREA (TYPICALLY POLYETHYLENE, UNLESS MORE STRINGENT PROTECTION REQUIRED BY THE ARCHITECT, ENGINEER, FLOOR COVERING MANUFACTURER, OR ACCEPTED PRACTICE). UNLESS OTHERWISE REQUIRED, BARRIER MAY BE OMITTED AT GARAGES, PORCHES AND PATIOS WITHOUT FLOOR COVERINGS. IT IS BEYOND THE SCOPE OF THESE PLANS TO DETERMINE THE APPLICABILITY OF THESE MORE STRINGENT REQUIREMENTS. BUILDER SHALL VERIFY PRIOR TO CONSTRUCTION.

### 4. REINFORCEMENT :

- IF CONSTRUCTED ON ACTIVE SOILS, THE LONG TERM PERFORMANCE OF THE FOUNDATION IS DEPENDENT ON MAINTENANCE BY THE OWNER. THUS THE BUILDER SHALL ADVISE THE OWNER OF THE FOLLOWING:

DRAINAGE MUST BE MAINTAINED. WATER SHALL NEVER BE ALLOWED TO POND NEAR THE

2. THE SOIL AROUND THE FOUNDATION SHALL BE MAINTAINED IN A RELATIVELY DAMP CONDITION, SUCH AS THAT REQUIRED TO KEEP A LAWN GREEN. IF IT DRIES OUT IT WILL SHRINK. IF IT GETS WET, IT WILL HEAVE UPWARD.

3. SLABS ON THE SHORTER SIDE USES MAIN BARS ARE USED IN THIS DIRECTION ONLY WITH SMALLER DIAMETER DISTRIBUTION BARS ARE PLACED, FORMING A MAT OR GRID.

4. ALL REINFORCEMENT BARS SIZE 10MM OR LARGER IN ACCORDANCE TO ASTM

ANCHOR BOLTS AT ALL EXTERIOR WALLS SHALL BE MINIMUM 1/2 INCH DIAMETER WITH A MAXIMUM SPACING OF 6'-0" ON CENTER, UNLESS NOTED OTHERWISE.
 ANCHOR BOLTS SHALL BE INSTALLED WITHIN 12 INCHES OF EACH END OF EACH SILL

PLATE WITH AT LEAST TWO ANCHOR BOLTS FOR EACH BOLTS FOR EACH SILL PLATE LONGER
THAN 12 INCHES.
5. SIMPSONS SILL ANCHORS MAYBE SUBSTITUTED FOR ANCHOR BOLTS AT THE SAME

SPACING.

6. EXTERIOR CONCRETE SLABS WHICH ARE NOT PART OF THE MAIN SLAB SHALL BE MINIMUM 4 INCHES THICK WITH NO STEEL REINFORCING BARS REQUIRED, UNLESS NOTED


## VERIFY THE FOLLOWING PRIOR TO POURING:

- 1. ALL HOLDDOWNS , STRAP, AND POST LOCATIONS.
- CONCRETE FINISHES. PANEL RISER LOCATION WHERE APPLICABLE.
- 3. UNDERSLAB MECHANICAL REQUIREMENTS. 4 STEM WALL BLOCKOLITS
- STEM WALL BLOCKOUTS.
   UNDERSLAB ELECTRICAL REQUIREMENTS AND PANEL RISER LOCATION. WHERE

OTHERWISE ON FOUNDATION PLAN.

- APPLICABLE.
- 6. PROVIDE THE FOLLOWING:
- PVC SLEEVES THROUGH FTG IF REQUIRED
   20' #4 COPPER GROUND BAR.
- 7. SLOPE FINISH GRADE AWAY FROM FOOTING.

**NOTE**: FIELD VERIFY ALL DIMENSIONS SEE DIMENSIONED ARCHITECTURAL DRAWINGS

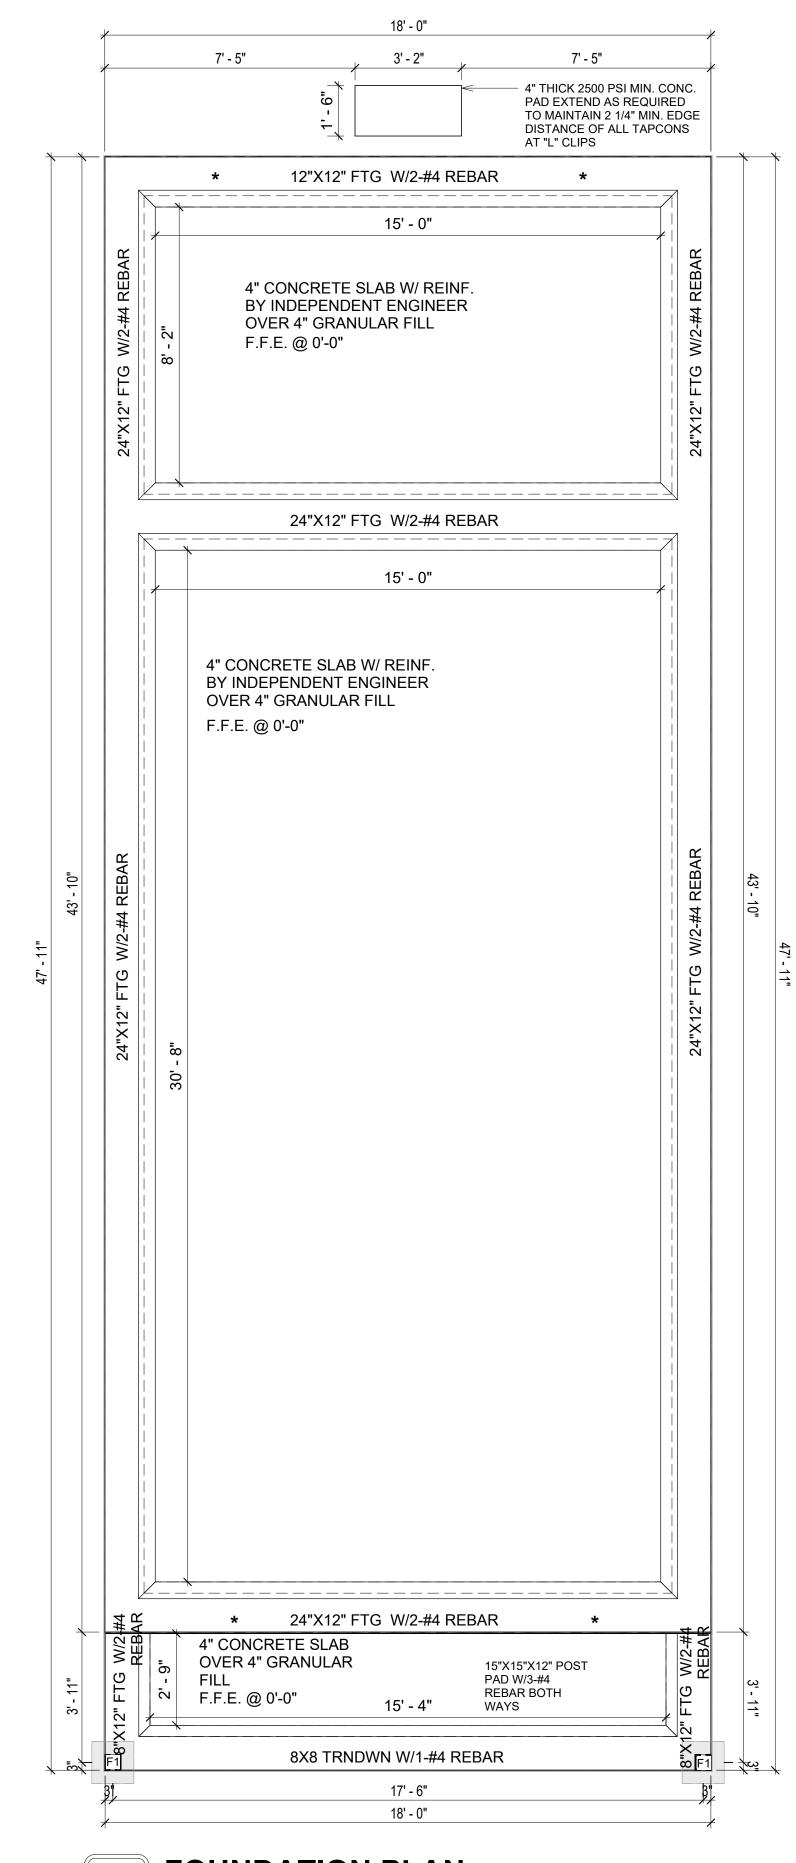

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**KEY PLAN** 

NO. DESCRIPTION DATE

NOTE:

LEGEND:

PROJECT

107 BENNETT 796 2Bd 2Ba MODERN 550

DRAWING NAME

**FOUNDATION PLAN** 

CLIENT NAME:

PROJECT NUMBER:

0061\_12

DATE:

3/10/2025 12:05:50 PM

DESIGNED BY:

DRAWN BY:

CHECKED BY:

Checker

S101

SCALE: 3/8" = 1'-0"

SQUARE FOOTAGE

863

LIVING

PORCH

TOTAL

1 FOUNDATION PLAN
3/8" = 1'-0"

### **GENERAL NOTES**

-ALL BEARING WALLS SHOULD HAVE A THICKENED SLAB PER SECTION PER DETAIL A401/5.

#### A) FOUNDATION PLAN NOTES:

1. CONCRETE SLAB SHALL BE 6" THICK WITH 1/2" DIAMETER TENDONS PER LAYOUT PLAN, CENTERED IN SLAB THICKNESS, OVER APPROVED SUBBASE PER GENERAL STRUCTURE

2. TERMITE PROTECTION SHALL BE PROVIDED PER IRC SECTION R318.1 3. NONE TYPICAL ANCHOR BOLT SPACING AT SHEAR WALL AND HOLD DOWN

SPECIFICATIONS PER APPROVED ARCHITECTURAL PLANS. 4. INSTALL HOLDOWNS BEFORE CONCRETE SLAB POUR.

5. EXISTING FILL ON-SITE SHALL BE COMPACTED IN ACCORDANCE WITH THE REQUIREMENTS IN THE GEOTECHNICAL REPORT.

6. ALL FLOOR SLABS ARE REINFORCED ON CONCRETE SLABS.

#### SPECIAL INSPECTION IS REQUIRED FOR THICKENED FOUNDATION CONSTRUCTION

1. REINFORCEMENT

2. 2300 PSI CONCRETE POUR


#### B) **REINFORCEMENT FOR CONCRETE**:


1. ALL REINFORCING SLABS BARS SIZE 10MM OR LARGER SHALL BE DEFORMED IN ACCORDANCE TO ASTM-A706, AND BARS SMALLER THAN 10 MM MAYBE PLAIN. 2. UNLESS OTHERWISE NOTED IN PLANS. THE YIELD STRENGTH OF REINFORCING BARS SHALL BE:


> A) FOOTING = 40,000 PSI B) NON-LOAD BEARING WALLS AND PARAPETS= 40,000 PSI

- SPLICES SHALL BE SECURELY WIRED TOGETHER AND SHALL LAP OR EXTEND
- GRADE OF STEEL FOR RCC WORKS SHALL BE GRADE 4 10.
- 5. BAR NOTATIONS GIVES INFORMATION
  - A) BAR SIZE B) SPACING(IF REQUIRED)
- 6. LAP REINFORCEMENT ONLY AT LOCATION SHOWN IN THE DRAWINGS
- 7. REINFORCEMENT SHALL NOT BE CUT, VENT OR HEATED ON SITE WITHOUT ENGINEERS' APPROVAL.
- C) CONCRETE SLAB NOTES
- 1. ALL SLAB REINFORCEMENT SHALL BE 20MM CLEAR MINIMUM FROM BOTTOM AND FROM
- 2. REINFORCEMENT IN CONTINUOUS ELEVATED SLAB SHALL BE CUT AS FOLLOWS.

- THIS IS A SCHEMATIC PLAN FOR THE PURPOSE OF LOCATING AND IDENTIFYING FOUNDATION REINFORCING ELEMENTS ONLY. VERIFY ALL DIMENSIONS, DROPS, OFFSETS AND FEATURES WITH THE ARCHITECTURAL PLANS BEFORE FORMING THE FOUNDATION.

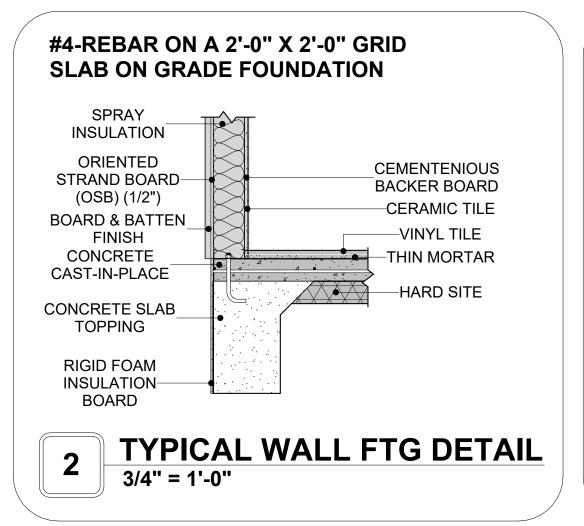

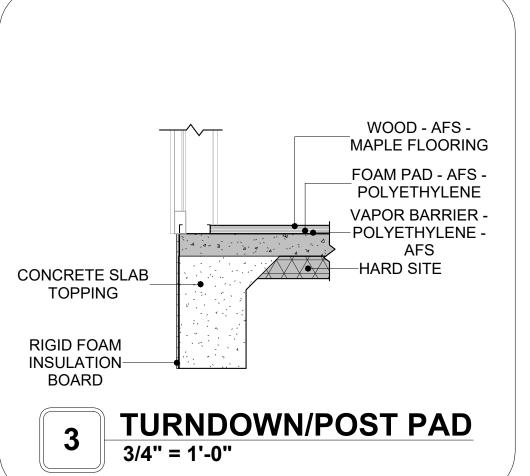

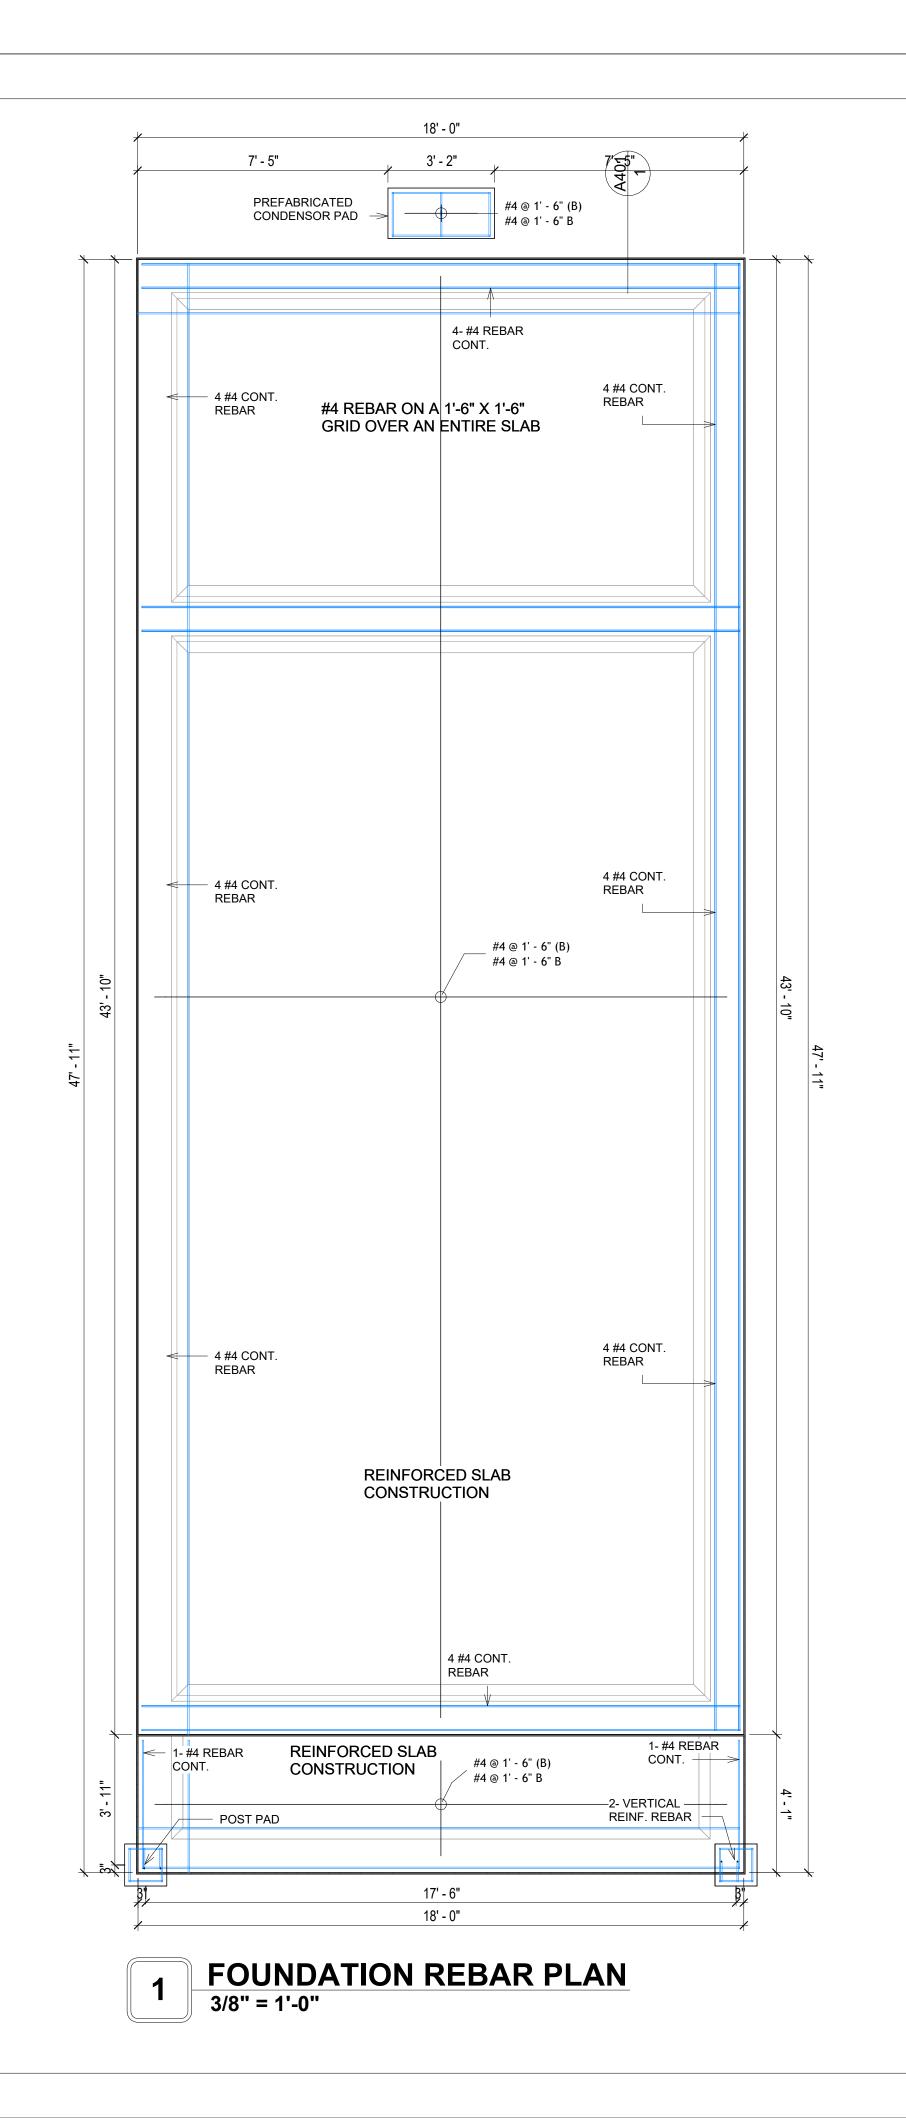



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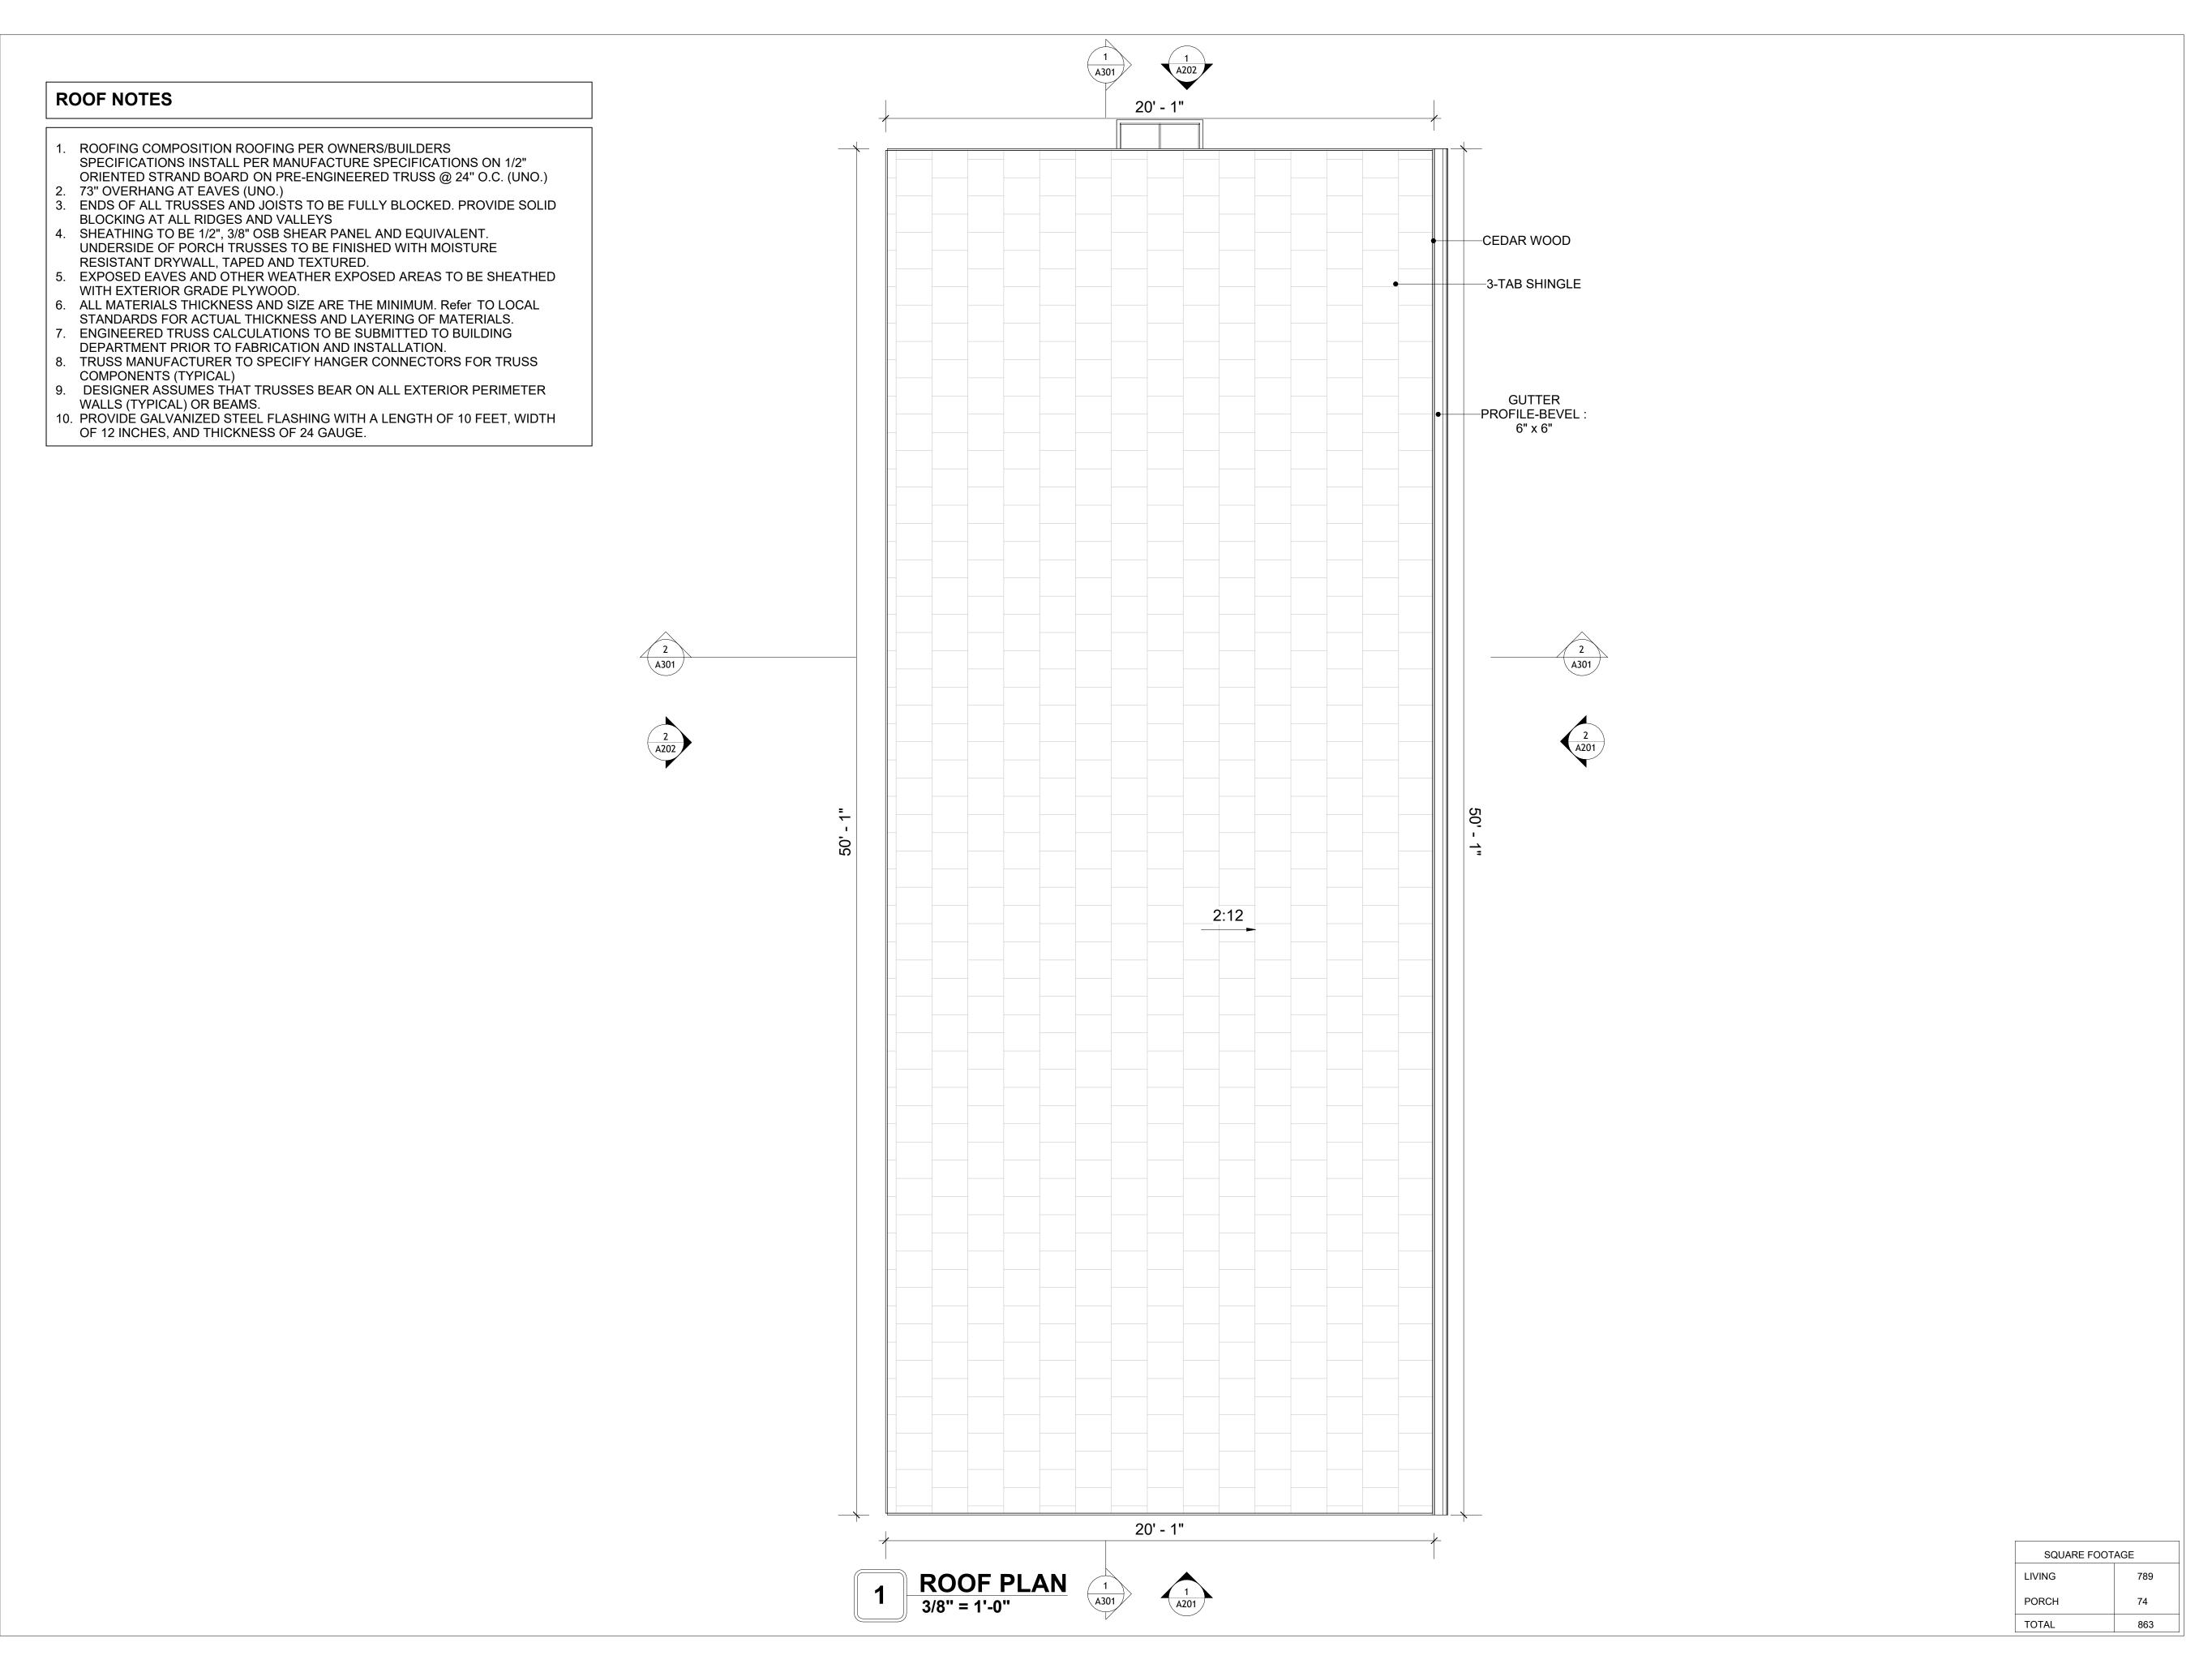
107 BENNETT 796 2Bd 2Ba MODERN 550

DRAWING NAME

STRUCTURAL FLOOR PLAN

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0061_12	PROJECT NUMBER:	
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**KEY PLAN** 

NO.	DESCRIPTION	DATE

NOTE:

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107 BENNETT 796 2Bd 2Ba MODERN 550

DRAWING NAME

**ROOF PLAN** 

Client Name	CLIENT NAME:
0061_12	PROJECT NUMBER:
3/10/2025 12:05:53 PM	DATE:
Designer	DESIGNED BY:
Author	DRAWN BY:
Checker	CHECKED BY:
<u> </u>	

A103

# **ABOUT WALL FINISHING**

#### **BOARD AND BATTEN**


BOARD AND BATTEN REFERS TO A TYPE OF EXTERIOR SIDING THAT USES WIDE VERTICAL BOARDS JOINED BY NARROW STRIPS OF WOOD, CALLED BATTENS, THAT COVER THE SEAMS. THIS PROVIDES A DISTINCTIVE TEXTURED APPEARANCE AND IS KNOWN FOR ITS DURABILITY AND RUSTIC CHARM.

#### **CEDAR WOOD**


CEDAR WOOD REFERS TO THE WOOD FROM VARIOUS SPECIES OF CEDAR TREES, WHICH ARE CONIFEROUS EVERGREEN TREES KNOWN FOR THEIR DISTINCT AROMA AND NATURAL RESISTANCE TO DECAY AND INSECTS. IN THIS SPECIFIC PROJECT, CEDAR WOOD IS USED AS A FURRING STRIP AND A FINISH MATERIAL ON BEAMS AND COLUMNS.

CEDAR WOOD AS A FURRING STRIPS PROVIDE THERMAL INSULATION, MOISTURE MANAGEMENT, AND AN AESTHETICALLY PLEASING, VERSATILE FRAMING SOLUTION WHEN INTEGRATED WITH CORONADO STONE AND CORRUGATED IRON SHEET CLADDING.

THE VERTICAL CEDAR WOOD FURRING STRIPS ARE ATTACHED TO HOME WRAP USING CORROSION-RESISTANT FASTENERS (HOT DIP GALVANIZED SCREWS), ENSURING PROPER PENETRATION INTO THE WALL FRAMING.

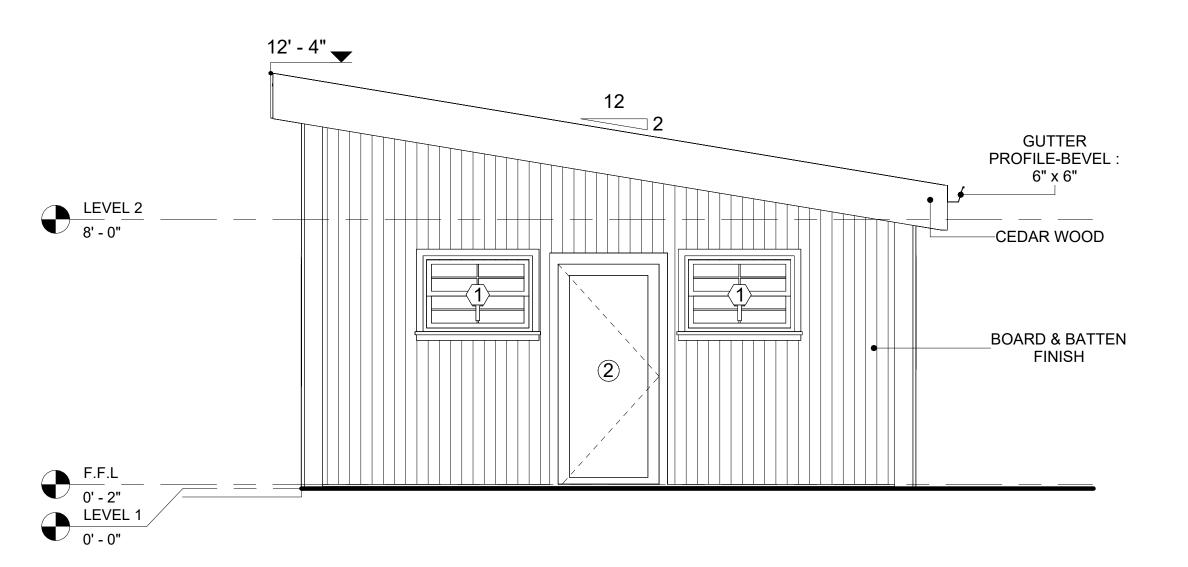


1 FRONT ELEVATION
3/8" = 1'-0"

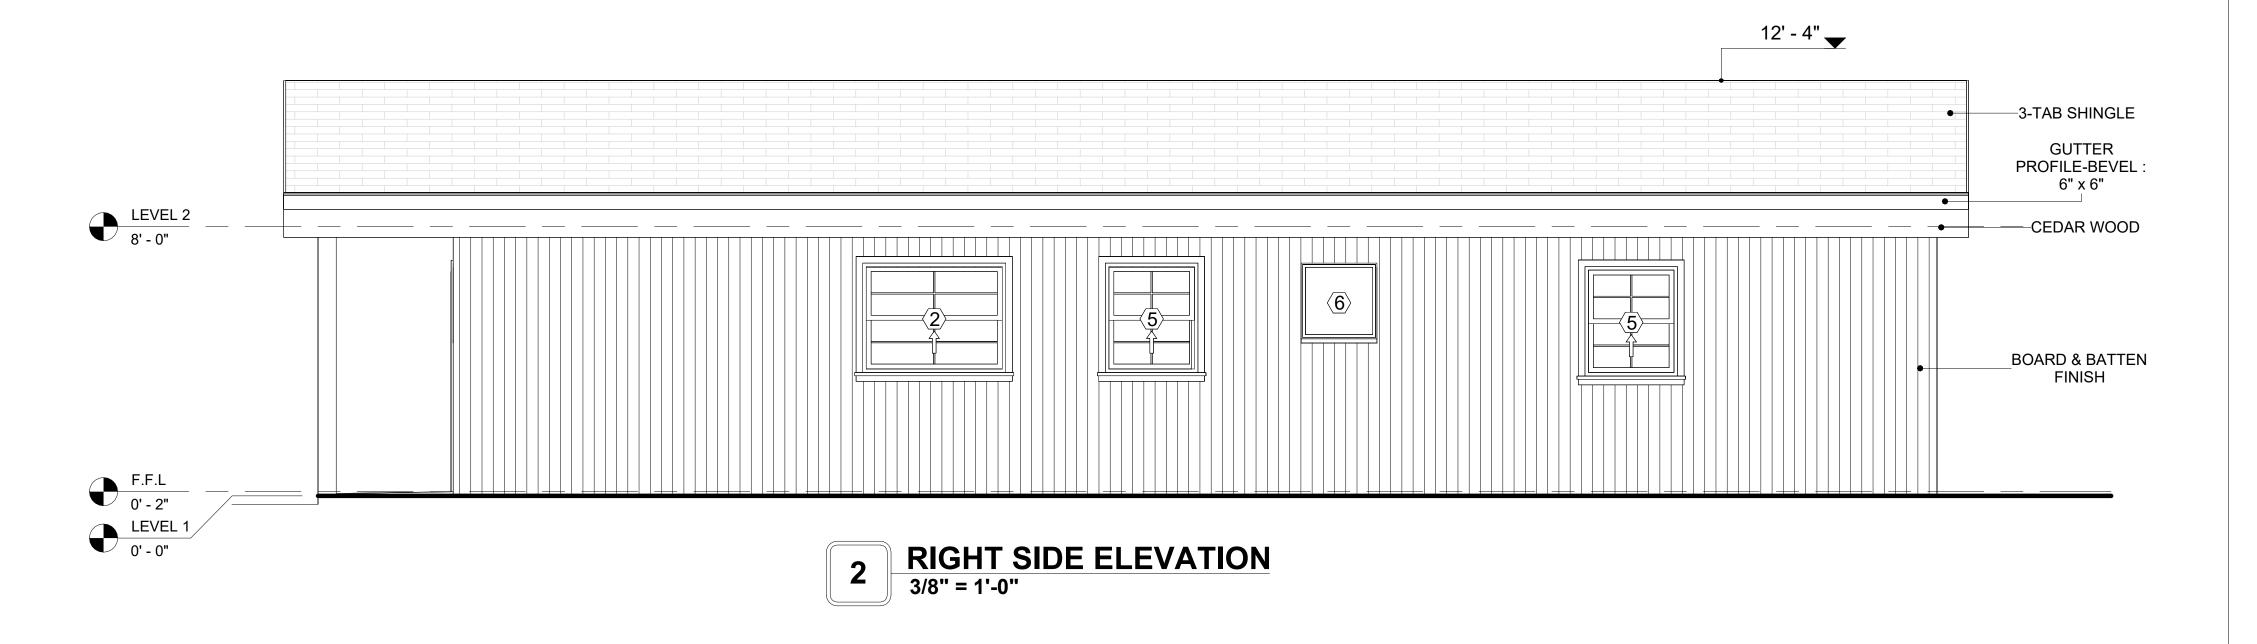

DOOR SCHEDULE						
TYPE	PE S				SIZE	
MAR K	SUPPLIER	DOOR TYPE	LOCATIO N	WIDTH	HEIGHT	COUNT
1	HOME DEPOT	INTERIOR SINGLE PANEL SWINGING	INTERIOR	2' - 6"	6' - 8"	1
2	HOME DEPOT	EXTERIOR SINGLE PANEL SWINGING	INTERIOR	3' - 0"	6' - 8"	2
3	HOME DEPOT	INTERIOR SINGLE PANEL SWINGING	INTERIOR	1' - 9"	6' - 8"	1
4	HOME DEPOT	INTERIOR SINGLE PANEL SWINGING	INTERIOR	3' - 0"	6' - 8"	1
5	HOME DEPOT	INTERIOR DOUBLE PANEL SLIDING	INTERIOR	6' - 0"	6' - 8"	1
6	HOME DEPOT	INTERIOR DOUBLE PANEL SLIDING	INTERIOR	9' - 0"	6' - 8"	1
7	HOME DEPOT	INTERIOR SINGLE PANEL SWINGING	INTERIOR	3' - 0"	6' - 8"	1
8	HOME DEPOT	INTERIOR SINGLE PANEL SWINGING	INTERIOR	2' - 6"	6' - 8"	1

WINDOW SCHEDULE						
SIZE						
TYPE MARK	SUPPLIER	WINDOW TYPE	WIDTH	HEIGHT	COUNT	
1	HOME DEPOT	SINGLE HUNG	3' - 3"	2' - 3"	2	
2	HOME DEPOT	SINGLE HUNG	4' - 3"	3' - 3"	2	
3	HOME DEPOT	AWNING	5' - 3"	3' - 9"	2	
4	HOME DEPOT	CASEMENT	2' - 3"	3' - 9"	2	
5	HOME DEPOT	SINGLE HUNG	2' - 9"	3' - 3"	2	
6	HOME DEPOT	AWNING	2' - 3"	2' - 3"	1	

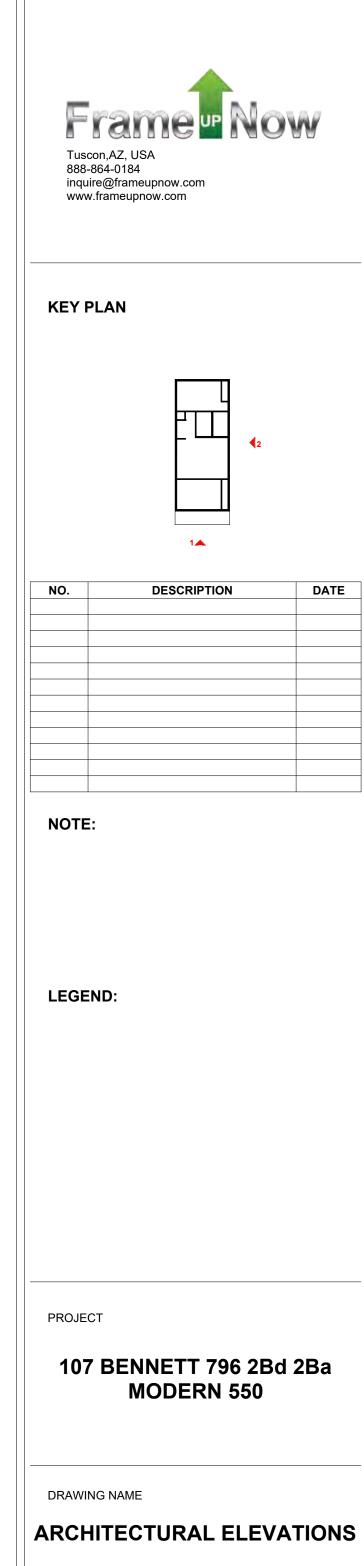

CLIENT NAME:	Client Name
PROJECT NUMBER:	0061_12
DATE:	3/10/2025 12:05:56 PM
DESIGNED BY:	Designer
DRAWN BY:	Author
CHECKED BY:	Checker

# **ABOUT WALL FINISHING**

#### **BOARD AND BATTEN**


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### **CEDAR WOOD**


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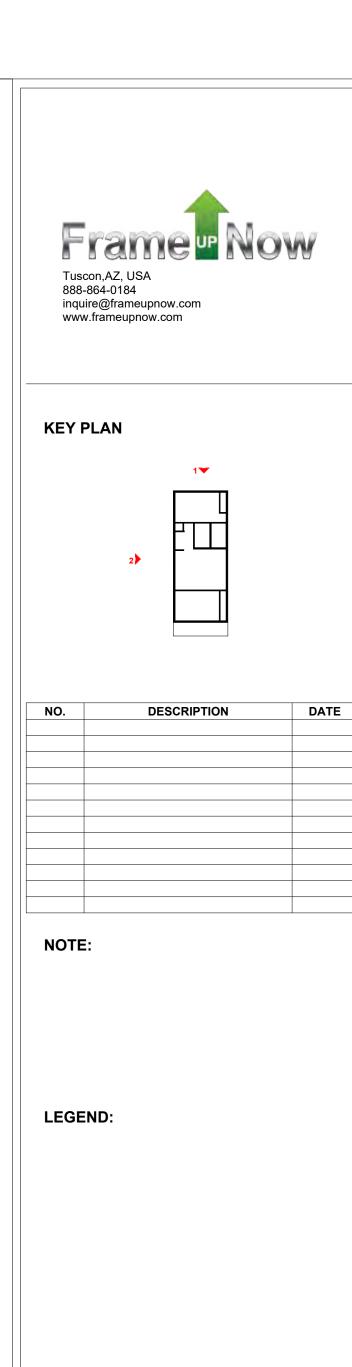
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1 REAR ELEVATION 3/8" = 1'-0"



2 LEFT SIDE ELEVATION
3/8" = 1'-0"

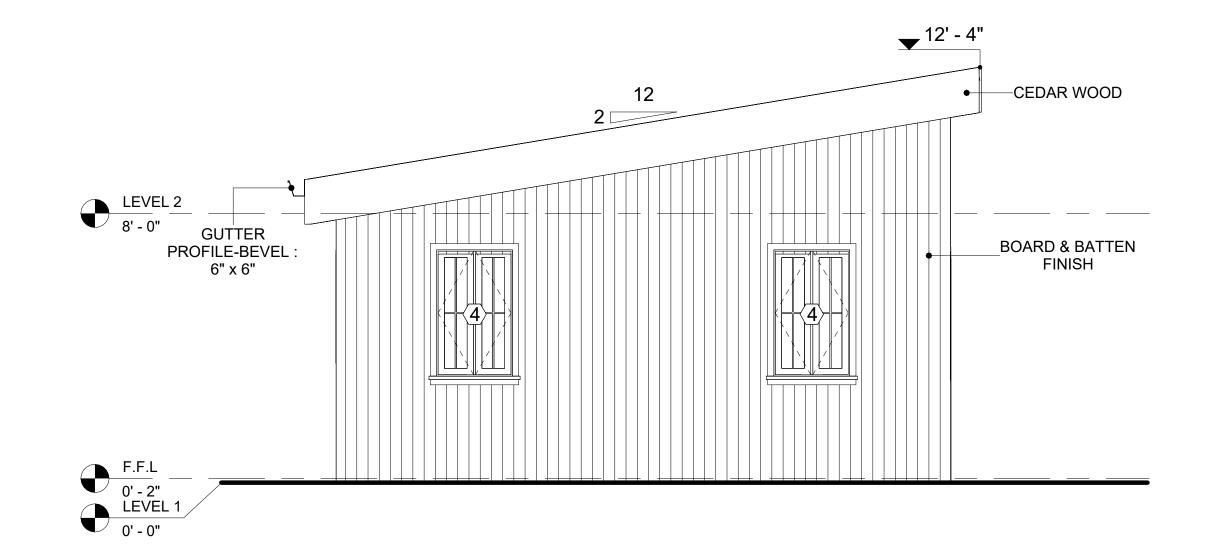

PROJECT

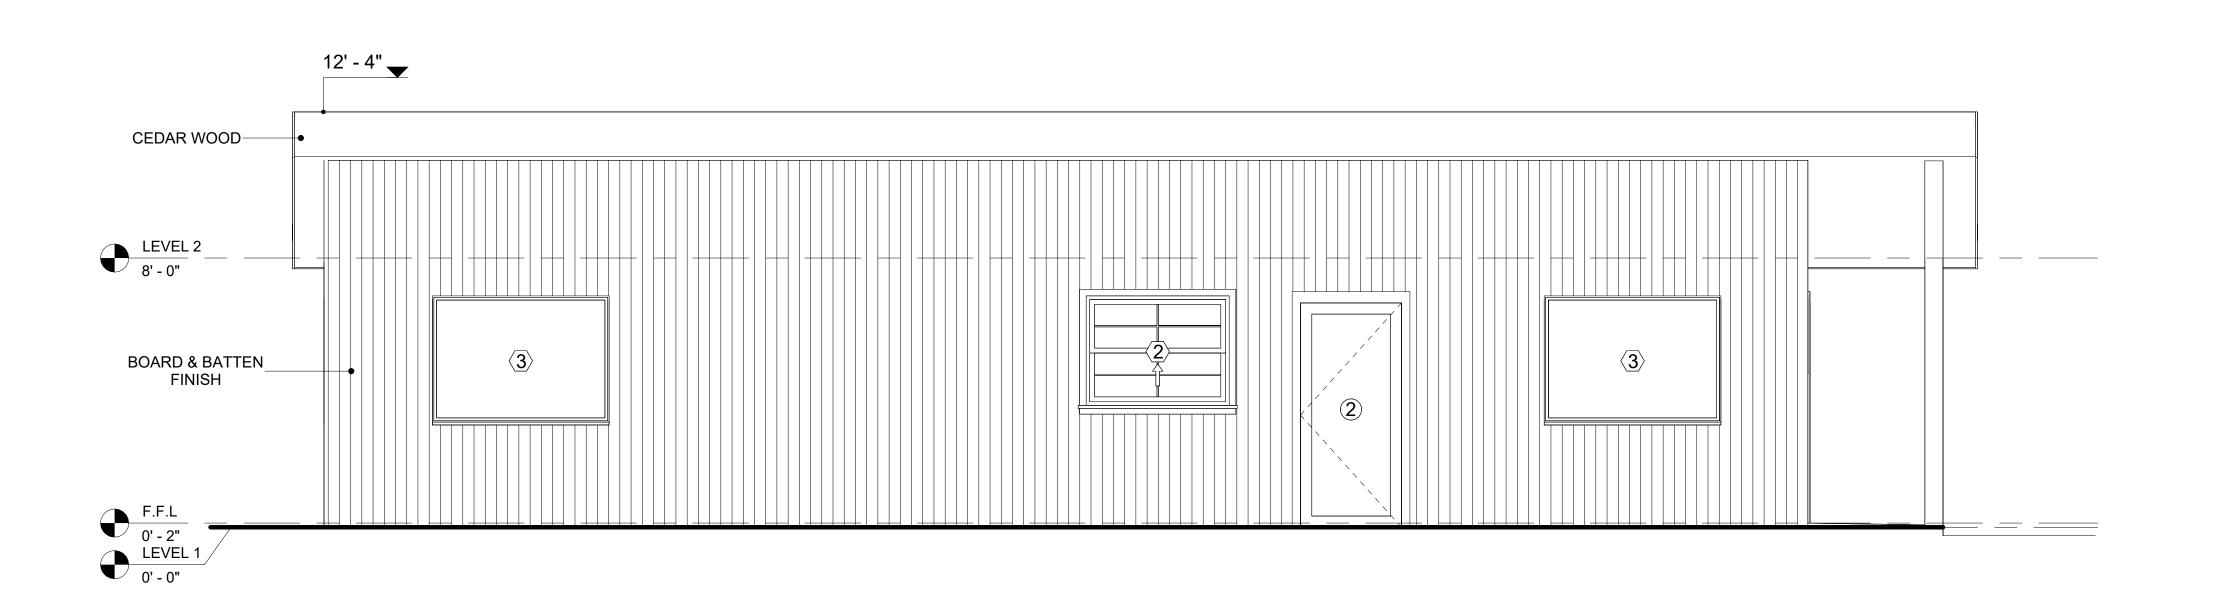
107 BENNETT 796 2Bd 2Ba MODERN 550


DRAWING NAME

ARCHITECTURAL ELEVATIONS

CLIENT NAME:	Client Name
PROJECT NUMBER:	0061_12
DATE:	3/10/2025 12:05:59 PM
DESIGNED BY:	Designer
DRAWN BY:	Author
CHECKED BY:	Checker

A202

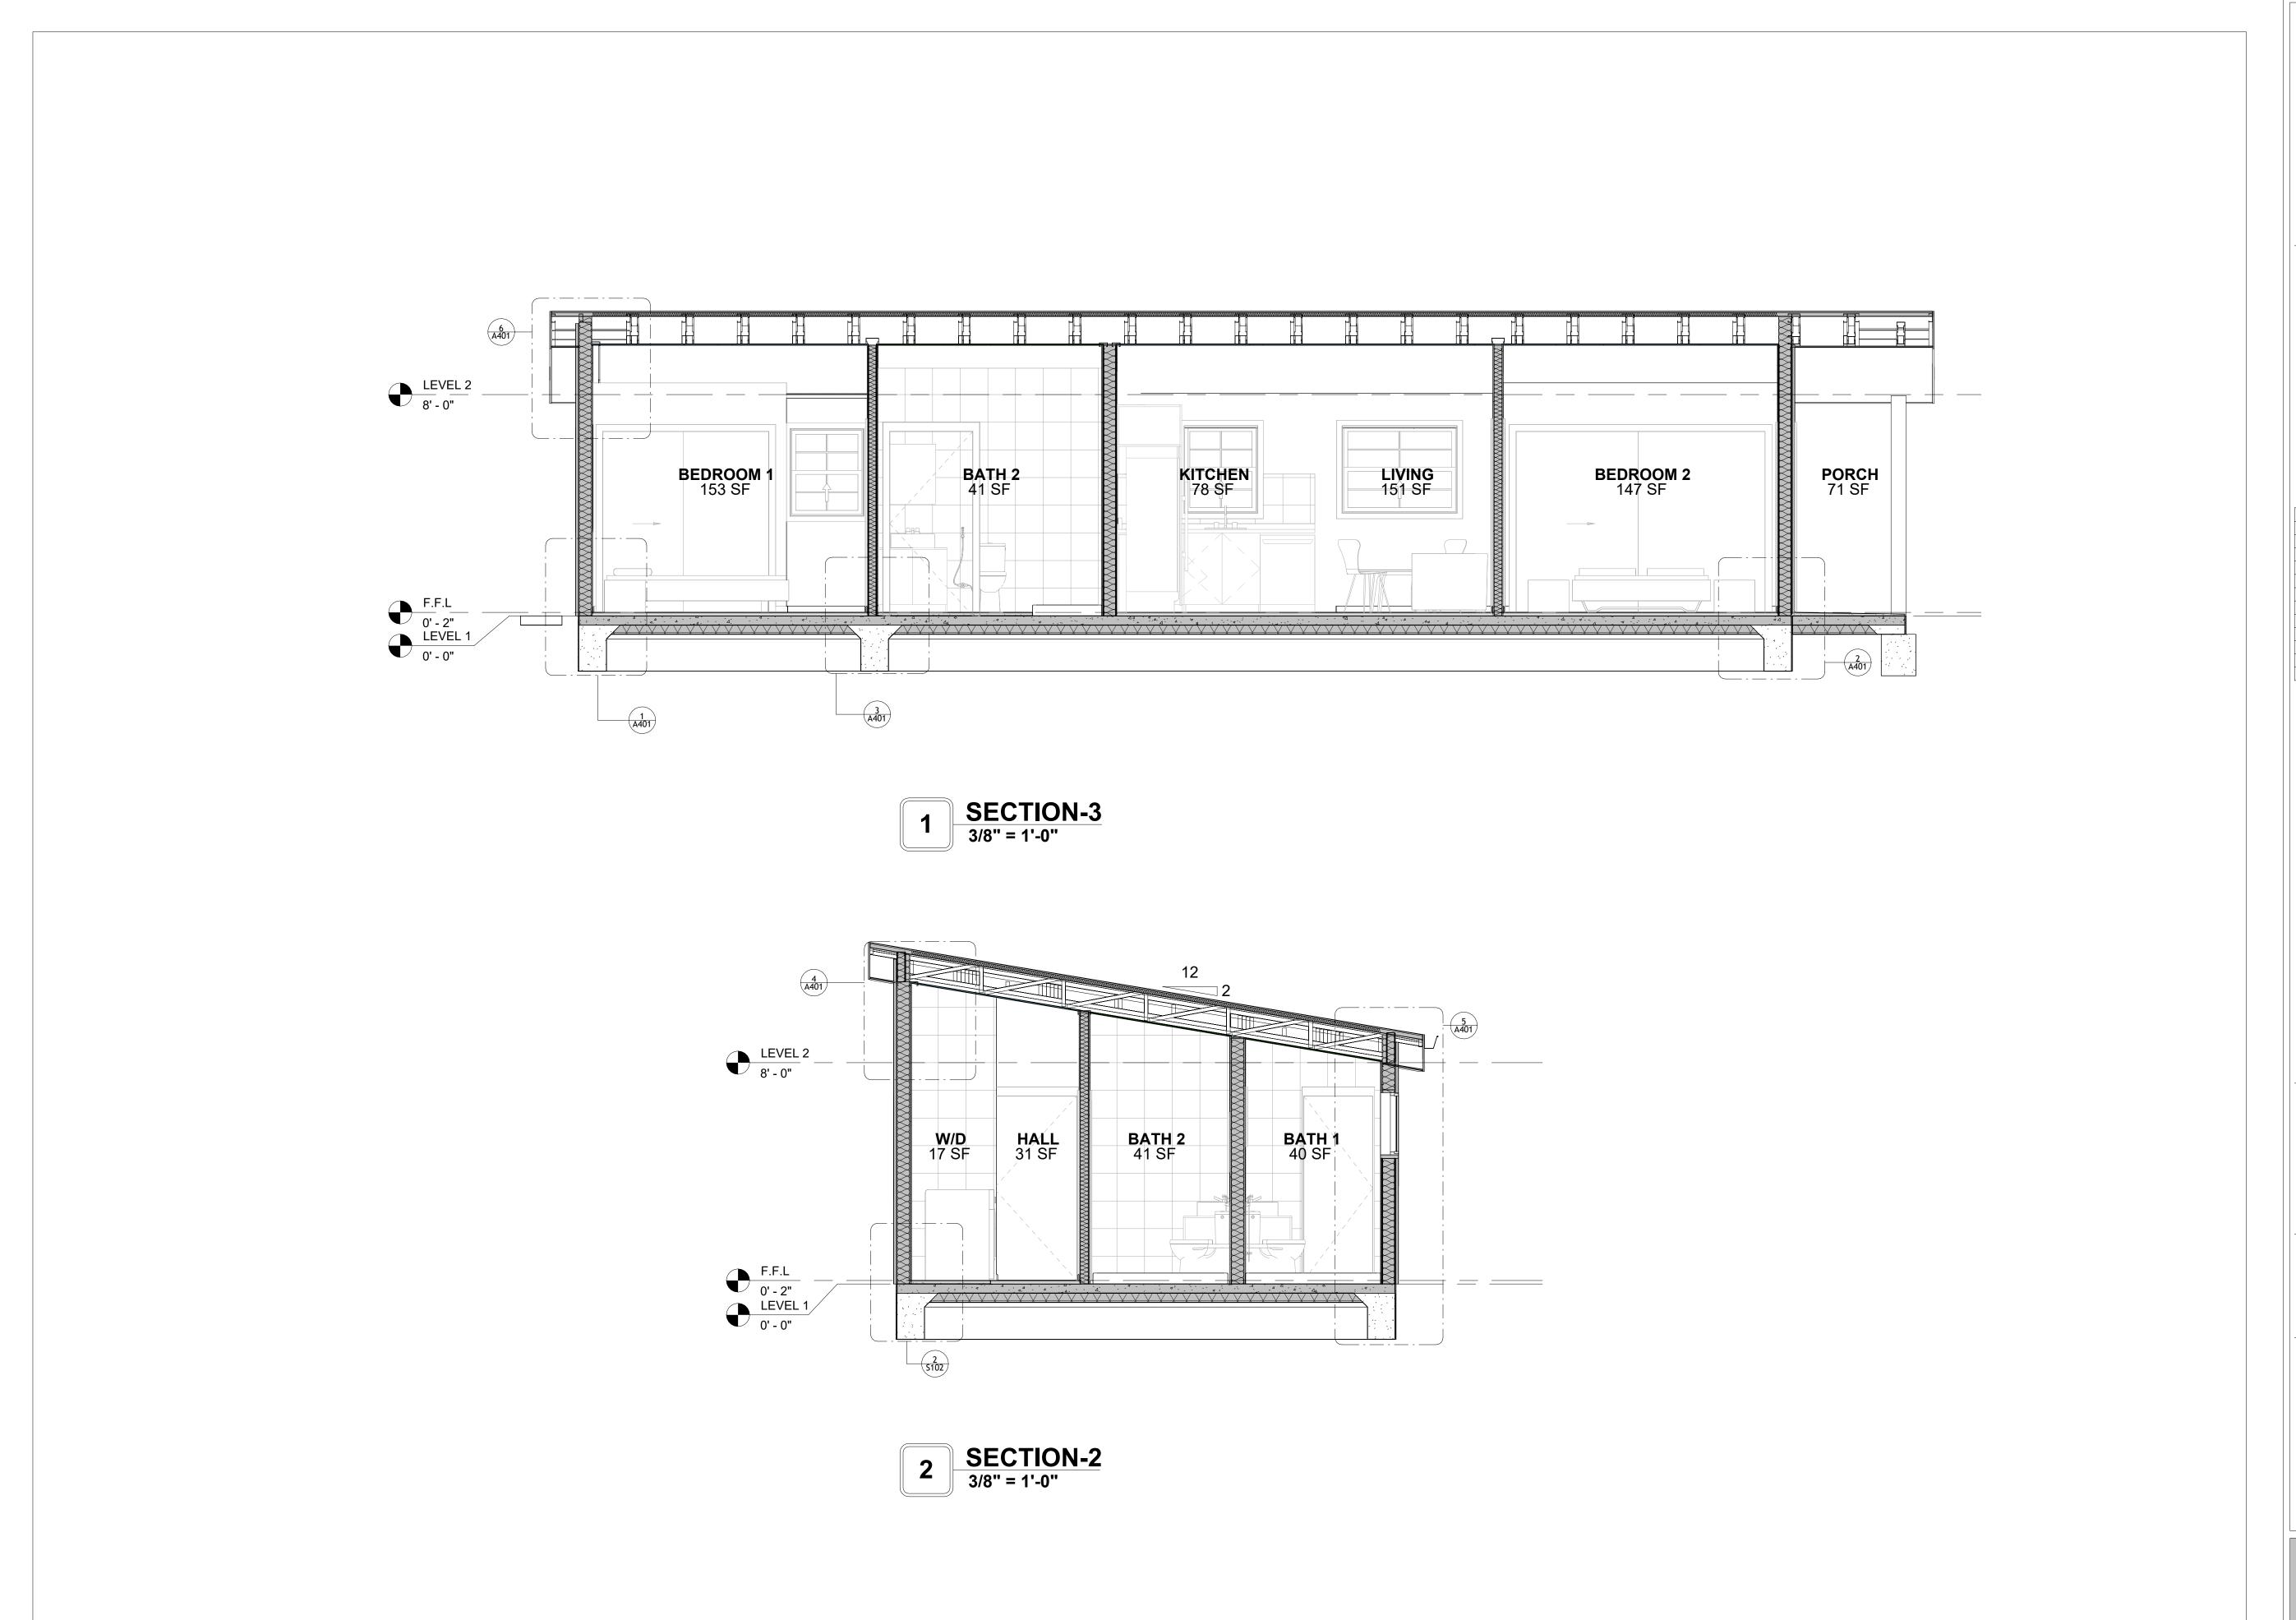

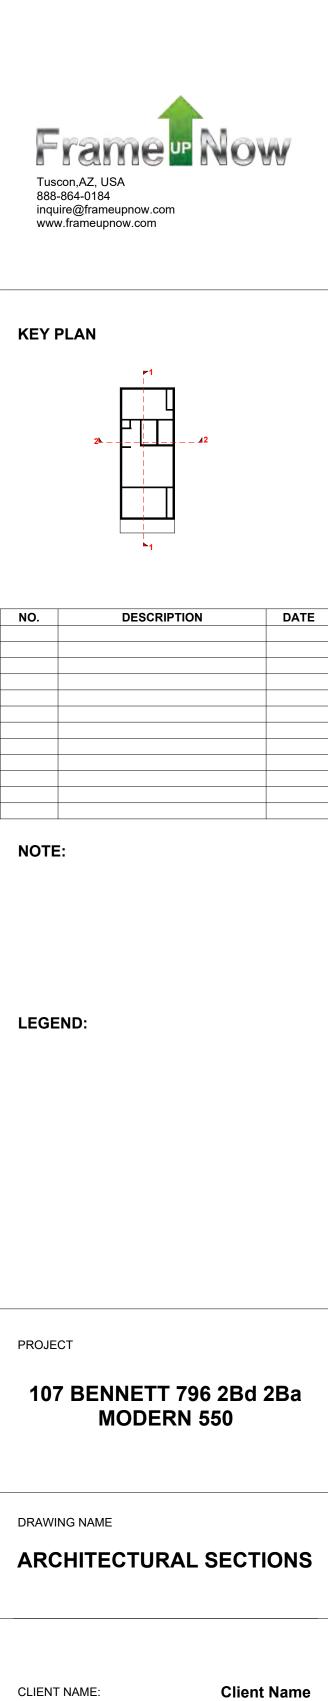

 CLIENT NAME:
 Client Name

 PROJECT NUMBER:
 0061\_12


 DATE:
 3/10/2025 12:06:00 PM


 DESIGNED BY:
 Designer


 DRAWN BY:
 Author


 CHECKED BY:
 Checker


A301

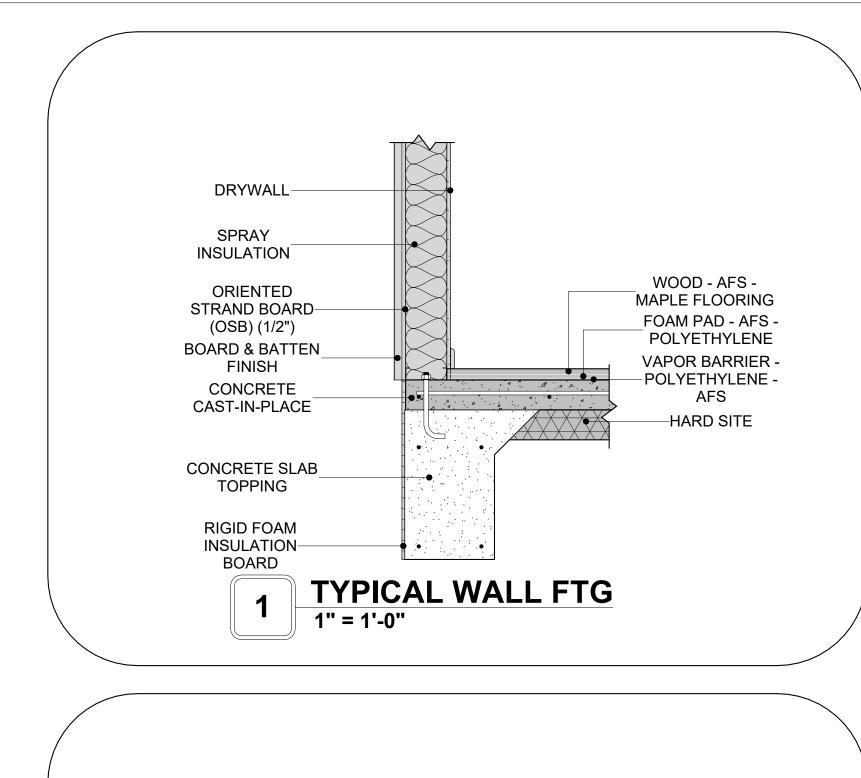


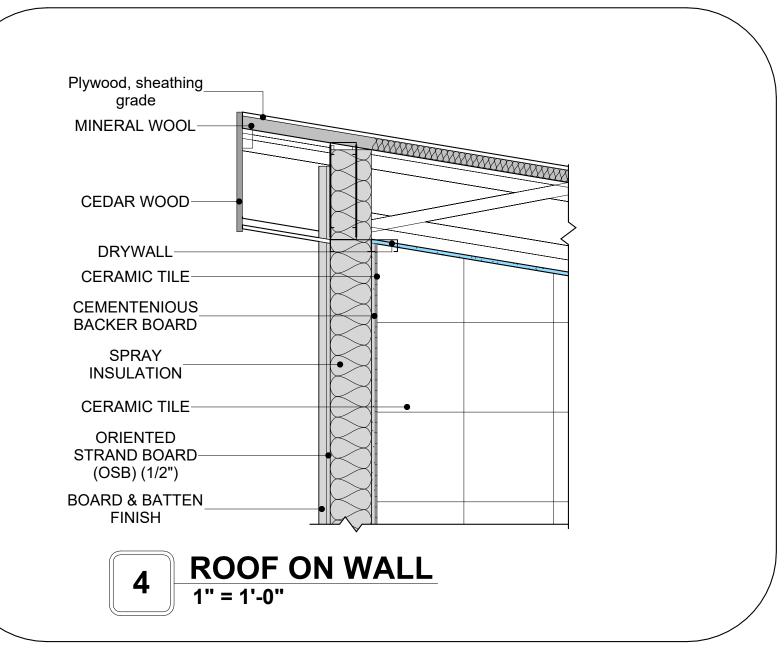


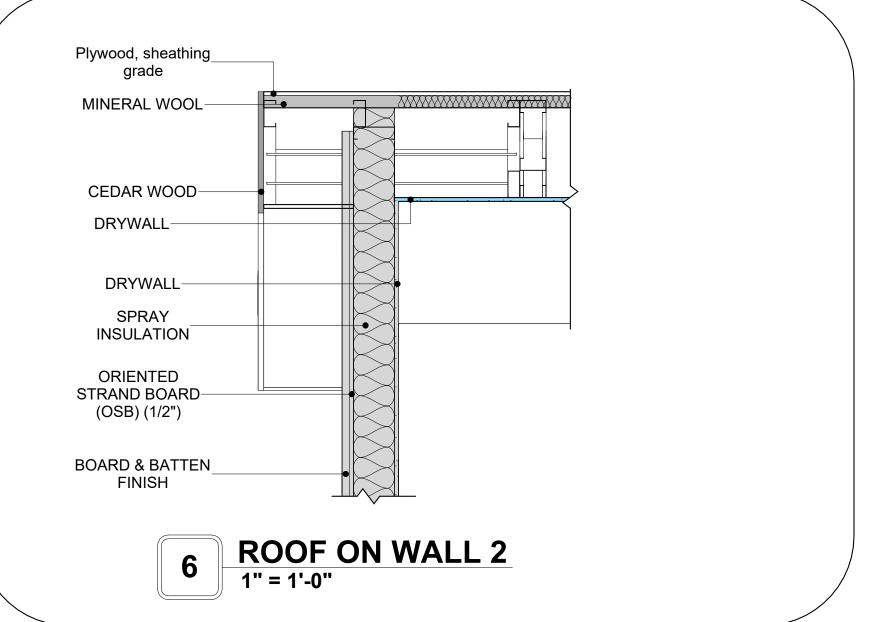

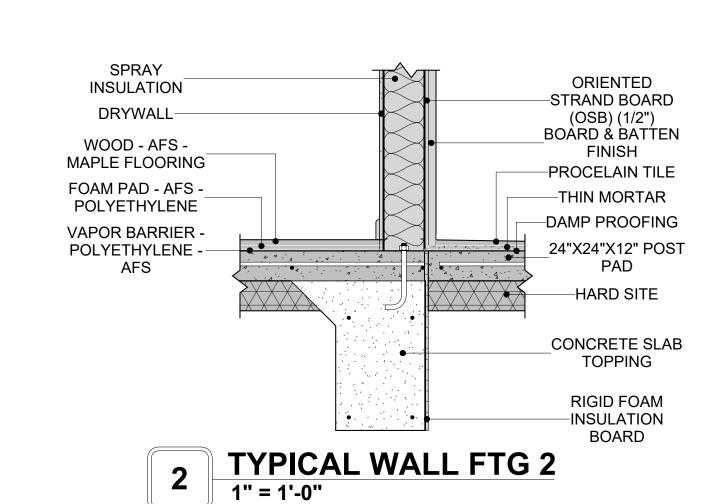

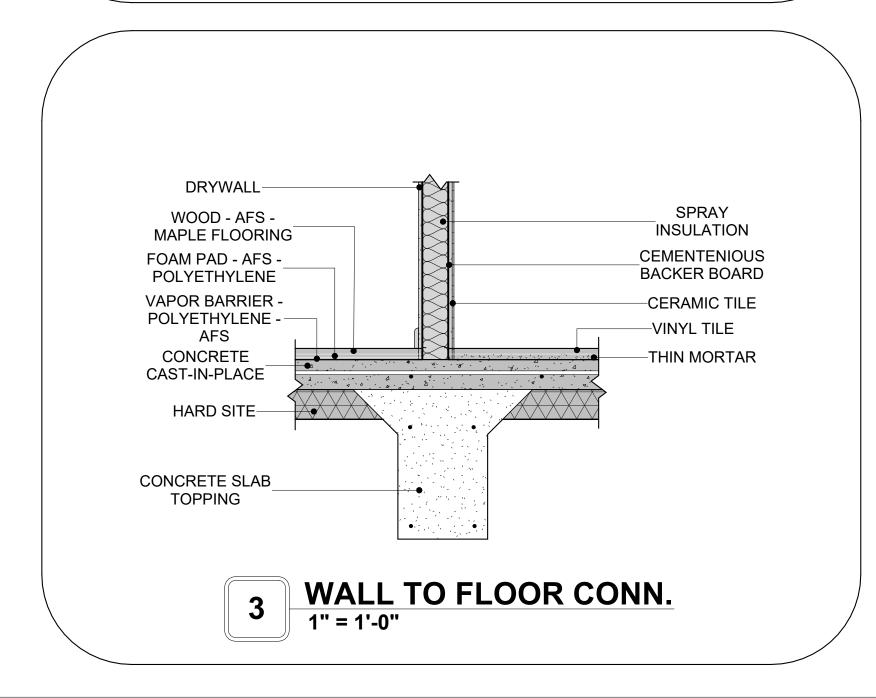

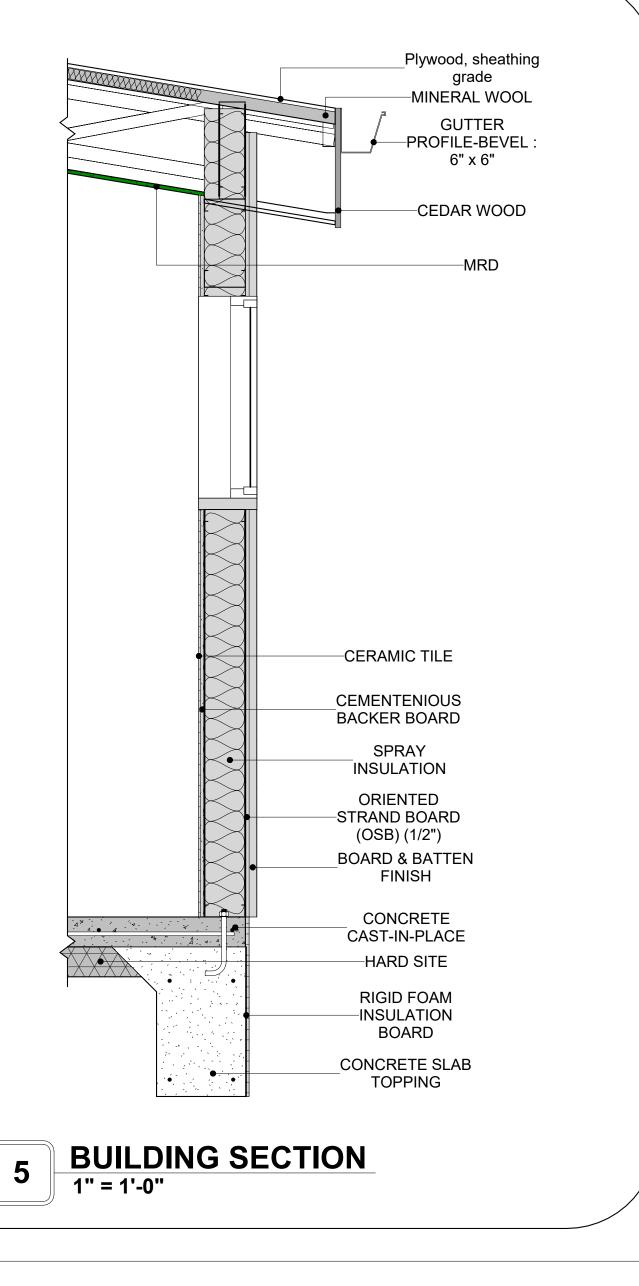

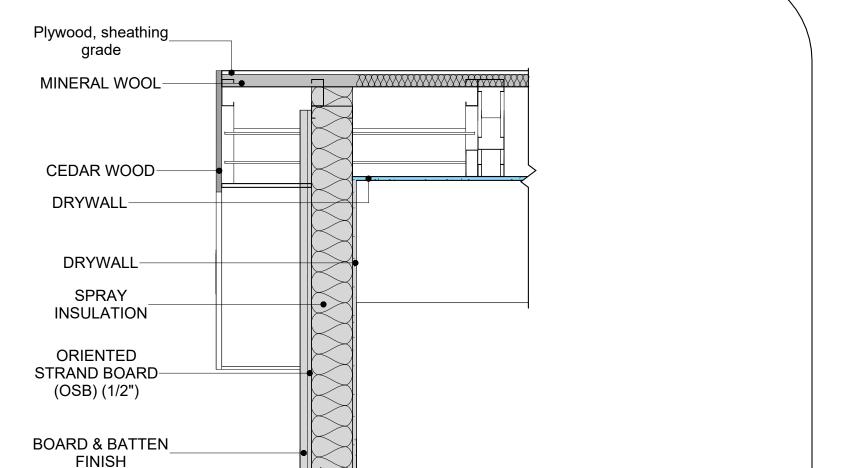

Tuscon,AZ, USA 888-864-0184 inquire@frameupnow.com www.frameupnow.com **KEY PLAN** 

DESCRIPTION DATE

NOTE:

LEGEND:

PROJECT

107 BENNETT 796 2Bd 2Ba **MODERN 550** 

DRAWING NAME

ARCHITECTURAL DETAILS

Client Name CLIENT NAME: PROJECT NUMBER: 0061\_12 3/10/2025 12:06:01 PM Designer DESIGNED BY: DRAWN BY: Author CHECKED BY: Checker

A401

SCALE: 1" = 1'-0"

# **CASEWORK GENERAL NOTES**

- ALL CABINET HEIGHTS INCLUDE COUNTERTOPS. DIMENSIONS ARE TO THE NEAREST INCH.
   DIVISIONS IN CASEWORK ARE SHOWN FOR CLARITY AND DO NOT REPRESENT BREAKS IN THE
- 2. DIVISIONS IN CASEWORK ARE SHOWN FOR CLARITY AND DO NOT REPRESENT BREAKS IN THE COUNTERTOP.
- 3. PROVIDE CONTINUOUS COUNTERTOP OVER ALL SIMILAR HEIGHT CASEWORK, UNLESS AND
- OTHERWISE NOTED.


  4. MANUFACTURER AND CATALOG NUMBERS ARE FOR REFERENCE AND ILLUSTRATION PURPOSES
- 5. DOTTED LINES INDICATE WALL HUNG CABINETS, DIVISIONS OF BASE CABINETS BELOW THE 6. COUNTERTOP, FURNITURE NOT IN THE CONTRACT OR PROJECTION SCREENS -SEE CASEWORK
- KEY AND SPECIFICATIONS.

  7. ALL CABINETS AND DRAWERS TO HAVE CAM LOCKS EXCEPT FOR SINK BASE CABINETS.
- 8. ALL EXPOSED SURFACES (EXPOSED TO VIEW FROM ANY PERSPECTIVE) TO BE COVERED WITH
- LAMINATE.

  9. ALL CASEWORK WHICH MEETS A WALL AT ONE OR BOTH ENDS, TO BE PROVIDED WITH FILLER PANELS AND SCRIBED TO THE WALL(S) AS REQUIRED.
- 10. ALL CABINETS AND DRAWERS ARE PROVIDED WITH RECESSED HANDLES.
- 11. CONTRACTOR TO FIELD VERIFY ALL CLEAR OPENINGS PRIOR TO MILLWORK OR CASEWORK
- 12. CASEWORK DRAWINGS ARE DIAGRAMMATIC IN NATURE TO SHOW DESIGN INTENT.


	CASEWORK SCHEDULE						
TYPE MAR K	TYPE	COUN T	HEIGHT	WIDTH	DEPTH	AREA	
01	LINEAR COUNTER TOP 12	1	0' - 4"	8' - 7"	2' - 1"	3 SF	
02	BASE CABINET DOUBLE DOOR 2	1	2' - 11"	2' - 9"	2' - 0"	8 SF	
03	BASE_CABINET_L-SHAPED 3	1	2' - 11"	3' - 3"	3' - 3"	9 SF	
04	HD_L-SHAPE_COUNTER_TOP11 2	1	0' - 4"	9' - 7"	4' - 0"	3 SF	
05	WALL_CABINET_SINGLE_DOOR	1	2' - 6"	2' - 7"	1' - 0"	6 SF	
06	HD_WALL_FILLER_4' HIGH	1	2' - 6"	0' - 8"	1' - 0"	2 SF	
07	WALL CABINET DOUBLE DOOR 1	1	2' - 6"	3' - 0"	1' - 0"	8 SF	
08	LINEAR COUNTER TOP	1	0' - 4"	3' - 8"	2' - 1"	1 SF	
09	BASE CABINET DOUBLE DOOR 2	1	2' - 11"	3' - 0"	2' - 0"	9 SF	
10	BASE_FILLER_1	1	2' - 11"	0' - 8"	2' - 0"	2 SF	
11	WALL FILLER	1	2' - 6"	0' - 8"	1' - 0"	2 SF	
12	REFRIGERATOR TOP	1	1' - 6"	2' - 0"	2' - 4"	3 SF	
13	VANITY	2	2' - 4"	2' - 6"	1' - 8"	6 SF	
14	RECESSED_MED_CABINET	2	2' - 0"	1' - 6"	0' - 3"	3 SF	
15	CLOSET 2	1	6' - 0"	9' - 11"	1' - 4"	60 SF	
16	CLOSET 4	1	6' - 0"	6' - 8"	1' - 4"	40 SF	
GRAND	GRAND TOTAL 18						

SPECIALTY EQUIPMENT SCHEDULE				
TYPE MARK	TYPE	COUNT		
		1.		
01	WASHER-FRONT-LOAD	1		
02	REFRIGERATOR	1		
03	RANGE	1		
04	DRYER-FRONT-LOAD	1		
05	DISHWASHER	1		
GRAND TOTAL: 5				

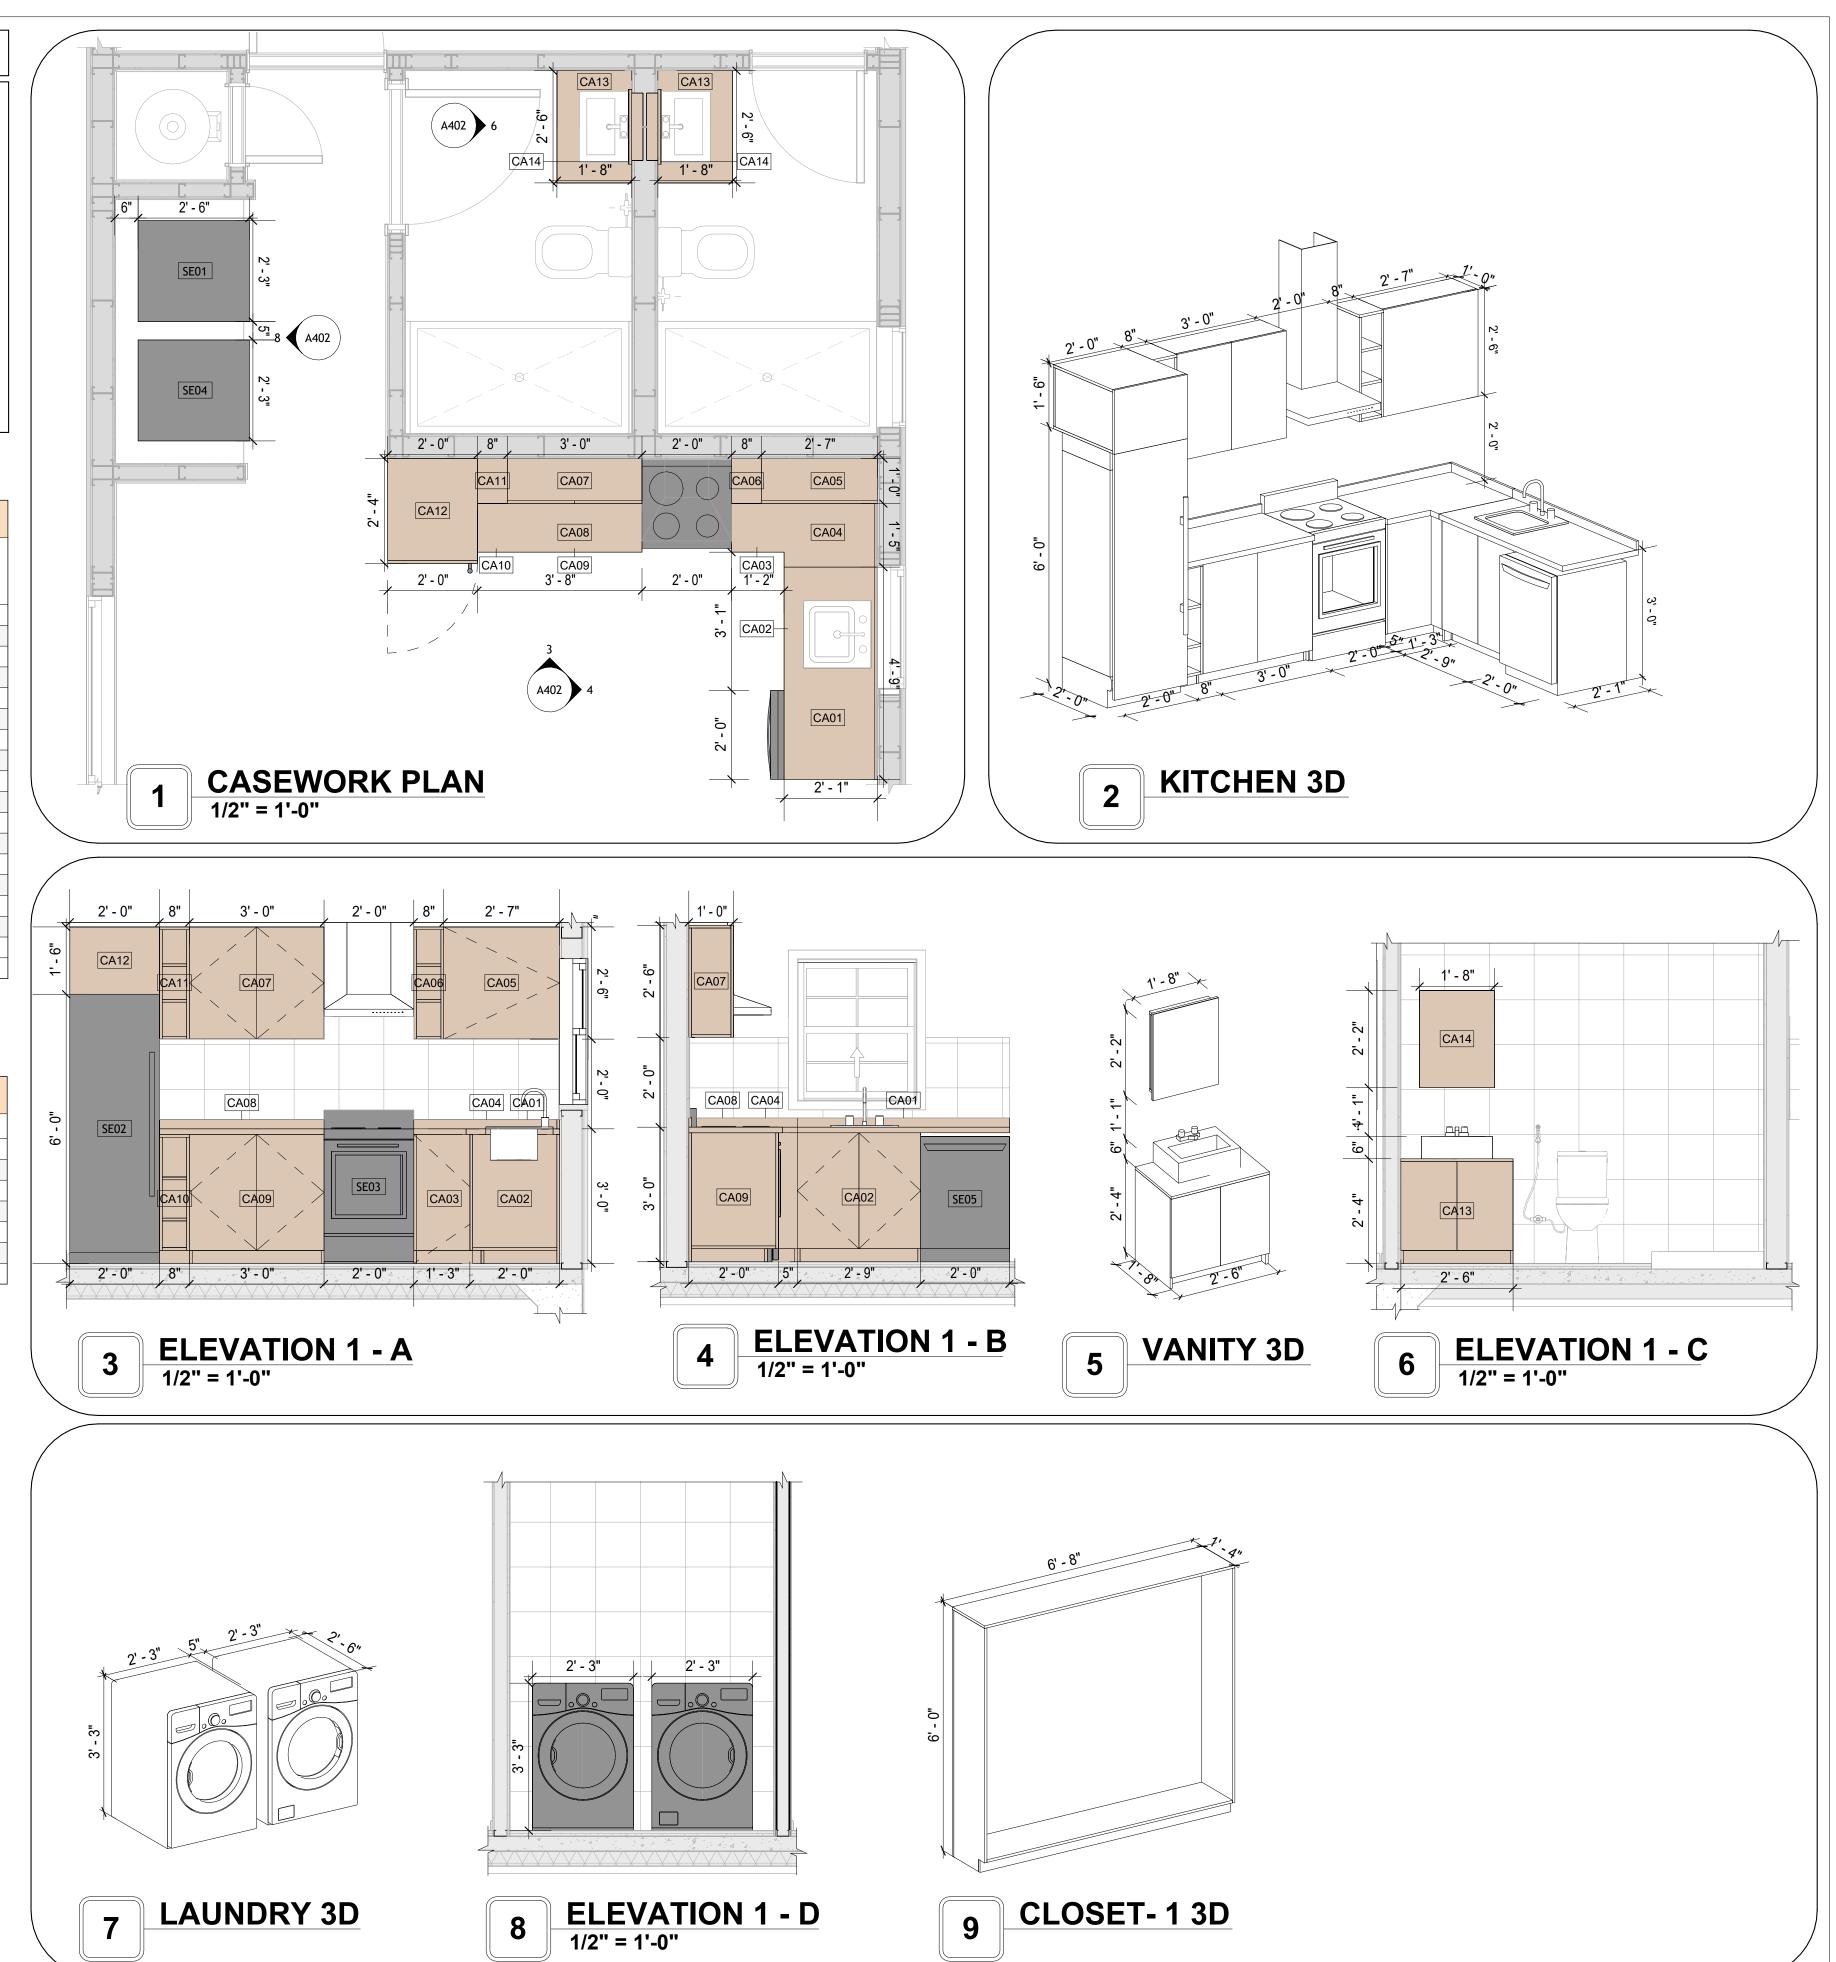



KEY PLAN

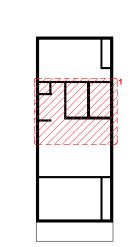

NO.	DESCRIPTION	DAT

NOTE:

LEGEND:

PROJECT

107 BENNETT 796 2Bd 2Ba MODERN 550

DRAWING NAME

ARCHITECTURAL CASEWORK

Client Name	CLIENT NAME:
0061_12	PROJECT NUMBER:
3/10/2025 12:06:04 PM	DATE:
Designer	DESIGNED BY:
Author	DRAWN BY:
Checker	CHECKED BY:

A402

## **GENERAL NOTES**

1. THIS DRAWING DEPICTS THE HVAC (HEATING, VENTILATION, AND AIR CONDITIONING) SYSTEM FOR THE BENNETT 2BD2BA MODERN\_NG. IT PROVIDES A VISUAL REPRESENTATION OF THE SYSTEM LAYOUT AND COMPONENTS.

2.THE HVAC SYSTEM IS DESIGNED TO MEET THE SPECIFIC REQUIREMENTS OF THE BUILDING, INCLUDING HEATING, COOLING, AND VENTILATION NEEDS, AS PER THE PROJECT SPECIFICATIONS AND APPLICABLE CODES AND STANDARDS.

3. THE HVAC SYSTEM INSTALLATION SHALL COMPLY WITH THE LATEST EDITION OF THE INTERNATIONAL MECHANICAL CODE (IMC), INTERNATIONAL RESIDENTIAL CODE (IRC), AND ALL OTHER APPLICABLE LOCAL, STATE, AND NATIONAL CODES AND REGULATIONS.

4. THE EQUIPMENT SHOWN ON THIS DRAWING INCLUDES BUT IS NOT LIMITED TO AIR HANDLING UNITS (AHUS), CHILLERS, BOILERS, COOLING TOWERS, PUMPS, DUCTWORK, DIFFUSERS, GRILLES, AND CONTROL DEVICES.

5. ALL EQUIPMENT, DUCTWORK, AND PIPING SHALL BE INSTALLED IN ACCORDANCE WITH MANUFACTURER'S SPECIFICATIONS, LOCAL CODES, AND

6. ALL DUCTWORK SHALL BE SIZED, FABRICATED, AND INSTALLED IN ACCORDANCE WITH THE LATEST EDITION OF THE ACCA MANUAL D AND THE SMACNA HVAC DUCT CONSTRUCTION STANDARDS. DUCTWORK SHALL BE INSTALLED IN A NEAT AND WORKMANLIKE MANNER, PROPERLY SUPPORTED AND BRACED TO PREVENT SAGGING, AIR LEAKAGE, OR VIBRATION.

7. CONDENSATE DRAINAGE PIPING SHALL BE PROPERLY PITCHED TO ENSURE POSITIVE DRAINAGE TO AN APPROVED DISPOSAL LOCATION, SUCH AS A FLOOR DRAIN, SUMP PUMP, OR EXTERIOR GRADE. CONDENSATE LINES SHALL BE INSULATED TO PREVENT SWEATING.

8. THE LOCATION OF CONTROL PANELS AND SENSORS INDICATED ON THIS DRAWING CAN BEMODIFY WITH THE SPECIFIC LOCATIONS AND WIRING DETAILS WILL BE DETERMINED DURING THE CONTROL SYSTEM DESIGN AND INSTALLATION.

9. THE HVAC SYSTEM DESIGN CONSIDER ENERGY EFFICIENCY, INDOOR AIR QUALITY, OCCUPANT COMFORT, AND NOISE CONTROL, FOLLOWING APPLICABLE GUIDELINES AND REGULATIONS.

10. COORDINATION WITH OTHER TREADS HAS BEEN DONE ON A DESIGN LEVEL. THIS DRAWING SHALL BE READ TOGETHER WITH THE AR, EL AND SN DESIGN DRAWINGS TO ENSURE PROPER INSTALLATION AND INTEGRATION OF THE HVAC SYSTEMS.

11. THE HVAC CONTRACTOR IS RESPONSIBLE FOR OBTAINING ALL NECESSARY PERMITS AND LICENSES, AND FOR SCHEDULING AND COORDINATING WITH THE LOCAL BUILDING DEPARTMENT AND UTILITY PROVIDERS TO ENSURE A TIMELY AND COMPLIANT INSTALLATION.

12. ALL DUCTWORK PENETRATIONS THROUGH WALLS, FLOORS, OR CEILINGS SHALL BE PROPERLY SEALED AND FIRE-STOPPED USING APPROVED METHODS AND MATERIALS TO MAINTAIN THE INTEGRITY OF THE BUILDING'S FIRE-RESISTANCE RATINGS.

13. HVAC EQUIPMENT SHALL BE INSTALLED LEVEL AND PLUMB, AND IN STRICT ACCORDANCE WITH THE MANUFACTURER'S INSTALLATION INSTRUCTIONS AND RECOMMENDATIONS. PROVIDE ADEQUATÉ CLEARANCES AROUND EQUIPMENT FOR PROPER AIRFLOW, SERVICE ACCESS, AND CODE COMPLIANCE.

14. ALL HVAC EQUIPMENT AND COMPONENTS, INCLUDING THERMOSTATS, DAMPERS, AND ACCESS PANELS, SHALL BE LOCATED IN ACCESSIBLE AREAS


15. THE HVAC SYSTEM SHALL BE BALANCED AND ADJUSTED TO ENSURE PROPER AIRFLOW, TEMPERATURE DISTRIBUTION, AND SYSTEM PERFORMANCE THROUGHOUT THE RESIDENCE. PROVIDE A WRITTEN REPORT DOCUMENTING THE FINAL SYSTEM BALANCE.


FOR EASY SERVICING AND MAINTENANCE. PROVIDE ADEQUATE SPACE AROUND EQUIPMENT FOR PROPER AIRFLOW AND SERVICE ACCESS.

16. ANY DEVIATIONS OR MODIFICATIONS TO THE HVAC SYSTEM DESIGN SHALL BE REVIEWED AND APPROVED BY THE RESPONSIBLE DESIGN PROFESSIONALS AND COMMUNICATED TO ALL RELEVANT PARTIES INVOLVED IN THE CONSTRUCTION PROCESS.

17. FOR ANY INQUIRIES OR CLARIFICATIONS REGARDING THE HVAC SYSTEM DESIGN, PLEASE CONSULT THE RESPONSIBLE DESIGN PROFESSIONALS OR THE PROJECT MANAGEMENT TEAM.

# SYMBOLS

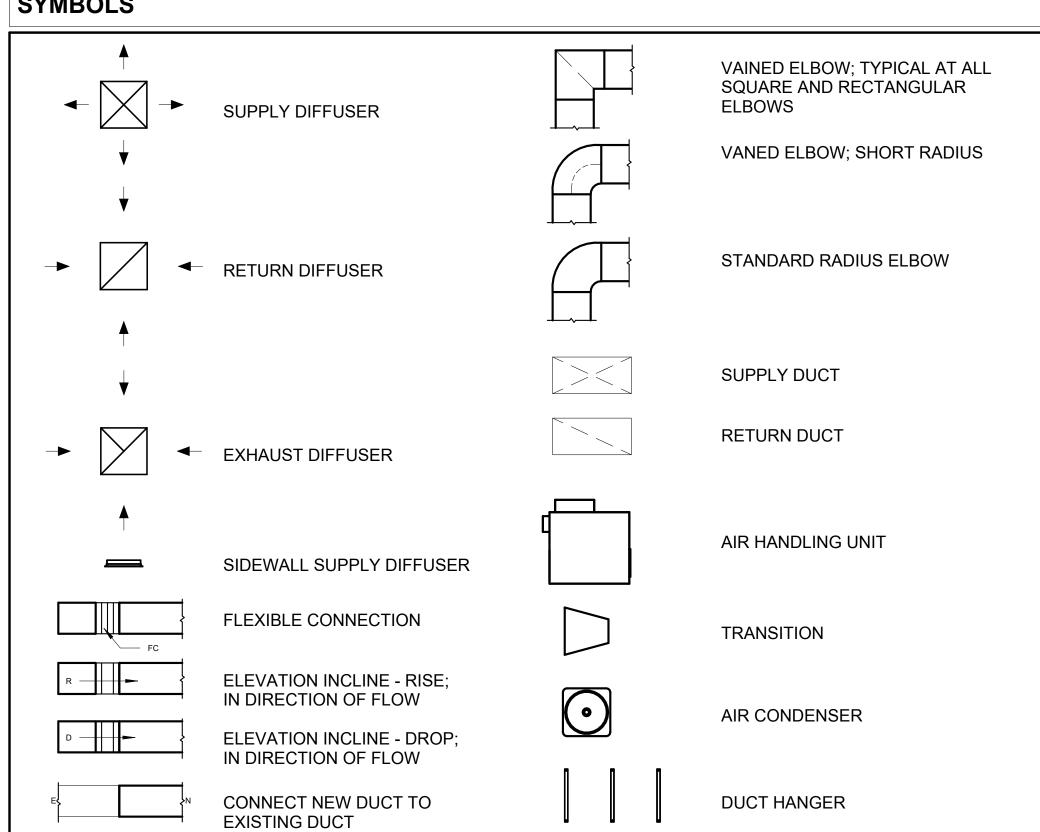

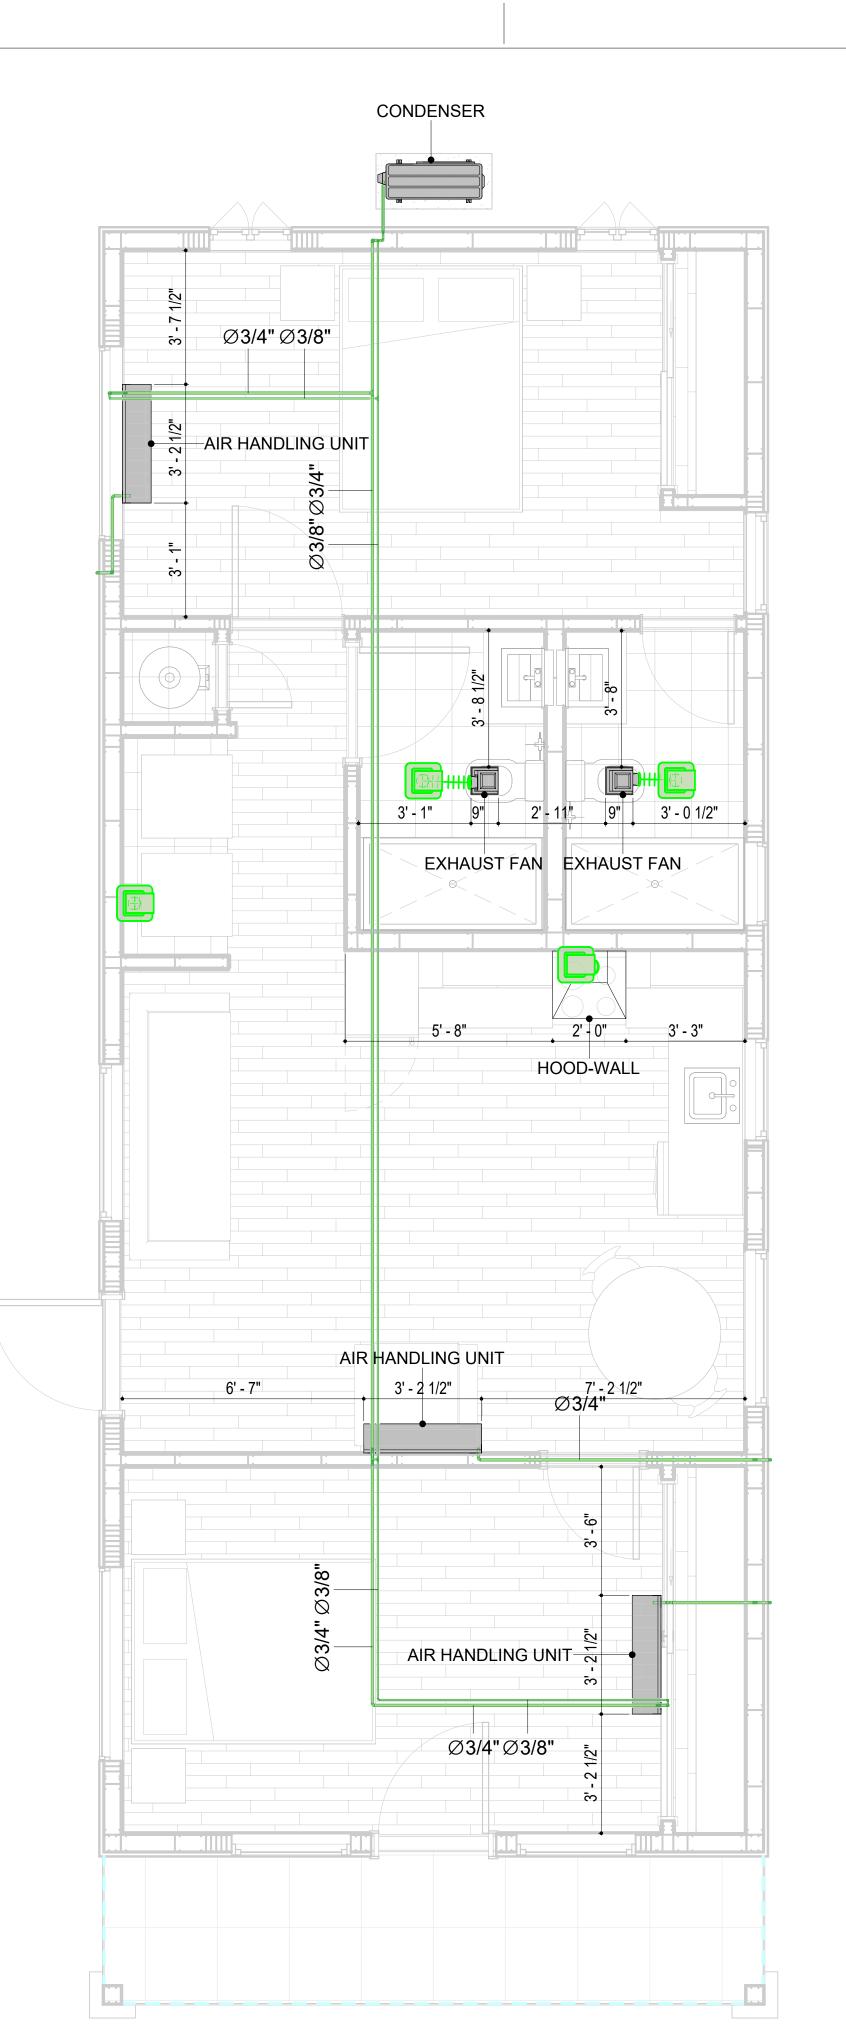

**HVAC PLAN** 

3/8" = 1'-0"



AIR CONDITIONING PIPE

REFRIGERANT LINE SCHEDULE					
CATAGORY DESCRIPTION DIAMETER LENGTH					
PIPE TYPES	COPPER	3/8"	75.15		
PIPE TYPES	COPPER	3/4"	112.11		

REFRIGERANT LINE FITTING SCHEDULE					
CATAGORY	DESCRIPTION	Size	Count		
ELBOW - GENERIC	ELBOW - GENERIC: STANDARD/HVAC	3/4"ø-3/4"ø	29		
ELBOW - GENERIC	ELBOW - GENERIC: STANDARD/HVAC	3/8"ø-3/8"ø	19		
TEE - GENERIC	TEE - GENERIC: STANDARD	3/4"ø-3/4"ø-3/ 4"ø	2		
TEE - GENERIC	TEE - GENERIC: STANDARD	3/8"ø-3/8"ø-3/ 8"ø	2		
TRANSITION - GENERIC	TRANSITION - GENERIC: STANDARD	3/4"ø-1/2"ø	4		
TRANSITION - GENERIC	TRANSITION - GENERIC: STANDARD	3/4"ø-5/8"ø	2		
TRANSITION - GENERIC	TRANSITION - GENERIC: STANDARD	3/8"ø-1/4"ø	1		

MECHANICAL EQUIPMENT SCHEDULE					
CATAGORY DESCRIPTION					
AIR HANDLING UNIT	AIR HANDLING UNIT: WALL MOUNTED	3			
CONDENSER	CONDENSER: OUT DOOR	1			
EXHAUST FAN	EXHAUST FAN: 75 CFM				
	HOOD-WALL: VENT	1			

DUCT FITTING SCHEDULE						
CATAGORY		DESCRIPTION	COUNT			
ROUND TRANSITION - ANGLE	45 DEGREE		7			

DUCT ACCESSORY SCHEDULE					
CATAGORY	DESCRIPTION	COUNT			
ROOF VENT	3" DIAMETER	4			

	FLEX DU	ICT SCHEDULE		
DESCRIPTION	DESCRIPTION	LENGTH	DIAMETER	COUNT
	I	T	I	
FLEX DUCT ROUND	FLEX-ROUND	15.40	4"	4
GRAND TOTAL: 4		15.40		



### **KEY PLAN**

NO.	DESCRIPTION	DATE

NOTE:

LEGEND:

PROJECT

# 107-Bennett-796 2Bd2Ba Modern-350

DRAWING NAME

# **HVAC PLAN**

CLIENT NAME:	Owner
PROJECT NUMBER:	15_0001
DATE:	3/6/2025 10:32:07 PM
DESIGNED BY:	Designer
DRAWN BY:	Author
CHECKED BY:	Checker

M101

SCALE: As indicated

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### **ELECTRICAL NOTES**

- 1. THIS DRAWING DEPICTS THE ELECTRICAL SYSTEM FOR THE 108\_Bennett\_796\_2Bd2Ba\_Ranch\_550. IT PROVIDES A VISUAL REPRESENTATION OF THE ELECTRICAL LAYOUT AND COMPONENTS, INCLUDING POWER DISTRIBUTION, LIGHTING, AND CONTROL SYSTEMS.
- 2. THE ELECTRICAL SYSTEM IS DESIGNED TO MEET THE SPECIFIC REQUIREMENTS OF THE BUILDING, INCLUDING POWER DISTRIBUTION, LIGHTING, AND SPECIALIZED ELECTRICAL EQUIPMENT NEEDS, AS PER THE PROJECT SPECIFICATIONS AND APPLICABLE CODES AND STANDARDS.
- 3. THE ELECTRICAL SYSTEM INSTALLATION SHALL COMPLY WITH THE LATEST EDITION OF THE NATIONAL ELECTRICAL CODE (NEC), INTERNATIONAL BUILDING CODE (IBC), AND ALL OTHER APPLICABLE LOCAL, STATE, AND NATIONAL CODES AND REGULATIONS.
- 4. LOCATIONS AS NEEDED, DEVICES ARE SHOWN ON PLANS IN APPROXIMATE IDEAL LOCATIONS, UNLESS SPECIFICALLY DIMMENSIONED.
- 5. OPEN WALLS AS NEEDED TO ALLOW FOR NEW ELECTRICAL INSTALLATIONS.
- 6. LABEL ALL CIRCUITS ON JUNCTION BOXES, RECEPTACLES, DATA, SMOKE DETECTOR, AND EQUIPMENT IN PANEL BOX.
- 7. INSTALL RACEWAY AS NEEDED FOR DDC, ACCESS CONTROL, LOW VOLTAGE WIRING & DATA.
- 8. RELABEL POWER, DATA & FIRE ALARM FOR ROOM #CHANGES.
  9. VERIFY ALL CIRCUITS LABELED ON PRINT ARE CORRECT BEFORE WORKING ON THEM.
- 10. NOTE ON SITE PLAN ALL CHANGES OR MISSING DETAIL TO BE INCORPORATED INTO THE MASTER PLAN.
- 11. DRAWINGS ARE DIAGRAMMATIC ONLY FOR THE PURPOSE OF SHOWING FIXTURE AND OUTLET LOCATIONS.
- 12. ELECTRICAL CONTRACTOR TO VERIFY SERVICE SIZE BY CALCULATION BASED UPON ACTUAL NAME PLATE RATINGS OF SELECTED EQUIPMENT.
- PLATE RATINGS OF SELECTED EQUIPMENT.

  13. VERIFY LOCATION OF SERVICE ENTRANCE WITH POWER COMPANY. PROVIDE UFER GROUND IN
- BUILDING FOUNDATION AT SERVICE ENTRANCE LOCATION.

  14. PROVIDE A MIN. OF 20 FEET OF ONE \*4 BARE COPPER UFER WIRE EMBEDDED IN CONCRETE FOOTING
- 14. PROVIDE A MIN. OF 20 FEET OF ONE \*4 BARE COPPER UFER WIRE EMBEDDED IN CONCRETE FOOTIN AT THE SERVICE ENTRANCE LOCATION WHERE APPROVED BY LOCAL SERVICE PROVIDER.
- 15. PROVIDE WATERPROOF FIXTURES IN ALL HIGH MOISTURE AREAS (EXTERIOR, SHOWER AND TUB CEILINGS ETC.)
- CEILINGS ETC.)
  16. PROVIDE DEDICATED CIRCUITS TO EACH BATH, DEN, FAMILY ROOM, BEDROOM, LOFT, KITCHEN
- REFRIGERATOR, KITCHEN FREEZER DISHWASHER, AND ANY AREA/ITEM SPECIFIED BY OWNER.

  17. INCANDESCENT FIXTURES WITH OPEN OR PARTIALLY ENCLOSED LAMPS, PENDANT FIXTURES, AND
- LAMP HOLDERS ARE NOT PERMITTED IN CLOSETS.
- 18. ALL WORKMANSHIP AND MATERIALS TO CONFORM WITH THE 2015 IRC.
  19. PROVIDE A MIN. OF 20 FEET OF ONE \*4 BARE COPPER UFER WIRE EMBEDDED IN CONCRETE FOOTING AT THE SERVICE ENTRANCE LOCATION WHERE APPROVED BY LOCAL SERVICE PROVIDER.
- 20. PROVIDE A BONDING CONDUCTOR CONSISTING OF A MINIMUM OF ONE \*4 BARE COPPER WIRE CONNECTING THE BUILDING'S METAL WATER PIPING SYSTEM TO THE SERVICE EQUIPMENT ENCLOSURE GROUNDING.

# MAIN PANEL CALCS

ELECTRICAL CALCS	
LIGHT AND OUTLETS 796 @ 3W	2,388 W
3 APPLIANCE CIRCUITS	4,500 W
DRYER	2,000 W
WASHER	2,000 W
RANGE	5,000 W
WATER HEATER	5,000 W
REFRIG.	1,800 W
DISHWASHER & DISPOSAL	3000 W
TOTAL	25,688 W
FRIST 10,000 @ 100% REMAINDER @ 40% MINI. SPLIT UNITS	10,000 W 6,275 W 10,000 W
TOTAL	26,275 W
26,275 W DIVIDED BY 240V =	109 AMPS TOTAL

(USE 200 AMP SERVICE)

# **ELECTRICAL ABBREVIATIONS LIST**

	1P	1 POLE (2P, 3P, 4P, ETC.)	CTR	CENTER	HT	HEIGHT
	Α	AMPERÈ	CU	COPPER	HTG	HEATING
	AC	ABOVE COUNTER OR AIR CONDITIONER	DCP	DOMESTIC WATER CIRCULATING PUMP	HTR	HEATER
	ACLG	ABOVE CEILING	DEPT	DEPARTMENT	HV	HIGH VOLTAGE
	ADO	AUTOMATIC DOOR OPENER	DET	DETAIL	HVAC	HEATING, VENTILATING AND AIR
	AF	AMP FRAME	DIA	DIAMETER	CONDITIONING	CONDITIONING
	AFF	ABOVE FINISHED FLOOR	DISC	DISCONNECT	HWP	HYDRONIC WATER PUMP
	AFG	ABOVE FINISHED GRADE	DIST	DISTRIBUTION	IC	INTERRUPTING CAPACITY
	AFI	ARC FAULT CIRCUIT INTERRUPTER	DN	DOWN	IG	ISOLATED GROUND
	AHU	AIR HANDLING UNIT	DPR	DAMPER	IMC	INTERMEDIATE METAL CONDUIT
	AL	ALUMINUM	DS	SAFETY DISCONNECT SWITCH	INCAND	INCANDESCENT
	ALT	ALTERNATE	DT	DOUBLE THROW	IR	INFRARED
	AMP	AMPERE	DWG	DRAWING	I/W	INTERLOCK WITH
	AMPL	AMPLIFIER	DDC	DIRECT DIGITAL CONTROL	J-BOX	JUNCTION BOX
	ANNUN	ANNUNCIATOR APPROX APPROXIMATELY	EC	ELECTRICAL CONTRACTOR	KV	KILOVOLT
	AQ-STAT	AQUASTAT	ELEC	ELECTRIC, ELECTRICAL	KVA	KILOVOLT-AMPERE
	ARCH	ARCHITECT, ARCHITECTURAL	ELEV	ELEVATOR	KVAR	KILOVOLT-AMPERE REACTIVE
	AS	AMP SWITCH	EM	EMERGENCY	KW	KILOWATT
	AT	AMP TRIP	EMS	ENERGY MANAGEMENT SYSTEM	KWH	KILOWATT HOUR
	ATS	AUTOMATIC TRANSFER SWITCH	EMT	ELECTRICAL METALLIC TUBING	LOC	LOCATE OR LOCATION
	AUTO	AUTOMATIC	EP	ELECTRIC PNEUMATIC	LT	LIGHT
	AUX	AUXILIARY	EQUIP	EQUIPMENT	LTG	LIGHTING
	AV	AUDIO VISUAL	EWC	ELECTRIC WATER COOLER	LTNG	LIGHTNING
	AWG	AMERICAN WIRE GAUGE	EXIST	EXISTING	LV	LOW VOLTAGE
	BATT	BATTERY	EXH	EXHAUST	MAX	MAXIMUM
	BD	BOARD	EXP	EXPLOSION PROOF	MAG.S	MAGNETIC STARTER
	BLDG	BUILDING	FA	FIRE ALARM	M/C	MOMENTARY CONTACT
	BMS	BUILDING MANAGEMENT SYSTEM	FABP	FIRE ALARM BOOSTER POWER	MC	MECHANICAL CONTRACTOR
	С	CONDUIT	SUPPLY PANEL	SUPPLY PANEL	MCB	MAIN CIRCUIT BREAKER
	CAB	CABINET	FACP	FIRE ALARM CONTROL PANEL	MCC	MOTOR CONTROL CENTER
	CAT	CATALOG	FCU	FAN COIL UNIT	MDC	MAIN DISTRIBUTION CENTER
	CATV	CABLE TELEVISION	FIXT	FIXTURE	MDP	MAIN DISTRIBUTION PANEL
	CB	CIRCUIT BREAKER	FLR	FLOOR	MFR	MANUFACTURERMAIN FUSED
	CCTV	CLOSED CIRCUIT TELEVISION	FLUOR	FLUORESCENT		DISCONNECT SWITCH
	CKT	CIRCUIT	FU	FUSE	MH	MANHOLE
	CLG	CEILING	FUDS	FUSED SAFETY DISCONNECT SWITCH	MIC	MICROPHONE
	COMB	COMBINATION	GA	GAUGE	MIN	MINIMUM
	CMPR	COMPRESSOR	GAL	GALLON	MISC	MISCELLANEOUS
	CONN	CONNECTION	GALV	GALVANIZED	MLO	MAIN LUGS ONLY
	CONST	CONSTRUCTION	GC	GENERAL CONTRACTOR	MMS	MANUAL MOTOR STARTER
	CONT	CONTINUATION OR CONTINUOUS	GEN	GENERATOR	MOA	MULTIOUTLET ASSEMBLY
	CONTR	CONTRACTOR	GFI	GROUND FAULT DROTTECTOR	MSP	MOTOR STARTER PANELBOARD
	CONV	CONVECTOR	GFP GND	GROUND FAULT PROTECTOR GROUND	MSBD	MAIN SWITCHBOARD
	CPT	CIRCULATING PUMP CATHODE-RAY TUBE	GRS		MT	MOUNT EMPTY CONDUIT
	CRT CT	CURRENT TRANSFORMER	GYP BD	GALVANIZED RIGID STEEL (CONDUIT) GYPSUM BOARD	MT.C UL	UNDERWRITERS LABORATORIES
	Ci	CONNEINT TRAINSFORMER	GIFDU	GIF30W BOAND	UL	UNDERWINITERS LADURATURIES
L						

**Branch Panel:** 

Location: CL 2 02
Supply From:
Mounting: Recessed
Enclosure: Type 1

Volts: 120/240 Single
Phases: 1
Wires: 3

A.I.C. Rating: Mains Type: Mains Rating: 200 A MCB Rating: 1 A

Notes

Circuit Numb er		Number of Elements	Rating	Length	Wire Size	A		1	В	Wire Size	Length	Rating	Number of Elements		Circu Num er
1	CONDENCER	1	60 A	41' - 6 7/32"	2-#6, 1-#6, 1-#10		720 VA			1-#12, 1-#12, 1-#12	64' - 0 3/16"	20 A	4	GFCI OUTDOOR RECEPTACLES	2
3								750 VA	400 VA	1-#12, 1-#12, 1-#12	33' - 11 3/16"	20 A	6	OUT DOOR LIGHT POINTS	4
5	BEDROOM 1 RECEPTACLES	5	20 A	64' - 1 3/4"	1-#12, 1-#12, 1-#12	900 VA	900 VA			1-#12, 1-#12, 1-#12	31' - 9 5/8"	20 A	5	BEDROOM 2 RECEPTACLES	6
7	WATER HEATER	1	30 A	54' - 0 15/16"	2-#10, 1-#10, 1-#10			750 VA	1500 VA	2-#10, 1-#10, 1-#10	49' - 2 1/16"	30 A	2	DRYER	8
9				-		750 VA	1500 VA						-		10
11	GFCI WASHER	2	20 A	50' - 1 7/16"	1-#8, 1-#8, 1-#8			2400 VA	1500 VA	1-#12, 1-#12, 1-#12	37' - 6"	20 A	1	REFRIGERATOR	12
13	GFCI KITCHEN	5	20 A	36' - 3 9/16"	1-#12, 1-#12, 1-#12	900 VA	750 VA			2-#8, 1-#8, 1-#10	32' - 3 1/8"	50 A	1	RANGE	14
15	BATH 1 UNITS	4	20 A	42' - 0 7/16"	1-#12, 1-#12, 1-#12			336 VA	750 VA						16
17	BATH 2 UNITS	4	20 A	40' - 3 25/32"	1-#12, 1-#12, 1-#12	336 VA	900 VA			1-#12, 1-#12, 1-#12	43' - 10 19/32"	20 A	5	LIVING ROOM RECEPTACLES	18
19	GFCI DISH WASHER	1	30 A	22' - 7 3/4"	1-#10, 1-#10, 1-#10			1200 VA	576 VA	1-#12, 1-#12, 1-#12	59' - 2 25/32"	20 A	13	LIVING ROOM AND HALL LIGHT POINTS	20
21	BEDROOM 1 LIGHT POINTS	10	20 A	72' - 4 13/32"	1-#12, 1-#12, 1-#12	568 VA	568 VA			1-#12, 1-#12, 1-#12	40' - 7 23/32"	20 A	10	BEDROOM 2 LIGHT POINTS	22
23															24
25															26
	1					9539	VA	1014	12 VA						
25						9539 79			12 VA 5 A						

Legena:	

Load Classification	Connected Load	Demand Factor	Estimated Demand	Panel	Totals
Lighting - Dwelling Unit	700 VA	100.00%	700 VA		
Other	1544 VA	100.00%	1544 VA	Total Conn. Load:	19681 VA
Receptacle	17280 VA	78.94%	13640 VA	Total Est. Demand:	16041 VA
Lighting	200 VA	100.00%	200 VA	Total Conn.:	82 A
				Total Est. Demand:	67 A
Notoci					



**KEY PLAN** 

NO. DESCRIPTION DATE

NOTE:

LEGEND:

PROJECT

108-BENNETT-796-2Bd2Ba RANCH-550

DRAWING NAME

**SCHEDULE** 

CLIENT NAME:

PROJECT NUMBER:

0037\_14

DATE:

3/6/2025 4:04:01 AM

DESIGNED BY:

DRAWN BY:

CHECKED BY:

Checker

E101

SCALE: 1/4" = 1'-0"

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# **ELECTRICAL NOTE**

- A. PROVIDE INTERCONNECTED SMOKE ALARMS IN EACH SLEEPING ROOMS, OUTSIDE EACH SLEEPING ROOM, ON EACH STORY, IN THE HALL OR ADJACENT ROOM LUHERE THE CEILING HEIGHT OF A ROOM OPEN TO THE HALL EXCEEDS THE HALL BY 24'. SMOKE ALARMS SHALL BE PERMANENTLY HARD WIRED WITH BATTERY BACKUP.
- B. RECEPTACLE OUTLETS FOR RANGES AND CLOTHES DRYERS SHALL BE A THREE POLE WITH GROUND TYPE. FOUR WIRE GROUNDING-TYPE FLEXIBLE CORDS WILL BE REQUIRED FOR CONNECTION OF RANGES AND CLOTHES DRYERS. THE BONDING JUMPER SHALL NOT BE CONNECTED BETWEEN NEUTRAL TERMINAL AND THE FRAME OF THE APPLIANCE.
- C. TWO OR MORE 20 AMP SMALL APPLIANCE CIRCUITS SHALL BE PROVIDED TO SERVE THE KITCHEN, BREAKFAST NOOK, AND DINING ROOM. SUCH CIRCUITS SHALL HAVE NO OTHER OUTLETS.
- D. AT LEAST ONE 20 AMP BRANCH CIRCUIT SHALL BE PROVIDED TO SERVICE THE LAUNDRY ROOM. THIS CIRCUIT SHALL HAVE NO OTHER OUTLETS.
- E. ALL RECEPTACLES WITH IN 6' OF A WET BAR SINK OR KITCHEN SINK TO SERVE COUNTER TOP SURFACES MUST BE GFCI. ON KITCHEN COUNTERS 12' OR WIDER NO POINT ALONG THE WALL SHALL BE MORE THAN 2' FROM A RECEPTACLE. ALL RECEPTACLES WITH IN 6' OF KITCHEN SINK MUST BE GFCI. AT LEAST ONE GFCI RECEPTACLE SHALL BE INSTALLED IN THE BATHROOM ADJACENT TO EACH BASIN.
- F. FIXTURES INCLUDING CEILING FANS THAT ARE LOCATED IN DAMP LOCATIONS SHALL BE LISTED TO BE SUITABLE FOR
- SUCH LOCATIONS PER 2012 IRC
  G. PROVIDE ONE (1) SWITCHED OUTLET @ ALL BEDROOMS AND DEN
- H. CEILING FANS NOT EXCEEDING 35 LBS. (WITH OR WITHOUT ACCESSORIES MAY BE SUPPORTED BY OUTLET BOXES PROVIDED THE OUTLET BOXES ARE IDENTIFIED FOR SUCH USE PER 2012 IRC
- I. ELECTRICAL OUTLET BOXES ON OPPOSITE SIDES OF FIRE RATED WALLS SHALL BE SEPARATED BY A HORIZONTAL DISTANCE OF NOT LESS THAN 24".
- J. OUTLET BOXES IN THE WALLS BETWEEN THE GARAGE AND DWELLING SHALL BE METAL OR U.L. APPROVED FIRE RESISTIVE PLASTIC. BOXES IN GARAGE CEILING SHALL BE METAL.
- K. ALL BRANCH CIRCUITS THAT SUPPLY 120 VOLTS SINGLE PHASE 15 AND 20 AMPS RECEPTACLE OUTLETS INSTALLED IN THE DWELLING SHALL BE PROTECTED BY AN ARC FAULT CIRCUIT INTERRUPTER, EXCEPT GFCI RECEPTICLES.

#### NOTE:

. RECEPTACLES MUST BE PROVIDED IN HALLWAYS 10'-0" OR MORE IN LENGTH. FOR A ONE FAMILY DWELLINGS AND EACH OF A TWO FAMILY DWELLING THAT IS AT GRADE LEVEL, AT LEAST ONE WP-GFCI RECEPTACLE OUTLET ACCESSIBLE AT GRADE LEVEL AND NOT MORE THAN 6'-6" ABOVE GRADE SHALL BE INSTALLED AT THE FRONT AND BACK OF THE DWELLING.

### **NOTE: APPLIANCE DISCONNECT**

### **E4001.5 GROUNDING OF ENCLOSURES.**

METAL ENCLOSURES FOR SWITCHES OR CIRCUIT BREAKERS SHALL BE CONNECTED TO AN

EQUIPMENT GROUNDING CONDUCTOR.

METAL ENCLOSURES FOR SWITCHES OR CIRCUIT BREAKERS USED AS SERVICE

EQUIPMENT SHALL COMPLY WITH THE PROVISIONS OF SECTION E3609.4. WHERE


NONMETALLIC ENCLOSURES ARE USED WITH METAL RACEWAYS OR METAL-ARMORED CABLES, PROVISIONS SHALL BE MADE FOR CONNECTING THE EQUIPMENT GROUNDING

CONDUCTOR.


NONMETALLIC BOXES FOR SWITCHES SHALL BE INSTALLED WITH A WIRING METHOD THAT

PROVIDES OR INCLUDES AN EQUIPMENT GROUNDING CONDUCTOR. (404.12)

# **ELECTRICAL LEGEND Electrical Lights With Fan Waterproof Recessed Can Light** 0 Pendant Light **Recessed Can Light** 0 **−**Ø **Wall Lamp Standalone linear** Single Switch **₩** ÷સ Three way Switch Fan Switch **Duplex Receptacle** Triplex Receptacle **GFCI Receptacle** $\mathbb{X}$ Exhaust Fan Smoke and heat detector

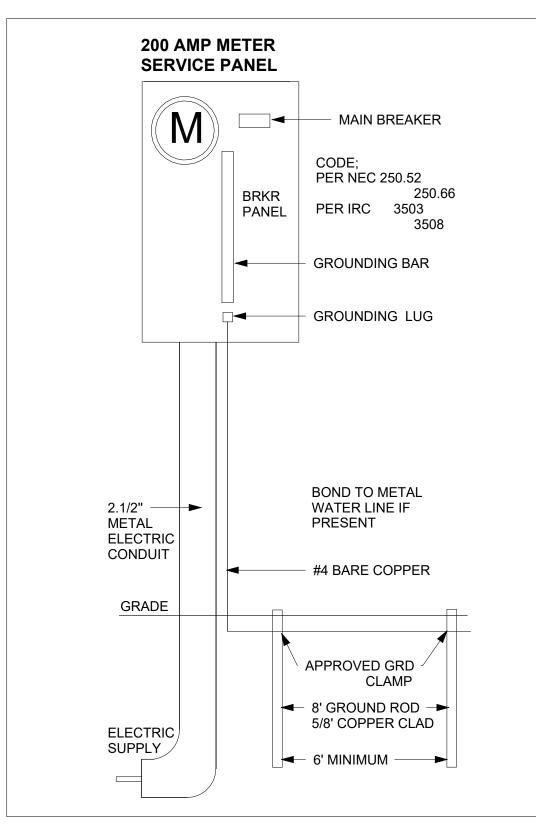



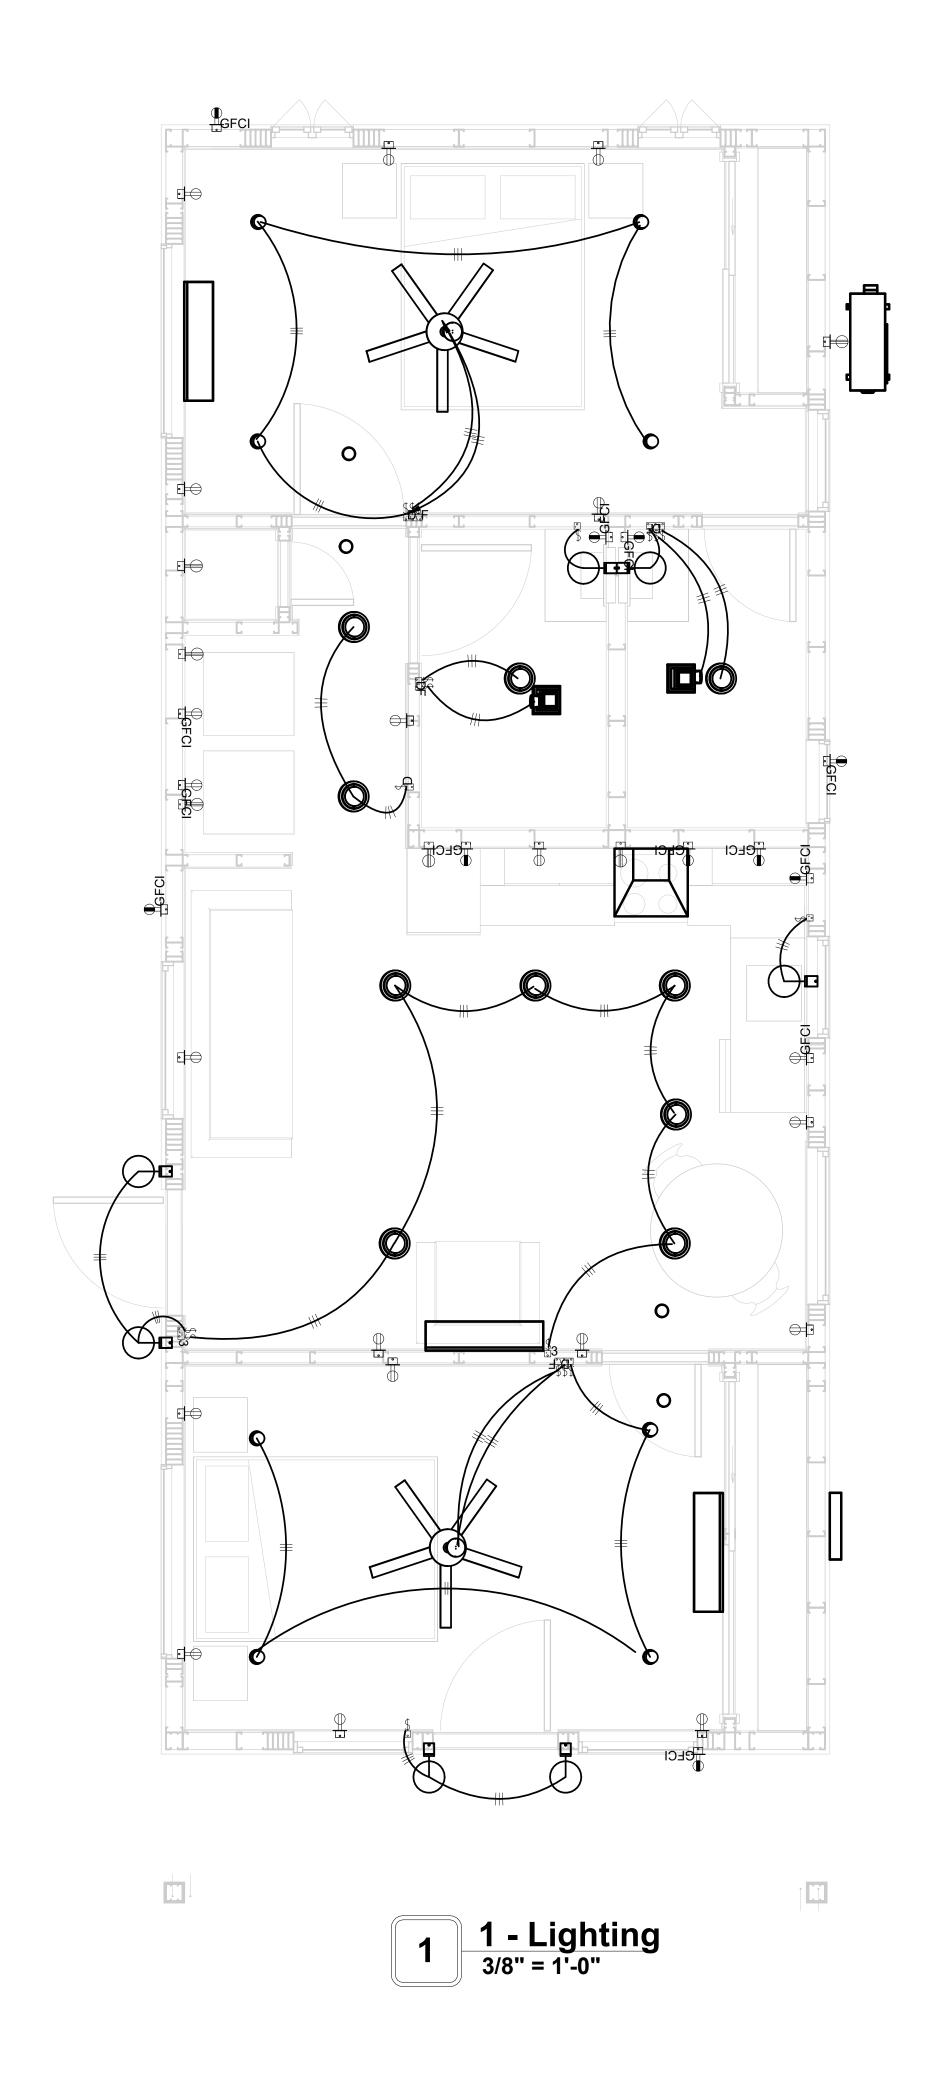



**KEY PLAN** 

NO.	DESCRIPTION	DATE

NOTE:

LEGEND:

PROJECT

108-BENNETT-796-2Bd2Ba RANCH-550

DRAWING NAME


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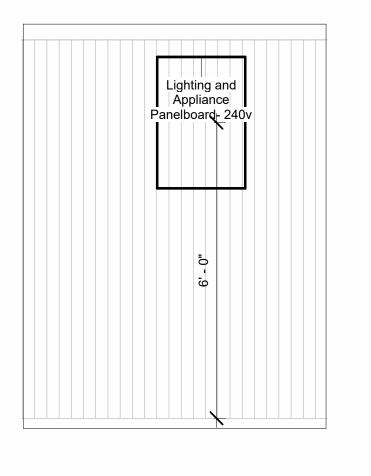
CLIENT NAME:	Owner
PROJECT NUMBER:	0037_14
DATE:	3/6/2025 4:04:03 AM
DESIGNED BY:	Designer
DRAWN BY:	Author
CHECKED BY:	Checker


E102


# **NOTES: CONDUIT, CABLE AND WIRING**


- Use Metalic Conduits (IMC) for cables running under concrete slabs.
   Use IMC for circuits with high voltage appliances (240 volts and above)
   For circuits with 120 volts consider using EMT or PVC conduits if needed.
   For Low voltage applications up to 50 volts consider using non metalic conduits.
   All conduits to be used in the project must conform to the latest National Electrical Code (NEC),
- All wiring and cables to be used in the project must also conform to the latest National Electrical Code (NEC), 2015.
- 7. All cables and wires used should be rated for their respective loading and should be gauged and conform to the NEC.



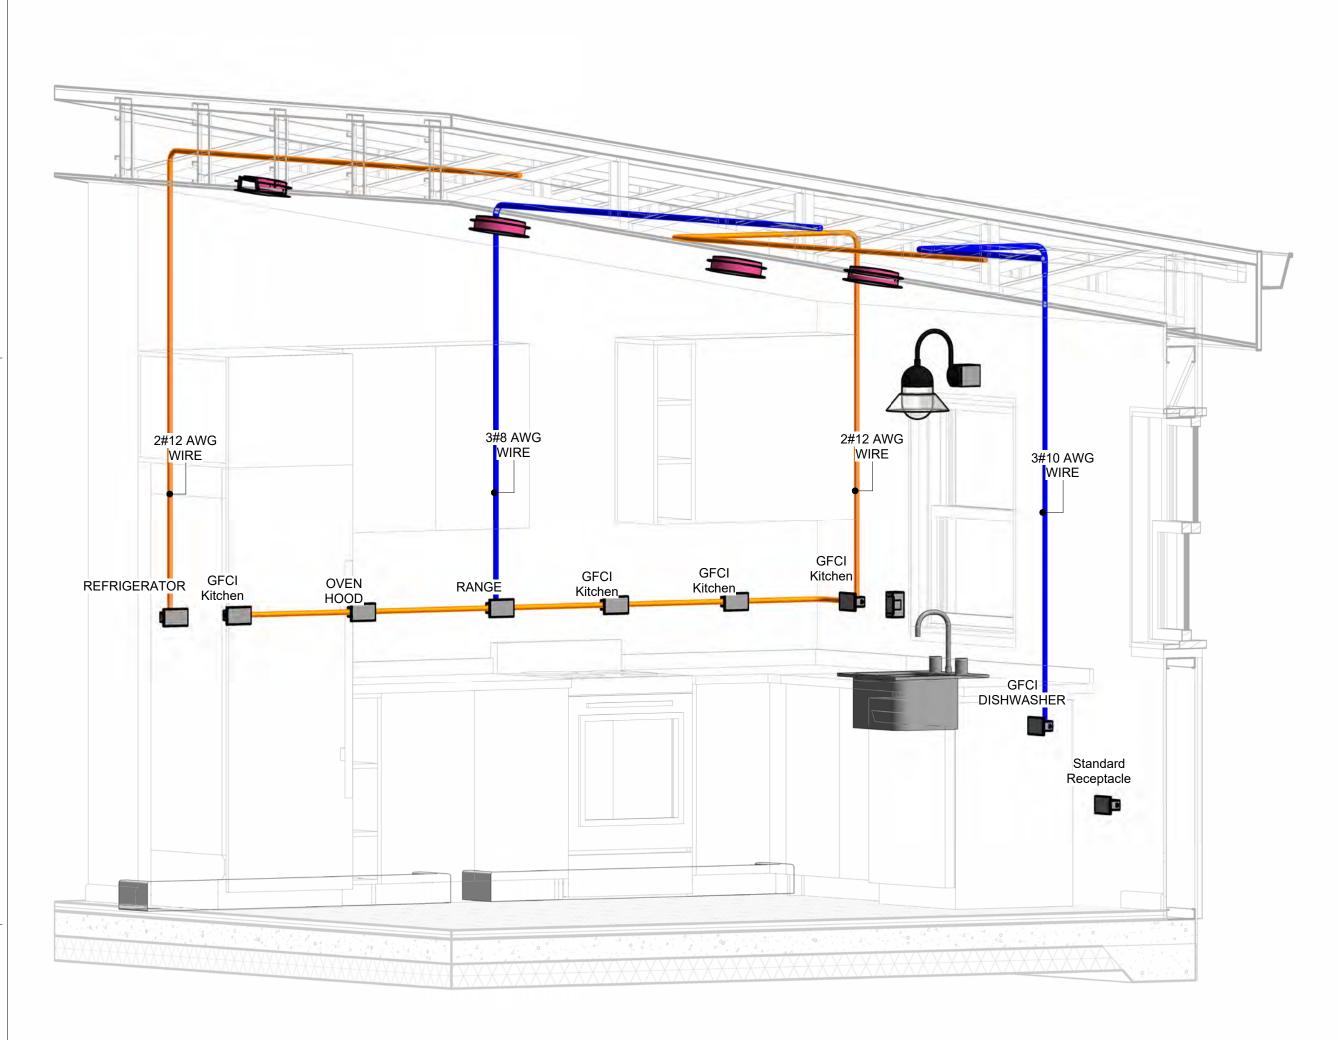

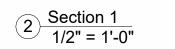

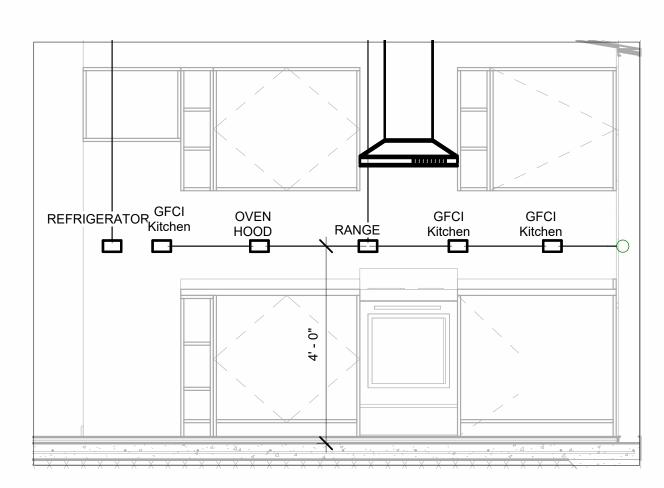

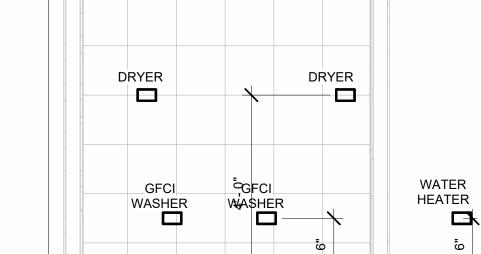



SWITCH

Standard Receptacle

3 Section 2 1/2" = 1'-0"


**3D-KITCHEN** 

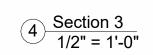

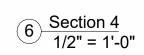



**KEY PLAN** 

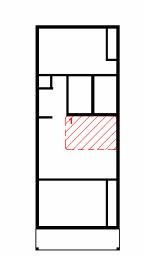

NO.	DESCRIPTION	DATE

NOTE:

LEGEND:

PROJECT

108-BENNETT-796-2Bd2Ba RANCH-550

DRAWING NAME

**POWER** 

CLIENT NAME:	Owner
PROJECT NUMBER:	0037_14
DATE:	3/6/2025 4:04:28 AM
DESIGNED BY:	Designer
DRAWN BY:	Author
CHECKED BY:	Checker

E103

SCALE: As indicated

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# **NOTES: LIGHT**

- 1. LIGHT FIXTURES AND LUMINARIES SHALL CONFORM TO THE NEC, THE IRC AND LOCAL SAFETY & BUILDING CODE.
- 2. ALL LIGHTING FIXTURES SHOULD CONFORM TO THE DESIGN ELECTRICAL LOAD AND SHALL BE PROPERLY WIRED AND MOUNTED BY QUALIFIED ELECTRICIAN FOLLOWING MANUFACTURERS SPECIFICATIONS.
- CEILING FANS AND FANS WITH LIGHT WITH WEIGHT EXCEEDING 35 LBS SHOULD BE PROVIDED WITH STRUCTURAL BACKING FOR SUPPORT AND SHALL BE FIXED AS PER MANUFACTURERS SPECIFICATIONS.
- 4. EXTERIOR LIGHTS SHALL CONFORM TO LOCAL BUILDING CODE AND GUIDELINES.

# NOTES: SWITCH JUNCTION BOX


- THE MINIMUM SIZE OF JUCTION BOX TO BE USED IS 2"X4"X(1.5" OR 3.5" DEEP) THIS ARE TO BE USED FOR SINGLE GANG SWITCH OR OUTLETS.
- 2. FOR DOUBLE GANG (2 GANG) OUTLETS AND SWITCHS THE MINIMUM SIZE OF THE
- JUCTION BOX TO BE PROVIDED SHALL NOT BE LESS THAN 4"X4"X(1.5" OR 3.5" DEEP)

  3. FOR THREE GANG (3 GANG) OUTLETS AND SWITCHS THE MINIMUM SIZE OF THE JUCTION
- 3. FOR THREE GANG (3 GANG) OUTLETS AND SWITCHS THE MINIMUM SIZE OF THE JUCTION BOX SHALL NOT BE LESS THAN 6"X4"X(1.5" OR 3.5" DEEP).

Electrical Fixture Schedule (SWITCH BOX)			
Туре	Count		
Double Gang Switch Box	2		
Single Gang Switch Box	5		
Triple Gang Switch Box	3		

Lighting Device		
Туре	Count	
Dimmer	5	
Fan switch	4	
Single Pole	7	
Three Way	2	

Lighting Fixture				
Lighting Fixture Type	Voltage	Electrical Load	Count	
Electrical_Lights_Fan-Light1	120 V/1-100 VA- 120 V/1-100 VA	200 A, 120 V/240 V, Single Phase, 3 Wires	2	
Lighting - Recessed	120 V/1-60 VA	200 A, 120 V/240 V, Single Phase, 3 Wires	10	
SASSO 100 round wallwasher trim	120 V/1-28 VA	200 A, 120 V/240 V, Single Phase, 3 Wires	8	
Wall Lamp - Bracket	120 V/1-100 VA	200 A, 120 V/240 V, Single Phase, 3 Wires	7	

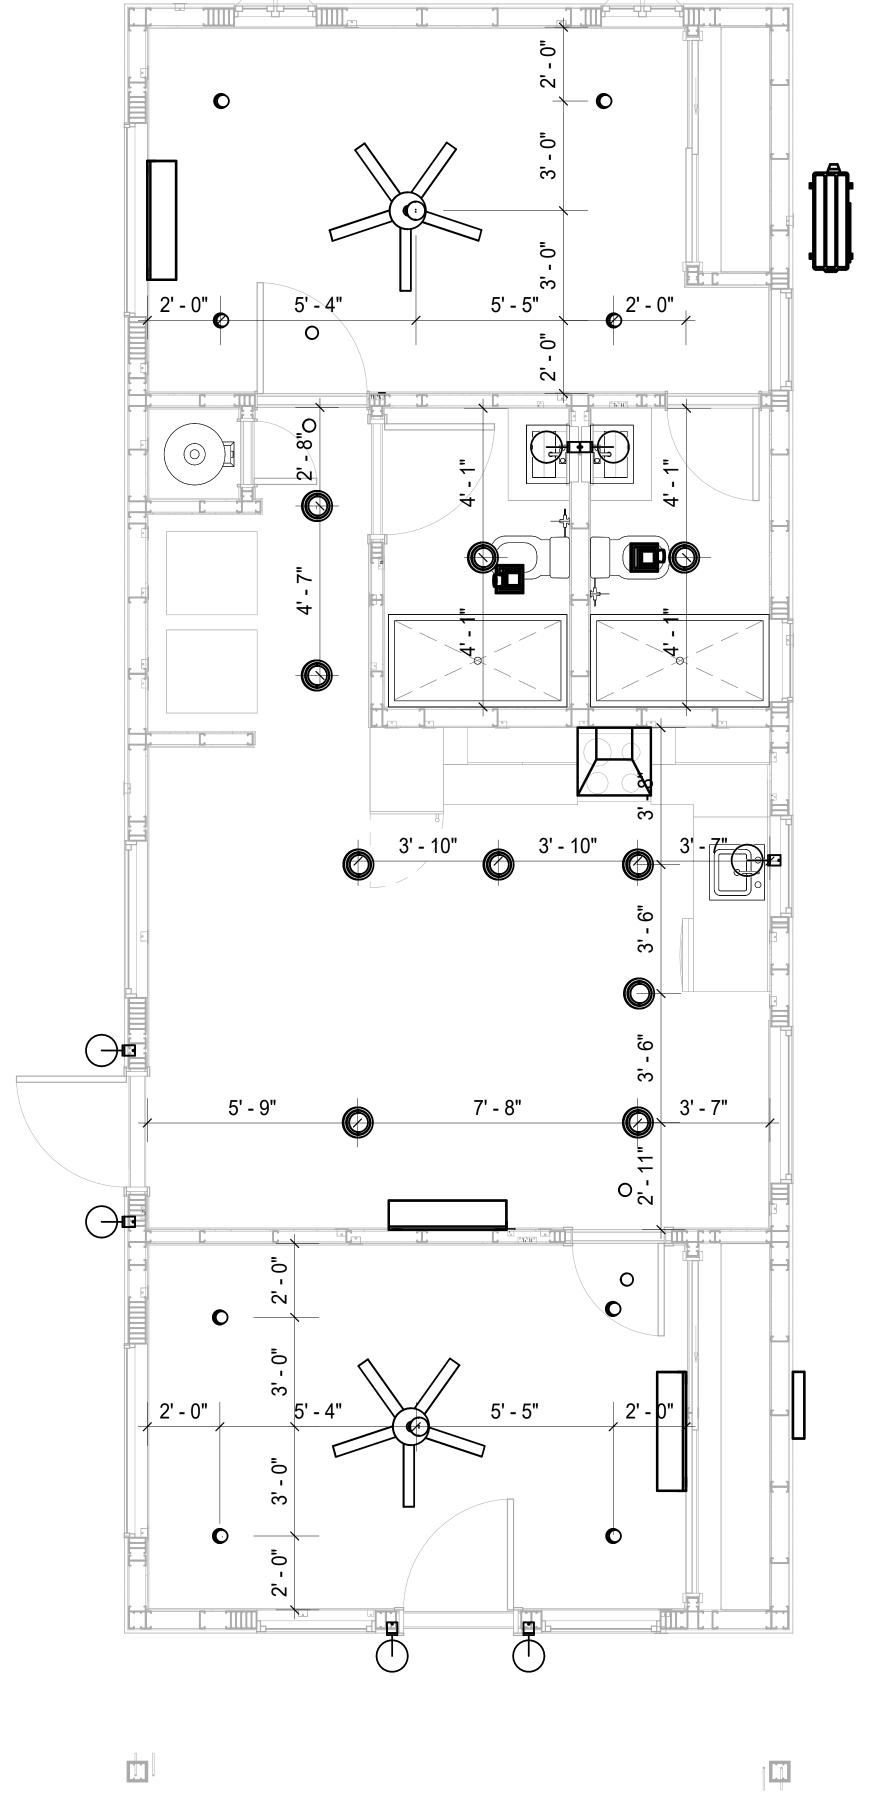



3/8" = 1'-0"



**KEY PLAN** 

NO.	DESCRIPTION	DATE

NOTE:

LEGEND:

PROJECT

108-BENNETT-796-2Bd2Ba RANCH-550

DRAWING NAME

# DIMENSION PLAN FOR LIGHT FIXTURES

CLIENT NAME:	Owner
PROJECT NUMBER:	0037_14
DATE:	3/6/2025 4:04:30 AM
DESIGNED BY:	Designer
DRAWN BY:	Author
CHECKED BY:	Checker

E104


SCALE: 3/8" = 1'-0"

# NOTES;

- 1. VERIFY EQUIPMENT PLUG CONFIGURATION BEFORE PURCHASING RECEPTACLES
- 2. FOR ALL EQUIPMENT.
- 3. COORDINATE EXACT LOCATION OF LIGHT FIXTURES, WALL SWITCHES, RECEPTACLES AND OTHER DEVICES WITH ARCHITECTURAL DRAWINGS.
- 4. USE METALLIC JUNCTION BOX WITH THE GFCI RECEPTACLES, WITH HIGHT VOLTAGE.

Electrical Fixture Schedule (Receptacle)		
Туре	Count	
CONDENSER	1	
DRYER	2	
GFCI BATH ROOM	2	
GFCI DISHWASHER	1	
GFCI Kitchen	4	
GFCI OUT DOOR	4	
GFCI WASHER	2	
OVEN HOOD	1	
RANGE	1	
REFRIGERATOR	1	
Standard Receptacle	16	
WATER HEATER	1	

Electrical Outlet Schedule			
Туре	Circuit Number	Electrical Data	Count
Standard Receptacle		120 V/1-180 VA	1
CONDENSER	1,3	240 V/2-1500 VA	1
GFCI OUT DOOR	2	120 V/1-180 VA	4
Standard Receptacle	5	120 V/1-180 VA	5
Standard Receptacle	6	120 V/1-180 VA	5
WATER HEATER	7,9	240 V/2-1500 VA	1
DRYER	8,10	240 V/2-1500 VA	2
GFCI WASHER	11	120 V/1-1200 VA	2
REFRIGERATOR	12	120 V/1-1500 VA	1
GFCI Kitchen	13	120 V/1-180 VA	4
OVEN HOOD	13	120 V/1-180 VA	1
RANGE	14,16	240 V/2-1500 VA	1
GFCI BATH ROOM	15	120 V/1-180 VA	1
GFCI BATH ROOM	17	120 V/1-180 VA	1
Standard Receptacle	18	120 V/1-180 VA	5
GFCI DISHWASHER	19	120 V/1-1200 VA	1

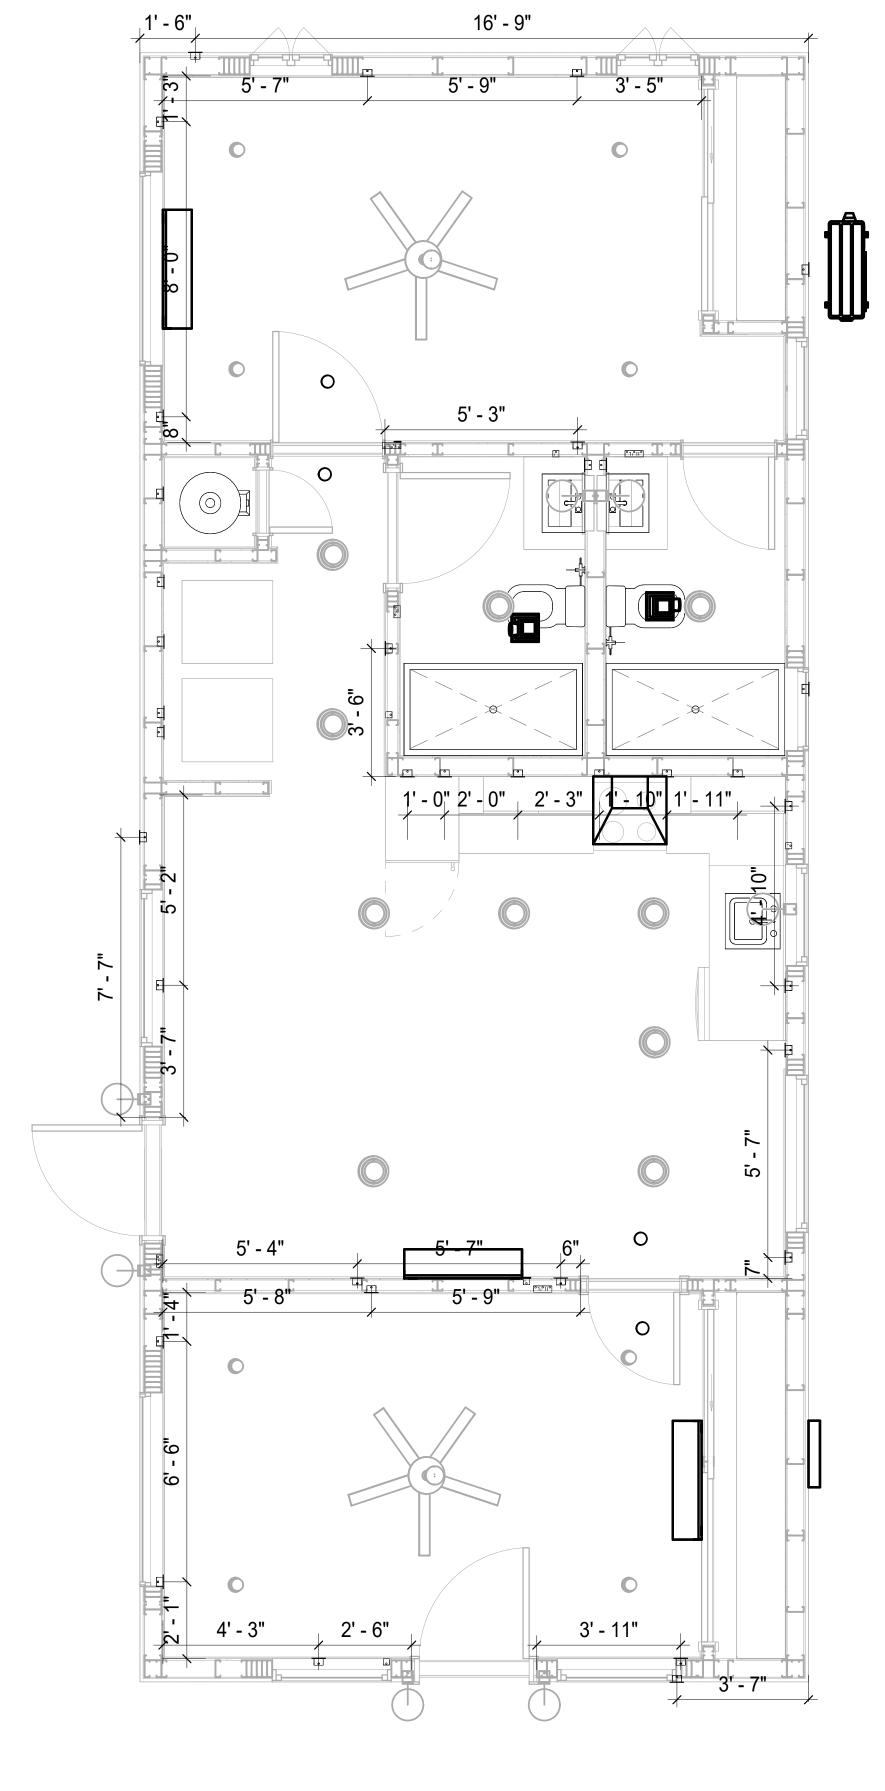





**KEY PLAN** 

NO.	DESCRIPTION	DATE

NOTE:

LEGEND:

PROJECT

108-BENNETT-796-2Bd2Ba RANCH-550

DRAWING NAME

# DIMENSION PLAN FOR FITTINGS

Owner
0037_14
3/6/2025 4:04:32 AM
Designer
Author
Checker

E105

SCALE: 3/8" = 1'-0"

## SHEET LIST

SHEET NUMBER SHEET NAME

P101 NOTE AND SCHEDULE
P102 WATER SUPPLY AND SEWAGE
SYSTEM

PIPE COLOR SCHEME	
DOMESTIC COLD WATER DOMESTIC HOT WATER	_
SANITARY VENT	`
SANITARY SEWER STORM DRAINAGE	
GRAY WATER	
GAS LINE	

### PLUMBING NOTES

- THE PLUMBING SYSTEM IS DESIGNED TO MEET THE BUILDING'S DOMESTIC WATER SUPPLY, SANITARY DRAINAGE, AND STORM DRAINAGE REQUIREMENTS, AS PER PROJECT SPECIFICATIONS AND APPLICABLE CODES.
- THE SYSTEM INSTALLATION SHALL COMPLY WITH THE LATEST INTERNATIONAL PLUMBING CODE (IPC), INTERNATIONAL RESIDENTIAL CODE (IRC), AND ALL OTHER RELEVANT LOCAL, STATE, AND NATIONAL REGULATIONS.
- 3. ALL PLUMBING WORK SHALL COMPLY WITH THE LATEST EDITION OF THE INTERNATIONAL PLUMBING CODE (IPC) AND THE LOCAL PLUMBING CODE.
- 4. PLUMBING SYSTEMS SHALL BE TESTED AND INSPECTED IN ACCORDANCE WITH THE LOCAL PLUMBING CODE REQUIREMENTS.
- 5. PLUMBING FIXTURES SHALL BE INSTALLED WITH THE APPROPRIATE TRIM, FITTINGS, AND ACCESSORIES, AS RECOMMENDED BY THE MANUFACTURER.
- 6. PIPING SHALL BE PROPERLY SUPPORTED AND SECURED TO PREVENT SAGGING,
- MOVEMENT, AND VIBRATION.
  7. SHUT-OFF VALVES SHALL BE PROVIDED AT ALL BRANCH CONNECTIONS AND AT THE
- INLET AND OUTLET OF EACH PIECE OF EQUIPMENT.

  8. BACKFLOW PREVENTION DEVICES SHALL BE INSTALLED AS REQUIRED BY THE LOCAL
- PLUMBING CODE TO PROTECT THE POTABLE WATER SYSTEM.

  9. PLUMBING FIXTURES AND EQUIPMENT SHALL BE ACCESSIBLE FOR MAINTENANCE AND
- 10. EXPOSED PLUMBING PIPING AND FIXTURES SHALL BE INSULATED TO PREVENT CONDENSATION AND ENERGY LOSS.
- 11. DEAD ENDS IN THE DRAINAGE SYSTEM MUST BE AVOIDED, EXCEPT WHERE NECESSARY TO INSTALL A CLEANOUT IN AN ACCESSIBLE LOCATION, AND MUST HAVE A VENTED CONNECTION TO THE OUTSIDE ATMOSPHERE.
- 12. THE VERTICAL DEFLECTION OF PVC PIPE MUST NOT EXCEED 5%, AND NO DEFLECTION IS PERMITTED FOR IRON PIPE.
- 13. WORK MUST BE PROPERLY COORDINATED WITH OTHER TRADES TO AVOID CONFLICTS, REFERRING TO THE ARCHITECTURAL AND STRUCTURAL DRAWINGS FOR INFORMATION REGARDING CEILING ELEVATIONS, SPACE CLEARANCES, WALL AND PARTITION LOCATIONS, ETC.
- 14. ALL FIXTURES SHALL HAVE ACCESSIBLE STOPS.
- 15. DOMESTIC WATER PIPING SHALL BE PEX, AND PVC PIPING IS NOT ACCEPTABLE FOR INTERIOR USE.
- 16. VENT TERMINATIONS SHALL BE LOCATED AT LEAST 10 FEET FROM OR 3 FEET ABOVE ANY OPERABLE WINDOW, DOOR OPENING, AIR INTAKE, OR VENT SHAFT, AND AT LEAST 3 FEET IN EVERY DIRECTION FROM ANY LOT LINE, ALLEY, OR STREET.
- 17. PIPE AND FITTINGS UTILIZED IN THE WATER SUPPLY SYSTEM SHALL HAVE A MAXIMUM OF 8 PERCENT LEAD.
- 18. ACRYLONITRILE BUTADIENE STYRENE (ABS) SHALL BE USED FOR THE SEWERAGE AND VENTILATION SYSTEM.
- 19. CROSS-LINKED POLYETHYLENE (PEX) SHALL BE USED FOR THE WATER SUPPLY SYSTEM.
- 20. POLYVINYL CHLORIDE (PVC) SHALL BÉ USED FOR THE RAIN WATER SYSTEM.
  21. THE MIMIMUM WATER SUPPLY DEPTH UNDER FLOOR FINISH SHOUD BE 1/2".
- 22. ANY PIPE INSTALLED UNDERGROUND MUST HAVE AT LEAST 12 INCHES OF CLEARANCE
- BETWEEN THE OUTSIDE OF THE PIPE AND ANY OTHER UNDERGROUND STRUCTURE.

  23. THE MINIMUM CLEARANCE BETWEEN COLD AND HOT WATER LINES IN RESIDENTIAL
- HOMES MAINTAIN A MINIMUM DISTANCE OF 6 INCHES.
- 24. HORIZONTAL SEPARATION BETWEEN WATER AND SEWER LINES: A MINIMUM OF 12 INCHES BETWEEN POTABLE WATER SUPPLY LINES (COLD AND HOT WATER) AND SANITARY SEWER LINES.

# **ABBREVIATIONS**

Ø	DIAMETER
ABS	ACRYLONITRILE BUTADIENE STYRENE
ABV	ABOVE
AD	AREA DRAIN
AFF	ABOVE FINISHED FLOOR
ALT	ALTERNATE
BFF	BELOW FINISHED FLOOR
BLW	BELOW
CO	CLEAN OUT
CW	COLD WATER
D	DEGREE
DFU	DRANAGE FIXTURE UNIT
DIA	DIAMETER
DN	DOWN
FCO	FLOOR CLEAN OUT
FD	FLOOR DRAIN
FL	FLOOR
FS	FLOOR SINK
FT	FOOT/FEET
HB	HOSE BIB
HW	HOT WATER
IN	INCH
MIN	MINIMUM
NO	NUMBER
NTS	NOT TO SCALE
PEX	CROSS-LINKED POLYETHYLENE
PLBG	PLUMBING
PVC	POLYVINYL CHLORIDE
QTY	QUANTITY
RD	ROOF DRAIN
RED	REDUCER
RM	ROOM
RW	RAIN WATER
SF	SQUARE FOOT
V	VENT
VTR	VENT THROUGH ROOF
W	WASTE
WCO	WALL CLEAN OUT
WSFU	WATER SUPPLY FIXTURE UNIT

# PLUMBING LEGEND

D	CAP
	BEND 45 DEG
B	BEND 90 DEG
	TEE REDUCING
	TEE
	CLEAN TWO-WAY
	WYE 45 DEG
	WYE 45 DEG DOUBLE
	WYE COMBINATION
	P-TRAP

PIPE SCHEDULE							
MATERIAL	DIAMETER	LENGTH					
ACRYLONITRILE BUTADIENE STYRENE (ABS)	1 1/2"	21 FT					
ACRYLONITRILE BUTADIENE STYRENE (ABS)	2"	38 FT					
ACRYLONITRILE BUTADIENE STYRENE (ABS)	3"	35 FT					
CROSS-LINKED POLYETHYLENE (PEX)	1/2"	95 FT					
CROSS-LINKED POLYETHYLENE (PEX)	3/4"	55 FT					
POLYVINYL CHLORIDE - RIGID	2"	41 FT					

TTING SCHEDULE	
SIZE	QTY
1/2"a 1/2"a	13
	2
	7
	3
	2
1 1 1	1
0,12 1/2	·
1/2"ø-1/2"ø	11
3/4"ø-3/4"ø	6
1/2"ø-1/2"ø	5
3/4"ø-3/4"ø-3/4"ø	1
3/4"ø-1/2"ø	1
2" ~ 2" ~	15
2 0-2 0	10
1 1/2"ø-1 1/2"ø	4
2"ø-2"ø	3
3"ø-3"ø	2
1 1/2"ø-1 1/2"ø	3
2"ø-2"ø	1
2"ø-1 1/2"ø	1
3"ø-1 1/2"ø	1
3"ø-2"ø	1
2"ø-2"ø-2"ø	1
3"ø-3"ø-3"ø	2
3"ø-3"ø-1 1/2"ø	2
3"ø-3"ø-2"ø	1
2"ø-2"ø	1
1 1/2"ø-1 1/2"ø-1 1/2"ø	1
2"ø-2"ø-2"ø	1
3"ø-3"ø-3"ø	1
4.4/011	4
1 1/2"Ø	1
2"ø	2
	1/2"ø-1/2"ø   3/4"ø-3/4"ø   1/2"ø-1/2"ø-1/2"ø   3/4"ø-3/4"ø   1/2"ø-1/2"ø   3/4"ø-3/4"ø   1"ø-3/4"ø   3/4"ø-1/2"ø   3/4"ø-1/2"ø   3/4"ø-1/2"ø   3/4"ø-3/4"ø   1/2"ø-1/2"ø   3/4"ø-3/4"ø   3/4"ø-3/4"ø   3/4"ø-1/2"ø   2"ø-2"ø   2"ø-2"ø-2"ø   2"ø-2"ø-2"ø   2"ø-2"ø-2"ø-2"ø   2"ø-2"ø-2"ø-2"ø   2"ø-2"ø-2"ø-2"ø-2"ø-2"ø   2"ø-2"ø-2"ø-2"ø   2"ø-2"ø-2"ø-2"ø-2"ø-2"ø-2"ø-2"ø-2"ø-2"ø-

FIXTURE CONNECTION SCHEDULE

W V TRAP CW HW QTY DFU TOT. WFU TOT.

**FAMILY** 

NOTES

	•			•					
DISHWASHER	2"	1-1/2"	1-1/2"	1/2"	1/2"	1	0		DRAIN TO SEWER SEE PLANS
DRYER	N/A	N/A	N/A	N/A	N/A	1	0		
HANGING PIPES CLAMP						10	0		
SHOWER TRAY	2"	1-1/2"	1-1/2"	1/2"	1/2"	2	0		
SHOWER TRIM	-	-	-	1/2"	1/2"	2	0		
SINK ISLAND SINGLE	2"	1-1/2"	1-1/2"	1/2"	1/2"	1	0		
VANITY SINK	2"	1-1/2"	1-1/2"	1/2"	1/2"	2	0		
WASHER	2"	1-1/2"	2"	1/2"	1/2"	1	0		DRAINS TO GRAY WATER OR SEWER SEE PLANS
WATER CLOSET						2	0		
WATER HEATER	N/A	N/A	N/A	3/4"	3/4"	1	0		

FIXTURE SCHEDULE						
FIXTURE	TURE QTY DESCRIPTION					
DISHWASHER	1	DRAIN TO SEWER SEE PLANS				
DRYER	1					
HANGING PIPES CLAMP	10					
SHOWER TRAY	2					
SHOWER TRIM	2					
SINK ISLAND SINGLE	1					
VANITY SINK	2					
WASHER	1	DRAINS TO GRAY WATER OR SEWER SEE PLANS				
WATER CLOSET	2					
WATER HEATER	1					

ACCESSORIES & FITTINGS SCHEDULE							
FIXTURE	QTY	DESCRIPTIONS					
DISHWASHER CONNECTOR	1						
HOSE BIB	1						
LAUNDRY SWEAT CONNECTOR	1						
SHUTOFF VALVE	8						

PLUMBING SCHEDULE								
FIXTURE	TRAP	WASTE	VENT	C.W	H.W			
DISHWASHER	1-1/2"	2"	1-1/2"	1/2"	1/2"			
DRYER	N/A	N/A	N/A	N/A	N/A			
SHOWER TRAY	1-1/2"	2"	1-1/2"	1/2"	1/2"			
SHOWER TRIM	-	-	-	1/2"	1/2"			
SINK ISLAND SINGLE	1-1/2"	2"	1-1/2"	1/2"	1/2"			
VANITY SINK	1-1/2"	2"	1-1/2"	1/2"	1/2"			
WASHER	2"	2"	1-1/2"	1/2"	1/2"			
WATER CLOSET								
WATER HEATER	N/A	N/A	N/A	3/4"	3/4"			

WATER FIXTURE UNIT SCHEDULE							
FAMILY	QTY	UNIT VALUE	TOTAL				
DIOLIMACHED							
DISHWASHER	1		0				
DRYER	1		0				
HANGING PIPES CLAMP	10		0				
SHOWER TRAY	2		0				
SHOWER TRIM	2		0				
SINK ISLAND SINGLE	1		0				
VANITY SINK	2		0				
WASHER	1		0				
WATER CLOSET	2		0				
WATER HEATER	1		0				

WASTE FIXTURE UNIT SCHEDULE							
FAMILY	QTY	DFU VALUES	TOTAL				
DISHWASHER	1	0					
DRYER	1	0					
HANGING PIPES CLAMP	10	0					
SHOWER TRAY	2	0					
SHOWER TRIM	2	0					
SINK ISLAND SINGLE	1	0					
VANITY SINK	2	0					
WASHER	1	0					
WATER CLOSET	2	0					
WATER HEATER	1	0					



**KEY PLAN** 

NO. DESCRIPTION DATE

NOTE:

LEGEND:

PROJECT

107-Bennett-796-2Bd/2Ba Modern-550

DRAWING NAME

NOTE AND SCHEDULE

CLIENT NAME:

 PROJECT NUMBER:
 0205\_13

 DATE:
 3/3/2025 4:10:33 PM


 DESIGNED BY:
 Designer

 DRAWN BY:
 Author

 CHECKED BY:
 Checker


P101

SCALE: 1/2" = 1'-0"

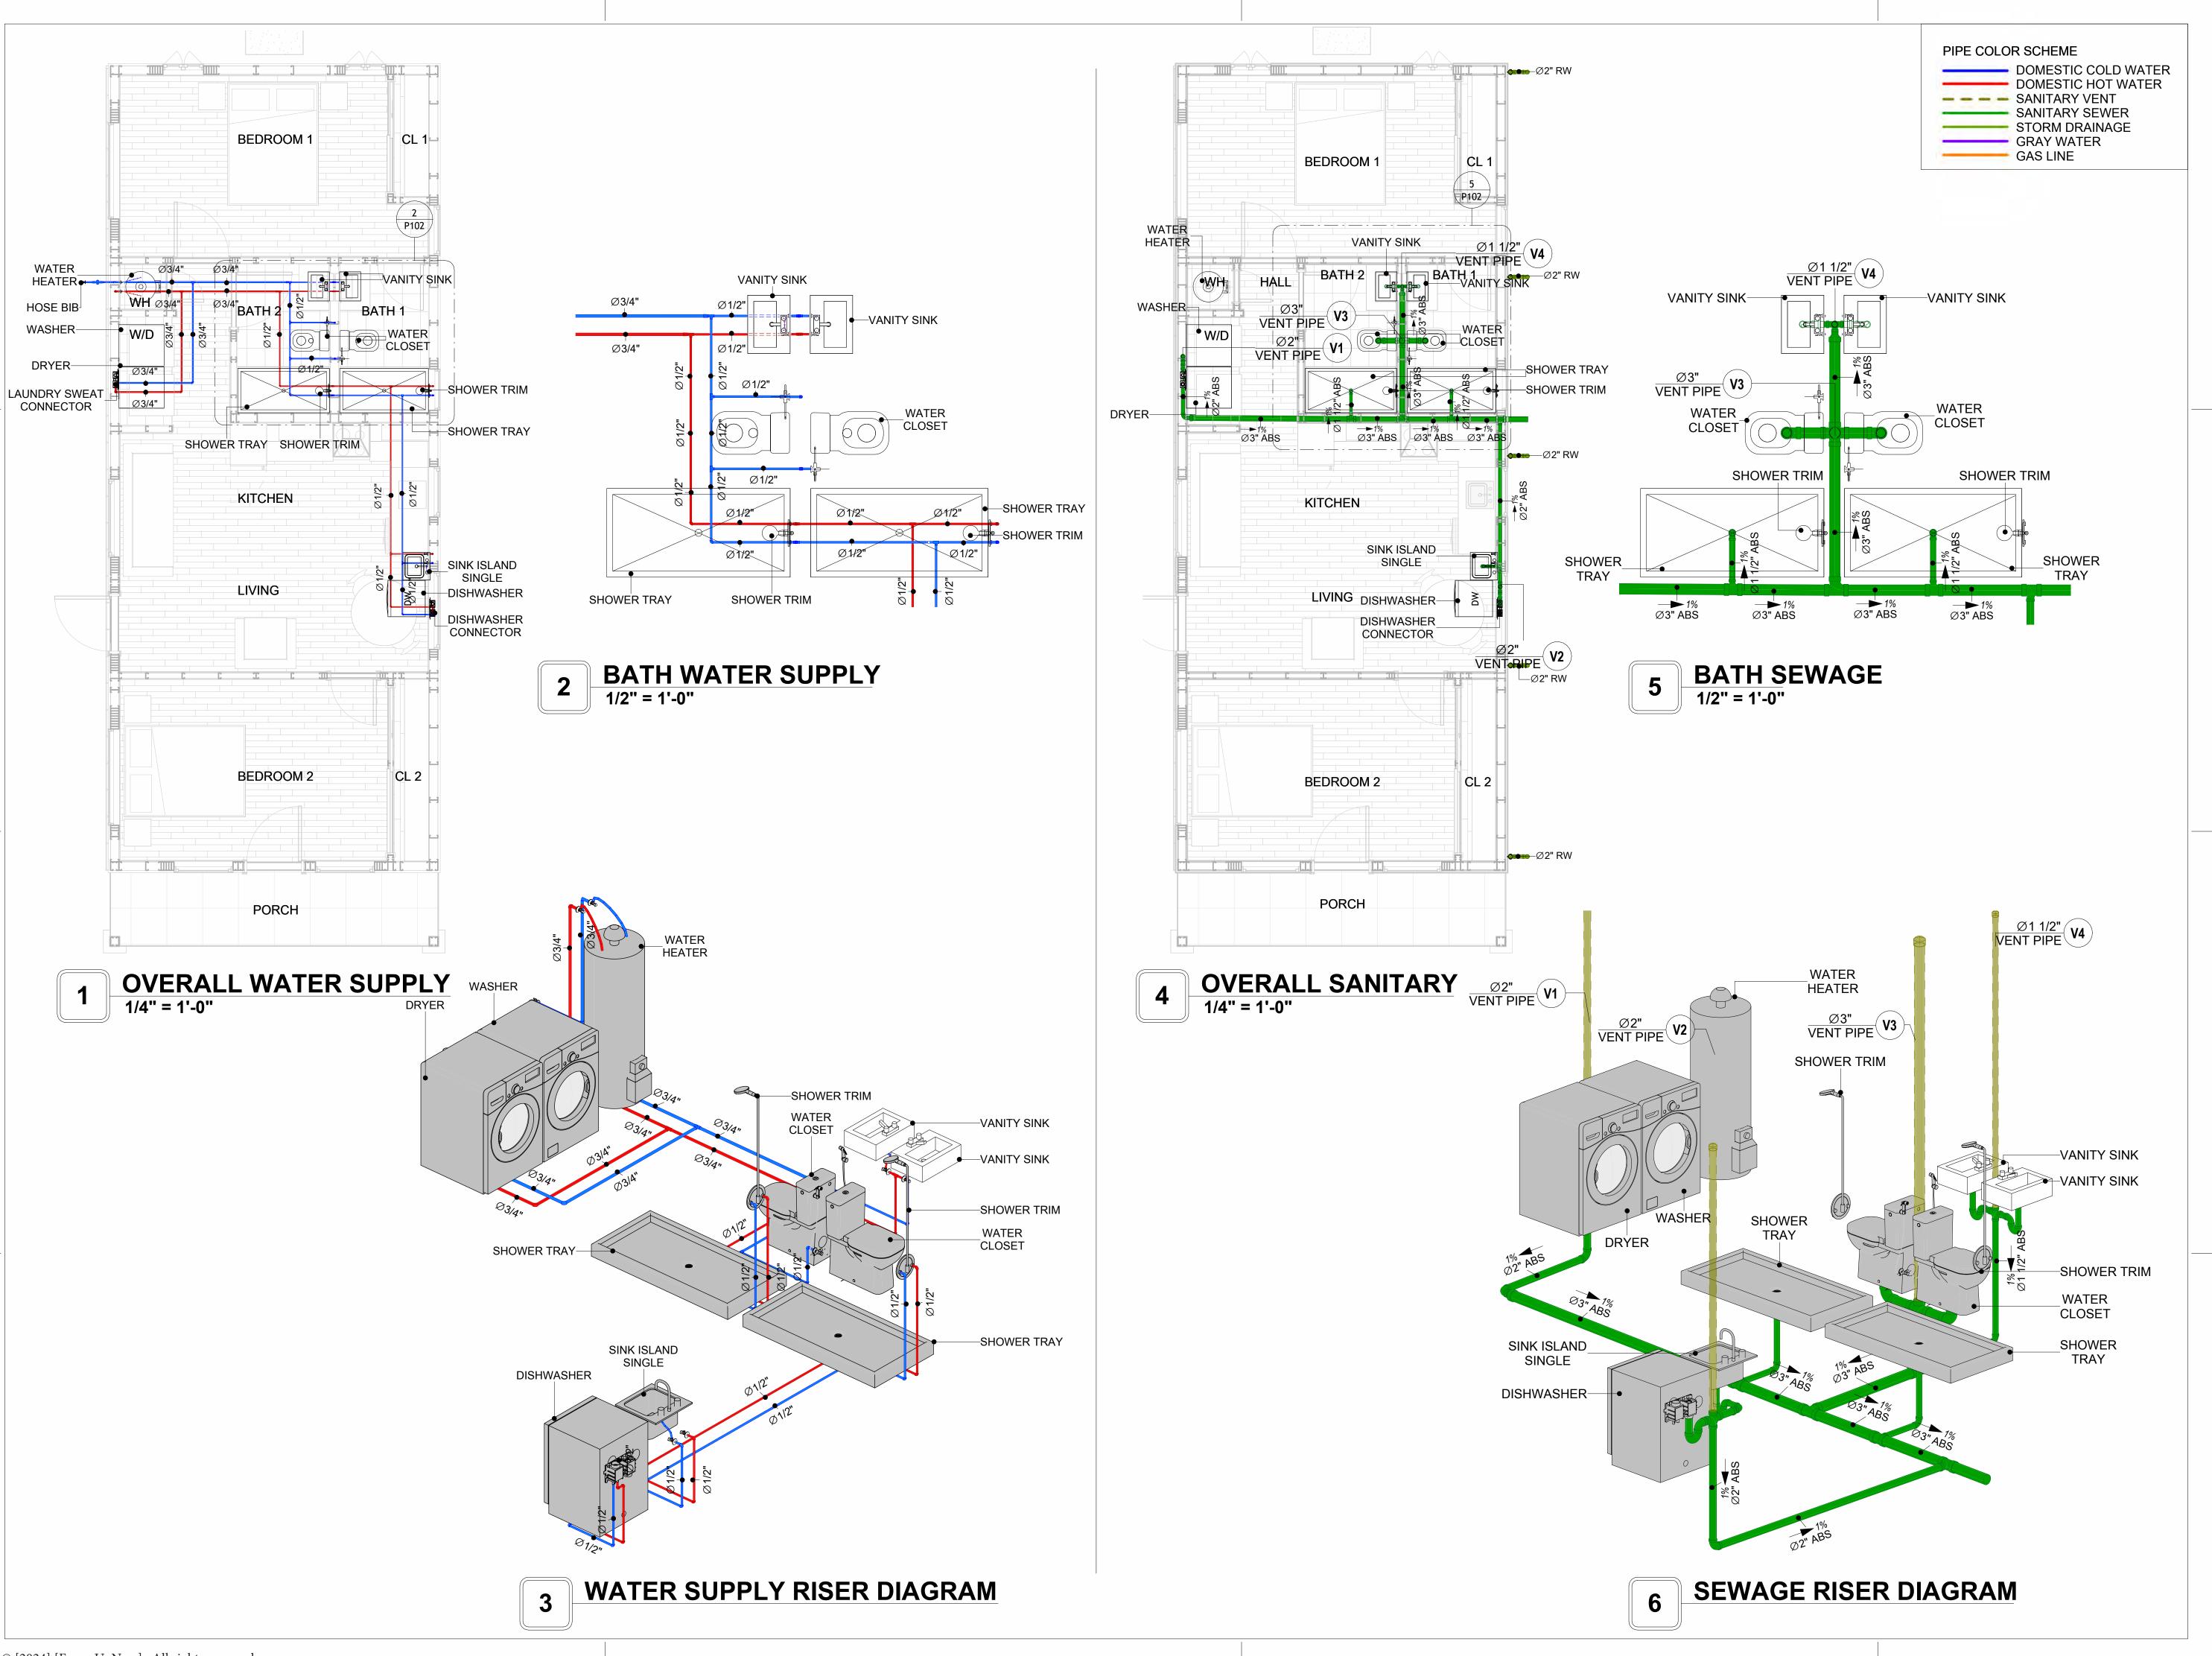



**KEY PLAN** 

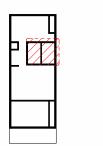

NO.	DESCRIPTION	DATE

NOTE:

LEGEND:

PROJECT

107-Bennett-796-2Bd/2Ba Modern-550

DRAWING NAME

# WATER SUPPLY AND SEWAGE SYSTEM

 CLIENT NAME:

 PROJECT NUMBER:
 0205\_13

 DATE:
 3/3/2025 4:11:06 PM

 DESIGNED BY:
 Designer

 DRAWN BY:
 Author

 CHECKED BY:
 Checker

P102

# Materials Shopping List

Please print and take this Materials Shopping List to your favorite Home Depot and ask for assistance in selecting the materials, fixtures and fittings to complete your new home.

Record your selection and the price of the item. Then do the math to determine the cost for your selections and the total cost of finishing your home.

#### **Have It Your Way!**

The material types listed in this document were selected based on personal preferences. The Customer is encouraged to make changes to the material types in accordance with local customs, regulations, and personal preferences.

Have It Your Way!



# 20 good reasons to frame a home with metal and not wood



Why build your ADU with metal vs wood	Wood	Metal	Explanation
1 DIY Construction Benefit		<b>~</b>	The wall frames, trusses and beams can be erected in a just a few days
2 Minimal Construction Skills Required		<b>~</b>	Pre-assembled walls and trusses require no specialized skills to errect
3 Build as DIY, Hybrid or by a General Contractor		<b>~</b>	Do it yourself, Hybrid (involve special contractors) or hire a General Contractor
4 Build It As You Can Afford It		<b>~</b>	Impervious to Weather - build as you have the time and money
5 Up Front Cost of Framing Materials	$\checkmark$		As to only the framing material, wood is less expensive
6 Total Cost To Build		<b>~</b>	Savings in time, labor, and other areas make light gauge steel LESS expensive
7 Termites and wood boring insects		<b>~</b>	Termites, carpenter ants and wood boring insects eat wood, not metal
8 Mold resistant		<b>~</b>	Metal does not attract mold
9 Damage caused by exterior and interior flooding		<b>~</b>	Metal needs no reconditioning after a flood
10 Fire Resistant		<b>~</b>	Non-combustible
11 Lower insurance rates		<b>~</b>	Many insurance underwriters now provide lower rates for metal framed homes
12 Walls, trusses, and beams retain their original form		<b>~</b>	Perfectly straight walls - no shimming of drywall
13 Corners are 90 degrees		<b>~</b>	No need for templating of countertops to adjust for out of square corners
14 Strength and weight		<b>~</b>	Metal is stronger than wood and weighs less - no need for crane to lift ADU trusses
15 IBC Engineered Stamp		<b>~</b>	If an engineering stamp is necessary, months of waiting are saved
16 Complete BOM (Materials Shopping List)		<b>~</b>	Take the materials shopping list to Home Depot and start shopping/pricing
17 Flexible in Seismic Areas - Won't Fracture		<b>~</b>	Light gauge steel is flexible and won't fracture when the earth moves
18 No Waste At Job Site		<b>~</b>	Steel is the most recycled material in the world. A typical wood home has 20-30% waste
19 Environmentally Friendly		<b>~</b>	Trees don't have to be destroyed and the source of most metal is from recycling
20 How-To Videos Included		<b>~</b>	How-to videos provide simple assembly instructions
21 Relationship Counselor		<b>~</b>	Eliminate emotional uphevels - save time, money, and preserve the relationship

#### Universal Requirements - some or all may be required

- 1 Site plan
- 2 Electrical Supply Connection
- 3 Sewer Connection
- 4 Fresh Water Supply Connection
- 5 Set Backs
- 6 Soils Evaluation

- 7 Earthquake (fault) evaluation
- 8 Foundation Plan subject to soils
- 9 Compliance with local energy codes: insulation home wrap and flashing
- 10 Engineering for wind speed and snow load.
- 11 State and Local ordinances regarding ADUs
- 12 Local Architect and/or Engineer may be necessary

#### Bennett-2Bd 2Ba-Modern





# Bennett-2Bd 2Ba-Modern MATERIAL SHOPPING LIST

#### **Have It Your Way!**

The material types listed in this document were selected based on personal preferences. The Customer is encouraged to make changes to the material types in accordance with local customs, regulations, and personal preferences. Have It Your Way!

#### TOC



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6	ARCHITECTURAL BOM	ARCHITECTURAL BOM	15

#### Have It Your Way!

The material types listed in this document were selected based on personal preferences. The Customer is encouraged to make changes to the material types in accordance with local customs, regulations, and personal preferences. Have It Your Way!

#### **GENERAL NOTES**

- 1 This BOM (Bill of Materials) is prepared as a Materials Shopping List to help builders and DIYers gain a complete understanding of most if not all elements required for the complete construction of this structure, according to the original design documents provided by FrameUpNow.
- 2 All quantities and specifications are subject to change based on the final design, field measurements, availability of products and customer preferences. The customer should verify all information prior to purchasing materials.
- 3 All products and elements in the list shall conform to the International Residential Code (IRC), or any other local and international building codes, safety regulations, and standards that are applicable to the location of the structure.
- 4 If any changes are made by the customer to the list of materials specified in this document, the customer is responsible for assuring that the correct type and quantity of materials are utilized in accordance with local building codes.
- FrameUpNow, will not be held responsible for any misuse of this document, the products listed, or for deviations from the content that are made due to changes in specifications, pricing, availability, or customer preferences.
- 6 The customer is advised to consult a qualified professional or technician prior to purchasing materials for specialized construction system items. Some items including but not limited to caseworks, doors and windows may require as built measurements prior to purchase to confirmation of final dimensions.
- 7 If there are additional trim elements or specific installation methods, the total amount of materials needed might vary. Consider any additional trim required for corners, intersections, or other architectural details that might cause this variations before proceeding to purchase and construction.

#### **ARCHITECTURAL BOM**



		Ве	ennett-Stud	dio-Spanish			
		ARCHITECTU	JRAL MATE	<b>ERIAL SHOP</b>	PING LIST		
Vo.	Item	Туре	Unit	Quantity	Unit Price	Total	Description
Δ	APPLIANCES						
1	Refrigerator		PCS	1			
2	Range		PCS	1			
3	Washer		PCS	1			
4	Dryer		PCS	1			
5	Dish Washer		PCS	1			
6	Oven		PCS	0			
7	Microwave		PCS	0			
Δ	CASEWORKS						
1	Kitchen Cabinet		FT	13.85			
2	Laundry Cabinet		FT	2.25			
3	Vanity Cabinet		FT	2.5			
4	Medicine Cabinet		PCS	1			
5	Kitchen countertop		SF	20.53			
6	Laundry Countertop		PCS	0			
7	Bathroom Countertop		SF	0			
8	Island		FT	0			
9	Peninsula		FT	0			
10	Closets		SF	20.98			
Δ	CEILING						
1	Ceiling Board	Dry Wall	SF	309			
2	Dry Wall Fastener	Screw	PCS	540			
3	Vapor Retarder	Polyethylene film	SF	417			
4	Vapor Retarder Fastener	Nails with washer heads	PCS	1252			
5	Ceiling Board (MRD)	Moisture resistant drywall	SF	44			
6	MRD Fastener		PCS	77			
7	Ceiling Board	Marine Plywood	SF	65			
8	Marine Plywood Fastener	Screw	PCS	114			
9	Dry Wall Tape		FT	209			
Δ	FLOORING	•					
1	Main Living Space		SF	280.3			
2	Bathroom		SF	48.03			
3	Porch		SF	71.33			
Δ	STRUCTURE						
1	Foundation		SF	459.95			
	WALLS EXTERIOR						
1	Stocco Finish		SF	868			
2	Wall Homewrap		SF	868			
3	Homewrap Fastener	Stapled fastener (200/pkt)	PKT	3.2984			
4	Wall Shteathing (OSB)		SF	868			
5	Shteathing Fastener	Self-drilling screws(100/pkt)	PKT	8.68			
6	Stone Copping		SF	0			
7	Wall Paint		SF	868			
8	Wall Insulation		SF	1890			
Δ	WALLS INTERIOR						
1	Cementitious Backer Board		SF	305			
2	Kerdi membrane		SF	305			
3	Kerdi membrane Fastener		SF	305			
4	Wall Ceramic Tile		SF	305			
5	Drywall Board		SF	725			
6	Drywall Fastener	Self-drilling screws(100/pkt)	PKT	7.25			
7	Wall Paint	J 2 2 2 2 ( 2 2 2 2 2 2 2 2 2 2 2 2 2 2	SF	725			
8	Drywall Tape		FT	136.2307945			
9	Wall Sweep		FT	88			

#### **ARCHITECTURAL BOM**



Δ	DOORS				
1	Interior Swinging	3' - 0" X 6'-8"	PCS	1	
2	Exterior Swinging	3' - 0" X 6'-8"	PCS	1	
3	Bifold	4' - 0" X 6'-8"	PCS	1	
4	Single Fold	3' - 0" X 6'-8"	PCS	1	
5	Exterior Door Trim		FT	16.3	
6	Interior Door Trim		FT	116	
7	Entry Lock set			1	
8	Privacy Lock set			1	
9	Passage Lock set			2	
Δ	WINDOWS				
1	Single Hung	3' - 3" X 3'-3"	PCS	4	
2	Awning	5' - 3" X 3'-3"	PCS	1	
3	Awning	3' - 3" X 1'-9"	PCS	1	
4	Exterior Window Trim		FT	80	
5	Interior Window Trim		FT	80	
	ROOF				
1	Roof Covering		SF	1139.0	
2	Roof Covering Fastener		PCS	570	
3	Roof Felt Paper		SF	1139.0	
4	Roof Felt Paper Fastener		PCS	3417.0	
5	Roof Sheathing		SF	1139	
6	Roof Sheathing Fastener		PCS	9112	
7	Batten		FT	278.0	
8	Batten Fastener		PCS	209.0	
9	Soffit		SF	93.0	
10	Soffit Fastener		PCS	46.5	
11	Fascia		FT	97.0	
	Fascia board fastener		PCS	49	
13	Roof Insulation		SF	1139.0	



Bennett-Studio-Spanish							
	FI FCTRIC	AL MATERIAL SHO	PPING LIST	-			
No.	Item	Type		Quantity	Description		
	LIGHTING FIXTURES						
1	Kitchen Ceiling Light		PCS	3			
2	Kitchen Wall Mounted Light		PCS	1			
3	Exterior Wall Mounted Light		PCS	1			
4	Livingroom Ceiling Light With Fan		PCS	1			
5	Bedroom Ceiling Light With Fan		PCS	0			
6	Dining Ceiling Light		PCS	0			
7	Bath Wall Mounted Light		PCS	1			
8	Bathroom Ceiling Light		PCS	2			
	Livingroom Ceiling Light		PCS	4			
	Bedroom Ceiling Light		PCS	0			
	Hall & Entry Ceiling Light		PCS	2			
	Closet Ceiling Light		PCS	0			
	Smoke Detector		PCS	0			
	ELECTRICAL FITTINGS						
	Standard Receptacle 120V	20A	PCS	5			
	GFCI Receptacle 120V	20 A	PCS	12			
16	·	30 A	PCS	2			
17	·	50 A	PCS	1			
18	·	60 A	PCS	1			
	Fan Switch		PCS	1			
_	Single Pole Switch		PCS	4			
_	Three Way Switch		PCS	4			
	Dimmer Switch		PCS	1			
	ELECTRICAL CONDUITS & WIRING		1 00				
	ROMEX 14 AWG	14/2/W/ground	FT	92			
	ROMEX 12 AWG	12/3/W/ground	FT	215			
	ROMEX 12 AWG	12/2/W/ground	FT	0			
	ROMEX 10 AWG	10/3/W/ground	FT	0			
_	ROMEX 10 AWG	10/2/W/ground	FT	79			
	Romex 8 AWG	8/3/W/ground	FT	0			
	Romex 8 AWG	8/2/W/ground	FT	24			
	ROMEX 6 AWG	6/3/W/ground	FT	45			
	Bare Copper Ground Wire 6 AWG	0/3/VV/ground	FT	0			
	ELECTRICAL BOXES & CIRCUTES		- 11	U			
_		200 AMD	PCS	1			
	Panelboard -240V 1 Phase MLO	200 AMP	PCS	3			
_	Circuit breaker	15 A	PCS	8			
	Circuit breaker	20 A	PCS	2			
	Circuit breaker	30 A	PCS				
	Circuit breaker	50 A		1			
	Circuit breaker	60 A	PCS	1			
	Single Gang Switch Box		PCS	4			
	Double Gang Switch Box		PCS	0			
	Triple Gang Switch Box	W4.14	PCS	2			
	Pull Box	#1/4	PCS	12			
13	Receptacle Box		PCS	23			

### **PLUMBING BOM**

### Bennett-Studio-Spanish

DITIMBING	CVCTEM		. Shopping	TOLL
FLUIVIDIING	<b>3131</b> E	I WAIERIAL	. JOUEFING	LIJI

		PLUMBING 2121FI	INAIEKIA	L SHUFF	ING LIST		
Vo.	Item	Туре	Unit	Quantity	Unit Price	Total	Description
Δ	PLUMBING FIXTURES & ACCESSORIES	·					
1	Bath Tub (Alcove Tub)		PCS	0			
2	Kitchen Sink		PCS	1			
3	Kitchen Faucets		PCS	1			
4	Vanity Sink		PCS	1			
5	Bath room Faucets		PCS	1			
6	Water Closet		PCS	1			
7	Shower Trim		PCS	1			
8	Shower Tray		PCS	1			
9	Water Heater		PCS	1			
10	Hose Bib		PCS	1			
11	Shutoff Valve		PCS	6			
12	Hanging pipe clamp		PCS	16			
13	Gate Valve		PCS	1			
14	Dishwasher Supply Single Connector		PCS	1			
15	Dishwasher Sewage Single Connector		PCS	1			
16	Laundry Sweat Connector		PCS	1			
Δ	SANITARY & PLUMBING PIPES						
1	ABS (Acrylonitrile Butadiene Styrene) Pipes	ø 1"	FT	0			
2	ABS (Acrylonitrile Butadiene Styrene) Pipes	ø 1 1/2"	FT	22			
3	ABS (Acrylonitrile Butadiene Styrene) Pipes	ø 2"	FT	45			
4	ABS (Acrylonitrile Butadiene Styrene) Pipes	ø 3"	FT	21			
5	PEX (Cross-linked polyethylene) Pipes	ø 1/2"	FT	81			
6	PEX (Cross-linked polyethylene) Pipes	ø 3/4"	FT	43			
7	PEX (Cross-linked polyethylene) Pipes	ø 1"	FT	1			
8	PVC Pipes Sch.80 - Rigid	ø 1 1/2"	FT	0			
9	PVC Pipes Sch.80 - Rigid	ø 2"	FT	34			
10	PVC Pipes Sch.80 - Rigid	ø 3"	FT	0			
11	Flex Pipe Round	ø 1/2"	PCS	6			

### **PLUMBING BOM**

	PIPE FITTINGS					
24	ABS 90 Degree Bend Elbow	1 1/2"ø-1 1/2"ø	PCS	2		
	ABS 90 Degree Bend Elbow	2"ø-2"ø	PCS	2		
	ABS 90 Degree Bend Elbow	3"ø-3"ø	PCS	1		
	ABS P-Trap	1 1/2"ø-1 1/2"ø	PCS	2		
	ABS P-Trap	2"ø-2"ø	PCS	2		
	ABS Reducer Elbow	2"ø-1 1/2"ø	PCS	1		
	ABS Reducer Elbow	3"ø-2"ø	PCS	1		
31	ABS TEE Elbow	1 1/2"ø-1 1/2"ø-1 1/2"ø	PCS	1		
32	ABS TEE Elbow	2"ø-2"ø-2"ø	PCS	1		
33	ABS TEE Elbow	3"ø-3"ø-3"ø	PCS	2		
34	ABS Tee Reducer Elbow	3"ø-3"ø-1 1/2"ø	PCS	2		
	ABS Tee Reducer Elbow	3"ø-3"ø-2"ø	PCS	1		
	ABS Vent Cap Elbow	1 1/2"ø	PCS	1		
	ABS Vent Cap Elbow	2"ø	PCS	2		
	ABS Vent Cap Elbow	3"ø	PCS	1		
	PEX 90 Degree Elbow	1/2"ø-1/2"ø	PCS	26		
40	PEX 90 Degree Elbow	3/4"ø-3/4"ø	PCS	3		
41	PEX Tee Elbow	1/2"ø-1/2"ø-1/2"ø	PCS	4		
	PEX Tee Elbow	3/4"ø-3/4"ø-3/4"ø	PCS	7		
	PEX Transition Elbow	1"ø-3/4"ø	PCS	1		
44	PEX Transition Elbow	3/4"ø-1/2"ø	PCS	7		
45	PVC 90 Deg Bend Elbow	2"ø-2"ø	PCS	12		
46	WASTE DOUBLE TEE	2"ø-2"ø-2"ø	PCS	1		

### **HVAC BOM**

	Bennett-Studio-Spanish								
	HVAC SYSTEM MATERIAL SHOPPING LIST								
No.	Item	Туре	Unit	Quantity	Unit Price	Total	Description		
$\triangle$	HVAC_DUCTS								
	PIPE (REFRIGERANT LINE)	1/4" (Ø)	FT	1.44					
2	PIPE (REFRIGERANT LINE)	3/8" (Ø)	FT	43.62					
3	PIPE (REFRIGERANT LINE)	1/2" (Ø)	FT	1.41					
4	PIPE (REFRIGERANT LINE)	3/4''' (Ø)	FT	51.05					
5	DRAYER HOSE	4" (Ø)	FT	4.3					
6	FLEX DUCT ROUND	4" (Ø)	FT	5.49					
	<b>DUCT FITTINGS &amp; ACCESSORIES</b>	· · ·	·						
7	ELBOW (REFRIGERANT LINE)	1/2" (Ø)-1/2" (Ø)	PCS	2					
8	ELBOW (REFRIGERANT LINE)	1/4" (Ø)-1/4" (Ø)	PCS	4					
	ELBOW (REFRIGERANT LINE)	3/4" (Ø)-3/4" (Ø)	PCS	9					
10	ELBOW (REFRIGERANT LINE)	3/8" (Ø)-3/8" (Ø)	PCS	7					
11	TRANSITION (REFRIGERANT	3/4" (Ø)-1/2" (Ø)	PCS	2					
12	TRANSITION (REFRIGERANT	3/4" (Ø)-5/8" (Ø)	PCS	1					
13	TRANSITION (REFRIGERANT	3/8" (Ø)-1/4" (Ø)	PCS	1					
Δ	HVAC_EQUIPMENTS					-			
14	AIR HANDLING UNIT	WALL MOUNTED	PCS	1					
15	CONDENSER	OUTDOOR UNIT	PCS	1					
16	EXHAUST FAN	75 CFM	PCS	1					
17	EXHAUST HOOD	WALL MOUNTED	PCS	1					
18	HOOD-WALL: VENT	HOOD-WALL: VENT	PCS	1					
19	DRAYER: VENT	DRAYER: VENT	PCS	1					
20	ROOF VENT	3"(Ø)	PCS	1					



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#### **Have It Your Way!**

The material types listed in this document were selected based on personal preferences. The Customer is encouraged to make changes to the material types in accordance with local customs, regulations, and personal preferences. Have It Your Way!

#### **GENERAL NOTES**

- This BOM (Bill of Materials) is prepared as a Materials Shopping List to help builders and DIYers gain a complete understanding of most if not all elements required for the complete construction of this structure, according to the original design documents provided by FrameUpNow.
- 2 All quantities and specifications are subject to change based on the final design, field measurements, availability of products and customer preferences. The customer should verify all information prior to purchasing materials.
- 3 All products and elements in the list shall conform to the International Residential Code (IRC), or any other local and international building codes, safety regulations, and standards that are applicable to the location of the structure.
- 4 If any changes are made by the customer to the list of materials specified in this document, the customer is responsible for assuring that the correct type and quantity of materials are utilized in accordance with local building codes.
- 5 FrameUpNow, will not be held responsible for any misuse of this document, the products listed, or for deviations from the content that are made due to changes in specifications, pricing, availability, or customer preferences.
- 6 The customer is advised to consult a qualified professional or technician prior to purchasing materials for specialized construction system items. Some items including but not limited to caseworks, doors and windows may require as built measurements prior to purchase to confirmation of final dimensions.
- 7 If there are additional trim elements or specific installation methods, the total amount of materials needed might vary. Consider any additional trim required for corners, intersections, or other architectural details that might cause this variations before procedding to purchase and construction.



			LIGHTING FIXTURES				
#	Item	Туре	Description, Manufacturer, SKU	Unit	Quantity	Unit Price	Total
1	Kitchen Ceiling Light			PCS	3		
2	Kitchen Wall Mounted Light			PCS	1		
3	Exterior Wall Mounted Light			PCS	1		
4	Livingroom Ceiling Light With Fan			PCS	1		
5	Bedroom Ceiling Light With Fan			PCS	0		
6	Dining Ceiling Light			PCS	0		
7	Bathroom Wall Mounted Light			PCS	1		
8	Bathroom Ceiling Light			PCS	2		
9	Livingroom Ceiling Light			PCS	4		
10	Bedroom Ceiling Light			PCS	0		
11	Hall & Entry Ceiling Light			PCS	2		
12	Closet Ceiling Light			PCS	0		
12	Smoke Detector			PCS	0		
13							
14							
15							



			ELECTRICAL FITTINGS				
#	Item	Туре	Description, Manufacturer, SKU	Unit	Quantity	Unit Price	Total
1	Standard Receptacle 120V	20A		PCS	5		
2	GFCI Receptacle 120V	20 A		PCS	12		
3	GFCI Receptacle 240V	30 A		PCS	2		
4	GFCI Receptacle 240V	50 A		PCS	1		
5	GFCI Receptacle 240V	60 A		PCS	1		
6	Fan Switch			PCS	1		
7	Single Pole Switch			PCS	4		
8	Three Way Switch			PCS	4		
9	Dimmer Switch			PCS	1		
10			·				
11							
12							
13							
14							
15							



		ELECTRI	CAL CONDUITS & WIRING				
#	Item	Туре	Description, Manufacturer, SKU	Unit	Quantity	Unit Price	Total
1	ROMEX 14 AWG	14/2/W/ground		FT	92		
2	ROMEX 12 AWG	12/3/W/ground		FT	215		
3	ROMEX 12 AWG	12/2/W/ground		FT	0		
4	ROMEX 10 AWG	10/3/W/ground		FT	0		
5	ROMEX 10 AWG	10/2/W/ground		FT	79		
6	Romex 8 AWG	8/3/W/ground		FT	0		
7	Romex 8 AWG	8/2/W/ground		FT	24		
8	ROMEX 6 AWG	6/2/W/ground		FT	45		
9	Bare Copper Ground Wire 6 AWG			FT			
10		+					
11							
12							
13							
14							
15							
16							



		ELEC	CTRICAL BOXES & CIRCUTES				
#	Item	Туре	Description, Manufacturer, SKU	Unit	Quantity	Unit Price	Total
1	Panelboard -240V 1 Phase MLO	200 AMP		PCS	1		
2	Circuit breaker	15 A		PCS	3		
3	Circuit breaker	20 A		PCS	8		
ļ	Circuit breaker	30 A		PCS	2		
5	Circuit breaker	50 A		PCS	1		
5	Circuit breaker	60 A		PCS	1		
7	Single Gang Switch Box			PCS	4		
3	Double Gang Switch Box			PCS	0		
)	Triple Gang Switch Box			PCS	2		
LO	Pull Box	#1/4		PCS	12		
1	Receptacle Box			PCS	23		
L2							
.3							
14							
L5							

# **HVAC BOM**

			HVAC_DUCTS 01			
#		Туре	Description, Manufacturer, SKU	Unit	Quantity	Unit Price Total
1	PIPE (REFRIGERANT LINE)	1/4" (Ø)		FT	1.44	
2	PIPE (REFRIGERANT LINE)	3/8" (Ø)		FT	43.62	
3	PIPE (REFRIGERANT LINE)	1/2" (Ø)		FT	1.41	
4	PIPE (REFRIGERANT LINE)	3/4''' (Ø)		FT	51.05	
5	DRAYER HOSE	4" (Ø)		FT	4.3	
6	FLEX DUCT ROUND	4" (Ø)		FT	5.49	

# **HVAC BOM**

		D	UCT FITTINGS & ACCESSORIES				
#	Item	Туре	Description, Manufacturer, SKU	Unit	Quantity	<b>Unit Price</b>	Total
1	ELBOW (REFRIGERANT LINE)	1/2" (Ø)-1/2" (Ø)		PCS	2		
2	ELBOW (REFRIGERANT LINE)	1/4" (Ø)-1/4" (Ø)		PCS	4		
3	ELBOW (REFRIGERANT LINE)	3/4" (Ø)-3/4" (Ø)		PCS	9		
4	ELBOW (REFRIGERANT LINE)	3/8" (Ø)-3/8" (Ø)		PCS	7		
5	TRANSITION (REFRIGERANT LINE)	3/4" (Ø)-1/2" (Ø)		PCS	2		
6	TRANSITION (REFRIGERANT LINE)	3/4" (Ø)-5/8" (Ø)		PCS	1		
7	TRANSITION (REFRIGERANT LINE)	3/8" (Ø)-1/4" (Ø)		PCS	1		

# **HVAC BOM**

		HVAC_EQUIPMENTS				
Item	Туре	Description, Manufacturer, SKU	Unit	Quantity	Unit Price	Total
AIR HANDLING UNIT	WALL MOUNTED		PCS	1		
CONDENSER	OUTDOOR UNIT		PCS	1		
EXHAUST FAN	75 CFM		PCS	1		
EXHAUST HOOD	WALL MOUNTED		PCS	1		
HOOD-WALL: VENT	HOOD-WALL: VENT		PCS	1		
DRAYER: VENT	DRAYER: VENT		PCS	1		
ROOF VENT	3"(Ø)		PCS	1		

	PLUMBING FIXTURES & ACCESSORIES									
#		уре	Description, Manufacturer, SKU	Unit	Quantity	Unit Price  Total				
1	Bath Tub (Alcove Tub)			PCS	0					
2	Kitchen Sink			PCS	1					
3	Kitchen faucets			PCS	1					
4	Vanity Sink			PCS	1					
5	Bath room faucets			PCS	1					
6	Water Closet			PCS	1					
7	Shower Trim			PCS	1					
8	Shower Tray			PCS	1					
9	Water Heater			PCS	1					
10	Hose Bib			PCS	1					
11	Shutoff Valve			PCS	6					
12	Hanging pipe clamp			PCS	16					
13	Gate Valve			PCS	1					
14	Dishwasher Supply Single Connector			PCS	1					
15	Dishwasher Sewage Single Connector			PCS	1					
16	Laundry Sweat Connector			PCS	1					

	SANITARY & PLUMBING PIPES								
#	Item	Туре	Description, Manufacturer, SKU	Unit	Quantity	Unit Price	Total		
1	ABS (Acrylonitrile Butadiene	ø 1"							
	Stvrene) Pipes			FT	0				
2	ABS (Acrylonitrile Butadiene	ø 1 1/2"							
	Stvrene) Pipes			FT	22				
3	ABS (Acrylonitrile Butadiene	Ø 2"		FT	45				
	Styrene) Pipes			FT	45				
4	ABS (Acrylonitrile Butadiene	Ø 3"		FT	21				
	Styrene) Pipes	4/01		FI	21				
5	PEX (Cross-linked	ø 1/2"		FT	81				
6	polvethylene) Pipes	ø 3/4"		1 1	01				
0	PEX (Cross-linked	0 3/4		FT	43				
7	polvethvlene) Pipes PEX (Cross-linked	ø 1"			10				
ļ′	polvethylene) Pipes			FT	1				
8	PVC Pipes Sch.80 - Rigid	ø 1 1/2"							
	Tronipos comoc ragia	~2		FT	0				
9	PVC Pipes Sch.80 - Rigid	ø 2"							
	'			FT	34				
10	PVC Pipes Sch.80 - Rigid	ø 3"							
				FT	0				
11	Flex Pipe Round	ø 1/2"		D00	,				
				PCS	6				
					1				

PIPE FITTINGS 01								
#	Item	Туре	Description, Manufacturer, SKU	Unit	Quantity	Unit Price	Total	
1	ABS 90 Degree Bend Elbow	1 1/2"ø-1 1/2"ø		PCS	2			
2	ABS 90 Degree Bend Elbow	2"ø-2"ø		PCS	2			
3	ABS 90 Degree Bend Elbow	3"ø-3"ø		PCS	1			
4	ABS P-Trap	1 1/2"ø-1 1/2"ø		PCS	2			
5	ABS P-Trap	2"ø-2"ø		PCS	2			
6	ABS Reducer Elbow	2"ø-1 1/2"ø		PCS	1			
7	ABS Reducer Elbow	3"ø-2"ø		PCS	1			
8	ABS TEE Elbow	1 1/2"ø-1 1/2"ø-1 1/2"ø		PCS	1			
9	ABS TEE Elbow	2"ø-2"ø-2"ø		PCS	1			
10	ABS TEE Elbow	3"ø-3"ø-3"ø		PCS	2			
11	ABS Tee Reducer Elbow	3"ø-3"ø-1 1/2"ø		PCS	2			
12	ABS Tee Reducer Elbow	3"ø-3"ø-2"ø		PCS	1			
13	ABS Vent Cap Elbow	1 1/2"ø		PCS	1			
14	ABS Vent Cap Elbow	2"ø		PCS	2			
15	ABS Vent Cap Elbow	3"ø		PCS	1			

	1		PIPE FITTINGS 02				
#	Item	Туре	Description, Manufacturer, SKU	Unit	Quantity	Unit Price	Total
1	PEX 90 Degree Elbow	1/2"ø-1/2"ø		PCS	26		
2	PEX 90 Degree Elbow	3/4"ø-3/4"ø		PCS	3		
3	PEX Tee Elbow	1/2"ø-1/2"ø-1/2"ø		PCS	4		
4	PEX Tee Elbow	3/4"ø-3/4"ø		PCS	7		
5	PEX Transition Elbow	1"ø-3/4"ø		PCS	1		
6	PEX Transition Elbow	3/4"ø-1/2"ø		PCS	7		
7	PVC 90 Degree Bend Elbow	2"ø-2"ø		PCS	24		
8	WASTE DOUBLE TEE	2"ø-2"ø-2"ø		PCS	1		



			APPLIANCES				
#	Item	Туре	Description, Manufacturer, SKU	Unit	Quantity	Unit Price	Total
1	Refrigerator			PCS		1	
2	Range			PCS		1	
3	Washer Front Load	Stackable		PCS		1	
4	Dryer Front Load	Stackable		PCS		1	
5	Dish Washer			PCS		1	
6	Oven			PCS		0	
7	Microwave			PCS		0	
8							
9							
10							
11							
12							
13							
14							
15							
16							



			CASEWORKS 01				
#	Item	Туре	Description, Manufacturer, SKU	Unit	Quantity	Unit Price	Total
1	Kitchen Cabinet			FT	13.85		
2	Laundry Cabinet			FT	2.25		
3	Vanity Cabinet			FT	2.5		
4	Medicine Cabinet			PCS	1		
5	Kitchen countertop			SF	20.53		
6	Laundry Countertop			PCS	0		
7	Bathroom Countertop			SF	0		
8	Island			FT	0		
9	Peninsula			FT	0		
10	Closets			SF	20.98		
11							
12							
13							
14							
15							



			CEILING 01				
#	Item	Туре	Description, Manufacturer, SKU	Unit	Quantity	Unit Price	Total
	STUDIO			SF	247.3		
1	Ceiling Board	Drywall		SF	247		
2	Drywall Fastener	Screw		PCS	433		
3	Vapor Retarder	Polyethylene film		SF	247.3		
4	Vapor Retarder Fastener	Nails with washer heads		PCS	742.0		
	BATHROOM			SF	43.9		
5	Ceiling Board	MRD (Moisture resistant drywall)		SF	44		
6	MRD Fastener	Screw		PCS	77		
	HALL + WD			SF	41.8		
7	Ceiling Board	Drywall		SF	42		
8	Drywall Fastener	Screw		PCS	73		
9	Vapor Retarder	Polyethylene film		SF	41.8		
10	Vapor Retarder Fastener	Nails with washer heads		PCS	125.4		
	PORCH			SF	64.9		
11	Ceiling Board	Marine Plywood		SF	65		
12	Exterior Grade Plywood	Screw		PCS	114		



			CEILING 02				
#	Item	Туре	Description, Manufacturer, SKU	Unit	Quantity	Unit Price	Total
	CLOSET			SF	7.8		
13	Ceiling Board	Drywall		SF	8		
14	Drywall Fastener	Screw		PCS	14		
15	Vapor Retarder	Polyethylene film		SF	7.8		
16	Vapor Retarder Fastener	Nails with washer heads		PCS	23.4		
	WH			SF	11.7		
17	Ceiling Board	Drywall		SF	12		
18	Drywall Fastener	Screw		PCS	20		
19	Vapor Retarder	Polyethylene film		SF	11.7		
20	Vapor Retarder Fastener	Nails with washer heads		PCS	35.0		



			FLOORING INTERIOR 01				
#	Item	Туре	Description, Manufacturer, SKU	Unit	Quantity	Unit Price	Total
	CL #1						
1	Closet Flooring			SF	7.64		
2	Wood underlay	Foam Pad Polyethylene		SF	7.64		
3	Vapor Retarder	Vapor Barrier Polyethylene		SF	7.64		
	LIVING ROOM AND KITCH	EN					
4	Living Area Flooring			SF	272.66		
5	Wood underlay	Foam Pad Polyethylene		SF	272.66		
6	Vapor Retarder	Vapor Barrier Polyethylene		SF	272.66		
	BATHROOM 1						
7	Tile Finish			SF	28.51		
8	Adhesive	1/2" Thin set Mortar		SF	28.51		
9	Vapor Retarder	Vapor Barrier Polyethylene		SF	28.51		



			FLOORING INTERIOR 02				
#	Item	Туре	Description, Manufacturer, SKU	Unit	Quantity	Unit Price	Total
	W/D						
10	Tile Finish			SF	8.18		
11	Adhesive	1/2" Thin set Mortar		SF	8.18		
12	Vapor Retarder	Vapor Barrier Polyethylene		SF	8.18		
	BOILER ROOM						
13	Tile Finish			SF	11.34		
14	Adhesive	1/2" Thin set Mortar		SF	11.34		
15	Vapor Retarder	Vapor Barrier Polyethylene		SF	11.34		



			FLOORING EXTERIOR			
#	Item	Туре	Description, Manufacturer, SKU	Unit	Quantity	Unit Price
	STRUCTURE			SF	459.95	
1	Concrete Slab	4"concrete cast in situ		CF	153.32	
2	Insulation	Rigid insulation		SF	176.31	
3	Hard core	Compacted soil		CF	111.34	
4	Re-bar	#4 re-bar		Ton	0.48	
5	Concrete Pad	4"concrete cast in situ		CF	1.58	
6	Slab edge	Turndown		CF	143.46	
	PORCH FRONT					
1	Tile Finish			SF	71.33	
2	Adhesive	1/2" Thin set Mortar		SF	71.33	
3	Vapor Retarder	Vapor Barrier Polyethylene		SF	71.33	



			WALLS: EXTERIOR				
#	Item	Туре	Description, Manufacturer, SKU	Unit	Quantity	Unit Price	Total
1	Stocco Finish			SF	868		
2	Wall Homewrap			SF	868		
3	Homewrap Fastener	Stapled fastener (200/pkt)		PKT	3.2984		
4	Wall Shteathing (OSB)			SF	868		
5	Shteathing Fastener	Self-drilling screws(100/pkt)		PKT	8.68		
6	Stone Copping			SF	0.00		
7	Wall Paint			SF	868.00		
8	Wall Insulation			SF	1890		



			WALLS: INTERIOR 01				
#	Item	Туре	Description, Manufacturer, SKU	Unit	Quantity	Unit Price	Total
	BATHROOM			SF	42.0		
1	Cementitious Backer Board			SF	215		
2	Kerdi membrane			SF	215		
3	Kerdi membrane Fastener			SF	215		
4	Wall Ceramic Tile			SF	215		
	CLOSET			SF	9.0		
5	Drywall Board			SF	86		
6	Drywall Fastener	Self-drilling screws(100/pkt)		PKT	0.86		
7	Wall Paint			SF	86		
8	Drywall Tape			FT	16.12		
	HALL	·		SF	29.0		
9	Drywall Board			SF	114		
10	Drywall Fastener	Self-drilling screws(100/pkt)		PKT	1.14		
11	Wall Paint			SF	114		
12	Drywall Tape			FT	21.37		



			WALLS: INTERIOR 02				
#	Item	Туре	Description, Manufacturer, SKU	Unit	Quantity	Unit Price	Total
	STUDIO			SF	112.0		
13	Drywall Board			SF	309		
14	Drywall Fastener	Self-drilling screws(100/pkt)		PKT	3.09		
15	Wall Paint			SF	309		
16	Drywall Tape			FT	57.97		
	KITCHEN			SF	55.0		
17	Cementitious Backer Board			SF	20		
18	Drywall Board			SF	128		
19	Drywall Fastener	Self-drilling screws(100/pkt)		PKT	1.28		
20	Kerdi membrane			SF	20		
21	Kerdi membrane Fastener			SF	20		
22	Wall Ceramic Tile			SF	20		
23	Wall Paint			SF	128		
24	Drywall Tape			FT	24.15		



			WALLS: INTERIOR 03				
#	Item	Туре	Description, Manufacturer, SKU	Unit	Quantity	Unit Price	Total
	WD			SF	7.0		
29	Cementitious Backer Board			SF	70		
30	Kerdi membrane			SF	70		
31	Kerdi membrane Fastener			SF	70		
32	Wall Ceramic Tile			SF	70		
	WH			SF	7.0		
33	Drywall Board			SF	88		
34	Drywall Fastener	Self-drilling screws(100/pkt)		PKT	0.88		
35	Wall Paint			SF	88		
36	Drywall Tape			FT	16.6		
1	Wall Cuson						
1	Wall Sweep			FT	88		



			DOORS				
#	Item	Туре	Description, Manufacturer, SKU	Unit	Quantity	Unit Price	Total
1	Interior Swinging	3' - 0" X 6'-8"		PCS	1		
2	Exterior Swinging	3' - 0" X 6'-8"		PCS	1		
3	Bifold	4' - 0" X 6'-8"		PCS	1		
4	Single Fold	3' - 0" X 6'-8"		PCS	1		
5	Exterior Door Trim			FT	16.3		
6	Interior Door Trim			FT	116		
7	Entry Lock set			PCS	1		
8	Privacy Lock set			PCS	1		
9	Passage Lock set			PCS	2		
10							
11							
12							
13							
14							
15							



			WINDOWS				
#	Item	Туре	Description, Manufacturer, SKU	Unit	Quantity	Unit Price	Total
1	Single Hung	3' - 3" X 3'-3"		PCS	4		
2	Awning	5' - 3" X 3'-3"		PCS	1		
3	Awning	3' - 3" X 1'-9"		PCS	1		
4	Exterior Window Trim			FT	80		
5	Interior Window Trim			FT	80		
6							
7							
8							
9							
10							
11							
12							
13							
14							
15							



			ROOF 01				
#	Item	Туре	Description, Manufacturer, SKU	Unit	Quantity	Unit Price	Total
1	Roof Covering			SF	1139.0		
2	Roof Covering Fastener			PCS	570		
3	Roof Felt Paper			SF	1139.0		
4	Roof Felt Paper Fastener			PCS	3417.0		
5	Roof Sheathing			SF	1139.0		
6	Roof Sheathing Fastener			PCS	9112		
7	Batten			FT	278.0		
8	Batten Fastener			PCS	209.0		
9	Soffit			SF	93.0		
10	Soffit Fastener			PCS	46.5		
11	Fascia			FT	97.0		
12	Fascia board fastener			PCS	49		
13	Roof Insulation			SF	1139.0		
14					1.000		
15							