

BENNETT

The Bennett is a charming and efficient twobedroom, two-bathroom Spanish-style home. Its exterior exudes a warm and inviting Mediterranean aesthetic. The walls are finished with a textured stucco in a warm, earthy tone, creating a classic and timeless appearance. A simple gable roof with terracotta tiles provides shelter and complements the overall Spanish design. A notable feature is the arched entryway leading to a covered porch, adding a touch of architectural elegance and creating a welcoming outdoor space.

Inside, the Bennett features a simple rectangular layout designed for comfortable living. The living and kitchen areas are centrally located and seamlessly merged into a single open room, creating a spacious and versatile living space. Two bedrooms are thoughtfully positioned on opposite ends of the house, offering privacy and quiet retreats for each resident. One of the bedrooms includes an en-suite bathroom, providing added convenience and luxury.

Materials Shopping List

Please print and take this Materials Shopping List to your favorite Home Depot and ask for assistance in selecting the materials, fixtures and fittings to complete your new home.

Record your selection and the price of the item. Then do the math to determine the cost for your selections and the total cost of finishing your home.

< CLICK HERE >

To Go To Materials Shopping List



W/D 18 SF


FLOOR PLAN

796 SF

2 Bed Rooms



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STRUCTURAL

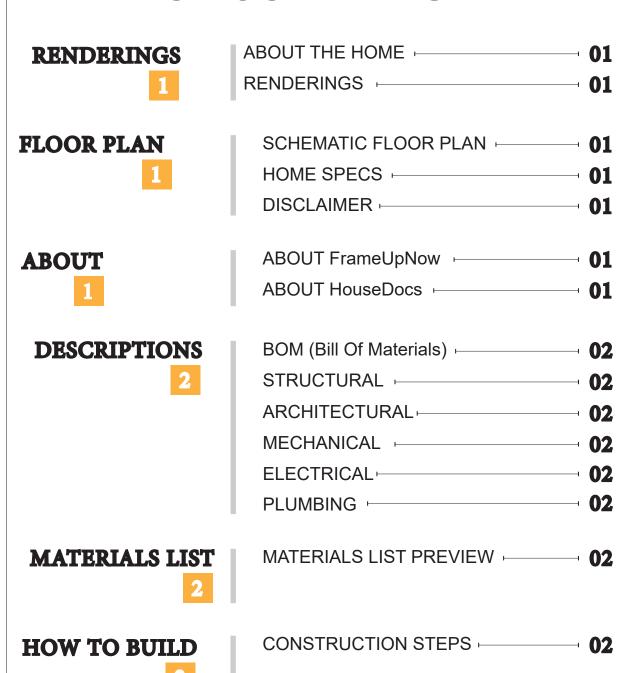MATERIALS

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MATERIALS SHOPPING LIST

ABOUT



FrameUpNow is a design and manufacturing company providing precision-engineered home framing solutions. We offer a catalog of Affordable Homes, Tiny Homes, Garages, Shops and Barndominiums. FrameUpNow manufactures cold-formed steel (CFS) also known as Light Gauge Steel (LGS) framing components that conform to our engineered metal house frame plans or can be purchased as DIY skeleton kits.

The CFS/LGS framing is lightweight, easily assembled, and does not require heavy equipment or specialized labor, enabling homeowners to erect the frame themselves in just a few days. Unlike wood, the steel framing is impervious termites and bores, warping, expansion, and fire.

Our home plans come complete with a structural engineered stamp for permit approvals. Customers receive a full BOM also known as a Materials Shopping List to purchase finish materials from a Building Materials retailer. FrameUpNow prides itself on the quality and efficiency of our precision-engineered home framing solutions for construction professionals and DIY homeowners.

DISCLAIMER

marketing content.

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KEY PLAN

NO.	DESCRIPTION	DATE
		*

NOTE:

LEGEND:

PROJECT

109-Bennett-796-2Bd2Ba-Spanish-550

DRAWING NAME

INTRODUCTION

CLIENT NAME:
PROJECT NUMBER:
DATE:
DESIGNED BY:
DRAWN BY:
CHECKED BY:

I101

DESCRIPTIONS

MATERIALS LIST

The BOM (Bill Of Materials) package, known as the Materials Shopping List document, provides:

Comprehensive Inventory: Detailed lists of essential materials sourced from architectural, mechanical, HVAC, electrical, and plumbing design drawing sets.

Precise Curation: Each item meticulously selected and organized for accuracy and efficiency in project planning.

Customizable Options: Customers can modify listed items to their preferences and calculate costs accordingly, ensuring alignment with personal project needs and budget.

Dedicated Space for Details: Includes tables for customers to note Home Depot SKU numbers or product descriptions for selected items, facilitating seamless purchasing and coordination with suppliers.

Customer Convenience: Take the list to Home Depot or preferred suppliers for accurate pricing, helping align the total home budget with personal financial plans.

Simplify your construction journey with our Materials Shopping List document, where detailed preparation meets streamlined implementation for your dream home.

Detailed HVAC Floor Plan: Precisely maps out the placement of air

HVAC Sections and Riser Diagrams: Technical drawings offering

critical cross-sectional details and piping schematics, ensuring

proper integration of the heating and cooling system into the home's

Bill of Materials: A complete list of all necessary HVAC components.

handlers, ductwork, and vents throughout the home's layout.

MECHANICAL

STRUCTURAL

The structural drawings package provides an exhaustive set of detailed plans essential for the precise assembly of your building. This comprehensive package includes:

Framing Plans: Detailed layouts for all framing components. Truss Layouts: Clear instructions for truss placement and

Panel Length Plans: Specifications for panel dimensions. Framing Elevations and Sections: Precise elevation and sectional views for accurate construction.

Truss and Wall Blocking Plans: Plans for truss and wall blocking to ensure structural integrity.

Hold-Down Plan: Detailed hold-down requirements for stability. Snap Sheet: Reference sheet for quick identification of components

Structural Details and Bracing Plans: Complete details and bracing plans for all structural elements.

Accompanying these plans is a comprehensive Bill of Materials (BOM) that lists every necessary building component, from cold formed steel (CFS) frames to fasteners.

ARCHITECTURAL

With the comprehensive architectural package, both builders and DIY homeowners can confidently execute the construction.

The architectural package includes:

Furnished Floor Plans: Complete with furniture layouts for a clear understanding of space utilization.

Detailed Dimension Plans: Ensures precise measurements, from the overall footprint down to the exact placement of windows and

Foundation Plan: Detailed plan to establish a solid foundation.

Wall Framing and Truss Layout: Comprehensive plans for wall framing and truss placement.

Architectural Elevations: Exterior views showcasing the design.

Strategic Building Sections: Critical cross-sectional details for a thorough understanding of the build.

Casework Drawings and Diagrams: Suggested designs for built-in caseworks, such as kitchen cabinets.

ELECTRICAL

The mechanical package includes everything needed to guide HVAC The electrical package includes all the plans and documentation needed to guide the installation of your home's electrical system:

> Detailed Power Plan: Precisely maps out the placement of outlets, switches, and other power components throughout the layout.

Comprehensive Lighting Plan: Shows the optimal locations for lighting fixtures, sconces, and other illumination sources to create a well-lit, functional interior.

Dimensioned Electrical Layout: Provides exact dimensions and measurements to ensure proper placement of all electrical elements.

Bill of Materials: A complete list of every component needed, from circuit breakers to wiring.

The plumbing package includes everything needed to guide the installation of your home's water supply and drainage systems:

Detailed Water Supply System Plan: Precisely maps out the placement of pipes, valves, and plumbing fixtures throughout the

Comprehensive Sewage System Plan: Shows the optimal routing and sizing of drain lines to effectively remove waste and ensure

Detailed Riser Diagrams: Provide information needed to properly

Bill of Materials: A complete list of every component needed, from


PLUMBING

proper drainage.

install all vertical plumbing risers and vent stacks.

pipes to fixtures.

BOM (Bill Of Materials) (Separately Attached)

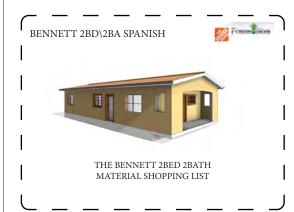



structure.


The Bill of Materials (BOM) is a crucial document that compiles the material requirements from different disciplines into a centralized inventory, enabling efficient procurement, inventory management, and cost estimation for a specified project or

ELECTRICAL BOM



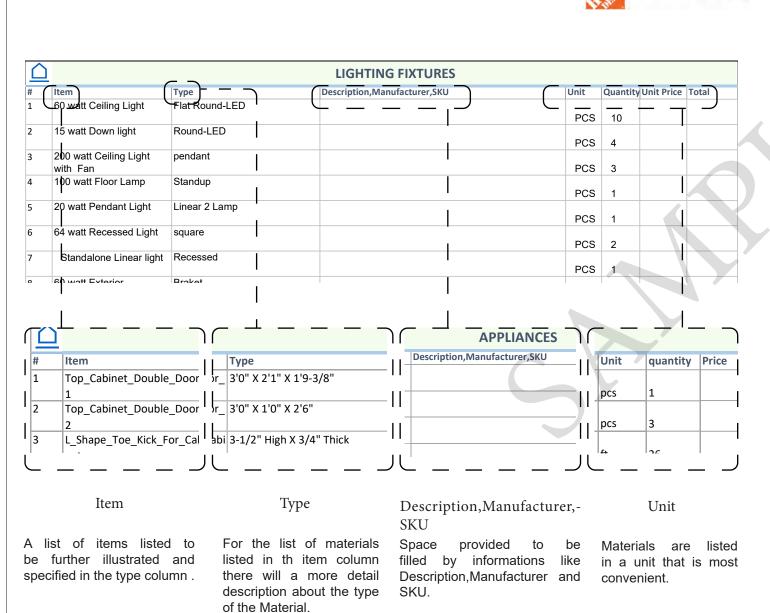

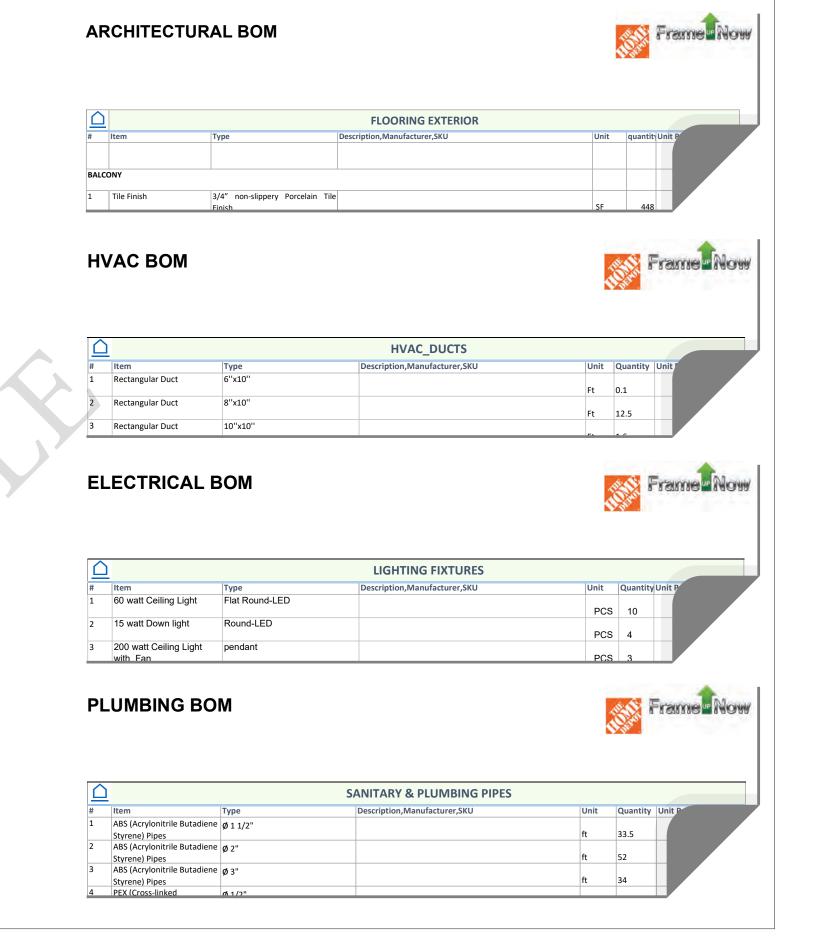

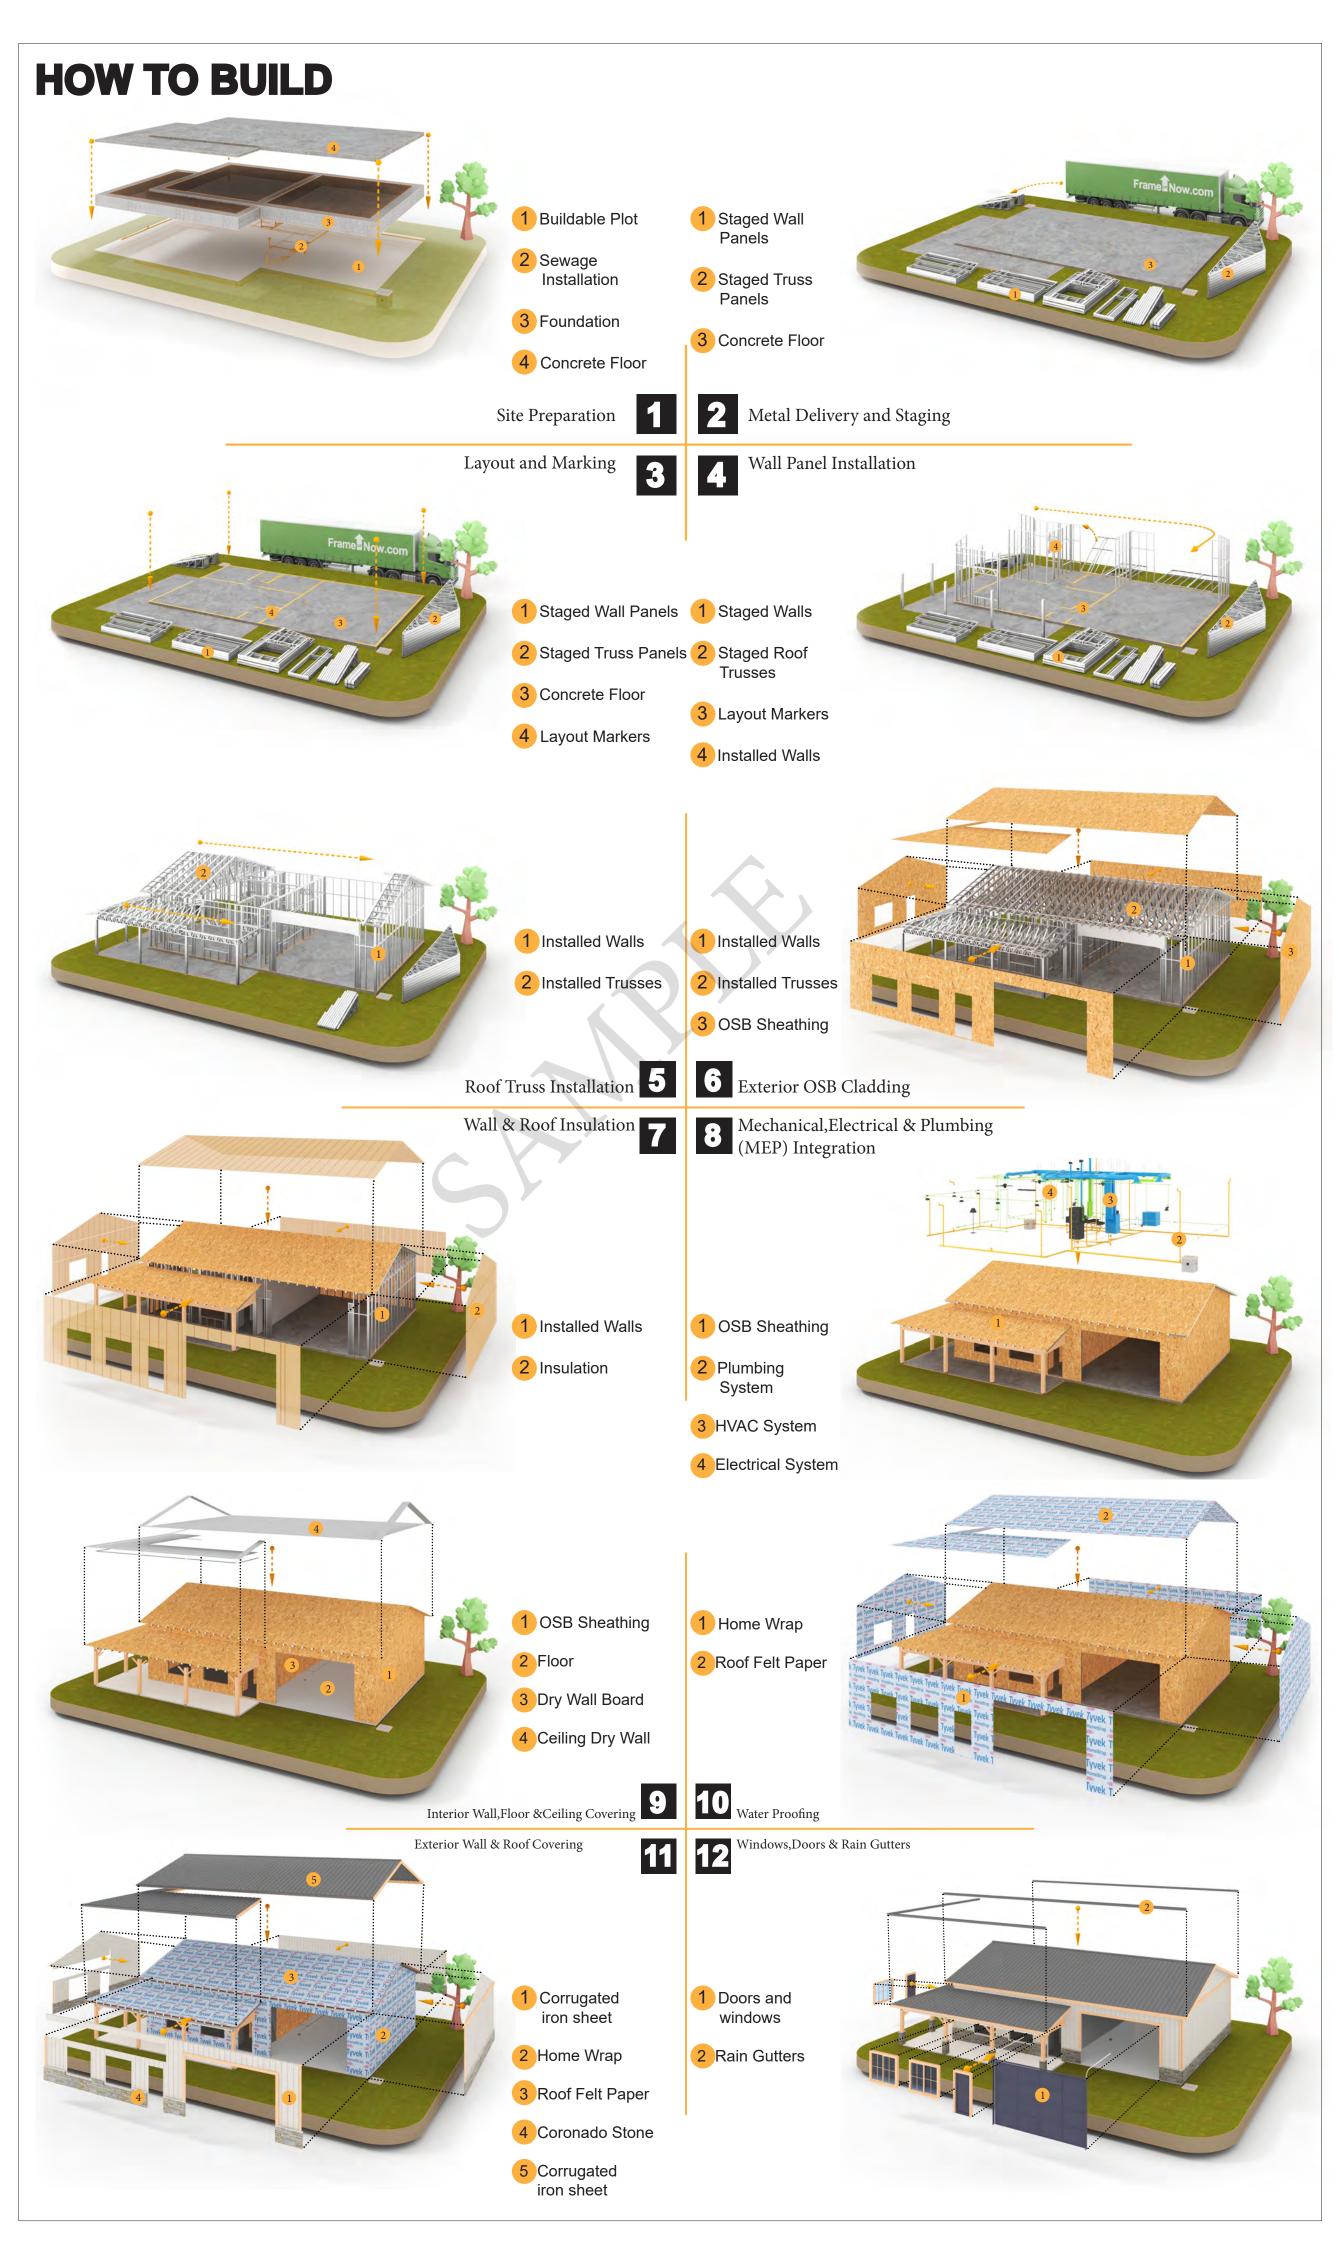



KEY PLAN

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NOTE:

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109-Bennett-796-2Bd2Ba-Spanish-550


DRAWING NAME

INTRODUCTION

CLIENT NAME: PROJECT NUMBER: DATE: **DESIGNED BY** DRAWN BY: CHECKED BY:

1102

SCALE:

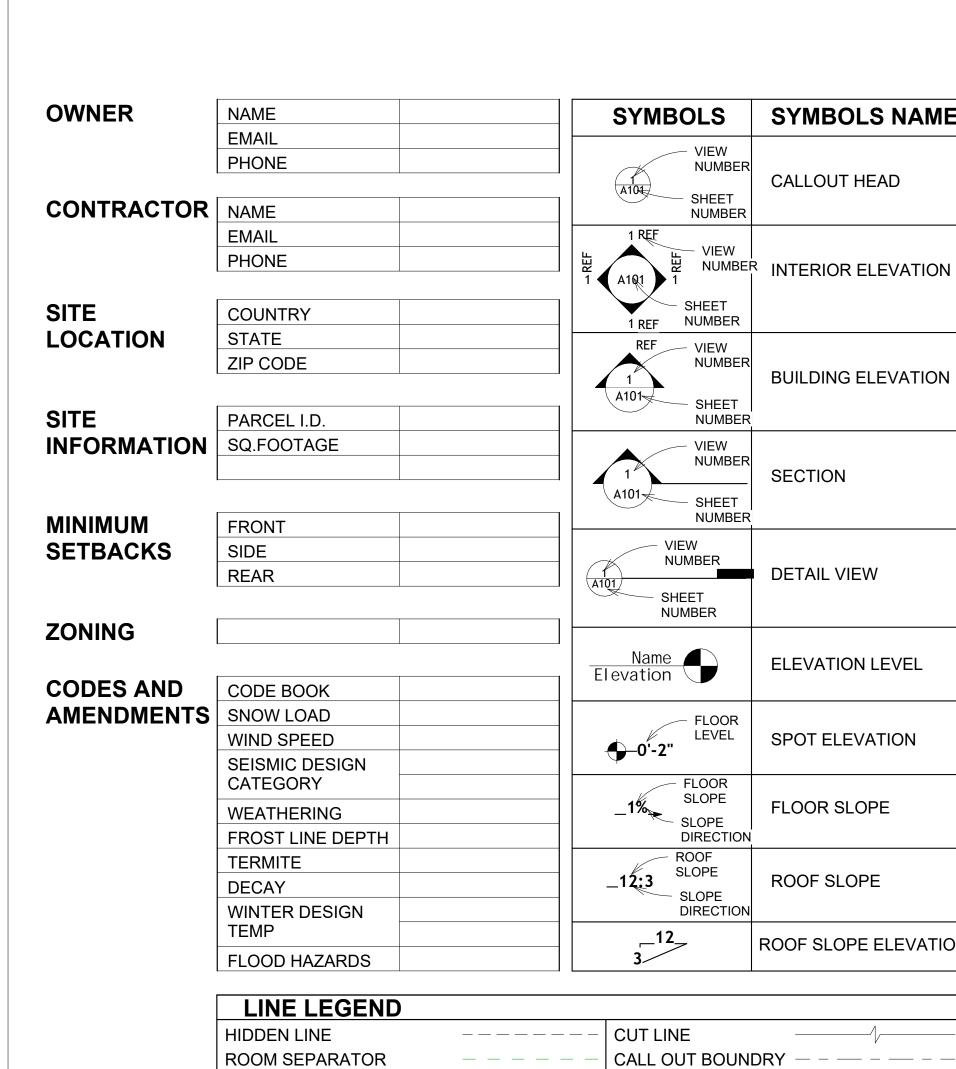

DOOR OPENING DIRECTION

OVER HEAD

		1		
BOLS	SYMBOLS NAME		PAGE INDEX	
— VIEW		G101	COVER SHEET	AFS
NUMBER	NUMBER		FLOOR PLAN	ASTM D
— SHEET	CALLOUT HEAD	A102	DIMENSION PLAN	
NUMBER		S101	FOUNDATION PLAN	CA
\/IE\//		S102	STRUCTURAL FLOOR PLAN	EL
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- SHEET NUMBER		A103	ROOF PLAN	FTG
- VIEW		A201	ELEVATIONS	HVAC
NUMBER		A202	ELEVATIONS	11177.0
	BUILDING ELEVATION	A301	SECTIONS	IRC
SHEET NUMBER		A401	DETAILS	
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VIEW NUMBER		A403	CASEWORK DETAILS	livic
	SECTION	E101	SCHEDULE	MAX.
SHEET NUMBER		E102	LIGHTING PLAN	ME
		E103	POWER PLAN	MIN.
/IEW IUMBER		E104	DIMENSION PLAN FOR LIGHT FIXTURE	NO.
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HEET UMBER		P101	COVER SHEET	OSB
		P102	WATER SUPPLY SYSTEM	PL
	ELEVATION LEVEL	P103	SEWAGE SYSTEM	PSI
	ELEVATION LEVEL	P104	RISER DIAGRAM	PVC
		M101	HVAC PLAN	REF
FLOOR LEVEL	FLOOR		HVAC SECTION	
'	SPOT ELEVATION	M103	RISER DIAGRAM	RG SE
- FLOOR				SF
SLOPE	FLOOR SLOPE			SIMP. S
SLOPE	5 5 5 _ 5		T	Slivir. S

TAG	TAG'S NAME
CA01	CASEWORK TAG
1	DOOR TAG
<u>(1)</u>	FURNITURE TAG
<u>(1)</u>	WINDOW TAG
SE01	SPECIALTY EQUIPMENT TAG
ME01	MECHANICAL EQUIPMENT TAG
PE01	PLUMBING EQUIPMENT TAG



SHEET NUMBER

NUMBER

NUMBER

FLOOR SLOPE

ROOF SLOPE

GROUND CUT

SLOPE DIRECTION

SHEET

ROOF SLOPE

ROOF SLOPE ELEVATION

ООБ	ONILIVILD STRAIND BOARD
PL	PLUMBING
PSI	POUNDS PER SQUARE INCH
PVC	POLYVINYL CHLORIDE
REF	REFERENCE
RG	RIGHT GARAGE
SE	SPECIAL EQUIPMENT
SF	SQUARE FEET
SIMP. STHD8	SIMPSON STRAP THE HOLDDOWN
SIMP. ABE66	SIMPSON ANCHOR BOLT EDGE
TV	TELEVISION
UNO	UNLESS NOTED OTHERWISE
W/	WITH
W/D	WASHER/DRYER
AC	AIR CONDITIONING UNIT
ACC	AIR COOLED CONDENSER
ACCU	AIR COOLED CONDSENSING
AHU	ANTHANDLING UNIT
CC	COOLING COIL
CD	CEILING DIFFUSER
CFm	Cubic Feet Per Minute
CR	CEILING REGISTER
CU	CONDENSING UNIT
CW	COLD WATER
E/A	EXHAUST AIR
EF	EXHAUST FAN
ET	EXPANSION TANK
EX.	EXISTING
FC	FLEXIBLE CONNECTION
FCU	FAN COIL UNIT
FLR.	FLOOR
HC	HEATING COIL
_	
HE LIV	AIR TO AIR HEAT EXCHANGER
HV	HEATING AND VENTILATING UNIT
IV	INLET VANES
MER	MECHANICAL ROOM
MAX.	MAXIMUM
MIN.	MINIMUM
R/A	RETURN AIR
RCU	RECIPROCATING CHILLER UNIT
RF	RETURN FAN
S/A	SUPPLY AIR
SCD	SMOKE CONTROL DAMPER
000	

ABBREVIATION

CASEWORK ELECTRICAL

FOOTINGS

MAXIMUM

MINIMUM

NUMBER

ON CENTER

MECHANICAL

ACTION FLOOR SYSTEMS

AMERICAN SOCIETY FOR

TESTING AND MATERIAL

FINISHED FLOOR LEVEL


FINISHED FLOOR ELEVATION

HEATING, VENTILATION & AIR CONDITIONING

INTERNATIONAL RESIDENCE

INTERNATIONAL MECHANICAL


ORIENTED STRAND BOARD

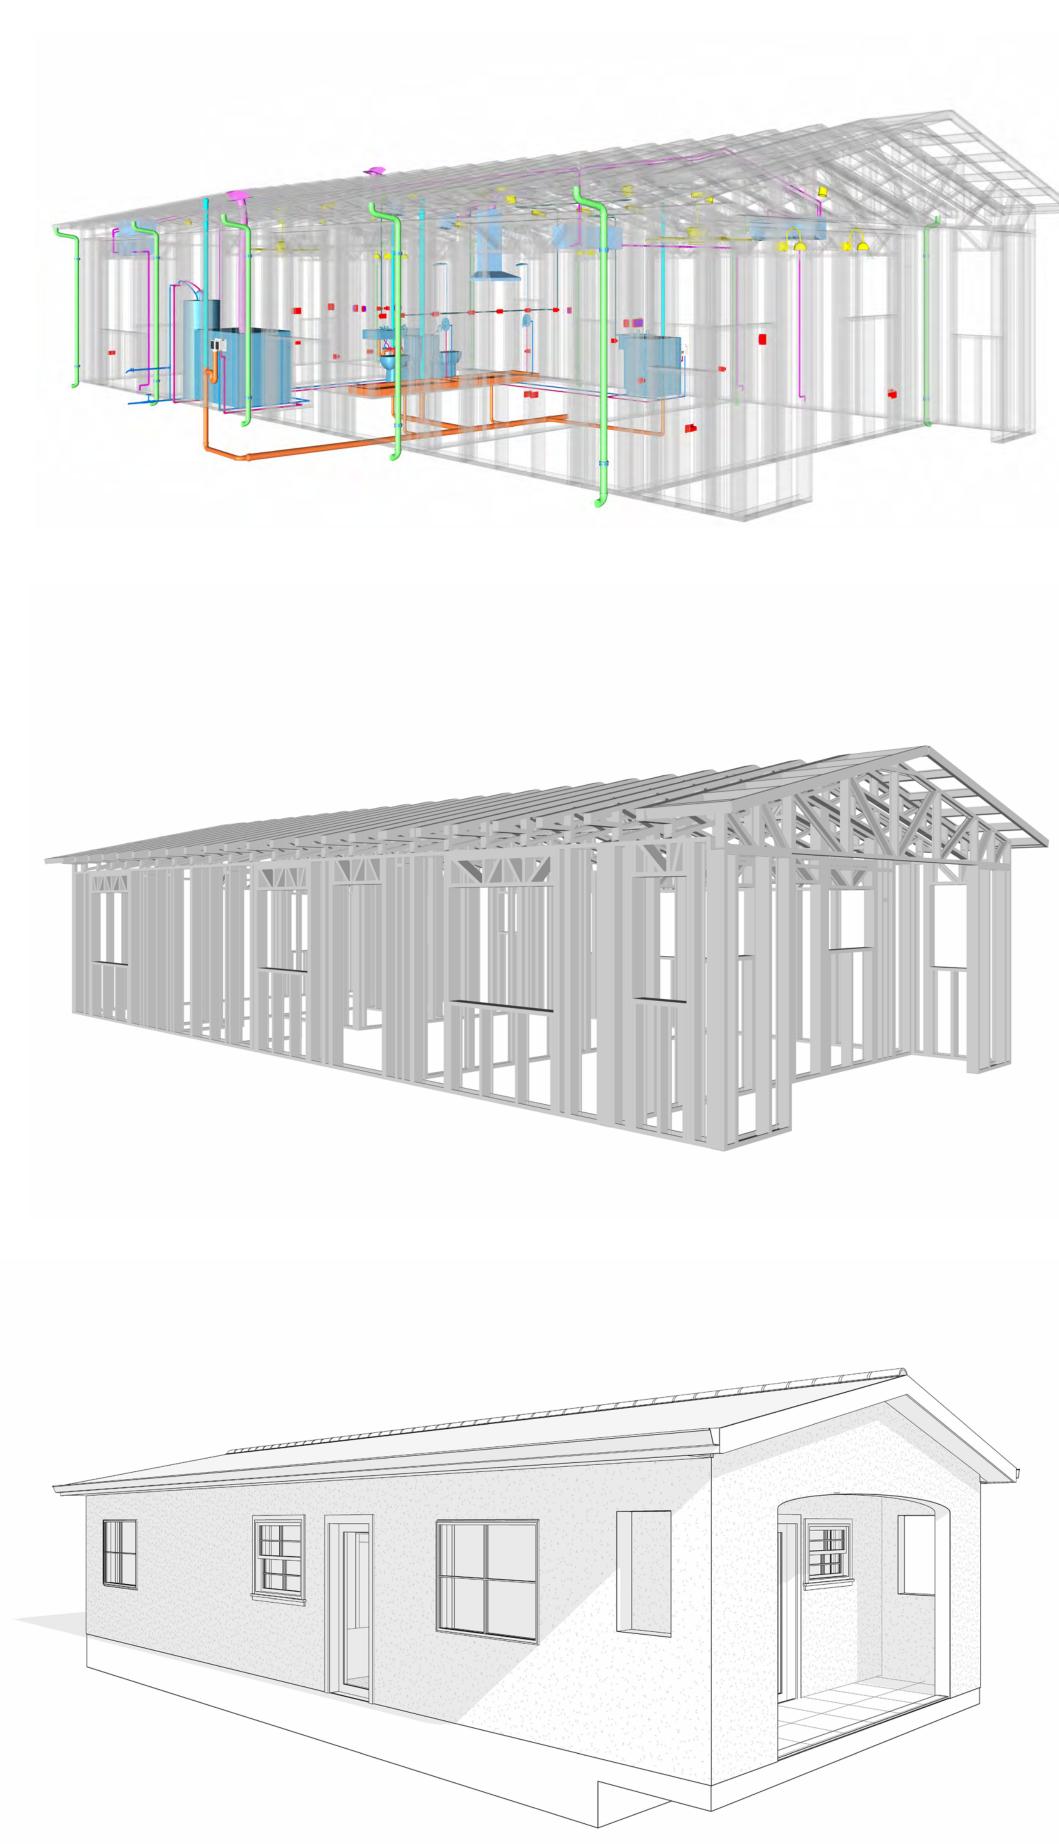

109 BENNETT 796 2Bd2Ba SPANISH 550

SQUARE FOOT	AGE
LIVIN G	789
PORCH	74
TOTAL	863



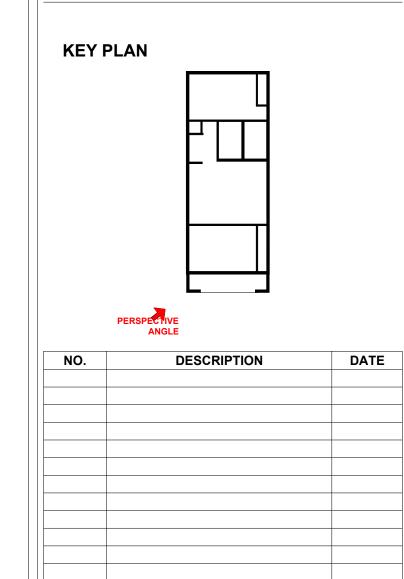

NOTE:

LEGEND:

PROJECT

109 BENNETT 796 2Bd2Ba **SPANISH 550**

DRAWING NAME

COVER SHEET

CLIENT NAME:	Client Name
PROJECT NUMBER:	0061_12
DATE:	3/10/2025 11:52:08 AM
DESIGNED BY:	Designer
DRAWN BY:	Author
CHECKED BY:	Checker

G101

GENERAL NOTES

- 1. THIS DRAWING DEPICTS THE ARCHITECTURAL (SPACE LAYOUT, FURNISHING, FLOOR, WALLS, ROOFS, FOUNDATION, WINDOWS AND DOORS) SYSTEMS. IT PROVIDES A VISUAL REPRESENTATION OF THE ARCHITECTURAL LAYOUT AND COMPONENTS.
- THE ARCHITECTURAL DRAWINGS ARE PREPARED TO MEET THE SPECIFIC REQUIREMENTS OF THE BUILDING, AS PER THE PROJECT SPECIFICATIONS AND APPLICABLE CODES AND STANDARDS.
- 3. THE CONSTRUCTION OF THIS HOME SHALL COMPLY WITH THE LATEST EDITION OF THE INTERNATIONAL RESIDENTIAL CODE (IRC), INTERNATIONAL MECHANICAL CODE (IMC), THE INTERNATIONAL PLUMBING STANDARD, THE NATIONAL ELECTRICAL STANDARD AND ALL OTHER APPLICABLE LOCAL, STATE, AND NATIONAL CODES AND REGULATIONS.
- I. COORDINATION WITH OTHER TRADES HAS BEEN DONE ON A DESIGN LEVEL. THIS DRAWING SHALL BE READ TOGETHER WITH THE ME, EL AND PL DESIGN DRAWINGS TO ENSURE PROPER CONSTRUCTION AND INTEGRATION OF THE BUILDING SYSTEMS.

ABOUT WALLS:

- 1. SHOWER WALL COVERING
- BATHTUB AND SHOWER SPACES (WALLS AND FLOORS) WITH INSTALLED SHOWER HEADS AND IN SHOWER COMPARTMENTS SHALL BE FINISHED WITH A NON-ABSORBENT SURFACE.
- 2. WALL PAINT (INTERNAL)
 - THE TYPICAL THICKNESS OF LATEX WALL PAINT IS 1/32 OF AN INCH FOR A SINGLE COAT. AND DOUBLE COAT (1/16") SHALL BE APPLIED FOR DURABILITY.
- 3. ADHESIVES:

THE ADVISABLE TYPE OF ADHESIVE FOR THIS PROJECT IS **EPOXY ADHESIVES**BECAUSE THEY ARE KNOWN FOR THEIR HIGH STRENGTH, DURABILITY, AND
RESISTANCE TO MOISTURE, CHEMICALS AND HEAT


REFER TO SHEETS A201 & A202 FOR GENERAL NOTES ON EXTERNAL FINISHING MATERIALS

ABOUT FLOORS:

- 1. THE SPOT ELEVATION INDICATES THE FINISHED FLOOR ELEVATION.
- 2. FINISHED FLOORS PER PLANS.
- 3. FIELD VERIFY FOR DIMENSION DROP 4" FOR SHOWER AND BATHTUB USE.
- 4. 1% SLOPE ON OUTDOOR BALCONIES FOR WATER RUN OFF.
- 5. 2% SLOPE TOWARDS THE SHOWER DRAIN FOR SUFFICIENT DRAINAGE.
- 2% SLOPE TOWARDS THE SHOWER DRAIN FOR SUFFICIENT DRAINAGE.
 4" DROP AT THE DOOR LEADING TO EXTERIOR BALCONY FROM THE MAIN LIVING AREA.
- 7. 5% SLOPE FOR GARAGE IS USED, WHICH SHOULD BE CHECKED WITH THE LOCAL GARAGING
- ZONING LAWS.

	FURNITURE SCHEDULE				
	TYPE MARK	TYPE		COUNT	
01		KING SIZE BED	2		
02		THREE SEAT SOFA	1		
03		DINING CHAIR	2		
04		COFFE TABLE	1		
05		ONE SEAT SOFA	1		

	ROOM FINISH SCHEDULE							
ROOM NUMBE R	ROOM NAME	FLOOR FINISH	BASE FINISH	WALL FINISH	CEILING FINISH	CEILING HEIGHT	COM MEN TS	
		1====		T				
01	BEDROOM 2	HARDWOOD	CONCRETE	WALL PAINT	DRY WALL	8' - 0"		
02	CL2	HARDWOOD	CONCRETE	WALL PAINT	DRY WALL	8' - 0"		
03	BEDROOM 1	HARDWOOD	CONCRETE	WALL PAINT	DRY WALL	8' - 0"		
04	BATH 2	VINYL TILES	CONCRETE	CERAMIC TILE	MRD	8' - 0"		
05	CL1	HARDWOOD	CONCRETE	WALL PAINT	DRY WALL	8' - 0"		
06	BATH 1	VINYL TILES	CONCRETE	CERAMIC TILE	MRD	8' - 0"		
07	KITCHEN	HARDWOOD	CONCRETE	WALL PAINT + CERAMIC	DRY WALL	8' - 0"		
08	LIVING	HARDWOOD	CONCRETE	WALL PAINT	DRY WALL	8' - 0"		
09	HALL	HARDWOOD	CONCRETE	WALL PAINT	DRY WALL	8' - 0"		
10	W/D	VINYL TILES	CONCRETE	CERAMIC TILE	DRY WALL	8' - 0"		
11	WH	VINYL TILES	CONCRETE	WALL PAINT	DRY WALL	8' - 0"		
12	PORCH	PROCELAIN TILE	CONCRETE	STUCCO FINISH	PLYWOOD	8' - 0"		

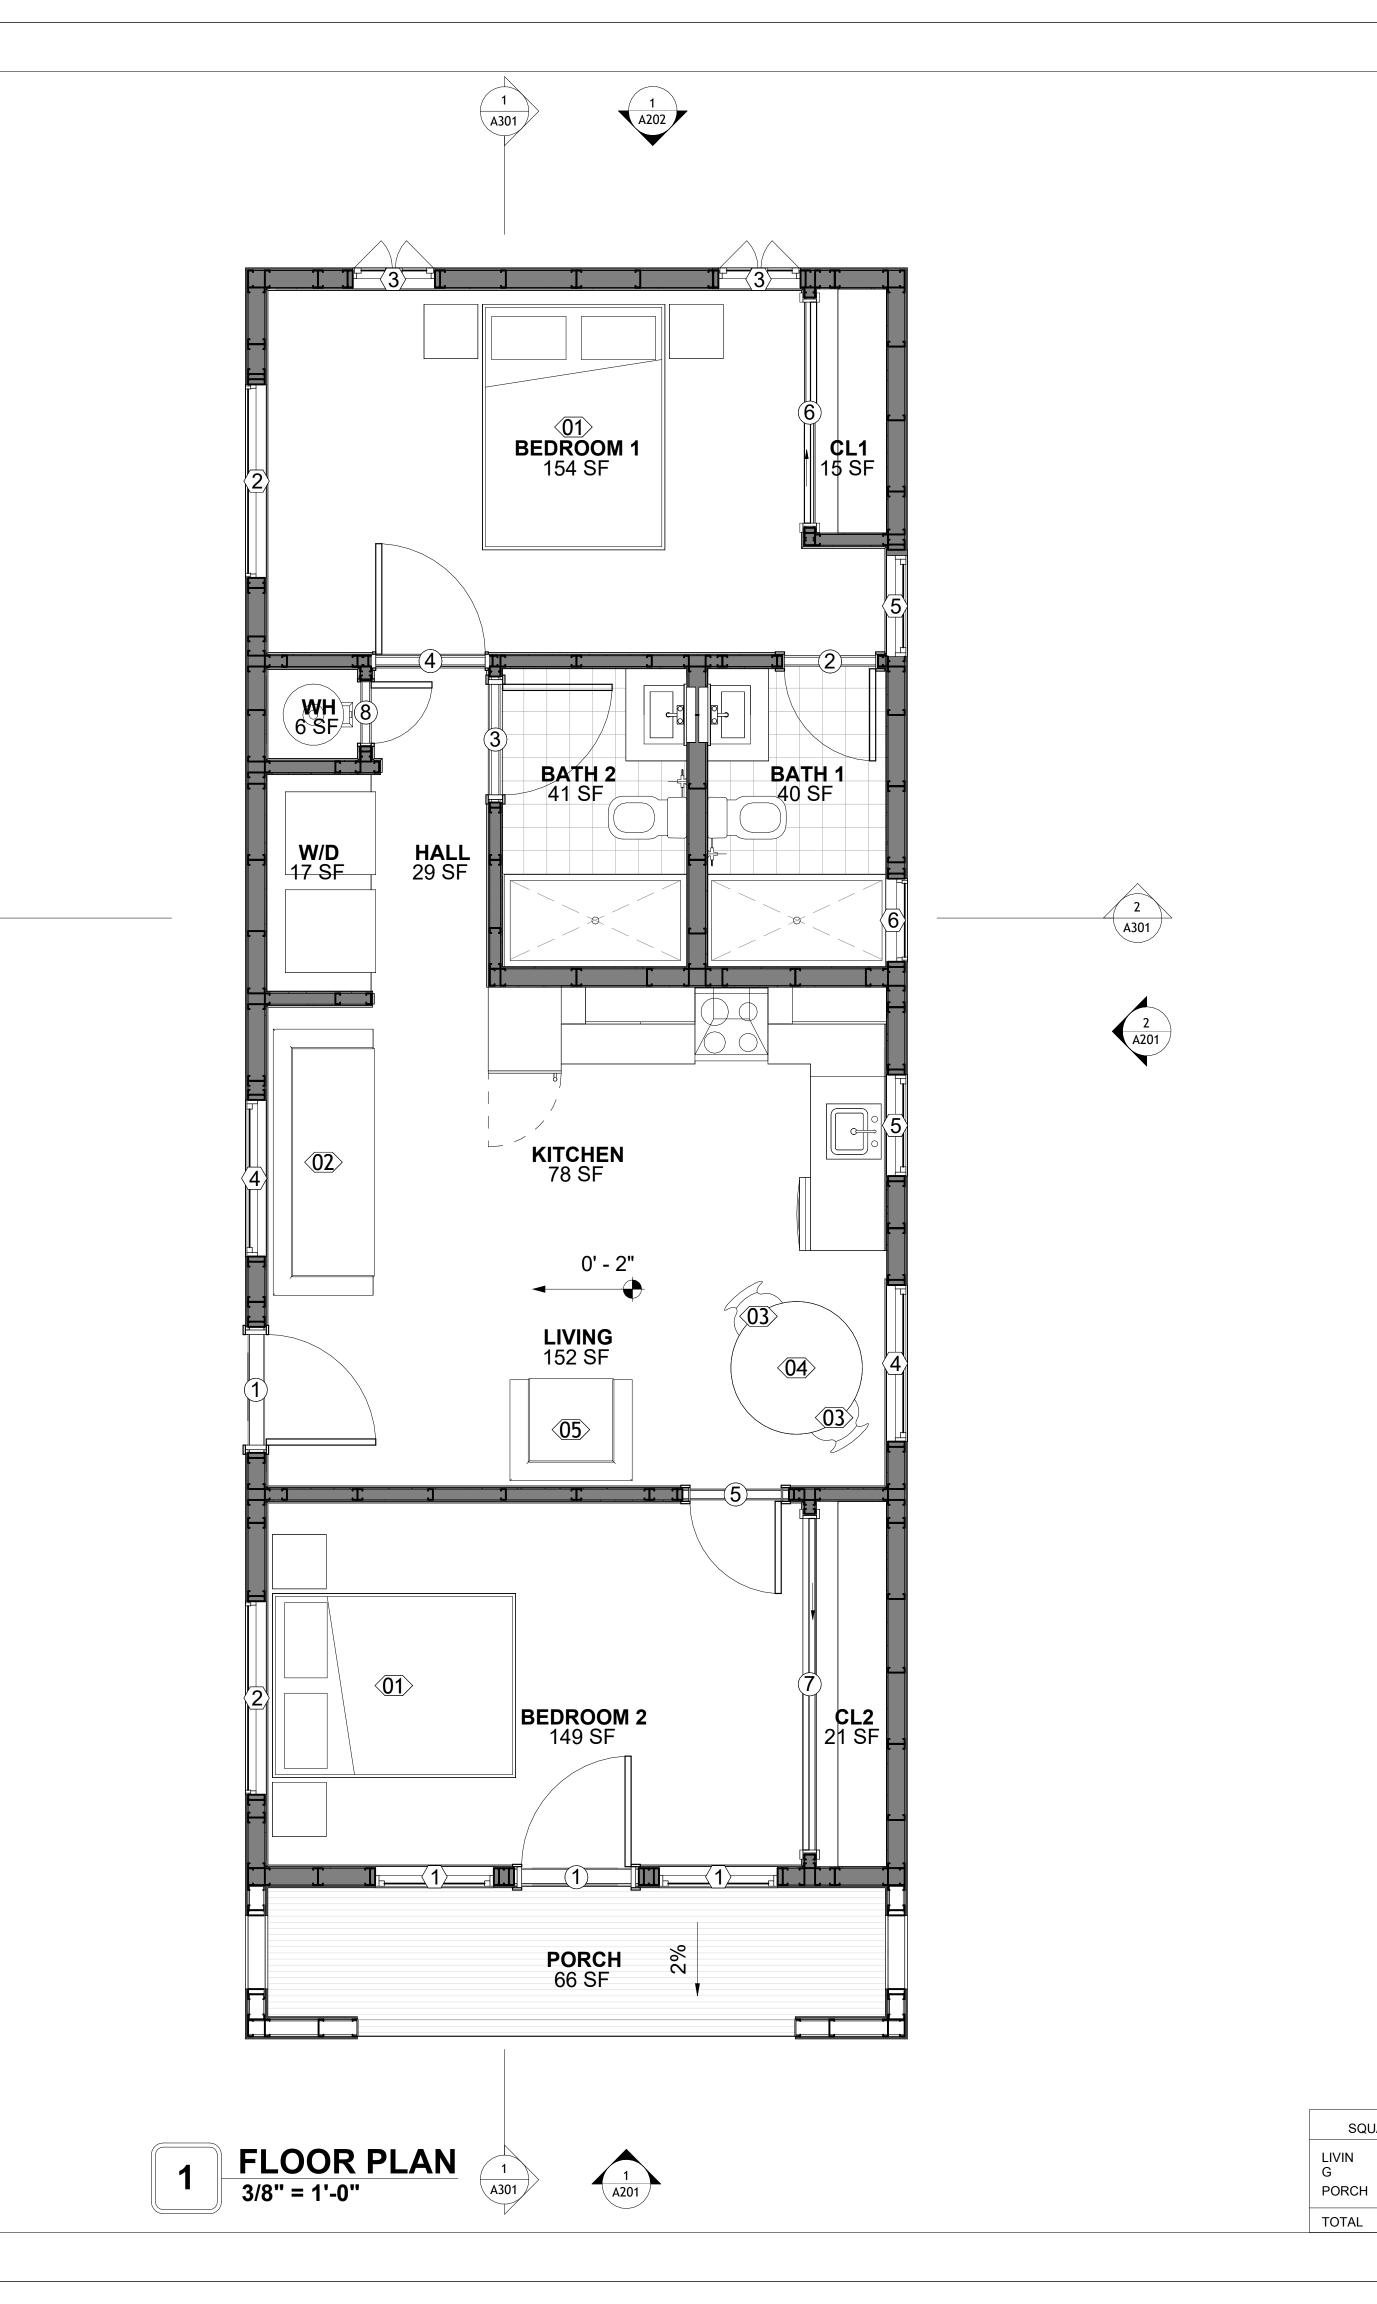



KEY PLAN

NO. DESCRIPTION DATE

NOTE:

LEGEND:

PROJECT

109 BENNETT 796 2Bd2Ba SPANISH 550

DRAWING NAME

FLOOR PLAN

CLIENT NAME:

PROJECT NUMBER:

0061_12

DATE:

3/10/2025 11:52:10 AM

DESIGNED BY:

DRAWN BY:

CHECKED BY:

Checker

A101

SCALE: As indicated


SQUARE FOOTAGE

789

74

863

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KEY PLAN

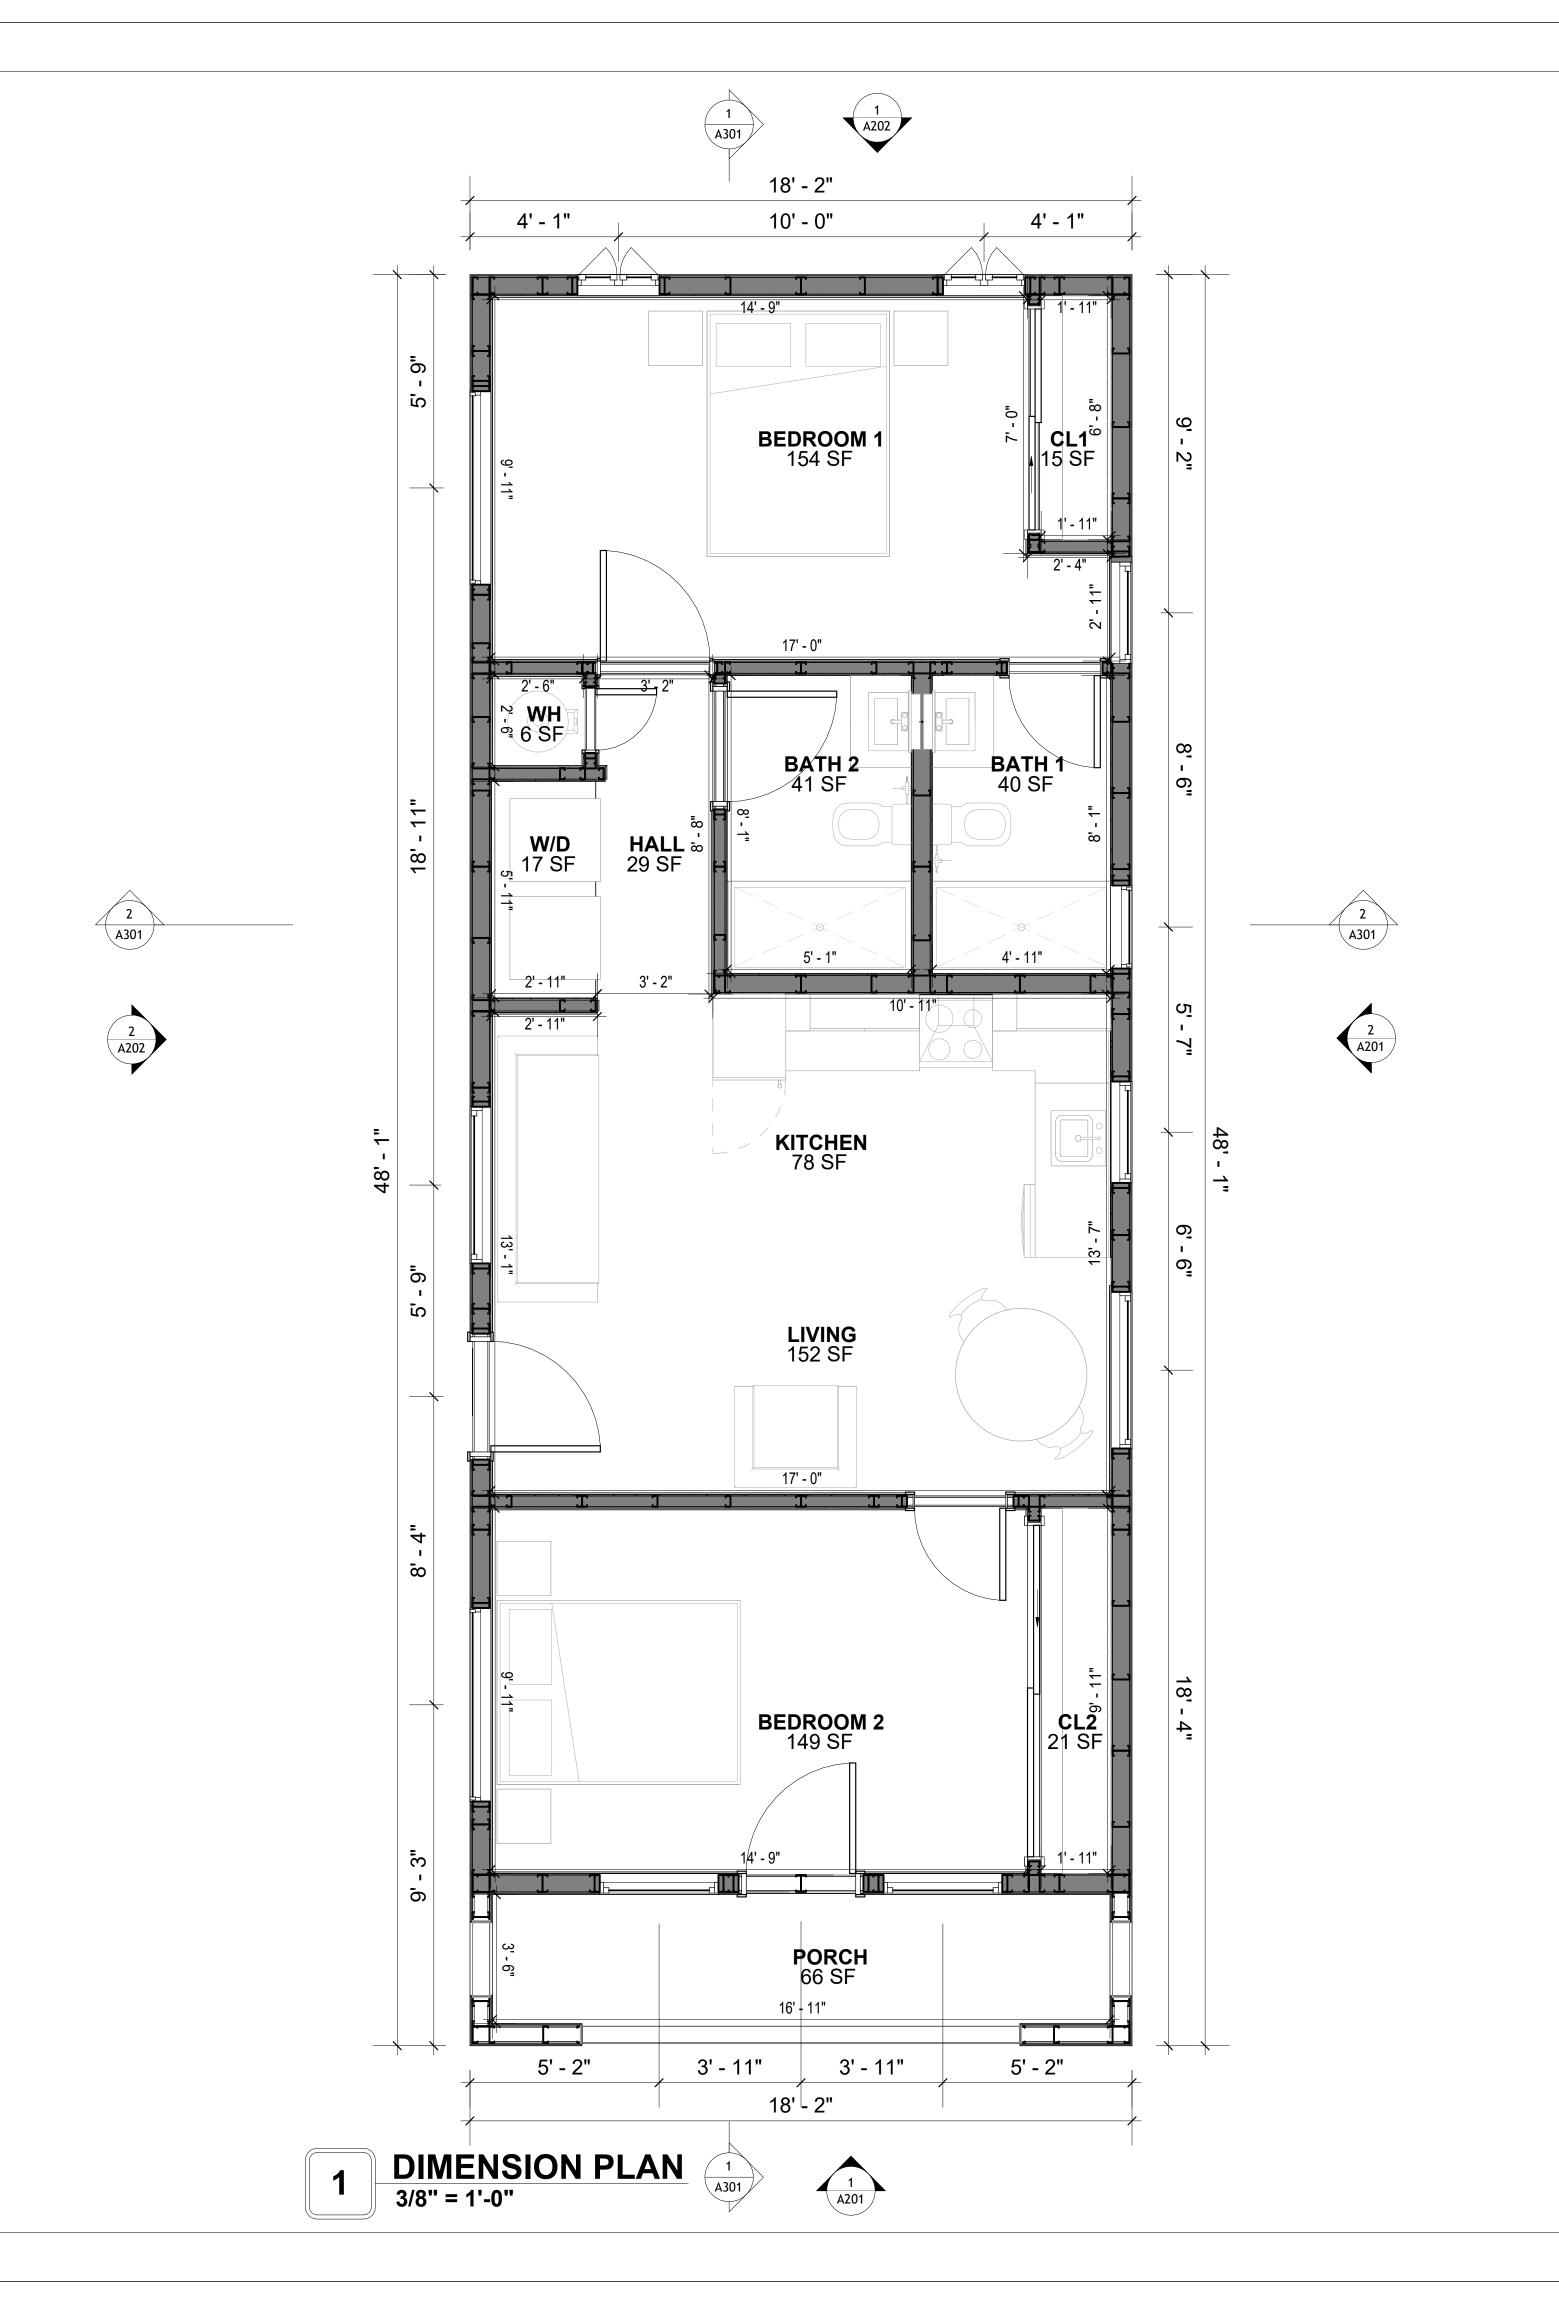NO.	DESCRIPTION	DATE

NOTE:

LEGEND:

PROJECT

109 BENNETT 796 2Bd2Ba SPANISH 550

DRAWING NAME

DIMENSION PLAN

ENT NAME:	Client Name
DJECT NUMBER:	0061_12
TE:	3/10/2025 11:52:11 AM
SIGNED BY:	Designer
AWN BY:	Author
ECKED BY:	Checker

A102

SCALE: 3/8" = 1'-0"

SQUARE FOOTAGE

PORCH

TOTAL

789

863

DIMENSIONS IN THE ARCHITECTURAL DRAWINGS CONSIDER FINISHING MATERIALS. FOR PRECISE MEASUREMENTS OF THE STRUCTUAL FRAMING, REFER TO THE ATTACHED STRUCTURAL PLAN SET.

FOUNDATION NOTES

NOTES:

TERMITES PRETREATMENT BY LICENSED CONTRACTOR UNDER SLAB AND AROUND FOOTINGS. ALL AREAS BELOW SLABS SHALL BE TREATED NO MORE THAN 24 HOURS PRIOR TO CONCRETE POUR. EVIDENCE OF TREATMENT MUST BE PROVIDED PRIOR TO PLACING OF CONCRETE.

MATERIALS:

ALL INTERIOR CONCRETE SLABS SHALL BE A MIN. OF 4" THICK CONCRETE OVER 4" COMPACTED AGGREGATE BASE (ASTM D698), FINISH ELEVATIONS AS NOTED ON DRAWINGS, 6" ABOVE ADJACENT GRADE, LEVEL SLABS TO 1/8"-10' MAX.. CONCRETE SLABS SHALL BE 2500# PSI AT 28 DAYS. A 4" ALLOWABLE SLUMP.

2. **PAD PREPARATION:**

EXCAVATION FOR FOOTING SHALL BE NEAT.

FOOTINGS SHALL BE POURED IMMEDIATELY AFTER EXCAVATION AND APPROPRIATE INSPECTION.

ALL REINFORCING STEEL MARKED "CONTINUOUS" SHALL BE LAPPED 36 BAR DIAMETERS AT SPLICES AND AROUND CORNERS OR INTERSECTIONS WITH A STANDARD 90 DEGREE BEND ON CORNER BARS. LAP WIRE MESH ONE FULL MESH AT SIDE AND END LAPS.

ALL HARDWARE TO BE SIMPSON OR EQUIVALENT. EXTERIOR FRAME WALL TO BE SECURED WITH 1/2"X10" ANCHOR BOLTS 4'-0" O.C. FOR 1-STORY AND 2'-8" O.C. FOR 2-STORY. BOLTS SHALL BE LOCATED WITHIN 1'-0" OF EACH END PIECE AND SHALL HAVE A MIN. OF TWO BOLTS PER PIECE.

-FOUNDATION ANCHOR STRAPS SHALL BE PERMITTED, ACCORDING TO RESIDENTIAL CODE

ALL INTERIOR WALLS TO BE SECURED WITH POWER DRIVEN PINS PER MANUFACTURER SPECIFICATION USE PIN SPACING EQUIVALENT TO 1/2" ANCHOR BOLTS.

ALL CONSTRUCTION TO CONFORM TO THE 2012 IRC · R-10 RIGID INSULATION OUTSIDE OF EXTERIOR FOUNDATION WALLS UNDER LIVING AREA. CONCRETE PAD FOR CONDENSER THICKNESS IS 4" MIN UNLESS OTHERWISE NOTED.

3. CONCRETE CONSTRUCTION:

- THE SLAB SHALL BE UNDERLAIN BY A VAPOR BARRIER/RETARDER IN THE LIVING AREA (TYPICALLY POLYETHYLENE, UNLESS MORE STRINGENT PROTECTION REQUIRED BY THE ARCHITECT, ENGINEER, FLOOR COVERING MANUFACTURER, OR ACCEPTED PRACTICE). UNLESS OTHERWISE REQUIRED, BARRIER MAY BE OMITTED AT GARAGES, PORCHES AND PATIOS WITHOUT FLOOR COVERINGS. IT IS BEYOND THE SCOPE OF THESE PLANS TO DETERMINE THE APPLICABILITY OF THESE MORE STRINGENT REQUIREMENTS. BUILDER SHALL VERIFY PRIOR TO CONSTRUCTION.

4. REINFORCEMENT:

IF CONSTRUCTED ON ACTIVE SOILS, THE LONG TERM PERFORMANCE OF THE FOUNDATION IS DEPENDENT ON MAINTENANCE BY THE OWNER. THUS THE BUILDER SHALL ADVISE THE OWNER OF THE FOLLOWING:

- DRAINAGE MUST BE MAINTAINED. WATER SHALL NEVER BE ALLOWED TO POND NEAR THE FOUNDATION.
- 2. THE SOIL AROUND THE FOUNDATION SHALL BE MAINTAINED IN A RELATIVELY DAMP CONDITION, SUCH AS THAT REQUIRED TO KEEP A LAWN GREEN. IF IT DRIES OUT IT WILL SHRINK. IF IT GETS WET, IT WILL HEAVE UPWARD.

3. SLABS ON THE SHORTER SIDE USES MAIN BARS ARE USED IN THIS DIRECTION ONLY WITH SMALLER DIAMETER DISTRIBUTION BARS ARE PLACED, FORMING A MAT OR GRID. ALL REINFORCEMENT BARS SIZE 10MM OR LARGER IN ACCORDANCE TO ASTM

- 3. ANCHOR BOLTS AT ALL EXTERIOR WALLS SHALL BE MINIMUM 1/2 INCH DIAMETER WITH A MAXIMUM SPACING OF 6'-0" ON CENTER, UNLESS NOTED OTHERWISE.
- 4. ANCHOR BOLTS SHALL BE INSTALLED WITHIN 12 INCHES OF EACH END OF EACH SILL PLATE WITH AT LEAST TWO ANCHOR BOLTS FOR EACH BOLTS FOR EACH SILL PLATE LONGER THAN 12 INCHES.


5. SIMPSONS SILL ANCHORS MAYBE SUBSTITUTED FOR ANCHOR BOLTS AT THE SAME SPACING.

6. EXTERIOR CONCRETE SLABS WHICH ARE NOT PART OF THE MAIN SLAB SHALL BE MINIMUM 4 INCHES THICK WITH NO STEEL REINFORCING BARS REQUIRED, UNLESS NOTED OTHERWISE ON FOUNDATION PLAN.

VERIFY THE FOLLOWING PRIOR TO POURING:

- ALL HOLDDOWNS, STRAP, AND POST LOCATIONS.
- CONCRETE FINISHES. PANEL RISER LOCATION WHERE APPLICABLE.
- . UNDERSLAB MECHANICAL REQUIREMENTS.
- STEM WALL BLOCKOUTS.
- 5. UNDERSLAB ELECTRICAL REQUIREMENTS AND PANEL RISER LOCATION. WHERE APPLICABLE.
- 6. PROVIDE THE FOLLOWING:
- PVC SLEEVES THROUGH FTG IF REQUIRED
- 20' #4 COPPER GROUND BAR.
- SLOPE FINISH GRADE AWAY FROM FOOTING.

NOTE: FIELD VERIFY ALL DIMENSIONS SEE DIMENSIONED ARCHITECTURAL DRAWINGS

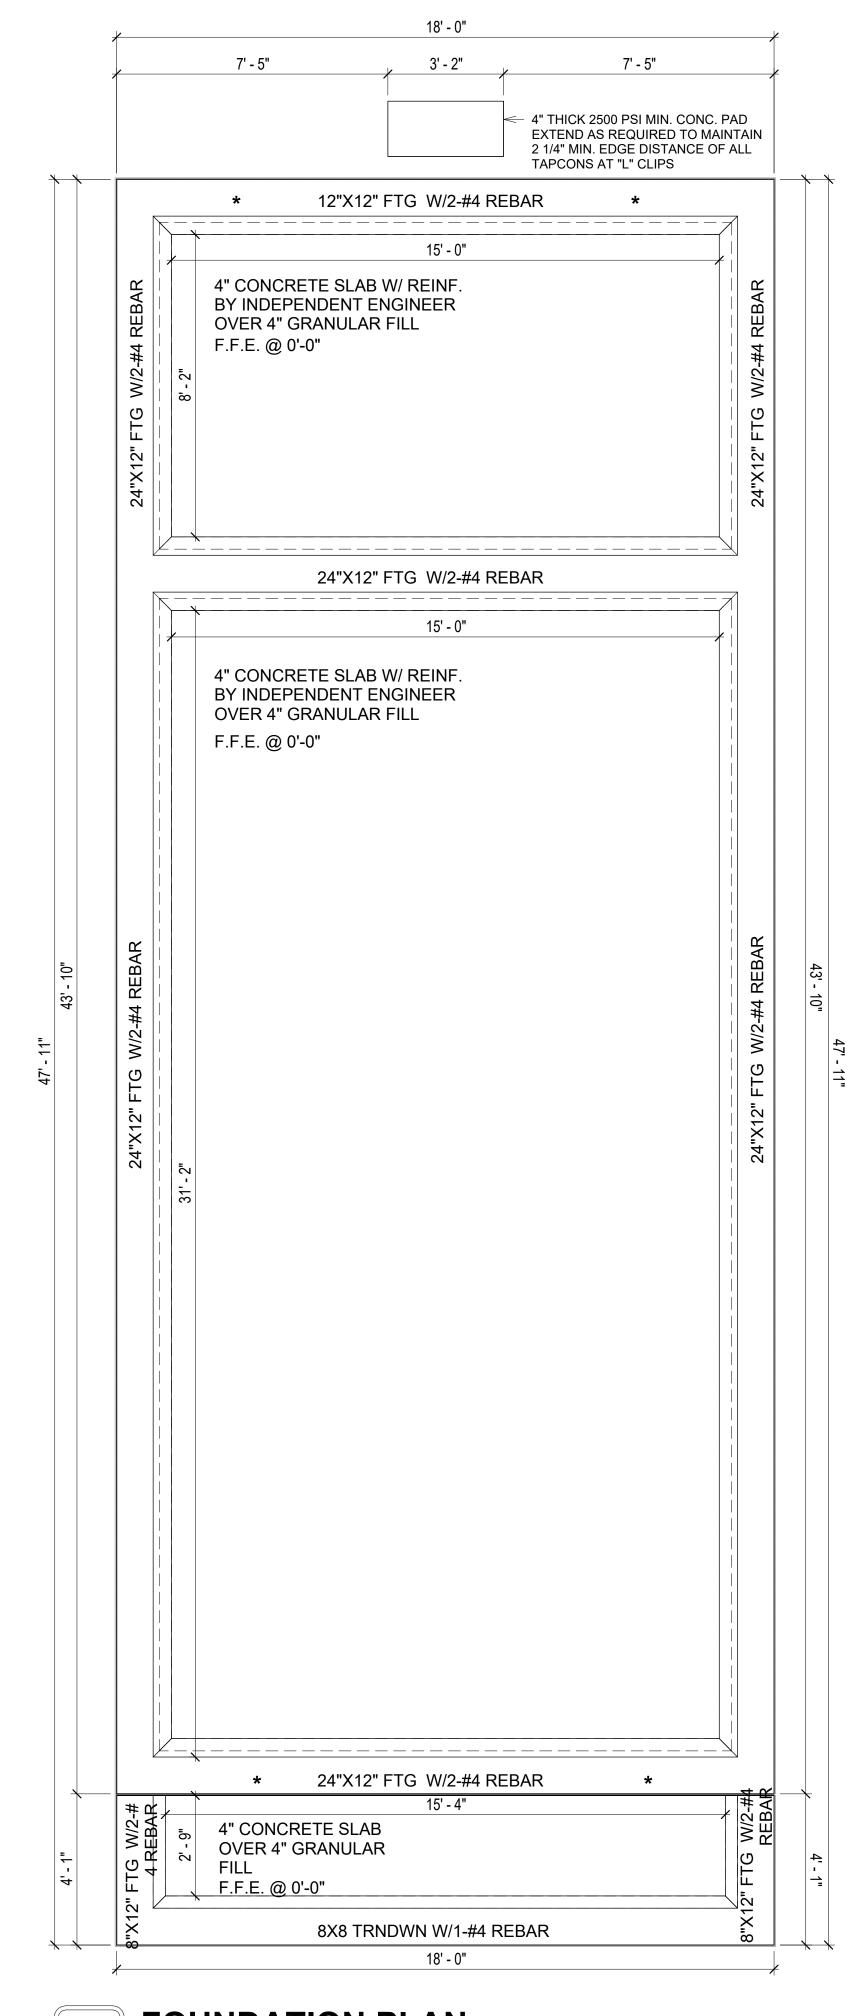

FOUNDATION PLAN 3/8" = 1'-0"



KEY PLAN

NO.	DESCRIPTION	DATE

NOTE:

LEGEND:

PROJECT

109 BENNETT 796 2Bd2Ba SPANISH 550

DRAWING NAME

FOUNDATION PLAN

CLIENT NAME:	Client Name
PROJECT NUMBER:	0061_12
DATE:	3/10/2025 11:52:11 AM
DESIGNED BY:	Designer
DRAWN BY:	Author
CHECKED BY:	Checker

S101

SCALE: 3/8" = 1'-0"

SQUARE FOOTAGE

74

863

PORCH

TOTAL

GENERAL NOTES

NOTES:

-ALL BEARING WALLS SHOULD HAVE A THICKENED SLAB PER SECTION PER DETAIL A401/5.

A) **FOUNDATION PLAN NOTES**:

- CONCRETE SLAB SHALL BE 6" THICK WITH 1/2" DIAMETER TENDONS PER LAYOUT PLAN, CENTERED IN SLAB THICKNESS, OVER APPROVED SUBBASE PER GENERAL STRUCTURE
- 2. TERMITE PROTECTION SHALL BE PROVIDED PER IRC SECTION R318.1 NONE TYPICAL ANCHOR BOLT SPACING AT SHEAR WALL AND HOLD DOWN
- SPECIFICATIONS PER APPROVED ARCHITECTURAL PLANS. 4. INSTALL HOLDOWNS BEFORE CONCRETE SLAB POUR.
- EXISTING FILL ON-SITE SHALL BE COMPACTED IN ACCORDANCE WITH THE
- REQUIREMENTS IN THE GEOTECHNICAL REPORT.
- 6. ALL FLOOR SLABS ARE REINFORCED ON CONCRETE SLABS.

SPECIAL INSPECTION IS REQUIRED FOR THICKENED FOUNDATION CONSTRUCTION

- 1. REINFORCEMENT
- 2. 2300 PSI CONCRETE POUR


B) **REINFORCEMENT FOR CONCRETE**:


1. ALL REINFORCING SLABS BARS SIZE 10MM OR LARGER SHALL BE DEFORMED IN ACCORDANCE TO ASTM-A706, AND BARS SMALLER THAN 10 MM MAYBE PLAIN. 2. UNLESS OTHERWISE NOTED IN PLANS, THE YIELD STRENGTH OF REINFORCING BARS SHALL BE:


> A) FOOTING = 40,000 PSI B) NON-LOAD BEARING WALLS AND PARAPETS= 40,000 PSI

- 3. SPLICES SHALL BE SECURELY WIRED TOGETHER AND SHALL LAP OR EXTEND
- 4. GRADE OF STEEL FOR RCC WORKS SHALL BE GRADE 4 10.
- BAR NOTATIONS GIVES INFORMATION
- A) BAR SIZE
- B) SPACING(IF REQUIRED)
- 6. LAP REINFORCEMENT ONLY AT LOCATION SHOWN IN THE DRAWINGS REINFORCEMENT SHALL NOT BE CUT, VENT OR HEATED ON SITE WITHOUT ENGINEERS'
- APPROVAL.
- C) **CONCRETE SLAB NOTES**
- 1. ALL SLAB REINFORCEMENT SHALL BE 20MM CLEAR MINIMUM FROM BOTTOM AND FROM TOP OF SLAB.
- 2. REINFORCEMENT IN CONTINUOUS ELEVATED SLAB SHALL BE CUT AS FOLLOWS.

- THIS IS A SCHEMATIC PLAN FOR THE PURPOSE OF LOCATING AND IDENTIFYING FOUNDATION REINFORCING ELEMENTS ONLY. VERIFY ALL DIMENSIONS, DROPS, OFFSETS AND FEATURES WITH THE ARCHITECTURAL PLANS BEFORE FORMING THE FOUNDATION.

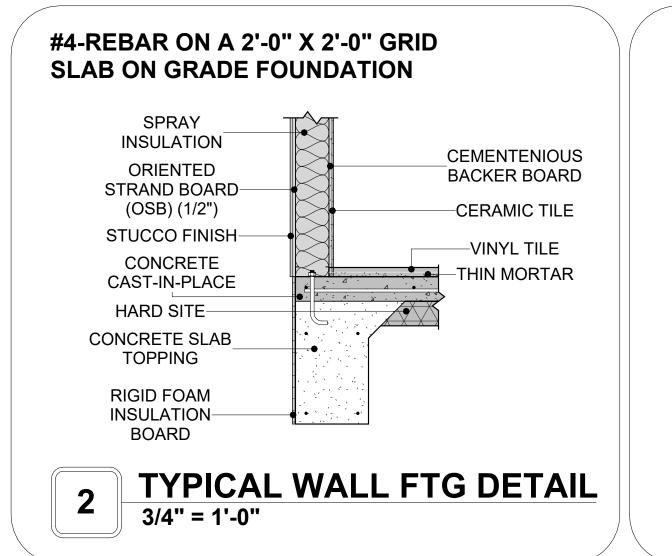

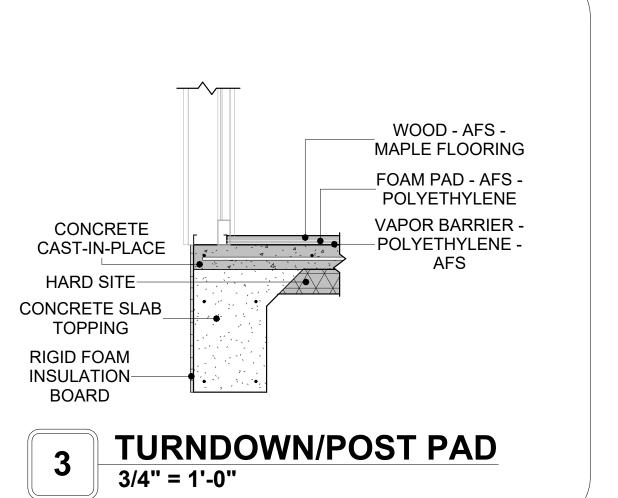

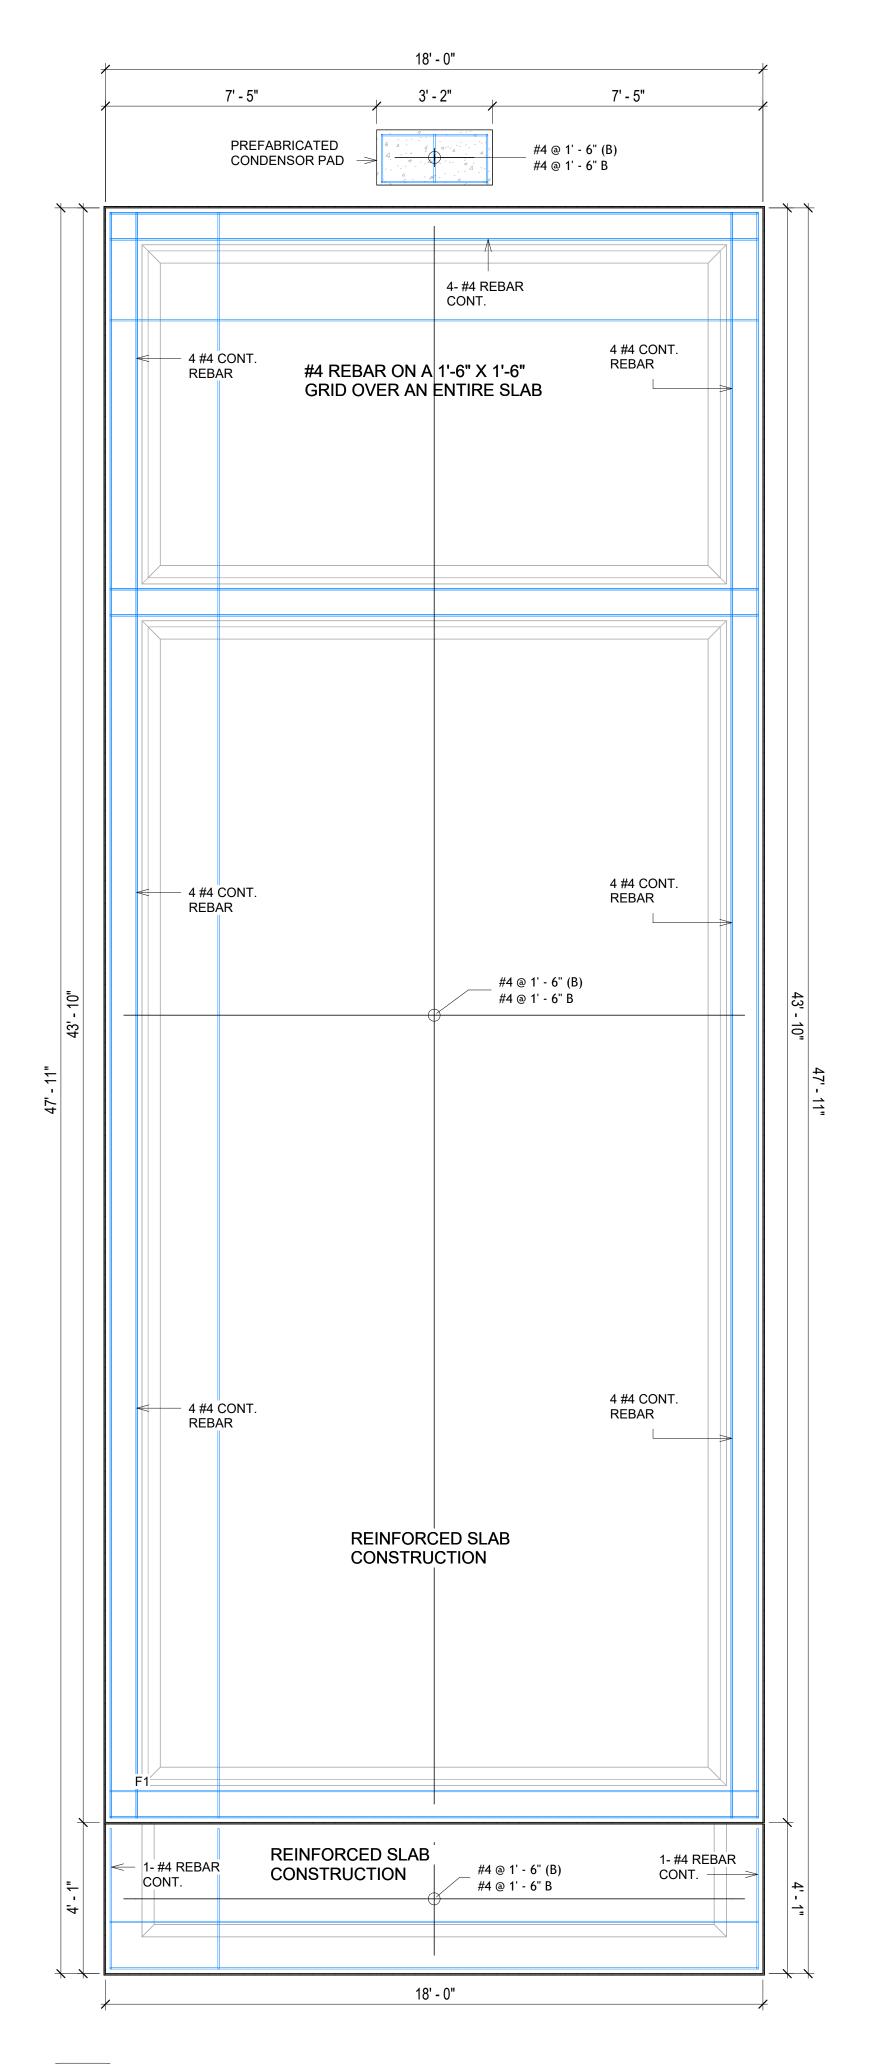

FOUNDATION REBAR PLAN 3/8" = 1'-0"



KEY PLAN

DESCRIPTION	DATE
	DESCRIPTION

NOTE:

LEGEND:

PROJECT

109 BENNETT 796 2Bd2Ba **SPANISH 550**

DRAWING NAME

STRUCTURAL FLOOR PLAN

CLIENT NAME: **Client Name** PROJECT NUMBER: 0061_12 3/10/2025 11:52:12 AM **DESIGNED BY:** Designer DRAWN BY: **Author** CHECKED BY: Checker


S102

ROOF NOTES

- ROOFING COMPOSITION ROOFING PER OWNERS/BUILDERS SPECIFICATIONS INSTALL PER MANUFACTURE SPECIFICATIONS ON 1/2" ORIENTED STRAND BOARD ON PRE-ENGINEERED TRUSS @ 24" O.C. (UNO.)
 73" OVERHANG AT EAVES (UNO.)
- 3. ENDS OF ALL TRUSSES AND JOISTS TO BE FULLY BLOCKED. PROVIDE SOLID
- BLOCKING AT ALL RIDGES AND VALLEYS

 4. SHEATHING TO BE 1/2", 3/8" OSB SHEAR PANEL AND EQUIVALENT.
 UNDERSIDE OF PORCH TRUSSES TO BE FINISHED WITH MOISTURE
- RESISTANT DRYWALL, TAPED AND TEXTURED.

 5. EXPOSED EAVES AND OTHER WEATHER EXPOSED AREAS TO BE SHEATHED WITH EXTERIOR GRADE PLYWOOD.
- 6. ALL MATERIALS THICKNESS AND SIZE ARE THE MINIMUM. Refer TO LOCAL STANDARDS FOR ACTUAL THICKNESS AND LAYERING OF MATERIALS.
- 7. ENGINEERED TRUSS CALCULATIONS TO BE SUBMITTED TO BUILDING DEPARTMENT PRIOR TO FABRICATION AND INSTALLATION.
- 8. TRUSS MANUFACTURER TO SPECIFY HANGER CONNECTORS FOR TRUSS COMPONENTS (TYPICAL)
- 9. DESIGNER ASSUMES THAT TRUSSES BEAR ON ALL EXTERIOR PERIMETER WALLS (TYPICAL) OR BEAMS.
- 10. PROVIDE GALVANIZED STEEL FLASHING WITH A LENGTH OF 10 FEET, WIDTH OF 12 INCHES, AND THICKNESS OF 24 GAUGE.

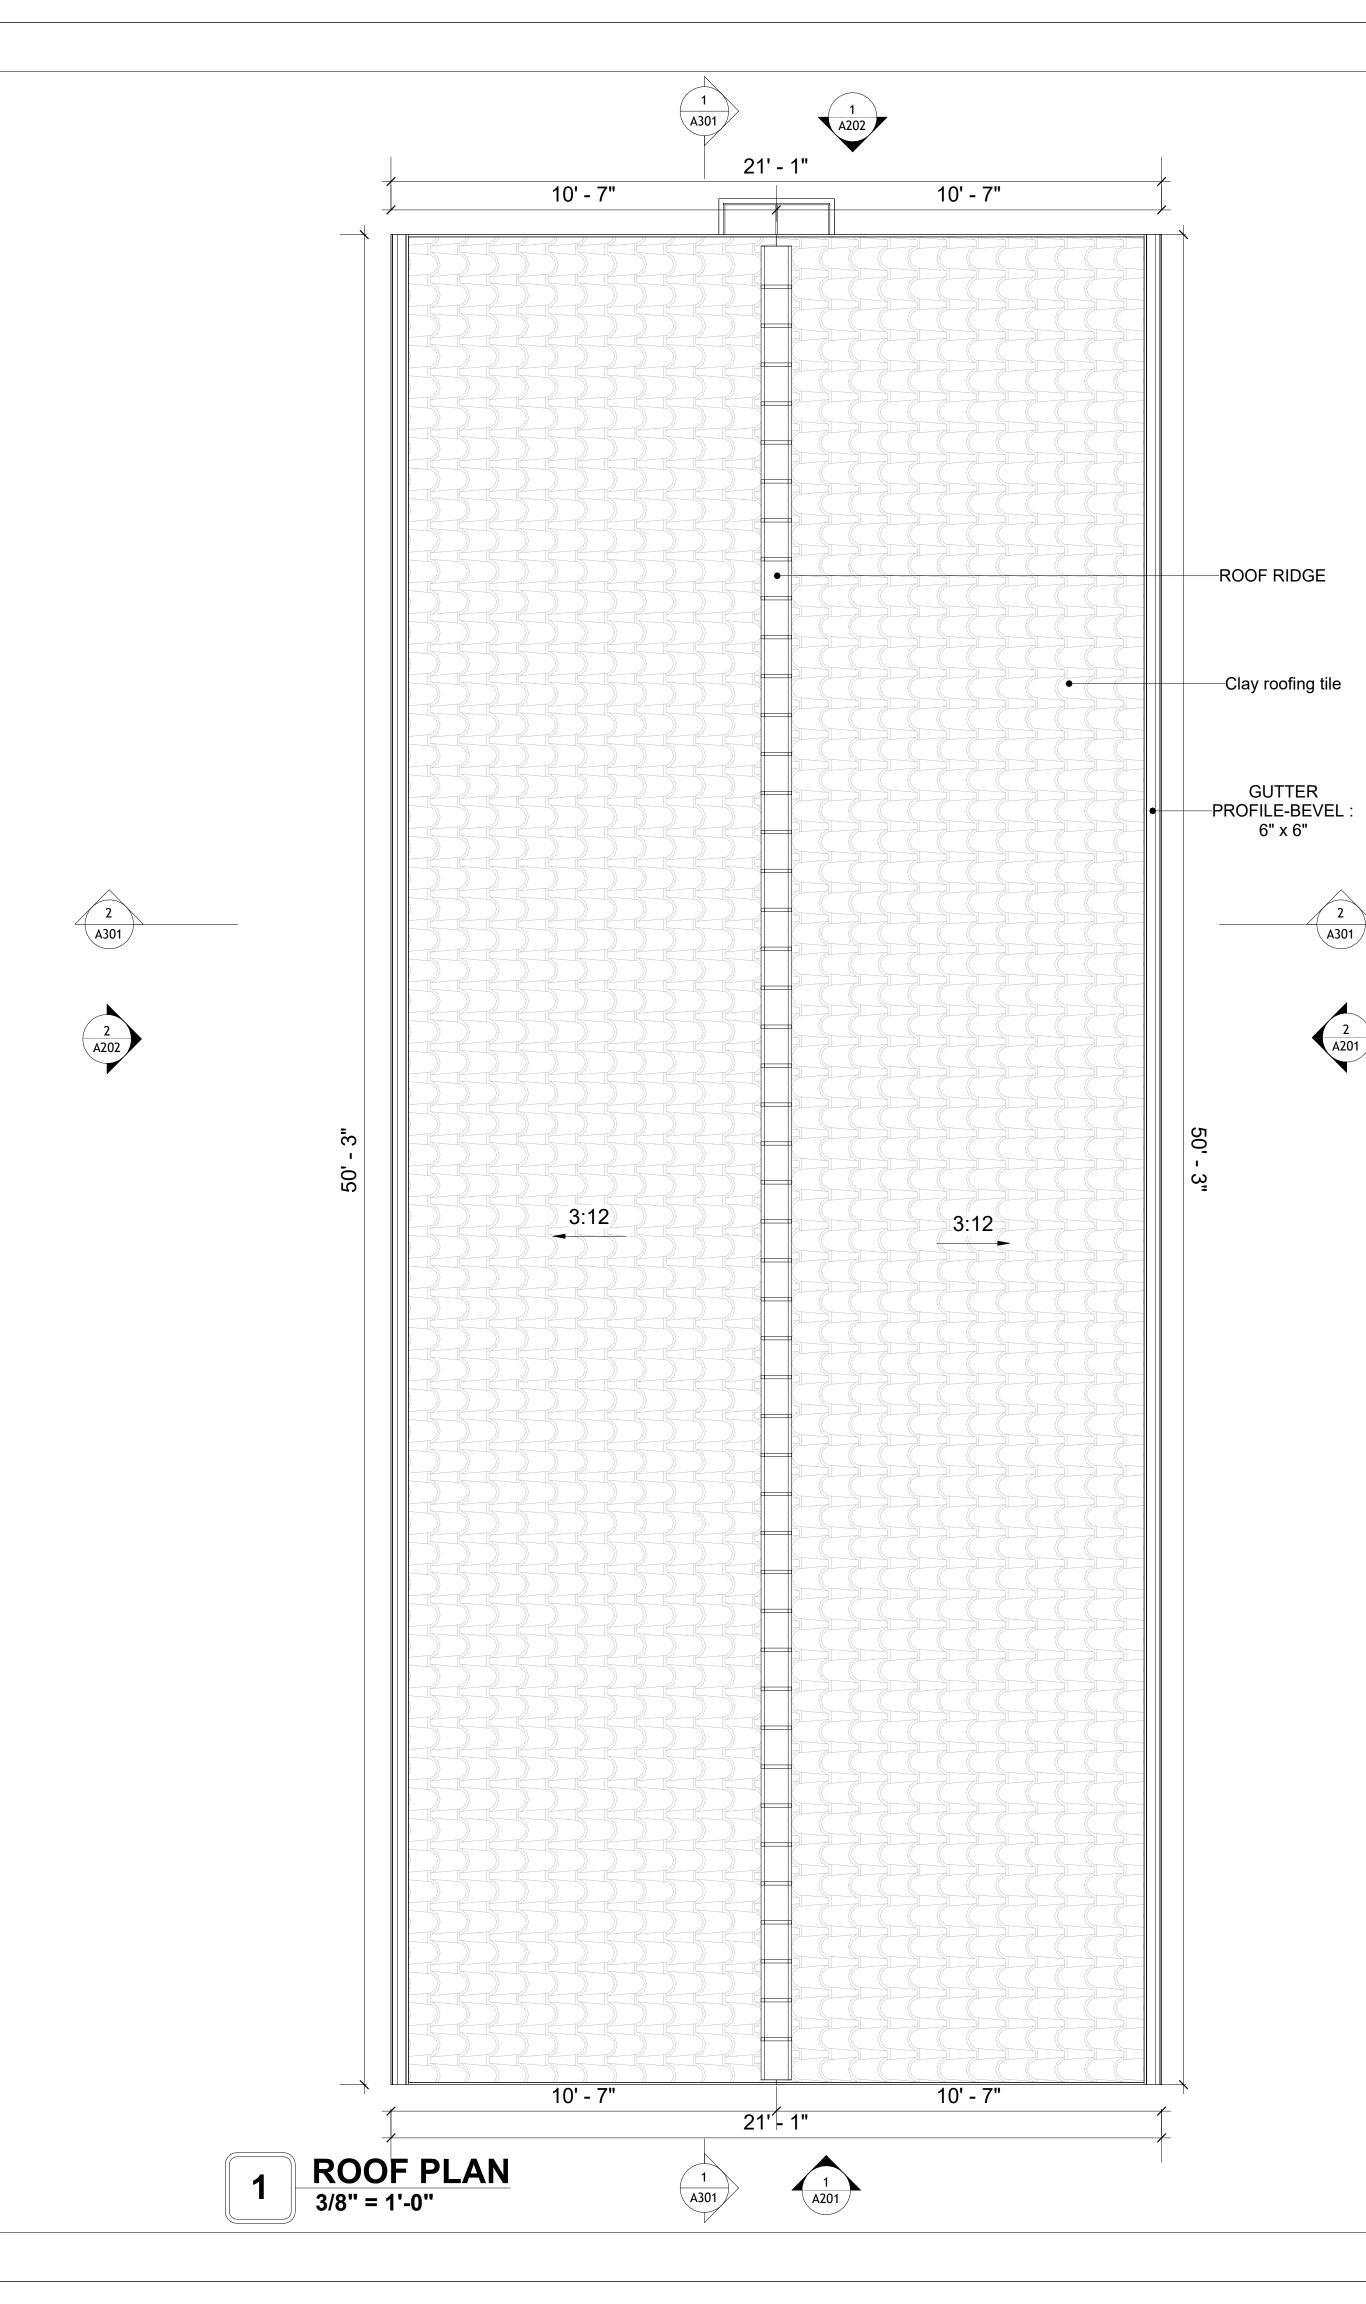



KEY PLAN

NO.	DESCRIPTION	DATE

NOTE:

LEGEND:

PROJECT

109 BENNETT 796 2Bd2Ba SPANISH 550

DRAWING NAME

ROOF PLAN

CLIENT NAME:	Client Name
PROJECT NUMBER:	0061_12
DATE:	3/10/2025 11:52:15 AM
DESIGNED BY:	Designer
DRAWN BY:	Author
CHECKED BY:	Checker

A103

SCALE: As indicated

SQUARE FOOTAGE

863

PORCH

TOTAL

ABOUT WALL FINISHING

STUCCO FINISH

STUCCO IS A CEMENT-BASED EXTERIOR WALL FINISH THAT OFFERS A DURABLE, WEATHER-RESISTANT, AND CUSTOMIZABLE CLADDING SOLUTION FOR BUILDINGS.

IN THIS SPECIFIC PROJECT, AMERICAN STUCCO SYSTEMS IS USED AS A FINISH MATERIAL BECAUSE IT IS GENERALLY CONSIDERED A WATER-RESISTANT EXTERIOR FINISH AND USES A THREE-COAT APPLICATION PROCESS.

3/8-INCH OF IT IS APPLIED AS AN EXTERNAL WALL FINISH AS IT IS THE MOST COMMON AND WIDELY ACCEPTED STANDARD THICKNESS FOR STUCCO EXTERIOR WALL FINISHES. THIS MULTI-LAYER APPROACH ALSO HELPS CREATE A STRONG, CRACK-RESISTANT STUCCO SURFACE.

THIS STANDARD STUCCO IS APPLIED OVER OSB SHEATHINGS (FOR COLD FORMED STRUCTURE CONSTRUCTION).


IT IS NOT DIRECTLY TROWELED OVER THE OSB BUT OVER A WATER-RESISTANT BARRIER (HOMEWRAP) AND METAL/PLASTIC LATH THAT ARE INSTALLED ON TOP SURFACE OF THE OSB TO PROVIDE AN ADDITIONAL LAYER OF PROTECTION AGAINST MOISTURE INTRUSION.

REGULAR INSPECTION AND PROMPT REPAIR OF ANY CRACKS, CHIPS, OR DAMAGE TO THE STUCCO FINISH IS IMPORTANT. THIS MAINTAINS THE STUCCO'S WATER-RESISTANT PROPERTIES OVER THE BUILDING'S LIFE SPAN.


CEDAR WOOD

CEDAR WOOD REFERS TO THE WOOD FROM VARIOUS SPECIES OF CEDAR TREES, WHICH ARE CONIFEROUS EVERGREEN TREES KNOWN FOR THEIR DISTINCT AROMA AND NATURAL RESISTANCE TO DECAY AND INSECTS.

IN THIS SPECIFIC PROJECT, CEDAR WOOD IS USED A FINISH MATERIAL ON BEAMS AND COLUMNS.

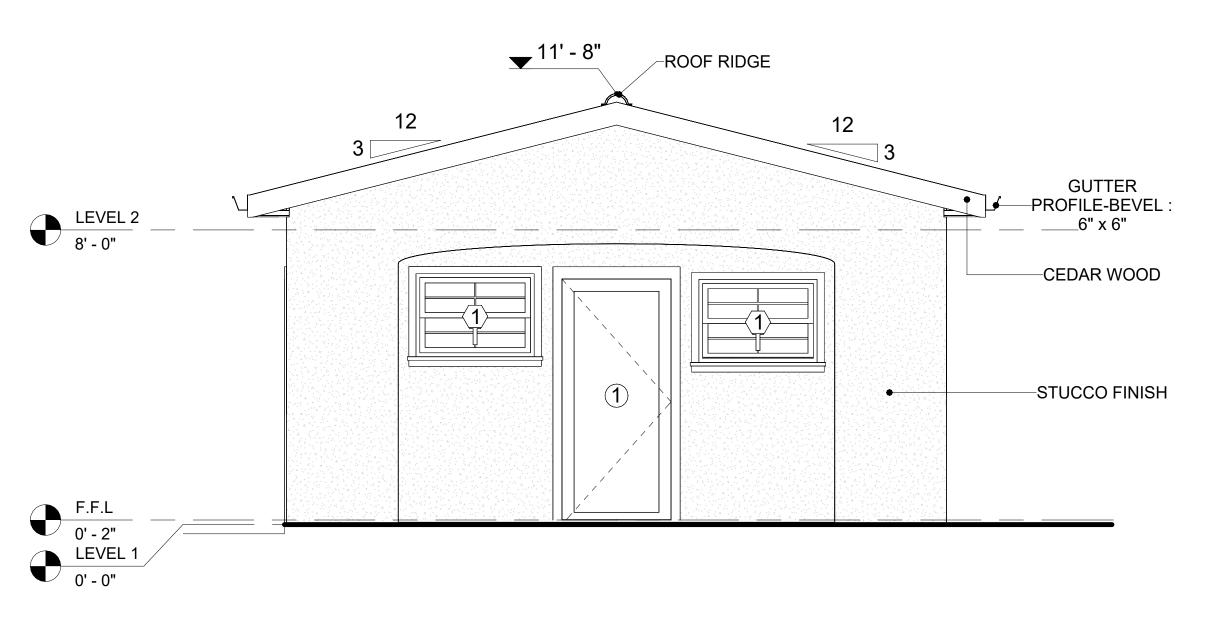


FRONT ELEVATION 3/8" = 1'-0"

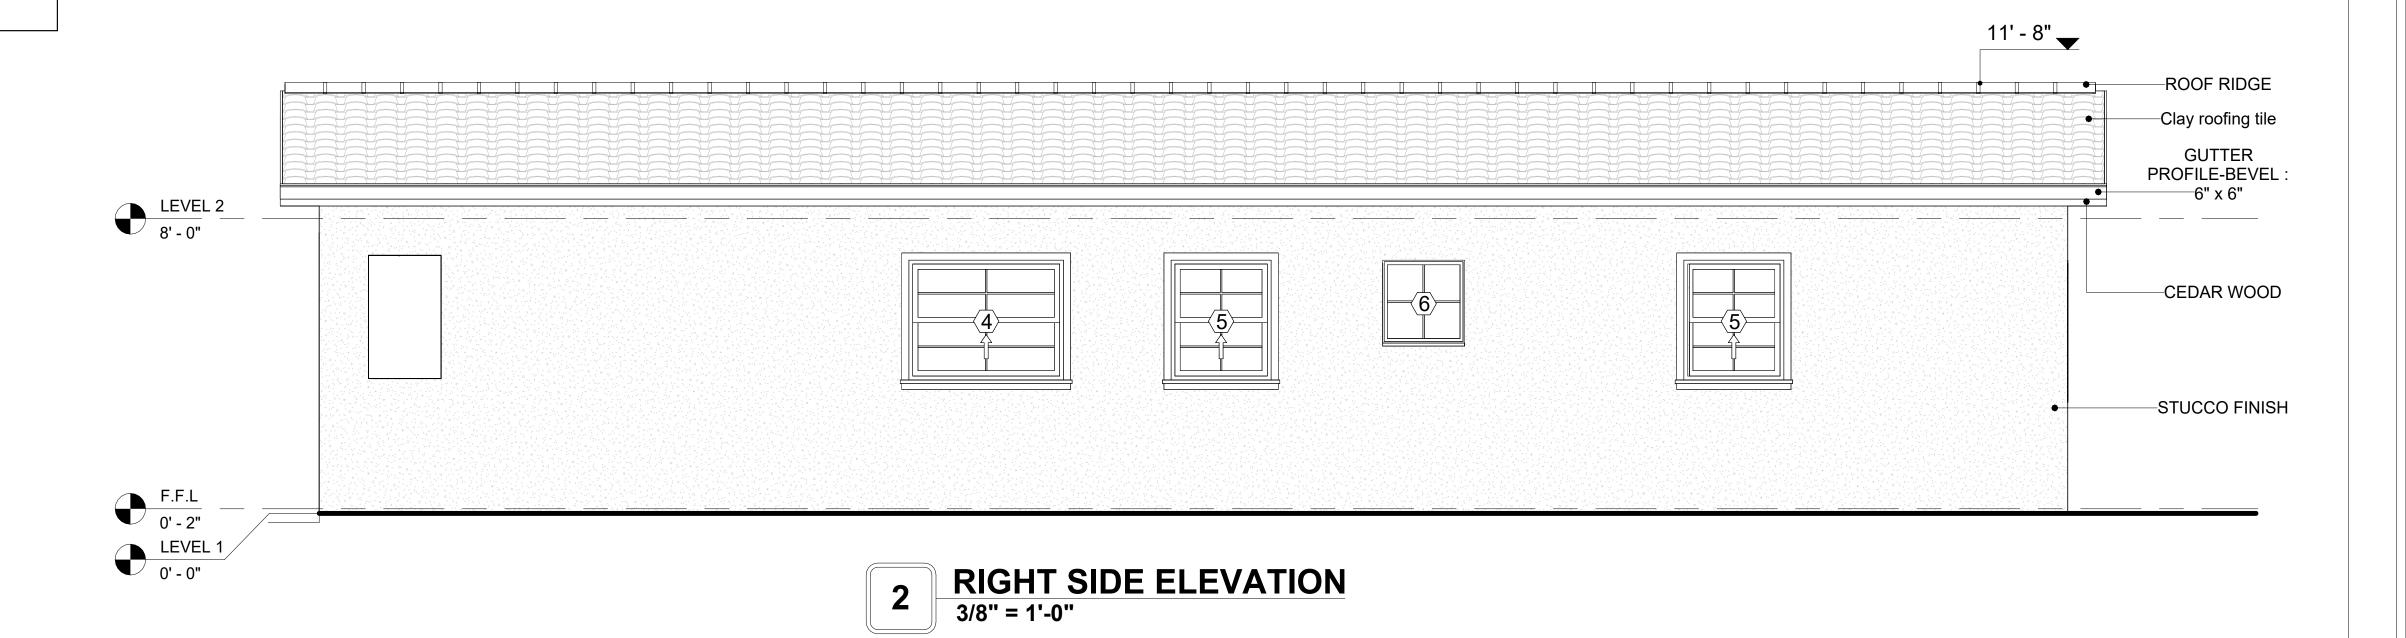

DOOR SCHEDULE						
TYPE				SIZE		
MAR K	SUPPLIER	DOOR TYPE	LOCATIO N	WIDTH	HEIGHT	COUNT
1	HOME DEPOT	EXTERIOR SINGLE PANEL SWINGING	INTERIOR	3' - 0"	6' - 8"	2
2	HOME DEPOT	INTERIOR SINGLE PANEL SWINGING	INTERIOR	2' - 6"	6' - 8"	1
3	HOME DEPOT	INTERIOR SINGLE PANEL SWINGING	INTERIOR	3' - 0"	6' - 8"	1
4	HOME DEPOT	INTERIOR SINGLE PANEL SWINGING	INTERIOR	3' - 0"	6' - 8"	1
5	HOME DEPOT	INTERIOR SINGLE PANEL SWINGING	INTERIOR	2' - 6"	6' - 8"	1
6	HOME DEPOT	INTERIOR DOUBLE PANEL SLIDING	INTERIOR	6' - 0"	6' - 8"	1
7	HOME DEPOT	INTERIOR DOUBLE PANEL SLIDING	INTERIOR	9' - 0"	6' - 8"	1
8	HOME DEPOT	INTERIOR SINGLE PANEL SWINGING	INTERIOR	1' - 8"	6' - 8"	1

WINDOW SCHEDULE					
			SIZE		
TYPE MARK	SUPPLIER	WINDOW TYPE	WIDTH	HEIGHT	COUNT
1	HOME DEPOT	SINGLE HUNG	3' - 3"	2' - 3"	2
2	HOME DEPOT	FIXED	5' - 3"	3' - 9"	2
3	HOME DEPOT	CASEMENT	2' - 3"	3' - 9"	2
4	HOME DEPOT	SINGLE HUNG	4' - 3"	3' - 3"	2
5	HOME DEPOT	SINGLE HUNG	2' - 9"	3' - 3"	2
6	HOME DEPOT	FIXED	2' - 3"	2' - 3"	1

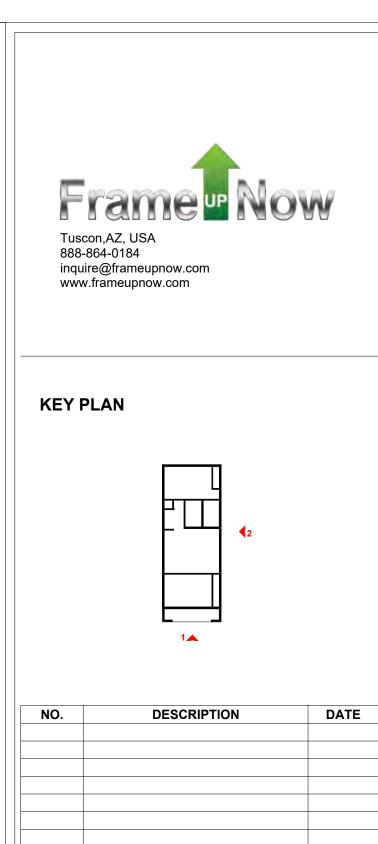

NO.	DESCRIPTION	DATE

NOTE:

LEGEND:

PROJECT

109 BENNETT 796 2Bd2Ba **SPANISH 550**

DRAWING NAME

ARCHITECTURAL ELEVATIONS

CLIENT NAME:	Client Name
PROJECT NUMBER:	0061_12
DATE:	3/10/2025 11:52:19 AM
DESIGNED BY:	Designer
DRAWN BY:	Author
CHECKED BY:	Checker

A201

ABOUT WALL FINISHING

STUCCO FINISH

STUCCO IS A CEMENT-BASED EXTERIOR WALL FINISH THAT OFFERS A DURABLE, WEATHER-RESISTANT, AND CUSTOMIZABLE CLADDING SOLUTION FOR BUILDINGS.

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3/8-INCH OF IT IS APPLIED AS AN EXTERNAL WALL FINISH AS IT IS THE MOST COMMON AND WIDELY ACCEPTED STANDARD THICKNESS FOR STUCCO EXTERIOR WALL FINISHES. THIS MULTI-LAYER APPROACH ALSO HELPS CREATE A STRONG, CRACK-RESISTANT STUCCO SURFACE.

THIS STANDARD STUCCO IS APPLIED OVER OSB SHEATHINGS (FOR COLD FORMED STRUCTURE CONSTRUCTION).


IT IS NOT DIRECTLY TROWELED OVER THE OSB BUT OVER A WATER-RESISTANT BARRIER (HOMEWRAP) AND METAL/PLASTIC LATH THAT ARE INSTALLED ON TOP SURFACE OF THE OSB TO PROVIDE AN ADDITIONAL LAYER OF PROTECTION AGAINST MOISTURE INTRUSION.

REGULAR INSPECTION AND PROMPT REPAIR OF ANY CRACKS, CHIPS, OR DAMAGE TO THE STUCCO FINISH IS IMPORTANT. THIS MAINTAINS THE STUCCO'S WATER-RESISTANT PROPERTIES OVER THE BUILDING'S LIFE SPAN.


CEDAR WOOD

CEDAR WOOD REFERS TO THE WOOD FROM VARIOUS SPECIES OF CEDAR TREES, WHICH ARE CONIFEROUS EVERGREEN TREES KNOWN FOR THEIR DISTINCT AROMA AND NATURAL RESISTANCE TO DECAY AND INSECTS.

IN THIS SPECIFIC PROJECT, CEDAR WOOD IS USED A FINISH MATERIAL ON BEAMS AND COLUMNS.

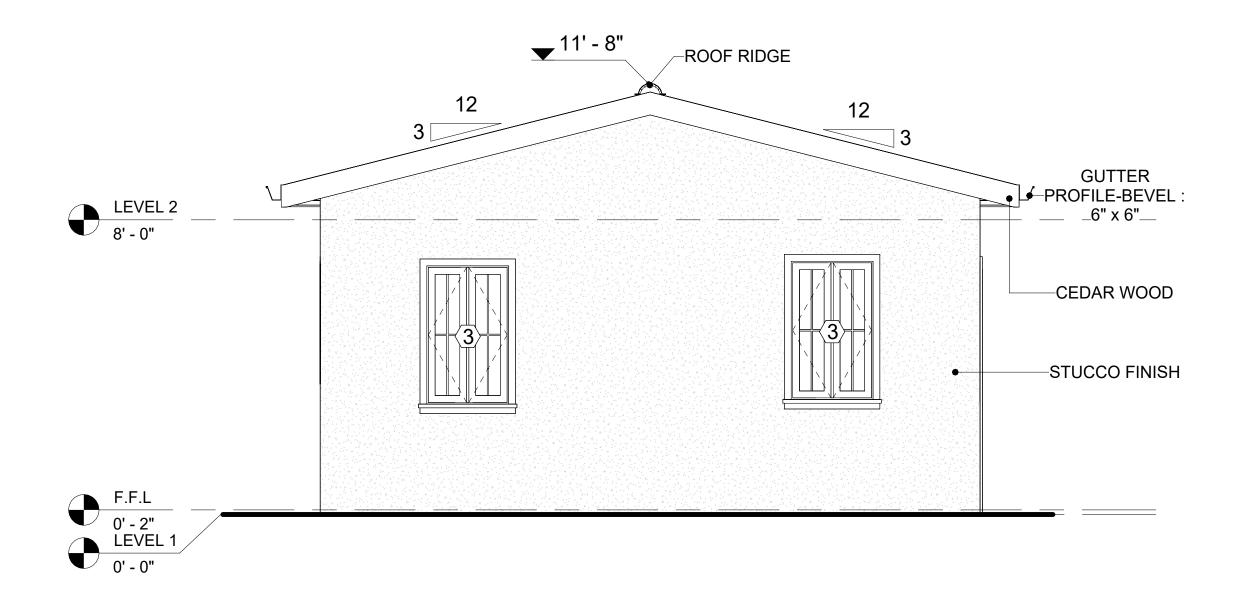


1 REAR ELEVATION
3/8" = 1'-0"

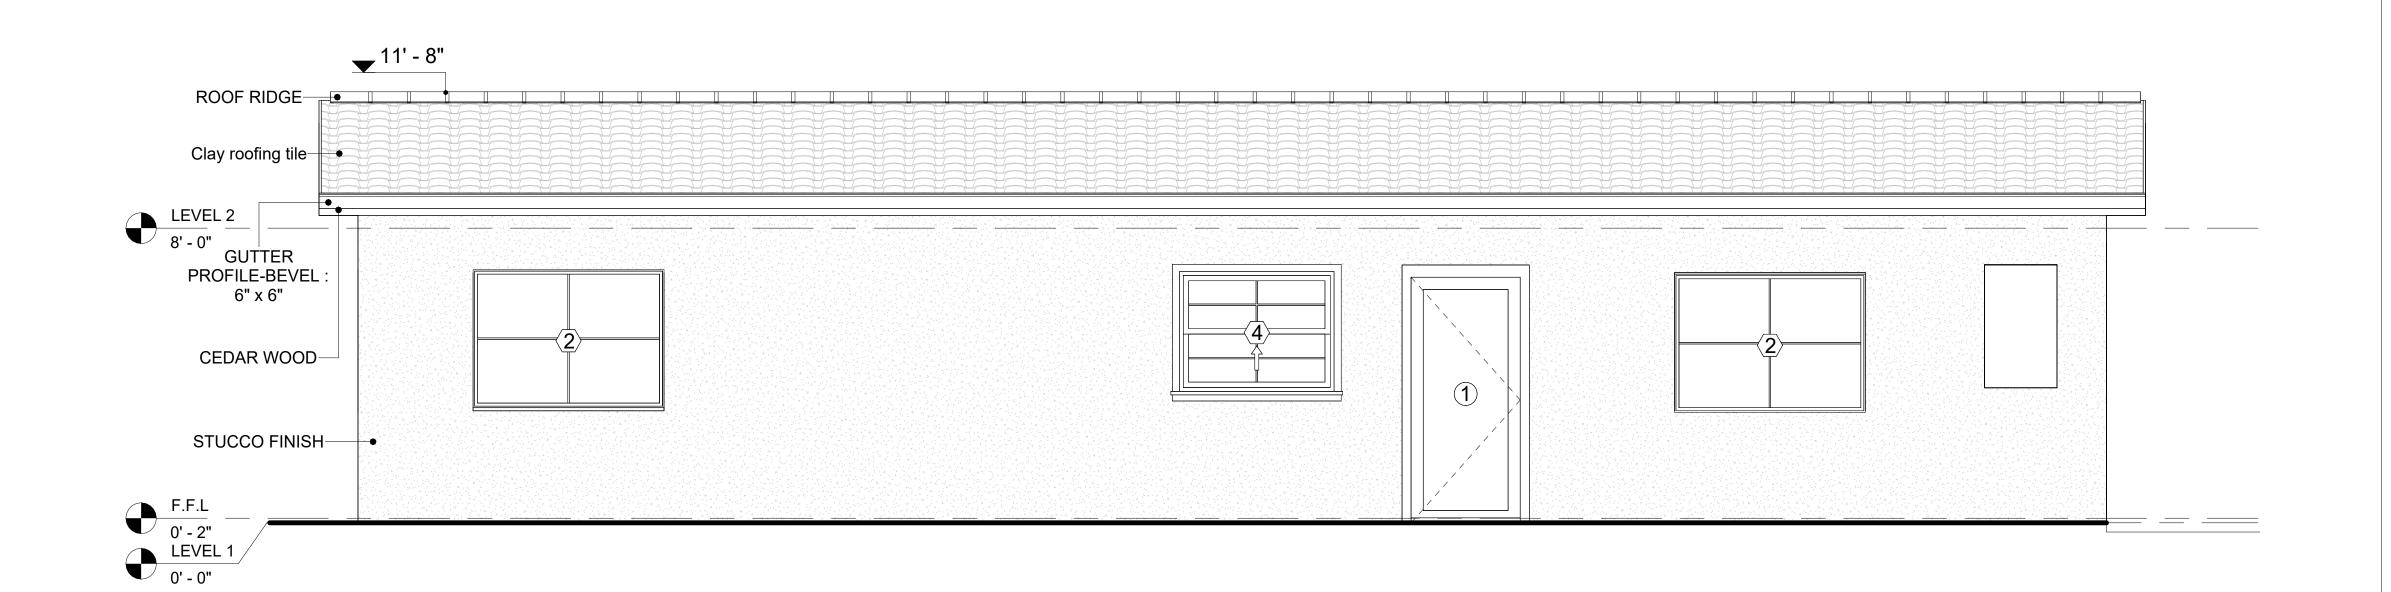

2 LEFT SIDE ELEVATION
3/8" = 1'-0"



KEY PLAN

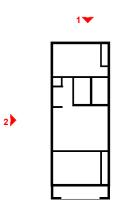

NO.	O. DESCRIPTION	

NOTE:

LEGEND:

PROJECT

109 BENNETT 796 2Bd2Ba SPANISH 550

DRAWING NAME

ARCHITECTURAL ELEVATIONS

 CLIENT NAME:
 Client Name

 PROJECT NUMBER:
 0061_12


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 3/10/2025 11:52:22 AM

 DESIGNED BY:
 Designer


 DRAWN BY:
 Author

 CHECKED BY:
 Checker

A202

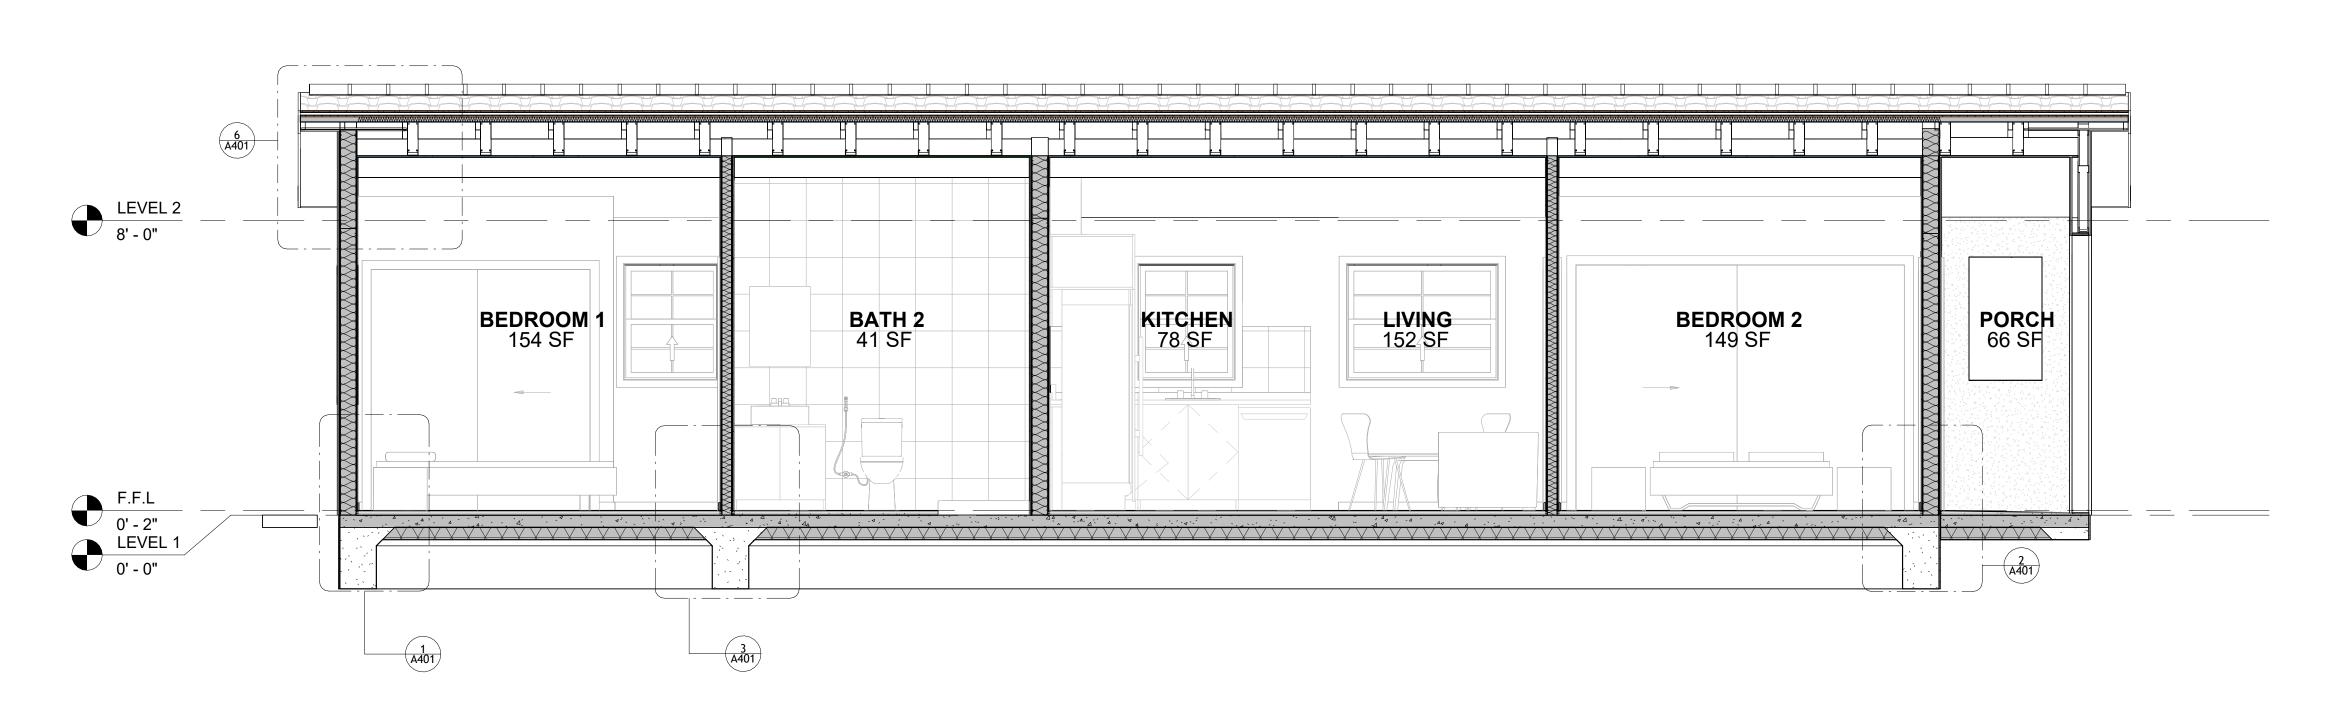


1 SECTION-3 3/8" = 1'-0"

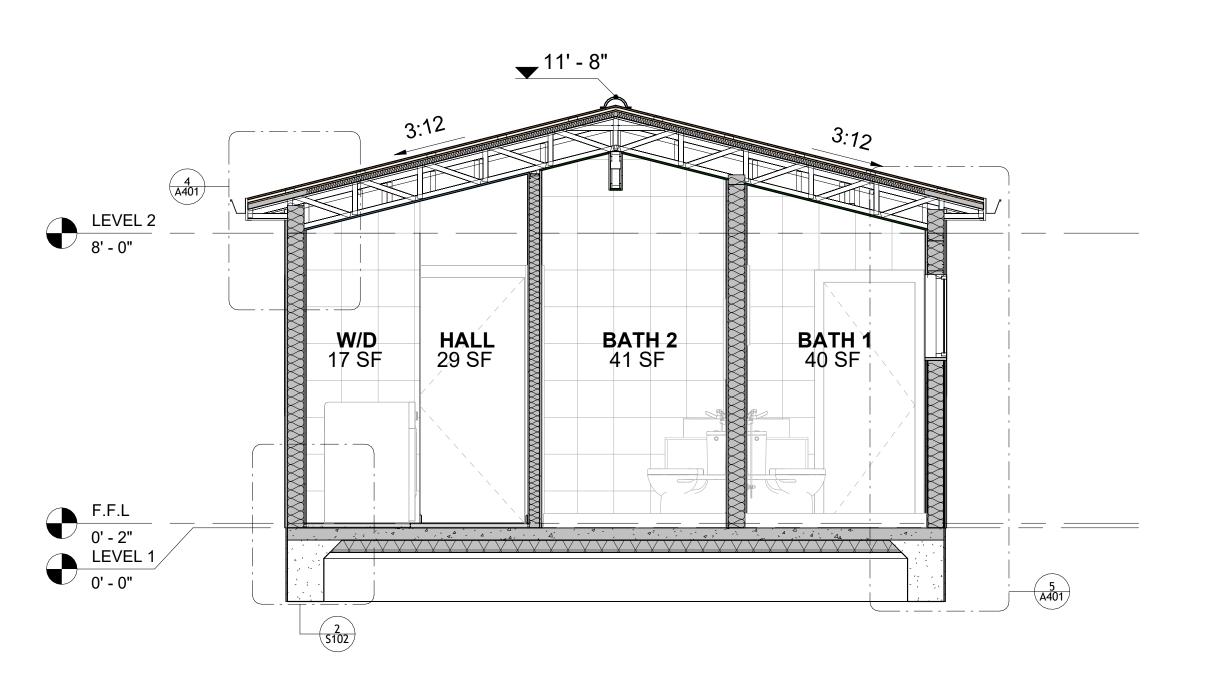

2 SECTION-2 3/8" = 1'-0"



KEY PLAN

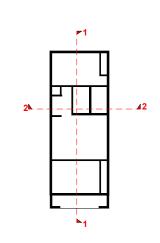

DESCRIPTION	DATE
	DESCRIPTION

NOTE:

LEGEND:

PROJECT


109 BENNETT 796 2Bd2Ba SPANISH 550


DRAWING NAME


ARCHITECTURAL SECTIONS


CLIENT NAME:	Client Name
PROJECT NUMBER:	0061_12
DATE:	3/10/2025 11:52:24 AM
DESIGNED BY:	Designer
DRAWN BY:	Author
CHECKED BY:	Checker


A301

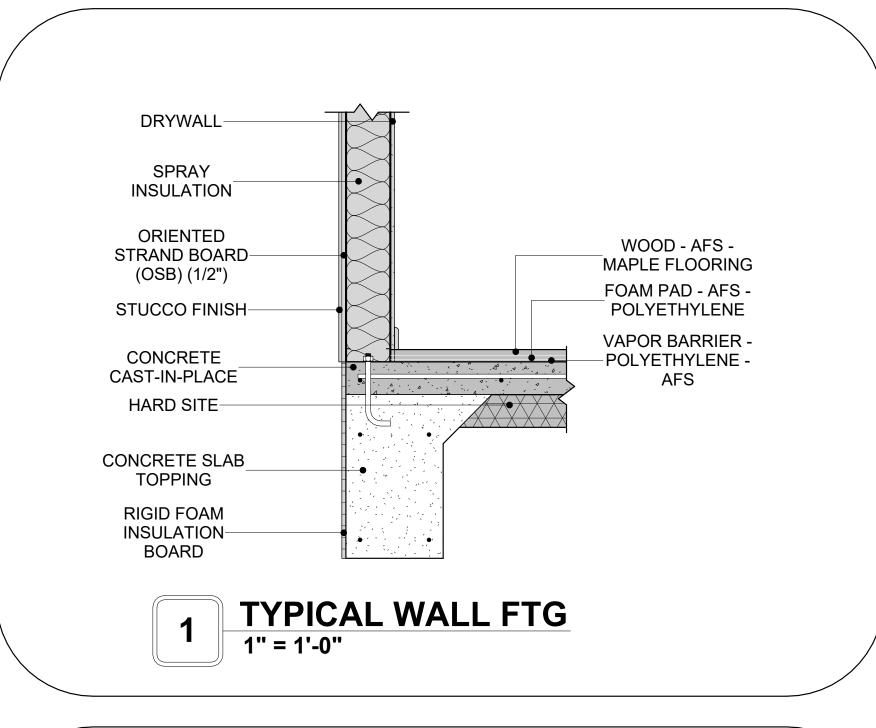


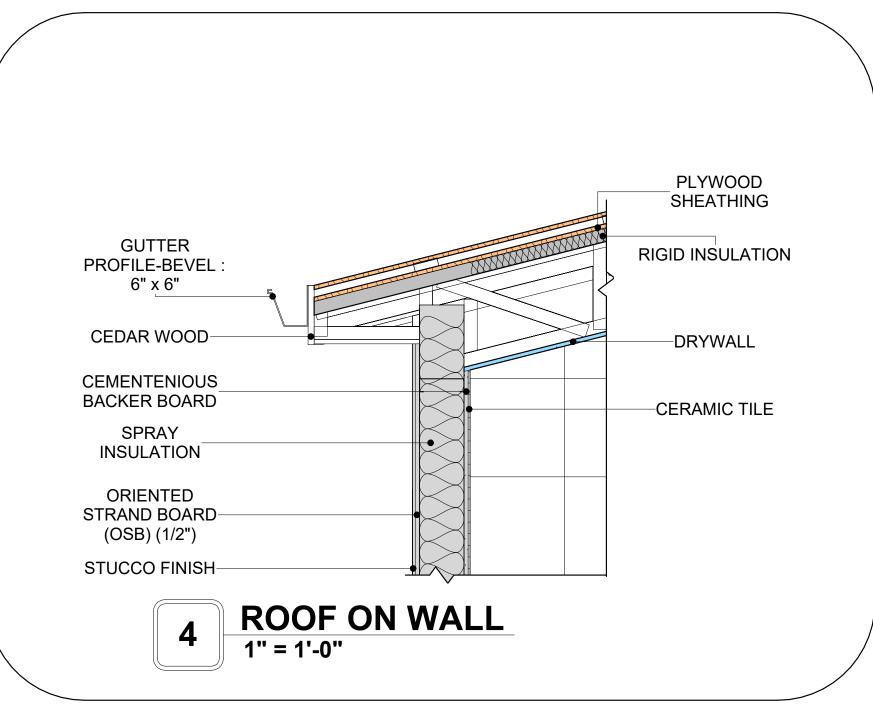

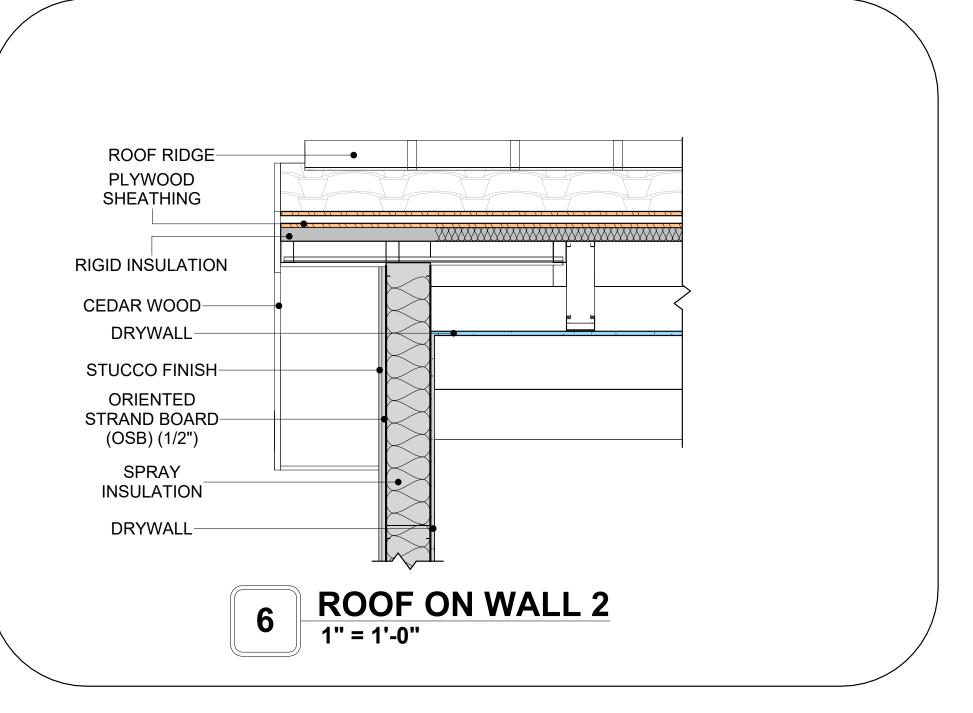

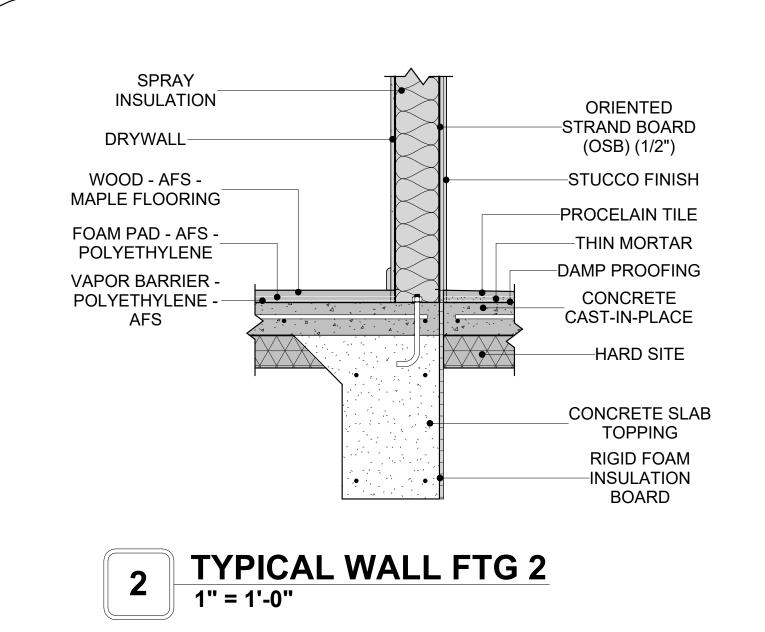

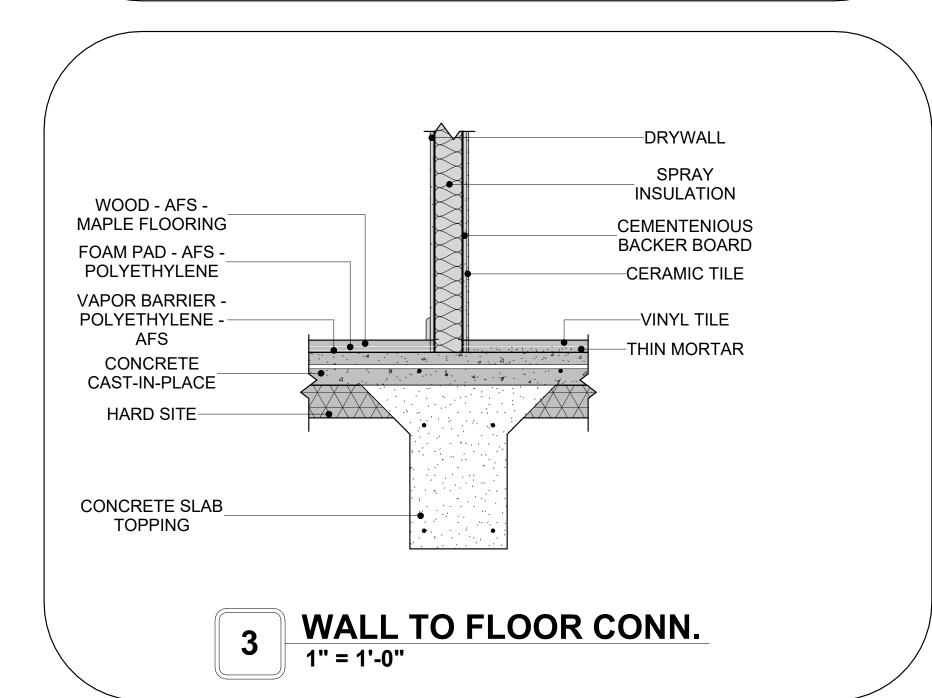

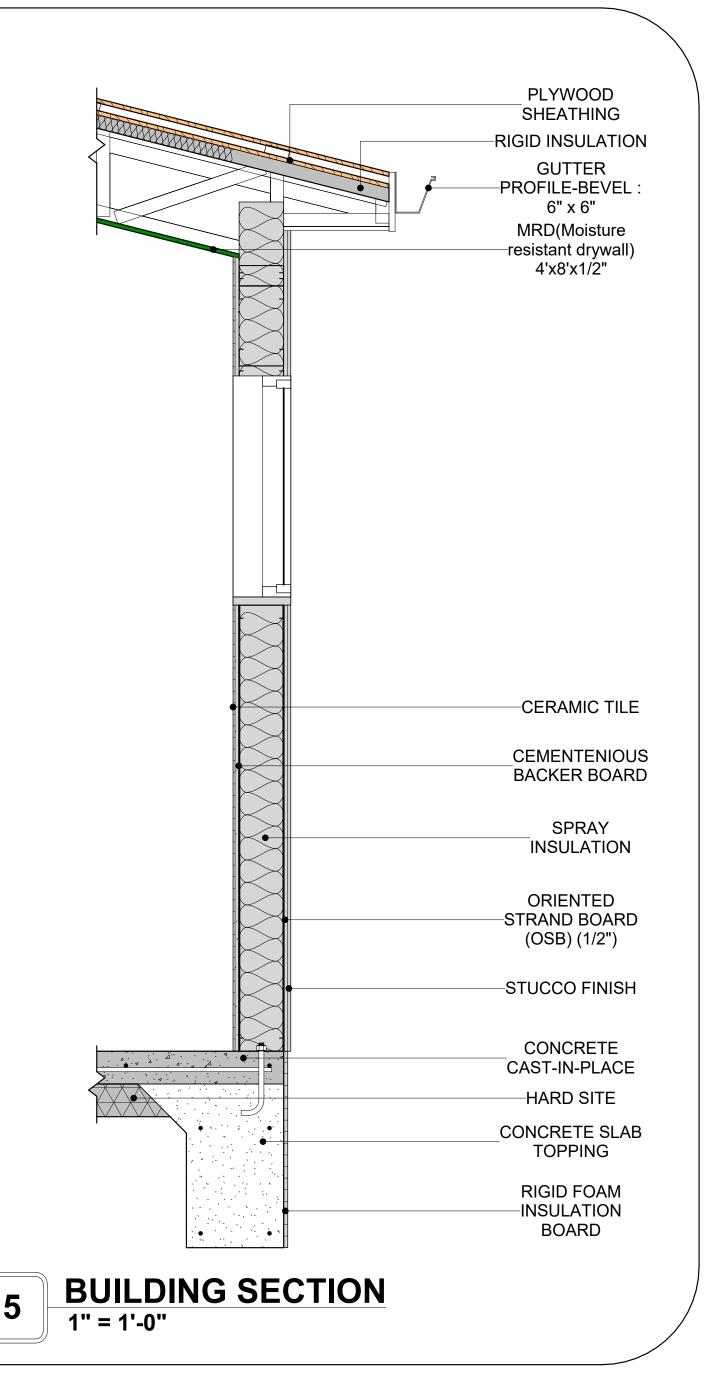



KEY PLAN

NO.	DESCRIPTION	DAT

NOTE:

LEGEND:

PROJECT

109 BENNETT 796 2Bd2Ba SPANISH 550

DRAWING NAME

ARCHITECTURAL DETAILS

	Client Name
:	0061_12
3/	0/2025 11:52:25 AM
	Designer
	Author
	Checker

A401


SCALE: 1" = 1'-0"


CASEWORK GENERAL NOTES


- ALL CABINET HEIGHTS INCLUDE COUNTERTOPS. DIMENSIONS ARE TO THE NEAREST INCH. DIVISIONS IN CASEWORK ARE SHOWN FOR CLARITY AND DO NOT REPRESENT BREAKS IN THE COUNTERTOP.
- PROVIDE CONTINUOUS COUNTERTOP OVER ALL SIMILAR HEIGHT CASEWORK, UNLESS AND OTHERWISE NOTED.
- MANUFACTURER AND CATALOG NUMBERS ARE FOR REFERENCE AND ILLUSTRATION PURPOSES
- DOTTED LINES INDICATE WALL HUNG CABINETS, DIVISIONS OF BASE CABINETS BELOW THE
- COUNTERTOP, FURNITURE NOT IN THE CONTRACT OR PROJECTION SCREENS -SEE CASEWORK KEY AND SPECIFICATIONS.
- ALL CABINETS AND DRAWERS TO HAVE CAM LOCKS EXCEPT FOR SINK BASE CABINETS. ALL EXPOSED SURFACES (EXPOSED TO VIEW FROM ANY PERSPECTIVE) TO BE COVERED WITH
- LAMINATE.
- ALL CASEWORK WHICH MEETS A WALL AT ONE OR BOTH ENDS, TO BE PROVIDED WITH FILLER PANELS AND SCRIBED TO THE WALL(S) AS REQUIRED.
- 10. ALL CABINETS AND DRAWERS ARE PROVIDED WITH RECESSED HANDLES.
- 11. CONTRACTOR TO FIELD VERIFY ALL CLEAR OPENINGS PRIOR TO MILLWORK OR CASEWORK FABRICATION.
- 12. CASEWORK DRAWINGS ARE DIAGRAMMATIC IN NATURE TO SHOW DESIGN INTENT.

	CAS	SEWOR	K SCHEDI	JLE		
TYPE MAR K	TYPE	COUN T	HEIGHT	WIDTH	DEPTH	AREA
01	LINEAR COUNTER TOP 12	1	0' - 4"	8' - 7"	2' - 1"	3 SF
02	BASE CABINET DOUBLE DOOR 2	1	2' - 11"	2' - 9"	2' - 0"	8 SF
03	BASE CABINET L-SHAPED 3	1	2' - 11"	3' - 3"	3' - 3"	9 SF
04	HD L-SHAPE COUNTER TOP11 2	1	0' - 4"	9' - 7"	4' - 0"	3 SF
05	WALL CABINET SINGLE DOOR	1	2' - 6"	2' - 7"	1' - 0"	6 SF
06	HD WALL FILLER 4' HIGH	1	2' - 6"	0' - 8"	1' - 0"	2 SF
07	WALL CABINET DOUBLE DOOR 1	1	2' - 6"	3' - 0"	1' - 0"	8 SF
08	WALL FILLER	1	2' - 6"	0' - 8"	1' - 0"	2 SF
09	LINEAR COUNTER TOP	1	0' - 4"	3' - 8"	2' - 1"	1 SF
10	BASE CABINET DOUBLE DOOR 2	1	2' - 11"	3' - 0"	2' - 0"	9 SF
11	BASE_FILLER_1	1	2' - 11"	0' - 8"	2' - 0"	2 SF
12	REFRIGERATOR TOP	1	1' - 6"	2' - 0"	2' - 4"	3 SF
13	RECESSED_MED_CABINET	2	2' - 0"	1' - 6"	0' - 3"	3 SF
14	VANITY	2	2' - 4"	2' - 6"	1' - 8"	6 SF
15	CLOSET 2	1	6' - 0"	9' - 11"	1' - 4"	60 SF
16	CLOSET 4	1	6' - 0"	6' - 8"	1' - 4"	40 SF
GRAND	TOTAL	18				

SPECIALTY EQUIPMENT SCHEDULE			
TYPE MARK	TYPE	COUNT	
01	WASHER-FRONT-LOAD	1	
02	REFRIGERATOR	1	
03	RANGE	1	
04	DRYER-FRONT-LOAD	1	
05	DISHWASHER	1	
GRAND TOTAL: 5		·	

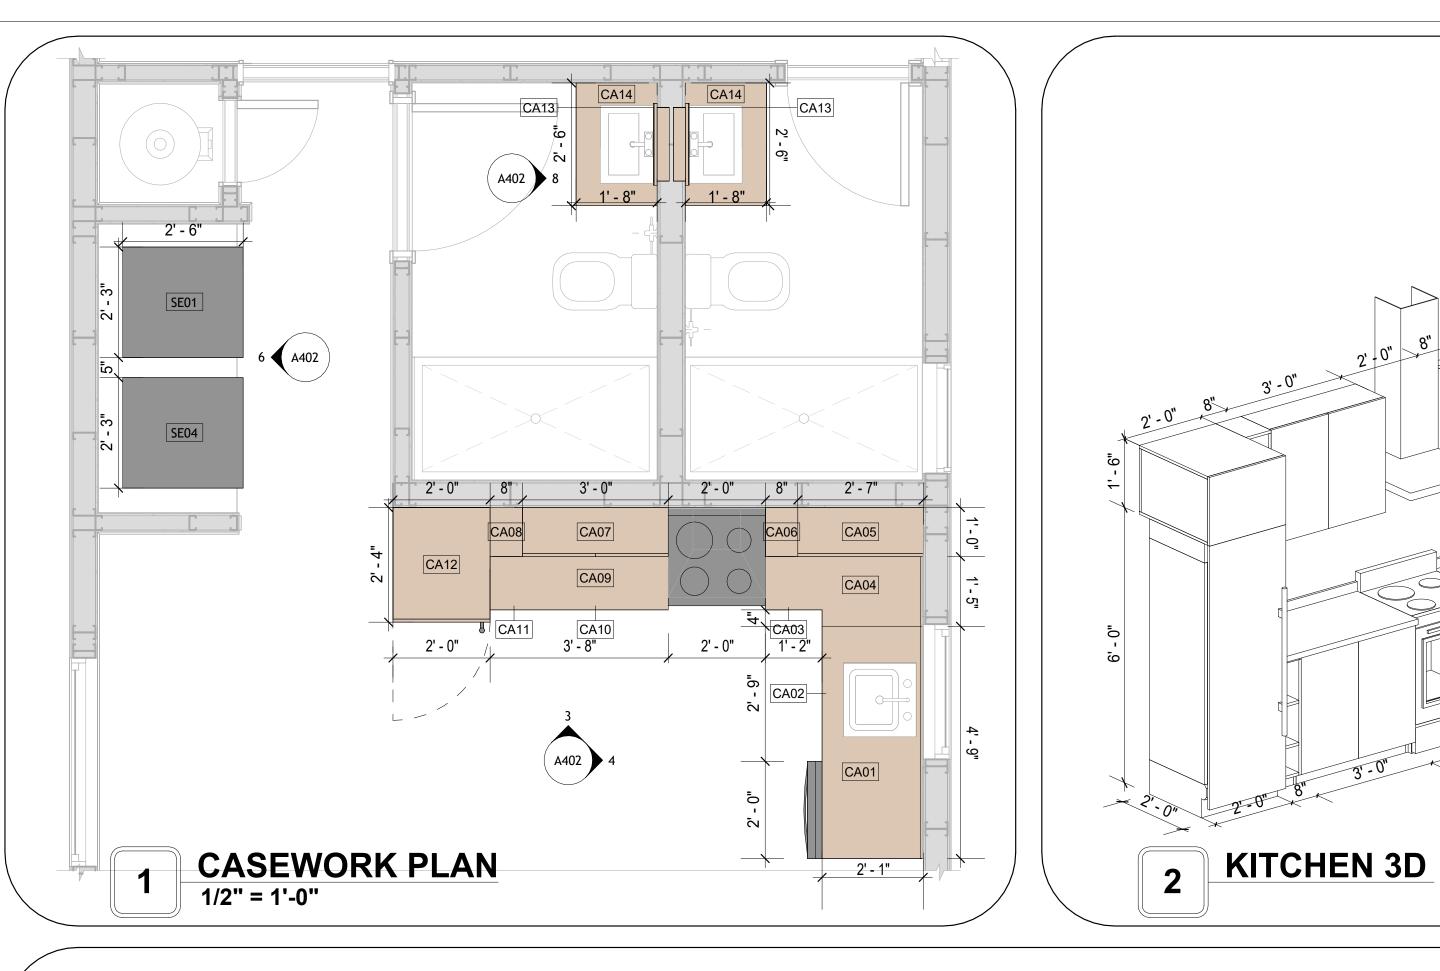


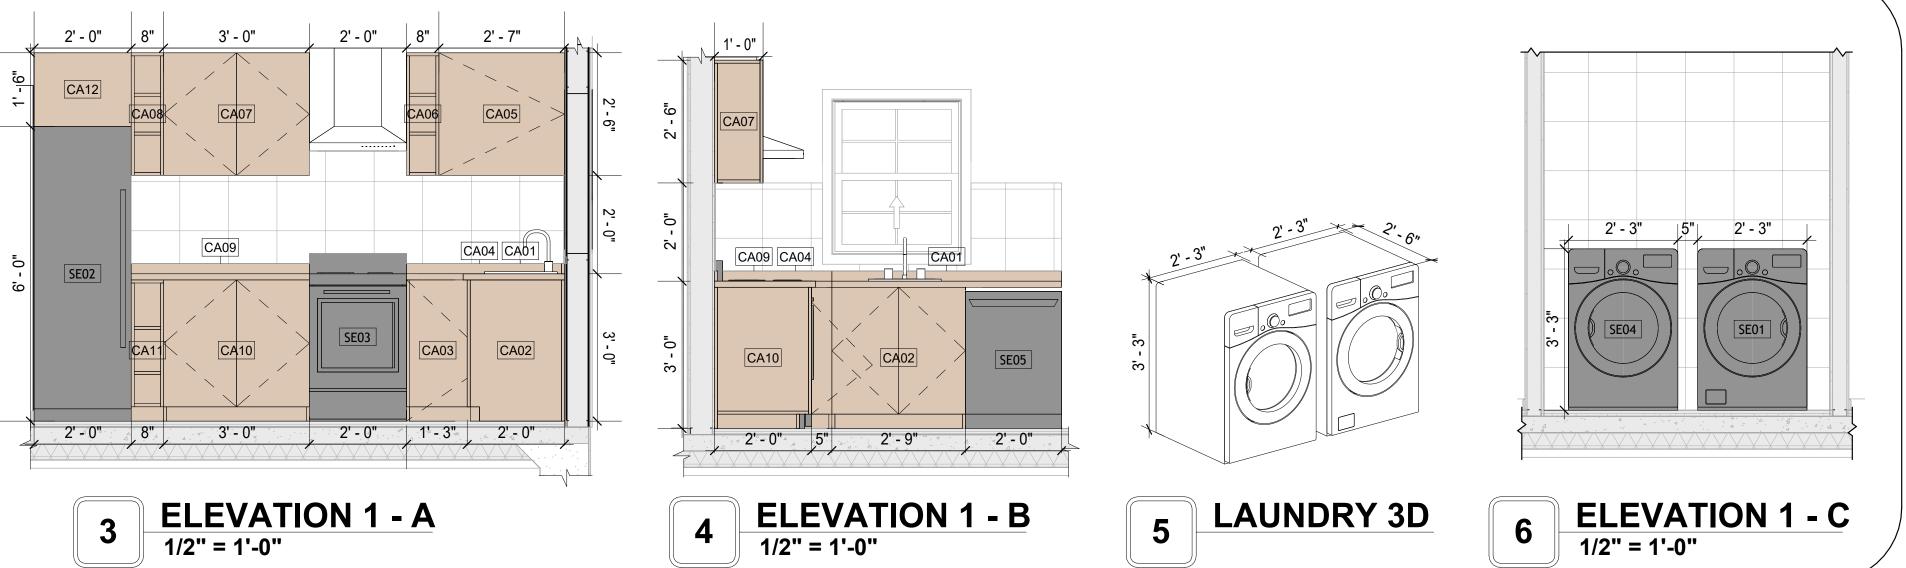

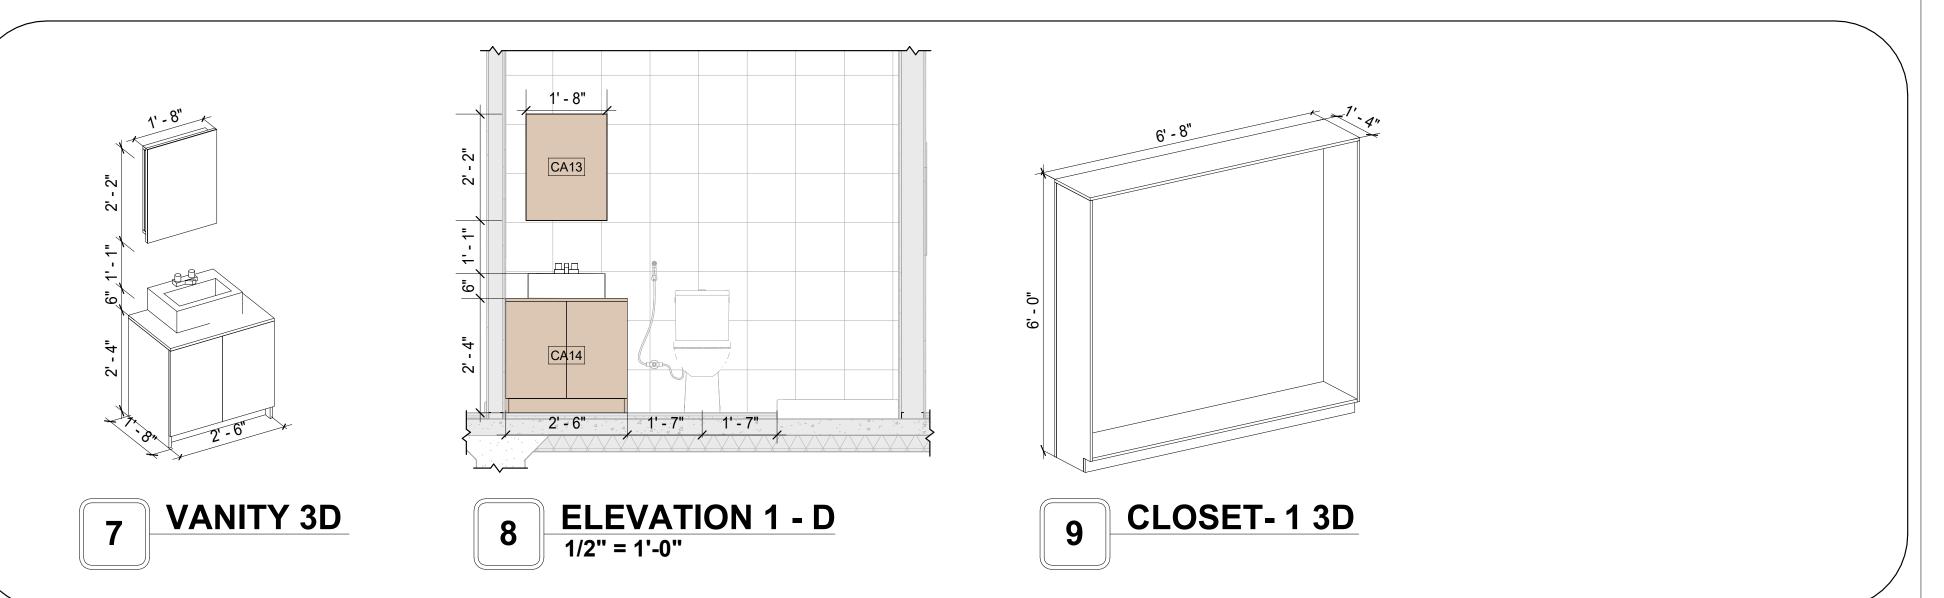



KEY PLAN

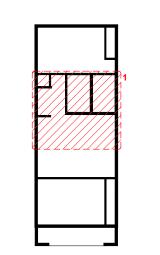

NO.	DESCRIPTION	DATE

NOTE:

LEGEND:

PROJECT

109 BENNETT 796 2Bd2Ba **SPANISH 550**

DRAWING NAME

ARCHITECTURAL CASEWORK

CLIENT NAME:	Client Name
PROJECT NUMBER:	0061_12
DATE:	3/10/2025 11:52:28 AM
DESIGNED BY:	Designer
DRAWN BY:	Author
CHECKED BY:	Checker

A402

GENERAL NOTES

1. THIS DRAWING DEPICTS THE HVAC (HEATING, VENTILATION, AND AIR CONDITIONING) SYSTEM FOR THE BENNETT 2BD2BA SPANISH _NG. IT PROVIDES A VISUAL REPRESENTATION OF THE SYSTEM LAYOUT AND COMPONENTS.

2.THE HVAC SYSTEM IS DESIGNED TO MEET THE SPECIFIC REQUIREMENTS OF THE BUILDING, INCLUDING HEATING, COOLING, AND VENTILATION NEEDS, AS PER THE PROJECT SPECIFICATIONS AND APPLICABLE CODES AND STANDARDS.

3. THE HVAC SYSTEM INSTALLATION SHALL COMPLY WITH THE LATEST EDITION OF THE INTERNATIONAL MECHANICAL CODE (IMC), INTERNATIONAL RESIDENTIAL CODE (IRC), AND ALL OTHER APPLICABLE LOCAL, STATE, AND NATIONAL CODES AND REGULATIONS.

4. THE EQUIPMENT SHOWN ON THIS DRAWING INCLUDES BUT IS NOT LIMITED TO AIR HANDLING UNITS (AHUS), CHILLERS, BOILERS, COOLING TOWERS, PUMPS, DUCTWORK, DIFFUSERS, GRILLES, AND CONTROL DEVICES.

5. ALL EQUIPMENT, DUCTWORK, AND PIPING SHALL BE INSTALLED IN ACCORDANCE WITH MANUFACTURER'S SPECIFICATIONS, LOCAL CODES, AND

6. ALL DUCTWORK SHALL BE SIZED, FABRICATED, AND INSTALLED IN ACCORDANCE WITH THE LATEST EDITION OF THE ACCA MANUAL D AND THE SMACNA HVAC DUCT CONSTRUCTION STANDARDS. DUCTWORK SHALL BE INSTALLED IN A NEAT AND WORKMANLIKE MANNER, PROPERLY SUPPORTED AND BRACED TO PREVENT SAGGING, AIR LEAKAGE, OR VIBRATION.

7. CONDENSATE DRAINAGE PIPING SHALL BE PROPERLY PITCHED TO ENSURE POSITIVE DRAINAGE TO AN APPROVED DISPOSAL LOCATION, SUCH AS A FLOOR DRAIN, SUMP PUMP, OR EXTERIOR GRADE. CONDENSATE LINES SHALL BE INSULATED TO PREVENT SWEATING.

8. THE LOCATION OF CONTROL PANELS AND SENSORS INDICATED ON THIS DRAWING CAN BEMODIFY WITH THE SPECIFIC LOCATIONS AND WIRING DETAILS WILL BE DETERMINED DURING THE CONTROL SYSTEM DESIGN AND INSTALLATION.

9. THE HVAC SYSTEM DESIGN CONSIDER ENERGY EFFICIENCY, INDOOR AIR QUALITY, OCCUPANT COMFORT, AND NOISE CONTROL, FOLLOWING APPLICABLE GUIDELINES AND REGULATIONS.

WITH THE LOCAL BUILDING DEPARTMENT AND UTILITY PROVIDERS TO ENSURE A TIMELY AND COMPLIANT INSTALLATION.

10. COORDINATION WITH OTHER TREADS HAS BEEN DONE ON A DESIGN LEVEL. THIS DRAWING SHALL BE READ TOGETHER WITH THE AR. EL AND SN

DESIGN DRAWINGS TO ENSURE PROPER INSTALLATION AND INTEGRATION OF THE HVAC SYSTEMS. 11. THE HVAC CONTRACTOR IS RESPONSIBLE FOR OBTAINING ALL NECESSARY PERMITS AND LICENSES, AND FOR SCHEDULING AND COORDINATING

12. ALL DUCTWORK PENETRATIONS THROUGH WALLS, FLOORS, OR CEILINGS SHALL BE PROPERLY SEALED AND FIRE-STOPPED USING APPROVED METHODS AND MATERIALS TO MAINTAIN THE INTEGRITY OF THE BUILDING'S FIRE-RESISTANCE RATINGS.

13. HVAC EQUIPMENT SHALL BE INSTALLED LEVEL AND PLUMB, AND IN STRICT ACCORDANCE WITH THE MANUFACTURER'S INSTALLATION INSTRUCTIONS AND RECOMMENDATIONS. PROVIDE ADEQUATÉ CLEARANCES AROUND EQUIPMENT FOR PROPER AIRFLOW, SERVICE ACCESS, AND

CODE COMPLIANCE. 14. ALL HVAC EQUIPMENT AND COMPONENTS, INCLUDING THERMOSTATS, DAMPERS, AND ACCESS PANELS, SHALL BE LOCATED IN ACCESSIBLE AREAS


15. THE HVAC SYSTEM SHALL BE BALANCED AND ADJUSTED TO ENSURE PROPER AIRFLOW, TEMPERATURE DISTRIBUTION, AND SYSTEM PERFORMANCE THROUGHOUT THE RESIDENCE. PROVIDE A WRITTEN REPORT DOCUMENTING THE FINAL SYSTEM BALANCE.


16. ANY DEVIATIONS OR MODIFICATIONS TO THE HVAC SYSTEM DESIGN SHALL BE REVIEWED AND APPROVED BY THE RESPONSIBLE DESIGN PROFESSIONALS AND COMMUNICATED TO ALL RELEVANT PARTIES INVOLVED IN THE CONSTRUCTION PROCESS.

FOR EASY SERVICING AND MAINTENANCE. PROVIDE ADEQUATE SPACE AROUND EQUIPMENT FOR PROPER AIRFLOW AND SERVICE ACCESS.

17. FOR ANY INQUIRIES OR CLARIFICATIONS REGARDING THE HVAC SYSTEM DESIGN, PLEASE CONSULT THE RESPONSIBLE DESIGN PROFESSIONALS OR THE PROJECT MANAGEMENT TEAM.

SYMBOLS

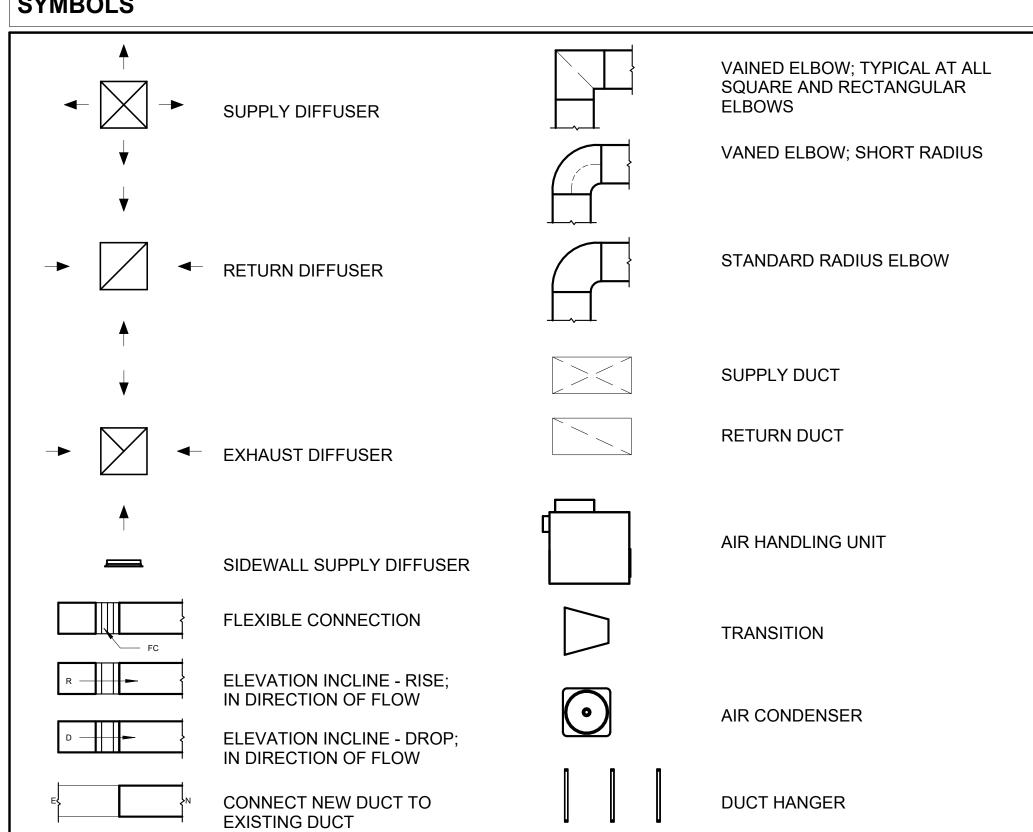


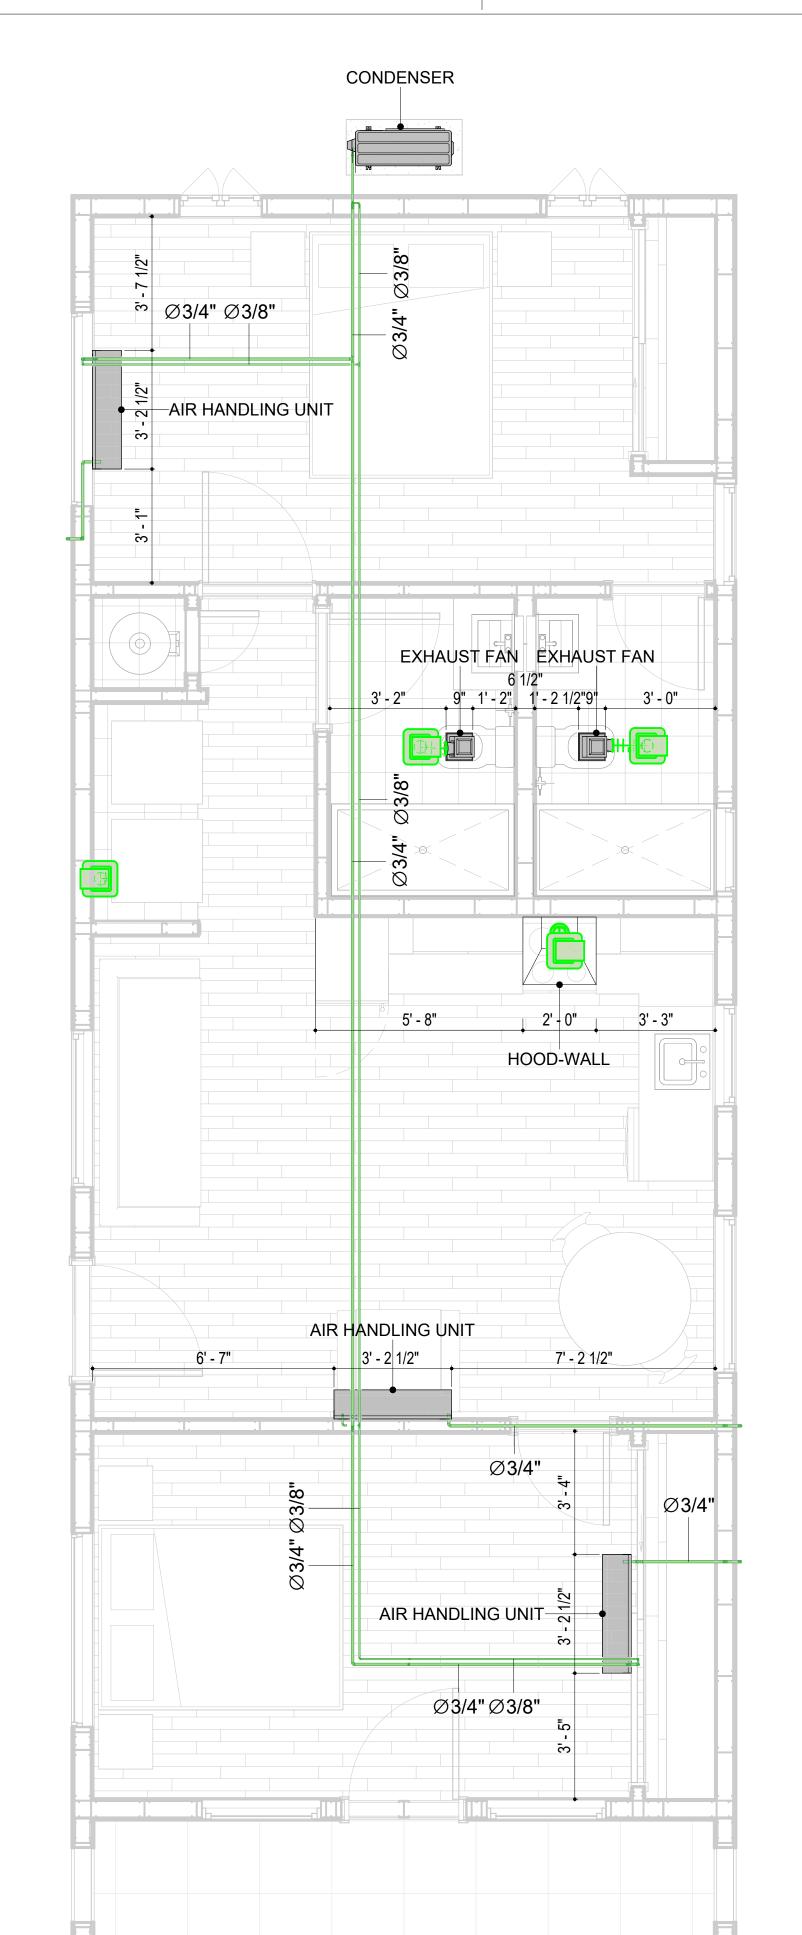

HVAC PLAN 3/8" = 1'-0"

HVAC COLOR SCHEME

AIR CONDITIONING PIPE

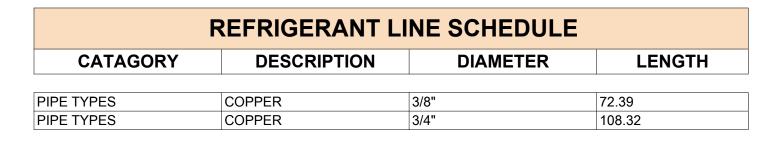

REFRIGERANT LINE FITTING SCHEDULE					
CATAGORY	DESCRIPTION	Size	Count		
ELBOW - GENERIC	ELBOW - GENERIC: STANDARD/HVAC	3/4"ø-3/4"ø	27		
ELBOW - GENERIC	ELBOW - GENERIC: STANDARD/HVAC	3/8"ø-3/8"ø	18		
TEE - GENERIC	TEE - GENERIC: STANDARD	3/4"ø-3/4"ø-3/ 4"ø	2		
TEE - GENERIC	TEE - GENERIC: STANDARD	3/8"ø-3/8"ø-3/ 8"ø	2		
TRANSITION - GENERIC	TRANSITION - GENERIC: STANDARD	3/4"ø-1/2"ø	4		
TRANSITION - GENERIC	TRANSITION - GENERIC: STANDARD	3/4"ø-5/8"ø	2		
TRANSITION - GENERIC	TRANSITION - GENERIC: STANDARD	3/8"ø-1/4"ø	1		

MECHANICAL EQUIPMENT SCHEDULE			
CATAGORY DESCRIPTION COL			
AIR HANDLING UNIT	AIR HANDLING UNIT: WALL MOUNTED	3	
	CONDENSER: OUT DOOR 1		
CONDENSER	CONDENSER: OUT DOOR	1	
CONDENSER EXHAUST FAN	CONDENSER: OUT DOOR EXHAUST FAN: 75 CFM	2	

DUCT FITTING SCHEDULE			
CATAGORY	DESCRIP	TION	COUNT
ROUND TRANSITION - ANGLE	45 DEGREE		8

DUCT ACCESSORY SCHEDULE				
CATAGORY	DESCRIPTION	COUNT		
ROOF VENT	3" DIAMETER	4		

FLEX DUCT SCHEDULE				
DESCRIPTION	DESCRIPTION	LENGTH	DIAMETER	COUNT
FLEX DUCT ROUND	FLEX-ROUND	12.66	4"	4
GRAND TOTAL: 4	•	12.66	•	•



KEY PLAN

NO.	DESCRIPTION	DATE

NOTE:

LEGEND:

PROJECT

109-Bennett-796 2Bd2Ba Spanish-550

DRAWING NAME

HVAC PLAN

CLIENT NAME:	Owner
PROJECT NUMBER:	15_0001
DATE:	3/6/2025 10:38:03 PM
DESIGNED BY:	Designer
DRAWN BY:	Author
CHECKED BY:	Checker

M101

SCALE: As indicated

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ELECTRICAL NOTES

- 1. THIS DRAWING DEPICTS THE ELECTRICAL SYSTEM FOR THE 109_Bennett_796_2Bd2Ba_Spanish_550. IT PROVIDES A VISUAL REPRESENTATION OF THE ELECTRICAL LAYOUT AND COMPONENT'S, INCLUDING POWER DISTRIBUTION, LIGHTING, AND CONTROL SYSTEMS.
- 2. THE ELECTRICAL SYSTEM IS DESIGNED TO MEET THE SPECIFIC REQUIREMENTS OF THE BUILDING, INCLUDING POWER DISTRIBUTION, LIGHTING, AND SPECIALIZED ELECTRICAL EQUIPMENT NEEDS, AS PER THE PROJECT SPECIFICATIONS AND APPLICABLE CODES AND STANDARDS.
- 3. THE ELECTRICAL SYSTEM INSTALLATION SHALL COMPLY WITH THE LATEST EDITION OF THE NATIONAL ELECTRICAL CODE (NEC), INTERNATIONAL BUILDING CODE (IBC), AND ALL OTHER APPLICABLE LOCAL, STATE, AND NATIONAL CODES AND REGULATIONS.
- 4. LOCATIONS AS NEEDED, DEVICES ARE SHOWN ON PLANS IN APPROXIMATE IDEAL LOCATIONS, UNLESS SPECIFICALLY DIMMENSIONED.
- OPEN WALLS AS NEEDED TO ALLOW FOR NEW ELECTRICAL INSTALLATIONS.
- 6. LABEL ALL CIRCUITS ON JUNCTION BOXES, RECEPTACLES, DATA, SMOKE DETECTOR, AND EQUIPMENT IN PANEL BOX.
- 7. INSTALL RACEWAY AS NEEDED FOR DDC, ACCESS CONTROL, LOW VOLTAGE WIRING & DATA.
- 8. RELABEL POWER, DATA & FIRE ALARM FOR ROOM #CHANGES.
- 9. VERIFY ALL CIRCUITS LABELED ON PRINT ARE CORRECT BEFORE WORKING ON THEM. 10. NOTE ON SITE PLAN – ALL CHANGES OR MISSING DETAIL TO BE INCORPORATED INTO THE MASTER PLAN.
- 11. DRAWINGS ARE DIAGRAMMATIC ONLY FOR THE PURPOSE OF SHOWING FIXTURE AND OUTLET LOCATIONS.
- 12. ELECTRICAL CONTRACTOR TO VERIFY SERVICE SIZE BY CALCULATION BASED UPON ACTUAL NAME PLATE RATINGS OF SELECTED EQUIPMENT.
- 13. VERIFY LOCATION OF SERVICE ENTRANCE WITH POWER COMPANY. PROVIDE UFER GROUND IN
- BUILDING FOUNDATION AT SERVICE ENTRANCE LOCATION.
- 14. PROVIDE A MIN. OF 20 FEET OF ONE *4 BARE COPPER UFER WIRE EMBEDDED IN CONCRETE FOOTING AT THE SERVICE ENTRANCE LOCATION WHERE APPROVED BY LOCAL SERVICE PROVIDER.
- 15. PROVIDE WATERPROOF FIXTURES IN ALL HIGH MOISTURE AREAS (EXTERIOR, SHOWER AND TUB CEILINGS ETC.)
- 16. PROVIDE DEDICATED CIRCUITS TO EACH BATH, DEN, FAMILY ROOM, BEDROOM, LOFT, KITCHEN
- REFRIGERATOR, KITCHEN FREEZER DISHWASHER, AND ANY AREA/ITEM SPECIFIED BY OWNER. 17. INCANDESCENT FIXTURES WITH OPEN OR PARTIALLY ENCLOSED LAMPS, PENDANT FIXTURES, AND
- LAMP HOLDERS ARE NOT PERMITTED IN CLOSETS.
- 18. ALL WORKMANSHIP AND MATERIALS TO CONFORM WITH THE 2015 IRC. 19. PROVIDE A MIN. OF 20 FEET OF ONE *4 BARE COPPER UFER WIRE EMBEDDED IN CONCRETE FOOTING
- AT THE SERVICE ENTRANCE LOCATION WHERE APPROVED BY LOCAL SERVICE PROVIDER. 20. PROVIDE A BONDING CONDUCTOR CONSISTING OF A MINIMUM OF ONE *4 BARE COPPER WIRE CONNECTING THE BUILDING'S METAL WATER PIPING SYSTEM TO THE SERVICE EQUIPMENT ENCLOSURE GROUNDING.

MAIN PANEL CALCS

	400 41400 TOTAL
TOTAL	26,275 W
MINI. SPLIT UNITS	10,000 W
FRIST 10,000 @ 100% REMAINDER @ 40%	10,000 W 6,275 W
	20,000
TOTAL	25,688 W
DISHWASHER & DISPOSAL	3000 W
REFRIG.	1,800 W
WATER HEATER	5,000 W
RANGE	5,000 W
WASHER	2,000 W
DRYER	2,000 W
3 APPLIANCE CIRCUITS	4,500 W
LIGHT AND OUTLETS 796 @ 3W	2,388 W
ELECTRICAL CALCS	

26,275 W DIVIDED BY 240V = 109 AMPS TOTAL

(USE 200 AMP SERVICE)

ELECTRICAL ABBREVIATIONS LIST

AMP	
A MERER ACLG ABOVE COUNTER OR AIR CONDITIONER ACLG ABOVE COLLING ADD ADD ADD ADD AMOVE COLLING ADD ADD AMOVE COLLING ADD ADD AMOVE CELLING DET DET DET DET DETAIL DETA	
ACLG	
ADO	
AFF	GE
AFF	ENTILATING AND AIR
AFG	1G
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	ERS LABORATORIES
CT CURRENT TRANSFORMER GYP BD GYPSUM BOARD UL UNDERWRITE	ENO LADUKATUKIES

Branch Panel:

Location: CL2 02 Supply From: Mounting: Recessed Enclosure: Type 1

Volts: 120/240 Single Phases: 1 Wires: 3

A.I.C. Rating: Mains Type: Mains Rating: 200 A MCB Rating: 1 A

Circuit Numb er		Number of Elements	Rating	Length	Wire Size	A		ı	3	Wire Size	Length	Rating	Number of Elements	l l	Circu Num er
1	CONDENCER	1	60 A	57' - 6 3/8"	2-#6, 1-#6, 1-#10	750 VA	720 VA			1-#12, 1-#12, 1-#12	64' - 8 1/8"	20 A	4	GFCI OUTDOOR RECEPTACLES	2
3								750 VA	400 VA	1-#12, 1-#12, 1-#12	34' - 1 9/16"	20 A	6	OUT DOOR LIGHT POINTS	4
5	BEDROOM 1 RECEPTACLES	5	20 A	64' - 1 5/8"	1-#12, 1-#12, 1-#12	900 VA	900 VA			1-#12, 1-#12, 1-#12	31' - 8 7/16"	20 A	5	BEDROOM 2 RECEPTACLES	6
7	WATER HEATER	1	30 A	54' - 0 13/16"	2-#10, 1-#10, 1-#10			750 VA	1500 VA	2-#10, 1-#10, 1-#10	49' - 1 15/16"	30 A	2	DRYER	8
9						750 VA	1500 VA				-				10
11	GFCI WASHER	2	20 A	50' - 1 5/16"	1-#8, 1-#8, 1-#8			2400 VA	1500 VA	1-#12, 1-#12, 1-#12	37' - 5 7/8"	20 A	1	REFRIGERATOR	12
13	GFCI KITCHEN	5	20 A	36' - 3 7/16"	1-#12, 1-#12, 1-#12	900 VA	750 VA			2-#8, 1-#8, 1-#10	32' - 3"	50 A	1	RANGE	14
15	BATH 1 UNITS	4	20 A	41' - 8 1/8"	1-#12, 1-#12, 1-#12			336 VA	750 VA						16
17	BATH 2 UNITS	4	20 A	40' - 3 5/8"	1-#12, 1-#12, 1-#12	336 VA	900 VA			1-#12, 1-#12, 1-#12	43' - 5 15/16"	20 A	5	LIVING ROOM RECEPTACLES	18
19	GFCI DISH WASHER	1	30 A	22' - 9 5/16"	1-#10, 1-#10, 1-#10			1200 VA	576 VA	1-#12, 1-#12, 1-#12	40' - 6 3/16"	20 A	13	LIVING ROOM AND HALL LIGHT POINTS	20
21	BEDROOM 1 LIGHT POINTS	10	20 A	54' - 2 31/32"	1-#12, 1-#12, 1-#12	568 VA	568 VA			1-#12, 1-#12, 1-#12	22' - 5 9/16"	20 A	10	BEDROOM 2 LIGHT POINTS	T 22
23															24
25															26
						9539 79			2 VA						

Legend:

Load Classification	Connected Load	Demand Factor	Estimated Demand	Panel	Totals
Lighting - Dwelling Unit	700 VA	100.00%	700 VA		
Other	1544 VA	100.00%	1544 VA	Total Conn. Load:	19681 VA
Receptacle	17280 VA	78.94%	13640 VA	Total Est. Demand:	16041 VA
Lighting	200 VA	100.00%	200 VA	Total Conn.:	82 A
				Total Est. Demand:	67 A



KEY PLAN

DESCRIPTION DATE

NOTE:

LEGEND:

PROJECT

109-BENNETT-796-2Bd2Ba **SPANISH-550**

DRAWING NAME

SCHEDULE

CLIENT NAME: Owner PROJECT NUMBER 0037_14 3/6/2025 4:11:12 AM Designer DESIGNED BY: DRAWN BY: CHECKED BY: Checker

E101

SCALE: 1/4" = 1'-0"

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ELECTRICAL NOTE

- PROVIDE INTERCONNECTED SMOKE ALARMS IN EACH SLEEPING ROOMS, OUTSIDE EACH SLEEPING ROOM, ON EACH STORY, IN THE HALL OR ADJACENT ROOM LUHERE THE CEILING HEIGHT OF A ROOM OPEN TO THE HALL EXCEEDS THE HALL BY 24'. SMOKE ALARMS SHALL BE PERMANENTLY HARD WIRED WITH BATTERY BACKUP.
- B. RECEPTACLE OUTLETS FOR RANGES AND CLOTHES DRYERS SHALL BE A THREE POLE WITH GROUND TYPE. FOUR WIRE GROUNDING-TYPE FLEXIBLE CORDS WILL BE REQUIRED FOR CONNECTION OF RANGES AND CLOTHES DRYERS. THE BONDING JUMPER SHALL NOT BE CONNECTED BETWEEN NEUTRAL TERMINAL AND THE FRAME OF THE **APPLIANCE**
- C. TWO OR MORE 20 AMP SMALL APPLIANCE CIRCUITS SHALL BE PROVIDED TO SERVE THE KITCHEN, BREAKFAST NOOK, AND DINING ROOM. SUCH CIRCUITS SHALL HAVE NO OTHER OUTLETS.
- D. AT LEAST ONE 20 AMP BRANCH CIRCUIT SHALL BE PROVIDED TO SERVICE THE LAUNDRY ROOM. THIS CIRCUIT SHALL HAVE NO OTHER OUTLETS.
- E. ALL RECEPTACLES WITH IN 6' OF A WET BAR SINK OR KITCHEN SINK TO SERVE COUNTER TOP SURFACES MUST BE GFCI. ON KITCHEN COUNTERS 12' OR WIDER NO POINT ALONG THE WALL SHALL BE MORE THAN 2' FROM A RECEPTACLE. ALL RECEPTACLES WITH IN 6' OF KITCHEN SINK MUST BE GFCI. AT LEAST ONE GFCI RECEPTACLE SHALL BE INSTALLED IN THE BATHROOM ADJACENT TO EACH BASIN.
- FIXTURES INCLUDING CEILING FANS THAT ARE LOCATED IN DAMP LOCATIONS SHALL BE LISTED TO BE SUITABLE FOR
- SUCH LOCATIONS PER 2012 IRC
- G. PROVIDE ONE (1) SWITCHED OUTLET @ ALL BEDROOMS AND DEN
- H. CEILING FANS NOT EXCEEDING 35 LBS. (WITH OR WITHOUT ACCESSORIES MAY BE SUPPORTED BY OUTLET BOXES PROVIDED THE OUTLET BOXES ARE IDENTIFIED FOR SUCH USE PER 2012 IRC
- ELECTRICAL OUTLET BOXES ON OPPOSITE SIDES OF FIRE RATED WALLS SHALL BE SEPARATED BY A HORIZONTAL DISTANCE OF NOT LESS THAN 24".
- OUTLET BOXES IN THE WALLS BETWEEN THE GARAGE AND DWELLING SHALL BE METAL OR U.L. APPROVED FIRE RESISTIVE PLASTIC. BOXES IN GARAGE CEILING SHALL BE METAL.
- K. ALL BRANCH CIRCUITS THAT SUPPLY 120 VOLTS SINGLE PHASE 15 AND 20 AMPS RECEPTACLE OUTLETS INSTALLED IN THE DWELLING SHALL BE PROTECTED BY AN ARC FAULT CIRCUIT INTERRUPTER, EXCEPT GFCI RECEPTICLES.

NOTE:

RECEPTACLES MUST BE PROVIDED IN HALLWAYS 10'-0" OR MORE IN LENGTH. FOR A ONE FAMILY DWELLINGS AND EACH OF A TWO FAMILY DWELLING THAT IS AT GRADE LEVEL, AT LEAST ONE WP-GFCI RECEPTACLE OUTLET ACCESSIBLE AT GRADE LEVEL AND NOT MORE THAN 6'-6" ABOVE GRADE SHALL BE INSTALLED AT THE FRONT AND BACK OF THE DWELLING.

NOTE: APPLIANCE DISCONNECT

E4001.5 GROUNDING OF ENCLOSURES.

METAL ENCLOSURES FOR SWITCHES OR CIRCUIT BREAKERS SHALL BE CONNECTED TO AN

EQUIPMENT GROUNDING CONDUCTOR.

METAL ENCLOSURES FOR SWITCHES OR CIRCUIT BREAKERS USED AS SERVICE

EQUIPMENT SHALL COMPLY WITH THE PROVISIONS OF SECTION E3609.4. WHERE


NONMETALLIC ENCLOSURES ARE USED WITH METAL RACEWAYS OR METAL-ARMORED CABLES, PROVISIONS SHALL BE MADE FOR CONNECTING THE EQUIPMENT GROUNDING

CONDUCTOR.


NONMETALLIC BOXES FOR SWITCHES SHALL BE INSTALLED WITH A WIRING METHOD THAT

PROVIDES OR INCLUDES AN EQUIPMENT GROUNDING CONDUCTOR. (404.12)

ELECTRICAL LEGEND Electrical Lights With Fan Waterproof Recessed Can Light 0 Pendant Light **Recessed Can Light** 0 **−**Ø Wall Lamp **Standalone linear** Single Switch **₩** ⊬₽ Three way Switch Fan Switch **Duplex Receptacle** Triplex Receptacle **GFCI Receptacle** \mathbb{X} Exhaust Fan Smoke and heat detector

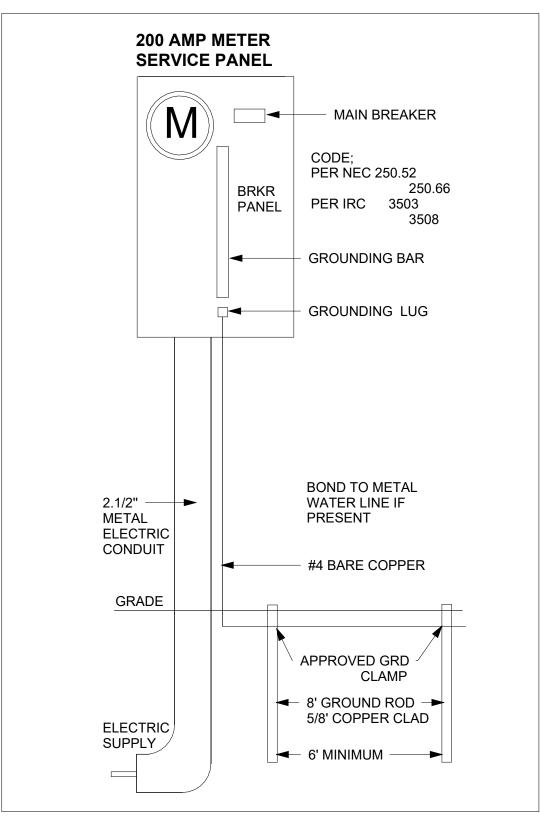



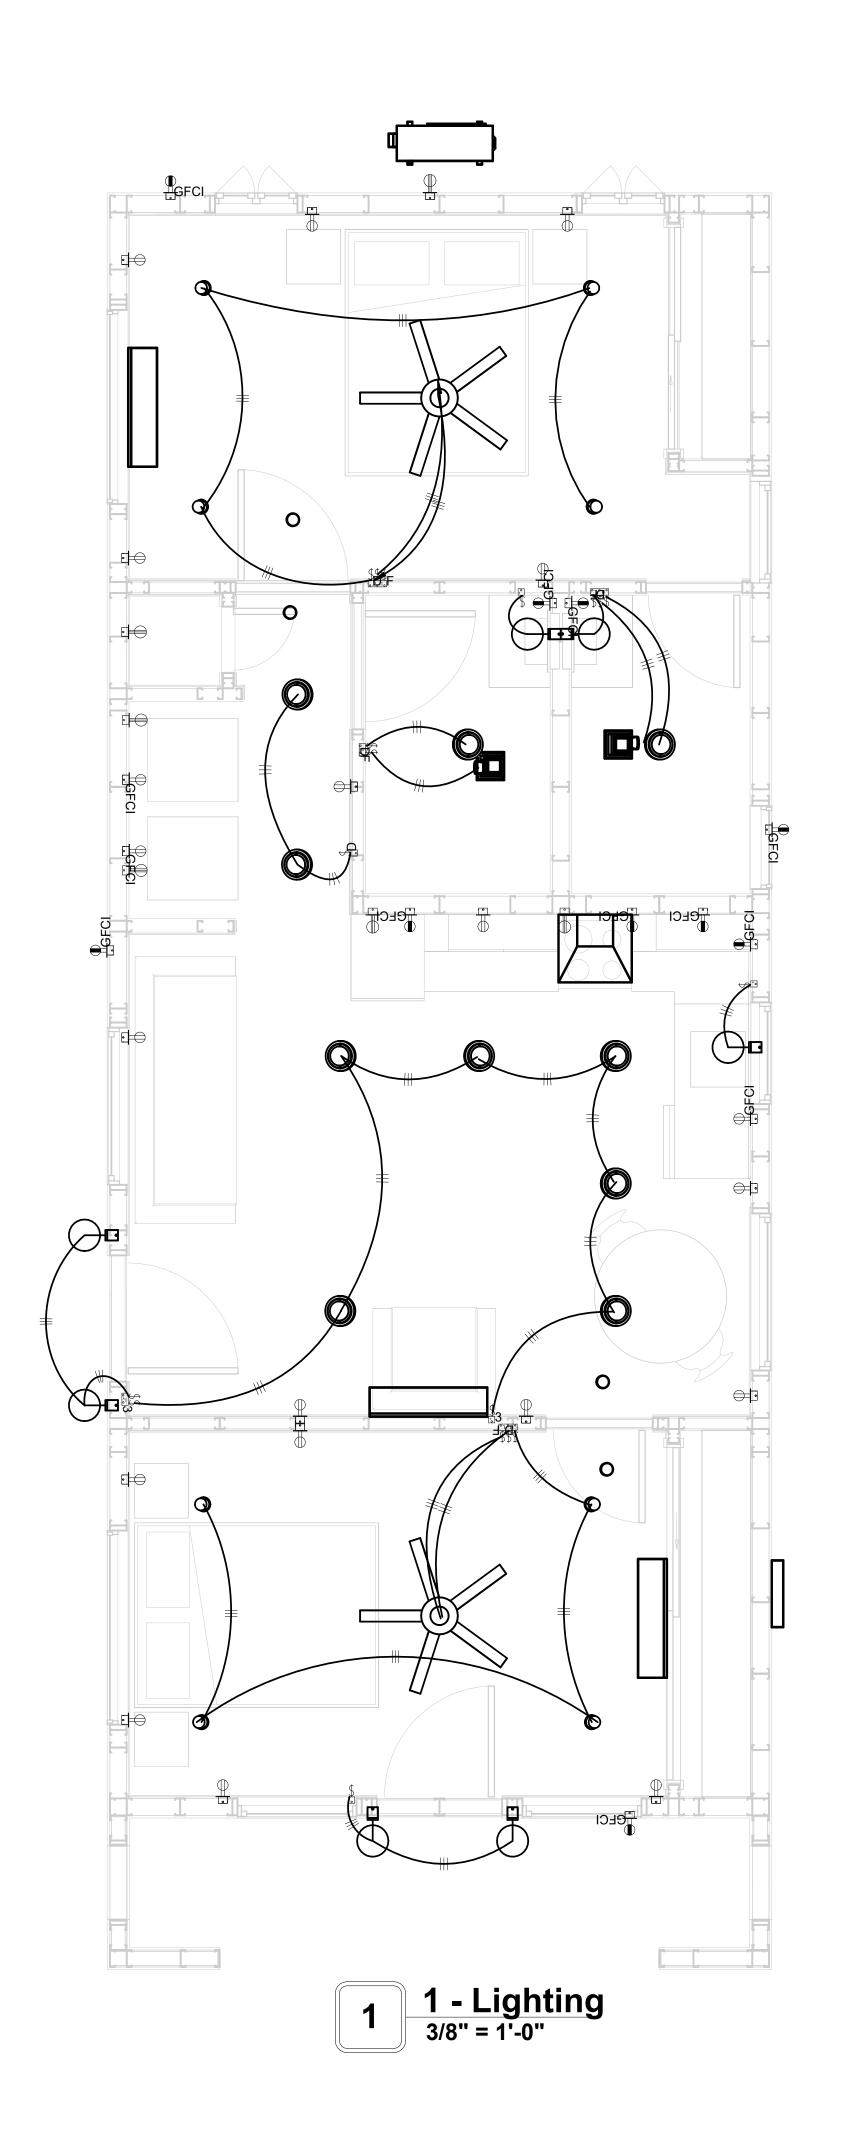



KEY PLAN

NO.	DESCRIPTION	DATE

NOTE:

LEGEND:

PROJECT

109-BENNETT-796-2Bd2Ba SPANISH-550

DRAWING NAME


LIGHTING


Owner	CLIENT NAME:
0037_14	PROJECT NUMBER:
3/6/2025 4:11:14 AM	DATE:
Designer	DESIGNED BY:
Author	DRAWN BY:
Checker	CHECKED BY:

E102

NOTES: CONDUIT, CABLE AND WIRING

- Use Metalic Conduits (IMC) for cables running under concrete slabs.
 Use IMC for circuits with high voltage appliances (240 volts and above)
 For circuits with 120 volts consider using EMT or PVC conduits if needed.
 For Low voltage applications up to 50 volts consider using non metalic conduits.
 All conduits to be used in the project must conform to the latest National Electrical Code (NEC),
- All wiring and cables to be used in the project must also conform to the latest National Electrical Code (NEC), 2015.
- 7. All cables and wires used should be rated for their respective loading and should be gauged and conform to the NEC.

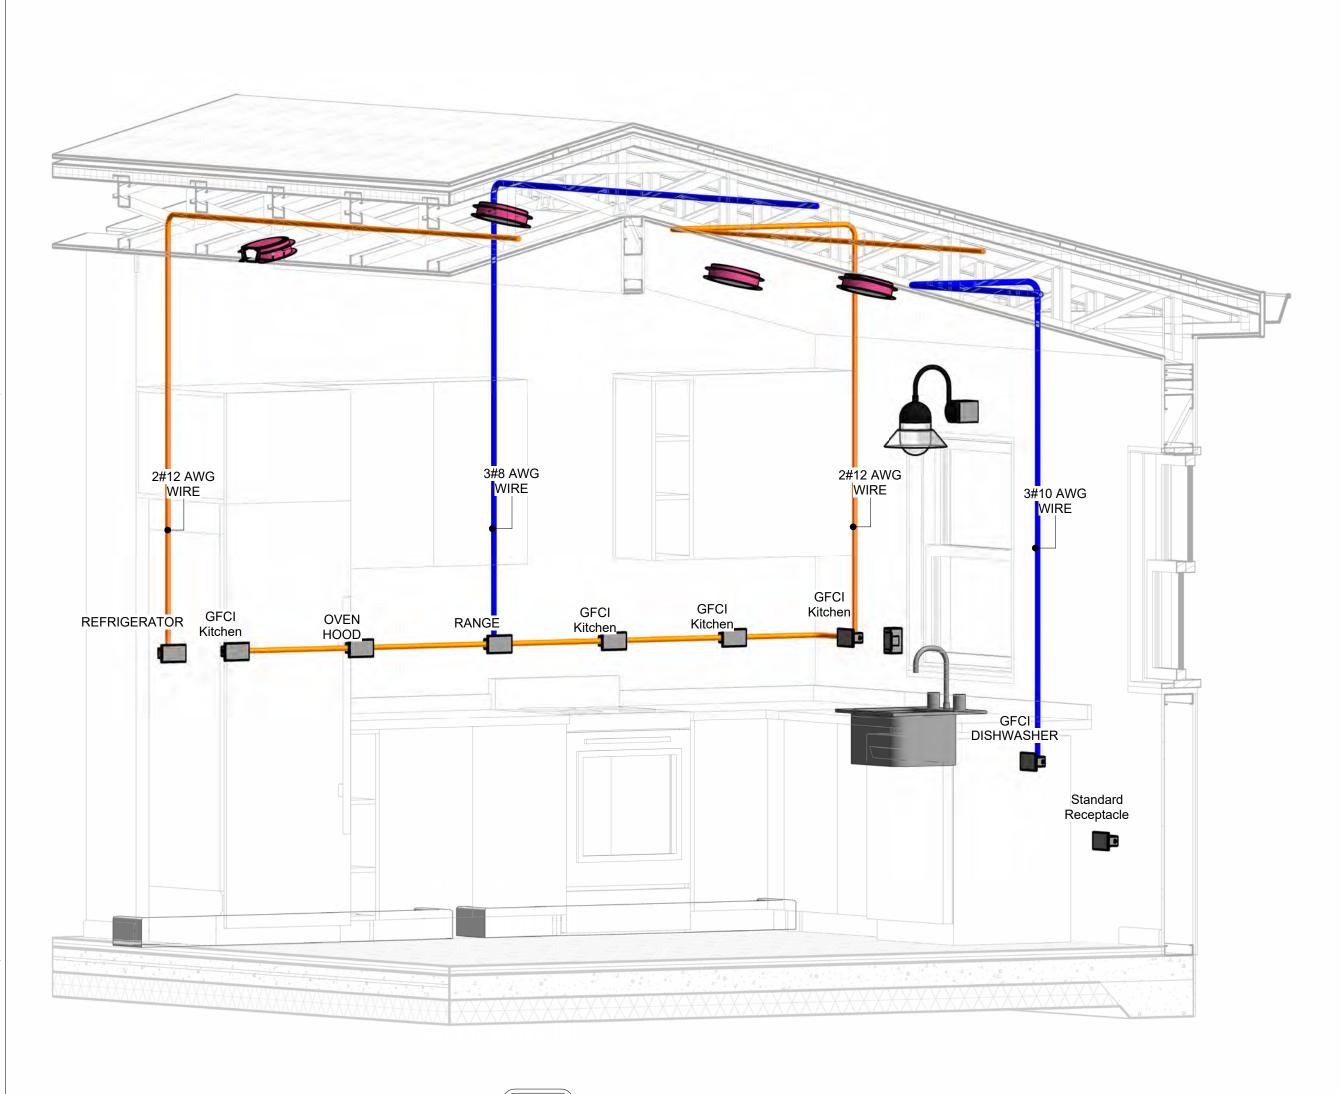

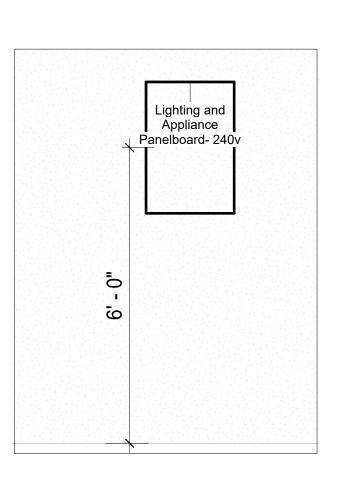



2 Section 1 1/2" = 1'-0"

OVEN HOOD


GFCI Kitchen


REFRIGERATOR Kitchen

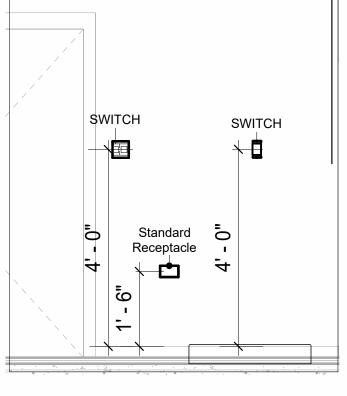

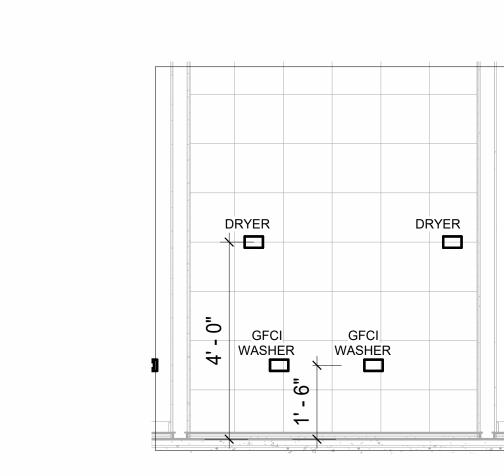

6 Section 4 1/2" = 1'-0"

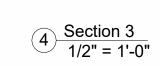

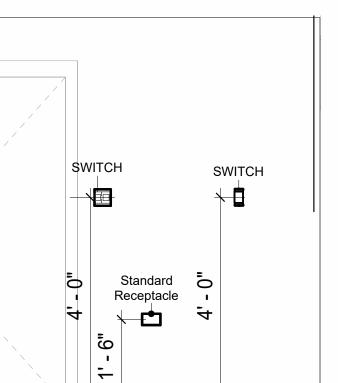

PROJECT

NOTE:

LEGEND:

KEY PLAN

DESCRIPTION

DATE

109-BENNETT-796-2Bd2Ba SPANISH-550

DRAWING NAME

POWER

E103

SCALE: As indicated

3D-KITCHEN

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WATER HEATER

3 Section 2 1/2" = 1'-0"

NOTES: LIGHT

- 1. LIGHT FIXTURES AND LUMINARIES SHALL CONFORM TO THE NEC, THE IRC AND LOCAL SAFETY & BUILDING CODE.
- 2. ALL LIGHTING FIXTURES SHOULD CONFORM TO THE DESIGN ELECTRICAL LOAD AND SHALL BE PROPERLY WIRED AND MOUNTED BY QUALIFIED ELECTRICIAN FOLLOWING MANUFACTURERS SPECIFICATIONS.
- 3. CEILING FANS AND FANS WITH LIGHT WITH WEIGHT EXCEEDING 35 LBS SHOULD BE PROVIDED WITH STRUCTURAL BACKING FOR SUPPORT AND SHALL BE FIXED AS PER MANUFACTURERS SPECIFICATIONS.
- 4. EXTERIOR LIGHTS SHALL CONFORM TO LOCAL BUILDING CODE AND GUIDELINES.

NOTES: SWITCH JUNCTION BOX


- THE MINIMUM SIZE OF JUCTION BOX TO BE USED IS 2"X4"X(1.5" OR 3.5" DEEP) THIS ARE TO BE USED FOR SINGLE GANG SWITCH OR OUTLETS.
- 2. FOR DOUBLE GANG (2 GANG) OUTLETS AND SWITCHS THE MINIMUM SIZE OF THE
- JUCTION BOX TO BE PROVIDED SHALL NOT BE LESS THAN 4"X4"X(1.5" OR 3.5" DEEP)

 3. FOR THREE GANG (3 GANG) OUTLETS AND SWITCHS THE MINIMUM SIZE OF THE JUCTION
- 3. FOR THREE GANG (3 GANG) OUTLETS AND SWITCHS THE MINIMUM SIZE OF THE JUCTIO BOX SHALL NOT BE LESS THAN 6"X4"X(1.5" OR 3.5" DEEP).

Electrical Fixture Schedule (SWITCH BOX)					
Туре	Count				
Double Gang Switch Box	2				
Single Gang Switch Box	5				
Triple Gang Switch Box	3				

Lighting Device							
Type Count							
Dimmer	5						
Fan switch	4						
Single Pole	7						
Single Pole Three Way	2						

Lighting Fixture								
Lighting Fixture Type Voltage Electrical Load								
Electrical_Lights_Fan-Light1	120 V/1-100 VA- 120 V/1-100 VA	200 A, 120 V/240 V, Single Phase, 3 Wires	2					
Lighting - Recessed	120 V/1-60 VA	200 A, 120 V/240 V, Single Phase, 3 Wires	10					
SASSO 100 round wallwasher trim	120 V/1-28 VA	200 A, 120 V/240 V, Single Phase, 3 Wires	8					
Wall Lamp - Bracket	120 V/1-100 VA	200 A, 120 V/240 V, Single Phase, 3 Wires	7					

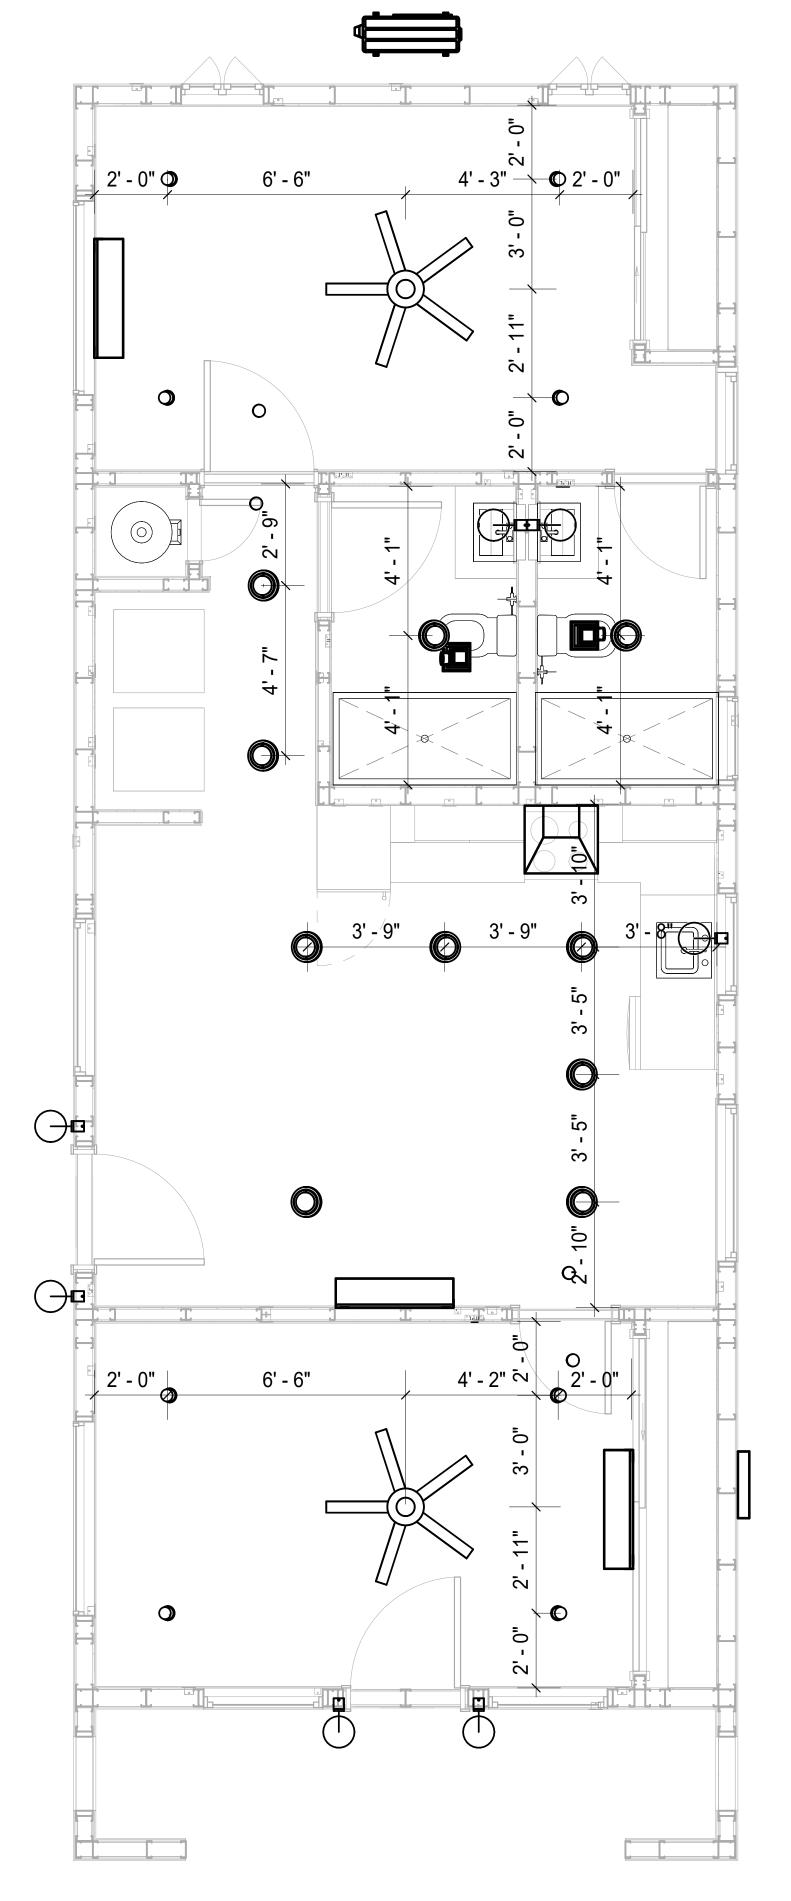

1 DIMENSION FOR LIGHT FIXTURES
3/8" = 1'-0"



KEY PLAN

NO. DESCRIPTION DATE

NOTE:

LEGEND:

PROJECT

109-BENNETT-796-2Bd2Ba SPANISH-550

DRAWING NAME

DIMENSION PLAN FOR LIGHT FIXTURES

CLIENT NAME:	Owner
PROJECT NUMBER:	0037_14
DATE:	3/6/2025 4:11:42 AM
DESIGNED BY:	Designer
DRAWN BY:	Author
CHECKED BY:	Checker

E104


SCALE: 3/8" = 1'-0"

NOTES;

- 1. VERIFY EQUIPMENT PLUG CONFIGURATION BEFORE PURCHASING RECEPTACLES
- 2. FOR ALL EQUIPMENT.
- 3. COORDINATE EXACT LOCATION OF LIGHT FIXTURES, WALL SWITCHES, RECEPTACLES AND OTHER DEVICES WITH ARCHITECTURAL DRAWINGS.
- 4. USE METALLIC JUNCTION BOX WITH THE GFCI RECEPTACLES, WITH HIGHT VOLTAGE.

Electrical Fixture Schedule (Receptacle)					
Туре	Count				
CONDENSER	1				
DRYER	2				
GFCI BATH ROOM	2				
GFCI DISHWASHER	1				
GFCI Kitchen	4				
GFCI OUT DOOR	4				
GFCI WASHER	2				
OVEN HOOD	1				
RANGE	1				
REFRIGERATOR	1				
Standard Receptacle	16				
WATER HEATER	1				

Electrical Outlet Schedule					
Туре	Circuit Number	Electrical Data	Count		
Standard Receptacle		120 V/1-180 VA	1		
CONDENSER	1,3	240 V/2-1500 VA	1		
GFCI OUT DOOR	2	120 V/1-180 VA	4		
Standard Receptacle	5	120 V/1-180 VA	5		
Standard Receptacle	6	120 V/1-180 VA	5		
WATER HEATER	7,9	240 V/2-1500 VA	1		
DRYER	8,10	240 V/2-1500 VA	2		
GFCI WASHER	11	120 V/1-1200 VA	2		
REFRIGERATOR	12	120 V/1-1500 VA	1		
GFCI Kitchen	13	120 V/1-180 VA	4		
OVEN HOOD	13	120 V/1-180 VA	1		
RANGE	14,16	240 V/2-1500 VA	1		
GFCI BATH ROOM	15	120 V/1-180 VA	1		
GFCI BATH ROOM	17	120 V/1-180 VA	1		
Standard Receptacle	18	120 V/1-180 VA	5		
GFCI DISHWASHER	19	120 V/1-1200 VA	1		

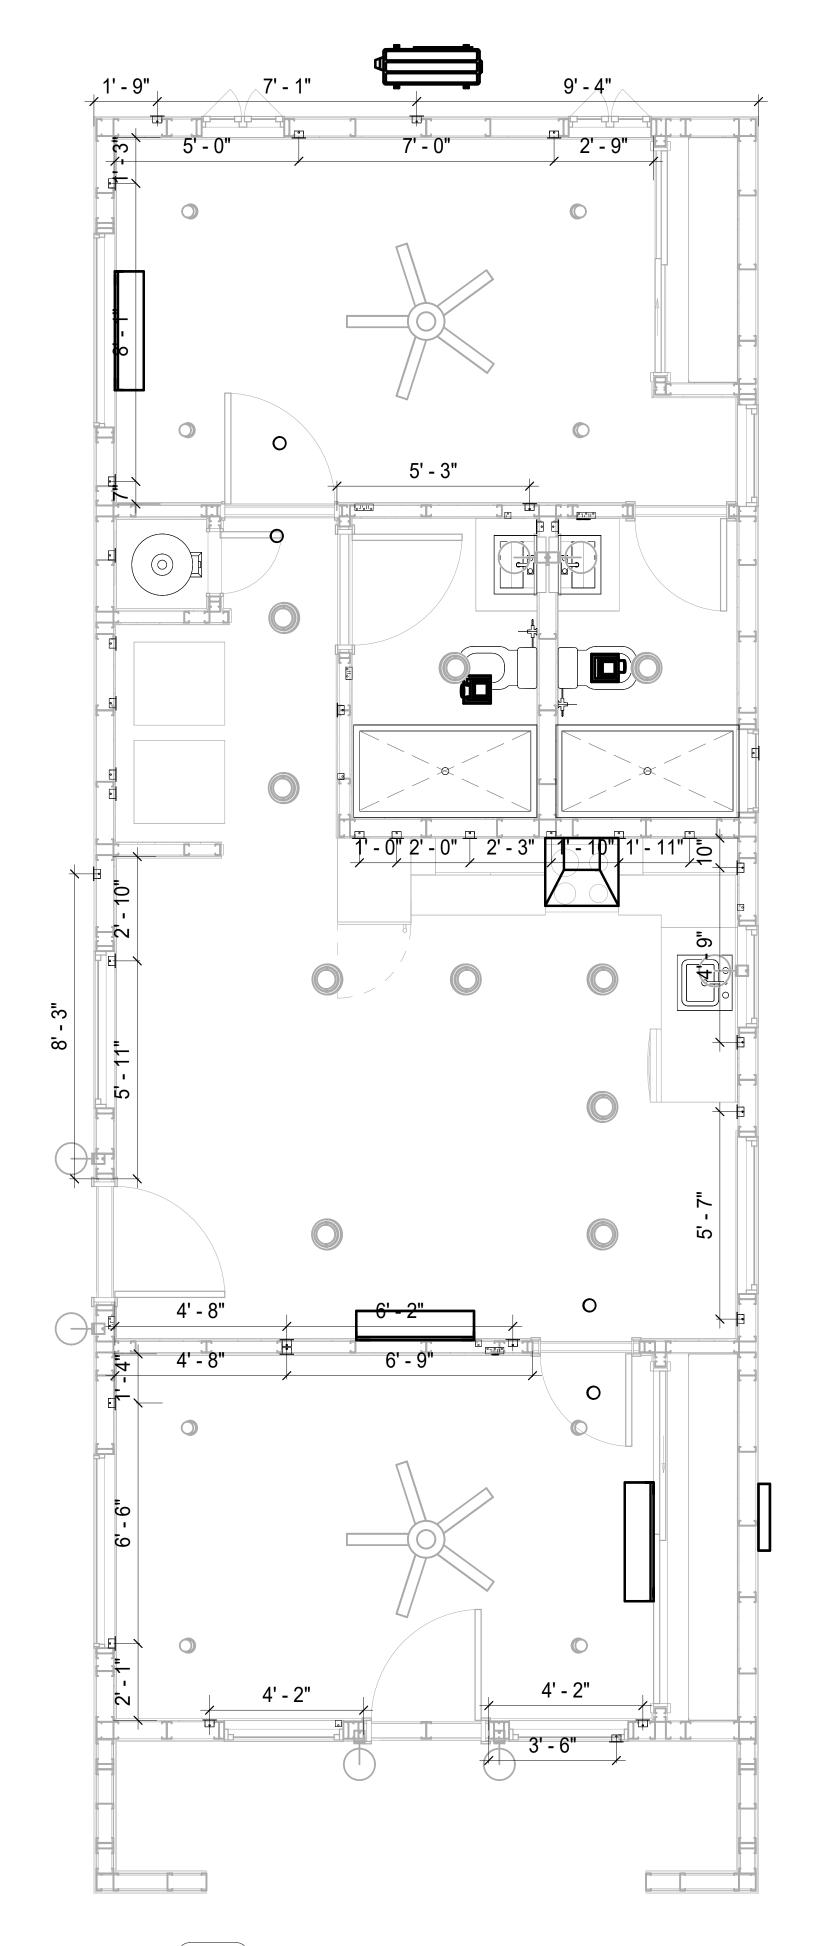

1 DIMENSION FOR FITTINGS
3/8" = 1'-0"

KEY PLAN

NO. DESCRIPTION DATE

NOTE:

LEGEND:

PROJECT

109-BENNETT-796-2Bd2Ba SPANISH-550

DRAWING NAME

DIMENSION PLAN FOR FITTINGS

CLIENT NAME:	Owner
PROJECT NUMBER:	0037_14
DATE:	3/6/2025 4:11:44 AM
DESIGNED BY:	Designer
DRAWN BY:	Author
CHECKED BY:	Checker

E105

SCALE: 3/8" = 1'-0"

SHEET LIST

SHEET NUMBER SHEET NAME

P101 NOTE AND SCHEDULE
P102 WATER SUPPLY AND SEWAGE
SYSTEM

PIPE CO	LOR SCHEME
	DOMESTIC COLD WATER
	DOMESTIC HOT WATERSANITARY VENT
	SANITARY SEWER
	 STORM DRAINAGE
-	GRAY WATER
	GAS LINE

PLUMBING NOTES

- THE PLUMBING SYSTEM IS DESIGNED TO MEET THE BUILDING'S DOMESTIC WATER SUPPLY, SANITARY DRAINAGE, AND STORM DRAINAGE REQUIREMENTS, AS PER PROJECT SPECIFICATIONS AND APPLICABLE CODES.
- THE SYSTEM INSTALLATION SHALL COMPLY WITH THE LATEST INTERNATIONAL PLUMBING CODE (IPC), INTERNATIONAL RESIDENTIAL CODE (IRC), AND ALL OTHER RELEVANT LOCAL, STATE, AND NATIONAL REGULATIONS.
- 3. ALL PLUMBING WORK SHALL COMPLY WITH THE LATEST EDITION OF THE INTERNATIONAL PLUMBING CODE (IPC) AND THE LOCAL PLUMBING CODE.
- 4. PLUMBING SYSTEMS SHALL BE TESTED AND INSPECTED IN ACCORDANCE WITH THE LOCAL PLUMBING CODE REQUIREMENTS.
- 5. PLUMBING FIXTURES SHALL BE INSTALLED WITH THE APPROPRIATE TRIM, FITTINGS, AND ACCESSORIES, AS RECOMMENDED BY THE MANUFACTURER.
- 6. PIPING SHALL BE PROPERLY SUPPORTED AND SECURED TO PREVENT SAGGING,
- MOVEMENT, AND VIBRATION.
 7. SHUT-OFF VALVES SHALL BE PROVIDED AT ALL BRANCH CONNECTIONS AND AT THE
- INLET AND OUTLET OF EACH PIECE OF EQUIPMENT.

 8. BACKFLOW PREVENTION DEVICES SHALL BE INSTALLED AS REQUIRED BY THE LOCAL
- PLUMBING CODE TO PROTECT THE POTABLE WATER SYSTEM.

 9. PLUMBING FIXTURES AND EQUIPMENT SHALL BE ACCESSIBLE FOR MAINTENANCE AND
- 10. EXPOSED PLUMBING PIPING AND FIXTURES SHALL BE INSULATED TO PREVENT
- CONDENSATION AND ENERGY LOSS.

 11. DEAD ENDS IN THE DRAINAGE SYSTEM MUST BE AVOIDED, EXCEPT WHERE NECESSARY TO INSTALL A CLEANOUT IN AN ACCESSIBLE LOCATION, AND MUST HAVE A VENTED CONNECTION TO THE OUTSIDE ATMOSPHERE.
- 12. THE VERTICAL DEFLECTION OF PVC PIPE MUST NOT EXCEED 5%, AND NO DEFLECTION IS PERMITTED FOR IRON PIPE.
- 13. WORK MUST BE PROPERLY COORDINATED WITH OTHER TRADES TO AVOID CONFLICTS, REFERRING TO THE ARCHITECTURAL AND STRUCTURAL DRAWINGS FOR INFORMATION REGARDING CEILING ELEVATIONS, SPACE CLEARANCES, WALL AND PARTITION LOCATIONS, ETC.
- 14. ALL FIXTURES SHALL HAVE ACCESSIBLE STOPS.
- 15. DOMESTIC WATER PIPING SHALL BE PEX, AND PVC PIPING IS NOT ACCEPTABLE FOR INTERIOR USE.
- 16. VENT TERMINATIONS SHALL BE LOCATED AT LEAST 10 FEET FROM OR 3 FEET ABOVE ANY OPERABLE WINDOW, DOOR OPENING, AIR INTAKE, OR VENT SHAFT, AND AT LEAST 3 FEET IN EVERY DIRECTION FROM ANY LOT LINE, ALLEY, OR STREET.
- 17. PIPE AND FITTINGS UTILIZED IN THE WATER SUPPLY SYSTEM SHALL HAVE A MAXIMUM OF 8 PERCENT LEAD.
- 18. ACRYLONITRILE BUTADIENE STYRENE (ABS) SHALL BE USED FOR THE SEWERAGE AND VENTILATION SYSTEM.
- 19. CROSS-LINKED POLYETHYLENE (PEX) SHALL BE USED FOR THE WATER SUPPLY SYSTEM.
- 20. POLYVINYL CHLORIDE (PVC) SHALL BÉ USED FOR THE RAIN WATER SYSTEM.
- 21. THE MIMIMUM WATER SUPPLY DEPTH UNDER FLOOR FINISH SHOUD BE 1/2".
- 22. ANY PIPE INSTALLED UNDERGROUND MUST HAVE AT LEAST 12 INCHES OF CLEARANCE BETWEEN THE OUTSIDE OF THE PIPE AND ANY OTHER UNDERGROUND STRUCTURE.
- 23. THE MINIMUM CLEARANCE BETWEEN COLD AND HOT WATER LINES IN RESIDENTIAL HOMES MAINTAIN A MINIMUM DISTANCE OF 6 INCHES.
- 24. HORIZONTAL SEPARATION BETWEEN WATER AND SEWER LINES: A MINIMUM OF 12 INCHES BETWEEN POTABLE WATER SUPPLY LINES (COLD AND HOT WATER) AND SANITARY SEWER LINES.

ABBREVIATIONS

Ø	DIAMETER						
ABS	ACRYLONITRILE BUTADIENE STYRENE						
ABV	ABOVE						
AD	AREA DRAIN						
AFF	ABOVE FINISHED FLOOR						
ALT	ALTERNATE						
BFF	BELOW FINISHED FLOOR						
BLW	BELOW						
CO	CLEAN OUT						
CW	COLD WATER						
D	DEGREE						
DFU	DRANAGE FIXTURE UNIT						
DIA	DIAMETER						
DN	DOWN						
FCO	FLOOR CLEAN OUT						
FD	FLOOR DRAIN						
FL	FLOOR						
FS	FLOOR SINK						
FT FT	FOOT/FEET						
HB	HOSE BIB						
HW	HOT WATER						
IN	INCH						
MIN	MINIMUM						
NO	NUMBER						
NTS	NOT TO SCALE						
PEX	CROSS-LINKED POLYETHYLENE						
PLBG	PLUMBING						
PVC	POLYVINYL CHLORIDE						
QTY	QUANTITY						
RD	ROOF DRAIN						
RED	REDUCER						
RM	ROOM						
RW	RAIN WATER						
SF	SQUARE FOOT						
V	VENT						
VTR	VENT THROUGH ROOF						
W	WASTE						
WCO	WALL CLEAN OUT						
WSFU	WATER SUPPLY FIXTURE UNIT						

PLUMBING LEGEND

D	CAP
	BEND 45 DEG
₽ B	BEND 90 DEG
	TEE REDUCING
	TEE
	CLEAN TWO-WAY
	WYE 45 DEG
	WYE 45 DEG DOUBLE
	WYE COMBINATION
	P-TRAP

PIPE SCHEDULE						
MATERIAL	DIAMETER	LENGTH				
ACRYLONITRILE BUTADIENE STYRENE (ABS)	1 1/2"	23 FT				
ACRYLONITRILE BUTADIENE STYRENE (ABS)	2"	41 FT				
ACRYLONITRILE BUTADIENE STYRENE (ABS)	3"	37 FT				
CROSS-LINKED POLYETHYLENE (PEX)	1/2"	95 FT				
CROSS-LINKED POLYETHYLENE (PEX)	3/4"	55 FT				
POLYVINYL CHLORIDE - RIGID	2"	83 FT				

F	ITTING SCHEDULE	
FITTING	SIZE	QTY
DOMESTIC COLD WATER	4/011 4/011	40
PEX 90 DEGREE ELBOW	1/2"ø-1/2"ø	13
PEX 90 DEGREE ELBOW	3/4"ø-3/4"ø	2
PEX TEE ELBOW	1/2"ø-1/2"ø-1/2"ø	7
PEX TEE ELBOW	3/4"ø-3/4"ø	3
PEX TRANSITION ELBOW	1"ø-3/4"ø	2
PEX TRANSITION ELBOW	3/4"ø-1/2"ø	1
DOMESTIC HOT WATER		
PEX 90 DEGREE ELBOW	1/2"ø-1/2"ø	11
PEX 90 DEGREE ELBOW	3/4"ø-3/4"ø	6
PEX TEE ELBOW	1/2"ø-1/2"ø	5
PEX TEE ELBOW	3/4"ø-3/4"ø-3/4"ø	1
PEX TRANSITION ELBOW	3/4"ø-1/2"ø	1
RAIN WATER		
PVC 90 DEG BEND ELBOW	2"ø-2"ø	30
SEWAGE ABS 90 DEGREE BEND ELBOW	1 1/2"ø-1 1/2"ø	4
ABS 90 DEGREE BEND ELBOW	2"ø-2"ø	3
ABS 90 DEGREE BEND ELBOW	3"ø-3"ø	2
ABS P-TRAP	1 1/2"ø-1 1/2"ø	3
ABS P-TRAP	2"ø-2"ø	1
ABS REDUCER ELBOW	2"ø-1 1/2"ø	1
ABS REDUCER ELBOW	3"ø-1 1/2"ø	1
ABS REDUCER ELBOW	3"ø-2"ø	1
ABS TEE ELBOW	2"ø-2"ø	1
ABS TEE ELBOW	3"ø-3"ø	2
ABS TEE REDUCER ELBOW	3"ø-3"ø-1 1/2"ø	2
ABS TEE REDUCER ELBOW	3"ø-3"ø-2"ø	1
ABS TRAP P	2"ø-2"ø	1
WASTE DOUBLE TEE	1 1/2"ø-1 1/2"ø-1 1/2"ø	1
WASTE DOUBLE TEE	2"ø-2"ø-2"ø	1
WASTE DOUBLE TEE	3"ø-3"ø-3"ø	1
VENT		
ABS VENT CAP ELBOW	1 1/2"ø	1
ABS VENT CAP ELBOW	2"ø	2
ABS VENT CAP ELBOW	3"ø	1

EIVELIDE CONNECTION COLLEDIUE
FIXTURE CONNECTION SCHEDULE
I INTO THE CONTROL OF

W V TRAP CW HW QTY DFU TOT. WFU TOT.

NOTES

FAMILY

DISHWASHER	2"	1-1/2"	1-1/2"	1/2"	1/2"	1)	DRAIN TO SEWER SEE PLANS
DRYER	N/A	N/A	N/A	N/A	N/A	1)	
HANGING PIPES CLAMP						20	()	
SHOWER TRAY	2"	1-1/2"	1-1/2"	1/2"	1/2"	2	()	
SHOWER TRIM	-	-	-	1/2"	1/2"	2	()	
SINK ISLAND SINGLE	2"	1-1/2"	1-1/2"	1/2"	1/2"	1	()	
VANITY SINK	2"	1-1/2"	1-1/2"	1/2"	1/2"	2	()	
WASHER	2"	1-1/2"	2"	1/2"	1/2"	1	()	DRAINS TO GRAY WATE OR SEWER SEE PLANS
WATER CLOSET						2	()	
WATER HEATER	N/A	N/A	N/A	3/4"	3/4"	1	()	

FIXTURE SCHEDULE						
FIXTURE	QTY	DESCRIPTION				
DISHWASHER	1	DRAIN TO SEWER SEE PLANS				
DRYER	1					
HANGING PIPES CLAMP	20					
SHOWER TRAY	2					
SHOWER TRIM	2					
SINK ISLAND SINGLE	1					
VANITY SINK	2					
WASHER	1	DRAINS TO GRAY WATER OR SEWER SEE PLANS				
WATER CLOSET	2					
WATER HEATER	1					

ACCESSORIES & FITTINGS SCHEDULE						
FIXTURE QTY DESCRIPTIONS						
DISHWASHER CONNECTOR	1					
HOSE BIB	1					
LAUNDRY SWEAT CONNECTOR	1					
SHUTOFF VALVE	8					

PLUMBING SCHEDULE									
FIXTURE TRAP WASTE VENT C.W H.W									
DIOLIMAGUED	4.4/01	Oll	4.4/011	4 /011	4 (01)				
DISHWASHER	1-1/2"	2"	1-1/2"	1/2"	1/2"				
DRYER	N/A	N/A	N/A	N/A	N/A				
SHOWER TRAY	1-1/2"	2"	1-1/2"	1/2"	1/2"				
SHOWER TRIM	-	-	-	1/2"	1/2"				
SINK ISLAND SINGLE	1-1/2"	2"	1-1/2"	1/2"	1/2"				
VANITY SINK	1-1/2"	2"	1-1/2"	1/2"	1/2"				
WASHER	2"	2"	1-1/2"	1/2"	1/2"				
WATER CLOSET									
WATER HEATER	N/A	N/A	N/A	3/4"	3/4"				

	WATER FIXTURE	UNIT SCHEDULE	
FAMILY	QTY	UNIT VALUE	TOTAL
DISHWASHER	1		0
DRYER	1		0
HANGING PIPES CLAMP	20		0
SHOWER TRAY	2		0
SHOWER TRIM	2		0
SINK ISLAND SINGLE	1		0
VANITY SINK	2		0
WASHER	1		0
WATER CLOSET	2		0
WATER HEATER	1		0

WASTE FIXTURE UNIT SCHEDULE						
FAMILY	QTY	DFU VALUES	TOTAL			
DISHWASHER	1)			
DRYER	1	0				
HANGING PIPES CLAMP	20	0				
SHOWER TRAY	2	0				
SHOWER TRIM	2	0				
SINK ISLAND SINGLE	1)			
VANITY SINK	2)			
WASHER	1)			
WATER CLOSET	2)			
WATER HEATER	1	0				



KEY PLAN

NO. DESCRIPTION DATE

NOTE:

LEGEND:

PROJECT

109-Bennett-796-2Bd/2Ba Spanish-550

DRAWING NAME

NOTE AND SCHEDULE

CLIENT NAME:

 PROJECT NUMBER:
 0207_13

 DATE:
 3/5/2025 11:05:05 AM


 DESIGNED BY:
 Designer

 DRAWN BY:
 Author

 CHECKED BY:
 Checker


P101

SCALE: 1/2" = 1'-0"

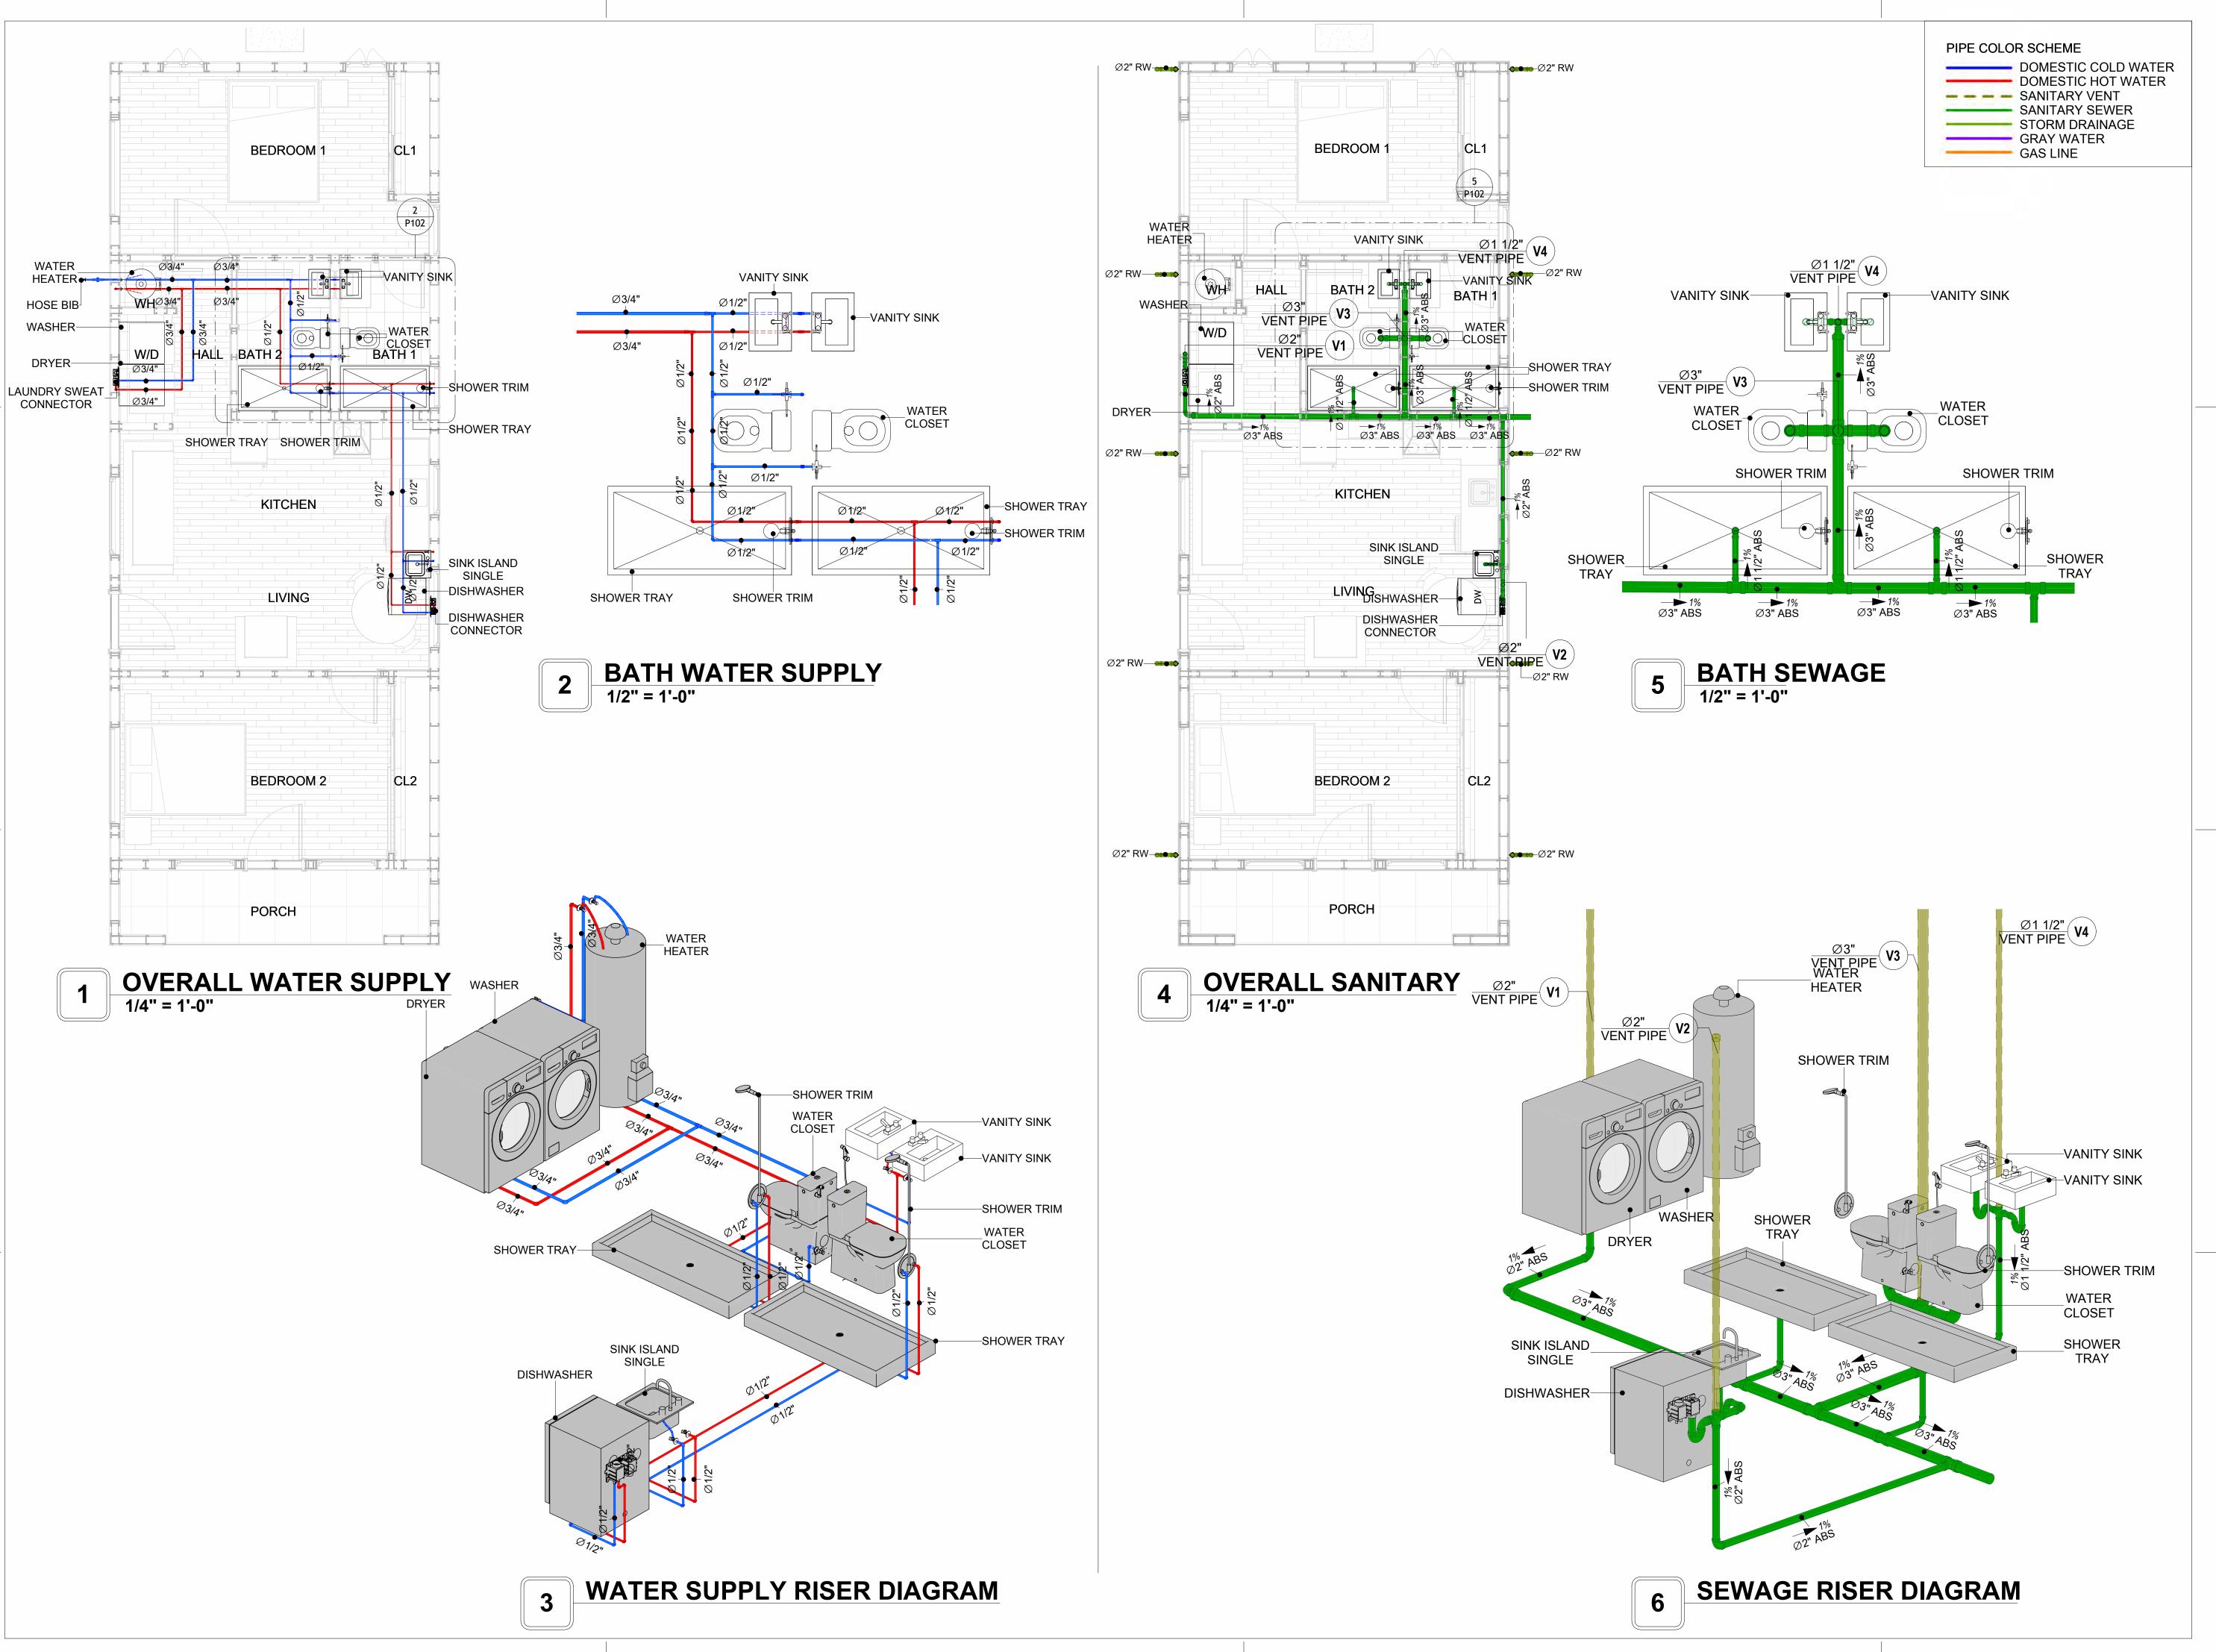



KEY PLAN

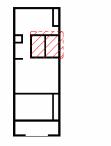

NO.	DESCRIPTION	DATE

NOTE:

LEGEND:

PROJECT

109-Bennett-796-2Bd/2Ba Spanish-550

DRAWING NAME

WATER SUPPLY AND SEWAGE SYSTEM

CLIENT NAME:

PROJECT NUMBER:

0207_13

DATE:

3/5/2025 11:05:37 AM

DESIGNED BY:

DRAWN BY:

CHECKED BY:

Checker

P102

SCALE: As indicated

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Materials Shopping List

Please print and take this Materials Shopping List to your favorite Home Depot and ask for assistance in selecting the materials, fixtures and fittings to complete your new home.

Record your selection and the price of the item. Then do the math to determine the cost for your selections and the total cost of finishing your home.

Have It Your Way!

The material types listed in this document were selected based on personal preferences. The Customer is encouraged to make changes to the material types in accordance with local customs, regulations, and personal preferences.

Have It Your Way!



20 good reasons to frame a home with metal and not wood



Why build your ADU with metal vs wood	Wood	Metal	Explanation
1 DIY Construction Benefit		~	The wall frames, trusses and beams can be erected in a just a few days
2 Minimal Construction Skills Required		~	Pre-assembled walls and trusses require no specialized skills to errect
3 Build as DIY, Hybrid or by a General Contractor		~	Do it yourself, Hybrid (involve special contractors) or hire a General Contractor
4 Build It As You Can Afford It		~	Impervious to Weather - build as you have the time and money
5 Up Front Cost of Framing Materials	\checkmark		As to only the framing material, wood is less expensive
6 Total Cost To Build		~	Savings in time, labor, and other areas make light gauge steel LESS expensive
7 Termites and wood boring insects		~	Termites, carpenter ants and wood boring insects eat wood, not metal
8 Mold resistant		~	Metal does not attract mold
9 Damage caused by exterior and interior flooding		~	Metal needs no reconditioning after a flood
10 Fire Resistant		~	Non-combustible
11 Lower insurance rates		~	Many insurance underwriters now provide lower rates for metal framed homes
12 Walls, trusses, and beams retain their original form		~	Perfectly straight walls - no shimming of drywall
13 Corners are 90 degrees		~	No need for templating of countertops to adjust for out of square corners
14 Strength and weight		~	Metal is stronger than wood and weighs less - no need for crane to lift ADU trusses
15 IBC Engineered Stamp		~	If an engineering stamp is necessary, months of waiting are saved
16 Complete BOM (Materials Shopping List)		~	Take the materials shopping list to Home Depot and start shopping/pricing
17 Flexible in Seismic Areas - Won't Fracture		~	Light gauge steel is flexible and won't fracture when the earth moves
18 No Waste At Job Site		~	Steel is the most recycled material in the world. A typical wood home has 20-30% waste
19 Environmentally Friendly		~	Trees don't have to be destroyed and the source of most metal is from recycling
20 How-To Videos Included		~	How-to videos provide simple assembly instructions
21 Relationship Counselor		~	Eliminate emotional uphevels - save time, money, and preserve the relationship

Universal Requirements - some or all may be required

- 1 Site plan
- 2 Electrical Supply Connection
- 3 Sewer Connection
- 4 Fresh Water Supply Connection
- 5 Set Backs
- 6 Soils Evaluation

- 7 Earthquake (fault) evaluation
- 8 Foundation Plan subject to soils
- 9 Compliance with local energy codes: insulation home wrap and flashing
- 10 Engineering for wind speed and snow load.
- 11 State and Local ordinances regarding ADUs
- 12 Local Architect and/or Engineer may be necessary

Bennett-2Bd 2Ba-Spanish





Bennett-2Bd 2Ba-Spanish MATERIAL SHOPPING LIST

Have It Your Way!

The material types listed in this document were selected based on personal preferences. The Customer is encouraged to make changes to the material types in accordance with local customs, regulations, and personal preferences. Have It Your Way!

TOC



	Table 9. content							
	Name Link Page No							
#	Name	Link	Page No					
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	2 TOC	TOC	2					
	3 ELECTRICAL BOM	ELECTRICAL BOM	3					
	5 HVAC BOM	HVAC BOM	7					
	4 PLUMBING BOM	PLUMBING BOM	10					
	6 ARCHITECTURAL BOM	ARCHITECTURAL BOM	15					

Table Of Content

Have It Your Way!

The material types listed in this document were selected based on personal preferences. The Customer is encouraged to make changes to the material types in accordance with local customs, regulations, and personal preferences. Have It Your Way!

GENERAL NOTES

- 1 This BOM (Bill of Materials) is prepared as a Materials Shopping List to help builders and DIYers gain a complete understanding of most if not all elements required for the complete construction of this structure, according to the original design documents provided by FrameUpNow.
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- 3 All products and elements in the list shall conform to the International Residential Code (IRC), or any other local and international building codes, safety regulations, and standards that are applicable to the location of the structure.
- 4 If any changes are made by the customer to the list of materials specified in this document, the customer is responsible for assuring that the correct type and quantity of materials are utilized in accordance with local building codes.
- 5 FrameUpNow, will not be held responsible for any misuse of this document, the products listed, or for deviations from the content that are made due to changes in specifications, pricing, availability, or customer preferences.
- 6 The customer is advised to consult a qualified professional or technician prior to purchasing materials for specialized construction system items. Some items including but not limited to caseworks, doors and windows may require as built measurements prior to purchase to confirmation of final dimensions.
- 7 If there are additional trim elements or specific installation methods, the total amount of materials needed might vary. Consider any additional trim required for corners, intersections, or other architectural details that might cause this variations before proceeding to purchase and construction.

ARCHITECTURAL BOM



				Ba-Spanisl					
	ARCHITECTURAL MATERIAL SHOPPING LIST								
No.	Item	Туре	Unit	Quantity	Unit Price	Total	Description		
	APPLIANCES		1000						
1	Refrigerator		PCS	1					
2	Range		PCS	1					
3	Washer		PCS	1					
4	Dryer		PCS	1					
5	Dish Washer		PCS	1					
6	Oven		PCS	0					
7	Microwave		PCS	0					
\triangle	CASEWORKS								
1	Kitchen Cabinet		FT	16					
	Laundry Cabinet		FT	0					
3	Vanity Cabinet		FT	5					
4	Medicine Cabinet		PCS	2					
5	Kitchen countertop		SF	24.95					
6	Laundry Countertop		PCS	0					
7	Bathroom Countertop		SF	0					
8	Island		FT	0					
9	Peninsula		FT	0					
10	Closets		SF	99.67					
Δ	CEILING								
1	Ceiling Board	Dry Wall	SF	639					
2	Dry Wall Fastener	Screw	PCS	1118					
3	Vapor Retarder	Polyethylene film	SF	796					
4	Vapor Retarder Fastener	Nails with washer heads	PCS	2388					
5	Ceiling Board (MRD)	Moisture resistant drywall	SF	86					
6	MRD Fastener		PCS	150					
7	Ceiling Board	Marine Plywood	SF	71					
8	Marine Plywood Fastener	Screw	PCS	124					
	Dry Wall Tape		FT	398					
Δ	FLOORING				ļ.				
1	Main Living Space		SF	260.2					
2	Bathroom		SF	81.3					
	Bedrooms		SF	339					
4	Porch		SF	67					
Δ	STRUCTURE		31	07					
	Foundation		SF	862.1					
÷	WALLS EXTERIOR		51	002.1					
1	Stucco Finish		SF	1149					
2	Wall Shteathing (OSB)		SF	1149					
3	Shteathing Fastener	Self-drilling screws(100/pkt)	PKT	11.49					
4	Wall Homewrap	Sell-drilling screws (100/pkt)	SF	11.47					
5	Homewrap Fastener	Stapled fastener (200/pkt)	PKT	4.3662					
6	Wall Paint	Stapieu iasteriei (200/pkt)	SF	1149					
7	Wall Insulation		SF	1520.0					
	WALLS INTERIOR		51	1520.0					
1	Cementitious Backer Board		CF.	567	Т				
2	Kerdi membrane		SF						
			SF	567					
3	Kerdi membrane Fastener		SF	567					
4	Wall Ceramic Tile		SF	567					
5	Drywall Board	0.15.1.00	SF	1491					
6	Drywall Fastener	Self-drilling screws(100/pkt)	PKT	14.91					
7	Wall Paint		SF	1491					
8	Drywall Tape		FT	281					
9	Wall Sweep		FT	168					

ARCHITECTURAL BOM



	2000				
	DOORS				
1	Exterior Swinging	3' - 0" X 6'-8"	PCS	2	
2	Interior Swinging	3' - 0" X 6'-8"	PCS	2	
3	Interior Sliding	6' - 0" X 6'-8"	PCS	1	
4	Interior Sliding	9' - 0" X 6'-8"	PCS	1	
5	Interior Swinging	2' - 6" X 6'-8"	PCS	2	
6	Interior Swinging	1' - 8" X 6'-8"	PCS	1	
7	Exterior Door Trim		FT	32.68	
8	Interior Door Trim		FT	274.68	
9	Entry Lock set		PCS	2	
10	Privacy Lock set		PCS	4	
	Passage Lock set		PCS	3	
Δ	WINDOWS		· ·		
1	Hung	4' - 3" X 3'-3"	PCS	2	
2	Hung	3' - 3" X 2'-3"	PCS	2	
3	Hung	2' - 9" X 3'-3"	PCS	2	
4	Awning	5' - 3" X 3'-9"	PCS	2	
5	Awning	2' - 3" X 2'-3"	PCS	1	
6	Casement	2' - 3" X 3'-9"	PCS	2	
7	Exterior Window Trim		FT	134	
8	Interior Window Trim		FT	134	
	ROOF	-			
1	Roof Covering		SF	1041.0	
2	Roof Covering Fastener		PCS	521	
3	Roof Felt Paper		SF	1041.0	
4	Roof Felt Paper Fastener		PCS	3123.0	
5	Roof Sheathing		SF	1041	
6	Roof Sheathing Fastener		PCS	8328	
7	Batten		FT	501.0	
8	Batten Fastener		PCS	376.7	
9	Soffit		SF	149.0	
10	Soffit Fastener		PCS	74.5	
11	Fascia		FT	142.0	
-	Fascia board fastener		PCS	71	
	Roof Insulation		SF	1041.0	
_ 10	Troot modication		51	1041.0	



Bennett-2Bd 2Ba-Spanish						
	FI FCTRIC	AL MATERIAL SHO	PPING LIST	Γ		
No.	Item	Type		Quantity	Description	
Δ	LIGHTING FIXTURES					
1	Kitchen Ceiling Light		PCS	4		
	Exterior Wall Mounted Light		PCS	4		
3	Livingroom Ceiling Light With Fan		PCS	0		
4	Bedroom Ceiling Light With Fan		PCS	2		
5	Dining Ceiling Light		PCS	0		
_	Bath Wall Mounted Light		PCS	2		
7	Bathroom Ceiling Light		PCS	2		
	Livingroom Ceiling Light		PCS	2		
	Bedroom Ceiling Light		PCS	8		
	Hall & Entry Ceiling Light		PCS	2		
	Closet Ceiling Light		PCS	0		
_	Smoke Detector		PCS	4		
	ELECTRICAL FITTINGS			• 1		
	Standard Receptacle 120V	20A	PCS	19		
	GFCI Receptacle 120V	20 A	PCS	14		
15	GFCI Receptacle 240V	30 A	PCS	3		
16	·	50 A	PCS	1		
17	GFCI Receptacle 240V	60 A	PCS	1		
	Fan Switch	0071	PCS	3		
	Single Pole Switch		PCS	15		
_	Three Way Switch		PCS	4		
	Dimmer Switch		PCS	3		
	ELECTRICAL CONDUITS & WIRING		1 00	3		
	ROMEX 14 AWG	14/2/W/ground	FT	0		
	ROMEX 12 AWG	12/3/W/ground	FT	0		
	ROMEX 12 AWG	12/2/W/ground	FT	566		
	ROMEX 12 AWG	10/3/W/ground	FT	127		
	ROMEX 10 AWG	10/2/W/ground	FT	0		
	Romex 8 AWG	8/3/W/ground	FT	33		
	Romex 8 AWG	8/2/W/ground	FT	0		
	ROMEX 6 AWG	6/3/W/ground	FT	42		
	Bare Copper Ground Wire 6 AWG	0/3/vv/ground	FT	0		
<u>3∪</u>	ELECTRICAL BOXES & CIRCUTES		11	U		
_		200 AMD	PCS	1		
	Panelboard -240V 1 Phase MLO	200 AMP	PCS			
	Circuit breaker	15 A	PCS	0		
	Circuit breaker	20 A	PCS	13		
	Circuit breaker	30 A	PCS	0		
	Circuit breaker	40 A	PCS			
	Circuit breaker	50 A		1		
	Circuit breaker	60 A	PCS	1		
	Single Gang Switch Box		PCS	5		
	Double Gang Switch Box		PCS	2		
	Triple Gang Switch Box	114.14	PCS	3		
	Pull Box	#1/4	PCS	20		
43	Receptacle Box		PCS	36		

PLUMBING BOM

Bennett-2Bd 2Ba-Spanish

	PLUMBING	SYSTEM	MATERIAL	. Shopping	LIST
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		LEONIBING 2121FI	INAIEKIA	L SHUFF	ING LIST		
Vo.	Item	Туре	Unit	Quantity	Unit Price	Total	Description
	PLUMBING FIXTURES & ACCESSORIES	·					
1	Bath Tub (Alcove Tub)		PCS	0			
2	Kitchen Sink		PCS	1			
3	Kitchen Faucets		PCS	1			
4	Vanity Sink		PCS	2			
5	Bath room Faucets		PCS	2			
6	Water Closet		PCS	2			
7	Shower Trim		PCS	2			
8	Shower Tray		PCS	2			
9	Water Heater		PCS	1			
10	Hose Bib		PCS	1			
11	Shutoff Valve		PCS	8			
12	Hanging pipe clamp		PCS	20			
13	Gate Valve		PCS	1			
14	Dishwasher Supply Single Connector		PCS	1			
15	Dishwasher Sewage Single Connector		PCS	1			
16	Laundry Sweat Connector		PCS	1			
Δ	SANITARY & PLUMBING PIPES						
1	ABS (Acrylonitrile Butadiene Styrene) Pipes	ø 1"	FT	0			
2	ABS (Acrylonitrile Butadiene Styrene) Pipes	ø 1 1/2"	FT	23			
3	ABS (Acrylonitrile Butadiene Styrene) Pipes	ø 2"	FT	41			
4	ABS (Acrylonitrile Butadiene Styrene) Pipes	ø 3"	FT	37			
5	PEX (Cross-linked polyethylene) Pipes	ø 1/2"	FT	95			
6	PEX (Cross-linked polyethylene) Pipes	ø 3/4"	FT	55			
7	PEX (Cross-linked polyethylene) Pipes	ø 1"	FT	0			
8	PVC Pipes Sch.80 - Rigid	ø 1 1/2"	FT	0			
9	PVC Pipes Sch.80 - Rigid	ø 2"	FT	83			
10	PVC Pipes Sch.80 - Rigid	ø 3"	FT	0			
11	Flex Pipe Round	ø 1/2"	PCS	8			

PLUMBING BOM

	PIPE FITTINGS					
24	ABS 90 Degree Bend Elbow	1 1/2"ø-1 1/2"ø	PCS	4		
	ABS 90 Degree Bend Elbow	2"ø-2"ø	PCS	3		
	ABS 90 Degree Bend Elbow	3"ø-3"ø	PCS	2		
	ABS P-Trap	1 1/2"ø-1 1/2"ø	PCS	3		
	ABS P-Trap	2"ø-2"ø	PCS	1		
	ABS Reducer Elbow	2"ø-1 1/2"ø	PCS	1		
30	ABS Reducer Elbow	3"ø-1 1/2"ø	PCS	1		
31	ABS Reducer Elbow	3"ø-2"ø	PCS	1		
32	ABS TEE Elbow	2"ø-2"ø-2"ø	PCS	1		
33	ABS TEE Elbow	3"ø-3"ø-3"ø	PCS	2		
34	ABS Tee Reducer Elbow	3"ø-3"ø-1 1/2"ø	PCS	2		
35	ABS Tee Reducer Elbow	3"ø-3"ø-2"ø	PCS	1		
36	ABS Trap P	2"ø-2"ø	PCS	1		
37	ABS Vent Cap Elbow	1 1/2"ø	PCS	1		
38	ABS Vent Cap Elbow	2"ø	PCS	2		
39	ABS Vent Cap Elbow	3"ø	PCS	1		
40	PEX 90 Degree Elbow	1/2"ø-1/2"ø	PCS	24		
41	PEX 90 Degree Elbow	3/4"ø-3/4"ø	PCS	8		
42	PEX Tee Elbow	1/2"ø-1/2"ø-1/2"ø	PCS	12		
	PEX Tee Elbow	3/4"ø-3/4"ø-3/4"ø	PCS	4		
44	PEX Transition Elbow	1"ø-3/4"ø	PCS	2		
45	PEX Transition Elbow	3/4"ø-1/2"ø	PCS	2		
46	PVC 90 Deg Bend Elbow	2"ø-2"ø	PCS	30		
47	WASTE DOUBLE TEE	1 1/2"ø-1 1/2"ø-1 1/2"ø-1	PCS	1		
48	WASTE DOUBLE TEE	2"ø-2"ø-2"ø	PCS	1		
49	WASTE DOUBLE TEE	3"ø-3"ø-3"ø-3"ø	PCS	1		

HVAC BOM

		Bennett	-2Bd 2Ba	Spanish			
		HVAC SYSTEM N	//ATERIAL	SHOPP	ING LIST		
No.	Item	Туре	Unit	Quantity	Unit Price	Total	Description
	HVAC_DUCTS						
1	PIPE (REFRIGERANT LINE)	3/8" (Ø)	FT	73.83			
2	PIPE (REFRIGERANT LINE)	3/4''' (Ø)	FT	109.8			
3	DRAYER HOSE	4" (Ø)	FT	9.2			
4	FLEX DUCT ROUND	4" (Ø)	FT	14.57			
	DUCT FITTINGS & ACCESSORIES						
5	ELBOW (REFRIGERANT LINE)	3/4" (Ø)-3/4" (Ø)	PCS	27			
6	ELBOW (REFRIGERANT LINE)	3/8" (Ø)-3/8" (Ø)	PCS	19			
7	TEE (REFRIGERANT LINE)	3/4" (Ø)-3/4" (Ø)-3/4" (Ø)	PCS	2			
8	TEE (REFRIGERANT LINE)	3/8" (Ø)-3/8" (Ø))-3/8" (Ø)	PCS	2			
9	TRANSITION (REFRIGERANT	3/4" (Ø)-1/2" (Ø)	PCS	4			
10	TRANSITION (REFRIGERANT	3/4" (Ø)-5/8" (Ø)	PCS	2			
11	TRANSITION (REFRIGERANT	3/8" (Ø)-1/4" (Ø)	PCS	1			
Δ	HVAC_EQUIPMENTS						
12	AIR HANDLING UNIT	WALL MOUNTED	PCS	3			
13	CONDENSER	OUTDOOR UNIT	PCS	1			
14	EXHAUST FAN	75 CFM	PCS	2			
15	EXHAUST HOOD	WALL MOUNTED	PCS	1			
16	HOOD-WALL: VENT	HOOD-WALL: VENT	PCS	1			
17	DRAYER: VENT	DRAYER: VENT	PCS	1			
18	ROOF VENT	3"(Ø)	PCS	2			



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4	PLUMBING BOM	PLUMBING BOM	10
6	ARCHITECTURAL BOM	ARCHITECTURAL BOM_	15

Have It Your Way!

The material types listed in this document were selected based on personal preferences. The Customer is encouraged to make changes to the material types in accordance with local customs, regulations, and personal preferences. Have It Your Way!

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			LIGHTING FIXTURES			
#	Item	Туре	Description, Manufacturer, SKU	Unit	Quantity Un	it Price Total
1	Kitchen Ceiling Light			PCS	4	
2	Exterior Wall Mounted Light			PCS	4	
3	Livingroom Ceiling Light With Fan			PCS	0	
4	Bedroom Ceiling Light With Fan			PCS	2	
5	Dining Ceiling Light			PCS	0	
6	Bath Wall Mounted Light			PCS	2	
7	Bathroom Ceiling Light			PCS	2	
8	Livingroom Ceiling Light			PCS	2	
9	Bedroom Ceiling Light			PCS	8	
10	Hall & Entry Ceiling Light			PCS	2	
11	Closet Ceiling Light			PCS	0	
12	Smoke Detector			PCS	4	



			ELECTRICAL FITTINGS				
#	Item	Туре	Description, Manufacturer, SKU	Unit	Quantity	Unit Price	Total
1	Standard Receptacle 120V	20A		PCS	19		
2	GFCI Receptacle 120V	20 A		PCS	14		
3	GFCI Receptacle 240V	30 A		PCS	3		
1	GFCI Receptacle 240V	50 A		PCS	1		
5	GFCI Receptacle 240V	60 A		PCS	1		
5	Fan Switch			PCS	3		
7	Single Pole Switch			PCS	15		
3	Three Way Switch			PCS	4		
)	Dimmer Switch			PCS	3		
LO							
l1							
L2							
13							
14							
15							



		ELECTRI	CAL CONDUITS & WIRING				
#	Item	Туре	Description, Manufacturer, SKU	Unit	Quantity	Unit Price	Total
1	ROMEX 14 AWG	14/2/W/ground		FT	0		
2	ROMEX 12 AWG	12/3/W/ground		FT	0		
3	ROMEX 12 AWG	12/2/W/ground		FT	566		
4	ROMEX 10 AWG	10/3/W/ground		FT	127		
5	ROMEX 10 AWG	10/2/W/ground		FT	0		
6	Romex 8 AWG	8/3/W/ground		FT	33		
7	Romex 8 AWG	8/2/W/ground		FT	0		
8	ROMEX 6 AWG	6/3/W/ground		FT	42		
9	Bare Copper Ground Wire 6 AWG			FT			
10							
11							
12							
13							
14							
15							
16							



		ELEC	CTRICAL BOXES & CIRCUTES				
#	Item	Туре	Description, Manufacturer, SKU	Unit	Quantity	Unit Price	Total
1	Panelboard -240V 1 Phase MLO	200 AMP		PCS	1		
2	Circuit breaker	15 A		PCS	0		
3	Circuit breaker	20 A		PCS	13		
4	Circuit breaker	30 A		PCS	3		
5	Circuit breaker	50 A		PCS	1		
6	Circuit breaker	60 A		PCS	1		
7	Single Gang Switch Box			PCS	5		
8	Double Gang Switch Box			PCS	2		
9	Triple Gang Switch Box			PCS	3		
10	Pull Box	#1/4		PCS	20		
11	Receptacle Box			PCS	36		
12							
13							
14							
15							

HVAC BOM

			HVAC_DUCTS 01				
#	Item	Туре	Description, Manufacturer, SKU	Unit		Unit Price	Total
1	PIPE (REFRIGERANT LINE)	3/8" (Ø)		FT	73.83		
2	PIPE (REFRIGERANT LINE)	3/4''' (Ø)		FT	109.8		
3	DRAYER HOSE	4" (Ø)		FT	9.2		
4	FLEX DUCT ROUND	4" (Ø)		FT	14.57		

HVAC BOM

		DI	UCT FITTINGS & ACCESSORIES				
#	Item	Туре	Description, Manufacturer, SKU	Unit	Quantity	Unit Price	Total
1	ELBOW (REFRIGERANT LINE)	3/4" (Ø)-3/4" (Ø)		PCS	27		
2	ELBOW (REFRIGERANT LINE)	3/8" (Ø)-3/8" (Ø)		PCS	19		
3	TEE (REFRIGERANT LINE)	3/4" (Ø)-3/4" (Ø)-3/4" (Ø)		PCS	2		
4	TEE (REFRIGERANT LINE)	3/8" (Ø)-3/8" (Ø))-3/8" (Ø)		PCS	2		
5	TRANSITION (REFRIGERANT LINE)	3/4" (Ø)-1/2" (Ø)		PCS	4		
6	TRANSITION (REFRIGERANT LINE)	3/4" (Ø)-5/8" (Ø)		PCS	2		
7	TRANSITION (REFRIGERANT LINE)	3/8" (Ø)-1/4" (Ø)		PCS	1		

HVAC BOM

			HVAC_EQUIPMENTS				
#	Item	Туре	Description, Manufacturer, SKU	Unit	Quantity	Unit Price	Total
1	AIR HANDLING UNIT	WALL MOUNTED		PCS	3		
2	CONDENSER	OUTDOOR UNIT		PCS	1		
3	EXHAUST FAN	75 CFM		PCS	2		
1	EXHAUST HOOD	WALL MOUNTED		PCS	1		
5	HOOD-WALL: VENT	HOOD-WALL: VENT		PCS	1		
6	DRAYER: VENT	DRAYER: VENT		PCS	1		
7	ROOF VENT	3"(Ø)		PCS	2		
3							
9							
10							
11							
12							
13							
14							

	PLUMBING FIXTURES & ACCESSORIES									
#	Item	Туре	Description, Manufacturer, SKU	Unit	Quantity	Unit Price	Total			
1	Bath Tub (Alcove Tub)			PCS	0					
2	Kitchen Sink			PCS	1					
3	Kitchen faucets			PCS	1					
4	Vanity Sink			PCS	2					
5	Bath room faucets			PCS	2					
6	Water Closet			PCS	2					
7	Shower Trim			PCS	2					
8	Shower Tray			PCS	2					
9	Water Heater			PCS	1					
10	Hose Bib			PCS	1					
11	Shutoff Valve			PCS	8					
12	Hanging pipe clamp			PCS	20					
13	Gate Valve			PCS	1					
14	Dishwasher Supply Single Connector			PCS	1					
15	Dishwasher Sewage Single Connector			PCS	1					
16	Laundry Sweat Connector			PCS	1					

		S	ANITARY & PLUMBING PIPES				
#	Item	Туре	Description, Manufacturer, SKU	Unit	Quantity	Unit Price	Total
1	ABS (Acrylonitrile Butadiene	ø 1"					
	Stvrene) Pipes			FT	0		
2	ABS (Acrylonitrile Butadiene	ø 1 1/2"					
	Stvrene) Pipes			FT	23		
3	ABS (Acrylonitrile Butadiene	ø 2"			44		
	Styrene) Pipes			FT	41		
4	ABS (Acrylonitrile Butadiene	ø 3"			27		
_	Styrene) Pipes	4.00		FT	37		
5	PEX (Cross-linked	ø 1/2"		FT	95		
6	polvethylene) Pipes	-: 2/4		ГІ	90		
В	PEX (Cross-linked	ø 3/4"		FT	55		
7	polvethylene) Pipes PEX (Cross-linked	ø 1"		1 1	33		
	polvethylene) Pipes	ו שן 		FT	0		
8	PVC Pipes Sch.80 - Rigid	ø 1 1/2"					
	1 VO 1 Ipc3 3c11.00 Rigid	<i>8</i> 1 1/2		FT	0		
9	PVC Pipes Sch.80 - Rigid	ø 2"					
	<u> </u>			FT	83		
10	PVC Pipes Sch.80 - Rigid	ø 3"					
				FT	0		
11	Flex Pipe Round	ø 1/2"		DOC			
				PCS	8		

		PIPE FITTINGS 01 Item Type Description, Manufacturer, SKU Unit Quantity Unit Price Total								
#	Item	Туре	Description, Manufacturer, SKU	Unit	Quantity	Unit Price	Total			
1	ABS 90 Degree Bend Elbow	1 1/2"ø-1 1/2"ø		PCS	4					
2	ABS 90 Degree Bend Elbow	2"ø-2"ø		PCS	3					
3	ABS 90 Degree Bend Elbow	3"ø-3"ø		PCS	2					
4	ABS P-Trap	1 1/2"ø-1 1/2"ø		PCS	3					
5	ABS P-Trap	2"ø-2"ø		PCS	1					
6	ABS Reducer Elbow	2"ø-1 1/2"ø		PCS	1					
7	ABS Reducer Elbow	3"ø-1 1/2"ø		PCS	1					
8	ABS Reducer Elbow	3"ø-2"ø		PCS	1					
9	ABS TEE Elbow	2"ø-2"ø-2"ø		PCS	1					
10	ABS TEE Elbow	3"ø-3"ø-3"ø		PCS	2					
11	ABS Tee Reducer Elbow	3"ø-3"ø-1 1/2"ø		PCS	2					
12	ABS Tee Reducer Elbow	3"ø-3"ø-2"ø		PCS	1					
13	ABS Trap P	2"ø-2"ø		PCS	1					
14	ABS Vent Cap Elbow	1 1/2"ø		PCS	1					
15	ABS Vent Cap Elbow	2"ø		PCS	2					

			PIPE FITTINGS 02				
#	Item	Туре	Description, Manufacturer, SKU	Unit	Quantity	Unit Price	Total
1	ABS Vent Cap Elbow	3"ø		PCS	1		
2	PEX 90 Degree Elbow	1/2"ø-1/2"ø		PCS	24		
3	PEX 90 Degree Elbow	3/4"ø-3/4"ø		PCS	8		
4	PEX Tee Elbow	1/2"ø-1/2"ø-1/2"ø		PCS	12		
5	PEX Tee Elbow	3/4"ø-3/4"ø-3/4"ø		PCS	4		
6	PEX Transition Elbow	1"ø-3/4"ø		PCS	2		
7	PEX Transition Elbow	3/4"ø-1/2"ø		PCS	2		
8	PVC 90 Deg Bend Elbow	2"ø-2"ø		PCS	30		
9	WASTE DOUBLE TEE	1 1/2"ø-1 1/2"ø-1 1/2"ø		PCS	1		
10	WASTE DOUBLE TEE	2"ø-2"ø-2"ø		PCS	1		
11	WASTE DOUBLE TEE	3"ø-3"ø-3"ø		PCS	1		



			APPLIANCES				
#	Item	Туре	Description, Manufacturer, SKU	Unit	Quantity	Unit Price	Total
1	Refrigerator			PCS	1		
2	Range			PCS	1		
3	Washer Front Load	Stackable		PCS	1		
4	Dryer Front Load	Stackable		PCS	1		
5	Dish Washer			PCS	1		
6	Oven			PCS	(
7	Microwave			PCS	(
8							
9							
10							
11							
12							
13							
14							
15							
16							



			CASEWORKS 01				
#	Item	Туре	Description, Manufacturer, SKU	Unit	Quantity	Unit Price	Total
1	Kitchen Cabinet			FT	16		
2	Laundry Cabinet			FT	0		
3	Vanity Cabinet			FT	5		
4	Medicine Cabinet			PCS	2		
5	Kitchen countertop			SF	24.95		
6	Laundry Countertop			PCS	0		
7	Bathroom Countertop			SF	0		
8	Island			FT	0		
9	Peninsula			FT	0		
10	Closets			SF	99.67		
11							
12							
13							
14							
15							



			CEILING 01				
#	Item	Туре	Description, Manufacturer, SKU	Unit	Quantity	Unit Price	Total
	LIVING ROOM + KITCHEN			SF	237.4		
1	Ceiling Board	Drywall		SF	237		
2	Drywall Fastener	Screw		PCS	415		
3	Vapor Retarder	Polyethylene film		SF	237		
4	Vapor Retarder Fastener	Nails with washer heads		PCS	712		
	BATH ROOM 1			SF	42.3		
5	Ceiling Board	MRD (Moisture resistant drywall)		SF	42		
6	MRD Fastener	Screw		PCS	74		
	BATH ROOM 2			SF	43.7		
7	Ceiling Board	MRD (Moisture resistant drywall)		SF	44		
8	MRD Fastener	Screw		PCS	76		
	HALL + WD			SF	48.7		
9	Ceiling Board	Drywall		SF	49		
10	Drywall Fastener	Screw		PCS	85		
11	Vapor Retarder	Polyethylene film		SF	49		
12	Vapor Retarder Fastener	Nails with washer heads		PCS	146		



			CEILING 02				
#	Item	Туре	Description, Manufacturer, SKU	Unit	Quantity	Unit Price	Total
	BED ROOM 1			SF	159.1		
13	Ceiling Board	Drywall		SF	159		
14	Drywall Fastener	Screw		PCS	278		
15	Vapor Retarder	Polyethylene film		SF	159		
16	Vapor Retarder Fastener	Nails with washer heads		PCS	477		
	BED ROOM 2			SF	152.4		
17	Ceiling Board	Drywall		SF	152		
18	Drywall Fastener	Screw		PCS	267		
19	Vapor Retarder	Polyethylene film		SF	152		
20	Vapor Retarder Fastener	Nails with washer heads		PCS	457		
	CLOSET 1			SF	13.9		
21	Ceiling Board	Drywall		SF	14		
22	Drywall Fastener	Screw		PCS	24		
23	Vapor Retarder	Polyethylene film		SF	14		
24	Vapor Retarder Fastener	Nails with washer heads		PCS	42		



			CEILING 03				
#	Item	Туре	Description, Manufacturer, SKU	Unit	Quantity	Unit Price	Total
	CLOSET 2			SF	20.6		
25	Ceiling Board	Drywall		SF	21		
26	Drywall Fastener	Screw		PCS	36)	
27	Vapor Retarder	Polyethylene film		SF	21		
28	Vapor Retarder Fastener	Nails with washer heads		PCS	62).	
	WH			SF	7.0		
29	Ceiling Board	Drywall		SF	7	,	
30	Drywall Fastener	Screw		PCS	12		
31	Vapor Retarder	Polyethylene film		SF	7	,	
32	Vapor Retarder Fastener	Nails with washer heads		PCS	21		
	PORCH			SF	71.0		
33	Ceiling Board	Marine Plywood		SF	71		
34	Exterior Grade Plywood	Screw		PCS	124		



			FLOORING INTERIOR 01				
#	Item	Туре	Description, Manufacturer, SKU	Unit	Quantity	Unit Price	Total
	BEDROOM #1						
1	Bedroom Flooring			SF	155		
2	Wood underlay	Foam Pad Polyethylene		SF	155		
3	Vapor Retarder	Vapor Barrier Polyethylene		SF	155		
	BEDROOM#2						
4	Bedroom Flooring			SF	151		
5	Wood underlay	Foam Pad Polyethylene		SF	151		
6	Vapor Retarder	Vapor Barrier Polyethylene		SF	151		
	CL#1						
7	Closet Flooring			SF	13		
8	Wood underlay	Foam Pad Polyethylene		SF	13		
9	Vapor Retarder	Vapor Barrier Polyethylene		SF	13		
	CL#2	·					
10	Closet Flooring			SF	20		
11	Wood underlay	Foam Pad Polyethylene		SF	20		
12	Vapor Retarder	Vapor Barrier Polyethylene		SF	20		



			FLOORING INTERIOR 02				
#	Item	Туре	Description, Manufacturer, SKU	Unit	Quantity	Unit Price	Total
	LIVING ROOM AND KITCH	EN					
13	Living Area Flooring			SF	260		
14	Wood underlay	Foam Pad Polyethylene		SF	260		
15	Vapor Retarder	Vapor Barrier Polyethylene		SF	260		
	BATHROOM#1						
16	Tile Finish			SF	28		
17	Adhesive	1/2" Thin set Mortar		SF	28		
18	Vapor Retarder	Vapor Barrier Polyethylene		SF	28		
	BATHROOM#2						
19	Tile Finish			SF	29		
20	Adhesive	1/2" Thin set Mortar		SF	29		
21	Vapor Retarder	Vapor Barrier Polyethylene		SF	29		
	W/D						
22	Tile Finish			SF	18		
23	Adhesive	1/2" Thin set Mortar		SF	18		
24	Vapor Retarder	Vapor Barrier Polyethylene		SF	18		



			FLOORING INTERIOR 03				
#	Item	Туре	Description, Manufacturer, SKU	Unit	Quantity	Unit Price	Total
	BOILER ROOM						
25	Tile Finish			SF	7		
26	Adhesive	1/2" Thin set Mortar		SF	7		
27	Vapor Retarder	Vapor Barrier Polyethylene		SF	7		



			FLOORING EXTERIOR			
#	Item	Туре	Description, Manufacturer, SKU	Unit	Quantity	Unit Price
	STRUCTURE			SF	862.1	
1	Concrete Slab	4"concrete cast in situ		CF	287.4	
2	Insulation	Rigid insulation		SF	267	
3	Hard core	Compacted soil		CF	217.5	
4	Re-bar	#4 re-bar		Ton	0.83	
5	Concrete Pad	4"concrete cast in situ		CF	1.58	
6	Slab edge	Turndown		CF	253.2	
	PORCH					
1	Tile Finish			SF	67	
2	Adhesive	1/2" Thin set Mortar		SF	67	
3	Vapor Retarder	Vapor Barrier Polyethylene		SF	67	



			WALLS: EXTERIOR				
#	Item	Туре	Description, Manufacturer, SKU	Unit	Quantity	Unit Price	Total
1	Stucco Finish			SF	1149		
2	Wall Shteathing (OSB)			SF	1149		
3	Shteathing Fastener	Self-drilling screws(100/pkt)		PKT	11.49		
4	Wall Homewrap			SF	1149		
5	Homewrap Fastener	Stapled fastener (200/pkt)		PKT	4.3662		
6	Wall Paint			SF	1149.00		
7	Wall Insulation			SF	1520.00		



			WALLS: INTERIOR 01				
#	Item	Туре	Description, Manufacturer, SKU	Unit	Quantity	Unit Price	Total
	BATH 1			SF	40.0		
1	Cementitious Backer Board			SF	207		
2	Kerdi membrane			SF	207		
3	Kerdi membrane Fastener			SF	207		
4	Wall Ceramic Tile			SF	207		
	BATH 2			SF	41.0		
5	Cementitious Backer Board			SF	233		
6	Kerdi membrane			SF	233		
7	Kerdi membrane Fastener			SF	233		
8	Wall Ceramic Tile			SF	233		
	BEDROOM 1			SF	154.0		
9	Drywall Board			SF	368		
10	Drywall Fastener	Self-drilling screws(100/pkt)		PKT	3.68		
11	Wall Paint			SF	368		
12	Drywall Tape			FT	69.0		



			WALLS: INTERIOR 02				
#	Item	Туре	Description, Manufacturer, SKU	Unit	Quantity	Unit Price	Total
	BEDROOM 2			SF	149.0		
13	Drywall Board			SF	318		
14	Drywall Fastener	Self-drilling screws(100/pkt)		PKT	3.18		
15	Wall Paint			SF	318		
16	Drywall Tape			FT	59.6		
	HALL			SF	29.0		
17	Drywall Board			SF	74		
18	Drywall Fastener	Self-drilling screws(100/pkt)		PKT	0.74		
19	Wall Paint			SF	74		
20	Drywall Tape			FT	14		
	LIVING ROOM	·		SF	152.0		
21	Drywall Board			SF	263		
22	Drywall Fastener	Self-drilling screws(100/pkt)		PKT	2.63		
23	Wall Paint			SF	263		
24	Drywall Tape			FT	49.3		



			WALLS: INTERIOR 03				
#	Item	Туре	Description, Manufacturer, SKU	Unit	Quantity	Unit Price	Total
	KITCHEN			SF	78.0		
25	Cementitious Backer Board			SF	28		
26	Drywall Board			SF	157		
27	Drywall Fastener	Self-drilling screws(100/pkt)		PKT	1.57		
28	Kerdi membrane			SF	28		
29	Kerdi membrane Fastener			SF	28		
30	Wall Ceramic Tile			SF	28		
31	Wall Paint			SF	157		
32	Drywall Tape			FT	29.6		
	CL 1			SF	15.0		
33	Drywall Board			SF	101		
34	Drywall Fastener	Self-drilling screws(100/pkt)		PKT	1.01		
35	Wall Paint			SF	101		
36	Drywall Tape			FT	18.9		



			WALLS: INTERIOR 04				
#	Item	Туре	Description, Manufacturer, SKU	Unit	Quantity	Unit Price	Total
	CL 2			SF	21.0		
37	Drywall Board			SF	136.0		
38	Drywall Fastener	Self-drilling screws(100/pkt)		PKT	1.4		
39	Wall Paint			SF	136.0		
40	Drywall Tape			FT	25.5		
	WD			SF	17.0		
41	Cementitious Backer Board			SF	99.0		
42	Kerdi membrane			SF	99.0		
43	Kerdi membrane Fastener			SF	99.0		
44	Wall Ceramic Tile			SF	99.0		
	WH			SF	6.0		
45	Drywall Board			SF	74.0		
46	Drywall Fastener	Self-drilling screws(100/pkt)		PKT	0.7		
47	Wall Paint			SF	74.0		
48	Drywall Tape			FT	14.0		
1	Wall Skirting	Ceramic		FT	168.0		



			DOORS				
#	Item	Туре	Description, Manufacturer, SKU	Unit	Quantity	Unit Price	Total
1	Exterior Swinging	3' - 0" X 6'-8"		PCS	2		
2	Interior Swinging	3' - 0" X 6'-8"		PCS	2		
3	Interior Sliding	6' - 0" X 6'-8"		PCS	1		
4	Interior Sliding	9' - 0" X 6'-8"		PCS	1		
5	Interior Swinging	2' - 6" X 6'-8"		PCS	2		
6	Interior Swinging	1' - 8" X 6'-8"		PCS	1		
7	Exterior Door Trim			FT	32.68		
8	Interior Door Trim			FT	274.68		
9	Entry Lock set			PCS	2		
10	Privacy Lock set			PCS	4		
11	Passage Lock set			PCS	3		
12							
13							
14							
15							



			WINDOWS				
#	Item	Туре	Description, Manufacturer, SKU	Unit	Quantity U	Jnit Price Tot	tal
1	Hung	4' - 3" X 3'-3"		PCS	2		
2	Hung	3' - 3" X 2'-3"		PCS	2		
3	Hung	2' - 9" X 3'-3"		PCS	2		
4	Awning	5' - 3" X 3'-9"		PCS	2		
5	Awning	2' - 3" X 2'-3"		PCS	1		
6	Casement	2' - 3" X 3'-9"		PCS	2		
7	Exterior Window Trim			FT	134		
8	Interior Window Trim			FT	134		
9							
10							
11							
12							
13							
14							
15							



			ROOF 01				
#	Item	Туре	Description, Manufacturer, SKU	Unit	Quantity	Unit Price	Total
1	Roof Covering			SF	1041.0		
2	Roof Covering Fastener			PCS	521		
3	Roof Felt Paper			SF	1041.0		
4	Roof Felt Paper Fastener			PCS	3123.0		
5	Roof Sheathing			SF	1041.0		
6	Roof Sheathing Fastener			PCS	8328		
7	Batten			FT	501.0		
8	Batten Fastener			PCS	376.7		
9	Soffit			SF	149.0		
10	Soffit Fastener			PCS	74.5		
11	Fascia			FT	142.0		
12	Fascia board fastener			PCS	71		
13	Roof Insulation			SF	1041.0		
14							
15							