

ORION

The Orion is a charming Craftsman-style studio home designed for efficient and comfortable living. Its exterior showcases classic Craftsman architectural elements with a touch of rustic charm. The walls are finished with horizontal siding in a warm, earthy tone, creating a clean and traditional aesthetic. The gable end features wood shingles, adding a touch of natural texture and visual interest. A simple gable roof with a decorative trim detail at the peak provides shelter and complements the overall design. The prominent double sliding glass doors at the front provide ample natural light and seamless access to the outdoors.

Inside, the Orion features a simple rectangular floor plan. The living, dining, kitchen, and sleeping areas are seamlessly merged into a single large open room, maximizing the feeling of spaciousness. Functional spaces, such as the bathroom and laundry, are strategically placed at the back of the plan, out of sight, creating a clean and uncluttered living area.

Materials Shopping List

Please print and take this Materials Shopping List to your favorite Home Depot and ask for assistance in selecting the materials, fixtures and fittings to complete your new home.

Record your selection and the price of the item. Then do the math to determine the cost for your selections and the total cost of finishing your home.

< CLICK HERE >

To Go To Materials Shopping List




18' - 0" KITCHEN 123 SF STUDIO AREA **GROUND FLOOR PLAN**

FLOOR PLAN

415 SF

Studio

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FLOOR PLAN +

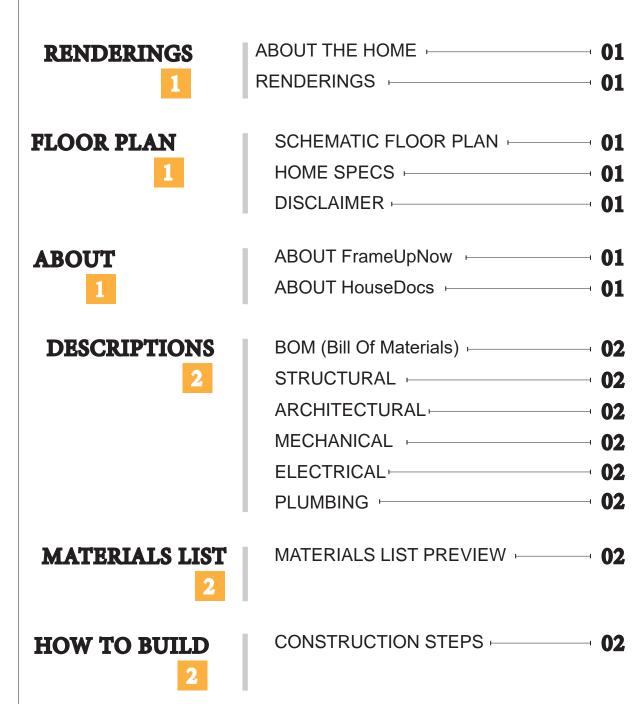DIMENSION PLAN + FOUNDATION PLAN STRUCTURAL FLOOR PLAN -WALL FRAME LAYOUT ROOF TRUSS LAYOUT ROOF PLAN + 10 ARCHITECTURAL ELEVATIONS -ARCHITECTURAL ELEVATIONS -**12** ARCHITECTURAL SECTIONS -ARCHITECTURAL DETAILS

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DISCLAIMER

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DIMENSION FOR FITTING

MATERIALS SHOPPING LIST MATERIALS SHOPPING LIST

ABOUT



FrameUpNow is a design and manufacturing company providing precision-engineered home framing solutions. We offer a catalog of Affordable Homes, Tiny Homes, Garages, Shops and Barndominiums. FrameUpNow manufactures cold-formed steel (CFS) also known as Light Gauge Steel (LGS) framing components that conform to our engineered metal house frame plans or can be purchased as DIY skeleton kits.

The CFS/LGS framing is lightweight, easily assembled, and does not require heavy equipment or specialized labor, enabling homeowners to erect the frame themselves in just a few days. Unlike wood, the steel framing is impervious termites and bores, warping, expansion, and fire.

Our home plans come complete with a structural engineered stamp for permit approvals. Customers receive a full BOM also known as a Materials Shopping List to purchase finish materials from a Building Materials retailer. FrameUpNow prides itself on the quality and efficiency of our precision-engineered home framing solutions for construction professionals and DIY homeowners.



KEY PLAN

NO.	DESCRIPTION	DATE
	,	

NOTE:

LEGEND:

PROJECT

121-Orion-415-Studio-Craftsman-**Base-550**

DRAWING NAME

INTRODUCTION

С	CLIENT NAME:
Р	PROJECT NUMBER:
D	DATE:
D	DESIGNED BY:
D	DRAWN BY:
С	CHECKED BY:

I101

SCALE:

DESCRIPTIONS

MATERIALS LIST

The BOM (Bill Of Materials) package, known as the Materials Shopping List document, provides:

Comprehensive Inventory: Detailed lists of essential materials sourced from architectural, mechanical, HVAC, electrical, and plumbing design drawing sets.

Precise Curation: Each item meticulously selected and organized for accuracy and efficiency in project planning.

Customizable Options: Customers can modify listed items to their preferences and calculate costs accordingly, ensuring alignment with personal project needs and budget.

Dedicated Space for Details: Includes tables for customers to note Home Depot SKU numbers or product descriptions for selected items,

facilitating seamless purchasing and coordination with suppliers.

Customer Convenience: Take the list to Home Depot or preferred suppliers for accurate pricing, helping align the total home budget with personal financial plans.

Simplify your construction journey with our Materials Shopping List document, where detailed preparation meets streamlined implementation for your dream home.

STRUCTURAL

The structural drawings package provides an exhaustive set of detailed plans essential for the precise assembly of your building. This comprehensive package includes:

Framing Plans: Detailed layouts for all framing components. Truss Layouts: Clear instructions for truss placement and

Panel Length Plans: Specifications for panel dimensions. Framing Elevations and Sections: Precise elevation and sectional views for accurate construction.

Truss and Wall Blocking Plans: Plans for truss and wall blocking to ensure structural integrity.

Hold-Down Plan: Detailed hold-down requirements for stability. Snap Sheet: Reference sheet for quick identification of components

Structural Details and Bracing Plans: Complete details and bracing plans for all structural elements.

Accompanying these plans is a comprehensive Bill of Materials (BOM) that lists every necessary building component, from cold formed steel (CFS) frames to fasteners.

ARCHITECTURAL

With the comprehensive architectural package, both builders and DIY homeowners can confidently execute the construction.

The architectural package includes:

Furnished Floor Plans: Complete with furniture layouts for a clear understanding of space utilization.

Detailed Dimension Plans: Ensures precise measurements, from the overall footprint down to the exact placement of windows and

Foundation Plan: Detailed plan to establish a solid foundation.

Wall Framing and Truss Layout: Comprehensive plans for wall framing and truss placement.

Architectural Elevations: Exterior views showcasing the design.

Strategic Building Sections: Critical cross-sectional details for a thorough understanding of the build.

Casework Drawings and Diagrams: Suggested designs for built-in caseworks, such as kitchen cabinets.

MECHANICAL ELECTRICAL

The mechanical package includes everything needed to guide HVAC

Detailed HVAC Floor Plan: Precisely maps out the placement of air handlers, ductwork, and vents throughout the home's layout.

HVAC Sections and Riser Diagrams: Technical drawings offering critical cross-sectional details and piping schematics, ensuring proper integration of the heating and cooling system into the home's structure.

Bill of Materials: A complete list of all necessary HVAC components.

The electrical package includes all the plans and documentation needed to guide the installation of your home's electrical system:

Detailed Power Plan: Precisely maps out the placement of outlets, switches, and other power components throughout the layout.

Comprehensive Lighting Plan: Shows the optimal locations for lighting fixtures, sconces, and other illumination sources to create a well-lit, functional interior.

Dimensioned Electrical Layout: Provides exact dimensions and measurements to ensure proper placement of all electrical elements.

Bill of Materials: A complete list of every component needed, from circuit breakers to wiring.

The plumbing package includes everything needed to guide the

Detailed Water Supply System Plan: Precisely maps out the placement of pipes, valves, and plumbing fixtures throughout the

Comprehensive Sewage System Plan: Shows the optimal routing and sizing of drain lines to effectively remove waste and ensure

Detailed Riser Diagrams: Provide information needed to properly install all vertical plumbing risers and vent stacks.

PLUMBING

installation of your home's water supply and drainage systems:

proper drainage.

Bill of Materials: A complete list of every component needed, from pipes to fixtures.


BOM (Bill Of Materials) (Separately Attached)





The Bill of Materials (BOM) is a crucial document that compiles the material requirements from different disciplines into a centralized inventory, enabling efficient procurement, inventory management, and cost estimation for a specified project or

ELECTRICAL BOM



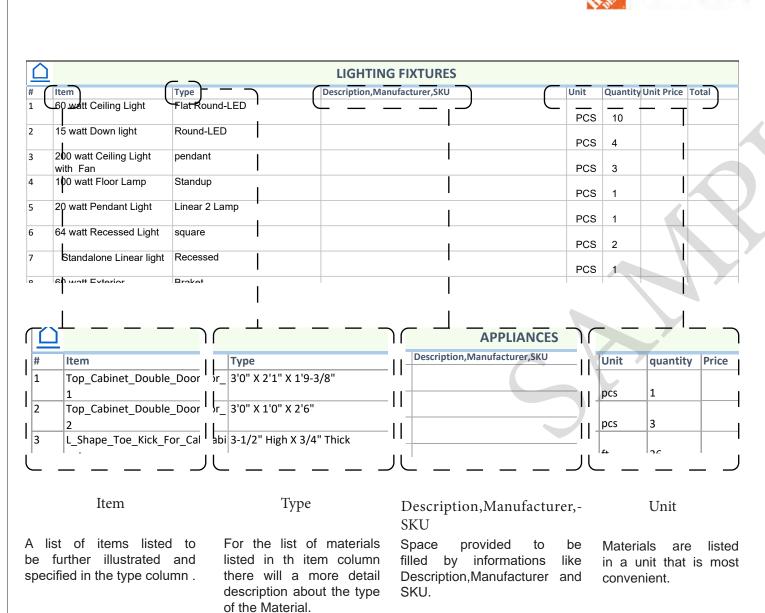

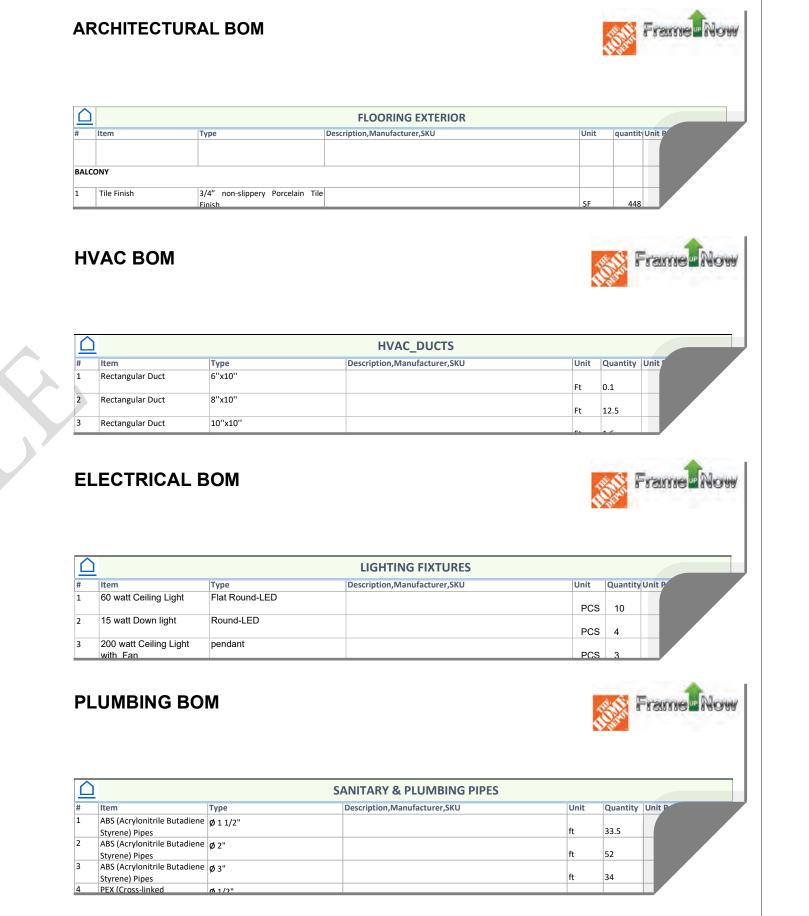

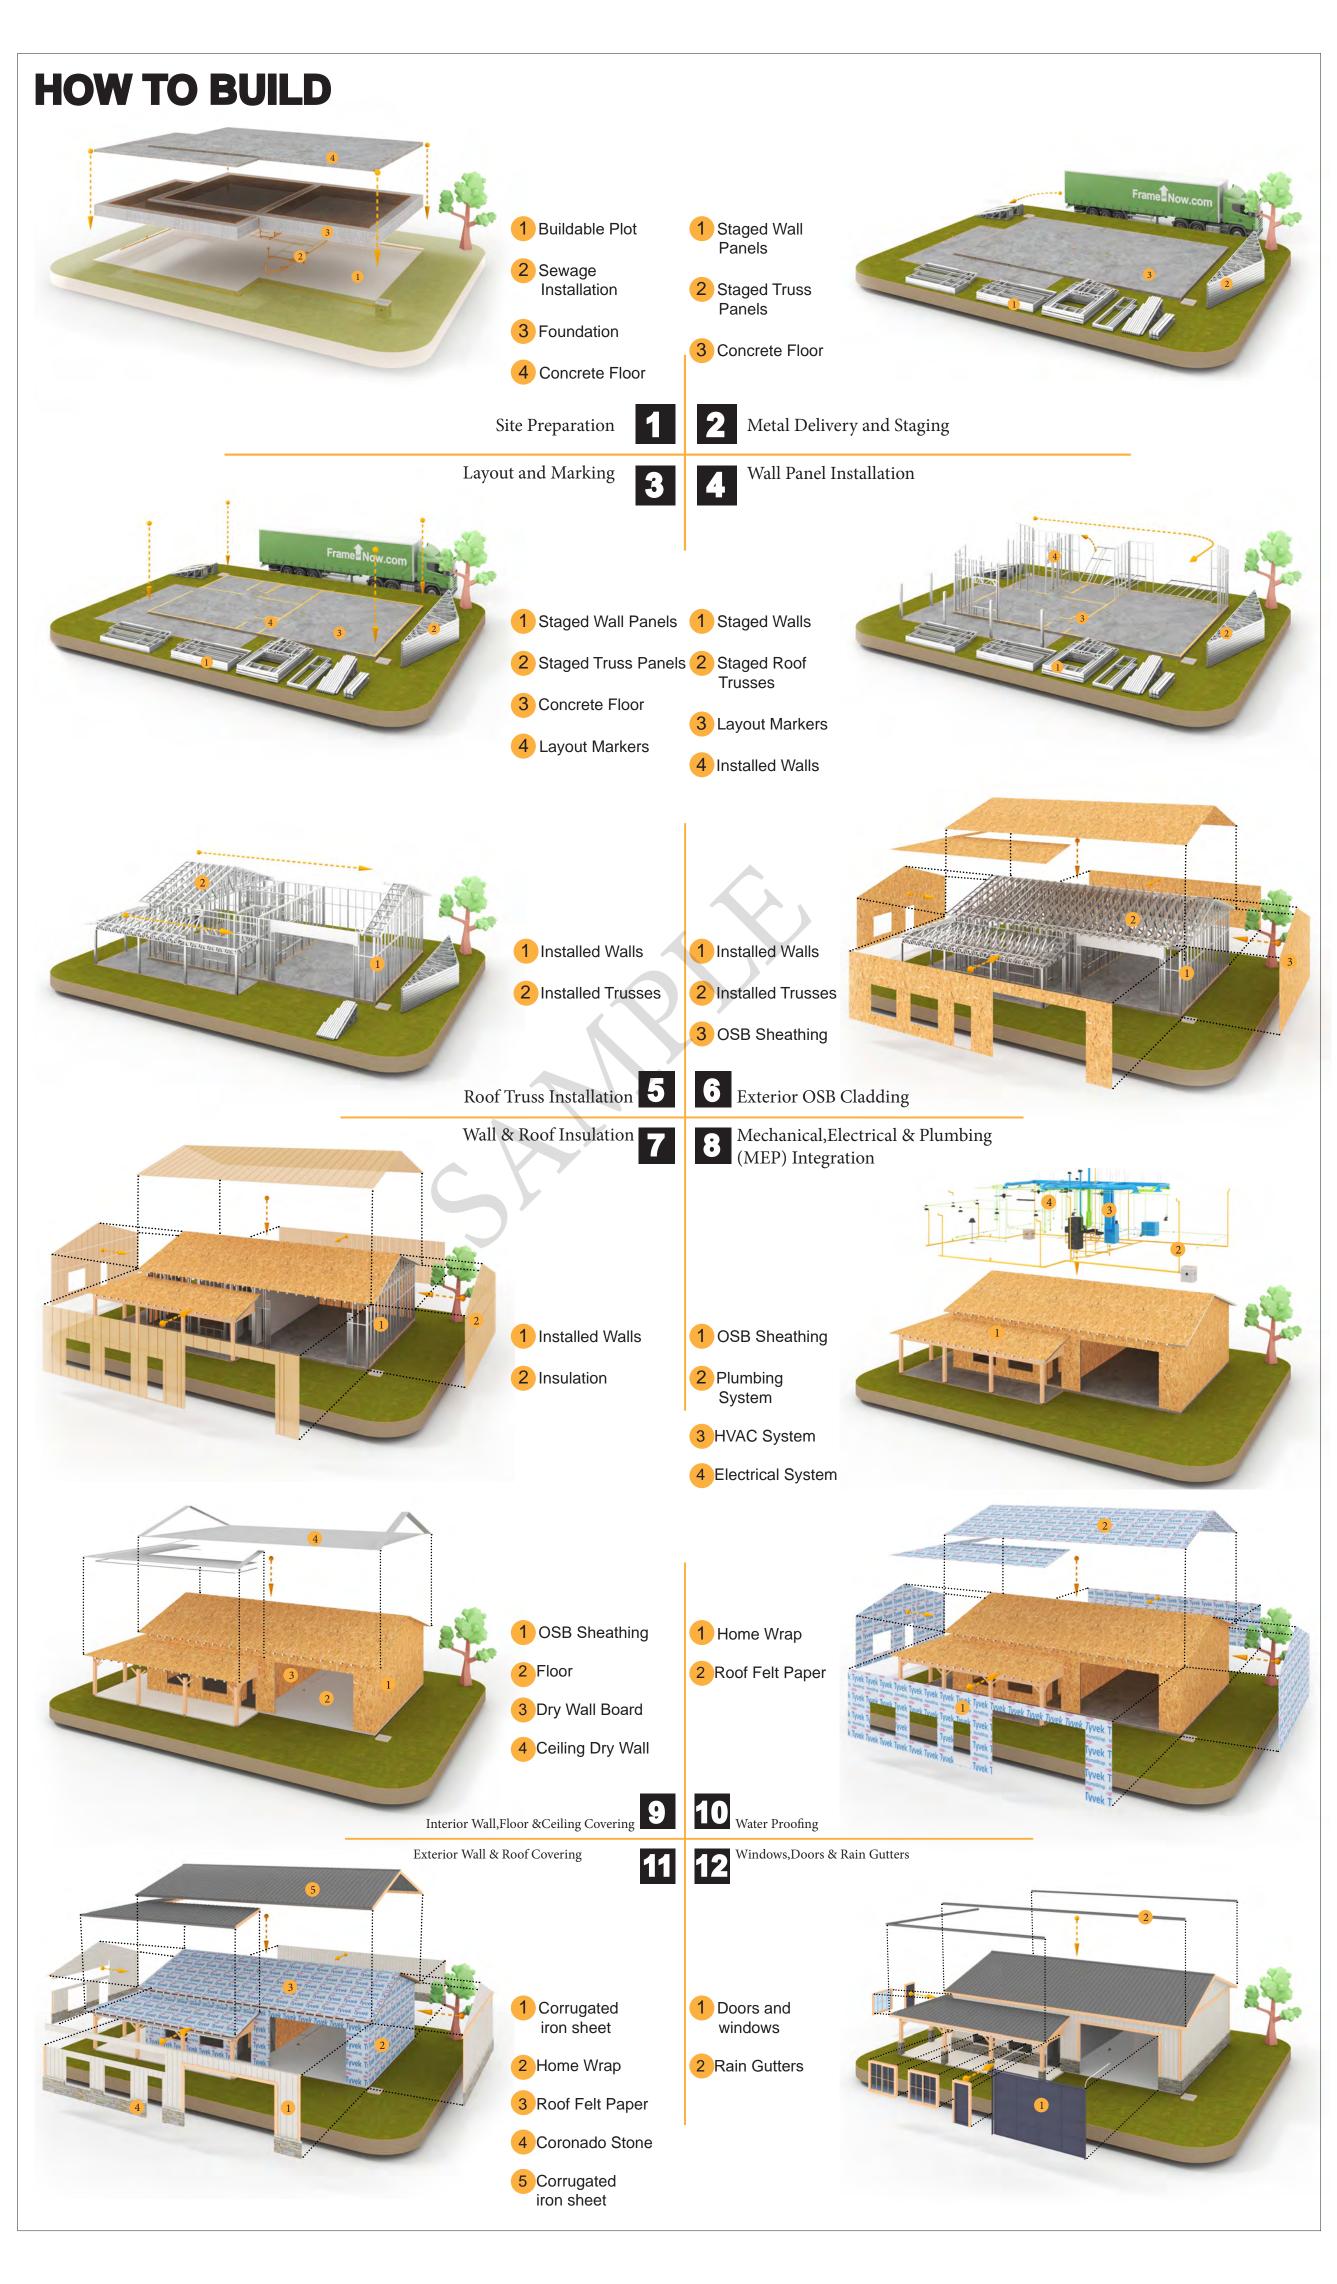



KEY PLAN

NO.	DESCRIPTION	DATE

NOTE:

LEGEND:

PROJECT

121-Orion-415-Studio-Craftsman-**Base-550**


DRAWING NAME

INTRODUCTION

CLIENT NAME: PROJECT NUMBER: DATE: **DESIGNED BY** DRAWN BY: CHECKED BY:

1102

SCALE:

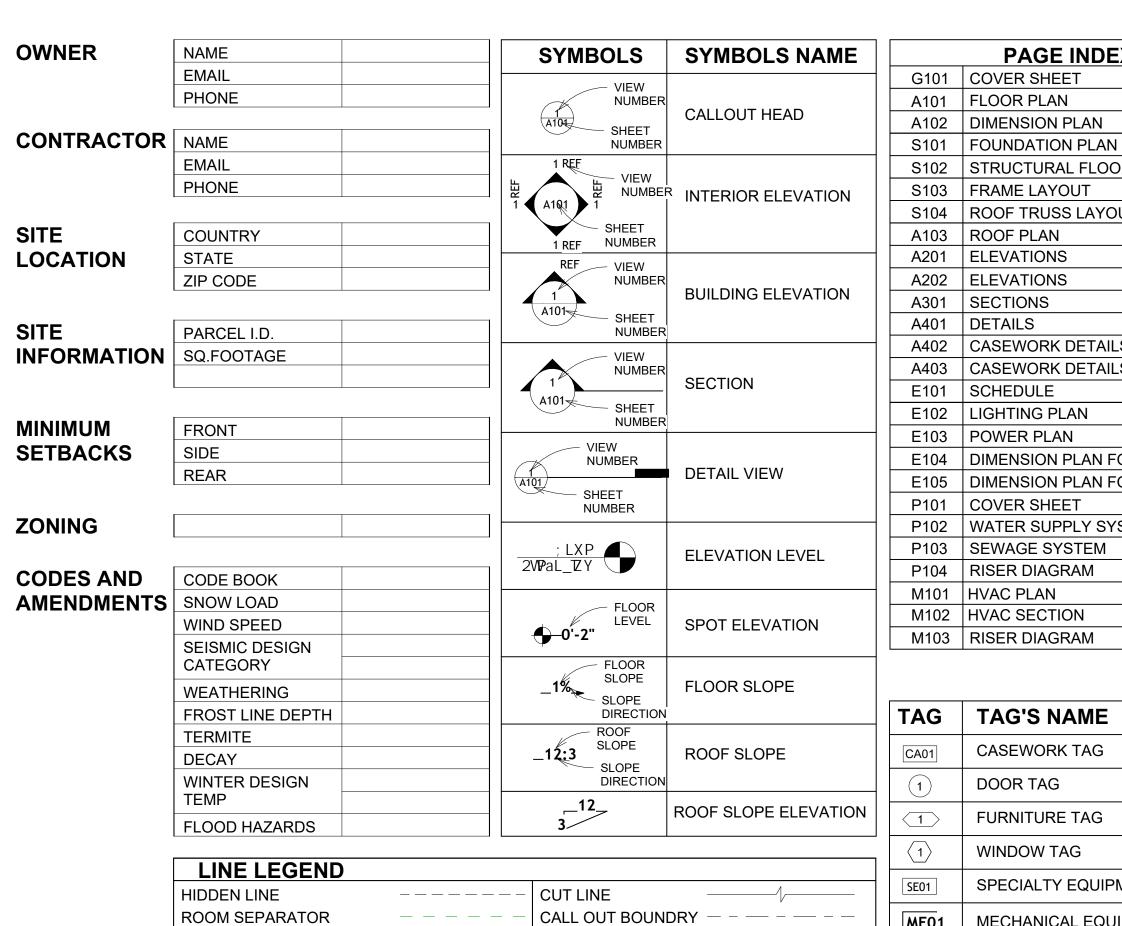

DOOR OPENING DIRECTION

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CASEWORK TAG

FURNITURE TAG

SPECIALTY EQUIPMENT TAG

MECHANICAL EQUIPMENT TAG

WINDOW TAG

| | LPE01 | PLUMBING EQUIPMENT TAG

DOOR TAG

SIMP. STHD8	SIMPSON STRAP THE HOLDDOWN
SIMP. ABE66	SIMPSON ANCHOR BOLT EDGE
TV	TELEVISION
UNO	UNLESS NOTED OTHERWISE
W/	WITH
W/D	WASHER/DRYER
AC	AIR CONDITIONING UNIT
ACC	AIR COOLED CONDENSER
ACCU	AIR COOLED CONDSENSING UNIT
AHU	AIR HANDLING UNIT
CC	COOLING COIL
CD	CEILING DIFFUSER
CFm	Cubic Feet Per Minute
CR	CEILING REGISTER
CU	CONDENSING UNIT
CW	COLD WATER
E/A	EXHAUST AIR
EF	EXHAUST FAN
ET	EXPANSION TANK
EX.	EXISTING
FC	FLEXIBLE CONNECTION
FCU	FAN COIL UNIT
FLR.	FLOOR
HC	HEATING COIL
HE	AIR TO AIR HEAT EXCHANGER
HV	HEATING AND VENTILATING UNI
IV	INLET VANES
MER	MECHANICAL ROOM
MAX.	MAXIMUM
MIN.	MINIMUM
R/A	RETURN AIR
RCU	RECIPROCATING CHILLER UNIT
RF	RETURN FAN
S/A	SUPPLY AIR
SCD	SMOKE CONTROL DAMPER
SP	STATIC PRESSURE

ABBREVIATION

ASTM D698 AMERICAN SOCIETY FOR

CASEWORK

ELECTRICAL

FOOTINGS

CODE

CODE

MAXIMUM

MINIMUM

NUMBER

ON CENTER

PLUMBING

REFERENCE

RIGHT GARAGE

SQUARE FEET

MECHANICAL

CONDITIONING

HVAC

MAX.

ACTION FLOOR SYSTEMS

TESTING AND MATERIAL

FINISHED FLOOR LEVEL

FINISHED FLOOR ELEVATION

HEATING, VENTILATION & AIR

INTERNATIONAL RESIDENCE


INTERNATIONAL MECHANICAL

ORIENTED STRAND BOARD

POUNDS PER SQUARE INCH

POLYVINYL CHLORIDE

SPECIAL EQUIPMENT

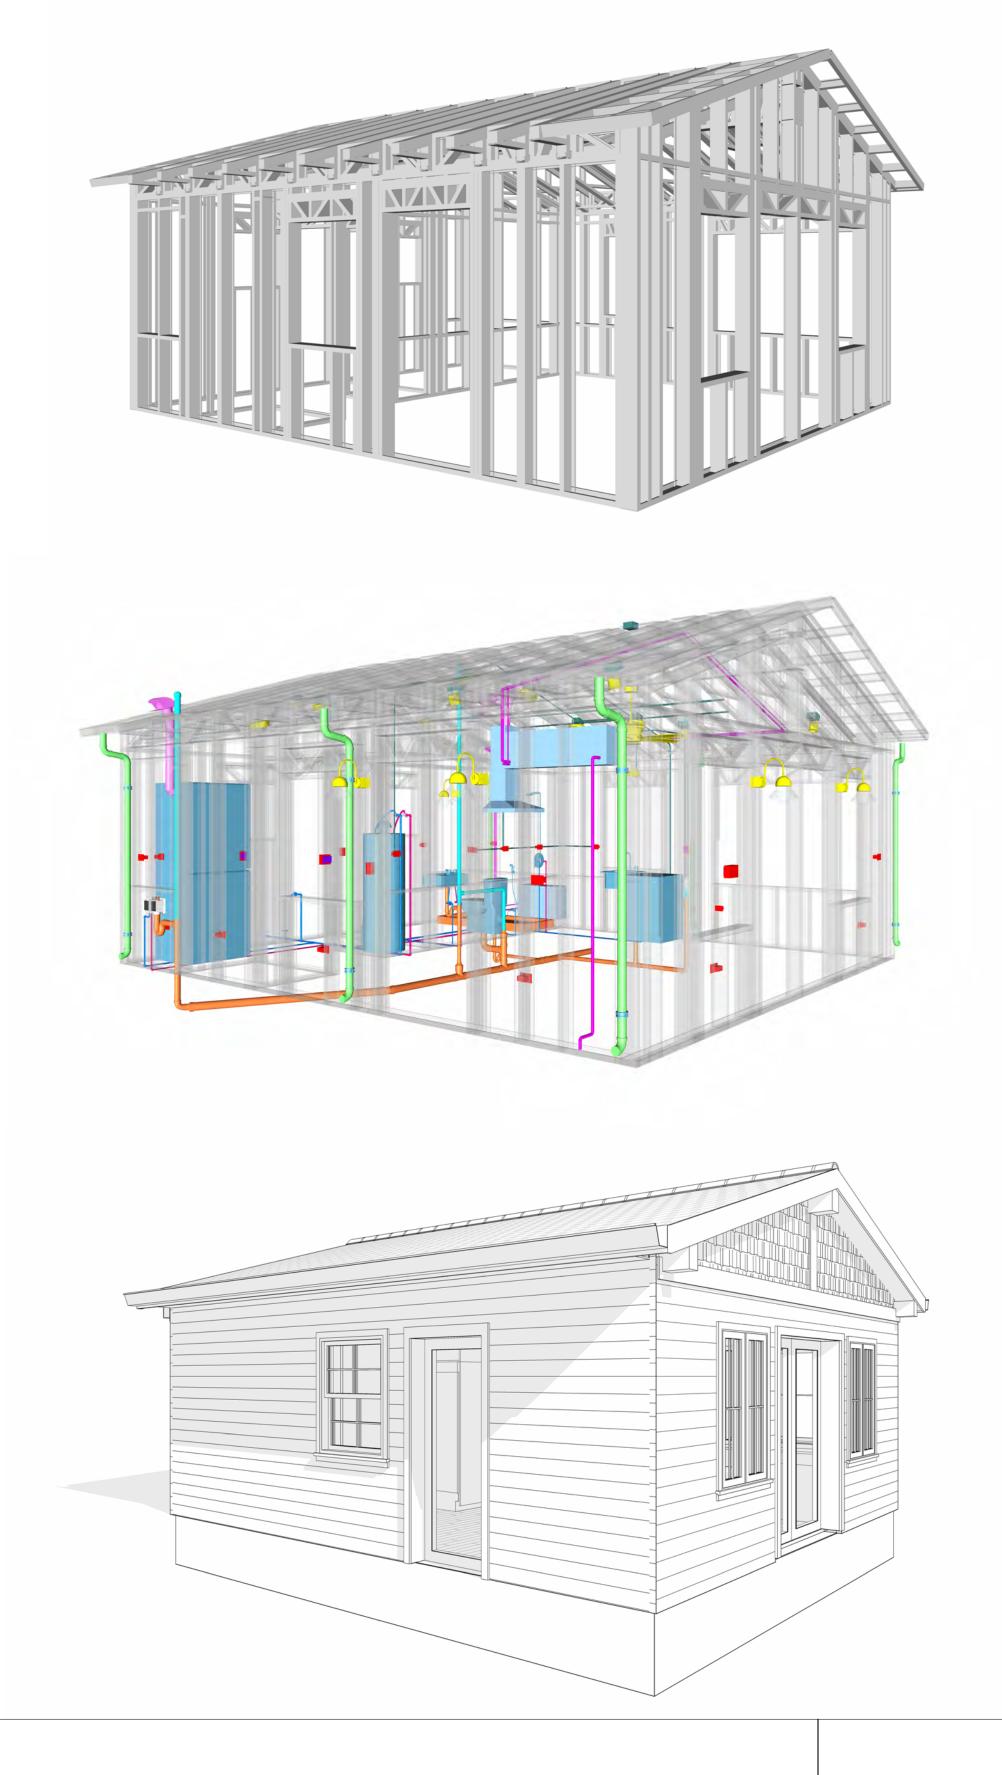


121 ORION 415 STUDIO CRAFTSMAN BASE 550

SQUARE FOOT	AGE
LIVING	414
TOTAL	414



KEY PLAN

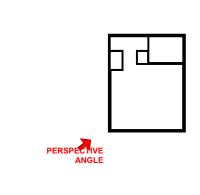

NO.	DESCRIPTION	DATE

NOTE:

LEGEND:

121 ORION 415 STUDIO CRAFTSMAN BASE 550

DRAWING NAME

COVER SHEET

Client Name	CLIENT NAME:	
0061_12	PROJECT NUMBER:	
3/21/2025 9:38:21 A	DATE:	
Designe	DESIGNED BY:	
Autho	DRAWN BY:	
Checke	CHECKED BY:	

G101

SCALE: As indicated



LEVEL

GENERAL NOTES

- 1. THIS DRAWING DEPICTS THE ARCHITECTURAL (SPACE LAYOUT, FURNISHING, FLOOR, WALLS, ROOFS, FOUNDATION, WINDOWS AND DOORS) SYSTEMS. IT PROVIDES A VISUAL REPRESENTATION OF THE ARCHITECTURAL LAYOUT AND COMPONENTS.
- THE ARCHITECTURAL DRAWINGS ARE PREPARED TO MEET THE SPECIFIC REQUIREMENTS OF THE BUILDING, AS PER THE PROJECT SPECIFICATIONS AND APPLICABLE CODES AND STANDARDS. THE CONSTRUCTION OF THIS HOME SHALL COMPLY WITH THE LATEST EDITION OF THE
- INTERNATIONAL RESIDENTIAL CODE (IRC), INTERNATIONAL MECHANICAL CODE (IMC), THE INTERNATIONAL PLUMBING STANDARD, THE NATIONAL ELECTRICAL STANDARD AND ALL OTHER APPLICABLE LOCAL, STATE, AND NATIONAL CODES AND REGULATIONS.
- 4. COORDINATION WITH OTHER TRADES HAS BEEN DONE ON A DESIGN LEVEL. THIS DRAWING SHALL BE READ TOGETHER WITH THE ME, EL AND PL DESIGN DRAWINGS TO ENSURE PROPER CONSTRUCTION AND INTEGRATION OF THE BUILDING SYSTEMS.

ABOUT WALLS:

SHOWER WALL COVERING

BATHTUB AND SHOWER SPACES (WALLS AND FLOORS) WITH INSTALLED SHOWER HEADS AND IN SHOWER COMPARTMENTS SHALL BE FINISHED WITH A NON-ABSORBENT SURFACE.

WALL PAINT (INTERNAL)

THE TYPICAL THICKNESS OF LATEX WALL PAINT IS 1/32 OF AN INCH FOR A SINGLE COAT. AND DOUBLE COAT (1/16") SHALL BE APPLIED FOR DURABILITY.

ADHESIVES:

THE ADVISABLE TYPE OF ADHESIVE FOR THIS PROJECT IS **EPOXY ADHESIVES**BECAUSE THEY ARE KNOWN FOR THEIR HIGH STRENGTH, DURABILITY, AND RESISTANCE TO MOISTURE, CHEMICALS AND

REFER TO SHEETS A201 & A202 FOR GENERAL NOTES ON EXTERNAL FINISHING MATERIALS

ABOUT FLOORS:

1. THE SPOT ELEVATION INDICATES THE FINISHED FLOOR ELEVATION.


FINISHED FLOORS PER PLANS.

FIELD VERIFY FOR DIMENSION DROP 4" FOR SHOWER AND BATHTUB USE.

1% SLOPE ON OUTDOOR BALCONIES FOR WATER RUN OFF.

2% SLOPE TOWARDS THE SHOWER DRAIN FOR SUFFICIENT DRAINAGE. 4" DROP AT THE DOOR LEADING TO EXTERIOR BALCONY FROM THE MAIN LIVING AREA.


5% SLOPE FOR GARAGE IS USED, WHICH SHOULD BE CHECKED WITH THE LOCAL GARAGING ZONING LAWS.

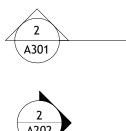



		FURNITURE SCHEDULE	
	TYPE MARK	TYPE	COUNT
01		CLOSED - 900 X 660MM 2	1
02		FOUR SIT 65" X 95"	1
03		DINING CHAIR	2
04		ONE SEAT SOFA	1

			ROOM FIN	ISH SCHEDULE			
ROOM NUMBE R	ROOM NAME	FLOOR FINISH	BASE FINISH	WALL FINISH	CEILING FINISH	CEILING HEIGHT	COMMENTS
					-		
01	KITCHEN	HARDWOOD	CONCRETE	WALL PAINT + CERAMIC	DRY WALL	8' - 0"	
02	STUDIO AREA	HARDWOOD	CONCRETE	WALL PAINT	DRY WALL	8' - 0"	
03	CL	HARDWOOD	CONCRETE	WALL PAINT	DRY WALL	8' - 0"	
04	WD	HARDWOOD	CONCRETE	WALL PAINT	DRY WALL	8' - 0"	
05	HALL	HARDWOOD	CONCRETE	WALL PAINT	DRY WALL	8' - 0"	
06	BATH	VINYL TILES	CONCRETE	CERAMIC TILE	MRD	8' - 0"	
07	WH	HARDWOOD	CONCRETE	WALL PAINT	DRY WALL	8' - 0"	



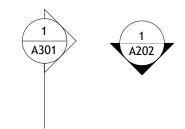

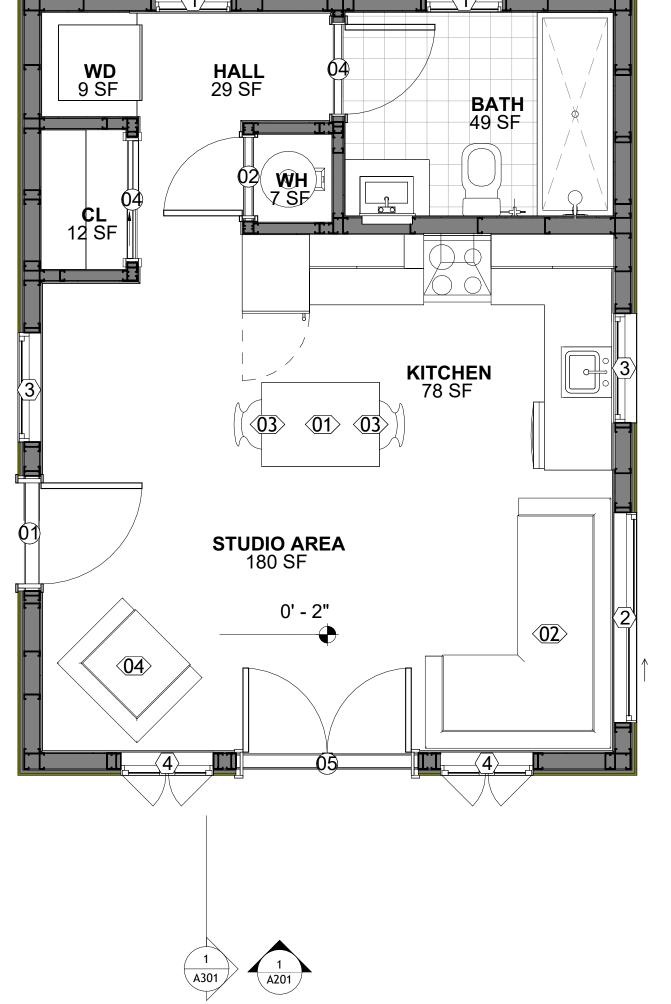

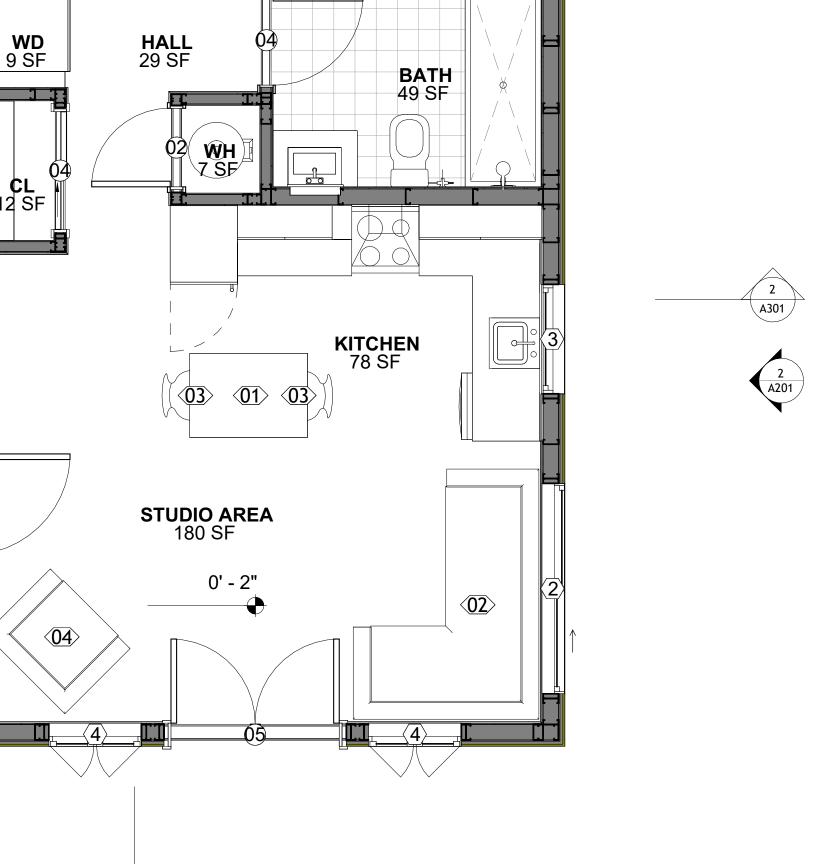



KEY PLAN

NO.	DESCRIPTION	DATE

NOTE:

LEGEND:


121 ORION 415 STUDIO CRAFTSMAN BASE 550


DRAWING NAME

FLOOR PLAN

Client Name	CLIENT NAME:
0061_12	PROJECT NUMBER:
3/21/2025 9:38:22 AM	DATE:
Designer	DESIGNED BY:
Author	DRAWN BY:
Checker	CHECKED BY:

SQUARE FOOTAGE TOTAL 414

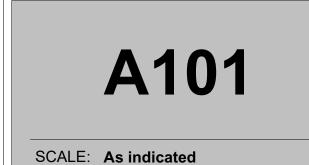

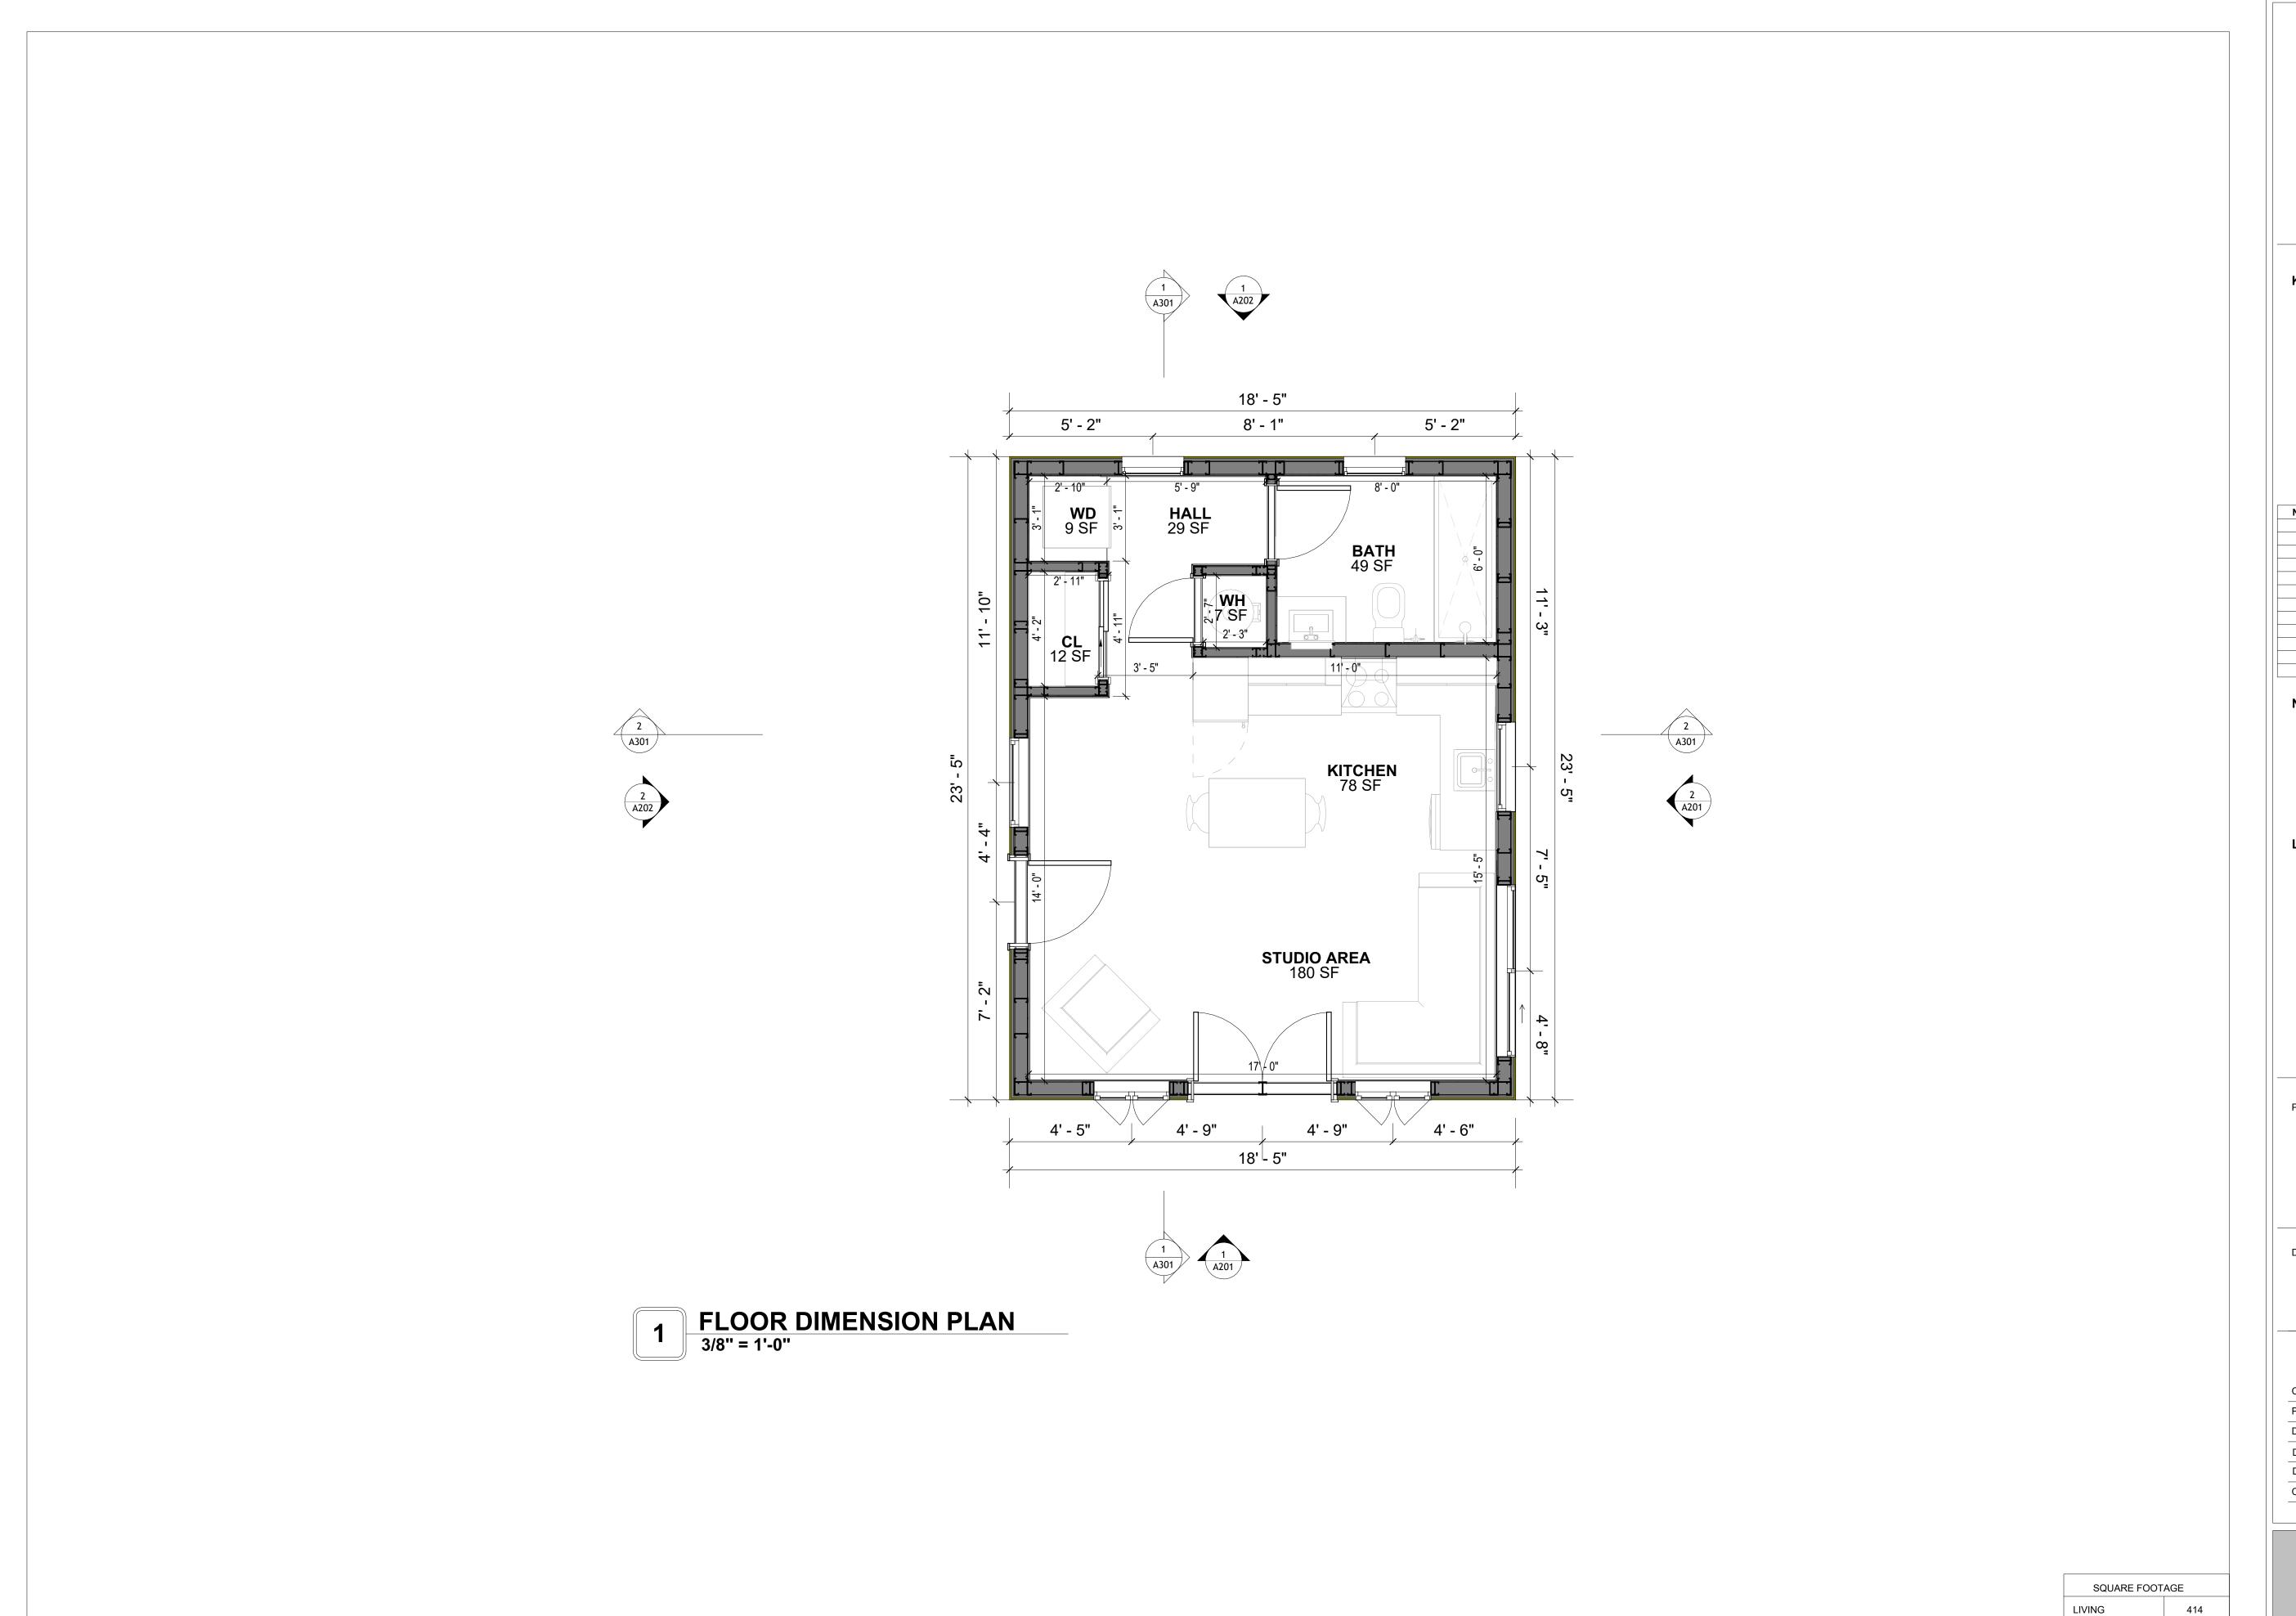



KEY PLAN

NO.	DESCRIPTION	DAT

NOTE:

LEGEND:

PROJECT

121 ORION 415 STUDIO CRAFTSMAN BASE 550

DRAWING NAME

DIMENSION PLAN

Client Name
0061_12
3/21/2025 9:38:23 AM
Designer
Author
Checker

A102

SCALE: 3/8" = 1'-0"

TOTAL

414

FOUNDATION NOTES

NOTES:

TERMITES PRETREATMENT BY LICENSED CONTRACTOR UNDER SLAB AND AROUND FOOTINGS. ALL AREAS BELOW SLABS SHALL BE TREATED NO MORE THAN 24 HOURS PRIOR TO CONCRETE POUR. EVIDENCE OF TREATMENT MUST BE PROVIDED PRIOR TO PLACING OF CONCRETE.

. MATERIALS:

ALL INTERIOR CONCRETE SLABS SHALL BE A MIN. OF 4" THICK CONCRETE OVER 4" COMPACTED AGGREGATE BASE (ASTM D698), FINISH ELEVATIONS AS NOTED ON DRAWINGS, 6" ABOVE ADJACENT GRADE, LEVEL SLABS TO 1/8"-10' MAX.. CONCRETE SLABS SHALL BE 2500# PSI AT 28 DAYS. A 4" ALLOWABLE SLUMP.

2. PAD PREPARATION:

- EXCAVATION FOR FOOTING SHALL BE NEAT.

- FOOTINGS SHALL BE POURED IMMEDIATELY AFTER EXCAVATION AND APPROPRIATE INSPECTION.

- ALL REINFORCING STEEL MARKED "CONTINUOUS" SHALL BE LAPPED 36 BAR DIAMETERS AT SPLICES AND AROUND CORNERS OR INTERSECTIONS WITH A STANDARD 90 DEGREE BEND ON CORNER BARS. LAP WIRE MESH ONE FULL MESH AT SIDE AND END LAPS.
- ALL HARDWARE TO BE SIMPSON OR EQUIVALENT.

- EXTERIOR FRAME WALL TO BE SECURED WITH 1/2"X10" ANCHOR BOLTS 4'-0" O.C. FOR 1-STORY AND 2'-8" O.C. FOR 2-STORY. BOLTS SHALL BE LOCATED WITHIN 1'-0" OF EACH END PIECE AND SHALL HAVE A MIN. OF TWO BOLTS PER PIECE.

-FOUNDATION ANCHOR STRAPS SHALL BE PERMITTED, ACCORDING TO RESIDENTIAL CODE 2021

- ALL INTERIOR WALLS TO BE SECURED WITH POWER DRIVEN PINS PER MANUFACTURER SPECIFICATION USE PIN SPACING EQUIVALENT TO 1/2" ANCHOR BOLTS.
- ALL CONSTRUCTION TO CONFORM TO THE 2012 IRC

R-10 RIGID INSULATION OUTSIDE OF EXTERIOR FOUNDATION WALLS UNDER LIVING AREA.
 CONCRETE PAD FOR CONDENSER THICKNESS IS 4" MIN UNLESS OTHERWISE NOTED.

3. CONCRETE CONSTRUCTION:

- THE SLAB SHALL BE UNDERLAIN BY A VAPOR BARRIER/RETARDER IN THE LIVING AREA (TYPICALLY POLYETHYLENE, UNLESS MORE STRINGENT PROTECTION REQUIRED BY THE ARCHITECT, ENGINEER, FLOOR COVERING MANUFACTURER, OR ACCEPTED PRACTICE). UNLESS OTHERWISE REQUIRED, BARRIER MAY BE OMITTED AT GARAGES, PORCHES AND PATIOS WITHOUT FLOOR COVERINGS. IT IS BEYOND THE SCOPE OF THESE PLANS TO DETERMINE THE APPLICABILITY OF THESE MORE STRINGENT REQUIREMENTS. BUILDER SHALL VERIFY PRIOR TO CONSTRUCTION.

4. REINFORCEMENT:

- IF CONSTRUCTED ON ACTIVE SOILS, THE LONG TERM PERFORMANCE OF THE FOUNDATION IS DEPENDENT ON MAINTENANCE BY THE OWNER. THUS THE BUILDER SHALL ADVISE THE OWNER OF THE FOLLOWING:

DRAINAGE MUST BE MAINTAINED. WATER SHALL NEVER BE ALLOWED TO POND NEAR THE

FOUNDATION.

2. THE SOIL AROUND THE FOUNDATION SHALL BE MAINTAINED IN A RELATIVELY DAMP CONDITION, SUCH AS THAT REQUIRED TO KEEP A LAWN GREEN. IF IT DRIES OUT IT WILL SHRINK. IF IT GETS WET, IT WILL HEAVE UPWARD.

3. SLABS ON THE SHORTER SIDE USES MAIN BARS ARE USED IN THIS DIRECTION ONLY WITH SMALLER DIAMETER DISTRIBUTION BARS ARE PLACED, FORMING A MAT OR GRID.

4. ALL REINFORCEMENT BARS SIZE 10MM OR LARGER IN ACCORDANCE TO ASTM

3. ANCHOR BOLTS AT ALL EXTERIOR WALLS SHALL BE MINIMUM 1/2 INCH DIAMETER WITH A MAXIMUM SPACING OF 6'-0" ON CENTER, UNLESS NOTED OTHERWISE.
4. ANCHOR BOLTS SHALL BE INSTALLED WITHIN 12 INCHES OF EACH END OF EACH SILL PLATE WITH AT LEAST TWO ANCHOR BOLTS FOR EACH BOLTS FOR EACH SILL PLATE LONGER

THAN 12 INCHES.


5. SIMPSONS SILL ANCHORS MAYBE SUBSTITUTED FOR ANCHOR BOLTS AT THE SAME

SPACING.
6. EXTERIOR CONCRETE SLABS WHICH ARE NOT PART OF THE MAIN SLAB SHALL BE MINIMUM 4 INCHES THICK WITH NO STEEL REINFORCING BARS REQUIRED, UNLESS NOTED OTHERWISE ON FOUNDATION PLAN.

VERIFY THE FOLLOWING PRIOR TO POURING:

- 1. ALL HOLDDOWNS , STRAP, AND POST LOCATIONS.
- 2. CONCRETE FINISHES. PANEL RISER LOCATION WHERE APPLICABLE.
- 3. UNDERSLAB MECHANICAL REQUIREMENTS.
- 4. STEM WALL BLOCKOUTS.
- 5. UNDERSLAB ELECTRICAL REQUIREMENTS AND PANEL RISER LOCATION. WHERE APPLICABLE.
- 6. PROVIDE THE FOLLOWING:
- PVC SLEEVES THROUGH FTG IF REQUIRED
- 20' #4 COPPER GROUND BAR.7. SLOPE FINISH GRADE AWAY FROM FOOTING.

NOTE: FIELD VERIFY ALL DIMENSIONS SEE DIMENSIONED ARCHITECTURAL DRAWINGS

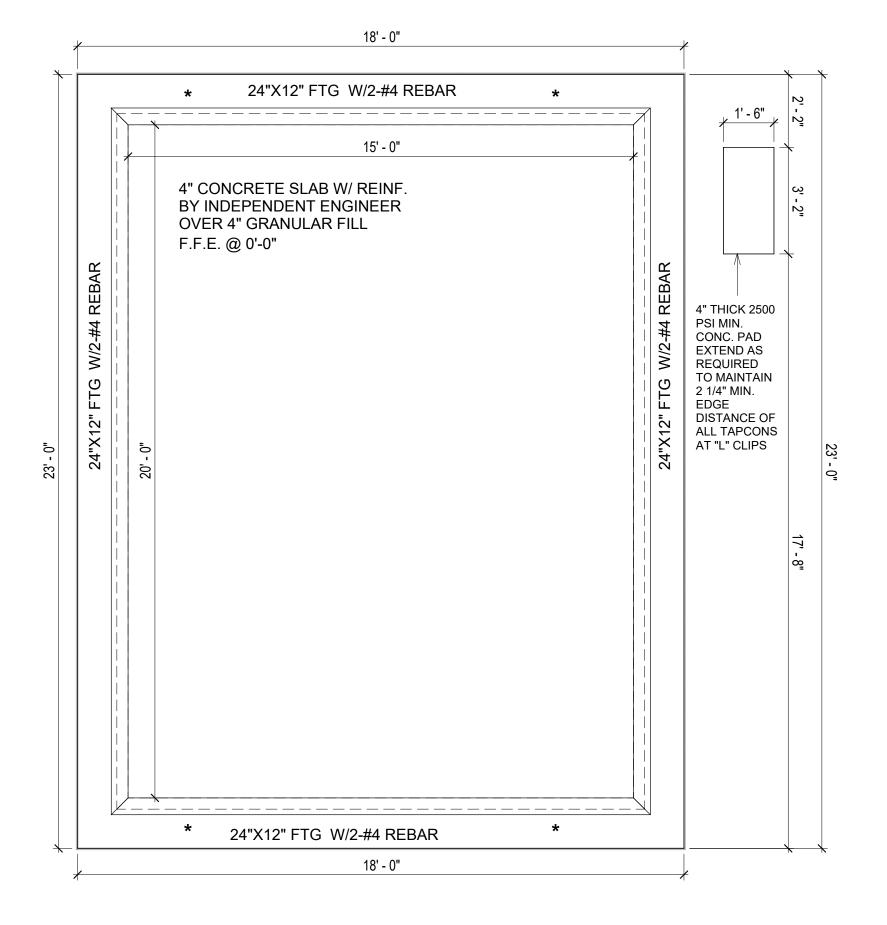





KEY PLAN

NO.	DESCRIPTION	DATE

NOTE:

LEGEND:

DBO IE

121 ORION 415 STUDIO CRAFTSMAN BASE 550

DRAWING NAME

FOUNDATION PLAN

Client Name	CLIENT NAME:	
0061_12	PROJECT NUMBER:	
3/21/2025 9:38:23 AN	DATE:	
Designer	DESIGNED BY:	
Author	DRAWN BY:	
Checker	CHECKED BY:	

414

TOTAL

SCALE: 3/8" = 1'-0"

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GENERAL NOTES

NOTES:

-ALL BEARING WALLS SHOULD HAVE A THICKENED SLAB PER SECTION PER DETAIL A401/5.

A) FOUNDATION PLAN NOTES:

1. CONCRETE SLAB SHALL BE 6" THICK WITH 1/2" DIAMETER TENDONS PER LAYOUT PLAN, CENTERED IN SLAB THICKNESS, OVER APPROVED SUBBASE PER GENERAL STRUCTURE NOTES

2. TERMITE PROTECTION SHALL BE PROVIDED PER IRC SECTION R318.1
3. NONE TYPICAL ANCHOR BOLT SPACING AT SHEAR WALL AND HOLD DOWN SPECIFICATIONS PER APPROVED ARCHITECTURAL PLANS.

INSTALL HOLDOWNS BEFORE CONCRETE SLAB POUR.
 EXISTING FILL ON-SITE SHALL BE COMPACTED IN ACCORDANCE WITH THE

REQUIREMENTS IN THE GEOTECHNICAL REPORT.

6. ALL FLOOR SLABS ARE REINFORCED ON CONCRETE SLABS.

SPECIAL INSPECTION IS REQUIRED FOR THICKENED FOUNDATION CONSTRUCTION

1. REINFORCEMENT 2. 2300 PSI CONCRETE POUR

B) **REINFORCEMENT FOR CONCRETE**:


 ALL REINFORCING SLABS BARS SIZE 10MM OR LARGER SHALL BE DEFORMED IN ACCORDANCE TO ASTM-A706, AND BARS SMALLER THAN 10 MM MAYBE PLAIN.
 UNLESS OTHERWISE NOTED IN PLANS, THE YIELD STRENGTH OF REINFORCING BARS SHALL BE:


> A) FOOTING = 40,000 PSI B) NON-LOAD BEARING WALLS AND PARAPETS= 40,000 PSI

- 3. SPLICES SHALL BE SECURELY WIRED TOGETHER AND SHALL LAP OR EXTEND
- 4. GRADE OF STEEL FOR RCC WORKS SHALL BE GRADE 4 10.
- 5. BAR NOTATIONS GIVES INFORMATION
 - A) BAR SIZE
 - B) SPACING(IF REQUIRED)
- 6. LAP REINFORCÈMENT ONLY AT LOCATION SHOWN IN THE DRAWINGS
 7. REINFORCEMENT SHALL NOT BE CUT, VENT OR HEATED ON SITE WITHOUT ENGINEERS'
- 7. REINFORGEMENT SHALL NOT BE CUT, VENT OR HEATED ON SITE WITHOUT ENGINEE APPROVAL.
- C) CONCRETE SLAB NOTES
- 1. ALL SLAB REINFORCEMENT SHALL BE 20MM CLEAR MINIMUM FROM BOTTOM AND FROM TOP OF SLAB.
- 2. REINFORCEMENT IN CONTINUOUS ELEVATED SLAB SHALL BE CUT AS FOLLOWS.

NOTE:

- THIS IS A SCHEMATIC PLAN FOR THE PURPOSE OF LOCATING AND IDENTIFYING FOUNDATION REINFORCING ELEMENTS ONLY. VERIFY ALL DIMENSIONS, DROPS, OFFSETS AND FEATURES WITH THE ARCHITECTURAL PLANS BEFORE FORMING THE FOUNDATION.

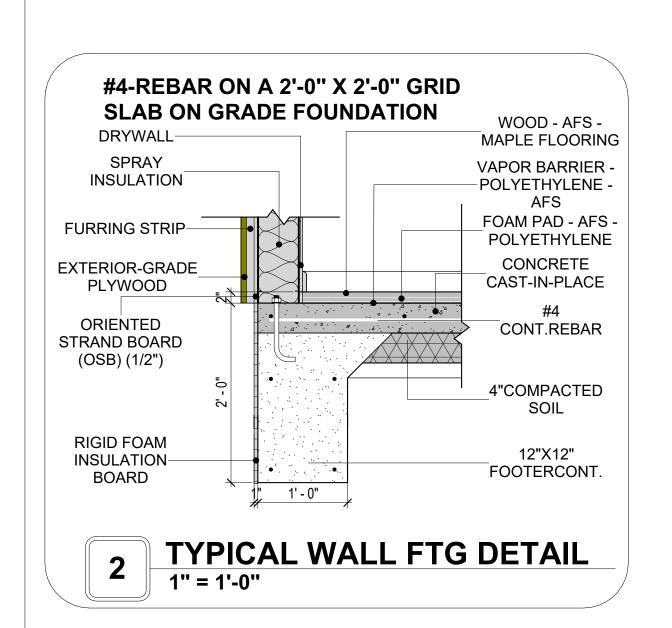

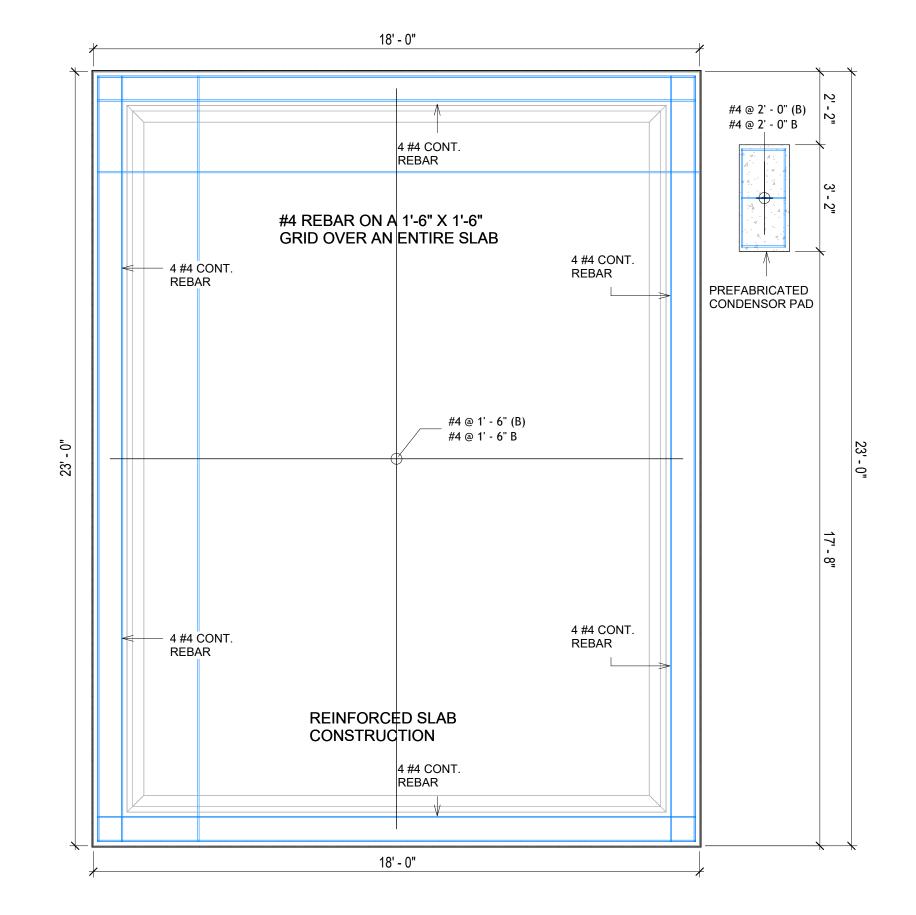

FOUNDATION REBAR PLAN
3/8" = 1'-0"



KEY PLAN

NO.	DESCRIPTION	DATE

NOTE:

LEGEND:

PROJECT

121 ORION 415 STUDIO CRAFTSMAN BASE 550

DRAWING NAME

STRUCTURAL FLOOR PLAN


Client Name	CLIENT NAME:	
0061_12	PROJECT NUMBER:	
3/21/2025 9:38:24 AN	DATE:	
Designer	DESIGNED BY:	
Author	DRAWN BY:	
Checker	CHECKED BY:	


S102


ROOF NOTES

- I. ROOFING COMPOSITION ROOFING PER OWNERS/BUILDERS
 SPECIFICATIONS INSTALL PER MANUFACTURE SPECIFICATIONS ON 1/2"
 ORIENTED STRAND BOARD ON PRE-ENGINEERED TRUSS @ 24" O.C. (UNO.)
- 2. 73" OVERHANG AT EAVES (UNO.)
 3. ENDS OF ALL TRUSSES AND JOISTS TO
- 3. ENDS OF ALL TRUSSES AND JOISTS TO BE FULLY BLOCKED. PROVIDE SOLID BLOCKING AT ALL RIDGES AND VALLEYS
- 4. SHEATHING TO BE 1/2", 3/8" OSB SHEAR PANEL AND EQUIVALENT. UNDERSIDE OF PORCH TRUSSES TO BE FINISHED WITH MOISTURE RESISTANT DRYWALL, TAPED AND TEXTURED.
- 5. EXPOSED EAVES AND OTHER WEATHER EXPOSED AREAS TO BE SHEATHED WITH EXTERIOR GRADE PLYWOOD.
- ALL MATERIALS THICKNESS AND SIZE ARE THE MINIMUM. Refer TO LOCAL STANDARDS FOR ACTUAL THICKNESS AND LAYERING OF MATERIALS.
- 7. ENGINEERED TRUSS CALCULATIONS TO BE SUBMITTED TO BUILDING
- DEPARTMENT PRIOR TO FABRICATION AND INSTALLATION.

 8. TRUSS MANUFACTURER TO SPECIFY HANGER CONNECTORS FOR TRUSS
- COMPONENTS (TYPICAL)
 9. DESIGNER ASSUMES THAT TRUSSES BEAR ON ALL EXTERIOR PERIMETER
- WALLS (TYPICAL) OR BEAMS.
- 10. PROVIDE GALVANIZED STEEL FLASHING WITH A LENGTH OF 10 FEET, WIDTH OF 12 INCHES, AND THICKNESS OF 24 GAUGE.

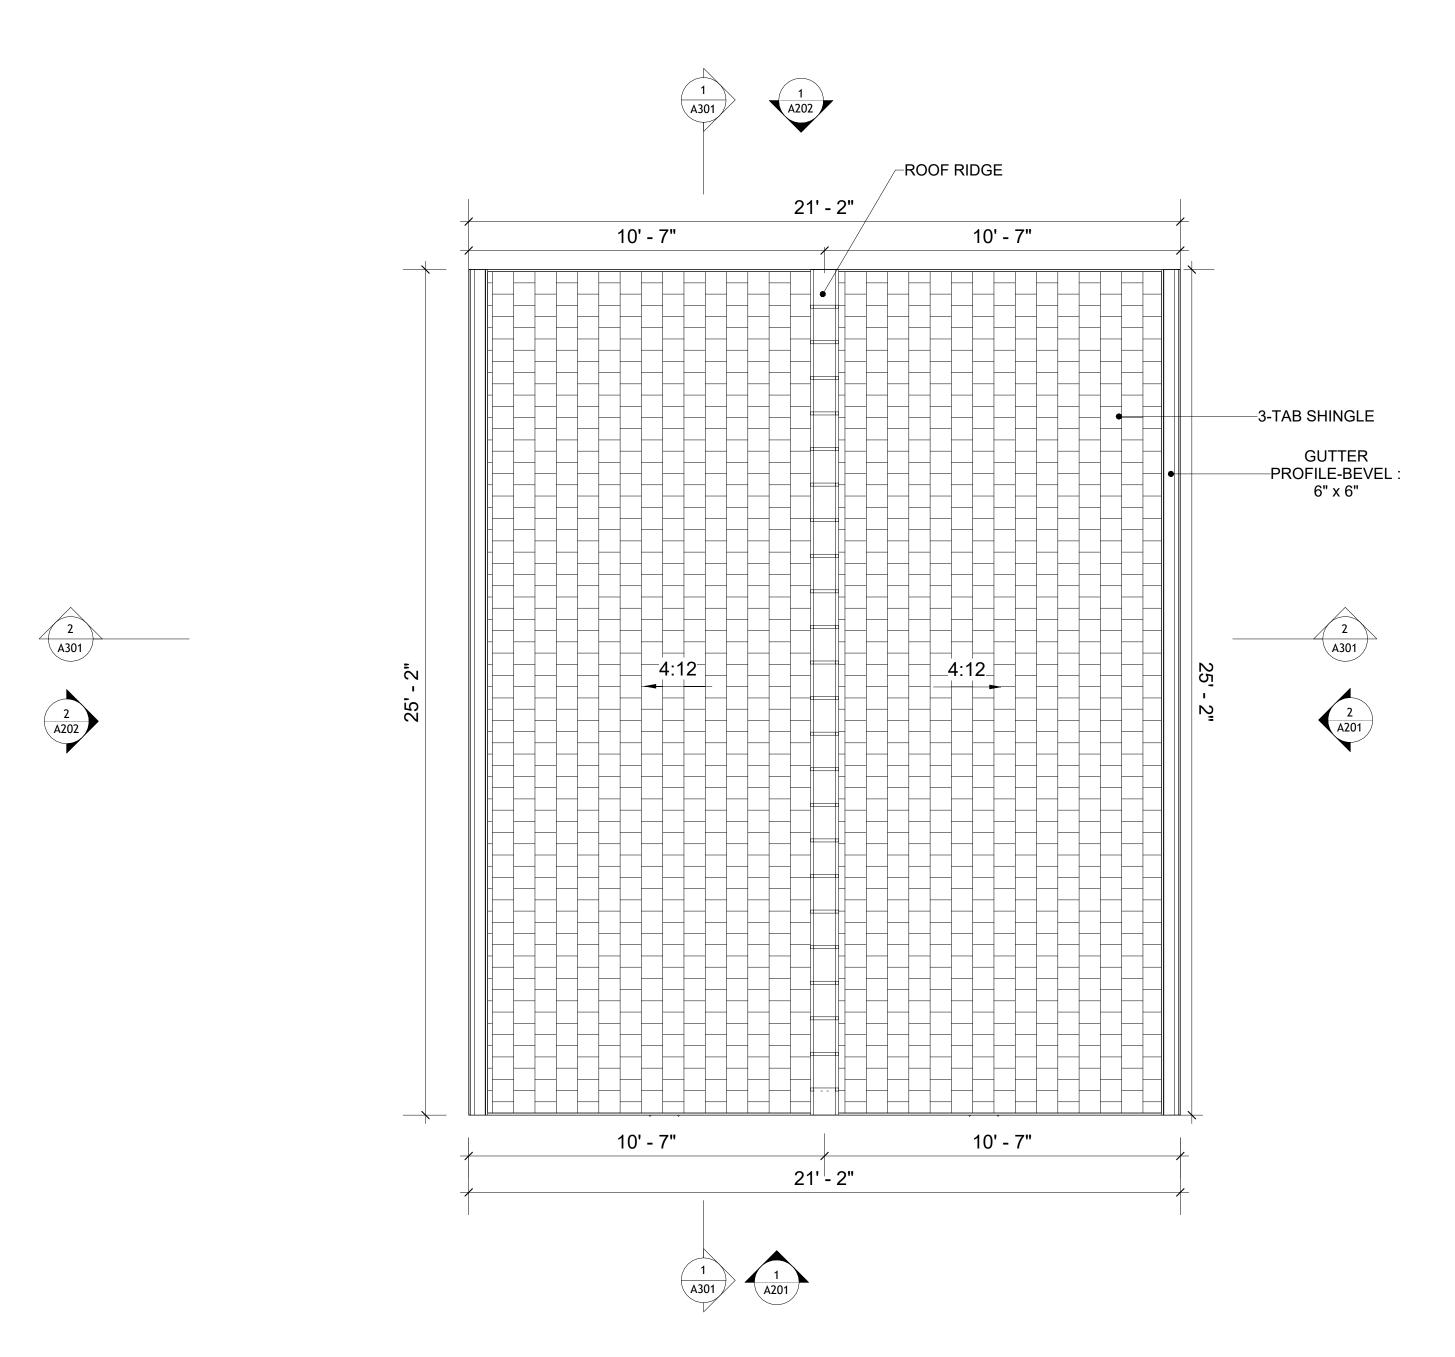

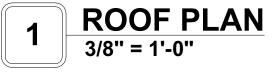

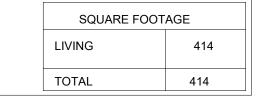



KEY PLAN

NO.	DESCRIPTION	DATE
•		•

NOTE:

LEGEND:

PROJE

121 ORION 415 STUDIO CRAFTSMAN BASE 550

DRAWING NAME

ROOF PLAN

Client Name	CLIENT NAME:
0061_12	PROJECT NUMBER:
3/21/2025 9:38:25 AM	DATE:
Designer	DESIGNED BY:
Author	DRAWN BY:
Checker	CHECKED BY:

A103

ABOUT WALL FINISHING

PLYWOOD WALL SIDING

WALL SIDING IS AN EXTERIOR CLADDING MATERIAL USED TO COVER AND PROTECT THE WALLS OF A BUILDING, PROVIDING BOTH FUNCTIONAL AND AESTHETIC BENEFITS.


IN THIS SPECIFIC PROJECT, PLYWOOD WALL PANELS ARE USED AS A FINISH SIDING BECAUSE THIS TYPE OF SIDING PROVIDES A DURABLE, COST-EFFECTIVE, AND VERSATILE EXTERIOR CLADDING THAT CAN BE EASILY INSTALLED, FINISHED, AND MAINTAINED TO ENHANCE THE AESTHETIC AND PROTECTIVE QUALITIES OF A BUILDING'S EXTERIOR.

STANDARD SIZES OF 1' X 8' EXTERIOR-GRADE PLYWOOD PANELS ARE INSTALLED ON THE FURRING STRIPS USING GALVANIZED STEEL SELF-DRILLING SCREWS.


WOOD SHINGLES

WOOD SHINGLES ARE THIN, TAPERED PIECES OF WOOD, TRADITIONALLY USED FOR ROOFING AND SIDING. THEY ARE TYPICALLY MADE FROM CEDAR WOOD, OR PINE DUE TO THEIR DURABILITY AND RESISTANCE TO DECAY. SHINLES ARE SAWN RATHER THAN SPLIT, GIVING THEM A SMOOTH, UNIFORM APPEARANCE. THEY PROVIDE A NATURAL, OFTEN RUSTIC LOOK, GOOD INSULATION, AND GOOD WEATHER RESISTANCE. WOOD SHINGLE ARE ECOFRIENDLY AND CAN BE STAINED OR PAINTED FOR CUSTOMIZATION.

IN THIS SPECIFIC PROJECT, WOOD SHINGLES ARE APPLIED AT THE TOP OF THE EXTERNAL WALL, CREATING AN EYE-CATCHING DETAIL THAT COMPLEMENTS THE OVERALL ARCHITECTURE AND ENSURES A STURDY, WEATHER-RESISTANT FINISH.

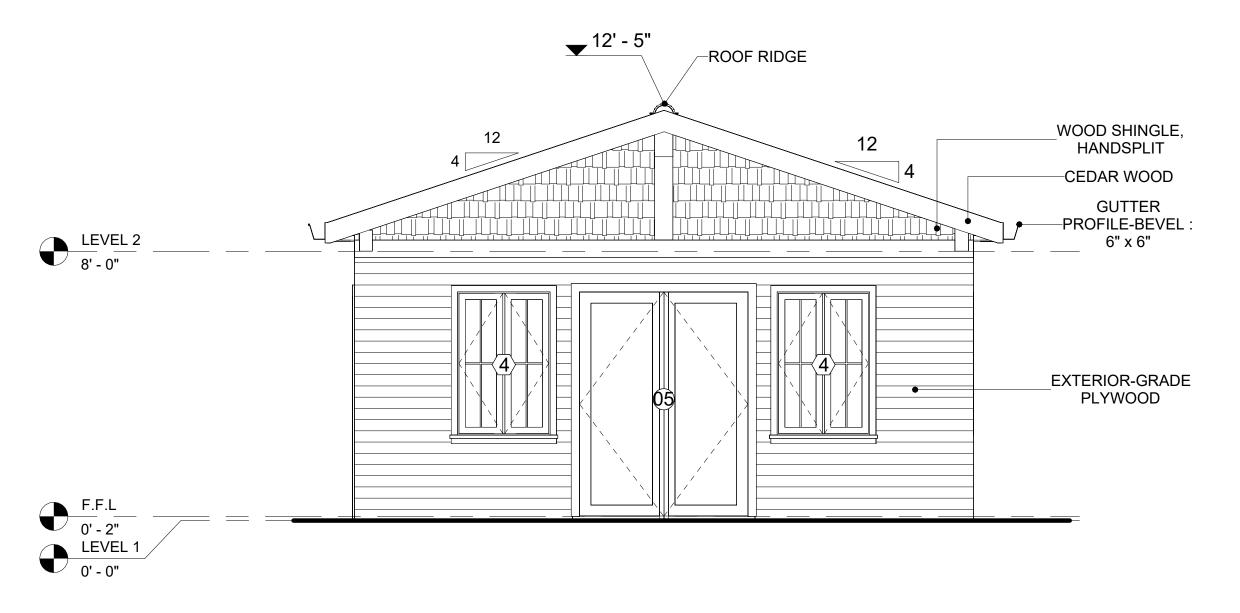


1 FRONT ELEVATION
3/8" = 1'-0"

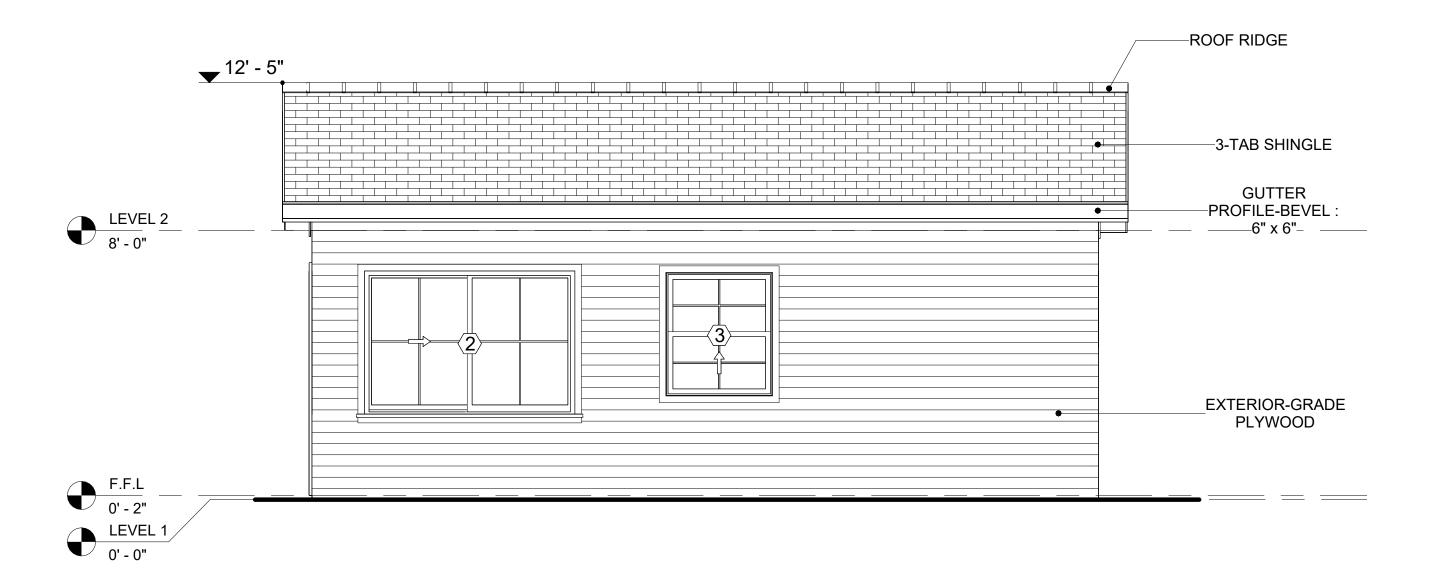



	DOOR SCHEDULE					
TYPE MAR K SUPPLIER			1.004710	SIZE		
		DOOR TYPE	LOCATIO	WIDTH	HEIGHT	COUNT
01	HOME DEPOT	EXTERIOR SINGLE PANEL SWINGING	INTERIOR	3' - 0"	6' - 8"	1
02	HOME DEPOT	INTERIOR SINGLE PANEL SWINGING	INTERIOR	2' - 4"	6' - 8"	1
04	HOME DEPOT	<varies></varies>	INTERIOR	<varies></varies>	6' - 8"	2
05	HOME DEPOT	EXTERIOR DOUBLE PANEL SWINGING	INTERIOR	5' - 0"	6' - 8"	1

WINDOW SCHEDULE					
				SIZE	
TYPE MARK	SUPPLIER	WINDOW TYPE	WIDTH	HEIGHT	COUNT
					·
1	HOME DEPOT	FIXED	2' - 3"	2' - 3"	2
2	HOME DEPOT	SLIDING	6' - 3"	4' - 3"	1
3	HOME DEPOT	SINGLE HUNG	3' - 3"	3' - 9"	2
4	HOME DEPOT	DOUBLE HUNG	2' - 9"	4' - 3"	2

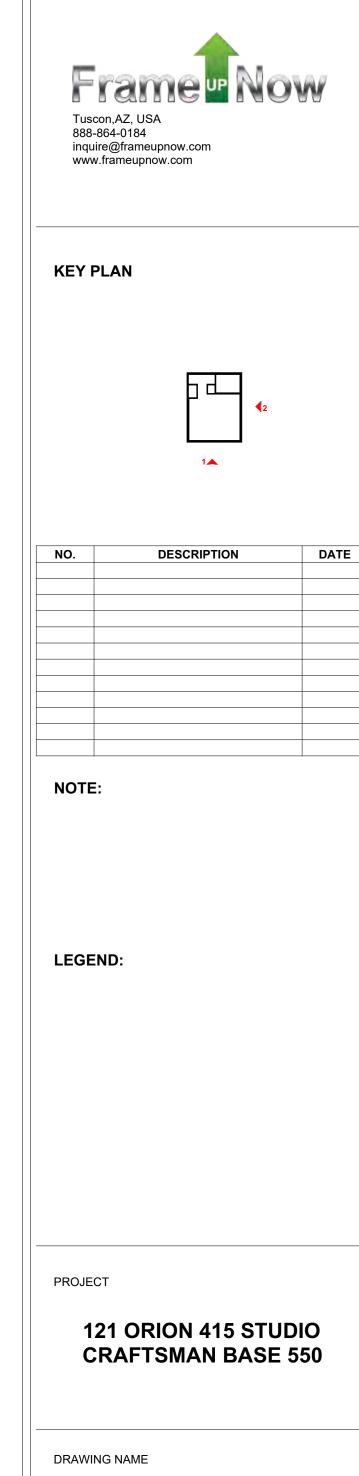

ARCHITECTURAL ELEVATIONS

	Client Name
	0061_12
3/2	21/2025 9:38:27 AM
	Designer
	Author
	Checker

ABOUT WALL FINISHING

PLYWOOD WALL SIDING

WALL SIDING IS AN EXTERIOR CLADDING MATERIAL USED TO COVER AND PROTECT THE WALLS OF A BUILDING, PROVIDING BOTH FUNCTIONAL AND AESTHETIC BENEFITS.


IN THIS SPECIFIC PROJECT, PLYWOOD WALL PANELS ARE USED AS A FINISH SIDING BECAUSE THIS TYPE OF SIDING PROVIDES A DURABLE, COST-EFFECTIVE, AND VERSATILE EXTERIOR CLADDING THAT CAN BE EASILY INSTALLED, FINISHED, AND MAINTAINED TO ENHANCE THE AESTHETIC AND PROTECTIVE QUALITIES OF A BUILDING'S EXTERIOR.


STANDARD SIZES OF 1' X 8' EXTERIOR-GRADE PLYWOOD PANELS ARE INSTALLED ON THE FURRING STRIPS USING GALVANIZED STEEL SELF-DRILLING SCREWS.

WOOD SHINGLES

WOOD SHINGLES ARE THIN, TAPERED PIECES OF WOOD, TRADITIONALLY USED FOR ROOFING AND SIDING. THEY ARE TYPICALLY MADE FROM CEDAR WOOD, OR PINE DUE TO THEIR DURABILITY AND RESISTANCE TO DECAY. SHINLES ARE SAWN RATHER THAN SPLIT, GIVING THEM A SMOOTH, UNIFORM APPEARANCE. THEY PROVIDE A NATURAL, OFTEN RUSTIC LOOK, GOOD INSULATION, AND GOOD WEATHER RESISTANCE. WOOD SHINGLE ARE ECO-FRIENDLY AND CAN BE STAINED OR PAINTED FOR CUSTOMIZATION.


IN THIS SPECIFIC PROJECT, WOOD SHINGLES ARE APPLIED AT THE TOP OF THE EXTERNAL WALL, CREATING AN EYE-CATCHING DETAIL THAT COMPLEMENTS THE OVERALL ARCHITECTURE AND ENSURES A STURDY, WEATHER-RESISTANT FINISH.

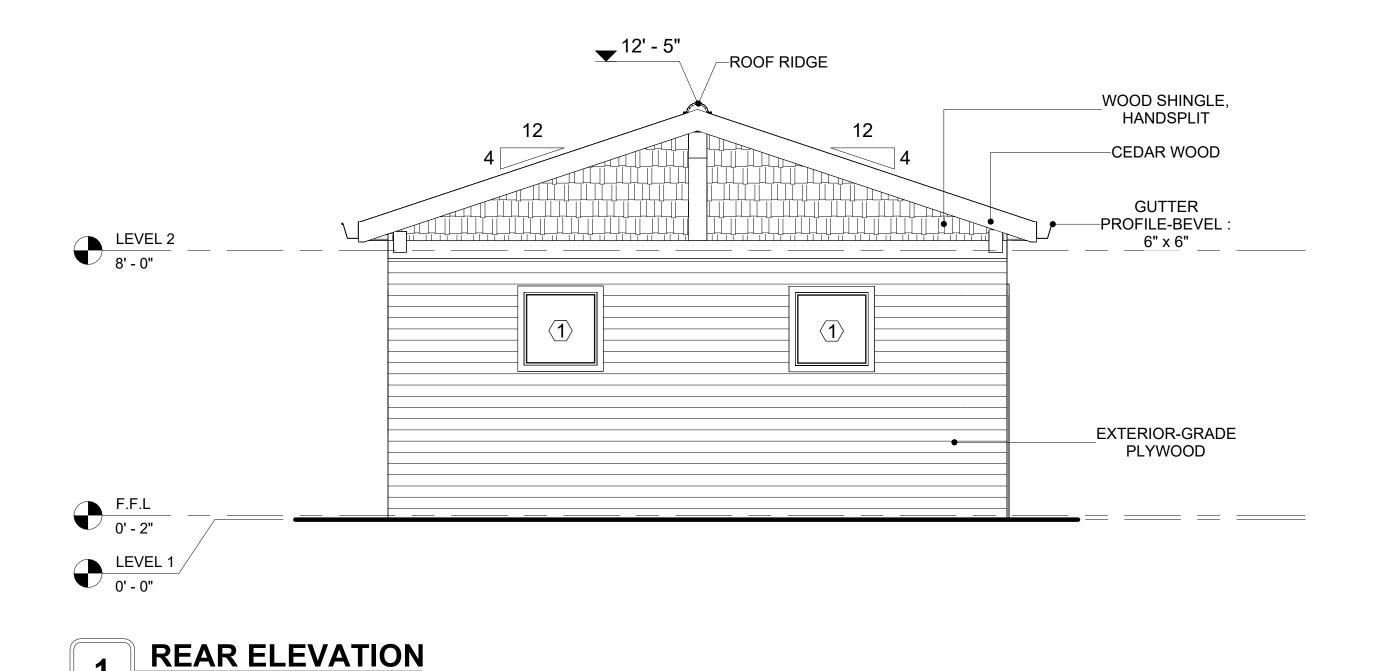

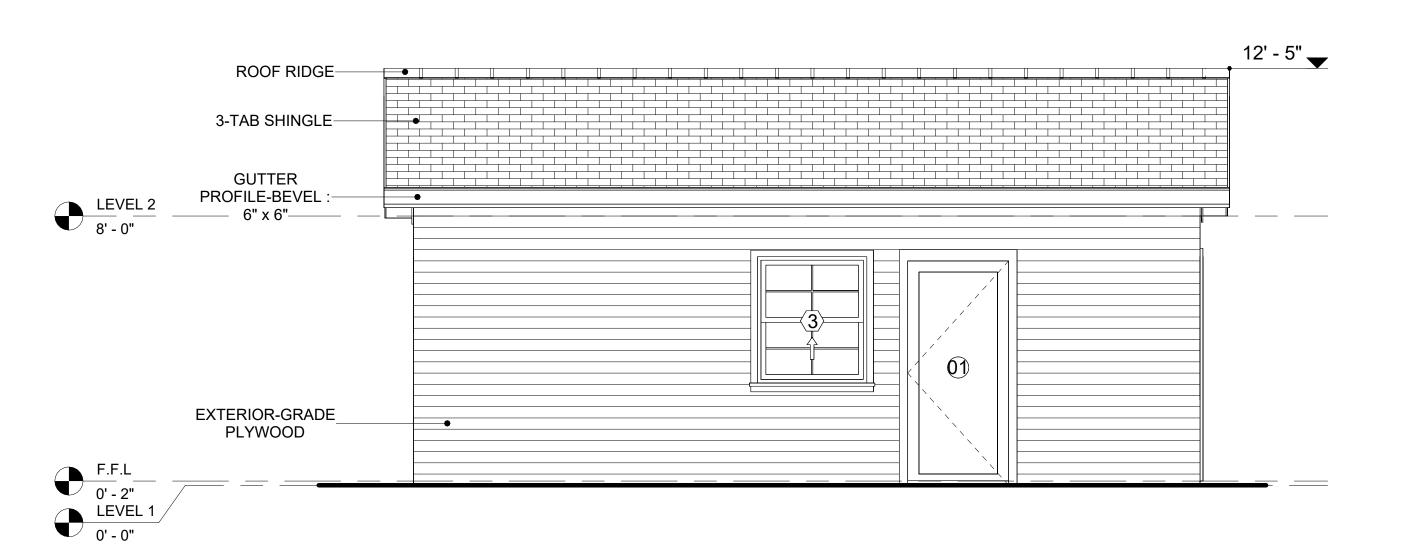


LEFT SIDE ELEVATION
3/8" = 1'-0"


3/8" = 1'-0"

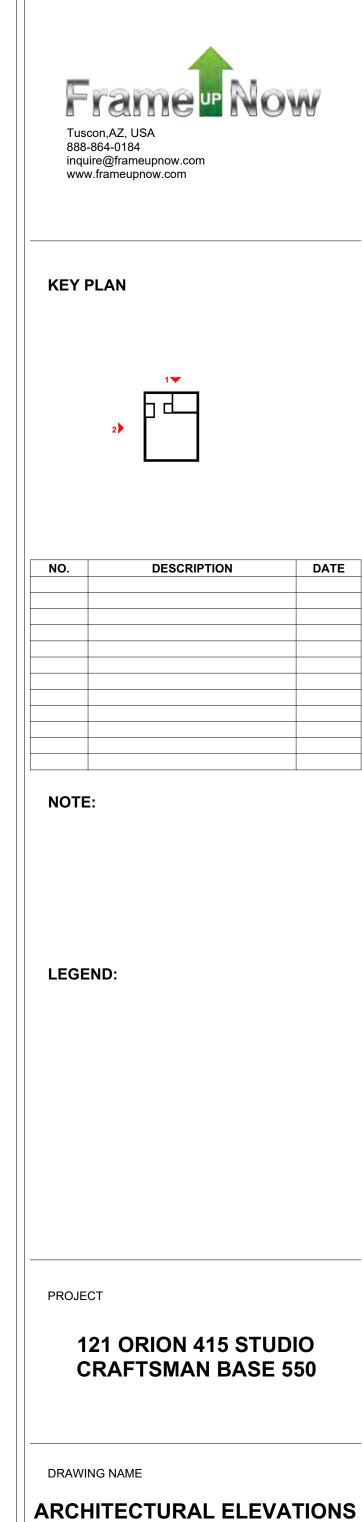

CLIENT NAME:	Client Name
PROJECT NUMBER:	0061_12
DATE:	3/21/2025 9:38:28 AM
DESIGNED BY:	Designer
DRAWN BY:	Author
CHECKED BY:	Checker

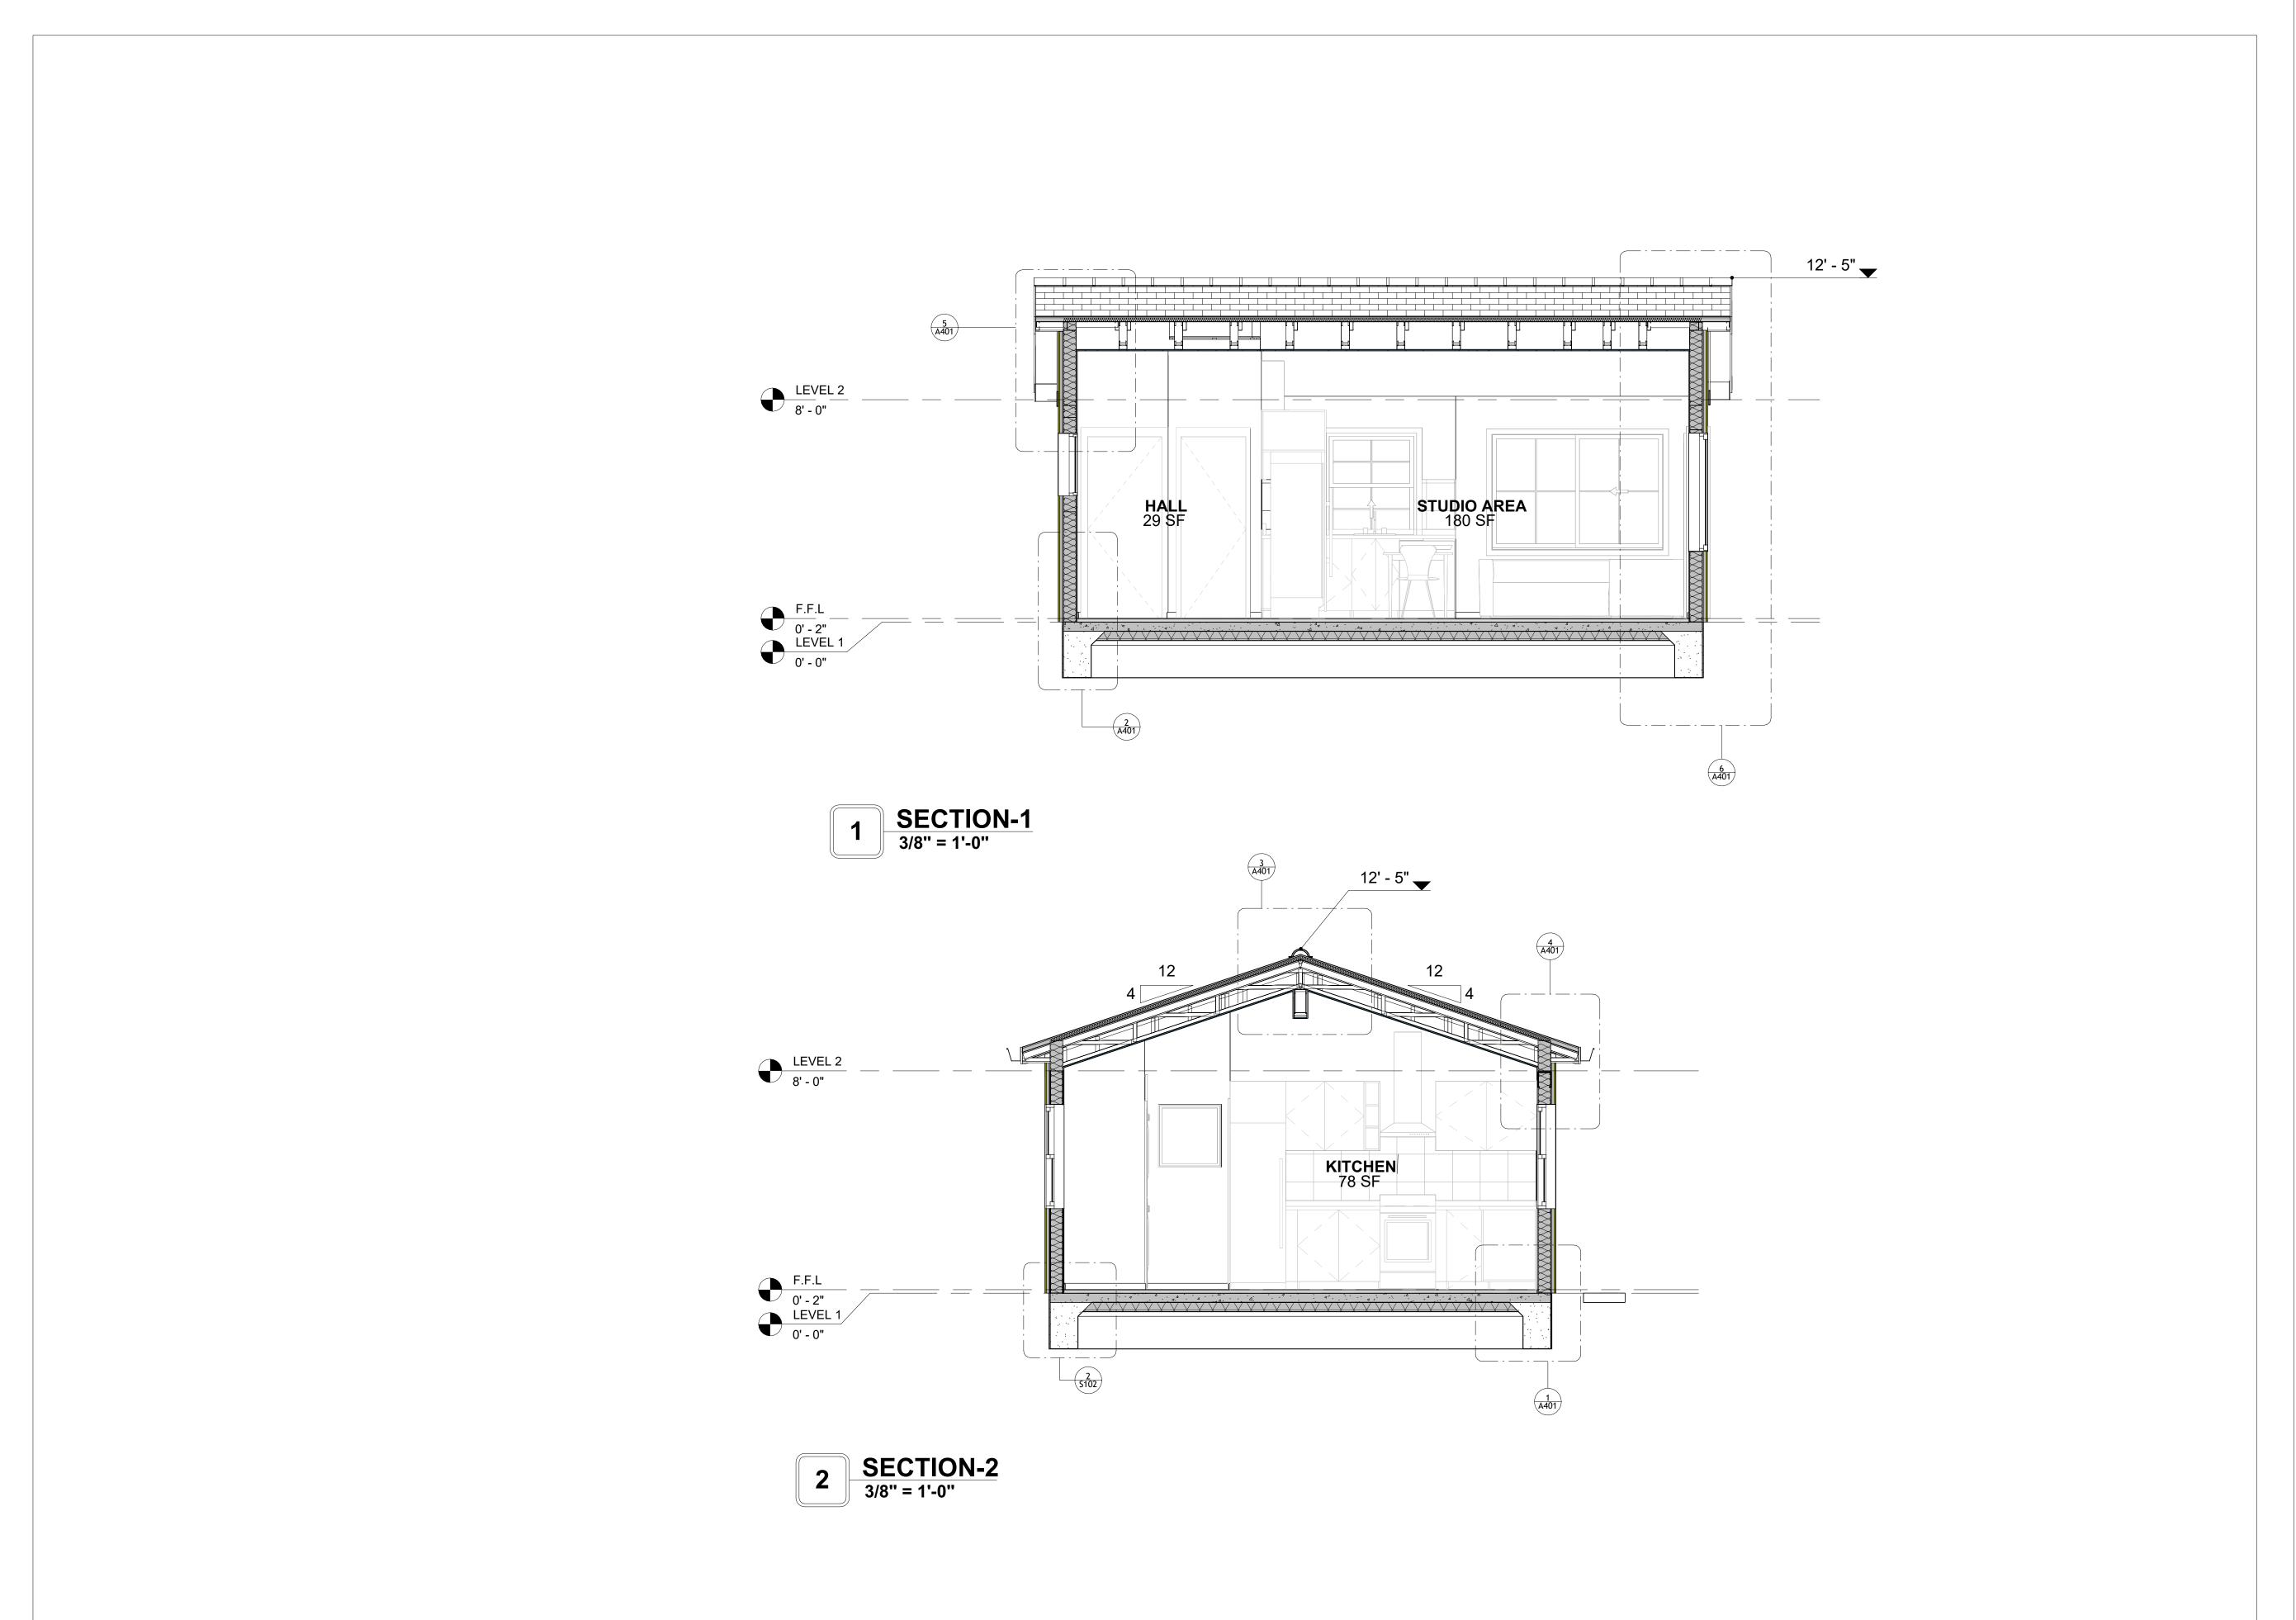

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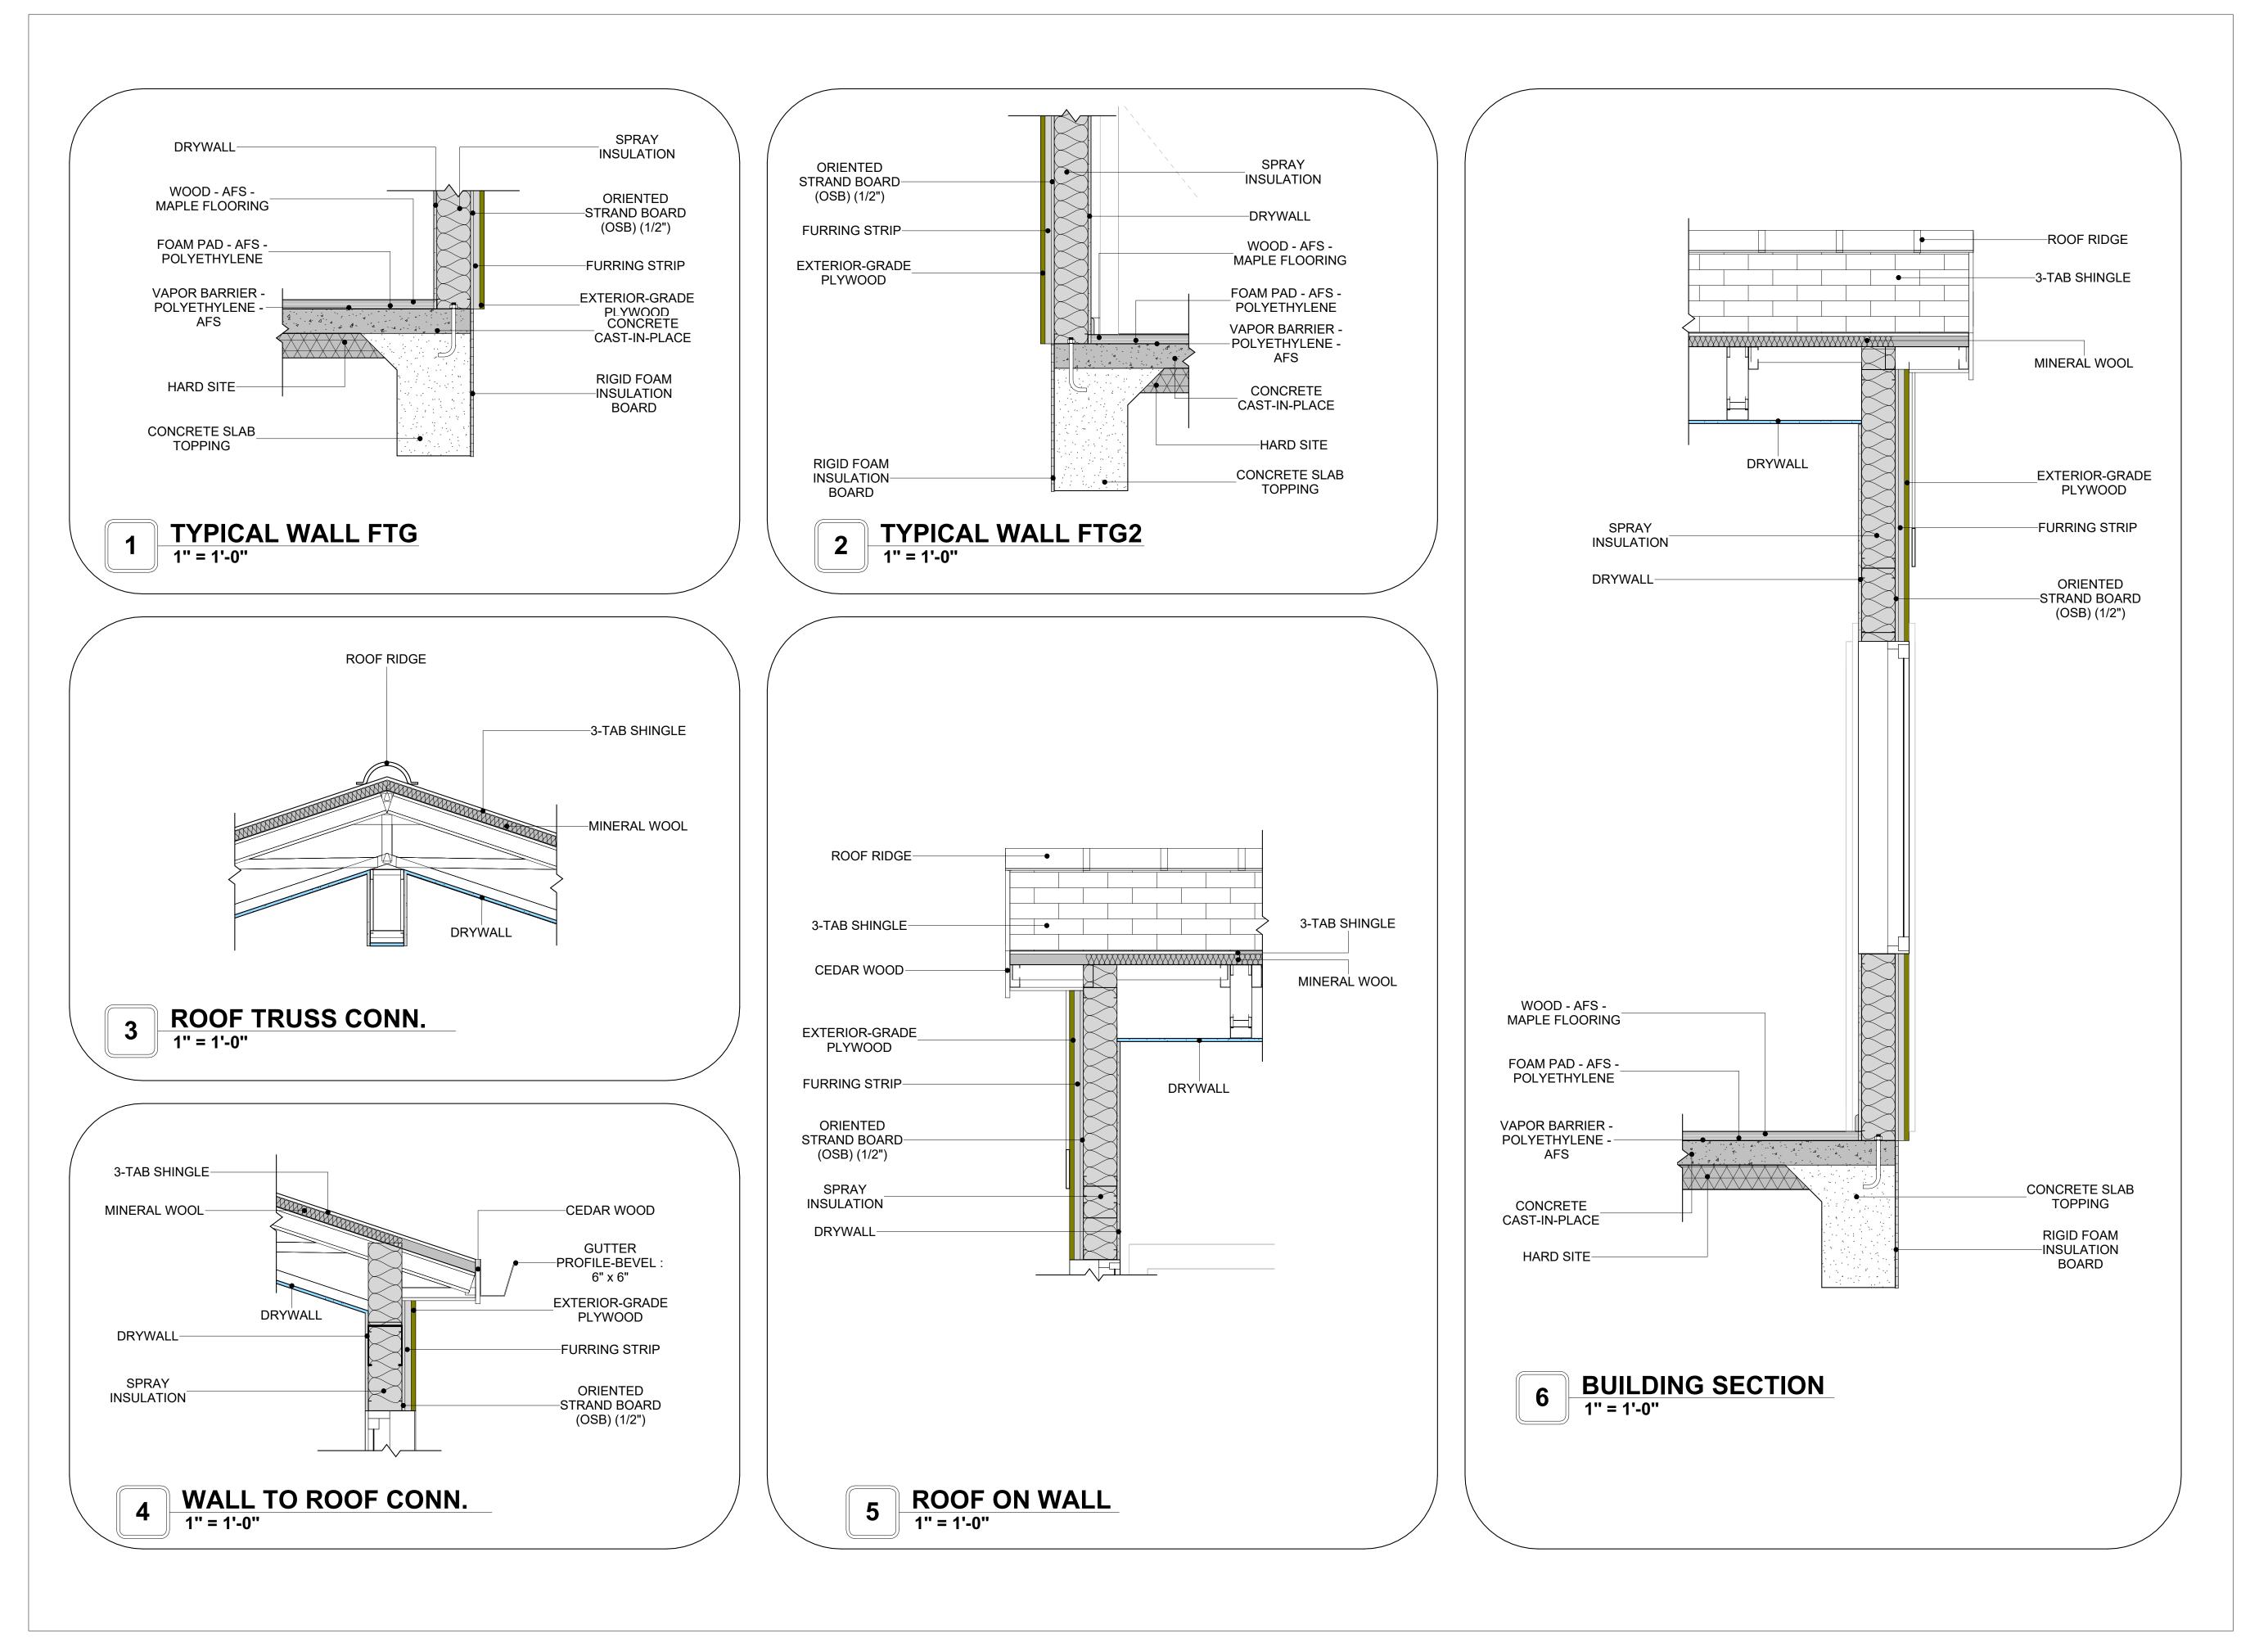
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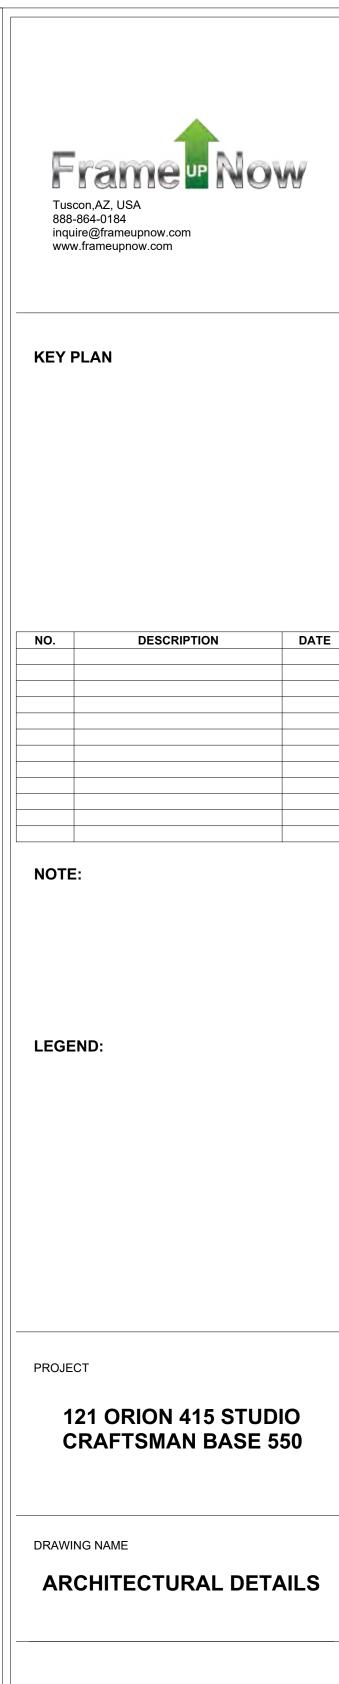
CHECKED BY:

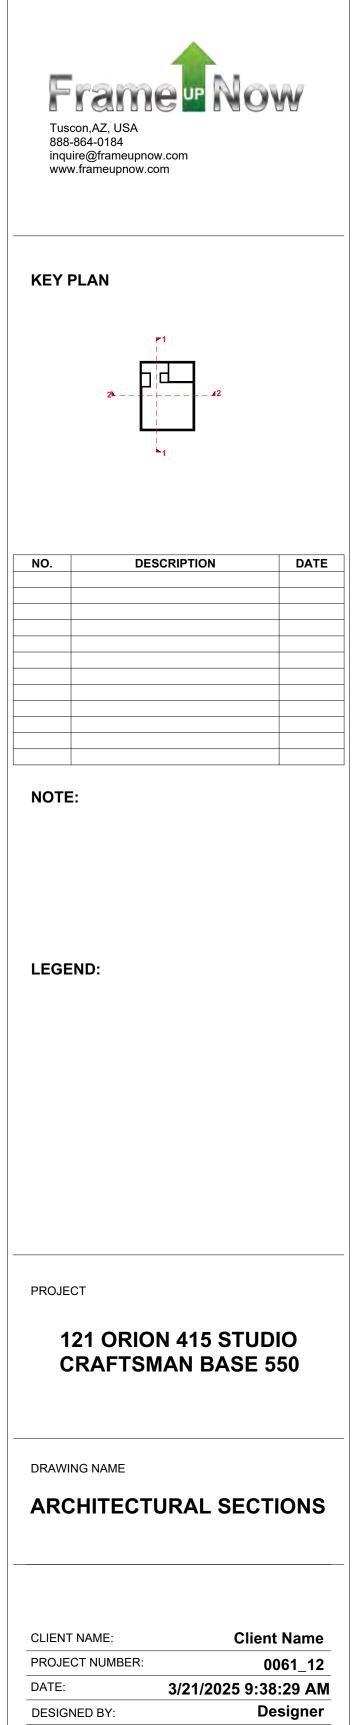A301

SCALE: As indicated

Author Checker





A401

SCALE: 1" = 1'-0"

CLIENT NAME:

DESIGNED BY:

CHECKED BY:

PROJECT NUMBER:

Client Name

3/21/2025 9:38:30 AM

0061_12

Designer

Author

Checker


CASEWORK GENERAL NOTES

- 1. ALL CABINET HEIGHTS INCLUDE COUNTERTOPS. DIMENSIONS ARE TO THE NEAREST INCH.
 2. DIVISIONS IN CASEWORK ARE SHOWN FOR CLARITY AND DO NOT REPRESENT BREAKS IN THE
- COUNTERTOP.
- 3. PROVIDE CONTINUOUS COUNTERTOP OVER ALL SIMILAR HEIGHT CASEWORK, UNLESS AND
- OTHERWISE NOTED.


 4. MANUFACTURER AND CATALOG NUMBERS ARE FOR REFERENCE AND ILLUSTRATION PURPOSES
- 5. DOTTED LINES INDICATE WALL HUNG CABINETS, DIVISIONS OF BASE CABINETS BELOW THE 6. COUNTERTOP, FURNITURE NOT IN THE CONTRACT OR PROJECTION SCREENS -SEE CASEWORK
- KEY AND SPECIFICATIONS.
 7. ALL CABINETS AND DRAWERS TO HAVE CAM LOCKS EXCEPT FOR SINK BASE CABINETS.
- 8. ALL EXPOSED SURFACES (EXPOSED TO VIEW FROM ANY PERSPECTIVE) TO BE COVERED WITH
- 9. ALL CASEWORK WHICH MEETS A WALL AT ONE OR BOTH ENDS, TO BE PROVIDED WITH FILLER PANELS AND SCRIBED TO THE WALL(S) AS REQUIRED.
- 10. ALL CABINETS AND DRAWERS ARE PROVIDED WITH RECESSED HANDLES.
- 11. CONTRACTOR TO FIELD VERIFY ALL CLEAR OPENINGS PRIOR TO MILLWORK OR CASEWORK
- 12. CASEWORK DRAWINGS ARE DIAGRAMMATIC IN NATURE TO SHOW DESIGN INTENT.

	CASEWORK SCHEDULE					
TYPE MAR K	TYPE	COUN T	HEIGHT	WIDTH	DEPTH	AREA
01	LAUNDRY OPEN CABINET 3	1	1' - 2"	2' - 3"	2' - 6"	3 SF
02	RECESSED MED CABINET 2	1	2' - 0"	1' - 6"	0' - 3"	3 SF
03	BASE CABINET L-SHAPED	1	2' - 11"	3' - 3"	3' - 3"	9 SF
04	WALL FILLER	1	2' - 11"	0' - 5"	2' - 0"	1 SF
05	VANITY	1	2' - 4"	2' - 6"	1' - 8"	6 SF
06	BASE CABINET DOUBLE DOOR 4	1	2' - 11"	3' - 0"	2' - 0"	9 SF
07	L-SHAPE COUNTER TOP 2	1	0' - 4"	7' - 0"	7' - 0"	2 SF
08	BASE CABINET DOUBLE DOOR 2	1	2' - 11"	1' - 9"	2' - 0"	5 SF
09	REFRIGERATOR TOP	1	1' - 6"	2' - 0"	2' - 4"	3 SF
10	WALL CABINET DOUBLE DOOR 3	1	2' - 6"	2' - 10"	1' - 0"	7 SF
11	LINEAR COUNTER TOP 3	1	0' - 4"	3' - 5"	2' - 1"	1 SF
12	WALL CABINET DOUBLE DOOR 2	1	2' - 6"	3' - 8"	1' - 0"	9 SF
13	WALL FILLER 2	1	2' - 11"	0' - 5"	2' - 0"	1 SF
14	WALL FILLER 2	1	2' - 6"	0' - 7"	1' - 0"	1 SF
15	CLOSET 3	1	6' - 0"	4' - 2"	1' - 4"	25 SF
GRAND	TOTAL	15				


	SPECIALTY EQUIPMENT SCHEDULE			
TYPE MARK TYPE COUNT				
01	WASHER-FRONT-LOAD	1		
02	REFRIGERATOR	1		
03	RANGE	1		
04	DRYER-FRONT-LOAD	1		
DISHWASHER 1				
GRAND TOTAL: 5				

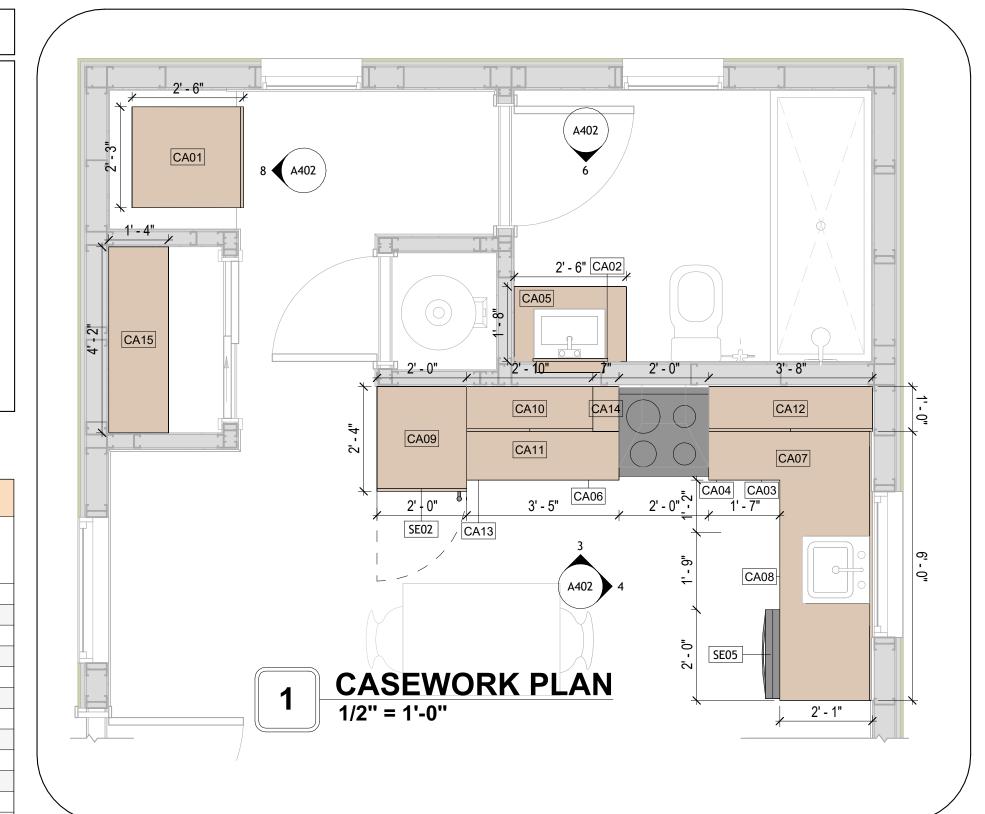

LAUNDRY 3D

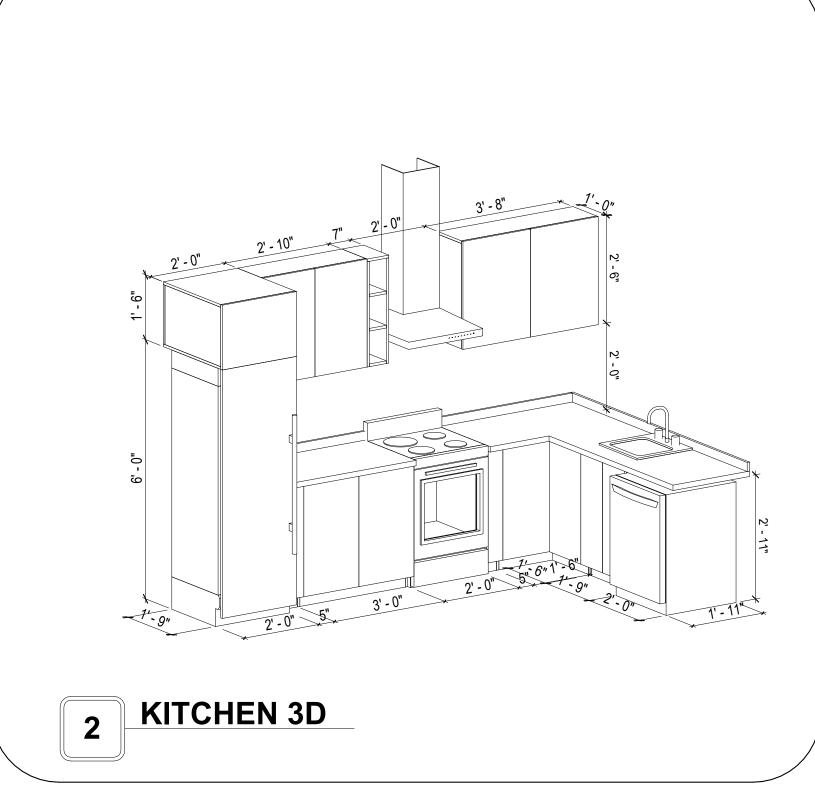


9 CLOSET 3D

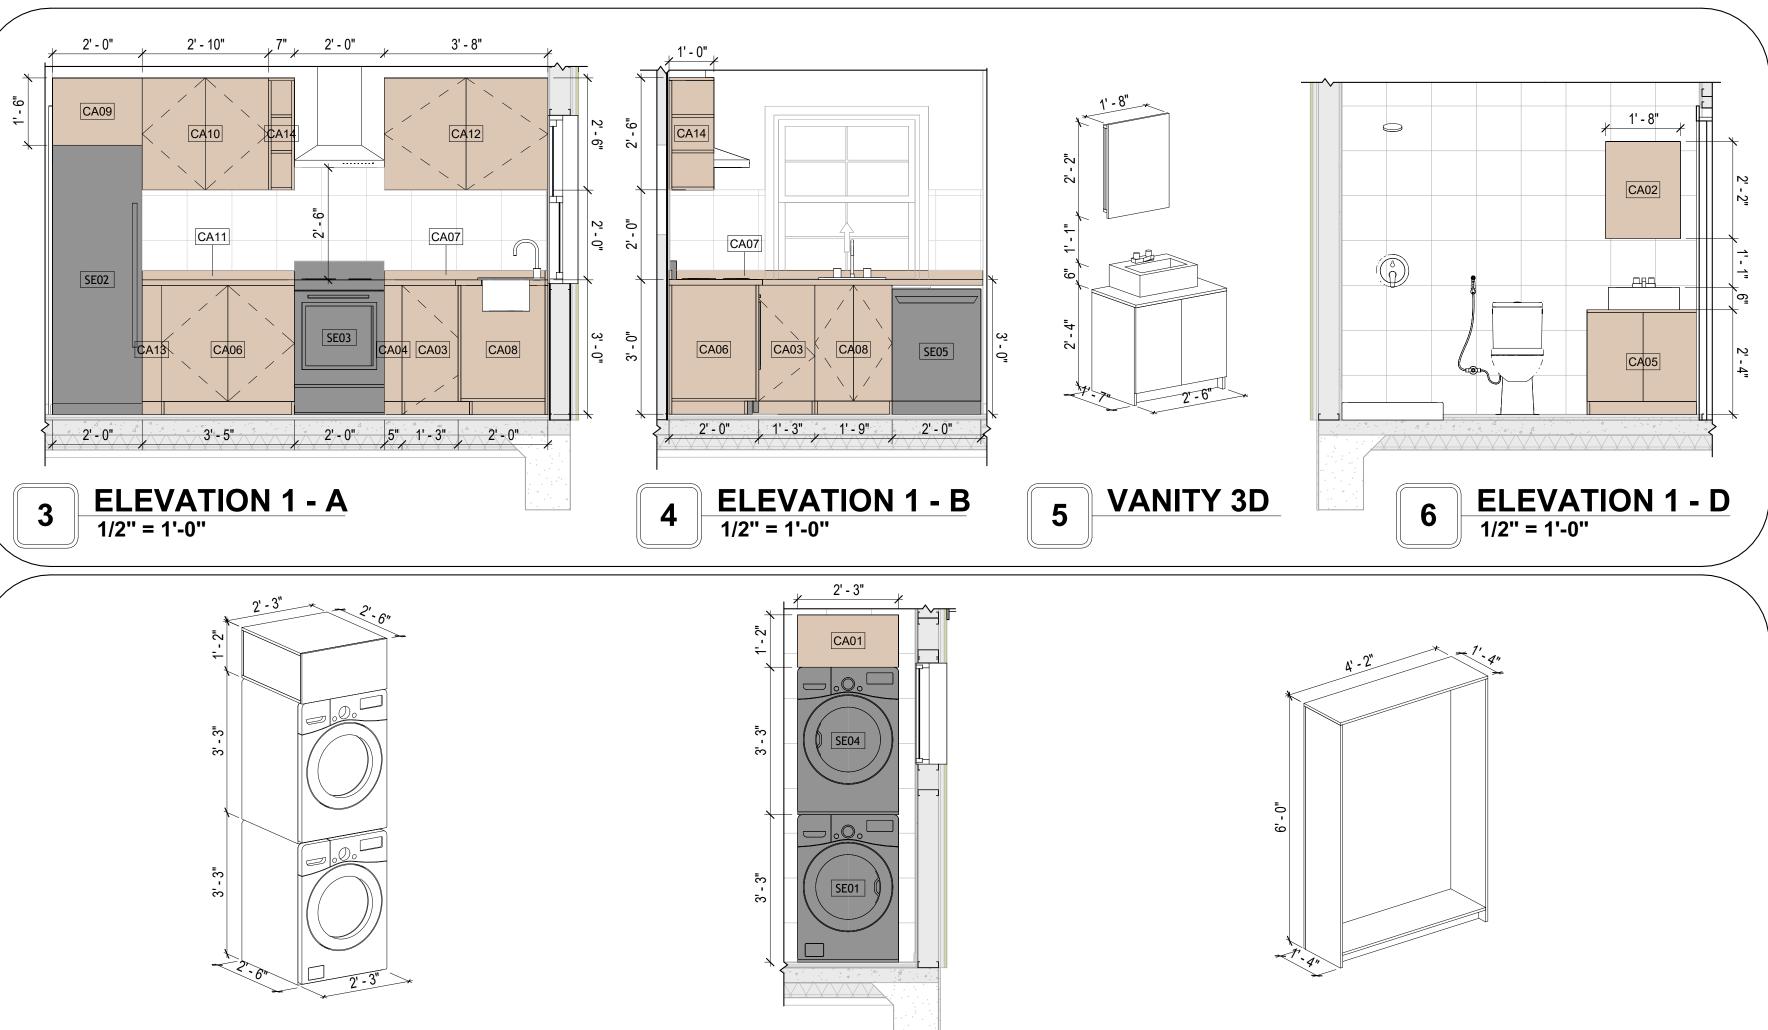

ELEVATION 1 - E 1/2" = 1'-0"



KEY PLAN

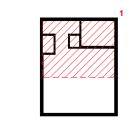

NO.	DESCRIPTION	DATI

NOTE:

LEGEND:

PROJECT

121 ORION 415 STUDIO CRAFTSMAN BASE 550

DRAWING NAME

ARCHITECTURAL CASEWORK

CLIENT NAME:	Client Name
PROJECT NUMBER:	0061_12
DATE:	3/21/2025 9:38:33 AM
DESIGNED BY:	Designer
DRAWN BY:	Author
CHECKED BY:	Checker

GENERAL NOTES

1. THIS DRAWING DEPICTS THE HVAC (HEATING, VENTILATION, AND AIR CONDITIONING) SYSTEM FOR THE ORION STUDIO CRAFTMAN BASE_NG. IT PROVIDES A VISUAL REPRESENTATION OF THE SYSTEM LAYOUT AND COMPONENTS.

2.THE HVAC SYSTEM IS DESIGNED TO MEET THE SPECIFIC REQUIREMENTS OF THE BUILDING, INCLUDING HEATING, COOLING, AND VENTILATION NEEDS, AS PER THE PROJECT SPECIFICATIONS AND APPLICABLE CODES AND STANDARDS.

3. THE HVAC SYSTEM INSTALLATION SHALL COMPLY WITH THE LATEST EDITION OF THE INTERNATIONAL MECHANICAL CODE (IMC), INTERNATIONAL RESIDENTIAL CODE (IRC), AND ALL OTHER APPLICABLE LOCAL, STATE, AND NATIONAL CODES AND REGULATIONS.

4. THE EQUIPMENT SHOWN ON THIS DRAWING INCLUDES BUT IS NOT LIMITED TO AIR HANDLING UNITS (AHUS), CHILLERS, BOILERS, COOLING TOWERS, PUMPS, DUCTWORK, DIFFUSERS, GRILLES, AND CONTROL DEVICES.

5. ALL EQUIPMENT, DUCTWORK, AND PIPING SHALL BE INSTALLED IN ACCORDANCE WITH MANUFACTURER'S SPECIFICATIONS, LOCAL CODES, AND

6. ALL DUCTWORK SHALL BE SIZED, FABRICATED, AND INSTALLED IN ACCORDANCE WITH THE LATEST EDITION OF THE ACCA MANUAL D AND THE SMACNA HVAC DUCT CONSTRUCTION STANDARDS. DUCTWORK SHALL BE INSTALLED IN A NEAT AND WORKMANLIKE MANNER, PROPERLY SUPPORTED AND BRACED TO PREVENT SAGGING, AIR LEAKAGE, OR VIBRATION.

7. CONDENSATE DRAINAGE PIPING SHALL BE PROPERLY PITCHED TO ENSURE POSITIVE DRAINAGE TO AN APPROVED DISPOSAL LOCATION, SUCH AS A FLOOR DRAIN, SUMP PUMP, OR EXTERIOR GRADE. CONDENSATE LINES SHALL BE INSULATED TO PREVENT SWEATING.

8. THE LOCATION OF CONTROL PANELS AND SENSORS INDICATED ON THIS DRAWING CAN BEMODIFY WITH THE SPECIFIC LOCATIONS AND WIRING DETAILS WILL BE DETERMINED DURING THE CONTROL SYSTEM DESIGN AND INSTALLATION.

9. THE HVAC SYSTEM DESIGN CONSIDER ENERGY EFFICIENCY, INDOOR AIR QUALITY, OCCUPANT COMFORT, AND NOISE CONTROL, FOLLOWING APPLICABLE GUIDELINES AND REGULATIONS.

WITH THE LOCAL BUILDING DEPARTMENT AND UTILITY PROVIDERS TO ENSURE A TIMELY AND COMPLIANT INSTALLATION.

10. COORDINATION WITH OTHER TREADS HAS BEEN DONE ON A DESIGN LEVEL. THIS DRAWING SHALL BE READ TOGETHER WITH THE AR, EL AND SN DESIGN DRAWINGS TO ENSURE PROPER INSTALLATION AND INTEGRATION OF THE HVAC SYSTEMS.

11. THE HVAC CONTRACTOR IS RESPONSIBLE FOR OBTAINING ALL NECESSARY PERMITS AND LICENSES, AND FOR SCHEDULING AND COORDINATING

12. ALL DUCTWORK PENETRATIONS THROUGH WALLS, FLOORS, OR CEILINGS SHALL BE PROPERLY SEALED AND FIRE-STOPPED USING APPROVED METHODS AND MATERIALS TO MAINTAIN THE INTEGRITY OF THE BUILDING'S FIRE-RESISTANCE RATINGS.

13. HVAC EQUIPMENT SHALL BE INSTALLED LEVEL AND PLUMB, AND IN STRICT ACCORDANCE WITH THE MANUFACTURER'S INSTALLATION INSTRUCTIONS AND RECOMMENDATIONS. PROVIDE ADEQUATE CLEARANCES AROUND EQUIPMENT FOR PROPER AIRFLOW, SERVICE ACCESS, AND

CODE COMPLIANCE.

14. ALL HVAC EQUIPMENT AND COMPONENTS, INCLUDING THERMOSTATS, DAMPERS, AND ACCESS PANELS, SHALL BE LOCATED IN ACCESSIBLE AREAS

15. THE HVAC SYSTEM SHALL BE BALANCED AND ADJUSTED TO ENSURE PROPER AIRFLOW, TEMPERATURE DISTRIBUTION, AND SYSTEM


FOR EASY SERVICING AND MAINTENANCE. PROVIDE ADEQUATE SPACE AROUND EQUIPMENT FOR PROPER AIRFLOW AND SERVICE ACCESS.

PERFORMANCE THROUGHOUT THE RESIDENCE. PROVIDE A WRITTEN REPORT DOCUMENTING THE FINAL SYSTEM BALANCE.

16. ANY DEVIATIONS OR MODIFICATIONS TO THE HVAC SYSTEM DESIGN SHALL BE REVIEWED AND APPROVED BY THE RESPONSIBLE DESIGN PROFESSIONALS AND COMMUNICATED TO ALL RELEVANT PARTIES INVOLVED IN THE CONSTRUCTION PROCESS.

17. FOR ANY INQUIRIES OR CLARIFICATIONS REGARDING THE HVAC SYSTEM DESIGN, PLEASE CONSULT THE RESPONSIBLE DESIGN PROFESSIONALS OR THE PROJECT MANAGEMENT TEAM.

SYMBOLS

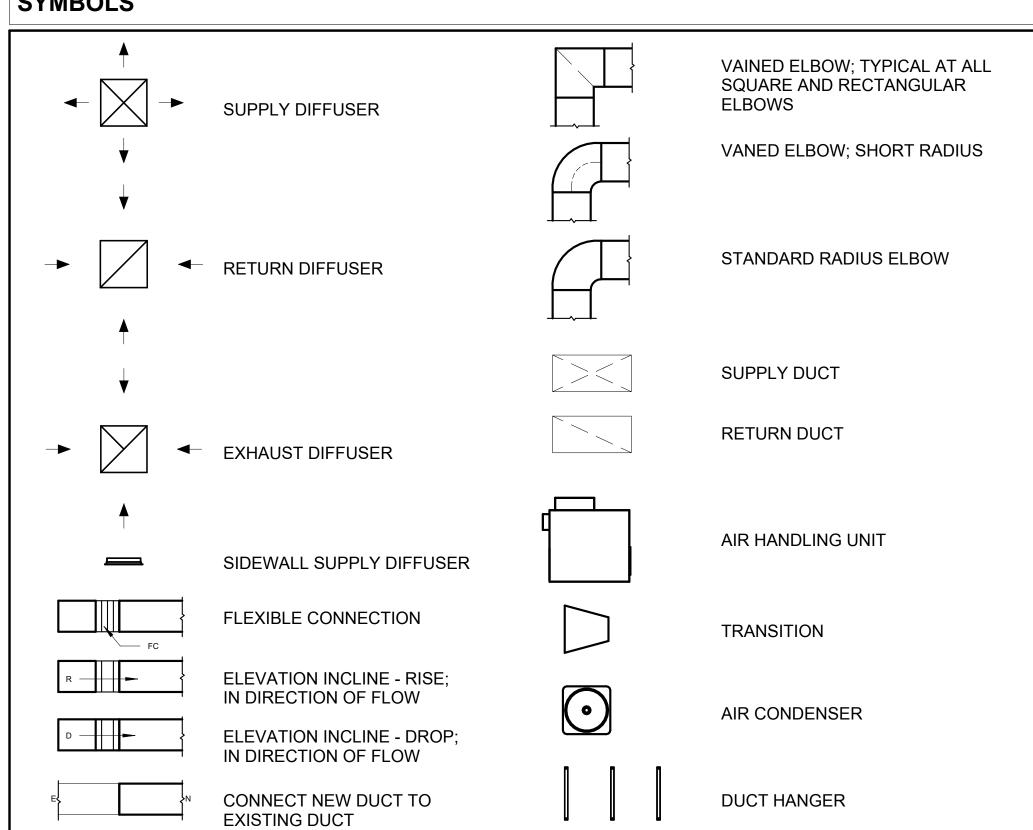



AIR CONDITIONING PIPE

REFRIGERANT LINE SCHEDULE				
CATAGORY DESCRIPTION		DIAMETER	LENGTH	
PIPE TYPES	COPPER	3/8"	47.11	
PIPE TYPES	COPPER	3/4"	54.00	

REFRIGERANT LINE FITTING SCHEDULE			
CATAGORY	DESCRIPTION	Size	Count
ELBOW - GENERIC: 3/ STANDARD/HVAC		3/4"ø-3/4"ø	12
ELBOW - GENERIC: 3/8"ø-3/8 STANDARD/HVAC		3/8"ø-3/8"ø	13
TRANSITION - GENERIC	TRANSITION - GENERIC: STANDARD	3/4"ø-1/2"ø	2
TRANSITION - GENERIC	TRANSITION - GENERIC: STANDARD	3/4"ø-5/8"ø	1
TRANSITION - GENERIC	TRANSITION - GENERIC: STANDARD	3/8"ø-1/4"ø	1

Ø3/4" CONDENSER

Ø3/8"

3' - 6 1/2"

EXHAUST FAN

HOOD-WALL

5' - 4 1/2"

Ø3/4" Ø3/8"

AIR HANDLING UNIT

HVAC PLAN

3/8" = 1'-0"

MECHANICAL EQUIPMENT SCHEDULE					
CATAGORY	DESCRIPTION	COUNT			
AIR HANDLING UNIT	AIR HANDLING UNIT: WALL MOUNTED	1			
CONDENSER	CONDENSER: OUT DOOR 1				
EXHAUST FAN	EXHAUST FAN: 75 CFM 1				
	HOOD-WALL: VENT	1			

DUCT FITTING SCHEDULE			
CATAGORY	DESCRIPTION	COUNT	
ROUND TRANSITION - ANGLE 45 DEGREE 5			

DUCT ACCESSORY SCHEDULE		
CATAGORY	DESCRIPTION	COUNT
ROOF VENT	3" DIAMETER	3

FLEX DUCT SCHEDULE					
DESCRIPTION	DESCRIPTION	LENGTH	DIAMETER	COUNT	
FLEX DUCT ROUND	FLEX-ROUND	8.31	4"	3	
GRAND TOTAL: 3		8.31			



KEY PLAN

NO.	DESCRIPTION	DATE

NOTE:

LEGEND:

PROJECT

121-Orion-415-Studio Craftman-Base-550

DRAWING NAME

HVAC PLAN

CLIENT NAME:	Owner
PROJECT NUMBER:	15_0001
DATE:	3/13/2025 6:34:48 AM
DESIGNED BY:	Designer
DRAWN BY:	Author
CHECKED BY:	Checker

M101

SCALE: As indicated

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ELECTRICAL NOTES

- 1. THIS DRAWING DEPICTS THE ELECTRICAL SYSTEM FOR THE 121-Orion-415-Studio Craftsman-Base-550. IT PROVIDES A VISUAL REPRESENTATION OF THE ELECTRICAL LAYOUT AND COMPONENTS, INCLUDING POWER DISTRIBUTION, LIGHTING, AND CONTROL SYSTEMS.
- 2. THE ELECTRICAL SYSTEM IS DESIGNED TO MEET THE SPECIFIC REQUIREMENTS OF THE BUILDING, INCLUDING POWER DISTRIBUTION, LIGHTING, AND SPECIALIZED ELECTRICAL EQUIPMENT NEEDS, AS PER THE PROJECT SPECIFICATIONS AND APPLICABLE CODES AND STANDARDS.
- 3. THE ELECTRICAL SYSTEM INSTALLATION SHALL COMPLY WITH THE LATEST EDITION OF THE NATIONAL ELECTRICAL CODE (NEC), INTERNATIONAL BUILDING CODE (IBC), AND ALL OTHER APPLICABLE LOCAL, STATE, AND NATIONAL CODES AND REGULATIONS.
- 4. LOCATIONS AS NEEDED, DEVICES ARE SHOWN ON PLANS IN APPROXIMATE IDEAL LOCATIONS, UNLESS SPECIFICALLY DIMMENSIONED.
- 5. OPEN WALLS AS NEEDED TO ALLOW FOR NEW ELECTRICAL INSTALLATIONS.
- 6. LABEL ALL CIRCUITS ON JUNCTION BOXES, RECEPTACLES, DATA, SMOKE DETECTOR, AND EQUIPMENT IN PANEL BOX.
- 7. INSTALL RACEWAY AS NEEDED FOR DDC, ACCESS CONTROL, LOW VOLTAGE WIRING & DATA.
- 8. RELABEL POWER, DATA & FIRE ALARM FOR ROOM #CHANGES.
- 9. VERIFY ALL CIRCUITS LABELED ON PRINT ARE CORRECT BEFORE WORKING ON THEM.
 10. NOTE ON SITE PLAN ALL CHANGES OR MISSING DETAIL TO BE INCORPORATED INTO THE MASTER PLAN.
- 11. DRAWINGS ARE DIAGRAMMATIC ONLY FOR THE PURPOSE OF SHOWING FIXTURE AND OUTLET LOCATIONS.
- 12. ELECTRICAL CONTRACTOR TO VERIFY SERVICE SIZE BY CALCULATION BASED UPON ACTUAL NAME PLATE RATINGS OF SELECTED FOLIPMENT
- PLATE RATINGS OF SELECTED EQUIPMENT.

 13. VERIFY LOCATION OF SERVICE ENTRANCE WITH POWER COMPANY. PROVIDE UFER GROUND IN
- 13. VERIFY LOCATION OF SERVICE ENTRANCE WITH POWER COMPANY. PROVIDE UFER GROUND IN BUILDING FOUNDATION AT SERVICE ENTRANCE LOCATION.
- 14. PROVIDE A MIN. OF 20 FEET OF ONE *4 BARE COPPER UFER WIRE EMBEDDED IN CONCRETE FOOTING AT THE SERVICE ENTRANCE LOCATION WHERE APPROVED BY LOCAL SERVICE PROVIDER.
- 15. PROVIDE WATERPROOF FIXTURES IN ALL HIGH MOISTURE AREAS (EXTERIOR, SHOWER AND TUB
- CEILINGS ETC.)

 16. PROVIDE DEDICATED CIRCUITS TO EACH BATH, DEN, EAMILY ROOM, BEDROOM, LOFT, KITCHEN
- 16. PROVIDE DEDIĆATED CIRCUITS TO EACH BATH, DEN, FAMILY ROOM, BEDROOM, LOFT, KITCHEN REFRIGERATOR, KITCHEN FREEZER DISHWASHER, AND ANY AREA/ITEM SPECIFIED BY OWNER.
- 17. INCANDESCENT FIXTURES WITH OPEN OR PARTIALLY ENCLOSED LAMPS, PENDANT FIXTURES, AND LAMP HOLDERS ARE NOT PERMITTED IN CLOSETS.
- 18. ALL WORKMANSHIP AND MATERIALS TO CONFORM WITH THE 2015 IRC.

ELECTRICAL ABBREVIATIONS LIST

- 19. PROVIDE A MIN. OF 20 FEET OF ONE *4 BARE COPPER UFER WIRE EMBEDDED IN CONCRETE FOOTING AT THE SERVICE ENTRANCE LOCATION WHERE APPROVED BY LOCAL SERVICE PROVIDER.
- 20. PROVIDE A BONDING CONDUCTOR CONSISTING OF A MINIMUM OF ONE *4 BARE COPPER WIRE CONNECTING THE BUILDING'S METAL WATER PIPING SYSTEM TO THE SERVICE EQUIPMENT ENCLOSURE GROUNDING.

MAIN PANEL CALCS

(USE 200 AMP SERVICE)

ELECTRICAL CALCS	
LIGHT AND OUTLETS 415 @ 3W	1,245 W
3 APPLIANCE CIRCUITS	4,500 W
DRYER	2,000 W
WASHER	2,000 W
RANGE	5,000 W
WATER HEATER	5,000 W
REFRIG.	1,800 W
DISHWASHER & DISPOSAL	3000 W
TOTAL	24,545 W
FRIST 10,000 @ 100% REMAINDER @ 40% MINI. SPLIT UNITS	10,000 W 5,818W 10,000 W
TOTAL	25,818 W
25,818 W DIVIDED BY 240V = 10	08 AMPS TOTAL

1P	1 POLE (2P, 3P, 4P, ETC.)	CTR	CENTER	HT	HEIGHT
Α	AMPERE	CU	COPPER	HTG	HEATING
AC	ABOVE COUNTER OR AIR CONDITIONER	DCP	DOMESTIC WATER CIRCULATING PUMP	HTR	HEATER
ACLG	ABOVE CEILING	DEPT	DEPARTMENT	HV	HIGH VOLTAGE
ADO	AUTOMATIC DOOR OPENER	DET	DETAIL	HVAC	HEATING, VENTILATING AND AIR
AF	AMP FRAME	DIA	DIAMETER	CONDITIONING	CONDITIONING
AFF	ABOVE FINISHED FLOOR	DISC	DISCONNECT	HWP	HYDRONIC WATER PUMP
AFG	ABOVE FINISHED GRADE	DIST	DISTRIBUTION	IC	INTERRUPTING CAPACITY
AFI	ARC FAULT CIRCUIT INTERRUPTER	DN	DOWN	İĞ	ISOLATED GROUND
AHU	AIR HANDLING UNIT	DPR	DAMPER	IMC	INTERMEDIATE METAL CONDUIT
AL	ALUMINUM	DS	SAFETY DISCONNECT SWITCH	INCAND	INCANDESCENT
ALT	ALTERNATE	DT	DOUBLE THROW	IR	INFRARED
AMP	AMPERE	DWG	DRAWING	I/W	INTERLOCK WITH
AMPL	AMPLIFIER	DDC	DIRECT DIGITAL CONTROL	J-BOX	JUNCTION BOX
ANNUN	ANNUNCIATOR APPROX APPROXIMATELY		ELECTRICAL CONTRACTOR	KV	KILOVOLT
AQ-STAT	AQUASTAT	ELEC	ELECTRICAL CONTRACTOR ELECTRICAL	KVA	KILOVOLT-AMPERE
ARCH	ARCHITECT, ARCHITECTURAL	ELEV	ELEVATOR	KVAR	KILOVOLT-AMPERE REACTIVE
ARCH	AMP SWITCH	EM	EMERGENCY	KW	KILOWATT
ATC	AMP TRIP	EMS	ENERGY MANAGEMENT SYSTEM	KWH	KILOWATT HOUR
ATS	AUTOMATIC	EMT	ELECTRICAL METALLIC TUBING	LOC	LOCATE OR LOCATION
AUTO	AUTOMATIC	EP	ELECTRIC PNEUMATIC	LT	LIGHT
AUX	AUXILIARY	EQUIP	EQUIPMENT	LTG	LIGHTING
AV	AUDIO VISUAL	EWC	ELECTRIC WATER COOLER	LTNG	LIGHTNING
AWG	AMERICAN WIRE GAUGE	EXIST	EXISTING	LV	LOW VOLTAGE
BATT	BATTERY	EXH	EXHAUST	MAX	MAXIMUM
BD	BOARD	EXP	EXPLOSION PROOF	MAG.S	MAGNETIC STARTER
BLDG	BUILDING	FA	FIRE ALARM	M/C	MOMENTARY CONTACT
BMS	BUILDING MANAGEMENT SYSTEM	FABP	FIRE ALARM BOOSTER POWER	MC	MECHANICAL CONTRACTOR
С	CONDUIT	SUPPLY PANEL	SUPPLY PANEL	MCB	MAIN CIRCUIT BREAKER
CAB	CABINET	FACP	FIRE ALARM CONTROL PANEL	MCC	MOTOR CONTROL CENTER
CAT	CATALOG	FCU	FAN COIL UNIT	MDC	MAIN DISTRIBUTION CENTER
CATV	CABLE TELEVISION	FIXT	FIXTURE	MDP	MAIN DISTRIBUTION PANEL
СВ	CIRCUIT BREAKER	FLR	FLOOR	MFR	MANUFACTURERMAIN FUSED
CCTV	CLOSED CIRCUIT TELEVISION	FLUOR	FLUORESCENT		DISCONNECT SWITCH
CKT	CIRCUIT	FU	FUSE	MH	MANHOLE
CLG	CEILING	FUDS	FUSED SAFETY DISCONNECT SWITCH	MIC	MICROPHONE
COMB	COMBINATION	GA	GAUGE	MIN	MINIMUM
CMPR	COMPRESSOR	GAL	GALLON	MISC	MISCELLANEOUS
CONN	CONNECTION	GALV	GALVANIZED	MLO	MAIN LUGS ONLY
CONST	CONSTRUCTION	GC	GENERAL CONTRACTOR	MMS	MANUAL MOTOR STARTER
CONT	CONTINUATION OR CONTINUOUS	GEN	GENERATOR	MOA	MULTIOUTLET ASSEMBLY
CONTR	CONTRACTOR	GFI	GROUND FAULT CIRCUIT INTERRUPTER	MSP	MOTOR STARTER PANELBOARD
CONV	CONVECTOR	GFP	GROUND FAULT PROTECTOR	MSBD	MAIN SWITCHBOARD
CP	CIRCULATING PUMP	GND	GROUND	MT	MOUNT
CRT	CATHODE-RAY TUBE	GRS	GALVANIZED RIGID STEEL (CONDUIT)	MT.C	EMPTY CONDUIT
CT	CURRENT TRANSFORMER	GYP BD	GYPSUM BOARD	UL	UNDERWRITERS LABORATORIES
.					

Branch Panel:

Location: STUDIO AREA 02
Supply From:
Mounting: Recessed

Enclosure: Type 1

Volts: 120/240 Single
Phases: 1
Wires: 3

A.I.C. Rating:
Mains Type:
Mains Rating: 200 A
MCB Rating: 1 A

otes:

Circuit Numb er	Circuit Description	Number of Elements	Rating	Length	Wire Size	A			3	Wire Size	Length	Rating	Number of Elements	Circuit Description	Circui Numb er
	BATH GFCI	7	20 A	20' - 7 3/4"	1-#12, 1-#12, 1-#12	576 VA	516 VA			1-#12, 1-#12, 1-#12	28' - 1 21/32"	20 A	13	KITCHEN & HALL LIGHT	2
3	REFRIGERATOR	1	20 A	26' - 4 15/16"	1-#12, 1-#12, 1-#12			1800 VA	540 VA	1-#12, 1-#12, 1-#12	22' - 0 1/32"	20 A	3	KITCHEN GFCI	4
5	RANGE	1	40 A	19' - 11 9/32"	2-#8, 1-#8, 1-#10	2500 VA	180 VA			1-#12, 1-#12, 1-#12	15' - 6 21/32"	20 A	1	OVEN HOOD	6
7								2500 VA	1200 VA	1-#12, 1-#12, 1-#12	12' - 3 17/32"	20 A	1	DISHWASHER	8
9	WATER HEATER	1	30 A	26' - 6 11/32"	2-#10, 1-#10, 1-#10	2250 VA	209 VA			1-#14, 1-#14, 1-#14	25' - 4 9/16"	15 A	7	LIV. LIGHT	10
11								2250 VA	400 VA	1-#12, 1-#12, 1-#12	29' - 1 15/16"	20 A	6	OUTDOOR LIGHT	12
13	LIV. RECEPTACLE	5	20 A	33' - 6 21/32"	1-#12, 1-#12, 1-#12	900 VA	1200 VA			1-#12, 1-#12, 1-#12	40' - 1 13/32"	20 A	1	WASHING MASHEIN	14
15	DRYER	1	30 A	37' - 11 9/32"	2-#10, 1-#10, 1-#10			2500 VA	2500 VA	2-#6, 1-#6, 1-#10	22' - 9 3/16"	60 A	1	CONDENSER	16
17						2500 VA	2500 VA								18
	OUTDOOR RECEPTACLE	3	20 A	41' - 0 13/32"	1-#12, 1-#12, 1-#12			540 VA							20
21															22
23															24
25															26
						13327	7 VA	1421	1 VA						
						111	Α	11	8 A					1	

Legend	
--------	--

oad Classification	Connected Load	Demand Factor	Estimated Demand	Panel Totals
IGHTING - DWELLING UNIT	600 VA	100.00%	600 VA	
THER	652 VA	100.00%	652 VA	Total Conn. Load: 27538 VA
ECEPTACLE	4920 VA	100.00%	4920 VA	Total Est. Demand: 26538 VA
IGHTING	100 VA	100.00%	100 VA	Total Conn.: 115 A
ONDENSER	5000 VA	100.00%	5000 VA	Total Est. Demand: 111 A
/ATER HEATER	4500 VA	100.00%	4500 VA	
ANGE	5000 VA	80.00%	4000 VA	
RYER	5000 VA	100.00%	5000 VA	
EFRIGERATOR	1800 VA	100.00%	1800 VA	
. (·		· · · · · · · · · · · · · · · · · · ·	·



KEY PLAN

NO.	DESCRIPTION	DATE

NOTE:

LEGEND:

PROJECT

121-Orion-415-Studio Craftsman-Base-550

DRAWING NAME

SCHEDULE

CLIENT NAME:	Owner
PROJECT NUMBER:	0350_11
DATE:	3/15/2025 3:03:59 PM
DESIGNED BY:	Designer
DRAWN BY:	Author
CHECKED BY:	Checker

E101

SCALE: 1/4" = 1'-0"

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ELECTRICAL NOTE

- A. PROVIDE INTERCONNECTED SMOKE ALARMS IN EACH SLEEPING ROOMS, OUTSIDE EACH SLEEPING ROOM, ON EACH STORY, IN THE HALL OR ADJACENT ROOM LUHERE THE CEILING HEIGHT OF A ROOM OPEN TO THE HALL EXCEEDS THE HALL BY 24'. SMOKE ALARMS SHALL BE PERMANENTLY HARD WIRED WITH BATTERY BACKUP.
- B. RECEPTACLE OUTLETS FOR RANGES AND CLOTHES DRYERS SHALL BE A THREE POLE WITH GROUND TYPE. FOUR WIRE GROUNDING-TYPE FLEXIBLE CORDS WILL BE REQUIRED FOR CONNECTION OF RANGES AND CLOTHES DRYERS. THE BONDING JUMPER SHALL NOT BE CONNECTED BETWEEN NEUTRAL TERMINAL AND THE FRAME OF THE APPLIANCE.
- C. TWO OR MORE 20 AMP SMALL APPLIANCE CIRCUITS SHALL BE PROVIDED TO SERVE THE KITCHEN, BREAKFAST NOOK, AND DINING ROOM. SUCH CIRCUITS SHALL HAVE NO OTHER OUTLETS.
- D. AT LEAST ONE 20 AMP BRANCH CIRCUIT SHALL BE PROVIDED TO SERVICE THE LAUNDRY ROOM. THIS CIRCUIT SHALL HAVE NO OTHER OUTLETS.
- E. ALL RECEPTACLES WITH IN 6' OF A WET BAR SINK OR KITCHEN SINK TO SERVE COUNTER TOP SURFACES MUST BE GFCI. ON KITCHEN COUNTERS 12' OR WIDER NO POINT ALONG THE WALL SHALL BE MORE THAN 2' FROM A RECEPTACLE. ALL RECEPTACLES WITH IN 6' OF KITCHEN SINK MUST BE GFCI. AT LEAST ONE GFCI RECEPTACLE SHALL
- BE INSTALLED IN THE BATHROOM ADJACENT TO EACH BASIN.

 F. FIXTURES INCLUDING CEILING FANS THAT ARE LOCATED IN DAMP LOCATIONS SHALL BE LISTED TO BE SUITABLE FOR
- SUCH LOCATIONS PER 2012 IRC
- G. PROVIDE ONE (1) SWITCHED OUTLET @ ALL BEDROOMS AND DEN
- H. CEILING FANS NOT EXCEEDING 35 LBS. (WITH OR WITHOUT ACCESSORIES MAY BE SUPPORTED BY OUTLET BOXES PROVIDED THE OUTLET BOXES ARE IDENTIFIED FOR SUCH USE PER 2012 IRC
- I. ELECTRICAL OUTLET BOXES ON OPPOSITE SIDES OF FIRE RATED WALLS SHALL BE SEPARATED BY A HORIZONTAL DISTANCE OF NOT LESS THAN 24".
- J. OUTLET BOXES IN THE WALLS BETWEEN THE GARAGE AND DWELLING SHALL BE METAL OR U.L. APPROVED FIRE RESISTIVE PLASTIC. BOXES IN GARAGE CEILING SHALL BE METAL.
- K. ALL BRANCH CIRCUITS THAT SUPPLY 120 VOLTS SINGLE PHASE 15 AND 20 AMPS RECEPTACLE OUTLETS INSTALLED IN THE DWELLING SHALL BE PROTECTED BY AN ARC FAULT CIRCUIT INTERRUPTER. EXCEPT GFCI RECEPTICLES.

NOTE:

A. RECEPTACLES MUST BE PROVIDED IN HALLWAYS 10'-0" OR MORE IN LENGTH. FOR A ONE FAMILY DWELLINGS AND EACH OF A TWO FAMILY DWELLING THAT IS AT GRADE LEVEL, AT LEAST ONE WP-GFCI RECEPTACLE OUTLET ACCESSIBLE AT GRADE LEVEL AND NOT MORE THAN 6'-6" ABOVE GRADE SHALL BE INSTALLED AT THE FRONT AND BACK OF THE DWELLING.

NOTE: APPLIANCE DISCONNECT

E4001.5 GROUNDING OF ENCLOSURES.

METAL ENCLOSURES FOR SWITCHES OR CIRCUIT BREAKERS SHALL BE CONNECTED TO AN

EQUIPMENT GROUNDING CONDUCTOR.

METAL ENCLOSURES FOR SWITCHES OR CIRCUIT BREAKERS USED AS SERVICE

EQUIPMENT SHALL COMPLY WITH THE PROVISIONS OF SECTION E3609.4. WHERE


NONMETALLIC ENCLOSURES ARE USED WITH METAL RACEWAYS OR METAL-ARMORED CABLES, PROVISIONS SHALL BE MADE FOR CONNECTING THE EQUIPMENT GROUNDING

CONDUCTOR.


NONMETALLIC BOXES FOR SWITCHES SHALL BE INSTALLED WITH A WIRING METHOD THAT

PROVIDES OR INCLUDES AN EQUIPMENT GROUNDING CONDUCTOR. (404.12)

ELECTRICAL LEGEND Electrical Lights With Fan 0 **Waterproof Recessed Can Light** Pendant Light **Recessed Can Light** 0 **−**Ø Wall Lamp **Standalone linear** Single Switch ₩Ð ₩ **Three way Switch** Fan Switch **₩ Duplex Receptacle Triplex Receptacle GFCI Receptacle** \mathbb{X} Exhaust Fan Smoke and heat detector

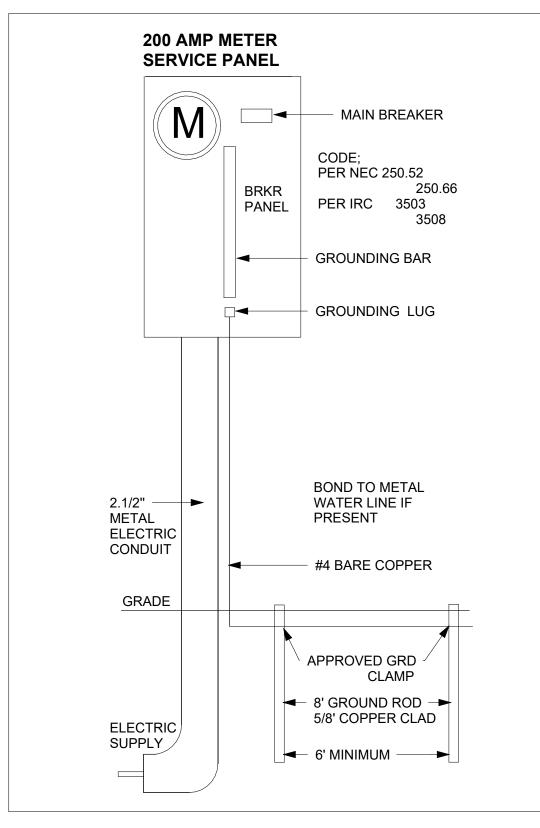



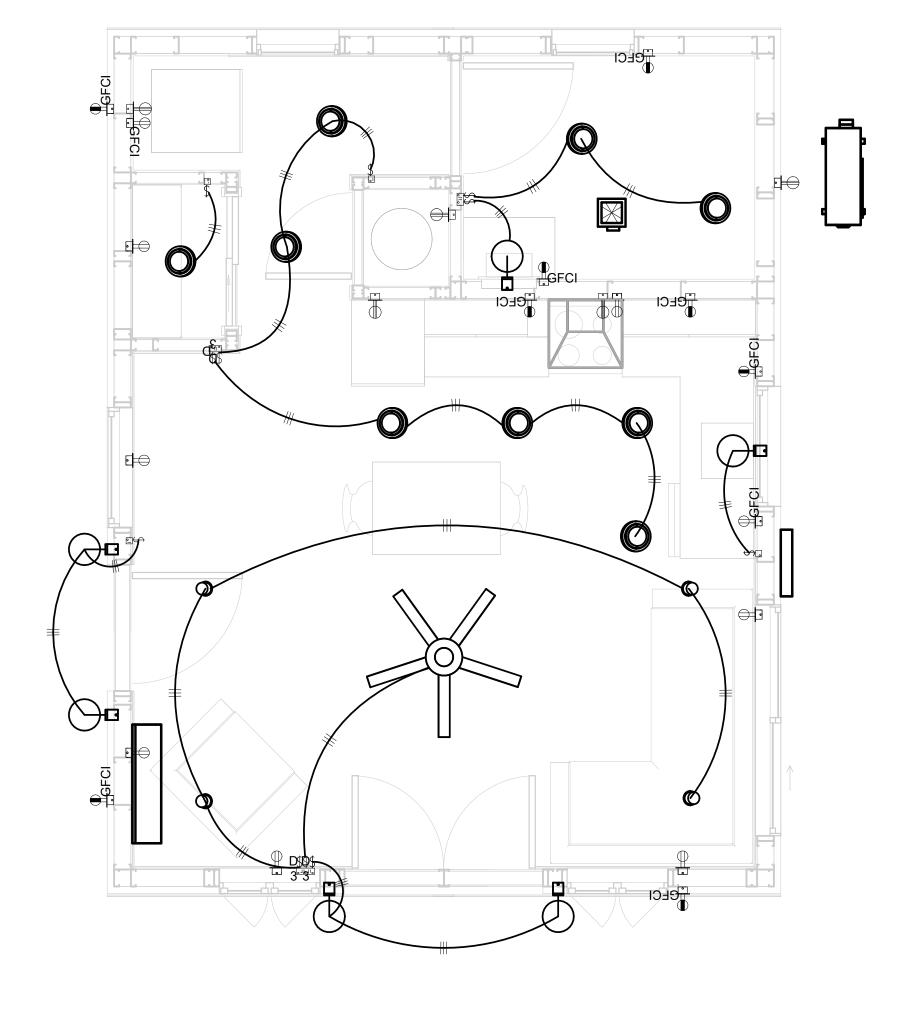

1 - Lighting 3/8" = 1'-0"



KEY PLAN

NO.	DESCRIPTION	DATE

NOTE:

LEGEND:

PROJECT

121-Orion-415-Studio Craftsman-Base-550

DRAWING NAME


LIGHTING

CLIENT NAME:	Owner
PROJECT NUMBER:	0350_11
DATE:	3/15/2025 3:04:01 PM
DESIGNED BY:	Designer
DRAWN BY:	Author
CHECKED BY:	Checker


E102

NOTES: CONDUIT, CABLE AND WIRING

- Use Metalic Conduits (IMC) for cables running under concrete slabs.
 Use IMC for circuits with high voltage appliances (240 volts and above)
 For circuits with 120 volts consider using EMT or PVC conduits if needed.
 For Low voltage applications up to 50 volts consider using non metalic conduits.
 All conduits to be used in the project must conform to the latest National Electrical Code (NEC),
- 6. All wiring and cables to be used in the project must also conform to the latest National Electrical
- 7. All cables and wires used should be rated for their respective loading and should be gauged and conform to the NEC.

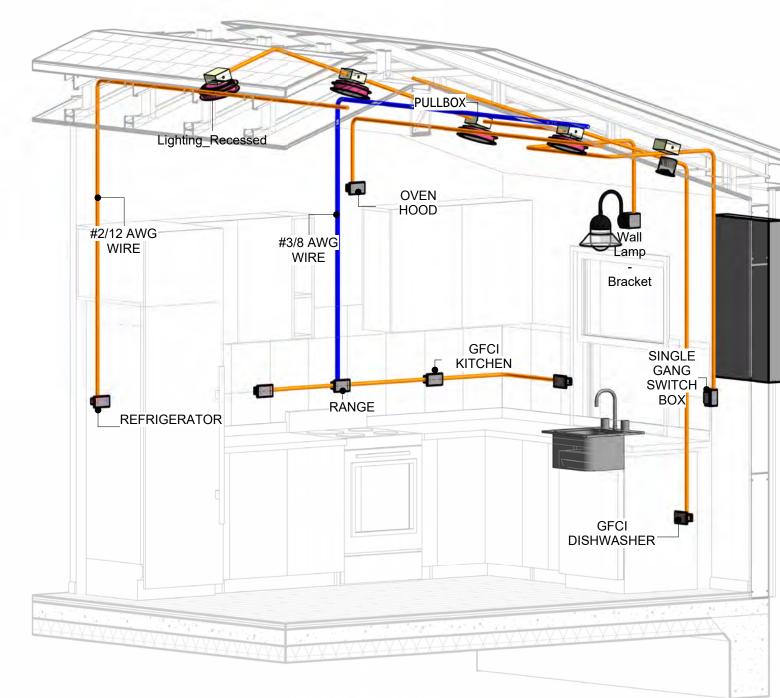


3D-KITCHEN

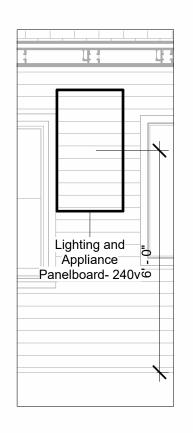


Panel 3/8" = 1'-0"


Dryer&Washer 3/8" = 1'-0"

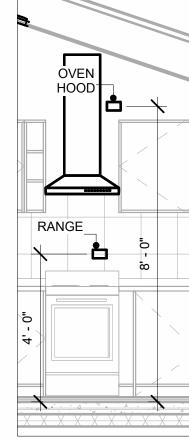

Range & OvenHood
3/8" = 1'-0"

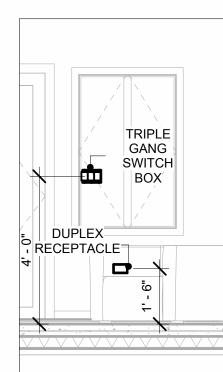

Switch&Receptacle 3/8" = 1'-0"

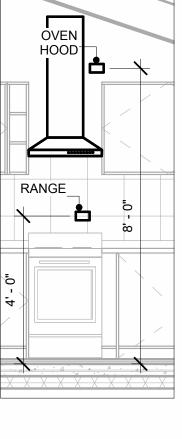

Craftsman-Base-550

121-Orion-415-Studio

Tuscon,AZ, USA 888-864-0184 inquire@frameupnow.com www.frameupnow.com

DESCRIPTION

DATE

KEY PLAN

NOTE:

LEGEND:


DRAWING NAME

PROJECT

POWER

Owne	CLIENT NAME:
0350_11	PROJECT NUMBER:
3/15/2025 3:04:26 PI	DATE:
Designe	DESIGNED BY:
Autho	DRAWN BY:
Checke	CHECKED BY:

E103

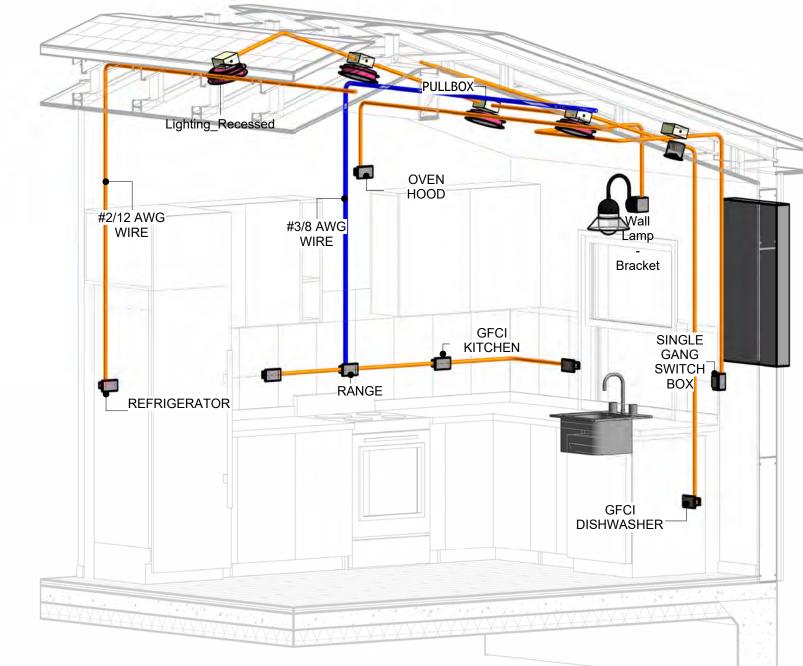

NOTES: LIGHT

- 1. LIGHT FIXTURES AND LUMINARIES SHALL CONFORM TO THE NEC, THE IRC AND LOCAL SAFETY & BUILDING CODE.
- 2. ALL LIGHTING FIXTURES SHOULD CONFORM TO THE DESIGN ELECTRICAL LOAD AND SHALL BE PROPERLY WIRED AND MOUNTED BY QUALIFIED ELECTRICIAN FOLLOWING MANUFACTURERS SPECIFICATIONS.
- 3. CEILING FANS AND FANS WITH LIGHT WITH WEIGHT EXCEEDING 35 LBS SHOULD BE PROVIDED WITH STRUCTURAL BACKING FOR SUPPORT AND SHALL BE FIXED AS PER MANUFACTURERS SPECIFICATIONS.
- 4. EXTERIOR LIGHTS SHALL CONFORM TO LOCAL BUILDING CODE AND GUIDELINES.

NOTES: SWITCH JUNCTION BOX


- 1. THE MINIMUM SIZE OF JUCTION BOX TO BE USED IS 2"X4"X(1.5" OR 3.5" DEEP) THIS ARE TO BE USED FOR SINGLE GANG SWITCH OR OUTLETS.
- 2. FOR DOUBLE GANG (2 GANG) OUTLETS AND SWITCHS THE MINIMUM SIZE OF THE
- JUCTION BOX TO BE PROVIDED SHALL NOT BE LESS THAN 4"X4"X(1.5" OR 3.5" DEEP)
- 3. FOR THREE GANG (3 GANG) OUTLETS AND SWITCHS THE MINIMUM SIZE OF THE JUĆTION BOX SHALL NOT BE LESS THAN 6"X4"X(1.5" OR 3.5" DEEP).

FITTING SCHEDULE(PULL BOX)						
FAMILY COUNT DESCRIPTION						
	1					
PULLBOX1	13	#1/4 PULLBOX				

ELECTRICAL FIXTURE SCHEDULE (SWITCH BOX)					
TYPE COUNT					
DOUBLE GANG SWITCH BOX	2				
SINGLE GANG SWITCH BOX	4				
TRIPLE GANG SWITCH BOX	1				

LIGHTING DEVICE	
TYPE	COUNT
DIMMER	1
SINGLE POLE	8
THREE WAY WITH DIMMER	2

LIGHTING FIXTURE			
LIGHTING FIXTURE TYPE	VOLTAGE	ELECTRICAL LOAD	COUNT
ELECTRICAL_LIGHTS_FAN-LIGHT1	120 V/1-100 VA- 120 V/1-100 VA	200 A, 120 V/240 V, SINGLE PHASE, 3 WIRES	1
LIGHTING_RECESSED	120 V/1-60 VA	200 A, 120 V/240 V, SINGLE PHASE, 3 WIRES	9
SASSO 100 ROUND WALLWASHER TRIM	120 V/1-28 VA	200 A, 120 V/240 V, SINGLE PHASE, 3 WIRES	4
WALL LAMP - BRACKET	120 V/1-100 VA	200 A, 120 V/240 V, SINGLE PHASE, 3 WIRES	6

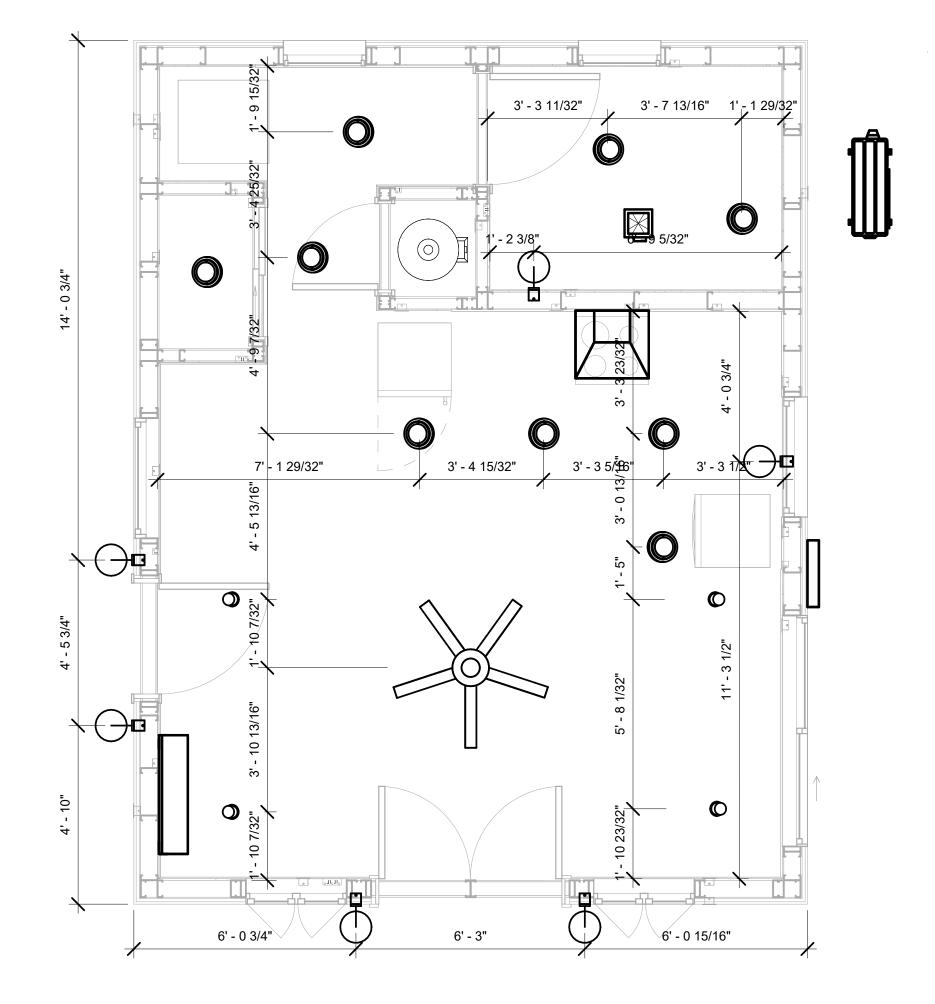

DIMENSION FOR LIGHT FIXTURES
3/8" = 1'-0"



KEY PLAN

NO.	DESCRIPTION	DATE

NOTE:

LEGEND:

PROJECT

121-Orion-415-Studio Craftsman-Base-550

DRAWING NAME

DIMENSION PLAN FOR LIGHT FIXTURES

CLIENT NAME:	Owner
PROJECT NUMBER:	0350_11
DATE:	3/15/2025 3:04:27 PM
DESIGNED BY:	Designer
DRAWN BY:	Author
CHECKED BY:	Checker


E104

NOTES;

- 1. VERIFY EQUIPMENT PLUG CONFIGURATION BEFORE PURCHASING RECEPTACLES
- 2. FOR ALL EQUIPMENT.
- 3. COORDINATE EXACT LOCATION OF LIGHT FIXTURES, WALL SWITCHES, RECEPTACLES AND OTHER DEVICES WITH ARCHITECTURAL DRAWINGS.
- 4. USE METALLIC JUNCTION BOX WITH THE GFCI RECEPTACLES, WITH HIGHT VOLTAGE.

ELECTRICAL FIXTURE SCHEDULE (RECEPTACLE)		
TYPE	COUNT	
CONDENSER	1	
DRYER	1	
DUPLEX RECEPTACLE	6	
GFCI BATH ROOM	2	
GFCI DISHWASHER	1	
GFCI KITCHEN	3	
GFCI OUT DOOR	3	
GFCI WASHER	1	
OVEN HOOD	1	
RANGE	1	
REFRIGERATOR	1	
WATER HEATER	1	

ELECTRICAL OUTLET SCHEDULE			
TYPE	CIRCUIT NUMBER	ELECTRICAL DATA	COUNT
DUPLEX RECEPTACLE		120 V/1-180 VA	1
GFCI BATH ROOM	1	120 V/1-180 VA	2
REFRIGERATOR	3	120 V/1-1800 VA	1
GFCI KITCHEN	4	120 V/1-180 VA	3
RANGE	5,7	240 V/2-5000 VA	1
OVEN HOOD	6	120 V/1-180 VA	1
GFCI DISHWASHER	8	120 V/1-1200 VA	1
WATER HEATER	9,11	240 V/2-4500 VA	1
DUPLEX RECEPTACLE	13	120 V/1-180 VA	5
GFCI WASHER	14	120 V/1-1200 VA	1
DRYER	15,17	240 V/2-5000 VA	1
CONDENSER	16,18	240 V/2-5000 VA	1
GFCI OUT DOOR	19	120 V/1-180 VA	3

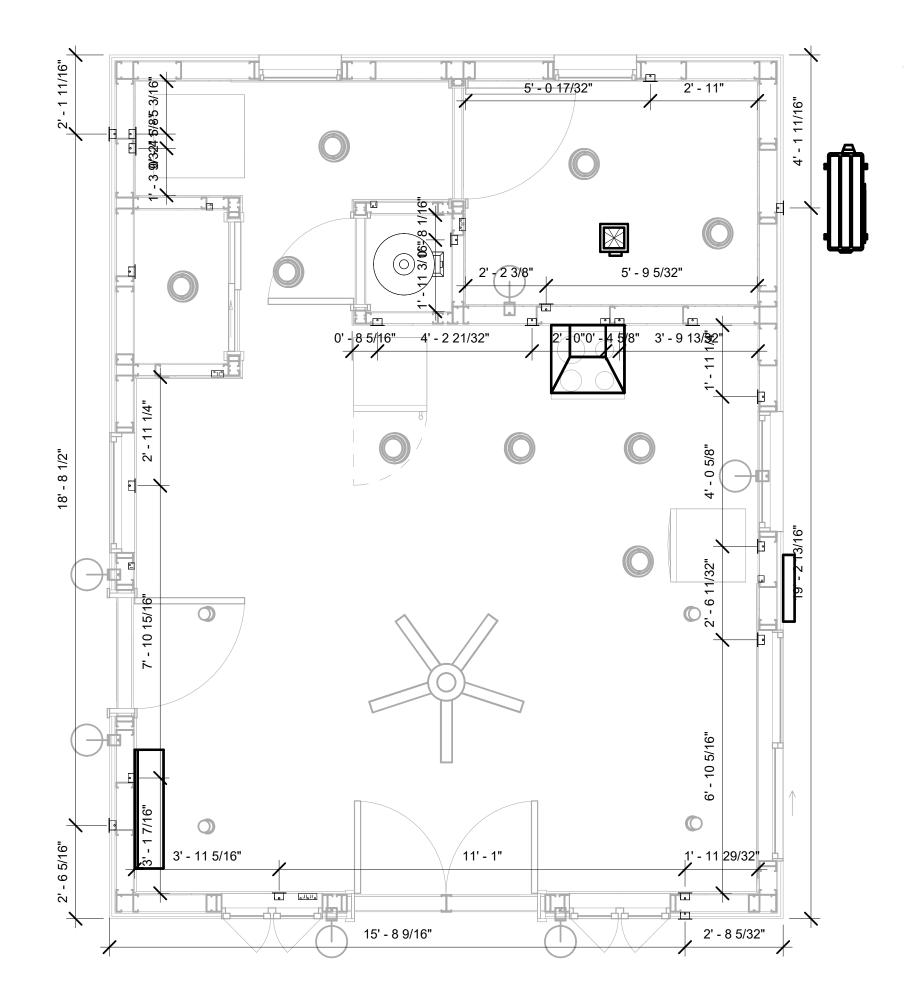

DIMENSION FOR FITTINGS
3/8" = 1'-0"



KEY PLAN

NO.	DESCRIPTION	DATE

NOTE:

LEGEND:

PROJECT

121-Orion-415-Studio Craftsman-Base-550

DRAWING NAME

DIMENSION PLAN FOR FITTINGS

CLIENT NAME:	Owner
PROJECT NUMBER:	0350_11
DATE:	3/15/2025 3:04:28 PM
DESIGNED BY:	Designer
DRAWN BY:	Author
CHECKED BY:	Checker

E105

SHEET LIST

Sheet Name Sheet Number

P101	NOTE AND SCHEDULE
	WATER SUPPLY AND SEWAGE SYSTEM

D WATE WATER T ER GE

PLUMBING NOTES

- The plumbing system is designed to meet the building's domestic water supply, sanitary drainage, and storm drainage requirements, as per project specifications and applicable codes.
- The system installation shall comply with the latest International Plumbing Code (IPC), International Residential Code (IRC), and all other relevant local, state, and national regulations.
- ALL PLUMBING WORK SHALL COMPLY WITH THE LATEST EDITION OF THE INTERNATIONAL PLUMBING CODE (IPC) AND THE LOCAL PLUMBING CODE.
- PLUMBING SYSTEMS SHALL BE TESTED AND INSPECTED IN ACCORDANCE WITH THE
- LOCAL PLUMBING CODE REQUIREMENTS. PLUMBING FIXTURES SHALL BE INSTALLED WITH THE APPROPRIATE TRIM, FITTINGS, AND
- ACCESSORIES, AS RECOMMENDED BY THE MANUFACTURER. 6. PIPING SHALL BE PROPERLY SUPPORTED AND SECURED TO PREVENT SAGGING,
- MOVEMENT, AND VIBRATION. SHUT-OFF VALVES SHALL BE PROVIDED AT ALL BRANCH CONNECTIONS AND AT THE
- INLET AND OUTLET OF EACH PIECE OF EQUIPMENT.
- BACKFLOW PREVENTION DEVICES SHALL BE INSTALLED AS REQUIRED BY THE LOCAL PLUMBING CODE TO PROTECT THE POTABLE WATER SYSTEM.
- PLUMBING FIXTURES AND EQUIPMENT SHALL BE ACCESSIBLE FOR MAINTENANCE AND SERVICING.
- EXPOSED PLUMBING PIPING AND FIXTURES SHALL BE INSULATED TO PREVENT CONDENSATION AND ENERGY LOSS.
- 11. DEAD ENDS IN THE DRAINAGE SYSTEM MUST BE AVOIDED, EXCEPT WHERE NECESSARY TO INSTALL A CLEANOUT IN AN ACCESSIBLE LOCATION, AND MUST HAVE A VENTED CONNECTION TO THE OUTSIDE ATMOSPHERE.
- 12. THE VERTICAL DEFLECTION OF PVC PIPE MUST NOT EXCEED 5%, AND NO DEFLECTION IS PERMITTED FOR IRON PIPE.
- 13. WORK MUST BE PROPERLY COORDINATED WITH OTHER TRADES TO AVOID CONFLICTS, REFERRING TO THE ARCHITECTURAL AND STRUCTURAL DRAWINGS FOR INFORMATION REGARDING CEILING ELEVATIONS, SPACE CLEARANCES, WALL AND PARTITION LOCATIONS, ETC.
- 14. ALL FIXTURES SHALL HAVE ACCESSIBLE STOPS.
- 15. DOMESTIC WATER PIPING SHALL BE PEX, AND PVC PIPING IS NOT ACCEPTABLE FOR INTERIOR USE
- 16. VENT TERMINATIONS SHALL BE LOCATED AT LEAST 10 FEET FROM OR 3 FEET ABOVE ANY OPERABLE WINDOW, DOOR OPENING, AIR INTAKE, OR VENT SHAFT, AND AT LEAST 3 FEET IN EVERY DIRECTION FROM ANY LOT LINE, ALLEY, OR STREET,
- 17. PIPE AND FITTINGS UTILIZED IN THE WATER SUPPLY SYSTEM SHALL HAVE A MAXIMUM OF 8 PERCENT LEAD.
- 18. ACRYLONITRILE BUTADIENE STYRENE (ABS) SHALL BE USED FOR THE SEWERAGE AND
- VENTILATION SYSTEM.
- 19. CROSS-LINKED POLYETHYLENE (PEX) SHALL BE USED FOR THE WATER SUPPLY SYSTEM. 20. POLYVINYL CHLORIDE (PVC) SHALL BE USED FOR THE RAIN WATER SYSTEM.
- 21. THE MIMIMUM WATER SUPPLY DEPTH UNDER FLOOR FINISH SHOUD BE 1/2".
- ANY PIPE INSTALLED UNDERGROUND MUST HAVE AT LEAST 12 INCHES OF CLEARANCE BETWEEN THE OUTSIDE OF THE PIPE AND ANY OTHER UNDERGROUND STRUCTURE.
- 23. THE MINIMUM CLEARANCE BETWEEN COLD AND HOT WATER LINES IN RESIDENTIAL
- HOMES MAINTAIN A MINIMUM DISTANCE OF 6 INCHES.
- 24. HORIZONTAL SEPARATION BETWEEN WATER AND SEWER LINES: A MINIMUM OF 12 INCHES BETWEEN POTABLE WATER SUPPLY LINES (COLD AND HOT WATER) AND SANITARY SEWER LINES.

ABBREVIATIONS

E
E

PLUMBING LEGEND

D	Сар
	Bend 45 Deg
B	Bend 90 Deg
	Tee Reducing
	Tee
	Clean Two-Way
	Wye 45 Deg
	Wye 45 Deg Double
	Wye Combination
	P-Trap

PIPE SCHEDULE								
Material Diameter Length								
Acrylonitrile Butadiene Styrene (ABS)	1 1/2"	22 ft						
Acrylonitrile Butadiene Styrene (ABS)	2"	31 ft						
Acrylonitrile Butadiene Styrene (ABS)	3"	19 ft						
Cross-linked polyethylene (PEX)	1/2"	68 ft						
Cross-linked polyethylene (PEX)	3/4"	42 ft						
Cross-linked polyethylene (PEX)	2"	2 ft						
Polyvinyl Chloride - Rigid	2"	44 ft						

FI	TTING SCHEDULE	
FITTING	Size	QTY
Domestic Cold Water		
PEX 90 Degree Elbow	1/2"ø-1/2"ø	12
PEX 90 Degree Elbow	3/4"ø-3/4"ø	4
PEX Tee Elbow	1/2"ø-1/2"ø-1/2"ø	2
PEX Tee Elbow	3/4"ø-3/4"ø-3/4"ø	5
PEX Transition Elbow	1"ø-3/4"ø	2
PEX Transition Elbow	3/4"ø-1/2"ø	4
	1	
Domestic Hot Water		
PEX 90 Degree Elbow	1/2"ø-1/2"ø	11
PEX 90 Degree Elbow	3/4"ø-3/4"ø	2
PEX Tee Elbow	1/2"ø-1/2"ø-1/2"ø	2
PEX Tee Elbow	3/4"ø-3/4"ø-3/4"ø	2
PEX Transition Elbow	3/4"ø-1/2"ø	3
Rain Water PVC 90 Deg Bend Elbow	2"ø-2"ø	18
Sewage		
ABS 90 Degree Bend Elbow	2"ø-2"ø	2
ABS 90 Degree Bend Elbow	3"ø-3"ø	2
ABS P-Trap	1 1/2"ø-1 1/2"ø	3
ABS P-Trap	2"ø-2"ø	2
ABS Reducer Elbow	2"ø-1 1/2"ø	1
ABS Reducer Elbow	3"ø-1 1/2"ø	2
ABS Reducer Elbow	3"ø-2"ø	1
ABS TEE Elbow	1 1/2"ø-1 1/2"ø-1 1/2"ø	1
ABS TEE Elbow	2"ø-2"ø-2"ø	4
ABS TEE Elbow	3"ø-3"ø-3"ø	3
ABS Tee Reducer Elbow	3"ø-3"ø-1 1/2"ø	1
ABS Tee Reducer Elbow	3"ø-3"ø-2"ø	1
Vent		
ABS 90 Degree Bend Elbow	1 1/2"ø-1 1/2"ø	1
ABS 90 Degree Bend Flhow	2"ø-2"ø	1

ABS 90 Degree Bend Elbow	1 1/2"ø-1 1/2"ø	1
ABS 90 Degree Bend Elbow	2"ø-2"ø	1
ABS TEE Elbow	1 1/2"ø-1 1/2"ø-1 1/2"ø	1
ABS TEE Elbow	2"ø-2"ø	1
ABS Vent Cap Elbow	1 1/2"ø	1
ABS Vent Cap Elbow	2"ø	2

FIXTURE CONNECTION SCHEDULE

Family	w	V	Trap	cw	HW	QT Y	DFU	тот.	WF U	TOT ·	NOTES
Dishwasher	2"	1-1/2"	1-1/2"	1/2"	1/2"	1		0			Drain to sewer see plans
Dryer	N/A	N/A	N/A	N/A	N/A	1		0			
Hanging pipes clamp						12		0			
Shower Tray	2"	1-1/2"	1-1/2"	1/2"	1/2"	1		0			
Shower Trim	-	-	-	1/2"	1/2"	1		0			
Sink Island Single	2"	1-1/2"	1-1/2"	1/2"	1/2"	1		0			
Vanity Sink	2"	1-1/2"	1-1/2"	1/2"	1/2"	1		0			
Washer	2"	1-1/2"	2"	1/2"	1/2"	1		0			DRAINS TO GRAY WATER OR SEWER SEE PLANS
Water Closet	3"	2"	3"	1/2"	1/2"	1		0			
Water Heater	N/A	N/A	N/A	3/4"	3/4"	1		0			

FIXTURE SCHEDULE

fixture	QTY	Description
		·
Dishwasher	1	Drain to sewer see plans
Dryer	1	
Hanging pipes clamp	12	
Shower Tray	1	
Shower Trim	1	
Sink Island Single	1	
Vanity Sink	1	
Washer	1	DRAINS TO GRAY WATER OR SEWER SEE PLANS
Water Closet	1	
Water Heater	1	

ACCESSORIES & FITTINGS SCHEDULE

fixture	QTY	Descriptions
DISHWASHER CONNECTOR	1	
Hose Bib	1	
LAUNDRY SWEAT CONNECTOR	1	
Shutoff Valve	6	

PLUMBING SCHEDULE									
FIXTURE	Trap	Waste	Vent	C.W	H.W				
Dishwasher	1-1/2"	2"	1-1/2"	1/2"	1/2"				
Dryer	N/A	N/A	N/A	N/A	N/A				
Shower Tray	1-1/2"	2"	1-1/2"	1/2"	1/2"				
Shower Trim	-	-	-	1/2"	1/2"				
Sink Island Single	1-1/2"	2"	1-1/2"	1/2"	1/2"				
Vanity Sink	1-1/2"	2"	1-1/2"	1/2"	1/2"				
Washer	2"	2"	1-1/2"	1/2"	1/2"				
Water Closet	3"	3"	2"	1/2"	1/2"				
Water Heater	N/A	N/A	N/A	3/4"	3/4"				

WATER FIXTURE UNIT SCHEDULE								
Family	QTY	UNIT VALUE	TOTAL					
D: 1								
Dishwasher	1		0					
Dryer	1		0					
Hanging pipes clamp	12		0					
Shower Tray	1		0					
Shower Trim	1		0					
Sink Island Single	1		0					
Vanity Sink	1		0					
Washer	1		0					
Water Closet	1		0					
Water Heater	1		0					

WASTE FIXTURE UNIT SCHEDULE							
Family	QTY	DFU Values	TOTAL				
Dishwasher	1		0				
Dryer	1		0				
Hanging pipes clamp	12		0				
Shower Tray	1		0				
Shower Trim	1		0				
Sink Island Single	1		0				
Vanity Sink	1		0				
Washer	1		0				
Water Closet	1		0				
Water Heater	1		0				



KEY PLAN

DESCRIPTION DATE

NOTE:

LEGEND:

PROJECT

121-Orion-415-Studio **Craftman-Base-550**

DRAWING NAME


NOTE AND SCHEDULE


CLIENT NAME:

PROJECT NUMBER: 0350_11 DATE: 3/17/2025 4:05:08 AM Designer DESIGNED BY: DRAWN BY: Author CHECKED BY: Checker


P101

SCALE: 1/2" = 1'-0"

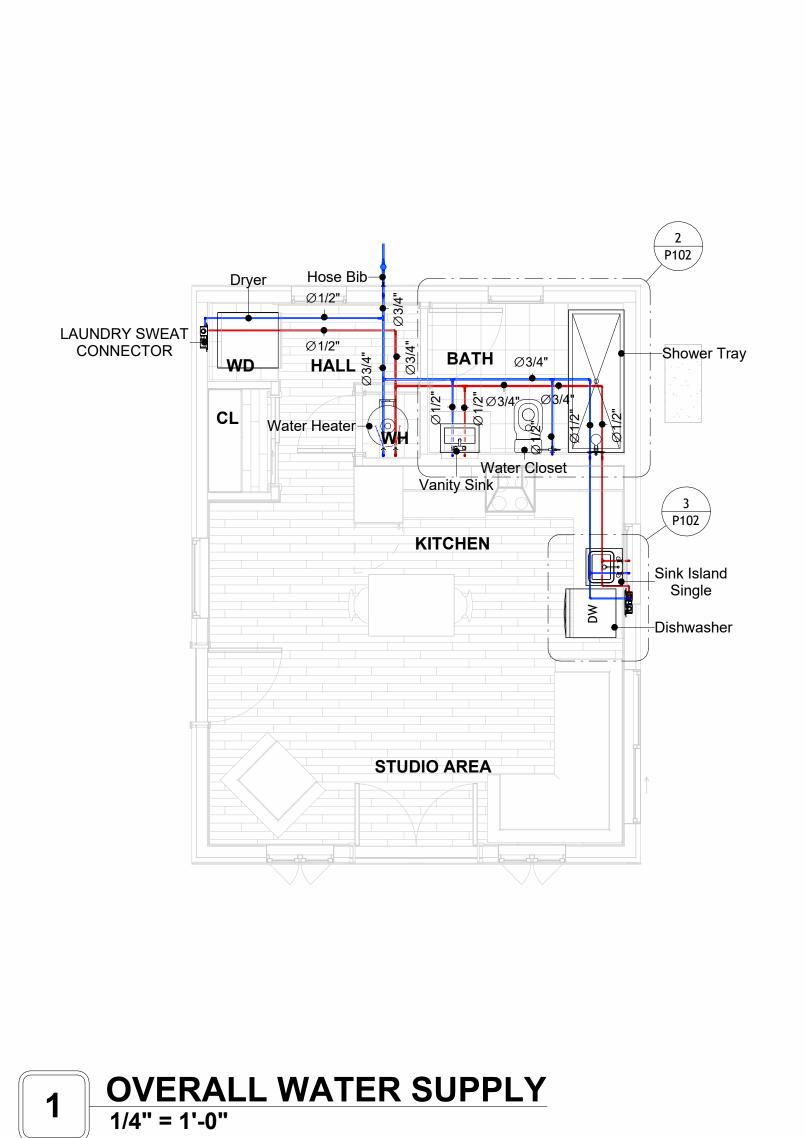


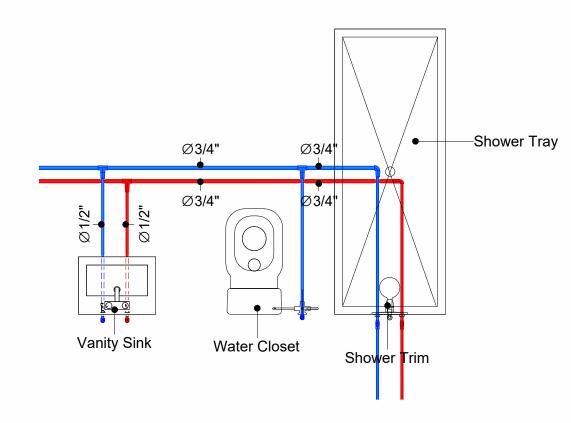


2 BATH WATER SUPPLY
1/2" = 1'-0"

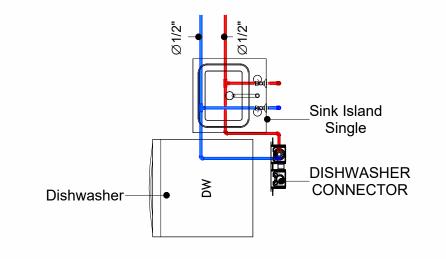


3 KITCHEN WATER SUPPLY

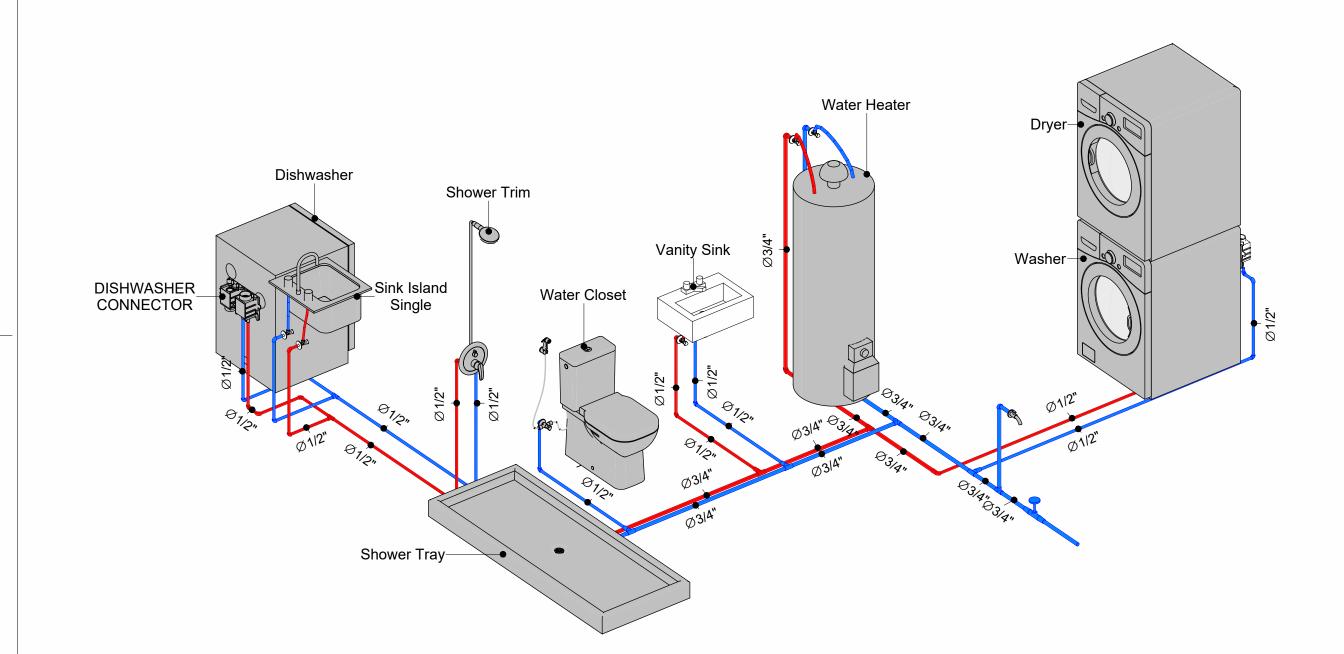

WATER SUPPLY RISER DIAGRAM

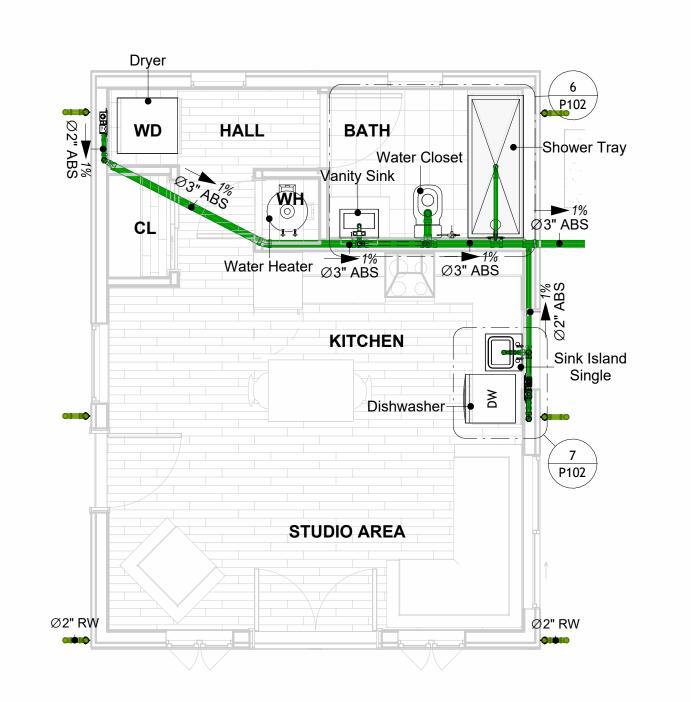

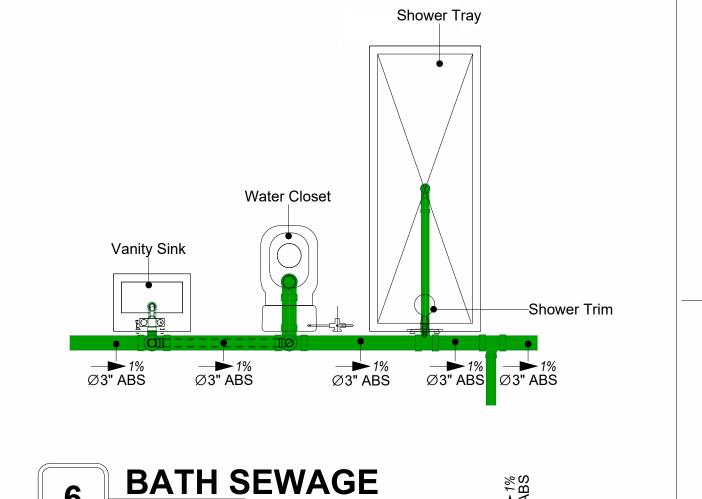


1/2" = 1'-0"

PIPe Color SCHEME

DOMESTIC COLD WATER
DOMESTIC HOT WATER


SANITARY VENT
SANITARY SEWER
STORM DRAINAGE

Gray Water
GAS LINE

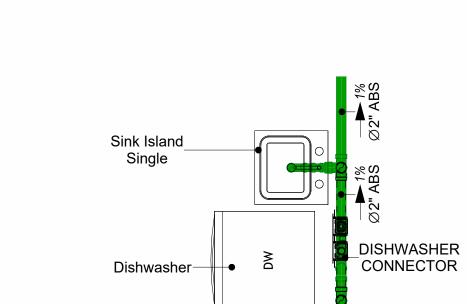

KITCHEN SEWAGE




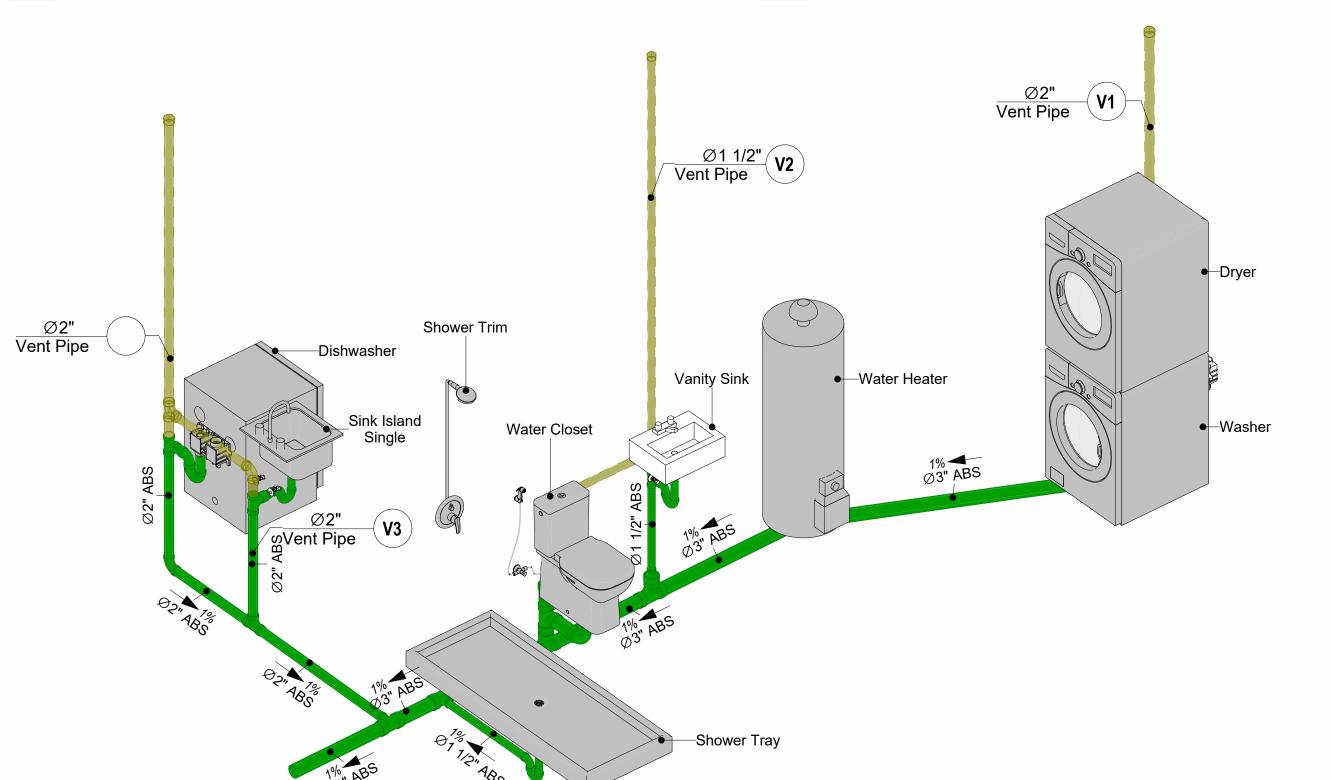

SEWAGE RISER DIAGRAM



KEY PLAN

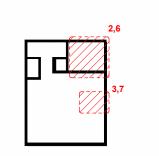

NO.	DESCRIPTION	DATE

NOTE:

LEGEND:

PROJECT

121-Orion-415-Studio Craftman-Base-550

DRAWING NAME

WATER SUPPLY AND SEWAGE SYSTEM

CLIENT NAME:

PROJECT NUMBER:

0350_11

DATE:
3/17/2025 4:05:34 AM

DESIGNED BY:

DRAWN BY:

CHECKED BY:

Checker

P102

Materials Shopping List

Please print and take this Materials Shopping List to your favorite Home Depot and ask for assistance in selecting the materials, fixtures and fittings to complete your new home.

Record your selection and the price of the item. Then do the math to determine the cost for your selections and the total cost of finishing your home.

Have It Your Way!

The material types listed in this document were selected based on personal preferences. The Customer is encouraged to make changes to the material types in accordance with local customs, regulations, and personal preferences.

Have It Your Way!



20 good reasons to frame a home with metal and not wood



Why build your ADU with metal vs wood	Wood	Metal	Explanation
1 DIY Construction Benefit		~	The wall frames, trusses and beams can be erected in a just a few days
2 Minimal Construction Skills Required		~	Pre-assembled walls and trusses require no specialized skills to errect
3 Build as DIY, Hybrid or by a General Contractor		✓	Do it yourself, Hybrid (involve special contractors) or hire a General Contractor
4 Build It As You Can Afford It		✓	Impervious to Weather - build as you have the time and money
5 Up Front Cost of Framing Materials	~		As to only the framing material, wood is less expensive
6 Total Cost To Build		~	Savings in time, labor, and other areas make light gauge steel LESS expensive
7 Termites and wood boring insects		Y	Termites, carpenter ants and wood boring insects eat wood, not metal
8 Mold resistant		~	Metal does not attract mold
9 Damage caused by exterior and interior flooding		~	Metal needs no reconditioning after a flood
10 Fire Resistant		~	Non-combustible
11 Lower insurance rates		Y	Many insurance underwriters now provide lower rates for metal framed homes
12 Walls, trusses, and beams retain their original form		~	Perfectly straight walls - no shimming of drywall
13 Corners are 90 degrees		✓	No need for templating of countertops to adjust for out of square corners
14 Strength and weight		✓	Metal is stronger than wood and weighs less - no need for crane to lift ADU trusses
15 IBC Engineered Stamp		✓	If an engineering stamp is necessary, months of waiting are saved
16 Complete BOM (Materials Shopping List)		~	Take the materials shopping list to Home Depot and start shopping/pricing
17 Flexible in Seismic Areas - Won't Fracture		~	Light gauge steel is flexible and won't fracture when the earth moves
18 No Waste At Job Site		~	Steel is the most recycled material in the world. A typical wood home has 20-30% waste
19 Environmentally Friendly		~	Trees don't have to be destroyed and the source of most metal is from recycling
20 How-To Videos Included		~	How-to videos provide simple assembly instructions
21 Relationship Counselor		✓	Eliminate emotional uphevels - save time, money, and preserve the relationship

Universal Requirements - some or all may be required

- 1 Site plan
- 2 Electrical Supply Connection
- 3 Sewer Connection
- 4 Fresh Water Supply Connection
- 5 Set Backs
- 6 Soils Evaluation

- 7 Earthquake (fault) evaluation
- 8 Foundation Plan subject to soils
- 9 Compliance with local energy codes: insulation home wrap and flashing
- 10 Engineering for wind speed and snow load.
- 11 State and Local ordinances regarding ADUs
- 12 Local Architect and/or Engineer may be necessary

Orion-Studio-Craftsman-Base





Orion-Studio-Craftsman-Base MATERIAL SHOPPING LIST

Have It Your Way!

The material types listed in this document were selected based on personal preferences. The Customer is encouraged to make changes to the material types in accordance with local customs, regulations, and personal preferences. Have It Your Way!

TOC



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Have It Your Way!

ARCHITECTURAL BOM

The material types listed in this document were selected based on personal preferences. The Customer is encouraged to make changes to the material types in accordance with local customs, regulations, and personal preferences. Have It Your Way!

GENERAL NOTES

6 ARCHITECTURAL BOM

- 1 This BOM (Bill of Materials) is prepared as a Materials Shopping List to help builders and DIYers gain a complete understanding of most if not all elements required for the complete construction of this structure, according to the original design documents provided by FrameUpNow.
- 2 All quantities and specifications are subject to change based on the final design, field measurements, availability of products and customer preferences. The customer should verify all information prior to purchasing materials.
- 3 All products and elements in the list shall conform to the International Residential Code (IRC), or any other local and international building codes, safety regulations, and standards that are applicable to the location of the structure.
- 4 If any changes are made by the customer to the list of materials specified in this document, the customer is responsible for assuring that the correct type and quantity of materials are utilized in accordance with local building codes.
- 5 FrameUpNow, will not be held responsible for any misuse of this document, the products listed, or for deviations from the content that are made due to changes in specifications, pricing, availability, or customer preferences.
- 6 The customer is advised to consult a qualified professional or technician prior to purchasing materials for specialized construction system items. Some items including but not limited to caseworks, doors and windows may require as built measurements prior to purchase to confirmation of final dimensions.
- 7 If there are additional trim elements or specific installation methods, the total amount of materials needed might vary. Consider any additional trim required for corners, intersections, or other architectural details that might cause this variations before procedding to purchase and construction.

ARCHITECTURAL BOM



	Orion-Studio-Craftsman-Base								
		ARCHITECTI	JRAL MATE	RIAL SHOP	PING LIST				
No.	Item	Туре	Unit	Quantity	Unit Price	Total	Description		
	APPLIANCES								
	Refrigerator		PCS	1					
2	Range		PCS	1					
3	Washer		PCS	1					
4	Dryer		PCS	1					
5	Dish Washer		PCS	1					
6	Oven		PCS	0					
7	Microwave		PCS	0					
\triangle	CASEWORKS								
	Kitchen Cabinet		FT	15.99					
2	Laundry Cabinet		FT	2.25					
3	Vanity Cabinet		FT	2.5					
4	Medicine Cabinet		PCS	1					
	Kitchen countertop		SF	24.94					
6	Laundry Countertop		PCS	0					
7	Bathroom Countertop		SF	0					
8	Island		FT	0					
9	Peninsula		FT	0					
10	Closets		SF	24.87					
Δ	CEILING								
1	Ceiling Board	Dry Wall	SF	303					
2	Dry Wall Fastener	Screw	PCS	530.25					
3	Vapor Retarder	Polyethylene film	SF	356					
4	Vapor Retarder Fastener	Nails with washer heads	PCS	1068					
	Ceiling Board (MRD)	Moisture resistant drywall	SF	53					
	MRD Fastener		PCS	92.75					
	Ceiling Board	Marine Plywood	SF	0					
	Marine Plywood Fastener	Screw	PCS	0					
	Dry Wall Tape		FT	178					
Δ	FLOORING	-							
	Main Living Space		SF	301.2					
2	Bathroom		SF	65.6					
	STRUCTURE		1	1 22.2					
	Foundation		SF	414.4					
	WALLS EXTERIOR	1	1						
1	Exterior-Grade Plywood		SF	609					
		Self-drilling screws(100/pkt)	PKT	6.09					
	Wall Shteathing (OSB)	een anning sereme(ree, p.m.)	SF	609					
	Shteathing Fastener	Self-drilling screws(100/pkt)	PKT	6.09					
	Wall Homewrap		SF	609					
	Homewrap Fastener	Stapled fastener (200/pkt)	PKT	2.3142					
	Furring Strip	otapiou iustorior (200/pikt)	PCS	76.125					
	Furring Strip Fastener	Self-drilling screws(100/pkt)	PKT	6.09					
	Wall Paint	Son unining screws (100/pkt)	SF	609					
	Stone Copping	Masonry stone	SF	0					
	Stone Veneer	-	SF	0					
	Mortar for Stone Veneer	Masonry stone	SF SF	0					
	Wall Insulation		SF SF	1790					
	WALLS INTERIOR		SF	1790					
1	Cementitious Backer Board		SF	331					
	Kerdi membrane		SF	331					
	Kerdi membrane Fastener		SF	331					
	Wall Ceramic Tile		SF	331					
	Drywall Board	0.15.1.111	SF	709					
	Drywall Fastener	Self-drilling screws(100/pkt)	PKT	7.09					
	Wall Paint		SF	709					
	Drywall Tape		FT	133.2522951					
9	Wall Sweep		FT	65					

ARCHITECTURAL BOM



Δ	DOORS						
<u></u>	Exterior Swinging	3' - 0" X 6'-8"	PCS	1			
2		2' - 4" X 6'-8"	PCS	1			
	Interior Swinging		PCS	1			
3	Interior Swinging	3' - 0" X 6'-8"		1			
4	Interior Sliding	3' - 6" X 6'-8"	PCS	1			
5	Exterior Swinging	5' - 0" X 6'-8"	PCS	1			
6	Exterior Door Trim		FT	35			
7	Interior Door Trim		FT	133			
8	Entry Lock set			2			
9	Privacy Lock set			1			
10	Passage Lock set			2			
Δ	WINDOWS					•	
1	Awning	2' - 3" X 2'-3"	PCS	2			
2	Sliding	6' - 3" X 4'-3"	PCS	1			
3	Hung	3' - 3" X 3'-9"	PCS	2			
4	Casement	2' - 3" X 4'-3"	PCS	2			
5	Exterior Window Trim		FT	95			
6	Interior Window Trim		FT	95			
	ROOF		1	1.0	1		
1	Roof Covering		SF	528			
2	Roof Covering Fastener		PCS	264			
3	Roof Felt Paper		SF	528			
4	Roof Felt Paper Fastener		PCS	1584			
5	Roof Sheathing		SF	528			
6	Roof Sheathing Fastener		PCS	4224			
7	Batten		FT	0			
8	Batten Fastener	+	PCS	0			
9	Soffit		SF	88			
	Soffit Fastener		PCS	44			
	Fascia		FT	92			
	Fascia board fastener		PCS	46			
13	Roof Insulation		SF	528			



	Orio	n-Studio-Craftsmar	n-Base		
	ELECTRIC	AL MATERIAL SHO	PPING LIS	T	
No.	Item	Type		Quantity	Description
Δ	LIGHTING FIXTURES				
1	Kitchen Ceiling Light		PCS	4	
2	Kitchen Wall Mounted Light		PCS	1	
3	Exterior Wall Mounted Light		PCS	4	
4	Livingroom Ceiling Light With Fan		PCS	1	
5	Bedroom Ceiling Light With Fan		PCS	0	
6	Dining Ceiling Light		PCS	0	
7	Bath Wall Mounted Light		PCS	1	
8	Bathroom Ceiling Light		PCS	2	
9	Livingroom Ceiling Light		PCS	4	
10	Bedroom Ceiling Light		PCS	0	
11	Hall & Entry Ceiling Light		PCS	2	
12	Closet Ceiling Light		PCS	1	
	Smoke Detector		PCS	0	
<u>13</u>	ELECTRICAL FITTINGS		, 00	0	
14	Standard Receptacle 120V	20A	PCS	6	
	GFCI Receptacle 120V	20 A	PCS	12	
	GFCI Receptacle 120V	30 A	PCS	2	
16		50 A			
17	GFCI Receptacle 240V		PCS	1	
18	GFCI Receptacle 240V	60 A	PCS	1	
19	Fan Switch		PCS	1	
	Single Pole Switch		PCS	8	
	Three Way Switch		PCS	2	
22	Dimmer Switch		PCS	1	
	ELECTRICAL CONDUITS & WIRING				
	ROMEX 14 AWG	14/3/W/ground	FT	26	
	ROMEX 12 AWG	12/3/W/ground	FT	267	
	ROMEX 12 AWG	12/2/W/ground	FT	0	
26	ROMEX 10 AWG	10/3/W/ground	FT	0	
27	ROMEX 10 AWG	10/2/W/ground	FT	65	
28	Romex 8 AWG	8/3/W/ground	FT	0	
29	Romex 8 AWG	8/2/W/ground	FT	20	
30	ROMEX 6 AWG	6/3/W/ground	FT	21	
31	Bare Copper Ground Wire 6 AWG		FT	0	
Δ	ELECTRICAL BOXES & CIRCUTES				
32	Panelboard -240V 1 Phase MLO	200 AMP	PCS	1	
	Circuit breaker	15 A	PCS	1	
	Circuit breaker	20 A	PCS	10	
	Circuit breaker	30 A	PCS	2	
	Circuit breaker	50 A	PCS	1	
	Circuit breaker	60 A	PCS	1	
	Single Gang Switch Box		PCS	4	
	Double Gang Switch Box		PCS	2	
	Triple Gang Switch Box		PCS	1	
	Pull Box	#1/4	PCS	13	
	Receptacle Box	# 11 T	PCS	22	



		Orion-Studio	o-Craftsm	an-Base			
	P	LUMBING SYSTEM I	MATERIAL	SHOPPII	NG LIST		
Vo.	Item	Туре	Unit	Quantity	Unit Price	Total	Description
	PLUMBING FIXTURES & ACCESSORIES						
	Bath Tub (Alcove Tub)		PCS	0			
	Kitchen Sink		PCS	1			
3	Kitchen Faucets		PCS	1			
4	Vanity Sink		PCS	1			
5	Bath room Faucets		PCS	1			
6	Water Closet		PCS	1			
7	Shower Trim		PCS	1			
8	Shower Tray		PCS	1			
9	Water Heater		PCS	1			
10	Hose Bib		PCS	1			
11	Shutoff Valve		PCS	6			
12	Hanging pipe clamp		PCS	12			
	Gate Valve		PCS	1			
14	Dishwasher Supply Single Connector		PCS	1			
	Dishwasher Sewage Single Connector		PCS	1			
	Laundry Sweat Connector		PCS	1			
	SANITARY & PLUMBING PIPES						
1	ABS (Acrylonitrile Butadiene Styrene) Pipes	ø 1"	FT	0			
2	ABS (Acrylonitrile Butadiene Styrene) Pipes	ø 1 1/2"	FT	23			
3	ABS (Acrylonitrile Butadiene Styrene) Pipes	ø 2"	FT	50			
4	ABS (Acrylonitrile Butadiene Styrene) Pipes	ø 3"	FT	19			
5	PEX (Cross-linked polyethylene) Pipes	ø 1/2"	FT	68			
	PEX (Cross-linked polyethylene) Pipes	ø 3/4"	FT	42			
	PEX (Cross-linked polyethylene) Pipes	ø 1"	FT	0			
8	PVC Pipes Sch.80 - Rigid	ø 1 1/2"	FT	0			
	PVC Pipes Sch.80 - Rigid	ø 2"	FT	44			
	PVC Pipes Sch.80 - Rigid	ø 3"	FT	0			
	Flex Pipe Round	ø 1/2"	PCS	8			
	PIPE FITTINGS	W 112	1 00				
	PEX 90 Degree Elbow	1/2"ø-1/2"ø	PCS	12			
	PEX 90 Degree Elbow	3/4"ø-3/4"ø	PCS	4			
	PEX Tee Elbow	1/2"ø-1/2"ø-1/2"ø	PCS	2			
	PEX Tee Elbow	3/4"ø-3/4"ø-3/4"ø	PCS	5			
	PEX Transition Elbow	1"ø-3/4"ø	PCS	2			
	PEX Transition Elbow	3/4"ø-1/2"ø	PCS	4			
	PEX 90 Degree Elbow	1/2"ø-1/2"ø	PCS	11			
	PEX 90 Degree Elbow	3/4"ø-3/4"ø	PCS	2			
9	PEX Tee Elbow	1/2"ø-1/2"ø-1/2"ø	PCS	2			
	PEX Tee Elbow	3/4"ø-3/4"ø-3/4"ø	PCS	2			
			PCS	3			
	PEX Transition Elbow PVC 90 Deg Bend Elbow	3/4"ø-1/2"ø 2"ø-2"ø	PCS	18			
	ABS 90 Degree Bend Elbow	2"ø-2"ø	PCS	2			
	ABS 90 Degree Bend Elbow	3"ø-3"ø	PCS	2			
	ABS P-Trap	1 1/2"ø-1 1/2"ø	PCS	3			
	ABS P-Trap	2"ø-2"ø	PCS	2			
	ABS Reducer Elbow	2"ø-1 1/2"ø	PCS	1			
	ABS Reducer Elbow	3"ø-1 1/2"ø	PCS	2			
	ABS Reducer Elbow	3"ø-2"ø	PCS	1			
	ABS TEE Elbow	1 1/2"ø-1 1/2"ø-1 1/2"ø	PCS	1			
	ABS TEE Elbow	2"ø-2"ø-2"ø	PCS	4			
	ABS TEE Elbow	3"ø-3"ø-3"ø	PCS	3			
	ABS Tee Reducer Elbow	3"ø-3"ø-1 1/2"ø	PCS	1			
	ABS Tee Reducer Elbow	3"ø-3"ø-2"ø	PCS	1			
	ABS 90 Degree Bend Elbow	1 1/2"ø-1 1/2"ø	PCS	1			
	ABS TEE Elbow	1 1/2"ø-1 1/2"ø-1 1/2"ø	PCS	1			
27	ABS Vent Cap Elbow	1 1/2"ø	PCS	1			
28	ABS Vent Cap Elbow	2"ø	PCS	3			



		Orion-Stud	io-Crafts	sman-Bas	se		
		HVAC SYSTEM MA	ATERIAL	SHOPP	ING LIST		
No.	Item	Туре	Unit	Quantity	Unit Price	Total	Description
	HVAC_DUCTS						
1	PIPE (REFRIGERANT LINE)	1/4" Ø	FT	0.8			
2	PIPE (REFRIGERANT LINE)	3/8" Ø	FT	96.46			
3	PIPE (REFRIGERANT LINE)	1/2" ø	FT	0.82			
4	PIPE (REFRIGERANT LINE)	3/4" Ø	FT	120.43			
5	DRAYER HOSE	5" Ø	FT	4			
6	FLEX DUCT ROUND	4"	FT	5.19			
	DUCT FITTINGS & ACCESSORIES						
7	ELBOW (REFRIGERANT LINE)	1/2" (Ø)-1/2" (Ø)	PCS	1			
8	ELBOW (REFRIGERANT LINE)	1/4" (Ø)-1/4" (Ø)	PCS	1			
9	ELBOW (REFRIGERANT LINE)	3/4" (Ø)-3/4" (Ø)	PCS	30			
10	ELBOW (REFRIGERANT LINE)	3/8" (Ø)-3/8" (Ø)	PCS	18			
11	TRANSITION (REFRIGERANT	3/4" (Ø)-1/2" (Ø)	PCS	5			
12	TRANSITION (REFRIGERANT	3/4" (Ø)-3/8" (Ø)	PCS	4			
13	TRANSITION (REFRIGERANT	3/8" (Ø)-1/4" (Ø)	PCS	1			
14	TEE (REFRIGERANT LINE)	3/4" (Ø)-3/4" (Ø)-3/4" (Ø)	PCS	1			
15	TEE (REFRIGERANT LINE)	3/8" (Ø)-3/8" (Ø)-3/8" (Ø)	PCS	1			
16	ROUND TRANSITION(ANGLE)	45 DEGREE	PCS	5			
	HVAC_EQUIPMENTS						
17	AIR HANDLING UNIT	WALL MOUNTED	PCS	4			
18	CONDENSER	OUTDOOR UNIT	PCS	1			
19	EXHAUST FAN	75 CFM	PCS	1			
20	EXHAUST HOOD	WALL MOUNTED	PCS	1			
21	HOOD-WALL: VENT	HOOD-WALL: VENT	PCS	1			
22	DRAYER: VENT	DRAYER: VENT	PCS	1			
23	ROOF VENT	3"(Ø)	PCS	1			



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Have It Your Way!

The material types listed in this document were selected based on personal preferences. The Customer is encouraged to make changes to the material types in accordance with local customs, regulations, and personal preferences. Have It Your Way!

GENERAL NOTES

- This BOM (Bill of Materials) is prepared as a Materials Shopping List to help builders and DIYers gain a complete understanding of most if not all elements required for the complete construction of this structure, according to the original design documents provided by FrameUpNow.
- 2 All quantities and specifications are subject to change based on the final design, field measurements, availability of products and customer preferences. The customer should verify all information prior to purchasing materials.
- 3 All products and elements in the list shall conform to the International Residential Code (IRC), or any other local and international building codes, safety regulations, and standards that are applicable to the location of the structure.
- 4 If any changes are made by the customer to the list of materials specified in this document, the customer is responsible for assuring that the correct type and quantity of materials are utilized in accordance with local building codes.
- FrameUpNow, will not be held responsible for any misuse of this document, the products listed, or for deviations from the content that are made due to changes in specifications, pricing, availability, or customer preferences.
- The customer is advised to consult a qualified professional or technician prior to purchasing materials for specialized construction system items. Some items including but not limited to caseworks, doors and windows may require as built measurements prior to purchase to confirmation of final dimensions.
- 7 If there are additional trim elements or specific installation methods, the total amount of materials needed might vary. Consider any additional trim required for corners, intersections, or other architectural details that might cause this variations before procedding to purchase and construction.



			LIGHTING FIXTURES				
#	Item	Туре	Description, Manufacturer, SKU	Unit	Quantity	Unit Price	Total
1	Kitchen Ceiling Light			PCS	4		
3	Kitchen Wall Mounted Light			PCS	1		
4	Exterior Wall Mounted Light			PCS	4		
5	Livingroom Ceiling Light With Fan			PCS	1		
6	Bedroom Ceiling Light With Fan			PCS	0		
7	Dining Ceiling Light			PCS	0		
8	Bath Wall Mounted Light			PCS	1		
9	Bathroom Ceiling Light			PCS	2		
10	Livingroom Ceiling Light			PCS	4		
11	Bedroom Ceiling Light			PCS	0		
12	Hall & Entry Ceiling Light			PCS	2		
12	Closet Ceiling Light			PCS	1		
13	Smoke Detector			PCS	0		
14							
15							



			ELECTRICAL FITTINGS				
#	Item	Туре	Description, Manufacturer, SKU	Unit	Quantity	Unit Price	Total
1	Standard Receptacle 120V	20A		PCS	6		
2	GFCI Receptacle 120V	20 A		PCS	12		
3	GFCI Receptacle 240V	30 A		PCS	2		
1	GFCI Receptacle 240V	50 A		PCS	1		
5	GFCI Receptacle 240V	60 A		PCS	1		
5	Fan Switch			PCS	1		
7	Single Pole Switch			PCS	8		
3	Three Way Switch			PCS	2		
)	Dimmer Switch			PCS	1		
LO		'					
11							
12							
13							
14							
15							



		ELECTR	ICAL CONDUITS & WIRING				
#	Item	Туре	Description, Manufacturer, SKU	Unit	Quantity	Unit Price	Total
1	ROMEX 14 AWG	14/3/W/ground		FT	26		
3	ROMEX 12 AWG	12/3/W/ground		FT	267		
4	ROMEX 12 AWG	12/2/W/ground		FT	0		
6	ROMEX 10 AWG	10/3/W/ground		FT	0		
8	ROMEX 10 AWG	10/2/W/ground		FT	65		
9	Romex 8 AWG	8/3/W/ground		FT	0		
10	Romex 8 AWG	8/2/W/ground		FT	20		
11	ROMEX 6 AWG	6/2/W/ground		FT	21		
12	Bare Copper Ground Wire 6 AWG			FT			
13							
14							
15							
16							



		ELEC	CTRICAL BOXES & CIRCUTES				
#	Item	Туре	Description, Manufacturer, SKU	Unit	Quantity	Unit Price	Total
1	Panelboard -240V 1 Phase MLO	200 AMP		PCS	1		
2	Circuit breaker	15 A		PCS	1		
3	Circuit breaker	20 A		PCS	10		
4	Circuit breaker	30 A		PCS	2		
5	Circuit breaker	50 A		PCS	1		
6	Circuit breaker	60 A		PCS	1		
7	Single Gang Switch Box			PCS	4		
8	Double Gang Switch Box			PCS	2		
9	Triple Gang Switch Box			PCS	1		
10	Pull Box	#1/4		PCS	13		
11	Receptacle Box			PCS	22		
12							
13							
14							
15							



			HVAC_DUCTS 01				
#	Item	Туре	Description, Manufacturer, SKU	Unit	Quantity	Unit Price	Total
1	PIPE (REFRIGERANT LINE)			FT	47.11		
2	PIPE (REFRIGERANT LINE)	3/4''' (Ø)		FT	54		
3	DRAYER HOSE	4" (Ø)		FT	3.8		
4	FLEX DUCT ROUND	4" (Ø)		FT	4.51		



		DUCT FITTINGS & ACCESSORIES				
‡ Item	Туре	Description, Manufacturer, SKU	Unit	Quantity	Unit Price	Total
ELBOW (REFRIGERANT LINE)	3/4" (Ø)-3/4" (Ø)		PCS	12		
ELBOW (REFRIGERANT LINE)	3/8" (Ø)-3/8" (Ø)		PCS	13		
TRANSITION (REFRIGERANT LINE)	3/4" (Ø)-1/2" (Ø)		PCS	2		
TRANSITION (REFRIGERANT LINE)	3/4" (Ø)-5/8" (Ø)		PCS	1		
TRANSITION (REFRIGERANT LINE)	3/8" (Ø)-1/4" (Ø)		PCS	1		



			HVAC_EQUIPMENTS				
#	Item	Туре	Description, Manufacturer, SKU	Unit	Quantity	Unit Price	Total
1	AIR HANDLING UNIT	WALL MOUNTED		PCS	1		
2	CONDENSER	OUTDOOR UNIT		PCS	1		
3	EXHAUST FAN	75 CFM		PCS	1		
4	EXHAUST HOOD	WALL MOUNTED		PCS	1		
5	HOOD-WALL: VENT	HOOD-WALL: VENT		PCS	1		
6	DRAYER: VENT	DRAYER: VENT		PCS	1		
7	ROOF VENT	3"(Ø)		PCS	1		
8							
9							
10							
11							
12							
13							
14							



		PLUMBII	NG FIXTURES & ACCESSORIES				
#	Item	Туре	Description, Manufacturer, SKU	Unit	Quantity	Unit Price	Total
1	Bath Tub (Alcove Tub)			PCS	0		
2	Kitchen Sink			PCS	1		
3	Kitchen faucets			PCS	1		
4	Vanity Sink			PCS	1		
5	Bath room faucets			PCS	1		
6	Water Closet			PCS	1		
7	Shower Trim			PCS	1		
8	Shower Tray			PCS	1		
9	Water Heater			PCS	1		
10	Hose Bib			PCS	1		
11	Shutoff Valve			PCS	6		
12	Hanging pipe clamp			PCS	12		
13	Gate Valve			PCS	1		
14	Dishwasher Supply Single Connector			PCS	1		
15	Dishwasher Sewage Single Connector			PCS	1		
16	Laundry Sweat Connector			PCS	1		



		SANI	TARY & PLUMBING PIPES				
#	Item	Туре	Description, Manufacturer, SKU	Unit	Quantity	Unit Price	Total
1	ABS (Acrylonitrile Butadiene Styrene) Pipes	ø 1"		FT	C		
2	ABS (Acrylonitrile Butadiene Styrene) Pipes	ø 1 1/2"		FT	23		
3	ABS (Acrylonitrile Butadiene Styrene) Pipes	ø 2"		FT	50		
4	ABS (Acrylonitrile Butadiene Styrene) Pipes	ø 3"		FT	19		
5	PEX (Cross-linked polyethylene) Pipes	ø 1/2"		FT	68		
6	PEX (Cross-linked polyethylene) Pipes	ø 3/4"		FT	42		
7	PEX (Cross-linked polyethylene) Pipes	ø 1"		FT	C		
8	PVC Pipes Sch.80 - Rigid	ø 1 1/2"		FT	C		
9	PVC Pipes Sch.80 - Rigid	ø 2"		FT	44		
10	PVC Pipes Sch.80 - Rigid	ø 3"		FT	C		
11	Flex Pipe Round	ø 1/2"		PCS	8		
12							
13							
14							
15							



		Р	IPE FITTINGS 01				
#	Item	Туре	Description, Manufacturer, SKU	Unit	Quantity	Unit Price	Total
1	ABS 90 Deg Bend Elbow	3"ø-3"ø		PCS	1		
2	ABS 90 Degree Bend Elbow	1 1/2"ø-1 1/2"ø		PCS	2		
3	ABS 90 Degree Bend Elbow	2"ø-2"ø		PCS	2		
4	ABS P-Trap	1 1/2"ø-1 1/2"ø		PCS	3		
5	ABS P-Trap	2"ø-2"ø		PCS	2		
6	ABS Reducer Elbow	2"ø-1 1/2"ø		PCS	1		
7	ABS Reducer Elbow	3"ø-2"ø		PCS	1		
8	ABS TEE Elbow	2"ø-2"ø-2"ø		PCS	1		
9	ABS TEE Elbow	3"ø-3"ø-3"ø		PCS	2		
10	ABS Tee Reducer Elbow	3"ø-3"ø-1 1/2"ø		PCS	2		
11	ABS Tee Reducer Elbow	3"ø-3"ø-2"ø		PCS	1		
12	ABS Vent Cap Elbow	2"Ø		PCS	2		
13	ABS Vent Cap Elbow	3"ø		PCS	1		
14	PEX 90 Degree Elbow	1/2"ø-1/2"ø		PCS	23		
15	PEX 90 Degree Elbow	3/4"ø-3/4"ø		PCS	4		



		PII	PE FITTINGS 02				
#	Item	Туре	Description, Manufacturer, SKU	Unit	Quantity U	nit Price Total	
1	PEX Tee Elbow	1/2"ø-1/2"ø-1/2"ø		PCS	7		
2	PEX Tee Elbow	3/4"ø-3/4"ø-3/4"ø		PCS	4		
3	PEX Transition Elbow	1"ø-3/4"ø		PCS	2		
4	PEX Transition Elbow	3/4"ø-1/2"ø		PCS	4		
5	PVC 90 Deg Bend Elbow	2"ø-2"ø		PCS	6		
6	WASTE DOUBLE TEE	2"ø-2"ø-2"ø		PCS	1		
7							
8							
9							
10							
11							
12							
13							
14							
15							



			APPLIANCES				
#	Item	Туре	Description, Manufacturer, SKU	Unit	Quantity	Unit Price	Total
1	Refrigerator			PCS			
2	Range			PCS			
3	Washer Front Load	Stackable		PCS			
4	Dryer Front Load	Stackable		PCS			
5	Dish Washer			PCS			
6	Oven			PCS	(
7	Microwave			PCS	(
8							
9							
10							
11							
12							
13							
14							
15							
16							



			CASEWORKS 01				
#	Item	Туре	Description, Manufacturer, SKU	Unit	Quantity	Unit Price	Total
1	Kitchen Cabinet			FT	15.99		
2	Laundry Cabinet			FT	2.25		
3	Vanity Cabinet			FT	2.5		
4	Medicine Cabinet			PCS	1		
5	Kitchen countertop			SF	24.94		
6	Laundry Countertop			PCS	0		
7	Bathroom Countertop			SF	0		
8	Island			FT	0		
9	Peninsula			FT	0		
10	Closets			SF	24.87		
11							
12							
13							
14							
15							



			CEILING 01				
#	Item	Туре	Description, Manufacturer, SKU	Unit	Quantity	Unit Price	Total
	STUDIO AREA			SF	274.0		
1	Ceiling Board	Drywall		SF	274		
2	Drywall Fastener	Screw		PCS	480		
3	Vapor Retarder	Polyethylene film		SF	274		
4	Vapor Retarder Fastener	Nails with washer heads		PCS	822		
	BATHROOM			SF	53.0		
5	Ceiling Board	MRD (Moisture resistant drywall)		SF	53		
6	MRD Fastener	Screw		PCS	93		
	W/H			SF	7.0		
7	Ceiling Board	Drywall		SF	7		
8	Drywall Fastener	Screw		PCS	12		
9	Vapor Retarder	Polyethylene film		SF	7		
10	Vapor Retarder Fastener	Nails with washer heads		PCS	21		



			CEILING 02				
#	Item	Туре	Description, Manufacturer, SKU	Unit	Quantity	Unit Price	Total
	W/D			SF	10.0		
11	Ceiling Board	Drywall		SF	10		
12	Drywall Fastener	Screw		PCS	18		
13	Vapor Retarder	Polyethylene film		SF	10		
14	Vapor Retarder Fastener	Nails with washer heads		PCS	30		
	CLOSET			SF	12.0		
15	Ceiling Board	Drywall		SF	12		
16	Drywall Fastener	Screw		PCS	21		
17	Vapor Retarder	Polyethylene film		SF	12		
18	Vapor Retarder Fastener	Nails with washer heads		PCS	36		
	HALL			SF	32.0		
19	Ceiling Board	Drywall		SF	32		
20	Drywall Fastener	Screw		PCS	56		
21	Vapor Retarder	Polyethylene film		SF	32		
22	Vapor Retarder Fastener	Nails with washer heads		PCS	96		



			FLOORING INTERIOR 01				
#	Item	Туре	Description, Manufacturer, SKU	Unit	Quantity	Unit Price	Total
	CL #1						
1	Closet Flooring			SF	11		
2	Wood underlay	Foam Pad Polyethylene		SF	11		
3	Vapor Retarder	Vapor Barrier Polyethylene		SF	11		
	LIVING ROOM AND KITCHI	EN					
4	Living Area Flooring			SF	290		
5	Wood underlay	Foam Pad Polyethylene		SF	290		
6	Vapor Retarder	Vapor Barrier Polyethylene		SF	290		
	BATHROOM 1						
7	Tile Finish			SF	50		
8	Adhesive	1/2" Thin set Mortar		SF	50		
9	Vapor Retarder	Vapor Barrier Polyethylene		SF	50		



			FLOORING INTERIOR 02				
#	Item	Туре	Description, Manufacturer, SKU	Unit	Quantity	Unit Price	Total
	W/D						
10	Tile Finish			SF	Q		
11	Adhesive	1/2" Thin set Mortar		SF	Ç		
12	Vapor Retarder	Vapor Barrier Polyethylene		SF	Ç)	
	BOILER ROOM						
13	Tile Finish			SF	(
14	Adhesive	1/2" Thin set Mortar		SF	(
15	Vapor Retarder	Vapor Barrier Polyethylene		SF	(



			FLOORING EXTERIOR				
#	Item	Туре	Description, Manufacturer, SKU	Unit	Quantity	Unit Price	
	STRUCTURE			SF	414.4		
1	Concrete Slab	4"concrete cast in situ		CF	138.1		
2	Insulation	Rigid insulation		SF	165		
3	Hard core	Compacted soil		CF	104.1		
4	Re-bar	#4 re-bar		Ton	0.42		
5	Concrete Pad	4"concrete cast in situ		CF	1.58		
6	Slab edge	Turndown		CF	139.2		



			WALLS: EXTERIOR				
#	Item	Туре	Description, Manufacturer, SKU	Unit	Quantity	Unit Price	Total
1	Exterior-Grade Plywood Horizontal Siding			SF	609		
2	Exterior-Grade Plywood Fastener 8/panel	Self-drilling screws(100/pkt)		PKT	6.09		
3	Wall Shteathing (OSB)			SF	609		
4	Shteathing Fastener	Self-drilling screws(100/pkt)		PKT	6.09		
5	Wall Homewrap			SF	609		
6	Homewrap Fastener	Stapled fastener (200/pkt)		PKT	2.31		
7	Furring Strip			PCS	76.13		
8	Furring Strip Fastener	Self-drilling screws(100/pkt)		PKT	6.09		
9	Wall Paint			SF	609		
10	Stone Copping	Masonry stone		SF	0		
11	Stone Veneer	Masonry stone		SF	0		
12	Mortar for Stone Veneer			SF	0		
13	Wall Insulation			SF	1790		
14							
15							



			WALLS: INTERIOR 01				
#	Item	Туре	Description, Manufacturer, SKU	Unit	Quantity	Unit Price	Total
	BATHROOM			SF	42.0		
1	Cementitious Backer Board			SF	237		
2	Kerdi membrane			SF	237		
3	Kerdi membrane Fastener			SF	237		
4	Wall Ceramic Tile			SF	237		
	CLOSET			SF	9.0		
5	Drywall Board			SF	90		
6	Drywall Fastener	Self-drilling screws(100/pkt)		PKT	0.9		
7	Wall Paint			SF	90		
8	Drywall Tape			FT	16.9		
	HALL			SF	29.0		
9	Drywall Board			SF	130		
10	Drywall Fastener	Self-drilling screws(100/pkt)		PKT	1.3		
11	Wall Paint			SF	130		
12	Drywall Tape			FT	24.4		



			WALLS: INTERIOR 02				
#	Item	Туре	Description, Manufacturer, SKU	Unit	Quantity	Unit Price	Total
	STUDIO			SF	112.0		
13	Drywall Board			SF	249		
14	Drywall Fastener	Self-drilling screws(100/pkt)		PKT	2.49		
15	Wall Paint			SF	249		
16	Drywall Tape			FT	46.7		
	KITCHEN			SF	55.0		
17	Cementitious Backer Board			SF	21		
18	Drywall Board			SF	152		
19	Drywall Fastener	Self-drilling screws(100/pkt)		PKT	1.52		
20	Kerdi membrane			SF	21		
21	Kerdi membrane Fastener			SF	21		
22	Wall Ceramic Tile			SF	21		
23	Wall Paint			SF	152		
24	Drywall Tape			FT	28.7		



			WALLS: INTERIOR 03				
#	Item	Туре	Description, Manufacturer, SKU	Unit	Quantity	Unit Price	Total
	WD			SF	7.0		
25	Cementitious Backer Board			SF	73		
26	Kerdi membrane			SF	73		
27	Kerdi membrane Fastener			SF	73		
28	Wall Ceramic Tile			SF	73		
	WH			SF	7.0		
29	Drywall Board			SF	88		
30	Drywall Fastener	Self-drilling screws(100/pkt)		PKT	0.88		
31	Wall Paint			SF	88		
32	Drywall Tape			FT	17		
1	Wall Sweep			FT	65		



			DOORS				
#	Item	Туре	Description, Manufacturer, SKU	Unit	Quantity	Unit Price	Total
1	Exterior Swinging	3' - 0" X 6'-8"		PCS	1		
2	Interior Swinging	2' - 4" X 6'-8"		PCS	1		
3	Interior Swinging	3' - 0" X 6'-8"		PCS	1		
4	Interior Sliding	3' - 6" X 6'-8"		PCS	1		
5	Exterior Swinging	5' - 0" X 6'-8"		PCS	1		
6	Exterior Door Trim			FT	35		
7	Interior Door Trim			FT	133		
8	Entry Lock set			PCS	2		
9	Privacy Lock set			PCS	1		
10	Passage Lock set			PCS	2		



			WINDOWS				
#	Item	Туре	Description, Manufacturer, SKU	Unit	Quantity	Unit Price	Total
1	Awning	2' - 3" X 2'-3"		PCS	2		
2	Sliding	6' - 3" X 4'-3"		PCS	1		
3	Hung	3' - 3" X 3'-9"		PCS	2		
4	Casement	2' - 3" X 4'-3"		PCS	2		
5	Exterior Window Trim			FT	95		
6	Interior Window Trim			FT	95		



			ROOF 01				
#	Item	Туре	Description, Manufacturer, SKU	Unit	Quantity	Unit Price	Total
1	Roof Covering			SF	528.0		
2	Roof Covering Fastener			PCS	264		
3	Roof Felt Paper			SF	528.0		
4	Roof Felt Paper Fastener			PCS	1584.0		
5	Roof Sheathing			SF	528.0		
6	Roof Sheathing Fastener			PCS	4224		
7	Batten			FT	0.0		
8	Batten Fastener			PCS	0.0		
9	Soffit			SF	88.0		
10	Soffit Fastener			PCS	44.0		
11	Fascia			FT	92.0		
12	Fascia board fastener			PCS	46		
13	Roof Insulation			SF	528.0		
14					320.0		
15							