

ORION

The Orion is a charming Craftsman-style studio home designed for efficient and comfortable living. Its exterior showcases classic Craftsman architectural elements with a touch of rustic charm. The walls are finished with horizontal siding in a warm, earthy tone, creating a clean and traditional aesthetic. The gable end features wood shingles, adding a touch of natural texture and visual interest. A simple gable roof with a decorative trim detail at the peak provides shelter and complements the overall design. A prominent covered porch spans the front of the home, supported by substantial stone-clad pillars and a decorative pergola, creating a welcoming outdoor space.

Inside, the Orion features a simple rectangular floor plan. The living, dining, kitchen, and sleeping areas are seamlessly merged into a single large open room, maximizing the feeling of spaciousness. Functional spaces, such as the bathroom and laundry, are strategically placed at the back of the plan, out of sight, creating a clean and uncluttered living area.

Materials Shopping List

Please print and take this Materials Shopping List to your favorite Home Depot and ask for assistance in selecting the materials, fixtures and fittings to complete your new home.

Record your selection and the price of the item. Then do the math to determine the cost for your selections and the total cost of finishing your home.

< CLICK HERE >

To Go To Materials Shopping List



Side Porch Side Porch Total P

FLOOR PLAN

415 SF

Studio

overed Porch

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DISCLAIMER

marketing content.

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COVER SHEET

ROOF TRUSS LAYOUT

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ARCHITECTURAL ELEVATIONS

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MATERIALS SHOPPING LIST

ABOUT



FrameUpNow is a design and manufacturing company providing precision-engineered home framing solutions. We offer a catalog of Affordable Homes, Tiny Homes, Garages, Shops and Barndominiums. FrameUpNow manufactures cold-formed steel (CFS) also known as Light Gauge Steel (LGS) framing components that conform to our engineered metal house frame plans or can be purchased as DIY skeleton kits.

The CFS/LGS framing is lightweight, easily assembled, and does not require heavy equipment or specialized labor, enabling homeowners to erect the frame themselves in just a few days. Unlike wood, the steel framing is impervious termites and bores, warping, expansion, and fire.

Our home plans come complete with a structural engineered stamp for permit approvals. Customers receive a full BOM also known as a Materials Shopping List to purchase finish materials from a Building Materials retailer. FrameUpNow prides itself on the quality and efficiency of our precision-engineered home framing solutions for construction professionals and DIY homeowners.



KEY PLAN

NO.	DESCRIPTION	DATE
	•	

NOTE:

LEGEND:

PROJECT

121-Orion-415-Studio-Craftsman-Porch-550

DRAWING NAME

INTRODUCTION

CLIENT NAME:	
PROJECT NUMBER:	
DATE:	
DESIGNED BY:	
DRAWN BY:	
CHECKED BY:	

I101

SCALE:

DESCRIPTIONS

MATERIALS LIST

The BOM (Bill Of Materials) package, known as the Materials Shopping List document, provides:

Comprehensive Inventory: Detailed lists of essential materials sourced from architectural, mechanical, HVAC, electrical, and plumbing design drawing sets.

Precise Curation: Each item meticulously selected and organized for accuracy and efficiency in project planning.

Customizable Options: Customers can modify listed items to their preferences and calculate costs accordingly, ensuring alignment with personal project needs and budget.

Dedicated Space for Details: Includes tables for customers to note Home Depot SKU numbers or product descriptions for selected items, facilitating seamless purchasing and coordination with suppliers.

Customer Convenience: Take the list to Home Depot or preferred suppliers for accurate pricing, helping align the total home budget with personal financial plans.

Simplify your construction journey with our Materials Shopping List document, where detailed preparation meets streamlined implementation for your dream home.

STRUCTURAL

The structural drawings package provides an exhaustive set of detailed plans essential for the precise assembly of your building. This comprehensive package includes:

Framing Plans: Detailed layouts for all framing components. Truss Layouts: Clear instructions for truss placement and

Panel Length Plans: Specifications for panel dimensions. Framing Elevations and Sections: Precise elevation and sectional views for accurate construction.

Truss and Wall Blocking Plans: Plans for truss and wall blocking to ensure structural integrity.

Hold-Down Plan: Detailed hold-down requirements for stability. Snap Sheet: Reference sheet for quick identification of components

Structural Details and Bracing Plans: Complete details and bracing plans for all structural elements.

Accompanying these plans is a comprehensive Bill of Materials (BOM) that lists every necessary building component, from cold formed steel (CFS) frames to fasteners.

ARCHITECTURAL

With the comprehensive architectural package, both builders and DIY homeowners can confidently execute the construction.

The architectural package includes:

Furnished Floor Plans: Complete with furniture layouts for a clear understanding of space utilization.

Detailed Dimension Plans: Ensures precise measurements, from the overall footprint down to the exact placement of windows and

Foundation Plan: Detailed plan to establish a solid foundation.

Wall Framing and Truss Layout: Comprehensive plans for wall framing and truss placement.

Architectural Elevations: Exterior views showcasing the design.

Strategic Building Sections: Critical cross-sectional details for a thorough understanding of the build.

Casework Drawings and Diagrams: Suggested designs for built-in caseworks, such as kitchen cabinets.

MECHANICAL ELECTRICAL

Description, Manufacturer,-

For the list of materials Space provided to be Materials are listed

there will a more detail Description, Manufacturer and convenient.

description about the type SKU.

of the Material.

listed in th item column filled by informations like in a unit that is most

The plumbing package includes everything needed to guide the

Detailed Water Supply System Plan: Precisely maps out the placement of pipes, valves, and plumbing fixtures throughout the

Comprehensive Sewage System Plan: Shows the optimal routing and sizing of drain lines to effectively remove waste and ensure

Detailed Riser Diagrams: Provide information needed to properly

SANITARY & PLUMBING PIPES

ABS (Acrylonitrile Butadiene Ø 1 1/2"

ABS (Acrylonitrile Butadiene Ø 2'


ABS (Acrylonitrile Butadiene Ø 3"


Styrene) Pipes

Styrene) Pipes

PLUMBING

Bill of Materials: A complete list of every component needed, from

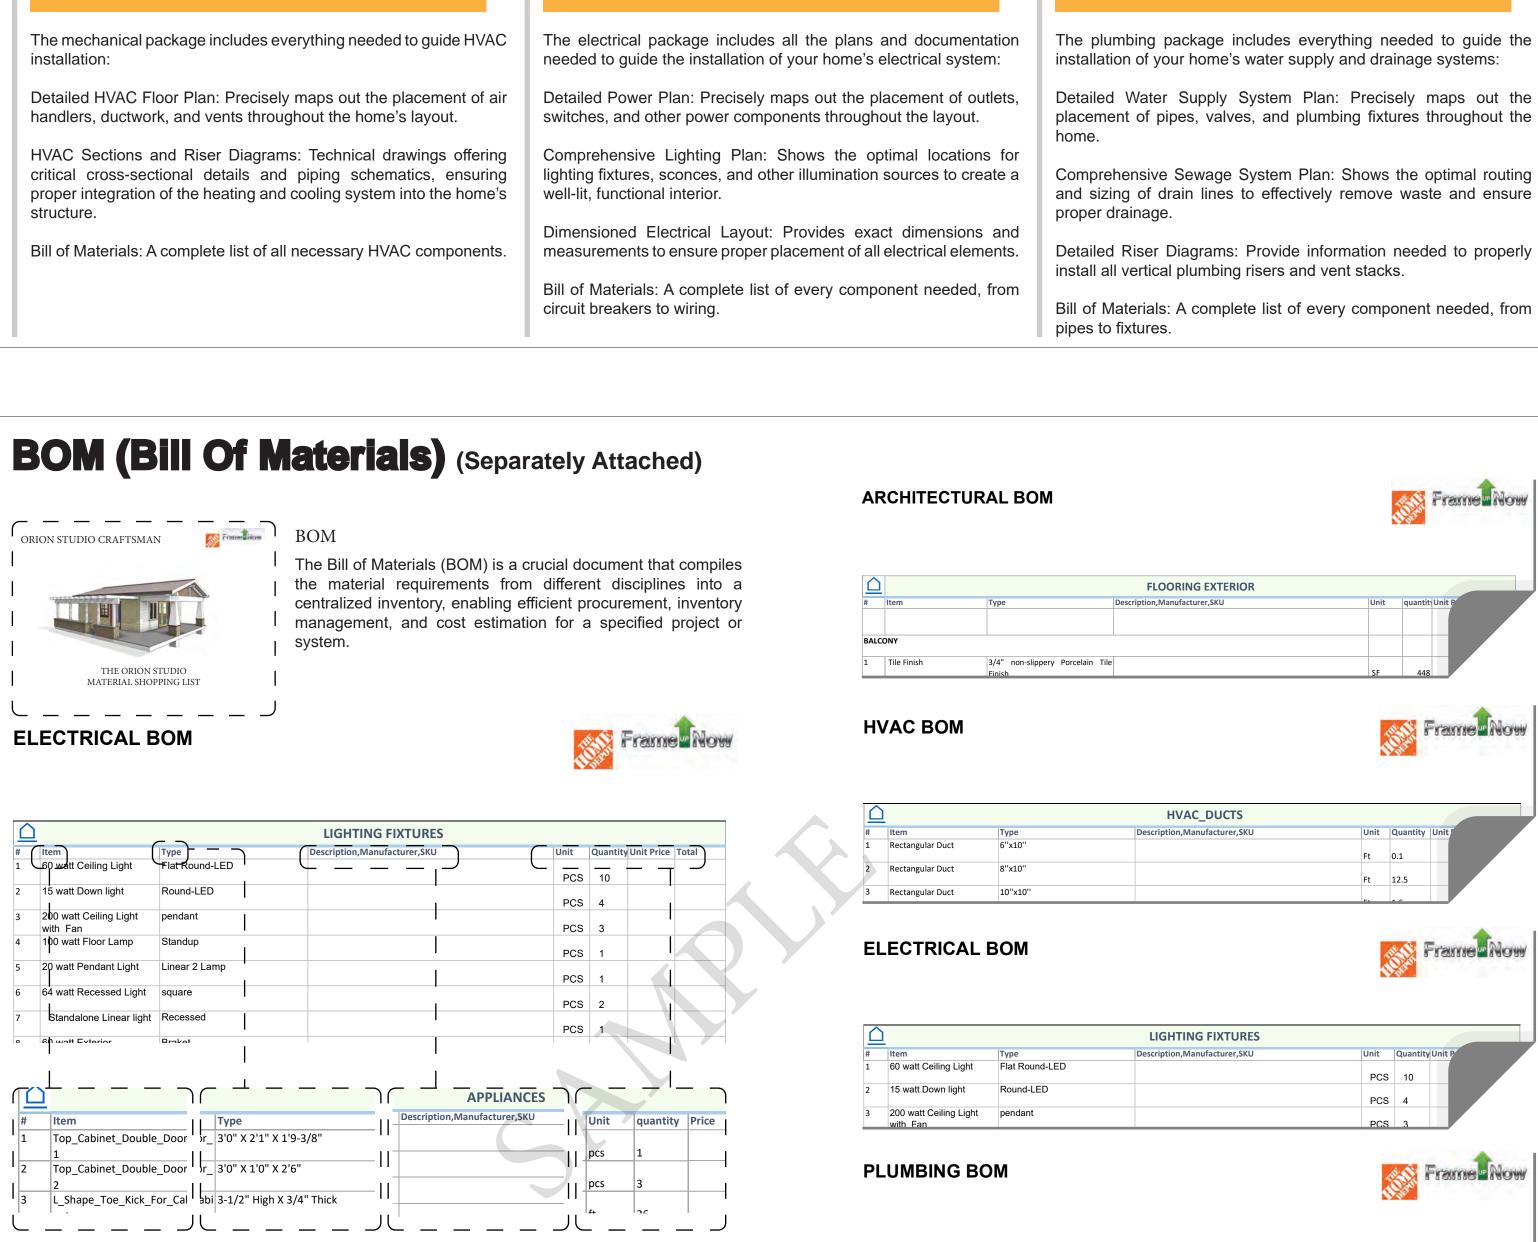

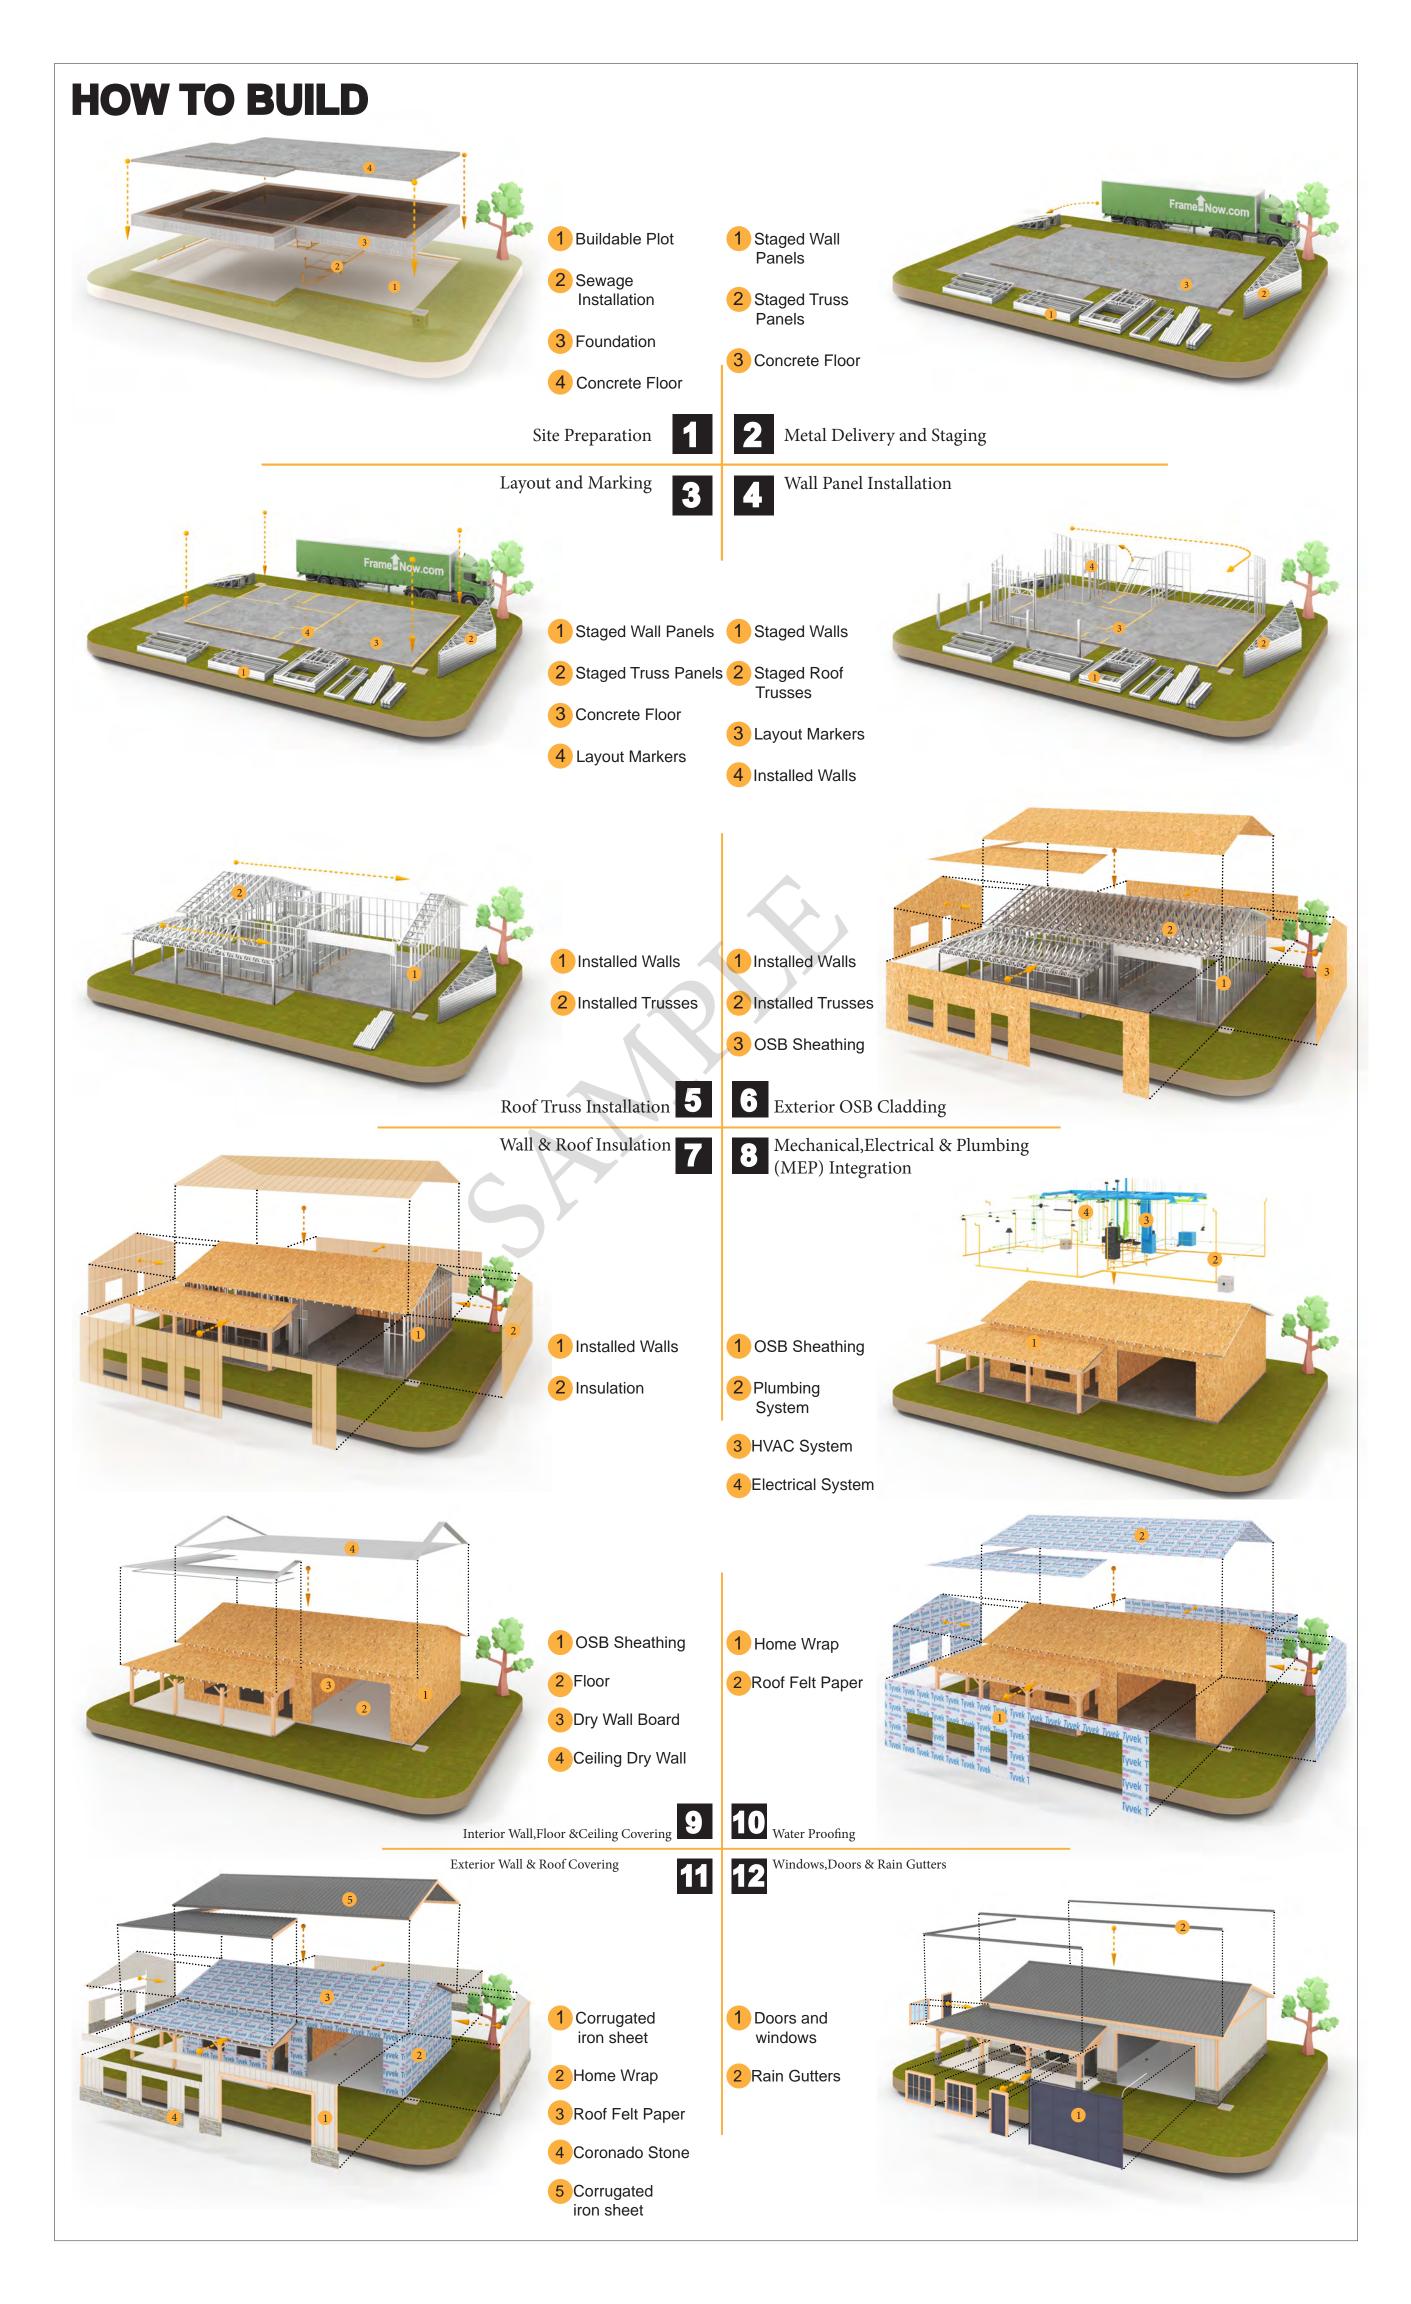



KEY PLAN

DESCRIPTION DATE

NOTE:

LEGEND:

PROJECT

121-Orion-415-Studio-Craftsman-Porch-550

DRAWING NAME

INTRODUCTION


CLIENT NAME: PROJECT NUMBER: DATE: **DESIGNED BY** DRAWN BY: CHECKED BY:

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specified in the type column.

SCALE:



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CASEWORK TAG

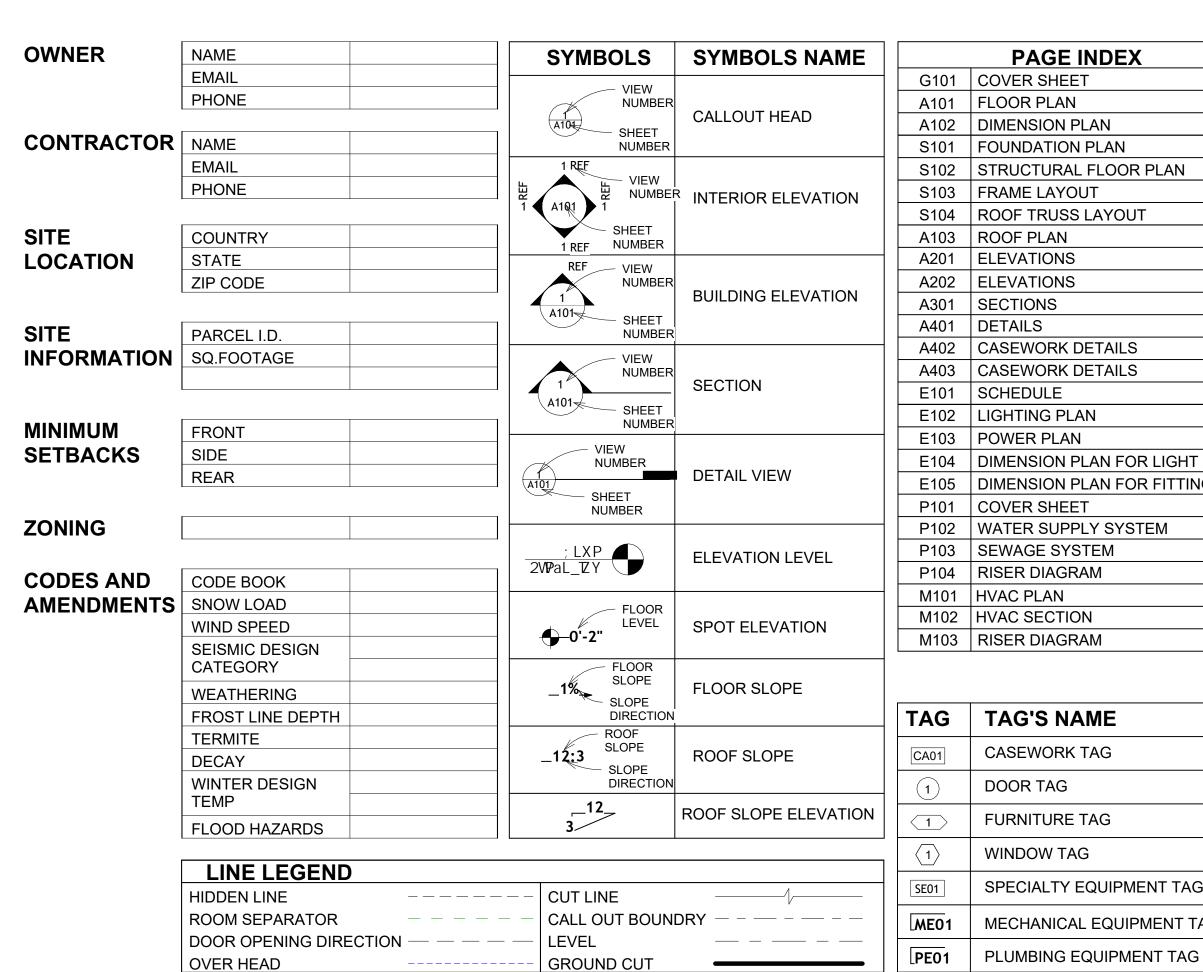FURNITURE TAG

SPECIALTY EQUIPMENT TAG

MECHANICAL EQUIPMENT TAG

WINDOW TAG

DOOR TAG

SIMP. ABE66	SIMPSON ANCHOR BOLT EDGE
TV	TELEVISION
UNO	UNLESS NOTED OTHERWISE
W/	WITH
W/D	WASHER/DRYER
AC	AIR CONDITIONING UNIT
ACC	AIR COOLED CONDENSER
ACCU	AIR COOLED CONDSENSING UNIT
AHU	AIR HANDLING UNIT
CC	COOLING COIL
CD	CEILING DIFFUSER
CFm	Cubic Feet Per Minute
CR	CEILING REGISTER
CU	CONDENSING UNIT
CW	COLD WATER
E/A	EXHAUST AIR
EF	EXHAUST FAN
ET	EXPANSION TANK
EX.	EXISTING
FC	FLEXIBLE CONNECTION
FCU	FAN COIL UNIT
FLR.	FLOOR
HC	HEATING COIL
HE	AIR TO AIR HEAT EXCHANGER
HV	HEATING AND VENTILATING UNIT
IV	INLET VANES
MER	MECHANICAL ROOM
MAX.	MAXIMUM
MIN.	MINIMUM
R/A	RETURN AIR
RCU	RECIPROCATING CHILLER UNIT
RF	RETURN FAN
S/A	SUPPLY AIR
SCD	SMOKE CONTROL DAMPER
SP	STATIC PRESSURE

ABBREVIATION

ASTM D698 | AMERICAN SOCIETY FOR

CASEWORK

ELECTRICAL

FOOTINGS

CODE

CODE

MAXIMUM

MINIMUM

NUMBER

ON CENTER

PLUMBING

REFERENCE

RIGHT GARAGE

SQUARE FEET

HOLDDOWN

SIMP. STHD8 | SIMPSON STRAP THE

MECHANICAL

CONDITIONING

F.F.E

F.F.L

HVAC

MAX.

ME

O.C

OSB

PVC

ACTION FLOOR SYSTEMS

TESTING AND MATERIAL

FINISHED FLOOR LEVEL

FINISHED FLOOR ELEVATION

HEATING, VENTILATION & AIR

INTERNATIONAL RESIDENCE


INTERNATIONAL MECHANICAL

ORIENTED STRAND BOARD

POUNDS PER SQUARE INCH


POLYVINYL CHLORIDE

SPECIAL EQUIPMENT

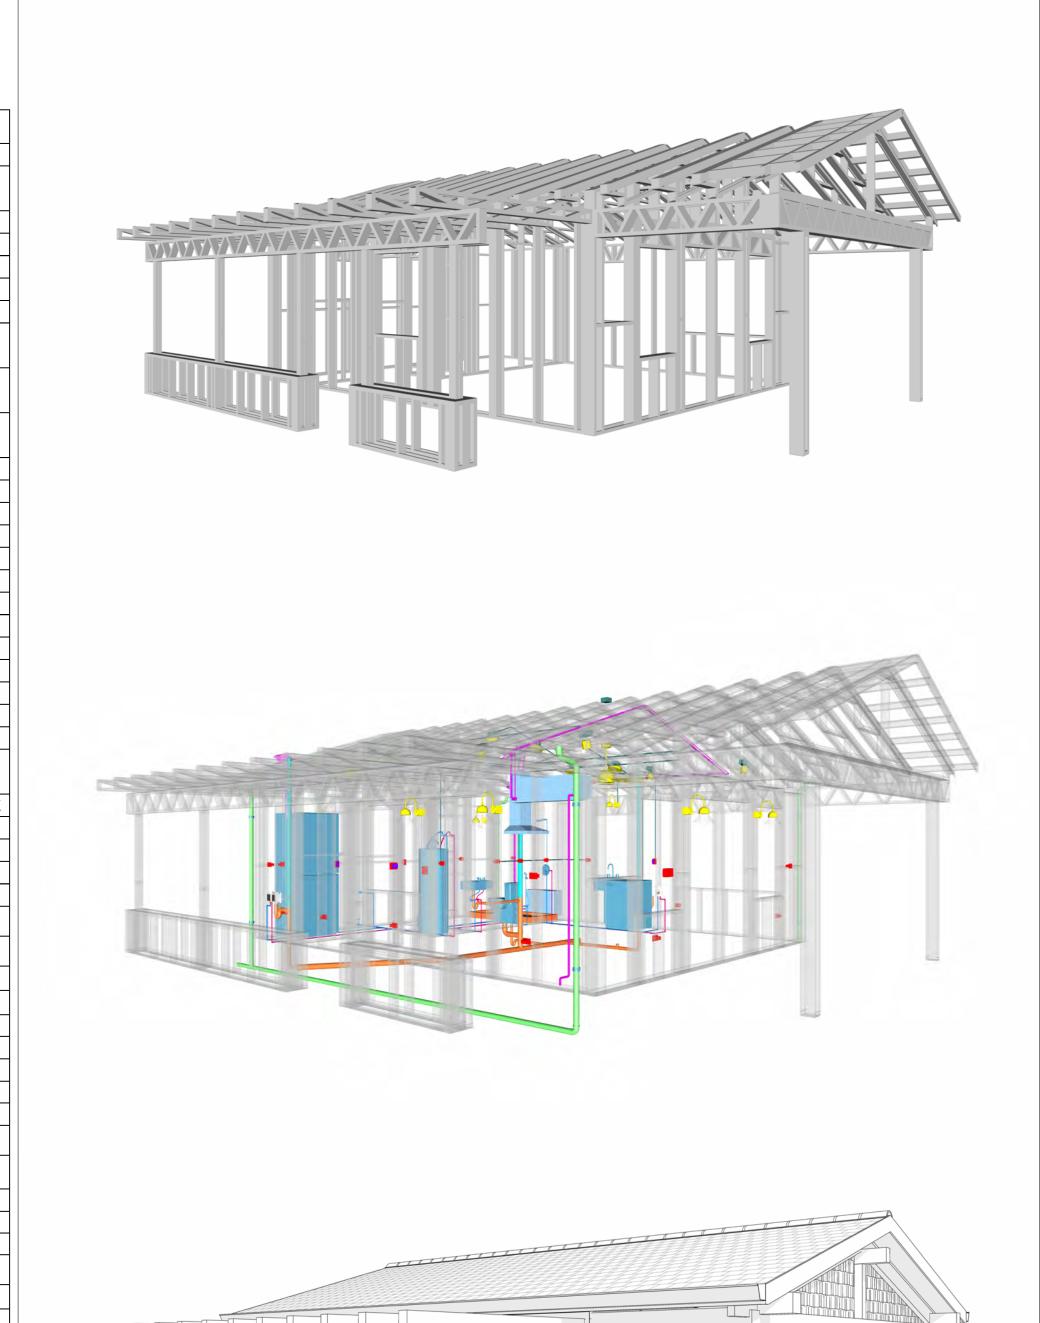



SQUARE FOOTAGE		
414		
318		
TOTAL 732		

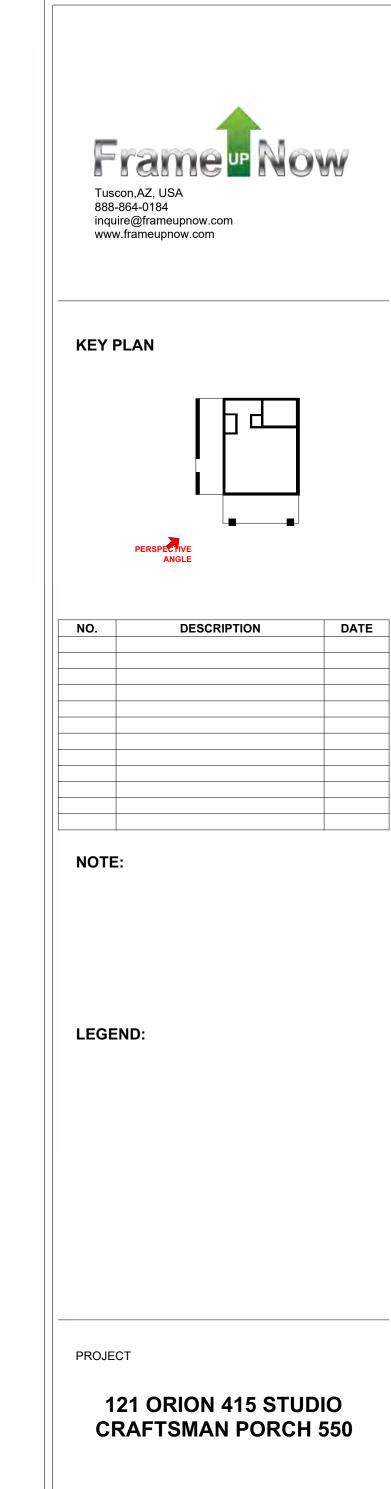

DRAWING NAME

COVER SHEET

Client Name	CLIENT NAME:
0061_12	PROJECT NUMBER:
3/21/2025 9:43:14 Al	DATE:
Designe	DESIGNED BY:
Autho	DRAWN BY:
Checker	CHECKED BY:

G101



GENERAL NOTES

- 1. THIS DRAWING DEPICTS THE ARCHITECTURAL (SPACE LAYOUT, FURNISHING, FLOOR, WALLS, ROOFS, FOUNDATION, WINDOWS AND DOORS) SYSTEMS. IT PROVIDES A VISUAL REPRESENTATION OF THE ARCHITECTURAL LAYOUT AND COMPONENTS.
- THE ARCHITECTURAL DRAWINGS ARE PREPARED TO MEET THE SPECIFIC REQUIREMENTS OF THE BUILDING, AS PER THE PROJECT SPECIFICATIONS AND APPLICABLE CODES AND STANDARDS.
- THE CONSTRUCTION OF THIS HOME SHALL COMPLY WITH THE LATEST EDITION OF THE INTERNATIONAL RESIDENTIAL CODE (IRC), INTERNATIONAL MECHANICAL CODE (IMC), THE INTERNATIONAL PLUMBING STANDARD, THE NATIONAL ELECTRICAL STANDARD AND ALL OTHER APPLICABLE LOCAL, STATE, AND NATIONAL CODES AND REGULATIONS.
- COORDINATION WITH OTHER TRADES HAS BEEN DONE ON A DESIGN LEVEL. THIS DRAWING SHALL BE READ TOGETHER WITH THE ME, EL AND PL DESIGN DRAWINGS TO ENSURE PROPER CONSTRUCTION AND INTEGRATION OF THE BUILDING SYSTEMS.

ABOUT WALLS:

SHOWER WALL COVERING

BATHTUB AND SHOWER SPACES (WALLS AND FLOORS) WITH INSTALLED SHOWER HEADS AND IN SHOWER COMPARTMENTS SHALL BE FINISHED WITH A NON-ABSORBENT SURFACE.

WALL PAINT (INTERNAL)


THE TYPICAL THICKNESS OF LATEX WALL PAINT IS 1/32 OF AN INCH FOR A SINGLE COAT. AND DOUBLE COAT (1/16") SHALL BE APPLIED FOR DURABILITY.

ADHESIVES: THE ADVISABLE TYPE OF ADHESIVE FOR THIS PROJECT IS **EPOXY ADHESIVES**BECAUSE THEY ARE KNOWN FOR THEIR HIGH STRENGTH, DURABILITY, AND RESISTANCE TO MOISTURE, CHEMICALS AND

REFER TO SHEETS A201 & A202 FOR GENERAL NOTES ON EXTERNAL FINISHING MATERIALS


ABOUT FLOORS:

- THE SPOT ELEVATION INDICATES THE FINISHED FLOOR ELEVATION.
- FINISHED FLOORS PER PLANS.
- FIELD VERIFY FOR DIMENSION DROP 4" FOR SHOWER AND BATHTUB USE.
- 1% SLOPE ON OUTDOOR BALCONIES FOR WATER RUN OFF.
- 2% SLOPE TOWARDS THE SHOWER DRAIN FOR SUFFICIENT DRAINAGE. 4" DROP AT THE DOOR LEADING TO EXTERIOR BALCONY FROM THE MAIN LIVING AREA.
- 5% SLOPE FOR GARAGE IS USED, WHICH SHOULD BE CHECKED WITH THE LOCAL GARAGING ZONING LAWS.

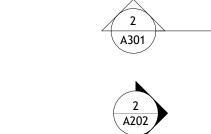

	FURNITURE SCHEDULE				
	TYPE MARK	TYPE	COUNT		
01		CLOSED - 900 X 660MM 2	1		
02		FOUR SIT 65" X 95" 2	1		
03		DINING CHAIR	2		
04		ONE SEAT SOFA	1		

	ROOM FINISH SCHEDULE						
ROOM NUMBE R	ROOM NAME	FLOOR FINISH	BASE FINISH	WALL FINISH	CEILING FINISH	CEILING HEIGHT	COMM ENTS
01	STUDIO AREA	HARDWOOD	CONCRETE	WALL PAINT	DRY WALL	8' - 0"	
02	KITCHEN	HARDWOOD	CONCRETE	WALL PAINTT + CERAMIC	DRY WALL	8' - 0"	
03	CL	HARDWOOD	CONCRETE	WALL PAINT	DRY WALL	8' - 0"	
04	WD	HARDWOOD	CONCRETE	WALL PAINT	DRY WALL	8' - 0"	
05	HALL	HARDWOOD	CONCRETE	WALL PAINT	DRY WALL	8' - 0"	
06	BATH	VINYL TILES	CONCRETE	CERAMIC TILE	MRD	8' - 0"	
07	WH	HARDWOOD	CONCRETE	WALL PAINT	DRY WALL	8' - 0"	
08	PORCH	PROCELAIN TILE	CONCRETE	EXTERIOR-GRADE PLYWOOD	PLYWOOD	8' - 0"	

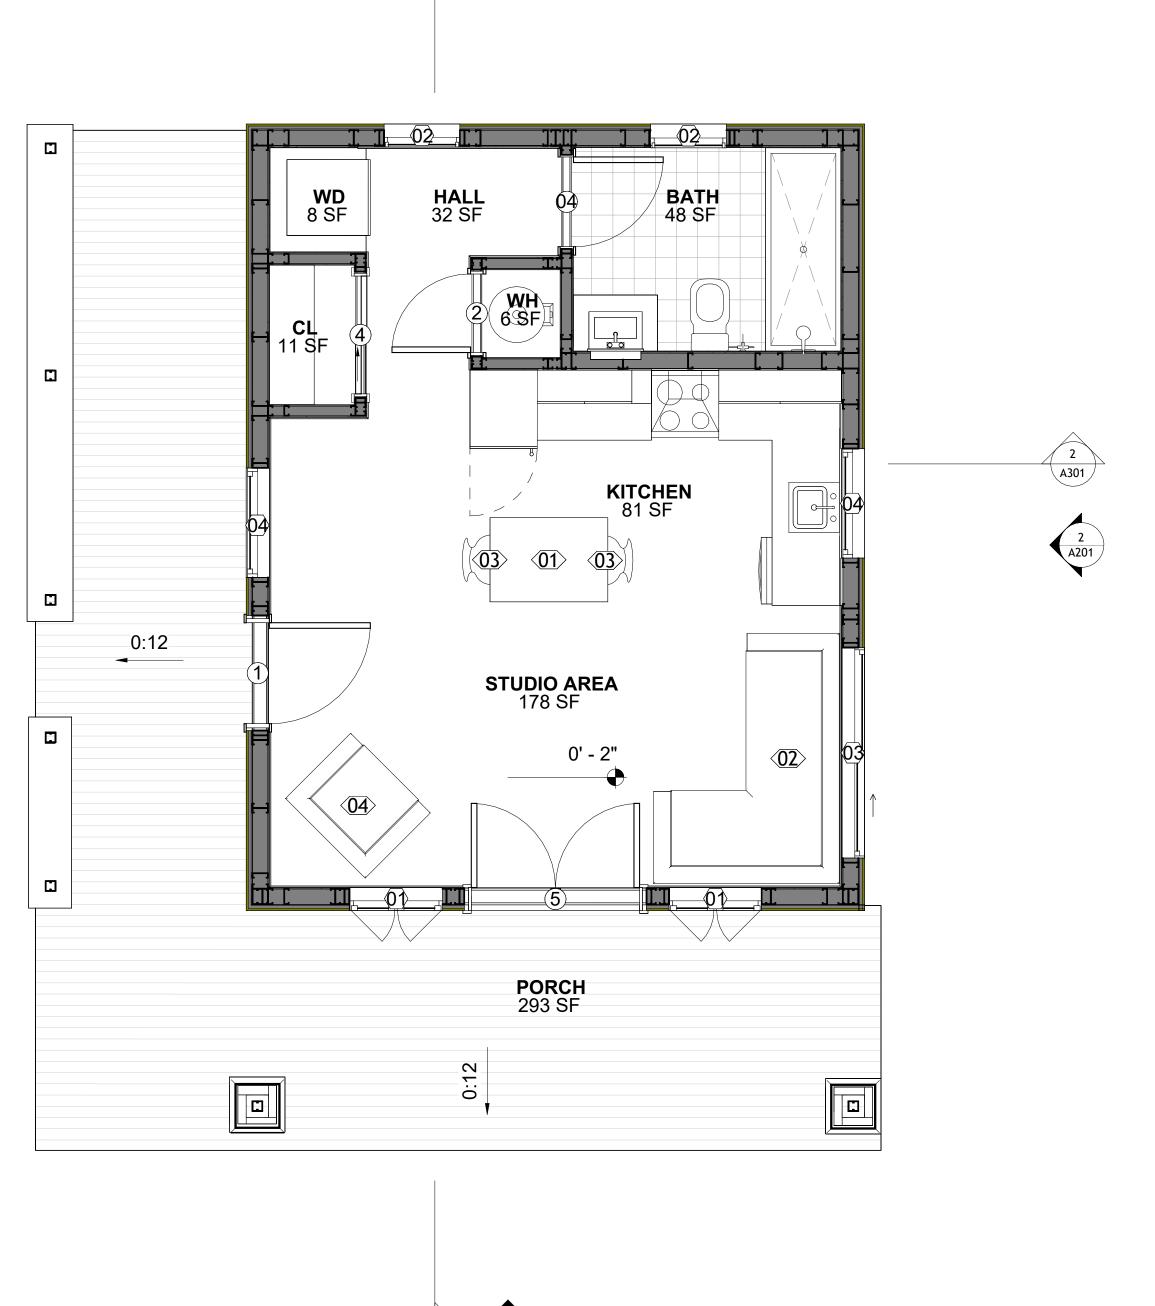



KEY PLAN

NO.	DESCRIPTION	DA
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NOTE:

LEGEND:


121 ORION 415 STUDIO CRAFTSMAN PORCH 550

DRAWING NAME

FLOOR PLAN

Client Name	CLIENT NAME:
0061_12	PROJECT NUMBER:
3/21/2025 9:43:14 A	DATE:
Designer	DESIGNED BY:
Author	DRAWN BY:
Checkei	CHECKED BY:

SQUARE FOOTAGE 318 732 TOTAL

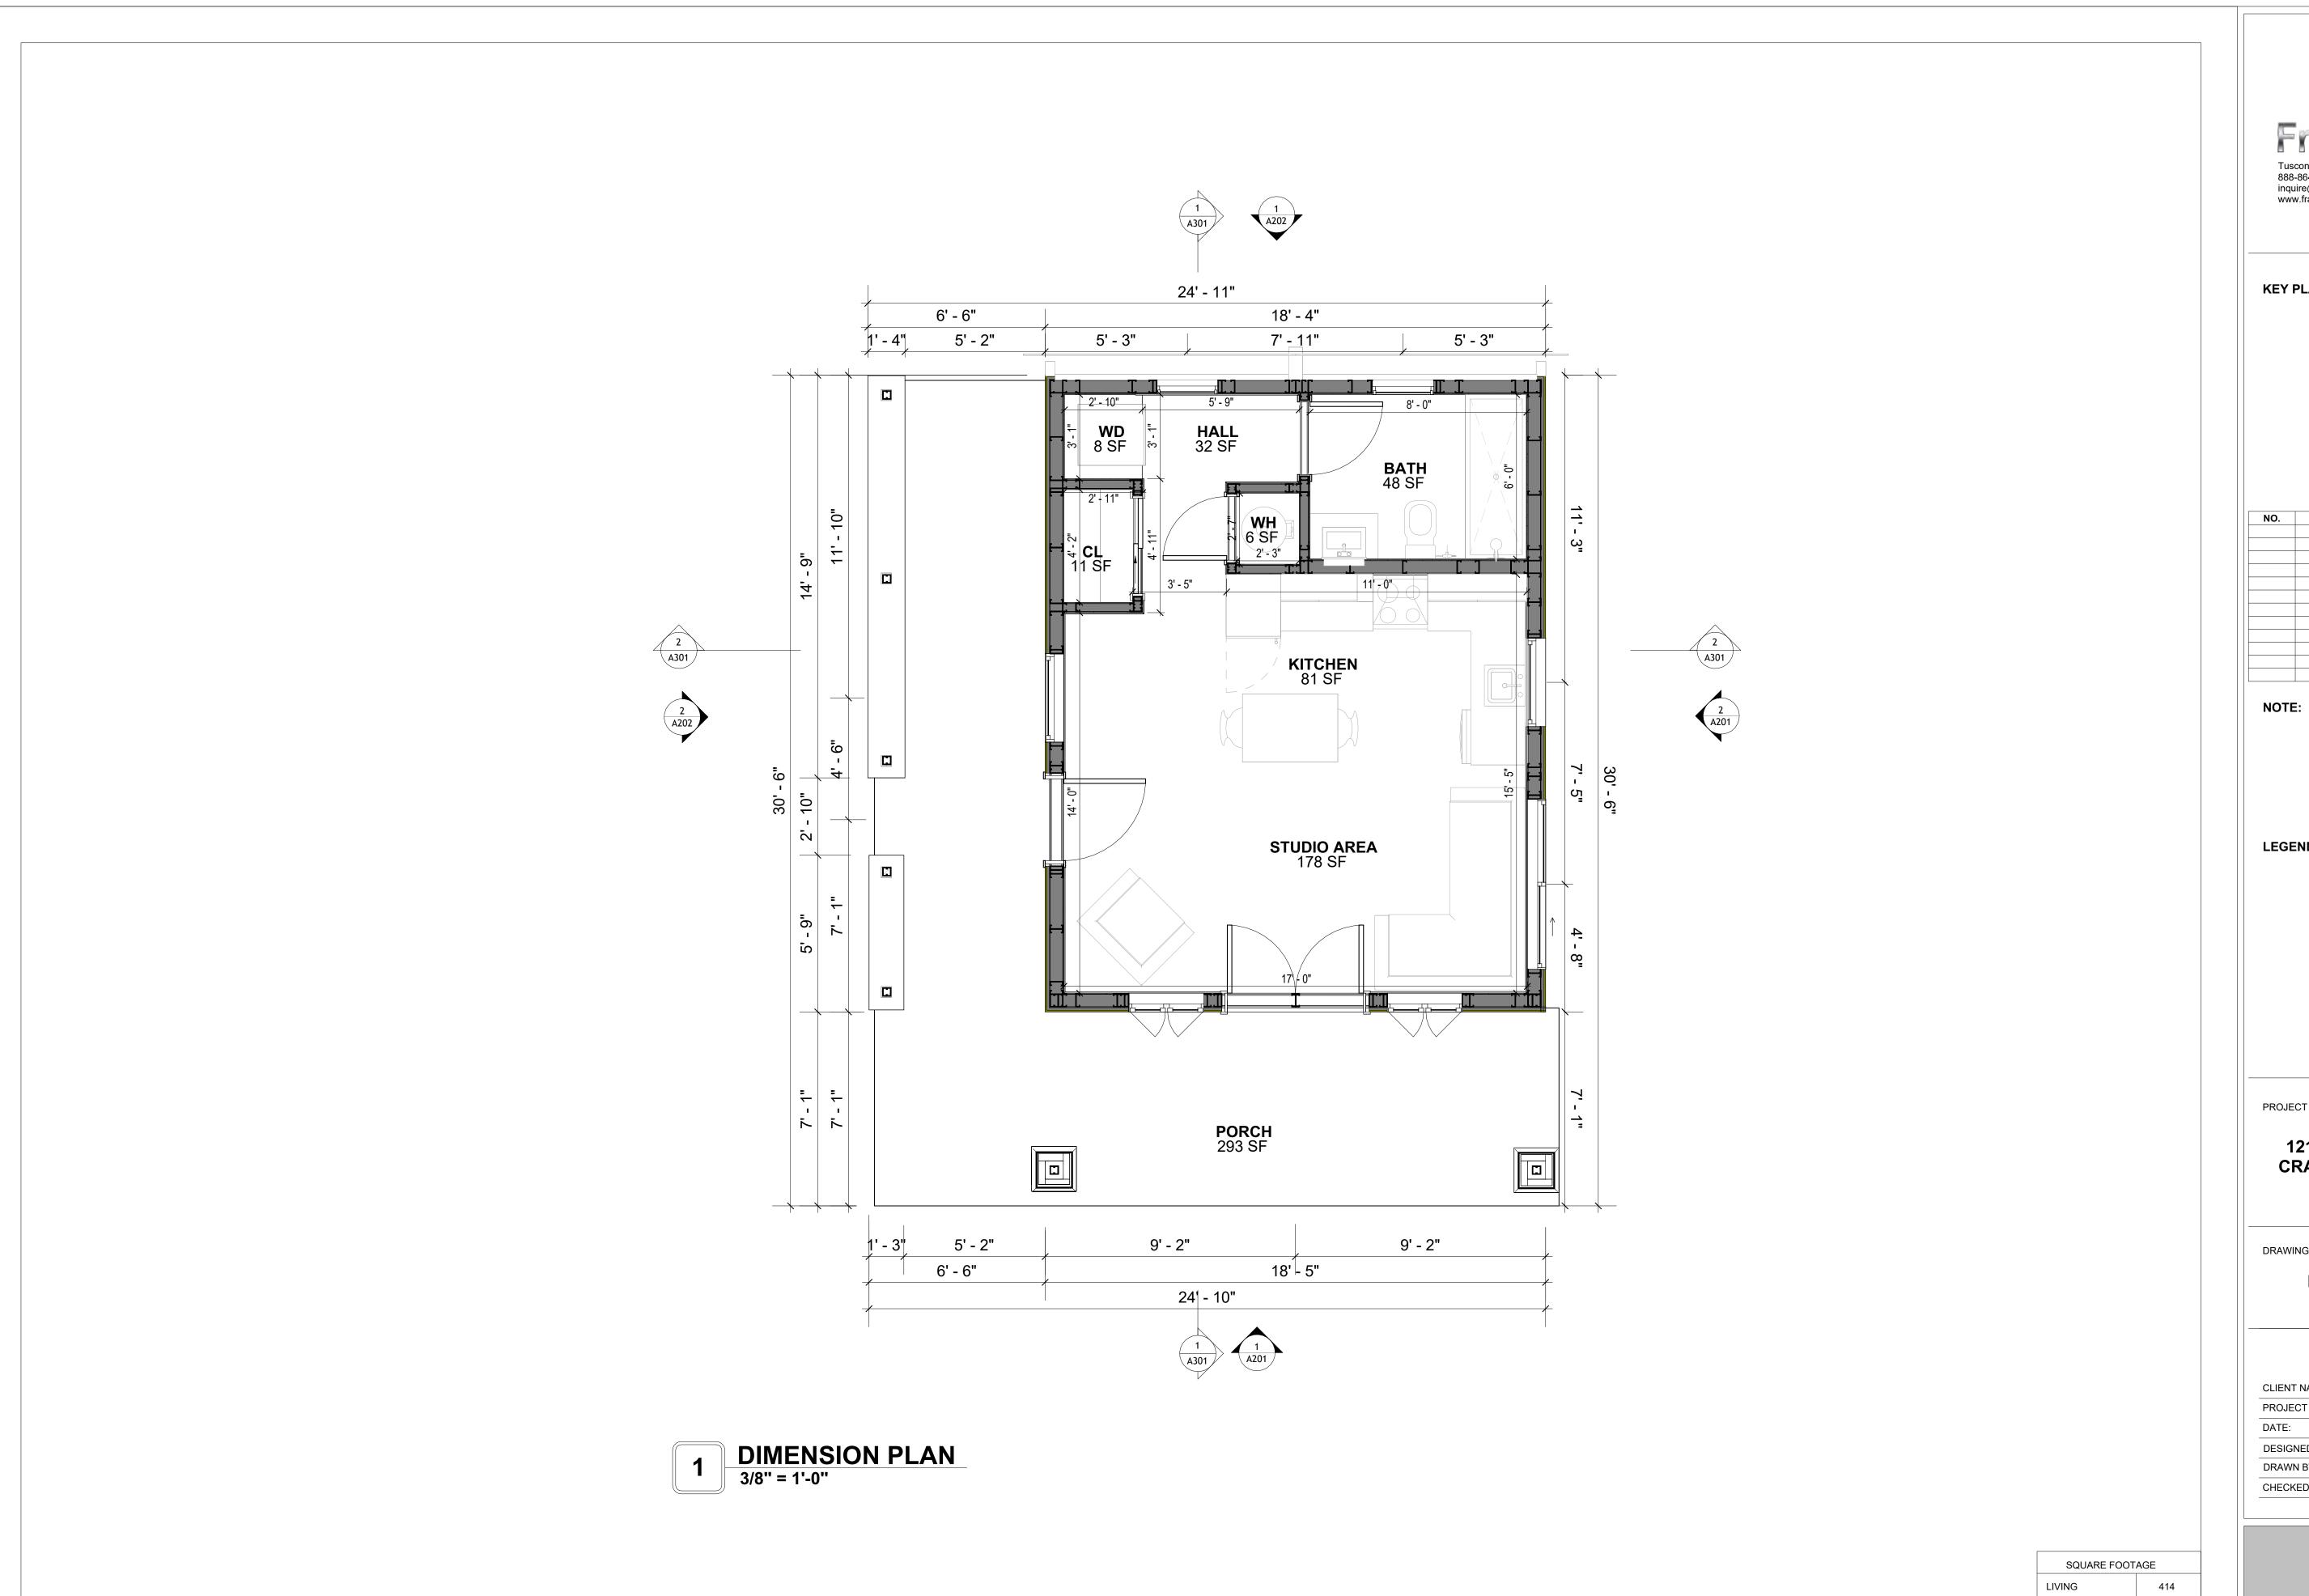



KEY PLAN

NO.	DESCRIPTION	DATE
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LEGEND:

PROJECT

121 ORION 415 STUDIO **CRAFTSMAN PORCH 550**

DRAWING NAME

DIMENSION PLAN

Client Name	CLIENT NAME:
0061_12	PROJECT NUMBER:
3/21/2025 9:43:15 AM	DATE:
Designer	DESIGNED BY:
Author	DRAWN BY:
Checker	CHECKED BY:

A102

SCALE: 3/8" = 1'-0"

318

732

TOTAL

FOUNDATION NOTES

NOTES:

TERMITES PRETREATMENT BY LICENSED CONTRACTOR UNDER SLAB AND AROUND FOOTINGS. ALL AREAS BELOW SLABS SHALL BE TREATED NO MORE THAN 24 HOURS PRIOR TO CONCRETE POUR. EVIDENCE OF TREATMENT MUST BE PROVIDED PRIOR TO PLACING OF CONCRETE.

. MATERIALS:

ALL INTERIOR CONCRETE SLABS SHALL BE A MIN. OF 4" THICK CONCRETE OVER 4" COMPACTED AGGREGATE BASE (ASTM D698), FINISH ELEVATIONS AS NOTED ON DRAWINGS, 6" ABOVE ADJACENT GRADE, LEVEL SLABS TO 1/8"-10' MAX.. CONCRETE SLABS SHALL BE 2500# PSI AT 28 DAYS. A 4" ALLOWABLE SLUMP.

2. PAD PREPARATION:

- EXCAVATION FOR FOOTING SHALL BE NEAT.

- FOOTINGS SHALL BE POURED IMMEDIATELY AFTER EXCAVATION AND APPROPRIATE INSPECTION.

- ALL REINFORCING STEEL MARKED "CONTINUOUS" SHALL BE LAPPED 36 BAR DIAMETERS AT SPLICES AND AROUND CORNERS OR INTERSECTIONS WITH A STANDARD 90 DEGREE BEND ON CORNER BARS. LAP WIRE MESH ONE FULL MESH AT SIDE AND END LAPS.
- ALL HARDWARE TO BE SIMPSON OR EQUIVALENT.

- EXTERIOR FRAME WALL TO BE SECURED WITH 1/2"X10" ANCHOR BOLTS 4'-0" O.C. FOR 1-STORY AND 2'-8" O.C. FOR 2-STORY. BOLTS SHALL BE LOCATED WITHIN 1'-0" OF EACH END PIECE AND SHALL HAVE A MIN. OF TWO BOLTS PER PIECE.

-FOUNDATION ANCHOR STRAPS SHALL BE PERMITTED, ACCORDING TO RESIDENTIAL CODE 2021

- ALL INTERIOR WALLS TO BE SECURED WITH POWER DRIVEN PINS PER MANUFACTURER SPECIFICATION USE PIN SPACING EQUIVALENT TO 1/2" ANCHOR BOLTS.

ALL CONSTRUCTION TO CONFORM TO THE 2012 IRC
 R-10 RIGID INSULATION OUTSIDE OF EXTERIOR FOUNDATION WALLS UNDER LIVING AREA.
 CONCRETE PAD FOR CONDENSER THICKNESS IS 4" MIN UNLESS OTHERWISE NOTED.

3. CONCRETE CONSTRUCTION:

- THE SLAB SHALL BE UNDERLAIN BY A VAPOR BARRIER/RETARDER IN THE LIVING AREA (TYPICALLY POLYETHYLENE, UNLESS MORE STRINGENT PROTECTION REQUIRED BY THE ARCHITECT, ENGINEER, FLOOR COVERING MANUFACTURER, OR ACCEPTED PRACTICE). UNLESS OTHERWISE REQUIRED, BARRIER MAY BE OMITTED AT GARAGES, PORCHES AND PATIOS WITHOUT FLOOR COVERINGS. IT IS BEYOND THE SCOPE OF THESE PLANS TO DETERMINE THE APPLICABILITY OF THESE MORE STRINGENT REQUIREMENTS. BUILDER SHALL VERIFY PRIOR TO CONSTRUCTION.

4. REINFORCEMENT:

- IF CONSTRUCTED ON ACTIVE SOILS, THE LONG TERM PERFORMANCE OF THE FOUNDATION IS DEPENDENT ON MAINTENANCE BY THE OWNER. THUS THE BUILDER SHALL ADVISE THE OWNER OF THE FOLLOWING:

DRAINAGE MUST BE MAINTAINED. WATER SHALL NEVER BE ALLOWED TO POND NEAR THE

FOLINDATION.

FOUNDATION.

2. THE SOIL AROUND THE FOUNDATION SHALL BE MAINTAINED IN A RELATIVELY DAMP CONDITION, SUCH AS THAT REQUIRED TO KEEP A LAWN GREEN. IF IT DRIES OUT IT WILL SHRINK. IF IT GETS WET, IT WILL HEAVE UPWARD.

SLABS ON THE SHORTER SIDE USES MAIN BARS ARE USED IN THIS DIRECTION ONLY WITH SMALLER DIAMETER DISTRIBUTION BARS ARE PLACED, FORMING A MAT OR GRID.
 ALL REINFORCEMENT BARS SIZE 10MM OR LARGER IN ACCORDANCE TO ASTM
 ANCHOR BOLTS AT ALL EXTERIOR WALLS SHALL BE MINIMUM 1/2 INCH DIAMETER WITH A

MAXIMUM SPACING OF 6'-0" ON CENTER, UNLESS NOTED OTHERWISE.

4. ANCHOR BOLTS SHALL BE INSTALLED WITHIN 12 INCHES OF EACH END OF EACH SILL PLATE WITH AT LEAST TWO ANCHOR BOLTS FOR EACH BOLTS FOR EACH SILL PLATE LONGER

THAN 12 INCHES.
5. SIMPSONS SILL ANCHORS MAYBE SUBSTITUTED FOR ANCHOR BOLTS AT THE SAME SPACING.


6. EXTERIOR CONCRETE SLABS WHICH ARE NOT PART OF THE MAIN SLAB SHALL BE MINIMUM 4 INCHES THICK WITH NO STEEL REINFORCING BARS REQUIRED, UNLESS NOTED OTHERWISE ON FOUNDATION PLAN.

VERIFY THE FOLLOWING PRIOR TO POURING:

- 1. ALL HOLDDOWNS , STRAP, AND POST LOCATIONS.
- CONCRETE FINISHES. PANEL RISER LOCATION WHERE APPLICABLE.
- 3. UNDERSLAB MECHANICAL REQUIREMENTS.4. STEM WALL BLOCKOUTS.
- 5. UNDERSLAB ELECTRICAL REQUIREMENTS AND PANEL RISER LOCATION. WHERE
- APPLICABLE.

 6. PROVIDE THE FOLLOWING:
- PVC SLEEVES THROUGH FTG IF REQUIRED
 20' #4 COPPER GROUND BAR.
- 7. SLOPE FINISH GRADE AWAY FROM FOOTING.

NOTE: FIELD VERIFY ALL DIMENSIONS SEE DIMENSIONED ARCHITECTURAL DRAWINGS

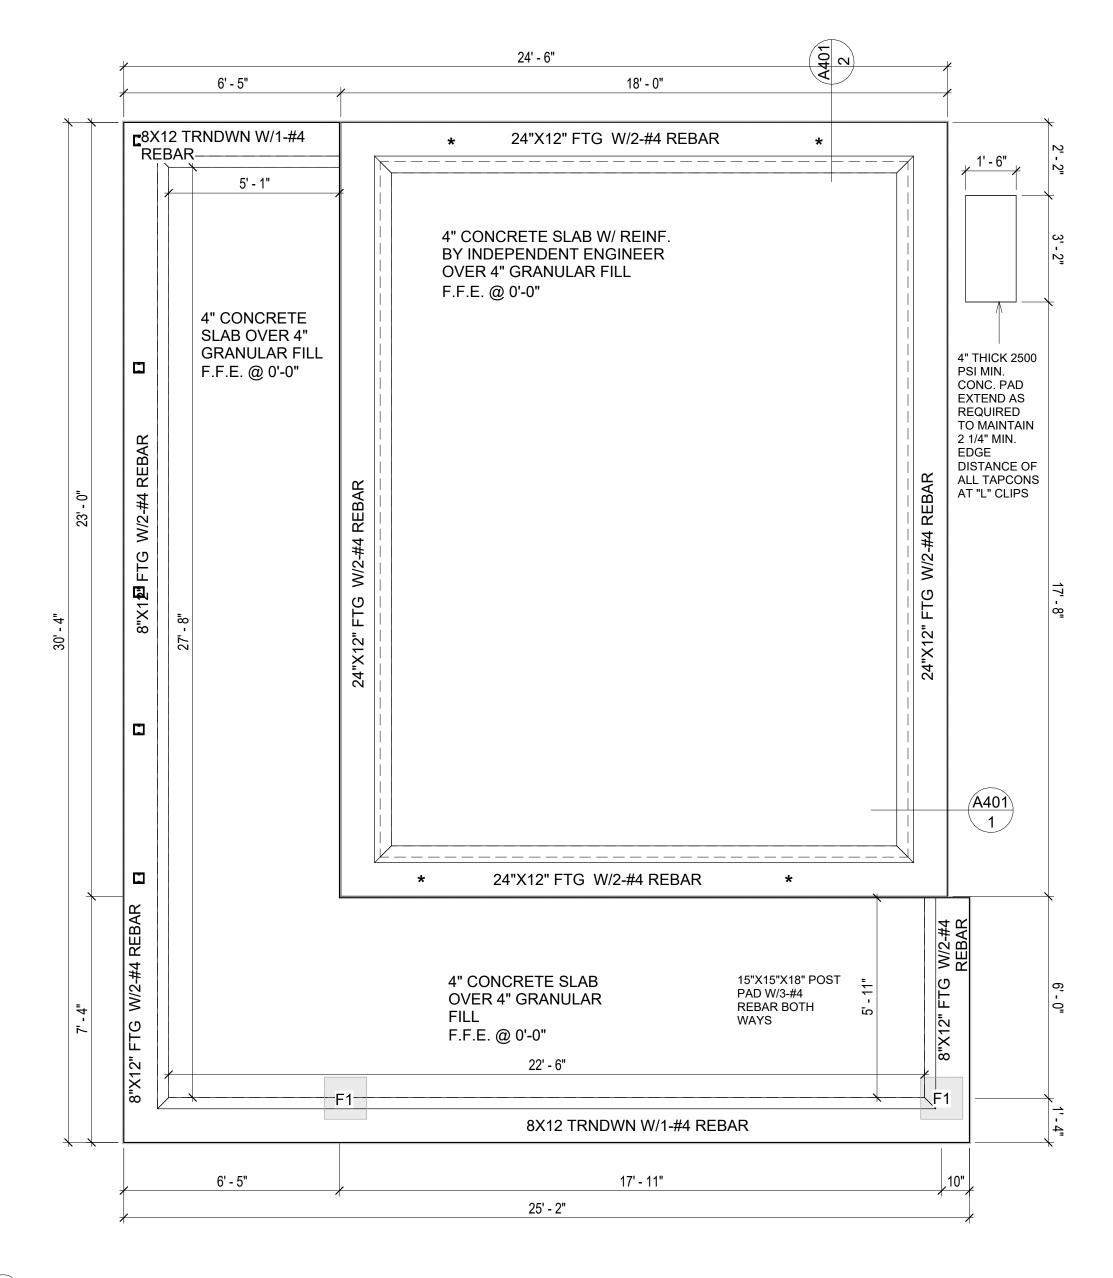





KEY PLAN

NO.	DESCRIPTION	DATE

NOTE:

LEGEND:

PROJECT

121 ORION 415 STUDIO CRAFTSMAN PORCH 550

DRAWING NAME

FOUNDATION PLAN

Client Name	CLIENT NAME:
0061_12	PROJECT NUMBER:
3/21/2025 9:43:16 AN	DATE:
Designer	DESIGNED BY:
Author	DRAWN BY:
Checker	CHECKED BY:

SQUARE FOOTAGE

LIVING 414

PORCH 318

TOTAL 732

S101

SCALE: 3/8" = 1'-0"

GENERAL NOTES

-ALL BEARING WALLS SHOULD HAVE A THICKENED SLAB PER SECTION PER DETAIL A401/5.

A) FOUNDATION PLAN NOTES:

. CONCRETE SLAB SHALL BE 6" THICK WITH 1/2" DIAMETER TENDONS PER LAYOUT PLAN, CENTERED IN SLAB THICKNESS, OVER APPROVED SUBBASE PER GENERAL STRUCTURE

2. TERMITE PROTECTION SHALL BE PROVIDED PER IRC SECTION R318.1 3. NONE TYPICAL ANCHOR BOLT SPACING AT SHEAR WALL AND HOLD DOWN

SPECIFICATIONS PER APPROVED ARCHITECTURAL PLANS.

4. INSTALL HOLDOWNS BEFORE CONCRETE SLAB POUR. 5. EXISTING FILL ON-SITE SHALL BE COMPACTED IN ACCORDANCE WITH THE

REQUIREMENTS IN THE GEOTECHNICAL REPORT.

6. ALL FLOOR SLABS ARE REINFORCED ON CONCRETE SLABS.

SPECIAL INSPECTION IS REQUIRED FOR THICKENED FOUNDATION CONSTRUCTION

1. REINFORCEMENT

2. 2300 PSI CONCRETE POUR

B) REINFORCEMENT FOR CONCRETE:


1. ALL REINFORCING SLABS BARS SIZE 10MM OR LARGER SHALL BE DEFORMED IN ACCORDANCE TO ASTM-A706, AND BARS SMALLER THAN 10 MM MAYBE PLAIN. 2. UNLESS OTHERWISE NOTED IN PLANS. THE YIELD STRENGTH OF REINFORCING BARS SHALL BE:


A) FOOTING = 40,000 PSI

B) NON-LOAD BEARING WALLS AND PARAPETS= 40,000 PSI

- SPLICES SHALL BE SECURELY WIRED TOGETHER AND SHALL LAP OR EXTEND
- GRADE OF STEEL FOR RCC WORKS SHALL BE GRADE 4 10.
- 5. BAR NOTATIONS GIVES INFORMATION
 - A) BAR SIZE
- B) SPACING(IF REQUIRED) 6. LAP REINFORCEMENT ONLY AT LOCATION SHOWN IN THE DRAWINGS
- REINFORCEMENT SHALL NOT BE CUT, VENT OR HEATED ON SITE WITHOUT ENGINEERS'
- APPROVAL.
- C) CONCRETE SLAB NOTES
- 1. ALL SLAB REINFORCEMENT SHALL BE 20MM CLEAR MINIMUM FROM BOTTOM AND FROM
- 2. REINFORCEMENT IN CONTINUOUS ELEVATED SLAB SHALL BE CUT AS FOLLOWS.

- THIS IS A SCHEMATIC PLAN FOR THE PURPOSE OF LOCATING AND IDENTIFYING FOUNDATION REINFORCING ELEMENTS ONLY. VERIFY ALL DIMENSIONS, DROPS, OFFSETS AND FEATURES WITH THE ARCHITECTURAL PLANS BEFORE FORMING THE FOUNDATION.

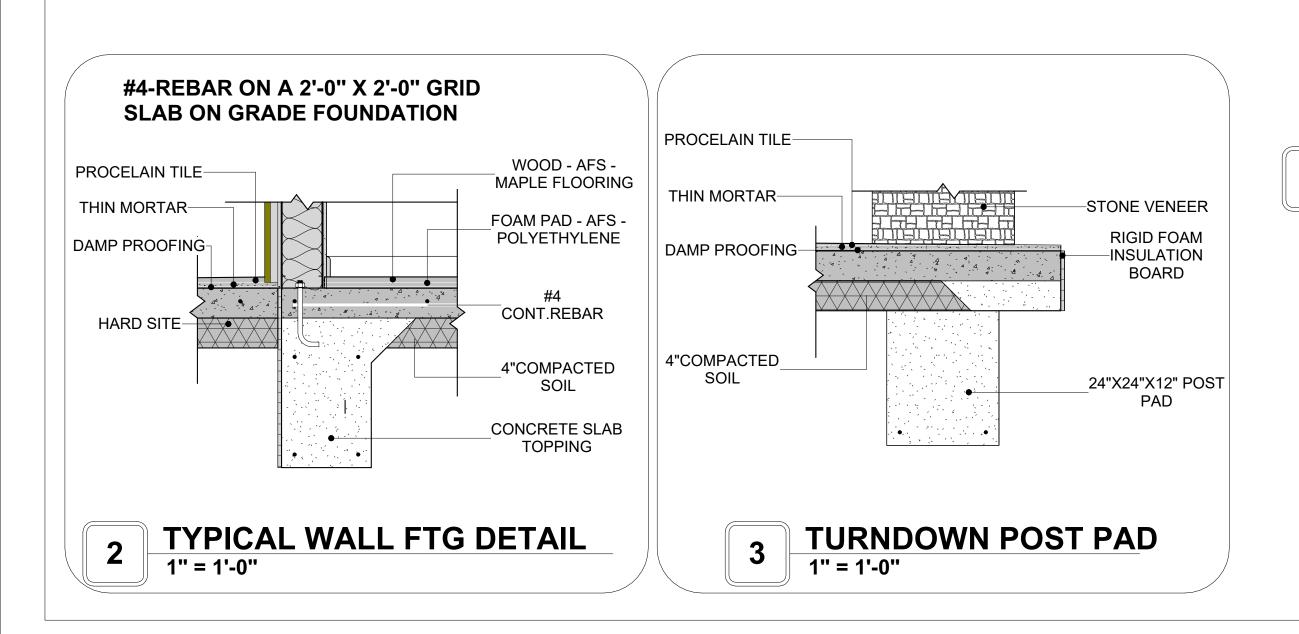

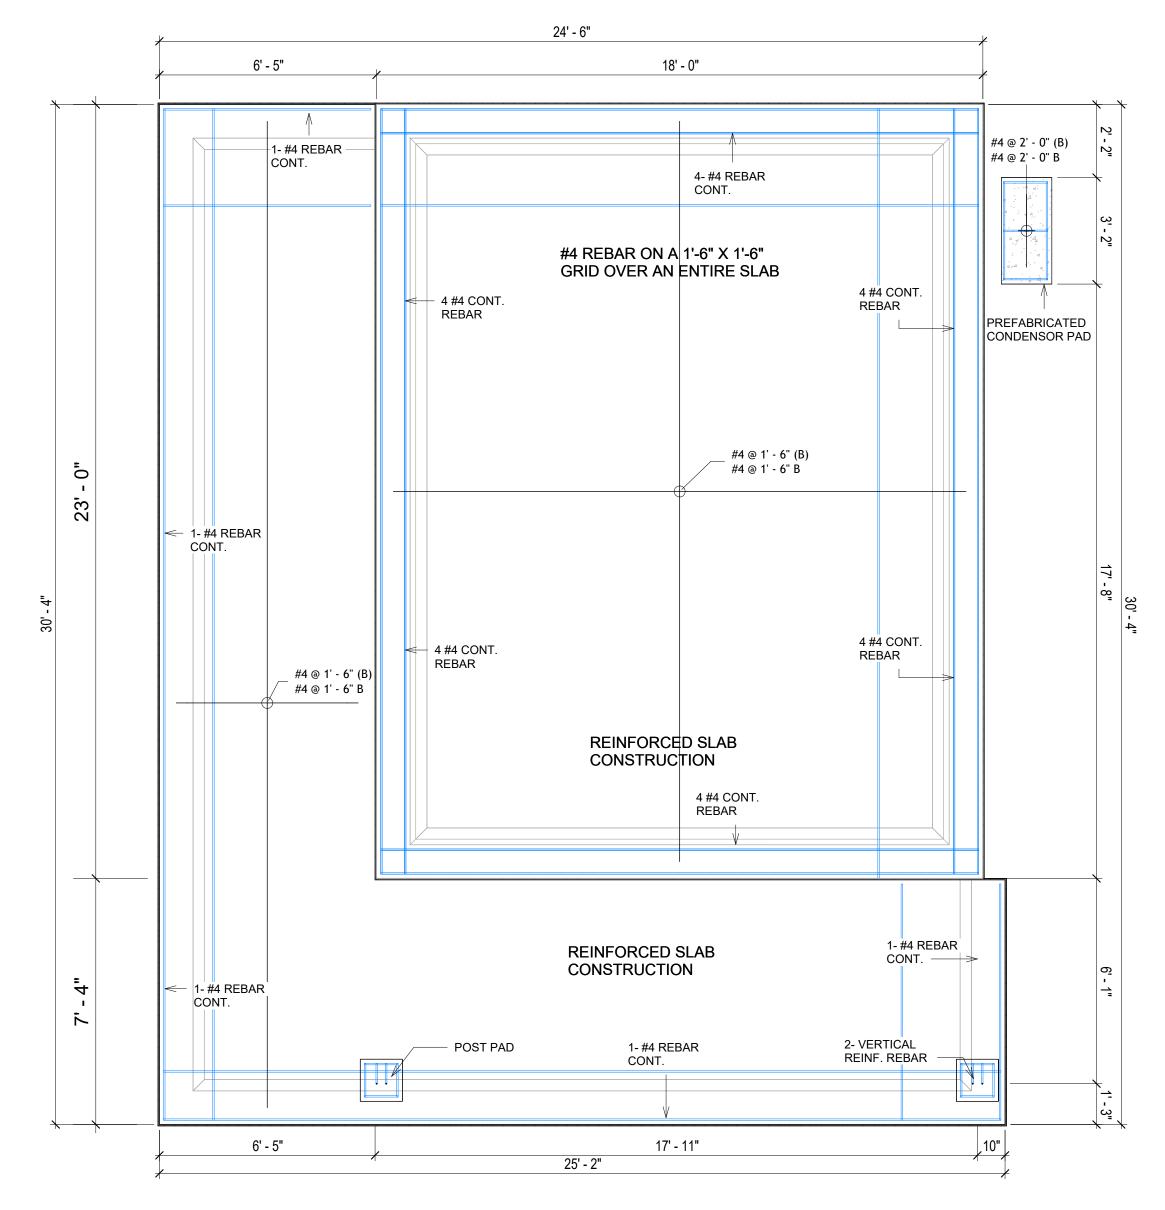

FOUNDATION REBAR PLAN 3/8" = 1'-0"



KEY PLAN

NO.	DESCRIPTION	DATE

NOTE:

LEGEND:

PROJECT

121 ORION 415 STUDIO CRAFTSMAN PORCH 550

DRAWING NAME


STRUCTURAL FLOOR PLAN

Client Name	CLIENT NAME:	
0061_12	PROJECT NUMBER:	
3/21/2025 9:43:17 AN	DATE:	
Designer	DESIGNED BY:	
Author	DRAWN BY:	
Checker	CHECKED BY:	

S102

ROOF NOTES

- 1. ROOFING COMPOSITION ROOFING PER OWNERS/BUILDERS SPECIFICATIONS INSTALL PER MANUFACTURE SPECIFICATIONS ON 1/2" ORIENTED STRAND BOARD ON PRE-ENGINEERED TRUSS @ 24" O.C. (UNO.)
- 73" OVERHANG AT EAVES (UNO.)
 ENDS OF ALL TRUSSES AND JOISTS TO BE FULLY BLOCKED. PROVIDE SOLID
- BLOCKING AT ALL RIDGES AND VALLEYS
- 4. SHEATHING TO BE 1/2", 3/8" OSB SHEAR PANEL AND EQUIVALENT. UNDERSIDE OF PORCH TRUSSES TO BE FINISHED WITH MOISTURE RESISTANT DRYWALL, TAPED AND TEXTURED.
- 5. EXPOSED EAVES AND OTHER WEATHER EXPOSED AREAS TO BE SHEATHED WITH EXTERIOR GRADE PLYWOOD.
- 6. ALL MATERIALS THICKNESS AND SIZE ARE THE MINIMUM. Refer TO LOCAL STANDARDS FOR ACTUAL THICKNESS AND LAYERING OF MATERIALS.
- 7. ENGINEERED TRUSS CALCULATIONS TO BE SUBMITTED TO BUILDING
- DEPARTMENT PRIOR TO FABRICATION AND INSTALLATION.
- 8. TRUSS MANUFACTURER TO SPECIFY HANGER CONNECTORS FOR TRUSS COMPONENTS (TYPICAL)
- 9. DESIGNER ASSUMES THAT TRUSSES BEAR ON ALL EXTERIOR PERIMETER
- WALLS (TYPICAL) OR BEAMS.
- 10. PROVIDE GALVANIZED STEEL FLASHING WITH A LENGTH OF 10 FEET, WIDTH OF 12 INCHES, AND THICKNESS OF 24 GAUGE.

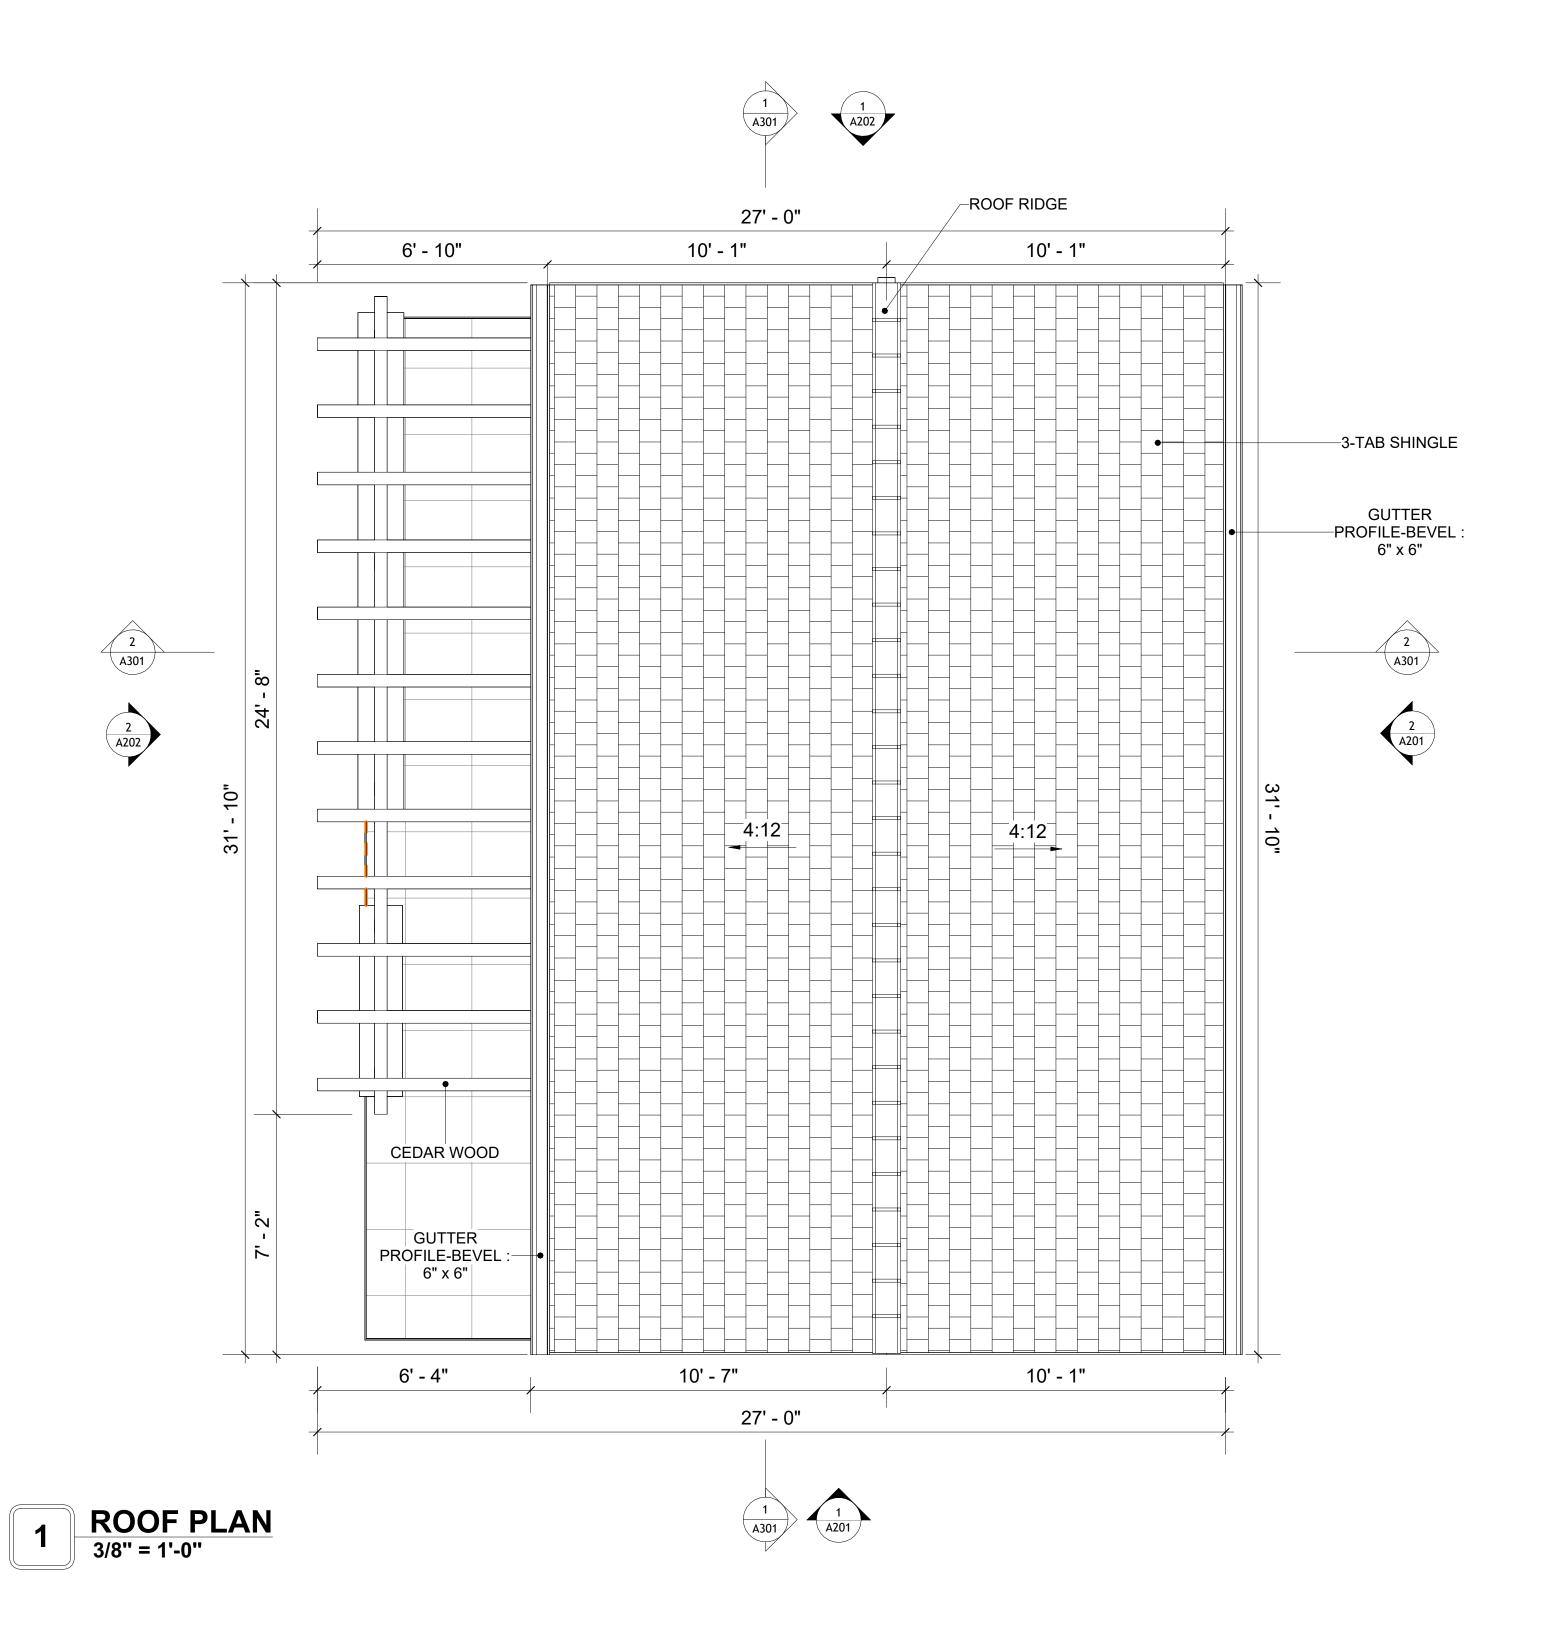



KEY PLAN

NO.	DESCRIPTION	DATE

NOTE:

LEGEND:

PROJECT

121 ORION 415 STUDIO CRAFTSMAN PORCH 550

DRAWING NAME

ROOF PLAN

CLIENT NAME:	Client Name
PROJECT NUMBER:	0061_12
DATE:	3/21/2025 9:43:19 A
DESIGNED BY:	Designer
DRAWN BY:	Author
CHECKED BY:	Checker

SQUARE FOOTAGE

LIVING 414

PORCH 318

TOTAL 732

A103

ABOUT WALL FINISHING

PLYWOOD WALL SIDING

WALL SIDING IS AN EXTERIOR CLADDING MATERIAL USED TO COVER AND PROTECT THE WALLS OF A BUILDING, PROVIDING BOTH FUNCTIONAL AND AESTHETIC BENEFITS.

IN THIS SPECIFIC PROJECT, PLYWOOD WALL PANELS ARE USED AS A FINISH SIDING BECAUSE THIS TYPE OF SIDING PROVIDES A DURABLE, COST-EFFECTIVE, AND VERSATILE EXTERIOR CLADDING THAT CAN BE EASILY INSTALLED, FINISHED, AND MAINTAINED TO ENHANCE THE AESTHETIC AND PROTECTIVE QUALITIES OF A BUILDING'S EXTERIOR.

STANDARD SIZES OF 1' X 8' EXTERIOR-GRADE PLYWOOD PANELS ARE INSTALLED ON THE FURRING STRIPS USING GALVANIZED STEEL SELF-DRILLING SCREWS.

STONE VENEER

STONE VENEER REFERS TO THIN LAYERS OF NATURAL OR MANUFACTURED STONE APPLIED TO A STRUCTURAL WALL, KNOWN FOR THEIR REALISTIC APPEARANCE AND RELATIVE LIGHTNESS. THESE VENEERS PROVIDE THE AESTHETIC OF STONE WITHOUT THE COST AND WEIGHT OF FULL STONE CONSTRUCTION, CONTRIBUTING TO A BEAUTIFUL AND COST-EFFECTIVE EXTERIOR FINISH.

IN THIS SPECIFIC PROJECT, STONE VENEER IS USED A FINISH MATERIAL ON EXTERIOR FINISH.

CEDAR WOOD

CEDAR WOOD REFERS TO THE WOOD FROM VARIOUS SPECIES OF CEDAR TREES, WHICH ARE CONIFEROUS EVERGREEN TREES KNOWN FOR THEIR DISTINCT AROMA AND NATURAL RESISTANCE TO DECAY AND INSECTS.

IN THIS SPECIFIC PROJECT, CEDAR WOOD IS USED A FINISH MATERIAL ON BEAMS AND COLUMNS.

GRANITE COPPING


GRANITE COPPING REFERS TO A STONE. TYPICALLY GRANITE, USED TO COVER THE TOP EDGE OR CAP OF A WALL, PARAPET, OR OTHER ARCHITECTURAL FEATURE, PROVIDING PROTECTION AND A FINISHED LOOK.

IN THIS PROJECT, GRANITE COPPING IS USED AS THE COPING MATERIAL, PROVIDING A DURABLE AND AESTHETIC FINISH THAT MIMICS THE APPEARANCE OF NATURAL STONE.

WOOD SHINGLES

WOOD SHINGLES ARE THIN, TAPERED PIECES OF WOOD, TRADITIONALLY USED FOR ROOFING AND SIDING. THEY ARE TYPICALLY MADE FROM CEDAR WOOD, OR PINE DUE TO THEIR DURABILITY AND RESISTANCE TO DECAY. SHINLES ARE SAWN RATHER THAN SPLIT, GIVING THEM A SMOOTH, UNIFORM APPEARANCE. THEY PROVIDE A NATURAL, OFTEN RUSTIC LOOK, GOOD INSULATION, AND GOOD WEATHER RESISTANCE. WOOD SHINGLE ARE ECO-FRIENDLY AND CAN BE STAINED OR PAINTED FOR CUSTOMIZATION.

IN THIS SPECIFIC PROJECT, WOOD SHINGLES ARE APPLIED AT THE TOP OF THE EXTERNAL WALL, CREATING AN EYE-CATCHING DETAIL THAT COMPLEMENTS THE OVERALL ARCHITECTURE AND ENSURES A STURDY, WEATHER-RESISTANT FINISH.

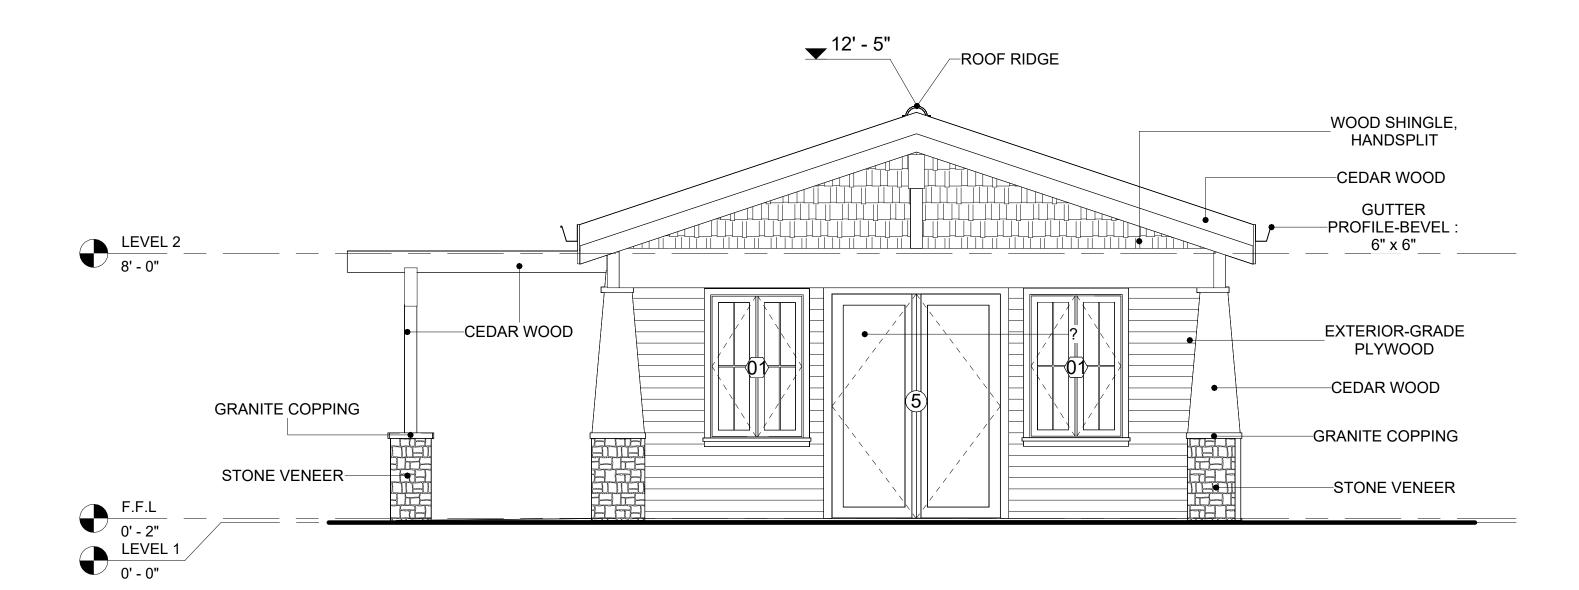


FRONT ELEVATION 3/8" = 1'-0"



RIGHT SIDE ELEVATION 3/8" = 1'-0"

		DOOR SCHE	EDULE			
TYPE					SIZE	
MAR K	SUPPLIER	DOOR TYPE	LOCATIO	WIDTH	HEIGHT	COUNT
1	HOME DEPOT	EXTERIOR SINGLE PANEL SWINGING	INTERIOR	3' - 0"	6' - 8"	1
2	HOME DEPOT	INTERIOR SINGLE PANEL SWINGING	INTERIOR	2' - 4"	6' - 8"	1
4	HOME DEPOT	INTERIOR DOUBLE PANEL SLIDING	INTERIOR	3' - 6"	6' - 8"	1
04	HOME DEPOT	INTERIOR SINGLE PANEL SWINGING	INTERIOR	2' - 8"	6' - 8"	1
5	HOME DEPOT	EXTERIOR DOUBLE PANEL SWINGING	INTERIOR	5' - 0"	6' - 8"	1

		WINDOV	V SCHEDULE		
				SIZE	
TYPE MARK	SUPPLIER	WINDOW TYPE	WIDTH	HEIGHT	COUNT
01	HOME DEPOT	DOUBLE HUNG	2' - 9"	4' - 3"	2
02	HOME DEPOT	FIXED	2' - 3"	2' - 3"	2
03	HOME DEPOT	SLIDING	6' - 3"	4' - 3"	1
04	HOME DEPOT	SINGLE HUNG	3' - 3"	3' - 9"	2

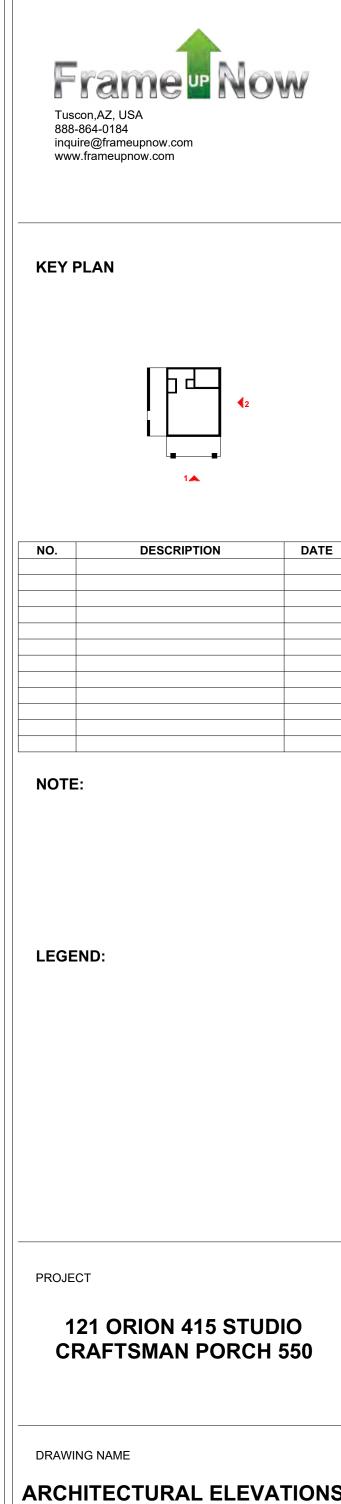

ARCHITECTURAL ELEVATIONS

Client Name	CLIENT NAME:
0061_12	PROJECT NUMBER:
3/21/2025 9:43:22 AM	DATE:
Designer	DESIGNED BY:
Author	DRAWN BY:
Checker	CHECKED BY:

A201

ABOUT WALL FINISHING

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STANDARD SIZES OF 1' X 8' EXTERIOR-GRADE PLYWOOD PANELS ARE INSTALLED ON THE FURRING STRIPS USING GALVANIZED STEEL SELF-DRILLING SCREWS.

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GRANITE COPPING


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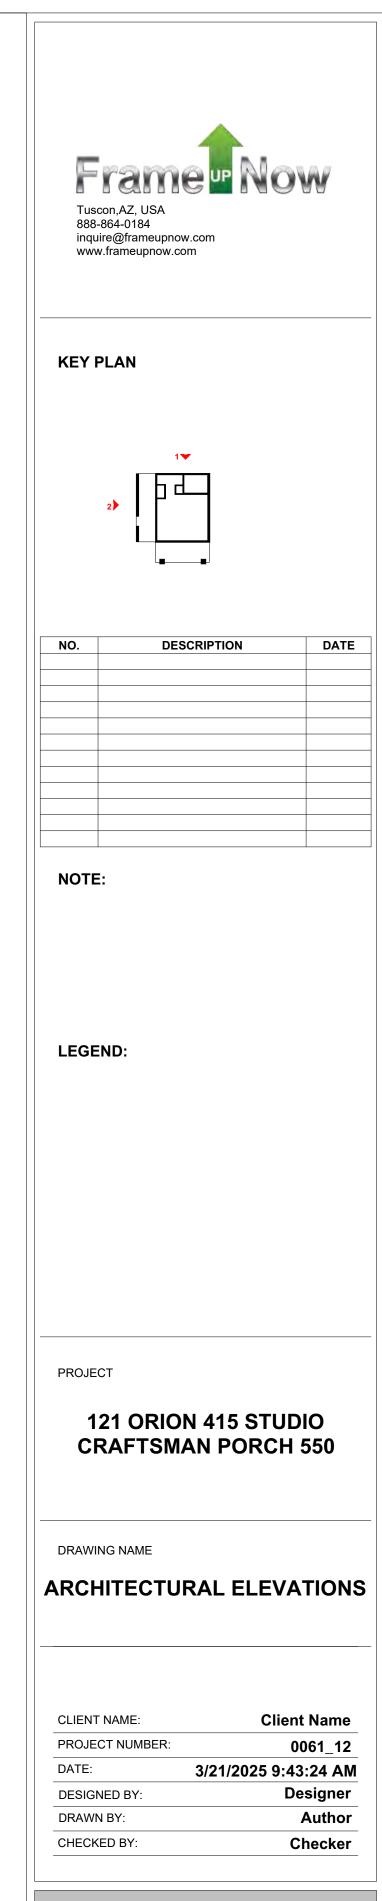
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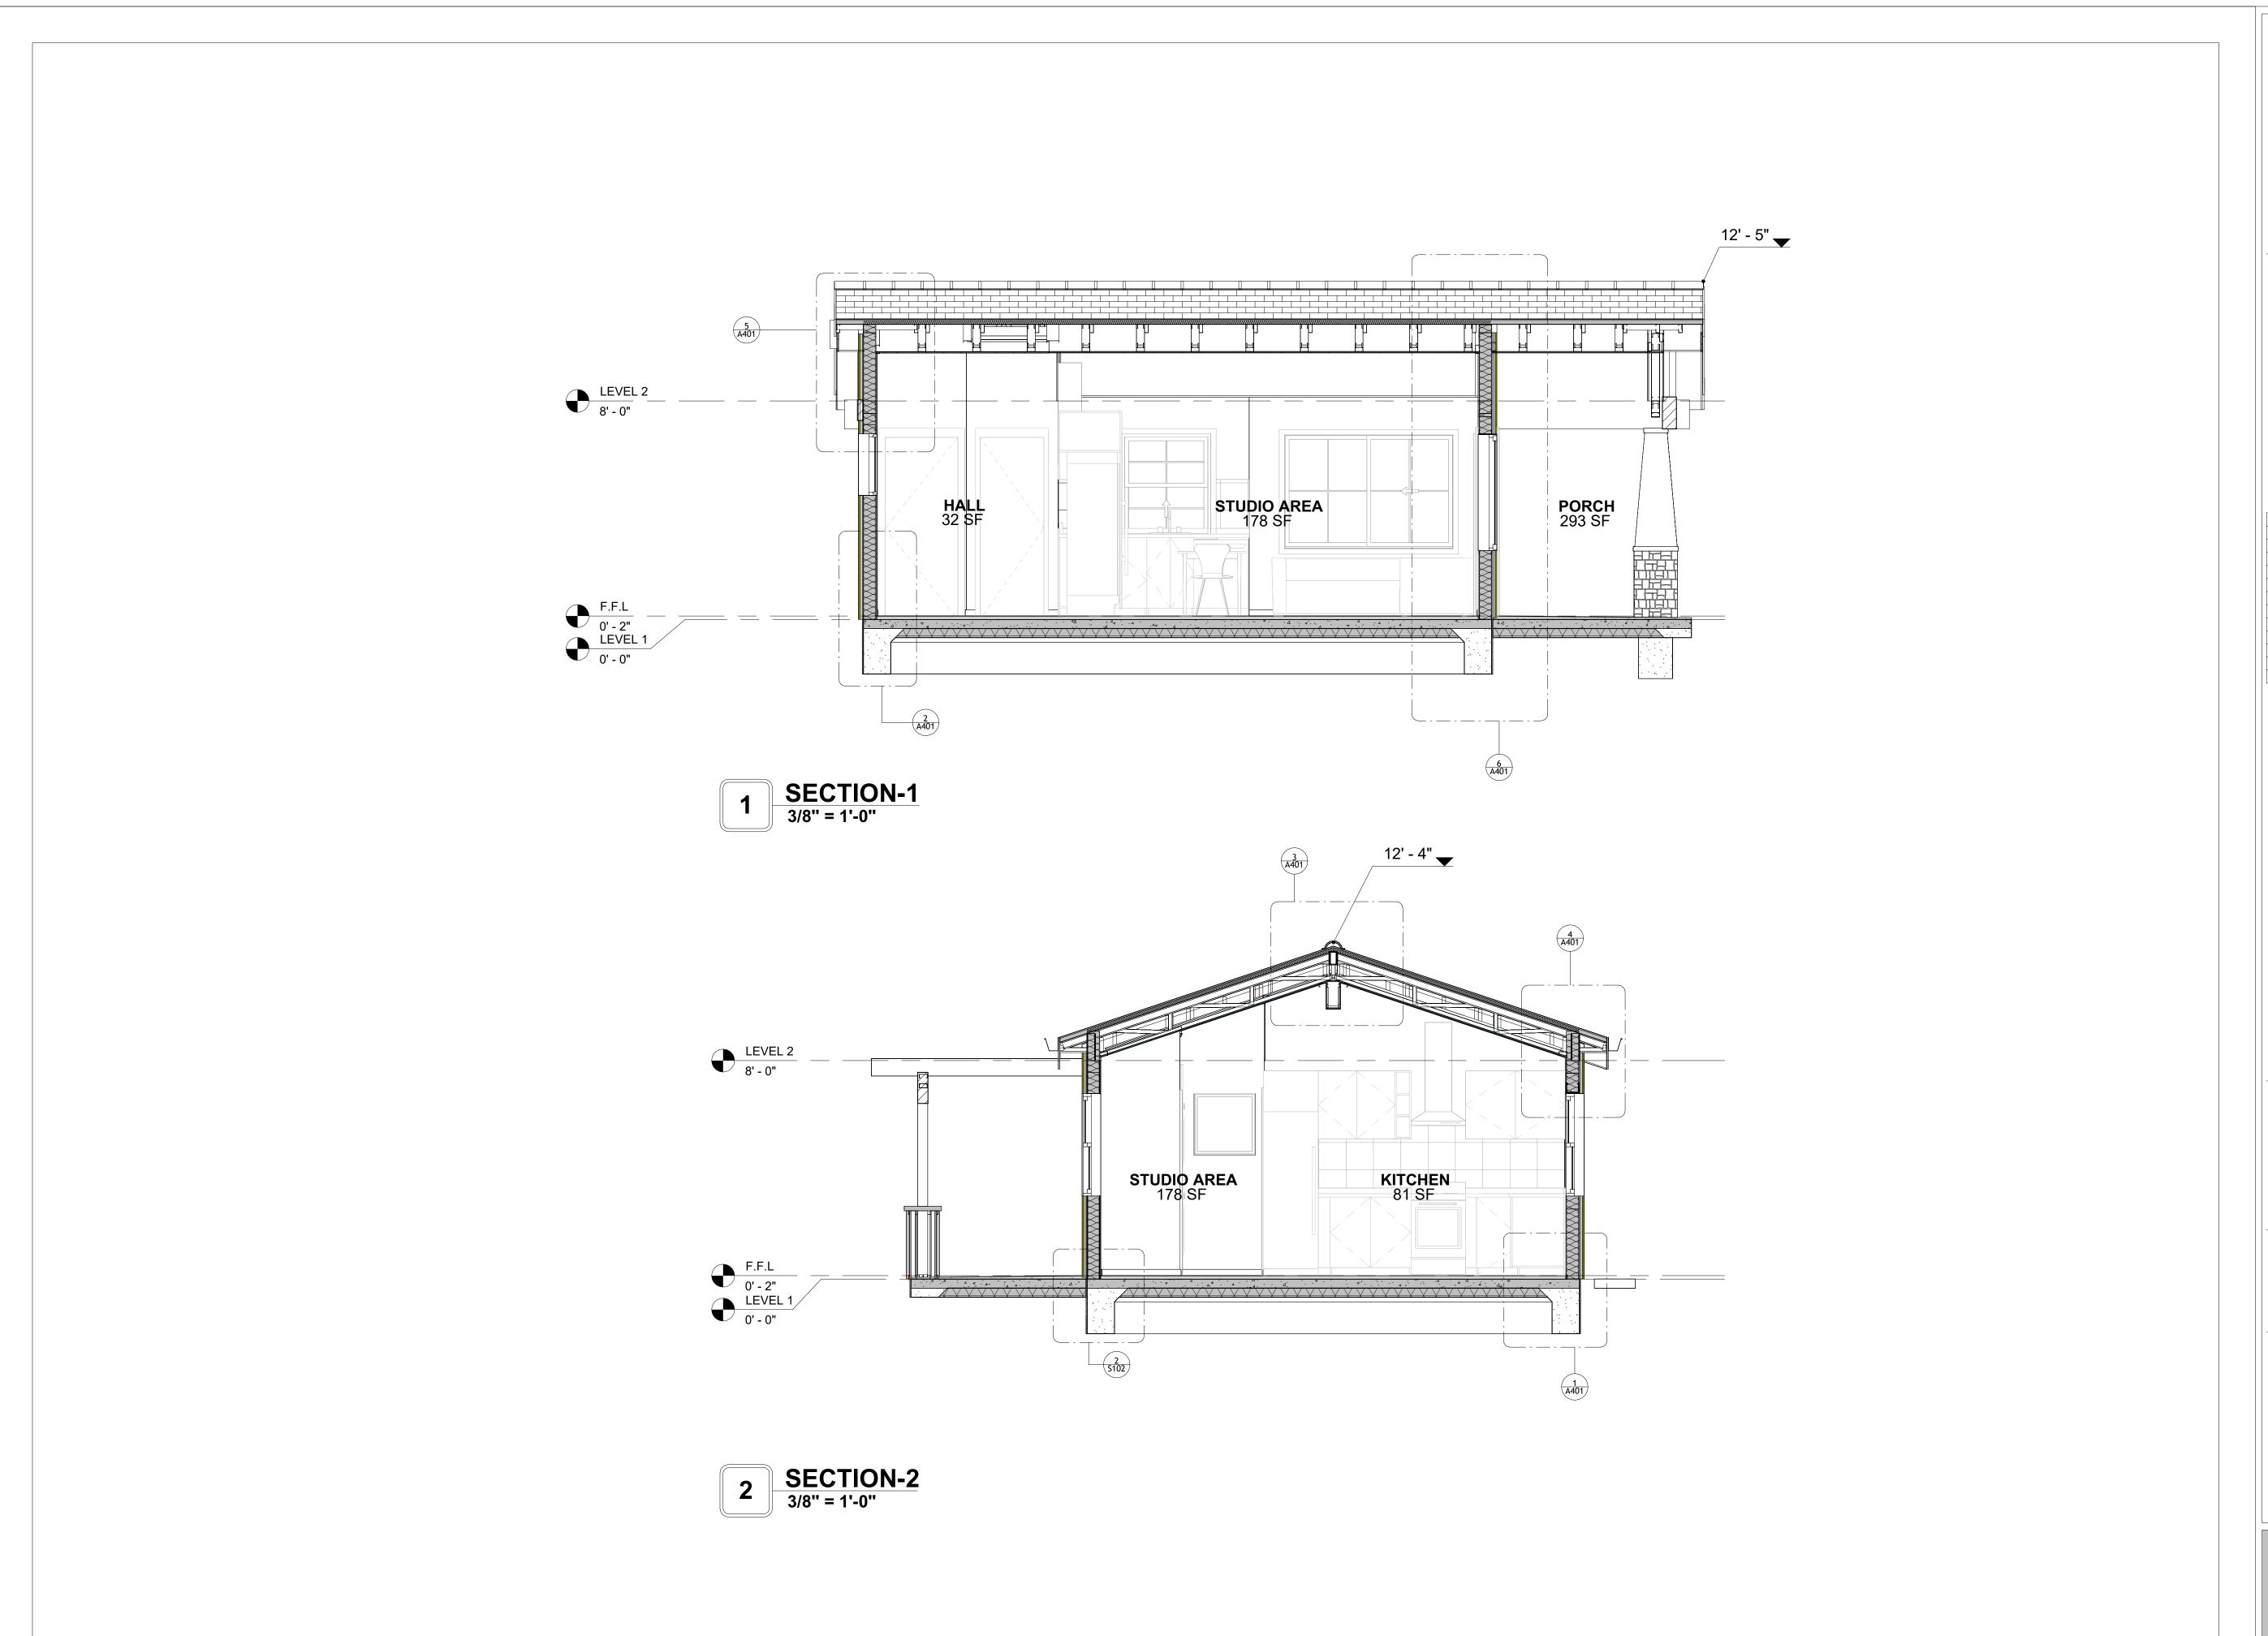
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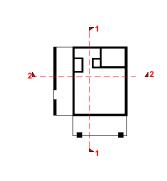








KEY PLAN

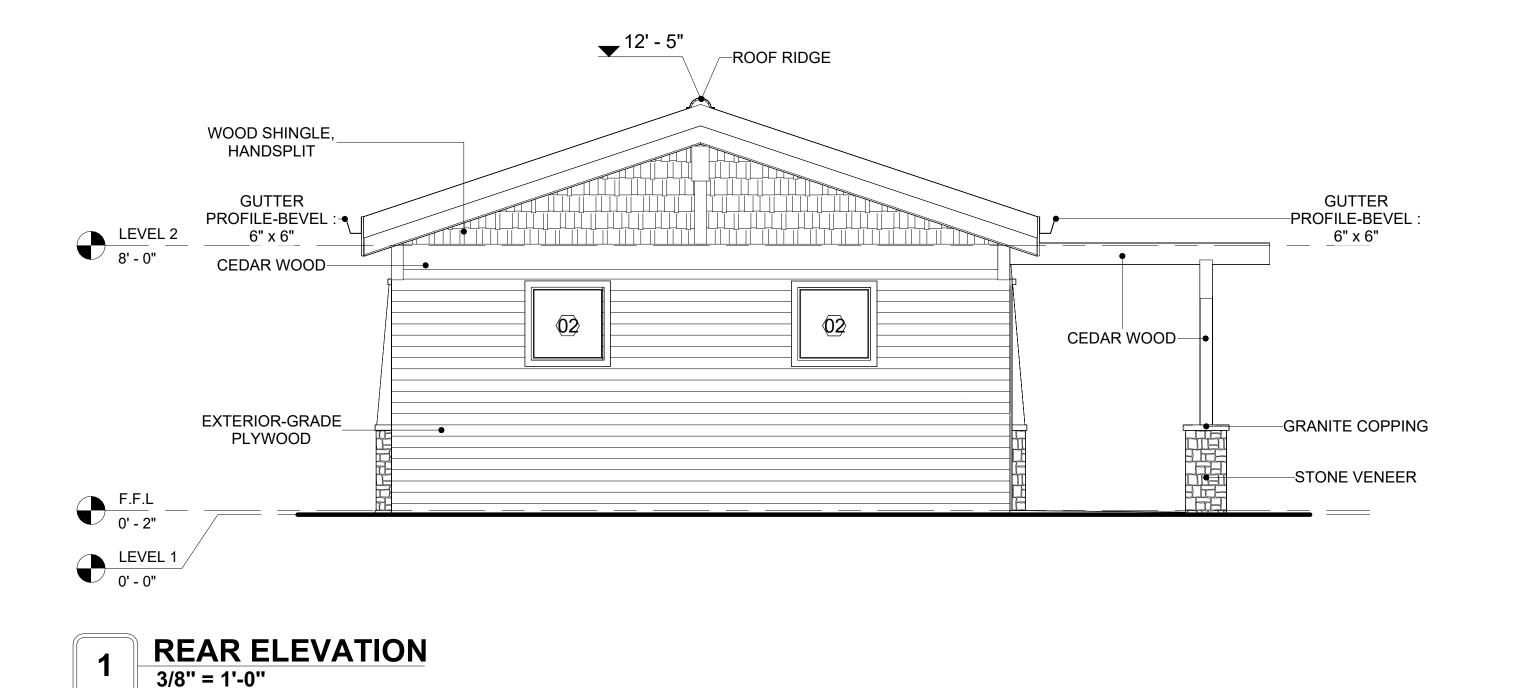

NO.	DESCRIPTION	DATE

NOTE:

LEGEND:

PROJECT


121 ORION 415 STUDIO CRAFTSMAN PORCH 550


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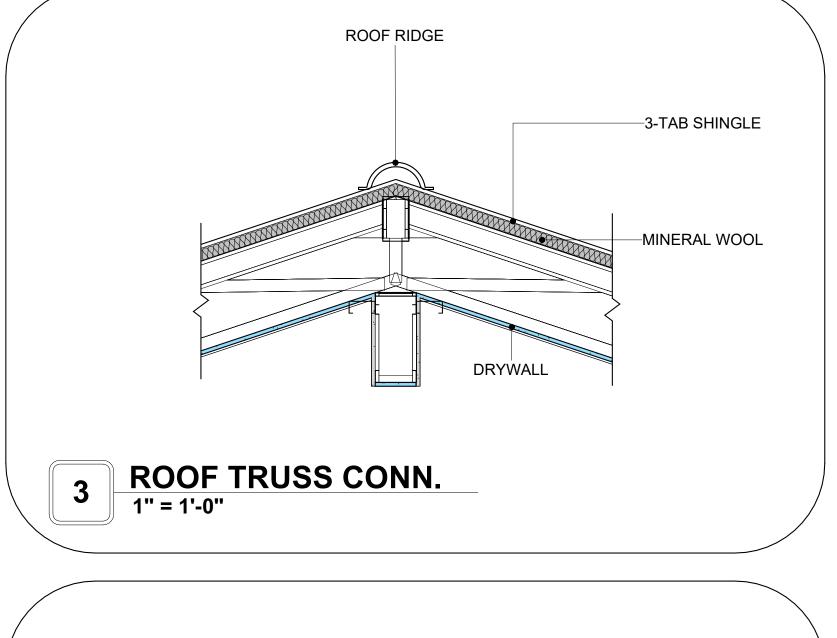
ARCHITECTURAL SECTIONS


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0061_12	PROJECT NUMBER:
3/21/2025 9:43:26 AM	DATE:
Designer	DESIGNED BY:
Author	DRAWN BY:
Checker	CHECKED BY:


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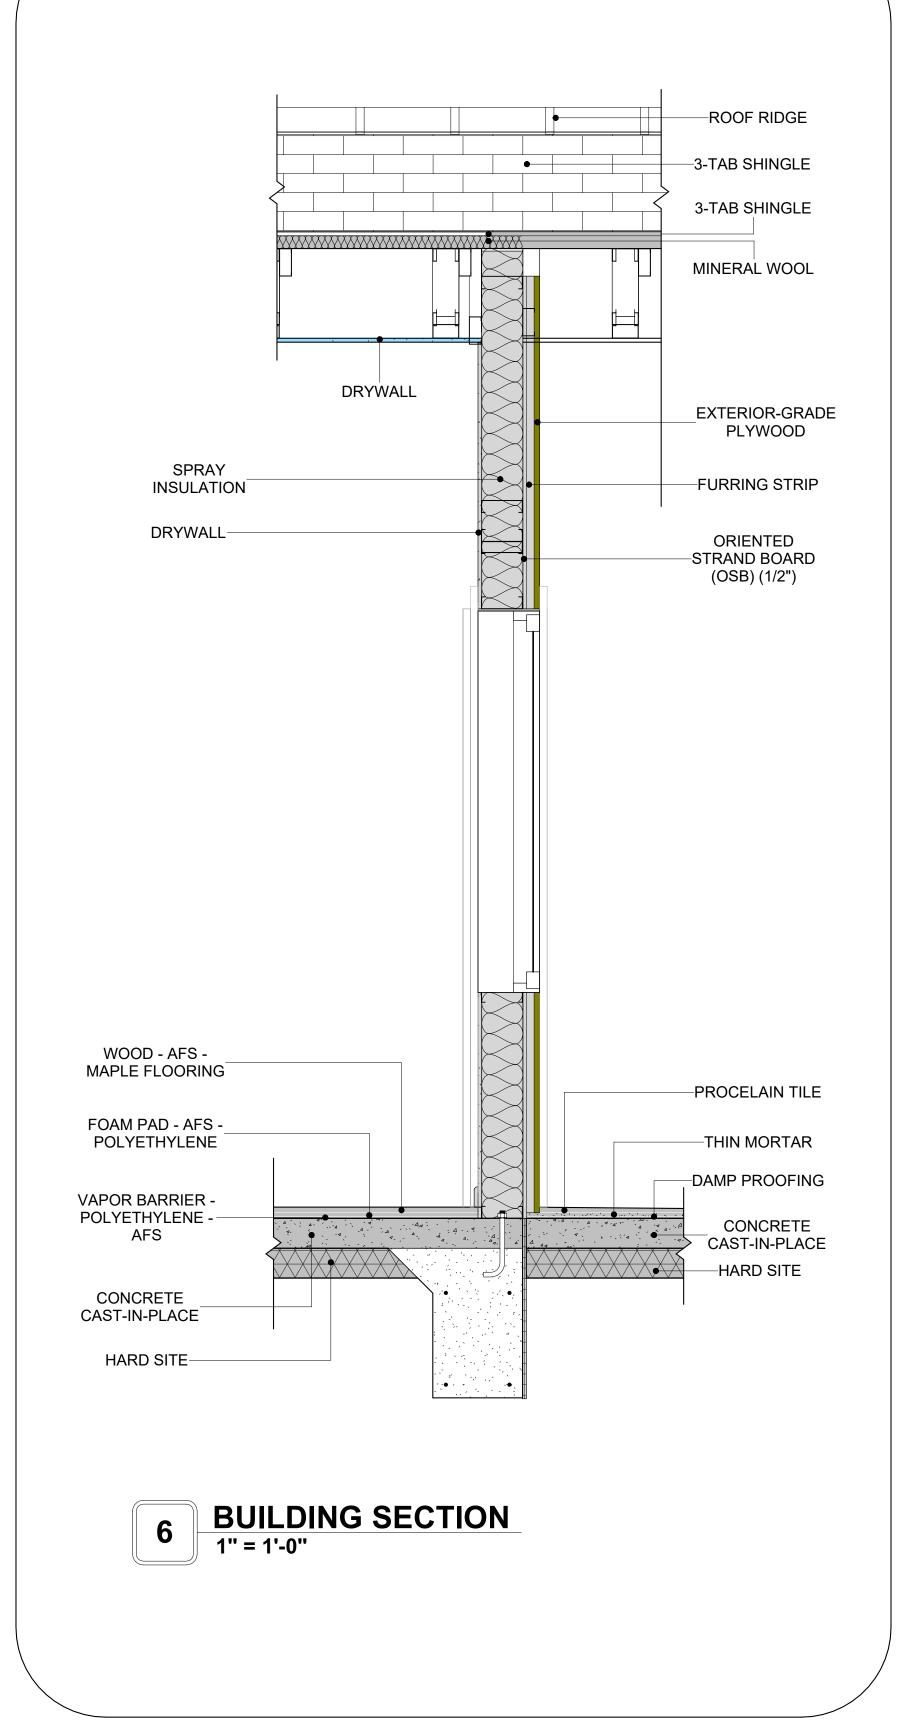




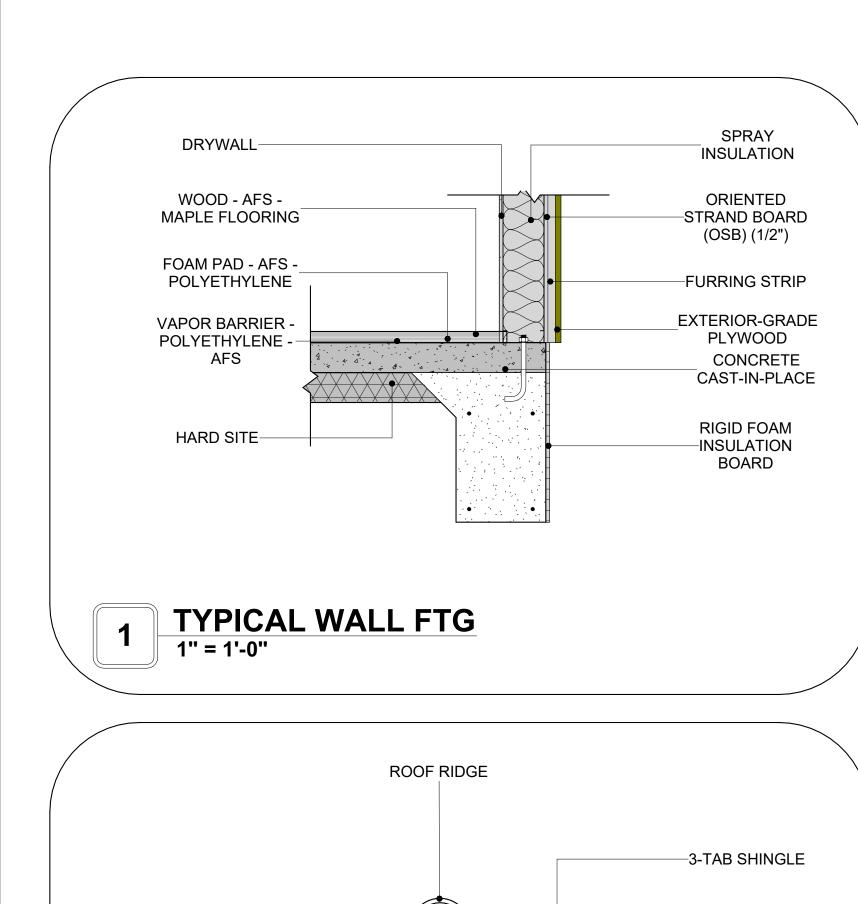

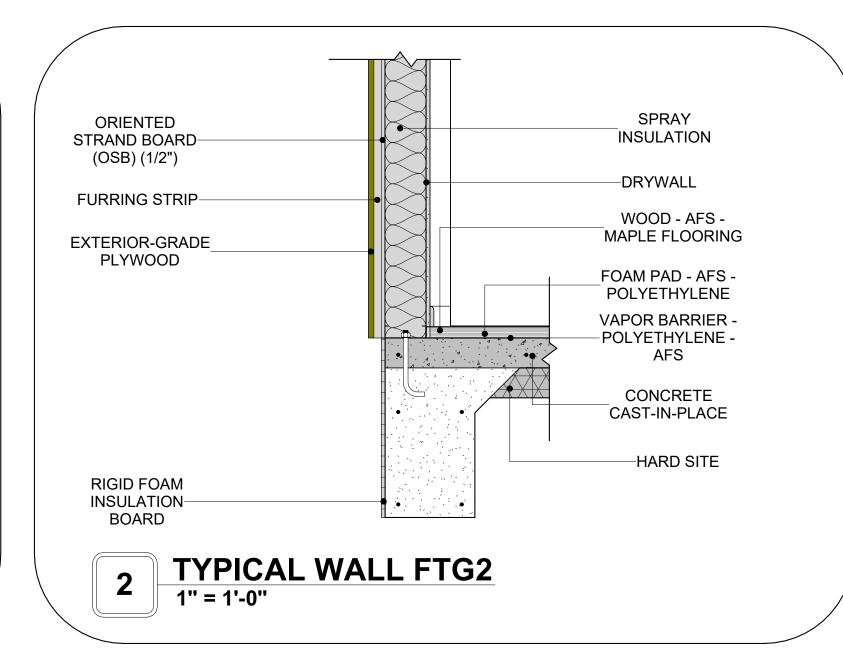

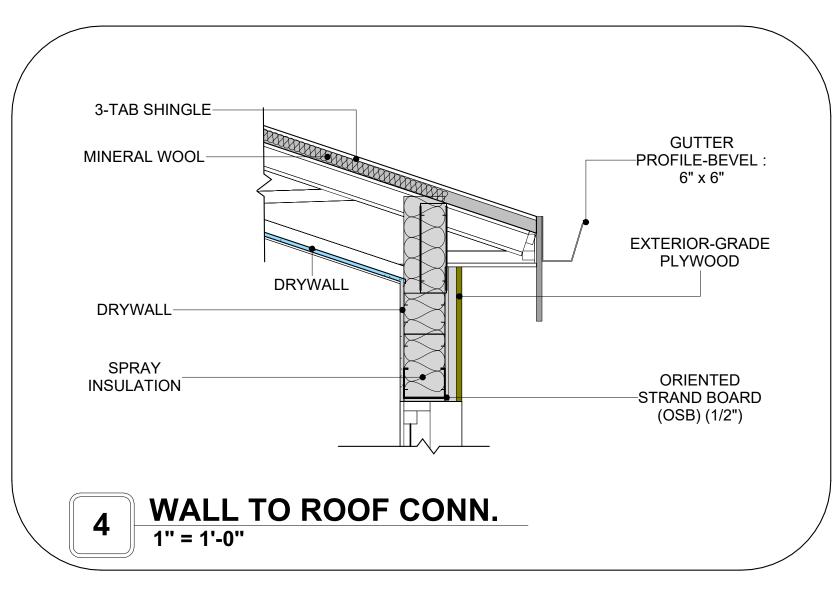

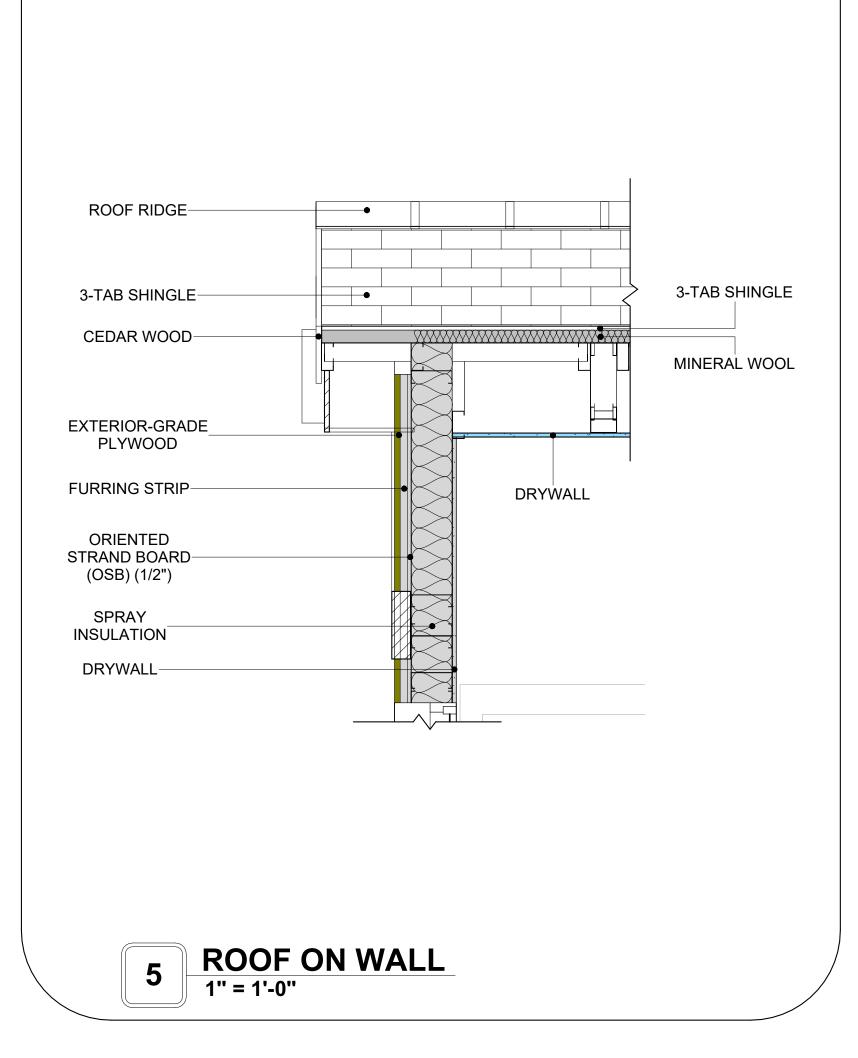



KEY PLAN

NO.	DESCRIPTION	DA

LEGEND:

PROJECT

121 ORION 415 STUDIO CRAFTSMAN PORCH 550

DRAWING NAME

ARCHITECTURAL DETAILS

Client Name	CLIENT NAME:	
0061_12	PROJECT NUMBER:	
3/21/2025 9:43:27 Al	DATE:	
Designe	DESIGNED BY:	
Autho	DRAWN BY:	
Checker	CHECKED BY:	

A401


SCALE: 1" = 1'-0"

CASEWORK GENERAL NOTES

- ALL CABINET HEIGHTS INCLUDE COUNTERTOPS. DIMENSIONS ARE TO THE NEAREST INCH.
 DIVISIONS IN CASEWORK ARE SHOWN FOR CLARITY AND DO NOT REPRESENT BREAKS IN THE
- DIVISIONS IN CASEWORK ARE SHOWN FOR CLARITY AND DO NOT REPRESENT BREAKS IN THE COUNTERTOP.
- 3. PROVIDE CONTINUOUS COUNTERTOP OVER ALL SIMILAR HEIGHT CASEWORK, UNLESS AND
- OTHERWISE NOTED.
 4. MANUFACTURER AND CATALOG NUMBERS ARE FOR REFERENCE AND ILLUSTRATION PURPOSES
- ONLY.
 5. DOTTED LINES INDICATE WALL HUNG CABINETS, DIVISIONS OF BASE CABINETS BELOW THE
- 6. COUNTERTOP, FURNITURE NOT IN THE CONTRACT OR PROJECTION SCREENS -SEE CASEWORK KEY AND SPECIFICATIONS.
- 7. ALL CABINETS AND DRAWERS TO HAVE CAM LOCKS EXCEPT FOR SINK BASE CABINETS.
 8. ALL EXPOSED SURFACES (EXPOSED TO VIEW FROM ANY PERSPECTIVE) TO BE COVERED WITH
- 8. ALL EXPOSED SURFACES (EXPOSED TO VIEW FROM ANY PERSPECTIVE) TO BE COVERED WIT LAMINATE.
- 9. ALL CASEWORK WHICH MEETS A WALL AT ONE OR BOTH ENDS, TO BE PROVIDED WITH FILLER PANELS AND SCRIBED TO THE WALL(S) AS REQUIRED.
- 10. ALL CABINETS AND DRAWERS ARE PROVIDED WITH RECESSED HANDLES.
- 11. CONTRACTOR TO FIELD VERIFY ALL CLEAR OPENINGS PRIOR TO MILLWORK OR CASEWORK
- 12. CASEWORK DRAWINGS ARE DIAGRAMMATIC IN NATURE TO SHOW DESIGN INTENT.

	CASEWORK SCHEDULE					
TYPE MAR K	TYPE	COUN	HEIGHT	WIDTH	DEPTH	AREA
0.4	LAUNDDY ODEN CADINET O	4	41 011	01 011	OL OIL	0.05
01	LAUNDRY OPEN CABINET 3	1	1' - 2"	2' - 3"	2' - 6"	3 SF
02	RECESSED_MED_CABINET 2	1	2' - 0"	1' - 6"	0' - 3"	3 SF
03	BASE CABINET L-SHAPED	1	2' - 11"	3' - 3"	3' - 3"	9 SF
04	WALL FILLER	1	2' - 11"	0' - 5"	2' - 0"	1 SF
05	VANITY	1	2' - 4"	2' - 6"	1' - 8"	6 SF
06	BASE CABINET DOUBLE DOOR 4	1	2' - 11"	3' - 0"	2' - 0"	9 SF
07	L-SHAPE COUNTER TOP 3	1	0' - 4"	7' - 0"	7' - 0"	2 SF
80	BASE CABINET DOUBLE DOOR 2	1	2' - 11"	1' - 9"	2' - 0"	5 SF
09	REFRIGERATOR TOP	1	1' - 6"	2' - 0"	2' - 4"	3 SF
10	WALL CABINET DOUBLE DOOR 3	1	2' - 6"	2' - 10"	1' - 0"	7 SF
11	LINEAR COUNTER TOP 3	1	0' - 4"	3' - 5"	2' - 1"	1 SF
12	WALL CABINET DOUBLE DOOR 2	1	2' - 6"	3' - 8"	1' - 0"	9 SF
13	WALL FILLER 2	1	2' - 11"	0' - 5"	2' - 0"	1 SF
14	WALL FILLER 2	1	2' - 6"	0' - 7"	1' - 0"	1 SF
15	CLOSET 3	1	6' - 0"	4' - 2"	1' - 4"	25 SF
GRAND	TOTAL	15				


SPECIALTY EQUIPMENT SCHEDULE				
TYPE MARK	ТҮРЕ	COUNT		
		1.		
01	WASHER-FRONT-LOAD	1		
02	REFRIGERATOR	1		
03	RANGE	1		
04	DRYER-FRONT-LOAD	1		
05	DISHWASHER	1		
GRAND TOTAL: 5				

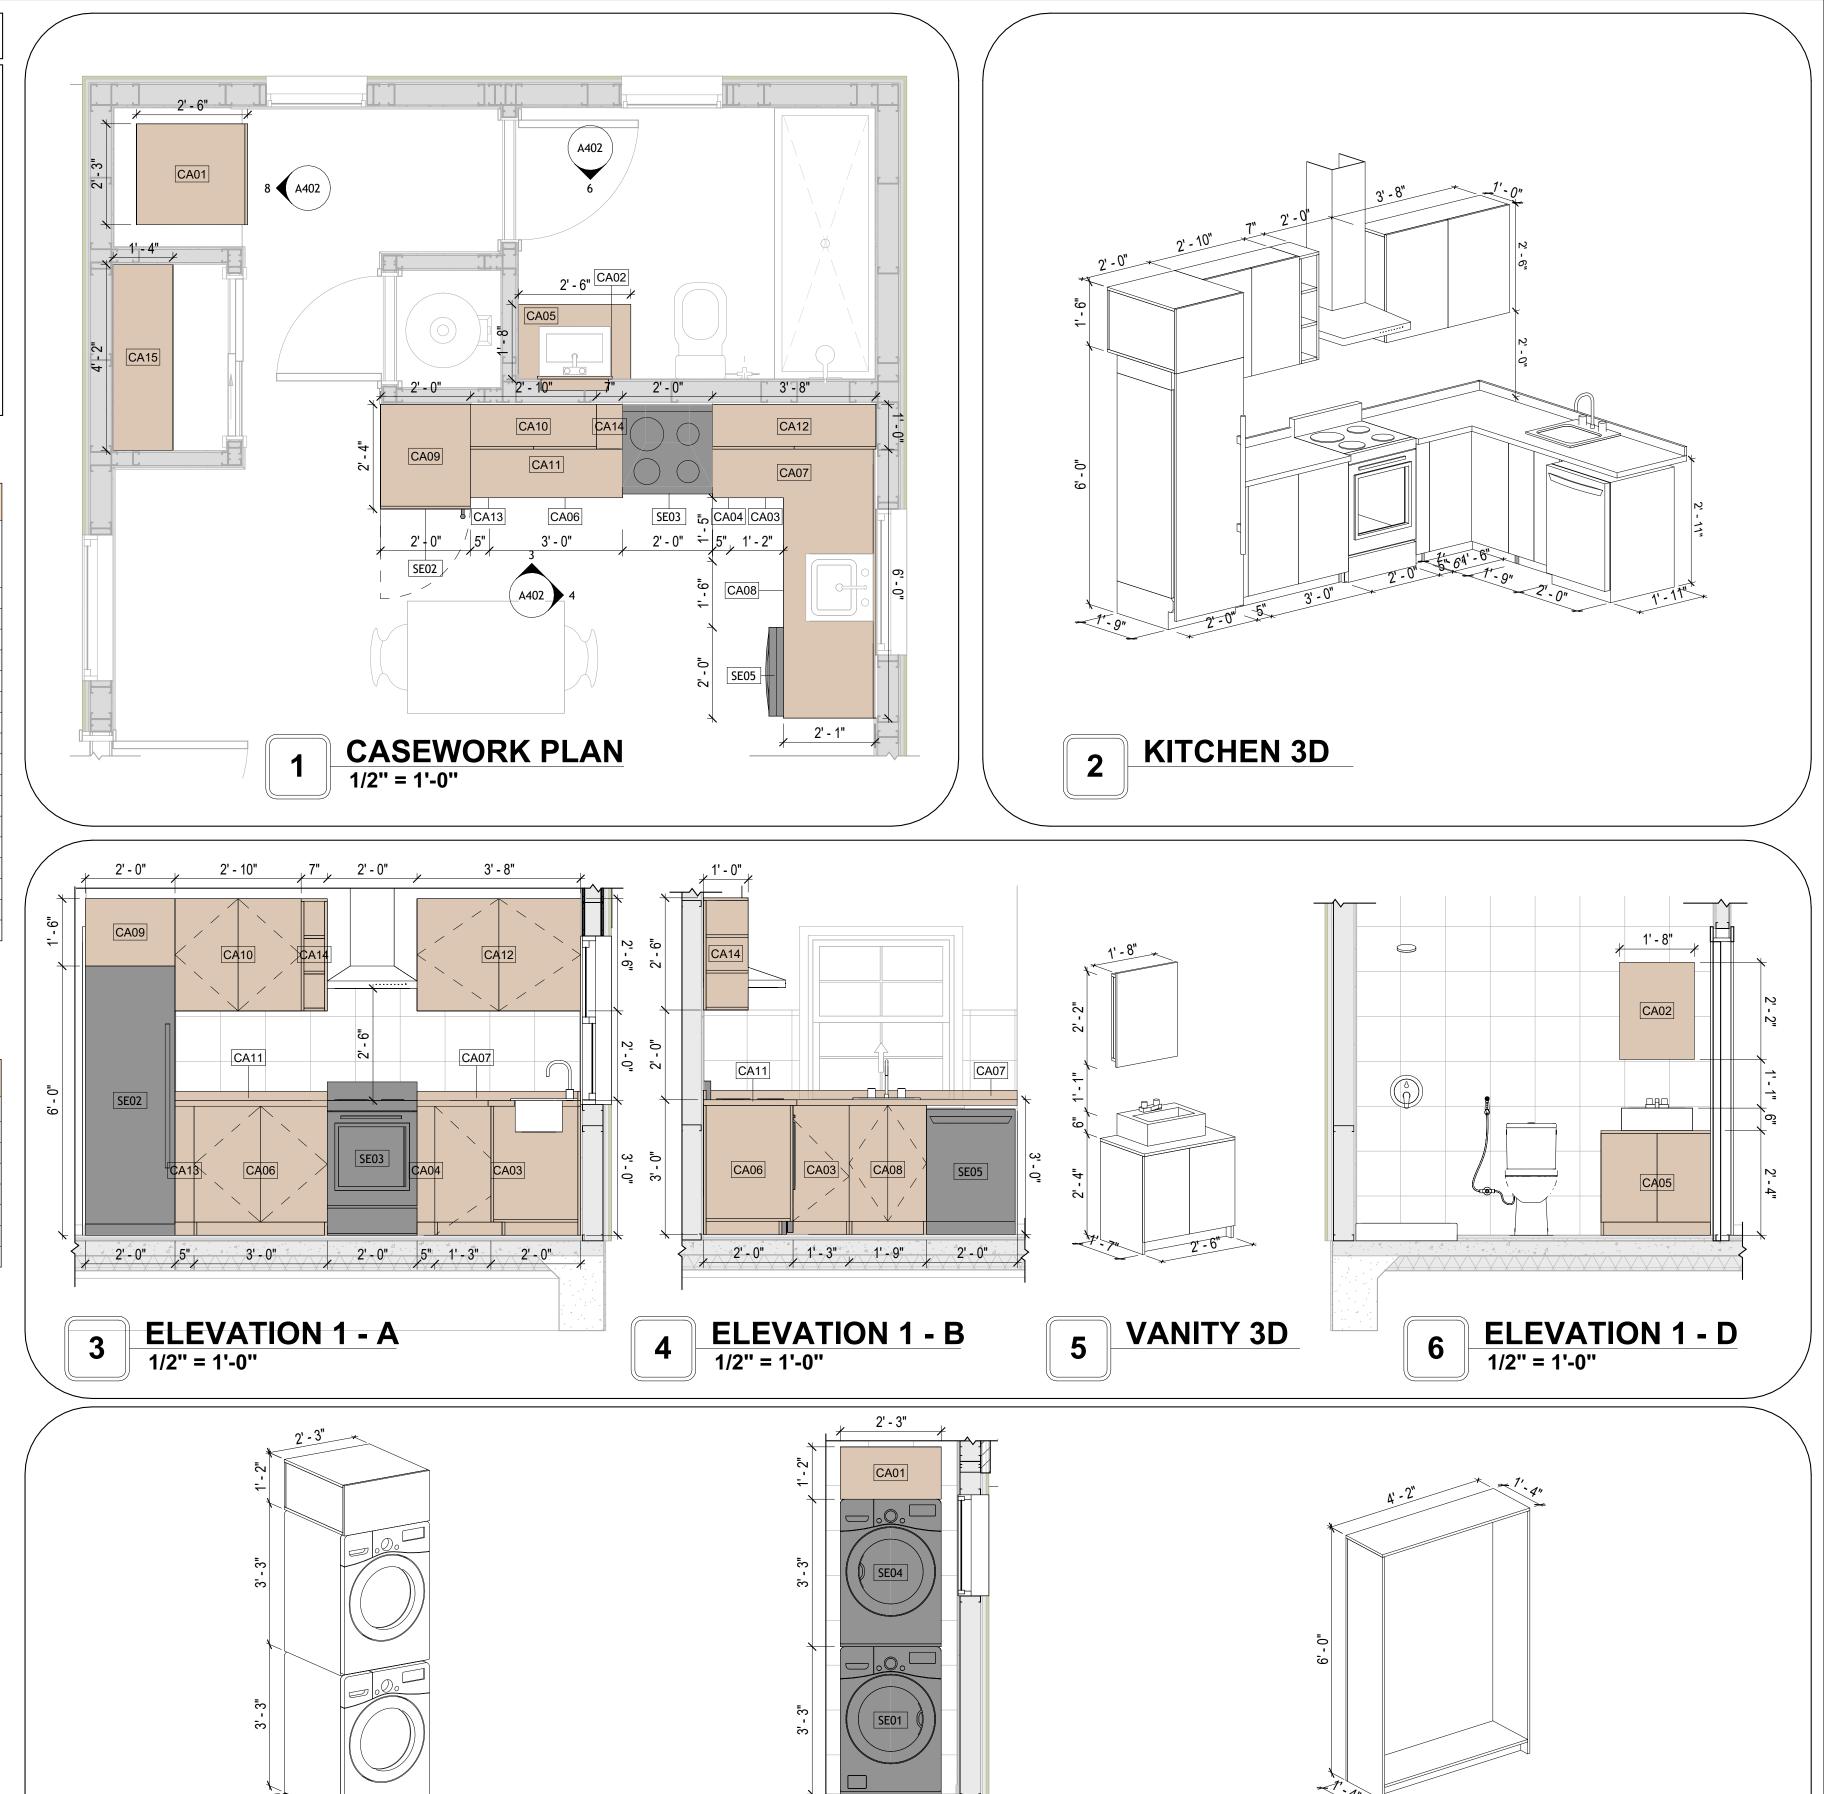

ELEVATION 1 - E 1/2" = 1'-0"

LAUNDRY 3D



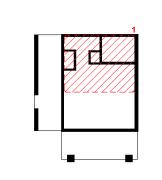

NO.	DESCRIPTION	DAT

NOTE:

LEGEND:

PROJECT

121 ORION 415 STUDIO CRAFTSMAN PORCH 550

DRAWING NAME

9 CLOSET 3D

ARCHITECTURAL CASEWORK

CLIENT NAME:	Client Name
PROJECT NUMBER:	0061_12
DATE:	3/21/2025 9:43:29 AM
DESIGNED BY:	Designer
DRAWN BY:	Author
CHECKED BY:	Checker

GENERAL NOTES

1. THIS DRAWING DEPICTS THE HVAC (HEATING, VENTILATION, AND AIR CONDITIONING) SYSTEM FOR THE ORION STUDIO CRAFTMAN PORCH_NG. IT PROVIDES A VISUAL REPRESENTATION OF THE SYSTEM LAYOUT AND COMPONENTS.

2.THE HVAC SYSTEM IS DESIGNED TO MEET THE SPECIFIC REQUIREMENTS OF THE BUILDING, INCLUDING HEATING, COOLING, AND VENTILATION NEEDS, AS PER THE PROJECT SPECIFICATIONS AND APPLICABLE CODES AND STANDARDS.

3. THE HVAC SYSTEM INSTALLATION SHALL COMPLY WITH THE LATEST EDITION OF THE INTERNATIONAL MECHANICAL CODE (IMC), INTERNATIONAL RESIDENTIAL CODE (IRC), AND ALL OTHER APPLICABLE LOCAL, STATE, AND NATIONAL CODES AND REGULATIONS.

4. THE EQUIPMENT SHOWN ON THIS DRAWING INCLUDES BUT IS NOT LIMITED TO AIR HANDLING UNITS (AHUS), CHILLERS, BOILERS, COOLING TOWERS, PUMPS, DUCTWORK, DIFFUSERS, GRILLES, AND CONTROL DEVICES.

5. ALL EQUIPMENT, DUCTWORK, AND PIPING SHALL BE INSTALLED IN ACCORDANCE WITH MANUFACTURER'S SPECIFICATIONS, LOCAL CODES, AND

6. ALL DUCTWORK SHALL BE SIZED, FABRICATED, AND INSTALLED IN ACCORDANCE WITH THE LATEST EDITION OF THE ACCA MANUAL D AND THE SMACNA HVAC DUCT CONSTRUCTION STANDARDS. DUCTWORK SHALL BE INSTALLED IN A NEAT AND WORKMANLIKE MANNER, PROPERLY SUPPORTED AND BRACED TO PREVENT SAGGING, AIR LEAKAGE, OR VIBRATION.

7. CONDENSATE DRAINAGE PIPING SHALL BE PROPERLY PITCHED TO ENSURE POSITIVE DRAINAGE TO AN APPROVED DISPOSAL LOCATION, SUCH AS A FLOOR DRAIN, SUMP PUMP, OR EXTERIOR GRADE. CONDENSATE LINES SHALL BE INSULATED TO PREVENT SWEATING.

8. THE LOCATION OF CONTROL PANELS AND SENSORS INDICATED ON THIS DRAWING CAN BEMODIFY WITH THE SPECIFIC LOCATIONS AND WIRING DETAILS WILL BE DETERMINED DURING THE CONTROL SYSTEM DESIGN AND INSTALLATION.

9. THE HVAC SYSTEM DESIGN CONSIDER ENERGY EFFICIENCY, INDOOR AIR QUALITY, OCCUPANT COMFORT, AND NOISE CONTROL, FOLLOWING APPLICABLE GUIDELINES AND REGULATIONS.

10. COORDINATION WITH OTHER TREADS HAS BEEN DONE ON A DESIGN LEVEL. THIS DRAWING SHALL BE READ TOGETHER WITH THE AR, EL AND SN DESIGN DRAWINGS TO ENSURE PROPER INSTALLATION AND INTEGRATION OF THE HVAC SYSTEMS.

11. THE HVAC CONTRACTOR IS RESPONSIBLE FOR OBTAINING ALL NECESSARY PERMITS AND LICENSES, AND FOR SCHEDULING AND COORDINATING WITH THE LOCAL BUILDING DEPARTMENT AND UTILITY PROVIDERS TO ENSURE A TIMELY AND COMPLIANT INSTALLATION.

12. ALL DUCTWORK PENETRATIONS THROUGH WALLS, FLOORS, OR CEILINGS SHALL BE PROPERLY SEALED AND FIRE-STOPPED USING APPROVED METHODS AND MATERIALS TO MAINTAIN THE INTEGRITY OF THE BUILDING'S FIRE-RESISTANCE RATINGS.

13. HVAC EQUIPMENT SHALL BE INSTALLED LEVEL AND PLUMB, AND IN STRICT ACCORDANCE WITH THE MANUFACTURER'S INSTALLATION INSTRUCTIONS AND RECOMMENDATIONS. PROVIDE ADEQUATE CLEARANCES AROUND EQUIPMENT FOR PROPER AIRFLOW, SERVICE ACCESS, AND

CODE COMPLIANCE. 14. ALL HVAC EQUIPMENT AND COMPONENTS, INCLUDING THERMOSTATS, DAMPERS, AND ACCESS PANELS, SHALL BE LOCATED IN ACCESSIBLE AREAS

15. THE HVAC SYSTEM SHALL BE BALANCED AND ADJUSTED TO ENSURE PROPER AIRFLOW, TEMPERATURE DISTRIBUTION, AND SYSTEM


PERFORMANCE THROUGHOUT THE RESIDENCE. PROVIDE A WRITTEN REPORT DOCUMENTING THE FINAL SYSTEM BALANCE.

16. ANY DEVIATIONS OR MODIFICATIONS TO THE HVAC SYSTEM DESIGN SHALL BE REVIEWED AND APPROVED BY THE RESPONSIBLE DESIGN PROFESSIONALS AND COMMUNICATED TO ALL RELEVANT PARTIES INVOLVED IN THE CONSTRUCTION PROCESS.

FOR EASY SERVICING AND MAINTENANCE. PROVIDE ADEQUATE SPACE AROUND EQUIPMENT FOR PROPER AIRFLOW AND SERVICE ACCESS.

17. FOR ANY INQUIRIES OR CLARIFICATIONS REGARDING THE HVAC SYSTEM DESIGN, PLEASE CONSULT THE RESPONSIBLE DESIGN PROFESSIONALS OR THE PROJECT MANAGEMENT TEAM.


SYMBOLS

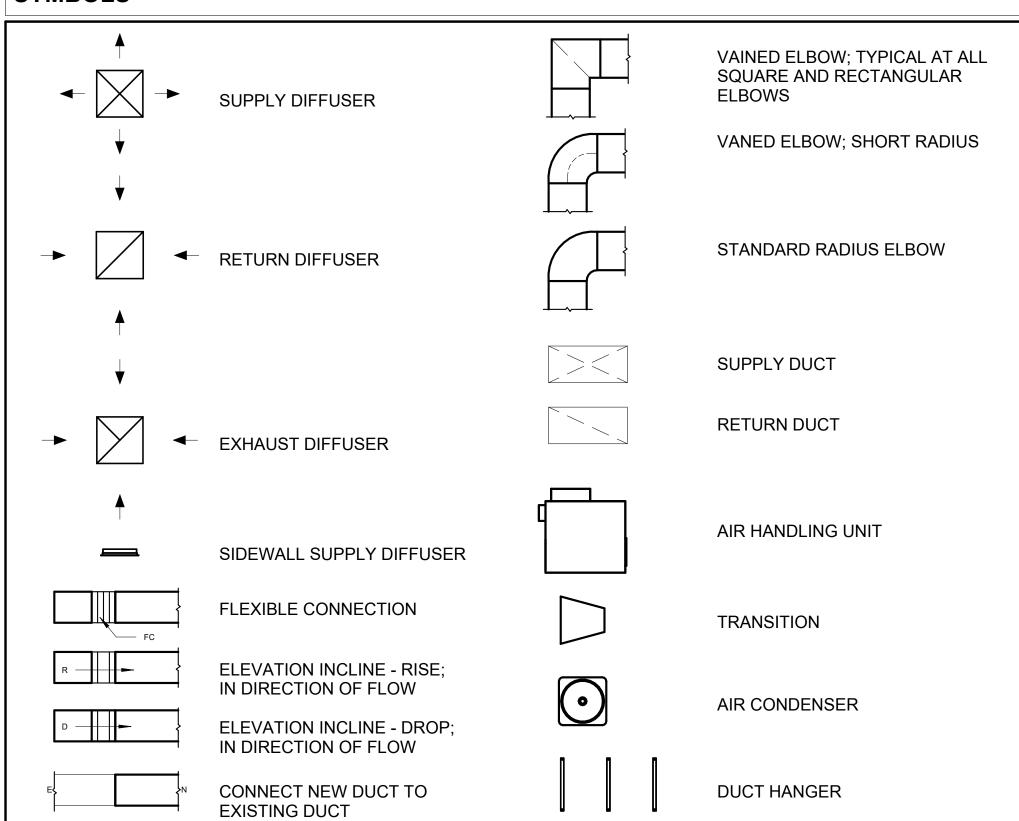

HVAC COLOR SCHEME

AIR CONDITIONING PIPE

REFRIGERANT LINE SCHEDULE				
CATAGORY	DESCRIPTION	DIAMETER	LENGTH	
PIPE TYPES	COPPER	3/8"	46.85	
PIPE TYPES	COPPER	3/4"	53.80	

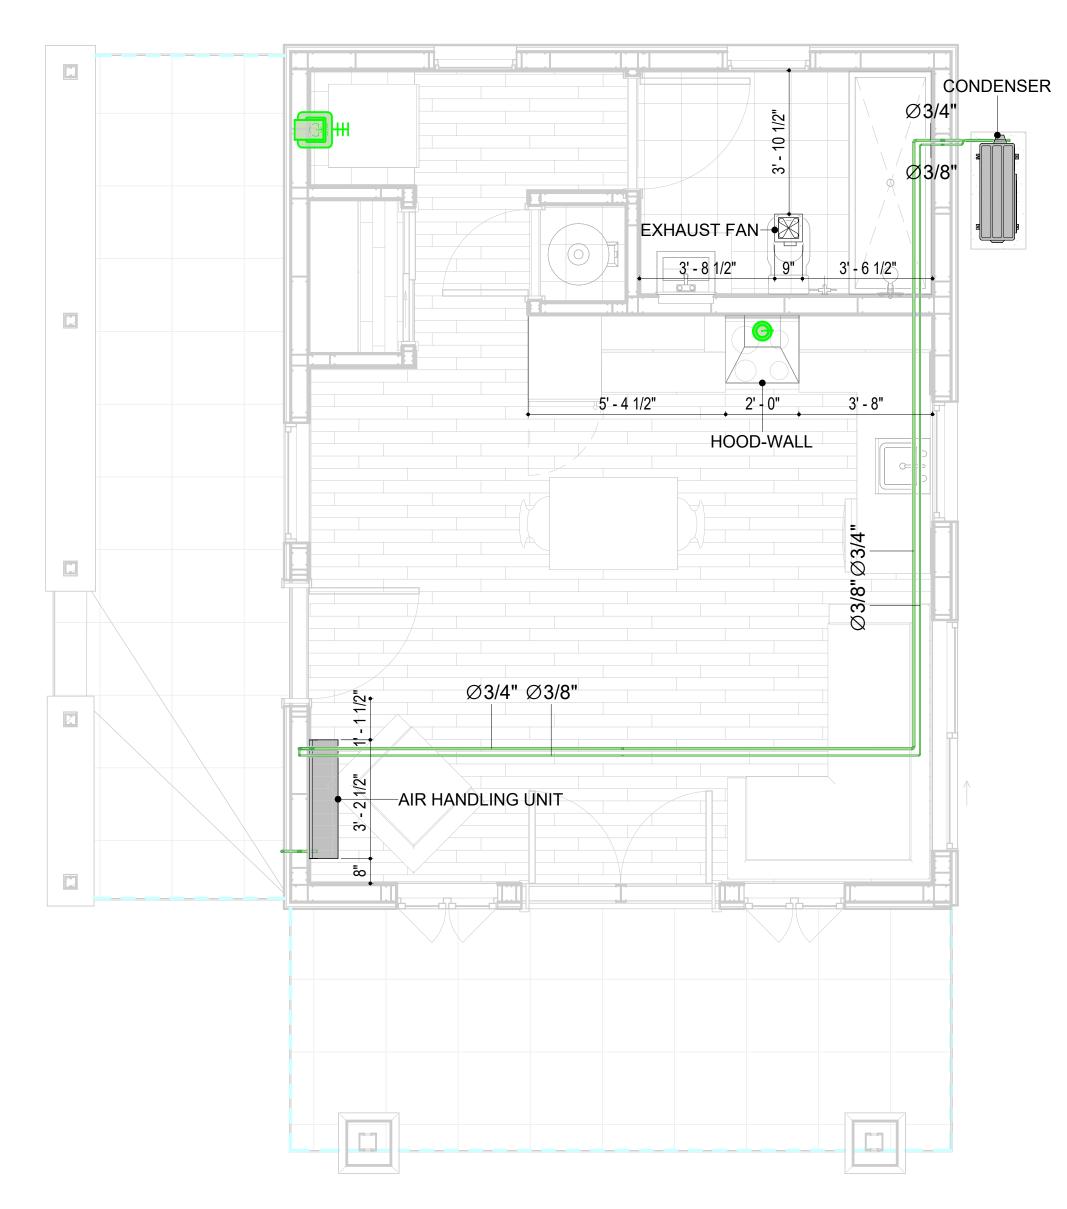

1	HVAC PLAN
	3/8" = 1'-0"

REFRIGERANT LINE FITTING SCHEDULE				
CATAGORY	DESCRIPTION	Size	Count	
ELBOW - GENERIC	ELBOW - GENERIC: STANDARD/HVAC	3/4"ø-3/4"ø	12	
ELBOW - GENERIC	ELBOW - GENERIC: STANDARD/HVAC	3/8"ø-3/8"ø	13	
TRANSITION - GENERIC	TRANSITION - GENERIC: STANDARD	3/4"ø-1/2"ø	2	
TRANSITION - GENERIC	TRANSITION - GENERIC: STANDARD	3/4"ø-5/8"ø	1	
TRANSITION - GENERIC	TRANSITION - GENERIC: STANDARD	3/8"ø-1/4"ø	1	

MECHANICAL EQUIPMENT SCHEDULE		
CATAGORY	DESCRIPTION	COUNT
AIR HANDLING UNIT	AIR HANDLING UNIT: WALL MOUNTED	1
	AIR HANDLING UNIT: WALL MOUNTED CONDENSER: OUT DOOR	1
AIR HANDLING UNIT CONDENSER EXHAUST FAN		1 1 1

DUCT FITTING SCHEDULE		
CATAGORY	DESCRIPTION	COUNT
ROUND TRANSITION - ANGLE	45 DEGREE	5

DUCT ACCESSORY SCHEDULE		
CATAGORY	DESCRIPTION	COUNT
ROOF VENT	3" DIAMETER	3

FLEX DUCT SCHEDULE								
DESCRIPTION	DESCRIPTION	LENGTH	DIAMETER	COUNT				
FLEX DUCT ROUND	FLEX-ROUND	8.31	4"	3				
GRAND TOTAL: 3		8.31						



KEY PLAN

NO.	DESCRIPTION	DATE

NOTE:

LEGEND:

PROJECT

121-Orion-415-Studio **Craftman Porch-550**

DRAWING NAME

HVAC PLAN

CLIENT NAME:	Owner
PROJECT NUMBER:	15_0001
DATE:	3/13/2025 6:45:27 AM
DESIGNED BY:	Designer
DRAWN BY:	Author
CHECKED BY:	Checker

M101

SCALE: As indicated

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ELECTRICAL NOTES

- 1. THIS DRAWING DEPICTS THE ELECTRICAL SYSTEM FOR THE 121-Orion-415-Studio Craftsman-Porch-550. IT PROVIDES A VISUAL REPRESENTATION OF THE ELECTRICAL LAYOUT AND COMPONENTS, INCLUDING POWER DISTRIBUTION, LIGHTING, AND CONTROL SYSTEMS.
- 2. THE ELECTRICAL SYSTEM IS DESIGNED TO MEET THE SPECIFIC REQUIREMENTS OF THE BUILDING, INCLUDING POWER DISTRIBUTION, LIGHTING, AND SPECIALIZED ELECTRICAL EQUIPMENT NEEDS, AS PER THE PROJECT SPECIFICATIONS AND APPLICABLE CODES AND STANDARDS.
- 3. THE ELECTRICAL SYSTEM INSTALLATION SHALL COMPLY WITH THE LATEST EDITION OF THE NATIONAL ELECTRICAL CODE (NEC), INTERNATIONAL BUILDING CODE (IBC), AND ALL OTHER APPLICABLE LOCAL, STATE, AND NATIONAL CODES AND REGULATIONS.
- 4. LOCATIONS AS NEEDED, DEVICES ARE SHOWN ON PLANS IN APPROXIMATE IDEAL LOCATIONS, UNLESS SPECIFICALLY DIMMENSIONED.
- 5. OPEN WALLS AS NEEDED TO ALLOW FOR NEW ELECTRICAL INSTALLATIONS.
- 6. LABEL ALL CIRCUITS ON JUNCTION BOXES, RECEPTACLES, DATA, SMOKE DETECTOR, AND EQUIPMENT IN PANEL BOX.
- 7. INSTALL RACEWAY AS NEEDED FOR DDC, ACCESS CONTROL, LOW VOLTAGE WIRING & DATA.
- 8. RELABEL POWER, DATA & FIRE ALARM FOR ROOM #CHANGES.
 9. VERIFY ALL CIRCUITS LABELED ON PRINT ARE CORRECT BEFORE WORKING ON THEM.
- 10. NOTE ON SITE PLAN ALL CHANGES OR MISSING DETAIL TO BE INCORPORATED INTO THE MASTER PLAN.
- 11. DRAWINGS ARE DIAGRAMMATIC ONLY FOR THE PURPOSE OF SHOWING FIXTURE AND OUTLET LOCATIONS.
- 12. ELECTRICAL CONTRACTOR TO VERIFY SERVICE SIZE BY CALCULATION BASED UPON ACTUAL NAME PLATE RATINGS OF SELECTED EQUIPMENT.
- PLATE RATINGS OF SELECTED EQUIPMENT.

 13. VERIFY LOCATION OF SERVICE ENTRANCE WITH POWER COMPANY. PROVIDE UFER GROUND IN
- BUILDING FOUNDATION AT SERVICE ENTRANCE LOCATION.

 14. PROVIDE A MIN. OF 20 FEET OF ONE *4 BARE COPPER UFER WIRE EMBEDDED IN CONCRETE FOOTING
- AT THE SERVICE ENTRANCE LOCATION WHERE APPROVED BY LOCAL SERVICE PROVIDER.
- 15. PROVIDE WATERPROOF FIXTURES IN ALL HIGH MOISTURE AREAS (EXTERIOR, SHOWER AND TUB CEILINGS ETC.)
- 16. PROVIDE DEDICATED CIRCUITS TO EACH BATH, DEN, FAMILY ROOM, BEDROOM, LOFT, KITCHEN
- REFRIGERATOR, KITCHEN FREEZER DISHWASHER, AND ANY AREA/ITEM SPECIFIED BY OWNER.

 17. INCANDESCENT FIXTURES WITH OPEN OR PARTIALLY ENCLOSED LAMPS, PENDANT FIXTURES, AND
- LAMP HOLDERS ARE NOT PERMITTED IN CLOSETS.

 18. ALL WORKMANSHIP AND MATERIALS TO CONFORM WITH THE 2015 IRC.
- 19. PROVIDE A MIN. OF 20 FEET OF ONE *4 BARE COPPER UFER WIRE EMBEDDED IN CONCRETE FOOTING AT THE SERVICE ENTRANCE LOCATION WHERE APPROVED BY LOCAL SERVICE PROVIDER.
- 20. PROVIDE A BONDING CONDUCTOR CONSISTING OF A MINIMUM OF ONE *4 BARE COPPER WIRE CONNECTING THE BUILDING'S METAL WATER PIPING SYSTEM TO THE SERVICE EQUIPMENT ENCLOSURE GROUNDING.

MAIN PANEL CALCS	MA	AIN	PAN	EL C	AL	CS
------------------	----	-----	------------	------	----	----

(USE 200 AMP SERVICE)

ELECTRICAL CALCS	
LIGHT AND OUTLETS 415 @ 3W	1,245 W
3 APPLIANCE CIRCUITS	4,500 W
DRYER	2,000 W
WASHER	2,000 W
RANGE	5,000 W
WATER HEATER	5,000 W
REFRIG.	1,800 W
DISHWASHER & DISPOSAL	3000 W
TOTAL	24,545 W
FRIST 10,000 @ 100% REMAINDER @ 40% MINI. SPLIT UNITS	10,000 W 5,818W 10,000 W
TOTAL	25,818 W
25,818 W DIVIDED BY 240V = 1	108 AMPS TOTAL

ELECTRICAL ABBREVIATIONS LIST

1P	1 POLE (2P, 3P, 4P, ETC.)	CTR	CENTER	HT	HEIGHT
Α	AMPERÈ	CU	COPPER	HTG	HEATING
AC	ABOVE COUNTER OR AIR CONDITIONER	DCP	DOMESTIC WATER CIRCULATING PUMP	HTR	HEATER
ACLG	ABOVE CEILING	DEPT	DEPARTMENT	HV	HIGH VOLTAGE
ADO	AUTOMATIC DOOR OPENER	DET	DETAIL	HVAC	HEATING, VENTILATING AND AIR
AF	AMP FRAME	DIA	DIAMETER	CONDITIONING	CONDITIONING
AFF	ABOVE FINISHED FLOOR	DISC	DISCONNECT	HWP	HYDRONIC WATER PUMP
AFG	ABOVE FINISHED FRADE	DIST	DISTRIBUTION	IC	INTERRUPTING CAPACITY
AFI	ARC FAULT CIRCUIT INTERRUPTER	DN	DOWN	IG	ISOLATED GROUND
AHU	AIR HANDLING UNIT	DPR	DAMPER	IMC	INTERMEDIATE METAL CONDUIT
	ALUMINUM		SAFETY DISCONNECT SWITCH		INCANDESCENT
AL ALT	ALTERNATE	DS DT	DOUBLE THROW	INCAND	INFRARED
AMP				IR I/W	
	AMPLIER	DWG	DRAWING		INTERLOCK WITH
AMPL	AMPLIFIER	DDC	DIRECT DIGITAL CONTROL	J-BOX	JUNCTION BOX
ANNUN	ANNUNCIATOR APPROX APPROXIMATELY	EC	ELECTRICAL CONTRACTOR	KV	KILOVOLT
AQ-STAT	AQUASTAT	ELEC	ELECTRIC, ELECTRICAL	KVA	KILOVOLT-AMPERE
ARCH	ARCHITECT, ARCHITECTURAL	ELEV	ELEVATOR	KVAR	KILOVOLT-AMPERE REACTIVE
AS	AMP SWITCH	EM	EMERGENCY	KW	KILOWATT
AT	AMP TRIP	EMS	ENERGY MANAGEMENT SYSTEM	KWH	KILOWATT HOUR
ATS	AUTOMATIC TRANSFER SWITCH	EMT	ELECTRICAL METALLIC TUBING	LOC	LOCATE OR LOCATION
AUTO	AUTOMATIC	EP	ELECTRIC PNEUMATIC	LT	LIGHT
AUX	AUXILIARY	EQUIP	EQUIPMENT	LTG	LIGHTING
AV	AUDIO VISUAL	EWC	ELECTRIC WATER COOLER	LTNG	LIGHTNING
AWG	AMERICAN WIRE GAUGE	EXIST	EXISTING	LV	LOW VOLTAGE
BATT	BATTERY	EXH	EXHAUST	MAX	MAXIMUM
BD	BOARD	EXP	EXPLOSION PROOF	MAG.S	MAGNETIC STARTER
BLDG	BUILDING	FA	FIRE ALARM	M/C	MOMENTARY CONTACT
BMS	BUILDING MANAGEMENT SYSTEM	FABP	FIRE ALARM BOOSTER POWER	MC	MECHANICAL CONTRACTOR
С	CONDUIT	SUPPLY PANEL	SUPPLY PANEL	MCB	MAIN CIRCUIT BREAKER
CAB	CABINET	FACP	FIRE ALARM CONTROL PANEL	MCC	MOTOR CONTROL CENTER
CAT	CATALOG	FCU	FAN COIL UNIT	MDC	MAIN DISTRIBUTION CENTER
CATV	CABLE TELEVISION	FIXT	FIXTURE	MDP	MAIN DISTRIBUTION PANEL
СВ	CIRCUIT BREAKER	FLR	FLOOR	MFR	MANUFACTURERMAIN FUSED
CCTV	CLOSED CIRCUIT TELEVISION	FLUOR	FLUORESCENT		DISCONNECT SWITCH
CKT	CIRCUIT	FU	FUSE	MH	MANHOLE
CLG	CEILING	FUDS	FUSED SAFETY DISCONNECT SWITCH	MIC	MICROPHONE
COMB	COMBINATION	GA	GAUGE	MIN	MINIMUM
CMPR	COMPRESSOR	GAL	GALLON	MISC	MISCELLANEOUS
CONN	CONNECTION	GALV	GALVANIZED	MLO	MAIN LUGS ONLY
CONST	CONSTRUCTION	GC	GENERAL CONTRACTOR	MMS	MANUAL MOTOR STARTER
CONT	CONTINUATION OR CONTINUOUS	GEN	GENERATOR	MOA	MULTIOUTLET ASSEMBLY
CONTR	CONTRACTOR	GFI	GROUND FAULT CIRCUIT INTERRUPTER	MSP	MOTOR STARTER PANELBOARD
CONV	CONVECTOR	GFP	GROUND FAULT PROTECTOR	MSBD	MAIN SWITCHBOARD
CP	CIRCULATING PUMP	GND	GROUND	MT	MOUNT
CRT	CATHODE-RAY TUBE	GRS	GALVANIZED RIGID STEEL (CONDUIT)	MT.C	EMPTY CONDUIT
CT	CURRENT TRANSFORMER	GYP BD	GYPSUM BOARD	UL	UNDERWRITERS LABORATORIES
	SOLUTION TO STATE OF THE STATE	011 00			S. T. C. T. C.

Branch Panel:

Location: KITCHEN 02
Supply From:
Mounting: Recessed

Enclosure: Type 1

Volts: 120/240 Single
Phases: 1
Wires: 3

A.I.C. Rating:
Mains Type:
Mains Rating: 200 A
MCB Rating: 1 A

otes:

Circuit Numb er		Number of Elements	Rating	Length	Wire Size	A			В	Wire Size	Length	Rating	Number of Elements	Circuit Description	Circuit Numb er
	BATH GFCI	7	20 A	20' - 7 3/4"	1-#12, 1-#12, 1-#12	576 VA	516 VA			1-#12, 1-#12, 1-#12	28' - 1 21/32"	20 A	13	KITCHEN & HALL LIGHT	2
3	REFRIGERATOR	1	20 A	26' - 5 19/32"	1-#12, 1-#12, 1-#12			1800 VA	540 VA	1-#12, 1-#12, 1-#12	22' - 0 1/32"	20 A	3	KITCHEN GFCI	4
5	RANGE	1	40 A	19' - 11 9/32"	2-#8, 1-#8, 1-#10	2500 VA	180 VA			1-#12, 1-#12, 1-#12	15' - 6 21/32"	20 A	1	OVEN HOOD	6
7								2500 VA	1200 VA	1-#12, 1-#12, 1-#12	12' - 3 17/32"	20 A	1	DISHWASHER	8
9	WATER HEATER	1	30 A	26' - 6 11/32"	2-#10, 1-#10, 1-#10	2250 VA	209 VA			1-#14, 1-#14, 1-#14	25' - 4 9/16"	15 A	7	LIV. LIGHT	10
11								2250 VA	400 VA	1-#12, 1-#12, 1-#12	29' - 1 15/16"	20 A	6	OUTDOOR LIGHT	12
13	LIV. RECEPTACLE	5	20 A	33' - 6 21/32"	1-#12, 1-#12, 1-#12	900 VA	1200 VA			1-#12, 1-#12, 1-#12	40' - 1 13/32"	20 A	1	WASHING MASHEIN	14
15	DRYER	1	30 A	37' - 11 9/32"	2-#10, 1-#10, 1-#10			2500 VA	2500 VA	2-#6, 1-#6, 1-#10	20' - 3 3/16"	60 A	1	CONDENSER	16
17						2500 VA	2500 VA								18
19	OUTDOOR RECEPTACLE	3	20 A	38' - 6 13/32"	1-#12, 1-#12, 1-#12			540 VA							20
21															22
23															24
25															26
	1					13327	'VA	1421	1 VA						1
						111	Α	11	8 A					1	

Legend

Connected Load	Demand Factor	Estimated Demand	Panel	Totals
600 VA	100.00%	600 VA		
652 VA	100.00%	652 VA	Total Conn. Load:	27538 VA
4920 VA	100.00%	4920 VA	Total Est. Demand:	26538 VA
100 VA	100.00%	100 VA	Total Conn.:	115 A
5000 VA	100.00%	5000 VA	Total Est. Demand:	111 A
4500 VA	100.00%	4500 VA		
5000 VA	80.00%	4000 VA		
5000 VA	100.00%	5000 VA		
1800 VA	100.00%	1800 VA		
	600 VA 652 VA 4920 VA 100 VA 5000 VA 4500 VA 5000 VA 5000 VA	600 VA 100.00% 652 VA 100.00% 4920 VA 100.00% 100 VA 100.00% 5000 VA 100.00% 4500 VA 100.00% 5000 VA 80.00% 5000 VA 100.00%	600 VA 100.00% 600 VA 652 VA 100.00% 652 VA 4920 VA 100.00% 100 VA 100 VA 100.00% 100 VA 5000 VA 100.00% 4500 VA 5000 VA 80.00% 4000 VA 5000 VA 100.00% 5000 VA	600 VA 100.00% 600 VA 652 VA 100.00% 652 VA Total Conn. Load: 4920 VA 100.00% 4920 VA Total Est. Demand: 100 VA 100.00% 100 VA Total Conn.: 5000 VA 100.00% 5000 VA Total Est. Demand: 4500 VA 4500 VA 4500 VA 5000 VA 80.00% 4000 VA 5000 VA 100.00% 5000 VA



KEY PLAN

NO. DESCRIPTION DATE

NOTE:

LEGEND:

PROJECT

121-Orion-415-Studio Craftsman-Porch-550

DRAWING NAME

SCHEDULE

CLIENT NAME:

PROJECT NUMBER:

0351_11

DATE:
3/15/2025 3:16:24 PM

DESIGNED BY:

DRAWN BY:

CHECKED BY:

Checker

E101

SCALE: 1/4" = 1'-0"

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ELECTRICAL NOTE

- A. PROVIDE INTERCONNECTED SMOKE ALARMS IN EACH SLEEPING ROOMS, OUTSIDE EACH SLEEPING ROOM, ON EACH STORY, IN THE HALL OR ADJACENT ROOM LUHERE THE CEILING HEIGHT OF A ROOM OPEN TO THE HALL EXCEEDS THE HALL BY 24'. SMOKE ALARMS SHALL BE PERMANENTLY HARD WIRED WITH BATTERY BACKUP.
- B. RECEPTACLE OUTLETS FOR RANGES AND CLOTHES DRYERS SHALL BE A THREE POLE WITH GROUND TYPE. FOUR WIRE GROUNDING-TYPE FLEXIBLE CORDS WILL BE REQUIRED FOR CONNECTION OF RANGES AND CLOTHES DRYERS. THE BONDING JUMPER SHALL NOT BE CONNECTED BETWEEN NEUTRAL TERMINAL AND THE FRAME OF THE APPLIANCE.
- C. TWO OR MORE 20 AMP SMALL APPLIANCE CIRCUITS SHALL BE PROVIDED TO SERVE THE KITCHEN, BREAKFAST NOOK, AND DINING ROOM. SUCH CIRCUITS SHALL HAVE NO OTHER OUTLETS.
- D. AT LEAST ONE 20 AMP BRANCH CIRCUIT SHALL BE PROVIDED TO SERVICE THE LAUNDRY ROOM. THIS CIRCUIT SHALL HAVE NO OTHER OUTLETS.
- E. ALL RECEPTACLES WITH IN 6' OF A WET BAR SINK OR KITCHEN SINK TO SERVE COUNTER TOP SURFACES MUST BE GFCI. ON KITCHEN COUNTERS 12' OR WIDER NO POINT ALONG THE WALL SHALL BE MORE THAN 2' FROM A RECEPTACLE. ALL RECEPTACLES WITH IN 6' OF KITCHEN SINK MUST BE GFCI. AT LEAST ONE GFCI RECEPTACLE SHALL
- BE INSTALLED IN THE BATHROOM ADJACENT TO EACH BASIN.

 F. FIXTURES INCLUDING CEILING FANS THAT ARE LOCATED IN DAMP LOCATIONS SHALL BE LISTED TO BE SUITABLE FOR
- SUCH LOCATIONS PER 2012 IRC
- G. PROVIDE ONE (1) SWITCHED OUTLET @ ALL BEDROOMS AND DEN
- H. CEILING FANS NOT EXCEEDING 35 LBS. (WITH OR WITHOUT ACCESSORIES MAY BE SUPPORTED BY OUTLET BOXES PROVIDED THE OUTLET BOXES ARE IDENTIFIED FOR SUCH USE PER 2012 IRC
- I. ELECTRICAL OUTLET BOXES ON OPPOSITE SIDES OF FIRE RATED WALLS SHALL BE SEPARATED BY A HORIZONTAL DISTANCE OF NOT LESS THAN 24".
- J. OUTLET BOXES IN THE WALLS BETWEEN THE GARAGE AND DWELLING SHALL BE METAL OR U.L. APPROVED FIRE RESISTIVE PLASTIC. BOXES IN GARAGE CEILING SHALL BE METAL.
- K. ALL BRANCH CIRCUITS THAT SUPPLY 120 VOLTS SINGLE PHASE 15 AND 20 AMPS RECEPTACLE OUTLETS INSTALLED IN THE DWELLING SHALL BE PROTECTED BY AN ARC FAULT CIRCUIT INTERRUPTER, EXCEPT GFCI RECEPTICLES.

NOTE:

A. RECEPTACLES MUST BE PROVIDED IN HALLWAYS 10'-0" OR MORE IN LENGTH. FOR A ONE FAMILY DWELLINGS AND EACH OF A TWO FAMILY DWELLING THAT IS AT GRADE LEVEL, AT LEAST ONE WP-GFCI RECEPTACLE OUTLET ACCESSIBLE AT GRADE LEVEL AND NOT MORE THAN 6'-6" ABOVE GRADE SHALL BE INSTALLED AT THE FRONT AND BACK OF THE DWELLING.

NOTE: APPLIANCE DISCONNECT

E4001.5 GROUNDING OF ENCLOSURES.

METAL ENCLOSURES FOR SWITCHES OR CIRCUIT BREAKERS SHALL BE CONNECTED TO AN

EQUIPMENT GROUNDING CONDUCTOR.

METAL ENCLOSURES FOR SWITCHES OR CIRCUIT BREAKERS USED AS SERVICE


EQUIPMENT SHALL COMPLY WITH THE PROVISIONS OF SECTION E3609.4. WHERE


NONMETALLIC ENCLOSURES ARE USED WITH METAL RACEWAYS OR METAL-ARMORED CABLES. PROVISIONS SHALL BE MADE FOR CONNECTING THE EQUIPMENT GROUNDING

CONDUCTOR.


NONMETALLIC BOXES FOR SWITCHES SHALL BE INSTALLED WITH A WIRING METHOD THAT


PROVIDES OR INCLUDES AN EQUIPMENT GROUNDING CONDUCTOR. (404.12)

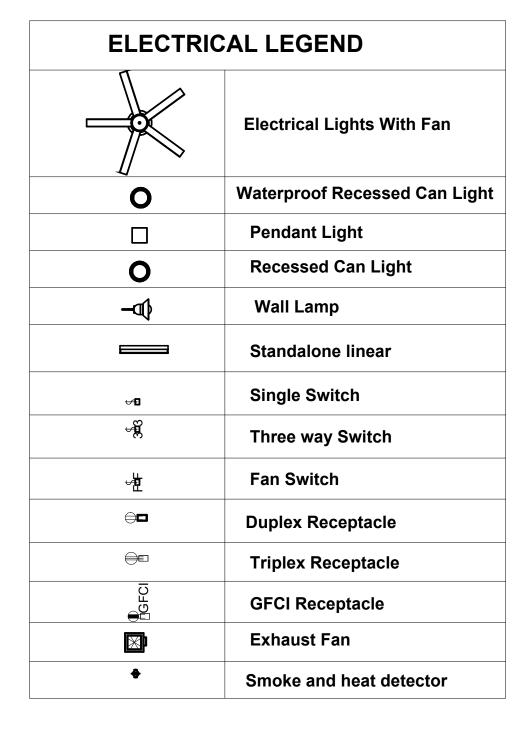

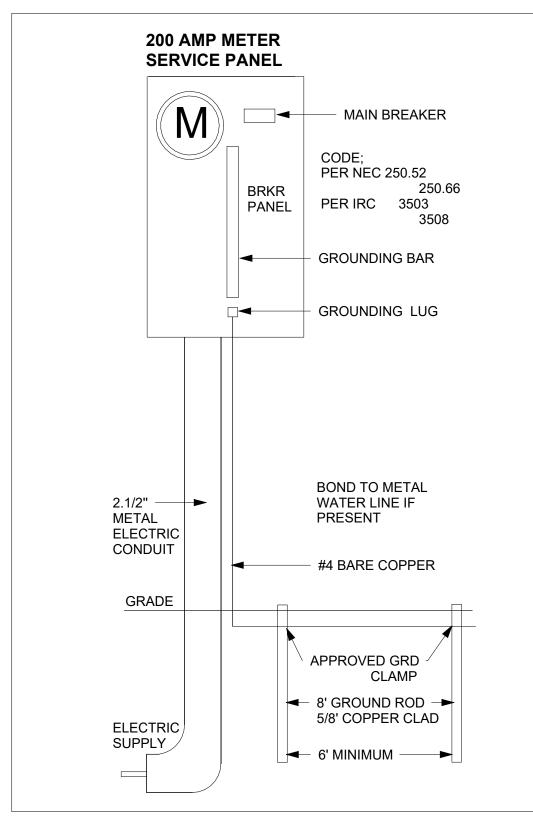



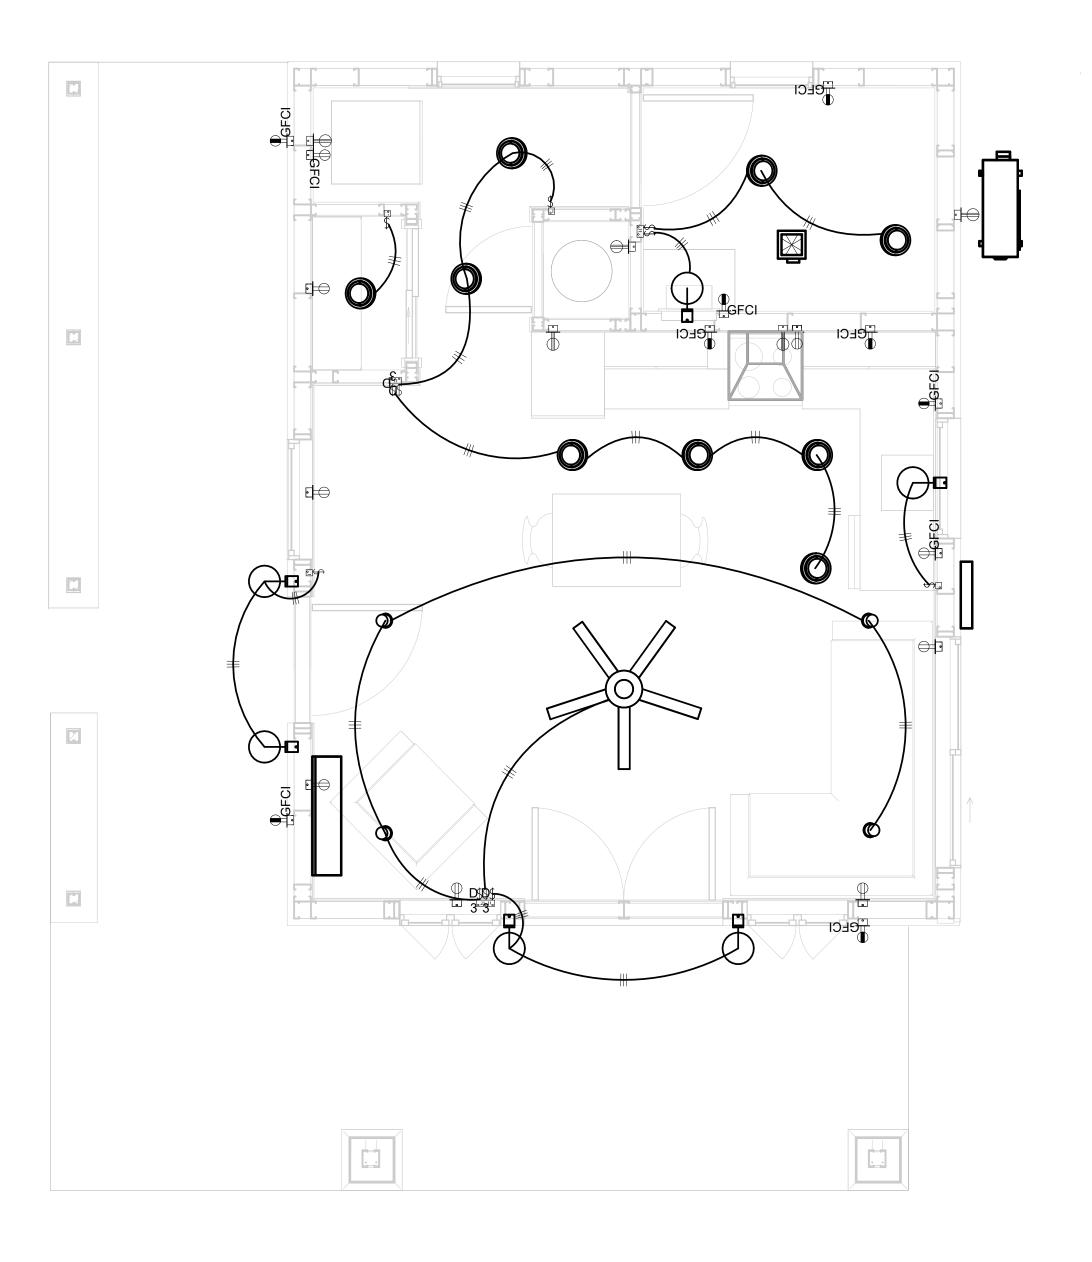

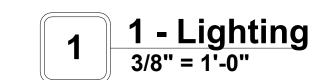



KEY PLAN

NO.	DESCRIPTION	DATE

NOTE:

LEGEND:

PROJECT

121-Orion-415-Studio Craftsman-Porch-550

DRAWING NAME


LIGHTING

CLIENT NAME:	Owner
PROJECT NUMBER:	0351_11
DATE:	3/15/2025 3:16:25 PM
DESIGNED BY:	Designer
DRAWN BY:	Author
CHECKED BY:	Checker


E102

NOTES: CONDUIT, CABLE AND WIRING

- Use Metalic Conduits (IMC) for cables running under concrete slabs.
 Use IMC for circuits with high voltage appliances (240 volts and above)
 For circuits with 120 volts consider using EMT or PVC conduits if needed.
 For Low voltage applications up to 50 volts consider using non metalic conduits.
 All conduits to be used in the project must conform to the latest National Electrical Code (NEC),
- 6. All wiring and cables to be used in the project must also conform to the latest National Electrical
- 7. All cables and wires used should be rated for their respective loading and should be gauged and conform to the NEC.

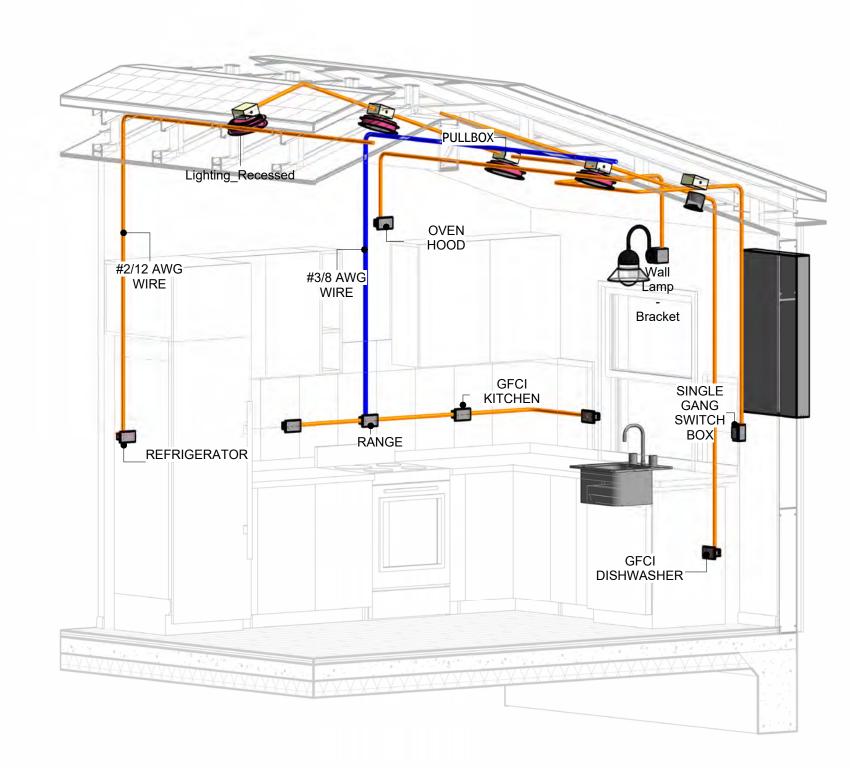


3D-KITCHEN

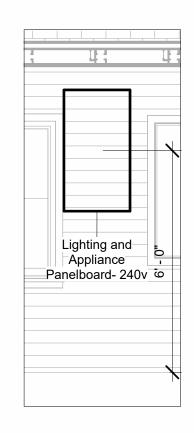


Panel 3/8" = 1'-0"




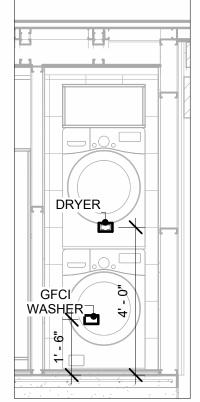

Dryer&Washer 3/8" = 1'-0"

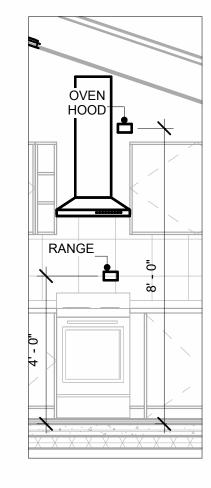


Range & OvenHood
3/8" = 1'-0"

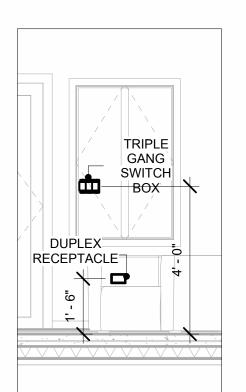

Switch&Receptacle 3/8" = 1'-0"



KEY PLAN

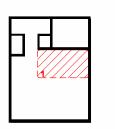

NO.	DESCRIPTION	DATE

NOTE:

LEGEND:

PROJECT

121-Orion-415-Studio Craftsman-Porch-550

DRAWING NAME

POWER

CLIENT NAME:	Owner
PROJECT NUMBER:	0351_11
DATE:	3/15/2025 3:16:51 PM
DESIGNED BY:	Designer
DRAWN BY:	Author
CHECKED BY:	Checker

E103

NOTES: LIGHT

- 1. LIGHT FIXTURES AND LUMINARIES SHALL CONFORM TO THE NEC, THE IRC AND LOCAL SAFETY & BUILDING CODE.
- 2. ALL LIGHTING FIXTURES SHOULD CONFORM TO THE DESIGN ELECTRICAL LOAD AND SHALL BE PROPERLY WIRED AND MOUNTED BY QUALIFIED ELECTRICIAN FOLLOWING MANUFACTURERS SPECIFICATIONS.
- 3. CEILING FANS AND FANS WITH LIGHT WITH WEIGHT EXCEEDING 35 LBS SHOULD BE PROVIDED WITH STRUCTURAL BACKING FOR SUPPORT AND SHALL BE FIXED AS PER MANUFACTURERS SPECIFICATIONS.
- 4. EXTERIOR LIGHTS SHALL CONFORM TO LOCAL BUILDING CODE AND GUIDELINES.

NOTES: SWITCH JUNCTION BOX


- 1. THE MINIMUM SIZE OF JUCTION BOX TO BE USED IS 2"X4"X(1.5" OR 3.5" DEEP) THIS ARE TO BE USED FOR SINGLE GANG SWITCH OR OUTLETS.
- 2. FOR DOUBLE GANG (2 GANG) OUTLETS AND SWITCHS THE MINIMUM SIZE OF THE
- JUCTION BOX TO BE PROVIDED SHALL NOT BE LESS THAN 4"X4"X(1.5" OR 3.5" DEEP)
- 3. FOR THREE GANG (3 GANG) OUTLETS AND SWITCHS THE MINIMUM SIZE OF THE JUĆTION BOX SHALL NOT BE LESS THAN 6"X4"X(1.5" OR 3.5" DEEP).

FITTING SCHEDULE(PULL BOX)			
FAMILY	COUNT	DESCRIPTION	
PULLBOX1	13	#1/4 PULLBOX	

ELECTRICAL FIXTURE SCHEDULE (SWITCH BOX)			
TYPE	COUNT		
DOUBLE GANG SWITCH BOX	2		
SINGLE GANG SWITCH BOX	4		
TRIPLE GANG SWITCH BOX	1		

LIGHTING DEVICE			
TYPE	COUNT		
DIMMER	1		
SINGLE POLE	8		
THREE WAY WITH DIMMER 2			

LIGHTING FIXTURE			
VOLTAGE	ELECTRICAL LOAD	COUNT	
120 V/1-100 VA- 120 V/1-100 VA	200 A, 120 V/240 V, SINGLE PHASE, 3 WIRES	1	
120 V/1-60 VA	200 A, 120 V/240 V, SINGLE PHASE, 3 WIRES	9	
120 V/1-28 VA	200 A, 120 V/240 V, SINGLE PHASE, 3 WIRES	4	
120 V/1-100 VA	200 A, 120 V/240 V, SINGLE PHASE, 3 WIRES	6	
	VOLTAGE 120 V/1-100 VA- 120 V/1-100 VA 120 V/1-60 VA 120 V/1-28 VA	VOLTAGE ELECTRICAL LOAD 120 V/1-100 VA- 120 V/1-100 VA PHASE, 3 WIRES 120 V/1-60 VA 200 A, 120 V/240 V, SINGLE PHASE, 3 WIRES 120 V/1-28 VA 200 A, 120 V/240 V, SINGLE PHASE, 3 WIRES 120 V/1-100 VA 200 A, 120 V/240 V, SINGLE PHASE, 3 WIRES 120 V/1-100 VA 200 A, 120 V/240 V, SINGLE	

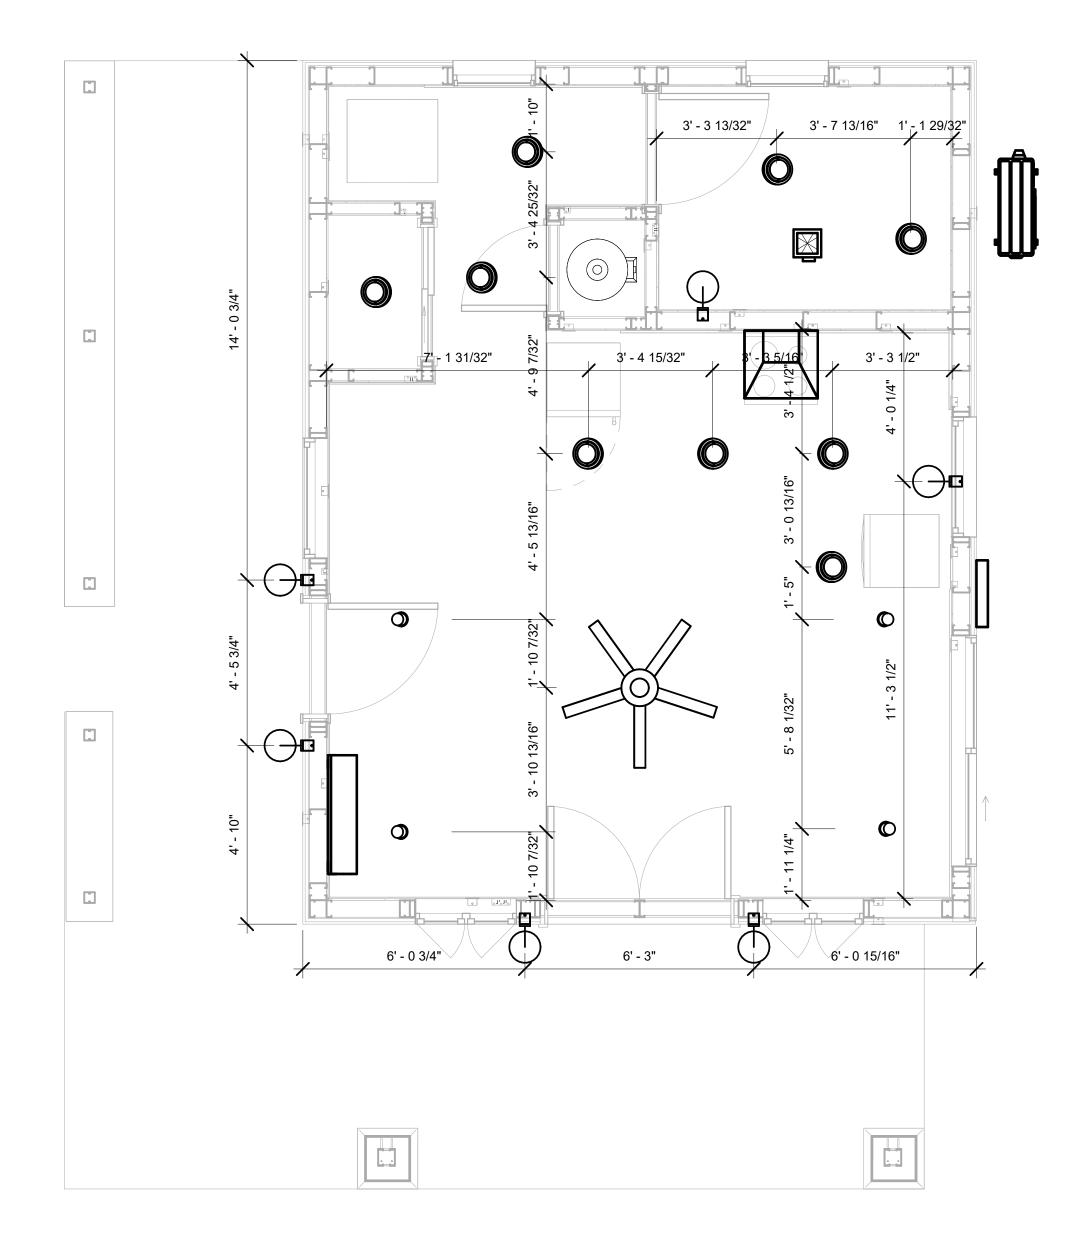

DIMENSION FOR LIGHT FIXTURES 3/8" = 1'-0"



KEY PLAN

NO.	DESCRIPTION	DATE

NOTE:

LEGEND:

PROJECT

121-Orion-415-Studio Craftsman-Porch-550

DRAWING NAME

DIMENSION PLAN FOR LIGHT FIXTURES

CLIENT NAME: Owner 0351_11 PROJECT NUMBER: 3/15/2025 3:16:51 PM Designer DESIGNED BY: DRAWN BY: Checker CHECKED BY:


E104

NOTES;

- 1. VERIFY EQUIPMENT PLUG CONFIGURATION BEFORE PURCHASING RECEPTACLES
- 2. FOR ALL EQUIPMENT.
- 3. COORDINATE EXACT LOCATION OF LIGHT FIXTURES, WALL SWITCHES, RECEPTACLES AND OTHER DEVICES WITH ARCHITECTURAL DRAWINGS.
- 4. USE METALLIC JUNCTION BOX WITH THE GFCI RECEPTACLES, WITH HIGHT VOLTAGE.

ELECTRICAL FIXTURE SCHEDULE (RECEPTACLE)			
COUNT			
1			
1			
6			
2			
1			
3			
3			
1			
1			
1			
1			
1			

ELECTRICAL OUTLET SCHEDULE			
TYPE	CIRCUIT NUMBER	ELECTRICAL DATA	COUNT
DUPLEX RECEPTACLE		120 V/1-180 VA	1
GFCI BATH ROOM	1	120 V/1-180 VA	2
REFRIGERATOR	3	120 V/1-1800 VA	1
GFCI KITCHEN	4	120 V/1-180 VA	3
RANGE	5,7	240 V/2-5000 VA	1
OVEN HOOD	6	120 V/1-180 VA	1
GFCI DISHWASHER	8	120 V/1-1200 VA	1
WATER HEATER	9,11	240 V/2-4500 VA	1
DUPLEX RECEPTACLE	13	120 V/1-180 VA	5
GFCI WASHER	14	120 V/1-1200 VA	1
DRYER	15,17	240 V/2-5000 VA	1
CONDENSER	16,18	240 V/2-5000 VA	1
GFCI OUT DOOR	19	120 V/1-180 VA	3

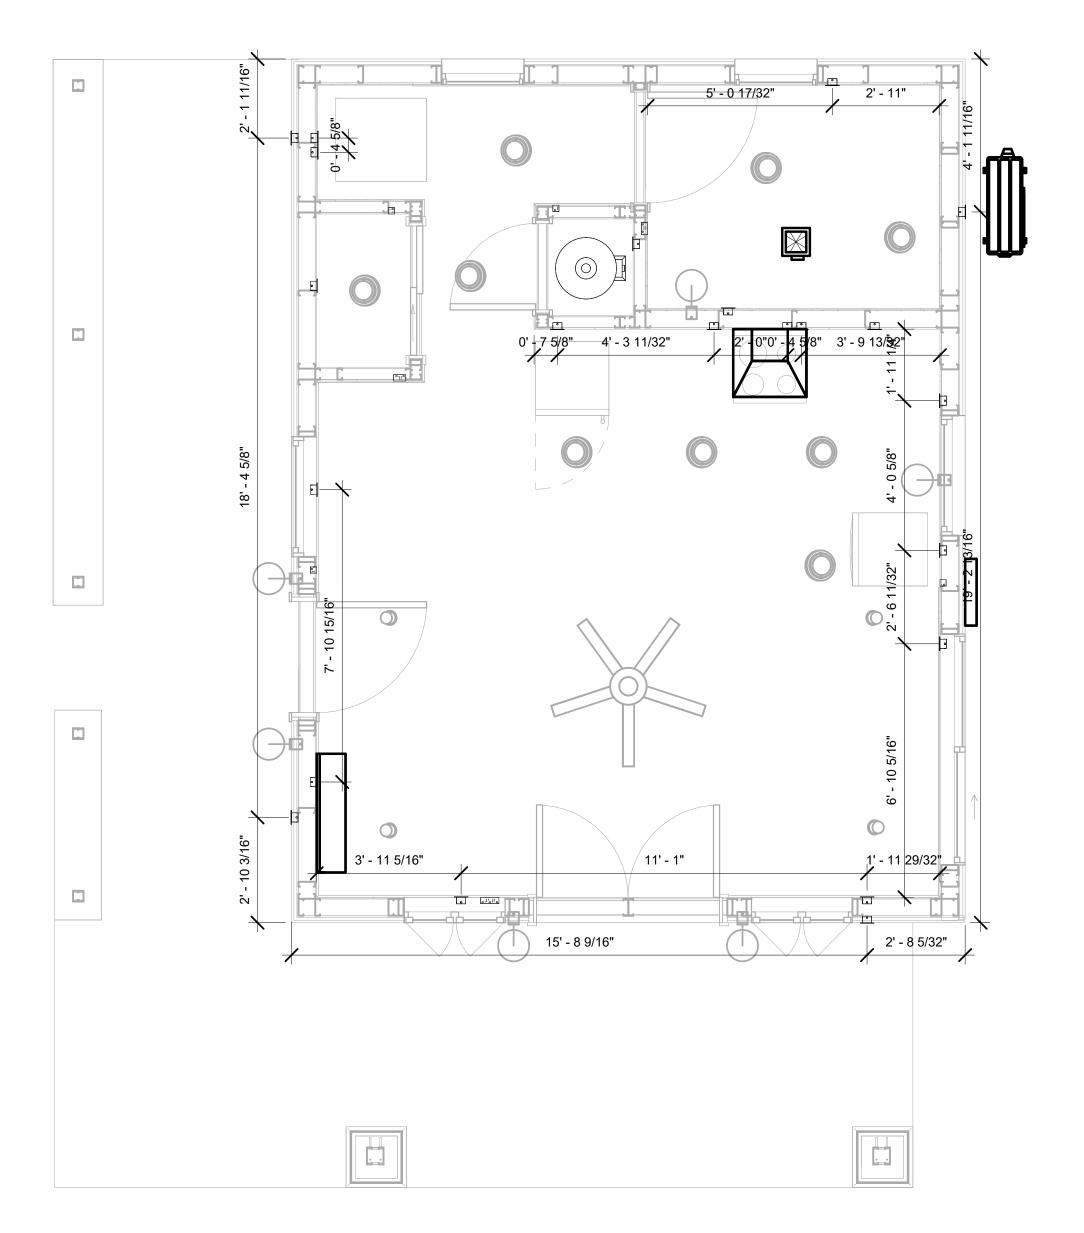

1 DIMENSION FOR FITTINGS
3/8" = 1'-0"



KEY PLAN

NO.	DESCRIPTION	DATE

NOTE:

LEGEND:

PROJECT

121-Orion-415-Studio Craftsman-Porch-550

DRAWING NAME

DIMENSION PLAN FOR FITTINGS

Owner	CLIENT NAME:
0351_11	PROJECT NUMBER:
3/15/2025 3:16:52 PM	DATE:
Designer	DESIGNED BY:
Author	DRAWN BY:
Checker	CHECKED BY:

E105

SHEET LIST

SHEET NUMBER SHEET NAME

P101 NOTE AND SCHEDULE
P102 WATER SUPPLY AND SEWAGE
SYSTEM

PIPE COLOR SCHEME DOMESTIC COLD WATER DOMESTIC HOT WATER SANITARY VENT SANITARY SEWER STORM DRAINAGE GRAY WATER GAS LINE

PLUMBING NOTES

- THE PLUMBING SYSTEM IS DESIGNED TO MEET THE BUILDING'S DOMESTIC WATER SUPPLY, SANITARY DRAINAGE, AND STORM DRAINAGE REQUIREMENTS, AS PER PROJECT SPECIFICATIONS AND APPLICABLE CODES.
- THE SYSTEM INSTALLATION SHALL COMPLY WITH THE LATEST INTERNATIONAL PLUMBING CODE (IPC), INTERNATIONAL RESIDENTIAL CODE (IRC), AND ALL OTHER RELEVANT LOCAL, STATE, AND NATIONAL REGULATIONS.
- 3. ALL PLUMBING WORK SHALL COMPLY WITH THE LATEST EDITION OF THE INTERNATIONAL PLUMBING CODE (IPC) AND THE LOCAL PLUMBING CODE.
- 4. PLUMBING SYSTEMS SHALL BE TESTED AND INSPECTED IN ACCORDANCE WITH THE LOCAL PLUMBING CODE REQUIREMENTS.
- 5. PLUMBING FIXTURES SHALL BE INSTALLED WITH THE APPROPRIATE TRIM, FITTINGS, AND ACCESSORIES, AS RECOMMENDED BY THE MANUFACTURER.
- 6. PIPING SHALL BE PROPERLY SUPPORTED AND SECURED TO PREVENT SAGGING, MOVEMENT, AND VIBRATION.
- 7. SHUT-OFF VALVES SHALL BE PROVIDED AT ALL BRANCH CONNECTIONS AND AT THE
- INLET AND OUTLET OF EACH PIECE OF EQUIPMENT.

 8. BACKFLOW PREVENTION DEVICES SHALL BE INSTALLED AS REQUIRED BY THE LOCAL
- PLUMBING CODE TO PROTECT THE POTABLE WATER SYSTEM.

 9. PLUMBING FIXTURES AND EQUIPMENT SHALL BE ACCESSIBLE FOR MAINTENANCE AND
- SERVICING.

 10. EXPOSED PLUMBING PIPING AND FIXTURES SHALL BE INSULATED TO PREVENT
- CONDENSATION AND ENERGY LOSS.

 11. DEAD ENDS IN THE DRAINAGE SYSTEM MUST BE AVOIDED, EXCEPT WHERE NECESSARY TO INSTALL A CLEANOUT IN AN ACCESSIBLE LOCATION, AND MUST HAVE A VENTED CONNECTION TO THE OUTSIDE ATMOSPHERE.
- 12. THE VERTICAL DEFLECTION OF PVC PIPE MUST NOT EXCEED 5%, AND NO DEFLECTION IS PERMITTED FOR IRON PIPE.
- 13. WORK MUST BE PROPERLY COORDINATED WITH OTHER TRADES TO AVOID CONFLICTS, REFERRING TO THE ARCHITECTURAL AND STRUCTURAL DRAWINGS FOR INFORMATION REGARDING CEILING ELEVATIONS, SPACE CLEARANCES, WALL AND PARTITION LOCATIONS, ETC.
- 14. ALL FIXTURES SHALL HAVE ACCESSIBLE STOPS.
- 15. DOMESTIC WATER PIPING SHALL BE PEX, AND PVC PIPING IS NOT ACCEPTABLE FOR INTERIOR USE.
- 16. VENT TERMINATIONS SHALL BE LOCATED AT LEAST 10 FEET FROM OR 3 FEET ABOVE ANY OPERABLE WINDOW, DOOR OPENING, AIR INTAKE, OR VENT SHAFT, AND AT LEAST 3 FEET IN EVERY DIRECTION FROM ANY LOT LINE, ALLEY, OR STREET.
- 17. PIPE AND FITTINGS UTILIZED IN THE WATER SUPPLY SYSTEM SHALL HAVE A MAXIMUM OF 8 PERCENT LEAD.
- 18. ACRYLONITRILE BUTADIENE STYRENE (ABS) SHALL BE USED FOR THE SEWERAGE AND
- VENTILATION SYSTEM.

 19. CROSS-LINKED POLYETHYLENE (PEX) SHALL BE USED FOR THE WATER SUPPLY SYSTEM.
- 20. POLYVINYL CHLORIDE (PVC) SHÀLL BÉ USED FOR THE RAIN WATER SYSTEM.
- 21. THE MIMIMUM WATER SUPPLY DEPTH UNDER FLOOR FINISH SHOUD BE 1/2".
 22. ANY PIPE INSTALLED UNDERGROUND MUST HAVE AT LEAST 12 INCHES OF CLEARANCE
- BETWEEN THE OUTSIDE OF THE PIPE AND ANY OTHER UNDERGROUND STRUCTURE.

 23. THE MINIMUM CLEARANCE BETWEEN COLD AND HOT WATER LINES IN RESIDENTIAL
- HOMES MAINTAIN A MINIMUM DISTANCE OF 6 INCHES.
- 24. HORIZONTAL SEPARATION BETWEEN WATER AND SEWER LINES: A MINIMUM OF 12 INCHES BETWEEN POTABLE WATER SUPPLY LINES (COLD AND HOT WATER) AND SANITARY SEWER LINES.

ABBREVIATIONS

~	DIAMETED
Ø	DIAMETER
ABS	ACRYLONITRILE BUTADIENE STYRENE
ABV	ABOVE
AD	AREA DRAIN
AFF	ABOVE FINISHED FLOOR
ALT	ALTERNATE
BFF	BELOW FINISHED FLOOR
BLW	BELOW
CO	CLEAN OUT
CW	COLD WATER
D	DEGREE
DFU	DRANAGE FIXTURE UNIT
DIA	DIAMETER
DN	DOWN
FCO	FLOOR CLEAN OUT
FD	FLOOR DRAIN
FL	FLOOR
FS	FLOOR SINK
FT	FOOT/FEET
HB	HOSE BIB
HW	HOT WATER
IN	INCH
MIN	MINIMUM
NO	NUMBER
NTS	NOT TO SCALE
PEX	CROSS-LINKED POLYETHYLENE
PLBG	PLUMBING
PVC	POLYVINYL CHLORIDE
QTY	QUANTITY
RD	ROOF DRAIN
RED	REDUCER
RM	ROOM
RW	RAIN WATER
SF	SQUARE FOOT
V	VENT
VTR	VENT THROUGH ROOF
W	WASTE
WCO	WALL CLEAN OUT
WSFU	WATER SUPPLY FIXTURE UNIT
11010	

PLUMBING LEGEND

CAP
BEND 45 DEG
BEND 90 DEG
TEE REDUCING
TEE
CLEAN TWO-WAY
WYE 45 DEG
WYE 45 DEG DOUBLE
WYE COMBINATION
P-TRAP

PIPE SCHEDULE			
MATERIAL	DIAMETER	LENGTH	
ACRYLONITRILE BUTADIENE STYRENE (ABS)	1 1/2"	9 FT	
ACRYLONITRILE BUTADIENE STYRENE (ABS)	2"	27 FT	
ACRYLONITRILE BUTADIENE STYRENE (ABS)	3"	29 FT	
CROSS-LINKED POLYETHYLENE (PEX)	1/2"	71 FT	
CROSS-LINKED POLYETHYLENE (PEX)	3/4"	40 FT	
POLYVINYL CHLORIDE - RIGID	2"	57 FT	

	FITTING SCHEDULE						
FITTING	SIZE	QTY					
OOMESTIC COLD WATER							
PEX 90 DEGREE ELBOW	1/2"ø-1/2"ø	13					
PEX 90 DEGREE ELBOW	3/4"ø-3/4"ø	4					
PEX TEE ELBOW	1/2"ø-1/2"ø	2					
PEX TEE ELBOW	3/4"ø-3/4"ø	3					
PEX TRANSITION ELBOW	1"ø-3/4"ø	2					
PEX TRANSITION ELBOW	1/2"ø-1/2"ø	1					
PEX TRANSITION ELBOW	3/4"ø-1/2"ø	4					
OOMESTIC HOT WATER							
PEX 90 DEGREE ELBOW	1/2"ø-1/2"ø	12					
PEX 90 DEGREE ELBOW	3/4"ø-3/4"ø	3					
PEX TEE ELBOW	1/2"ø-1/2"ø-1/2"ø	2					
PEX TRANSITION ELBOW	1/2"ø-1/2"ø	1					
PEX TRANSITION ELBOW	3/4"ø-1/2"ø	3					
RAIN WATER		,					
PVC 90 DEG BEND ELBOW	2"ø-2"ø	10					
PVC 90 DEGREE BEND ELBOW	2"ø-2"ø	1					
	2"ø-2"ø 2"ø-2"ø	1 1					
PVC TEE ELBOW		•					
PVC TEE ELBOW SEWAGE	2"ø-2"ø-2"ø	1					
PVC TEE ELBOW SEWAGE ABS 90 DEGREE BEND ELBOW	2"ø-2"ø-2"ø 1 1/2"ø-1 1/2"ø	1 2					
SEWAGE ABS 90 DEGREE BEND ELBOW ABS 90 DEGREE BEND ELBOW	2"ø-2"ø-2"ø 1 1/2"ø-1 1/2"ø 2"ø-2"ø	2 2					
PVC TEE ELBOW SEWAGE ABS 90 DEGREE BEND ELBOW ABS 90 DEGREE BEND ELBOW ABS 90 DEGREE BEND ELBOW	2"ø-2"ø-2"ø 1 1/2"ø-1 1/2"ø 2"ø-2"ø 3"ø-3"ø	2 2 2 2					
SEWAGE ABS 90 DEGREE BEND ELBOW ABS P-TRAP	2"ø-2"ø-2"ø 1 1/2"ø-1 1/2"ø 2"ø-2"ø 3"ø-3"ø 1 1/2"ø-1 1/2"ø	2 2 2 2 3					
SEWAGE ABS 90 DEGREE BEND ELBOW ABS P-TRAP ABS P-TRAP	2"ø-2"ø-2"ø 1 1/2"ø-1 1/2"ø 2"ø-2"ø 3"ø-3"ø 1 1/2"ø-1 1/2"ø 2"ø-2"ø	2 2 2 2					
SEWAGE ABS 90 DEGREE BEND ELBOW ABS P-TRAP ABS P-TRAP ABS REDUCER ELBOW	2"ø-2"ø-2"ø 1 1/2"ø-1 1/2"ø 2"ø-2"ø 3"ø-3"ø 1 1/2"ø-1 1/2"ø 2"ø-2"ø 2"ø-1 1/2"ø	2 2 2 2 3					
EWAGE ABS 90 DEGREE BEND ELBOW ABS P-TRAP ABS P-TRAP ABS REDUCER ELBOW ABS REDUCER ELBOW	2"ø-2"ø-2"ø 1 1/2"ø-1 1/2"ø 2"ø-2"ø 3"ø-3"ø 1 1/2"ø-1 1/2"ø 2"ø-2"ø 2"ø-2"ø 3"ø-2"ø	2 2 2 2 3					
SEWAGE ABS 90 DEGREE BEND ELBOW ABS 90 DEGREE BEND ELBOW ABS 90 DEGREE BEND ELBOW ABS P-TRAP ABS P-TRAP ABS REDUCER ELBOW ABS REDUCER ELBOW ABS TEE ELBOW	2"ø-2"ø-2"ø 1 1/2"ø-1 1/2"ø 2"ø-2"ø 3"ø-3"ø 1 1/2"ø-1 1/2"ø 2"ø-2"ø 2"ø-2"ø 2"ø-2"ø 2"ø-2"ø	2 2 2 2 3 2 1 1					
SEWAGE ABS 90 DEGREE BEND ELBOW ABS 90 DEGREE BEND ELBOW ABS 90 DEGREE BEND ELBOW ABS P-TRAP ABS P-TRAP ABS REDUCER ELBOW ABS REDUCER ELBOW ABS TEE ELBOW ABS TEE ELBOW	2"ø-2"ø-2"ø 1 1/2"ø-1 1/2"ø 2"ø-2"ø 3"ø-3"ø 1 1/2"ø-1 1/2"ø 2"ø-2"ø 2"ø-2"ø 2"ø-2"ø 2"ø-2"ø 3"ø-2"ø 3"ø-3"ø-3"ø	2 2 2 2 3					
SEWAGE ABS 90 DEGREE BEND ELBOW ABS P-TRAP ABS P-TRAP ABS REDUCER ELBOW ABS REDUCER ELBOW ABS TEE ELBOW ABS TEE ELBOW ABS TEE REDUCER ELBOW	2"ø-2"ø-2"ø 1 1/2"ø-1 1/2"ø 2"ø-2"ø 3"ø-3"ø 1 1/2"ø-1 1/2"ø 2"ø-2"ø 2"ø-2"ø 2"ø-2"ø 2"ø-2"ø 2"ø-2"ø-2"ø 3"ø-3"ø-3"ø 2"ø-2"ø-1 1/2"ø	2 2 2 2 3 2 1 1 1 2					
SEWAGE ABS 90 DEGREE BEND ELBOW ABS 90 DEGREE BEND ELBOW ABS 90 DEGREE BEND ELBOW ABS P-TRAP ABS P-TRAP ABS REDUCER ELBOW ABS REDUCER ELBOW ABS TEE ELBOW ABS TEE ELBOW	2"ø-2"ø-2"ø 1 1/2"ø-1 1/2"ø 2"ø-2"ø 3"ø-3"ø 1 1/2"ø-1 1/2"ø 2"ø-2"ø 2"ø-2"ø 2"ø-2"ø 2"ø-2"ø 3"ø-2"ø 3"ø-3"ø-3"ø	2 2 2 2 3 2 1 1					

ABS VENT CAP ELBOW						2"ø					2
ARC VENT CAR ELROW						2"~					1
		FIX	TURE	CC	NN	ECT	ΓΙΟΝ	SCH	HEDI	JLE	
FAMILY	W	V	TRAP	CW	HW	QTY	DFU	TOT.	WFU	TOT.	NOTES
DISHWASHER	2"	1-1/2"	1-1/2"	1/2"	1/2"	1		0			DRAIN TO SEWER SEE PLANS
DRYER	N/A	N/A	N/A	N/A	N/A	1		0			
HANGING PIPES CLAMP						8		0			
SHOWER TRAY	2"	1-1/2"	1-1/2"	1/2"	1/2"	1		0			
SHOWER TRIM	-	-	-	1/2"	1/2"	1		0			
SINK ISLAND SINGLE	2"	1-1/2"	1-1/2"	1/2"	1/2"	1		0			
VANITY SINK	2"	1-1/2"	1-1/2"	1/2"	1/2"	1		0			
WASHER	2"	1-1/2"	2"	1/2"	1/2"	1		0			DRAINS TO GRAY WATER OR SEWER SEE PLANS
WATER CLOSET	3"	2"	3"	1/2"	1/2"	1		0			
WATER HEATER	N/A	N/A	N/A	3/4"	3/4"	1		0			

FIXTURE SCHEDULE						
FIXTURE	QTY	DESCRIPTION				
DISHWASHER	1	DRAIN TO SEWER SEE PLANS				
DRYER	1					
HANGING PIPES CLAMP	8					
SHOWER TRAY	1					
SHOWER TRIM	1					
SINK ISLAND SINGLE	1					
VANITY SINK	1					
WASHER	1	DRAINS TO GRAY WATER OR SEWER SEE PLANS				
WATER CLOSET	1					
WATER HEATER	1					

ACCESSORIES & FITTINGS SCHEDULE						
FIXTURE QTY DESCRIPTIONS						
DISHWASHER CONNECTOR	1					
HOSE BIB	1					
LAUNDRY SWEAT CONNECTOR	1					
SHUTOFF VALVE	6					

PLUMBING SCHEDULE								
FIXTURE	TRAP	WASTE	VENT	C.W	H.W			
DISHWASHER	1-1/2"	2"	1-1/2"	1/2"	1/2"			
DRYER	N/A	N/A	N/A	N/A	N/A			
SHOWER TRAY	1-1/2"	2"	1-1/2"	1/2"	1/2"			
SHOWER TRIM	-	-	-	1/2"	1/2"			
SINK ISLAND SINGLE	1-1/2"	2"	1-1/2"	1/2"	1/2"			
VANITY SINK	1-1/2"	2"	1-1/2"	1/2"	1/2"			
WASHER	2"	2"	1-1/2"	1/2"	1/2"			
WATER CLOSET	3"	3"	2"	1/2"	1/2"			
WATER HEATER	N/A	N/A	N/A	3/4"	3/4"			

WATER FIXTURE UNIT SCHEDULE						
FAMILY	QTY	UNIT VALUE	TOTAL			
DISHWASHER	1		0			
DRYER	1		0			
HANGING PIPES CLAMP	8		0			
SHOWER TRAY	1		0			
SHOWER TRIM	1		0			
SINK ISLAND SINGLE	1		0			
VANITY SINK	1		0			
WASHER	1		0			
WATER CLOSET	1		0			
WATER HEATER	1		0			

WASTE FIXTURE UNIT SCHEDULE						
FAMILY	QTY	DFU VALUES	TOTAL			
DISHWASHER	1		0			
DRYER	1		0			
HANGING PIPES CLAMP	8		0			
SHOWER TRAY	1		0			
SHOWER TRIM	1		0			
SINK ISLAND SINGLE	1		0			
VANITY SINK	1		0			
WASHER	1		0			
WATER CLOSET	1		0			
WATER HEATER	1		0			



KEY PLAN

NO. DESCRIPTION DATE

NOTE:

LEGEND:

PROJECT

121-Orion-415 Studio-Craftsman-Porch-550

DRAWING NAME

NOTE AND SCHEDULE

 CLIENT NAME:

 PROJECT NUMBER:
 0351_11

 DATE:
 3/14/2025 10:42:40 AM

 DESIGNED BY:
 Designer


 DRAWN BY:
 Author

 CHECKED BY:
 Checker

P101


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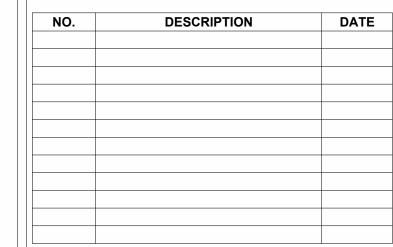




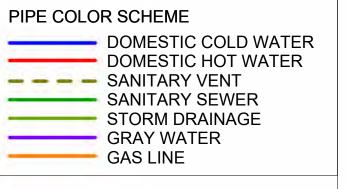

KEY PLAN



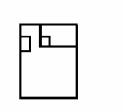

NOTE:

LEGEND:

PROJECT

121-Orion-415 Studio-Craftsman-Porch-550

DRAWING NAME

WATER SUPPLY AND **SEWAGE SYSTEM**


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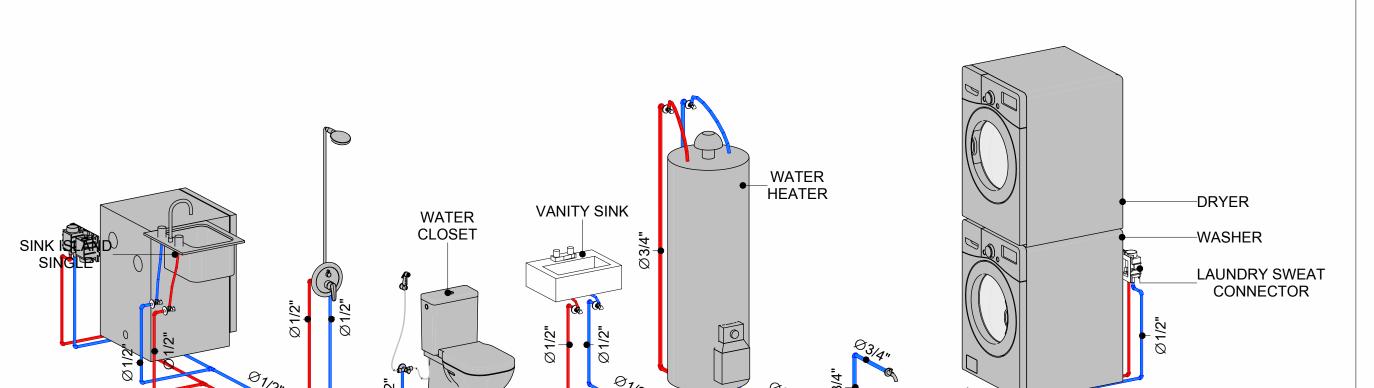
P102

SHOWER TRAY SINK ISLAND SINGLE SIDE PORCH STUDIO AREA VANITY SINK CLOSET Ø2" R₩ -SHOWER TRIM — 1% — 1% Ø3" ABS Ø1 1/2" ABS —**►** 1% Ø3" ABS —**►** 1% Ø3" ABS FRONT PORCH **BATH SEWAGE** 1/2" = 1'-0" **OVERALL SANITARY**

Ø2"
VENT PIPE
V1 VENT PIPE V2 VENT PIPE V3 SINK ISLAND SINGLE SHOWER TRIM VANITY SINK _WATER HEATER ----DRYER _LAUNDRY SWEAT CONNECTOR -WASHER SHOWER TRAY-__WATER CLOSET —**►** 1% Ø3" ABS

SEWAGE RISER DIAGRAM



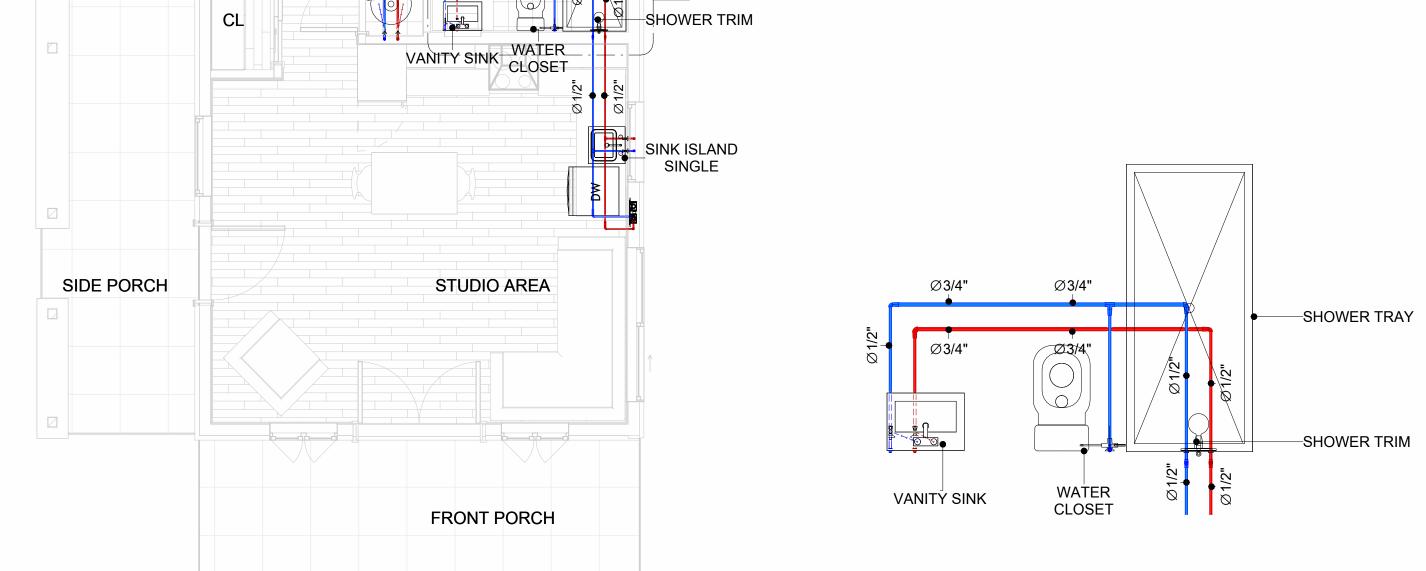

BATH WATER SUPPLY

WATER SUPPLY RISER DIAGRAM

SHOWER TRAY-

HOSE BIB-

OVERALL WATER SUPPLY

Ø 1/2"

DRYER -

LAUNDRY SWEAT CONNECTOR

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Materials Shopping List

Please print and take this Materials Shopping List to your favorite Home Depot and ask for assistance in selecting the materials, fixtures and fittings to complete your new home.

Record your selection and the price of the item. Then do the math to determine the cost for your selections and the total cost of finishing your home.

Have It Your Way!

The material types listed in this document were selected based on personal preferences. The Customer is encouraged to make changes to the material types in accordance with local customs, regulations, and personal preferences.

Have It Your Way!



20 good reasons to frame a home with metal and not wood



Why build your ADU with metal vs wood	Wood	Metal	Explanation
1 DIY Construction Benefit		~	The wall frames, trusses and beams can be erected in a just a few days
2 Minimal Construction Skills Required		~	Pre-assembled walls and trusses require no specialized skills to errect
3 Build as DIY, Hybrid or by a General Contractor		✓	Do it yourself, Hybrid (involve special contractors) or hire a General Contractor
4 Build It As You Can Afford It		✓	Impervious to Weather - build as you have the time and money
5 Up Front Cost of Framing Materials	~		As to only the framing material, wood is less expensive
6 Total Cost To Build		~	Savings in time, labor, and other areas make light gauge steel LESS expensive
7 Termites and wood boring insects		Y	Termites, carpenter ants and wood boring insects eat wood, not metal
8 Mold resistant		~	Metal does not attract mold
9 Damage caused by exterior and interior flooding		~	Metal needs no reconditioning after a flood
10 Fire Resistant		~	Non-combustible
11 Lower insurance rates		Y	Many insurance underwriters now provide lower rates for metal framed homes
12 Walls, trusses, and beams retain their original form		~	Perfectly straight walls - no shimming of drywall
13 Corners are 90 degrees		✓	No need for templating of countertops to adjust for out of square corners
14 Strength and weight		✓	Metal is stronger than wood and weighs less - no need for crane to lift ADU trusses
15 IBC Engineered Stamp		✓	If an engineering stamp is necessary, months of waiting are saved
16 Complete BOM (Materials Shopping List)		~	Take the materials shopping list to Home Depot and start shopping/pricing
17 Flexible in Seismic Areas - Won't Fracture		~	Light gauge steel is flexible and won't fracture when the earth moves
18 No Waste At Job Site		~	Steel is the most recycled material in the world. A typical wood home has 20-30% waste
19 Environmentally Friendly		~	Trees don't have to be destroyed and the source of most metal is from recycling
20 How-To Videos Included		~	How-to videos provide simple assembly instructions
21 Relationship Counselor		✓	Eliminate emotional uphevels - save time, money, and preserve the relationship

Universal Requirements - some or all may be required

- 1 Site plan
- 2 Electrical Supply Connection
- 3 Sewer Connection
- 4 Fresh Water Supply Connection
- 5 Set Backs
- 6 Soils Evaluation

- 7 Earthquake (fault) evaluation
- 8 Foundation Plan subject to soils
- 9 Compliance with local energy codes: insulation home wrap and flashing
- 10 Engineering for wind speed and snow load.
- 11 State and Local ordinances regarding ADUs
- 12 Local Architect and/or Engineer may be necessary

Orion-Studio-Craftsman-Porch





Orion-Studio-Craftsman-Porch MATERIAL SHOPPING LIST

Have It Your Way!

The material types listed in this document were selected based on personal preferences. The Customer is encouraged to make changes to the material types in accordance with local customs, regulations, and personal preferences. Have It Your Way!

TOC



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6	ARCHITECTURAL BOM	ARCHITECTURAL BOM	15

Have It Your Way!

The material types listed in this document were selected based on personal preferences. The Customer is encouraged to make changes to the material types in accordance with local customs, regulations, and personal preferences. Have It Your Way!

GENERAL NOTES

- 1 This BOM (Bill of Materials) is prepared as a Materials Shopping List to help builders and DIYers gain a complete understanding of most if not all elements required for the complete construction of this structure, according to the original design documents provided by FrameUpNow.
- 2 All quantities and specifications are subject to change based on the final design, field measurements, availability of products and customer preferences. The customer should verify all information prior to purchasing materials.
- 3 All products and elements in the list shall conform to the International Residential Code (IRC), or any other local and international building codes, safety regulations, and standards that are applicable to the location of the structure.
- 4 If any changes are made by the customer to the list of materials specified in this document, the customer is responsible for assuring that the correct type and quantity of materials are utilized in accordance with local building codes.
- FrameUpNow, will not be held responsible for any misuse of this document, the products listed, or for deviations from the content that are made due to changes in specifications, pricing, availability, or customer preferences.
- 6 The customer is advised to consult a qualified professional or technician prior to purchasing materials for specialized construction system items. Some items including but not limited to caseworks, doors and windows may require as built measurements prior to purchase to confirmation of final dimensions.
- 7 If there are additional trim elements or specific installation methods, the total amount of materials needed might vary. Consider any additional trim required for corners, intersections, or other architectural details that might cause this variations before proceeding to purchase and construction.

ARCHITECTURAL BOM



	Orion-Studio-Craftsman-Porch									
	ARCHITECTURAL MATERIAL SHOPPING LIST									
No.	Item	Туре	Unit	Quantity	Unit Price	Total	Description			
	APPLIANCES	1	DOG							
	Refrigerator		PCS PCS	1						
2	Range									
3	Washer		PCS	1						
5	Dryer Dish Washer		PCS PCS	1						
	Dish Washer Oven		PCS	1 0						
7			PCS	0						
	Microwave CASEWORKS		PCS	0						
<u> </u>	Kitchen Cabinet	I	FT	15.99						
2	Laundry Cabinet		FT	2.25						
3	Vanity Cabinet		FT	2.23						
	Medicine Cabinet		PCS	1						
5	Kitchen countertop		SF	24.94						
	Laundry Countertop		PCS	24.94						
7	Bathroom Countertop		SF	0						
8	Island		FT	0						
9	Peninsula		FT	0						
	Closets		SF	24.87						
	CEILING		SF	24.87						
<u> </u>	Ceiling Board	Dry Wall	SF	332.44		T				
	Dry Wall Fastener	Screw	PCS	581.77						
3	Vapor Retarder	Polyethylene film	SF	558.56						
			PCS	1675.68						
	Vapor Retarder Fastener Ceiling Board (MRD)	Nails with washer heads Moisture resistant drywall	SF	113.06						
	MRD Fastener	INDISTUTE TESISTATIL ULYWAII	PCS	197.855						
7		Marina Dhuuaad	SF	113.06						
	Ceiling Board Marine Plywood Fastener	Marine Plywood Screw	PCS	197.855						
0	Dry Wall Tape	Sciew	FT	279.28						
	FLOORING		FI	219.28						
	Main Living Space	I	SF	289						
2	Bathroom		SF	48.6						
	Porch		SF	326						
	STRUCTURE		SF	320						
	Foundation	I	SF	739.8						
1	WALLS EXTERIOR		31	/ / / / / / / / / / / / / / / / / / / /						
1	Exterior-Grade Plywood	I	SF	609						
	Exterior-Grade Plywood Fastener	Self-drilling screws(100/pkt)	PKT	6.09						
	Wall Shteathing (OSB)	Self-utiliting screws(100/pkt)	SF	609						
4	Shteathing Fastener	Self-drilling screws(100/pkt)	PKT	6.09						
	Wall Homewrap	Sell-drilling Screws (100/pkt)	SF	6.09						
	Homewrap Fastener	Stapled fastener (200/pkt)	PKT	2.3142						
7	Furring Strip	Stapieu iasteriei (200/pkt)	PCS	76.125						
8	Furring Strip Fastener	Self-drilling screws(100/pkt)	PKT	6.09						
9	Wall Paint	Self-drilling Screws (100/pkt)	SF	609						
	Stone Copping	Maconny stono	SF	63						
	Stone Copping Stone Veneer	Masonry stone Masonry stone	SF	111						
		INIASUTILY STUTIE	SF							
	Mortar for Stone Veneer		SF	111 1790						
	Wall Insulation WALLS INTERIOR		SF	1/90						
	Cementitious Backer Board	I	SF	333	1					
	Kerdi membrane		SF	333						
	Kerdi membrane Fastener		SF	333						
	Wall Ceramic Tile		SF SF	333						
	Drywall Board		SF	709						
		Colf drilling corous (100/pl-t)								
	Drywall Fastener	Self-drilling screws(100/pkt)	PKT	7.09 709						
	Wall Paint		SF FT	133						
	Drywall Tape Wall Sweep									
9	I vvali Sweep	<u> </u>	FT	65						

ARCHITECTURAL BOM



Δ	DOORS				
1	Exterior Swinging	3' - 0" X 6'-8"	PCS	1	
2	Interior Swinging	2' - 4" X 6'-8"	PCS	1	
3	Interior Swinging	2' - 8" X 6'-8"	PCS	1	
4	Interior Sliding	3' - 6" X 6'-8"	PCS	1	
5	Exterior Swinging	5' - 0" X 6'-8"	PCS	1	
6	Exterior Door Trim		FT	35	
7	Interior Door Trim		FT	133	
8	Entry Lock set			2	
9	Privacy Lock set			1	
10	Passage Lock set			2	
Δ	WINDOWS				
1	Awning	2' - 3" X 2'-3"	PCS	2	
2	Sliding	6' - 3" X 4'-3"	PCS	1	
3	Hung	3' - 3" X 3'-9"	PCS	2	
4	Casement	2' - 9" X 4'-3"	PCS	2	
5	Exterior Window Trim		FT	95	
6	Interior Window Trim		FT	95	
Δ	ROOF				
1	Roof Covering		SF	669	
2	Roof Covering Fastener		PCS	334.5	
3	Roof Felt Paper		SF	669	
4	Roof Felt Paper Fastener		PCS	2007	
5	Roof Sheathing		SF	669	
6	Roof Sheathing Fastener		PCS	5352	
7	Batten		FT	0	
8	Batten Fastener		PCS	0	
9	Soffit		SF	128	
10	Soffit Fastener		PCS	64	
11	Fascia		FT	106	
	Fascia board fastener		PCS	53	
13	Roof Insulation		SF	669	



	Orion-Studio-Craftsman-Porch									
	ELECTRICAL MATERIAL SHOPPING LIST									
No.	Item	Type	Unit	Quantity	Description					
Δ	LIGHTING FIXTURES									
1	Kitchen Ceiling Light		PCS	4						
2	Kitchen Wall Mounted Light		PCS	1						
3	Exterior Wall Mounted Light		PCS	4						
4	Livingroom Ceiling Light With Fan		PCS	1						
5	Bedroom Ceiling Light With Fan		PCS	0						
6	Dining Ceiling Light		PCS	0						
7	Bath Wall Mounted Light		PCS	1						
8	Bathroom Ceiling Light		PCS	2						
9	Livingroom Ceiling Light		PCS	4						
10	Bedroom Ceiling Light		PCS	0						
11	Hall & Entry Ceiling Light		PCS	2						
	Closet Ceiling Light		PCS	1						
	Smoke Detector		PCS	0						
	ELECTRICAL FITTINGS		1. 55	,						
	Standard Receptacle 120V	20A	PCS	6						
	GFCI Receptacle 120V	20 A	PCS	12						
16	GFCI Receptacle 240V	30 A	PCS	2						
17	GFCI Receptacle 240V	50 A	PCS	1						
18	GFCI Receptacle 240V	60 A	PCS	1						
19	Fan Switch	00 A	PCS	1						
	Single Pole Switch			8						
20			PCS							
21	Three Way Switch Dimmer Switch		PCS	2						
22			PCS	1						
22	ROMEX 14 AWG	4.4/2/14//	FT	26						
_		14/3/W/ground	FT	26						
_	ROMEX 12 AWG	12/3/W/ground		267						
_	ROMEX 12 AWG	12/2/W/ground	FT	0						
	ROMEX 10 AWG	10/3/W/ground	FT	0						
27	ROMEX 10 AWG	10/2/W/ground	FT	65						
	Romex 8 AWG	8/3/W/ground	FT	0						
	Romex 8 AWG	8/2/W/ground	FT	20						
	ROMEX 6 AWG	6/3/W/ground	FT	21						
	Bare Copper Ground Wire 6 AWG		FT	0						
	ELECTRICAL BOXES & CIRCUTES									
	Panelboard -240V 1 Phase MLO	200 AMP	PCS	1						
	Circuit breaker	15 A	PCS	1						
	Circuit breaker	20 A	PCS	10						
	Circuit breaker	30 A	PCS	2						
	Circuit breaker	50 A	PCS	1						
	Circuit breaker	60 A	PCS	1						
39	Single Gang Switch Box		PCS	4						
40	Double Gang Switch Box		PCS	2						
41	Triple Gang Switch Box		PCS	1						
	Pull Box	#1/4	PCS	13						
43	Receptacle Box		PCS	22						

PLUMBING BOM



Orion-Studio-Craftsman-Porch PLUMBING SYSTEM MATERIAL SHOPPING LIST Type Unit Quantity Unit Price Total

No.	Item	Туре	Unit	Quantity	Unit Price	Total	Description
Δ	PLUMBING FIXTURES & ACCESSORIES						
1	Bath Tub (Alcove Tub)		PCS	0			
2	Kitchen Sink		PCS	1			
3	Kitchen Faucets		PCS	1			
4	Vanity Sink		PCS	1			
5	Bath room Faucets		PCS	1			
6	Water Closet		PCS	1			
7	Shower Trim		PCS	1			
8	Shower Tray		PCS	1			
9	Water Heater		PCS	1			
	Hose Bib		PCS	2			
11	Shutoff Valve		PCS	6			
	Hanging pipe clamp		PCS	19			
	Gate Valve		PCS	1			
	Dishwasher Supply Single Connector		PCS	1			
	Dishwasher Sewage Single Connector		PCS	1			
	Laundry Sweat Connector		PCS	1 1			
	SANITARY & PLUMBING PIPES		PCS				
1		ø 1"	ГТ	1 0			
	ABS (Acrylonitrile Butadiene Styrene) Pipes ABS (Acrylonitrile Butadiene Styrene) Pipes	Ø 1 1/2"	FT	9			
			FT				
	ABS (Acrylonitrile Butadiene Styrene) Pipes	ø 2"	FT	27			
	ABS (Acrylonitrile Butadiene Styrene) Pipes	ø 3"	FT	29			
	PEX (Cross-linked polyethylene) Pipes	ø 1/2"	FT	71			
6	PEX (Cross-linked polyethylene) Pipes	ø 3/4"	FT	40			
	PEX (Cross-linked polyethylene) Pipes	ø 1"	FT	0			
	PVC Pipes Sch.80 - Rigid	ø 1 1/2"	FT	0			
	PVC Pipes Sch.80 - Rigid	ø 2"	FT	57			
	PVC Pipes Sch.80 - Rigid	ø 3"	FT	0			
11	Flex Pipe Round	ø 1/2"	PCS	6			
	PIPE FITTINGS						
	ABS 90 Degree Bend Elbow	1 1/2"ø-1 1/2"ø	PCS	2			
	ABS 90 Degree Bend Elbow	2"ø-2"ø	PCS	2			
3	ABS 90 Degree Bend Elbow	3"ø-3"ø	PCS	2			
4	ABS P-Trap	1 1/2"ø-1 1/2"ø	PCS	3			
5	ABS P-Trap	2"ø-2"ø	PCS	2			
6	ABS Reducer Elbow	2"ø-1 1/2"ø	PCS	1			
7	ABS Reducer Elbow	3"ø-2"ø	PCS	1			
8	ABS TEE Elbow	2"ø-2"ø-2"ø	PCS	1			
	ABS TEE Elbow	3"ø-3"ø-3"ø	PCS	2			
	ABS Tee Reducer Elbow	2"ø-2"ø-1 1/2"ø	PCS	1			
	ABS Tee Reducer Elbow	3"ø-3"ø-1 1/2"ø	PCS	2			
	ABS Tee Reducer Elbow	3"ø-3"ø-2"ø	PCS	1			
	ABS Vent Cap Elbow	2"ø	PCS	2			
	ABS Vent Cap Elbow	3"ø	PCS	1			
	PEX 90 Degree Elbow	1/2"ø-1/2"ø	PCS	25			
	PEX 90 Degree Elbow	3/4"ø-3/4"ø	PCS	7			
	PEX Tee Elbow	1/2"ø-1/2"ø-1/2"ø	PCS	4			
			_				
	PEX Tee Elbow	3/4"ø-3/4"ø	PCS	3			
	PEX Transition Elbow	1"ø-3/4"ø	PCS	2			
	PEX Transition Elbow	1/2"ø-1/2"ø	PCS	2			
	PEX Transition Elbow	3/4"ø-1/2"ø	PCS	7			
	PVC 90 Deg Bend Elbow	2"ø-2"ø	PCS	10			
	PVC 90 Degree Bend Elbow	2"ø-2"ø	PCS	1			
	PVC TEE Elbow	2"ø-2"ø-2"ø	PCS	1			
25	WASTE DOUBLE TEE	2"ø-2"ø-2"ø	PCS	1	Ι Τ		



		Orion-Studio	-Crafts	man-Por	ch		
		HVAC SYSTEM MA	TERIAL	SHOPP	ING LIST		
No.	Item	Туре	Unit	Quantity	Unit Price	Total	Description
	HVAC_DUCTS						
1	PIPE (REFRIGERANT LINE)	3/8" (Ø)	FT	46.85			
2	PIPE (REFRIGERANT LINE)	3/4''' (Ø)	FT	53.8			
3	DRAYER HOSE	4" (Ø)	FT	3.8			
4	FLEX DUCT ROUND	4" (Ø)	FT	4.51			
\triangle	DUCT FITTINGS & ACCESSORIES						
5	ELBOW (REFRIGERANT LINE)	3/4" (Ø)-3/4" (Ø)	PCS	12			
6	ELBOW (REFRIGERANT LINE)	3/8" (Ø)-3/8" (Ø)	PCS	13			
7	TRANSITION (REFRIGERANT	3/4" (Ø)-1/2" (Ø)	PCS	2			
8	TRANSITION (REFRIGERANT	3/4" (Ø)-5/8" (Ø)	PCS	1			
9	TRANSITION (REFRIGERANT	3/8" (Ø)-1/4" (Ø)	PCS	1			
\triangle	HVAC_EQUIPMENTS						
10	AIR HANDLING UNIT	WALL MOUNTED	PCS	1			
11	CONDENSER	OUTDOOR UNIT	PCS	1			
12	EXHAUST FAN	75 CFM	PCS	1			
13	EXHAUST HOOD	WALL MOUNTED	PCS	1			
14	HOOD-WALL: VENT	HOOD-WALL: VENT	PCS	1			
15	DRAYER: VENT	DRAYER: VENT	PCS	1			
16	ROOF VENT	3"(Ø)	PCS	1			



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Have It Your Way!

The material types listed in this document were selected based on personal preferences. The Customer is encouraged to make changes to the material types in accordance with local customs, regulations, and personal preferences. Have It Your Way!

GENERAL NOTES

- This BOM (Bill of Materials) is prepared as a Materials Shopping List to help builders and DIYers gain a complete understanding of most if not all elements required for the complete construction of this structure, according to the original design documents provided by FrameUpNow.
- 2 All quantities and specifications are subject to change based on the final design, field measurements, availability of products and customer preferences. The customer should verify all information prior to purchasing materials.
- 3 All products and elements in the list shall conform to the International Residential Code (IRC), or any other local and international building codes, safety regulations, and standards that are applicable to the location of the structure.
- 4 If any changes are made by the customer to the list of materials specified in this document, the customer is responsible for assuring that the correct type and quantity of materials are utilized in accordance with local building codes.
- 5 FrameUpNow, will not be held responsible for any misuse of this document, the products listed, or for deviations from the content that are made due to changes in specifications, pricing, availability, or customer preferences.
- The customer is advised to consult a qualified professional or technician prior to purchasing materials for specialized construction system items. Some items including but not limited to caseworks, doors and windows may require as built measurements prior to purchase to confirmation of final dimensions.
- 7 If there are additional trim elements or specific installation methods, the total amount of materials needed might vary. Consider any additional trim required for corners, intersections, or other architectural details that might cause this variations before proceeding to purchase and construction.



			LIGHTING FIXTURES				
#	Item	Туре	Description, Manufacturer, SKU	Unit	Quantity	Unit Price	Total
1	Kitchen Ceiling Light			PCS	4		
3	Kitchen Wall Mounted Light			PCS	1		
4	Exterior Wall Mounted Light			PCS	4		
5	Livingroom Ceiling Light With Fan			PCS	1		
6	Bedroom Ceiling Light With Fan			PCS	0		
7	Dining Ceiling Light			PCS	0		
8	Bath Wall Mounted Light			PCS	1		
9	Bathroom Ceiling Light			PCS	2		
10	Livingroom Ceiling Light			PCS	4		
11	Bedroom Ceiling Light			PCS	0		
12	Hall & Entry Ceiling Light			PCS	2		
12	Closet Ceiling Light			PCS	1		
13	Smoke Detector			PCS	0		
14							
15							



			ELECTRICAL FITTINGS				
#	Item	Туре	Description, Manufacturer, SKU	Unit	Quantity	Unit Price	Total
1	Standard Receptacle 120V	20A		PCS	6		
2	GFCI Receptacle 120V	20 A		PCS	12		
3	GFCI Receptacle 240V	30 A		PCS	2		
4	GFCI Receptacle 240V	50 A		PCS	1		
5	GFCI Receptacle 240V	60 A		PCS	1		
6	Fan Switch			PCS	1		
7	Single Pole Switch			PCS	8		
8	Three Way Switch			PCS	2		
9	Dimmer Switch			PCS	1		
10							
11							
12							
13							
14							
15							



		ELECTR	ICAL CONDUITS & WIRING				
#	Item	Туре	Description, Manufacturer, SKU	Unit	Quantity	Unit Price	Total
1	ROMEX 14 AWG	14/3/W/ground		FT	26		
3	ROMEX 12 AWG	12/3/W/ground		FT	267		
ļ	ROMEX 12 AWG	12/2/W/ground		FT	0		
5	ROMEX 10 AWG	10/3/W/ground		FT	0		
3	ROMEX 10 AWG	10/2/W/ground		FT	65		
)	Romex 8 AWG	8/3/W/ground		FT	0		
10	Romex 8 AWG	8/2/W/ground		FT	20		
11	ROMEX 6 AWG	6/2/W/ground		FT	21		
12	Bare Copper Ground Wire 6 AWG			FT			
L3							
L4							
L5							
L6							



		ELEC	CTRICAL BOXES & CIRCUTES				
#	Item	Туре	Description, Manufacturer, SKU	Unit	Quantity	Unit Price	Total
1	Panelboard -240V 1 Phase MLO	200 AMP		PCS	1		
2	Circuit breaker	15 A		PCS	1		
3	Circuit breaker	20 A		PCS	10		
4	Circuit breaker	30 A		PCS	2		
5	Circuit breaker	50 A		PCS	1		
6	Circuit breaker	60 A		PCS	1		
7	Single Gang Switch Box			PCS	4		
8	Double Gang Switch Box			PCS	2		
9	Triple Gang Switch Box			PCS	1		
10	Pull Box	#1/4		PCS	13		
11	Receptacle Box			PCS	22		
12							
13							
14							
15							



			HVAC_DUCTS 01				
#	Item	Туре	Description, Manufacturer, SKU	Unit	Quantity	Unit Price	Total
1	PIPE (REFRIGERANT LINE)			FT	46.85		
2	PIPE (REFRIGERANT LINE)	3/4"' (Ø)		FT	53.8		
3		4" (Ø)		FT	3.8		
4	FLEX DUCT ROUND	4" (Ø)		FT	4.51		



		DUCT FITTINGS & ACCESSORIES				
# Item	Туре	Description, Manufacturer, SKU	Unit	Quantity	Unit Price	Total
1 ELBOW (REFRIGERANT	3/4" (Ø)-3/4" (Ø)		DOC	12		
LINE)	2/01/ (0) 2/01/ (0)		PCS	10		
ELBOW (REFRIGERANT LINE)	3/8" (Ø)-3/8" (Ø)		PCS	13		
TRANSITION	3/4" (Ø)-1/2" (Ø)			2		
(REFRIGERANT LINE)			PCS			
TRANSITION	3/4" (Ø)-5/8" (Ø)		DCC	1		
(REFRIGERANT LINE)	2/01/(0) 4/41/(0)		PCS	1		
TRANSITION (REFRIGERANT LINE)	3/8" (Ø)-1/4" (Ø)		PCS	'		
(KLI KIGLKAIVI LIIVL)			00			



			HVAC_EQUIPMENTS				
#	Item	Туре	Description, Manufacturer, SKU	Unit	Quantity	Unit Price	Total
1	AIR HANDLING UNIT	WALL MOUNTED		PCS	1		
2	CONDENSER	OUTDOOR UNIT		PCS	1		
	EXHAUST FAN	75 CFM		PCS	1		
ļ	EXHAUST HOOD	WALL MOUNTED		PCS	1		
i	HOOD-WALL: VENT	HOOD-WALL: VENT		PCS	1		
5	DRAYER: VENT	DRAYER: VENT		PCS	1		
7	ROOF VENT	3"(Ø)		PCS	1		
3							
)							
LO							
1							
12							
13							
L4							



		PLUMBI	NG FIXTURES & ACCESSORIES				
#	Item	Туре	Description, Manufacturer, SKU	Unit	Quantity	Unit Price	Total
1	Bath Tub (Alcove Tub)			PCS	0		
2	Kitchen Sink			PCS	1		
3	Kitchen faucets			PCS	1		
4	Vanity Sink			PCS	1		
5	Bath room faucets			PCS	1		
6	Water Closet			PCS	1		
7	Shower Trim			PCS	1		
8	Shower Tray			PCS	1		
9	Water Heater			PCS	1		
10	Hose Bib			PCS	2		
11	Shutoff Valve			PCS	6		
12	Hanging pipe clamp			PCS	8		
13	Gate Valve			PCS	1		
14	Dishwasher Supply Single Connector			PCS	1		
15	Dishwasher Sewage Single Connector			PCS	1		
16	Laundry Sweat Connector			PCS	1		



		SANI	ITARY & PLUMBING PIPES				
#	Item	Туре	Description, Manufacturer, SKU	Unit	Quantity	Unit Price	Total
1	ABS (Acrylonitrile Butadiene Styrene) Pipes	ø 1"		FT	C		
2	ABS (Acrylonitrile Butadiene Styrene) Pipes	ø 1 1/2"		FT	9		
3	ABS (Acrylonitrile Butadiene Styrene) Pipes	ø 2"		FT	27		
4	ABS (Acrylonitrile Butadiene Styrene) Pipes	ø 3"		FT	29		
5	PEX (Cross-linked polyethylene) Pipes	ø 1/2"		FT	71		
6	PEX (Cross-linked polyethylene) Pipes	ø 3/4"		FT	40		
7	PEX (Cross-linked polyethylene) Pipes	ø 1"		FT	C		
8	PVC Pipes Sch.80 - Rigid	ø 1 1/2"		FT	C		
9	PVC Pipes Sch.80 - Rigid	ø 2"		FT	57		
10	PVC Pipes Sch.80 - Rigid	ø 3"		FT	О		
11	Flex Pipe Round	ø 1/2"		PCS	6		
12							
13							
14							
15							



	1	Р	PCS 2 2"Ø PCS 2 3"Ø PCS 2 3"Ø PCS 2 2"Ø-1 1/2"Ø PCS 3 2"Ø-1 1/2"Ø PCS 3 2"Ø PCS 1 1 1/2"Ø PCS 1 2"Ø PCS 1 3"Ø-2"Ø PCS 1 3"Ø-3"Ø PCS 2				
#	Item	Туре	Description, Manufacturer, SKU	Unit	Quantity	Unit Price	Total
1	ABS 90 Degree Bend Elbow	1 1/2"ø-1 1/2"ø		PCS	2		
2	ABS 90 Degree Bend Elbow	2"Ø-2"Ø		PCS	2		
3	ABS 90 Degree Bend Elbow	3"ø-3"ø		PCS	2		
4	ABS P-Trap	1 1/2"ø-1 1/2"ø		PCS	3		
5	ABS P-Trap	2"ø-2"ø		PCS	2		
6	ABS Reducer Elbow	2"ø-1 1/2"ø		PCS	1		
7	ABS Reducer Elbow	3"ø-2"ø		PCS	1		
8	ABS TEE Elbow	2"Ø-2"Ø-2"Ø		PCS	1		
9	ABS TEE Elbow	3"ø-3"ø-3"ø		PCS	2		
10	ABS Tee Reducer Elbow	2"ø-2"ø-1 1/2"ø		PCS	1		
11	ABS Tee Reducer Elbow	3"ø-3"ø-1 1/2"ø		PCS	2		
12	ABS Tee Reducer Elbow	3"ø-3"ø-2"ø		PCS	1		
13	ABS Vent Cap Elbow	2"ø		PCS	2		
14	ABS Vent Cap Elbow	3"ø		PCS	1		
15	PEX 90 Degree Elbow	1/2"ø-1/2"ø		PCS	25		



		PI	PE FITTINGS 02				
#	Item	Туре	Description, Manufacturer, SKU	Unit	Quantity	Unit Price	Total
1	PEX 90 Degree Elbow	3/4"ø-3/4"ø		PCS	7		
2	PEX Tee Elbow	1/2"ø-1/2"ø-1/2"ø		PCS	4		
3	PEX Tee Elbow	3/4"ø-3/4"ø-3/4"ø		PCS	3		
4	PEX Transition Elbow	1"ø-3/4"ø		PCS	2		
5	PEX Transition Elbow	1/2"ø-1/2"ø		PCS	2		
6	PEX Transition Elbow	3/4"ø-1/2"ø		PCS	7		
7	PVC 90 Deg Bend Elbow	2"ø-2"ø		PCS	10		
8	PVC 90 Degree Bend Elbow	2"ø-2"ø		PCS	1		
9	PVC TEE Elbow	2"ø-2"ø-2"ø		PCS	1		
10	WASTE DOUBLE TEE	2"ø-2"ø-2"ø		PCS	1		
11							
12							
13							
14							
15							



			APPLIANCES				
#	Item	Туре	Description, Manufacturer, SKU	Unit	Quantity	Unit Price	Total
1	Refrigerator			PCS			
2	Range			PCS			
3	Washer Front Load	Stackable		PCS			
4	Dryer Front Load	Stackable		PCS			
5	Dish Washer			PCS			
6	Oven			PCS	(
7	Microwave			PCS	(
8							
9							
10							
11							
12							
13							
14							
15							
16							



			CASEWORKS 01				
#	Item	Туре	Description, Manufacturer, SKU	Unit	Quantity	Unit Price	Total
1	Kitchen Cabinet			FT	15.99		
2	Laundry Cabinet			FT	2.25		
3	Vanity Cabinet			FT	2.5		
4	Medicine Cabinet			PCS	1		
5	Kitchen countertop			SF	24.94		
6	Laundry Countertop			PCS	0		
7	Bathroom Countertop			SF	0		
8	Island			FT	0		
9	Peninsula			FT	0		
10	Closets			SF	24.87		
11							
12							
13							
14							
15							



	1		CEILING 01				
ŧ	Item	Туре	Description, Manufacturer, SKU	Unit	Quantity	Unit Price	Total
	LIVING ROOM + KITCHEN			SF	274.0		
	Ceiling Board	Drywall		SF	274		
	Drywall Fastener	Screw		PCS	479		
	Vapor Retarder	Polyethylene film		SF	274		
	Vapor Retarder Fastener	Nails with washer heads		PCS	822		
	BATH ROOM			SF	52.3		
	Ceiling Board	MRD (Moisture resistant drywall)		SF	52		
	MRD Fastener	Screw		PCS	91		
	WH	·		SF	5.6	5.6	
	Ceiling Board	Drywall		SF	6		
	Drywall Fastener	Screw		PCS	10		
	Vapor Retarder	Polyethylene film		SF	6		
0	Vapor Retarder Fastener	Nails with washer heads		PCS	17		
	SHADE			SF	113.1		
1	Ceiling Board	Marine Plywood		SF	113		
.2	Exterior Grade Plywood	Screw		PCS	198		



			CEILING 02				
#	Item	Туре	Description, Manufacturer, SKU	Unit	Quantity	Unit Price	Total
	HALL+WD			SF	41.3		
13	Ceiling Board	Drywall		SF	41		
14	Drywall Fastener	Screw		PCS	72		
15	Vapor Retarder	Polyethylene film		SF	41		
16	Vapor Retarder Fastener	Nails with washer heads		PCS	124		
	CL 1			SF	11.6		
17	Ceiling Board	Drywall		SF	12		
18	Drywall Fastener	Screw		PCS	20		
19	Vapor Retarder	Polyethylene film		SF	12		
20	Vapor Retarder Fastener	Nails with washer heads		PCS	35		



			FLOORING INTERIOR 01				
#	Item	Туре	Description, Manufacturer, SKU	Unit	Quantity	Unit Price	Total
	CL #1						
1	Closet Flooring			SF	11		
2	Wood underlay	Foam Pad Polyethylene		SF	11		
3	Vapor Retarder	Vapor Barrier Polyethylene		SF	11		
	LIVING ROOM AND KITCHE	EN					
4	Living Area Flooring			SF	289		
5	Wood underlay	Foam Pad Polyethylene		SF	289		
6	Vapor Retarder	Vapor Barrier Polyethylene		SF	289		
	BATHROOM 1						
7	Tile Finish			SF	32.9		
8	Adhesive	1/2" Thin set Mortar		SF	32.9		
9	Vapor Retarder	Vapor Barrier Polyethylene		SF	32.9		



			FLOORING INTERIOR 02				
#	Item	Туре	Description, Manufacturer, SKU	Unit	Quantity	Unit Price	Total
	W/D						
10	Tile Finish			SF	9.3		
11	Adhesive	1/2" Thin set Mortar		SF	9.3		
12	Vapor Retarder	Vapor Barrier Polyethylene		SF	9.3		
	BOILER ROOM						
13	Tile Finish			SF	6.4		
14	Adhesive	1/2" Thin set Mortar		SF	6.4		
15	Vapor Retarder	Vapor Barrier Polyethylene		SF	6.4		



	1		FLOORING EXTERIOR			
#	Item	Туре	Description, Manufacturer, SKU	Unit	Quantity	Unit Price
	STRUCTURE			SF	739.8	
1	Concrete Slab	4"concrete cast in situ		CF	246.6	
2	Insulation	Rigid insulation		SF	211	
3	Hard core	Compacted soil		CF	187.8	
4	Re-bar	#4 re-bar		Ton	0.67	
5	Concrete Pad	4"concrete cast in situ		CF	1.58	
6	Slab edge	Turndown		CF	164.4	
7	Footing	Cast-in-place concrete		CF	4.68	
	PORCH					
8	Tile Finish			SF	326	
9	Adhesive	1/2" Thin set Mortar		SF	326	
10	Vapor Retarder	Vapor Barrier Polyethylene		SF	326	



			WALLS: EXTERIOR				
#	Item	Туре	Description, Manufacturer, SKU	Unit	Quantity	Unit Price	Total
1	Exterior-Grade Plywood Horizontal Siding			SF	609		
2	Exterior-Grade Plywood Fastener 8/panel	Self-drilling screws(100/pkt)		PKT	6.09		
3	Wall Shteathing (OSB)			SF	609		
4	Shteathing Fastener	Self-drilling screws(100/pkt)		PKT	6.09		
5	Wall Homewrap			SF	609		
6	Homewrap Fastener	Stapled fastener (200/pkt)		PKT	2.31		
7	Furring Strip			PCS	76.13		
8	Furring Strip Fastener	Self-drilling screws(100/pkt)		PKT	6.09		
9	Wall Paint			SF	609		
10	Stone Copping	Masonry stone		SF	63		
11	Stone Veneer	Masonry stone		SF	111		
12	Mortar for Stone Veneer			SF	111		
13	Wall Insulation			SF	1790		
14							
15							



			WALLS: INTERIOR 01				
#	Item	Туре	Description, Manufacturer, SKU	Unit	Quantity	Unit Price	Total
	BATHROOM			SF	49.0		
1	Cementitious Backer Board			SF	237		
2	Kerdi membrane			SF	237		
3	Kerdi membrane Fastener			SF	237		
4	Wall Ceramic Tile			SF	237		
	CL			SF	12.0		
5	Drywall Board			SF	90		
6	Drywall Fastener	Self-drilling screws(100/pkt)		PKT	0.9		
7	Wall Paint			SF	90		
8	Drywall Tape			FT	16.9		
	HALL			SF	29.0		
9	Drywall Board			SF	130		
10	Drywall Fastener	Self-drilling screws(100/pkt)		PKT	1.3		
11	Wall Paint			SF	130		
12	Drywall Tape			FT	24.4		



			WALLS: INTERIOR 02				
#	Item	Туре	Description, Manufacturer, SKU	Unit	Quantity	Unit Price	Total
	STUDIO			SF	180.0		
13	Drywall Board			SF	249		
14	Drywall Fastener	Self-drilling screws(100/pkt)		PKT	2.49		
15	Wall Paint			SF	249		
16	Drywall Tape			FT	46.7		
	KITCHEN			SF	78.0		
17	Cementitious Backer Board			SF	23		
18	Drywall Board			SF	152		
19	Drywall Fastener	Self-drilling screws(100/pkt)		PKT	1.52		
20	Kerdi membrane			SF	23		
21	Kerdi membrane Fastener			SF	23		
22	Wall Ceramic Tile			SF	23		
23	Wall Paint			SF	152		
24	Drywall Tape			FT	28.7		



			WALLS: INTERIOR 03				
#	Item	Туре	Description, Manufacturer, SKU	Unit	Quantity	Unit Price	Total
	WD			SF	9.0		
25	Cementitious Backer Board			SF	73		
26	Kerdi membrane			SF	73		
27	Kerdi membrane Fastener			SF	73		
28	Wall Ceramic Tile			SF	73		
	WH			SF	7.0		
29	Drywall Board			SF	88		
30	Drywall Fastener	Self-drilling screws(100/pkt)		PKT	0.88		
31	Wall Paint			SF	88		
32	Drywall Tape			FT	17		
1	Wall Sweep			FT	65		



			DOORS				
#	Item	Туре	Description, Manufacturer, SKU	Unit	Quantity	Unit Price	Total
1	Exterior Swinging	3' - 0" X 6'-8"		PCS	1		
2	Interior Swinging	2' - 4" X 6'-8"		PCS	1		
3	Interior Swinging	2' - 8" X 6'-8"		PCS	1		
4	Interior Sliding	3' - 6" X 6'-8"		PCS	1		
5	Exterior Swinging	5' - 0" X 6'-8"		PCS	1		
6	Exterior Door Trim			FT	35		
7	Interior Door Trim			FT	133		
8	Entry Lock set			PCS	2		
9	Privacy Lock set			PCS	1		
10	Passage Lock set			PCS	2		



			WINDOWS				
#	Item	Туре	Description, Manufacturer, SKU	Unit	Quantity	Unit Price	Total
1	Awning	2' - 3" X 2'-3"		PCS	2		
2	Sliding	6' - 3" X 4'-3"		PCS	1		
3	Hung	3' - 3" X 3'-9"		PCS	2		
4	Casement	2' - 9" X 4'-3"		PCS	2		
5	Exterior Window Trim			FT	95		
6	Interior Window Trim			FT	95		



			ROOF 01				
#	Item	Туре	Description, Manufacturer, SKU	Unit	Quantity	Unit Price	Total
1	Roof Covering			SF	669.0		
2	Roof Covering Fastener			PCS	335		
3	Roof Felt Paper			SF	669.0		
4	Roof Felt Paper Fastener			PCS	2007.0		
5	Roof Sheathing			SF	669.0		
6	Roof Sheathing Fastener			PCS	5352		
7	Batten			FT	0.0		
8	Batten Fastener			PCS	0.0		
9	Soffit			SF	128.0		
10	Soffit Fastener			PCS	64.0		
11	Fascia			FT	106.0		
12	Fascia board fastener			PCS	53		
13	Roof Insulation			SF	669.0		
14					10710		
15							