



ORION

The Orion is a charming Ranch-style studio home designed for efficient and comfortable living. Its exterior features a harmonious blend of textures and materials. The lower portion of the walls is constructed from stone, adding a touch of rustic elegance and grounding the structure. The upper walls are finished with light-colored horizontal siding, creating a classic and clean aesthetic. A simple gable roof provides shelter and complements the overall design.

Inside, the Orion embraces an open floor plan layout. The living, sleeping, and kitchen areas are seamlessly merged into one large, versatile room, maximizing space and creating a sense of openness. Functional spaces like the bathroom and laundry are thoughtfully placed at the back of the house, ensuring privacy and maintaining a clean living area.

Materials Shopping List


Please print and take this Materials Shopping List to your favorite Home Depot and ask for assistance in selecting the materials, fixtures and fittings to complete your new home.

Record your selection and the price of the item. Then do the math to determine the cost for your selections and the total cost of finishing your home.

< CLICK HERE >

To Go To Materials Shopping List



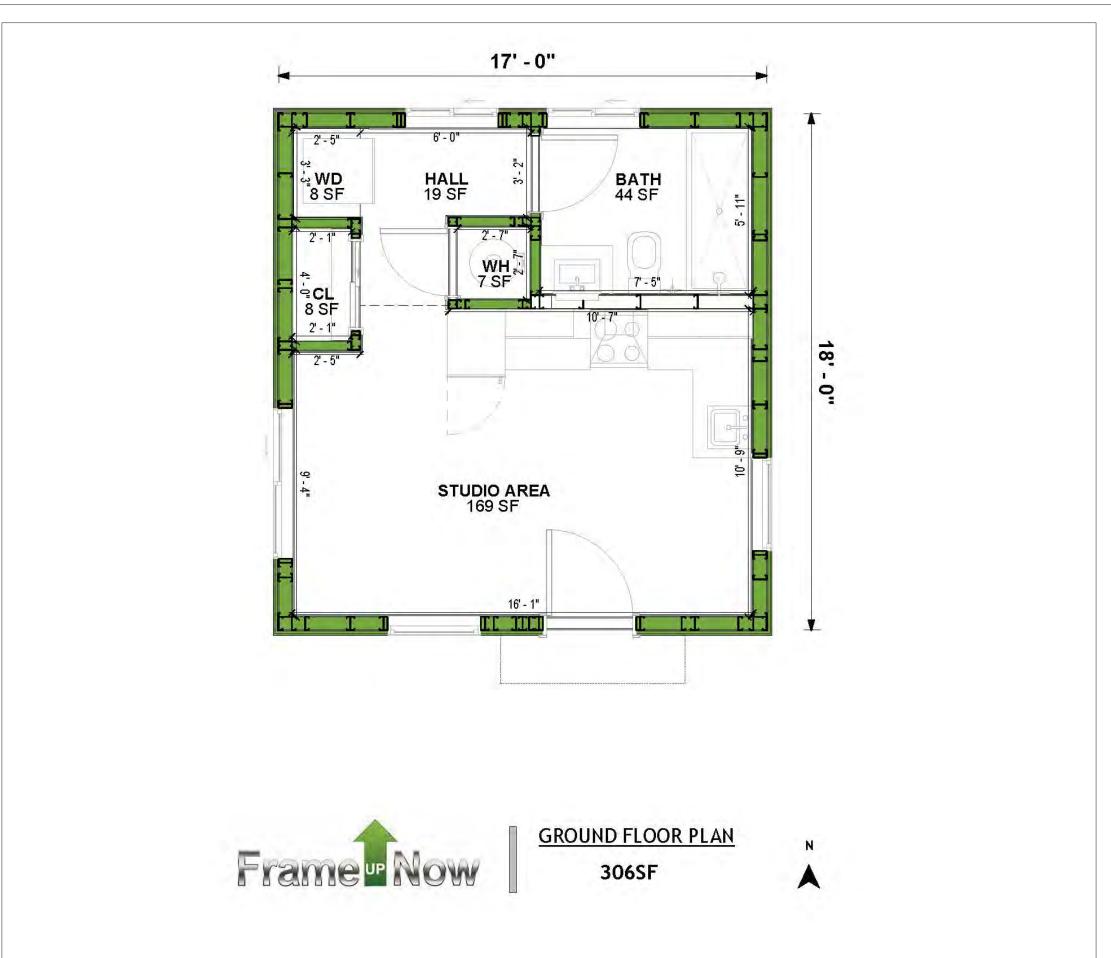

FLOOR PLAN



306 SF



ELECTRICAL

LIGHTING POWER PLAN DIMENSION FOR LIGHTING

PLUMBING

NOTES AND SCHEDULES WATER SUPPLY & SEWAGE SYSTEM # 38

DISCLAIMER

marketing content.

DISCLAIMER: This documentation and all it's contents are the intellectual property of FrameUpNow. It is provided solely for marketing the services of FrameUpNow.

The preliminary information is not approved for actual construction use and is

not warranted to be complete or accurate. Unauthorized copying, distribution, or application of these proprietary materials, in any form or format, is strictly prohibited. FrameUpNow assumes no liability for any issues arising from improper use of this

MATERIALS SHOPPING LIST

TABLE OF CONTENTS

RENDERINGS	ABOUT THE HOME -	01
1	RENDERINGS -	01
FLOOR PLAN	SCHEMATIC FLOOR PLAN	01
1	HOME SPECS -	— 01
	DISCLAIMER -	01
ABOUT	ABOUT FrameUpNow -	— 01
1	ABOUT HouseDocs -	01
DESCRIPTIONS	BOM (Bill Of Materials) ⊢	02
2	STRUCTURAL -	02
_	ARCHITECTURAL-	— 02
	MECHANICAL -	02
	ELECTRICAL	02

PLUMBING

MATERIALS LIST MATERIALS LIST PREVIEW -

03

CONSTRUCTION STEPS

HOW TO BUILD

COVER SHEET ARCHITECTURAL FLOOR PLAN + DIMENSION PLAN -

FOUNDATION PLAN STRUCTURAL FLOOR PLAN -WALL FRAME LAYOUT ROOF TRUSS LAYOUT ROOF PLAN + ARCHITECTURAL ELEVATIONS -ARCHITECTURAL ELEVATIONS -ARCHITECTURAL SECTIONS -ARCHITECTURAL DETAILS

ARCHITECTURAL CASEWORK -

STRUCTURAL

COVER SHEET	16
GENERAL NOTES	17
WALL FRAME LAYOUT	18
WALL PANEL & LAYOUT PLAN	19
ROOF TRUSS LAYOUT	20
STRUCTURAL SECTIONS	21
WALL BRACING LAYOUT	22
HOLD-DOWN PLAN	23
STRUCTURAL DETAILS 1	24
STRUCTURAL DETAILS 2	25
STRUCTURAL DETAILS 3	26
TRUSS BLOCKING LAYOUT	27
SHEETROCK BACKING	
ROOF BRACING LAYOUT	29
COVER SHEET -	30
	GENERAL NOTES WALL FRAME LAYOUT WALL PANEL & LAYOUT PLAN ROOF TRUSS LAYOUT STRUCTURAL SECTIONS WALL BRACING LAYOUT HOLD-DOWN PLAN STRUCTURAL DETAILS 1 STRUCTURAL DETAILS 2 STRUCTURAL DETAILS 3 TRUSS BLOCKING LAYOUT SHEETROCK BACKING

MECHANICAL SCHEDULE **32**

DIMENSION FOR FITTING

MATERIALS SHOPPING LIST

ABOUT



FrameUpNow is a design and manufacturing company providing precision-engineered home framing solutions. We offer a catalog of Affordable Homes, Tiny Homes, Garages, Shops and Barndominiums. FrameUpNow manufactures cold-formed steel (CFS) also known as Light Gauge Steel (LGS) framing components that conform to our engineered metal house frame plans or can be purchased as DIY skeleton kits.

The CFS/LGS framing is lightweight, easily assembled, and does not require heavy equipment or specialized labor, enabling homeowners to erect the frame themselves in just a few days. Unlike wood, the steel framing is impervious termites and bores, warping, expansion, and fire.

Our home plans come complete with a structural engineered stamp for permit approvals. Customers receive a full BOM also known as a Materials Shopping List to purchase finish materials from a Building Materials retailer. FrameUpNow prides itself on the quality and efficiency of our precision-engineered home framing solutions for construction professionals and DIY homeowners.



KEY PLAN

NO.	DESCRIPTION	DATE

NOTE:

LEGEND:

PROJECT

123-Orion-306-Studio-Ranch-**Base-550**

DRAWING NAME

INTRODUCTION

С	CLIENT NAME:
Р	PROJECT NUMBER:
D	DATE:
D	DESIGNED BY:
D	DRAWN BY:
С	CHECKED BY:

I101

SCALE:

DESCRIPTIONS

MATERIALS LIST

The BOM (Bill Of Materials) package, known as the Materials Shopping List document, provides:

Comprehensive Inventory: Detailed lists of essential materials sourced from architectural, mechanical, HVAC, electrical, and plumbing design drawing sets.

Precise Curation: Each item meticulously selected and organized for accuracy and efficiency in project planning.

Customizable Options: Customers can modify listed items to their preferences and calculate costs accordingly, ensuring alignment with personal project needs and budget.

Dedicated Space for Details: Includes tables for customers to note Home Depot SKU numbers or product descriptions for selected items, facilitating seamless purchasing and coordination with suppliers.

Customer Convenience: Take the list to Home Depot or preferred suppliers for accurate pricing, helping align the total home budget with personal financial plans.

Simplify your construction journey with our Materials Shopping List document, where detailed preparation meets streamlined implementation for your dream home.

STRUCTURAL

The structural drawings package provides an exhaustive set of detailed plans essential for the precise assembly of your building. This comprehensive package includes:

Framing Plans: Detailed layouts for all framing components. Truss Layouts: Clear instructions for truss placement and

Panel Length Plans: Specifications for panel dimensions. Framing Elevations and Sections: Precise elevation and sectional views for accurate construction.

Truss and Wall Blocking Plans: Plans for truss and wall blocking to ensure structural integrity.

Hold-Down Plan: Detailed hold-down requirements for stability. Snap Sheet: Reference sheet for quick identification of components

Structural Details and Bracing Plans: Complete details and bracing plans for all structural elements.

Accompanying these plans is a comprehensive Bill of Materials (BOM) that lists every necessary building component, from cold formed steel (CFS) frames to fasteners.

ARCHITECTURAL

With the comprehensive architectural package, both builders and DIY homeowners can confidently execute the construction.

The architectural package includes:

Furnished Floor Plans: Complete with furniture layouts for a clear understanding of space utilization.

Detailed Dimension Plans: Ensures precise measurements, from the overall footprint down to the exact placement of windows and

Foundation Plan: Detailed plan to establish a solid foundation.

Wall Framing and Truss Layout: Comprehensive plans for wall framing and truss placement.

Architectural Elevations: Exterior views showcasing the design.

Strategic Building Sections: Critical cross-sectional details for a thorough understanding of the build.

Casework Drawings and Diagrams: Suggested designs for built-in caseworks, such as kitchen cabinets.

MECHANICAL

The mechanical package includes everything needed to guide HVAC

Detailed HVAC Floor Plan: Precisely maps out the placement of air handlers, ductwork, and vents throughout the home's layout.

HVAC Sections and Riser Diagrams: Technical drawings offering critical cross-sectional details and piping schematics, ensuring proper integration of the heating and cooling system into the home's structure.

Bill of Materials: A complete list of all necessary HVAC components.

ELECTRICAL

The electrical package includes all the plans and documentation needed to guide the installation of your home's electrical system:

Detailed Power Plan: Precisely maps out the placement of outlets, switches, and other power components throughout the layout.

Comprehensive Lighting Plan: Shows the optimal locations for lighting fixtures, sconces, and other illumination sources to create a well-lit, functional interior.

Dimensioned Electrical Layout: Provides exact dimensions and measurements to ensure proper placement of all electrical elements.

Bill of Materials: A complete list of every component needed, from circuit breakers to wiring.

PLUMBING


The plumbing package includes everything needed to guide the installation of your home's water supply and drainage systems:

Detailed Water Supply System Plan: Precisely maps out the placement of pipes, valves, and plumbing fixtures throughout the

Comprehensive Sewage System Plan: Shows the optimal routing and sizing of drain lines to effectively remove waste and ensure proper drainage.

Detailed Riser Diagrams: Provide information needed to properly install all vertical plumbing risers and vent stacks.

Bill of Materials: A complete list of every component needed, from pipes to fixtures.

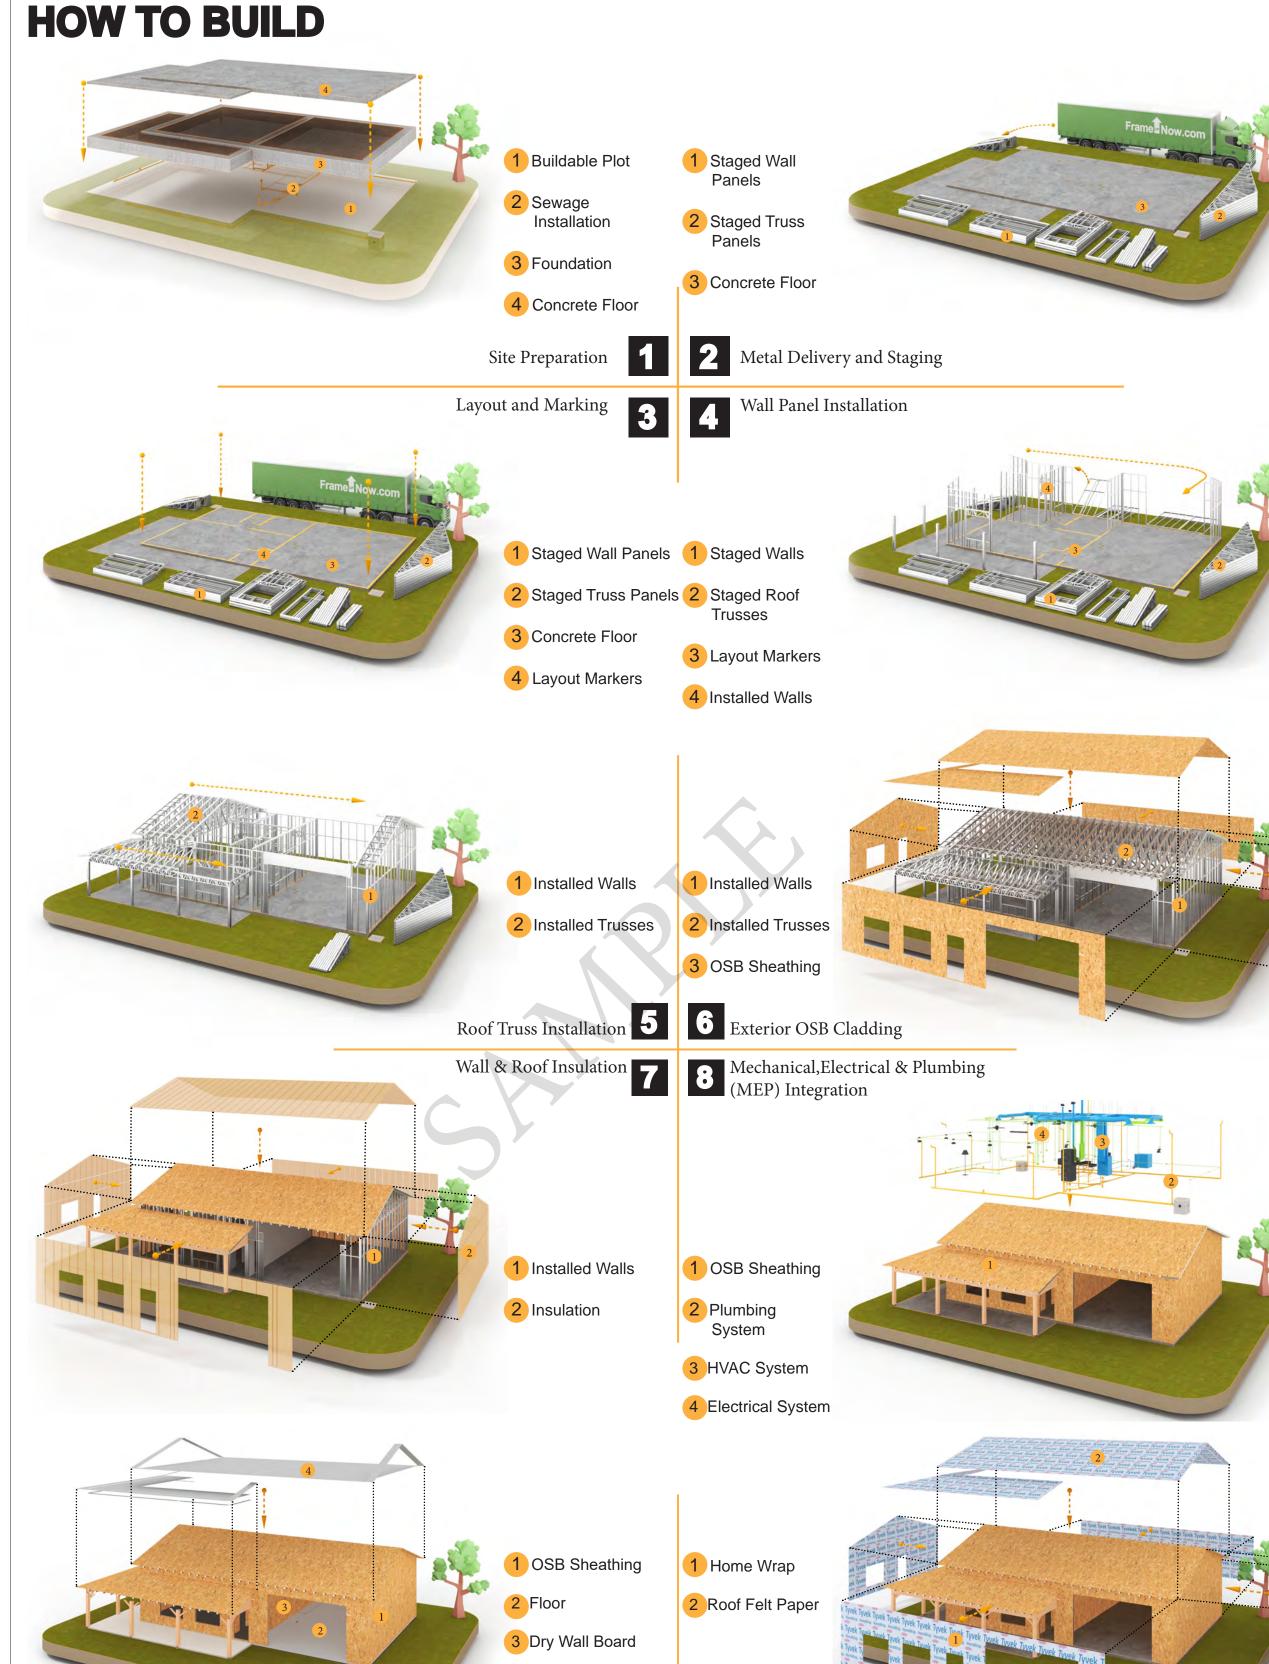



KEY PLAN

DESCRIPTION	DATE

NOTE:

LEGEND:

PROJECT

123-Orion-306-Studio-Ranch-**Base-550**

DRAWING NAME

INTRODUCTION

CLIENT NAME: PROJECT NUMBER: DATE: **DESIGNED BY** DRAWN BY: CHECKED BY:

1102


SCALE:


BOM (Bill Of Materials) (Separately Attached)





The Bill of Materials (BOM) is a crucial document that compiles the material requirements from different disciplines into a centralized inventory, enabling efficient procurement, inventory management, and cost estimation for a specified project or



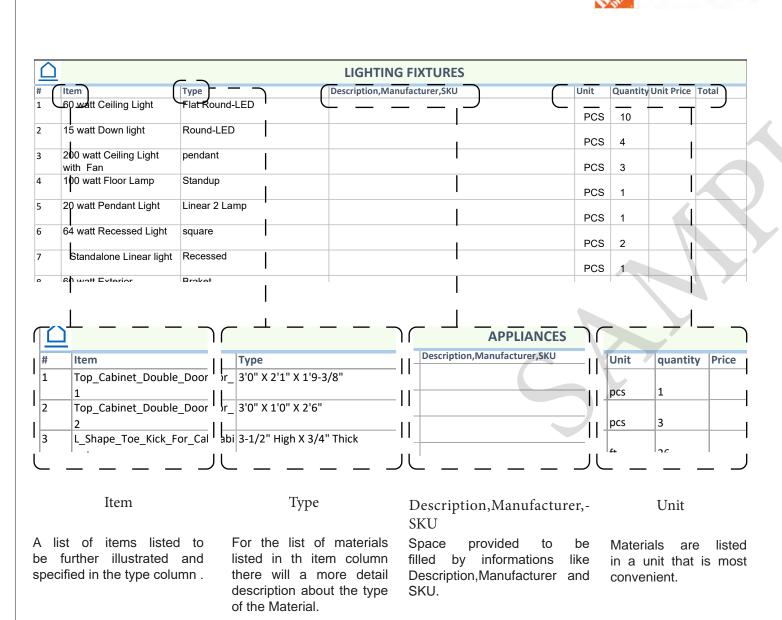

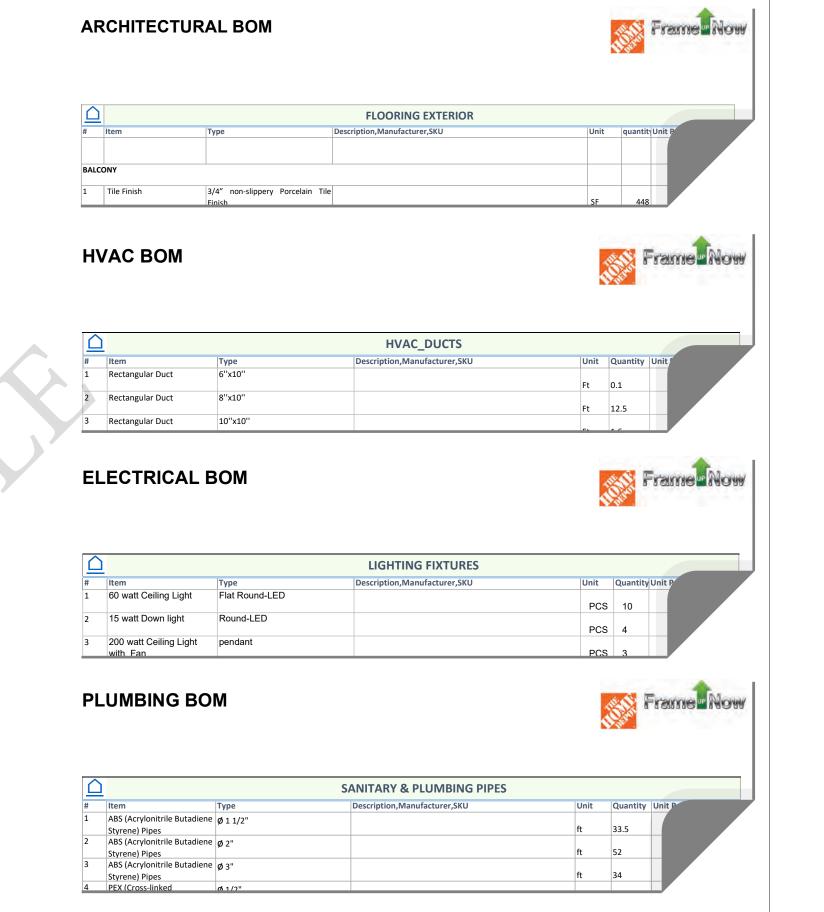

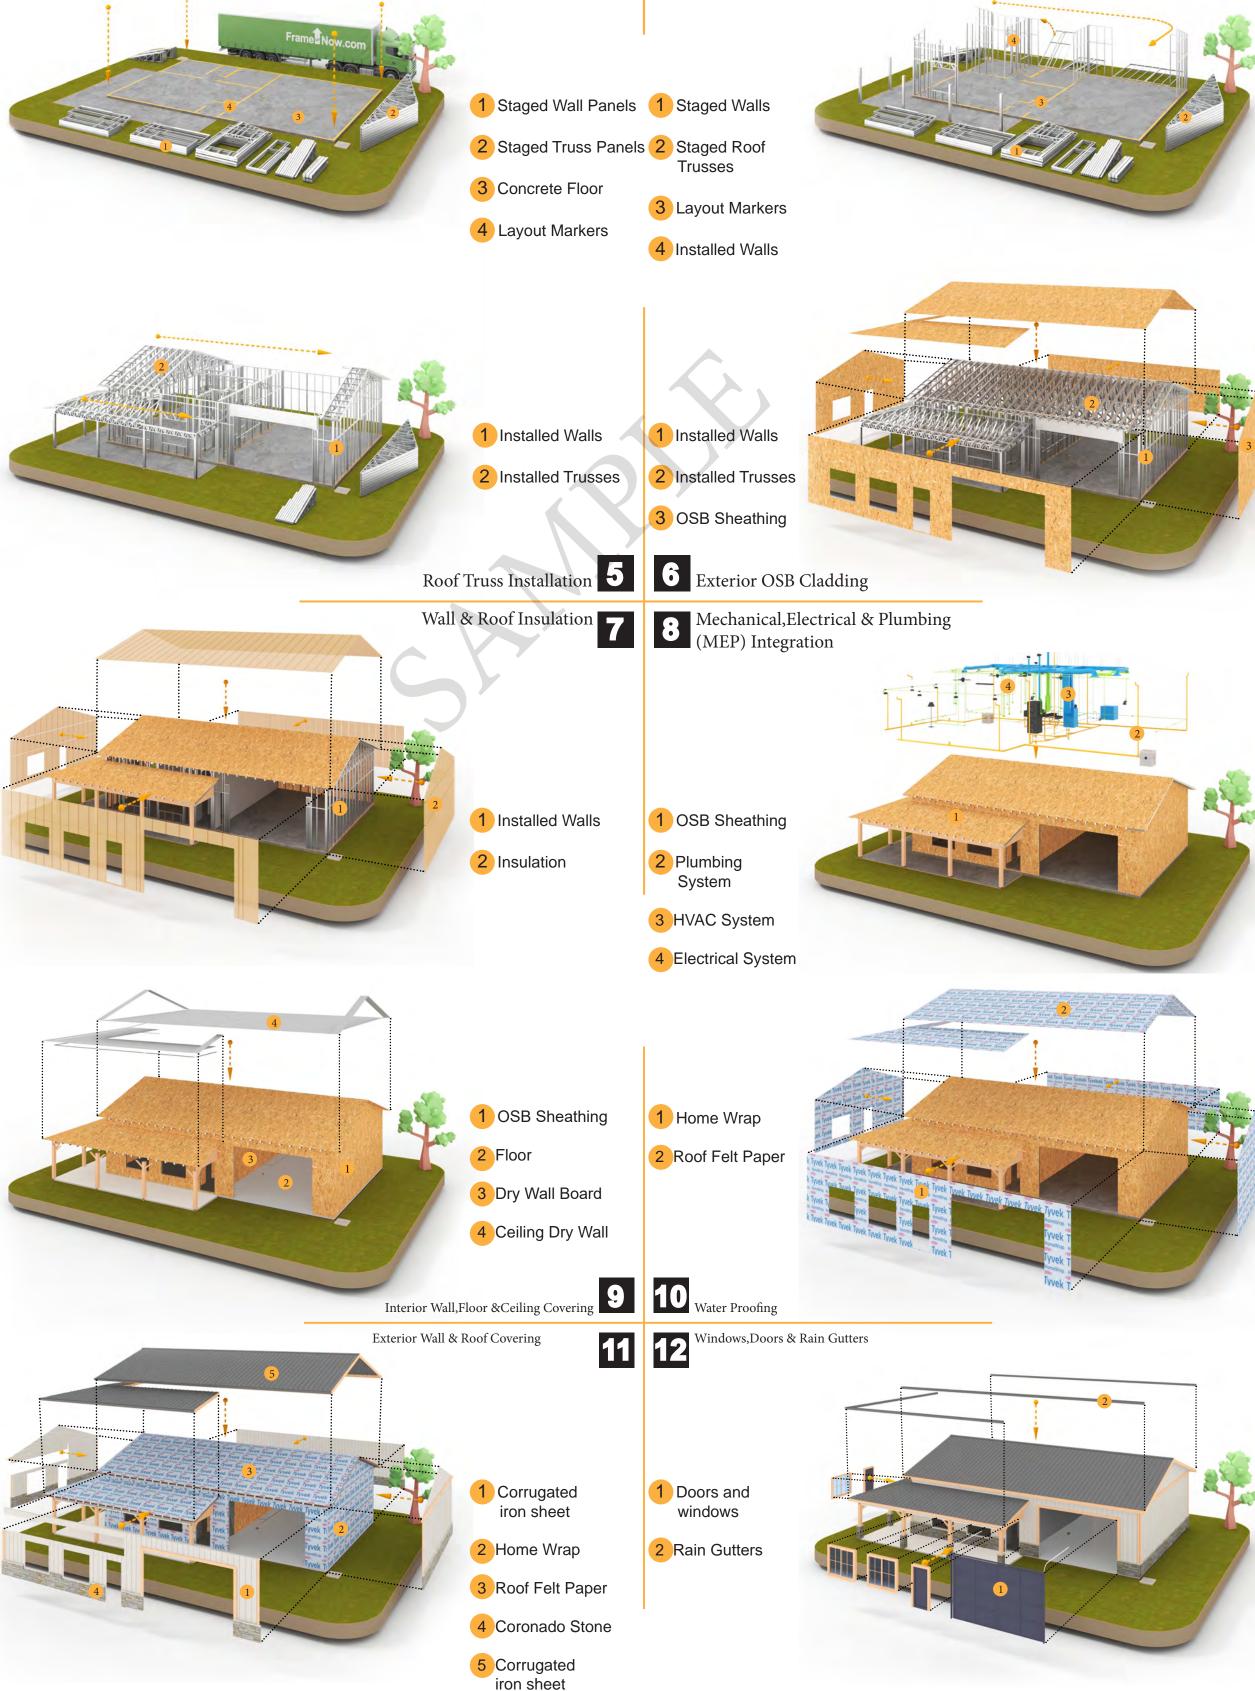

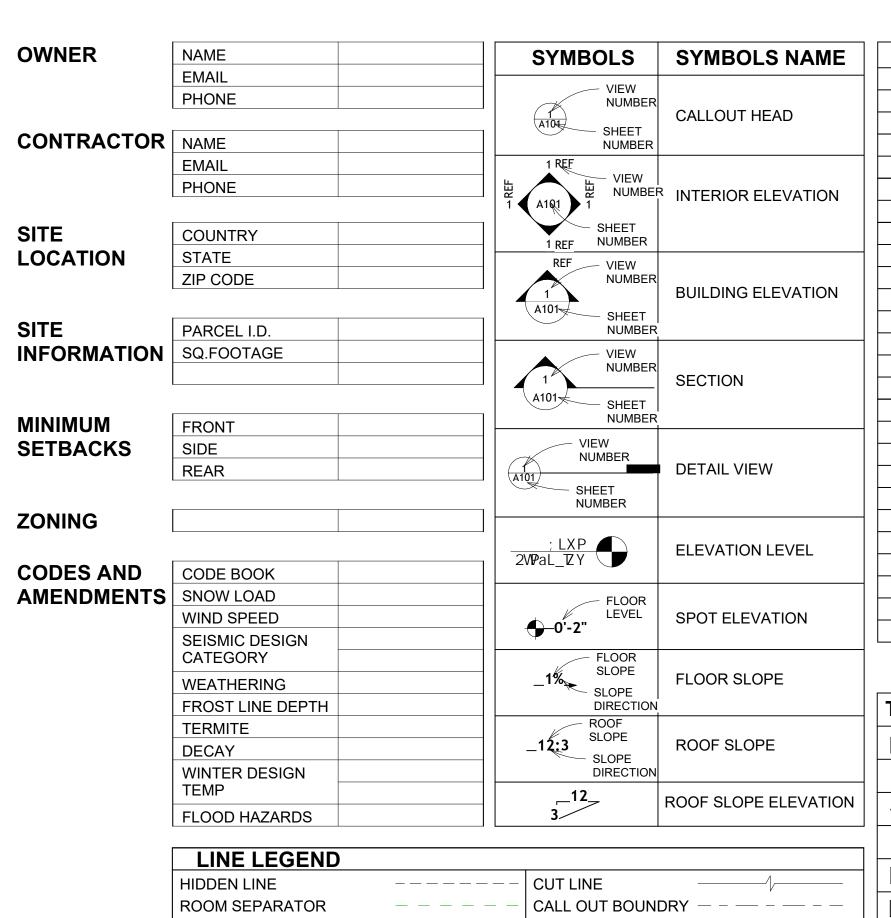

- — — — | LEVEL

DOOR OPENING DIRECTION

OVER HEAD

G101	PAGE INDEX COVER SHEET
A101	FLOOR PLAN
A102	DIMENSION PLAN
S101	FOUNDATION PLAN
S102	STRUCTURAL FLOOR PLAN
S103	FRAME LAYOUT
S104	ROOF TRUSS LAYOUT
A103	ROOF PLAN
A201	ELEVATIONS
A202	ELEVATIONS
A301	SECTIONS
A401	DETAILS
A402	CASEWORK DETAILS
A403	CASEWORK DETAILS
E101	SCHEDULE
E102	LIGHTING PLAN
E103	POWER PLAN
E104	DIMENSION PLAN FOR LIGHT FIXTURE
E105	DIMENSION PLAN FOR FITTING
P101	COVER SHEET
P102	WATER SUPPLY SYSTEM
P103	SEWAGE SYSTEM
P104	RISER DIAGRAM
M101	HVAC PLAN
M102	HVAC SECTION
M103	RISER DIAGRAM

\G	TAG'S NAME
۸01	CASEWORK TAG
1)	DOOR TAG
1	FURNITURE TAG
1	WINDOW TAG
01	SPECIALTY EQUIPMENT TAG
E01	MECHANICAL EQUIPMENT TAG
E01	PLUMBING EQUIPMENT TAG



IXLI	INLILINOL
RG	RIGHT GARAGE
SE	SPECIAL EQUIPMENT
SF	SQUARE FEET
SIMP. STHD8	SIMPSON STRAP THE HOLDDOWN
SIMP. ABE66	SIMPSON ANCHOR BOLT EDGE
TV	TELEVISION
UNO	UNLESS NOTED OTHERWISE
W/	WITH
W/D	WASHER/DRYER
AC	AIR CONDITIONING UNIT
ACC	AIR COOLED CONDENSER
ACCU	AIR COOLED CONDSENSING UNIT
AHU	AIR HANDLING UNIT
CC	COOLING COIL
CD	CEILING DIFFUSER
CFm	Cubic Feet Per Minute
CR	CEILING REGISTER
CU	CONDENSING UNIT
CW	COLD WATER
E/A	EXHAUST AIR
EF	EXHAUST FAN
ET	EXPANSION TANK
EX.	EXISTING
FC	FLEXIBLE CONNECTION
FCU	FAN COIL UNIT
FLR.	FLOOR
HC	HEATING COIL
HE	AIR TO AIR HEAT EXCHANGER
HV	HEATING AND VENTILATING UNIT
IV	INLET VANES
MER	MECHANICAL ROOM
MAX.	MAXIMUM
MIN.	MINIMUM
R/A	RETURN AIR
RCU	RECIPROCATING CHILLER UNIT
RF	RETURN FAN
S/A	SUPPLY AIR
SCD	SMOKE CONTROL DAMPER
SP	STATIC PRESSURE

ABBREVIATION

ASTM D698 AMERICAN SOCIETY FOR

CASEWORK ELECTRICAL

FOOTINGS

MAXIMUM MECHANICAL

MINIMUM

NUMBER

ON CENTER

PLUMBING

REFERENCE

CONDITIONING

FTG

MIN.

REF

HVAC

ACTION FLOOR SYSTEMS

TESTING AND MATERIAL

FINISHED FLOOR LEVEL

FINISHED FLOOR ELEVATION

HEATING, VENTILATION & AIR


INTERNATIONAL RESIDENCE

INTERNATIONAL MECHANICAL

ORIENTED STRAND BOARD

POUNDS PER SQUARE INCH

POLYVINYL CHLORIDE

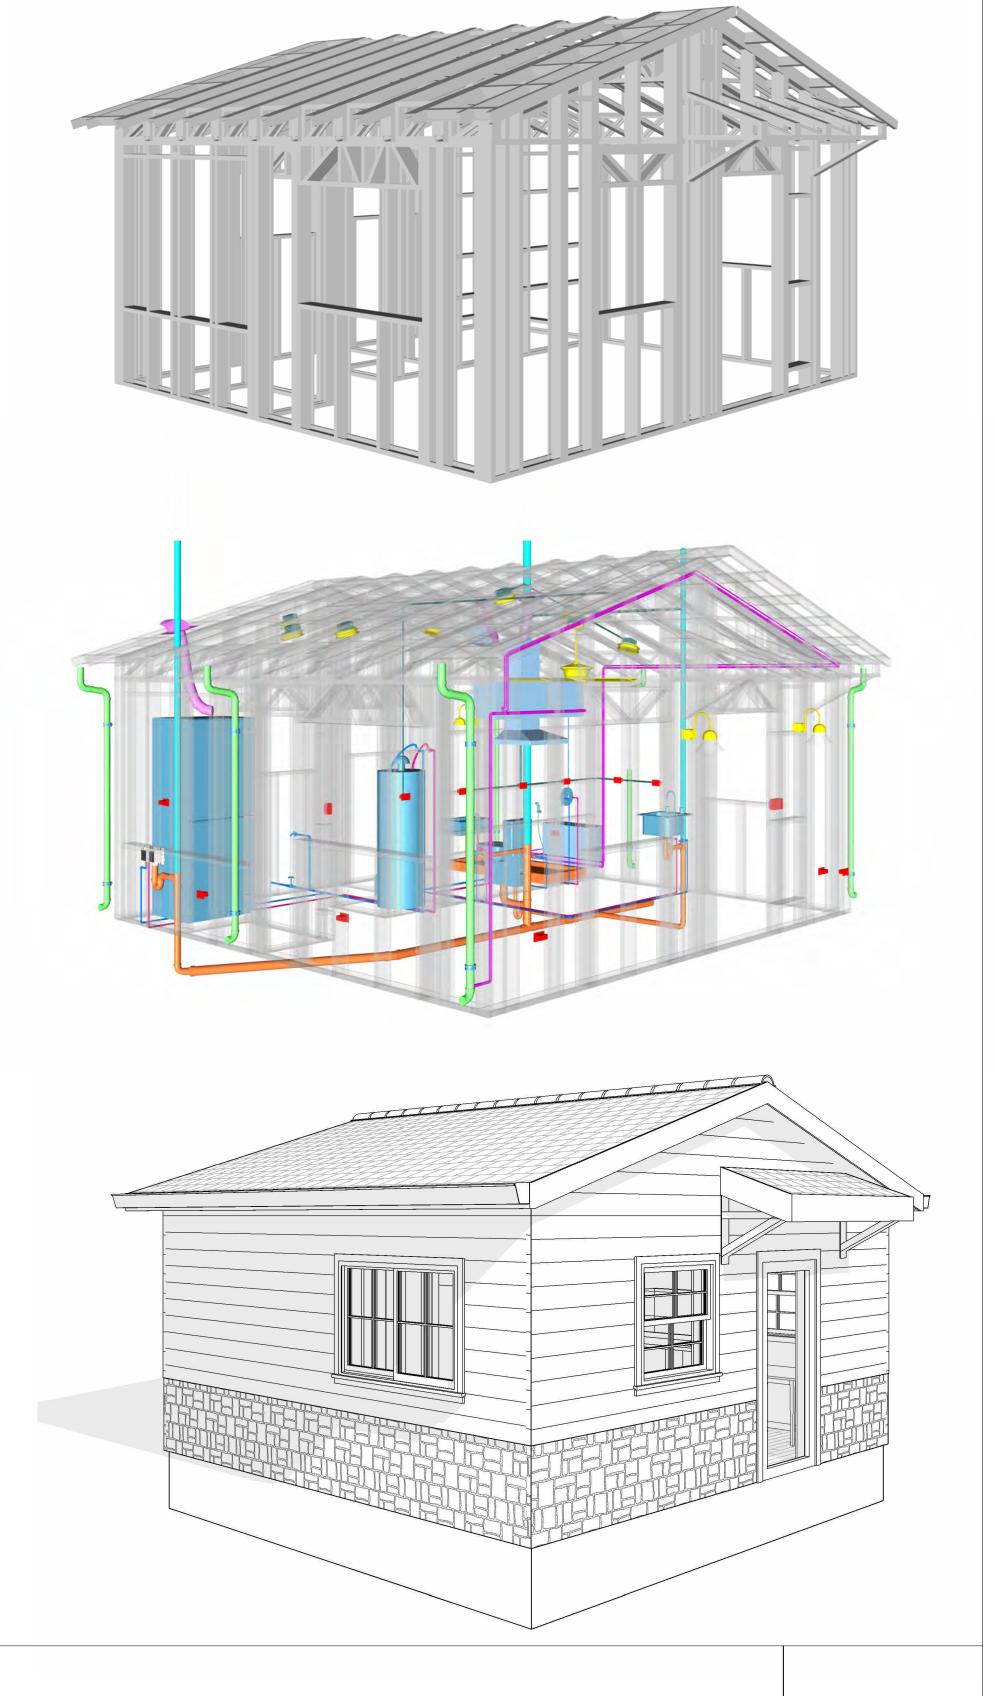


123-ORION-306-STUDIO-RANCH BASE-550

SQUARE FOOTAGE		
LIVIN G	306	
TOTAL	306	



KEY PLAN

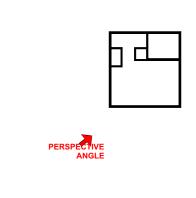

NO.	DESCRIPTION	DAT

NOTE

LEGEND:

PROJECT

123 ORION 306 STUDIO RANCH BASE 550

DRAWING NAME

COVER SHEET

CLIENT NAME:	Client Name
PROJECT NUMBER:	0061_12
DATE:	3/20/2025 12:15:22 PM
DESIGNED BY:	Designer
DRAWN BY:	Author
CHECKED BY:	Checker

G101

GENERAL NOTES

- 1. THIS DRAWING DEPICTS THE ARCHITECTURAL (SPACE LAYOUT, FURNISHING, FLOOR, WALLS, ROOFS, FOUNDATION, WINDOWS AND DOORS) SYSTEMS. IT PROVIDES A VISUAL REPRESENTATION OF THE ARCHITECTURAL LAYOUT AND COMPONENTS.
- 2. THE ARCHITECTURAL DRAWINGS ARE PREPARED TO MEET THE SPECIFIC REQUIREMENTS OF THE BUILDING, AS PER THE PROJECT SPECIFICATIONS AND APPLICABLE CODES AND STANDARDS.
- THE CONSTRUCTION OF THIS HOME SHALL COMPLY WITH THE LATEST EDITION OF THE INTERNATIONAL RESIDENTIAL CODE (IRC), INTERNATIONAL MECHANICAL CODE (IMC), THE INTERNATIONAL PLUMBING STANDARD, THE NATIONAL ELECTRICAL STANDARD AND ALL OTHER APPLICABLE LOCAL, STATE, AND NATIONAL CODES AND REGULATIONS.
- 4. COORDINATION WITH OTHER TRADES HAS BEEN DONE ON A DESIGN LEVEL. THIS DRAWING SHALL BE READ TOGETHER WITH THE ME, EL AND PL DESIGN DRAWINGS TO ENSURE PROPER CONSTRUCTION AND INTEGRATION OF THE BUILDING SYSTEMS.

ABOUT WALLS:

1. SHOWER WALL COVERING

BATHTUB AND SHOWER SPACES (WALLS AND FLOORS) WITH INSTALLED SHOWER HEADS AND IN SHOWER COMPARTMENTS SHALL BE FINISHED WITH A NON-ABSORBENT SURFACE.

2. WALL PAINT (INTERNAL)

THE TYPICAL THICKNESS OF LATEX WALL PAINT IS 1/32 OF AN INCH FOR A SINGLE COAT. AND DOUBLE COAT (1/16") SHALL BE APPLIED FOR DURABILITY.

3. ADHESIVES:

THE ADVISABLE TYPE OF ADHESIVE FOR THIS PROJECT IS EPOXY ADHESIVES BECAUSE THEY ARE KNOWN FOR THEIR HIGH STRENGTH, DURABILITY, AND RESISTANCE TO MOISTURE, CHEMICALS AND HEAT.

REFER TO SHEETS A201 & A202 FOR GENERAL NOTES ON EXTERNAL FINISHING MATERIALS

ABOUT FLOORS:

1. THE SPOT ELEVATION INDICATES THE FINISHED FLOOR ELEVATION.


. FINISHED FLOORS PER PLANS.


FIELD VERIFY FOR DIMENSION DROP 4" FOR SHOWER AND BATHTUB USE.

. 1% SLOPE ON OUTDOOR BALCONIES FOR WATER RUN OFF.

2% SLOPE TOWARDS THE SHOWER DRAIN FOR SUFFICIENT DRAINAGE.
4" DROP AT THE DOOR LEADING TO EXTERIOR BALCONY FROM THE MAIN LIVING AREA.


7. 5% SLOPE FOR GARAGE IS USED, WHICH SHOULD BE CHECKED WITH THE LOCAL GARAGING ZONING LAWS.

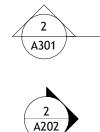


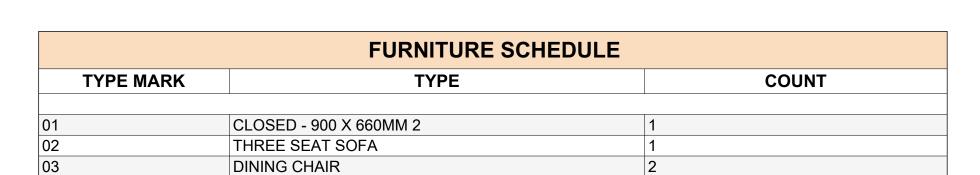

	ROOM FINISH SCHEDULE							
ROOM NUMBE R	ROOM NAME	FLOOR FINISH	BASE FINISH	WALL FINISH	CEILING FINISH	CEILING HEIGHT	COMMENTS	
01	KITCHEN	HARDWOOD	CONCRETE	WALL PAINT + CERAMIC	DRY WALL	8' - 0"		
02	STUDIO AREA	HARDWOOD	CONCRETE	WALL PAINT	DRY WALL	8' - 0"		
03	CL	HARDWOOD	CONCRETE	WALL PAINT	DRY WALL	8' - 0"		
04	WD	HARDWOOD	CONCRETE	WALL PAINT	DRY WALL	8' - 0"		
05	HALL	HARDWOOD	CONCRETE	WALL PAINT	DRY WALL	8' - 0"		
06	BATH	VINYL TILES	CONCRETE	CERAMIC TILE	MRD	8' - 0"		
07	WH	HARDWOOD	CONCRETE	WALL PAINT	DRY WALL	8' - 0"		



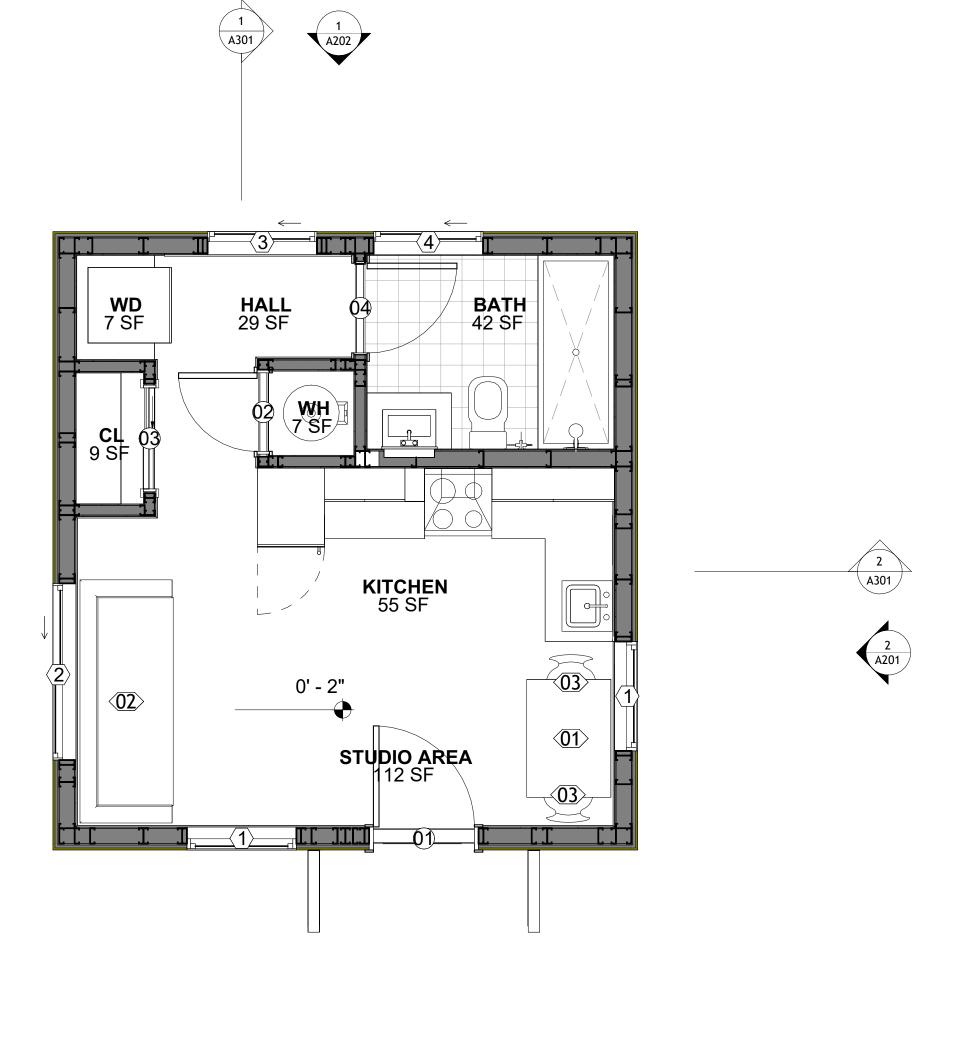

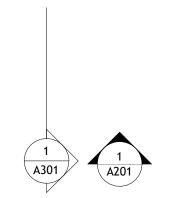



KEY PLAN

NO.	DESCRIPTION	DATE

NOTE:

LEGEND:

PROJECT

123 ORION 306 STUDIO RANCH BASE 550

DRAWING NAME

FLOOR PLAN


Client Name	CLIENT NAME:	
0061_12	PROJECT NUMBER:	
3/20/2025 12:15:22 PM	DATE:	
Designer	DESIGNED BY:	
Author	DRAWN BY:	
Checker	CHECKED BY:	

SQUARE FOOTAGE

LIVIN 306

G

TOTAL 306

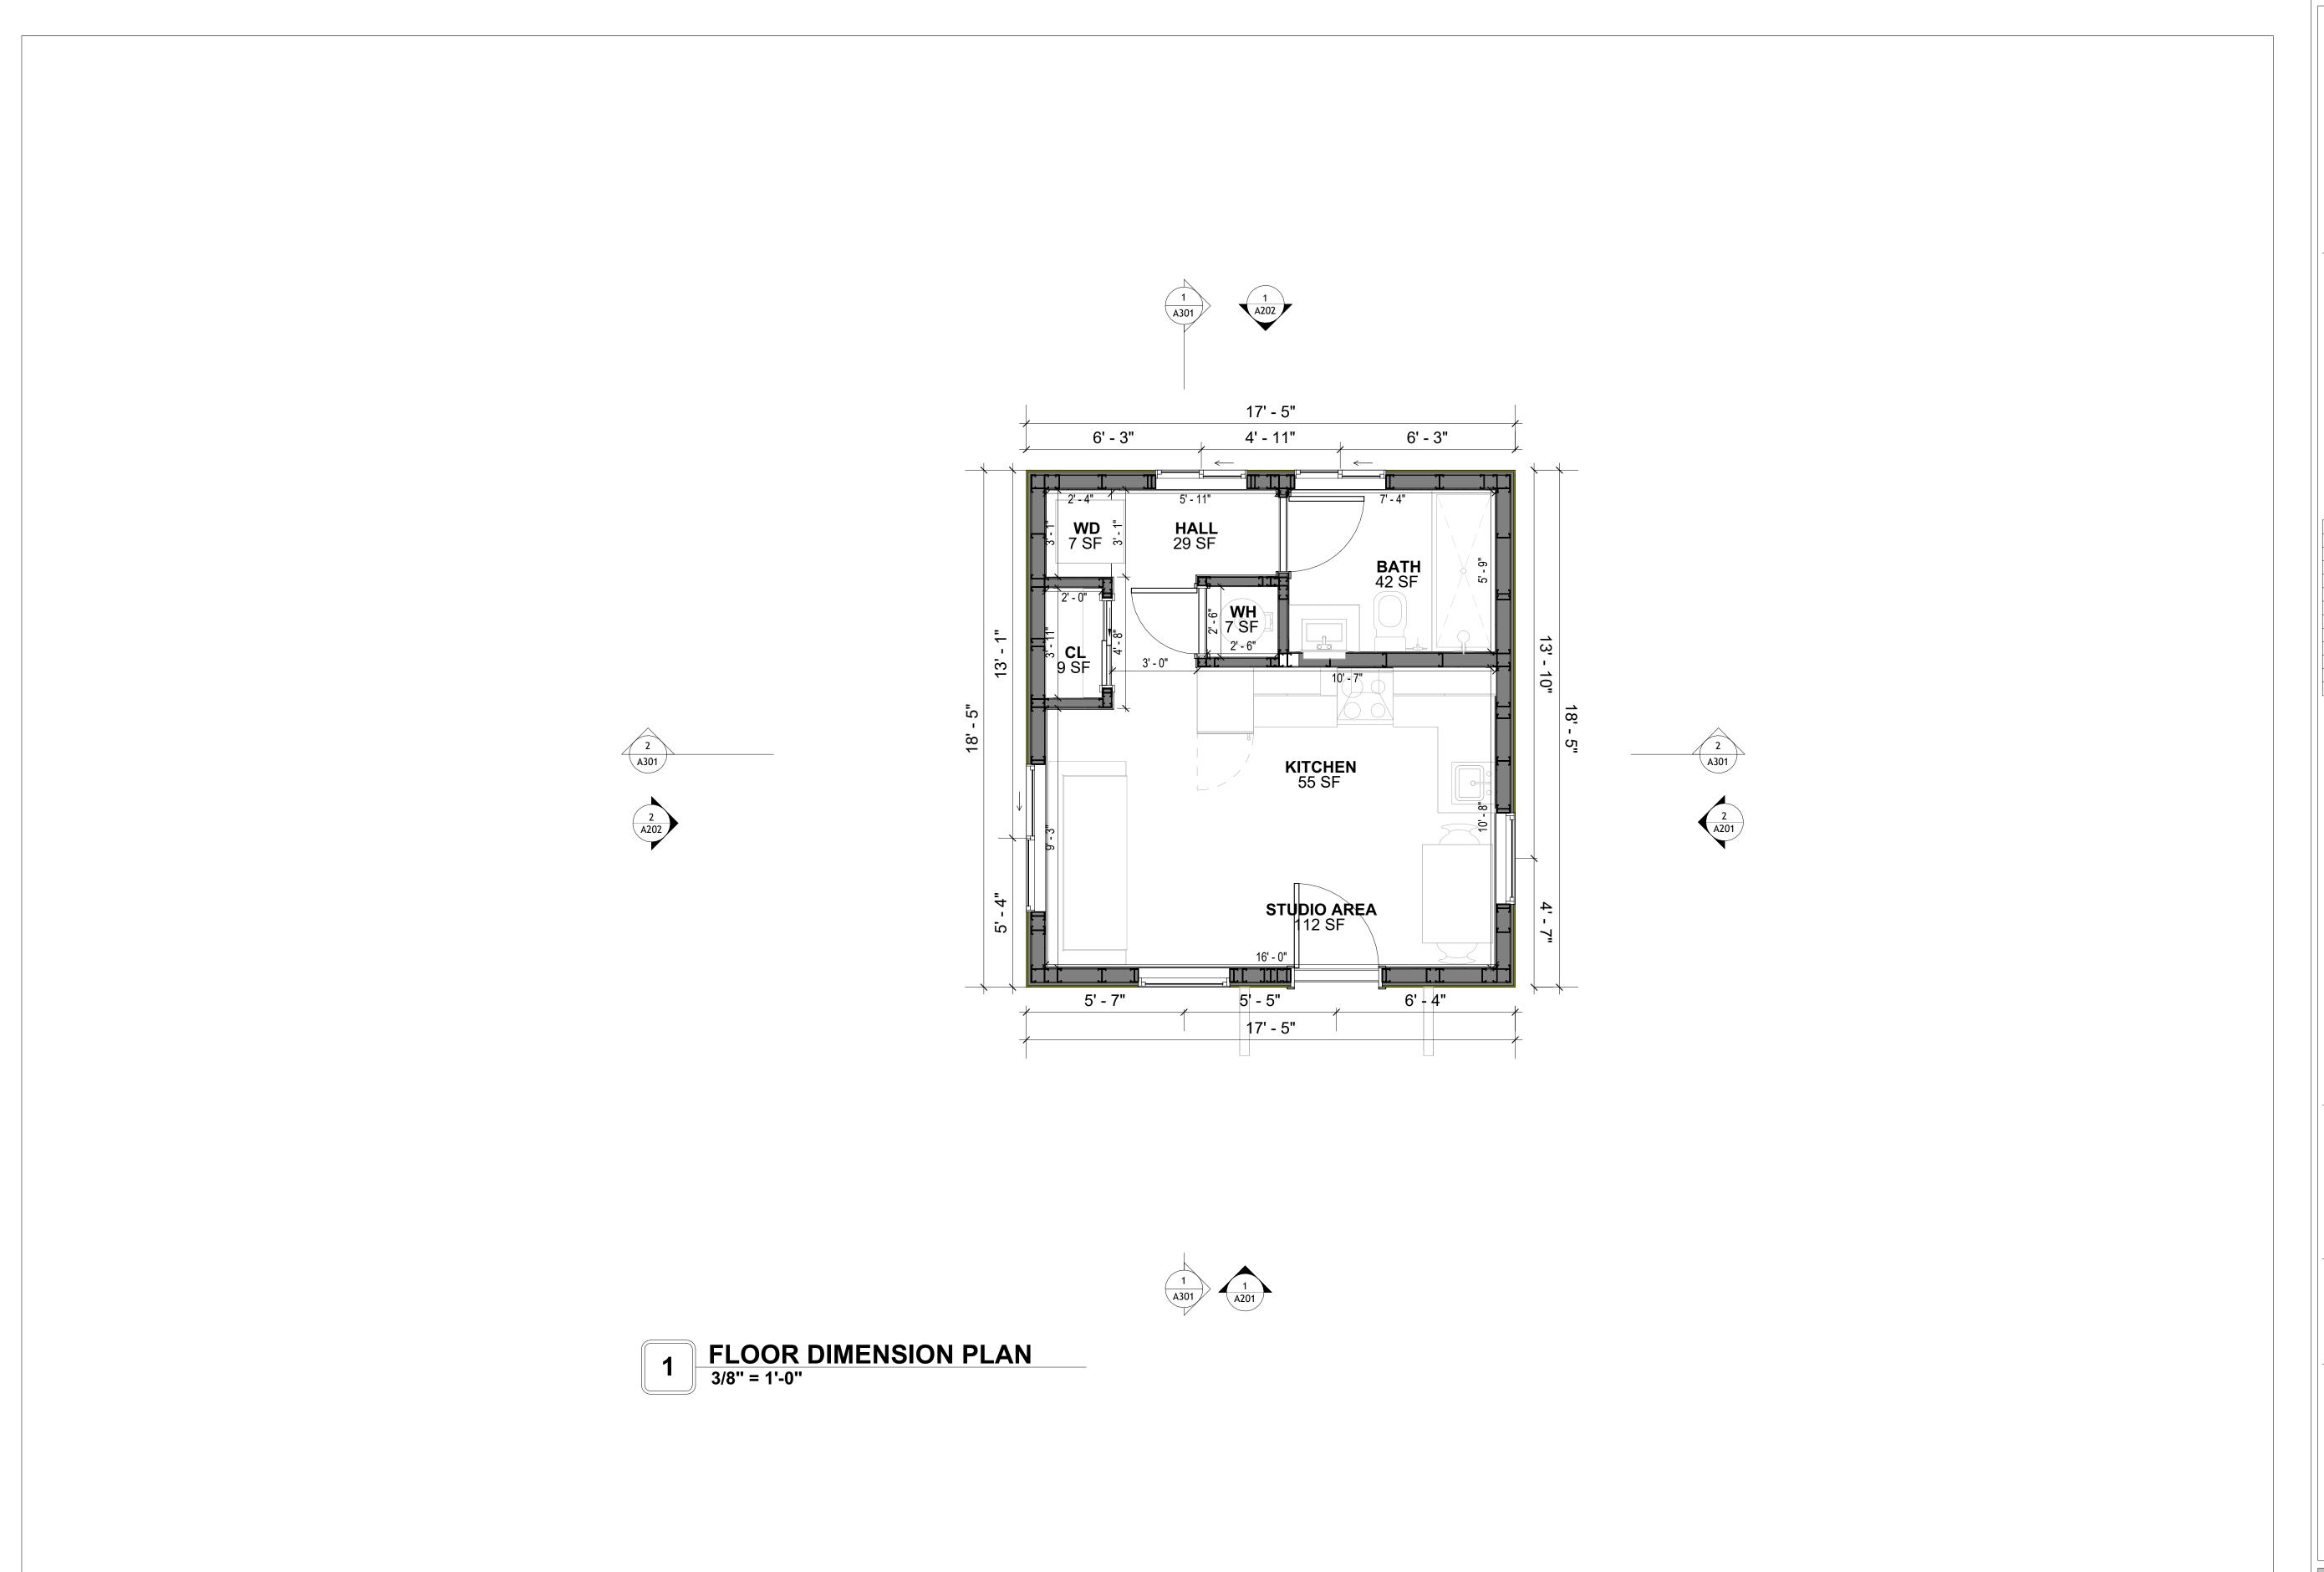



KEY PLAN

NO.	DESCRIPTION	DATE

NOTE:

LEGEND:

PROJECT

123 ORION 306 STUDIO RANCH BASE 550

DRAWING NAME

DIMENSION PLAN

Client Name	CLIENT NAME:
0061_12	PROJECT NUMBER:
3/20/2025 12:15:23 PM	DATE:
Designer	DESIGNED BY:
Author	DRAWN BY:
Checker	CHECKED BY:

A102

SQUARE FOOTAGE

306

TOTAL

SCALE: 3/8" = 1'-0"

FOUNDATION NOTES

NOTES:

TERMITES PRETREATMENT BY LICENSED CONTRACTOR UNDER SLAB AND AROUND FOOTINGS. ALL AREAS BELOW SLABS SHALL BE TREATED NO MORE THAN 24 HOURS PRIOR TO CONCRETE POUR. EVIDENCE OF TREATMENT MUST BE PROVIDED PRIOR TO PLACING OF CONCRETE.

. MATERIALS:

ALL INTERIOR CONCRETE SLABS SHALL BE A MIN. OF 4" THICK CONCRETE OVER 4" COMPACTED AGGREGATE BASE (ASTM D698), FINISH ELEVATIONS AS NOTED ON DRAWINGS, 6" ABOVE ADJACENT GRADE, LEVEL SLABS TO 1/8"-10' MAX.. CONCRETE SLABS SHALL BE 2500# PSI AT 28 DAYS. A 4" ALLOWABLE SLUMP.

2. PAD PREPARATION:

- EXCAVATION FOR FOOTING SHALL BE NEAT.

- FOOTINGS SHALL BE POURED IMMEDIATELY AFTER EXCAVATION AND APPROPRIATE

INSPECTION.
- ALL REINFORCING STEEL MARKED "CONTINUOUS" SHALL BE LAPPED 36 BAR DIAMETERS AT SPLICES AND AROUND CORNERS OR INTERSECTIONS WITH A STANDARD 90 DEGREE BEND ON CORNER BARS. LAP WIRE MESH ONE FULL MESH AT SIDE AND END LAPS.

- ALL HARDWARE TO BE SIMPSON OR EQUIVALENT.
- EXTERIOR FRAME WALL TO BE SECURED WITH 1/2"X10" ANCHOR BOLTS 4'-0" O.C. FOR 1-STORY AND 2'-8" O.C. FOR 2-STORY. BOLTS SHALL BE LOCATED WITHIN 1'-0" OF EACH END PIECE AND SHALL HAVE A MIN. OF TWO BOLTS PER PIECE.

-FOUNDATION ANCHOR STRAPS SHALL BE PERMITTED, ACCORDING TO RESIDENTIAL CODE 2021

- ALL INTERIOR WALLS TO BE SECURED WITH POWER DRIVEN PINS PER MANUFACTURER SPECIFICATION USE PIN SPACING EQUIVALENT TO 1/2" ANCHOR BOLTS.

SPECIFICATION USE PIN SPACING EQUIVALENT TO 1/2" ANCHOR BOLTS.
- ALL CONSTRUCTION TO CONFORM TO THE 2012 IRC

R-10 RIGID INSULATION OUTSIDE OF EXTERIOR FOUNDATION WALLS UNDER LIVING AREA.
 CONCRETE PAD FOR CONDENSER THICKNESS IS 4" MIN UNLESS OTHERWISE NOTED.

3. CONCRETE CONSTRUCTION:

- THE SLAB SHALL BE UNDERLAIN BY A VAPOR BARRIER/RETARDER IN THE LIVING AREA (TYPICALLY POLYETHYLENE, UNLESS MORE STRINGENT PROTECTION REQUIRED BY THE ARCHITECT, ENGINEER, FLOOR COVERING MANUFACTURER, OR ACCEPTED PRACTICE). UNLESS OTHERWISE REQUIRED, BARRIER MAY BE OMITTED AT GARAGES, PORCHES AND PATIOS WITHOUT FLOOR COVERINGS. IT IS BEYOND THE SCOPE OF THESE PLANS TO DETERMINE THE APPLICABILITY OF THESE MORE STRINGENT REQUIREMENTS. BUILDER SHALL VERIFY PRIOR TO CONSTRUCTION.

4. REINFORCEMENT:

- IF CONSTRUCTED ON ACTIVE SOILS, THE LONG TERM PERFORMANCE OF THE FOUNDATION IS DEPENDENT ON MAINTENANCE BY THE OWNER. THUS THE BUILDER SHALL ADVISE THE OWNER OF THE FOLLOWING:

1. DRAINAGE MUST BE MAINTAINED. WATER SHALL NEVER BE ALLOWED TO POND NEAR THE FOUNDATION.

THE SOIL AROUND THE FOUNDATION SHALL BE MAINTAINED IN A RELATIVELY DAMP CONDITION, SUCH AS THAT REQUIRED TO KEEP A LAWN GREEN. IF IT DRIES OUT IT WILL SHRINK. IF IT GETS WET, IT WILL HEAVE UPWARD.
 SLABS ON THE SHORTER SIDE USES MAIN BARS ARE USED IN THIS DIRECTION ONLY

WITH SMALLER DIAMETER DISTRIBUTION BARS ARE PLACED, FORMING A MAT OR GRID.

4. ALL REINFORCEMENT BARS SIZE 10MM OR LARGER IN ACCORDANCE TO ASTM

3. ANCHOR BOLTS AT ALL EXTERIOR WALLS SHALL BE MINIMUM 1/2 INCH DIAMETER WITH A

MAXIMUM SPACING OF 6'-0" ON CENTER, UNLESS NOTED OTHERWISE.

4. ANCHOR BOLTS SHALL BE INSTALLED WITHIN 12 INCHES OF EACH END OF EACH SILL PLATE WITH AT LEAST TWO ANCHOR BOLTS FOR EACH BOLTS FOR EACH SILL PLATE LONGER THAN 12 INCHES.

5. SIMPSONS SILL ANCHORS MAYBE SUBSTITUTED FOR ANCHOR BOLTS AT THE SAME

SPACING.
6. EXTERIOR CONCRETE SLABS WHICH ARE NOT PART OF THE MAIN SLAB SHALL BE MINIMUM 4 INCHES THICK WITH NO STEEL REINFORCING BARS REQUIRED, UNLESS NOTED OTHERWISE ON FOUNDATION PLAN.

VERIFY THE FOLLOWING PRIOR TO POURING:

1. ALL HOLDDOWNS , STRAP, AND POST LOCATIONS.

2. CONCRETE FINISHES. PANEL RISER LOCATION - WHERE APPLICABLE.

3. UNDERSLAB MECHANICAL REQUIREMENTS.

STEM WALL BLOCKOUTS.
 UNDERSLAB ELECTRICAL REQUIREMENTS AND PANEL RISER LOCATION. WHERE


APPLICABLE.

6. PROVIDE THE FOLLOWING:

- PVC SLEEVES THROUGH FTG IF REQUIRED - 20' #4 COPPER GROUND BAR.

7. SLOPE FINISH GRADE AWAY FROM FOOTING.

NOTE: FIELD VERIFY ALL DIMENSIONS SEE DIMENSIONED ARCHITECTURAL DRAWINGS

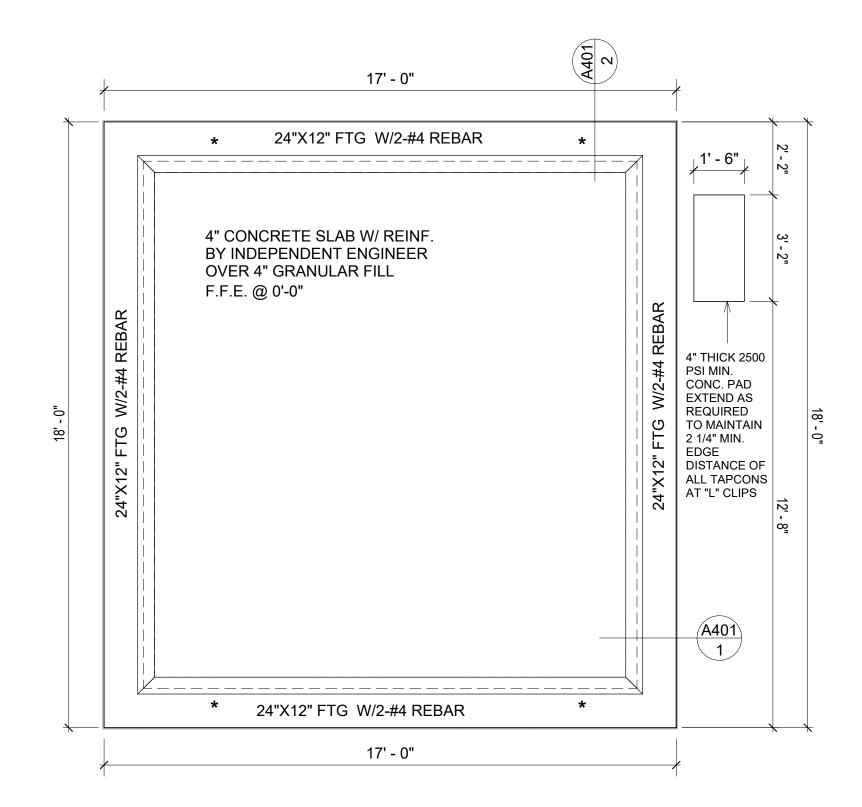

1 FOUNDATION PLAN
3/8" = 1'-0"



KEY PLAN

NO.	DESCRIPTION	DATE

NOTE:

LEGEND:

PROJECT

123 ORION 306 STUDIO RANCH BASE 550

DRAWING NAME

FOUNDATION PLAN

Client Name	CLIENT NAME:
0061_12	PROJECT NUMBER:
3/20/2025 12:15:23 PM	DATE:
Designer	DESIGNED BY:
Author	DRAWN BY:
Checker	CHECKED BY:

S101

SCALE: 3/8" = 1'-0"

SQUARE FOOTAGE

306

TOTAL

© [2024] [FrameUpNow] . All rights reserved

GENERAL NOTES

NOTES:

-ALL BEARING WALLS SHOULD HAVE A THICKENED SLAB PER SECTION PER DETAIL A401/5.

A) FOUNDATION PLAN NOTES:

1. CONCRETE SLAB SHALL BE 6" THICK WITH 1/2" DIAMETER TENDONS PER LAYOUT PLAN, CENTERED IN SLAB THICKNESS, OVER APPROVED SUBBASE PER GENERAL STRUCTURE NOTES

2. TERMITE PROTECTION SHALL BE PROVIDED PER IRC SECTION R318.1
3. NONE TYPICAL ANCHOR BOLT SPACING AT SHEAR WALL AND HOLD DOWN
SPECIFICATIONS PER APPROVED ARCHITECTURAL PLANS.

 INSTALL HOLDOWNS BEFORE CONCRETE SLAB POUR.
 EXISTING FILL ON-SITE SHALL BE COMPACTED IN ACCORDANCE WITH THE REQUIREMENTS IN THE GEOTECHNICAL REPORT.

6. ALL FLOOR SLABS ARE REINFORCED ON CONCRETE SLABS.

SPECIAL INSPECTION IS REQUIRED FOR THICKENED FOUNDATION CONSTRUCTION

1. REINFORCEMENT 2. 2300 PSI CONCRETE POUR

B) **REINFORCEMENT FOR CONCRETE**:


ALL REINFORCING SLABS BARS SIZE 10MM OR LARGER SHALL BE DEFORMED IN ACCORDANCE TO ASTM-A706, AND BARS SMALLER THAN 10 MM MAYBE PLAIN.
 UNLESS OTHERWISE NOTED IN PLANS, THE YIELD STRENGTH OF REINFORCING BARS SHALL BE:


A) FOOTING = 40,000 PSI B) NON-LOAD BEARING WALLS AND PARAPETS= 40,000 PSI

- ______
- SPLICES SHALL BE SECURELY WIRED TOGETHER AND SHALL LAP OR EXTEND
 GRADE OF STEEL FOR RCC WORKS SHALL BE GRADE 4 10.
- 5. BAR NOTATIONS GIVES INFORMATION
 - A) BAR SIZEB) SPACING(IF REQUIRED)
- 6. LAP REINFORCEMENT ONLY AT LOCATION SHOWN IN THE DRAWINGS
- 7. REINFORCEMENT SHALL NOT BE CUT, VENT OR HEATED ON SITE WITHOUT ENGINEERS' APPROVAL.
- C) CONCRETE SLAB NOTES
- 1. ALL SLAB REINFORCEMENT SHALL BE 20MM CLEAR MINIMUM FROM BOTTOM AND FROM TOP OF SLAB.
- 2. REINFORCEMENT IN CONTINUOUS ELEVATED SLAB SHALL BE CUT AS FOLLOWS.

NOTE:

- THIS IS A SCHEMATIC PLAN FOR THE PURPOSE OF LOCATING AND IDENTIFYING FOUNDATION REINFORCING ELEMENTS ONLY. VERIFY ALL DIMENSIONS, DROPS, OFFSETS AND FEATURES WITH THE ARCHITECTURAL PLANS BEFORE FORMING THE FOUNDATION.

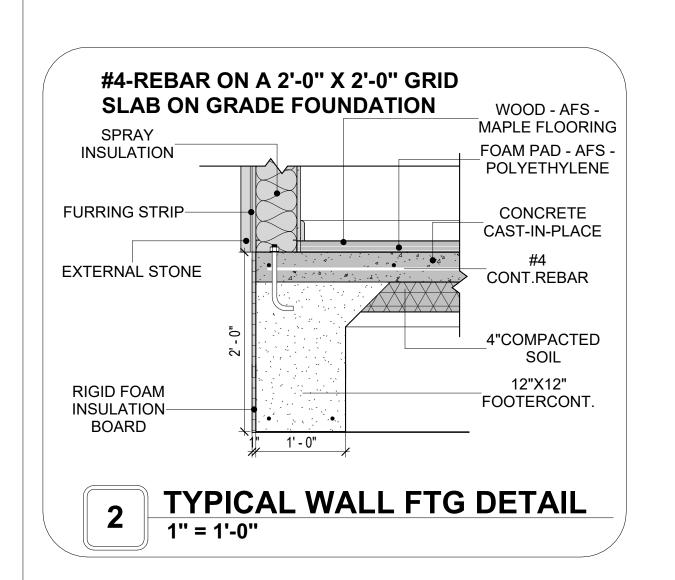

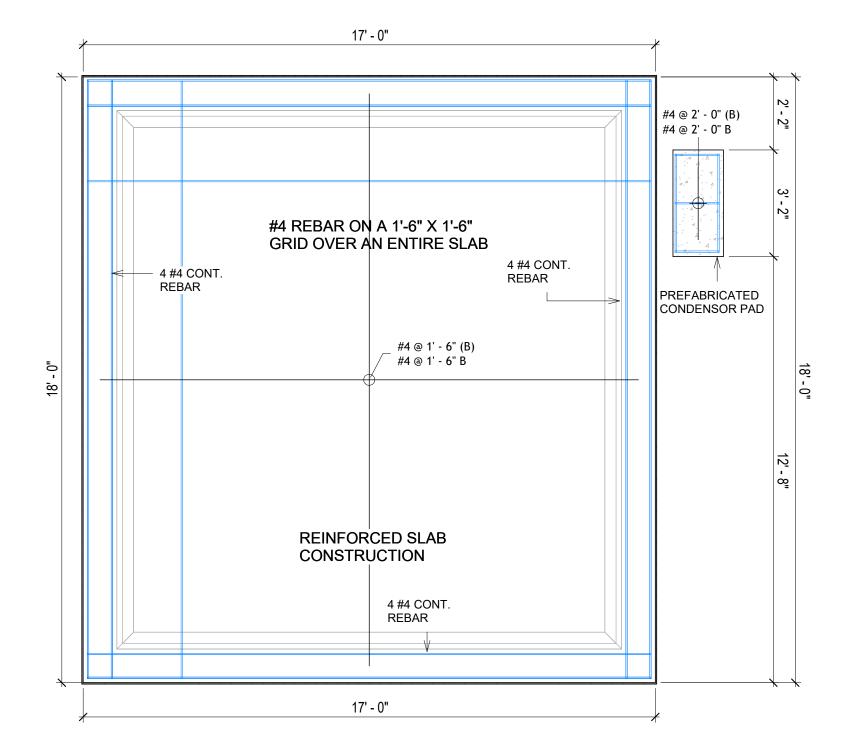

FOUNDATION REBAR PLAN
3/8" = 1'-0"



KEY PLAN

NO.	DESCRIPTION	DATE

NOTE:

LEGEND:

PROJECT

123 ORION 306 STUDIO RANCH BASE 550

DRAWING NAME

STRUCTURAL FLOOR PLAN


Client Name	CLIENT NAME:	
0061_12	PROJECT NUMBER:	
3/20/2025 12:15:24 PN	DATE:	
Designer	DESIGNED BY:	
Author	DRAWN BY:	
Checker	CHECKED BY:	


S102

ROOF NOTES


- 1. ROOFING COMPOSITION ROOFING PER OWNERS/BUILDERS SPECIFICATIONS INSTALL PER MANUFACTURE SPECIFICATIONS ON 1/2" ORIENTED STRAND BOARD ON PRE-ENGINEERED TRUSS @ 24" O.C. (UNO.)
- 2. 73" OVERHANG AT EAVES (UNO.)
 3. ENDS OF ALL TRUSSES AND JOISTS TO
- 3. ENDS OF ALL TRUSSES AND JOISTS TO BE FULLY BLOCKED. PROVIDE SOLID BLOCKING AT ALL RIDGES AND VALLEYS
- 4. SHEATHING TO BE 1/2", 3/8" OSB SHEAR PANEL AND EQUIVALENT. UNDERSIDE OF PORCH TRUSSES TO BE FINISHED WITH MOISTURE RESISTANT DRYWALL, TAPED AND TEXTURED.
- 5. EXPOSED EAVES AND OTHER WEATHER EXPOSED AREAS TO BE SHEATHED WITH EXTERIOR GRADE PLYWOOD.
- 6. ALL MATERIALS THICKNESS AND SIZE ARE THE MINIMUM. Refer TO LOCAL STANDARDS FOR ACTUAL THICKNESS AND LAYERING OF MATERIALS.
- 7. ENGINEERED TRUSS CALCULATIONS TO BE SUBMITTED TO BUILDING
- DEPARTMENT PRIOR TO FABRICATION AND INSTALLATION.

 8. TRUSS MANUFACTURER TO SPECIFY HANGER CONNECTORS FOR TRUSS
- COMPONENTS (TYPICAL)
- 9. DESIGNER ASSUMES THAT TRUSSES BEAR ON ALL EXTERIOR PERIMETER WALLS (TYPICAL) OR BEAMS.
- 10. PROVIDE GALVANIZED STEEL FLASHING WITH A LENGTH OF 10 FEET, WIDTH OF 12 INCHES, AND THICKNESS OF 24 GAUGE.

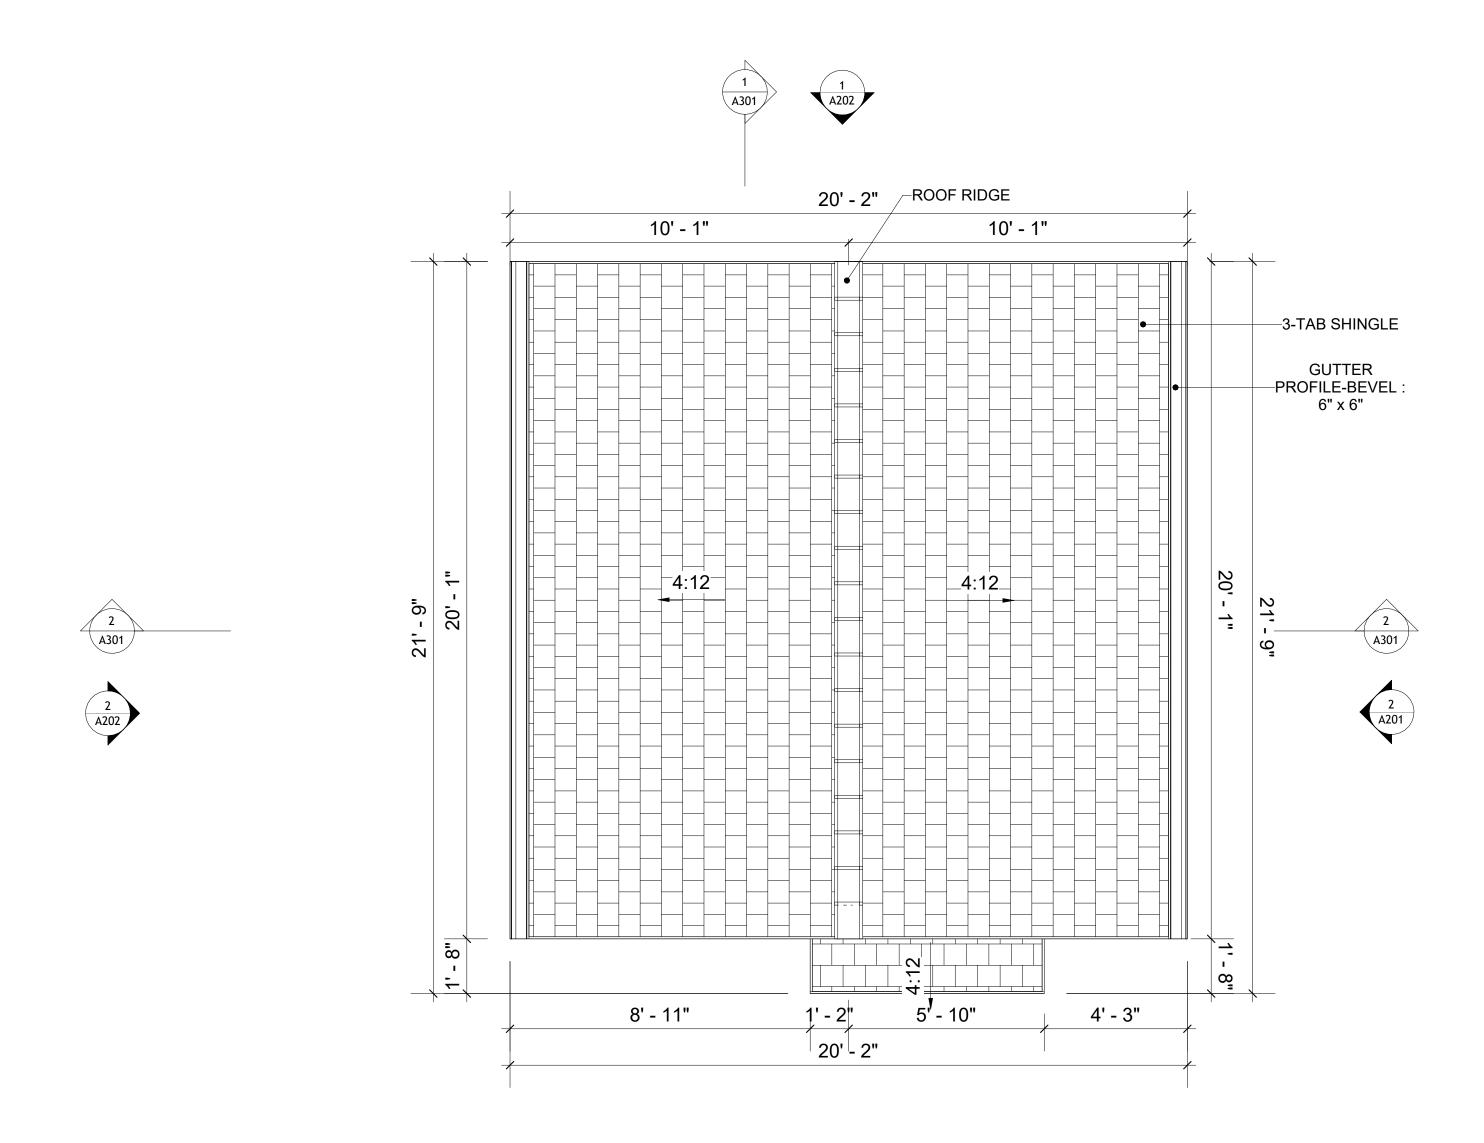

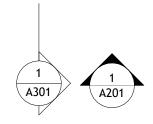



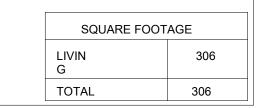



KEY PLAN

NO.	DESCRIPTION	DATE

NOTE:

LEGEND:

PROJEC

123 ORION 306 STUDIO RANCH BASE 550

DRAWING NAME

ROOF PLAN

Client Name	CLIENT NAME:
0061_12	PROJECT NUMBER:
3/20/2025 12:15:26 PM	DATE:
Designer	DESIGNED BY:
Author	DRAWN BY:
Checker	CHECKED BY:

A103

ABOUT WALL FINISHING

PLYWOOD WALL SIDING

WALL SIDING IS AN EXTERIOR CLADDING MATERIAL USED TO COVER AND PROTECT THE WALLS OF A BUILDING, PROVIDING BOTH FUNCTIONAL AND AESTHETIC BENEFITS.


IN THIS SPECIFIC PROJECT, PLYWOOD WALL PANELS ARE USED AS A FINISH SIDING BECAUSE THIS TYPE OF SIDING PROVIDES A DURABLE, COST-EFFECTIVE, AND VERSATILE EXTERIOR CLADDING THAT CAN BE EASILY INSTALLED, FINISHED, AND MAINTAINED TO ENHANCE THE AESTHETIC AND PROTECTIVE QUALITIES OF A BUILDING'S EXTERIOR.

STANDARD SIZES OF 1' X 8' EXTERIOR-GRADE PLYWOOD PANELS ARE INSTALLED ON THE FURRING STRIPS USING GALVANIZED STEEL SELF-DRILLING SCREWS.


EXTERNAL STONE

THESE STONE PRODUCTS ARE MADE FROM A BLEND OF NATURAL AGGREGATES, CEMENT, AND OTHER PROPRIETARY MATERIALS.

THE STONE FINISH IS DIRECTLY ATTACHED TO COLD-FORMED STEEL (CS) FRAMING. (FOR COLUMN FINISH) EXTERNAL STONE CAN BE AN EXCELLENT EXTERIOR CLADDING OPTION FOR CSFRAMED BUILDINGS. IN THIS SCENARIO, THE EXTERNAL STONE WOULD BE ADHERED TO THE CS FRAME USING A SCRATCH COAT AND MORTAR-BASED ADHESIVE.

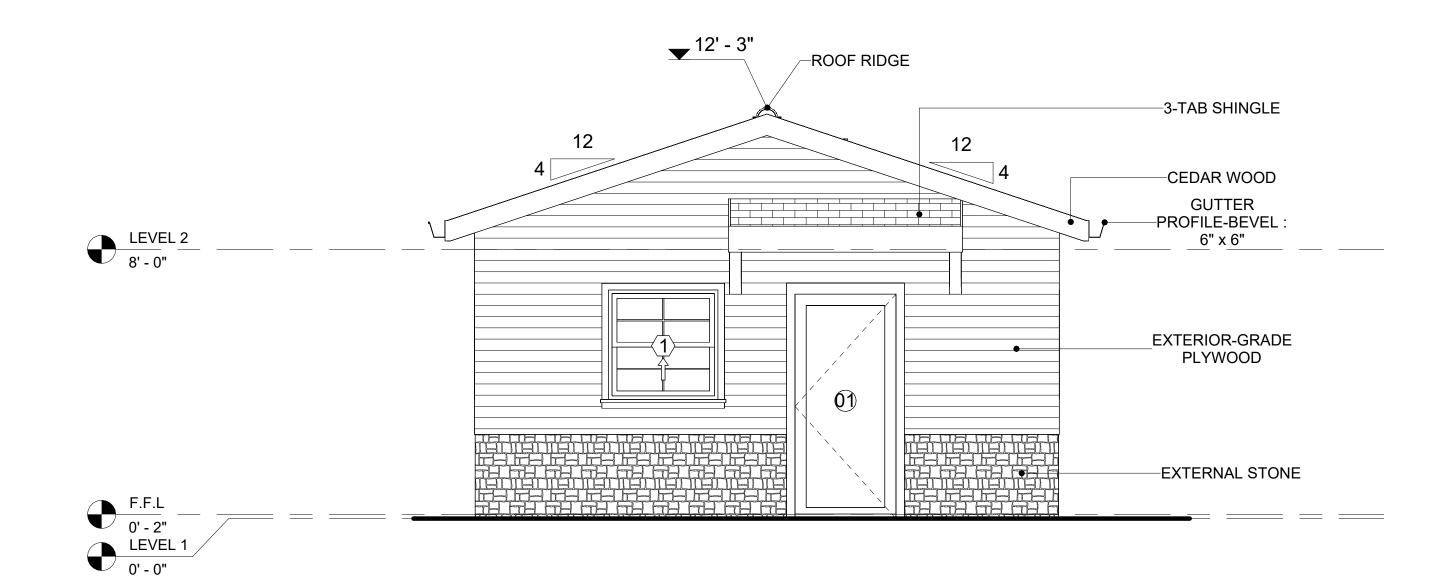


1 FRONT ELEVATION 3/8" = 1'-0"

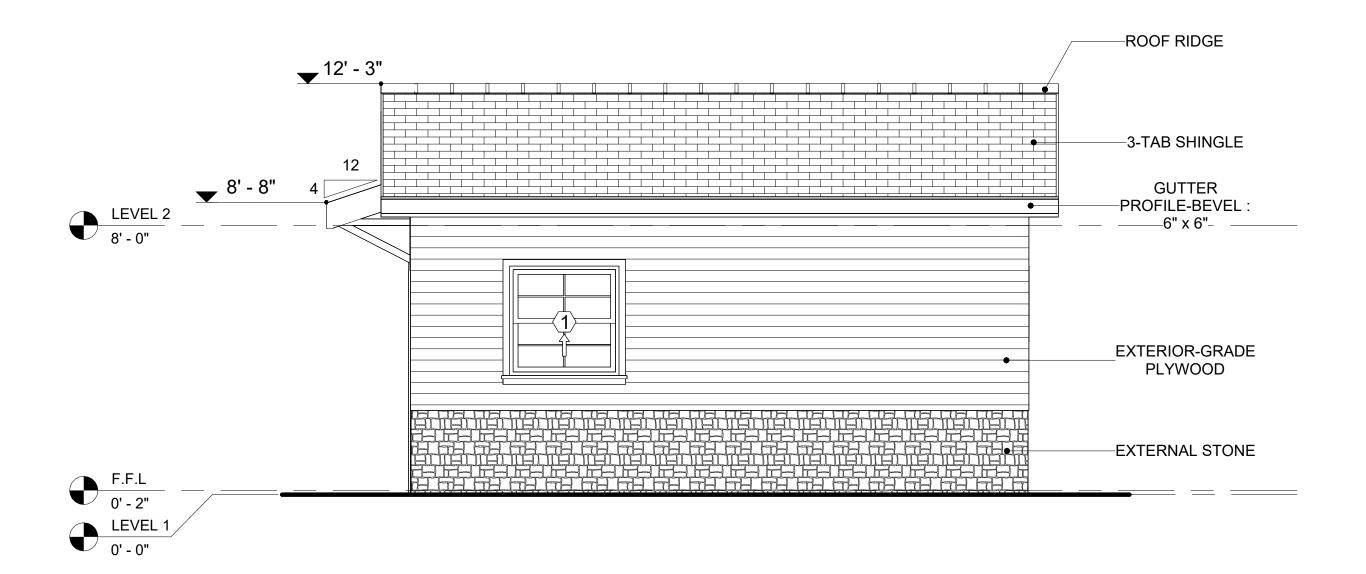

2 RIGHT SIDE ELEVATION 3/8" = 1'-0"

	DOOR SCHEDULE						
TYPE				S	SIZE		
MAR K	SUPPLIER	DOOR TYPE	LOCATIO	WIDTH	HEIGHT	COUNT	
01	HOME DEPOT	EXTERIOR SINGLE PANEL SWINGING	INTERIOR	3' - 0"	6' - 8"	1	
02	HOME DEPOT	INTERIOR SINGLE PANEL SWINGING	INTERIOR	2' - 4"	6' - 8"	1	
03	HOME DEPOT	INTERIOR DOUBLE PANEL SLIDING	INTERIOR	3' - 0"	6' - 8"	1	
04	HOME DEPOT	INTERIOR SINGLE PANEL SWINGING	INTERIOR	2' - 8"	6' - 8"	1	

WINDOW SCHEDULE							
TYPE MARK	SUPPLIER	WINDOW TYPE	WIDTH	HEIGHT	COUNT		
1	HOME DEPOT	SINGLE HUNG	3' - 3"	3' - 3"	2		
2	HOME DEPOT	SLIDING	5' - 3"	3' - 3"	1		
3	HOME DEPOT	SLIDING	3' - 3"	2' - 3"	1		
4	HOME DEPOT	SLIDING	3' - 3"	1' - 9"	1		

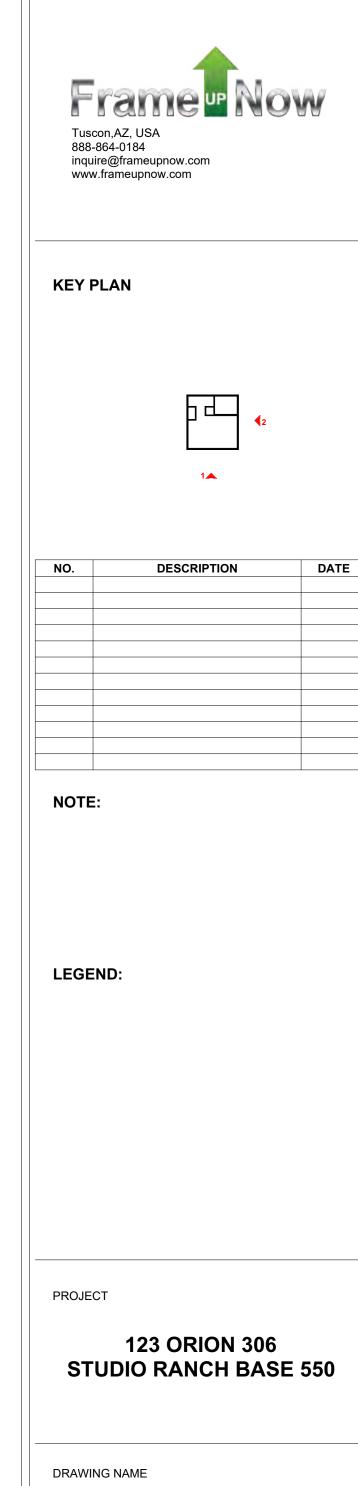

ARCHITECTURAL ELEVATIONS

CLIENT NAME:	Client Name
PROJECT NUMBER:	0061_12
DATE:	3/20/2025 12:15:27 PM
DESIGNED BY:	Designer
DRAWN BY:	Author
CHECKED BY:	Checker

ABOUT WALL FINISHING

PLYWOOD WALL SIDING

WALL SIDING IS AN EXTERIOR CLADDING MATERIAL USED TO COVER AND PROTECT THE WALLS OF A BUILDING, PROVIDING BOTH FUNCTIONAL AND AESTHETIC BENEFITS.


IN THIS SPECIFIC PROJECT, PLYWOOD WALL PANELS ARE USED AS A FINISH SIDING BECAUSE THIS TYPE OF SIDING PROVIDES A DURABLE, COST-EFFECTIVE, AND VERSATILE EXTERIOR CLADDING THAT CAN BE EASILY INSTALLED, FINISHED, AND MAINTAINED TO ENHANCE THE AESTHETIC AND PROTECTIVE QUALITIES OF A BUILDING'S EXTERIOR.

STANDARD SIZES OF 1' X 8' EXTERIOR-GRADE PLYWOOD PANELS ARE INSTALLED ON THE FURRING STRIPS USING GALVANIZED STEEL SELF-DRILLING SCREWS.


EXTERNAL STONE

THESE STONE PRODUCTS ARE MADE FROM A BLEND OF NATURAL AGGREGATES, CEMENT, AND OTHER PROPRIETARY MATERIALS.


THE STONE FINISH IS DIRECTLY ATTACHED TO COLD-FORMED STEEL (CS) FRAMING. (FOR COLUMN FINISH) EXTERNAL STONE CAN BE AN EXCELLENT EXTERIOR CLADDING OPTION FOR CS-FRAMED BUILDINGS. IN THIS SCENARIO, THE EXTERNAL STONE WOULD BE ADHERED TO THE CS FRAME USING A SCRATCH COAT AND MORTAR-BASED ADHESIVE.

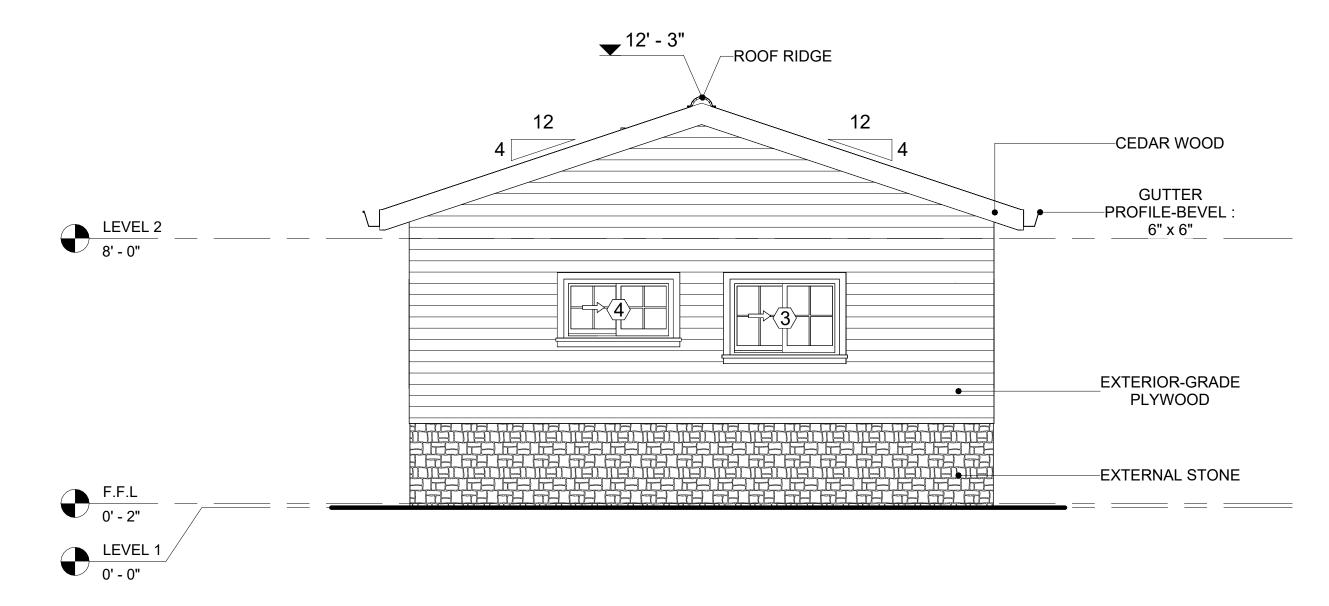



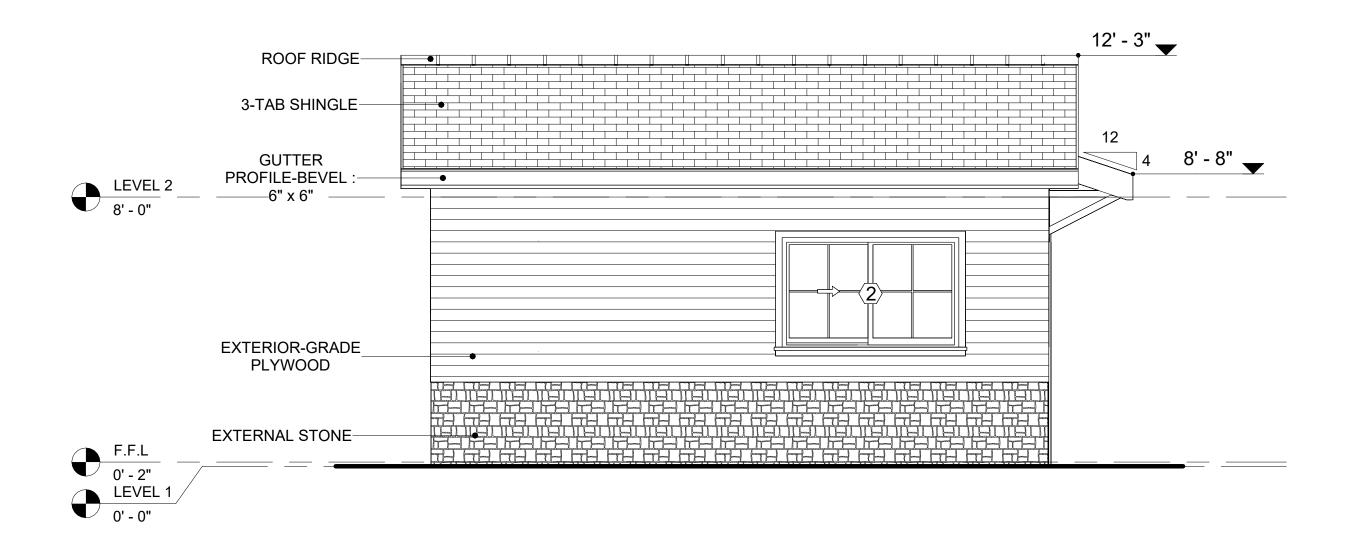

LEFT SIDE ELEVATION
3/8" = 1'-0"

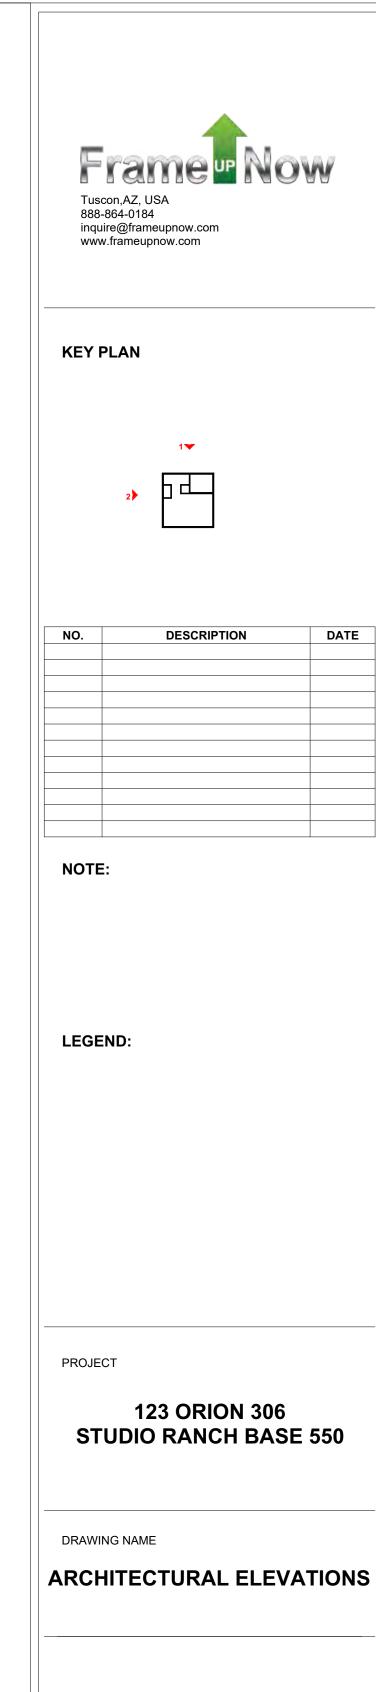

DATE

A202 SCALE: As indicated

CLIENT NAME:

DESIGNED BY:

DRAWN BY:

CHECKED BY:

PROJECT NUMBER:

Client Name


3/20/2025 12:15:29 PM


0061_12

Designer

Author

Checker

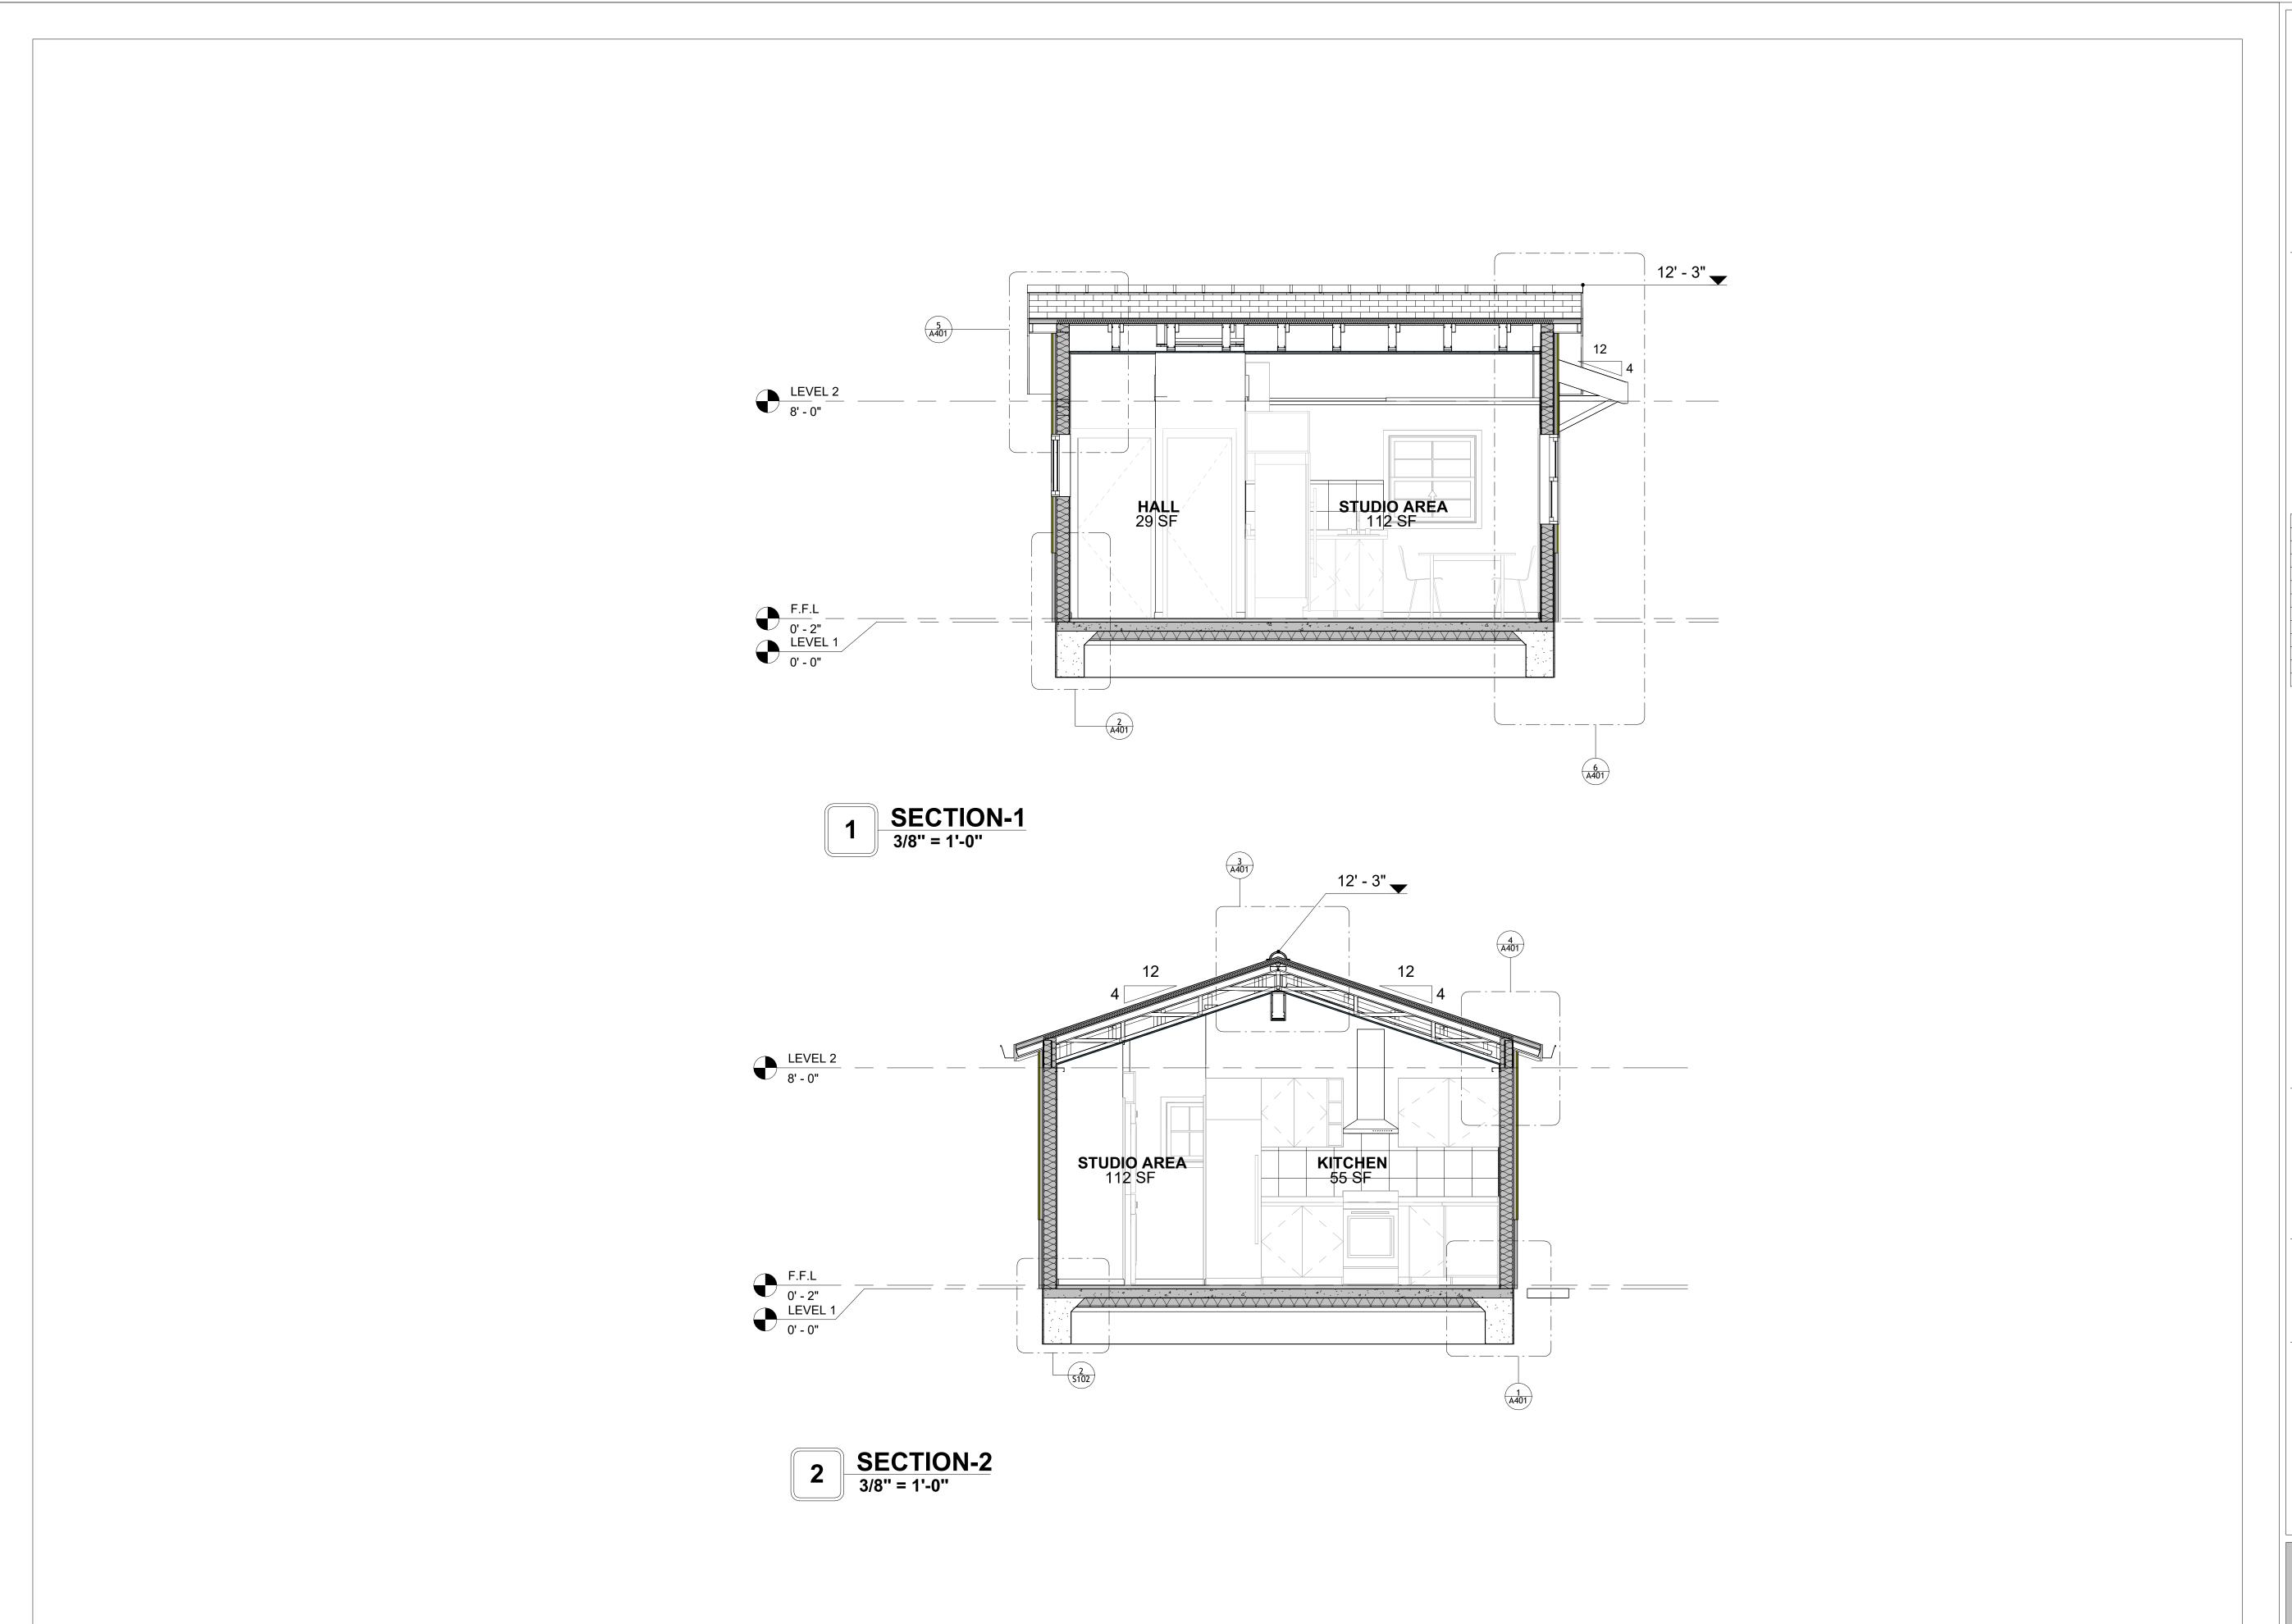

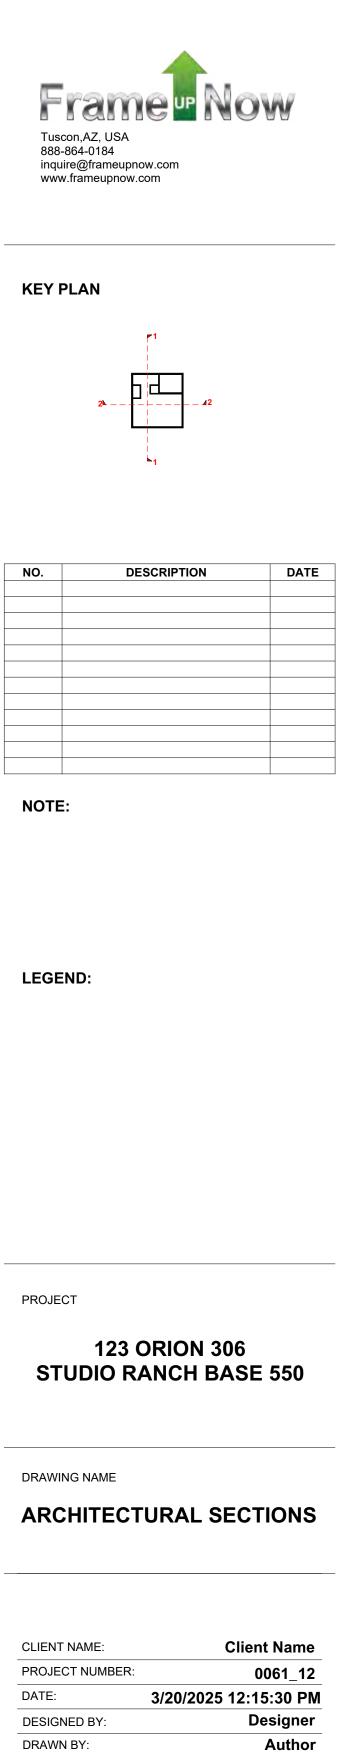


Checker


CHECKED BY:


A301


SCALE: As indicated

© [2024] [FrameUpNow] . All rights reserved

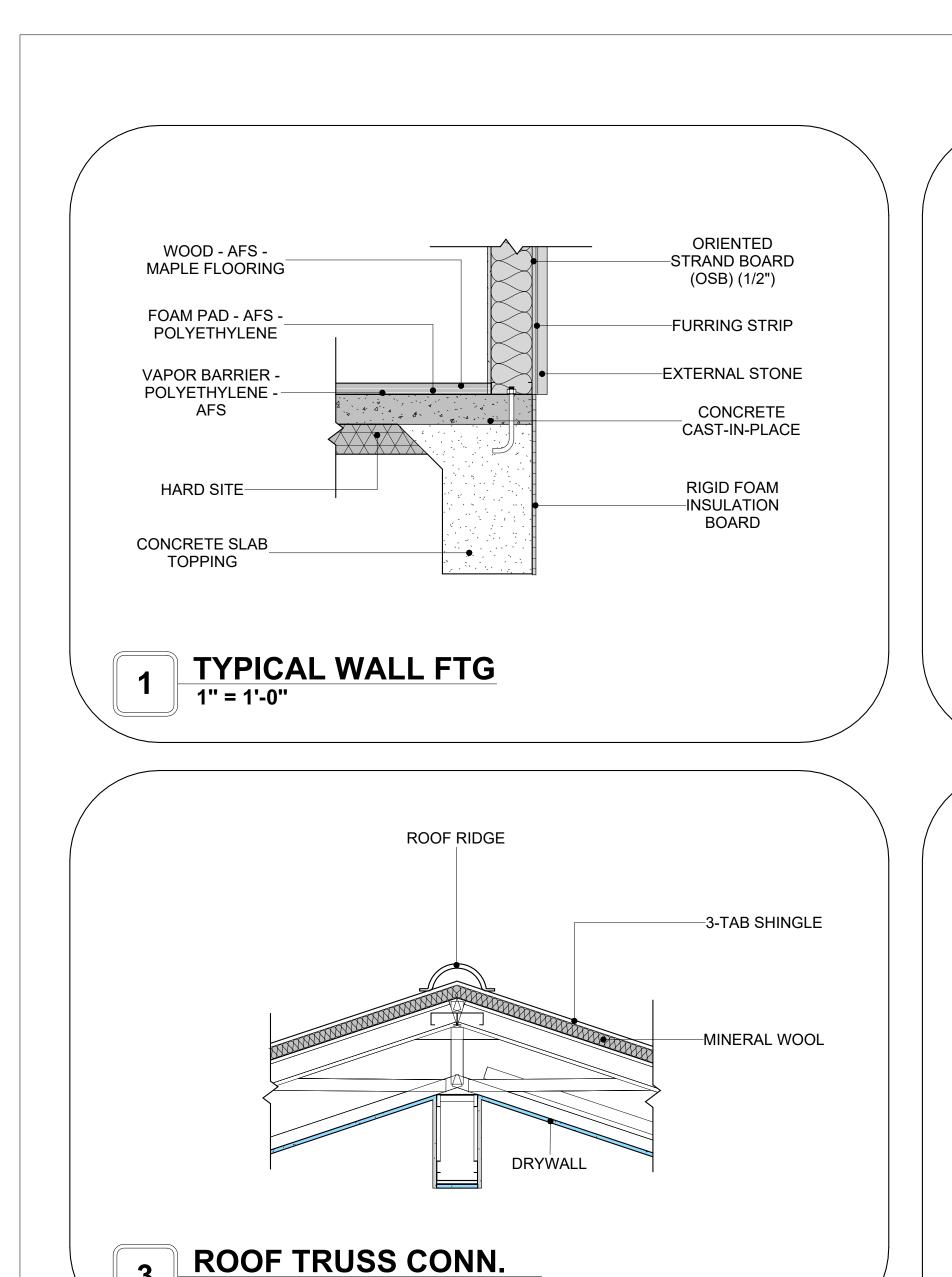

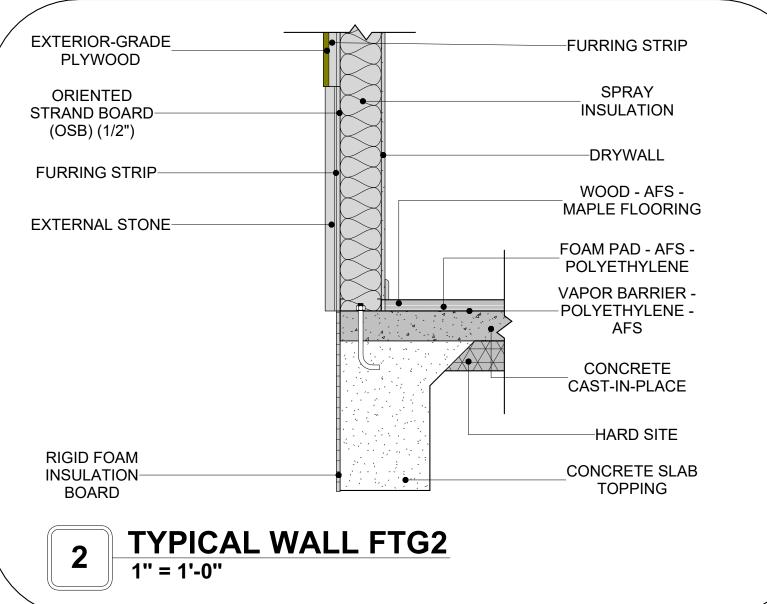

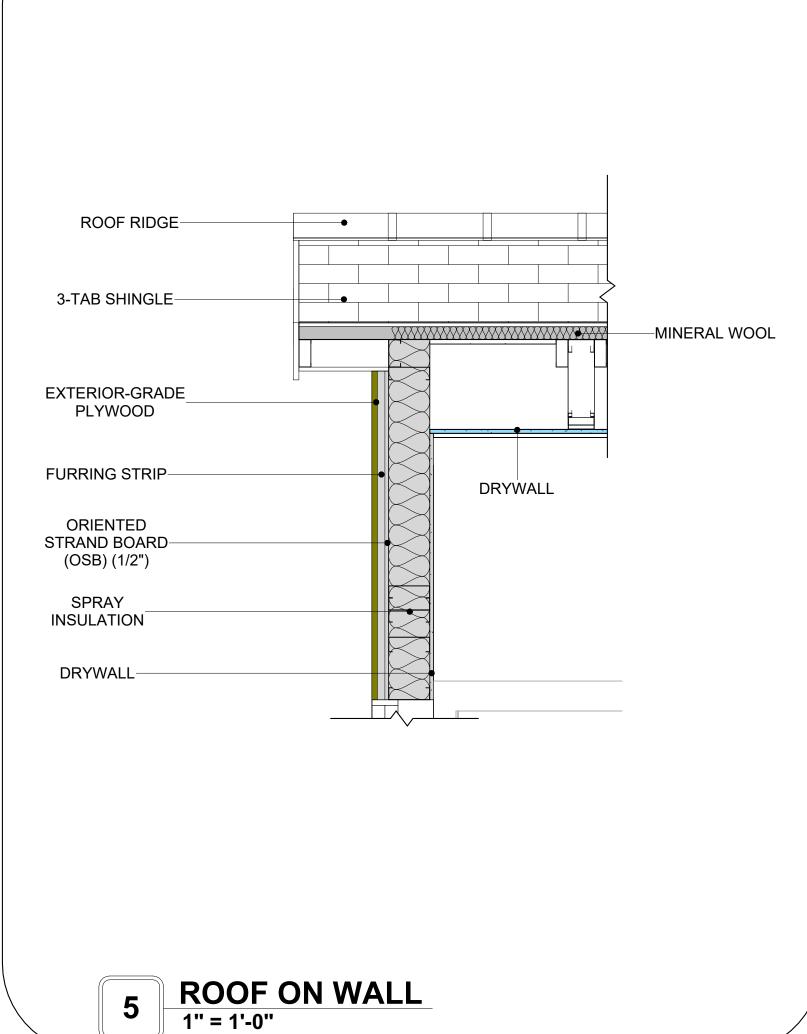

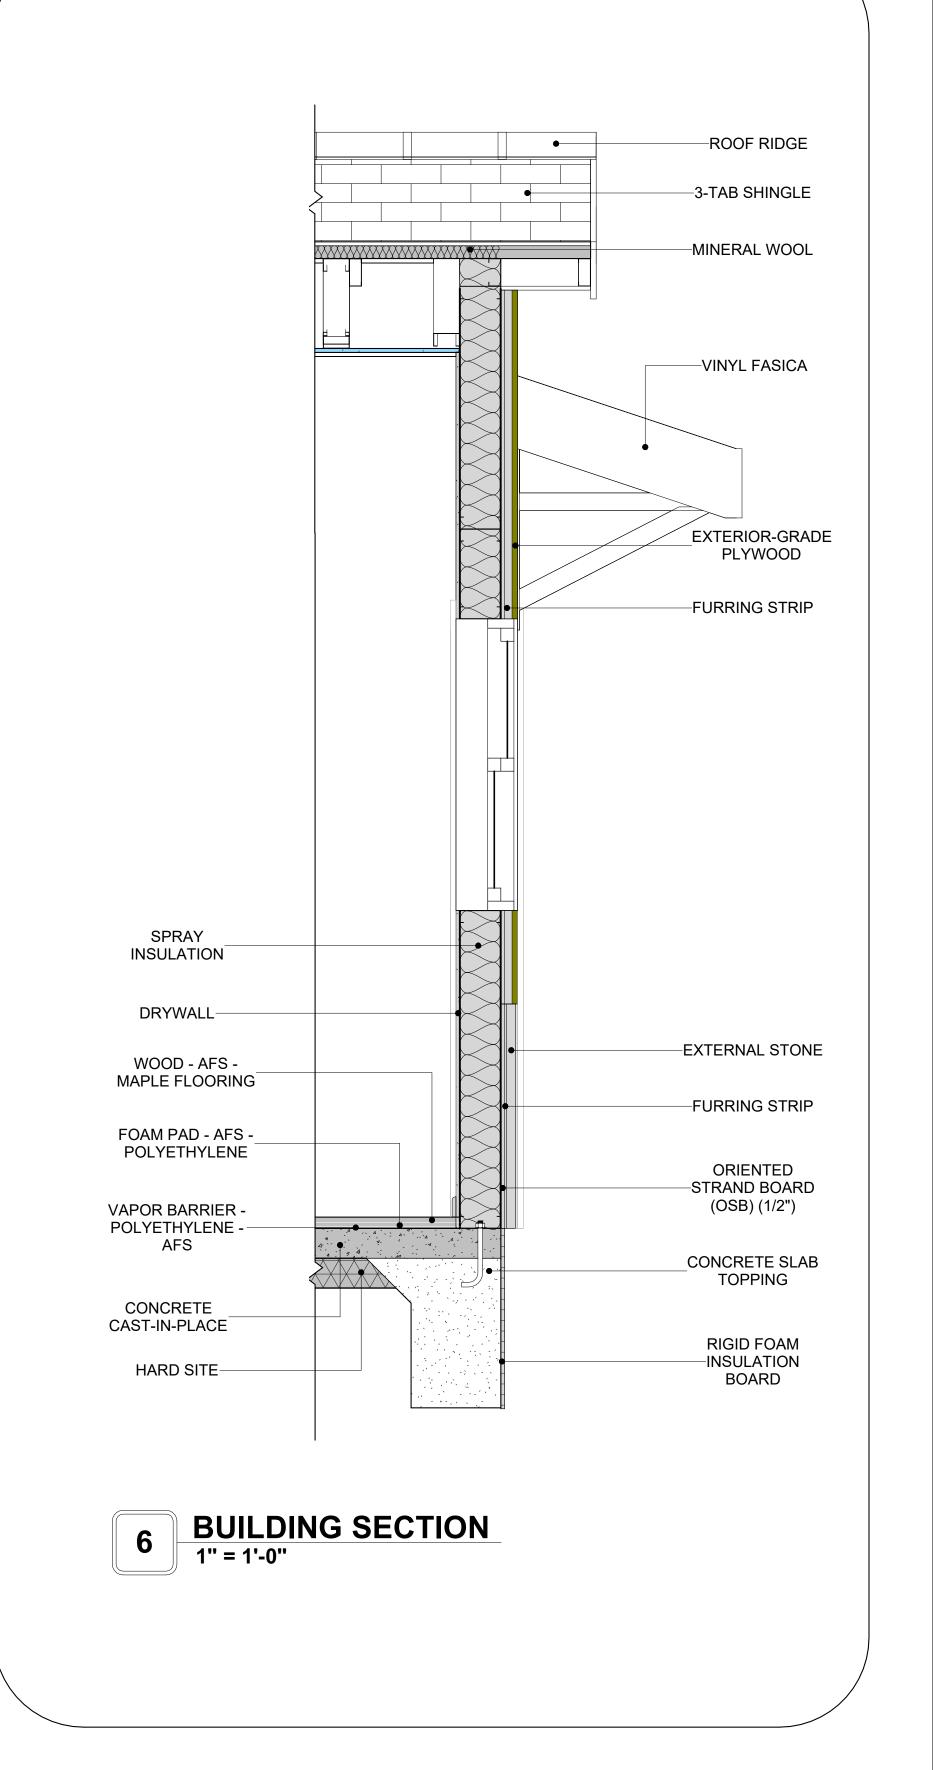



KEY PLAN

NO.	DESCRIPTION	DAT
NOTE:		

LEGEND:

PROJECT

123 ORION 306 STUDIO RANCH BASE 550


DRAWING NAME

ARCHITECTURAL DETAILS

Client Name	CLIENT NAME:	
0061_12	PROJECT NUMBER:	
3/20/2025 12:15:31 P	DATE:	
Designe	DESIGNED BY:	
Autho	DRAWN BY:	
Checke	CHECKED BY:	

A401

SCALE: 1" = 1'-0"

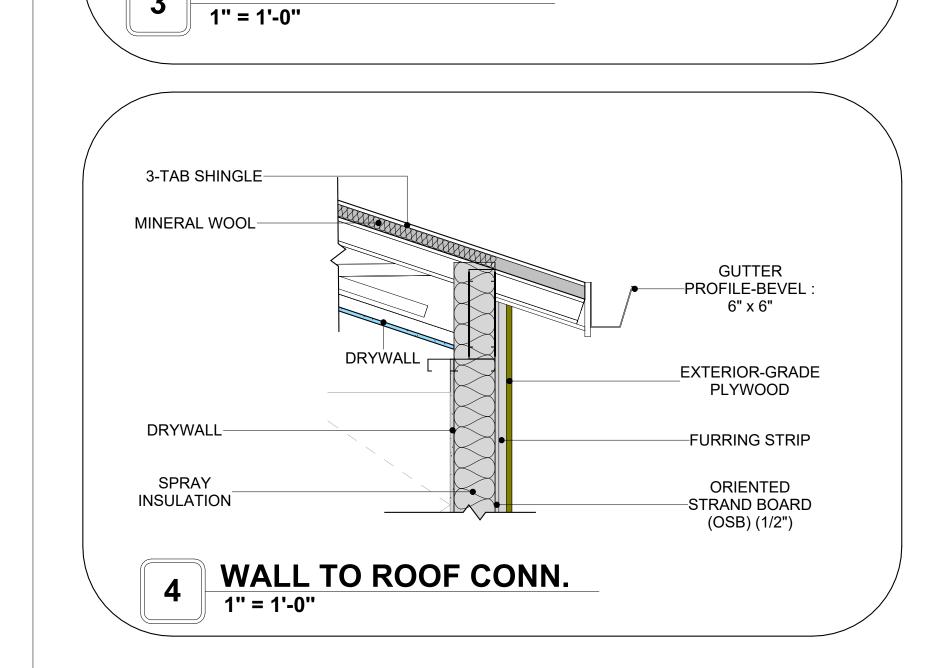


CASEWORK GENERAL NOTES


- ALL CABINET HEIGHTS INCLUDE COUNTERTOPS. DIMENSIONS ARE TO THE NEAREST INCH.
- DIVISIONS IN CASEWORK ARE SHOWN FOR CLARITY AND DO NOT REPRESENT BREAKS IN THE
- PROVIDE CONTINUOUS COUNTERTOP OVER ALL SIMILAR HEIGHT CASEWORK, UNLESS AND
- OTHERWISE NOTED. MANUFACTURER AND CATALOG NUMBERS ARE FOR REFERENCE AND ILLUSTRATION PURPOSES
- DOTTED LINES INDICATE WALL HUNG CABINETS, DIVISIONS OF BASE CABINETS BELOW THE
- COUNTERTOP, FURNITURE NOT IN THE CONTRACT OR PROJECTION SCREENS -SEE CASEWORK KEY AND SPECIFICATIONS.
- ALL CABINETS AND DRAWERS TO HAVE CAM LOCKS EXCEPT FOR SINK BASE CABINETS. 8. ALL EXPOSED SURFACES (EXPOSED TO VIEW FROM ANY PERSPECTIVE) TO BE COVERED WITH
- 9. ALL CASEWORK WHICH MEETS A WALL AT ONE OR BOTH ENDS, TO BE PROVIDED WITH FILLER PANELS AND SCRIBED TO THE WALL(S) AS REQUIRED.
- 10. ALL CABINETS AND DRAWERS ARE PROVIDED WITH RECESSED HANDLES.
- 11. CONTRACTOR TO FIELD VERIFY ALL CLEAR OPENINGS PRIOR TO MILLWORK OR CASEWORK
- 12. CASEWORK DRAWINGS ARE DIAGRAMMATIC IN NATURE TO SHOW DESIGN INTENT.

	CAS	SEWOR	K SCHEDI	JLE		
TYPE MAR K	TYPE	COUN T	HEIGHT	WIDTH	DEPTH	AREA
01	LAUNDRY OPEN CABINET 3	1	1' - 2"	2' - 3"	2' - 6"	3 SF
02	RECESSED_MED_CABINET 2	1	2' - 0"	1' - 6"	0' - 3"	3 SF
03	BASE CABINET L-SHAPED	1	2' - 11"	3' - 3"	3' - 3"	9 SF
04	WALL FILLER	1	2' - 11"	0' - 5"	2' - 0"	1 SF
05	VANITY	1	2' - 4"	2' - 6"	1' - 8"	6 SF
06	BASE CABINET DOUBLE DOOR 4	1	2' - 11"	3' - 0"	2' - 0"	9 SF
07	L-SHAPE COUNTER TOP 2	1	0' - 4"	7' - 0"	7' - 0"	2 SF
08	BASE CABINET DOUBLE DOOR 2	1	2' - 11"	1' - 9"	2' - 0"	5 SF
09	REFRIGERATOR TOP	1	1' - 6"	2' - 0"	2' - 4"	3 SF
10	WALL CABINET DOUBLE DOOR 3	1	2' - 6"	2' - 5"	1' - 0"	6 SF
11	LINEAR COUNTER TOP 3	1	0' - 4"	3' - 0"	2' - 1"	1 SF
12	WALL CABINET DOUBLE DOOR 2	1	2' - 6"	3' - 8"	1' - 0"	9 SF
14	WALL FILLER 2	1	2' - 6"	0' - 7"	1' - 0"	1 SF
15	CLOSET 3	1	6' - 0"	3' - 11"	1' - 4"	23 SF
GRAND	TOTAL	14				


	SPECIALTY EQUIPMENT SCHEDULE			
TYPE MARK TYPE COUNT				
01	WASHER-FRONT-LOAD	1		
02	REFRIGERATOR	1		
03	RANGE	1		
04	DRYER-FRONT-LOAD	1		
GRAND TOTAL: 4				

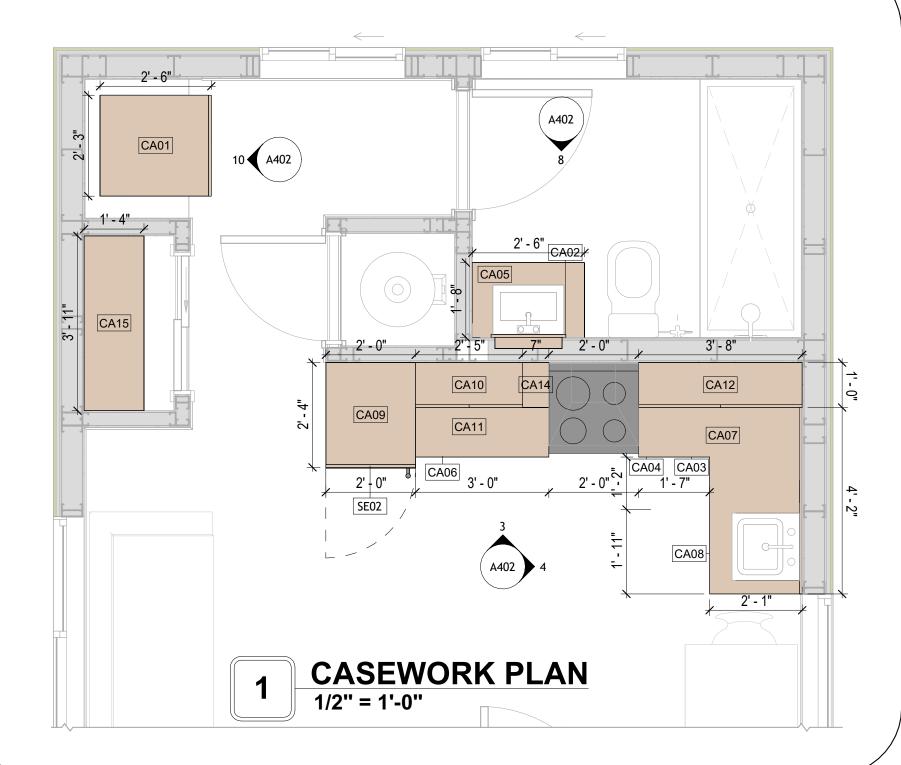

LAUNDRY 3D

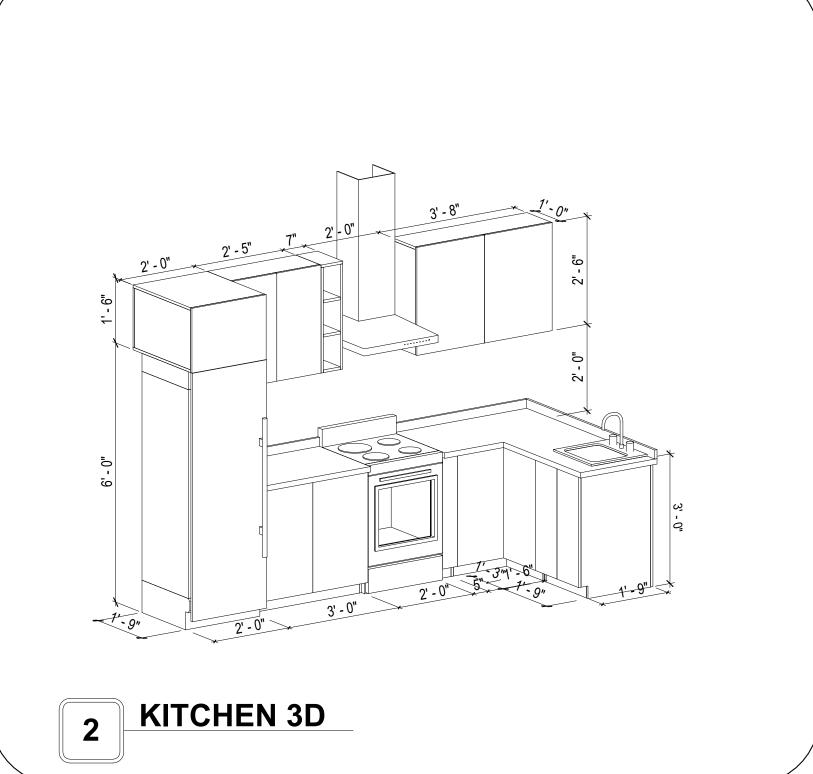


CLOSET 3D

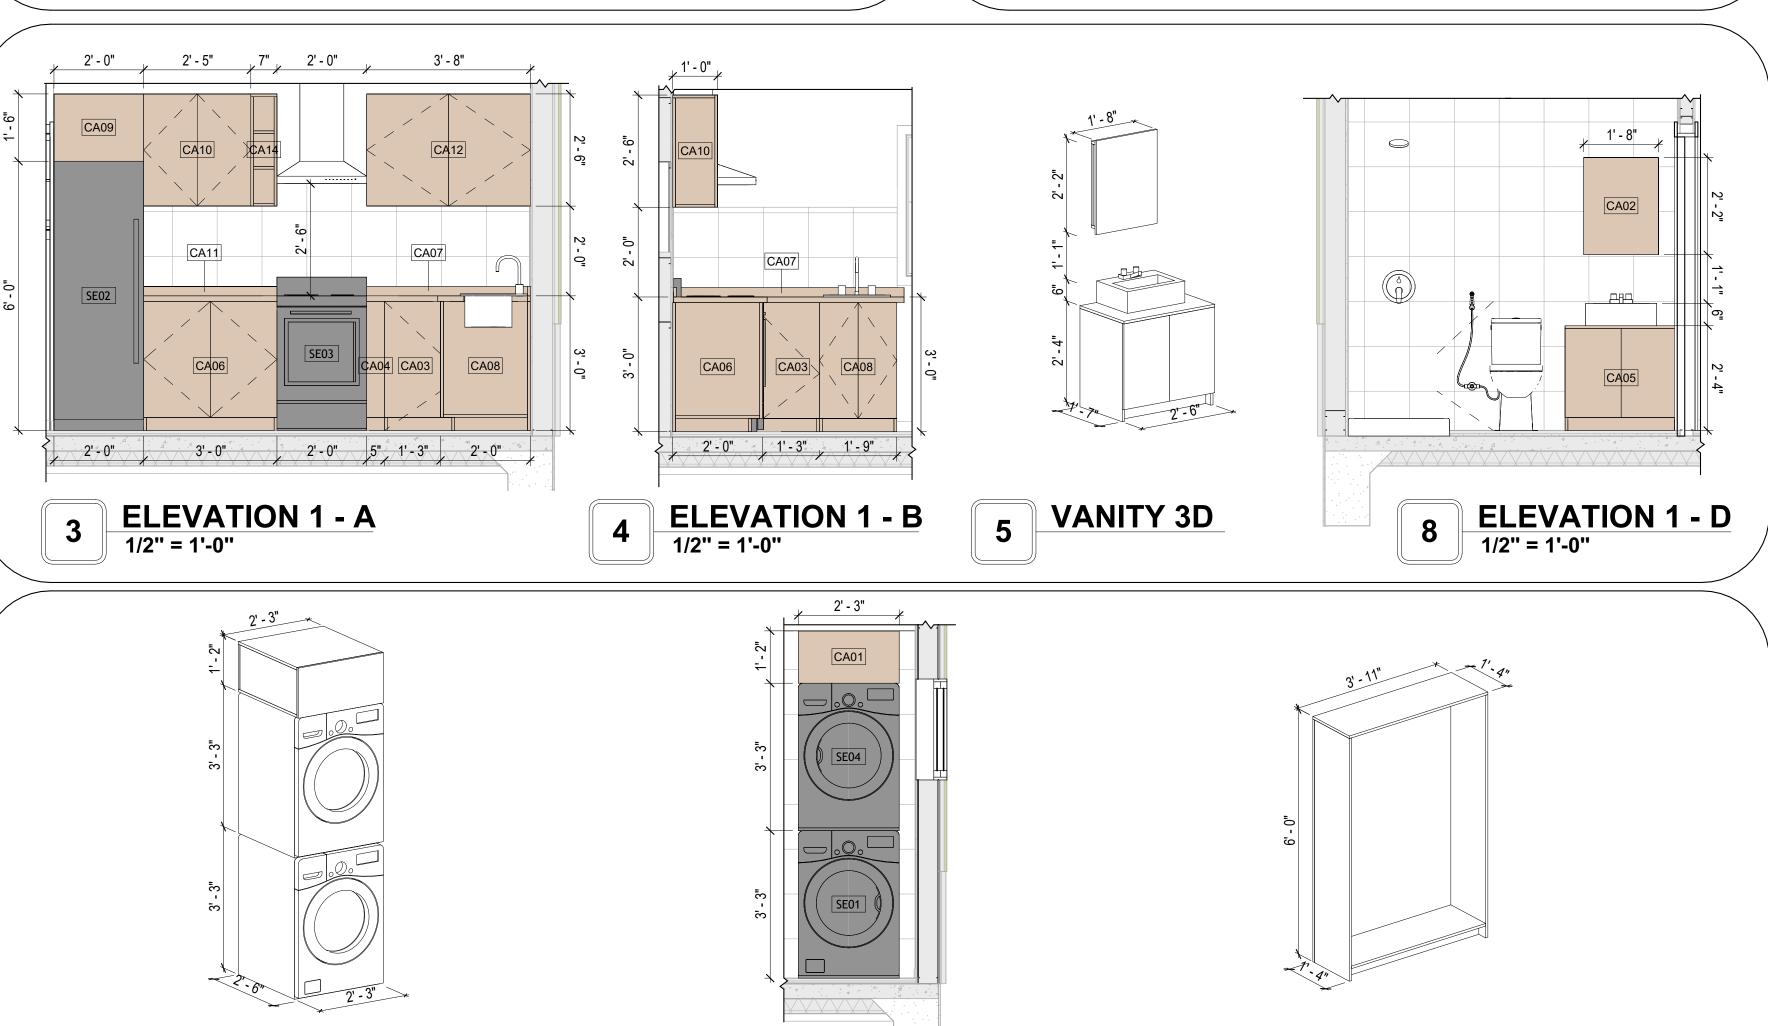

ELEVATION 1 - E 1/2" = 1'-0"



KEY PLAN

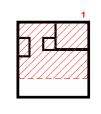

NO.	DESCRIPTION	DATE

NOTE:

LEGEND:

PROJECT

123 ORION 306 STUDIO RANCH BASE 550

DRAWING NAME

ARCHITECTURAL CASEWORK

CLIENT NAME:	Client Name
PROJECT NUMBER:	0061_12
DATE:	3/20/2025 12:15:33 PM
DESIGNED BY:	Designer
DRAWN BY:	Author
CHECKED BY:	Checker

A402

GENERAL NOTES

T1. THIS DRAWING DEPICTS THE HVAC (HEATING, VENTILATION, AND AIR CONDITIONING) SYSTEM FOR THE ORION STUDIO RANCH BASE. IT PROVIDES A VISUAL REPRESENTATION OF THE SYSTEM LAYOUT AND COMPONENTS.

2.THE HVAC SYSTEM IS DESIGNED TO MEET THE SPECIFIC REQUIREMENTS OF THE BUILDING, INCLUDING HEATING, COOLING, AND VENTILATION NEEDS AS PER THE PROJECT SPECIFICATIONS AND APPLICABLE CODES AND STANDARDS.

3. THE HVAC SYSTEM INSTALLATION SHALL COMPLY WITH THE LATEST EDITION OF THE INTERNATIONAL MECHANICAL CODE (IMC), INTERNATIONAL RESIDENTIAL CODE (IRC), AND ALL OTHER APPLICABLE LOCAL, STATE, AND NATIONAL CODES AND REGULATIONS.

4. THE EQUIPMENT SHOWN ON THIS DRAWING INCLUDES BUT IS NOT LIMITED TO AIR HANDLING UNITS (AHUS), CHILLERS, BOILERS, COOLING TOWERS, PUMPS, DUCTWORK, DIFFUSERS, GRILLES, AND CONTROL DEVICES.

5. ALL EQUIPMENT, DUCTWORK, AND PIPING SHALL BE INSTALLED IN ACCORDANCE WITH MANUFACTURER'S SPECIFICATIONS, LOCAL CODES, AND INDUSTRY BEST PRACTICES.

6. ALL DUCTWORK SHALL BE SIZED, FABRICATED, AND INSTALLED IN ACCORDANCE WITH THE LATEST EDITION OF THE ACCA MANUAL D AND THE SMACNA HVAC DUCT CONSTRUCTION STANDARDS. DUCTWORK SHALL BE INSTALLED IN A NEAT AND WORKMANLIKE MANNER, PROPERLY SUPPORTED AND BRACED TO PREVENT SAGGING, AIR LEAKAGE, OR VIBRATION.

7. CONDENSATE DRAINAGE PIPING SHALL BE PROPERLY PITCHED TO ENSURE POSITIVE DRAINAGE TO AN APPROVED DISPOSAL LOCATION, SUCH AS A FLOOR DRAIN, SUMP PUMP, OR EXTERIOR GRADE. CONDENSATE LINES SHALL BE INSULATED TO PREVENT SWEATING.

8. THE LOCATION OF CONTROL PANELS AND SENSORS INDICATED ON THIS DRAWING CAN BEMODIFY with THE SPECIFIC LOCATIONS AND WIRING DETAILS WILL BE DETERMINED DURING THE CONTROL SYSTEM DESIGN AND INSTALLATION.

9. THE HVAC SYSTEM DESIGN CONSIDER ENERGY EFFICIENCY, INDOOR AIR QUALITY, OCCUPANT COMFORT, AND NOISE CONTROL, FOLLOWING APPLICABLE GUIDELINES AND REGULATIONS.

10. COORDINATION WITH OTHER TREADS HAS BEEN DONE ON A DESIGN LEVEL. THIS DRAWING SHALL BE READ TOGETHER WITH THE AR, EL AND SN DESIGN DRAWINGS TO ENSURE PROPER INSTALLATION AND INTEGRATION OF THE HVAC SYSTEMS.

11. THE HVAC CONTRACTOR IS RESPONSIBLE FOR OBTAINING ALL NECESSARY PERMITS AND LICENSES, AND FOR SCHEDULING AND COORDINATING WITH THE LOCAL BUILDING DEPARTMENT AND UTILITY PROVIDERS TO ENSURE A TIMELY AND COMPLIANT INSTALLATION.

12. ALL DUCTWORK PENETRATIONS THROUGH WALLS, FLOORS, OR CEILINGS SHALL BE PROPERLY SEALED AND FIRE-STOPPED USING APPROVED METHODS AND MATERIALS TO MAINTAIN THE INTEGRITY OF THE BUILDING'S FIRE-RESISTANCE RATINGS.

13. HVAC EQUIPMENT SHALL BE INSTALLED LEVEL AND PLUMB, AND IN STRICT ACCORDANCE WITH THE MANUFACTURER'S INSTALLATION INSTRUCTIONS AND RECOMMENDATIONS. PROVIDE ADEQUATE CLEARANCES AROUND EQUIPMENT FOR PROPER AIRFLOW, SERVICE ACCESS, AND CODE COMPLIANCE.


14. ALL HVAC EQUIPMENT AND COMPONENTS, INCLUDING THERMOSTATS, DAMPERS, AND ACCESS PANELS, SHALL BE LOCATED IN ACCESSIBLE AREAS FOR EASY SERVICING AND MAINTENANCE. PROVIDE ADEQUATE SPACE AROUND EQUIPMENT FOR PROPER AIRFLOW AND SERVICE ACCESS.


15. THE HVAC SYSTEM SHALL BE BALANCED AND ADJUSTED TO ENSURE PROPER AIRFLOW, TEMPERATURE DISTRIBUTION, AND SYSTEM PERFORMANC THROUGHOUT THE RESIDENCE. PROVIDE A WRITTEN REPORT DOCUMENTING THE FINAL SYSTEM BALANCE.

16. ANY DEVIATIONS OR MODIFICATIONS TO THE HVAC SYSTEM DESIGN SHALL BE REVIEWED AND APPROVED BY THE RESPONSIBLE DESIGN PROFESSIONALS AND COMMUNICATED TO ALL RELEVANT PARTIES INVOLVED IN THE CONSTRUCTION PROCESS.

17. FOR ANY INQUIRIES OR CLARIFICATIONS REGARDING THE HVAC SYSTEM DESIGN, PLEASE CONSULT THE RESPONSIBLE DESIGN PROFESSIONALS OR THE PROJECT MANAGEMENT TEAM.

SYMBOLS

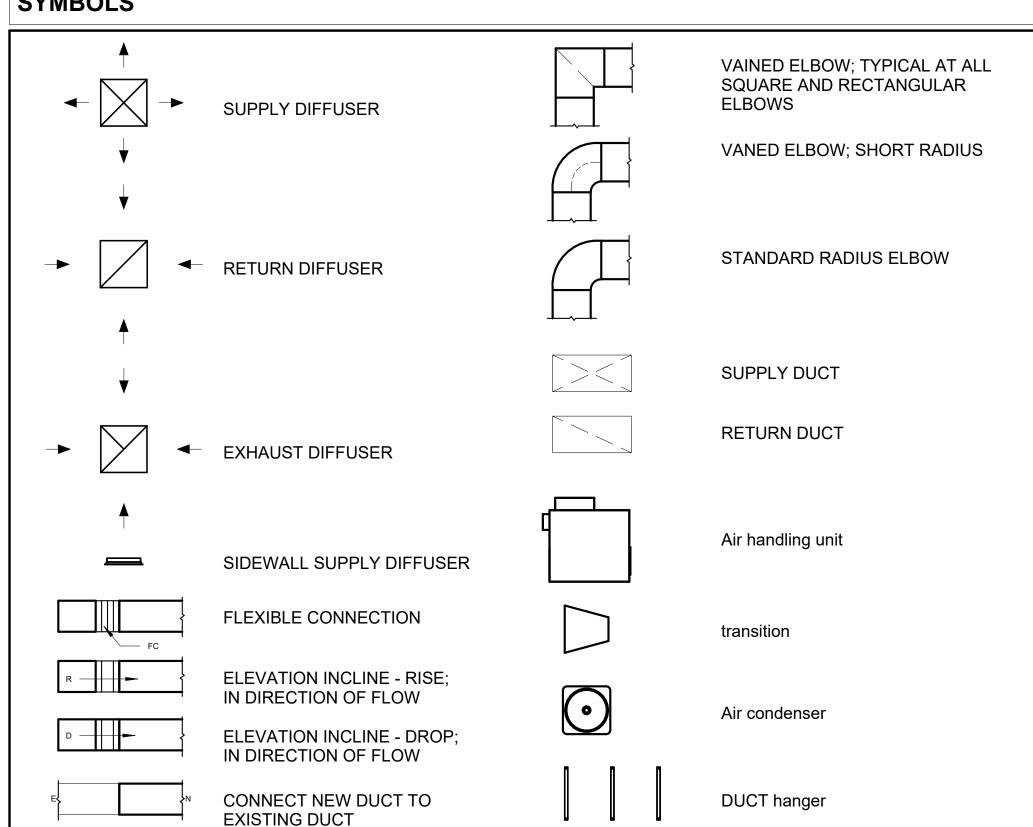

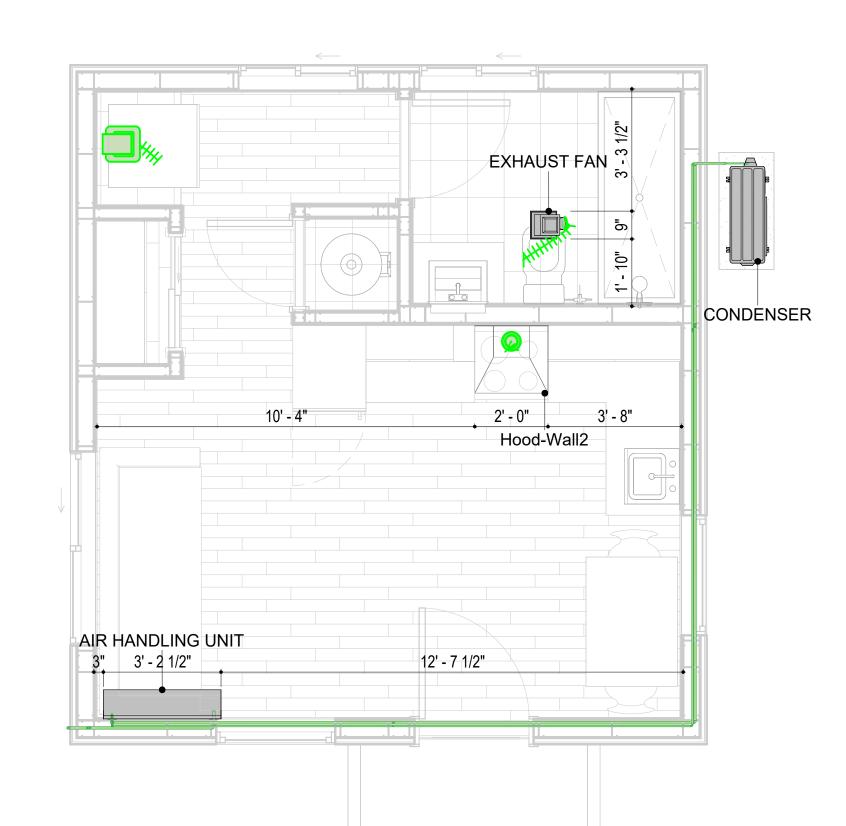

3/8" = 1'-0"

Hvac Color scheme

air conditioning pipe line

REFRIGERANT LINE SCHEDULE			
CATAGORY	DESCRIPTION	DIAMETER	LENGTH
Pipe Types	Copper	1/4"	0.59
Pipe Types	Copper	3/8"	42.03
Pipe Types	Copper	1/2"	0.62
Pipe Types	Copper	3/4"	51.94

REFRIG	ERANT LINE FITTING S	CHEDULE	=
CATAGORY	DESCRIPTION	Size	Count
Elbow - Generic	Elbow - Generic: Standard/HVAC	1/2"ø-1/2"ø	1
Elbow - Generic	Elbow - Generic: Standard/HVAC	3/4"ø-3/4"ø	12
Elbow - Generic	Elbow - Generic: Standard/HVAC	3/8"ø-3/8"ø	8
Transition - Generic	Transition - Generic: Standard	3/4"ø-1/2"ø	2
Transition - Generic	Transition - Generic: Standard	3/4"ø-5/8"ø	1
Transition - Generic	Transition - Generic: Standard	3/8"ø-1/4"ø	1

MECHANICAL EQUIPMENT SCHEDULE		
CATAGORY	DESCRIPTION	COUNT
	·	·
AIR HANDLING UNIT	AIR HANDLING UNIT: WALL MOUNTED	1
CONDENSER	CONDENSER: OUT DOOR	1
Exhaust Fan	EXHAUST FAN: 75 CFM	1
	Hood-Wall2: VENT 2	1

DU	ICT FITTING SCHEDULE	
CATAGORY	DESCRIPTION	COUNT
Round Transition - Angle	45 Degree	6

DESCRIPTION	COUNT
3" DIAMETER	

FLEX DUCT SCHEDULE					
DESCRIPTION	DESCRIPTION	LENGTH	DIAMETER	COUNT	
Flex Duct Round	FLEX-ROUND	9.23	4"	3	
Grand total: 3		9.23		•	



KEY PLAN

١٥.	DESCRIPTION	DATE

NOTE:

LEGEND:

PROJECT

123-Orion-306-Studio Ranch-Base-550

DRAWING NAME

HVAC PLAN

CLIENT NAME: Owner PROJECT NUMBER: 15_0001 DATE: 3/9/2025 11:40:59 PM Designer DESIGNED BY: DRAWN BY: Author CHECKED BY: Checker

M101

© [2024] [FrameUpNow] . All rights reserved

ELECTRICAL NOTES

- 1. THIS DRAWING DEPICTS THE ELECTRICAL SYSTEM FOR THE 123-Orion-306-Studio Ranch-Base-550. IT PROVIDES A VISUAL REPRESENTATION OF THE ELECTRICAL LAYOUT AND COMPONENTS, INCLUDING POWER DISTRIBUTION, LIGHTING, AND CONTROL SYSTEMS.
- 2. THE ELECTRICAL SYSTEM IS DESIGNED TO MEET THE SPECIFIC REQUIREMENTS OF THE BUILDING, INCLUDING POWER DISTRIBUTION, LIGHTING, AND SPECIALIZED ELECTRICAL EQUIPMENT NEEDS, AS PER THE PROJECT SPECIFICATIONS AND APPLICABLE CODES AND STANDARDS.
- 3. THE ELECTRICAL SYSTEM INSTALLATION SHALL COMPLY WITH THE LATEST EDITION OF THE NATIONAL ELECTRICAL CODE (NEC), INTERNATIONAL BUILDING CODE (IBC), AND ALL OTHER APPLICABLE LOCAL, STATE, AND NATIONAL CODES AND REGULATIONS.
- 4. LOCATIONS AS NEEDED, DEVICES ARE SHOWN ON PLANS IN APPROXIMATE IDEAL LOCATIONS, UNLESS SPECIFICALLY DIMMENSIONED.
- 5. OPEN WALLS AS NEEDED TO ALLOW FOR NEW ELECTRICAL INSTALLATIONS.
- 6. LABEL ALL CIRCUITS ON JUNCTION BOXES, RECEPTACLES, DATA, SMOKE DETECTOR, AND EQUIPMENT IN PANEL BOX.
- 7. INSTALL RACEWAY AS NEEDED FOR DDC, ACCESS CONTROL, LOW VOLTAGE WIRING & DATA.
- 8. RELABEL POWER, DATA & FIRE ALARM FOR ROOM #CHANGES.
- VERIFY ALL CIRCUITS LABELED ON PRINT ARE CORRECT BEFORE WORKING ON THEM.
 NOTE ON SITE PLAN ALL CHANGES OR MISSING DETAIL TO BE INCORPORATED INTO THE MASTER PLAN.
- 11. DRAWINGS ARE DIAGRAMMATIC ONLY FOR THE PURPOSE OF SHOWING FIXTURE AND OUTLET LOCATIONS.
- 12. ELECTRICAL CONTRACTOR TO VERIFY SERVICE SIZE BY CALCULATION BASED UPON ACTUAL NAME PLATE RATINGS OF SELECTED FOLLIPMENT
- PLATE RATINGS OF SELECTED EQUIPMENT.

 13. VERIEV LOCATION OF SERVICE ENTRANCE WITH POWER COMPANY PROVIDE LIFER GROUND IN
- 13. VERIFY LOCATION OF SERVICE ENTRANCE WITH POWER COMPANY. PROVIDE UFER GROUND IN BUILDING FOUNDATION AT SERVICE ENTRANCE LOCATION.
- 14. PROVIDE A MIN. OF 20 FEET OF ONE *4 BARE COPPER UFER WIRE EMBEDDED IN CONCRETE FOOTING AT THE SERVICE ENTRANCE LOCATION WHERE APPROVED BY LOCAL SERVICE PROVIDER.
- 15. PROVIDE WATERPROOF FIXTURES IN ALL HIGH MOISTURE AREAS (EXTERIOR, SHOWER AND TUB
- CEILINGS ETC.)
 16. PROVIDE DEDICATED CIRCUITS TO EACH BATH, DEN, FAMILY ROOM, BEDROOM, LOFT, KITCHEN
- REFRIGERATOR, KITCHEN FREEZER DISHWASHER, AND ANY AREA/ITEM SPECIFIED BY OWNER.

 17. INCANDESCENT FIXTURES WITH OPEN OR PARTIALLY ENCLOSED LAMPS. PENDANT FIXTURES. AND
- LAMP HOLDERS ARE NOT PERMITTED IN CLOSETS.
- 18. ALL WORKMANSHIP AND MATERIALS TO CONFORM WITH THE 2015 IRC.19. PROVIDE A MIN. OF 20 FEET OF ONE *4 BARE COPPER UFER WIRE EMBEDDED IN CONCRETE FOOTING
- AT THE SERVICE ENTRANCE LOCATION WHERE APPROVED BY LOCAL SERVICE PROVIDER.

 20. PROVIDE A BONDING CONDUCTOR CONSISTING OF A MINIMUM OF ONE *4 BARE COPPER WIRE
- CONNECTING THE BUILDING'S METAL WATER PIPING SYSTEM TO THE SERVICE EQUIPMENT ENCLOSURE GROUNDING.

MAIN PANEL CALCS

ELECTRICAL CALCS	
LIGHT AND OUTLETS 306 @ 3W	918 W
3 APPLIANCE CIRCUITS	4,500 W
DRYER	2,000 W
WASHER	2,000 W
RANGE	5,000 W
WATER HEATER	5,000 W
REFRIG.	1,800 W
DISHWASHER & DISPOSAL	3000 W
TOTAL	24218W
FRIST 10,000 @ 100% REMAINDER @ 40% MINI. SPLIT UNITS	10,000 W 5687 W 10,000 W
TOTAL	25687 W

25687W DIVIDED BY 240V = 107 AMPS TOTAL

(USE 200 AMP SERVICE)

ELECTRICAL ABBREVIATIONS LIST

1P A AC ACLG ADO AF AFF AFG AFI AHU ALT AMP AMPL ANNUN AQ-STAT ARCH AS AT ATS AUTO AUX AWG BATT BD	1 POLE (2P, 3P, 4P, ETC.) AMPERE ABOVE COUNTER OR AIR CONDITIONER ABOVE CEILING AUTOMATIC DOOR OPENER AMP FRAME ABOVE FINISHED FLOOR ABOVE FINISHED GRADE ARC FAULT CIRCUIT INTERRUPTER AIR HANDLING UNIT ALUMINUM ALTERNATE AMPERE AMPLIFIER ANNUNCIATOR APPROX APPROXIMATELY AQUASTAT ARCHITECT, ARCHITECTURAL AMP SWITCH AMP TRIP AUTOMATIC TRANSFER SWITCH AUTOMATIC AUXILIARY AUDIO VISUAL AMERICAN WIRE GAUGE BATTERY BOARD	CTR CU DCP DEPT DET DIA DISC DIST DN DPR DS DT DWG DDC ELEC ELEV EM EMS EMT EP EQUIP EWC EXIST EXH EXP	CENTER COPPER DOMESTIC WATER CIRCULATING PUMP DEPARTMENT DETAIL DIAMETER DISCONNECT DISTRIBUTION DOWN DAMPER SAFETY DISCONNECT SWITCH DOUBLE THROW DRAWING DIRECT DIGITAL CONTROL ELECTRICAL CONTRACTOR ELECTRIC, ELECTRICAL ELEVATOR EMERGENCY ENERGY MANAGEMENT SYSTEM ELECTRICAL METALLIC TUBING ELECTRIC PNEUMATIC EQUIPMENT ELECTRIC WATER COOLER EXISTING EXHAUST EXPLOSION PROOF	HT HTG HTR HV HVAC CONDITIONING HWP IC IG IMC INCAND IR I/W J-BOX KV KVA KVAR KW KWH LOC LT LTG LTNG LV MAX MAG.S	HEIGHT HEATING HEATER HIGH VOLTAGE HEATING, VENTILATING AND AIR CONDITIONING HYDRONIC WATER PUMP INTERRUPTING CAPACITY ISOLATED GROUND INTERMEDIATE METAL CONDUIT INCANDESCENT INFRARED INTERLOCK WITH JUNCTION BOX KILOVOLT KILOVOLT-AMPERE KILOVOLT-AMPERE REACTIVE KILOWATT KILOWATT KILOWATT HOUR LOCATE OR LOCATION LIGHT LIGHTING LIGHTNING LOW VOLTAGE MAXIMUM MAGNETIC STARTER
C CAB	CONDUIT CABINET	SUPPLY PANEL FACP	SUPPLY PANEL FIRE ALARM CONTROL PANEL	MCB MCC	MAIN CIRCUIT BREAKER MOTOR CONTROL CENTER
CAT	CATALOG	FCU	FAN COIL UNIT	MDC	MAIN DISTRIBUTION CENTER
CATV	CABLE TELEVISION	FIXT	FIXTURE	MDP	MAIN DISTRIBUTION PANEL
CB CCTV	CIRCUIT BREAKER CLOSED CIRCUIT TELEVISION	FLR FLUOR	FLOOR FLUORESCENT	MFR	MANUFACTURERMAIN FUSED DISCONNECT SWITCH
CKT	CIRCUIT	FU	FUSE	MH	MANHOLE
CLG	CEILING	FUDS	FUSED SAFETY DISCONNECT SWITCH	MIC	MICROPHONE
COMB	COMBINATION	GA	GAUGE	MIN	MINIMUM
CMPR	COMPRESSOR	GAL	GALLON	MISC	MISCELLANEOUS
CONN	CONNECTION	GALV	GALVANIZED	MLO	MAIN LUGS ONLY
CONST	CONSTRUCTION	GC	GENERAL CONTRACTOR	MMS	MANUAL MOTOR STARTER
CONTR	CONTINUATION OR CONTINUOUS	GEN GFI		MOA MSP	MULTIOUTLET ASSEMBLY
CONTR CONV	CONTRACTOR CONVECTOR	GFP	GROUND FAULT CIRCUIT INTERRUPTER GROUND FAULT PROTECTOR	MSP MSBD	MOTOR STARTER PANELBOARD MAIN SWITCHBOARD
CP	CIRCULATING PUMP	GND	GROUND	MT	MOUNT
CRT	CATHODE-RAY TUBE	GRS	GALVANIZED RIGID STEEL (CONDUIT)	MT.C	EMPTY CONDUIT
CT	CURRENT TRANSFORMER	GYP BD	GYPSUM BOARD	UL	UNDERWRITERS LABORATORIES

Branch Panel:

Location: KITCHEN 01
Supply From:
Mounting: Recessed

Enclosure: Type 1

Volts: 120/240 Single
Phases: 1
Wires: 3

A.I.C. Rating:
Mains Type:
Mains Rating: 200 A
MCB Rating: 1 A

Notes:

Circuit Numb er	Circuit Description	Number of Elements	Rating	Length	Wire Size	A		E	3	Wire Size	Length	Rating	Number of Elements	Circuit Description	Circuit Numb er
1	HALL LIGHT	4	15 A	22' - 3 5/32"	1-#14, 1-#14, 1-#14	180 VA	2250 VA			2-#10, 1-#10, 1-#10	20' - 7 7/16"	30 A	1	WATER HEATER	2
3	WASHING MASHEIN	1	20 A	33' - 10 7/32"	1-#12, 1-#12, 1-#12			1200 VA	2250 VA						4
5	LIV. RECEPTACLE	3	20 A	34' - 3 5/8"	1-#12, 1-#12, 1-#12	540 VA	474 VA			1-#14, 1-#14, 1-#14	27' - 7 29/32"	15 A	8	LIV. & KITCHEN LIGHT	6
7	KITCHEN GFCI	4	20 A	17' - 7 15/32"	1-#12, 1-#12, 1-#12			720 VA	540 VA	1-#12, 1-#12, 1-#12	28' - 1 15/16"	20 A	3	OUTDOOR GFCI	8
9	RIFRIGRATOR	1	20 A	20' - 5 1/32"	1-#12, 1-#12, 1-#12	1500 VA	180 VA			1-#12, 1-#12, 1-#12	10' - 5 11/32"	20 A	1	OVEN HOOD	10
11	CONDENSER	1	60 A	14' - 2 13/16"	2-#6, 1-#6, 1-#10			2500 VA	2500 VA	2-#8, 1-#8, 1-#10	14' - 9 23/32"	50 A	1	RANGE	12
13						2500 VA	2500 VA								14
15	DRYER	1	30 A	30' - 10 13/32"	2-#10, 1-#10, 1-#10			2500 VA							16
17						2500 VA									18
19															20
21															22
23															24
25															26
						12615	VA	1221	0 VA						1
						12615 105		1221 102							

Legend

Load Classification	Connected Load	Demand Factor	Estimated Demand	Panel	Totals
Lighting - Dwelling Unit	200 VA	100.00%	200 VA		
Other	360 VA	100.00%	360 VA	Total Conn. Load:	24825 VA
Receptacle	4680 VA	100.00%	4680 VA	Total Est. Demand:	23825 VA
Lighting	100 VA	100.00%	100 VA	Total Conn.:	103 A
CONDENSER	5000 VA	100.00%	5000 VA	Total Est. Demand:	99 A
WATER HEATER	4500 VA	100.00%	4500 VA		
RANGE	5000 VA	80.00%	4000 VA		
DRYER	5000 VA	100.00%	5000 VA		
Mataa		•	·		•



KEY PLAN

NO. DESCRIPTION DATE

NOTE:

LEGEND:

PROJECT

123-Orion-306-Studio Ranch-Base-550

DRAWING NAME

SCHEDULE

CLIENT NAME:

PROJECT NUMBER:

0213_11

DATE:

2/25/2025 12:35:56 PM

DESIGNED BY:

DRAWN BY:

CHECKED BY:

Checker

E101

SCALE: 1/4" = 1'-0"

© [2024] [FrameUpNow] . All rights reserved

ELECTRICAL NOTE

- A. PROVIDE INTERCONNECTED SMOKE ALARMS IN EACH SLEEPING ROOMS, OUTSIDE EACH SLEEPING ROOM, ON EACH STORY, IN THE HALL OR ADJACENT ROOM LUHERE THE CEILING HEIGHT OF A ROOM OPEN TO THE HALL EXCEEDS THE HALL BY 24'. SMOKE ALARMS SHALL BE PERMANENTLY HARD WIRED WITH BATTERY BACKUP.
- B. RECEPTACLE OUTLETS FOR RANGES AND CLOTHES DRYERS SHALL BE A THREE POLE WITH GROUND TYPE. FOUR WIRE GROUNDING-TYPE FLEXIBLE CORDS WILL BE REQUIRED FOR CONNECTION OF RANGES AND CLOTHES DRYERS. THE BONDING JUMPER SHALL NOT BE CONNECTED BETWEEN NEUTRAL TERMINAL AND THE FRAME OF THE APPLIANCE
- C. TWO OR MORE 20 AMP SMALL APPLIANCE CIRCUITS SHALL BE PROVIDED TO SERVE THE KITCHEN, BREAKFAST NOOK, AND DINING ROOM. SUCH CIRCUITS SHALL HAVE NO OTHER OUTLETS.
- D. AT LEAST ONE 20 AMP BRANCH CIRCUIT SHALL BE PROVIDED TO SERVICE THE LAUNDRY ROOM. THIS CIRCUIT SHALL HAVE NO OTHER OUTLETS.
- E. ALL RECEPTACLES WITH IN 6' OF A WET BAR SINK OR KITCHEN SINK TO SERVE COUNTER TOP SURFACES MUST BE GFCI. ON KITCHEN COUNTERS 12' OR WIDER NO POINT ALONG THE WALL SHALL BE MORE THAN 2' FROM A RECEPTACLE. ALL RECEPTACLES WITH IN 6' OF KITCHEN SINK MUST BE GFCI. AT LEAST ONE GFCI RECEPTACLE SHALL BE INSTALLED IN THE BATHROOM ADJACENT TO EACH BASIN.
- F. FIXTURES INCLUDING CEILING FANS THAT ARE LOCATED IN DAMP LOCATIONS SHALL BE LISTED TO BE SUITABLE FOR
- SUCH LOCATIONS PER 2012 IRC
- G. PROVIDE ONE (1) SWITCHED OUTLET @ ALL BEDROOMS AND DEN
- H. CEILING FANS NOT EXCEEDING 35 LBS. (WITH OR WITHOUT ACCESSORIES MAY BE SUPPORTED BY OUTLET BOXES PROVIDED THE OUTLET BOXES ARE IDENTIFIED FOR SUCH USE PER 2012 IRC
- I. ELECTRICAL OUTLET BOXES ON OPPOSITE SIDES OF FIRE RATED WALLS SHALL BE SEPARATED BY A HORIZONTAL DISTANCE OF NOT LESS THAN 24".
- J. OUTLET BOXES IN THE WALLS BETWEEN THE GARAGE AND DWELLING SHALL BE METAL OR U.L. APPROVED FIRE RESISTIVE PLASTIC. BOXES IN GARAGE CEILING SHALL BE METAL.
- K. ALL BRANCH CIRCUITS THAT SUPPLY 120 VOLTS SINGLE PHASE 15 AND 20 AMPS RECEPTACLE OUTLETS INSTALLED IN THE DWELLING SHALL BE PROTECTED BY AN ARC FAULT CIRCUIT INTERRUPTER, EXCEPT GFCI RECEPTICLES.

NOTE:

. RECEPTACLES MUST BE PROVIDED IN HALLWAYS 10'-0" OR MORE IN LENGTH. FOR A ONE FAMILY DWELLINGS AND EACH OF A TWO FAMILY DWELLING THAT IS AT GRADE LEVEL, AT LEAST ONE WP-GFCI RECEPTACLE OUTLET ACCESSIBLE AT GRADE LEVEL AND NOT MORE THAN 6'-6" ABOVE GRADE SHALL BE INSTALLED AT THE FRONT AND BACK OF THE DWELLING.

NOTE: APPLIANCE DISCONNECT

E4001.5 GROUNDING OF ENCLOSURES.

METAL ENCLOSURES FOR SWITCHES OR CIRCUIT BREAKERS SHALL BE CONNECTED TO AN

EQUIPMENT GROUNDING CONDUCTOR.

METAL ENCLOSURES FOR SWITCHES OR CIRCUIT BREAKERS USED AS SERVICE EQUIPMENT SHALL COMPLY WITH THE PROVISIONS OF SECTION E3609.4. WHERE


NONMETALLIC ENCLOSURES ARE USED WITH METAL RACEWAYS OR METAL-ARMORED

CABLES, PROVISIONS SHALL BE MADE FOR CONNECTING THE EQUIPMENT GROUNDING


NONMETALLIC BOXES FOR SWITCHES SHALL BE INSTALLED WITH A WIRING METHOD THAT

PROVIDES OR INCLUDES AN EQUIPMENT GROUNDING CONDUCTOR. (404.12)

ELECTRIC	CAL LEGEND
	Electrical Lights With Fan
0	Waterproof Recessed Can Light
	Pendant Light
0	Recessed Can Light
- Φ	Wall Lamp
	Standalone linear
√1	Single Switch
Æ	Three way Switch
₩	Fan Switch
	Duplex Receptacle
	Triplex Receptacle
⊕ GFC	GFCI Receptacle
	Exhaust Fan
•	Smoke and heat detector

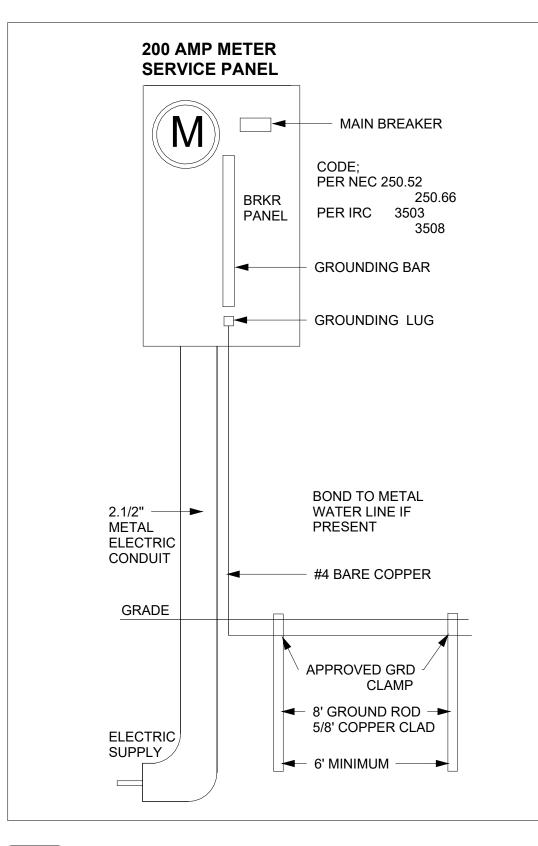



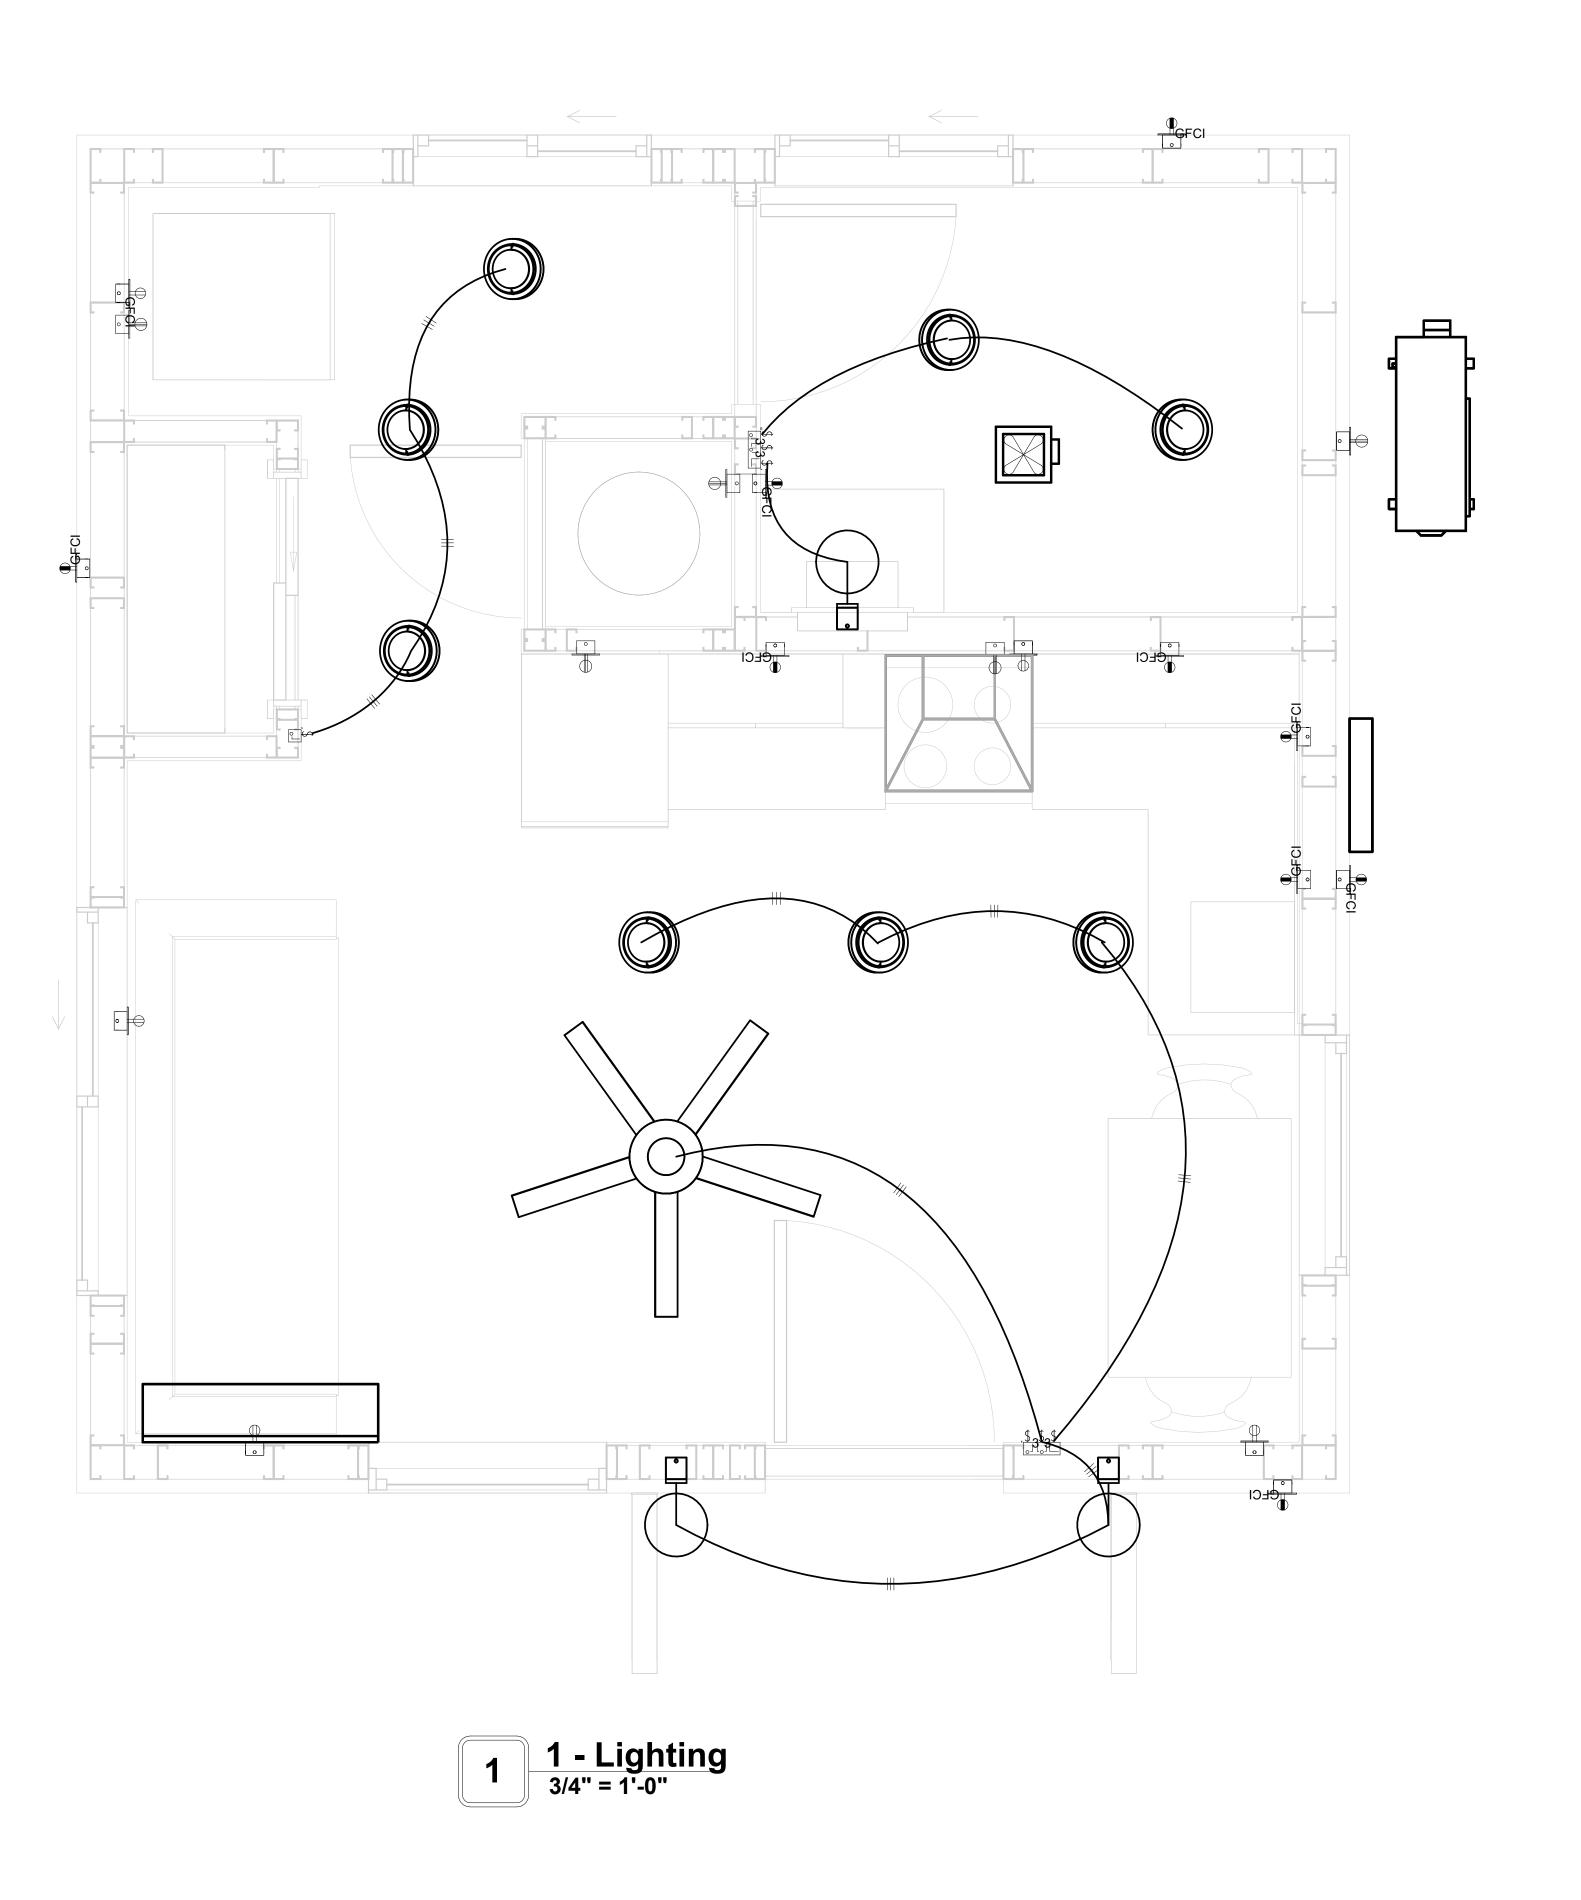



KEY PLAN

NO. DESCRIPTION DATE

NOTE:

LEGEND:

PROJECT

123-Orion-306-Studio Ranch-Base-550

DRAWING NAME

LIGHTING

CLIENT NAME:

PROJECT NUMBER:

0213_11

DATE:
2/25/2025 12:35:58 PM

DESIGNED BY:

DRAWN BY:


CHECKED BY:


Checker

E102


NOTES: CONDUIT, CABLE AND WIRING

- Use Metalic Conduits (IMC) for cables running under concrete slabs.
 Use IMC for circuits with high voltage appliances (240 volts and above)
 For circuits with 120 volts consider using EMT or PVC conduits if needed.
 For Low voltage applications up to 50 volts consider using non metalic conduits.
 All conduits to be used in the project must conform to the latest National Electrical Code (NEC),
- 6. All wiring and cables to be used in the project must also conform to the latest National Electrical Code (NEC), 2015.
 7. All cables and wires used should be rated for their respective loading and should be gauged and
- conform to the NEC.

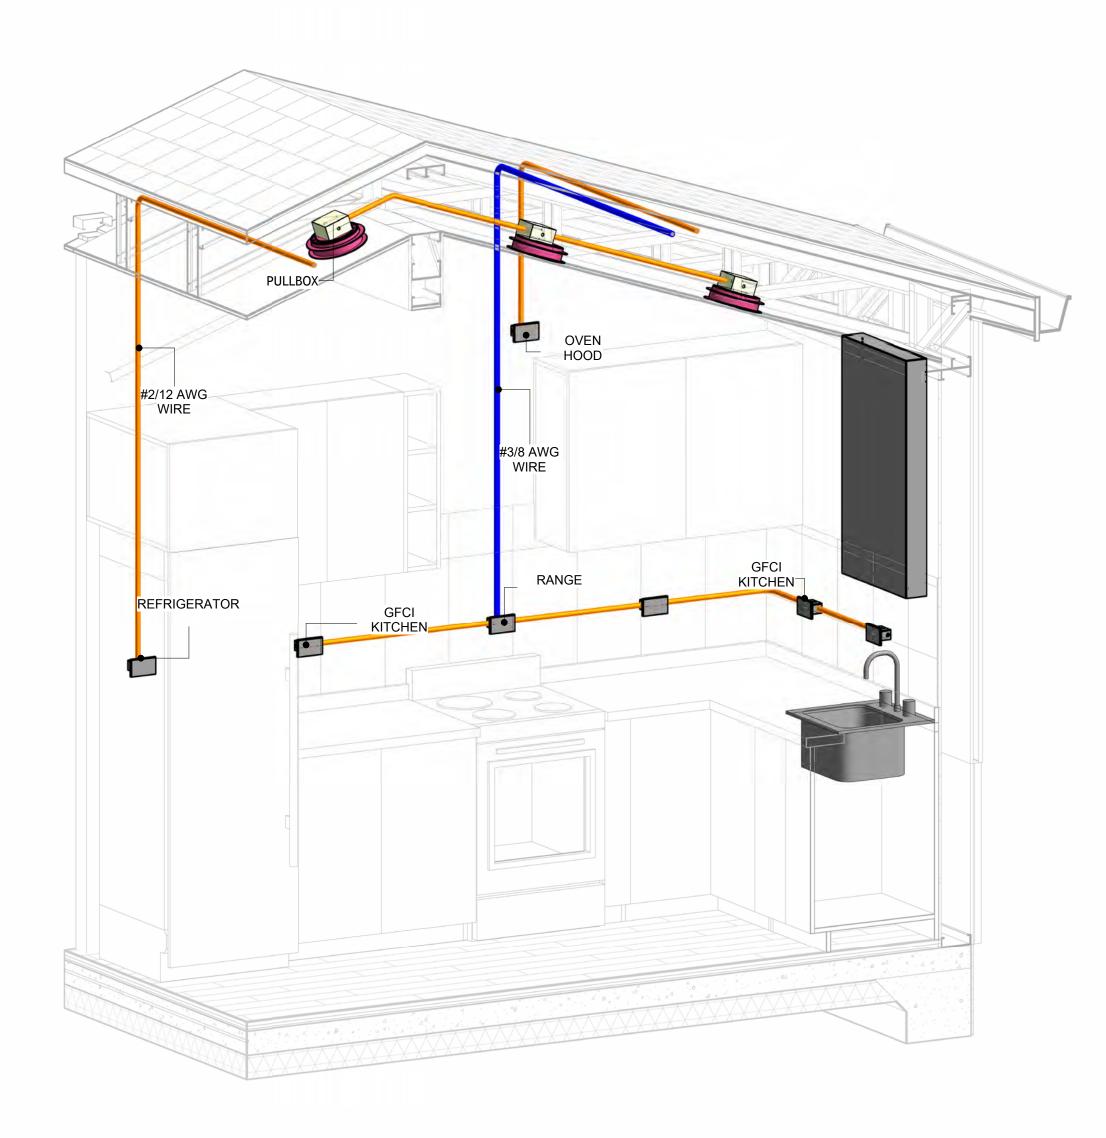


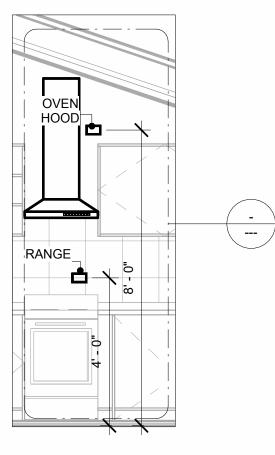


Section 1 3/8" = 1'-0"

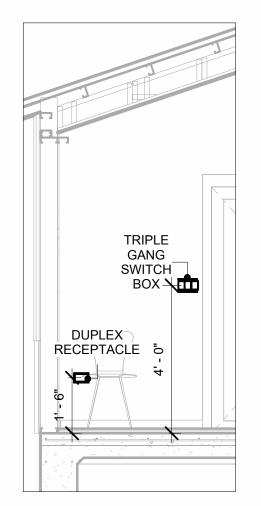

Section 3
3/8" = 1'-0"

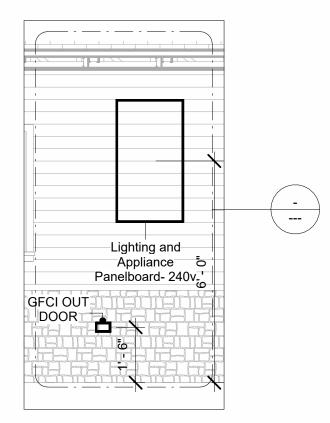


Section 2 3/8" = 1'-0"

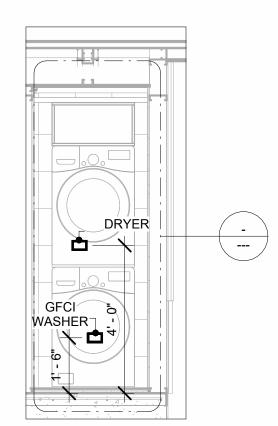

Section 4 3/8" = 1'-0"



KEY PLAN

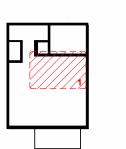

NO.	DESCRIPTION	DATE

NOTE:

LEGEND:

PROJECT

123-Orion-306-Studio Ranch-Base-550

DRAWING NAME

POWER

Owner	CLIENT NAME:	
0213_11	PROJECT NUMBER:	
2/25/2025 12:36:25 PM	DATE:	
Designer	DESIGNED BY:	
Author	DRAWN BY:	
Checker	CHECKED BY:	

E103

SCALE: As indicated

3D-KITCHEN

NOTES: LIGHT

- 1. LIGHT FIXTURES AND LUMINARIES SHALL CONFORM TO THE NEC, THE IRC AND LOCAL SAFETY & BUILDING CODE.
- 2. ALL LIGHTING FIXTURES SHOULD CONFORM TO THE DESIGN ELECTRICAL LOAD AND SHALL BE PROPERLY WIRED AND MOUNTED BY QUALIFIED ELECTRICIAN FOLLOWING MANUFACTURERS SPECIFICATIONS.
- 3. CEILING FANS AND FANS WITH LIGHT WITH WEIGHT EXCEEDING 35 LBS SHOULD BE PROVIDED WITH STRUCTURAL BACKING FOR SUPPORT AND SHALL BE FIXED AS PER MANUFACTURERS SPECIFICATIONS.
- 4. EXTERIOR LIGHTS SHALL CONFORM TO LOCAL BUILDING CODE AND GUIDELINES.

NOTES: SWITCH JUNCTION BOX


- 1. THE MINIMUM SIZE OF JUCTION BOX TO BE USED IS 2"X4"X(1.5" OR 3.5" DEEP) THIS ARE TO BE USED FOR SINGLE GANG SWITCH OR OUTLETS.
- 2. FOR DOUBLE GANG (2 GANG) OUTLETS AND SWITCHS THE MINIMUM SIZE OF THE
- JUCTION BOX TO BE PROVIDED SHALL NOT BE LESS THAN 4"X4"X(1.5" OR 3.5" DEEP)
- 3. FOR THREE GANG (3 GANG) OUTLETS AND SWITCHS THE MINIMUM SIZE OF THE JUĆTION BOX SHALL NOT BE LESS THAN 6"X4"X(1.5" OR 3.5" DEEP).

FITTING SCHEDULE(PULL BOX)				
FAMILY COUNT DESCRIP				
PULLBOX1	9	#1/4 PULLBOX		

ELECTRICAL FIXTURE SCHEDULE (SWITCH BOX)				
TYPE	COUNT			
SINGLE GANG SWITCH BOX	1			
TRIPLE GANG SWITCH BOX	2			

LIGHTING DEVICE					
TYPE	COUNT				
SINGLE POLE	5				
THREE WAY	2				

LIGHTING FIXTURE								
LIGHTING FIXTURE TYPE	VOLTAGE	ELECTRICAL LOAD	COUNT					
ELECTRICAL_LIGHTS_FAN-LIGHT1	120 V/1-100 VA- 120 V/1-100 VA	200 A, 120 V/240 V, SINGLE PHASE, 3 WIRES	1					
LIGHTING - RECESSED	120 V/1-60 VA	<varies></varies>	5					
LIGHTING_RECESSED	120 V/1-60 VA	200 A, 120 V/240 V, SINGLE PHASE, 3 WIRES	3					
WALL LAMP - BRACKET	120 V/1-100 VA	<varies></varies>	3					

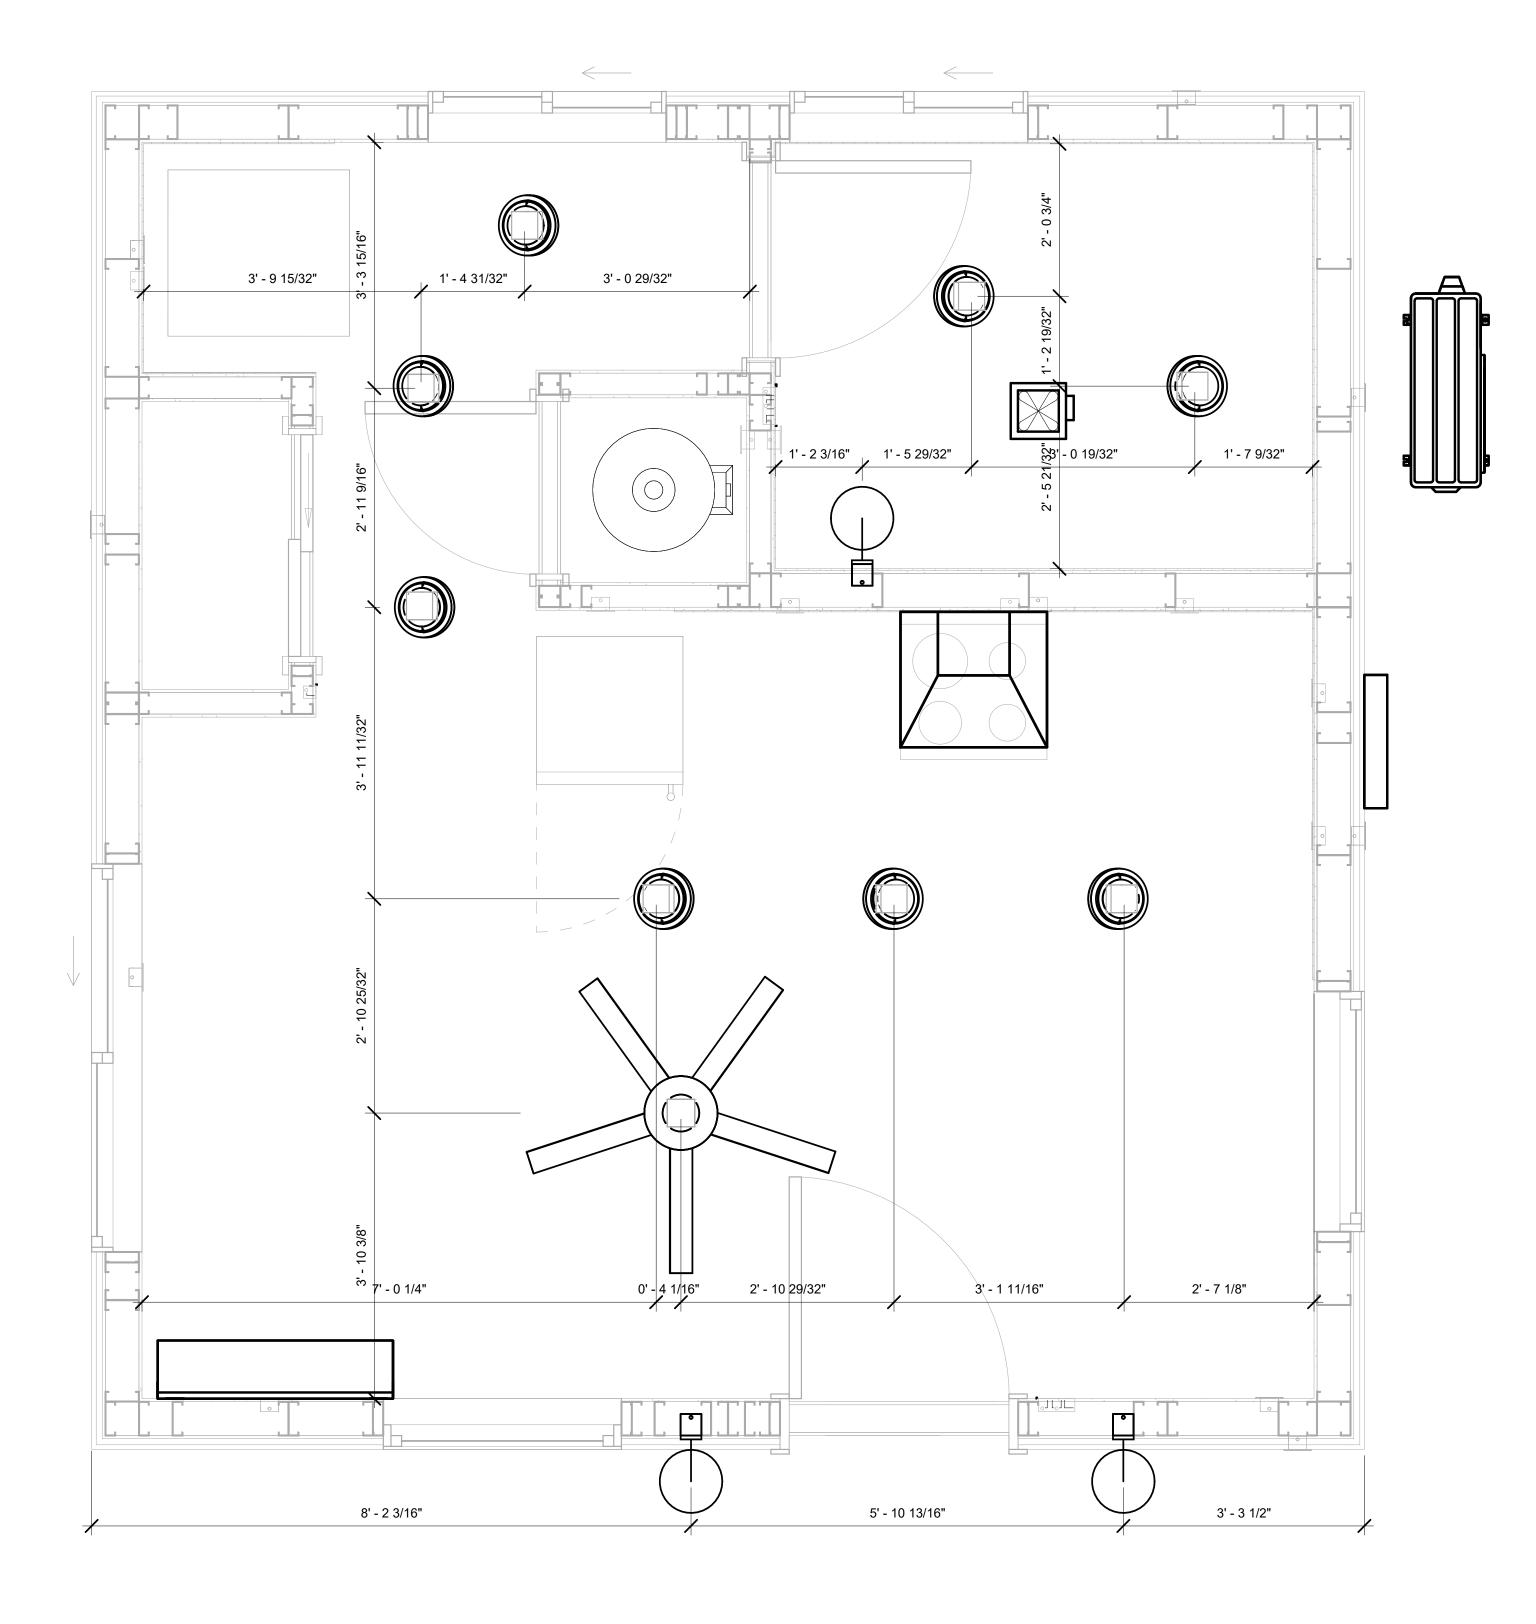





KEY PLAN

DESCRIPTION DATE

NOTE:

LEGEND:

PROJECT

123-Orion-306-Studio Ranch-Base-550

DRAWING NAME

DIMENSION PLAN FOR LIGHT FIXTURES

Owner CLIENT NAME: PROJECT NUMBER: 0213_11 2/25/2025 12:36:26 PM DESIGNED BY: DRAWN BY: Checker CHECKED BY:


E104

NOTES;

- 1. VERIFY EQUIPMENT PLUG CONFIGURATION BEFORE PURCHASING RECEPTACLES
- 2. FOR ALL EQUIPMENT.
- 3. COORDINATE EXACT LOCATION OF LIGHT FIXTURES, WALL SWITCHES, RECEPTACLES AND OTHER DEVICES WITH ARCHITECTURAL DRAWINGS.
- 4. USE METALLIC JUNCTION BOX WITH THE GFCI RECEPTACLES, WITH HIGHT VOLTAGE.

ELECTRICAL FIXTURE SCHEDULE (RECEPTACLE)						
TYPE	COUNT					
CONDENSER	1					
DRYER	1					
DUPLEX RECEPTACLE	3					
GFCI BATH ROOM	1					
GFCI KITCHEN	4					
GFCI OUT DOOR	4					
GFCI WASHER	1					
OVEN HOOD	1					
RANGE	1					
REFRIGERATOR	1					
WATER HEATER	1					

ELECTRICAL OUTLET SCHEDULE								
TYPE	COUNT							
GFCI BATH ROOM		120 V/1-180 VA	1					
GFCI OUT DOOR		120 V/1-180 VA	1					
WATER HEATER	2,4	240 V/2-4500 VA	1					
GFCI WASHER	3	120 V/1-1200 VA	1					
DUPLEX RECEPTACLE	5	120 V/1-180 VA	3					
GFCI KITCHEN	7	120 V/1-180 VA	4					
GFCI OUT DOOR	8	120 V/1-180 VA	3					
REFRIGERATOR	9	120 V/1-1500 VA	1					
OVEN HOOD	10	120 V/1-180 VA	1					
CONDENSER	11,13	240 V/2-5000 VA	1					
RANGE	12,14	240 V/2-5000 VA	1					
DRYER	15,17	240 V/2-5000 VA	1					

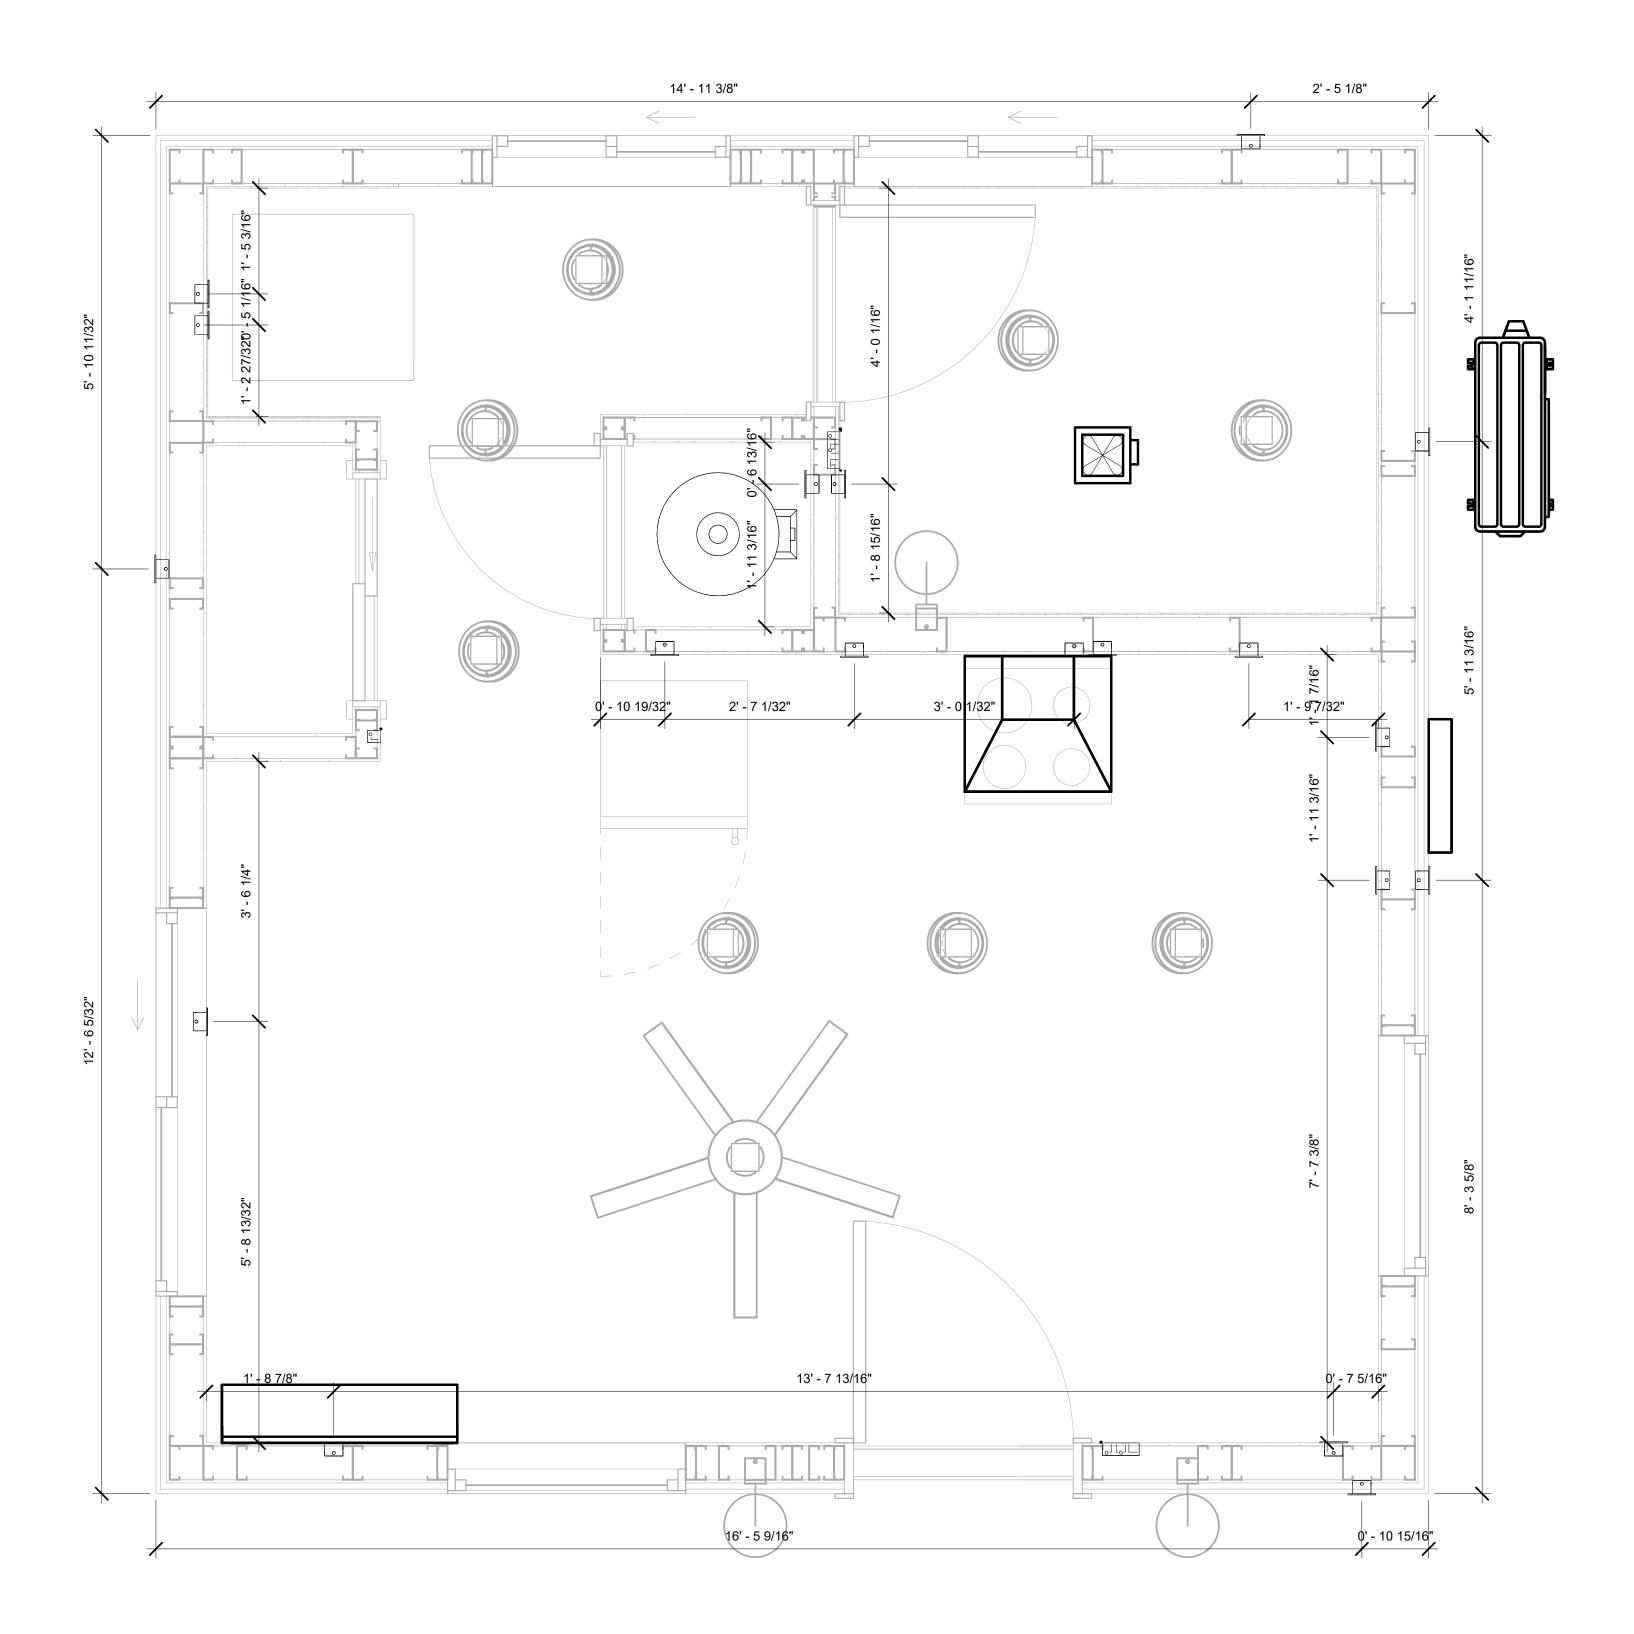

1 DIMENSION FOR FITTINGS
3/4" = 1'-0"



KEY PLAN

NO.	DESCRIPTION	DATE		

NOTE:

LEGEND:

PROJECT

123-Orion-306-Studio Ranch-Base-550

DRAWING NAME

DIMENSION PLAN FOR FITTINGS

CLIENT NAME:

PROJECT NUMBER:

0213_11

DATE:
2/25/2025 12:36:27 PM

DESIGNED BY:
Designer

DRAWN BY:
Author

CHECKED BY:
Checker

E105

SHEET LIST

SHEET NUMBER SHEET NAME

P101 NOTE AND SCHEDULE
P102 WATER SUPPLY AND SEWAGE
SYSTEM

DOMESTIC COLD WATER DOMESTIC HOT WATER DOMESTIC HOT WATER SANITARY VENT SANITARY SEWER STORM DRAINAGE GRAY WATER GAS LINE

PLUMBING NOTES

- 1. THE PLUMBING SYSTEM IS DESIGNED TO MEET THE BUILDING'S DOMESTIC WATER SUPPLY, SANITARY DRAINAGE, AND STORM DRAINAGE REQUIREMENTS, AS PER PROJECT SPECIFICATIONS AND APPLICABLE CODES.
- 2. THE SYSTEM INSTALLATION SHALL COMPLY WITH THE LATEST INTERNATIONAL PLUMBING CODE (IPC), INTERNATIONAL RESIDENTIAL CODE (IRC), AND ALL OTHER RELEVANT LOCAL, STATE, AND NATIONAL REGULATIONS.
- ALL PLUMBING WORK SHALL COMPLY WITH THE LATEST EDITION OF THE INTERNATIONAL PLUMBING CODE (IPC) AND THE LOCAL PLUMBING CODE.
- 4. PLUMBING SYSTEMS SHALL BE TESTED AND INSPECTED IN ACCORDANCE WITH THE LOCAL PLUMBING CODE REQUIREMENTS.
- 5. PLUMBING FIXTURES SHALL BE INSTALLED WITH THE APPROPRIATE TRIM, FITTINGS, AND ACCESSORIES, AS RECOMMENDED BY THE MANUFACTURER.
- 6. PIPING SHALL BE PROPERLY SUPPORTED AND SECURED TO PREVENT SAGGING,
- MOVEMENT, AND VIBRATION.
 7. SHUT-OFF VALVES SHALL BE PROVIDED AT ALL BRANCH CONNECTIONS AND AT THE
- INLET AND OUTLET OF EACH PIECE OF EQUIPMENT.

 8. BACKFLOW PREVENTION DEVICES SHALL BE INSTALLED AS REQUIRED BY THE LOCAL
- PLUMBING CODE TO PROTECT THE POTABLE WATER SYSTEM.

 9. PLUMBING FIXTURES AND EQUIPMENT SHALL BE ACCESSIBLE FOR MAINTENANCE AND
- SERVICING.

 10. EXPOSED PLUMBING PIPING AND FIXTURES SHALL BE INSULATED TO PREVENT CONDENSATION AND ENERGY LOSS.
- 11. DEAD ENDS IN THE DRAINAGE SYSTEM MUST BE AVOIDED, EXCEPT WHERE NECESSARY TO INSTALL A CLEANOUT IN AN ACCESSIBLE LOCATION, AND MUST HAVE A VENTED CONNECTION TO THE OUTSIDE ATMOSPHERE.
- 12. THE VERTICAL DEFLECTION OF PVC PIPE MUST NOT EXCEED 5%, AND NO DEFLECTION IS PERMITTED FOR IRON PIPE.
- 13. WORK MUST BE PROPERLY COORDINATED WITH OTHER TRADES TO AVOID CONFLICTS, REFERRING TO THE ARCHITECTURAL AND STRUCTURAL DRAWINGS FOR INFORMATION REGARDING CEILING ELEVATIONS, SPACE CLEARANCES, WALL AND PARTITION LOCATIONS, ETC.
- 14. ALL FIXTURES SHALL HAVE ACCESSIBLE STOPS.
- 15. DOMESTIC WATER PIPING SHALL BE PEX, AND PVC PIPING IS NOT ACCEPTABLE FOR INTERIOR USE.
- 16. VENT TERMINATIONS SHALL BE LOCATED AT LEAST 10 FEET FROM OR 3 FEET ABOVE ANY OPERABLE WINDOW, DOOR OPENING, AIR INTAKE, OR VENT SHAFT, AND AT LEAST 3 FEET IN EVERY DIRECTION FROM ANY LOT LINE, ALLEY, OR STREET.
- 17. PIPE AND FITTINGS UTILIZED IN THE WATER SUPPLY SYSTEM SHALL HAVE A MAXIMUM OF 8 PERCENT LEAD.
- 18. ACRYLONITRILE BUTADIENE STYRENE (ABS) SHALL BE USED FOR THE SEWERAGE AND
- VENTILATION SYSTEM.

 19. CROSS-LINKED POLYETHYLENE (PEX) SHALL BE USED FOR THE WATER SUPPLY SYSTEM.
- 20. POLYVINYL CHLORIDE (PVC) SHALL BE USED FOR THE WATER SUPPL 20. POLYVINYL CHLORIDE (PVC) SHALL BE USED FOR THE RAIN WATER SYSTEM.
- 20. POLYVINYL CHLORIDE (PVC) SHALL BE USED FOR THE RAIN WATER SYSTEM.
 21. THE MIMIMUM WATER SUPPLY DEPTH UNDER FLOOR FINISH SHOUD BE 1/2".
- 22. ANY PIPE INSTALLED UNDERGROUND MUST HAVE AT LEAST 12 INCHES OF CLEARANCE BETWEEN THE OUTSIDE OF THE PIPE AND ANY OTHER UNDERGROUND STRUCTURE.
- 23. THE MINIMUM CLEARANCE BETWEEN COLD AND HOT WATER LINES IN RESIDENTIAL
- HOMES MAINTAIN A MINIMUM DISTANCE OF 6 INCHES.

 24. HORIZONTAL SEPARATION BETWEEN WATER AND SEWER LINES: A MINIMUM OF 12
- INCHES BETWEEN POTABLE WATER SUPPLY LINES (COLD AND HOT WATER) AND SANITARY SEWER LINES.

ABBREVIATIONS

Ø	DIAMETER
ABS	ACRYLONITRILE BUTADIENE STYRENE
ABV	ABOVE
AD	AREA DRAIN
AFF	ABOVE FINISHED FLOOR
ALT	ALTERNATE
BFF	BELOW FINISHED FLOOR
BLW	BELOW
СО	CLEAN OUT
CW	COLD WATER
D	DEGREE
DFU	DRANAGE FIXTURE UNIT
DIA	DIAMETER
DN	DOWN
FCO	FLOOR CLEAN OUT
FD	FLOOR DRAIN
FL	FLOOR
FS	FLOOR SINK
FT	FOOT/FEET
НВ	HOSE BIB
HW	HOT WATER
IN	INCH
MIN	MINIMUM
NO	NUMBER
NTS	NOT TO SCALE
PEX	CROSS-LINKED POLYETHYLENE
PLBG	PLUMBING
PVC	POLYVINYL CHLORIDE
QTY	QUANTITY
RD	ROOF DRAIN
RED	REDUCER
RM	ROOM
RW	RAIN WATER
SF	SQUARE FOOT
V	VENT
VTR	VENT THROUGH ROOF
W	WASTE
WCO	WALL CLEAN OUT
WSFU	WATER SUPPLY FIXTURE UNIT
WCO	WALL CLEAN OUT

PLUMBING LEGEND

D	CAP
	BEND 45 DEG
\Box	BEND 90 DEG
	TEE REDUCING
	TEE
	CLEAN TWO-WAY
	WYE 45 DEG
	WYE 45 DEG DOUBLE
	WYE COMBINATION
	P-TRAP

PIPE SCHEDULE								
MATERIAL DIAMETER LENGTH								
ACRYLONITRILE BUTADIENE STYRENE (ABS)	1 1/2"	8 FT						
ACRYLONITRILE BUTADIENE STYRENE (ABS)	2"	34 FT						
ACRYLONITRILE BUTADIENE STYRENE (ABS)	3"	33 FT						
CROSS-LINKED POLYETHYLENE (PEX)	1/2"	70 FT						
CROSS-LINKED POLYETHYLENE (PEX)	3/4"	36 FT						
POLYVINYL CHLORIDE - RIGID	2"	44 FT						

FITTING SCHEDULE					
FITTING	SIZE	QTY			
DOMESTIC COLD WATER					
PEX 90 DEGREE ELBOW	1/2"ø-1/2"ø	12			
PEX 90 DEGREE ELBOW	3/4"ø-3/4"ø	4			
PEX TEE ELBOW	1/2"ø-1/2"ø	1			
PEX TEE ELBOW	3/4"ø-3/4"ø	3			
PEX TRANSITION ELBOW	1"ø-3/4"ø	2			
PEX TRANSITION ELBOW	3/4"ø-1/2"ø	4			
DOMESTIC HOT WATER					
PEX 90 DEGREE ELBOW	1/2"ø-1/2"ø	9			
PEX 90 DEGREE ELBOW PEX 90 DEGREE ELBOW	3/4"ø-3/4"ø	3			
PEX TEE ELBOW	1/2"ø-1/2"ø	1			
PEX TRANSITION ELBOW	3/4"ø-1/2"ø	3			
RAIN WATER PVC 90 DEG BEND ELBOW	2"ø-2"ø	18			
PVC 90 DEG BEND ELBOW	2"ø-2"ø	18			
SEWAGE					
ABS 90 DEGREE BEND ELBOW	1 1/2"ø-1 1/2"ø	1			
ABS 90 DEGREE BEND ELBOW	2"ø-2"ø	2			
ABS 90 DEGREE BEND ELBOW	3"ø-3"ø	2			
ABS P-TRAP	1 1/2"ø-1 1/2"ø	3			
ABS P-TRAP	2"ø-2"ø	1			
ABS REDUCER ELBOW	2"ø-1 1/2"ø	1			
ABS REDUCER ELBOW	3"ø-2"ø	1			
ABS TEE ELBOW	2"ø-2"ø	2			
ABS TEE ELBOW	3"ø-3"ø	2			
ABS TEE REDUCER ELBOW	3"ø-3"ø-1 1/2"ø	2			
ABS TEE REDUCER ELBOW	3"ø-3"ø-2"ø	1			
VENT					
ABS VENT CAP ELBOW	2"ø	2			
ABS VENT CAP ELBOW	3"ø	1			

FIXTURE CONNECTION SCHEDULE											
FAMILY	W	V	TRAP	CW	HW	QTY	DFU	TOT.	WFU	TOT.	NOTES
DRYER	N/A	N/A	N/A	N/A	N/A	1		0			
HANGING PIPES CLAMP						12		0			
SHOWER TRAY	2"	1-1/2"	1-1/2"	1/2"	1/2"	1		0			
SHOWER TRIM	-	-	-	1/2"	1/2"	1		0			
SINK ISLAND SINGLE	2"	1-1/2"	1-1/2"	1/2"	1/2"	1		0			
VANITY SINK	2"	1-1/2"	1-1/2"	1/2"	1/2"	1		0			
WASHER	2"	1-1/2"	2"	1/2"	1/2"	1		0			DRAINS TO GRAY WATER OR SEWER SEE PLANS
WATER CLOSET	3"	2"	3"	1/2"	1/2"	1		0			
WATER HEATER	N/A	N/A	N/A	3/4"	3/4"	1		0			

FIXTURE SCHEDULE						
FIXTURE QTY DESCRIPTION						
	·					
DRYER	1					
HANGING PIPES CLAMP	12					
SHOWER TRAY	1					
SHOWER TRIM	1					
SINK ISLAND SINGLE	1					
VANITY SINK	1					
WASHER	1	DRAINS TO GRAY WATER OR SEWER SEE PLANS				
WATER CLOSET	1					
WATER HEATER	1					

ACCESSORIES & FITTINGS SCHEDULE							
FIXTURE	FIXTURE QTY DESCRIPTIONS						
HOSE BIB	1						
LAUNDRY SWEAT CONNECTOR	1						
SHUTOFF VALVE	6						

PLUMBING SCHEDULE								
FIXTURE	TRAP	WASTE	VENT	C.W	H.W			
DRYER	N/A	N/A	N/A	N/A	N/A			
SHOWER TRAY	1-1/2"	2"	1-1/2"	1/2"	1/2"			
SHOWER TRIM	-	-	-	1/2"	1/2"			
SINK ISLAND SINGLE	1-1/2"	2"	1-1/2"	1/2"	1/2"			
VANITY SINK	1-1/2"	2"	1-1/2"	1/2"	1/2"			
WASHER	2"	2"	1-1/2"	1/2"	1/2"			
WATER CLOSET	3"	3"	2"	1/2"	1/2"			
WATER HEATER	N/A	N/A	N/A	3/4"	3/4"			

WATER FIXTURE UNIT SCHEDULE									
FAMILY QTY UNIT VALUE TOTAL									
		T	T ₂						
DRYER	1		0						
HANGING PIPES CLAMP	12		0						
SHOWER TRAY	1		0						
SHOWER TRIM	1		0						
SINK ISLAND SINGLE	1		0						
VANITY SINK	1		0						
WASHER	1		0						
WATER CLOSET	1		0						
WATER HEATER	1		0						

WASTE FIXTURE UNIT SCHEDULE									
FAMILY	QTY	DFU VALUES	TOTAL						
DDVED									
DRYER	1	0							
HANGING PIPES CLAMP	12	0							
SHOWER TRAY	1	0							
SHOWER TRIM	1	0							
SINK ISLAND SINGLE	1	0							
VANITY SINK	1	0							
WASHER	1	0							
WATER CLOSET	1	0							
WATER HEATER	1	0							



KEY PLAN

NO. DESCRIPTION DATE

NOTE:

LEGEND:

PROJECT

123-Orion-306-Studio Ranch-Base-550

DRAWING NAME

NOTE AND SCHEDULE

CLIENT NAME:

 PROJECT NUMBER:
 0213_11

 DATE:
 3/8/2025 4:06:33 PM

 DESIGNED BY:
 Designer


 DRAWN BY:
 Author


 CHECKED BY:
 Checker


P101


SCALE: 1/2" = 1'-0"




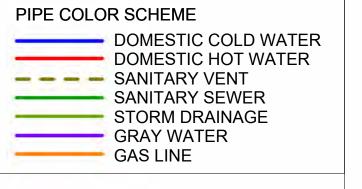

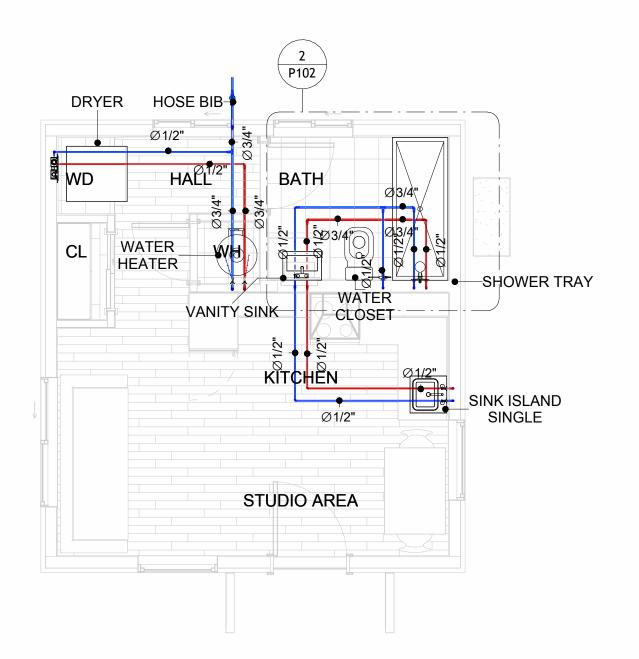

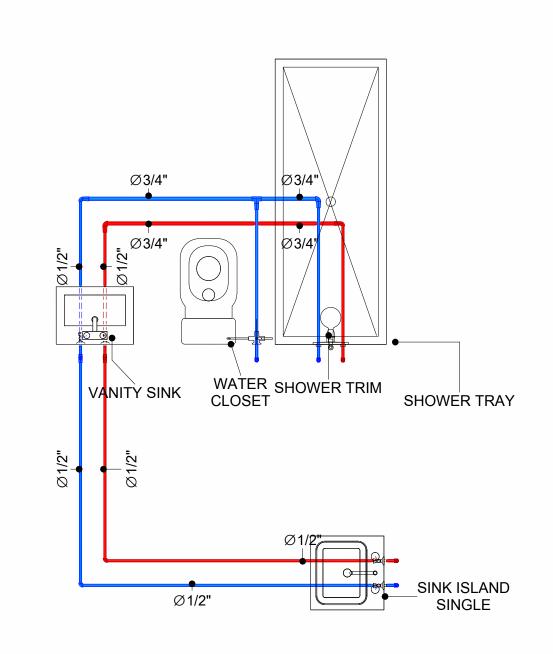

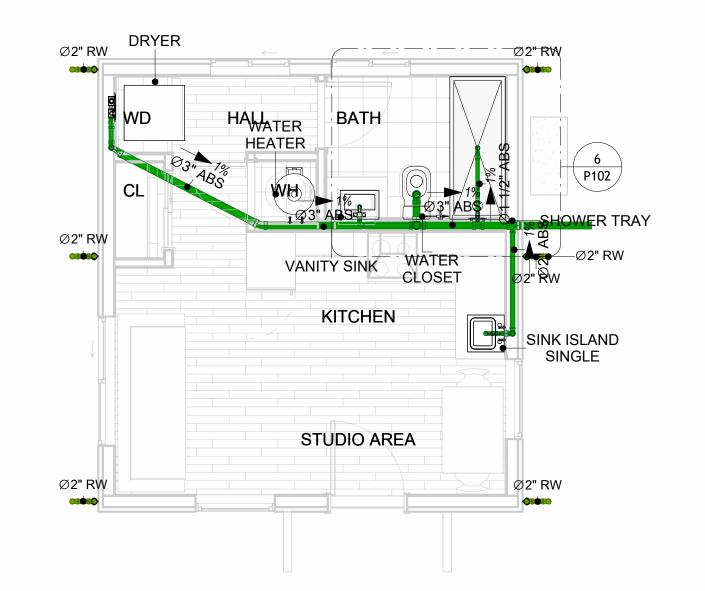

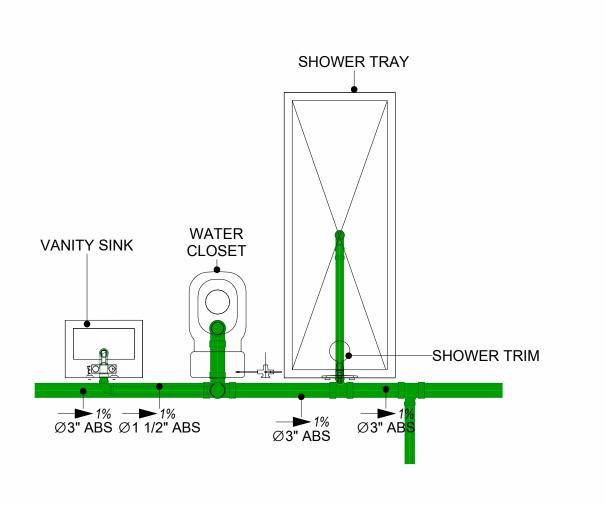


OVERALL WATER SUPPLY 1/4" = 1'-0"


BATH WATER SUPPLY 1/2" = 1'-0"



BATH SEWAGE 1/2" = 1'-0"

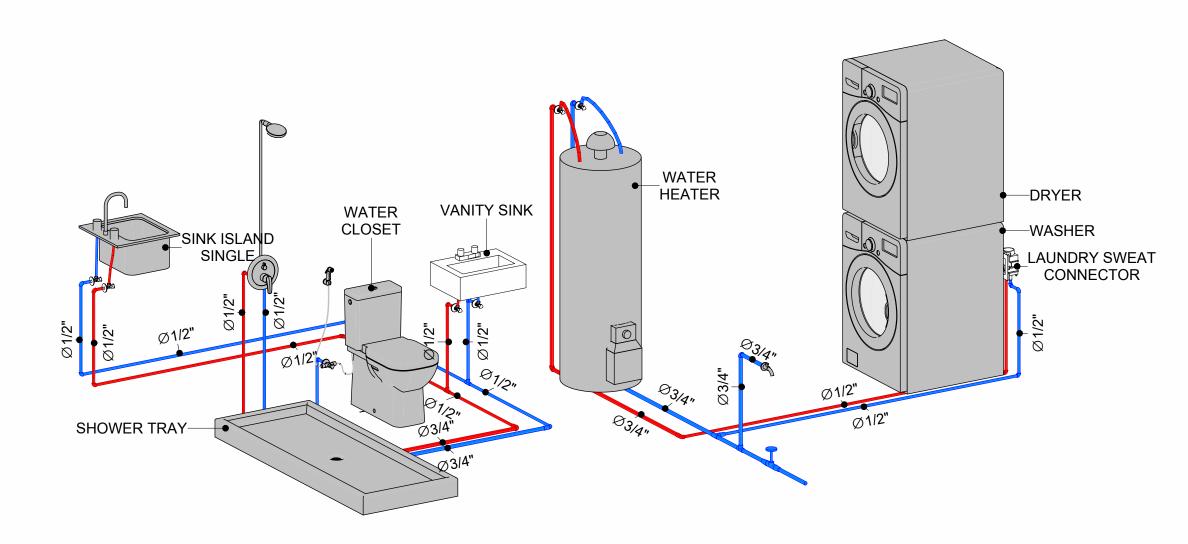


WATER SUPPLY RISER DIAGRAM

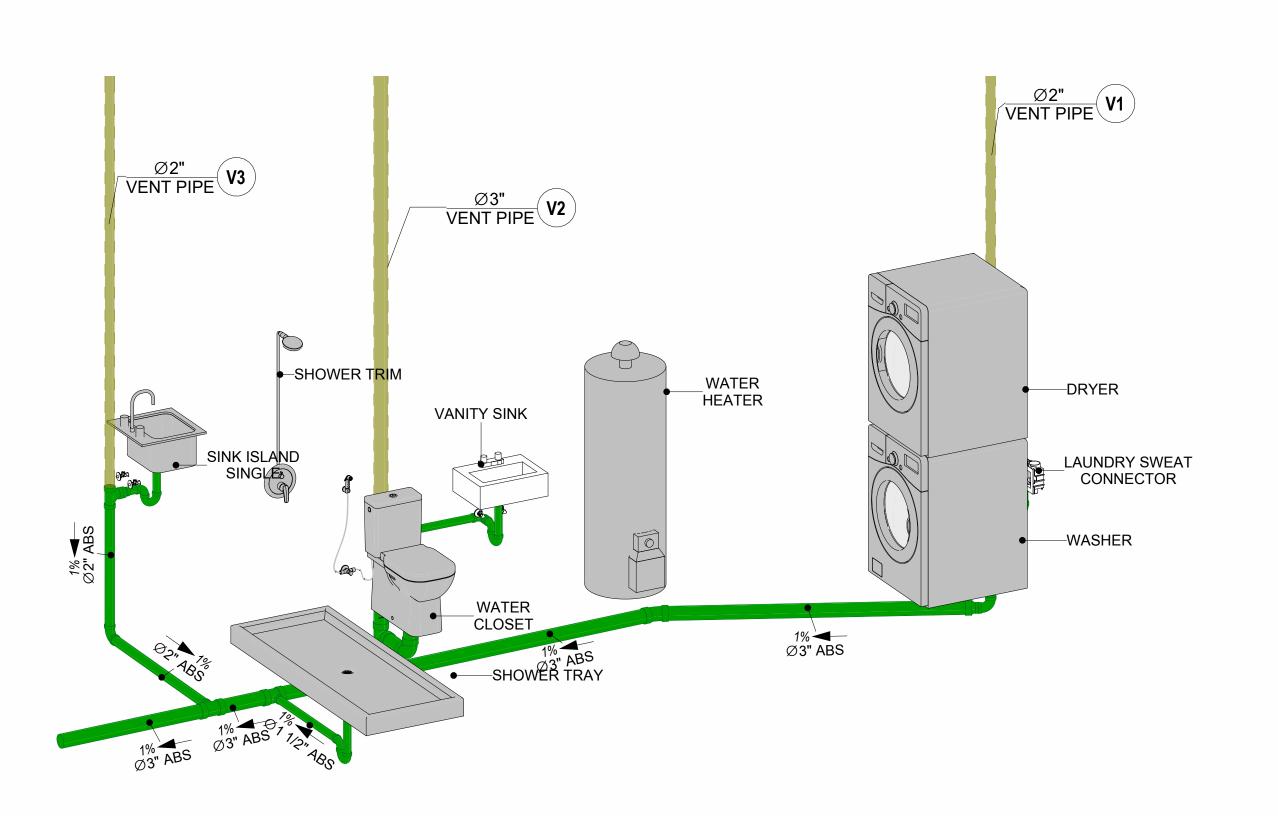

SEWAGE RISER DIAGRAM



KEY PLAN

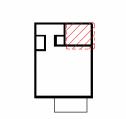

NO.	DESCRIPTION	DATE

NOTE:

LEGEND:

PROJECT

123-Orion-306-Studio Ranch-Base-550

DRAWING NAME

WATER SUPPLY AND **SEWAGE SYSTEM**

CLIENT NAME: 0213_11 PROJECT NUMBER: 3/8/2025 4:07:04 PM Designer DESIGNED BY: DRAWN BY: CHECKED BY: Checker

P102

Materials Shopping List

Please print and take this Materials Shopping List to your favorite Home Depot and ask for assistance in selecting the materials, fixtures and fittings to complete your new home.

Record your selection and the price of the item. Then do the math to determine the cost for your selections and the total cost of finishing your home.

Have It Your Way!

The material types listed in this document were selected based on personal preferences. The Customer is encouraged to make changes to the material types in accordance with local customs, regulations, and personal preferences.

Have It Your Way!



20 good reasons to frame a home with metal and not wood



Why build your ADU with metal vs wood	Wood	Metal	Explanation
1 DIY Construction Benefit		~	The wall frames, trusses and beams can be erected in a just a few days
2 Minimal Construction Skills Required		~	Pre-assembled walls and trusses require no specialized skills to errect
3 Build as DIY, Hybrid or by a General Contractor		✓	Do it yourself, Hybrid (involve special contractors) or hire a General Contractor
4 Build It As You Can Afford It		✓	Impervious to Weather - build as you have the time and money
5 Up Front Cost of Framing Materials	~		As to only the framing material, wood is less expensive
6 Total Cost To Build		~	Savings in time, labor, and other areas make light gauge steel LESS expensive
7 Termites and wood boring insects		Y	Termites, carpenter ants and wood boring insects eat wood, not metal
8 Mold resistant		~	Metal does not attract mold
9 Damage caused by exterior and interior flooding		~	Metal needs no reconditioning after a flood
10 Fire Resistant		~	Non-combustible
11 Lower insurance rates		Y	Many insurance underwriters now provide lower rates for metal framed homes
12 Walls, trusses, and beams retain their original form		~	Perfectly straight walls - no shimming of drywall
13 Corners are 90 degrees		✓	No need for templating of countertops to adjust for out of square corners
14 Strength and weight		✓	Metal is stronger than wood and weighs less - no need for crane to lift ADU trusses
15 IBC Engineered Stamp		✓	If an engineering stamp is necessary, months of waiting are saved
16 Complete BOM (Materials Shopping List)		~	Take the materials shopping list to Home Depot and start shopping/pricing
17 Flexible in Seismic Areas - Won't Fracture		~	Light gauge steel is flexible and won't fracture when the earth moves
18 No Waste At Job Site		~	Steel is the most recycled material in the world. A typical wood home has 20-30% waste
19 Environmentally Friendly		~	Trees don't have to be destroyed and the source of most metal is from recycling
20 How-To Videos Included		~	How-to videos provide simple assembly instructions
21 Relationship Counselor		✓	Eliminate emotional uphevels - save time, money, and preserve the relationship

Universal Requirements - some or all may be required

- 1 Site plan
- 2 Electrical Supply Connection
- 3 Sewer Connection
- 4 Fresh Water Supply Connection
- 5 Set Backs
- 6 Soils Evaluation

- 7 Earthquake (fault) evaluation
- 8 Foundation Plan subject to soils
- 9 Compliance with local energy codes: insulation home wrap and flashing
- 10 Engineering for wind speed and snow load.
- 11 State and Local ordinances regarding ADUs
- 12 Local Architect and/or Engineer may be necessary

Orion-Studio-Ranch-Base





Orion-Studio-Ranch-Base MATERIAL SHOPPING LIST

Have It Your Way!

The material types listed in this document were selected based on personal preferences. The Customer is encouraged to make changes to the material types in accordance with local customs, regulations, and personal preferences. Have It Your Way!

TOC



10

15

Name | Link | Page No | 1 Cover Page | Cover Page | 1 | 2 TOC | TOC | 2 | 3 ELECTRICAL BOM | ELECTRICAL BOM | 3 | 5 HVAC BOM | HVAC BOM | 7

PLUMBING BOM

Table Of Content

Have It Your Way!

ARCHITECTURAL BOM

The material types listed in this document were selected based on personal preferences. The Customer is encouraged to make changes to the material types in accordance with local customs, regulations, and personal preferences. Have It Your Way!

GENERAL NOTES

4 PLUMBING BOM

6 ARCHITECTURAL BOM

- 1 This BOM (Bill of Materials) is prepared as a Materials Shopping List to help builders and DIYers gain a complete understanding of most if not all elements required for the complete construction of this structure, according to the original design documents provided by FrameUpNow.
- 2 All quantities and specifications are subject to change based on the final design, field measurements, availability of products and customer preferences. The customer should verify all information prior to purchasing materials.
- 3 All products and elements in the list shall conform to the International Residential Code (IRC), or any other local and international building codes, safety regulations, and standards that are applicable to the location of the structure.
- 4 If any changes are made by the customer to the list of materials specified in this document, the customer is responsible for assuring that the correct type and quantity of materials are utilized in accordance with local building codes.
- 5 FrameUpNow, will not be held responsible for any misuse of this document, the products listed, or for deviations from the content that are made due to changes in specifications, pricing, availability, or customer preferences.
- 6 The customer is advised to consult a qualified professional or technician prior to purchasing materials for specialized construction system items. Some items including but not limited to caseworks, doors and windows may require as built measurements prior to purchase to confirmation of final dimensions.
- 7 If there are additional trim elements or specific installation methods, the total amount of materials needed might vary. Consider any additional trim required for corners, intersections, or other architectural details that might cause this variations before proceeding to purchase and construction.

ARCHITECTURAL BOM



	Orion-Studio-Ranch-Base						
		ARCHITECTURA	L MATE	RIAL SHOP	PING LIST		
No.	Item	Туре	Unit	Quantity	Unit Price	Total	Description
Δ	APPLIANCES						
1	Refrigerator		PCS	1			
2	Range		PCS	1			
3	Washer		PCS	1			
4	Dryer		PCS	1			
5	Dish Washer		PCS	0			
6	Oven		PCS	0			
7	Microwave		PCS	0			
<u>′</u>	CASEWORKS	I	1 00	0			
1	Kitchen Cabinet		FT	13.7			
2	Laundry Cabinet		FT	2.25			
				2.25			
3	Vanity Cabinet		FT				
4	Medicine Cabinet	1	PCS	1 20 01			
5	Kitchen countertop		SF	20.21			
6	Laundry Countertop		PCS	0			
7	Bathroom Countertop		SF	0			
8	Island		FT	0			
9	Peninsula		FT	0			
10	Closets		SF	23.37			
Δ	CEILING						
1	Ceiling Board	Dry Wall	SF	314.17			
2	Dry Wall Fastener	Screw	PCS	549.7975			
3	Vapor Retarder	Polyethylene film	SF	368.11			
4	Vapor Retarder Fastener	Nails with washer heads	PCS	1104.33			
5			SF	53.94			
_	Ceiling Board (MRD)	Moisture resistant drywall					
6	MRD Fastener		PCS	94.395			
7	Ceiling Board	Marine Plywood	SF	0			
8	Marine Plywood Fastener	Screw	PCS	0			
9	Dry Wall Tape		FT	184.055			
Δ	FLOORING						
1	Main Living Space		SF	206.6			
2	Bathroom		SF	44.54			
Δ	STRUCTURE						
1	Foundation		SF	306			
_	WALLS EXTERIOR	·					1
1	Exterior Stone		SF	169			
2	Exterior-Grade Plywood		SF	418			
3	Exterior-Grade Plywood Fastener	Self-drilling screws(100/pkt)	PKT	4.18			
4	Wall Shteathing (OSB)	John drilling scrows (100/pkt)	SF	587			
		Colf drilling coroug(100/pls)	PKT	5.87			
5	Shteathing Fastener	Self-drilling screws(100/pkt)					
6	Wall Homewrap	0. 1.15 1. (0.02.1.2)	SF	587			
7	Homewrap Fastener	Stapled fastener (200/pkt)	PKT	2.2306			
8	Furring Strip		PCS	52.25			
9	Furring Strip Fastener	Self-drilling screws(100/pkt)	PKT	4.18			
10	Wall Paint		SF	587			
11	Stone Copping	Masonry stone	SF	0			
2	Stone Veneer	Masonry stone	SF	0			
	Mortar for Stone Veneer	,	SF	0			
	Wall Insulation		SF	1676			
	WALLS INTERIOR	1	JJI	1070			<u> </u>
<u>=</u> _	Cementitious Backer Board	I	SF	312			
	Kerdi membrane		SF	312			
	Kerdi membrane Fastener		SF	312			
4	Wall Ceramic Tile		SF	312			
			SF	668			
6	Drywall Fastener	Self-drilling screws(100/pkt)	PKT	6.68			
7	Wall Paint		SF	668			
8	Drywall Tape		FT	125.5542422			
	Wall Sweep	i e	FT	45.5			i

ARCHITECTURAL BOM



Δ	DOORS				
1	Exterior Swinging	3' - 0" X 6'-8"	PCS	1	
2	Interior Swinging	2' - 4" X 6'-8"	PCS	1	
3	Interior Sliding	3' - 0" X 6'-8"	PCS	1	
4	Interior Swinging	2' - 8" X 6'-8"	PCS	1	
5	Exterior Door Trim		FT	16.3	
6	Interior Door Trim		FT	112	
7	Entry Lock set			1	
8	Privacy Lock set			1	
9	Passage Lock set			2	
Δ	WINDOWS				
1	Single Hung	3' - 3" X 3'-3"	PCS	2	
2	Sliding	5' - 3" X 3'-3"	PCS	1	
3	Sliding	3' - 3" X 2'-3"	PCS	1	
4	Sliding	3' - 3" X 1'-9"	PCS	1	
5	Exterior Window Trim		FT	65	
6	Interior Window Trim		FT	65	
Δ	ROOF				
1	Roof Covering		SF	827	
2	Roof Covering Fastener		PCS	413.5	
3	Roof Felt Paper		SF	827	
4	Roof Felt Paper Fastener		PCS	2481	
5	Roof Sheathing		SF	827	
6	Roof Sheathing Fastener		PCS	6616	
7	Batten		FT	215	
8	Batten Fastener		PCS	161.6541353	
9	Soffit		SF	0	
10	Soffit Fastener		PCS	0	
11	Fascia		FT	82	
12	Fascia board fastener		PCS	41	
13	Roof Insulation		SF	827	



		Orion-Stud	lio-Ranch-E	Base			
	F	LECTRICAL MATER	PIAL SHOP	PINGLI	ST.		
No.	Item	Type	Unit		Unit Price	Total	Description
Δ	LIGHTING FIXTURES		:				
1	Kitchen Ceiling Light		PCS	3			
	Kitchen Wall Mounted Light		PCS	0			
	Exterior Wall Mounted Light		PCS	2			
	Livingroom Ceiling Light With Fan		PCS	1			
5	Bedroom Ceiling Light With Fan		PCS	0			
	Dining Ceiling Light		PCS	0			
	Bath Wall Mounted Light		PCS	1			
	Bathroom Ceiling Light		PCS	2			
	Livingroom Ceiling Light		PCS	3			
	Bedroom Ceiling Light		PCS	0			
	Hall & Entry Ceiling Light		PCS	3			
	Closet Ceiling Light		PCS	0			
	Smoke Detector		PCS	0			
	ELECTRICAL FITTINGS		1 65	0			
	Standard Receptacle 120V	20.4	PCS	3			
		20A	PCS	8			
	GFCI Receptacle 120V	20 A	PCS	- 1			
	GFCI Receptacle 240V	30 A	PCS	2			
17	GFCI Receptacle 240V	50 A		1			
18	GFCI Receptacle 240V	60 A	PCS	1			
	Fan Switch		PCS	1			
	Single Pole Switch		PCS	5			
	Three Way Switch		PCS	2			
	Dimmer Switch		PCS	1			
	ELECTRICAL CONDUITS & WIRING						
	ROMEX 14 AWG	14/2/W/ground	FT	50			
24	ROMEX 12 AWG	12/3/W/ground	FT	190			
25	ROMEX 12 AWG	12/2/W/ground	FT	0			
26	ROMEX 10 AWG	10/3/W/ground	FT	0			
27	ROMEX 10 AWG	10/2/W/ground	FT	52			
28	Romex 8 AWG	8/3/W/ground	FT	0			
	Romex 8 AWG	8/2/W/ground	FT	15			
	ROMEX 6 AWG	6/3/W/ground	FT	14			
	Bare Copper Ground Wire 6 AWG	5, 5, 11, g, 2 5, 11	FT	0			
Δ	ELECTRICAL BOXES & CIRCUTES						
_	Panelboard -240V 1 Phase MLO	200 AMP	PCS	1			
	Circuit breaker	15 A	PCS	2			
	Circuit breaker	20 A	PCS	8			
	Circuit breaker	30 A	PCS	2			
	Circuit breaker	50 A	PCS	1			
	Circuit breaker	60 A	PCS	1			
	Single Gang Switch Box	00 A	PCS	1			
			PCS	0			
	Double Gang Switch Box		PCS	2			
	Triple Gang Switch Box	114.14					
	Pull Box	#1/4	PCS	9			
43	Receptacle Box		PCS	19			

PLUMBING BOM

WASTE DOUBLE TEE



Orion-Studio-Ranch-Base PLUMBING SYSTEM MATERIAL SHOPPING LIST Item Unit Quantity Unit Price Total Description 1 Bath Tub (Alcove Tub) PCS 2 Kitchen Sink PCS 1 3 Kitchen Faucets PCS 4 Vanity Sink PCS 1 5 Bath room Faucets PCS 6 Water Closet PCS 7 Shower Trim PCS 8 Shower Tray PCS 9 Water Heater PCS 10 Hose Bib PCS 1 11 Shutoff Valve PCS 12 Hanging pipe clamp PCS 16 13 Gate Valve PCS 14 Dishwasher Supply Single Connector PCS 1 15 Dishwasher Sewage Single Connector PCS 16 Laundry Sweat Connector PCS 1 △ SANITARY & PLUMBING PIPE 1 ABS (Acrylonitrile Butadiene Styrene) Pipes 2 ABS (Acrylonitrile Butadiene Styrene) Pipes ø 1" FT 0 ø 1 1/2 FT 9 3 ABS (Acrylonitrile Butadiene Styrene) Pipes ø 2" FT 35 4 ABS (Acrylonitrile Butadiene Styrene) Pipes ø 3" FT 34 5 PEX (Cross-linked polyethylene) Pipes ø 1/2' FT 88 6 PEX (Cross-linked polyethylene) Pipes ø 3/4" FT 38 7 PEX (Cross-linked polyethylene) Pipes ø 1" FT 0 8 PVC Pipes Sch.80 - Rigid ø 1 1/2" FT 0 9 PVC Pipes Sch.80 - Rigid ø 2" FT 91 10 PVC Pipes Sch.80 - Rigid ø 3" FT 0 ø 1/2" 11 Flex Pipe Round PCS 6 1 ABS 90 Degree Bend Elbow 1 1/2"ø-1 1/2"ø PCS 2 ABS 90 Degree Bend Elbow PCS 2"ø-2"ø 2 3 ABS 90 Degree Bend Elbow 3"ø-3"ø PCS 2 4 ABS P-Trap 1 1/2"ø-1 1/2"ø PCS 3 5 ABS P-Trap 2"ø-2"ø PCS 6 ABS Reducer Elbow 2"ø-1 1/2"ø PCS 7 ABS Reducer Elbow 3"ø-2"ø PCS 8 ABS TEE Elbow 2"ø-2"ø-2"ø PCS 1 9 ABS TEE Elbow 3"ø-3"ø-3"ø PCS 10 ABS Tee Reducer Elbow PCS 3"ø-3"ø-1 1/2"ø 11 ABS Tee Reducer Elbow 3"ø-3"ø-2"ø PCS 12 ABS Vent Cap Elbow PCS 2"ø 13 ABS Vent Cap Elbow 3"ø PCS 14 PEX 90 Degree Elbow 1/2"ø-1/2"ø PCS 27 15 PEX 90 Degree Elbow 3/4"ø-3/4"ø PCS 16 PEX Tee Elbow 1/2"ø-1/2"ø-1/2"ø PCS 4 17 PEX Tee Elbow 3/4"ø-3/4"ø-3/4"ø PCS 18 PEX Transition Elbow PCS 1"ø-3/4"ø 19 PEX Transition Elbow 3/4"ø-1/2"ø PCS 20 PVC 90 Deg Bend Elbow PCS 2"ø-2"ø 21 21 PVC TEE Elbow 2"ø-2"ø-2"ø PCS 3

PCS

1

2"ø-2"ø-2"ø-2"ø



		Orion-S	tudio-R	anch-Bas	e		
		HVAC SYSTEM MA	TERIAL	_ SHOPP	ING LIST		
No.	Item	Туре	Unit	Quantity	Unit Price	Total	Description
	HVAC_DUCTS						
1	PIPE (REFRIGERANT LINE)	1/4" (Ø)	FT	0.59			
2	PIPE (REFRIGERANT LINE)	3/8" (Ø)	FT	42.03			
3	PIPE (REFRIGERANT LINE)	1/2" (Ø)	FT	0.62			
4	PIPE (REFRIGERANT LINE)	3/4''' (Ø)	FT	51.94			
5	DRAYER HOSE	4" (Ø)	FT	4.07			
6	FLEX DUCT ROUND	4" (Ø)	FT	7.97			
	DUCT FITTINGS & ACCESSORIES						
7	ELBOW (REFRIGERANT LINE)	1/2" (Ø)-1/2" (Ø)	PCS	1			
8	ELBOW (REFRIGERANT LINE)	3/4" (Ø)-3/4" (Ø)	PCS	12			
9	ELBOW (REFRIGERANT LINE)	3/8" (Ø)-3/8" (Ø)	PCS	8			
10	TRANSITION (REFRIGERANT LINE	3/4" (Ø)-1/2" (Ø)	PCS	2			
11	TRANSITION (REFRIGERANT LINE	3/4" (Ø)-5/8" (Ø)	PCS	1			
12	TRANSITION (REFRIGERANT LINE	3/8" (Ø)-1/4" (Ø)	PCS	1			
	HVAC_EQUIPMENTS						
14	AIR HANDLING UNIT	WALL MOUNTED	PCS	1			
15	CONDENSER	OUTDOOR UNIT	PCS	1			
16	EXHAUST FAN	75 CFM	PCS	1			
17	EXHAUST HOOD	WALL MOUNTED	PCS	1			
18	HOOD-WALL: VENT	HOOD-WALL: VENT	PCS	1			
19	DRAYER: VENT	DRAYER: VENT	PCS	1			
20	ROOF VENT	3"(Ø)	PCS	1			



Table Of Content

#	Name	Link	Page No
1	Cover Page	Cover Page	1
2	TOC	TOC	2
3	ELECTRICAL BOM	ELECTRICAL BOM	3
5	HVAC BOM	HVAC BOM	7
4	PLUMBING BOM	PLUMBING BOM	10
6	ARCHITECTURAL BOM	ARCHITECTURAL BOM_	15

Have It Your Way!

The material types listed in this document were selected based on personal preferences. The Customer is encouraged to make changes to the material types in accordance with local customs, regulations, and personal preferences. Have It Your Way!

GENERAL NOTES

- This BOM (Bill of Materials) is prepared as a Materials Shopping List to help builders and DIYers gain a complete understanding of most if not all elements required for the complete construction of this structure, according to the original design documents provided by FrameUpNow.
- 2 All quantities and specifications are subject to change based on the final design, field measurements, availability of products and customer preferences. The customer should verify all information prior to purchasing materials.
- 3 All products and elements in the list shall conform to the International Residential Code (IRC), or any other local and international building codes, safety regulations, and standards that are applicable to the location of the structure.
- 4 If any changes are made by the customer to the list of materials specified in this document, the customer is responsible for assuring that the correct type and quantity of materials are utilized in accordance with local building codes.
- FrameUpNow, will not be held responsible for any misuse of this document, the products listed, or for deviations from the content that are made due to changes in specifications, pricing, availability, or customer preferences.
- 6 The customer is advised to consult a qualified professional or technician prior to purchasing materials for specialized construction system items. Some items including but not limited to caseworks, doors and windows may require as built measurements prior to purchase to confirmation of final dimensions.
- 7 If there are additional trim elements or specific installation methods, the total amount of materials needed might vary. Consider any additional trim required for corners, intersections, or other architectural details that might cause this variations before procedding to purchase and construction.



			LIGHTING FIXTURES				
#	Lighting	Туре	Description, Manufacturer, SKU	Unit	Quantity	Unit Price	Total
1	Kitchen Ceiling Light			PCS	3		
2	Kitchen Wall Mounted Light			PCS	0		
3	Exterior Wall Mounted Light			PCS	2		
4	Livingroom Ceiling Light With Fan			PCS	1		
5	Bedroom Ceiling Light With Fan			PCS	0		
6	Dining Ceiling Light			PCS	0		
7	Bath Wall Mounted Light			PCS	1		
8	Bathroom Ceiling Light			PCS	2		
9	Livingroom Ceiling Light			PCS	3		
10	Bedroom Ceiling Light			PCS	0		
11	Hall & Entry Ceiling Light			PCS	3		
12	Closet Ceiling Light			PCS	0		
13	Smoke Detector			PCS	0		
14							
15							



			ELECTRICAL FITTINGS				
#	Item	Туре	Description, Manufacturer, SKU	Unit	Quantity	Unit Price	Total
1	Standard Receptacle 120V	20A		PCS	3		
2	GFCI Receptacle 120V	20 A		PCS	8		
3	GFCI Receptacle 240V	30 A		PCS	2		
4	GFCI Receptacle 240V	50 A		PCS	1		
5	GFCI Receptacle 240V	60 A		PCS	1		
6	Fan Switch			PCS	1		
7	Single Pole Switch			PCS	5		
8	Three Way Switch			PCS	2		
9	Dimmer Switch			PCS	1		
10							
11							
12							
13							
14							
15							



			ELECTRICAL CONDUITS & WIRING				
#	Item	Туре	Description, Manufacturer, SKU	Unit	Quantity	Unit Price	Total
L	ROMEX 14 AWG	14/2/W/ground		FT	50		
2	ROMEX 12 AWG	12/3/W/ground		FT	190		
3	ROMEX 12 AWG	12/2/W/ground		FT	0		
ļ	ROMEX 10 AWG	10/3/W/ground		FT	0		
5	ROMEX 10 AWG	10/2/W/ground		FT	52		
5	Romex 8 AWG	8/3/W/ground		FT	0		
7	Romex 8 AWG	8/2/W/ground		FT	15		
3	ROMEX 6 AWG	6/2/W/ground		FT	14		
9	Bare Copper Ground Wire 6 AWG			FT			
LO							
l1							
12							
L3							
L4							
L5							



	1		ELECTRICAL BOXES & CIRCUTE	S			
‡	Item	Туре	Description, Manufacturer, SKU	Unit	Quantity	Unit Price	Total
1	Panelboard -240V 1 Phase MLO	200 AMP		PCS	1		
2	Circuit breaker	15 A		PCS	2		
3	Circuit breaker	20 A		PCS	8		
1	Circuit breaker	30 A		PCS	2		
5	Circuit breaker	50 A		PCS	1		
6	Circuit breaker	60 A		PCS	1		
7	Single Gang Switch Box			PCS	1		
8	Double Gang Switch Box			PCS	0		
9	Triple Gang Switch Box			PCS	2		
10	Pull Box	#1/4		PCS	9		
11	Receptacle Box			PCS	19		
12							
13							
14							
15							



			HVAC_DUCTS 01				
#	Item	Туре	Description, Manufacturer, SKU	Unit	Quantity	Unit Price	Total
1	PIPE (REFRIGERANT LINE)			FT	0.59		
2	PIPE (REFRIGERANT LINE)	3/8" (Ø)		FT	42.03		
3	PIPE (REFRIGERANT LINE)	1/2" (Ø)		FT	0.62		
4	PIPE (REFRIGERANT LINE)	3/4"' (Ø)		FT	51.94		
5	DRAYER HOSE	4" (Ø)		FT	4.07		
6	FLEX DUCT ROUND	4" (Ø)		FT	7.97		



			DUCT FITTINGS & ACCESSORIES				
#	Item	Туре	Description, Manufacturer, SKU	Unit	Quantity	Unit Price	Total
1	ELBOW (REFRIGERANT LINE)	1/2" (Ø)-1/2" (Ø)		PCS	1		
2	ELBOW (REFRIGERANT LINE)	3/4" (Ø)-3/4" (Ø)		PCS	12		
3	ELBOW (REFRIGERANT LINE)	3/8" (Ø)-3/8" (Ø)		PCS	8		
4	TRANSITION (REFRIGERANT LINE)	3/4" (Ø)-1/2" (Ø)		PCS	2		
5	TRANSITION (REFRIGERANT LINE)	3/4" (Ø)-5/8" (Ø)		PCS	1		
6	TRANSITION (REFRIGERANT LINE)	3/8" (Ø)-1/4" (Ø)		PCS	1		
7							
8							
9							
10							
11							
12							



			HVAC_EQUIPMENTS				
#	Item	Туре	Description, Manufacturer, SKU	Unit	Quantity	Unit Price	Total
1	AIR HANDLING UNIT	WALL MOUNTED		PCS	1		
2	CONDENSER	OUTDOOR UNIT		PCS	1		
3	EXHAUST FAN	75 CFM		PCS	1		
1	EXHAUST HOOD	WALL MOUNTED		PCS	1		
5	HOOD-WALL: VENT	HOOD-WALL: VENT		PCS	1		
5	DRAYER: VENT	DRAYER: VENT		PCS	1		
7	ROOF VENT	3"(Ø)		PCS	1		



	PLUMBING FIXTURES & ACCESSORIES									
#	Item	Туре	Description, Manufacturer, SKU	Unit	Quantity	Unit Price	Total			
1	Bath Tub (Alcove Tub)			PCS	0					
2	Kitchen Sink			PCS	1					
3	Kitchen faucets			PCS	1					
4	Vanity Sink			PCS	1					
5	Bath room faucets			PCS	1					
6	Water Closet			PCS	1					
7	Shower Trim			PCS	1					
8	Shower Tray			PCS	1					
9	Water Heater			PCS	1					
10	Hose Bib			PCS	1					
11	Shutoff Valve			PCS	6					
12	Hanging pipe clamp			PCS	16					
13	Gate Valve			PCS	1					
14	Dishwasher Supply Single Connector			PCS	1					
15	Dishwasher Sewage Single Connector			PCS	1					
16	Laundry Sweat Connector			PCS	1					



		SAN	ITARY & PLUMBING PIPES				
#	Item	Туре	Description, Manufacturer, SKU	Unit	Quantity	Unit Price	Total
1	ABS (Acrylonitrile Butadiene Styrene) Pipes	ø 1"		FT	0		
2	ABS (Acrylonitrile Butadiene Styrene) Pipes	ø 1 1/2"		FT	9		
3	ABS (Acrylonitrile Butadiene Styrene) Pipes	ø 2"		FT	35		
4	ABS (Acrylonitrile Butadiene Styrene) Pipes	ø 3"		FT	34		
5	PEX (Cross-linked polyethylene) Pipes	ø 1/2"		FT	88		
6	PEX (Cross-linked polyethylene) Pipes	ø 3/4"		FT	38		
7	PEX (Cross-linked polyethylene) Pipes	ø 1"		FT	0		
8	PVC Pipes Sch.80 - Rigid	ø 1 1/2"		FT	0		
9	PVC Pipes Sch.80 - Rigid	ø 2"		FT	91		
10	PVC Pipes Sch.80 - Rigid	ø 3"		FT	0		
11	Flex Pipe Round	ø 1/2"		PCS	6		
12							
13							
14							
15							



		Р	IPE FITTINGS 01				
#	Item	Туре	Description, Manufacturer, SKU	Unit	Quantity	Unit Price	Total
1	ABS 90 Degree Bend Elbow	1 1/2"ø-1 1/2"ø		PCS	2		
2	ABS 90 Degree Bend Elbow	2"ø-2"ø		PCS	2		
3	ABS 90 Degree Bend Elbow	3"ø-3"ø		PCS	2		
4	ABS P-Trap	1 1/2"ø-1 1/2"ø		PCS	3		
5	ABS P-Trap	2"ø-2"ø		PCS	2		
6	ABS Reducer Elbow	2"ø-1 1/2"ø		PCS	1		
7	ABS Reducer Elbow	3"ø-2"ø		PCS	1		
8	ABS TEE Elbow	2"ø-2"ø-2"ø		PCS	1		
9	ABS TEE Elbow	3"ø-3"ø-3"ø		PCS	2		
10	ABS Tee Reducer Elbow	3"ø-3"ø-1 1/2"ø		PCS	2		
11	ABS Tee Reducer Elbow	3"ø-3"ø-2"ø		PCS	1		
12	ABS Vent Cap Elbow	2"ø		PCS	2		
13	ABS Vent Cap Elbow	3"ø		PCS	1		
14	PEX 90 Degree Elbow	1/2"ø-1/2"ø		PCS	27		
15	PEX 90 Degree Elbow	3/4"ø-3/4"ø		PCS	7		



		PI	PE FITTINGS 02				
#	Item	Туре	Description, Manufacturer, SKU	Unit	Quantity	Unit Price	Total
1	PEX Tee Elbow	1/2"ø-1/2"ø-1/2"ø		PCS	4		
2	PEX Tee Elbow	3/4"ø-3/4"ø-3/4"ø		PCS	3		
3	PEX Transition Elbow	1"ø-3/4"ø		PCS	2		
4	PEX Transition Elbow	3/4"ø-1/2"ø		PCS	7	,	
5	PVC 90 Deg Bend Elbow	2"ø-2"ø		PCS	21		
6	PVC TEE Elbow	2"ø-2"ø-2"ø		PCS	3		
7	WASTE DOUBLE TEE	2"ø-2"ø-2"ø		PCS	1		
8							
9							
10							
11							
12							
13							
14							
15							



			APPLIANCES				
#	Item	Туре	Description, Manufacturer, SKU	Unit	Quantity	Unit Price	Total
1	Refrigerator			PCS		1	
2	Range			PCS		1	
3	Washer Front Load	Stackable		PCS		1	
4	Dryer Front Load	Stackable		PCS		1	
5	Dish Washer			PCS		0	
6	Oven			PCS		0	
7	Microwave			PCS		0	
8							
9							
10							
11							
12							
13							
14							
15							
16							



			CASEWORKS 01				
#	Item	Туре	Description, Manufacturer, SKU	Unit	Quantity	Unit Price	Total
1	Kitchen Cabinet			FT	13.7		
2	Laundry Cabinet			FT	2.25		
3	Vanity Cabinet			FT	2.5		
4	Medicine Cabinet			PCS	1		
5	Kitchen countertop			SF	20.21		
6	Laundry Countertop			PCS	0		
7	Bathroom Countertop			SF	0		
8	Island			FT	0		
9	Peninsula			FT	0		
10	Closets			SF	23.37		
11							
12							
13							
14							
15							



			CEILING 01				
#	Item	Туре	Description, Manufacturer, SKU	Unit	Quantity	Unit Price	Total
	LIVINGROOM + KITCHEN			SF	268.5		
1	Ceiling Board	Drywall		SF	268		
2	Drywall Fastener	Screw		PCS	470		
3	Vapor Retarder	Polyethylene film		SF	268		
4	Vapor Retarder Fastener	Nails with washer heads		PCS	805		
	BATHROOM			SF	54		
5	Ceiling Board	MRD (Moisture resistant drywall)		SF	54		
6	MRD Fastener	Screw		PCS	94		
	HALL + WD			SF	26.3		
7	Ceiling Board	Drywall		SF	26		
8	Drywall Fastener	Screw		PCS	46		
9	Vapor Retarder	Polyethylene film		SF	26		
10	Vapor Retarder Fastener	Nails with washer heads		PCS	79		



			CEILING 02				
#	Item	Туре	Description, Manufacturer, SKU	Unit	Quantity	Unit Price	Total
	CLOSET			SF	12.2		
13	Ceiling Board	Drywall		SF	12		
14	Drywall Fastener	Screw		PCS	21		
15	Vapor Retarder	Polyethylene film		SF	12		
16	Vapor Retarder Fastener	Nails with washer heads		PCS	37		
	WH			SF	7.3		
17	Ceiling Board	Drywall		SF	7		
18	Drywall Fastener	Screw		PCS	13		
19	Vapor Retarder	Polyethylene film		SF	7		
20	Vapor Retarder Fastener	Nails with washer heads		PCS	22		



			FLOORING INTERIOR 01				
#	Item	Туре	Description, Manufacturer, SKU	Unit	Quantity	Unit Price	Total
	CLOSET						
1	Closet Flooring			SF	8		
2	Wood underlay	Foam Pad Polyethylene		SF	8		
3	Vapor Retarder	Vapor Barrier Polyethylene		SF	8		
	LIVING ROOM AND KITCHE	EN					
4	Living Area Flooring			SF	198		
5	Wood underlay	Foam Pad Polyethylene		SF	198		
6	Vapor Retarder	Vapor Barrier Polyethylene		SF	198		
	BATHROOM						
7	Tile Finish			SF	30		
8	Adhesive	1/2" Thin set Mortar		SF	30		
9	Vapor Retarder	Vapor Barrier Polyethylene		SF	30		
	W/D						
10	Tile Finish			SF	8		
11	Adhesive	1/2" Thin set Mortar		SF	8		
12	Vapor Retarder	Vapor Barrier Polyethylene		SF	8		



			FLOORING INTERIOR 02				
#	Item	Туре	Description, Manufacturer, SKU	Unit	Quantity	Unit Price	Total
	BOILER ROOM						
1	Tile Finish			SF	7		
2	Adhesive	1/2" Thin set Mortar		SF	7		
3	Vapor Retarder	Vapor Barrier Polyethylene		SF	7		



			FLOORING EXTERIOR				
#	Item	Туре	Description, Manufacturer, SKU	Unit	Quantity	Unit Price	
	STRUCTURE			SF	306.0		
1	Concrete Slab	4"concrete cast in situ		CF	102		
2	Insulation	Rigid insulation		SF	141		
3	Hard core	Compacted soil		CF	73.28		
4	Re-bar	#4 re-bar		Ton	0.33		
5	Concrete Pad	4"concrete cast in situ		CF	1.58		
6	Slab edge	Turndown		CF	117.6		



			WALLS: EXTERIOR				
#	Item	Туре	Description, Manufacturer, SKU	Unit	Quantity	Unit Price	Total
1	Exterior Stone			SF	169		
2	Exterior-Grade Plywood Horizontal Siding			SF	418		
3	Exterior-Grade Plywood Fastener 8/panel	Self-drilling screws(100/pkt)		PKT	4.18		
4	Wall Shteathing (OSB)			SF	587		
5	Shteathing Fastener	Self-drilling screws(100/pkt)		PKT	5.87		
6	Wall Homewrap			SF	587.00		
7	Homewrap Fastener	Stapled fastener (200/pkt)		PKT	2.23		
8	Furring Strip			PCS	52.25		
9	Furring Strip Fastener	Self-drilling screws(100/pkt)		PKT	4.18		
10	Wall Paint			SF	587		
11	Stone Copping	Masonry stone		SF	0		
12	Stone Veneer	Masonry stone		SF	0		
13	Mortar for Stone Veneer			SF	0		
14	Wall Insulation			SF	1676		
15							



			WALLS: INTERIOR 01				
#	Item	Туре	Description, Manufacturer, SKU	Unit	Quantity	Unit Price	Total
	BATHROOM			SF	42.0		
1	Cementitious Backer Board			SF	219		
2	Kerdi membrane			SF	219		
3	Kerdi membrane Fastener			SF	219		
4	Wall Ceramic Tile			SF	219		
	CLOSET			SF	9.0		
5	Drywall Board			SF	79		
6	Drywall Fastener	Self-drilling screws(100/pkt)		PKT	0.79		
7	Wall Paint			SF	79		
8	Drywall Tape			FT	14.81342584		
	HALL			SF	29.0		
9	Drywall Board			SF	125		
10	Drywall Fastener	Self-drilling screws(100/pkt)		PKT	1.25		
11	Wall Paint			SF	125		
12	Drywall Tape			FT	23.43896494		



			WALLS: INTERIOR 02				
#	Item	Туре	Description, Manufacturer, SKU	Unit	Quantity	Unit Price	Total
	STUDIO			SF	112.0		
13	Drywall Board			SF	231		
14	Drywall Fastener	Self-drilling screws(100/pkt)		PKT	2.31		
15	Wall Paint			SF	231		
16	Drywall Tape			FT	43.33958724		
	KITCHEN			SF	55.0		
17	Cementitious Backer Board			SF	25		
18	Drywall Board			SF	143		
19	Drywall Fastener	Self-drilling screws(100/pkt)		PKT	1.43		
20	Kerdi membrane			SF	25		
21	Kerdi membrane Fastener			SF	25		
22	Wall Ceramic Tile			SF	25		
23	Wall Paint			SF	143		
24	Drywall Tape			FT	26.98113208		



			WALLS: INTERIOR 03				
#	Item	Туре	Description, Manufacturer, SKU	Unit	Quantity	Unit Price	Total
	WD			SF	7.0		
29	Cementitious Backer Board			SF	68		
30	Kerdi membrane			SF	68		
31	Kerdi membrane Fastener			SF	68		
32	Wall Ceramic Tile			SF	68		
	WH			SF	7.0		
33	Drywall Board			SF	90		
34	Drywall Fastener	Self-drilling screws(100/pkt)		PKT	0.9		
35	Wall Paint			SF	90		
36	Drywall Tape			FT	16.98113208		
1	Wall Sweep						
				FT	45.5		



			DOORS				
#	Item	Туре	Description, Manufacturer, SKU	Unit	Quantity	Unit Price	Total
1	Exterior Swinging	3' - 0" X 6'-8"		PCS	1		
2	Interior Swinging	2' - 4" X 6'-8"		PCS	1		
3	Interior Sliding	3' - 0" X 6'-8"		PCS	1		
4	Interior Swinging	2' - 8" X 6'-8"		PCS	1		
5	Exterior Door Trim			FT	16.3	3	
6	Interior Door Trim			FT	112		
7	Entry Lock set			PCS	1		
8	Privacy Lock set			PCS	1		
9	Passage Lock set			PCS	2		
10							
11							
12							
13							
14							
15							



			WINDOWS				
#	Item	Туре	Description, Manufacturer, SKU	Unit	Quantity	Unit Price	Total
1	Single Hung	3' - 3" X 3'-3"		PCS	2		
2	Sliding	5' - 3" X 3'-3"		PCS	1		
3	Sliding	3' - 3" X 2'-3"		PCS	1		
4	Sliding	3' - 3" X 1'-9"		PCS	1		
5	Exterior Window Trim			FT	65		
6	Interior Window Trim			FT	65		
7							
8							
9							
10							
11							
12							
13							
14							
15							



			ROOF 01				
#	Item	Туре	Description, Manufacturer, SKU	Unit	Quantity	Unit Price	Total
1	Roof Covering			SF	827.0		
2	Roof Covering Fastener			PCS	414		
3	Roof Felt Paper			SF	827.0		
4	Roof Felt Paper Fastener			PCS	2481.0		
5	Roof Sheathing			SF	827.0		
6	Roof Sheathing Fastener			PCS	6616		
7	Batten			FT	215.0		
8	Batten Fastener			PCS	161.7		
9	Soffit			SF	0.0		
10	Soffit Fastener			PCS	0.0		
11	Fascia			FT	82.0		
12	Fascia board fastener			PCS	41		
13	Roof Insulation			SF	827.0		
14							
15							