

ORION

The Orion is a charming Craftsman-style onebedroom, one-bathroom home designed for comfortable and efficient living. The exterior walls are finished with horizontal siding in a warm, earthy tone, creating a clean and traditional aesthetic. The gable end features wood shingles, adding a touch of natural texture and visual interest. A prominent covered porch spans the front of the home, supported by substantial stone-clad pillars and a decorative pergola, creating a welcoming outdoor space.

Inside, the Orion features a simple rectangular plan. The living, dining, and kitchen areas are seamlessly merged into a single large room at one end of the house, creating a spacious and versatile living space. The bedroom is thoughtfully located on the other end of the plan, offering a private and quiet retreat. Functional spaces, such as the bathroom and laundry, are strategically placed between the living area and the bedroom, creating a clear separation and enhancing the overall functionality of the home.

Materials Shopping List

Please print and take this Materials Shopping List to your favorite Home Depot and ask for assistance in selecting the materials, fixtures and fittings to complete your new home.

Record your selection and the price of the item. Then do the math to determine the cost for your selections and the total cost of finishing your home.

< CLICK HERE >

To Go To Materials Shopping List



PORCH 262 SF 10' - 10"

FLOOR PLAN

730 SF

PLUMBING

MECHANICAL

ELECTRICAL

MATERIALS

WATER SUPPLY & SEWAGE SYSTEM # 38

SHOPPING LIST

MATERIALS SHOPPING LIST -

TABLE OF CONTENTS

RENDERINGS	■ ABOUT THE HOME ⊢	— 01
1	RENDERINGS -	— 01
FLOOR PLAN	SCHEMATIC FLOOR PLAN	0 1
1	HOME SPECS -	— 01
	DISCLAIMER -	 01
ABOUT	ABOUT FrameUpNow ⊢	— 01
1	ABOUT HouseDocs -	— 01
DESCRIPTIONS	BOM (Bill Of Materials) ⊢	— 02
2	STRUCTURAL	 02
	ARCHITECTURAL	─ 0 2
	MECHANICAL -	 02
	ELECTRICAL	 02
	PLUMBING -	 02
MATERIALS LIST	MATERIALS LIST PREVIEW	02
HOW TO BUILD	CONSTRUCTION STEPS -	 02

ARCHITECTURAL

COVER SHEET
FLOOR PLAN
DIMENSION PLAN
FOUNDATION PLAN
STRUCTURAL FLOOR PLAN
WALL FRAME LAYOUT
ROOF TRUSS LAYOUT
ROOF PLAN - 1
ARCHITECTURAL ELEVATIONS - 1
ARCHITECTURAL ELEVATIONS - 1
ARCHITECTURAL SECTIONS - 1
ARCHITECTURAL DETAILS - 1
ARCHITECTURAL CASEWORK 1
OOVED OUEET

STRUCTURAL

COVER SHEET -	⊣ 16
GENERAL NOTES	⊣ 17
WALL FRAME LAYOUT	⊣ 18
WALL PANEL & LAYOUT PLAN	⊣ 19
ROOF TRUSS LAYOUT	→ 20
STRUCTURAL SECTIONS	□ 21
WALL BRACING LAYOUT	□ 22
HOLD-DOWN PLAN	→ 23
STRUCTURAL DETAILS 1	- 24
STRUCTURAL DETAILS 2	□ 25
STRUCTURAL DETAILS 3	⊸ 26
TRUSS BLOCKING LAYOUT	⊸ 27
SHEETROCK BACKING -	− 28
ROOF BRACING LAYOUT	− 29
COVER SHEET -	30
HVAC PLAN -	⊣ 31
COLIEDUILE	20
SCHEDULE -	~
LIGHTING -	
POWER PLAN	
DIMENSION FOR LIGHTING -	
DIMENSION FOR FITTING -	⊣ 36
NOTES AND SCHEDULES -	⊣ 37

DISCLAIMER

DISCLAIMER: This documentation and all it's contents are the intellectual property of FrameUpNow. It is provided solely for marketing the services of FrameUpNow. The preliminary information is not approved for actual construction use and is not warranted to be complete or accurate. Unauthorized copying, distribution, or application of these proprietary materials, in any form or format, is strictly prohibited. FrameUpNow assumes no liability for any issues arising from improper use of this marketing content.





FrameUpNow is a design and manufacturing company providing precision-engineered home framing solutions. We offer a catalog of Affordable Homes, Tiny Homes, Garages, Shops and Barndominiums. FrameUpNow manufactures cold-formed steel (CFS) also known as Light Gauge Steel (LGS) framing components that conform to our engineered metal house frame plans or can be purchased as DIY skeleton kits.

The CFS/LGS framing is lightweight, easily assembled, and does not require heavy equipment or specialized labor, enabling homeowners to erect the frame themselves in just a few days. Unlike wood, the steel framing is impervious termites and bores, warping, expansion, and fire.

Our home plans come complete with a structural engineered stamp for permit approvals. Customers receive a full BOM also known as a Materials Shopping List to purchase finish materials from a Building Materials retailer. FrameUpNow prides itself on the quality and efficiency of our precision-engineered home framing solutions for construction professionals and DIY homeowners.



KEY PLAN

NO.	DESCRIPTION	DATE
	,	

NOTE:

LEGEND:

PROJECT

125-Orion-730-1Bd1Ba-Craftsman-Porch-550

DRAWING NAME

INTRODUCTION

CLIENT NAME:
PROJECT NUMBER:
DATE:
DESIGNED BY:
DRAWN BY:
CHECKED BY:

I101

SCALE:

DESCRIPTIONS

MATERIALS LIST

The BOM (Bill Of Materials) package, known as the Materials Shopping List document, provides:

Comprehensive Inventory: Detailed lists of essential materials sourced from architectural, mechanical, HVAC, electrical, and plumbing design drawing sets.

Precise Curation: Each item meticulously selected and organized for accuracy and efficiency in project planning.

Customizable Options: Customers can modify listed items to their preferences and calculate costs accordingly, ensuring alignment with personal project needs and budget.

Dedicated Space for Details: Includes tables for customers to note Home Depot SKU numbers or product descriptions for selected items, facilitating seamless purchasing and coordination with suppliers.

Customer Convenience: Take the list to Home Depot or preferred suppliers for accurate pricing, helping align the total home budget with personal financial plans.

Simplify your construction journey with our Materials Shopping List document, where detailed preparation meets streamlined implementation for your dream home.

STRUCTURAL

The structural drawings package provides an exhaustive set of detailed plans essential for the precise assembly of your building. This comprehensive package includes:

Framing Plans: Detailed layouts for all framing components. Truss Layouts: Clear instructions for truss placement and

Panel Length Plans: Specifications for panel dimensions. Framing Elevations and Sections: Precise elevation and sectional views for accurate construction.

Truss and Wall Blocking Plans: Plans for truss and wall blocking to ensure structural integrity.

Hold-Down Plan: Detailed hold-down requirements for stability. Snap Sheet: Reference sheet for quick identification of components

Structural Details and Bracing Plans: Complete details and bracing plans for all structural elements.

Accompanying these plans is a comprehensive Bill of Materials (BOM) that lists every necessary building component, from cold formed steel (CFS) frames to fasteners.

ARCHITECTURAL

With the comprehensive architectural package, both builders and DIY homeowners can confidently execute the construction.

The architectural package includes:

Furnished Floor Plans: Complete with furniture layouts for a clear understanding of space utilization.

Detailed Dimension Plans: Ensures precise measurements, from the overall footprint down to the exact placement of windows and

Foundation Plan: Detailed plan to establish a solid foundation.

Wall Framing and Truss Layout: Comprehensive plans for wall framing and truss placement.

Architectural Elevations: Exterior views showcasing the design.

Strategic Building Sections: Critical cross-sectional details for a thorough understanding of the build.

Casework Drawings and Diagrams: Suggested designs for built-in caseworks, such as kitchen cabinets.

MECHANICAL

The mechanical package includes everything needed to guide HVAC

Detailed HVAC Floor Plan: Precisely maps out the placement of air handlers, ductwork, and vents throughout the home's layout.

HVAC Sections and Riser Diagrams: Technical drawings offering critical cross-sectional details and piping schematics, ensuring proper integration of the heating and cooling system into the home's structure.

Bill of Materials: A complete list of all necessary HVAC components.

ELECTRICAL

The electrical package includes all the plans and documentation needed to guide the installation of your home's electrical system:

Detailed Power Plan: Precisely maps out the placement of outlets, switches, and other power components throughout the layout.

Comprehensive Lighting Plan: Shows the optimal locations for lighting fixtures, sconces, and other illumination sources to create a well-lit, functional interior.

Dimensioned Electrical Layout: Provides exact dimensions and measurements to ensure proper placement of all electrical elements.

Bill of Materials: A complete list of every component needed, from circuit breakers to wiring.

The plumbing package includes everything needed to guide the installation of your home's water supply and drainage systems:

Detailed Water Supply System Plan: Precisely maps out the placement of pipes, valves, and plumbing fixtures throughout the

Comprehensive Sewage System Plan: Shows the optimal routing and sizing of drain lines to effectively remove waste and ensure

Detailed Riser Diagrams: Provide information needed to properly install all vertical plumbing risers and vent stacks.

pipes to fixtures.

PLUMBING

proper drainage.

Bill of Materials: A complete list of every component needed, from


BOM (Bill Of Materials) (Separately Attached)





The Bill of Materials (BOM) is a crucial document that compiles the material requirements from different disciplines into a centralized inventory, enabling efficient procurement, inventory management, and cost estimation for a specified project or

ELECTRICAL BOM



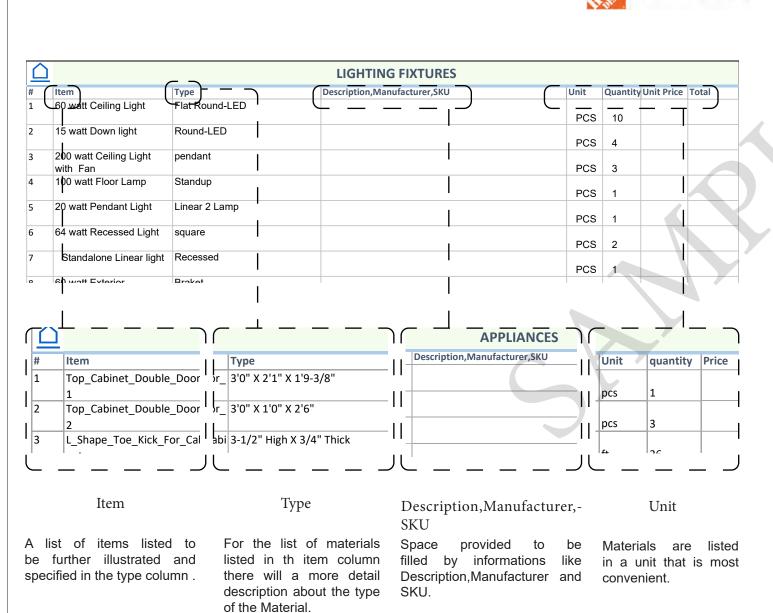

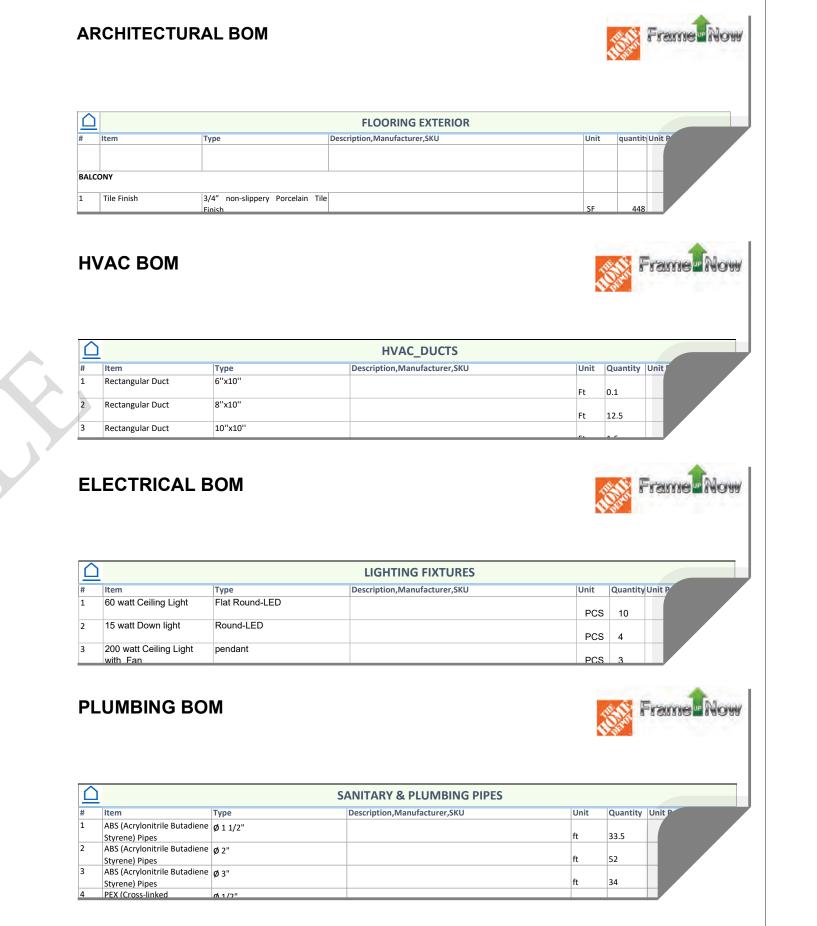

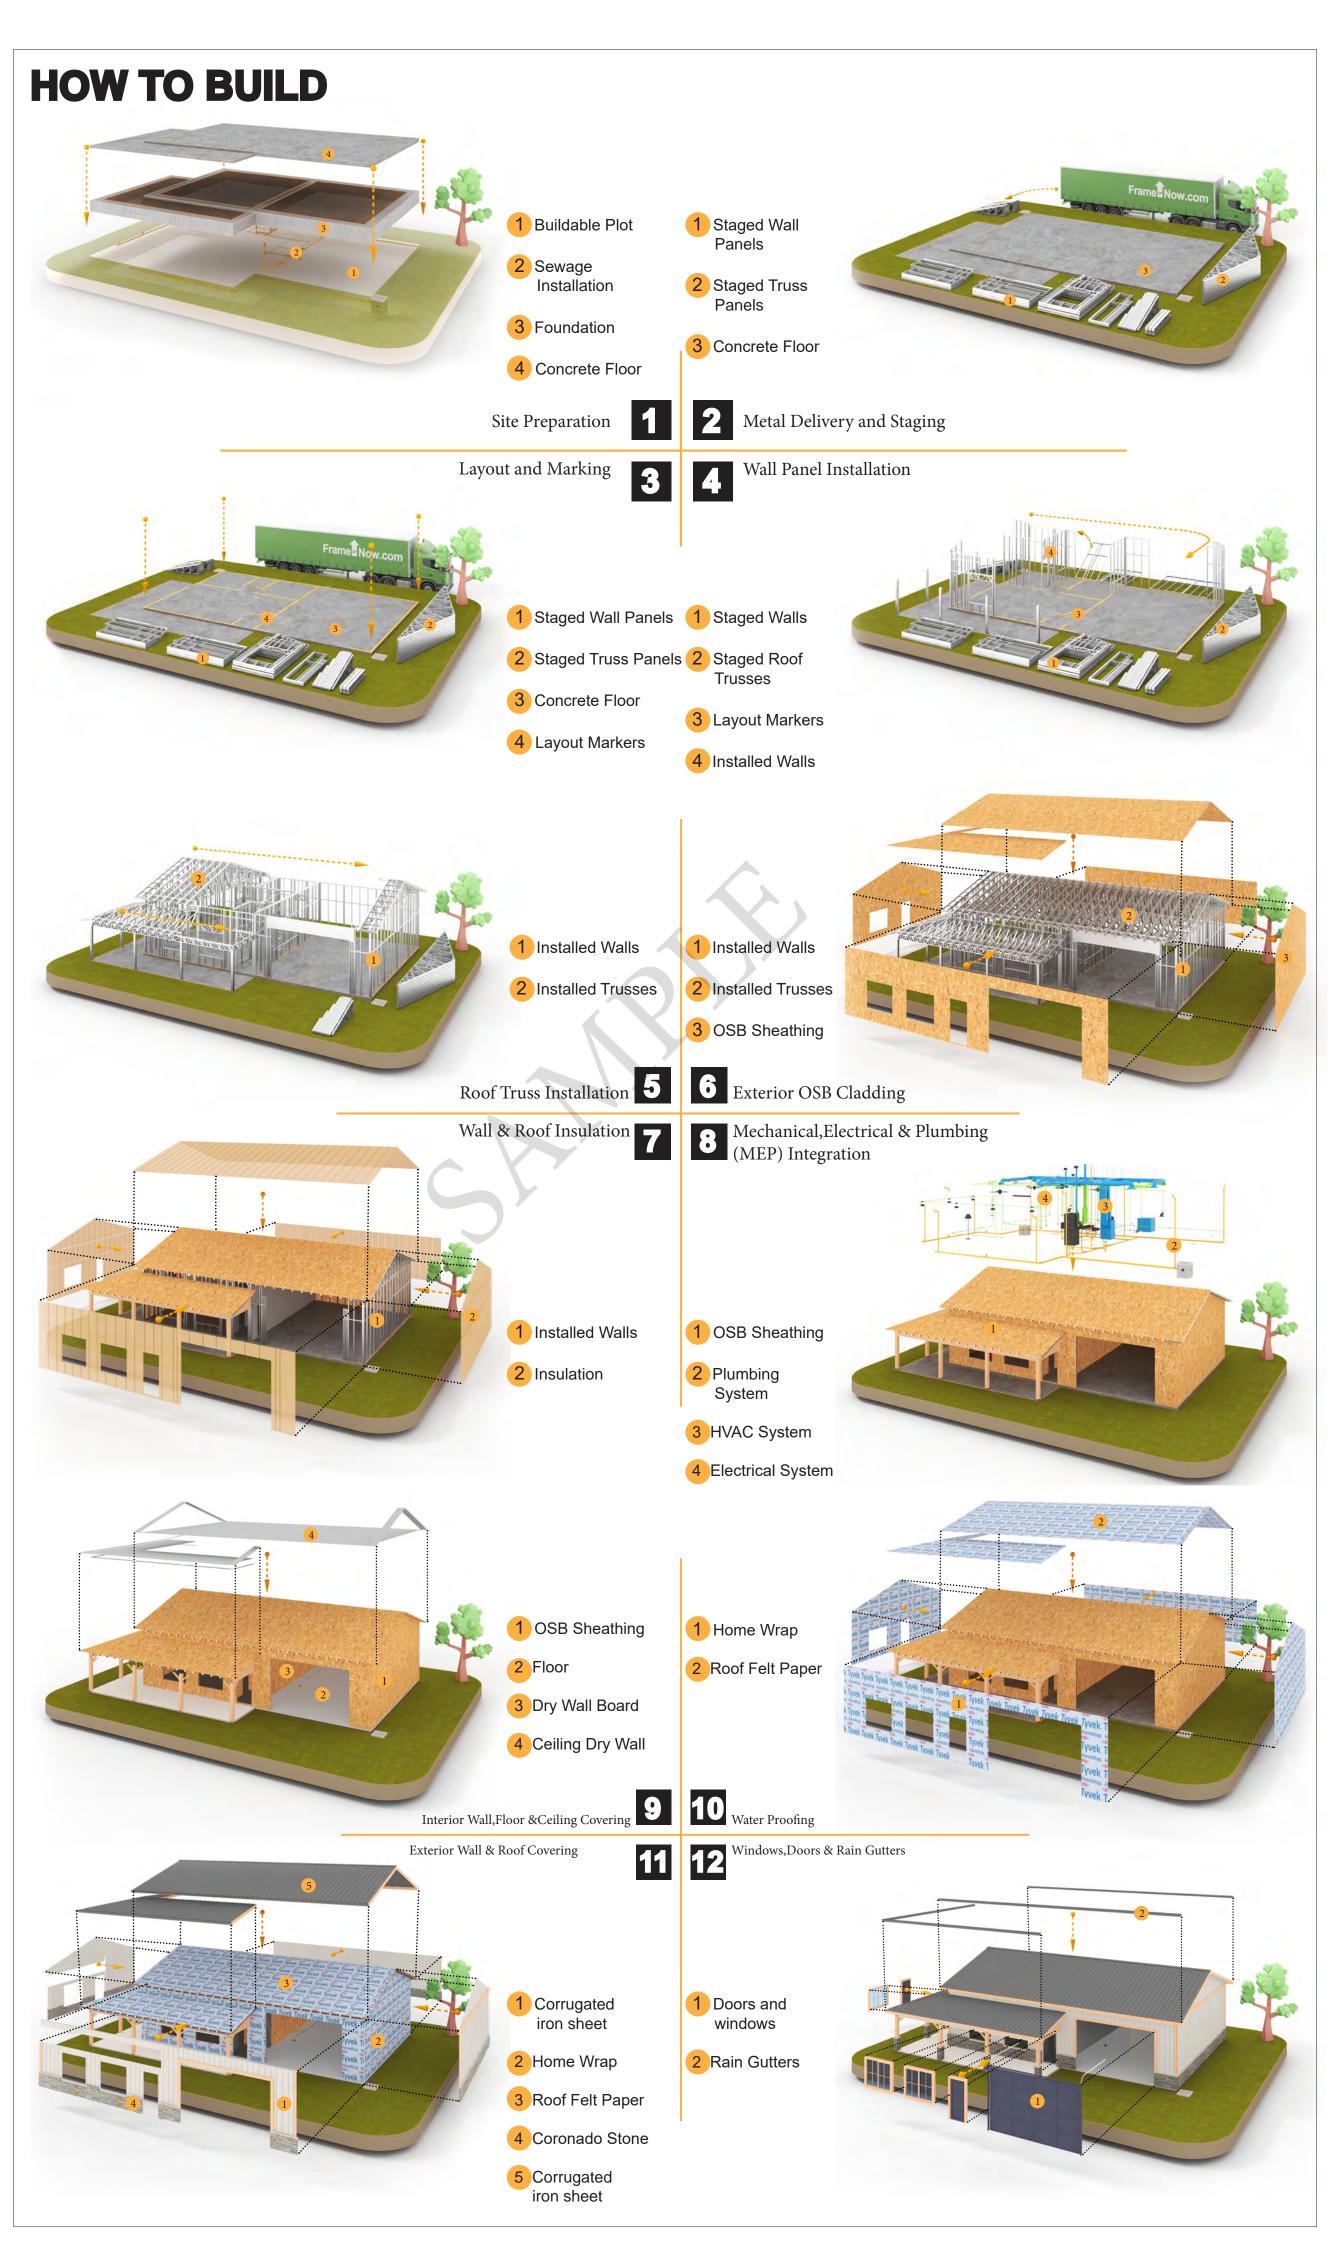



KEY PLAN

DESCRIPTION DATE

NOTE:

LEGEND:

PROJECT

125-Orion-730-1Bd1Ba-Craftsman-Porch-550


DRAWING NAME

INTRODUCTION

CLIENT NAME: PROJECT NUMBER: DATE: **DESIGNED BY** DRAWN BY: CHECKED BY:

1102

SCALE:

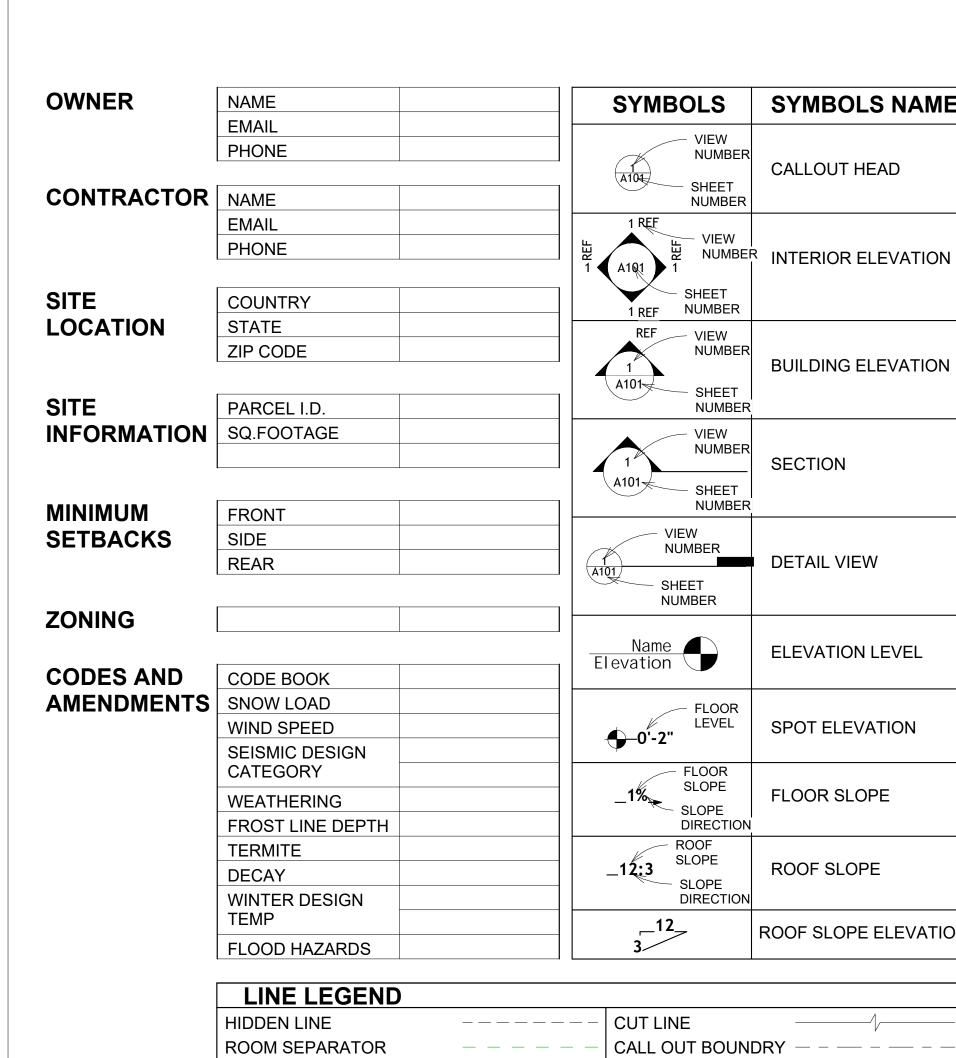

DOOR OPENING DIRECTION

OVER HEAD

OLS	SYMBOLS NAME		PAGE INDEX
– VIEW		G101	COVER SHEET
NUMBER		A101	FLOOR PLAN
SHEET	CALLOUT HEAD	A102	DIMENSION PLAN
NUMBER		S101	FOUNDATION PLAN
– VIEW		S102	STRUCTURAL FLOOR PLAN
NUMBER	INTERIOR ELEVATION	S103	FRAME LAYOUT
		S104	ROOF TRUSS LAYOUT
SHEET NUMBER		A103	ROOF PLAN
VIEW		A201	ELEVATIONS
NUMBER	D. III D.N. 10 E. E. V. E. 20	A202	ELEVATIONS
	BUILDING ELEVATION	A301	SECTIONS
SHEET NUMBER		A401	DETAILS
VIEW		A402	CASEWORK DETAILS
NUMBER	SECTION	A403	CASEWORK DETAILS
		E101	SCHEDULE
SHEET NUMBER		E102	LIGHTING PLAN
-		E103	POWER PLAN
W MBER	DETAIL VIEW	E104	DIMENSION PLAN FOR LIGHT FIXTUR
		E105	DIMENSION PLAN FOR FITTING
ET IBER		P101	COVER SHEET
		P102	WATER SUPPLY SYSTEM
	ELEVATION LEVEL	P103	SEWAGE SYSTEM
		P104	RISER DIAGRAM
		M101	HVAC PLAN
FLOOR LEVEL	SPOT ELEVATION	M102	HVAC SECTION
	OI OI LLLVATION	M103	RISER DIAGRAM
LOOR SLOPE	FLOOR SLOPE		
SLOPE			

TAG'S NAME

CASEWORK TAG

FURNITURE TAG

PE01 PLUMBING EQUIPMENT TAG

SPECIALTY EQUIPMENT TAG

MECHANICAL EQUIPMENT TAG

WINDOW TAG

DOOR TAG

0.0	ON OLIVILIX
OSB	ORIENTED STRAND BOARD
PL	PLUMBING
PSI	POUNDS PER SQUARE INCH
PVC	POLYVINYL CHLORIDE
REF	REFERENCE
RG	RIGHT GARAGE
SE	SPECIAL EQUIPMENT
SF	SQUARE FEET
SIMP. STHD8	SIMPSON STRAP THE HOLDDOWN
SIMP. ABE66	SIMPSON ANCHOR BOLT EDGE
TV	TELEVISION
UNO	UNLESS NOTED OTHERWISE
W/	WITH
W/D	WASHER/DRYER
4.0	ALD CONDITIONING LINET
AC	AIR CONDITIONING UNIT
ACC	AIR COOLED CONDENSER
ACCU	AIR COOLED CONDSENSING UNIT
AHU	AIR HANDLING UNIT
CC	COOLING COIL
CD	CEILING DIFFUSER
CFm	Cubic Feet Per Minute
CR	CEILING REGISTER
CU	CONDENSING UNIT
CW	COLD WATER
E/A	EXHAUST AIR
EF	EXHAUST FAN
ET	EXPANSION TANK
EX.	EXISTING
FC	FLEXIBLE CONNECTION
FCU	FAN COIL UNIT
FLR.	FLOOR
HC	HEATING COIL
HE	AIR TO AIR HEAT EXCHANGER
HV	HEATING AND VENTILATING UNIT
IV	INLET VANES
MER	MECHANICAL ROOM
MAX.	MAXIMUM
MIN.	MINIMUM
R/A	RETURN AIR
RCU	RECIPROCATING CHILLER UNIT
RF	RETURN FAN
	SUPPLY AIR
S/A SCD	SMOKE CONTROL DAMPER
	STATIC PRESSURE
SP	

ABBREVIATION

CASEWORK

ELECTRICAL

FOOTINGS

MAXIMUM

MINIMUM

NUMBER

ON CENTER

MECHANICAL

CONDITIONING

F.F.L

NO.

ACTION FLOOR SYSTEMS

AMERICAN SOCIETY FOR **TESTING AND MATERIAL**


FINISHED FLOOR ELEVATION

HEATING, VENTILATION & AIR

INTERNATIONAL RESIDENCE

INTERNATIONAL MECHANICAL


FINISHED FLOOR LEVEL

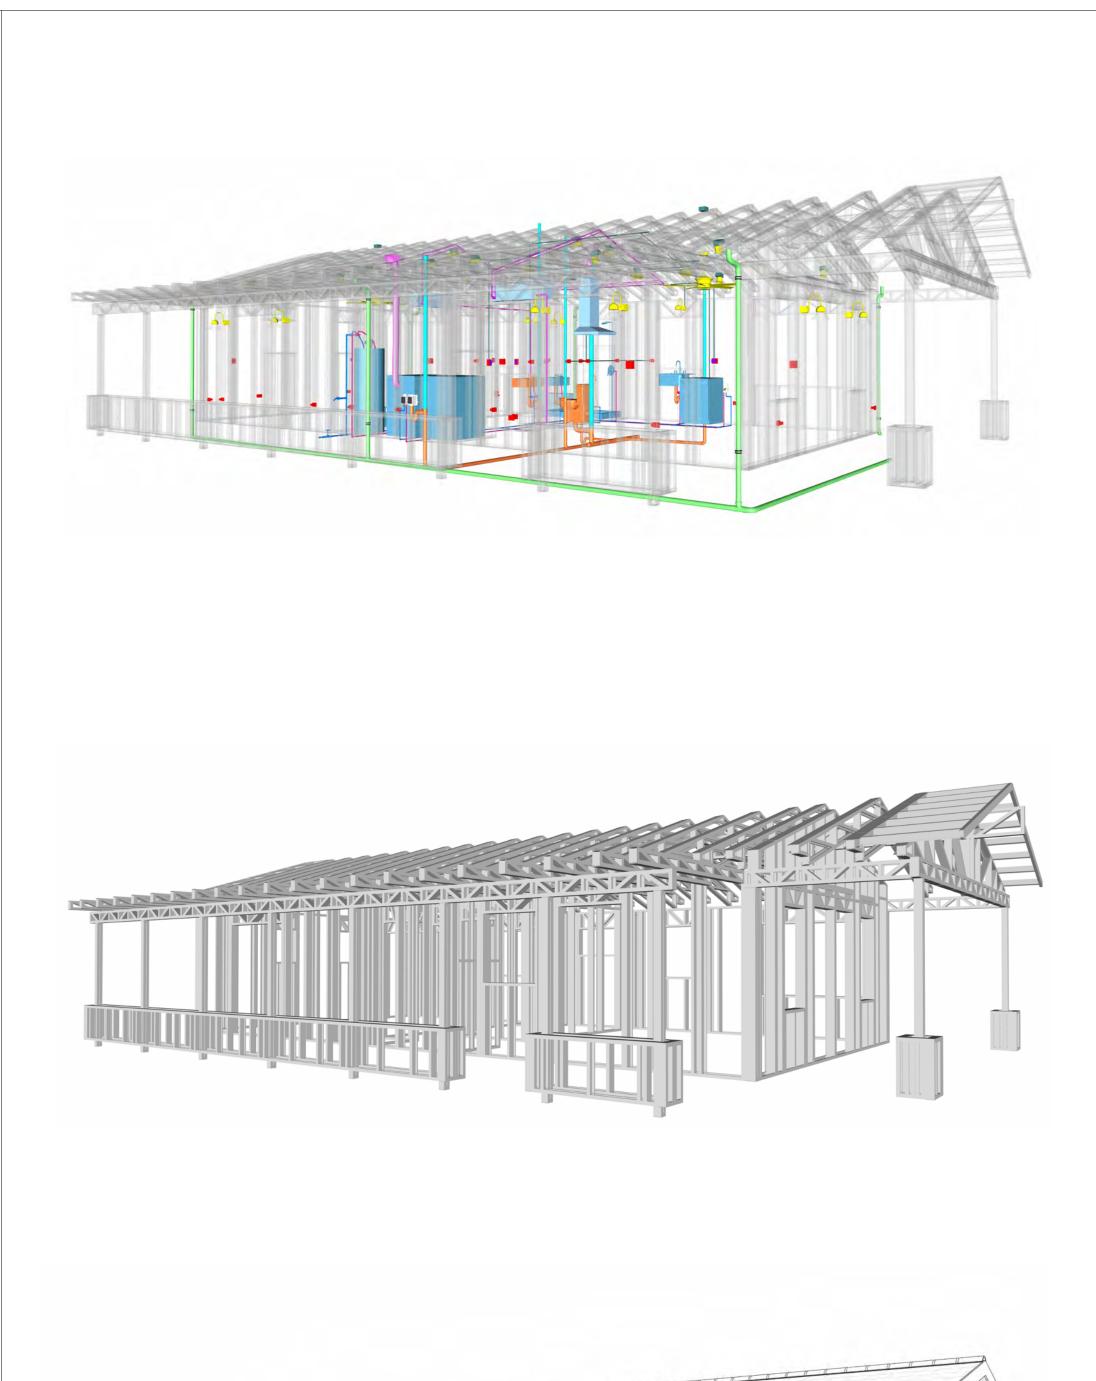



\	SQUARE FOOT	AGE
	LIVING	720
	PORCH	374
	TOTAL	1094



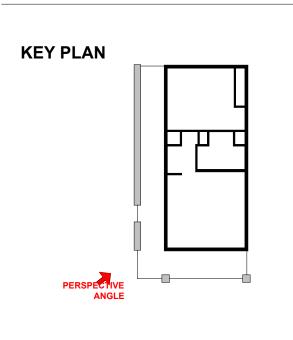

NO.	DESCRIPTION	DATE
	NO.	NO. DESCRIPTION

NOTE:

LEGEND:

PROJECT

125 ORION 730 1Bd/1Ba **CRAFTSMAN PORCH 550**

DRAWING NAME

COVER SHEET

CLIENT NAME:	Client Name
PROJECT NUMBER:	0061_12
DATE:	3/18/2025 12:53:42 PM
DESIGNED BY:	Designer
DRAWN BY:	Author
CHECKED BY:	Checker

G101

SCALE: As indicated



NUMBER

- FLOOR SLOPE

SLOPE

ROOF SLOPE

SLOPE

DIRECTION

ROOF SLOPE

ROOF SLOPE ELEVATION

SHEET NUMBER

GENERAL NOTES

- 1. THIS DRAWING DEPICTS THE ARCHITECTURAL (SPACE LAYOUT, FURNISHING, FLOOR, WALLS, ROOFS, FOUNDATION, WINDOWS AND DOORS) SYSTEMS. IT PROVIDES A VISUAL REPRESENTATION OF THE ARCHITECTURAL LAYOUT AND COMPONENTS.
- THE ARCHITECTURAL DRAWINGS ARE PREPARED TO MEET THE SPECIFIC REQUIREMENTS OF THE BUILDING, AS PER THE PROJECT SPECIFICATIONS AND APPLICABLE CODES AND STANDARDS.
- 3. THE CONSTRUCTION OF THIS HOME SHALL COMPLY WITH THE LATEST EDITION OF THE INTERNATIONAL RESIDENTIAL CODE (IRC), INTERNATIONAL MECHANICAL CODE (IMC), THE INTERNATIONAL PLUMBING STANDARD, THE NATIONAL ELECTRICAL STANDARD AND ALL OTHER APPLICABLE LOCAL, STATE, AND NATIONAL CODES AND REGULATIONS.
- 4. COORDINATION WITH OTHER TRADES HAS BEEN DONE ON A DESIGN LEVEL. THIS DRAWING SHALL BE READ TOGETHER WITH THE ME, EL AND PL DESIGN DRAWINGS TO ENSURE PROPER CONSTRUCTION AND INTEGRATION OF THE BUILDING SYSTEMS.

ABOUT WALLS:

1. SHOWER WALL COVERING

BATHTUB AND SHOWER SPACES (WALLS AND FLOORS) WITH INSTALLED SHOWER HEADS AND IN SHOWER COMPARTMENTS SHALL BE FINISHED WITH A NON-ABSORBENT SURFACE.

2 WALL PAINT (INTERNAL

THE TYPICAL THICKNESS OF LATEX WALL PAINT IS 1/32 OF AN INCH FOR A SINGLE COAT. AND DOUBLE COAT (1/16") SHALL BE APPLIED FOR DURABILITY.

ADHESIVES:

THE ADVISABLE TYPE OF ADHESIVE FOR THIS PROJECT IS **EPOXY ADHESIVES**BECAUSE THEY ARE KNOWN FOR THEIR HIGH STRENGTH, DURABILITY, AND RESISTANCE TO MOISTURE, CHEMICALS AND HEAT.


REFER TO SHEETS A201 & A202 FOR GENERAL NOTES ON EXTERNAL FINISHING MATERIALS

ABOUT FLOORS:

- . THE SPOT ELEVATION INDICATES THE FINISHED FLOOR ELEVATION.
- 2. FINISHED FLOORS PER PLANS.
- 3. FIELD VERIFY FOR DIMENSION DROP 4" FOR SHOWER AND BATHTUB USE.
- 4. 1% SLOPE ON OUTDOOR BALCONIES FOR WATER RUN OFF.
- 5. 2% SLOPE TOWARDS THE SHOWER DRAIN FOR SUFFICIENT DRAINAGE.
- 6. 4" DROP AT THE DOOR LEADING TO EXTERIOR BALCONY FROM THE MAIN LIVING AREA.
- 7. 5% SLOPE FOR GARAGE IS USED, WHICH SHOULD BE CHECKED WITH THE LOCAL GARAGING ZONING LAWS.

FURNITURE SCHEDULE					
TYPE MARK	TYPE	COUNT			
01	KING SIZE BED	1			
02	DINING CHAIR	2			
03	25" X 60" Dining	1			
04	Four Sit 65" X 95"	1			
05	ONE SEAT SOFA	1			

	ROOM FINISH SCHEDULE						
ROOM NUMBE R	ROOM NAME	FLOOR FINISH	BASE FINISH	WALL FINISH	CEILING FINISH	CEILING HEIGHT	COM MEN TS
01	BEDROOM	HARDWOOD	CONCRETE	WALL PAINT	DRY WALL	8' - 0"	
02	CL	HARDWOOD	CONCRETE	WALL PAINT	DRY WALL	8' - 0"	
03	CL 3	HARDWOOD	CONCRETE	CERAMIC TILE	DRY WALL	8' - 0"	
04	CL 2	HARDWOOD	CONCRETE	WALL PAINT	DRY WALL	8' - 0"	
05	WH	VINYL TILES	CONCRETE	WALL PAINT	DRY WALL	8' - 0"	
06	BATH	VINYL TILES	CONCRETE	CERAMIC TILE	MRD	8' - 0"	
07	KITCHEN	HARDWOOD	CONCRETE	WALL PAINT + CERAMIC	DRY WALL	8' - 0"	
08	W/D	HARDWOOD	CONCRETE	CERAMIC TILE	DRY WALL	8' - 0"	
09	HALL	HARDWOOD	CONCRETE	WALL PAINT	DRY WALL	8' - 0"	
10	LIVING ROOM	HARDWOOD	CONCRETE	WALL PAINT	DRY WALL	8' - 0"	
11	PORCH	PROCELAIN TILE	CONCRETE	EXTERIOR-GRADE PLYWOOD	PLYWOOD	8' - 0"	

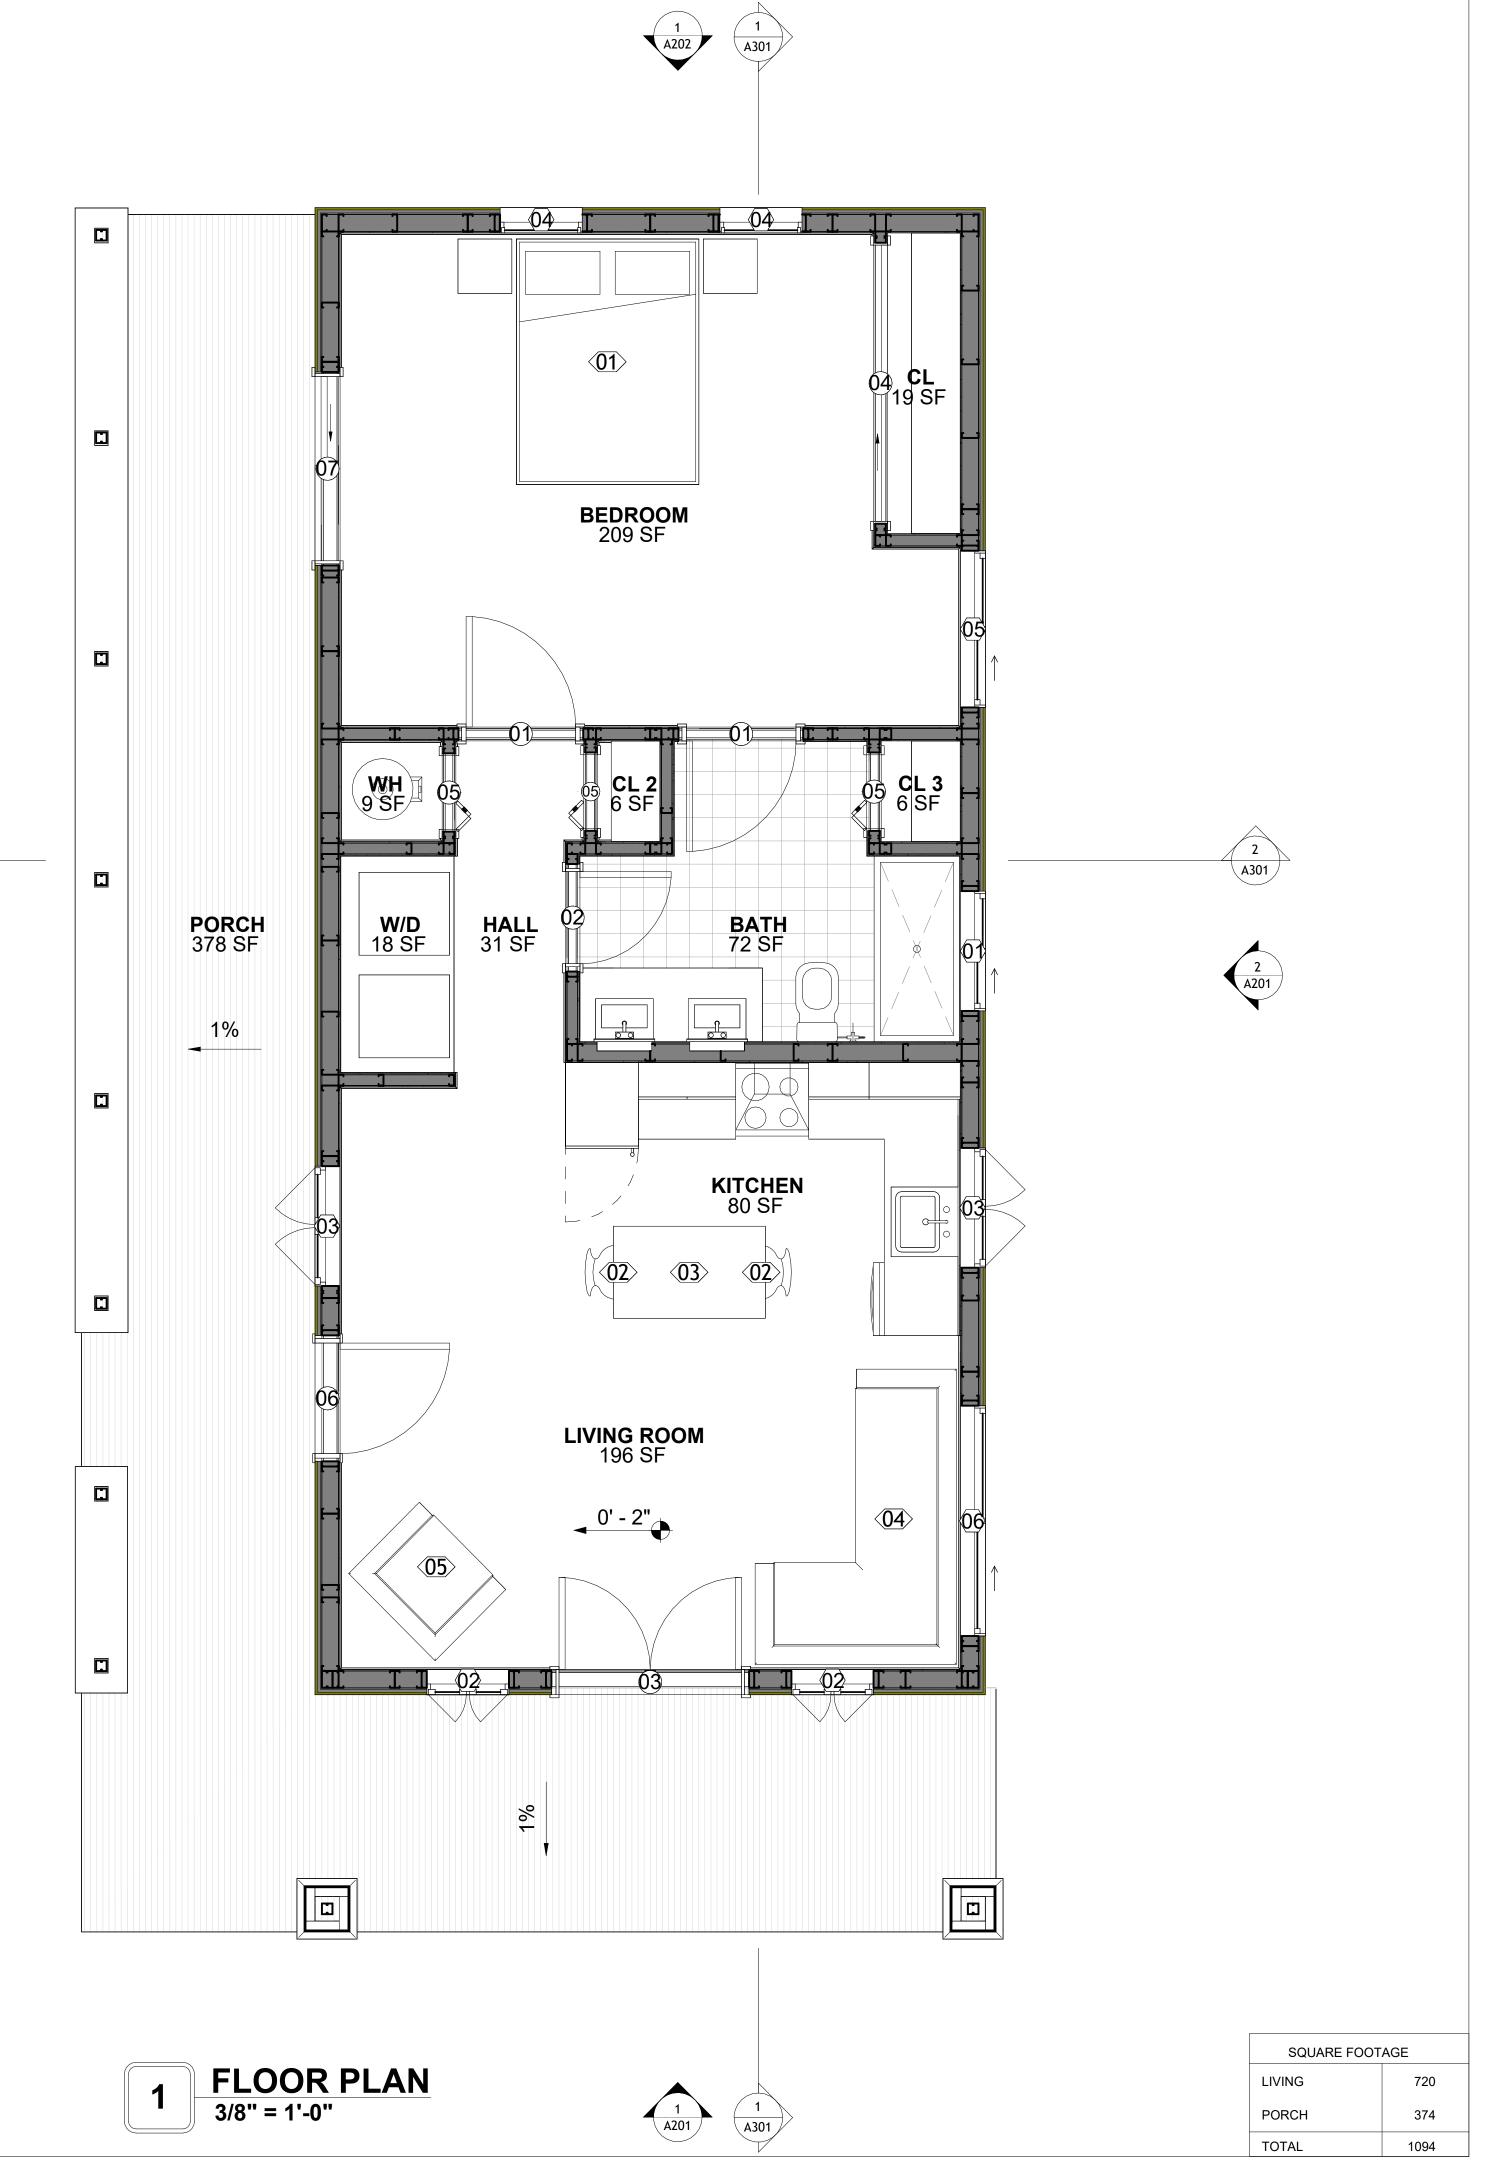



KEY PLAN

NO.	DESCRIPTION	DATE

NOTE:

LEGEND:

PROJECT


125 ORION 730 1Bd/1Ba CRAFTSMAN PORCH 550

DRAWING NAME

FLOOR PLAN

CLIENT NAME:	Client Name
PROJECT NUMBER:	0061_12
DATE:	3/18/2025 12:53:43 PM
DESIGNED BY:	Designer
DRAWN BY:	Author
CHECKED BY:	Checker

A101

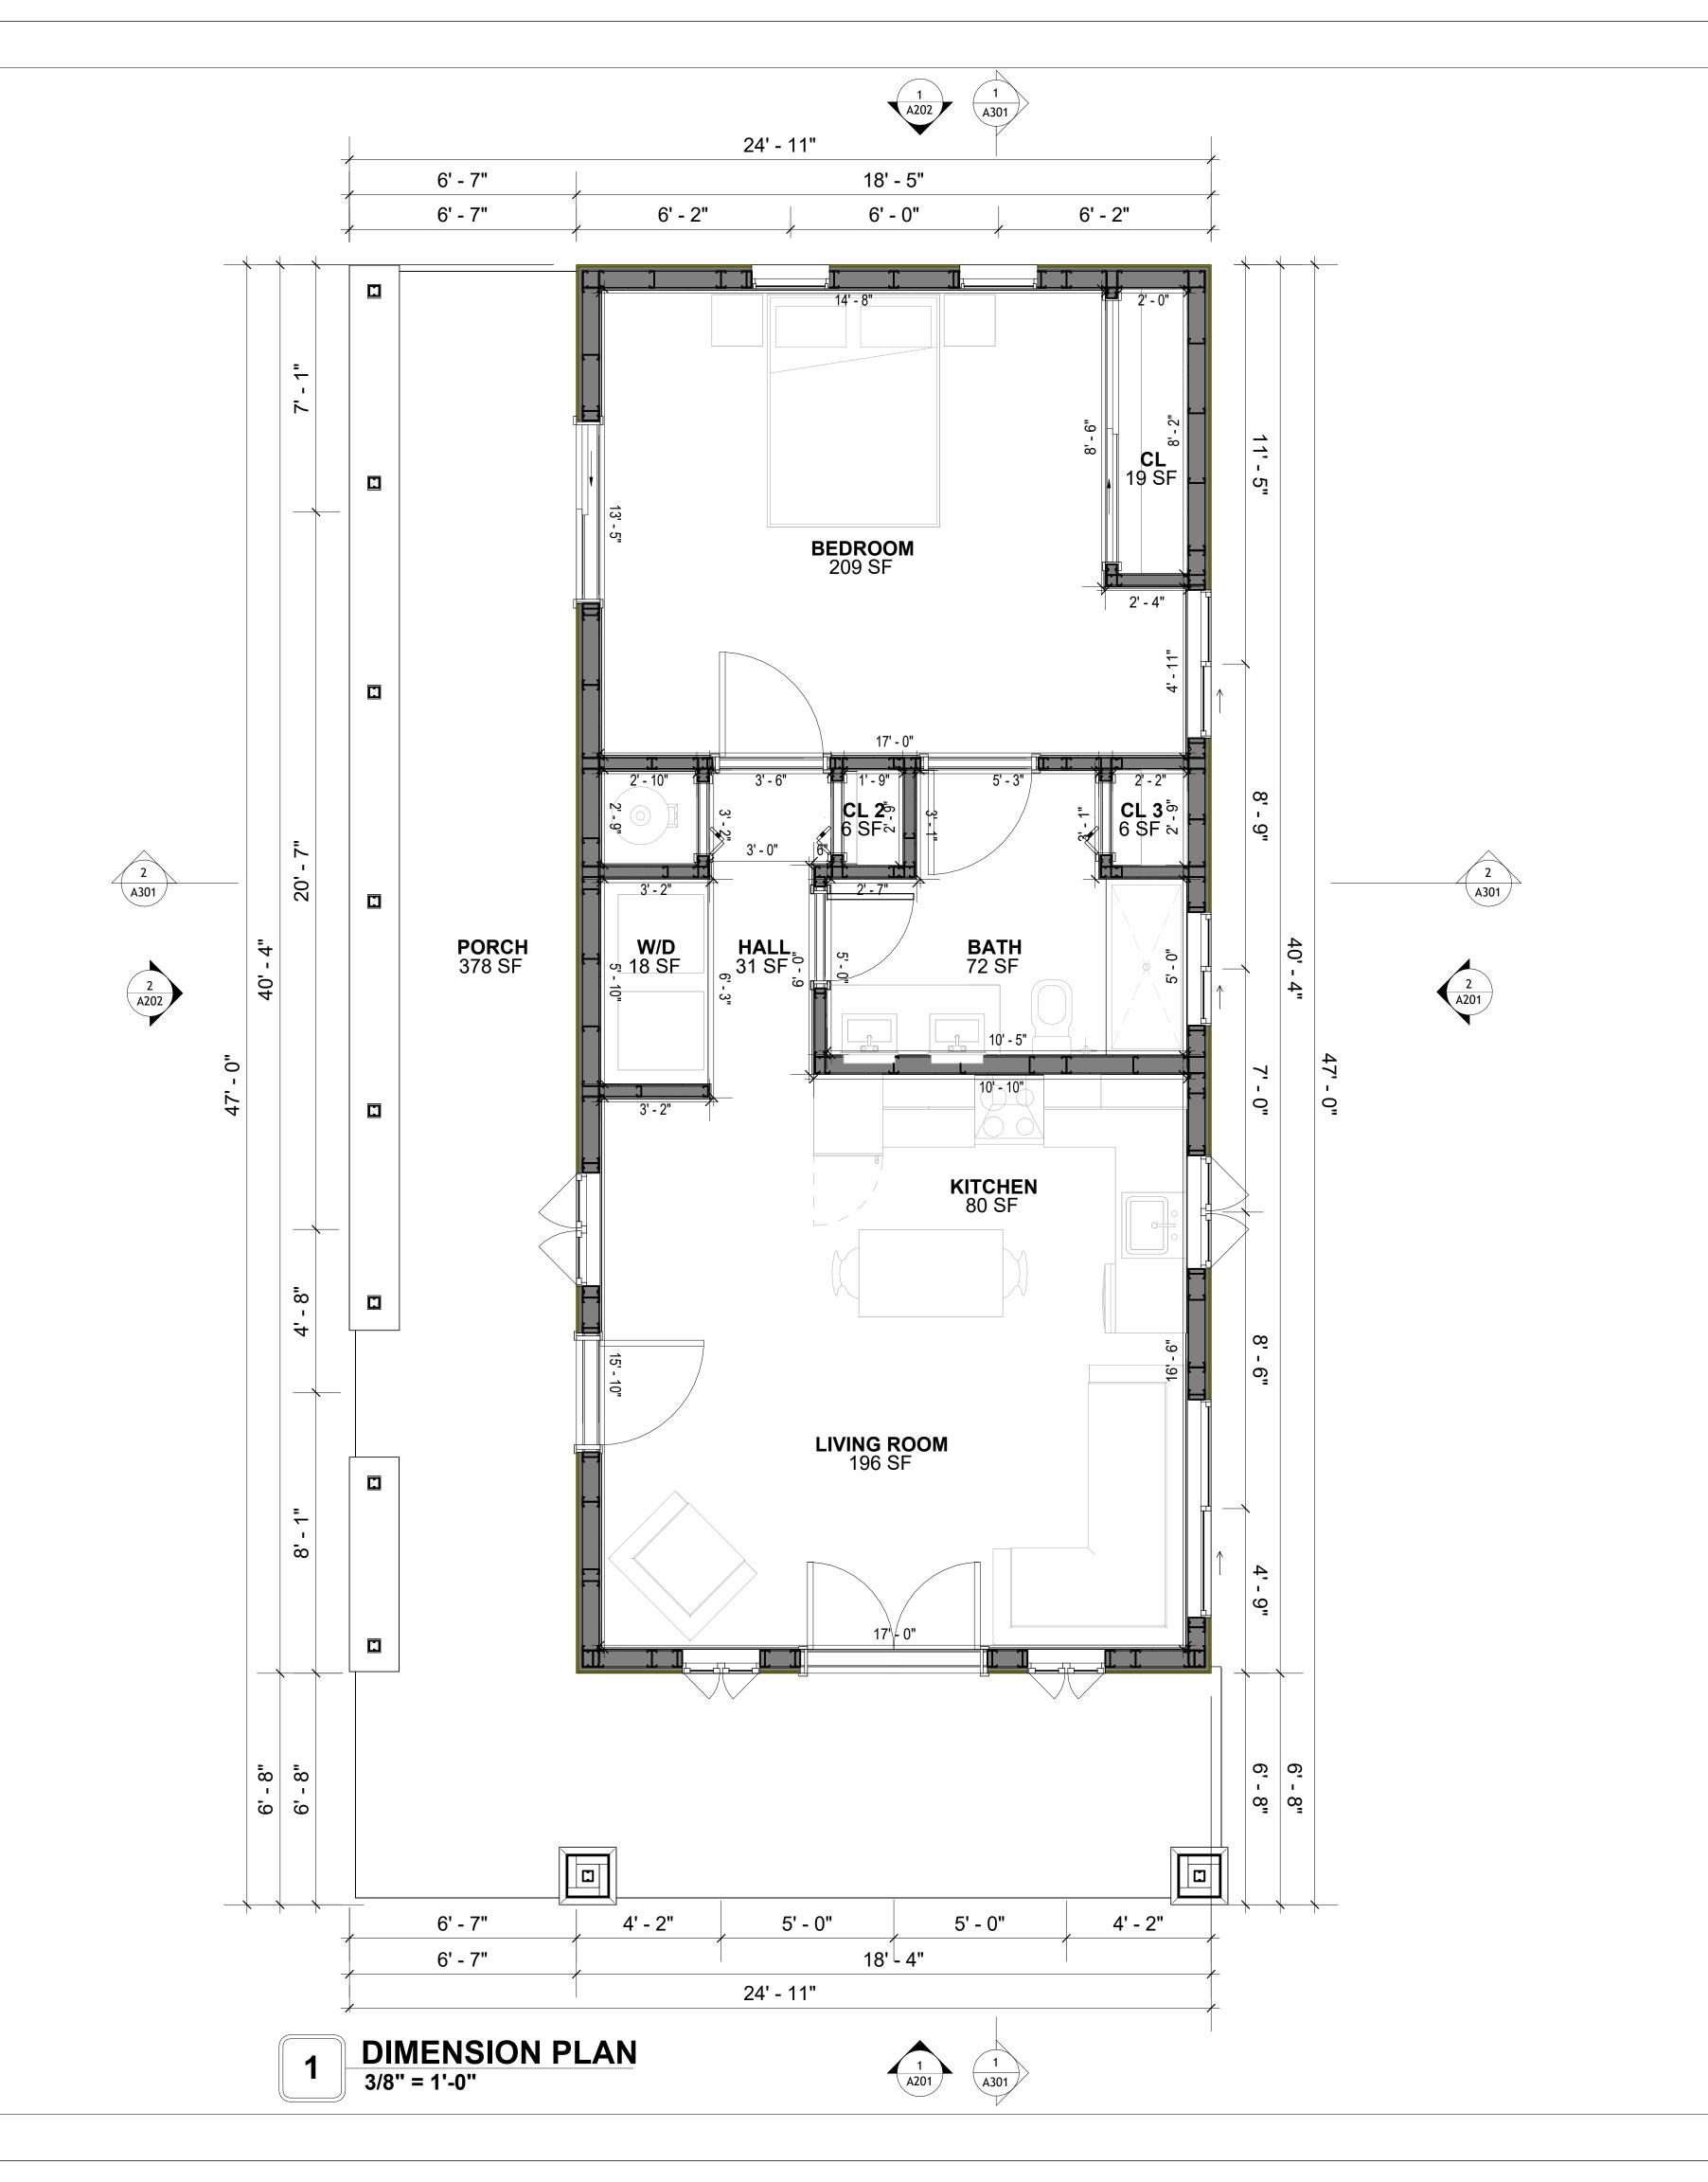



KEY PLAN

NO.	DESCRIPTION	DATE

NOTE:

LEGEND:

PROJECT

125 ORION 730 1Bd/1Ba CRAFTSMAN PORCH 550

DRAWING NAME

DIMENSION PLAN

CLIENT NAME:	Client Name
PROJECT NUMBER:	0061_12
DATE:	3/18/2025 12:53:44 PM
DESIGNED BY:	Designer
DRAWN BY:	Author
CHECKED BY:	Checker

A102

SCALE: 3/8" = 1'-0"

SQUARE FOOTAGE

PORCH

TOTAL

720

374

1094

FOUNDATION NOTES

NOTES:

TERMITES PRETREATMENT BY LICENSED CONTRACTOR UNDER SLAB AND AROUND FOOTINGS. ALL AREAS BELOW SLABS SHALL BE TREATED NO MORE THAN 24 HOURS PRIOR TO CONCRETE POUR. EVIDENCE OF TREATMENT MUST BE PROVIDED PRIOR TO PLACING OF CONCRETE.

1. MATERIALS:

ALL INTERIOR CONCRETE SLABS SHALL BE A MIN. OF 4" THICK CONCRETE OVER 4" COMPACTED AGGREGATE BASE (ASTM D698), FINISH ELEVATIONS AS NOTED ON DRAWINGS, 6" ABOVE ADJACENT GRADE, LEVEL SLABS TO 1/8"-10' MAX.. CONCRETE SLABS SHALL BE 2500# PSI AT 28 DAYS. A 4" ALLOWABLE SLUMP.

2. PAD PREPARATION:

- EXCAVATION FOR FOOTING SHALL BE NEAT.

- FOOTINGS SHALL BE POURED IMMEDIATELY AFTER EXCAVATION AND APPROPRIATE INSPECTION.

- ALL REINFORCING STEEL MARKED "CONTINUOUS" SHALL BE LAPPED 36 BAR DIAMETERS AT SPLICES AND AROUND CORNERS OR INTERSECTIONS WITH A STANDARD 90 DEGREE BEND ON CORNER BARS. LAP WIRE MESH ONE FULL MESH AT SIDE AND END LAPS.

- ALL HARDWARE TO BE SIMPSON OR EQUIVALENT.
- EXTERIOR FRAME WALL TO BE SECURED WITH 1/2"X10" ANCHOR BOLTS 4'-0" O.C. FOR 1-STORY AND 2'-8" O.C. FOR 2-STORY. BOLTS SHALL BE LOCATED WITHIN 1'-0" OF EACH END PIECE AND SHALL HAVE A MIN. OF TWO BOLTS PER PIECE.

-FOUNDATION ANCHOR STRAPS SHALL BE PERMITTED, ACCORDING TO RESIDENTIAL CODE 2021

- ALL INTERIOR WALLS TO BE SECURED WITH POWER DRIVEN PINS PER MANUFACTURER SPECIFICATION USE PIN SPACING EQUIVALENT TO 1/2" ANCHOR BOLTS.

- ALL CONSTRUCTION TO CONFORM TO THE 2012 IRC
- R-10 RIGID INSULATION OUTSIDE OF EXTERIOR FOUNDATION WALLS UNDER LIVING AREA.

- CONCRETE PAD FOR CONDENSER THICKNESS IS 4" MIN UNLESS OTHERWISE NOTED.

3. CONCRETE CONSTRUCTION:

- THE SLAB SHALL BE UNDERLAIN BY A VAPOR BARRIER/RETARDER IN THE LIVING AREA (TYPICALLY POLYETHYLENE, UNLESS MORE STRINGENT PROTECTION REQUIRED BY THE ARCHITECT, ENGINEER, FLOOR COVERING MANUFACTURER, OR ACCEPTED PRACTICE). UNLESS OTHERWISE REQUIRED, BARRIER MAY BE OMITTED AT GARAGES, PORCHES AND PATIOS WITHOUT FLOOR COVERINGS. IT IS BEYOND THE SCOPE OF THESE PLANS TO DETERMINE THE APPLICABILITY OF THESE MORE STRINGENT REQUIREMENTS. BUILDER SHALL VERIFY PRIOR TO CONSTRUCTION.

4. REINFORCEMENT:

- IF CONSTRUCTED ON ACTIVE SOILS, THE LONG TERM PERFORMANCE OF THE FOUNDATION IS DEPENDENT ON MAINTENANCE BY THE OWNER. THUS THE BUILDER SHALL ADVISE THE OWNER OF THE FOLLOWING:

- 1. DRAINAGE MUST BE MAINTAINED. WATER SHALL NEVER BE ALLOWED TO POND NEAR THE FOUNDATION.
- 2. THE SOIL AROUND THE FOUNDATION SHALL BE MAINTAINED IN A RELATIVELY DAMP CONDITION, SUCH AS THAT REQUIRED TO KEEP A LAWN GREEN. IF IT DRIES OUT IT WILL

SHRINK. IF IT GETS WET, IT WILL HEAVE UPWARD.

3. SLABS ON THE SHORTER SIDE USES MAIN BARS ARE USED IN THIS DIRECTION ONLY WITH SMALLER DIAMETER DISTRIBUTION BARS ARE PLACED, FORMING A MAT OR GRID.


- 4. ALL REINFORCEMENT BARS SIZE 10MM OR LARGER IN ACCORDANCE TO ASTM
 3. ANCHOR BOLTS AT ALL EXTERIOR WALLS SHALL BE MINIMUM 1/2 INCH DIAMETER WITH A MAXIMUM SPACING OF 6'-0" ON CENTER, UNLESS NOTED OTHERWISE.
- 4. ANCHOR BOLTS SHALL BE INSTALLED WITHIN 12 INCHES OF EACH END OF EACH SILL PLATE WITH AT LEAST TWO ANCHOR BOLTS FOR EACH BOLTS FOR EACH SILL PLATE LONGER THAN 12 INCHES.
- 5. SIMPSONS SILL ANCHORS MAYBE SUBSTITUTED FOR ANCHOR BOLTS AT THE SAME SPACING.

6. EXTERIOR CONCRETE SLABS WHICH ARE NOT PART OF THE MAIN SLAB SHALL BE MINIMUM 4 INCHES THICK WITH NO STEEL REINFORCING BARS REQUIRED, UNLESS NOTED OTHERWISE ON FOUNDATION PLAN.

VERIFY THE FOLLOWING PRIOR TO POURING:

- 1. ALL HOLDDOWNS , STRAP, AND POST LOCATIONS.
- 2. CONCRETE FINISHES. PANEL RISER LOCATION WHERE APPLICABLE.
- 3. UNDERSLAB MECHANICAL REQUIREMENTS.
- 4. STEM WALL BLOCKOUTS.
- 5. UNDERSLAB ELECTRICAL REQUIREMENTS AND PANEL RISER LOCATION. WHERE APPLICABLE.
- 6. PROVIDE THE FOLLOWING:
- PVC SLEEVES THROUGH FTG IF REQUIRED
- 20' #4 COPPER GROUND BAR.
- 7. SLOPE FINISH GRADE AWAY FROM FOOTING.

NOTE: FIELD VERIFY ALL DIMENSIONS SEE DIMENSIONED ARCHITECTURAL DRAWINGS

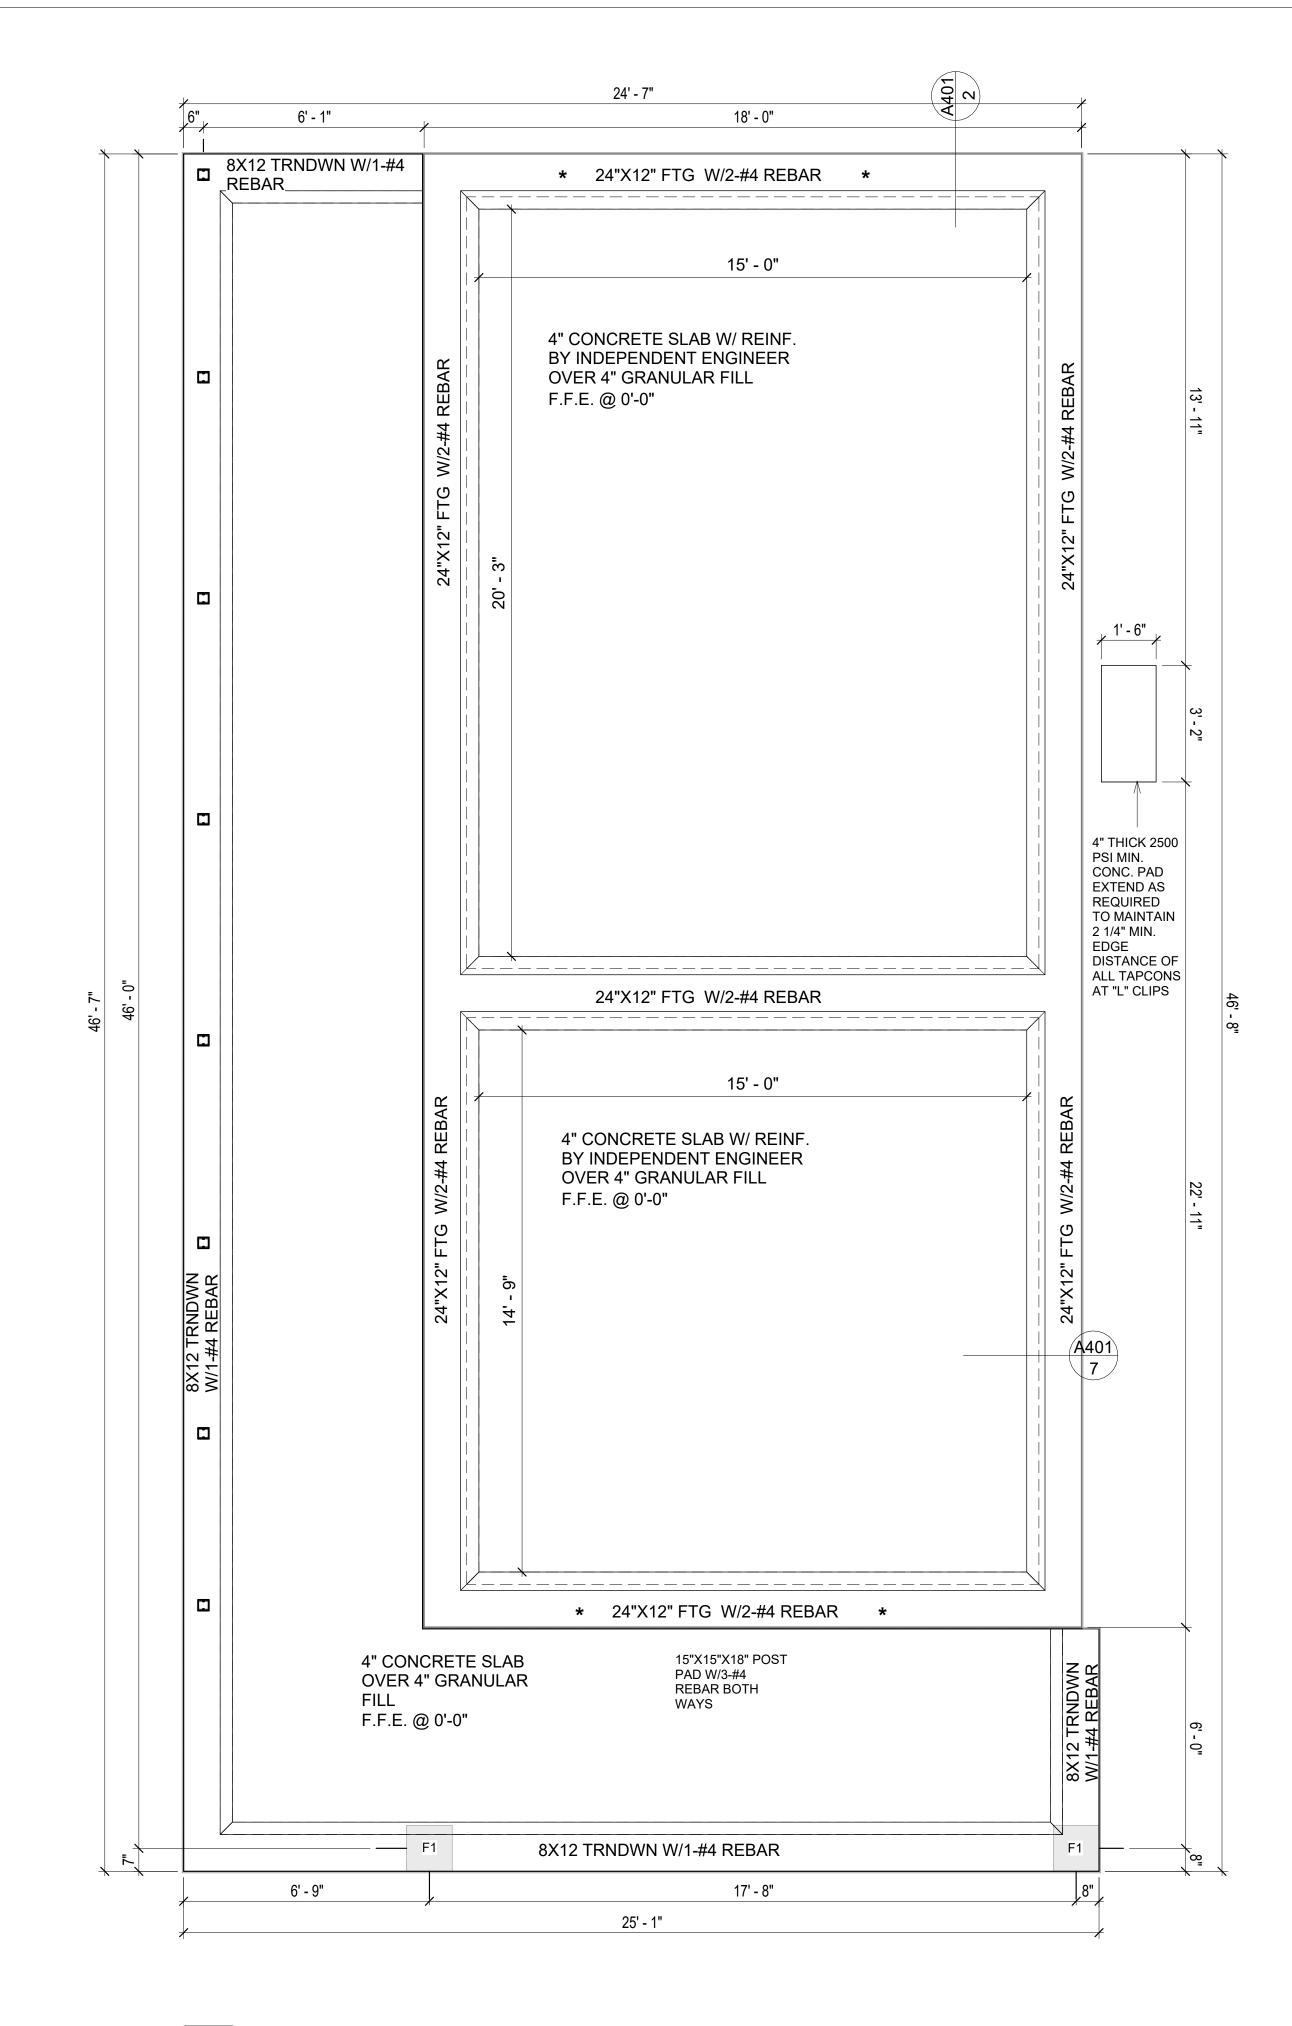

1 FOUNDATION PLAN
3/8" = 1'-0"

SQUARE FOOT	SQUARE FOOTAGE		
LIVING	LIVING 720		
PORCH	374		
TOTAL	1094		



KEY PLAN

NO.	DESCRIPTION	DATE

NOTE:

LEGEND:

PROJECT

125 ORION 730 1Bd/1Ba CRAFTSMAN PORCH 550

DRAWING NAME

FOUNDATION PLAN

CLIENT NAME:	Client Name
PROJECT NUMBER:	0061_12
DATE:	3/18/2025 12:53:44 PN
DESIGNED BY:	Designer
DRAWN BY:	Author
CHECKED BY:	Checker

S101

SCALE: 3/8" = 1'-0"

GENERAL NOTES

NOTES:

-ALL BEARING WALLS SHOULD HAVE A THICKENED SLAB PER SECTION PER DETAIL A401/5.

A) **FOUNDATION PLAN NOTES**:

- CONCRETE SLAB SHALL BE 6" THICK WITH 1/2" DIAMETER TENDONS PER LAYOUT PLAN. CENTERED IN SLAB THICKNESS, OVER APPROVED SUBBASE PER GENERAL STRUCTURE NOTES.
- 2. TERMITE PROTECTION SHALL BE PROVIDED PER IRC SECTION R318.1 NONE TYPICAL ANCHOR BOLT SPACING AT SHEAR WALL AND HOLD DOWN
- SPECIFICATIONS PER APPROVED ARCHITECTURAL PLANS.
- 4. INSTALL HOLDOWNS BEFORE CONCRETE SLAB POUR. EXISTING FILL ON-SITE SHALL BE COMPACTED IN ACCORDANCE WITH THE
- REQUIREMENTS IN THE GEOTECHNICAL REPORT.
- 6. ALL FLOOR SLABS ARE REINFORCED ON CONCRETE SLABS.

SPECIAL INSPECTION IS REQUIRED FOR THICKENED FOUNDATION CONSTRUCTION

- 1. REINFORCEMENT
- 2. 2300 PSI CONCRETE POUR


B) **REINFORCEMENT FOR CONCRETE**:


1. ALL REINFORCING SLABS BARS SIZE 10MM OR LARGER SHALL BE DEFORMED IN ACCORDANCE TO ASTM-A706, AND BARS SMALLER THAN 10 MM MAYBE PLAIN. 2. UNLESS OTHERWISE NOTED IN PLANS, THE YIELD STRENGTH OF REINFORCING BARS SHALL BE:


> A) FOOTING = 40,000 PSI B) NON-LOAD BEARING WALLS AND PARAPETS= 40,000 PSI

- 3. SPLICES SHALL BE SECURELY WIRED TOGETHER AND SHALL LAP OR EXTEND
- 4. GRADE OF STEEL FOR RCC WORKS SHALL BE GRADE 4 10.
- BAR NOTATIONS GIVES INFORMATION
- A) BAR SIZE
- B) SPACING(IF REQUIRED)
- 6. LAP REINFORCEMENT ONLY AT LOCATION SHOWN IN THE DRAWINGS
- REINFORCEMENT SHALL NOT BE CUT, VENT OR HEATED ON SITE WITHOUT ENGINEERS' APPROVAL.
- C) **CONCRETE SLAB NOTES**
- 1. ALL SLAB REINFORCEMENT SHALL BE 20MM CLEAR MINIMUM FROM BOTTOM AND FROM TOP OF SLAB.
- 2. REINFORCEMENT IN CONTINUOUS ELEVATED SLAB SHALL BE CUT AS FOLLOWS.

- THIS IS A SCHEMATIC PLAN FOR THE PURPOSE OF LOCATING AND IDENTIFYING FOUNDATION REINFORCING ELEMENTS ONLY. VERIFY ALL DIMENSIONS, DROPS OFFSETS AND FEATURES WITH THE ARCHITECTURAL PLANS BEFORE FORMING THE FOUNDATION.

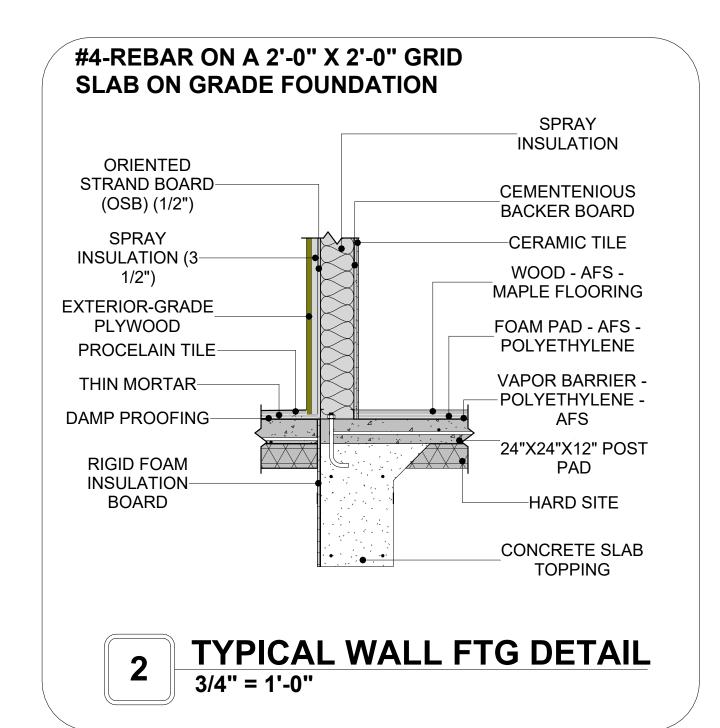

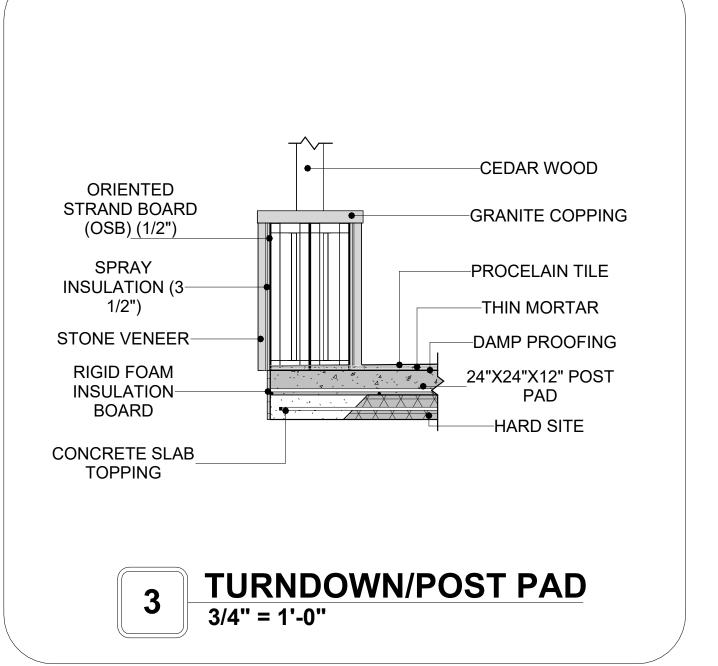

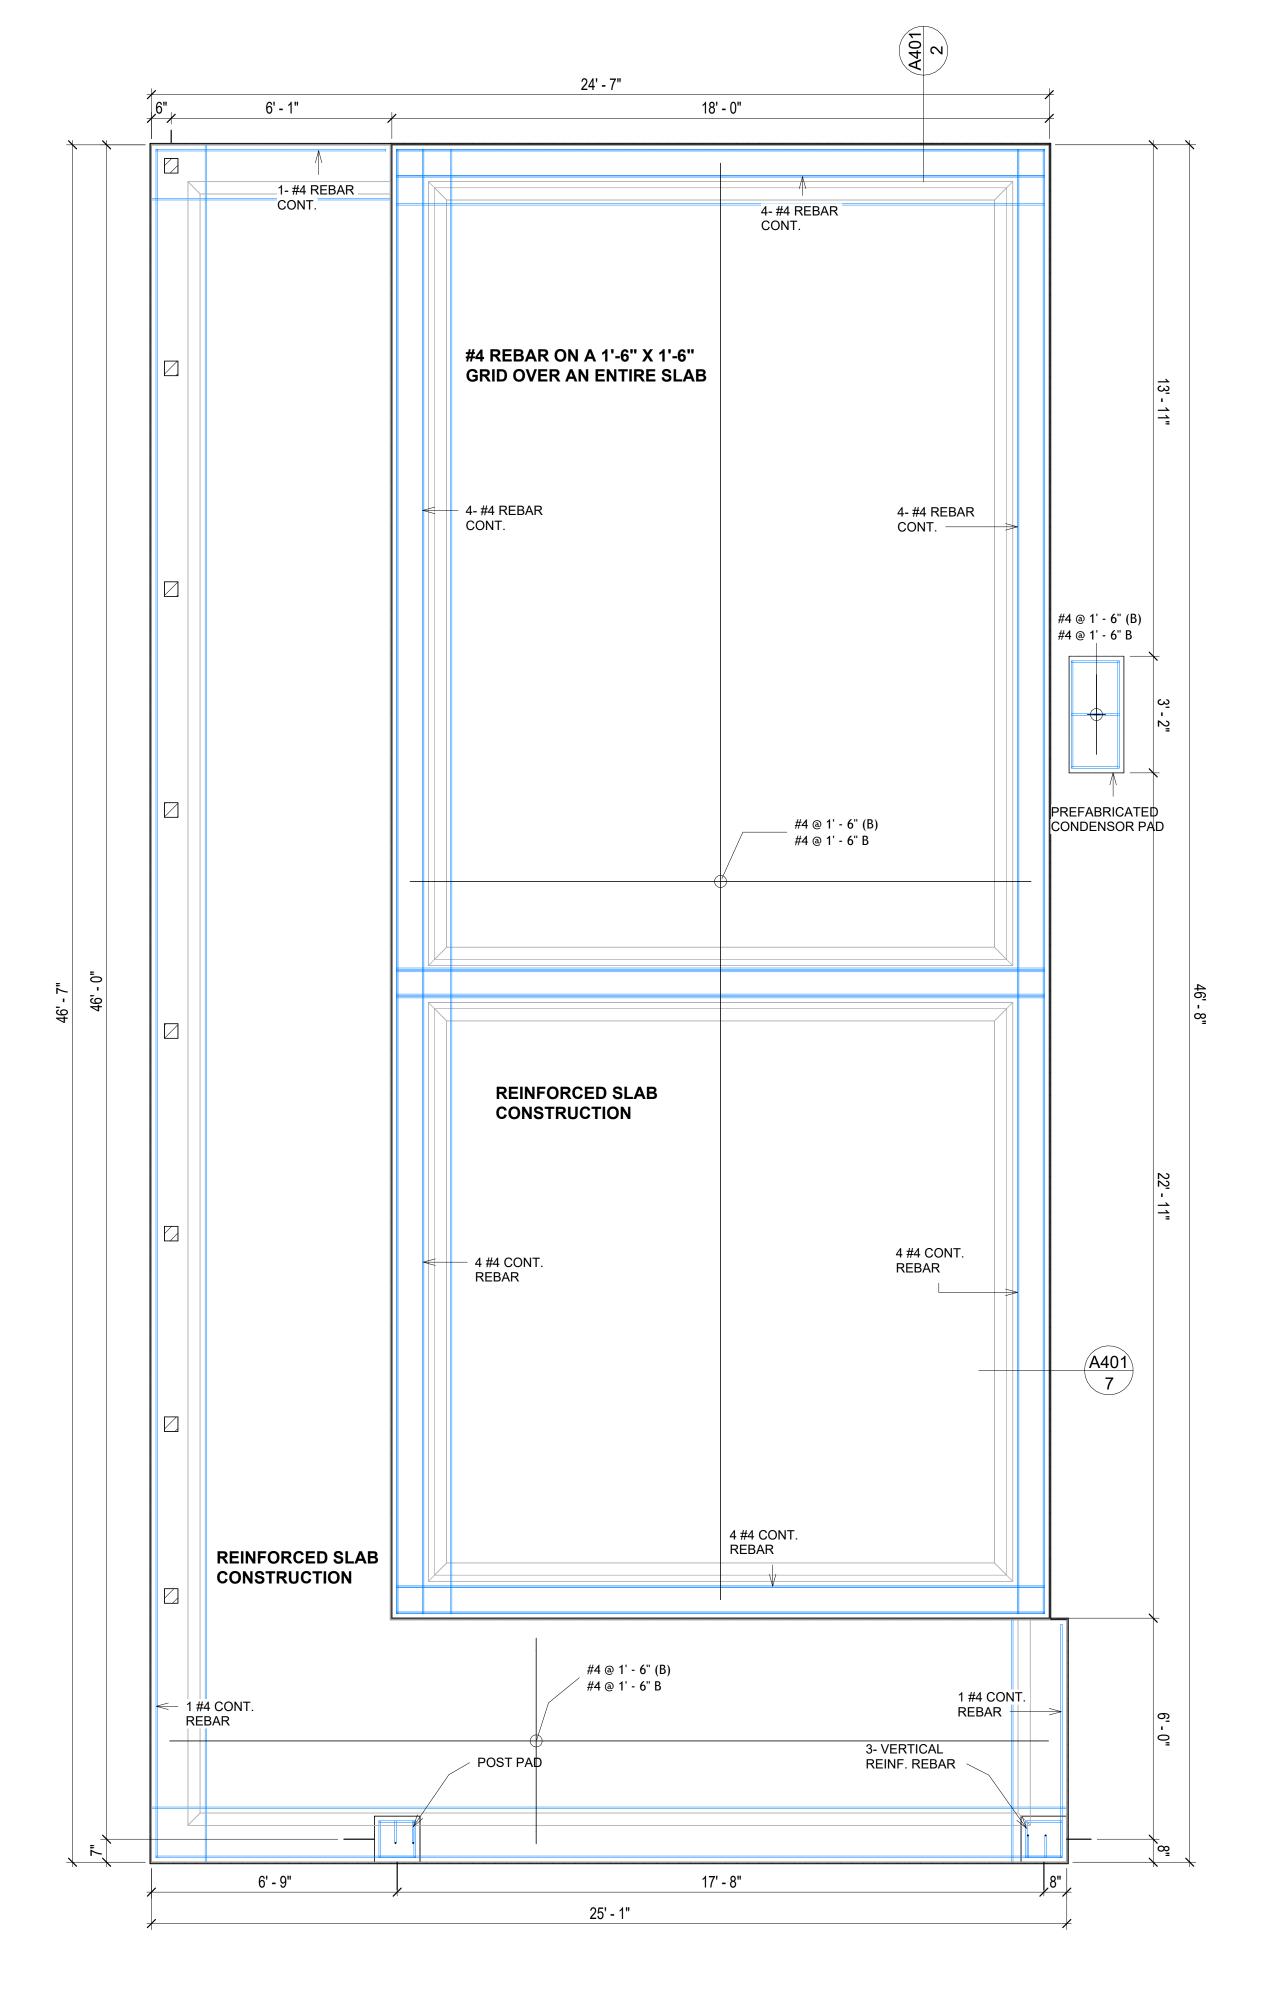

FOUNDATION REBAR PLAN 3/8" = 1'-0"



KEY PLAN

DESCRIPTION DATE

NOTE:

LEGEND:

PROJECT

125 ORION 730 1Bd/1Ba **CRAFTSMAN PORCH 550**

DRAWING NAME

STRUCTURAL FLOOR PLAN

CLIENT NAME: **Client Name** PROJECT NUMBER: 0061_12 3/18/2025 12:53:45 PM Designer **DESIGNED BY:** DRAWN BY: **Author** CHECKED BY: Checker

S102

ROOF NOTES


- ROOFING COMPOSITION ROOFING PER OWNERS/BUILDERS
 SPECIFICATIONS INSTALL PER MANUFACTURE SPECIFICATIONS ON 1/2"
 ORIENTED STRAND BOARD ON PRE-ENGINEERED TRUSS @ 24" O.C. (UNO.)
 73" OVERHANG AT EAVES (UNO.)
- 3. ENDS OF ALL TRUSSES AND JOISTS TO BE FULLY BLOCKED. PROVIDE SOLID
- BLOCKING AT ALL RIDGES AND VALLEYS

 4. SHEATHING TO BE 1/2", 3/8" OSB SHEAR PANEL AND EQUIVALENT.
 UNDERSIDE OF PORCH TRUSSES TO BE FINISHED WITH MOISTURE
- RESISTANT DRYWALL, TAPED AND TEXTURED.

 5. EXPOSED EAVES AND OTHER WEATHER EXPOSED AREAS TO BE SHEATHED
- WITH EXTERIOR GRADE PLYWOOD.

 6. ALL MATERIALS THICKNESS AND SIZE ARE THE MINIMUM. Refer TO LOCAL
- STANDARDS FOR ACTUAL THICKNESS AND LAYERING OF MATERIALS.

 7. ENGINEERED TRUSS CALCULATIONS TO BE SUBMITTED TO BUILDING
- 7. ENGINEERED TRUSS CALCULATIONS TO BE SUBMITTED TO BUILDING DEPARTMENT PRIOR TO FABRICATION AND INSTALLATION.
- 8. TRUSS MANUFACTURER TO SPECIFY HANGER CONNECTORS FOR TRUSS COMPONENTS (TYPICAL)
- 9. DESIGNER ASSUMES THAT TRUSSES BEAR ON ALL EXTERIOR PERIMETER WALLS (TYPICAL) OR BEAMS.
- 10. PROVIDE GALVANIZED STEEL FLASHING WITH A LENGTH OF 10 FEET, WIDTH OF 12 INCHES, AND THICKNESS OF 24 GAUGE.

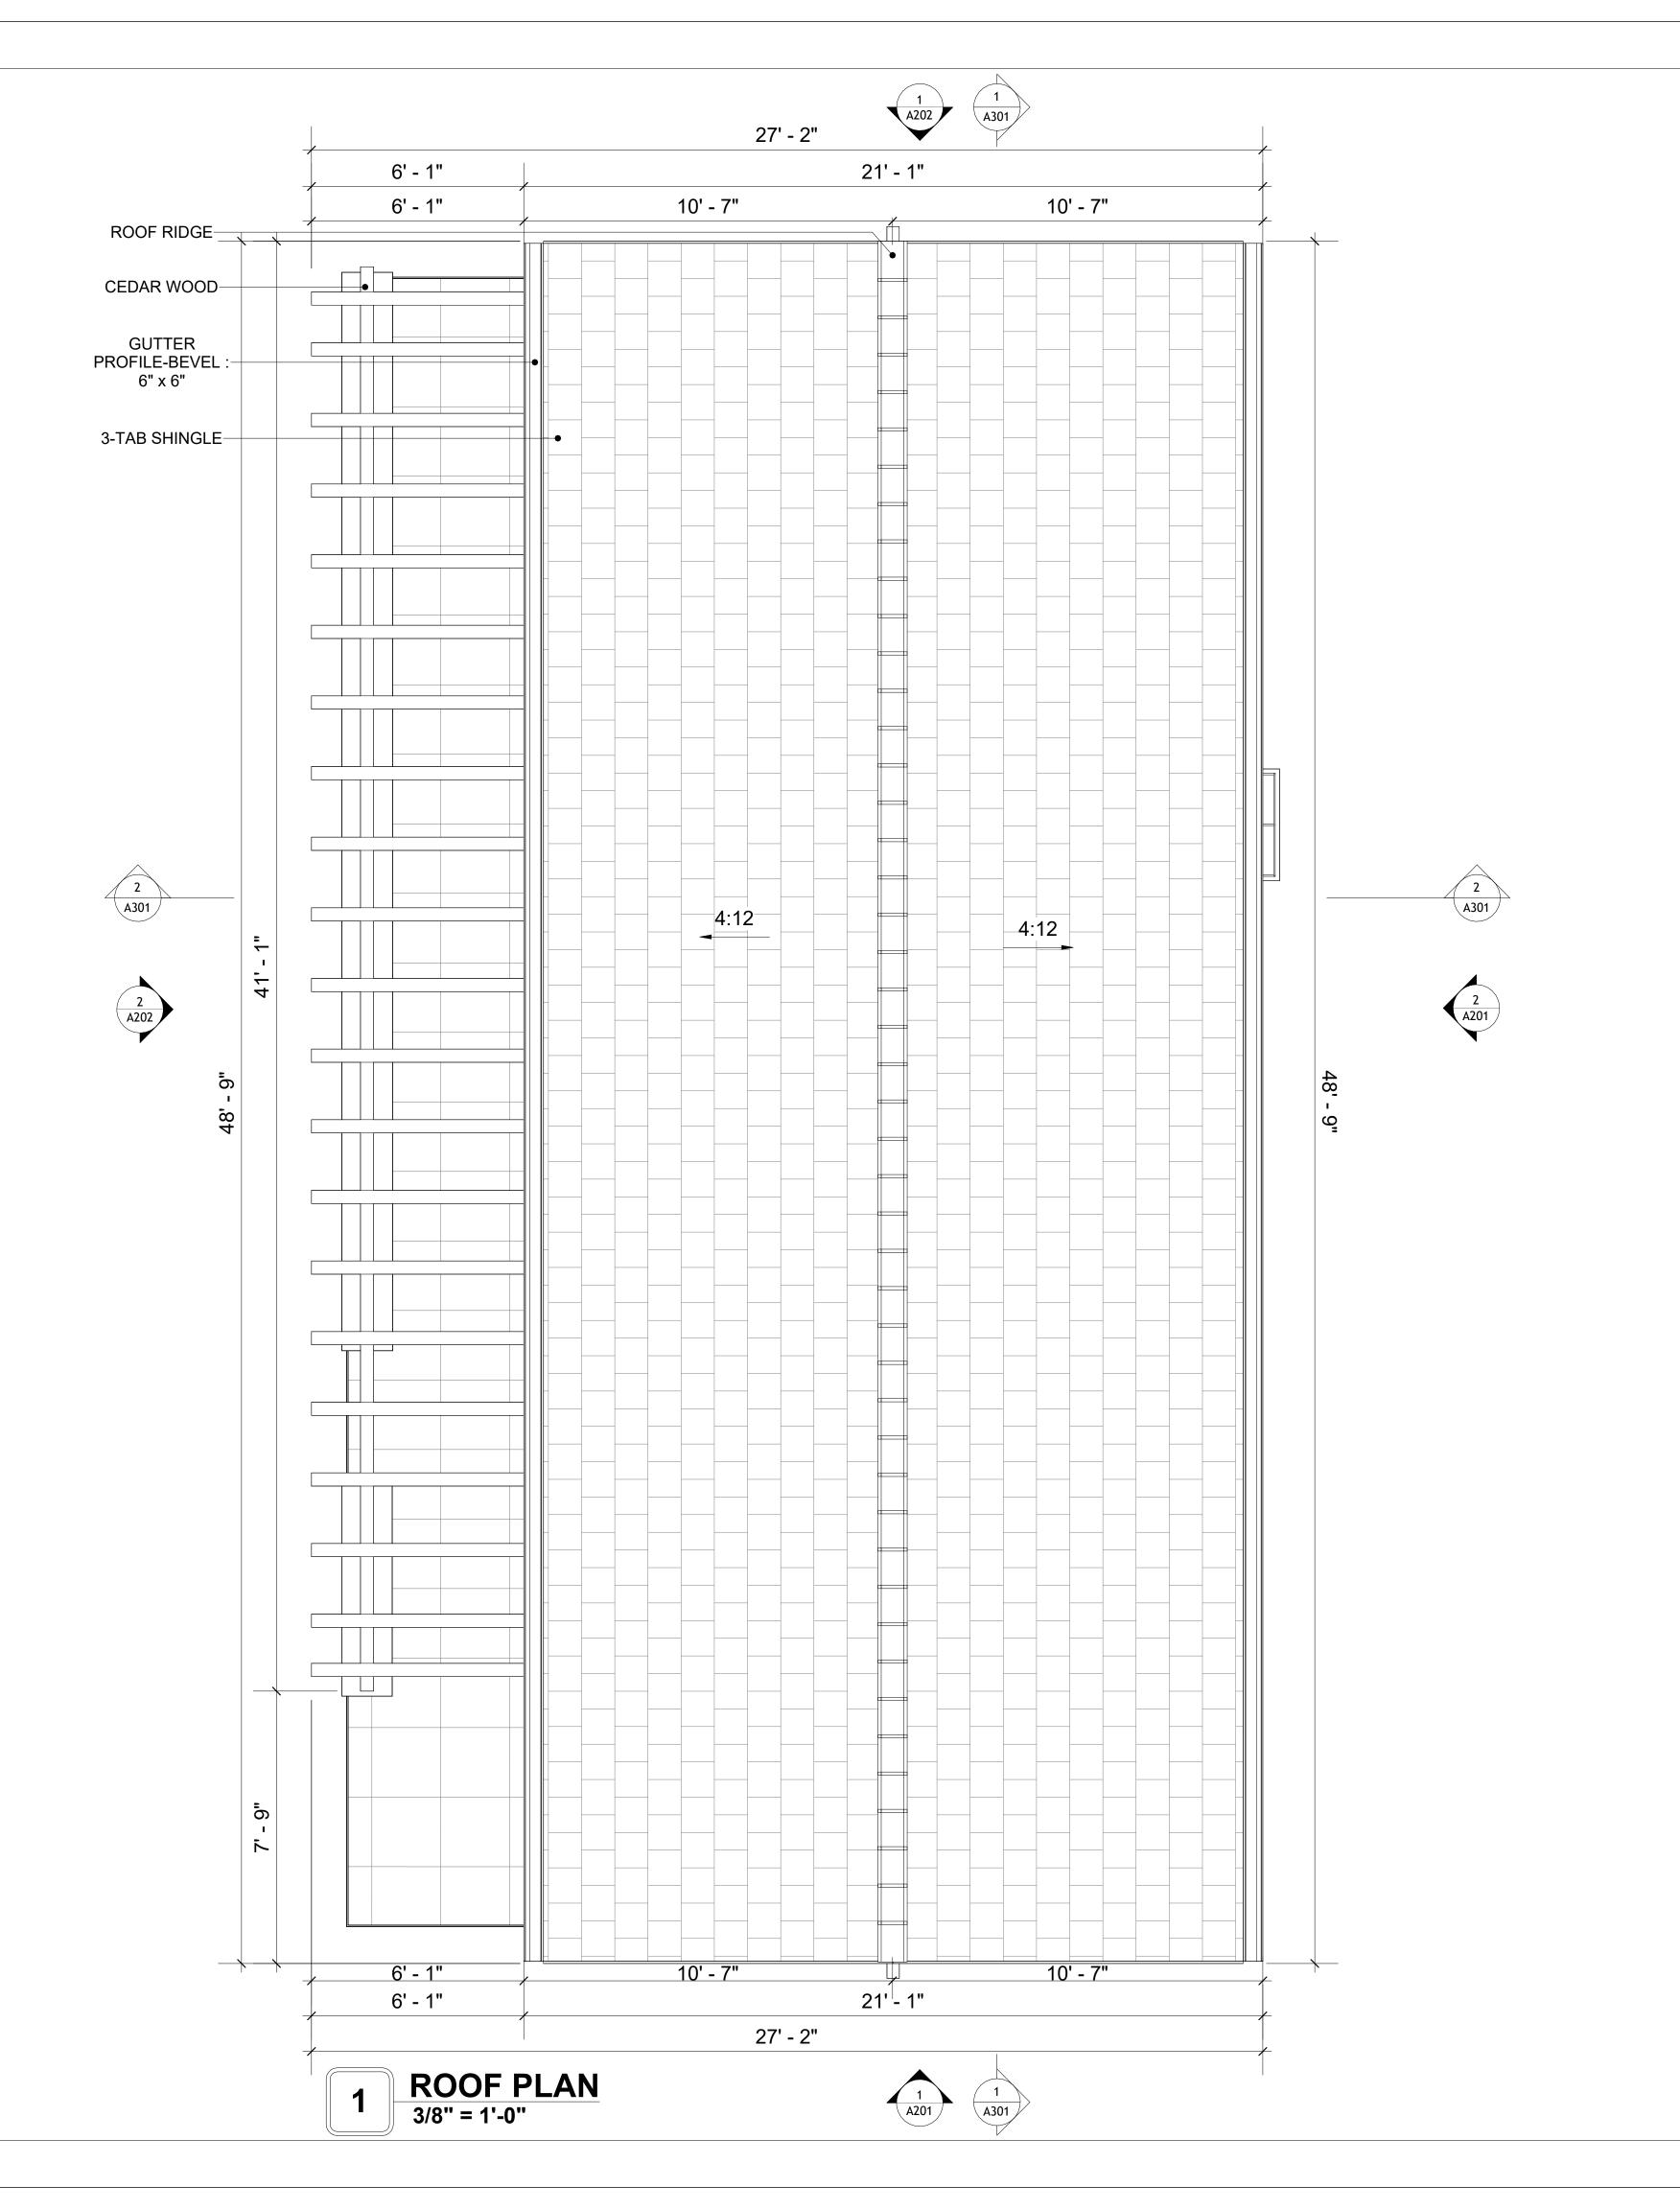



KEY PLAN

NO.	DESCRIPTION	DATE

NOTE:

LEGEND:

PROJECT

125 ORION 730 1Bd/1Ba CRAFTSMAN PORCH 550

DRAWING NAME

ROOF PLAN

CLIENT NAME:	Client Name
PROJECT NUMBER:	0061_12
DATE:	3/18/2025 12:53:46 PM
DESIGNED BY:	Designer
DRAWN BY:	Author
CHECKED BY:	Checker

A103

SCALE: As indicated

SQUARE FOOTAGE

PORCH

TOTAL

374

1094

ABOUT WALL FINISHING

PLYWOOD WALL SIDING

WALL SIDING IS AN EXTERIOR CLADDING MATERIAL USED TO COVER AND PROTECT THE WALLS OF A BUILDING, PROVIDING BOTH FUNCTIONAL AND AESTHETIC BENEFITS.

IN THIS SPECIFIC PROJECT, **PLYWOOD WALL PANELS** ARE USED AS A FINISH SIDING BECAUSE THIS TYPE OF SIDING PROVIDES A DURABLE, COST-EFFECTIVE, AND VERSATILE EXTERIOR CLADDING THAT CAN BE EASILY INSTALLED, FINISHED, AND MAINTAINED TO ENHANCE THE AESTHETIC AND PROTECTIVE QUALITIES OF A BUILDING'S EXTERIOR.

STANDARD SIZES OF 1' X 8' EXTERIOR-GRADE PLYWOOD PANELS ARE INSTALLED ON THE FURRING STRIPS USING GALVANIZED STEEL SELF-DRILLING SCREWS.

CEDAR WOOD

CEDAR WOOD REFERS TO THE WOOD FROM VARIOUS SPECIES OF CEDAR TREES, WHICH ARE CONIFEROUS EVERGREEN TREES KNOWN FOR THEIR DISTINCT AROMA AND NATURAL RESISTANCE TO DECAY AND INSECTS. IN THIS SPECIFIC PROJECT, CEDAR WOOD IS USED AS A FURRING STRIP AND A FINISH MATERIAL ON BEAMS AND COLUMNS.

CEDAR WOOD AS A FURRING STRIPS PROVIDE THERMAL INSULATION, MOISTURE MANAGEMENT, AND AN AESTHETICALLY PLEASING, VERSATILE FRAMING SOLUTION WHEN INTEGRATED WITH CORONADO STONE AND CORRUGATED IRON SHEET CLADDING.

THE VERTICAL CEDAR WOOD FURRING STRIPS ARE ATTACHED TO HOME WRAP USING CORROSION-RESISTANT FASTENERS (HOT DIP GALVANIZED SCREWS), ENSURING PROPER PENETRATION INTO THE WALL FRAMING.

WOOD SHINGLE

WOOD SHINGLES ARE THIN, TAPERED PIECES OF WOOD, TRADITIONALLY USED FOR ROOFING AND SIDING. THEY ARE TYPICALLY MADE FROM CEDAR WOOD, OR PINE DUE TO THEIR DURABILITY AND RESISTANCE TO DECAY. SHINLES ARE SAWN RATHER THAN SPLIT, GIVING THEM A SMOOTH, UNIFORM APPEARANCE. THEY PROVIDE A NATURAL, OFTEN RUSTIC LOOK, GOOD INSULATION, AND GOOD WEATHER RESISTANCE. WOOD SHINGLES ARE ECO-FRIENDLY AND CAN BE STAINED OR PAINTED FOR CUSTOMIZATION.

IN THIS SPECIFIC PROJECT, WOOD SHINGLES ARE APPLIED AT THE TOP OF THE EXTERNAL WALL, CREATING AN EYE-CATCHING DETAIL THAT COMPLEMENTS THE OVERALL ARCHITECTURE AND ENSURES A STURDY, WEATHER-RESISTANT FINISH.


GRANITE COPPING

GRANITE COPPING REFERS TO A STONE, TYPICALLY GRANITE, USED TO COVER THE TOP EDGE OR CAP OF A WALL, PARAPET, OR OTHER ARCHITECTURAL FEATURE, PROVIDING PROTECTION AND A FINISHED LOOK.


STONE VENEER

STONE VENEER REFERS TO THIN LAYERS OF NATURAL OR MANUFACTURED STONE APPLIED TO A STRUCTURAL WALL, KNOWN FOR THEIR REALISTIC APPEARANCE AND RELATIVE LIGHTNESS. THESE VENEERS PROVIDE THE AESTHETIC OF STONE WITHOUT THE COST AND WEIGHT OF FULL STONE CONSTRUCTION, CONTRIBUTING TO A BEAUTIFUL AND COST-EFFECTIVE EXTERIOR FINISH.

IN THIS SPECIFIC PROJECT, STONE VENEER IS USED A FINISH MATERIAL ON EXTERIOR FINISH.

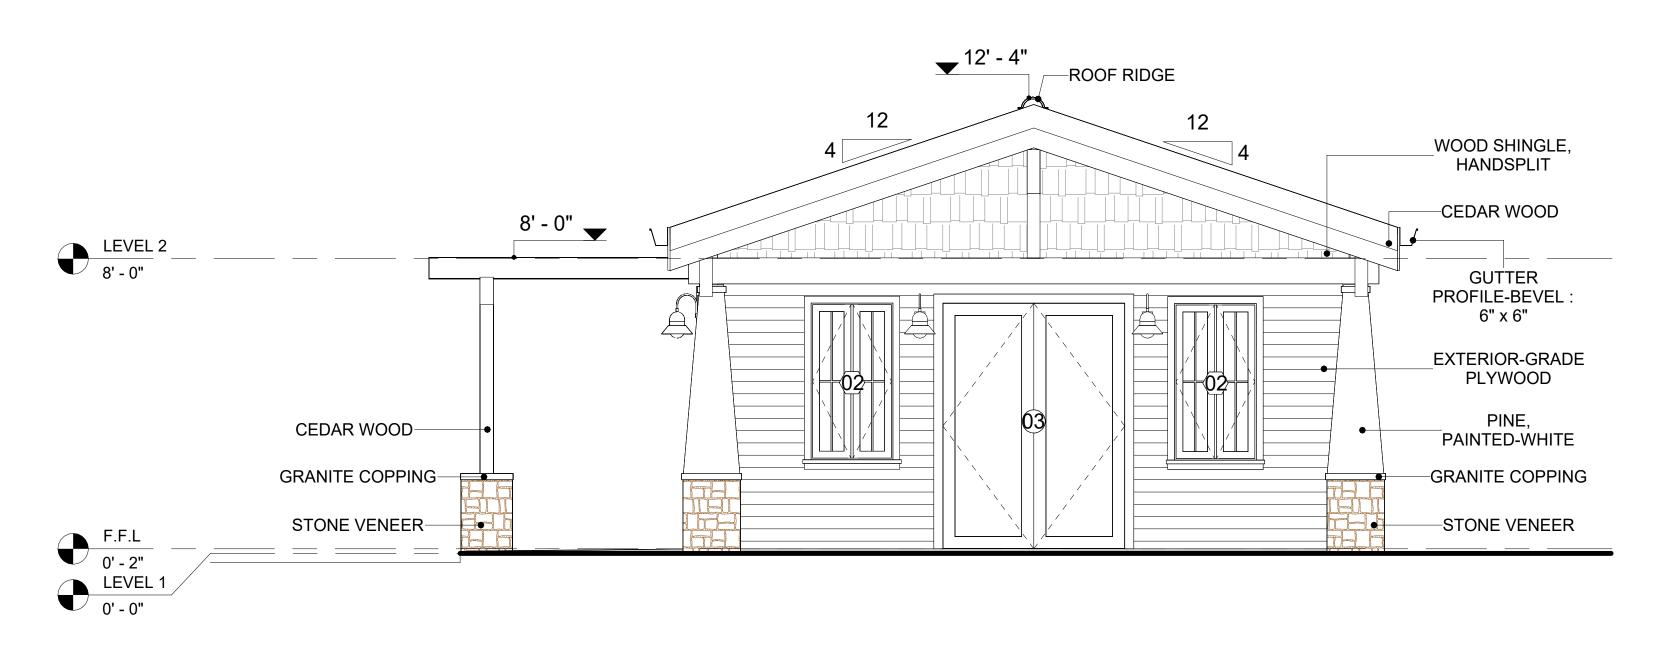

1 FRONT ELEVATION
3/8" = 1'-0"

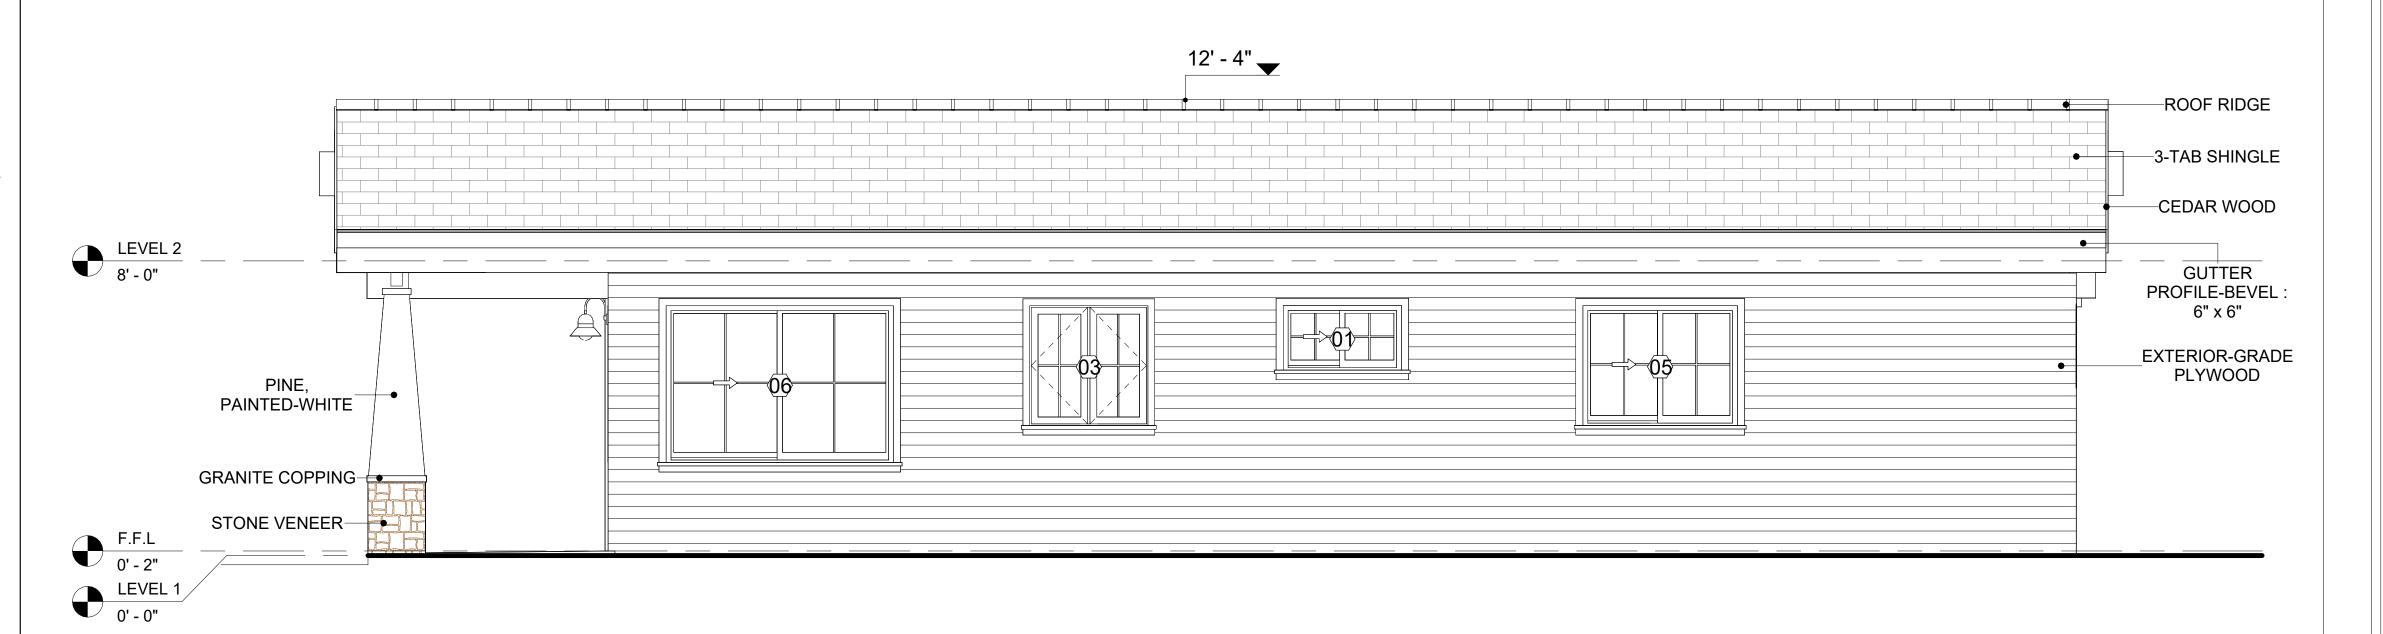


2 RIGHT SIDE ELEVATION
3/8" = 1'-0"

	DOOR SCHEDULE					
TYPE				SIZE		
MAR K	SUPPLIER	DOOR TYPE	LOCATIO N	WIDTH	HEIGHT	COUNT
01	HOME DEPOT	Interior Single Panel Swinging	Interior	3' - 0"	6' - 8"	2
02	HOME DEPOT	Interior Single Panel Swinging	Interior	2' - 6"	6' - 8"	1
03	HOME DEPOT	Exterior Double Panel Swinging	Interior	5' - 0"	6' - 8"	1
04	HOME DEPOT	Interior Double Panel Sliding	Interior	7' - 6"	6' - 8"	1
05	HOME DEPOT	single fold 2	Interior	2' - 0"	6' - 8"	3
06	HOME DEPOT	Exterior Single Panel Swinging	Interior	3' - 0"	6' - 8"	1
07	HOME DEPOT	Patio_Double Panel_Sliding	Exterior	5' - 0"	6' - 8"	1

WINDOW SCHEDULE					
			SIZE		
TYPE MARK	SUPPLIER	WINDOW TYPE	WIDTH	HEIGHT	COUNT
			1	1	,
01	Home Depot	Sliding	3' - 3"	1' - 9"	1
02	Home Depot	Casement	2' - 3"	4' - 3"	2
03	Home Depot	Casement	3' - 3"	3' - 3"	2
04	Home Depot	FIXED	2' - 3"	2' - 3"	2
05	Home Depot	Sliding	4' - 3"	3' - 3"	1
06	Home Depot	Sliding	6' - 3"	4' - 3"	1



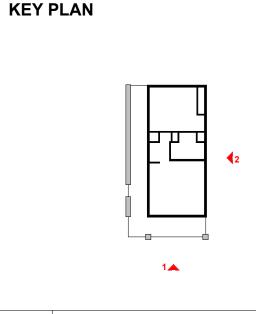

NO.	DESCRIPTION	D

NOTE:

LEGEND:

PROJECT

125 ORION 730 1Bd/1Ba CRAFTSMAN PORCH 550

DRAWING NAME

ARCHITECTURAL ELEVATIONS

CLIENT NAME:	Client Name
PROJECT NUMBER:	0061_12
DATE:	3/18/2025 12:53:48 PM
DESIGNED BY:	Designer
DRAWN BY:	Author
CHECKED BY:	Checker

A201

ABOUT WALL FINISHING

PLYWOOD WALL SIDING

WALL SIDING IS AN EXTERIOR CLADDING MATERIAL USED TO COVER AND PROTECT THE WALLS OF A BUILDING, PROVIDING BOTH FUNCTIONAL AND AESTHETIC BENEFITS.

IN THIS SPECIFIC PROJECT, **PLYWOOD WALL PANELS** ARE USED AS A FINISH SIDING BECAUSE THIS TYPE OF SIDING PROVIDES A DURABLE, COST-EFFECTIVE, AND VERSATILE EXTERIOR CLADDING THAT CAN BE EASILY INSTALLED, FINISHED, AND MAINTAINED TO ENHANCE THE AESTHETIC AND PROTECTIVE QUALITIES OF A BUILDING'S EXTERIOR.

STANDARD SIZES OF 1' X 8' EXTERIOR-GRADE PLYWOOD PANELS ARE INSTALLED ON THE FURRING STRIPS USING GALVANIZED STEEL SELF-DRILLING SCREWS.

CEDAR WOOD

CEDAR WOOD REFERS TO THE WOOD FROM VARIOUS SPECIES OF CEDAR TREES, WHICH ARE CONIFEROUS EVERGREEN TREES KNOWN FOR THEIR DISTINCT AROMA AND NATURAL RESISTANCE TO DECAY AND INSECTS. IN THIS SPECIFIC PROJECT, CEDAR WOOD IS USED AS A FURRING STRIP AND A FINISH MATERIAL ON BEAMS AND COLUMNS.

CEDAR WOOD AS A FURRING STRIPS PROVIDE THERMAL INSULATION, MOISTURE MANAGEMENT, AND AN AESTHETICALLY PLEASING, VERSATILE FRAMING SOLUTION WHEN INTEGRATED WITH CORONADO STONE AND CORRUGATED IRON SHEET CLADDING.

THE VERTICAL CEDAR WOOD FURRING STRIPS ARE ATTACHED TO HOME WRAP USING CORROSION-RESISTANT FASTENERS (HOT DIP GALVANIZED SCREWS), ENSURING PROPER PENETRATION INTO THE WALL FRAMING.

WOOD SHINGLE

WOOD SHINGLES ARE THIN, TAPERED PIECES OF WOOD, TRADITIONALLY USED FOR ROOFING AND SIDING. THEY ARE TYPICALLY MADE FROM CEDAR WOOD, OR PINE DUE TO THEIR DURABILITY AND RESISTANCE TO DECAY. SHINLES ARE SAWN RATHER THAN SPLIT, GIVING THEM A SMOOTH, UNIFORM APPEARANCE. THEY PROVIDE A NATURAL, OFTEN RUSTIC LOOK, GOOD INSULATION, AND GOOD WEATHER RESISTANCE. WOOD SHINGLES ARE ECO-FRIENDLY AND CAN BE STAINED OR PAINTED FOR CUSTOMIZATION.

IN THIS SPECIFIC PROJECT, WOOD SHINGLES ARE APPLIED AT THE TOP OF THE EXTERNAL WALL, CREATING AN EYE-CATCHING DETAIL THAT COMPLEMENTS THE OVERALL ARCHITECTURE AND ENSURES A STURDY, WEATHER-RESISTANT FINISH.


GRANITE COPPING

GRANITE COPPING REFERS TO A STONE, TYPICALLY GRANITE, USED TO COVER THE TOP EDGE OR CAP OF A WALL, PARAPET, OR OTHER ARCHITECTURAL FEATURE, PROVIDING PROTECTION AND A FINISHED LOOK.


STONE VENEER

STONE VENEER REFERS TO THIN LAYERS OF NATURAL OR MANUFACTURED STONE APPLIED TO A STRUCTURAL WALL, KNOWN FOR THEIR REALISTIC APPEARANCE AND RELATIVE LIGHTNESS. THESE VENEERS PROVIDE THE AESTHETIC OF STONE WITHOUT THE COST AND WEIGHT OF FULL STONE CONSTRUCTION, CONTRIBUTING TO A BEAUTIFUL AND COSTEFFECTIVE EXTERIOR FINISH.

IN THIS SPECIFIC PROJECT, STONE VENEER IS USED A FINISH MATERIAL ON EXTERIOR FINISH.

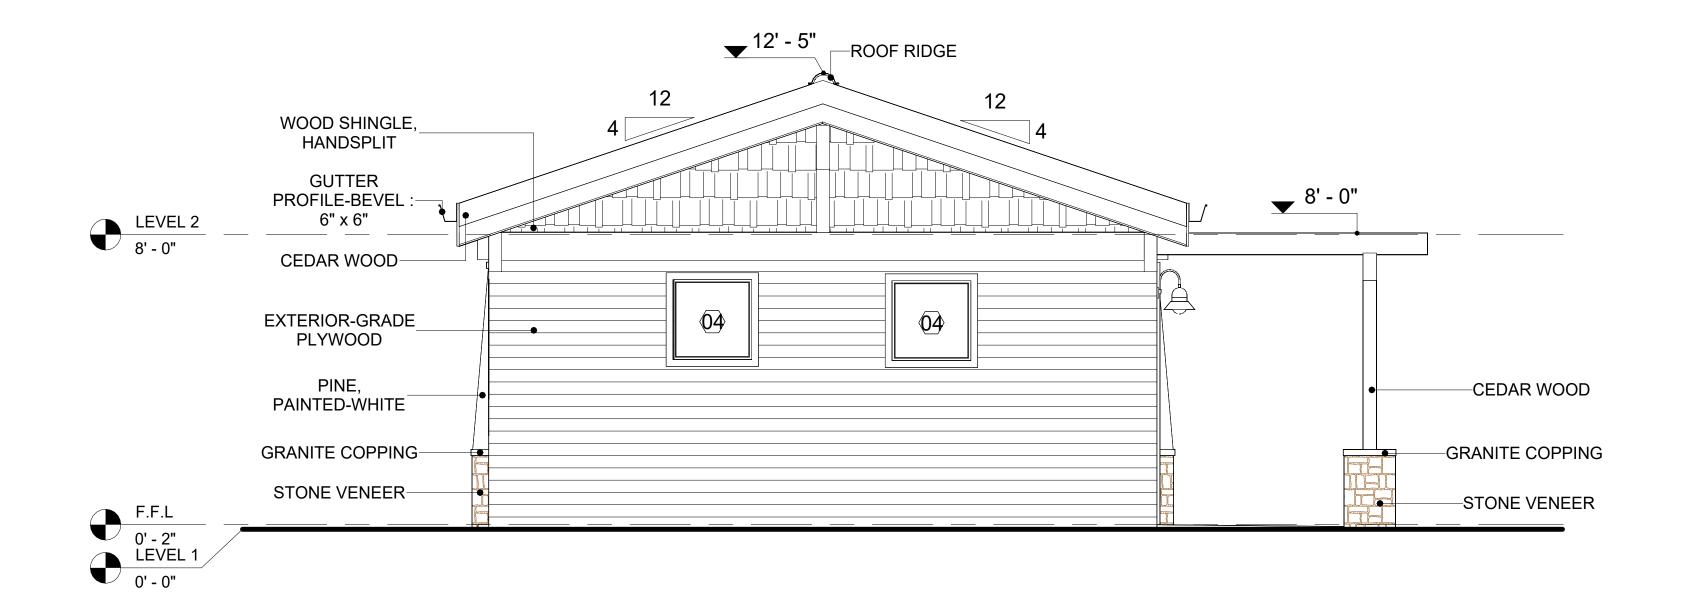

1 REAR ELEVATION
3/8" = 1'-0"

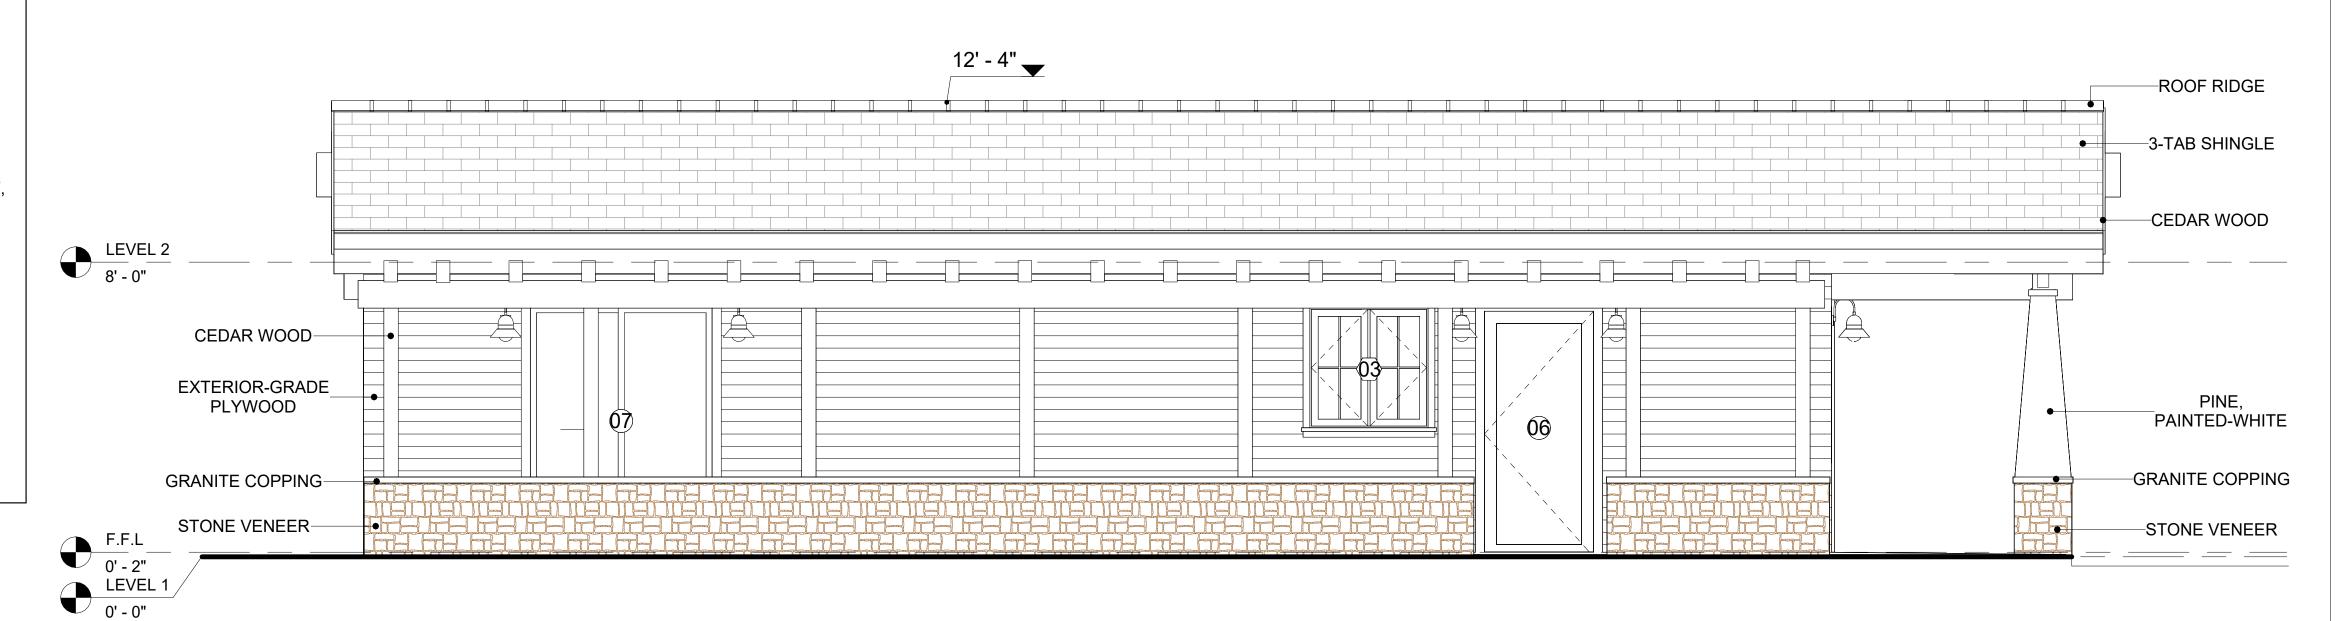

2 LEFT SIDE ELEVATION
3/8" = 1'-0"



KEY PLAN

NO.	DESCRIPTION	DATE

NOTE:

LEGEND:

PROJECT

125 ORION 730 1Bd/1Ba CRAFTSMAN PORCH 550

DRAWING NAME

ARCHITECTURAL ELEVATIONS

CLIENT NAME:

PROJECT NUMBER:

0061_12

DATE:

3/18/2025 12:53:51 PM


DESIGNED BY:

DRAWN BY:


CHECKED BY:

Checker

A202

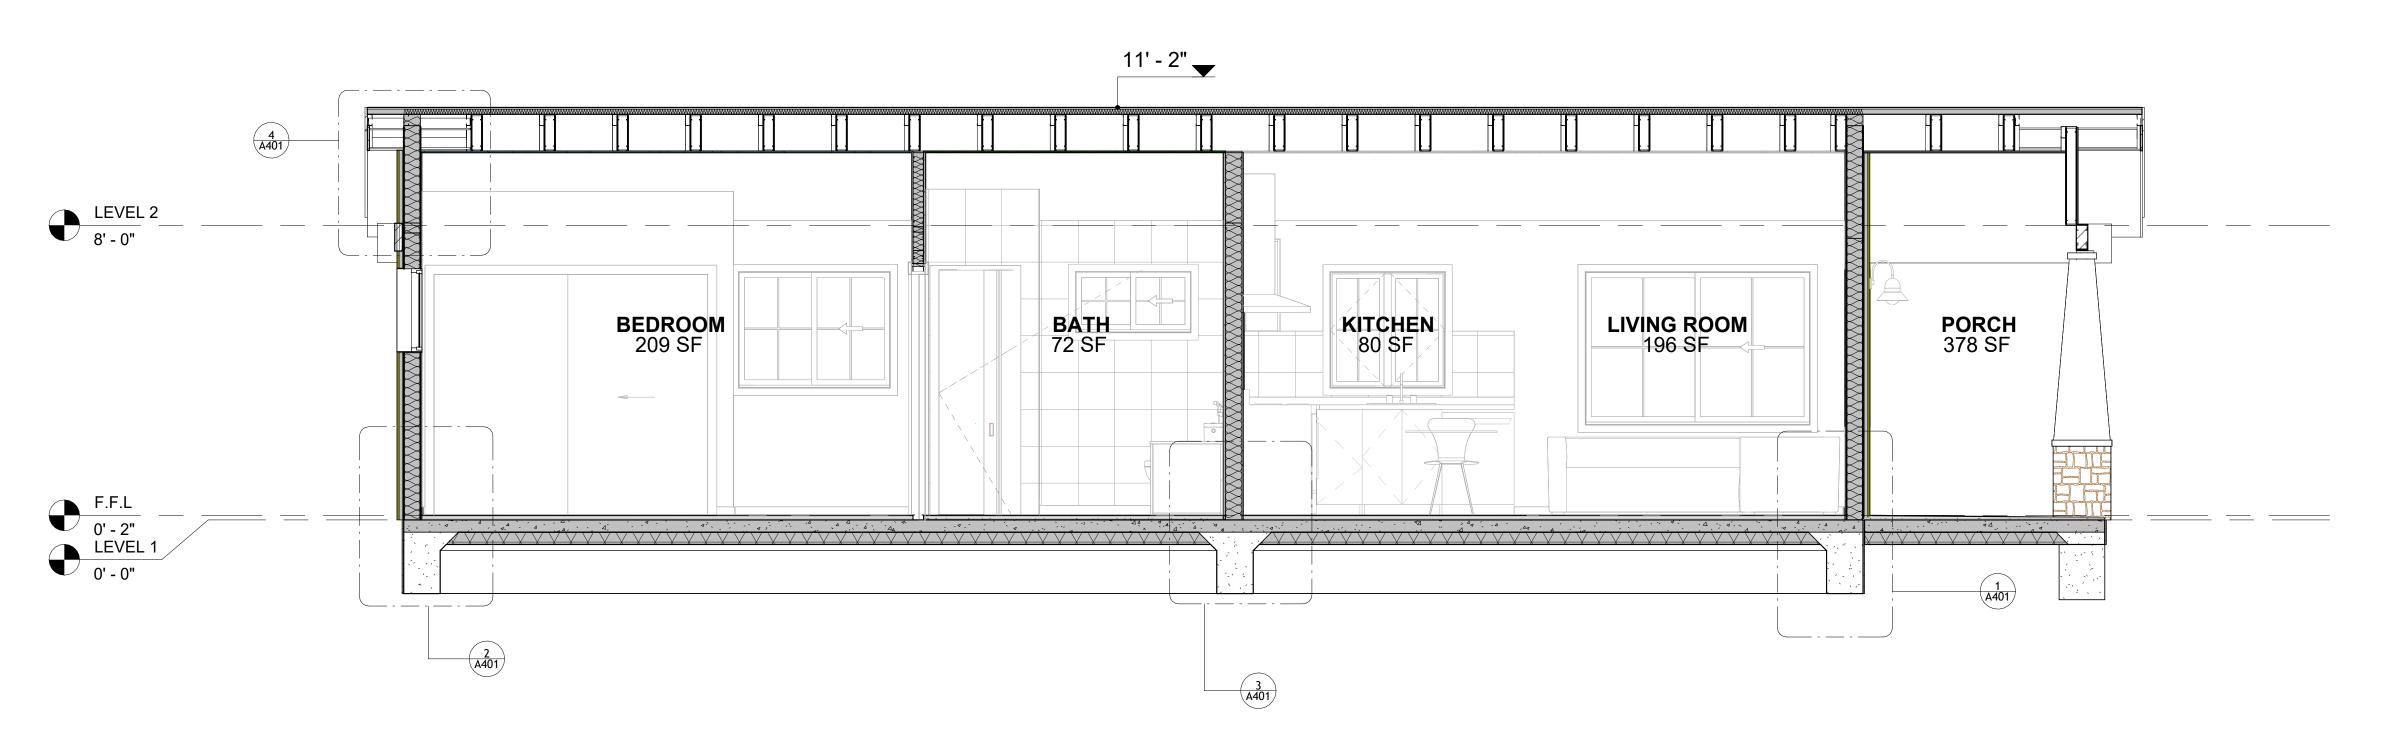


1 SECTION-1 3/8" = 1'-0"

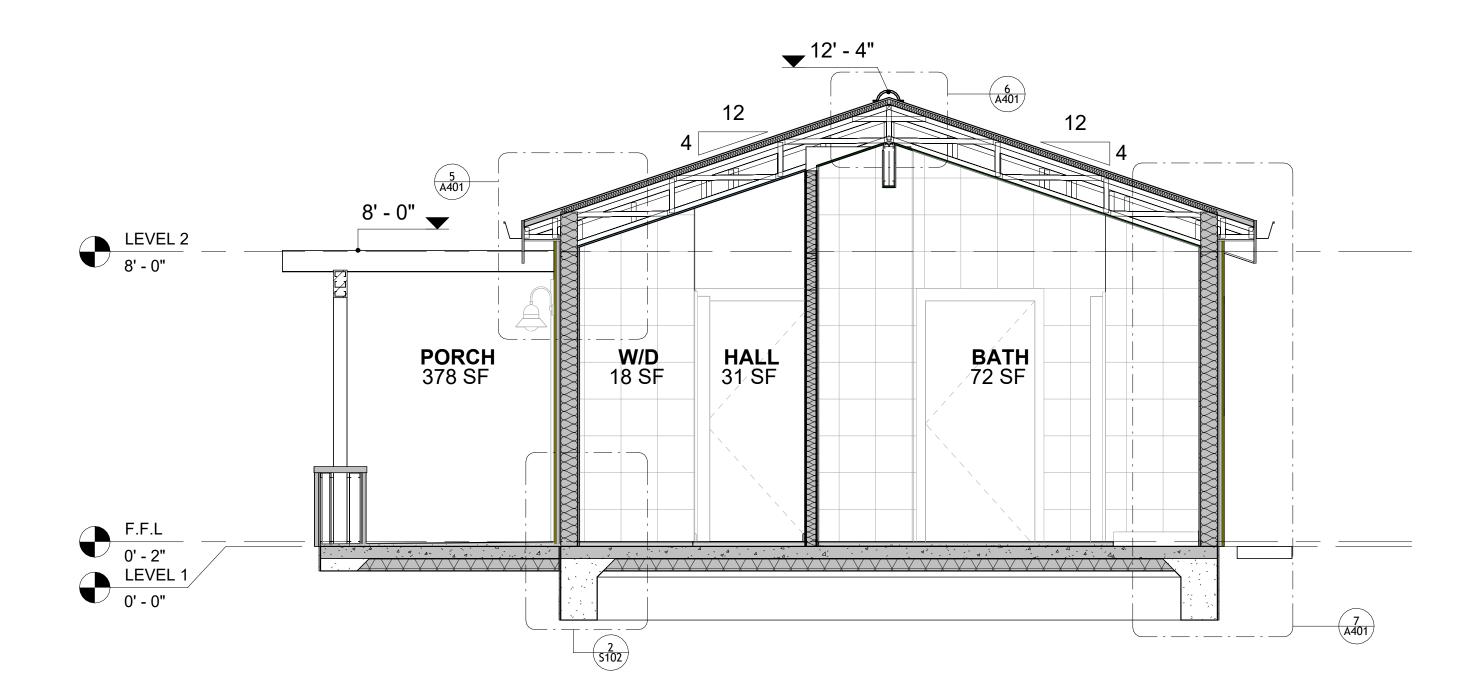

2 SECTION-2 3/8" = 1'-0"



KEY PLAN

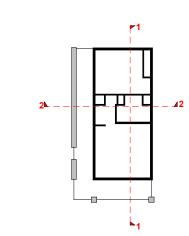

NO.	DESCRIPTION	DATE

NOTE:

LEGEND:

PROJECT


125 ORION 730 1Bd/1Ba CRAFTSMAN PORCH 550

DRAWING NAME


ARCHITECTURAL SECTIONS


LIENT NAME:	Client Name
ROJECT NUMBER:	0061_12
ATE:	3/18/2025 12:53:52 PM
ESIGNED BY:	Designer
RAWN BY:	Author
HECKED BY:	Checker

A301

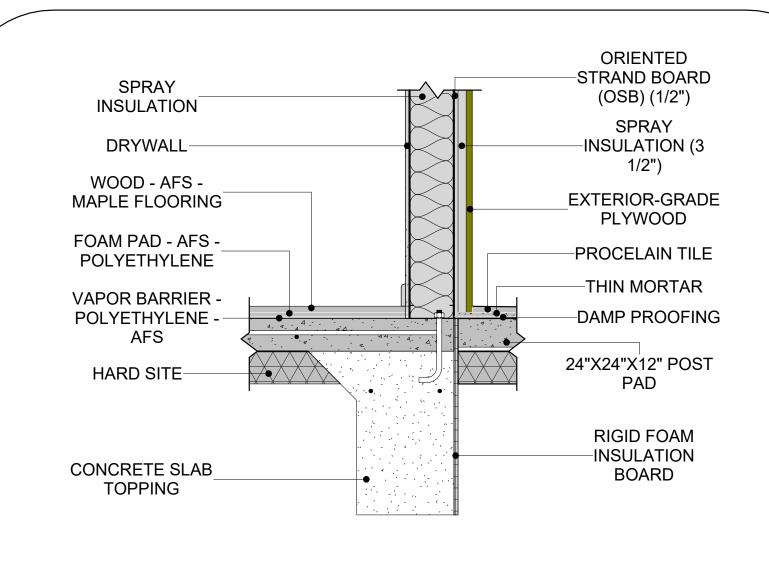



1 TYPICAL WALL FTG

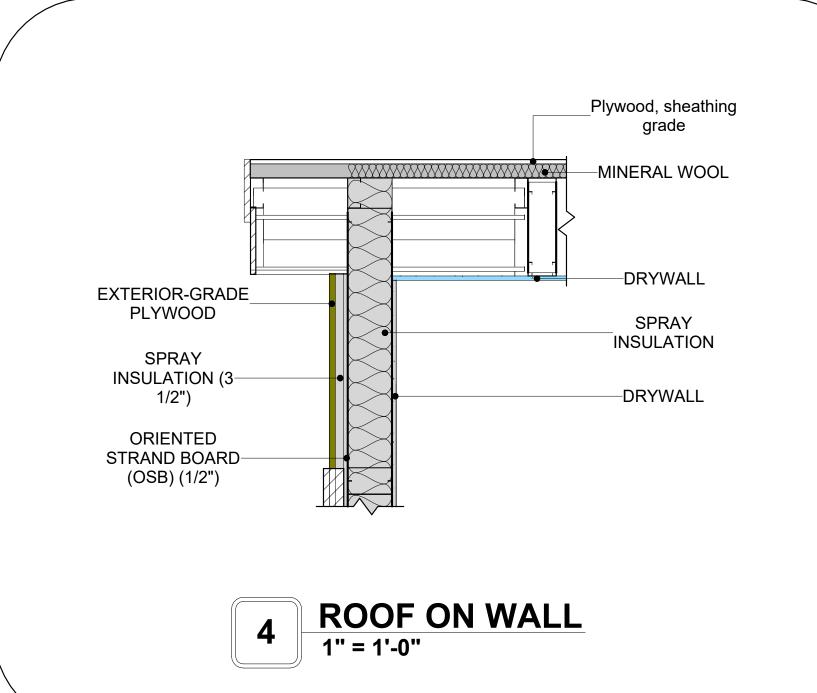


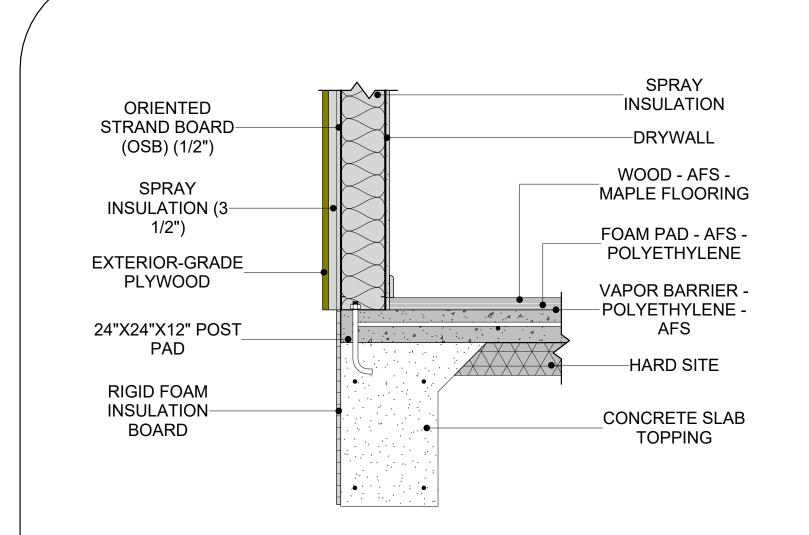


2 TYPICAL WALL FTG 1
1" = 1'-0"

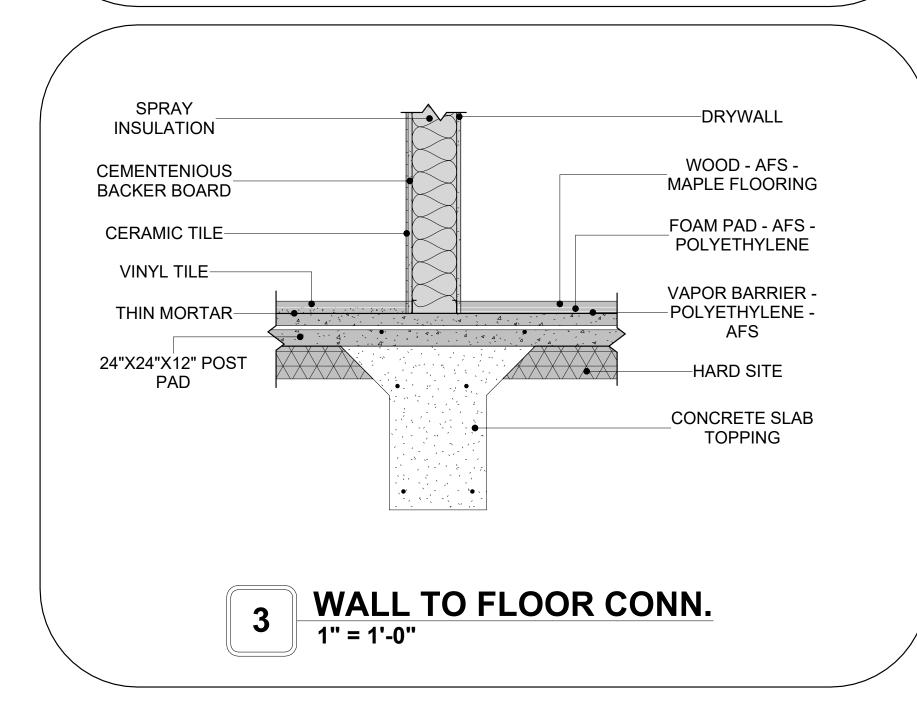

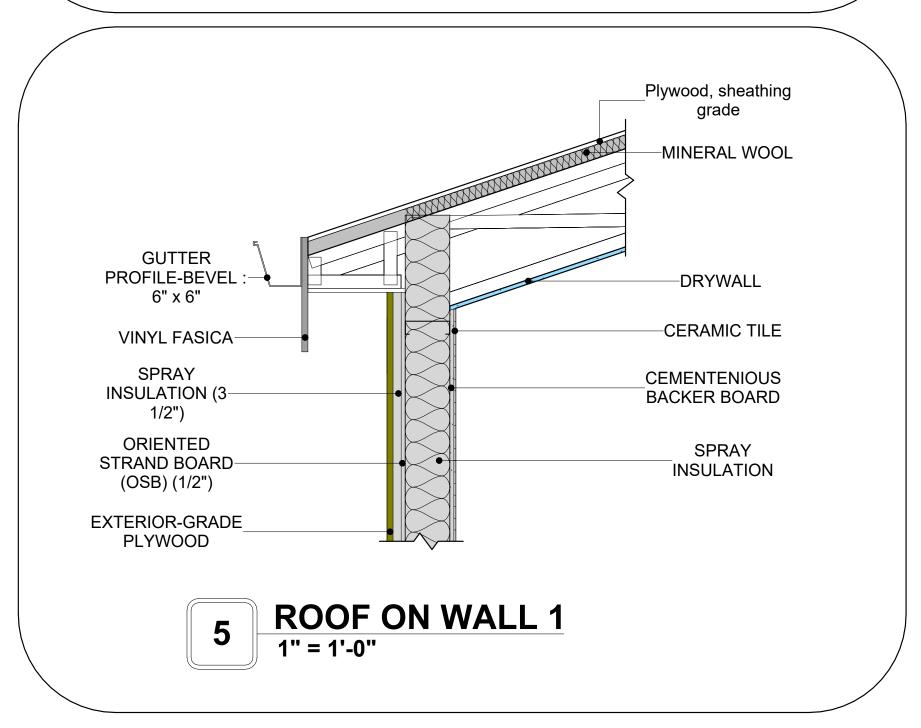

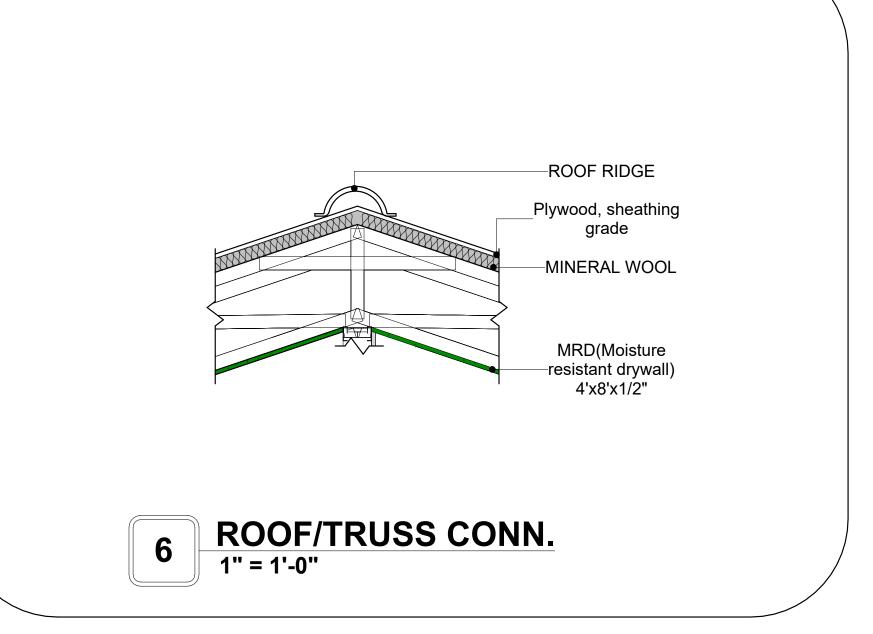

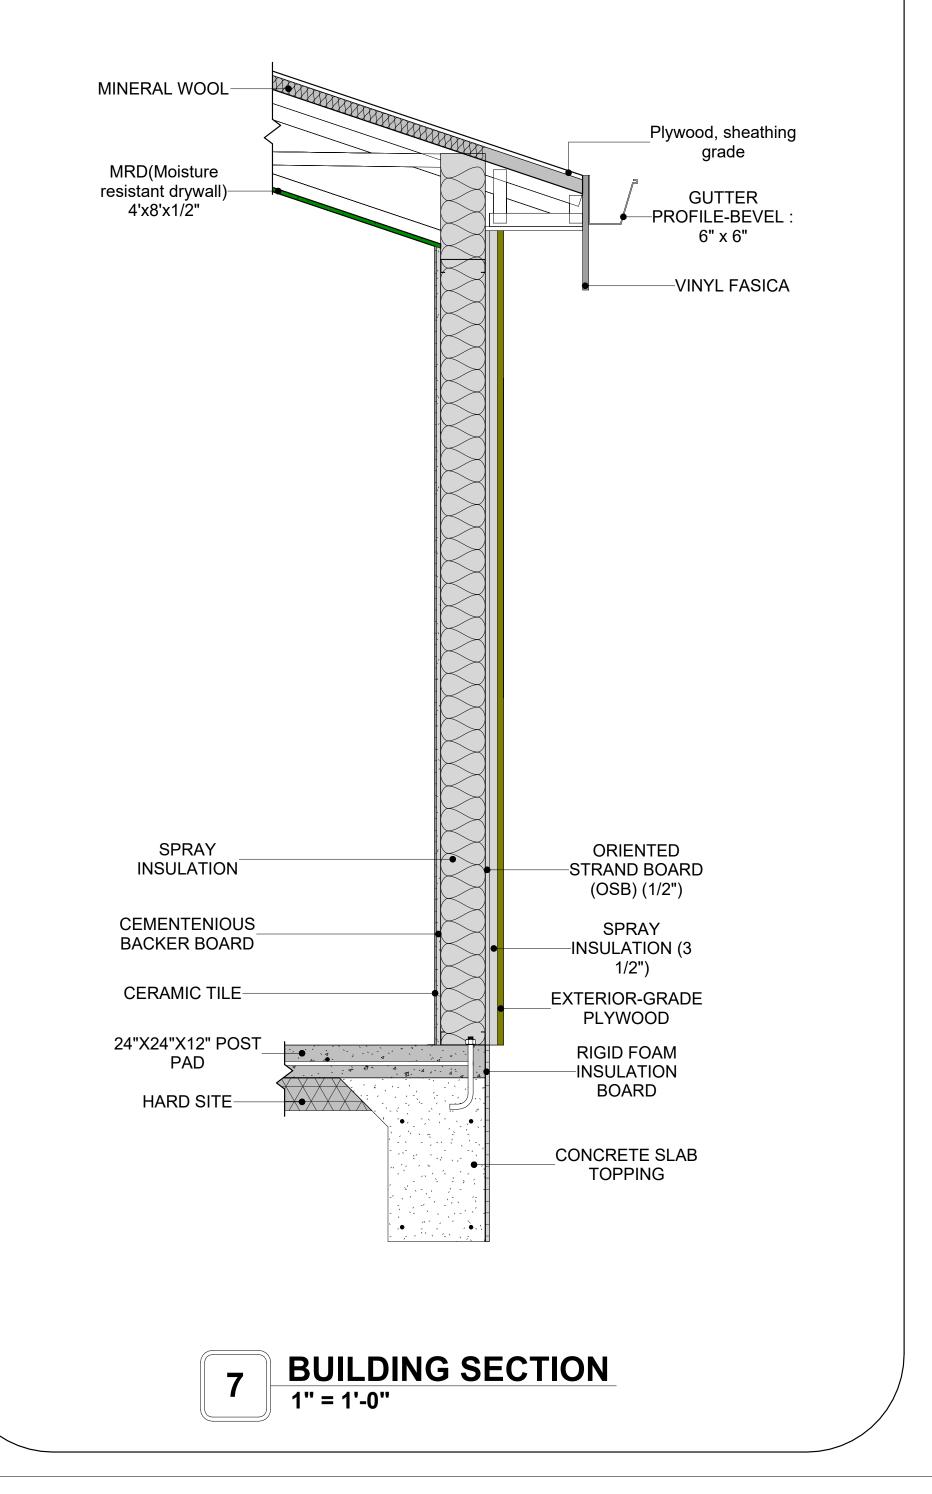



KEY PLAN

NO.	DESCRIPTION	DATE

NOTE:

LEGEND:

PROJECT

125 ORION 730 1Bd/1Ba CRAFTSMAN PORCH 550

DRAWING NAME

ARCHITECTURAL DETAILS

CLIENT NAME:	Client Name
PROJECT NUMBER:	0061_12
DATE:	3/18/2025 12:53:52 PM
DESIGNED BY:	Designer
DRAWN BY:	Author
CHECKED BY:	Checker

A401


SCALE: 1" = 1'-0"


CASEWORK GENERAL NOTES


- ALL CABINET HEIGHTS INCLUDE COUNTERTOPS. DIMENSIONS ARE TO THE NEAREST INCH. DIVISIONS IN CASEWORK ARE SHOWN FOR CLARITY AND DO NOT REPRESENT BREAKS IN THE COUNTERTOP.
- PROVIDE CONTINUOUS COUNTERTOP OVER ALL SIMILAR HEIGHT CASEWORK, UNLESS AND OTHERWISE NOTED.
- MANUFACTURER AND CATALOG NUMBERS ARE FOR REFERENCE AND ILLUSTRATION PURPOSES
- DOTTED LINES INDICATE WALL HUNG CABINETS, DIVISIONS OF BASE CABINETS BELOW THE
- COUNTERTOP, FURNITURE NOT IN THE CONTRACT OR PROJECTION SCREENS -SEE CASEWORK KEY AND SPECIFICATIONS.
- ALL CABINETS AND DRAWERS TO HAVE CAM LOCKS EXCEPT FOR SINK BASE CABINETS. ALL EXPOSED SURFACES (EXPOSED TO VIEW FROM ANY PERSPECTIVE) TO BE COVERED WITH
- LAMINATE.
- ALL CASEWORK WHICH MEETS A WALL AT ONE OR BOTH ENDS, TO BE PROVIDED WITH FILLER PANELS AND SCRIBED TO THE WALL(S) AS REQUIRED.
- 10. ALL CABINETS AND DRAWERS ARE PROVIDED WITH RECESSED HANDLES.
- 11. CONTRACTOR TO FIELD VERIFY ALL CLEAR OPENINGS PRIOR TO MILLWORK OR CASEWORK FABRICATION.
- 12. CASEWORK DRAWINGS ARE DIAGRAMMATIC IN NATURE TO SHOW DESIGN INTENT.


	CASEWORK SCHEDULE					
TYPE MAR K	TYPE	COUN T	HEIGHT	WIDTH	DEPTH	AREA
04	nofui a proto n to n	4	1' - 6"	2' - 0"	2' - 4"	3 SF
01	refrigerator top	1	2' - 6"	2' - 8"	1' - 0"	
02	Wall Cabinet Double Door 1	•	_			7 SF
03	Linear Counter Top	1	0' - 4"	2' - 8"	2' - 1"	1 SF
04	Base Cabinet Double Door 2	1	2' - 11"	2' - 8"	2' - 0"	8 SF
05	Wall_Cabinet_Single_Door	1	2' - 6"	1' - 8"	1' - 0"	4 SF
06	Wall_Cabinet_Single_Door	1	2' - 6"	2' - 6"	1' - 0"	6 SF
07	Base_Filler_1	1	2' - 11"	0' - 11"	2' - 0"	3 SF
08	Base Cabinet L-Shaped	1	2' - 11"	3' - 3"	3' - 3"	9 SF
09	HD_L-Shape_Counter_Top w sink hole	1	0' - 4"	4' - 6"	8' - 1"	1 SF
10	Base Cabinet Double Door 2	1	2' - 11"	2' - 2"	2' - 0"	6 SF
11	DOUBLE SINK VANITY	1	3' - 0"	5' - 0"	2' - 0"	15 SF
12	RECESSED_MED_CABINET	2	2' - 0"	1' - 6"	0' - 3"	3 SF
13	Closet 5	1	6' - 0"	2' - 9"	1' - 4"	16 SF
14	Closet 1	1	6' - 0"	2' - 9"	1' - 4"	16 SF
16	Closet 4	1	6' - 0"	8' - 2"	1' - 4"	49 SF
Grand t	otal	16	-	•		


SPECIALTY EQUIPMENT SCHEDULE			
TYPE MARK	TYPE	COUNT	
01	WASHER-FRONT-LOAD	1	
02	REFRIGERATOR	1	
03	RANGE	1	
04	DRYER-FRONT-LOAD	1	
05	Dishwasher	1	
Grand total: 5			

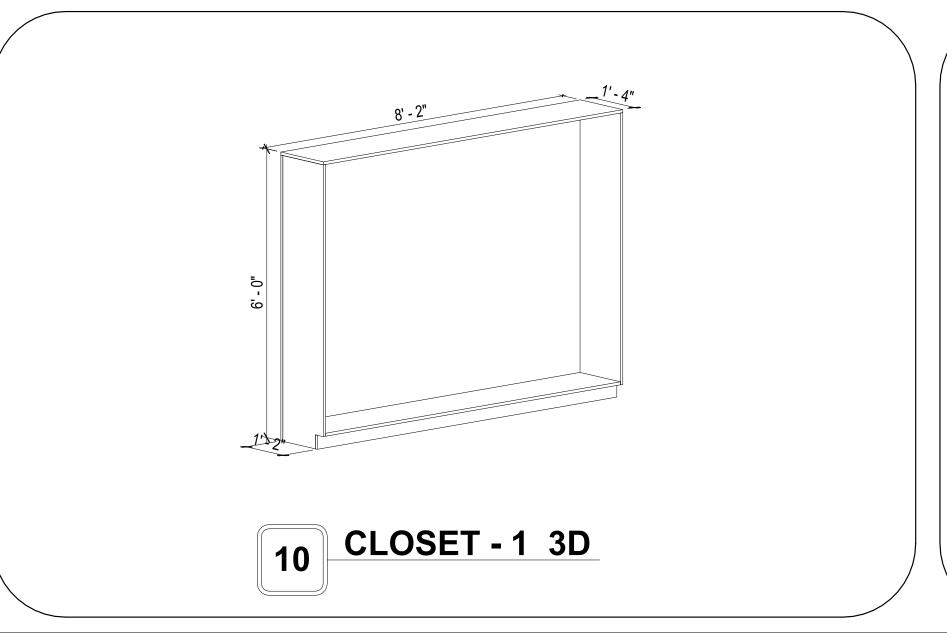

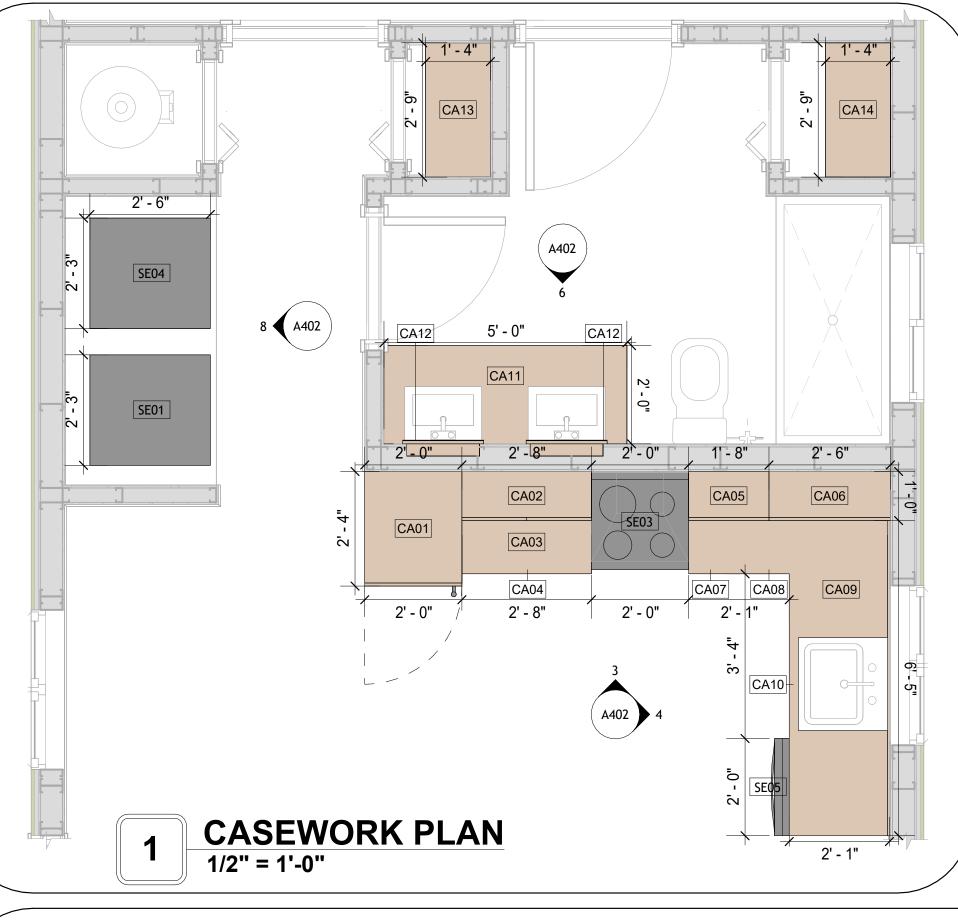

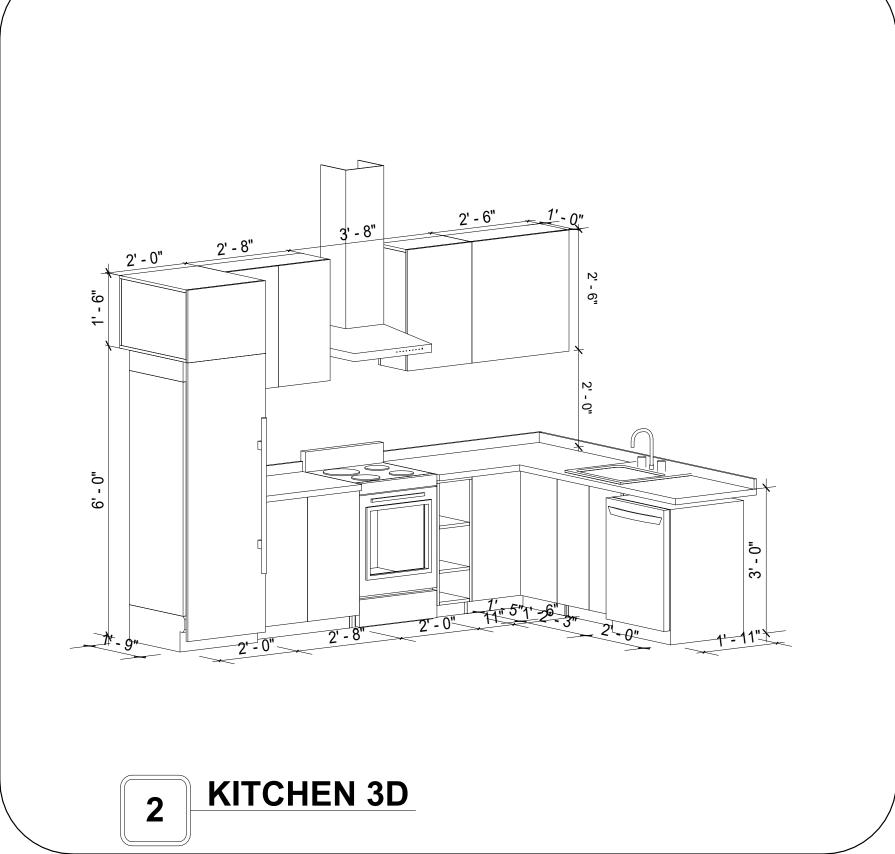


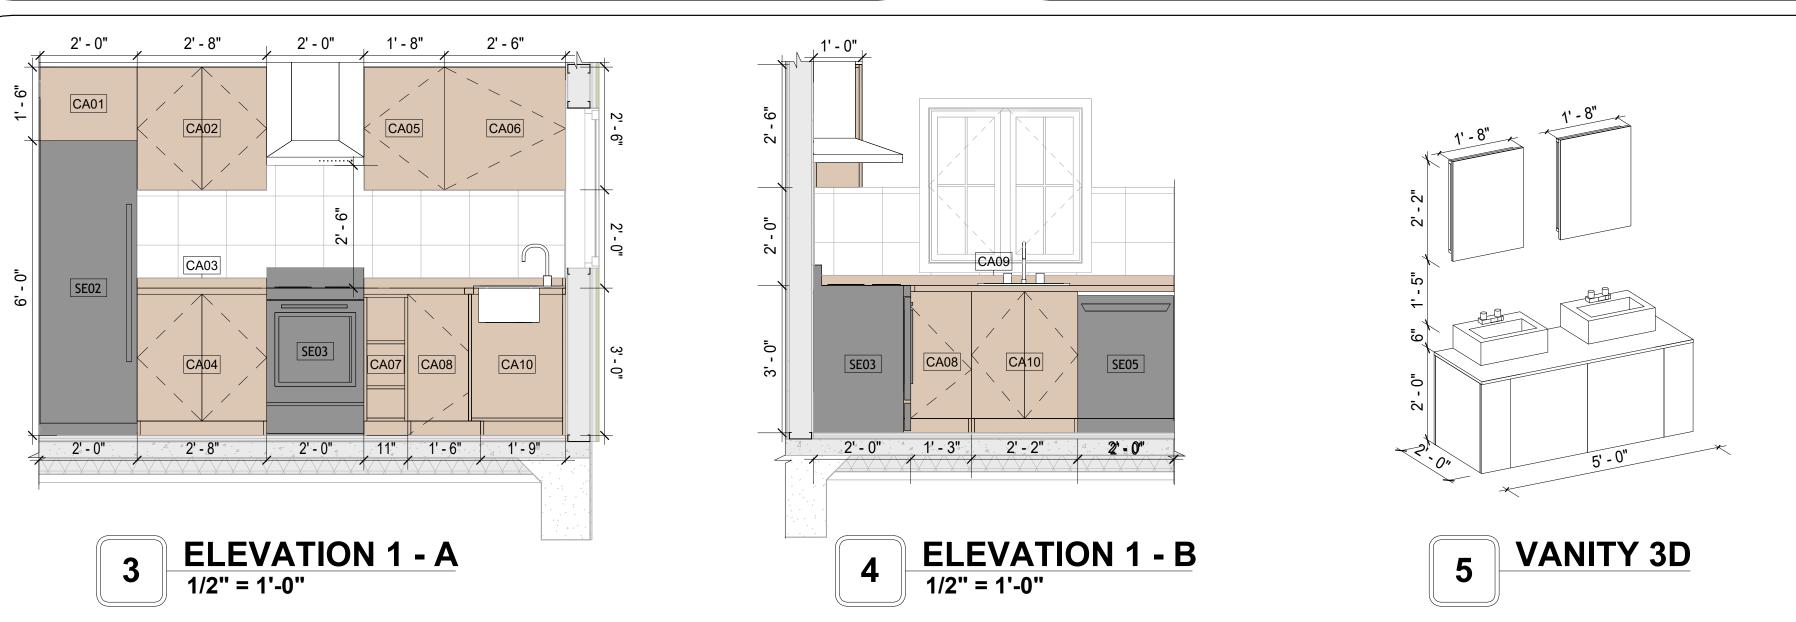

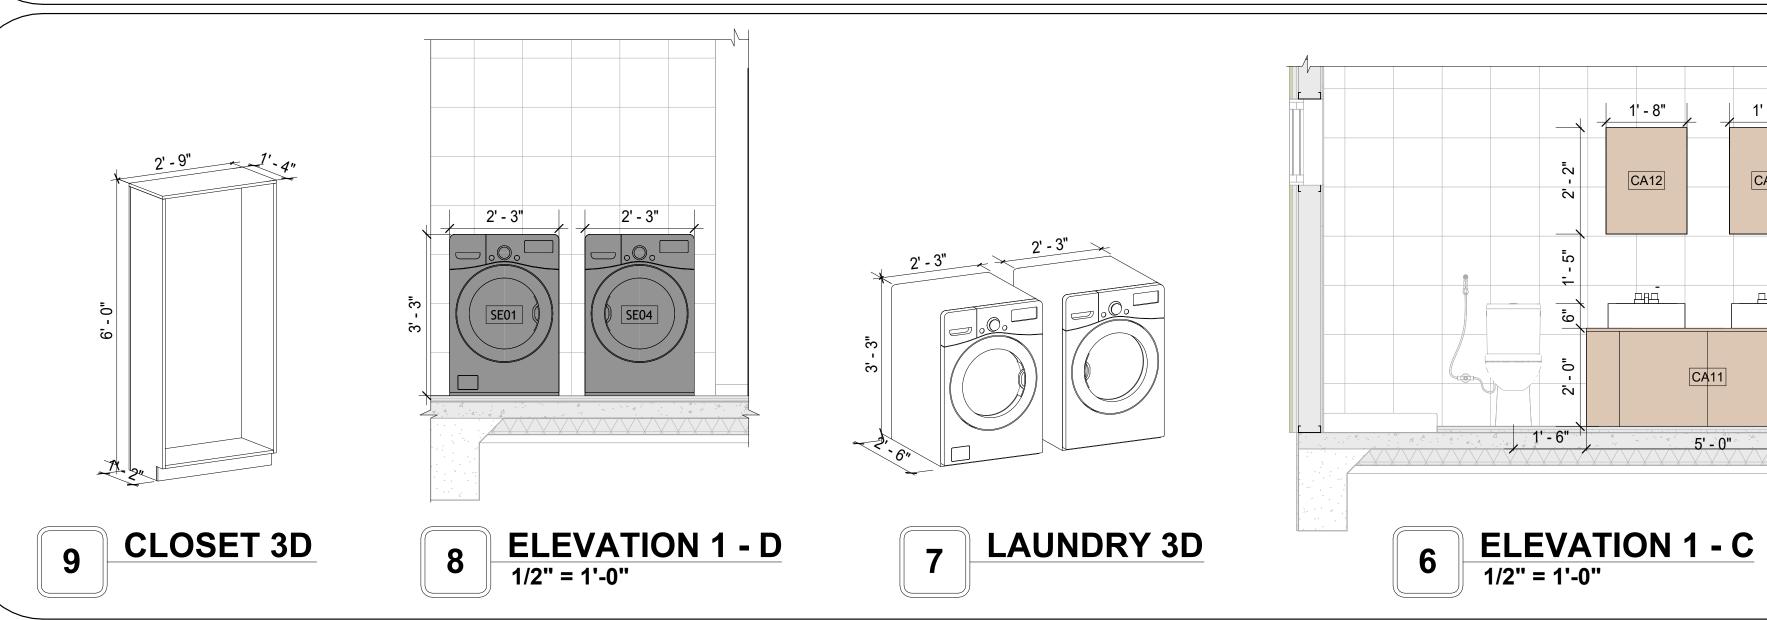



KEY PLAN

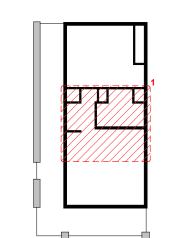

NO.	DESCRIPTION	DATE

NOTE:

LEGEND:

PROJECT

125 ORION 730 1Bd/1Ba **CRAFTSMAN PORCH 550**

DRAWING NAME

CA12

ARCHITECTURAL CASEWORK

CLIENT NAME:	Client Name
PROJECT NUMBER:	0061_12
DATE:	3/18/2025 12:53:54 PM
DESIGNED BY:	Designer
DRAWN BY:	Author
CHECKED BY:	Checker

A402

GENERAL NOTES

1. THIS DRAWING DEPICTS THE HVAC (HEATING, VENTILATION, AND AIR CONDITIONING) SYSTEM FOR THE ORION 1BD1BA CRAFTSMAN PORCH. IT PROVIDES A VISUAL REPRESENTATION OF THE SYSTEM LAYOUT AND COMPONENTS.

2.THE HVAC SYSTEM IS DESIGNED TO MEET THE SPECIFIC REQUIREMENTS OF THE BUILDING, INCLUDING HEATING, COOLING, AND VENTILATION NEEDS, AS PER THE PROJECT SPECIFICATIONS AND APPLICABLE CODES AND STANDARDS.

3. THE HVAC SYSTEM INSTALLATION SHALL COMPLY WITH THE LATEST EDITION OF THE INTERNATIONAL MECHANICAL CODE (IMC), INTERNATIONAL RESIDENTIAL CODE (IRC), AND ALL OTHER APPLICABLE LOCAL, STATE, AND NATIONAL CODES AND REGULATIONS.

4. THE EQUIPMENT SHOWN ON THIS DRAWING INCLUDES BUT IS NOT LIMITED TO AIR HANDLING UNITS (AHUS), CHILLERS, BOILERS, COOLING TOWERS, PUMPS, DUCTWORK, DIFFUSERS, GRILLES, AND CONTROL DEVICES.

5. ALL EQUIPMENT, DUCTWORK, AND PIPING SHALL BE INSTALLED IN ACCORDANCE WITH MANUFACTURER'S SPECIFICATIONS, LOCAL CODES, AND

6. ALL DUCTWORK SHALL BE SIZED, FABRICATED, AND INSTALLED IN ACCORDANCE WITH THE LATEST EDITION OF THE ACCA MANUAL D AND THE SMACNA HVAC DUCT CONSTRUCTION STANDARDS. DUCTWORK SHALL BE INSTALLED IN A NEAT AND WORKMANLIKE MANNER, PROPERLY SUPPORTED AND BRACED TO PREVENT SAGGING, AIR LEAKAGE, OR VIBRATION.

7. CONDENSATE DRAINAGE PIPING SHALL BE PROPERLY PITCHED TO ENSURE POSITIVE DRAINAGE TO AN APPROVED DISPOSAL LOCATION, SUCH AS A FLOOR DRAIN, SUMP PUMP, OR EXTERIOR GRADE. CONDENSATE LINES SHALL BE INSULATED TO PREVENT SWEATING.

8. THE LOCATION OF CONTROL PANELS AND SENSORS INDICATED ON THIS DRAWING CAN BEMODIFY WITH THE SPECIFIC LOCATIONS AND WIRING DETAILS WILL BE DETERMINED DURING THE CONTROL SYSTEM DESIGN AND INSTALLATION.

9. THE HVAC SYSTEM DESIGN CONSIDER ENERGY EFFICIENCY, INDOOR AIR QUALITY, OCCUPANT COMFORT, AND NOISE CONTROL, FOLLOWING APPLICABLE GUIDELINES AND REGULATIONS.

WITH THE LOCAL BUILDING DEPARTMENT AND UTILITY PROVIDERS TO ENSURE A TIMELY AND COMPLIANT INSTALLATION.

10. COORDINATION WITH OTHER TREADS HAS BEEN DONE ON A DESIGN LEVEL. THIS DRAWING SHALL BE READ TOGETHER WITH THE AR, EL AND SN DESIGN DRAWINGS TO ENSURE PROPER INSTALLATION AND INTEGRATION OF THE HVAC SYSTEMS.

11. THE HVAC CONTRACTOR IS RESPONSIBLE FOR OBTAINING ALL NECESSARY PERMITS AND LICENSES, AND FOR SCHEDULING AND COORDINATING

12. ALL DUCTWORK PENETRATIONS THROUGH WALLS, FLOORS, OR CEILINGS SHALL BE PROPERLY SEALED AND FIRE-STOPPED USING APPROVED

METHODS AND MATERIALS TO MAINTAIN THE INTEGRITY OF THE BUILDING'S FIRE-RESISTANCE RATINGS.

13. HVAC EQUIPMENT SHALL BE INSTALLED LEVEL AND PLUMB, AND IN STRICT ACCORDANCE WITH THE MANUFACTURER'S INSTALLATION INSTRUCTIONS AND RECOMMENDATIONS. PROVIDE ADEQUATE CLEARANCES AROUND EQUIPMENT FOR PROPER AIRFLOW, SERVICE ACCESS, AND CODE COMPLIANCE.


14. ALL HVAC EQUIPMENT AND COMPONENTS, INCLUDING THERMOSTATS, DAMPERS, AND ACCESS PANELS, SHALL BE LOCATED IN ACCESSIBLE AREAS FOR EASY SERVICING AND MAINTENANCE. PROVIDE ADEQUATE SPACE AROUND EQUIPMENT FOR PROPER AIRFLOW AND SERVICE ACCESS.


15. THE HVAC SYSTEM SHALL BE BALANCED AND ADJUSTED TO ENSURE PROPER AIRFLOW, TEMPERATURE DISTRIBUTION, AND SYSTEM PERFORMANCE THROUGHOUT THE RESIDENCE. PROVIDE A WRITTEN REPORT DOCUMENTING THE FINAL SYSTEM BALANCE.


16. ANY DEVIATIONS OR MODIFICATIONS TO THE HVAC SYSTEM DESIGN SHALL BE REVIEWED AND APPROVED BY THE RESPONSIBLE DESIGN PROFESSIONALS AND COMMUNICATED TO ALL RELEVANT PARTIES INVOLVED IN THE CONSTRUCTION PROCESS.

17. FOR ANY INQUIRIES OR CLARIFICATIONS REGARDING THE HVAC SYSTEM DESIGN, PLEASE CONSULT THE RESPONSIBLE DESIGN PROFESSIONALS OR THE PROJECT MANAGEMENT TEAM.

SYMBOLS

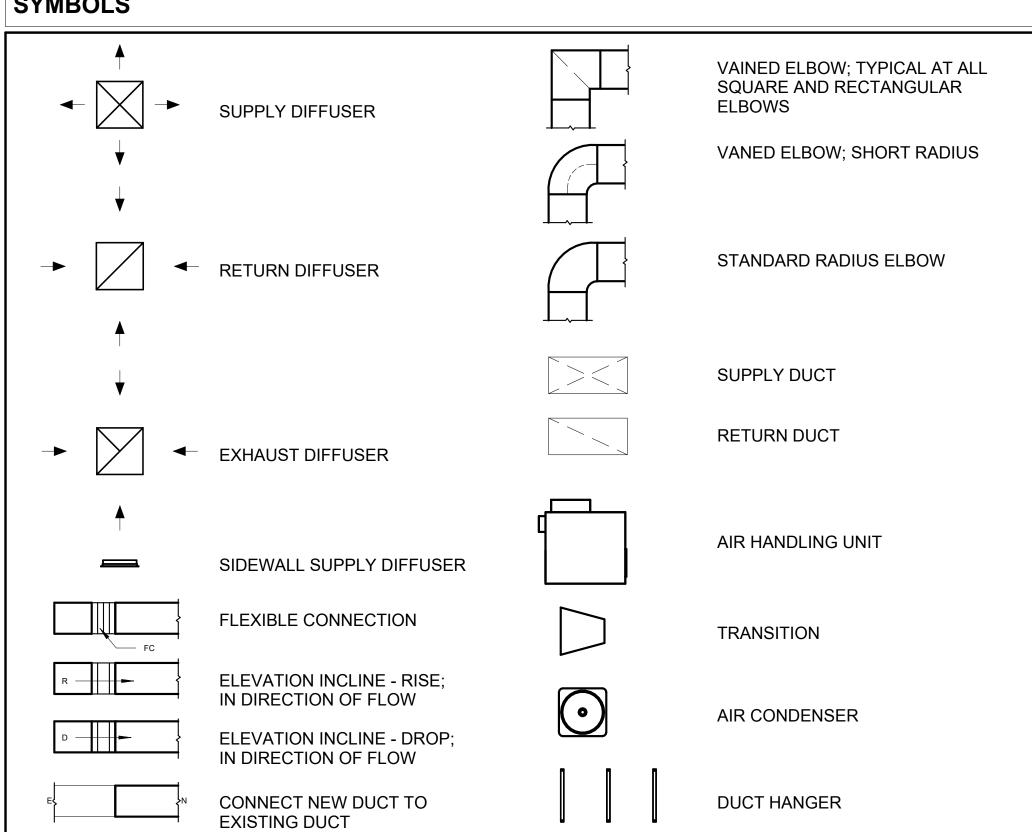

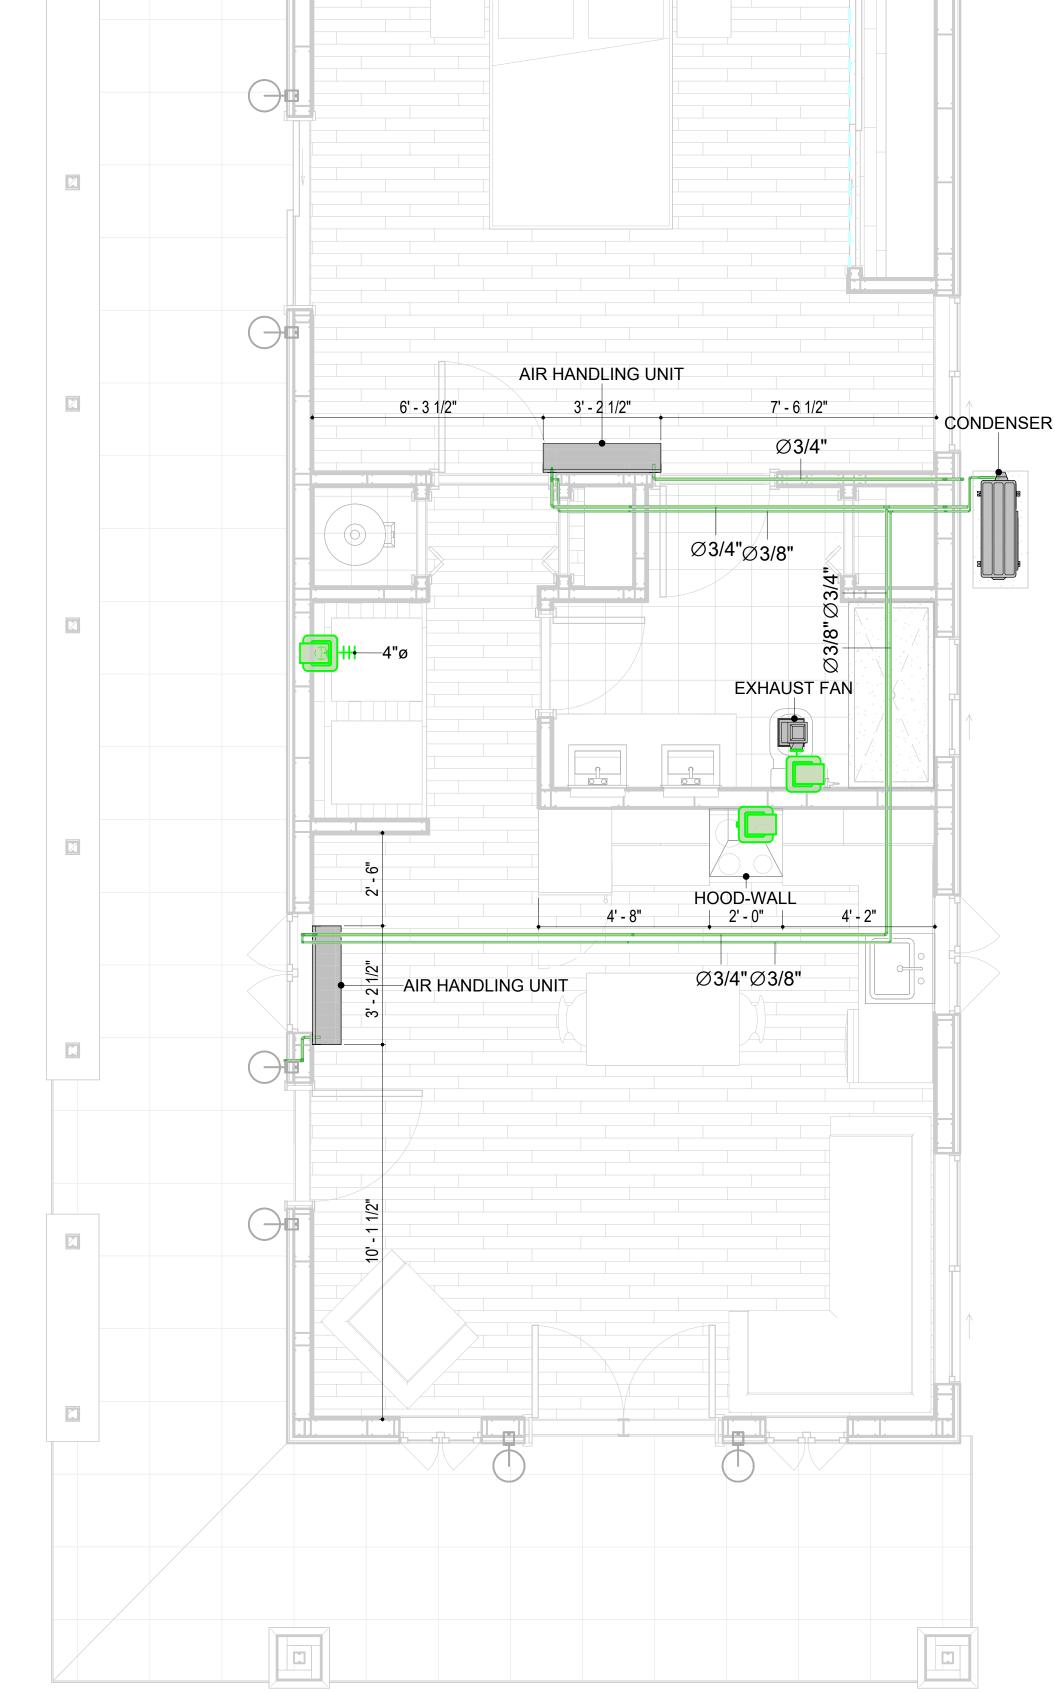

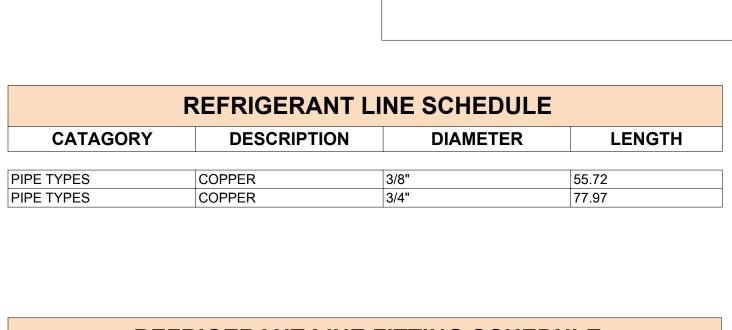

HVAC COLOR SCHEME

AIR CONDITIONING PIPE


REFRIGERANT LINE FITTING SCHEDULE				
CATAGORY	DESCRIPTION	Size	Count	
ELBOW - GENERIC	ELBOW - GENERIC: STANDARD/HVAC	3/4"ø-3/4"ø	23	
ELBOW - GENERIC	ELBOW - GENERIC: STANDARD/HVAC	3/8"ø-3/8"ø	17	
TEE - GENERIC	TEE - GENERIC: STANDARD	3/4"ø-3/4"ø-3/ 4"ø	1	
TEE - GENERIC	TEE - GENERIC: STANDARD	3/8"ø-3/8"ø-3/ 8"ø	1	
TRANSITION - GENERIC	TRANSITION - GENERIC: STANDARD	3/4"ø-1/2"ø	3	
TRANSITION - GENERIC	TRANSITION - GENERIC: STANDARD	3/4"ø-5/8"ø	2	
TRANSITION - GENERIC	TRANSITION - GENERIC: STANDARD	3/8"ø-1/4"ø	1	

MECHANICAL EQUIPMENT SCHEDULE		
CATAGORY	DESCRIPTION	COUNT
AIR HANDLING UNIT	AIR HANDLING UNIT: WALL MOUNTED	2
CONDENSER	CONDENSER: OUT DOOR 1	
EXHAUST FAN	EXHAUST FAN: 75 CFM 1	
	HOOD-WALL: VENT	1

DUCT FITTING SCHEDULE					
CATAGORY	DESCRIPTIO	N COUNT			
ROUND TRANSITION - ANGLE	45 DEGREE	5			

DUCT ACCESSORY SCHEDULE				
CATAGORY	DESCRIPTION	COUNT		
ROOF VENT	3" DIAMETER	2		

FLEX DUCT SCHEDULE							
DESCRIPTION	DESCRIPTION	LENGTH	DIAMETER	COUNT			
FLEX DUCT ROUND	FLEX-ROUND	12.50	4"	3			
GRAND TOTAL: 3		12.50					

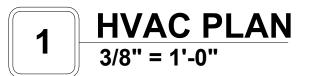



KEY PLAN

NO.	DESCRIPTION	DATE

NOTE:

LEGEND:

PROJECT

125-Orion-730-1Bd1Ba Craftsman-Porch-550

DRAWING NAME

HVAC PLAN

CLIENT NAME:	Owner
PROJECT NUMBER:	15_0001
DATE:	3/15/2025 1:12:06 AM
DESIGNED BY:	Designer
DRAWN BY:	Author
CHECKED BY:	Checker

M101

ELECTRICAL NOTES

- 1. THIS DRAWING DEPICTS THE ELECTRICAL SYSTEM FOR THE 125-Orion-730-1Bd 1Ba- Craftsman-Porch-550. IT PROVIDES A VISUAL REPRESENTATION OF THE ELECTRICAL LAYOUT AND COMPONENTS, INCLUDING POWER DISTRIBUTION, LIGHTING, AND CONTROL SYSTEMS.
- THE ELECTRICAL SYSTEM IS DESIGNED TO MEET THE SPECIFIC REQUIREMENTS OF THE BUILDING, INCLUDING POWER DISTRIBUTION, LIGHTING, AND SPECIALIZED ELECTRICAL EQUIPMENT NEEDS, AS PER THE PROJECT SPECIFICATIONS AND APPLICABLE CODES AND STANDARDS.
- THE ELECTRICAL SYSTEM INSTALLATION SHALL COMPLY WITH THE LATEST EDITION OF THE NATIONAL ELECTRICAL CODE (NEC), INTERNATIONAL BUILDING CODE (IBC), AND ALL OTHER APPLICABLE LOCAL, STATE, AND NATIONAL CODES AND REGULATIONS.
- LOCATIONS AS NEEDED, DEVICES ARE SHOWN ON PLANS IN APPROXIMATE IDEAL LOCATIONS, UNLESS SPECIFICALLY DIMMENSIONED.
- 5. OPEN WALLS AS NEEDED TO ALLOW FOR NEW ELECTRICAL INSTALLATIONS.
- 6. LABEL ALL CIRCUITS ON JUNCTION BOXES, RECEPTACLES, DATA, SMOKE DETECTOR, AND EQUIPMENT IN PANEL BOX.
- 7. INSTALL RACEWAY AS NEEDED FOR DDC, ACCESS CONTROL, LOW VOLTAGE WIRING & DATA.
- 8. RELABEL POWER, DATA & FIRE ALARM FOR ROOM #CHANGES.
- 9. VERIFY ALL CIRCUITS LABELED ON PRINT ARE CORRECT BEFORE WORKING ON THEM.
- 10. NOTE ON SITE PLAN ALL CHANGES OR MISSING DETAIL TO BE INCORPORATED INTO THE MASTER PLAN.
- 11. DRAWINGS ARE DIAGRAMMATIC ONLY FOR THE PURPOSE OF SHOWING FIXTURE AND OUTLET LOCATIONS.
- 12. ELECTRICAL CONTRACTOR TO VERIFY SERVICE SIZE BY CALCULATION BASED UPON ACTUAL NAME PLATE RATINGS OF SELECTED EQUIPMENT.
- 13. VERIFY LOCATION OF SERVICE ENTRANCE WITH POWER COMPANY. PROVIDE UFER GROUND IN
- BUILDING FOUNDATION AT SERVICE ENTRANCE LOCATION.
- 14. PROVIDE A MIN. OF 20 FEET OF ONE *4 BARE COPPER UFER WIRE EMBEDDED IN CONCRETE FOOTING AT THE SERVICE ENTRANCE LOCATION WHERE APPROVED BY LOCAL SERVICE PROVIDER.
- 15. PROVIDE WATERPROOF FIXTURES IN ALL HIGH MOISTURE AREAS (EXTERIOR, SHOWER AND TUB CEILINGS ETC.)
- 16. PROVIDE DEDICATED CIRCUITS TO EACH BATH, DEN, FAMILY ROOM, BEDROOM, LOFT, KITCHEN REFRIGERATOR, KITCHEN FREEZER DISHWASHER, AND ANY AREA/ITEM SPECIFIED BY OWNER.
- 17. INCANDESCENT FIXTURES WITH OPEN OR PARTIALLY ENCLOSED LAMPS, PENDANT FIXTURES, AND LAMP HOLDERS ARE NOT PERMITTED IN CLOSETS.
- 18. ALL WORKMANSHIP AND MATERIALS TO CONFORM WITH THE 2015 IRC.
- 19. PROVIDE A MIN. OF 20 FEET OF ONE *4 BARE COPPER UFER WIRE EMBEDDED IN CONCRETE FOOTING AT THE SERVICE ENTRANCE LOCATION WHERE APPROVED BY LOCAL SERVICE PROVIDER.
- 20. PROVIDE A BONDING CONDUCTOR CONSISTING OF A MINIMUM OF ONE *4 BARE COPPER WIRE CONNECTING THE BUILDING'S METAL WATER PIPING SYSTEM TO THE SERVICE EQUIPMENT ENCLOSURE GROUNDING.

MAIN PANEL CALCS

ELECTRICAL CALCS	
LIGHT AND OUTLETS 730 @ 3W	2,190 W
3 APPLIANCE CIRCUITS	4,500 W
DRYER	2,000 W
WASHER	2,000 W
RANGE	5,000 W
WATER HEATER	5,000 W
REFRIG.	1,800 W
DISHWASHER & DISPOSAL	3000 W
TOTAL	25,490 W
FRIST 10,000 @ 100% REMAINDER @ 40% MINI. SPLIT UNITS	10,000 W 6,196W 10,000 W

26,196 W DIVIDED BY 240V = 109 AMPS TOTAL

26,196 W

(USE 200 AMP SERVICE)

TOTAL

ELECTRICAL ABBREVIATIONS LIST

Γ						
	1P	1 POLE (2P, 3P, 4P, ETC.)	CTR	CENTER	нт	HEIGHT
	A	AMPERE	CU	COPPER	HTG	HEATING
	AC	ABOVE COUNTER OR AIR CONDITIONER	DCP	DOMESTIC WATER CIRCULATING PUMP	HTR	HEATER
	ACLG	ABOVE CEILING	DEPT	DEPARTMENT	HV	HIGH VOLTAGE
	ADO	AUTOMATIC DOOR OPENER	DET	DETAIL	HVAC	HEATING, VENTILATING AND AIR
	AF	AMP FRAME	DIA	DIAMETER	CONDITIONING	CONDITIONING
	AFF	ABOVE FINISHED FLOOR	DISC	DISCONNECT	HWP	HYDRONIC WATER PUMP
	AFG	ABOVE FINISHED GRADE	DIST	DISTRIBUTION	IC	INTERRUPTING CAPACITY
	AFI	ARC FAULT CIRCUIT INTERRUPTER	DN	DOWN	IG	ISOLATED GROUND
	AHU	AIR HANDLING UNIT	DPR	DAMPER	IMC	INTERMEDIATE METAL CONDUIT
	AL	ALUMINUM	DS	SAFETY DISCONNECT SWITCH	INCAND	INCANDESCENT
	ALT	ALTERNATE	DT	DOUBLE THROW	IR	INFRARED
	AMP	AMPERE	DWG	DRAWING	I/W	INTERLOCK WITH
	AMPL	AMPLIFIER	DDC	DIRECT DIGITAL CONTROL	J-BOX	JUNCTION BOX
	ANNUN	ANNUNCIATOR APPROX APPROXIMATELY	EC	ELECTRICAL CONTRACTOR	KV	KILOVOLT
	AQ-STAT	AQUASTAT	ELEC	ELECTRIC, ELECTRICAL	KVA	KILOVOLT-AMPERE
	ARCH	ARCHITECT, ARCHITECTURAL	ELEV	ELEVATOR	KVAR	KILOVOLT-AMPERE REACTIVE
	AS	AMP SWITCH	EM	EMERGENCY	KW	KILOWATT
	AT	AMP TRIP	EMS	ENERGY MANAGEMENT SYSTEM	KWH	KILOWATT HOUR
	ATS	AUTOMATIC TRANSFER SWITCH	EMT	ELECTRICAL METALLIC TUBING	LOC	LOCATE OR LOCATION
	AUTO	AUTOMATIC	EP	ELECTRIC PNEUMATIC	LT	LIGHT
	AUX	AUXILIARY	EQUIP	EQUIPMENT	LTG	LIGHTING
	AV	AUDIO VISUAL	EWC	ELECTRIC WATER COOLER	LTNG	LIGHTNING
	AWG	AMERICAN WIRE GAUGE	EXIST	EXISTING	LV	LOW VOLTAGE
	BATT	BATTERY	EXH	EXHAUST	MAX	MAXIMUM
	BD	BOARD	EXP	EXPLOSION PROOF	MAG.S	MAGNETIC STARTER
	BLDG	BUILDING	FA	FIRE ALARM	M/C	MOMENTARY CONTACT
	BMS	BUILDING MANAGEMENT SYSTEM	FABP	FIRE ALARM BOOSTER POWER	MC	MECHANICAL CONTRACTOR
	С	CONDUIT	SUPPLY PANEL	SUPPLY PANEL	MCB	MAIN CIRCUIT BREAKER
	CAB	CABINET	FACP	FIRE ALARM CONTROL PANEL	MCC	MOTOR CONTROL CENTER
	CAT	CATALOG	FCU	FAN COIL UNIT	MDC	MAIN DISTRIBUTION CENTER
	CATV	CABLE TELEVISION	FIXT	FIXTURE	MDP	MAIN DISTRIBUTION PANEL
	СВ	CIRCUIT BREAKER	FLR	FLOOR	MFR	MANUFACTURERMAIN FUSED
	CCTV	CLOSED CIRCUIT TELEVISION	FLUOR	FLUORESCENT		DISCONNECT SWITCH
	CKT	CIRCUIT	FU	FUSE	MH	MANHOLE
	CLG	CEILING	FUDS	FUSED SAFETY DISCONNECT SWITCH	MIC	MICROPHONE
	COMB	COMBINATION	GA	GAUGE	MIN	MINIMUM
	CMPR	COMPRESSOR	GAL	GALLON	MISC	MISCELLANEOUS
	CONN	CONNECTION	GALV	GALVANIZED	MLO	MAIN LUGS ONLY
	CONST	CONSTRUCTION	GC	GENERAL CONTRACTOR	MMS	MANUAL MOTOR STARTER
	CONT	CONTINUATION OR CONTINUOUS	GEN	GENERATOR	MOA	MULTIOUTLET ASSEMBLY
	CONTR	CONTRACTOR	GFI	GROUND FAULT CIRCUIT INTERRUPTER	MSP	MOTOR STARTER PANELBOARD
	CONV	CONVECTOR	GFP	GROUND FAULT PROTECTOR	MSBD	MAIN SWITCHBOARD
	CP	CIRCULATING PUMP	GND	GROUND	MT	MOUNT
	CRT	CATHODE-RAY TUBE	GRS	GALVANIZED RIGID STEEL (CONDUIT)	MT.C	EMPTY CONDUIT
	СТ	CURRENT TRANSFORMER	GYP BD	GYPSUM BOARD	UL	UNDERWRITERS LABORATORIES

Branch Panel:

Location: LIVING ROOM 10 Supply From:

Enclosure: Type 1

Mounting: Recessed

Volts: 120/240 Single Phases: 1

A.I.C. Rating: Mains Type: Mains Rating: 200 A MCB Rating: 1 A

Circuit Numb er		Number of Elements	Rating	Length	Wire Size	A			3	Wire Size	Length	Rating	Number of Elements	Circuit Description	Circuit Numb er
1	BED LIGHT	9	15 A	47' - 1 3/4"	1-#14, 1-#14, 1-#14	568 VA	600 VA			1-#14, 1-#14, 1-#14	52' - 0 1/32"	15 A	8	OUTDOOR LIGHT	2
3	KITCHEN & HALL LIGHT	11	15 A	30' - 5 27/32"	1-#14, 1-#14, 1-#14			516 VA	209 VA	1-#14, 1-#14, 1-#14	25' - 8 27/32"	15 A	8	LIVING LIGHT	4
5	BED RECEPTACLE	5	20 A	56' - 6 1/16"	1-#12, 1-#12, 1-#12	900 VA	673 VA			1-#12, 1-#12, 1-#12	30' - 10 7/16"	20 A	7	BATH GFCI	6
7	DRYER	1	30 A	39' - 4 1/2"	2-#10, 1-#10, 1-#10			2500 VA	1200 VA	1-#12, 1-#12, 1-#12	37' - 6 3/16"	20 A	1	WASHEING MASHEIN	8
9						2500 VA	2250 VA			2-#10, 1-#10, 1-#10	43' - 3 15/16"	30 A	1	WATER HEATER	10
11	OUTDOOR RECEPTACLE	4	20 A	57' - 5 9/16"	1-#12, 1-#12, 1-#12			720 VA	2250 VA						12
13	CONDENSER	1	60 A	23' - 2 1/2"	2-#6, 1-#6, 1-#10	2500 VA	900 VA			1-#12, 1-#12, 1-#12	33' - 3 5/32"	20 A	5	LIV. RECEPTACLE	14
15								2500 VA	540 VA	1-#12, 1-#12, 1-#12	23' - 0 23/32"	20 A	3	KITCHEN RECEPTACLE	16
17	REFRIGERATOR	1	20 A	26' - 9 5/8"	1-#12, 1-#12, 1-#12	1800 VA	2500 VA			2-#8, 1-#8, 1-#10	21' - 2 31/32"	40 A	1	RANGE	18
19	OVENHOOD	1	20 A	16' - 4"	1-#12, 1-#12, 1-#12			180 VA	2500 VA						20
21	DISHWASHER	1	20 A	12' - 7 9/16"	1-#12, 1-#12, 1-#12	1200 VA									22
23															24
25															26
	1					16359	VA	1311	2 VA						
						136	Α	10	9 A					1	

Load Classification	Connected Load	Demand Factor	Estimated Demand	Panel	Totals
LIGHTING - DWELLING UNIT	900 VA	100.00%	900 VA		
OTHER	1124 VA	100.00%	1124 VA	Total Conn. Load:	29471 VA
RECEPTACLE	6000 VA	100.00%	6000 VA	Total Est. Demand:	28471 VA
LIGHTING	200 VA	100.00%	200 VA	Total Conn.:	123 A
CONDENSER	5000 VA	100.00%	5000 VA	Total Est. Demand:	119 A
WATER HEATER	4500 VA	100.00%	4500 VA		
RANGE	5000 VA	80.00%	4000 VA		
DRYER	5000 VA	100.00%	5000 VA		
REFRIGERATOR	1800 VA	100.00%	1800 VA		



KEY PLAN

NO.	DESCRIPTION	DATE

NOTE:

LEGEND:

PROJECT

125-Orion-730-1Bd 1Ba-Craftsman-Porch-550

DRAWING NAME

SCHEDULE

CLIENT NAME:	Owner
PROJECT NUMBER:	0359_12
DATE:	3/15/2025 4:40:07 PM
DESIGNED BY:	Designer
DRAWN BY:	Author
CHECKED BY:	Checker

E101

SCALE: 1/4" = 1'-0"

© [2024] [FrameUpNow] . All rights reserved

ELECTRICAL NOTE

- A. PROVIDE INTERCONNECTED SMOKE ALARMS IN EACH SLEEPING ROOMS, OUTSIDE EACH SLEEPING ROOM, ON EACH STORY, IN THE HALL OR ADJACENT ROOM LUHERE THE CEILING HEIGHT OF A ROOM OPEN TO THE HALL EXCEEDS THE HALL BY 24'. SMOKE ALARMS SHALL BE PERMANENTLY HARD WIRED WITH BATTERY BACKUP.
- B. RECEPTACLE OUTLETS FOR RANGES AND CLOTHES DRYERS SHALL BE A THREE POLE WITH GROUND TYPE. FOUR WIRE GROUNDING-TYPE FLEXIBLE CORDS WILL BE REQUIRED FOR CONNECTION OF RANGES AND CLOTHES DRYERS. THE BONDING JUMPER SHALL NOT BE CONNECTED BETWEEN NEUTRAL TERMINAL AND THE FRAME OF THE APPLIANCE.
- C. TWO OR MORE 20 AMP SMALL APPLIANCE CIRCUITS SHALL BE PROVIDED TO SERVE THE KITCHEN, BREAKFAST NOOK, AND DINING ROOM. SUCH CIRCUITS SHALL HAVE NO OTHER OUTLETS.
- D. AT LEAST ONE 20 AMP BRANCH CIRCUIT SHALL BE PROVIDED TO SERVICE THE LAUNDRY ROOM. THIS CIRCUIT SHALL HAVE NO OTHER OUTLETS.
- E. ALL RECEPTACLES WITH IN 6' OF A WET BAR SINK OR KITCHEN SINK TO SERVE COUNTER TOP SURFACES MUST BE GFCI. ON KITCHEN COUNTERS 12' OR WIDER NO POINT ALONG THE WALL SHALL BE MORE THAN 2' FROM A RECEPTACLE. ALL RECEPTACLES WITH IN 6' OF KITCHEN SINK MUST BE GFCI. AT LEAST ONE GFCI RECEPTACLE SHALL BE INSTALLED IN THE BATHROOM ADJACENT TO EACH BASIN.
- F. FIXTURES INCLUDING CEILING FANS THAT ARE LOCATED IN DAMP LOCATIONS SHALL BE LISTED TO BE SUITABLE FOR **SUCH LOCATIONS PER 2012 IRC**
- G. PROVIDE ONE (1) SWITCHED OUTLET @ ALL BEDROOMS AND DEN
- H. CEILING FANS NOT EXCEEDING 35 LBS. (WITH OR WITHOUT ACCESSORIES MAY BE SUPPORTED BY OUTLET BOXES
- PROVIDED THE OUTLET BOXES ARE IDENTIFIED FOR SUCH USE PER 2012 IRC
- ELECTRICAL OUTLET BOXES ON OPPOSITE SIDES OF FIRE RATED WALLS SHALL BE SEPARATED BY A HORIZONTAL DISTANCE OF NOT LESS THAN 24".
- OUTLET BOXES IN THE WALLS BETWEEN THE GARAGE AND DWELLING SHALL BE METAL OR U.L. APPROVED FIRE RESISTIVE PLASTIC. BOXES IN GARAGE CEILING SHALL BE METAL.
- K. ALL BRANCH CIRCUITS THAT SUPPLY 120 VOLTS SINGLE PHASE 15 AND 20 AMPS RECEPTACLE OUTLETS INSTALLED IN
- THE DWELLING SHALL BE PROTECTED BY AN ARC FAULT CIRCUIT INTERRUPTER, EXCEPT GFCI RECEPTICLES.

NOTE:

A. RECEPTACLES MUST BE PROVIDED IN HALLWAYS 10'-0" OR MORE IN LENGTH. FOR A ONE FAMILY DWELLINGS AND EACH OF A TWO FAMILY DWELLING THAT IS AT GRADE LEVEL, AT LEAST ONE WP-GFCI RECEPTACLE OUTLET ACCESSIBLE AT GRADE LEVEL AND NOT MORE THAN 6'-6" ABOVE GRADE SHALL BE INSTALLED AT THE FRONT AND BACK OF THE DWELLING.

NOTE: APPLIANCE DISCONNECT

E4001.5 GROUNDING OF ENCLOSURES.

METAL ENCLOSURES FOR SWITCHES OR CIRCUIT BREAKERS SHALL BE CONNECTED TO AN

EQUIPMENT GROUNDING CONDUCTOR.

METAL ENCLOSURES FOR SWITCHES OR CIRCUIT BREAKERS USED AS SERVICE


EQUIPMENT SHALL COMPLY WITH THE PROVISIONS OF SECTION E3609.4. WHERE NONMETALLIC ENCLOSURES ARE USED WITH METAL RACEWAYS OR METAL-ARMORED

CABLES, PROVISIONS SHALL BE MADE FOR CONNECTING THE EQUIPMENT GROUNDING


CONDUCTOR. NONMETALLIC BOXES FOR SWITCHES SHALL BE INSTALLED WITH A WIRING METHOD THAT

PROVIDES OR INCLUDES AN EQUIPMENT GROUNDING CONDUCTOR. (404.12)

ELECTRICAL LEGEND Electrical Lights With Fan Waterproof Recessed Can Light 0 **Pendant Light** 0 Recessed Can Light **-**₫ Wall Lamp Standalone linear Single Switch ₩ ₩ Three way Switch Fan Switch ₩ \ominus **Duplex Receptacle** $\bigoplus \blacksquare$ Triplex Receptacle **GFCI Receptacle** \boxtimes **Exhaust Fan** Smoke and heat detector

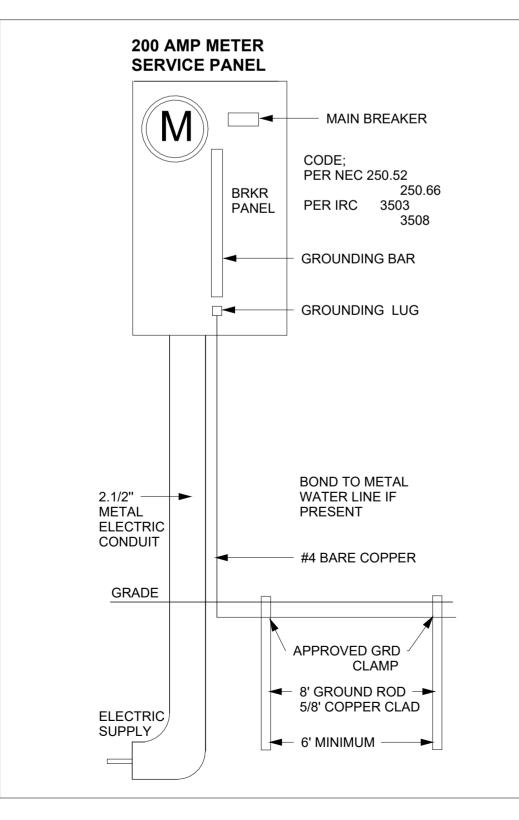



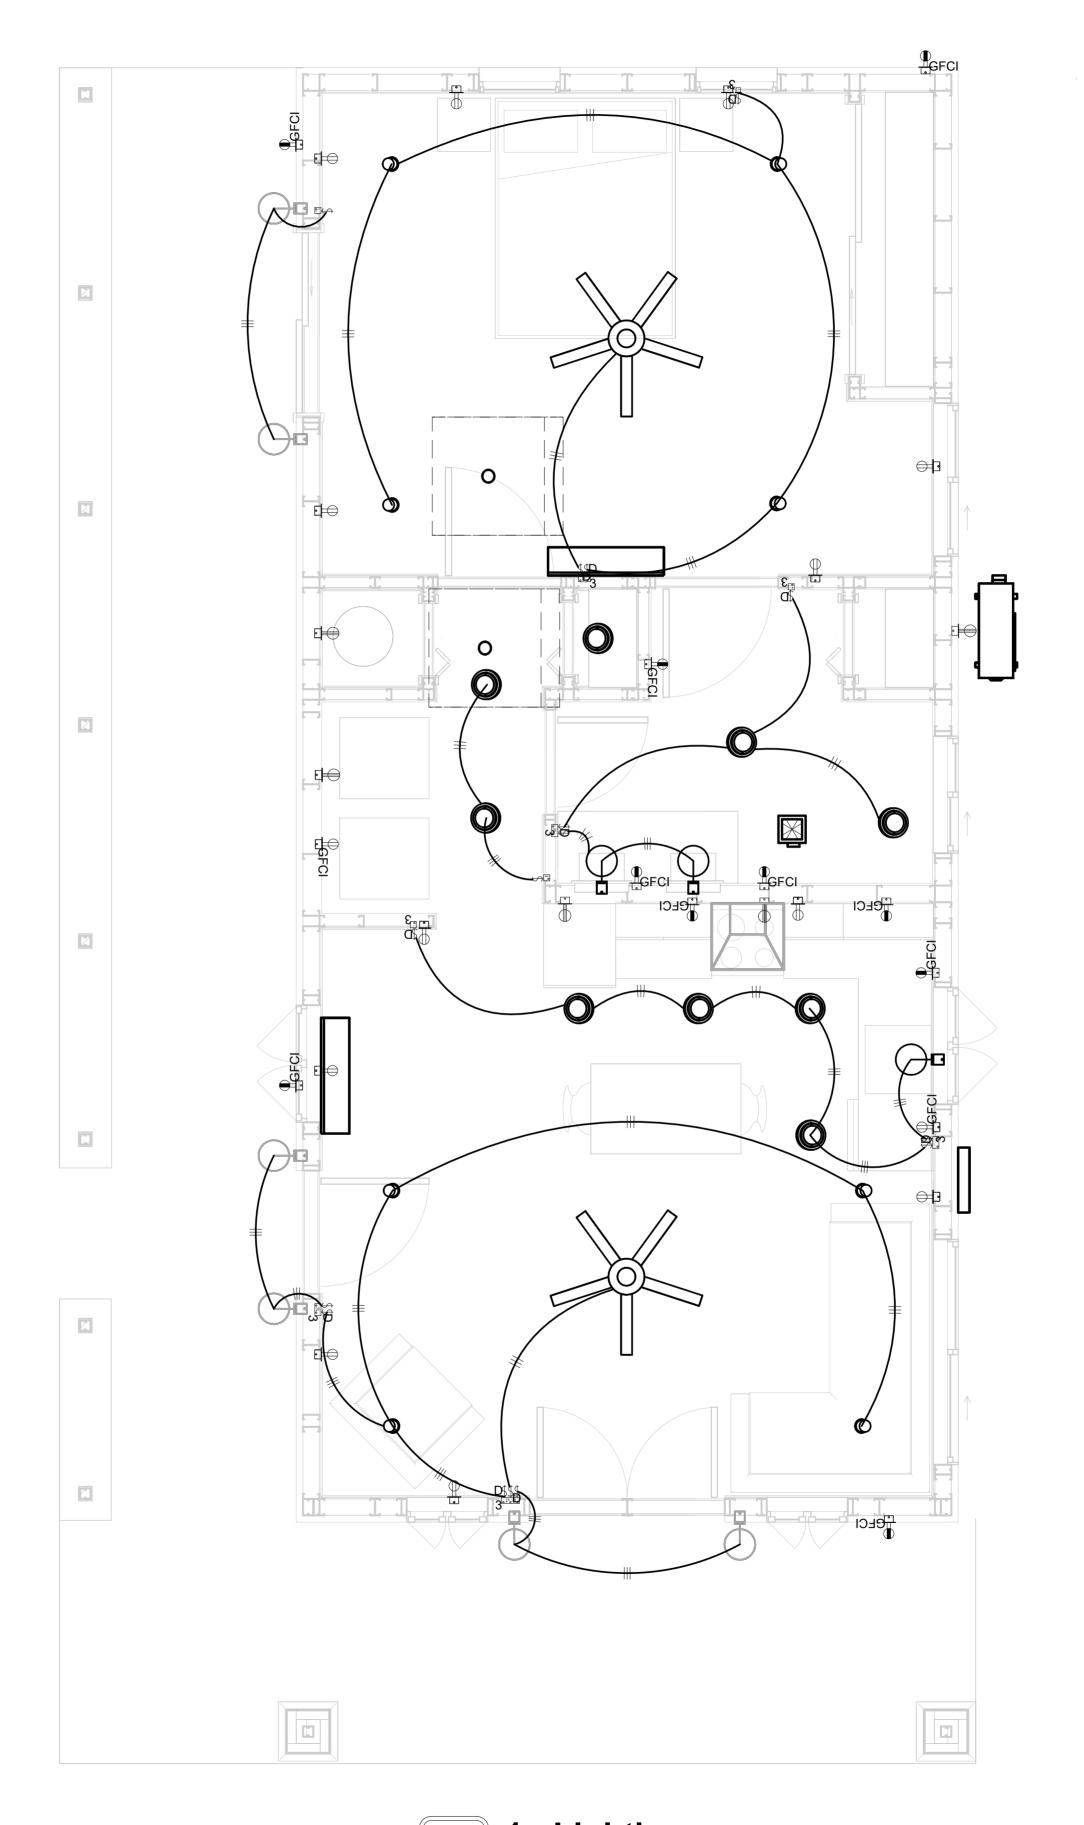



KEY PLAN

NO.	DESCRIPTION	DATE

NOTE:

LEGEND:

PROJECT

125-Orion-730-1Bd 1Ba-Craftsman-Porch-550

DRAWING NAME


LIGHTING

Owner	CLIENT NAME:
0359_12	PROJECT NUMBER:
3/15/2025 4:40:10 PM	DATE:
Designer	DESIGNED BY:
Author	DRAWN BY:
Checker	CHECKED BY:
	-


E102

NOTES: CONDUIT, CABLE AND WIRING


- Use Metalic Conduits (IMC) for cables running under concrete slabs.
 Use IMC for circuits with high voltage appliances (240 volts and above)
 For circuits with 120 volts consider using EMT or PVC conduits if needed.
 For Low voltage applications up to 50 volts consider using non metalic conduits.
 All conduits to be used in the project must conform to the latest National Electrical Code (NEC),
- 6. All wiring and cables to be used in the project must also conform to the latest National Electrical Code (NEC), 2015.
 7. All cables and wires used should be rated for their respective loading and should be gauged and
- conform to the NEC.

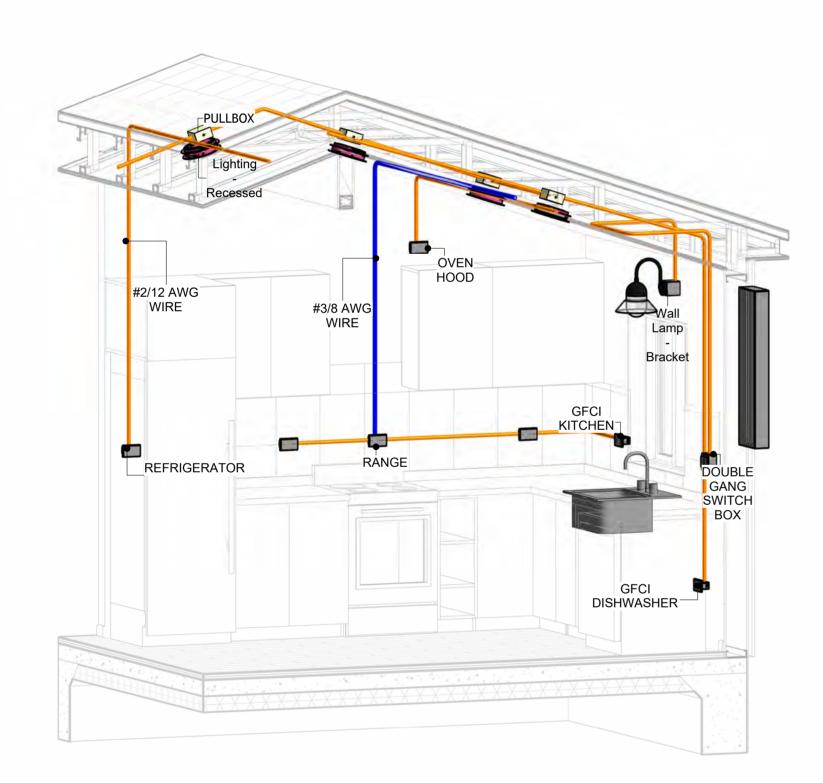


3D-KITCHEN

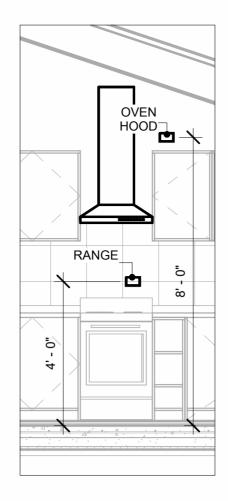


2 Range & OvenHood 3/8" = 1'-0"

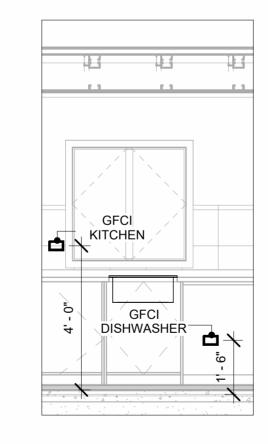

Gfci & Dishwasher

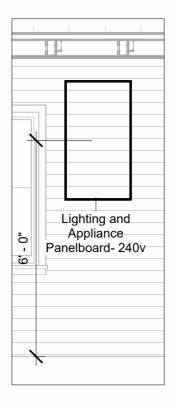


Panel 3/8" = 1'-0"

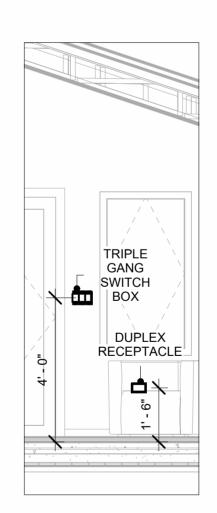

Switch & Receptacle



KEY PLAN

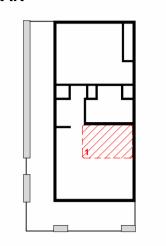

NO.	DESCRIPTION	DATE
	<u> </u>	<u>'</u>

NOTE:

LEGEND:

PROJECT

125-Orion-730-1Bd 1Ba-Craftsman-Porch-550

DRAWING NAME

POWER

Owner	CLIENT NAME:	
0359_12	PROJECT NUMBER:	
3/15/2025 4:40:34 PM	DATE:	
Designer	DESIGNED BY:	
Author	DRAWN BY:	
Checker	CHECKED BY:	
		1 1

E103

SCALE: As indicated

© [2024] [FrameUpNow] . All rights reserved

NOTES: LIGHT

- 1. LIGHT FIXTURES AND LUMINARIES SHALL CONFORM TO THE NEC, THE IRC AND LOCAL SAFETY & BUILDING CODE.
- 2. ALL LIGHTING FIXTURES SHOULD CONFORM TO THE DESIGN ELECTRICAL LOAD AND SHALL BE PROPERLY WIRED AND MOUNTED BY QUALIFIED ELECTRICIAN FOLLOWING MANUFACTURERS SPECIFICATIONS.
- 3. CEILING FANS AND FANS WITH LIGHT WITH WEIGHT EXCEEDING 35 LBS SHOULD BE PROVIDED WITH STRUCTURAL BACKING FOR SUPPORT AND SHALL BE FIXED AS PER MANUFACTURERS SPECIFICATIONS.
- 4. EXTERIOR LIGHTS SHALL CONFORM TO LOCAL BUILDING CODE AND GUIDELINES.

NOTES: SWITCH JUNCTION BOX


- 1. THE MINIMUM SIZE OF JUCTION BOX TO BE USED IS 2"X4"X(1.5" OR 3.5" DEEP) THIS ARE TO BE USED FOR SINGLE GANG SWITCH OR OUTLETS.
- 2. FOR DOUBLE GANG (2 GANG) OUTLETS AND SWITCHS THE MINIMUM SIZE OF THE
- JUCTION BOX TO BE PROVIDED SHALL NOT BE LESS THAN 4"X4"X(1.5" OR 3.5" DEEP)
- 3. FOR THREE GANG (3 GANG) OUTLETS AND SWITCHS THE MINIMUM SIZE OF THE JUCTION BOX SHALL NOT BE LESS THAN 6"X4"X(1.5" OR 3.5" DEEP).

FITTING SCHEDULE(PULL BOX)		
FAMILY	COUNT	DESCRIPTION
PULLBOX1	21	#1/4 PULLBOX

ELECTRICAL FIXTURE SCHEDULE (SWITCH BOX)		
TYPE	COUNT	
DOUBLE GANG SWITCH BOX	4	
SINGLE GANG SWITCH BOX	4	
TRIPLE GANG SWITCH BOX	1	

L	IGHTING DEVICE
TYPE	COUNT
DIMMER	2
SINGLE POLE	6
THREE WAY WITH DIMMER	8

LIGHTING FIXTURE				
LIGHTING FIXTURE TYPE	VOLTAGE	ELECTRICAL LOAD	COUNT	
ELECTRICAL_LIGHTS_FAN-LIGHT1	120 V/1-100 VA- 120 V/1-100 VA	200 A, 120 V/240 V, SINGLE PHASE, 3 WIRES	2	
LIGHTING - RECESSED	120 V/1-60 VA	200 A, 120 V/240 V, SINGLE PHASE, 3 WIRES	9	
SASSO 100 ROUND WALLWASHER TRIM	120 V/1-28 VA	200 A, 120 V/240 V, SINGLE PHASE, 3 WIRES	8	
WALL LAMP - BRACKET	120 V/1-100 VA	200 A, 120 V/240 V, SINGLE PHASE, 3 WIRES	9	

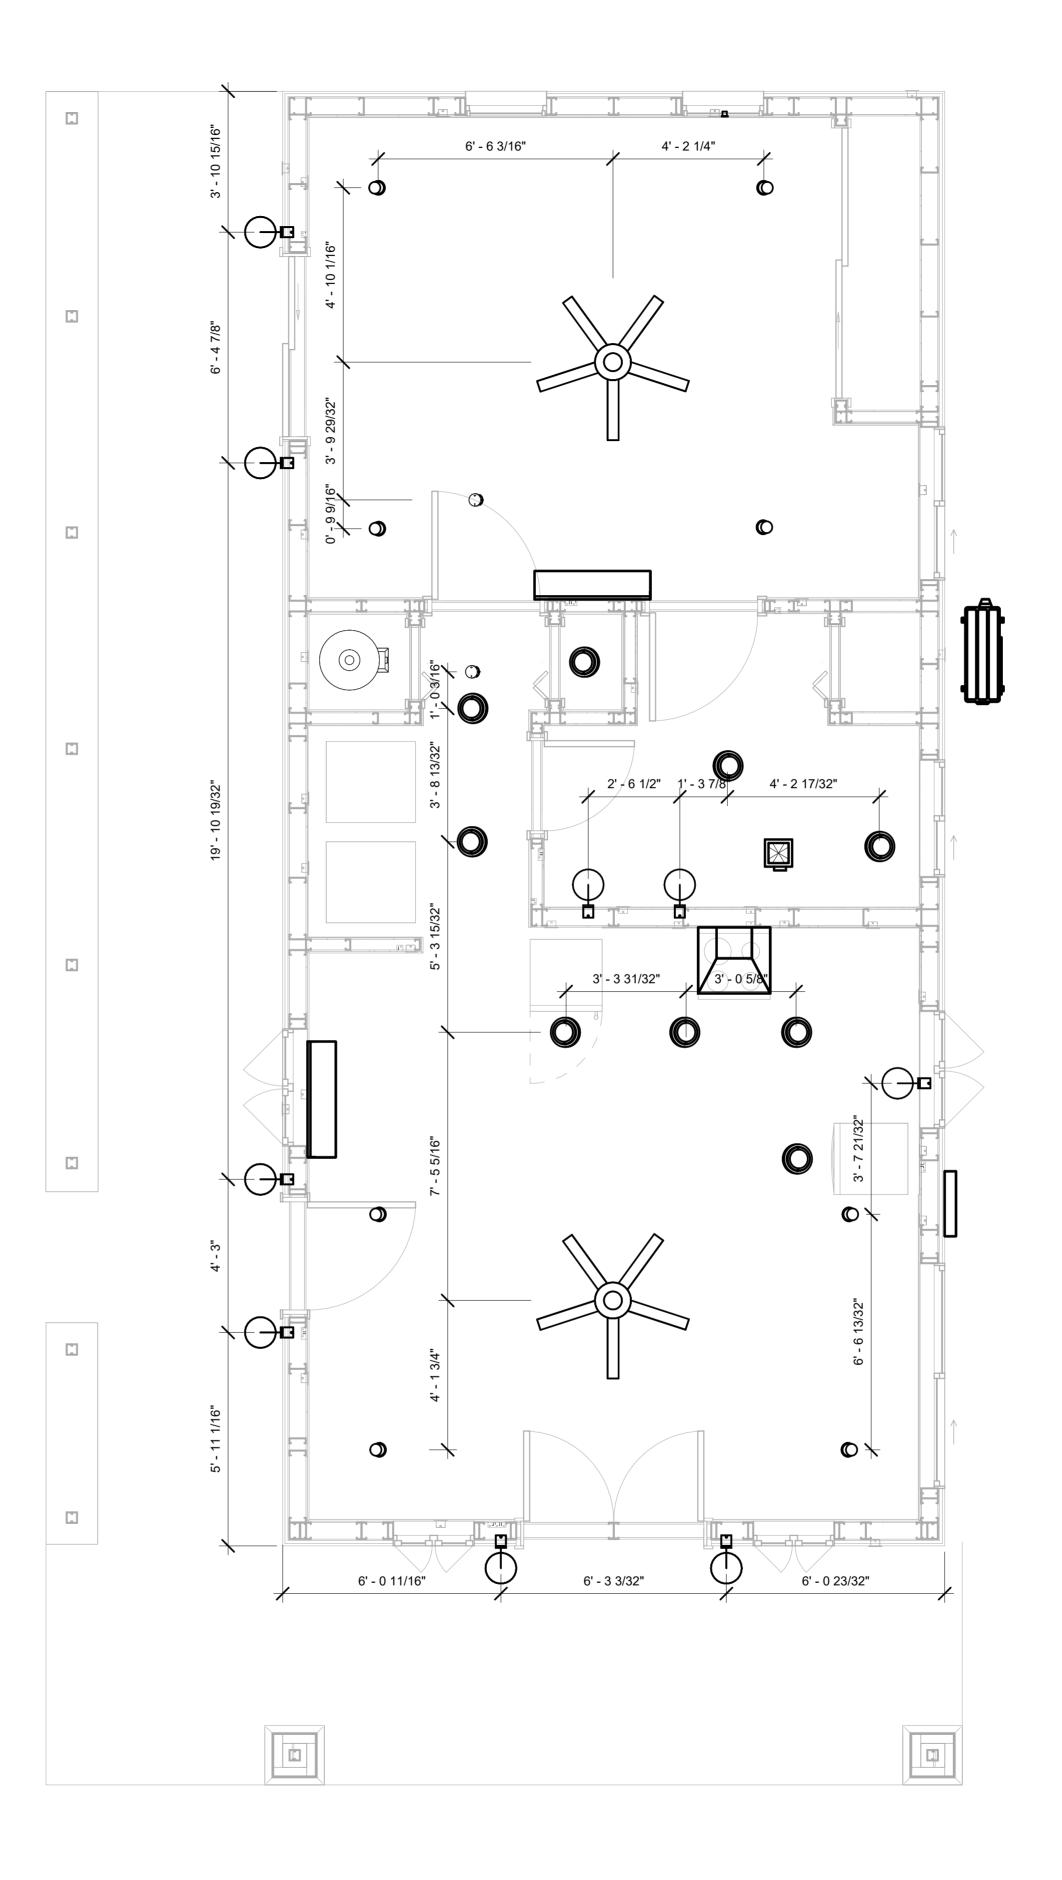

1 DIMENSION FOR LIGHT FIXTURES
3/8" = 1'-0"



KEY PLAN

NO.	DESCRIPTION	DATE

NOTE:

LEGEND:

PROJECT

125-Orion-730-1Bd 1Ba-Craftsman-Porch-550

DRAWING NAME

DIMENSION PLAN FOR LIGHT FIXTURES

CLIENT NAME:	Owner
PROJECT NUMBER:	0359_12
DATE:	3/15/2025 4:40:35 PM
DESIGNED BY:	Designer
DRAWN BY:	Author
CHECKED BY:	Checker
·	


E104

NOTES;

- 1. VERIFY EQUIPMENT PLUG CONFIGURATION BEFORE PURCHASING RECEPTACLES
- 2. FOR ALL EQUIPMENT.
- COORDINATE EXACT LOCATION OF LIGHT FIXTURES, WALL SWITCHES, RECEPTACLES AND OTHER DEVICES WITH ARCHITECTURAL DRAWINGS.
 USE METALLIC JUNCTION BOX WITH THE GFCI RECEPTACLES, WITH HIGHT VOLTAGE.

ELECTRICAL FIXTURE SCHEDULE (RECEPTACLE)		
TYPE	COUNT	
CONDENSER	1	
DRYER	1	
DUPLEX RECEPTACLE	11	
GFCI BATH ROOM	3	
GFCI DISHWASHER	1	
GFCI KITCHEN	3	
GFCI OUT DOOR	4	
GFCI WASHER	1	
OVEN HOOD	1	
RANGE	1	
REFRIGERATOR	1	
WATER HEATER	1	

	ELECTRICAL O	UTLET SCHEDULE	Ξ
TYPE	CIRCUIT NUMBER	ELECTRICAL DATA	COUNT
DUPLEX RECEPTACLE		120 V/1-180 VA	1
GFCI BATH ROOM		120 V/1-180 VA	1
DUPLEX RECEPTACLE	5	120 V/1-180 VA	5
GFCI BATH ROOM	6	120 V/1-180 VA	2
DRYER	7,9	240 V/2-5000 VA	1
GFCI WASHER	8	120 V/1-1200 VA	1
WATER HEATER	10,12	240 V/2-4500 VA	1
GFCI OUT DOOR	11	120 V/1-180 VA	4
CONDENSER	13,15	240 V/2-5000 VA	1
DUPLEX RECEPTACLE	14	120 V/1-180 VA	5
GFCI KITCHEN	16	120 V/1-180 VA	3
REFRIGERATOR	17	120 V/1-1800 VA	1
RANGE	18,20	240 V/2-5000 VA	1
OVEN HOOD	19	120 V/1-180 VA	1
GFCI DISHWASHER	21	120 V/1-1200 VA	1

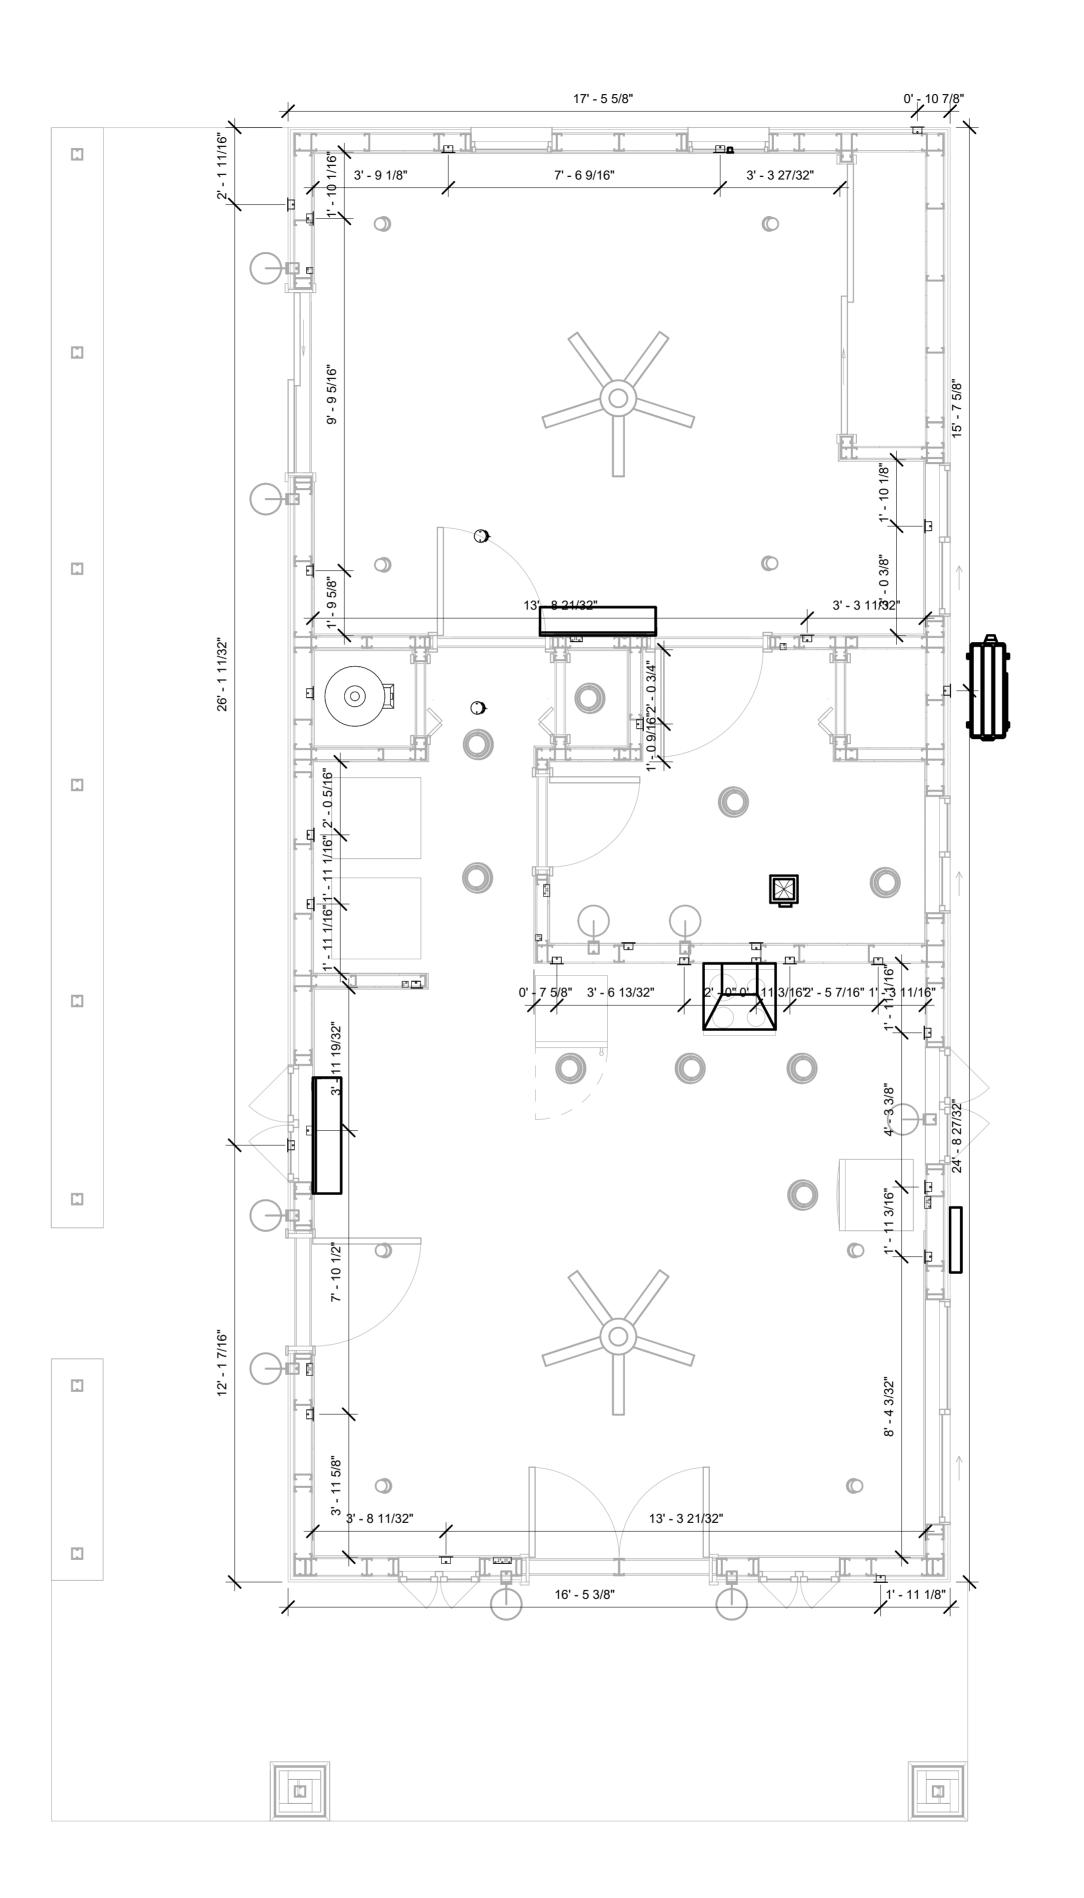

DIMENSION FOR FITTINGS 3/8" = 1'-0"



KEY PLAN

NO.	DESCRIPTION	DATE

NOTE:

LEGEND:

PROJECT

125-Orion-730-1Bd 1Ba-Craftsman-Porch-550

DRAWING NAME

DIMENSION PLAN FOR FITTINGS

CLIENT NAME:	Owner
PROJECT NUMBER:	0359_12
DATE:	3/15/2025 4:40:37 PM
DESIGNED BY:	Designer
DRAWN BY:	Author
CHECKED BY:	Checker

E105

SHEET LIST

SHEET NUMBER SHEET NAME

P101 NOTE AND SCHEDULE
P102 WATER SUPPLY AND SEWAGE
SYSTEM

PIPE COLOR SCHEME

DOMESTIC COLD WATER
DOMESTIC HOT WATER
SANITARY VENT
SANITARY SEWER
STORM DRAINAGE

PLUMBING NOTES

- THE PLUMBING SYSTEM IS DESIGNED TO MEET THE BUILDING'S DOMESTIC WATER SUPPLY, SANITARY DRAINAGE, AND STORM DRAINAGE REQUIREMENTS, AS PER PROJECT SPECIFICATIONS AND APPLICABLE CODES.
- 2. THE SYSTEM INSTALLATION SHALL COMPLY WITH THE LATEST INTERNATIONAL PLUMBING CODE (IPC), INTERNATIONAL RESIDENTIAL CODE (IRC), AND ALL OTHER RELEVANT LOCAL, STATE, AND NATIONAL REGULATIONS.
- ALL PLUMBING WORK SHALL COMPLY WITH THE LATEST EDITION OF THE INTERNATIONAL PLUMBING CODE (IPC) AND THE LOCAL PLUMBING CODE.
- 4. PLUMBING SYSTEMS SHALL BE TESTED AND INSPECTED IN ACCORDANCE WITH THE LOCAL PLUMBING CODE REQUIREMENTS.
- 5. PLUMBING FIXTURES SHALL BE INSTALLED WITH THE APPROPRIATE TRIM, FITTINGS, AND ACCESSORIES, AS RECOMMENDED BY THE MANUFACTURER.
- 6. PIPING SHALL BE PROPERLY SUPPORTED AND SECURED TO PREVENT SAGGING, MOVEMENT, AND VIBRATION.
- 7. SHUT-OFF VALVES SHALL BE PROVIDED AT ALL BRANCH CONNECTIONS AND AT THE INLET AND OUTLET OF EACH PIECE OF EQUIPMENT.
- 8. BACKFLOW PREVENTION DEVICES SHALL BE INSTALLED AS REQUIRED BY THE LOCAL
- PLUMBING CODE TO PROTECT THE POTABLE WATER SYSTEM.

 9. PLUMBING FIXTURES AND EQUIPMENT SHALL BE ACCESSIBLE FOR MAINTENANCE AND
- 10. EXPOSED PLUMBING PIPING AND FIXTURES SHALL BE INSULATED TO PREVENT CONDENSATION AND ENERGY LOSS.
- 11. DEAD ENDS IN THE DRAINAGE SYSTEM MUST BE AVOIDED, EXCEPT WHERE NECESSARY TO INSTALL A CLEANOUT IN AN ACCESSIBLE LOCATION, AND MUST HAVE A VENTED CONNECTION TO THE OUTSIDE ATMOSPHERE.
- 12. THE VERTICAL DEFLECTION OF PVC PIPE MUST NOT EXCEED 5%, AND NO DEFLECTION IS PERMITTED FOR IRON PIPE.
- 13. WORK MUST BE PROPERLY COORDINATED WITH OTHER TRADES TO AVOID CONFLICTS, REFERRING TO THE ARCHITECTURAL AND STRUCTURAL DRAWINGS FOR INFORMATION REGARDING CEILING ELEVATIONS, SPACE CLEARANCES, WALL AND PARTITION LOCATIONS, ETC.
- 14. ALL FIXTURES SHALL HAVE ACCESSIBLE STOPS.
- 15. DOMESTIC WATER PIPING SHALL BE PEX, AND PVC PIPING IS NOT ACCEPTABLE FOR
- 16. VENT TERMINATIONS SHALL BE LOCATED AT LEAST 10 FEET FROM OR 3 FEET ABOVE ANY OPERABLE WINDOW, DOOR OPENING, AIR INTAKE, OR VENT SHAFT, AND AT LEAST 3 FEET IN EVERY DIRECTION FROM ANY LOT LINE, ALLEY, OR STREET.
- 17. PIPE AND FITTINGS UTILIZED IN THE WATER SUPPLY SYSTEM SHALL HAVE A MAXIMUM OF 8 PERCENT LEAD.
- 18. ACRYLONITRILE BUTADIENE STYRENE (ABS) SHALL BE USED FOR THE SEWERAGE AND
- VENTILATION SYSTEM.

 19. CROSS-LINKED POLYETHYLENE (PEX) SHALL BE USED FOR THE WATER SUPPLY SYSTEM.
- 20. POLYVINYL CHLORIDE (PVC) SHÀLL BÉ USED FOR THE RAIN WATER SYSTEM.
- 21. THE MIMIMUM WATER SUPPLY DEPTH UNDER FLOOR FINISH SHOUD BE 1/2".
- 22. ANY PIPE INSTALLED UNDERGROUND MUST HAVE AT LEAST 12 INCHES OF CLEARANCE BETWEEN THE OUTSIDE OF THE PIPE AND ANY OTHER UNDERGROUND STRUCTURE.
- 23. THE MINIMUM CLEARANCE BETWEEN COLD AND HOT WATER LINES IN RESIDENTIAL HOMES MAINTAIN A MINIMUM DISTANCE OF 6 INCHES.
- 24. HORIZONTAL SEPARATION BETWEEN WATER AND SEWER LINES: A MINIMUM OF 12 INCHES BETWEEN POTABLE WATER SUPPLY LINES (COLD AND HOT WATER) AND

ABBREVIATIONS

SANITARY SEWER LINES.

Ø	DIAMETER			
ABS	ACRYLONITRILE BUTADIENE STYRENE			
ABV				
AD AREA DRAIN				
AFF	ABOVE FINISHED FLOOR			
ALT	ALTERNATE			
BFF	BELOW FINISHED FLOOR			
BLW	BELOW			
CO	CLEAN OUT			
CW	COLD WATER			
D	DEGREE			
DFU	DRANAGE FIXTURE UNIT			
DIA	DIAMETER			
DN	DOWN			
FCO	FLOOR CLEAN OUT			
FD	FLOOR DRAIN			
FL	FLOOR			
FS	FLOOR SINK			
FT	FOOT/FEET			
HB	HOSE BIB			
HW	HOT WATER			
IN	INCH			
MIN	MINIMUM			
NO	NUMBER			
NTS	NOT TO SCALE			
PEX	CROSS-LINKED POLYETHYLENE			
PLBG	PLUMBING			
PVC	POLYVINYL CHLORIDE			
QTY	QUANTITY			
RD	ROOF DRAIN			
RED	REDUCER			
RM	ROOM			
RW	RAIN WATER			
SF	SQUARE FOOT			
V	VENT			
VTR	VENT THROUGH ROOF			
W	WASTE			
WCO	WALL CLEAN OUT			
WSFU	WATER SUPPLY FIXTURE UNIT			

PLUMBING LEGEND

П	CAP
	BEND 45 DEG
\Box	BEND 90 DEG
	TEE REDUCING
	TEE
	CLEAN TWO-WAY
	WYE 45 DEG
	WYE 45 DEG DOUBLE
	WYE COMBINATION
	P-TRAP

PIPE SCHEDULE				
MATERIAL	DIAMETER	LENGTH		
ACRYLONITRILE BUTADIENE STYRENE (ABS)	3/4"	0 FT		
ACRYLONITRILE BUTADIENE STYRENE (ABS)	1 1/2"	29 FT		
ACRYLONITRILE BUTADIENE STYRENE (ABS)	2"	42 FT		
ACRYLONITRILE BUTADIENE STYRENE (ABS)	3"	16 FT		
CROSS-LINKED POLYETHYLENE (PEX)	1/2"	88 FT		
CROSS-LINKED POLYETHYLENE (PEX)	3/4"	34 FT		
POLYVINYL CHLORIDE - RIGID	2"	108 FT		

FITTING SCHEDULE				
FITTING	SIZE	QTY		
ABS 90 DEGREE BEND ELBOW	1 1/2"ø-1 1/2"ø	1		
ABS 90 DEGREE BEND ELBOW	2"ø-2"ø	3		
ABS 90 DEGREE BEND ELBOW	3"ø-3"ø	1		
ABS P-TRAP	1 1/2"ø-1 1/2"ø	4		
ABS P-TRAP	2"ø-2"ø	1		
ABS REDUCER ELBOW	2"ø-1 1/2"ø	3		
ABS REDUCER ELBOW	3"ø-2"ø	1		
ABS TEE ELBOW	1 1/2"ø-1 1/2"ø	2		
ABS TEE ELBOW	2"ø-2"ø	2		
ABS TEE ELBOW	3"ø-3"ø	1		
ABS TEE REDUCER ELBOW	2"ø-2"ø-2"ø	1		
ABS TEE REDUCER ELBOW	3"ø-3"ø-1 1/2"ø	1		
ABS TEE REDUCER ELBOW	3"ø-3"ø-2"ø	1		
ABS TEE REDUCER ELBOW	3"ø-3"ø-3"ø	1		
ABS TRAP P	2"ø-2"ø	1		
ABS VENT CAP ELBOW	1 1/2"ø	2		
ABS VENT CAP ELBOW	2"ø	2		
ABS VENT CAP ELBOW	3"ø	1		
ABS WASTE DOUBLE TEE	2"ø-2"ø-2"ø	1		
PEX 90 DEG ELBOW	1/2"ø-1/2"ø	4		
PEX 90 DEGREE ELBOW	1/2"ø-1/2"ø	24		
PEX 90 DEGREE ELBOW	3/4"ø-3/4"ø	5		
PEX TEE ELBOW	1/2"ø-1/2"ø-1/2"ø	6		
PEX TEE ELBOW	3/4"ø-3/4"ø	7		
PEX TRANSITION ELBOW	1"ø-3/4"ø	2		
PEX TRANSITION ELBOW	3/4"ø-1/2"ø	13		
PVC 90 DEG BEND ELBOW	2"ø-2"ø	15		
PVC 90 DEGREE BEND ELBOW	2"ø-2"ø	2		
PVC TEE ELBOW	2"ø-2"ø-2"ø	2		

WATER FIXTURE UNIT SCHEDULE						
FAMILY QTY UNIT VALUE TOTAL						
DISHWASHER	1	1.4	1.4			
SHOWER TRAY	1	1.4	1.4			
SHOWER TRIM	1	1.4	1.4			
SINK ISLAND SINGLE	1	1.4	1.4			
VANITY SINK	2	0.7	1.4			
WASHER	1		0			
WATER CLOSET	1	2.2	2.2			

WASTE FIXTURE UNIT SCHEDULE							
FAMILY QTY DFU VALUES TOTAL							
DISHWASHER	1	2	2				
SHOWER TRAY	1	2	2				
SINK ISLAND SINGLE	1	2	2				
VANITY SINK	2	1	2				
WASHER	1		0				
WATER CLOSET	1	3	3				

FIXTURE SCHEDULE				
FIXTURE	QTY	DESCRIPTION		
DISHWASHER	1			
DRYER	1			
SHOWER TRAY	1			
SHOWER TRIM	1			
SINK ISLAND SINGLE	1			
VANITY SINK	2			
WASHER	1			
WATER CLOSET	1			
WATER HEATER	1			

PLUMBING SCHEDULE							
FIXTURE	TRAP	WASTE	VENT	C.W	H.W		
DISHWASHER	1-1/2"	2"	1-1/2"	1/2"	1/2"		
DRYER	N/A	N/A	N/A	N/A	N/A		
SHOWER TRAY	1-1/2"	2"	N/A	1/2"	1/2"		
SHOWER TRIM	-	-	-	1/2"	1/2"		
SINK ISLAND SINGLE	1-1/2"	2"	1-1/2"	1/2"	1/2"		
VANITY SINK	1-1/2"	2"	1-1/2"	1/2"	1/2"		
WASHER	2"	2"	1-1/2"	1/2"	1/2"		
WATER CLOSET	3"	3"	2"	1/2"	1/2"		
WATER HEATER	N/A	N/A	N/A	3/4"	3/4"		

ACCESSORIES & FITTINGS SCHEDULE							
FIXTURE	QTY	DESCRIPTIONS					
HANGING PIPES CLAMP	12						
HOSE BIB	1						
LAUNDRY SWEAT CONNECTOR	2						
SHUTOFF VALVE 8							



KEY PLAN

NO. DESCRIPTION DATE

NOTE:

LEGEND:

PROJECT

125-Orion-730-1Bd/1Ba Craftsman-Porch-550

DRAWING NAME

CHECKED BY:

NOTE AND SCHEDULE

CLIENT NAME:

PROJECT NUMBER:

DATE:

3/15/2025 5:12:36 PM

DESIGNED BY:


DRAWN BY:

Author


P101

Checker

SCALE: 1/2" = 1'-0"

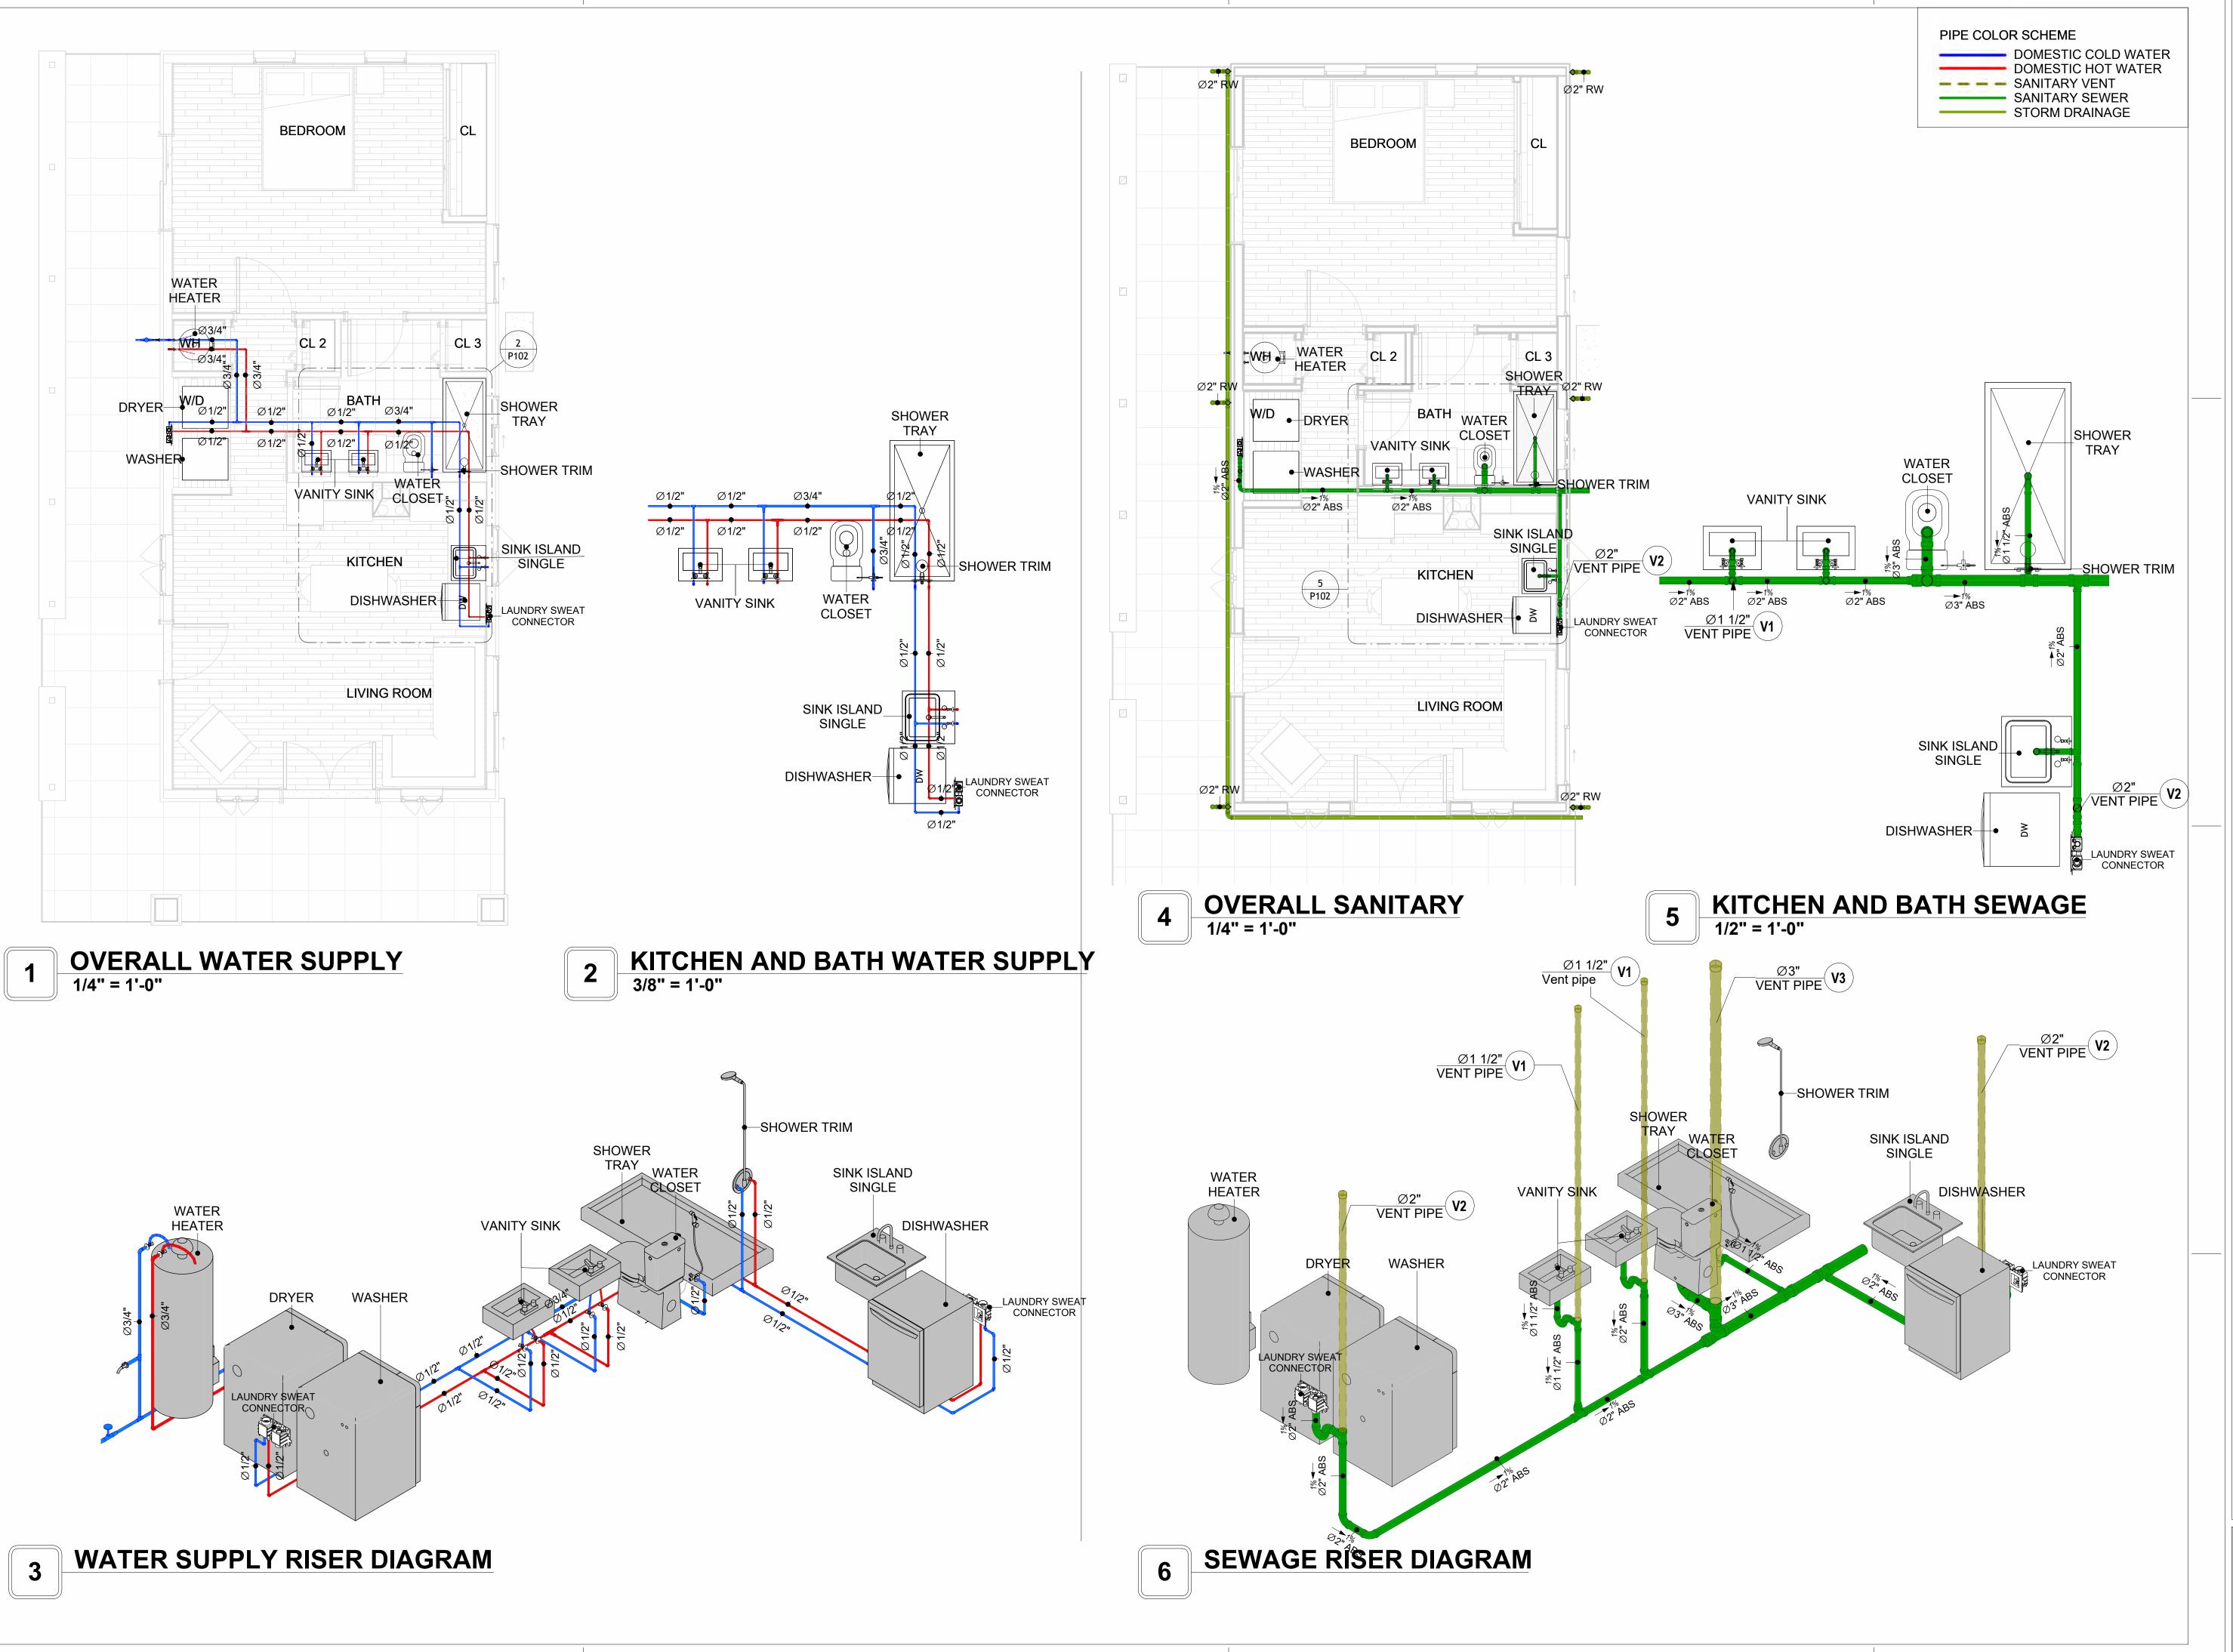



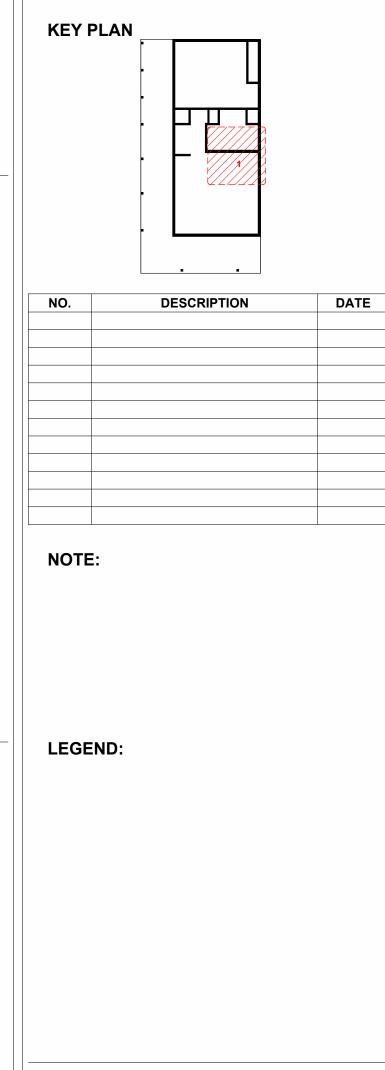

WATER SUPPLY AND SEWAGE SYSTEM

125-Orion-730-1Bd/1Ba

Craftsman-Porch-550

PROJECT

DRAWING NAME

	CLIENT NAME:
0359_12	PROJECT NUMBER:
3/15/2025 5:13:13 PM	DATE:
Designer	DESIGNED BY:
Author	DRAWN BY:
Checker	CHECKED BY:

Materials Shopping List

Please print and take this Materials Shopping List to your favorite Home Depot and ask for assistance in selecting the materials, fixtures and fittings to complete your new home.

Record your selection and the price of the item. Then do the math to determine the cost for your selections and the total cost of finishing your home.

Have It Your Way!

The material types listed in this document were selected based on personal preferences. The Customer is encouraged to make changes to the material types in accordance with local customs, regulations, and personal preferences.

Have It Your Way!



20 good reasons to frame a home with metal and not wood



Why build your ADU with metal vs wood	Wood N	Metal	Explanation
1 DIY Construction Benefit		\checkmark	The wall frames, trusses and beams can be erected in a just a few days
2 Minimal Construction Skills Required		~	Pre-assembled walls and trusses require no specialized skills to errect
3 Build as DIY, Hybrid or by a General Contractor		~	Do it yourself, Hybrid (involve special contractors) or hire a General Contractor
4 Build It As You Can Afford It		\checkmark	Impervious to Weather - build as you have the time and money
5 Up Front Cost of Framing Materials	~		As to only the framing material, wood is less expensive
6 Total Cost To Build		\checkmark	Savings in time, labor, and other areas make light gauge steel LESS expensive
7 Termites and wood boring insects		~	Termites, carpenter ants and wood boring insects eat wood, not metal
8 Mold resistant		\checkmark	Metal does not attract mold
9 Damage caused by exterior and interior flooding		~	Metal needs no reconditioning after a flood
10 Fire Resistant		~	Non-combustible
11 Lower insurance rates		~	Many insurance underwriters now provide lower rates for metal framed homes
12 Walls, trusses, and beams retain their original form		~	Perfectly straight walls - no shimming of drywall
13 Corners are 90 degrees		\checkmark	No need for templating of countertops to adjust for out of square corners
14 Strength and weight		~	Metal is stronger than wood and weighs less - no need for crane to lift ADU trusses
15 IBC Engineered Stamp		~	If an engineering stamp is necessary, months of waiting are saved
16 Complete BOM (Materials Shopping List)		~	Take the materials shopping list to Home Depot and start shopping/pricing
17 Flexible in Seismic Areas - Won't Fracture		~	Light gauge steel is flexible and won't fracture when the earth moves
18 No Waste At Job Site		~	Steel is the most recycled material in the world. A typical wood home has 20-30% waste
19 Environmentally Friendly		~	Trees don't have to be destroyed and the source of most metal is from recycling
20 How-To Videos Included		Y	How-to videos provide simple assembly instructions
21 Relationship Counselor		~	Eliminate emotional uphevels - save time, money, and preserve the relationship

Universal Requirements - some or all may be required

- 1 Site plan
- 2 Electrical Supply Connection
- 3 Sewer Connection
- 4 Fresh Water Supply Connection
- 5 Set Backs
- 6 Soils Evaluation

- 7 Earthquake (fault) evaluation
- 8 Foundation Plan subject to soils
- 9 Compliance with local energy codes: insulation home wrap and flashing
- 10 Engineering for wind speed and snow load.
- 11 State and Local ordinances regarding ADUs
- 12 Local Architect and/or Engineer may be necessary







Orion-1Bd 1Ba-Craftsman-Porch MATERIAL SHOPPING LIST

Have It Your Way!

The material types listed in this document were selected based on personal preferences. The Customer is encouraged to make changes to the material types in accordance with local customs, regulations, and personal preferences. Have It Your Way!

TOC



10

15

Name Link Page No 1 Cover Page Cover Page 2 TOC TOC 2 3 ELECTRICAL BOM **ELECTRICAL BOM** 3 5 HVAC BOM **HVAC BOM** 7

Table Of Content

Have It Your Way!

ARCHITECTURAL BOM

PLUMBING BOM

The material types listed in this document were selected based on personal preferences. The Customer is encouraged to make changes to the material types in accordance with local customs, regulations, and personal preferences. Have It Your Way!

GENERAL NOTES

4 PLUMBING BOM

6 ARCHITECTURAL BOM

- 1 This BOM (Bill of Materials) is prepared as a Materials Shopping List to help builders and DIYers gain a complete understanding of most if not all elements required for the complete construction of this structure, according to the original design documents provided by FrameUpNow.
- 2 All quantities and specifications are subject to change based on the final design, field measurements, availability of products and customer preferences. The customer should verify all information prior to purchasing materials.
- 3 All products and elements in the list shall conform to the International Residential Code (IRC), or any other local and international building codes, safety regulations, and standards that are applicable to the location of the structure.
- 4 If any changes are made by the customer to the list of materials specified in this document, the customer is responsible for assuring that the correct type and quantity of materials are utilized in accordance with local building
- 5 FrameUpNow, will not be held responsible for any misuse of this document, the products listed, or for deviations from the content that are made due to changes in specifications, pricing, availability, or customer preferences.
- 6 The customer is advised to consult a qualified professional or technician prior to purchasing materials for specialized construction system items. Some items including but not limited to caseworks, doors and windows may require as built measurements prior to purchase to confirmation of final dimensions.
- If there are additional trim elements or specific installation methods, the total amount of materials needed might vary. Consider any additional trim required for corners, intersections, or other architectural details that might cause this variations before procedding to purchase and construction.

ARCHITECTURAL BOM



		Orion-					
NI.	lu.			RIAL SHOPP		T-4-I	Dec. 1.11
No.	Item	Туре	Unit	Quantity	Unit Price	Total	Description
1	APPLIANCES Defrigerator	1	PCS	1		1	
1	Refrigerator		PCS	1			
3	Range Washer		PCS	1			
4			PCS	1			
5	Dryer Dish Washer		PCS	1			
6	Oven		PCS	0			
7	Microwave		PCS	0			
	CASEWORKS		PC3	0			
1	Kitchen Cabinet	T	FT	16.16			
2	Laundry Cabinet		FT	0			
3	Vanity Cabinet		FT	5			
4	Medicine Cabinet		PCS	2			
5	Kitchen countertop		SF	25.32			
6	Laundry Countertop		PCS	20.52			
			SF				
7	Bathroom Countertop			0		-	
9	Island Peninsula		FT	0			
			FT			-	
	Closets		SF	81.96			
1	Ceiling Poord	Dry Woll	SF	F22 / 4			
	Ceiling Board Dry Wall Fastener	Dry Wall	PCS	522.64 914.62			
2		Screw					
3	Vapor Retarder	Polyethylene film	SF	606.09			
4	Vapor Retarder Fastener	Nails with washer heads	PCS	1818.27			
5	Ceiling Board (MRD)	Moisture resistant drywall	SF	74.89			
6	MRD Fastener		PCS	131.0575			
7	Ceiling Board	Marine Plywood	SF	8.56			
8	Marine Plywood Fastener	Screw	PCS	14.98			
9	Dry Wall Tape		FT	303.045			
<u>^</u>	FLOORING	1	lo.E	044.04			
1	Main Living Space		SF	314.31			
2	Bathroom		SF	92.2			
3	Bedroom		SF	227.51			
4	Porch		SF	396.17			
<u>^</u>	STRUCTURE	1	lo.E	4440.75			
1	Foundation		SF	1113.75			
1	WALLS EXTERIOR	1	CE	020		I	
1	Exterior-Grade Plywood	0.15 1.332 (4.00/ 1.1)	SF	828			
2		Self-drilling screws(100/pkt)	PKT	8.28			
3	Wall Shteathing (OSB)	C 15 1 1111 (400/ 11)	SF	828			
4	Shteathing Fastener	Self-drilling screws(100/pkt)	PKT	8.28			
5	Wall Homewrap	Ctll ft (000/ L)	SF	828			
6	Homewrap Fastener	Stapled fastener (200/pkt)	PKT	3.1464			
7	Furring Strip	0 16 1 1111 (4007 1 1)	PCS	103.5			
8	Furring Strip Fastener	Self-drilling screws(100/pkt)	PKT	8.28			
9	Wall Paint	Manager	SF	828			
10	Stone Copping	Masonry stone	SF	119			
	Stone Veneer	Masonry stone	SF	178			
	Mortar for Stone Veneer		SF	178			
	Wall Insulation		SF	2696			
<u>^</u>	WALLS INTERIOR		lo-				
	Cementitious Backer Board		SF	419			
	Kerdi membrane		SF	419			
	Kerdi membrane Fastener		SF	419			
	Wall Ceramic Tile		SF	419			
5	Drywall Board		SF	1262			
	Drywall Fastener	Self-drilling screws(100/pkt)	PKT	12.62			
7	Wall Paint		SF	1262			
	Drywall Tape		FT	237			
8	Wall Sweep		FT	123			

ARCHITECTURAL BOM



	DOORS				
1	Interior Swinging	3' - 0" X 6'-8"	PCS	2	
2	Interior Swinging	2' - 6" X 6'-8"	PCS	1	
3	Exterior Swinging	5' - 0" X 6'-8"	PCS	1	
4	Exterior Sliding	5' - 0" X 6'-8"	PCS	1	
5	Exterior Swinging	3' - 0" X 6'-8"	PCS	1	
6	Interior Sliding	7' - 6" X 6'-8"	PCS	1	
7	Folding	2' - 0" X 6'-8"	PCS	3	
8	Exterior Door Trim	2 0 1 0 0	FT	53	
9	Interior Door Trim		FT	284	
	Entry Lock set			3	
11	Privacy Lock set			3	
12	Passage Lock set			4	
^-	WINDOWS			.1	
1	Sliding	3' - 3" X 1'-9"	PCS	1	
2	Casement	2' - 3" X 4'-3"	PCS	2	
3	Casement	3' - 3" X 3'-3"	PCS	2	
4	Awning	2' - 3" X 2'-3"	PCS	2	
5	Sliding	4' - 3" X 3'-3"	PCS	1	
6	Sliding	6' - 3" X 4'-3"	PCS	1	
7	Exterior Window Trim		FT	118	
8	Interior Window Trim		FT	118	
Δ	ROOF	'			·
1	Roof Covering		SF	1056	
2	Roof Covering Fastener		PCS	528	
3	Roof Felt Paper		SF	1056	
4	Roof Felt Paper Fastener		PCS	3168	
5	Roof Sheathing		SF	1056	
6	Roof Sheathing Fastener		PCS	8448	
7	Batten		FT	0	
8	Batten Fastener		PCS	0	
9	Soffit		SF	151	
10	Soffit Fastener		PCS	75.5	
11	Fascia		FT	150	
12	Fascia board fastener		PCS	75	
13	Roof Insulation		SF	1056	



	Orion	-1Bd 1Ba-Craftsma	n-Porch		
	FI FCTRIC	AL MATERIAL SHO	PPING LIS	T	
No.	Item	Type	Unit	Quantity	Description
Δ	LIGHTING FIXTURES			,	
1	Kitchen Ceiling Light		PCS	4	
2	Kitchen Wall Mounted Light		PCS	1	
3	Exterior Wall Mounted Light		PCS	6	
4	Livingroom Ceiling Light With Fan		PCS	1	
5	Bedroom Ceiling Light With Fan		PCS	1	
6	Dining Ceiling Light		PCS	0	
7	Bath Wall Mounted Light		PCS	2	
8	Bathroom Ceiling Light		PCS	1	
9	Livingroom Ceiling Light		PCS	4	
10	Bedroom Ceiling Light		PCS	4	
11	Hall & Entry Ceiling Light		PCS	2	
12	Closet Ceiling Light		PCS	1	
	Smoke Detector		PCS	2	
			1 03	۷	
1/	ELECTRICAL FITTINGS Standard Receptacle 120V	20A	DCC	11	
	·	20A 20 A	PCS	11	
	GFCI Receptacle 120V	-	PCS	14	
16	GFCI Receptacle 240V	30 A	PCS	2	
17	GFCI Receptacle 240V	40 A	PCS	1	
18	GFCI Receptacle 240V	60 A	PCS	1	
19	Fan Switch		PCS	1	
	Single Pole Switch		PCS	6	
	Three Way Switch		PCS	8	
22	Dimmer Switch		PCS	2	
	ELECTRICAL CONDUITS & WIRING				
	ROMEX 14 AWG	14/3/W/ground	FT	156	
24	ROMEX 12 AWG	12/3/W/ground	FT	295	
25	ROMEX 12 AWG	12/2/W/ground	FT	0	
26	ROMEX 10 AWG	10/3/W/ground	FT	0	
27	ROMEX 10 AWG	10/2/W/ground	FT	83	
28	Romex 8 AWG	8/3/W/ground	FT	0	
29	Romex 8 AWG	8/2/W/ground	FT	22	
30	ROMEX 6 AWG	6/3/W/ground	FT	24	
31	Bare Copper Ground Wire 6 AWG		FT	0	
Δ	ELECTRICAL BOXES & CIRCUTES				
	Panelboard -240V 1 Phase MLO	200 AMP	PCS	1	
	Circuit breaker	15 A	PCS	4	
	Circuit breaker	20 A	PCS	9	
	Circuit breaker	30 A	PCS	2	
	Circuit breaker	40 A	PCS	1	
	Circuit breaker	60 A	PCS	1	
	Single Gang Switch Box	0071	PCS	4	
	Double Gang Switch Box		PCS	4	
	Triple Gang Switch Box		PCS	1	
	Pull Box	#1/4	PCS	21	
	Receptacle Box	π 1/4	PCS	29	

PLUMBING BOM



Orion-1Bd 1Ba-Craftsman-Porch PLUMBING SYSTEM MATERIAL SHOPPING LIST

	PLUMBING SYSTEM MATERIAL SHOPPING LIST								
Vo.	Item	Type	Unit	Quantity	Unit Price	Total	Description		
Δ	PLUMBING FIXTURES & ACCESSORIES	, ,,		,			•		
_	Bath Tub (Alcove Tub)		PCS	0					
2	Kitchen Sink		PCS	1					
3	Kitchen Faucets		PCS	1					
4	Vanity Sink		PCS	2					
5	Bath room Faucets		PCS	2					
6	Water Closet		PCS	1					
7	Shower Trim		PCS						
				1					
8	Shower Tray		PCS	1					
9	Water Heater		PCS	1					
	Hose Bib		PCS	1					
	Shutoff Valve		PCS	8					
	Hanging pipe clamp		PCS	19					
	Gate Valve		PCS	1					
14	Dishwasher Supply Single Connector		PCS	1					
15	Dishwasher Sewage Single Connector		PCS	1					
16	Laundry Sweat Connector		PCS	1					
Δ	SANITARY & PLUMBING PIPES	'							
1	ABS (Acrylonitrile Butadiene Styrene) Pipes	ø 1"	FT	0					
	ABS (Acrylonitrile Butadiene Styrene) Pipes	ø 1 1/2"	FT	29					
	ABS (Acrylonitrile Butadiene Styrene) Pipes	ø 2"	FT	42					
	ABS (Acrylonitrile Butadiene Styrene) Pipes	ø 3"	FT	16					
	PEX (Cross-linked polyethylene) Pipes	ø 1/2"	FT	88					
	PEX (Cross-linked polyethylene) Pipes	Ø 3/4"	FT	34					
	PEX (Cross-linked polyethylene) Pipes	Ø 1"	FT	47					
	PVC Pipes Sch.80 - Rigid	ø 1 1/2"	FT	0					
	PVC Pipes Sch.80 - Rigid	ø 2"	FT	0					
	PVC Pipes Sch.80 - Rigid	ø 3"	FT	0					
	Flex Pipe Round	ø 1/2"	PCS	0					
	PIPE FITTINGS								
	ABS 90 Degree Bend Elbow	1 1/2"ø-1 1/2"ø	PCS	1					
	ABS 90 Degree Bend Elbow	2"ø-2"ø	PCS	3					
3	ABS 90 Degree Bend Elbow	3"ø-3"ø	PCS	1					
4	ABS P-Trap	1 1/2"ø-1 1/2"ø	PCS	4					
5	ABS P-Trap	2"ø-2"ø	PCS	1					
6	ABS Reducer Elbow	2"ø-1 1/2"ø	PCS	3					
7	ABS Reducer Elbow	3"ø-2"ø	PCS	1					
8	ABS TEE Elbow	1 1/2"ø-1 1/2"ø-1 1/2"ø	PCS	2					
	ABS TEE Elbow	2"ø-2"ø-2"ø	PCS	2					
	ABS TEE Elbow	3"ø-3"ø-3"ø	PCS	1					
	ABS Tee Reducer Elbow	2"ø-2"ø-2"ø	PCS	1					
	ABS Tee Reducer Elbow	3"ø-3"ø-1 1/2"ø	PCS	1					
	ABS Tee Reducer Elbow		PCS	1					
		3"ø-3"ø-2"ø							
	ABS Tee Reducer Elbow	3"ø-3"ø-3"ø	PCS	1					
	ABS Trap P	2"ø-2"ø	PCS	1					
	ABS Vent Cap Elbow	1 1/2"ø	PCS	2					
	ABS Vent Cap Elbow	2"ø	PCS	2					
	ABS Vent Cap Elbow	3"ø	PCS	1					
	ABS WASTE DOUBLE TEE	2"ø-2"ø-2"ø	PCS	1					
20	PEX 90 Deg Elbow	1/2"ø-1/2"ø	PCS	4					
21	PEX 90 Degree Elbow	1/2"ø-1/2"ø	PCS	24					
	PEX 90 Degree Elbow	3/4"ø-3/4"ø	PCS	5					
	PEX Tee Elbow	1/2"ø-1/2"ø-1/2"ø	PCS	6					
	PEX Tee Elbow	3/4"ø-3/4"ø-3/4"ø	PCS	7					
	PEX Transition Elbow	1"ø-3/4"ø	PCS	2					
	PEX Transition Elbow	3/4"ø-1/2"ø	PCS	13					
	PVC 90 Deg Bend Elbow	2"ø-2"ø	PCS						
21	F V C 70 Deg dellu EIDOW	L W-L W	1 203	18					



		Orion-1Bd 1B	a-Craft	sman-Po	rch		
		HVAC SYSTEM MA	TERIAL	SHOPP	ING LIST		
No.	Item	Туре	Unit	Quantity	Unit Price	Total	Description
	HVAC_DUCTS						
1	PIPE (REFRIGERANT LINE)	3/8" (Ø)	FT	55.72			
2	PIPE (REFRIGERANT LINE)	3/4''' (Ø)	FT	77.94			
3	DRAYER HOSE	4" (Ø)	FT	7.3			
4	FLEX DUCT ROUND	4" (Ø)	FT	5.2			
	DUCT FITTINGS & ACCESSORIES						
5	ELBOW (REFRIGERANT LINE)	3/4" (Ø)-3/4" (Ø)	PCS	23			
6	ELBOW (REFRIGERANT LINE)	3/8" (Ø)-3/8" (Ø)	PCS	17			
7	TEE (REFRIGERANT LINE)	3/4" (Ø)-3/4" (Ø)-3/4" (Ø)	PCS	1			
8	TEE (REFRIGERANT LINE)	3/8" (Ø)-3/8" (Ø))-3/8" (Ø)	PCS	1			
9	TRANSITION (REFRIGERANT	3/4" (Ø)-1/2" (Ø)	PCS	3			
10	TRANSITION (REFRIGERANT	3/4" (Ø)-5/8" (Ø)	PCS	2			
11	TRANSITION (REFRIGERANT	3/8" (Ø)-1/4" (Ø)	PCS	1			
Δ	HVAC_EQUIPMENTS						
12	AIR HANDLING UNIT	WALL MOUNTED	PCS	2			
13	CONDENSER	OUTDOOR UNIT	PCS	1			
14	EXHAUST FAN	75 CFM	PCS	1			
15	EXHAUST HOOD	WALL MOUNTED	PCS	1			
16	HOOD-WALL: VENT	HOOD-WALL: VENT	PCS	1			
17	DRAYER: VENT	DRAYER: VENT	PCS	1			
18	ROOF VENT	3"(Ø)	PCS	1			



Table Of Content

#	Name	Link	Page No
1	Cover Page	<u>Cover Page</u>	1
2	TOC	TOC	2
3	ELECTRICAL BOM	ELECTRICAL BOM	3
5	HVAC BOM	HVAC BOM	7
4	PLUMBING BOM	PLUMBING BOM	10
6	ARCHITECTURAL BOM	ARCHITECTURAL BOM	15

Have It Your Way!

The material types listed in this document were selected based on personal preferences. The Customer is encouraged to make changes to the material types in accordance with local customs, regulations, and personal preferences. Have It Your Way!

GENERAL NOTES

- This BOM (Bill of Materials) is prepared as a Materials Shopping List to help builders and DIYers gain a complete understanding of most if not all elements required for the complete construction of this structure, according to the original design documents provided by FrameUpNow.
- 2 All quantities and specifications are subject to change based on the final design, field measurements, availability of products and customer preferences. The customer should verify all information prior to purchasing materials.
- 3 All products and elements in the list shall conform to the International Residential Code (IRC), or any other local and international building codes, safety regulations, and standards that are applicable to the location of the structure.
- 4 If any changes are made by the customer to the list of materials specified in this document, the customer is responsible for assuring that the correct type and quantity of materials are utilized in accordance with local building codes.
- 5 FrameUpNow, will not be held responsible for any misuse of this document, the products listed, or for deviations from the content that are made due to changes in specifications, pricing, availability, or customer preferences.
- The customer is advised to consult a qualified professional or technician prior to purchasing materials for specialized construction system items. Some items including but not limited to caseworks, doors and windows may require as built measurements prior to purchase to confirmation of final dimensions.
- 7 If there are additional trim elements or specific installation methods, the total amount of materials needed might vary. Consider any additional trim required for corners, intersections, or other architectural details that might cause this variations before procedding to purchase and construction.



			LIGHTING FIXTURES				
#	Item	Туре	Description, Manufacturer, SKU	Unit	Quantity	Unit Price	Total
1	Kitchen Ceiling Light			PCS	4		
3	Kitchen Wall Mounted Light			PCS	1		
4	Exterior Wall Mounted Light			PCS	6		
5	Livingroom Ceiling Light With Fan			PCS	1		
6	Bedroom Ceiling Light With Fan			PCS	1		
7	Dining Ceiling Light			PCS	0		
8	Bath Wall Mounted Light			PCS	2		
9	Bathroom Ceiling Light			PCS	1		
10	Livingroom Ceiling Light			PCS	4		
11	Bedroom Ceiling Light			PCS	4		
12	Hall & Entry Ceiling Light			PCS	2		
12	Closet Ceiling Light			PCS	1		
13	Smoke Detector			PCS	2		
14							
15							



			ELECTRICAL FITTINGS				
#	Item	Туре	Description, Manufacturer, SKU	Unit	Quantity	Unit Price	Total
1	Standard Receptacle 120V	20A		PCS	11		
2	GFCI Receptacle 120V	20 A		PCS	14		
3	GFCI Receptacle 240V	30 A		PCS	2		
1	GFCI Receptacle 240V	50 A		PCS	1		
5	GFCI Receptacle 240V	60 A		PCS	1		
5	Fan Switch			PCS	1		
7	Single Pole Switch			PCS	6		
3	Three Way Switch			PCS	8		
9	Dimmer Switch			PCS	2		
.0							
.1							
.2							
.3							
L4							
L5							



		ELECTR	ICAL CONDUITS & WIRING				
#	Item	Туре	Description, Manufacturer, SKU	Unit	Quantity U	Jnit Price	Total
1	ROMEX 14 AWG	14/3/W/ground		FT	156		
3	ROMEX 12 AWG	12/3/W/ground		FT	295		
4	ROMEX 12 AWG	12/2/W/ground		FT	0		
6	ROMEX 10 AWG	10/3/W/ground		FT	0		
8	ROMEX 10 AWG	10/2/W/ground		FT	83		
9	Romex 8 AWG	8/3/W/ground		FT	0		
10	Romex 8 AWG	8/2/W/ground		FT	22		
11	ROMEX 6 AWG	6/2/W/ground		FT	24		
12	Bare Copper Ground Wire 6 AWG			FT			
13							
14							
15							
16							



		ELEC	CTRICAL BOXES & CIRCUTES				
#	Item	Туре	Description, Manufacturer, SKU	Unit	Quantity	Unit Price	Total
1	Panelboard -240V 1 Phase MLO	200 AMP		PCS	1		
2	Circuit breaker	15 A		PCS	4		
3	Circuit breaker	20 A		PCS	9		
4	Circuit breaker	30 A		PCS	2		
5	Circuit breaker	40 A		PCS	1		
6	Circuit breaker	60 A		PCS	1		
7	Single Gang Switch Box			PCS	4		
8	Double Gang Switch Box			PCS	4		
9	Triple Gang Switch Box			PCS	1		
10	Pull Box	#1/4		PCS	21		
11	Receptacle Box			PCS	29		
12							
13							
14							
15							



			HVAC_DUCTS 01				
#	Item	Туре	Description, Manufacturer, SKU	Unit	Quantity	Unit Price	Total
1	PIPE (REFRIGERANT LINE)			FT	55.72		
2	PIPE (REFRIGERANT LINE)			FT	77.94		
3	DRAYER HOSE	4" (Ø)		FT	7.3		
4	FLEX DUCT ROUND	4" (Ø)		FT	5.2		



		С	OUCT FITTINGS & ACCESSORIES				
#	Item	Туре	Description, Manufacturer, SKU	Unit	Quantity	Unit Price	Total
1	ELBOW (REFRIGERANT LINE)	3/4" (Ø)-3/4" (Ø)		PCS	23		
2		3/8" (Ø)-3/8" (Ø)		PCS	17		
3	TEE (REFRIGERANT LINE)	3/4" (Ø)-3/4" (Ø)-3/4" (Ø)		PCS	1		
4	TEE (REFRIGERANT LINE)	3/8" (Ø)-3/8" (Ø))-3/8" (Ø)		PCS	1		
5	TRANSITION (REFRIGERANT LINE)	3/4" (Ø)-1/2" (Ø)		PCS	3		
6	TRANSITION (REFRIGERANT LINE)	3/4" (Ø)-5/8" (Ø)		PCS	2		
7	TRANSITION (REFRIGERANT LINE)	3/8" (Ø)-1/4" (Ø)		PCS	1		



	HVAC_EQUIPMENTS						
#	Item	Туре	Description, Manufacturer, SKU	Unit	Quantity	Unit Price	Total
1	AIR HANDLING UNIT	WALL MOUNTED		PCS	2		
2	CONDENSER	OUTDOOR UNIT		PCS	1		
3	EXHAUST FAN	75 CFM		PCS	1		
1	EXHAUST HOOD	WALL MOUNTED		PCS	1		
5	HOOD-WALL: VENT	HOOD-WALL: VENT		PCS	1		
6	DRAYER: VENT	DRAYER: VENT		PCS	1		
7	ROOF VENT	3"(Ø)		PCS	1		
8							
9							
10							
11							
12							
13							
14							



	PLUMBING FIXTURES & ACCESSORIES								
#	Item	Туре	Description, Manufacturer, SKU	Unit	Quantity	Unit Price	Total		
1	Bath Tub (Alcove Tub)			PCS	C				
2	Kitchen Sink			PCS	1				
3	Kitchen faucets			PCS	1				
4	Vanity Sink			PCS	2				
5	Bath room faucets			PCS	2				
6	Water Closet			PCS	1				
7	Shower Trim			PCS	1				
8	Shower Tray			PCS	1				
9	Water Heater			PCS	1				
10	Hose Bib			PCS	1				
11	Shutoff Valve			PCS	8				
12	Hanging pipe clamp			PCS	12				
13	Gate Valve			PCS	1				
14	Dishwasher Supply Single Connector			PCS	1				
15	Dishwasher Sewage Single Connector			PCS	1				
16	Laundry Sweat Connector			PCS	1				



		SAN	ITARY & PLUMBING PIPES				
#	Item	Туре	Description, Manufacturer, SKU	Unit	Quantity	Unit Price	Total
1	Acrylonitrile Butadiene Styrene (ABS)	3/4"		FT	0		
2	Acrylonitrile Butadiene Styrene (ABS)	1 1/2"		FT	29		
3	Acrylonitrile Butadiene Styrene (ABS)	2"		FT	42		
4	Acrylonitrile Butadiene Styrene (ABS)	3"		FT	16		
5	Cross-linked polyethylene (PEX)	1/2"		FT	88		
6	Cross-linked polyethylene (PEX)	3/4"		FT	34		
7	Polyvinyl Chloride - Rigid	2"		FT	47		



		PIPE	FITTINGS 01				
#	Item	Туре	Description, Manufacturer, SKU	Unit	Quantity	Unit Price	Total
1	ABS 90 Degree Bend Elbow	1 1/2"ø-1 1/2"ø		PCS	1		
2	ABS 90 Degree Bend Elbow	2"ø-2"ø		PCS	3		
3	ABS 90 Degree Bend Elbow	3"ø-3"ø		PCS	1		
4	ABS P-Trap	1 1/2"ø-1 1/2"ø		PCS	4		
5	ABS P-Trap	2"ø-2"ø		PCS	1		
6	ABS Reducer Elbow	2"ø-1 1/2"ø		PCS	3		
7	ABS Reducer Elbow	3"ø-2"ø		PCS	1		
8	ABS TEE Elbow	1 1/2"ø-1 1/2"ø-1 1/2"ø		PCS	2		
9	ABS TEE Elbow	2"ø-2"ø-2"ø		PCS	2		
10	ABS TEE Elbow	3"ø-3"ø-3"ø		PCS	1		
11	ABS Tee Reducer Elbow	2"ø-2"ø-2"ø		PCS	1		
12	ABS Tee Reducer Elbow	3"ø-3"ø-1 1/2"ø		PCS	1		
13	ABS Tee Reducer Elbow	3"ø-3"ø-2"ø		PCS	1		
14	ABS Tee Reducer Elbow	3"ø-3"ø-3"ø		PCS	1		
15	ABS Trap P	2"ø-2"ø		PCS	1		



		PI	PE FITTINGS 02		_	_	
#	Item	Туре	Description, Manufacturer, SKU	Unit	Quantity	Unit Price	Total
I	ABS Vent Cap Elbow	1 1/2"ø		PCS	2		
	ABS Vent Cap Elbow	2"Ø		PCS	2		
	ABS Vent Cap Elbow	3"Ø		PCS	1		
	ABS WASTE DOUBLE TEE	2"ø-2"ø-2"ø		PCS	1		
	PEX 90 Deg Elbow	1/2"ø-1/2"ø		PCS	4		
	PEX 90 Degree Elbow	1/2"ø-1/2"ø		PCS	24		
	PEX 90 Degree Elbow	3/4"ø-3/4"ø		PCS	5		
	PEX Tee Elbow	1/2"ø-1/2"ø-1/2"ø		PCS	6		
	PEX Tee Elbow	3/4"ø-3/4"ø-3/4"ø		PCS	7		
)	PEX Transition Elbow	1"ø-3/4"ø		PCS	2		
1	PEX Transition Elbow	3/4"ø-1/2"ø		PCS	13		
2	PVC 90 Deg Bend Elbow	2"ø-2"ø		PCS	18		



			APPLIANCES				
#	Item	Туре	Description, Manufacturer, SKU	Unit	Quantity	Unit Price	Total
1	Refrigerator			PCS			
2	Range			PCS			
3	Washer Front Load	Stackable		PCS			
4	Dryer Front Load	Stackable		PCS			
5	Dish Washer			PCS			
6	Oven			PCS	(
7	Microwave			PCS	(
8							
9							
10							
11							
12							
13							
14							
15							
16							



			CASEWORKS 01				
#	Item	Туре	Description, Manufacturer, SKU	Unit	Quantity	Unit Price	Total
1	Kitchen Cabinet			FT	16.16		
2	Laundry Cabinet			FT	0		
3	Vanity Cabinet			FT	5		
4	Medicine Cabinet			PCS	2		
5	Kitchen countertop			SF	25.32		
6	Laundry Countertop			PCS	0		
7	Bathroom Countertop			SF	0		
8	Island			FT	0		
9	Peninsula			FT	0		
10	Closets			SF	81.96		
11							
12							
13							
14							
15							



			CEILING 01				
#	Item	Туре	Description, Manufacturer, SKU	Unit	Quantity	Unit Price	Total
	LIVING ROOM + KITCHEN			SF	295.8	1	
1	Ceiling Board	Drywall		SF	296		
2	Drywall Fastener	Screw		PCS	518		
3	Vapor Retarder	Polyethylene film		SF	296		
1	Vapor Retarder Fastener	Nails with washer heads		PCS	887		
	BATH ROOM	·		SF	74.9		
5	Ceiling Board	MRD (Moisture resistant drywall)		SF	75		
5	MRD Fastener	Screw		PCS	131		
	WH			SF	8.6		
7	Ceiling Board	Drywall		SF	9		
3	Drywall Fastener	Screw		PCS	15		
)	Vapor Retarder	Polyethylene film		SF	9		
LO	Vapor Retarder Fastener	Nails with washer heads		PCS	26		
	PATIO			SF	152.3		
11	Ceiling Board	Marine Plywood		SF	152		
12	Exterior Grade Plywood	Screw		PCS	267		



			CEILING 02				
#	Item	Туре	Description, Manufacturer, SKU	Unit	Quantity	Unit Price	Total
	HALL+WD			SF	49.6	,	
13	Ceiling Board	Drywall		SF	50		
14	Drywall Fastener	Screw		PCS	87		
15	Vapor Retarder	Polyethylene film		SF	50		
16	Vapor Retarder Fastener	Nails with washer heads		PCS	149		
	CL 1			SF	18.1		
17	Ceiling Board	Drywall		SF	18		
18	Drywall Fastener	Screw		PCS	32		
19	Vapor Retarder	Polyethylene film		SF	18		
20	Vapor Retarder Fastener	Nails with washer heads		PCS	54		
	CL 2			SF	5.3		
21	Ceiling Board	Drywall		SF	5		
22	Drywall Fastener	Screw		PCS	9		
23	Vapor Retarder	Polyethylene film		SF	5		
24	Vapor Retarder Fastener	Nails with washer heads		PCS	16		



			CEILING 03				
#	Item	Туре	Description, Manufacturer, SKU	Unit	Quantity	Unit Price	Total
	CL 3			SF	6.7		
25	Ceiling Board	Drywall		SF	7		
26	Drywall Fastener	Screw		PCS	12		
27	Vapor Retarder	Polyethylene film		SF	7		
28	Vapor Retarder Fastener	Nails with washer heads		PCS	20		
	BEDROOM			SF	121.5		
29	Ceiling Board	Drywall		SF	122		
30	Drywall Fastener	Screw		PCS	213		
31	Vapor Retarder	Polyethylene film		SF	122		
32	Vapor Retarder Fastener	Nails with washer heads		PCS	365		



			FLOORING INTERIOR 01				
#	Item	Туре	Description, Manufacturer, SKU	Unit	Quantity	Unit Price	Total
	BEDROOM						
1	Bedroom Flooring			SF	210		
2	Wood underlay	Foam Pad Polyethylene		SF	210		
3	Vapor Retarder	Vapor Barrier Polyethylene		SF	210		
	CLOSET 1						
4	Closet Flooring			SF	17		
5	Wood underlay	Foam Pad Polyethylene		SF	17		
6	Vapor Retarder	Vapor Barrier Polyethylene		SF	17		
	CLOSET 2						
7	Closet Flooring			SF	5		
8	Wood underlay	Foam Pad Polyethylene		SF	5		
9	Vapor Retarder	Vapor Barrier Polyethylene		SF	5		
	CLOSET 3						
10	Closet Flooring			SF	6		
11	Wood underlay	Foam Pad Polyethylene		SF	6		
12	Vapor Retarder	Vapor Barrier Polyethylene		SF	6		



	<u>1</u>		FLOORING INTERIOR 02				
#	Item	Туре	Description, Manufacturer, SKU	Unit	Quantity	Unit Price	Total
	LIVING ROOM AND KITCH	EN					
13	Living Area Flooring			SF	309		
14	Wood underlay	Foam Pad Polyethylene		SF	309		
15	Vapor Retarder	Vapor Barrier Polyethylene		SF	309		
	BATHROOM						
16	Tile Finish			SF	59		
17	Adhesive	1/2" Thin set Mortar		SF	59		
18	Vapor Retarder	Vapor Barrier Polyethylene		SF	59		
	W/D						
19	Tile Finish			SF	19		
20	Adhesive	1/2" Thin set Mortar		SF	19		
21	Vapor Retarder	Vapor Barrier Polyethylene		SF	19		
	BOILER ROOM						
22	Tile Finish			SF	8		
23	Adhesive	1/2" Thin set Mortar		SF	8		
24	Vapor Retarder	Vapor Barrier Polyethylene		SF	8		



			FLOORING EXTERIOR			
#	Item	Туре	Description, Manufacturer, SKU	Unit	Quantity	Unit Price
	STRUCTURE			SF	1113.8	
1	Concrete Slab	4"concrete cast in situ		CF	371	
2	Insulation	Rigid insulation		SF	287.46	
3	Hard core	Compacted soil		CF	282.83	
4	Re-bar	#4 re-bar		Ton	0.99	
5	Concrete Pad	4"concrete cast in situ		CF	1.58	
6	Slab edge	Turndown		CF	261	
7	Footing	Cast-in-place concrete		CF	4.68	
	PORCH FRONT					
8	Tile Finish			SF	396.17	
9	Adhesive	1/2" Thin set Mortar		SF	396.17	
10	Vapor Retarder	Vapor Barrier Polyethylene		SF	396.17	



		WALLS: EXTERIOR							
#	Item	Туре	Description, Manufacturer, SKU	Unit	Quantity	Unit Price	Total		
1	Exterior-Grade Plywood Horizontal Siding			SF	828				
2	Exterior-Grade Plywood Fastener 8/panel	Self-drilling screws(100/pkt)		PKT	8.28				
3	Wall Shteathing (OSB)			SF	828				
4	Shteathing Fastener	Self-drilling screws(100/pkt)		PKT	8.28				
5	Wall Homewrap			SF	828				
6	Homewrap Fastener	Stapled fastener (200/pkt)		PKT	3.15				
7	Furring Strip			PCS	103.50				
8	Furring Strip Fastener	Self-drilling screws(100/pkt)		PKT	8.28				
9	Wall Paint			SF	828				
10	Stone Copping	Masonry stone		SF	119				
11	Stone Veneer	Masonry stone		SF	178				
12	Mortar for Stone Veneer			SF	178				
13	Wall Insulation			SF	2696				
14									
15									



			WALLS: INTERIOR 01				
#	Item	Туре	Description, Manufacturer, SKU	Unit	Quantity	Unit Price	Total
	BATHROOM			SF	72.0		
1	Cementitious Backer Board			SF	294		
2	Kerdi membrane			SF	294		
3	Kerdi membrane Fastener			SF	294		
4	Wall Ceramic Tile			SF	294		
	BEDROOM			SF	209.0		
5	Drywall Board			SF	387		
6	Drywall Fastener	Self-drilling screws(100/pkt)		PKT	3.87		
7	Wall Paint			SF	387		
8	Drywall Tape			FT	72.6		
	HALL			SF	31.0		
9	Drywall Board			SF	89		
10	Drywall Fastener	Self-drilling screws(100/pkt)		PKT	0.89		
11	Wall Paint			SF	89		
12	Drywall Tape			FT	17		



			WALLS: INTERIOR 02				
#	Item	Туре	Description, Manufacturer, SKU	Unit	Quantity	Unit Price	Total
	LIVING ROOM			SF	196.0		
13	Drywall Board			SF	275		
14	Drywall Fastener	Self-drilling screws(100/pkt)		PKT	2.75		
15	Wall Paint			SF	275		
16	Drywall Tape			FT	51.6		
	KITCHEN			SF	80.0		
17	Cementitious Backer Board			SF	23		
18	Drywall Board			SF	155		
19	Drywall Fastener	Self-drilling screws(100/pkt)		PKT	1.55		
20	Kerdi membrane			SF	23		
21	Kerdi membrane Fastener			SF	23		
22	Wall Ceramic Tile			SF	23		
23	Wall Paint			SF	155		
24	Drywall Tape			FT	29.2		



		WALLS: INTERIOR 03							
#	Item	Туре	Description, Manufacturer, SKU	Unit	Quantity	Unit Price	Total		
	CL 1			SF	19.0				
25	Drywall Board			SF	122				
26	Drywall Fastener	Self-drilling screws(100/pkt)		PKT	1.22				
27	Wall Paint			SF	122				
28	Drywall Tape			FT	22.9				
	CL 2			SF	6.0				
29	Drywall Board			SF	82				
30	Drywall Fastener	Self-drilling screws(100/pkt)		PKT	0.82				
31	Wall Paint			SF	82				
32	Drywall Tape			FT	15.4				
	CL 3			SF	6.0				
33	Drywall Board			SF	70				
34	Drywall Fastener	Self-drilling screws(100/pkt)		PKT	0.7				
35	Wall Paint			SF	70				
36	Drywall Tape			FT	13.1				



			WALLS: INTERIOR 04				
#	Item	Туре	Description, Manufacturer, SKU	Unit	Quantity	Unit Price	Total
	WD			SF	18.0		
37	Cementitious Backer Board			SF	102		
38	Kerdi membrane			SF	102		
39	Kerdi membrane Fastener			SF	102		
40	Wall Ceramic Tile			SF	102		
	WH			SF	9.0		
41	Drywall Board			SF	82		
42	Drywall Fastener	Self-drilling screws(100/pkt)		PKT	0.82		
43	Wall Paint			SF	82		
44	Drywall Tape			FT	15.47		
1	Wall Skirting	Ceramic		FT	123		
					120		



			DOORS				
#	Item	Туре	Description, Manufacturer, SKU	Unit	Quantity	Unit Price	Total
1	Interior Swinging	3' - 0" X 6'-8"		PCS	2		
2	Interior Swinging	2' - 6" X 6'-8"		PCS	1		
3	Exterior Swinging	5' - 0" X 6'-8"		PCS	1		
4	Exterior Sliding	5' - 0" X 6'-8"		PCS	1		
5	Exterior Swinging	3' - 0" X 6'-8"		PCS	1		
6	Interior Sliding	7' - 6" X 6'-8"		PCS	1		
7	Folding	2' - 0" X 6'-8"		PCS	3		
8	Exterior Door Trim			FT	53		
9	Interior Door Trim			FT	284		
10	Entry Lock set			PCS	3		
11	Privacy Lock set			PCS	3		
12	Passage Lock set			PCS	4		



			WINDOWS				
#	Item	Туре	Description, Manufacturer, SKU	Unit	Quantity	Unit Price	Total
1	Sliding	3' - 3" X 1'-9"		PCS	1		
2	Casement	2' - 3" X 4'-3"		PCS	2		
3	Casement	3' - 3" X 3'-3"		PCS	2		
4	Awning	2' - 3" X 2'-3"		PCS	2		
5	Sliding	4' - 3" X 3'-3"		PCS	1		
6	Sliding	6' - 3" X 4'-3"		PCS	1		
7	Exterior Window Trim			FT	118		
8	Interior Window Trim			FT	118		
9							
10							
11							
12							
13							
14							
15							



		ROOF 01							
#	Item	Туре	Description, Manufacturer, SKU	Unit	Quantity	Unit Price	Total		
1	Roof Covering			SF	1056.0				
2	Roof Covering Fastener			PCS	528				
3	Roof Felt Paper			SF	1056.0				
4	Roof Felt Paper Fastener			PCS	3168.0				
5	Roof Sheathing			SF	1056.0				
6	Roof Sheathing Fastener			PCS	8448				
7	Batten			FT	0.0				
8	Batten Fastener			PCS	0.0				
9	Soffit			SF	151.0				
10	Soffit Fastener			PCS	75.5				
11	Fascia			FT	150.0				
12	Fascia board fastener			PCS	75				
13	Roof Insulation			SF	1056.0				
14									
15									