

ORION

The Orion is a charming Spanish-style onebedroom, one-bathroom home designed for comfortable and efficient living. The exterior walls are finished with a light stucco, creating a warm and traditional aesthetic. A simple gable roof covered in terracotta tiles provides shelter and complements the overall Spanish style. A prominent covered porch spans the front of the home, featuring arched openings supported by substantial pillars and a pergola, creating a welcoming and elegant outdoor space.

Inside, the Orion features a simple rectangular plan. The living, dining, and kitchen areas are seamlessly merged into a single large room at one end of the house, creating a spacious and versatile living space. The bedroom is thoughtfully located on the other end of the plan, offering a private and quiet retreat. Functional spaces, such as the bathroom and laundry, are strategically placed between the living area and the bedroom, creating a clear separation and enhancing the overall functionality of the home.

Materials Shopping List

Please print and take this Materials Shopping List to your favorite Home Depot and ask for assistance in selecting the materials, fixtures and fittings to complete your new home.

Record your selection and the price of the item. Then do the math to determine the cost for your selections and the total cost of finishing your home.

< CLICK HERE >

To Go To Materials Shopping List



24' - 7" PORCH 263 SF 85 SF FLOOR PLAN

FLOOR PLAN

730 SF

1 Bed Room

TABLE OF CONTENTS

RENDERINGS	ABOUT THE HOME -	─ 01
1	RENDERINGS -	— 01
FLOOR PLAN	SCHEMATIC FLOOR PLAN	— 01
1	HOME SPECS -	— 01
	DISCLAIMER -	— 01
ABOUT	■ ABOUT FrameUpNow ⊢	— 01
1	ABOUT HouseDocs -	— 01
DESCRIPTIONS	BOM (Bill Of Materials) ⊢	─ 02
2	STRUCTURAL -	─ 02
	ARCHITECTURAL	─ 02
	MECHANICAL -	─ 02
	ELECTRICAL	─ 02
	PLUMBING -	— 02
MATERIALS LIST	MATERIALS LIST PREVIEW	─ 02
HOW TO BUILD	CONSTRUCTION STEPS -	─ 02

COVER SHEET

FLOOR PLAN +

DIMENSION PLAN

FOUNDATION PLAN STRUCTURAL FLOOR PLAN -WALL FRAME LAYOUT ROOF TRUSS LAYOUT ROOF PLAN + ARCHITECTURAL ELEVATIONS ARCHITECTURAL ELEVATIONS -ARCHITECTURAL SECTIONS -ARCHITECTURAL DETAILS

03

29

34

DISCLAIMER

marketing content.

DISCLAIMER: This documentation and all it's contents are the intellectual property of FrameUpNow. It is provided solely for marketing the services of FrameUpNow.

The preliminary information is not approved for actual construction use and is

not warranted to be complete or accurate. Unauthorized copying, distribution, or application of these proprietary materials, in any form or format, is strictly prohibited. FrameUpNow assumes no liability for any issues arising from improper use of this

COVER SHEET GENERAL NOTES WALL FRAME LAYOUT WALL PANEL & LAYOUT PLAN 20 ROOF TRUSS LAYOUT 21 **STRUCTURAL SECTIONS** -WALL BRACING LAYOUT HOLD-DOWN PLAN **STRUCTURAL DETAILS 1 STRUCTURAL DETAILS 2 STRUCTURAL DETAILS 3 27**

TRUSS BLOCKING LAYOUT

SHEETROCK BACKING

ROOF BRACING LAYOUT

DIMENSION FOR LIGHTING

DIMENSION FOR FITTING

ARCHITECTURAL CASEWORK

MECHANICAL COVER SHEET 30 HVAC PLAN 31 **ELECTRICAL** SCHEDULE 32 LIGHTING

POWER PLAN

PLUMBING

ARCHITECTURAL

STRUCTURAL

NOTES AND SCHEDULES WATER SUPPLY & SEWAGE SYSTEM # 38

MATERIALS SHOPPING LIST

MATERIALS SHOPPING LIST

ABOUT



FrameUpNow is a design and manufacturing company providing precision-engineered home framing solutions. We offer a catalog of Affordable Homes, Tiny Homes, Garages, Shops and Barndominiums. FrameUpNow manufactures cold-formed steel (CFS) also known as Light Gauge Steel (LGS) framing components that conform to our engineered metal house frame plans or can be purchased as DIY skeleton kits.

The CFS/LGS framing is lightweight, easily assembled, and does not require heavy equipment or specialized labor, enabling homeowners to erect the frame themselves in just a few days. Unlike wood, the steel framing is impervious termites and bores, warping, expansion, and fire.

Our home plans come complete with a structural engineered stamp for permit approvals. Customers receive a full BOM also known as a Materials Shopping List to purchase finish materials from a Building Materials retailer. FrameUpNow prides itself on the quality and efficiency of our precision-engineered home framing solutions for construction professionals and DIY homeowners.



KEY PLAN

NO.	DESCRIPTION	DATE

NOTE:

LEGEND:

PROJECT

126-Orion-730-1Bd1Ba-Spanish-Porch-550

DRAWING NAME

INTRODUCTION

	CLIENT NAME:
	PROJECT NUMBER:
	DATE:
	DESIGNED BY:
	DRAWN BY:
	CHECKED BY:
1	

I101

SCALE:

DESCRIPTIONS

MATERIALS LIST

The BOM (Bill Of Materials) package, known as the Materials Shopping List document, provides:

Comprehensive Inventory: Detailed lists of essential materials sourced from architectural, mechanical, HVAC, electrical, and plumbing design drawing sets.

Precise Curation: Each item meticulously selected and organized for accuracy and efficiency in project planning.

Customizable Options: Customers can modify listed items to their preferences and calculate costs accordingly, ensuring alignment with personal project needs and budget.

Dedicated Space for Details: Includes tables for customers to note Home Depot SKU numbers or product descriptions for selected items, facilitating seamless purchasing and coordination with suppliers.

Customer Convenience: Take the list to Home Depot or preferred suppliers for accurate pricing, helping align the total home budget with personal financial plans.

Simplify your construction journey with our Materials Shopping List document, where detailed preparation meets streamlined implementation for your dream home.

Bill of Materials: A complete list of all necessary HVAC components.

MECHANICAL

STRUCTURAL

The structural drawings package provides an exhaustive set of detailed plans essential for the precise assembly of your building. This comprehensive package includes:

Framing Plans: Detailed layouts for all framing components. Truss Layouts: Clear instructions for truss placement and

Panel Length Plans: Specifications for panel dimensions. Framing Elevations and Sections: Precise elevation and sectional views for accurate construction.

Truss and Wall Blocking Plans: Plans for truss and wall blocking to ensure structural integrity.

Hold-Down Plan: Detailed hold-down requirements for stability. Snap Sheet: Reference sheet for quick identification of components

Structural Details and Bracing Plans: Complete details and bracing plans for all structural elements.

Accompanying these plans is a comprehensive Bill of Materials (BOM) that lists every necessary building component, from cold formed steel (CFS) frames to fasteners.

ARCHITECTURAL

With the comprehensive architectural package, both builders and DIY homeowners can confidently execute the construction.

The architectural package includes:

Furnished Floor Plans: Complete with furniture layouts for a clear understanding of space utilization.

Detailed Dimension Plans: Ensures precise measurements, from the overall footprint down to the exact placement of windows and

Foundation Plan: Detailed plan to establish a solid foundation.

Wall Framing and Truss Layout: Comprehensive plans for wall framing and truss placement.

Architectural Elevations: Exterior views showcasing the design.

Strategic Building Sections: Critical cross-sectional details for a thorough understanding of the build.

Casework Drawings and Diagrams: Suggested designs for built-in caseworks, such as kitchen cabinets.

ELECTRICAL

The mechanical package includes everything needed to guide HVAC The electrical package includes all the plans and documentation needed to guide the installation of your home's electrical system:

Detailed HVAC Floor Plan: Precisely maps out the placement of air Detailed Power Plan: Precisely maps out the placement of outlets, handlers, ductwork, and vents throughout the home's layout. switches, and other power components throughout the layout.

HVAC Sections and Riser Diagrams: Technical drawings offering Comprehensive Lighting Plan: Shows the optimal locations for lighting fixtures, sconces, and other illumination sources to create a critical cross-sectional details and piping schematics, ensuring well-lit, functional interior. proper integration of the heating and cooling system into the home's

> Dimensioned Electrical Layout: Provides exact dimensions and measurements to ensure proper placement of all electrical elements.

Bill of Materials: A complete list of every component needed, from circuit breakers to wiring.

The plumbing package includes everything needed to guide the

Detailed Water Supply System Plan: Precisely maps out the placement of pipes, valves, and plumbing fixtures throughout the

Comprehensive Sewage System Plan: Shows the optimal routing and sizing of drain lines to effectively remove waste and ensure

Detailed Riser Diagrams: Provide information needed to properly

PLUMBING

installation of your home's water supply and drainage systems:

proper drainage.

install all vertical plumbing risers and vent stacks.

Bill of Materials: A complete list of every component needed, from pipes to fixtures.

BOM (Bill Of Materials) (Separately Attached)





structure.


The Bill of Materials (BOM) is a crucial document that compiles the material requirements from different disciplines into a centralized inventory, enabling efficient procurement, inventory management, and cost estimation for a specified project or

ELECTRICAL BOM



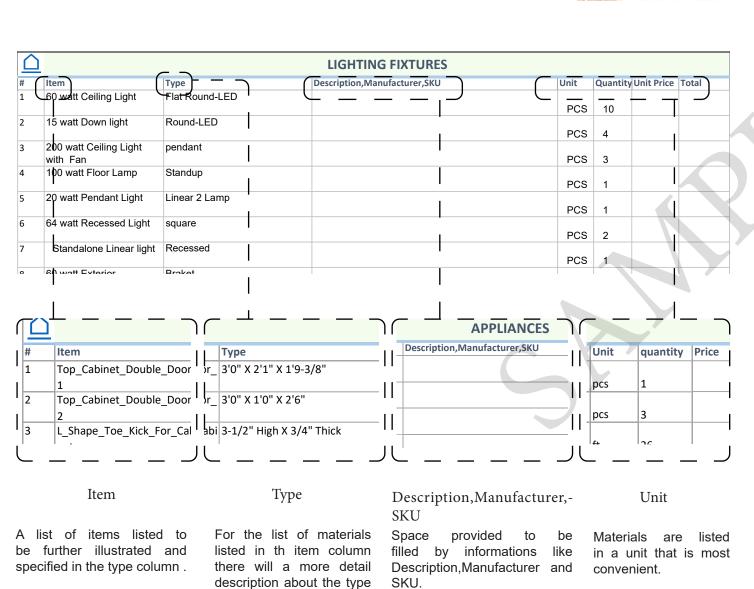

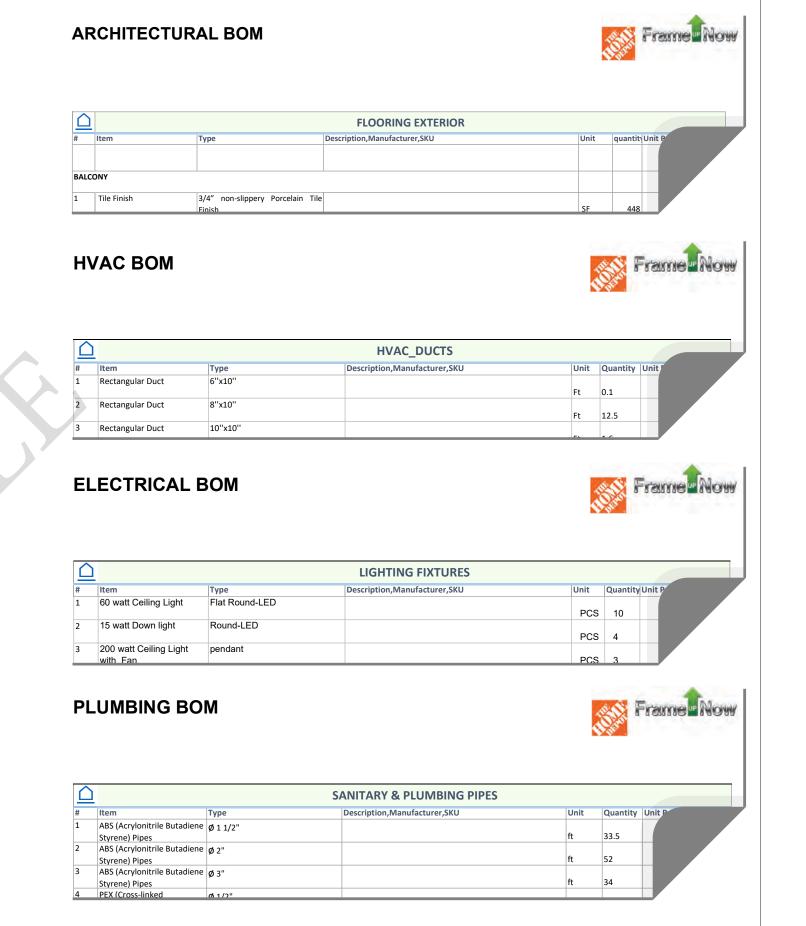

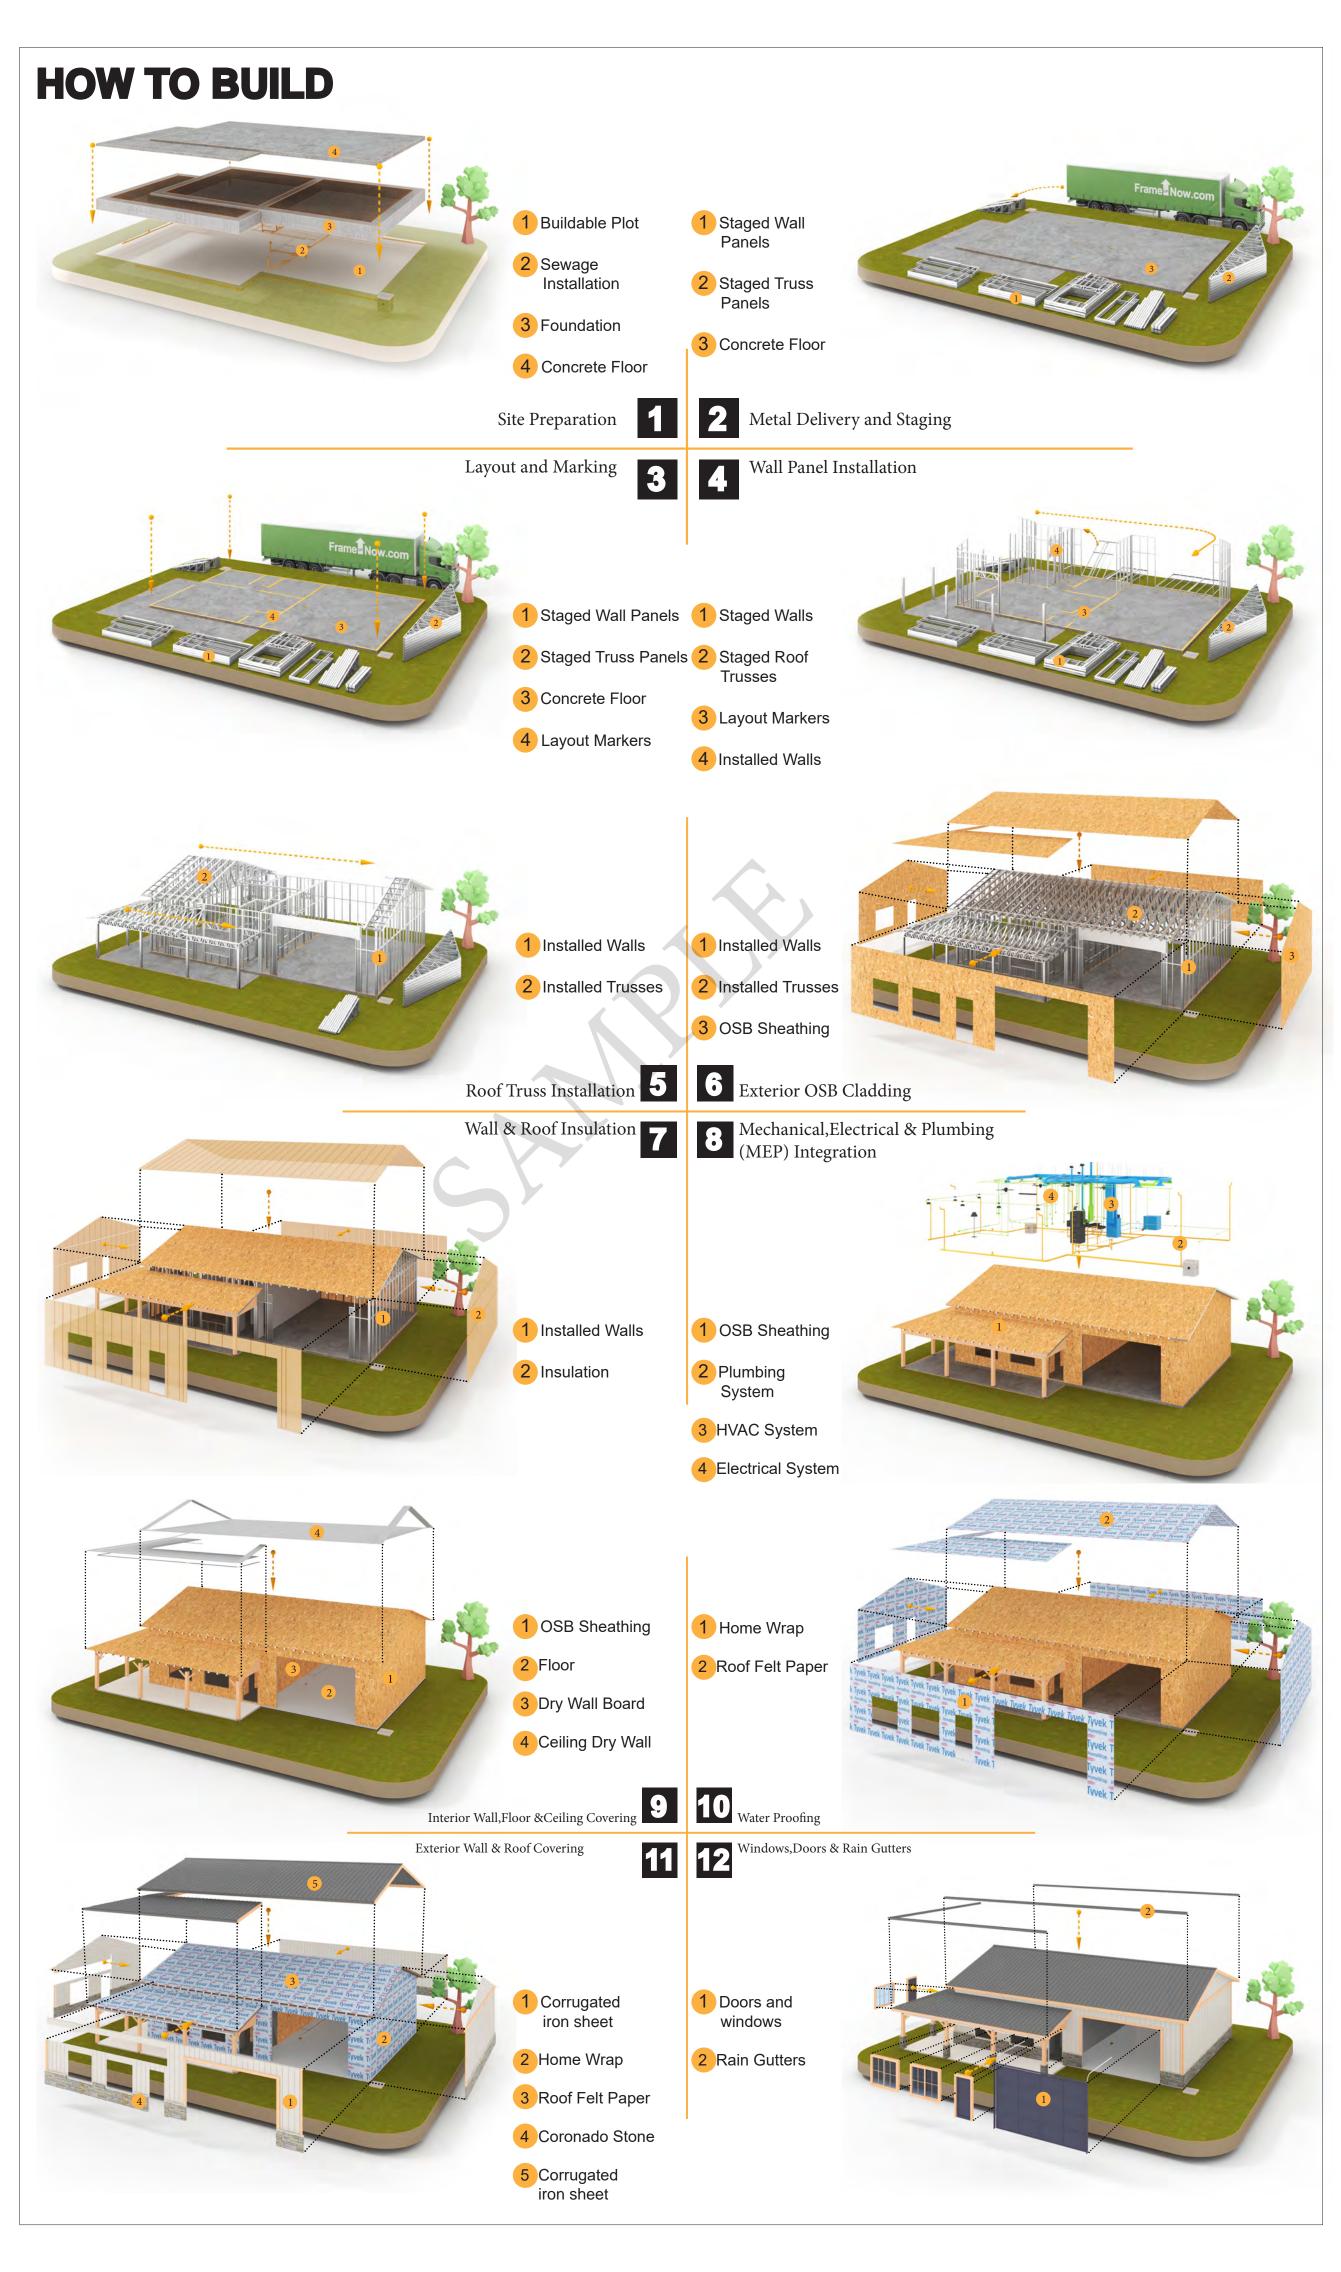



KEY PLAN

NO.	DESCRIPTION	DATE

NOTE:

LEGEND:

PROJECT

126-Orion-730-1Bd1Ba-Spanish-Porch-550

DRAWING NAME


INTRODUCTION

CLIENT NAME: DATE: **DESIGNED BY** DRAWN BY: CHECKED BY:

1102

SCALE:

of the Material.

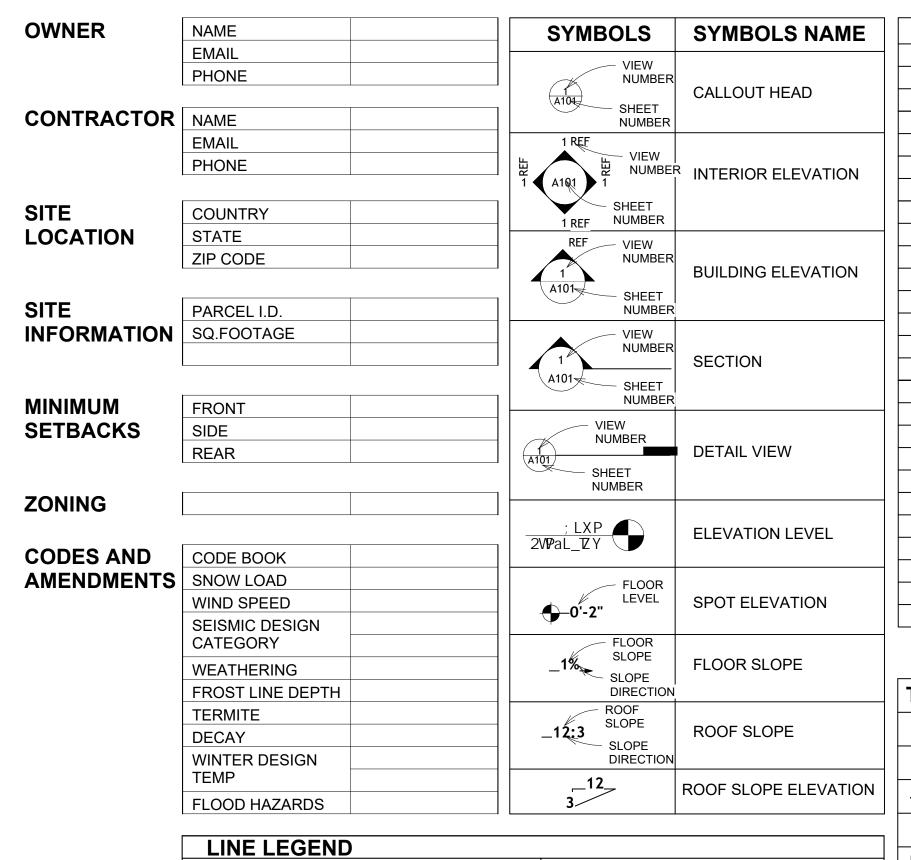

---- CUT LINE

ROOM SEPARATOR

	PAGE INDEX
G101	COVER SHEET
A101	FLOOR PLAN
A102	DIMENSION PLAN
S101	FOUNDATION PLAN
S102	STRUCTURAL FLOOR PLAN
S103	FRAME LAYOUT
S104	ROOF TRUSS LAYOUT
A103	ROOF PLAN
A201	ELEVATIONS
A202	ELEVATIONS
A301	SECTIONS
A401	DETAILS
A402	CASEWORK DETAILS
A403	CASEWORK DETAILS
E101	SCHEDULE
E102	LIGHTING PLAN
E103	POWER PLAN
E104	DIMENSION PLAN FOR LIGHT FIXTURE
E105	DIMENSION PLAN FOR FITTING
P101	COVER SHEET
P102	WATER SUPPLY SYSTEM
P103	SEWAGE SYSTEM
P104	RISER DIAGRAM
M101	HVAC PLAN
M102	HVAC SECTION
M103	RISER DIAGRAM
TAG	TAG'S NAME
	1110011111111
CA01	CASEWORK TAG
1	DOOR TAG
<u>1</u>	FURNITURE TAG
1	WINDOW TAG
SE01	SPECIALTY EQUIPMENT TAG

MECHANICAL EQUIPMENT TAG

PE01 PLUMBING EQUIPMENT TAG



CALL OUT BOUNDRY — — — — —

CA	CASEWORK
EL	ELECTRICAL
F.F.E	FINISHED FLOOR ELEVATION
F.F.L	FINISHED FLOOR LEVEL
FTG	FOOTINGS
HVAC	HEATING, VENTILATION & AIR CONDITIONING
IRC	INTERNATIONAL RESIDENCE CODE
IMC	INTERNATIONAL MECHANICAL CODE
MAX.	MAXIMUM
ME	MECHANICAL
MIN.	MINIMUM
NO.	NUMBER
O.C	ON CENTER
OSB	ORIENTED STRAND BOARD
PL	PLUMBING
PSI	POUNDS PER SQUARE INCH
PVC	POLYVINYL CHLORIDE
REF	REFERENCE
RG	RIGHT GARAGE
SE	SPECIAL EQUIPMENT
SF	SQUARE FEET
SIMP. STHD8	
SIIVIF. STADO	HOLDDOWN
OIMAD ADDICE	
SIMP. ABE66	SIMPSON ANCHOR BOLT EDGE
TV	TELEVISION
UNO	UNLESS NOTED OTHERWISE
W/	WITH
W/D	WASHER/DRYER
AC	AIR CONDITIONING UNIT
ACC	AIR COOLED CONDENSER
ACCU	AIR COOLED CONDSENSING UNIT
AHU	
CC	AIR HANDLING UNIT COOLING COIL
CD	CEILING DIFFUSER
CFm	Cubic Feet Per Minute
CR	CEILING REGISTER
CU	CONDENSING UNIT
CW	COLD WATER
E/A	EXHAUST AIR
EF	EXHAUST FAN
ET	EXPANSION TANK
EX.	EXISTING
FC	FLEXIBLE CONNECTION
FCU	FAN COIL UNIT
FLR.	
	FLOOR
HC	HEATING COIL
HE	AIR TO AIR HEAT EXCHANGER
HV	HEATING AND VENTILATING UNI
IV	INLET VANES
MER	MECHANICAL ROOM
MAX.	MAXIMUM
MIN.	MINIMUM
R/A	RETURN AIR
RCU	RECIPROCATING CHILLER UNIT
RF	RETURN FAN
S/A	SUPPLY AIR
200	
SCD SP	SMOKE CONTROL DAMPER STATIC PRESSURE


ABBREVIATION


ASTM D698 AMERICAN SOCIETY FOR

CASEWORK

ACTION FLOOR SYSTEMS


TESTING AND MATERIAL

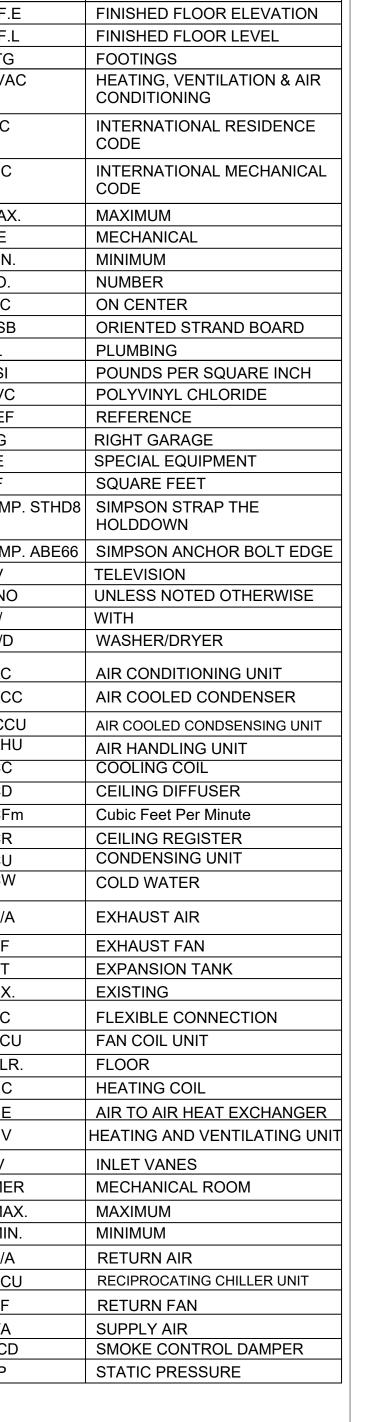

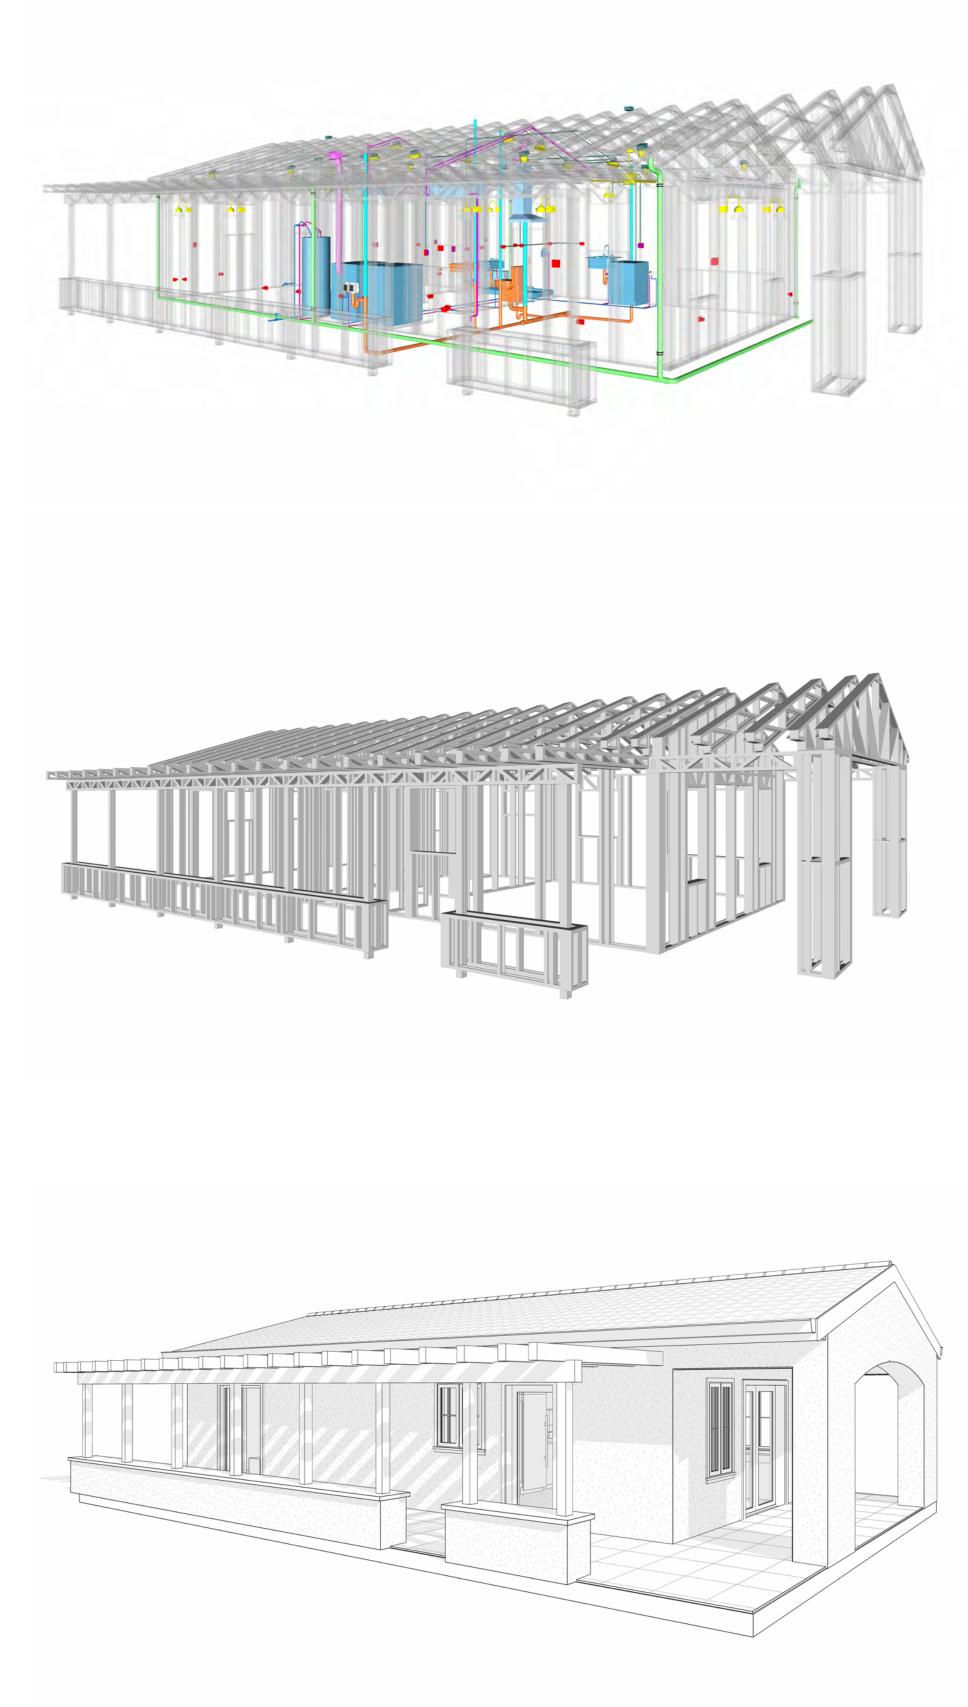

126 ORION 730 1Bd/1Ba **SPANISH PORCH 550**

	SQUARE FOOTAGE			
	LIVING	720		
	PORCH	382		
	TOTAL	1102		
•				

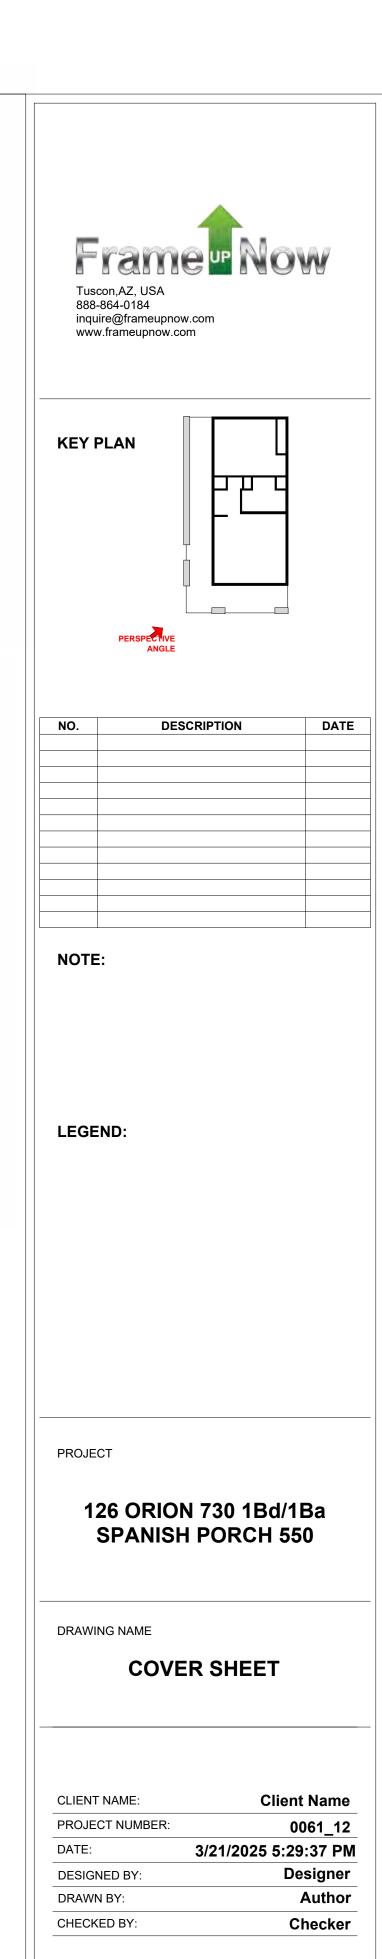

G101

GENERAL NOTES

- 1. THIS DRAWING DEPICTS THE ARCHITECTURAL (SPACE LAYOUT, FURNISHING, FLOOR, WALLS, ROOFS, FOUNDATION, WINDOWS AND DOORS) SYSTEMS. IT PROVIDES A VISUAL REPRESENTATION OF THE ARCHITECTURAL LAYOUT AND COMPONENTS.
- THE ARCHITECTURAL DRAWINGS ARE PREPARED TO MEET THE SPECIFIC REQUIREMENTS OF THE BUILDING, AS PER THE PROJECT SPECIFICATIONS AND APPLICABLE CODES AND STANDARDS.
 THE CONSTRUCTION OF THIS HOME SHALL COMPLY WITH THE LATEST EDITION OF THE INTERNATIONAL RESIDENTIAL CODE (IRC), INTERNATIONAL MECHANICAL CODE (IMC), THE INTERNATIONAL PLUMBING STANDARD, THE NATIONAL ELECTRICAL STANDARD AND ALL OTHER
- APPLICABLE LOCAL, STATE, AND NATIONAL CODES AND REGULATIONS.

 4. COORDINATION WITH OTHER TRADES HAS BEEN DONE ON A DESIGN LEVEL. THIS DRAWING SHALL BE READ TOGETHER WITH THE ME, EL AND PL DESIGN DRAWINGS TO ENSURE PROPER CONSTRUCTION AND INTEGRATION OF THE BUILDING SYSTEMS.

ABOUT WALLS:

SHOWER WALL COVERING

BATHTUB AND SHOWER SPACES (WALLS AND FLOORS) WITH INSTALLED SHOWER HEADS AND IN SHOWER COMPARTMENTS SHALL BE FINISHED WITH A NON-ABSORBENT SURFACE.

2. WALL PAINT (INTERNAL)

THE TYPICAL THICKNESS OF LATEX WALL PAINT IS 1/32 OF AN INCH FOR A SINGLE COAT. AND DOUBLE COAT (1/16") SHALL BE APPLIED FOR DURABILITY.

3. ADHESIVE

THE ADVISABLE TYPE OF ADHESIVE FOR THIS PROJECT IS **EPOXY ADHESIVES**BECAUSE THEY ARE KNOWN FOR THEIR HIGH STRENGTH, DURABILITY, AND RESISTANCE TO MOISTURE, CHEMICALS AND HEAT.

REFER TO SHEETS A201 & A202 FOR GENERAL NOTES ON EXTERNAL FINISHING MATERIALS

ABOUT FLOORS:

- 1. THE SPOT ELEVATION INDICATES THE FINISHED FLOOR ELEVATION.
- FINISHED FLOORS PER PLANS.
- FIELD VERIFY FOR DIMENSION DROP 4" FOR SHOWER AND BATHTUB USE.


 1% SLOPE ON OUTDOOR BALCONIES FOR WATER RUN OFF.
- 5. 2% SLOPE TOWARDS THE SHOWER DRAIN FOR SUFFICIENT DRAINAGE.

ONE SEAT SOFA

- 5. 4" DROP AT THE DOOR LEADING TO EXTERIOR BALCONY FROM THE MAIN LIVING AREA.
- 7. 5% SLOPE FOR GARAGE IS USED, WHICH SHOULD BE CHECKED WITH THE LOCAL GARAGING ZONING LAWS.

	FURNITURE SCHEDULE	
TYPE MARK	TYPE	COUNT
01	KING SIZE BED	1
02	DINING CHAIR	2
03	25" X 60" Dining	1
04	Four Sit 65" X 95"	1

	ROOM FINISH SCHEDULE						
ROOM NUMBE R ROOM NAME FLOOR FINISH FINISH WALL FINISH		CEILING FINISH	CEILING HEIGHT	COM MEN TS			
04	DEDDOOM	HARDWOOD	CONCRETE	MALL DAINT	DDV MALL	8' - 0"	
01	BEDROOM CL	HARDWOOD HARDWOOD	CONCRETE	WALL PAINT WALL PAINT	DRY WALL	8' - 0"	
03	CL 3	HARDWOOD	CONCRETE	CERAMIC TILE	DRY WALL	8' - 0"	
04	CL 2	HARDWOOD	CONCRETE	WALL PAINT	DRY WALL	8' - 0"	
05	WH	VINYL TILES	CONCRETE	WALL PAINT	DRY WALL	8' - 0"	
06	BATH	VINYL TILES	CONCRETE	CERAMIC TILE	MRD	8' - 0"	
07	KITCHEN	HARDWOOD	CONCRETE	WALL PAINT + CERAMIC	DRY WALL	8' - 0"	
08	W/D	HARDWOOD	CONCRETE	CERAMIC TILE	DRY WALL	8' - 0"	
09	HALL	HARDWOOD	CONCRETE	WALL PAINT	DRY WALL	8' - 0"	
10	LIVING ROOM	HARDWOOD	CONCRETE	WALL PAINT	DRY WALL	8' - 0"	
11	PORCH	PROCELAIN TILE	CONCRETE	STUCCO FINISH	PLYWOOD	8' - 0"	

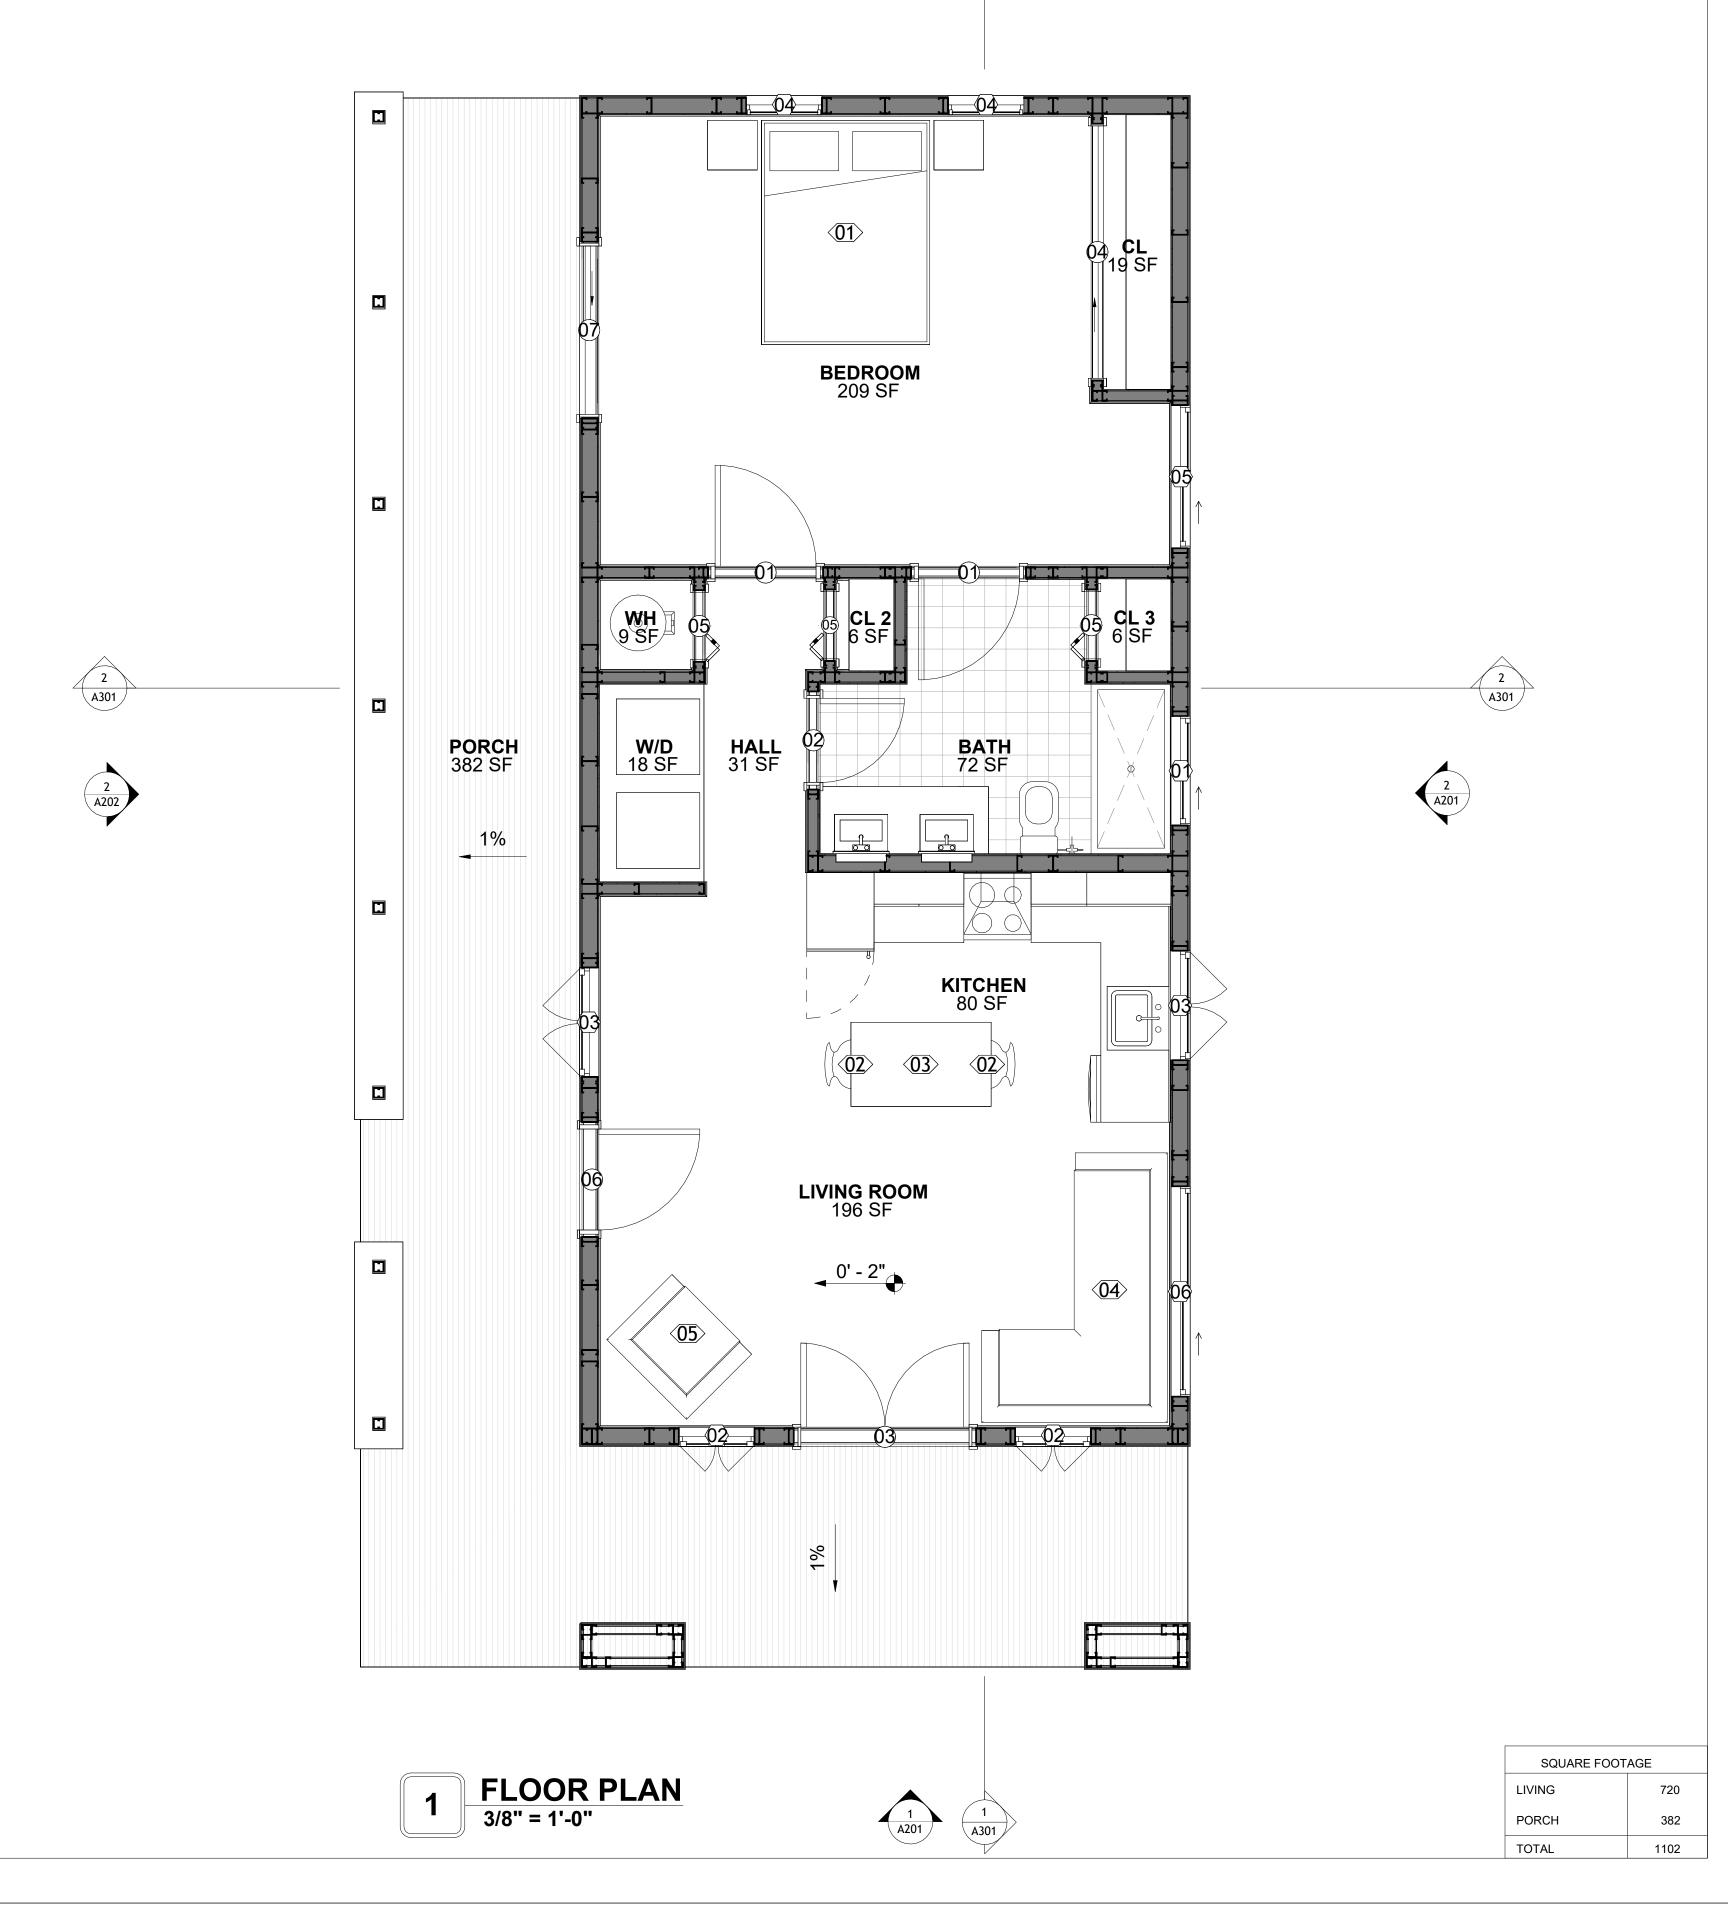



KEY PLAN

NO.	DESCRIPTION	DAT

NOTE:

LEGEND:

PROJECT


126 ORION 730 1Bd/1Ba SPANISH PORCH 550

DRAWING NAME

FLOOR PLAN

Client Name	CLIENT NAME:
0061_12	PROJECT NUMBER:
3/21/2025 5:29:37 PM	DATE:
Designer	DESIGNED BY:
Author	DRAWN BY:
Checker	CHECKED BY:

A101

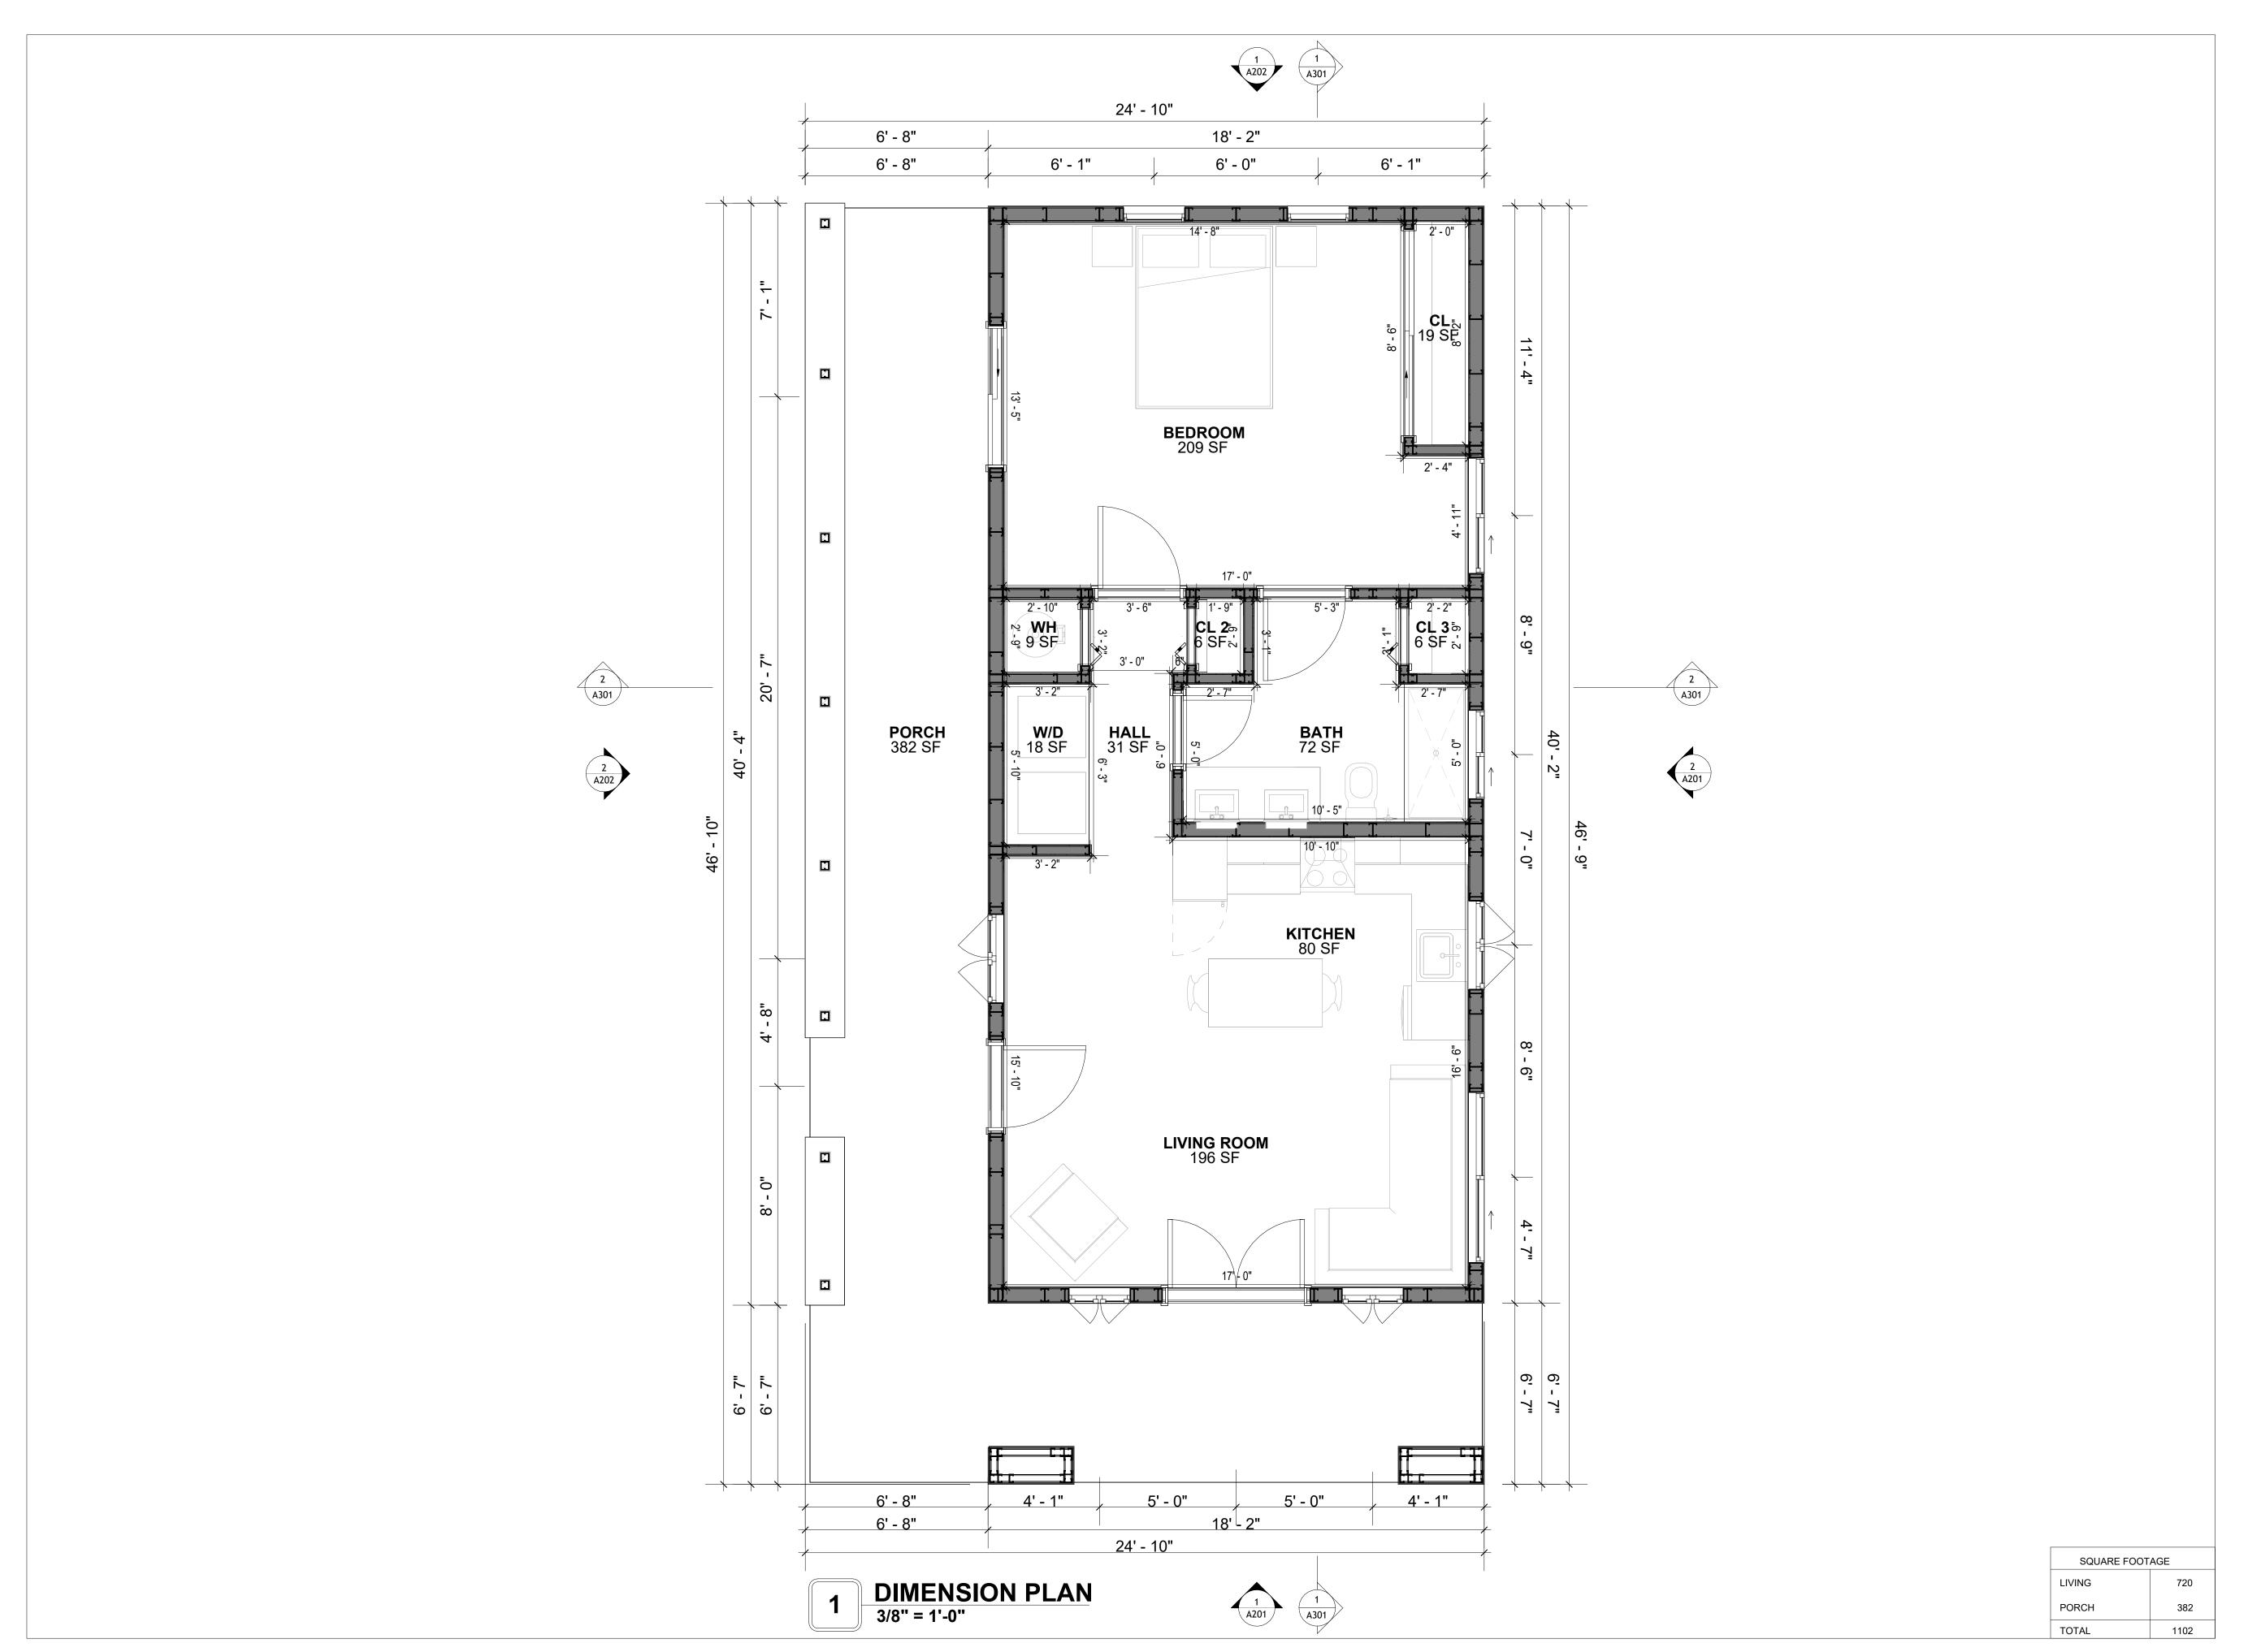



KEY PLAN

NO.	DESCRIPTION	DAIE
1		-

NOTE:

LEGEND:

PROJECT

126 ORION 730 1Bd/1Ba SPANISH PORCH 550

DRAWING NAME

DIMENSION PLAN

Client Name	CLIENT NAME:
0061_12	PROJECT NUMBER:
3/21/2025 5:29:38 PM	DATE:
Designer	DESIGNED BY:
Author	DRAWN BY:
Checker	CHECKED BY:

A102

SCALE: 3/8" = 1'-0"

FOUNDATION NOTES

TERMITES PRETREATMENT BY LICENSED CONTRACTOR UNDER SLAB AND AROUND FOOTINGS. ALL AREAS BELOW SLABS SHALL BE TREATED NO MORE THAN 24 HOURS PRIOR TO CONCRETE POUR. EVIDENCE OF TREATMENT MUST BE PROVIDED PRIOR TO PLACING OF CONCRETE.

1. **MATERIALS:**

ALL INTERIOR CONCRETE SLABS SHALL BE A MIN. OF 4" THICK CONCRETE OVER 4" COMPACTED AGGREGATE BASE (ASTM D698), FINISH ELEVATIONS AS NOTED ON DRAWINGS, 6" ABOVE ADJACENT GRADE, LEVEL SLABS TO 1/8"-10' MAX.. CONCRETE SLABS SHALL BE 2500# PSI AT 28 DAYS. A 4" ALLOWABLE SLUMP.

2. **PAD PREPARATION:**

- EXCAVATION FOR FOOTING SHALL BE NEAT.

- FOOTINGS SHALL BE POURED IMMEDIATELY AFTER EXCAVATION AND APPROPRIATE INSPECTION.

- ALL REINFORCING STEEL MARKED "CONTINUOUS" SHALL BE LAPPED 36 BAR DIAMETERS AT SPLICES AND AROUND CORNERS OR INTERSECTIONS WITH A STANDARD 90 DEGREE BEND ON CORNER BARS. LAP WIRE MESH ONE FULL MESH AT SIDE AND END LAPS. - ALL HARDWARE TO BE SIMPSON OR EQUIVALENT.

- EXTERIOR FRAME WALL TO BE SECURED WITH 1/2"X10" ANCHOR BOLTS 4'-0" O.C. FOR 1-STORY AND 2'-8" O.C. FOR 2-STORY. BOLTS SHALL BE LOCATED WITHIN 1'-0" OF EACH END PIECE AND SHALL HAVE A MIN. OF TWO BOLTS PER PIECE.

-FOUNDATION ANCHOR STRAPS SHALL BE PERMITTED, ACCORDING TO RESIDENTIAL CODE

- ALL INTERIOR WALLS TO BE SECURED WITH POWER DRIVEN PINS PER MANUFACTURER SPECIFICATION USE PIN SPACING EQUIVALENT TO 1/2" ANCHOR BOLTS.

- ALL CONSTRUCTION TO CONFORM TO THE 2012 IRC R-10 RIGID INSULATION OUTSIDE OF EXTERIOR FOUNDATION WALLS UNDER LIVING AREA. CONCRETE PAD FOR CONDENSER THICKNESS IS 4" MIN UNLESS OTHERWISE NOTED.

3. CONCRETE CONSTRUCTION:

- THE SLAB SHALL BE UNDERLAIN BY A VAPOR BARRIER/RETARDER IN THE LIVING AREA (TYPICALLY POLYETHYLENE, UNLESS MORE STRINGENT PROTECTION REQUIRED BY THE ARCHITECT, ENGINEER, FLOOR COVERING MANUFACTURER, OR ACCEPTED PRACTICE). UNLESS OTHERWISE REQUIRED, BARRIER MAY BE OMITTED AT GARAGES, PORCHES AND PATIOS WITHOUT FLOOR COVERINGS. IT IS BEYOND THE SCOPE OF THESE PLANS TO DETERMINE THE APPLICABILITY OF THESE MORE STRINGENT REQUIREMENTS. BUILDER SHALL VERIFY PRIOR TO CONSTRUCTION.

- IF CONSTRUCTED ON ACTIVE SOILS, THE LONG TERM PERFORMANCE OF THE FOUNDATION IS DEPENDENT ON MAINTENANCE BY THE OWNER. THUS THE BUILDER SHALL ADVISE THE OWNER OF THE FOLLOWING:

I. DRAINAGE MUST BE MAINTAINED. WATER SHALL NEVER BE ALLOWED TO POND NEAR THE FOUNDATION.

2. THE SOIL AROUND THE FOUNDATION SHALL BE MAINTAINED IN A RELATIVELY DAMP CONDITION, SUCH AS THAT REQUIRED TO KEEP A LAWN GREEN. IF IT DRIES OUT IT WILL SHRINK. IF IT GETS WET, IT WILL HEAVE UPWARD.

3. SLABS ON THE SHORTER SIDE USES MAIN BARS ARE USED IN THIS DIRECTION ONLY WITH SMALLER DIAMETER DISTRIBUTION BARS ARE PLACED, FORMING A MAT OR GRID. 4. ALL REINFORCEMENT BARS SIZE 10MM OR LARGER IN ACCORDANCE TO ASTM

ANCHOR BOLTS AT ALL EXTERIOR WALLS SHALL BE MINIMUM 1/2 INCH DIAMETER WITH A MAXIMUM SPACING OF 6'-0" ON CENTER, UNLESS NOTED OTHERWISE.

4. ANCHOR BOLTS SHALL BE INSTALLED WITHIN 12 INCHES OF EACH END OF EACH SILL PLATE WITH AT LEAST TWO ANCHOR BOLTS FOR EACH BOLTS FOR EACH SILL PLATE LONGER THAN 12 INCHES.


5. SIMPSONS SILL ANCHORS MAYBE SUBSTITUTED FOR ANCHOR BOLTS AT THE SAME SPACING.

6. EXTERIOR CONCRETE SLABS WHICH ARE NOT PART OF THE MAIN SLAB SHALL BE MINIMUM 4 INCHES THICK WITH NO STEEL REINFORCING BARS REQUIRED, UNLESS NOTED OTHERWISE ON FOUNDATION PLAN.

VERIFY THE FOLLOWING PRIOR TO POURING:

- . ALL HOLDDOWNS, STRAP, AND POST LOCATIONS.
- 2. CONCRETE FINISHES. PANEL RISER LOCATION WHERE APPLICABLE.
- 3. UNDERSLAB MECHANICAL REQUIREMENTS.
- 4. STEM WALL BLOCKOUTS. 5. UNDERSLAB ELECTRICAL REQUIREMENTS AND PANEL RISER LOCATION. WHERE
- APPLICABLE.
- 6. PROVIDE THE FOLLOWING:
- PVC SLEEVES THROUGH FTG IF REQUIRED - 20' #4 COPPER GROUND BAR.
- . SLOPE FINISH GRADE AWAY FROM FOOTING.

NOTE: FIELD VERIFY ALL DIMENSIONS SEE DIMENSIONED ARCHITECTURAL DRAWINGS

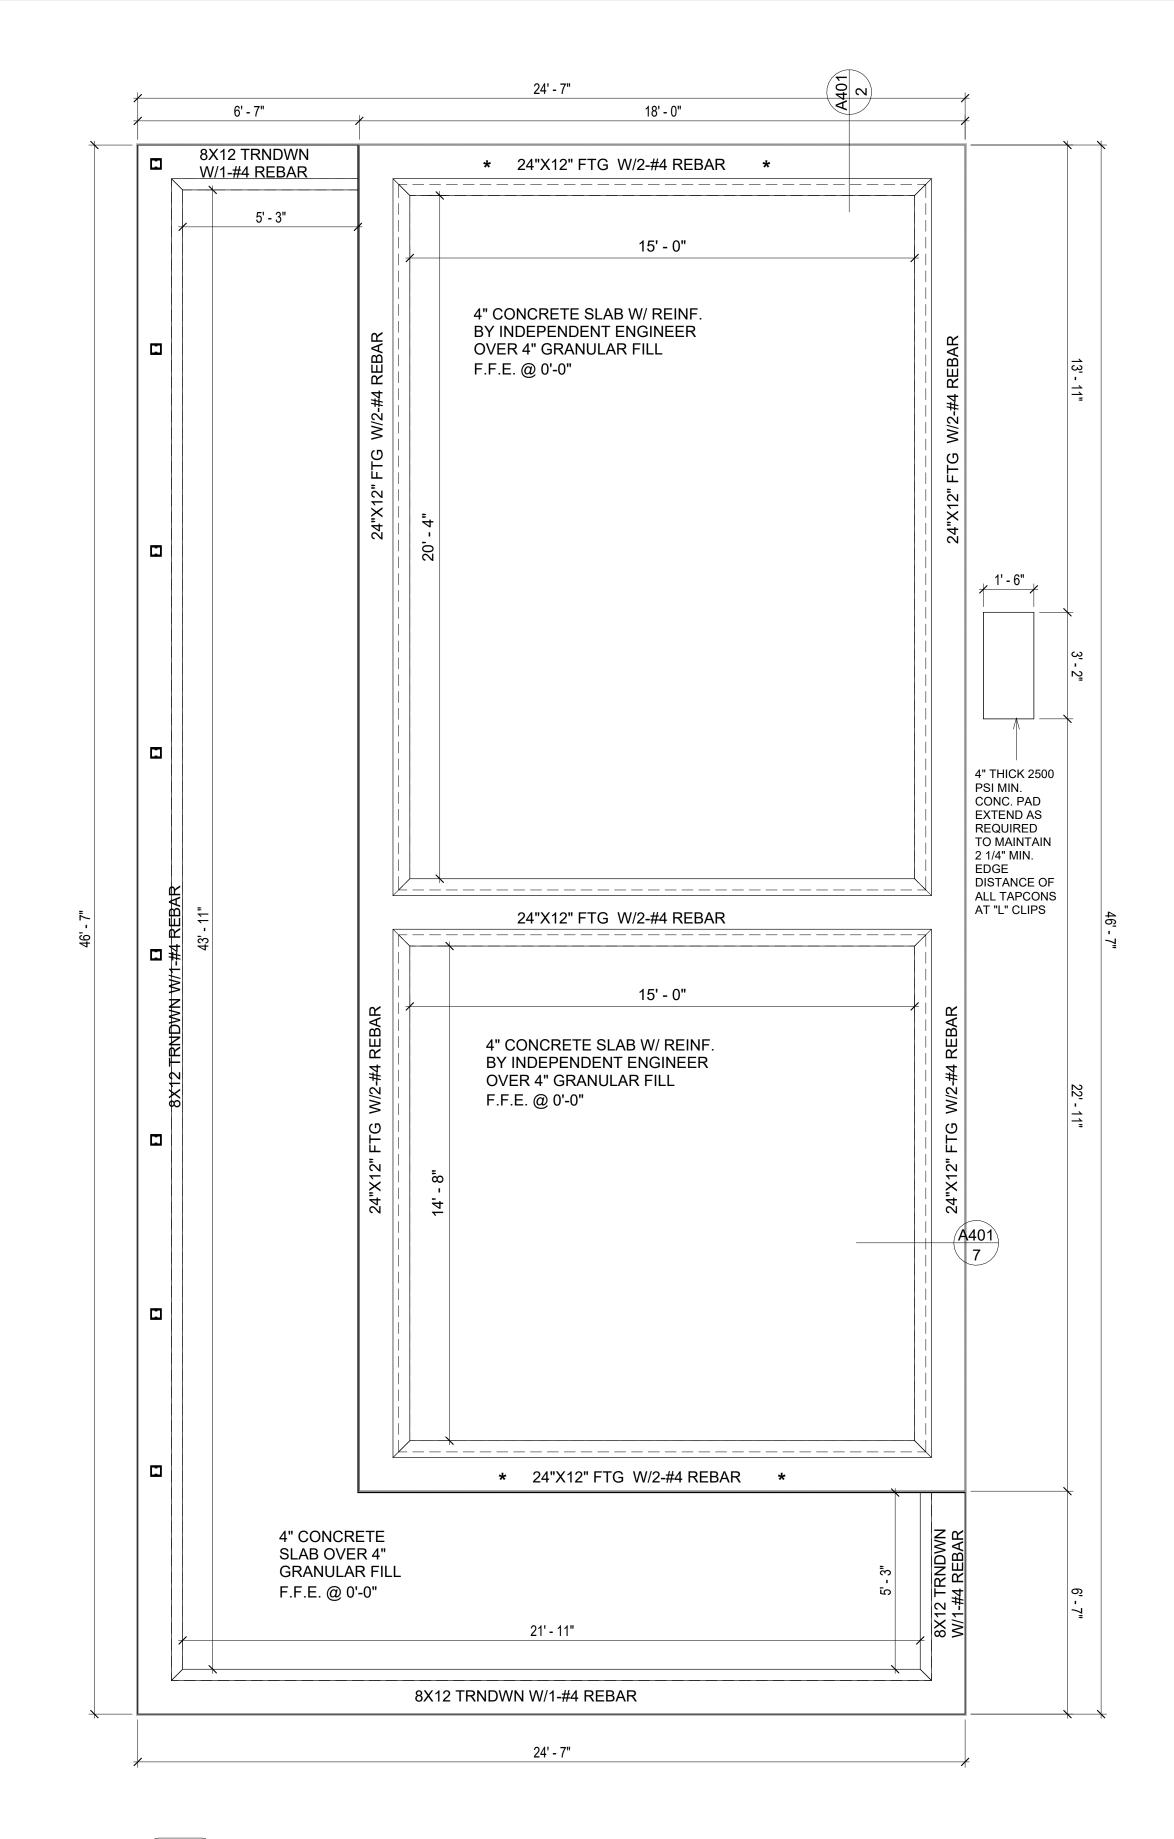

FOUNDATION PLAN 3/8" = 1'-0"

SQUARE FOOT	AGE
LIVING	720
PORCH	382
TOTAL	1102



KEY PLAN

NO.	DESCRIPTION	DATE

NOTE:

LEGEND:

PROJECT

126 ORION 730 1Bd/1Ba **SPANISH PORCH 550**

DRAWING NAME

FOUNDATION PLAN

Client Name	CLIENT NAME:
0061_1	PROJECT NUMBER:
3/21/2025 5:29:39 P	DATE:
Designe	DESIGNED BY:
Autho	DRAWN BY:
Checke	CHECKED BY:

S101

SCALE: 3/8" = 1'-0"

GENERAL NOTES

NOTES:

-ALL BEARING WALLS SHOULD HAVE A THICKENED SLAB PER SECTION PER DETAIL A401/5.

A) FOUNDATION PLAN NOTES:

1. CONCRETE SLAB SHALL BE 6" THICK WITH 1/2" DIAMETER TENDONS PER LAYOUT PLAN, CENTERED IN SLAB THICKNESS, OVER APPROVED SUBBASE PER GENERAL STRUCTURE NOTES

 TERMITE PROTECTION SHALL BE PROVIDED PER IRC SECTION R318.1
 NONE TYPICAL ANCHOR BOLT SPACING AT SHEAR WALL AND HOLD DOWN SPECIFICATIONS PER APPROVED ARCHITECTURAL PLANS.

INSTALL HOLDOWNS BEFORE CONCRETE SLAB POUR.
 EXISTING FILL ON-SITE SHALL BE COMPACTED IN ACCORDANCE WITH THE

REQUIREMENTS IN THE GEOTECHNICAL REPORT.

6. ALL FLOOR SLABS ARE REINFORCED ON CONCRETE SLABS.

SPECIAL INSPECTION IS REQUIRED FOR THICKENED FOUNDATION CONSTRUCTION

1. REINFORCEMENT 2. 2300 PSI CONCRETE POUR

B) REINFORCEMENT FOR CONCRETE:


 ALL REINFORCING SLABS BARS SIZE 10MM OR LARGER SHALL BE DEFORMED IN ACCORDANCE TO ASTM-A706, AND BARS SMALLER THAN 10 MM MAYBE PLAIN.
 UNLESS OTHERWISE NOTED IN PLANS, THE YIELD STRENGTH OF REINFORCING BARS SHALL BE:


> A) FOOTING = 40,000 PSI B) NON-LOAD BEARING WALLS AND PARAPETS= 40,000 PSI


- 3. SPLICES SHALL BE SECURELY WIRED TOGETHER AND SHALL LAP OR EXTEND
- 4. GRADE OF STEEL FOR RCC WORKS SHALL BE GRADE 4 10.
- 5. BAR NOTATIONS GIVES INFORMATION
 - A) BAR SIZE
 B) SPACING(IF REQUIRED)
- 6. LAP REINFORCEMENT ONLY AT LOCATION SHOWN IN THE DRAWINGS
- 7. REINFORCEMENT SHALL NOT BE CUT, VENT OR HEATED ON SITE WITHOUT ENGINEERS' APPROVAL.
- C) CONCRETE SLAB NOTES
- 1. ALL SLAB REINFORCEMENT SHALL BE 20MM CLEAR MINIMUM FROM BOTTOM AND FROM TOP OF SLAB.
- 2. REINFORCEMENT IN CONTINUOUS ELEVATED SLAB SHALL BE CUT AS FOLLOWS.

NOTE:

- THIS IS A SCHEMATIC PLAN FOR THE PURPOSE OF LOCATING AND IDENTIFYING FOUNDATION REINFORCING ELEMENTS ONLY. VERIFY ALL DIMENSIONS, DROPS, OFFSETS AND FEATURES WITH THE ARCHITECTURAL PLANS BEFORE FORMING THE FOUNDATION.

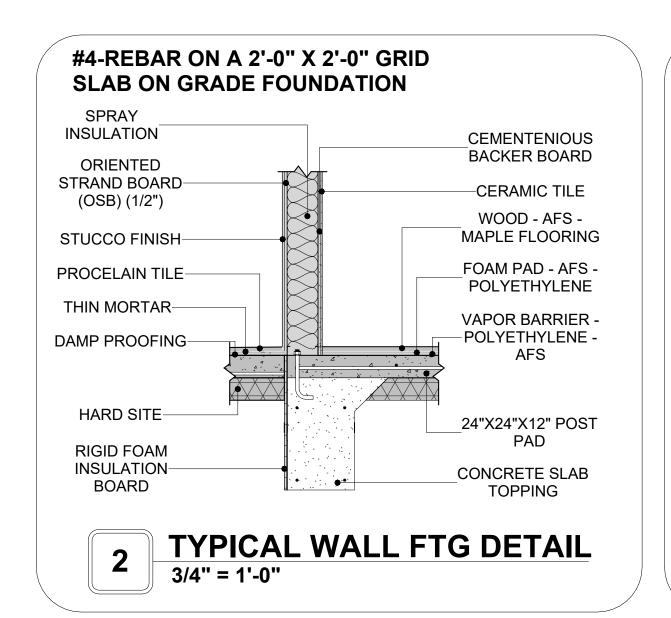

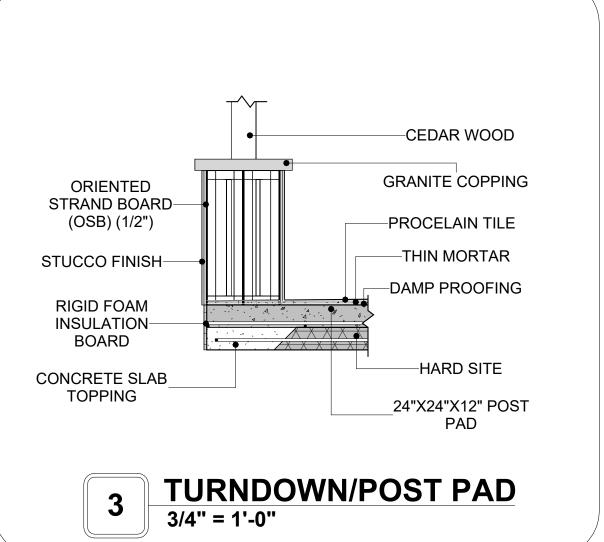

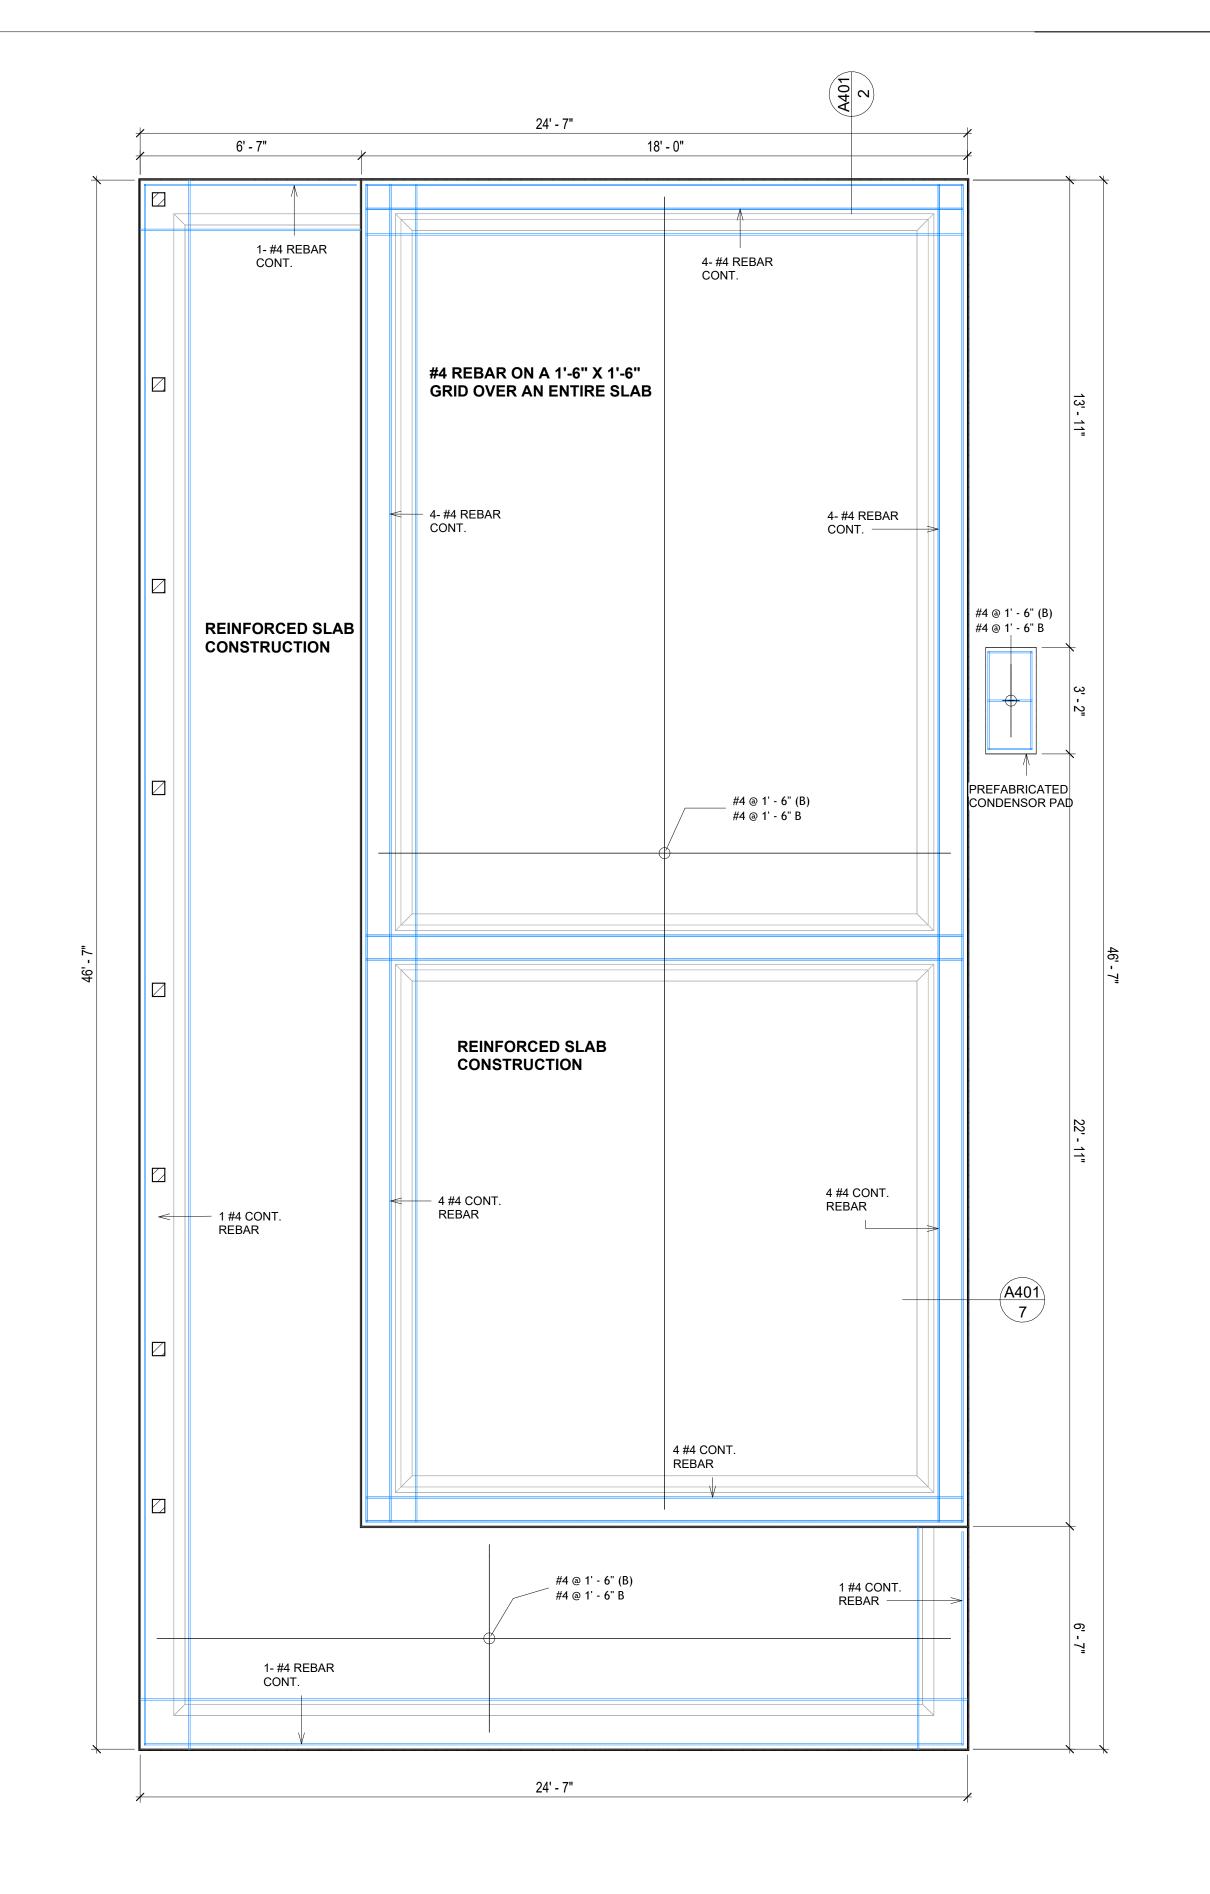





KEY PLAN

NO.	DESCRIPTION	DATE
NOT	E:	

LEGEND:

PROJECT


126 ORION 730 1Bd/1Ba SPANISH PORCH 550

DRAWING NAME

STRUCTURAL FLOOR PLAN

Client Name	CLIENT NAME:
0061_12	PROJECT NUMBER:
3/21/2025 5:29:39 PM	DATE:
Designer	DESIGNED BY:
Author	DRAWN BY:
Checker	CHECKED BY:

S102

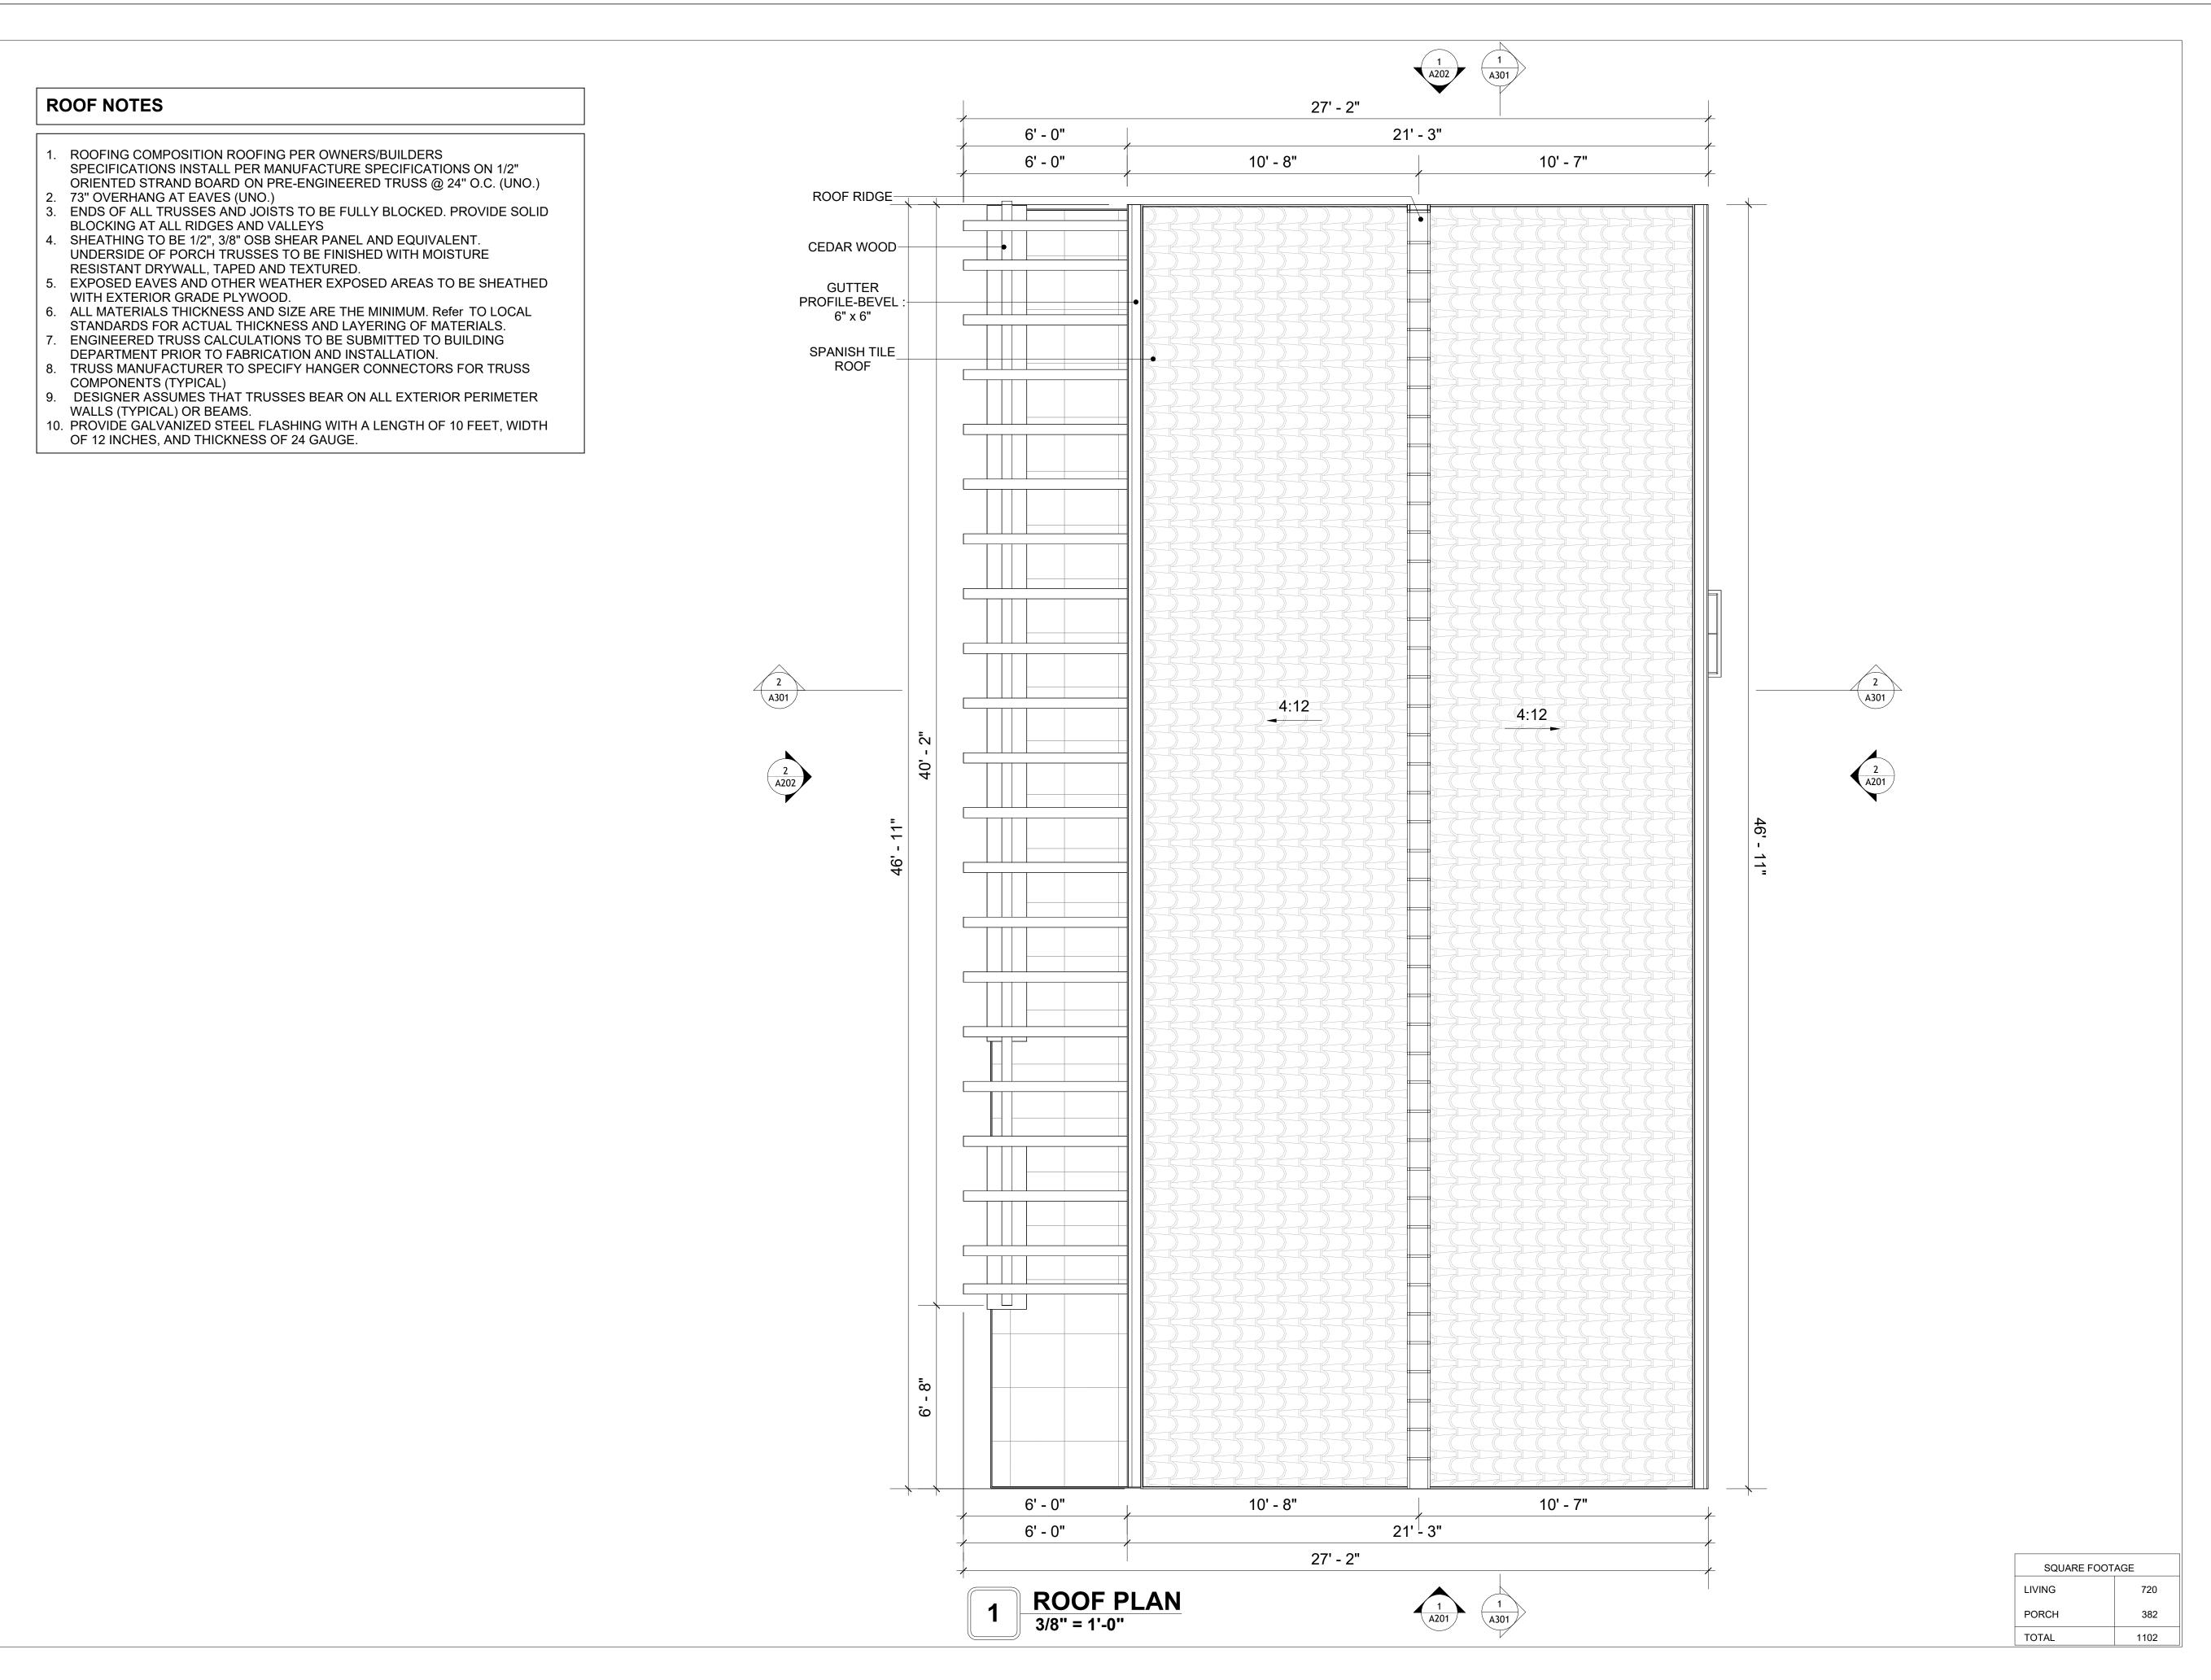



KEY PLAN

NO.	DESCRIPTION	DATE

NOTE:

LEGEND:

PROJECT

126 ORION 730 1Bd/1Ba SPANISH PORCH 550

DRAWING NAME

ROOF PLAN

CLIENT NAME:	Client Name
PROJECT NUMBER:	0061_12
DATE:	3/21/2025 5:29:41 PM
DESIGNED BY:	Designer
DRAWN BY:	Author
CHECKED BY:	Checker

A103

ABOUT WALL FINISHING

STUCCO FINISH

STUCCO IS A CEMENT-BASED EXTERIOR WALL FINISH THAT OFFERS A DURABLE, WEATHER-RESISTANT, AND CUSTOMIZABLE CLADDING SOLUTION FOR BUILDINGS.

IN THIS SPECIFIC PROJECT, **AMERICAN STUCCO SYSTEMS** IS USED AS A FINISH MATERIAL BECAUSE IT IS GENERALLY CONSIDERED A WATER-RESISTANT EXTERIOR FINISH AND USES A THREE-COAT APPLICATION PROCESS.

3/8-INCH OF IT IS APPLIED AS AN EXTERNAL WALL FINISH AS IT IS THE MOST COMMON AND WIDELY ACCEPTED STANDARD THICKNESS FOR STUCCO EXTERIOR WALL FINISHES. THIS MULTI-LAYER APPROACH ALSO HELPS CREATE A STRONG, CRACK-RESISTANT STUCCO SURFACE.

THIS STANDARD STUCCO IS APPLIED OVER OSB SHEATHINGS (FOR COLD FORMED STRUCTURE CONSTRUCTION).

IT IS NOT DIRECTLY TROWELED OVER THE OSB BUT OVER A WATER-RESISTANT BARRIER (HOMEWRAP) AND METAL/PLASTIC LATH THAT ARE INSTALLED ON TOP SURFACE OF THE OSB TO PROVIDE AN ADDITIONAL LAYER OF PROTECTION AGAINST MOISTURE INTRUSION.

REGULAR INSPECTION AND PROMPT REPAIR OF ANY CRACKS, CHIPS, OR DAMAGE TO THE STUCCO FINISH IS IMPORTANT. THIS MAINTAINS THE STUCCO'S WATER-RESISTANT PROPERTIES OVER THE BUILDING'S LIFE SPAN.

CEDAR WOOD


CEDAR WOOD REFERS TO THE WOOD FROM VARIOUS SPECIES OF CEDAR TREES, WHICH ARE CONIFEROUS EVERGREEN TREES KNOWN FOR THEIR DISTINCT AROMA AND NATURAL RESISTANCE TO DECAY AND INSECTS. IN THIS SPECIFIC PROJECT, CEDAR WOOD IS USED AS A FURRING STRIP AND A FINISH MATERIAL ON BEAMS AND COLUMNS.

CEDAR WOOD AS A FURRING STRIPS PROVIDE THERMAL INSULATION, MOISTURE MANAGEMENT, AND AN AESTHETICALLY PLEASING, VERSATILE FRAMING SOLUTION WHEN INTEGRATED WITH CORONADO STONE AND CORRUGATED IRON SHEET CLADDING.


THE VERTICAL CEDAR WOOD FURRING STRIPS ARE ATTACHED TO HOME WRAP USING CORROSION-RESISTANT FASTENERS (HOT DIP GALVANIZED SCREWS), ENSURING PROPER PENETRATION INTO THE WALL FRAMING.

GRANITE COPPING

GRANITE COPPING REFERS TO A STONE, TYPICALLY GRANITE, USED TO COVER THE TOP EDGE OR CAP OF A WALL, PARAPET, OR OTHER ARCHITECTURAL FEATURE, PROVIDING PROTECTION AND A FINISHED LOOK.

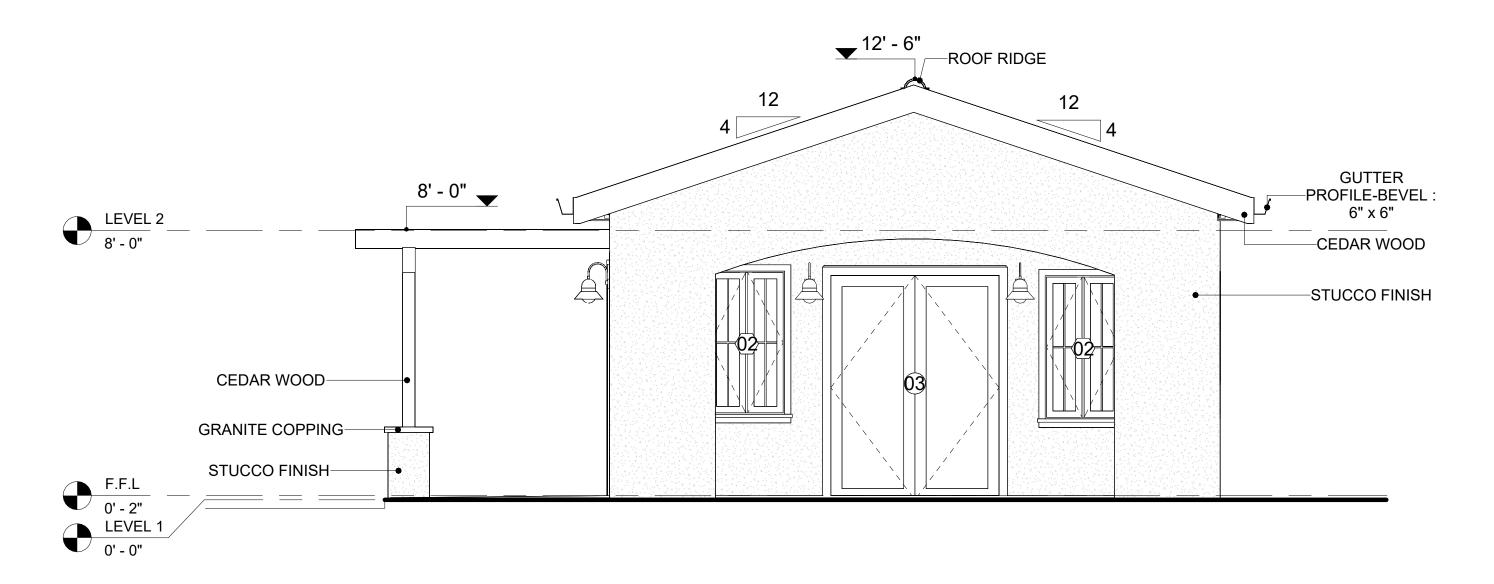


1 FRONT ELEVATION
3/8" = 1'-0"

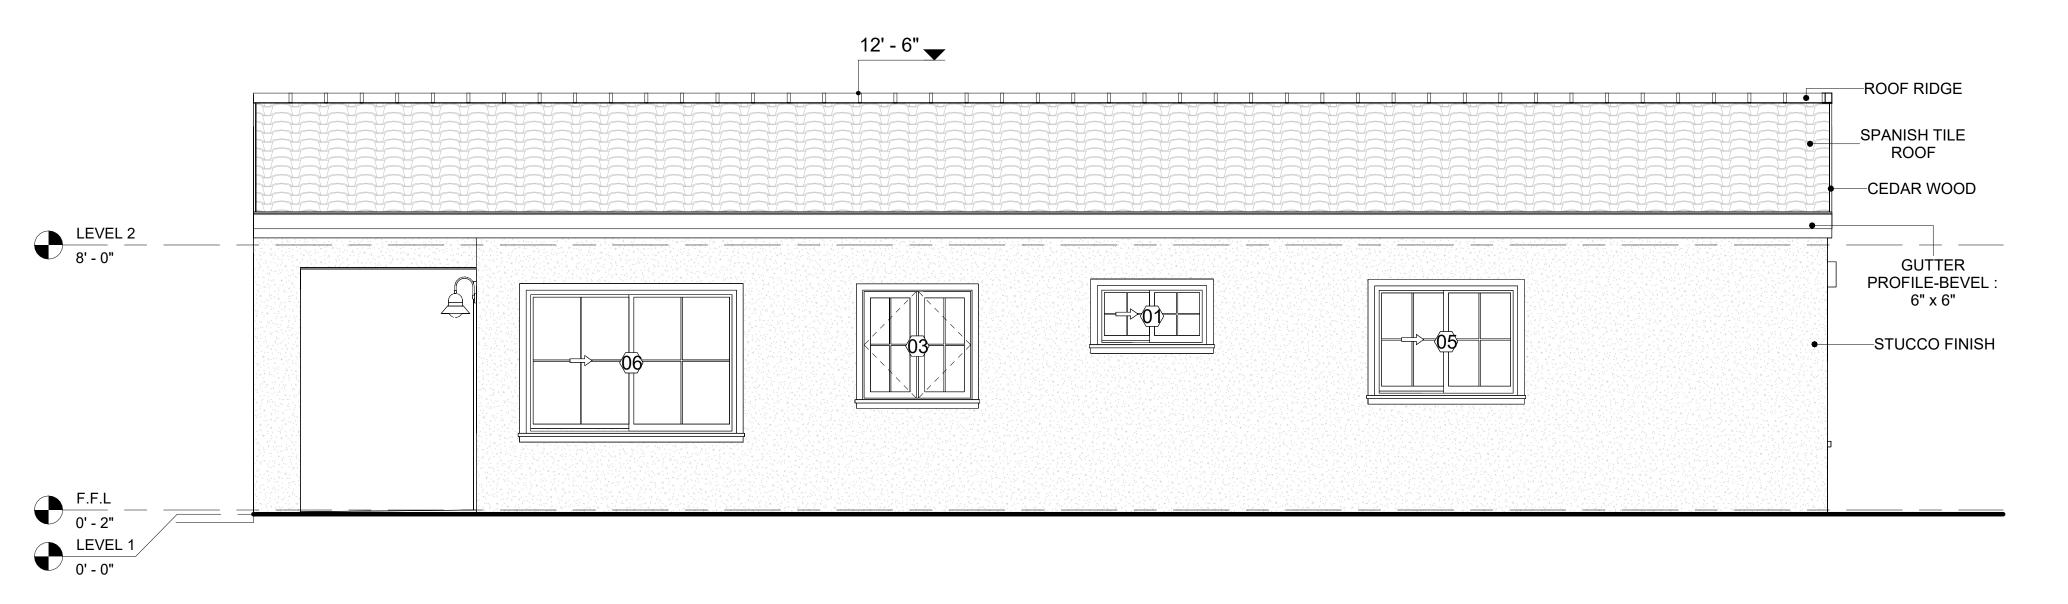

2 RIGHT SIDE ELEVATION
3/8" = 1'-0"

		DOOR S	CHEDULE			
TYPE					SIZE	
MAR K	SUPPLIER	DOOR TYPE	LOCATIO N	WIDTH	HEIGHT	COUNT
01	HOME DEPOT	Interior Single Panel Swinging	Interior	3' - 0"	6' - 8"	2
02	HOME DEPOT	Interior Single Panel Swinging	Interior	2' - 6"	6' - 8"	1
03	HOME DEPOT	Exterior Double Panel Swinging	Interior	5' - 0"	6' - 8"	1
04	HOME DEPOT	Interior Double Panel Sliding	Interior	7' - 6"	6' - 8"	1
05	HOME DEPOT	single fold 2	Interior	2' - 0"	6' - 8"	3
06	HOME DEPOT	Exterior Single Panel Swinging	Interior	3' - 0"	6' - 8"	1
07	HOME DEPOT	Patio_Double Panel_Sliding	Exterior	5' - 0"	6' - 8"	1

		WINDOV	SCHEDULE		
				SIZE	
TYPE MARK	SUPPLIER	WINDOW TYPE	WIDTH	HEIGHT	COUNT
			·		
01	Home Depot	Sliding	3' - 3"	1' - 9"	1
02	Home Depot	Casement	2' - 3"	4' - 3"	2
03	Home Depot	Casement	3' - 3"	3' - 3"	2
04	Home Depot	FIXED	2' - 3"	2' - 3"	2
05	Home Depot	Sliding	4' - 3"	3' - 3"	1
06	Home Depot	Sliding	6' - 3"	4' - 3"	1

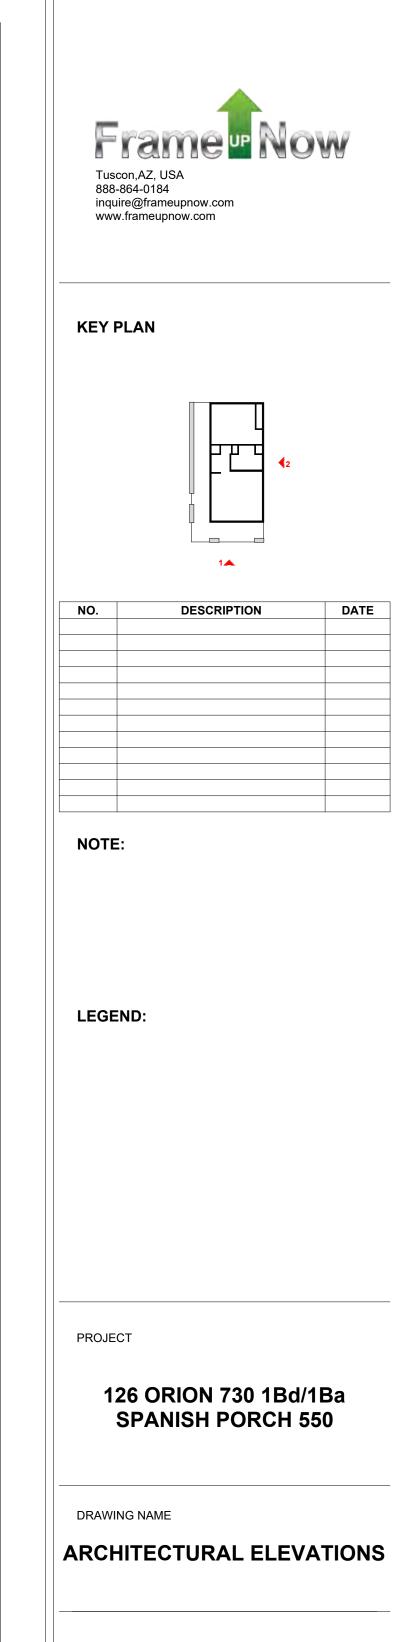

CLIENT NAME:	Client Name
PROJECT NUMBER:	0061_12
DATE:	3/21/2025 5:29:43 PM
DESIGNED BY:	Designer
DRAWN BY:	Author
CHECKED BY:	Checker

A201

ABOUT WALL FINISHING

STUCCO FINISH

STUCCO IS A CEMENT-BASED EXTERIOR WALL FINISH THAT OFFERS A DURABLE, WEATHER-RESISTANT, AND CUSTOMIZABLE CLADDING SOLUTION FOR BUILDINGS.

IN THIS SPECIFIC PROJECT, **AMERICAN STUCCO SYSTEMS** IS USED AS A FINISH MATERIAL BECAUSE IT IS GENERALLY CONSIDERED A WATER-RESISTANT EXTERIOR FINISH AND USES A THREE-COAT APPLICATION PROCESS.

3/8-INCH OF IT IS APPLIED AS AN EXTERNAL WALL FINISH AS IT IS THE MOST COMMON AND WIDELY ACCEPTED STANDARD THICKNESS FOR STUCCO EXTERIOR WALL FINISHES. THIS MULTI-LAYER APPROACH ALSO HELPS CREATE A STRONG, CRACK-RESISTANT STUCCO SURFACE.

THIS STANDARD STUCCO IS APPLIED OVER OSB SHEATHINGS (FOR COLD FORMED STRUCTURE CONSTRUCTION).

IT IS NOT DIRECTLY TROWELED OVER THE OSB BUT OVER A WATER-RESISTANT BARRIER (HOMEWRAP) AND METAL/PLASTIC LATH THAT ARE INSTALLED ON TOP SURFACE OF THE OSB TO PROVIDE AN ADDITIONAL LAYER OF PROTECTION AGAINST MOISTURE INTRUSION.

REGULAR INSPECTION AND PROMPT REPAIR OF ANY CRACKS, CHIPS, OR DAMAGE TO THE STUCCO FINISH IS IMPORTANT. THIS MAINTAINS THE STUCCO'S WATER-RESISTANT PROPERTIES OVER THE BUILDING'S LIFE SPAN.

CEDAR WOOD


CEDAR WOOD REFERS TO THE WOOD FROM VARIOUS SPECIES OF CEDAR TREES, WHICH ARE CONIFEROUS EVERGREEN TREES KNOWN FOR THEIR DISTINCT AROMA AND NATURAL RESISTANCE TO DECAY AND INSECTS. IN THIS SPECIFIC PROJECT, CEDAR WOOD IS USED AS A FURRING STRIP AND A FINISH MATERIAL ON BEAMS AND COLUMNS.

CEDAR WOOD AS A FURRING STRIPS PROVIDE THERMAL INSULATION, MOISTURE MANAGEMENT, AND AN AESTHETICALLY PLEASING, VERSATILE FRAMING SOLUTION WHEN INTEGRATED WITH CORONADO STONE AND CORRUGATED IRON SHEET CLADDING.


THE VERTICAL CEDAR WOOD FURRING STRIPS ARE ATTACHED TO HOME WRAP USING CORROSION-RESISTANT FASTENERS (HOT DIP GALVANIZED SCREWS), ENSURING PROPER PENETRATION INTO THE WALL FRAMING.

GRANITE COPPING

GRANITE COPPING REFERS TO A STONE, TYPICALLY GRANITE, USED TO COVER THE TOP EDGE OR CAP OF A WALL, PARAPET, OR OTHER ARCHITECTURAL FEATURE, PROVIDING PROTECTION AND A FINISHED LOOK.

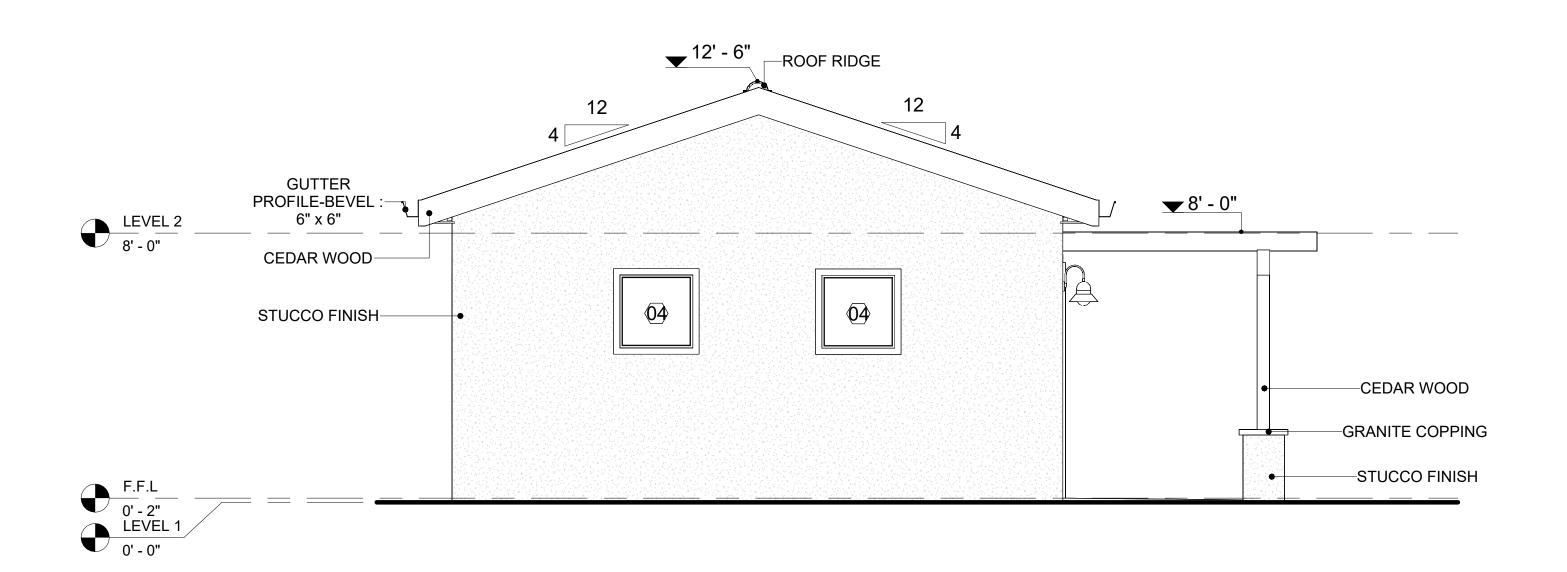


1 REAR ELEVATION
3/8" = 1'-0"

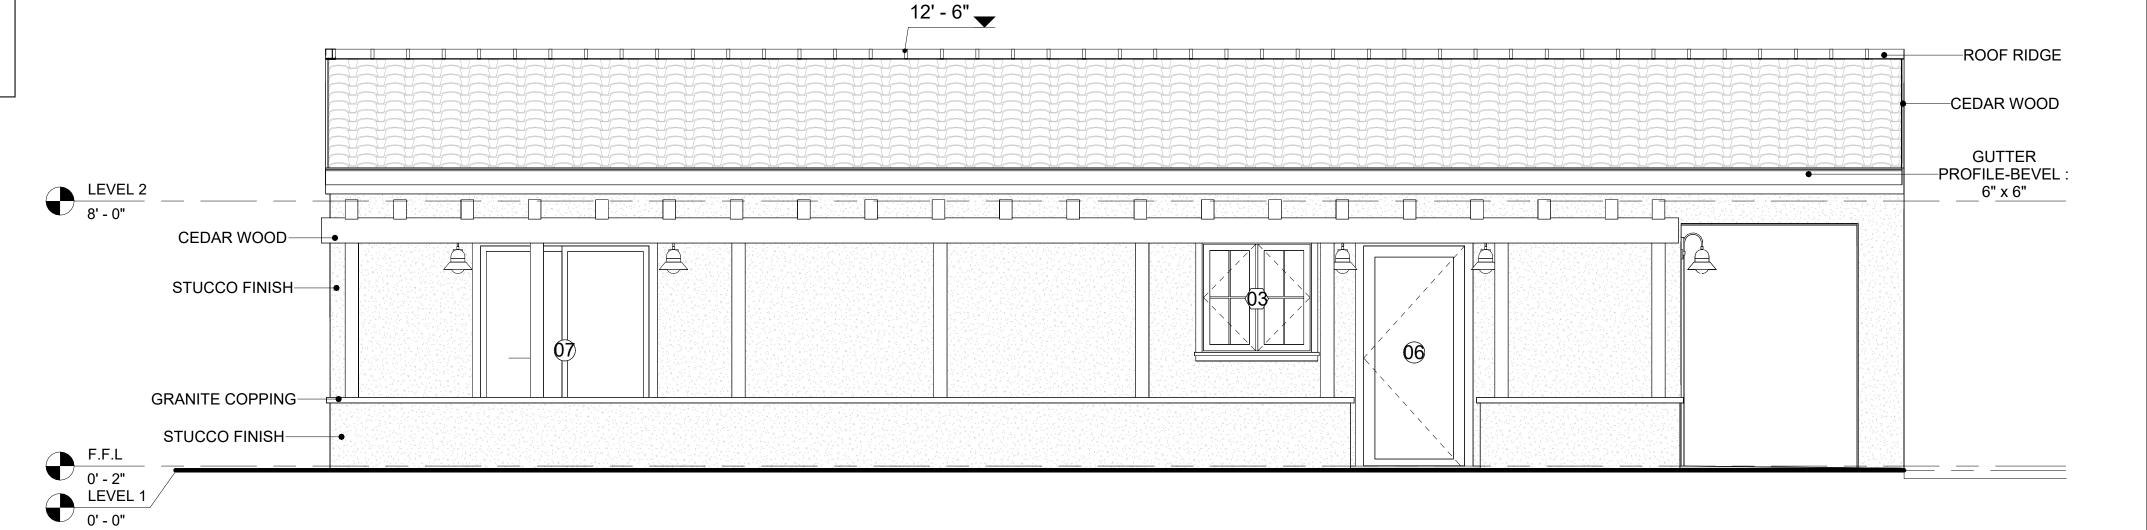

2 LEFT SIDE ELEVATION
3/8" = 1'-0"



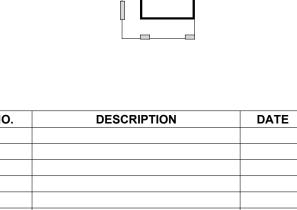

NOTE:

LEGEND:

PROJECT


126 ORION 730 1Bd/1Ba SPANISH PORCH 550

DRAWING NAME

ARCHITECTURAL ELEVATIONS


Client Name	CLIENT NAME:
0061_12	PROJECT NUMBER:
3/21/2025 5:29:46 PM	DATE:
Designer	DESIGNED BY:
Author	DRAWN BY:
Checker	CHECKED BY:

A202

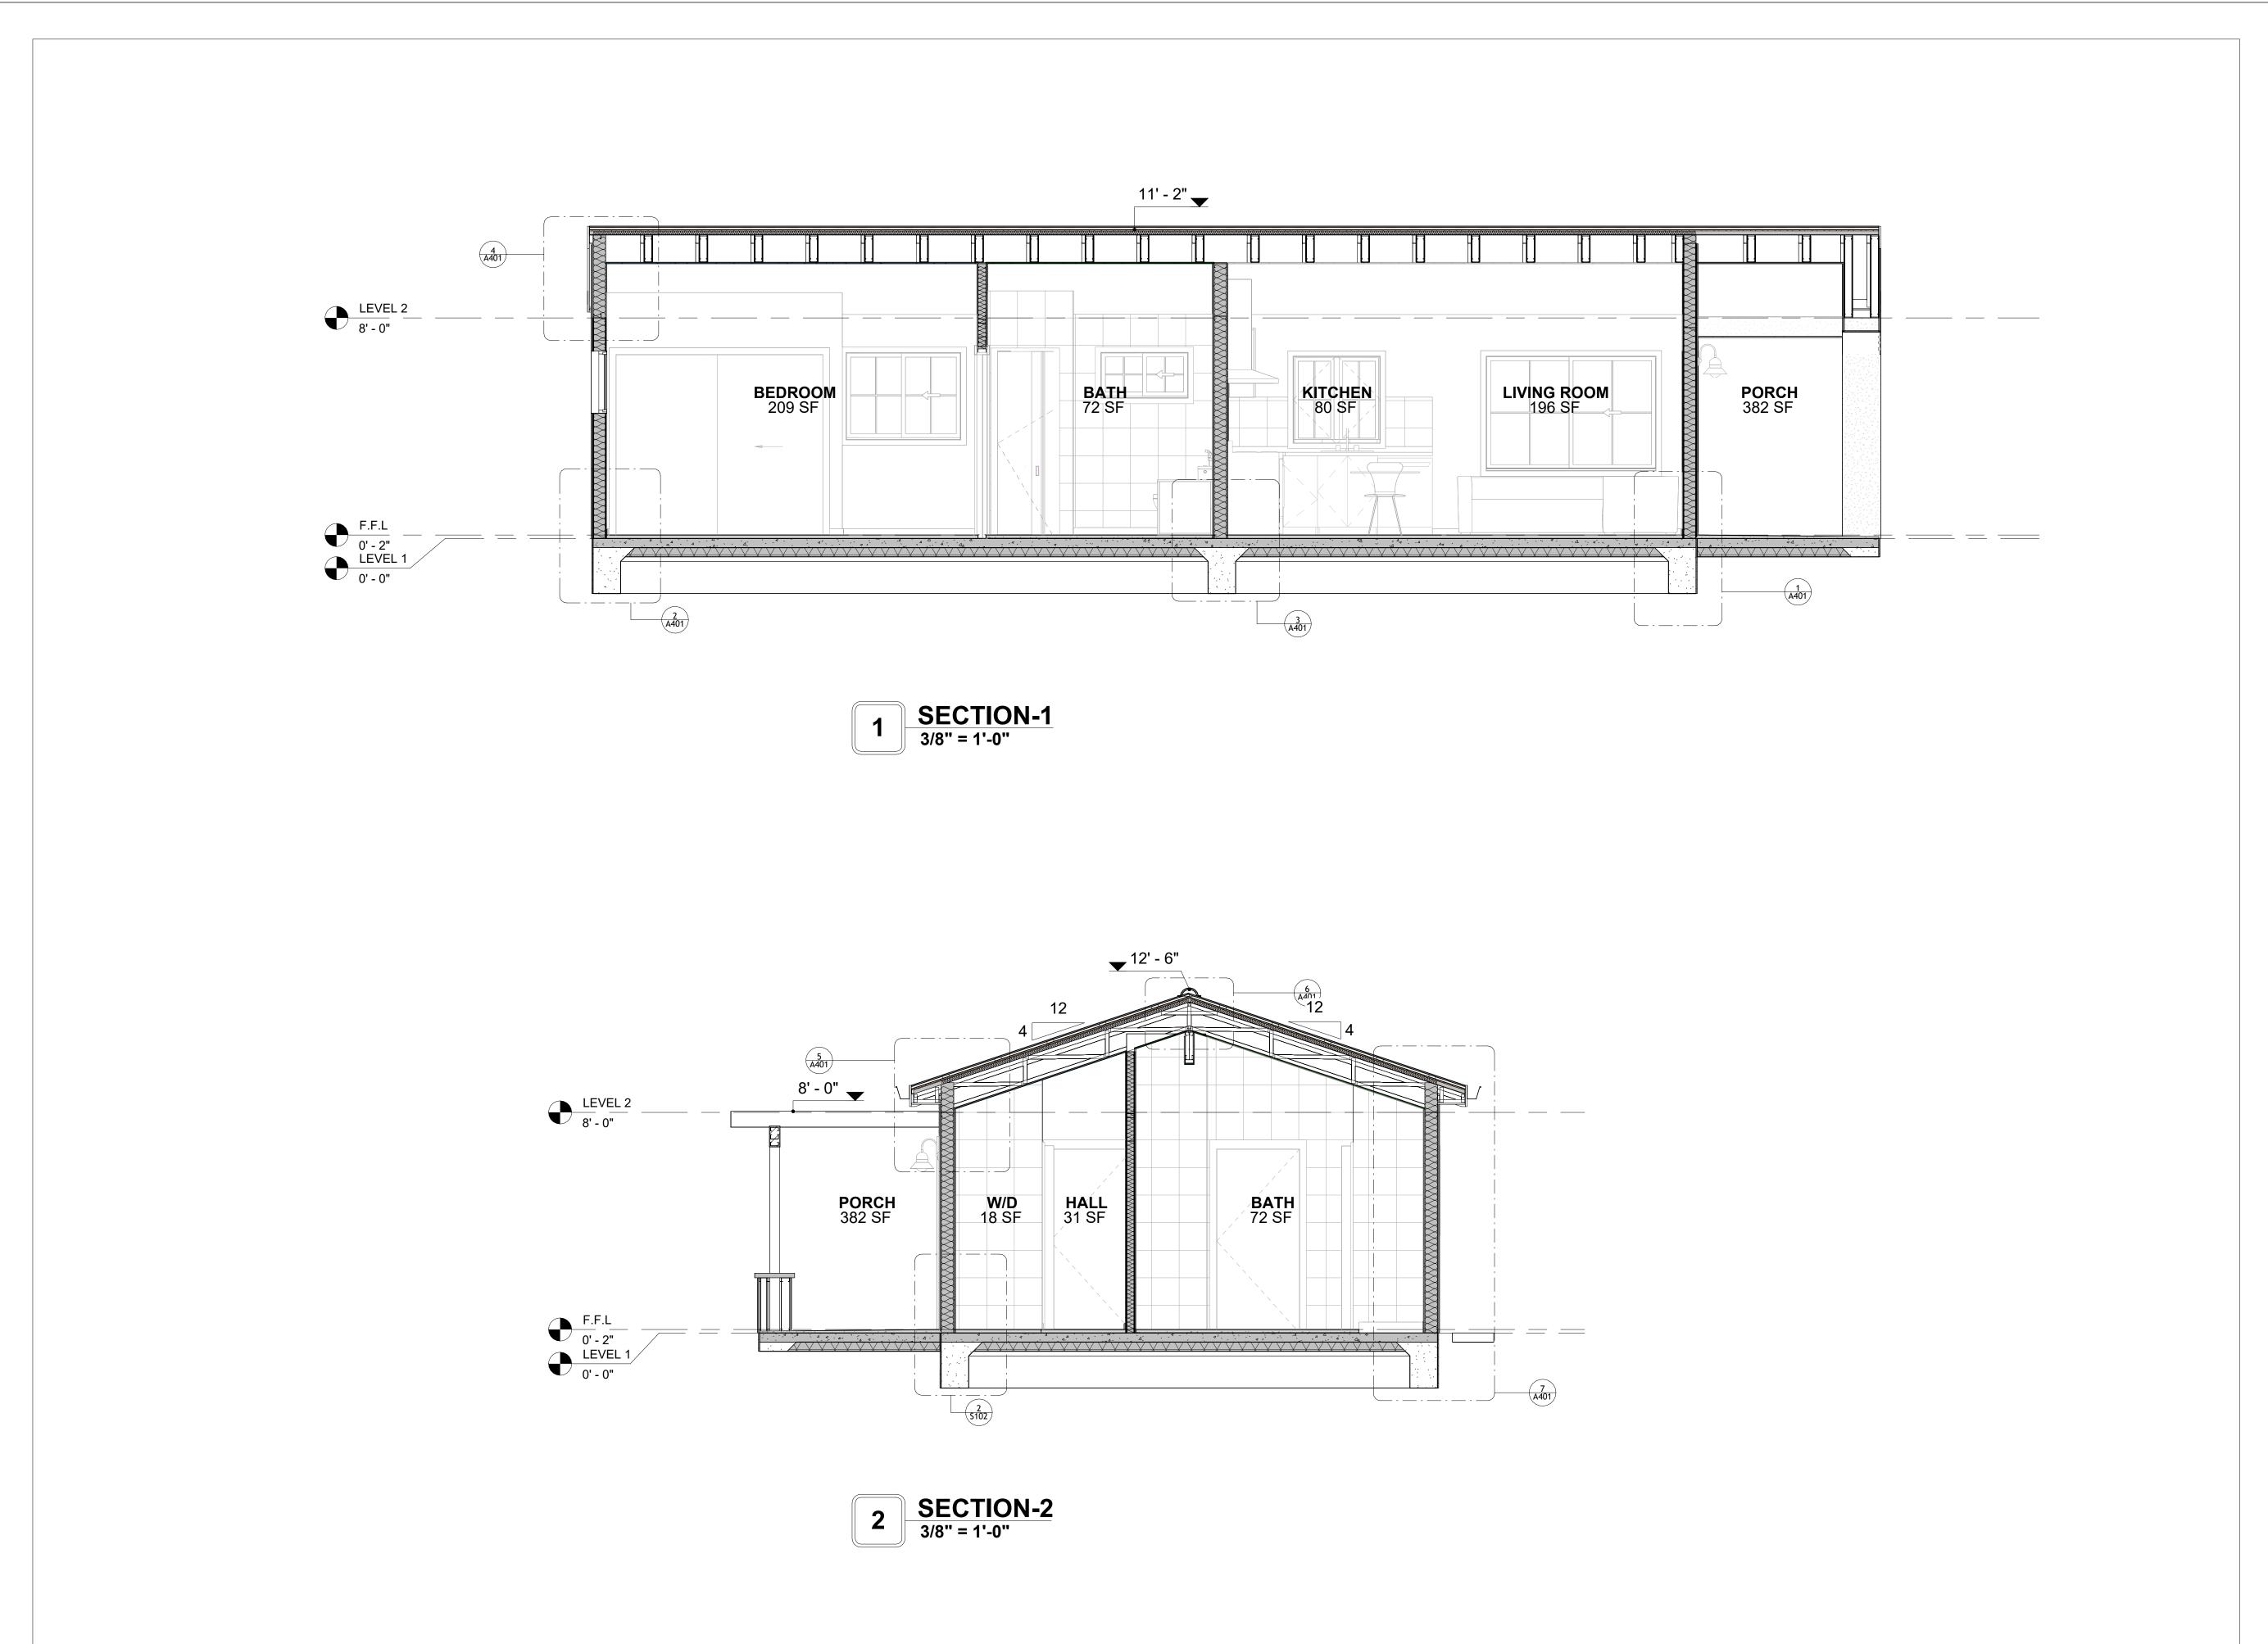



KEY PLAN

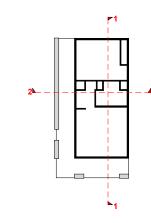

DESCRIPTION	DATE
	DESCRIPTION

NOTE:

LEGEND:

PROJECT


126 ORION 730 1Bd/1Ba SPANISH PORCH 550

DRAWING NAME

ARCHITECTURAL SECTIONS

Client Name	CLIENT NAME:
0061_12	PROJECT NUMBER:
3/21/2025 5:29:47 PM	DATE:
Designer	DESIGNED BY:
Author	DRAWN BY:
Checker	CHECKED BY:

A301

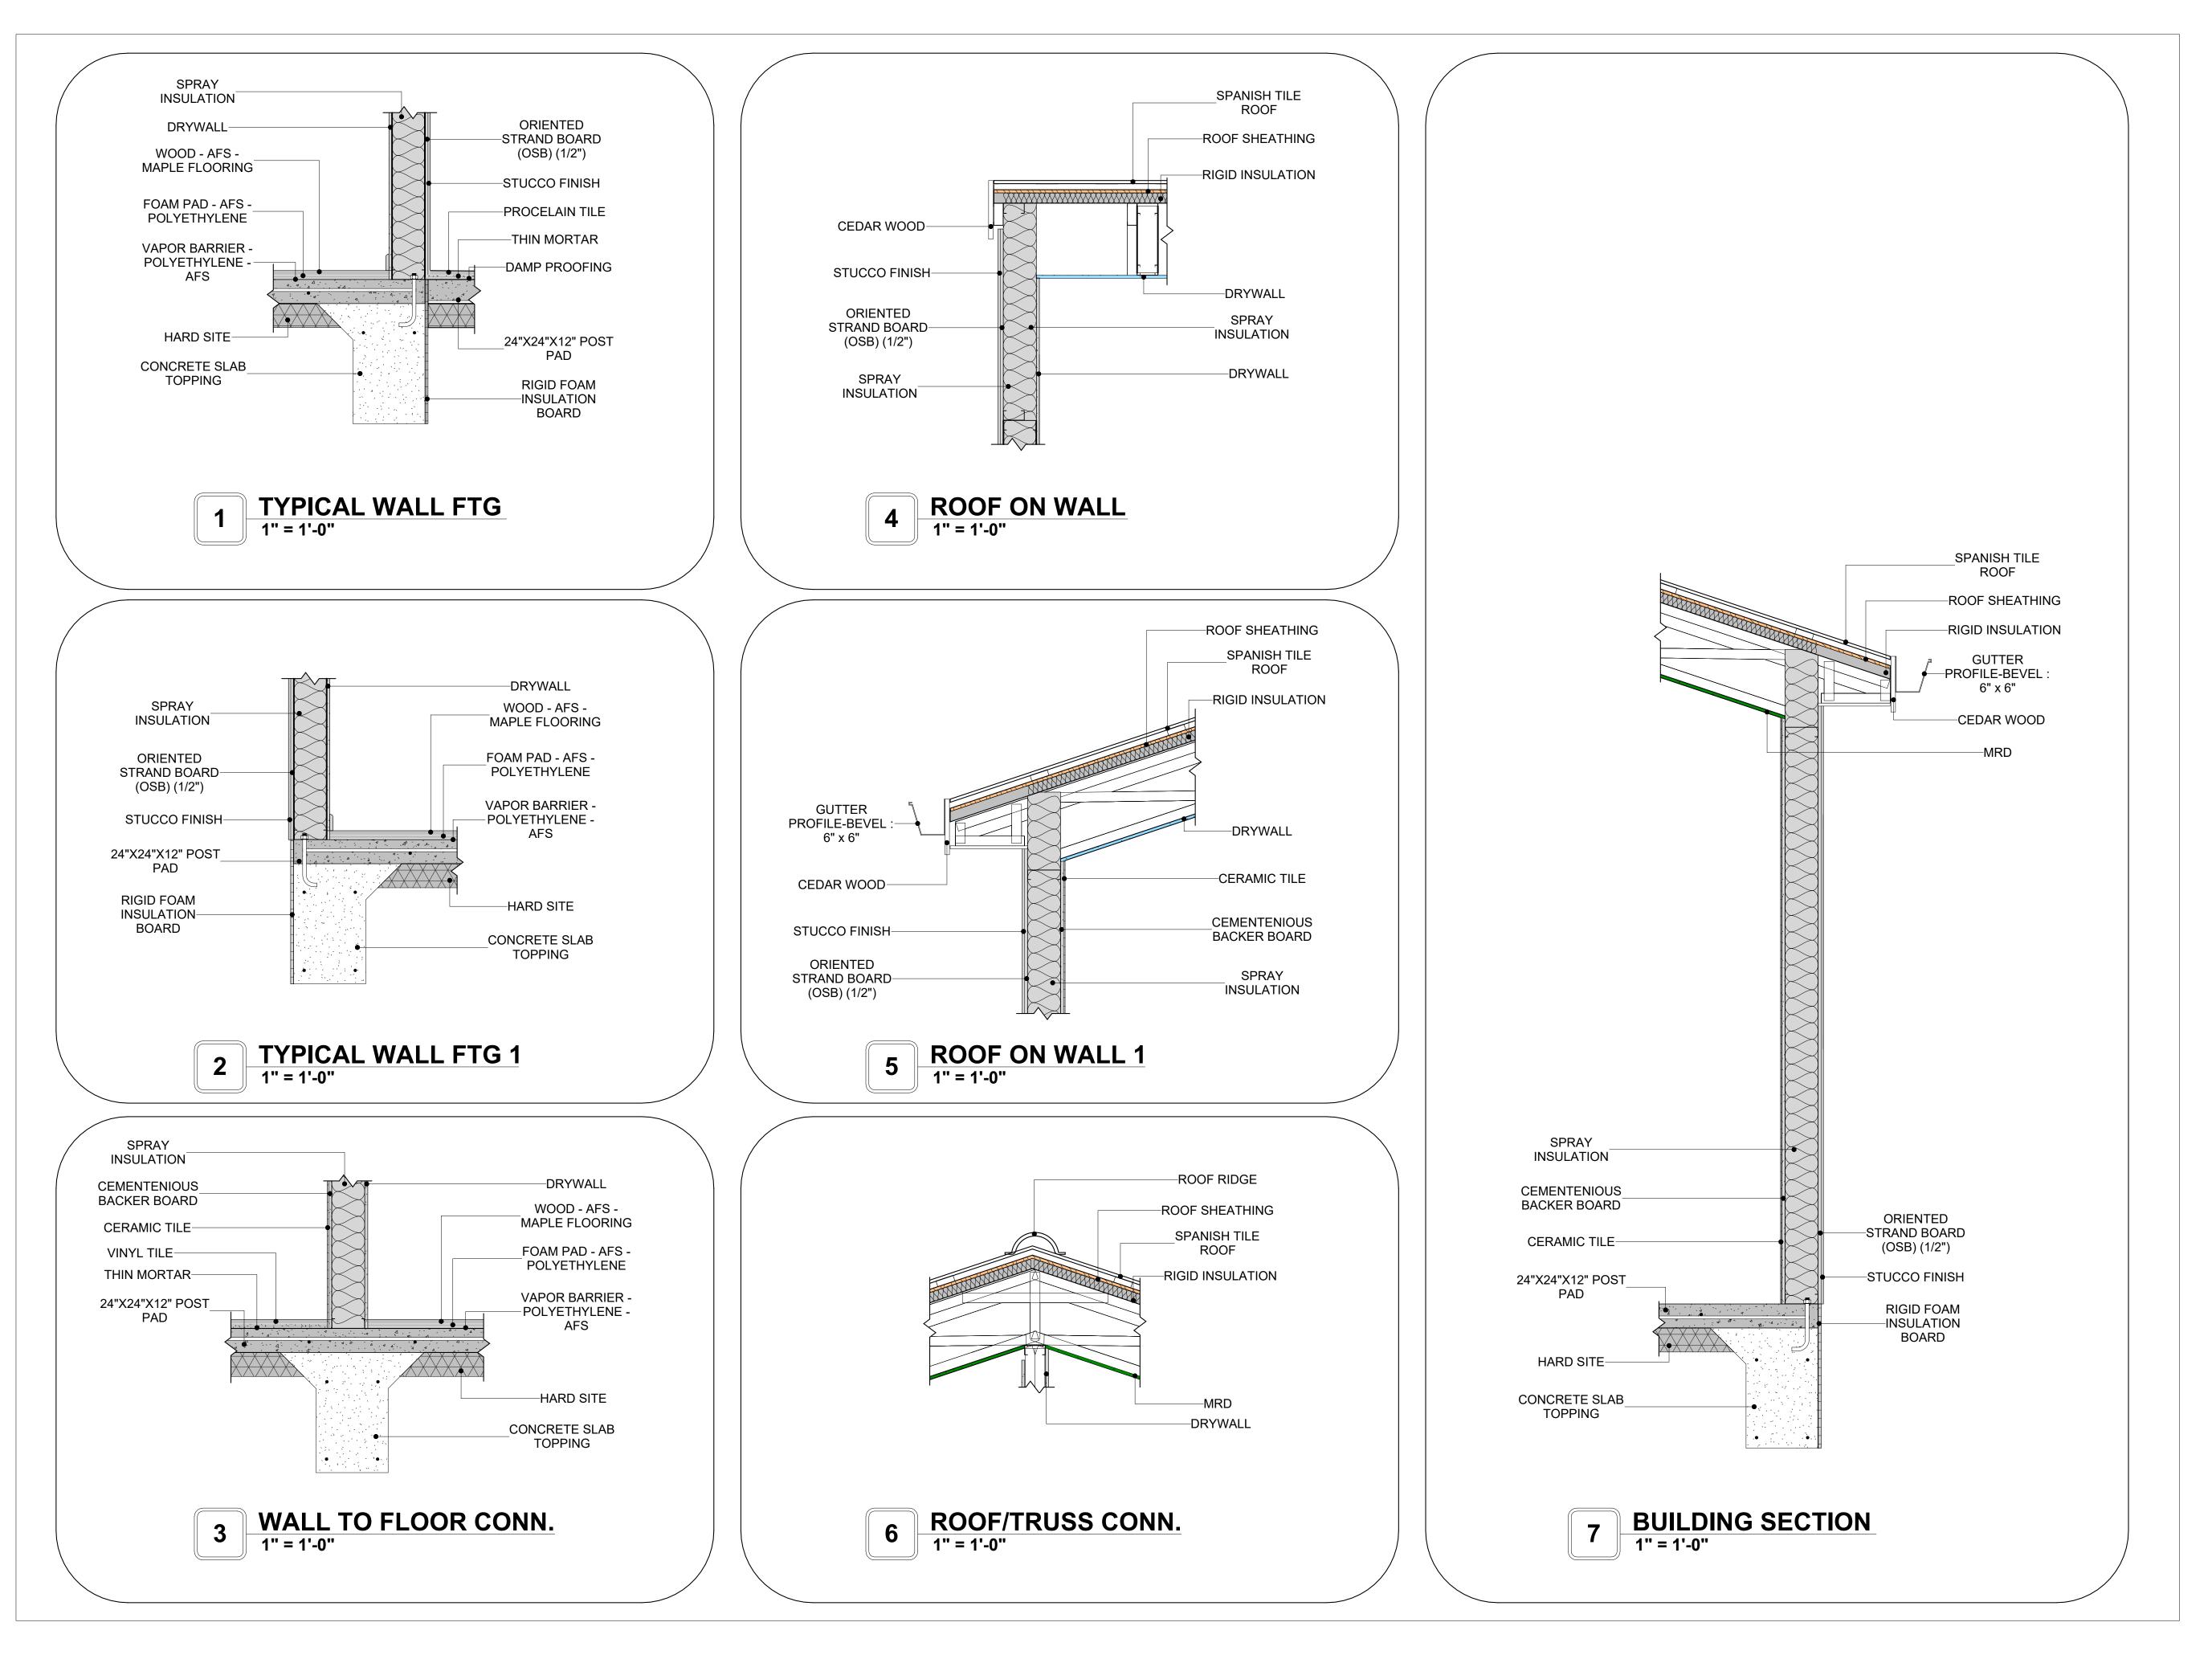



126 ORION 730 1Bd/1Ba

SPANISH PORCH 550

DRAWING NAME

ARCHITECTURAL DETAILS

Client Name	CLIENT NAME:	
0061_12	PROJECT NUMBER:	
3/21/2025 5:29:47 PM	DATE:	
Designer	DESIGNED BY:	
Author	DRAWN BY:	
Checker	CHECKED BY:	

A401

SCALE: 1" = 1'-0"

CASEWORK GENERAL NOTES

RECESSED MED CABINET

Closet 5

Closet 1

Closet 4

14

Grand total

- ALL CABINET HEIGHTS INCLUDE COUNTERTOPS. DIMENSIONS ARE TO THE NEAREST INCH. DIVISIONS IN CASEWORK ARE SHOWN FOR CLARITY AND DO NOT REPRESENT BREAKS IN THE
- PROVIDE CONTINUOUS COUNTERTOP OVER ALL SIMILAR HEIGHT CASEWORK, UNLESS AND OTHERWISE NOTED.
- MANUFACTURER AND CATALOG NUMBERS ARE FOR REFERENCE AND ILLUSTRATION PURPOSES
- DOTTED LINES INDICATE WALL HUNG CABINETS, DIVISIONS OF BASE CABINETS BELOW THE COUNTERTOP, FURNITURE NOT IN THE CONTRACT OR PROJECTION SCREENS -SEE CASEWORK
- KEY AND SPECIFICATIONS. ALL CABINETS AND DRAWERS TO HAVE CAM LOCKS EXCEPT FOR SINK BASE CABINETS.
- 8. ALL EXPOSED SURFACES (EXPOSED TO VIEW FROM ANY PERSPECTIVE) TO BE COVERED WITH
- ALL CASEWORK WHICH MEETS A WALL AT ONE OR BOTH ENDS, TO BE PROVIDED WITH FILLER
- PANELS AND SCRIBED TO THE WALL(S) AS REQUIRED. 10. ALL CABINETS AND DRAWERS ARE PROVIDED WITH RECESSED HANDLES.
- 11. CONTRACTOR TO FIELD VERIFY ALL CLEAR OPENINGS PRIOR TO MILLWORK OR CASEWORK
- 12. CASEWORK DRAWINGS ARE DIAGRAMMATIC IN NATURE TO SHOW DESIGN INTENT.

	CASEWORK SCHEDULE					
TYPE MAR K	TYPE	COUN	HEIGHT	WIDTH	DEPTH	AREA
01	refrigerator top	1	1' - 6"	2' - 0"	2' - 4"	3 SF
02	Wall Cabinet Double Door 1	1	2' - 6"	2' - 8"	1' - 0"	7 SF
03	Linear Counter Top	1	0' - 4"	2' - 8"	2' - 1"	1 SF
04	Base Cabinet Double Door 2	1	2' - 11"	2' - 8"	2' - 0"	8 SF
05	Wall_Cabinet_Single_Door	1	2' - 6"	1' - 8"	1' - 0"	4 SF
06	Wall_Cabinet_Single_Door	1	2' - 6"	2' - 6"	1' - 0"	6 SF
07	Base_Filler_1	1	2' - 11"	0' - 11"	2' - 0"	3 SF
08	Base Cabinet L-Shaped	1	2' - 11"	3' - 3"	3' - 3"	9 SF
09	HD_L-Shape_Counter_Top w sink hole	1	0' - 4"	4' - 6"	8' - 1"	1 SF
10	Base Cabinet Double Door 2	1	2' - 11"	2' - 2"	2' - 0"	6 SF
11	DOUBLE SINK VANITY	1	3' - 0"	5' - 0"	2' - 0"	15 SF

2' - 0"

6' - 0"

6' - 0"


6' - 0"

1' - 6"

2' - 9"

2' - 9"

SPECIALTY EQUIPMENT SCHEDULE				
TYPE MARK	TYPE MARK TYPE			
01	WASHER-FRONT-LOAD	1		
02	REFRIGERATOR	1		
03	RANGE	1		
04	DRYER-FRONT-LOAD	1		
05	Dishwasher	1		

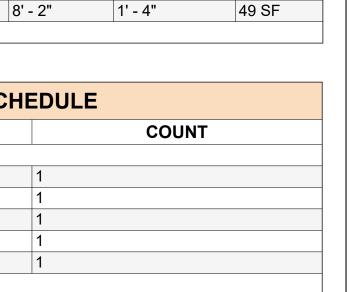

3 SF

16 SF

16 SF

0' - 3"

1' - 4"

1' - 4"



SE04

8 **(**A402)

5' - 0"

2' - 8"

CA01

CASEWORK PLAN

4 2'-8" 1'-9"

1' - 8"

1/2" = 1'-0"


CA01

2' - 8" 2 - 0"

1' - 8"

2' - 6"


2' - 1"

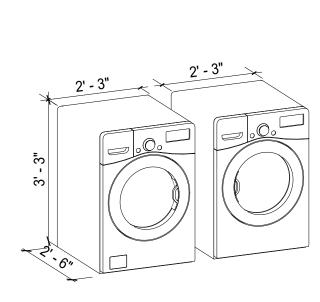

2'-0" 4 2'-0"

ELEVATION 1 - B 1/2" = 1'-0"



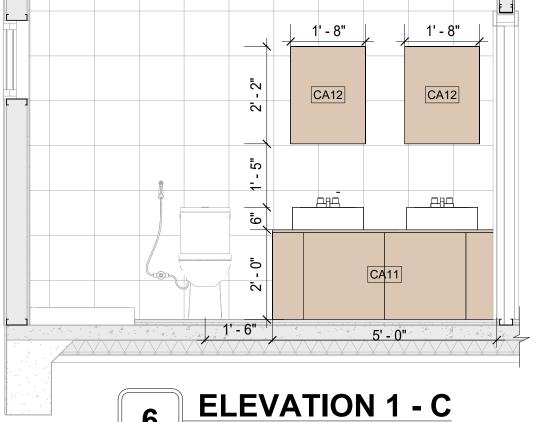


VANITY 3D

KITCHEN 3D

ELEVATION 1 - C 1/2" = 1'-0"

Tuscon,AZ, USA 888-864-0184 inquire@frameupnow.com www.frameupnow.com

KEY PLAN

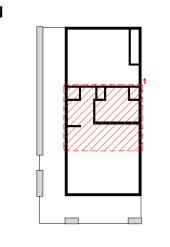

NO.	DESCRIPTION	DATE

NOTE:

LEGEND:


PROJECT


126 ORION 730 1Bd/1Ba **SPANISH PORCH 550**

DRAWING NAME

ARCHITECTURAL CASEWORK

CLIENT NAME:	Client Name
PROJECT NUMBER:	0061_12
DATE:	3/21/2025 5:29:49 PM
DESIGNED BY:	Designer
DRAWN BY:	Author
CHECKED BY:	Checker

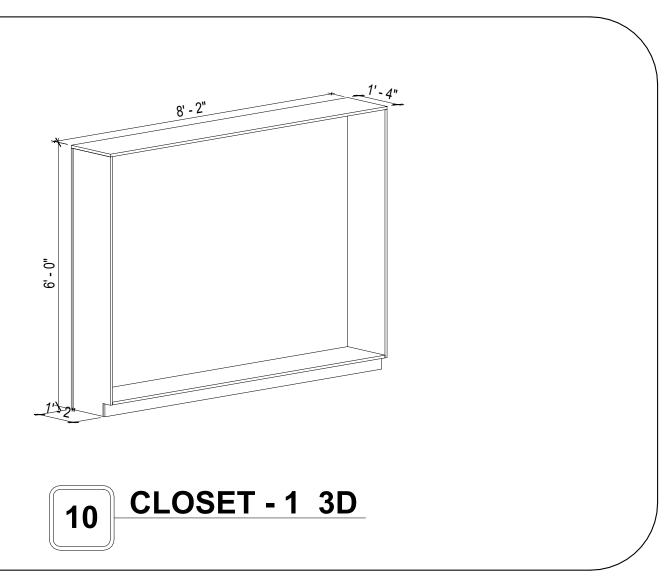

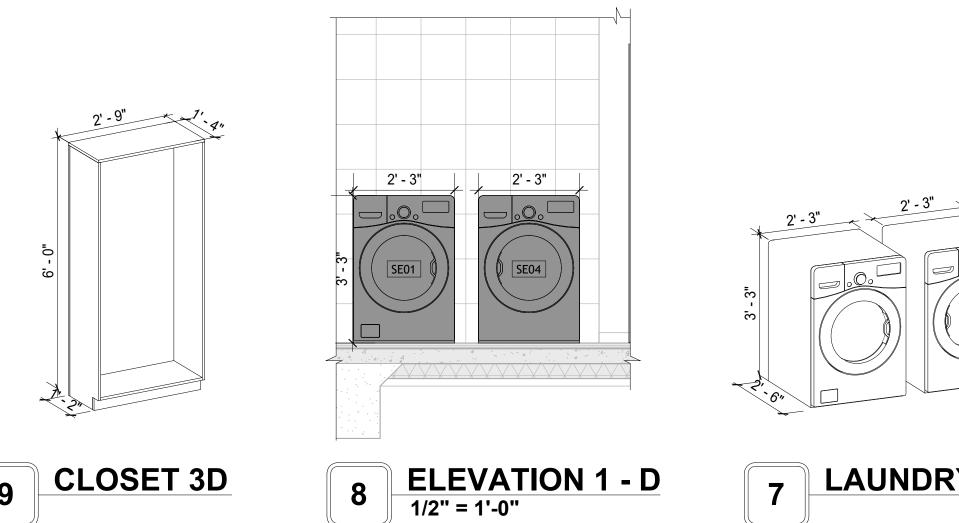

GENERAL NOTES

1. THIS DRAWING DEPICTS THE HVAC (HEATING, VENTILATION, AND AIR CONDITIONING) SYSTEM FOR THE ORION 1BD1BA SPANISH PORCH. IT PROVIDES A VISUAL REPRESENTATION OF THE SYSTEM LAYOUT AND COMPONENTS.

2.THE HVAC SYSTEM IS DESIGNED TO MEET THE SPECIFIC REQUIREMENTS OF THE BUILDING, INCLUDING HEATING, COOLING, AND VENTILATION NEEDS, AS PER THE PROJECT SPECIFICATIONS AND APPLICABLE CODES AND STANDARDS.

3. THE HVAC SYSTEM INSTALLATION SHALL COMPLY WITH THE LATEST EDITION OF THE INTERNATIONAL MECHANICAL CODE (IMC), INTERNATIONAL RESIDENTIAL CODE (IRC), AND ALL OTHER APPLICABLE LOCAL, STATE, AND NATIONAL CODES AND REGULATIONS.

4. THE EQUIPMENT SHOWN ON THIS DRAWING INCLUDES BUT IS NOT LIMITED TO AIR HANDLING UNITS (AHUS), CHILLERS, BOILERS, COOLING TOWERS, PUMPS, DUCTWORK, DIFFUSERS, GRILLES, AND CONTROL DEVICES.

5. ALL EQUIPMENT, DUCTWORK, AND PIPING SHALL BE INSTALLED IN ACCORDANCE WITH MANUFACTURER'S SPECIFICATIONS, LOCAL CODES, AND

6. ALL DUCTWORK SHALL BE SIZED, FABRICATED, AND INSTALLED IN ACCORDANCE WITH THE LATEST EDITION OF THE ACCA MANUAL D AND THE SMACNA HVAC DUCT CONSTRUCTION STANDARDS. DUCTWORK SHALL BE INSTALLED IN A NEAT AND WORKMANLIKE MANNER, PROPERLY SUPPORTED AND BRACED TO PREVENT SAGGING, AIR LEAKAGE, OR VIBRATION.

7. CONDENSATE DRAINAGE PIPING SHALL BE PROPERLY PITCHED TO ENSURE POSITIVE DRAINAGE TO AN APPROVED DISPOSAL LOCATION, SUCH AS A FLOOR DRAIN, SUMP PUMP, OR EXTERIOR GRADE. CONDENSATE LINES SHALL BE INSULATED TO PREVENT SWEATING.

8. THE LOCATION OF CONTROL PANELS AND SENSORS INDICATED ON THIS DRAWING CAN BEMODIFY WITH THE SPECIFIC LOCATIONS AND WIRING

DETAILS WILL BE DETERMINED DURING THE CONTROL SYSTEM DESIGN AND INSTALLATION. 9. THE HVAC SYSTEM DESIGN CONSIDER ENERGY EFFICIENCY, INDOOR AIR QUALITY, OCCUPANT COMFORT, AND NOISE CONTROL, FOLLOWING

APPLICABLE GUIDELINES AND REGULATIONS.

10. COORDINATION WITH OTHER TREADS HAS BEEN DONE ON A DESIGN LEVEL. THIS DRAWING SHALL BE READ TOGETHER WITH THE AR. EL AND SN DESIGN DRAWINGS TO ENSURE PROPER INSTALLATION AND INTEGRATION OF THE HVAC SYSTEMS.

11. THE HVAC CONTRACTOR IS RESPONSIBLE FOR OBTAINING ALL NECESSARY PERMITS AND LICENSES, AND FOR SCHEDULING AND COORDINATING WITH THE LOCAL BUILDING DEPARTMENT AND UTILITY PROVIDERS TO ENSURE A TIMELY AND COMPLIANT INSTALLATION.

12. ALL DUCTWORK PENETRATIONS THROUGH WALLS, FLOORS, OR CEILINGS SHALL BE PROPERLY SEALED AND FIRE-STOPPED USING APPROVED METHODS AND MATERIALS TO MAINTAIN THE INTEGRITY OF THE BUILDING'S FIRE-RESISTANCE RATINGS.


13. HVAC EQUIPMENT SHALL BE INSTALLED LEVEL AND PLUMB, AND IN STRICT ACCORDANCE WITH THE MANUFACTURER'S INSTALLATION INSTRUCTIONS AND RECOMMENDATIONS. PROVIDE ADEQUATE CLEARANCES AROUND EQUIPMENT FOR PROPER AIRFLOW, SERVICE ACCESS, AND CODE COMPLIANCE.


14. ALL HVAC EQUIPMENT AND COMPONENTS, INCLUDING THERMOSTATS, DAMPERS, AND ACCESS PANELS, SHALL BE LOCATED IN ACCESSIBLE AREAS FOR EASY SERVICING AND MAINTENANCE. PROVIDE ADEQUATE SPACE AROUND EQUIPMENT FOR PROPER AIRFLOW AND SERVICE ACCESS.

15. THE HVAC SYSTEM SHALL BE BALANCED AND ADJUSTED TO ENSURE PROPER AIRFLOW, TEMPERATURE DISTRIBUTION, AND SYSTEM PERFORMANCE THROUGHOUT THE RESIDENCE. PROVIDE A WRITTEN REPORT DOCUMENTING THE FINAL SYSTEM BALANCE.

16. ANY DEVIATIONS OR MODIFICATIONS TO THE HVAC SYSTEM DESIGN SHALL BE REVIEWED AND APPROVED BY THE RESPONSIBLE DESIGN PROFESSIONALS AND COMMUNICATED TO ALL RELEVANT PARTIES INVOLVED IN THE CONSTRUCTION PROCESS.

17. FOR ANY INQUIRIES OR CLARIFICATIONS REGARDING THE HVAC SYSTEM DESIGN, PLEASE CONSULT THE RESPONSIBLE DESIGN PROFESSIONALS OR THE PROJECT MANAGEMENT TEAM.

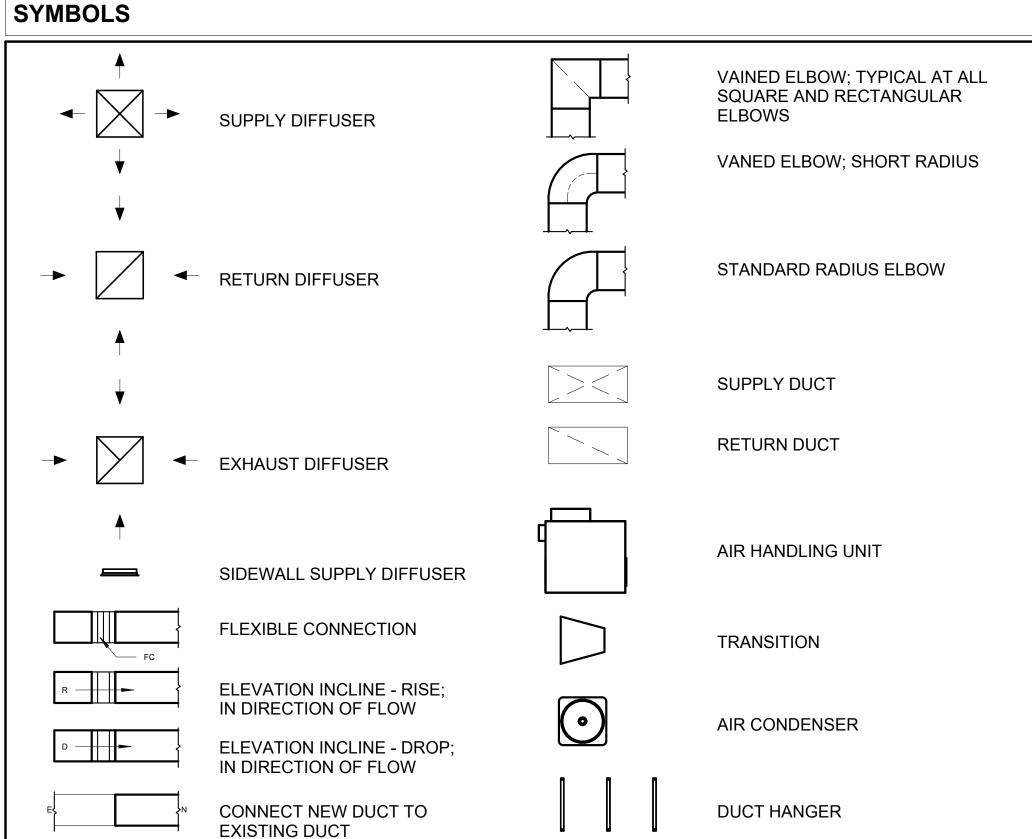

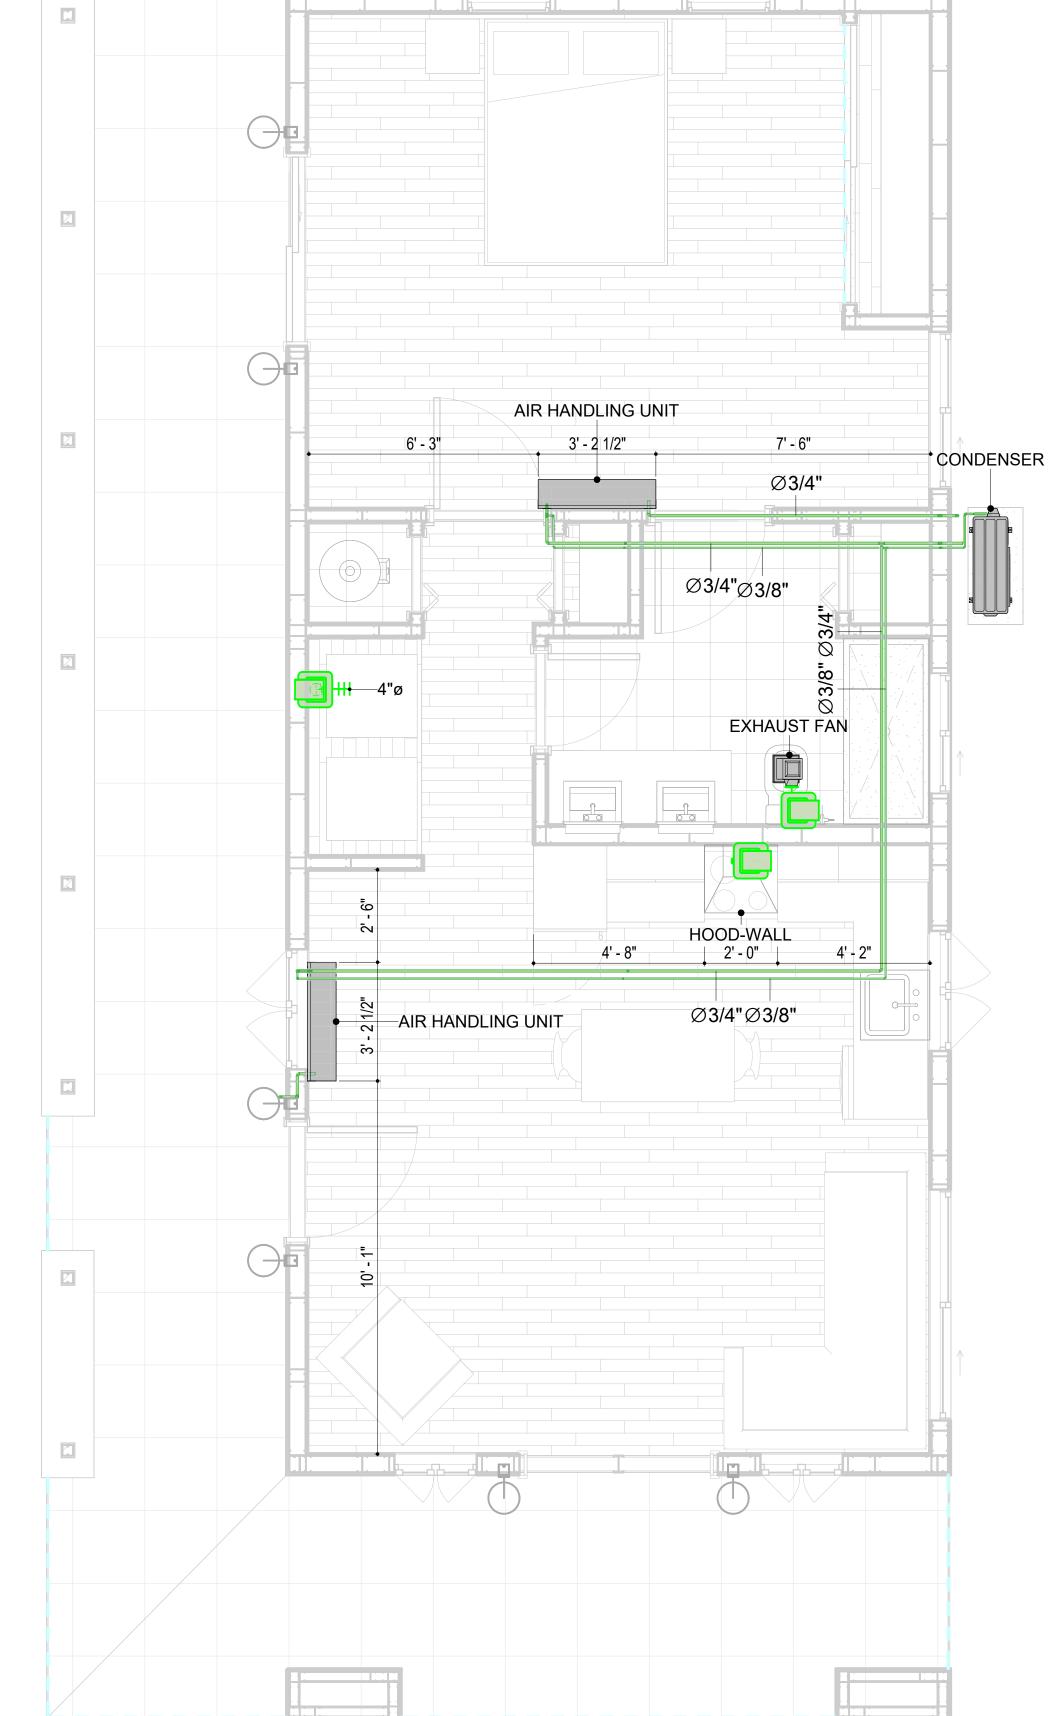

HVAC PLAN 3/8" = 1'-0"

HVAC COLOR SCHEME

AIR CONDITIONING PIPE LINE

REFRIGERANT LINE SCHEDULE				
CATAGORY	DESCRIPTION	DIAMETER	LENGTH	
PIPE TYPES	COPPER	3/8"	55.66	
PIPE TYPES	COPPER	3/4"	77.97	

REFRIGERANT LINE FITTING SCHEDULE				
CATAGORY	DESCRIPTION	Size	Count	
ELBOW - GENERIC	ELBOW - GENERIC: STANDARD/HVAC	3/4"ø-3/4"ø	23	
ELBOW - GENERIC	ELBOW - GENERIC: STANDARD/HVAC	3/8"ø-3/8"ø	17	
TEE - GENERIC	TEE - GENERIC: STANDARD	3/4"ø-3/4"ø-3/ 4"ø	1	
TEE - GENERIC	TEE - GENERIC: STANDARD	3/8"ø-3/8"ø-3/ 8"ø	1	
TRANSITION - GENERIC	TRANSITION - GENERIC: STANDARD	3/4"ø-1/2"ø	3	
TRANSITION - GENERIC	TRANSITION - GENERIC: STANDARD	3/4"ø-5/8"ø	2	
TRANSITION - GENERIC	TRANSITION - GENERIC: STANDARD	3/8"ø-1/4"ø	1	

MECHANICAL EQUIPMENT SCHEDULE		
CATAGORY	DESCRIPTION	COUNT
AID HANDLING HNIT	AID HANDLING LINIT, WALL MOUNTED	0
AIR HANDLING UNIT	AIR HANDLING UNIT: WALL MOUNTED CONDENSER: OUT DOOR	1
EXHAUST FAN	EXHAUST FAN: 75 CFM	1
	HOOD-WALL: VENT	1

DUCT FITTING SCHEDULE		
CATAGORY	DESCRIPTION	N COUNT
ROUND TRANSITION - ANGLE	45 DEGREE	E

DUCT ACCESSORY SCHEDULE		
CATAGORY	DESCRIPTION	COUNT
ROOF VENT	3" DIAMETER	3

	FLEX DU	ICT SCHEDULE		
DESCRIPTION	DESCRIPTION	LENGTH	DIAMETER	COUNT
FLEX DUCT ROUND	FLEX-ROUND	12.50	4"	3
GRAND TOTAL: 3		12.50	•	·



KEY PLAN

DESCRIPTION DATE

NOTE:

LEGEND:

PROJECT

126-Orion-730-1Bd1Ba Spanish-Porch-550

DRAWING NAME

HVAC PLAN

CLIENT NAME: Owner PROJECT NUMBER 15_0001 DATE: 3/15/2025 1:43:16 AM Designer DESIGNED BY: DRAWN BY: Author CHECKED BY: Checker

M101

ELECTRICAL NOTES

- 1. THIS DRAWING DEPICTS THE ELECTRICAL SYSTEM FOR THE 125-Orion-730-1Bd 1Ba- Spanish-Porch-550. IT PROVIDES A VISUAL REPRESENTATION OF THE ELECTRICAL LAYOUT AND COMPONENTS, INCLUDING POWER DISTRIBUTION, LIGHTING, AND CONTROL SYSTEMS.
- 2. THE ELECTRICAL SYSTEM IS DESIGNED TO MEET THE SPECIFIC REQUIREMENTS OF THE BUILDING, INCLUDING POWER DISTRIBUTION, LIGHTING, AND SPECIALIZED ELECTRICAL EQUIPMENT NEEDS, AS PER THE PROJECT SPECIFICATIONS AND APPLICABLE CODES AND STANDARDS.
- THE ELECTRICAL SYSTEM INSTALLATION SHALL COMPLY WITH THE LATEST EDITION OF THE NATIONAL ELECTRICAL CODE (NEC), INTERNATIONAL BUILDING CODE (IBC), AND ALL OTHER APPLICABLE LOCAL, STATE, AND NATIONAL CODES AND REGULATIONS.
- LOCATIONS AS NEEDED, DEVICES ARE SHOWN ON PLANS IN APPROXIMATE IDEAL LOCATIONS, UNLESS SPECIFICALLY DIMMENSIONED.
- 5. OPEN WALLS AS NEEDED TO ALLOW FOR NEW ELECTRICAL INSTALLATIONS.
- 6. LABEL ALL CIRCUITS ON JUNCTION BOXES, RECEPTACLES, DATA, SMOKE DETECTOR, AND EQUIPMENT IN PANEL BOX.
- 7. INSTALL RACEWAY AS NEEDED FOR DDC, ACCESS CONTROL, LOW VOLTAGE WIRING & DATA.
- 8. RELABEL POWER, DATA & FIRE ALARM FOR ROOM #CHANGES.
- 9. VERIFY ALL CIRCUITS LABELED ON PRINT ARE CORRECT BEFORE WORKING ON THEM.
- 10. NOTE ON SITE PLAN ALL CHANGES OR MISSING DETAIL TO BE INCORPORATED INTO THE MASTER PLAN.
- 11. DRAWINGS ARE DIAGRAMMATIC ONLY FOR THE PURPOSE OF SHOWING FIXTURE AND OUTLET LOCATIONS.
- 12. ELECTRICAL CONTRACTOR TO VERIFY SERVICE SIZE BY CALCULATION BASED UPON ACTUAL NAME PLATE RATINGS OF SELECTED EQUIPMENT.
- 13. VERIFY LOCATION OF SERVICE ENTRANCE WITH POWER COMPANY. PROVIDE UFER GROUND IN
- BUILDING FOUNDATION AT SERVICE ENTRANCE LOCATION.
- 14. PROVIDE A MIN. OF 20 FEET OF ONE *4 BARE COPPER UFER WIRE EMBEDDED IN CONCRETE FOOTING AT THE SERVICE ENTRANCE LOCATION WHERE APPROVED BY LOCAL SERVICE PROVIDER.
- 15. PROVIDE WATERPROOF FIXTURES IN ALL HIGH MOISTURE AREAS (EXTERIOR, SHOWER AND TUB CEILINGS ETC.)
- 16. PROVIDE DEDICATED CIRCUITS TO EACH BATH, DEN, FAMILY ROOM, BEDROOM, LOFT, KITCHEN REFRIGERATOR, KITCHEN FREEZER DISHWASHER, AND ANY AREA/ITEM SPECIFIED BY OWNER.
- 17. INCANDESCENT FIXTURES WITH OPEN OR PARTIALLY ENCLOSED LAMPS, PENDANT FIXTURES, AND LAMP HOLDERS ARE NOT PERMITTED IN CLOSETS.
- 18. ALL WORKMANSHIP AND MATERIALS TO CONFORM WITH THE 2015 IRC.
- 19. PROVIDE A MIN. OF 20 FEET OF ONE *4 BARE COPPER UFER WIRE EMBEDDED IN CONCRETE FOOTING AT THE SERVICE ENTRANCE LOCATION WHERE APPROVED BY LOCAL SERVICE PROVIDER.
- 20. PROVIDE A BONDING CONDUCTOR CONSISTING OF A MINIMUM OF ONE *4 BARE COPPER WIRE CONNECTING THE BUILDING'S METAL WATER PIPING SYSTEM TO THE SERVICE EQUIPMENT ENCLOSURE GROUNDING.

ELECTRICAL CALCS	
LIGHT AND OUTLETS 730 @ 3W	2,190 W
3 APPLIANCE CIRCUITS	4,500 W
DRYER	2,000 W
WASHER	2,000 W
RANGE	5,000 W
WATER HEATER	5,000 W
REFRIG.	1,800 W
DISHWASHER & DISPOSAL	3000 W
TOTAL	25,490 W
FRIST 10,000 @ 100% REMAINDER @ 40% MINI. SPLIT UNITS	10,000 W 6,196W 10,000 W

TOTAL 26,196 W

26,196 W DIVIDED BY 240V = 109 AMPS TOTAL

(USE 200 AMP SERVICE)

ELECTRICAL ABBREVIATIONS LIST

1P	1 POLE (2P, 3P, 4P, ETC.)	CTR	CENTER	HT	HEIGHT
A	AMPERÈ	CU	COPPER	HTG	HEATING
AC	ABOVE COUNTER OR AIR CONDITIONER	DCP	DOMESTIC WATER CIRCULATING PUMP	HTR	HEATER
ACLG	ABOVE CEILING	DEPT	DEPARTMENT	HV	HIGH VOLTAGE
ADO	AUTOMATIC DOOR OPENER	DET	DETAIL	HVAC	HEATING, VENTILATING AND AIR
AF	AMP FRAME	DIA	DIAMETER	CONDITIONING	CONDITIONING
AFF	ABOVE FINISHED FLOOR	DISC	DISCONNECT	HWP	HYDRONIC WATER PUMP
AFG	ABOVE FINISHED GRADE	DIST	DISTRIBUTION	IC	INTERRUPTING CAPACITY
AFI	ARC FAULT CIRCUIT INTERRUPTER	DN	DOWN	iG	ISOLATED GROUND
AHU	AIR HANDLING UNIT	DPR	DAMPER	IMC	INTERMEDIATE METAL CONDUIT
AL	ALUMINUM	DS	SAFETY DISCONNECT SWITCH	INCAND	INCANDESCENT
ALT	ALTERNATE	DT	DOUBLE THROW	IR	INFRARED
AMP	AMPERE	DWG	DRAWING	I/W	INTERLOCK WITH
AMPL	AMPLIFIER	DDC	DIRECT DIGITAL CONTROL	J-BOX	JUNCTION BOX
ANNUN	ANNUNCIATOR APPROX APPROXIMATELY		ELECTRICAL CONTRACTOR	KV	KILOVOLT
AQ-STAT	AQUASTAT	ELEC	ELECTRICAL CONTRACTOR	KVA	KILOVOLT-AMPERE
ARCH	ARCHITECT, ARCHITECTURAL	ELEV	ELEVATOR	KVAR	KILOVOLT-AMPERE REACTIVE
ARCH	AMP SWITCH	ELEV	EMERGENCY	KW	KILOVOLT-AMPERE REACTIVE KILOWATT
AS AT	AMP TRIP	EMS	ENERGENCY ENERGY MANAGEMENT SYSTEM	1	KILOWATT KILOWATT HOUR
				KWH	
ATS	AUTOMATIC	EMT EP	ELECTRICAL METALLIC TUBING	LOC	LOCATE OR LOCATION
AUTO	AUTOMATIC		ELECTRIC PNEUMATIC		LIGHT
AUX	AUXILIARY	EQUIP	EQUIPMENT	LTG	LIGHTING
AV	AUDIO VISUAL	EWC	ELECTRIC WATER COOLER	LTNG	LIGHTNING
AWG	AMERICAN WIRE GAUGE	EXIST	EXISTING	LV	LOW VOLTAGE
BATT	BATTERY	EXH	EXHAUST	MAX	MAXIMUM
BD	BOARD	EXP	EXPLOSION PROOF	MAG.S	MAGNETIC STARTER
BLDG	BUILDING	FA	FIRE ALARM	M/C	MOMENTARY CONTACT
BMS	BUILDING MANAGEMENT SYSTEM	FABP	FIRE ALARM BOOSTER POWER	MC	MECHANICAL CONTRACTOR
C	CONDUIT	SUPPLY PANEL	SUPPLY PANEL	MCB	MAIN CIRCUIT BREAKER
CAB	CABINET	FACP	FIRE ALARM CONTROL PANEL	MCC	MOTOR CONTROL CENTER
CAT	CATALOG	FCU	FAN COIL UNIT	MDC	MAIN DISTRIBUTION CENTER
CATV	CABLE TELEVISION	FIXT	FIXTURE	MDP	MAIN DISTRIBUTION PANEL
СВ	CIRCUIT BREAKER	FLR	FLOOR	MFR	MANUFACTURERMAIN FUSED
CCTV	CLOSED CIRCUIT TELEVISION	FLUOR	FLUORESCENT		DISCONNECT SWITCH
CKT	CIRCUIT	FU	FUSE	MH	MANHOLE
CLG	CEILING	FUDS	FUSED SAFETY DISCONNECT SWITCH	MIC	MICROPHONE
COMB	COMBINATION	GA	GAUGE	MIN	MINIMUM
CMPR	COMPRESSOR	GAL	GALLON	MISC	MISCELLANEOUS
CONN	CONNECTION	GALV	GALVANIZED	MLO	MAIN LUGS ONLY
CONST	CONSTRUCTION	GC	GENERAL CONTRACTOR	MMS	MANUAL MOTOR STARTER
CONT	CONTINUATION OR CONTINUOUS	GEN	GENERATOR	MOA	MULTIOUTLET ASSEMBLY
CONTR	CONTRACTOR	GFI	GROUND FAULT CIRCUIT INTERRUPTER	MSP	MOTOR STARTER PANELBOARD
CONV	CONVECTOR	GFP	GROUND FAULT PROTECTOR	MSBD	MAIN SWITCHBOARD
CP	CIRCULATING PUMP	GND	GROUND	MT	MOUNT
CRT	CATHODE-RAY TUBE	GRS	GALVANIZED RIGID STEEL (CONDUIT)	MT.C	EMPTY CONDUIT
CT	CURRENT TRANSFORMER	GYP BD	GYPSUM BOARD	UL	UNDERWRITERS LABORATORIES

Branch Panel:

Location: LIVING ROOM 10 Supply From:

Enclosure: Type 1

Mounting: Recessed

Volts: 120/240 Single Phases: 1

A.I.C. Rating: Mains Type: Mains Rating: 200 A MCB Rating: 1 A

Circuit Numb er		Number of Elements	Rating	Length	Wire Size	A		ı	В	Wire Size	Length	Rating	Number of Elements		Circuit Numb er
1	BED LIGHT	9	15 A	47' - 0 3/8"	1-#14, 1-#14, 1-#14	568 VA	600 VA			1-#14, 1-#14, 1-#14	51' - 9 9/32"	15 A	8	OUTDOOR LIGHT	2
3	KITCHEN & HALL LIGHT	11	15 A	30' - 4 15/32"	1-#14, 1-#14, 1-#14			516 VA	209 VA	1-#14, 1-#14, 1-#14	25' - 7 15/32"	15 A	8	LIVING LIGHT	4
5	BED RECEPTACLE	5	20 A	56' - 4 11/16"	1-#12, 1-#12, 1-#12	900 VA	673 VA			1-#12, 1-#12, 1-#12	30' - 9 1/16"	20 A	7	BATH GFCI	6
7	DRYER	1	30 A	39' - 3 1/8"	2-#10, 1-#10, 1-#10			2500 VA	1200 VA	1-#12, 1-#12, 1-#12	37' - 4 13/16"	20 A	1	WASHEING MASHEIN	8
9						2500 VA	2250 VA			2-#10, 1-#10, 1-#10	43' - 2 9/16"	30 A	1	WATER HEATER	10
11	OUTDOOR RECEPTACLE	4	20 A	57' - 2 13/16"	1-#12, 1-#12, 1-#12			720 VA	2250 VA			-			12
13	CONDENSER	1	60 A	23' - 2 1/2"	2-#6, 1-#6, 1-#10	2500 VA	900 VA			1-#12, 1-#12, 1-#12	33' - 1 25/32"	20 A	5	LIV. RECEPTACLE	14
15								2500 VA	540 VA	1-#12, 1-#12, 1-#12	22' - 11 11/32"	20 A	3	KITCHEN RECEPTACLE	16
17	REFRIGERATOR	1	20 A	26' - 8 1/4"	1-#12, 1-#12, 1-#12	1800 VA	2500 VA			2-#8, 1-#8, 1-#10	21' - 1 19/32"	40 A	1	RANGE	18
19	OVENHOOD	1	20 A	16' - 2 5/8"	1-#12, 1-#12, 1-#12			180 VA	2500 VA		-				20
21	DISHWASHER	1	20 A	12' - 6 3/16"	1-#12, 1-#12, 1-#12	1200 VA									22
23															24
25															26
						16359	VA	1311	l2 VA						'
						136	A	10	9 A						

Load Classification	Connected Load	Demand Factor	Estimated Demand	Panel	Totals
LIGHTING - DWELLING UNIT	900 VA	100.00%	900 VA		
OTHER	1124 VA	100.00%	1124 VA	Total Conn. Load:	29471 VA
RECEPTACLE	6000 VA	100.00%	6000 VA	Total Est. Demand:	28471 VA
LIGHTING	200 VA	100.00%	200 VA	Total Conn.:	123 A
CONDENSER	5000 VA	100.00%	5000 VA	Total Est. Demand:	119 A
WATER HEATER	4500 VA	100.00%	4500 VA		
RANGE	5000 VA	80.00%	4000 VA		
DRYER	5000 VA	100.00%	5000 VA		
REFRIGERATOR	1800 VA	100.00%	1800 VA		



KEY PLAN

NO.	DESCRIPTION	DATE

NOTE:

LEGEND:

PROJECT

126-Orion-730-1Bd 1Ba-Spanish-Porch-550

DRAWING NAME

SCHEDULE

CLIENT NAME:	Owner
PROJECT NUMBER:	0361_12
DATE:	3/15/2025 4:27:18 PM
DESIGNED BY:	Designer
DRAWN BY:	Author
CHECKED BY:	Checker

E101

SCALE: 1/4" = 1'-0"

© [2024] [FrameUpNow] . All rights reserved

ELECTRICAL NOTE

- A. PROVIDE INTERCONNECTED SMOKE ALARMS IN EACH SLEEPING ROOMS, OUTSIDE EACH SLEEPING ROOM, ON EACH STORY, IN THE HALL OR ADJACENT ROOM LUHERE THE CEILING HEIGHT OF A ROOM OPEN TO THE HALL EXCEEDS THE HALL BY 24'. SMOKE ALARMS SHALL BE PERMANENTLY HARD WIRED WITH BATTERY BACKUP.
- B. RECEPTACLE OUTLETS FOR RANGES AND CLOTHES DRYERS SHALL BE A THREE POLE WITH GROUND TYPE. FOUR WIRE GROUNDING-TYPE FLEXIBLE CORDS WILL BE REQUIRED FOR CONNECTION OF RANGES AND CLOTHES DRYERS. THE BONDING JUMPER SHALL NOT BE CONNECTED BETWEEN NEUTRAL TERMINAL AND THE FRAME OF THE APPLIANCE.
- C. TWO OR MORE 20 AMP SMALL APPLIANCE CIRCUITS SHALL BE PROVIDED TO SERVE THE KITCHEN, BREAKFAST NOOK, AND DINING ROOM. SUCH CIRCUITS SHALL HAVE NO OTHER OUTLETS.
- D. AT LEAST ONE 20 AMP BRANCH CIRCUIT SHALL BE PROVIDED TO SERVICE THE LAUNDRY ROOM. THIS CIRCUIT SHALL HAVE NO OTHER OUTLETS.
- E. ALL RECEPTACLES WITH IN 6' OF A WET BAR SINK OR KITCHEN SINK TO SERVE COUNTER TOP SURFACES MUST BE GFCI. ON KITCHEN COUNTERS 12' OR WIDER NO POINT ALONG THE WALL SHALL BE MORE THAN 2' FROM A RECEPTACLE. ALL RECEPTACLES WITH IN 6' OF KITCHEN SINK MUST BE GFCI. AT LEAST ONE GFCI RECEPTACLE SHALL BE INSTALLED IN THE BATHROOM ADJACENT TO EACH BASIN.
- F. FIXTURES INCLUDING CEILING FANS THAT ARE LOCATED IN DAMP LOCATIONS SHALL BE LISTED TO BE SUITABLE FOR SUCH LOCATIONS PER 2012 IRC
- G. PROVIDE ONE (1) SWITCHED OUTLET @ ALL BEDROOMS AND DEN
- H. CEILING FANS NOT EXCEEDING 35 LBS. (WITH OR WITHOUT ACCESSORIES MAY BE SUPPORTED BY OUTLET BOXES
- PROVIDED THE OUTLET BOXES ARE IDENTIFIED FOR SUCH USE PER 2012 IRC
- ELECTRICAL OUTLET BOXES ON OPPOSITE SIDES OF FIRE RATED WALLS SHALL BE SEPARATED BY A HORIZONTAL DISTANCE OF NOT LESS THAN 24".
- OUTLET BOXES IN THE WALLS BETWEEN THE GARAGE AND DWELLING SHALL BE METAL OR U.L. APPROVED FIRE RESISTIVE PLASTIC. BOXES IN GARAGE CEILING SHALL BE METAL.
- K. ALL BRANCH CIRCUITS THAT SUPPLY 120 VOLTS SINGLE PHASE 15 AND 20 AMPS RECEPTACLE OUTLETS INSTALLED IN THE DWELLING SHALL BE PROTECTED BY AN ARC FAULT CIRCUIT INTERRUPTER, EXCEPT GFCI RECEPTICLES.

NOTE:

A. RECEPTACLES MUST BE PROVIDED IN HALLWAYS 10'-0" OR MORE IN LENGTH. FOR A ONE FAMILY DWELLINGS AND EACH OF A TWO FAMILY DWELLING THAT IS AT GRADE LEVEL, AT LEAST ONE WP-GFCI RECEPTACLE OUTLET ACCESSIBLE AT GRADE LEVEL AND NOT MORE THAN 6'-6" ABOVE GRADE SHALL BE INSTALLED AT THE FRONT AND BACK OF THE DWELLING.

NOTE: APPLIANCE DISCONNECT

E4001.5 GROUNDING OF ENCLOSURES.

METAL ENCLOSURES FOR SWITCHES OR CIRCUIT BREAKERS SHALL BE CONNECTED TO AN

EQUIPMENT GROUNDING CONDUCTOR.

METAL ENCLOSURES FOR SWITCHES OR CIRCUIT BREAKERS USED AS SERVICE


EQUIPMENT SHALL COMPLY WITH THE PROVISIONS OF SECTION E3609.4. WHERE NONMETALLIC ENCLOSURES ARE USED WITH METAL RACEWAYS OR METAL-ARMORED CABLES, PROVISIONS SHALL BE MADE FOR CONNECTING THE EQUIPMENT GROUNDING

CONDUCTOR.


NONMETALLIC BOXES FOR SWITCHES SHALL BE INSTALLED WITH A WIRING METHOD THAT

PROVIDES OR INCLUDES AN EQUIPMENT GROUNDING CONDUCTOR. (404.12)

ELECTRICAL LEGEND Electrical Lights With Fan Waterproof Recessed Can Light 0 **Pendant Light** 0 Recessed Can Light **-**□ Wall Lamp Standalone linear Single Switch ₩ ₩ Three way Switch Fan Switch ₩ \ominus **Duplex Receptacle** $\bigoplus \blacksquare$ **Triplex Receptacle GFCI Receptacle** \boxtimes Exhaust Fan Smoke and heat detector

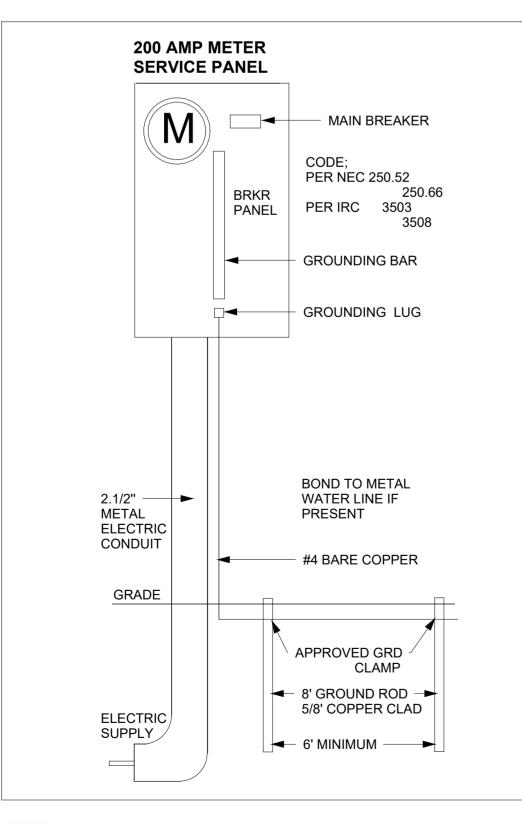



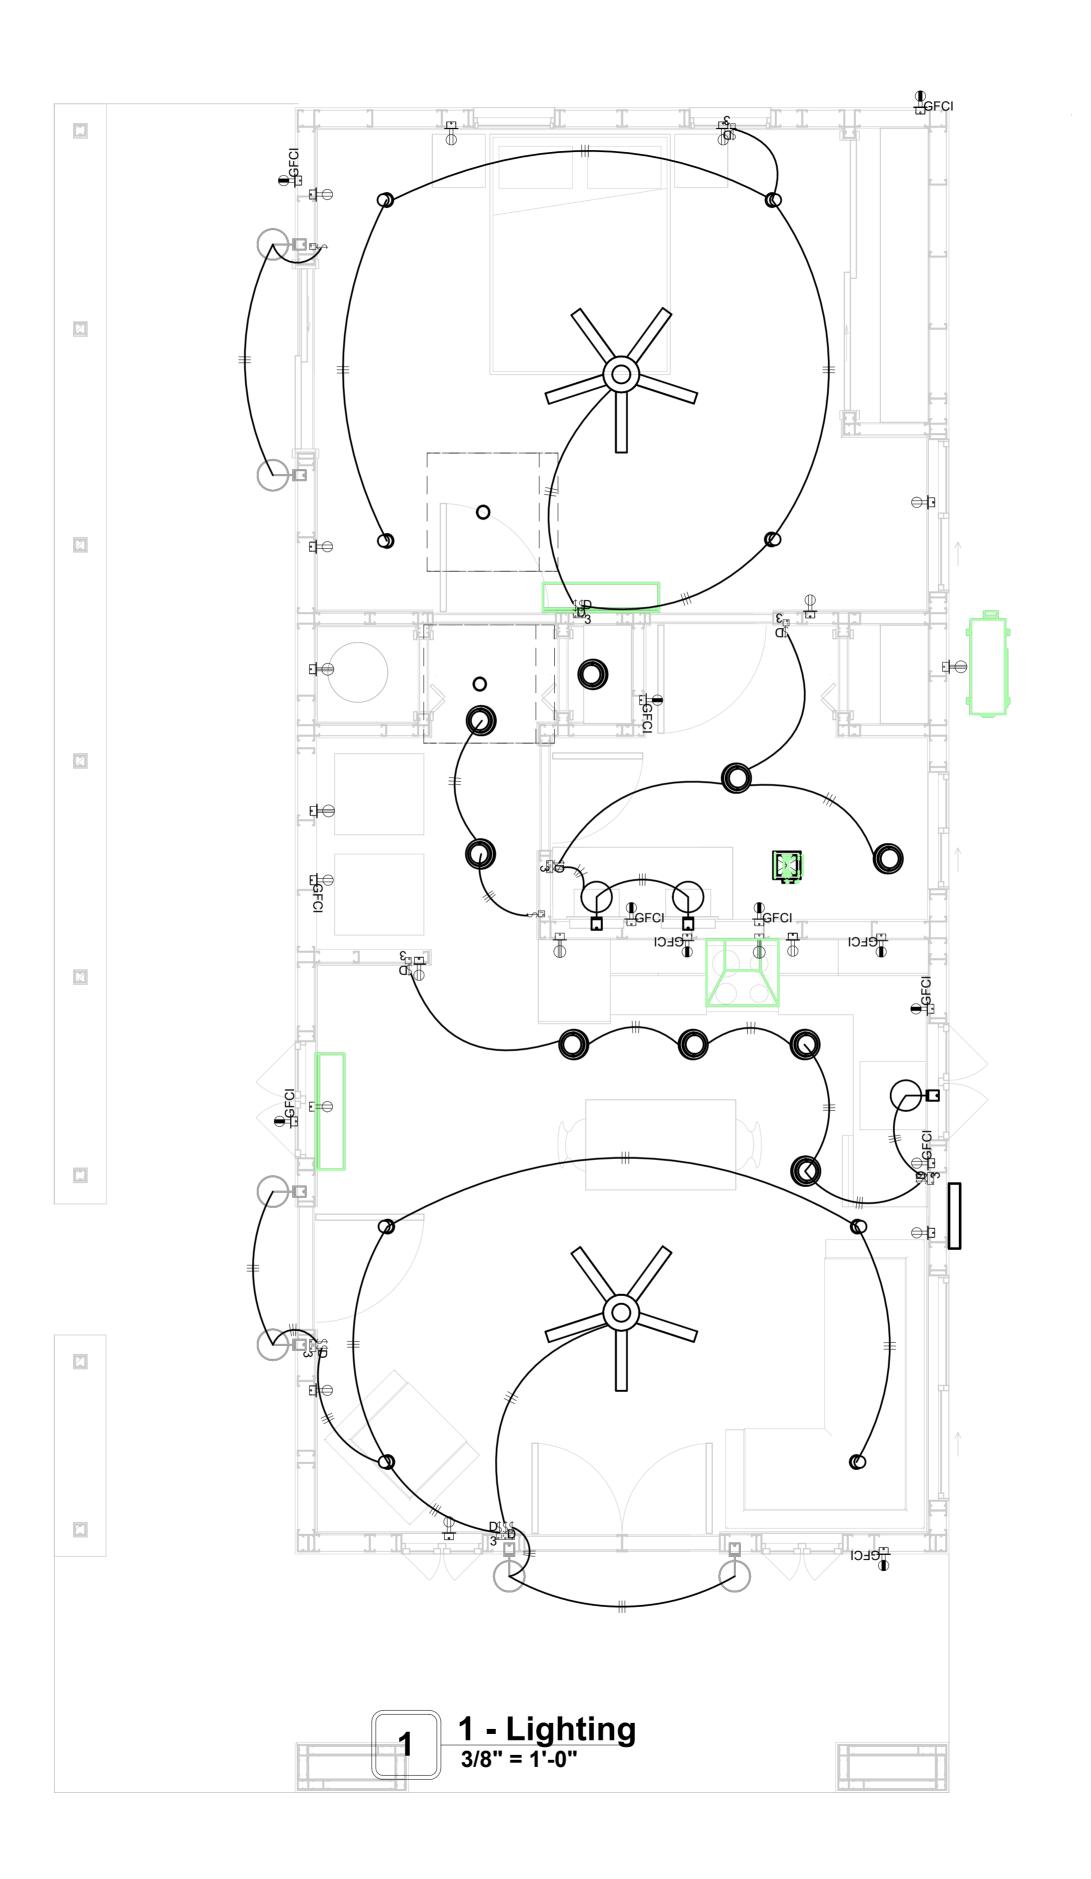



KEY PLAN

NO.	DESCRIPTION	DATE

NOTE:

LEGEND:

PROJECT

126-Orion-730-1Bd 1Ba-Spanish-Porch-550

DRAWING NAME


LIGHTING

CLIENT NAME:	Owner
PROJECT NUMBER:	0361_12
DATE:	3/15/2025 4:27:21 PM
DESIGNED BY:	Designer
DRAWN BY:	Author
CHECKED BY:	Checker


E102

NOTES: CONDUIT, CABLE AND WIRING


- Use Metalic Conduits (IMC) for cables running under concrete slabs.
 Use IMC for circuits with high voltage appliances (240 volts and above)
 For circuits with 120 volts consider using EMT or PVC conduits if needed.
 For Low voltage applications up to 50 volts consider using non metalic conduits.
 All conduits to be used in the project must conform to the latest National Electrical Code (NEC),
- 6. All wiring and cables to be used in the project must also conform to the latest National Electrical Code (NEC), 2015.
 7. All cables and wires used should be rated for their respective loading and should be gauged and conform to the NEC.

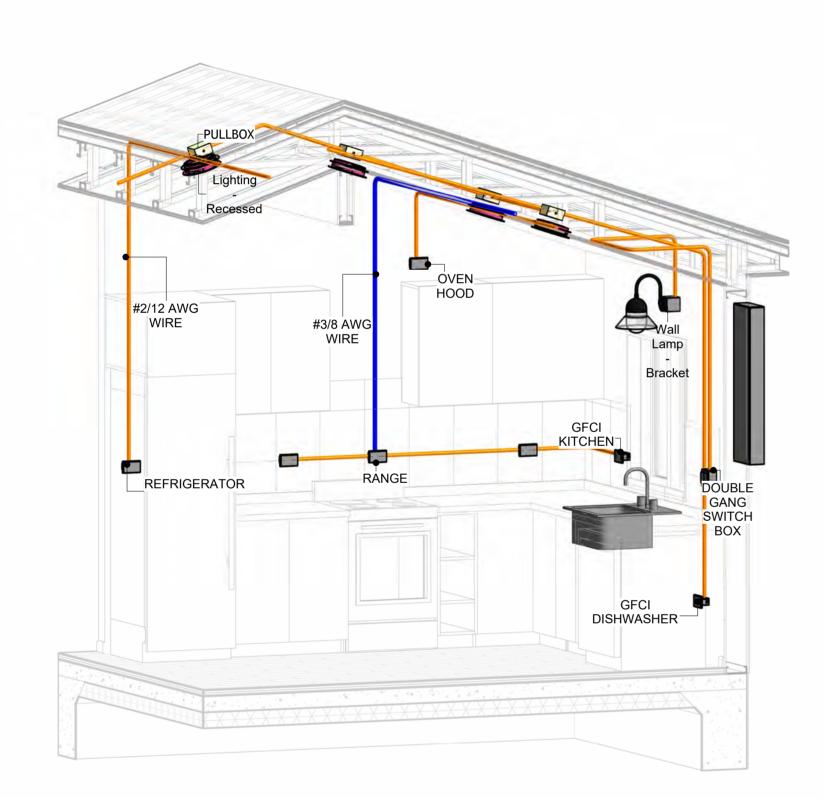


3D-KITCHEN

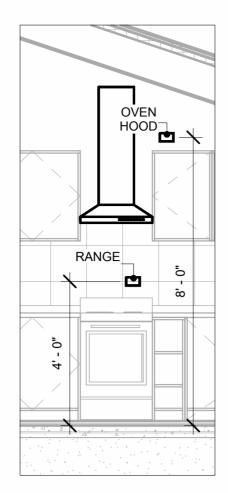


2 Range & OvenHood 3/8" = 1'-0"

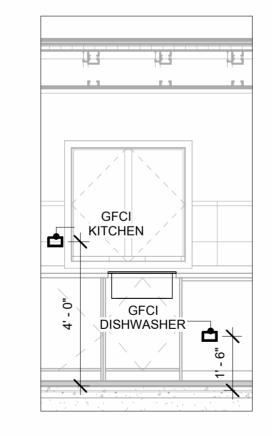

Gfci & Dishwasher

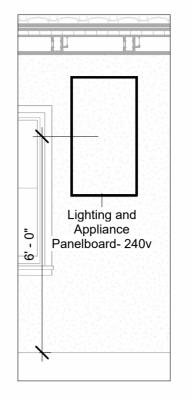


Panel 3/8" = 1'-0"

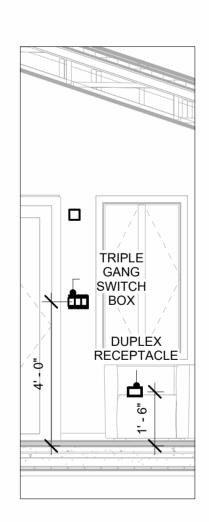

Switch & Receptacle 3/8" = 1'-0"



KEY PLAN

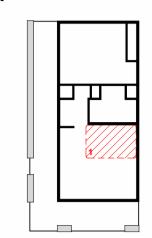

NO.	DESCRIPTION	DATE

NOTE:

LEGEND:

PROJECT

126-Orion-730-1Bd 1Ba-Spanish-Porch-550

DRAWING NAME

POWER

Owner	CLIENT NAME:
0361_12	PROJECT NUMBER:
3/15/2025 4:27:47 PN	DATE:
Designer	DESIGNED BY:
Author	DRAWN BY:
Checker	CHECKED BY:

E103

© [2024] [FrameUpNow] . All rights reserved

NOTES: LIGHT

PULLBOX1

- 1. LIGHT FIXTURES AND LUMINARIES SHALL CONFORM TO THE NEC, THE IRC AND LOCAL SAFETY & BUILDING CODE.
- 2. ALL LIGHTING FIXTURES SHOULD CONFORM TO THE DESIGN ELECTRICAL LOAD AND SHALL BE PROPERLY WIRED AND MOUNTED BY QUALIFIED ELECTRICIAN FOLLOWING MANUFACTURERS SPECIFICATIONS.
- 3. CEILING FANS AND FANS WITH LIGHT WITH WEIGHT EXCEEDING 35 LBS SHOULD BE PROVIDED WITH STRUCTURAL BACKING FOR SUPPORT AND SHALL BE FIXED AS PER MANUFACTURERS SPECIFICATIONS.
- 4. EXTERIOR LIGHTS SHALL CONFORM TO LOCAL BUILDING CODE AND GUIDELINES.

NOTES: SWITCH JUNCTION BOX

- THE MINIMUM SIZE OF JUCTION BOX TO BE USED IS 2"X4"X(1.5" OR 3.5" DEEP) THIS ARE
 TO BE USED FOR SINGLE GANG SWITCH OR OUTLETS.
- 2. FOR DOUBLE GANG (2 GANG) OUTLETS AND SWITCHS THE MINIMUM SIZE OF THE
- JUCTION BOX TO BE PROVIDED SHALL NOT BE LESS THAN 4"X4"X(1.5" OR 3.5" DEEP)

 3. FOR THREE GANG (3 GANG) OUTLETS AND SWITCHS THE MINIMUM SIZE OF THE JUCTION BOX SHALL NOT BE LESS THAN 6"X4"X(1.5" OR 3.5" DEEP).


FITTING SCHEDULE(PULL BOX)		
COUNT	DESCRIPTION	
	,	

#1/4 PULLBOX

ELECTRICAL FIXTURE SCHEDULE (SWITCH BOX)	
TYPE	COUNT
DOUBLE GANG SWITCH BOX	4
SINGLE GANG SWITCH BOX	4
TRIPLE GANG SWITCH BOX	1

LIGH	TING DEVICE
TYPE	COUNT
DIMMER	2
SINGLE POLE	6
THREE WAY WITH DIMMER	8

LIGHTING FIXTURE			
LIGHTING FIXTURE TYPE	VOLTAGE	ELECTRICAL LOAD	COUNT
ELECTRICAL_LIGHTS_FAN-LIGHT1	120 V/1-100 VA- 120 V/1-100 VA	200 A, 120 V/240 V, SINGLE PHASE, 3 WIRES	2
LIGHTING - RECESSED	120 V/1-60 VA	200 A, 120 V/240 V, SINGLE PHASE, 3 WIRES	9
SASSO 100 ROUND WALLWASHER TRIM	120 V/1-28 VA	200 A, 120 V/240 V, SINGLE PHASE, 3 WIRES	8
WALL LAMP - BRACKET	120 V/1-100 VA	200 A, 120 V/240 V, SINGLE PHASE, 3 WIRES	9

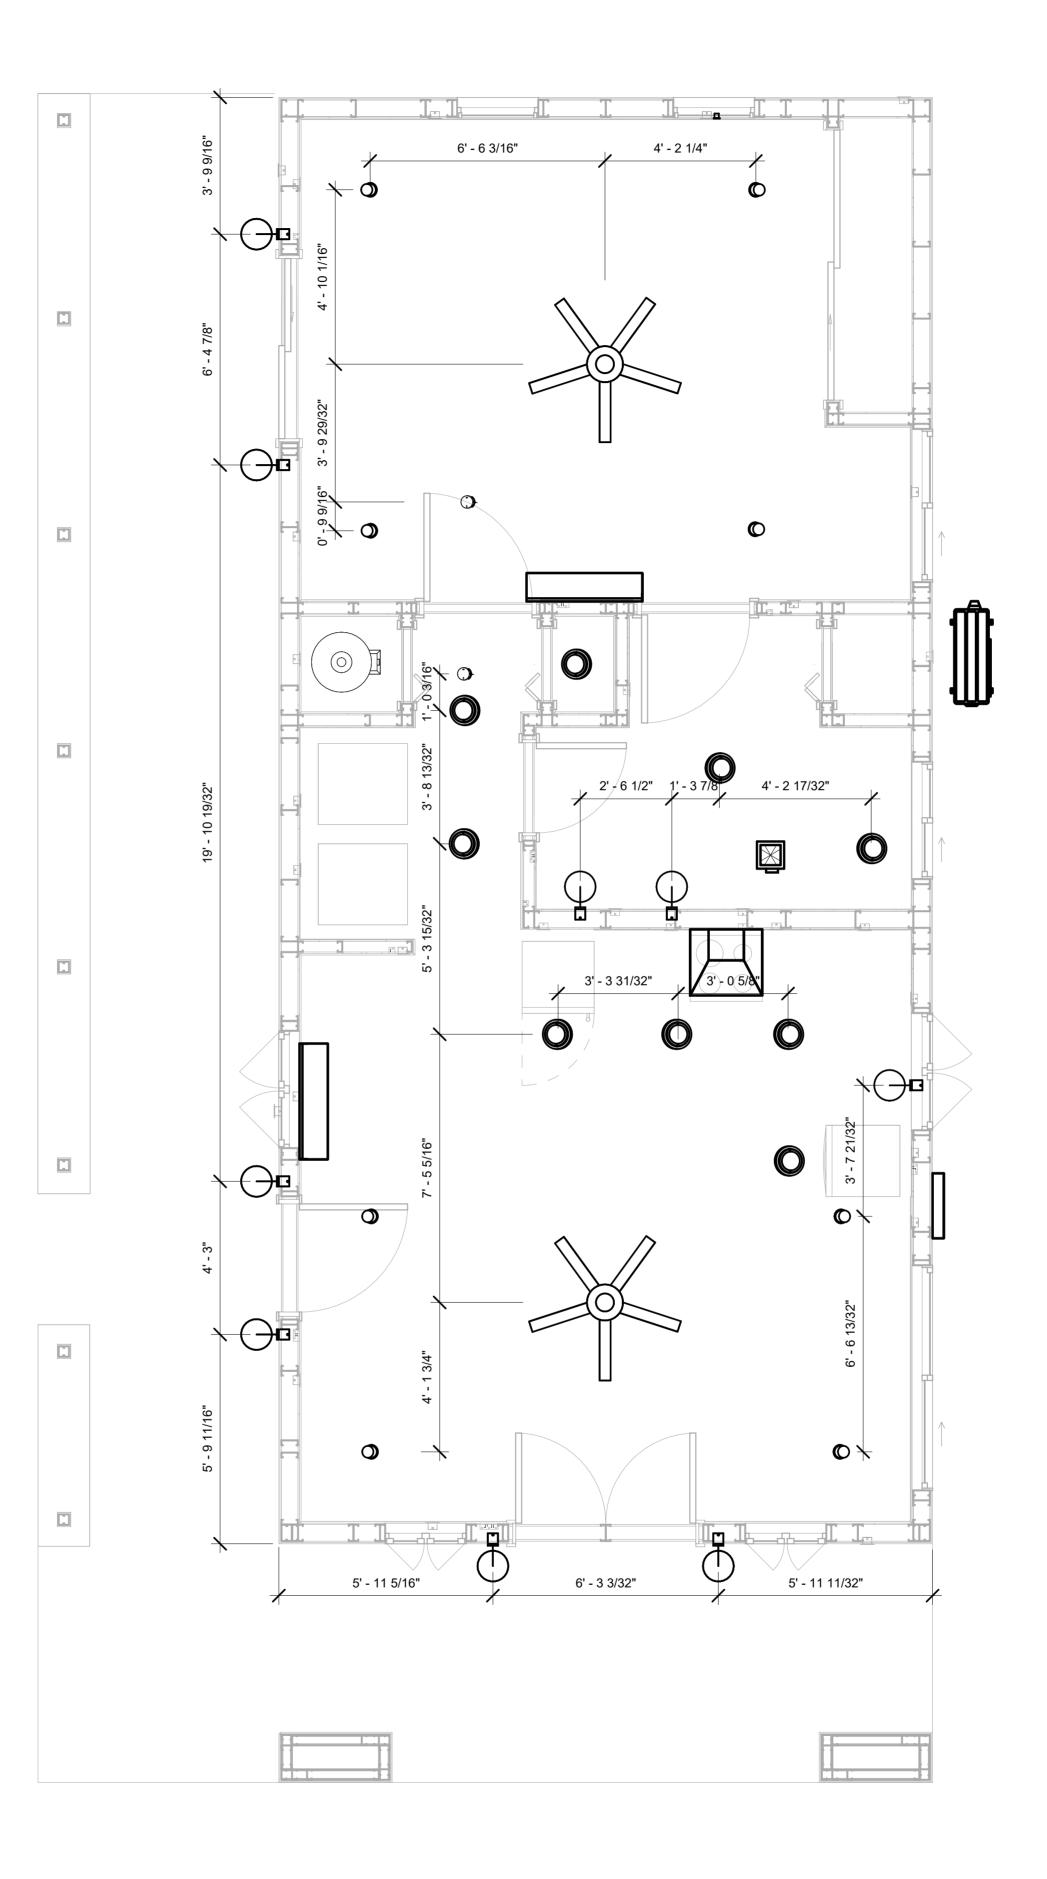

1 DIMENSION FOR LIGHT FIXTURES
3/8" = 1'-0"



KEY PLAN

NO.	DESCRIPTION	DATE

NOTE:

LEGEND:

PROJECT

126-Orion-730-1Bd 1Ba-Spanish-Porch-550

DRAWING NAME

DIMENSION PLAN FOR LIGHT FIXTURES

CLIENT NAME:	Owner
PROJECT NUMBER:	0361_12
DATE:	3/15/2025 4:27:48 PM
DESIGNED BY:	Designer
DRAWN BY:	Author
CHECKED BY:	Checker

E104

SCALE: As indicated


© [2024] [FrameUpNow] . All rights reserved

NOTES;

- 1. VERIFY EQUIPMENT PLUG CONFIGURATION BEFORE PURCHASING RECEPTACLES
- 2. FOR ALL EQUIPMENT.
- COORDINATE EXACT LOCATION OF LIGHT FIXTURES, WALL SWITCHES, RECEPTACLES AND OTHER DEVICES WITH ARCHITECTURAL DRAWINGS.
 USE METALLIC JUNCTION BOX WITH THE GFCI RECEPTACLES, WITH HIGHT VOLTAGE.

ELECTRICAL FIXTURE SCHEDULE (RECEPTACLE)	
TYPE	COUNT
CONDENSER	1
DRYER	1
DUPLEX RECEPTACLE	11
GFCI BATH ROOM	3
GFCI DISHWASHER	1
GFCI KITCHEN	3
GFCI OUT DOOR	4
GFCI WASHER	1
OVEN HOOD	1
RANGE	1
REFRIGERATOR	1
WATER HEATER	1

	ELECTRICAL O	UTLET SCHEDULE	
TYPE	CIRCUIT NUMBER	ELECTRICAL DATA	COUNT
DUPLEX RECEPTACLE		120 V/1-180 VA	1
GFCI BATH ROOM		120 V/1-180 VA	1
DUPLEX RECEPTACLE	5	120 V/1-180 VA	5
GFCI BATH ROOM	6	120 V/1-180 VA	2
DRYER	7,9	240 V/2-5000 VA	1
GFCI WASHER	8	120 V/1-1200 VA	1
WATER HEATER	10,12	240 V/2-4500 VA	1
GFCI OUT DOOR	11	120 V/1-180 VA	4
CONDENSER	13,15	240 V/2-5000 VA	1
DUPLEX RECEPTACLE	14	120 V/1-180 VA	5
GFCI KITCHEN	16	120 V/1-180 VA	3
REFRIGERATOR	17	120 V/1-1800 VA	1
RANGE	18,20	240 V/2-5000 VA	1
OVEN HOOD	19	120 V/1-180 VA	1
GFCI DISHWASHER	21	120 V/1-1200 VA	1

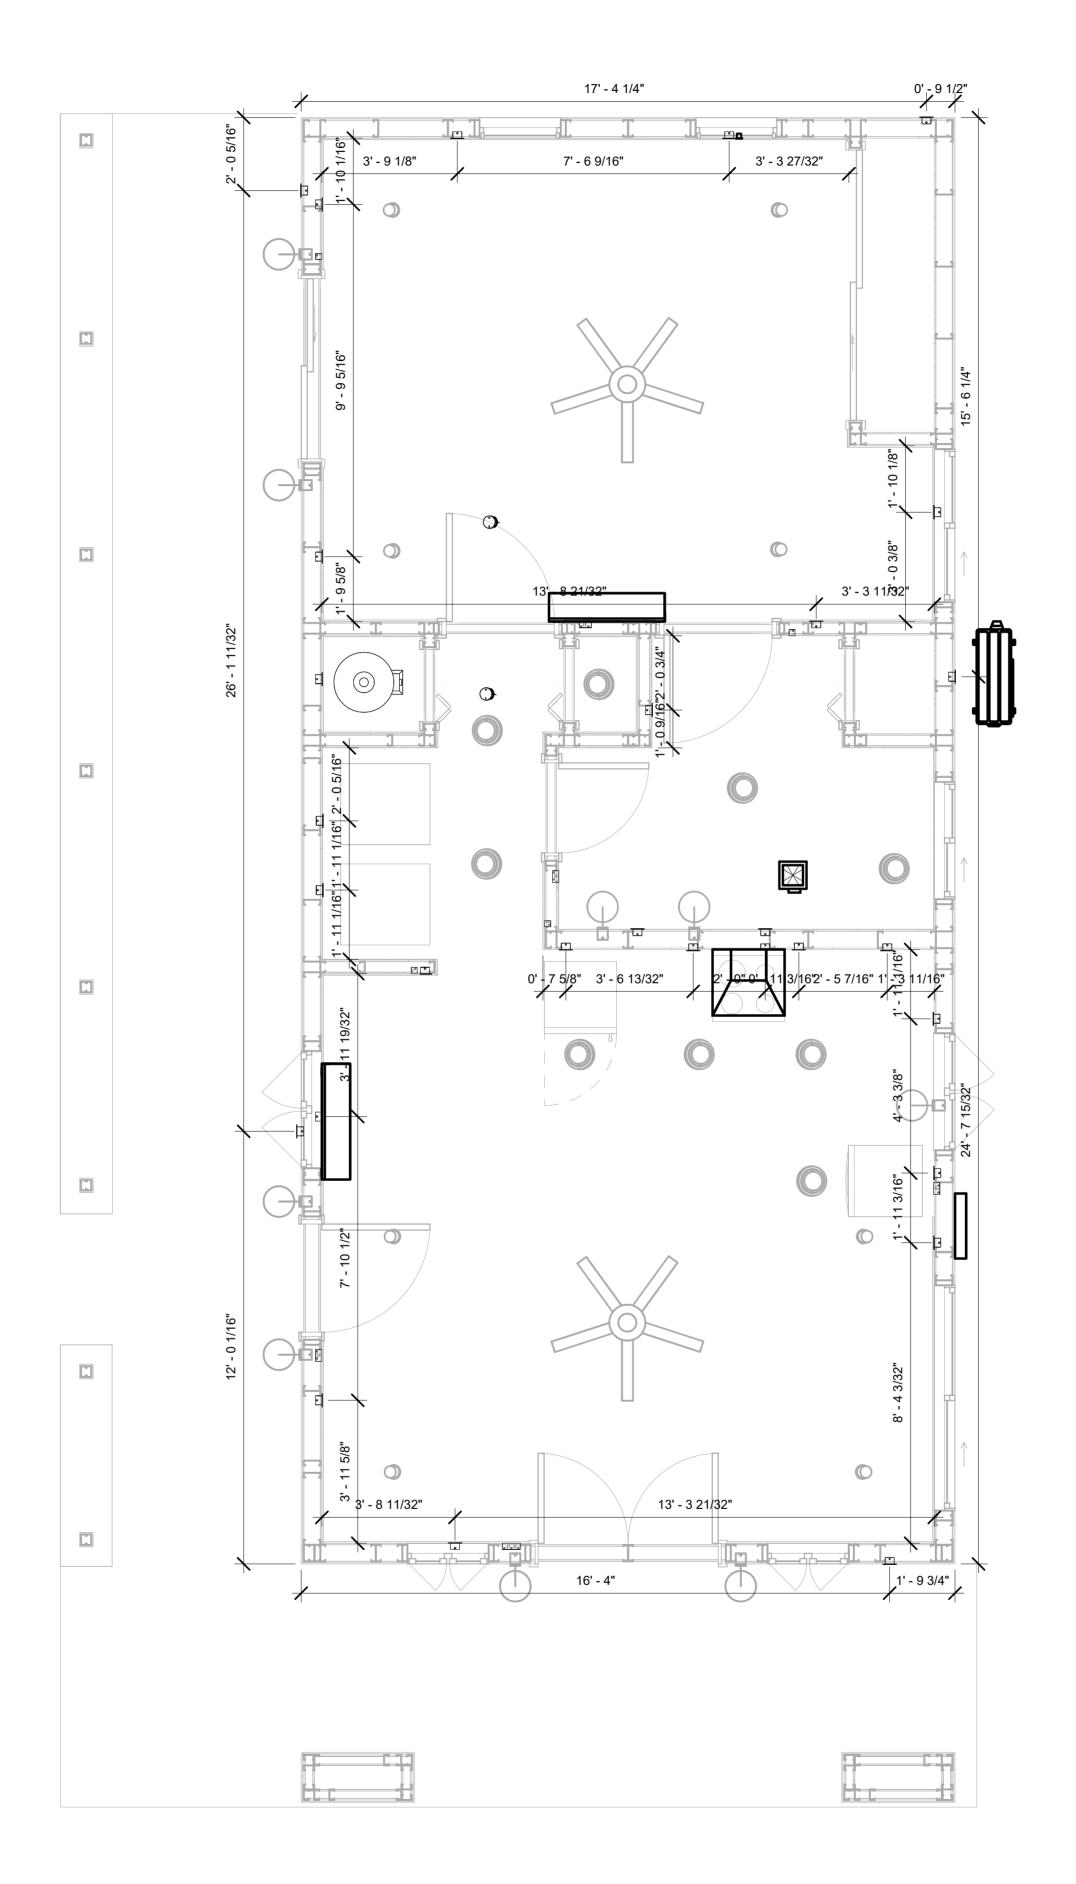

DIMENSION FOR FITTINGS
3/8" = 1'-0"



KEY PLAN

NO.	DESCRIPTION	DATE

NOTE:

LEGEND:

PROJECT

126-Orion-730-1Bd 1Ba-Spanish-Porch-550

DRAWING NAME

DIMENSION PLAN FOR FITTINGS

CLIENT NAME:	Owner
PROJECT NUMBER:	0361_12
DATE:	3/15/2025 4:27:50 PM
DESIGNED BY:	Designer
DRAWN BY:	Author
CHECKED BY:	Checker

E105

© [2024] [FrameUpNow] . All rights reserved

SHEET LIST

SHEET NUMBER SHEET NAME

P101 NOTE AND SCHEDULE
P102 WATER SUPPLY AND SEWAGE
SYSTEM

PIPE COLOR SCHEME

DOMESTIC COLD WATER
DOMESTIC HOT WATER
SANITARY VENT
SANITARY SEWER
STORM DRAINAGE

PLUMBING NOTES

- THE PLUMBING SYSTEM IS DESIGNED TO MEET THE BUILDING'S DOMESTIC WATER SUPPLY, SANITARY DRAINAGE, AND STORM DRAINAGE REQUIREMENTS, AS PER PROJECT SPECIFICATIONS AND APPLICABLE CODES.
- 2. THE SYSTEM INSTALLATION SHALL COMPLY WITH THE LATEST INTERNATIONAL PLUMBING CODE (IPC), INTERNATIONAL RESIDENTIAL CODE (IRC), AND ALL OTHER RELEVANT LOCAL, STATE, AND NATIONAL REGULATIONS.
- 3. ALL PLUMBING WORK SHALL COMPLY WITH THE LATEST EDITION OF THE INTERNATIONAL PLUMBING CODE (IPC) AND THE LOCAL PLUMBING CODE.
- 4. PLUMBING SYSTEMS SHALL BE TESTED AND INSPECTED IN ACCORDANCE WITH THE LOCAL PLUMBING CODE REQUIREMENTS.
- 5. PLUMBING FIXTURES SHALL BE INSTALLED WITH THE APPROPRIATE TRIM, FITTINGS, AND ACCESSORIES, AS RECOMMENDED BY THE MANUFACTURER.
- 6. PIPING SHALL BE PROPERLY SUPPORTED AND SECURED TO PREVENT SAGGING, MOVEMENT, AND VIBRATION.
- 7. SHUT-OFF VALVES SHALL BE PROVIDED AT ALL BRANCH CONNECTIONS AND AT THE INLET AND OUTLET OF EACH PIECE OF EQUIPMENT.
- 8. BACKFLOW PREVENTION DEVICES SHALL BE INSTALLED AS REQUIRED BY THE LOCAL
- PLUMBING CODE TO PROTECT THE POTABLE WATER SYSTEM.

 9. PLUMBING FIXTURES AND EQUIPMENT SHALL BE ACCESSIBLE FOR MAINTENANCE AND
- 10. EXPOSED PLUMBING PIPING AND FIXTURES SHALL BE INSULATED TO PREVENT CONDENSATION AND ENERGY LOSS.
- 11. DEAD ENDS IN THE DRAINAGE SYSTEM MUST BE AVOIDED, EXCEPT WHERE NECESSARY TO INSTALL A CLEANOUT IN AN ACCESSIBLE LOCATION, AND MUST HAVE A VENTED CONNECTION TO THE OUTSIDE ATMOSPHERE.
- 12. THE VERTICAL DEFLECTION OF PVC PIPE MUST NOT EXCEED 5%, AND NO DEFLECTION IS PERMITTED FOR IRON PIPE.
- 13. WORK MUST BE PROPERLY COORDINATED WITH OTHER TRADES TO AVOID CONFLICTS, REFERRING TO THE ARCHITECTURAL AND STRUCTURAL DRAWINGS FOR INFORMATION REGARDING CEILING ELEVATIONS, SPACE CLEARANCES, WALL AND PARTITION LOCATIONS, ETC.
- 14. ALL FIXTURES SHALL HAVE ACCESSIBLE STOPS.
- 15. DOMESTIC WATER PIPING SHALL BE PEX, AND PVC PIPING IS NOT ACCEPTABLE FOR INTERIOR USE.
- 16. VENT TERMINATIONS SHALL BE LOCATED AT LEAST 10 FEET FROM OR 3 FEET ABOVE ANY OPERABLE WINDOW, DOOR OPENING, AIR INTAKE, OR VENT SHAFT, AND AT LEAST 3 FEET IN EVERY DIRECTION FROM ANY LOT LINE, ALLEY, OR STREET.
- 17. PIPE AND FITTINGS UTILIZED IN THE WATER SUPPLY SYSTEM SHALL HAVE A MAXIMUM OF 8 PERCENT LEAD.
- 18. ACRYLONITRILE BUTADIENE STYRENE (ABS) SHALL BE USED FOR THE SEWERAGE AND
- VENTILATION SYSTEM.

 19. CROSS-LINKED POLYETHYLENE (PEX) SHALL BE USED FOR THE WATER SUPPLY SYSTEM.
- 20. POLYVINYL CHLORIDE (PVC) SHALL BE USED FOR THE RAIN WATER SYSTEM.
- 21. THE MIMIMUM WATER SUPPLY DEPTH UNDER FLOOR FINISH SHOUD BE 1/2".
- 22. ANY PIPE INSTALLED UNDERGROUND MUST HAVE AT LEAST 12 INCHES OF CLEARANCE BETWEEN THE OUTSIDE OF THE PIPE AND ANY OTHER UNDERGROUND STRUCTURE.
- 23. THE MINIMUM CLEARANCE BETWEEN COLD AND HOT WATER LINES IN RESIDENTIAL
- HOMES MAINTAIN A MINIMUM DISTANCE OF 6 INCHES.

 24. HORIZONTAL SEPARATION BETWEEN WATER AND SEWER LINES: A MINIMUM OF 12
- INCHES BETWEEN POTABLE WATER SUPPLY LINES (COLD AND HOT WATER) AND SANITARY SEWER LINES.

ABBREVIATIONS

α	DIAMETED
Ø	DIAMETER
ABS	ACRYLONITRILE BUTADIENE STYRENE
ABV	ABOVE
AD	AREA DRAIN
AFF	ABOVE FINISHED FLOOR
ALT	ALTERNATE
BFF	BELOW FINISHED FLOOR
BLW	BELOW
CO	CLEAN OUT
CW	COLD WATER
D	DEGREE
DFU	DRANAGE FIXTURE UNIT
DIA	DIAMETER
DN	DOWN
FCO	FLOOR CLEAN OUT
FD	FLOOR DRAIN
FL FL	FLOOR
FS	FLOOR SINK
FT FT	FOOT/FEET
HB	HOSE BIB
HW	HOT WATER
IN	INCH
MIN	MINIMUM
NO	NUMBER
NTS	NOT TO SCALE
PEX	CROSS-LINKED POLYETHYLENE
PLBG	PLUMBING
PVC	POLYVINYL CHLORIDE
QTY	QUANTITY
RD	ROOF DRAIN
RED	REDUCER
RM	ROOM
RW	RAIN WATER
SF	SQUARE FOOT
V	VENT
VTR	VENT THROUGH ROOF
W	WASTE
WCO	WALL CLEAN OUT
WSFU	WATER SUPPLY FIXTURE UNIT

PLUMBING LEGEND

D	CAP
	BEND 45 DEG
5	BEND 90 DEG
	TEE REDUCING
	TEE
	CLEAN TWO-WAY
	WYE 45 DEG
	WYE 45 DEG DOUBLE
	WYE COMBINATION
	P-TRAP

PIPE SCHEDULE					
MATERIAL	DIAMETER	LENGTH			
ACRYLONITRILE BUTADIENE STYRENE (ABS)	3/4"	0 FT			
ACRYLONITRILE BUTADIENE STYRENE (ABS)	1 1/2"	29 FT			
ACRYLONITRILE BUTADIENE STYRENE (ABS)	2"	42 FT			
ACRYLONITRILE BUTADIENE STYRENE (ABS)	3"	16 FT			
CROSS-LINKED POLYETHYLENE (PEX)	1/2"	88 FT			
CROSS-LINKED POLYETHYLENE (PEX)	3/4"	34 FT			
POLYVINYL CHLORIDE - RIGID	2"	106 FT			

FITTING SCHEDULE					
FITTING	SIZE	QTY			
	·	1			
ABS 90 DEGREE BEND ELBOW	1 1/2"ø-1 1/2"ø	1			
ABS 90 DEGREE BEND ELBOW	2"ø-2"ø	3			
ABS 90 DEGREE BEND ELBOW	3"ø-3"ø	1			
ABS P-TRAP	1 1/2"ø-1 1/2"ø	4			
ABS P-TRAP	2"ø-2"ø	1			
ABS REDUCER ELBOW	2"ø-1 1/2"ø	3			
ABS REDUCER ELBOW	3"ø-2"ø	1			
ABS TEE ELBOW	1 1/2"ø-1 1/2"ø-1 1/2"ø	2			
ABS TEE ELBOW	2"ø-2"ø-2"ø	2			
ABS TEE ELBOW	3"ø-3"ø-3"ø	1			
ABS TEE REDUCER ELBOW	2"ø-2"ø-2"ø	1			
ABS TEE REDUCER ELBOW	3"ø-3"ø-1 1/2"ø	1			
ABS TEE REDUCER ELBOW	3"ø-3"ø-2"ø	1			
ABS TEE REDUCER ELBOW	3"ø-3"ø-3"ø	1			
ABS TRAP P	2"ø-2"ø	1			
ABS VENT CAP ELBOW	1 1/2"ø	2			
ABS VENT CAP ELBOW	2"ø	2			
ABS VENT CAP ELBOW	3"ø	1			
ABS WASTE DOUBLE TEE	2"ø-2"ø-2"ø	1			
PEX 90 DEG ELBOW	1/2"ø-1/2"ø	4			
PEX 90 DEGREE ELBOW	1/2"ø-1/2"ø	24			
PEX 90 DEGREE ELBOW	3/4"ø-3/4"ø	5			
PEX TEE ELBOW	1/2"ø-1/2"ø	6			
PEX TEE ELBOW	3/4"ø-3/4"ø-3/4"ø	7			
PEX TRANSITION ELBOW	1"ø-3/4"ø	2			
PEX TRANSITION ELBOW	3/4"ø-1/2"ø	13			
PVC 90 DEG BEND ELBOW	2"ø-2"ø	15			
PVC 90 DEGREE BEND ELBOW	2"ø-2"ø	2			
PVC TEE ELBOW	2"ø-2"ø-2"ø	2			

WATER FIXTURE UNIT SCHEDULE									
FAMILY QTY UNIT VALUE TOTAL									
DISHWASHER	1	1.4	1.4						
SHOWER TRAY	1	1.4	1.4						
SHOWER TRIM	1	1.4	1.4						
SINK ISLAND SINGLE	1	1.4	1.4						
VANITY SINK	2	0.7	1.4						
WASHER	1		0						
WATER CLOSET	1	2.2	2.2						

WASTE FIXTURE UNIT SCHEDULE								
FAMILY QTY DFU VALUES TOTAL								
DISHWASHER	1	2	2					
SHOWER TRAY	1	2	2					
SINK ISLAND SINGLE	1	2	2					
VANITY SINK	2	1	2					
WASHER	1		0					
WATER CLOSET	1	3	3					

FIXTURE SCHEDULE								
FIXTURE QTY DESCRIPTION								
DISHWASHER	1							
DRYER	1							
SHOWER TRAY	1							
SHOWER TRIM	1							
SINK ISLAND SINGLE	1							
VANITY SINK	2							
WASHER	1							
WATER CLOSET	1							
WATER HEATER	1							

PLUMBING SCHEDULE							
FIXTURE	TRAP	WASTE	VENT	C.W	H.W		
DISHWASHER	1-1/2"	2"	1-1/2"	1/2"	1/2"		
DRYER	N/A	N/A	N/A	N/A	N/A		
SHOWER TRAY	1-1/2"	2"	N/A	1/2"	1/2"		
SHOWER TRIM	-	-	-	1/2"	1/2"		
SINK ISLAND SINGLE	1-1/2"	2"	1-1/2"	1/2"	1/2"		
VANITY SINK	1-1/2"	2"	1-1/2"	1/2"	1/2"		
WASHER	2"	2"	1-1/2"	1/2"	1/2"		
WATER CLOSET	3"	3"	2"	1/2"	1/2"		
WATER HEATER	N/A	N/A	N/A	3/4"	3/4"		

ACCESSORIES & FITTINGS SCHEDULE							
FIXTURE QTY DESCRIPTIONS							
HANGING PIPES CLAMP	12						
HOSE BIB	1						
LAUNDRY SWEAT CONNECTOR 2							
SHUTOFF VALVE	8						



KEY PLAN

NO.	DESCRIPTION	DATE

NOTE:

LEGEND:

PROJECT

126-Orion-730-1Bd/1Ba Spanish-Porch-550

DRAWING NAME


NOTE AND SCHEDULE

CLIENT NAME:


PROJECT NUMBER:	0361_12
DATE:	3/18/2025 9:26:48 AM
DESIGNED BY:	Designer
DRAWN BY:	Author
CHECKED BY:	Checker

P101

SCALE: 1/2" = 1'-0"

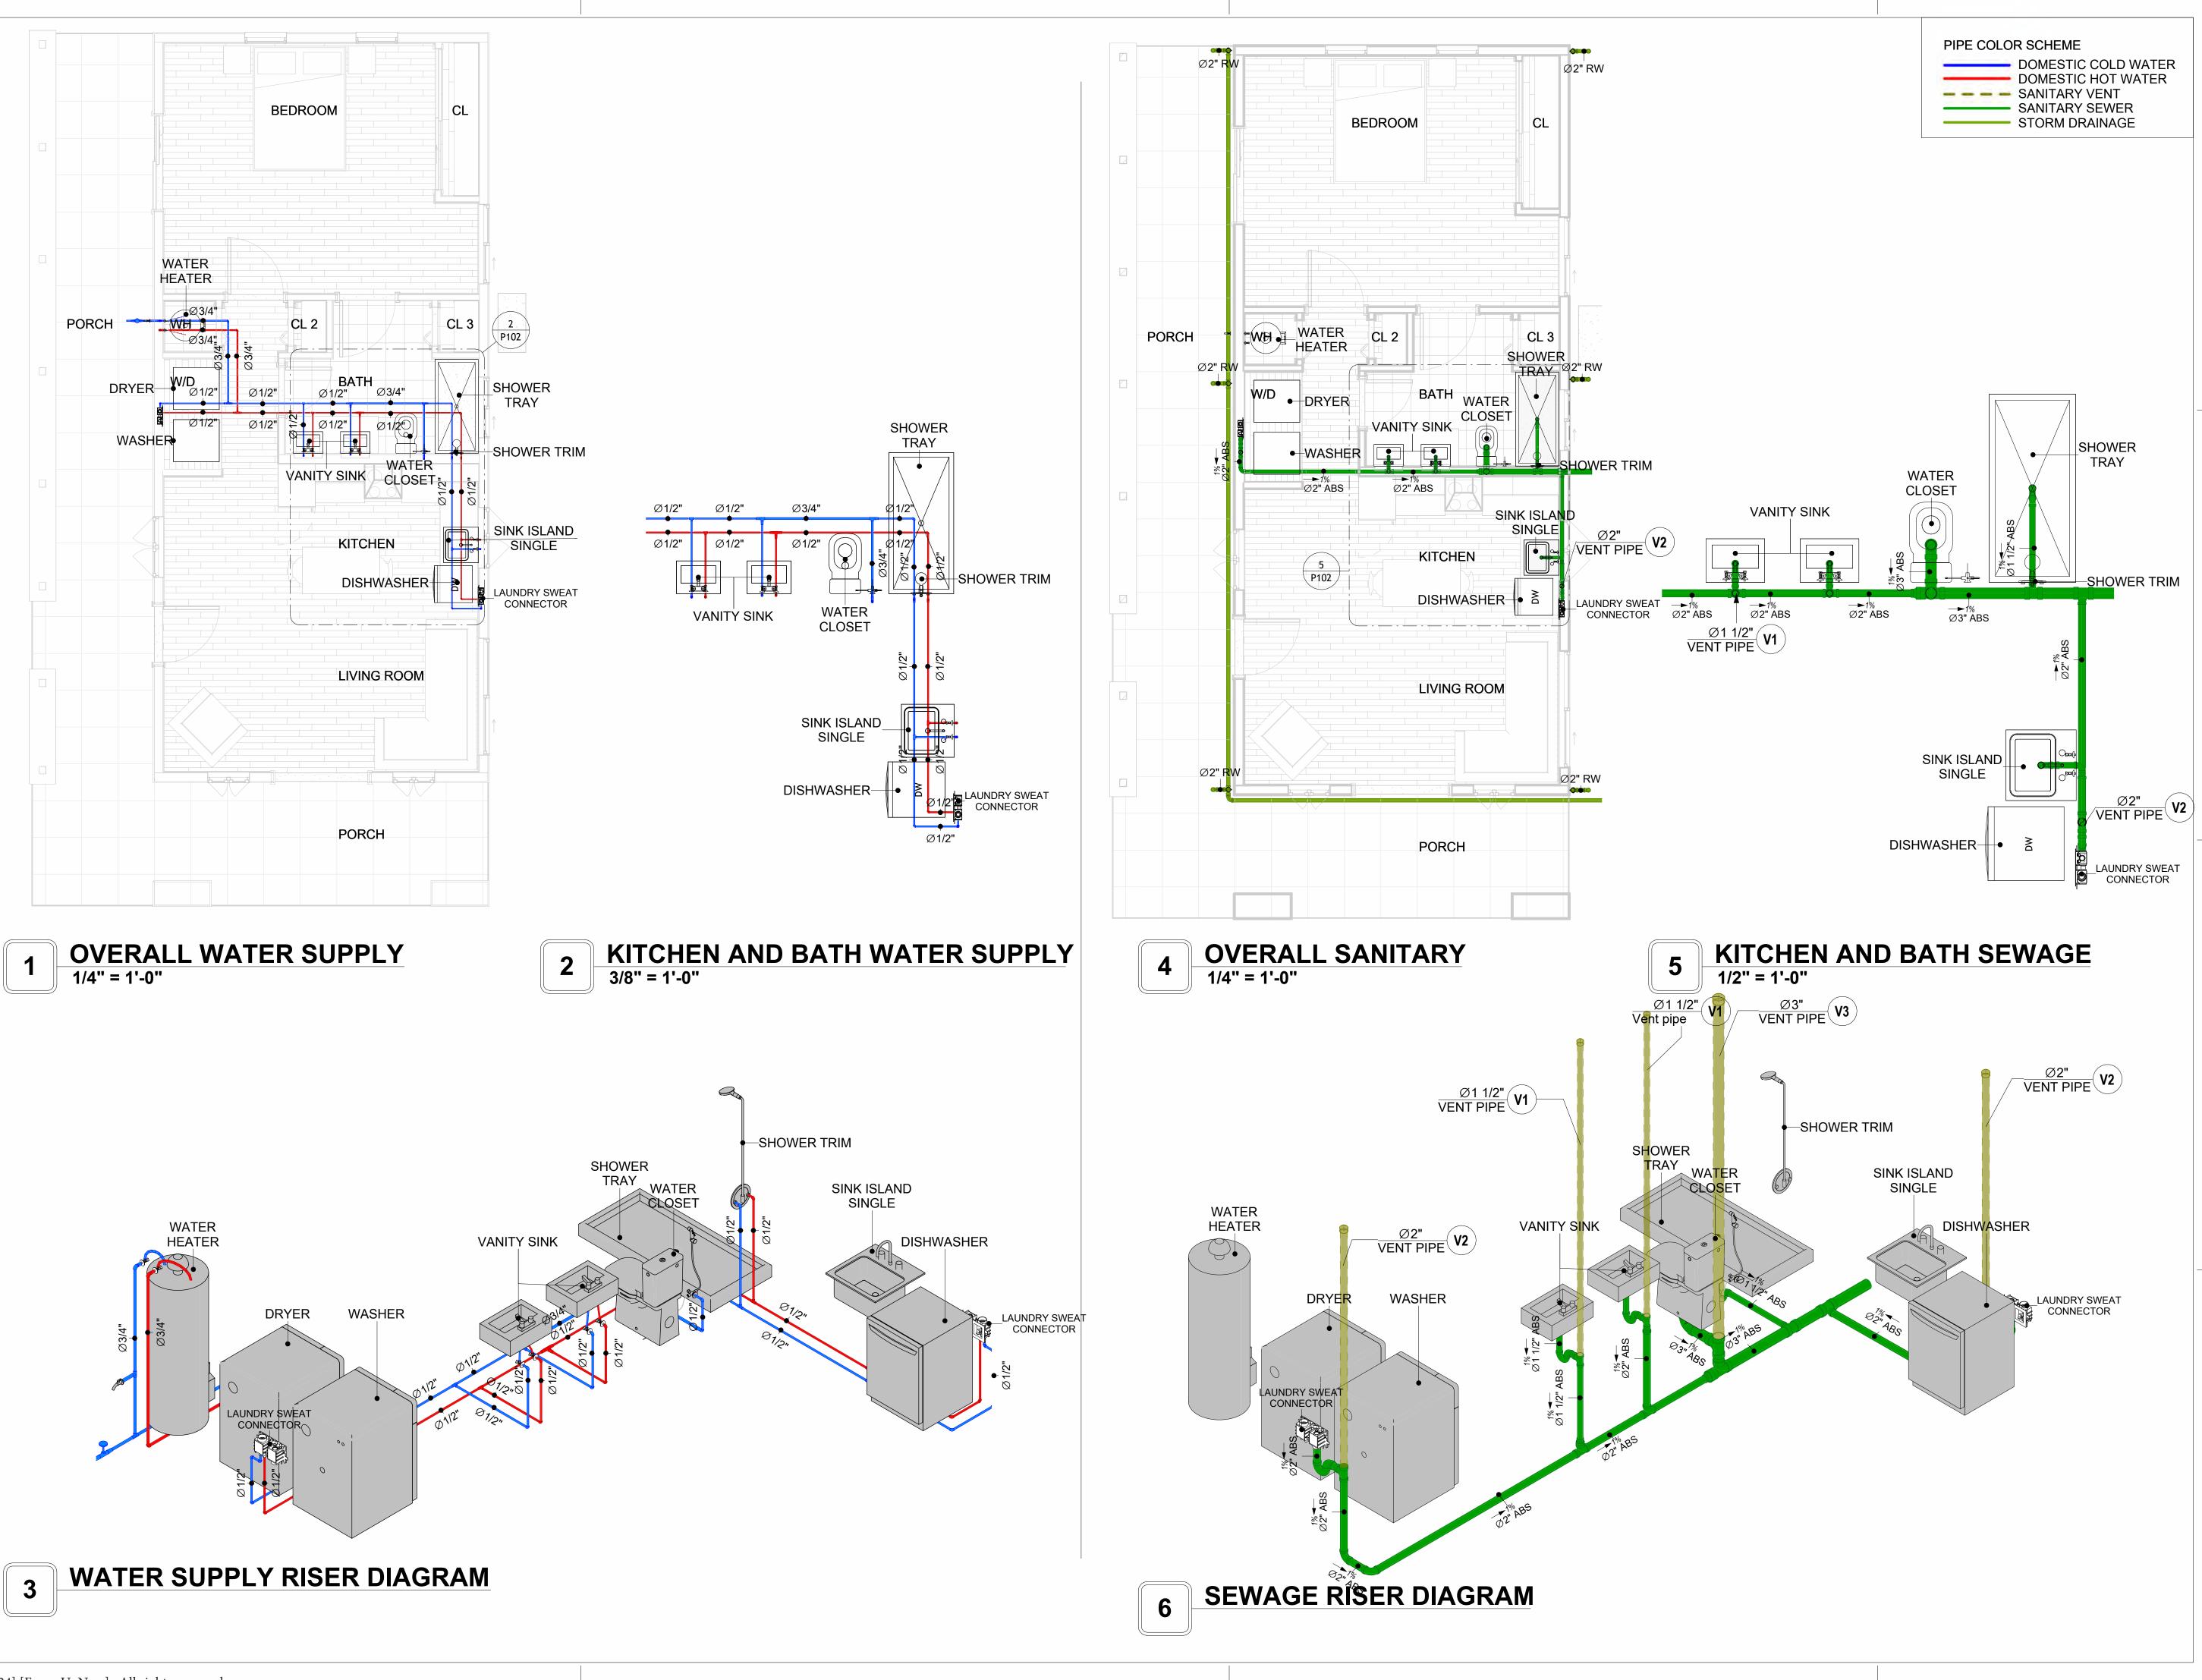



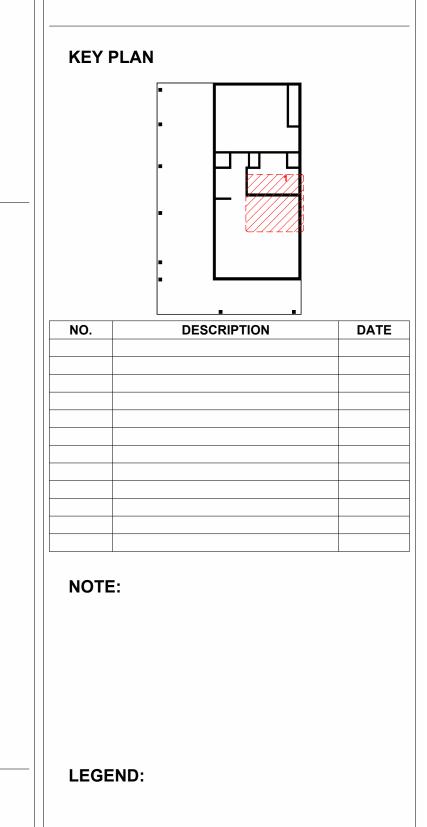

126-Orion-730-1Bd/1Ba Spanish-Porch-550

DRAWING NAME

WATER SUPPLY AND SEWAGE SYSTEM

CLIENT NAME:	
PROJECT NUMBER:	0361_12
DATE:	3/18/2025 9:27:44 AM
DESIGNED BY:	Designer
DRAWN BY:	Author
CHECKED BY:	Checker

Materials Shopping List

Please print and take this Materials Shopping List to your favorite Home Depot and ask for assistance in selecting the materials, fixtures and fittings to complete your new home.

Record your selection and the price of the item. Then do the math to determine the cost for your selections and the total cost of finishing your home.

Have It Your Way!

The material types listed in this document were selected based on personal preferences. The Customer is encouraged to make changes to the material types in accordance with local customs, regulations, and personal preferences.

Have It Your Way!



20 good reasons to frame a home with metal and not wood



Why build your ADU with metal vs wood	Wood	Metal	Explanation
1 DIY Construction Benefit		~	The wall frames, trusses and beams can be erected in a just a few days
2 Minimal Construction Skills Required		~	Pre-assembled walls and trusses require no specialized skills to errect
3 Build as DIY, Hybrid or by a General Contractor		~	Do it yourself, Hybrid (involve special contractors) or hire a General Contractor
4 Build It As You Can Afford It		~	Impervious to Weather - build as you have the time and money
5 Up Front Cost of Framing Materials	~		As to only the framing material, wood is less expensive
6 Total Cost To Build		~	Savings in time, labor, and other areas make light gauge steel LESS expensive
7 Termites and wood boring insects		~	Termites, carpenter ants and wood boring insects eat wood, not metal
8 Mold resistant		~	Metal does not attract mold
9 Damage caused by exterior and interior flooding		~	Metal needs no reconditioning after a flood
10 Fire Resistant		~	Non-combustible
11 Lower insurance rates		~	Many insurance underwriters now provide lower rates for metal framed homes
12 Walls, trusses, and beams retain their original form		~	Perfectly straight walls - no shimming of drywall
13 Corners are 90 degrees		~	No need for templating of countertops to adjust for out of square corners
14 Strength and weight		~	Metal is stronger than wood and weighs less - no need for crane to lift ADU trusses
15 IBC Engineered Stamp		~	If an engineering stamp is necessary, months of waiting are saved
16 Complete BOM (Materials Shopping List)		~	Take the materials shopping list to Home Depot and start shopping/pricing
17 Flexible in Seismic Areas - Won't Fracture		~	Light gauge steel is flexible and won't fracture when the earth moves
18 No Waste At Job Site		~	Steel is the most recycled material in the world. A typical wood home has 20-30% waste
19 Environmentally Friendly		~	Trees don't have to be destroyed and the source of most metal is from recycling
20 How-To Videos Included		~	How-to videos provide simple assembly instructions
21 Relationship Counselor		~	Eliminate emotional uphevels - save time, money, and preserve the relationship

Universal Requirements - some or all may be required

- 1 Site plan
- 2 Electrical Supply Connection
- 3 Sewer Connection
- 4 Fresh Water Supply Connection
- 5 Set Backs
- 6 Soils Evaluation

- 7 Earthquake (fault) evaluation
- 8 Foundation Plan subject to soils
- 9 Compliance with local energy codes: insulation home wrap and flashing
- 10 Engineering for wind speed and snow load.
- 11 State and Local ordinances regarding ADUs
- 12 Local Architect and/or Engineer may be necessary

Orion-1Bd 1Ba-Spanish-Porch





Orion-1Bd 1Ba-Spanish-Porch MATERIAL SHOPPING LIST

Have It Your Way!

The material types listed in this document were selected based on personal preferences. The Customer is encouraged to make changes to the material types in accordance with local customs, regulations, and personal preferences. Have It Your Way!

TOC



15

Name Link Page No 1 Cover Page Cover Page 2 TOC TOC 2 3 ELECTRICAL BOM **ELECTRICAL BOM** 3 5 HVAC BOM **HVAC BOM** 7 PLUMBING BOM 4 PLUMBING BOM 10 ARCHITECTURAL BOM

Table Of Content

Have It Your Way!

The material types listed in this document were selected based on personal preferences. The Customer is encouraged to make changes to the material types in accordance with local customs, regulations, and personal preferences. Have It Your Way!

GENERAL NOTES

6 ARCHITECTURAL BOM

- 1 This BOM (Bill of Materials) is prepared as a Materials Shopping List to help builders and DIYers gain a complete understanding of most if not all elements required for the complete construction of this structure, according to the original design documents provided by FrameUpNow.
- 2 All quantities and specifications are subject to change based on the final design, field measurements, availability of products and customer preferences. The customer should verify all information prior to purchasing materials.
- 3 All products and elements in the list shall conform to the International Residential Code (IRC), or any other local and international building codes, safety regulations, and standards that are applicable to the location of the structure.
- 4 If any changes are made by the customer to the list of materials specified in this document, the customer is responsible for assuring that the correct type and quantity of materials are utilized in accordance with local building
- 5 FrameUpNow, will not be held responsible for any misuse of this document, the products listed, or for deviations from the content that are made due to changes in specifications, pricing, availability, or customer preferences.
- 6 The customer is advised to consult a qualified professional or technician prior to purchasing materials for specialized construction system items. Some items including but not limited to caseworks, doors and windows may require as built measurements prior to purchase to confirmation of final dimensions.
- If there are additional trim elements or specific installation methods, the total amount of materials needed might vary. Consider any additional trim required for corners, intersections, or other architectural details that might cause this variations before procedding to purchase and construction.

ARCHITECTURAL BOM



	Orion-1Bd 1Ba-Spanish-Porch						
		ARCHITECTI					
Vo.	Item	Туре	Unit	Quantity	Unit Price	Total	Description
Δ	APPLIANCES						
1	Refrigerator		PCS	1			
2	Range		PCS	1			
3	Washer		PCS	1			
4	Dryer		PCS	1			
5	Dish Washer		PCS	1			
6	Oven		PCS	0			
7	Microwave		PCS	0			
Δ	CASEWORKS						
1	Kitchen Cabinet		FT	16.16			
2	Laundry Cabinet		FT	0			
3	Vanity Cabinet		FT	5			
4	Medicine Cabinet		PCS	2			
5	Kitchen countertop		SF	25.32			
6	Laundry Countertop		PCS	0			
7	Bathroom Countertop		SF	0			
8	Island		FT	0			
9	Peninsula		FT	0			
10	Closets		SF	81.96			
Δ	CEILING		1.	1			
1	Ceiling Board	Dry Wall	SF	889.54			
2	Dry Wall Fastener	Screw	PCS	1556.695			
3	Vapor Retarder	Polyethylene film	SF	1026.19			
4	Vapor Retarder Fastener	Nails with washer heads	PCS	3078.57			
5	Ceiling Board (MRD)	Moisture resistant drywall	SF	43.93			
6	MRD Fastener	Moisture resistant drywan	PCS	76.8775			
7	Ceiling Board	Marine Plywood	SF	92.72			
8	Marine Plywood Fastener	Screw	PCS	162.26			
9	Dry Wall Tape	Suew	FT	513.095			
	FLOORING		FI	313.093			
<u>0</u> 1	Main Living Space		SF	314.31			
2	Bathroom		SF	92.2			
3			SF	227.51			
_	Bedroom		SF				
4	Porch		SF	407.74			
<u>_</u>	STRUCTURE		CE	1107.70			
1	Foundation		SF	1127.72			
1	WALLS EXTERIOR		SF	1001			
1	Exterior-Grade Plywood			1221			
2	Wall Shteathing (OSB)	Call delling and (400/11)	SF	1221			
3	Shteathing Fastener	Self-drilling screws(100/pkt)	PKT	12.21			
4	Wall Homewrap	0. 1.16 1. (2221.12)	SF	1221			
5	Homewrap Fastener	Stapled fastener (200/pkt)	PKT	4.6398			
6	Wall Paint		SF	1221			
7	Stone Copping	Masonry stone	SF	119			
8	Stone Veneer	Masonry stone	SF	0			
9	Mortar for Stone Veneer		SF	0			
10	Wall Insulation		SF	2696			
Δ	WALLS INTERIOR						
1	Cementitious Backer Board		SF	419			
2	Kerdi membrane		SF	419			
3	Kerdi membrane Fastener		SF	419			
4	Wall Ceramic Tile		SF	419			
5	Drywall Board		SF	1266			
6	Drywall Fastener	Self-drilling screws(100/pkt)	PKT	12.66			
7	Wall Paint		SF	1266			
8	Drywall Tape		FT	238			
9	Wall Sweep		FT	123			

ARCHITECTURAL BOM



Δ	DOORS				
1	Interior Swinging	3' - 0" X 6'-8"	PCS	2	
2	Interior Swinging	2' - 6" X 6'-8"	PCS	1	
3	Exterior Swinging	5' - 0" X 6'-8"	PCS	1	
4	Exterior Sliding	5' - 0" X 6'-8"	PCS	1	
5	Exterior Swinging	3' - 0" X 6'-8"	PCS	1	
6	Interior Sliding	7' - 6" X 6'-8"	PCS	1	
7	Folding	2' - 0" X 6'-8"	PCS	3	
8	Exterior Door Trim	ZONOO	FT	53	
9	Interior Door Trim		FT	284	
	Entry Lock set			3	
11	Privacy Lock set			3	
12	Passage Lock set			4	
	WINDOWS				
1	Sliding	3' - 3" X 1'-9"	PCS	1	
2	Casement	2' - 3" X 4'-3"	PCS	2	
3	Casement	3' - 3" X 3'-3"	PCS	2	
4	Awning	2' - 3" X 2'-3"	PCS	2	
5	Sliding	4' - 3" X 3'-3"	PCS	1	
6	Sliding	6' - 3" X 4'-3"	PCS	1	
7	Exterior Window Trim		FT	118	
8	Interior Window Trim		FT	118	
Δ	ROOF				
1	Roof Covering		SF	1286	
2	Roof Covering Fastener		PCS	643	
3	Roof Felt Paper		SF	1286	
4	Roof Felt Paper Fastener		PCS	3858	
5	Roof Sheathing		SF	1286	
6	Roof Sheathing Fastener		PCS	10288	
7	Batten		FT	0	
8	Batten Fastener		PCS	0	
9	Soffit		SF	145	
10	Soffit Fastener		PCS	72.5	
11	Fascia		FT	215	
12	Fascia board fastener		PCS	107.5	
13	Roof Insulation		SF	1286	



	Orio	n-1Bd 1Ba-Spanish	-Porch		
	ELECTRIC	AL MATERIAL SHO	OPPING LIS	Т	
No.	Item	Type		Quantity	Description
Δ	LIGHTING FIXTURES				
1	Kitchen Ceiling Light		PCS	4	
2	Kitchen Wall Mounted Light		PCS	1	
	Exterior Wall Mounted Light		PCS	6	
4	Livingroom Ceiling Light With Fan		PCS	1	
5	Bedroom Ceiling Light With Fan		PCS	1	
6	Dining Ceiling Light		PCS	0	
7	Bath Wall Mounted Light		PCS	2	
8	Bathroom Ceiling Light		PCS	1	
9	Livingroom Ceiling Light		PCS	4	
	Bedroom Ceiling Light		PCS	4	
	Hall & Entry Ceiling Light		PCS	2	
	Closet Ceiling Light		PCS	1	
	Smoke Detector		PCS	2	
	ELECTRICAL FITTINGS		1 00		
	Standard Receptacle 120V	20A	PCS	11	
	·	20 A			
	GFCI Receptacle 120V	30 A	PCS	14	
16		40 A	PCS	2	
17			PCS	1	
18		60 A	PCS	1	
	Fan Switch		PCS	1	
	Single Pole Switch		PCS	6	
	Three Way Switch		PCS	8	
	Dimmer Switch		PCS	2	
	ELECTRICAL CONDUITS & WIRING				
	ROMEX 14 AWG	14/3/W/ground	FT	156	
	ROMEX 12 AWG	12/3/W/ground	FT	295	
	ROMEX 12 AWG	12/2/W/ground	FT	0	
	ROMEX 10 AWG	10/3/W/ground	FT	0	
	ROMEX 10 AWG	10/2/W/ground	FT	83	
28	Romex 8 AWG	8/3/W/ground	FT	0	
29	Romex 8 AWG	8/2/W/ground	FT	22	
30	ROMEX 6 AWG	6/3/W/ground	FT	24	
31	Bare Copper Ground Wire 6 AWG		FT	0	
Δ	ELECTRICAL BOXES & CIRCUTES			-	
32	Panelboard -240V 1 Phase MLO	200 AMP	PCS	1	
	Circuit breaker	15 A	PCS	4	
	Circuit breaker	20 A	PCS	9	
	Circuit breaker	30 A	PCS	2	
	Circuit breaker	40 A	PCS	1	
	Circuit breaker	60 A	PCS	1	
	Single Gang Switch Box	3071	PCS	4	
	Double Gang Switch Box		PCS	4	
	Triple Gang Switch Box		PCS	1	
	Pull Box	#1/4	PCS	21	
	Receptacle Box	π 114	PCS	29	
43	inductions but		103	23	

PLUMBING BOM



Orion-1Bd 1Ba-Spanish-Porch PLUMBING SYSTEM MATERIAL SHOPPING LIST

	P	LUMBING SYSTEM M	aterial	. Shoppii	ig list		
No.	Item	Туре	Unit	Quantity	Unit Price	Total	Description
Δ	PLUMBING FIXTURES & ACCESSORIES			, ,			
1	Bath Tub (Alcove Tub)		PCS	0			
2	Kitchen Sink		PCS	1			
3	Kitchen Faucets		PCS	1			
4	Vanity Sink		PCS	2			
5	Bath room Faucets		PCS	2			
6	Water Closet		PCS	1			
7	Shower Trim		PCS	1			
8	Shower Tray		PCS	1			
9	Water Heater		PCS	1			
	Hose Bib		PCS	1			
11	Shutoff Valve		PCS	8			
_	Hanging pipe clamp		PCS	19			
	Gate Valve		PCS	1			
	Dishwasher Supply Single Connector		PCS	1			
			PCS				
	Dishwasher Sewage Single Connector		PCS	1			
	Laundry Sweat Connector		PC2	1			
	SANITARY & PLUMBING PIPES ARE (Applications Plumbing Pipes) Pipes	α 1"	Гт				
	ABS (Acrylonitrile Butadiene Styrene) Pipes	Ø 1"	FT	0			
2	ABS (Acrylonitrile Butadiene Styrene) Pipes	ø 1 1/2"	FT	29			
3	ABS (Acrylonitrile Butadiene Styrene) Pipes	ø 2"	FT	42			
4	ABS (Acrylonitrile Butadiene Styrene) Pipes	ø 3"	FT	16			
5	PEX (Cross-linked polyethylene) Pipes	ø 1/2"	FT	88			
6	PEX (Cross-linked polyethylene) Pipes	ø 3/4"	FT	34			
7	PEX (Cross-linked polyethylene) Pipes	ø 1"	FT	47			
8	PVC Pipes Sch.80 - Rigid	ø 1 1/2"	FT	0			
9	PVC Pipes Sch.80 - Rigid	ø 2"	FT	0			
10	PVC Pipes Sch.80 - Rigid	ø 3"	FT	0			
11	Flex Pipe Round	ø 1/2"	PCS	0			
Δ	PIPE FITTINGS						
1	ABS 90 Degree Bend Elbow	1 1/2"ø-1 1/2"ø	PCS	2			
2	ABS 90 Degree Bend Elbow	2"ø-2"ø	PCS	3			
3	ABS 90 Degree Bend Elbow	3"ø-3"ø	PCS	2			
4	ABS P-Trap	1 1/2"ø-1 1/2"ø	PCS	3			
5	ABS P-Trap	2"ø-2"ø	PCS	2			
6	ABS Reducer Elbow	2"ø-1 1/2"ø	PCS	1			
7	ABS Reducer Elbow	3"ø-1 1/2"ø	PCS	1			
8	ABS Reducer Elbow	3"ø-2"ø	PCS	1			
9	ABS TEE Elbow	2"ø-2"ø-2"ø	PCS	1			
	ABS TEE Elbow	3"ø-3"ø-3"ø	PCS	2			
	ABS Tee Reducer Elbow	3"ø-3"ø-1 1/2"ø	PCS	2			
	ABS Tee Reducer Elbow	3"ø-3"ø-2"ø	PCS	1			
	ABS Trap P	1 1/2"ø-1 1/2"ø	PCS	2			
	ABS Vent Cap Elbow						
		1 1/2"ø	PCS	1			
	ABS Vent Cap Elbow	2"ø	PCS	2			
	ABS Vent Cap Elbow	3"Ø	PCS	1			
	PEX 90 Degree Elbow	1/2"ø-1/2"ø	PCS	19			
	PEX 90 Degree Elbow	3/4"ø-3/4"ø	PCS	15			
	PEX Tee Elbow	1/2"ø-1/2"ø-1/2"ø	PCS	8			
	PEX Tee Elbow	3/4"ø-3/4"ø-3/4"ø	PCS	6			
_	PEX Transition Elbow	3/4"ø-1/2"ø	PCS	6			
	PVC 90 Deg Bend Elbow	2"ø-2"ø	PCS	30			
_	WASTE DOUBLE TEE	1 1/2"ø-1 1/2"ø-1 1/2"ø-1	PCS	1			
	WASTE DOUBLE TEE	2"ø-2"ø-2"ø	PCS	1			
25	WASTE DOUBLE TEE	3"ø-3"ø-3"ø-3"ø	PCS	1			



		Orion-1Bd 1E	3a-Spa	nish-Por	ch		
		HVAC SYSTEM MA	TERIAL	SHOPP	ING LIST		
No.	Item	Туре	Unit	Quantity	Unit Price	Total	Description
	HVAC_DUCTS						
1	PIPE (REFRIGERANT LINE)	3/8" (Ø)	FT	55.72			
2	PIPE (REFRIGERANT LINE)	3/4''' (Ø)	FT	77.94			
3	DRAYER HOSE	4" (Ø)	FT	7.3			
4	FLEX DUCT ROUND	4" (Ø)	FT	5.2			
	DUCT FITTINGS & ACCESSORIES						
5	ELBOW (REFRIGERANT LINE)	3/4" (Ø)-3/4" (Ø)	PCS	23			
6	ELBOW (REFRIGERANT LINE)	3/8" (Ø)-3/8" (Ø)	PCS	17			
7	TEE (REFRIGERANT LINE)	3/4" (Ø)-3/4" (Ø)-3/4" (Ø)	PCS	1			
8	TEE (REFRIGERANT LINE)	3/8" (Ø)-3/8" (Ø))-3/8" (Ø)	PCS	1			
9	TRANSITION (REFRIGERANT	3/4" (Ø)-1/2" (Ø)	PCS	3			
10	TRANSITION (REFRIGERANT	3/4" (Ø)-5/8" (Ø)	PCS	2			
11	TRANSITION (REFRIGERANT	3/8" (Ø)-1/4" (Ø)	PCS	1			
Δ	HVAC_EQUIPMENTS						
12	AIR HANDLING UNIT	WALL MOUNTED	PCS	2			
13	CONDENSER	OUTDOOR UNIT	PCS	1			
14	EXHAUST FAN	75 CFM	PCS	1			
15	EXHAUST HOOD	WALL MOUNTED	PCS	1			
16	HOOD-WALL: VENT	HOOD-WALL: VENT	PCS	1			
17	DRAYER: VENT	DRAYER: VENT	PCS	1			
18	ROOF VENT	3"(Ø)	PCS	1			



Table Of Content

#	Name	Link	Page No
1	Cover Page	<u>Cover Page</u>	1
2	TOC	TOC	2
3	ELECTRICAL BOM	ELECTRICAL BOM	3
5	HVAC BOM	HVAC BOM	7
4	PLUMBING BOM	PLUMBING BOM	10
6	ARCHITECTURAL BOM	ARCHITECTURAL BOM_	15

Have It Your Way!

The material types listed in this document were selected based on personal preferences. The Customer is encouraged to make changes to the material types in accordance with local customs, regulations, and personal preferences. Have It Your Way!

GENERAL NOTES

- This BOM (Bill of Materials) is prepared as a Materials Shopping List to help builders and DIYers gain a complete understanding of most if not all elements required for the complete construction of this structure, according to the original design documents provided by FrameUpNow.
- 2 All quantities and specifications are subject to change based on the final design, field measurements, availability of products and customer preferences. The customer should verify all information prior to purchasing materials.
- 3 All products and elements in the list shall conform to the International Residential Code (IRC), or any other local and international building codes, safety regulations, and standards that are applicable to the location of the structure.
- 4 If any changes are made by the customer to the list of materials specified in this document, the customer is responsible for assuring that the correct type and quantity of materials are utilized in accordance with local building codes.
- FrameUpNow, will not be held responsible for any misuse of this document, the products listed, or for deviations from the content that are made due to changes in specifications, pricing, availability, or customer preferences.
- The customer is advised to consult a qualified professional or technician prior to purchasing materials for specialized construction system items. Some items including but not limited to caseworks, doors and windows may require as built measurements prior to purchase to confirmation of final dimensions.
- 7 If there are additional trim elements or specific installation methods, the total amount of materials needed might vary. Consider any additional trim required for corners, intersections, or other architectural details that might cause this variations before procedding to purchase and construction.



			LIGHTING FIXTURES				
#	Item	Туре	Description, Manufacturer, SKU	Unit	Quantity	Unit Price	Total
1	Kitchen Ceiling Light			PCS	4		
3	Kitchen Wall Mounted Light			PCS	1		
4	Exterior Wall Mounted Light			PCS	6		
5	Livingroom Ceiling Light With Fan			PCS	1		
6	Bedroom Ceiling Light With Fan			PCS	1		
7	Dining Ceiling Light			PCS	0		
8	Bath Wall Mounted Light			PCS	2		
9	Bathroom Ceiling Light			PCS	1		
10	Livingroom Ceiling Light			PCS	4		
11	Bedroom Ceiling Light			PCS	4		
12	Hall & Entry Ceiling Light			PCS	2		
12	Closet Ceiling Light			PCS	1		
13	Smoke Detector			PCS	2		
14							
15							



			ELECTRICAL FITTINGS				
#	Item	Туре	Description, Manufacturer, SKU	Unit	Quantity	Unit Price	Total
1	Standard Receptacle 120V	20A		PCS	11		
2	GFCI Receptacle 120V	20 A		PCS	14		
3	GFCI Receptacle 240V	30 A		PCS	2		
1	GFCI Receptacle 240V	50 A		PCS	1		
5	GFCI Receptacle 240V	60 A		PCS	1		
5	Fan Switch			PCS	1		
7	Single Pole Switch			PCS	6		
3	Three Way Switch			PCS	8		
9	Dimmer Switch			PCS	2		
.0							
.1							
.2							
.3							
L4							
L5							



		ELECTR	ICAL CONDUITS & WIRING				
#	Item	Туре	Description, Manufacturer, SKU	Unit	Quantity U	Jnit Price	Total
1	ROMEX 14 AWG	14/3/W/ground		FT	156		
3	ROMEX 12 AWG	12/3/W/ground		FT	295		
4	ROMEX 12 AWG	12/2/W/ground		FT	0		
6	ROMEX 10 AWG	10/3/W/ground		FT	0		
8	ROMEX 10 AWG	10/2/W/ground		FT	83		
9	Romex 8 AWG	8/3/W/ground		FT	0		
10	Romex 8 AWG	8/2/W/ground		FT	22		
11	ROMEX 6 AWG	6/2/W/ground		FT	24		
12	Bare Copper Ground Wire 6 AWG			FT			
13							
14							
15							
16							



		ELEC	CTRICAL BOXES & CIRCUTES				
#	Item	Туре	Description, Manufacturer, SKU	Unit	Quantity	Unit Price	Total
1	Panelboard -240V 1 Phase MLO	200 AMP		PCS	1		
)	Circuit breaker	15 A		PCS	4		
}	Circuit breaker	20 A		PCS	9		
l	Circuit breaker	30 A		PCS	2		
5	Circuit breaker	40 A		PCS	1		
5	Circuit breaker	60 A		PCS	1		
7	Single Gang Switch Box			PCS	4		
3	Double Gang Switch Box			PCS	4		
)	Triple Gang Switch Box			PCS	1		
LO	Pull Box	#1/4		PCS	21		
l1	Receptacle Box			PCS	29		
12							
13							
14							
15							



			HVAC_DUCTS 01				
#	Item	Туре	Description, Manufacturer, SKU	Unit	Quantity	Unit Price	Total
1	PIPE (REFRIGERANT LINE)			FT	55.72		
2	PIPE (REFRIGERANT LINE)			FT	77.94		
3	DRAYER HOSE	4" (Ø)		FT	7.3		
4	FLEX DUCT ROUND	4" (Ø)		FT	5.2		



			DUCT FITTINGS & ACCESSORIES				
:	Item	Туре	Description, Manufacturer, SKU	Unit	Quantity	Unit Price	Total
	ELBOW (REFRIGERANT	3/4" (Ø)-3/4" (Ø)			23		
	LINE)			PCS			
	ELBOW (REFRIGERANT	3/8" (Ø)-3/8" (Ø)		PCS	17		
	LINE) TEE (REFRIGERANT LINE)	2/4" (@) 2/4" (@) 2/4" (@)		PUS	1		
	TEE (REFRIGERAINT LINE)	314 (12)-314 (12)-314 (12)		PCS	'		
	TEE (REFRIGERANT LINE)	3/8" (Ø)-3/8" (Ø))-3/8" (Ø)			1		
	,			PCS			
	TRANSITION	3/4" (Ø)-1/2" (Ø)			3		
	(REFRIGERANT LINE)			PCS			
	TRANSITION	3/4" (Ø)-5/8" (Ø)		DCC	2		
	(REFRIGERANT LINE)	0.0011 (00) 4.1411 (00)		PCS	1		
	TRANSITION (DEEDICE DANT LINE)	3/8" (Ø)-1/4" (Ø)		PCS	1		
	(REFRIGERANT LINE)			F C S			
					+		



			HVAC_EQUIPMENTS				
#	Item	Туре	Description, Manufacturer, SKU	Unit	Quantity	Unit Price	Total
L	AIR HANDLING UNIT	WALL MOUNTED		PCS	2		
	CONDENSER	OUTDOOR UNIT		PCS	1		
	EXHAUST FAN	75 CFM		PCS	1		
l	EXHAUST HOOD	WALL MOUNTED		PCS	1		
,	HOOD-WALL: VENT	HOOD-WALL: VENT		PCS	1		
5	DRAYER: VENT	DRAYER: VENT		PCS	1		
7	ROOF VENT	3"(Ø)		PCS	1		



		PLUMBII	NG FIXTURES & ACCESSORIES				
#	Item	Туре	Description, Manufacturer, SKU	Unit	Quantity	Unit Price	Total
1	Bath Tub (Alcove Tub)			PCS	C		
2	Kitchen Sink			PCS	1		
3	Kitchen faucets			PCS	1		
4	Vanity Sink			PCS	2		
5	Bath room faucets			PCS	2		
6	Water Closet			PCS	1		
7	Shower Trim			PCS	1		
8	Shower Tray			PCS	1		
9	Water Heater			PCS	1		
10	Hose Bib			PCS	1		
11	Shutoff Valve			PCS	8		
12	Hanging pipe clamp			PCS	12		
13	Gate Valve			PCS	1		
14	Dishwasher Supply Single Connector			PCS	1		
15	Dishwasher Sewage Single Connector			PCS	1		
16	Laundry Sweat Connector			PCS	1		



		SAN	IITARY & PLUMBING PIPES				
#	Item	Туре	Description, Manufacturer, SKU	Unit	Quantity	Unit Price	Total
1	Acrylonitrile Butadiene Styrene (ABS)	3/4"		FT	C		
2	Acrylonitrile Butadiene Styrene (ABS)	1 1/2"		FT	29		
3	Acrylonitrile Butadiene Styrene (ABS)	2"		FT	42		
4	Acrylonitrile Butadiene Styrene (ABS)	3"		FT	16		
5	Cross-linked polyethylene (PEX)	1/2"		FT	88		
6	Cross-linked polyethylene (PEX)	3/4"		FT	34		
7	Polyvinyl Chloride - Rigid	2"		FT	47		



		PIPE	FITTINGS 01				
#	Item	Туре	Description, Manufacturer, SKU	Unit	Quantity	Unit Price	Total
1	ABS 90 Degree Bend Elbow	1 1/2"ø-1 1/2"ø		PCS	1		
2	ABS 90 Degree Bend Elbow	2"ø-2"ø		PCS	3		
3	ABS 90 Degree Bend Elbow	3"ø-3"ø		PCS	1		
4	ABS P-Trap	1 1/2"ø-1 1/2"ø		PCS	4		
5	ABS P-Trap	2"ø-2"ø		PCS	1		
6	ABS Reducer Elbow	2"ø-1 1/2"ø		PCS	3		
7	ABS Reducer Elbow	3"ø-2"ø		PCS	1		
8	ABS TEE Elbow	1 1/2"ø-1 1/2"ø-1 1/2"ø		PCS	2		
9	ABS TEE Elbow	2"ø-2"ø-2"ø		PCS	2		
10	ABS TEE Elbow	3"ø-3"ø-3"ø		PCS	1		
11	ABS Tee Reducer Elbow	2"ø-2"ø-2"ø		PCS	1		
12	ABS Tee Reducer Elbow	3"ø-3"ø-1 1/2"ø		PCS	1		
13	ABS Tee Reducer Elbow	3"Ø-3"Ø-2"Ø		PCS	1		
14	ABS Tee Reducer Elbow	3"Ø-3"Ø-3"Ø		PCS	1		
15	ABS Trap P	2"ø-2"ø		PCS	1		



		PI	PE FITTINGS 02		_	_	
#	Item	Туре	Description, Manufacturer, SKU	Unit	Quantity	Unit Price	Total
	ABS Vent Cap Elbow	1 1/2"ø		PCS	2		
)	ABS Vent Cap Elbow	2"Ø		PCS	2		
	ABS Vent Cap Elbow	3"Ø		PCS	1		
1	ABS WASTE DOUBLE TEE	2"ø-2"ø-2"ø		PCS	1		
)	PEX 90 Deg Elbow	1/2"ø-1/2"ø		PCS	4		
)	PEX 90 Degree Elbow	1/2"ø-1/2"ø		PCS	24		
,	PEX 90 Degree Elbow	3/4"ø-3/4"ø		PCS	5		
}	PEX Tee Elbow	1/2"ø-1/2"ø-1/2"ø		PCS	6		
)	PEX Tee Elbow	3/4"ø-3/4"ø-3/4"ø		PCS	7		
0	PEX Transition Elbow	1"ø-3/4"ø		PCS	2		
1	PEX Transition Elbow	3/4"ø-1/2"ø		PCS	13		
2	PVC 90 Deg Bend Elbow	2"Ø-2"Ø		PCS	18		
3							
4							
5							



			APPLIANCES				
#	Item	Туре	Description, Manufacturer, SKU	Unit	Quantity	Unit Price	Total
1	Refrigerator			PCS			
2	Range			PCS			
3	Washer Front Load	Stackable		PCS			
4	Dryer Front Load	Stackable		PCS			
5	Dish Washer			PCS			
6	Oven			PCS	(
7	Microwave			PCS	(
8							
9							
10							
11							
12							
13							
14							
15							
16							



			CASEWORKS 01				
#	Item	Туре	Description, Manufacturer, SKU	Unit	Quantity	Unit Price	Total
1	Kitchen Cabinet			FT	16.16		
2	Laundry Cabinet			FT	0		
3	Vanity Cabinet			FT	5		
4	Medicine Cabinet			PCS	2		
5	Kitchen countertop			SF	25.32		
6	Laundry Countertop			PCS	0		
7	Bathroom Countertop			SF	0		
8	Island			FT	0		
9	Peninsula			FT	0		
10	Closets			SF	81.96		
11							
12							
13							
14							
15							



			CEILING 01				
‡	Item	Туре	Description, Manufacturer, SKU	Unit	Quantity	Unit Price	Total
	LIVING ROOM + KITCHEN			SF	277.2		
L	Ceiling Board	Drywall		SF	277		
	Drywall Fastener	Screw		PCS	485		
}	Vapor Retarder	Polyethylene film		SF	277		
	Vapor Retarder Fastener	Nails with washer heads		PCS	832		
	BATH 1			SF	43.9		
i	Ceiling Board	MRD (Moisture resistant drywall)		SF	44		
•	MRD Fastener	Screw		PCS	77		
	HALL +WD			SF	62.5		
,	Ceiling Board	Drywall		SF	63		
	Drywall Fastener	Screw		PCS	109		
	Vapor Retarder	Polyethylene film		SF	63		
0	Vapor Retarder Fastener	Nails with washer heads		PCS	188		
	BED ROOM 1			SF	159.8		
.1	Ceiling Board	Drywall		SF	160		
2	Drywall Fastener	Screw		PCS	280		
3	Vapor Retarder	Polyethylene film		SF	160		
.4	Vapor Retarder Fastener	Nails with washer heads		PCS	479		



			CEILING 02				
#	Item	Туре	Description, Manufacturer, SKU	Unit	Quantity	Unit Price	Total
	BED ROOM 2			SF	157.4		
1	Ceiling Board	Drywall		SF	157		
2	Drywall Fastener	Screw		PCS	275		
3	Vapor Retarder	Polyethylene film		SF	157		
4	Vapor Retarder Fastener	Nails with washer heads		PCS	472		
	BED ROOM 3			SF	159.4		
5	Ceiling Board	Drywall		SF	159		
6	Drywall Fastener	Screw		PCS	279		
	Vapor Retarder	Polyethylene film		SF	159		
7	Vapor Retarder Fastener	Nails with washer heads		PCS	478		
8	SHADE			SF	92.7		
9	Ceiling Board	Marine Plywood		SF	93		
10	Exterior Grade Plywood	Screw		PCS	162		
	CLOSET 1			SF	17.9		
11	Ceiling Board	Drywall		SF	18		
12	Drywall Fastener	Screw		PCS	31		
13	Vapor Retarder	Polyethylene film		SF	18		
14	Vapor Retarder Fastener	Nails with washer heads		PCS	53.8		



			CEILING 03				
#	Item	Туре	Description, Manufacturer, SKU	Unit	Quantity	Unit Price	Total
	CLOSET 2			SF	24.3		
15	Ceiling Board	Drywall		SF	24		
16	Drywall Fastener	Screw		PCS	42		
17	Vapor Retarder	Polyethylene film		SF	24		
18	Vapor Retarder Fastener	Nails with washer heads		PCS	73		
	CLOSET 3			SF	24.1		
19	Ceiling Board	Drywall		SF	24		
20	Drywall Fastener	Screw		PCS	42		
21	Vapor Retarder	Polyethylene film		SF	24		
22	Vapor Retarder Fastener	Nails with washer heads		PCS	72		
	WH			SF	7.1		
23	Ceiling Board	Drywall		SF	7		
24	Drywall Fastener	Screw		PCS	12		
25	Vapor Retarder	Polyethylene film		SF	7		
26	Vapor Retarder Fastener	Nails with washer heads		PCS	21		



	<u>1</u>		FLOORING INTERIOR 01				
#	Item	Туре	Description, Manufacturer, SKU	Unit	Quantity	Unit Price	Total
	BEDROOM						
1	Bedroom Flooring			SF	210		
2	Wood underlay	Foam Pad Polyethylene		SF	210		
3	Vapor Retarder	Vapor Barrier Polyethylene		SF	210		
	CLOSET 1						
4	Closet Flooring			SF	17		
5	Wood underlay	Foam Pad Polyethylene		SF	17		
6	Vapor Retarder	Vapor Barrier Polyethylene		SF	17		
	CLOSET 2						
7	Closet Flooring			SF	5		
8	Wood underlay	Foam Pad Polyethylene		SF	5		
9	Vapor Retarder	Vapor Barrier Polyethylene		SF	5		
	CLOSET 3						
10	Closet Flooring			SF	6		
11	Wood underlay	Foam Pad Polyethylene		SF	6		
12	Vapor Retarder	Vapor Barrier Polyethylene		SF	6		



	1		FLOORING INTERIOR 02				
#	Item	Туре	Description, Manufacturer, SKU	Unit	Quantity	Unit Price	Total
	LIVING ROOM AND KITCH	HEN					
13	Living Area Flooring			SF	309)	
14	Wood underlay	Foam Pad Polyethylene		SF	309)	
15	Vapor Retarder	Vapor Barrier Polyethylene		SF	309		
	BATHROOM	·					
16	Tile Finish			SF	59		
17	Adhesive	1/2" Thin set Mortar		SF	59)	
18	Vapor Retarder	Vapor Barrier Polyethylene		SF	59		
	W/D						
19	Tile Finish			SF	19		
20	Adhesive	1/2" Thin set Mortar		SF	19)	
21	Vapor Retarder	Vapor Barrier Polyethylene		SF	19)	
	BOILER ROOM						
22	Tile Finish			SF	8	3	
23	Adhesive	1/2" Thin set Mortar		SF	8	3	
24	Vapor Retarder	Vapor Barrier Polyethylene		SF	8	3	



			FLOORING EXTERIOR			
#	Item	Туре	Description, Manufacturer, SKU	Unit	Quantity	Unit Price
	STRUCTURE			SF	1127.7	
1	Concrete Slab	4"concrete cast in situ		CF	375.91	
2	Insulation	Rigid insulation		SF	288.1	
3	Hard core	Compacted soil		CF	287.08	
4	Re-bar	#4 re-bar		Ton	1.02	
5	Concrete Pad	4"concrete cast in situ		CF	1.58	
6	Slab edge	Turndown		CF	261.4	
	PORCH FRONT					
7	Tile Finish			SF	407.74	
8	Adhesive	1/2" Thin set Mortar		SF	407.74	
9	Vapor Retarder	Vapor Barrier Polyethylene		SF	407.74	



			WALLS: EXTERIOR				
#	Item	Туре	Description, Manufacturer, SKU	Unit	Quantity	Unit Price	Total
1	Stucco Finish			SF	1221		
2	Wall Shteathing (OSB)			SF	1221		
3	Shteathing Fastener	Self-drilling screws(100/pkt)		PKT	12.21		
4	Wall Homewrap			SF	1221		
5	Homewrap Fastener	Stapled fastener (200/pkt)		PKT	4.6398		
6	Wall Paint			SF	1221.00		
7	Stone Copping	Masonry stone		SF	119.00		
8	Stone Veneer	Masonry stone		SF	0		
9	Mortar for Stone Veneer			SF	0		
10	Wall Insulation			SF	2696		



			WALLS: INTERIOR 01				
#	Item	Туре	Description, Manufacturer, SKU	Unit	Quantity	Unit Price	Total
	BATHROOM			SF	72.0		
1	Cementitious Backer Board			SF	294	ļ	
2	Kerdi membrane			SF	294		
3	Kerdi membrane Fastener			SF	294	Į.	
4	Wall Ceramic Tile			SF	294		
	BEDROOM			SF	209.0		
5	Drywall Board			SF	391		
6	Drywall Fastener	Self-drilling screws(100/pkt)		PKT	3.91		
7	Wall Paint			SF	391		
8	Drywall Tape			FT	73.3	3	
	HALL	,		SF	31.0		
9	Drywall Board			SF	89		
10	Drywall Fastener	Self-drilling screws(100/pkt)		PKT	0.89		
11	Wall Paint			SF	89		
12	Drywall Tape			FT	17		



			WALLS: INTERIOR 02				
#	Item	Туре	Description, Manufacturer, SKU	Unit	Quantity	Unit Price	Total
	LIVING ROOM			SF	196.0		
13	Drywall Board			SF	275		
14	Drywall Fastener	Self-drilling screws(100/pkt)		PKT	2.75		
15	Wall Paint			SF	275		
16	Drywall Tape			FT	51.6		
	KITCHEN			SF	80.0		
17	Cementitious Backer Board			SF	23		
18	Drywall Board			SF	155		
19	Drywall Fastener	Self-drilling screws(100/pkt)		PKT	1.55		
20	Kerdi membrane			SF	23		
21	Kerdi membrane Fastener			SF	23		
22	Wall Ceramic Tile			SF	23		
23	Wall Paint			SF	155		
24	Drywall Tape			FT	29.2		



		WALLS: INTERIOR 03							
#	Item	Туре	Description, Manufacturer, SKU	Unit	Quantity	Unit Price	Total		
	CL 1			SF	19.0				
25	Drywall Board			SF	122				
26	Drywall Fastener	Self-drilling screws(100/pkt)		PKT	1.22				
27	Wall Paint			SF	122				
28	Drywall Tape			FT	22.9				
	CL 2			SF	6.0				
29	Drywall Board			SF	82				
30	Drywall Fastener	Self-drilling screws(100/pkt)		PKT	0.82				
31	Wall Paint			SF	82				
32	Drywall Tape			FT	15.4				
	CL 3			SF	6.0				
33	Drywall Board			SF	70				
34	Drywall Fastener	Self-drilling screws(100/pkt)		PKT	0.7				
35	Wall Paint			SF	70				
36	Drywall Tape			FT	13.1				



			WALLS: INTERIOR 04				
#	Item	Туре	Description, Manufacturer, SKU	Unit	Quantity	Unit Price	Total
	WD			SF	18.0		
37	Cementitious Backer Board			SF	102		
38	Kerdi membrane			SF	102		
39	Kerdi membrane Fastener			SF	102		
40	Wall Ceramic Tile			SF	102		
	WH			SF	9.0		
41	Drywall Board			SF	82		
42	Drywall Fastener	Self-drilling screws(100/pkt)		PKT	0.82		
43	Wall Paint			SF	82		
44	Drywall Tape			FT	15		
1	Wall Skirting	Ceramic					
_	Train Civiling	Solution		FT	123		



			DOORS				
#	Item	Туре	Description, Manufacturer, SKU	Unit	Quantity	Unit Price	Total
1	Interior Swinging	3' - 0" X 6'-8"		PCS	2		
2	Interior Swinging	2' - 6" X 6'-8"		PCS	1		
3	Exterior Swinging	5' - 0" X 6'-8"		PCS	1		
4	Exterior Sliding	5' - 0" X 6'-8"		PCS	1		
5	Exterior Swinging	3' - 0" X 6'-8"		PCS	1		
6	Interior Sliding	7' - 6" X 6'-8"		PCS	1		
7	Folding	2' - 0" X 6'-8"		PCS	3		
8	Exterior Door Trim			FT	53		
9	Interior Door Trim			FT	284		
10	Entry Lock set			PCS	3		
11	Privacy Lock set			PCS	3		
12	Passage Lock set			PCS	4		



			WINDOWS				
#	Item	Туре	Description, Manufacturer, SKU	Unit	Quantity	Unit Price	Total
1	Sliding	3' - 3" X 1'-9"		PCS	1		
2	Casement	2' - 3" X 4'-3"		PCS	2		
3	Casement	3' - 3" X 3'-3"		PCS	2		
4	Awning	2' - 3" X 2'-3"		PCS	2		
5	Sliding	4' - 3" X 3'-3"		PCS	1		
6	Sliding	6' - 3" X 4'-3"		PCS	1		
7	Exterior Window Trim			FT	118		
8	Interior Window Trim			FT	118		
9							
10							
11							
12							
13							
14							
15							



			ROOF 01				
#	Item	Туре	Description, Manufacturer, SKU	Unit	Quantity	Unit Price	Total
1	Roof Covering			SF	1286.0		
2	Roof Covering Fastener			PCS	643		
3	Roof Felt Paper			SF	1286.0		
4	Roof Felt Paper Fastener			PCS	3858.0		
5	Roof Sheathing			SF	1286.0		
6	Roof Sheathing Fastener			PCS	10288		
7	Batten			FT	0.0		
8	Batten Fastener			PCS	0.0		
9	Soffit			SF	145.0		
10	Soffit Fastener			PCS	72.5		
11	Fascia			FT	215.0		
12	Fascia board fastener			PCS	108		
13	Roof Insulation			SF	1286.0		
14							
15							