

ORION
The Orion is a charming Spanish-style twobedroom, two-bathroom home designed for comfortable and efficient living. The exterior walls are finished with a light stucco, creating a warm and traditional aesthetic. A simple gable roof covered in terracotta tiles provides shelter and complements the overall Spanish style. A notable architectural feature is the integrated tower element, adding vertical interest and a unique focal point to the design. The prominent covered porch and pergola supported by substantial timber posts, creating a welcoming outdoor space. Arched openings and decorative window details further enhance the Spanish architectural character.

Inside, the Orion features a simple L-shaped plan. The living, dining, and kitchen areas are seamlessly merged into a single large room at one end of the house, creating a spacious and versatile living space. The bedrooms are thoughtfully located on the other end of the plan, offering private and quiet retreats. Functional spaces, such as the bathrooms and laundry, are strategically placed between the living area and the bedrooms, creating a clear separation and enhancing the overall functionality of the home.

Materials Shopping List

Please print and take this Materials Shopping List to your favorite Home Depot and ask for assistance in selecting the materials, fixtures and fittings to complete your new home.

Record your selection and the price of the item. Then do the math to determine the cost for your selections and the total cost of finishing your home. < CLICK HERE >

To Go To Materials Shopping List



BEDROOM 2 161 SF SIDE PORCH TOWER 42 SF


FLOOR PLAN

910 SF

2 Bed Rooms



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MATERIALS SHOPPING LIST -

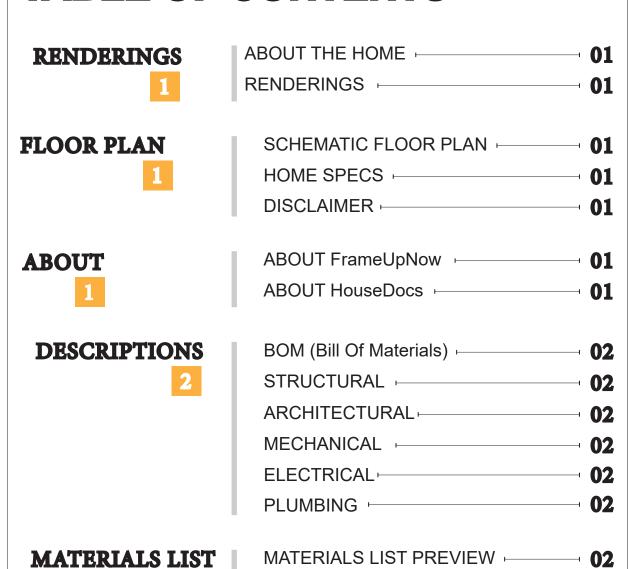ABOUT



FrameUpNow is a design and manufacturing company providing precision-engineered home framing solutions. We offer a catalog of Affordable Homes, Tiny Homes, Garages, Shops and Barndominiums. FrameUpNow manufactures cold-formed steel (CFS) also known as Light Gauge Steel (LGS) framing components that conform to our engineered metal house frame plans or can be purchased as DIY skeleton kits.

The CFS/LGS framing is lightweight, easily assembled, and does not require heavy equipment or specialized labor, enabling homeowners to erect the frame themselves in just a few days. Unlike wood, the steel framing is impervious termites and bores, warping, expansion, and fire.

Our home plans come complete with a structural engineered stamp for permit approvals. Customers receive a full BOM also known as a Materials Shopping List to purchase finish materials from a Building Materials retailer. FrameUpNow prides itself on the quality and efficiency of our precision-engineered home framing solutions for construction professionals and DIY homeowners.



KEY PLAN

NO.	DESCRIPTION	DATE

NOTE:

LEGEND:

PROJECT

130-Orion-910-2Bd2Ba-Spanish-Tower-550

DRAWING NAME

INTRODUCTION

CLIE	ENT NAME:	
PRO	DJECT NUMBER:	
DATI	E:	
DES	SIGNED BY:	
DRA	AWN BY:	
CHE	ECKED BY:	

I101

SCALE:

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DESCRIPTIONS

MATERIALS LIST

The BOM (Bill Of Materials) package, known as the Materials Shopping List document, provides:

Comprehensive Inventory: Detailed lists of essential materials sourced from architectural, mechanical, HVAC, electrical, and plumbing design drawing sets.

Precise Curation: Each item meticulously selected and organized for accuracy and efficiency in project planning.

Customizable Options: Customers can modify listed items to their preferences and calculate costs accordingly, ensuring alignment with personal project needs and budget.

Dedicated Space for Details: Includes tables for customers to note Home Depot SKU numbers or product descriptions for selected items, facilitating seamless purchasing and coordination with suppliers.

Customer Convenience: Take the list to Home Depot or preferred suppliers for accurate pricing, helping align the total home budget with personal financial plans.

Simplify your construction journey with our Materials Shopping List document, where detailed preparation meets streamlined implementation for your dream home.

MECHANICAL

STRUCTURAL

The structural drawings package provides an exhaustive set of detailed plans essential for the precise assembly of your building. This comprehensive package includes:

Framing Plans: Detailed layouts for all framing components. Truss Layouts: Clear instructions for truss placement and

Panel Length Plans: Specifications for panel dimensions. Framing Elevations and Sections: Precise elevation and sectional views for accurate construction.

Truss and Wall Blocking Plans: Plans for truss and wall blocking to ensure structural integrity.

Hold-Down Plan: Detailed hold-down requirements for stability. Snap Sheet: Reference sheet for quick identification of components

Structural Details and Bracing Plans: Complete details and bracing plans for all structural elements.

Accompanying these plans is a comprehensive Bill of Materials (BOM) that lists every necessary building component, from cold formed steel (CFS) frames to fasteners.

ARCHITECTURAL

With the comprehensive architectural package, both builders and DIY homeowners can confidently execute the construction.

The architectural package includes:

Furnished Floor Plans: Complete with furniture layouts for a clear understanding of space utilization.

Detailed Dimension Plans: Ensures precise measurements, from the overall footprint down to the exact placement of windows and

Foundation Plan: Detailed plan to establish a solid foundation.

Wall Framing and Truss Layout: Comprehensive plans for wall framing and truss placement.

Architectural Elevations: Exterior views showcasing the design.

Strategic Building Sections: Critical cross-sectional details for a thorough understanding of the build.

Casework Drawings and Diagrams: Suggested designs for built-in caseworks, such as kitchen cabinets.

ELECTRICAL

The mechanical package includes everything needed to guide HVAC

Detailed HVAC Floor Plan: Precisely maps out the placement of air handlers, ductwork, and vents throughout the home's layout.

HVAC Sections and Riser Diagrams: Technical drawings offering critical cross-sectional details and piping schematics, ensuring proper integration of the heating and cooling system into the home's structure.

Bill of Materials: A complete list of all necessary HVAC components.

The electrical package includes all the plans and documentation needed to guide the installation of your home's electrical system:

Detailed Power Plan: Precisely maps out the placement of outlets, switches, and other power components throughout the layout.

Comprehensive Lighting Plan: Shows the optimal locations for lighting fixtures, sconces, and other illumination sources to create a well-lit, functional interior.

Dimensioned Electrical Layout: Provides exact dimensions and measurements to ensure proper placement of all electrical elements.

Bill of Materials: A complete list of every component needed, from circuit breakers to wiring.

installation of your home's water supply and drainage systems:

Detailed Water Supply System Plan: Precisely maps out the placement of pipes, valves, and plumbing fixtures throughout the

Comprehensive Sewage System Plan: Shows the optimal routing and sizing of drain lines to effectively remove waste and ensure

Detailed Riser Diagrams: Provide information needed to properly

PLUMBING

The plumbing package includes everything needed to guide the

proper drainage.

install all vertical plumbing risers and vent stacks.

Bill of Materials: A complete list of every component needed, from pipes to fixtures.


BOM (Bill Of Materials) (Separately Attached)





The Bill of Materials (BOM) is a crucial document that compiles the material requirements from different disciplines into a centralized inventory, enabling efficient procurement, inventory management, and cost estimation for a specified project or

ELECTRICAL BOM



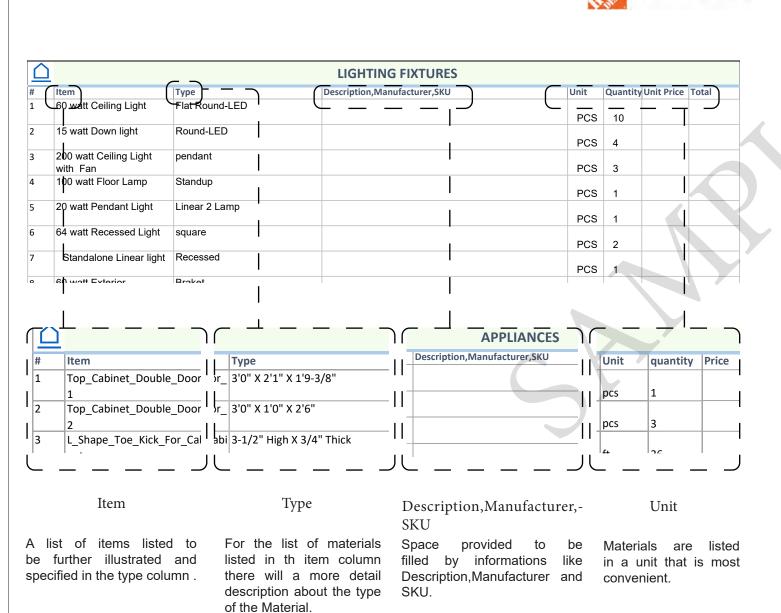

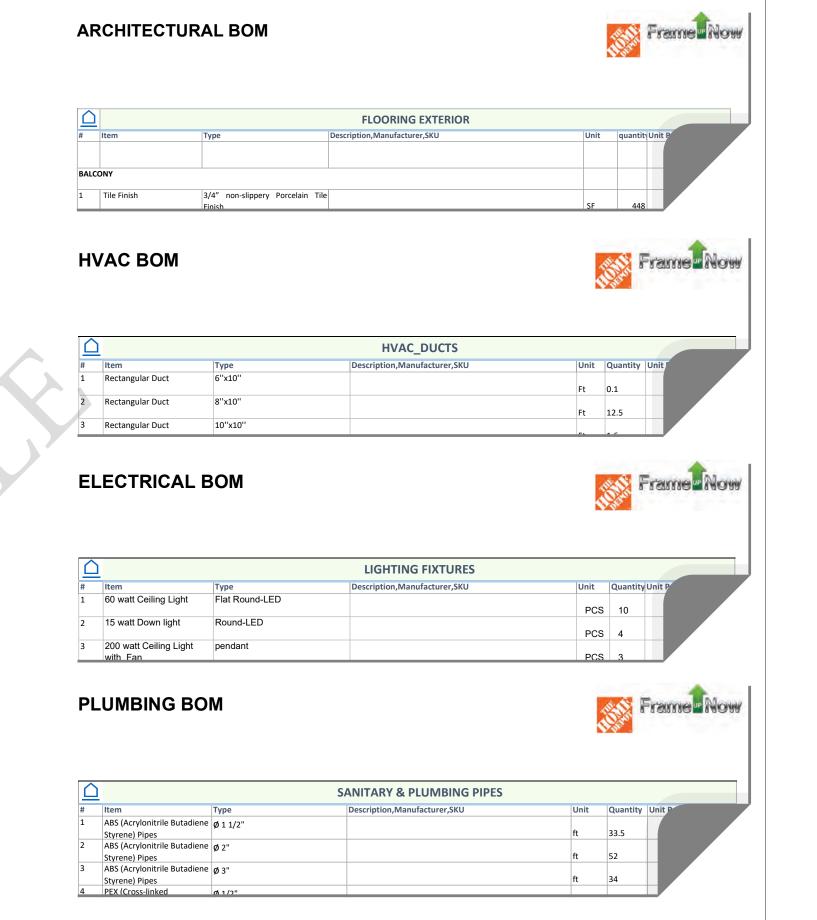

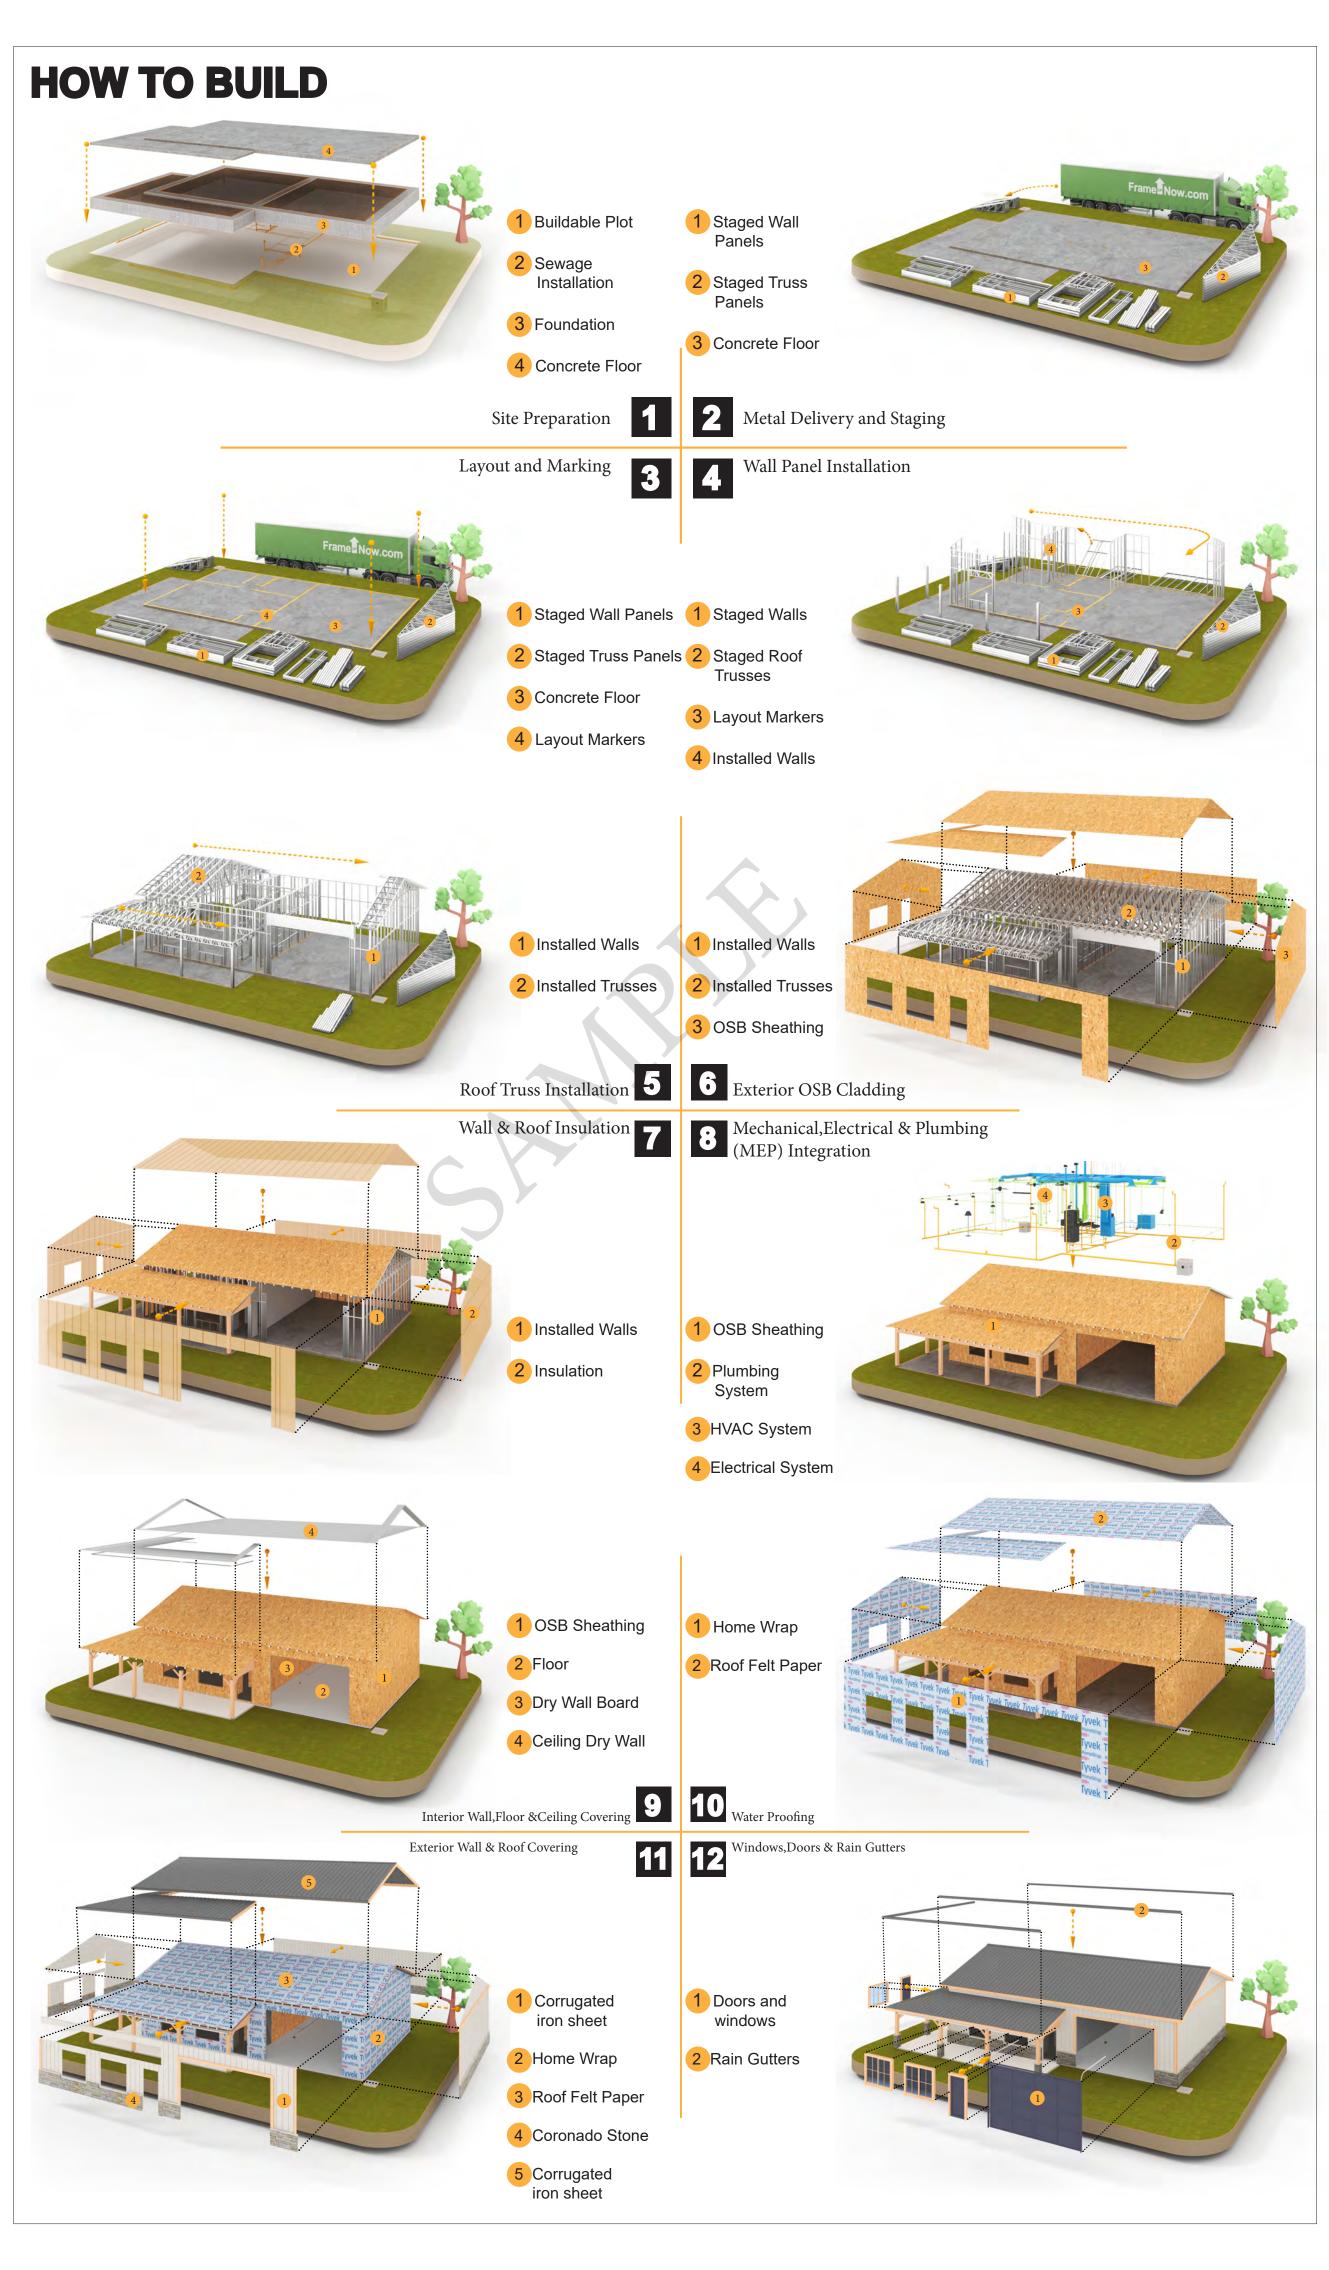



KEY PLAN

NO.	DESCRIPTION	DATE

NOTE:

LEGEND:

PROJECT

130-Orion-910-2Bd2Ba-Spanish-Tower-550


DRAWING NAME

INTRODUCTION

CLIENT NAME: DATE: **DESIGNED BY** DRAWN BY: CHECKED BY:

1102


SCALE:

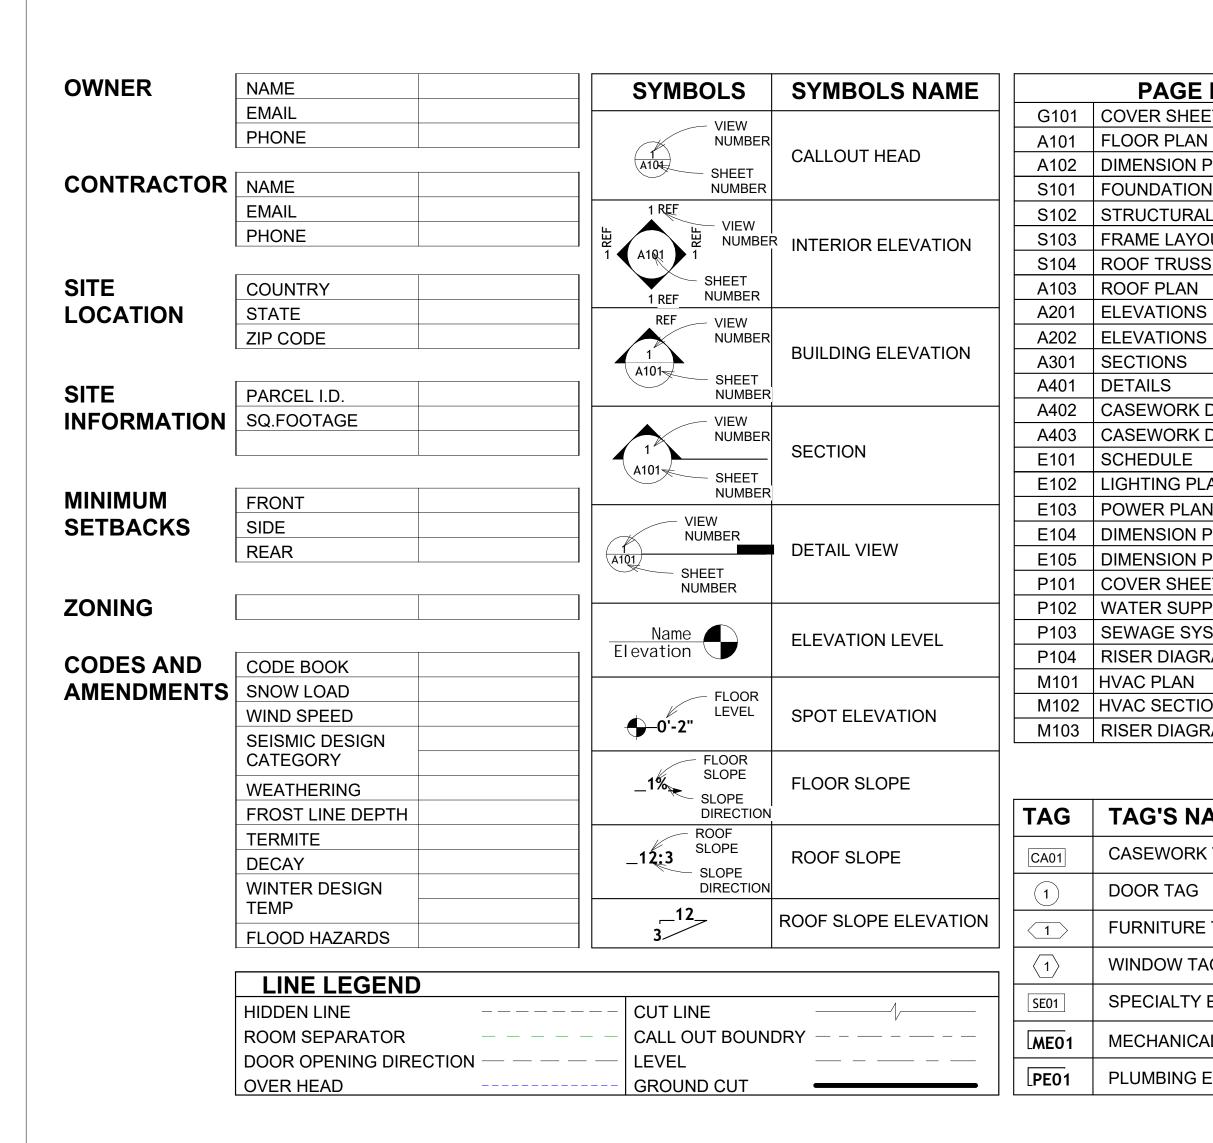

		711 0
A101	FLOOR PLAN	ASTM D698
A102	DIMENSION PLAN	
S101	FOUNDATION PLAN	CA
S102	STRUCTURAL FLOOR PLAN	EL
S103	FRAME LAYOUT	F.F.E
S104	ROOF TRUSS LAYOUT	F.F.L
A103	ROOF PLAN	FTG
A201	ELEVATIONS	HVAC
A202	ELEVATIONS	
A301	SECTIONS	IRC
A401	DETAILS	
A402	CASEWORK DETAILS	IMC
A403	CASEWORK DETAILS	
E101	SCHEDULE	MAX.
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E104	DIMENSION PLAN FOR LIGHT FIXTURE	NO.
E105	DIMENSION PLAN FOR FITTING	O.C
P101	COVER SHEET	OSB
P102	WATER SUPPLY SYSTEM	PL
P103	SEWAGE SYSTEM	PSI
P104	RISER DIAGRAM	PVC
M101	HVAC PLAN	REF
M102	HVAC SECTION	RG
M103	RISER DIAGRAM	SE
		SF
		SIMP. STHD8
TAG	TAG'S NAME	
CA04	CASEWORK TAG	SIMP. ABE66
CA01	ONOEWONK INC	TV
1	DOOR TAG	UNO
<u> </u>	FURNITURE TAG	W/D
$\langle 1 \rangle$	WINDOW TAG	AC
SE01	SPECIALTY EQUIPMENT TAG	ACC
		ACCU
LME01	MECHANICAL EQUIPMENT TAG	AHU
PE01	PLUMBING EQUIPMENT TAG	CC
		CD
		CFm
		CB

PAGE INDEX

G101 | COVER SHEET

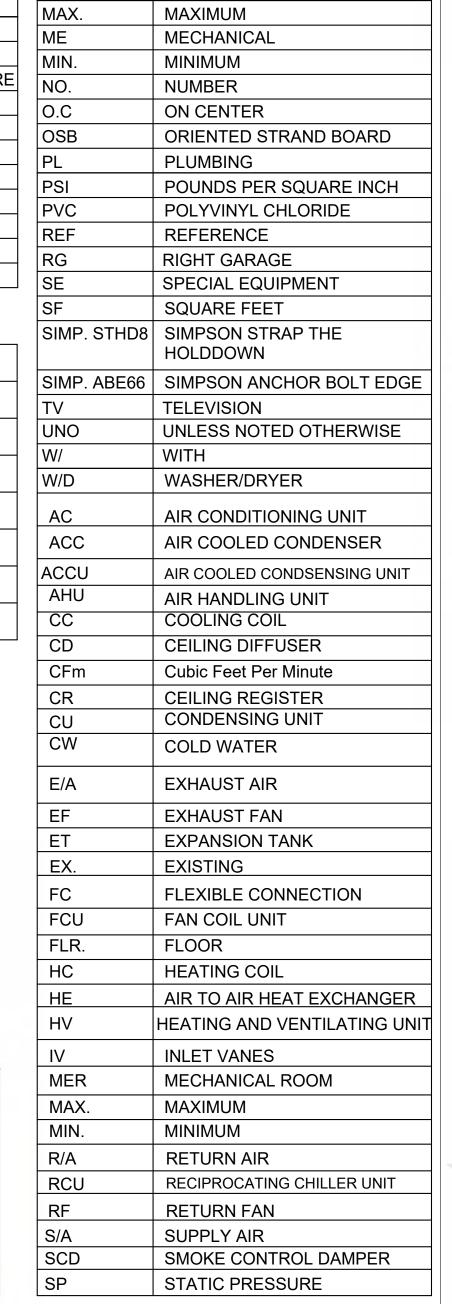

ABBREVIATION

CASEWORK

ELECTRICAL

FOOTINGS

CODE

CONDITIONING

ACTION FLOOR SYSTEMS

AMERICAN SOCIETY FOR

TESTING AND MATERIAL

FINISHED FLOOR LEVEL


FINISHED FLOOR ELEVATION

HEATING, VENTILATION & AIR

INTERNATIONAL RESIDENCE

INTERNATIONAL MECHANICAL


AFS

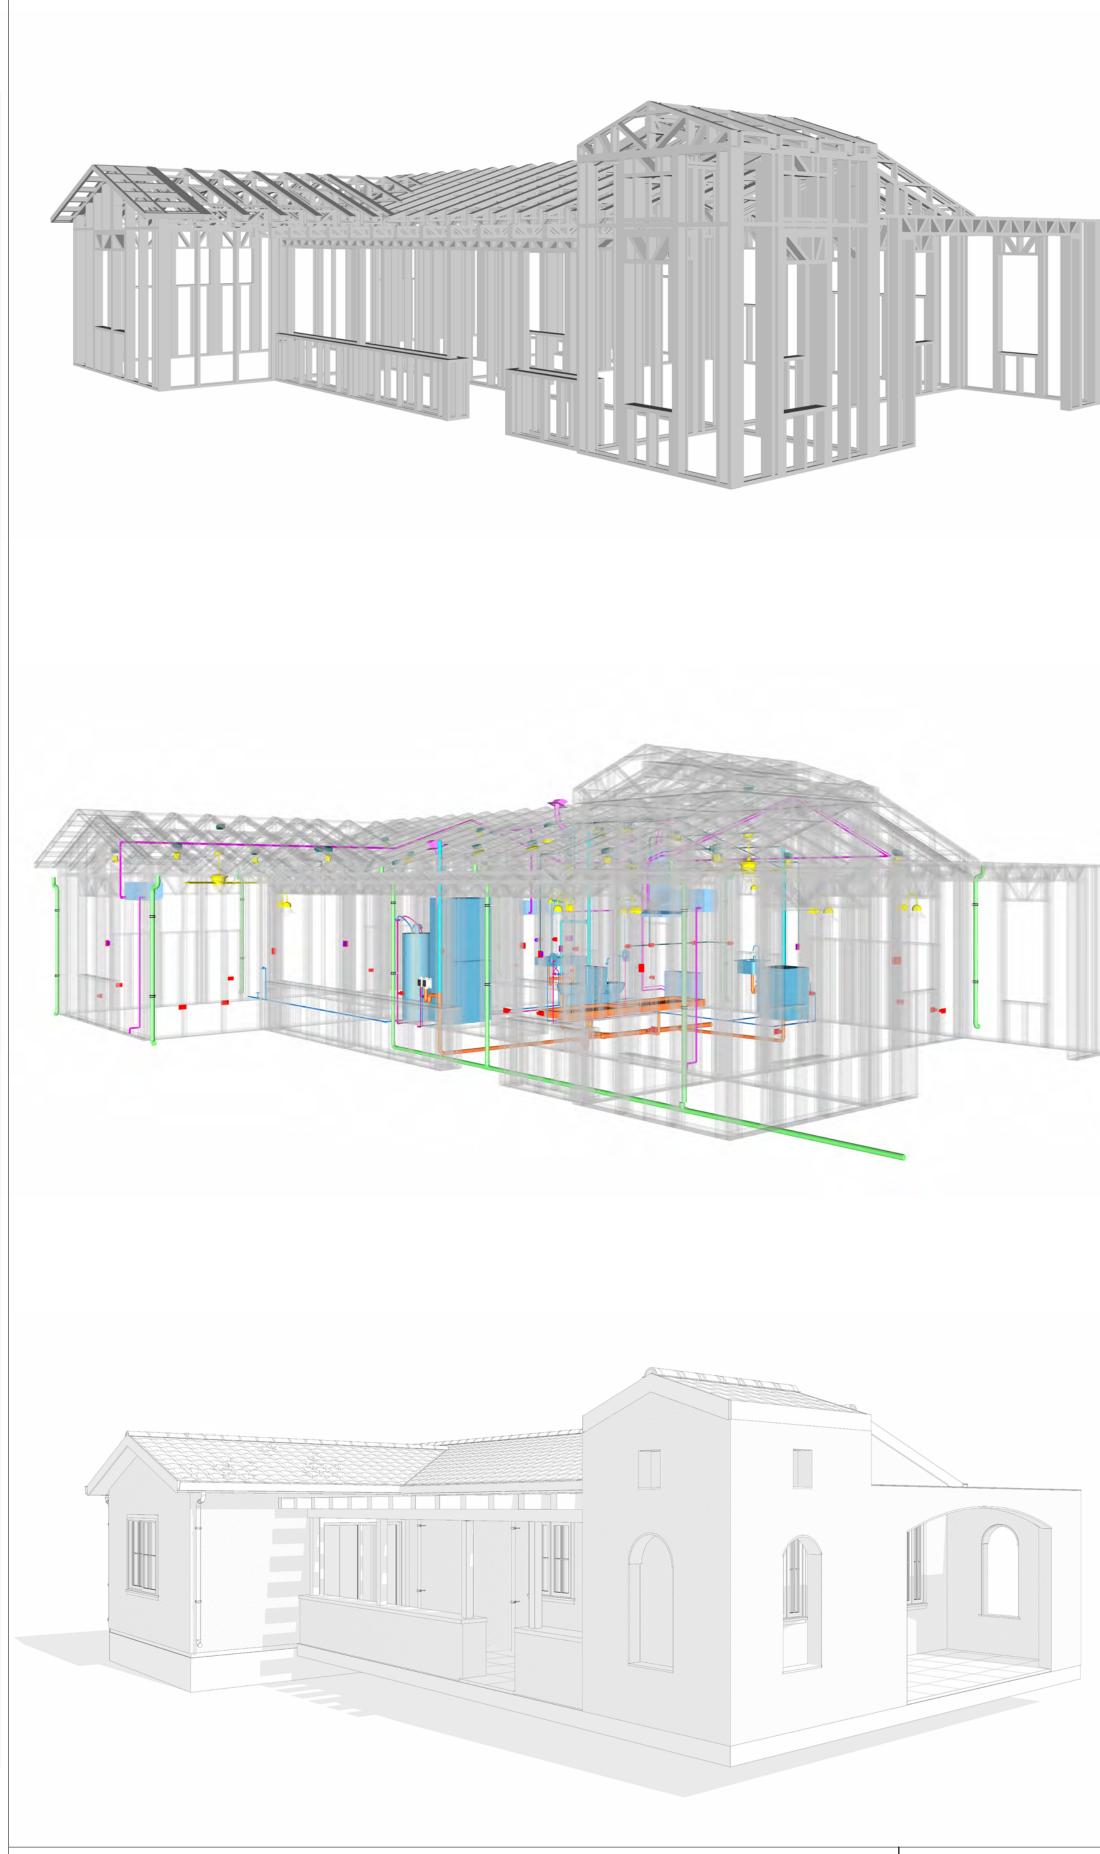

130 ORION 910 2BD 2BA **SPANISH TOWER 550**

SQUARE FOOT	AGE
LIVING	909
PORCH	347
TOTAL	1256



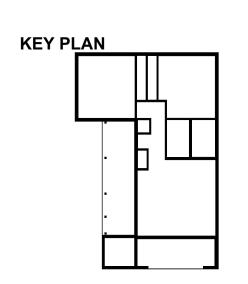

PERSPECTIVE ANGLE		
NO.	DESCRIPTION	DATE

NOTE:

LEGEND:

PROJECT

130-ORION-910-2BD 2BA-SPANISH-TOWER-550

DRAWING NAME

COVER SHEET

П		
	CLIENT NAME:	Client Name
	PROJECT NUMBER:	0033_15
	DATE:	3/22/2025 11:48:05 AM
	DESIGNED BY:	Designer
	DRAWN BY:	Author
	CHECKED BY:	Checker
ı		

G101



GENERAL NOTES

- 1. THIS DRAWING DEPICTS THE ARCHITECTURAL (SPACE LAYOUT, FURNISHING, FLOOR, WALLS, ROOFS, FOUNDATION, WINDOWS AND DOORS) SYSTEMS. IT PROVIDES A VISUAL REPRESENTATION OF THE ARCHITECTURAL LAYOUT AND COMPONENTS.
- 2. THE ARCHITECTURAL DRAWINGS ARE PREPARED TO MEET THE SPECIFIC REQUIREMENTS OF THE BUILDING, AS PER THE PROJECT SPECIFICATIONS AND APPLICABLE CODES AND STANDARDS.
- 3. THE CONSTRUCTION OF THIS HOME SHALL COMPLY WITH THE LATEST EDITION OF THE INTERNATIONAL RESIDENTIAL CODE (IRC), INTERNATIONAL MECHANICAL CODE (IMC), THE INTERNATIONAL PLUMBING STANDARD, THE NATIONAL ELECTRICAL STANDARD AND ALL OTHER APPLICABLE LOCAL, STATE, AND NATIONAL CODES AND REGULATIONS.
- 4. COORDINATION WITH OTHER TRADES HAS BEEN DONE ON A DESIGN LEVEL. THIS DRAWING SHALL BE READ TOGETHER WITH THE ME, EL AND PL DESIGN DRAWINGS TO ENSURE PROPER CONSTRUCTION AND INTEGRATION OF THE BUILDING SYSTEMS.

ABOUT WALLS:

1. SHOWER WALL COVERING

BATHTUB AND SHOWER SPACES (WALLS AND FLOORS) WITH INSTALLED SHOWER HEADS AND IN SHOWER COMPARTMENTS SHALL BE FINISHED WITH A NON-ABSORBENT SURFACE.

2. WALL PAINT (INTERNAL)

THE TYPICAL THICKNESS OF LATEX WALL PAINT IS 1/32 OF AN INCH FOR A SINGLE COAT.
AND DOUBLE COAT (1/16") SHALL BE APPLIED FOR DURABILITY.


3. ADHESIVES:

THE ADVISABLE TYPE OF ADHESIVE FOR THIS PROJECT IS **EPOXY ADHESIVES** BECAUSE THEY ARE KNOWN FOR THEIR HIGH STRENGTH, DURABILITY, AND RESISTANCE TO MOISTURE, CHEMICALS AND HEAT.

REFER TO SHEETS A201 & A202 FOR GENERAL NOTES ON EXTERNAL FINISHING MATERIALS


ABOUT FLOORS:

- 1. THE SPOT ELEVATION INDICATES THE FINISHED FLOOR ELEVATION.
- 2. FINISHED FLOORS PER PLANS.
- 3. FIELD VERIFY FOR DIMENSION DROP 4" FOR SHOWER AND BATHTUB USE.
- 4. 1% SLOPE ON OUTDOOR BALCONIES FOR WATER RUN OFF.
- 5. 2% SLOPE TOWARDS THE SHOWER DRAIN FOR SUFFICIENT DRAINAGE.
- 6. 4" DROP AT THE DOOR LEADING TO EXTERIOR BALCONY FROM THE MAIN LIVING AREA.
- 7. 5% SLOPE FOR GARAGE IS USED, WHICH SHOULD BE CHECKED WITH THE LOCAL GARAGING ZONING LAWS.

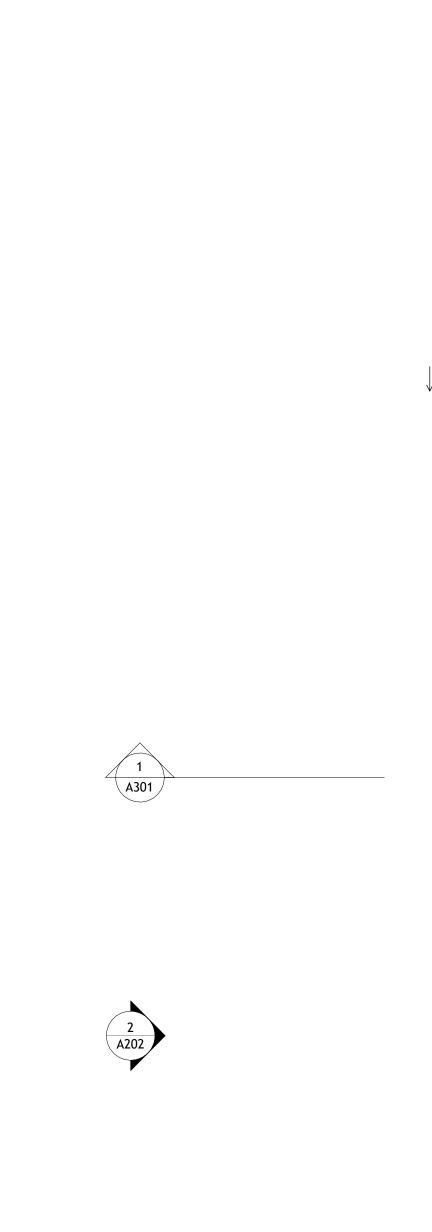

FURNITURE SCHEDULE A					
TYPE MARK	TYPE	COUNT			
01	KING SIZE BED	2			
02	DINING CHAIR	2			
03	THREE SEAT SOFA	1			
04	25" X 60" DINING 2	1			
05	ONE SEAT SOFA	1			

	ROOM FINISH SCHEDULE A						
ROOM NUMBE R	ROOM NAME	FLOOR FINISH	BASE FINISH	WALL FINISH	CEILING FINISH	CEILING HEIGHT	COMMENT S
01	BATH 1	VINYL TILES	CONCRETE	CERAMIC TILE	MRD	8' - 0"	
02	BEDROOM 2	HARDWOOD	CONCRETE	WALL PAINT	DRY WALL	8' - 0"	
03	BATH 2	VINYL TILES	CONCRETE	CERAMIC TILE	MRD	8' - 0"	
04	KITCHEN	HARDWOOD	CONCRETE	WALL PAINTT + CERAMIC	DRY WALL	8' - 0"	
05	LIVING ROOM	HARDWOOD	CONCRETE	WALL PAINT	DRY WALL	8' - 0"	
06	CL 3	HARDWOOD	CONCRETE	WALL PAINT	DRY WALL	8' - 0"	
07	WD	HARDWOOD	CONCRETE	WALL PAINT	DRY WALL	8' - 0"	
08	WH	HARDWOOD	CONCRETE	WALL PAINT	DRY WALL	8' - 0"	
09	CL 2	HARDWOOD	CONCRETE	WALL PAINT	DRY WALL	8' - 0"	
10	CL 1	HARDWOOD	CONCRETE	WALL PAINT	DRY WALL	8' - 0"	
12	BEDROOM 1	HARDWOOD	CONCRETE	WALL PAINT	DRY WALL	8' - 0"	
13	HALL	HARDWOOD	CONCRETE	WALL PAINT	DRY WALL	8' - 0"	
14	PORCH	PROCELAIN TILE	CONCRETE	STUCCO FINISH	PLYWOOD	8' - 0"	

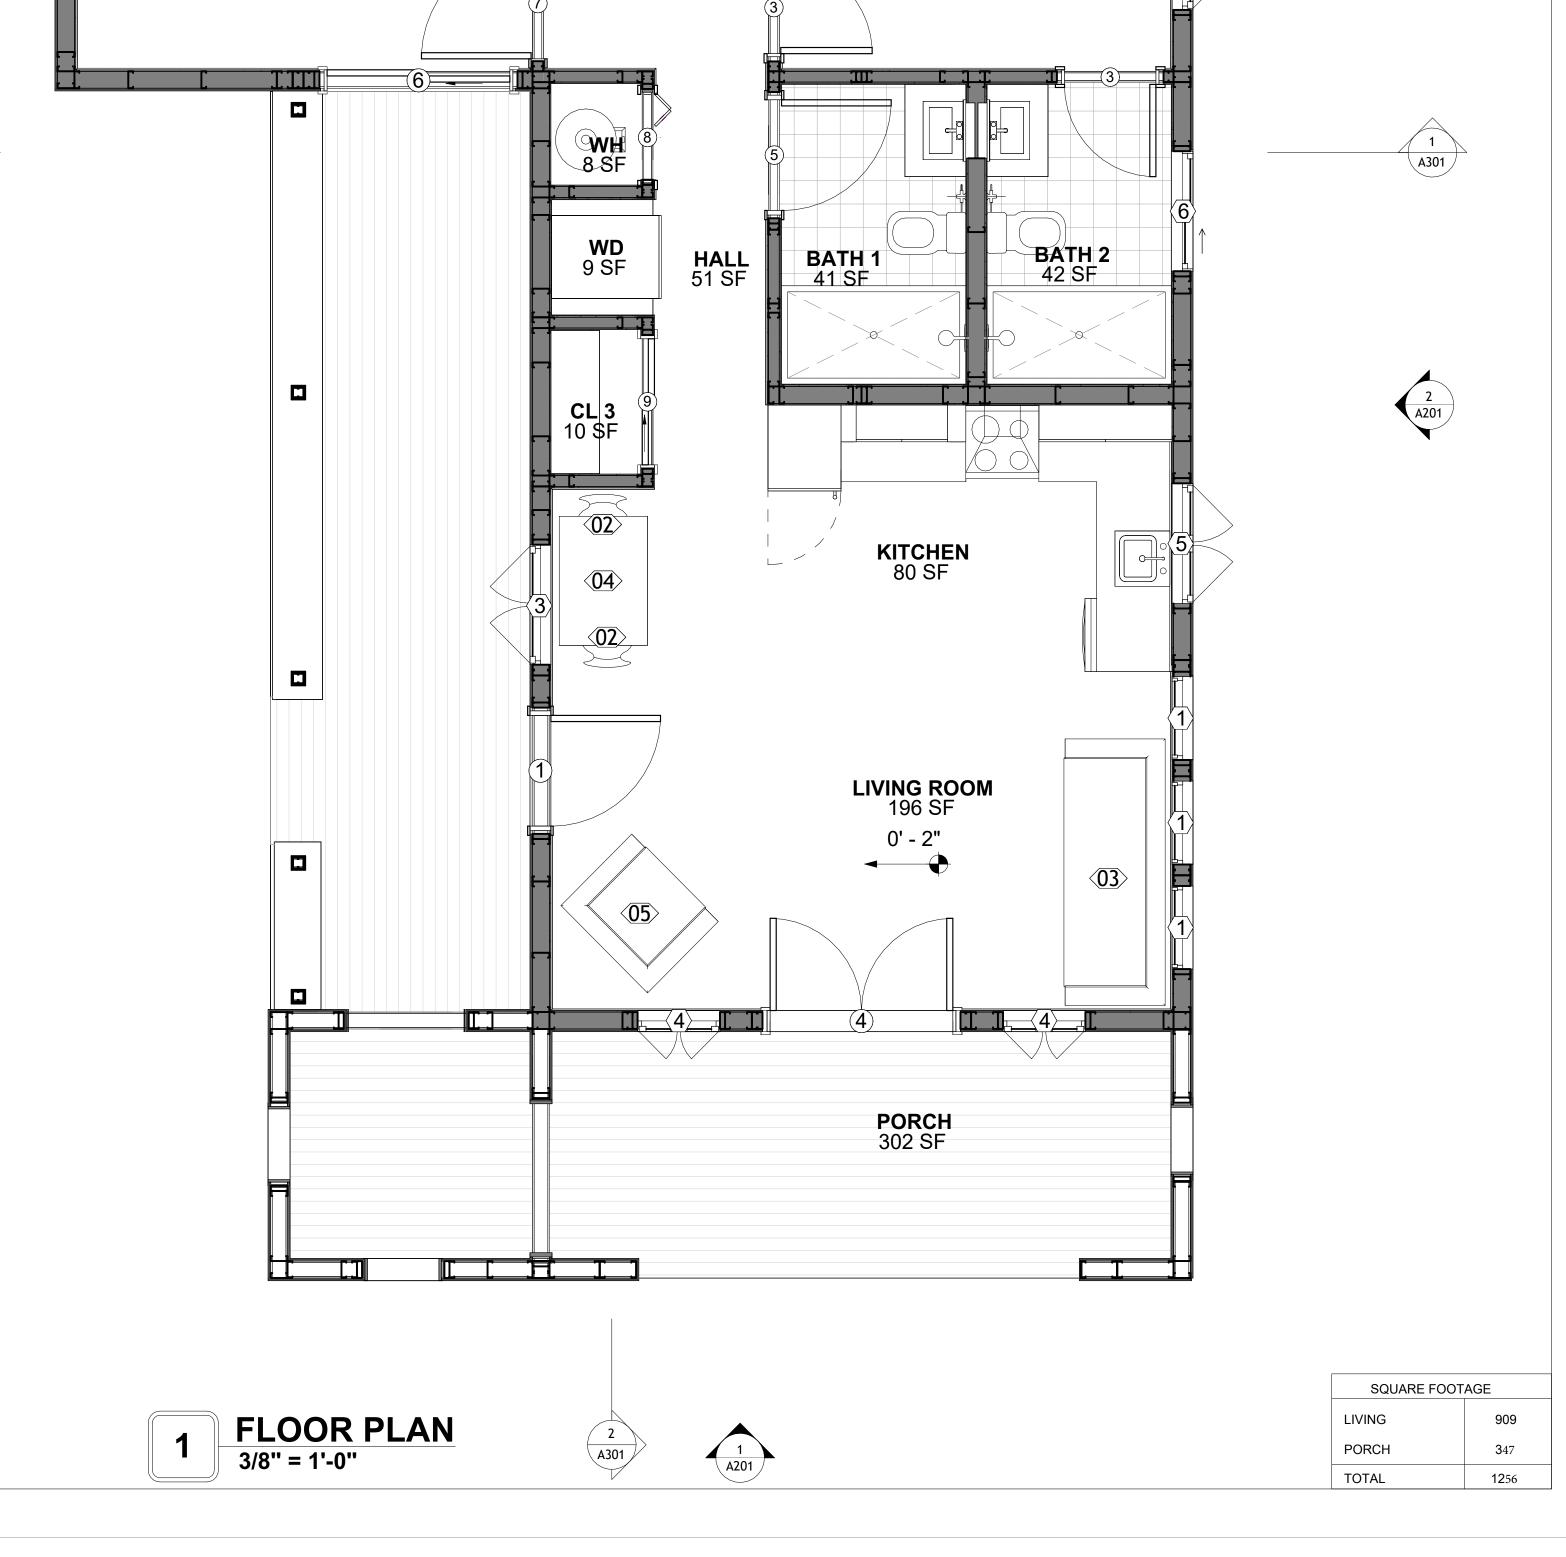

2 A301

CL 1 CL 2 24 SF 22 SF

<u>(01)</u>

BEDROOM 1

188 SF

A202

(01)

BEDROOM 2

159 SF



KEY PLAN

NO.	DESCRIPTION	DATE

NOTE:

LEGEND:

PROJECT

130-ORION-910-2BD 2BA-SPANISH-TOWER-550

DRAWING NAME


FLOOR PLAN

Client Name
0033_15
3/22/2025 11:48:06 AM
Designer
Author
Checker

A101

SCALE: As indicated

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KEY PLAN

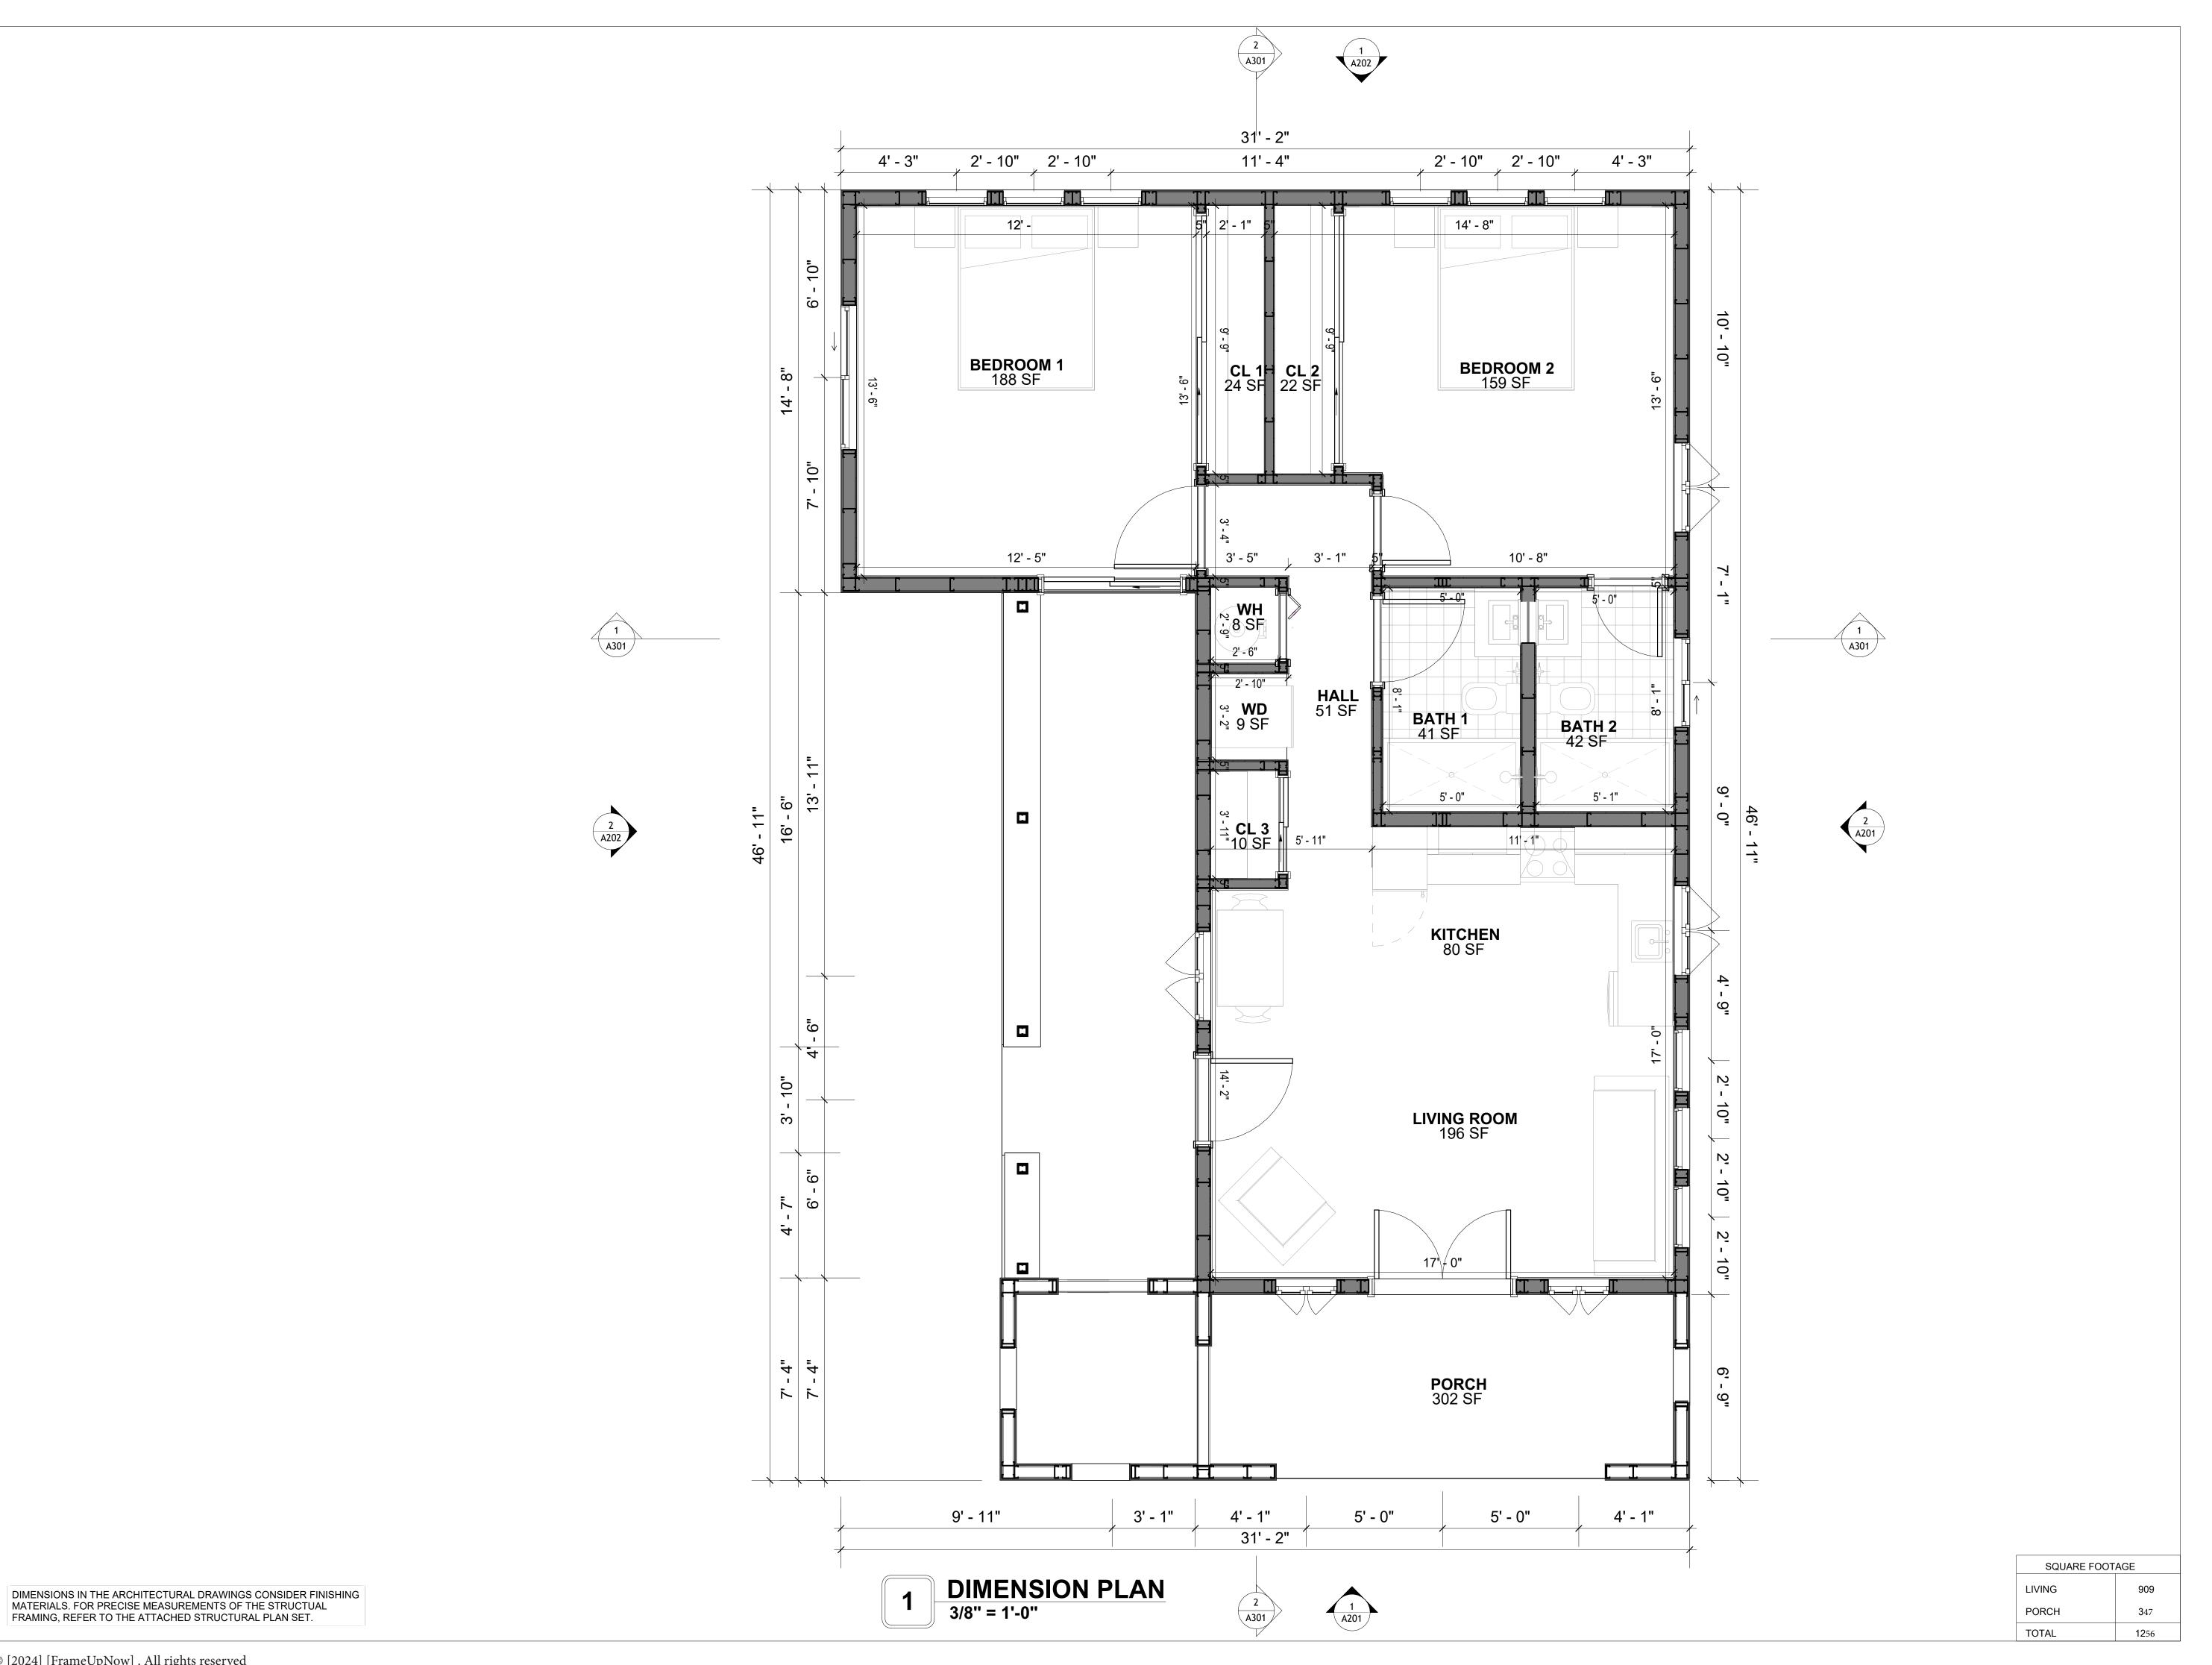NO.	DESCRIPTION	DATE

NOTE:

LEGEND:

PROJECT

130-ORION-910-2BD 2BA-SPANISH-TOWER-550

DRAWING NAME

DIMENSION PLAN

Client Name
0033_15
3/22/2025 11:48:07 AM
Designer
Author
Checker

A102

SCALE: 3/8" = 1'-0"

FOUNDATION NOTES

TERMITES PRETREATMENT BY LICENSED CONTRACTOR UNDER SLAB AND AROUND FOOTINGS. ALL AREAS BELOW SLABS SHALL BE TREATED NO MORE THAN 24 HOURS PRIOR TO CONCRETE POUR. EVIDENCE OF TREATMENT MUST BE PROVIDED PRIOR TO PLACING OF CONCRETE.

MATERIALS:

ALL INTERIOR CONCRETE SLABS SHALL BE A MIN. OF 4" THICK CONCRETE OVER 4" COMPACTED AGGREGATE BASE (ASTM D698), FINISH ELEVATIONS AS NOTED ON DRAWINGS, 6" ABOVE ADJACENT GRADE, LEVEL SLABS TO 1/8"-10' MAX.. CONCRETE SLABS SHALL BE 2500# PSI AT 28 DAYS. A 4" ALLOWABLE SLUMP.

2. **PAD PREPARATION:**

- EXCAVATION FOR FOOTING SHALL BE NEAT.

- FOOTINGS SHALL BE POURED IMMEDIATELY AFTER EXCAVATION AND APPROPRIATE **INSPECTION**

- ALL REINFORCING STEEL MARKED "CONTINUOUS" SHALL BE LAPPED 36 BAR DIAMETERS AT SPLICES AND AROUND CORNERS OR INTERSECTIONS WITH A STANDARD 90 DEGREE BEND ON CORNER BARS. LAP WIRE MESH ONE FULL MESH AT SIDE AND END LAPS.

- ALL HARDWARE TO BE SIMPSON OR EQUIVALENT.

- EXTERIOR FRAME WALL TO BE SECURED WITH 1/2"X10" ANCHOR BOLTS 4'-0" O.C. FOR 1-STORY AND 2'-8" O.C. FOR 2-STORY. BOLTS SHALL BE LOCATED WITHIN 1'-0" OF EACH END PIECE AND SHALL HAVE A MIN. OF TWO BOLTS PER PIECE.

-FOUNDATION ANCHOR STRAPS SHALL BE PERMITTED. ACCORDING TO RESIDENTIAL CODE

- ALL INTERIOR WALLS TO BE SECURED WITH POWER DRIVEN PINS PER MANUFACTURER SPECIFICATION USE PIN SPACING EQUIVALENT TO 1/2" ANCHOR BOLTS.

- ALL CONSTRUCTION TO CONFORM TO THE 2012 IRC

R-10 RIGID INSULATION OUTSIDE OF EXTERIOR FOUNDATION WALLS UNDER LIVING AREA. CONCRETE PAD FOR CONDENSER THICKNESS IS 4" MIN UNLESS OTHERWISE NOTED.

3. CONCRETE CONSTRUCTION:

- THE SLAB SHALL BE UNDERLAIN BY A VAPOR BARRIER/RETARDER IN THE LIVING AREA (TYPICALLY POLYETHYLENE, UNLESS MORE STRINGENT PROTECTION REQUIRED BY THE ARCHITECT, ENGINEER, FLOOR COVERING MANUFACTURER, OR ACCEPTED PRACTICE). UNLESS OTHERWISE REQUIRED, BARRIER MAY BE OMITTED AT GARAGES, PORCHES AND PATIOS WITHOUT FLOOR COVERINGS. IT IS BEYOND THE SCOPE OF THESE PLANS TO DETERMINE THE APPLICABILITY OF THESE MORE STRINGENT REQUIREMENTS. BUILDER SHALL VERIFY PRIOR TO CONSTRUCTION.

4. REINFORCEMENT

- IF CONSTRUCTED ON ACTIVE SOILS, THE LONG TERM PERFORMANCE OF THE FOUNDATION IS DEPENDENT ON MAINTENANCE BY THE OWNER. THUS THE BUILDER SHALL ADVISE THE OWNER OF THE FOLLOWING:

1. DRAINAGE MUST BE MAINTAINED. WATER SHALL NEVER BE ALLOWED TO POND NEAR THE FOUNDATION.

2. THE SOIL AROUND THE FOUNDATION SHALL BE MAINTAINED IN A RELATIVELY DAMP CONDITION, SUCH AS THAT REQUIRED TO KEEP A LAWN GREEN. IF IT DRIES OUT IT WILL SHRINK. IF IT GETS WET, IT WILL HEAVE UPWARD.

SLABS ON THE SHORTER SIDE USES MAIN BARS ARE USED IN THIS DIRECTION ONLY WITH SMALLER DIAMETER DISTRIBUTION BARS ARE PLACED, FORMING A MAT OR GRID.

4. ALL REINFORCEMENT BARS SIZE 10MM OR LARGER IN ACCORDANCE TO ASTM ANCHOR BOLTS AT ALL EXTERIOR WALLS SHALL BE MINIMUM 1/2 INCH DIAMETER WITH A

MAXIMUM SPACING OF 6'-0" ON CENTER, UNLESS NOTED OTHERWISE

ANCHOR BOLTS SHALL BE INSTALLED WITHIN 12 INCHES OF EACH END OF EACH SILL PLATE WITH AT LEAST TWO ANCHOR BOLTS FOR EACH BOLTS FOR EACH SILL PLATE LONGER THAN 12 INCHES.


5. SIMPSONS SILL ANCHORS MAYBE SUBSTITUTED FOR ANCHOR BOLTS AT THE SAME SPACING.

EXTERIOR CONCRETE SLABS WHICH ARE NOT PART OF THE MAIN SLAB SHALL BE MINIMUM 4 INCHES THICK WITH NO STEEL REINFORCING BARS REQUIRED, UNLESS NOTED OTHERWISE ON FOUNDATION PLAN.

VERIFY THE FOLLOWING PRIOR TO POURING:

- ALL HOLDDOWNS, STRAP, AND POST LOCATIONS.
- CONCRETE FINISHES. PANEL RISER LOCATION WHERE APPLICABLE.
- 3. UNDERSLAB MECHANICAL REQUIREMENTS.
- 4. STEM WALL BLOCKOUTS.
- 5. UNDERSLAB ELECTRICAL REQUIREMENTS AND PANEL RISER LOCATION. WHERE
- 6. PROVIDE THE FOLLOWING:
- PVC SLEEVES THROUGH FTG IF REQUIRED
- 20' #4 COPPER GROUND BAR.
- SLOPE FINISH GRADE AWAY FROM FOOTING.

NOTE: FIELD VERIFY ALL DIMENSIONS SEE DIMENSIONED ARCHITECTURAL DRAWINGS

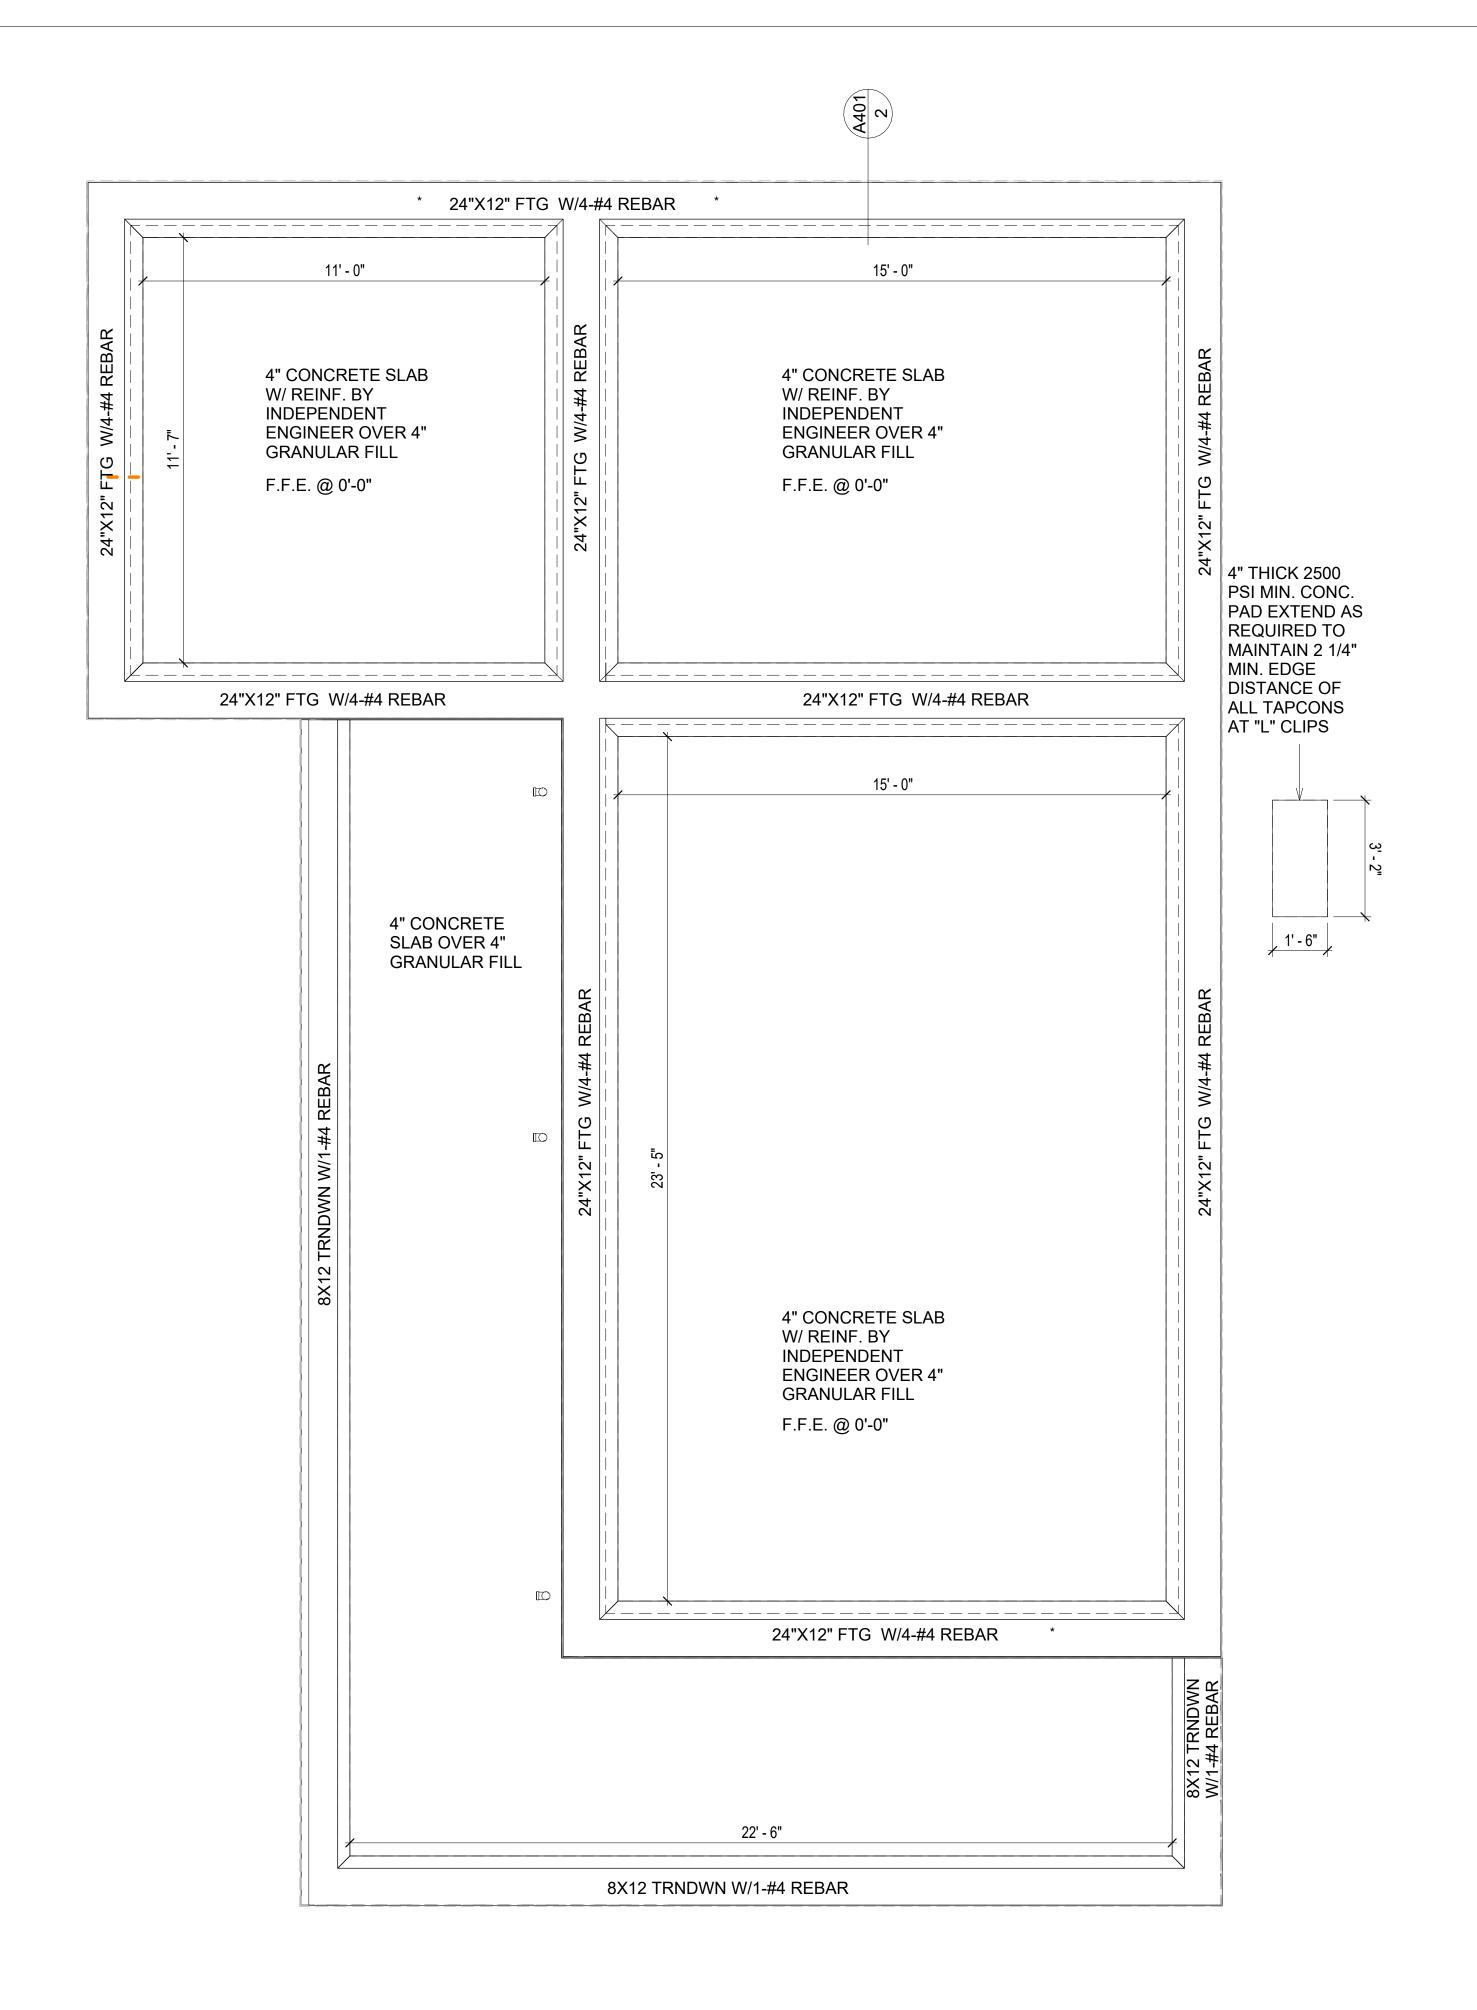

FOUNDATION PLAN 3/8" = 1'-0"

SQUARE FOOTAGE **PORCH 3**47 TOTAL 1256



KEY PLAN

	DESCRIPTION	DATE
TE:		

LEGEND:

PROJECT

130-ORION-910-2BD 2BA-SPANISH-TOWER-550

DRAWING NAME

FOUNDATION PLAN

CLIENT NAME:	Client Name
PROJECT NUMBER:	0033_15
DATE:	3/22/2025 11:48:08 AM
DESIGNED BY:	Designer
DRAWN BY:	Author
CHECKED BY:	Checker

S101

SCALE: 3/8" = 1'-0"

GENERAL NOTES

NOTES:

-ALL BEARING WALLS SHOULD HAVE A THICKENED SLAB PER SECTION PER DETAIL A401/5.

A) **FOUNDATION PLAN NOTES**:

- 1. CONCRETE SLAB SHALL BE 6" THICK WITH 1/2" DIAMETER TENDONS PER LAYOUT PLAN, CENTERED IN SLAB THICKNESS, OVER APPROVED SUBBASE PER GENERAL STRUCTURE NOTES.
- 2. TERMITE PROTECTION SHALL BE PROVIDED PER IRC SECTION R318.1
 3. NONE TYPICAL ANCHOR BOLT SPACING AT SHEAR WALL AND HOLD DOWN SPECIFICATIONS PER APPROVED ARCHITECTURAL PLANS.
- INSTALL HOLDOWNS BEFORE CONCRETE SLAB POUR.
 EXISTING FILL ON-SITE SHALL BE COMPACTED IN ACCORDANCE WITH THE
- REQUIREMENTS IN THE GEOTECHNICAL REPORT.

 6. ALL FLOOR SLABS ARE REINFORCED ON CONCRETE SLABS.

SPECIAL INSPECTION IS REQUIRED FOR THICKENED FOUNDATION CONSTRUCTION

- 1. REINFORCEMENT
- 2. 2300 PSI CONCRETE POUR

B) REINFORCEMENT FOR CONCRETE:


ALL REINFORCING SLABS BARS SIZE 10MM OR LARGER SHALL BE DEFORMED IN ACCORDANCE TO ASTM-A706, AND BARS SMALLER THAN 10 MM MAYBE PLAIN.
 UNLESS OTHERWISE NOTED IN PLANS, THE YIELD STRENGTH OF REINFORCING BARS SHALL BE:


A) FOOTING = 40,000 PSI B) NON-LOAD BEARING WALLS AND PARAPETS= 40,000 PSI

- 3. SPLICES SHALL BE SECURELY WIRED TOGETHER AND SHALL LAP OR EXTEND
- 4. GRADE OF STEEL FOR RCC WORKS SHALL BE GRADE 4 10.
- BAR NOTATIONS GIVES INFORMATION
- A) BAR SIZE
- B) SPACING(IF REQUIRED)
- 6. LAP REINFORCEMENT ONLY AT LOCATION SHOWN IN THE DRAWINGS7. REINFORCEMENT SHALL NOT BE CUT, VENT OR HEATED ON SITE WITHOUT ENGINEERS'
- 7. REINFORCEMENT SHALL NOT BE CUT, VENT OR HEATED ON SITE WITHOUT ENGINEER APPROVAL.
- C) **CONCRETE SLAB NOTES**
- 1. ALL SLAB REINFORCEMENT SHALL BE 20MM CLEAR MINIMUM FROM BOTTOM AND FROM TOP OF SLAB.
- 2. REINFORCEMENT IN CONTINUOUS ELEVATED SLAB SHALL BE CUT AS FOLLOWS.

NOTE

- THIS IS A SCHEMATIC PLAN FOR THE PURPOSE OF LOCATING AND IDENTIFYING FOUNDATION REINFORCING ELEMENTS ONLY. VERIFY ALL DIMENSIONS, DROPS, OFFSETS AND FEATURES WITH THE ARCHITECTURAL PLANS BEFORE FORMING THE FOUNDATION.

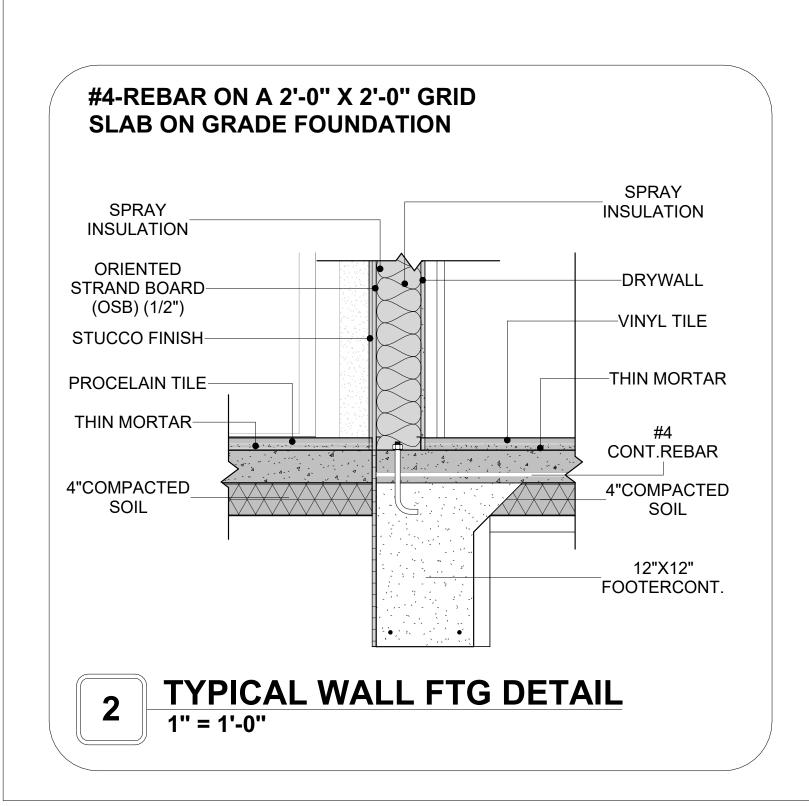

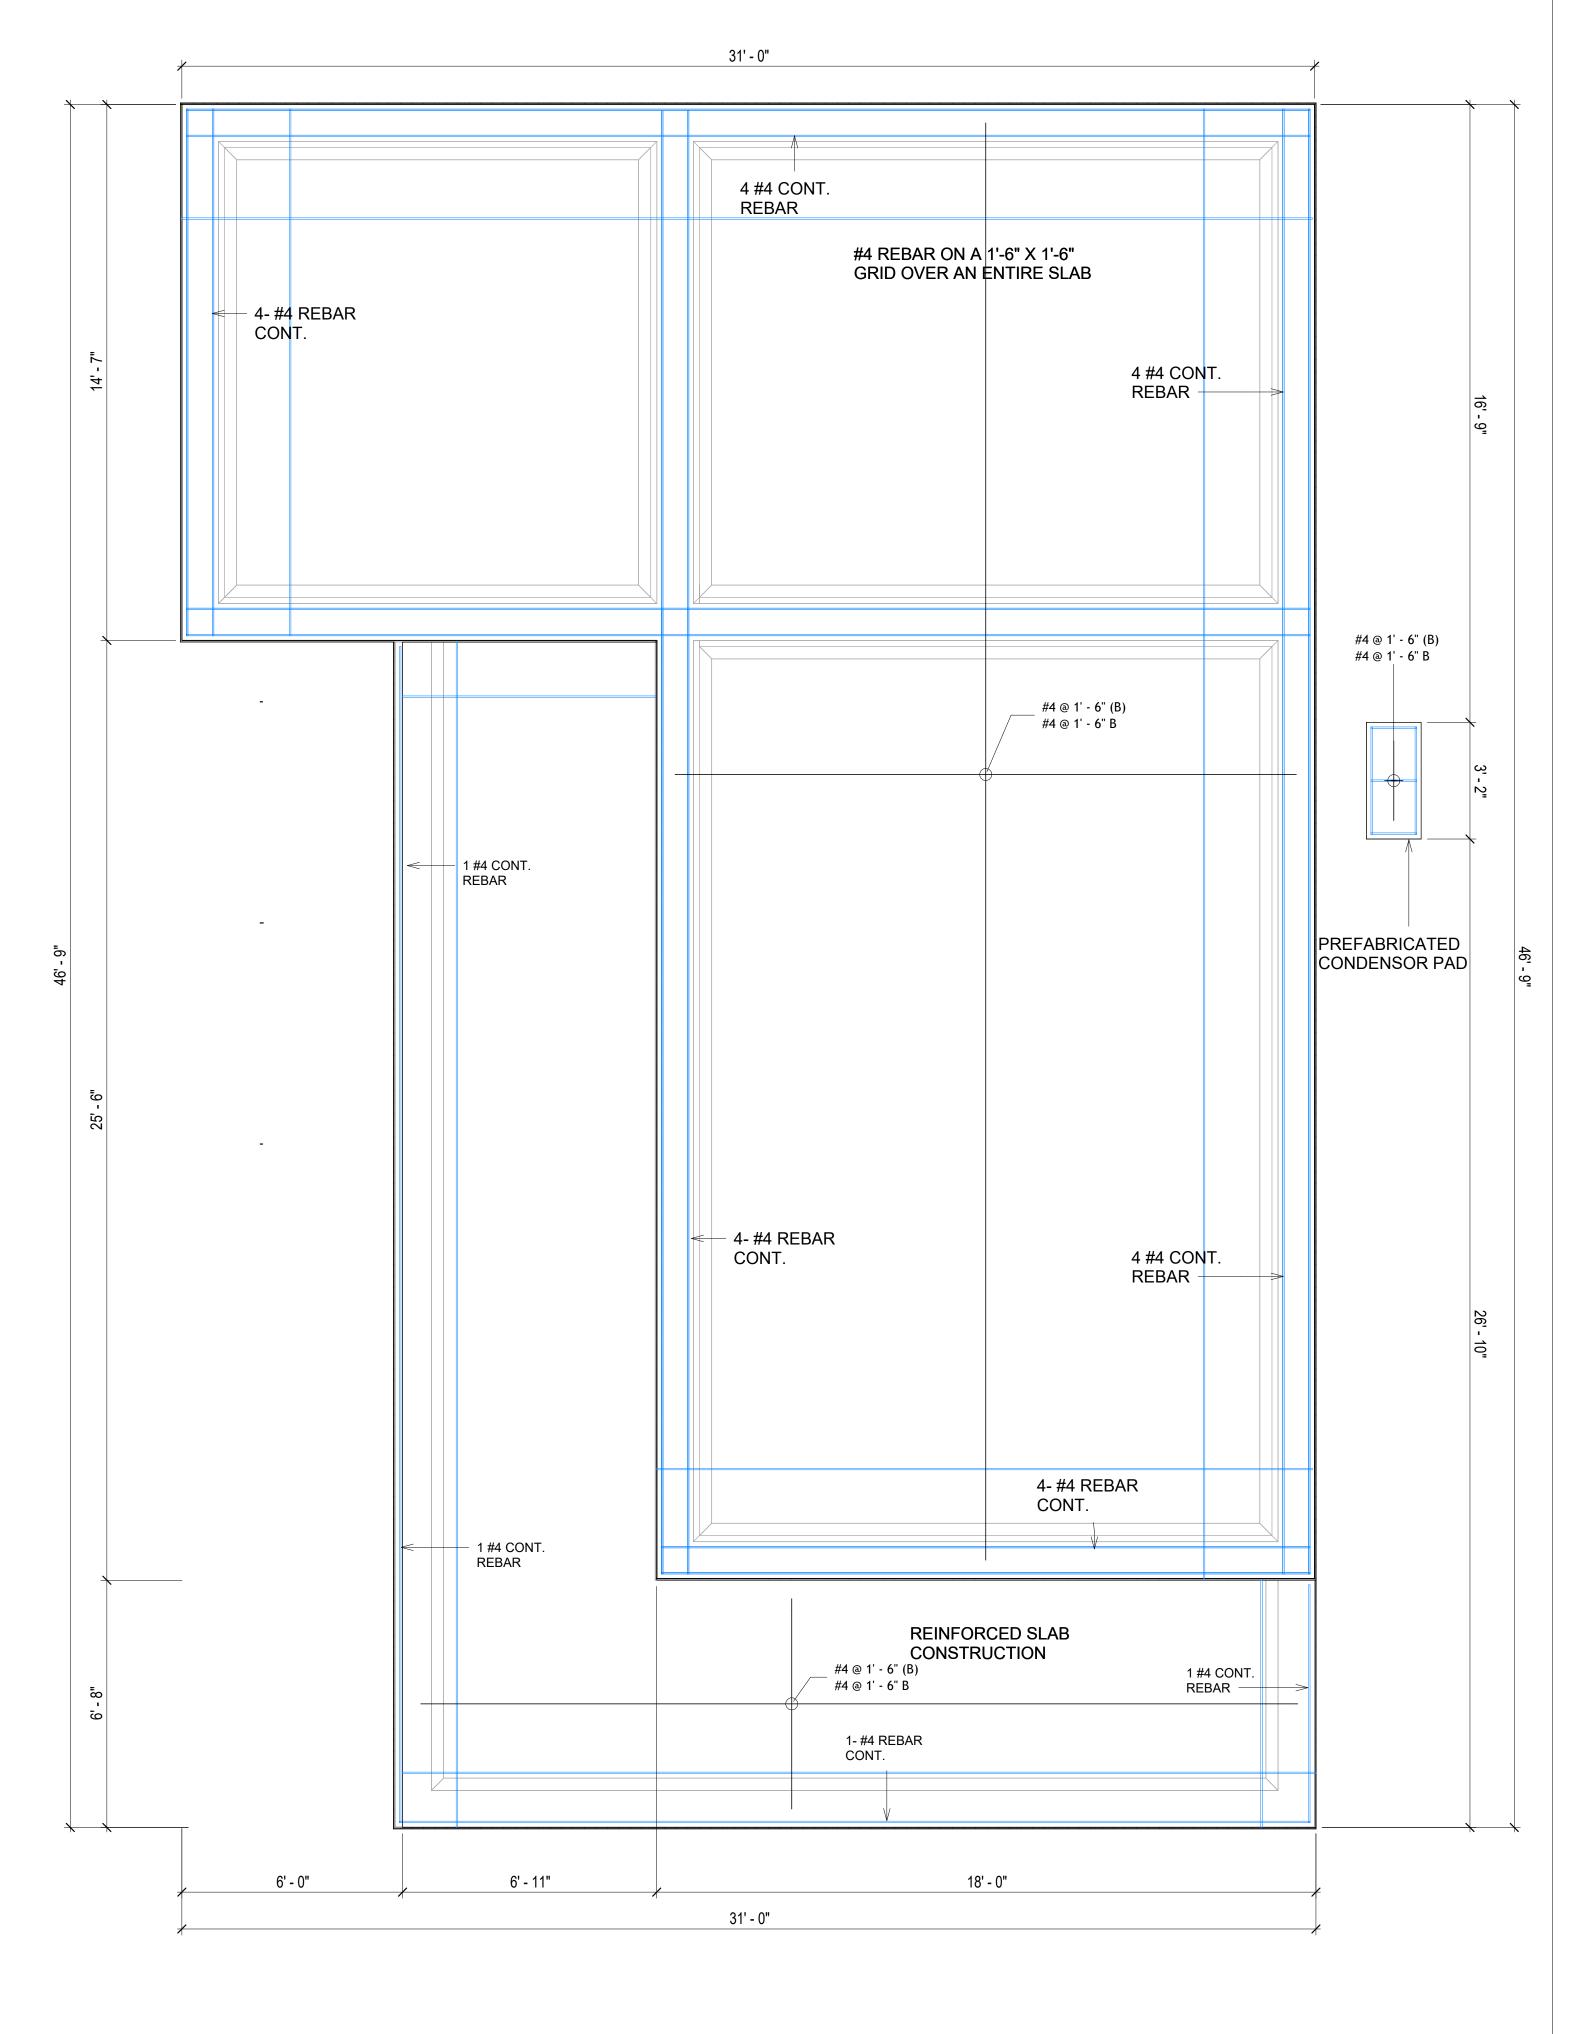

Tuscon,AZ, USA 888-864-0184 inquire@frameupnow.com www.frameupnow.com

KEY PLAN

NO. DESCRIPTION DATE

NOTE:

LEGEND:

PROJECT

130-ORION-910-2BD 2BA-SPANISH-TOWER-550

DRAWING NAME

STRUCTURAL FLOOR PLAN

CLIENT NAME:

PROJECT NUMBER:

0033_15

DATE:

3/22/2025 11:48:09 AM

DESIGNED BY:

DRAWN BY:


CHECKED BY:

Checker

S102

SCALE: As indicated

FOUNDATION REBAR PLAN
3/8" = 1'-0"

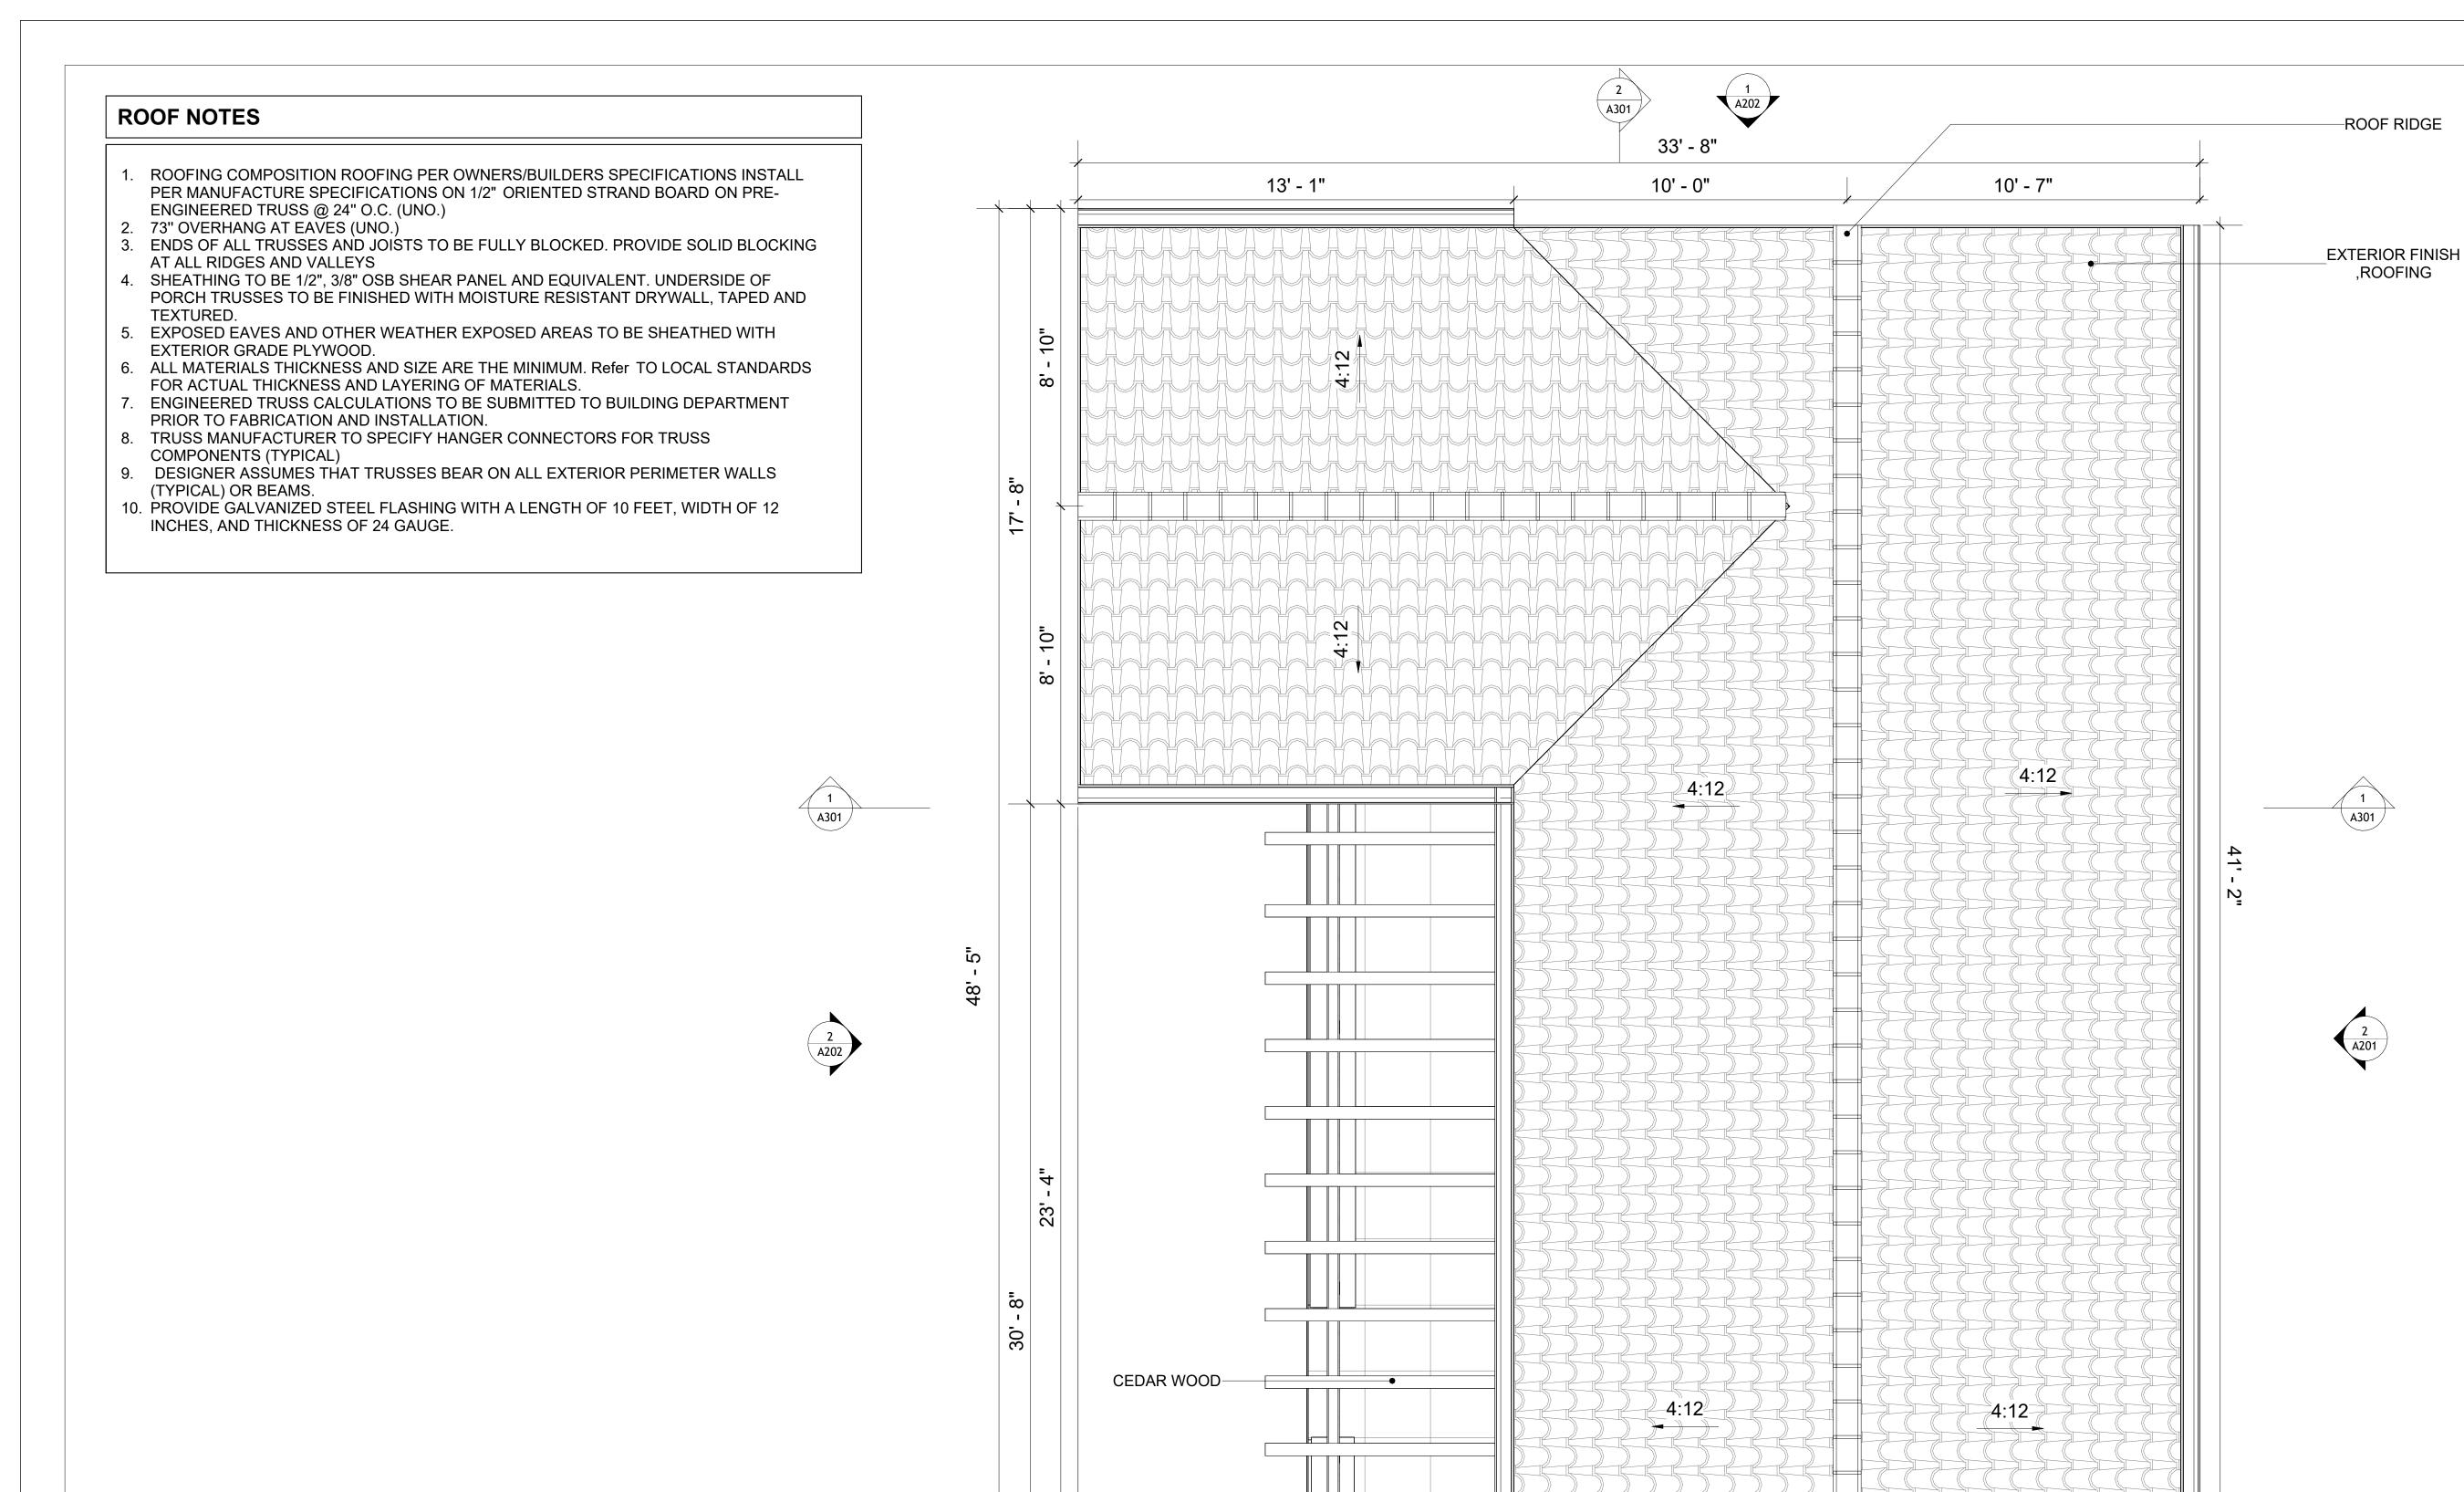

EXTERIOR FINISH_ ,ROOFING


6' - 10"

ROOF PLAN 3/8" = 1'-0"

7' - 9"

ROOF RIDGE-

\ \ \

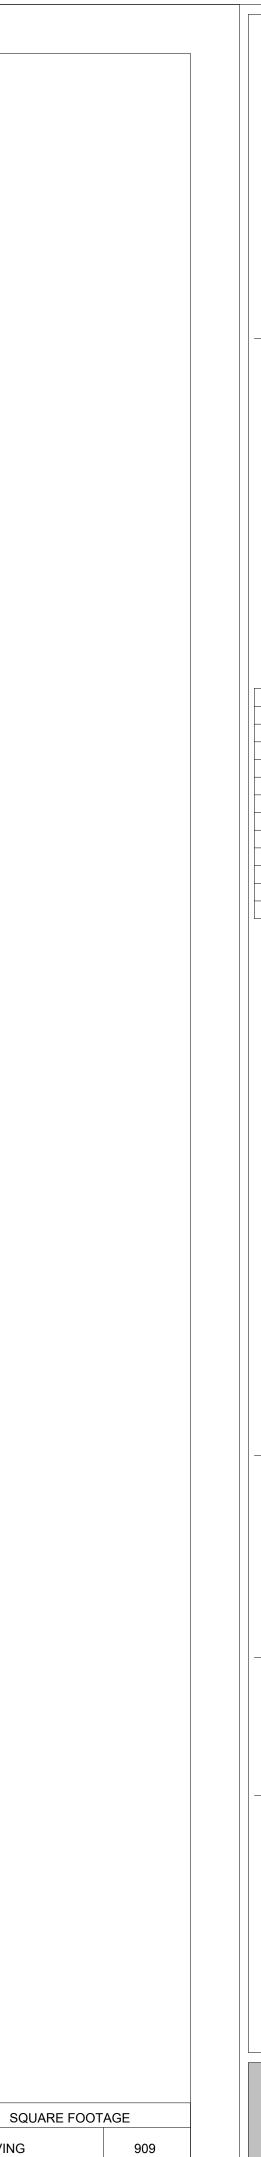



KEY PLAN

-ROOF RIDGE

,ROOFING

A301

EXTERIOR FINISH ,ROOFING

LIVING

PORCH

TOTAL

1256

8' - 6"

33' - 8"

10' - 7"

NO.	DESCRIPTION	DATE

NOTE:

LEGEND:

PROJECT

130-ORION-910-2BD 2BA-SPANISH-TOWER-550

DRAWING NAME

ROOF PLAN

Client Name
0033_15
3/22/2025 11:48:12 AM
Designer
Author
Checker

A103

SCALE: As indicated

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ABOUT WALL FINISHING

STUCCO FINISH

STUCCO IS A CEMENT-BASED EXTERIOR WALL FINISH THAT OFFERS A DURABLE, WEATHER-RESISTANT, AND CUSTOMIZABLE CLADDING SOLUTION FOR BUILDINGS.

IN THIS SPECIFIC PROJECT, AMERICAN STUCCO SYSTEMS IS USED AS A FINISH MATERIAL BECAUSE IT IS GENERALLY CONSIDERED A WATER-RESISTANT EXTERIOR FINISH AND USES A THREE-COAT APPLICATION PROCESS.

3/8-INCH OF IT IS APPLIED AS AN EXTERNAL WALL FINISH AS IT IS THE MOST COMMON AND WIDELY ACCEPTED STANDARD THICKNESS FOR STUCCO EXTERIOR WALL FINISHES. THIS MULTI-LAYER APPROACH ALSO HELPS CREATE A STRONG, CRACK-RESISTANT STUCCO SURFACE.

THIS STANDARD STUCCO IS APPLIED OVER OSB SHEATHINGS (FOR COLD FORMED STRUCTURE CONSTRUCTION).

IT IS NOT DIRECTLY TROWELED OVER THE OSB BUT OVER A WATER-RESISTANT BARRIER (HOMEWRAP) AND METAL/PLASTIC LATH THAT ARE INSTALLED ON TOP SURFACE OF THE OSB TO PROVIDE AN ADDITIONAL LAYER OF PROTECTION AGAINST MOISTURE INTRUSION.


REGULAR INSPECTION AND PROMPT REPAIR OF ANY CRACKS, CHIPS, OR DAMAGE TO THE STUCCO FINISH IS IMPORTANT. THIS MAINTAINS THE STUCCO'S WATER-RESISTANT PROPERTIES OVER THE BUILDING'S LIFE SPAN.

CEDAR WOOD


CEDAR WOOD REFERS TO THE WOOD FROM VARIOUS SPECIES OF CEDAR TREES, WHICH ARE CONIFEROUS EVERGREEN TREES KNOWN FOR THEIR DISTINCT AROMA AND NATURAL RESISTANCE TO DECAY AND INSECTS.

IN THIS SPECIFIC PROJECT, CEDAR WOOD IS USED AS A FURRING STRIP AND A FINISH MATERIAL ON BEAMS AND COLUMNS.

CEDAR WOOD AS A FURRING STRIPS PROVIDE THERMAL INSULATION AND MOISTURE MANAGEMENT. THE VERTICAL CEDAR WOOD FURRING STRIPS ARE ATTACHED TO HOME WRAP USING CORROSION-RESISTANT FASTENERS (HOT-DIP GALVANIZED SCREWS), ENSURING PROPER PENETRATION INTO THE WALL FRAMING.

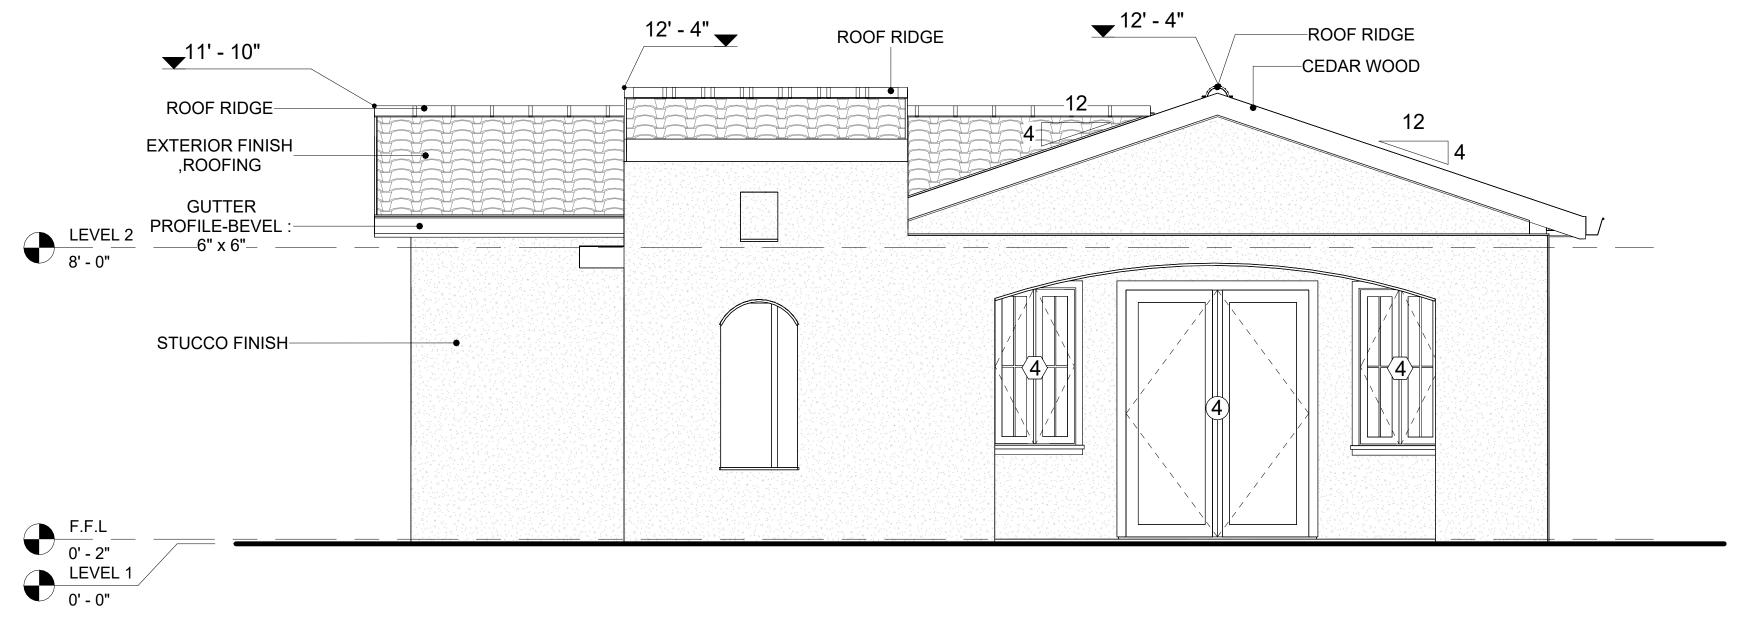

1 FRONT ELEVATION
3/8" = 1'-0"

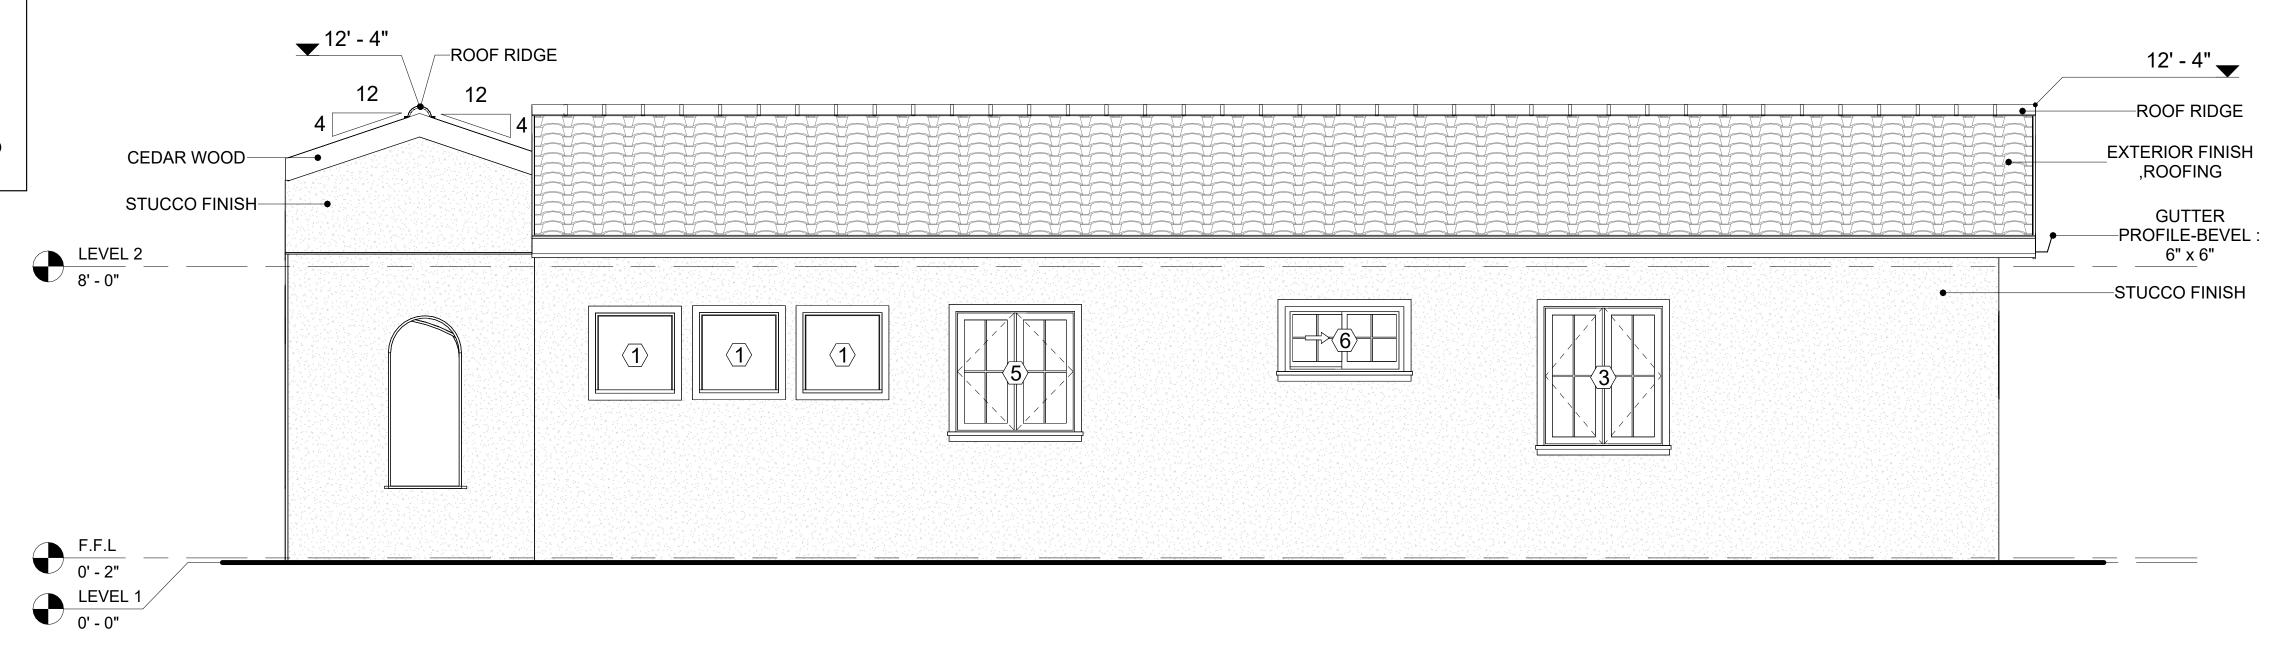


2 RIGHT SIDE ELEVATION
3/8" = 1'-0"

DOOR SCHEDULE						
TYPE MAR				SIZE		
K	SUPPLIER	DOOR TYPE	LOCATION	WIDTH	HEIGHT	COUNT
1	HOME DEPOT	EXTERIOR SINGLE PANEL SWINGING	INTERIOR	3' - 0"	6' - 8"	1
2	HOME DEPOT	INTERIOR DOUBLE PANEL SLIDING	INTERIOR	9' - 0"	6' - 8"	2
3	HOME DEPOT	INTERIOR SINGLE PANEL SWINGING	INTERIOR	2' - 6"	6' - 8"	2
4	HOME DEPOT	EXTERIOR DOUBLE PANEL SWINGING	INTERIOR	5' - 0"	6' - 8"	1
5	HOME DEPOT	INTERIOR SINGLE PANEL SWINGING	INTERIOR	3' - 0"	6' - 8"	1
6	HOME DEPOT	PATIO_DOUBLE PANEL_SLIDING	INTERIOR	5' - 0"	6' - 8"	1
7	HOME DEPOT	INTERIOR SINGLE PANEL SWINGING	INTERIOR	3' - 0"	6' - 8"	1
8	HOME DEPOT	SINGLE FOLD 2	INTERIOR	2' - 4"	6' - 8"	1
9	HOME DEPOT	INTERIOR DOUBLE PANEL SLIDING	INTERIOR	3' - 5"	6' - 8"	1

WINDOW SCHEDULE					
				SIZE	
TYPE MARK	SUPPLIER	WINDOW TYPE	WIDTH	HEIGHT	COUNT
1	HOME DEPOT	FIXED	2' - 3"	2' - 3"	9
2	HOME DEPOT	SLIDING	5' - 3"	4' - 3"	1
3	HOME DEPOT	DOUBLE HUNG	3' - 3"	3' - 9"	2
4	HOME DEPOT	DOUBLE HUNG	2' - 3"	4' - 3"	2
5	HOME DEPOT	DOUBLE HUNG	3' - 3"	3' - 3"	1
6	HOME DEPOT	SLIDING	3' - 3"	1' - 9"	1



KEY PLAN

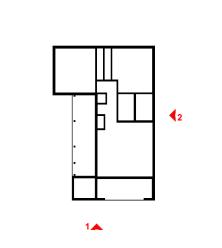

NO.	DESCRIPTION	DATE

NOTE:

LEGEND:

PROJECT

130-ORION-910-2BD 2BA-SPANISH-TOWER-550

DRAWING NAME

ARCHITECTURAL ELEVATIONS

Client Name
0033_15
3/22/2025 11:48:16 AM
Designer
Author
Checker

A201

ABOUT WALL FINISHING

STUCCO FINISH

STUCCO IS A CEMENT-BASED EXTERIOR WALL FINISH THAT OFFERS A DURABLE, WEATHER-RESISTANT, AND CUSTOMIZABLE CLADDING SOLUTION FOR BUILDINGS.

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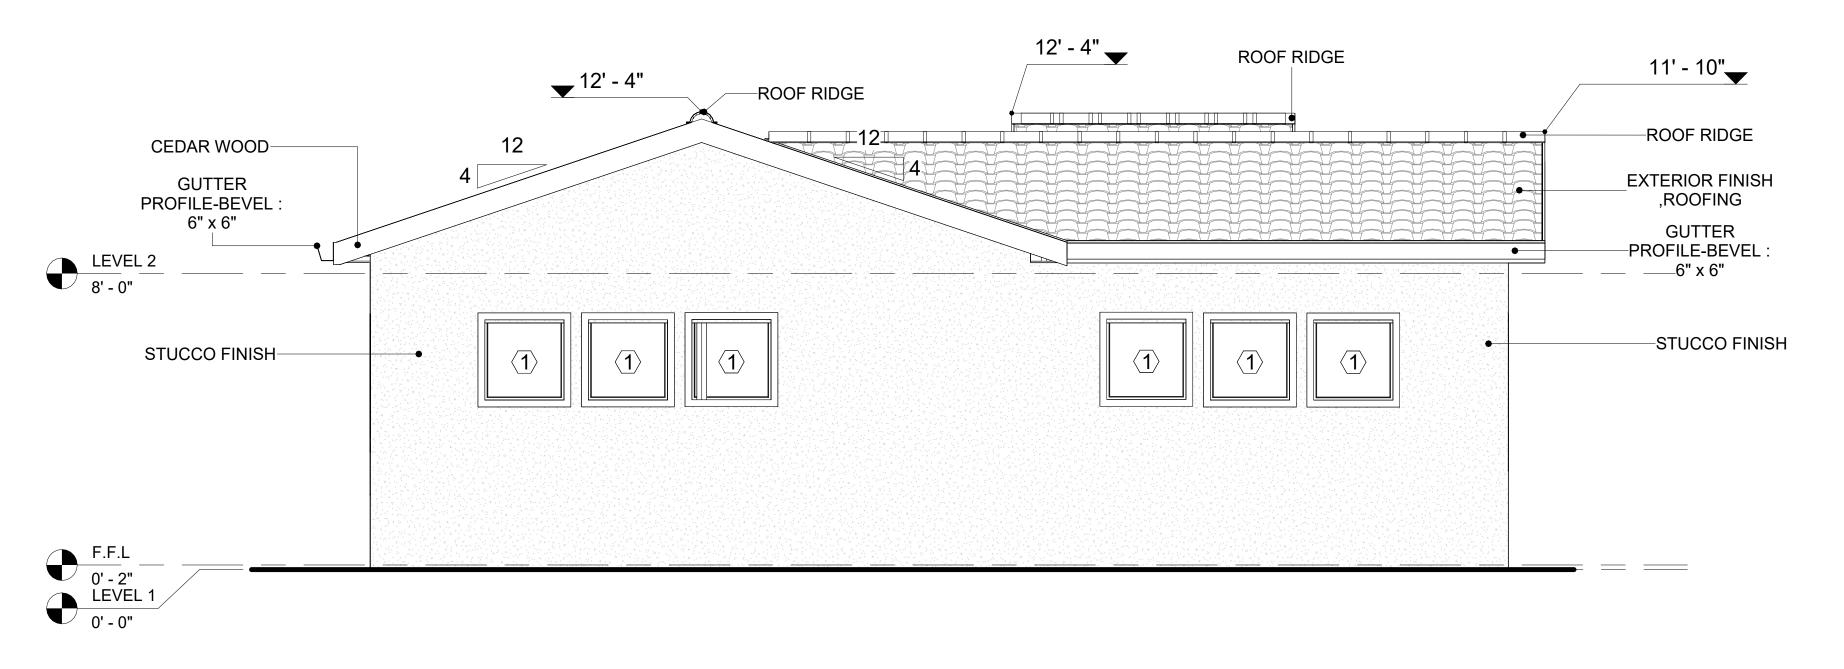
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CEDAR WOOD


CEDAR WOOD REFERS TO THE WOOD FROM VARIOUS SPECIES OF CEDAR TREES, WHICH ARE CONIFEROUS EVERGREEN TREES KNOWN FOR THEIR DISTINCT AROMA AND NATURAL RESISTANCE TO DECAY AND INSECTS.

IN THIS SPECIFIC PROJECT, CEDAR WOOD IS USED AS A FURRING STRIP AND A FINISH MATERIAL ON BEAMS AND COLUMNS.

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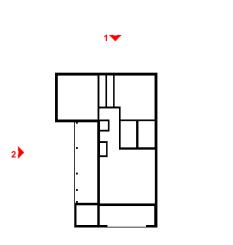
1 REAR ELEVATION
3/8" = 1'-0"



2 LEFT SIDE ELEVATION
3/8" = 1'-0"

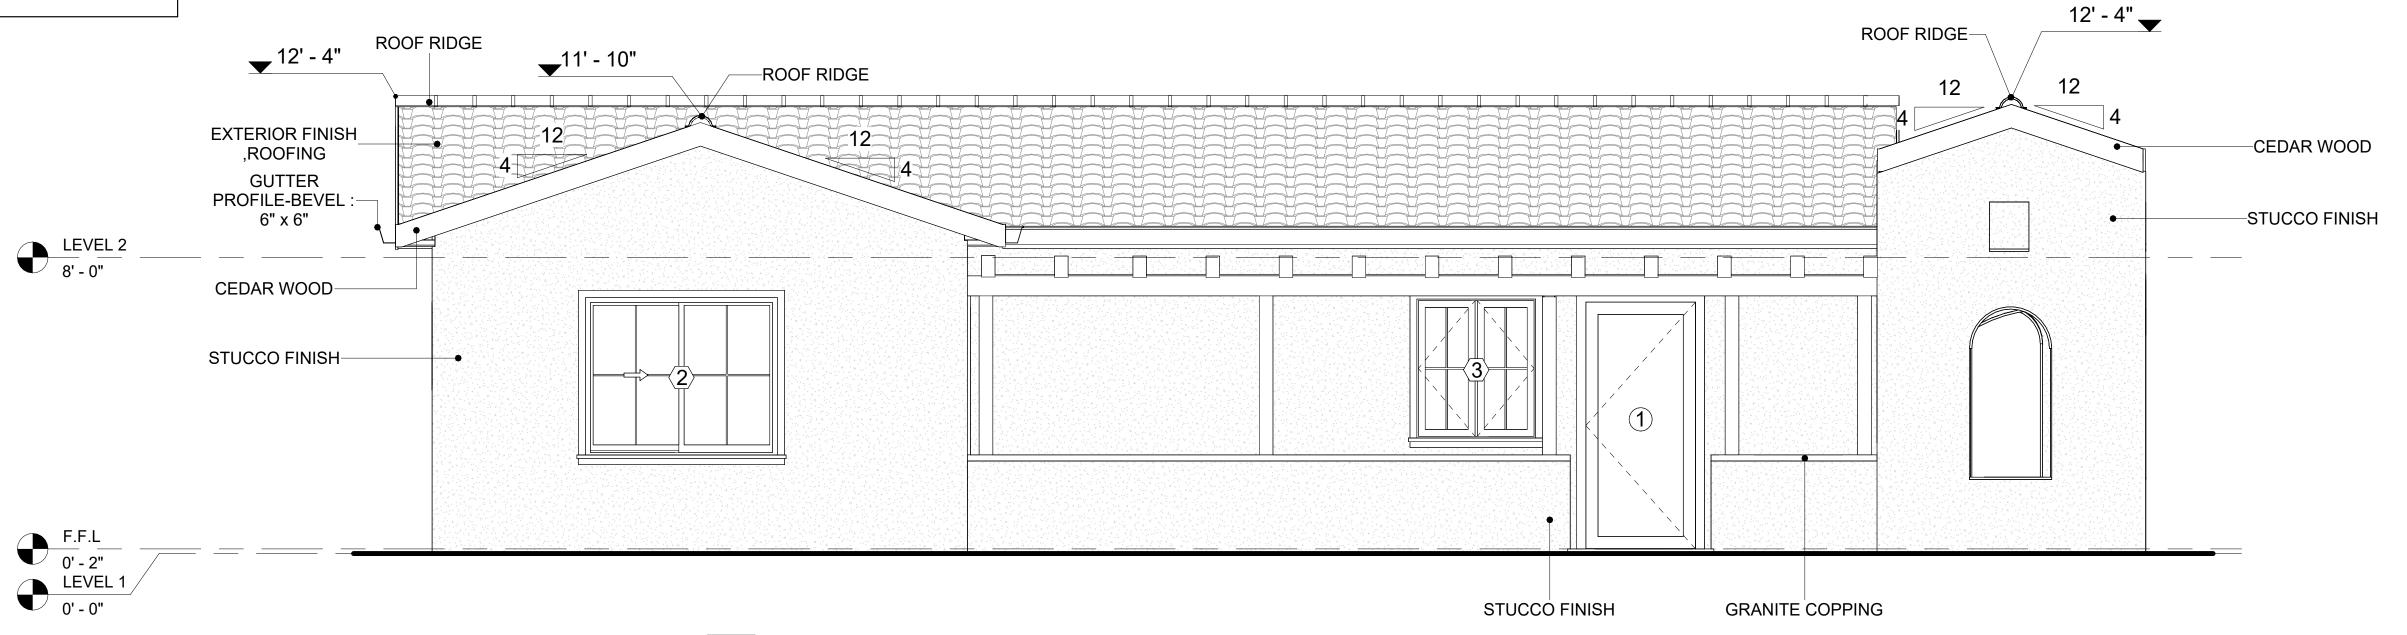

KEY PLAN



NO.	DESCRIPTION	DATE

NOTE:

LEGEND:

PROJECT


130-ORION-910-2BD 2BA-SPANISH-TOWER-550


DRAWING NAME

ARCHITECTURAL ELEVATIONS

NT NAME:	Client Name
JECT NUMBER:	0033_15
Ξ:	3/22/2025 11:48:20 AM
IGNED BY:	Designer
WN BY:	Author
CKED BY:	Checker


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KEY PLAN

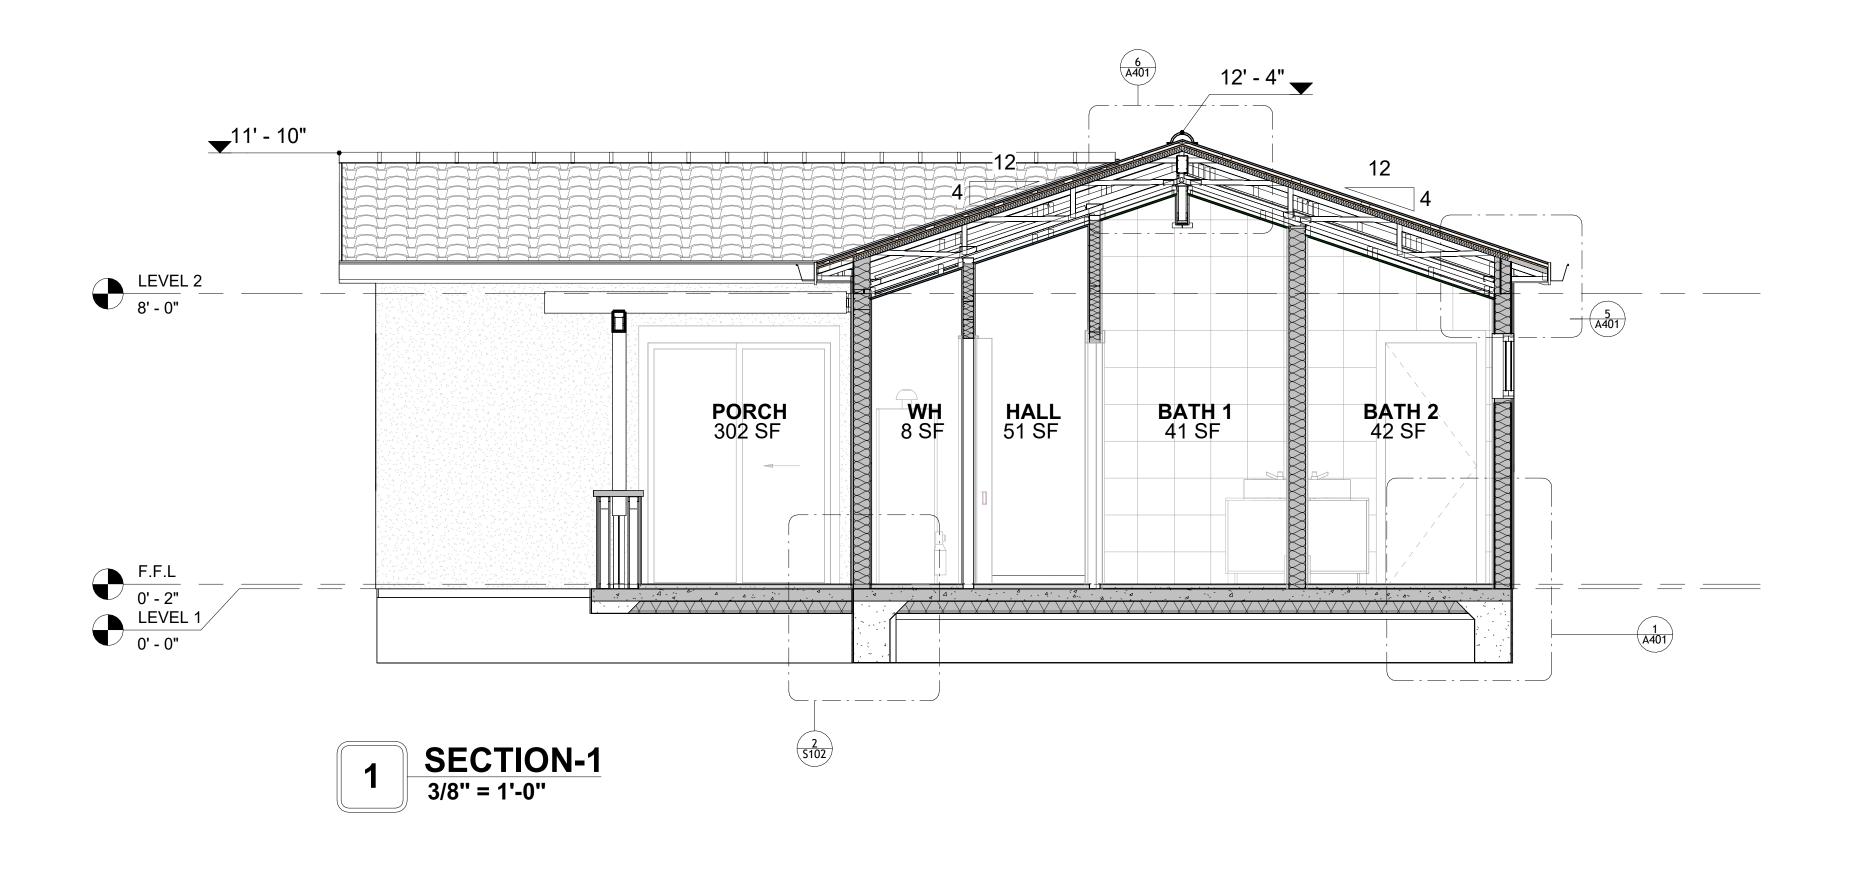

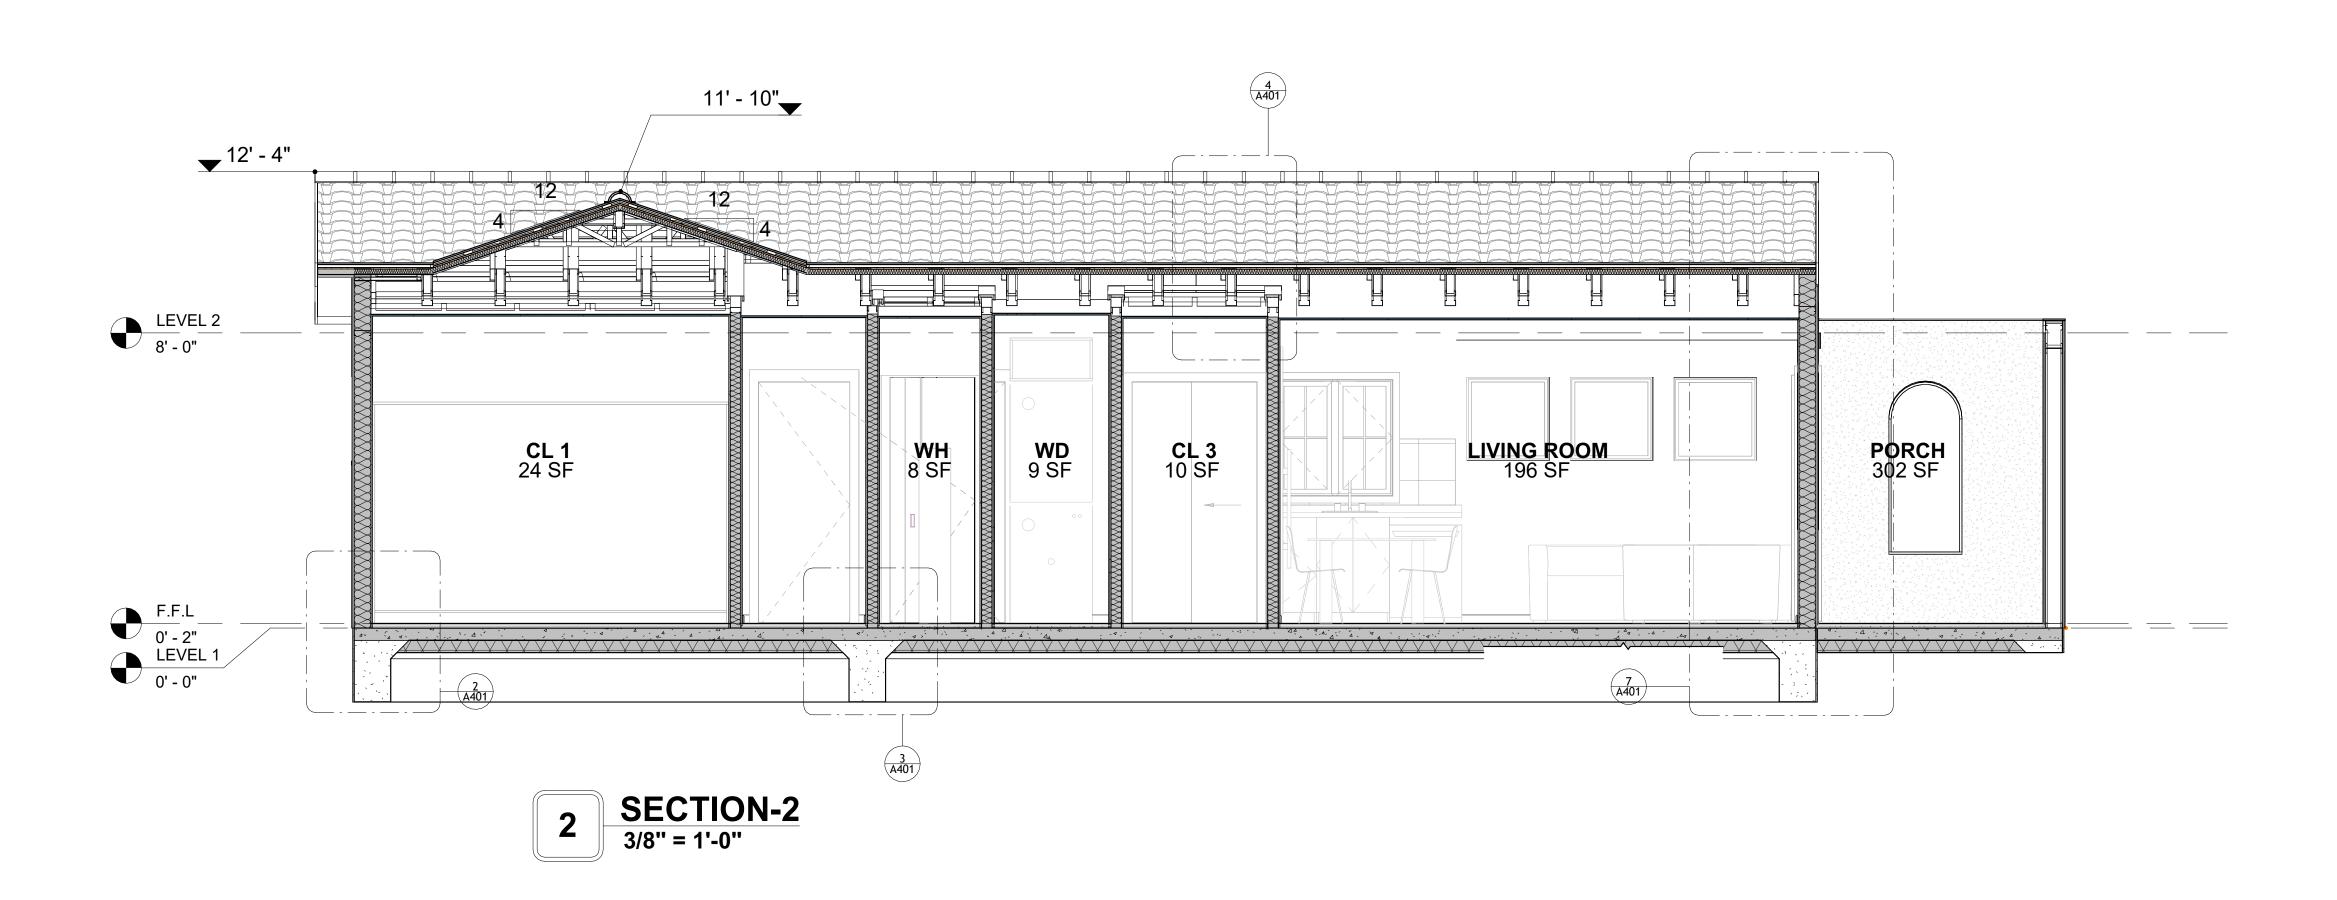NO.	DESCRIPTION	DATE

NOTE:

LEGEND:

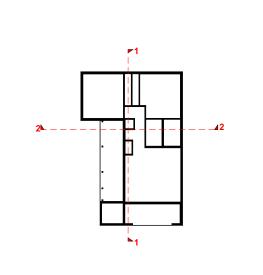PROJECT


130-ORION-910-2BD 2BA-SPANISH-TOWER-550


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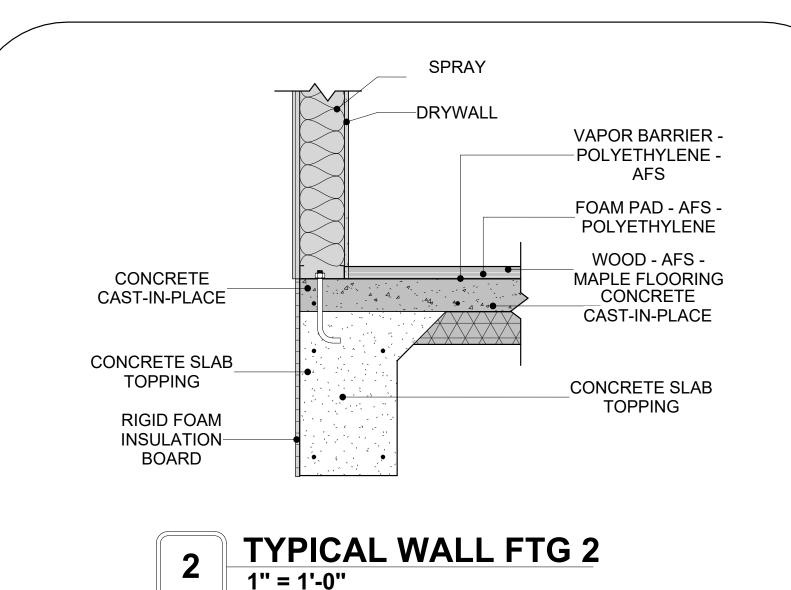
ARCHITECTURAL SECTIONS


CLIENT NAME:	Client Name
PROJECT NUMBER:	0033_15
DATE:	3/22/2025 11:48:22 AM
DESIGNED BY:	Designer
DRAWN BY:	Author
CHECKED BY:	Checker


A301




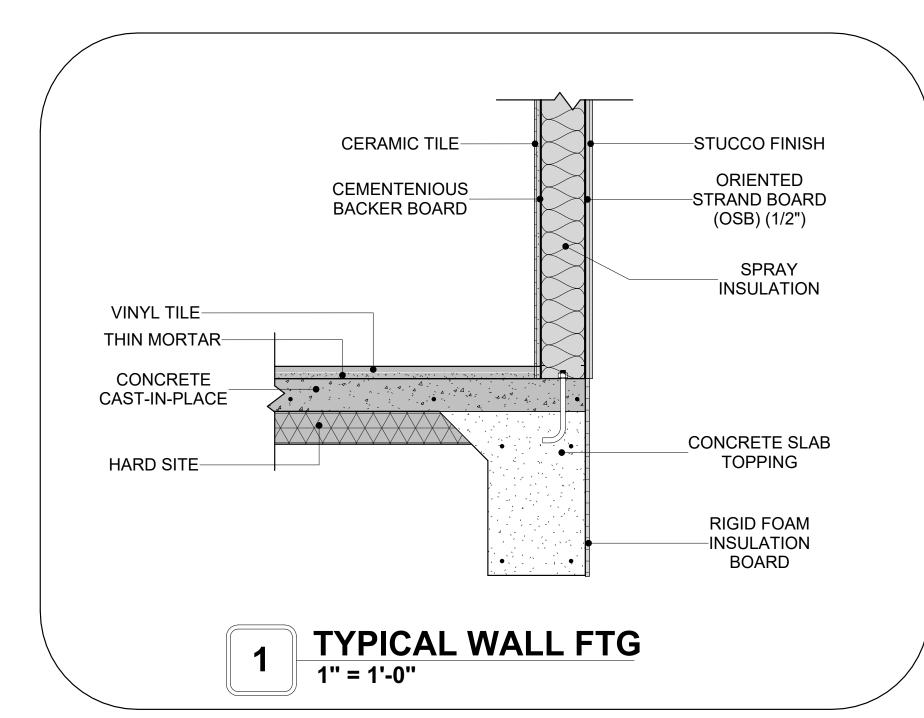


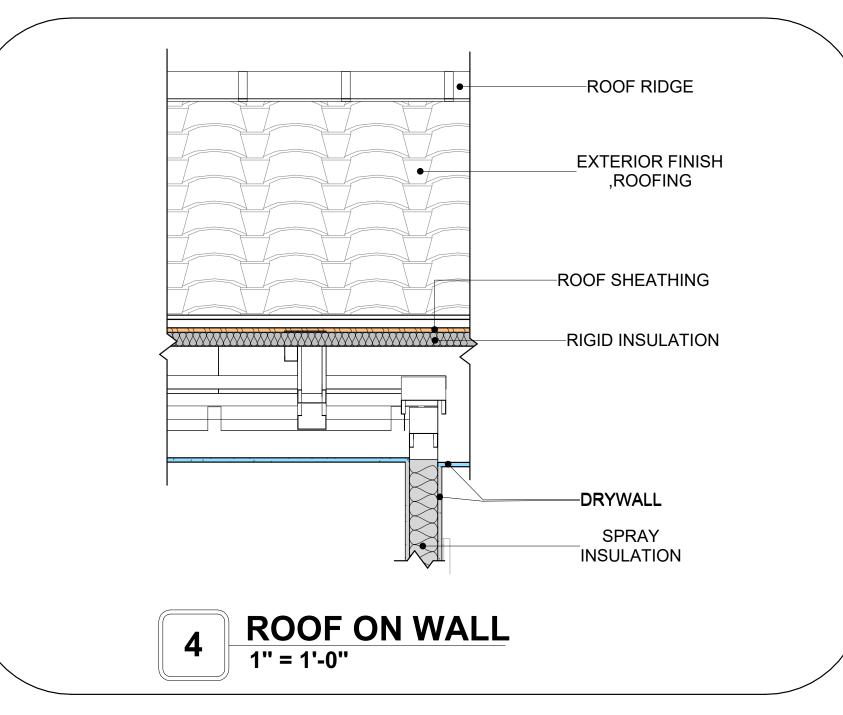

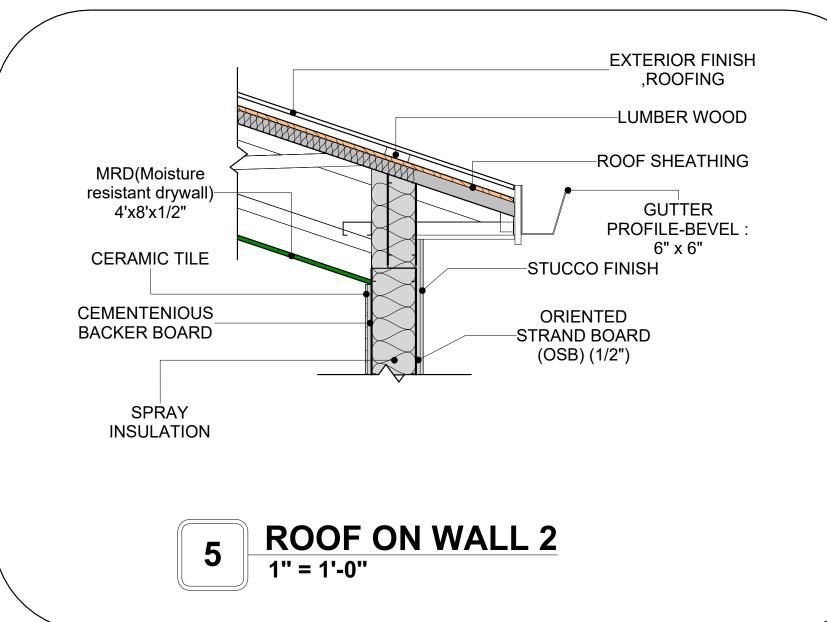

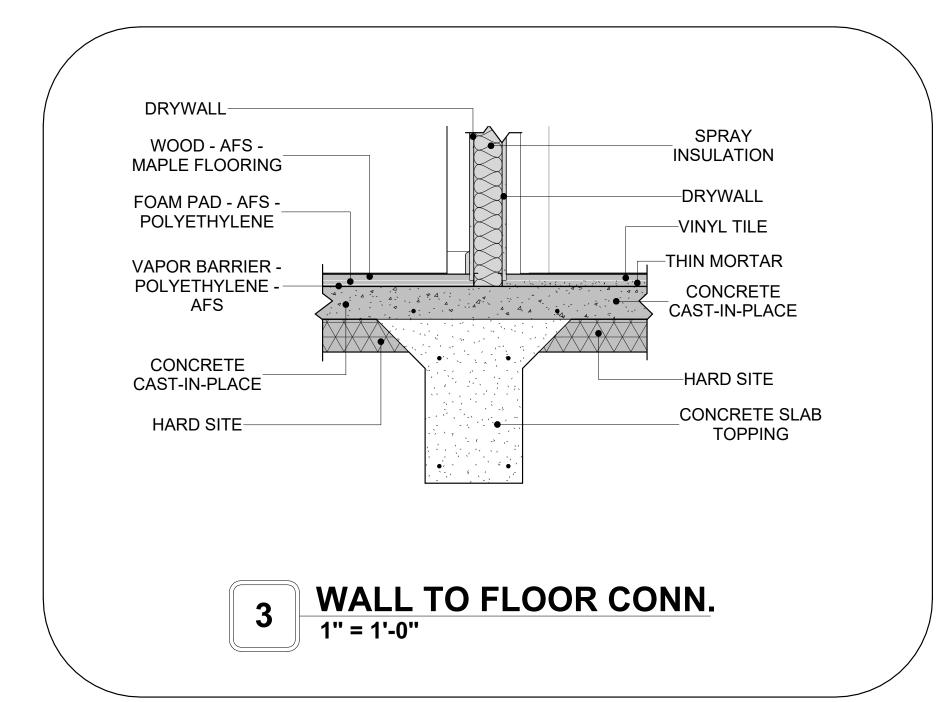

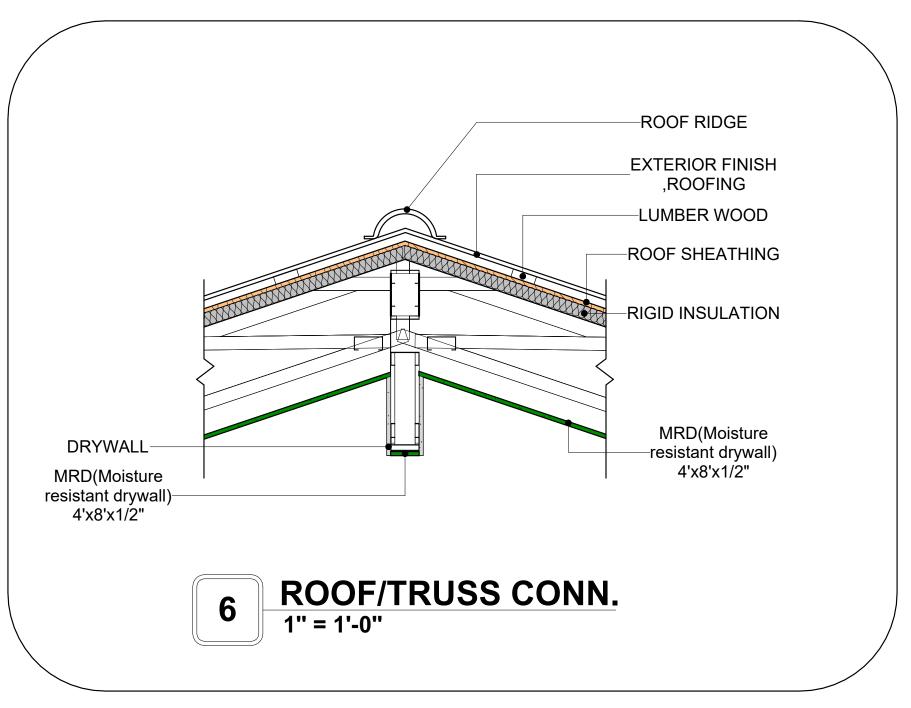

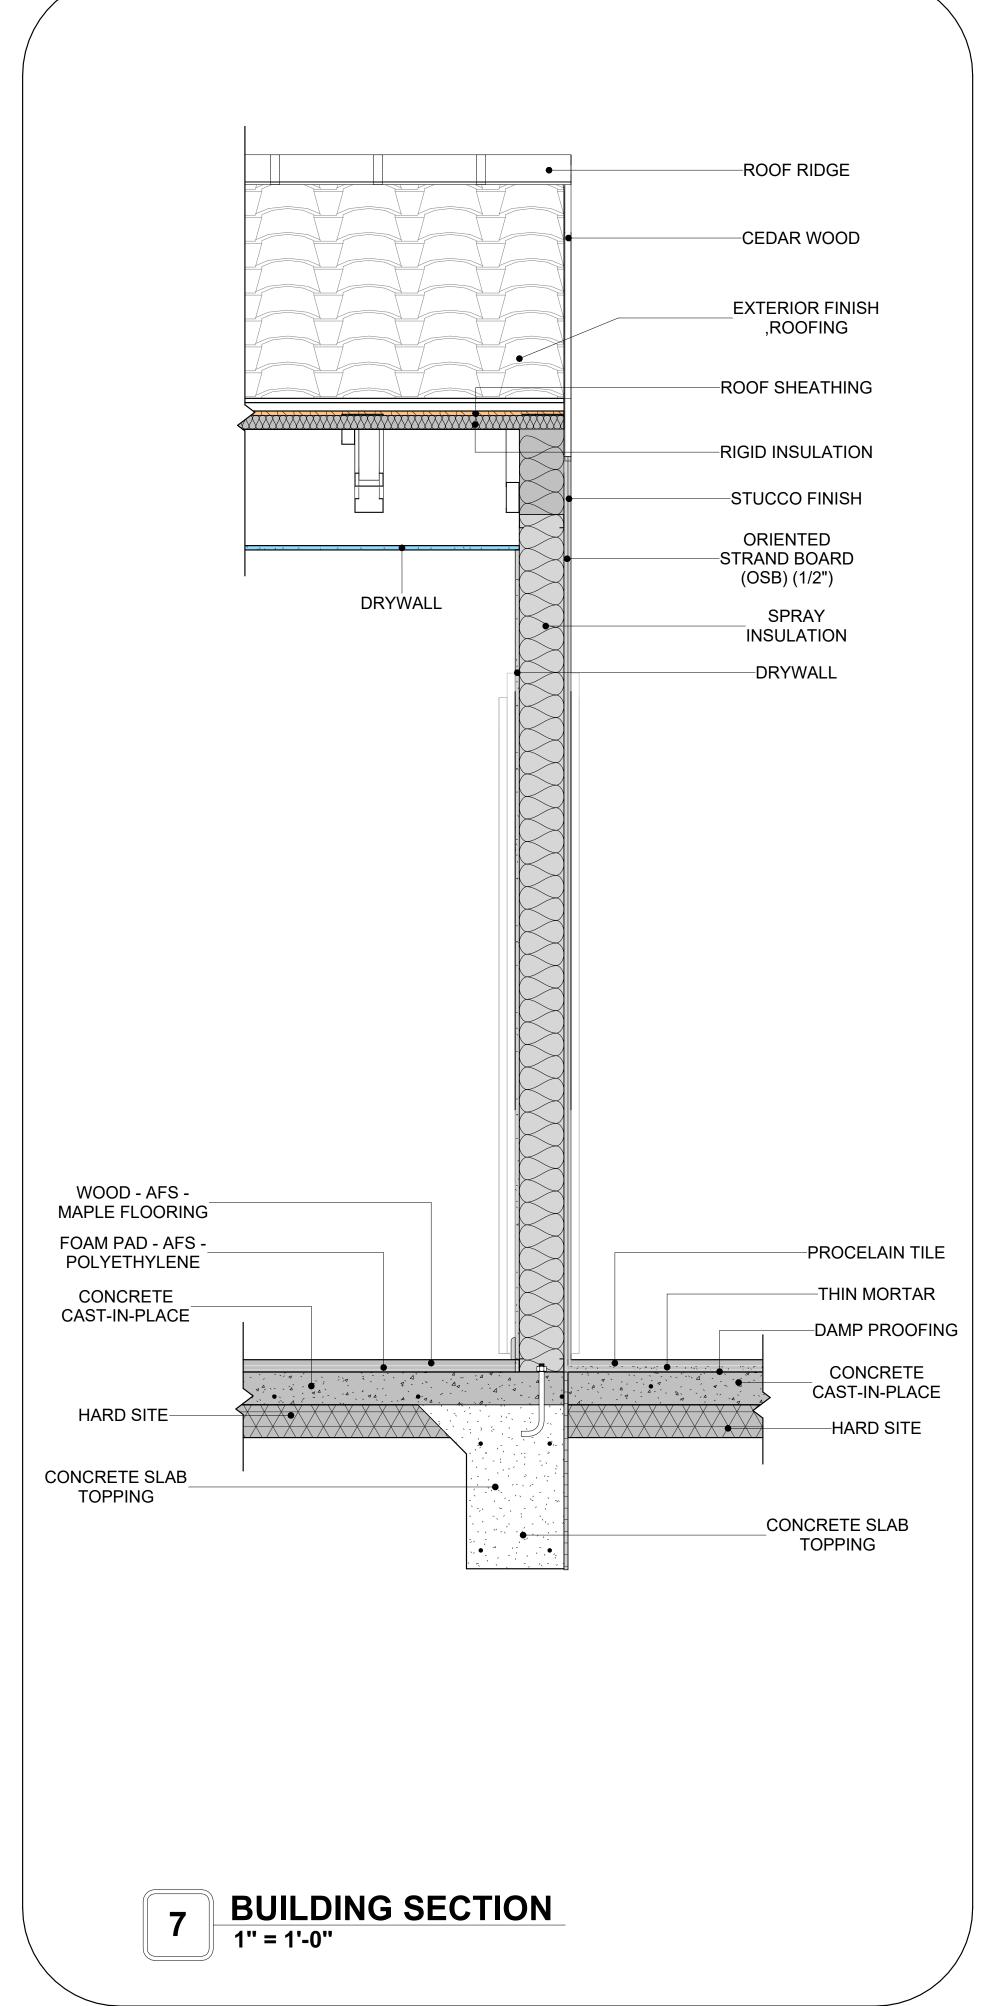



KEY PLAN

NO. DESCRIPTION DATE

NOTE:

LEGEND:

PROJECT

130-ORION-910-2BD 2BA-SPANISH-TOWER-550

DRAWING NAME

ARCHITECTURAL DETAILS

CLIENT NAME:

PROJECT NUMBER:

0033_15

DATE:

3/22/2025 11:48:23 AM

DESIGNED BY:

DRAWN BY:

CHECKED BY:

Checker

A401

SCALE: 1" = 1'-0"

CASEWORK GENERAL NOTES


- ALL CABINET HEIGHTS INCLUDE COUNTERTOPS. DIMENSIONS ARE TO THE NEAREST INCH.
 DIVISIONS IN CASEWORK ARE SHOWN FOR CLARITY AND DO NOT REPRESENT BREAKS IN THE COUNTERTOP.
- 3. PROVIDE CONTINUOUS COUNTERTOP OVER ALL SIMILAR HEIGHT CASEWORK, UNLESS AND OTHERWISE NOTED.
- 4. MANUFACTURER AND CATALOG NUMBERS ARE FOR REFERENCE AND ILLUSTRATION PURPOSES
- 5. DOTTED LINES INDICATE WALL HUNG CABINETS, DIVISIONS OF BASE CABINETS BELOW THE
- 6. COUNTERTOP, FURNITURE NOT IN THE CONTRACT OR PROJECTION SCREENS -SEE CASEWORK KEY AND SPECIFICATIONS.
- ALL CABINETS AND DRAWERS TO HAVE CAM LOCKS EXCEPT FOR SINK BASE CABINETS.
 ALL EXPOSED SURFACES (EXPOSED TO VIEW FROM ANY PERSPECTIVE) TO BE COVERED WITH
- LAMINATE.


 9. ALL CASEWORK WHICH MEETS A WALL AT ONE OR BOTH ENDS, TO BE PROVIDED WITH FILLER
- PANELS AND SCRIBED TO THE WALL(S) AS REQUIRED.


 10. ALL CABINETS AND DRAWERS ARE PROVIDED WITH RECESSED HANDLES.
- 11. CONTRACTOR TO FIELD VERIFY ALL CLEAR OPENINGS PRIOR TO MILLWORK OR CASEWORK FABRICATION.
- 12. CASEWORK DRAWINGS ARE DIAGRAMMATIC IN NATURE TO SHOW DESIGN INTENT.

	CASEWORK SCHEDULE						
TYPE MAR K	TYPE	COUN	HEIGHT	WIDTH	DEPTH	AREA	
00	BASE CABINET L-SHAPED 2	1	2' - 11"	3' - 3"	3' - 3"	9 SF	
01	L-SHAPE COUNTER TOP	1	0' - 4"	7' - 0"	7' - 0"	2 SF	
02	BASE CABINET DOUBLE DOOR 1	1	2' - 11"	2' - 0"	2' - 0"	6 SF	
04	WALL FILLER	1	2' - 11"	0' - 5"	2' - 0"	1 SF	
05	BASE CABINET DOUBLE DOOR 2	1	2' - 11"	3' - 0"	2' - 0"	9 SF	
07	WALL CABINET DOUBLE DOOR 1	1	2' - 6"	3' - 8"	1' - 0"	9 SF	
08	WALL FILLER	1	2' - 6"	0' - 6"	1' - 0"	1 SF	
09	WALL CABINET DOUBLE DOOR 2	1	2' - 6"	2' - 6"	1' - 0"	6 SF	
10	LAUNDRY OPEN CABINET	1	1' - 6"	2' - 0"	2' - 4"	3 SF	
11	CLOSET 1	1	6' - 0"	3' - 11"	1' - 4"	23 SF	
12	RECESSED_MED_CABINET	2	2' - 0"	1' - 6"	0' - 3"	3 SF	
13	LAUNDRY OPEN CABINET 2	1	1' - 2"	2' - 3"	3' - 0"	3 SF	
14	VANITY	2	2' - 4"	2' - 6"	1' - 8"	6 SF	
15	CLOSET 2	2	6' - 0"	9' - 9"	1' - 4"	58 SF	
16	LINEAR COUNTER TOP 2.2	1	0' - 4"	3' - 5"	2' - 1"	1 SF	
17	WALL FILLER 2.2	1	2' - 6"	0' - 5"	1' - 0"	1 SF	
18	BASE_FILLER_1 2.2	1	2' - 11"	0' - 5"	2' - 0"	1 SF	
GRAND	TOTAL	20					

SPECIALTY EQUIPMENT SCHEDULE			
TYPE MARK	TYPE	COUNT	
		·	
01	WASHER-FRONT-LOAD	1	
02	REFRIGERATOR	1	
03	RANGE	1	
04	DRYER-FRONT-LOAD	1	
05	DISHWASHER	1	
GRAND TOTAL: 5	,	,	

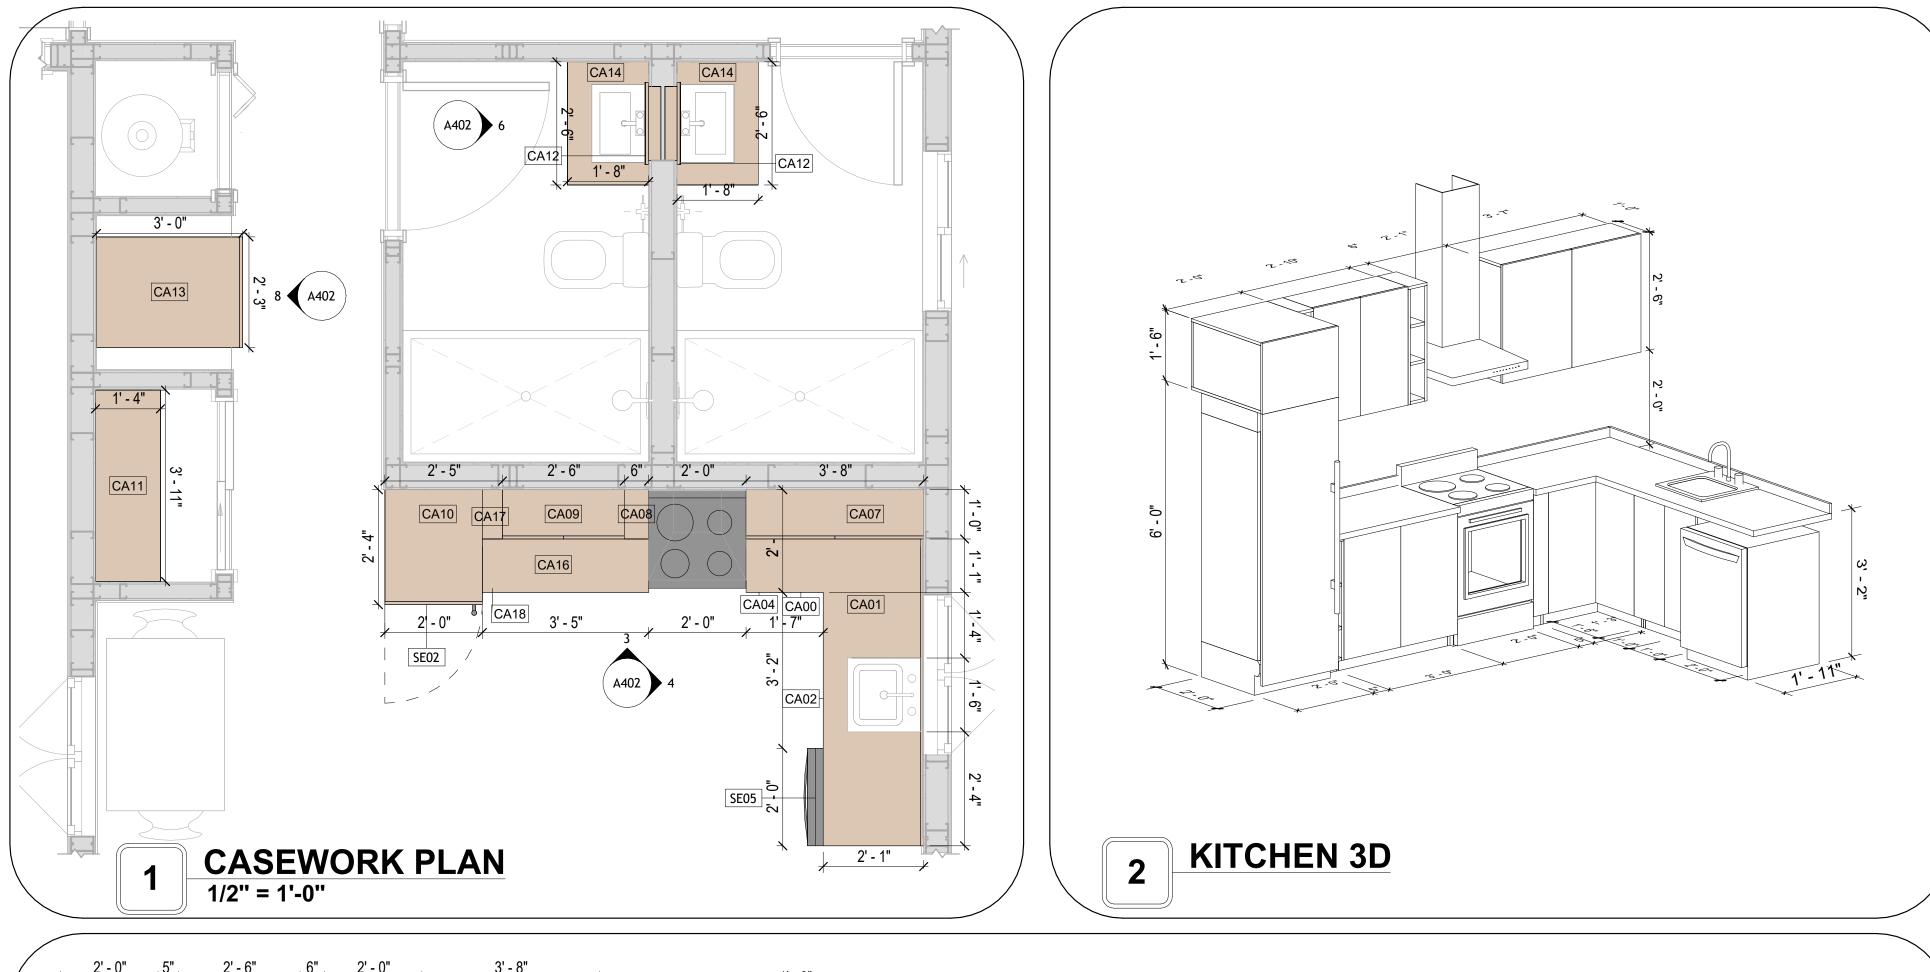

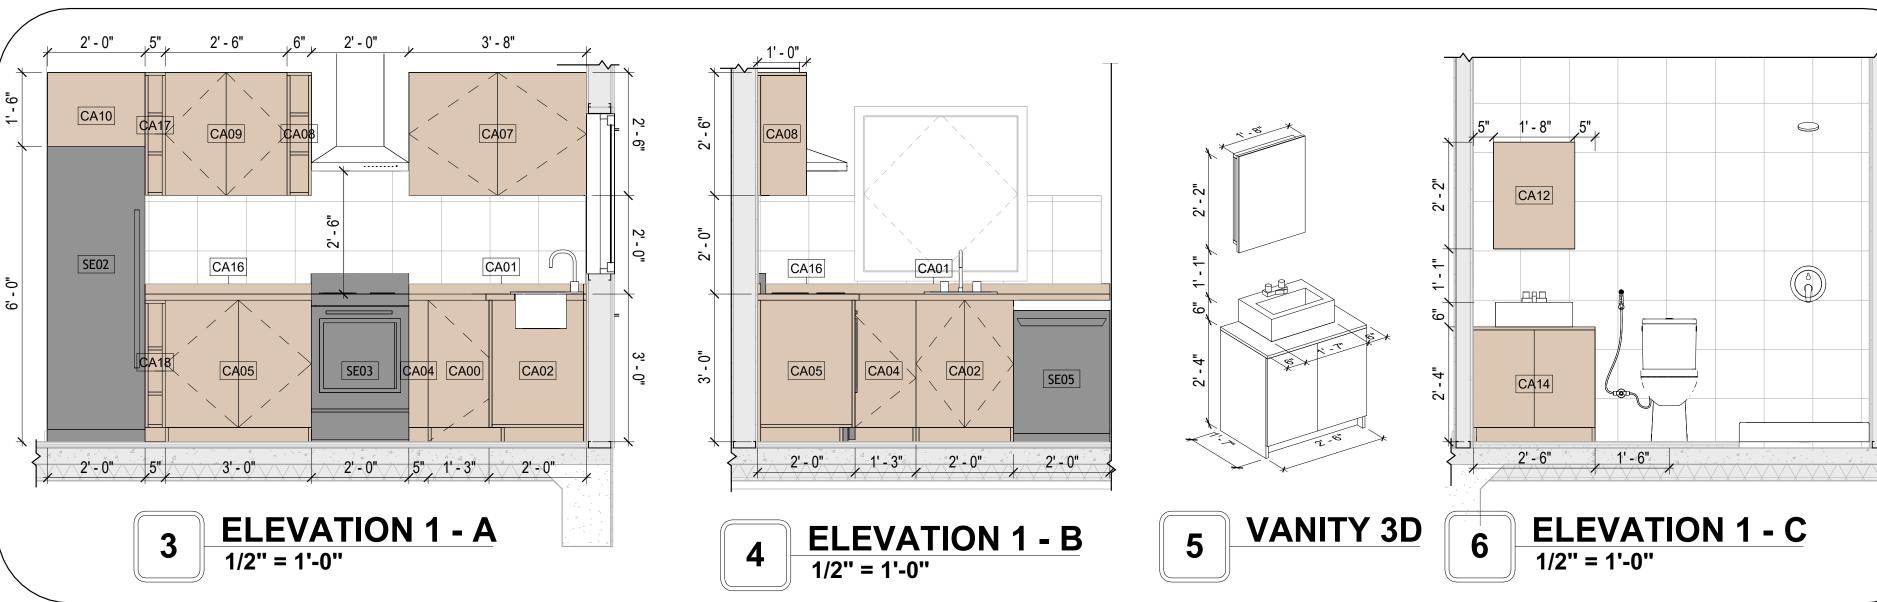

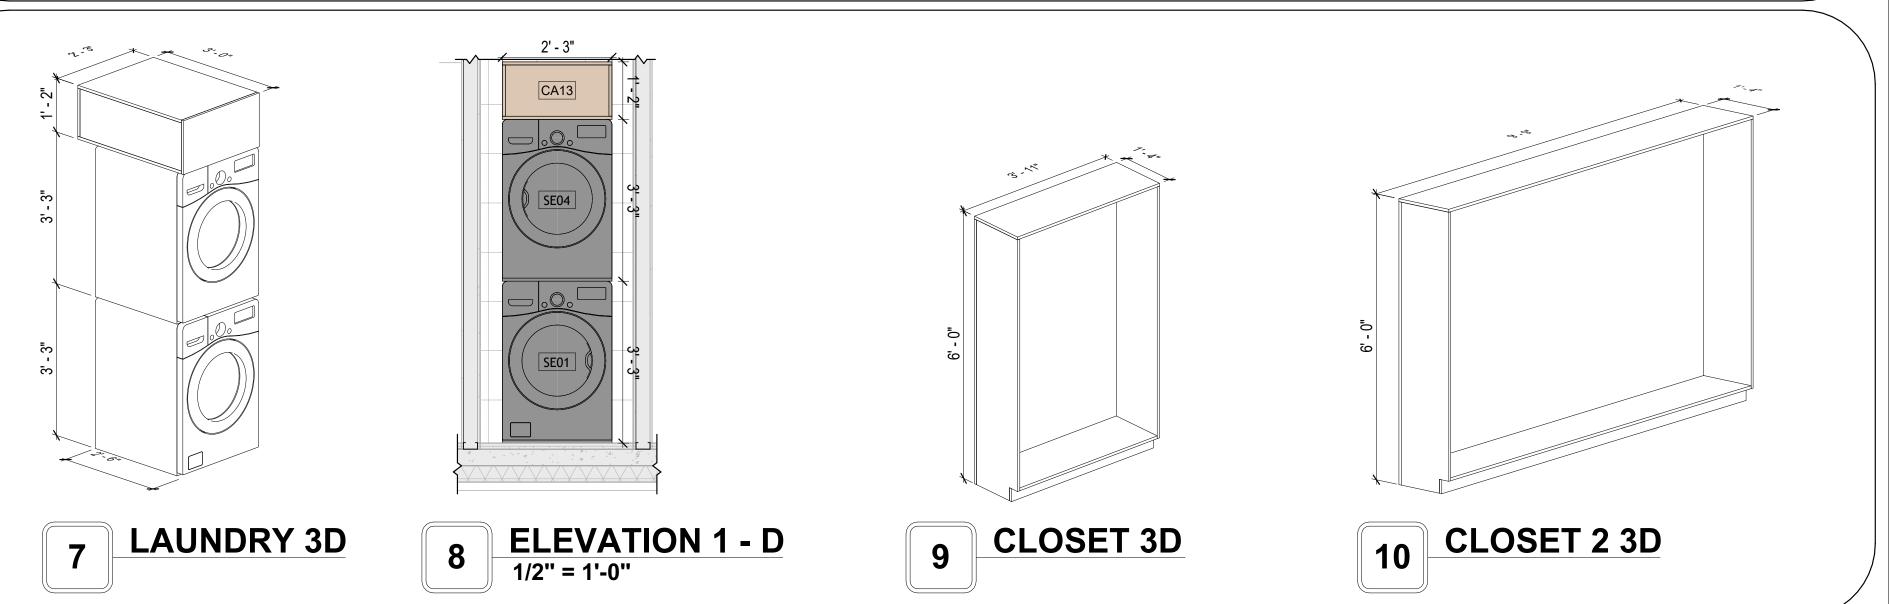



KEY PLAN

Ο.	DESCRIPTION	DATE

NOTE:

LEGEND:

PROJECT

130-ORION-910-2BD 2BA-SPANISH-TOWER-550

DRAWING NAME

ARCHITECTURAL CASEWORK

CLIENT NAME:	Client Name
PROJECT NUMBER:	0033_15
DATE:	3/22/2025 11:48:26 AM
DESIGNED BY:	Designer
DRAWN BY:	Author
CHECKED BY:	Checker

A402

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GENERAL NOTES

1. THIS DRAWING DEPICTS THE HVAC (HEATING, VENTILATION, AND AIR CONDITIONING) SYSTEM FOR THE ORION 2BD1BA SPANISH TOWER. IT PROVIDES A VISUAL REPRESENTATION OF THE SYSTEM LAYOUT AND COMPONENTS.

2.THE HVAC SYSTEM IS DESIGNED TO MEET THE SPECIFIC REQUIREMENTS OF THE BUILDING, INCLUDING HEATING, COOLING, AND VENTILATION NEEDS, AS PER THE PROJECT SPECIFICATIONS AND APPLICABLE CODES AND STANDARDS.

3. THE HVAC SYSTEM INSTALLATION SHALL COMPLY WITH THE LATEST EDITION OF THE INTERNATIONAL MECHANICAL CODE (IMC), INTERNATIONAL RESIDENTIAL CODE (IRC), AND ALL OTHER APPLICABLE LOCAL, STATE, AND NATIONAL CODES AND REGULATIONS.

4. THE EQUIPMENT SHOWN ON THIS DRAWING INCLUDES BUT IS NOT LIMITED TO AIR HANDLING UNITS (AHUS), CHILLERS, BOILERS, COOLING TOWERS, PUMPS, DUCTWORK, DIFFUSERS, GRILLES, AND CONTROL DEVICES.

5. ALL EQUIPMENT, DUCTWORK, AND PIPING SHALL BE INSTALLED IN ACCORDANCE WITH MANUFACTURER'S SPECIFICATIONS, LOCAL CODES, AND

6. ALL DUCTWORK SHALL BE SIZED, FABRICATED, AND INSTALLED IN ACCORDANCE WITH THE LATEST EDITION OF THE ACCA MANUAL D AND THE SMACNA HVAC DUCT CONSTRUCTION STANDARDS. DUCTWORK SHALL BE INSTALLED IN A NEAT AND WORKMANLIKE MANNER, PROPERLY SUPPORTED AND BRACED TO PREVENT SAGGING, AIR LEAKAGE, OR VIBRATION.

7. CONDENSATE DRAINAGE PIPING SHALL BE PROPERLY PITCHED TO ENSURE POSITIVE DRAINAGE TO AN APPROVED DISPOSAL LOCATION, SUCH AS A FLOOR DRAIN, SUMP PUMP, OR EXTERIOR GRADE. CONDENSATE LINES SHALL BE INSULATED TO PREVENT SWEATING.

8. THE LOCATION OF CONTROL PANELS AND SENSORS INDICATED ON THIS DRAWING CAN BEMODIFY WITH THE SPECIFIC LOCATIONS AND WIRING DETAILS WILL BE DETERMINED DURING THE CONTROL SYSTEM DESIGN AND INSTALLATION.

9. THE HVAC SYSTEM DESIGN CONSIDER ENERGY EFFICIENCY, INDOOR AIR QUALITY, OCCUPANT COMFORT, AND NOISE CONTROL, FOLLOWING APPLICABLE GUIDELINES AND REGULATIONS.

WITH THE LOCAL BUILDING DEPARTMENT AND UTILITY PROVIDERS TO ENSURE A TIMELY AND COMPLIANT INSTALLATION.

10. COORDINATION WITH OTHER TREADS HAS BEEN DONE ON A DESIGN LEVEL. THIS DRAWING SHALL BE READ TOGETHER WITH THE AR. EL AND SN DESIGN DRAWINGS TO ENSURE PROPER INSTALLATION AND INTEGRATION OF THE HVAC SYSTEMS.

11. THE HVAC CONTRACTOR IS RESPONSIBLE FOR OBTAINING ALL NECESSARY PERMITS AND LICENSES, AND FOR SCHEDULING AND COORDINATING

12. ALL DUCTWORK PENETRATIONS THROUGH WALLS, FLOORS, OR CEILINGS SHALL BE PROPERLY SEALED AND FIRE-STOPPED USING APPROVED METHODS AND MATERIALS TO MAINTAIN THE INTEGRITY OF THE BUILDING'S FIRE-RESISTANCE RATINGS.

13. HVAC EQUIPMENT SHALL BE INSTALLED LEVEL AND PLUMB, AND IN STRICT ACCORDANCE WITH THE MANUFACTURER'S INSTALLATION INSTRUCTIONS AND RECOMMENDATIONS. PROVIDE ADEQUATE CLEARANCES AROUND EQUIPMENT FOR PROPER AIRFLOW, SERVICE ACCESS, AND

CODE COMPLIANCE. 14. ALL HVAC EQUIPMENT AND COMPONENTS, INCLUDING THERMOSTATS, DAMPERS, AND ACCESS PANELS, SHALL BE LOCATED IN ACCESSIBLE AREAS


15. THE HVAC SYSTEM SHALL BE BALANCED AND ADJUSTED TO ENSURE PROPER AIRFLOW, TEMPERATURE DISTRIBUTION, AND SYSTEM PERFORMANCE THROUGHOUT THE RESIDENCE. PROVIDE A WRITTEN REPORT DOCUMENTING THE FINAL SYSTEM BALANCE.


16. ANY DEVIATIONS OR MODIFICATIONS TO THE HVAC SYSTEM DESIGN SHALL BE REVIEWED AND APPROVED BY THE RESPONSIBLE DESIGN PROFESSIONALS AND COMMUNICATED TO ALL RELEVANT PARTIES INVOLVED IN THE CONSTRUCTION PROCESS.

FOR EASY SERVICING AND MAINTENANCE. PROVIDE ADEQUATE SPACE AROUND EQUIPMENT FOR PROPER AIRFLOW AND SERVICE ACCESS.

17. FOR ANY INQUIRIES OR CLARIFICATIONS REGARDING THE HVAC SYSTEM DESIGN, PLEASE CONSULT THE RESPONSIBLE DESIGN PROFESSIONALS OR THE PROJECT MANAGEMENT TEAM.

SYMBOLS

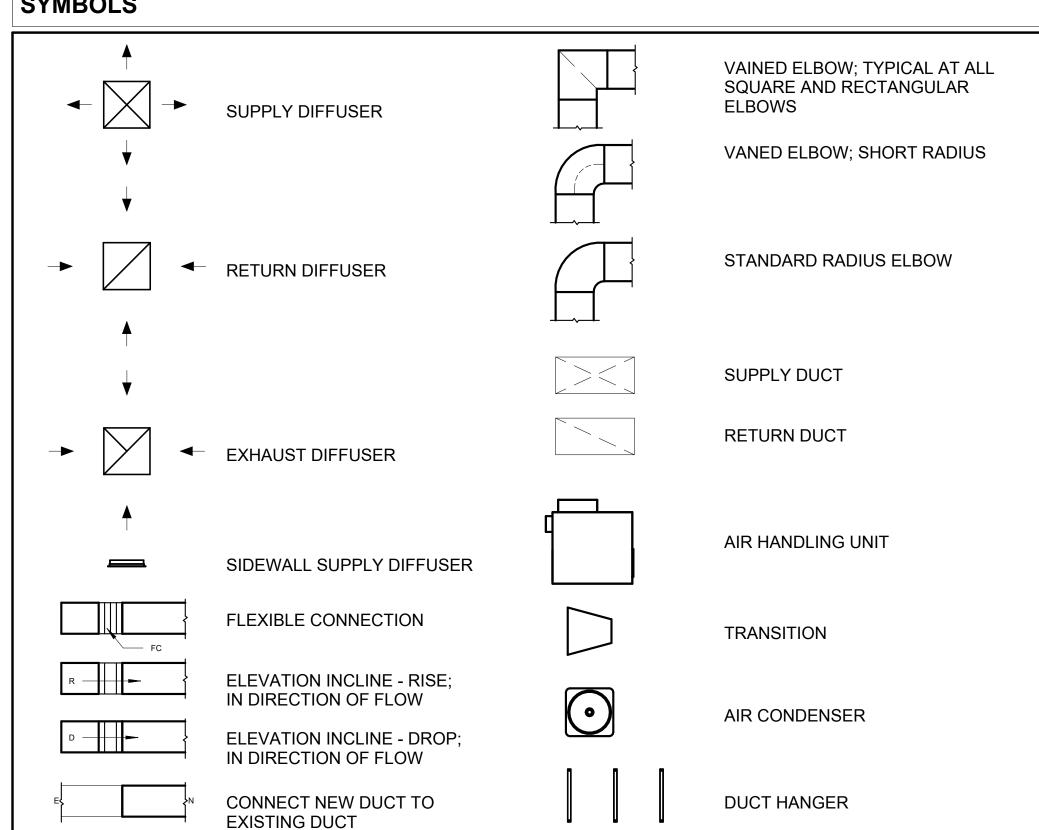

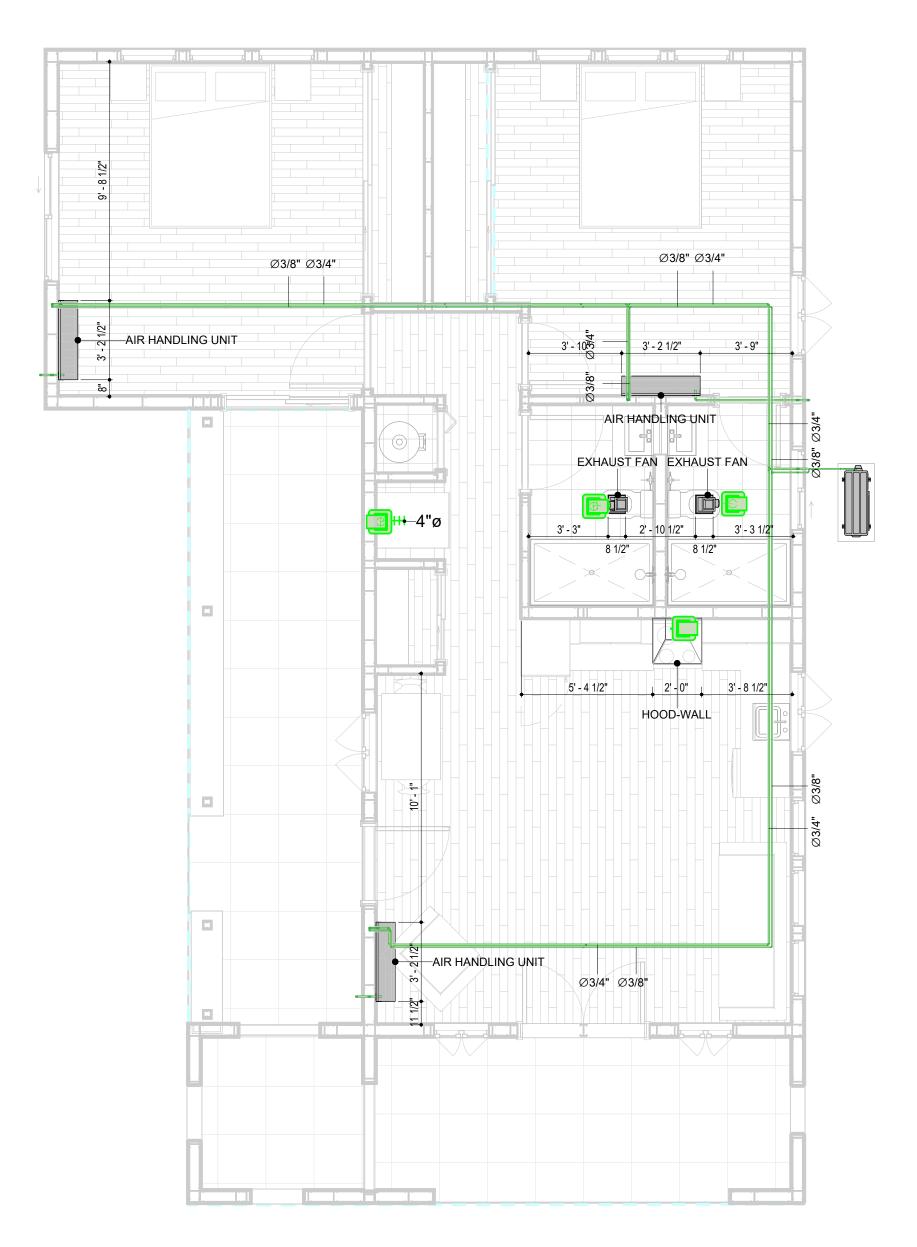

HVAC PLAN 1/4" = 1'-0"

HVAC COLOR SCHEME

AIR CONDITIONING PIPE

REFRIGERANT LINE SCHEDULE				
CATAGORY	DESCRIPTION	DIAMETER	LENGTH	
PIPE TYPES	COPPER	1/4"	2.02	
PIPE TYPES	COPPER	3/8"	98.08	
PIPE TYPES	COPPER	1/2"	0.68	
PIPE TYPES	COPPER	3/4"	122.23	

REFRIGERANT LINE FITTING SCHEDULE					
CATAGORY	DESCRIPTION	Size	Count		
ELBOW - GENERIC	ELBOW - GENERIC: STANDARD/HVAC	1/2"ø-1/2"ø	1		
ELBOW - GENERIC	ELBOW - GENERIC: STANDARD/HVAC	1/4"ø-1/4"ø	3		
ELBOW - GENERIC	ELBOW - GENERIC: STANDARD/HVAC	3/4"ø-3/4"ø	28		
ELBOW - GENERIC	ELBOW - GENERIC: STANDARD/HVAC	3/8"ø-3/8"ø	21		
TEE - GENERIC	TEE - GENERIC: STANDARD	3/4"ø-3/4"ø-3/4"ø	2		
TEE - GENERIC	TEE - GENERIC: STANDARD	3/8"ø-3/8"ø-3/8"ø	2		
TRANSITION - GENERIC	TRANSITION - GENERIC: STANDARD	3/4"ø-1/2"ø	4		
TRANSITION - GENERIC	TRANSITION - GENERIC: STANDARD	3/4"ø-5/8"ø	3		
TRANSITION - GENERIC	TRANSITION - GENERIC: STANDARD	3/8"ø-1/4"ø	1		

MECHANICAL EQUIPMENT SCHEDULE			
CATAGORY	DESCRIPTION	COUNT	
AIR HANDLING UNIT	AIR HANDLING UNIT: WALL MOUNTED	3	
	CONDENSER: OUT DOOR	1	
CONDENSER EXHAUST FAN	CONDENSER: OUT DOOR EXHAUST FAN: 75 CFM	2	

DUCT FITTING SCHEDULE			
CATAGORY	DESCRIPTION	COUNT	
ROUND TRANSITION - ANGLE	45 DEGREE	7	

DUCT ACCESSORY SCHEDULE			
CATAGORY	DESCRIPTION	COUNT	
ROOF VENT	3" DIAMETER	4	

FLEX DUCT SCHEDULE						
DESCRIPTION	DESCRIPTION	LENGTH	DIAMETER	COUNT		
	ELEV DOLIND	40.50	411	4		
FLEX DUCT ROUND GRAND TOTAL: 4	FLEX-ROUND	10.58	4"	4		



KEY PLAN

NO.	DESCRIPTION	DATE

NOTE:

LEGEND:

PROJECT

130-Orion-910-2Bd 2Ba Spanish-Tower-550

DRAWING NAME

HVAC COVER

CLIENT NAME: Owner PROJECT NUMBER: 15_0001 DATE: 3/22/2025 1:28:10 AM Designer DESIGNED BY: DRAWN BY: Author CHECKED BY: Checker

M101

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ELECTRICAL NOTES

- THIS DRAWING DEPICTS THE ELECTRICAL SYSTEM FOR THE130-Orion-910-2Bd 1Ba-Spanish-Porch-550. IT PROVIDES A VISUAL REPRESENTATION OF THE ELECTRICAL LAYOUT AND COMPONENTS, INCLUDING POWER DISTRIBUTION, LIGHTING, AND CONTROL SYSTEMS.
- 2. THE ELECTRICAL SYSTEM IS DESIGNED TO MEET THE SPECIFIC REQUIREMENTS OF THE BUILDING, INCLUDING POWER DISTRIBUTION, LIGHTING, AND SPECIALIZED ELECTRICAL EQUIPMENT NEEDS, AS PER THE PROJECT SPECIFICATIONS AND APPLICABLE CODES AND STANDARDS.
- 3. THE ELECTRICAL SYSTEM INSTALLATION SHALL COMPLY WITH THE LATEST EDITION OF THE NATIONAL ELECTRICAL CODE (NEC), INTERNATIONAL BUILDING CODE (IBC), AND ALL OTHER APPLICABLE LOCAL, STATE, AND NATIONAL CODES AND REGULATIONS.
- 4. LOCATIONS AS NEEDED, DEVICES ARE SHOWN ON PLANS IN APPROXIMATE IDEAL LOCATIONS, UNLESS SPECIFICALLY DIMMENSIONED.
- OPEN WALLS AS NEEDED TO ALLOW FOR NEW ELECTRICAL INSTALLATIONS.
- 6. LABEL ALL CIRCUITS ON JUNCTION BOXES, RECEPTACLES, DATA, SMOKE DETECTOR, AND EQUIPMENT IN PANEL BOX.
- 7. INSTALL RACEWAY AS NEEDED FOR DDC, ACCESS CONTROL, LOW VOLTAGE WIRING & DATA.
- 8. RELABEL POWER, DATA & FIRE ALARM FOR ROOM #CHANGES. 9. VERIFY ALL CIRCUITS LABELED ON PRINT ARE CORRECT BEFORE WORKING ON THEM.
- 10. NOTE ON SITE PLAN ALL CHANGES OR MISSING DETAIL TO BE INCORPORATED INTO THE MASTER PLAN.
- 11. DRAWINGS ARE DIAGRAMMATIC ONLY FOR THE PURPOSE OF SHOWING FIXTURE AND OUTLET LOCATIONS.
- 12. ELECTRICAL CONTRACTOR TO VERIFY SERVICE SIZE BY CALCULATION BASED UPON ACTUAL NAME
- PLATE RATINGS OF SELECTED EQUIPMENT.
- 13. VERIFY LOCATION OF SERVICE ENTRANCE WITH POWER COMPANY. PROVIDE UFER GROUND IN
- BUILDING FOUNDATION AT SERVICE ENTRANCE LOCATION. 14. PROVIDE A MIN. OF 20 FEET OF ONE *4 BARE COPPER UFER WIRE EMBEDDED IN CONCRETE FOOTING
- AT THE SERVICE ENTRANCE LOCATION WHERE APPROVED BY LOCAL SERVICE PROVIDER.
- 15. PROVIDE WATERPROOF FIXTURES IN ALL HIGH MOISTURE AREAS (EXTERIOR, SHOWER AND TUB CEILINGS ETC.)
- 16. PROVIDE DEDICATED CIRCUITS TO EACH BATH, DEN, FAMILY ROOM, BEDROOM, LOFT, KITCHEN REFRIGERATOR, KITCHEN FREEZER DISHWASHER, AND ANY AREA/ITEM SPECIFIED BY OWNER.
- 17. INCANDESCENT FIXTURES WITH OPEN OR PARTIALLY ENCLOSED LAMPS, PENDANT FIXTURES, AND LAMP HOLDERS ARE NOT PERMITTED IN CLOSETS.
- 18. ALL WORKMANSHIP AND MATERIALS TO CONFORM WITH THE 2015 IRC.
- 19. PROVIDE A MIN. OF 20 FEET OF ONE *4 BARE COPPER UFER WIRE EMBEDDED IN CONCRETE FOOTING AT THE SERVICE ENTRANCE LOCATION WHERE APPROVED BY LOCAL SERVICE PROVIDER.
- 20. PROVIDE A BONDING CONDUCTOR CONSISTING OF A MINIMUM OF ONE *4 BARE COPPER WIRE CONNECTING THE BUILDING'S METAL WATER PIPING SYSTEM TO THE SERVICE EQUIPMENT ENCLOSURE GROUNDING.

MAIN PANEL CALCS

(USE 200 AMP SERVICE)

ELECTRICAL CALCS	
LIGHT AND OUTLETS 910 @ 3W	2,730 W
3 APPLIANCE CIRCUITS	4,500 W
DRYER	2,000 W
WASHER	2,000 W
RANGE	5,000 W
WATER HEATER	5,000 W
REFRIG.	1,800 W
DISHWASHER & DISPOSAL	3000 W
TOTAL	26,030 W
FRIST 10,000 @ 100% REMAINDER @ 40% MINI. SPLIT UNITS	10,000 W 6,412W 10,000 W
TOTAL	26,412 W
26,412 W DIVIDED BY 240V = 1	10 AMPS TOTAL

ELECTRICAL ABBREVIATIONS LIST

15	1 (0.77	0-11		
1P	1 POLE (2P, 3P, 4P, ETC.)	CTR	CENTER	HT	HEIGHT
A	AMPERE	CU	COPPER	HTG	HEATING
AC	ABOVE COUNTER OR AIR CONDITIONER	DCP	DOMESTIC WATER CIRCULATING PUMP	HTR	HEATER
ACLG	ABOVE CEILING	DEPT	DEPARTMENT	HV	HIGH VOLTAGE
ADO	AUTOMATIC DOOR OPENER	DET	DETAIL	HVAC	HEATING, VENTILATING AND AIR
AF	AMP FRAME	DIA	DIAMETER	CONDITIONING	CONDITIONING
AFF	ABOVE FINISHED FLOOR	DISC	DISCONNECT	HWP	HYDRONIC WATER PUMP
AFG	ABOVE FINISHED FEOOR	DIST	DISTRIBUTION	IC	INTERRUPTING CAPACITY
				IG	
AFI	ARC FAULT CIRCUIT INTERRUPTER	DN	DOWN		ISOLATED GROUND
AHU	AIR HANDLING UNIT	DPR	DAMPER	IMC	INTERMEDIATE METAL CONDUIT
AL	ALUMINUM	DS	SAFETY DISCONNECT SWITCH	INCAND	INCANDESCENT
ALT	ALTERNATE	DT	DOUBLE THROW	IR	INFRARED
AMP	AMPERE	DWG	DRAWING	I/W	INTERLOCK WITH
AMPL	AMPLIFIER	DDC	DIRECT DIGITAL CONTROL	J-BOX	JUNCTION BOX
ANNUN	ANNUNCIATOR APPROX APPROXIMATELY	EC	ELECTRICAL CONTRACTOR	KV	KILOVOLT
AQ-STAT	AQUASTAT	ELEC	ELECTRIC, ELECTRICAL	KVA	KILOVOLT-AMPERE
ARCH	ARCHITECT, ARCHITECTURAL	ELEV	ELEVATOR	KVAR	KILOVOLT-AMPERE REACTIVE
ANCIT	AMP SWITCH	EM	EMERGENCY	KW	KILOWATT
AT	AMP TRIP	EMS	ENERGY MANAGEMENT SYSTEM	KWH	KILOWATT HOUR
ATS	AUTOMATIC TRANSFER SWITCH	EMT	ELECTRICAL METALLIC TUBING	LOC	LOCATE OR LOCATION
AUTO	AUTOMATIC	EP	ELECTRIC PNEUMATIC	LT	LIGHT
AUX	AUXILIARY	EQUIP	EQUIPMENT	LTG	LIGHTING
AV	AUDIO VISUAL	EWC	ELECTRIC WATER COOLER	LTNG	LIGHTNING
AWG	AMERICAN WIRE GAUGE	EXIST	EXISTING	LV	LOW VOLTAGE
BATT	BATTERY	EXH	EXHAUST	MAX	MAXIMUM
BD	BOARD	EXP	EXPLOSION PROOF	MAG.S	MAGNETIC STARTER
BLDG	BUILDING	FA	FIRE ALARM	M/C	MOMENTARY CONTACT
BMS	BUILDING MANAGEMENT SYSTEM	FABP	FIRE ALARM BOOSTER POWER	MC	MECHANICAL CONTRACTOR
C	CONDUIT	SUPPLY PANEL	SUPPLY PANEL	MCB	MAIN CIRCUIT BREAKER
CAB	CABINET	FACP	FIRE ALARM CONTROL PANEL	MCC	MOTOR CONTROL CENTER
CAT	CATALOG	FCU	FAN COIL UNIT	MDC	MAIN DISTRIBUTION CENTER
CATV	CABLE TELEVISION	FIXT	FIXTURE	MDP	MAIN DISTRIBUTION PANEL
СВ	CIRCUIT BREAKER	FLR	FLOOR	MFR	MANUFACTURERMAIN FUSED
CCTV	CLOSED CIRCUIT TELEVISION	FLUOR	FLUORESCENT		DISCONNECT SWITCH
CKT	CIRCUIT	FU	FUSE	MH	MANHOLE
CLG	CEILING	FUDS	FUSED SAFETY DISCONNECT SWITCH	MIC	MICROPHONE
COMB	COMBINATION	GA	GAUGE	MIN	MINIMUM
CMPR	COMPRESSOR	GAL	GALLON	MISC	MISCELLANEOUS
CONN	CONNECTION	GALV	GALVANIZED	MLO	MAIN LUGS ONLY
CONST	CONSTRUCTION	GC	GENERAL CONTRACTOR	MMS	MANUAL MOTOR STARTER
CONT	CONTINUATION OR CONTINUOUS	GEN	GENERATOR	MOA	MULTIOUTLET ASSEMBLY
CONTR	CONTRACTOR	GFI	GROUND FAULT CIRCUIT INTERRUPTER	MSP	MOTOR STARTER PANELBOARD
CONV	CONVECTOR	GFP	GROUND FAULT PROTECTOR	MSBD	MAIN SWITCHBOARD
CP	CIRCULATING PUMP	GND	GROUND	MT	MOUNT
CRT	CATHODE-RAY TUBE	GRS	GALVANIZED RIGID STEEL (CONDUIT)	MT.C	EMPTY CONDUIT
CT	CURRENT TRANSFORMER	GYP BD	GYPSUM BOARD	UL	UNDERWRITERS LABORATORIES
	CONTROL OF WILLY				
	- L		· ·		1

Branch Panel:

Location: CL 1 10 **Supply From:** Mounting: Recessed

Enclosure: Type 1

Volts: 120/240 Single Phases: 1 Wires: 3

A.I.C. Rating: Mains Type: Mains Rating: 200 A MCB Rating: 1 A

Circuit Numb er		Number of Elements	Rating	Length	Wire Size	A			3	Wire Size	Length	Rating	Number of Elements	Circuit Description	Circu Num er
1	BED 1& 2 LIGHT AND SMOKEDETECTER	19	20 A	30' - 0 15/32"	1-#12, 1-#12, 1-#12	956 VA	456 VA			1-#12, 1-#12, 1-#12	53' - 11 23/32"	20 A	11	KITCHEN &HALL LIGHT	2
3	OUTDOOR LIGHT	8	15 A	58' - 4 19/32"	1-#14, 1-#14, 1-#14			500 VA	209 VA	1-#14, 1-#14, 1-#14	55' - 3 7/32"	15 A	6	LIVING LIGHT	4
5	WATER HEATER	1	30 A	27' - 5 15/32"	2-#10, 1-#10, 1-#10	2250 VA	2500 VA			2-#10, 1-#10, 1-#10	28' - 11 7/32"	30 A	1	DRYER	6
7								2250 VA	2500 VA						8
9	WASHEING MASHEIN	1	20 A	29' - 7 19/32"	1-#12, 1-#12, 1-#12	1200 VA	2500 VA			2-#8, 1-#8, 1-#10	42' - 2 27/32"	40 A	1	RANGE	10
11	KITCHEN GFCI	3	20 A	49' - 1 13/16"	1-#12, 1-#12, 1-#12			540 VA	2500 VA						12
13	REFRIGERATOR	1	20 A	36' - 6 9/16"	1-#12, 1-#12, 1-#12	1800 VA	1200 VA			1-#12, 1-#12, 1-#12	55' - 8 21/32"	20 A	1	DISHWASHER	14
15	LIV. RECEPTACLE	6	20 A	64' - 5 13/32"	1-#12, 1-#12, 1-#12			1080 VA	396 VA	1-#12, 1-#12, 1-#12	51' - 10 13/16"	20 A	6	BATH 1 LIGHT & GFCI	16
17	OUTDOOR GFCI	4	20 A	64' - 7 29/32"	1-#12, 1-#12, 1-#12	720 VA	2500 VA			2-#6, 1-#6, 1-#10	44' - 11 7/16"	60 A	1	CONDENSER	18
19	BED 2 LIGHT & GFCI	7	20 A	37' - 4 3/32"	1-#12, 1-#12, 1-#12			396 VA	2500 VA						20
21	OVEN HOOD	1	20 A	39' - 9 5/32"	1-#12, 1-#12, 1-#12	180 VA									22
23															24
25															26
						16259	VA	1284	4 VA						
						135	A	10	7 A						

Load Classification	Connected Load	Demand Factor	Estimated Demand	Panel	Totals
LIGHTING - DWELLING UNIT	800 VA	100.00%	800 VA		
OTHER	1476 VA	100.00%	1476 VA	Total Conn. Load:	29103 VA
RECEPTACLE	5280 VA	100.00%	5280 VA	Total Est. Demand:	28103 VA
LIGHTING	300 VA	100.00%	300 VA	Total Conn.:	121 A
CONDENSER	5000 VA	100.00%	5000 VA	Total Est. Demand:	117 A
WATER HEATER	4500 VA	100.00%	4500 VA		
RANGE	5000 VA	80.00%	4000 VA		
DRYER	5000 VA	100.00%	5000 VA		
REFRIGERATOR	1800 VA	100.00%	1800 VA		



KEY PLAN

DESCRIPTION DATE

NOTE:

LEGEND:

PROJECT

134-Orion-910-2Bd 2Ba-Spanish-Tower-550

DRAWING NAME

SCHEDULE

CLIENT NAME: Owner PROJECT NUMBER 0379_13 DATE: 3/21/2025 5:11:03 PM Designer DESIGNED BY: DRAWN BY: CHECKED BY: Checker

E101

SCALE: 1/4" = 1'-0"

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ELECTRICAL NOTE

- PROVIDE INTERCONNECTED SMOKE ALARMS IN EACH SLEEPING ROOMS, OUTSIDE EACH SLEEPING ROOM, ON EACH STORY, IN THE HALL OR ADJACENT ROOM LUHERE THE CEILING HEIGHT OF A ROOM OPEN TO THE HALL EXCEEDS THE HALL BY 24'. SMOKE ALARMS SHALL BE PERMANENTLY HARD WIRED WITH BATTERY BACKUP.
- B. RECEPTACLE OUTLETS FOR RANGES AND CLOTHES DRYERS SHALL BE A THREE POLE WITH GROUND TYPE. FOUR WIRE GROUNDING-TYPE FLEXIBLE CORDS WILL BE REQUIRED FOR CONNECTION OF RANGES AND CLOTHES DRYERS. THE BONDING JUMPER SHALL NOT BE CONNECTED BETWEEN NEUTRAL TERMINAL AND THE FRAME OF THE
- C. TWO OR MORE 20 AMP SMALL APPLIANCE CIRCUITS SHALL BE PROVIDED TO SERVE THE KITCHEN, BREAKFAST NOOK, AND DINING ROOM. SUCH CIRCUITS SHALL HAVE NO OTHER OUTLETS.
- D. AT LEAST ONE 20 AMP BRANCH CIRCUIT SHALL BE PROVIDED TO SERVICE THE LAUNDRY ROOM. THIS CIRCUIT SHALL HAVE NO OTHER OUTLETS.
- E. ALL RECEPTACLES WITH IN 6' OF A WET BAR SINK OR KITCHEN SINK TO SERVE COUNTER TOP SURFACES MUST BE GFCI. ON KITCHEN COUNTERS 12' OR WIDER NO POINT ALONG THE WALL SHALL BE MORE THAN 2' FROM A RECEPTACLE. ALL RECEPTACLES WITH IN 6' OF KITCHEN SINK MUST BE GFCI. AT LEAST ONE GFCI RECEPTACLE SHALL BE INSTALLED IN THE BATHROOM ADJACENT TO EACH BASIN.
- FIXTURES INCLUDING CEILING FANS THAT ARE LOCATED IN DAMP LOCATIONS SHALL BE LISTED TO BE SUITABLE FOR
- SUCH LOCATIONS PER 2012 IRC
- G. PROVIDE ONE (1) SWITCHED OUTLET @ ALL BEDROOMS AND DEN
- H. CEILING FANS NOT EXCEEDING 35 LBS. (WITH OR WITHOUT ACCESSORIES MAY BE SUPPORTED BY OUTLET BOXES PROVIDED THE OUTLET BOXES ARE IDENTIFIED FOR SUCH USE PER 2012 IRC
- ELECTRICAL OUTLET BOXES ON OPPOSITE SIDES OF FIRE RATED WALLS SHALL BE SEPARATED BY A HORIZONTAL DISTANCE OF NOT LESS THAN 24".
- OUTLET BOXES IN THE WALLS BETWEEN THE GARAGE AND DWELLING SHALL BE METAL OR U.L. APPROVED FIRE RESISTIVE PLASTIC. BOXES IN GARAGE CEILING SHALL BE METAL.
- K. ALL BRANCH CIRCUITS THAT SUPPLY 120 VOLTS SINGLE PHASE 15 AND 20 AMPS RECEPTACLE OUTLETS INSTALLED IN THE DWELLING SHALL BE PROTECTED BY AN ARC FAULT CIRCUIT INTERRUPTER, EXCEPT GFCI RECEPTICLES.

RECEPTACLES MUST BE PROVIDED IN HALLWAYS 10'-0" OR MORE IN LENGTH. FOR A ONE FAMILY DWELLINGS AND EACH OF A TWO FAMILY DWELLING THAT IS AT GRADE LEVEL, AT LEAST ONE WP-GFCI RECEPTACLE OUTLET ACCESSIBLE AT GRADE LEVEL AND NOT MORE THAN 6'-6" ABOVE GRADE SHALL BE INSTALLED AT THE FRONT AND BACK OF THE DWELLING.

NOTE: APPLIANCE DISCONNECT

E4001.5 GROUNDING OF ENCLOSURES.

METAL ENCLOSURES FOR SWITCHES OR CIRCUIT BREAKERS SHALL BE CONNECTED TO AN

EQUIPMENT GROUNDING CONDUCTOR.


METAL ENCLOSURES FOR SWITCHES OR CIRCUIT BREAKERS USED AS SERVICE


EQUIPMENT SHALL COMPLY WITH THE PROVISIONS OF SECTION E3609.4. WHERE NONMETALLIC ENCLOSURES ARE USED WITH METAL RACEWAYS OR METAL-ARMORED

CABLES, PROVISIONS SHALL BE MADE FOR CONNECTING THE EQUIPMENT GROUNDING


NONMETALLIC BOXES FOR SWITCHES SHALL BE INSTALLED WITH A WIRING METHOD THAT


PROVIDES OR INCLUDES AN EQUIPMENT GROUNDING CONDUCTOR. (404.12)

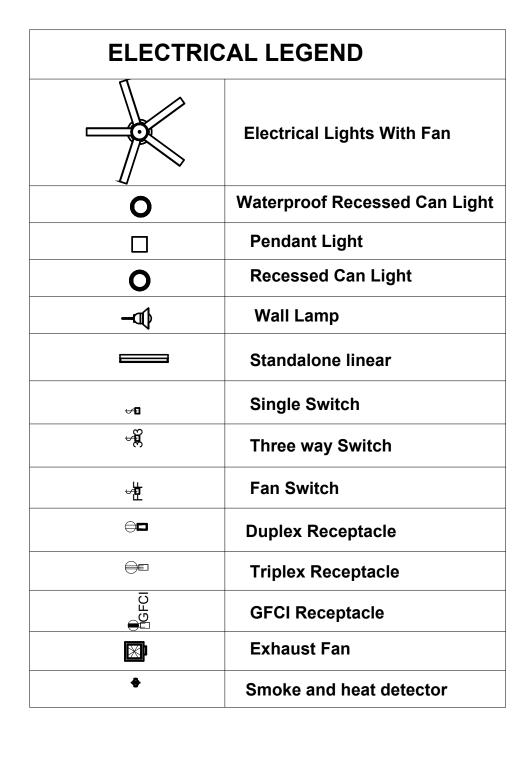

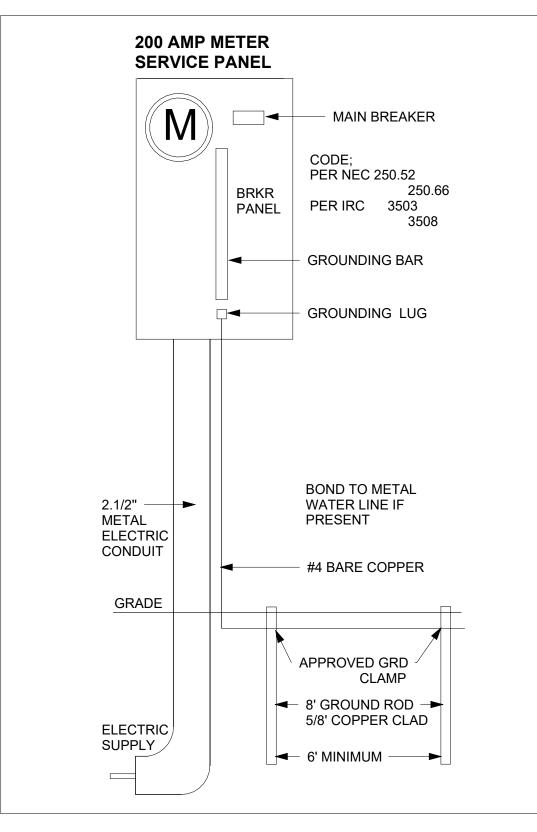



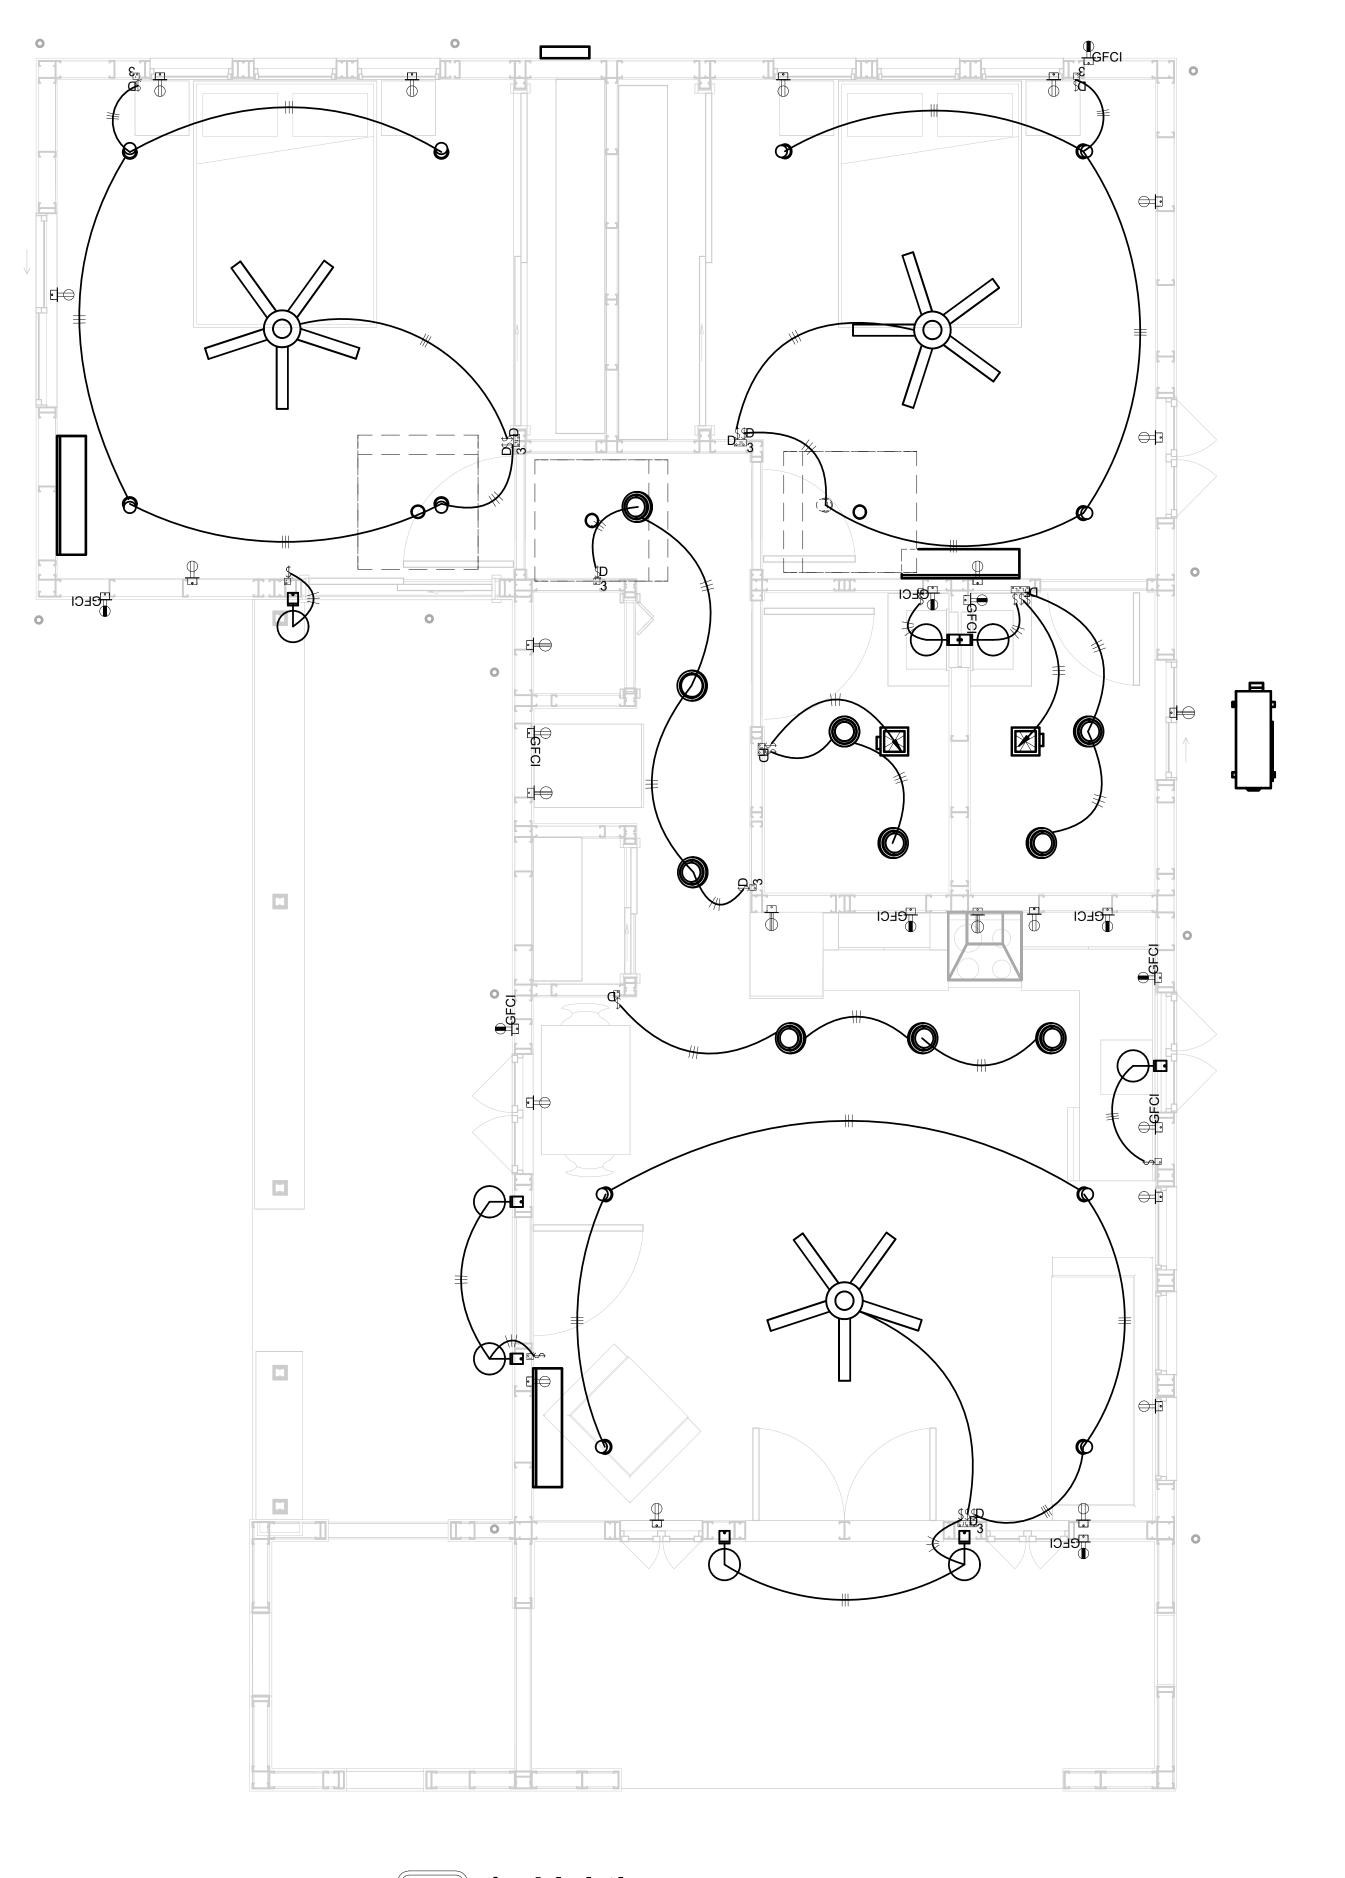

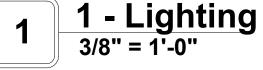



KEY PLAN

DESCRIPTION

NOTE:

LEGEND:

PROJECT

134-Orion-910-2Bd 2Ba-Spanish-Tower-550

DRAWING NAME


LIGHTING

Owner
0379_13
3/21/2025 5:11:07 PM
Designer
Author
Checker


E102

NOTES: CONDUIT, CABLE AND WIRING


- Use Metalic Conduits (IMC) for cables running under concrete slabs.
 Use IMC for circuits with high voltage appliances (240 volts and above)
 For circuits with 120 volts consider using EMT or PVC conduits if needed.
 For Low voltage applications up to 50 volts consider using non metalic conduits.
 All conduits to be used in the project must conform to the latest National Electrical Code (NEC),
- 6. All wiring and cables to be used in the project must also conform to the latest National Electrical
- 7. All cables and wires used should be rated for their respective loading and should be gauged and conform to the NEC.

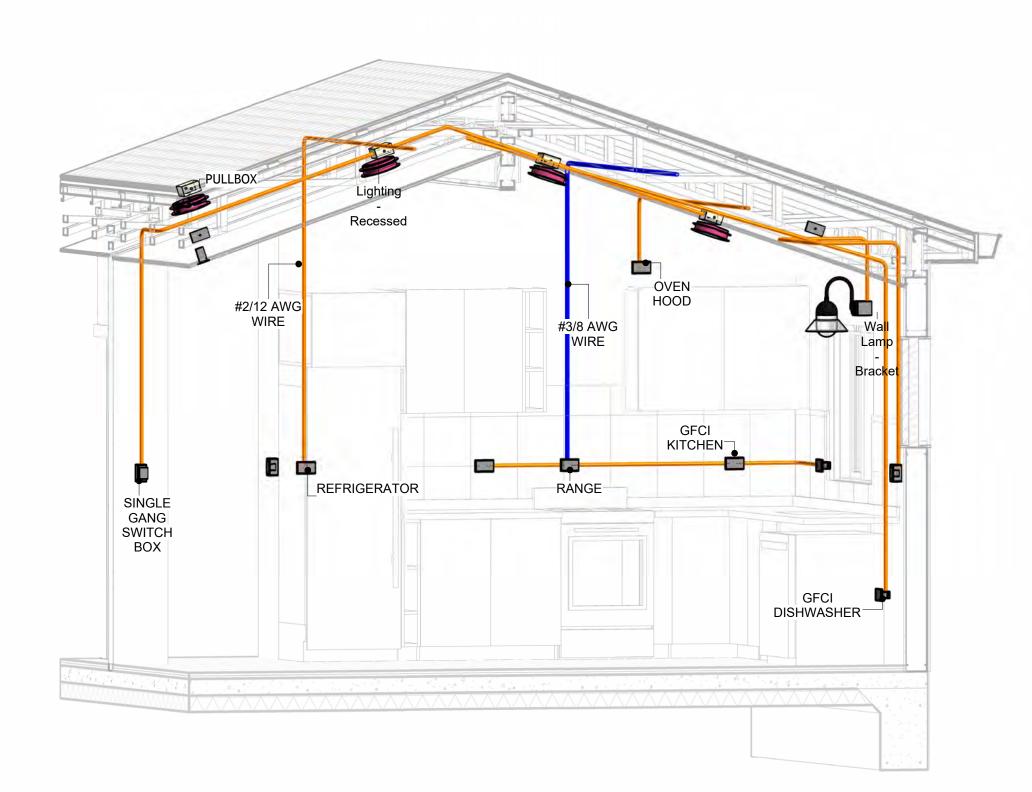


3D-KITCHEN

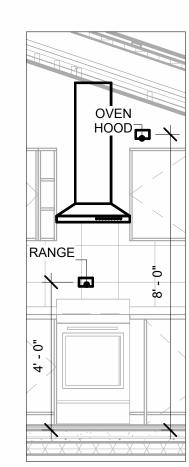


Range & OvenHood
3/8" = 1'-0"

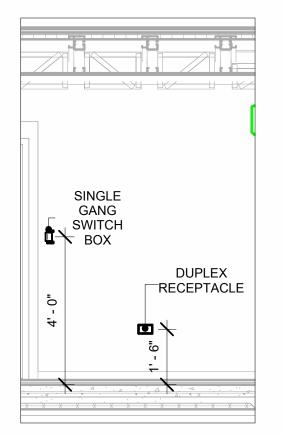

Switch & Receptacle 3/8" = 1'-0"

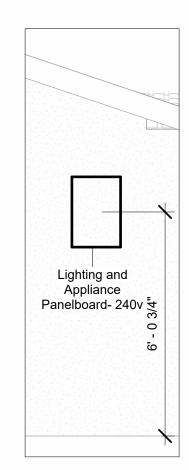


Panel 3/8" = 1'-0"

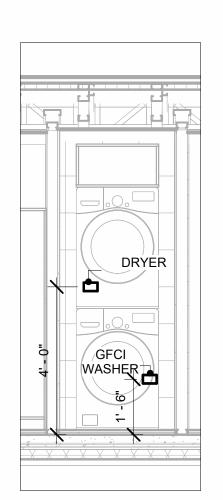

Dryer & Washer 3/8" = 1'-0"



KEY PLAN

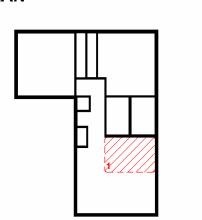

NO.	DESCRIPTION	DATE

NOTE:

LEGEND:

PROJECT

134-Orion-910-2Bd 2Ba-Spanish-Tower-550

DRAWING NAME

POWER

CLIENT NAME:	Owner
PROJECT NUMBER:	0379_13
DATE:	3/21/2025 5:11:34 PM
DESIGNED BY:	Designer
DRAWN BY:	Author
CHECKED BY:	Checker

E103

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NOTES: LIGHT

- 1. LIGHT FIXTURES AND LUMINARIES SHALL CONFORM TO THE NEC, THE IRC AND LOCAL SAFETY & BUILDING CODE.
- 2. ALL LIGHTING FIXTURES SHOULD CONFORM TO THE DESIGN ELECTRICAL LOAD AND SHALL BE PROPERLY WIRED AND MOUNTED BY QUALIFIED ELECTRICIAN FOLLOWING MANUFACTURERS SPECIFICATIONS.
- CEILING FANS AND FANS WITH LIGHT WITH WEIGHT EXCEEDING 35 LBS SHOULD BE PROVIDED WITH STRUCTURAL BACKING FOR SUPPORT AND SHALL BE FIXED AS PER MANUFACTURERS SPECIFICATIONS.
- 4. EXTERIOR LIGHTS SHALL CONFORM TO LOCAL BUILDING CODE AND GUIDELINES.

NOTES: SWITCH JUNCTION BOX


- THE MINIMUM SIZE OF JUCTION BOX TO BE USED IS 2"X4"X(1.5" OR 3.5" DEEP) THIS ARE TO BE USED FOR SINGLE GANG SWITCH OR OUTLETS.
- 2. FOR DOUBLE GANG (2 GANG) OUTLETS AND SWITCHS THE MINIMUM SIZE OF THE
- JUCTION BOX TO BE PROVIDED SHALL NOT BE LESS THAN 4"X4"X(1.5" OR 3.5" DEEP)
- 3. FOR THREE GANG (3 GANG) OUTLETS AND SWITCHS THE MINIMUM SIZE OF THE JUĆTION BOX SHALL NOT BE LESS THAN 6"X4"X(1.5" OR 3.5" DEEP).

FITTING SCHEDULE(PULL BOX)					
FAMILY	COUNT	DESCRIPTION			
DUIL DOV4	20	#4/4 DUILL DOV			
PULLBOX1	28	#1/4 PULLBOX			

ELECTRICAL FIXTURE SCHEDULE (SWITCH BOX)							
TYPE	COUNT						
DOUBLE GANG SWITCH BOX	3						
SINGLE GANG SWITCH BOX	8						
TRIPLE GANG SWITCH BOX	2						

LIGHTING DEVICE						
TYPE	COUNT					
DIMMER	6					
FAN SWITCH	2					
SINGLE POLE	6					
THREE WAY WITH DIMMER	7					

LIGHTING FIXTURE				
LIGHTING FIXTURE TYPE	VOLTAGE	ELECTRICAL LOAD	COUNT	
ELECTRICAL_LIGHTS_FAN-LIGHT1	120 V/1-100 VA- 120 V/1-100 VA	200 A, 120 V/240 V, SINGLE PHASE, 3 WIRES	3	
LIGHTING - RECESSED	120 V/1-60 VA	200 A, 120 V/240 V, SINGLE PHASE, 3 WIRES	10	
SASSO 100 ROUND WALLWASHER TRIM	120 V/1-28 VA	200 A, 120 V/240 V, SINGLE PHASE, 3 WIRES	12	
WALL LAMP - BRACKET	120 V/1-100 VA	200 A, 120 V/240 V, SINGLE PHASE, 3 WIRES	8	

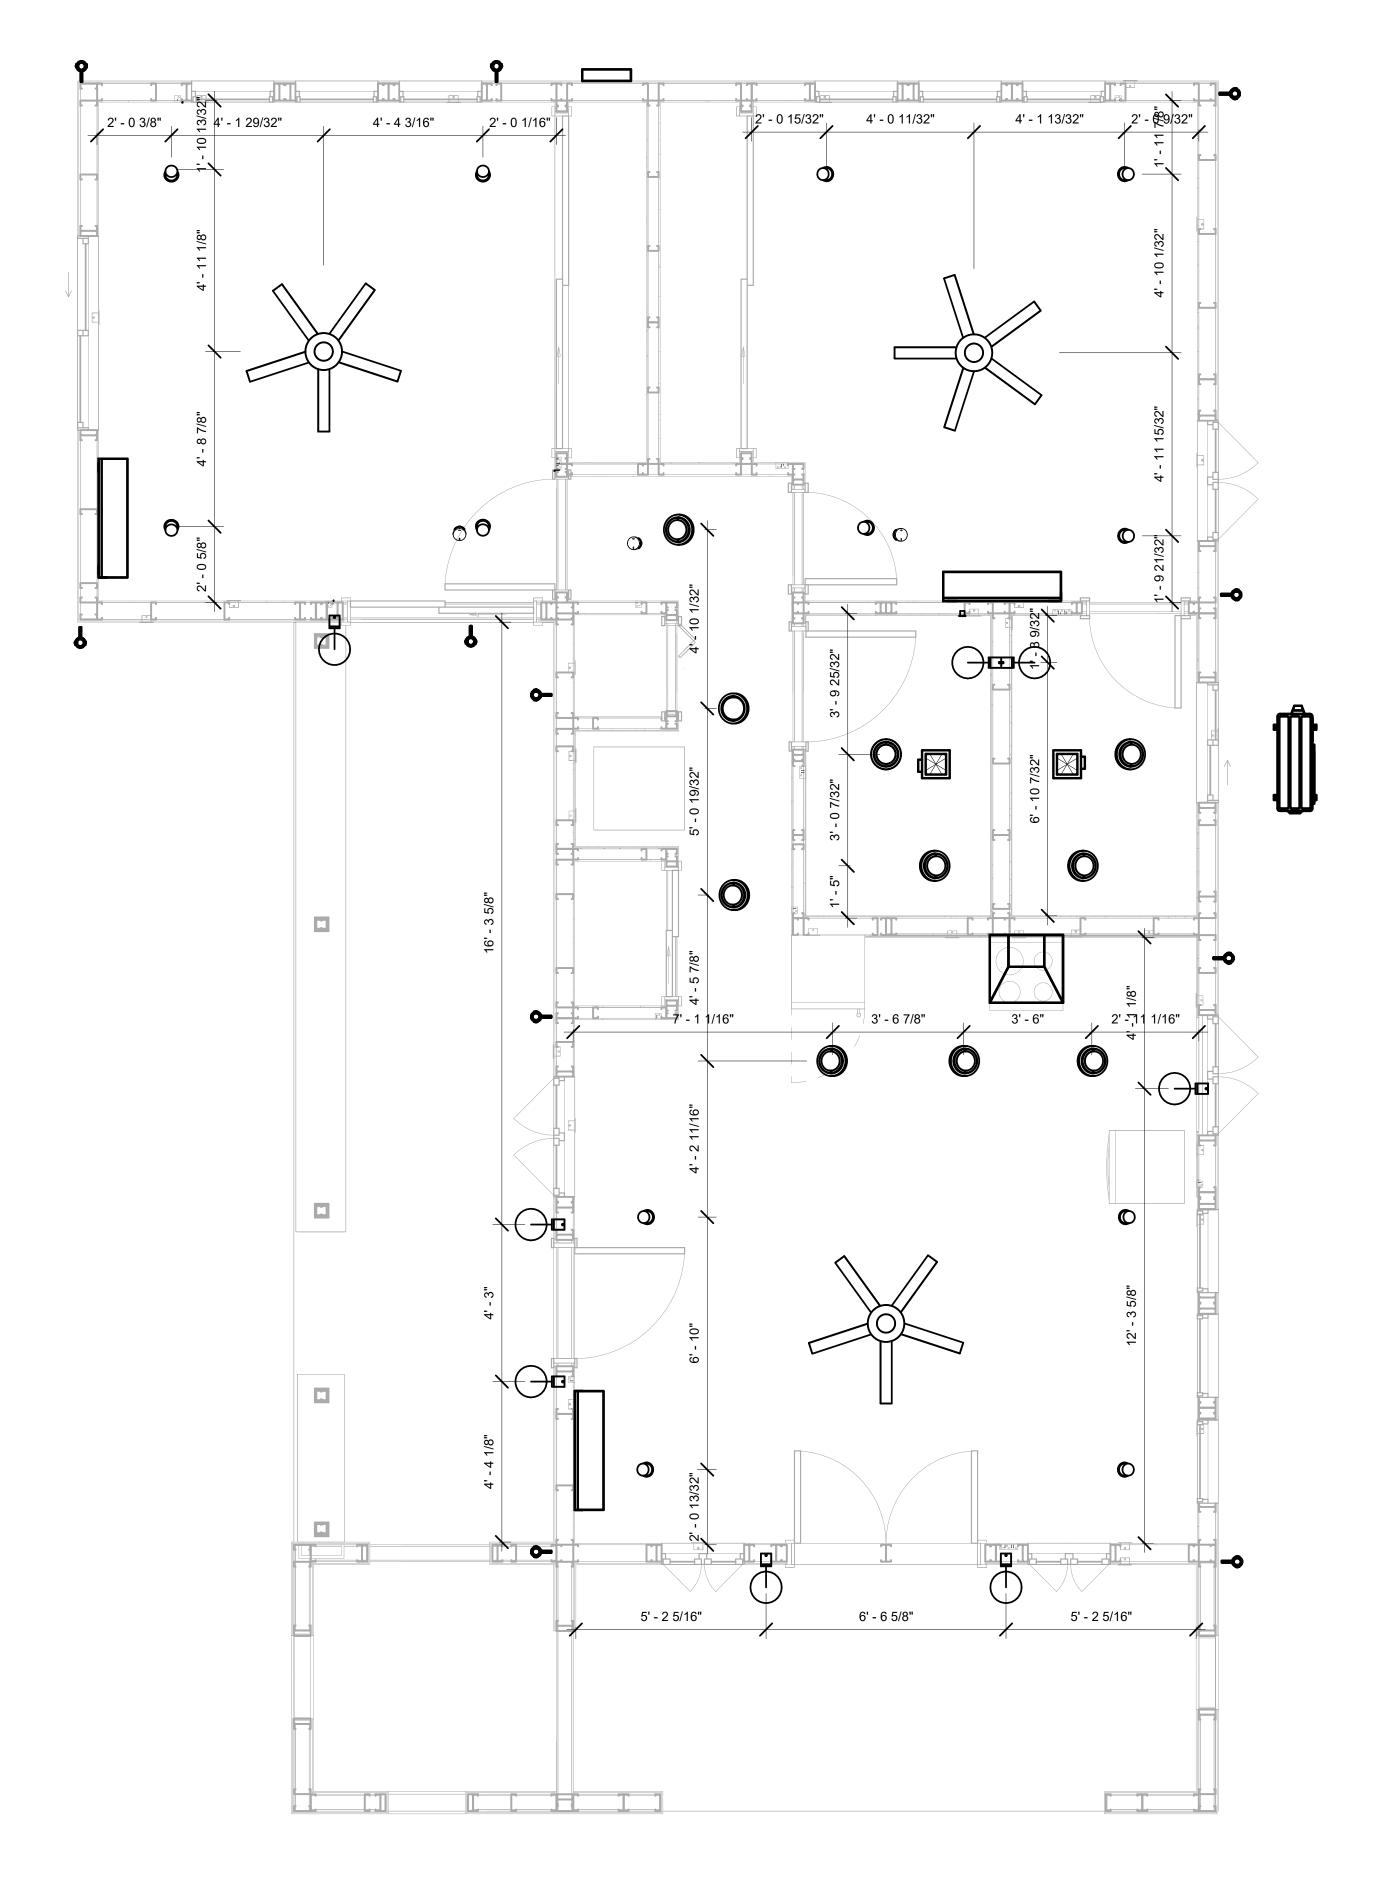

DIMENSION FOR LIGHT FIXTURES
3/8" = 1'-0"



KEY PLAN

NO.	DESCRIPTION	DATE

NOTE:

LEGEND:

PROJECT

134-Orion-910-2Bd 2Ba-Spanish-Tower-550

DRAWING NAME

DIMENSION PLAN FOR LIGHT FIXTURES

CLIENT NAME:	Owner
PROJECT NUMBER:	0379_13
DATE:	3/21/2025 5:11:37 PM
DESIGNED BY:	Designer
DRAWN BY:	Author
CHECKED BY:	Checker


E104

NOTES;

- 1. VERIFY EQUIPMENT PLUG CONFIGURATION BEFORE PURCHASING RECEPTACLES
- 2. FOR ALL EQUIPMENT.
- 3. COORDINATE EXACT LOCATION OF LIGHT FIXTURES, WALL SWITCHES, RECEPTACLES AND OTHER DEVICES WITH ARCHITECTURAL DRAWINGS.
- 4. USE METALLIC JUNCTION BOX WITH THE GFCI RECEPTACLES, WITH HIGHT VOLTAGE.

ELECTRICAL FIXTURE SCHEDULE (RECEPTACLE)		
TYPE	COUNT	
CONDENSER	1	
DRYER	1	
DUPLEX RECEPTACLE	15	
GFCI BATH ROOM	2	
GFCI DISHWASHER	1	
GFCI KITCHEN	3	
GFCI OUT DOOR	4	
GFCI WASHER	1	
OVEN HOOD	1	
RANGE	1	
REFRIGERATOR	1	
WATER HEATER	1	

	ELECTRICAL OUTLET SCHEDULE				
TYPE	CIRCUIT NUMBER	ELECTRICAL DATA	COUNT		
DUPLEX RECEPTACLE		120 V/1-180 VA	9		
WATER HEATER	5,7	240 V/2-4500 VA	1		
DRYER	6,8	240 V/2-5000 VA	1		
GFCI WASHER	9	120 V/1-1200 VA	1		
RANGE	10,12	240 V/2-5000 VA	1		
GFCI KITCHEN	11	120 V/1-180 VA	3		
REFRIGERATOR	13	120 V/1-1800 VA	1		
GFCI DISHWASHER	14	120 V/1-1200 VA	1		
DUPLEX RECEPTACLE	15	120 V/1-180 VA	6		
GFCI BATH ROOM	16	120 V/1-180 VA	1		
GFCI OUT DOOR	17	120 V/1-180 VA	4		
CONDENSER	18,20	240 V/2-5000 VA	1		
GFCI BATH ROOM	19	120 V/1-180 VA	1		
OVEN HOOD	21	120 V/1-180 VA	1		

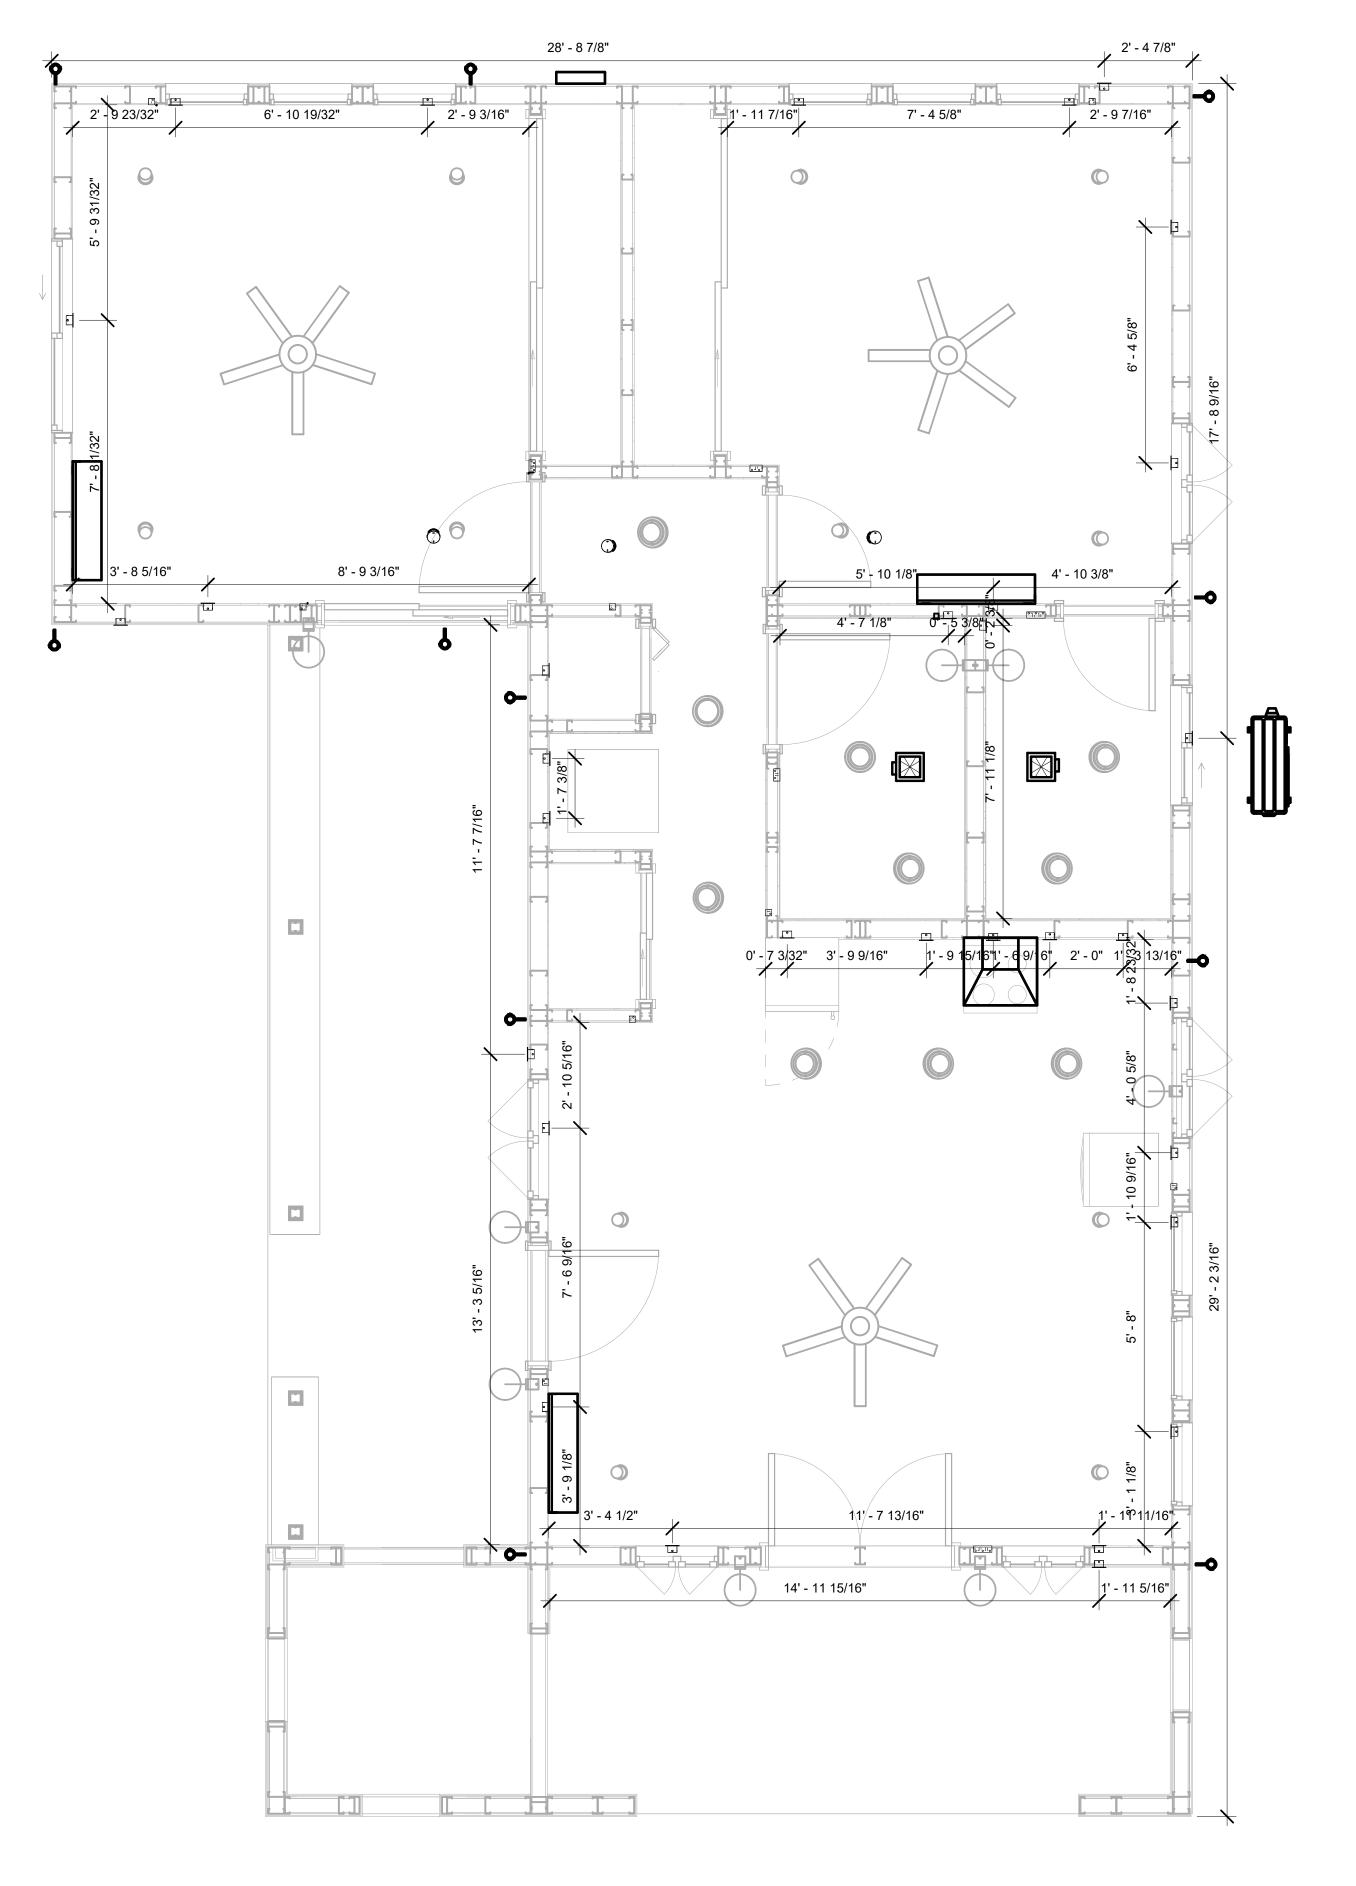

1 DIMENSION FOR FITTINGS 3/8" = 1'-0"



KEY PLAN

NO.	DESCRIPTION	DATE

NOTE:

LEGEND:

PROJECT

134-Orion-910-2Bd 2Ba-Spanish-Tower-550

DRAWING NAME

DIMENSION PLAN FOR FITTINGS

	Owner
	0379_13
3/2	2025 5:11:39 PM
	Designer
	Author
	Checker

E105

SCALE: 3/8" = 1'-0"

SHEET LIST

Sheet Number Sheet Name

P101 NOTE AND SCHEDULE
P102 WATER SUPPLY AND SEWAGE
SYSTEM

DOMESTIC COLD WATER DOMESTIC HOT WATER SANITARY VENT SANITARY SEWER

STORM DRAINAGE

PLUMBING NOTES

- I. The plumbing system is designed to meet the building's domestic water supply, sanitary drainage, and storm drainage requirements, as per project specifications and applicable codes.
- The system installation shall comply with the latest International Plumbing Code (IPC), International Residential Code (IRC), and all other relevant local, state, and national regulations.
- 3. ALL PLUMBING WORK SHALL COMPLY WITH THE LATEST EDITION OF THE INTERNATIONAL PLUMBING CODE (IPC) AND THE LOCAL PLUMBING CODE.
- 4. PLUMBING SYSTEMS SHALL BE TESTED AND INSPECTED IN ACCORDANCE WITH THE LOCAL PLUMBING CODE REQUIREMENTS.
- 5. PLUMBING FIXTURES SHALL BE INSTALLED WITH THE APPROPRIATE TRIM, FITTINGS, AND ACCESSORIES, AS RECOMMENDED BY THE MANUFACTURER.
- 6. PIPING SHALL BE PROPERLY SUPPORTED AND SECURED TO PREVENT SAGGING,
- MOVEMENT, AND VIBRATION.
 7. SHUT-OFF VALVES SHALL BE PROVIDED AT ALL BRANCH CONNECTIONS AND AT THE
- INLET AND OUTLET OF EACH PIECE OF EQUIPMENT.

 8. BACKFLOW PREVENTION DEVICES SHALL BE INSTALLED AS REQUIRED BY THE LOCAL
- PLUMBING CODE TO PROTECT THE POTABLE WATER SYSTEM.

 9. PLUMBING FIXTURES AND EQUIPMENT SHALL BE ACCESSIBLE FOR MAINTENANCE AND
- SERVICING.

 10. EXPOSED PLUMBING PIPING AND FIXTURES SHALL BE INSULATED TO PREVENT
- CONDENSATION AND ENERGY LOSS.
- 11. DEAD ENDS IN THE DRAINAGE SYSTEM MUST BE AVOIDED, EXCEPT WHERE NECESSARY TO INSTALL A CLEANOUT IN AN ACCESSIBLE LOCATION, AND MUST HAVE A VENTED CONNECTION TO THE OUTSIDE ATMOSPHERE.
- 12. THE VERTICAL DEFLECTION OF PVC PIPE MUST NOT EXCEED 5%, AND NO DEFLECTION IS PERMITTED FOR IRON PIPE.
- 13. WORK MUST BE PROPERLY COORDINATED WITH OTHER TRADES TO AVOID CONFLICTS, REFERRING TO THE ARCHITECTURAL AND STRUCTURAL DRAWINGS FOR INFORMATION REGARDING CEILING ELEVATIONS, SPACE CLEARANCES, WALL AND PARTITION LOCATIONS, ETC.
- 14. ALL FIXTURES SHALL HAVE ACCESSIBLE STOPS.
- 15. DOMESTIC WATER PIPING SHALL BE PEX, AND PVC PIPING IS NOT ACCEPTABLE FOR INTERIOR USE.
- 16. VENT TERMINATIONS SHALL BE LOCATED AT LEAST 10 FEET FROM OR 3 FEET ABOVE ANY OPERABLE WINDOW, DOOR OPENING, AIR INTAKE, OR VENT SHAFT, AND AT LEAST 3 FEET IN EVERY DIRECTION FROM ANY LOT LINE. ALLEY, OR STREET.
- 17. PIPE AND FITTINGS UTILIZED IN THE WATER SUPPLY SYSTEM SHALL HAVE A MAXIMUM OF 8 PERCENT LEAD.
- 18. ACRYLONITRILE BUTADIENE STYRENE (ABS) SHALL BE USED FOR THE SEWERAGE AND VENTILATION SYSTEM.
- 19. CROSS-LINKED POLYETHYLENE (PEX) SHALL BE USED FOR THE WATER SUPPLY SYSTEM.
- 20. POLYVINYL CHLORIDE (PVC) SHALL BE USED FOR THE RAIN WATER SYSTEM.
- THE MIMIMUM WATER SUPPLY DEPTH UNDER FLOOR FINISH SHOUD BE 1/2".
 ANY PIPE INSTALLED UNDERGROUND MUST HAVE AT LEAST 12 INCHES OF CLEARANCE
- BETWEEN THE OUTSIDE OF THE PIPE AND ANY OTHER UNDERGROUND STRUCTURE.
- 23. THE MINIMUM CLEARANCE BETWEEN COLD AND HOT WATER LINES IN RESIDENTIAL
- HOMES MAINTAIN A MINIMUM DISTANCE OF 6 INCHES.
- 24. HORIZONTAL SEPARATION BETWEEN WATER AND SEWER LINES: A MINIMUM OF 12 INCHES BETWEEN POTABLE WATER SUPPLY LINES (COLD AND HOT WATER) AND SANITARY SEWER LINES.

ABBREVIATIONS

ABS ACRYLONITRILE BUTADIENE STYRENE ABV ABOVE AD AREA DRAIN AFF ABOVE FINISHED FLOOR ALT ALTERNATE BFF BELOW FINISHED FLOOR BLW BELOW CO CLEAN OUT CW COLD WATER D DEGREE DFU Dranage FIXTURE UNIT DIA DIAMETER DN DOWN FCO FLOOR CLEAN OUT FD FLOOR DRAIN FL FLOOR FS FLOOR SINK FT FOOT/FEET HB HOSE BIB HW HOT WATER IN INCH MIN MINIMUM NO NUMBER NTS NOT TO SCALE PEX CROSS-LINKED POLYETHYLENE PLBG PLUMBING PVC POLYVINYL CHLORIDE QTY Quantity RD ROOF DRAIN RED REDUCER RM ROOM RW RAIN WATER SF SQUARE FOOT V VENT VTR VENT THROUGH ROOF W WASTE WCO WALL CLEAN OUT WSFU WATER SUPPLY FIXTURE UNIT		
ABV ABOVE AD AREA DRAIN AFF ABOVE FINISHED FLOOR ALT ALTERNATE BFF BELOW FINISHED FLOOR BLW BELOW CO CLEAN OUT CW COLD WATER D DEGREE DFU Dranage FIXTURE UNIT DIA DIAMETER DN DOWN FCO FLOOR CLEAN OUT FD FLOOR DRAIN FL FLOOR FS FLOOR SINK FT FOOT/FEET HB HOSE BIB HW HOT WATER IN INCH MIN MINIMUM NO NUMBER NTS NOT TO SCALE PEX CROSS-LINKED POLYETHYLENE PLBG PLUMBING PVC POLYVINYL CHLORIDE QTY QUANTITY RD ROOF DRAIN RED REDUCER RM ROOM RW RAIN WATER SF SQUARE FOOT V VENT VTR VENT THROUGH ROOF W WASTE WCO WALL CLEAN OUT	Ø	Diameter
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PEX CROSS-LINKED POLYETHYLENE PLBG PLUMBING PVC POLYVINYL CHLORIDE QTY Quantity RD ROOF DRAIN RED REDUCER RM ROOM RW RAIN WATER SF SQUARE FOOT V VENT VTR VENT THROUGH ROOF W WASTE WCO WALL CLEAN OUT	NO	NUMBER
PLBG PLUMBING PVC POLYVINYL CHLORIDE QTY Quantity RD ROOF DRAIN RED REDUCER RM ROOM RW RAIN WATER SF SQUARE FOOT V VENT VTR VENT THROUGH ROOF W WASTE WCO WALL CLEAN OUT	NTS	NOT TO SCALE
PVC POLYVINYL CHLORIDE QTY Quantity RD ROOF DRAIN RED REDUCER RM ROOM RW RAIN WATER SF SQUARE FOOT V VENT VTR VENT THROUGH ROOF W WASTE WCO WALL CLEAN OUT	PEX	CROSS-LINKED POLYETHYLENE
QTY Quantity RD ROOF DRAIN RED REDUCER RM ROOM RW RAIN WATER SF SQUARE FOOT V VENT VTR VENT THROUGH ROOF W WASTE WCO WALL CLEAN OUT	PLBG	PLUMBING
RD ROOF DRAIN RED REDUCER RM ROOM RW RAIN WATER SF SQUARE FOOT V VENT VTR VENT THROUGH ROOF W WASTE WCO WALL CLEAN OUT	PVC	POLYVINYL CHLORIDE
RED REDUCER RM ROOM RW RAIN WATER SF SQUARE FOOT V VENT VTR VENT THROUGH ROOF W WASTE WCO WALL CLEAN OUT	QTY	Quantity
RM ROOM RW RAIN WATER SF SQUARE FOOT V VENT VTR VENT THROUGH ROOF W WASTE WCO WALL CLEAN OUT	RD	ROOF DRAIN
RW RAIN WATER SF SQUARE FOOT V VENT VTR VENT THROUGH ROOF W WASTE WCO WALL CLEAN OUT	RED	REDUCER
SF SQUARE FOOT V VENT VTR VENT THROUGH ROOF W WASTE WCO WALL CLEAN OUT	RM	ROOM
V VENT VTR VENT THROUGH ROOF W WASTE WCO WALL CLEAN OUT	RW	RAIN WATER
VTR VENT THROUGH ROOF W WASTE WCO WALL CLEAN OUT	SF	SQUARE FOOT
W WASTE WCO WALL CLEAN OUT	V	VENT
WCO WALL CLEAN OUT	VTR	VENT THROUGH ROOF
	W	WASTE
WSFU WATER SUPPLY FIXTURE UNIT	WCO	WALL CLEAN OUT
	WSFU	WATER SUPPLY FIXTURE UNIT

PLUMBING LEGEND

D	Сар
	Bend 45 Deg
Ŋ	Bend 90 Deg
	Tee Reducing
	Tee
	Clean Two-Way
	Wye 45 Deg
	Wye 45 Deg Double
	Wye Combination
	P-Trap

PIPE SCHEDULE		
Material	Diameter	Length
Acrylonitrile Butadiene Styrene (ABS)	1 1/2"	13 ft
Acrylonitrile Butadiene Styrene (ABS)	2"	56 ft
Acrylonitrile Butadiene Styrene (ABS)	3"	9 ft
Cross-linked polyethylene (PEX)	1/2"	101 ft
Cross-linked polyethylene (PEX)	3/4"	63 ft
Polyvinyl Chloride - Rigid	2"	108 ft

FITT	ING SCHEDULE	
FITTING	Size	QTY
Domostic Cold Water		
Domestic Cold Water	1/2"ø-1/2"ø	16
PEX 90 Degree Elbow PEX 90 Degree Elbow	3/4"ø-3/4"ø	4
PEX Tee Elbow	1/2"ø-1/2"ø	4
PEX Tee Elbow	3/4"ø-3/4"ø-3/4"ø	7
PEX Transition Elbow	1"ø-3/4"ø	2
PEX Transition Elbow	3/4"ø-1/2"ø	6
Domestic Hot Water		
PEX 90 Degree Elbow	1/2"ø-1/2"ø	10
PEX 90 Degree Elbow	3/4"ø-3/4"ø	3
PEX Tee Elbow	1/2"ø-1/2"ø	6
PEX Transition Elbow	3/4"ø-1/2"ø	6
Rain Water		
Bend Rain Water System	2"ø-2"ø	20
Bend Sewerage System	2"ø-2"ø	7
PVC 90 Degree Bend Elbow	2"ø-2"ø	 1
PVC TEE Elbow	2"ø-2"ø	2
Sewage		
ABS 90 Degree Bend Elbow	1 1/2"ø-1 1/2"ø	2
ABS 90 Degree Bend Elbow	2"ø-2"ø	2
ABS 90 Degree Bend Elbow	3"ø-3"ø	2
ABS Bend Long Sweep Elbow	2"ø-2"ø	1
ABS P-Trap	1 1/2"ø-1 1/2"ø	4
ABS P-Trap	2"ø-2"ø	1
ABS Reducer Elbow	2"ø-1 1/2"ø	2
ABS Reducer Elbow	3"ø-2"ø	3
ABS TEE Elbow	2"ø-2"ø	1
ABS TEE Elbow	3"ø-3"ø-3"ø	1
ABS Trap P	2"ø-2"ø	1
ABS WASTE DOUBLE TEE	1 1/2"ø-1 1/2"ø-1 1/2"ø-1 1/2"ø	1
ABS WASTE DOUBLE TEE	2"ø-2"ø-2"ø	1
ABS WASTE DOUBLE TEE	3"ø-3"ø-3"ø	1
ABS Wye Combination with 8th Bend Elbow	2"ø-2"ø-1 1/2"ø	1
ABS Wye Combination with 8th Bend Elbow	3"ø-3"ø-1 1/2"ø	1
ABS Wye Combination with 8th Bend Elbow	3"ø-3"ø-2"ø	1
ABS Wye Combination with 8th Bend Elbow	3"ø-3"ø-3"ø	1

WATER FIXTURE UNIT SCHEDULE		
		·
ABS Vent Cap Elbow	2"ø	3
ABS TEE Elbow	2"ø-2"ø	1
ABS Reducer Elbow	2"ø-1 1/2"ø	1
ABS 90 Degree Bend Elbow	1 1/2"ø-1 1/2"ø	1

VVA		WATER TIXTORE UNIT SCHEDULE								
Family	QTY	UNIT VALUE	TOTAL							
Dishwasher	1	1.4	1.4							
Shower Tray	2		0							
Shower Trim	2	1.4	2.8							
Sink Island Single	1	1.4	1.4							
Vanity Sink	2		0							
Washer	1	1.4	1.4							
Water Closet	2	<varies></varies>	2.2							

WASTE FIXTURE UNIT SCHEDULE							
Family	TOTAL						
Dishwasher	1	2	2				
Shower Tray	2		0				
Sink Island Single	1	2	2				
Vanity Sink	2		0				
Washer	1	2	2				
Water Closet	2	<varies></varies>	3				

FIXTURE SCHEDULE						
fixture	QTY	Description				
Dishwasher	1					
Dryer	1					
Shower Tray	2					
Shower Trim	2					
Sink Island Single	1					
Vanity Sink	2					
Washer	1					
Water Closet	2					
Water Heater	1					

PLUMBING SCHEDULE							
FIXTURE	Trap	Waste	Vent	C.W	H.W		
Dishwasher	1-1/2"	2"	1-1/2"	1/2"	1/2"		
Dryer	N/A	N/A	N/A	N/A	N/A		
Shower Tray							
Shower Trim	-	-	-	1/2"	1/2"		
Sink Island Single	1-1/2"	2"	1-1/2"	1/2"	1/2"		
Vanity Sink	1-1/2"	2"	1-1/2"	1/2"	1/2"		
Washer	2"	2"	1-1/2"	1/2"	1/2"		
Water Closet	3"	3"	2"	1/2"	1/2"		
Water Heater	N/A	N/A	N/A	3/4"	3/4"		

ACCESSORIES & FITTINGS SCHEDULE						
fixture	QTY	Descriptions				
DISHWASHER SUPPLY SINGLE CONNECTOR	1					
DISHWASHER SEWAGE SINGLE CONNECTOR	1					
Hanging pipe clamp	20					
Hose Bib	2					
LAUNDRY SWEAT CONNECTOR1	1					
Shutoff Valve	8					



KEY PLAN

Tuscon, AZ, USA

NO. DESCRIPTION DATE

NOTE:

LEGEND:

PROJECT

134-Orion-910-2Bd 2Ba Spanish-Tower-550

DRAWING NAME


NOTE AND SCHEDULE

CLIENT NAME:

PROJECT NUMBER:	0379_13
DATE:	3/21/2025 7:49:04 AM
DESIGNED BY:	Designer
DRAWN BY:	Author
CHECKED BY:	Checker

P101

SCALE: 1/2" = 1'-0"

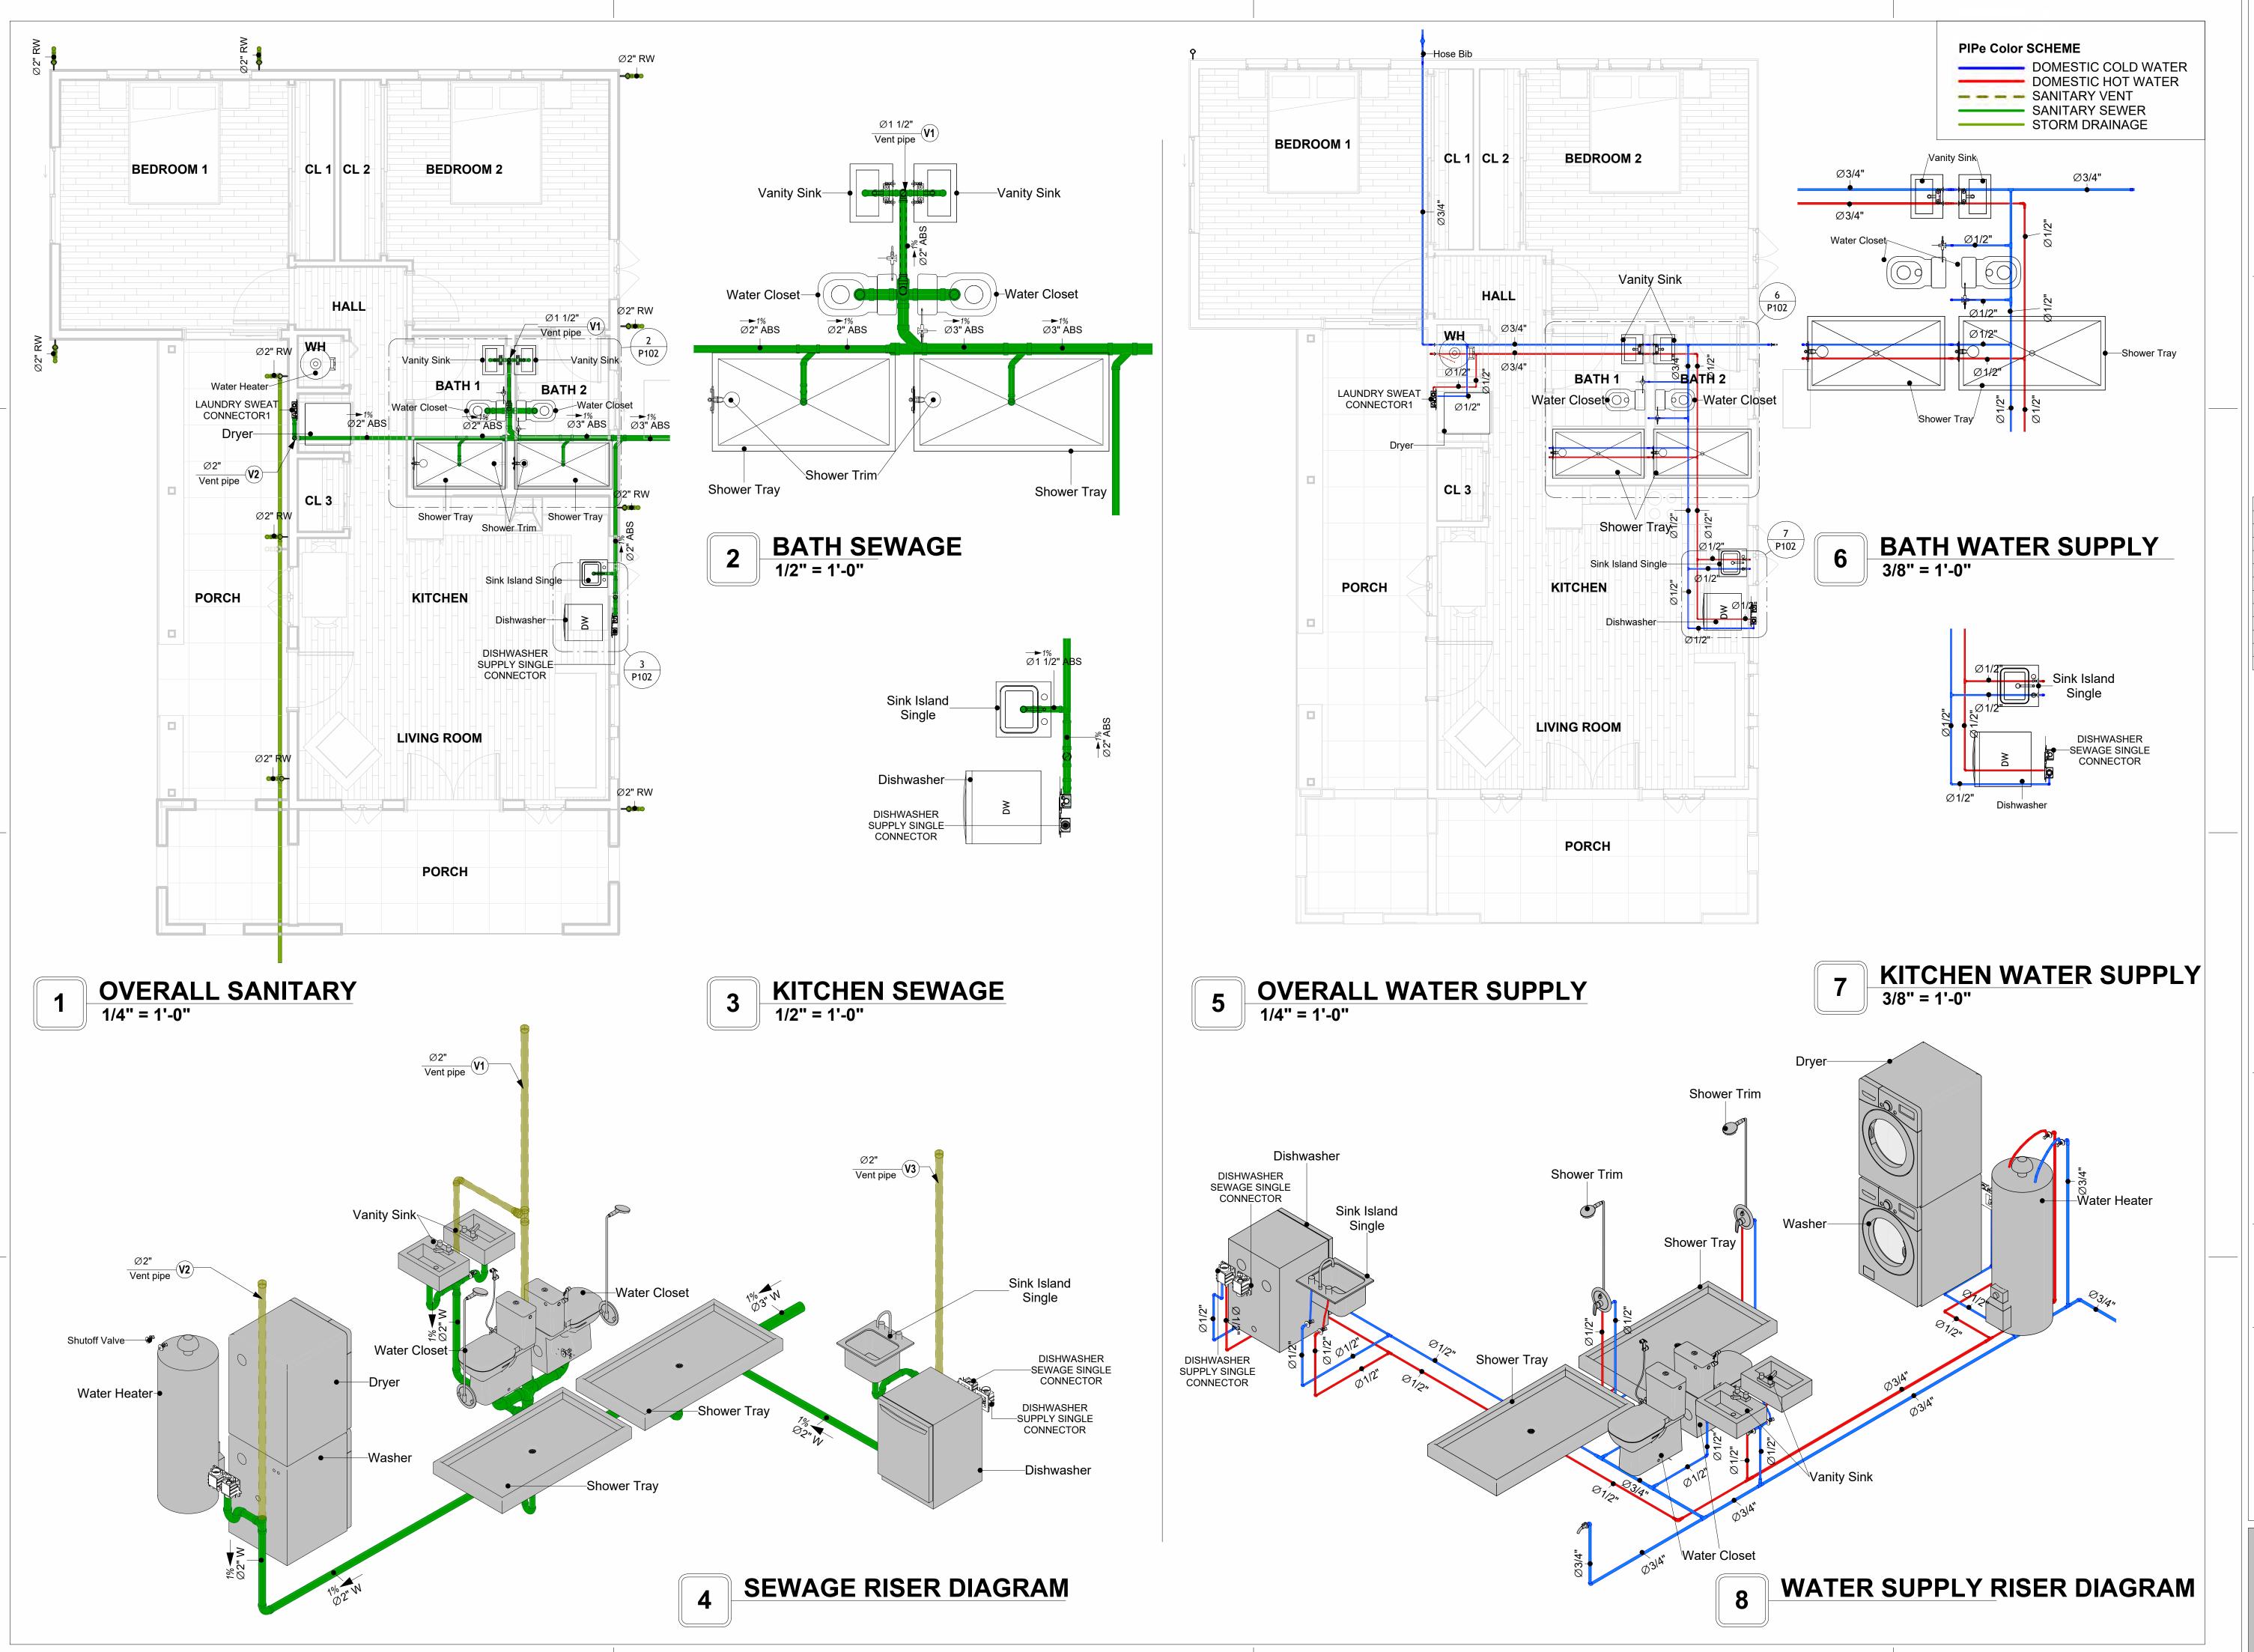



Tuscon.AZ. USA

KEY PLAN

NO. DESCRIPTION DATE

NOTE:

LEGEND:

PROJECT

134-Orion-910-2Bd 2Ba Spanish-Tower-550

DRAWING NAME

WATER SUPPLY AND SEWAGE SYSTEM

 CLIENT NAME:

 PROJECT NUMBER:
 0379_13

 DATE:
 3/21/2025 7:49:30 AM

 DESIGNED BY:
 Designer

 DRAWN BY:
 Author

 CHECKED BY:
 Checker

P102

Materials Shopping List

Please print and take this Materials Shopping List to your favorite Home Depot and ask for assistance in selecting the materials, fixtures and fittings to complete your new home.

Record your selection and the price of the item. Then do the math to determine the cost for your selections and the total cost of finishing your home.

Have It Your Way!

The material types listed in this document were selected based on personal preferences. The Customer is encouraged to make changes to the material types in accordance with local customs, regulations, and personal preferences.

Have It Your Way!



20 good reasons to frame a home with metal and not wood



Why build your ADU with metal vs wood	Wood	Metal	Explanation
1 DIY Construction Benefit		~	The wall frames, trusses and beams can be erected in a just a few days
2 Minimal Construction Skills Required		~	Pre-assembled walls and trusses require no specialized skills to errect
3 Build as DIY, Hybrid or by a General Contractor		~	Do it yourself, Hybrid (involve special contractors) or hire a General Contractor
4 Build It As You Can Afford It		~	Impervious to Weather - build as you have the time and money
5 Up Front Cost of Framing Materials	~		As to only the framing material, wood is less expensive
6 Total Cost To Build		~	Savings in time, labor, and other areas make light gauge steel LESS expensive
7 Termites and wood boring insects		~	Termites, carpenter ants and wood boring insects eat wood, not metal
8 Mold resistant		~	Metal does not attract mold
9 Damage caused by exterior and interior flooding		~	Metal needs no reconditioning after a flood
10 Fire Resistant		~	Non-combustible
11 Lower insurance rates		~	Many insurance underwriters now provide lower rates for metal framed homes
12 Walls, trusses, and beams retain their original form		~	Perfectly straight walls - no shimming of drywall
13 Corners are 90 degrees		~	No need for templating of countertops to adjust for out of square corners
14 Strength and weight		~	Metal is stronger than wood and weighs less - no need for crane to lift ADU trusses
15 IBC Engineered Stamp		~	If an engineering stamp is necessary, months of waiting are saved
16 Complete BOM (Materials Shopping List)		~	Take the materials shopping list to Home Depot and start shopping/pricing
17 Flexible in Seismic Areas - Won't Fracture		~	Light gauge steel is flexible and won't fracture when the earth moves
18 No Waste At Job Site		~	Steel is the most recycled material in the world. A typical wood home has 20-30% waste
19 Environmentally Friendly		~	Trees don't have to be destroyed and the source of most metal is from recycling
20 How-To Videos Included		~	How-to videos provide simple assembly instructions
21 Relationship Counselor		~	Eliminate emotional uphevels - save time, money, and preserve the relationship

Universal Requirements - some or all may be required

- 1 Site plan
- 2 Electrical Supply Connection
- 3 Sewer Connection
- 4 Fresh Water Supply Connection
- 5 Set Backs
- 6 Soils Evaluation

- 7 Earthquake (fault) evaluation
- 8 Foundation Plan subject to soils
- 9 Compliance with local energy codes: insulation home wrap and flashing
- 10 Engineering for wind speed and snow load.
- 11 State and Local ordinances regarding ADUs
- 12 Local Architect and/or Engineer may be necessary

Orion-2Bd 2Ba-Spanish-Tower





Orion-2Bd 2Ba-Spanish-Tower MATERIAL SHOPPING LIST

Have It Your Way!

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Have It Your Way!

PLUMBING BOM

ARCHITECTURAL BOM

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GENERAL NOTES

4 PLUMBING BOM

6 ARCHITECTURAL BOM

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ARCHITECTURAL BOM



	Orion-2Bd 2Ba-Spanish-Tower							
		ARCHITECT	URAL MATE	RIAL SHOPP	ING LIST			
No.	Item	Туре	Unit	Quantity		tal	Description	
\triangle	APPLIANCES							
1	Refrigerator		PCS	1				
2	Range		PCS	1				
3	Washer		PCS	1				
4	Dryer		PCS	1				
5	Dish Washer		PCS	1				
6	Oven		PCS	0				
7	Microwave		PCS	0				
Δ	CASEWORKS							
1	Kitchen Cabinet		FT	16.23				
2	Laundry Cabinet		FT	2.25				
3	Vanity Cabinet		FT	2.5				
4	Medicine Cabinet		PCS	2				
5	Kitchen countertop		SF	25.55				
6	Laundry Countertop		PCS	1				
7	Bathroom Countertop		SF	0				
8	Island		FT	0				
9	Peninsula	+	FT	0				
10	Closets		SF	140.31				
<u> </u>	CEILING	ls	los.	(04)				
1	Ceiling Board	Dry Wall	SF	681				
2	Dry Wall Fastener	Screw	PCS	1192				
3	Vapor Retarder	Polyethylene film	SF	771				
4	Vapor Retarder Fastener	Nails with washer heads	PCS	2313				
5	Ceiling Board (MRD)	Moisture resistant drywall	SF	90				
6	MRD Fastener		PCS	158				
7	Ceiling Board	Marine Plywood	SF	0				
8	Marine Plywood Fastener	Screw	PCS	0				
9	Dry Wall Tape		FT	386				
\triangle	FLOORING	•	·		•			
1	Main Living Space		SF	335.49				
2	Bathroom		SF	73.83				
3	Bedroom		SF	374.7				
4	Porch		SF	348.06				
Δ	STRUCTURE							
1	Foundation		SF	1,254.72				
	WALLS EXTERIOR	'						
1	Stucco Finish		SF	1827				
2	Wall Paint		SF	1827				
3	Wall Shteathing (OSB)		SF	1827				
4	Shteathing Fastener	Self-drilling screws(100/pkt)	PKT	18.27				
5	Wall Insulation	Son drining screws(100/pkt)	SF	3238				
6	Wall Homewrap		SF	1827				
7	Home wrap Fastener	Stapled fastener (200/pkt)	PKT	7				
			SF	0				
8	Stone Copping	Masonry stone						
9	Stone Veneer	Masonry stone	SF	0				
<u> </u>	WALLS INTERIOR		CF	F/6	1			
	Cementitious Backer Board		SF	562				
2	Kerdi membrane		SF	562				
3	Kerdi membrane Fastener		SF	562				
4	Wall Ceramic Tile		SF	562				
5	Drywall Board		SF	1663				
6	Drywall Fastener	Self-drilling screws(100/pkt)	PKT	16.63				
7	Wall Paint		SF	1663				
	Drywall Tape		FT	312				
8	Wall Skerting		FT	133				

ARCHITECTURAL BOM



	DOORS				
	Exterior Swinging	3' - 0" X 6'-8"	PCS	1	
	Interior Swinging	3' - 0" X 6'-8"	PCS	1	
3	Interior Sliding	9' - 0" X 6'-8"	PCS	2	
4	Interior Swinging	2' - 6" X 6'-8"	PCS	2	
5	Patio Sliding	5' - 0" X 6'-8"	PCS	1	
6		5' - 0" X 6'-8"	PCS	1	
_	Exterior Swinging		PCS	-	
7	Interior Swinging	3' - 0" X 6'-8"		1	
8	Folding	2' - 4" X 6'-8"	PCS	1	
9	Interior Sliding	3' - 5" X 6'-8"	PCS	1	
	Exterior Door Trim		FT	53	
	Interior Door Trim		FT	336	
	Entry Lock set		PCS	3	
	Privacy Lock set		PCS	4	
14	Passage Lock set		PCS	4	
△	WINDOWS				
1	Awning	2' - 3" X 2'-3"	PCS	9	
2	Sliding	5' - 3" X 4'-3"	PCS	1	
3	Casement	3' - 3" X 3'-9"	PCS	2	
4	Casement	2' - 3" X 4'-3"	PCS	2	
5	Casement	3' - 3" X 3'-3"	PCS	1	
6	Sliding	3' - 3" X 1'-9"	PCS	1	
7	Exterior Window Trim		FT	181	
8	Interior Window Trim		FT	181	
	ROOF				
1	Roof Covering		SF	2326.0	
2	Roof Covering Fastener		PCS	1163	
3	Roof Felt Paper		SF	1163.0	
4	Roof Felt Paper Fastener		PCS	6978.0	
5	Roof Sheathing		SF	1163	
6	Roof Sheathing Fastener		PCS	9304	
7	Batten		FT	586.0	
8	Batten Fastener		PCS	440.6	
9	Soffit		SF	130.0	
10	Soffit Fastener		PCS	65.0	
	Fascia		FT	182.0	
12	Fascia board fastener		PCS	91	
	Roof Insulation		SF		
13	KOOI IIISUIAIIOII		51	2326.0	



	Orion-2Bd 2Ba-Spanish-Tower								
	ELECTRICAL MATERIAL SHOPPING LIST								
No.	Item	Type		Quantity	Description				
	LIGHTING FIXTURES		, , , ,						
1	Kitchen Ceiling Light		PCS	3					
2	Exterior Wall Mounted Light		PCS	3					
	Livingroom Ceiling Light With Fan		PCS	1					
4	Bedroom Ceiling Light With Fan		PCS	3					
5	Dining Ceiling Light		PCS	1					
6	Bath Wall Mounted Light		PCS	1					
7	Bathroom Ceiling Light		PCS	1					
8	Livingroom Ceiling Light		PCS	2					
9	Bedroom Ceiling Light		PCS	12					
	Hall & Entry Ceiling Light		PCS	3					
11	Closet Ceiling Light		PCS	0					
	Smoke Detector		PCS	6					
	ELECTRICAL FITTINGS		1 00	0					
	Standard Receptacle 120V	20A	PCS	23					
	GFCI Receptacle 120V	20 A	PCS	13					
15	· · · · · · · · · · · · · · · · · · ·	30 A	PCS	3					
16	·	50 A	PCS	1					
17	GFCI Receptacle 240V	60 A	PCS	1					
	Fan Switch	00 A	PCS	4					
	Single Pole Switch								
	Three Way Switch		PCS	10					
	Dimmer Switch		PCS	2					
			PCS	3					
	ELECTRICAL CONDUITS & WIRING	4.4/2/14/1	ГТ	0					
	ROMEX 14 AWG	14/2/W/ground	FT	0					
	ROMEX 12 AWG	12/3/W/ground	FT	0					
	ROMEX 12 AWG	12/2/W/ground	FT	524					
	ROMEX 10 AWG	10/3/W/ground	FT	71					
	ROMEX 10 AWG	10/2/W/ground	FT	0					
	Romex 8 AWG	8/3/W/ground	FT	13					
	Romex 8 AWG	8/2/W/ground	FT	0					
	ROMEX 6 AWG	6/3/W/ground	FT	14					
	Bare Copper Ground Wire 6 AWG		FT	0					
	ELECTRICAL BOXES & CIRCUTES								
	Panelboard -240V 1 Phase MLO	200 AMP	PCS	1					
	Circuit breaker	15 A	PCS	0					
	Circuit breaker	20 A	PCS	14					
	Circuit breaker	30 A	PCS	3					
	Circuit breaker	40 A	PCS	0					
	Circuit breaker	50 A	PCS	1					
	Circuit breaker	60 A	PCS	1					
	Single Gang Switch Box		PCS	2					
40	Double Gang Switch Box		PCS	1					
41	Triple Gang Switch Box		PCS	5					
42	Pull Box	#1/4	PCS	26					
43	Receptacle Box		PCS	41					

13 ABS WASTE DOUBLE TEE

14 ABS WASTE DOUBLE TEE

15 ABS WASTE DOUBLE TEE

20 Bend Rain Water System

21 Bend Sewerage System

22 PEX 90 Degree Elbow

23 PEX 90 Degree Elbow

26 PEX Transition Elbow

27 PEX Transition Elbow

28 PVC 90 Degree Bend Elbow

24 PEX Tee Elbow

25 PEX Tee Elbow

16 ABS Wye Combination with 8th Bend Elbow

17 ABS Wye Combination with 8th Bend Elbow

18 ABS Wye Combination with 8th Bend Elbow

19 ABS Wye Combination with 8th Bend Elbow



Orion-2Bd 2Ba-Spanish-Tower PLUMBING SYSTEM MATERIAL SHOPPING LIST Item Unit Quantity Unit Price Total Description 1 Bath Tub (Alcove Tub) PCS 2 Kitchen Sink PCS 1 3 Kitchen Faucets PCS 4 Vanity Sink PCS 1 5 Bath room Faucets PCS 6 Water Closet PCS 7 Shower Trim PCS 8 Shower Tray PCS 9 Water Heater PCS 10 Hose Bib PCS 1 11 Shutoff Valve PCS 12 Hanging pipe clamp PCS 12 13 Gate Valve PCS 14 Dishwasher Supply Single Connector PCS 1 15 Dishwasher Sewage Single Connector PCS 16 Laundry Sweat Connector PCS 1 1 ABS (Acrylonitrile Butadiene Styrene) Pipes ø 1" FT 0 2 ABS (Acrylonitrile Butadiene Styrene) Pipes ø 1 1/2 FT 13 3 ABS (Acrylonitrile Butadiene Styrene) Pipes ø 2" FT 56 4 ABS (Acrylonitrile Butadiene Styrene) Pipes ø 3" FT 9 5 PEX (Cross-linked polyethylene) Pipes ø 1/2' FT 101 6 PEX (Cross-linked polyethylene) Pipes ø 3/4' FT 63 7 PEX (Cross-linked polyethylene) Pipes ø 1" FT 0 8 PVC Pipes Sch.80 - Rigid ø 1 1/2" FT 0 9 PVC Pipes Sch.80 - Rigid ø 2" FT 79 10 PVC Pipes Sch.80 - Rigid ø 3" FT 0 11 Flex Pipe Round ø 1/2" PCS 8 12 Flex Pipe Round ø 3/4" **PCS** 0 13 Flex Pipe Round ø 1" PCS 0 1 ABS 90 Degree Bend Elbow 1 1/2"ø-1 1/2"ø PCS 2 ABS 90 Degree Bend Elbow 2"ø-2"ø PCS 2 3 ABS 90 Degree Bend Elbow 3"ø-3"ø PCS 4 ABS Bend Long Sweep Elbow 2"ø-2"ø **PCS** 5 ABS P-Trap 1 1/2"ø-1 1/2"ø PCS 4 6 ABS P-Trap 2"ø-2"ø PCS 1 7 ABS Reducer Elbow 2"ø-1 1/2"ø PCS 8 ABS Reducer Elbow 3"ø-2"ø PCS 3 9 ABS TEE Elbow 2"ø-2"ø-2"ø PCS 2 10 ABS TEE Elbow 3"ø-3"ø-3"ø **PCS** 11 ABS Trap P 2"ø-2"ø PCS 12 ABS Vent Cap Elbow PCS 2"a 3

1 1/2"ø-1 1/2"ø-1 1/2"ø-1

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	Orion-2Bd 2Ba-Spanish-Tower							
	HVAC SYSTEM MATERIAL SHOPPING LIST							
No.	Item	Туре	Unit	Quantity	Unit Price	Total	Description	
	HVAC_DUCTS							
1	PIPE (REFRIGERANT LINE)	1/4" (Ø)	FT	2.02				
2	PIPE (REFRIGERANT LINE)	3/8" (Ø)	FT	98.08				
3	PIPE (REFRIGERANT LINE)	1/2''' (Ø)	FT	0.68				
4	PIPE (REFRIGERANT LINE)	3/4''' (Ø)	FT	122.23				
5	DRAYER HOSE	4" (Ø)	FT	3.1				
6	FLEX DUCT ROUND	4" (Ø)	FT	7.48				
	DUCT FITTINGS & ACCESSORIES							
7	ELBOW (REFRIGERANT LINE)	1/2" (Ø)-1/2" (Ø)	PCS	1				
8	ELBOW (REFRIGERANT LINE)	1/4" (Ø)-1/4" (Ø)	PCS	3				
9	ELBOW (REFRIGERANT LINE)	3/4" (Ø)-3/4" (Ø)	PCS	28				
10	ELBOW (REFRIGERANT LINE)	3/8" (Ø)-3/8" (Ø)	PCS	21				
11	TEE (REFRIGERANT LINE)	3/4" (Ø)-3/4" (Ø)-3/4" (Ø)	PCS	2				
12	TEE (REFRIGERANT LINE)	3/8" (Ø)-3/8" (Ø))-3/8" (Ø)	PCS	2				
13	TRANSITION (REFRIGERANT	3/4" (Ø)-1/2" (Ø)	PCS	4				
14	TRANSITION (REFRIGERANT	3/4" (Ø)-5/8" (Ø)	PCS	3				
15	TRANSITION (REFRIGERANT	3/8" (Ø)-1/4" (Ø)	PCS	1				
	HVAC_EQUIPMENTS							
16	AIR HANDLING UNIT	WALL MOUNTED	PCS	3				
17	CONDENSER	OUTDOOR UNIT	PCS	1				
18	EXHAUST FAN	75 CFM	PCS	2				
19	EXHAUST HOOD	WALL MOUNTED	PCS	1				
20	HOOD-WALL: VENT	HOOD-WALL: VENT	PCS	1				
21	DRAYER: VENT	DRAYER: VENT	PCS	1				
22	ROOF VENT	3"(Ø)	PCS	2				



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			LIGHTING FIXTURES				
#	Item	Туре	Description, Manufacturer, SKU	Unit	Quantity	Unit Price	Total
1	Kitchen Ceiling Light			PCS	3		
3	Kitchen Wall Mounted Light			PCS	1		
4	Exterior Wall Mounted Light			PCS	5		
5	Livingroom Ceiling Light With Fan			PCS	1		
6	Bedroom Ceiling Light With Fan			PCS	2		
7	Dining Ceiling Light			PCS	0		
8	Bath Wall Mounted Light			PCS	2		
9	Bathroom Ceiling Light			PCS	4		
10	Livingroom Ceiling Light			PCS	4		
11	Bedroom Ceiling Light			PCS	8		
12	Hall & Entry Ceiling Light			PCS	2		
12	Closet Ceiling Light			PCS	0		
13	Smoke Detector			PCS	4		
14							
15							



			ELECTRICAL FITTINGS				
#	Item	Туре	Description, Manufacturer, SKU	Unit	Quantity	Unit Price	Total
1	Standard Receptacle 120V	20A		PCS	15		
2	GFCI Receptacle 120V	20 A		PCS	13		
3	GFCI Receptacle 240V	30 A		PCS	2		
4	GFCI Receptacle 240V	50 A		PCS	1		
5	GFCI Receptacle 240V	60 A		PCS	1		
6	Fan Switch			PCS	2		
7	Single Pole Switch			PCS	6		
8	Three Way Switch			PCS	7		
9	Dimmer Switch			PCS	6		
10							
11							
12							
13							
14							
15							



		ELECTR	ICAL CONDUITS & WIRING				
#	Item	Туре	Description, Manufacturer, SKU	Unit	Quantity	Unit Price	Total
1	ROMEX 14 AWG	14/3/W/ground		FT	114		
3	ROMEX 12 AWG	12/3/W/ground		FT	517		
4	ROMEX 12 AWG	12/2/W/ground		FT	0		
6	ROMEX 10 AWG	10/3/W/ground		FT	0		
8	ROMEX 10 AWG	10/2/W/ground		FT	57		
9	Romex 8 AWG	8/3/W/ground		FT	0		
10	Romex 8 AWG	8/2/W/ground		FT	43		
11	ROMEX 6 AWG	6/3/W/ground		FT	43		
12	Bare Copper Ground Wire 6 AWG			FT			
13							
14							
15							
16							



		ELEC	CTRICAL BOXES & CIRCUTES				
#	Item	Туре	Description, Manufacturer, SKU	Unit	Quantity	Unit Price	Total
1	Panelboard -240V 1 Phase MLO	200 AMP		PCS	1		
2	Circuit breaker	15 A		PCS	2		
3	Circuit breaker	20 A		PCS	11		
4	Circuit breaker	30 A		PCS	2		
5	Circuit breaker	50 A		PCS	1		
6	Circuit breaker	60 A		PCS	1		
7	Single Gang Switch Box			PCS	8		
8	Double Gang Switch Box			PCS	3		
9	Triple Gang Switch Box			PCS	2		
10	Pull Box	#1/4		PCS	28		
11	Receptacle Box			PCS	32		
12							
13							
14							
15							

			HVAC_DUCTS 01			
#		Туре	Description, Manufacturer, SKU	Unit	Quantity	Unit Price Total
1	PIPE (REFRIGERANT LINE)			FT	2.02	
2	PIPE (REFRIGERANT LINE)	[3/8" (Ø)		FT	98.08	
3	PIPE (REFRIGERANT LINE)	1/2''' (Ø)		FT	0.68	
4	PIPE (REFRIGERANT LINE)	3/4"' (Ø)		FT	122.23	
5	DRAYER HOSE	4" (Ø)		FT	3.1	
6	FLEX DUCT ROUND	4" (Ø)		FT	7.48	
7						
8						
9						
10						
11						
12						
13						
14						
15						
16						

			DUCT FITTINGS & ACCESSORIES				
ŧ	Item	Туре	Description, Manufacturer, SKU	Unit	Quantity	Unit Price	Total
-	ELBOW (REFRIGERANT LINE)	1/2" (Ø)-1/2" (Ø)		PCS	1		
	ELBOW (REFRIGERANT LINE)	1/4" (Ø)-1/4" (Ø)		PCS	3		
	ELBOW (REFRIGERANT LINE)	3/4" (Ø)-3/4" (Ø)		PCS	28		
	ELBOW (REFRIGERANT LINE)	3/8" (Ø)-3/8" (Ø)		PCS	21		
	TEE (REFRIGERANT LINE)	3/4" (Ø)-3/4" (Ø)-3/4" (Ø)		PCS	2		
	TEE (REFRIGERANT LINE)	3/8" (Ø)-3/8" (Ø))-3/8" (Ø)		PCS	2		
	TRANSITION (REFRIGERANT LINE)	3/4" (Ø)-1/2" (Ø)		PCS	4		
	TRANSITION (REFRIGERANT LINE)	3/4" (Ø)-5/8" (Ø)		PCS	3		
	TRANSITION (REFRIGERANT LINE)	3/8" (Ø)-1/4" (Ø)		PCS	1		
	,						

			HVAC_EQUIPMENTS				
#	Item	Туре	Description, Manufacturer, SKU	Unit	Quantity	Unit Price	Total
1	AIR HANDLING UNIT	WALL MOUNTED		PCS	3		
2	CONDENSER	OUTDOOR UNIT		PCS	1		
3	EXHAUST FAN	75 CFM		PCS	2		
4	EXHAUST HOOD	WALL MOUNTED		PCS	1		
5	HOOD-WALL: VENT	HOOD-WALL: VENT		PCS	1		
6	DRAYER: VENT	DRAYER: VENT		PCS	1		
7	ROOF VENT	3"(Ø)		PCS	2		
8							
9							
10							
11							
12							
13							
14							



		PLUMBIN	NG FIXTURES & ACCESSORIES				
#	Item	Туре	Description, Manufacturer, SKU	Unit	Quantity	Unit Price	Total
1	Bath Tub (Alcove Tub)			PCS	C		
2	Kitchen Sink			PCS	1		
3	Kitchen faucets			PCS	1		
4	Vanity Sink			PCS	1		
5	Bath room faucets			PCS	1		
6	Water Closet			PCS	1		
7	Shower Trim			PCS	1		
8	Shower Tray			PCS	1		
9	Water Heater			PCS	1		
10	Hose Bib			PCS	1		
11	Shutoff Valve			PCS	6		
12	Hanging pipe clamp			PCS	12		
13	Globe Valve			PCS	1		
14	Dishwasher Supply Single Connector			PCS	1		
15	Dishwasher Sewage Single Connector			PCS	1		
16	Laundry Sweat Connector			PCS	1		



		SANI	TARY & PLUMBING PIPES				
#	Item	Туре	Description, Manufacturer, SKU	Unit	Quantity	Unit Price	Total
1	ABS (Acrylonitrile Butadiene Styrene) Pipes	ø 1"		FT	C		
<u>)</u>	ABS (Acrylonitrile Butadiene Styrene) Pipes	ø 1 1/2"		FT	13		
}	ABS (Acrylonitrile Butadiene Styrene) Pipes	ø 2"		FT	56		
ļ	ABS (Acrylonitrile Butadiene Styrene) Pipes	ø 3"		FT	9		
)	PEX (Cross-linked polyethylene) Pipes	ø 1/2"		FT	101		
,)	PEX (Cross-linked polyethylene) Pipes	ø 3/4"		FT	63		
'	PEX (Cross-linked polyethylene) Pipes	Ø 1"		FT	C		
}	PVC Pipes Sch.80 - Rigid	ø 1 1/2"		FT	C		
)	PVC Pipes Sch.80 - Rigid	ø 2"		FT	79		
0	PVC Pipes Sch.80 - Rigid	ø 3"		FT	C		
1	Flex Pipe Round	ø 1/2"		FT	8		
12	Flex Pipe Round	ø 3/4"		FT	C		
13	Flex Pipe Round	ø 1"		FT	C		
14							
15							



		PIPE FI	TTINGS 01				
#	Item	Туре	Description, Manufacturer, SKU	Unit	Quantity	Unit Price	Total
1	ABS 90 Degree Bend Elbow	1 1/2"ø-1 1/2"ø		PCS	3		
2	ABS 90 Degree Bend Elbow	2"Ø-2"Ø		PCS	2		
3	ABS 90 Degree Bend Elbow	3"Ø-3"Ø		PCS	2		
4	ABS Bend Long Sweep Elbow	2"Ø-2"Ø		PCS	1		
5	ABS P-Trap	1 1/2"ø-1 1/2"ø		PCS	4		
6	ABS P-Trap	2"Ø-2"Ø		PCS	1		
7	ABS Reducer Elbow	2"ø-1 1/2"ø		PCS	3		
8	ABS Reducer Elbow	3"ø-2"ø		PCS	3		
9	ABS TEE Elbow	2"ø-2"ø-2"ø		PCS	2		
10	ABS TEE Elbow	3"ø-3"ø-3"ø		PCS	1		
11	ABS Trap P	2"ø-2"ø		PCS	1		
12	ABS Vent Cap Elbow	2"ø		PCS	3		
13	ABS WASTE DOUBLE TEE	1 1/2"ø-1 1/2"ø-1 1/2"ø-1 1/2"ø		PCS	1		
14	ABS WASTE DOUBLE TEE	2"ø-2"ø-2"ø		PCS	1		
15	ABS WASTE DOUBLE TEE	3"Ø-3"Ø-3"Ø		PCS	1		



		PII	PE FITTINGS 02				
#	Item	Туре	Description, Manufacturer, SKU	Unit	Quantity	Unit Price	Total
1	ABS Wye Combination with 8th Bend Elbow	2"ø-2"ø-1 1/2"ø		PCS	1		
2	ABS Wye Combination with 8th Bend Elbow	3"ø-3"ø-1 1/2"ø		PCS	1		
3	ABS Wye Combination with 8th Bend Elbow	3"ø-3"ø-2"ø		PCS	1		
4	ABS Wye Combination with 8th Bend Elbow	3"ø-3"ø-3"ø		PCS	1		
5	Bend Rain Water System	2"Ø-2"Ø		PCS	20		
6	Bend Sewerage System	2"Ø-2"Ø		PCS	7		
7	PEX 90 Degree Elbow	1/2"ø-1/2"ø		PCS	26		
8	PEX 90 Degree Elbow	3/4"ø-3/4"ø		PCS	7		
9	PEX Tee Elbow	1/2"ø-1/2"ø-1/2"ø		PCS	10		
10	PEX Tee Elbow	3/4"ø-3/4"ø-3/4"ø		PCS	7		
11	PEX Transition Elbow	1"ø-3/4"ø		PCS	2		
12	PEX Transition Elbow	3/4"ø-1/2"ø		PCS	12		
13	PVC 90 Degree Bend Elbow	2"Ø-2"Ø		PCS	3		
14							
15							



			APPLIANCES				
#	Item	Туре	Description, Manufacturer, SKU	Unit	Quantity	Unit Price	Total
1	Refrigerator			PCS	1		
2	Range			PCS	1		
3	Washer Front Load	Stackable		PCS	1		
4	Dryer Front Load	Stackable		PCS	1		
5	Dish Washer			PCS	1		
6	Oven			PCS	(
7	Microwave			PCS	(
8							
9							
10							
11							
12							
13							
14							
15							
16							



			CASEWORKS 01				
#	Item	Туре	Description, Manufacturer, SKU	Unit	Quantity	Unit Price	Total
1	Kitchen Cabinet			FT	16.23		
2	Laundry Cabinet			FT	2.25		
3	Vanity Cabinet			FT	2.5		
4	Medicine Cabinet			PCS	2		
5	Kitchen countertop			SF	25.55		
6	Laundry Countertop			PCS	1		
7	Bathroom Countertop			SF	0		
8	Island			FT	0		
9	Peninsula			FT	0		
10	Closets			SF	140.31		
11							
12							
13							
14							
15							



			CEILING 01				
#	Item	Туре	Description, Manufacturer, SKU	Unit	Quantity	Unit Price	Total
	LIVING ROOM AND KITCHEN	l		SF	291.0		
L	Ceiling Board	Drywall		SF	291		
2	Drywall Fastener	Screw		PCS	509		
3	Vapor Retarder	Polyethylene film		SF	291		
1	Vapor Retarder Fastener	Nails with washer heads		PCS	873		
	BATHROOM 1			SF	45.0		
5	Ceiling Board	MRD (Moisture resistant drywall)		SF	45		
5	MRD Fastener	Screw		PCS	79		
	BATHROOM 2			SF	45.0		
7	Ceiling Board	MRD (Moisture resistant drywall)		SF	45		
3	MRD Fastener	Screw		PCS	79		
	W/H			SF	8.0		
)	Ceiling Board	Drywall		SF	8		
LO	Drywall Fastener	Screw		PCS	14		
l1	Vapor Retarder	Polyethylene film		SF	8		
12	Vapor Retarder Fastener	Nails with washer heads		PCS	24		



			CEILING 02				
#	Item	Туре	Description, Manufacturer, SKU	Unit	Quantity	Unit Price	Total
	W/D			SF	10.0		
13	Ceiling Board	Drywall		SF	10		
14	Drywall Fastener	Screw		PCS	18		
15	Vapor Retarder	Polyethylene film		SF	10		
16	Vapor Retarder Fastener	Nails with washer heads		PCS	30		
	BEDROOM 1			SF	170.0		
17	Ceiling Board	Drywall		SF	170		
18	Drywall Fastener	Screw		PCS	298		
19	Vapor Retarder	Polyethylene film		SF	170		
20	Vapor Retarder Fastener	Nails with washer heads		PCS	510		
	BEDROOM 2			SF	92.0		
21	Ceiling Board	Drywall		SF	92		
22	Drywall Fastener	Screw		PCS	161		
23	Vapor Retarder	Polyethylene film		SF	92		
24	Vapor Retarder Fastener	Nails with washer heads		PCS	276		



			CEILING 03				
#	Item	Туре	Description, Manufacturer, SKU	Unit	Quantity	Unit Price	Total
	CLOSET 1			SF	23.0		
25	Ceiling Board	Drywall		SF	23		
26	Drywall Fastener	Screw		PCS	40		
27	Vapor Retarder	Polyethylene film		SF	23		
28	Vapor Retarder Fastener	Nails with washer heads		PCS	69		
	CLOSET 2			SF	23.0		
29	Ceiling Board	Drywall		SF	23		
30	Drywall Fastener	Screw		PCS	40		
31	Vapor Retarder	Polyethylene film		SF	23		
32	Vapor Retarder Fastener	Nails with washer heads		PCS	69		
	CLOSET 3			SF	11.0		
33	Ceiling Board	Drywall		SF	11		
34	Drywall Fastener	Screw		PCS	19		
35	Vapor Retarder	Polyethylene film		SF	11		
36	Vapor Retarder Fastener	Nails with washer heads		PCS	33		



			CEILING 03				
#	Item	Туре	Description, Manufacturer, SKU	Unit	Quantity	Unit Price	Total
	HALL			SF	53.0		
37	Ceiling Board	Drywall		SF	53		
38	Drywall Fastener	Screw		PCS	93		
39	Vapor Retarder	Polyethylene film		SF	53		
40	Vapor Retarder Fastener	Nails with washer heads		PCS	159		
	PORCH			SF	23.0		
41	Ceiling Board	Marine Plywood		SF	23		
42	Exterior Grade Plywood	Screw		PCS	40		



			FLOORING INTERIOR 01				
#	Item	Туре	Description, Manufacturer, SKU	Unit	Quantity	Unit Price	Total
	BEDROOM 1						
1	Bedroom Flooring			SF	161		
2	Wood underlay	Foam Pad Polyethylene		SF	161		
3	Vapor Retarder	Vapor Barrier Polyethylene		SF	161		
	BEDROOM 2						
4	Bedroom Flooring			SF	170		
5	Wood underlay	Foam Pad Polyethylene		SF	170		
6	Vapor Retarder	Vapor Barrier Polyethylene		SF	170		
	CLOSET 1						
7	Closet Flooring			SF	22		
8	Wood underlay	Foam Pad Polyethylene		SF	22		
9	Vapor Retarder	Vapor Barrier Polyethylene		SF	22		
	CLOSET 2						
10	Closet Flooring			SF	22		
11	Wood underlay	Foam Pad Polyethylene		SF	22		
12	Vapor Retarder	Vapor Barrier Polyethylene		SF	22		



			FLOORING INTERIOR 02				
#	Item	Туре	Description, Manufacturer, SKU	Unit	Quantity	Unit Price	Total
	CLOSET 3						
13	Closet Flooring			SF	10		
14	Wood underlay	Foam Pad Polyethylene		SF	10		
15	Vapor Retarder	Vapor Barrier Polyethylene		SF	10		
	LIVING ROOM AND KITCHI	EN					
16	Living Area Flooring			SF	325		
17	Wood underlay	Foam Pad Polyethylene		SF	325		
18	Vapor Retarder	Vapor Barrier Polyethylene		SF	325		
	BATHROOM 1						
19	Tile Finish			SF	29		
20	Adhesive	1/2" Thin set Mortar		SF	29		
21	Vapor Retarder	Vapor Barrier Polyethylene		SF	29		
	BATHROOM 2						
22	Tile Finish			SF	28		
23	Adhesive	1/2" Thin set Mortar		SF	28		
24	Vapor Retarder	Vapor Barrier Polyethylene		SF	28		



			FLOORING INTERIOR 03				
#	Item	Туре	Description, Manufacturer, SKU	Unit	Quantity	Unit Price	Total
	W/D						
25	Tile Finish			SF	9		
26	Adhesive	1/2" Thin set Mortar		SF	9		
27	Vapor Retarder	Vapor Barrier Polyethylene		SF	9		
	BOILER ROOM						
28	Tile Finish			SF	7		
29	Adhesive	1/2" Thin set Mortar		SF	7		
30	Vapor Retarder	Vapor Barrier Polyethylene		SF	7		



			FLOORING EXTERIOR			
#	Item	Туре	Description, Manufacturer, SKU	Unit	Quantity	Unit Price
	STRUCTURE			SF	1,254.72	
1	Concrete Slab	4"concrete cast in situ		CF	418.24	
2	Insulation	Rigid insulation		SF	321.78	
3	Hard core	Compacted soil		CF	318.45	
4	Re-bar	#4 re-bar		Ton	1.04	
5	Concrete Pad	4"concrete cast in situ		CF	2	
6	Slab edge	Turndown		CF	324.43	
	PORCH FRONT					
7	Tile Finish			SF	348.06	
8	Adhesive	1/2" Thin set Mortar		SF	348.06	
9	Vapor Retarder	Vapor Barrier Polyethylene		SF	348.06	



			WALLS: EXTERIOR				
#	Item	Туре	Description, Manufacturer, SKU	Unit	Quantity	Unit Price	Total
1	Stucco Finish			SF	1827		
2	Wall Shteathing (OSB)			SF	1827		
3	Shteathing Fastener	Self-drilling screws(100/pkt)		PKT	18.27		
4	Wall Homewrap			SF	1827		
5	Homewrap Fastener	Stapled fastener (200/pkt)		PKT	7		
6	Wall Paint			SF	1827.00		
7	Stone Copping	Masonry stone		SF	0.00		
8	Stone Veneer	Masonry stone		SF	0		
9	Mortar for Stone Veneer			SF	0		
10	Wall Insulation			SF	3238		



			WALLS: INTERIOR 01				
#	Item	Туре	Description, Manufacturer, SKU	Unit	Quantity	Unit Price	Total
	BATHROOM 1			SF	41.0		
1	Cementitious Backer Board			SF	243		
2	Kerdi membrane			SF	243		
3	Kerdi membrane Fastener			SF	243		
4	Wall Ceramic Tile			SF	243		
	BATHROOM 2			SF	42.0		
5	Cementitious Backer Board			SF	205		
6	Kerdi membrane			SF	205		
7	Kerdi membrane Fastener			SF	205		
8	Wall Ceramic Tile			SF	205		
	BEDROOM 1			SF	172.0		
9	Drywall Board			SF	294		
10	Drywall Fastener	Self-drilling screws(100/pkt)		PKT	2.94		
11	Wall Paint			SF	294		
12	Drywall Tape			FT	55.1		



			WALLS: INTERIOR 02				
#	Item	Туре	Description, Manufacturer, SKU	Unit	Quantity	Unit Price	Total
	BEDROOM 2			SF	159.0		
13	Drywall Board			SF	331		
14	Drywall Fastener	Self-drilling screws(100/pkt)		PKT	3.31		
15	Wall Paint			SF	331		
16	Drywall Tape			FT	62.1		
	KITCHEN			SF	80.0		
17	Cementitious Backer Board			SF	41		
18	Drywall Board			SF	152		
19	Drywall Fastener	Self-drilling screws(100/pkt)		PKT	1.52		
20	Kerdi membrane			SF	41		
21	Kerdi membrane Fastener			SF	41		
22	Wall Ceramic Tile			SF	41		
23	Wall Paint			SF	152		
24	Drywall Tape			FT	28.7		



			WALLS: INTERIOR 03				
#	Item	Туре	Description, Manufacturer, SKU	Unit	Quantity	Unit Price	Total
	LIVING ROOM			SF	196.0		
25	Drywall Board			SF	255	i	
26	Drywall Fastener	Self-drilling screws(100/pkt)		PKT	2.55		
27	Wall Paint			SF	255		
28	Drywall Tape			FT	47.8	3	
	CL 1			SF	24.0		
29	Drywall Board			SF	132		
30	Drywall Fastener	Self-drilling screws(100/pkt)		PKT	1.32		
31	Wall Paint			SF	132		
32	Drywall Tape			FT	24.8	3	
	CL 2			SF	22.0		
33	Drywall Board			SF	152		
34	Drywall Fastener	Self-drilling screws(100/pkt)		PKT	1.52		
35	Wall Paint			SF	152		
36	Drywall Tape			FT	28.5		



			WALLS: INTERIOR 04				
#	Item	Туре	Description, Manufacturer, SKU	Unit	Quantity	Unit Price	Total
	CL 3			SF	10.0		
37	Drywall Board			SF	83		
38	Drywall Fastener	Self-drilling screws(100/pkt)		PKT	0.83		
39	Wall Paint			SF	83		
40	Drywall Tape			FT	15.6		
	HALL			SF	51.0		
41	Drywall Board			SF	193		
42	Drywall Fastener	Self-drilling screws(100/pkt)		PKT	1.93		
43	Wall Paint			SF	193		
44	Drywall Tape			FT	36		
	WD			SF	9.0		
45	Cementitious Backer Board			SF	73		
46	Kerdi membrane			SF	73		
47	Kerdi membrane Fastener			SF	73		
48	Wall Ceramic Tile			SF	73		



			WALLS: INTERIOR 05				
#	Item	Туре	Description, Manufacturer, SKU	Unit	Quantity	Unit Price	Total
	WH			SF	8.0		
49	Drywall Board			SF	71		
50	Drywall Fastener	Self-drilling screws(100/pkt)		PKT	0.71		
51	Wall Paint			SF	71		
52	Drywall Tape			FT	13		
1	Wall Skirting	Ceramic		FT	133		



			DOORS				
#	Item	Туре	Description, Manufacturer, SKU	Unit	Quantity	Unit Price	Total
1	Exterior Swinging	3' - 0" X 6'-8"		PCS	1		
2	Interior Swinging	3' - 0" X 6'-8"		PCS	1		
3	Interior Sliding	9' - 0" X 6'-8"		PCS	2		
4	Interior Swinging	2' - 6" X 6'-8"		PCS	2		
5	Patio Sliding	5' - 0" X 6'-8"		PCS	1		
6	Exterior Swinging	5' - 0" X 6'-8"		PCS	1		
7	Interior Swinging	3' - 0" X 6'-8"		PCS	1		
8	Folding	2' - 4" X 6'-8"		PCS	1		
9	Interior Sliding	3' - 5" X 6'-8"		PCS	1		
10	Exterior Door Trim			FT	53	3	
11	Interior Door Trim			FT	336		
12	Entry Lock set			PCS	3		
13	Privacy Lock set			PCS	4		
14	Passage Lock set			PCS	4		
15							



		WINDOWS				
Item	Туре	Description, Manufacturer, SKU	Unit	Quantity	Unit Price	Total
Awning	2' - 3" X 2'-3"		PCS	9		
Sliding	5' - 3" X 4'-3"		PCS	1		
Casement	3' - 3" X 3'-9"		PCS	2		
Casement	2' - 3" X 4'-3"		PCS	2		
Casement	3' - 3" X 3'-3"		PCS	1		
Sliding	3' - 3" X 1'-9"		PCS	1		
Exterior Window Trim			FT	181		
Interior Window Trim			FT	181		



			ROOF 01				
#	Item	Туре	Description, Manufacturer, SKU	Unit	Quantity	Unit Price	Total
1	Roof Covering			SF	1163.0		
2	Roof Covering Fastener			PCS	581.5		
3	Roof Felt Paper			SF	1163.0		
4	Roof Felt Paper Fastener			PCS	3489.0		
5	Roof Sheathing			SF	1163.0		
6	Roof Sheathing Fastener			PCS	9304.0		
7	Batten			FT	586.0		
8	Batten Fastener			PCS	440.6		
9	Soffit			SF	130.0		
10	Soffit Fastener			PCS	65.0		
11	Fascia			FT	182.0		
12	Fascia board fastener			PCS	91.0		
13	Roof Insulation			SF	1163.0		



			ROOF 02				
#	Item	Туре	Description, Manufacturer, SKU	Unit	Quantity	Unit Price	Total
1	Roof Covering			SF	1163.0		
2	Roof Covering Fastener			PCS	582		
3	Roof Felt Paper			SF	1163.0		
4	Roof Felt Paper Fastener			PCS	3489.0		
5	Roof Sheathing			SF	1163.0		
6	Roof Sheathing Fastener			PCS	9304		
7	Batten			FT	0.0		
8	Batten Fastener			PCS	0.0		
9	Soffit			SF	0.0		
10	Soffit Fastener			PCS	0.0		
11	Fascia			FT	0.0		
12	Fascia board fastener			PCS	0		
13	Roof Insulation			SF	1163.0		
14							
15							