

ORION

The Orion is a charming Craftsman-style threebedroom, two-bathroom home designed for comfortable and efficient living. The exterior walls are finished with horizontal siding in a warm, earthy tone, creating a clean and traditional aesthetic. The gable ends feature wood shingles, adding a touch of natural texture and visual interest. A prominent covered porch spans the front of the home, featuring substantial stone-clad pillars and a decorative pergola, creating a welcoming outdoor space.

Inside, the Orion features a simple L-shaped plan. The living, dining, and kitchen areas are seamlessly merged into a single large room at one end of the house, creating a spacious and versatile living space. The bedrooms are thoughtfully located on the other end of the plan, offering private and quiet retreats. Functional spaces, such as the bathrooms and laundry, are strategically placed between the living area and the bedrooms, creating a clear separation and enhancing the overall functionality of the home.

Materials Shopping List

Please print and take this Materials Shopping List to your favorite Home Depot and ask for assistance in selecting the materials, fixtures and fittings to complete your new home.

Record your selection and the price of the item. Then do the math to determine the cost for your selections and the total cost of finishing your home.

< CLICK HERE >

To Go To Materials Shopping List



FRONT PORCH 123 SF

FLOOR PLAN

1198 SF

3 Bed Rooms

TABLE OF CONTENTS

RENDERINGS	ABOUT THE HOME	
FLOOR PLAN	SCHEMATIC FLOOR PLAN	─ 01
1	HOME SPECS -	 01
	DISCLAIMER -	 01
ABOUT	ABOUT FrameUpNow ⊢	─ 01
1	ABOUT HouseDocs -	─ 01
DESCRIPTIONS	BOM (Bill Of Materials) ⊢	— 02
2	STRUCTURAL -	─ 02
	ARCHITECTURAL	 02
	MECHANICAL -	 02
	ELECTRICAL	─ 02
	PLUMBING -	─ 02
MATERIALS LIST 2	MATERIALS LIST PREVIEW	 02
HOW TO BUILD	CONSTRUCTION STEPS -	─ 02

COVER SHEET

FLOOR PLAN +

DIMENSION PLAN +

FOUNDATION PLAN

STRUCTURAL FLOOR PLAN -WALL FRAME LAYOUT ROOF TRUSS LAYOUT ROOF PLAN + ARCHITECTURAL ELEVATIONS ARCHITECTURAL ELEVATIONS -ARCHITECTURAL SECTIONS -ARCHITECTURAL DETAILS ARCHITECTURAL CASEWORK

03

COVER SHEET GENERAL NOTES WALL FRAME LAYOUT WALL PANEL & LAYOUT PLAN 19 20 ROOF TRUSS LAYOUT STRUCTURAL SECTIONS 21 WALL BRACING LAYOUT HOLD-DOWN PLAN **STRUCTURAL DETAILS 1 STRUCTURAL DETAILS 2 STRUCTURAL DETAILS 3 27** TRUSS BLOCKING LAYOUT SHEETROCK BACKING 1 **ROOF BRACING LAYOUT** 29 30

MECHANICAL COVER SHEET HVAC PLAN 31 **ELECTRICAL** SCHEDULE **32** LIGHTING POWER PLAN DIMENSION FOR LIGHTING DIMENSION FOR FITTING

PLUMBING

ARCHITECTURAL

STRUCTURAL

NOTES AND SCHEDULES WATER SUPPLY & SEWAGE SYSTEM # 38

34

DISCLAIMER

marketing content.

DISCLAIMER: This documentation and all it's contents are the intellectual property of FrameUpNow. It is provided solely for marketing the services of FrameUpNow.

The preliminary information is not approved for actual construction use and is

not warranted to be complete or accurate. Unauthorized copying, distribution, or application of these proprietary materials, in any form or format, is strictly prohibited. FrameUpNow assumes no liability for any issues arising from improper use of this

MATERIALS SHOPPING LIST MATERIALS SHOPPING LIST

ABOUT



FrameUpNow is a design and manufacturing company providing precision-engineered home framing solutions. We offer a catalog of Affordable Homes, Tiny Homes, Garages, Shops and Barndominiums. FrameUpNow manufactures cold-formed steel (CFS) also known as Light Gauge Steel (LGS) framing components that conform to our engineered metal house frame plans or can be purchased as DIY skeleton kits.

The CFS/LGS framing is lightweight, easily assembled, and does not require heavy equipment or specialized labor, enabling homeowners to erect the frame themselves in just a few days. Unlike wood, the steel framing is impervious termites and bores, warping, expansion, and fire.

Our home plans come complete with a structural engineered stamp for permit approvals. Customers receive a full BOM also known as a Materials Shopping List to purchase finish materials from a Building Materials retailer. FrameUpNow prides itself on the quality and efficiency of our precision-engineered home framing solutions for construction professionals and DIY homeowners.



KEY PLAN

NO.	DESCRIPTION	DATE

NOTE:

LEGEND:

PROJECT

133-Orion-1198-3Bd2Ba-Craftsman-Porch-550

DRAWING NAME

INTRODUCTION

CLIENT NAME:	
PROJECT NUMBER:	
DATE:	
DESIGNED BY:	
DRAWN BY:	
CHECKED BY:	

I101

SCALE:

DESCRIPTIONS

MATERIALS LIST

The BOM (Bill Of Materials) package, known as the Materials Shopping List document, provides:

Comprehensive Inventory: Detailed lists of essential materials sourced from architectural, mechanical, HVAC, electrical, and plumbing design drawing sets.

Precise Curation: Each item meticulously selected and organized for accuracy and efficiency in project planning.

Customizable Options: Customers can modify listed items to their preferences and calculate costs accordingly, ensuring alignment with personal project needs and budget.

Dedicated Space for Details: Includes tables for customers to note Home Depot SKU numbers or product descriptions for selected items, facilitating seamless purchasing and coordination with suppliers.

Customer Convenience: Take the list to Home Depot or preferred suppliers for accurate pricing, helping align the total home budget with personal financial plans.

Simplify your construction journey with our Materials Shopping List document, where detailed preparation meets streamlined implementation for your dream home.

STRUCTURAL

The structural drawings package provides an exhaustive set of detailed plans essential for the precise assembly of your building. This comprehensive package includes:

Framing Plans: Detailed layouts for all framing components. Truss Layouts: Clear instructions for truss placement and

Panel Length Plans: Specifications for panel dimensions. Framing Elevations and Sections: Precise elevation and sectional views for accurate construction.

Truss and Wall Blocking Plans: Plans for truss and wall blocking to ensure structural integrity.

Hold-Down Plan: Detailed hold-down requirements for stability. Snap Sheet: Reference sheet for quick identification of components

Structural Details and Bracing Plans: Complete details and bracing plans for all structural elements.

Accompanying these plans is a comprehensive Bill of Materials (BOM) that lists every necessary building component, from cold formed steel (CFS) frames to fasteners.

ARCHITECTURAL

With the comprehensive architectural package, both builders and DIY homeowners can confidently execute the construction.

The architectural package includes:

Furnished Floor Plans: Complete with furniture layouts for a clear understanding of space utilization.

Detailed Dimension Plans: Ensures precise measurements, from the overall footprint down to the exact placement of windows and

Foundation Plan: Detailed plan to establish a solid foundation.

Wall Framing and Truss Layout: Comprehensive plans for wall framing and truss placement.

Architectural Elevations: Exterior views showcasing the design.

Strategic Building Sections: Critical cross-sectional details for a thorough understanding of the build.

Casework Drawings and Diagrams: Suggested designs for built-in caseworks, such as kitchen cabinets.

MECHANICAL ELECTRICAL

The mechanical package includes everything needed to guide HVAC

Detailed HVAC Floor Plan: Precisely maps out the placement of air handlers, ductwork, and vents throughout the home's layout.

HVAC Sections and Riser Diagrams: Technical drawings offering critical cross-sectional details and piping schematics, ensuring proper integration of the heating and cooling system into the home's structure.

Bill of Materials: A complete list of all necessary HVAC components.

The electrical package includes all the plans and documentation needed to guide the installation of your home's electrical system:

Detailed Power Plan: Precisely maps out the placement of outlets, switches, and other power components throughout the layout.

Comprehensive Lighting Plan: Shows the optimal locations for lighting fixtures, sconces, and other illumination sources to create a well-lit, functional interior.

Dimensioned Electrical Layout: Provides exact dimensions and measurements to ensure proper placement of all electrical elements.

Bill of Materials: A complete list of every component needed, from circuit breakers to wiring.

PLUMBING

The plumbing package includes everything needed to guide the installation of your home's water supply and drainage systems:

Detailed Water Supply System Plan: Precisely maps out the placement of pipes, valves, and plumbing fixtures throughout the

Comprehensive Sewage System Plan: Shows the optimal routing and sizing of drain lines to effectively remove waste and ensure proper drainage.

Detailed Riser Diagrams: Provide information needed to properly install all vertical plumbing risers and vent stacks.

Bill of Materials: A complete list of every component needed, from pipes to fixtures.


BOM (Bill Of Materials) (Separately Attached)





The Bill of Materials (BOM) is a crucial document that compiles the material requirements from different disciplines into a centralized inventory, enabling efficient procurement, inventory management, and cost estimation for a specified project or

ELECTRICAL BOM



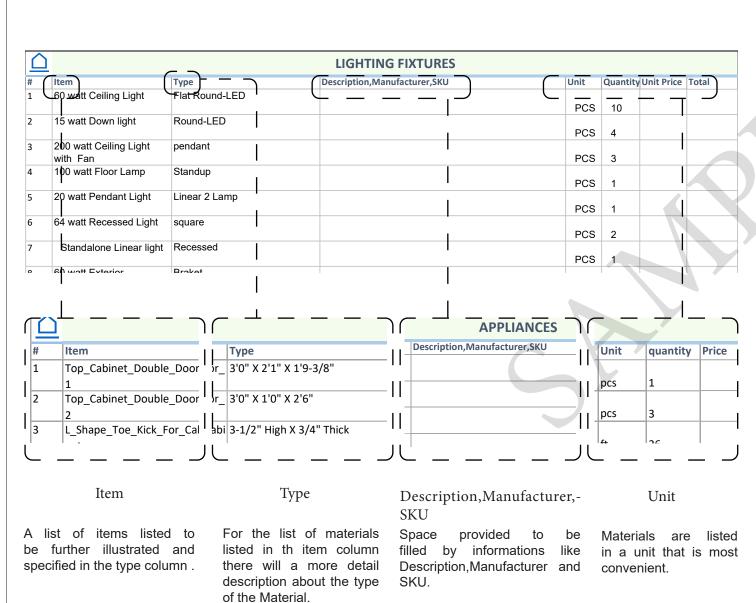

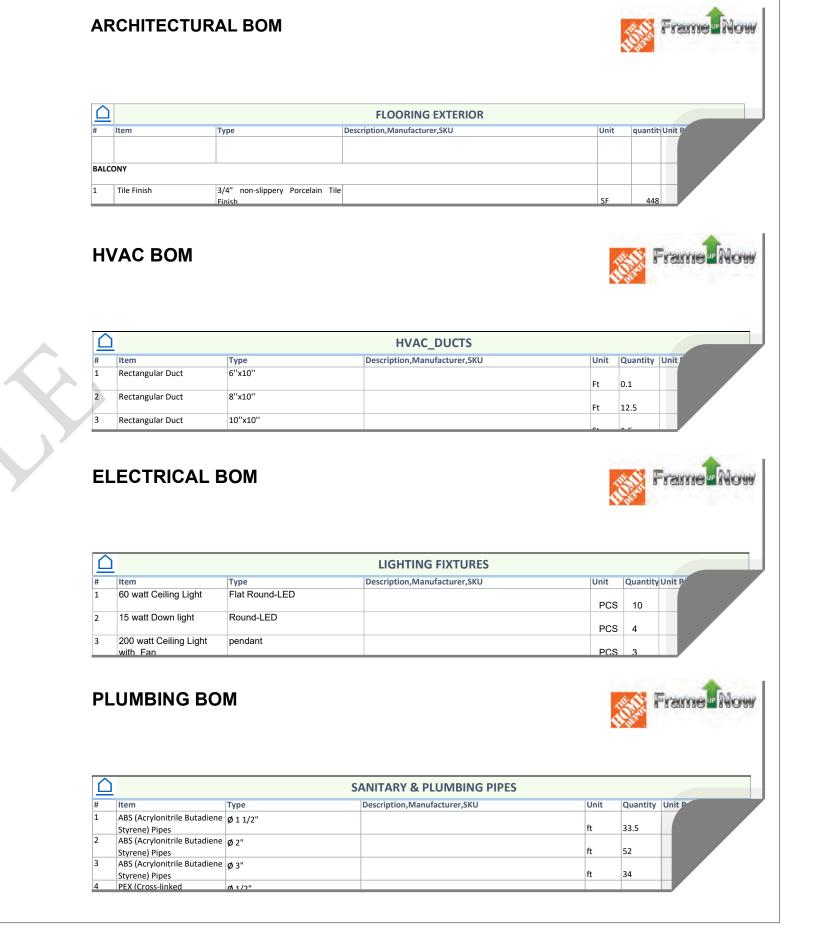

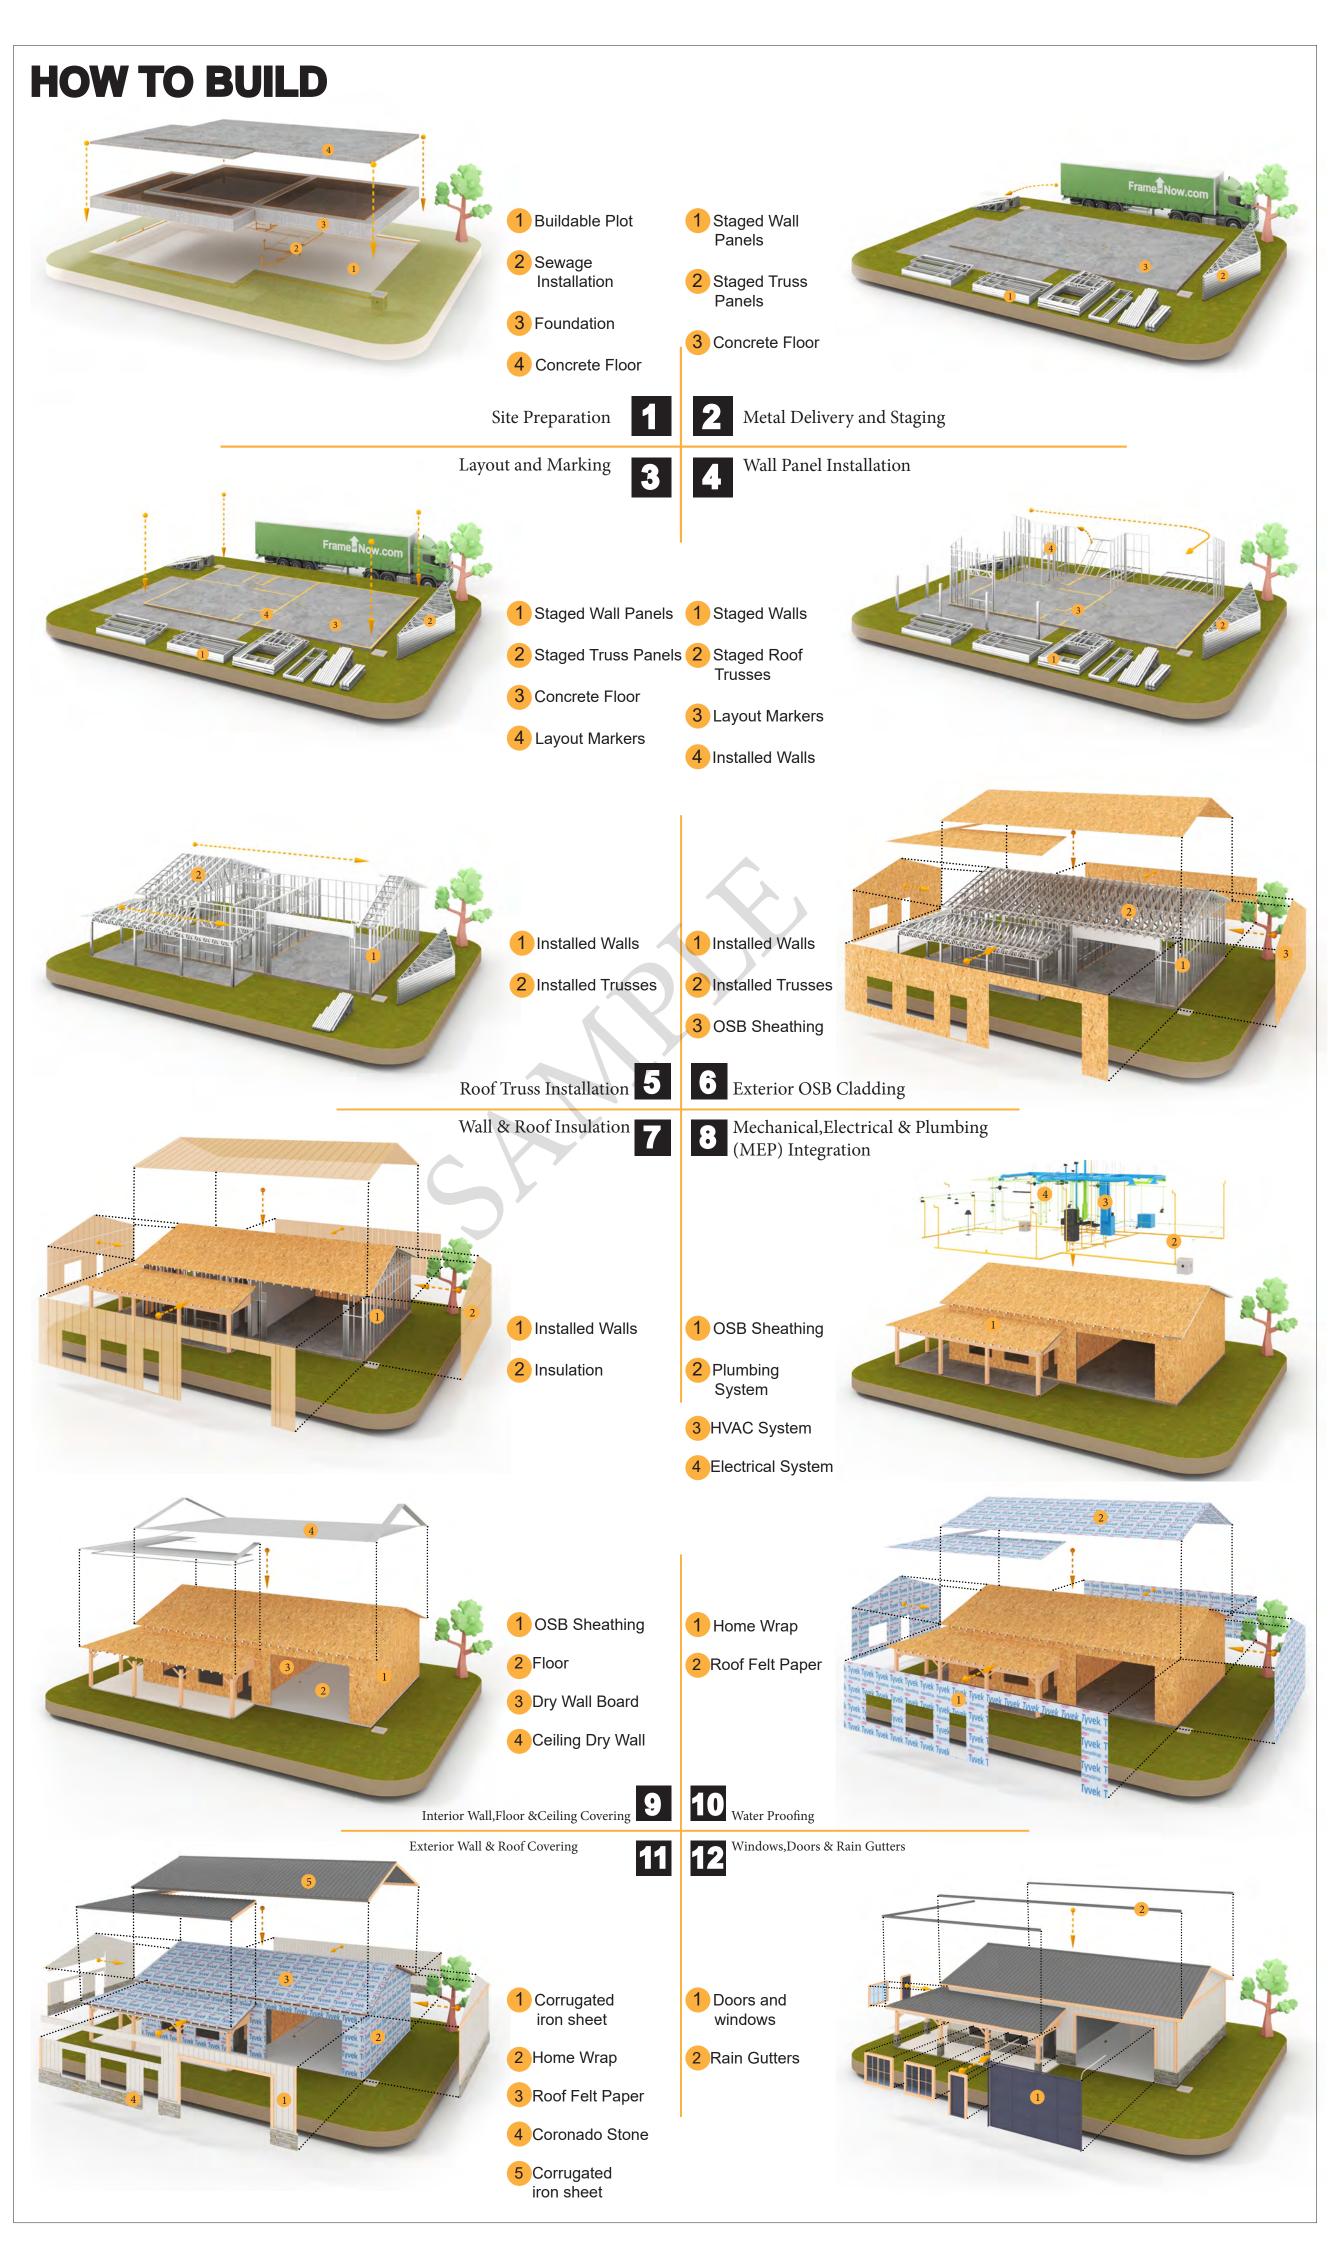



KEY PLAN

DESCRIPTION DATE

NOTE:

LEGEND:

PROJECT

133-Orion-1198-3Bd2Ba-Craftsman-Porch-550


DRAWING NAME

INTRODUCTION

CLIENT NAME: PROJECT NUMBER: DATE: **DESIGNED BY** DRAWN BY: CHECKED BY:

1102

SCALE:

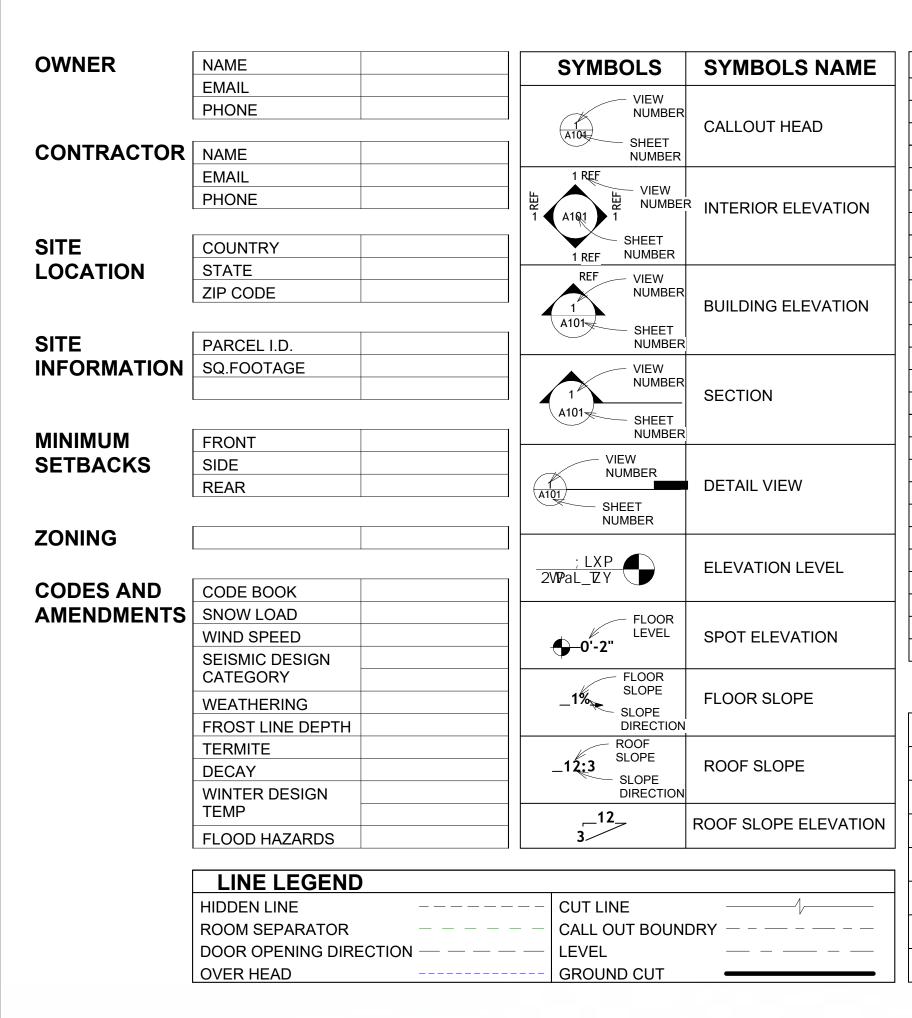

_		
		PAGE INDEX
1	G101	COVER SHEET
	A101	FLOOR PLAN
	A102	DIMENSION PLAN
	S101	FOUNDATION PLAN
	S102	STRUCTURAL FLOOR PLAN
	S103	FRAME LAYOUT
	S104	ROOF TRUSS LAYOUT
	A103	ROOF PLAN
\dashv	A201	ELEVATIONS
	A202	ELEVATIONS
	A301	SECTIONS
	A401	DETAILS
\dashv	A402	CASEWORK DETAILS
	A403	CASEWORK DETAILS
	E101	SCHEDULE
	E102	LIGHTING PLAN
\dashv	E103	POWER PLAN
	E104	DIMENSION PLAN FOR LIGHT FIXTURE
	E105	DIMENSION PLAN FOR FITTING
	P101	COVER SHEET
\dashv	P102	WATER SUPPLY SYSTEM
	P103	SEWAGE SYSTEM
	P104	RISER DIAGRAM
\dashv	M101	HVAC PLAN
	M102	HVAC SECTION
	M103	RISER DIAGRAM

CA01

SE01

ME01

		SF	SQUARE FEET
1	TAG'S NAME	SIMP. STHD8	SIMPSON STRAP THE HOLDDOWN
	TAG 5 NAME	SIMP. ABE66	SIMPSON ANCHOR BOLT ED
	CASEWORK TAG	TV	TELEVISION
	DOOR TAG	UNO	UNLESS NOTED OTHERWISI
1	FUDNITUDE TAC	W/	WITH
1	FURNITURE TAG	W/D	WASHER/DRYER
	WINDOW TAG	AC	AIR CONDITIONING UNIT
	SPECIALTY EQUIPMENT TAG	ACC	AIR COOLED CONDENSER
	MECHANICAL EQUIPMENT TAG	ACCU	AIR COOLED CONDSENSING UN
	MECHANICAL EQUIFIMENT TAG	AHU	AIR HANDLING UNIT
	PLUMBING EQUIPMENT TAG	CC	COOLING COIL
_		CD	CEILING DIFFUSER
		CFm	Cubic Feet Per Minute
		CR	CEILING REGISTER
		CU	CONDENSING UNIT
		CW	COLD WATER
		E/A	EXHAUST AIR
		EF	EXHAUST FAN
		ET	EXPANSION TANK
		EX.	EXISTING
		FC	FLEXIBLE CONNECTION
		FCU	FAN COIL UNIT
		FLR.	FLOOR
		НС	HEATING COIL
		HE	AIR TO AIR HEAT EXCHANG
		HV	HEATING AND VENTILATING
		IV	INLET VANES
		MER	MECHANICAL ROOM
/		MAX.	MAXIMUM
		MIN.	MINIMUM
		R/A	RETURN AIR
		RCU	RECIPROCATING CHILLER UNIT
	~	RF	RETURN FAN
			•


SUPPLY AIR

STATIC PRESSURE

SMOKE CONTROL DAMPER

MAX.


ME

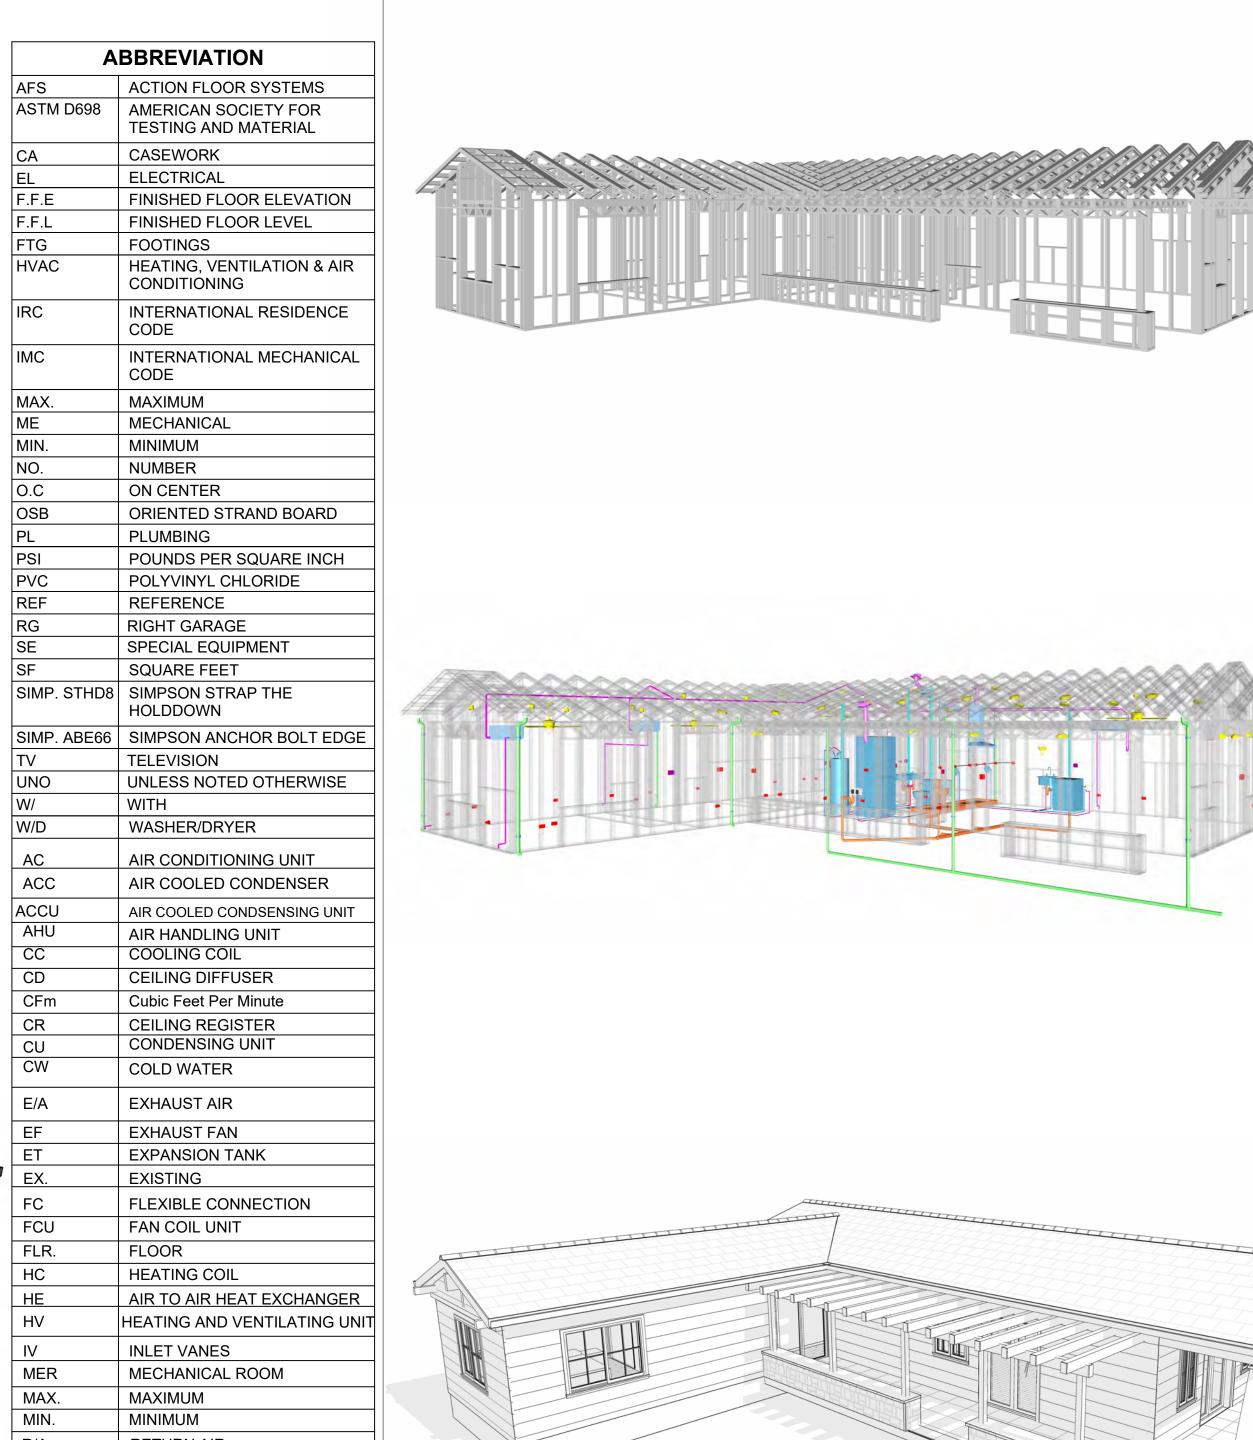



SQUARE FOOT	AGE
LIVING	1200
PORCH	327
TOTAL	1527



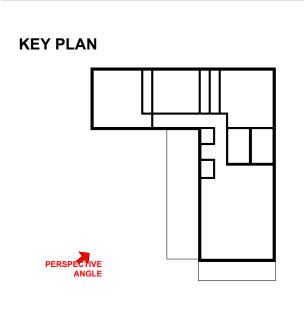

NO.	DESCRIPTION	DATE

LEGEND:

133 ORION 1198 3Bd 2Ba **CRAFTSMAN PORCH 550**

DRAWING NAME

COVER SHEET

Client Name	CLIENT NAME:	
0061_1	PROJECT NUMBER:	
3/20/2025 5:30:40 P	DATE:	
Designe	DESIGNED BY:	
Autho	DRAWN BY:	
Checke	CHECKED BY:	

G101

GENERAL NOTES

- 1. THIS DRAWING DEPICTS THE ARCHITECTURAL (SPACE LAYOUT, FURNISHING, FLOOR, WALLS, ROOFS, FOUNDATION, WINDOWS AND DOORS) SYSTEMS. IT PROVIDES A VISUAL REPRESENTATION OF THE ARCHITECTURAL LAYOUT AND COMPONENTS.
- THE ARCHITECTURAL DRAWINGS ARE PREPARED TO MEET THE SPECIFIC REQUIREMENTS OF THE BUILDING, AS PER THE PROJECT SPECIFICATIONS AND APPLICABLE CODES AND STANDARDS. THE CONSTRUCTION OF THIS HOME SHALL COMPLY WITH THE LATEST EDITION OF THE
- INTERNATIONAL RESIDENTIAL CODE (IRC), INTERNATIONAL MECHANICAL CODE (IMC), THE INTERNATIONAL PLUMBING STANDARD, THE NATIONAL ELECTRICAL STANDARD AND ALL OTHER APPLICABLE LOCAL, STATE, AND NATIONAL CODES AND REGULATIONS.
- 4. COORDINATION WITH OTHER TRADES HAS BEEN DONE ON A DESIGN LEVEL. THIS DRAWING SHALL BE READ TOGETHER WITH THE ME, EL AND PL DESIGN DRAWINGS TO ENSURE PROPER CONSTRUCTION AND INTEGRATION OF THE BUILDING SYSTEMS.

ABOUT WALLS:

SHOWER WALL COVERING

BATHTUB AND SHOWER SPACES (WALLS AND FLOORS) WITH INSTALLED SHOWER HEADS AND IN SHOWER COMPARTMENTS SHALL BE FINISHED WITH A NON-ABSORBENT SURFACE.

WALL PAINT (INTERNAL)

THE TYPICAL THICKNESS OF LATEX WALL PAINT IS 1/32 OF AN INCH FOR A SINGLE COAT. AND DOUBLE COAT (1/16") SHALL BE APPLIED FOR DURABILITY.

ADHESIVES:

THE ADVISABLE TYPE OF ADHESIVE FOR THIS PROJECT IS **EPOXY ADHESIVES**BECAUSE THEY ARE KNOWN FOR THEIR HIGH STRENGTH, DURABILITY, AND RESISTANCE TO MOISTURE, CHEMICALS AND

REFER TO SHEETS A201 & A202 FOR GENERAL NOTES ON EXTERNAL FINISHING MATERIALS

ABOUT FLOORS:

1. THE SPOT ELEVATION INDICATES THE FINISHED FLOOR ELEVATION.

FINISHED FLOORS PER PLANS.

FIELD VERIFY FOR DIMENSION DROP 4" FOR SHOWER AND BATHTUB USE. 1% SLOPE ON OUTDOOR BALCONIES FOR WATER RUN OFF.

2% SLOPE TOWARDS THE SHOWER DRAIN FOR SUFFICIENT DRAINAGE.


4" DROP AT THE DOOR LEADING TO EXTERIOR BALCONY FROM THE MAIN LIVING AREA.

5% SLOPE FOR GARAGE IS USED, WHICH SHOULD BE CHECKED WITH THE LOCAL GARAGING ZONING LAWS.



	FURNITURE SCI	HEDULE
TYPE MARK	TYPE	COUNT
01	KING SIZE BED	3
02	FOUR SIT 65" X 95"	1
03	ONE SEAT SOFA	1
04	COFFE TABLE	1
05	DINING CHAIR	4

		RO	OM FINISH	SCHEDULE			
ROOM NUMBE R	ROOM NAME	FLOOR FINISH	BASE FINISH	WALL FINISH	CEILING FINISH	CEILING HEIGHT	COM MEN TS
01	LIVING ROOM	HARDWOOD	CONCRETE	WALL PAINT	DRY WALL	8' - 0"	
02	KITCHEN	HARDWOOD	CONCRETE	WALL PAINT + CERAMIC	DRY WALL	8' - 0"	
03	BEDROOM 1	HARDWOOD	CONCRETE	WALL PAINT	DRY WALL	8' - 0"	
04	BEDROOM 2	HARDWOOD	CONCRETE	WALL PAINT	DRY WALL	8' - 0"	
05	BEDROOM 3	HARDWOOD	CONCRETE	WALL PAINT	DRY WALL	8' - 0"	
06	CL 1	HARDWOOD	CONCRETE	WALL PAINT	DRY WALL	8' - 0"	
07	CL 2	HARDWOOD	CONCRETE	WALL PAINT	DRY WALL	8' - 0"	
08	CL 3	HARDWOOD	CONCRETE	WALL PAINT	DRY WALL	8' - 0"	
09	CL 4	HARDWOOD	CONCRETE	WALL PAINT	DRY WALL	8' - 0"	
10	BATH 2	VINYL TILES	CONCRETE	CERAMIC TILE	MRD	8' - 0"	
11	HALL	HARDWOOD	CONCRETE	WALL PAINT	DRY WALL	8' - 0"	
12	W/D	VINYL TILES	CONCRETE	CERAMIC TILE	DRY WALL	8' - 0"	
13	WH	VINYL TILES	CONCRETE	WALL PAINT	DRY WALL	8' - 0"	
14	BATH 1	VINYL TILES	CONCRETE	CERAMIC TILE	DRY WALL	8' - 0"	
15	PORCH 1	PROCELAIN TILE	CONCRETE	CORRUGATED IRON	PLYWOOD	8' - 0"	
16	PORCH 2	PROCELAIN TILE	CONCRETE	CORRUGATED IRON	PLYWOOD	8' - 0"	

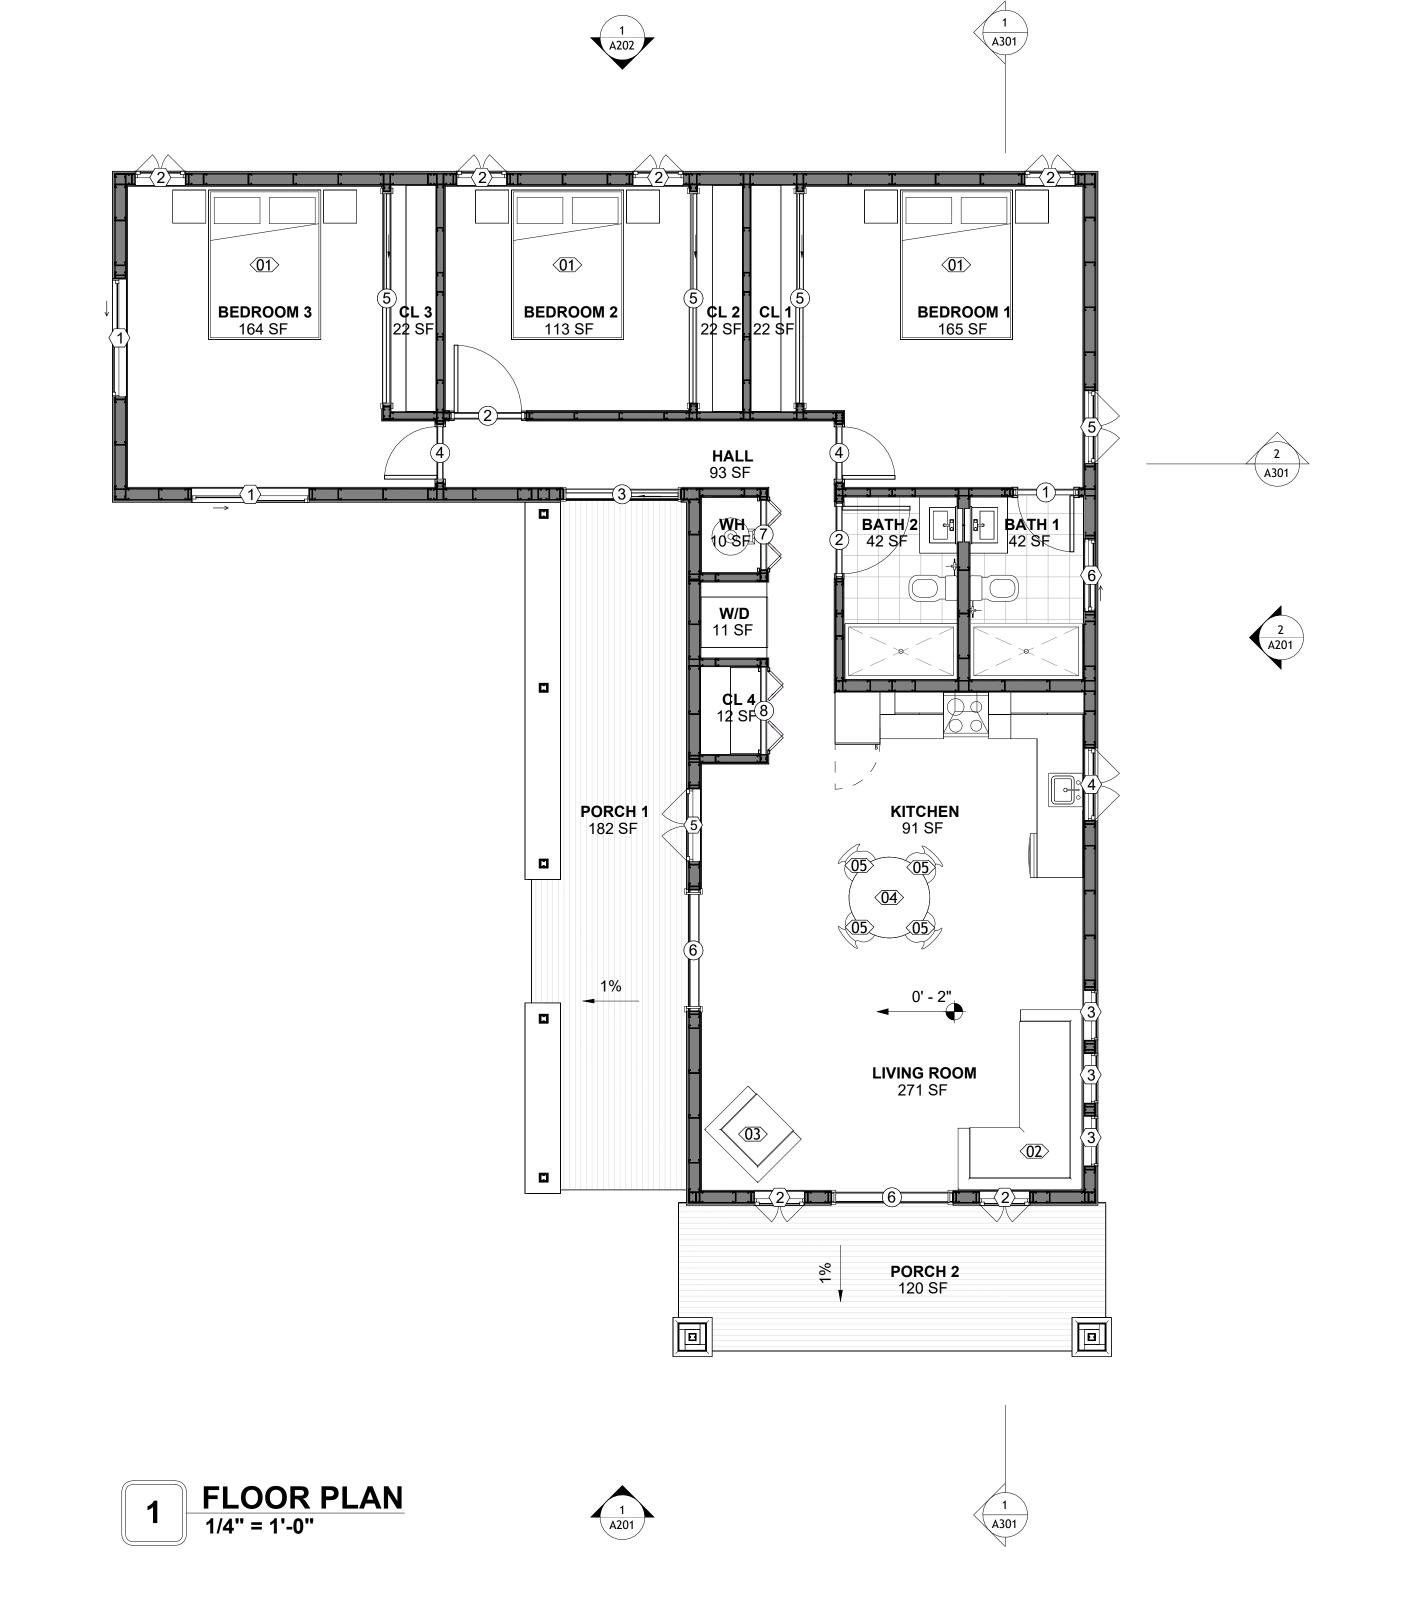



KEY PLAN

DATE

NOTE:

LEGEND:

133 ORION 1198 3Bd 2Ba **CRAFTSMAN PORCH 550**

DRAWING NAME

FLOOR PLAN


Client Name	CLIENT NAME:
0061_12	PROJECT NUMBER:
3/20/2025 5:30:43 PM	DATE:
Designer	DESIGNED BY:
Author	DRAWN BY:
Checker	CHECKED BY:

SQUARE FOOTAGE 1200 1527

TOTAL

A101

SCALE: 1/4" = 1'-0"

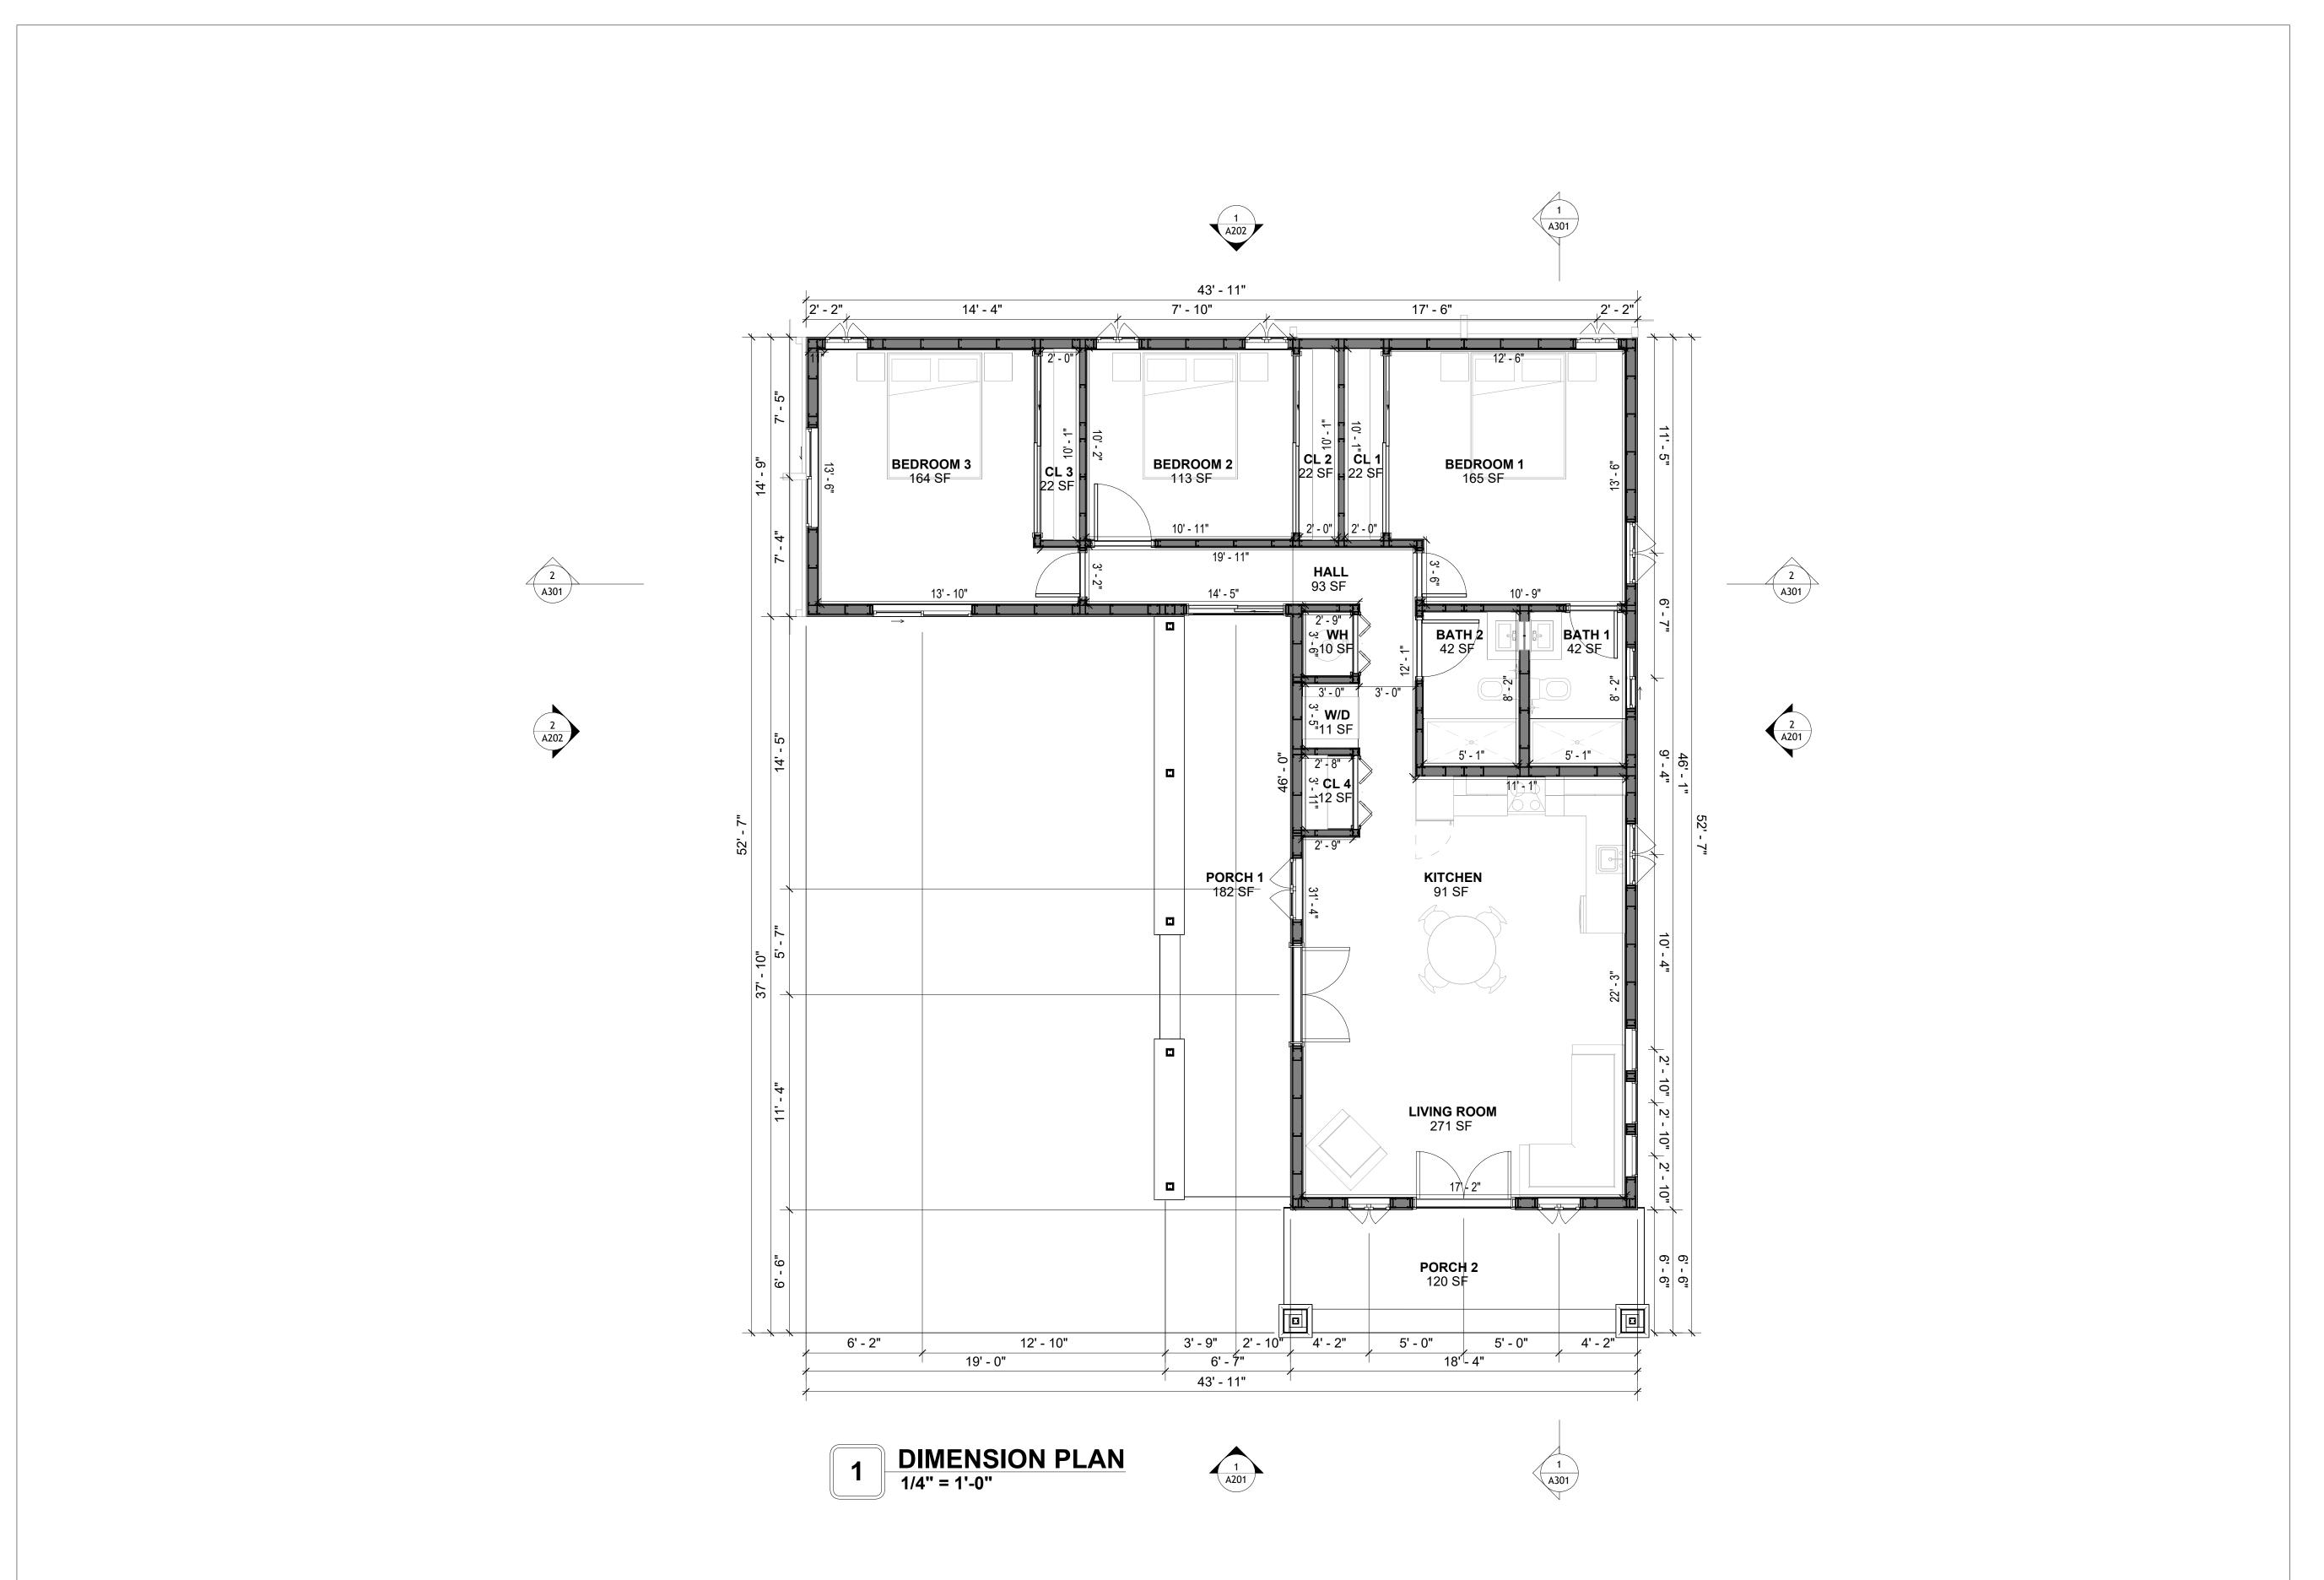

Tuscon,AZ, USA 888-864-0184 inquire@frameupnow.com www.frameupnow.com

KEY PLAN

NO.	DESCRIPTION	DATE
	•	

NOTE:

LEGEND:

PROJECT

133 ORION 1198 3Bd 2Ba CRAFTSMAN PORCH 550

DRAWING NAME

DIMENSION PLAN

Client Name	CLIENT NAME:
0061_1	PROJECT NUMBER:
3/20/2025 5:30:45 P	DATE:
Designe	DESIGNED BY:
Autho	DRAWN BY:
Checke	CHECKED BY:

1200 327 **A 1 0 2**

SQUARE FOOTAGE

1527

TOTAL

SCALE: 1/4" = 1'-0"

DIMENSIONS IN THE ARCHITECTURAL DRAWINGS CONSIDER FINISHING MATERIALS. FOR PRECISE MEASUREMENTS OF THE STRUCTUAL FRAMING, REFER TO THE ATTACHED STRUCTURAL PLAN SET.

FOUNDATION NOTES

NOTES:

TERMITES PRETREATMENT BY LICENSED CONTRACTOR UNDER SLAB AND AROUND FOOTINGS. ALL AREAS BELOW SLABS SHALL BE TREATED NO MORE THAN 24 HOURS PRIOR TO CONCRETE POUR. EVIDENCE OF TREATMENT MUST BE PROVIDED PRIOR TO PLACING OF CONCRETE.

MATERIALS:

ALL INTERIOR CONCRETE SLABS SHALL BE A MIN. OF 4" THICK CONCRETE OVER 4" COMPACTED AGGREGATE BASE (ASTM D698), FINISH ELEVATIONS AS NOTED ON DRAWINGS, 6" ABOVE ADJACENT GRADE, LEVEL SLABS TO 1/8"-10' MAX.. CONCRETE SLABS SHALL BE 2500# PSI AT 28 DAYS. A 4" ALLOWABLE SLUMP.

2. PAD PREPARATION:

- EXCAVATION FOR FOOTING SHALL BE NEAT.

- FOOTINGS SHALL BE POURED IMMEDIATELY AFTER EXCAVATION AND APPROPRIATE

- ALL REINFORCING STEEL MARKED "CONTINUOUS" SHALL BE LAPPED 36 BAR DIAMETERS AT SPLICES AND AROUND CORNERS OR INTERSECTIONS WITH A STANDARD 90 DEGREE BEND ON CORNER BARS. LAP WIRE MESH ONE FULL MESH AT SIDE AND END LAPS.

- ALL HARDWARE TO BE SIMPSON OR EQUIVALENT.
- EXTERIOR FRAME WALL TO BE SECURED WITH 1/2"X10" ANCHOR BOLTS 4'-0" O.C. FOR 1-STORY AND 2'-8" O.C. FOR 2-STORY. BOLTS SHALL BE LOCATED WITHIN 1'-0" OF EACH END

PIECE AND SHALL HAVE A MIN. OF TWO BOLTS PER PIECE.
-FOUNDATION ANCHOR STRAPS SHALL BE PERMITTED, ACCORDING TO RESIDENTIAL CODE

- ALL INTERIOR WALLS TO BE SECURED WITH POWER DRIVEN PINS PER MANUFACTURER SPECIFICATION USE PIN SPACING EQUIVALENT TO 1/2" ANCHOR BOLTS.

ALL CONSTRUCTION TO CONFORM TO THE 2012 IRC
 R-10 RIGID INSULATION OUTSIDE OF EXTERIOR FOUNDATION WALLS UNDER LIVING AREA.
 CONCRETE PAD FOR CONDENSER THICKNESS IS 4" MIN UNLESS OTHERWISE NOTED.

3. CONCRETE CONSTRUCTION:

- THE SLAB SHALL BE UNDERLAIN BY A VAPOR BARRIER/RETARDER IN THE LIVING AREA (TYPICALLY POLYETHYLENE, UNLESS MORE STRINGENT PROTECTION REQUIRED BY THE ARCHITECT, ENGINEER, FLOOR COVERING MANUFACTURER, OR ACCEPTED PRACTICE). UNLESS OTHERWISE REQUIRED, BARRIER MAY BE OMITTED AT GARAGES, PORCHES AND PATIOS WITHOUT FLOOR COVERINGS. IT IS BEYOND THE SCOPE OF THESE PLANS TO DETERMINE THE APPLICABILITY OF THESE MORE STRINGENT REQUIREMENTS. BUILDER SHALL VERIFY PRIOR TO CONSTRUCTION.

4. REINFORCEMENT:

- IF CONSTRUCTED ON ACTIVE SOILS, THE LONG TERM PERFORMANCE OF THE FOUNDATION IS DEPENDENT ON MAINTENANCE BY THE OWNER. THUS THE BUILDER SHALL ADVISE THE OWNER OF THE FOLLOWING:

1. DRAINAGE MUST BE MAINTAINED. WATER SHALL NEVER BE ALLOWED TO POND NEAR THE FOUNDATION.

2. THE SOIL AROUND THE FOUNDATION SHALL BE MAINTAINED IN A RELATIVELY DAMP CONDITION, SUCH AS THAT REQUIRED TO KEEP A LAWN GREEN. IF IT DRIES OUT IT WILL

SHRINK. IF IT GETS WET, IT WILL HEAVE UPWARD.

3. SLABS ON THE SHORTER SIDE USES MAIN BARS ARE USED IN THIS DIRECTION ONLY WITH SMALLER DIAMETER DISTRIBUTION BARS ARE PLACED, FORMING A MAT OR GRID.

ALL REINFORCEMENT BARS SIZE 10MM OR LARGER IN ACCORDANCE TO ASTM
 ANCHOR BOLTS AT ALL EXTERIOR WALLS SHALL BE MINIMUM 1/2 INCH DIAMETER WITH A MAXIMUM SPACING OF 6'-0" ON CENTER, UNLESS NOTED OTHERWISE.

4. ANCHOR BOLTS SHALL BE INSTALLED WITHIN 12 INCHES OF EACH END OF EACH SILL PLATE WITH AT LEAST TWO ANCHOR BOLTS FOR EACH BOLTS FOR EACH SILL PLATE LONGER THAN 12 INCHES.

5. SIMPSONS SILL ANCHORS MAYBE SUBSTITUTED FOR ANCHOR BOLTS AT THE SAME

6. EXTERIOR CONCRETE SLABS WHICH ARE NOT PART OF THE MAIN SLAB SHALL BE MINIMUM 4 INCHES THICK WITH NO STEEL REINFORCING BARS REQUIRED, UNLESS NOTED OTHERWISE ON FOUNDATION PLAN.

VERIFY THE FOLLOWING PRIOR TO POURING:

1. ALL HOLDDOWNS, STRAP, AND POST LOCATIONS.

2. CONCRETE FINISHES. PANEL RISER LOCATION - WHERE APPLICABLE.

3. UNDERSLAB MECHANICAL REQUIREMENTS.
4. STEM WALL BLOCKOLTS

4. STEM WALL BLOCKOUTS.
5. LINDERSLAB ELECTRICAL

5. UNDERSLAB ELECTRICAL REQUIREMENTS AND PANEL RISER LOCATION. WHERE APPLICABLE.


6. PROVIDE THE FOLLOWING:

- PVC SLEEVES THROUGH FTG IF REQUIRED

- 20' #4 COPPER GROUND BAR.

7. SLOPE FINISH GRADE AWAY FROM FOOTING.

NOTE: FIELD VERIFY ALL DIMENSIONS SEE DIMENSIONED ARCHITECTURAL DRAWINGS

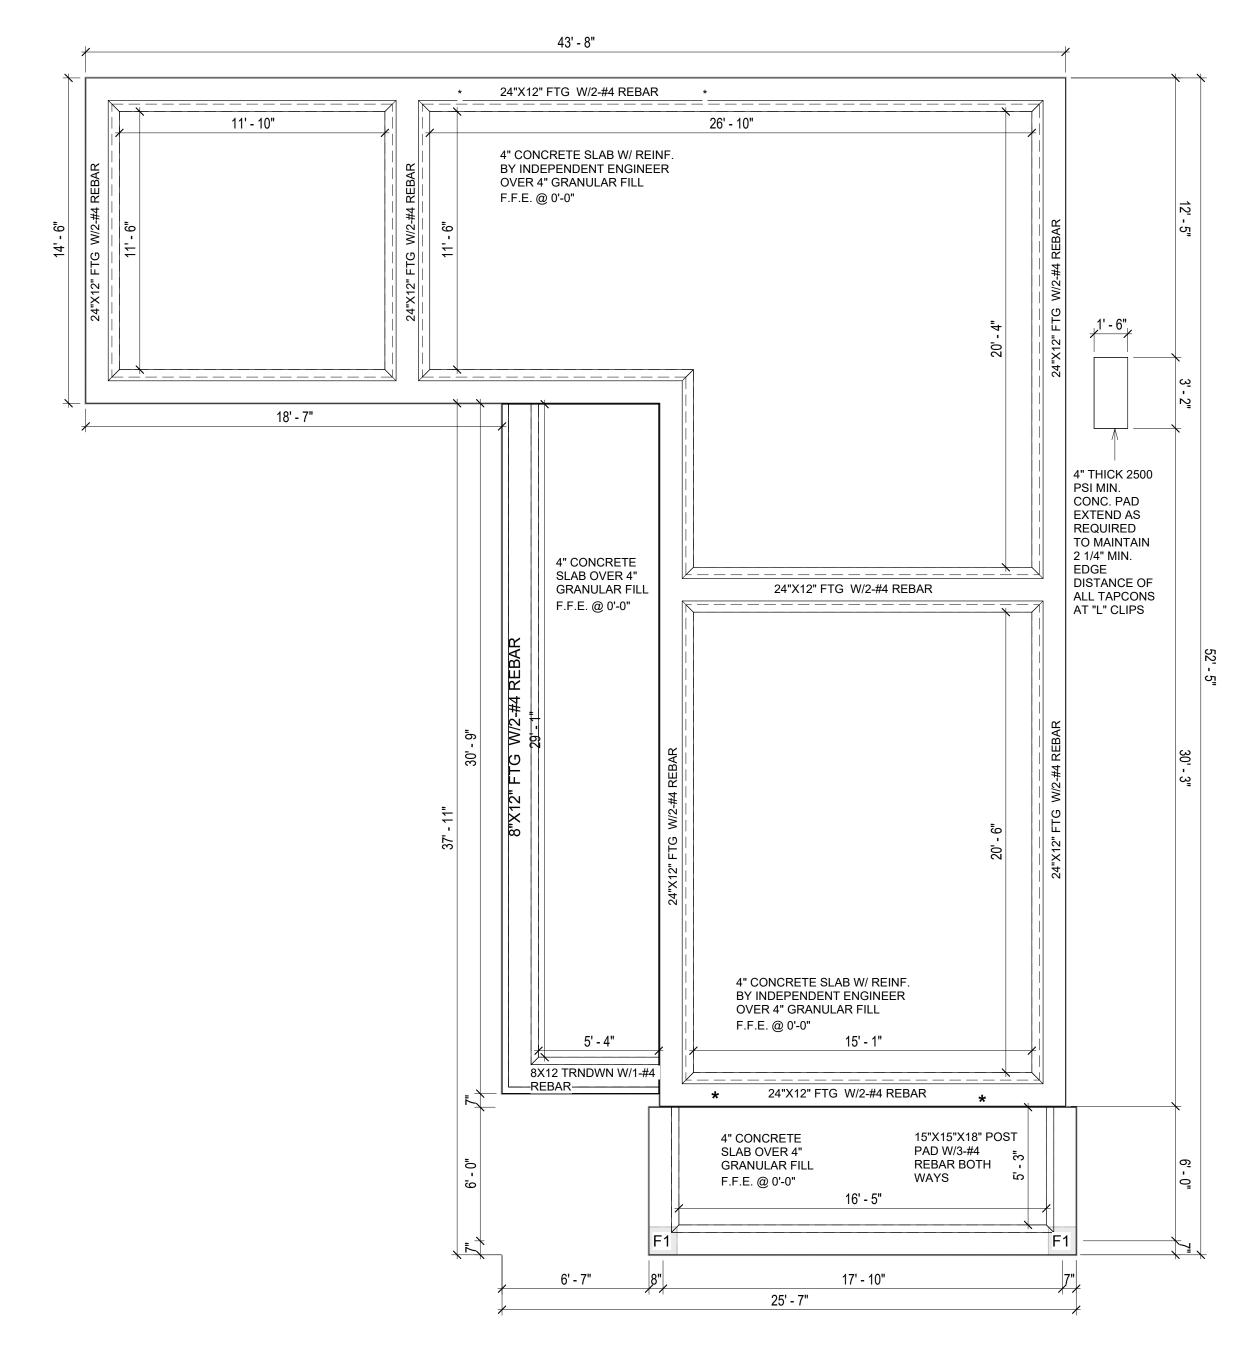

1 FOUNDATION PLAN
1/4" = 1'-0"



KEY PLAN

NO.	DESCRIPTION	DATE
		•

NOTE:

LEGEND:

PROJECT

133 ORION 1198 3Bd 2Ba CRAFTSMAN PORCH 550

DRAWING NAME

FOUNDATION PLAN

Client Name	CLIENT NAME:
0061_12	PROJECT NUMBER:
3/20/2025 5:30:46 PM	DATE:
Designer	DESIGNED BY:
Author	DRAWN BY:
Checker	CHECKED BY:

SQUARE FOOTAGE

LIVING 1200

PORCH 327

TOTAL 1527

S101

SCALE: 1/4" = 1'-0"

GENERAL NOTES

NOTES:

-ALL BEARING WALLS SHOULD HAVE A THICKENED SLAB PER SECTION PER DETAIL A401/5.

A) **FOUNDATION PLAN NOTES**:

1. CONCRETE SLAB SHALL BE 6" THICK WITH 1/2" DIAMETER TENDONS PER LAYOUT PLAN, CENTERED IN SLAB THICKNESS, OVER APPROVED SUBBASE PER GENERAL STRUCTURE NOTES.

2. TERMITE PROTECTION SHALL BE PROVIDED PER IRC SECTION R318.1
3. NONE TYPICAL ANCHOR BOLT SPACING AT SHEAR WALL AND HOLD DOWN SPECIFICATIONS PER APPROVED ARCHITECTURAL PLANS.

 INSTALL HOLDOWNS BEFORE CONCRETE SLAB POUR.
 EXISTING FILL ON-SITE SHALL BE COMPACTED IN ACCORDANCE WITH THE REQUIREMENTS IN THE GEOTECHNICAL REPORT.

6. ALL FLOOR SLABS ARE REINFORCED ON CONCRETE SLABS.

SPECIAL INSPECTION IS REQUIRED FOR THICKENED FOUNDATION CONSTRUCTION

1. REINFORCEMENT 2. 2300 PSI CONCRETE POUR

B) **REINFORCEMENT FOR CONCRETE**:

ALL REINFORCING SLABS BARS SIZE 10MM OR LARGER SHALL BE DEFORMED IN ACCORDANCE TO ASTM-A706, AND BARS SMALLER THAN 10 MM MAYBE PLAIN.
 UNLESS OTHERWISE NOTED IN PLANS, THE YIELD STRENGTH OF REINFORCING BARS SHALL BE:


A) FOOTING = 40,000 PSI B) NON-LOAD BEARING WALLS AND PARAPETS= 40,000 PSI


- 3. SPLICES SHALL BE SECURELY WIRED TOGETHER AND SHALL LAP OR EXTEND
- 4. GRADE OF STEEL FOR RCC WORKS SHALL BE GRADE 4 10.
- 5. BAR NOTATIONS GIVES INFORMATION
 - A) BAR SIZE
- B) SPACING(IF REQUIRED)

 6. LAP REINFORCEMENT ONLY AT LOCATION SHOWN IN THE DRAWINGS
- 7. REINFORCEMENT SHALL NOT BE CUT, VENT OR HEATED ON SITE WITHOUT ENGINEERS'
- APPROVAL.
- C) CONCRETE SLAB NOTES
- 1. ALL SLAB REINFORCEMENT SHALL BE 20MM CLEAR MINIMUM FROM BOTTOM AND FROM TOP OF SLAB.
- 2. REINFORCEMENT IN CONTINUOUS ELEVATED SLAB SHALL BE CUT AS FOLLOWS.

NOTE:

- THIS IS A SCHEMATIC PLAN FOR THE PURPOSE OF LOCATING AND IDENTIFYING FOUNDATION REINFORCING ELEMENTS ONLY. VERIFY ALL DIMENSIONS, DROPS, OFFSETS AND FEATURES WITH THE ARCHITECTURAL PLANS BEFORE FORMING THE FOUNDATION.

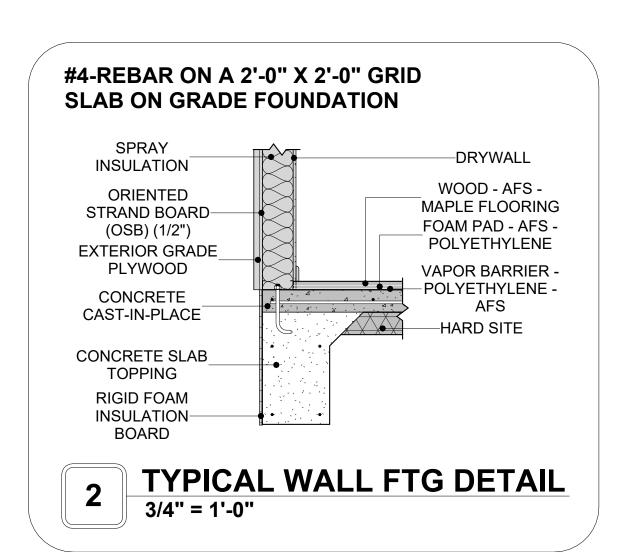

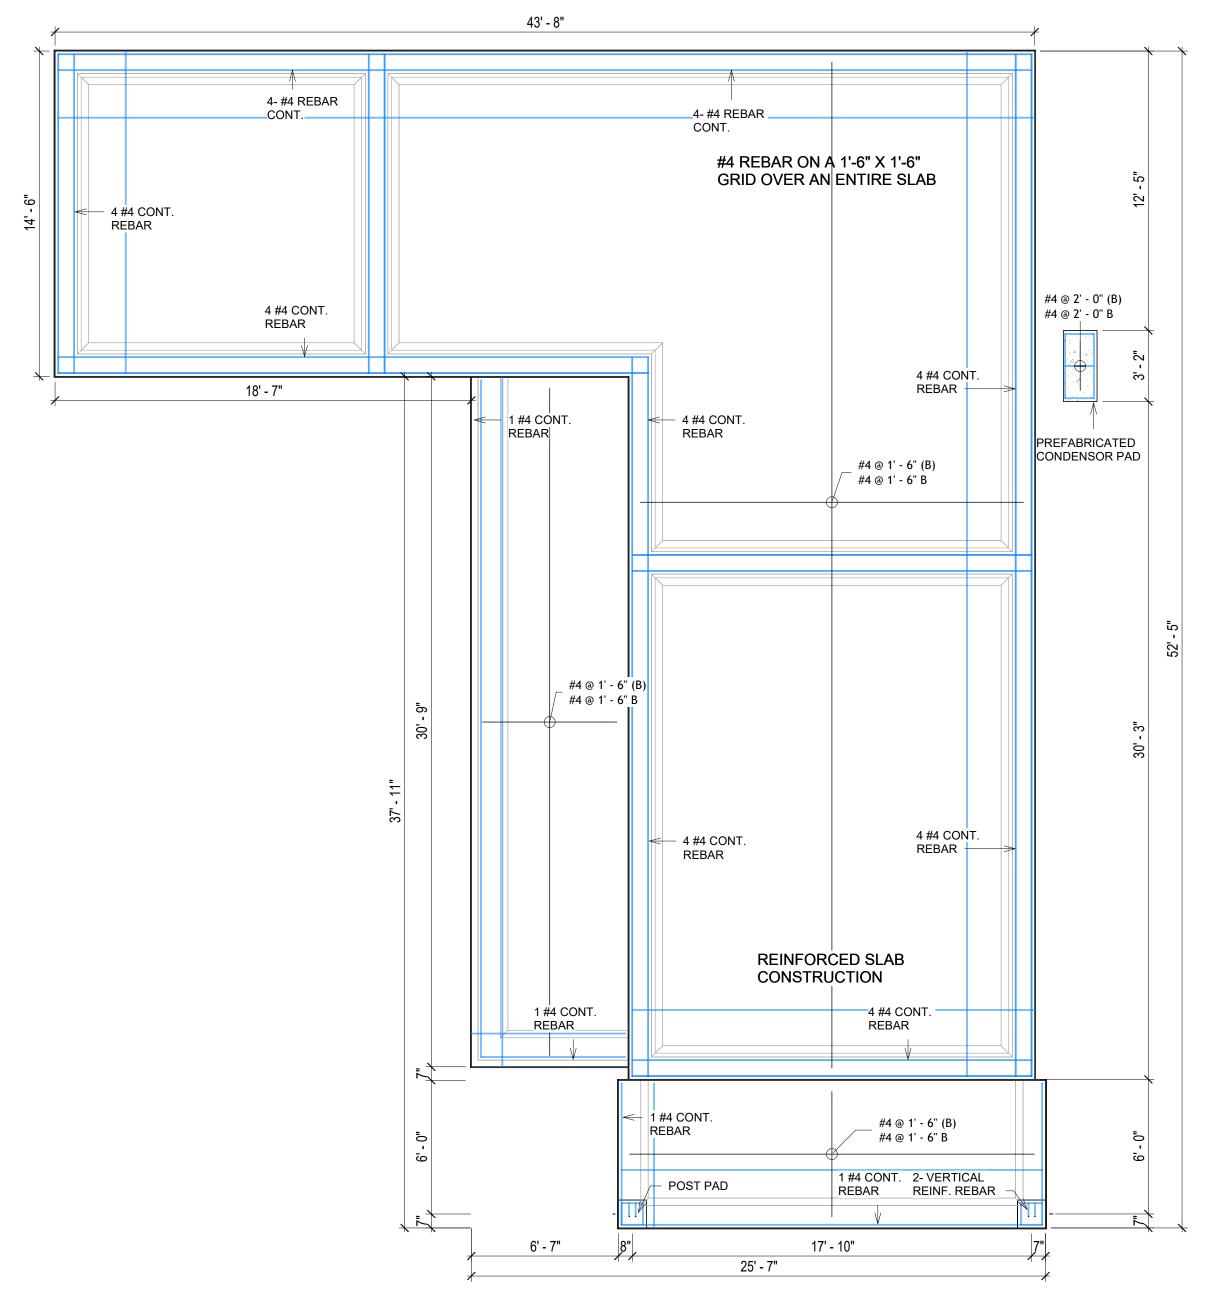

FOUNDATION REBAR PLAN
1/4" = 1'-0"



KEY PLAN

NO.	DESCRIPTION	DATE

NOTE:

LEGEND:

PROJECT

133 ORION 1198 3Bd 2Ba CRAFTSMAN PORCH 550

DRAWING NAME

STRUCTURAL FLOOR PLAN

Client Name	CLIENT NAME:	
0061_12	PROJECT NUMBER:	
3/20/2025 5:30:47 PM	DATE:	
Designer	DESIGNED BY:	
Author	DRAWN BY:	
Checker	CHECKED BY:	

S102


ROOF NOTES

- 1. ROOFING COMPOSITION ROOFING PER OWNERS/BUILDERS SPECIFICATIONS INSTALL PER MANUFACTURE SPECIFICATIONS ON 1/2" ORIENTED STRAND BOARD ON PRE-ENGINEERED TRUSS @ 24" O.C. (UNO.)
- 73" OVERHANG AT EAVES (UNO.)
 ENDS OF ALL TRUSSES AND JOISTS TO BE FULLY BLOCKED. PROVIDE SOLID
- BLOCKING AT ALL RIDGES AND VALLEYS
 4. SHEATHING TO BE 1/2", 3/8" OSB SHEAR PANEL AND EQUIVALENT.
- UNDERSIDE OF PORCH TRUSSES TO BE FINISHED WITH MOISTURE RESISTANT DRYWALL, TAPED AND TEXTURED.
- EXPOSED EAVES AND OTHER WEATHER EXPOSED AREAS TO BE SHEATHED WITH EXTERIOR GRADE PLYWOOD.
- 6. ALL MATERIALS THICKNESS AND SIZE ARE THE MINIMUM. Refer TO LOCAL STANDARDS FOR ACTUAL THICKNESS AND LAYERING OF MATERIALS.
- 7. ENGINEERED TRUSS CALCULATIONS TO BE SUBMITTED TO BUILDING
- DEPARTMENT PRIOR TO FABRICATION AND INSTALLATION.

 8. TRUSS MANUFACTURER TO SPECIFY HANGER CONNECTORS FOR TRUSS
- COMPONENTS (TYPICAL)

 9. DESIGNER ASSUMES THAT TRUSSES BEAR ON ALL EXTERIOR PERIMETER
- WALLS (TYPICAL) OR BEAMS.

 10. PROVIDE GALVANIZED STEEL ELASHING WITH A LENGTH OF 10 FEET. WID
- 10. PROVIDE GALVANIZED STEEL FLASHING WITH A LENGTH OF 10 FEET, WIDTH OF 12 INCHES, AND THICKNESS OF 24 GAUGE.

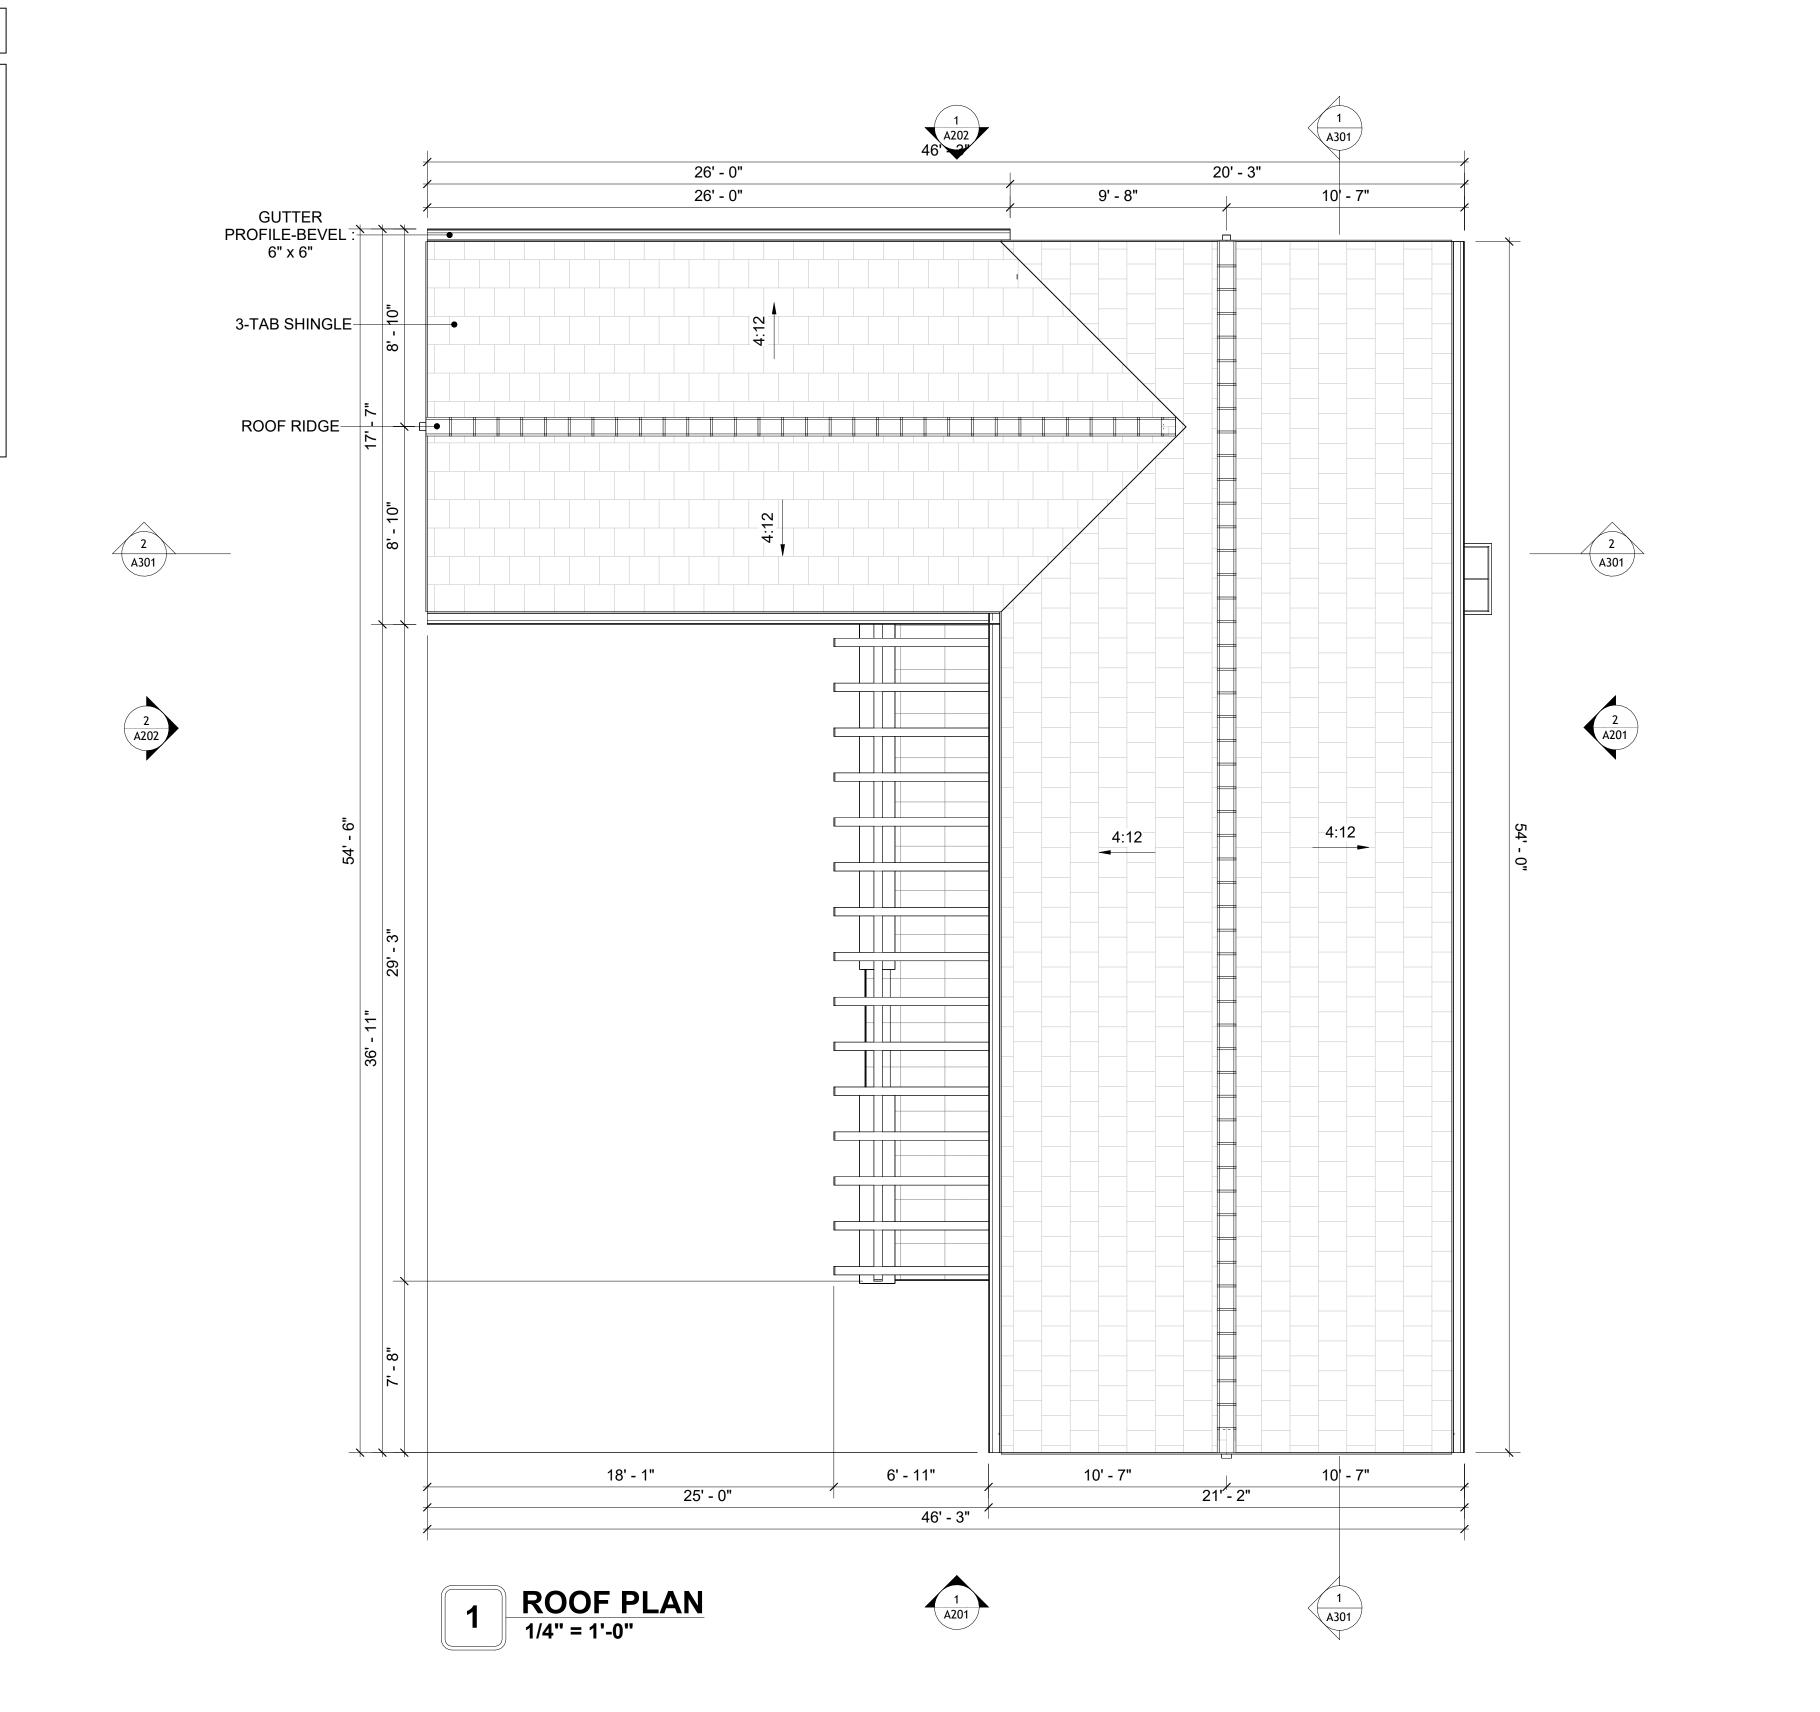



KEY PLAN

NO.	DESCRIPTION	DATE

NOTE:

LEGEND:

PROJE

133 ORION 1198 3Bd 2Ba CRAFTSMAN PORCH 550

DRAWING NAME

ROOF PLAN

Client Name	CLIENT NAME:
0061_12	PROJECT NUMBER:
3/20/2025 5:30:51 PI	DATE:
Designe	DESIGNED BY:
Autho	DRAWN BY:
Checke	CHECKED BY:

SQUARE FOOTAGE

LIVING 1200

PORCH 327

TOTAL 1527

A103

SCALE: 1/4" = 1'-0"

ABOUT WALL FINISHING

PLYWOOD WALL SIDING

WALL SIDING IS AN EXTERIOR CLADDING MATERIAL USED TO COVER AND PROTECT THE WALLS OF A BUILDING, PROVIDING BOTH FUNCTIONAL AND AESTHETIC BENEFITS.

IN THIS SPECIFIC PROJECT, PLYWOOD WALL PANELS ARE USED AS A FINISH SIDING BECAUSE THIS TYPE OF SIDING PROVIDES A DURABLE, COST-EFFECTIVE, AND VERSATILE EXTERIOR CLADDING THAT CAN BE EASILY INSTALLED, FINISHED, AND MAINTAINED TO ENHANCE THE AESTHETIC AND PROTECTIVE QUALITIES OF A BUILDING'S EXTERIOR.

STANDARD SIZES OF 1' X 8' EXTERIOR-GRADE PLYWOOD PANELS ARE INSTALLED ON THE FURRING STRIPS USING GALVANIZED STEEL SELF-DRILLING SCREWS.

CAST MANUFACTURED STONE

MANUFACTURED STONE, ALSO KNOWN AS CULTURED OR ARTIFICIAL STONE, IS A SYNTHETIC BUILDING MATERIAL MADE FROM A BLEND OF CEMENT, AGGREGATES, AND PIGMENTS TO MIMIC THE APPEARANCE OF NATURAL STONE. IT IS LIGHTWEIGHT, DURABLE, AND CUSTOMIZABLE IN COLOR AND TEXTURE.

IN THIS PROJECT, MANUFACTURED STONE IS USED AS THE COPING MATERIAL, PROVIDING A DURABLE AND AESTHETIC FINISH THAT MIMICS THE APPEARANCE OF NATURAL STONE.

STONE VENEER

STONE VENEER REFERS TO THIN LAYERS OF NATURAL OR MANUFACTURED STONE APPLIED TO A STRUCTURAL WALL, KNOWN FOR THEIR REALISTIC APPEARANCE AND RELATIVE LIGHTNESS. THESE VENEERS PROVIDE THE AESTHETIC OF STONE WITHOUT THE COST AND WEIGHT OF FULL STONE CONSTRUCTION, CONTRIBUTING TO A BEAUTIFUL AND COSTEFFECTIVE EXTERIOR FINISH.

IN THIS SPECIFIC PROJECT, STONE VENEER IS USED A FINISH MATERIAL ON EXTERIOR WALL.

CEDAR WOOD

CEDAR WOOD REFERS TO THE WOOD FROM VARIOUS SPECIES OF CEDAR TREES, WHICH ARE CONIFEROUS EVERGREEN TREES KNOWN FOR THEIR DISTINCT AROMA AND NATURAL RESISTANCE TO DECAY AND INSECTS.


IN THIS SPECIFIC PROJECT, CEDAR WOOD IS USED AS A FURRING STRIP AND A FINISH MATERIAL ON BEAMS AND


CEDAR WOOD AS A FURRING STRIPS PROVIDE THERMAL INSULATION AND MOISTURE MANAGEMENT. THE VERTICAL CEDAR WOOD FURRING STRIPS ARE ATTACHED TO HOME WRAP USING CORROSION-RESISTANT FASTENERS (HOT-DIP GALVANIZED SCREWS), ENSURING PROPER PENETRATION INTO THE WALL FRAMING.

WOOD SHINGLE

WOOD SHINGLES ARE THIN, TAPERED PIECES OF WOOD, TRADITIONALLY USED FOR ROOFING AND SIDING. THEY ARE TYPICALLY MADE FROM CEDAR WOOD, OR PINE DUE TO THEIR DURABILITY AND RESISTANCE TO DECAY. SHINLES ARE SAWN RATHER THAN SPLIT, GIVING THEM A SMOOTH, UNIFORM APPEARANCE. THEY PROVIDE A NATURAL, OFTEN RUSTIC LOOK, GOOD INSULATION, AND GOOD WEATHER RESISTANCE. WOOD SHINGLES ARE ECO-FRIENDLY AND CAN BE STAINED OR PAINTED FOR CUSTOMIZATION.


IN THIS SPECIFIC PROJECT, WOOD SHINGLES ARE APPLIED AT THE TOP OF THE EXTERNAL WALL, CREATING AN EYE-CATCHING DETAIL THAT COMPLEMENTS THE OVERALL ARCHITECTURE AND ENSURES A STURDY, WEATHER-RESISTANT FINISH.

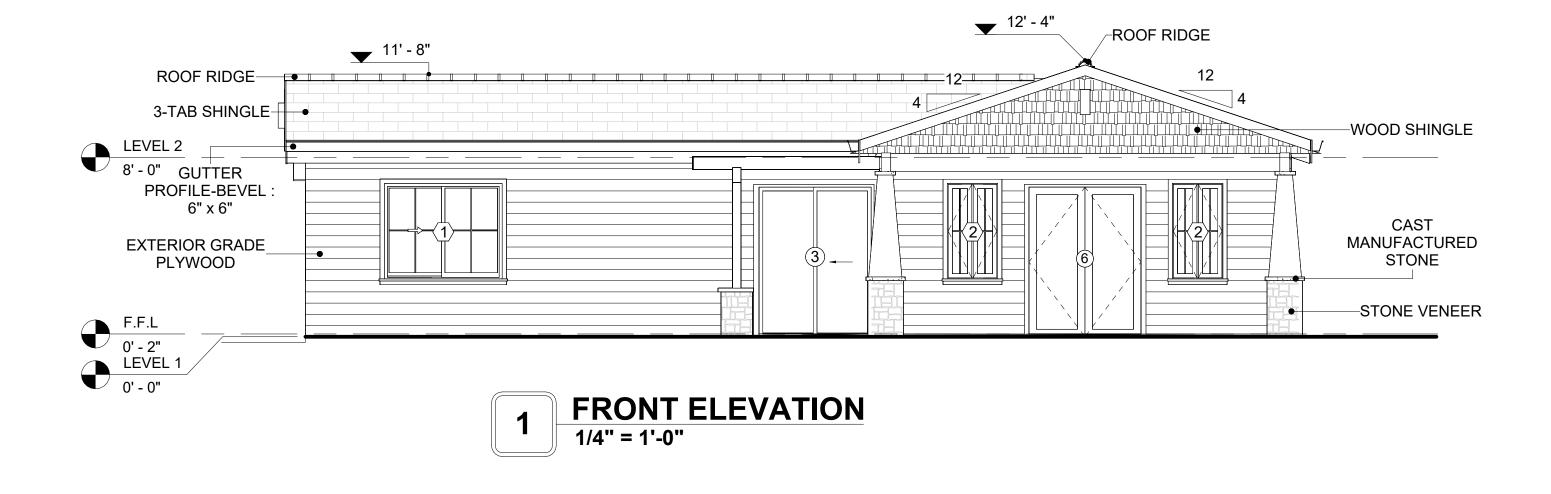

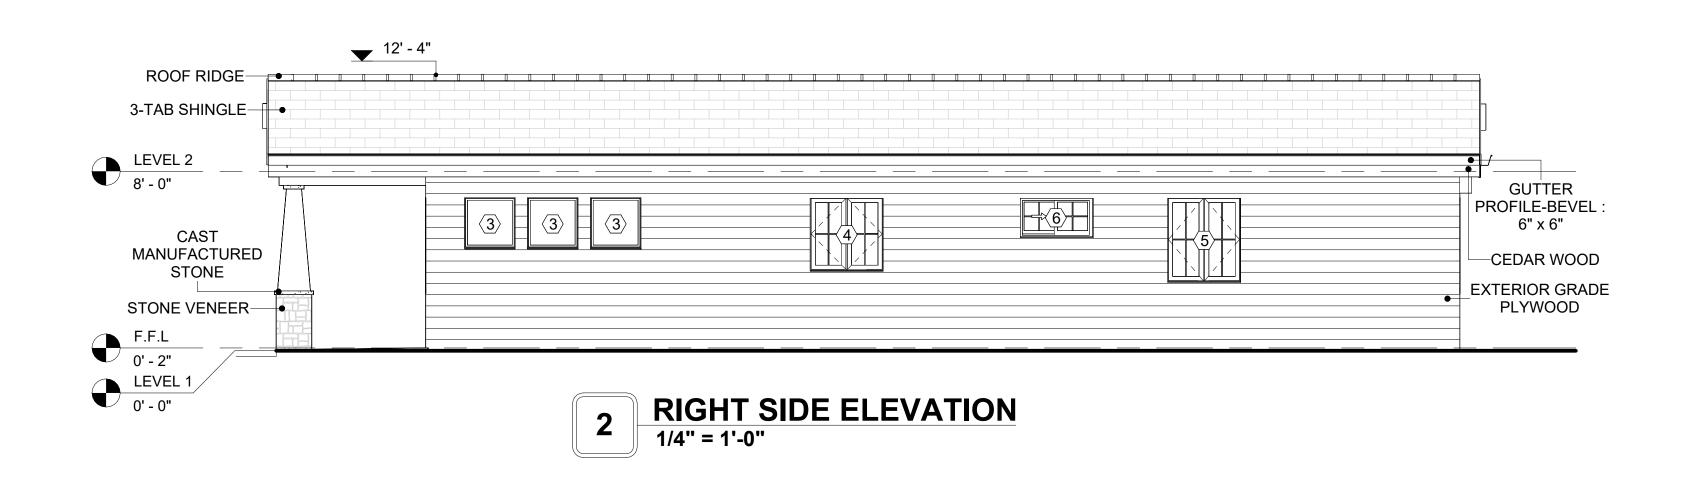

		DOOR SCHE	DULE			
TYPE				5	SIZE	
MAR K	SUPPLIER	DOOR TYPE	LOCATIO N	WIDTH	HEIGHT	COUNT
4	LIGHT DEDGT	INTERIOR ONLO E PANEL OMINIONIO	WITEDIOD	01 011	01 011	14
1	HOME DEPOT	INTERIOR SINGLE PANEL SWINGING	INTERIOR	2' - 6"	6' - 8"	1
2	HOME DEPOT	INTERIOR SINGLE PANEL SWINGING	INTERIOR	3' - 0"	6' - 8"	2
3	HOME DEPOT	PATIO_DOUBLE PANEL_SLIDING	EXTERIOR	5' - 0"	6' - 8"	1
4	HOME DEPOT	INTERIOR SINGLE PANEL SWINGING	INTERIOR	2' - 4"	6' - 8"	2
5	HOME DEPOT	INTERIOR DOUBLE PANEL SLIDING	INTERIOR	9' - 4"	6' - 8"	3
6	HOME DEPOT	EXTERIOR DOUBLE PANEL SWINGING	INTERIOR	5' - 0"	6' - 8"	2
7	HOME DEPOT	DOOR-BIFOLD_9052	INTERIOR	3' - 0"	6' - 8"	1
8	HOME DEPOT	DOOR-BIFOLD 9052	INTERIOR	3' - 6"	6' - 8"	1

		WINDOV	V SCHEDULE		
				SIZE	
TYPE MARK	SUPPLIER	WINDOW TYPE	WIDTH	HEIGHT	COUNT
1	HOME DEPOT	SLIDING	5' - 3"	4' - 3"	2
2	HOME DEPOT	CASEMENT	2' - 3"	4' - 3"	6
3	HOME DEPOT	AWNING	2' - 3"	2' - 3"	3
4	HOME DEPOT	CASEMENT	3' - 3"	3' - 3"	1
5	HOME DEPOT	CASEMENT	3' - 3"	3' - 9"	2
6	HOME DEPOT	SLIDING	3' - 3"	1' - 9"	1

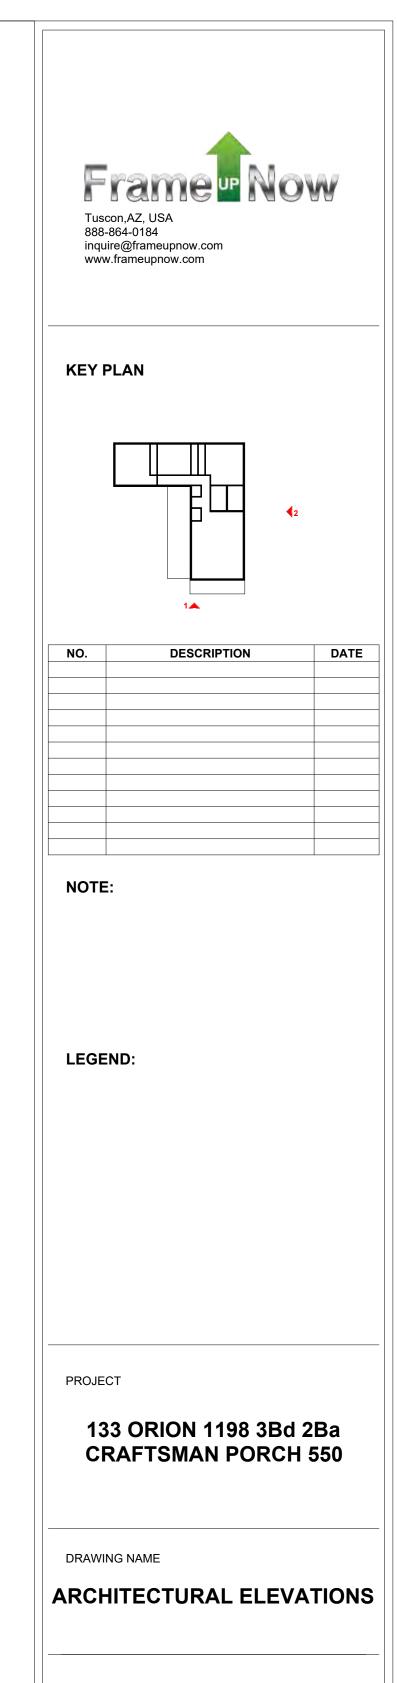

Client Name	CLIENT NAME:
0061_12	PROJECT NUMBER:
3/20/2025 5:30:57 PM	DATE:
Designer	DESIGNED BY:
Author	DRAWN BY:
Checker	CHECKED BY:

ABOUT WALL FINISHING

PLYWOOD WALL SIDING

WALL SIDING IS AN EXTERIOR CLADDING MATERIAL USED TO COVER AND PROTECT THE WALLS OF A BUILDING, PROVIDING BOTH FUNCTIONAL AND AESTHETIC BENEFITS.

IN THIS SPECIFIC PROJECT, PLYWOOD WALL PANELS ARE USED AS A FINISH SIDING BECAUSE THIS TYPE OF SIDING PROVIDES A DURABLE, COST-EFFECTIVE, AND VERSATILE EXTERIOR CLADDING THAT CAN BE EASILY INSTALLED, FINISHED, AND MAINTAINED TO ENHANCE THE AESTHETIC AND PROTECTIVE QUALITIES OF A BUILDING'S EXTERIOR.

STANDARD SIZES OF 1' X 8' EXTERIOR-GRADE PLYWOOD PANELS ARE INSTALLED ON THE FURRING STRIPS USING GALVANIZED STEEL SELF-DRILLING SCREWS.

CAST MANUFACTURED STONE

MANUFACTURED STONE, ALSO KNOWN AS CULTURED OR ARTIFICIAL STONE, IS A SYNTHETIC BUILDING MATERIAL MADE FROM A BLEND OF CEMENT, AGGREGATES, AND PIGMENTS TO MIMIC THE APPEARANCE OF NATURAL STONE. IT IS LIGHTWEIGHT, DURABLE, AND CUSTOMIZABLE IN COLOR AND TEXTURE.

IN THIS PROJECT, MANUFACTURED STONE IS USED AS THE COPING MATERIAL, PROVIDING A DURABLE AND AESTHETIC FINISH THAT MIMICS THE APPEARANCE OF NATURAL STONE.

STONE VENEER

STONE VENEER REFERS TO THIN LAYERS OF NATURAL OR MANUFACTURED STONE APPLIED TO A STRUCTURAL WALL, KNOWN FOR THEIR REALISTIC APPEARANCE AND RELATIVE LIGHTNESS. THESE VENEERS PROVIDE THE AESTHETIC OF STONE WITHOUT THE COST AND WEIGHT OF FULL STONE CONSTRUCTION, CONTRIBUTING TO A BEAUTIFUL AND COST-EFFECTIVE EXTERIOR FINISH.

IN THIS SPECIFIC PROJECT, STONE VENEER IS USED A FINISH MATERIAL ON EXTERIOR WALL.

CEDAR WOOD

CEDAR WOOD REFERS TO THE WOOD FROM VARIOUS SPECIES OF CEDAR TREES, WHICH ARE CONIFEROUS EVERGREEN TREES KNOWN FOR THEIR DISTINCT AROMA AND NATURAL RESISTANCE TO DECAY AND INSECTS.


IN THIS SPECIFIC PROJECT, CEDAR WOOD IS USED AS A FURRING STRIP AND A FINISH MATERIAL ON BEAMS AND

CEDAR WOOD AS A FURRING STRIPS PROVIDE THERMAL INSULATION AND MOISTURE MANAGEMENT. THE VERTICAL CEDAR WOOD FURRING STRIPS ARE ATTACHED TO HOME WRAP USING CORROSION-RESISTANT FASTENERS (HOT-DIP GALVANIZED SCREWS), ENSURING PROPER PENETRATION INTO THE WALL FRAMING.


WOOD SHINGLE

WOOD SHINGLES ARE THIN, TAPERED PIECES OF WOOD, TRADITIONALLY USED FOR ROOFING AND SIDING. THEY ARE TYPICALLY MADE FROM CEDAR WOOD, OR PINE DUE TO THEIR DURABILITY AND RESISTANCE TO DECAY. SHINLES ARE SAWN RATHER THAN SPLIT, GIVING THEM A SMOOTH, UNIFORM APPEARANCE. THEY PROVIDE A NATURAL, OFTEN RUSTIC LOOK, GOOD INSULATION, AND GOOD WEATHER RESISTANCE. WOOD SHINGLES ARE ECO-FRIENDLY AND CAN BE STAINED OR PAINTED FOR CUSTOMIZATION.


IN THIS SPECIFIC PROJECT, WOOD SHINGLES ARE APPLIED AT THE TOP OF THE EXTERNAL WALL, CREATING AN EYE-CATCHING DETAIL THAT COMPLEMENTS THE OVERALL ARCHITECTURE AND ENSURES A STURDY, WEATHER-RESISTANT FINISH.

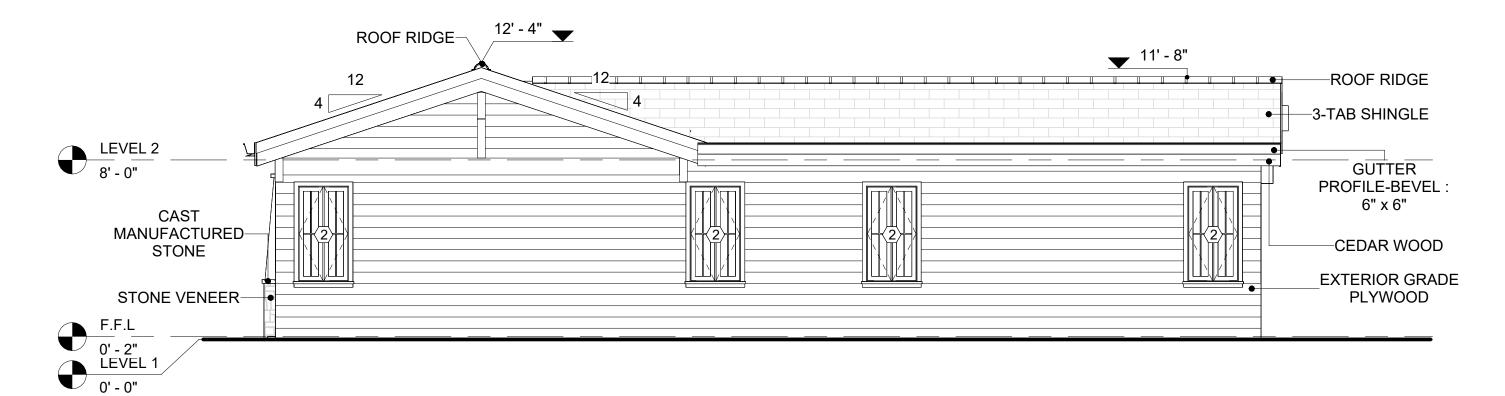

REAR ELEVATION 1/4" = 1'-0"

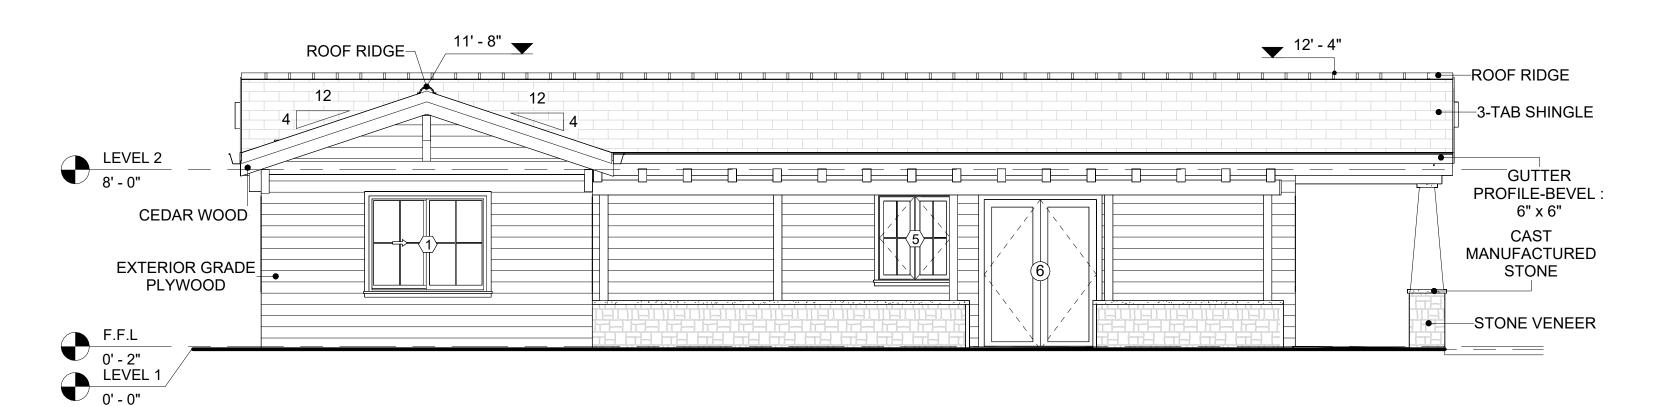


LEFT SIDE ELEVATION

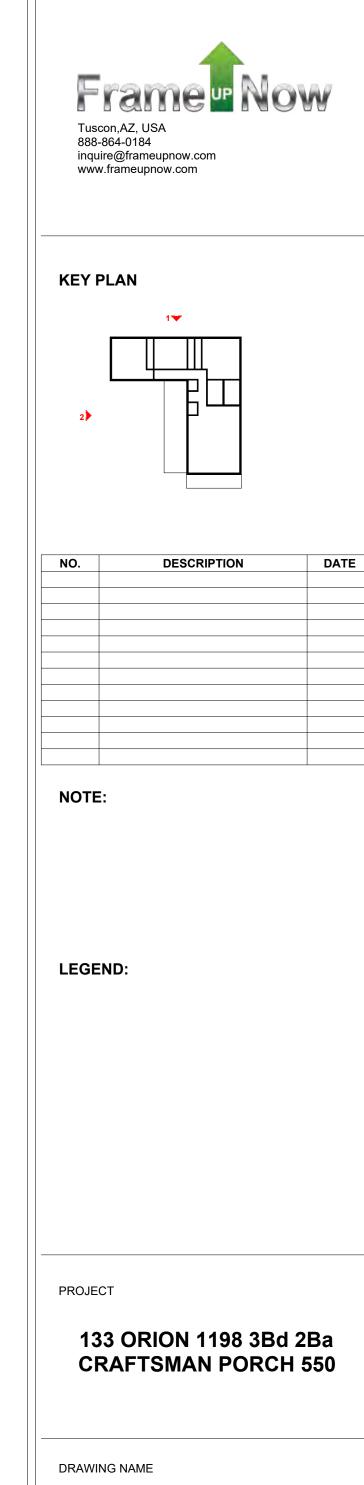

ARCHITECTURAL ELEVATIONS


Client Name	CLIENT NAME:
0061_12	PROJECT NUMBER:
3/20/2025 5:31:02 PI	DATE:
Designe	DESIGNED BY:
Autho	DRAWN BY:
Checke	CHECKED BY:

A202

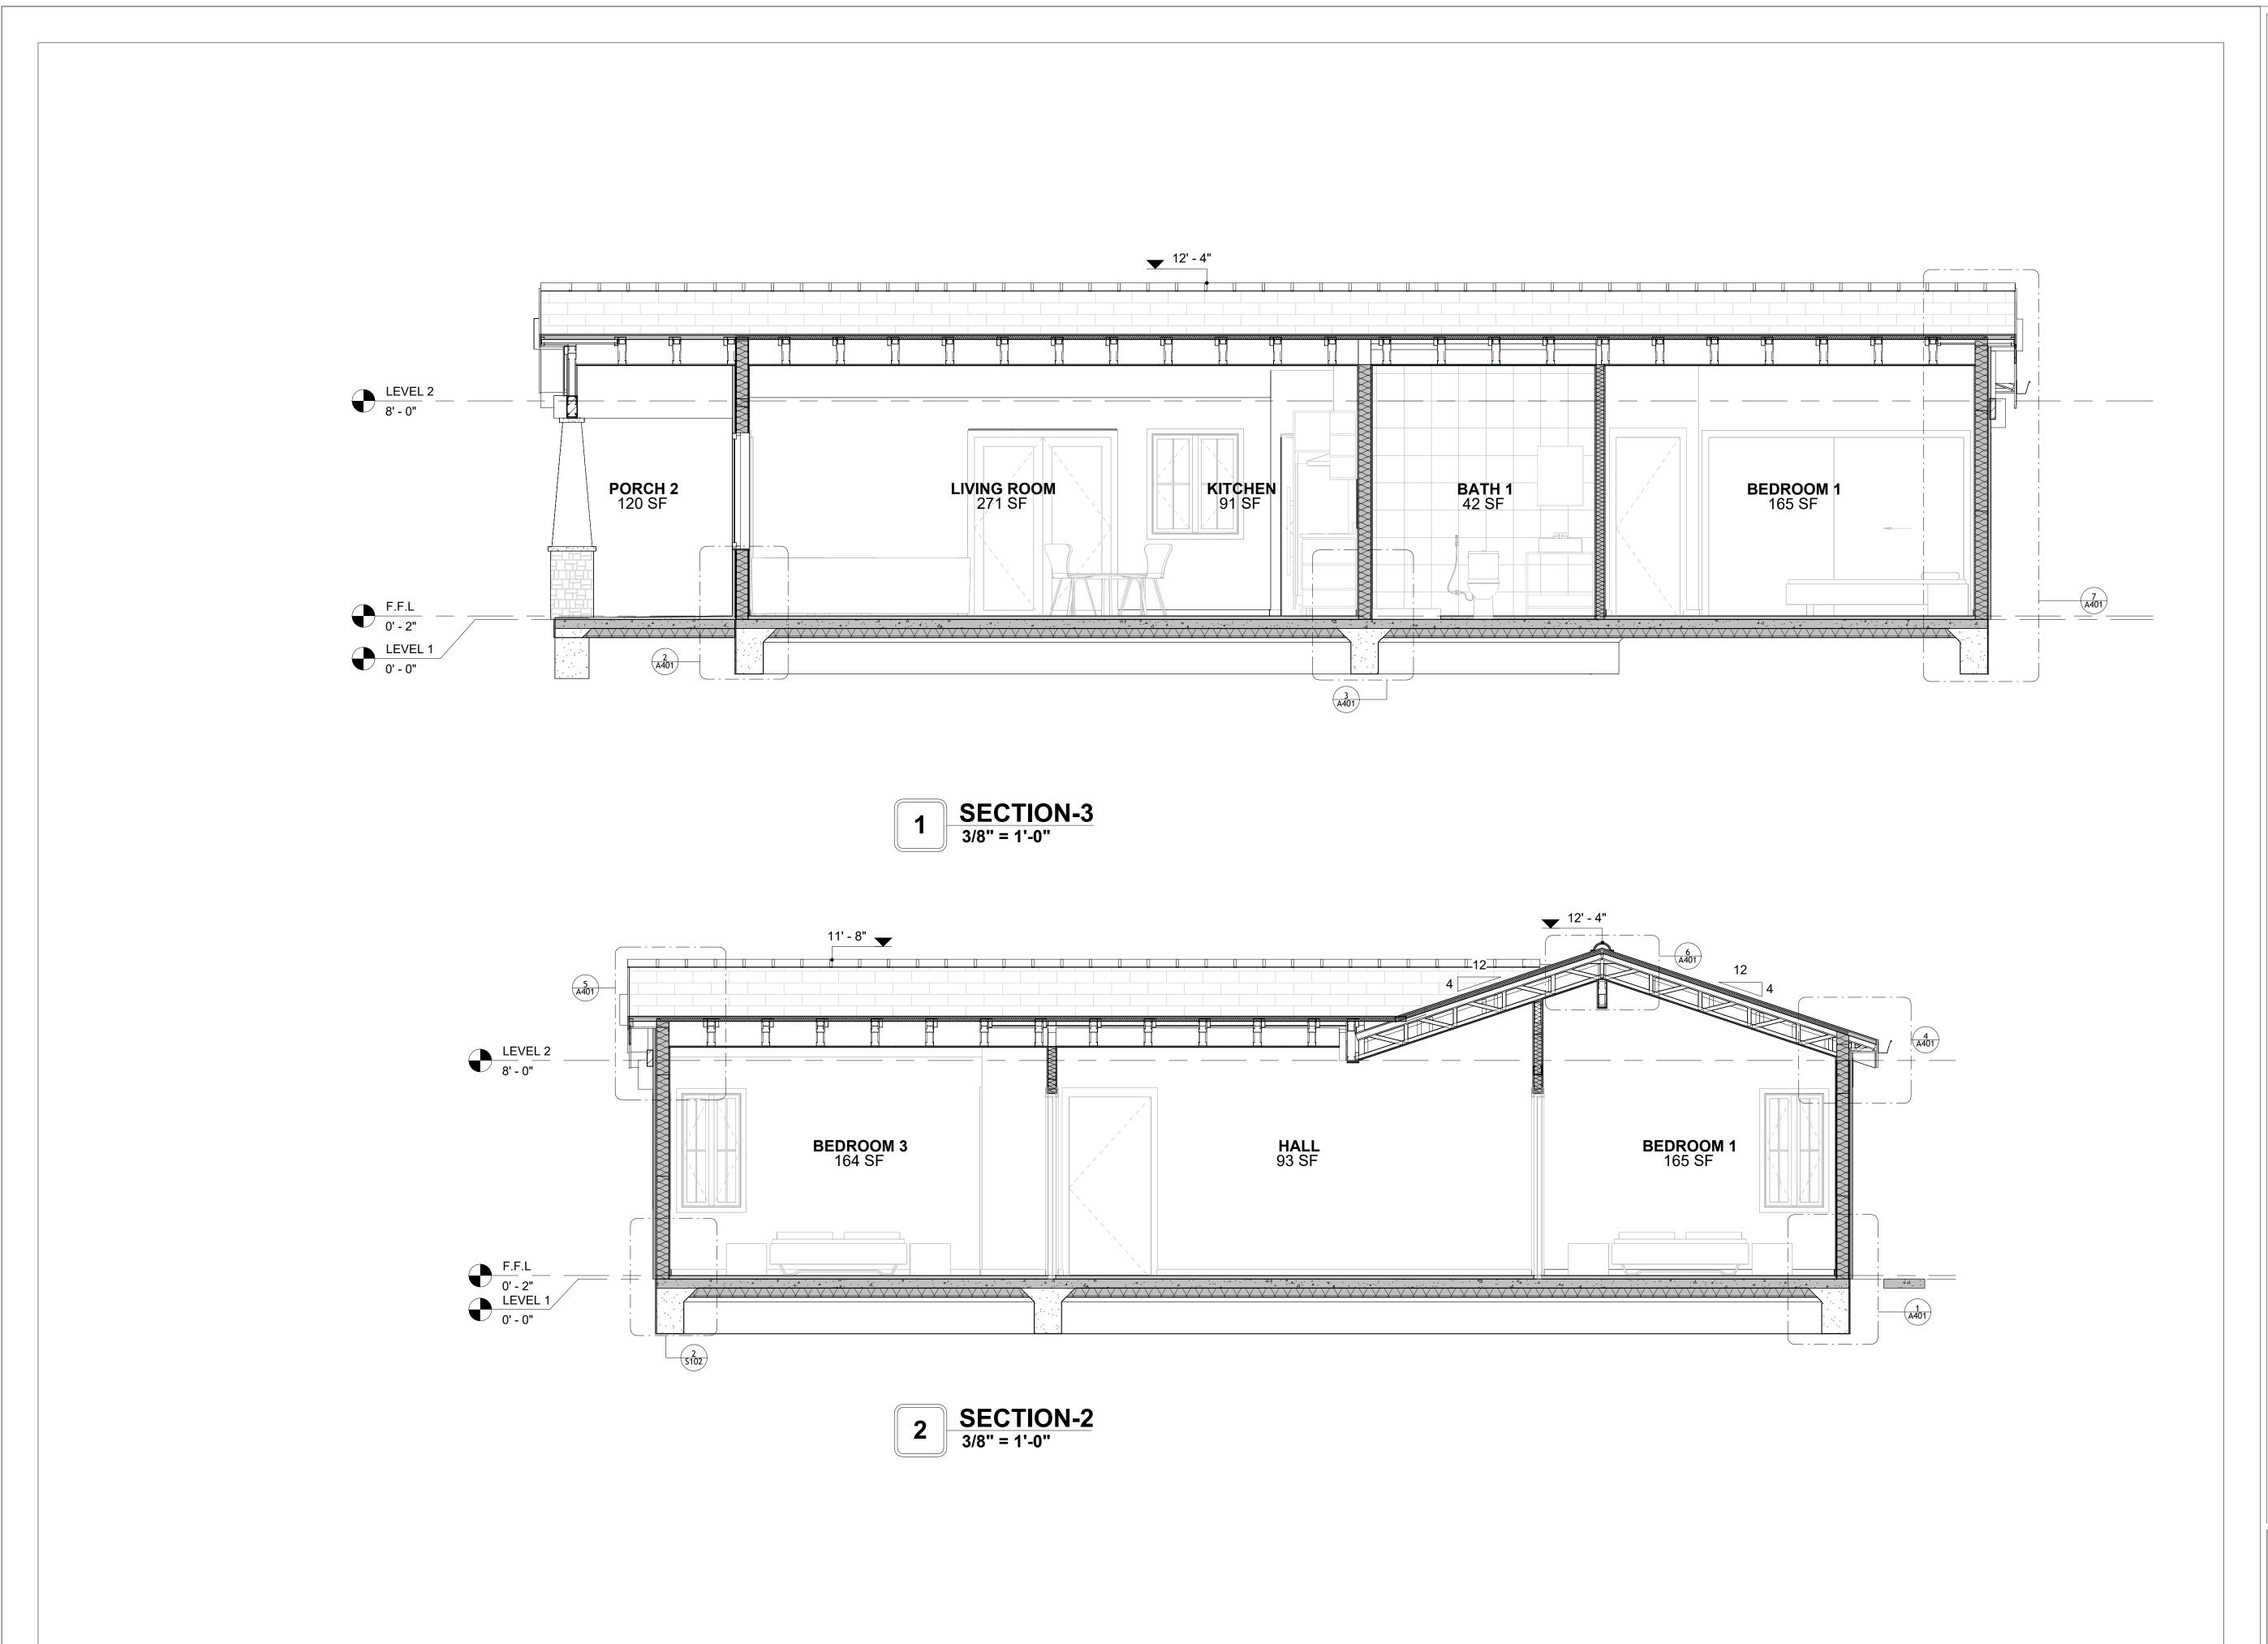



KEY PLAN

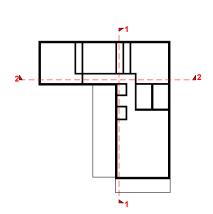

NO.	DESCRIPTION	DATE

NOTE:

LEGEND:

PROJECT


133 ORION 1198 3Bd 2Ba CRAFTSMAN PORCH 550

DRAWING NAME

ARCHITECTURAL SECTIONS

Client Name	CLIENT NAME:	
0061_12	PROJECT NUMBER:	
3/20/2025 5:31:04 PI	DATE:	
Designe	DESIGNED BY:	
Autho	DRAWN BY:	
Checke	CHECKED BY:	

A301

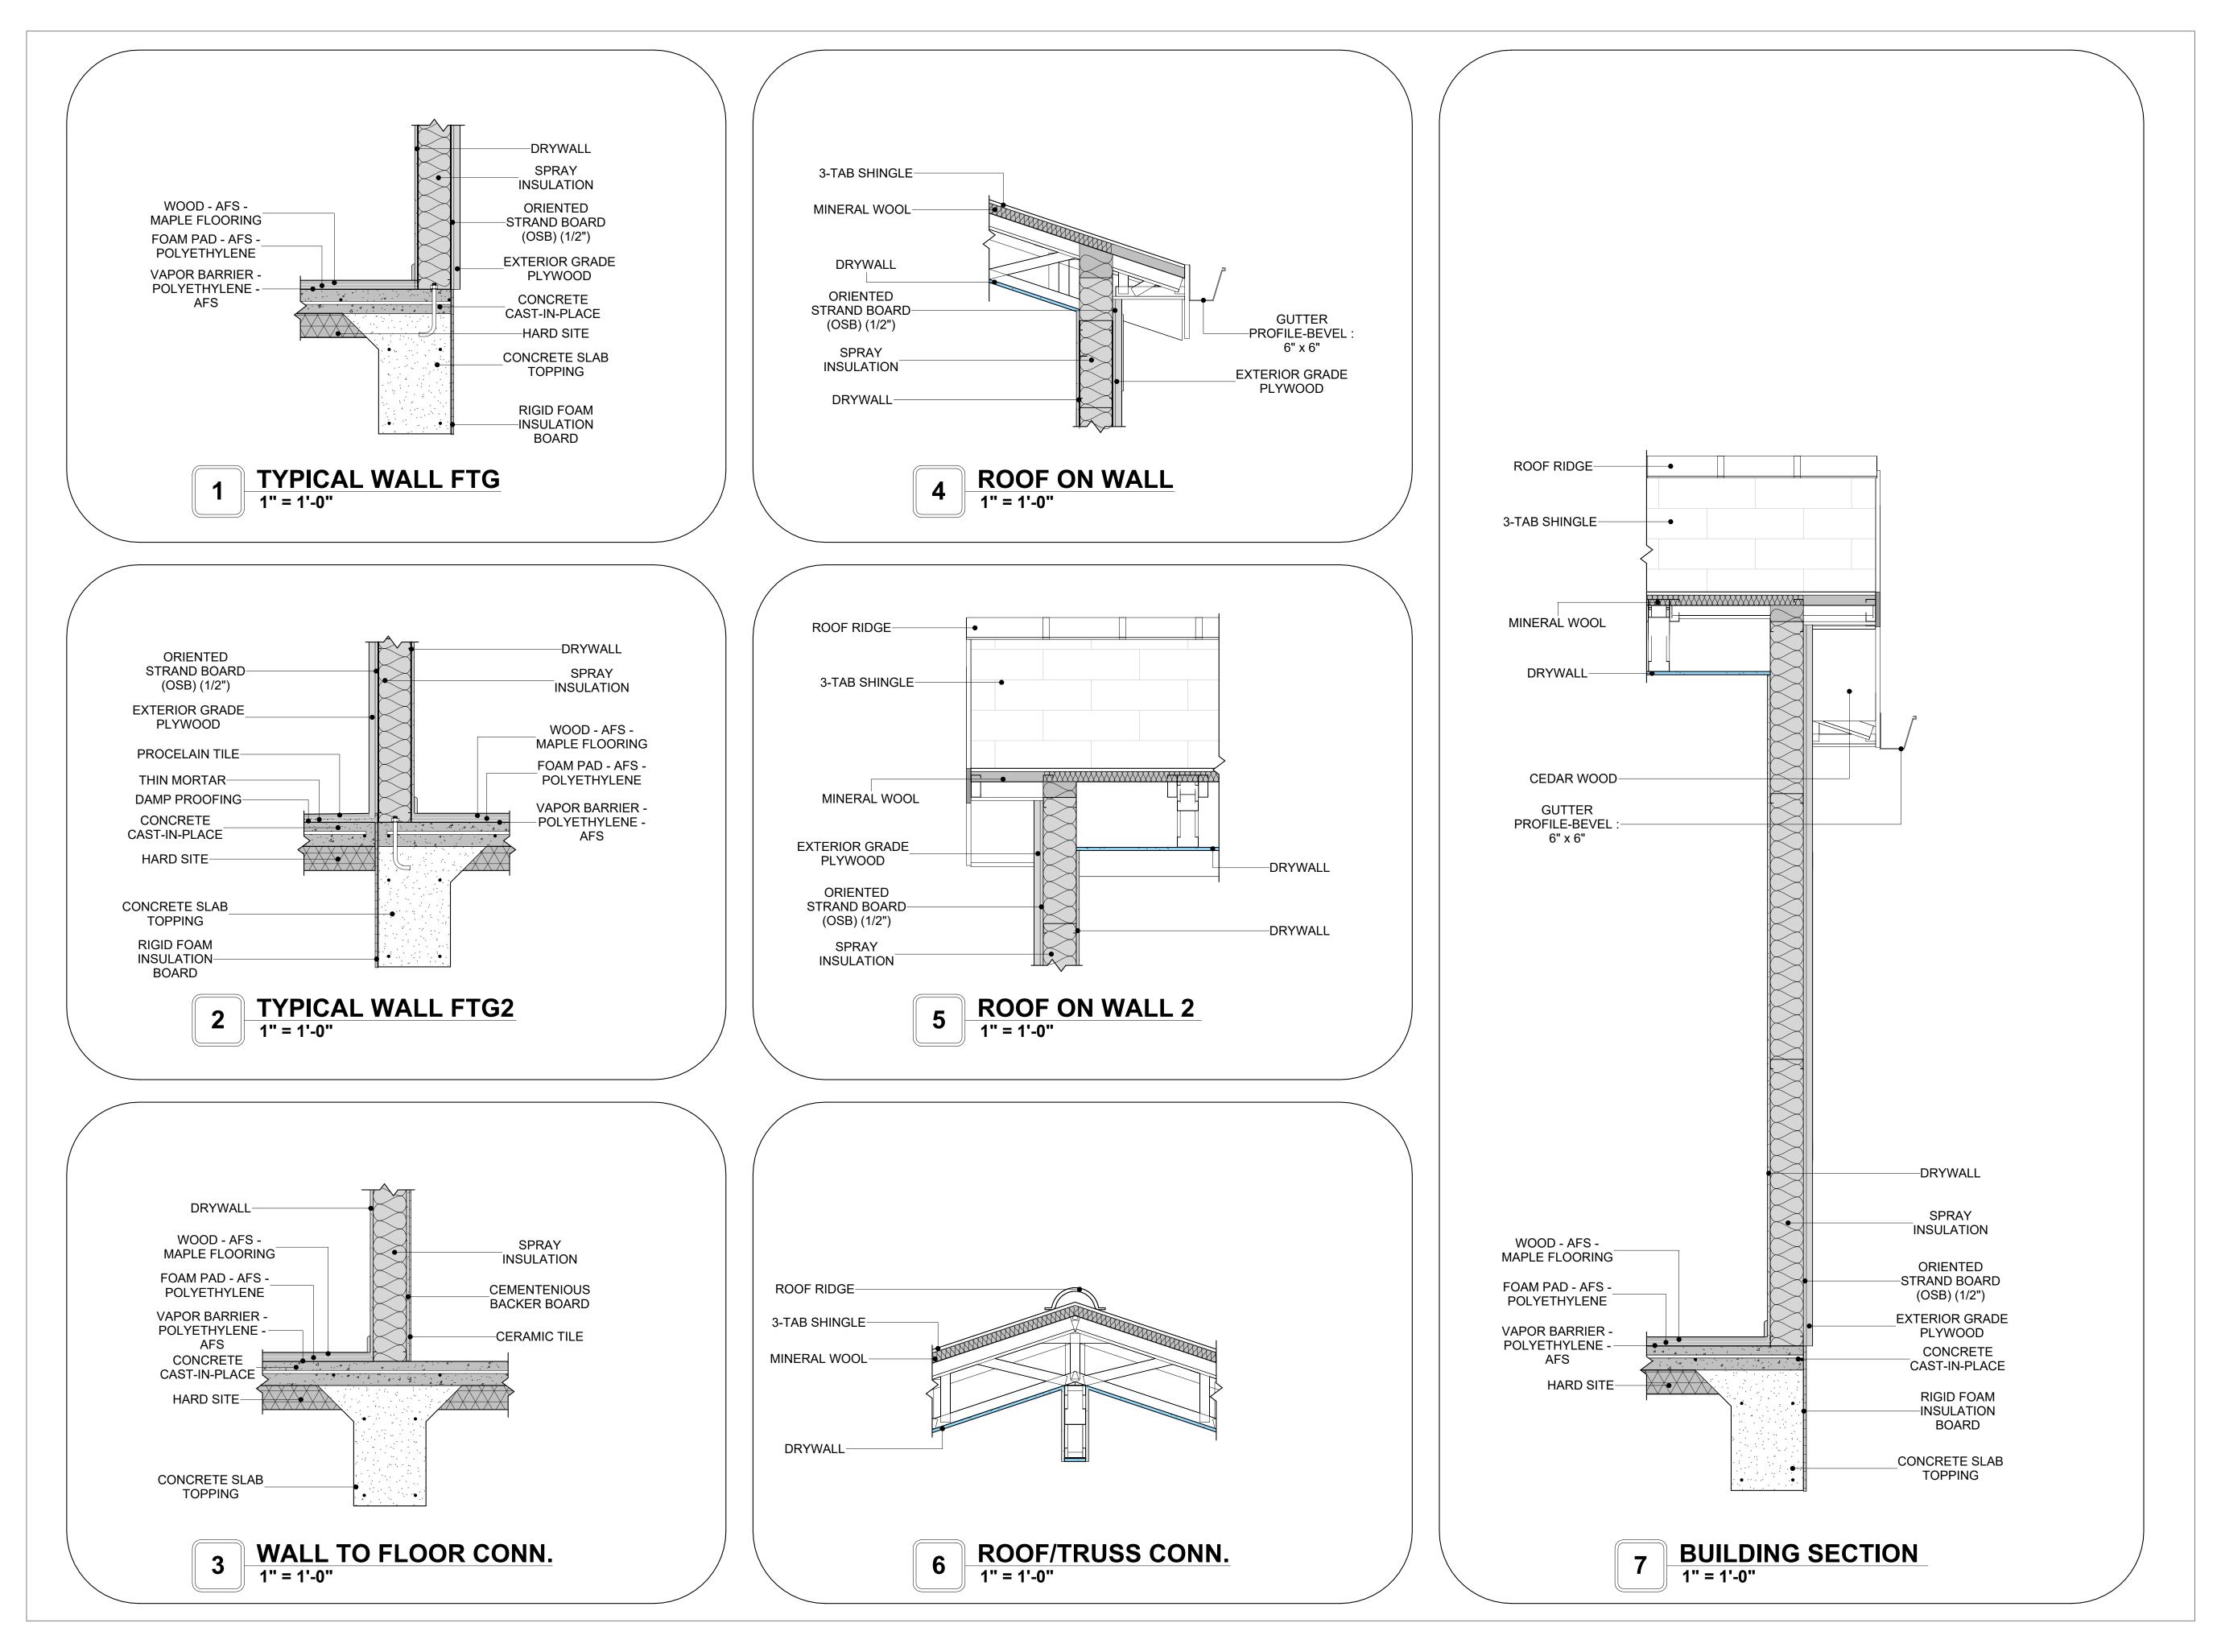



CLIENT NAME:

PROJECT NUMBER:

DATE:

DATE:

DESIGNED BY:

DRAWN BY:

CHECKED BY:

CHECKED BY:

Client Name

0061_12

0720/2025 5:31:06 PM

Designer

Author

Checker

A401

SCALE: 1"=1'-0"

CASEWORK GENERAL NOTES


- . ALL CABINET HEIGHTS INCLUDE COUNTERTOPS. DIMENSIONS ARE TO THE NEAREST INCH.
 . DIVISIONS IN CASEWORK ARE SHOWN FOR CLARITY AND DO NOT REPRESENT BREAKS IN THE
- 2. DIVISIONS IN CASEWORK ARE SHOWN FOR CLARITY AND DO NOT REPRESENT BREAKS IN THE COUNTERTOP.
- 3. PROVIDE CONTINUOUS COUNTERTOP OVER ALL SIMILAR HEIGHT CASEWORK, UNLESS AND
- OTHERWISE NOTED.

 4. MANUFACTURER AND CATALOG NUMBERS ARE FOR REFERENCE AND ILLUSTRATION PURPOSES
- 5. DOTTED LINES INDICATE WALL HUNG CABINETS, DIVISIONS OF BASE CABINETS BELOW THE
- 6. COUNTERTOP, FURNITURE NOT IN THE CONTRACT OR PROJECTION SCREENS -SEE CASEWORK KEY AND SPECIFICATIONS.
- 7. ALL CABINETS AND DRAWERS TO HAVE CAM LOCKS EXCEPT FOR SINK BASE CABINETS.
 8. ALL EXPOSED SURFACES (EXPOSED TO VIEW FROM ANY PERSPECTIVE) TO BE COVERED WITH
- LAMINATE.


 9. ALL CASEWORK WHICH MEETS A WALL AT ONE OR BOTH ENDS, TO BE PROVIDED WITH FILLER PANELS AND SCRIBED TO THE WALL(S) AS REQUIRED.
- 10. ALL CABINETS AND DRAWERS ARE PROVIDED WITH RECESSED HANDLES.
- 11. CONTRACTOR TO FIELD VERIFY ALL CLEAR OPENINGS PRIOR TO MILLWORK OR CASEWORK
- FABRICATION.
- 12. CASEWORK DRAWINGS ARE DIAGRAMMATIC IN NATURE TO SHOW DESIGN INTENT.

	CASEWORK SCHEDULE					
TYPE MAR K	TYPE	COUN T	HEIGHT	WIDTH	DEPTH	AREA
01	L-SHAPE COUNTER TOP 158	1	0' - 4"	7' - 0"	7' - 0"	2 SF
02	BASE CABINET DOUBLE DOOR 2	1	2' - 11"	3' - 1"	2' - 0"	9 SF
03	BASE CABINET L-SHAPED	1	2' - 11"	3' - 3"	3' - 3"	9 SF
04	WALL CABINET DOUBLE DOOR 2 158	1	2' - 6"	3' - 3"	1' - 0"	8 SF
05	WALL FILLER 2	1	2' - 6"	1' - 0"	1' - 0"	3 SF
06	LINEAR COUNTER TOP 2 159.186 2 2	1	0' - 4"	1' - 0"	2' - 1"	0 SF
07	BASE_FILLER_1 2	1	2' - 11"	1' - 0"	2' - 0"	3 SF
80	WALL CABINET DOUBLE DOOR 3 159.186 2	1	2' - 6"	2' - 2"	1' - 0"	5 SF
09	LINEAR COUNTER TOP 2 159.186 2	1	0' - 4"	2' - 10"	2' - 1"	1 SF
10	BASE_CABINET_DOUBLE_DOOR	1	2' - 11"	2' - 2"	2' - 0"	6 SF
11	WALL FILLER	1	2' - 6"	0' - 8"	1' - 0"	2 SF
12	BASE_FILLER_1	1	2' - 11"	0' - 8"	2' - 0"	2 SF
13	LAUNDRY OPEN CABINET	1	1' - 6"	2' - 0"	2' - 4"	3 SF
14	LAUNDRY OPEN CABINET 3 159.186	1	1' - 1"	2' - 3"	3' - 0"	2 SF
15	RECESSED_MED_CABINET	2	2' - 0"	1' - 6"	0' - 3"	3 SF
16	VANITY 2	2	2' - 4"	2' - 6"	1' - 8"	6 SF
17	CLOSET_3	3	5' - 11"	10' - 1"	1' - 4"	60 SF
18	CLOSET	1	5' - 11"	3' - 11"	1' - 4"	23 SF
GRAND	TOTAL	22				

SPECIALTY EQUIPMENT SCHEDULE			
TYPE MARK	TYPE	COUNT	
01	WASHER-FRONT-LOAD	1	
02	REFRIGERATOR	1	
03	RANGE	1	
04	DRYER-FRONT-LOAD	1	
05	DISHWASHER	1	

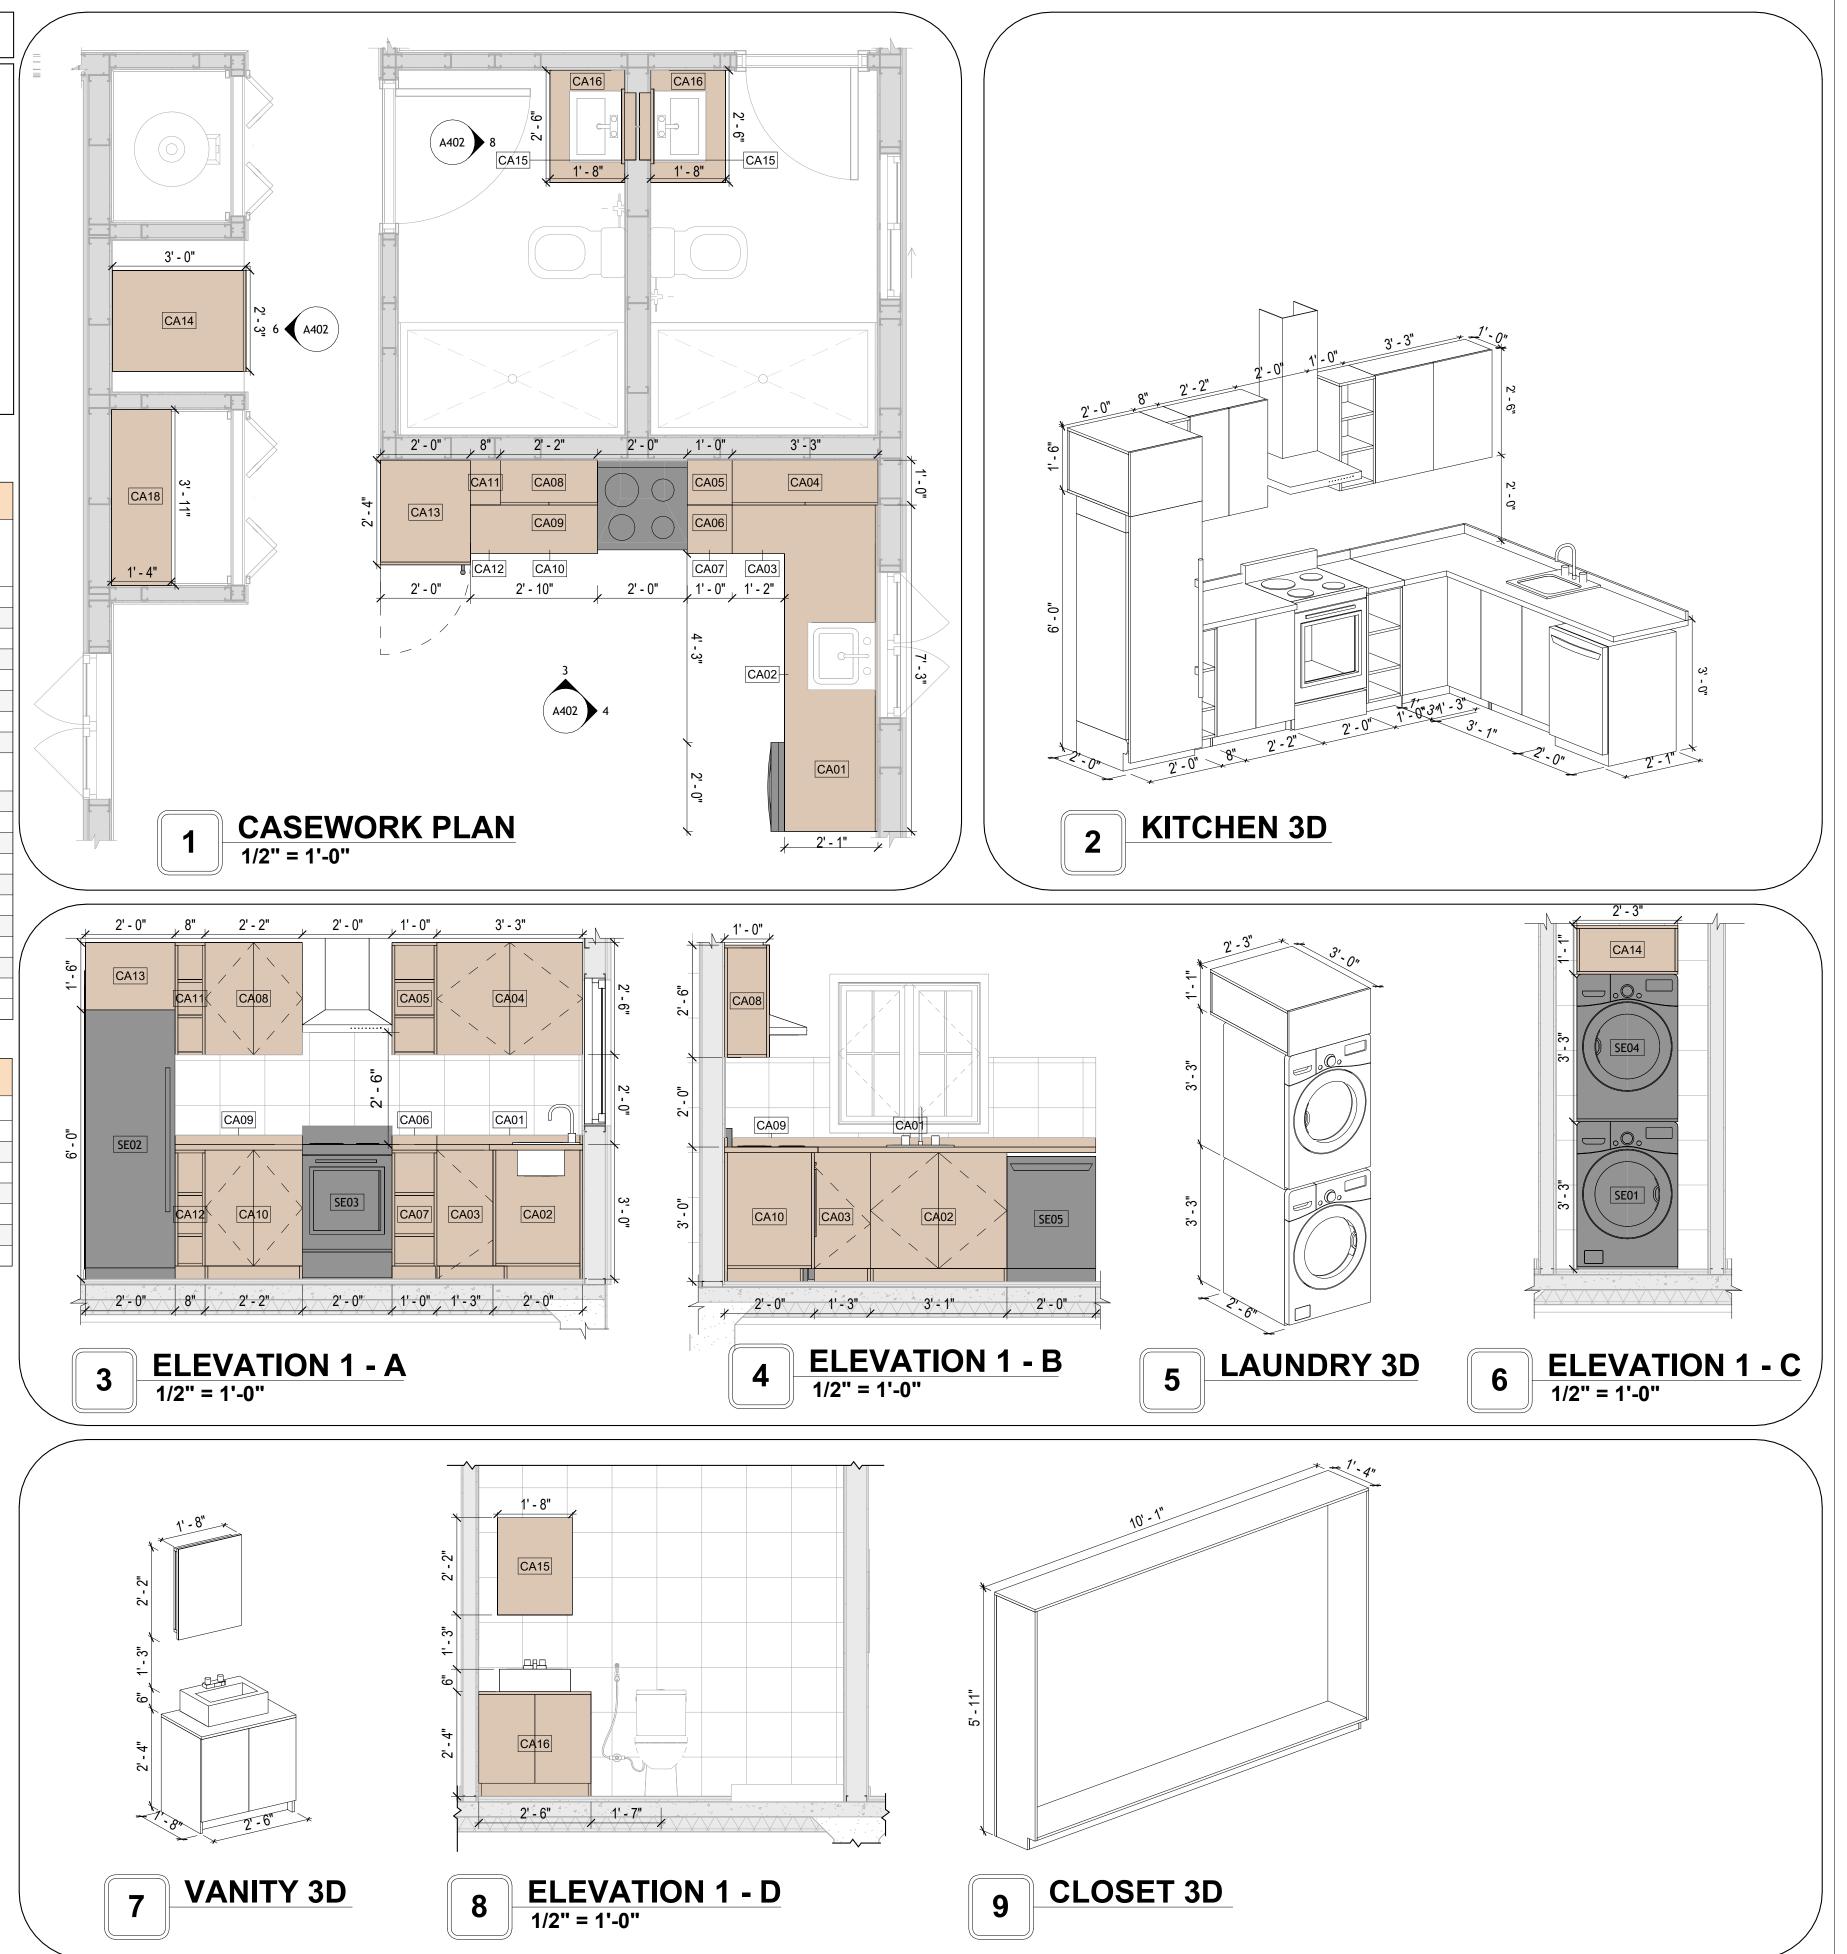



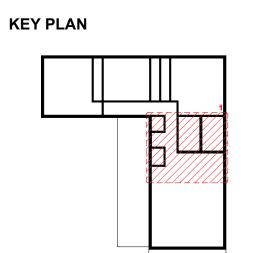

NO.	DESCRIPTION	DATE

NOTE:

LEGEND:

PROJECT

133 ORION 1198 3Bd 2Ba CRAFTSMAN PORCH 550

DRAWING NAME

ARCHITECTURAL CASEWORK

Client Name	CLIENT NAME:
0061_12	PROJECT NUMBER:
3/20/2025 5:31:09 PM	DATE:
Designer	DESIGNED BY:
Author	DRAWN BY:
Checker	CHECKED BY:

A402

GENERAL NOTES

1. THIS DRAWING DEPICTS THE HVAC (HEATING, VENTILATION, AND AIR CONDITIONING) SYSTEM FOR THE ORION 3BD1BA CRAFTSMAN PORCH NG. IT PROVIDES A VISUAL REPRESENTATION OF THE SYSTEM LAYOUT AND COMPONENTS.

2.THE HVAC SYSTEM IS DESIGNED TO MEET THE SPECIFIC REQUIREMENTS OF THE BUILDING, INCLUDING HEATING, COOLING, AND VENTILATION NEEDS, AS PER THE PROJECT SPECIFICATIONS AND APPLICABLE CODES AND STANDARDS.

3. THE HVAC SYSTEM INSTALLATION SHALL COMPLY WITH THE LATEST EDITION OF THE INTERNATIONAL MECHANICAL CODE (IMC), INTERNATIONAL RESIDENTIAL CODE (IRC), AND ALL OTHER APPLICABLE LOCAL, STATE, AND NATIONAL CODES AND REGULATIONS.

4. THE EQUIPMENT SHOWN ON THIS DRAWING INCLUDES BUT IS NOT LIMITED TO AIR HANDLING UNITS (AHUS), CHILLERS, BOILERS, COOLING TOWERS, PUMPS, DUCTWORK, DIFFUSERS, GRILLES, AND CONTROL DEVICES.

5. ALL EQUIPMENT, DUCTWORK, AND PIPING SHALL BE INSTALLED IN ACCORDANCE WITH MANUFACTURER'S SPECIFICATIONS, LOCAL CODES, AND

6. ALL DUCTWORK SHALL BE SIZED, FABRICATED, AND INSTALLED IN ACCORDANCE WITH THE LATEST EDITION OF THE ACCA MANUAL D AND THE SMACNA HVAC DUCT CONSTRUCTION STANDARDS. DUCTWORK SHALL BE INSTALLED IN A NEAT AND WORKMANLIKE MANNER, PROPERLY SUPPORTED AND BRACED TO PREVENT SAGGING, AIR LEAKAGE, OR VIBRATION.

7. CONDENSATE DRAINAGE PIPING SHALL BE PROPERLY PITCHED TO ENSURE POSITIVE DRAINAGE TO AN APPROVED DISPOSAL LOCATION, SUCH AS A FLOOR DRAIN, SUMP PUMP, OR EXTERIOR GRADE. CONDENSATE LINES SHALL BE INSULATED TO PREVENT SWEATING.

8. THE LOCATION OF CONTROL PANELS AND SENSORS INDICATED ON THIS DRAWING CAN BEMODIFY WITH THE SPECIFIC LOCATIONS AND WIRING DETAILS WILL BE DETERMINED DURING THE CONTROL SYSTEM DESIGN AND INSTALLATION.

9. THE HVAC SYSTEM DESIGN CONSIDER ENERGY EFFICIENCY, INDOOR AIR QUALITY, OCCUPANT COMFORT, AND NOISE CONTROL, FOLLOWING APPLICABLE GUIDELINES AND REGULATIONS.

10. COORDINATION WITH OTHER TREADS HAS BEEN DONE ON A DESIGN LEVEL. THIS DRAWING SHALL BE READ TOGETHER WITH THE AR, EL AND SN DESIGN DRAWINGS TO ENSURE PROPER INSTALLATION AND INTEGRATION OF THE HVAC SYSTEMS.

11. THE HVAC CONTRACTOR IS RESPONSIBLE FOR OBTAINING ALL NECESSARY PERMITS AND LICENSES, AND FOR SCHEDULING AND COORDINATING WITH THE LOCAL BUILDING DEPARTMENT AND UTILITY PROVIDERS TO ENSURE A TIMELY AND COMPLIANT INSTALLATION.

12. ALL DUCTWORK PENETRATIONS THROUGH WALLS, FLOORS, OR CEILINGS SHALL BE PROPERLY SEALED AND FIRE-STOPPED USING APPROVED METHODS AND MATERIALS TO MAINTAIN THE INTEGRITY OF THE BUILDING'S FIRE-RESISTANCE RATINGS.

13. HVAC EQUIPMENT SHALL BE INSTALLED LEVEL AND PLUMB, AND IN STRICT ACCORDANCE WITH THE MANUFACTURER'S INSTALLATION INSTRUCTIONS AND RECOMMENDATIONS. PROVIDE ADEQUATE CLEARANCES AROUND EQUIPMENT FOR PROPER AIRFLOW, SERVICE ACCESS, AND CODE COMPLIANCE.


14. ALL HVAC EQUIPMENT AND COMPONENTS, INCLUDING THERMOSTATS, DAMPERS, AND ACCESS PANELS, SHALL BE LOCATED IN ACCESSIBLE AREAS FOR EASY SERVICING AND MAINTENANCE. PROVIDE ADEQUATE SPACE AROUND EQUIPMENT FOR PROPER AIRFLOW AND SERVICE ACCESS.

15. THE HVAC SYSTEM SHALL BE BALANCED AND ADJUSTED TO ENSURE PROPER AIRFLOW, TEMPERATURE DISTRIBUTION, AND SYSTEM PERFORMANCE THROUGHOUT THE RESIDENCE. PROVIDE A WRITTEN REPORT DOCUMENTING THE FINAL SYSTEM BALANCE.

16. ANY DEVIATIONS OR MODIFICATIONS TO THE HVAC SYSTEM DESIGN SHALL BE REVIEWED AND APPROVED BY THE RESPONSIBLE DESIGN PROFESSIONALS AND COMMUNICATED TO ALL RELEVANT PARTIES INVOLVED IN THE CONSTRUCTION PROCESS.

17. FOR ANY INQUIRIES OR CLARIFICATIONS REGARDING THE HVAC SYSTEM DESIGN, PLEASE CONSULT THE RESPONSIBLE DESIGN PROFESSIONALS OR THE PROJECT MANAGEMENT TEAM.


SYMBOLS

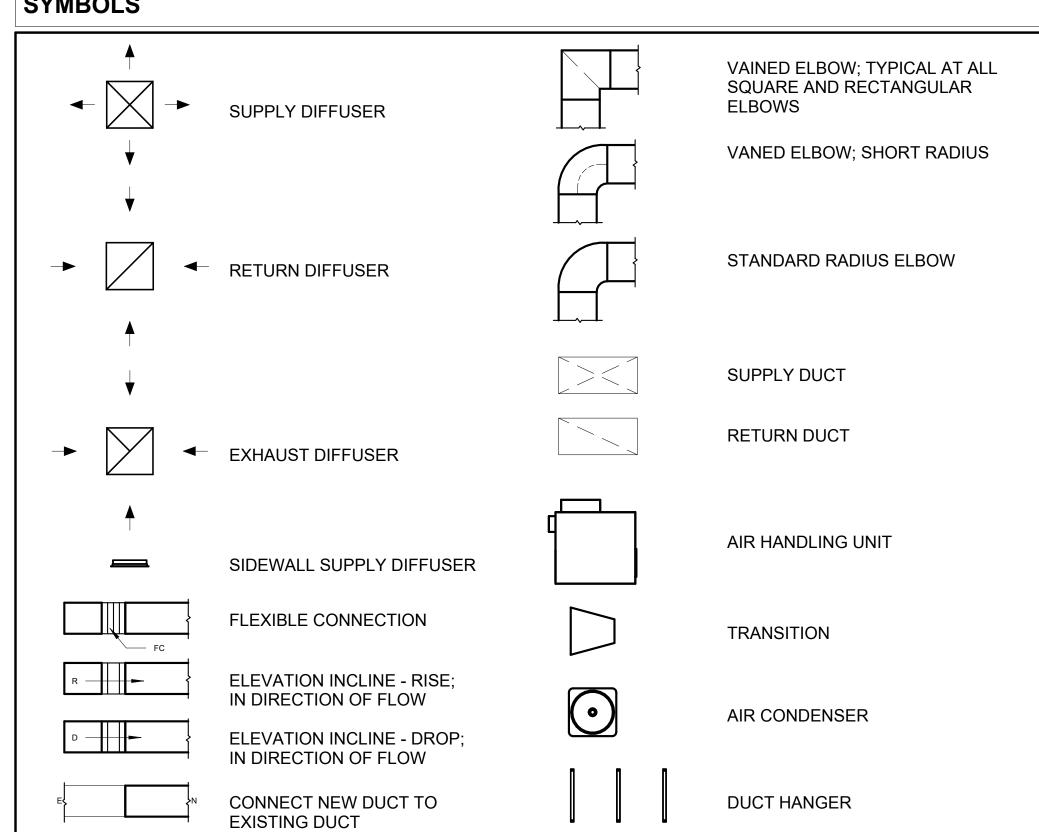



AIR CONDITIONING PIPE

REFRIGERANT LINE SCHEDULE					
CATAGORY DESCRIPTION DIAMETER LENGTH					
PIPE TYPES	COPPER	3/8"	105.01		
PIPE TYPES	COPPER	3/4"	139.44		

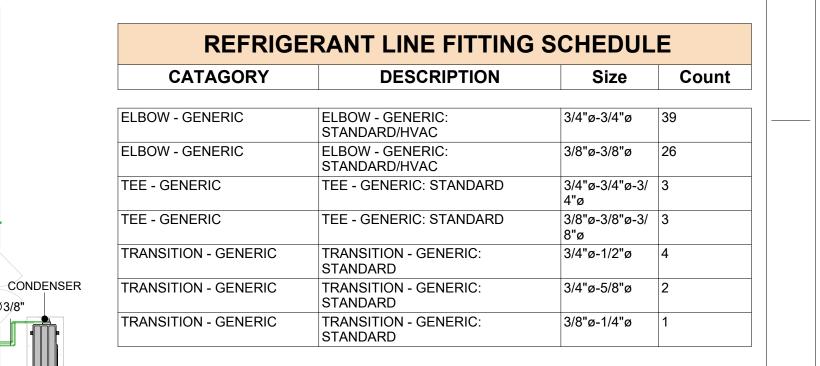

-AIR HANDLING UNIT

Ø3/4" Ø3/8"

AIR HANDLING UNIT

HVAC PLAN

1/4" = 1'-0"

Ø3/4" Ø3/8"

AIR HANDLING UNIT

8 1/2"

EXHAUST FAN EXHAUST FAN

HOOD-WALL

AIR HANDLING UNIT-

3' - 2 1/2"

MECHANICAL EQUIPMENT SCHEDULE			
CATAGORY	DESCRIPTION	COUNT	
AIR HANDLING UNIT	AIR HANDLING UNIT: WALL MOUNTED	4	
CONDENSER	CONDENSER: OUT DOOR	1	
EXHAUST FAN	EXHAUST FAN: 75 CFM 2		
	HOOD-WALL: VENT	1	

DUCT FITTING SCHEDULE				
CATAGORY	DESCRIPTION	COUNT		
ROUND TRANSITION - ANGLE	45 DEGREE	7		

DUCT ACCESSORY SCHEDULE		
CATAGORY	DESCRIPTIO	N COUNT
ROOF VENT	3" DIAMETER	4

FLEX DUCT SCHEDULE				
DESCRIPTION DESCRIPTION LENGTH DIAMETER COUNT				
FLEX DUCT ROUND	FLEX-ROUND	9.99	4"	4
GRAND TOTAL: 4		9.99		



KEY PLAN

NO.	DESCRIPTION	DATE

NOTE:

LEGEND:

PROJECT

133-Orion-1198 3Bd1Ba Craftsman-Porch-550

DRAWING NAME

HVAC PLAN

Owner
15_0001
3/17/2025 12:22:50 AM
Designer
Author
Checker

M101

SCALE: As indicated

© [2024] [FrameUpNow] . All rights reserved

ELECTRICAL NOTES

- 1. THIS DRAWING DEPICTS THE ELECTRICAL SYSTEMFORTHE133 Orion 1198 Craftsman Porch 3Bd2Ba 550. IT PROVIDES A VISUAL REPRESENTATION OF THE ELECTRICAL LAYOUT AND COMPONENTS, INCLUDING POWER DISTRIBUTION, LIGHTING, AND CONTROL SYSTEMS.
- 2. THE ELECTRICAL SYSTEM IS DESIGNED TO MEET THE SPECIFIC REQUIREMENTS OF THE BUILDING, INCLUDING POWER DISTRIBUTION, LIGHTING, AND SPECIALIZED ELECTRICAL EQUIPMENT NEEDS, AS PER THE PROJECT SPECIFICATIONS AND APPLICABLE CODES AND STANDARDS.
- THE ELECTRICAL SYSTEM INSTALLATION SHALL COMPLY WITH THE LATEST EDITION OF THE NATIONAL ELECTRICAL CODE (NEC), INTERNATIONAL BUILDING CODE (IBC), AND ALL OTHER APPLICABLE LOCAL, STATE, AND NATIONAL CODES AND REGULATIONS.
- . LOCATIONS AS NEEDED, DEVICES ARE SHOWN ON PLANS IN APPROXIMATE IDEAL LOCATIONS, UNLESS SPECIFICALLY DIMMENSIONED.
- 5. OPEN WALLS AS NEEDED TO ALLOW FOR NEW ELECTRICAL INSTALLATIONS.
- 6. LABEL ALL CIRCUITS ON JUNCTION BOXES, RECEPTACLES, DATA, SMOKE DETECTOR, AND EQUIPMENT IN PANEL BOX.
- 7. INSTALL RACEWAY AS NEEDED FOR DDC, ACCESS CONTROL, LOW VOLTAGE WIRING & DATA.
- 8. RELABEL POWER, DATA & FIRE ALARM FOR ROOM #CHANGES.
- 9. VERIFY ALL CIRCUITS LABELED ON PRINT ARE CORRECT BEFORE WORKING ON THEM.
- 10. NOTE ON SITE PLAN ALL CHANGES OR MISSING DETAIL TO BE INCORPORATED INTO THE MASTER PLAN.
- 11. DRAWINGS ARE DIAGRAMMATIC ONLY FOR THE PURPOSE OF SHOWING FIXTURE AND OUTLET LOCATIONS.
- 12. ELECTRICAL CONTRACTOR TO VERIFY SERVICE SIZE BY CALCULATION BASED UPON ACTUAL NAME PLATE RATINGS OF SELECTED EQUIPMENT.
- 13. VERIFY LOCATION OF SERVICE ENTRANCE WITH POWER COMPANY. PROVIDE UFER GROUND IN
- BUILDING FOUNDATION AT SERVICE ENTRANCE LOCATION.
- 14. PROVIDE A MIN. OF 20 FEET OF ONE *4 BARE COPPER UFER WIRE EMBEDDED IN CONCRETE FOOTING AT THE SERVICE ENTRANCE LOCATION WHERE APPROVED BY LOCAL SERVICE PROVIDER.
- 15. PROVIDE WATERPROOF FIXTURES IN ALL HIGH MOISTURE AREAS (EXTERIOR, SHOWER AND TUB
- CEILINGS ETC.) 16. PROVIDE DEDICATED CIRCUITS TO EACH BATH, DEN, FAMILY ROOM, BEDROOM, LOFT, KITCHEN
- REFRIGERATOR, KITCHEN FREEZER DISHWASHER, AND ANY AREA/ITEM SPECIFIED BY OWNER.
- 17. INCANDESCENT FIXTURES WITH OPEN OR PARTIALLY ENCLOSED LAMPS, PENDANT FIXTURES, AND LAMP HOLDERS ARE NOT PERMITTED IN CLOSETS.
- 18. ALL WORKMANSHIP AND MATERIALS TO CONFORM WITH THE 2015 IRC.
- 19. PROVIDE A MIN. OF 20 FEET OF ONE *4 BARE COPPER UFER WIRE EMBEDDED IN CONCRETE FOOTING AT THE SERVICE ENTRANCE LOCATION WHERE APPROVED BY LOCAL SERVICE PROVIDER.
- 20. PROVIDE A BONDING CONDUCTOR CONSISTING OF A MINIMUM OF ONE *4 BARE COPPER WIRE CONNECTING THE BUILDING'S METAL WATER PIPING SYSTEM TO THE SERVICE EQUIPMENT ENCLOSURE GROUNDING.

MAIN PANEL CALCS

ELECTRICAL CALCS	
LIGHT AND OUTLETS 1,198	3 @ 3W 3,594 W
3 APPLIANCE CIRCUITS	4,500 W
DRYER	2,000 W
WASHER	2,000 W
RANGE	5,000 W
WATER HEATER	5,000 W
REFRIG.	1,800 W
DISHWASHER & DISPOSAL	3000 W
TOTAL	26,894 W
FRIST 10,000 @ 100% REMAINDER @ 40% MINI. SPLIT UNITS	10,000 W 6,758 W 10,000 W
TOTAL	26,758 W

26,758 W DIVIDED BY 240V = 111 AMPS TOTAL

(USE 200 AMP SERVICE)

ELECTRICAL ABBREVIATIONS LIST

1	P 1 POLE (2P, 3P, 4P, ETC.)	CTR	CENTER	HT	HEIGHT
	A AMPERE	CU	COPPER	HTG	HEATING
A		DCP	DOMESTIC WATER CIRCULATING PUMP	HTR	HEATER
ACL		DEPT	DEPARTMENT	HV	HIGH VOLTAGE
AD		DET	DETAIL	HVAC	HEATING, VENTILATING AND AIR
A		DIA	DIAMETER	CONDITIONING	CONDITIONING
AF		DISC	DISCONNECT	HWP	HYDRONIC WATER PUMP
AF		DIST	DISTRIBUTION	IC	INTERRUPTING CAPACITY
Al		DN	DOWN	iG	ISOLATED GROUND
AH		DPR	DAMPER	IMC	INTERMEDIATE METAL CONDUIT
	L ALUMINUM	DS	SAFETY DISCONNECT SWITCH	INCAND	INCANDESCENT
ÁL		DT	DOUBLE THROW	IR	INFRARED
AM		DWG	DRAWING	I/W	INTERLOCK WITH
AMF		DDC	DIRECT DIGITAL CONTROL	J-BOX	JUNCTION BOX
ANNU			ELECTRICAL CONTRACTOR	KV	KILOVOLT
AQ-STA		ELEC	ELECTRIC, ELECTRICAL	KVA	KILOVOLT-AMPERE
ARC		ELEV	ELEVATOR	KVAR	KILOVOLT-AMPERE REACTIVE
A		EM	EMERGENCY	KW	KILOWATT
A		EMS	ENERGY MANAGEMENT SYSTEM	KWH	KILOWATT HOUR
AT		EMT	ELECTRICAL METALLIC TUBING	LOC	LOCATE OR LOCATION
AUT		EP	ELECTRIC PNEUMATIC	LT	LIGHT
AU		EQUIP	EQUIPMENT	LTG	LIGHTING
A		EWC	ELECTRIC WATER COOLER	LTNG	LIGHTNING
AW		EXIST	EXISTING	LV	LOW VOLTAGE
BAT		EXH	EXHAUST	MAX	MAXIMUM
В	D BOARD	EXP	EXPLOSION PROOF	MAG.S	MAGNETIC STARTER
BLD	G BUILDING	FA	FIRE ALARM	M/C	MOMENTARY CONTACT
BM	S BUILDING MANAGEMENT SYSTEM	FABP	FIRE ALARM BOOSTER POWER	MC	MECHANICAL CONTRACTOR
	C CONDUIT	SUPPLY PANEL	SUPPLY PANEL	MCB	MAIN CIRCUIT BREAKER
CA	B CABINET	FACP	FIRE ALARM CONTROL PANEL	MCC	MOTOR CONTROL CENTER
CA		FCU	FAN COIL UNIT	MDC	MAIN DISTRIBUTION CENTER
CAT	V CABLE TELEVISION	FIXT	FIXTURE	MDP	MAIN DISTRIBUTION PANEL
C		FLR	FLOOR	MFR	MANUFACTURERMAIN FUSED
CCT		FLUOR	FLUORESCENT		DISCONNECT SWITCH
CK		FU	FUSE	MH	MANHOLE
CL		FUDS	FUSED SAFETY DISCONNECT SWITCH	MIC	MICROPHONE
COM		GA	GAUGE	MIN	MINIMUM
CMP		GAL	GALLON	MISC	MISCELLANEOUS
CON		GALV	GALVANIZED	MLO	MAIN LUGS ONLY
CONS		GC	GENERAL CONTRACTOR	MMS	MANUAL MOTOR STARTER
CON		GEN	GENERATOR	MOA	MULTIOUTLET ASSEMBLY
CONT		GFI	GROUND FAULT CIRCUIT INTERRUPTER	MSP	MOTOR STARTER PANELBOARD
CON		GFP	GROUND FAULT PROTECTOR	MSBD	MAIN SWITCHBOARD
C		GND	GROUND	MT	MOUNT
CR C		GRS	GALVANIZED RIGID STEEL (CONDUIT)	MT.C	EMPTY CONDUIT
	T CURRENT TRANSFORMER	GYP BD	GYPSUM BOARD	UL	UNDERWRITERS LABORATORIES

Branch Panel:

Location: BEDROOM 1 03 Supply From: Mounting: Recessed Enclosure: Type 1

Volts: 120/240 Single Phases: 1 Wires: 3

A.I.C. Rating: Mains Type: Mains Rating: 200 A MCB Rating: 1 A

Circuit Numb er	Circuit Description	Number of Elements	Rating	Length	Wire Size	A		Į.	3	Wire Size	Length	Rating	Number of Elements	Circuit Description	Circuit Numb er
1	CONDENCER	1	60 A	21' - 6 7/32"	2-#6, 1-#6, 1-#10	750 VA	750 VA			2-#10, 1-#10, 1-#10	44' - 9 1/16"	30 A	1	DRYER	2
3								750 VA	750 VA						4
5	RANGE	1	50 A	36' - 1 1/2"	2-#8, 1-#8, 1-#10	750 VA	396 VA			1-#12, 1-#12, 1-#12	46' - 2 7/8"	20 A	8	KITCHEN LIGHT POINTS	6
7								750 VA	1200 VA	1-#10, 1-#10, 1-#10	38' - 3 9/16"	30 A	1	DISH WASHER	8
9	WATER HEATER	1	30 A	42' - 10 11/16"	2-#10, 1-#10, 1-#10	750 VA	336 VA			1-#12, 1-#12, 1-#12	23' - 1 3/8"	20 A	5	BATH 1 UNITS	10
11								750 VA	336 VA	1-#12, 1-#12, 1-#12	36' - 0 1/2"	20 A	5	BATH 2 UNITS	12
13	BEDROOM 1 LIGHT POINTS	10	20 A	27' - 2 11/32"	1-#12, 1-#12, 1-#12	568 VA	336 VA			1-#12, 1-#12, 1-#12	57' - 0 19/32"	20 A	8	LIVING ROOM LIGHT POINTS	14
15	BEDROOM 1 RECEPTACLES	6	20 A	27' - 6 1/2"	1-#12, 1-#12, 1-#12			1080 VA	1440 VA	1-#10, 1-#10, 1-#10	71' - 9 25/32"	20 A	8	LIVING ROOM AND HALL RECEPTACLES	16
17	BEDROOM 2 LIGHT UNITS	10	20 A	40' - 11 27/32"	1-#12, 1-#12, 1-#12	568 VA	1200 VA			1-#12, 1-#12, 1-#12	46' - 8 3/16"	20 A	1	GFCI WASHER	18
19	REFRIGERATOR	1	20 A	40' - 9 1/4"	1-#12, 1-#12, 1-#12			1500 VA	900 VA	1-#12, 1-#12, 1-#12	38' - 4 1/2"	20 A	5	GFCI KITCHEN RECEPTACLES	20
21	BEDROOM 2 RECEPTACLES	5	20 A	43' - 4 7/32"	1-#12, 1-#12, 1-#12	900 VA	300 VA			1-#12, 1-#12, 1-#12	48' - 0 1/2"	20 A	9	HALL LIGHT POINTS	22
23	BEDROOM 3 LIGHT POINTS	9	20 A	54' - 11 7/16"	1-#12, 1-#12, 1-#12			388 VA	500 VA	1-#12, 1-#12, 1-#12	62' - 10 17/32"	20 A	8	OUTDOOR LIGHT POINTS	24
25	BEDROOM 3 RECEPTACLES	5	20 A	63' - 9 13/32"	1-#12, 1-#12, 1-#12	900 VA	720 VA			1-#12, 1-#12, 1-#12	65' - 4 3/4"	20 A	4	GFCI OUT-DOOR RECEPTACLES	26
						9220	VA	1031	9 VA						
						77	Α	86	6 A						

L	-eć	ge	nd	:

Load Classification	Connected Load	Demand Factor	Estimated Demand	Panel Totals
Lighting - Dwelling Unit	800 VA	100.00%	800 VA	
Other	2196 VA	100.00%	2196 VA	Total Conn. Load: 19540 VA
Receptacle	16200 VA	80.86%	13100 VA	Total Est. Demand: 16440 VA
Lighting	400 VA	100.00%	400 VA	Total Conn.: 81 A
				Total Est. Demand: 69 A

Tuscon,AZ, USA 888-864-0184 inquire@frameupnow.com

KEY PLAN

www.frameupnow.com

NO.	DESCRIPTION	DATE

NOTE:

LEGEND:

133-ORION-1198-3Bd2Ba **CRAFTSMAN-PORCH-550**

DRAWING NAME

SCHEDULE

CLIENT NAME:	Owner
PROJECT NUMBER:	0375_15
DATE:	3/15/2025 1:34:10 AM
DESIGNED BY:	Designer
DRAWN BY:	Author
CHECKED BY:	Checker

E101

SCALE: 1/4" = 1'-0"

© [2024] [FrameUpNow] . All rights reserved

ELECTRICAL NOTE

- A. PROVIDE INTERCONNECTED SMOKE ALARMS IN EACH SLEEPING ROOMS, OUTSIDE EACH SLEEPING ROOM, ON EACH STORY, IN THE HALL OR ADJACENT ROOM LUHERE THE CEILING HEIGHT OF A ROOM OPEN TO THE HALL EXCEEDS THE HALL BY 24'. SMOKE ALARMS SHALL BE PERMANENTLY HARD WIRED WITH BATTERY BACKUP.
- B. RECEPTACLE OUTLETS FOR RANGES AND CLOTHES DRYERS SHALL BE A THREE POLE WITH GROUND TYPE. FOUR WIRE GROUNDING-TYPE FLEXIBLE CORDS WILL BE REQUIRED FOR CONNECTION OF RANGES AND CLOTHES DRYERS. THE BONDING JUMPER SHALL NOT BE CONNECTED BETWEEN NEUTRAL TERMINAL AND THE FRAME OF THE APPLIANCE.
- C. TWO OR MORE 20 AMP SMALL APPLIANCE CIRCUITS SHALL BE PROVIDED TO SERVE THE KITCHEN, BREAKFAST NOOK, AND DINING ROOM. SUCH CIRCUITS SHALL HAVE NO OTHER OUTLETS.
- D. AT LEAST ONE 20 AMP BRANCH CIRCUIT SHALL BE PROVIDED TO SERVICE THE LAUNDRY ROOM. THIS CIRCUIT SHALL HAVE NO OTHER OUTLETS.
- E. ALL RECEPTACLES WITH IN 6' OF A WET BAR SINK OR KITCHEN SINK TO SERVE COUNTER TOP SURFACES MUST BE GFCI. ON KITCHEN COUNTERS 12' OR WIDER NO POINT ALONG THE WALL SHALL BE MORE THAN 2' FROM A RECEPTACLE. ALL RECEPTACLES WITH IN 6' OF KITCHEN SINK MUST BE GFCI. AT LEAST ONE GFCI RECEPTACLE SHALL BE INSTALLED IN THE BATHROOM ADJACENT TO EACH BASIN.
- F. FIXTURES INCLUDING CEILING FANS THAT ARE LOCATED IN DAMP LOCATIONS SHALL BE LISTED TO BE SUITABLE FOR SUCH LOCATIONS PER 2012 IRC
- G. PROVIDE ONE (1) SWITCHED OUTLET @ ALL BEDROOMS AND DEN
- H. CEILING FANS NOT EXCEEDING 35 LBS. (WITH OR WITHOUT ACCESSORIES MAY BE SUPPORTED BY OUTLET BOXES
- PROVIDED THE OUTLET BOXES ARE IDENTIFIED FOR SUCH USE PER 2012 IRC
- I. ELECTRICAL OUTLET BOXES ON OPPOSITE SIDES OF FIRE RATED WALLS SHALL BE SEPARATED BY A HORIZONTAL DISTANCE OF NOT LESS THAN 24".
- J. OUTLET BOXES IN THE WALLS BETWEEN THE GARAGE AND DWELLING SHALL BE METAL OR U.L. APPROVED FIRE
- RESISTIVE PLASTIC. BOXES IN GARAGE CEILING SHALL BE METAL.
- K. ALL BRANCH CIRCUITS THAT SUPPLY 120 VOLTS SINGLE PHASE 15 AND 20 AMPS RECEPTACLE OUTLETS INSTALLED IN THE DWELLING SHALL BE PROTECTED BY AN ARC FAULT CIRCUIT INTERRUPTER, EXCEPT GFCI RECEPTICLES.

NOTE:

A. RECEPTACLES MUST BE PROVIDED IN HALLWAYS 10'-0" OR MORE IN LENGTH. FOR A ONE FAMILY DWELLINGS AND EACH OF A TWO FAMILY DWELLING THAT IS AT GRADE LEVEL, AT LEAST ONE WP-GFCI RECEPTACLE OUTLET ACCESSIBLE AT GRADE LEVEL AND NOT MORE THAN 6'-6" ABOVE GRADE SHALL BE INSTALLED AT THE FRONT AND BACK OF THE DWELLING.

NOTE: APPLIANCE DISCONNECT

E4001.5 GROUNDING OF ENCLOSURES.

METAL ENCLOSURES FOR SWITCHES OR CIRCUIT BREAKERS SHALL BE CONNECTED TO AN

EQUIPMENT GROUNDING CONDUCTOR.


METAL ENCLOSURES FOR SWITCHES OR CIRCUIT BREAKERS USED AS SERVICE


EQUIPMENT SHALL COMPLY WITH THE PROVISIONS OF SECTION E3609.4. WHERE NONMETALLIC ENCLOSURES ARE USED WITH METAL RACEWAYS OR METAL-ARMORED

NONMETALLIC ENCLOSURES ARE USED WITH METAL RACEWAYS OR METAL-ARMORED CABLES, PROVISIONS SHALL BE MADE FOR CONNECTING THE EQUIPMENT GROUNDING


CONDUCTOR.

NONMETALLIC BOXES FOR SWITCHES SHALL BE INSTALLED WITH A WIRING METHOD THAT PROVIDES OR INCLUDES AN EQUIPMENT GROUNDING CONDUCTOR. (404.12)

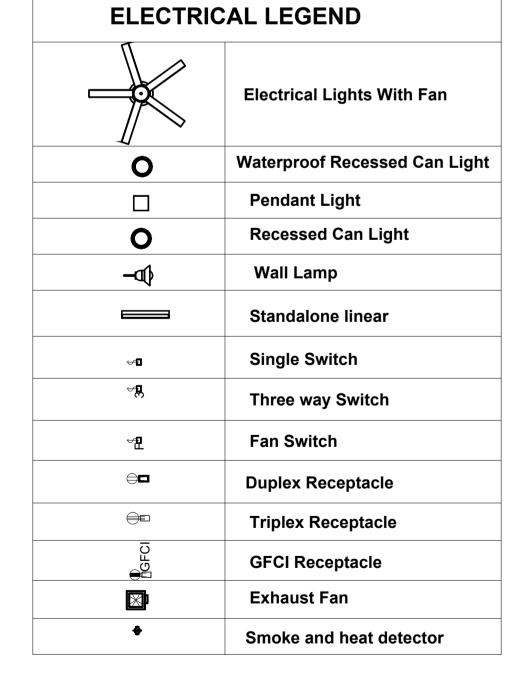

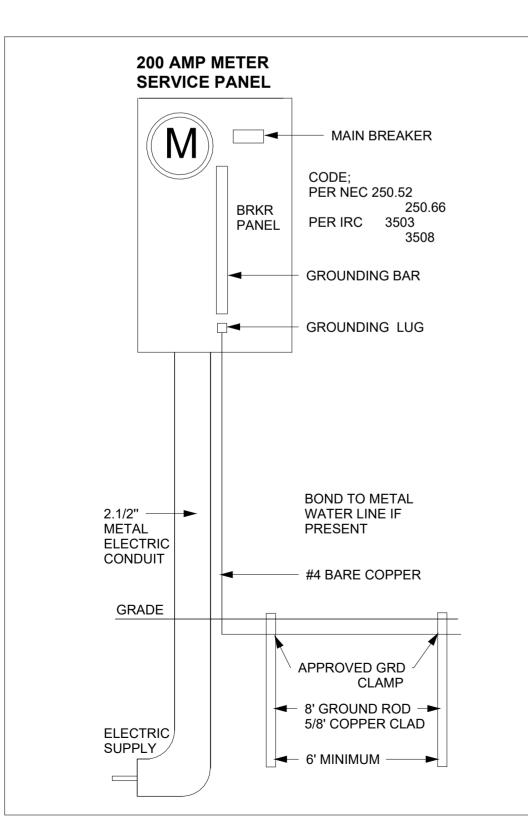



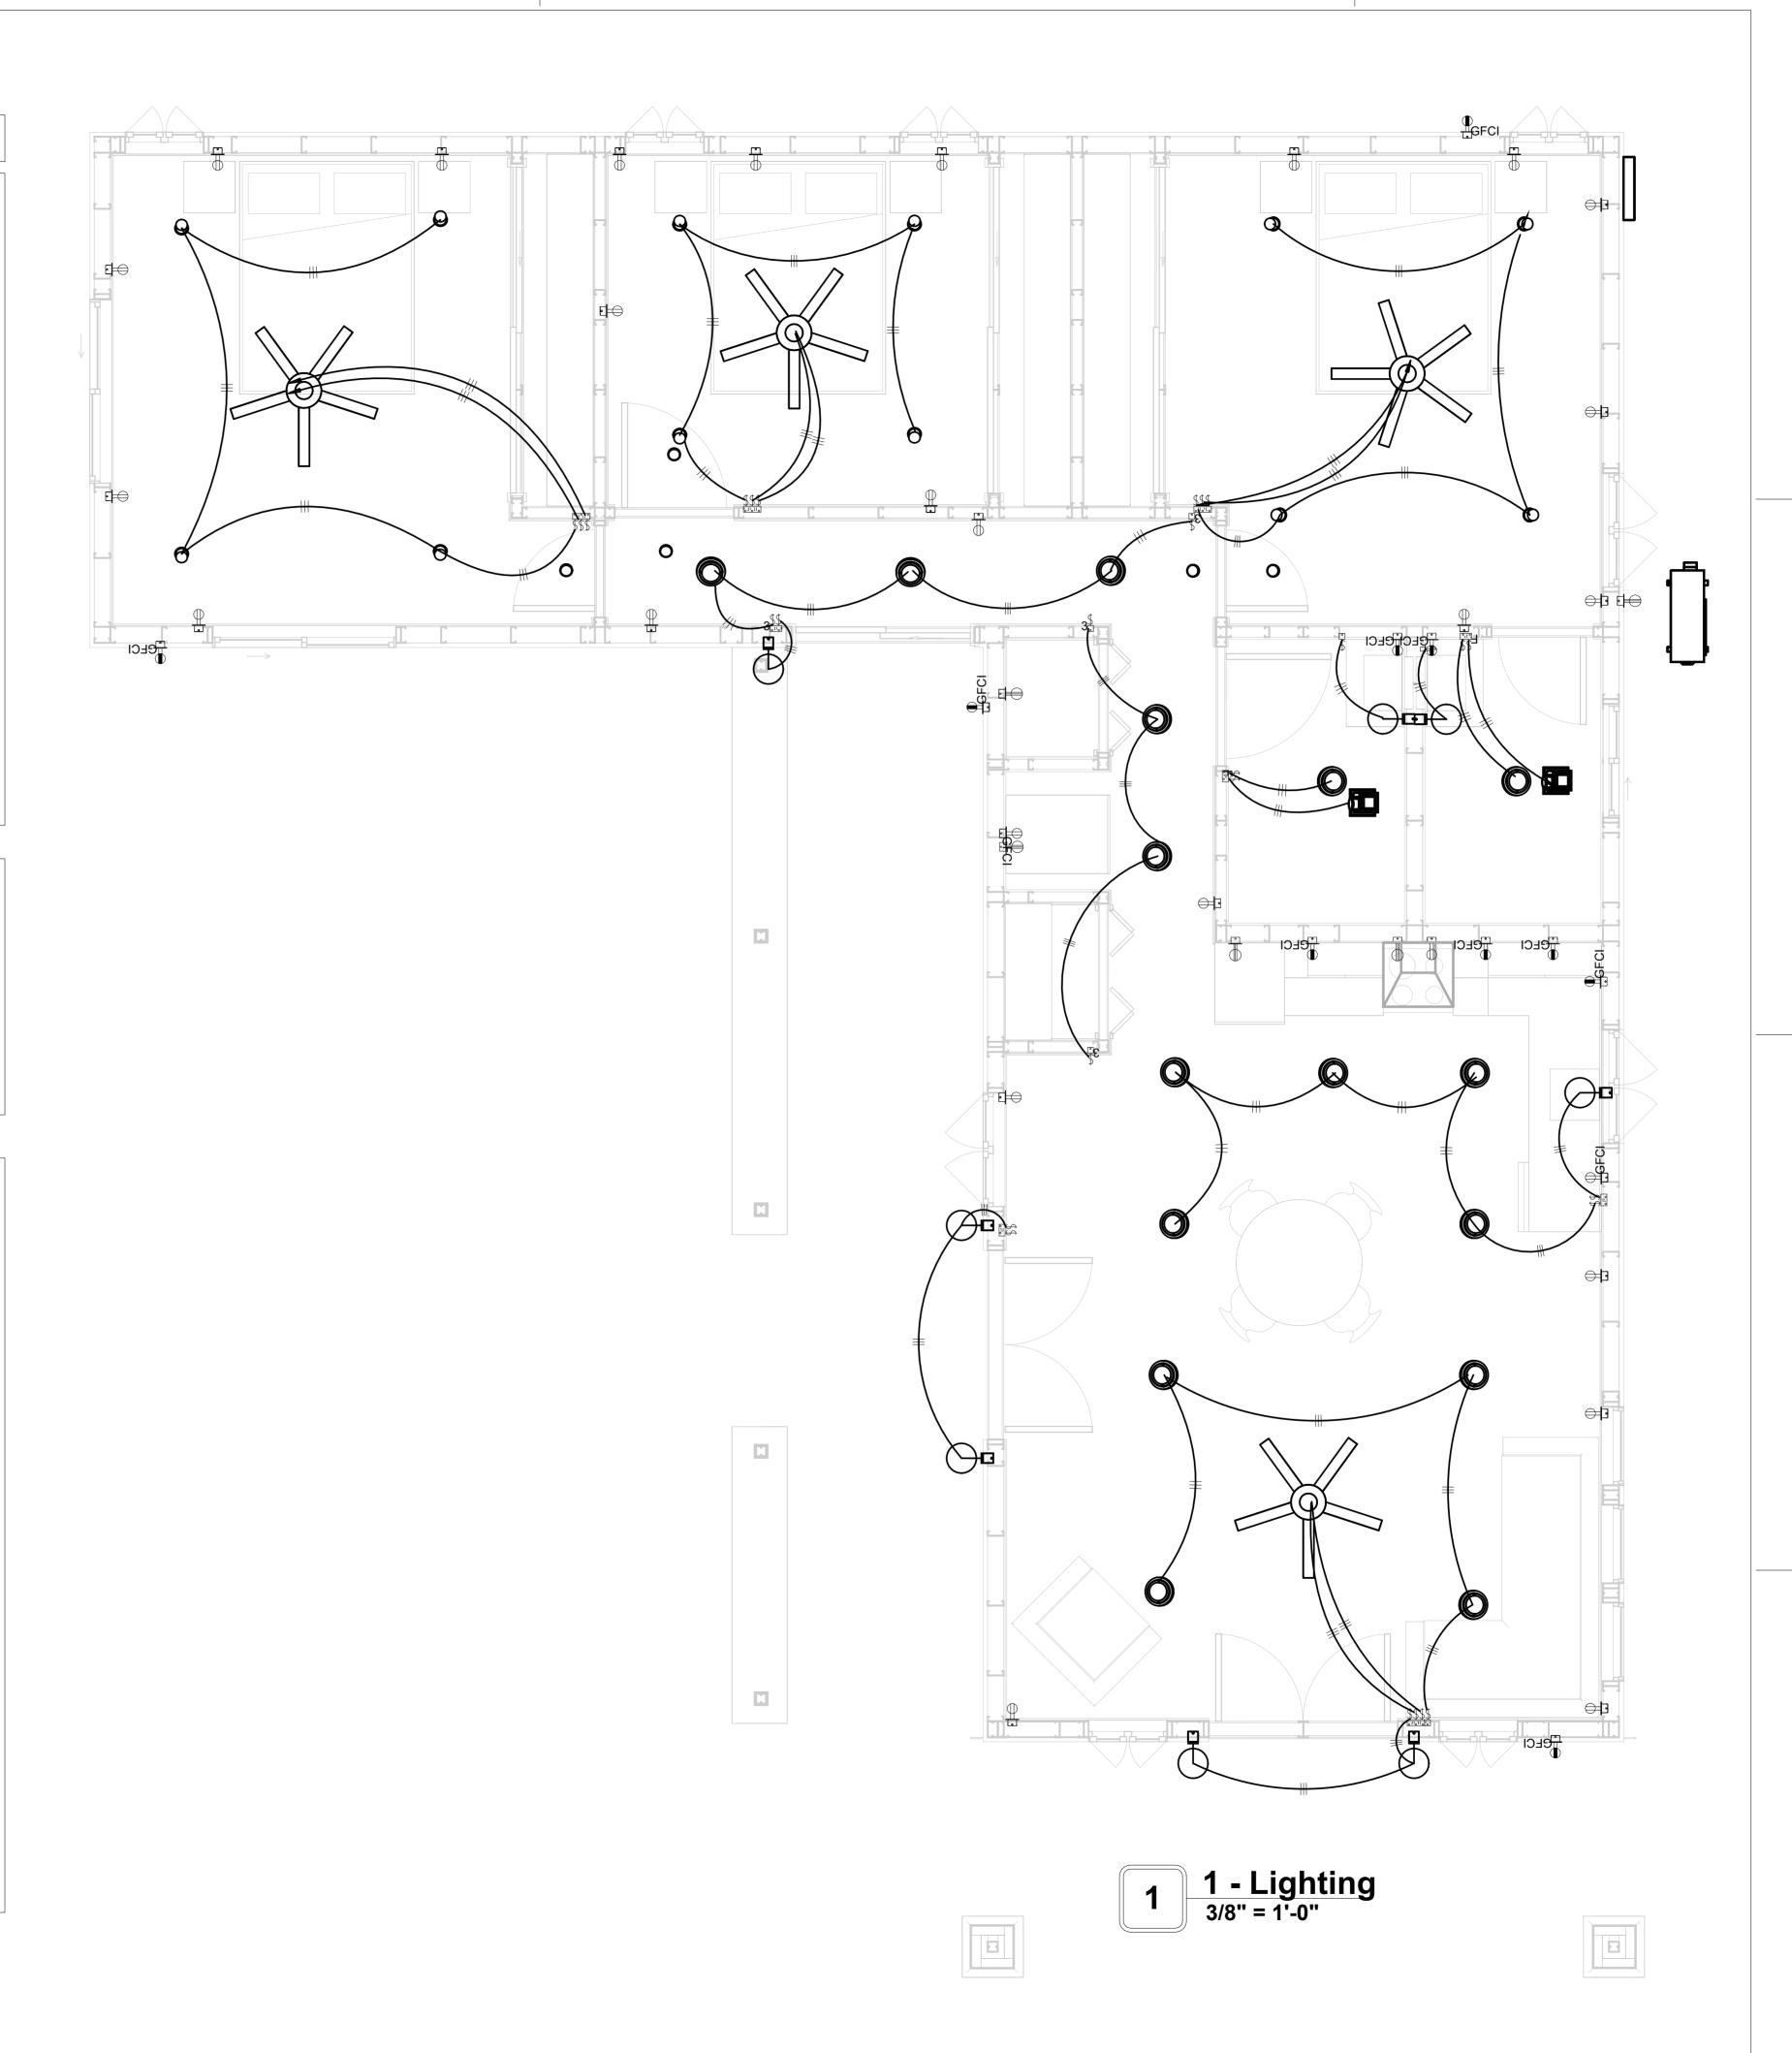



KEY PLAN

NO.	DESCRIPTION	DATE

NOTE:

LEGEND:

PROJECT

133-ORION-1198-3Bd2Ba CRAFTSMAN-PORCH-550

DRAWING NAME

LIGHTING


Owner	CLIENT NAME:
0375_15	PROJECT NUMBER:
3/15/2025 1:34:12 AN	DATE:
Designer	DESIGNED BY:
Author	DRAWN BY:
Checker	CHECKED BY:


E102


NOTES: CONDUIT, CABLE AND WIRING


- Use Metalic Conduits (IMC) for cables running under concrete slabs.
 Use IMC for circuits with high voltage appliances (240 volts and above)
 For circuits with 120 volts consider using EMT or PVC conduits if needed.
 For Low voltage applications up to 50 volts consider using non metalic conduits.
 All conduits to be used in the project must conform to the latest National Electrical Code (NEC),
- 6. All wiring and cables to be used in the project must also conform to the latest National Electrical Code (NEC), 2015.
 7. All cables and wires used should be rated for their respective loading and should be gauged and
- conform to the NEC.


Conduit Schedule						
Туре	Length	Size				
2#12 AWG WIRE	10.67 ft	1/2"ø				
3#8 AWG WIRE	5.73 ft	1/2"ø				
3#10 AWG WIRE	5.62 ft	1/2"ø				
Electrical Metallic Tubing (EMT)	7.99 ft	1/2"ø				
Intermidate Metal Conduit	9.47 ft	1/2"ø				

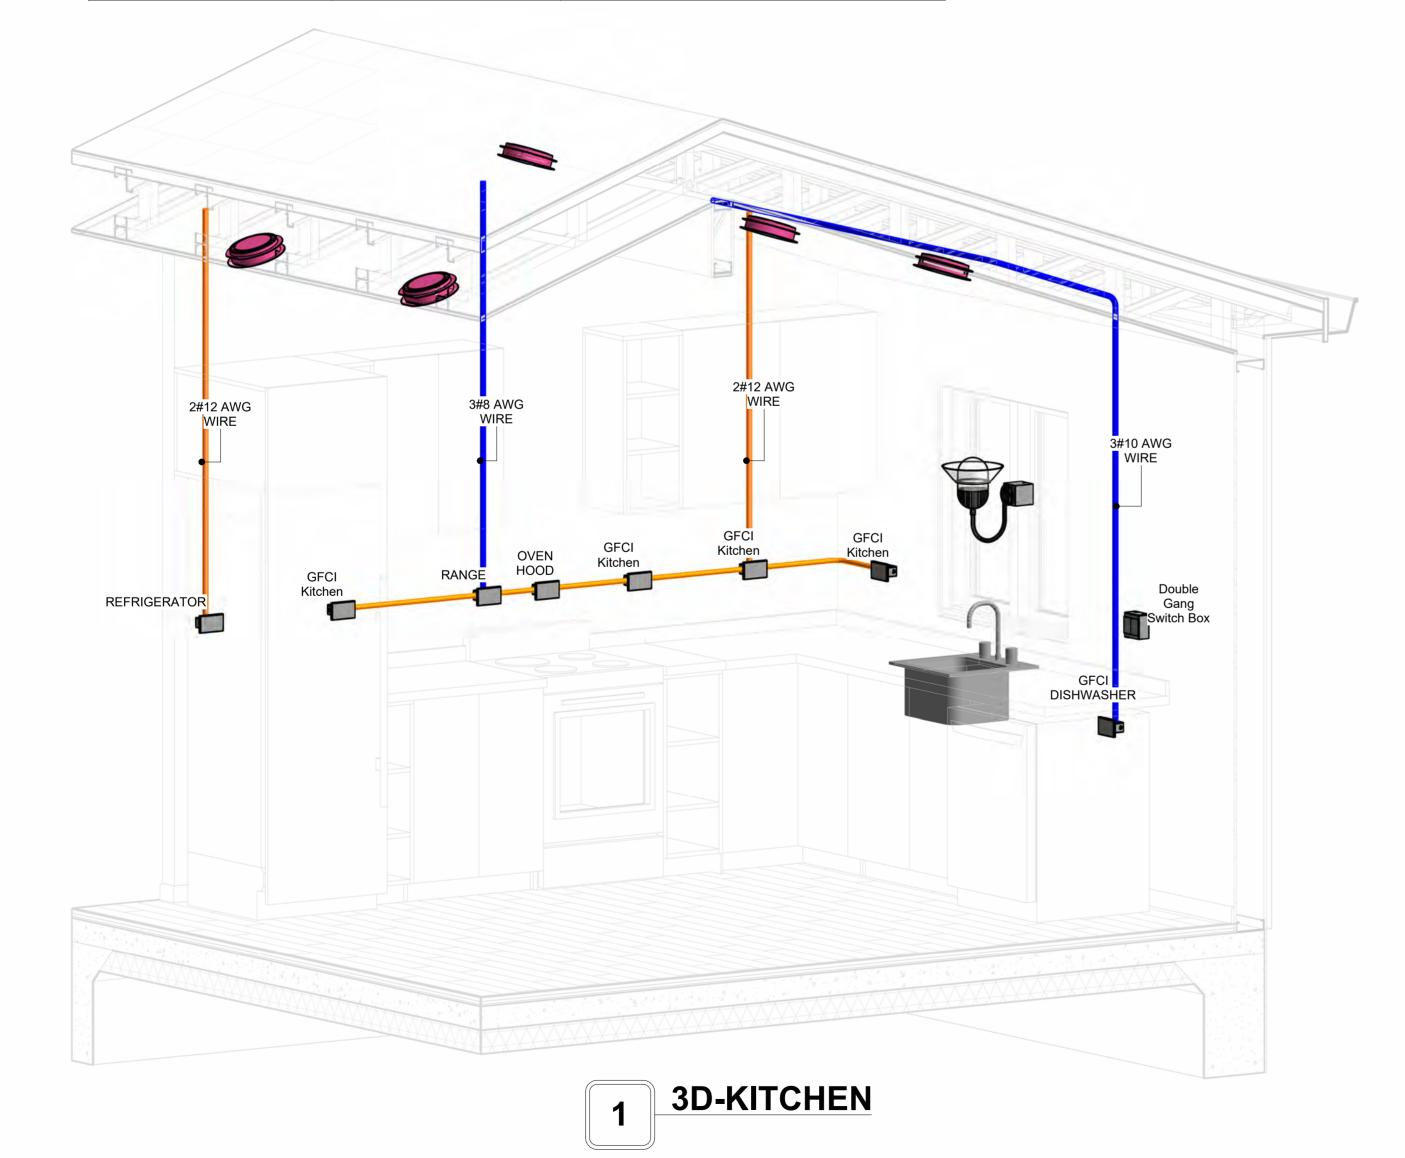


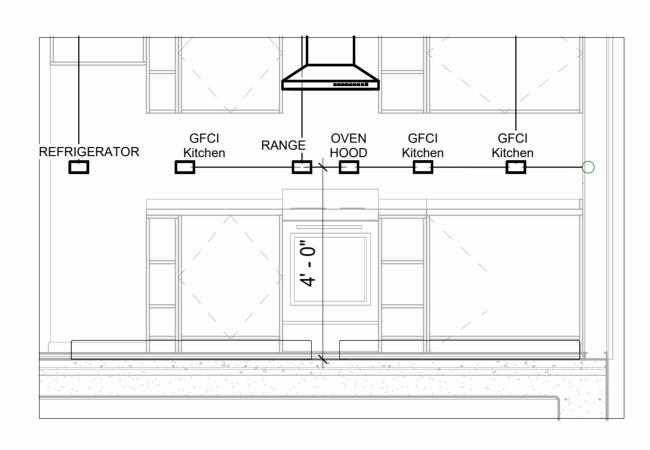


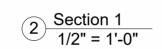

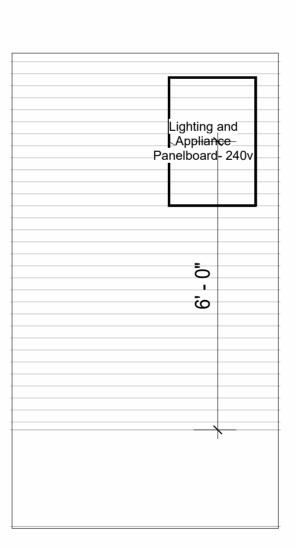

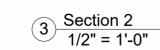


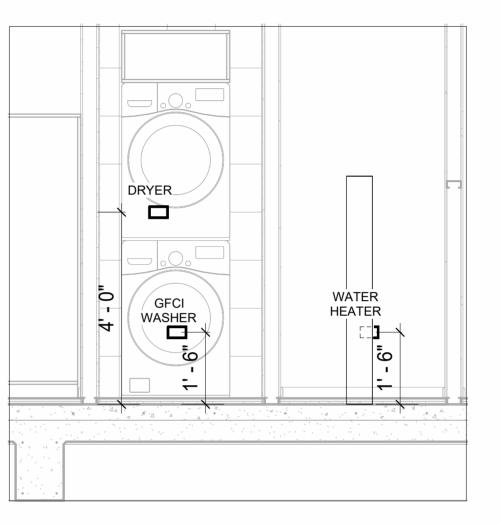

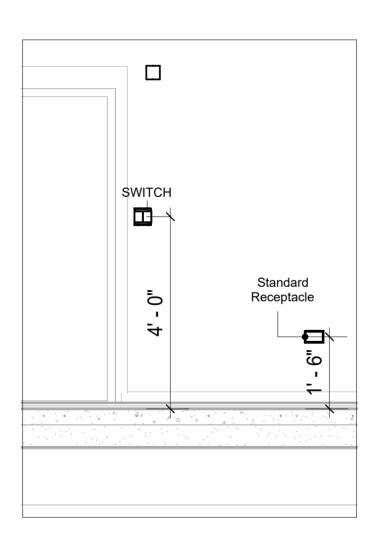

6 Section 4 1/2" = 1'-0"



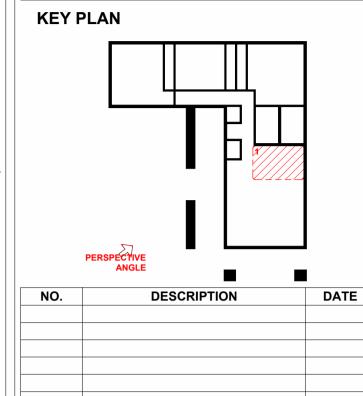

NOTE:

LEGEND:

PROJECT

133-ORION-1198-3Bd2Ba **CRAFTSMAN-PORCH-550**

DRAWING NAME

POWER

CLIENT NAME:	Owner
PROJECT NUMBER:	0375_15
DATE:	3/15/2025 1:34:39 AM
DESIGNED BY:	Designer
DRAWN BY:	Author
CHECKED BY:	Checker

E103

© [2024] [FrameUpNow] . All rights reserved

NOTES: LIGHT

- 1. LIGHT FIXTURES AND LUMINARIES SHALL CONFORM TO THE NEC, THE IRC AND LOCAL SAFETY & BUILDING CODE.
- 2. ALL LIGHTING FIXTURES SHOULD CONFORM TO THE DESIGN ELECTRICAL LOAD AND SHALL BE PROPERLY WIRED AND MOUNTED BY QUALIFIED ELECTRICIAN FOLLOWING MANUFACTURERS SPECIFICATIONS.
- 3. CEILING FANS AND FANS WITH LIGHT WITH WEIGHT EXCEEDING 35 LBS SHOULD BE PROVIDED WITH STRUCTURAL BACKING FOR SUPPORT AND SHALL BE FIXED AS PER MANUFACTURERS SPECIFICATIONS.
- 4. EXTERIOR LIGHTS SHALL CONFORM TO LOCAL BUILDING CODE AND GUIDELINES.

NOTES: SWITCH JUNCTION BOX

- 1. THE MINIMUM SIZE OF JUCTION BOX TO BE USED IS 2"X4"X(1.5" OR 3.5" DEEP) THIS ARE TO BE USED FOR SINGLE GANG SWITCH OR OUTLETS.
- 2. FOR DOUBLE GANG (2 GANG) OUTLETS AND SWITCHS THE MINIMUM SIZE OF THE
- JUCTION BOX TO BE PROVIDED SHALL NOT BE LESS THAN 4"X4"X(1.5" OR 3.5" DEEP)


 3. FOR THREE GANG (3 GANG) OUTLETS AND SWITCHS THE MINIMUM SIZE OF THE JUCTION BOX SHALL NOT BE LESS THAN 6"X4"X(1.5" OR 3.5" DEEP).

Conduit Fitting So	chedule(junction bo	x)
Family	Count	Description
-		•

Electrical Fixture Schedule (SWITCH BOX)	
Туре	Count
Double Gang Switch Box	5
Single Gang Switch Box	5
Triple Gang Switch Box	4

	Lighting Device
Туре	Count
Fan switch	2
Single Pole	22
Three Way	4

Lighting Fixture			
Lighting Fixture Type	Voltage	Electrical Load	Count
Electrical_Lights_Fan-Light1	120 V/1-100 VA- 120 V/1-100 VA	200 A, 120 V/240 V, Single Phase, 3 Wires	4
Lighting_Recessed	120 V/1-60 VA	200 A, 120 V/240 V, Single Phase, 3 Wires	16
SASSO 100 round wallwasher trim	120 V/1-28 VA	200 A, 120 V/240 V, Single Phase, 3 Wires	12
Wall Lamp - Bracket	120 V/1-100 VA	200 A, 120 V/240 V, Single Phase, 3 Wires	8

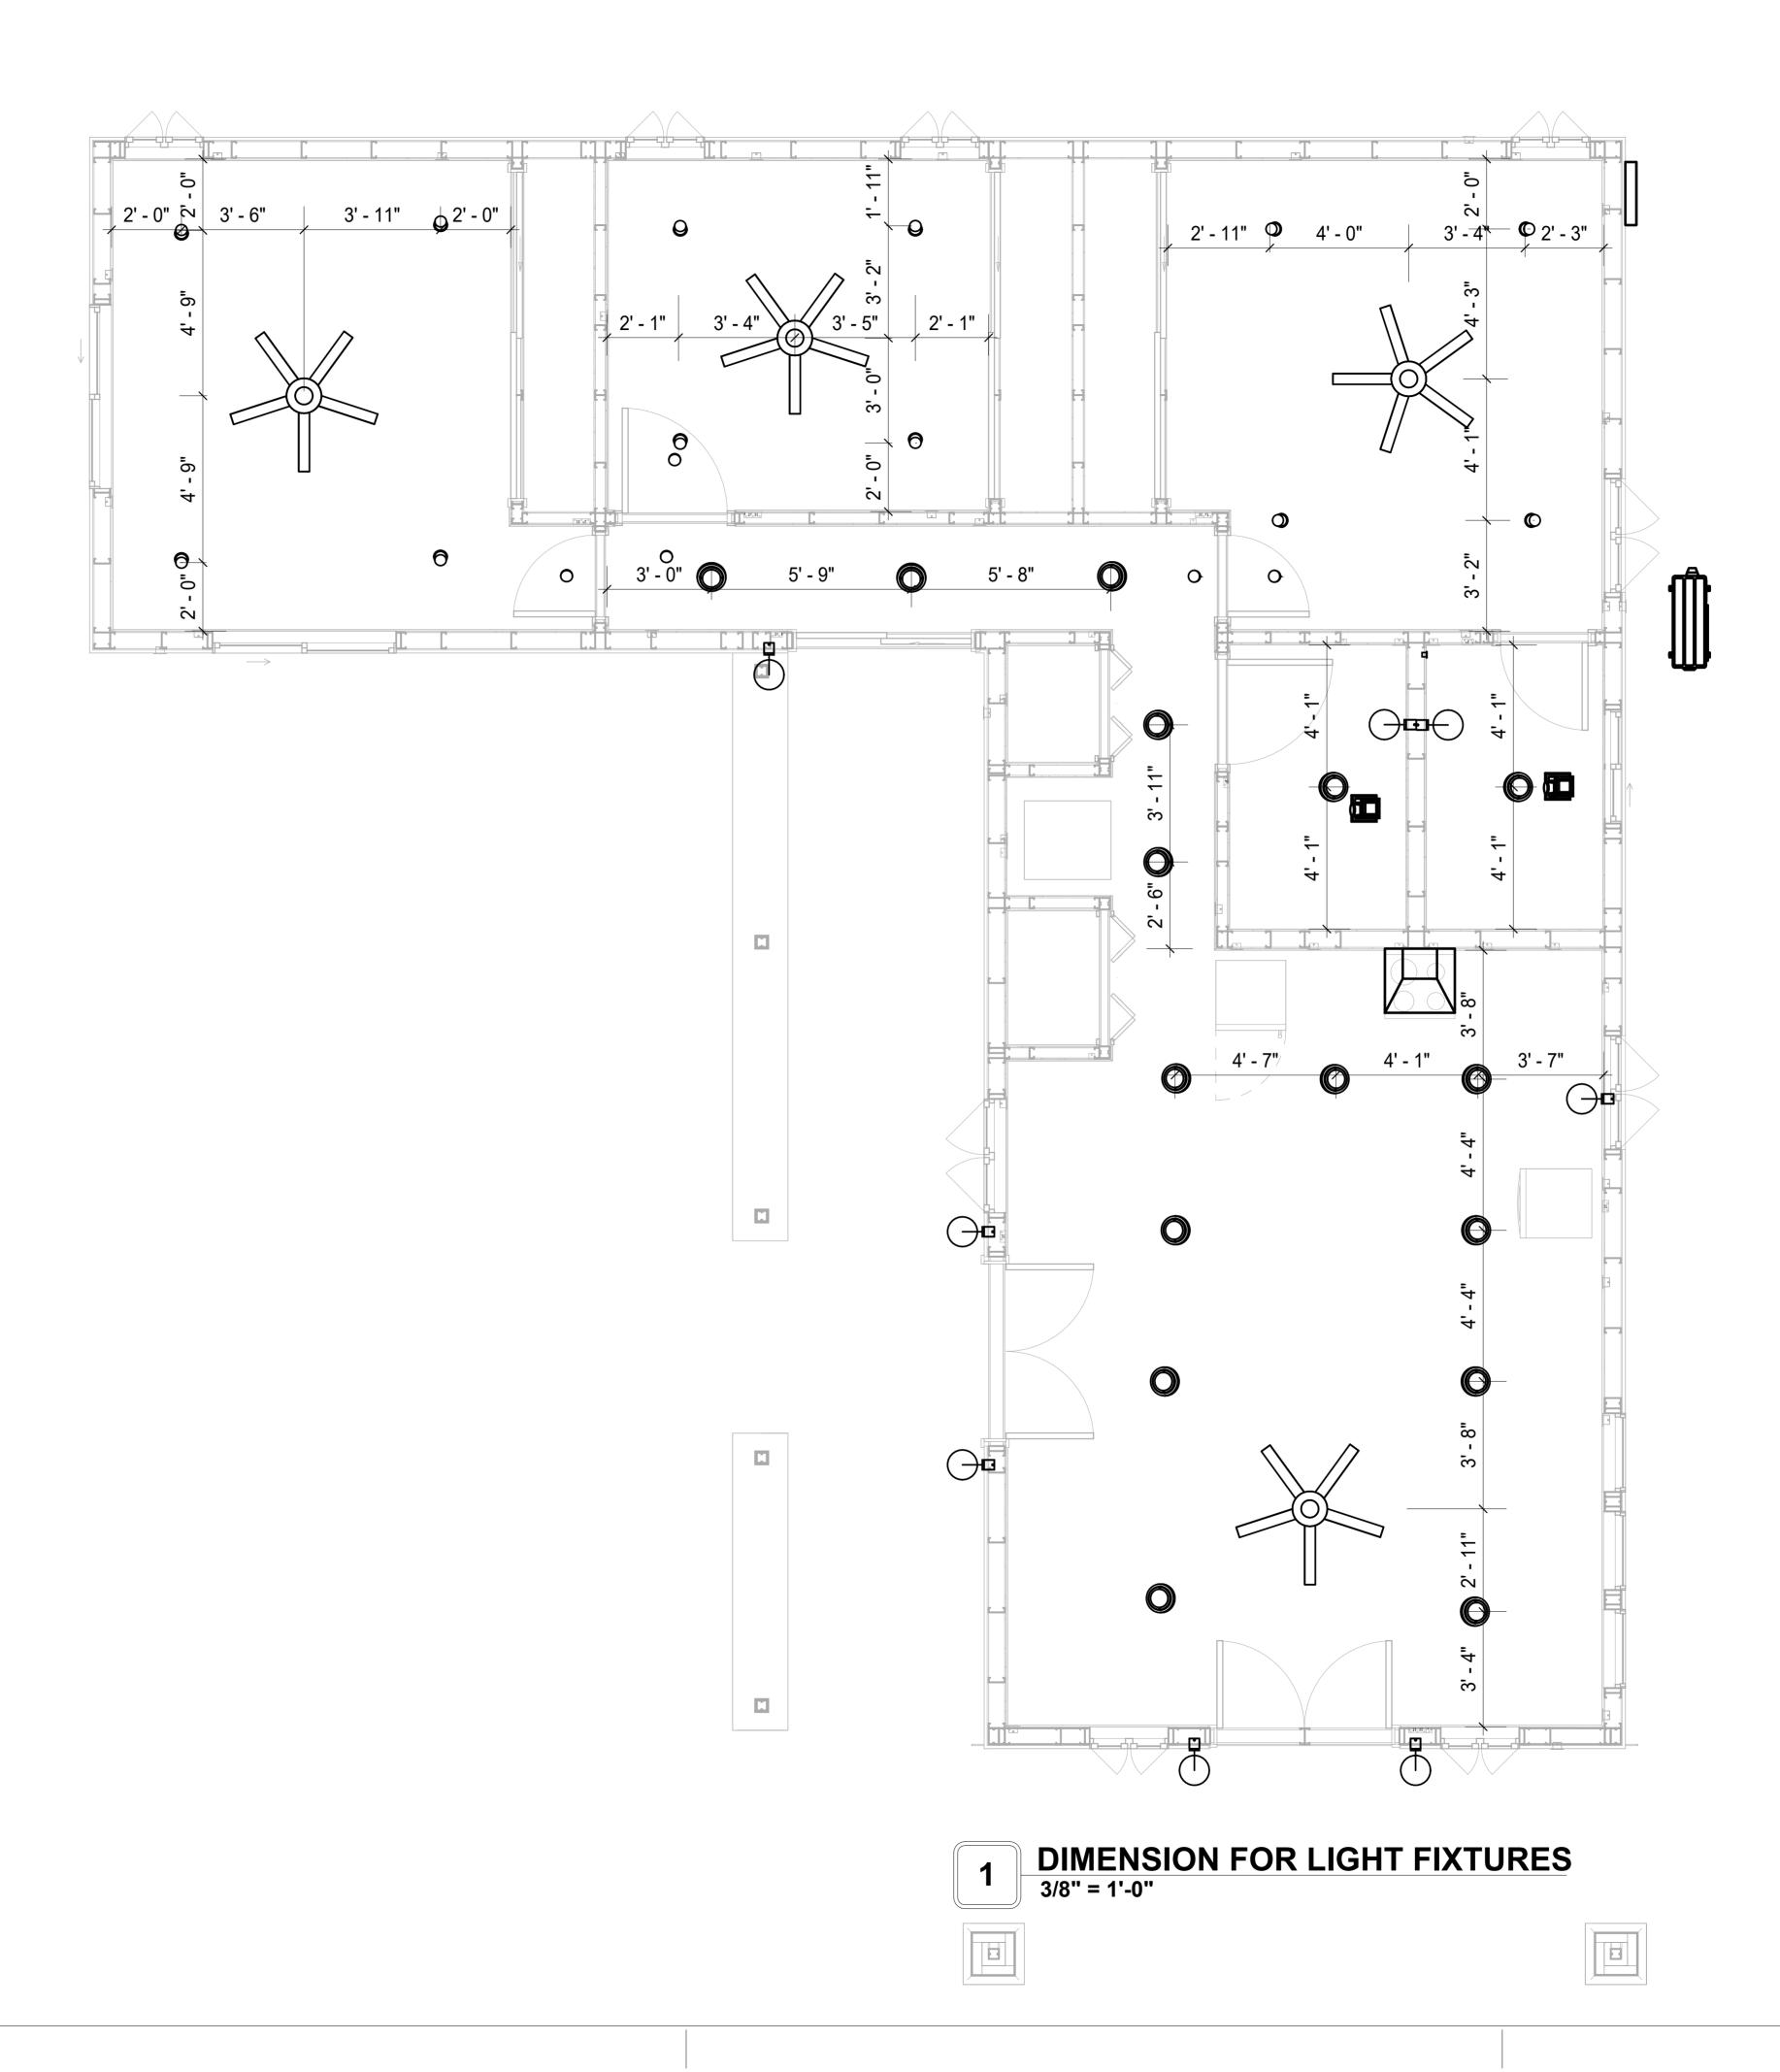



KEY PLAN

NO.	DESCRIPTION	DATE

NOTE:

LEGEND:

PROJECT

133-ORION-1198-3Bd2Ba CRAFTSMAN-PORCH-550

DRAWING NAME

DIMENSION PLAN FOR LIGHT FIXTURES

Owner
0375_15
3/15/2025 1:34:42 AM
Designer
Author
Checker

E104

SCALE: 3/8" = 1'-0"


© [2024] [FrameUpNow] . All rights reserved

NOTES;

- 1. VERIFY EQUIPMENT PLUG CONFIGURATION BEFORE PURCHASING RECEPTACLES
- 2. FOR ALL EQUIPMENT.
- COORDINATE EXACT LOCATION OF LIGHT FIXTURES, WALL SWITCHES, RECEPTACLES AND OTHER DEVICES WITH ARCHITECTURAL DRAWINGS.
 USE METALLIC JUNCTION BOX WITH THE GFCI RECEPTACLES, WITH HIGHT VOLTAGE.

Electrical Fixture Schedule (Receptacle)	
Туре	Count
CONDENSER	1
DRYER	1
GFCI BATH ROOM	2
GFCI DISHWASHER	1
GFCI Kitchen	4
GFCI OUT DOOR	4
GFCI WASHER	1
OVEN HOOD	1
RANGE	1
REFRIGERATOR	1
Standard	23
Standard Receptacle	1
WATER HEATER	1

Electrical Outlet Schedule			
Туре	Circuit Number	Electrical Data	Count
CONDENSER	1,3	240 V/2-1500 VA	1
DRYER	2,4	240 V/2-1500 VA	1
RANGE	5,7	240 V/2-1500 VA	1
GFCI DISHWASHER	8	120 V/1-1200 VA	1
WATER HEATER	9,11	240 V/2-1500 VA	1
GFCI BATH ROOM	10	120 V/1-180 VA	1
GFCI BATH ROOM	12	120 V/1-180 VA	1
Standard	15	120 V/1-180 VA	6
Standard	16	120 V/1-180 VA	7
Standard Receptacle	16	120 V/1-180 VA	1
GFCI WASHER	18	120 V/1-1200 VA	1
REFRIGERATOR	19	120 V/1-1500 VA	1
GFCI Kitchen	20	120 V/1-180 VA	4
OVEN HOOD	20	120 V/1-180 VA	1
Standard	21	120 V/1-180 VA	5
Standard	25	120 V/1-180 VA	5
GFCI OUT DOOR	26	120 V/1-180 VA	4

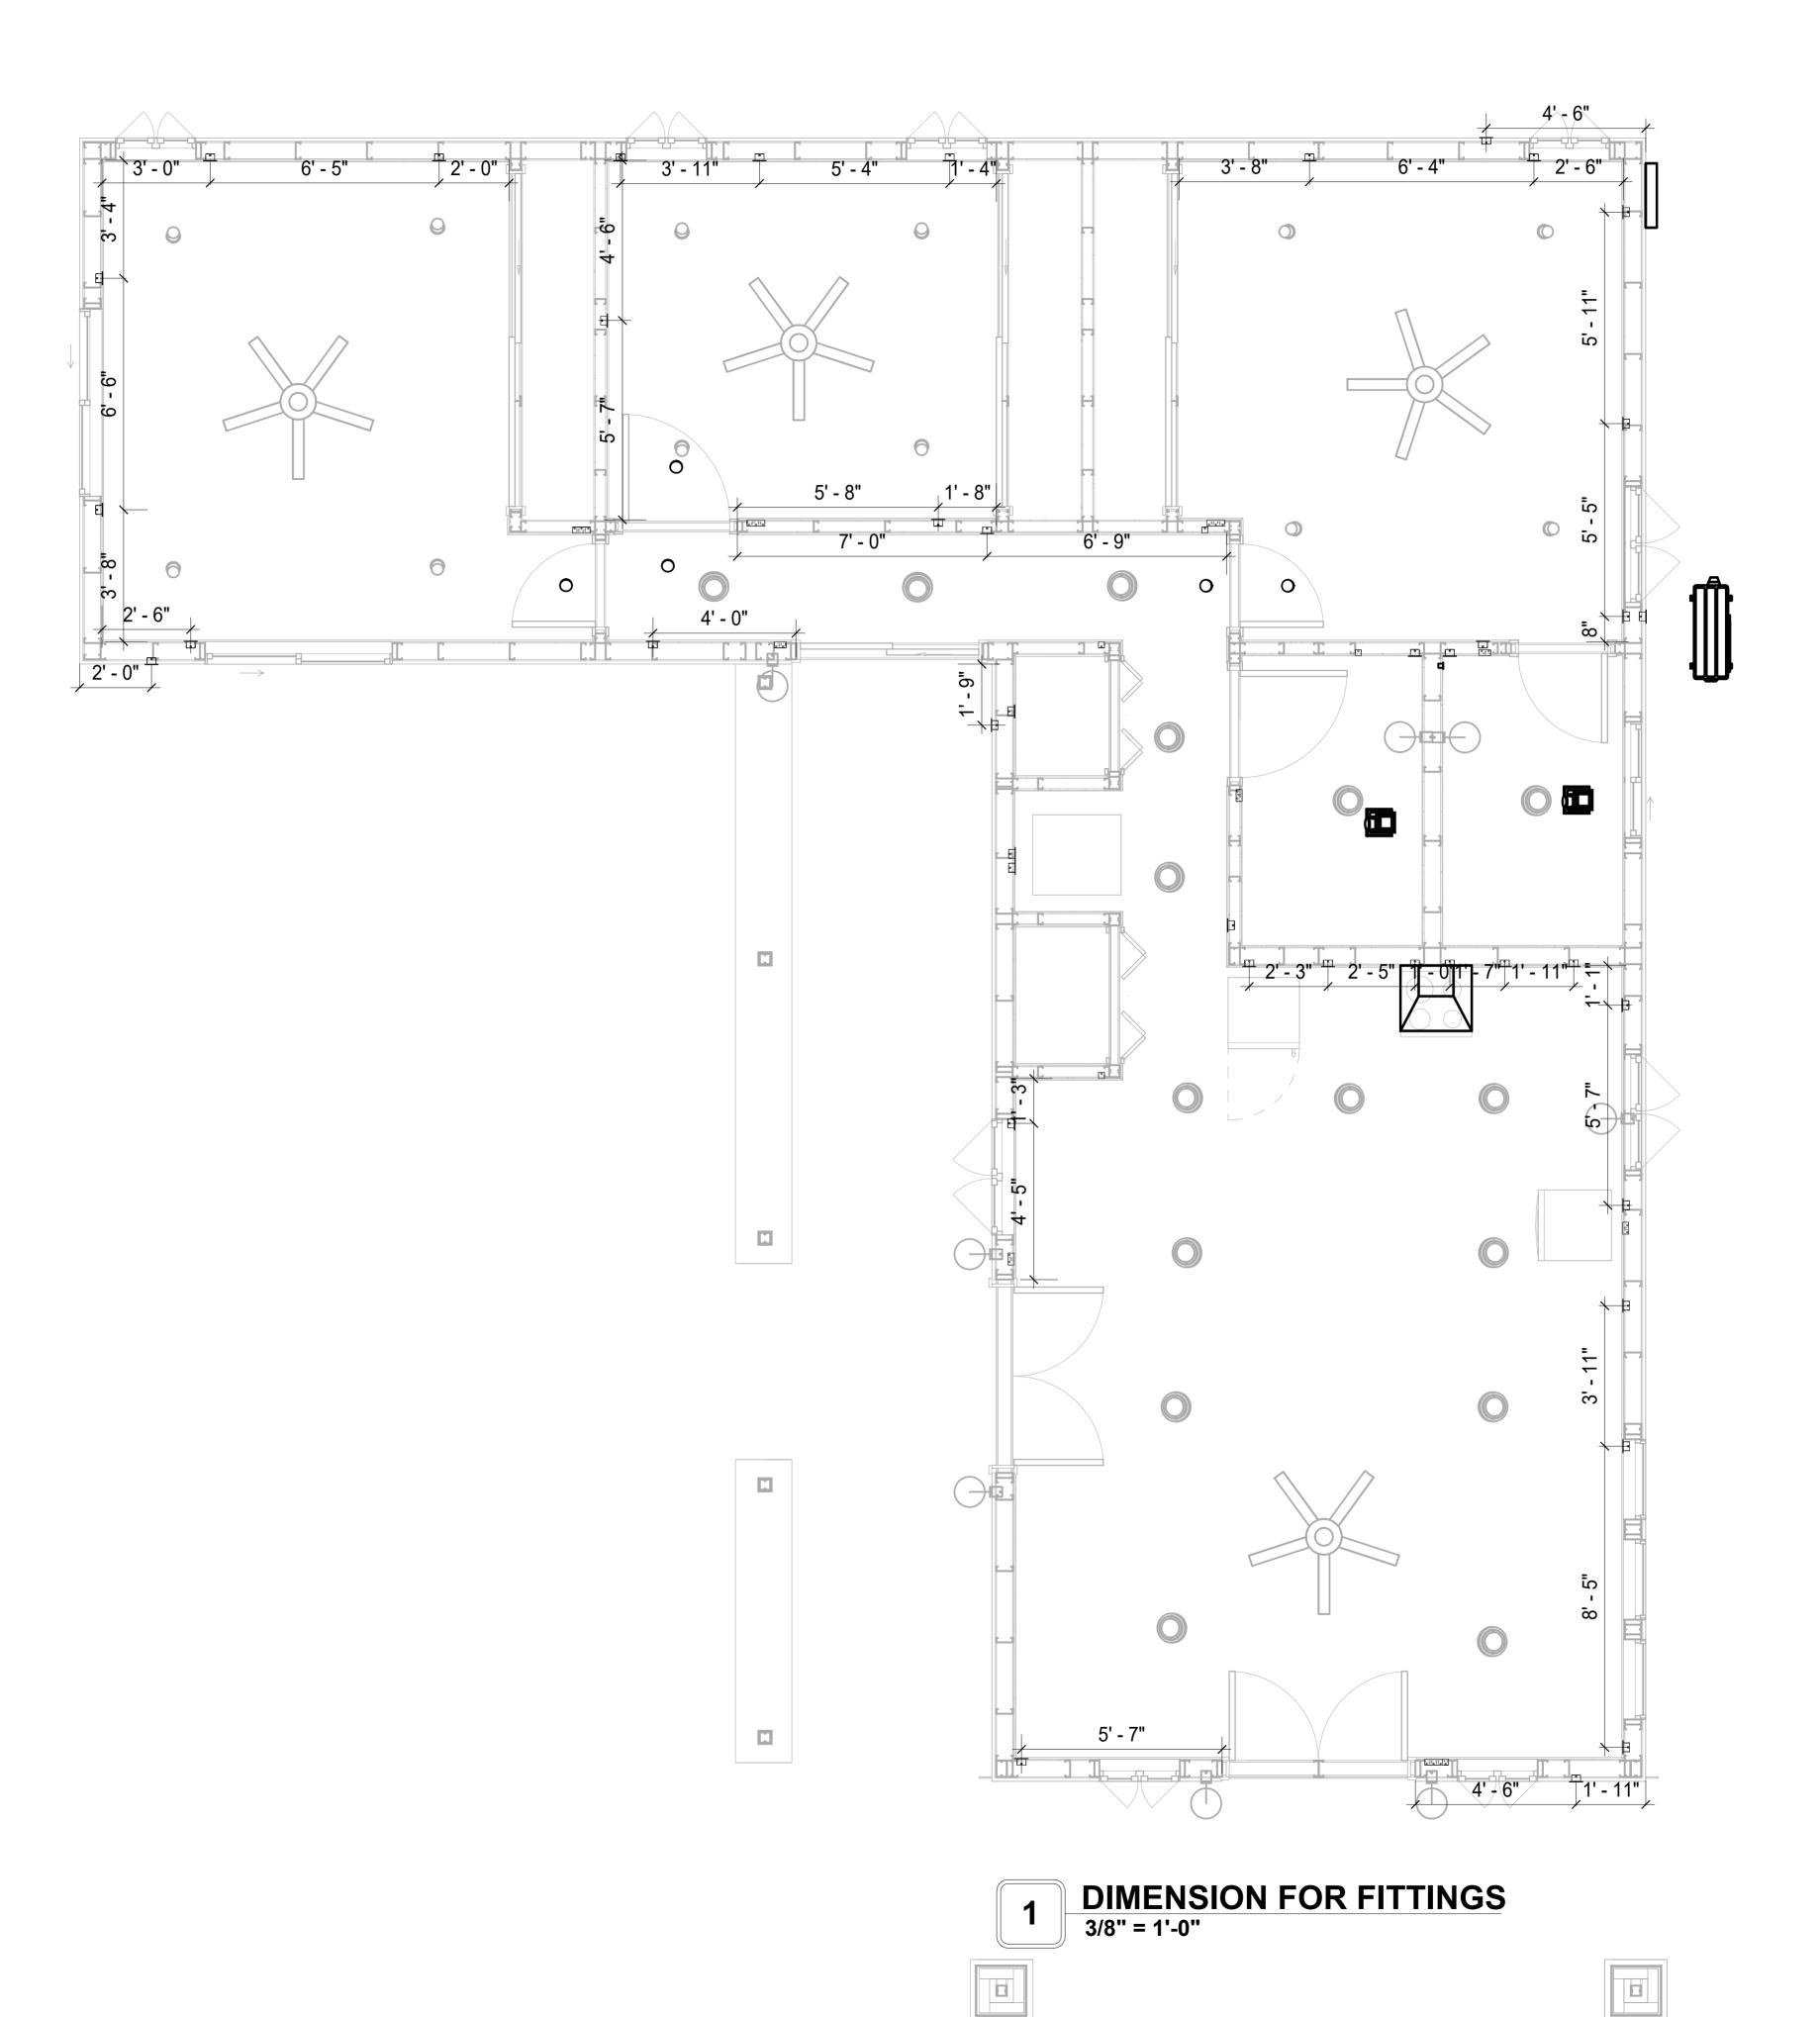



KEY PLAN

NO.	DESCRIPTION	DATE

NOTE:

LEGEND:

PROJECT

133-ORION-1198-3Bd2Ba CRAFTSMAN-PORCH-550

DRAWING NAME

DIMENSION PLAN FOR FITTINGS

0375_15 025 1:34:44 AM
125 1·34·44 ΔM
20 1.07.77 AW
Designer
Author
Checker

E105

© [2024] [FrameUpNow] . All rights reserved

SCALE: 3/8" = 1'-0"

SHEET LIST PIPE COLOR SCHEME	
HEET NUMBER SHEET NAME DOMESTIC COLD WA	
01 NOTE AND SCHEDULE 02 WATER SUPPLY AND SEWAGE SYSTEM SANITARY VENT SANITARY SEWER STORM DRAINAGE GRAY WATER	
GAS LINE	

PLUMBING NOTES

- THE PLUMBING SYSTEM IS DESIGNED TO MEET THE BUILDING'S DOMESTIC WATER SUPPLY, SANITARY DRAINAGE, AND STORM DRAINAGE REQUIREMENTS, AS PER PROJECT SPECIFICATIONS AND APPLICABLE CODES.
- THE SYSTEM INSTALLATION SHALL COMPLY WITH THE LATEST INTERNATIONAL PLUMBING CODE (IPC), INTERNATIONAL RESIDENTIAL CODE (IRC), AND ALL OTHER RELEVANT LOCAL, STATE, AND NATIONAL REGULATIONS.
- ALL PLUMBING WORK SHALL COMPLY WITH THE LATEST EDITION OF THE INTERNATIONAL PLUMBING CODE (IPC) AND THE LOCAL PLUMBING CODE.
- PLUMBING SYSTEMS SHALL BE TESTED AND INSPECTED IN ACCORDANCE WITH THE
- LOCAL PLUMBING CODE REQUIREMENTS.
- PLUMBING FIXTURES SHALL BE INSTALLED WITH THE APPROPRIATE TRIM, FITTINGS, AND ACCESSORIES, AS RECOMMENDED BY THE MANUFACTURER.
- PIPING SHALL BE PROPERLY SUPPORTED AND SECURED TO PREVENT SAGGING,
- MOVEMENT, AND VIBRATION. SHUT-OFF VALVES SHALL BE PROVIDED AT ALL BRANCH CONNECTIONS AND AT THE
- INLET AND OUTLET OF EACH PIECE OF EQUIPMENT.
- BACKFLOW PREVENTION DEVICES SHALL BE INSTALLED AS REQUIRED BY THE LOCAL PLUMBING CODE TO PROTECT THE POTABLE WATER SYSTEM.
- PLUMBING FIXTURES AND EQUIPMENT SHALL BE ACCESSIBLE FOR MAINTENANCE AND
- SERVICING. EXPOSED PLUMBING PIPING AND FIXTURES SHALL BE INSULATED TO PREVENT
- CONDENSATION AND ENERGY LOSS.
- 11. DEAD ENDS IN THE DRAINAGE SYSTEM MUST BE AVOIDED, EXCEPT WHERE NECESSARY TO INSTALL A CLEANOUT IN AN ACCESSIBLE LOCATION, AND MUST HAVE A VENTED CONNECTION TO THE OUTSIDE ATMOSPHERE.
- 12. THE VERTICAL DEFLECTION OF PVC PIPE MUST NOT EXCEED 5%, AND NO DEFLECTION IS PERMITTED FOR IRON PIPE.
- 13. WORK MUST BE PROPERLY COORDINATED WITH OTHER TRADES TO AVOID CONFLICTS, REFERRING TO THE ARCHITECTURAL AND STRUCTURAL DRAWINGS FOR INFORMATION REGARDING CEILING ELEVATIONS, SPACE CLEARANCES, WALL AND PARTITION LOCATIONS, ETC.
- 14. ALL FIXTURES SHALL HAVE ACCESSIBLE STOPS.
- DOMESTIC WATER PIPING SHALL BE PEX, AND PVC PIPING IS NOT ACCEPTABLE FOR
- 16. VENT TERMINATIONS SHALL BE LOCATED AT LEAST 10 FEET FROM OR 3 FEET ABOVE ANY OPERABLE WINDOW, DOOR OPENING, AIR INTAKE, OR VENT SHAFT, AND AT LEAST 3 FEET IN EVERY DIRECTION FROM ANY LOT LINE, ALLEY, OR STREET.
- 17. PIPE AND FITTINGS UTILIZED IN THE WATER SUPPLY SYSTEM SHALL HAVE A MAXIMUM OF 8 PERCENT LEAD.
- 18. ACRYLONITRILE BUTADIENE STYRENE (ABS) SHALL BE USED FOR THE SEWERAGE AND
- VENTILATION SYSTEM. CROSS-LINKED POLYETHYLENE (PEX) SHALL BE USED FOR THE WATER SUPPLY SYSTEM.
- POLYVINYL CHLORIDE (PVC) SHALL BE USED FOR THE RAIN WATER SYSTEM.
- 21. THE MIMIMUM WATER SUPPLY DEPTH UNDER FLOOR FINISH SHOUD BE 1/2".
- 22. ANY PIPE INSTALLED UNDERGROUND MUST HAVE AT LEAST 12 INCHES OF CLEARANCE BETWEEN THE OUTSIDE OF THE PIPE AND ANY OTHER UNDERGROUND STRUCTURE.
- THE MINIMUM CLEARANCE BETWEEN COLD AND HOT WATER LINES IN RESIDENTIAL HOMES MAINTAIN A MINIMUM DISTANCE OF 6 INCHES.
- 24. HORIZONTAL SEPARATION BETWEEN WATER AND SEWER LINES: A MINIMUM OF 12 INCHES BETWEEN POTABLE WATER SUPPLY LINES (COLD AND HOT WATER) AND SANITARY SEWER LINES.

ABBREVIATIONS

Ø	DIAMETER
ABS	ACRYLONITRILE BUTADIENE STYRENE
ABV	ABOVE
AD	AREA DRAIN
AFF	ABOVE FINISHED FLOOR
ALT	ALTERNATE
BFF	BELOW FINISHED FLOOR
BLW	BELOW
CO	CLEAN OUT
CW	COLD WATER
D	DEGREE
DFU	DRANAGE FIXTURE UNIT
DIA	DIAMETER
DN	DOWN
FCO	FLOOR CLEAN OUT
FD	FLOOR DRAIN
FL	FLOOR
FS	FLOOR SINK
FT	FOOT/FEET
HB	HOSE BIB
HW	HOT WATER
IN	INCH
MIN	MINIMUM
NO	NUMBER
NTS	NOT TO SCALE
PEX	CROSS-LINKED POLYETHYLENE
PLBG	PLUMBING
PVC	POLYVINYL CHLORIDE
QTY	QUANTITY
RD	ROOF DRAIN
RED	REDUCER
RM	ROOM
RW	RAIN WATER
SF	SQUARE FOOT
V	VENT
VTR	VENT THROUGH ROOF
W	WASTE
WCO	WALL CLEAN OUT
WSFU	WATER SUPPLY FIXTURE UNIT

PLUMBING LEGEND					
D	CAP				
△	BEND 45 DEG				
D	BEND 90 DEG				
	TEE REDUCING				
	TEE				
	CLEAN TWO-WAY				
	WYE 45 DEG				
	WYE 45 DEG DOUBLE				
	WYE COMBINATION				
	P-TRAP				

PIPE SCHEDULE						
MATERIAL	DIAMETER	LENGTH				
ACRYLONITRILE BUTADIENE STYRENE (ABS)	1 1/2"	23 FT				
ACRYLONITRILE BUTADIENE STYRENE (ABS)	2"	37 FT				
ACRYLONITRILE BUTADIENE STYRENE (ABS)	3"	29 FT				
CROSS-LINKED POLYETHYLENE (PEX)	1/2"	89 FT				
CROSS-LINKED POLYETHYLENE (PEX)	3/4"	63 FT				
POLYVINYL CHLORIDE - RIGID	2"	115 FT				

F	ITTING SCHEDULE	
FITTING	SIZE	QTY
DOMESTIC COLD WATER		
DOMESTIC COLD WATER	4/0" ~ 4/0" ~	0
PEX 90 DEGREE ELBOW	1/2"ø-1/2"ø	8
PEX 90 DEGREE ELBOW PEX TEE ELBOW	3/4"ø-3/4"ø 1/2"ø-1/2"ø-1/2"ø	10
PEX TEE ELBOW	3/4"ø-3/4"ø-3/4"ø	4 4
PEX TRANSITION ELBOW	3/4 Ø-3/4 Ø-3/4 Ø 3/4"Ø-1/2"Ø	3
PEX TRANSITION ELBOW	3/4 Ø-1/2 Ø	J
DOMESTIC HOT WATER		
PEX 90 DEGREE ELBOW	1/2"ø-1/2"ø	11
PEX 90 DEGREE ELBOW	3/4"ø-3/4"ø	5
PEX TEE ELBOW	1/2"ø-1/2"ø-1/2"ø	4
PEX TEE ELBOW	3/4"ø-3/4"ø-3/4"ø	2
PEX TRANSITION ELBOW	3/4"ø-1/2"ø	3
RAIN WATER		
PVC 90 DEG BEND ELBOW	2"ø-2"ø	28
PVC TEE ELBOW	2"ø-2"ø-2"ø	2
SEWAGE ABS 90 DEGREE BEND ELBOW	1 1/2"ø-1 1/2"ø	2
ABS 90 DEGREE BEND ELBOW	2"ø-2"ø	3
ABS 90 DEGREE BEND ELBOW	3"ø-3"ø	2
ABS P-TRAP	1 1/2"ø-1 1/2"ø	3
ABS P-TRAP	2"ø-2"ø	2
ABS REDUCER ELBOW	2"ø-1 1/2"ø	1
ABS REDUCER ELBOW	3"ø-1 1/2"ø	1
ABS REDUCER ELBOW	3"ø-2"ø	<u></u>
ABS TEE ELBOW	2"ø-2"ø	1
ABS TEE ELBOW	3"ø-3"ø-3"ø	2
ABS TEE REDUCER ELBOW	3"ø-3"ø-1 1/2"ø	2
ABS TEE REDUCER ELBOW	3"ø-3"ø-2"ø	1
ABS TRAP P	1 1/2"ø-1 1/2"ø	2
WASTE DOUBLE TEE	1 1/2"ø-1 1/2"ø-1 1/2"ø	
WASTE DOUBLE TEE	2"ø-2"ø-2"ø	1
WASTE DOUBLE TEE	3"ø-3"ø-3"ø-3"ø	1
VENT		
ABS VENT CAP ELBOW	1 1/2"ø	1
ABS VENT CAP ELBOW	2"ø	2
ABS VENT CAP ELBOW	3"ø	

FIXTLIRE	CONNECTION	J SCHEDI II E

W V TRAP CW HW QTY DFU TOT. WFU TOT.

NOTES

FAMILY

						-			
DISHWASHER	2"	1-1/2"	1-1/2"	1/2"	1/2"	1	0		DRAIN TO SEWER SEE PLANS
DRYER	N/A	N/A	N/A	N/A	N/A	1	0		
HANGING PIPES CLAMP						20	0		
SHOWER TRAY	2"	1-1/2"	1-1/2"	1/2"	1/2"	2	0		
SHOWER TRIM	-	-	-	1/2"	1/2"	2	0		
SINK ISLAND SINGLE	2"	1-1/2"	1-1/2"	1/2"	1/2"	1	0		
VANITY SINK	2"	1-1/2"	1-1/2"	1/2"	1/2"	2	0		
WASHER	2"	1-1/2"	2"	1/2"	1/2"	1	0		DRAINS TO GRAY WATER OR SEWER SEE PLANS
WATER CLOSET	3"	2"	3"	1/2"	1/2"	2	0		
WATER HEATER	N/A	N/A	N/A	3/4"	3/4"	1	0		

FIXTURE SCHEDULE						
FIXTURE QTY DESCRIPTION						
DISHWASHER	1	DRAIN TO SEWER SEE PLANS				
DRYER	1					
HANGING PIPES CLAMP	20					
SHOWER TRAY	2					
SHOWER TRIM	2					
SINK ISLAND SINGLE	1					
VANITY SINK	2					
WASHER	1	DRAINS TO GRAY WATER OR SEWER SEE PLANS				
WATER CLOSET	2					
WATER HEATER	1					

ACCESSORIES & FITTINGS SCHEDULE					
FIXTURE QTY DESCRIPTIONS					
DISHWASHER CONNECTOR	1				
LAUNDRY SWEAT CONNECTOR	1				
SHUTOFF VALVE	8				

PLUMBING SCHEDULE					
FIXTURE	TRAP	WASTE	VENT	C.W	H.W
DICLIMACLIED	4.4/01	011	4.4/0!!	4 /0!!	4 /011
DISHWASHER	1-1/2"	2"	1-1/2"	1/2"	1/2"
DRYER	N/A	N/A	N/A	N/A	N/A
SHOWER TRAY	1-1/2"	2"	1-1/2"	1/2"	1/2"
SHOWER TRIM	-	-	-	1/2"	1/2"
SINK ISLAND SINGLE	1-1/2"	2"	1-1/2"	1/2"	1/2"
VANITY SINK	1-1/2"	2"	1-1/2"	1/2"	1/2"
WASHER	2"	2"	1-1/2"	1/2"	1/2"
WATER CLOSET	3"	3"	2"	1/2"	1/2"
WATER HEATER	N/A	N/A	N/A	3/4"	3/4"

V	WATER FIXTURE UNIT SCHEDULE					
FAMILY	QTY	UNIT VALUE	TOTAL			
DISHWASHER	1		0			
DRYER	1		0			
HANGING PIPES CLAMP	20		0			
SHOWER TRAY	2		0			
SHOWER TRIM	2		0			
SINK ISLAND SINGLE	1		0			
VANITY SINK	2		0			
WASHER	1		0			
WATER CLOSET	2		0			
WATER HEATER	1		0			

WASTE FIXTURE UNIT SCHEDULE				
FAMILY	QTY	DFU VALUES	TOTAL	
DISHWASHER	4		0	
	1		0	
DRYER	1		0	
HANGING PIPES CLAMP	20		0	
SHOWER TRAY	2		0	
SHOWER TRIM	2		0	
SINK ISLAND SINGLE	1		0	
VANITY SINK	2		0	
WASHER	1		0	
WATER CLOSET	2		0	
WATER HEATER	1		0	



KEY PLAN

NO.	DESCRIPTION	DATE

NOTE:

LEGEND:

PROJECT

133-Orion-1198-3Bd/1Ba Craftsman-Porch-550

DRAWING NAME


NOTE AND SCHEDULE

CLIENT NAME:

PROJECT NUMBER:	00375_15
DATE:	3/13/2025 4:38:52 PM
DESIGNED BY:	Designer
DRAWN BY:	Author
CHECKED BY:	Checker


P101

SCALE: 1/2" = 1'-0"

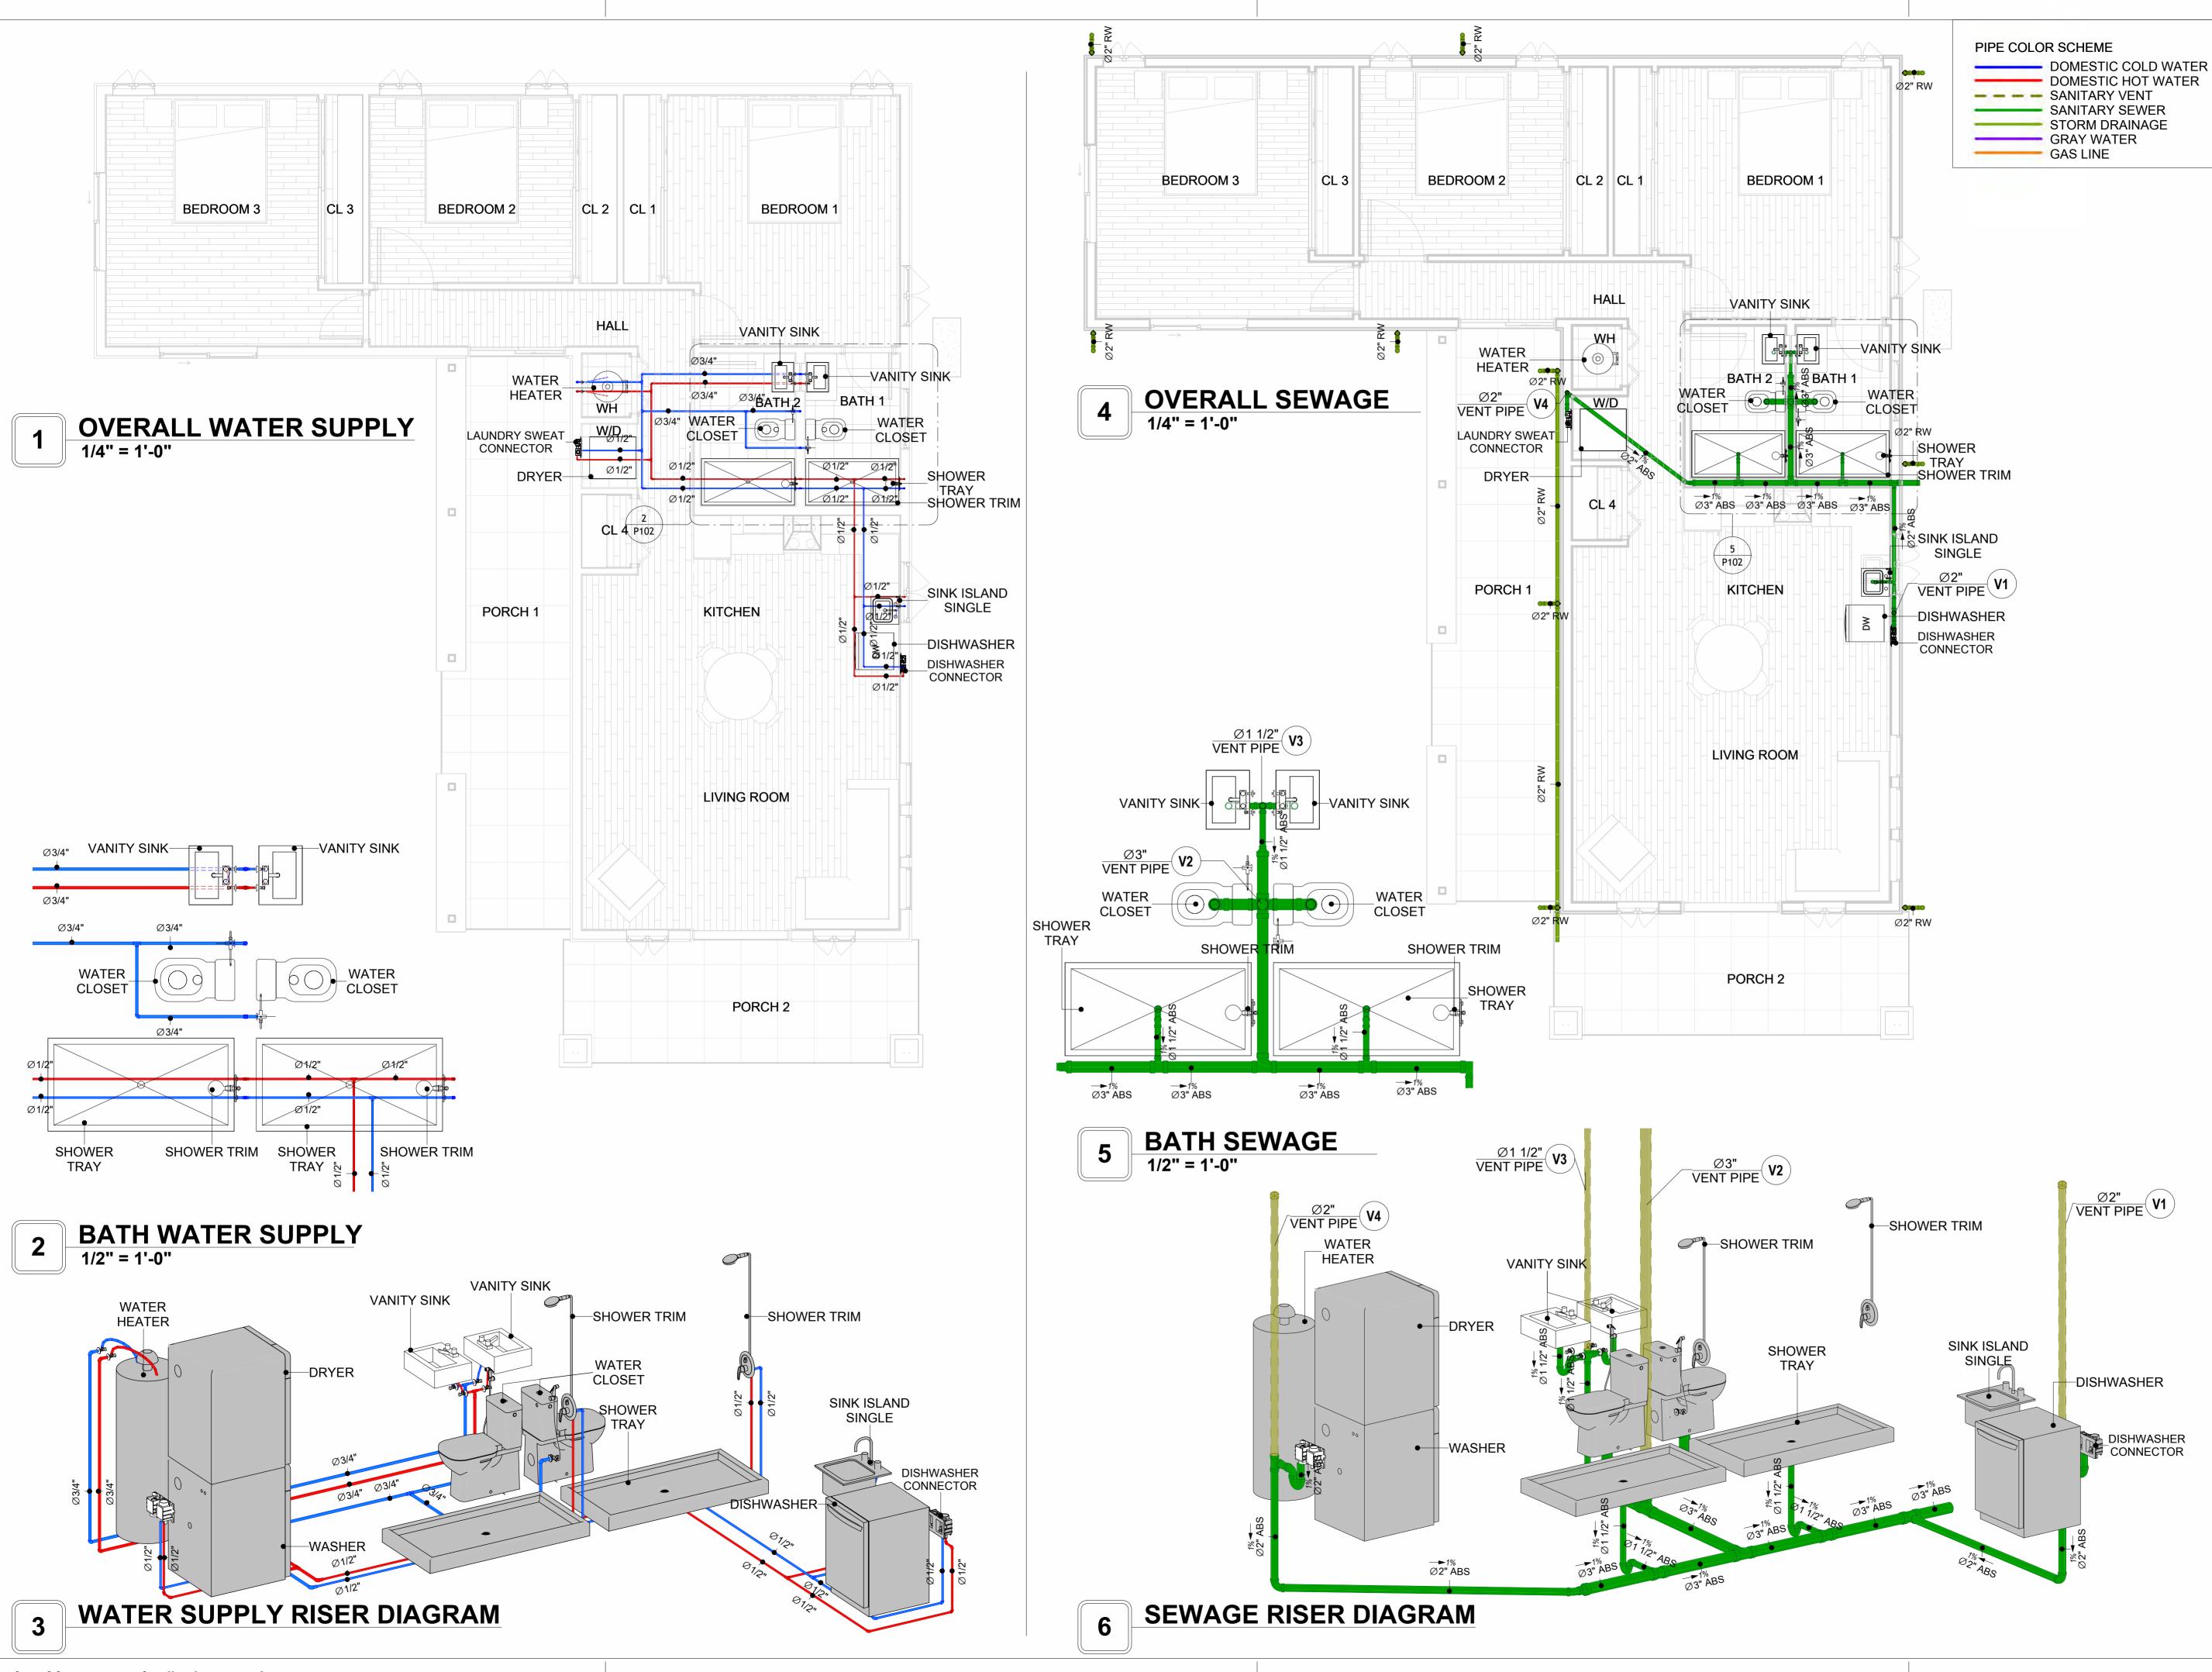



KEY PLAN

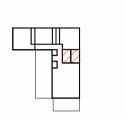

NO.	DESCRIPTION	DATE

NOTE:

LEGEND:

PROJECT

133-Orion-1198-3Bd/1Ba Craftsman-Porch-550

DRAWING NAME

WATER SUPPLY AND SEWAGE SYSTEM

CLIENT NAME:

PROJECT NUMBER: 00375_15

DATE: 3/13/2025 4:39:24 PM

DESIGNED BY: Designer

DRAWN BY: Author

CHECKED BY: Checker

P102

Materials Shopping List

Please print and take this Materials Shopping List to your favorite Home Depot and ask for assistance in selecting the materials, fixtures and fittings to complete your new home.

Record your selection and the price of the item. Then do the math to determine the cost for your selections and the total cost of finishing your home.

Have It Your Way!

The material types listed in this document were selected based on personal preferences. The Customer is encouraged to make changes to the material types in accordance with local customs, regulations, and personal preferences.

Have It Your Way!



20 good reasons to frame a home with metal and not wood



Why build your ADU with metal vs wood	Wood	Metal	Explanation
1 DIY Construction Benefit		~	The wall frames, trusses and beams can be erected in a just a few days
2 Minimal Construction Skills Required		~	Pre-assembled walls and trusses require no specialized skills to errect
3 Build as DIY, Hybrid or by a General Contractor		~	Do it yourself, Hybrid (involve special contractors) or hire a General Contractor
4 Build It As You Can Afford It		~	Impervious to Weather - build as you have the time and money
5 Up Front Cost of Framing Materials	\checkmark		As to only the framing material, wood is less expensive
6 Total Cost To Build		~	Savings in time, labor, and other areas make light gauge steel LESS expensive
7 Termites and wood boring insects		~	Termites, carpenter ants and wood boring insects eat wood, not metal
8 Mold resistant		~	Metal does not attract mold
9 Damage caused by exterior and interior flooding		~	Metal needs no reconditioning after a flood
10 Fire Resistant		~	Non-combustible
11 Lower insurance rates		~	Many insurance underwriters now provide lower rates for metal framed homes
12 Walls, trusses, and beams retain their original form		~	Perfectly straight walls - no shimming of drywall
13 Corners are 90 degrees		~	No need for templating of countertops to adjust for out of square corners
14 Strength and weight		~	Metal is stronger than wood and weighs less - no need for crane to lift ADU trusses
15 IBC Engineered Stamp		~	If an engineering stamp is necessary, months of waiting are saved
16 Complete BOM (Materials Shopping List)		~	Take the materials shopping list to Home Depot and start shopping/pricing
17 Flexible in Seismic Areas - Won't Fracture		~	Light gauge steel is flexible and won't fracture when the earth moves
18 No Waste At Job Site		~	Steel is the most recycled material in the world. A typical wood home has 20-30% waste
19 Environmentally Friendly		~	Trees don't have to be destroyed and the source of most metal is from recycling
20 How-To Videos Included		~	How-to videos provide simple assembly instructions
21 Relationship Counselor		~	Eliminate emotional uphevels - save time, money, and preserve the relationship

Universal Requirements - some or all may be required

- 1 Site plan
- 2 Electrical Supply Connection
- 3 Sewer Connection
- 4 Fresh Water Supply Connection
- 5 Set Backs
- 6 Soils Evaluation

- 7 Earthquake (fault) evaluation
- 8 Foundation Plan subject to soils
- 9 Compliance with local energy codes: insulation home wrap and flashing
- 10 Engineering for wind speed and snow load.
- 11 State and Local ordinances regarding ADUs
- 12 Local Architect and/or Engineer may be necessary

Orion-3Bd 2Ba-Craftsman-Porch





Orion-3Bd 2Ba-Craftsman-Porch MATERIAL SHOPPING LIST

Have It Your Way!

The material types listed in this document were selected based on personal preferences. The Customer is encouraged to make changes to the material types in accordance with local customs, regulations, and personal preferences. Have It Your Way!

TOC



15

Name Link Page No 1 Cover Page Cover Page 2 TOC TOC 2 3 ELECTRICAL BOM **ELECTRICAL BOM** 3 5 HVAC BOM **HVAC BOM** 7 PLUMBING BOM 4 PLUMBING BOM 10

Table Of Content

Have It Your Way!

ARCHITECTURAL BOM

The material types listed in this document were selected based on personal preferences. The Customer is encouraged to make changes to the material types in accordance with local customs, regulations, and personal preferences. Have It Your Way!

GENERAL NOTES

6 ARCHITECTURAL BOM

- 1 This BOM (Bill of Materials) is prepared as a Materials Shopping List to help builders and DIYers gain a complete understanding of most if not all elements required for the complete construction of this structure, according to the original design documents provided by FrameUpNow.
- 2 All quantities and specifications are subject to change based on the final design, field measurements, availability of products and customer preferences. The customer should verify all information prior to purchasing materials.
- 3 All products and elements in the list shall conform to the International Residential Code (IRC), or any other local and international building codes, safety regulations, and standards that are applicable to the location of the structure.
- 4 If any changes are made by the customer to the list of materials specified in this document, the customer is responsible for assuring that the correct type and quantity of materials are utilized in accordance with local building codes.
- FrameUpNow, will not be held responsible for any misuse of this document, the products listed, or for deviations from the content that are made due to changes in specifications, pricing, availability, or customer preferences.
- 6 The customer is advised to consult a qualified professional or technician prior to purchasing materials for specialized construction system items. Some items including but not limited to caseworks, doors and windows may require as built measurements prior to purchase to confirmation of final dimensions.
- 7 If there are additional trim elements or specific installation methods, the total amount of materials needed might vary. Consider any additional trim required for corners, intersections, or other architectural details that might cause this variations before proceeding to purchase and construction.

ARCHITECTURAL BOM



		Orion-	3Bd 2Ba-Cı	raftsman-Po	orch		
		ARCHITECTI					
No.	Item	Туре	Unit	Quantity	Unit Price	Total	Description
	APPLIANCES						
	Refrigerator		PCS	1			
2	Range		PCS	1			
3	Washer		PCS	1			
4	Dryer		PCS	1			
5	Dish Washer		PCS	1			
6	Oven		PCS	0			
7	Microwave		PCS	0			
<u>_</u>	CASEWORKS		FT	47.05			
1	Kitchen Cabinet		FT	17.25			
2	Laundry Cabinet		FT	2.25			
3	Vanity Cabinet		FT	5			
4	Medicine Cabinet		PCS	2			
5	Kitchen countertop		SF	27.51			
6	Laundry Countertop		PCS	0			
7	Bathroom Countertop		SF	0			
8	Island		FT	0			
9	Peninsula		FT	0			
10	Closets		SF	196.1			
<u></u>	CEILING	ls w."	lor.	40:-		1	
1	Ceiling Board	Dry Wall	SF	1062			
	Dry Wall Fastener	Screw	PCS	1858.5			
3	Vapor Retarder	Polyethylene film	SF	1161			
4	Vapor Retarder Fastener	Nails with washer heads	PCS	3483			
	Ceiling Board (MRD)	Moisture resistant drywall	SF	89			
6	MRD Fastener		PCS	155.75			
7	Ceiling Board	Marine Plywood	SF	10			
8	Marine Plywood Fastener	Screw	PCS	17.5			
	Dry Wall Tape		FT	580.5			
<u></u>	FLOORING		lo-	1511			
	Main Living Space		SF	456.4			
2	Bathroom		SF	78.8			
3	Bedrooms		SF	513.3			
4	Porch		SF	310			
<u>^</u>	STRUCTURE		lo-	1500.0			
1	Foundation		SF	1539.8			
_	WALLS EXTERIOR		lor.	1004			
	Horizintal Siding	0 15 1 311 (400/ 11)	SF	1334			
2	Fastner for Horizontal Siding	Self-drilling screws(100/pkt)	PKT	13.34			
3	Stone Veneer		SF	135			
4	Mortar for Stone Veneer		SF	135			
5	Wall Homewrap	0, 1, 15, 1, (222,11)	SF	1334			
	Homewrap Fastener	Stapled fastener (200/pkt)	PKT	5.0692			
	Furring Strip	0.15.1.111. (2001.1.0)	PCS	166.75			
	Furring Strip Fastner	Self-drilling screws(100/pkt)	PKT	13.34			
	Wall Shteathing (OSB)	0.15.1.111. (2001.1.0)	SF	1334			
	Shteathing Fastener	Self-drilling screws(100/pkt)	PKT	13.34			
	Wall Paint		SF	1334			
	Wall Insulation		FT	2307			
<u>∩</u>	WALLS INTERIOR		CF	F70		1	
1	Cementitious Backer Board		SF	573			
2	Kerdi membrane		SF	573			
	Kerdi membrane Fastener		SF	573			
	Wall Ceramic Tile		SF	573			
	Drywall Board		SF	2491			
6	Drywall Fastener	Self-drilling screws(100/pkt)	PKT	24.91			
7	Wall Paint		SF	2491			
	Drywall Tape		FT	470			
8	Wall Sweep		FT	284			

ARCHITECTURAL BOM



Δ	DOORS				
1	Exterior Sliding	5' - 0" X 6'-8"	PCS	1	
	Exterior Swinging	5' - 0" X 6'-8'	PCS	2	
3	Interior Sliding	9' - 4" X 6'-8'	PCS	3	
4	Interior Bifold	3' - 0" X 6'-8'	PCS	1	
5	Interior Bifold	3' - 6" X 6'-8'	PCS	1	
6	Interior Swinging	3' - 0" X 6'-8'	PCS	2	
7	Interior Swinging	2' - 6" X 6'-8'	PCS	3	
8	Exterior Door Trim		FT	55.02	
9	Interior Door Trim		FT	417.8	
10	Entry Lock Set		PCS	3	
11	Privacy Lock Set		PCS	5	
12	Passage Lock Set		PCS	5	
	WINDOWS	<u> </u>		·	
1	Casement	2' - 3" X 4'-3"	PCS	6	
2	Casement	3' - 3" X 3'-9"	PCS	1	
3	Casement	3' - 3" X 3'-3"	PCS	1	
4	Sliding	5' - 3" X 4'-3"	PCS	2	
5	Sliding	3' - 3" X 1'-9"	PCS	1	
6	Awning	2' - 3" X 2'-3"	PCS	3	
7	Exterior Window Trim		FT	166	
8	Interior Window Trim		FT	166	
	ROOF				
1	Roof Covering		SF	1588	
2	Roof Covering Fastener		PCS	794	
3	Roof Felt Paper		SF	1588	
4	Roof Felt Paper Fastener		PCS	4764	
5	Roof Sheathing		SF	1588	
6	Roof Sheathing Fastener		PCS	12704	
7	Batten		FT	0	
8	Batten Fastener		PCS	0	
9	Soffit		SF	199	
10	Soffit Fastener		PCS	99.5	
	Fascia		FT	202	
	Fascia board fastener		PCS	101	
13	Roof Insulation		SF	1588	



	Orion-	·3Bd 2Ba-Craftsma	n-Porch		
	EL ECTRIC	AL MATERIAL SHO	DEDING LIS	T	
No.	Item	Type	Unit	Quantity	Description
	LIGHTING FIXTURES	. , , , ,	, 0		2 000
1	Kitchen Ceiling Light		PCS	4	
2	Exterior Wall Mounted Light		PCS	5	
3	Livingroom Ceiling Light With Fan		PCS	1	
4	Bedroom Ceiling Light With Fan		PCS	3	
5	Dining Ceiling Light		PCS	1	
6	Bath Wall Mounted Light		PCS	2	
7	Bathroom Ceiling Light		PCS	2	
8	Livingroom Ceiling Light		PCS	4	
9	Bedroom Ceiling Light		PCS	12	
10	Hall & Entry Ceiling Light		PCS	5	
11	Closet Ceiling Light		PCS	0	
	Smoke Detector		PCS	5	
	ELECTRICAL FITTINGS		1 00	<u> </u>	
_	Standard Receptacle 120V	20A	PCS	24	
	GFCI Receptacle 120V	20 A	PCS	13	
15	GFCI Receptacle 240V	30 A	PCS	3	
	GFCI Receptacle 240V	50 A	PCS	1	
16	GFCI Receptacle 240V	60 A		1	
17	Fan Switch	00 A	PCS	2	
	Single Pole Switch		PCS	22	
			PCS		
	Three Way Switch		PCS	4	
	Dimmer Switch		PCS	0	
22	ELECTRICAL CONDUITS & WIRING	4.40.004	FT		
	ROMEX 14 AWG	14/2/W/ground	FT	0	
	ROMEX 12 AWG	12/3/W/ground	FT	790	
	ROMEX 12 AWG	12/2/W/ground			
	ROMEX 10 AWG	10/3/W/ground	FT	127	
	ROMEX 10 AWG	10/2/W/ground	FT	0	
27	Romex 8 AWG	8/3/W/ground	FT	36	
	Romex 8 AWG	8/2/W/ground	FT	0	
	ROMEX 6 AWG	6/3/W/ground	FT	22	
	Bare Copper Ground Wire 6 AWG		FT	0	
	ELECTRICAL BOXES & CIRCUTES	200 1115	DOC		
	Panelboard -240V 1 Phase MLO	200 AMP	PCS	1	
	Circuit breaker	15 A	PCS	0	
	Circuit breaker	20 A	PCS	17	
	Circuit breaker	30 A	PCS	3	
	Circuit breaker	40 A	PCS	0	
	Circuit breaker	50 A	PCS	1	
	Circuit breaker	60 A	PCS	1	
	Single Gang Switch Box		PCS	5	
	Double Gang Switch Box		PCS	5	
	Triple Gang Switch Box		PCS	4	
	Pull Box	#1/4	PCS	32	
43	Receptacle Box		PCS	42	

PLUMBING BOM



Orion-3Bd 2Ba-Craftsman-Porch PLUMBING SYSTEM MATERIAL SHOPPING LIST

	PLUMBING SYSTEM MATERIAL SHOPPING LIST									
No.	Item	Туре	Unit	Quantity	Unit Price	Total	Description			
Δ	PLUMBING FIXTURES & ACCESSORIES					-	·			
1	Bath Tub (Alcove Tub)		PCS	0						
2	Kitchen Sink		PCS	1						
3	Kitchen Faucets		PCS	1						
4	Vanity Sink		PCS	2						
5	Bath room Faucets		PCS	2						
6	Water Closet		PCS	2						
7	Shower Trim		PCS	2						
8	Shower Tray		PCS	2						
9	Water Heater		PCS	1						
	Hose Bib		PCS	2						
	Shutoff Valve		PCS	8						
	Hanging pipe clamp		PCS	19						
	Gate Valve		PCS	1						
	Dishwasher Supply Single Connector		PCS	1						
	Dishwasher Sewage Single Connector		PCS	1						
	Laundry Sweat Connector		PCS	1						
	SANITARY & PLUMBING PIPES		PCS	<u> </u>						
<u>_</u>		ø 1"	ГТ	0						
	ABS (Acrylonitrile Butadiene Styrene) Pipes		FT	0						
	ABS (Acrylonitrile Butadiene Styrene) Pipes	ø 1 1/2"	FT	23						
	ABS (Acrylonitrile Butadiene Styrene) Pipes	ø 2"	FT	37						
	ABS (Acrylonitrile Butadiene Styrene) Pipes	ø 3"	FT	29						
	PEX (Cross-linked polyethylene) Pipes	ø 1/2"	FT	89						
	PEX (Cross-linked polyethylene) Pipes	ø 3/4"	FT	63						
	PEX (Cross-linked polyethylene) Pipes	ø 1"	FT	0						
	PVC Pipes Sch.80 - Rigid	ø 1 1/2"	FT	0						
	PVC Pipes Sch.80 - Rigid	ø 2"	FT	115						
	PVC Pipes Sch.80 - Rigid	ø 3"	FT	0						
	Flex Pipe Round	ø 1/2"	PCS	8						
_	PIPE FITTINGS									
1	ABS 90 Degree Bend Elbow	1 1/2"ø-1 1/2"ø	PCS	2						
	ABS 90 Degree Bend Elbow	2"ø-2"ø	PCS	3						
3	ABS 90 Degree Bend Elbow	3"ø-3"ø	PCS	2						
4	ABS P-Trap	1 1/2"ø-1 1/2"ø	PCS	3						
5	ABS P-Trap	2"ø-2"ø	PCS	2						
6	ABS Reducer Elbow	2"ø-1 1/2"ø	PCS	1						
7	ABS Reducer Elbow	3"ø-1 1/2"ø	PCS	1						
8	ABS Reducer Elbow	3"ø-2"ø	PCS	1						
9	ABS TEE Elbow	2"ø-2"ø-2"ø	PCS	1						
10	ABS TEE Elbow	3"ø-3"ø-3"ø	PCS	2						
11	ABS Tee Reducer Elbow	3"ø-3"ø-1 1/2"ø	PCS	2						
	ABS Tee Reducer Elbow	3"ø-3"ø-2"ø	PCS	1						
	ABS Trap P	1 1/2"ø-1 1/2"ø	PCS	2						
	ABS Vent Cap Elbow	1 1/2"ø	PCS	1						
	ABS Vent Cap Elbow	2"ø	PCS	2						
	ABS Vent Cap Elbow	3"ø	PCS	1						
	PEX 90 Degree Elbow	1/2"ø-1/2"ø	PCS	19						
	PEX 90 Degree Elbow	3/4"ø-3/4"ø	PCS	15						
	PEX Tee Elbow	1/2"ø-1/2"ø-1/2"ø	PCS	8						
	PEX Tee Elbow	3/4"ø-3/4"ø-3/4"ø	PCS	6						
	PEX Transition Elbow	3/4"ø-1/2"ø	PCS	6						
	PVC 90 Deg Bend Elbow	2"Ø-2"Ø	PCS	30						
	WASTE DOUBLE TEE	1 1/2"ø-1 1/2"ø-1 1/2"ø-1	PCS	1						
	WASTE DOUBLE TEE	2"ø-2"ø-2"ø	PCS	1						
	WASTE DOUBLE TEE	3"ø-3"ø-3"ø	PCS	1						
	ABS Vent Cap Elbow	1 1/2"ø	PCS	1						
	ABS Vent Cap Elbow	2"ø	PCS	2						
28	ABS Vent Cap Elbow	3"ø	PCS	1						



	Orion-3Bd 2Ba-Craftsman-Porch								
		HVAC SYSTEM MA	TERIAI	SHOPP	ING LIST				
No.	Item	Туре	Unit	Quantity	Unit Price	Total	Description		
	HVAC_DUCTS								
1	PIPE (REFRIGERANT LINE)	3/8" (Ø)	FT	105.01					
2	PIPE (REFRIGERANT LINE)	3/4'" (Ø)	FT	139.44					
3	DRAYER HOSE	4" (Ø)	FT	3.6					
4	FLEX DUCT ROUND	4" (Ø)	FT	6.39					
	DUCT FITTINGS & ACCESSORIES								
6	ELBOW (REFRIGERANT LINE)	3/4" (Ø)-3/4" (Ø)	PCS	36					
7	ELBOW (REFRIGERANT LINE)	3/8" (Ø)-3/8" (Ø)	PCS	26					
8	TEE (REFRIGERANT LINE)	3/4" (Ø)-3/4" (Ø)-3/4" (Ø)	PCS	3					
9	TEE (REFRIGERANT LINE)	3/8" (Ø)-3/8" (Ø))-3/8" (Ø)	PCS	3					
10	TRANSITION (REFRIGERANT	3/4" (Ø)-1/2" (Ø)	PCS	3					
11	TRANSITION (REFRIGERANT	3/4" (Ø)-5/8" (Ø)	PCS	2					
12	TRANSITION (REFRIGERANT	3/8" (Ø)-1/4" (Ø)	PCS	1					
	HVAC_EQUIPMENTS								
13	AIR HANDLING UNIT	WALL MOUNTED	PCS	4					
14	CONDENSER	OUTDOOR UNIT	PCS	1					
15	EXHAUST FAN	75 CFM	PCS	2					
16	EXHAUST HOOD	WALL MOUNTED	PCS	1					
17	HOOD-WALL: VENT	HOOD-WALL: VENT	PCS	1					
18	DRAYER: VENT	DRAYER: VENT	PCS	1					
19	ROOF VENT	3"(Ø)	PCS	2					



Table Of Content

#	Name	Link	Page No
1	Cover Page	<u>Cover Page</u>	1
2	TOC	TOC	2
3	ELECTRICAL BOM	ELECTRICAL BOM	3
5	HVAC BOM	HVAC BOM	7
4	PLUMBING BOM	PLUMBING BOM	10
6	ARCHITECTURAL BOM	ARCHITECTURAL BOM	15

Have It Your Way!

The material types listed in this document were selected based on personal preferences. The Customer is encouraged to make changes to the material types in accordance with local customs, regulations, and personal preferences. Have It Your Way!

GENERAL NOTES

- This BOM (Bill of Materials) is prepared as a Materials Shopping List to help builders and DIYers gain a complete understanding of most if not all elements required for the complete construction of this structure, according to the original design documents provided by FrameUpNow.
- 2 All quantities and specifications are subject to change based on the final design, field measurements, availability of products and customer preferences. The customer should verify all information prior to purchasing materials.
- 3 All products and elements in the list shall conform to the International Residential Code (IRC), or any other local and international building codes, safety regulations, and standards that are applicable to the location of the structure.
- 4 If any changes are made by the customer to the list of materials specified in this document, the customer is responsible for assuring that the correct type and quantity of materials are utilized in accordance with local building codes.
- FrameUpNow, will not be held responsible for any misuse of this document, the products listed, or for deviations from the content that are made due to changes in specifications, pricing, availability, or customer preferences.
- The customer is advised to consult a qualified professional or technician prior to purchasing materials for specialized construction system items. Some items including but not limited to caseworks, doors and windows may require as built measurements prior to purchase to confirmation of final dimensions.
- 7 If there are additional trim elements or specific installation methods, the total amount of materials needed might vary. Consider any additional trim required for corners, intersections, or other architectural details that might cause this variations before procedding to purchase and construction.



			LIGHTING FIXTURES				
#	Item	Туре	Description, Manufacturer, SKU	Unit	Quantity	Unit Price	Total
1	Kitchen Ceiling Light			PCS	4		
3	Exterior Wall Mounted Light			PCS	5		
4	Livingroom Ceiling Light With Fan			PCS	1		
5	Bedroom Ceiling Light With Fan			PCS	3		
6	Dining Ceiling Light			PCS	1		
7	Bath Wall Mounted Light			PCS	2		
8	Bathroom Ceiling Light			PCS	2		
9	Livingroom Ceiling Light			PCS	4		
10	Bedroom Ceiling Light			PCS	12		
11	Hall & Entry Ceiling Light			PCS	5		
12	Closet Ceiling Light			PCS	0		
12	Smoke Detector			PCS	5		
13							
14							
15							



			ELECTRICAL FITTINGS			
#	Item	Туре	Description, Manufacturer, SKU	Unit	Quantity Unit	Price Total
1	Standard Receptacle 120V	20A		PCS	24	
2	GFCI Receptacle 120V	20 A		PCS	13	
3	GFCI Receptacle 240V	30 A		PCS	3	
4	GFCI Receptacle 240V	50 A		PCS	1	
5	GFCI Receptacle 240V	60 A		PCS	1	
6	Fan Switch			PCS	2	
7	Single Pole Switch			PCS	22	
8	Three Way Switch			PCS	4	
9	Dimmer Switch			PCS	0	
10						
11						
12						
13						
14						
15						



		ELECTR	ICAL CONDUITS & WIRING				
#	Item	Туре	Description, Manufacturer, SKU	Unit	Quantity	Unit Price	Total
1	ROMEX 14 AWG	14/2/W/ground		FT	0		
3	ROMEX 12 AWG	12/2/W/ground		FT	790		
4	ROMEX 10 AWG	10/3/W/ground		FT	127		
5	Romex 8 AWG	8/3/W/ground		FT	36		
8	ROMEX 6 AWG	6/3/W/ground		FT	22		
9	Bare Copper Ground Wire 6 AWG			FT			
10		-					
11							
12							
13							
14							
15							
16							



		ELEC	TRICAL BOXES & CIRCUTES				
#	Item	Туре	Description, Manufacturer, SKU	Unit	Quantity	Unit Price	Total
1	Panelboard -240V 1 Phase MLO	200 AMP		PCS	1		
2	Circuit breaker	15 A		PCS	0		
3	Circuit breaker	20 A		PCS	17		
4	Circuit breaker	30 A		PCS	3		
5	Circuit breaker	50 A		PCS	1		
6	Circuit breaker	60 A		PCS	1		
7	Single Gang Switch Box			PCS	5		
8	Double Gang Switch Box			PCS	5		
9	Triple Gang Switch Box			PCS	4		
10	Pull Box	#1/4		PCS	32		
11	Receptacle Box			PCS	42		
12							
13							
14							
15							



		HVAC_DUCTS 01							
#	Item	Туре	Description, Manufacturer, SKU	Unit	Quantity	Unit Price	Total		
1	PIPE (REFRIGERANT LINE)			FT	105.01				
2	PIPE (REFRIGERANT LINE)	3/4''' (Ø)		FT	139.44				
3	DRAYER HOSE	4" (Ø)		FT	3.6				
4	FLEX DUCT ROUND	4" (Ø)		FT	6.39				



DUCT FITTINGS & ACCESSORIES							
#	Item	Туре	Description, Manufacturer, SKU	Unit	Quantity	Unit Price	Total
1	ELBOW (REFRIGERANT LINE)	3/4" (Ø)-3/4" (Ø)		PCS	36		
2		3/8" (Ø)-3/8" (Ø)		PCS	26		
3	TEE (REFRIGERANT LINE)	3/4" (Ø)-3/4" (Ø)-3/4" (Ø)		PCS	3		
4	TEE (REFRIGERANT LINE)	3/8" (Ø)-3/8" (Ø))-3/8" (Ø)		PCS	3		
5	TRANSITION (REFRIGERANT LINE)	3/4" (Ø)-1/2" (Ø)		PCS	3		
6	TRANSITION (REFRIGERANT LINE)	3/4" (Ø)-5/8" (Ø)		PCS	2		
7	TRANSITION (REFRIGERANT LINE)	3/8" (Ø)-1/4" (Ø)		PCS	1		



		HVAC_EQUIPMENTS							
#	Item	Туре	Description, Manufacturer, SKU	Unit	Quantity	Unit Price	Total		
1	AIR HANDLING UNIT	WALL MOUNTED		PCS	4				
2	CONDENSER	OUTDOOR UNIT		PCS	1				
3	EXHAUST FAN	75 CFM		PCS	2				
4	EXHAUST HOOD	WALL MOUNTED		PCS	1				
5	HOOD-WALL: VENT	HOOD-WALL: VENT		PCS	1				
6	DRAYER: VENT	DRAYER: VENT		PCS	1				
7	ROOF VENT	3"(Ø)		PCS	2				
8									
9									
10									
11									
12									
13									
14									



		PLUMBII	NG FIXTURES & ACCESSORIES				
#	Item	Туре	Description, Manufacturer, SKU	Unit	Quantity	Unit Price	Total
1	Bath Tub (Alcove Tub)			PCS	C		
2	Kitchen Sink			PCS	1		
3	Kitchen faucets			PCS	1		
4	Vanity Sink			PCS	2		
5	Bath room faucets			PCS	2		
6	Water Closet			PCS	2		
7	Shower Trim			PCS	2		
8	Shower Tray			PCS	2		
9	Water Heater			PCS	1		
10	Hose Bib			PCS	2		
11	Shutoff Valve			PCS	8		
12	Hanging pipe clamp			PCS	20		
13	Gate Valve			PCS	1		
14	Dishwasher Supply Single Connector			PCS	1		
15	Dishwasher Sewage Single Connector			PCS	1		
16	Laundry Sweat Connector			PCS	1		



		SANI	ITARY & PLUMBING PIPES				
#	Item	Туре	Description, Manufacturer, SKU	Unit	Quantity	Unit Price	Total
1	ABS (Acrylonitrile Butadiene Styrene) Pipes	ø 1"		FT	0		
2	ABS (Acrylonitrile Butadiene Styrene) Pipes	ø 1 1/2"		FT	23		
3	ABS (Acrylonitrile Butadiene Styrene) Pipes	ø 2"		FT	37		
4	ABS (Acrylonitrile Butadiene Styrene) Pipes	ø 3"		FT	29		
5	PEX (Cross-linked polyethylene) Pipes	ø 1/2"		FT	89		
6	PEX (Cross-linked polyethylene) Pipes	ø 3/4"		FT	63		
7	PEX (Cross-linked polyethylene) Pipes	ø 1"		FT	0		
8	PVC Pipes Sch.80 - Rigid	ø 1 1/2"		FT	0		
9	PVC Pipes Sch.80 - Rigid	ø 2"		FT	115		
10	PVC Pipes Sch.80 - Rigid	ø 3"		FT	0		
11	Flex Pipe Round	ø 1/2"		PCS	8		
12							
13							
14							
15							



	1	Р	IPE FITTINGS 01				
#	Item	Туре	Description, Manufacturer, SKU	Unit	Quantity	Unit Price	Total
1	ABS 90 Degree Bend Elbow	1 1/2"ø-1 1/2"ø		PCS	2		
2	ABS 90 Degree Bend Elbow	2"ø-2"ø		PCS	3		
3	ABS 90 Degree Bend Elbow	3"ø-3"ø		PCS	2		
4	ABS P-Trap	1 1/2"ø-1 1/2"ø		PCS	3		
5	ABS P-Trap	2"Ø-2"Ø		PCS	2		
6	ABS Reducer Elbow	2"ø-1 1/2"ø		PCS	1		
7	ABS Reducer Elbow	3"ø-1 1/2"ø		PCS	1		
8	ABS Reducer Elbow	3"Ø-2"Ø		PCS	1		
9	ABS TEE Elbow	2"ø-2"ø-2"ø		PCS	1		
10	ABS TEE Elbow	3"ø-3"ø-3"ø		PCS	2		
11	ABS Tee Reducer Elbow	3"ø-3"ø-1 1/2"ø		PCS	2		
12	ABS Tee Reducer Elbow	3"ø-3"ø-2"ø		PCS	1		
13	ABS Trap P	1 1/2"ø-1 1/2"ø		PCS	2		
14	ABS Vent Cap Elbow	1 1/2"ø		PCS	1		
15	ABS Vent Cap Elbow	2"Ø		PCS	2		



		PIPE F	ITTINGS 02				
#	Item	Туре	Description, Manufacturer, SKU	Unit	Quantity	Unit Price	Total
1	ABS Vent Cap Elbow	3"ø		PCS	1		
2	PEX 90 Degree Elbow	1/2"ø-1/2"ø		PCS	19		
}	PEX 90 Degree Elbow	3/4"ø-3/4"ø		PCS	15		
1	PEX Tee Elbow	1/2"ø-1/2"ø-1/2"ø		PCS	8		
5	PEX Tee Elbow	3/4"ø-3/4"ø-3/4"ø		PCS	6		
5	PEX Transition Elbow	3/4"ø-1/2"ø		PCS	6		
7	PVC 90 Deg Bend Elbow	2"ø-2"ø		PCS	30		
3	WASTE DOUBLE TEE	1 1/2"ø-1 1/2"ø-1 1/2"ø-1 1/2"ø		PCS	1		
)	WASTE DOUBLE TEE	2"Ø-2"Ø-2"Ø		PCS	1		
10	WASTE DOUBLE TEE	3"ø-3"ø-3"ø		PCS	1		
11	ABS Vent Cap Elbow	1 1/2"ø		PCS	1		
12	ABS Vent Cap Elbow	2"ø		PCS	2		
3	ABS Vent Cap Elbow	3"Ø		PCS	1		
14							
15							



			APPLIANCES				
#	Item	Туре	Description, Manufacturer, SKU	Unit	Quantity	Unit Price	Total
1	Refrigerator			PCS	1		
2	Range			PCS	1		
3	Washer Front Load	Stackable		PCS	1		
4	Dryer Front Load	Stackable		PCS	1		
5	Dish Washer			PCS	1		
6	Oven			PCS	(
7	Microwave			PCS	(
8							
9							
10							
11							
12							
13							
14							
15							
16							



			CASEWORKS 01				
#	Item	Туре	Description, Manufacturer, SKU	Unit	Quantity	Unit Price	Total
1	Kitchen Cabinet			FT	17.25		
2	Laundry Cabinet			FT	2.25		
3	Vanity Cabinet			FT	5		
4	Medicine Cabinet			PCS	2		
5	Kitchen countertop			SF	27.51		
6	Laundry Countertop			PCS	0		
7	Bathroom Countertop			SF	0		
8	Island			FT	0		
9	Peninsula			FT	0		
10	Closets			SF	196.1		
11							
12							
13							
14							
15							



			CEILING 01				
ŧ	Item	Туре	Description, Manufacturer, SKU	Unit	Quantity	Unit Price	Total
	LIVING ROOM + KITCHEN			SF	394.0		
	Ceiling Board	Drywall		SF	394		
	Drywall Fastener	Screw		PCS	690		
	Vapor Retarder	Polyethylene film		SF	394		
	Vapor Retarder Fastener	Nails with washer heads		PCS	1182		
	BATH 1			SF	45.0		
	Ceiling Board	MRD (Moisture resistant drywall)		SF	45		
	MRD Fastener	Screw		PCS	79		
	BATH 2			SF	44.0		
	Ceiling Board	MRD (Moisture resistant drywall)		SF	44		
	MRD Fastener	Screw		PCS	77		
	HALL +WD			SF	98.0		
)	Ceiling Board	Drywall		SF	98		
	Drywall Fastener	Screw		PCS	172		
1	Vapor Retarder	Polyethylene film		SF	98		
2	Vapor Retarder Fastener	Nails with washer heads		PCS	294		



			CEILING 02				
#	Item	Туре	Description, Manufacturer, SKU	Unit	Quantity	Unit Price	Total
	BED ROOM 1			SF	173.0		
12	Ceiling Board	Drywall		SF	173		
13	Drywall Fastener	Screw		PCS	303		
14	Vapor Retarder	Polyethylene film		SF	173		
15	Vapor Retarder Fastener	Nails with washer heads		PCS	519		
	BED ROOM 2	'		SF	147.0		
16	Ceiling Board	Drywall		SF	147		
17	Drywall Fastener	Screw		PCS	257		
18	Vapor Retarder	Polyethylene film		SF	147		
19	Vapor Retarder Fastener	Nails with washer heads		PCS	441		
	BED ROOM 3			SF	172.0		
20	Ceiling Board	Drywall		SF	172		
21	Drywall Fastener	Screw		PCS	301		
22	Vapor Retarder	Polyethylene film		SF	172		
23	Vapor Retarder Fastener	Nails with washer heads		PCS	516		



			CEILING 03				
#	Item	Туре	Description, Manufacturer, SKU	Unit	Quantity	Unit Price	Total
	CLOSET 1			SF	22.0		
24	Ceiling Board	Drywall		SF	22		
25	Drywall Fastener	Screw		PCS	39		
26	Vapor Retarder	Polyethylene film		SF	22		
27	Vapor Retarder Fastener	Nails with washer heads		PCS	66		
	CLOSET 2			SF	22.0		
28	Ceiling Board	Drywall		SF	22		
29	Drywall Fastener	Screw		PCS	39		
30	Vapor Retarder	Polyethylene film		SF	22		
31	Vapor Retarder Fastener	Nails with washer heads		PCS	66		
	CLOSET 3			SF	23.0		
32	Ceiling Board	Drywall		SF	23		
33	Drywall Fastener	Screw		PCS	40		
34	Vapor Retarder	Polyethylene film		SF	23		
35	Vapor Retarder Fastener	Nails with washer heads		PCS	69		



			CEILING 04				
#	Item	Туре	Description, Manufacturer, SKU	Unit	Quantity	Unit Price	Total
	CLOSET 4			SF	11.0		
36	Ceiling Board	Drywall		SF	11		
37	Drywall Fastener	Screw		PCS	19)	
38	Vapor Retarder	Polyethylene film		SF	11		
39	Vapor Retarder Fastener	Nails with washer heads		PCS	33		
	WH			SF	10.0		
40	Ceiling Board	Drywall		SF	10		
41	Drywall Fastener	Screw		PCS	18		
42	Vapor Retarder	Polyethylene film		SF	10		
43	Vapor Retarder Fastener	Nails with washer heads		PCS	30		
	PORCH			SF	117.0		
44	Ceiling Board	Marine Plywood		SF	117	,	
45	Exterior Grade Plywood	Screw		PCS	205		



			FLOORING INTERIOR 01				
#	Item	Туре	Description, Manufacturer, SKU	Unit	Quantity	Unit Price	Total
	BEDROOM #1						
1	Bedroom Flooring			SF	164		
2	Wood underlay	Foam Pad Polyethylene		SF	164		
3	Vapor Retarder	Vapor Barrier Polyethylene		SF	164		
	BEDROOM#2	·					
4	Bedroom Flooring			SF	112		
5	Wood underlay	Foam Pad Polyethylene		SF	112		
6	Vapor Retarder	Vapor Barrier Polyethylene		SF	112		
	BEDROOM#3						
7	Bedroom Flooring			SF	164		
8	Wood underlay	Foam Pad Polyethylene		SF	164		
9	Vapor Retarder	Vapor Barrier Polyethylene		SF	164		
	CL#1						
10	Closet Flooring			SF	21		
11	Wood underlay	Foam Pad Polyethylene		SF	21		
12	Vapor Retarder	Vapor Barrier Polyethylene		SF	21		



	1		FLOORING INTERIOR 02				
#	Item	Туре	Description, Manufacturer, SKU	Unit	Quantity	Unit Price	Total
	CL#2						
13	Closet Flooring			SF	21		
14	Wood underlay	Foam Pad Polyethylene		SF	21		
15	Vapor Retarder	Vapor Barrier Polyethylene		SF	21		
	CL#3						
16	Closet Flooring			SF	21		
17	Wood underlay	Foam Pad Polyethylene		SF	21		
18	Vapor Retarder	Vapor Barrier Polyethylene		SF	21		
	CL#4						
19	Closet Flooring			SF	11		
20	Wood underlay	Foam Pad Polyethylene		SF	11		
21	Vapor Retarder	Vapor Barrier Polyethylene		SF	11		
	LIVING ROOM AND KITCH	EN					
22	Living Area Flooring			SF	456		
23	Wood underlay	Foam Pad Polyethylene		SF	456		
24	Vapor Retarder	Vapor Barrier Polyethylene		SF	456		



	1		FLOORING INTERIOR 03				
#	Item	Туре	Description, Manufacturer, SKU	Unit	Quantity	Unit Price	Total
	BATHROOM#1						
25	Tile Finish			SF	29		
26	Adhesive	1/2" Thin set Mortar		SF	29		
27	Vapor Retarder	Vapor Barrier Polyethylene		SF	29		
	BATHROOM#2						
28	Tile Finish			SF	29		
29	Adhesive	1/2" Thin set Mortar		SF	29		
30	Vapor Retarder	Vapor Barrier Polyethylene		SF	29		
	W/D						
31	Tile Finish			SF	11		
32	Adhesive	1/2" Thin set Mortar		SF	11		
33	Vapor Retarder	Vapor Barrier Polyethylene		SF	10.5		
	BOILER ROOM						
34	Tile Finish			SF	10		
35	Adhesive	1/2" Thin set Mortar		SF	10		
36	Vapor Retarder	Vapor Barrier Polyethylene		SF	9.5		



	<u>1</u>		FLOORING EXTERIOR			
#	Item	Туре	Description, Manufacturer, SKU	Unit	Quantity	Unit Price
	STRUCTURE			SF	1539.8	
1	Concrete Slab	4"concrete cast in situ		CF	513	
2	Insulation	Rigid insulation		SF	411	
3	Hard core	Compacted soil		CF	453	
4	Re-bar	#4 re-bar		Ton	1	
5	Concrete Pad	4"concrete cast in situ		CF	2	
6	Slab edge	Turndown		CF	392.6	
7	Footing	Cast-in-place concrete		CF	4.68	
	PORCH FRONT					
8	Tile Finish			SF	122.2	
9	Adhesive	1/2" Thin set Mortar		SF	122.2	
10	Vapor Retarder	Vapor Barrier Polyethylene		SF	122.2	
	PORCH SIDE					
11	Tile Finish			SF	187.8	
12	Adhesive	1/2" Thin set Mortar		SF	187.8	
13	Vapor Retarder	Vapor Barrier Polyethylene		SF	187.8	



			WALLS: EXTERIOR				
#	Item	Туре	Description, Manufacturer, SKU	Unit	Quantity	Unit Price	Total
1	Horizintal Siding			SF	1334		
2	Fastner for Horizontal Siding	Self-drilling screws(100/pkt)		PKT	13.34		
3	Stone Veneer			SF	135		
4	Mortar for Stone Veneer			SF	135		
5	Wall Homewrap			SF	1334		
6	Homewrap Fastener	Stapled fastener (200/pkt)		PKT	5.1		
7	Furring Strip			PCS	166.8		
8	Furring Strip Fastner	Self-drilling screws(100/pkt)		PKT	13.3		
9	Wall Shteathing (OSB)			SF	1334		
10	Shteathing Fastener	Self-drilling screws(100/pkt)		PKT	13.34		
11	Wall Paint			SF	1334		
12	Wall Insulation			FT	2307		
13							
14							
15							



			WALLS: INTERIOR 01				
#	Item	Туре	Description, Manufacturer, SKU	Unit	Quantity	Unit Price	Total
	BATH 1			SF	42		
1	Cementitious Backer Board			SF	213		
2	Kerdi membrane			SF	213		
3	Kerdi membrane Fastener			SF	213		
4	Wall Ceramic Tile			SF	213		
	BATH 2			SF	42		
5	Cementitious Backer Board			SF	251		
6	Kerdi membrane			SF	251		
7	Kerdi membrane Fastener			SF	251		
8	Wall Ceramic Tile			SF	251		
	BEDROOM 1			SF	164		
9	Drywall Board			SF	363		
10	Drywall Fastener	Self-drilling screws(100/pkt)		PKT	3.63		
11	Wall Paint			SF	363		
12	Drywall Tape			FT	68.1		



			WALLS: INTERIOR 02				
#	Item	Туре	Description, Manufacturer, SKU	Unit	Quantity	Unit Price	Total
	BEDROOM 2			SF	113		
13	Drywall Board			SF	259		
14	Drywall Fastener	Self-drilling screws(100/pkt)		PKT	2.59		
15	Wall Paint			SF	259		
16	Drywall Tape			FT	48.6		
	BEDROOM 3			SF	162		
17	Drywall Board			SF	341		
18	Drywall Fastener	Self-drilling screws(100/pkt)		PKT	3.41		
19	Wall Paint			SF	341		
20	Drywall Tape			FT	63.9		
	LIVING ROOM			SF	270		
21	Drywall Board			SF	387		
22	Drywall Fastener	Self-drilling screws(100/pkt)		PKT	3.87		
23	Wall Paint			SF	387		
24	Drywall Tape			FT	73		



			WALLS: INTERIOR 03				
#	Item	Туре	Description, Manufacturer, SKU	Unit	Quantity	Unit Price	Total
	WH			SF	10		
25	Drywall Board			SF	84		
26	Drywall Fastener	Self-drilling screws(100/pkt)		PKT	0.84		
27	Wall Paint			SF	84		
28	Drywall Tape			FT	15.8		
	KITCHEN			SF	91		
29	Cementitious Backer Board			SF	30		
30	Drywall Board			SF	165		
31	Drywall Fastener	Self-drilling screws(100/pkt)		PKT	1.65		
32	Kerdi membrane			SF	30		
33	Kerdi membrane Fastener			SF	30		
34	Wall Ceramic Tile			SF	30		
35	Wall Paint			SF	165		
36	Drywall Tape			FT	31.1		



			WALLS: INTERIOR 04				
#	Item	Туре	Description, Manufacturer, SKU	Unit	Quantity	Unit Price	Total
	CL 1			SF	22		
37	Drywall Board			SF	160		
38	Drywall Fastener	Self-drilling screws(100/pkt)		PKT	1.6		
39	Wall Paint			SF	160		
40	Drywall Tape			FT	30		
	CL 2			SF	22		
41	I .			SF	141		
42	Drywall Fastener	Self-drilling screws(100/pkt)		PKT	1.41		
43	Wall Paint			SF	141		
44	Drywall Tape			FT	27		
	CL 3			SF	20		
45	Drywall Board			SF	161		
46	Drywall Fastener	Self-drilling screws(100/pkt)		PKT	1.61		
47	Wall Paint			SF	161		
48	Drywall Tape			FT	30		



			WALLS: INTERIOR 05				
#	Item	Туре	Description, Manufacturer, SKU	Unit	Quantity	Unit Price	Total
	CL 4			SF	11		
49	Drywall Board			SF	87		
50	Drywall Fastener	Self-drilling screws(100/pkt)		PKT	0.87	,	
51	Wall Paint			SF	87		
52	Drywall Tape			FT	16		
	WD			SF	11		
53	Cementitious Backer Board			SF	79		
54	Kerdi membrane			SF	79		
55	Kerdi membrane Fastener			SF	79		
56	Wall Ceramic Tile			SF	79		
	HALL			SF	93		
57	Drywall Board			SF	343		
58	Drywall Fastener	Self-drilling screws(100/pkt)		PKT	3.43		
59	Wall Paint			SF	343		
60	Drywall Tape			FT	65		
1	Wall Skirting			FT	284		



			DOORS				
#	Item	Туре	Description, Manufacturer, SKU	Unit	Quantity	Unit Price	Total
1	Exterior Sliding	5' - 0" X 6'-8"		PCS	1		
2	Exterior Swinging	5' - 0" X 6'-8'		PCS	2		
3	Interior Sliding	9' - 4" X 6'-8'		PCS	3		
4	Interior Bifold	3' - 0" X 6'-8'		PCS	1		
5	Interior Bifold	3' - 6" X 6'-8'		PCS	1		
6	Interior Swinging	3' - 0" X 6'-8'		PCS	2		
7	Interior Swinging	2' - 6" X 6'-8'		PCS	3		
8	Exterior Door Trim			FT	55.02		
9	Interior Door Trim			FT	417.8		
10	Entry Lock Set			PCS	3		
11	Privacy Lock Set			PCS	5		
12	Passage Lock Set			PCS			



			WINDOWS				
#	Item	Туре	Description, Manufacturer, SKU	Unit	Quantity	Unit Price	Total
1	Casement	2' - 3" X 4'-3"		PCS	6		
2	Casement	3' - 3" X 3'-9"		PCS	1		
3	Casement	3' - 3" X 3'-3"		PCS	1		
4	Sliding	5' - 3" X 4'-3"		PCS	2		
5	Sliding	3' - 3" X 1'-9"		PCS			
6	Awning	2' - 3" X 2'-3"		PCS	3		
7	Exterior Window Trim			FT	166		
8	Interior Window Trim			FT	166		
9							
10							
11							
12							
13							
14							
15							



			ROOF 01				
#	Item	Туре	Description, Manufacturer, SKU	Unit	Quantity	Unit Price	Total
1	Roof Covering			SF	1588.0		
2	Roof Covering Fastener			PCS	794		
3	Roof Felt Paper			SF	1588.0		
4	Roof Felt Paper Fastener			PCS	4764.0		
5	Roof Sheathing			SF	1588.0		
6	Roof Sheathing Fastener			PCS	12704		
7	Batten			FT	0.0		
8	Batten Fastener			PCS	0.0		
9	Soffit			SF	199.0		
10	Soffit Fastener			PCS	99.5		
11	Fascia			FT	202.0		
12	Fascia board fastener			PCS	101		
13	Roof Insulation			SF	1588.0		
14							
15							