

HAVEN

The Haven is a modern one-bedroom, onebathroom home with a distinct Alpine architectural influence, designed to harmonize with natural surroundings. The main body of the home is clad in dark gray vertical metal siding, warm-toned wood siding, and a section of stone veneer adding a rustic touch and grounds the structure. The slightly angled roofline and covered porch, featuring a modern pergola-style structure, provides a welcoming outdoor space.

Inside, the Haven boasts a simple L-shaped plan. The living, dining, and kitchen areas are seamlessly integrated into a single open space at one end of the house, promoting a sense of spaciousness and flow. The bedroom is thoughtfully located at the other end of the plan, offering a private and quiet retreat. Functional spaces, such as the bathroom, are tucked into a corner of the home, maximizing privacy and convenience.



Please print and take this Materials Shopping List to your favorite Home Depot and ask for assistance in selecting the materials, fixtures and fittings to complete your new home.

Record your selection and the price of the item. Then do the math to determine the cost for your selections and the total cost of finishing your home.

< CLICK HERE >

To Go To Materials Shopping List



23' - 10 1/4" BEDROOM 103 SF KITCHEN 62 SF HALL 32 SF W/D 11 SF LIVING AREA 148 SF

GROUND FLOOR PLAN

FLOOR PLAN

491 SF

1 Bed Room

PLUMBING

NOTES AND SCHEDULES WATER SUPPLY & SEWAGE SYSTEM + 39

DIMENSION FOR LIGHTING

DIMENSION FOR FITTING

MATERIALS SHOPPING LIST

MECHANICAL

ELECTRICAL

MATERIALS SHOPPING LIST

TABLE OF CONTENTS

RENDERINGS	ABOUT THE HOME -	 01
1	RENDERINGS -	─ 01
FLOOR PLAN	SCHEMATIC FLOOR PLAN	— 01
1	HOME SPECS -	 01
	DISCLAIMER -	— 01
ABOUT	ABOUT FrameUpNow -	— 01
1	ABOUT HouseDocs	─ 01
DESCRIPTIONS	BOM (Bill Of Materials) ⊢	— 02
2	STRUCTURAL -	─ 02
	ARCHITECTURAL-	 02
	MECHANICAL -	 02
	ELECTRICAL⊢	─ 0 2
	PLUMBING -	 02
MATERIALS LIST	MATERIALS LIST PREVIEW	02
HOW TO BUILD	CONSTRUCTION STEPS -	02

COVER SHEET

FLOOR PLAN +

ROOF PLAN +

COVER SHEET

GENERAL NOTES

WALL FRAME LAYOUT

ROOF TRUSS LAYOUT

STRUCTURAL SECTIONS

WALL BRACING LAYOUT

STRUCTURAL DETAILS 1

STRUCTURAL DETAILS 2

STRUCTURAL DETAILS 3

SHEETROCK BACKING 1

ROOF BRACING LAYOUT

COVER SHEET

HVAC PLAN

SCHEDULE

LIGHTING

POWER PLAN

TRUSS BLOCKING LAYOUT

HOLD-DOWN PLAN

DIMENSION PLAN +

FOUNDATION PLAN

WALL FRAME LAYOUT

ROOF TRUSS LAYOUT

STRUCTURAL FLOOR PLAN -

ARCHITECTURAL ELEVATIONS -

ARCHITECTURAL ELEVATIONS -

ARCHITECTURAL SECTIONS -

ARCHITECTURAL CASEWORK

WALL PANEL & LAYOUT PLAN

ARCHITECTURAL DETAILS

03

19

20

21

22

27

28

29

31

32

33

ARCHITECTURAL

STRUCTURAL

ABOUT



FrameUpNow is a design and manufacturing company providing precision-engineered home framing solutions. We offer a catalog of Affordable Homes, Tiny Homes, Garages, Shops and Barndominiums. FrameUpNow manufactures cold-formed steel (CFS) also known as Light Gauge Steel (LGS) framing components that conform to our engineered metal house frame plans or can be purchased as DIY skeleton kits.

The CFS/LGS framing is lightweight, easily assembled, and does not require heavy equipment or specialized labor, enabling homeowners to erect the frame themselves in just a few days. Unlike wood, the steel framing is impervious termites and bores, warping, expansion, and fire.

Our home plans come complete with a structural engineered stamp for permit approvals. Customers receive a full BOM also known as a Materials Shopping List to purchase finish materials from a Building Materials retailer. FrameUpNow prides itself on the quality and efficiency of our precision-engineered home framing solutions for construction professionals and DIY homeowners.



KEY PLAN

NO.	DESCRIPTION	DATE

NOTE:

LEGEND:

PROJECT

154-Haven-491-1Bd1Ba-Alpine-550

DRAWING NAME

INTRODUCTION

CLIENT NAME:
PROJECT NUMBER:
DATE:
DESIGNED BY:
DRAWN BY:
CHECKED BY:

I101

SCALE:

DISCLAIMER

DISCLAIMER: This documentation and all it's contents are the intellectual property of FrameUpNow. It is provided solely for marketing the services of FrameUpNow. The preliminary information is not approved for actual construction use and is not warranted to be complete or accurate. Unauthorized copying, distribution, or application of these proprietary materials, in any form or format, is strictly prohibited. FrameUpNow assumes no liability for any issues arising from improper use of this marketing content.

DESCRIPTIONS

MATERIALS LIST

The BOM (Bill Of Materials) package, known as the Materials Shopping List document, provides:

Comprehensive Inventory: Detailed lists of essential materials sourced from architectural, mechanical, HVAC, electrical, and plumbing design drawing sets.

Precise Curation: Each item meticulously selected and organized for accuracy and efficiency in project planning.

Customizable Options: Customers can modify listed items to their preferences and calculate costs accordingly, ensuring alignment with personal project needs and budget.

Dedicated Space for Details: Includes tables for customers to note Home Depot SKU numbers or product descriptions for selected items,

Customer Convenience: Take the list to Home Depot or preferred suppliers for accurate pricing, helping align the total home budget with personal financial plans.

facilitating seamless purchasing and coordination with suppliers.

Simplify your construction journey with our Materials Shopping List document, where detailed preparation meets streamlined implementation for your dream home.

handlers, ductwork, and vents throughout the home's layout.

HVAC Sections and Riser Diagrams: Technical drawings offering

critical cross-sectional details and piping schematics, ensuring

proper integration of the heating and cooling system into the home's

Bill of Materials: A complete list of all necessary HVAC components.

MECHANICAL

structure.

STRUCTURAL

The structural drawings package provides an exhaustive set of detailed plans essential for the precise assembly of your building. This comprehensive package includes:

Framing Plans: Detailed layouts for all framing components. Truss Layouts: Clear instructions for truss placement and

Panel Length Plans: Specifications for panel dimensions. Framing Elevations and Sections: Precise elevation and sectional views for accurate construction.

Truss and Wall Blocking Plans: Plans for truss and wall blocking to ensure structural integrity.

Hold-Down Plan: Detailed hold-down requirements for stability. Snap Sheet: Reference sheet for quick identification of components

Structural Details and Bracing Plans: Complete details and bracing plans for all structural elements.

Accompanying these plans is a comprehensive Bill of Materials (BOM) that lists every necessary building component, from cold formed steel (CFS) frames to fasteners.

ARCHITECTURAL

With the comprehensive architectural package, both builders and DIY homeowners can confidently execute the construction.

The architectural package includes:

Furnished Floor Plans: Complete with furniture layouts for a clear understanding of space utilization.

Detailed Dimension Plans: Ensures precise measurements, from the overall footprint down to the exact placement of windows and

Foundation Plan: Detailed plan to establish a solid foundation.

Wall Framing and Truss Layout: Comprehensive plans for wall framing and truss placement.

Architectural Elevations: Exterior views showcasing the design.

Strategic Building Sections: Critical cross-sectional details for a thorough understanding of the build.

Casework Drawings and Diagrams: Suggested designs for built-in caseworks, such as kitchen cabinets.

ELECTRICAL

The mechanical package includes everything needed to guide HVAC The electrical package includes all the plans and documentation needed to guide the installation of your home's electrical system:

Detailed HVAC Floor Plan: Precisely maps out the placement of air Detailed Power Plan: Precisely maps out the placement of outlets, switches, and other power components throughout the layout.

> Comprehensive Lighting Plan: Shows the optimal locations for lighting fixtures, sconces, and other illumination sources to create a well-lit, functional interior.

Dimensioned Electrical Layout: Provides exact dimensions and measurements to ensure proper placement of all electrical elements.

Bill of Materials: A complete list of every component needed, from circuit breakers to wiring.

The plumbing package includes everything needed to guide the installation of your home's water supply and drainage systems:

Detailed Water Supply System Plan: Precisely maps out the placement of pipes, valves, and plumbing fixtures throughout the

Comprehensive Sewage System Plan: Shows the optimal routing and sizing of drain lines to effectively remove waste and ensure

Detailed Riser Diagrams: Provide information needed to properly

Bill of Materials: A complete list of every component needed, from

PLUMBING

proper drainage.

install all vertical plumbing risers and vent stacks.

pipes to fixtures.


BOM (Bill Of Materials) (Separately Attached)





The Bill of Materials (BOM) is a crucial document that compiles the material requirements from different disciplines into a centralized inventory, enabling efficient procurement, inventory management, and cost estimation for a specified project or

ELECTRICAL BOM



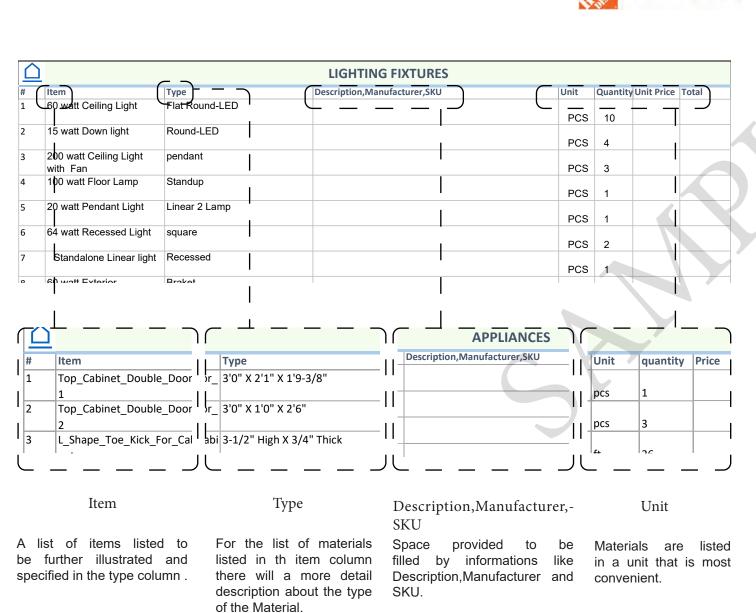

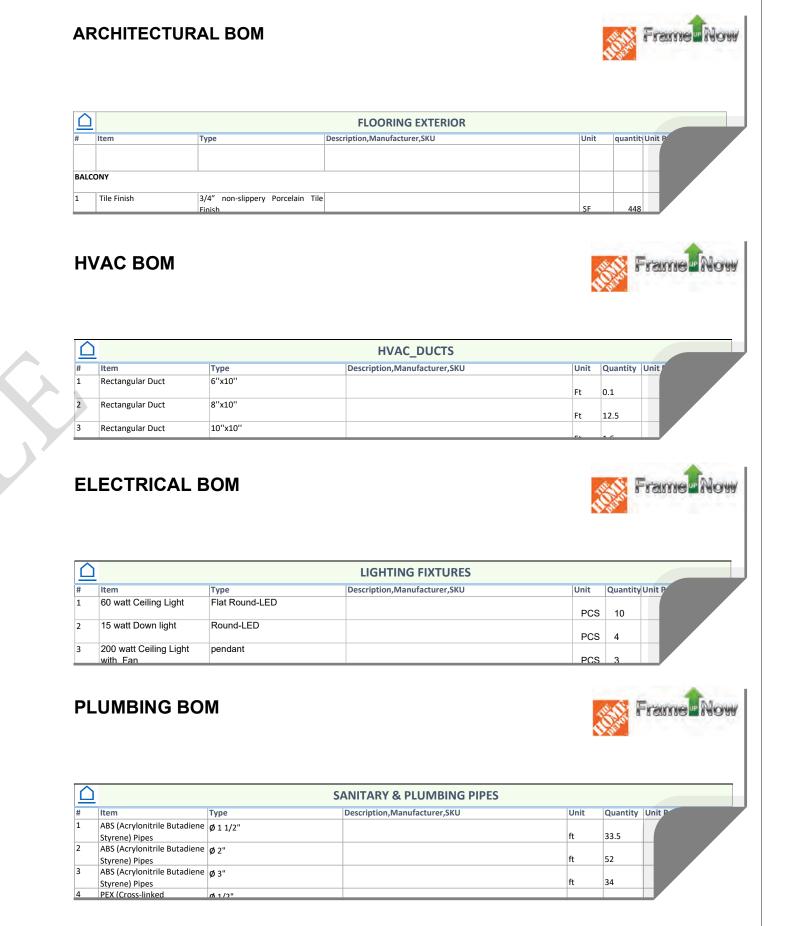

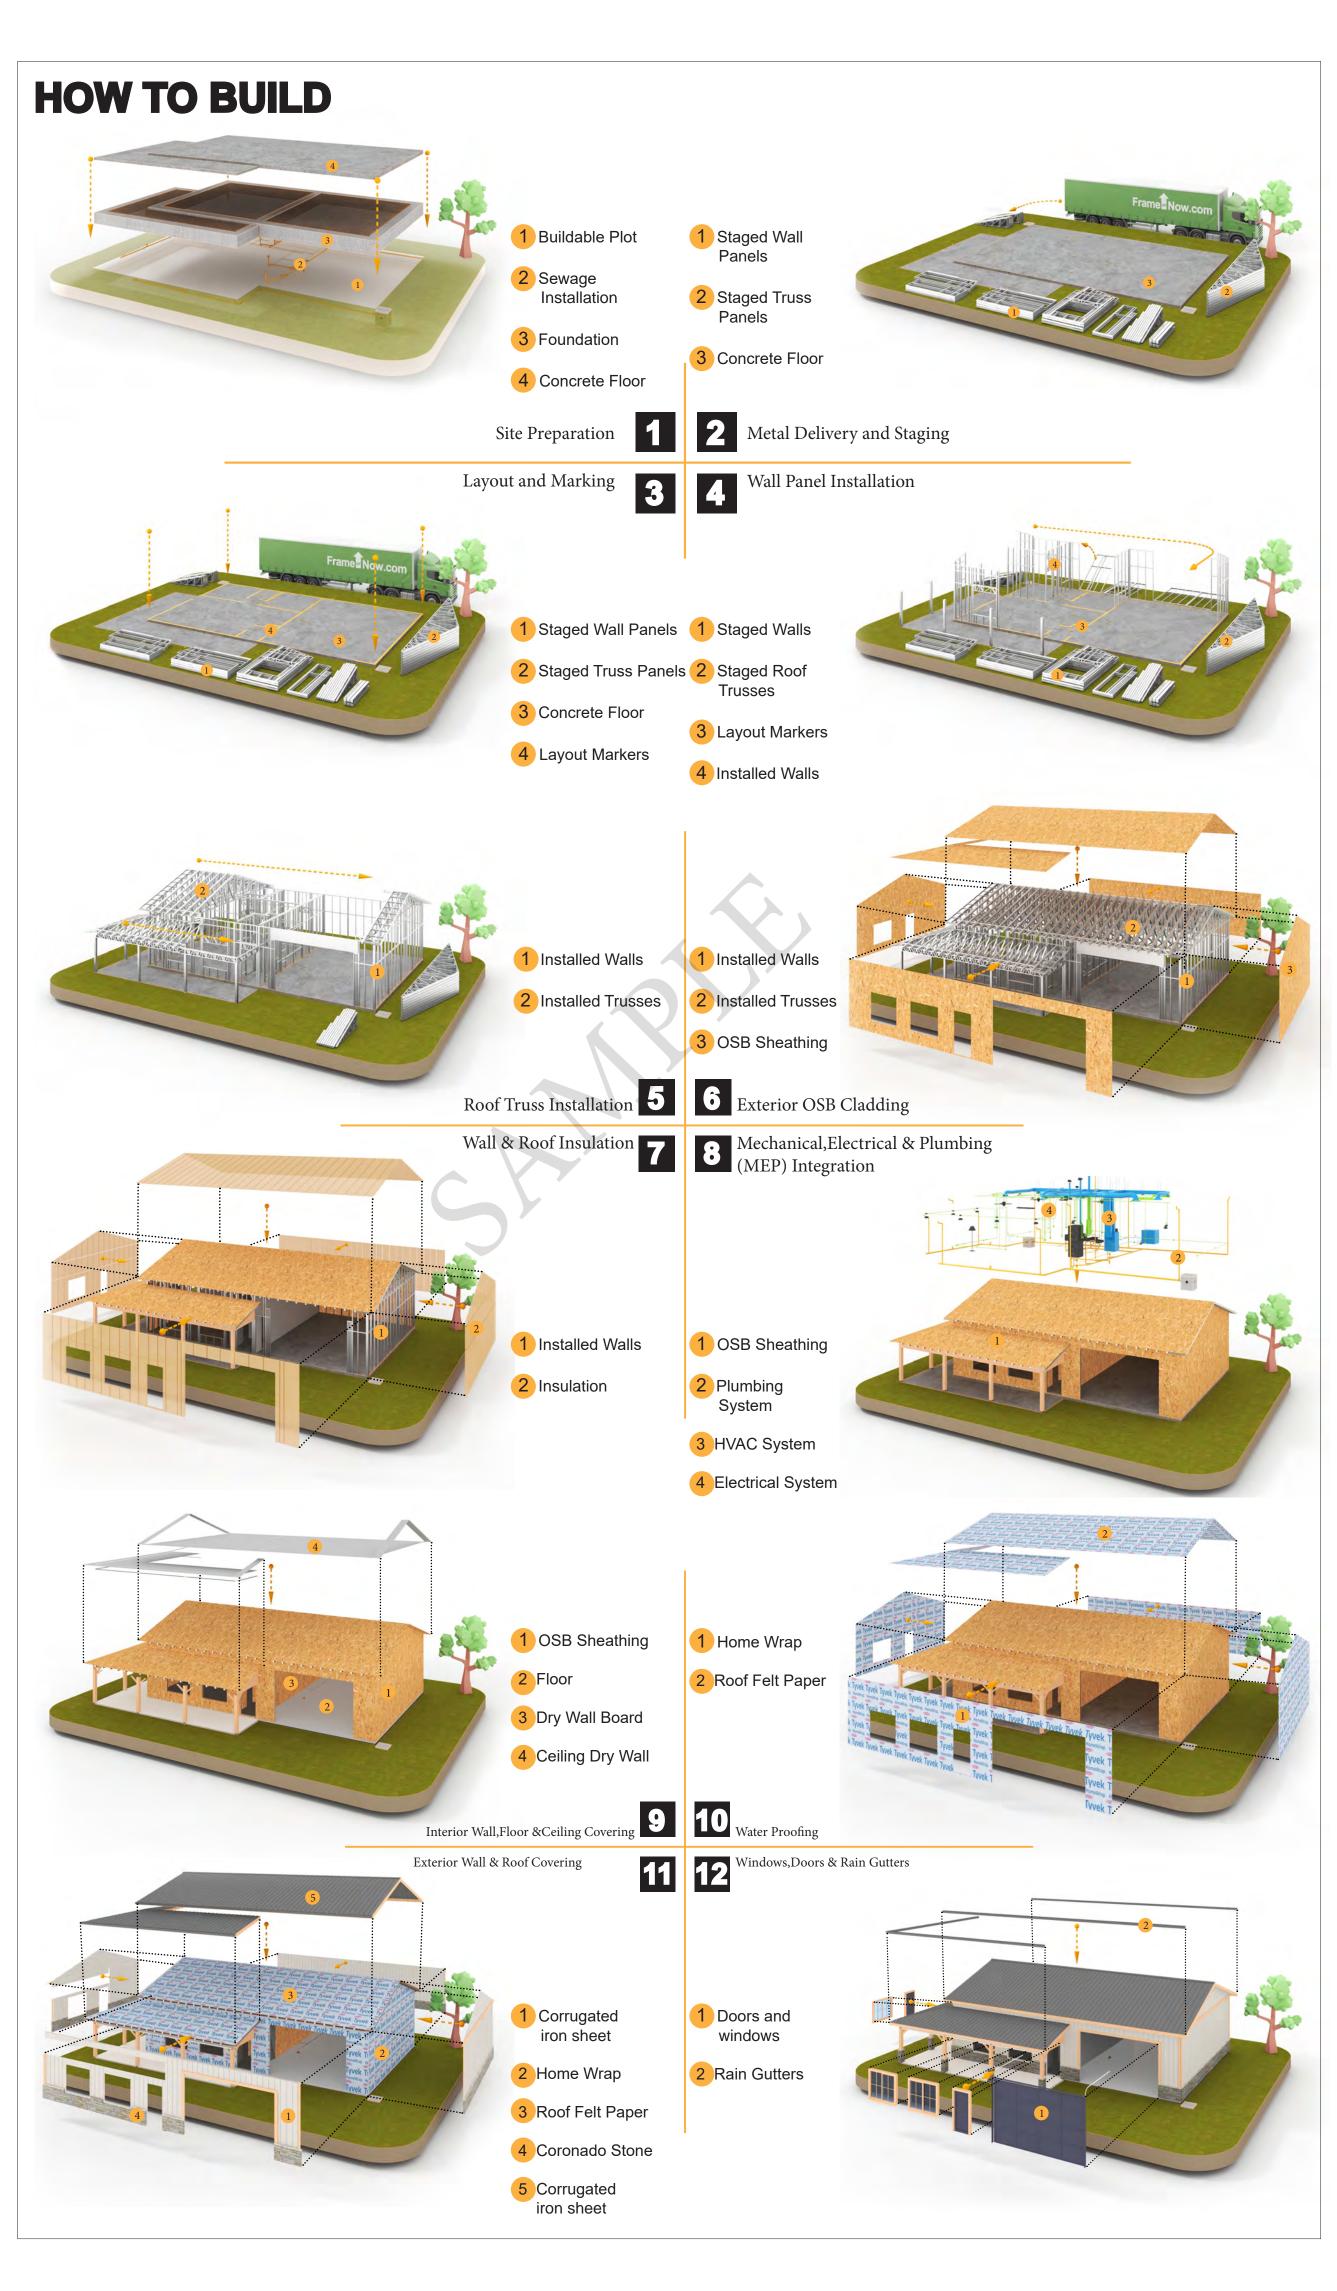



KEY PLAN

NO.	DESCRIPTION	DATE

NOTE:

LEGEND:

PROJECT

154-Haven-491-1Bd1Ba-Alpine-550


DRAWING NAME

INTRODUCTION

CLIENT NAME: PROJECT NUMBER: DATE: **DESIGNED BY** DRAWN BY: CHECKED BY:

1102

SCALE:

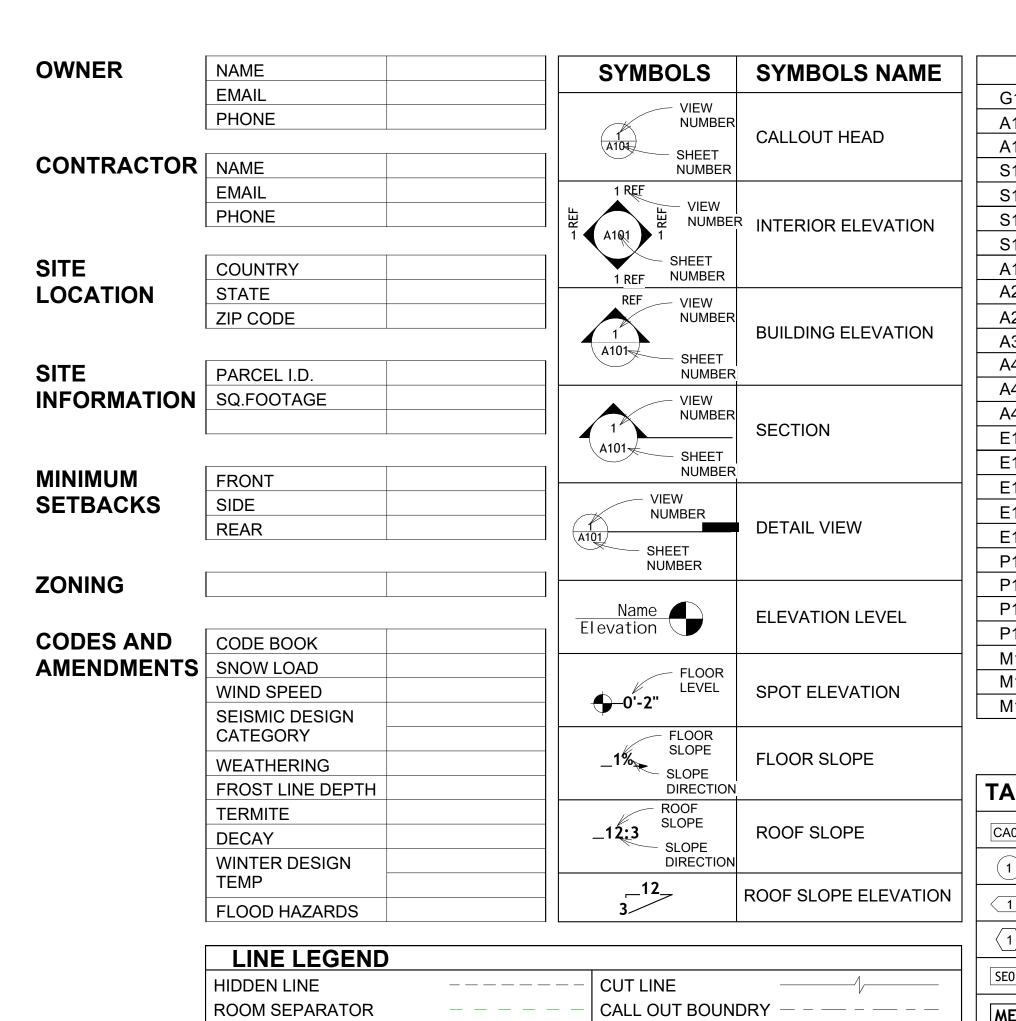


DOOR OPENING DIRECTION


OVER HEAD

	PAGE INDEX	A	BBREVIATION
G101	COVER SHEET	AFS	ACTION FLOOR SYSTEMS
A101	FLOOR PLAN	ASTM D698	AMERICAN SOCIETY FOR
A102	DIMENSION PLAN		TESTING AND MATERIAL
S101	FOUNDATION PLAN	CA	CASEWORK
S102	STRUCTURAL FLOOR PLAN	EL	ELECTRICAL
S103	FRAME LAYOUT	F.F.E	FINISHED FLOOR ELEVATION
S104	ROOF TRUSS LAYOUT	F.F.L	FINISHED FLOOR LEVEL
A103	ROOF PLAN	FTG	FOOTINGS
A201	ELEVATIONS	HVAC	HEATING, VENTILATION & A
A202	ELEVATIONS		CONDITIONING
A301	SECTIONS	IRC	INTERNATIONAL RESIDENC
A401	DETAILS		CODE
A402	CASEWORK DETAILS	IMC	INTERNATIONAL MECHANIC
A403	CASEWORK DETAILS		CODE
E101	SCHEDULE	MAX.	MAXIMUM
E102	LIGHTING PLAN	ME	MECHANICAL
E103	POWER PLAN	MIN.	MINIMUM
E104	DIMENSION PLAN FOR LIGHT FIXTURE	NO.	NUMBER
E105	DIMENSION PLAN FOR FITTING	0.C	ON CENTER
P101	COVER SHEET	OSB	ORIENTED STRAND BOARD
P102	WATER SUPPLY SYSTEM	PL	PLUMBING
P103	SEWAGE SYSTEM	PSI	POUNDS PER SQUARE INC
P104	RISER DIAGRAM	PVC	POLYVINYL CHLORIDE
M101	HVAC PLAN	REF	REFERENCE
M102	HVAC SECTION	RG	RIGHT GARAGE
M103	RISER DIAGRAM	SE	SPECIAL EQUIPMENT
		SF	SQUARE FEET
		SIMP. STHD8	SIMPSON STRAP THE
TAG	TAG'S NAME		HOLDDOWN
1710		SIMP. ABE66	SIMPSON ANCHOR BOLT E
CA01	CASEWORK TAG	TV	TELEVISION
(1)	DOOR TAG	UNO	UNLESS NOTED OTHERWIS
		W/	WITH
1	FURNITURE TAG	W/D	WASHER/DRYER
	WINDOW TAG	AC	AIR CONDITIONING UNIT
SE01	SPECIALTY EQUIPMENT TAG	ACC	AIR COOLED CONDENSER
MEO1	MECHANICAL EQUIPMENT TAG	ACCU AHU	AIR COOLED CONDSENSING U
DEC.4	DI LIMBING EQUIDATAT TAG	CC	AIR HANDLING UNIT COOLING COIL
LPE01	PLUMBING EQUIPMENT TAG	CD	CEILING DIFFLISER
			· · · · · · · · · · · · · · · · · ·



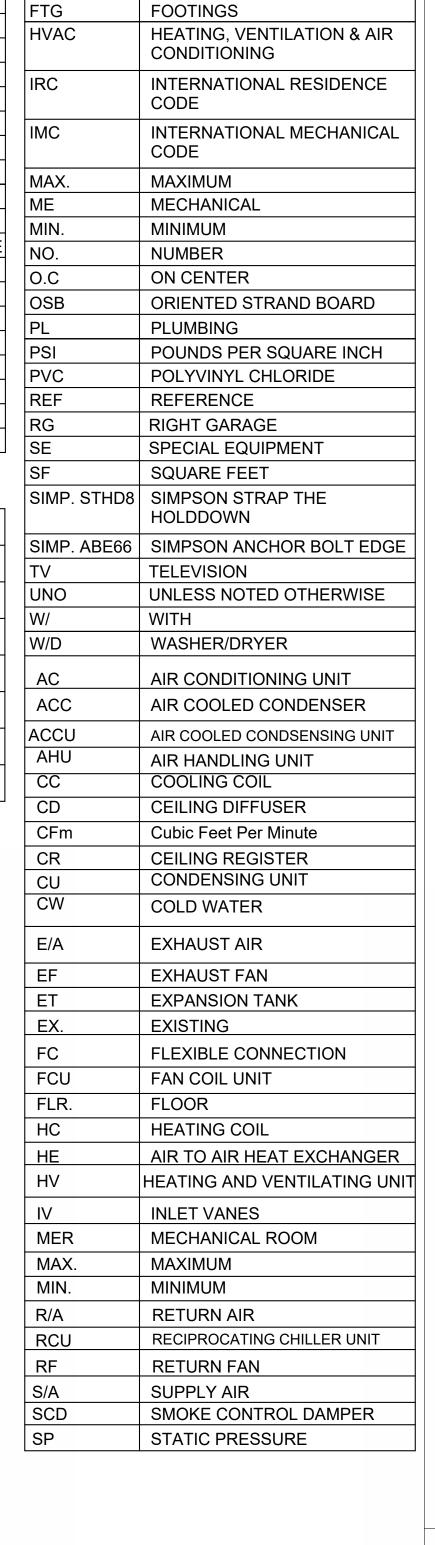

FINISHED FLOOR ELEVATION

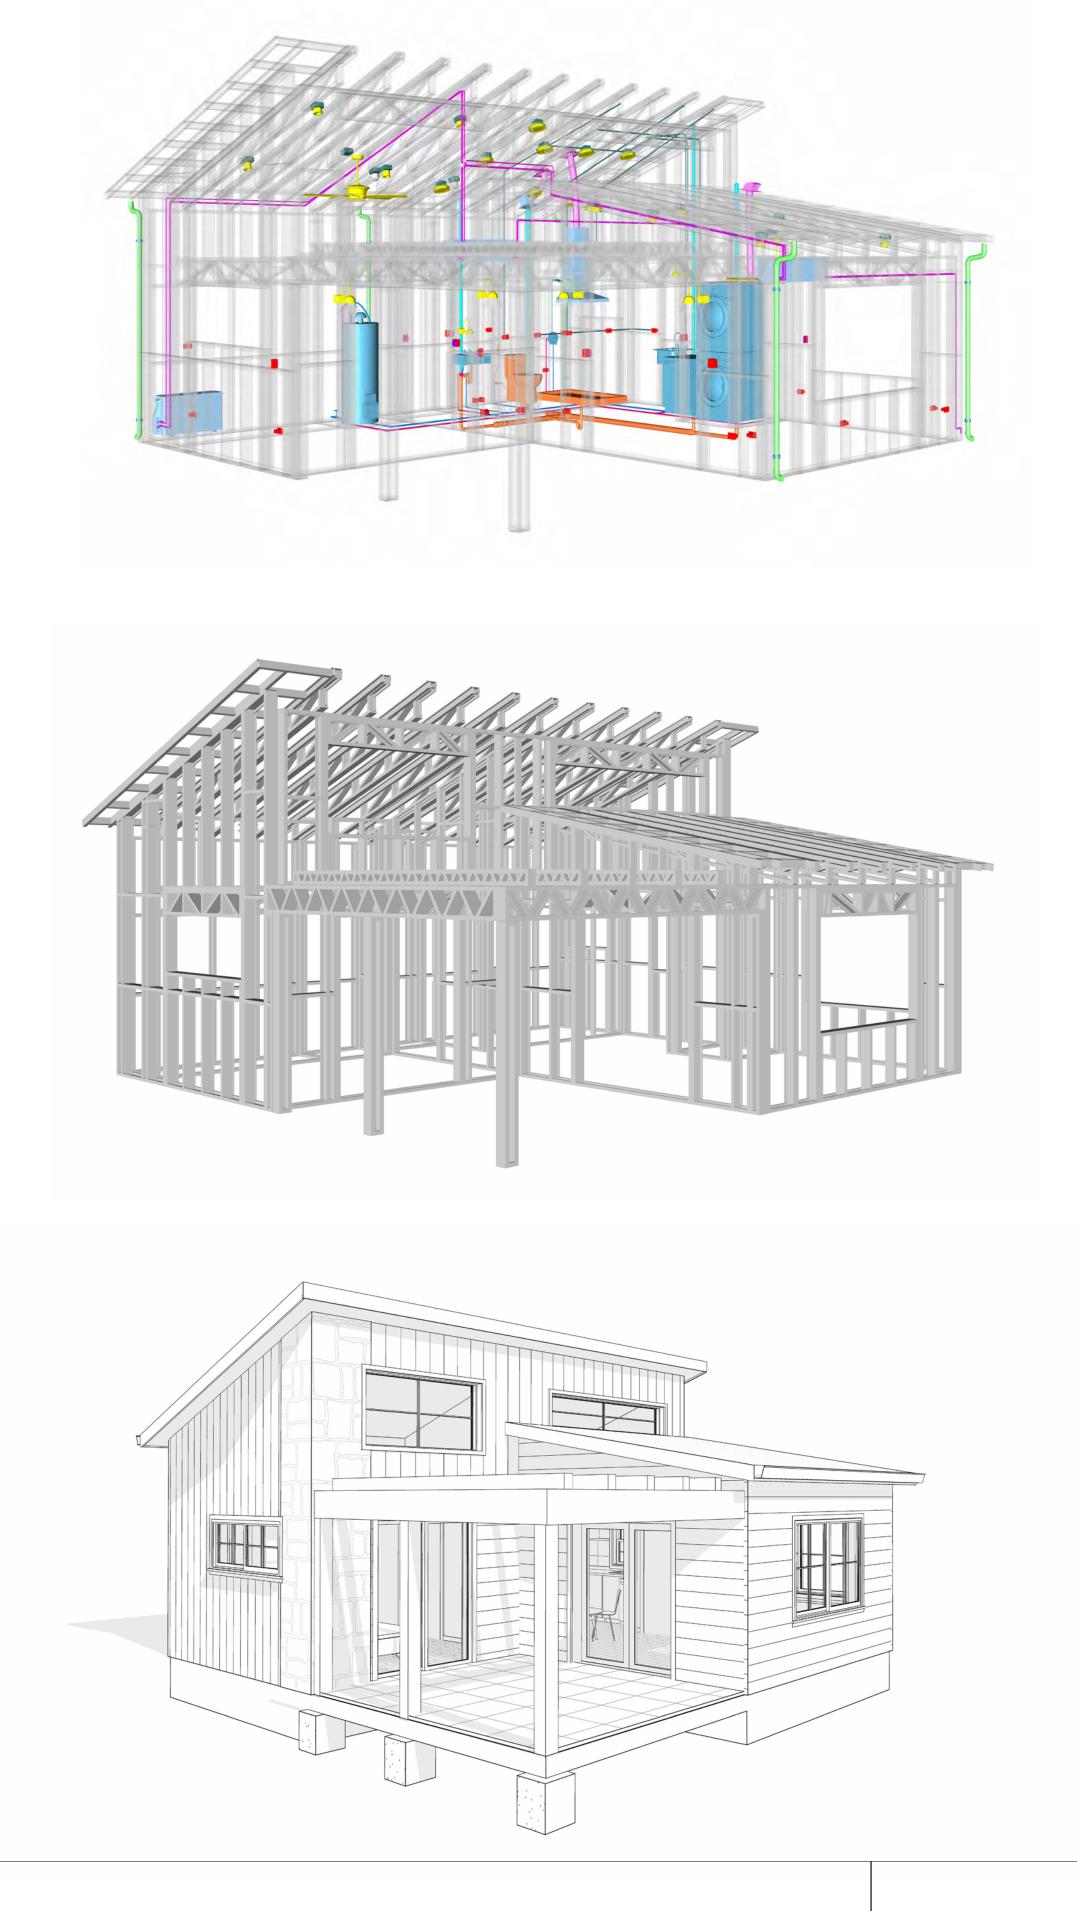


154 HAVEN 491 1Bd/1Ba **ALPINE 550**

SQUARE FOOT	AGE
LIVING	491
PORCH	147
TOTAL	638



KEY PLAN

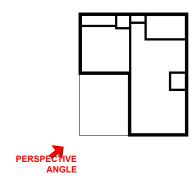

NO.	DESCRIPTION	DATE
	•	

NOTE:

LEGEND:

PROJECT

154 HAVEN 491 1Bd/1Ba **ALPINE 550**

DRAWING NAME

COVER SHEET

CLIENT NAME:	Client Name
PROJECT NUMBER:	0061_12
DATE:	4/1/2025 12:59:21 PM
DESIGNED BY:	Designer
DRAWN BY:	Author
CHECKED BY:	Checker

G101

GENERAL NOTES

- 1. THIS DRAWING DEPICTS THE ARCHITECTURAL (SPACE LAYOUT, FURNISHING, FLOOR, WALLS, ROOFS, FOUNDATION, WINDOWS AND DOORS) SYSTEMS. IT PROVIDES A VISUAL REPRESENTATION OF THE ARCHITECTURAL LAYOUT AND COMPONENTS.
- 2. THE ARCHITECTURAL DRAWINGS ARE PREPARED TO MEET THE SPECIFIC REQUIREMENTS OF THE BUILDING, AS PER THE PROJECT SPECIFICATIONS AND APPLICABLE CODES AND STANDARDS.
- THE CONSTRUCTION OF THIS HOME SHALL COMPLY WITH THE LATEST EDITION OF THE INTERNATIONAL RESIDENTIAL CODE (IRC), INTERNATIONAL MECHANICAL CODE (IMC), THE INTERNATIONAL PLUMBING STANDARD, THE NATIONAL ELECTRICAL STANDARD AND ALL OTHER APPLICABLE LOCAL, STATE, AND NATIONAL CODES AND REGULATIONS.
- COORDINATION WITH OTHER TRADES HAS BEEN DONE ON A DESIGN LEVEL. THIS DRAWING SHALL BE READ TOGETHER WITH THE ME, EL AND PL DESIGN DRAWINGS TO ENSURE PROPER CONSTRUCTION AND INTEGRATION OF THE BUILDING SYSTEMS.

ABOUT WALLS:

- 1. SHOWER WALL COVERING
 - BATHTUB AND SHOWER SPACES (WALLS AND FLOORS) WITH INSTALLED SHOWER HEADS AND IN SHOWER COMPARTMENTS SHALL BE FINISHED WITH A NON-ABSORBENT SURFACE.
- 2 WALL PAINT (INTERNAL)
- THE TYPICAL THICKNESS OF LATEX WALL PAINT IS 1/32 OF AN INCH FOR A SINGLE COAT. AND DOUBLE COAT (1/16") SHALL BE APPLIED FOR DURABILITY.

B. ADHESIVES

THE ADVISABLE TYPE OF ADHESIVE FOR THIS PROJECT IS **EPOXY ADHESIVES**BECAUSE THEY ARE KNOWN FOR THEIR HIGH STRENGTH, DURABILITY, AND RESISTANCE TO MOISTURE, CHEMICALS AND HEAT.

REFER TO SHEETS A201 & A202 FOR GENERAL NOTES ON EXTERNAL FINISHING MATERIALS

ABOUT FLOORS:

- THE SPOT ELEVATION INDICATES THE FINISHED FLOOR ELEVATION.
- 2. FINISHED FLOORS PER PLANS.
- 3. FIELD VERIFY FOR DIMENSION DROP 4" FOR SHOWER AND BATHTUB USE.
- 4. 1% SLOPE ON OUTDOOR BALCONIES FOR WATER RUN OFF.
- 5. 2% SLOPE TOWARDS THE SHOWER DRAIN FOR SUFFICIENT DRAINAGE.


DINING CHAIR
Coffe Table

- 6. 4" DROP AT THE DOOR LEADING TO EXTERIOR BALCONY FROM THE MAIN LIVING AREA.
- 5% SLOPE FOR GARAGE IS USED, WHICH SHOULD BE CHECKED WITH THE LOCAL GARAGING ZONING LAWS.

	FURNIT	URE SCHEDULE	
TYPE MARK	TYPE	COUNT	_
1	60" X 80" - Queen	1	
2	THREE SEAT SOFA	1	

		RC	OM FINIS	SH SCHEDULE			
ROOM NUMBE R	ROOM NAME	FLOOR FINISH	BASE FINISH	WALL FINISH	CEILING FINISH	CEILING HEIGHT	COM MEN TS
		1					
1	KITCHEN	HARDWOOD	CONCRETE	WALL PAINT + CERAMIC	DRY WALL	8' - 0"	
2	LIVING AREA	HARDWOOD	CONCRETE	WALL PAINT	DRY WALL	8' - 0"	
3	W/D	VINYL TILES	CONCRETE	CERAMIC TILE	DRY WALL	8' - 0"	
4	BEDROOM	HARDWOOD	CONCRETE	WALL PAINT	DRY WALL	8' - 0"	
5	CL 1	HARDWOOD	CONCRETE	WALL PAINT	DRY WALL	8' - 0"	
6	WH	VINYL TILES	CONCRETE	WALL PAINT	DRY WALL	8' - 0"	
7	CL 2	HARDWOOD	CONCRETE	WALL PAINT	DRY WALL	8' - 0"	
8	BATH	VINYL TILES	CONCRETE	CERAMIC TILE	MRD	8' - 0"	
9	HALL	HARDWOOD	CONCRETE	WALL PAINT	DRY WALL	8' - 0"	
10	PATIO	PROCELAIN TILE	CONCRETE	EXTERIOR-GRADE PLYWOOD	PLYWOOD	8' - 0"	



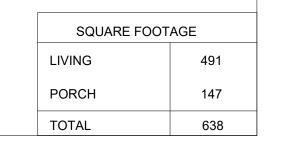



KEY PLAN

NO.	DESCRIPTION	DATE

NOTE:

LEGEND:

PROJECT


154 HAVEN 491 1Bd/1Ba ALPINE 550

DRAWING NAME

FLOOR PLAN

Client Name	CLIENT NAME:
0061_12	PROJECT NUMBER:
4/1/2025 12:59:21 PM	DATE:
Designer	DESIGNED BY:
Author	DRAWN BY:
Checker	CHECKED BY:

A101

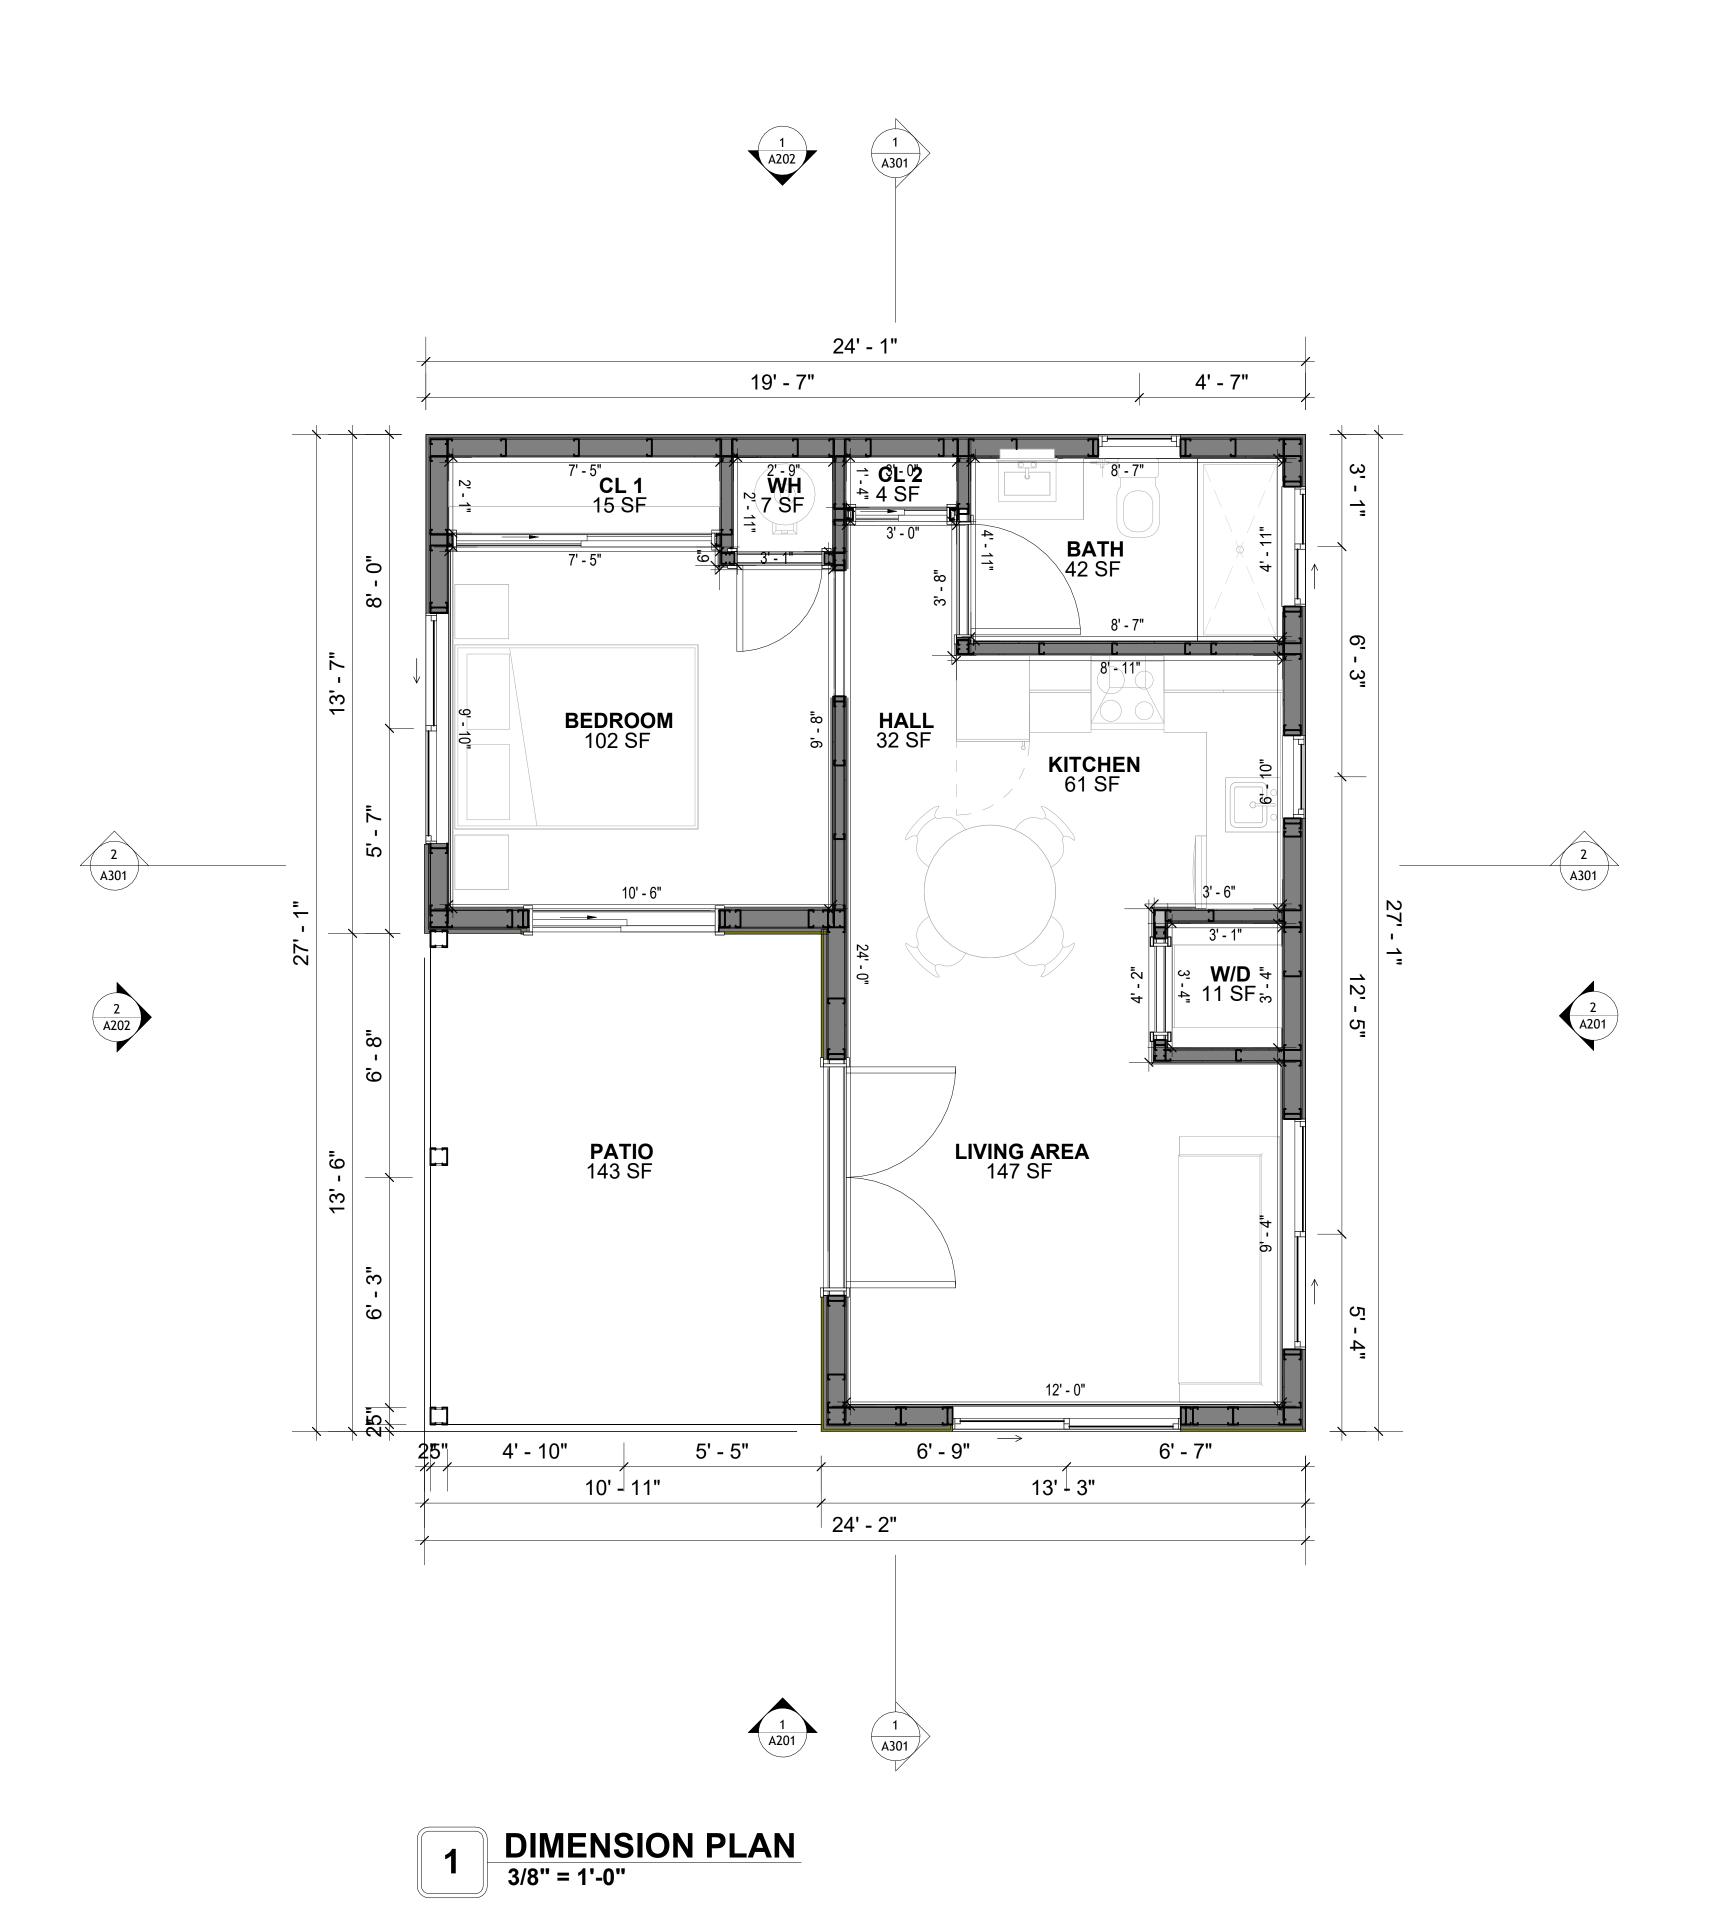

SQUARE FOOTAGE

LIVING 491

PORCH 147

TOTAL 638



KEY PLAN

NO.	DESCRIPTION	DATE

NOTE:

LEGEND:

PROJECT

154 HAVEN 491 1Bd/1Ba ALPINE 550

DRAWING NAME

DIMENSION PLAN

CLIENT NAME:	Client Name
PROJECT NUMBER:	0061_12
DATE:	4/1/2025 12:59:22 PM
DESIGNED BY:	Designer
DRAWN BY:	Author
CHECKED BY:	Checker

A102

SCALE: 3/8" = 1'-0"

DIMENSIONS IN THE ARCHITECTURAL DRAWINGS CONSIDER FINISHING MATERIALS. FOR PRECISE MEASUREMENTS OF THE STRUCTUAL FRAMING, REFER TO THE ATTACHED STRUCTURAL PLAN SET.

FOUNDATION NOTES

NOTES:

TERMITES PRETREATMENT BY LICENSED CONTRACTOR UNDER SLAB AND AROUND FOOTINGS. ALL AREAS BELOW SLABS SHALL BE TREATED NO MORE THAN 24 HOURS PRIOR TO CONCRETE POUR. EVIDENCE OF TREATMENT MUST BE PROVIDED PRIOR TO PLACING OF CONCRETE.

MATERIALS:

ALL INTERIOR CONCRETE SLABS SHALL BE A MIN. OF 4" THICK CONCRETE OVER 4" COMPACTED AGGREGATE BASE (ASTM D698), FINISH ELEVATIONS AS NOTED ON DRAWINGS, 6" ABOVE ADJACENT GRADE, LEVEL SLABS TO 1/8"-10' MAX.. CONCRETE SLABS SHALL BE 2500# PSI AT 28 DAYS. A 4" ALLOWABLE SLUMP.

2. **PAD PREPARATION:**

EXCAVATION FOR FOOTING SHALL BE NEAT.

FOOTINGS SHALL BE POURED IMMEDIATELY AFTER EXCAVATION AND APPROPRIATE INSPECTION.

ALL REINFORCING STEEL MARKED "CONTINUOUS" SHALL BE LAPPED 36 BAR DIAMETERS AT SPLICES AND AROUND CORNERS OR INTERSECTIONS WITH A STANDARD 90 DEGREE BEND ON CORNER BARS. LAP WIRE MESH ONE FULL MESH AT SIDE AND END LAPS.

ALL HARDWARE TO BE SIMPSON OR EQUIVALENT. EXTERIOR FRAME WALL TO BE SECURED WITH 1/2"X10" ANCHOR BOLTS 4'-0" O.C. FOR 1-STORY AND 2'-8" O.C. FOR 2-STORY. BOLTS SHALL BE LOCATED WITHIN 1'-0" OF EACH END PIECE AND SHALL HAVE A MIN. OF TWO BOLTS PER PIECE.

-FOUNDATION ANCHOR STRAPS SHALL BE PERMITTED.ACCORDING TO RESIDENTIAL CODE

- ALL INTERIOR WALLS TO BE SECURED WITH POWER DRIVEN PINS PER MANUFACTURER SPECIFICATION USE PIN SPACING EQUIVALENT TO 1/2" ANCHOR BOLTS.

ALL CONSTRUCTION TO CONFORM TO THE 2012 IRC · R-10 RIGID INSULATION OUTSIDE OF EXTERIOR FOUNDATION WALLS UNDER LIVING AREA.

CONCRETE PAD FOR CONDENSER THICKNESS IS 4" MIN UNLESS OTHERWISE NOTED.

3. CONCRETE CONSTRUCTION:

- THE SLAB SHALL BE UNDERLAIN BY A VAPOR BARRIER/RETARDER IN THE LIVING AREA (TYPICALLY POLYETHYLENE, UNLESS MORE STRINGENT PROTECTION REQUIRED BY THE ARCHITECT, ENGINEER, FLOOR COVERING MANUFACTURER, OR ACCEPTED PRACTICE). UNLESS OTHERWISE REQUIRED, BARRIER MAY BE OMITTED AT GARAGES, PORCHES AND PATIOS WITHOUT FLOOR COVERINGS. IT IS BEYOND THE SCOPE OF THESE PLANS TO DETERMINE THE APPLICABILITY OF THESE MORE STRINGENT REQUIREMENTS. BUILDER SHALL VERIFY PRIOR TO CONSTRUCTION.

4. REINFORCEMENT:

IF CONSTRUCTED ON ACTIVE SOILS, THE LONG TERM PERFORMANCE OF THE FOUNDATION IS DEPENDENT ON MAINTENANCE BY THE OWNER. THUS THE BUILDER SHALL ADVISE THE OWNER OF THE FOLLOWING:

- DRAINAGE MUST BE MAINTAINED. WATER SHALL NEVER BE ALLOWED TO POND NEAR THE FOUNDATION.
- 2. THE SOIL AROUND THE FOUNDATION SHALL BE MAINTAINED IN A RELATIVELY DAMP CONDITION, SUCH AS THAT REQUIRED TO KEEP A LAWN GREEN. IF IT DRIES OUT IT WILL

SHRINK. IF IT GETS WET, IT WILL HEAVE UPWARD. 3. SLABS ON THE SHORTER SIDE USES MAIN BARS ARE USED IN THIS DIRECTION ONLY WITH SMALLER DIAMETER DISTRIBUTION BARS ARE PLACED, FORMING A MAT OR GRID.


- 4. ALL REINFORCEMENT BARS SIZE 10MM OR LARGER IN ACCORDANCE TO ASTM 3. ANCHOR BOLTS AT ALL EXTERIOR WALLS SHALL BE MINIMUM 1/2 INCH DIAMETER WITH A
- MAXIMUM SPACING OF 6'-0" ON CENTER, UNLESS NOTED OTHERWISE. 4. ANCHOR BOLTS SHALL BE INSTALLED WITHIN 12 INCHES OF EACH END OF EACH SILL PLATE WITH AT LEAST TWO ANCHOR BOLTS FOR EACH BOLTS FOR EACH SILL PLATE LONGER
- THAN 12 INCHES. 5. SIMPSONS SILL ANCHORS MAYBE SUBSTITUTED FOR ANCHOR BOLTS AT THE SAME SPACING.

6. EXTERIOR CONCRETE SLABS WHICH ARE NOT PART OF THE MAIN SLAB SHALL BE MINIMUM 4 INCHES THICK WITH NO STEEL REINFORCING BARS REQUIRED, UNLESS NOTED OTHERWISE ON FOUNDATION PLAN.

VERIFY THE FOLLOWING PRIOR TO POURING:

- ALL HOLDDOWNS, STRAP, AND POST LOCATIONS.
- 2. CONCRETE FINISHES. PANEL RISER LOCATION WHERE APPLICABLE.
- B. UNDERSLAB MECHANICAL REQUIREMENTS.
- . STEM WALL BLOCKOUTS.
- 5. UNDERSLAB ELECTRICAL REQUIREMENTS AND PANEL RISER LOCATION. WHERE APPLICABLE.
- PROVIDE THE FOLLOWING:
- PVC SLEEVES THROUGH FTG IF REQUIRED
- 20' #4 COPPER GROUND BAR.
- SLOPE FINISH GRADE AWAY FROM FOOTING.

NOTE: FIELD VERIFY ALL DIMENSIONS SEE DIMENSIONED ARCHITECTURAL DRAWINGS

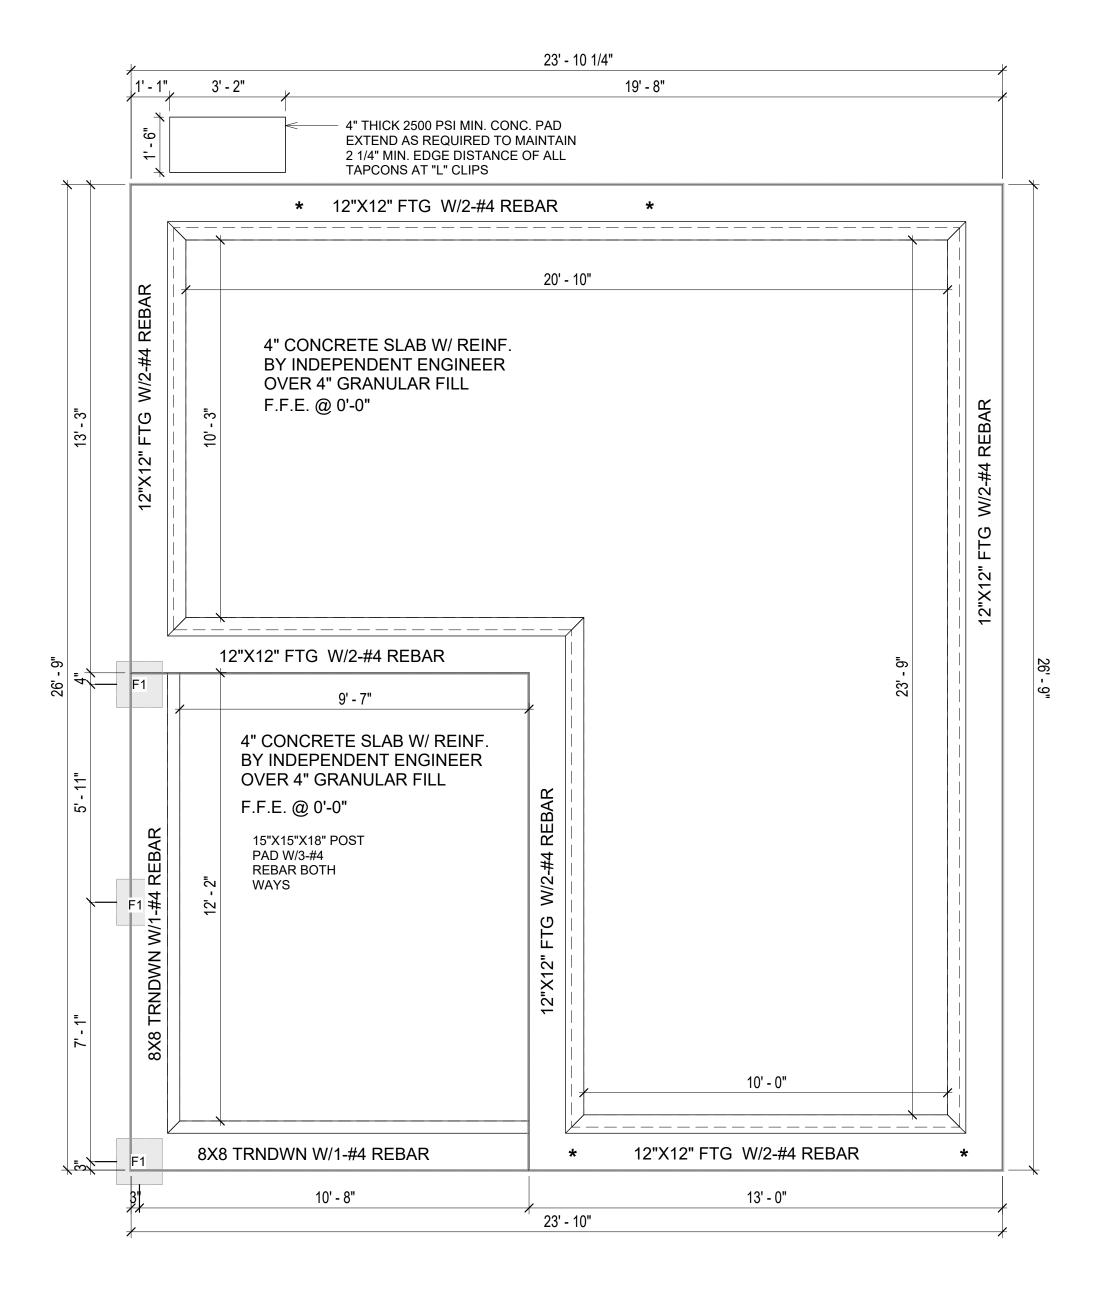

FOUNDATION PLAN 3/8" = 1'-0"



KEY PLAN

NO.	DESCRIPTION	DATE

NOTE:

LEGEND:

PROJECT

154 HAVEN 491 1Bd/1Ba **ALPINE 550**

DRAWING NAME

FOUNDATION PLAN

Client Name	CLIENT NAME:
0061_12	PROJECT NUMBER:
4/1/2025 12:59:22 PM	DATE:
Designer	DESIGNED BY:
Author	DRAWN BY:
Checker	CHECKED BY:

S101

SQUARE FOOTAGE

491

147

638

LIVING

PORCH

TOTAL

© [2024] [FrameUpNow] . All rights reserved

SCALE: 3/8" = 1'-0"

GENERAL NOTES

NOTES:

-ALL BEARING WALLS SHOULD HAVE A THICKENED SLAB PER SECTION PER DETAIL A401/5.

A) **FOUNDATION PLAN NOTES**:

- 1. CONCRETE SLAB SHALL BE 6" THICK WITH 1/2" DIAMETER TENDONS PER LAYOUT PLAN, CENTERED IN SLAB THICKNESS, OVER APPROVED SUBBASE PER GENERAL STRUCTURE NOTES.
- TERMITE PROTECTION SHALL BE PROVIDED PER IRC SECTION R318.1
 NONE TYPICAL ANCHOR BOLT SPACING AT SHEAR WALL AND HOLD DOWN
- SPECIFICATIONS PER APPROVED ARCHITECTURAL PLANS.

 4. INSTALL HOLDOWNS BEFORE CONCRETE SLAB POUR.
- 5. EXISTING FILL ON-SITE SHALL BE COMPACTED IN ACCORDANCE WITH THE
- REQUIREMENTS IN THE GEOTECHNICAL REPORT.

 6. ALL FLOOR SLABS ARE REINFORCED ON CONCRETE SLABS.

SPECIAL INSPECTION IS REQUIRED FOR THICKENED FOUNDATION CONSTRUCTION

- 1. REINFORCEMENT
- 2. 2300 PSI CONCRETE POUR

B) REINFORCEMENT FOR CONCRETE:


 ALL REINFORCING SLABS BARS SIZE 10MM OR LARGER SHALL BE DEFORMED IN ACCORDANCE TO ASTM-A706, AND BARS SMALLER THAN 10 MM MAYBE PLAIN.
 UNLESS OTHERWISE NOTED IN PLANS, THE YIELD STRENGTH OF REINFORCING BARS SHALL BE:


> A) FOOTING = 40,000 PSI B) NON-LOAD BEARING WALLS AND PARAPETS= 40,000 PSI

- 3. SPLICES SHALL BE SECURELY WIRED TOGETHER AND SHALL LAP OR EXTEND
- 4. GRADE OF STEEL FOR RCC WORKS SHALL BE GRADE 4 10.
- . BAR NOTATIONS GIVES INFORMATION
- A) BAR SIZE
- B) SPACING(IF REQUIRED)
- 6. LAP REINFORCEMENT ONLY AT LOCATION SHOWN IN THE DRAWINGS
 7. REINFORCEMENT SHALL NOT BE CLIT, VENT OR HEATED ON SITE WITH
- 7. REINFORCEMENT SHALL NOT BE CUT, VENT OR HEATED ON SITE WITHOUT ENGINEERS' APPROVAL.
- C) CONCRETE SLAB NOTES
- 1. ALL SLAB REINFORCEMENT SHALL BE 20MM CLEAR MINIMUM FROM BOTTOM AND FROM TOP OF SLAB.
- 2. REINFORCEMENT IN CONTINUOUS ELEVATED SLAB SHALL BE CUT AS FOLLOWS.

NOTE

- THIS IS A SCHEMATIC PLAN FOR THE PURPOSE OF LOCATING AND IDENTIFYING FOUNDATION REINFORCING ELEMENTS ONLY. VERIFY ALL DIMENSIONS, DROPS, OFFSETS AND FEATURES WITH THE ARCHITECTURAL PLANS BEFORE FORMING THE FOUNDATION.

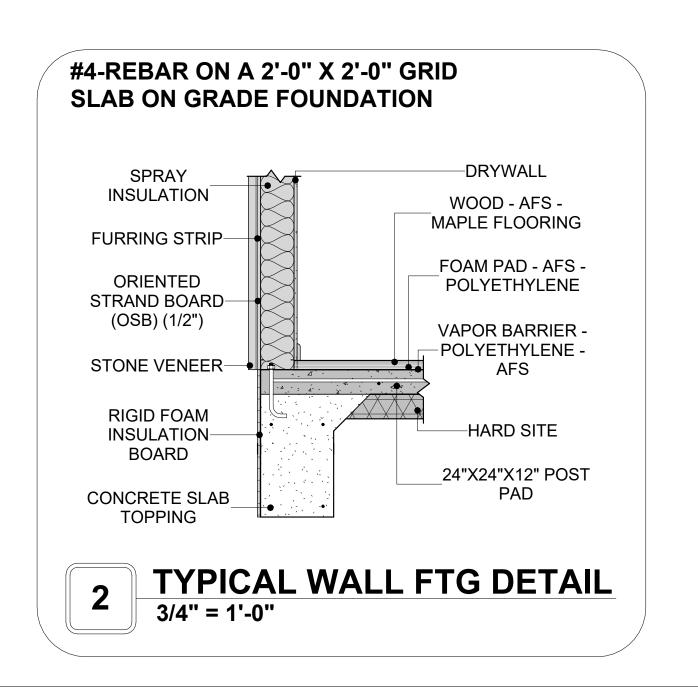

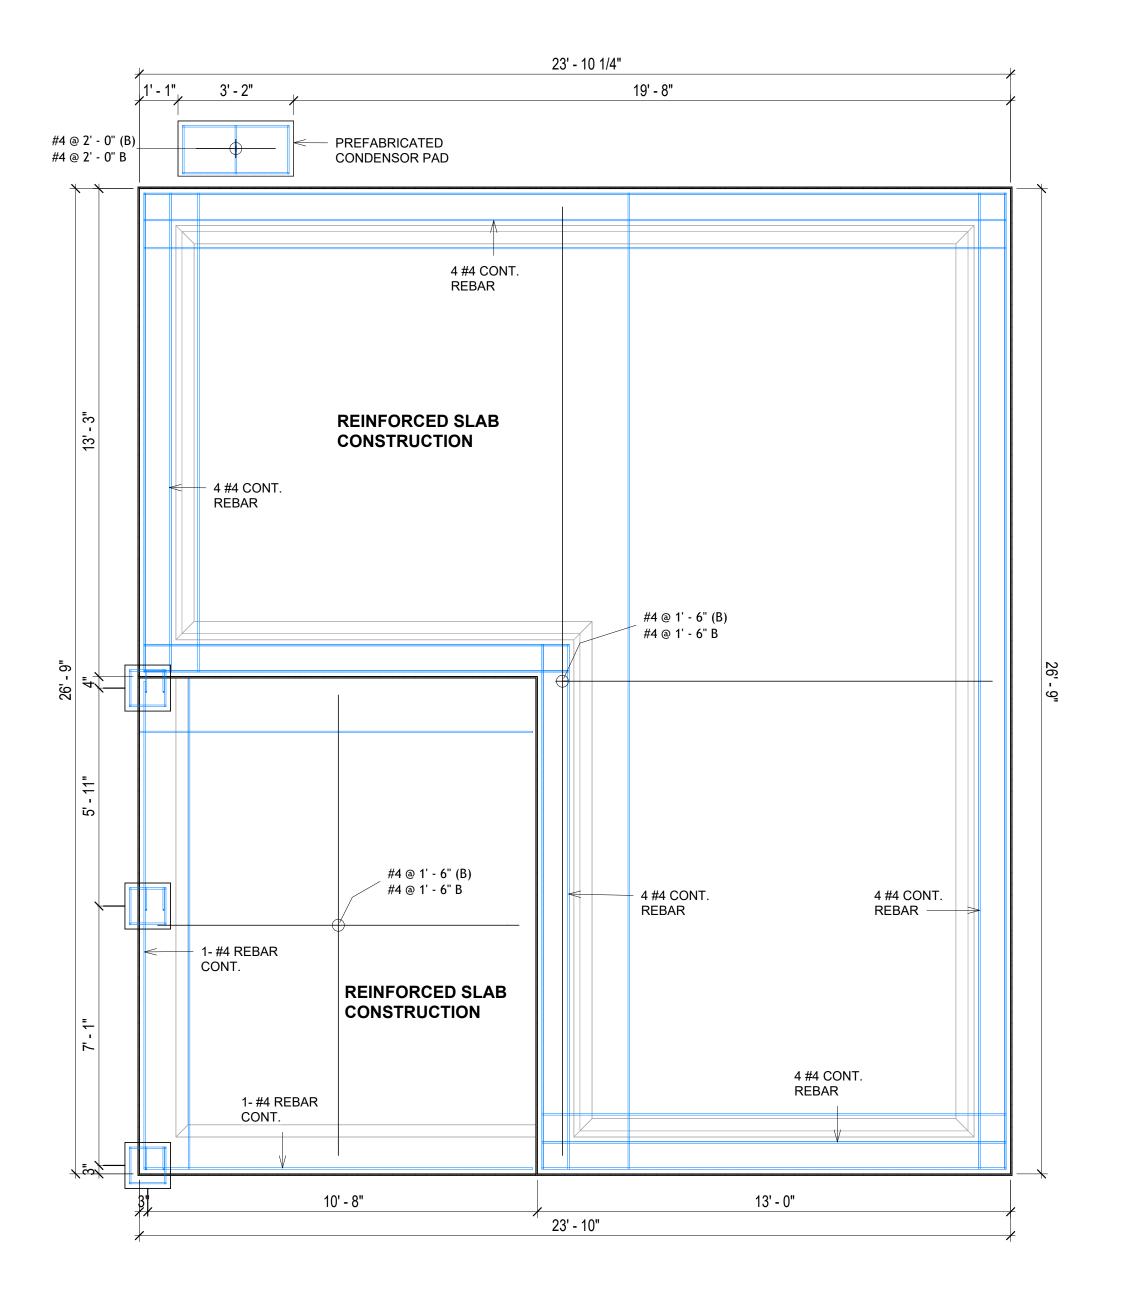

FOUNDATION REBAR PLAN
3/8" = 1'-0"



KEY PLAN

NO.	DESCRIPTION	DATE

NOTE:

LEGEND:

PROJECT

154 HAVEN 491 1Bd/1Ba ALPINE 550

DRAWING NAME

STRUCTURAL FLOOR PLAN

CLIENT NAME:

PROJECT NUMBER:

0061_12

DATE:

4/1/2025 12:59:23 PM

DESIGNED BY:

DRAWN BY:


CHECKED BY:


Checker

S102

ROOF NOTES

- ROOFING COMPOSITION ROOFING PER OWNERS/BUILDERS SPECIFICATIONS INSTALL PER MANUFACTURE SPECIFICATIONS ON 1/2" ORIENTED STRAND BOARD ON PRE-ENGINEERED TRUSS @ 24" O.C. (UNO.)
- 2. 73" OVERHANG AT EAVES (UNO.) ENDS OF ALL TRUSSES AND JOISTS TO BE FULLY BLOCKED. PROVIDE SOLID
- BLOCKING AT ALL RIDGES AND VALLEYS
- 4. SHEATHING TO BE 1/2", 3/8" OSB SHEAR PANEL AND EQUIVALENT. UNDERSIDE OF PORCH TRUSSES TO BE FINISHED WITH MOISTURE RESISTANT DRYWALL, TAPED AND TEXTURED.
- 5. EXPOSED EAVES AND OTHER WEATHER EXPOSED AREAS TO BE SHEATHED WITH EXTERIOR GRADE PLYWOOD.
- 6. ALL MATERIALS THICKNESS AND SIZE ARE THE MINIMUM. Refer TO LOCAL STANDARDS FOR ACTUAL THICKNESS AND LAYERING OF MATERIALS.
- ENGINEERED TRUSS CALCULATIONS TO BE SUBMITTED TO BUILDING
- DEPARTMENT PRIOR TO FABRICATION AND INSTALLATION. TRUSS MANUFACTURER TO SPECIFY HANGER CONNECTORS FOR TRUSS COMPONENTS (TYPICAL)
- 9. DESIGNER ASSUMES THAT TRUSSES BEAR ON ALL EXTERIOR PERIMETER
- WALLS (TYPICAL) OR BEAMS.
- 10. PROVIDE GALVANIZED STEEL FLASHING WITH A LENGTH OF 10 FEET, WIDTH OF 12 INCHES, AND THICKNESS OF 24 GAUGE.

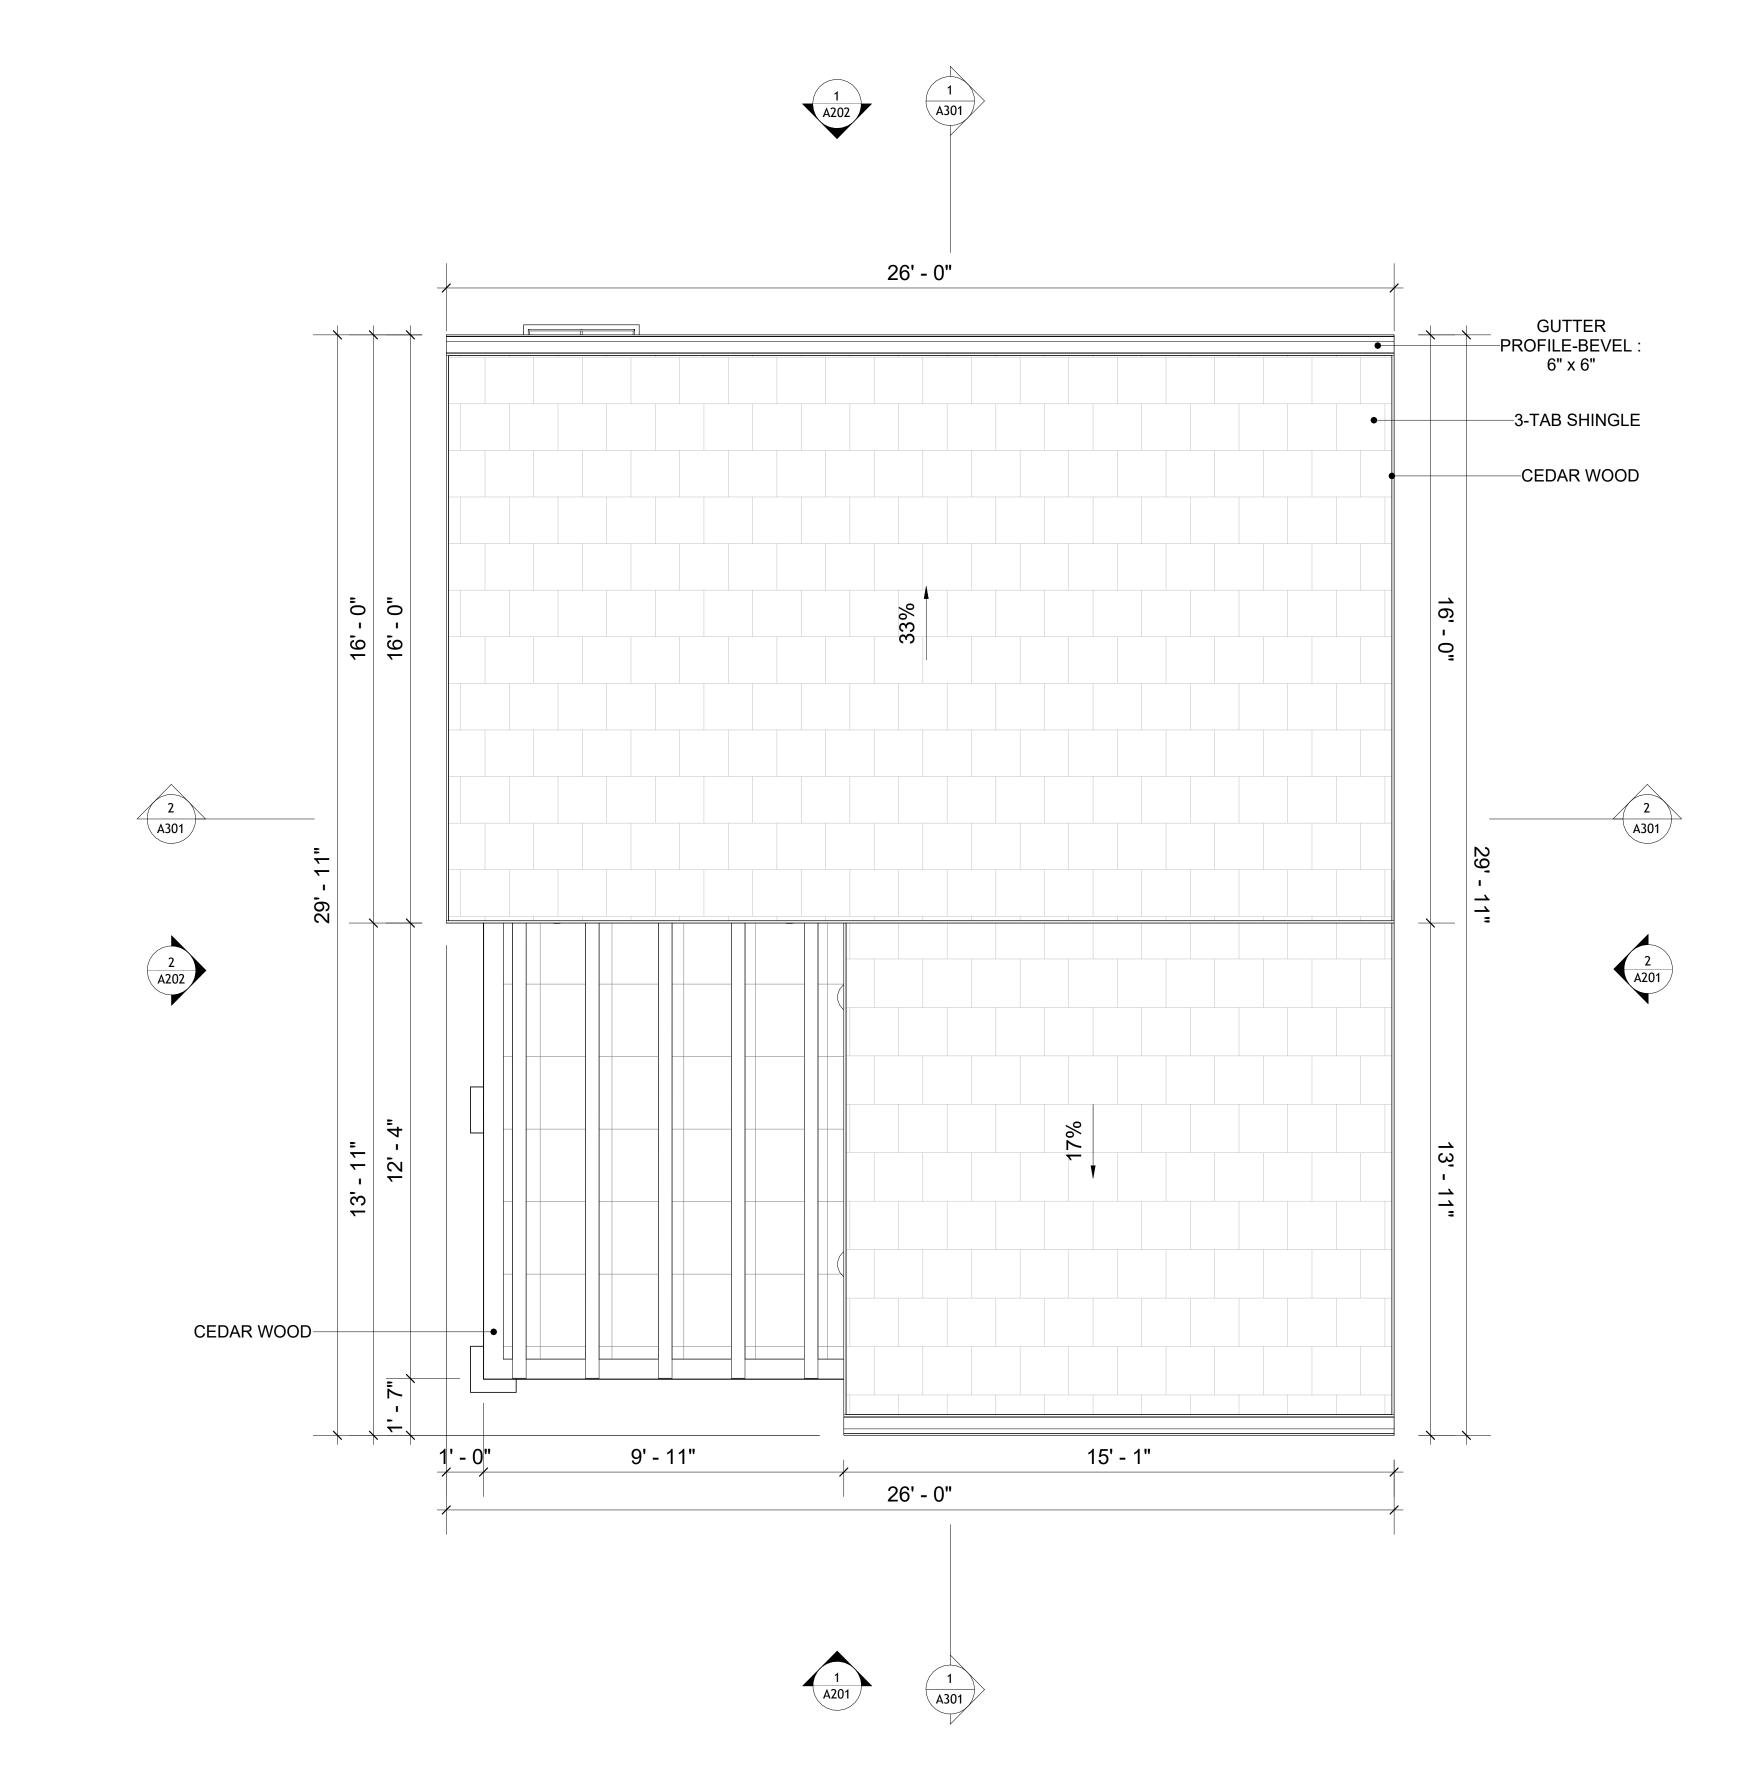

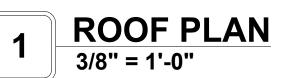



KEY PLAN

NO.	DESCRIPTION	DATE	

NOTE:

LEGEND:

PROJECT

154 HAVEN 491 1Bd/1Ba **ALPINE 550**

DRAWING NAME

ROOF PLAN

Client Name	CLIENT NAME:
0061_12	PROJECT NUMBER:
4/1/2025 12:59:25 PM	DATE:
Designer	DESIGNED BY:
Author	DRAWN BY:
Checker	CHECKED BY:

A103

SCALE: As indicated

SQUARE FOOTAGE 147 PORCH TOTAL 638

ABOUT WALL FINISHING

PLYWOOD WALL SIDING

WALL SIDING IS AN EXTERIOR CLADDING MATERIAL USED TO COVER AND PROTECT THE WALLS OF A BUILDING, PROVIDING BOTH FUNCTIONAL AND AESTHETIC BENEFITS.

IN THIS SPECIFIC PROJECT, **PLYWOOD WALL PANELS** ARE USED AS A FINISH SIDING BECAUSE THIS TYPE OF SIDING PROVIDES A DURABLE, COST-EFFECTIVE, AND VERSATILE EXTERIOR CLADDING THAT CAN BE EASILY INSTALLED, FINISHED, AND MAINTAINED TO ENHANCE THE AESTHETIC AND PROTECTIVE QUALITIES OF A BUILDING'S EXTERIOR.

STANDARD SIZES OF 1' X 8' EXTERIOR-GRADE PLYWOOD PANELS ARE INSTALLED ON THE FURRING STRIPS USING GALVANIZED STEEL SELF-DRILLING SCREWS.

CORRUGATED IRON SHEET

CORRUGATED IRON IS A FINISHING MATERIAL MADE FROM STEEL THAT HAS BEEN GALVANIZED (COATED WITH A THIN LAYER OF ZINC) TO PROTECT IT FROM CORROSION AND RUST.

IN THIS SPECIFIC PROJECT, THE CORRUGATED IRON SHEETS ARE INSTALLED HORIZONTALLY ON VERTICAL FURRING STRIPS THAT ARE DIRECTLY ATTACHED ONTO THE PROPERLY INSTALLED AND SEALED HOME WRAP, USING SELF-DRILLING SCREWS THAT ARE DRIVEN THROUGH THE RIDGES OR VALLEYS OF THE CORRUGATIONS.

STONE VENEER

STONE VENEER REFERS TO THIN LAYERS OF NATURAL OR MANUFACTURED STONE APPLIED TO A STRUCTURAL WALL, KNOWN FOR THEIR REALISTIC APPEARANCE AND RELATIVE LIGHTNESS. THESE VENEERS PROVIDE THE AESTHETIC OF STONE WITHOUT THE COST AND WEIGHT OF FULL STONE CONSTRUCTION, CONTRIBUTING TO A BEAUTIFUL AND COSTEFFECTIVE EXTERIOR FINISH.

IN THIS SPECIFIC PROJECT, STONE VENEER IS USED A FINISH MATERIAL ON EXTERIOR FINISH.


CEDAR WOOD


CEDAR WOOD REFERS TO THE WOOD FROM VARIOUS SPECIES OF CEDAR TREES, WHICH ARE CONIFEROUS EVERGREEN TREES KNOWN FOR THEIR DISTINCT AROMA AND NATURAL RESISTANCE TO DECAY AND INSECTS.

IN THIS SPECIFIC PROJECT, CEDAR WOOD IS USED AS A FURRING STRIP AND A FINISH MATERIAL ON BEAMS AND COLUMNS.

CEDAR WOOD AS A FURRING STRIPS PROVIDE THERMAL INSULATION, MOISTURE MANAGEMENT, AND AN AESTHETICALLY PLEASING, VERSATILE FRAMING SOLUTION WHEN INTEGRATED WITH CORONADO STONE AND CORRUGATED IRON SHEET CLADDING.

THE VERTICAL CEDAR WOOD FURRING STRIPS ARE ATTACHED TO HOME WRAP USING CORROSION-RESISTANT FASTENERS (HOT DIP GALVANIZED SCREWS), ENSURING PROPER PENETRATION INTO THE WALL FRAMING.

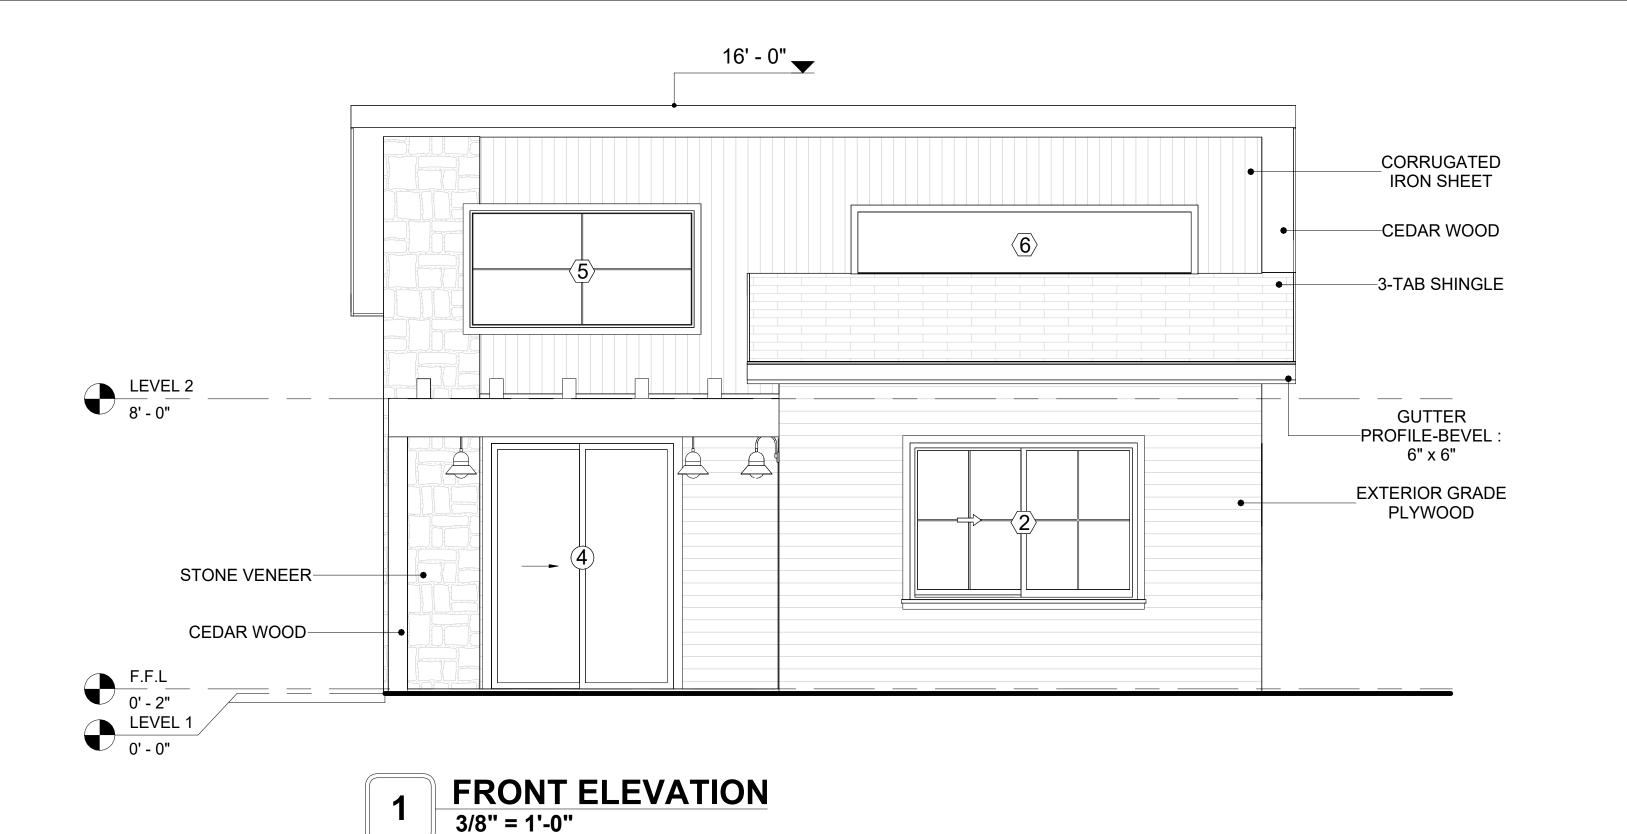

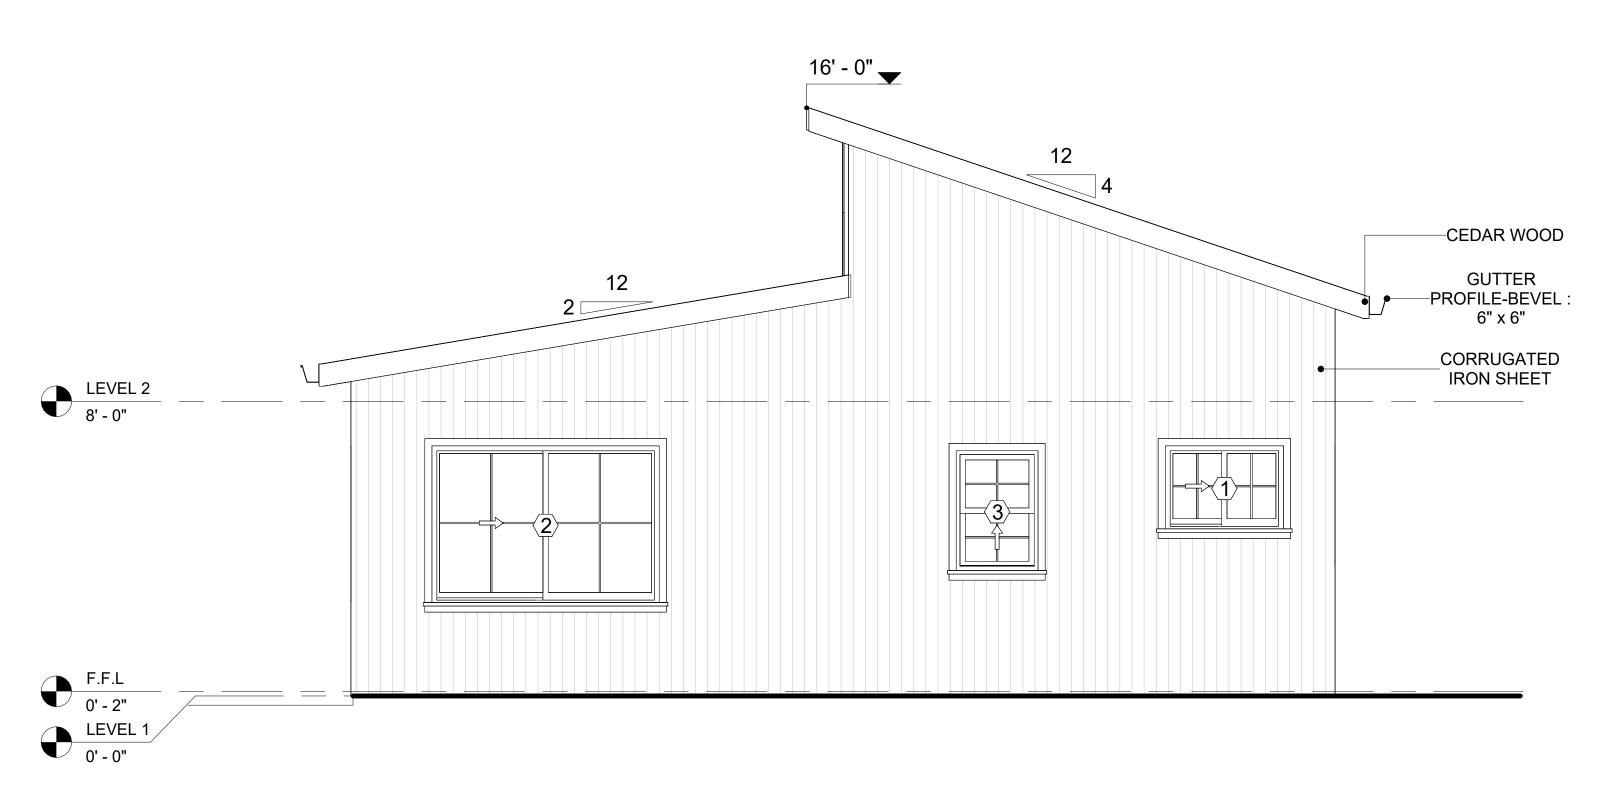

2 RIGHT SIDE ELEVATION
3/8" = 1'-0"

	DOOR SCHEDULE					
TYPE				SIZE		
MAR K	SUPPLIER	DOOR TYPE	LOCATIO N	WIDTH	HEIGHT	COUNT
1	HOME DEPOT	Interior Single Panel Swinging	Interior	3' - 0"	6' - 8"	1
2	HOME DEPOT	Interior Single Panel Swinging	Interior	2' - 4"	6' - 8"	1
3	HOME DEPOT	Interior Single Panel Swinging	Interior	3' - 0"	6' - 8"	1
4	HOME DEPOT	Patio_Double Panel_Sliding	Exterior	5' - 0"	6' - 8"	1
5	HOME DEPOT	Interior Single Panel Swinging	Interior	2' - 4"	6' - 8"	1
6	HOME DEPOT	Interior Double Panel Sliding	Interior	7' - 0"	6' - 8"	1
7	HOME DEPOT	Interior Double Panel Sliding	Interior	2' - 6"	6' - 8"	1
8	HOME DEPOT	Exterior Double Panel Swinging	Interior	6' - 0"	6' - 8"	1

WINDOW SCHEDULE						
				SIZE		
TYPE MARK	SUPPLIER	WINDOW TYPE	WIDTH	HEIGHT	COUNT	
1	Home Depot	Sliding	3' - 3"	2' - 3"	1	
2	Home Depot	Sliding	6' - 3"	4' - 3"	2	
3	Home Depot	Single Hung	2' - 3"	3' - 3"	2	
4	Home Depot	Sliding	6' - 3"	2' - 3"	1	
5	Home Depot	Fixed	6' - 3"	3' - 3"	1	
6	Home Depot	Fixed	9' - 3"	1' - 9"	1	



KEY PLAN

NO.	DESCRIPTION	DATE

NOTE:

LEGEND:

PROJECT

154 HAVEN 491 1Bd/1Ba ALPINE 550

DRAWING NAME

ARCHITECTURAL ELEVATIONS

CLIENT NAME:

PROJECT NUMBER:

0061_12

DATE:

4/1/2025 12:59:26 PM

DESIGNED BY:

DRAWN BY:

CHECKED BY:

Checker

A201

ABOUT WALL FINISHING

PLYWOOD WALL SIDING

WALL SIDING IS AN EXTERIOR CLADDING MATERIAL USED TO COVER AND PROTECT THE WALLS OF A BUILDING, PROVIDING BOTH FUNCTIONAL AND AESTHETIC BENEFITS.

IN THIS SPECIFIC PROJECT, **PLYWOOD WALL PANELS** ARE USED AS A FINISH SIDING BECAUSE THIS TYPE OF SIDING PROVIDES A DURABLE, COST-EFFECTIVE, AND VERSATILE EXTERIOR CLADDING THAT CAN BE EASILY INSTALLED, FINISHED, AND MAINTAINED TO ENHANCE THE AESTHETIC AND PROTECTIVE QUALITIES OF A BUILDING'S EXTERIOR.

STANDARD SIZES OF 1' X 8' EXTERIOR-GRADE PLYWOOD PANELS ARE INSTALLED ON THE FURRING STRIPS USING GALVANIZED STEEL SELF-DRILLING SCREWS.

CORRUGATED IRON SHEET

CORRUGATED IRON IS A FINISHING MATERIAL MADE FROM STEEL THAT HAS BEEN GALVANIZED (COATED WITH A THIN LAYER OF ZINC) TO PROTECT IT FROM CORROSION AND RUST.

IN THIS SPECIFIC PROJECT, THE CORRUGATED IRON SHEETS ARE INSTALLED HORIZONTALLY ON VERTICAL FURRING STRIPS THAT ARE DIRECTLY ATTACHED ONTO THE PROPERLY INSTALLED AND SEALED HOME WRAP, USING SELF-DRILLING SCREWS THAT ARE DRIVEN THROUGH THE RIDGES OR VALLEYS OF THE CORRUGATIONS.

STONE VENEER

STONE VENEER REFERS TO THIN LAYERS OF NATURAL OR MANUFACTURED STONE APPLIED TO A STRUCTURAL WALL, KNOWN FOR THEIR REALISTIC APPEARANCE AND RELATIVE LIGHTNESS. THESE VENEERS PROVIDE THE AESTHETIC OF STONE WITHOUT THE COST AND WEIGHT OF FULL STONE CONSTRUCTION, CONTRIBUTING TO A BEAUTIFUL AND COST-EFFECTIVE EXTERIOR FINISH.

IN THIS SPECIFIC PROJECT, STONE VENEER IS USED A FINISH MATERIAL ON EXTERIOR FINISH.


CEDAR WOOD

CEDAR WOOD REFERS TO THE WOOD FROM VARIOUS SPECIES OF CEDAR TREES, WHICH ARE CONIFEROUS EVERGREEN TREES KNOWN FOR THEIR DISTINCT AROMA AND NATURAL RESISTANCE TO DECAY AND INSECTS.


IN THIS SPECIFIC PROJECT, CEDAR WOOD IS USED AS A FURRING STRIP AND A FINISH MATERIAL ON BEAMS AND COLUMNS.

CEDAR WOOD AS A FURRING STRIPS PROVIDE THERMAL INSULATION, MOISTURE MANAGEMENT, AND AN AESTHETICALLY PLEASING, VERSATILE FRAMING SOLUTION WHEN INTEGRATED WITH CORONADO STONE AND CORRUGATED IRON SHEET CLADDING.

THE VERTICAL CEDAR WOOD FURRING STRIPS ARE ATTACHED TO HOME WRAP USING CORROSION-RESISTANT FASTENERS (HOT DIP GALVANIZED SCREWS), ENSURING PROPER PENETRATION INTO THE WALL FRAMING.

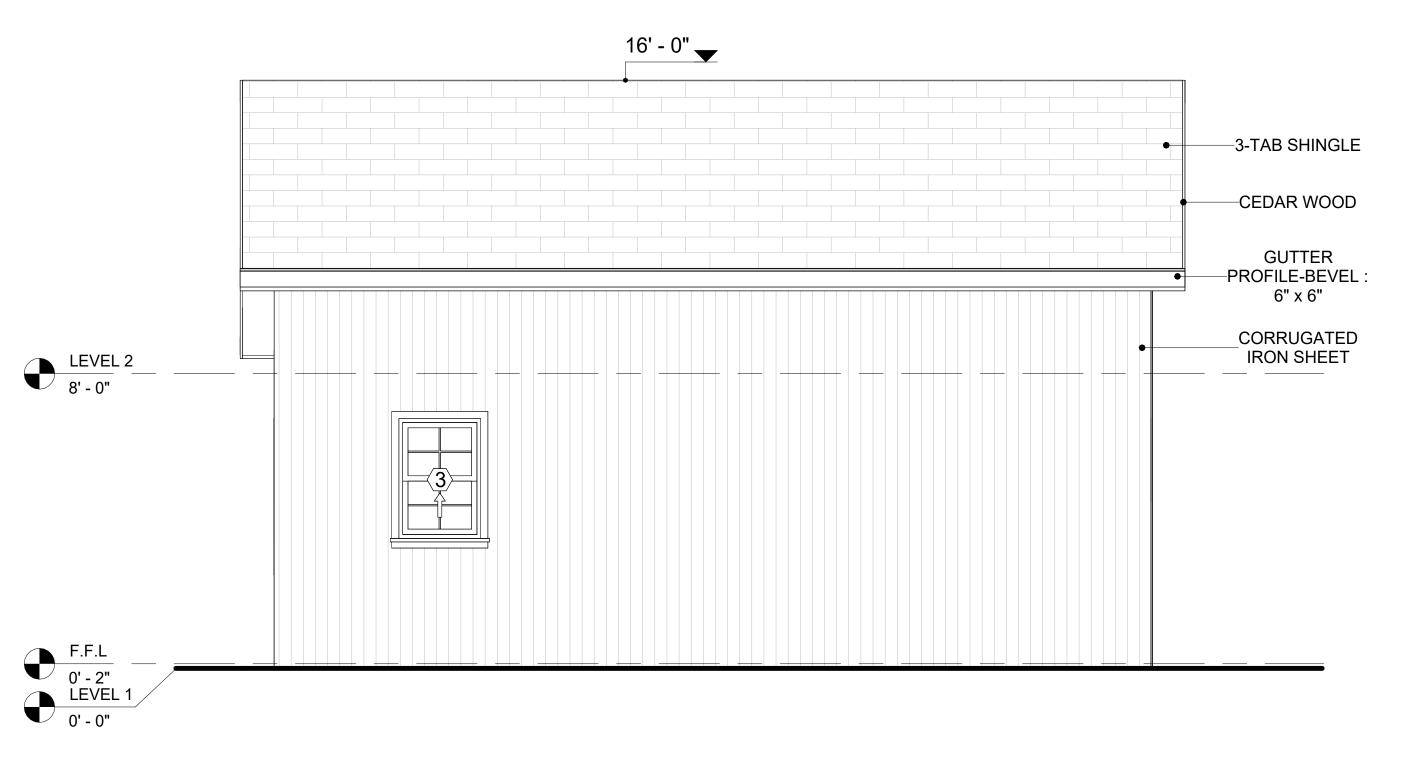


1 REAR ELEVATION 3/8" = 1'-0"

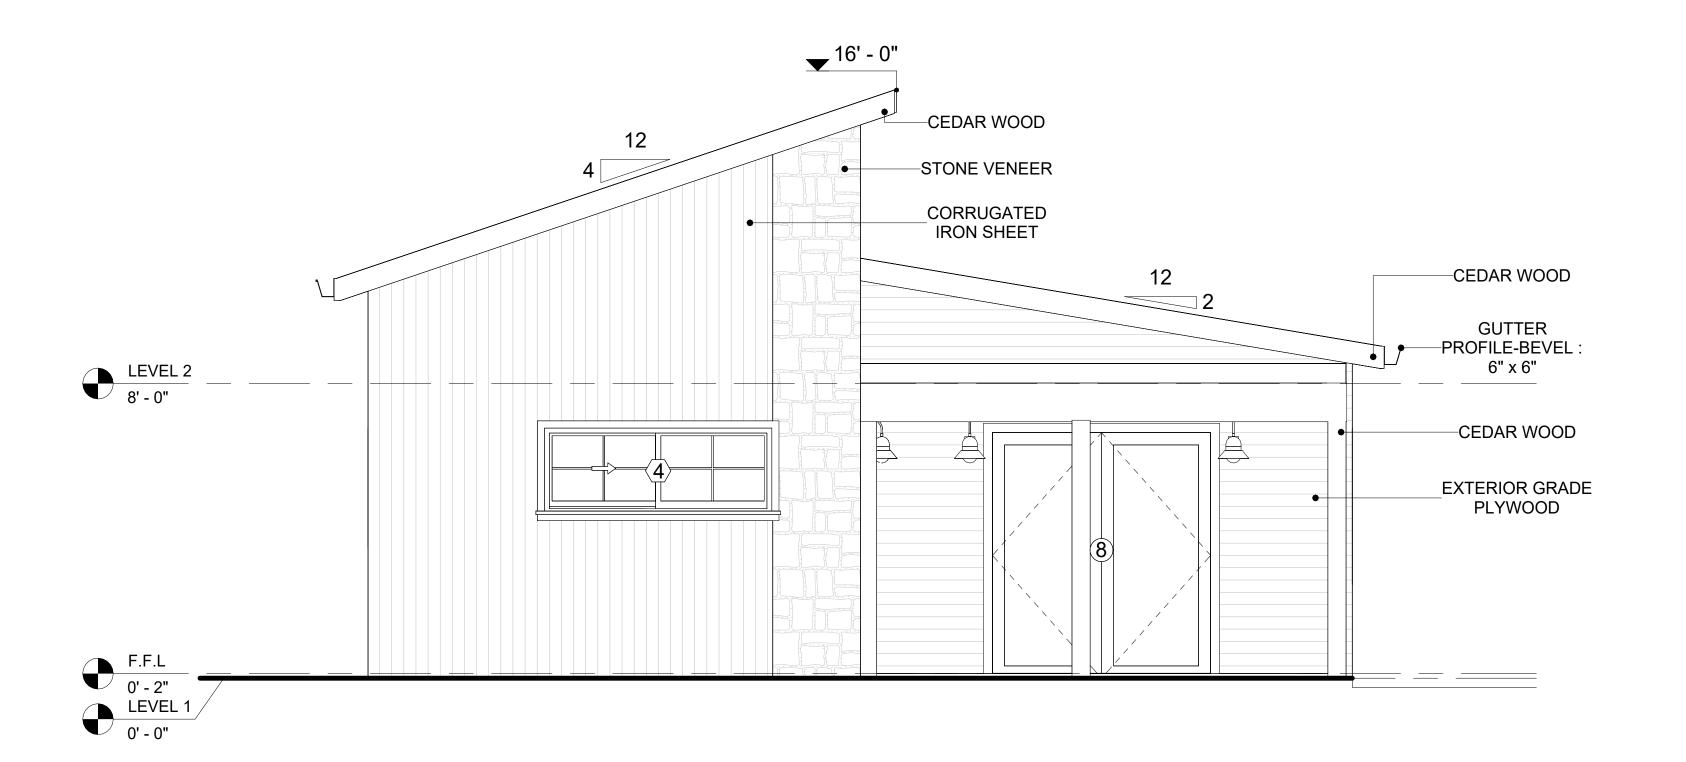

2 LEFT SIDE ELEVATION
3/8" = 1'-0"



KEY PLAN

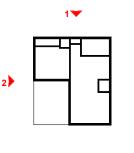

NO.	DESCRIPTION	DATE

NOTE:

LEGEND:

PROJECT

154 HAVEN 491 1Bd/1Ba ALPINE 550

DRAWING NAME

ARCHITECTURAL ELEVATIONS

CLIENT NAME:

PROJECT NUMBER:

0061_12

DATE:

4/1/2025 12:59:28 PM


DESIGNED BY:


DRAWN BY:

CHECKED BY:

Checker


A202

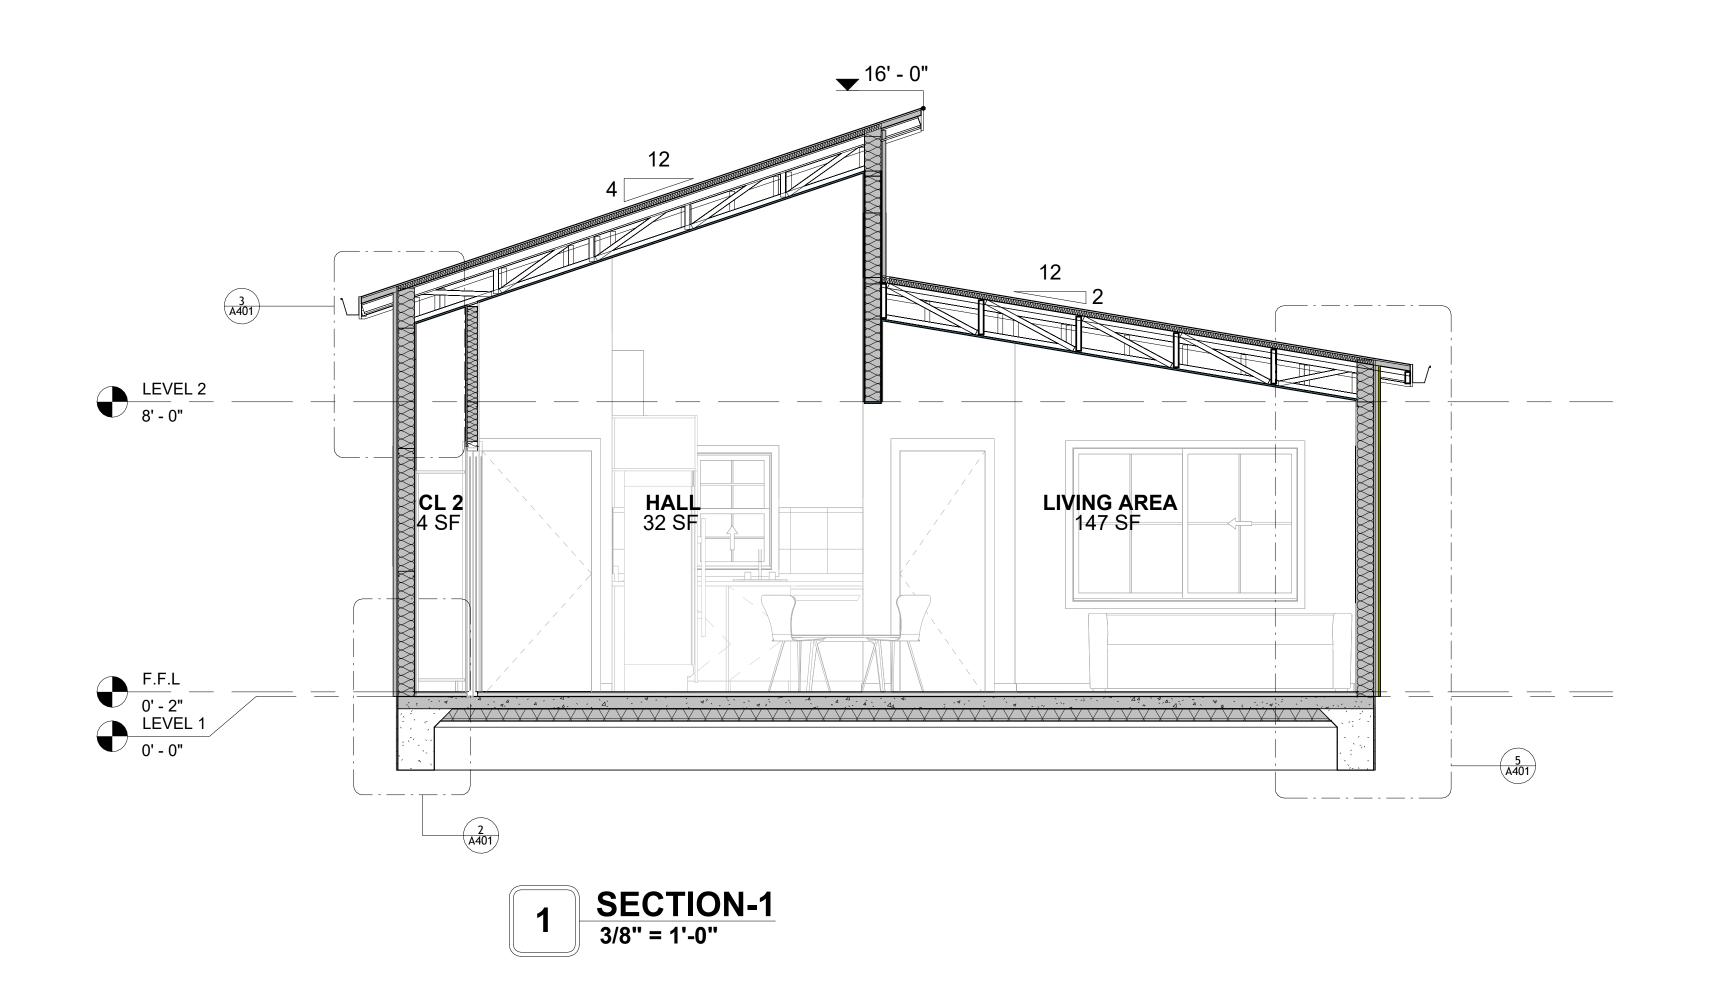

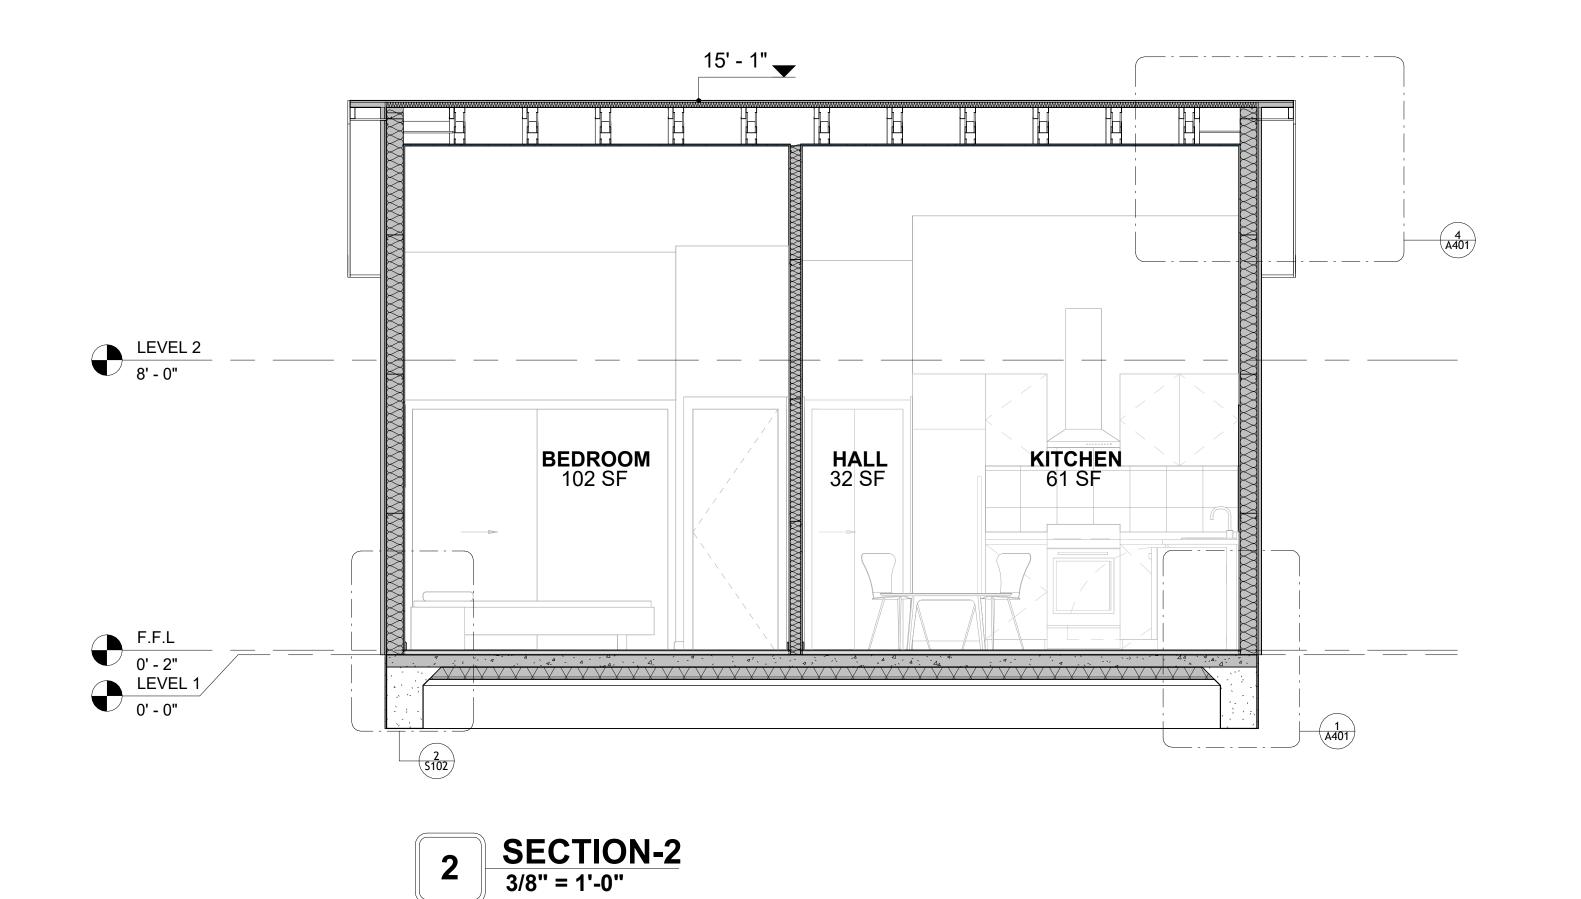



KEY PLAN

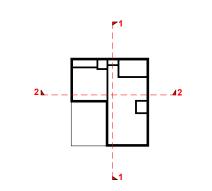

DESCRIPTION	DATE
	DESCRIPTION

NOTE:

LEGEND:

PROJECT


154 HAVEN 491 1Bd/1Ba ALPINE 550


DRAWING NAME


ARCHITECTURAL SECTIONS

Client Name
0061_12
4/1/2025 12:59:28 PM
Designer
Author
Checker

A301

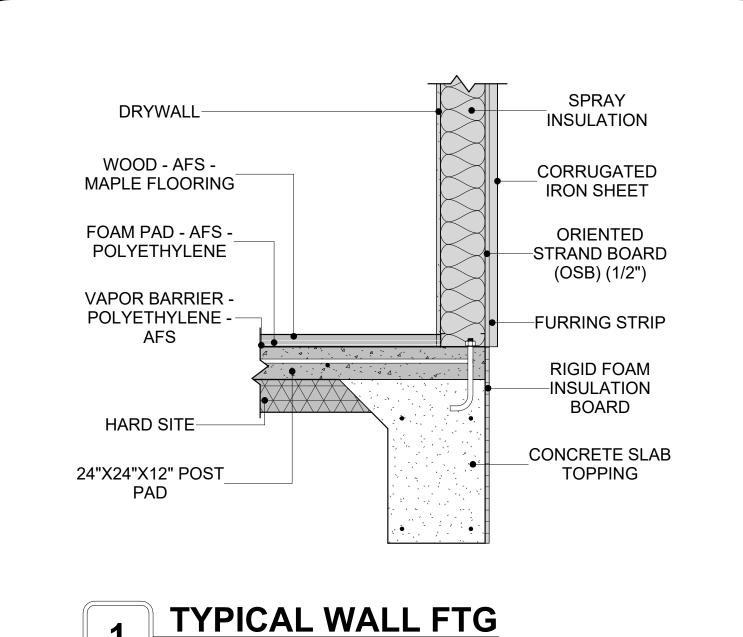


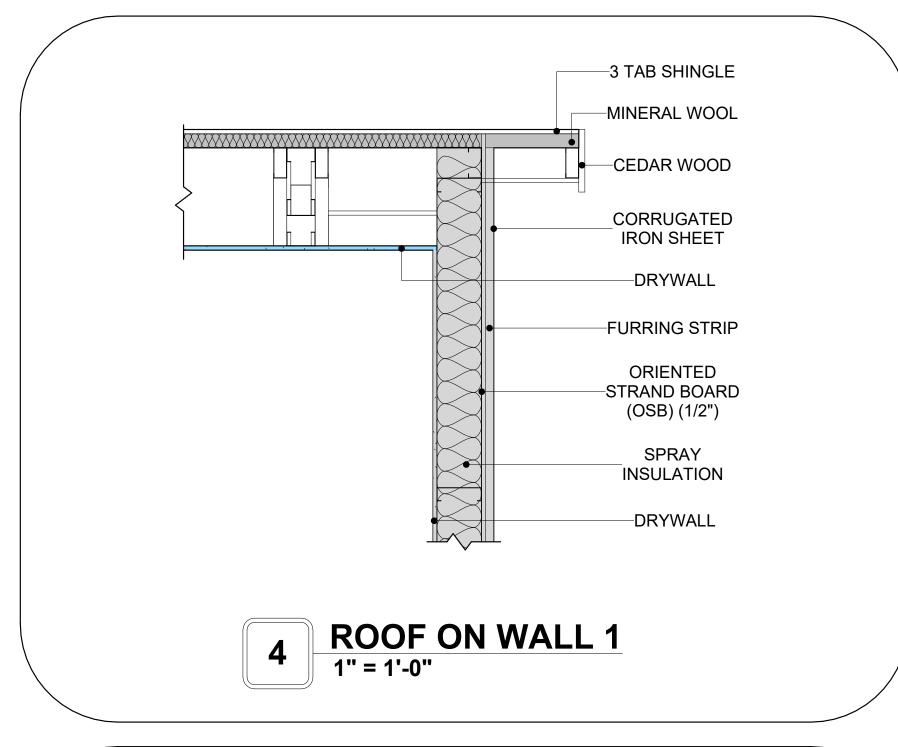


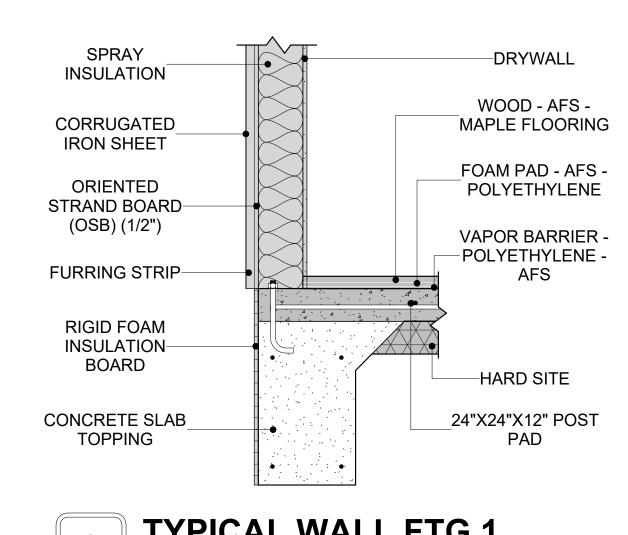

1" = 1'-0"

2 TYPICAL WALL FTG 1
1" = 1'-0"

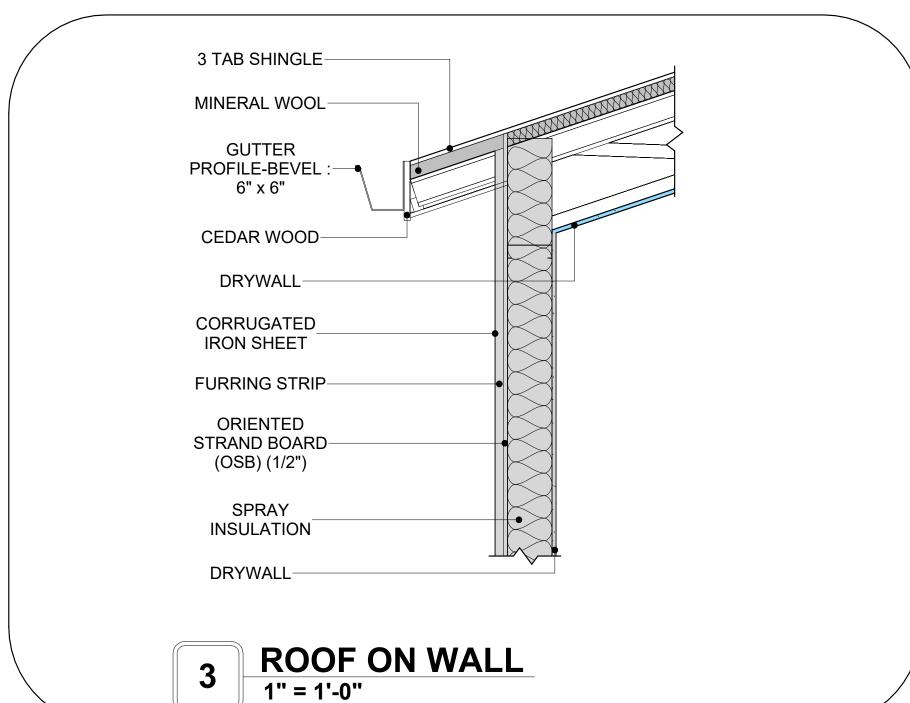

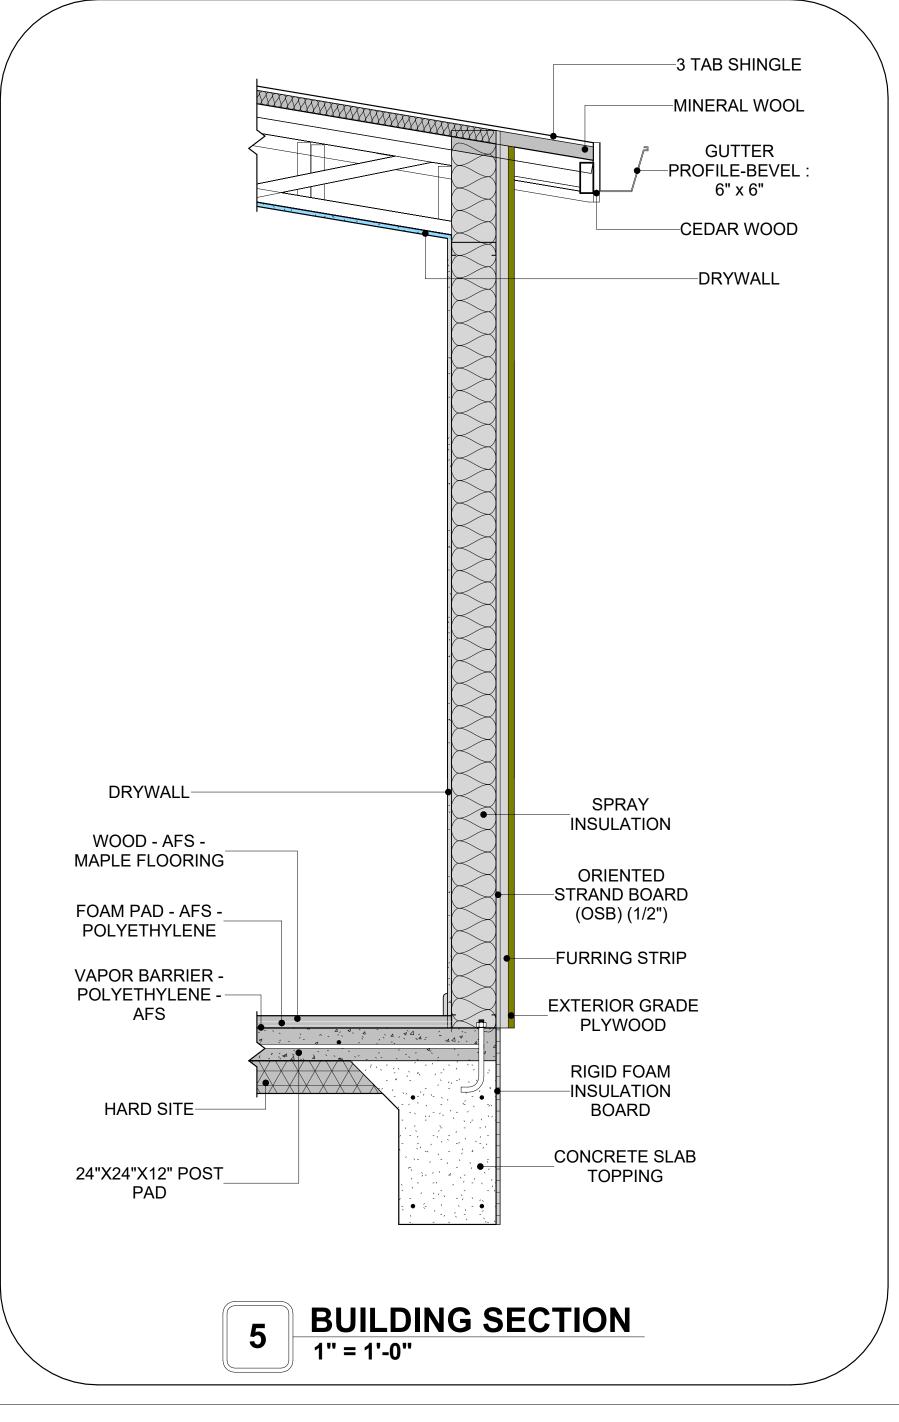



KEY PLAN

NO.	DESCRIPTION	DATE

NOTE:

LEGEND:

PROJECT

154 HAVEN 491 1Bd/1Ba ALPINE 550

DRAWING NAME

ARCHITECTURAL DETAILS

CLIENT NAME:	Client Name
PROJECT NUMBER:	0061_12
DATE:	4/1/2025 12:59:29 PM
DESIGNED BY:	Designer
DRAWN BY:	Author
CHECKED BY:	Checker

A401


SCALE: 1" = 1'-0"


CASEWORK GENERAL NOTES


- ALL CABINET HEIGHTS INCLUDE COUNTERTOPS. DIMENSIONS ARE TO THE NEAREST INCH. DIVISIONS IN CASEWORK ARE SHOWN FOR CLARITY AND DO NOT REPRESENT BREAKS IN THE COUNTERTOP.
- PROVIDE CONTINUOUS COUNTERTOP OVER ALL SIMILAR HEIGHT CASEWORK, UNLESS AND OTHERWISE NOTED.
- MANUFACTURER AND CATALOG NUMBERS ARE FOR REFERENCE AND ILLUSTRATION PURPOSES
- DOTTED LINES INDICATE WALL HUNG CABINETS, DIVISIONS OF BASE CABINETS BELOW THE
- COUNTERTOP, FURNITURE NOT IN THE CONTRACT OR PROJECTION SCREENS -SEE CASEWORK KEY AND SPECIFICATIONS.
- ALL CABINETS AND DRAWERS TO HAVE CAM LOCKS EXCEPT FOR SINK BASE CABINETS. ALL EXPOSED SURFACES (EXPOSED TO VIEW FROM ANY PERSPECTIVE) TO BE COVERED WITH LAMINATE.
- ALL CASEWORK WHICH MEETS A WALL AT ONE OR BOTH ENDS, TO BE PROVIDED WITH FILLER PANELS AND SCRIBED TO THE WALL(S) AS REQUIRED.
- 10. ALL CABINETS AND DRAWERS ARE PROVIDED WITH RECESSED HANDLES.
- 11. CONTRACTOR TO FIELD VERIFY ALL CLEAR OPENINGS PRIOR TO MILLWORK OR CASEWORK FABRICATION.
- 12. CASEWORK DRAWINGS ARE DIAGRAMMATIC IN NATURE TO SHOW DESIGN INTENT.


	CASEWORK SCHEDULE						
TYPE MAR K	TYPE	COUN T	HEIGHT	WIDTH	DEPTH	AREA	
01	refrigerator top	1	1' - 6"	2' - 0"	2' - 4"	3 SF	
02	Wall_Cabinet_Single_Door	1	2' - 6"	1' - 8"	1' - 0"	4 SF	
03	HD_Linear_Counter_Top 2	1	0' - 4"	1' - 8"	2' - 1"	1 SF	
04	Base_Cabinet_Single_Door	1	2' - 7"	1' - 8"	2' - 0"	4 SF	
05	Wall Cabinet Double Door 2	1	2' - 6"	3' - 3"	1' - 0"	8 SF	
06	Base_Cabinet_L-Shaped	1	2' - 11"	3' - 3"	3' - 3"	9 SF	
07	HD_L-Shape_Counter_Top w sink hole	1	0' - 4"	4' - 6"	8' - 1"	1 SF	
09	Base_Cabinet_Single_Door 2	1	2' - 7"	1' - 8"	2' - 0"	4 SF	
10	LAUNDRY OPEN CABINET 2	1	1' - 2"	2' - 3"	3' - 0"	3 SF	
11	VANITY	1	2' - 4"	3' - 1"	1' - 8"	7 SF	
12	RECESSED_MED_CABINET	1	2' - 0"	1' - 6"	0' - 3"	3 SF	
13	Closet 1	1	6' - 0"	3' - 0"	1' - 4"	18 SF	
14	Closet 2	1	6' - 0"	7' - 5"	1' - 4"	45 SF	
Grand to	otal	13					


SPECIALTY EQUIPMENT SCHEDULE				
TYPE MARK	TYPE	COUNT		
01	REFRIGERATOR	1		
02	RANGE	1		
03	Dishwasher	1		
04	DRYER-FRONT-LOAD	1		
05	WASHER-FRONT-LOAD	1		
Grand total: 5	,			

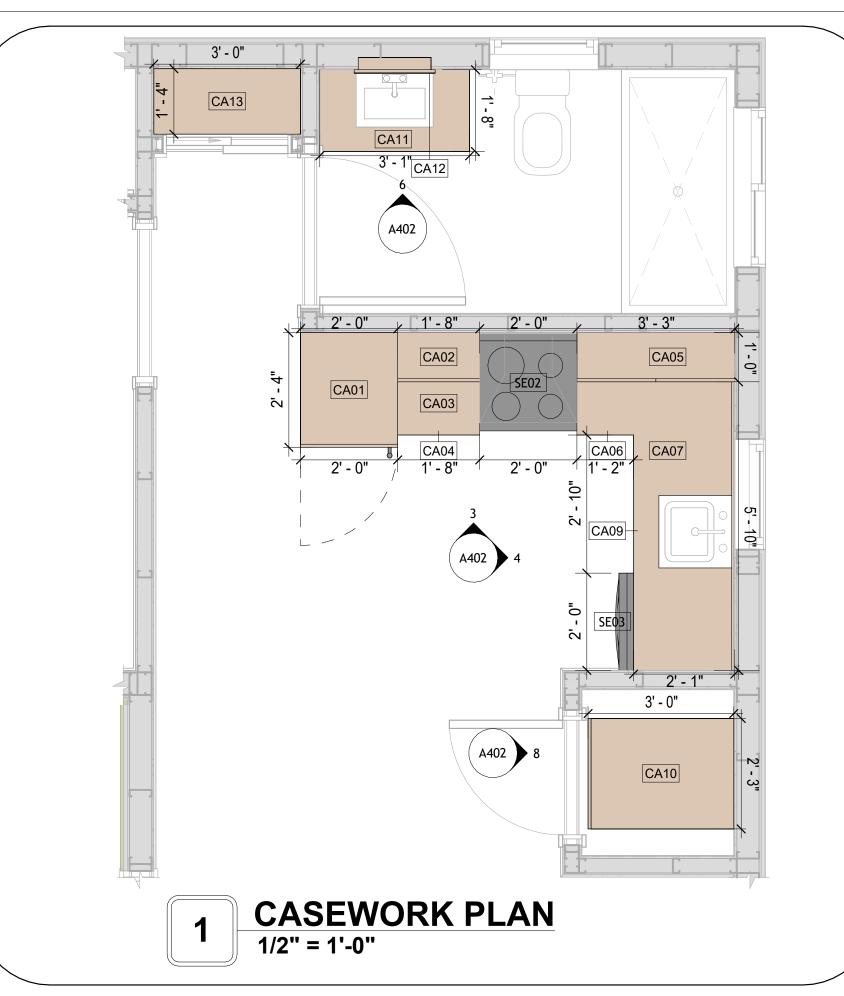

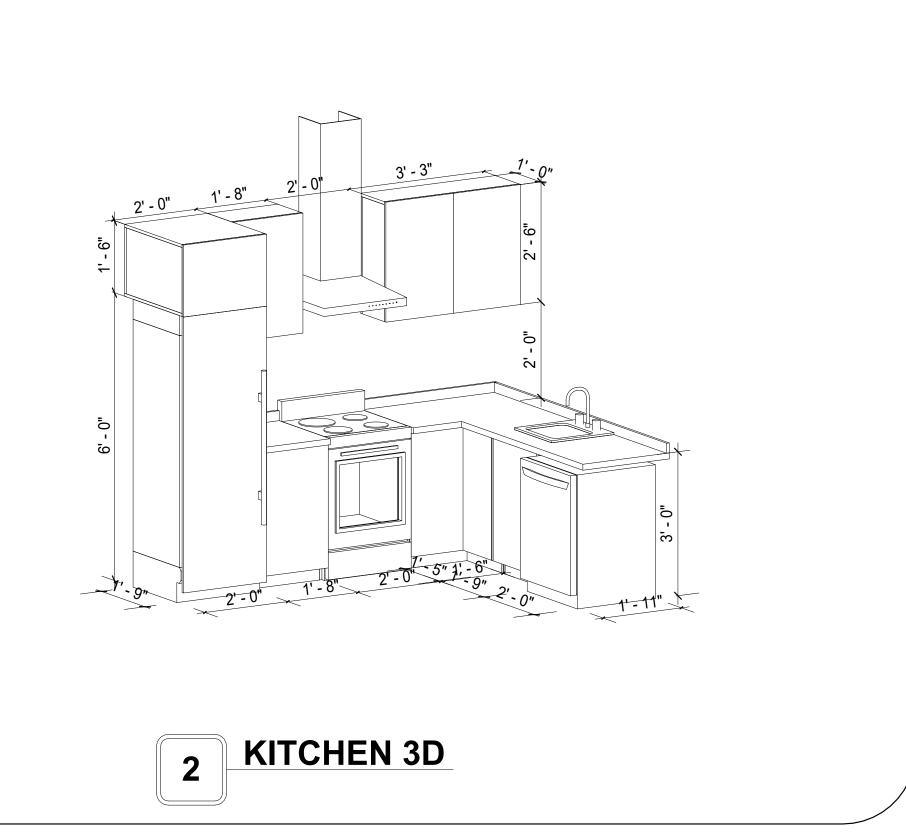

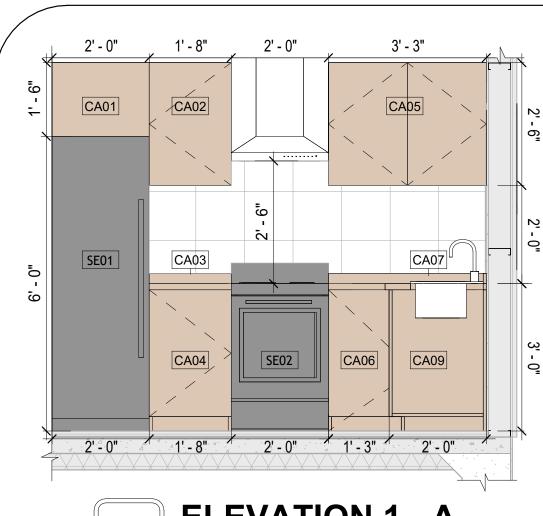

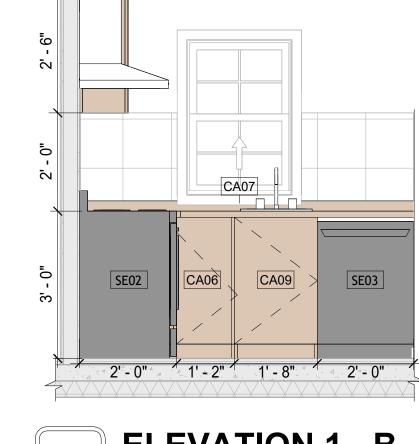

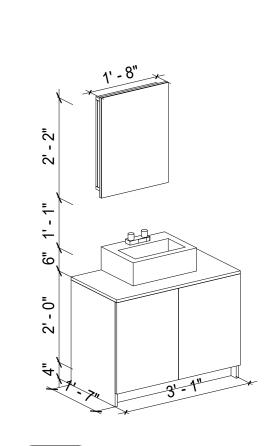





ELEVATION 1 - A 1/2" = 1'-0"

ELEVATION 1 - B 1/2" = 1'-0"


VANITY 3D

ELEVATION 1 - C 1/2" = 1'-0"

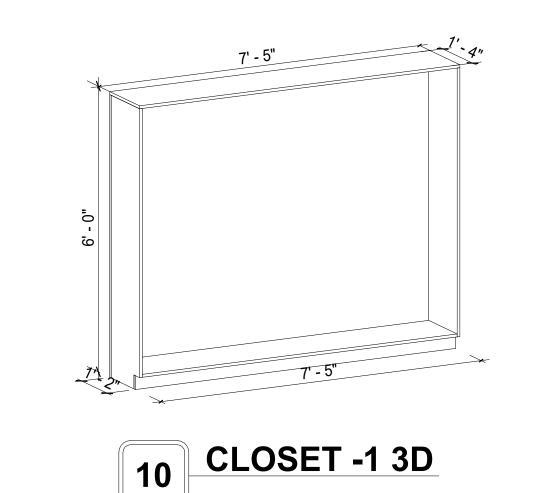


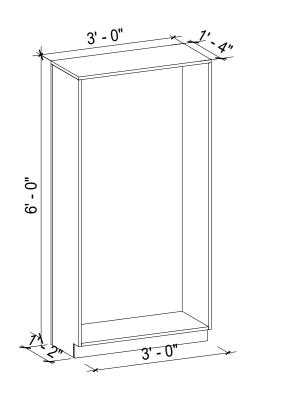

CLOSET 3D

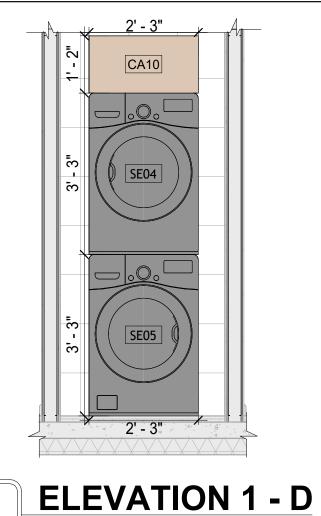


1/2" = 1'-0"

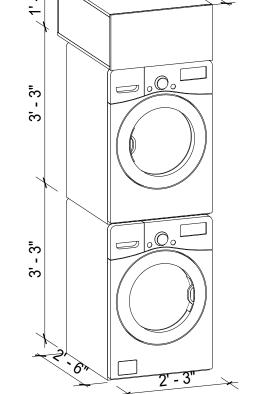

LAUNDRY 3D

Tuscon,AZ, USA 888-864-0184 inquire@frameupnow.com www.frameupnow.com

KEY PLAN

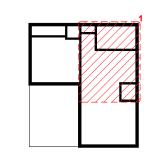

NO.	DESCRIPTION	DATE

NOTE:

LEGEND:

PROJECT

154 HAVEN 491 1Bd/1Ba **ALPINE 550**

DRAWING NAME

ARCHITECTURAL CASEWORK

CLIENT NAME:	Client Name
PROJECT NUMBER:	0061_12
DATE:	4/1/2025 12:59:30 PM
DESIGNED BY:	Designer
DRAWN BY:	Author
CHECKED BY:	Checker

A402

GENERAL NOTES

T1. THIS DRAWING DEPICTS THE HVAC (HEATING, VENTILATION, AND AIR CONDITIONING) SYSTEM FOR THE HAVEN 1BD1BA ALPINE. IT PROVIDES A VISUAL REPRESENTATION OF THE SYSTEM LAYOUT AND COMPONENTS.

2.THE HVAC SYSTEM IS DESIGNED TO MEET THE SPECIFIC REQUIREMENTS OF THE BUILDING, INCLUDING HEATING, COOLING, AND VENTILATION NEEDS AS PER THE PROJECT SPECIFICATIONS AND APPLICABLE CODES AND STANDARDS.

CONDENSER

AIR HANDLING UNIT

6' - 9 1/2"

HVAC PLAN

3/8" = 1'-0"

3. THE HVAC SYSTEM INSTALLATION SHALL COMPLY WITH THE LATEST EDITION OF THE INTERNATIONAL MECHANICAL CODE (IMC), INTERNATIONAL RESIDENTIAL CODE (IRC), AND ALL OTHER APPLICABLE LOCAL, STATE, AND NATIONAL CODES AND REGULATIONS.

4. THE EQUIPMENT SHOWN ON THIS DRAWING INCLUDES BUT IS NOT LIMITED TO AIR HANDLING UNITS (AHUS), CHILLERS, BOILERS, COOLING TOWERS, PUMPS, DUCTWORK, DIFFUSERS, GRILLES, AND CONTROL DEVICES.

5. ALL EQUIPMENT, DUCTWORK, AND PIPING SHALL BE INSTALLED IN ACCORDANCE WITH MANUFACTURER'S SPECIFICATIONS, LOCAL CODES, AND INDUSTRY BEST PRACTICES.

6. ALL DUCTWORK SHALL BE SIZED, FABRICATED, AND INSTALLED IN ACCORDANCE WITH THE LATEST EDITION OF THE ACCA MANUAL D AND THE SMACNA HVAC DUCT CONSTRUCTION STANDARDS. DUCTWORK SHALL BE INSTALLED IN A NEAT AND WORKMANLIKE MANNER, PROPERLY SUPPORTED AND BRACED TO PREVENT SAGGING, AIR LEAKAGE, OR VIBRATION.

7. CONDENSATE DRAINAGE PIPING SHALL BE PROPERLY PITCHED TO ENSURE POSITIVE DRAINAGE TO AN APPROVED DISPOSAL LOCATION, SUCH AS A FLOOR DRAIN, SUMP PUMP, OR EXTERIOR GRADE. CONDENSATE LINES SHALL BE INSULATED TO PREVENT SWEATING.

8. THE LOCATION OF CONTROL PANELS AND SENSORS INDICATED ON THIS DRAWING CAN BEMODIFY with THE SPECIFIC LOCATIONS AND WIRING DETAILS WILL BE DETERMINED DURING THE CONTROL SYSTEM DESIGN AND INSTALLATION.

9. THE HVAC SYSTEM DESIGN CONSIDER ENERGY EFFICIENCY, INDOOR AIR QUALITY, OCCUPANT COMFORT, AND NOISE CONTROL, FOLLOWING APPLICABLE GUIDELINES AND REGULATIONS.

10. COORDINATION WITH OTHER TREADS HAS BEEN DONE ON A DESIGN LEVEL. THIS DRAWING SHALL BE READ TOGETHER WITH THE AR, EL AND SN DESIGN DRAWINGS TO ENSURE PROPER INSTALLATION AND INTEGRATION OF THE HVAC SYSTEMS.

11. THE HVAC CONTRACTOR IS RESPONSIBLE FOR OBTAINING ALL NECESSARY PERMITS AND LICENSES, AND FOR SCHEDULING AND COORDINATING WITH THE LOCAL BUILDING DEPARTMENT AND UTILITY PROVIDERS TO ENSURE A TIMELY AND COMPLIANT INSTALLATION.

12. ALL DUCTWORK PENETRATIONS THROUGH WALLS, FLOORS, OR CEILINGS SHALL BE PROPERLY SEALED AND FIRE-STOPPED USING APPROVED METHODS AND MATERIALS TO MAINTAIN THE INTEGRITY OF THE BUILDING'S FIRE-RESISTANCE RATINGS.

13. HVAC EQUIPMENT SHALL BE INSTALLED LEVEL AND PLUMB, AND IN STRICT ACCORDANCE WITH THE MANUFACTURER'S INSTALLATION INSTRUCTIONS AND RECOMMENDATIONS. PROVIDE ADEQUATE CLEARANCES AROUND EQUIPMENT FOR PROPER AIRFLOW, SERVICE ACCESS, AND

CODE COMPLIANCE.

14. ALL HVAC EQUIPMENT AND COMPONENTS, INCLUDING THERMOSTATS, DAMPERS, AND ACCESS PANELS, SHALL BE LOCATED IN ACCESSIBLE AREAS


15. THE HVAC SYSTEM SHALL BE BALANCED AND ADJUSTED TO ENSURE PROPER AIRFLOW, TEMPERATURE DISTRIBUTION, AND SYSTEM PERFORMANC THROUGHOUT THE RESIDENCE. PROVIDE A WRITTEN REPORT DOCUMENTING THE FINAL SYSTEM BALANCE.

16. ANY DEVIATIONS OR MODIFICATIONS TO THE HVAC SYSTEM DESIGN SHALL BE REVIEWED AND APPROVED BY THE RESPONSIBLE DESIGN PROFESSIONALS AND COMMUNICATED TO ALL RELEVANT PARTIES INVOLVED IN THE CONSTRUCTION PROCESS.

FOR EASY SERVICING AND MAINTENANCE. PROVIDE ADEQUATE SPACE AROUND EQUIPMENT FOR PROPER AIRFLOW AND SERVICE ACCESS.


17. FOR ANY INQUIRIES OR CLARIFICATIONS REGARDING THE HVAC SYSTEM DESIGN, PLEASE CONSULT THE RESPONSIBLE DESIGN PROFESSIONALS OR THE PROJECT MANAGEMENT TEAM.

SYMBOLS

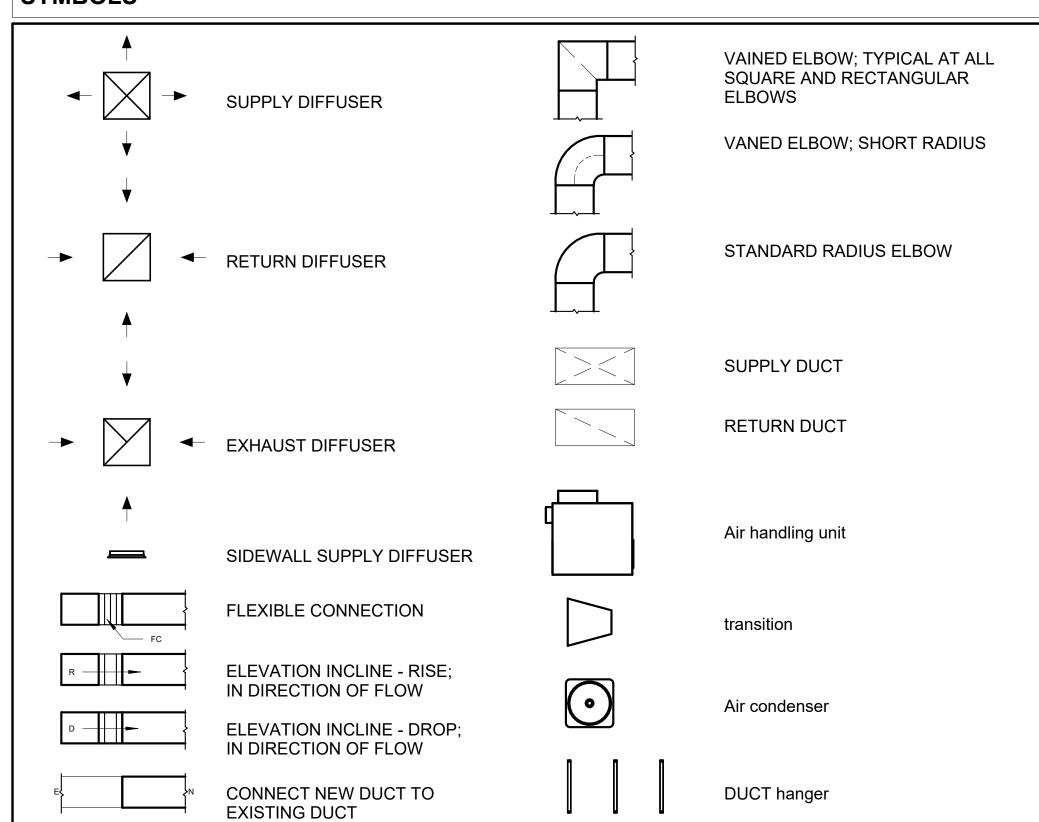

Hvac Color scheme

air conditioning pipe line

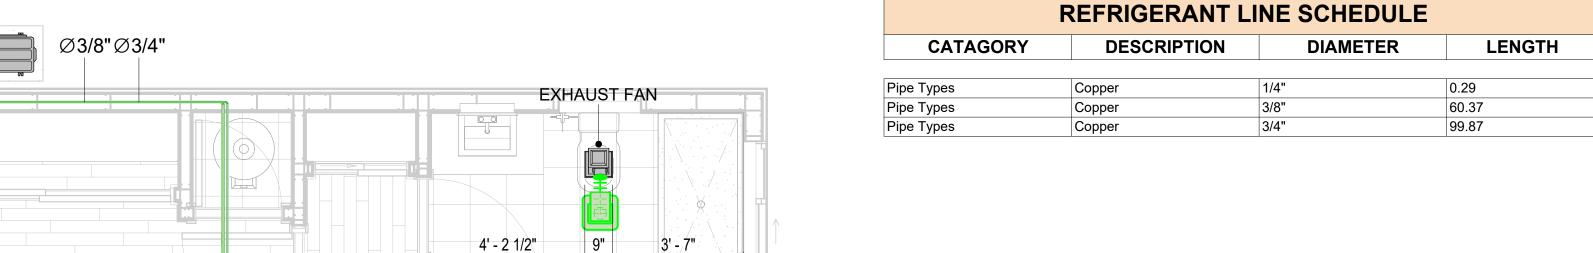

3' - 8 1/2"

AIR HANDLING UNIT

3' - 2 1/2"

Hood-Wall

8' - 3"

REFRIG	REFRIGERANT LINE FITTING SCHEDULE						
CATAGORY	DESCRIPTION	Size	Count				
	1		1.				
Elbow - Generic	Elbow - Generic: Standard/HVAC	1/4"ø-1/4"ø	1				
Elbow - Generic	Elbow - Generic: Standard/HVAC	3/4"ø-3/4"ø	23				
Elbow - Generic	Elbow - Generic: Standard/HVAC	3/8"ø-3/8"ø	20				
Tee - Generic	Tee - Generic: Standard	3/4"ø-3/4"ø-3/ 4"ø	1				
Tee - Generic	Tee - Generic: Standard	3/8"ø-3/8"ø-3/ 8"ø	1				
Transition - Generic	Transition - Generic: Standard	3/4"ø-1/2"ø	3				
Transition - Generic	Transition - Generic: Standard	3/4"ø-5/8"ø	2				
Transition - Generic	Transition - Generic: Standard	3/8"ø-1/4"ø	1				

MECHANICAL EQUIPMENT SCHEDULE					
CATAGORY	GORY DESCRIPTION COUN				
AIR HANDLING UNIT	AIR HANDLING UNIT: WALL MOUNTED	2			
CONDENSER	CONDENSER: OUT DOOR 1				
Exhaust Fan	EXHAUST FAN: 75 CFM 1				
	Hood-Wall: VENT	1			

DUCT FITTING SCHEDULE				
CATAGORY	DESCRIPTION	COUNT		
Round Transition - Angle	45 Degree	5		

DUCT ACCESSORY SCHEDULE			
CATAGORY	DESCRIPTION	COUNT	
ROOF VENT	3" DIAMETER	3	

FLEX DUCT SCHEDULE						
DESCRIPTION	DESCRIPTION	LENGTH	DIAMETER	COUNT		
Flore Decet December	ELEV DOLIND	40.44	A"	0		
Flex Duct Round Grand total: 3	FLEX-ROUND	13.44	4"	3		



KEY PLAN

NO.	DESCRIPTION	DATE

NOTE:

LEGEND:

PROJECT

154-Haven-491 1Bd1Ba-Alpine-550

DRAWING NAME

HVAC PLAN

CLIENT NAME:

PROJECT NUMBER:

15_0001

DATE:

3/29/2025 2:19:08 AM

DESIGNED BY:

DRAWN BY:

CHECKED BY:

Checker

M101

SCALE: As indicated

© [2024] [FrameUpNow] . All rights reserved

ELECTRICAL NOTES

- 1. THIS DRAWING DEPICTS THE ELECTRICAL SYSTEM FOR THE 154-Haven-491-1Bd 1Ba Alpine-550. IT PROVIDES A VISUAL REPRESENTATION OF THE ELECTRICAL LAYOUT AND COMPONENTS, INCLUDING POWER DISTRIBUTION, LIGHTING, AND CONTROL SYSTEMS.
- 2. THE ELECTRICAL SYSTEM IS DESIGNED TO MEET THE SPECIFIC REQUIREMENTS OF THE BUILDING, INCLUDING POWER DISTRIBUTION, LIGHTING, AND SPECIALIZED ELECTRICAL EQUIPMENT NEEDS, AS PER THE PROJECT SPECIFICATIONS AND APPLICABLE CODES AND STANDARDS.
- 3. THE ELECTRICAL SYSTEM INSTALLATION SHALL COMPLY WITH THE LATEST EDITION OF THE NATIONAL ELECTRICAL CODE (NEC), INTERNATIONAL BUILDING CODE (IBC), AND ALL OTHER APPLICABLE LOCAL, STATE, AND NATIONAL CODES AND REGULATIONS.
- 4. LOCATIONS AS NEEDED, DEVICES ARE SHOWN ON PLANS IN APPROXIMATE IDEAL LOCATIONS, UNLESS SPECIFICALLY DIMMENSIONED.
- 5. OPEN WALLS AS NEEDED TO ALLOW FOR NEW ELECTRICAL INSTALLATIONS.
- 6. LABEL ALL CIRCUITS ON JUNCTION BOXES, RECEPTACLES, DATA, SMOKE DETECTOR, AND EQUIPMENT IN PANEL BOX.
- 7. INSTALL RACEWAY AS NEEDED FOR DDC, ACCESS CONTROL, LOW VOLTAGE WIRING & DATA.
- 8. RELABEL POWER, DATA & FIRE ALARM FOR ROOM #CHANGES.
- 9. VERIFY ALL CIRCUITS LABELED ON PRINT ARE CORRECT BEFORE WORKING ON THEM.
 10. NOTE ON SITE PLAN ALL CHANGES OR MISSING DETAIL TO BE INCORPORATED INTO THE MASTER PLAN.
- 11. DRAWINGS ARE DIAGRAMMATIC ONLY FOR THE PURPOSE OF SHOWING FIXTURE AND OUTLET LOCATIONS.
- 12. ELECTRICAL CONTRACTOR TO VERIFY SERVICE SIZE BY CALCULATION BASED UPON ACTUAL NAME PLATE RATINGS OF SELECTED FOLIPMENT
- PLATE RATINGS OF SELECTED EQUIPMENT.

 13. VERIFY LOCATION OF SERVICE ENTRANCE WITH POWER COMPANY. PROVIDE UFER GROUND IN
- BUILDING FOUNDATION AT SERVICE ENTRANCE LOCATION.

 14. PROVIDE A MIN. OF 20 FEET OF ONE *4 BARE COPPER UFER WIRE EMBEDDED IN CONCRETE FOOTING
- 14. PROVIDE A MIN. OF 20 FEET OF ONE *4 BARE COPPER UFER WIRE EMBEDDED IN CONCRETE FOOTING AT THE SERVICE ENTRANCE LOCATION WHERE APPROVED BY LOCAL SERVICE PROVIDER.
- 15. PROVIDE WATERPROOF FIXTURES IN ALL HIGH MOISTURE AREAS (EXTERIOR, SHOWER AND TUB CEILINGS ETC.)
- 16. PROVIDE DEDICATED CIRCUITS TO EACH BATH, DEN, FAMILY ROOM, BEDROOM, LOFT, KITCHEN
- REFRIGERATOR, KITCHEN FREEZER DISHWASHER, AND ANY AREA/ITEM SPECIFIED BY OWNER.

 17. INCANDESCENT FIXTURES WITH OPEN OR PARTIALLY ENCLOSED LAMPS, PENDANT FIXTURES, AND
- LAMP HOLDERS ARE NOT PERMITTED IN CLOSETS.

 18. ALL WORKMANSHIP AND MATERIALS TO CONFORM WITH THE 2015 IRC.
- 19. PROVIDE A MIN. OF 20 FEET OF ONE *4 BARE COPPER UFER WIRE EMBEDDED IN CONCRETE FOOTING AT THE SERVICE ENTRANCE LOCATION WHERE APPROVED BY LOCAL SERVICE PROVIDER.
- 20. PROVIDE A BONDING CONDUCTOR CONSISTING OF A MINIMUM OF ONE *4 BARE COPPER WIRE CONNECTING THE BUILDING'S METAL WATER PIPING SYSTEM TO THE SERVICE EQUIPMENT ENCLOSURE GROUNDING.

MAIN PANEL CALCS

(USE 200 AMP SERVICE)

ELECTRICAL CALCS	
LIGHT AND OUTLETS 491 @ 3W	1,473 W
3 APPLIANCE CIRCUITS	4,500 W
DRYER	2,000 W
WASHER	2,000 W
RANGE	5,000 W
WATER HEATER	5,000 W
REFRIG.	1,800 W
DISHWASHER & DISPOSAL	3000 W
TOTAL	24,773 W
FRIST 10,000 @ 100% REMAINDER @ 40% MINI. SPLIT UNITS	10,000 W 5,909 W 10,000 W
TOTAL	25,909 W
25,909 W DIVIDED BY 240V = 10	8 AMPS TOTAL

ELECTRICAL ABBREVIATIONS LIST

Г						
	1P	1 POLE (2P, 3P, 4P, ETC.)	CTR	CENTER	HT	HEIGHT
	A	AMPERE	CU	COPPER	HTG	HEATING
	AC	ABOVE COUNTER OR AIR CONDITIONER	DCP	DOMESTIC WATER CIRCULATING PUMP	HTR	HEATER
					1	
	ACLG	ABOVE CEILING	DEPT	DEPARTMENT	HV	HIGH VOLTAGE
	ADO	AUTOMATIC DOOR OPENER	DET	DETAIL	HVAC	HEATING, VENTILATING AND AIR
	AF	AMP FRAME	DIA	DIAMETER	CONDITIONING	CONDITIONING
	AFF	ABOVE FINISHED FLOOR	DISC	DISCONNECT	HWP	HYDRONIC WATER PUMP
	AFG	ABOVE FINISHED GRADE	DIST	DISTRIBUTION	IC	INTERRUPTING CAPACITY
	AFI	ARC FAULT CIRCUIT INTERRUPTER	DN	DOWN	IG	ISOLATED GROUND
	AHU	AIR HANDLING UNIT	DPR	DAMPER	IMC	INTERMEDIATE METAL CONDUIT
	AL	ALUMINUM	DS	SAFETY DISCONNECT SWITCH	INCAND	INCANDESCENT
	ALT	ALTERNATE	DT	DOUBLE THROW	IR	INFRARED
	AMP	AMPERE	DWG	DRAWING	I/W	INTERLOCK WITH
	AMPL	AMPLIFIER	DDC	DIRECT DIGITAL CONTROL	J-BOX	JUNCTION BOX
		ANNUNCIATOR APPROX APPROXIMATELY			KV KV	KILOVOLT
	ANNUN			ELECTRICAL CONTRACTOR	1	
	AQ-STAT	AQUASTAT	ELEC	ELECTRIC, ELECTRICAL	KVA	KILOVOLT-AMPERE
	ARCH	ARCHITECT, ARCHITECTURAL	ELEV	ELEVATOR	KVAR	KILOVOLT-AMPERE REACTIVE
	AS	AMP SWITCH	EM	EMERGENCY	KW	KILOWATT
	AT	AMP TRIP	EMS	ENERGY MANAGEMENT SYSTEM	KWH	KILOWATT HOUR
	ATS	AUTOMATIC TRANSFER SWITCH	EMT	ELECTRICAL METALLIC TUBING	LOC	LOCATE OR LOCATION
	AUTO	AUTOMATIC	EP	ELECTRIC PNEUMATIC	LT	LIGHT
	AUX	AUXILIARY	EQUIP	EQUIPMENT	LTG	LIGHTING
	AV	AUDIO VISUAL	EWC	ELECTRIC WATER COOLER	LTNG	LIGHTNING
	AWG	AMERICAN WIRE GAUGE	EXIST	EXISTING	LV	LOW VOLTAGE
	BATT	BATTERY	EXH	EXHAUST	MAX	MAXIMUM
	BD	BOARD	EXP	EXPLOSION PROOF	MAG.S	MAGNETIC STARTER
	BLDG	BUILDING	FA	FIRE ALARM	M/C	MOMENTARY CONTACT
	BMS	BUILDING MANAGEMENT SYSTEM	FABP	FIRE ALARM BOOSTER POWER	MC	MECHANICAL CONTRACTOR
		CONDUIT		SUPPLY PANEL	MCB	
	CAR		SUPPLY PANEL			MAIN CIRCUIT BREAKER
	CAB	CABINET	FACP	FIRE ALARM CONTROL PANEL	MCC	MOTOR CONTROL CENTER
	CAT	CATALOG	FCU	FAN COIL UNIT	MDC	MAIN DISTRIBUTION CENTER
	CATV	CABLE TELEVISION	FIXT	FIXTURE	MDP	MAIN DISTRIBUTION PANEL
	CB	CIRCUIT BREAKER	FLR	FLOOR	MFR	MANUFACTURERMAIN FUSED
	CCTV	CLOSED CIRCUIT TELEVISION	FLUOR	FLUORESCENT		DISCONNECT SWITCH
	CKT	CIRCUIT	FU	FUSE	MH	MANHOLE
	CLG	CEILING	FUDS	FUSED SAFETY DISCONNECT SWITCH	MIC	MICROPHONE
	COMB	COMBINATION	GA	GAUGE	MIN	MINIMUM
	CMPR	COMPRESSOR	GAL	GALLON	MISC	MISCELLANEOUS
	CONN	CONNECTION	GALV	GALVANIZED	MLO	MAIN LUGS ONLY
	CONST	CONSTRUCTION	GC	GENERAL CONTRACTOR	MMS	MANUAL MOTOR STARTER
	CONT	CONTINUATION OR CONTINUOUS	GEN	GENERATOR	MOA	MULTIOUTLET ASSEMBLY
	CONTR	CONTRACTOR	GFI	GROUND FAULT CIRCUIT INTERRUPTER	MSP	MOTOR STARTER PANELBOARD
		CONVECTOR	GFP	GROUND FAULT PROTECTOR	MSBD	MAIN SWITCHBOARD
	CONV					
	CP	CIRCULATING PUMP	GND	GROUND	MT	MOUNT
	CRT	CATHODE-RAY TUBE	GRS	GALVANIZED RIGID STEEL (CONDUIT)	MT.C	EMPTY CONDUIT
	CT	CURRENT TRANSFORMER	GYP BD	GYPSUM BOARD	UL	UNDERWRITERS LABORATORIES

Branch Panel:

Location: LIVING AREA 2
Supply From:
Mounting: Recessed

Enclosure: Type 1

Volts: 120/240 Single
Phases: 1
Wires: 3

A.I.C. Rating: Mains Type: Mains Rating: 200 A MCB Rating: 1 A

Notes

ATH GFCI IALL & KITCHEN IVING LIGHT CONDENSER	7 12 7	20 A 20 A 15 A	41' - 7 3/32" 54' - 1 29/32" 21' - 7 11/32"	1-#12, 1-#12, 1-#12 1-#12, 1-#12 1-#14, 1-#14, 1-#14,	576 VA	209 VA	576 VA	400 VA	1-#12, 1-#12, 1-#12 1-#14, 1-#14,	62' - 8 23/32" 39' - 10 1/16"	20 A 15 A	7	BED LIGHT OUTDOOR LIGHT	2
IVING LIGHT	7	15 A	21' - 7 11/32"	1-#12, 1-#12 1-#14, 1-#14,			576 VA	400 VA		30' - 10 1/16"	15 A	6	OUTDOOP LIGHT	4
				1-#14,					1-#14	39 - 10 1/10			OUTDOOK LIGHT	4
CONDENSER	1	60.4		1-11-11-1	209 VA	900 VA			1-#12, 1-#12, 1-#12	38' - 0 9/16"	20 A	5	OUTDOOR GFCI	6
		00 A	55' - 5 13/16"	2-#6, 1-#6, 1-#10			2500 VA	2500 VA	2-#8, 1-#8, 1-#10	33' - 1 21/32"	50 A	1	RANGE	8
					2500 VA	2500 VA								10
VENHOOD	1	20 A	27' - 1 29/32"	1-#12, 1-#12, 1-#12			180 VA	1200 VA	1-#12, 1-#12, 1-#12	25' - 10 3/32"	20 A	1	DISHWASHER	12
ITCHEN GFCI	3	20 A	34' - 11 13/32"	1-#12, 1-#12, 1-#12	540 VA	1800 VA			1-#12, 1-#12, 1-#12	37' - 1 3/32"	20 A	1	REFRIGERATOR	14
VATER HEATER	1	30 A	50' - 2 1/32"	2-#10, 1-#10, 1-#10			2250 VA	720 VA	1-#12, 1-#12, 1-#12	55' - 4 3/8"	20 A	4	BED RECEPTACLE	16
					2250 VA	900 VA			1-#12, 1-#12, 1-#12	33' - 9 9/32"	20 A	5	LIVING RECEPTACLE	18
RYER	1	30 A	20' - 1 11/16"	2-#10, 1-#10, 1-#10			2500 VA	1200 VA	1-#12, 1-#12, 1-#12	22' - 0 27/32"	20 A	1	WASHER	20
					2500 VA									22
														24
														26
					14879) VA	1400)6 VA						
\/\/	TCHEN GFCI	/ENHOOD 1 ICHEN GFCI 3 ATER HEATER 1	7ENHOOD 1 20 A TCHEN GFCI 3 20 A ATER HEATER 1 30 A RYER 1 30 A	/ENHOOD 1 20 A 27' - 1 29/32" TCHEN GFCI 3 20 A 34' - 11 13/32" ATER HEATER 1 30 A 50' - 2 1/32" RYER 1 30 A 20' - 1 11/16"	/ENHOOD 1 20 A 27' - 1 29/32" 1-#12, 1-#12 TCHEN GFCI 3 20 A 34' - 11 13/32" 1-#12, 1-#12 ATER HEATER 1 30 A 50' - 2 1/32" 2-#10, 1-#10 RYER 1 30 A 20' - 1 11/16" 2-#10, 1-#10, 1-#10	/ENHOOD 1 20 A 27' - 1 29/32" 1-#12, 1-#12	/ENHOOD 1 20 A 27' - 1 29/32" 1-#12, 1-#12, 1-#12 TCHEN GFCI 3 20 A 34' - 11 13/32" 1-#12, 1-#12 ATER HEATER 1 30 A 50' - 2 1/32" 2-#10, 1-#10 2250 VA 900 VA RYER 1 30 A 20' - 1 11/16" 2-#10, 1-#10	/ENHOOD 1 20 A 27' - 1 29/32" 1-#12, 1-#12, 1-#12	/ENHOOD 1 20 A 27' - 1 29/32" 1-#12, 1-#12, 1-#12, 1-#12, 1-#12, 1-#12, 1-#12, 1-#12, 1-#12, 1-#12, 1-#12, 1-#10,	/ENHOOD 1 20 A 27' - 1 29/32" 1.#12, 1.#12, 1.#12 180 VA 1200 VA 1.#12, 1.#12 TCHEN GFCI 3 20 A 34' - 11 13/32" 1.#12, 1.#12, 1.#12 ATER HEATER 1 30 A 50' - 2 1/32" 2.#10, 1.#10, 1.#10 2250 VA 900 VA 1200 VA 1.#12, 1.#12 EYER 1 30 A 20' - 1 11/16" 1.#10, 1.#10, 1.#10 2500 VA 14006 VA 14006 VA	/ENHOOD 1 20 A 27' - 1 29/32" 1.#12,	ZENHOOD 1 20 A 27' - 1 29/32" 1.#12, 1.#12, 1.#12 1.#12 25' - 10 3/32" 20 A TCHEN GFCI 3 20 A 34' - 11 13/32" 1.#12, 1.#12, 1.#12 540 VA 1800	ZENHOOD 1 20 A 27' - 1 29/32" 1.#12, 1.#12, 1.#12	1

	Legen
--	-------

Load Classification	Connected Load	Demand Factor	Estimated Demand	Panel	Totals
LIGHTING - DWELLING UNIT	600 VA	100.00%	600 VA		
OTHER	824 VA	100.00%	824 VA	Total Conn. Load:	28885 VA
RECEPTACLE	6000 VA	100.00%	6000 VA	Total Est. Demand:	27885 VA
LIGHTING	200 VA	100.00%	200 VA	Total Conn.:	120 A
CONDENSER	5000 VA	100.00%	5000 VA	Total Est. Demand:	116 A
WATER HEATER	4500 VA	100.00%	4500 VA		
RANGE	5000 VA	80.00%	4000 VA		
DRYER	5000 VA	100.00%	5000 VA		
REFRIGERATOR	1800 VA	100.00%	1800 VA		



KEY PLAN

NO. DESCRIPTION DATE

NOTE:

LEGEND:

PROJECT

154-Haven-491-1Bd 1Ba Alpine-550

DRAWING NAME

SCHEDULE

CLIENT NAME:

PROJECT NUMBER:

0250_12

DATE:

3/31/2025 10:43:57 AM

DESIGNED BY:

DRAWN BY:

CHECKED BY:

Checker

E101

SCALE: 1/4" = 1'-0"

© [2024] [FrameUpNow] . All rights reserved

ELECTRICAL NOTE

- A. PROVIDE INTERCONNECTED SMOKE ALARMS IN EACH SLEEPING ROOMS, OUTSIDE EACH SLEEPING ROOM, ON EACH STORY, IN THE HALL OR ADJACENT ROOM LUHERE THE CEILING HEIGHT OF A ROOM OPEN TO THE HALL EXCEEDS THE HALL BY 24'. SMOKE ALARMS SHALL BE PERMANENTLY HARD WIRED WITH BATTERY BACKUP.
- B. RECEPTACLE OUTLETS FOR RANGES AND CLOTHES DRYERS SHALL BE A THREE POLE WITH GROUND TYPE. FOUR WIRE GROUNDING-TYPE FLEXIBLE CORDS WILL BE REQUIRED FOR CONNECTION OF RANGES AND CLOTHES DRYERS. THE BONDING JUMPER SHALL NOT BE CONNECTED BETWEEN NEUTRAL TERMINAL AND THE FRAME OF THE APPLIANCE.
- C. TWO OR MORE 20 AMP SMALL APPLIANCE CIRCUITS SHALL BE PROVIDED TO SERVE THE KITCHEN, BREAKFAST NOOK, AND DINING ROOM. SUCH CIRCUITS SHALL HAVE NO OTHER OUTLETS.
- D. AT LEAST ONE 20 AMP BRANCH CIRCUIT SHALL BE PROVIDED TO SERVICE THE LAUNDRY ROOM. THIS CIRCUIT SHALL HAVE NO OTHER OUTLETS.
- E. ALL RECEPTACLES WITH IN 6' OF A WET BAR SINK OR KITCHEN SINK TO SERVE COUNTER TOP SURFACES MUST BE GFCI. ON KITCHEN COUNTERS 12' OR WIDER NO POINT ALONG THE WALL SHALL BE MORE THAN 2' FROM A RECEPTACLE. ALL RECEPTACLES WITH IN 6' OF KITCHEN SINK MUST BE GFCI. AT LEAST ONE GFCI RECEPTACLE SHALL
- BE INSTALLED IN THE BATHROOM ADJACENT TO EACH BASIN.

 F. FIXTURES INCLUDING CEILING FANS THAT ARE LOCATED IN DAMP LOCATIONS SHALL BE LISTED TO BE SUITABLE FOR
- SUCH LOCATIONS PER 2012 IRC
- G. PROVIDE ONE (1) SWITCHED OUTLET @ ALL BEDROOMS AND DEN
- H. CEILING FANS NOT EXCEEDING 35 LBS. (WITH OR WITHOUT ACCESSORIES MAY BE SUPPORTED BY OUTLET BOXES PROVIDED THE OUTLET BOXES ARE IDENTIFIED FOR SUCH USE PER 2012 IRC
- I. ELECTRICAL OUTLET BOXES ON OPPOSITE SIDES OF FIRE RATED WALLS SHALL BE SEPARATED BY A HORIZONTAL DISTANCE OF NOT LESS THAN 24".
- J. OUTLET BOXES IN THE WALLS BETWEEN THE GARAGE AND DWELLING SHALL BE METAL OR U.L. APPROVED FIRE RESISTIVE PLASTIC. BOXES IN GARAGE CEILING SHALL BE METAL.
- K. ALL BRANCH CIRCUITS THAT SUPPLY 120 VOLTS SINGLE PHASE 15 AND 20 AMPS RECEPTACLE OUTLETS INSTALLED IN THE DWELLING SHALL BE PROTECTED BY AN ARC FAULT CIRCUIT INTERRUPTER, EXCEPT GFCI RECEPTICLES.

NOTE:

A. RECEPTACLES MUST BE PROVIDED IN HALLWAYS 10'-0" OR MORE IN LENGTH. FOR A ONE FAMILY DWELLINGS AND EACH OF A TWO FAMILY DWELLING THAT IS AT GRADE LEVEL, AT LEAST ONE WP-GFCI RECEPTACLE OUTLET ACCESSIBLE AT GRADE LEVEL AND NOT MORE THAN 6'-6" ABOVE GRADE SHALL BE INSTALLED AT THE FRONT AND BACK OF THE DWELLING.

NOTE: APPLIANCE DISCONNECT

E4001.5 GROUNDING OF ENCLOSURES.

METAL ENCLOSURES FOR SWITCHES OR CIRCUIT BREAKERS SHALL BE CONNECTED TO AN

EQUIPMENT GROUNDING CONDUCTOR.

METAL ENCLOSURES FOR SWITCHES OR CIRCUIT BREAKERS USED AS SERVICE

EQUIPMENT SHALL COMPLY WITH THE PROVISIONS OF SECTION E3609.4. WHERE


NONMETALLIC ENCLOSURES ARE USED WITH METAL RACEWAYS OR METAL-ARMORED CABLES, PROVISIONS SHALL BE MADE FOR CONNECTING THE EQUIPMENT GROUNDING

CONDUCTOR.


NONMETALLIC BOXES FOR SWITCHES SHALL BE INSTALLED WITH A WIRING METHOD THAT

PROVIDES OR INCLUDES AN EQUIPMENT GROUNDING CONDUCTOR. (404.12)

ELECTRICAL LEGEND Electrical Lights With Fan Waterproof Recessed Can Light 0 Pendant Light **Recessed Can Light** 0 **−**Ø Wall Lamp **Standalone linear** Single Switch ₩Ð ₩ **Three way Switch** Fan Switch **₩ Duplex Receptacle Triplex Receptacle GFCI Receptacle** \mathbb{X} Exhaust Fan Smoke and heat detector

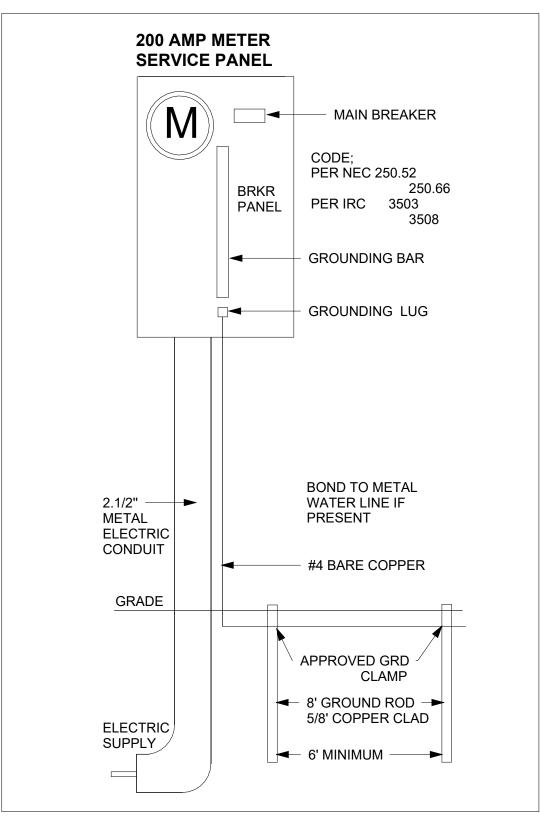



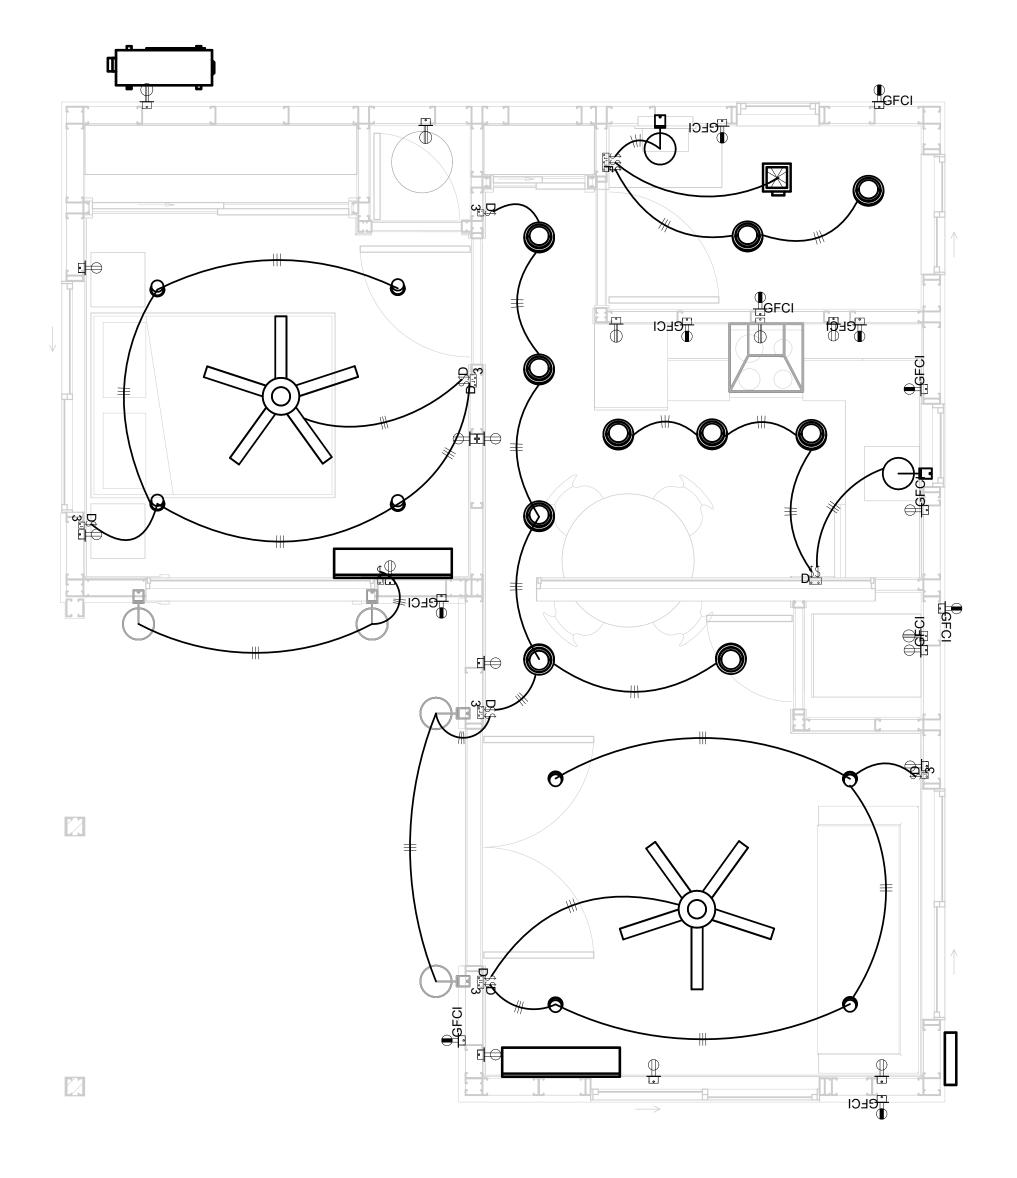

1 - Lighting 3/8" = 1'-0"



KEY PLAN

NO.	DESCRIPTION	DATE

NOTE:

LEGEND:

PROJECT

154-Haven-491-1Bd 1Ba Alpine-550

DRAWING NAME


LIGHTING

CLIENT NAME:	Owner
PROJECT NUMBER:	0250_12
DATE:	3/31/2025 10:44:00 AM
DESIGNED BY:	Designer
DRAWN BY:	Author
CHECKED BY:	Checker


E102

NOTES: CONDUIT, CABLE AND WIRING


- Use Metalic Conduits (IMC) for cables running under concrete slabs.
 Use IMC for circuits with high voltage appliances (240 volts and above)
 For circuits with 120 volts consider using EMT or PVC conduits if needed.
 For Low voltage applications up to 50 volts consider using non metalic conduits.
 All conduits to be used in the project must conform to the latest National Electrical Code (NEC),
- 6. All wiring and cables to be used in the project must also conform to the latest National Electrical
- 7. All cables and wires used should be rated for their respective loading and should be gauged and conform to the NEC.

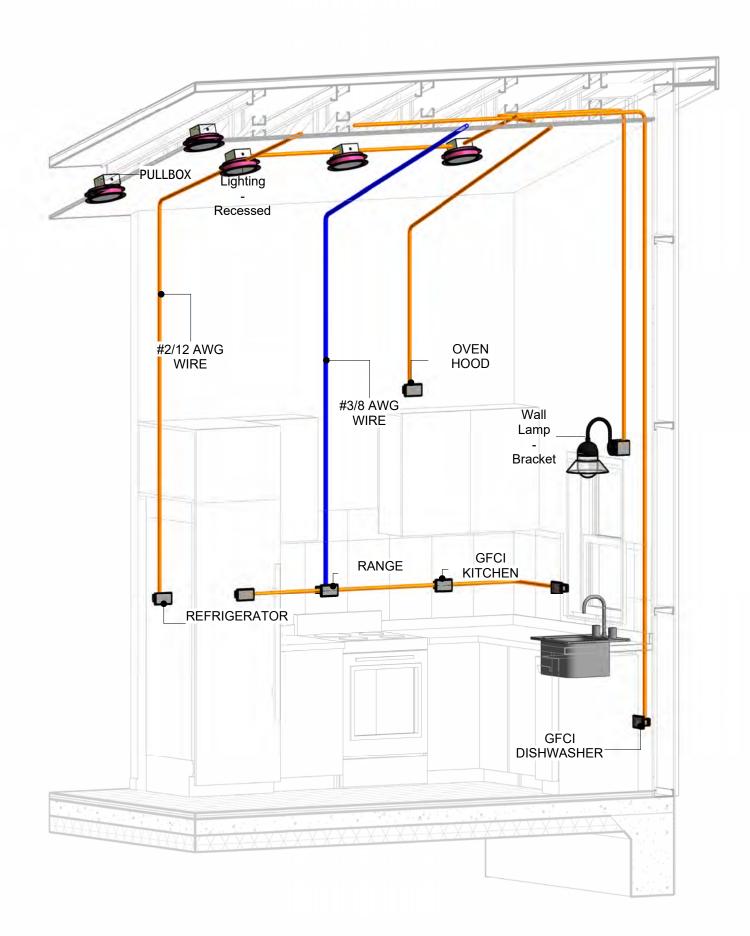


3D-KITCHEN

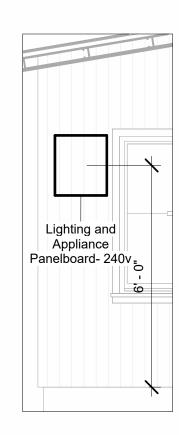


PANEL 3/8" = 1'-0"

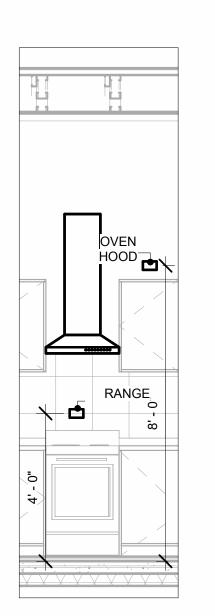

OVENHOOD & RANGE

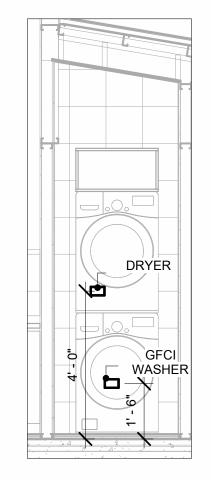


DRYER & WASHER 3/8" = 1'-0"

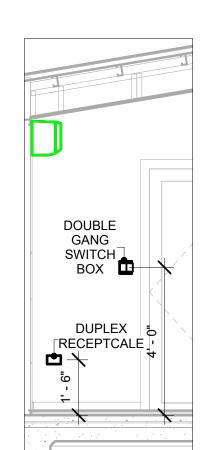

SWITCH & RECEPTACLE 3/8" = 1'-0"



KEY PLAN

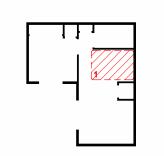

NO.	DESCRIPTION	DATE

NOTE:

LEGEND:

PROJECT

154-Haven-491-1Bd 1Ba Alpine-550

DRAWING NAME

POWER

CLIENT NAME:	Owner
PROJECT NUMBER:	0250_12
DATE:	3/31/2025 10:44:25 AM
DESIGNED BY:	Designer
DRAWN BY:	Author
CHECKED BY:	Checker

E103

NOTES: LIGHT

- 1. LIGHT FIXTURES AND LUMINARIES SHALL CONFORM TO THE NEC, THE IRC AND LOCAL SAFETY & BUILDING CODE.
- 2. ALL LIGHTING FIXTURES SHOULD CONFORM TO THE DESIGN ELECTRICAL LOAD AND SHALL BE PROPERLY WIRED AND MOUNTED BY QUALIFIED ELECTRICIAN FOLLOWING MANUFACTURERS SPECIFICATIONS.
- 3. CEILING FANS AND FANS WITH LIGHT WITH WEIGHT EXCEEDING 35 LBS SHOULD BE PROVIDED WITH STRUCTURAL BACKING FOR SUPPORT AND SHALL BE FIXED AS PER MANUFACTURERS SPECIFICATIONS.
- 4. EXTERIOR LIGHTS SHALL CONFORM TO LOCAL BUILDING CODE AND GUIDELINES.

NOTES: SWITCH JUNCTION BOX


- 1. THE MINIMUM SIZE OF JUCTION BOX TO BE USED IS 2"X4"X(1.5" OR 3.5" DEEP) THIS ARE TO BE USED FOR SINGLE GANG SWITCH OR OUTLETS.
- 2. FOR DOUBLE GANG (2 GANG) OUTLETS AND SWITCHS THE MINIMUM SIZE OF THE
- JUCTION BOX TO BE PROVIDED SHALL NOT BE LESS THAN 4"X4"X(1.5" OR 3.5" DEEP)
- 3. FOR THREE GANG (3 GANG) OUTLETS AND SWITCHS THE MINIMUM SIZE OF THE JUĆTION BOX SHALL NOT BE LESS THAN 6"X4"X(1.5" OR 3.5" DEEP).

FITTING SCHEDULE(PULL BOX)							
FAMILY	COUNT	DESCRIPTION					
PULLBOX1	22	#1/4 PULLBOX					

ELECTRICAL FIXTURE SCHEDULE (SWITCH BOX)						
TYPE	COUNT					
DOUBLE GANG SWITCH BOX	4					
SINGLE GANG SWITCH BOX	4					
TRIPLE GANG SWITCH BOX	1					

LIGHTING DEVICE			
TYPE	COUNT		
DIMMER	3		
FAN SWITCH	1		
SINGLE POLE	5		
THREE WAY WITH DIMMER	6		

LIGHTING FIXTURE				
LIGHTING FIXTURE TYPE	VOLTAGE	ELECTRICAL LOAD	COUNT	
ELECTRICAL_LIGHTS_FAN-LIGHT1	120 V/1-100 VA- 120 V/1-100 VA	200 A, 120 V/240 V, SINGLE PHASE, 3 WIRES	2	
LIGHTING - RECESSED	120 V/1-60 VA	200 A, 120 V/240 V, SINGLE PHASE, 3 WIRES	10	
SASSO 100 ROUND WALLWASHER TRIM	120 V/1-28 VA	200 A, 120 V/240 V, SINGLE PHASE, 3 WIRES	8	
WALL LAMP - BRACKET	120 V/1-100 VA	200 A, 120 V/240 V, SINGLE PHASE, 3 WIRES	6	

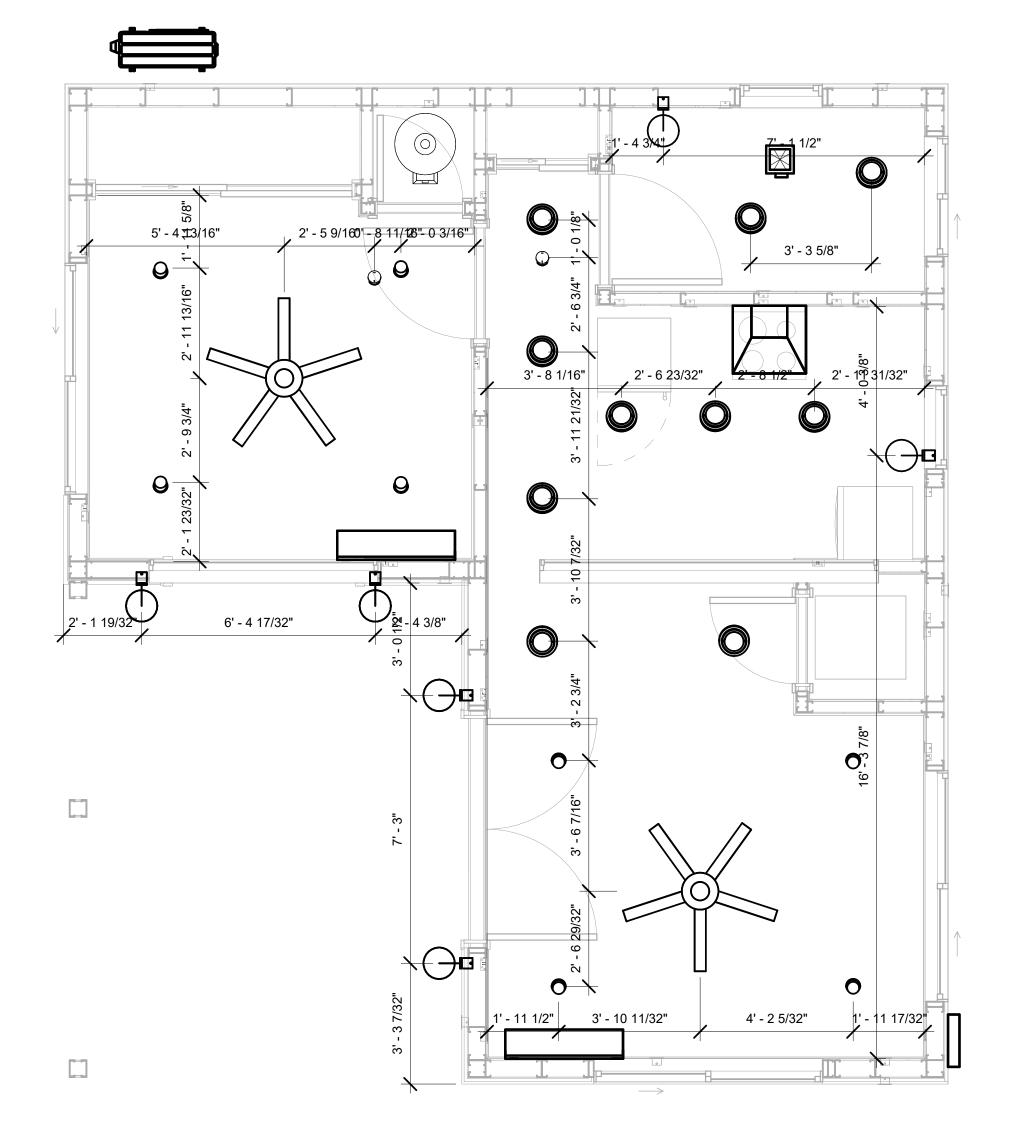





KEY PLAN

NO.	DESCRIPTION	DATE

NOTE:

LEGEND:

PROJECT

154-Haven-491-1Bd 1Ba Alpine-550

DRAWING NAME

DIMENSION PLAN FOR LIGHT FIXTURES

CLIENT NAME:	Owner
PROJECT NUMBER:	0250_12
DATE:	3/31/2025 10:44:26 AM
DESIGNED BY:	Designer
DRAWN BY:	Author
CHECKED BY:	Checker


E104

NOTES;

- 1. VERIFY EQUIPMENT PLUG CONFIGURATION BEFORE PURCHASING RECEPTACLES
- 2. FOR ALL EQUIPMENT.
- 3. COORDINATE EXACT LOCATION OF LIGHT FIXTURES, WALL SWITCHES, RECEPTACLES AND OTHER DEVICES WITH ARCHITECTURAL DRAWINGS.
- 4. USE METALLIC JUNCTION BOX WITH THE GFCI RECEPTACLES, WITH HIGHT VOLTAGE.

ELECTRICAL FIXTURE SCHEDULE (RECEPTACLE)			
COUNT			
1			
1			
1			
2			
1			
3			
5			
1			
1			
1			
1			
9			
1			

ELECTRICAL OUTLET SCHEDULE			
TYPE	CIRCUIT NUMBER	ELECTRICAL DATA	COUNT
STANDARD		120 V/1-180 VA	1
GFCI BATH ROOM	1	120 V/1-180 VA	2
GFCI OUT DOOR	6	120 V/1-180 VA	5
CONDENSER	7,9	240 V/2-5000 VA	1
RANGE	8,10	240 V/2-5000 VA	1
OVEN HOOD	11	120 V/1-180 VA	1
GFCI DISHWASHER	12	120 V/1-1200 VA	1
GFCI KITCHEN	13	120 V/1-180 VA	3
REFRIGERATOR	14	120 V/1-1800 VA	1
WATER HEATER	15,17	240 V/2-4500 VA	1
STANDARD	16	120 V/1-180 VA	4
DUPLEX RECEPTCALE	18	120 V/1-180 VA	1
STANDARD	18	120 V/1-180 VA	4
DRYER	19,21	240 V/2-5000 VA	1
GFCI WASHER	20	120 V/1-1200 VA	1

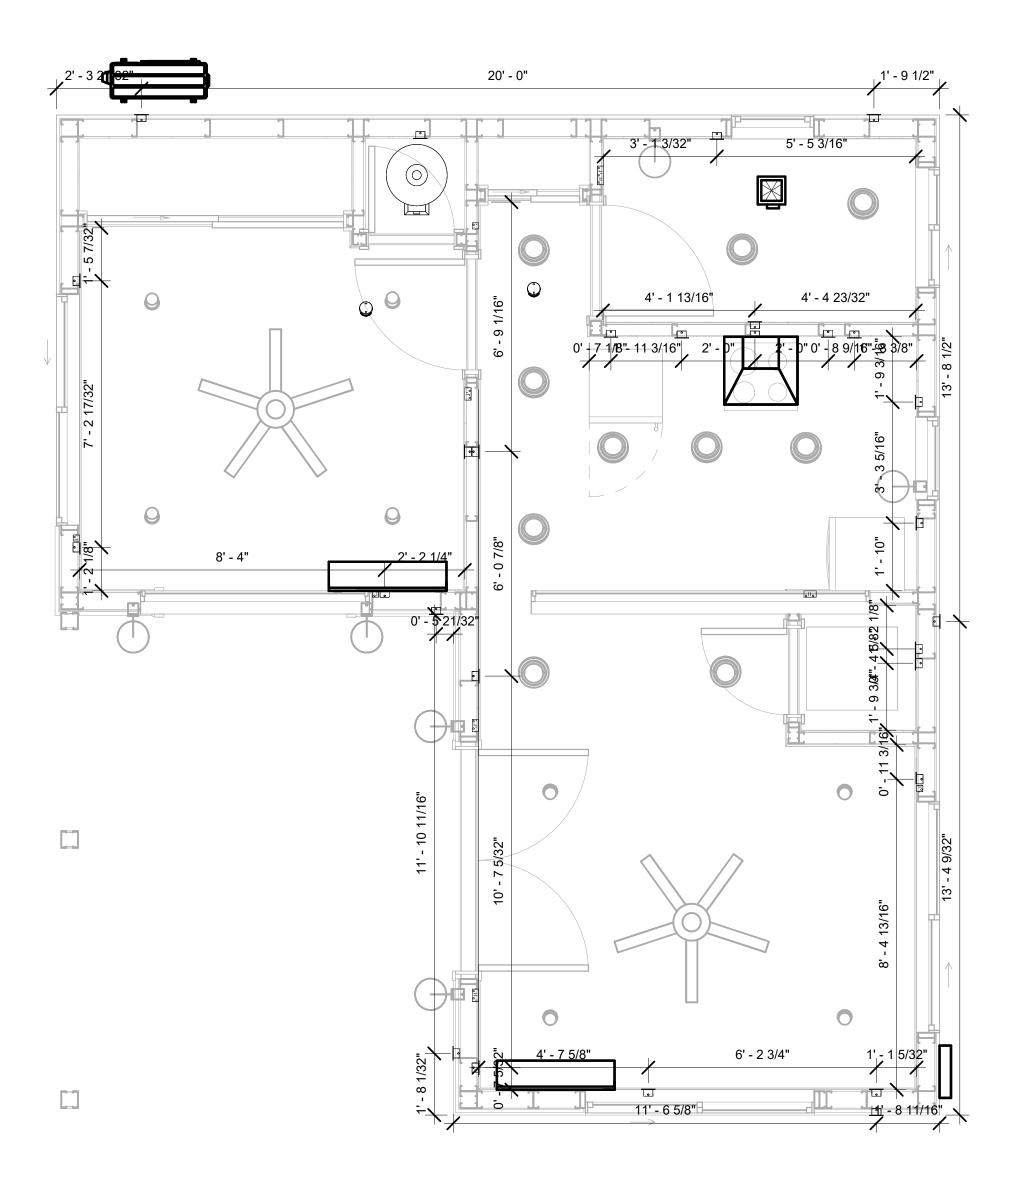

1 DIMENSION FOR FITTINGS 3/8" = 1'-0"



KEY PLAN

NO.	DESCRIPTION	DATE

NOTE:

LEGEND:

PROJECT

154-Haven-491-1Bd 1Ba Alpine-550

DRAWING NAME

DIMENSION PLAN FOR FITTINGS

CLIENT NAME:	Owner
PROJECT NUMBER:	0250_12
DATE:	3/31/2025 10:44:27 AM
DESIGNED BY:	Designer
DRAWN BY:	Author
CHECKED BY:	Checker

E105

SHEET LIST

SHEET NUMBER SHEET NAME

P101 NOTE AND SCHEDULE P102 WATER SUPPLY AND SEWAGE SYSTEM

PIPE COLOR SCHEME DOMESTIC COLD WATER DOMESTIC HOT WATER - - - SANITARY VENT SANITARY SEWER ----- STORM DRAINAGE GRAY WATER GAS LINE

PLUMBING NOTES

- THE PLUMBING SYSTEM IS DESIGNED TO MEET THE BUILDING'S DOMESTIC WATER SUPPLY, SANITARY DRAINAGE, AND STORM DRAINAGE REQUIREMENTS, AS PER PROJECT SPECIFICATIONS AND APPLICABLE CODES.
- THE SYSTEM INSTALLATION SHALL COMPLY WITH THE LATEST INTERNATIONAL PLUMBING CODE (IPC), INTERNATIONAL RESIDENTIAL CODE (IRC), AND ALL OTHER RELEVANT LOCAL, STATE, AND NATIONAL REGULATIONS.
- ALL PLUMBING WORK SHALL COMPLY WITH THE LATEST EDITION OF THE INTERNATIONAL PLUMBING CODE (IPC) AND THE LOCAL PLUMBING CODE.
- PLUMBING SYSTEMS SHALL BE TESTED AND INSPECTED IN ACCORDANCE WITH THE LOCAL PLUMBING CODE REQUIREMENTS.
- 5. PLUMBING FIXTURES SHALL BE INSTALLED WITH THE APPROPRIATE TRIM, FITTINGS, AND ACCESSORIES, AS RECOMMENDED BY THE MANUFACTURER.
- 6. PIPING SHALL BE PROPERLY SUPPORTED AND SECURED TO PREVENT SAGGING,
- MOVEMENT, AND VIBRATION. SHUT-OFF VALVES SHALL BE PROVIDED AT ALL BRANCH CONNECTIONS AND AT THE
- INLET AND OUTLET OF EACH PIECE OF EQUIPMENT. BACKFLOW PREVENTION DEVICES SHALL BE INSTALLED AS REQUIRED BY THE LOCAL
- PLUMBING CODE TO PROTECT THE POTABLE WATER SYSTEM. PLUMBING FIXTURES AND EQUIPMENT SHALL BE ACCESSIBLE FOR MAINTENANCE AND
- 10. EXPOSED PLUMBING PIPING AND FIXTURES SHALL BE INSULATED TO PREVENT CONDENSATION AND ENERGY LOSS.
- 11. DEAD ENDS IN THE DRAINAGE SYSTEM MUST BE AVOIDED, EXCEPT WHERE NECESSARY TO INSTALL A CLEANOUT IN AN ACCESSIBLE LOCATION, AND MUST HAVE A VENTED CONNECTION TO THE OUTSIDE ATMOSPHERE.
- 12. THE VERTICAL DEFLECTION OF PVC PIPE MUST NOT EXCEED 5%, AND NO DEFLECTION IS PERMITTED FOR IRON PIPE.
- 13. WORK MUST BE PROPERLY COORDINATED WITH OTHER TRADES TO AVOID CONFLICTS, REFERRING TO THE ARCHITECTURAL AND STRUCTURAL DRAWINGS FOR INFORMATION REGARDING CEILING ELEVATIONS, SPACE CLEARANCES, WALL AND PARTITION LOCATIONS, ETC.
- 14. ALL FIXTURES SHALL HAVE ACCESSIBLE STOPS.
- 15. DOMESTIC WATER PIPING SHALL BE PEX, AND PVC PIPING IS NOT ACCEPTABLE FOR INTERIOR USE.
- 16. VENT TERMINATIONS SHALL BE LOCATED AT LEAST 10 FEET FROM OR 3 FEET ABOVE ANY OPERABLE WINDOW, DOOR OPENING, AIR INTAKE, OR VENT SHAFT, AND AT LEAST 3 FEET IN EVERY DIRECTION FROM ANY LOT LINE, ALLEY, OR STREET.
- 17. PIPE AND FITTINGS UTILIZED IN THE WATER SUPPLY SYSTEM SHALL HAVE A MAXIMUM OF 8 PERCENT LEAD.
- 18. ACRYLONITRILE BUTADIENE STYRENE (ABS) SHALL BE USED FOR THE SEWERAGE AND VENTILATION SYSTEM.
- 19. CROSS-LINKED POLYETHYLENE (PEX) SHALL BE USED FOR THE WATER SUPPLY SYSTEM.
- POLYVINYL CHLORIDE (PVC) SHALL BE USED FOR THE RAIN WATER SYSTEM.
- 21. THE MIMIMUM WATER SUPPLY DEPTH UNDER FLOOR FINISH SHOUD BE 1/2".
- 22. ANY PIPE INSTALLED UNDERGROUND MUST HAVE AT LEAST 12 INCHES OF CLEARANCE BETWEEN THE OUTSIDE OF THE PIPE AND ANY OTHER UNDERGROUND STRUCTURE.
- 23. THE MINIMUM CLEARANCE BETWEEN COLD AND HOT WATER LINES IN RESIDENTIAL HOMES MAINTAIN A MINIMUM DISTANCE OF 6 INCHES.
- HORIZONTAL SEPARATION BETWEEN WATER AND SEWER LINES: A MINIMUM OF 12 INCHES BETWEEN POTABLE WATER SUPPLY LINES (COLD AND HOT WATER) AND SANITARY SEWER LINES.

ABBREVIATIONS

Ø	DIAMETER
ABS	ACRYLONITRILE BUTADIENE STYRENE
ABV	ABOVE
AD	AREA DRAIN
AFF	ABOVE FINISHED FLOOR
ALT	ALTERNATE
BFF	BELOW FINISHED FLOOR
BLW	BELOW
CO	CLEAN OUT
CW	COLD WATER
D	DEGREE
DFU	DRANAGE FIXTURE UNIT
DIA	DIAMETER
DN	DOWN
FCO	FLOOR CLEAN OUT
FD	FLOOR DRAIN
FL	FLOOR
FS	FLOOR SINK
FT	FOOT/FEET
НВ	HOSE BIB
HW	HOT WATER
IN	INCH
MIN	MINIMUM
NO	NUMBER
NTS	NOT TO SCALE
PEX	CROSS-LINKED POLYETHYLENE
PLBG	PLUMBING
PVC	POLYVINYL CHLORIDE
QTY	QUANTITY
RD	ROOF DRAIN
RED	REDUCER
RM	ROOM
RW	RAIN WATER
SF	SQUARE FOOT
V	VENT
VTR	VENT THROUGH ROOF
W	WASTE
WCO	WALL CLEAN OUT
WSFU	WATER SUPPLY FIXTURE UNIT

PLUMBING LEGEND

D	CAP
	BEND 45 DEG
\Box	BEND 90 DEG
	TEE REDUCING
	TEE
	CLEAN TWO-WAY
	WYE 45 DEG
	WYE 45 DEG DOUBLE
	WYE COMBINATION
	P-TRAP

PIPE SCHEDULE				
MATERIAL DIAMETER LENGTH				
ACRYLONITRILE BUTADIENE STYRENE (ABS)	1 1/2"	34 FT		
ACRYLONITRILE BUTADIENE STYRENE (ABS)	2"	16 FT		
ACRYLONITRILE BUTADIENE STYRENE (ABS) 3" 27 FT				
CROSS-LINKED POLYETHYLENE (PEX)	1/2"	42 FT		
CROSS-LINKED POLYETHYLENE (PEX)	3/4"	71 FT		
POLYVINYL CHLORIDE - RIGID	2"	45 FT		

FITTING SCHEDULE		
FITTING	SIZE	QTY
ABS 90 DEGREE BEND ELBOW	1 1/2"ø-1 1/2"ø	2
ABS 90 DEGREE BEND ELBOW	2"ø-2"ø	1
ABS 90 DEGREE BEND ELBOW	3"ø-3"ø	1
ABS P-TRAP	1 1/2"ø-1 1/2"ø	1
ABS P-TRAP	2"ø-2"ø	2
ABS REDUCER ELBOW	2"ø-1 1/2"ø	1
ABS REDUCER ELBOW	3"ø-1 1/2"ø	1
ABS TEE ELBOW	1 1/2"ø-1 1/2"ø-1 1/2"ø	1
ABS TEE ELBOW	2"ø-2"ø	1
ABS TEE ELBOW	3"ø-3"ø-3"ø	2
ABS TEE REDUCER ELBOW	3"ø-2"ø-1 1/2"ø	1
ABS TEE REDUCER ELBOW	3"ø-3"ø-1 1/2"ø	1
ABS TEE REDUCER ELBOW	3"ø-3"ø-3"ø	1
ABS TRAP P	1 1/2"ø-1 1/2"ø	2
ABS VENT CAP ELBOW	1 1/2"ø	2
ABS VENT CAP ELBOW	2"ø	1
ABS VENT CAP ELBOW	3"ø	1
PEX 90 DEGREE ELBOW	1/2"ø-1/2"ø	20
PEX 90 DEGREE ELBOW	3/4"ø-3/4"ø	9
PEX TEE ELBOW	3/4"ø-3/4"ø-3/4"ø	11
PEX TRANSITION ELBOW	1"ø-3/4"ø	2
PEX TRANSITION ELBOW	3/4"ø-1/2"ø	9
PVC 90 DEG BEND ELBOW	2"ø-2"ø	15
WASTE DOUBLE TEE	1 1/2"ø-1 1/2"ø-1 1/2"ø	1

	FIXTURE CONNECTION SCHEDULE										
FAMILY	W	V	TRAP	CW	HW	QTY	DFU	TOT.	WFU	TOT.	NOTES
DISHWASHER	2"	1-1/2"	1-1/2"	1/2"	1/2"	1		0			DRAIN TO SEWER SEE PLANS
DRYER	N/A	N/A	N/A	N/A	N/A	1		0			
HANGING PIPES CLAMP						10		0			
SHOWER TRAY	2"	1-1/2"	1-1/2"	1/2"	1/2"	1		0			
SHOWER TRIM	-	-	-	1/2"	1/2"	1		0			
SINK ISLAND SINGLE	2"	1-1/2"	1-1/2"	1/2"	1/2"	1		0			
VANITY SINK	2"	1-1/2"	1-1/2"	1/2"	1/2"	1		0			

2" | 1-1/2" | 2" | 1/2" | 1/2" | 1

3" 2" 3" 1/2" 1/2" 1

N/A N/A N/A 3/4" 3/4" 1

WASHER

WATER CLOSET

WATER HEATER

DRAINS TO GRAY WATER

OR SEWER SEE PLANS

	FIX	TURE SCHEDULE
FIXTURE	QTY	DESCRIPTION
DISHWASHER	1	DRAIN TO SEWER SEE PLANS
DRYER	1	
HANGING PIPES CLAMP	10	
SHOWER TRAY	1	
SHOWER TRIM	1	
SINK ISLAND SINGLE	1	
VANITY SINK	1	
WASHER	1	DRAINS TO GRAY WATER OR SEWER SEE PLANS
WATER CLOSET	1	
WATER HEATER	1	

ACCESSORIES & FITTINGS SCHEDULE							
FIXTURE QTY DESCRIPTIONS							
DISHWASHER CONNECTOR	1						
HOSE BIB	1						
LAUNDRY SWEAT CONNECTOR1 1							
SHUTOFF VALVE	6						

PLUMBING SCHEDULE								
FIXTURE	TRAP	WASTE	VENT	C.W	H.W			
DISHWASHER	1-1/2"	2"	1-1/2"	1/2"	1/2"			
DRYER	N/A	N/A	N/A	N/A	N/A			
SHOWER TRAY	1-1/2"	2"	1-1/2"	1/2"	1/2"			
SHOWER TRIM	-	-	-	1/2"	1/2"			
SINK ISLAND SINGLE	1-1/2"	2"	1-1/2"	1/2"	1/2"			
VANITY SINK	1-1/2"	2"	1-1/2"	1/2"	1/2"			
WASHER	2"	2"	1-1/2"	1/2"	1/2"			
WATER CLOSET	3"	3"	2"	1/2"	1/2"			
WATER HEATER	N/A	N/A	N/A	3/4"	3/4"			

WATER FIXTURE UNIT SCHEDULE							
FAMILY	QTY	UNIT VALUE	TOTAL				
DISHWASHER	1		0				
DRYER	1		0				
HANGING PIPES CLAMP	10		0				
SHOWER TRAY	1		0				
SHOWER TRIM	1		0				
SINK ISLAND SINGLE	1		0				
VANITY SINK	1		0				
WASHER	1		0				
WATER CLOSET	1		0				
WATER HEATER	1		0				

WASTE FIXTURE UNIT SCHEDULE							
FAMILY	QTY	DFU VALUES	TOTAL				
DISHWASHER	1		0				
DRYER	1		0				
HANGING PIPES CLAMP	10		0				
SHOWER TRAY	1		0				
SHOWER TRIM	1		0				
SINK ISLAND SINGLE	1		0				
VANITY SINK	1		0				
WASHER	1		0				
WATER CLOSET	1		0				
WATER HEATER	1		0				



KEY PLAN

DESCRIPTION DATE

NOTE:

LEGEND:

PROJECT

154-Haven-491-1Bd/1Ba Alpine-550

DRAWING NAME


NOTE AND SCHEDULE


CLIENT NAME:

PROJECT NUMBER: 0250_12 DATE: 3/28/2025 10:39:39 AM Designer DESIGNED BY: DRAWN BY: Author CHECKED BY: Checker


P101


SCALE: 1/2" = 1'-0"

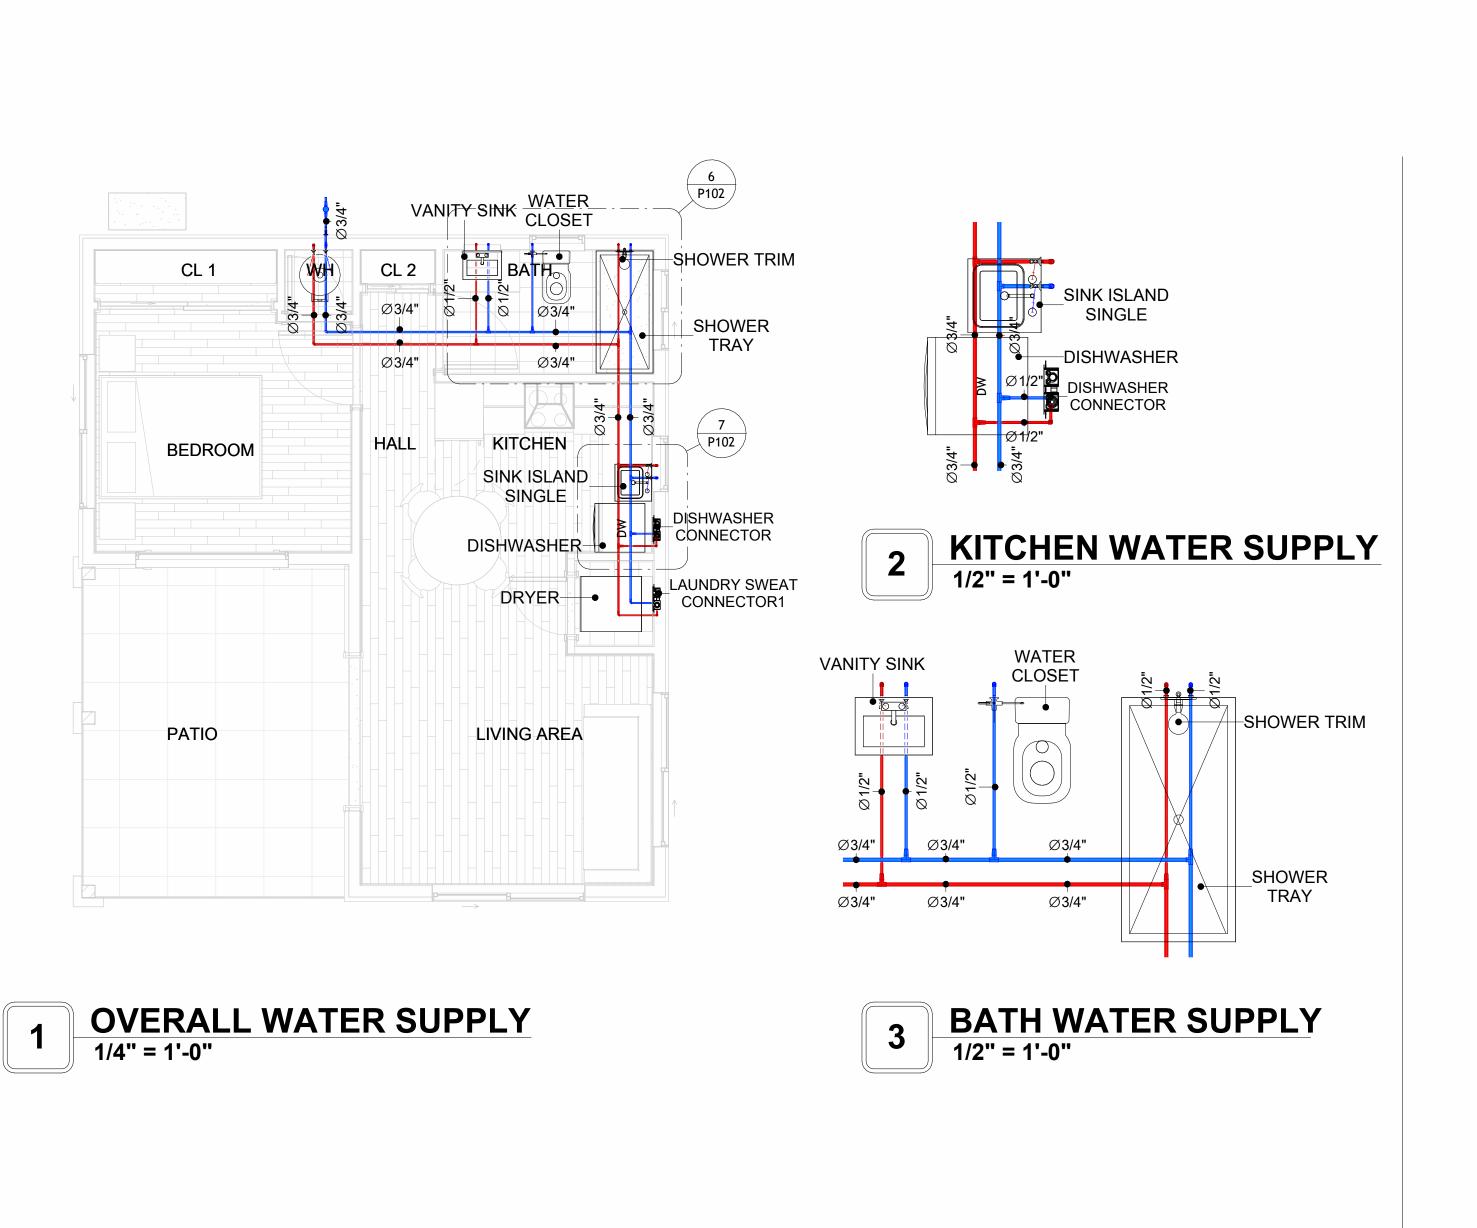

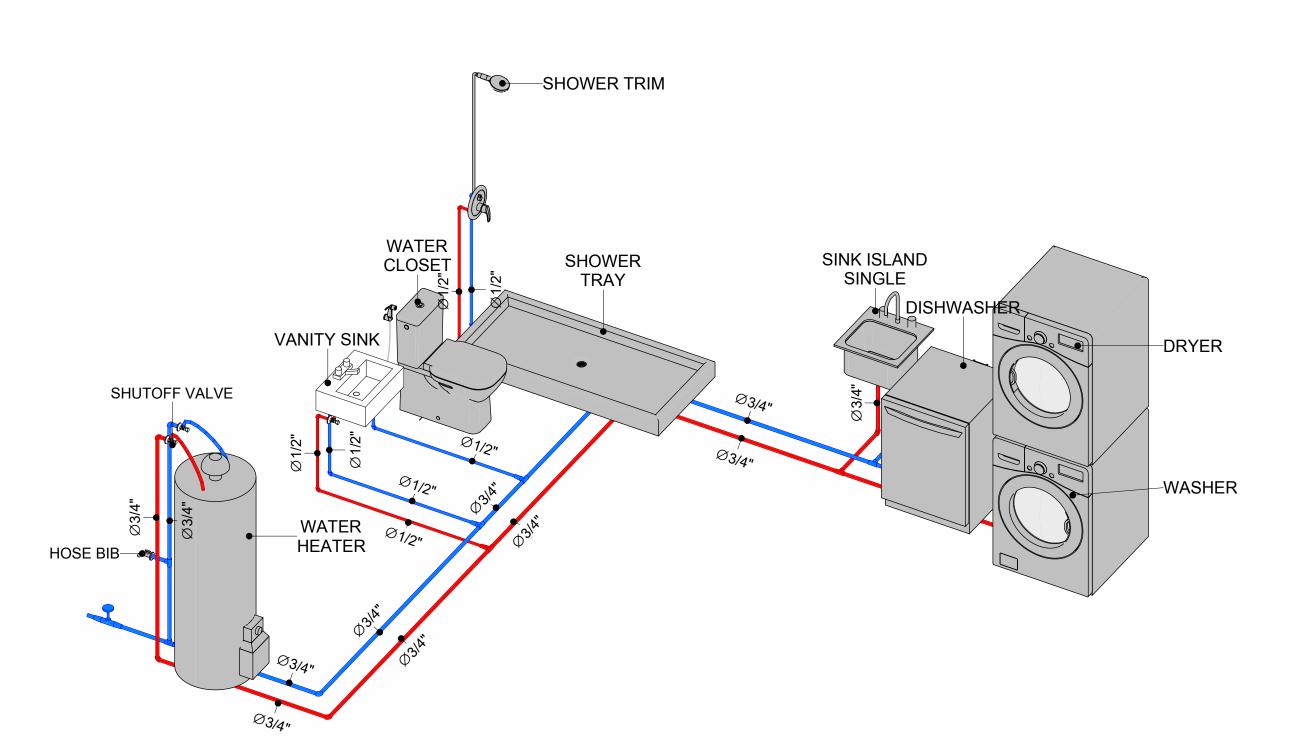

WATER SUPPLY RISER DIAGRAM

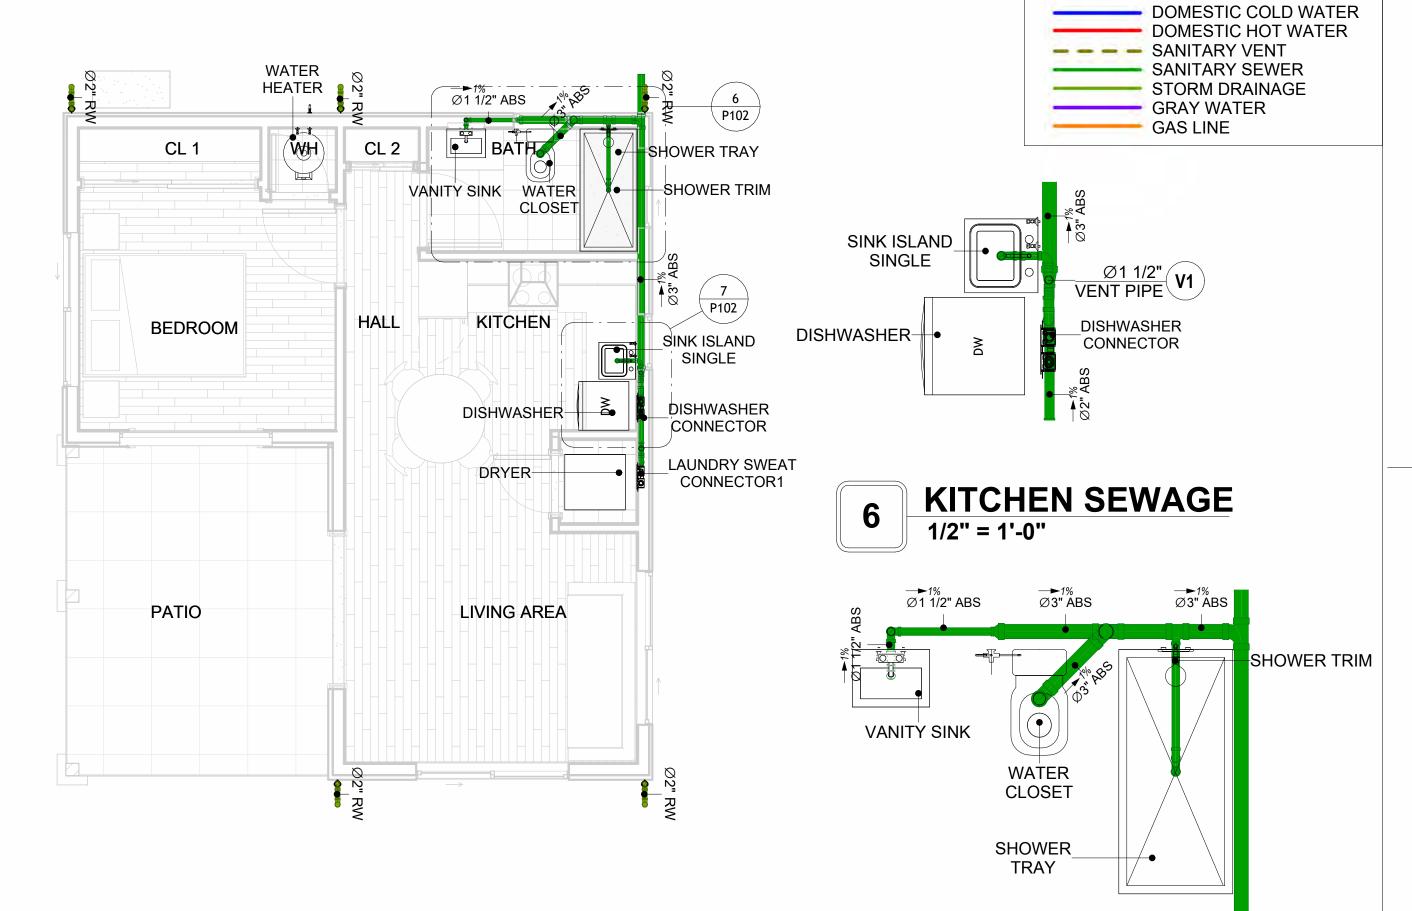

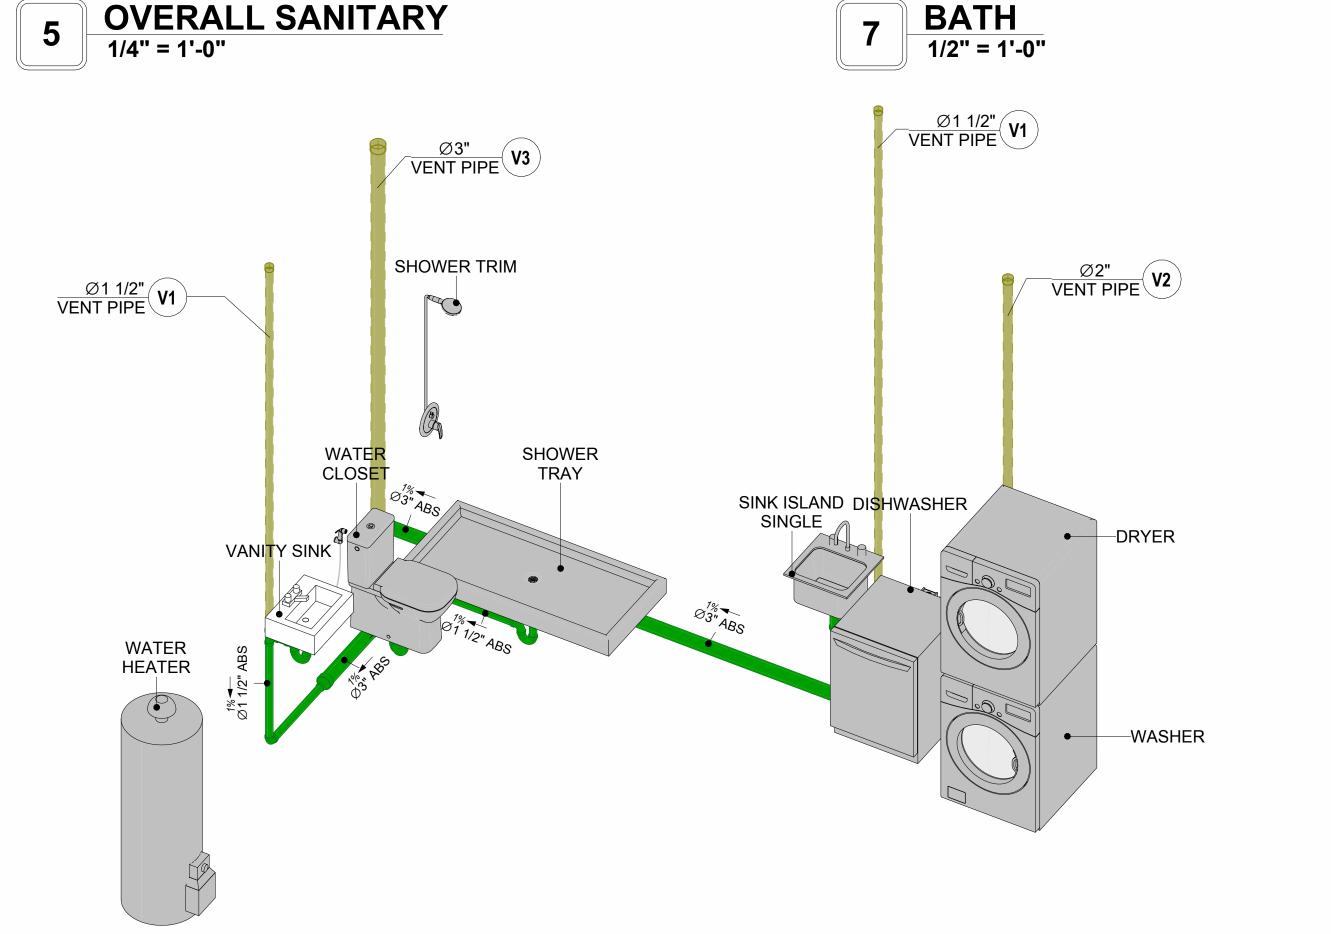


8 SEWAGE RISER DIAGRAM



KEY PLAN

PIPE COLOR SCHEME

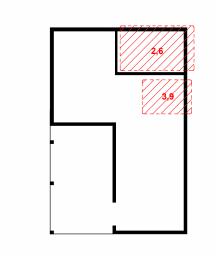

DESCRIPTION	DATE
	DESCRIPTION

NOTE:

LEGEND:

PROJECT

154-Haven-491-1Bd/1Ba Alpine-550

DRAWING NAME

WATER SUPPLY AND SEWAGE SYSTEM

CLIENT NAME:	
PROJECT NUMBER:	0250_12
DATE:	3/28/2025 10:40:12 AM
DESIGNED BY:	Designer
DRAWN BY:	Author
CHECKED BY:	Checker

P102

Materials Shopping List

Please print and take this Materials Shopping List to your favorite Home Depot and ask for assistance in selecting the materials, fixtures and fittings to complete your new home.

Record your selection and the price of the item. Then do the math to determine the cost for your selections and the total cost of finishing your home.

Have It Your Way!

The material types listed in this document were selected based on personal preferences. The Customer is encouraged to make changes to the material types in accordance with local customs, regulations, and personal preferences.

Have It Your Way!



20 good reasons to frame a home with metal and not wood



Why build your ADU with metal vs wood	Wood	Metal	Explanation
1 DIY Construction Benefit		~	The wall frames, trusses and beams can be erected in a just a few days
2 Minimal Construction Skills Required		~	Pre-assembled walls and trusses require no specialized skills to errect
3 Build as DIY, Hybrid or by a General Contractor		✓	Do it yourself, Hybrid (involve special contractors) or hire a General Contractor
4 Build It As You Can Afford It		✓	Impervious to Weather - build as you have the time and money
5 Up Front Cost of Framing Materials	~		As to only the framing material, wood is less expensive
6 Total Cost To Build		~	Savings in time, labor, and other areas make light gauge steel LESS expensive
7 Termites and wood boring insects		Y	Termites, carpenter ants and wood boring insects eat wood, not metal
8 Mold resistant		~	Metal does not attract mold
9 Damage caused by exterior and interior flooding		~	Metal needs no reconditioning after a flood
10 Fire Resistant		~	Non-combustible
11 Lower insurance rates		Y	Many insurance underwriters now provide lower rates for metal framed homes
12 Walls, trusses, and beams retain their original form		~	Perfectly straight walls - no shimming of drywall
13 Corners are 90 degrees		✓	No need for templating of countertops to adjust for out of square corners
14 Strength and weight		✓	Metal is stronger than wood and weighs less - no need for crane to lift ADU trusses
15 IBC Engineered Stamp		✓	If an engineering stamp is necessary, months of waiting are saved
16 Complete BOM (Materials Shopping List)		~	Take the materials shopping list to Home Depot and start shopping/pricing
17 Flexible in Seismic Areas - Won't Fracture		~	Light gauge steel is flexible and won't fracture when the earth moves
18 No Waste At Job Site		~	Steel is the most recycled material in the world. A typical wood home has 20-30% waste
19 Environmentally Friendly		~	Trees don't have to be destroyed and the source of most metal is from recycling
20 How-To Videos Included		~	How-to videos provide simple assembly instructions
21 Relationship Counselor		~	Eliminate emotional uphevels - save time, money, and preserve the relationship

Universal Requirements - some or all may be required

- 1 Site plan
- 2 Electrical Supply Connection
- 3 Sewer Connection
- 4 Fresh Water Supply Connection
- 5 Set Backs
- 6 Soils Evaluation

- 7 Earthquake (fault) evaluation
- 8 Foundation Plan subject to soils
- 9 Compliance with local energy codes: insulation home wrap and flashing
- 10 Engineering for wind speed and snow load.
- 11 State and Local ordinances regarding ADUs
- 12 Local Architect and/or Engineer may be necessary





Haven-1Bd 1Ba-Alpine MATERIAL SHOPPING LIST

Have It Your Way!

The material types listed in this document were selected based on personal preferences. The Customer is encouraged to make changes to the material types in accordance with local customs, regulations, and personal preferences. Have It Your Way!

TOC



Table Of Content # Name Link Page No 1 Cover Page Cover Page 2 TOC TOC 2 3 ELECTRICAL BOM **ELECTRICAL BOM** 3 5 HVAC BOM **HVAC BOM** 7 PLUMBING BOM 4 PLUMBING BOM 10 6 ARCHITECTURAL BOM ARCHITECTURAL BOM 15

Have It Your Way!

The material types listed in this document were selected based on personal preferences. The Customer is encouraged to make changes to the material types in accordance with local customs, regulations, and personal preferences. Have It Your Way!

GENERAL NOTES

- 1 This BOM (Bill of Materials) is prepared as a Materials Shopping List to help builders and DIYers gain a complete understanding of most if not all elements required for the complete construction of this structure, according to the original design documents provided by FrameUpNow.
- 2 All quantities and specifications are subject to change based on the final design, field measurements, availability of products and customer preferences. The customer should verify all information prior to purchasing materials.
- 3 All products and elements in the list shall conform to the International Residential Code (IRC), or any other local and international building codes, safety regulations, and standards that are applicable to the location of the structure.
- 4 If any changes are made by the customer to the list of materials specified in this document, the customer is responsible for assuring that the correct type and quantity of materials are utilized in accordance with local building codes.
- FrameUpNow, will not be held responsible for any misuse of this document, the products listed, or for deviations from the content that are made due to changes in specifications, pricing, availability, or customer preferences.
- 6 The customer is advised to consult a qualified professional or technician prior to purchasing materials for specialized construction system items. Some items including but not limited to caseworks, doors and windows may require as built measurements prior to purchase to confirmation of final dimensions.
- 7 If there are additional trim elements or specific installation methods, the total amount of materials needed might vary. Consider any additional trim required for corners, intersections, or other architectural details that might cause this variations before procedding to purchase and construction.

ARCHITECTURAL BOM



			laven-1Bd 1				
NI.	1	ARCHITECT				Tatal	December 11
No.	Item	Туре	Unit	Quantity	Unit Price	Total	Description
<u>△</u> 1	APPLIANCES Defrigerator	I	PCS	1			
2	Refrigerator Range		PCS	1			
3	Ü		PCS	1			
	Washer						
4	Dryer Disk Washan		PCS	1			
5	Dish Washer		PCS	1			
6	Oven		PCS	0			
7	Microwave		PCS	0			
<u> </u>	CASEWORKS	I	le r	40.77			
1	Kitchen Cabinet		FT	13.66			
2	Laundry Cabinet		FT	2.25			
3	Vanity Cabinet		FT	3.08			
4	Medicine Cabinet		PCS	1			
5	Kitchen countertop		SF	20.27			
6	Laundry Countertop		PCS	0			
7	Bathroom Countertop		SF	0			
8	Island		FT	0			
9	Peninsula		FT	0			
10	Closets		SF	62.46			
△	CEILING						
1	Ceiling Board	Dry Wall	SF	396			
2	Dry Wall Fastener	Screw	PCS	694			
3	Vapor Retarder	Polyethylene film	SF	443			
4	Vapor Retarder Fastener	Nails with washer heads	PCS	1328			
5	Ceiling Board (MRD)	Moisture resistant drywall	SF	46			
6	MRD Fastener		PCS	81			
7	Ceiling Board	Marine Plywood	SF	0			
8	Marine Plywood Fastener	Screw	PCS	0			
	Dry Wall Tape		FT	221			
Δ	FLOORING		1: -				
	Main Living Space		SF	247.69			
2	Bathroom		SF	50.62			
3	Bedroom		SF	119.54			
4	Porch		SF	147.09			
	STRUCTURE	I .	51	147.07			
_	Foundation		SF	638.13			
-	WALLS EXTERIOR		31	030.13			
1	Stone Veneer	I	SF	34			
	Exterior-Grade Plywood Siding		SF	792			
		Self-drilling screws(100/pkt)	PKT	7.92			
3	Exterior-Grade Plywood Fastener	Self-drilling Screws (100/pkt)	SF	826			
4	Wall Shteathing (OSB)	(400/ 11)					
5	Shteathing Fastener	Self-drilling screws(100/pkt)	PKT	8.26			
6	Wall Homewrap	0. 1.15 1. (000/11)	SF	826			
7	Homewrap Fastener	Stapled fastener (200/pkt)	PKT	3.1388			
8	Furring Strip		PCS	99			
	Furring Strip Fastener	Self-drilling screws(100/pkt)	PKT	7.92			
	Wall Paint		SF	826			
	Stone Copping	Masonry stone	SF	0			
	Stone Veneer	Masonry stone	SF	0			
	Mortar for Stone Veneer		SF	0			
	Wall Insulation		SF	2858			
1	Cementitious Backer Board		SF	397			
2	Kerdi membrane		SF	397			
3	Kerdi membrane Fastener		SF	397			
	Wall Ceramic Tile		SF	397			
	Drywall Board		SF	1289			
	Drywall Fastener	Self-drilling screws(100/pkt)	PKT	12.89			
7	Wall Paint	J 2 2 2 2 2 2 2 2 2 2 2 2 2 2 2 2 2 2 2	SF	1289			
	Drywall Tape		FT	242			

ARCHITECTURAL BOM



_	20020				
<u></u>	DOORS			.1	
1	Interior Swinging	3' - 0" X 6'-8"	PCS	1	
2	Interior Swinging	2' - 4" X 6'-8"	PCS	1	
3	Interior Swinging	3' - 0" X 6'-8"	PCS	1	
4	Patio Sliding	5' - 0" X 6'-8"	PCS	1	
	Interior Swinging	2' - 4" X 6'-8"	PCS	1	
	Interior Sliding	7' - 0" X 6'-8"	PCS	1	
7	Interior Sliding	2' - 6" X 6'-8"	PCS	1	
8	Exterior Swinging	6' - 0" X 6'-8"	PCS	1	
9	Exterior Door Trim		FT	38	
10	Interior Door Trim		FT	238	
11	Entry Lock set			2	
	Privacy Lock set			2	
	Passage Lock set			4	
	WINDOWS	· ·			 ·
1	Sliding	3' - 3" X 2'-3"	PCS	1	
2	Sliding	6' - 3" X 4'-3"	PCS	2	
3	Single Hung	2' - 3" X 3'-3"	PCS	2	
4	Sliding	6' - 3" X 2'-3"	PCS	1	
5	Fixed	6' - 3" X 3'-3"	PCS	1	
6	Fixed	9' - 3" X 1'-9"	PCS	1	
	Exterior Window Trim	7 0 7.1 7	FT	135	
	Interior Window Trim		FT	135	
	ROOF		ļ. ·	100	
	Roof Covering		SF	638	
	Roof Covering Fastener		PCS	319	
	Roof Felt Paper		SF	638	
4	Roof Felt Paper Fastener		PCS	1914	
5	Roof Sheathing		SF	638	
6	Roof Sheathing Fastener		PCS	5104	
7	Batten		FT	0	
8	Batten Fastener		PCS	0	
9	Soffit		SF	127	
10	Soffit Fastener		PCS	63.5	
	Fascia		FT	130	
	Fascia board fastener		PCS	65	
13	Roof Insulation		SF	638	



Haven-1Bd 1Ba-Alpine								
	ELECTRIC	AL MATERIAL SHO	PPING LIS	T				
No.	Item	Туре	Unit	Quantity	Description			
	LIGHTING FIXTURES							
1	Kitchen Ceiling Light		PCS	3				
2	Kitchen Wall Mounted Light		PCS	1				
3	Exterior Wall Mounted Light		PCS	4				
4	Livingroom Ceiling Light With Fan		PCS	1				
5	Bedroom Ceiling Light With Fan		PCS	1				
6	Dining Ceiling Light		PCS	0				
7	Bath Wall Mounted Light		PCS	1				
8	Bathroom Ceiling Light		PCS	2				
9	Livingroom Ceiling Light		PCS	7				
10	Bedroom Ceiling Light		PCS	4				
11	Hall & Entry Ceiling Light		PCS	2				
12	Closet Ceiling Light		PCS	0				
	Smoke Detector		PCS	2				
	ELECTRICAL FITTINGS		1 00					
_	Standard Receptacle 120V	20A	PCS	10				
	GFCI Receptacle 120V	20 A	PCS	13				
16	GFCI Receptacle 240V	30 A	PCS	2				
	GFCI Receptacle 240V	50 A	PCS	1				
17		60 A	PCS					
18	GFCI Receptacle 240V Fan Switch	00 A	PCS	1				
19				1				
	Single Pole Switch		PCS	5				
	Three Way Switch		PCS	6				
	Dimmer Switch		PCS	3				
	ELECTRICAL CONDUITS & WIRING							
	ROMEX 14 AWG	14/3/W/ground	FT	62				
	ROMEX 12 AWG	12/3/W/ground	FT	433				
	ROMEX 12 AWG	12/2/W/ground	FT	0				
26	ROMEX 10 AWG	10/3/W/ground	FT	0				
27	ROMEX 10 AWG	10/2/W/ground	FT	70				
28	Romex 8 AWG	8/3/W/ground	FT	0				
29	Romex 8 AWG	8/2/W/ground	FT	33				
30	ROMEX 6 AWG	6/3/W/ground	FT	56				
31	Bare Copper Ground Wire 6 AWG		FT					
Δ	ELECTRICAL BOXES & CIRCUTES							
	Panelboard -240V 1 Phase MLO	200 AMP	PCS	1				
	Circuit breaker	15 A	PCS	2				
	Circuit breaker	20 A	PCS	11				
	Circuit breaker	30 A	PCS	2				
	Circuit breaker	50 A	PCS	1				
	Circuit breaker	60 A	PCS	1				
	Single Gang Switch Box	0071	PCS	4				
	Double Gang Switch Box		PCS	4				
	Triple Gang Switch Box		PCS	1				
	Pull Box	#1/4	PCS	22				
		# 1/4	PCS	28				
43	Receptacle Box		FUS	20				

PLUMBING BOM



Haven-1Bd 1Ba-Alpine PLUMBING SYSTEM MATERIAL SHOPPING LIST

No.	Item	Туре	Unit	Quantity	Unit Price	Total	Description
Δ	PLUMBING FIXTURES & ACCESSORIES	71					1
1	Bath Tub (Alcove Tub)		PCS	0			
2	Kitchen Sink		PCS	1			
3	Kitchen Faucets		PCS	1			
4	Vanity Sink		PCS	1			
5	Bath room Faucets		PCS	1			
6	Water Closet		PCS	1			
7	Shower Trim		PCS	1			
8	Shower Tray		PCS	1			
9	Water Heater		PCS	1			
	Hose Bib		PCS	1			
11	Shutoff Valve		PCS	6			
12	Hanging pipe clamp		PCS	19			
13	Gate Valve		PCS	1			
14	Dishwasher Supply Single Connector		PCS	1			
15	Dishwasher Sewage Single Connector		PCS	1			
	Laundry Sweat Connector		PCS	1			
Δ	SANITARY & PLUMBING PIPES	1		· · · ·	1		
1	ABS (Acrylonitrile Butadiene Styrene) Pipes	ø 1"	FT	0			
	ABS (Acrylonitrile Butadiene Styrene) Pipes	ø 1 1/2"	FT	34			
3	ABS (Acrylonitrile Butadiene Styrene) Pipes	ø 2"	FT	16			
4	ABS (Acrylonitrile Butadiene Styrene) Pipes	ø 3"	FT	27			
	PEX (Cross-linked polyethylene) Pipes	Ø 1/2"	FT	42			
	1 3 3 1 1	Ø 3/4"					
	PEX (Cross-linked polyethylene) Pipes	12 21 1	FT	71			
7	PEX (Cross-linked polyethylene) Pipes	ø 1"	FT	0			
8	PVC Pipes Sch.80 - Rigid	ø 1 1/2"	FT	0			
	PVC Pipes Sch.80 - Rigid	ø 2"	FT	45			
	PVC Pipes Sch.80 - Rigid	ø 3"	FT	0			
11	Flex Pipe Round	ø 1/2"	PCS	6			
\triangle	PIPE FITTINGS						
1	ABS 90 Degree Bend Elbow	1 1/2"ø-1 1/2"ø	PCS	2			
2	ABS 90 Degree Bend Elbow	2"ø-2"ø	PCS	1			
3	ABS 90 Degree Bend Elbow	3"ø-3"ø	PCS	1			
	ABS P-Trap	1 1/2"ø-1 1/2"ø	PCS	1			
5	ABS P-Trap	2"ø-2"ø	PCS	2			
	ABS Reducer Elbow	2"ø-1 1/2"ø	PCS	1			
7	ABS Reducer Elbow	3"ø-1 1/2"ø	PCS	1			
8	ABS TEE Elbow	1 1/2"ø-1 1/2"ø-1 1/2"ø	PCS	1			
	ABS TEE Elbow	2"ø-2"ø-2"ø	PCS	1			
			PCS				
	ABS TEE Elbow	3"ø-3"ø-3"ø		2			
	ABS Tee Reducer Elbow	3"ø-2"ø-1 1/2"ø	PCS	1			
	ABS Tee Reducer Elbow	3"ø-3"ø-1 1/2"ø	PCS	1			
	ABS Tee Reducer Elbow	3"ø-3"ø-3"ø	PCS	1			
	ABS Trap P	1 1/2"ø-1 1/2"ø	PCS	2			
	ABS Vent Cap Elbow	1 1/2"ø	PCS	2			
16	ABS Vent Cap Elbow	2"ø	PCS	1			
17	ABS Vent Cap Elbow	3"ø	PCS	1			
18	PEX 90 Degree Elbow	1/2"ø-1/2"ø	PCS	20			
	PEX 90 Degree Elbow	3/4"ø-3/4"ø	PCS	9			
	PEX Tee Elbow	3/4"ø-3/4"ø-3/4"ø	PCS	11			
	PEX Transition Elbow	1"ø-3/4"ø	PCS	2			
	PEX Transition Elbow	3/4"ø-1/2"ø	PCS	9			
	PVC 90 Deg Bend Elbow	2"ø-2"ø	PCS	15			
		1 1/2"ø-1 1/2"ø-1 1/2"ø-1	PCS	1			
۷4	WASTE DOUBLE TEE	1 1/2 10-1 1/2 10-1 1/2 10-1	PC2	1 1	1		

		Haven-1E	3d 1Ba	-Alpine			
		HVAC SYSTEM MA	TERIAL	SHOPP	ING LIST		
No.	Item	Туре	Unit	Quantity	Unit Price	Total	Description
	HVAC_DUCTS						
1	PIPE (REFRIGERANT LINE)	3/8" (Ø)	FT	48.36			
2	PIPE (REFRIGERANT LINE)	3/4''' (Ø)	FT	100.2			
3	DRAYER HOSE	4" (Ø)	FT	3.7			
4	FLEX DUCT ROUND	4" (Ø)	FT	5.28			
	DUCT FITTINGS & ACCESSORIES						
5	ELBOW (REFRIGERANT LINE)	3/4" (Ø)-3/4" (Ø)	PCS	25			
6	ELBOW (REFRIGERANT LINE)	3/8" (Ø)-3/8" (Ø)	PCS	14			
7	TEE (REFRIGERANT LINE)	3/4" (Ø)-3/4" (Ø)-3/4" (Ø)	PCS	1			
8	TEE (REFRIGERANT LINE)	3/8" (Ø)-3/8" (Ø))-3/8" (Ø)	PCS	1			
9	TRANSITION (REFRIGERANT	3/4" (Ø)-1/2" (Ø)	PCS	3			
10	TRANSITION (REFRIGERANT	3/4" (Ø)-5/8" (Ø)	PCS	2			
11	TRANSITION (REFRIGERANT	3/8" (Ø)-1/4" (Ø)	PCS	1			
	HVAC_EQUIPMENTS						
12	AIR HANDLING UNIT	WALL MOUNTED	PCS	2			
13	CONDENSER	OUTDOOR UNIT	PCS	1			
14	EXHAUST FAN	75 CFM	PCS	1			
15	EXHAUST HOOD	WALL MOUNTED	PCS	1			
16	HOOD-WALL: VENT	HOOD-WALL: VENT	PCS	1			
17	DRAYER: VENT	DRAYER: VENT	PCS	1			
18	ROOF VENT	3"(Ø)	PCS	1			



Table Of Content

#	Name	Link	Page No
1	Cover Page	<u>Cover Page</u>	1
2	TOC	TOC	2
3	ELECTRICAL BOM	ELECTRICAL BOM	3
5	HVAC BOM	HVAC BOM	7
4	PLUMBING BOM	PLUMBING BOM	10
6	ARCHITECTURAL BOM	ARCHITECTURAL BOM_	15

Have It Your Way!

The material types listed in this document were selected based on personal preferences. The Customer is encouraged to make changes to the material types in accordance with local customs, regulations, and personal preferences. Have It Your Way!

GENERAL NOTES

- 1 This BOM (Bill of Materials) is prepared as a Materials Shopping List to help builders and DIYers gain a complete understanding of most if not all elements required for the complete construction of this structure, according to the original design documents provided by FrameUpNow.
- 2 All quantities and specifications are subject to change based on the final design, field measurements, availability of products and customer preferences. The customer should verify all information prior to purchasing materials.
- 3 All products and elements in the list shall conform to the International Residential Code (IRC), or any other local and international building codes, safety regulations, and standards that are applicable to the location of the structure.
- 4 If any changes are made by the customer to the list of materials specified in this document, the customer is responsible for assuring that the correct type and quantity of materials are utilized in accordance with local building codes.
- 5 FrameUpNow, will not be held responsible for any misuse of this document, the products listed, or for deviations from the content that are made due to changes in specifications, pricing, availability, or customer preferences.
- 6 The customer is advised to consult a qualified professional or technician prior to purchasing materials for specialized construction system items. Some items including but not limited to caseworks, doors and windows may require as built measurements prior to purchase to confirmation of final dimensions.
- 7 If there are additional trim elements or specific installation methods, the total amount of materials needed might vary. Consider any additional trim required for corners, intersections, or other architectural details that might cause this variations before procedding to purchase and construction.



			LIGHTING FIXTURES				
#	Item	Туре	Description, Manufacturer, SKU	Unit	Quantity	Unit Price	Total
1	Kitchen Ceiling Light			PCS	3		
3	Kitchen Wall Mounted Light			PCS	1		
4	Exterior Wall Mounted Light			PCS	4		
5	Livingroom Ceiling Light With Fan			PCS	1		
6	Bedroom Ceiling Light With Fan			PCS	1		
7	Dining Ceiling Light			PCS	0		
8	Bath Wall Mounted Light			PCS	1		
9	Bathroom Ceiling Light			PCS	2		
10	Livingroom Ceiling Light			PCS	7		
11	Bedroom Ceiling Light			PCS	4		
12	Hall & Entry Ceiling Light			PCS	2		
12	Closet Ceiling Light			PCS	0		
13	Smoke Detector			PCS	2		
14							
15							



			ELECTRICAL FITTINGS			
#	Item	Туре	Description, Manufacturer, SKU	Unit	Quantity Unit P	rice Total
1	Standard Receptacle 120V	20A		PCS	10	
2	GFCI Receptacle 120V	20 A		PCS	13	
3	GFCI Receptacle 240V	30 A		PCS	2	
4	GFCI Receptacle 240V	50 A		PCS	1	
5	GFCI Receptacle 240V	60 A		PCS	1	
6	Fan Switch			PCS	1	
7	Single Pole Switch			PCS	5	
8	Three Way Switch			PCS	6	
9	Dimmer Switch			PCS	3	
10						
11						
12						
13						
14						
15						



		ELECTR	ICAL CONDUITS & WIRING				
#	Item	Туре	Description, Manufacturer, SKU	Unit	Quantity	Unit Price	Total
1	ROMEX 14 AWG	14/3/W/ground		FT	62		
3	ROMEX 12 AWG	12/3/W/ground		FT	433		
4	ROMEX 12 AWG	12/2/W/ground		FT	0		
6	ROMEX 10 AWG	10/3/W/ground		FT	0		
8	ROMEX 10 AWG	10/2/W/ground		FT	70		
9	Romex 8 AWG	8/3/W/ground		FT	0		
10	Romex 8 AWG	8/2/W/ground		FT	33		
11	ROMEX 6 AWG	6/2/W/ground		FT	56		
12	Bare Copper Ground Wire 6 AWG			FT			
13							
14							
15							
16							



		ELEC	CTRICAL BOXES & CIRCUTES				
#	Item	Туре	Description, Manufacturer, SKU	Unit	Quantity	Unit Price	Total
1	Panelboard -240V 1 Phase MLO	200 AMP		PCS	1		
2	Circuit breaker	15 A		PCS	2		
3	Circuit breaker	20 A		PCS	11		
4	Circuit breaker	30 A		PCS	2		
5	Circuit breaker	50 A		PCS	1		
6	Circuit breaker	60 A		PCS	1		
7	Single Gang Switch Box			PCS	4		
8	Double Gang Switch Box			PCS	4		
9	Triple Gang Switch Box			PCS	1		
10	Pull Box	#1/4		PCS	22		
11	Receptacle Box			PCS	28		
12							
13							
14							
15							

			HVAC_DUCTS 01				
#		Туре	Description, Manufacturer, SKU	Unit	Quantity	Unit Price	Total
1	PIPE (REFRIGERANT LINE)			FT	0.29		
2	PIPE (REFRIGERANT LINE)	3/8" (Ø)		FT	58.82		
3	PIPE (REFRIGERANT LINE)	3/4''' (Ø)		FT	98.41		
4	DRAYER HOSE	4" (Ø)		FT	5.6		
5	FLEX DUCT ROUND	4" (Ø)		FT	7.84		

			DUCT FITTINGS & ACCESSORIES				
#	Item	Туре	Description, Manufacturer, SKU	Unit	Quantity	Unit Price	Total
1	ELBOW (REFRIGERANT LINE)	1/4" (Ø)-1/4" (Ø)		PCS	1		
2	ELBOW (REFRIGERANT LINE)	3/4" (Ø)-3/4" (Ø)		PCS	22		
3	ELBOW (REFRIGERANT LINE)	3/8" (Ø)-3/8" (Ø)		PCS	20		
4	TEE (REFRIGERANT LINE)	3/4" (Ø)-3/4" (Ø)-3/4" (Ø)		PCS	1		
5	TEE (REFRIGERANT LINE)	3/8" (Ø)-3/8" (Ø))-3/8" (Ø)		PCS	1		
6	TRANSITION (REFRIGERANT LINE)	3/4" (Ø)-1/2" (Ø)		PCS	3		
7	TRANSITION (REFRIGERANT LINE)	3/4" (Ø)-5/8" (Ø)		PCS	2		
8	TRANSITION (REFRIGERANT LINE)	3/8" (Ø)-1/4" (Ø)		PCS	1		

			HVAC_EQUIPMENTS				
#	Item	Туре	Description, Manufacturer, SKU	Unit	Quantity	Unit Price	Total
1	AIR HANDLING UNIT	WALL MOUNTED		PCS	2		
2	CONDENSER	OUTDOOR UNIT		PCS	1		
3	EXHAUST FAN	75 CFM		PCS	1		
4	EXHAUST HOOD	WALL MOUNTED		PCS	1		
5	HOOD-WALL: VENT	HOOD-WALL: VENT		PCS	1		
6	DRAYER: VENT	DRAYER: VENT		PCS	1		
7	ROOF VENT	3"(Ø)		PCS	1		
8							
9							
10							
11							
12							
13							
14							



	PLUMBING FIXTURES & ACCESSORIES									
#	Item	Туре	Description, Manufacturer, SKU	Unit	Quantity	Unit Price	Total			
1	Bath Tub (Alcove Tub)			PCS	C					
2	Kitchen Sink			PCS	1					
3	Kitchen faucets			PCS	1					
4	Vanity Sink			PCS	1					
5	Bath room faucets			PCS	1					
6	Water Closet			PCS	1					
7	Shower Trim			PCS	1					
8	Shower Tray			PCS	1					
9	Water Heater			PCS	1					
10	Hose Bib			PCS	1					
11	Shutoff Valve			PCS	6					
12	Hanging pipe clamp			PCS	10					
13	Gate Valve			PCS	1					
14	Dishwasher Supply Single Connector			PCS	1					
15	Dishwasher Sewage Single Connector			PCS	1					
16	Laundry Sweat Connector			PCS	1					



		SANI	ITARY & PLUMBING PIPES				
#	Item	Туре	Description, Manufacturer, SKU	Unit	Quantity	Unit Price	Total
1	ABS (Acrylonitrile Butadiene Styrene) Pipes	ø 1"		FT	0		
2	ABS (Acrylonitrile Butadiene Styrene) Pipes	ø 1 1/2"		FT	34		
3	ABS (Acrylonitrile Butadiene Styrene) Pipes	ø 2"		FT	16		
4	ABS (Acrylonitrile Butadiene Styrene) Pipes	ø 3"		FT	27		
5	PEX (Cross-linked polyethylene) Pipes	ø 1/2"		FT	42		
6	PEX (Cross-linked polyethylene) Pipes	ø 3/4"		FT	71		
7	PEX (Cross-linked polyethylene) Pipes	ø 1"		FT	0		
8	PVC Pipes Sch.80 - Rigid	ø 1 1/2"		FT	0		
9	PVC Pipes Sch.80 - Rigid	ø 2"		FT	45		
10	PVC Pipes Sch.80 - Rigid	ø 3"		FT	0		
11	Flex Pipe Round	ø 1/2"		PCS	6		
12							
13							
14							
15							



		PIPE FITTINGS 01								
#	Item	Туре	Description, Manufacturer, SKU	Unit	Quantity	Unit Price	Total			
1	ABS 90 Degree Bend Elbow	1 1/2"ø-1 1/2"ø		PCS	2					
2	ABS 90 Degree Bend Elbow	2"ø-2"ø		PCS	1					
3	ABS 90 Degree Bend Elbow	3"ø-3"ø		PCS	1					
4	ABS P-Trap	1 1/2"ø-1 1/2"ø		PCS	1					
5	ABS P-Trap	2"ø-2"ø		PCS	2					
6	ABS Reducer Elbow	2"ø-1 1/2"ø		PCS	1					
7	ABS Reducer Elbow	3"ø-1 1/2"ø		PCS	1					
8	ABS TEE Elbow	1 1/2"ø-1 1/2"ø-1 1/2"ø		PCS	1					
9	ABS TEE Elbow	2"ø-2"ø-2"ø		PCS	1					
10	ABS TEE Elbow	3"ø-3"ø-3"ø		PCS	2					
11	ABS Tee Reducer Elbow	3"ø-2"ø-1 1/2"ø		PCS	1					
12	ABS Tee Reducer Elbow	3"ø-3"ø-1 1/2"ø		PCS	1					
13	ABS Tee Reducer Elbow	3"ø-3"ø-3"ø		PCS	1					
14	ABS Trap P	1 1/2"ø-1 1/2"ø		PCS	2					
15	ABS Vent Cap Elbow	1 1/2"ø		PCS	2					



		PIPE FI	TTINGS 02				
#	Item	Туре	Description, Manufacturer, SKU	Unit	Quantity	Unit Price	Total
1	ABS Vent Cap Elbow	2"Ø		PCS	1		
2	ABS Vent Cap Elbow	3"Ø		PCS	1		
3	PEX 90 Degree Elbow	1/2"ø-1/2"ø		PCS	20		
4	PEX 90 Degree Elbow	3/4"ø-3/4"ø		PCS	9		
5	PEX Tee Elbow	3/4"ø-3/4"ø-3/4"ø		PCS	11		
6	PEX Transition Elbow	1"ø-3/4"ø		PCS	2		
7	PEX Transition Elbow	3/4"ø-1/2"ø		PCS	9		
8	PVC 90 Deg Bend Elbow	2"Ø-2"Ø		PCS	15		
9	WASTE DOUBLE TEE	1 1/2"ø-1 1/2"ø-1 1/2"ø-1 1/2"ø		PCS	1		
10							
11							
12							
13							
14							
15							



			APPLIANCES				
#	Item	Туре	Description, Manufacturer, SKU	Unit	Quantity	Unit Price	Total
1	Refrigerator			PCS			
2	Range			PCS			
3	Washer Front Load	Stackable		PCS			
4	Dryer Front Load	Stackable		PCS			
5	Dish Washer			PCS			
6	Oven			PCS	(
7	Microwave			PCS	(
8							
9							
10							
11							
12							
13							
14							
15							
16							



			CASEWORKS 01				
#	Item	Туре	Description, Manufacturer, SKU	Unit	Quantity	Unit Price	Total
1	Kitchen Cabinet			FT	13.66		
2	Laundry Cabinet			FT	2.25		
3	Vanity Cabinet			FT	3.08		
4	Medicine Cabinet			PCS	1		
5	Kitchen countertop			SF	20.27		
6	Laundry Countertop			PCS	0		
7	Bathroom Countertop			SF	0		
8	Island			FT	0		
9	Peninsula			FT	0		
10	Closets			SF	62.46		
11							
12							
13							
14							
15							



			CEILING 01				
#	Item	Туре	Description, Manufacturer, SKU	Unit	Quantity	Unit Price	Total
	LIVINGROOM			SF	146.2		
1	Ceiling Board	Drywall		SF	146		
2	Drywall Fastener	Screw		PCS	256		
3	Vapor Retarder	Polyethylene film		SF	146		
4	Vapor Retarder Fastener	Nails with washer heads		PCS	439		
	KITCHEN + HALL			SF	100.3		
5	Ceiling Board	Drywall		SF	100		
6	Drywall Fastener	Screw		PCS	175		
7	Vapor Retarder	Polyethylene film		SF	100		
8	Vapor Retarder Fastener	Nails with washer heads		PCS	301		
	BEDROOM	,		SF	109.1		
9	Ceiling Board	Drywall		SF	109		
10	Drywall Fastener	Screw		PCS	191		
11	Vapor Retarder	Polyethylene film		SF	109		
12	Vapor Retarder Fastener	Nails with washer heads		PCS	327		



			CEILING 02				
#	Item	Туре	Description, Manufacturer, SKU	Unit	Quantity	Unit Price	Total
	W/D			SF	11.5		
13	Ceiling Board	Drywall		SF	12		
14	Drywall Fastener	Screw		PCS	20		
15	Vapor Retarder	Polyethylene film		SF	12		
16	Vapor Retarder Fastener	Nails with washer heads		PCS	35		
	CL 1			SF	16.9		
17	Ceiling Board	Drywall		SF	17		
18	Drywall Fastener	Screw		PCS	30		
19	Vapor Retarder	Polyethylene film		SF	17		
20	Vapor Retarder Fastener	Nails with washer heads		PCS	51		
	CL 2			SF	4.7		
21	Ceiling Board	Drywall		SF	5		
22	Drywall Fastener	Screw		PCS	8		
23	Vapor Retarder	Polyethylene film		SF	5		
24	Vapor Retarder Fastener	Nails with washer heads		PCS	14		



			CEILING 03				
#	Item	Туре	Description, Manufacturer, SKU	Unit	Quantity	Unit Price	Total
	BATH ROOM			SF	46.3		
25	Ceiling Board	MRD (Moisture resistant drywall)		SF	46		
26	MRD Fastener	Screw		PCS	81		
	WH			SF	7.8		
27	Ceiling Board	Drywall		SF	8		
28	Drywall Fastener	Screw		PCS	14		
29	Vapor Retarder	Polyethylene film		SF	8		
30	Vapor Retarder Fastener	Nails with washer heads		PCS	23		



			FLOORING INTERIOR 01				
#	Item	Туре	Description, Manufacturer, SKU	Unit	Quantity	Unit Price	Total
	BEDROOM 1						
1	Bedroom Flooring			SF	104		
2	Wood underlay	Foam Pad Polyethylene		SF	104		
3	Vapor Retarder	Vapor Barrier Polyethylene		SF	104		
	CLOSET 1						
4	Closet Flooring			SF	16		
5	Wood underlay	Foam Pad Polyethylene		SF	16		
6	Vapor Retarder	Vapor Barrier Polyethylene		SF	16		
	CLOSET 2						
7	Closet Flooring			SF	4		
8	Wood underlay	Foam Pad Polyethylene		SF	4		
9	Vapor Retarder	Vapor Barrier Polyethylene		SF	4		
	LIVING ROOM AND KITCHE	EN					
10	Living Area Flooring			SF	243		
11	Wood underlay	Foam Pad Polyethylene		SF	243		
12	Vapor Retarder	Vapor Barrier Polyethylene		SF	243		



			FLOORING INTERIOR 02				
#	Item	Туре	Description, Manufacturer, SKU	Unit	Quantity	Unit Price	Total
	BATHROOM						
13	Tile Finish			SF	32		
14	Adhesive	1/2" Thin set Mortar		SF	32		
15	Vapor Retarder	Vapor Barrier Polyethylene		SF	32		
	W/D						
16	Tile Finish			SF	11		
17	Adhesive	1/2" Thin set Mortar		SF	11		
18	Vapor Retarder	Vapor Barrier Polyethylene		SF	11		
	BOILER ROOM						
19	Tile Finish			SF	7		
20	Adhesive	1/2" Thin set Mortar		SF	7		
21	Vapor Retarder	Vapor Barrier Polyethylene		SF	7		



			FLOORING EXTERIOR			
#	Item	Туре	Description, Manufacturer, SKU	Unit	Quantity	Unit Price
	STRUCTURE			SF	638.1	
1	Concrete Slab	4"concrete cast in situ		CF	213	
2	Insulation	Rigid insulation		SF	218.98	
3	Hard core	Compacted soil		CF	161.08	
4	Re-bar	#4 re-bar		Ton	0.62	
5	Concrete Pad	4"concrete cast in situ		CF	1.58	
6	Slab edge	Turndown		CF	182.53	
7	Footing	Cast-in-place concrete		CF	7.02	
	PORCH					
8	Tile Finish			SF	147.09	
9	Adhesive	1/2" Thin set Mortar		SF	147.09	
10	Vapor Retarder	Vapor Barrier Polyethylene		SF	147.09	



	WALLS: EXTERIOR						
#	Item	Туре	Description, Manufacturer, SKU	Unit	Quantity	Unit Price	Total
1	Stone Veneer			SF	34		
2	Exterior-Grade Plywood Siding			SF	792		
3	Exterior-Grade Plywood Fastener 8/panel	Self-drilling screws(100/pkt)		PKT	7.92		
4	Wall Shteathing (OSB)			SF	826		
5	Shteathing Fastener	Self-drilling screws(100/pkt)		PKT	8.26		
6	Wall Homewrap			SF	826.00		
7	Homewrap Fastener	Stapled fastener (200/pkt)		PKT	3.14		
8	Furring Strip			PCS	99		
9	Furring Strip Fastener	Self-drilling screws(100/pkt)		PKT	7.92		
10	Wall Paint			SF	826		
11	Stone Copping	Masonry stone		SF	0		
12	Stone Veneer	Masonry stone		SF	0		
13	Mortar for Stone Veneer			SF	0		
14	Wall Insulation			SF	2858		
15							



			WALLS: INTERIOR 01				
#	Item	Туре	Description, Manufacturer, SKU	Unit	Quantity	Unit Price	Total
	BATHROOM			SF	43.0		
1	Cementitious Backer Board			SF	262		
2	Kerdi membrane			SF	262		
3	Kerdi membrane Fastener			SF	262		
4	Wall Ceramic Tile			SF	262		
	BEDROOM			SF	106.0		
5	Drywall Board			SF	355		
6	Drywall Fastener	Self-drilling screws(100/pkt)		PKT	3.55		
7	Wall Paint			SF	355		
8	Drywall Tape			FT	66.6		
	HALL			SF	32.0		
9	Drywall Board			SF	68		
10	Drywall Fastener	Self-drilling screws(100/pkt)		PKT	0.68		
11	Wall Paint			SF	68		
12	Drywall Tape			FT	13		



			WALLS: INTERIOR 02				
#	Item	Туре	Description, Manufacturer, SKU	Unit	Quantity	Unit Price	Total
	LIVING ROOM			SF	147.0		
13	Drywall Board			SF	335		
14	Drywall Fastener	Self-drilling screws(100/pkt)		PKT	3.35		
15	Wall Paint			SF	335		
16	Drywall Tape			FT	62.9		
	KITCHEN			SF	61.0		
17	Cementitious Backer Board			SF	22		
18	Drywall Board			SF	218		
19	Drywall Fastener	Self-drilling screws(100/pkt)		PKT	2.18		
20	Kerdi membrane			SF	22		
21	Kerdi membrane Fastener			SF	22		
22	Wall Ceramic Tile			SF	22		
23	Wall Paint			SF	218		
24	Drywall Tape			FT	41.1		
24	Drywall Tape			FT	73		



			WALLS: INTERIOR 03				
#	Item	Туре	Description, Manufacturer, SKU	Unit	Quantity	Unit Price	Total
	CLOSET 1			SF	15.0		
25	Drywall Board			SF	151		
26	Drywall Fastener	Self-drilling screws(100/pkt)		PKT	1.51		
27	Wall Paint			SF	151		
28	Drywall Tape			FT	28.3		
	CLOSET 2			SF	4.0		
29	Drywall Board			SF	74		
30	Drywall Fastener	Self-drilling screws(100/pkt)		PKT	0.74		
31	Wall Paint			SF	74		
32	Drywall Tape			FT	13.9		



			WALLS: INTERIOR 04				
#	Item	Туре	Description, Manufacturer, SKU	Unit	Quantity	Unit Price	Total
	WD			SF	11.0		
33	Cementitious Backer Board			SF	113		
34	Kerdi membrane			SF	113		
35	Kerdi membrane Fastener			SF	113		
36	Wall Ceramic Tile			SF	113		
	WH			SF	7.0		
37	Drywall Board			SF	88		
38	Drywall Fastener	Self-drilling screws(100/pkt)		PKT	0.88		
39	Wall Paint			SF	88		
40	Drywall Tape			FT	17		
1	Wall Skirting	Ceramic		FT	104		



			DOORS				
#	Item	Туре	Description, Manufacturer, SKU	Unit	Quantity	Unit Price	Total
1	Interior Swinging	3' - 0" X 6'-8"		PCS	1		
2	Interior Swinging	2' - 4" X 6'-8"		PCS	1		
3	Interior Swinging	3' - 0" X 6'-8"		PCS	1		
4	Patio Sliding	5' - 0" X 6'-8"		PCS	1		
5	Interior Swinging	2' - 4" X 6'-8"		PCS	1		
6	Interior Sliding	7' - 0" X 6'-8"		PCS	1		
7	Interior Sliding	2' - 6" X 6'-8"		PCS	1		
8	Exterior Swinging	6' - 0" X 6'-8"		PCS	1		
9	Exterior Door Trim			FT	38		
10	Interior Door Trim			FT	238		
11	Entry Lock set			PCS	2		
12	Privacy Lock set			PCS	2		
	Passage Lock set			PCS	4		
14							
15							



			WINDOWS				
#	Item	Туре	Description, Manufacturer, SKU	Unit	Quantity	Unit Price	Total
1	Sliding	3' - 3" X 2'-3"		PCS	1		
2	Sliding	6' - 3" X 4'-3"		PCS	2		
3	Single Hung	2' - 3" X 3'-3"		PCS	2		
4	Sliding	6' - 3" X 2'-3"		PCS	1		
5	Fixed	6' - 3" X 3'-3"		PCS	1		
6	Fixed	9' - 3" X 1'-9"		PCS	1		
7	Exterior Window Trim			FT	135		
8	Interior Window Trim			FT	135		
9							
10							
11							
12							
13							
14							
15							



		ROOF 01						
#	Item	Туре	Description, Manufacturer, SKU	Unit	Quantity	Unit Price	Total	
1	Roof Covering			SF	638.0			
2	Roof Covering Fastener			PCS	319			
3	Roof Felt Paper			SF	638.0			
4	Roof Felt Paper Fastener			PCS	1914.0			
5	Roof Sheathing			SF	638.0			
6	Roof Sheathing Fastener			PCS	5104			
7	Batten			FT	0.0			
8	Batten Fastener			PCS	0.0			
9	Soffit			SF	127.0			
10	Soffit Fastener			PCS	63.5			
11	Fascia			FT	130.0			
12	Fascia board fastener			PCS	65			
13	Roof Insulation			SF	638.0			
14					100.0			
15								