

# **HAVEN**

The Haven is a charming Craftsman-style twobedroom, one-bathroom home designed for comfortable and efficient living. The walls are finished with horizontal siding in a light, neutral tone, creating a clean and traditional aesthetic. The gable end features wood shingles, adding a touch of natural texture and visual interest. A simple gable roof provides shelter and complements the overall design. A prominent covered porch spans the front of the home, supported by substantial stone-clad pillars, creating a welcoming outdoor space.

Inside, the Haven boasts a simple, open-plan rectangular layout. The living, dining, and kitchen areas are seamlessly merged into a single large space at the center of the house, promoting a sense of spaciousness and flow. The two bedrooms are thoughtfully located at opposite ends of the plan, offering private and quiet retreats. The bathroom is strategically placed between the living area and one of the bedrooms, enhancing convenience and functionality.

#### Materials Shopping List

Please print and take this Materials Shopping List to your favorite Home Depot and ask for assistance in selecting the materials, fixtures and fittings to complete your new home.

Record your selection and the price of the item. Then do the math to determine the cost for your selections and the total cost of finishing your home.

#### < CLICK HERE >

To Go To Materials Shopping List



# BATH 51 SF 123 SF France Now 733 SF

# **FLOOR PLAN**

733 SF

2 Bed Rooms

# TABLE OF CONTENTS

RENDERINGS	ABOUT THE HOME -	<b>—</b> 01
1	RENDERINGS -	<b>01</b>
FLOOR PLAN	SCHEMATIC FLOOR PLAN	<b>—</b> 01
1	HOME SPECS ⊢	<b>—</b> 01
	DISCLAIMER -	<b>—</b> 01
ABOUT	ABOUT FrameUpNow ⊢	<b>—</b> 01
1	ABOUT HouseDocs	<b>—</b> 01
DESCRIPTIONS	BOM (Bill Of Materials)	<b>02</b>
2	STRUCTURAL -	<b>—</b> 02
	ARCHITECTURAL-	<b>—</b> 02
	MECHANICAL -	<b>—</b> 02
	ELECTRICAL	<b>02</b>
	PLUMBING -	<b></b> 02
MATERIALS LIST	MATERIALS LIST PREVIEW	<b></b> 02
HOW TO BUILD	CONSTRUCTION STEPS -	<b></b> 02
ARCHITECTURAL	COVER SHEET -	<b>─</b> 03

FLOOR PLAN + DIMENSION PLAN FOUNDATION PLAN

STRUCTURAL FLOOR PLAN -WALL FRAME LAYOUT ROOF TRUSS LAYOUT ROOF PLAN + ARCHITECTURAL ELEVATIONS ARCHITECTURAL ELEVATIONS -ARCHITECTURAL SECTIONS -ARCHITECTURAL DETAILS ARCHITECTURAL CASEWORK

STRUCTURAL **COVER SHEET GENERAL NOTES** WALL FRAME LAYOUT WALL PANEL & LAYOUT PLAN

ROOF TRUSS LAYOUT 20 STRUCTURAL SECTIONS 21 WALL BRACING LAYOUT HOLD-DOWN PLAN **STRUCTURAL DETAILS 1 STRUCTURAL DETAILS 2 STRUCTURAL DETAILS 3 27** TRUSS BLOCKING LAYOUT

SHEETROCK BACKING 1 **ROOF BRACING LAYOUT** 29 **MECHANICAL COVER SHEET** 30 HVAC PLAN 31

**ELECTRICAL** 

SCHEDULE 32 LIGHTING POWER PLAN 34 DIMENSION FOR LIGHTING

DIMENSION FOR FITTING

**PLUMBING** 

NOTES AND SCHEDULES WATER SUPPLY & SEWAGE SYSTEM # 38

**DISCLAIMER** 

marketing content.

DISCLAIMER: This documentation and all it's contents are the intellectual property

of FrameUpNow. It is provided solely for marketing the services of FrameUpNow.

The preliminary information is not approved for actual construction use and is

not warranted to be complete or accurate. Unauthorized copying, distribution, or application of these proprietary materials, in any form or format, is strictly prohibited. FrameUpNow assumes no liability for any issues arising from improper use of this

**MATERIALS SHOPPING LIST** 

MATERIALS SHOPPING LIST

# **ABOUT**



FrameUpNow is a design and manufacturing company providing precision-engineered home framing solutions. We offer a catalog of Affordable Homes, Tiny Homes, Garages, Shops and Barndominiums. FrameUpNow manufactures cold-formed steel (CFS) also known as Light Gauge Steel (LGS) framing components that conform to our engineered metal house frame plans or can be purchased as DIY skeleton kits.

The CFS/LGS framing is lightweight, easily assembled, and does not require heavy equipment or specialized labor, enabling homeowners to erect the frame themselves in just a few days. Unlike wood, the steel framing is impervious termites and bores, warping, expansion, and fire.

Our home plans come complete with a structural engineered stamp for permit approvals. Customers receive a full BOM also known as a Materials Shopping List to purchase finish materials from a Building Materials retailer. FrameUpNow prides itself on the quality and efficiency of our precision-engineered home framing solutions for construction professionals and DIY homeowners.



**KEY PLAN** 

NO.	DESCRIPTION	DAIL

NOTE:

LEGEND:

PROJECT

160-Haven-733-2Bd1Ba-Craftsman-550

DRAWING NAME

# INTRODUCTION

CLIENT NAME:
PROJECT NUMBER:
DATE:
DESIGNED BY:
DRAWN BY:
CHECKED BY:

**I101** 

SCALE:

# **DESCRIPTIONS**

# MATERIALS LIST

The BOM (Bill Of Materials) package, known as the Materials Shopping List document, provides:

Comprehensive Inventory: Detailed lists of essential materials sourced from architectural, mechanical, HVAC, electrical, and plumbing design drawing sets.

Precise Curation: Each item meticulously selected and organized for accuracy and efficiency in project planning.

Customizable Options: Customers can modify listed items to their preferences and calculate costs accordingly, ensuring alignment with personal project needs and budget.

Dedicated Space for Details: Includes tables for customers to note Home Depot SKU numbers or product descriptions for selected items, facilitating seamless purchasing and coordination with suppliers.

Customer Convenience: Take the list to Home Depot or preferred suppliers for accurate pricing, helping align the total home budget with personal financial plans.

Simplify your construction journey with our Materials Shopping List document, where detailed preparation meets streamlined implementation for your dream home.

# STRUCTURAL

The structural drawings package provides an exhaustive set of detailed plans essential for the precise assembly of your building. This comprehensive package includes:

Framing Plans: Detailed layouts for all framing components. Truss Layouts: Clear instructions for truss placement and

Panel Length Plans: Specifications for panel dimensions. Framing Elevations and Sections: Precise elevation and sectional views for accurate construction.

Truss and Wall Blocking Plans: Plans for truss and wall blocking to ensure structural integrity.

Hold-Down Plan: Detailed hold-down requirements for stability. Snap Sheet: Reference sheet for quick identification of components

Structural Details and Bracing Plans: Complete details and bracing plans for all structural elements.

Accompanying these plans is a comprehensive Bill of Materials (BOM) that lists every necessary building component, from cold formed steel (CFS) frames to fasteners.

# ARCHITECTURAL

With the comprehensive architectural package, both builders and DIY homeowners can confidently execute the construction.

The architectural package includes:

Furnished Floor Plans: Complete with furniture layouts for a clear understanding of space utilization.

Detailed Dimension Plans: Ensures precise measurements, from the overall footprint down to the exact placement of windows and

Foundation Plan: Detailed plan to establish a solid foundation.

Wall Framing and Truss Layout: Comprehensive plans for wall framing and truss placement.

Architectural Elevations: Exterior views showcasing the design.

Strategic Building Sections: Critical cross-sectional details for a thorough understanding of the build.

Casework Drawings and Diagrams: Suggested designs for built-in caseworks, such as kitchen cabinets.

# **MECHANICAL**

The mechanical package includes everything needed to guide HVAC

Detailed HVAC Floor Plan: Precisely maps out the placement of air handlers, ductwork, and vents throughout the home's layout.

HVAC Sections and Riser Diagrams: Technical drawings offering critical cross-sectional details and piping schematics, ensuring proper integration of the heating and cooling system into the home's structure.

Bill of Materials: A complete list of all necessary HVAC components.

# **ELECTRICAL**

The electrical package includes all the plans and documentation needed to guide the installation of your home's electrical system:

Detailed Power Plan: Precisely maps out the placement of outlets, switches, and other power components throughout the layout.

Comprehensive Lighting Plan: Shows the optimal locations for lighting fixtures, sconces, and other illumination sources to create a well-lit, functional interior.

Dimensioned Electrical Layout: Provides exact dimensions and measurements to ensure proper placement of all electrical elements.

Bill of Materials: A complete list of every component needed, from circuit breakers to wiring.

The plumbing package includes everything needed to guide the installation of your home's water supply and drainage systems:

Detailed Water Supply System Plan: Precisely maps out the placement of pipes, valves, and plumbing fixtures throughout the

Comprehensive Sewage System Plan: Shows the optimal routing and sizing of drain lines to effectively remove waste and ensure

Detailed Riser Diagrams: Provide information needed to properly

# **PLUMBING**

proper drainage.

install all vertical plumbing risers and vent stacks.

Bill of Materials: A complete list of every component needed, from pipes to fixtures.


# BOM (Bill Of Materials) (Separately Attached) **ARCHITECTURAL BOM** HAVEN 2BD/1BA CRAFTSMAN The Bill of Materials (BOM) is a crucial document that compiles


**ELECTRICAL BOM** 




the material requirements from different disciplines into a

centralized inventory, enabling efficient procurement, inventory management, and cost estimation for a specified project or

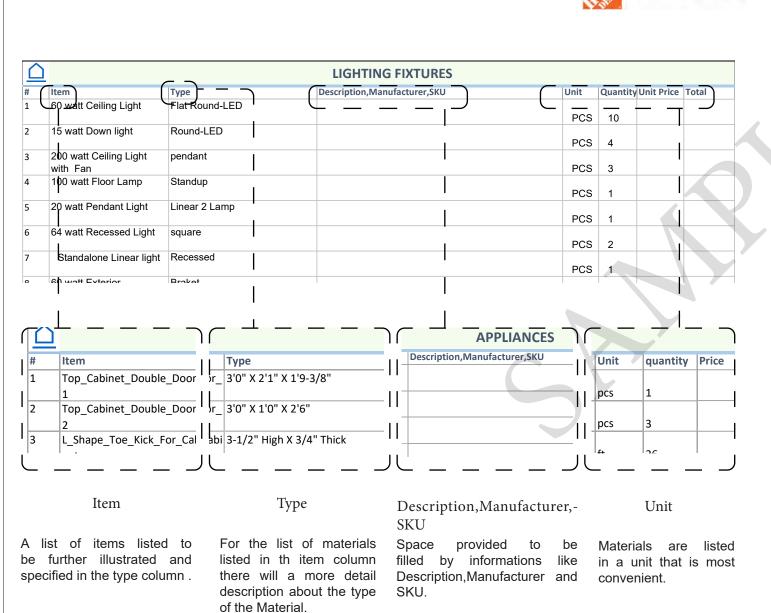

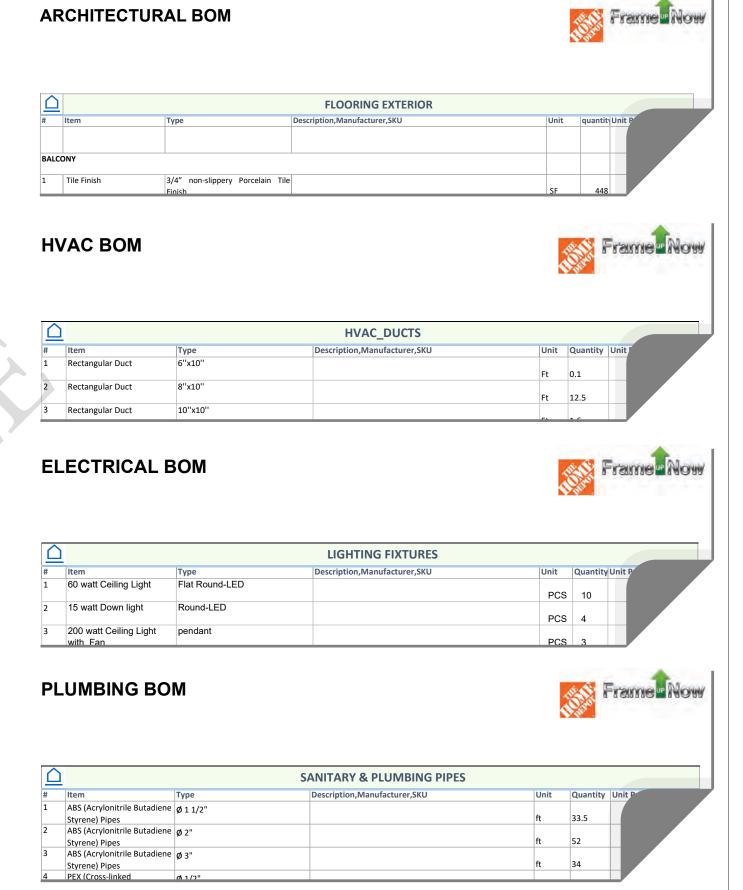

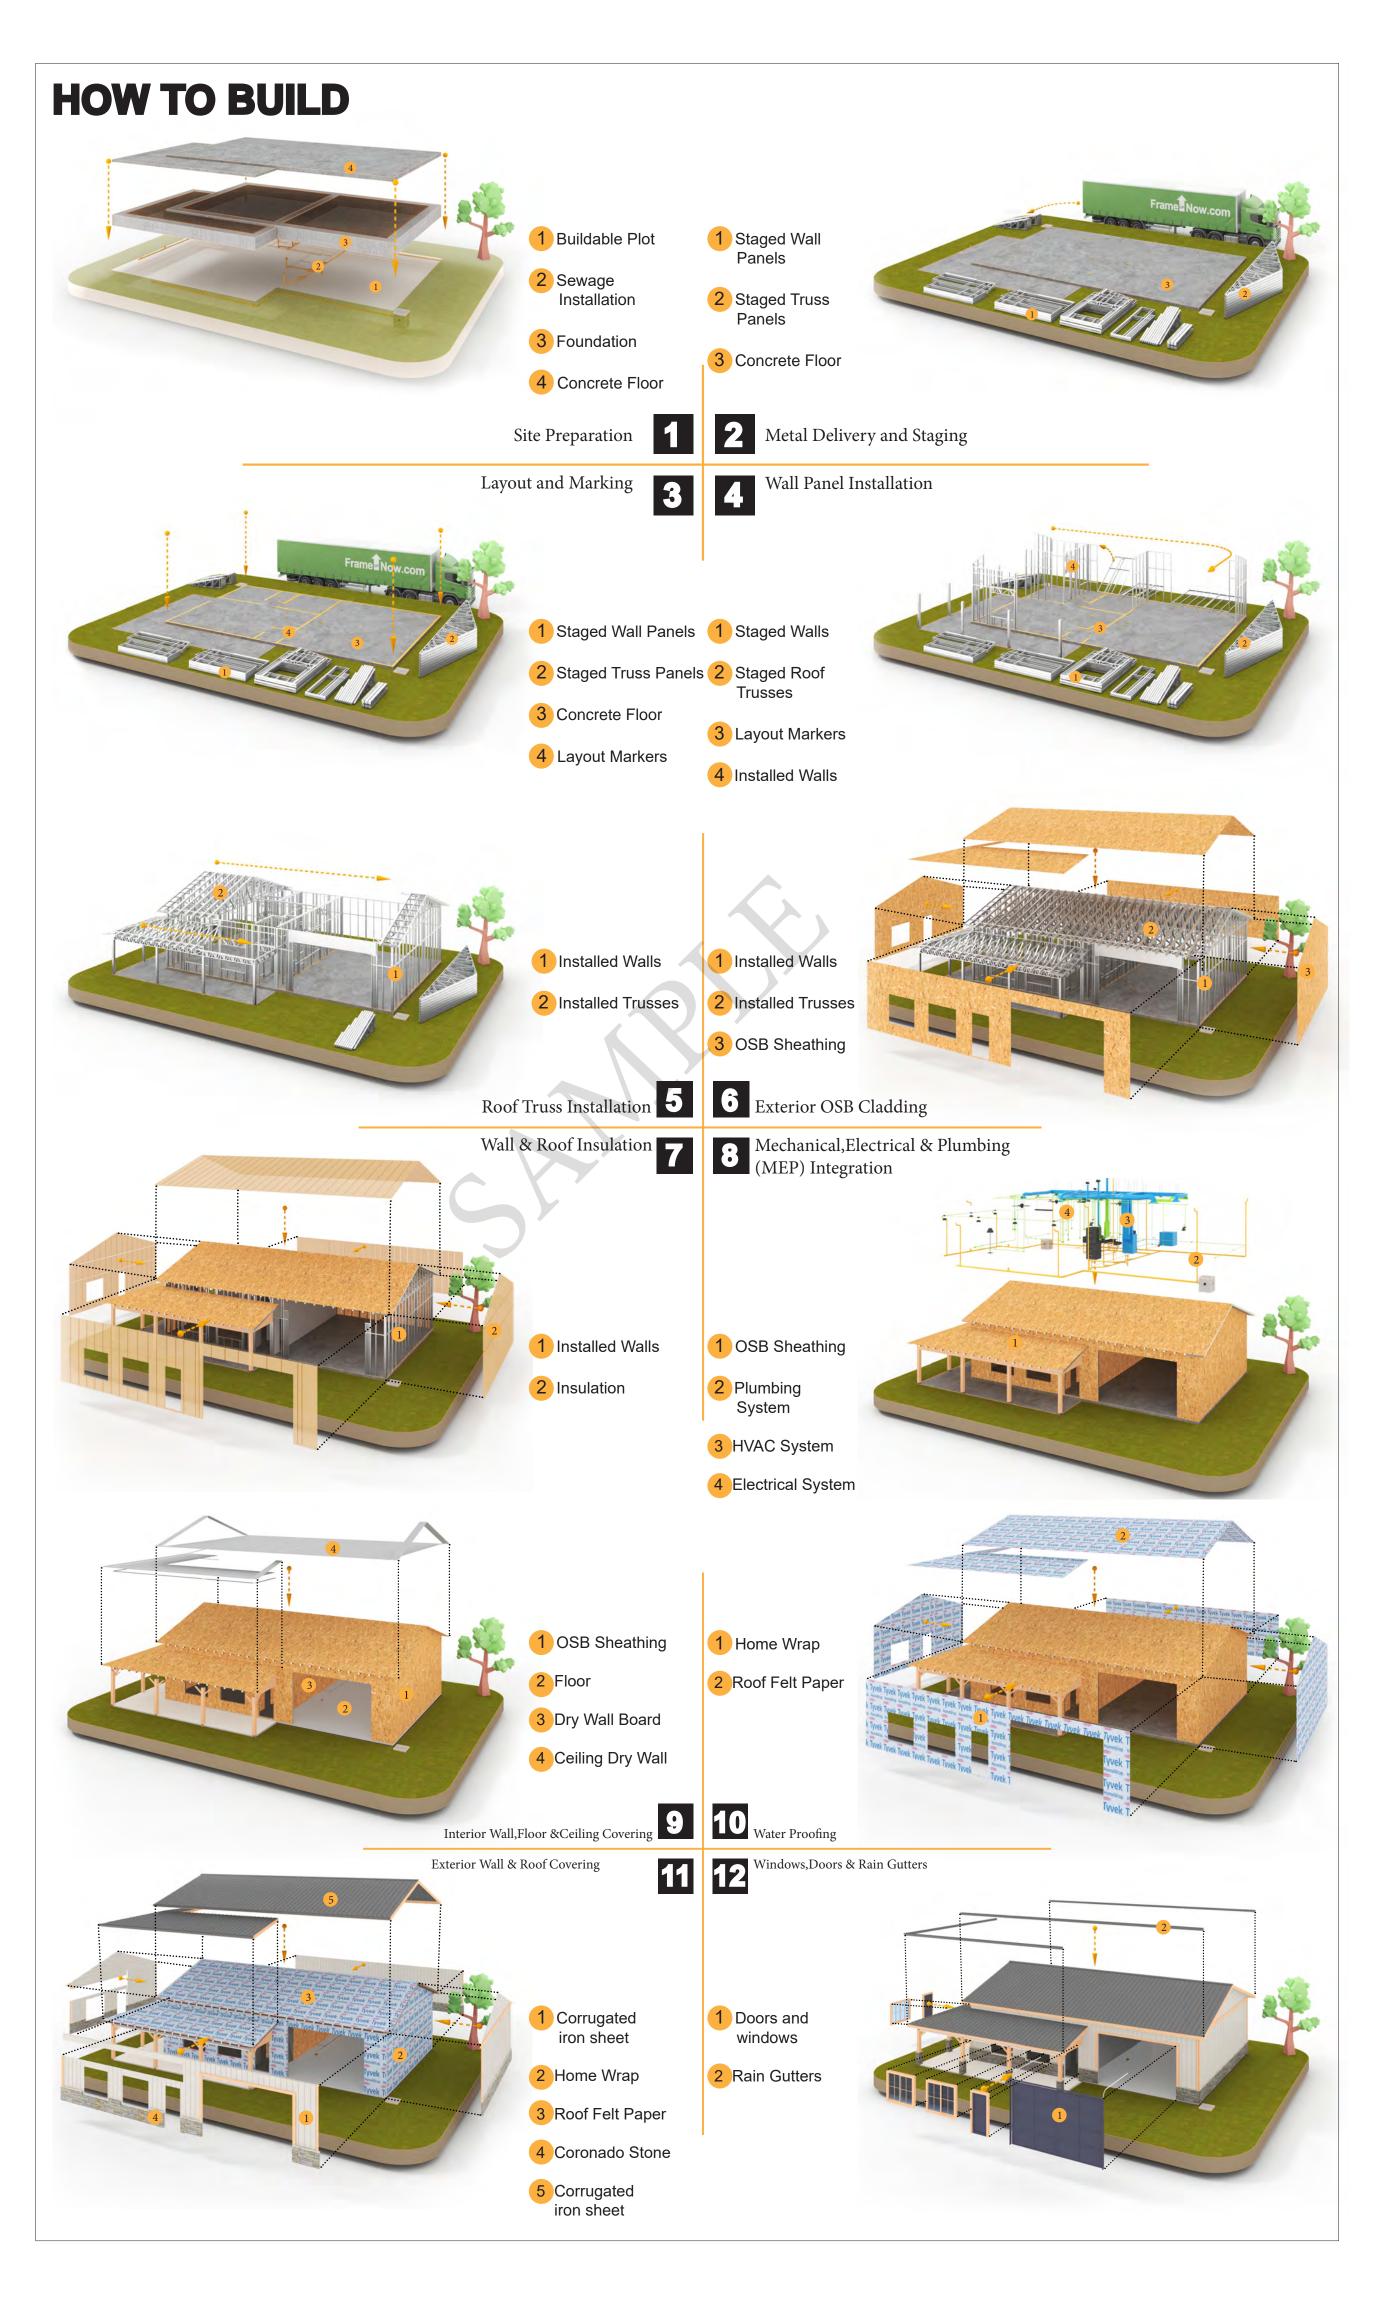



**KEY PLAN** 

NO.	DESCRIPTION	DATE

NOTE:

LEGEND:

PROJECT

160-Haven-733-2Bd1Ba-Craftsman-550


DRAWING NAME

# INTRODUCTION

CLIENT NAME: PROJECT NUMBER: DATE: **DESIGNED BY** DRAWN BY: CHECKED BY:

1102

SCALE:

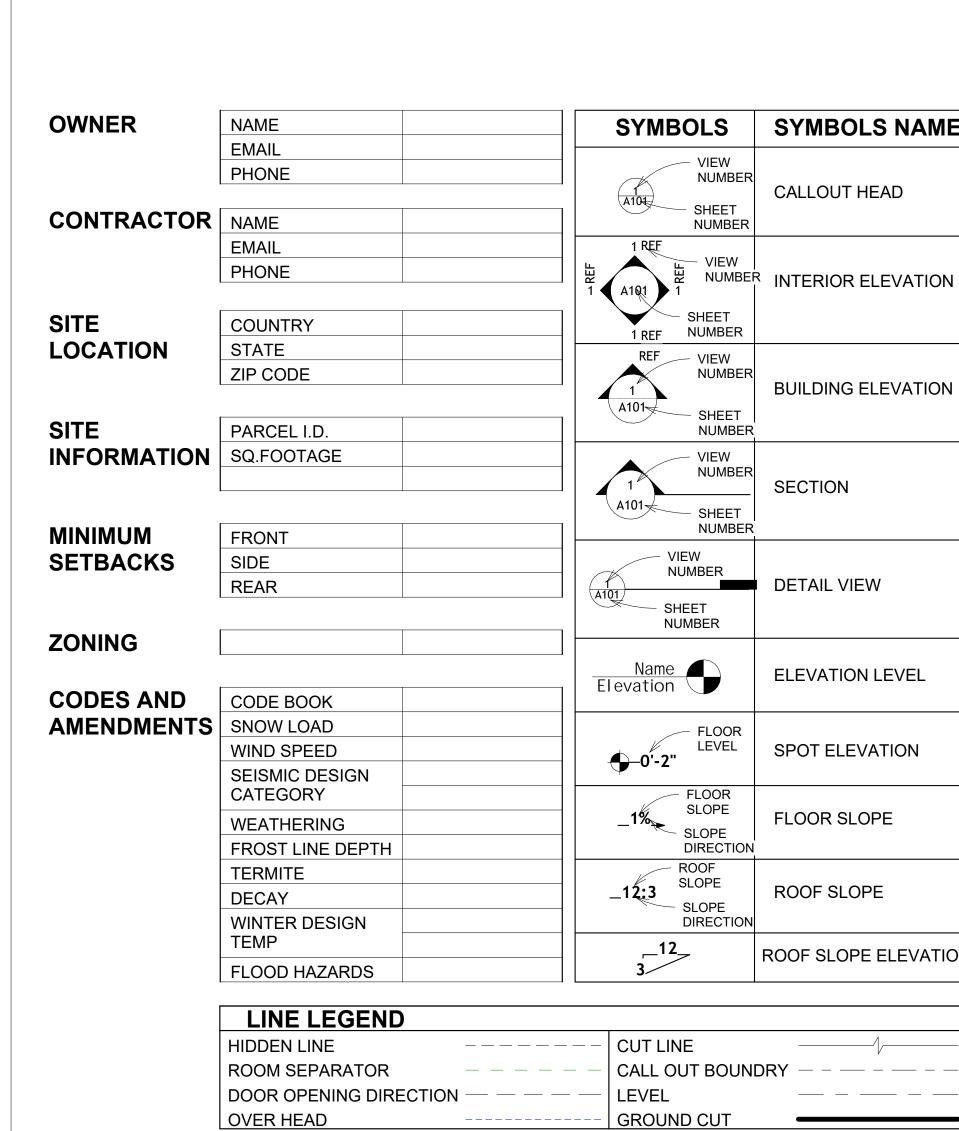

DIRECTION

**ROOF SLOPE** 

ROOF SLOPE ELEVATION

SLOPE

SLOPE

<b>IBOLS</b>	SYMBOLS NAME		PAGE INDEX
VIEW		G101	COVER SHEET
NUMBER		A101	FLOOR PLAN
SHEET	CALLOUT HEAD	A102	DIMENSION PLAN
NUMBER		S101	FOUNDATION PLAN
F VIEW		S102	STRUCTURAL FLOOR PLAN
MOMBER NIEW	R INTERIOR ELEVATION	S103	FRAME LAYOUT
<b>)</b> 1		S104	ROOF TRUSS LAYOUT
SHEET F NUMBER		A103	ROOF PLAN
F VIEW		A201	ELEVATIONS
NUMBER		A202	ELEVATIONS
	BUILDING ELEVATION	A301	SECTIONS
SHEET NUMBER		A401	DETAILS
VIEW		A402	CASEWORK DETAILS
NUMBER		A403	CASEWORK DETAILS
	SECTION	E101	SCHEDULE
SHEET NUMBER		E102	LIGHTING PLAN
- VIEW		E103	POWER PLAN
NUMBER		E104	DIMENSION PLAN FOR LIGHT FIXTURE
CHEET	DETAIL VIEW	E105	DIMENSION PLAN FOR FITTING
SHEET NUMBER		P101	COVER SHEET
		P102	WATER SUPPLY SYSTEM
me 🔳	ELEVATION LEVEL	P103	SEWAGE SYSTEM
on 🛡		P104	RISER DIAGRAM
FLOOR LEVEL		M101	HVAC PLAN
	SPOT ELEVATION	M102	HVAC SECTION
-2"	or or elevation	M103	RISER DIAGRAM
FLOOR SLOPE SLOPE	FLOOR SLOPE		
DIDECTION		TAO	TA OLO NIA NAT

TAG'S NAME

CASEWORK TAG

**FURNITURE TAG** 


PE01 PLUMBING EQUIPMENT TAG

SPECIALTY EQUIPMENT TAG

MECHANICAL EQUIPMENT TAG

WINDOW TAG

**DOOR TAG** 

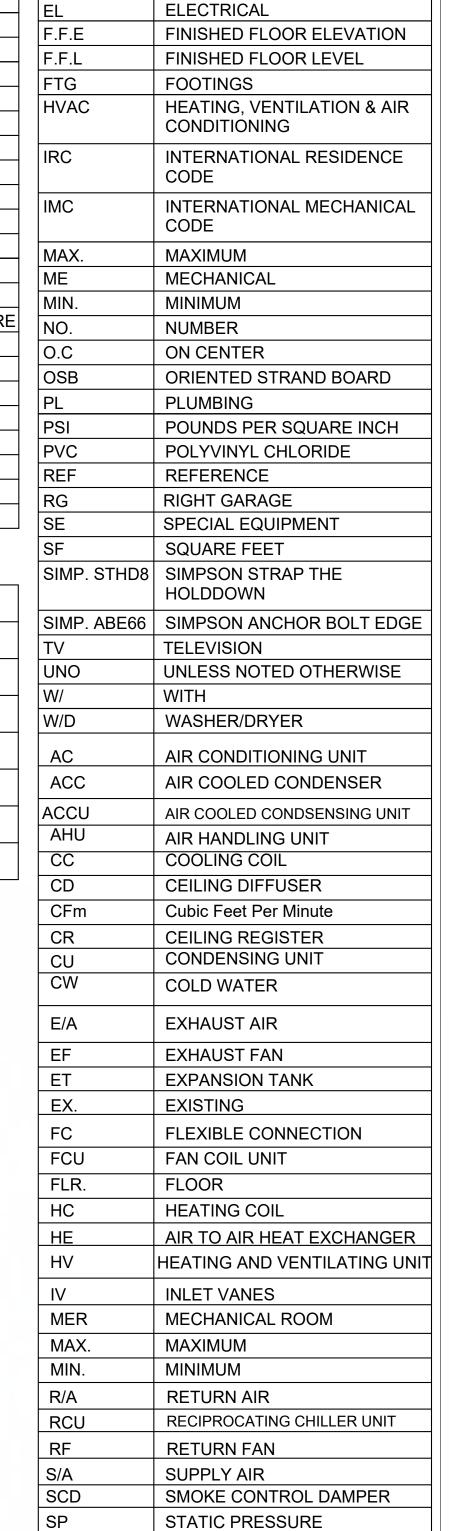



**ABBREVIATION** 


CASEWORK

ACTION FLOOR SYSTEMS

AMERICAN SOCIETY FOR **TESTING AND MATERIAL** 

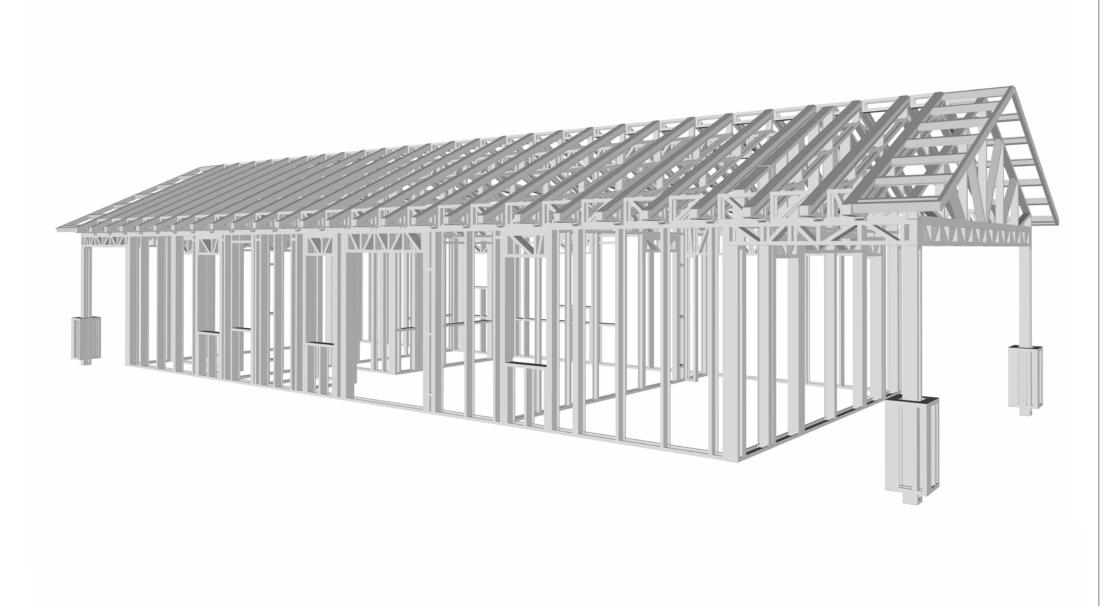

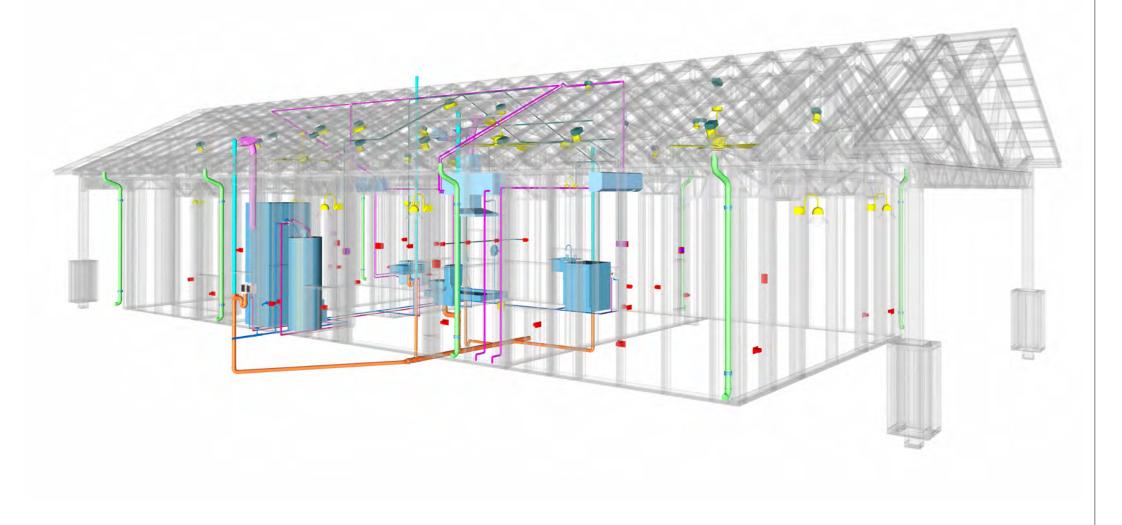


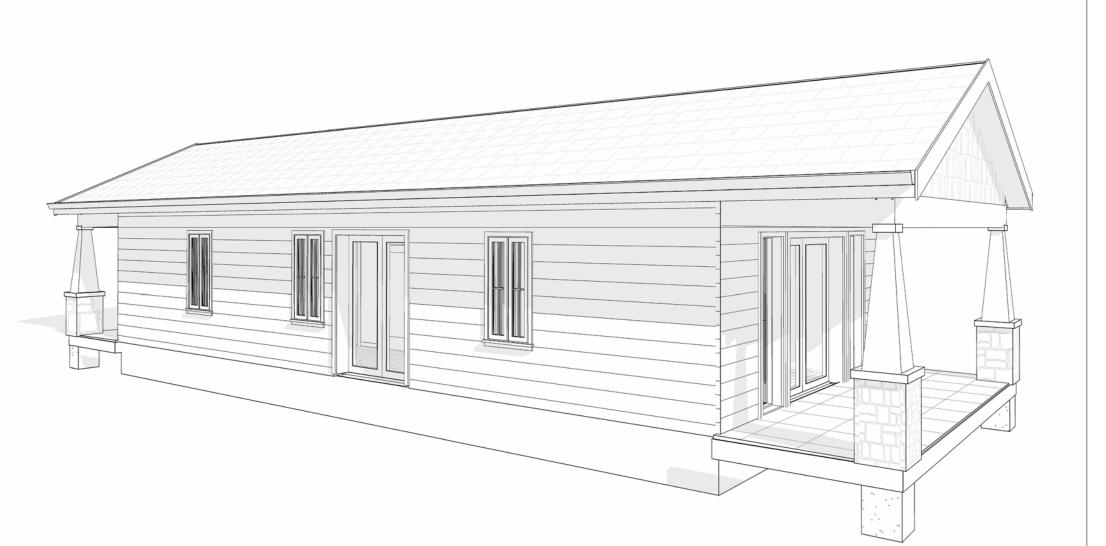

160 HAVEN 733 2Bd1Ba CRAFTSMAN 550

SQUARE FOOT	AGE
LIVING	733
R&L-SIDE PORCH	205
TOTAL	938



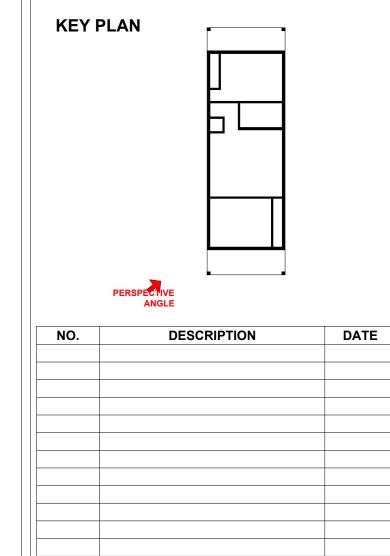

NOTE:

**LEGEND:** 

PROJECT

160 HAVEN 733 2Bd1Ba **CRAFTSMAN 550** 

DRAWING NAME

**COVER SHEET** 

CLIENT NAME:	Client Name
PROJECT NUMBER:	0061_12
DATE:	4/2/2025 5:56:49 PM
DESIGNED BY:	Designer
DRAWN BY:	Author
CHECKED BY:	Checker

G101

SCALE: As indicated

© [2024] [FrameUpNow] . All rights reserved

#### **GENERAL NOTES**

- THIS DRAWING DEPICTS THE ARCHITECTURAL (SPACE LAYOUT, FURNISHING, FLOOR, WALLS, ROOFS, FOUNDATION, WINDOWS AND DOORS) SYSTEMS. IT PROVIDES A VISUAL REPRESENTATION OF THE ARCHITECTURAL LAYOUT AND COMPONENTS.
- THE ARCHITECTURAL DRAWINGS ARE PREPARED TO MEET THE SPECIFIC REQUIREMENTS OF THE BUILDING, AS PER THE PROJECT SPECIFICATIONS AND APPLICABLE CODES AND STANDARDS.
- 3. THE CONSTRUCTION OF THIS HOME SHALL COMPLY WITH THE LATEST EDITION OF THE INTERNATIONAL RESIDENTIAL CODE (IRC), INTERNATIONAL MECHANICAL CODE (IMC), THE INTERNATIONAL PLUMBING STANDARD, THE NATIONAL ELECTRICAL STANDARD AND ALL OTHER APPLICABLE LOCAL, STATE, AND NATIONAL CODES AND REGULATIONS.
- COORDINATION WITH OTHER TRADES HAS BEEN DONE ON A DESIGN LEVEL. THIS DRAWING SHALL BE READ TOGETHER WITH THE ME, EL AND PL DESIGN DRAWINGS TO ENSURE PROPER CONSTRUCTION AND INTEGRATION OF THE BUILDING SYSTEMS.

#### ABOUT WALLS:

#### SHOWER WALL COVERING

BATHTUB AND SHOWER SPACES (WALLS AND FLOORS) WITH INSTALLED SHOWER HEADS AND IN SHOWER COMPARTMENTS SHALL BE FINISHED WITH A NON-ABSORBENT SURFACE.

#### 2. WALL PAINT (INTERNAL)

THE TYPICAL THICKNESS OF LATEX WALL PAINT IS 1/32 OF AN INCH FOR A SINGLE COAT. AND DOUBLE COAT (1/16") SHALL BE APPLIED FOR DURABILITY.

#### 3. ADHESIVES:

THE ADVISABLE TYPE OF ADHESIVE FOR THIS PROJECT IS **EPOXY ADHESIVES**BECAUSE THEY ARE KNOWN FOR THEIR HIGH STRENGTH, DURABILITY, AND RESISTANCE TO MOISTURE, CHEMICALS AND

REFER TO SHEETS A201 & A202 FOR GENERAL NOTES ON EXTERNAL FINISHING MATERIALS


#### ABOUT FLOORS:


- THE SPOT ELEVATION INDICATES THE FINISHED FLOOR ELEVATION.
- FINISHED FLOORS PER PLANS.
- FIELD VERIFY FOR DIMENSION DROP 4" FOR SHOWER AND BATHTUB USE.
- 1% SLOPE ON OUTDOOR BALCONIES FOR WATER RUN OFF.
- 2% SLOPE TOWARDS THE SHOWER DRAIN FOR SUFFICIENT DRAINAGE.
- 4" DROP AT THE DOOR LEADING TO EXTERIOR BALCONY FROM THE MAIN LIVING AREA.
- 5% SLOPE FOR GARAGE IS USED, WHICH SHOULD BE CHECKED WITH THE LOCAL GARAGING ZONING LAWS.


2
A301
2
A202

FURNITURE SCHEDULE		
TYPE MARK	TYPE	COUNT
01	KING SIZE BED	2
02	THREE SEAT SOFA	1
03	DINING CHAIR	2
04	COFFE TABLE	1


	ROOM FINISH SCHEDULE						
ROOM NUMBE R	ROOM NAME	FLOOR FINISH	BASE FINISH	WALL FINISH	CEILING FINISH	CEILING HEIGHT	COM MEN TS
			CONODETE	NAVALL DAINE	DD\(\)\(\)\(\)	01 011	
01	LIVING ROOM	HARDWOOD	CONCRETE	WALL PAINT	DRY WALL	8' - 0"	
02	KITCHEN	HARDWOOD	CONCRETE	WALL PAINT + CERAMIC	DRY WALL	8' - 0"	
03	BEDROOM 1	HARDWOOD	CONCRETE	WALL PAINT	DRY WALL	8' - 0"	
04	BEDROOM 2	HARDWOOD	CONCRETE	WALL PAINT	DRY WALL	8' - 0"	
05	CL 1	HARDWOOD	CONCRETE	WALL PAINT	DRY WALL	8' - 0"	
06	BATH	VINYL TILES	CONCRETE	CERAMIC TILE	MRD	8' - 0"	
07	W/D	VINYL TILES	CONCRETE	CERAMIC TILE	DRY WALL	8' - 0"	
08	WH	VINYL TILES	CONCRETE	WALL PAINT	DRY WALL	8' - 0"	
09	HALL	HARDWOOD	CONCRETE	WALL PAINT	DRY WALL	8' - 0"	
10	CL 2	HARDWOOD	CONCRETE	WALL PAINT	DRY WALL	8' - 0"	
11	PORCH 1	PROCELAIN TILE	CONCRETE	EXTERIOR-GRADE PLYWOOD	PLYWOOD	8' - 0"	
12	PORCH 2	PROCELAIN TILE	CONCRETE	EXTERIOR-GRADE PLYWOOD	PLYWOOD	8' - 0"	

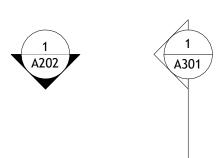

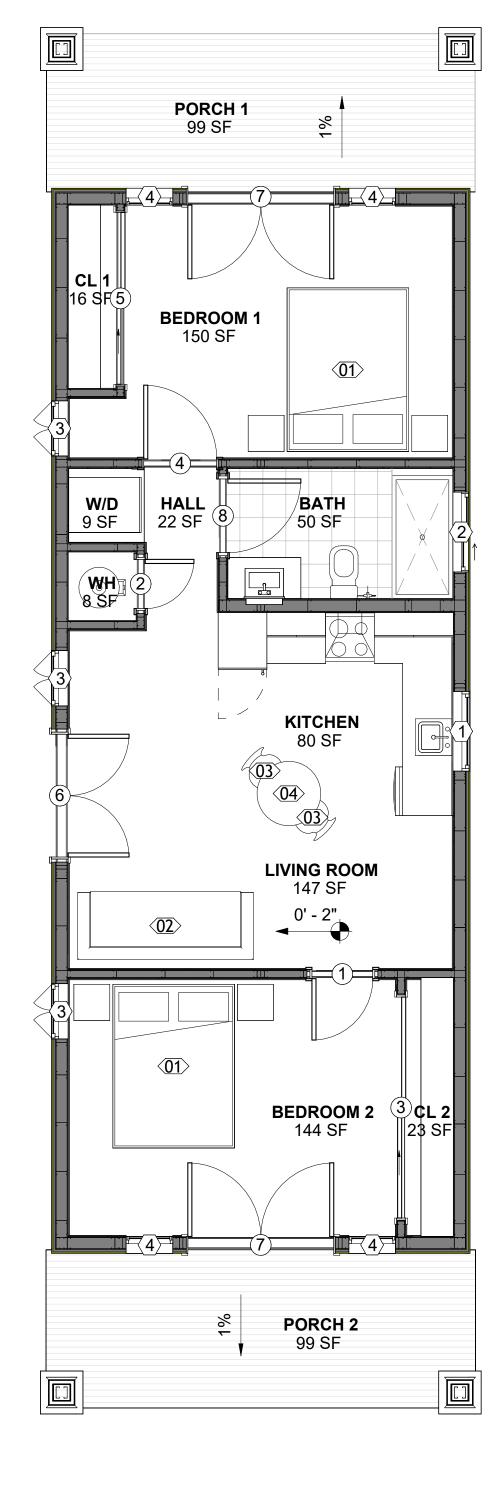

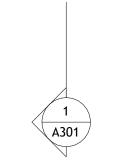

**FLOOR PLAN**1/4" = 1'-0"

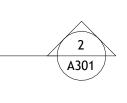



**KEY PLAN** 

NO.	DESCRIPTION	DATE

NOTE:

LEGEND:

PROJECT

160 HAVEN 733 2Bd1Ba **CRAFTSMAN 550** 

DRAWING NAME


**FLOOR PLAN** 

CLIENT NAME:	Client Name
PROJECT NUMBER:	0061_12
DATE:	4/2/2025 5:56:49 PM
DESIGNED BY:	Designer
DRAWN BY:	Author
CHECKED BY:	Checker

A101

SCALE: 1/4" = 1'-0"

SQUARE FOOTAGE 733 R&L-SIDE PORCH 205 TOTAL 938

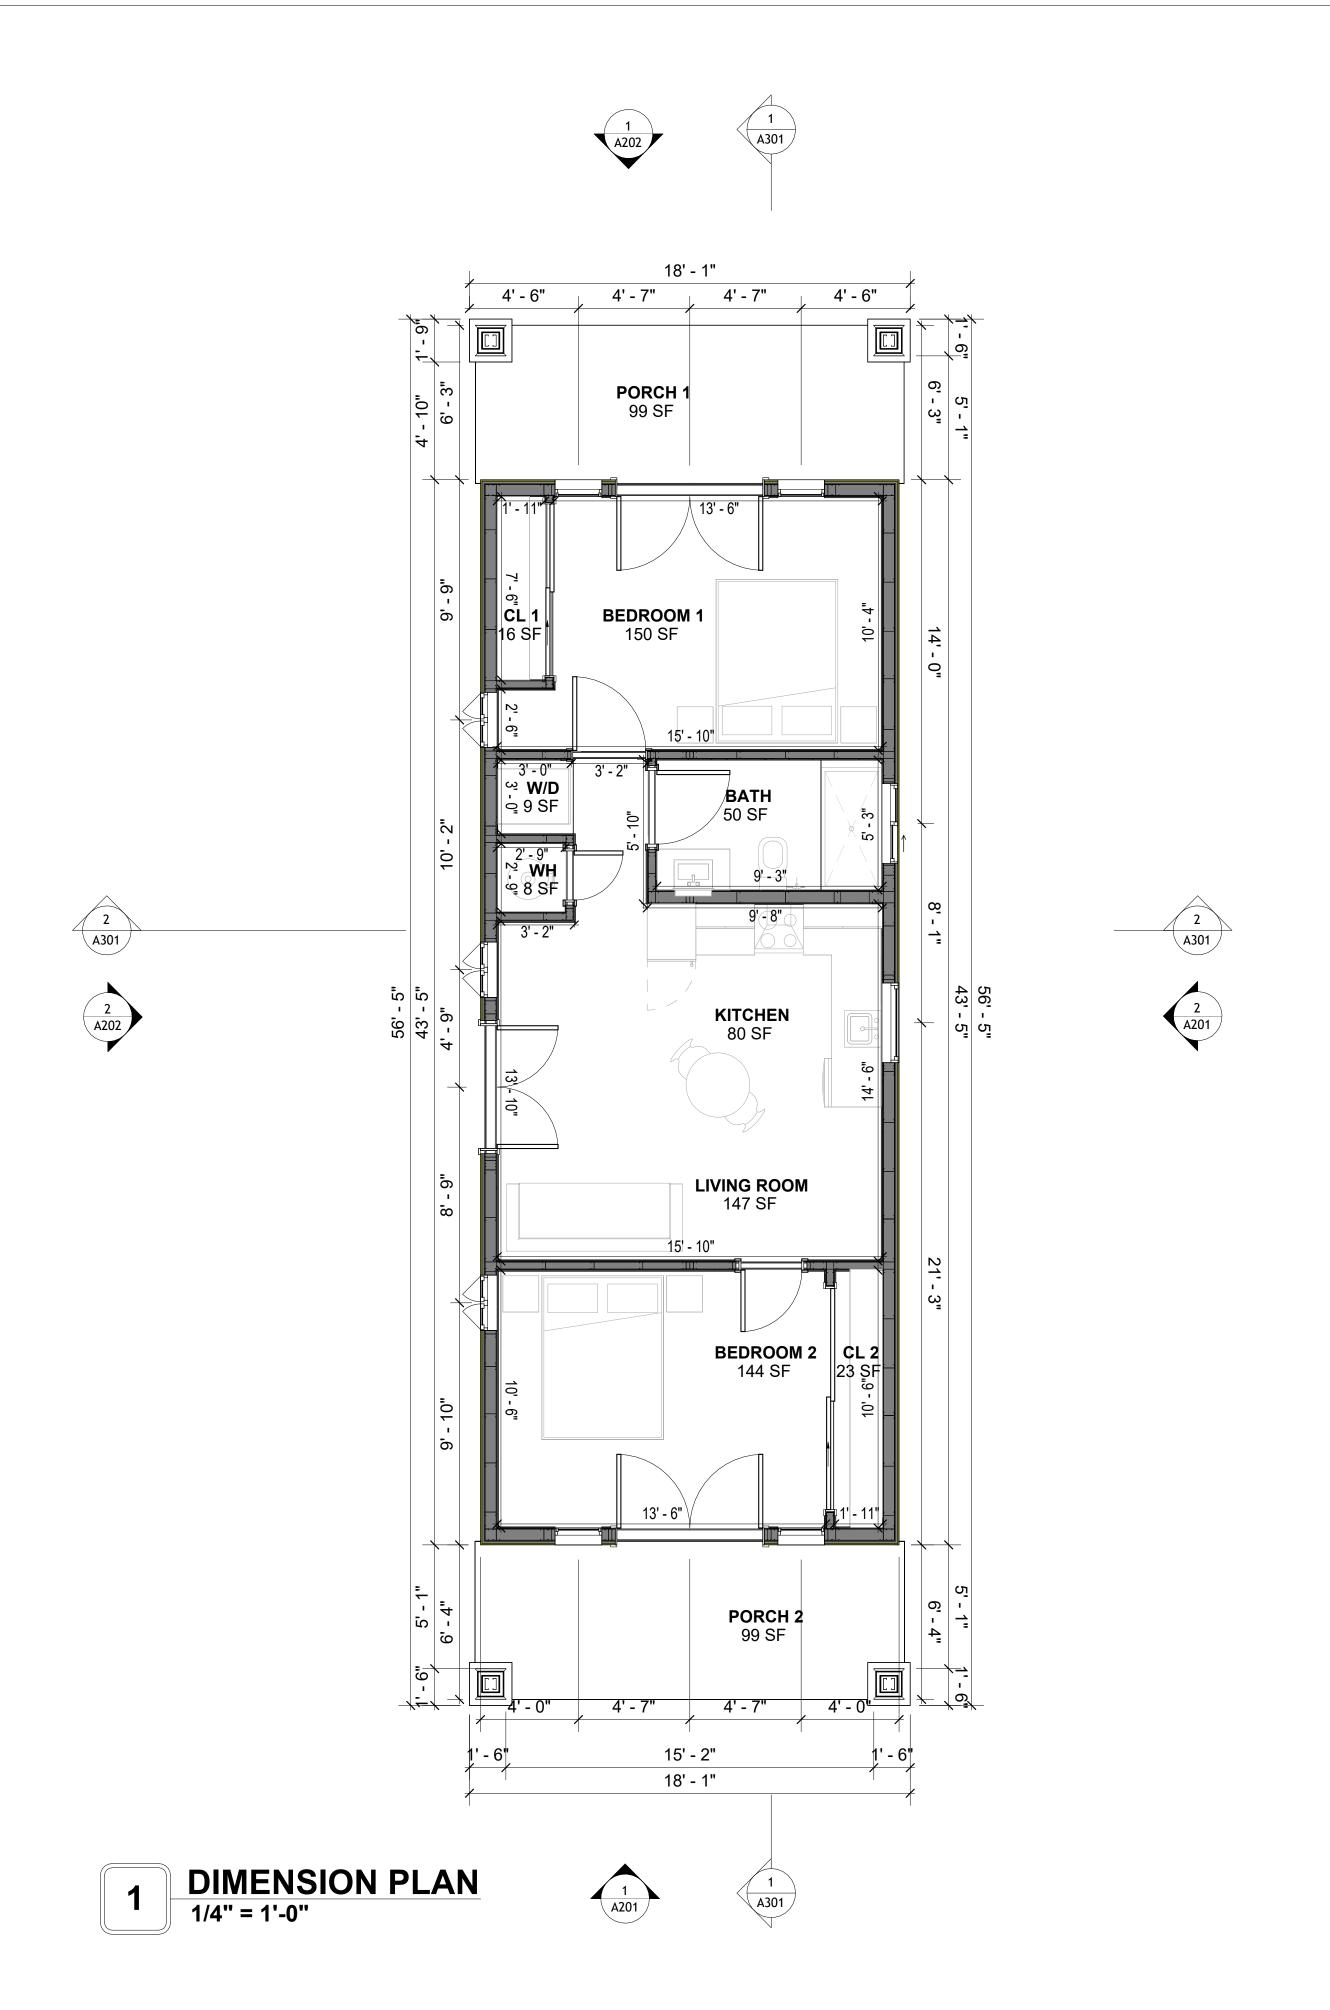



**KEY PLAN** 

NO.	DESCRIPTION	DATE

NOTE:

LEGEND:

PROJECT

160 HAVEN 733 2Bd1Ba CRAFTSMAN 550

DRAWING NAME

DIMENSION PLAN

CLIENT NAME:	Client Name
PROJECT NUMBER:	0061_12
DATE:	4/2/2025 5:56:51 PM
DESIGNED BY:	Designer
DRAWN BY:	Author
CHECKED BY:	Checker

A102

SQUARE FOOTAGE

LIVING 733

R&L-SIDE PORCH 205

TOTAL 938

DIMENSIONS IN THE ARCHITECTURAL DRAWINGS CONSIDER FINISHING MATERIALS. FOR PRECISE MEASUREMENTS OF THE STRUCTUAL FRAMING, REFER TO THE ATTACHED STRUCTURAL PLAN SET.

#### FOUNDATION NOTES

#### **NOTES:**

TERMITES PRETREATMENT BY LICENSED CONTRACTOR UNDER SLAB AND AROUND FOOTINGS. ALL AREAS BELOW SLABS SHALL BE TREATED NO MORE THAN 24 HOURS PRIOR TO CONCRETE POUR. EVIDENCE OF TREATMENT MUST BE PROVIDED PRIOR TO PLACING OF CONCRETE.

#### **MATERIALS:**

ALL INTERIOR CONCRETE SLABS SHALL BE A MIN. OF 4" THICK CONCRETE OVER 4" COMPACTED AGGREGATE BASE (ASTM D698), FINISH ELEVATIONS AS NOTED ON DRAWINGS, 6" ABOVE ADJACENT GRADE, LEVEL SLABS TO 1/8"-10' MAX.. CONCRETE SLABS SHALL BE 2500# PSI AT 28 DAYS. A 4" ALLOWABLE SLUMP.

#### 2. **PAD PREPARATION:**

EXCAVATION FOR FOOTING SHALL BE NEAT.

FOOTINGS SHALL BE POURED IMMEDIATELY AFTER EXCAVATION AND APPROPRIATE INSPECTION.

ALL REINFORCING STEEL MARKED "CONTINUOUS" SHALL BE LAPPED 36 BAR DIAMETERS AT SPLICES AND AROUND CORNERS OR INTERSECTIONS WITH A STANDARD 90 DEGREE BEND ON CORNER BARS. LAP WIRE MESH ONE FULL MESH AT SIDE AND END LAPS.

ALL HARDWARE TO BE SIMPSON OR EQUIVALENT. EXTERIOR FRAME WALL TO BE SECURED WITH 1/2"X10" ANCHOR BOLTS 4'-0" O.C. FOR 1-STORY AND 2'-8" O.C. FOR 2-STORY. BOLTS SHALL BE LOCATED WITHIN 1'-0" OF EACH END PIECE AND SHALL HAVE A MIN. OF TWO BOLTS PER PIECE.

-FOUNDATION ANCHOR STRAPS SHALL BE PERMITTED, ACCORDING TO RESIDENTIAL CODE 2021

ALL INTERIOR WALLS TO BE SECURED WITH POWER DRIVEN PINS PER MANUFACTURER

SPECIFICATION USE PIN SPACING EQUIVALENT TO 1/2" ANCHOR BOLTS.

ALL CONSTRUCTION TO CONFORM TO THE 2012 IRC R-10 RIGID INSULATION OUTSIDE OF EXTERIOR FOUNDATION WALLS UNDER LIVING AREA. CONCRETE PAD FOR CONDENSER THICKNESS IS 4" MIN UNLESS OTHERWISE NOTED.

#### 3. CONCRETE CONSTRUCTION:

THE SLAB SHALL BE UNDERLAIN BY A VAPOR BARRIER/RETARDER IN THE LIVING AREA (TYPICALLY POLYETHYLENE, UNLESS MORE STRINGENT PROTECTION REQUIRED BY THE ARCHITECT, ENGINEER, FLOOR COVERING MANUFACTURER, OR ACCEPTED PRACTICE). UNLESS OTHERWISE REQUIRED, BARRIER MAY BE OMITTED AT GARAGES, PORCHES AND PATIOS WITHOUT FLOOR COVERINGS. IT IS BEYOND THE SCOPE OF THESE PLANS TO DETERMINE THE APPLICABILITY OF THESE MORE STRINGENT REQUIREMENTS. BUILDER SHALL VERIFY PRIOR TO CONSTRUCTION.

#### 4. REINFORCEMENT:

- IF CONSTRUCTED ON ACTIVE SOILS, THE LONG TERM PERFORMANCE OF THE FOUNDATION IS DEPENDENT ON MAINTENANCE BY THE OWNER. THUS THE BUILDER SHALL ADVISE THE OWNER OF THE FOLLOWING:

. DRAINAGE MUST BE MAINTAINED. WATER SHALL NEVER BE ALLOWED TO POND NEAR THE FOUNDATION.

2. THE SOIL AROUND THE FOUNDATION SHALL BE MAINTAINED IN A RELATIVELY DAMP CONDITION, SUCH AS THAT REQUIRED TO KEEP A LAWN GREEN. IF IT DRIES OUT IT WILL SHRINK. IF IT GETS WET, IT WILL HEAVE UPWARD.

SLABS ON THE SHORTER SIDE USES MAIN BARS ARE USED IN THIS DIRECTION ONLY WITH SMALLER DIAMETER DISTRIBUTION BARS ARE PLACED, FORMING A MAT OR GRID.

ALL REINFORCEMENT BARS SIZE 10MM OR LARGER IN ACCORDANCE TO ASTM ANCHOR BOLTS AT ALL EXTERIOR WALLS SHALL BE MINIMUM 1/2 INCH DIAMETER WITH A MAXIMUM SPACING OF 6'-0" ON CENTER, UNLESS NOTED OTHERWISE.

. ANCHOR BOLTS SHALL BE INSTALLED WITHIN 12 INCHES OF EACH END OF EACH SILL PLATE WITH AT LEAST TWO ANCHOR BOLTS FOR EACH BOLTS FOR EACH SILL PLATE LONGER THAN 12 INCHES.

5. SIMPSONS SILL ANCHORS MAYBE SUBSTITUTED FOR ANCHOR BOLTS AT THE SAME

SPACING. 6. EXTERIOR CONCRETE SLABS WHICH ARE NOT PART OF THE MAIN SLAB SHALL BE MINIMUM 4 INCHES THICK WITH NO STEEL REINFORCING BARS REQUIRED, UNLESS NOTED OTHERWISE ON FOUNDATION PLAN.

#### **VERIFY THE FOLLOWING PRIOR TO POURING:**

ALL HOLDDOWNS, STRAP, AND POST LOCATIONS.

CONCRETE FINISHES. PANEL RISER LOCATION - WHERE APPLICABLE.

3. UNDERSLAB MECHANICAL REQUIREMENTS.

STEM WALL BLOCKOUTS.


UNDERSLAB ELECTRICAL REQUIREMENTS AND PANEL RISER LOCATION. WHERE APPLICABLE.

6. PROVIDE THE FOLLOWING:

- PVC SLEEVES THROUGH FTG IF REQUIRED - 20' #4 COPPER GROUND BAR.

SLOPE FINISH GRADE AWAY FROM FOOTING.

**NOTE**: FIELD VERIFY ALL DIMENSIONS SEE DIMENSIONED ARCHITECTURAL DRAWINGS

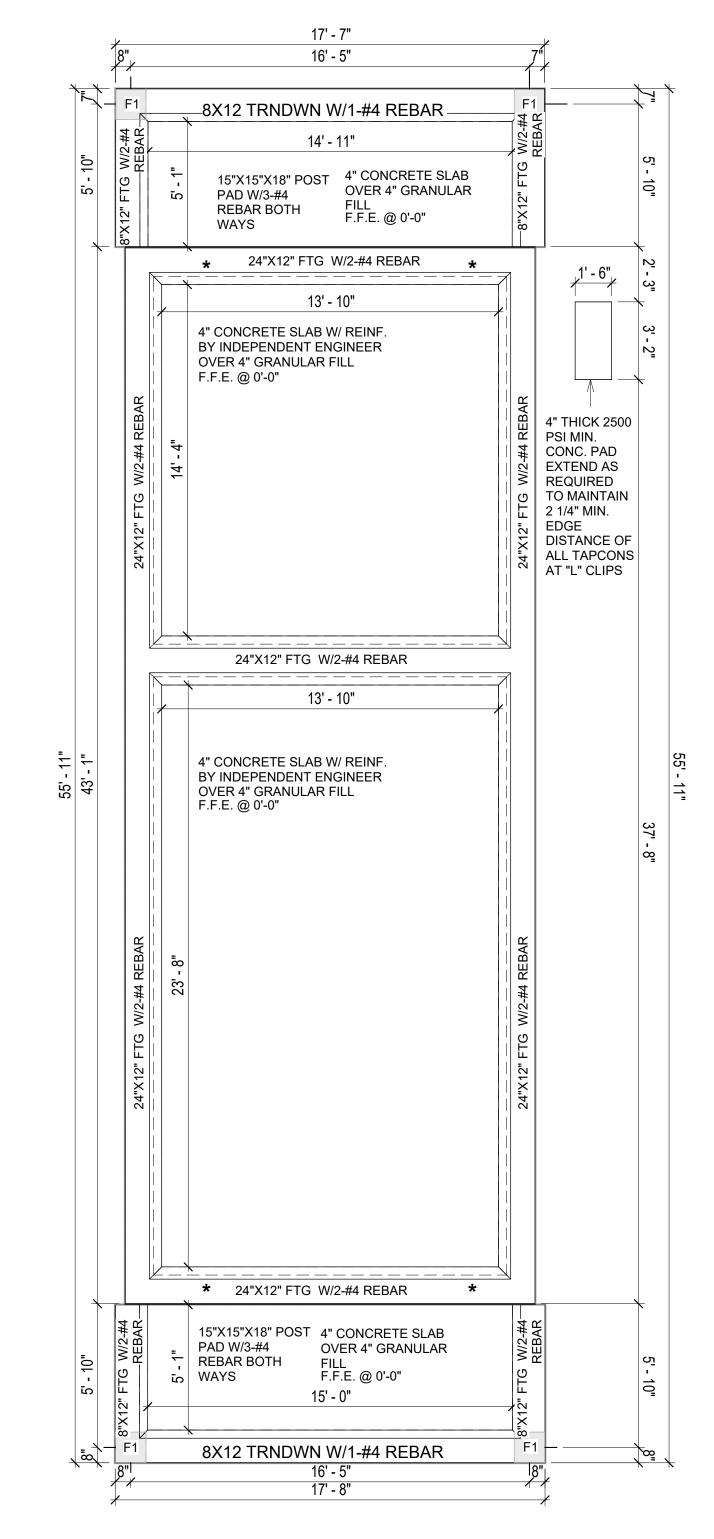





**KEY PLAN** 

NO.	DESCRIPTION	DATE

NOTE:

**LEGEND:** 

PROJECT

160 HAVEN 733 2Bd1Ba **CRAFTSMAN 550** 

DRAWING NAME

FOUNDATION PLAN

CLIENT NAME:	Client Name
PROJECT NUMBER:	0061_12
DATE:	4/2/2025 5:56:51 PM
DESIGNED BY:	Designer
DRAWN BY:	Author
CHECKED BY:	Checker

**S101** 

SCALE: 1/4" = 1'-0"

SQUARE FOOTAGE R&L-SIDE PORCH 205 TOTAL 938

#### **GENERAL NOTES**

#### NOTES:

-ALL BEARING WALLS SHOULD HAVE A THICKENED SLAB PER SECTION PER DETAIL A401/5.

#### A) **FOUNDATION PLAN NOTES**:

- CONCRETE SLAB SHALL BE 6" THICK WITH 1/2" DIAMETER TENDONS PER LAYOUT PLAN, CENTERED IN SLAB THICKNESS, OVER APPROVED SUBBASE PER GENERAL STRUCTURE
- 2. TERMITE PROTECTION SHALL BE PROVIDED PER IRC SECTION R318.1 NONE TYPICAL ANCHOR BOLT SPACING AT SHEAR WALL AND HOLD DOWN
- SPECIFICATIONS PER APPROVED ARCHITECTURAL PLANS. 4. INSTALL HOLDOWNS BEFORE CONCRETE SLAB POUR.
- EXISTING FILL ON-SITE SHALL BE COMPACTED IN ACCORDANCE WITH THE
- REQUIREMENTS IN THE GEOTECHNICAL REPORT.
- 6. ALL FLOOR SLABS ARE REINFORCED ON CONCRETE SLABS.

#### SPECIAL INSPECTION IS REQUIRED FOR THICKENED FOUNDATION CONSTRUCTION

- 1. REINFORCEMENT
- 2. 2300 PSI CONCRETE POUR


#### B) **REINFORCEMENT FOR CONCRETE**:

1. ALL REINFORCING SLABS BARS SIZE 10MM OR LARGER SHALL BE DEFORMED IN ACCORDANCE TO ASTM-A706, AND BARS SMALLER THAN 10 MM MAYBE PLAIN. 2. UNLESS OTHERWISE NOTED IN PLANS, THE YIELD STRENGTH OF REINFORCING BARS SHALL BE:

> A) FOOTING = 40,000 PSI B) NON-LOAD BEARING WALLS AND PARAPETS= 40,000 PSI

- 3. SPLICES SHALL BE SECURELY WIRED TOGETHER AND SHALL LAP OR EXTEND
- 4. GRADE OF STEEL FOR RCC WORKS SHALL BE GRADE 4 10.
- BAR NOTATIONS GIVES INFORMATION
- A) BAR SIZE
- B) SPACING(IF REQUIRED)
- 6. LAP REINFORCEMENT ONLY AT LOCATION SHOWN IN THE DRAWINGS
- REINFORCEMENT SHALL NOT BE CUT, VENT OR HEATED ON SITE WITHOUT ENGINEERS' APPROVAL.
- C) **CONCRETE SLAB NOTES**
- 1. ALL SLAB REINFORCEMENT SHALL BE 20MM CLEAR MINIMUM FROM BOTTOM AND FROM TOP OF SLAB.
- 2. REINFORCEMENT IN CONTINUOUS ELEVATED SLAB SHALL BE CUT AS FOLLOWS.

- THIS IS A SCHEMATIC PLAN FOR THE PURPOSE OF LOCATING AND IDENTIFYING FOUNDATION REINFORCING ELEMENTS ONLY. VERIFY ALL DIMENSIONS, DROPS, OFFSETS AND FEATURES WITH THE ARCHITECTURAL PLANS BEFORE FORMING THE FOUNDATION.

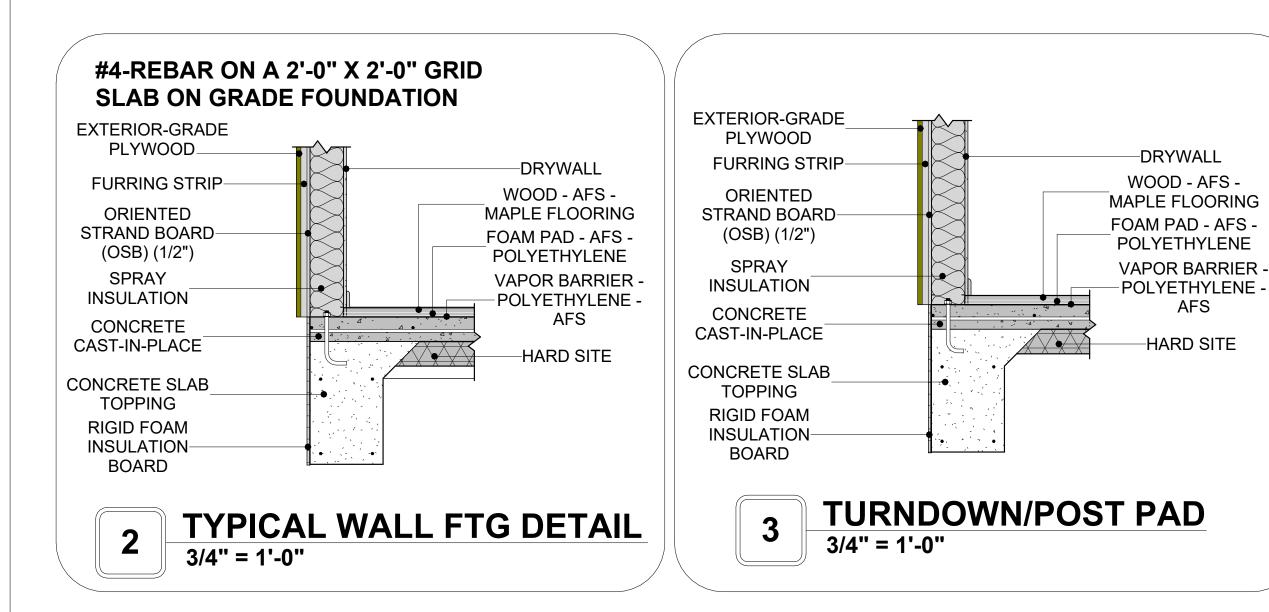


-DRYWALL

WOOD - AFS -

AFS

HARD SITE

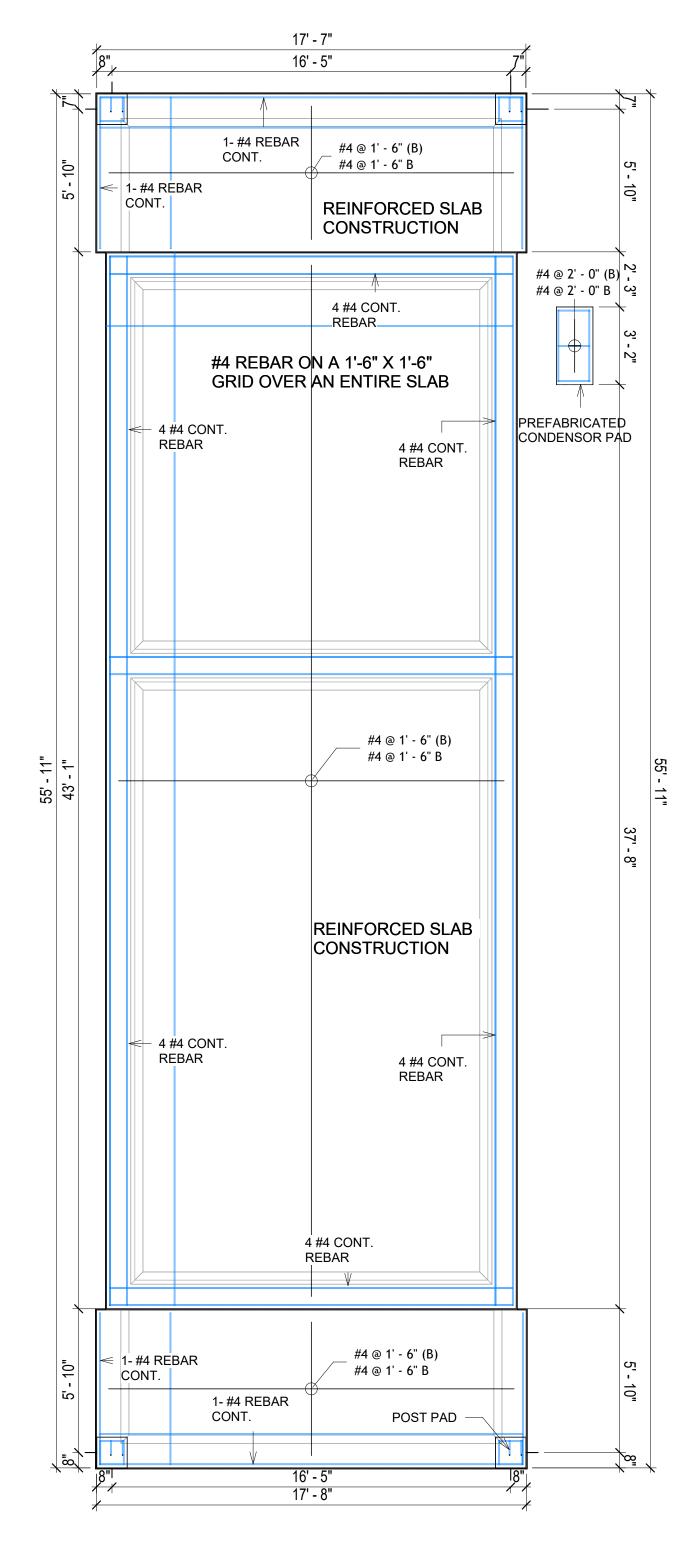





**KEY PLAN** 

NO.	DESCRIPTION	DATE

NOTE:

LEGEND:

PROJECT

160 HAVEN 733 2Bd1Ba **CRAFTSMAN 550** 

DRAWING NAME

STRUCTURAL FLOOR PLAN

CLIENT NAME: **Client Name** PROJECT NUMBER: 0061\_12 4/2/2025 5:56:53 PM Designer **DESIGNED BY:** DRAWN BY: **Author** CHECKED BY: Checker


**S102** 

#### **ROOF NOTES**

- ROOFING COMPOSITION ROOFING PER OWNERS/BUILDERS SPECIFICATIONS INSTALL PER MANUFACTURE SPECIFICATIONS ON 1/2" ORIENTED STRAND BOARD ON PRE-ENGINEERED TRUSS @ 24" O.C. (UNO.)
   73" OVERHANG AT EAVES (UNO.)
- 3. ENDS OF ALL TRUSSES AND JOISTS TO BE FULLY BLOCKED. PROVIDE SOLID
- BLOCKING AT ALL RIDGES AND VALLEYS

  4. SHEATHING TO BE 1/2", 3/8" OSB SHEAR PANEL AND EQUIVALENT.
  UNDERSIDE OF PORCH TRUSSES TO BE FINISHED WITH MOISTURE
- RESISTANT DRYWALL, TAPED AND TEXTURED.

  5. EXPOSED EAVES AND OTHER WEATHER EXPOSED AREAS TO BE SHEATHED WITH EXTERIOR GRADE PLYWOOD.
- 6. ALL MATERIALS THICKNESS AND SIZE ARE THE MINIMUM. Refer TO LOCAL
- STANDARDS FOR ACTUAL THICKNESS AND LAYERING OF MATERIALS.
  7. ENGINEERED TRUSS CALCULATIONS TO BE SUBMITTED TO BUILDING
- 7. ENGINEERED TRUSS CALCULATIONS TO BE SUBMITTED TO BUILDING DEPARTMENT PRIOR TO FABRICATION AND INSTALLATION.
- 8. TRUSS MANUFACTURER TO SPECIFY HANGER CONNECTORS FOR TRUSS COMPONENTS (TYPICAL)
- 9. DESIGNER ASSUMES THAT TRUSSES BEAR ON ALL EXTERIOR PERIMETER
- WALLS (TYPICAL) OR BEAMS.
- 10. PROVIDE GALVANIZED STEEL FLASHING WITH A LENGTH OF 10 FEET, WIDTH OF 12 INCHES, AND THICKNESS OF 24 GAUGE.

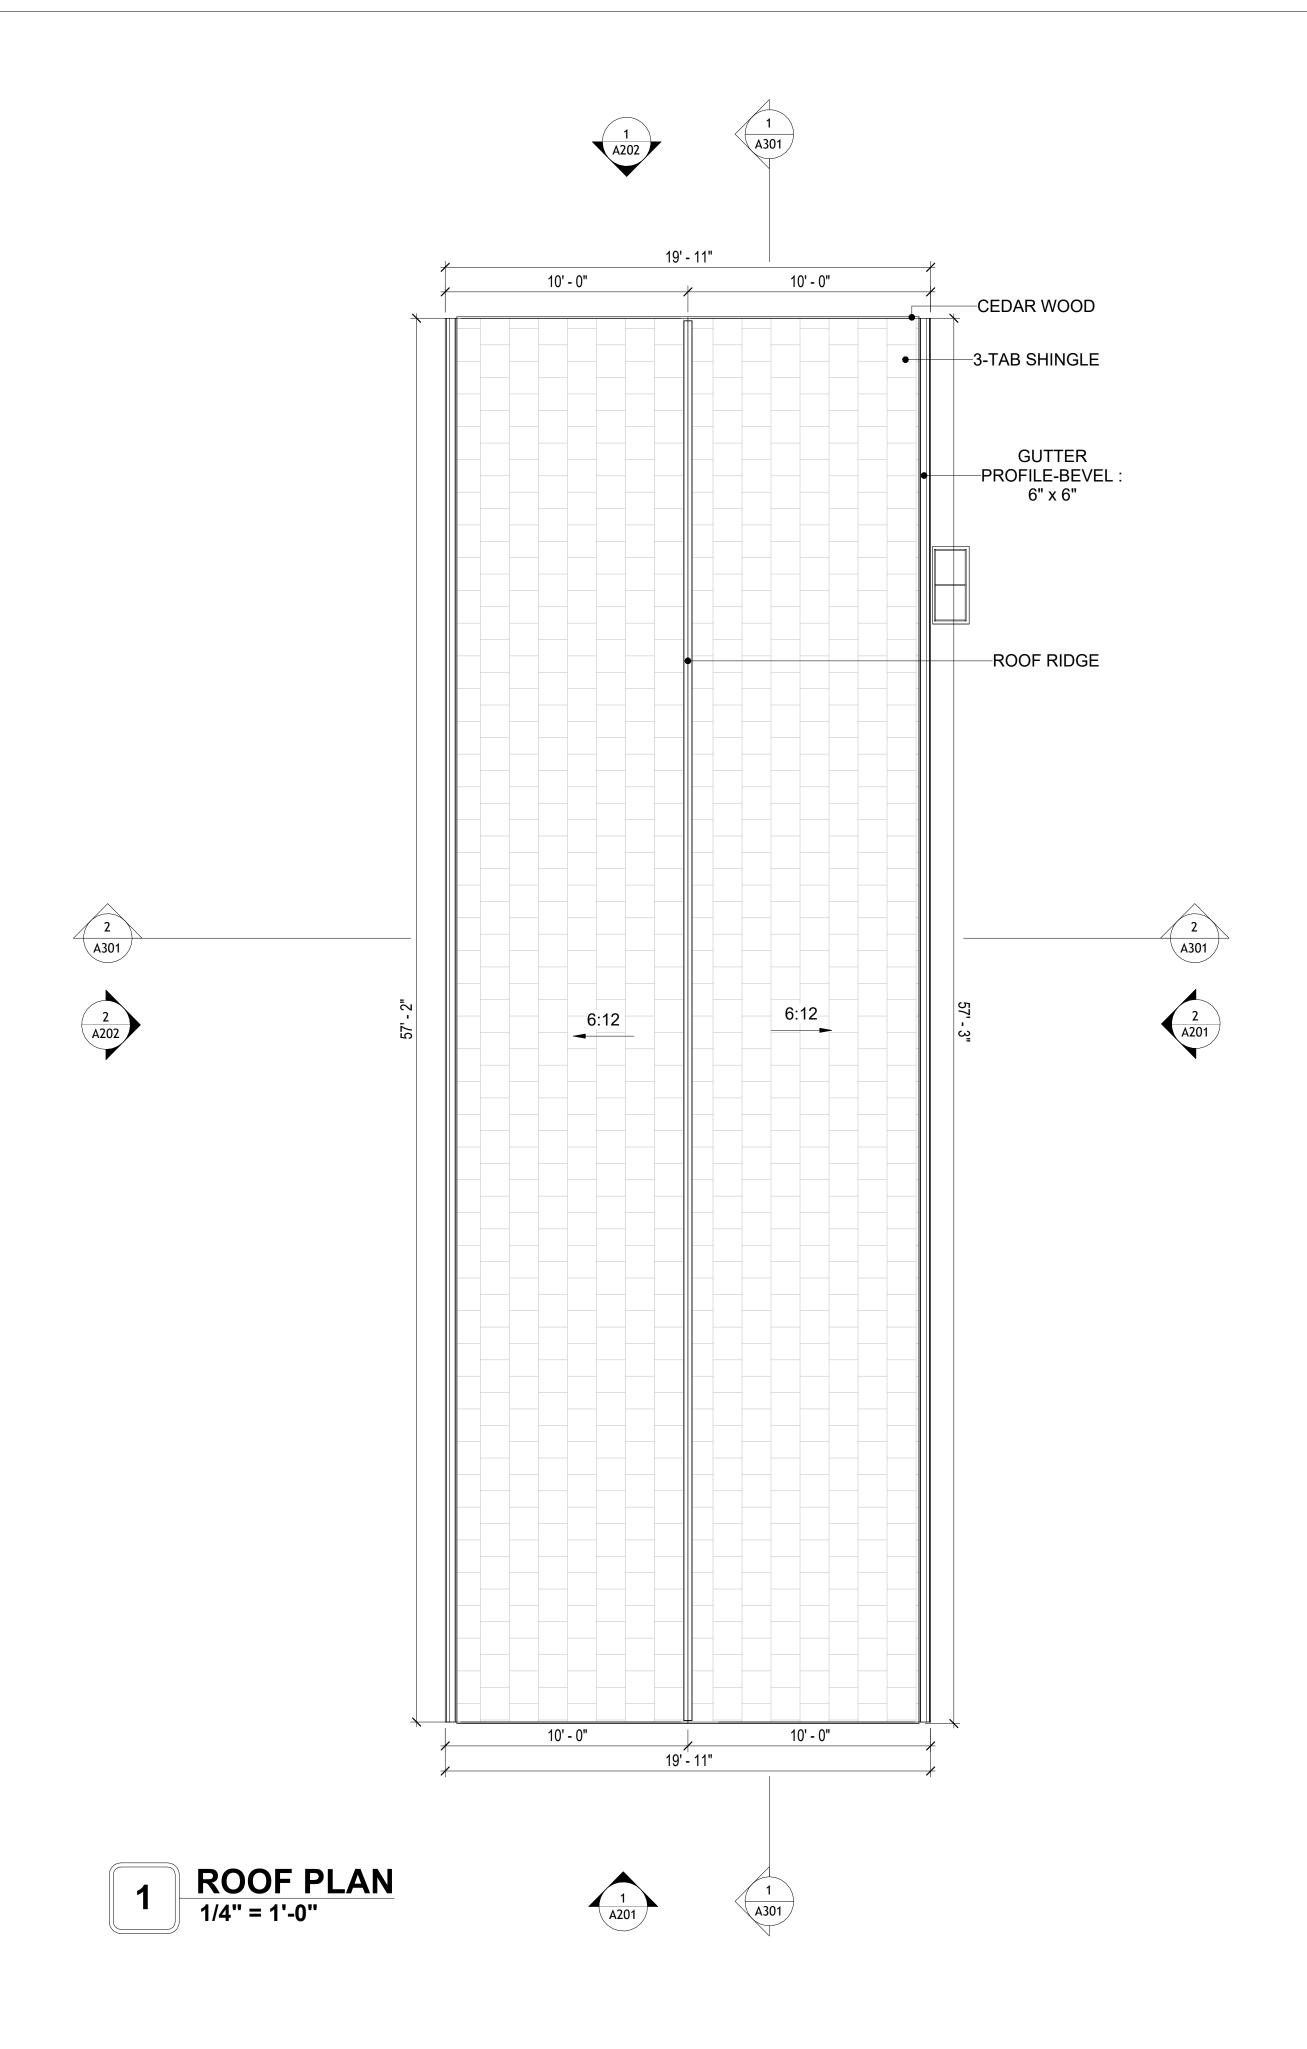



**KEY PLAN** 

NO.	DESCRIPTION	DATE

NOTE:

LEGEND:

PROJECT

160 HAVEN 733 2Bd1Ba CRAFTSMAN 550

DRAWING NAME

**ROOF PLAN** 

CLIENT NAME:	Client Name
PROJECT NUMBER:	0061_12
DATE:	4/2/2025 5:56:56 PM
DESIGNED BY:	Designer
DRAWN BY:	Author
CHECKED BY:	Checker

SQUARE FOOTAGE

LIVING 733

R&L-SIDE PORCH 205

TOTAL 938

A103

SCALE: 1/4" = 1'-0"

#### **ABOUT WALL FINISHING**

#### PLYWOOD WALL SIDING

WALL SIDING IS AN EXTERIOR CLADDING MATERIAL USED TO COVER AND PROTECT THE WALLS OF A BUILDING, PROVIDING BOTH FUNCTIONAL AND AESTHETIC BENEFITS.

IN THIS SPECIFIC PROJECT, PLYWOOD WALL PANELS ARE USED AS A FINISH SIDING BECAUSE THIS TYPE OF SIDING PROVIDES A DURABLE, COST-EFFECTIVE, AND VERSATILE EXTERIOR CLADDING THAT CAN BE EASILY INSTALLED, FINISHED, AND MAINTAINED TO ENHANCE THE AESTHETIC AND PROTECTIVE QUALITIES OF A BUILDING'S EXTERIOR.

STANDARD SIZES OF 1' X 8' EXTERIOR-GRADE PLYWOOD PANELS ARE INSTALLED ON THE FURRING STRIPS USING GALVANIZED STEEL SELF-DRILLING SCREWS.

#### **CEDAR WOOD**


CEDAR WOOD REFERS TO THE WOOD FROM VARIOUS SPECIES OF CEDAR TREES, WHICH ARE CONIFEROUS EVERGREEN TREES KNOWN FOR THEIR DISTINCT AROMA AND NATURAL RESISTANCE TO DECAY AND INSECTS.

IN THIS SPECIFIC PROJECT, CEDAR WOOD IS USED A FINISH MATERIAL ON BEAMS AND COLUMNS.


#### **WOOD SHAKE**

WOOD SHAKES ARE ROUGH-SAWN PIECES OF WOOD, TYPICALLY MADE FROM CEDAR OR REDWOOD, USED FOR ROOFING OR WALL CLADDING. THEY OFFER A RUSTIC, TEXTURED LOOK BUT REQUIRE REGULAR MAINTENANCE FOR DURABILITY AND PROTECTION AGAINST THE ELEMENTS.

IN THIS SPECIFIC PROJECT, WOOD SHAKES ARE APPLIED AT THE TOP OF THE EXTERNAL WALL, CREATING AN EYE-CATCHING DETAIL THAT COMPLEMENTS THE OVERALL ARCHITECTURE AND ENSURES A STURDY, WEATHER-RESISTANT FINISH.

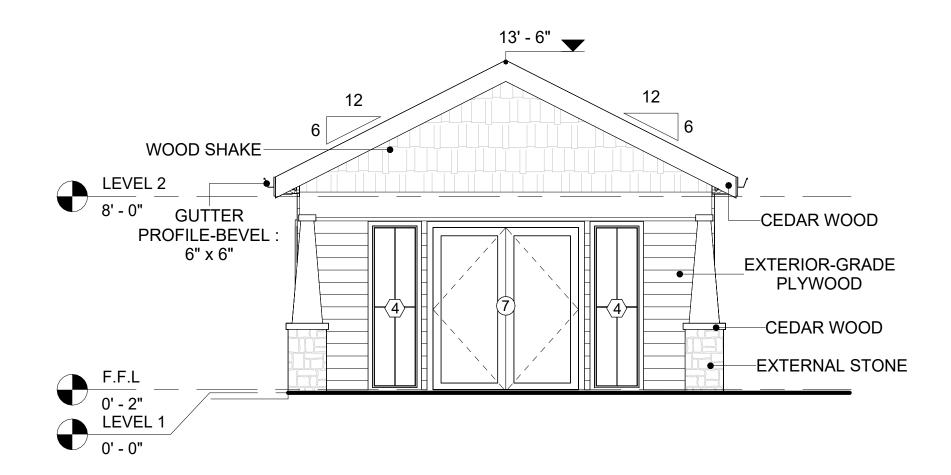

1 FRONT ELEVATION
1/4" = 1'-0"

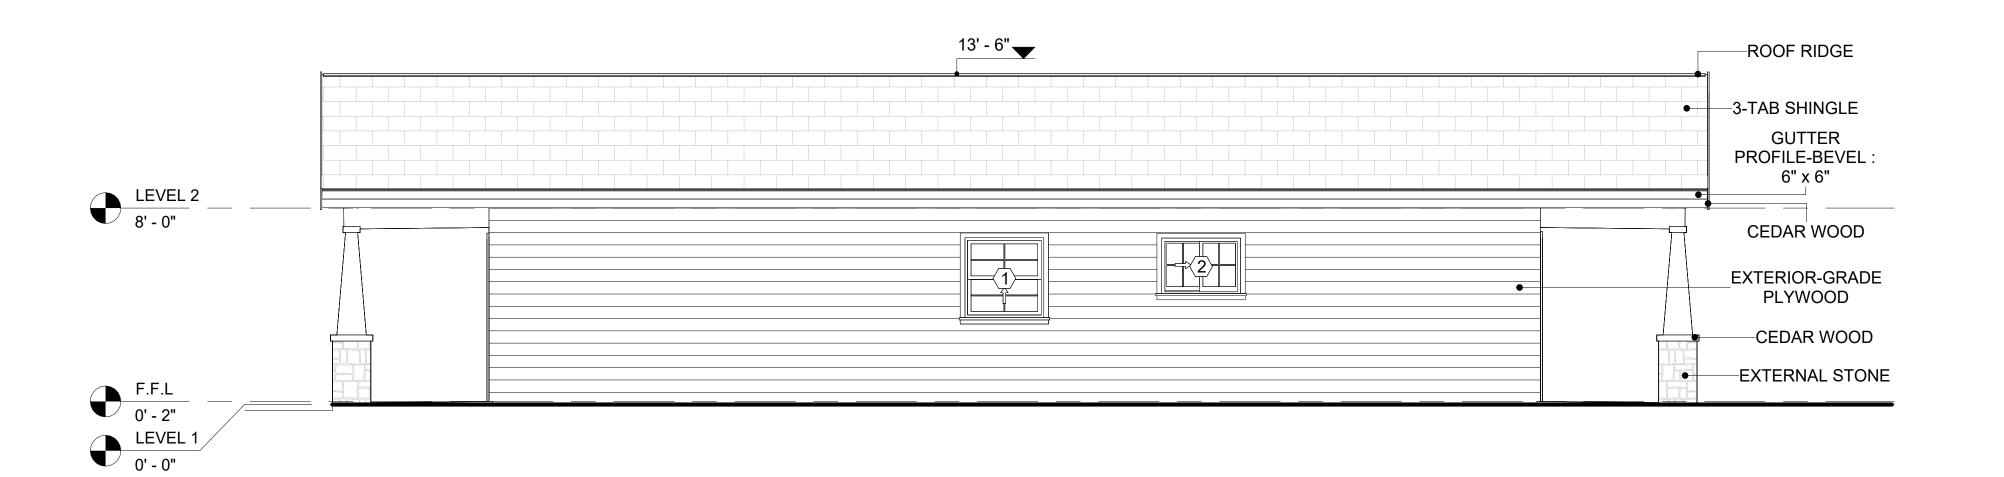

2 RIGHT SIDE ELEVATION
1/4" = 1'-0"

DOOR SCHEDULE						
TYPE				SIZE		
MAR K	SUPPLIER	DOOR TYPE	LOCATIO	WIDTH	HEIGHT	COUNT
1	HOME DEPOT	INTERIOR SINGLE PANEL SWINGING	INTERIOR	2' - 6"	6' - 8"	1
2	HOME DEPOT	INTERIOR SINGLE PANEL SWINGING	INTERIOR	2' - 0"	6' - 8"	1
3	HOME DEPOT	INTERIOR DOUBLE PANEL SLIDING	INTERIOR	9' - 0"	6' - 8"	1
4	HOME DEPOT	INTERIOR SINGLE PANEL SWINGING	INTERIOR	3' - 0"	6' - 8"	1
5	HOME DEPOT	INTERIOR DOUBLE PANEL SLIDING	INTERIOR	7' - 0"	6' - 8"	1
6	HOME DEPOT	EXTERIOR DOUBLE PANEL SWINGING	INTERIOR	5' - 0"	6' - 8"	1
7	HOME DEPOT	EXTERIOR DOUBLE PANEL SWINGING	INTERIOR	6' - 0"	6' - 8"	2
8	HOME DEPOT	INTERIOR SINGLE PANEL SWINGING	INTERIOR	3' - 0"	6' - 8"	1

WINDOW SCHEDULE					
				SIZE	
TYPE MARK	SUPPLIER	WINDOW TYPE	WIDTH	HEIGHT	COUNT
1	HOME DEPOT	SINGLE HUNG	3' - 3"	3' - 3"	1
2	HOME DEPOT	SLIDING	3' - 3"	2' - 3"	1
3	HOME DEPOT	CASEMENT	2' - 3"	4' - 3"	3
4	HOME DEPOT	FIXED	1' - 11"	6' - 8"	4



KEY PLAN

NO.	DESCRIPTION	DAT

NOTE:

LEGEND:

PROJECT

160 HAVEN 733 2Bd1Ba CRAFTSMAN 550

DRAWING NAME

ARCHITECTURAL ELEVATIONS

CLIENT NAME:

PROJECT NUMBER:

0061\_12

DATE:

4/2/2025 5:56:59 PM

DESIGNED BY:

DRAWN BY:

CHECKED BY:

Checker

A201

#### **ABOUT WALL FINISHING**

#### PLYWOOD WALL SIDING

WALL SIDING IS AN EXTERIOR CLADDING MATERIAL USED TO COVER AND PROTECT THE WALLS OF A BUILDING, PROVIDING BOTH FUNCTIONAL AND AESTHETIC BENEFITS.

IN THIS SPECIFIC PROJECT, PLYWOOD WALL PANELS ARE USED AS A FINISH SIDING BECAUSE THIS TYPE OF SIDING PROVIDES A DURABLE, COST-EFFECTIVE, AND VERSATILE EXTERIOR CLADDING THAT CAN BE EASILY INSTALLED, FINISHED, AND MAINTAINED TO ENHANCE THE AESTHETIC AND PROTECTIVE QUALITIES OF A BUILDING'S EXTERIOR.

STANDARD SIZES OF 1' X 8' EXTERIOR-GRADE PLYWOOD PANELS ARE INSTALLED ON THE FURRING STRIPS USING GALVANIZED STEEL SELF-DRILLING SCREWS.

#### **CEDAR WOOD**


CEDAR WOOD REFERS TO THE WOOD FROM VARIOUS SPECIES OF CEDAR TREES, WHICH ARE CONIFEROUS EVERGREEN TREES KNOWN FOR THEIR DISTINCT AROMA AND NATURAL RESISTANCE TO DECAY AND INSECTS.

IN THIS SPECIFIC PROJECT, CEDAR WOOD IS USED A FINISH MATERIAL ON BEAMS AND COLUMNS.

#### **WOOD SHAKE**

WOOD SHAKES ARE ROUGH-SAWN PIECES OF WOOD, TYPICALLY MADE FROM CEDAR OR REDWOOD, USED FOR ROOFING OR WALL CLADDING. THEY OFFER A RUSTIC, TEXTURED LOOK BUT REQUIRE REGULAR MAINTENANCE FOR DURABILITY AND PROTECTION AGAINST THE ELEMENTS.

IN THIS SPECIFIC PROJECT, WOOD SHAKES ARE APPLIED AT THE TOP OF THE EXTERNAL WALL, CREATING AN EYE-CATCHING DETAIL THAT COMPLEMENTS THE OVERALL ARCHITECTURE AND ENSURES A STURDY, WEATHER-RESISTANT FINISH.

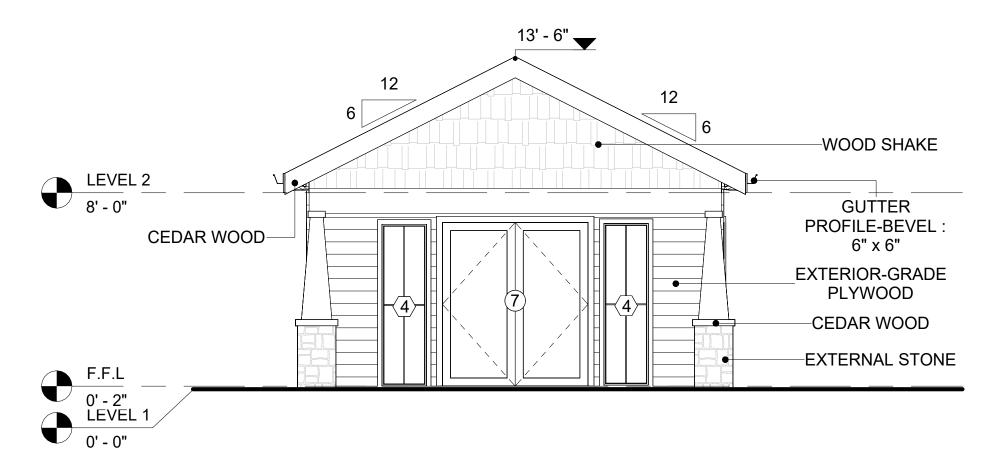


1 REAR ELEVATION
1/4" = 1'-0"



2 LEFT SIDE ELEVATION
1/4" = 1'-0"



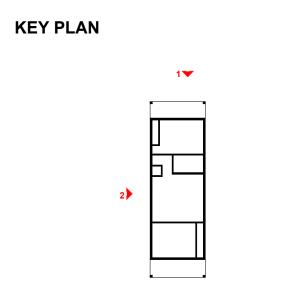

NO.	DESCRIPTION	DATE

NOTE:

LEGEND:

PROJECT

160 HAVEN 733 2Bd1Ba CRAFTSMAN 550

DRAWING NAME

ARCHITECTURAL ELEVATIONS

CLIENT NAME:

PROJECT NUMBER:

0061\_12

DATE:

4/2/2025 5:57:03 PM


DESIGNED BY:

DRAWN BY:


CHECKED BY:

Checker

A202

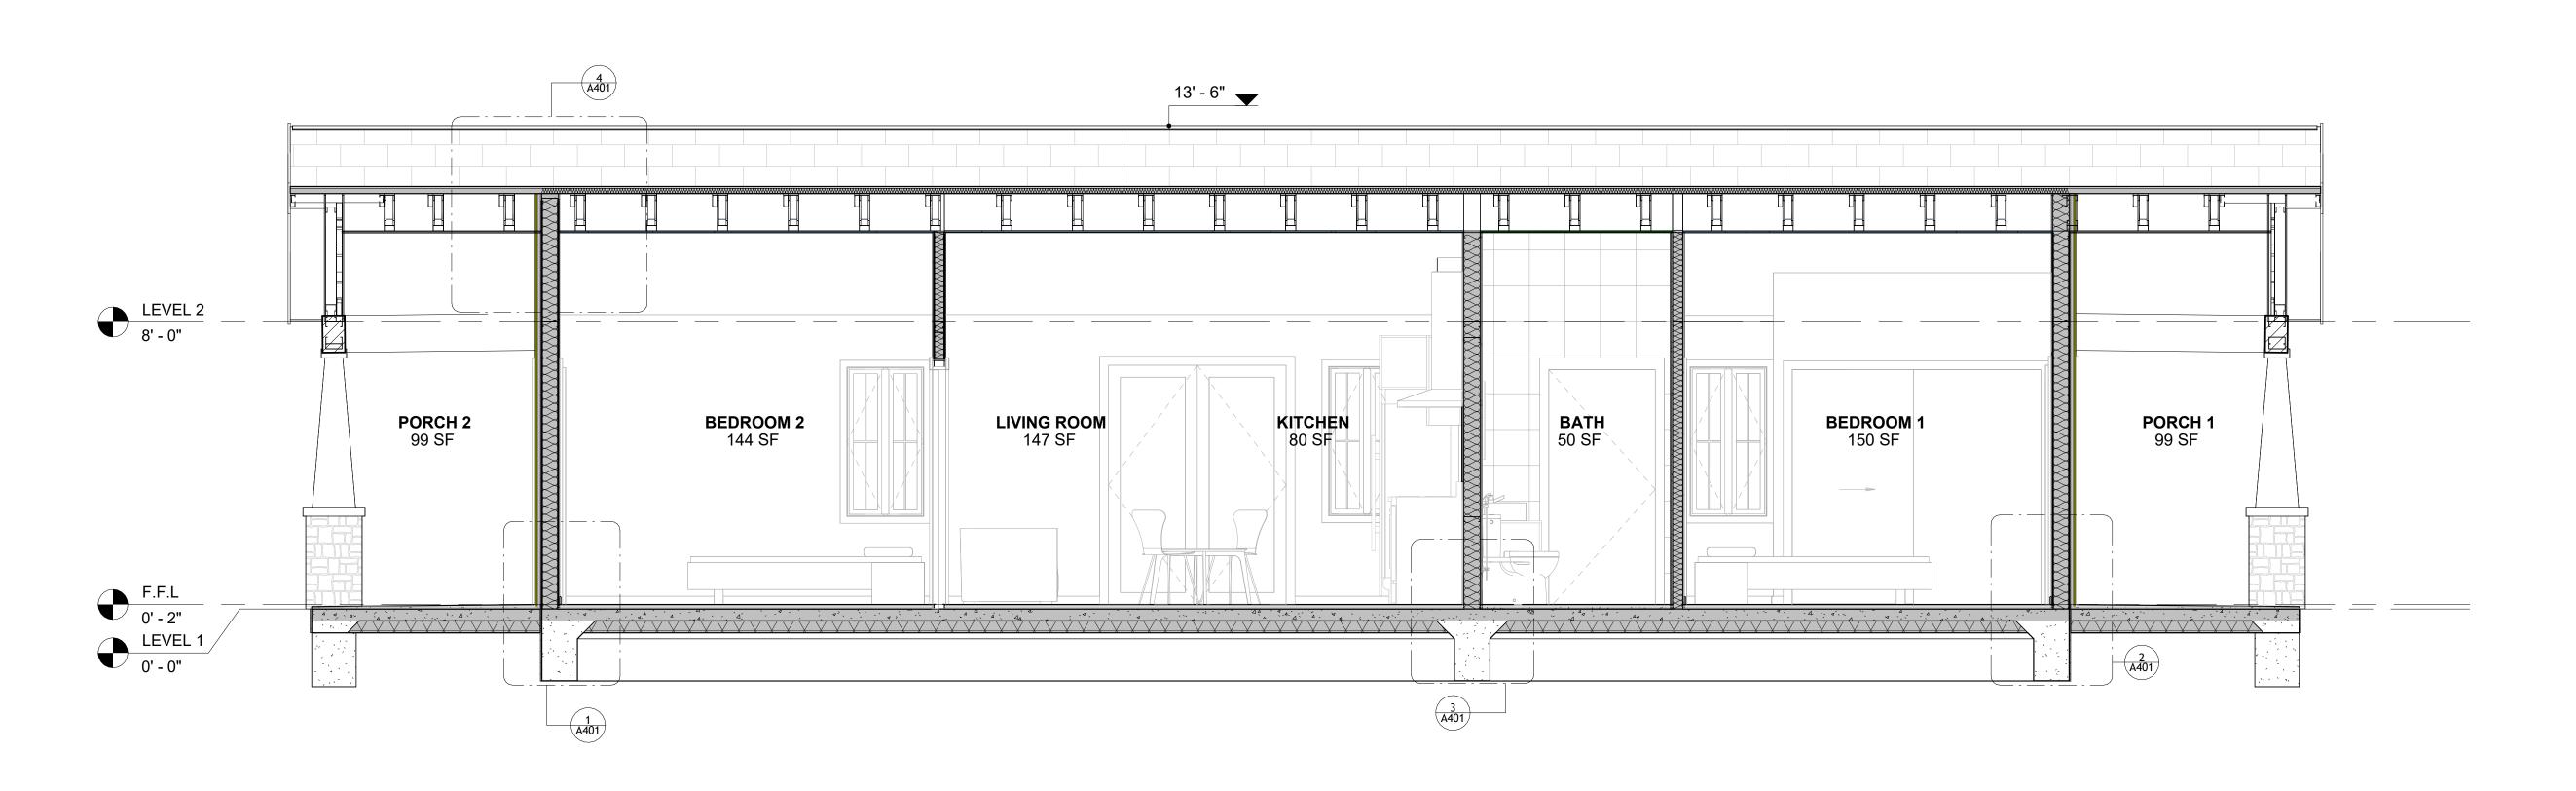




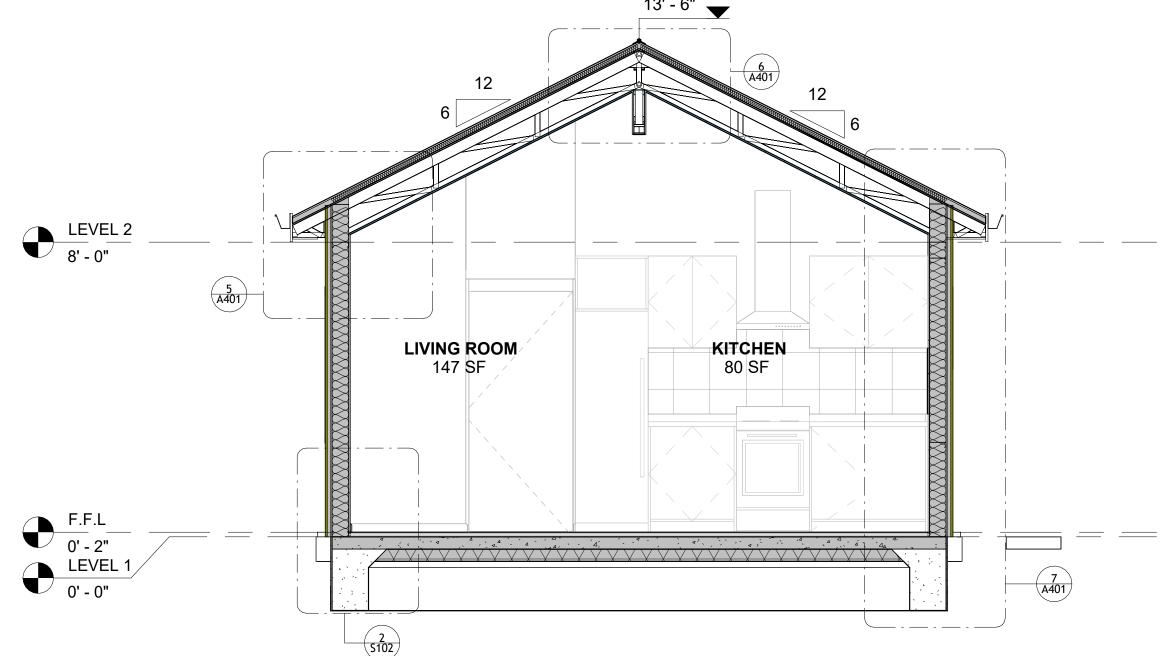

2 SECTION-2 3/8" = 1'-0"



**KEY PLAN** 

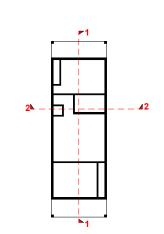

NO.	DESCRIPTION	DATE

NOTE:

LEGEND:

PROJECT


160 HAVEN 733 2Bd1Ba CRAFTSMAN 550


DRAWING NAME


ARCHITECTURAL SECTIONS


Client Name	CLIENT NAME:
0061_12	PROJECT NUMBER:
4/2/2025 5:57:05 PN	DATE:
Designer	DESIGNED BY:
Author	DRAWN BY:
Checker	CHECKED BY:


A301

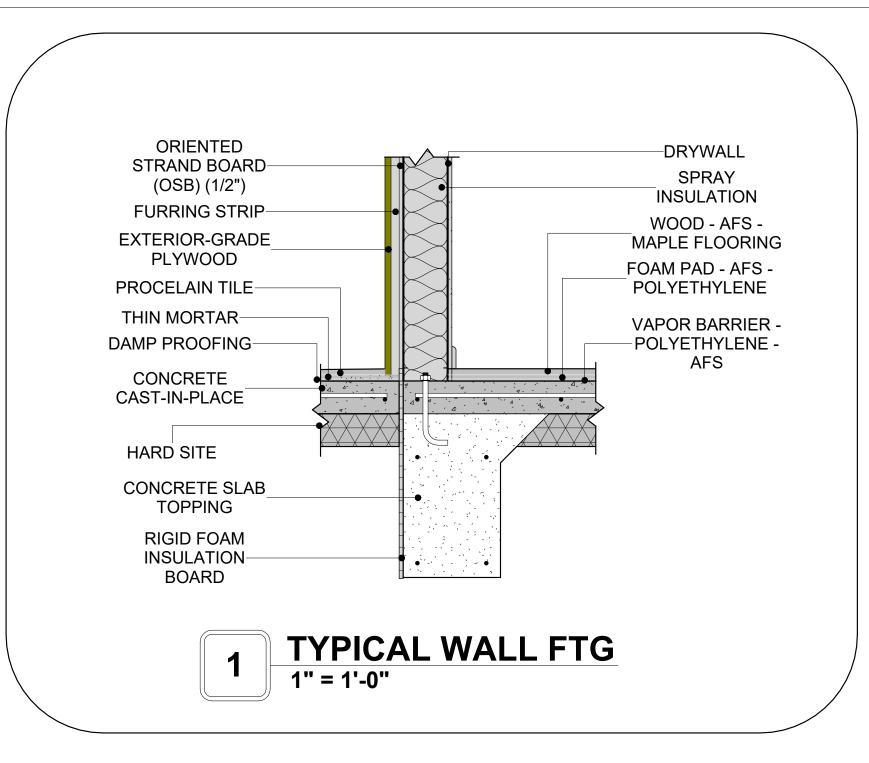


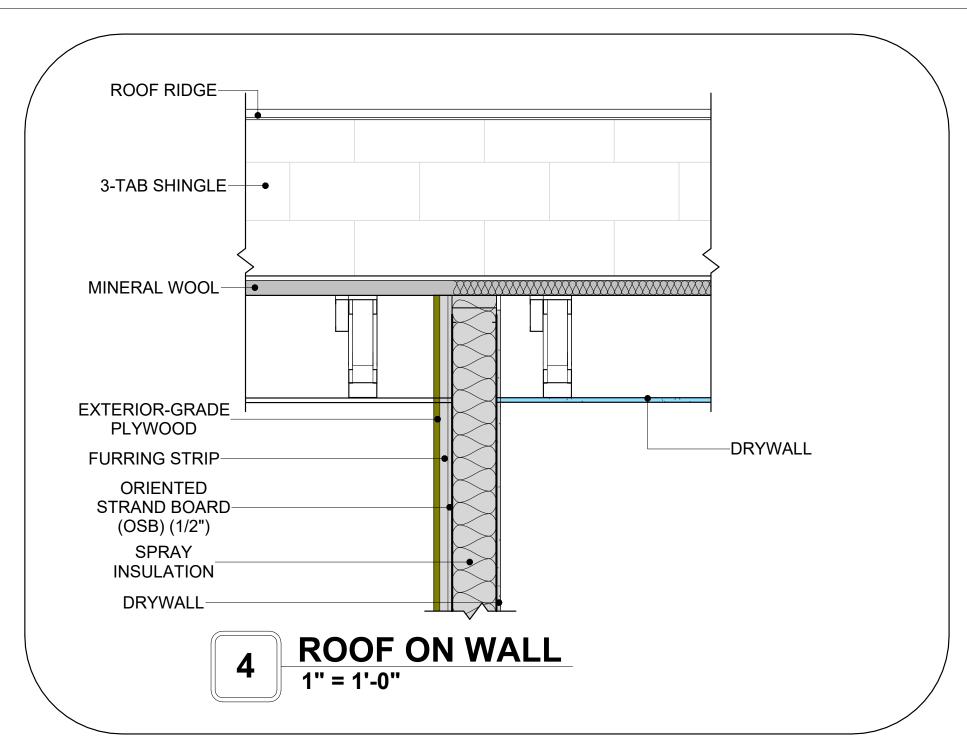


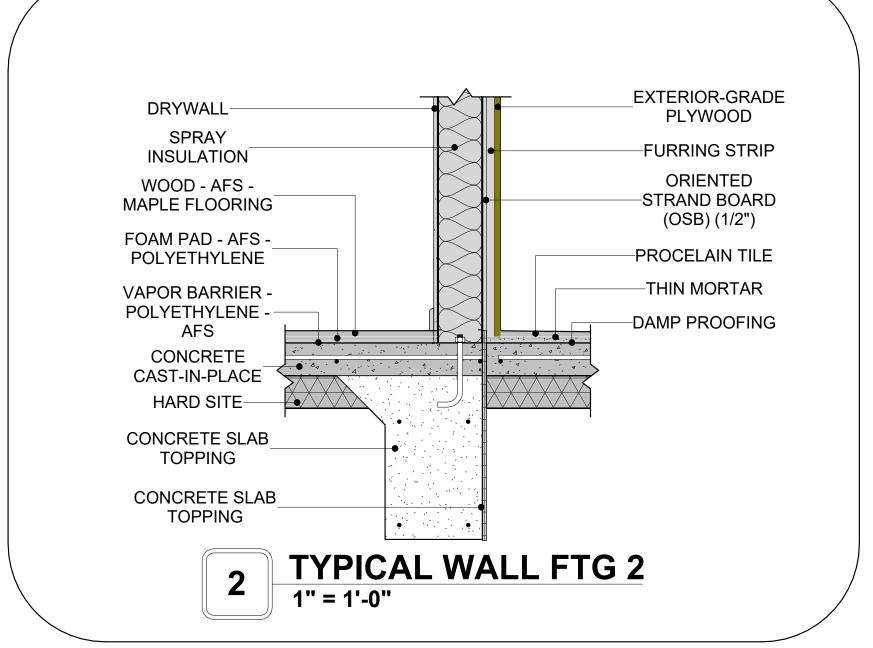

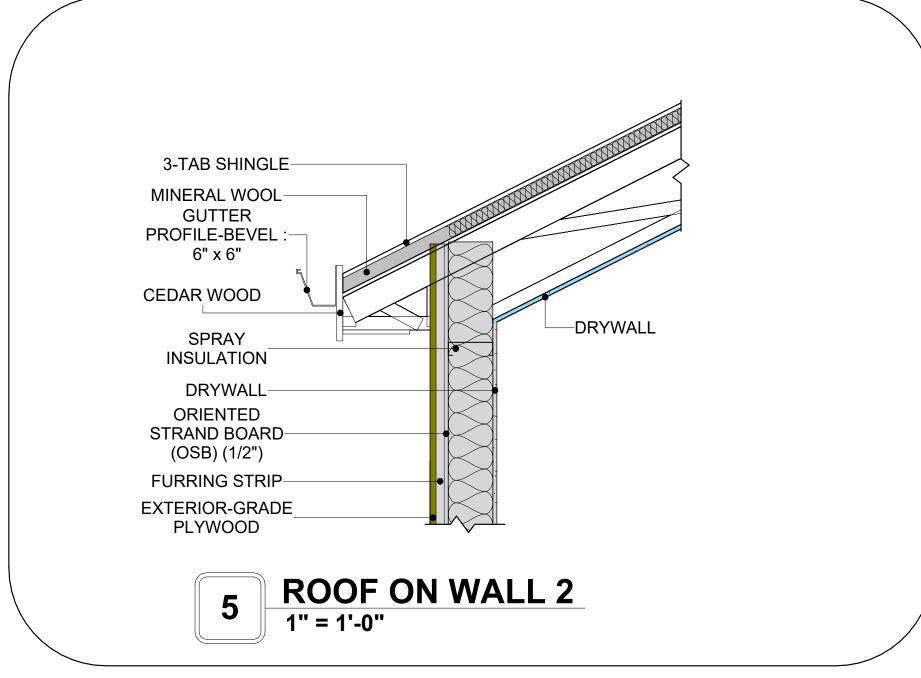

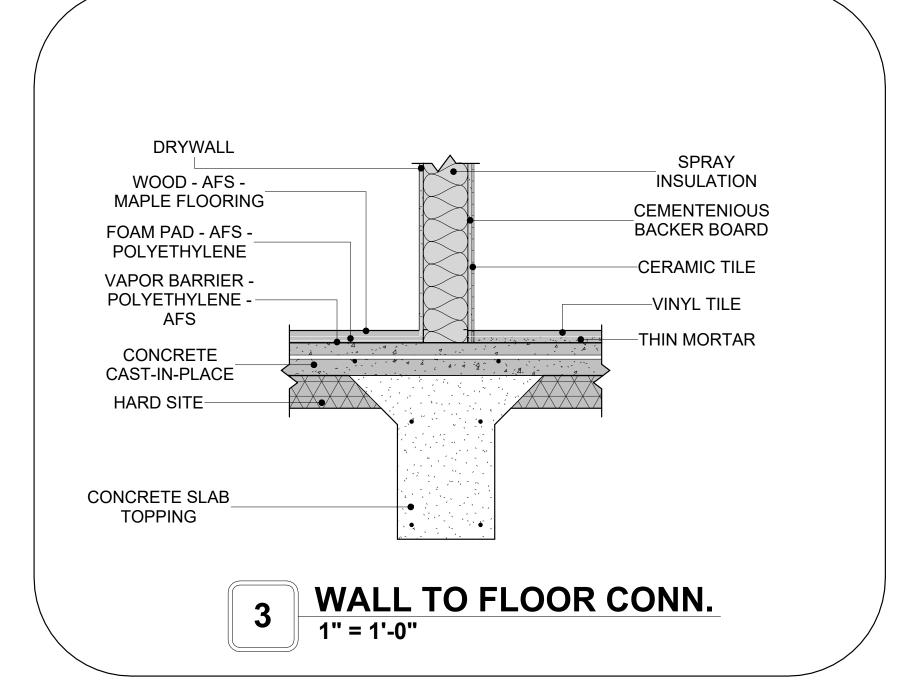

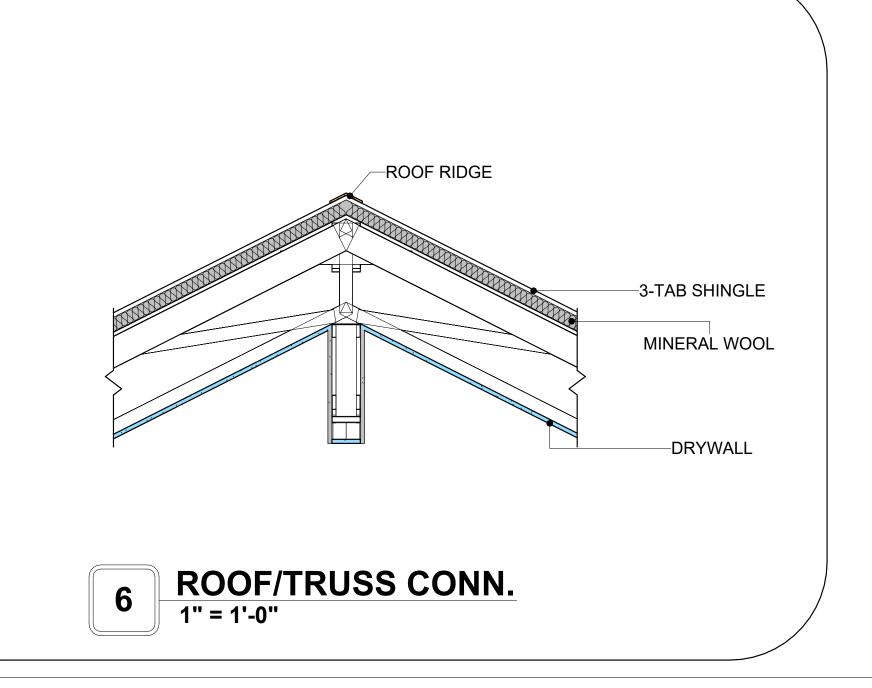

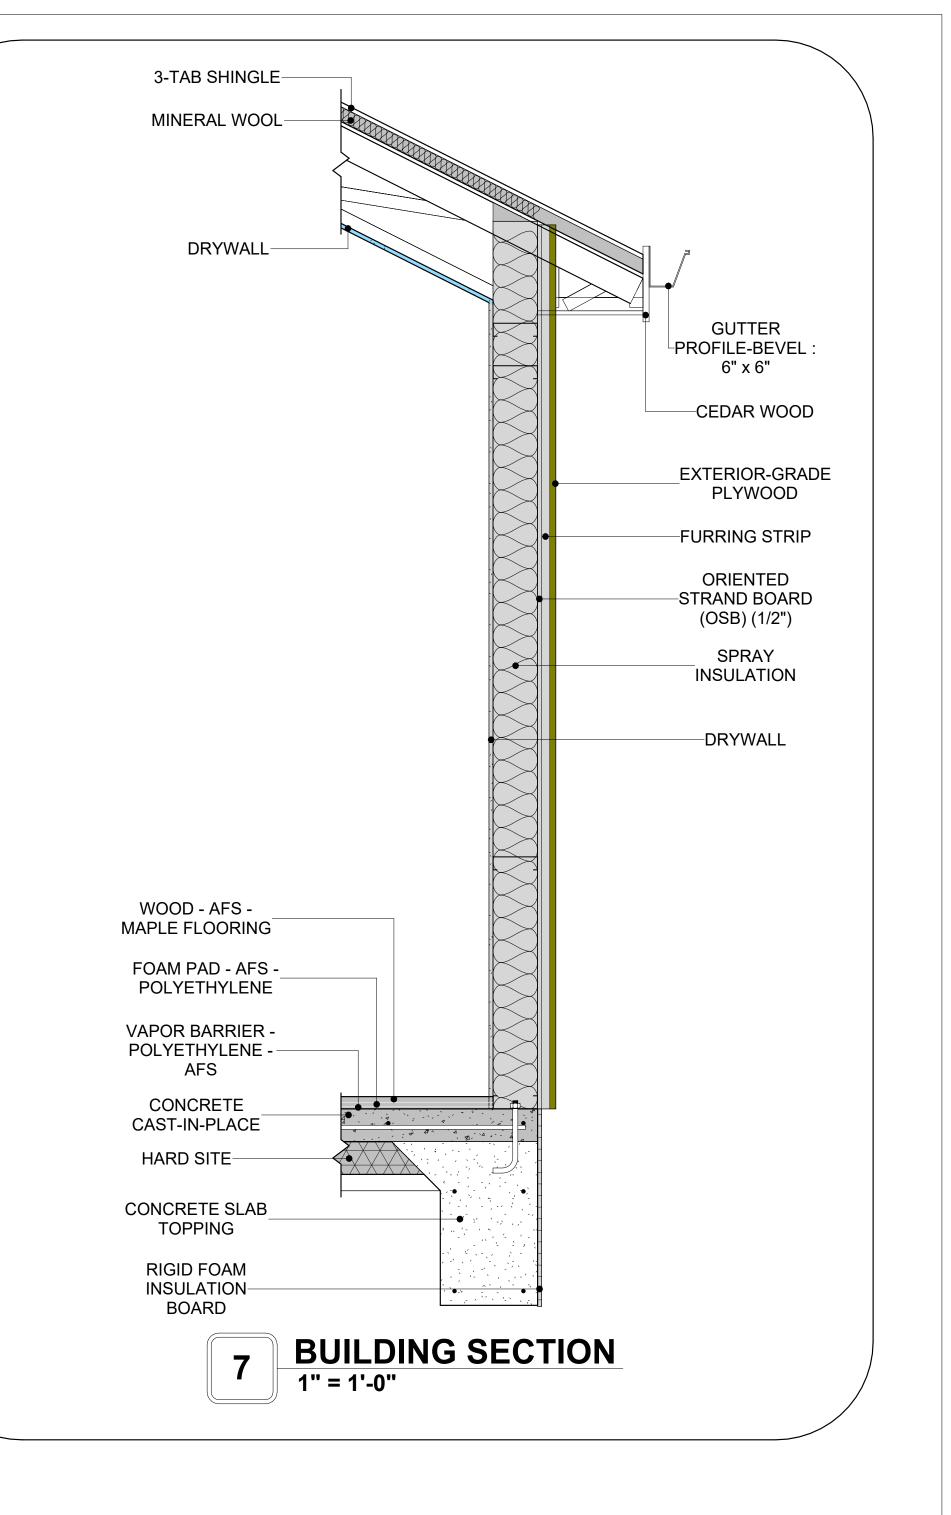



**KEY PLAN** 

NO.	DESCRIPTION	DATE

NOTE:

LEGEND:

PROJECT

160 HAVEN 733 2Bd1Ba CRAFTSMAN 550

DRAWING NAME

ARCHITECTURAL DETAILS

CLIENT NAME:	Client Name
PROJECT NUMBER:	0061_12
DATE:	4/2/2025 5:57:07 PM
DESIGNED BY:	Designer
DRAWN BY:	Author
CHECKED BY:	Checker

A401


SCALE: 1" = 1'-0"


#### **CASEWORK GENERAL NOTES**


- ALL CABINET HEIGHTS INCLUDE COUNTERTOPS. DIMENSIONS ARE TO THE NEAREST INCH. DIVISIONS IN CASEWORK ARE SHOWN FOR CLARITY AND DO NOT REPRESENT BREAKS IN THE COUNTERTOP.
- PROVIDE CONTINUOUS COUNTERTOP OVER ALL SIMILAR HEIGHT CASEWORK, UNLESS AND OTHERWISE NOTED.
- MANUFACTURER AND CATALOG NUMBERS ARE FOR REFERENCE AND ILLUSTRATION PURPOSES
- DOTTED LINES INDICATE WALL HUNG CABINETS, DIVISIONS OF BASE CABINETS BELOW THE
- COUNTERTOP, FURNITURE NOT IN THE CONTRACT OR PROJECTION SCREENS -SEE CASEWORK KEY AND SPECIFICATIONS.
- ALL CABINETS AND DRAWERS TO HAVE CAM LOCKS EXCEPT FOR SINK BASE CABINETS.
  ALL EXPOSED SURFACES (EXPOSED TO VIEW FROM ANY PERSPECTIVE) TO BE COVERED WITH
- LAMINATE.
- ALL CASEWORK WHICH MEETS A WALL AT ONE OR BOTH ENDS, TO BE PROVIDED WITH FILLER PANELS AND SCRIBED TO THE WALL(S) AS REQUIRED.
- 10. ALL CABINETS AND DRAWERS ARE PROVIDED WITH RECESSED HANDLES.
- 11. CONTRACTOR TO FIELD VERIFY ALL CLEAR OPENINGS PRIOR TO MILLWORK OR CASEWORK FABRICATION.
- 12. CASEWORK DRAWINGS ARE DIAGRAMMATIC IN NATURE TO SHOW DESIGN INTENT.


	CASEWORK SCHEDULE					
TYPE MAR K	TYPE	COUN T	HEIGHT	WIDTH	DEPTH	AREA
01	L-SHAPE COUNTER TOP 158	1	0' - 4"	7' - 0"	7' - 0"	2 SF
02	BASE CABINET DOUBLE DOOR 2	1	2' - 11"	3' - 1"	2' - 0"	9 SF
03	BASE_CABINET_L-SHAPED	1	2' - 11"	3' - 3"	3' - 3"	9 SF
04	WALL CABINET DOUBLE DOOR 2 158	1	2' - 6"	3' - 3"	1' - 0"	8 SF
05	WALL CABINET DOUBLE DOOR 3 159.186 2	1	2' - 6"	2' - 5"	1' - 0"	6 SF
06	LINEAR COUNTER TOP 2 159.186 2	1	0' - 4"	2' - 5"	2' - 1"	1 SF
07	BASE_CABINET_DOUBLE_DOOR	1	2' - 11"	2' - 5"	2' - 0"	7 SF
08	LAUNDRY OPEN CABINET	1	1' - 6"	2' - 0"	2' - 4"	3 SF
09	RECESSED_MED_CABINET	1	2' - 0"	1' - 6"	0' - 3"	3 SF
10	VANITY 2	1	2' - 4"	3' - 0"	1' - 8"	7 SF
11	LAUNDRY OPEN CABINET 3 159.186	1	1' - 1"	2' - 3"	3' - 0"	2 SF
12	CLOSET_3	1	5' - 11"	7' - 6"	1' - 4"	44 SF
13	CLOSET_4	1	5' - 11"	10' - 6"	1' - 4"	62 SF
GRAND	TOTAL	13				


SPECIALTY EQUIPMENT SCHEDULE				
TYPE MARK	TYPE	COUNT		
01	WASHER-FRONT-LOAD	1		
02	REFRIGERATOR	1		
03	RANGE	1		
04	DRYER-FRONT-LOAD	1		
05	DISHWASHER	1		
GRAND TOTAL: 5				

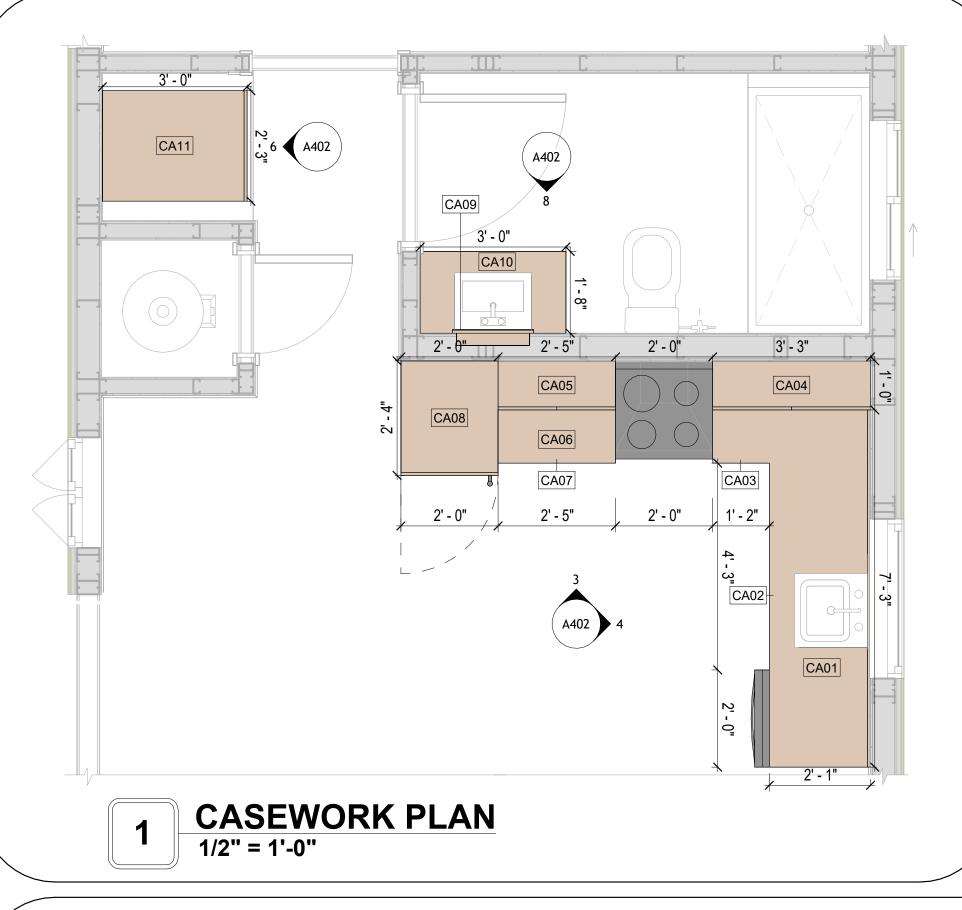

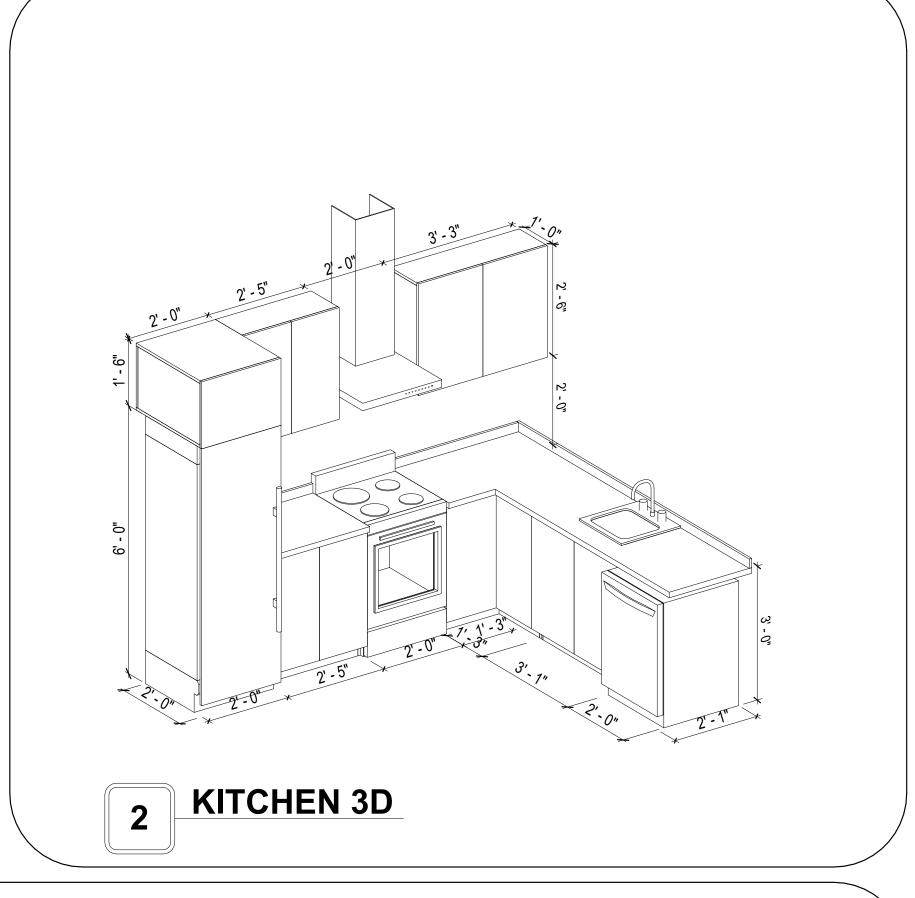


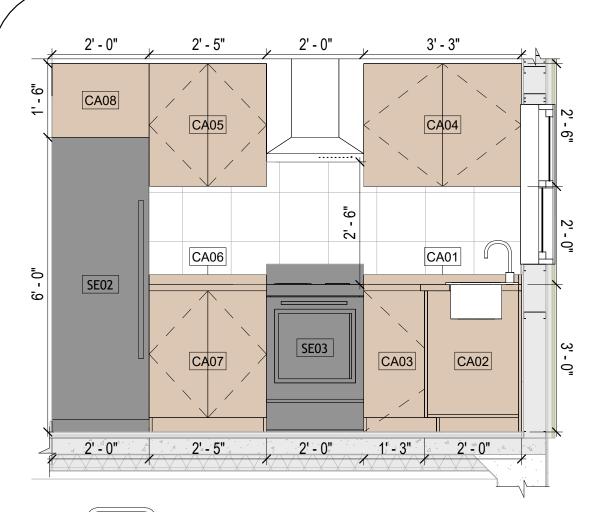

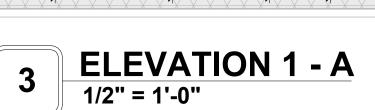


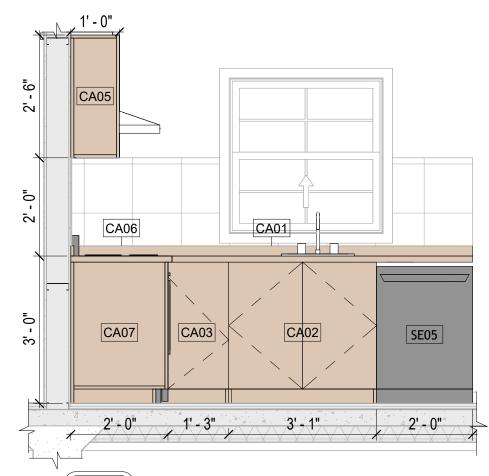




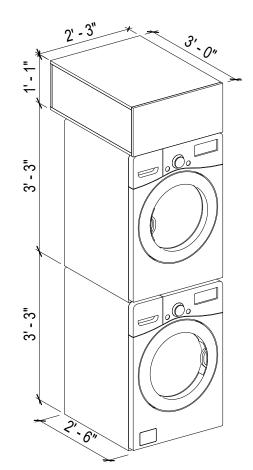


5 LAUNDRY 3D

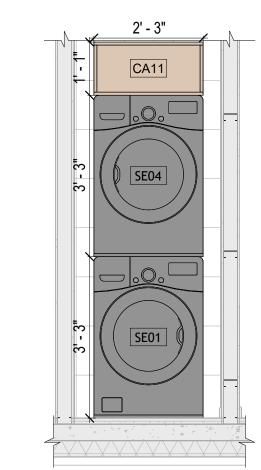


**ELEVATION 1 - C** 1/2" = 1'-0"

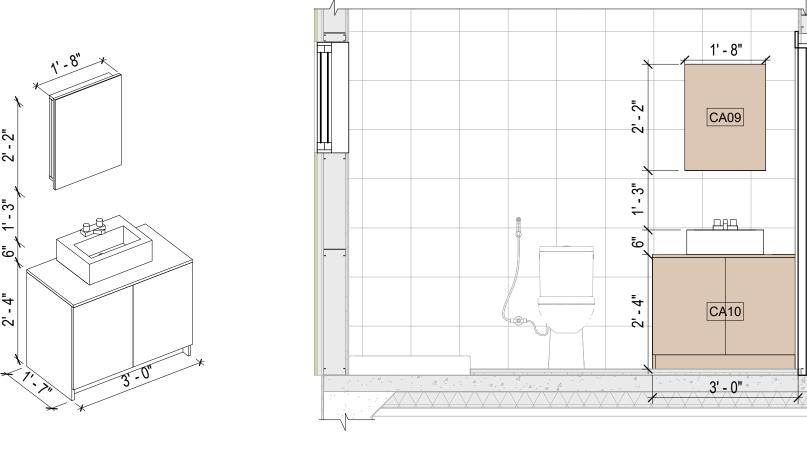

**VANITY 3D** 

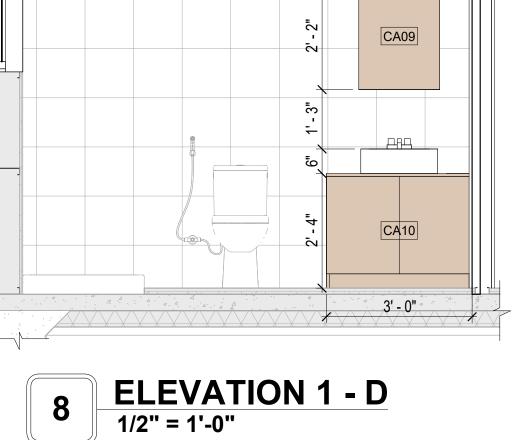

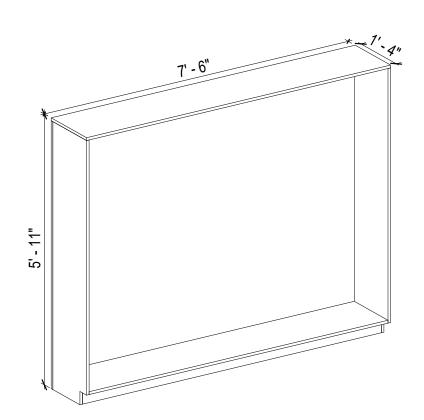

9 CLOSET 3D



KEY PLAN	

NO.	DESCRIPTION	DATE

NOTE:

LEGEND:

PROJECT

160 HAVEN 733 2Bd1Ba **CRAFTSMAN 550** 

DRAWING NAME

ARCHITECTURAL CASEWORK

CLIENT NAME:	Client Name
PROJECT NUMBER:	0061_12
DATE:	4/2/2025 5:57:10 PM
DESIGNED BY:	Designer
DRAWN BY:	Author
CHECKED BY:	Checker

A402

#### **GENERAL NOTES**

T1. THIS DRAWING DEPICTS THE HVAC (HEATING, VENTILATION, AND AIR CONDITIONING) SYSTEM FOR THE HAVEN 2BD1BA CRAFTSMAN. IT PROVIDES A VISUAL REPRESENTATION OF THE SYSTEM LAYOUT AND COMPONENTS.

2.THE HVAC SYSTEM IS DESIGNED TO MEET THE SPECIFIC REQUIREMENTS OF THE BUILDING, INCLUDING HEATING, COOLING, AND VENTILATION NEEDS AS PER THE PROJECT SPECIFICATIONS AND APPLICABLE CODES AND STANDARDS.

3. THE HVAC SYSTEM INSTALLATION SHALL COMPLY WITH THE LATEST EDITION OF THE INTERNATIONAL MECHANICAL CODE (IMC), INTERNATIONAL RESIDENTIAL CODE (IRC), AND ALL OTHER APPLICABLE LOCAL, STATE, AND NATIONAL CODES AND REGULATIONS.

4. THE EQUIPMENT SHOWN ON THIS DRAWING INCLUDES BUT IS NOT LIMITED TO AIR HANDLING UNITS (AHUS), CHILLERS, BOILERS, COOLING TOWERS, PUMPS, DUCTWORK, DIFFUSERS, GRILLES, AND CONTROL DEVICES.

5. ALL EQUIPMENT, DUCTWORK, AND PIPING SHALL BE INSTALLED IN ACCORDANCE WITH MANUFACTURER'S SPECIFICATIONS, LOCAL CODES, AND INDUSTRY BEST PRACTICES.

6. ALL DUCTWORK SHALL BE SIZED, FABRICATED, AND INSTALLED IN ACCORDANCE WITH THE LATEST EDITION OF THE ACCA MANUAL D AND THE SMACNA HVAC DUCT CONSTRUCTION STANDARDS. DUCTWORK SHALL BE INSTALLED IN A NEAT AND WORKMANLIKE MANNER, PROPERLY SUPPORTED AND BRACED TO PREVENT SAGGING, AIR LEAKAGE, OR VIBRATION.

7. CONDENSATE DRAINAGE PIPING SHALL BE PROPERLY PITCHED TO ENSURE POSITIVE DRAINAGE TO AN APPROVED DISPOSAL LOCATION, SUCH AS A FLOOR DRAIN, SUMP PUMP, OR EXTERIOR GRADE. CONDENSATE LINES SHALL BE INSULATED TO PREVENT SWEATING.

8. THE LOCATION OF CONTROL PANELS AND SENSORS INDICATED ON THIS DRAWING CAN BEMODIFY with THE SPECIFIC LOCATIONS AND WIRING DETAILS WILL BE DETERMINED DURING THE CONTROL SYSTEM DESIGN AND INSTALLATION.

9. THE HVAC SYSTEM DESIGN CONSIDER ENERGY EFFICIENCY, INDOOR AIR QUALITY, OCCUPANT COMFORT, AND NOISE CONTROL, FOLLOWING APPLICABLE GUIDELINES AND REGULATIONS.

10. COORDINATION WITH OTHER TREADS HAS BEEN DONE ON A DESIGN LEVEL. THIS DRAWING SHALL BE READ TOGETHER WITH THE AR, EL AND SN DESIGN DRAWINGS TO ENSURE PROPER INSTALLATION AND INTEGRATION OF THE HVAC SYSTEMS.

11. THE HVAC CONTRACTOR IS RESPONSIBLE FOR OBTAINING ALL NECESSARY PERMITS AND LICENSES, AND FOR SCHEDULING AND COORDINATING WITH THE LOCAL BUILDING DEPARTMENT AND UTILITY PROVIDERS TO ENSURE A TIMELY AND COMPLIANT INSTALLATION.

12. ALL DUCTWORK PENETRATIONS THROUGH WALLS, FLOORS, OR CEILINGS SHALL BE PROPERLY SEALED AND FIRE-STOPPED USING APPROVED METHODS AND MATERIALS TO MAINTAIN THE INTEGRITY OF THE BUILDING'S FIRE-RESISTANCE RATINGS.

13. HVAC EQUIPMENT SHALL BE INSTALLED LEVEL AND PLUMB. AND IN STRICT ACCORDANCE WITH THE MANUFACTURER'S INSTALLATION INSTRUCTIONS AND RECOMMENDATIONS. PROVIDE ADEQUATE CLEARANCES AROUND EQUIPMENT FOR PROPER AIRFLOW, SERVICE ACCESS, AND CODE COMPLIANCE.


14. ALL HVAC EQUIPMENT AND COMPONENTS, INCLUDING THERMOSTATS, DAMPERS, AND ACCESS PANELS, SHALL BE LOCATED IN ACCESSIBLE AREAS FOR EASY SERVICING AND MAINTENANCE. PROVIDE ADEQUATE SPACE AROUND EQUIPMENT FOR PROPER AIRFLOW AND SERVICE ACCESS.


15. THE HVAC SYSTEM SHALL BE BALANCED AND ADJUSTED TO ENSURE PROPER AIRFLOW, TEMPERATURE DISTRIBUTION, AND SYSTEM PERFORMANC THROUGHOUT THE RESIDENCE. PROVIDE A WRITTEN REPORT DOCUMENTING THE FINAL SYSTEM BALANCE.

16. ANY DEVIATIONS OR MODIFICATIONS TO THE HVAC SYSTEM DESIGN SHALL BE REVIEWED AND APPROVED BY THE RESPONSIBLE DESIGN PROFESSIONALS AND COMMUNICATED TO ALL RELEVANT PARTIES INVOLVED IN THE CONSTRUCTION PROCESS.

17. FOR ANY INQUIRIES OR CLARIFICATIONS REGARDING THE HVAC SYSTEM DESIGN, PLEASE CONSULT THE RESPONSIBLE DESIGN PROFESSIONALS

OR THE PROJECT MANAGEMENT TEAM.

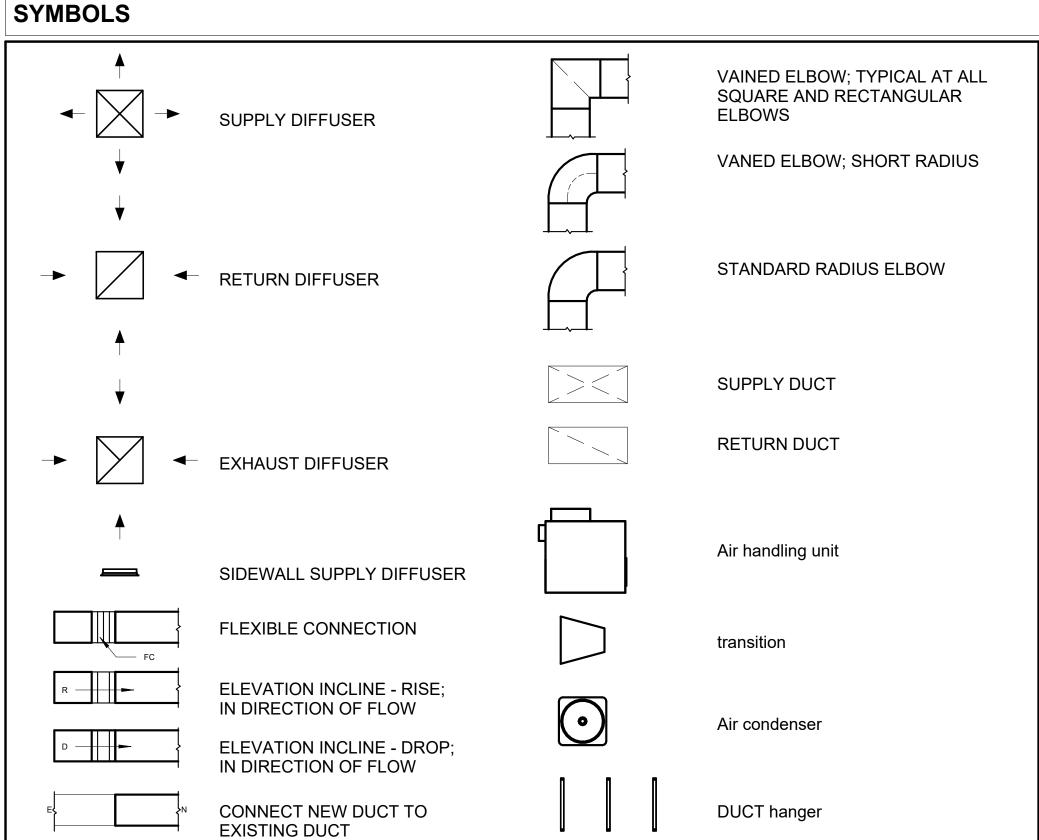

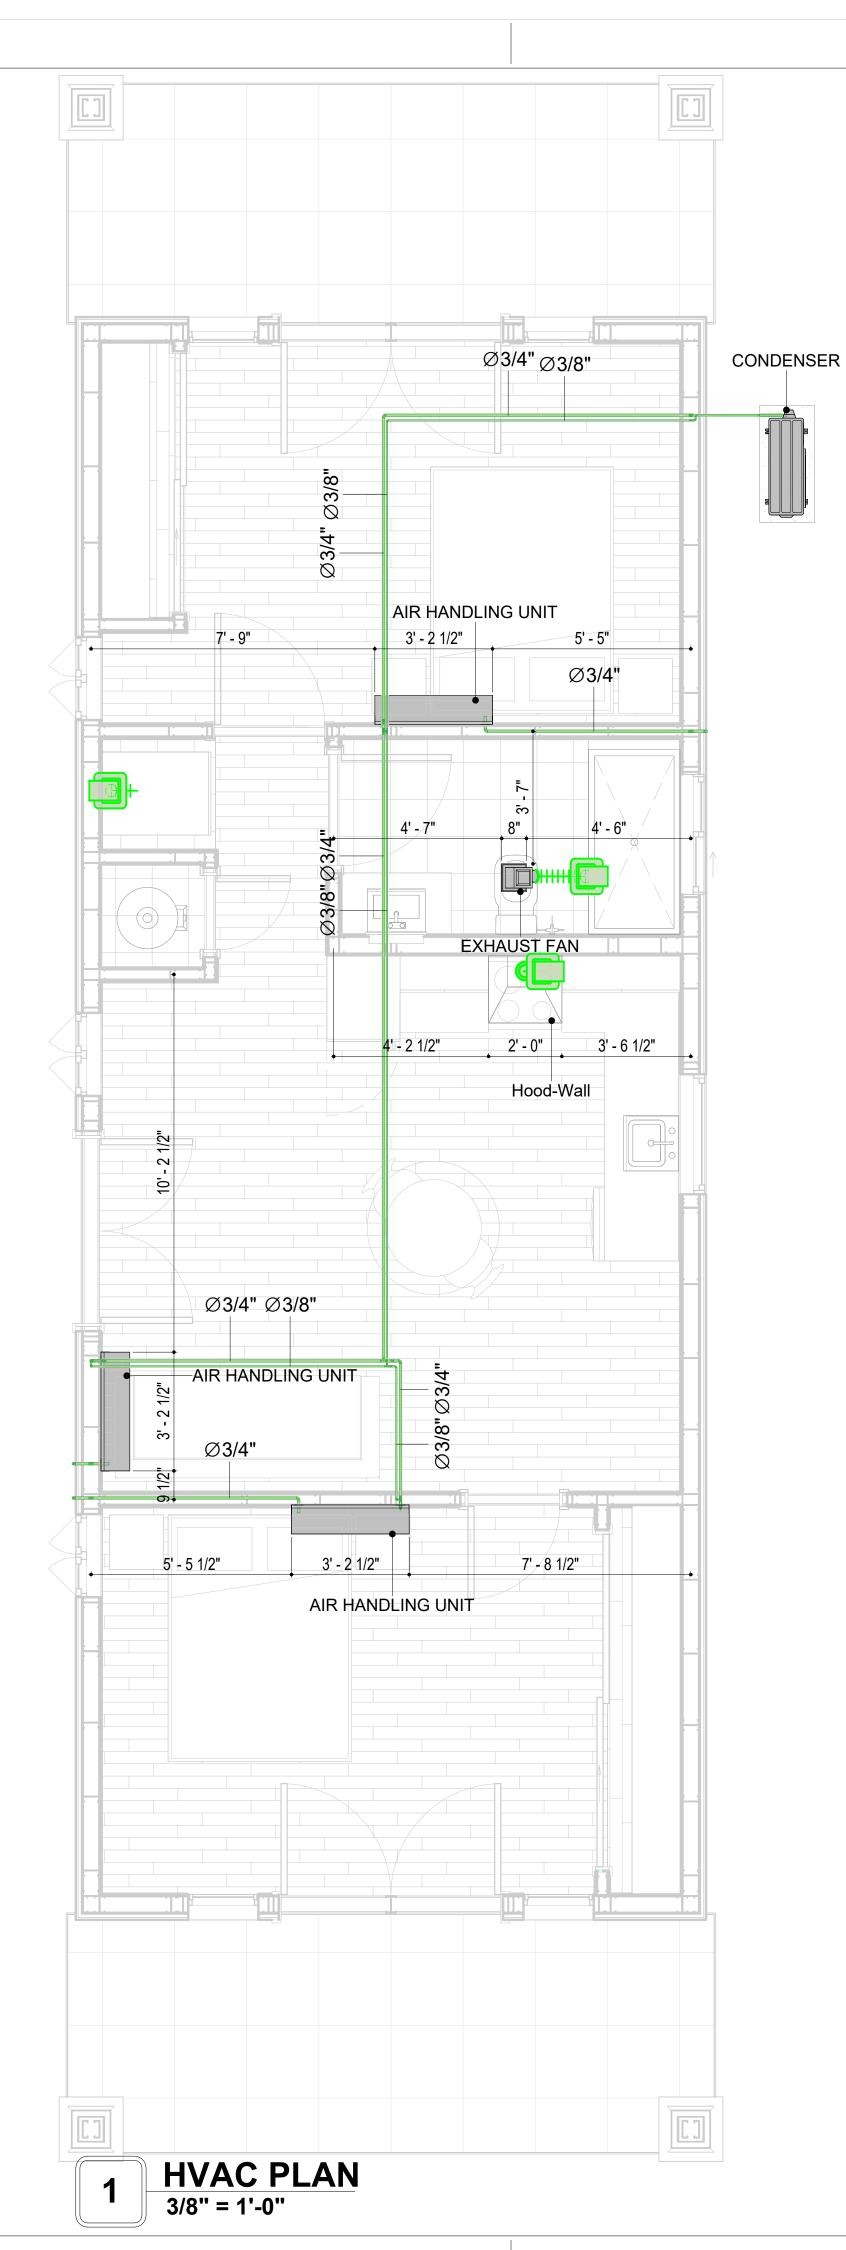



air conditioning pipe line

REFRIGERANT LINE SCHEDULE					
CATAGORY DESCRIPTION DIAMETER LENGTH					
Pipe Types	Copper	3/8"	70.91		
Pipe Types	Copper	3/4"	103.60		

CATAGORY	DESCRIPTION	Size	Count
Elbow - Generic	Elbow - Generic: Standard/HVAC	3/4"ø-3/4"ø	25
Elbow - Generic	Elbow - Generic: Standard/HVAC	3/8"ø-3/8"ø	21
Tee - Generic	Tee - Generic: Standard	3/4"ø-3/4"ø-3/ 4"ø	2
Tee - Generic	Tee - Generic: Standard	3/8"ø-3/8"ø-3/ 8"ø	2
Transition - Generic	Transition - Generic: Standard	3/4"ø-1/2"ø	4
Transition - Generic	Transition - Generic: Standard	3/4"ø-3/4"ø	1
Transition - Generic	Transition - Generic: Standard	3/4"ø-5/8"ø	3
Transition - Generic	Transition - Generic: Standard	3/8"ø-1/4"ø	1

MECHANICAL EQUIPMENT SCHEDULE				
CATAGORY DESCRIPTION COUNT				
AIR HANDLING UNIT	AIR HANDLING UNIT: WALL MOUNTED 3			
CONDENSER	CONDENSER: OUT DOOR 1			
Exhaust Fan	EXHAUST FAN: 75 CFM 1			
	Hood-Wall: VENT	1		

DUCT FITTING SCHEDULE				
CATAGORY	DESCRIPTION	COUNT		
Round Transition - Angle	45 Degree	5		

DUCT ACCESSORY SCHEDULE				
CATAGORY	DESCRIPTION	COUNT		

FLEX DUCT SCHEDULE						
DESCRIPTION	DESCRIPTION	LENGTH	DIAMETER	COUNT		
Flex Duct Round	FLEX-ROUND	11.23	4"	3		
Grand total: 3		11.23				



#### **KEY PLAN**

NO.	DESCRIPTION	DATE

#### NOTE:

#### LEGEND:

# PROJECT

# 160-Haven-733 2Bd1Ba-Craftsman-550

DRAWING NAME

# **HVAC PLAN**

CLIENT NAME:	Owner
PROJECT NUMBER:	15_0001
DATE:	4/2/2025 3:26:43 AM
DESIGNED BY:	Designer
DRAWN BY:	Author
CHECKED BY:	Checker

M101

SCALE: As indicated

© [2024] [FrameUpNow] . All rights reserved

#### **ELECTRICAL NOTES**

- 1. THIS DRAWING DEPICTS THE ELECTRICAL SYSTEM FOR THE 160-Haven-733-2Bd 1Ba Craftsman-550. IT PROVIDES A VISUAL REPRESENTATION OF THE ELECTRICAL LAYOUT AND COMPONENTS, INCLUDING POWER DISTRIBUTION, LIGHTING, AND CONTROL SYSTEMS.
- 2. THE ELECTRICAL SYSTEM IS DESIGNED TO MEET THE SPECIFIC REQUIREMENTS OF THE BUILDING, INCLUDING POWER DISTRIBUTION, LIGHTING, AND SPECIALIZED ELECTRICAL EQUIPMENT NEEDS, AS PER THE PROJECT SPECIFICATIONS AND APPLICABLE CODES AND STANDARDS.
- 3. THE ELECTRICAL SYSTEM INSTALLATION SHALL COMPLY WITH THE LATEST EDITION OF THE NATIONAL ELECTRICAL CODE (NEC), INTERNATIONAL BUILDING CODE (IBC), AND ALL OTHER APPLICABLE LOCAL, STATE, AND NATIONAL CODES AND REGULATIONS.
- 4. LOCATIONS AS NEEDED, DEVICES ARE SHOWN ON PLANS IN APPROXIMATE IDEAL LOCATIONS, UNLESS SPECIFICALLY DIMMENSIONED.
- 5. OPEN WALLS AS NEEDED TO ALLOW FOR NEW ELECTRICAL INSTALLATIONS.
- 6. LABEL ALL CIRCUITS ON JUNCTION BOXES, RECEPTACLES, DATA, SMOKE DETECTOR, AND EQUIPMENT IN PANEL BOX.
- 7. INSTALL RACEWAY AS NEEDED FOR DDC, ACCESS CONTROL, LOW VOLTAGE WIRING & DATA.
- 8. RELABEL POWER, DATA & FIRE ALARM FOR ROOM #CHANGES.
- 9. VERIFY ALL CIRCUITS LABELED ON PRINT ARE CORRECT BEFORE WORKING ON THEM.
   10. NOTE ON SITE PLAN ALL CHANGES OR MISSING DETAIL TO BE INCORPORATED INTO THE MASTER PLAN.
- 11. DRAWINGS ARE DIAGRAMMATIC ONLY FOR THE PURPOSE OF SHOWING FIXTURE AND OUTLET LOCATIONS.
- 12. ELECTRICAL CONTRACTOR TO VERIFY SERVICE SIZE BY CALCULATION BASED UPON ACTUAL NAME PLATE RATINGS OF SELECTED FOLIPMENT
- PLATE RATINGS OF SELECTED EQUIPMENT.

  13. VERIFY LOCATION OF SERVICE ENTRANCE WITH POWER COMPANY. PROVIDE UFER GROUND IN
- 13. VERIFY LOCATION OF SERVICE ENTRANCE WITH POWER COMPANY. PROVIDE UFER GROUND IN BUILDING FOUNDATION AT SERVICE ENTRANCE LOCATION.
- 14. PROVIDE A MIN. OF 20 FEET OF ONE \*4 BARE COPPER UFER WIRE EMBEDDED IN CONCRETE FOOTING
- AT THE SERVICE ENTRANCE LOCATION WHERE APPROVED BY LOCAL SERVICE PROVIDER.

  15. PROVIDE WATERPROOF FIXTURES IN ALL HIGH MOISTURE AREAS (EXTERIOR, SHOWER AND TURE).
- 15. PROVIDE WATERPROOF FIXTURES IN ALL HIGH MOISTURE AREAS (EXTERIOR, SHOWER AND TUB CEILINGS ETC.)
- 16. PROVIDE DEDICATED CIRCUITS TO EACH BATH, DEN, FAMILY ROOM, BEDROOM, LOFT, KITCHEN
- REFRIGERATOR, KITCHEN FREEZER DISHWASHER, AND ANY AREA/ITEM SPECIFIED BY OWNER.

  17. INCANDESCENT FIXTURES WITH OPEN OR PARTIALLY ENCLOSED LAMPS, PENDANT FIXTURES, AND
- LAMP HOLDERS ARE NOT PERMITTED IN CLOSETS.

  18. ALL WORKMANSHIP AND MATERIALS TO CONFORM WITH THE 2015 IRC.
- 19. PROVIDE A MIN. OF 20 FEET OF ONE \*4 BARE COPPER UFER WIRE EMBEDDED IN CONCRETE FOOTING AT THE SERVICE ENTRANCE LOCATION WHERE APPROVED BY LOCAL SERVICE PROVIDER.
- 20. PROVIDE A BONDING CONDUCTOR CONSISTING OF A MINIMUM OF ONE \*4 BARE COPPER WIRE CONNECTING THE BUILDING'S METAL WATER PIPING SYSTEM TO THE SERVICE EQUIPMENT ENCLOSURE GROUNDING.

#### MAIN PANEL CALCS

ELECTRICAL CALCS         LIGHT AND OUTLETS 733 @ 3W       2,199 W         3 APPLIANCE CIRCUITS       4,500 W         DRYER       2,000 W         WASHER       2,000 W         RANGE       5,000 W         WATER HEATER       5,000 W         REFRIG.       1,800 W         DISHWASHER & DISPOSAL       3000 W         TOTAL       25,499 W         FRIST 10,000 @ 100%       10,000 W         REMAINDER @ 40%       6,200W         MINI. SPLIT UNITS       10,000 W         TOTAL       26,200 W		
3 APPLIANCE CIRCUITS 4,500 W  DRYER 2,000 W  WASHER 2,000 W  RANGE 5,000 W  WATER HEATER 5,000 W  REFRIG. 1,800 W  DISHWASHER & DISPOSAL 3000 W  TOTAL 25,499 W  FRIST 10,000 @ 100% 10,000 W  REMAINDER @ 40% 6,200W MINI. SPLIT UNITS 10,000 W	ELECTRICAL CALCS	
DRYER 2,000 W  WASHER 2,000 W  RANGE 5,000 W  WATER HEATER 5,000 W  REFRIG. 1,800 W  DISHWASHER & DISPOSAL 3000 W  TOTAL 25,499 W  FRIST 10,000 @ 100% REMAINDER @ 40% MINI. SPLIT UNITS 10,000 W	LIGHT AND OUTLETS 733 @ 3W	2,199 W
WASHER 2,000 W  RANGE 5,000 W  WATER HEATER 5,000 W  REFRIG. 1,800 W  DISHWASHER & DISPOSAL 3000 W  TOTAL 25,499 W  FRIST 10,000 @ 100% REMAINDER @ 40% MINI. SPLIT UNITS 10,000W	3 APPLIANCE CIRCUITS	4,500 W
RANGE       5,000 W         WATER HEATER       5,000 W         REFRIG.       1,800 W         DISHWASHER & DISPOSAL       3000 W         TOTAL       25,499 W         FRIST 10,000 @ 100%       10,000 W         REMAINDER @ 40%       6,200W         MINI. SPLIT UNITS       10,000 W	DRYER	2,000 W
WATER HEATER 5,000 W  REFRIG. 1,800 W  DISHWASHER & DISPOSAL 3000 W  TOTAL 25,499 W  FRIST 10,000 @ 100% 10,000 W REMAINDER @ 40% 6,200W MINI. SPLIT UNITS 10,000W	WASHER	2,000 W
REFRIG. 1,800 W  DISHWASHER & DISPOSAL 3000 W  TOTAL 25,499 W  FRIST 10,000 @ 100% 10,000 W REMAINDER @ 40% 6,200W MINI. SPLIT UNITS 10,000W	RANGE	5,000 W
TOTAL 25,499 W  FRIST 10,000 @ 100% 10,000 W REMAINDER @ 40% 6,200W MINI. SPLIT UNITS 10,000W	WATER HEATER	5,000 W
TOTAL 25,499 W  FRIST 10,000 @ 100% 10,000 W REMAINDER @ 40% 6,200W MINI. SPLIT UNITS 10,000W	REFRIG.	1,800 W
FRIST 10,000 @ 100%	DISHWASHER & DISPOSAL	3000 W
REMAINDER @ 40% 6,200W MINI. SPLIT UNITS 10,000W	TOTAL	25,499 W
TOTAL 26,200 W	REMAINDER @ 40%	6,200W
	TOTAL	26,200 W

26,200 W DIVIDED BY 240V = 110 AMPS TOTAL

(USE 200 AMP SERVICE)

#### **ELECTRICAL ABBREVIATIONS LIST**

1P	1 POLE (2P, 3P, 4P, ETC.)	CTR	CENTER	нт	HEIGHT
A	AMPERE	CU	COPPER	HTG	HEATING
AC	ABOVE COUNTER OR AIR CONDITIONER	DCP	DOMESTIC WATER CIRCULATING PUMP	HTR	HEATER
ACLG	ABOVE COUNTER OR AIR CONDITIONER	DEPT	DEPARTMENT	HV	HIGH VOLTAGE
ADO	AUTOMATIC DOOR OPENER	DET	DETAIL	HVAC	HEATING, VENTILATING AND AIR
AF	AMP FRAME	DIA	DIAMETER	CONDITIONING	CONDITIONING
AFF	ABOVE FINISHED FLOOR	DISC	DISCONNECT	HWP	HYDRONIC WATER PUMP
AFG	ABOVE FINISHED GRADE	DIST	DISTRIBUTION	IC	INTERRUPTING CAPACITY
AFI	ARC FAULT CIRCUIT INTERRUPTER	DN	DOWN	IG	ISOLATED GROUND
AHU	AIR HANDLING UNIT	DPR	DAMPER	IMC	INTERMEDIATE METAL CONDUIT
AL	ALUMINUM	DS	SAFETY DISCONNECT SWITCH	INCAND	INCANDESCENT
ALT	ALTERNATE	DT	DOUBLE THROW	IR	INFRARED
AMP	AMPERE	DWG	DRAWING	I/W	INTERLOCK WITH
AMPL	AMPLIFIER	DDC	DIRECT DIGITAL CONTROL	J-BOX	JUNCTION BOX
ANNUN	ANNUNCIATOR APPROX APPROXIMATELY	EC	ELECTRICAL CONTRACTOR	KV	KILOVOLT
AQ-STAT	AQUASTAT	ELEC	ELECTRIC, ELECTRICAL	KVA	KILOVOLT-AMPERE
ARCH	ARCHITECT, ARCHITECTURAL	ELEV	ELEVATOR	KVAR	KILOVOLT-AMPERE REACTIVE
AS	AMP SWITCH	EM	EMERGENCY	KW	KILOWATT
AT	AMP TRIP	EMS	ENERGY MANAGEMENT SYSTEM	KWH	KILOWATT HOUR
ATS	AUTOMATIC TRANSFER SWITCH	EMT	ELECTRICAL METALLIC TUBING	LOC	LOCATE OR LOCATION
AUTO	AUTOMATIC	EP	ELECTRIC PNEUMATIC	LT	LIGHT
AUX	AUXILIARY	EQUIP	EQUIPMENT	LTG	LIGHTING
AV	AUDIO VISUAL	EWC	ELECTRIC WATER COOLER	LTNG	LIGHTNING
AWG	AMERICAN WIRE GAUGE	EXIST	EXISTING	LV	LOW VOLTAGE
BATT	BATTERY	EXH	EXHAUST	MAX	MAXIMUM
BD	BOARD	EXP	EXPLOSION PROOF	MAG.S	MAGNETIC STARTER
BLDG	BUILDING	FA	FIRE ALARM	M/C	MOMENTARY CONTACT
BMS	BUILDING MANAGEMENT SYSTEM	FABP	FIRE ALARM BOOSTER POWER	MC	MECHANICAL CONTRACTOR
C	CONDUIT	SUPPLY PANEL	SUPPLY PANEL	MCB	MAIN CIRCUIT BREAKER
CAB	CABINET	FACP	FIRE ALARM CONTROL PANEL	MCC	MOTOR CONTROL CENTER
CAT	CATALOG	FCU	FAN COIL UNIT	MDC	MAIN DISTRIBUTION CENTER
CATV	CATALOG CABLE TELEVISION	FIXT	FIXTURE	MDP	MAIN DISTRIBUTION PANEL
CB	CIRCUIT BREAKER	FLR	FLOOR	MFR	MANUFACTURERMAIN FUSED
CCTV	CLOSED CIRCUIT TELEVISION	FLUOR	FLUORESCENT	IVIFIX	DISCONNECT SWITCH
CKT			FUSE	MH	MANHOLE
	CIRCUIT	FU	FUSED SAFETY DISCONNECT SWITCH		
CLG	CEILING	FUDS		MIC	MICROPHONE
COMB	COMBINATION	GA	GAUGE	MIN	MINIMUM
CMPR	COMPRESSOR	GAL	GALLON	MISC	MISCELLANEOUS
CONN	CONNECTION	GALV	GALVANIZED	MLO	MAIN LUGS ONLY
CONST	CONSTRUCTION	GC	GENERAL CONTRACTOR	MMS	MANUAL MOTOR STARTER
CONT	CONTINUATION OR CONTINUOUS	GEN	GENERATOR	MOA	MULTIOUTLET ASSEMBLY
CONTR	CONTRACTOR	GFI	GROUND FAULT CIRCUIT INTERRUPTER	MSP	MOTOR STARTER PANELBOARD
CONV	CONVECTOR	GFP	GROUND FAULT PROTECTOR	MSBD	MAIN SWITCHBOARD
CP	CIRCULATING PUMP	GND	GROUND	MT	MOUNT
CRT	CATHODE-RAY TUBE	GRS	GALVANIZED RIGID STEEL (CONDUIT)	MT.C	EMPTY CONDUIT
СТ	CURRENT TRANSFORMER	GYP BD	GYPSUM BOARD	UL	UNDERWRITERS LABORATORIES

#### **Branch Panel:**

Location: KITCHEN 02
Supply From:
Mounting: Recessed

Enclosure: Type 1

Volts: 120/240 Single
Phases: 1
Wires: 3

A.I.C. Rating:
Mains Type:
Mains Rating: 200 A
MCB Rating: 1 A

#### Notes

t	Circuit Description	Number of Elements	Rating	Length	Wire Size	A			В	Wire Size	Length	Rating	Number of Elements		Circuit Numb er
	BED 1 LIGHT	9	15 A	33' - 8 21/32"	1-#14, 1-#14, 1-#14	568 VA	576 VA			1-#12, 1-#12, 1-#12	31' - 11 7/8"	20 A	7	BATH GFCI	2
	KITCHEN & HALL LIGHT	11	15 A	39' - 7 19/32"	1-#14, 1-#14, 1-#14			456 VA	237 VA	1-#14, 1-#14, 1-#14	35' - 4 21/32"	15 A	9	LIVING LIGHT	4
	BED 2 LIGHT	9	20 A	39' - 8 19/32"	1-#12, 1-#12, 1-#12	568 VA	600 VA			1-#14, 1-#14, 1-#14	46' - 3 11/32"	15 A	9	OUTDOOR LIGHT	6
	KITCHEN GFCI	3	20 A	16' - 8 7/16"	1-#12, 1-#12, 1-#12			540 VA	180 VA	1-#12, 1-#12, 1-#12	8' - 10 11/16"	20 A	1	OVENHOOD	8
	RANGE	1	50 A	14' - 10 5/32"	2-#8, 1-#8, 1-#10	2500 VA	1800 VA			1-#12, 1-#12, 1-#12	19' - 3 11/16"	20 A	1	REFRIGERATOR	10
								2500 VA	2500 VA	2-#10, 1-#10, 1-#10	31' - 3 13/16"	30 A	1	DRYER	12
	WATER HEATER	1	30 A	30' - 2 11/16"	2-#10, 1-#10, 1-#10	2250 VA	2500 VA								14
								2250 VA	1200 VA	1-#12, 1-#12, 1-#12	34' - 3 3/16"	20 A	1	WASHEIN MASHEIN	16
	BED 1 RECEPTACLE	6	20 A	42' - 3 27/32"	1-#12, 1-#12, 1-#12	1080 VA	900 VA			1-#12, 1-#12, 1-#12	36' - 10 11/16"	20 A	5	LIVING RECEPTACLE	18
	BED 2 RECEPTACLE	5	20 A	49' - 3 5/8"	1-#12, 1-#12, 1-#12			900 VA	720 VA	1-#12, 1-#12, 1-#12	37' - 4 1/4"	20 A	4	OUTDOOR RECEPTACLE	20
															22
															24
															26
_	1					13312	2 VA	1148	30 VA						-
						13312		1	80 VA						

#### Legend

Load Classification	Connected Load	<b>Demand Factor</b>	Estimated Demand	Panel	Totals
LIGHTING - DWELLING UNIT	800 VA	100.00%	800 VA		
OTHER	1564 VA	100.00%	1564 VA	Total Conn. Load:	24791 VA
RECEPTACLE	5880 VA	100.00%	5880 VA	Total Est. Demand:	23791 VA
LIGHTING	300 VA	100.00%	300 VA	Total Conn.:	103 A
WATER HEATER	4500 VA	100.00%	4500 VA	Total Est. Demand:	99 A
RANGE	5000 VA	80.00%	4000 VA		
DRYER	5000 VA	100.00%	5000 VA		
REFRIGERATOR	1800 VA	100.00%	1800 VA		



**KEY PLAN** 

NO. DESCRIPTION DATE

NOTE:

LEGEND:

PROJECT

160-Haven-733-2Bd 1Ba Craftsman-550

DRAWING NAME

# **SCHEDULE**

 CLIENT NAME:
 Owner

 PROJECT NUMBER:
 0383\_13

 DATE:
 4/2/2025 3:31:08 PM

 DESIGNED BY:
 Designer

 DRAWN BY:
 Author

 CHECKED BY:
 Checker

E101

SCALE: 1/4" = 1'-0"

© [2024] [FrameUpNow] . All rights reserved

#### **ELECTRICAL NOTE**

- A. PROVIDE INTERCONNECTED SMOKE ALARMS IN EACH SLEEPING ROOMS, OUTSIDE EACH SLEEPING ROOM, ON EACH STORY, IN THE HALL OR ADJACENT ROOM LUHERE THE CEILING HEIGHT OF A ROOM OPEN TO THE HALL EXCEEDS THE HALL BY 24'. SMOKE ALARMS SHALL BE PERMANENTLY HARD WIRED WITH BATTERY BACKUP.
- B. RECEPTACLE OUTLETS FOR RANGES AND CLOTHES DRYERS SHALL BE A THREE POLE WITH GROUND TYPE. FOUR WIRE GROUNDING-TYPE FLEXIBLE CORDS WILL BE REQUIRED FOR CONNECTION OF RANGES AND CLOTHES DRYERS. THE BONDING JUMPER SHALL NOT BE CONNECTED BETWEEN NEUTRAL TERMINAL AND THE FRAME OF THE APPLIANCE.
- C. TWO OR MORE 20 AMP SMALL APPLIANCE CIRCUITS SHALL BE PROVIDED TO SERVE THE KITCHEN, BREAKFAST NOOK, AND DINING ROOM. SUCH CIRCUITS SHALL HAVE NO OTHER OUTLETS.
- D. AT LEAST ONE 20 AMP BRANCH CIRCUIT SHALL BE PROVIDED TO SERVICE THE LAUNDRY ROOM. THIS CIRCUIT SHALL HAVE NO OTHER OUTLETS.
- E. ALL RECEPTACLES WITH IN 6' OF A WET BAR SINK OR KITCHEN SINK TO SERVE COUNTER TOP SURFACES MUST BE GFCI. ON KITCHEN COUNTERS 12' OR WIDER NO POINT ALONG THE WALL SHALL BE MORE THAN 2' FROM A RECEPTACLE. ALL RECEPTACLES WITH IN 6' OF KITCHEN SINK MUST BE GFCI. AT LEAST ONE GFCI RECEPTACLE SHALL BE INSTALLED IN THE BATHROOM ADJACENT TO EACH BASIN.
- F. FIXTURES INCLUDING CEILING FANS THAT ARE LOCATED IN DAMP LOCATIONS SHALL BE LISTED TO BE SUITABLE FOR
- SUCH LOCATIONS PER 2012 IRC
- G. PROVIDE ONE (1) SWITCHED OUTLET @ ALL BEDROOMS AND DEN
- H. CEILING FANS NOT EXCEEDING 35 LBS. (WITH OR WITHOUT ACCESSORIES MAY BE SUPPORTED BY OUTLET BOXES PROVIDED THE OUTLET BOXES ARE IDENTIFIED FOR SUCH USE PER 2012 IRC
- I. ELECTRICAL OUTLET BOXES ON OPPOSITE SIDES OF FIRE RATED WALLS SHALL BE SEPARATED BY A HORIZONTAL DISTANCE OF NOT LESS THAN 24".
- J. OUTLET BOXES IN THE WALLS BETWEEN THE GARAGE AND DWELLING SHALL BE METAL OR U.L. APPROVED FIRE RESISTIVE PLASTIC. BOXES IN GARAGE CEILING SHALL BE METAL.
- K. ALL BRANCH CIRCUITS THAT SUPPLY 120 VOLTS SINGLE PHASE 15 AND 20 AMPS RECEPTACLE OUTLETS INSTALLED IN THE DWELLING SHALL BE PROTECTED BY AN ARC FAULT CIRCUIT INTERRUPTER, EXCEPT GFCI RECEPTICLES.

#### NOTE:

. RECEPTACLES MUST BE PROVIDED IN HALLWAYS 10'-0" OR MORE IN LENGTH. FOR A ONE FAMILY DWELLINGS AND EACH OF A TWO FAMILY DWELLING THAT IS AT GRADE LEVEL, AT LEAST ONE WP-GFCI RECEPTACLE OUTLET ACCESSIBLE AT GRADE LEVEL AND NOT MORE THAN 6'-6" ABOVE GRADE SHALL BE INSTALLED AT THE FRONT AND BACK OF THE DWELLING.

#### **NOTE: APPLIANCE DISCONNECT**

#### **E4001.5 GROUNDING OF ENCLOSURES.**

METAL ENCLOSURES FOR SWITCHES OR CIRCUIT BREAKERS SHALL BE CONNECTED TO AN

EQUIPMENT GROUNDING CONDUCTOR.

METAL ENCLOSURES FOR SWITCHES OR CIRCUIT BREAKERS USED AS SERVICE

EQUIPMENT SHALL COMPLY WITH THE PROVISIONS OF SECTION E3609.4. WHERE NONMETALLIC ENCLOSURES ARE USED WITH METAL RACEWAYS OR METAL-ARMORED


NONMETALLIC ENCLOSURES ARE USED WITH METAL RACEWAYS OR METAL-ARMORED CABLES, PROVISIONS SHALL BE MADE FOR CONNECTING THE EQUIPMENT GROUNDING

CONDUCTOR.


NONMETALLIC BOXES FOR SWITCHES SHALL BE INSTALLED WITH A WIRING METHOD THAT


PROVIDES OR INCLUDES AN EQUIPMENT GROUNDING CONDUCTOR. (404.12)

ELECTRI	CAL LEGEND	
	Electrical Lights With Fan	
0	Waterproof Recessed Can Light	
	Pendant Light	
0	Recessed Can Light	
	Wall Lamp	
	Standalone linear	
<b>√</b> 1	Single Switch	
¥g	Three way Switch	
<del>A</del> L	Fan Switch	
	Duplex Receptacle	
	Triplex Receptacle	
⊕ □GFCI	GFCI Receptacle	
Exhaust Fan		
•	Smoke and heat detector	

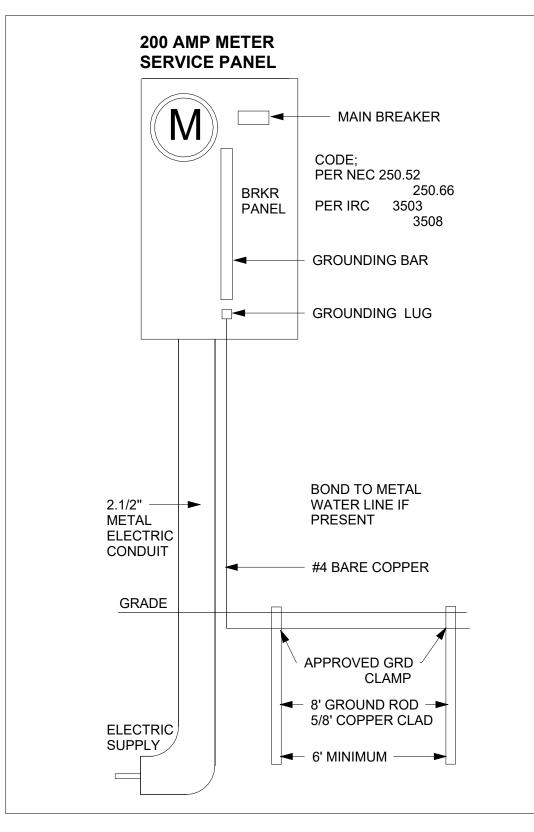



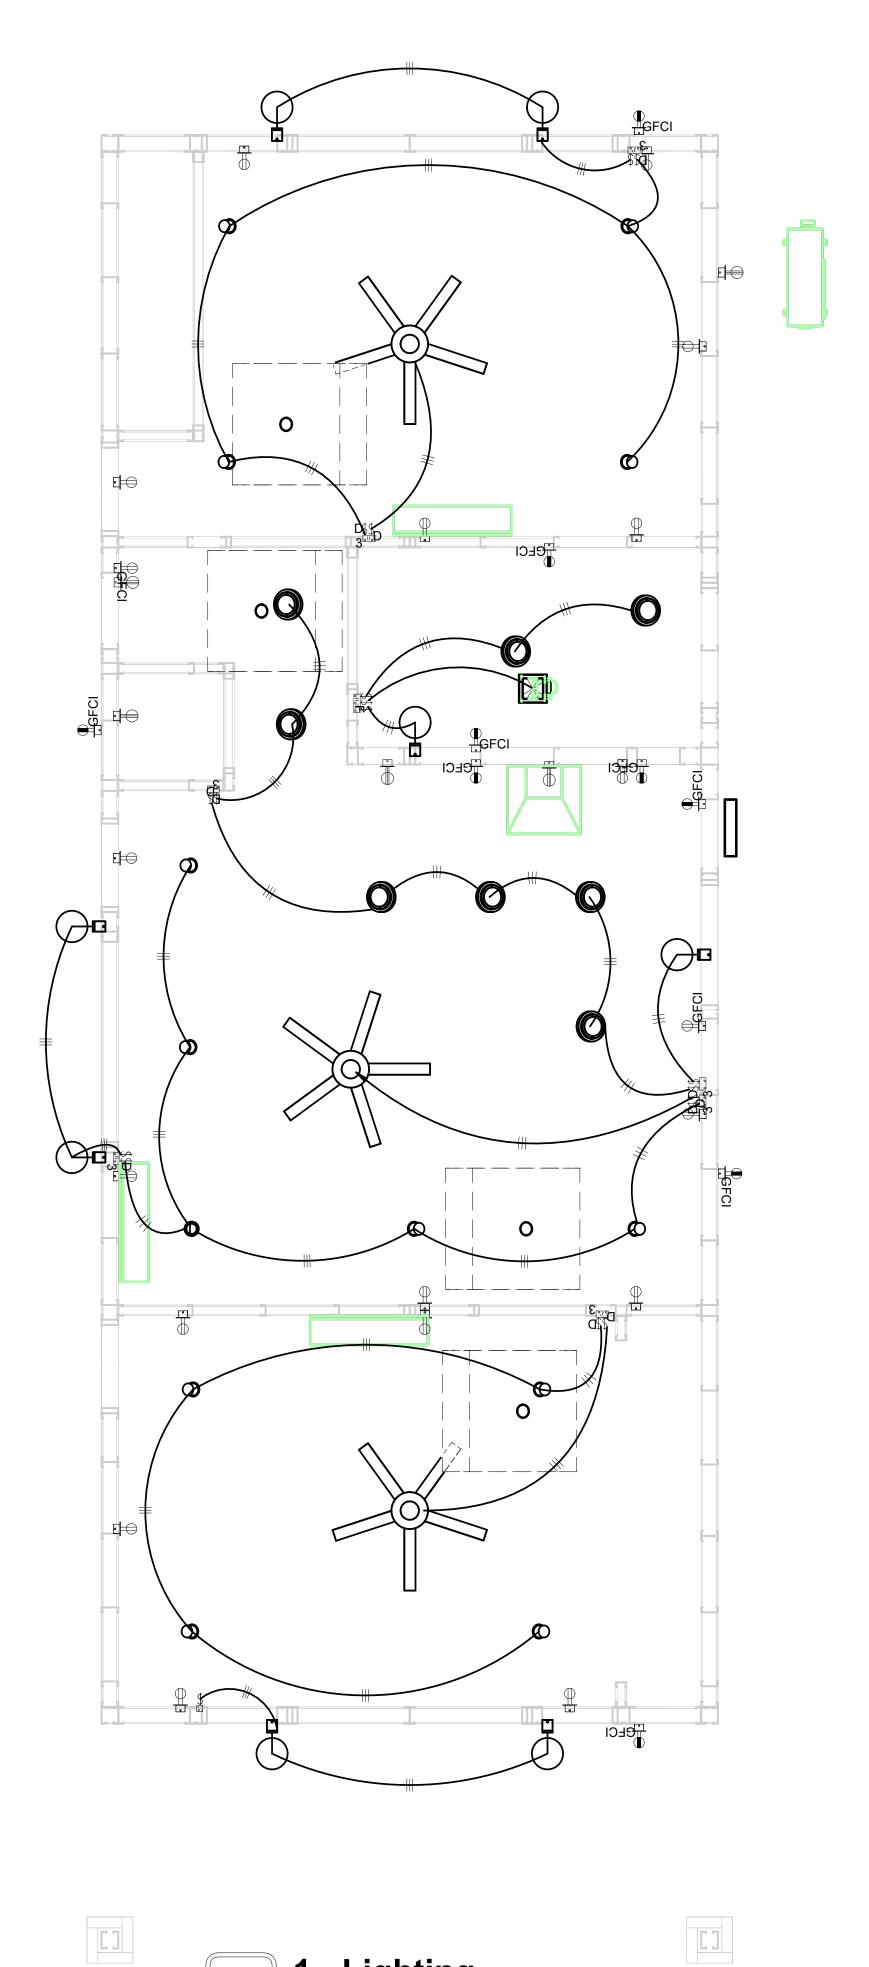

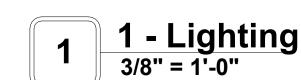



**KEY PLAN** 

NO.	DESCRIPTION	DATE

NOTE:

LEGEND:

PROJECT

160-Haven-733-2Bd 1Ba Craftsman-550

DRAWING NAME


# LIGHTING

CLIENT NAME:	Owner
PROJECT NUMBER:	0383_13
DATE:	4/2/2025 3:31:10 PM
DESIGNED BY:	Designer
DRAWN BY:	Author
CHECKED BY:	Checker


E102

#### **NOTES: CONDUIT, CABLE AND WIRING**


- Use Metalic Conduits (IMC) for cables running under concrete slabs.
   Use IMC for circuits with high voltage appliances (240 volts and above)
   For circuits with 120 volts consider using EMT or PVC conduits if needed.
   For Low voltage applications up to 50 volts consider using non metalic conduits.
   All conduits to be used in the project must conform to the latest National Electrical Code (NEC),
- 6. All wiring and cables to be used in the project must also conform to the latest National Electrical Code (NEC), 2015.
  7. All cables and wires used should be rated for their respective loading and should be gauged and
- conform to the NEC.

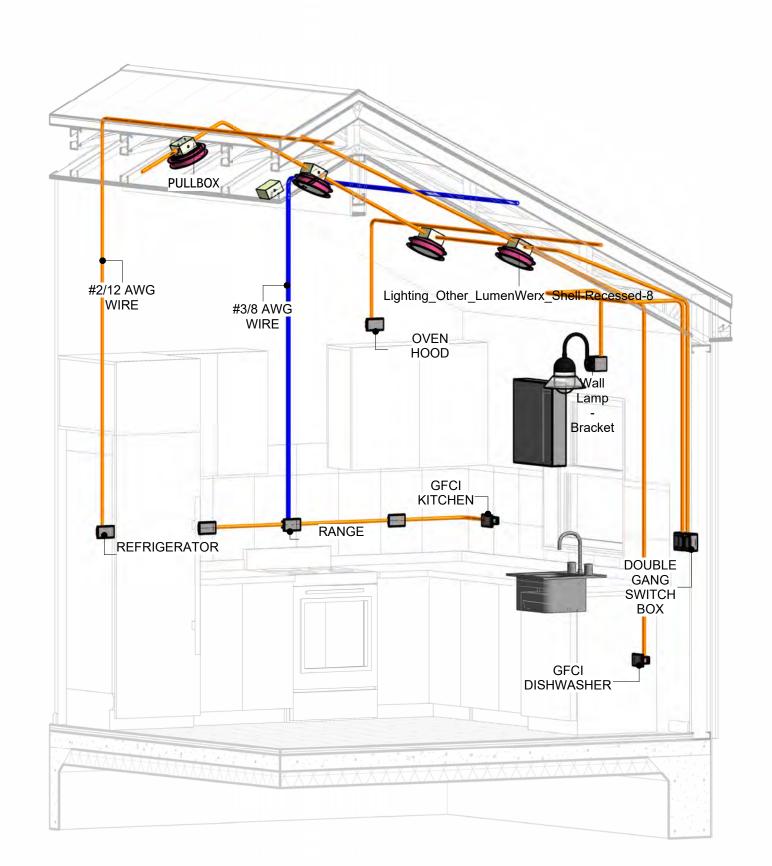


**3D-KITCHEN** 

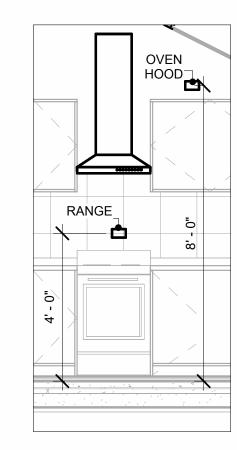


Range & OvenHood
3/8" = 1'-0"

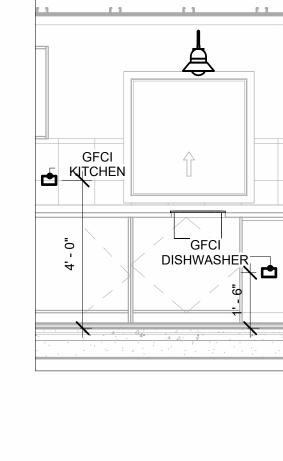

**Gfci** 3/8" = 1'-0"

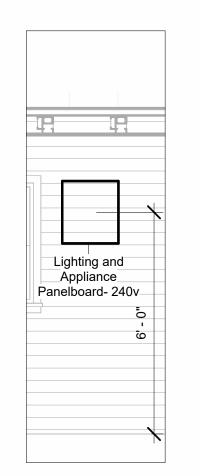

Panel 3/8" = 1'-0"

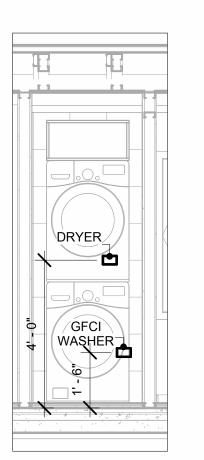

**Dryer & Washer** 3/8" = 1'-0"



**KEY PLAN** DESCRIPTION DATE

NOTE:

LEGEND:

PROJECT

160-Haven-733-2Bd 1Ba Craftsman-550

DRAWING NAME

**POWER** 

Owner CLIENT NAME: 0383\_13 PROJECT NUMBER: 4/2/2025 3:31:35 PM DATE: Designer DESIGNED BY: DRAWN BY: CHECKED BY: Checker

E103

SCALE: As indicated

© [2024] [FrameUpNow] . All rights reserved



- 1. LIGHT FIXTURES AND LUMINARIES SHALL CONFORM TO THE NEC, THE IRC AND LOCAL SAFETY & BUILDING CODE.
- 2. ALL LIGHTING FIXTURES SHOULD CONFORM TO THE DESIGN ELECTRICAL LOAD AND SHALL BE PROPERLY WIRED AND MOUNTED BY QUALIFIED ELECTRICIAN FOLLOWING MANUFACTURERS SPECIFICATIONS.
- 3. CEILING FANS AND FANS WITH LIGHT WITH WEIGHT EXCEEDING 35 LBS SHOULD BE PROVIDED WITH STRUCTURAL BACKING FOR SUPPORT AND SHALL BE FIXED AS PER MANUFACTURERS SPECIFICATIONS.
- 4. EXTERIOR LIGHTS SHALL CONFORM TO LOCAL BUILDING CODE AND GUIDELINES.

#### **NOTES: SWITCH JUNCTION BOX**


- 1. THE MINIMUM SIZE OF JUCTION BOX TO BE USED IS 2"X4"X(1.5" OR 3.5" DEEP) THIS ARE TO BE USED FOR SINGLE GANG SWITCH OR OUTLETS.
- 2. FOR DOUBLE GANG (2 GANG) OUTLETS AND SWITCHS THE MINIMUM SIZE OF THE
- JUCTION BOX TO BE PROVIDED SHALL NOT BE LESS THAN 4"X4"X(1.5" OR 3.5" DEEP)
- 3. FOR THREE GANG (3 GANG) OUTLETS AND SWITCHS THE MINIMUM SIZE OF THE JUĆTION BOX SHALL NOT BE LESS THAN 6"X4"X(1.5" OR 3.5" DEEP).

FITTING SCHEDULE(PULL BOX)							
FAMILY COUNT DESCRIPTION							
PULLBOX1 28 #1/4 PULLBOX							

ELECTRICAL FIXTURE SCHEDULE (SWITCH BOX)		
TYPE	COUNT	
DOUBLE GANG SWITCH BOX	7	
SINGLE GANG SWITCH BOX	1	
TRIPLE GANG SWITCH BOX	1	

LIGHT	ING DEVICE
TYPE	COUNT
DIMMER	4
FAN SWITCH	1
SINGLE POLE	6
THREE WAY WITH DIMMER	7

LIGHTING FIXTURE			
LIGHTING FIXTURE TYPE	VOLTAGE	ELECTRICAL LOAD	COUNT
ELECTRICAL_LIGHTS_FAN-LIGHT1	120 V/1-100 VA- 120 V/1-100 VA	200 A, 120 V/240 V, SINGLE PHASE, 3 WIRES	3
LIGHTING_OTHER_LUMENWE RX_SHELL-RECESSED-8	120 V/1-60 VA	200 A, 120 V/240 V, SINGLE PHASE, 3 WIRES	8
SASSO 100 ROUND WALLWASHER TRIM	120 V/1-28 VA	200 A, 120 V/240 V, SINGLE PHASE, 3 WIRES	13
WALL LAMP - BRACKET	120 V/1-100 VA	200 A, 120 V/240 V, SINGLE PHASE, 3 WIRES	8

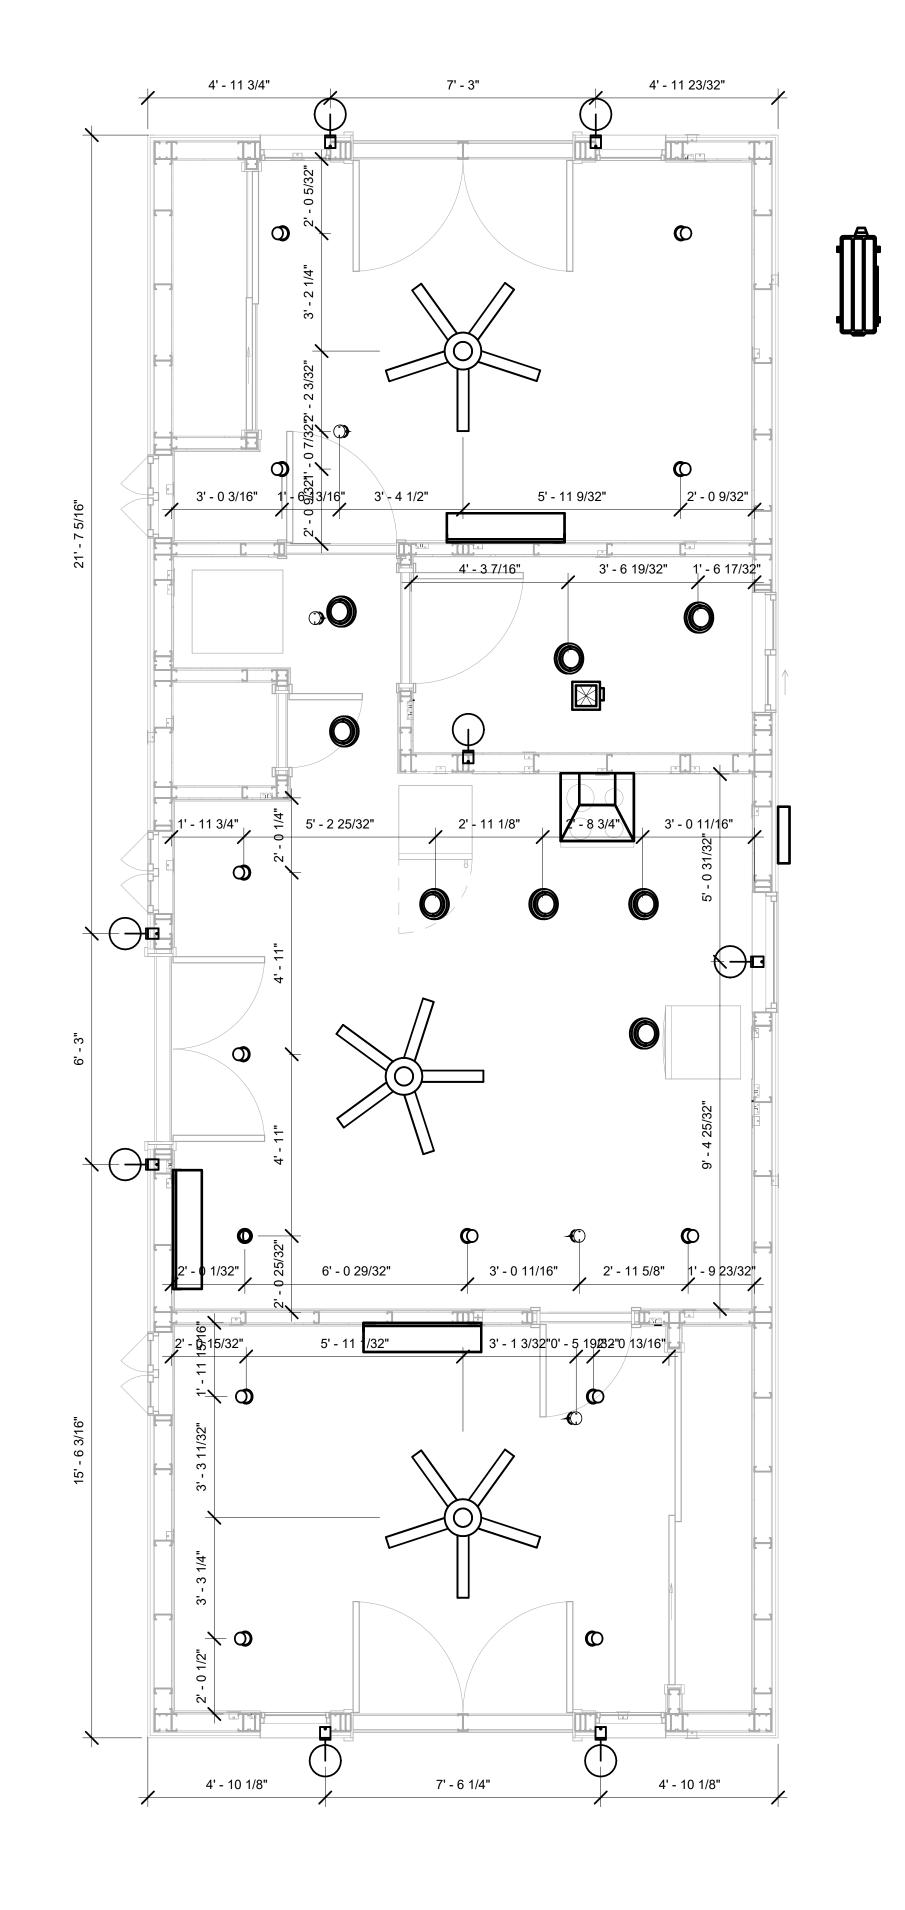





**KEY PLAN** 

NO.	DESCRIPTION	DATE

NOTE:

LEGEND:

PROJECT

160-Haven-733-2Bd 1Ba Craftsman-550

DRAWING NAME

# **DIMENSION PLAN** FOR LIGHT FIXTURES

CLIENT NAME:	Owner
PROJECT NUMBER:	0383_13
DATE:	4/2/2025 3:31:36 PM
DESIGNED BY:	Designer
DRAWN BY:	Author
CHECKED BY:	Checker


E104



- 1. VERIFY EQUIPMENT PLUG CONFIGURATION BEFORE PURCHASING RECEPTACLES
- 2. FOR ALL EQUIPMENT.
- 3. COORDINATE EXACT LOCATION OF LIGHT FIXTURES, WALL SWITCHES, RECEPTACLES AND OTHER DEVICES WITH ARCHITECTURAL DRAWINGS.
- 4. USE METALLIC JUNCTION BOX WITH THE GFCI RECEPTACLES, WITH HIGHT VOLTAGE.

ELECTRICAL FIXTURE SCHEDULE (RECEPTACLE)		
TYPE	COUNT	
CONDENSER	1	
DRYER	1	
DUPLEX RECEPTACLE	16	
GFCI BATH ROOM	2	
GFCI DISHWASHER	1	
GFCI KITCHEN	3	
GFCI OUT DOOR	4	
GFCI WASHER	1	
OVEN HOOD	1	
RANGE	1	
REFRIGERATOR	1	
WATER HEATER	1	

ELECTRICAL OUTLET SCHEDULE			
TYPE	CIRCUIT NUMBER	ELECTRICAL DATA	COUNT
CONDENSER		120 V/1-1500 VA	1
GFCI DISHWASHER		120 V/1-1200 VA	1
GFCI BATH ROOM	2	120 V/1-180 VA	2
GFCI KITCHEN	7	120 V/1-180 VA	3
OVEN HOOD	8	120 V/1-180 VA	1
RANGE	9,11	240 V/2-5000 VA	1
REFRIGERATOR	10	120 V/1-1800 VA	1
DRYER	12,14	240 V/2-5000 VA	1
WATER HEATER	13,15	240 V/2-4500 VA	1
GFCI WASHER	16	120 V/1-1200 VA	1
DUPLEX RECEPTACLE	17	120 V/1-180 VA	6
DUPLEX RECEPTACLE	18	120 V/1-180 VA	5
DUPLEX RECEPTACLE	19	120 V/1-180 VA	5
GFCI OUT DOOR	20	120 V/1-180 VA	4

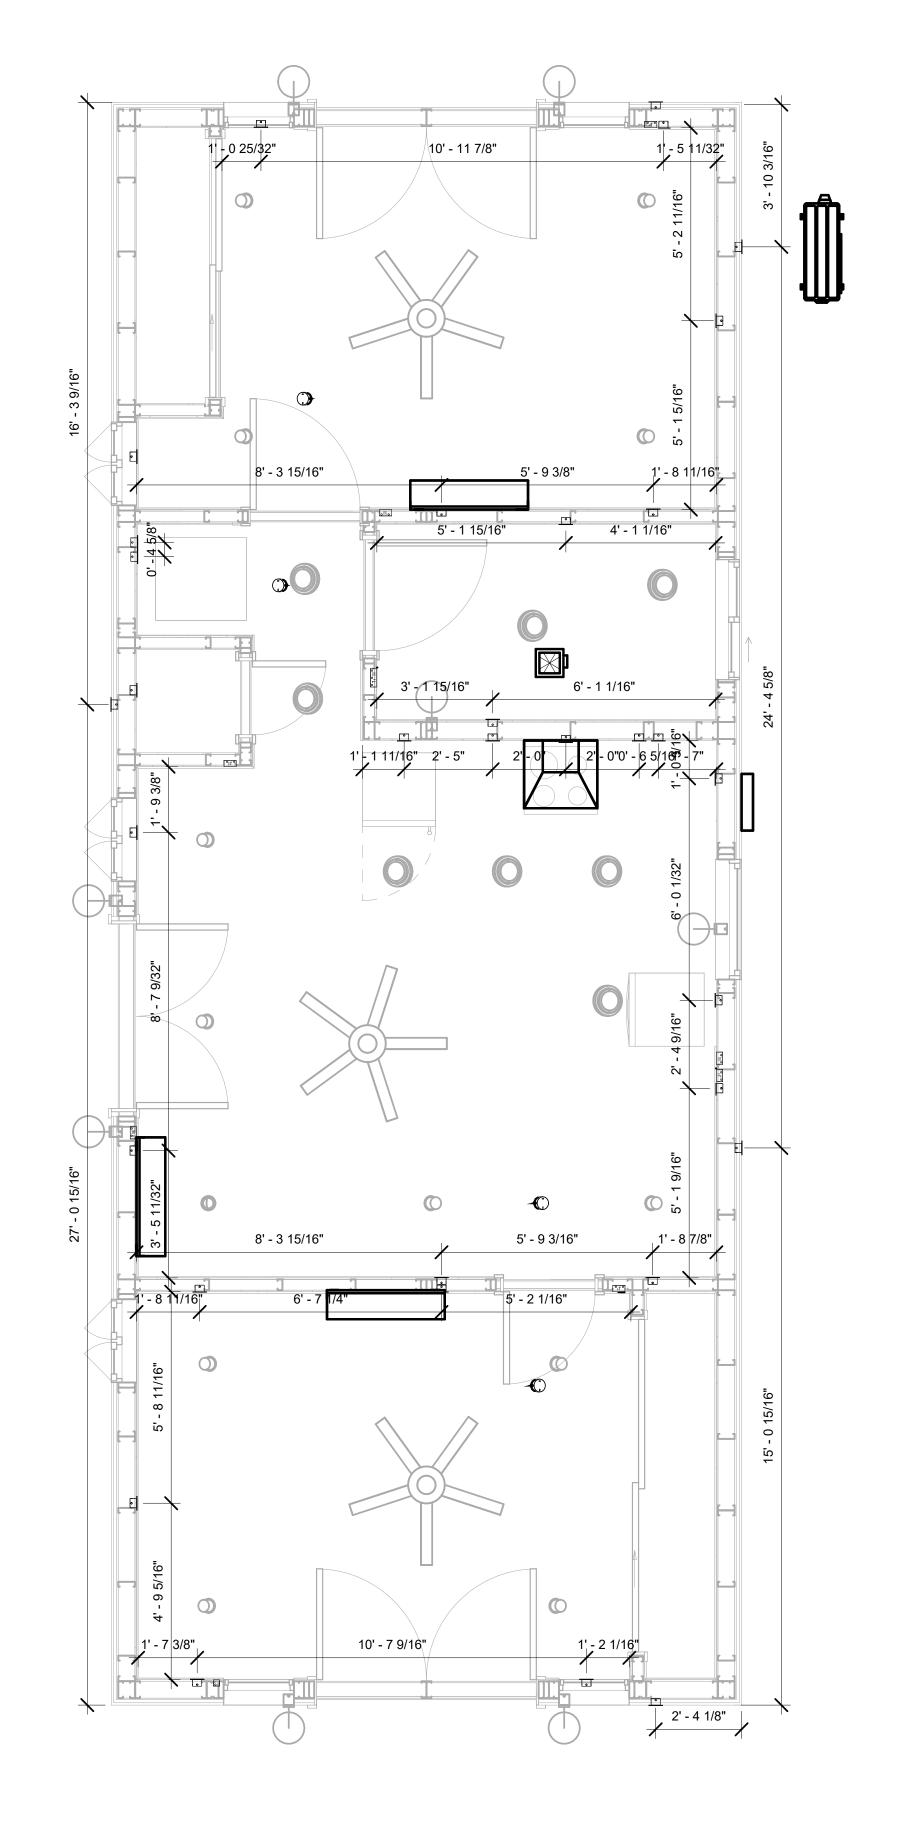





**KEY PLAN** 

NO.	DESCRIPTION	DATE

NOTE:

LEGEND:

PROJECT

160-Haven-733-2Bd 1Ba Craftsman-550

DRAWING NAME

# DIMENSION PLAN FOR FITTINGS

CLIENT NAME:	Owner
PROJECT NUMBER:	0383_13
DATE:	4/2/2025 3:31:38 PM
DESIGNED BY:	Designer
DRAWN BY:	Author
CHECKED BY:	Checker

E105

#### SHEET LIST

SHEET NUMBER SHEET NAME

P101 NOTE AND SCHEDULE
P102 WATER SUPPLY AND SEWAGE
SYSTEM

PIPE COLOF	RSCHEME
	DOMESTIC COLD WATE
	DOMESTIC HOT WATER
	SANITARY VENT
	SANITARY SEWER
	STORM DRAINAGE
	GRAY WATER
	GAS LINE

#### PLUMBING NOTES

- THE PLUMBING SYSTEM IS DESIGNED TO MEET THE BUILDING'S DOMESTIC WATER SUPPLY, SANITARY DRAINAGE, AND STORM DRAINAGE REQUIREMENTS, AS PER PROJECT SPECIFICATIONS AND APPLICABLE CODES.
- THE SYSTEM INSTALLATION SHALL COMPLY WITH THE LATEST INTERNATIONAL PLUMBING CODE (IPC), INTERNATIONAL RESIDENTIAL CODE (IRC), AND ALL OTHER RELEVANT LOCAL, STATE, AND NATIONAL REGULATIONS.
- ALL PLUMBING WORK SHALL COMPLY WITH THE LATEST EDITION OF THE INTERNATIONAL PLUMBING CODE (IPC) AND THE LOCAL PLUMBING CODE.
- 4. PLUMBING SYSTEMS SHALL BE TESTED AND INSPECTED IN ACCORDANCE WITH THE LOCAL PLUMBING CODE REQUIREMENTS.
- 5. PLUMBING FIXTURES SHALL BE INSTALLED WITH THE APPROPRIATE TRIM, FITTINGS, AND ACCESSORIES, AS RECOMMENDED BY THE MANUFACTURER.
- 6. PIPING SHALL BE PROPERLY SUPPORTED AND SECURED TO PREVENT SAGGING,
- MOVEMENT, AND VIBRATION.

  7. SHUT-OFF VALVES SHALL BE PROVIDED AT ALL BRANCH CONNECTIONS AND AT THE INLET AND OUTLET OF EACH PIECE OF EQUIPMENT.
- 8. BACKFLOW PREVENTION DEVICES SHALL BE INSTALLED AS REQUIRED BY THE LOCAL PLUMBING CODE TO PROTECT THE POTABLE WATER SYSTEM.
- 9. PLUMBING FIXTURES AND EQUIPMENT SHALL BE ACCESSIBLE FOR MAINTENANCE AND SERVICING
- 10. EXPOSED PLUMBING PIPING AND FIXTURES SHALL BE INSULATED TO PREVENT CONDENSATION AND ENERGY LOSS.
- 11. DEAD ENDS IN THE DRAINAGE SYSTEM MUST BE AVOIDED, EXCEPT WHERE NECESSARY TO INSTALL A CLEANOUT IN AN ACCESSIBLE LOCATION, AND MUST HAVE A VENTED CONNECTION TO THE OUTSIDE ATMOSPHERE.
- 12. THE VERTICAL DEFLECTION OF PVC PIPE MUST NOT EXCEED 5%, AND NO DEFLECTION IS PERMITTED FOR IRON PIPE.
- 13. WORK MUST BE PROPERLY COORDINATED WITH OTHER TRADES TO AVOID CONFLICTS, REFERRING TO THE ARCHITECTURAL AND STRUCTURAL DRAWINGS FOR INFORMATION REGARDING CEILING ELEVATIONS, SPACE CLEARANCES, WALL AND PARTITION LOCATIONS, ETC.
- 14. ALL FIXTURES SHALL HAVE ACCESSIBLE STOPS.
- 15. DOMESTIC WATER PIPING SHALL BE PEX, AND PVC PIPING IS NOT ACCEPTABLE FOR INTERIOR USE.
- 16. VENT TERMINATIONS SHALL BE LOCATED AT LEAST 10 FEET FROM OR 3 FEET ABOVE ANY OPERABLE WINDOW, DOOR OPENING, AIR INTAKE, OR VENT SHAFT, AND AT LEAST 3 FEET IN EVERY DIRECTION FROM ANY LOT LINE, ALLEY, OR STREET.
- 17. PIPE AND FITTINGS UTILIZED IN THE WATER SUPPLY SYSTEM SHALL HAVE A MAXIMUM OF 8 PERCENT LEAD.
- 18. ACRYLONITRILE BUTADIENE STYRENE (ABS) SHALL BE USED FOR THE SEWERAGE AND
- VENTILATION SYSTEM.

  19. CROSS-LINKED POLYETHYLENE (PEX) SHALL BE USED FOR THE WATER SUPPLY SYSTEM.
- 20. POLYVINYL CHLORIDE (PVC) SHALL BE USED FOR THE WATER SUPPLY
- 20. POLYVINYL CHLORIDE (PVC) SHALL BE USED FOR THE RAIN WATER SYSTEM.
  21. THE MIMIMUM WATER SUPPLY DEPTH UNDER FLOOR FINISH SHOUD BE 1/2".
- 22. ANY PIPE INSTALLED UNDERGROUND MUST HAVE AT LEAST 12 INCHES OF CLEARANCE BETWEEN THE OUTSIDE OF THE PIPE AND ANY OTHER UNDERGROUND STRUCTURE.
- 23. THE MINIMUM CLEARANCE BETWEEN COLD AND HOT WATER LINES IN RESIDENTIAL HOMES MAINTAIN A MINIMUM DISTANCE OF 6 INCHES.
- 24. HORIZONTAL SEPARATION BETWEEN WATER AND SEWER LINES: A MINIMUM OF 12 INCHES BETWEEN POTABLE WATER SUPPLY LINES (COLD AND HOT WATER) AND

#### **ABBREVIATIONS**

SANITARY SEWER LINES.

Ø	DIAMETER
ABS	ACRYLONITRILE BUTADIENE STYRENE
ABV	ABOVE
AD	AREA DRAIN
AFF	ABOVE FINISHED FLOOR
ALT	ALTERNATE
BFF	BELOW FINISHED FLOOR
BLW	BELOW
СО	CLEAN OUT
CW	COLD WATER
D	DEGREE
DFU	DRANAGE FIXTURE UNIT
DIA	DIAMETER
DN	DOWN
FCO	FLOOR CLEAN OUT
FD	FLOOR DRAIN
FL	FLOOR
FS	FLOOR SINK
FT	FOOT/FEET
НВ	HOSE BIB
HW	HOT WATER
IN	INCH
MIN	MINIMUM
NO	NUMBER
NTS	NOT TO SCALE
PEX	CROSS-LINKED POLYETHYLENE
PLBG	PLUMBING
PVC	POLYVINYL CHLORIDE
QTY	QUANTITY
RD	ROOF DRAIN
RED	REDUCER
RM	ROOM
RW	RAIN WATER
SF	SQUARE FOOT
V	VENT
VTR	VENT THROUGH ROOF
W	WASTE
WCO	WALL CLEAN OUT
WSFU	WATER SUPPLY FIXTURE UNIT

# PLUMBING LEGEND

D	CAP
	BEND 45 DEG
B	BEND 90 DEG
	TEE REDUCING
	TEE
	CLEAN TWO-WAY
	WYE 45 DEG
	WYE 45 DEG DOUBLE
	WYE COMBINATION
	P-TRAP

PIPE SCHEDULE							
MATERIAL	DIAMETER	LENGTH					
ACRYLONITRILE BUTADIENE STYRENE (ABS)	1 1/2"	23 FT					
ACRYLONITRILE BUTADIENE STYRENE (ABS)	2"	40 FT					
ACRYLONITRILE BUTADIENE STYRENE (ABS)	3"	23 FT					
CROSS-LINKED POLYETHYLENE (PEX)	1/2"	94 FT					
CROSS-LINKED POLYETHYLENE (PEX)	3/4"	20 FT					
CROSS-LINKED POLYETHYLENE (PEX)	1"	1 FT					
POLYVINYL CHLORIDE - RIGID	2"	58 FT					

FITTING SCHEDULE						
FITTING	SIZE	QTY				
DOMESTIC COLD WATER						
PEX 90 DEGREE ELBOW	1/2"ø-1/2"ø	14				
PEX 90 DEGREE ELBOW	3/4"ø-3/4"ø	1				
PEX TEE ELBOW	1/2"ø-1/2"ø-1/2"ø	5				
PEX TEE ELBOW	3/4"ø-3/4"ø-3/4"ø	2				
PEX TRANSITION ELBOW	1"ø-3/4"ø	1				
PEX TRANSITION ELBOW	3/4"ø-1/2"ø	1				
DOMESTIC HOT WATER						
PEX 90 DEGREE ELBOW	1/2"ø-1/2"ø	12				
PEX 90 DEGREE ELBOW	3/4"ø-3/4"ø	2				
PEX TEE ELBOW	1/2"ø-1/2"ø	4				
PEX TRANSITION ELBOW	3/4"ø-1/2"ø	1				
RAIN WATER PVC 90 DEG BEND ELBOW PVC 90 DEGREE BEND ELBOW	2"ø-2"ø 2"ø-2"ø	8 16				
SEWAGE ABS 90 DEGREE BEND ELBOW	1 1/2"ø-1 1/2"ø	1				
ABS 90 DEGREE BEND ELBOW	2"ø-2"ø	3				
ABS 90 DEGREE BEND ELBOW	3"ø-3"ø	1				
ABS P-TRAP	1 1/2"ø-1 1/2"ø	3				
ABS P-TRAP	2"ø-2"ø	2				
ABS REDUCER ELBOW	2"ø-1 1/2"ø	1				
ABS REDUCER ELBOW	3"ø-2"ø	1				
ABS TEE ELBOW	1 1/2"ø-1 1/2"ø	1				
ABS TEE ELBOW	2"ø-2"ø	1				
ABS TEE ELBOW	3"ø-3"ø	2				
ABS TEE REDUCER ELBOW	3"ø-3"ø-1 1/2"ø	2				
ABS TEE REDUCER ELBOW	3"ø-3"ø-2"ø	1				
WASTE DOUBLE TEE	2"ø-2"ø-2"ø	1				
VENT						
ABS VENT CAP ELBOW	1 1/2"ø	1				
ABS VENT CAP ELBOW	2"ø	2				
ADO VENT OAD ELDOW	011	4				

FIXTURE CONNECTION SCHEDULE											
FAMILY	W	V	TRAP	CW	HW	QTY	DFU	TOT.	WFU	TOT.	NOTES
DISHWASHER	2"	1-1/2"	1-1/2"	1/2"	1/2"	1		0			DRAIN TO SEWER SEE PLANS
DRYER	N/A	N/A	N/A	N/A	N/A	1		0			
HANGING PIPES CLAMP						16		0			
SHOWER TRAY	2"	1-1/2"	1-1/2"	1/2"	1/2"	1		0			
SHOWER TRIM	-	-	-	1/2"	1/2"	1		0			
SINK ISLAND SINGLE	2"	1-1/2"	1-1/2"	1/2"	1/2"	1		0			
VANITY SINK	2"	1-1/2"	1-1/2"	1/2"	1/2"	1		0			
WASHER	2"	1-1/2"	2"	1/2"	1/2"	1		0			DRAINS TO GRAY WATER OR SEWER SEE PLANS
WATER CLOSET						1		0			
WATER HEATER	N/A	N/A	N/A	3/4"	3/4"	1		0			

3"ø

ABS VENT CAP ELBOW

FIXTURE SCHEDULE							
FIXTURE	DESCRIPTION						
DISHWASHER	1	DRAIN TO SEWER SEE PLANS					
DRYER	1						
HANGING PIPES CLAMP	16						
SHOWER TRAY	1						
SHOWER TRIM	1						
SINK ISLAND SINGLE	1						
VANITY SINK	1						
WASHER	1	DRAINS TO GRAY WATER OR SEWER SEE PLANS					
WATER CLOSET	1						
WATER HEATER	1						

ACCESSORIES & FITTINGS SCHEDULE							
FIXTURE QTY DESCRIPTIONS							
DISHWASHER CONNECTOR	2						
HOSE BIB	1						
SHUTOFF VALVE	6						

PLUMBING SCHEDULE											
FIXTURE	TRAP	WASTE	VENT	C.W	H.W						
DISHWASHER	1-1/2"	2"	1-1/2"	1/2"	1/2"						
DRYER	N/A	N/A	N/A	N/A	N/A						
SHOWER TRAY	1-1/2"	2"	1-1/2"	1/2"	1/2"						
SHOWER TRIM	-	-	-	1/2"	1/2"						
SINK ISLAND SINGLE	1-1/2"	2"	1-1/2"	1/2"	1/2"						
VANITY SINK	1-1/2"	2"	1-1/2"	1/2"	1/2"						
WASHER	2"	2"	1-1/2"	1/2"	1/2"						
WATER CLOSET											
WATER HEATER	N/A	N/A	N/A	3/4"	3/4"						

WATER FIXTURE UNIT SCHEDULE									
FAMILY	QTY	UNIT VALUE	TOTAL						
DISHWASHER	1		0						
DRYER	1		0						
HANGING PIPES CLAMP	16		0						
SHOWER TRAY	1		0						
SHOWER TRIM	1		0						
SINK ISLAND SINGLE	1		0						
VANITY SINK	1		0						
WASHER	1		0						
WATER CLOSET	1		0						
WATER HEATER	1		0						

WASTE FIXTURE UNIT SCHEDULE								
FAMILY	QTY	DFU VALUES	TOTAL					
DISHWASHER	1	0						
DRYER	1	0						
HANGING PIPES CLAMP	16	0						
SHOWER TRAY	1	0						
SHOWER TRIM	1	0						
SINK ISLAND SINGLE	1	0						
VANITY SINK	1	0						
WASHER	1	0						
WATER CLOSET	1	0						
WATER HEATER	1	0						



**KEY PLAN** 

NO.	DESCRIPTION	DATE

NOTE:

LEGEND:

PROJECT

160-Haven-733 2Bd/1BaCraftsman-550

DRAWING NAME

NOTE AND SCHEDULE

 CLIENT NAME:

 PROJECT NUMBER:
 0383\_12

 DATE:
 3/26/2025 3:14:18 PM


 DESIGNED BY:
 Designer

 DRAWN BY:
 Author

 CHECKED BY:
 Checker

P101

SCALE: 1/2" = 1'-0"

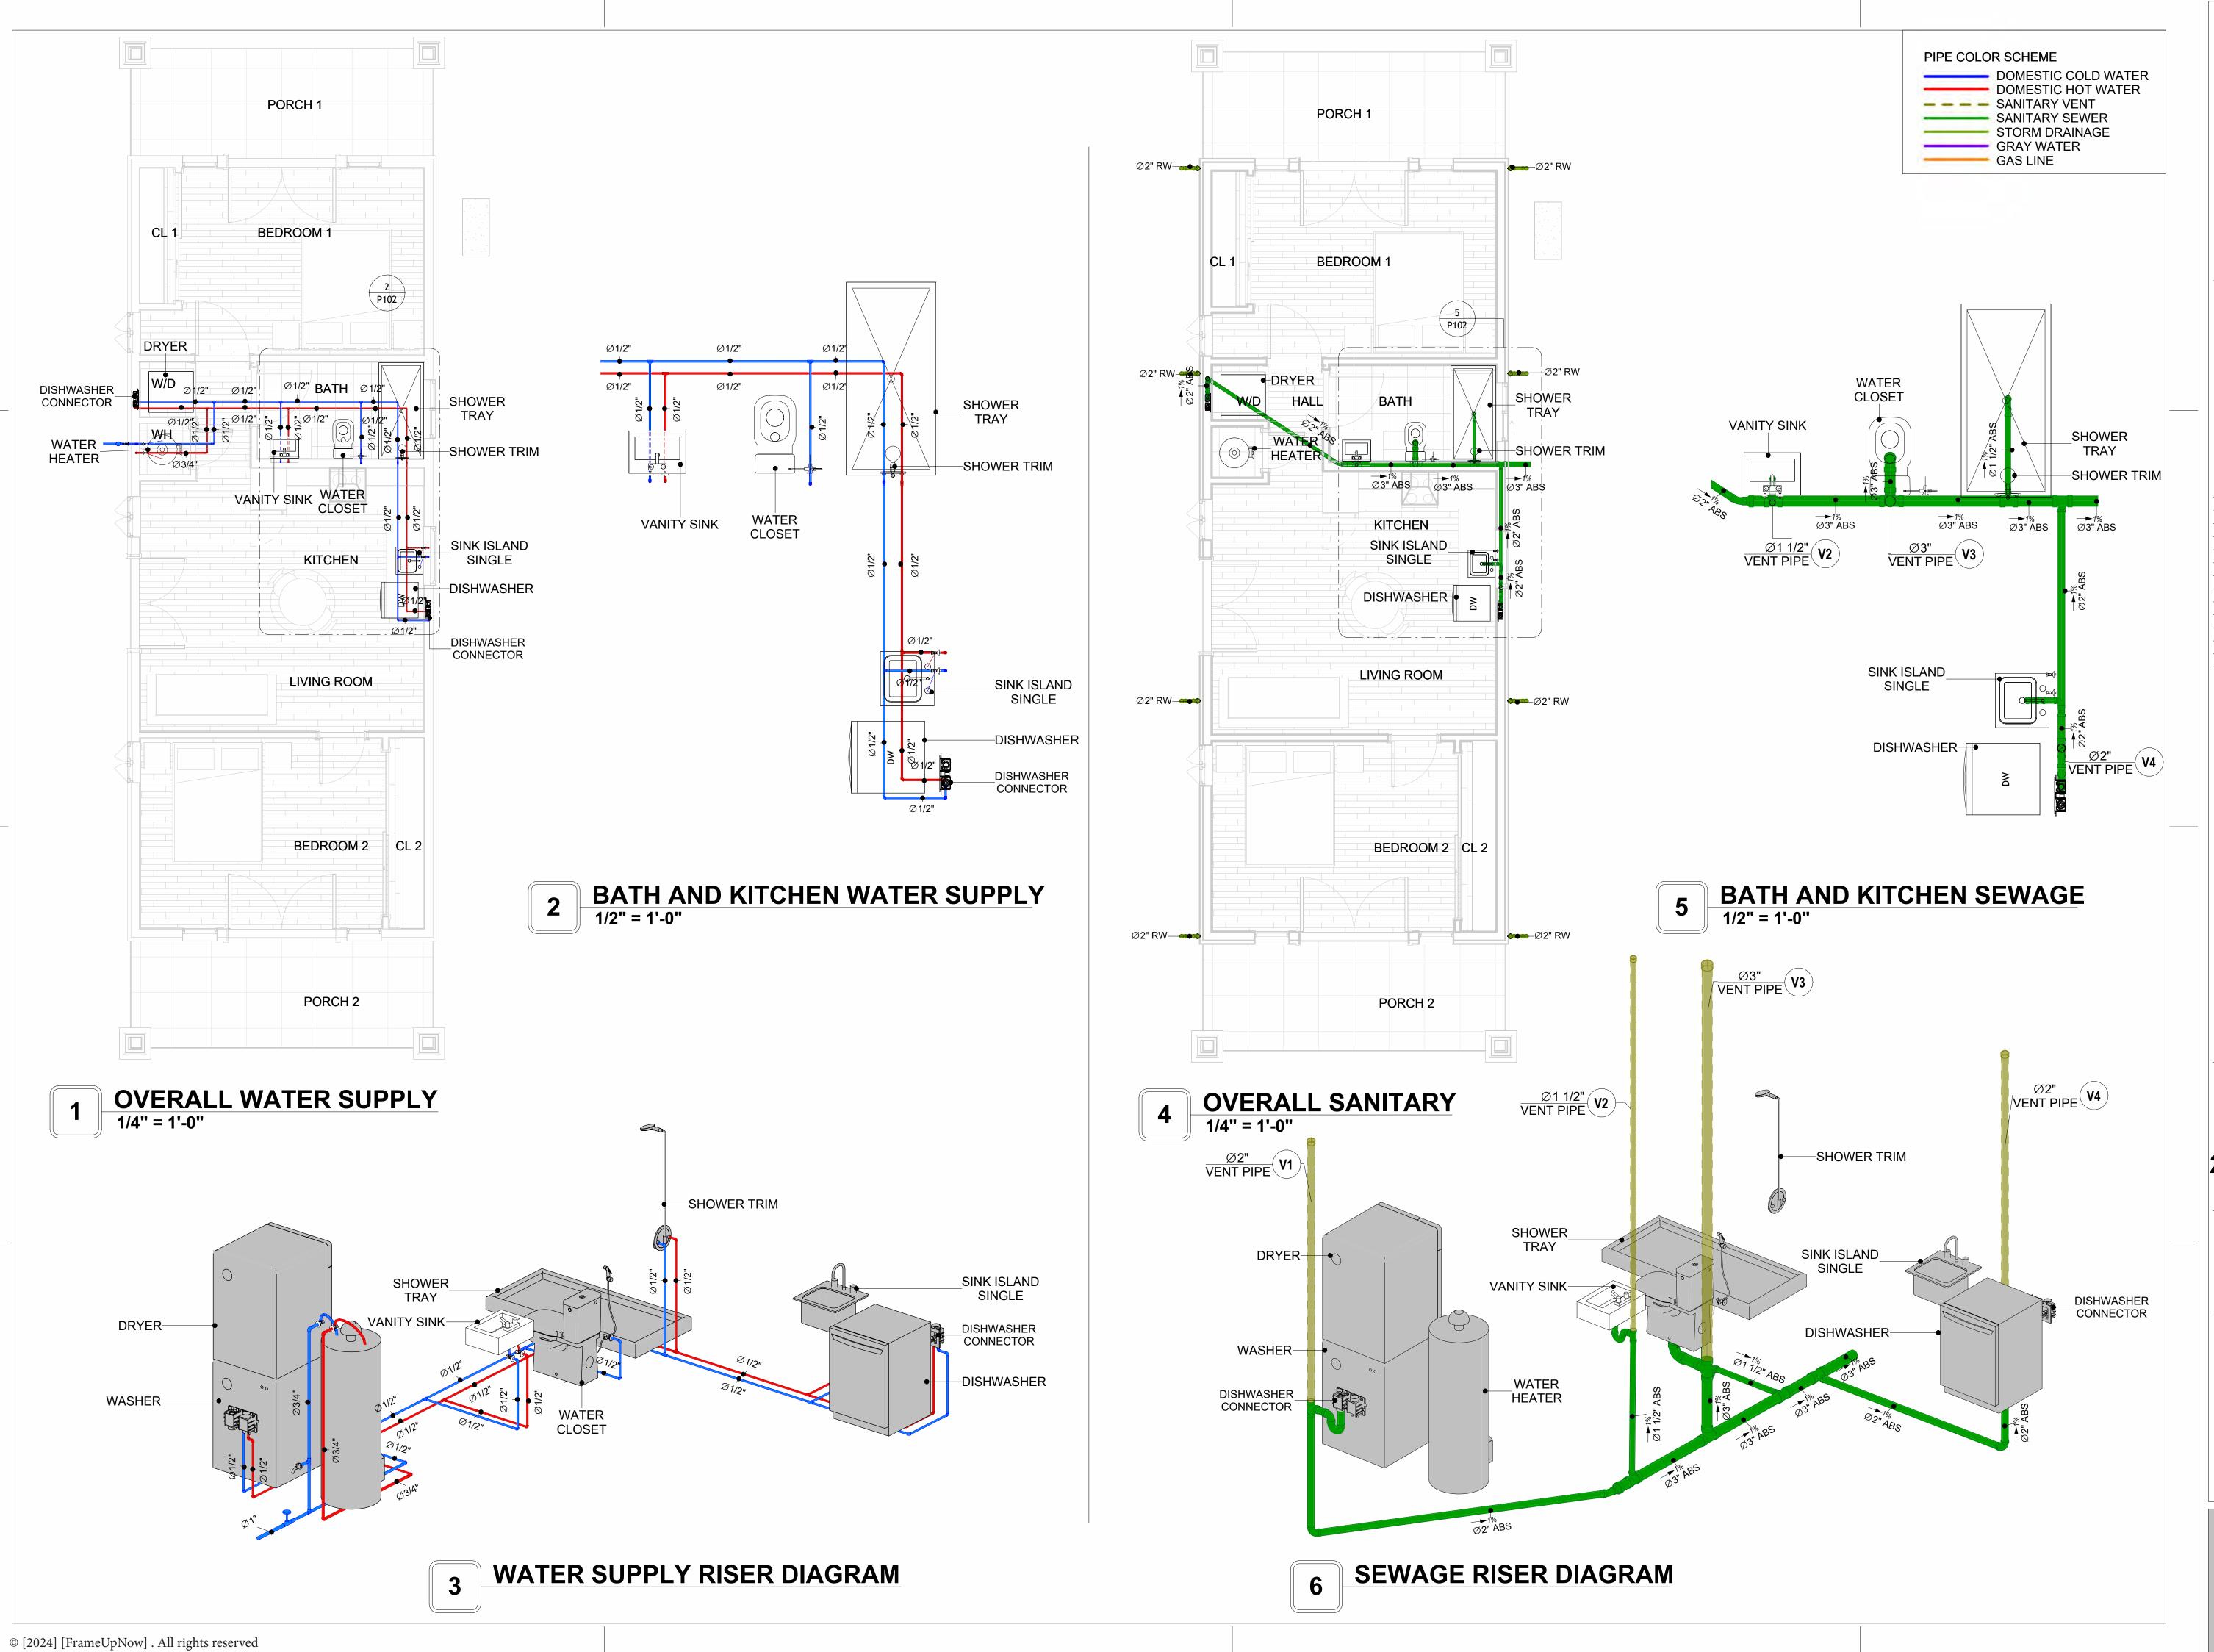



**KEY PLAN** 

NO. DESCRIPTION DATE

NOTE:

PROJECT

LEGEND:

160-Haven-733 2Bd/1BaCraftsman-550

DRAWING NAME

# WATER SUPPLY AND SEWAGE SYSTEM

CLIENT NAME:

PROJECT NUMBER:

0383\_12

DATE:

3/26/2025 3:14:47 PM

DESIGNED BY:

DRAWN BY:

CHECKED BY:

Checker

P102

# Materials Shopping List

Please print and take this Materials Shopping List to your favorite Home Depot and ask for assistance in selecting the materials, fixtures and fittings to complete your new home.

Record your selection and the price of the item. Then do the math to determine the cost for your selections and the total cost of finishing your home.

#### **Have It Your Way!**

The material types listed in this document were selected based on personal preferences. The Customer is encouraged to make changes to the material types in accordance with local customs, regulations, and personal preferences.

Have It Your Way!



# 20 good reasons to frame a home with metal and not wood



Why build your ADU with metal vs wood	Wood	Metal	Explanation
1 DIY Construction Benefit		<b>~</b>	The wall frames, trusses and beams can be erected in a just a few days
2 Minimal Construction Skills Required		<b>~</b>	Pre-assembled walls and trusses require no specialized skills to errect
3 Build as DIY, Hybrid or by a General Contractor		<b>~</b>	Do it yourself, Hybrid (involve special contractors) or hire a General Contractor
4 Build It As You Can Afford It		<b>~</b>	Impervious to Weather - build as you have the time and money
5 Up Front Cost of Framing Materials	~		As to only the framing material, wood is less expensive
6 Total Cost To Build		<b>~</b>	Savings in time, labor, and other areas make light gauge steel LESS expensive
7 Termites and wood boring insects		<b>~</b>	Termites, carpenter ants and wood boring insects eat wood, not metal
8 Mold resistant		<b>~</b>	Metal does not attract mold
9 Damage caused by exterior and interior flooding		<b>~</b>	Metal needs no reconditioning after a flood
10 Fire Resistant		<b>✓</b>	Non-combustible
11 Lower insurance rates		<b>~</b>	Many insurance underwriters now provide lower rates for metal framed homes
12 Walls, trusses, and beams retain their original form		<b>~</b>	Perfectly straight walls - no shimming of drywall
13 Corners are 90 degrees		<b>~</b>	No need for templating of countertops to adjust for out of square corners
14 Strength and weight		<b>~</b>	Metal is stronger than wood and weighs less - no need for crane to lift ADU trusses
15 IBC Engineered Stamp		<b>~</b>	If an engineering stamp is necessary, months of waiting are saved
16 Complete BOM (Materials Shopping List)		<b>~</b>	Take the materials shopping list to Home Depot and start shopping/pricing
17 Flexible in Seismic Areas - Won't Fracture		<b>~</b>	Light gauge steel is flexible and won't fracture when the earth moves
18 No Waste At Job Site		<b>~</b>	Steel is the most recycled material in the world. A typical wood home has 20-30% waste
19 Environmentally Friendly		<b>~</b>	Trees don't have to be destroyed and the source of most metal is from recycling
20 How-To Videos Included		<b>~</b>	How-to videos provide simple assembly instructions
21 Relationship Counselor		<b>~</b>	Eliminate emotional uphevels - save time, money, and preserve the relationship

#### Universal Requirements - some or all may be required

- 1 Site plan
- 2 Electrical Supply Connection
- 3 Sewer Connection
- 4 Fresh Water Supply Connection
- 5 Set Backs
- 6 Soils Evaluation

- 7 Earthquake (fault) evaluation
- 8 Foundation Plan subject to soils
- 9 Compliance with local energy codes: insulation home wrap and flashing
- 10 Engineering for wind speed and snow load.
- 11 State and Local ordinances regarding ADUs
- 12 Local Architect and/or Engineer may be necessary

#### Haven-2Bd1Ba-Craftsman





# Haven-2Bd1Ba-Craftsman MATERIAL SHOPPING LIST

#### **Have It Your Way!**

The material types listed in this document were selected based on personal preferences. The Customer is encouraged to make changes to the material types in accordance with local customs, regulations, and personal preferences. Have It Your Way!

#### TOC



#	Name	Link	Page No						
	1 Cover Page	Cover Page	1						
	2 TOC	TOC	2						
	3 ELECTRICAL BOM	ELECTRICAL BOM	3						
	5 HVAC BOM	HVAC BOM	7						
	4 PLUMBING BOM	PLUMBING BOM	10						
	6 ARCHITECTURAL BOM	ARCHITECTURAL BOM	15						

**Table Of Content** 

#### Have It Your Way!

The material types listed in this document were selected based on personal preferences. The Customer is encouraged to make changes to the material types in accordance with local customs, regulations, and personal preferences. Have It Your Way!

#### **GENERAL NOTES**

- 1 This BOM (Bill of Materials) is prepared as a Materials Shopping List to help builders and DIYers gain a complete understanding of most if not all elements required for the complete construction of this structure, according to the original design documents provided by FrameUpNow.
- 2 All quantities and specifications are subject to change based on the final design, field measurements, availability of products and customer preferences. The customer should verify all information prior to purchasing materials.
- 3 All products and elements in the list shall conform to the International Residential Code (IRC), or any other local and international building codes, safety regulations, and standards that are applicable to the location of the structure.
- 4 If any changes are made by the customer to the list of materials specified in this document, the customer is responsible for assuring that the correct type and quantity of materials are utilized in accordance with local building codes.
- 5 FrameUpNow, will not be held responsible for any misuse of this document, the products listed, or for deviations from the content that are made due to changes in specifications, pricing, availability, or customer preferences.
- 6 The customer is advised to consult a qualified professional or technician prior to purchasing materials for specialized construction system items. Some items including but not limited to caseworks, doors and windows may require as built measurements prior to purchase to confirmation of final dimensions.
- 7 If there are additional trim elements or specific installation methods, the total amount of materials needed might vary. Consider any additional trim required for corners, intersections, or other architectural details that might cause this variations before procedding to purchase and construction.

#### **ARCHITECTURAL BOM**



	Haven-2Bd1Ba-Craftsman										
	ARCHITECTURAL MATERIAL SHOPPING LIST										
No.	Item	Туре	Unit	Quantity	Unit Price	Total	Description				
	APPLIANCES										
	Refrigerator		PCS	1							
	Range		PCS	1							
3	Washer		PCS	1							
	Dryer		PCS	1							
5	Dish Washer		PCS	1							
6	Oven		PCS	0							
	Microwave		PCS	0							
	CASEWORKS		le-r	45.00							
	Kitchen Cabinet		FT	15.82							
	Laundry Cabinet		FT	2.25							
	Vanity Cabinet		FT	3							
	Medicine Cabinet		PCS	1							
	Kitchen countertop		SF	24.56							
	Laundry Countertop		PCS	0							
	Bathroom Countertop		SF	0							
	Island		FT	0							
	Peninsula		FT								
	Closets		SF	106.37							
_		D W-II	CE	(50							
	Ceiling Board Dry Wall Fastener	Dry Wall Screw	SF PCS	650 1137.5							
		1									
	Vapor Retarder	Polyethylene film	SF	954							
	Vapor Retarder Fastener	Nails with washer heads	PCS	2862							
	Ceiling Board (MRD)	Moisture resistant drywall	SF	57							
	MRD Fastener	Mada - Dhara - d	PCS	99.75							
	Ceiling Board	Marine Plywood	SF PCS	247 432.25							
	Marine Plywood Fastener Dry Wall Tape	Screw	FT	432.25							
	FLOORING		FI	4//							
	Main Living Space	I	SF	248.65							
	Bathroom		SF	55.05							
	Bedroom		SF	333.11							
	Porch		SF	227.09							
	STRUCTURE	I .	51	227.07							
	Foundation		SF	950.87							
	WALLS EXTERIOR	1	ĮO.	700.07							
1	External Stone		SF	302							
	Exterior-Grade Plywood		SF	683							
	Exterior-Grade Plywood Fastener	Self-drilling screws(100/pkt)	PKT	6.83							
	Wall Shteathing (OSB)	J	SF	985							
	Shteathing Fastener	Self-drilling screws(100/pkt)	PKT	9.85							
	Wall Homewrap	J,	SF	985							
	Homewrap Fastener	Stapled fastener (200/pkt)	PKT	3.743							
	Furring Strip		PCS	85.375							
	Furring Strip Fastener	Self-drilling screws(100/pkt)	PKT	6.83							
	Wall Paint	J,	SF	985							
	Stone Copping	Masonry stone	SF	0							
	Stone Veneer	Masonry stone	SF	0							
	Mortar for Stone Veneer		SF	0							
14	Wall Insulation		SF	2992.8							
	WALLS INTERIOR										
	Cementitious Backer Board		SF	323							
2	Kerdi membrane		SF	323							
	Kerdi membrane Fastener		SF	323							
	Wall Ceramic Tile		SF	323							
	Drywall Board		SF	1591							
	Drywall Fastener	Self-drilling screws(100/pkt)	PKT	15.91							
7	Wall Paint		SF	1591							
	Drywall Tape		FT	298.8							
9	Wall Sweep		FT	127							

#### **ARCHITECTURAL BOM**



$\cap$	DOORS				
1	Interior Swinging	3' - 0" X 6'-8"	PCS	1	
1		2' - 6" X 6'-8"	PCS	1	
2	Interior Swinging			1	
3	Interior Swinging	2' - 4" X 6'-8"	PCS	<u>'</u>	
4	Interior Sliding	10' - 0" X 6'- 8"	PCS	2	
5	Interior Swinging	2' - 8" X 6'-8"	PCS	1	
6	Exterior Swinging	5' - 0" X 6'-8"	PCS	1	
7	Exterior Door Trim		FT	18.4	
8	Interior Door Trim		FT	239.4	
9	Entry Lock set			1	
10	Privacy Lock set			3	
11	Passage Lock set			3	
	WINDOWS	-			
1	Single Hung	3' - 3" X 3'-3"	PCS	2	
2	Sliding	3' - 3" X 2'-3"	PCS	4	
3	Sliding	3' - 3" X 1'-9"	PCS	1	
4	Casment	2' - 9" X 3'-9"	PCS	6	
5	Exterior Window Trim		FT	160	
6	Interior Window Trim		FT	160	
	ROOF				
1	Roof Covering		SF	1200	
2	Roof Covering Fastener		PCS	600	
3	Roof Felt Paper		SF	1200	
4	Roof Felt Paper Fastener		PCS	3600	
5	Roof Sheathing		SF	1200	
6	Roof Sheathing Fastener		PCS	9600	
7	Batten		FT	0	
8	Batten Fastener		PCS	0	
9	Soffit		SF	152	
10	Soffit Fastener		PCS	76	
11	Fascia		FT	156	
12	Fascia board fastener		PCS	78	
13	Roof Insulation		SF	1200	



	Haven-2Bd1B	Ba-Craftsm	an			
FI	LECTRICAL MATER	RIAL SHOP	PING LI	ST		
No. Item	Type	Unit		Unit Price	Total	Description
1 Kitchen Ceiling Light		PCS	4			
2 Kitchen Wall Mounted Light		PCS	1			
3 Exterior Wall Mounted Light		PCS	6			
4 Livingroom Ceiling Light With Fan		PCS	1			
5 Bedroom Ceiling Light With Fan		PCS	2			
6 Dining Ceiling Light		PCS	0			
7 Bath Wall Mounted Light		PCS	1			
8 Bathroom Ceiling Light		PCS	2			
9 Livingroom Ceiling Light		PCS	6			
10 Bedroom Ceiling Light		PCS	8			
11 Hall & Entry Ceiling Light		PCS	2			
12 Closet Ceiling Light		PCS	0			
13 Smoke Detector		PCS	4			
☐ ELECTRICAL FITTINGS		1 03	4			
14 Standard Receptacle 120V	20A	PCS	16			
15 GFCI Receptacle 120V	20 A	PCS	13			
16 GFCI Receptacle 240V	30 A	PCS	2			
17 GFCI Receptacle 240V	50 A	PCS	1			
18 GFCI Receptacle 240V	60 A	PCS	1			
19 Fan Switch		PCS	1			
20 Single Pole Switch		PCS	6			
21 Three Way Switch		PCS	7			
22 Dimmer Switch		PCS	4			
23 ROMEX 14 AWG	14/3/W/ground	FT	155			
24 ROMEX 12 AWG	12/3/W/ground	FT	317			
25 ROMEX 12 AWG	12/2/W/ground	FT	0			
26 ROMEX 10 AWG	10/3/W/ground	FT	0			
27 ROMEX 10 AWG	10/2/W/ground	FT	62			
28 Romex 8 AWG	8/3/W/ground	FT	0			
29 Romex 8 AWG	8/2/W/ground	FT	15			
30 ROMEX 6 AWG	6/3/W/ground	FT	26			
31 Bare Copper Ground Wire 6 AWG		FT				
△ ELECTRICAL BOXES & CIRCUTES						
32 Panelboard -240V 1 Phase MLO	200 AMP	PCS	1			
33 Circuit breaker	15 A	PCS	4			
34 Circuit breaker	20 A	PCS	10			
36 Circuit breaker	30 A	PCS	2			
37 Circuit breaker	50 A	PCS	1			
38 Circuit breaker	60 A	PCS	1			
39 Single Gang Switch Box	UU M	PCS	1			
	+	PCS	7			
40 Double Gang Switch Box		PCS	1			
<ul><li>41 Triple Gang Switch Box</li><li>42 Pull Box</li></ul>	#1//	PCS	28			
	#1/4					
43 Receptacle Box		PCS	33			

#### **PLUMBING BOM**



# Haven-2Bd1Ba-Craftsman PLUMBING SYSTEM MATERIAL SHOPPING LIST

	PLUMBING SYSTEM MATERIAL SHOPPING LIST									
No.	Item	Туре	Unit	Quantity	Unit Price	Total	Description			
Δ	PLUMBING FIXTURES & ACCESSORIES	, , , , , , , , , , , , , , , , , , , ,	-1				·			
1	Bath Tub (Alcove Tub)		PCS	0						
2	Kitchen Sink		PCS	1						
3	Kitchen Faucets		PCS	1						
4	Vanity Sink		PCS	1						
5	Bath room Faucets		PCS	1						
6	Water Closet		PCS	1						
7	Shower Trim		PCS	1						
8	Shower Tray		PCS	1						
9	Water Heater		PCS	1						
10	Hose Bib		PCS	1						
11	Shutoff Valve		PCS	6						
	Hanging pipe clamp		PCS	19						
13	Gate Valve		PCS	1						
	Dishwasher Supply Single Connector		PCS	1						
	Dishwasher Sewage Single Connector		PCS	1						
	Laundry Sweat Connector		PCS	1						
	SANITARY & PLUMBING PIPES		F C 3							
	ABS (Acrylonitrile Butadiene Styrene) Pipes	ø 1"	FT	0						
	ABS (Acrylonitrile Butadiene Styrene) Pipes	ø 1 1/2"	FT	23						
	ABS (Acrylonitrile Butadiene Styrene) Pipes	Ø 2"	FT	40						
4	ABS (Acrylonitrile Butadiene Styrene) Pipes	Ø 3"	FT	23						
5	PEX (Cross-linked polyethylene) Pipes	Ø 1/2"	FT	94						
	PEX (Cross-linked polyethylene) Pipes	ø 3/4"	FT							
	1 3 3 7 1			20						
7	PEX (Cross-linked polyethylene) Pipes	Ø 1"	FT	1						
9	PVC Pipes Sch.80 - Rigid	ø 1 1/2"	FT	0						
	PVC Pipes Sch.80 - Rigid	ø 2"	FT	58						
	PVC Pipes Sch.80 - Rigid	Ø 3"	FT	0						
	Flex Pipe Round	ø 1/2"	PCS	8						
<u></u>	PIPE FITTINGS	1 1 0 0 1 1 1 1 1 1 1 1 1 1 1 1 1 1 1 1	D00		1					
	ABS 90 Degree Bend Elbow	1 1/2"ø-1 1/2"ø	PCS	1						
	ABS 90 Degree Bend Elbow	2"ø-2"ø	PCS	3						
3	ABS 90 Degree Bend Elbow	3"ø-3"ø	PCS	1						
4	ABS P-Trap	1 1/2"ø-1 1/2"ø	PCS	3						
	ABS P-Trap	2"ø-2"ø	PCS	2						
6	ABS Reducer Elbow	2"ø-1 1/2"ø	PCS	1						
7	ABS Reducer Elbow	3"ø-2"ø	PCS	1						
8	ABS TEE Elbow	1 1/2"ø-1 1/2"ø-1 1/2"ø	PCS	1						
9	ABS TEE Elbow	2"ø-2"ø-2"ø	PCS	1						
	ABS TEE Elbow	3"ø-3"ø-3"ø	PCS	2						
	ABS Tee Reducer Elbow	3"ø-3"ø-1 1/2"ø	PCS	2						
	ABS Tee Reducer Elbow	3"ø-3"ø-2"ø	PCS	1						
	ABS Vent Cap Elbow	1 1/2"ø	PCS	1						
	ABS Vent Cap Elbow	2"ø	PCS	2						
15	ABS Vent Cap Elbow	3"ø	PCS	1						
	PEX 90 Degree Elbow	1/2"ø-1/2"ø	PCS	26						
17	PEX 90 Degree Elbow	3/4"ø-3/4"ø	PCS	3						
18	PEX Tee Elbow	1/2"ø-1/2"ø-1/2"ø	PCS	9						
19	PEX Tee Elbow	3/4"ø-3/4"ø-3/4"ø	PCS	2						
20	PEX Transition Elbow	1"ø-3/4"ø	PCS	1						
21	PEX Transition Elbow	3/4"ø-1/2"ø	PCS	2						
	PVC 90 Deg Bend Elbow	2"ø-2"ø	PCS	16						
	WASTE DOUBLE TEE	2"ø-2"ø-2"ø-2"ø	PCS	1						

		Haven-2	Bd1Ba-Cı	aftsman			
		HVAC SYSTEM N	//ATERIAL	SHOPP	ING LIST		
No.	Item	Туре	Unit	Quantity	Unit Price	Total	Description
	HVAC_DUCTS						
1	PIPE (REFRIGERANT LINE)	3/8" (Ø)	FT	70.91			
2	PIPE (REFRIGERANT LINE)	3/4''' (Ø)	FT	103.6			
3	DRAYER HOSE	4" (Ø)	FT	5			
4	FLEX DUCT ROUND	4" (Ø)	FT	6.23			
$\triangle$	DUCT FITTINGS & ACCESSORIES						
5	ELBOW (REFRIGERANT LINE)	3/4" (Ø)-3/4" (Ø)	PCS	25			
6	ELBOW (REFRIGERANT LINE)	3/8" (Ø)-3/8" (Ø)	PCS	21			
7	TEE (REFRIGERANT LINE)	3/4" (Ø)-3/4" (Ø)-3/4" (Ø)	PCS	2			
8	TEE (REFRIGERANT LINE)	3/8" (Ø)-3/8" (Ø))-3/8" (Ø)	PCS	2			
9	TRANSITION (REFRIGERANT	3/4" (Ø)-1/2" (Ø)	PCS	4			
10	TRANSITION (REFRIGERANT	3/4" (Ø)-3/4" (Ø)	PCS	1			
11	TRANSITION (REFRIGERANT	3/4" (Ø)-5/8" (Ø)	PCS	3			
12	TRANSITION (REFRIGERANT	3/8" (Ø)-1/4" (Ø)	PCS	1			
<u></u>	HVAC_EQUIPMENTS						
13	AIR HANDLING UNIT	WALL MOUNTED	PCS	3			
14	CONDENSER	OUTDOOR UNIT	PCS	1			
15	EXHAUST FAN	75 CFM	PCS	1			
16	EXHAUST HOOD	WALL MOUNTED	PCS	1			
17	HOOD-WALL: VENT	HOOD-WALL: VENT	PCS	1			
18	DRAYER: VENT	DRAYER: VENT	PCS	1			
19	ROOF VENT	3"(Ø)	PCS	1			



#### **Table Of Content**

#	Name	Link	Page No
1	Cover Page	<u>Cover Page</u>	1
2	TOC	TOC	2
3	ELECTRICAL BOM	ELECTRICAL BOM	3
5	HVAC BOM	HVAC BOM	7
4	PLUMBING BOM	PLUMBING BOM	10
6	ARCHITECTURAL BOM	ARCHITECTURAL BOM_	15

#### **Have It Your Way!**

The material types listed in this document were selected based on personal preferences. The Customer is encouraged to make changes to the material types in accordance with local customs, regulations, and personal preferences. Have It Your Way!

#### **GENERAL NOTES**

- 1 This BOM (Bill of Materials) is prepared as a Materials Shopping List to help builders and DIYers gain a complete understanding of most if not all elements required for the complete construction of this structure, according to the original design documents provided by FrameUpNow.
- 2 All quantities and specifications are subject to change based on the final design, field measurements, availability of products and customer preferences. The customer should verify all information prior to purchasing materials.
- 3 All products and elements in the list shall conform to the International Residential Code (IRC), or any other local and international building codes, safety regulations, and standards that are applicable to the location of the structure.
- 4 If any changes are made by the customer to the list of materials specified in this document, the customer is responsible for assuring that the correct type and quantity of materials are utilized in accordance with local building codes.
- FrameUpNow, will not be held responsible for any misuse of this document, the products listed, or for deviations from the content that are made due to changes in specifications, pricing, availability, or customer preferences.
- The customer is advised to consult a qualified professional or technician prior to purchasing materials for specialized construction system items. Some items including but not limited to caseworks, doors and windows may require as built measurements prior to purchase to confirmation of final dimensions.
- 7 If there are additional trim elements or specific installation methods, the total amount of materials needed might vary. Consider any additional trim required for corners, intersections, or other architectural details that might cause this variations before procedding to purchase and construction.



			LIGHTING FIXTURES				
#	Item	Туре	Description, Manufacturer, SKU	Unit	Quantity	Unit Price	Total
1	Kitchen Ceiling Light			PCS	4		
3	Kitchen Wall Mounted Light			PCS	1		
4	Exterior Wall Mounted Light			PCS	6		
5	Livingroom Ceiling Light With Fan			PCS	1		
6	Bedroom Ceiling Light With Fan			PCS	2		
7	Dining Ceiling Light			PCS	0		
8	Bath Wall Mounted Light			PCS	1		
9	Bathroom Ceiling Light			PCS	2		
10	Livingroom Ceiling Light			PCS	6		
11	Bedroom Ceiling Light			PCS	8		
12	Hall & Entry Ceiling Light			PCS	2		
12	Closet Ceiling Light			PCS	0		
13	Smoke Detector			PCS	4		
14							
15							



			ELECTRICAL FITTINGS				
#	Item	Туре	Description, Manufacturer, SKU	Unit	Quantity	Unit Price	Total
1	Standard Receptacle 120V	20A		PCS	16		
2	GFCI Receptacle 120V	20 A		PCS	13		
3	GFCI Receptacle 240V	30 A		PCS	2		
4	GFCI Receptacle 240V	50 A		PCS	1		
5	GFCI Receptacle 240V	60 A		PCS	1		
5	Fan Switch			PCS	1		
7	Single Pole Switch			PCS	6		
3	Three Way Switch			PCS	7		
)	Dimmer Switch			PCS	4		
LO							
11							
12							
L3							
14							
15							



		ELECTR	ICAL CONDUITS & WIRING			
#	Item	Туре	Description, Manufacturer, SKU	Unit	Quantity U	nit Price   Total
1	ROMEX 14 AWG	14/3/W/ground		FT	155	
3	ROMEX 12 AWG	12/3/W/ground		FT	317	
4	ROMEX 12 AWG	12/2/W/ground		FT	0	
5	ROMEX 10 AWG	10/3/W/ground		FT	0	
8	ROMEX 10 AWG	10/2/W/ground		FT	62	
9	Romex 8 AWG	8/3/W/ground		FT	0	
10	Romex 8 AWG	8/2/W/ground		FT	15	
11	ROMEX 6 AWG	6/3/W/ground		FT	26	
12	Bare Copper Ground Wire 6 AWG			FT		
13						
14						
15						
16						



		ELEC	CTRICAL BOXES & CIRCUTES				
#	Item	Туре	Description, Manufacturer, SKU	Unit	Quantity	Unit Price	Total
1	Panelboard -240V 1 Phase MLO	200 AMP		PCS	1		
2	Circuit breaker	15 A		PCS	4		
3	Circuit breaker	20 A		PCS	10		
4	Circuit breaker	30 A		PCS	2		
5	Circuit breaker	50 A		PCS	1		
6	Circuit breaker	60 A		PCS	1		
7	Single Gang Switch Box			PCS	1		
8	Double Gang Switch Box			PCS	7		
9	Triple Gang Switch Box			PCS	1		
10	Pull Box	#1/4		PCS	28		
11	Receptacle Box			PCS	33		
12							
13							
14							
15							

			HVAC_DUCTS 01				
#	Item	Туре	Description, Manufacturer, SKU	Unit		<b>Unit Price</b>	Total
1	PIPE (REFRIGERANT LINE)			FT	50.2`		
2	PIPE (REFRIGERANT LINE)	3/4''' (Ø)		FT	88.33		
3	DRAYER HOSE	4" (Ø)		FT	6.3		
4	FLEX DUCT ROUND	4" (Ø)		FT	7.12		
5							
6							
7							
8							
9							
10							
11							
12							
13							
14							
15							
16							

			DUCT FITTINGS & ACCESSORIES				
#	Item	Туре	Description, Manufacturer, SKU	Unit	Quantity	<b>Unit Price</b>	Total
1	ELBOW (REFRIGERANT LINE)	3/4" (Ø)-3/4" (Ø)		PCS	25		
2	ELBOW (REFRIGERANT LINE)	3/8" (Ø)-3/8" (Ø)		PCS	21		
	TEE (REFRIGERANT LINE)	3/4" (Ø)-3/4" (Ø)-3/4" (Ø)		PCS	2		
1	TEE (REFRIGERANT LINE)	3/8" (Ø)-3/8" (Ø))-3/8" (Ø)		PCS	2		
5	TRANSITION (REFRIGERANT LINE)	3/4" (Ø)-1/2" (Ø)		PCS	4		
5	TRANSITION (REFRIGERANT LINE)	3/4" (Ø)-3/4" (Ø)		PCS	1		
,	TRANSITION (REFRIGERANT LINE)	3/4" (Ø)-5/8" (Ø)		PCS	3		
3	TRANSITION (REFRIGERANT LINE)	3/8" (Ø)-1/4" (Ø)		PCS	1		
)							
.0							
1							
.2							
.3							
.4							
.5							
16							

			HVAC_EQUIPMENTS				
#	Item	Туре	Description, Manufacturer, SKU	Unit	Quantity	<b>Unit Price</b>	Total
1	AIR HANDLING UNIT	WALL MOUNTED		PCS	3		
2	CONDENSER	OUTDOOR UNIT		PCS	1		
3	EXHAUST FAN	75 CFM		PCS	1		
1	EXHAUST HOOD	WALL MOUNTED		PCS	1		
5	HOOD-WALL: VENT	HOOD-WALL: VENT		PCS	1		
5	DRAYER: VENT	DRAYER: VENT		PCS	1		
7	ROOF VENT	3"(Ø)		PCS	1		
8							
9							
10							
11							
12							
13							
14							



		PLUMBIN	NG FIXTURES & ACCESSORIES				
#	Item	Туре	Description, Manufacturer, SKU	Unit	Quantity	Unit Price	Total
1	Bath Tub (Alcove Tub)			PCS	0		
2	Kitchen Sink			PCS	1		
3	Kitchen faucets			PCS	1		
4	Vanity Sink			PCS	1		
5	Bath room faucets			PCS	1		
6	Water Closet			PCS	1		
7	Shower Trim			PCS	1		
8	Shower Tray			PCS	1		
9	Water Heater			PCS	1		
10	Hose Bib			PCS	1		
11	Shutoff Valve			PCS	6		
12	Hanging pipe clamp			PCS	16		
13	Gate Valve			PCS	1		
14	Dishwasher Supply Single Connector			PCS	1		
15	Dishwasher Sewage Single Connector			PCS	1		
16	Laundry Sweat Connector			PCS	1		



		SANI	TARY & PLUMBING PIPES				
#	Item	Туре	Description, Manufacturer, SKU	Unit	Quantity	Unit Price	Total
1	ABS (Acrylonitrile Butadiene Styrene) Pipes	ø 1"		FT	0		
2	ABS (Acrylonitrile Butadiene Styrene) Pipes	ø 1 1/2"		FT	23		
3	ABS (Acrylonitrile Butadiene Styrene) Pipes	ø 2"		FT	40		
4	ABS (Acrylonitrile Butadiene Styrene) Pipes	ø 3"		FT	23		
5	PEX (Cross-linked polyethylene) Pipes	ø 1/2"		FT	94		
6	PEX (Cross-linked polyethylene) Pipes	ø 3/4"		FT	20		
7	PEX (Cross-linked polyethylene) Pipes	ø 1"		FT	1		
8	PVC Pipes Sch.80 - Rigid	ø 1 1/2"		FT	0		
9	PVC Pipes Sch.80 - Rigid	ø 2"		FT	58		
10	PVC Pipes Sch.80 - Rigid	ø 3"		FT	0		
11	Flex Pipe Round	ø 1/2"		PCS	8		
12							
13							
14							
15							



		PIPE	FITTINGS 01				
#	Item	Туре	Description, Manufacturer, SKU	Unit	Quantity	Unit Price	Total
	ABS 90 Degree Bend Elbow	1 1/2"ø-1 1/2"ø		PCS	1		
	ABS 90 Degree Bend Elbow	2"ø-2"ø		PCS	3		
	ABS 90 Degree Bend Elbow	3"ø-3"ø		PCS	1		
	ABS P-Trap	1 1/2"ø-1 1/2"ø		PCS	3		
	ABS P-Trap	2"ø-2"ø		PCS	2		
	ABS Reducer Elbow	2"ø-1 1/2"ø		PCS	1		
	ABS Reducer Elbow	3"Ø-2"Ø		PCS	1		
	ABS TEE Elbow	1 1/2"ø-1 1/2"ø-1 1/2"ø		PCS	1		
	ABS TEE Elbow	2"ø-2"ø		PCS	1		
)	ABS TEE Elbow	3"ø-3"ø-3"ø		PCS	2		
l	ABS Tee Reducer Elbow	3"ø-3"ø-1 1/2"ø		PCS	2		
2	ABS Tee Reducer Elbow	3"ø-3"ø-2"ø		PCS	1		
3	ABS Vent Cap Elbow	1 1/2"ø		PCS	1		
1	ABS Vent Cap Elbow	2"ø		PCS	2		
5	ABS Vent Cap Elbow	3"ø		PCS	1		



		PII	PE FITTINGS 02				
#	Item	Туре	Description, Manufacturer, SKU	Unit	Quantity	Unit Price	Total
1	PEX 90 Degree Elbow	1/2"ø-1/2"ø		PCS	26		
2	PEX 90 Degree Elbow	3/4"ø-3/4"ø		PCS	3		
3	PEX Tee Elbow	1/2"ø-1/2"ø-1/2"ø		PCS	9		
4	PEX Tee Elbow	3/4"ø-3/4"ø-3/4"ø		PCS	2		
5	PEX Transition Elbow	1"ø-3/4"ø		PCS	1		
6	PEX Transition Elbow	3/4"ø-1/2"ø		PCS	2		
7	PVC 90 Deg Bend Elbow	2"ø-2"ø		PCS	16		
8	WASTE DOUBLE TEE	2"ø-2"ø-2"ø		PCS	1		
9							
10							
11							
12							
13							
14							
15							



			APPLIANCES				
#	Item	Туре	Description, Manufacturer, SKU	Unit	Quantity	Unit Price	Total
1	Refrigerator			PCS	1		
2	Range			PCS	1		
3	Washer Front Load	Stackable		PCS	1		
4	Dryer Front Load	Stackable		PCS	1		
5	Dish Washer			PCS	1		
6	Oven			PCS	(		
7	Microwave			PCS	(		
8							
9							
10							
11							
12							
13							
14							
15							
16							



			CASEWORKS 01				
#	Item	Туре	Description, Manufacturer, SKU	Unit	Quantity	Unit Price	Total
1	Kitchen Cabinet			FT	15.82		
2	Laundry Cabinet			FT	2.25		
3	Vanity Cabinet			FT	3		
4	Medicine Cabinet			PCS	1		
5	Kitchen countertop			SF	24.56		
6	Laundry Countertop			PCS	0		
7	Bathroom Countertop			SF	0		
8	Island			FT	0		
9	Peninsula			FT	0		
10	Closets			SF	106.37		
11							
12							
13							
14							
15							



	<u>1</u>		CEILING 01				
#	Item	Туре	Description, Manufacturer, SKU	Unit	Quantity	Unit Price	Total
	LIVING ROOM + KITCHEN			SF	257.0		
L	Ceiling Board	Drywall		SF	257		
	Drywall Fastener	Screw		PCS	450		
1	Vapor Retarder	Polyethylene film		SF	257		
ļ	Vapor Retarder Fastener	Nails with washer heads		PCS	771		
	BATH ROOM			SF	57.0		
,	Ceiling Board	MRD (Moisture resistant drywall)		SF	57		
	MRD Fastener	Screw		PCS	100		
	HALL + WD			SF	21.0		
,	Ceiling Board	Drywall		SF	21		
	Drywall Fastener	Screw		PCS	37		
	Vapor Retarder	Polyethylene film		SF	21		
.0	Vapor Retarder Fastener	Nails with washer heads		PCS	63		
	SHADE			SF	40.0		
.1	Ceiling Board	Marine Plywood		SF	40		
L2	Exterior Grade Plywood	Screw		PCS	70		



			CEILING 02				
#	Item	Туре	Description, Manufacturer, SKU	Unit	Quantity	Unit Price	Total
	CLOSET 1			SF	17.0		
13	Ceiling Board	Drywall		SF	17		
14	Drywall Fastener	Screw		PCS	30		
15	Vapor Retarder	Polyethylene film		SF	17		
16	Vapor Retarder Fastener	Nails with washer heads		PCS	51		
	CLOSET 2			SF	21.0		
17	Ceiling Board	Drywall		SF	21		
18	Drywall Fastener	Screw		PCS	37		
19	Vapor Retarder	Polyethylene film		SF	21		
20	Vapor Retarder Fastener	Nails with washer heads		PCS	63		
	WH			SF	9.0		
21	Ceiling Board	Drywall		SF	9		
22	Drywall Fastener	Screw		PCS	16		
23	Vapor Retarder	Polyethylene film		SF	9		
24	Vapor Retarder Fastener	Nails with washer heads		PCS	27		



			CEILING 03				
#	Item	Туре	Description, Manufacturer, SKU	Unit	Quantity	Unit Price	Total
	BED ROOM 1			SF	165.0		
25	Ceiling Board	Drywall		SF	165		
26	Drywall Fastener	Screw		PCS	289		
27	Vapor Retarder	Polyethylene film		SF	165		
28	Vapor Retarder Fastener	Nails with washer heads		PCS	495		
	BED ROOM 2			SF	160.0		
29	Ceiling Board	Drywall		SF	160		
30	Drywall Fastener	Screw		PCS	280		
31	Vapor Retarder	Polyethylene film		SF	160		
32	Vapor Retarder Fastener	Nails with washer heads		PCS	480		
	PORCH 1			SF	103.0		
33	Ceiling Board	Marine Plywood		SF	103		
34	Exterior Grade Plywood	Screw		PCS	180		
	PORCH 2			SF	104.0		
35	Ceiling Board	Marine Plywood		SF	104		
36	Exterior Grade Plywood	Screw		PCS	182		



			FLOORING INTERIOR 01				
#	Item	Туре	Description, Manufacturer, SKU	Unit	Quantity	Unit Price	Total
	BEDROOM 1						
1	Bedroom Flooring			SF	150		
2	Wood underlay	Foam Pad Polyethylene		SF	150		
3	Vapor Retarder	Vapor Barrier Polyethylene		SF	150		
	BEDROOM 2						
1	Bedroom Flooring			SF	146		
2	Wood underlay	Foam Pad Polyethylene		SF	146		
3	Vapor Retarder	Vapor Barrier Polyethylene		SF	146		
	CLOSET 1						
1	Closet Flooring			SF	15		
2	Wood underlay	Foam Pad Polyethylene		SF	15		
3	Vapor Retarder	Vapor Barrier Polyethylene		SF	15		
	CLOSET 2						
1	Closet Flooring			SF	22		
2	Wood underlay	Foam Pad Polyethylene		SF	22		
3	Vapor Retarder	Vapor Barrier Polyethylene		SF	22		



			FLOORING INTERIOR 02				
#	Item	Туре	Description, Manufacturer, SKU	Unit	Quantity	Unit Price	Total
	LIVING ROOM AND KITCH	EN					
1	Living Area Flooring			SF	249		
2	Wood underlay	Foam Pad Polyethylene		SF	249		
3	Vapor Retarder	Vapor Barrier Polyethylene		SF	249		
	BATHROOM	'					
1	Tile Finish			SF	37		
2	Adhesive	1/2" Thin set Mortar		SF	37		
3	Vapor Retarder	Vapor Barrier Polyethylene		SF	37		
	W/D						
1	Tile Finish			SF	10		
2	Adhesive	1/2" Thin set Mortar		SF	10		
3	Vapor Retarder	Vapor Barrier Polyethylene		SF	10		
	BOILER ROOM						
1	Tile Finish			SF	8		
2	Adhesive	1/2" Thin set Mortar		SF	8		
3	Vapor Retarder	Vapor Barrier Polyethylene		SF	8		



			FLOORING INTERIOR 03				
#	Item	Туре	Description, Manufacturer, SKU	Unit	Quantity	Unit Price	Total
	W/D						
25	Tile Finish			SF	10		
26	Adhesive	1/2" Thin set Mortar		SF	10		
27	Vapor Retarder	Vapor Barrier Polyethylene		SF	10		
	BOILER ROOM						
28	Tile Finish			SF	7		
29	Adhesive	1/2" Thin set Mortar		SF	7		
30	Vapor Retarder	Vapor Barrier Polyethylene		SF	7		



	FLOORING EXTERIOR							
#	Item	Туре	Description, Manufacturer, SKU	Unit	Quantity	Unit Price		
	STRUCTURE			SF	950.87			
1	Concrete Slab	4"concrete cast in situ		CF	316.96			
2	Insulation	Rigid insulation		SF	287.04			
3	Hard core	Compacted soil		CF	236.4			
4	Re-bar	#4 re-bar		Ton	0.94			
5	Concrete Pad	4"concrete cast in situ		CF	1.58			
6	Slab edge	Turndown		CF	236.48			
7	Footing	Cast-in-place concrete		CF	9.36			
	PORCH FRONT							
8	Tile Finish			SF	113.45			
9	Adhesive	1/2" Thin set Mortar		SF	113.45			
10	Vapor Retarder	Vapor Barrier Polyethylene		SF	113.45			
	PORCH BACK							
11	Tile Finish			SF	113.64			
12	Adhesive	1/2" Thin set Mortar		SF	113.64			
13	Vapor Retarder	Vapor Barrier Polyethylene		SF	113.64			



		WALLS: EXTERIOR							
#	Item	Туре	Description, Manufacturer, SKU	Unit	Quantity	Unit Price	Total		
1	External Stone			SF	302				
2	Exterior-Grade Plywood Horizontal Siding			SF	683				
3	Exterior-Grade Plywood Fastener 8/panel	Self-drilling screws(100/pkt)		PKT	6.83				
4	Wall Shteathing (OSB)			SF	985				
5	Shteathing Fastener	Self-drilling screws(100/pkt)		PKT	9.85				
6	Wall Homewrap			SF	985.00				
7	Homewrap Fastener	Stapled fastener (200/pkt)		PKT	3.74				
8	Furring Strip			PCS	85.375				
9	Furring Strip Fastener	Self-drilling screws(100/pkt)		PKT	6.83				
10	Wall Paint			SF	985				
11	Stone Copping	Masonry stone		SF	0				
12	Stone Veneer	Masonry stone		SF	0				
13	Mortar for Stone Veneer			SF	0				
14	Wall Insulation			SF	2992.8				
15									



			WALLS: INTERIOR 01				
#	Item	Туре	Description, Manufacturer, SKU	Unit	Quantity	Unit Price	Total
	BATHROOM			SF	40.0		
1	Cementitious Backer Board			SF	224	ļ.	
2	Kerdi membrane			SF	224		
3	Kerdi membrane Fastener			SF	224		
4	Wall Ceramic Tile			SF	224		
	BEDROOM 1			SF	149.0		
5	Drywall Board			SF	311		
6	Drywall Fastener	Self-drilling screws(100/pkt)		PKT	3.11		
7	Wall Paint			SF	311		
8	Drywall Tape			FT	58.3	3	
	BEDROOM 2			SF	149.0		
9	Drywall Board			SF	313		
10	Drywall Fastener	Self-drilling screws(100/pkt)		PKT	3.13		
11	Wall Paint			SF	313		
12	Drywall Tape			FT	58.7		



			WALLS: INTERIOR 02				
#	Item	Туре	Description, Manufacturer, SKU	Unit	Quantity	Unit Price	Total
	LIVING ROOM			SF	185.0		
13	Drywall Board			SF	305		
14	Drywall Fastener	Self-drilling screws(100/pkt)		PKT	3.05		
15	Wall Paint			SF	305		
16	Drywall Tape			FT	57.2		
	KITCHEN			SF	72.0		
17	Cementitious Backer Board			SF	22		
18	Drywall Board			SF	149		
19	Drywall Fastener	Self-drilling screws(100/pkt)		PKT	1.49		
20	Kerdi membrane			SF	22		
21	Kerdi membrane Fastener			SF	22		
22	Wall Ceramic Tile			SF	22		
23	Wall Paint			SF	149		
24	Drywall Tape			FT	28.1		



			WALLS: INTERIOR 03				
#	Item	Туре	Description, Manufacturer, SKU	Unit	Quantity	Unit Price	Total
	CLOSET 1			SF	22.0		
25	Drywall Board			SF	149		
26	Drywall Fastener	Self-drilling screws(100/pkt)		PKT	1.49		
27	Wall Paint			SF	149		
28	Drywall Tape			FT	27.9		
	CLOSET 2			SF	22.0		
29	Drywall Board			SF	149		
30	Drywall Fastener	Self-drilling screws(100/pkt)		PKT	1.49		
31	Wall Paint			SF	149		
32	Drywall Tape			FT	27.9		
	CLOSET 3			SF	3.0		
33	Drywall Board			SF	52		
34	Drywall Fastener	Self-drilling screws(100/pkt)		PKT	0.52		
35	Wall Paint			SF	52		
36	Drywall Tape			FT	9.8		



			WALLS: INTERIOR 04				
#	Item	Туре	Description, Manufacturer, SKU	Unit	Quantity	Unit Price	Total
	WD			SF	9.0		
37	Cementitious Backer Board			SF	77		
38	Kerdi membrane			SF	77		
39	Kerdi membrane Fastener			SF	77		
40	Wall Ceramic Tile			SF	77		
	WH			SF	8.0		
41	Drywall Board			SF	84		
42	Drywall Fastener	Self-drilling screws(100/pkt)		PKT	0.84		
43	Wall Paint			SF	84		
44	Drywall Tape			FT	16		
	HALL			SF	27.0		
45	Drywall Board			SF	79		
46	Drywall Fastener	Self-drilling screws(100/pkt)		PKT	0.79		
47	Wall Paint			SF	79		
48	Drywall Tape			FT	15		
1	Wall Skirting	Ceramic		FT	127		



			DOORS				
#	Item	Туре	Description, Manufacturer, SKU	Unit	Quantity	Unit Price	Total
1	Exterior Sliding	5' - 0" X 6'-8"		PCS	1		
2	Exterior Swinging	3' - 0" X 6'-8'		PCS	1		
3	Interior Sliding	10' - 0" X 6'-8'		PCS	2		
4	Interior Sliding	7' - 0" X 6'-8'		PCS	1		
5	Interior Swinging	3' - 0" X 6'-8'		PCS	1		
6	Interior Swinging	2' - 8" X 6'-8'		PCS	1		
7	Interior Swinging	2' - 6" X 6'-8'		PCS	2		
8	Interior Swinging	2' - 0" X 6'-8'		PCS	1		
9	Exterior Door Trim			FT	34.68	3	
10	Interior Door Trim			FT	328.46		
11	Entry Lock Set			PCS	2		
12	Privacy Lock Set			PCS	5		
13	Passage Lock Set			PCS	3		
14							
15							



			WINDOWS				
#	Item	Туре	Description, Manufacturer, SKU	Unit	Quantity	Unit Price	Total
1	Sliding	5' - 3" X 3'-9"		PCS	3		
2	Sliding	2' - 3" X 2'-3"		PCS	5		
3	Sliding	2' - 3" X 1'-9"		PCS	1		
4	Swinging	2' - 3" X 3'-3"		PCS	4		
5	Swinging	3' - 3" X 3'-3"		PCS	3		
6	Exterior Window Trim			FT	171		
7	Interior Window Trim			FT	171		
8							
9							
10							
11							
12							
13							
14							
15							



			ROOF 01				
#	Item	Туре	Description, Manufacturer, SKU	Unit	Quantity	Unit Price	Total
1	Roof Covering			SF	1200.0		
2	Roof Covering Fastener			PCS	600		
3	Roof Felt Paper			SF	1200.0		
4	Roof Felt Paper Fastener			PCS	3600.0		
5	Roof Sheathing			SF	1200.0		
6	Roof Sheathing Fastener			PCS	9600		
7	Batten			FT	0.0		
8	Batten Fastener			PCS	0.0		
9	Soffit			SF	152.0		
10	Soffit Fastener			PCS	76.0		
11	Fascia			FT	156.0		
12	Fascia board fastener			PCS	78		
13	Roof Insulation			SF	1200.0		
14					1.20010		
15							