


# **HAVEN**

The Haven is a modern Ranch-style two-bedroom, one-bathroom home designed for comfortable and efficient living. The walls are clad in white vertical siding, creating a bright and timeless look. A prominent gable end, featuring exposed structural beams and a large triangular window, adds architectural interest and a touch of rustic charm. A covered porch, supported by timber posts, extends from the main entrance, providing a welcoming outdoor space.


Inside, the Haven boasts a simple, open-plan rectangular layout. The living, dining, and kitchen areas are seamlessly merged into a single large space at the center of the house, promoting a sense of spaciousness and flow. The two bedrooms are thoughtfully located at opposite ends of the plan, offering private and quiet retreats. The bathroom is strategically placed between the living area and one of the bedrooms, enhancing convenience and functionality.

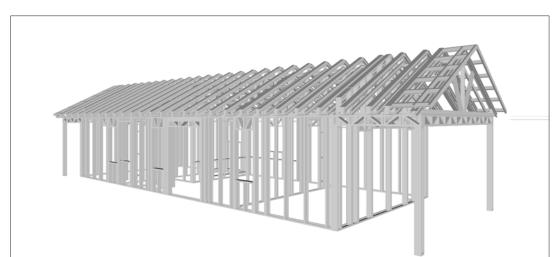

# Materials Shopping List

Please print and take this Materials Shopping List to your favorite Home Depot and ask for assistance in selecting the materials, fixtures and fittings to complete your new home.


Record your selection and the price of the item. Then do the math to determine the cost for your selections and the total cost of finishing your home.

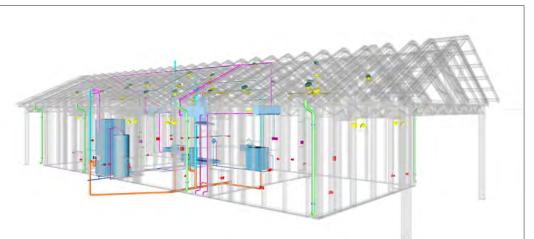

# < CLICK HERE >

To Go To Materials Shopping List



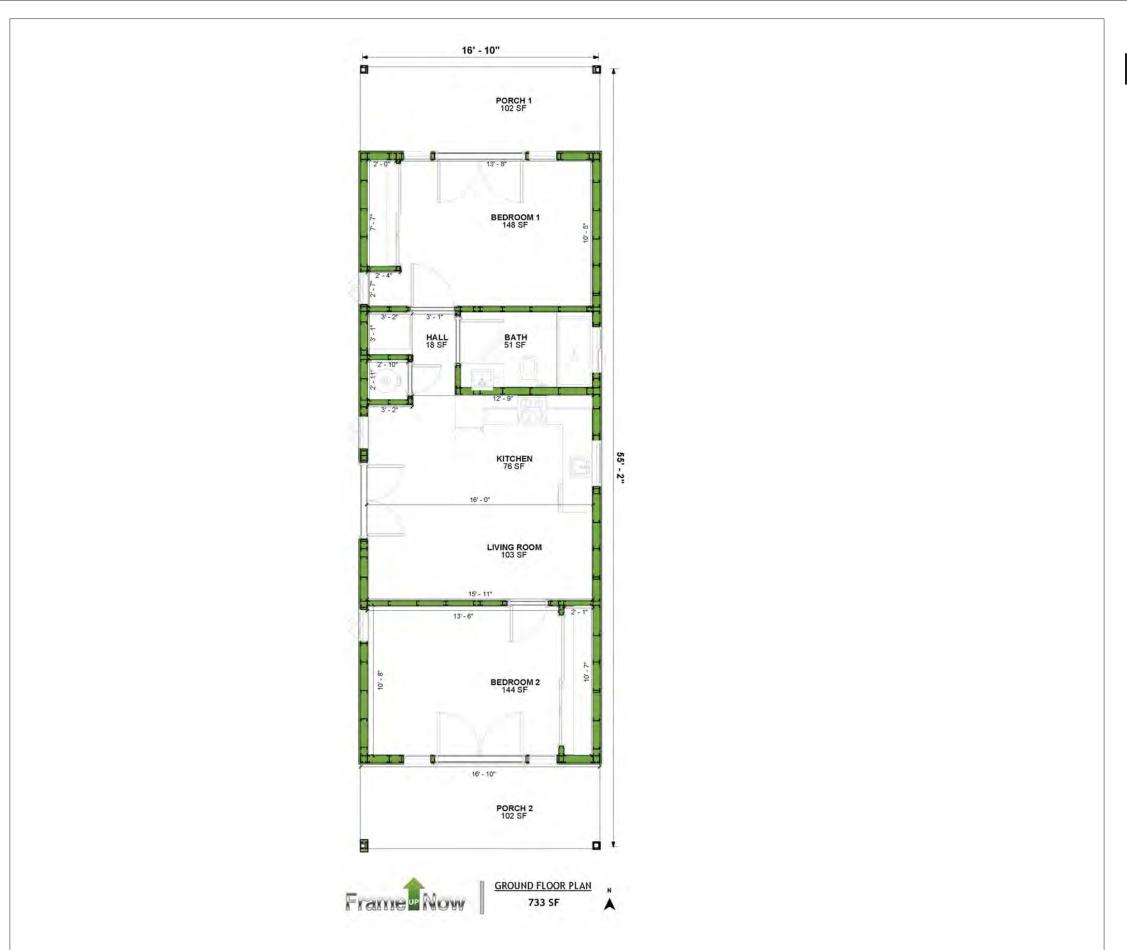

# **FLOOR PLAN**

499 SF

Studio Studio

Covered Porch

# **TABLE OF CONTENTS**

RENDERINGS	ABOUT THE HOME -	<b>—</b> 01
1	RENDERINGS -	<b>—</b> 01
FLOOR PLAN	SCHEMATIC FLOOR PLAN	<b>—</b> 01
1	HOME SPECS -	<b>—</b> 01
	DISCLAIMER -	<b>—</b> 01
ABOUT	ABOUT FrameUpNow -	<b>0</b> 1
1	ABOUT HouseDocs -	<b>0</b> 1
DESCRIPTIONS	BOM (Bill Of Materials) ⊢	<b>02</b>
2	STRUCTURAL -	<b></b> 02
	ARCHITECTURAL-	<b></b> 02
	MECHANICAL -	<b></b> 02
	ELECTRICAL	<b></b> 02
	PLUMBING -	<b></b> 02
MATERIALS LIST 2	MATERIALS LIST PREVIEW	<b>—</b> 02
HOW TO BUILD	CONSTRUCTION STEPS -	<b></b> 02

ARCHITECTURAL

COVER SHEET 

FLOOR PLAN 

DIMENSION PLAN

03

29

**DISCLAIMER** 

marketing content.

DISCLAIMER: This documentation and all it's contents are the intellectual property of FrameUpNow. It is provided solely for marketing the services of FrameUpNow.

The preliminary information is not approved for actual construction use and is

not warranted to be complete or accurate. Unauthorized copying, distribution, or application of these proprietary materials, in any form or format, is strictly prohibited. FrameUpNow assumes no liability for any issues arising from improper use of this

**COVER SHEET** GENERAL NOTES WALL FRAME LAYOUT WALL PANEL & LAYOUT PLAN 20 ROOF TRUSS LAYOUT STRUCTURAL SECTIONS 21 WALL BRACING LAYOUT 22 HOLD-DOWN PLAN STRUCTURAL DETAILS 1 **STRUCTURAL DETAILS 2 STRUCTURAL DETAILS 3 27** TRUSS BLOCKING LAYOUT 28 SHEETROCK BACKING 1

 MECHANICAL
 COVER SHEET
 30

 HVAC PLAN
 31

 SCHEDULE
 32

 LIGHTING
 33

 POWER PLAN
 34

**ROOF BRACING LAYOUT** 

DIMENSION FOR LIGHTING

DIMENSION FOR FITTING

PLUMBING
37

STRUCTURAL

NOTES AND SCHEDULES - 37
WATER SUPPLY & SEWAGE SYSTEM + 38

MATERIALS
SHOPPING LIST

# **ABOUT**



FrameUpNow is a design and manufacturing company providing precision-engineered home framing solutions. We offer a catalog of Affordable Homes, Tiny Homes, Garages, Shops and Barndominiums. FrameUpNow manufactures cold-formed steel (CFS) also known as Light Gauge Steel (LGS) framing components that conform to our engineered metal house frame plans or can be purchased as DIY skeleton kits.

The CFS/LGS framing is lightweight, easily assembled, and does not require heavy equipment or specialized labor, enabling homeowners to erect the frame themselves in just a few days. Unlike wood, the steel framing is impervious termites and bores, warping, expansion, and fire.

Our home plans come complete with a structural engineered stamp for permit approvals. Customers receive a full BOM also known as a Materials Shopping List to purchase finish materials from a Building Materials retailer. FrameUpNow prides itself on the quality and efficiency of our precision-engineered home framing solutions for construction professionals and DIY homeowners.



**KEY PLAN** 

NO.	DESCRIPTION	DATE
•		,

NOTE:

LEGEND:

PROJECT

161-Haven-733-2Bd1Ba-Ranch-550

DRAWING NAME

# INTRODUCTION

CLIENT NAME:
PROJECT NUMBER:
DATE:
DESIGNED BY:
DRAWN BY:
CHECKED BY:

1101

SCALE:

# **DESCRIPTIONS**

# MATERIALS LIST

The BOM (Bill Of Materials) package, known as the Materials Shopping List document, provides:

Comprehensive Inventory: Detailed lists of essential materials sourced from architectural, mechanical, HVAC, electrical, and plumbing design drawing sets.

Precise Curation: Each item meticulously selected and organized for accuracy and efficiency in project planning.

Customizable Options: Customers can modify listed items to their preferences and calculate costs accordingly, ensuring alignment with personal project needs and budget.

Dedicated Space for Details: Includes tables for customers to note Home Depot SKU numbers or product descriptions for selected items,

facilitating seamless purchasing and coordination with suppliers.

Customer Convenience: Take the list to Home Depot or preferred suppliers for accurate pricing, helping align the total home budget with personal financial plans.

Simplify your construction journey with our Materials Shopping List document, where detailed preparation meets streamlined implementation for your dream home.

# STRUCTURAL

The structural drawings package provides an exhaustive set of detailed plans essential for the precise assembly of your building. This comprehensive package includes:

Framing Plans: Detailed layouts for all framing components. Truss Layouts: Clear instructions for truss placement and

Panel Length Plans: Specifications for panel dimensions. Framing Elevations and Sections: Precise elevation and sectional views for accurate construction.

Truss and Wall Blocking Plans: Plans for truss and wall blocking to ensure structural integrity.

Hold-Down Plan: Detailed hold-down requirements for stability. Snap Sheet: Reference sheet for quick identification of components

Structural Details and Bracing Plans: Complete details and bracing plans for all structural elements.

Accompanying these plans is a comprehensive Bill of Materials (BOM) that lists every necessary building component, from cold formed steel (CFS) frames to fasteners.

# ARCHITECTURAL

With the comprehensive architectural package, both builders and DIY homeowners can confidently execute the construction.

The architectural package includes:

Furnished Floor Plans: Complete with furniture layouts for a clear understanding of space utilization.

Detailed Dimension Plans: Ensures precise measurements, from the overall footprint down to the exact placement of windows and

Foundation Plan: Detailed plan to establish a solid foundation.

Wall Framing and Truss Layout: Comprehensive plans for wall framing and truss placement.

Architectural Elevations: Exterior views showcasing the design.

Strategic Building Sections: Critical cross-sectional details for a thorough understanding of the build.

Casework Drawings and Diagrams: Suggested designs for built-in caseworks, such as kitchen cabinets.

# **MECHANICAL**

The mechanical package includes everything needed to guide HVAC

Detailed HVAC Floor Plan: Precisely maps out the placement of air handlers, ductwork, and vents throughout the home's layout.

HVAC Sections and Riser Diagrams: Technical drawings offering critical cross-sectional details and piping schematics, ensuring proper integration of the heating and cooling system into the home's structure.

Bill of Materials: A complete list of all necessary HVAC components.

# **ELECTRICAL**

The electrical package includes all the plans and documentation needed to guide the installation of your home's electrical system:

Detailed Power Plan: Precisely maps out the placement of outlets, switches, and other power components throughout the layout.

Comprehensive Lighting Plan: Shows the optimal locations for lighting fixtures, sconces, and other illumination sources to create a well-lit, functional interior.

Dimensioned Electrical Layout: Provides exact dimensions and measurements to ensure proper placement of all electrical elements.

Bill of Materials: A complete list of every component needed, from circuit breakers to wiring.

The plumbing package includes everything needed to guide the

Detailed Water Supply System Plan: Precisely maps out the placement of pipes, valves, and plumbing fixtures throughout the

Comprehensive Sewage System Plan: Shows the optimal routing and sizing of drain lines to effectively remove waste and ensure

Detailed Riser Diagrams: Provide information needed to properly

# **PLUMBING**

installation of your home's water supply and drainage systems:

proper drainage.

install all vertical plumbing risers and vent stacks.

Bill of Materials: A complete list of every component needed, from pipes to fixtures.


# BOM (Bill Of Materials) (Separately Attached)





The Bill of Materials (BOM) is a crucial document that compiles the material requirements from different disciplines into a centralized inventory, enabling efficient procurement, inventory management, and cost estimation for a specified project or

**ELECTRICAL BOM** 



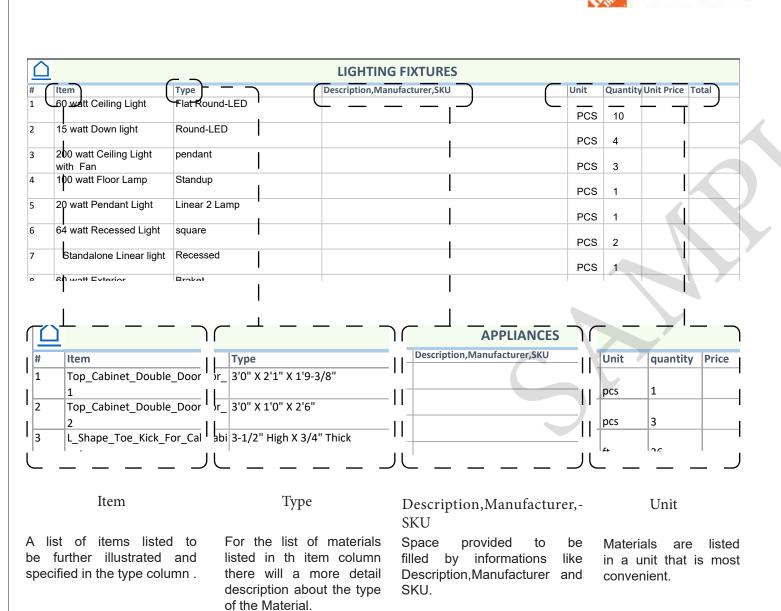

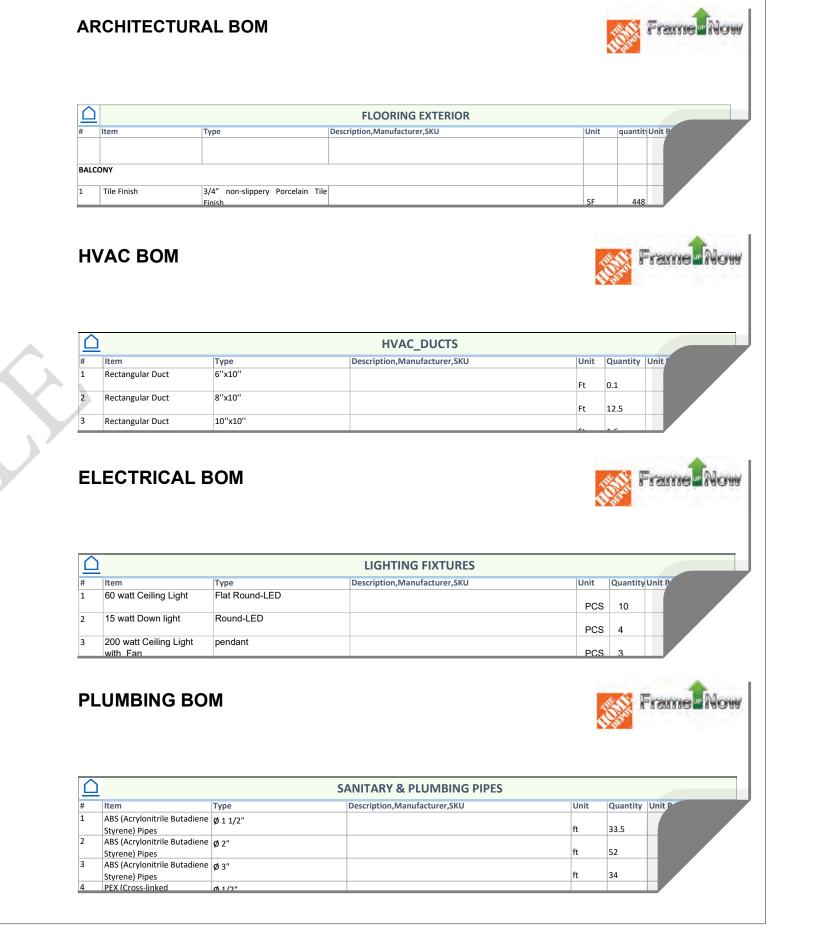

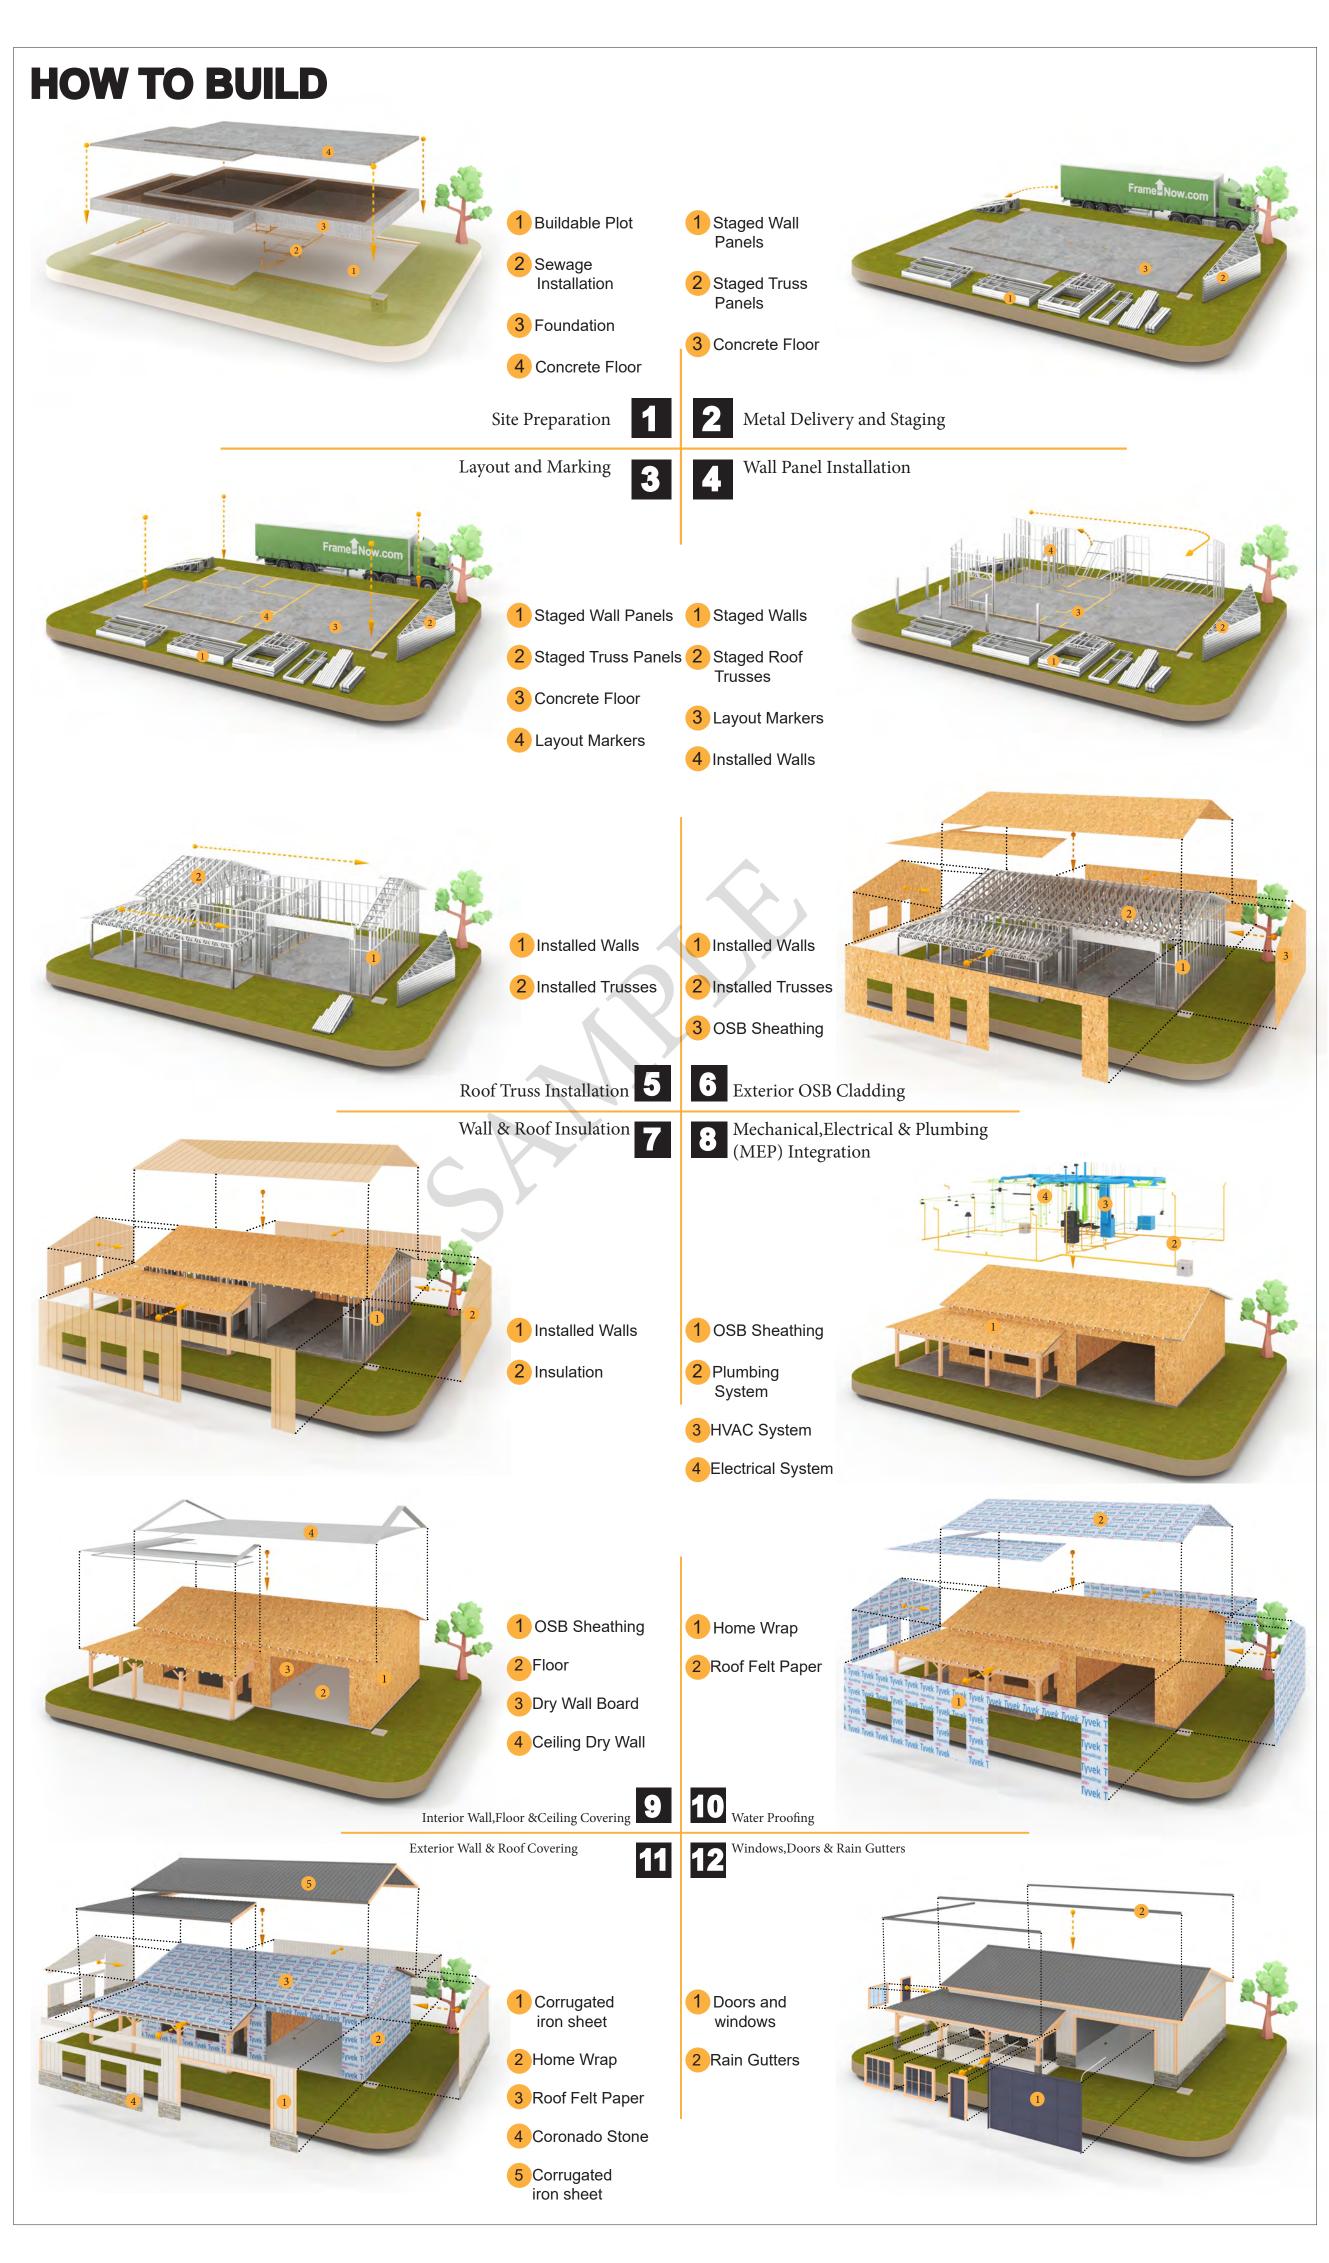



**KEY PLAN** 

NO.	DESCRIPTION	DATE

NOTE:

LEGEND:

PROJECT

161-Haven-733-2Bd1Ba-Ranch-550

DRAWING NAME


# INTRODUCTION

CLIENT NAME: PROJECT NUMBER: DATE: **DESIGNED BY** DRAWN BY: CHECKED BY:

1102

© [2024] [FrameUpNow] . All rights reserved

SCALE:

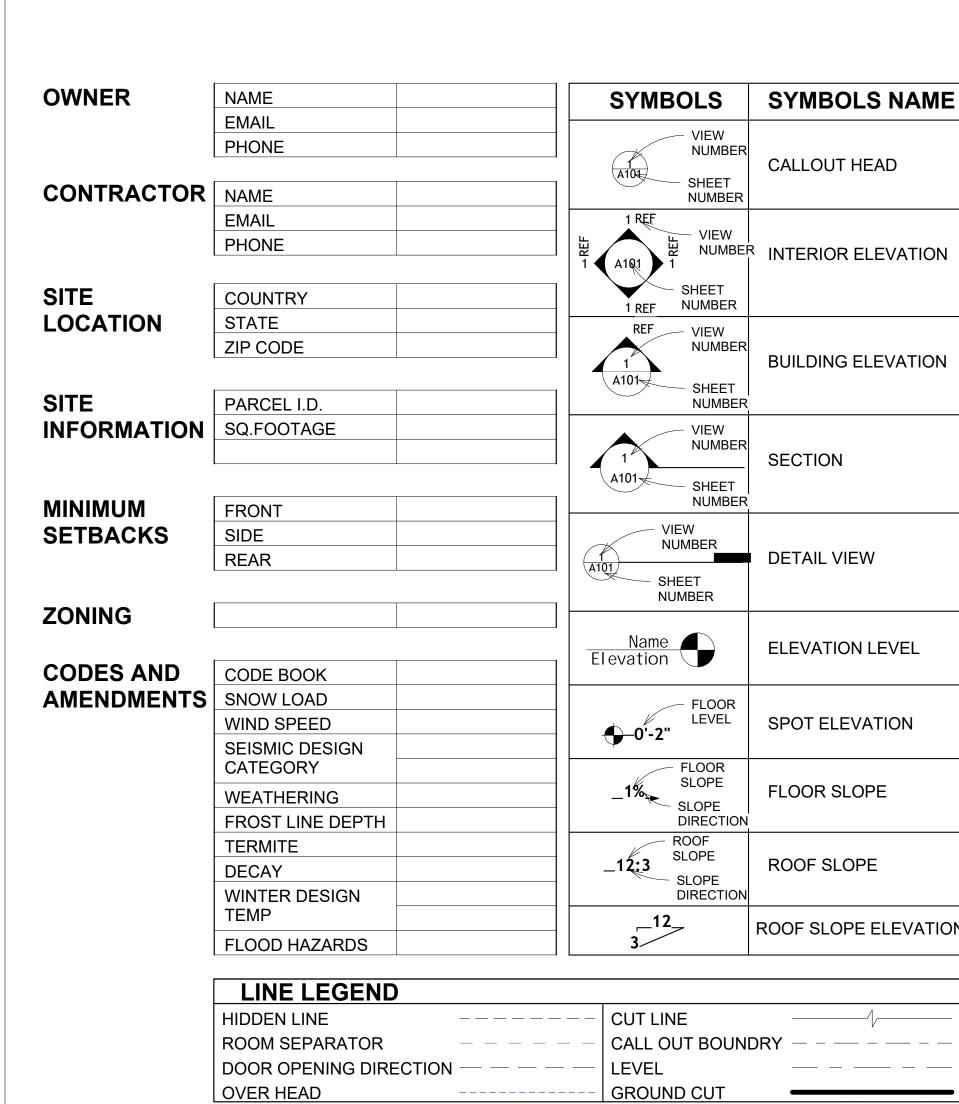

MBOLS	SYMBOLS NAME	PAGE INDEX		
VIEW		G101	COVER SHEET	
NUMBER		A101	FLOOR PLAN	
SHEET	CALLOUT HEAD	A102	DIMENSION PLAN	
NUMBER		S101	FOUNDATION PLAN	
EF		S102	STRUCTURAL FLOOR PLAN	
W VIEW	INTERIOR ELEVATION	S103	FRAME LAYOUT	
<b>)</b> 1		S104	ROOF TRUSS LAYOUT	
SHEET NUMBER		A103	ROOF PLAN	
EF NUMBER   EF VIEW		A201	ELEVATIONS	
NUMBER		A202	ELEVATIONS	
	BUILDING ELEVATION	A301	SECTIONS	
SHEET NUMBER		A401	DETAILS	
	SECTION	A402	CASEWORK DETAILS	
VIEW NUMBER		A403	CASEWORK DETAILS	
		E101	SCHEDULE	
SHEET NUMBER		E102	LIGHTING PLAN	
		E103	POWER PLAN	
VIEW NUMBER			DIMENSION PLAN FOR LIGHT FIXTURE	
	DETAIL VIEW	E105	DIMENSION PLAN FOR FITTING	
<ul><li>SHEET</li><li>NUMBER</li></ul>		P101	COVER SHEET	
		P102	WATER SUPPLY SYSTEM	
ame 🔔	ELEVATION LEVEL	P103	SEWAGE SYSTEM	
tion 📗	ELEVATION LEVEL	P104	RISER DIAGRAM	
		M101	HVAC PLAN	
FLOOR LEVEL	SPOT ELEVATION	M102	HVAC SECTION	
)'-2"	OF OT ELEVATION	M103	RISER DIAGRAM	
FLOOR SLOPE	FLOOR SLOPE			

TAG

FLOOR SLOPE

**ROOF SLOPE** 

ROOF SLOPE ELEVATION

SLOPE

DIRECTION

SLOPE DIRECTION

	DIOED DIA ODAM	[F3]	FOUNDS FER 30
	RISER DIAGRAM	PVC	POLYVINYL CHLO
_	HVAC PLAN	REF	REFERENCE
<u>-</u>	HVAC SECTION	RG	RIGHT GARAGE
3	RISER DIAGRAM	SE	SPECIAL EQUIPM
		SF	SQUARE FEET
	TAG'S NAME	SIMP. STHD8	SIMPSON STRAP HOLDDOWN
	TAGGINAME	SIMP. ABE66	SIMPSON ANCHO
	CASEWORK TAG	TV	TELEVISION
	DOOR TAG	UNO	UNLESS NOTED
		W/	WITH
	FURNITURE TAG	W/D	WASHER/DRYER
	WINDOW TAG	AC	AIR CONDITIONII
	SPECIALTY EQUIPMENT TAG	ACC	AIR COOLED CO
	1450114111041 50111D145117 74 0	ACCU	AIR COOLED COND
	MECHANICAL EQUIPMENT TAG	AHU	AIR HANDLING U
	PLUMBING EQUIPMENT TAG	CC	COOLING COIL
		CD	CEILING DIFFUSI
		CFm	Cubic Feet Per Mi
		CR	CEILING REGIST
1	11/1/1/1/1/1/1/1/1/1/1/1/1/1/1/1/1/1/1/1	CU	CONDENSING U
7		CW	COLD WATER
1		E/A	EXHAUST AIR
		EF	EXHAUST FAN
1		ET	EXPANSION TAN
		EX.	EXISTING
		FC	FLEXIBLE CONNI
		FCU	FAN COIL UNIT
		FLR.	FLOOR
		HC	HEATING COIL
		HE	AIR TO AIR HEAT
		HV	HEATING AND VE

**ABBREVIATION** 

CASEWORK ELECTRICAL

ASTM D698

F.F.L

FTG

HVAC

MAX.

MIN.

OSB

**ACTION FLOOR SYSTEMS** 


AMERICAN SOCIETY FOR

TESTING AND MATERIAL



	ELECTRICAL	
	FINISHED FLOOR ELEVATION	
	FINISHED FLOOR LEVEL	
	FOOTINGS	
C	HEATING, VENTILATION & AIR CONDITIONING	
	INTERNATIONAL RESIDENCE CODE	
	INTERNATIONAL MECHANICAL CODE	
	MAXIMUM	
	MECHANICAL	
	MINIMUM	
	NUMBER	
	ON CENTER	
	ORIENTED STRAND BOARD	
	PLUMBING	
	POUNDS PER SQUARE INCH	
	POLYVINYL CHLORIDE	
	REFERENCE	
	RIGHT GARAGE	
	SPECIAL EQUIPMENT	
	SQUARE FEET	
. STHD8		
	HOLDDOWN	
. ABE66	SIMPSON ANCHOR BOLT EDGE	
	TELEVISION	
	UNLESS NOTED OTHERWISE	
	WITH	
	WASHER/DRYER	
	AIR CONDITIONING UNIT	
<u> </u>	AIR COOLED CONDENSER	
· 		
J I	AIR COOLED CONDSENSING UNIT	
,	AIR HANDLING UNIT COOLING COIL	
	CEILING DIFFUSER	
<u> </u>	Cubic Feet Per Minute	
ı		
	CEILING REGISTER CONDENSING UNIT	
	COLD WATER	
	EXHAUST AIR	
	EXHAUST FAN	
	EXPANSION TANK	
	EXISTING	
	FLEXIBLE CONNECTION	
	FAN COIL UNIT	
· 	FLOOR	
•	HEATING COIL	
	AIR TO AIR HEAT EXCHANGER	
	HEATING AND VENTILATING UNIT	
	INLET VANES	
₹	MECHANICAL ROOM	
ζ.	MAXIMUM	
	MINIMUM	
	RETURN AIR	
]	RECIPROCATING CHILLER UNIT	
	RETURN FAN	
	SUPPLY AIR	
	SMOKE CONTROL DAMPER	
	STATIC PRESSURE	



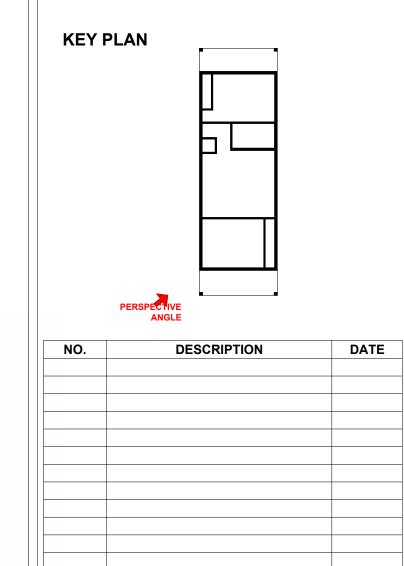

NOTE:

LEGEND:

PROJECT

161 HAVEN 733 2Bd 1Ba RANCH 550

DRAWING NAME

**COVER SHEET** 

Client Name
0061_12
4/2/2025 2:33:27 PM
Designer
Author
Checker

G101

SCALE: As indicated

SQUARE FOOTAGE

733

161 HAVEN 733 2Bd 1Ba **RANCH 550** 

IV
MER
MAX.
MIN.
R/A
RCU
RF
S/A
SCD
SP

### **GENERAL NOTES**

- THIS DRAWING DEPICTS THE ARCHITECTURAL (SPACE LAYOUT, FURNISHING, FLOOR, WALLS, ROOFS, FOUNDATION, WINDOWS AND DOORS) SYSTEMS. IT PROVIDES A VISUAL REPRESENTATION OF THE ARCHITECTURAL LAYOUT AND COMPONENTS.
- THE ARCHITECTURAL DRAWINGS ARE PREPARED TO MEET THE SPECIFIC REQUIREMENTS OF THE BUILDING, AS PER THE PROJECT SPECIFICATIONS AND APPLICABLE CODES AND STANDARDS.
- THE CONSTRUCTION OF THIS HOME SHALL COMPLY WITH THE LATEST EDITION OF THE INTERNATIONAL RESIDENTIAL CODE (IRC), INTERNATIONAL MECHANICAL CODE (IMC), THE INTERNATIONAL PLUMBING STANDARD, THE NATIONAL ELECTRICAL STANDARD AND ALL OTHER APPLICABLE LOCAL, STATE, AND NATIONAL CODES AND REGULATIONS.
- COORDINATION WITH OTHER TRADES HAS BEEN DONE ON A DESIGN LEVEL. THIS DRAWING SHALL BE READ TOGETHER WITH THE ME, EL AND PL DESIGN DRAWINGS TO ENSURE PROPER CONSTRUCTION AND INTEGRATION OF THE BUILDING SYSTEMS.

### ABOUT WALLS:

- SHOWER WALL COVERING
- BATHTUB AND SHOWER SPACES (WALLS AND FLOORS) WITH INSTALLED SHOWER HEADS AND IN SHOWER COMPARTMENTS SHALL BE FINISHED WITH A NON-ABSORBENT SURFACE.
- 2. WALL PAINT (INTERNAL)
  - THE TYPICAL THICKNESS OF LATEX WALL PAINT IS 1/32 OF AN INCH FOR A SINGLE COAT. AND DOUBLE COAT (1/16") SHALL BE APPLIED FOR DURABILITY.

3. ADHESIVES: THE ADVISABLE TYPE OF ADHESIVE FOR THIS PROJECT IS **EPOXY ADHESIVES**BECAUSE THEY ARE KNOWN FOR THEIR HIGH STRENGTH, DURABILITY, AND RESISTANCE TO MOISTURE, CHEMICALS AND

REFER TO SHEETS A201 & A202 FOR GENERAL NOTES ON EXTERNAL FINISHING MATERIALS

### ABOUT FLOORS:


- THE SPOT ELEVATION INDICATES THE FINISHED FLOOR ELEVATION.
- FINISHED FLOORS PER PLANS.
- FIELD VERIFY FOR DIMENSION DROP 4" FOR SHOWER AND BATHTUB USE.

COFFE TABLE

- 1% SLOPE ON OUTDOOR BALCONIES FOR WATER RUN OFF.
- 2% SLOPE TOWARDS THE SHOWER DRAIN FOR SUFFICIENT DRAINAGE.
- 4" DROP AT THE DOOR LEADING TO EXTERIOR BALCONY FROM THE MAIN LIVING AREA.
- 5% SLOPE FOR GARAGE IS USED, WHICH SHOULD BE CHECKED WITH THE LOCAL GARAGING ZONING LAWS.

**FURNITURE SCHEDULE** TYPE **TYPE MARK** COUNT KING SIZE BED THREE SEAT SOFA DINING CHAIR

	ROOM FINISH SCHEDULE						
ROOM NUMBE R	ROOM NAME	FLOOR FINISH	BASE FINISH	WALL FINISH	CEILING FINISH	CEILING HEIGHT	COM MEN TS
				I			
01	LIVING ROOM	HARDWOOD	CONCRETE	WALL PAINT	DRY WALL	8' - 0"	
02	KITCHEN	HARDWOOD	CONCRETE	WALL PAINT + CERAMIC	DRY WALL	8' - 0"	
03	BEDROOM 1	HARDWOOD	CONCRETE	WALL PAINT	DRY WALL	8' - 0"	
04	BEDROOM 2	HARDWOOD	CONCRETE	WALL PAINT	DRY WALL	8' - 0"	
05	CL 1	HARDWOOD	CONCRETE	WALL PAINT	DRY WALL	8' - 0"	
06	BATH	VINYL TILES	CONCRETE	CERAMIC TILE	MRD	8' - 0"	
07	W/D	VINYL TILES	CONCRETE	CERAMIC TILE	DRY WALL	8' - 0"	
08	WH	VINYL TILES	CONCRETE	WALL PAINT	DRY WALL	8' - 0"	
09	HALL	HARDWOOD	CONCRETE	WALL PAINT	DRY WALL	8' - 0"	
10	CL 2	HARDWOOD	CONCRETE	WALL PAINT	DRY WALL	8' - 0"	
11	PORCH 1	PROCELAIN TILE	CONCRETE	CORRUGATED IRON	PLYWOOD	8' - 0"	
12	PORCH 2	PROCELAIN TILE	CONCRETE	CORRUGATED IRON	PLYWOOD	8' - 0"	

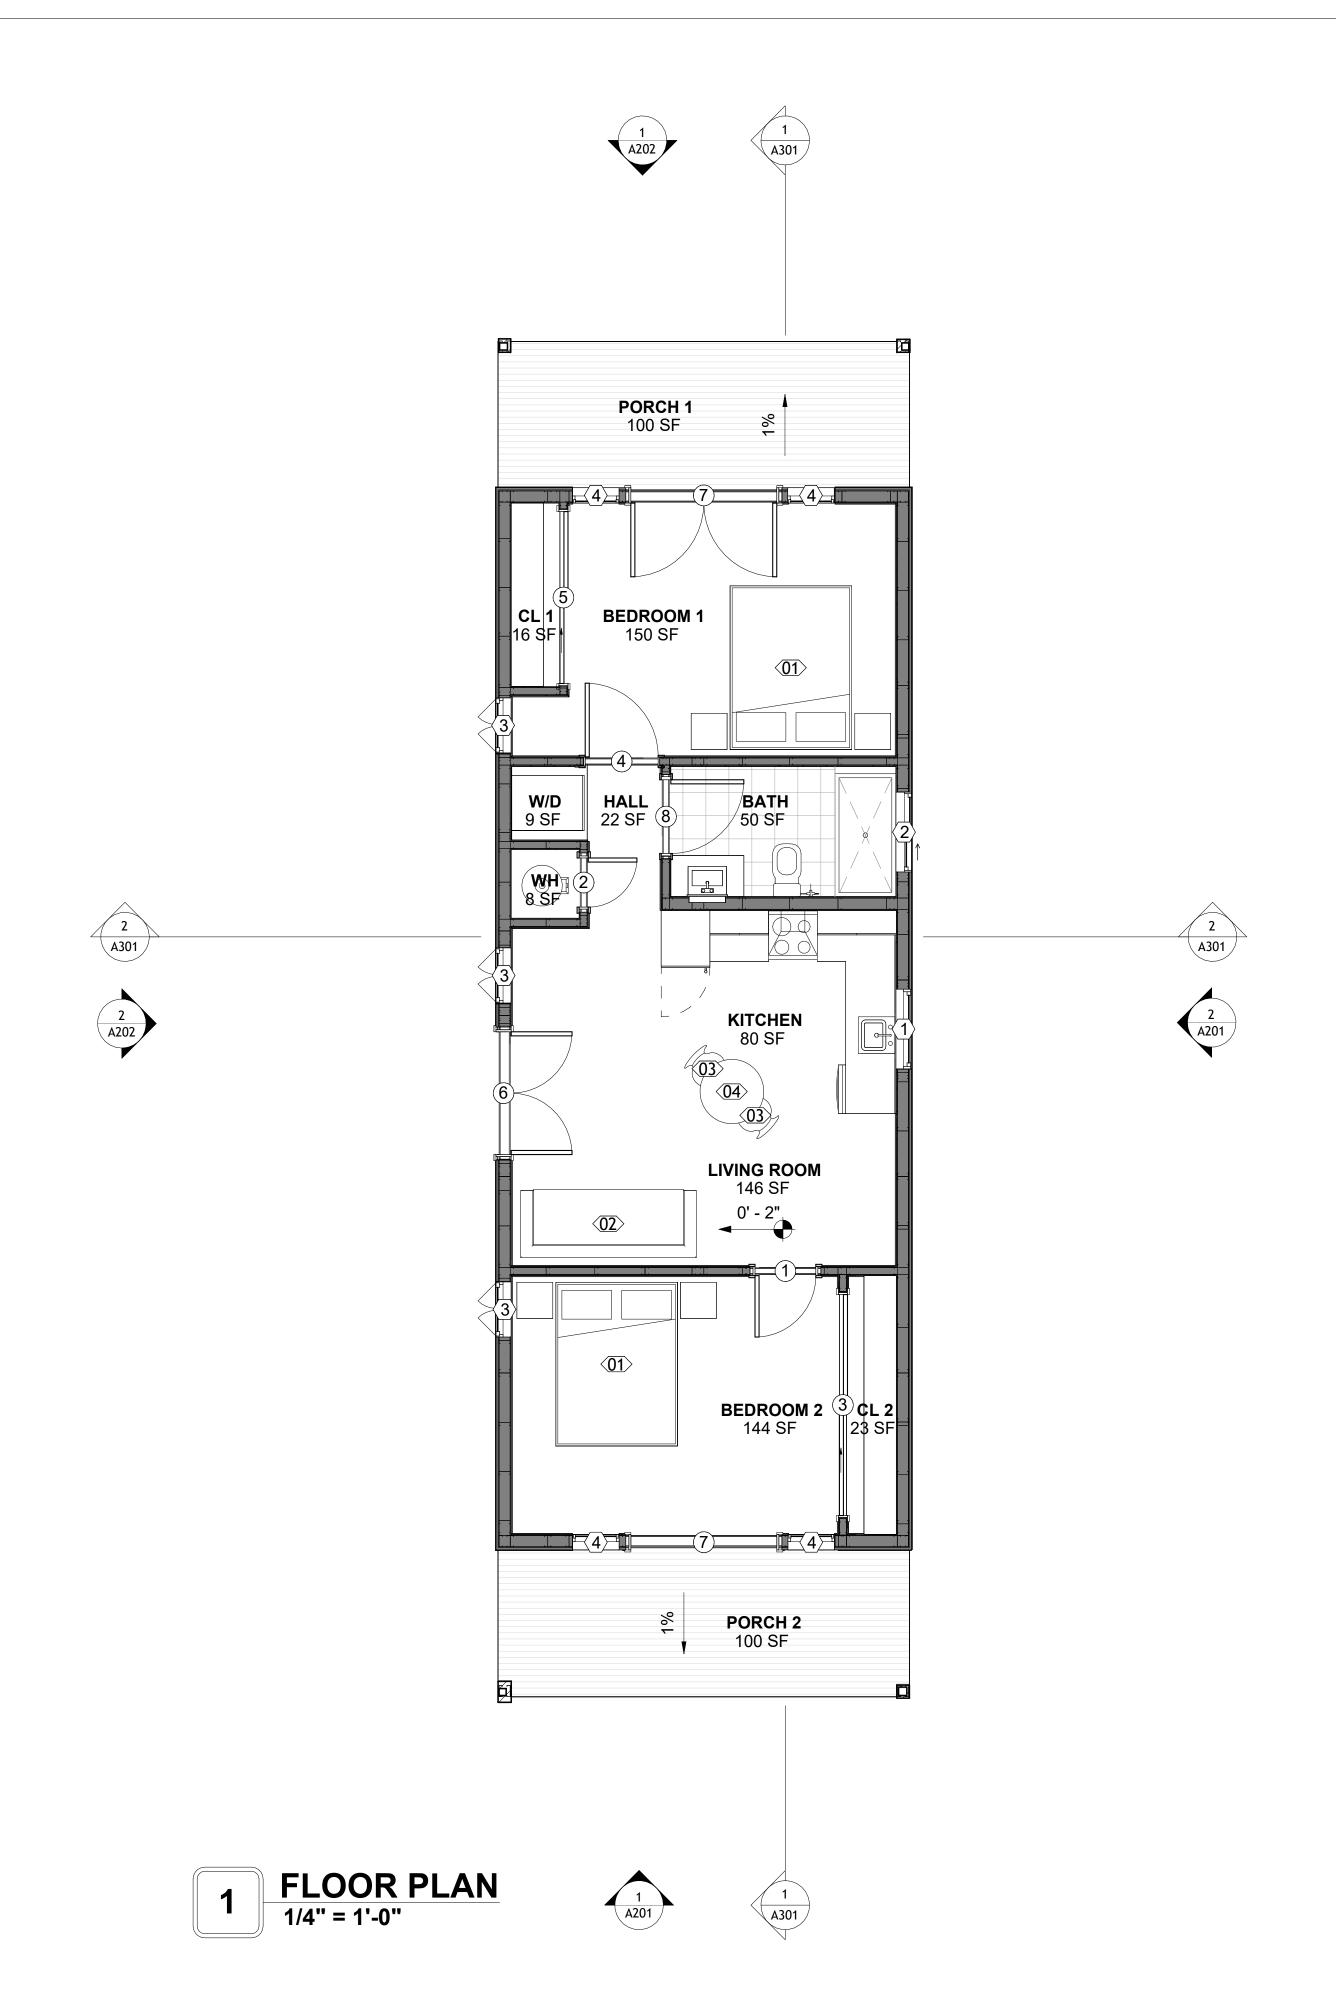



**KEY PLAN** 

DESCRIPTION DATE

NOTE:

LEGEND:

PROJECT

161 HAVEN 733 2Bd 1Ba **RANCH 550** 

DRAWING NAME

**FLOOR PLAN** 

CLIENT NAME:	Client Name
PROJECT NUMBER:	0061_12
DATE:	4/2/2025 2:33:29 PM
DESIGNED BY:	Designer
DRAWN BY:	Author
CHECKED BY:	Checker

SQUARE FOOTAGE 733 204


937

PORCH

TOTAL

A101

SCALE: 1/4" = 1'-0"

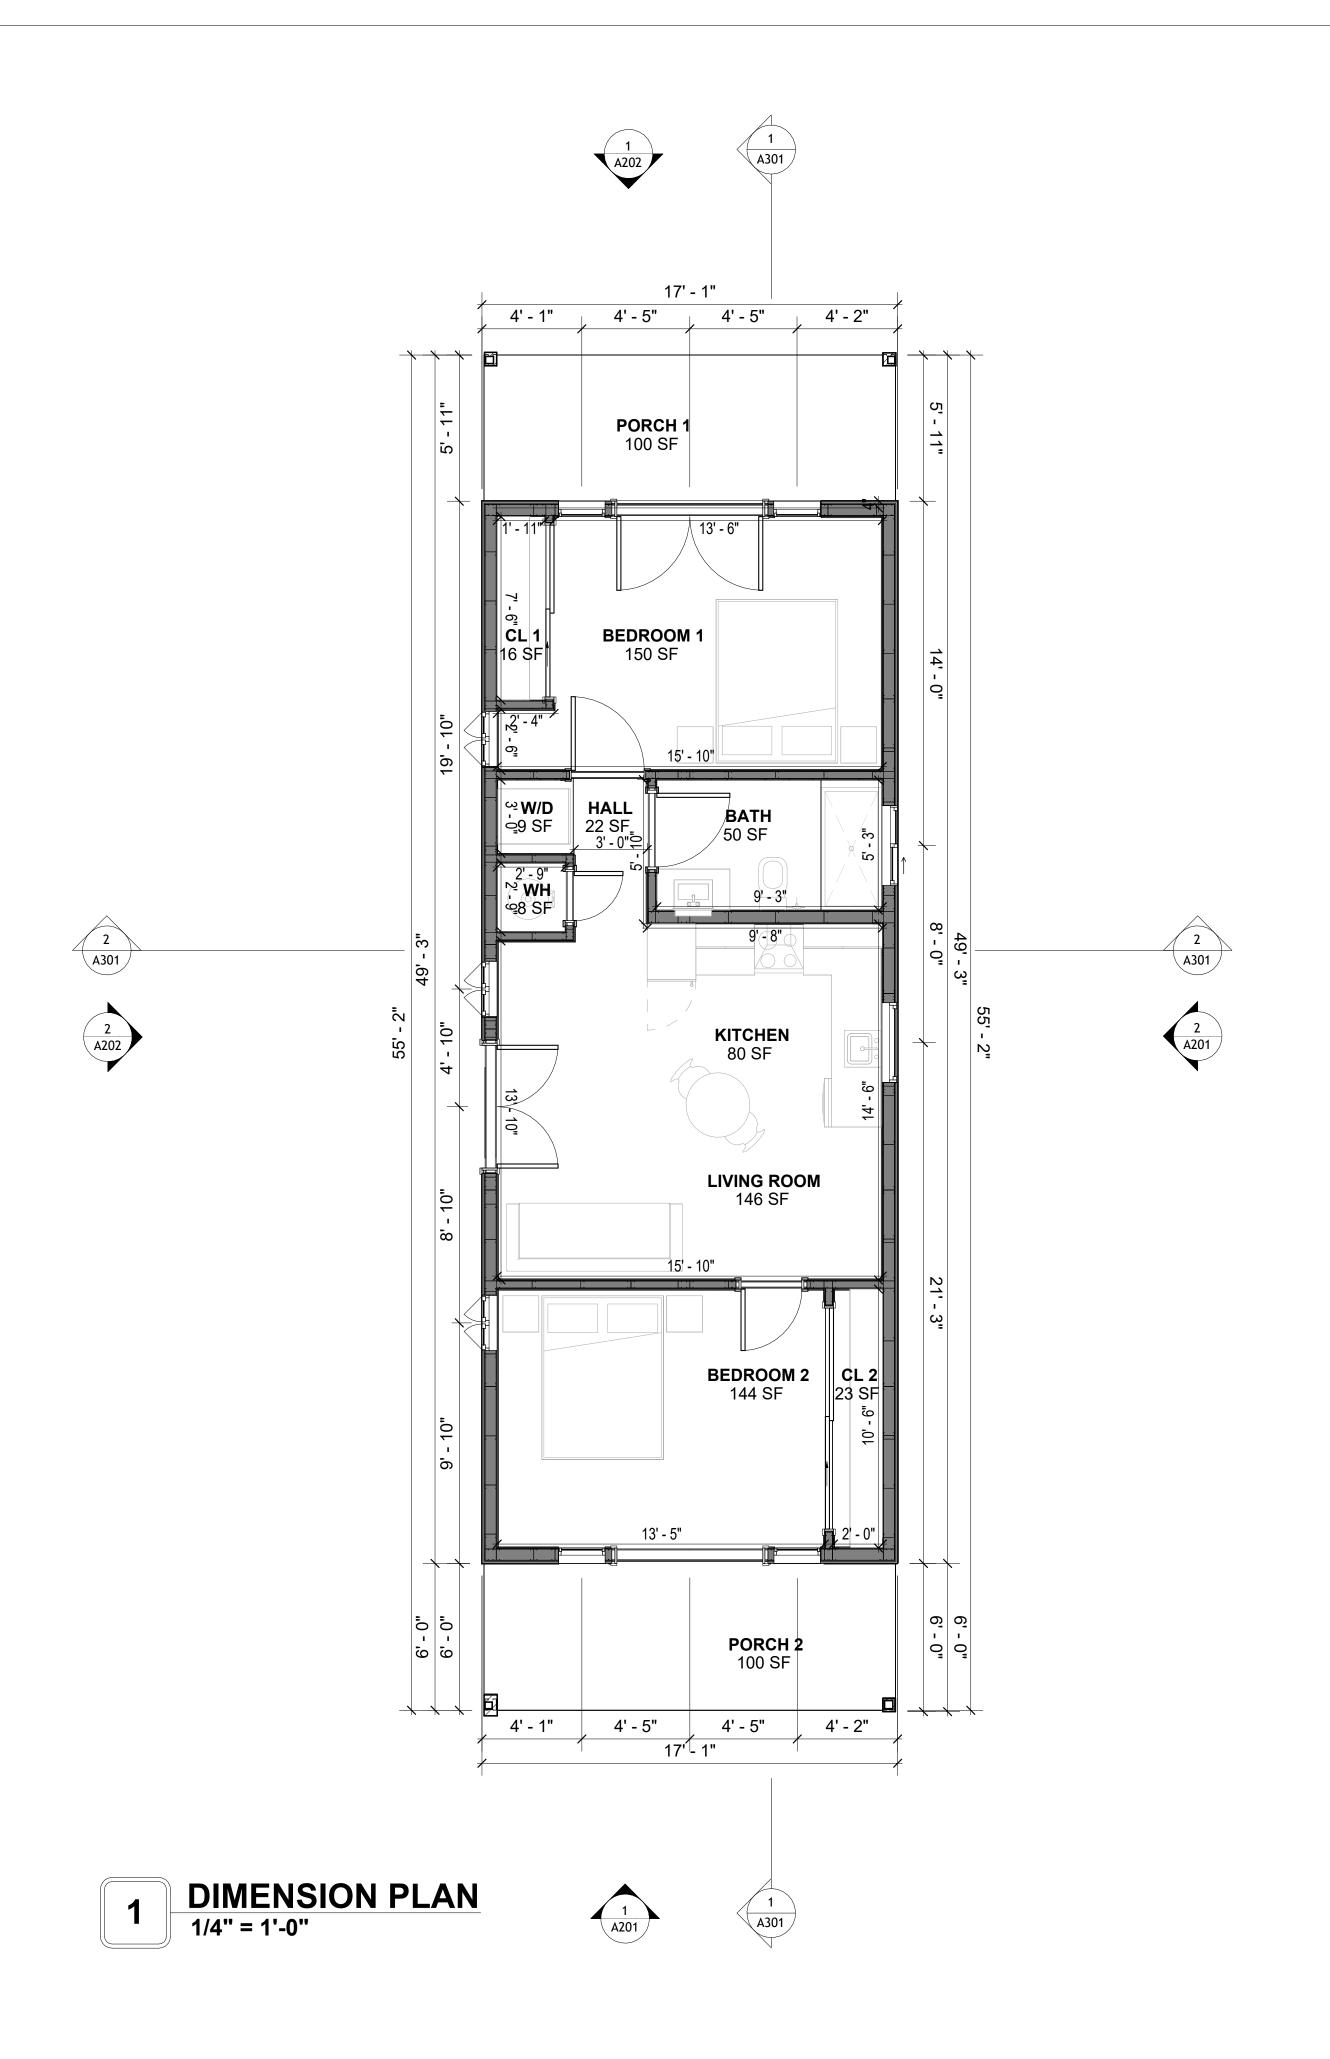



**KEY PLAN** 

NO.	DESCRIPTION	DATE

NOTE:

LEGEND:

PROJECT

161 HAVEN 733 2Bd 1Ba RANCH 550

DRAWING NAME

**DIMENSION PLAN** 

LIENT NAME:	Client Name
ROJECT NUMBER:	0061_12
ATE:	4/2/2025 2:33:30 PM
ESIGNED BY:	Designer
RAWN BY:	Author
HECKED BY:	Checker

A102

SQUARE FOOTAGE

LIVING 733

PORCH 204

TOTAL 937

DIMENSIONS IN THE ARCHITECTURAL DRAWINGS CONSIDER FINISHING MATERIALS. FOR PRECISE MEASUREMENTS OF THE STRUCTUAL FRAMING, REFER TO THE ATTACHED STRUCTURAL PLAN SET.

SCALE: 1/4" = 1'-0"

### **FOUNDATION NOTES**

### NOTES:

TERMITES PRETREATMENT BY LICENSED CONTRACTOR UNDER SLAB AND AROUND FOOTINGS. ALL AREAS BELOW SLABS SHALL BE TREATED NO MORE THAN 24 HOURS PRIOR TO CONCRETE POUR. EVIDENCE OF TREATMENT MUST BE PROVIDED PRIOR TO PLACING OF CONCRETE.

#### 1. MATERIALS:

ALL INTERIOR CONCRETE SLABS SHALL BE A MIN. OF 4" THICK CONCRETE OVER 4" COMPACTED AGGREGATE BASE (ASTM D698), FINISH ELEVATIONS AS NOTED ON DRAWINGS, 6" ABOVE ADJACENT GRADE, LEVEL SLABS TO 1/8"-10' MAX.. CONCRETE SLABS SHALL BE 2500# PSI AT 28 DAYS. A 4" ALLOWABLE SLUMP.

### 2. **PAD PREPARATION:**

EXCAVATION FOR FOOTING SHALL BE NEAT.

- FOOTINGS SHALL BE POURED IMMEDIATELY AFTER EXCAVATION AND APPROPRIATE INSPECTION.

- ALL REINFORCING STEEL MARKED "CONTINUOUS" SHALL BE LAPPED 36 BAR DIAMETERS AT SPLICES AND AROUND CORNERS OR INTERSECTIONS WITH A STANDARD 90 DEGREE BEND ON CORNER BARS. LAP WIRE MESH ONE FULL MESH AT SIDE AND END LAPS.

ALL HARDWARE TO BE SIMPSON OR EQUIVALENT.

- EXTERIOR FRAME WALL TO BE SECURED WITH 1/2"X10" ANCHOR BOLTS 4'-0" O.C. FOR 1-STORY AND 2'-8" O.C. FOR 2-STORY. BOLTS SHALL BE LOCATED WITHIN 1'-0" OF EACH END PIECE AND SHALL HAVE A MIN. OF TWO BOLTS PER PIECE.

-FOUNDATION ANCHOR STRAPS SHALL BE PERMITTED, ACCORDING TO RESIDENTIAL CODE 2021

- ALL INTERIOR WALLS TO BE SECURED WITH POWER DRIVEN PINS PER MANUFACTURER SPECIFICATION USE PIN SPACING EQUIVALENT TO 1/2" ANCHOR BOLTS.

- ALL CONSTRUCTION TO CONFORM TO THE 2012 IRC

- R-10 RIGID INSULATION OUTSIDE OF EXTERIOR FOUNDATION WALLS UNDER LIVING AREA.

- CONCRETE PAD FOR CONDENSER THICKNESS IS 4" MIN UNLESS OTHERWISE NOTED.

### 3. CONCRETE CONSTRUCTION:

- THE SLAB SHALL BE UNDERLAIN BY A VAPOR BARRIER/RETARDER IN THE LIVING AREA (TYPICALLY POLYETHYLENE, UNLESS MORE STRINGENT PROTECTION REQUIRED BY THE ARCHITECT, ENGINEER, FLOOR COVERING MANUFACTURER, OR ACCEPTED PRACTICE). UNLESS OTHERWISE REQUIRED, BARRIER MAY BE OMITTED AT GARAGES, PORCHES AND PATIOS WITHOUT FLOOR COVERINGS. IT IS BEYOND THE SCOPE OF THESE PLANS TO DETERMINE THE APPLICABILITY OF THESE MORE STRINGENT REQUIREMENTS. BUILDER SHALL VERIFY PRIOR TO CONSTRUCTION.

### 4. REINFORCEMENT:

- IF CONSTRUCTED ON ACTIVE SOILS, THE LONG TERM PERFORMANCE OF THE FOUNDATION IS DEPENDENT ON MAINTENANCE BY THE OWNER. THUS THE BUILDER SHALL ADVISE THE OWNER OF THE FOLLOWING:

1. DRAINAGE MUST BE MAINTAINED. WATER SHALL NEVER BE ALLOWED TO POND NEAR THE FOUNDATION.

2. THE SOIL AROUND THE FOUNDATION SHALL BE MAINTAINED IN A RELATIVELY DAMP CONDITION, SUCH AS THAT REQUIRED TO KEEP A LAWN GREEN. IF IT DRIES OUT IT WILL SHRINK. IF IT GETS WET, IT WILL HEAVE UPWARD.

3. SLABS ON THE SHORTER SIDE USES MAIN BARS ARE USED IN THIS DIRECTION ONLY WITH SMALLER DIAMETER DISTRIBUTION BARS ARE PLACED, FORMING A MAT OR GRID.

4. ALL REINFORCEMENT BARS SIZE 10MM OR LARGER IN ACCORDANCE TO ASTM
3. ANCHOR BOLTS AT ALL EXTERIOR WALLS SHALL BE MINIMUM 1/2 INCH DIAMETER WITH A

MAXIMUM SPACING OF 6'-0" ON CENTER, UNLESS NOTED OTHERWISE.

4. ANCHOR BOLTS SHALL BE INSTALLED WITHIN 12 INCHES OF EACH END OF EACH SILL PLATE WITH AT LEAST TWO ANCHOR BOLTS FOR EACH BOLTS FOR EACH SILL PLATE LONGER

THAN 12 INCHES.

5. SIMPSONS SILL ANCHORS MAYBE SUBSTITUTED FOR ANCHOR BOLTS AT THE SAME

SPACING.

6. EXTERIOR CONCRETE SLABS WHICH ARE NOT PART OF THE MAIN SLAB SHALL BE MINIMUM 4 INCHES THICK WITH NO STEEL REINFORCING BARS REQUIRED, UNLESS NOTED

### **VERIFY THE FOLLOWING PRIOR TO POURING:**

OTHERWISE ON FOUNDATION PLAN.

1. ALL HOLDDOWNS, STRAP, AND POST LOCATIONS.

2. CONCRETE FINISHES. PANEL RISER LOCATION - WHERE APPLICABLE.

3. UNDERSLAB MECHANICAL REQUIREMENTS.

4. STEM WALL BLOCKOUTS.

5. UNDERSLAB ELECTRICAL REQUIREMENTS AND PANEL RISER LOCATION. WHERE APPLICABLE.


6. PROVIDE THE FOLLOWING:

- PVC SLEEVES THROUGH FTG IF REQUIRED

- 20' #4 COPPER GROUND BAR.

7. SLOPE FINISH GRADE AWAY FROM FOOTING.

**NOTE**: FIELD VERIFY ALL DIMENSIONS SEE DIMENSIONED ARCHITECTURAL DRAWINGS

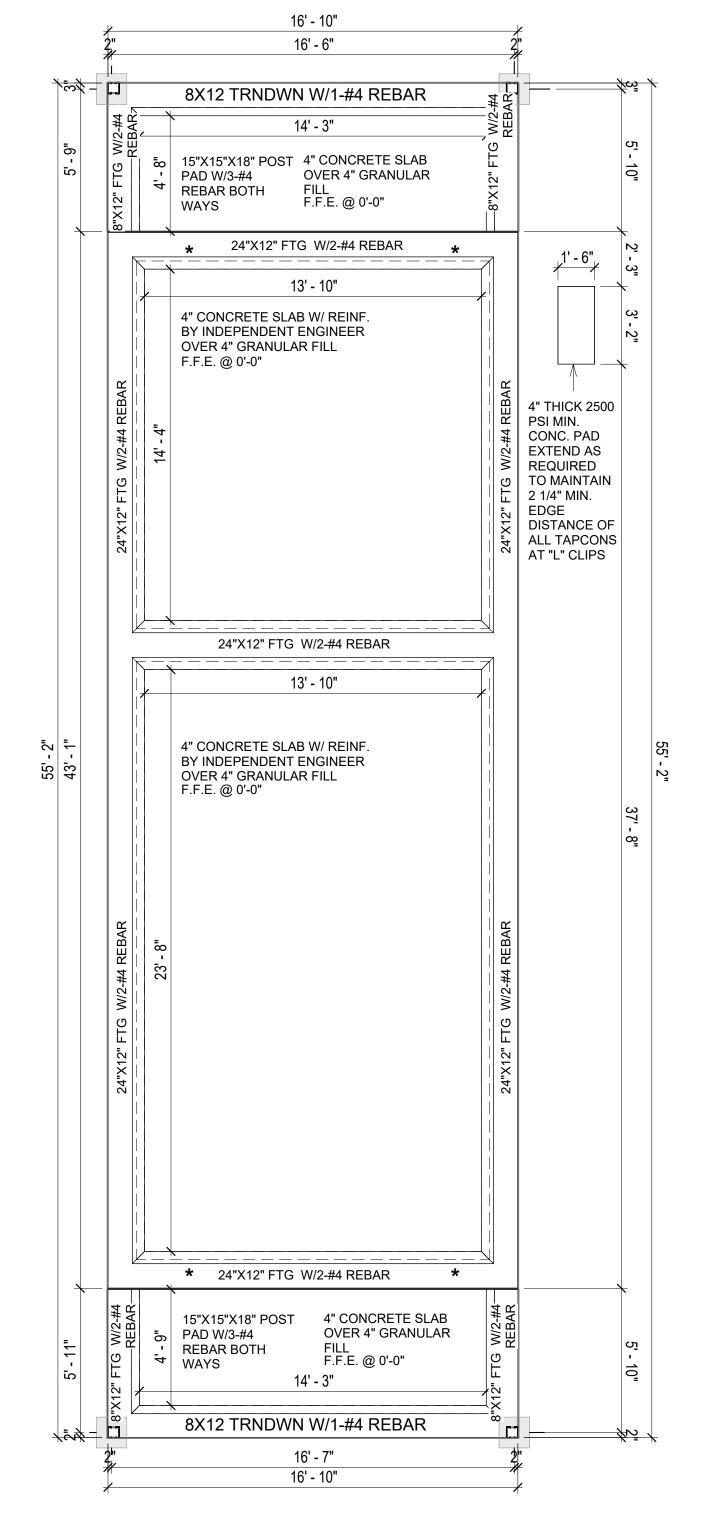

1 FOUNDATION PLAN
1/4" = 1'-0"



**KEY PLAN** 

NO.	DESCRIPTION	DATE

NOTE:

LEGEND:

PROJECT

161 HAVEN 733 2Bd 1Ba RANCH 550

DRAWING NAME

**FOUNDATION PLAN** 

CLIENT NAME:	Client Name
PROJECT NUMBER:	0061_12
DATE:	4/2/2025 2:33:31 PM
DESIGNED BY:	Designer
DRAWN BY:	Author
CHECKED BY:	Checker

**S101** 

SCALE: 1/4" = 1'-0"

SQUARE FOOTAGE

LIVING

PORCH

TOTAL

733

204

937

### **GENERAL NOTES**

### NOTES:

-ALL BEARING WALLS SHOULD HAVE A THICKENED SLAB PER SECTION PER DETAIL A401/5.

### A) **FOUNDATION PLAN NOTES**:

- CONCRETE SLAB SHALL BE 6" THICK WITH 1/2" DIAMETER TENDONS PER LAYOUT PLAN, CENTERED IN SLAB THICKNESS, OVER APPROVED SUBBASE PER GENERAL STRUCTURE NOTES.
- 2. TERMITE PROTECTION SHALL BE PROVIDED PER IRC SECTION R318.1 NONE TYPICAL ANCHOR BOLT SPACING AT SHEAR WALL AND HOLD DOWN
- SPECIFICATIONS PER APPROVED ARCHITECTURAL PLANS. 4. INSTALL HOLDOWNS BEFORE CONCRETE SLAB POUR.
- EXISTING FILL ON-SITE SHALL BE COMPACTED IN ACCORDANCE WITH THE
- REQUIREMENTS IN THE GEOTECHNICAL REPORT.
- 6. ALL FLOOR SLABS ARE REINFORCED ON CONCRETE SLABS.

### SPECIAL INSPECTION IS REQUIRED FOR THICKENED FOUNDATION CONSTRUCTION

- 1. REINFORCEMENT
- 2. 2300 PSI CONCRETE POUR


### B) **REINFORCEMENT FOR CONCRETE**:


1. ALL REINFORCING SLABS BARS SIZE 10MM OR LARGER SHALL BE DEFORMED IN ACCORDANCE TO ASTM-A706, AND BARS SMALLER THAN 10 MM MAYBE PLAIN. 2. UNLESS OTHERWISE NOTED IN PLANS, THE YIELD STRENGTH OF REINFORCING BARS SHALL BE:

> A) FOOTING = 40,000 PSI B) NON-LOAD BEARING WALLS AND PARAPETS= 40,000 PSI

- 3. SPLICES SHALL BE SECURELY WIRED TOGETHER AND SHALL LAP OR EXTEND
- 4. GRADE OF STEEL FOR RCC WORKS SHALL BE GRADE 4 10.
- BAR NOTATIONS GIVES INFORMATION
- A) BAR SIZE
- B) SPACING(IF REQUIRED)
- 6. LAP REINFORCEMENT ONLY AT LOCATION SHOWN IN THE DRAWINGS
- REINFORCEMENT SHALL NOT BE CUT, VENT OR HEATED ON SITE WITHOUT ENGINEERS' APPROVAL.
- C) **CONCRETE SLAB NOTES**
- 1. ALL SLAB REINFORCEMENT SHALL BE 20MM CLEAR MINIMUM FROM BOTTOM AND FROM TOP OF SLAB.
- 2. REINFORCEMENT IN CONTINUOUS ELEVATED SLAB SHALL BE CUT AS FOLLOWS.

- THIS IS A SCHEMATIC PLAN FOR THE PURPOSE OF LOCATING AND IDENTIFYING FOUNDATION REINFORCING ELEMENTS ONLY. VERIFY ALL DIMENSIONS, DROPS, OFFSETS AND FEATURES WITH THE ARCHITECTURAL PLANS BEFORE FORMING THE FOUNDATION.

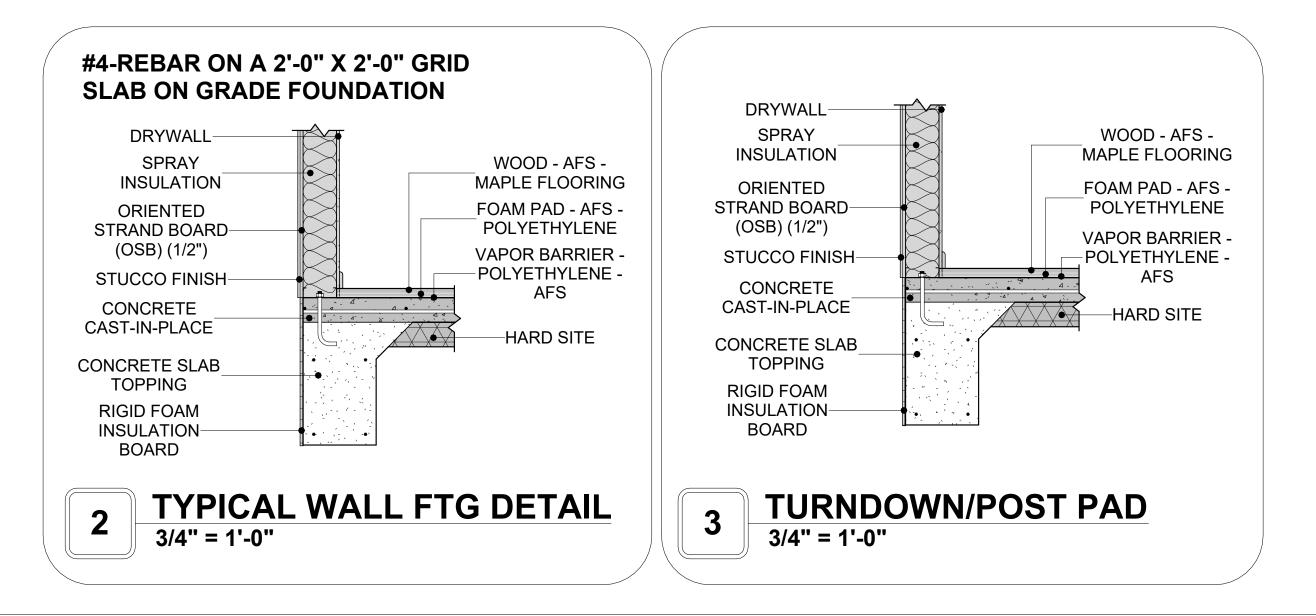

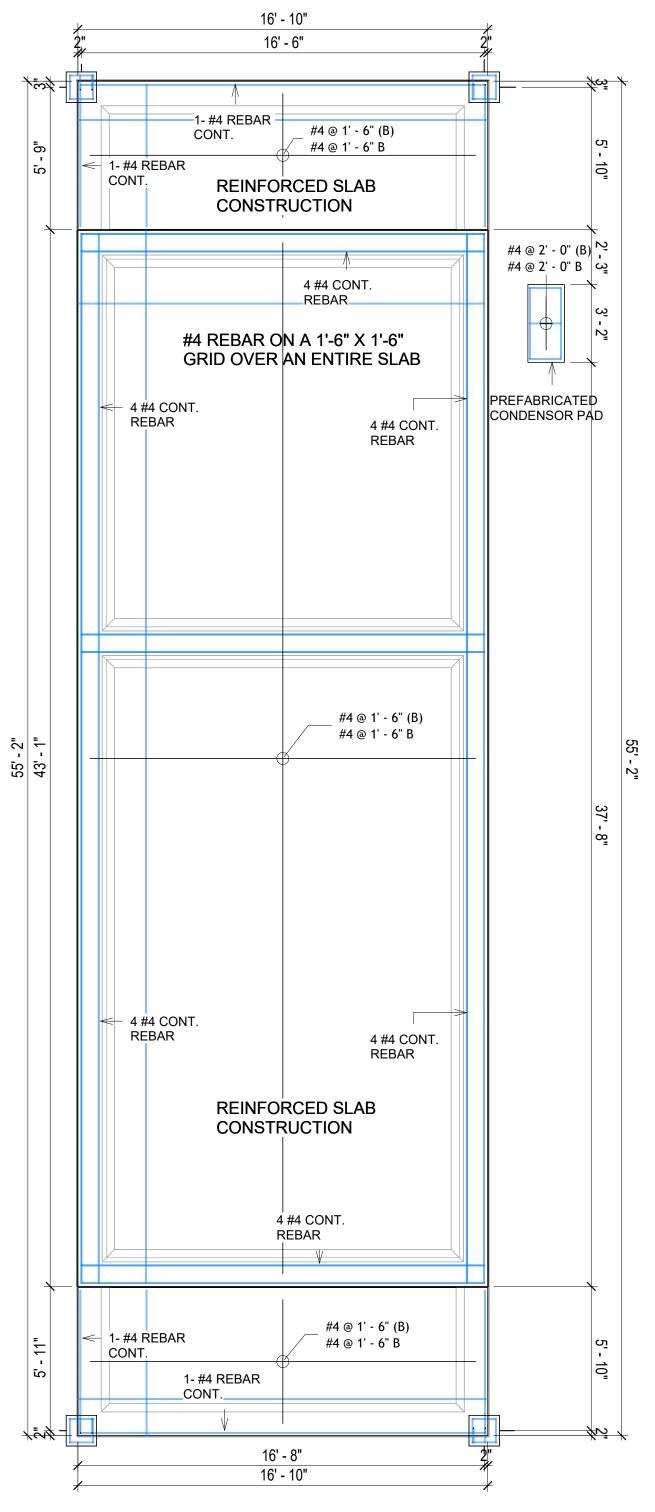

FOUNDATION REBAR PLAN 1/4" = 1'-0"



**KEY PLAN** 

NO.	DESCRIPTION	DATE

NOTE:

LEGEND:

PROJECT

161 HAVEN 733 2Bd 1Ba **RANCH 550** 

DRAWING NAME

STRUCTURAL FLOOR PLAN


CLIENT NAME: **Client Name** PROJECT NUMBER: 0061\_12 4/2/2025 2:33:32 PM Designer **DESIGNED BY:** DRAWN BY: **Author** CHECKED BY: Checker

**S102** 

# **ROOF NOTES**

ROOFING COMPOSITION ROOFING PER OWNERS/BUILDERS SPECIFICATIONS INSTALL PER MANUFACTURE SPECIFICATIONS ON 1/2" ORIENTED STRAND BOARD ON PRE-ENGINEERED TRUSS @ 24" O.C. (UNO.) 2. 73" OVERHANG AT EAVES (UNO.)

- ENDS OF ALL TRUSSES AND JOISTS TO BE FULLY BLOCKED. PROVIDE SOLID BLOCKING AT ALL RIDGES AND VALLEYS
- 4. SHEATHING TO BE 1/2", 3/8" OSB SHEAR PANEL AND EQUIVALENT. UNDERSIDE OF PORCH TRUSSES TO BE FINISHED WITH MOISTURE RESISTANT DRYWALL, TAPED AND TEXTURED.
- 5. EXPOSED EAVES AND OTHER WEATHER EXPOSED AREAS TO BE SHEATHED WITH EXTERIOR GRADE PLYWOOD.
- 6. ALL MATERIALS THICKNESS AND SIZE ARE THE MINIMUM. Refer TO LOCAL STANDARDS FOR ACTUAL THICKNESS AND LAYERING OF MATERIALS.
- ENGINEERED TRUSS CALCULATIONS TO BE SUBMITTED TO BUILDING DEPARTMENT PRIOR TO FABRICATION AND INSTALLATION.
- TRUSS MANUFACTURER TO SPECIFY HANGER CONNECTORS FOR TRUSS COMPONENTS (TYPICAL)
- 9. DESIGNER ASSUMES THAT TRUSSES BEAR ON ALL EXTERIOR PERIMETER WALLS (TYPICAL) OR BEAMS.
- 10. PROVIDE GALVANIZED STEEL FLASHING WITH A LENGTH OF 10 FEET, WIDTH OF 12 INCHES, AND THICKNESS OF 24 GAUGE.

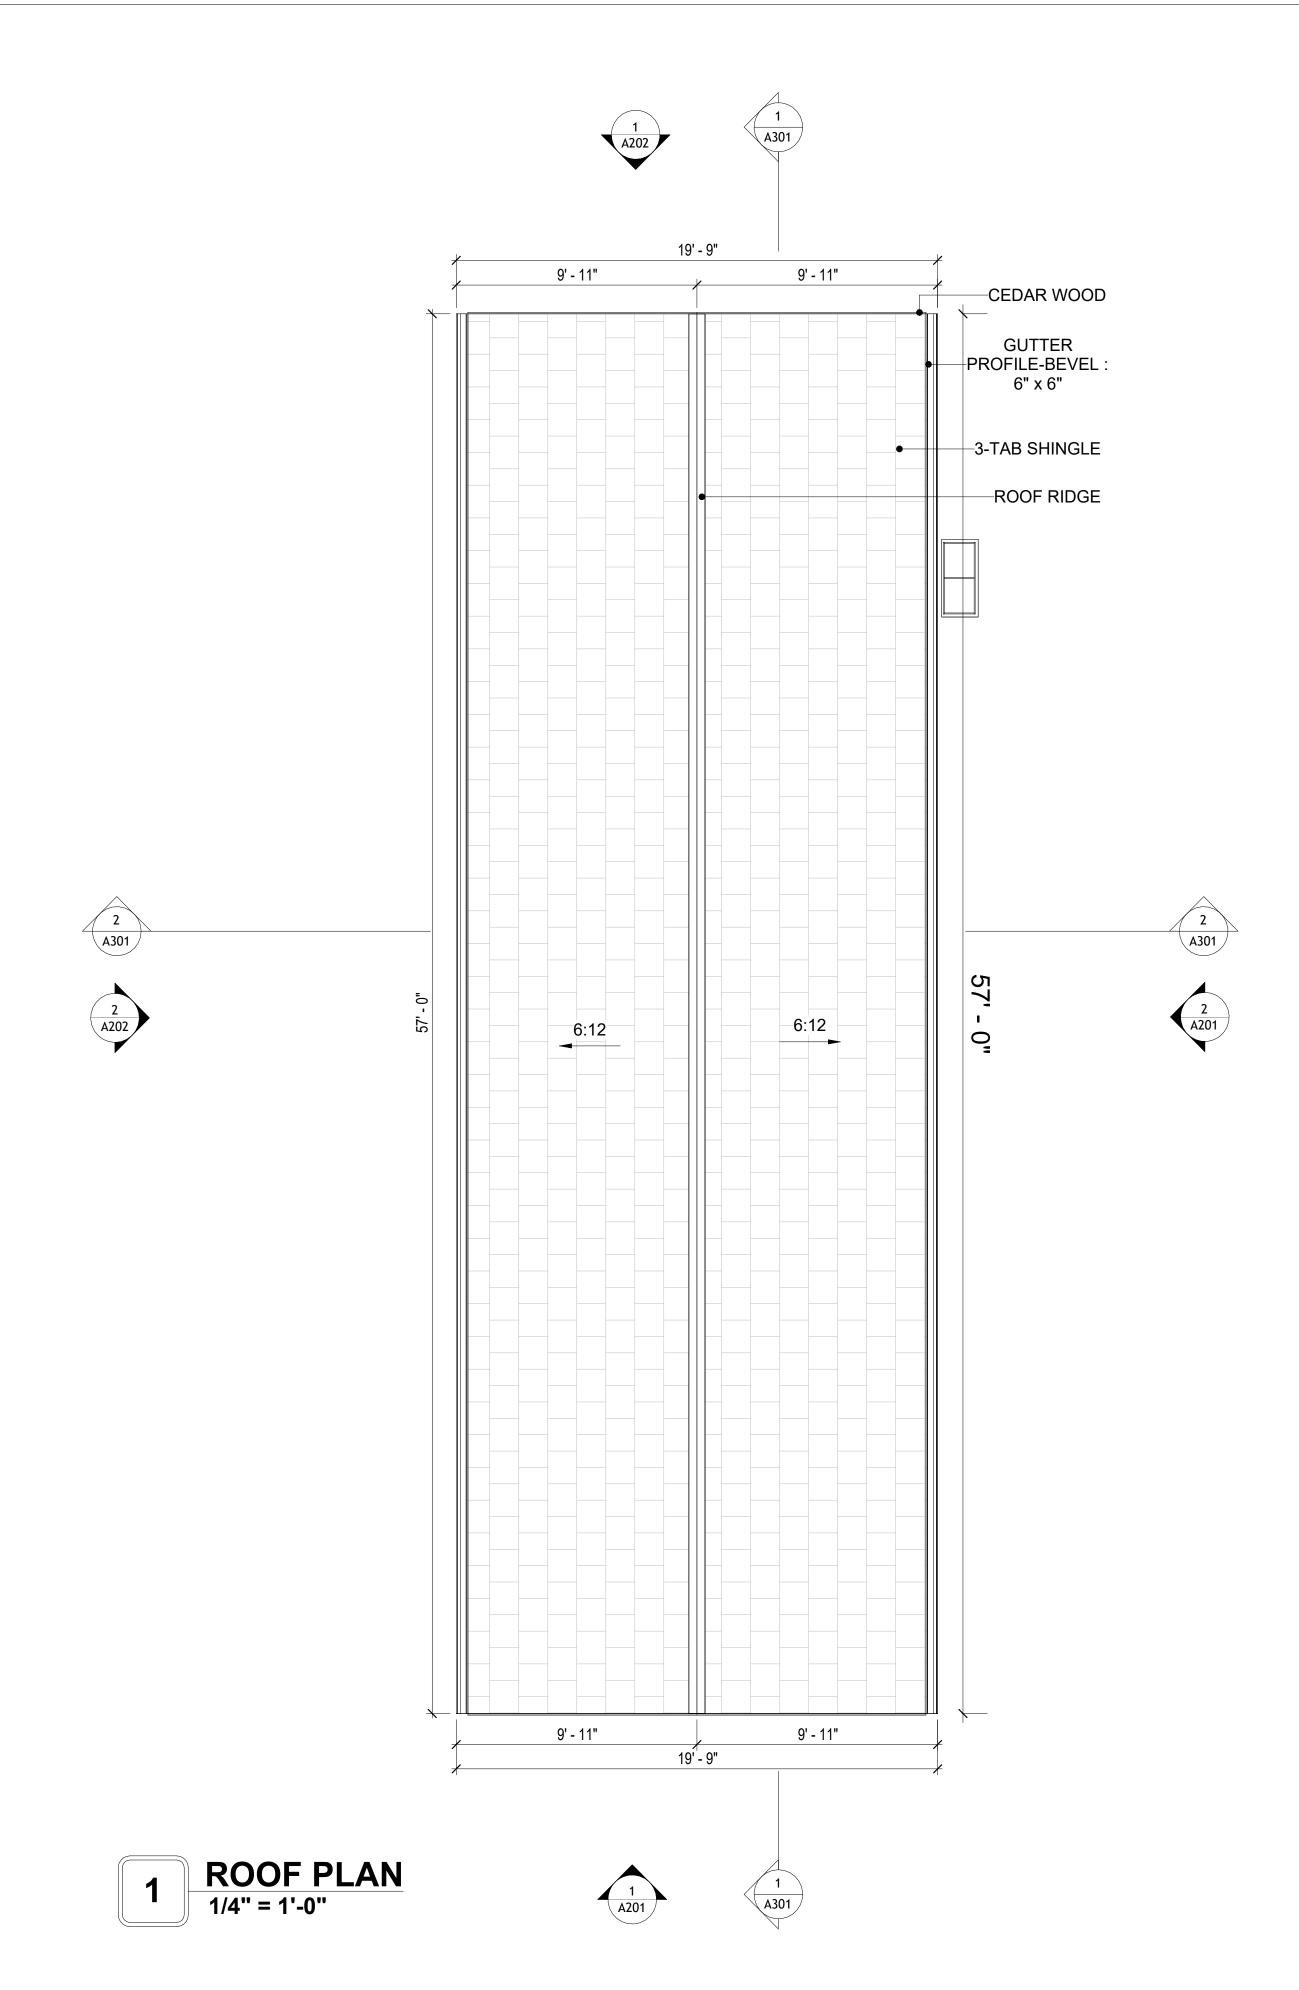



**KEY PLAN** 

NO.	DESCRIPTION	DATE

NOTE:

LEGEND:

PROJECT

161 HAVEN 733 2Bd 1Ba RANCH 550

DRAWING NAME

**ROOF PLAN** 

CLIENT NAME:	Client Name
PROJECT NUMBER:	0061_12
DATE:	4/2/2025 2:33:35 PM
DESIGNED BY:	Designer
DRAWN BY:	Author
CHECKED BY:	Checker

SQUARE FOOTAGE 733 PORCH 204 TOTAL 937

A103

SCALE: 1/4" = 1'-0"

### **ABOUT WALL FINISHING**

### **CORRUGATED IRON SHEET**

CORRUGATED IRON IS A FINISHING MATERIAL MADE FROM STEEL THAT HAS BEEN GALVANIZED (COATED WITH A THIN LAYER OF ZINC) TO PROTECT IT FROM CORROSION AND RUST.

IN THIS SPECIFIC PROJECT, THE CORRUGATED IRON SHEETS ARE INSTALLED HORIZONTALLY ON VERTICAL FURRING STRIPS THAT ARE DIRECTLY ATTACHED ONTO THE PROPERLY INSTALLED AND SEALED HOME WRAP, USING SELF-DRILLING SCREWS THAT ARE DRIVEN THROUGH THE RIDGES OR VALLEYS OF THE CORRUGATIONS.

### STUCCO FINISH

STUCCO IS A CEMENT-BASED EXTERIOR WALL FINISH THAT OFFERS A DURABLE, WEATHER-RESISTANT, AND CUSTOMIZABLE CLADDING SOLUTION FOR BUILDINGS.

IN THIS SPECIFIC PROJECT, AMERICAN STUCCO SYSTEMS IS USED AS A FINISH MATERIAL BECAUSE IT IS GENERALLY CONSIDERED A WATER-RESISTANT EXTERIOR FINISH AND USES A THREE-COAT APPLICATION PROCESS.

3/8-INCH OF IT IS APPLIED AS AN EXTERNAL WALL FINISH AS IT IS THE MOST COMMON AND WIDELY ACCEPTED STANDARD THICKNESS FOR STUCCO EXTERIOR WALL FINISHES. THIS MULTI-LAYER APPROACH ALSO HELPS CREATE A STRONG, CRACK-RESISTANT STUCCO SURFACE.

THIS STANDARD STUCCO IS APPLIED OVER OSB SHEATHINGS (FOR COLD FORMED STRUCTURE CONSTRUCTION).


IT IS NOT DIRECTLY TROWELED OVER THE OSB BUT OVER A WATER-RESISTANT BARRIER (HOMEWRAP) AND METAL/PLASTIC LATH THAT ARE INSTALLED ON TOP SURFACE OF THE OSB TO PROVIDE AN ADDITIONAL LAYER OF PROTECTION AGAINST MOISTURE INTRUSION.

REGULAR INSPECTION AND PROMPT REPAIR OF ANY CRACKS, CHIPS, OR DAMAGE TO THE STUCCO FINISH IS IMPORTANT. THIS MAINTAINS THE STUCCO'S WATER-RESISTANT PROPERTIES OVER THE BUILDING'S LIFE SPAN.


### **CEDAR WOOD**

CEDAR WOOD REFERS TO THE WOOD FROM VARIOUS SPECIES OF CEDAR TREES, WHICH ARE CONIFEROUS EVERGREEN TREES KNOWN FOR THEIR DISTINCT AROMA AND NATURAL RESISTANCE TO DECAY AND INSECTS.

IN THIS SPECIFIC PROJECT, CEDAR WOOD IS USED A FINISH MATERIAL ON BEAMS AND COLUMNS.

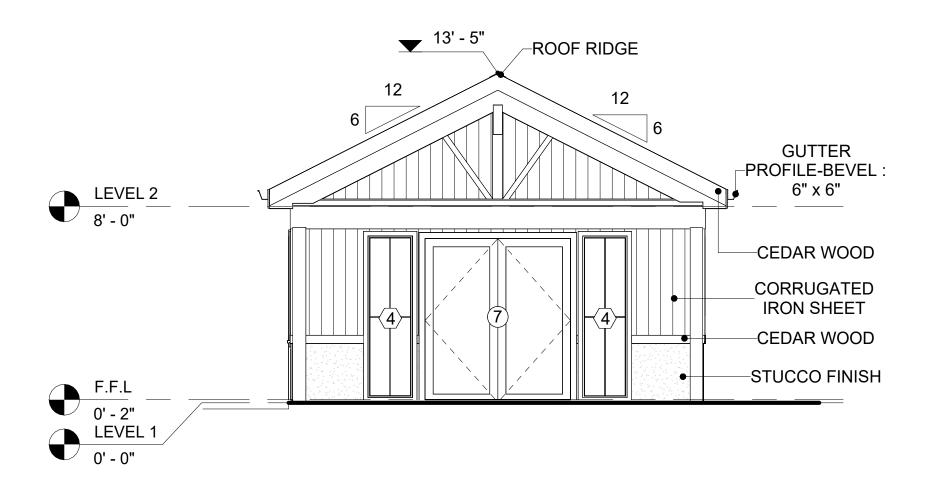

1 FRONT ELEVATION
1/4" = 1'-0"

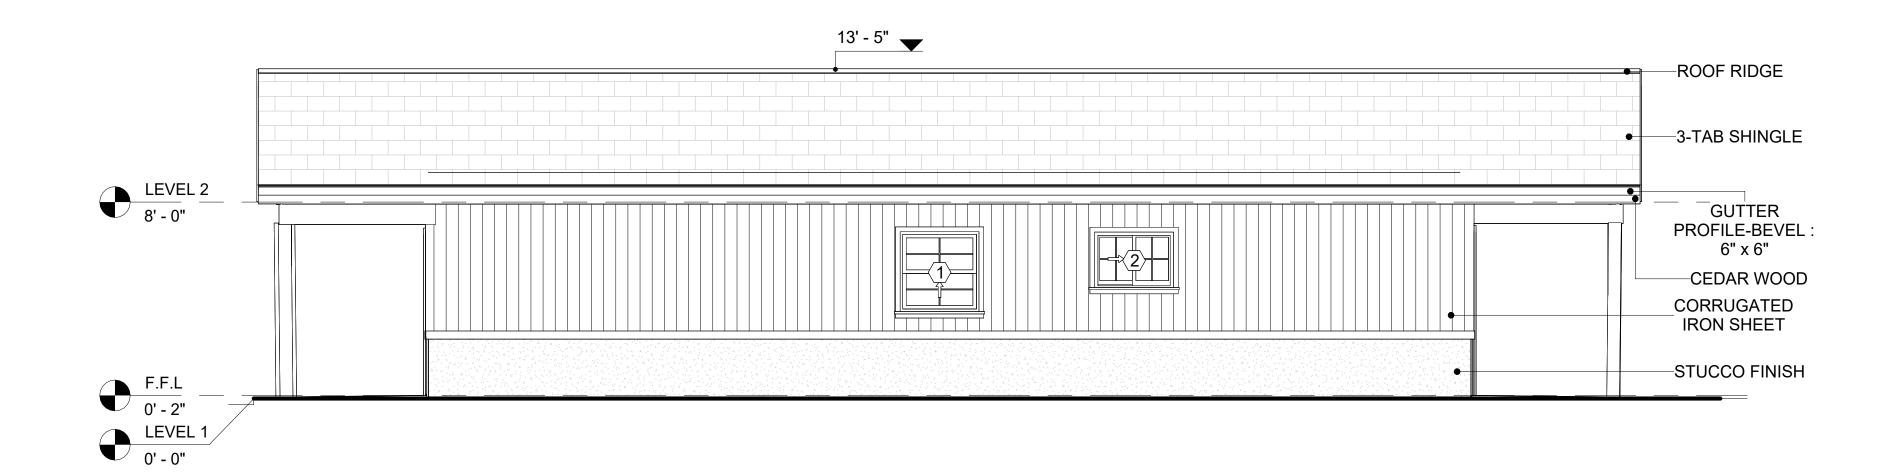

2 RIGHT SIDE ELEVATION
1/4" = 1'-0"

DOOR SCHEDULE						
TYPE				SIZE		
MAR K	SUPPLIER	DOOR TYPE	LOCATIO	WIDTH	HEIGHT	COUNT
1	HOME DEPOT	INTERIOR SINGLE PANEL SWINGING	INTERIOR	2' - 6"	6' - 8"	1
2	HOME DEPOT	INTERIOR SINGLE PANEL SWINGING	INTERIOR	2' - 0"	6' - 8"	1
3	HOME DEPOT	INTERIOR DOUBLE PANEL SLIDING	INTERIOR	9' - 0"	6' - 8"	1
4	HOME DEPOT	INTERIOR SINGLE PANEL SWINGING	INTERIOR	3' - 0"	6' - 8"	1
5	HOME DEPOT	INTERIOR DOUBLE PANEL SLIDING	INTERIOR	7' - 0"	6' - 8"	1
6	HOME DEPOT	EXTERIOR DOUBLE PANEL SWINGING	INTERIOR	5' - 0"	6' - 8"	1
7	HOME DEPOT	EXTERIOR DOUBLE PANEL SWINGING	INTERIOR	6' - 0"	6' - 8"	2
8	HOME DEPOT	INTERIOR SINGLE PANEL SWINGING	INTERIOR	3' - 0"	6' - 8"	1

WINDOW SCHEDULE					
			SIZE		
TYPE MARK	SUPPLIER	WINDOW TYPE	WIDTH	HEIGHT	COUNT
1	HOME DEPOT	SINGLE HUNG	3' - 3"	3' - 3"	1
2	HOME DEPOT	SLIDING	3' - 3"	2' - 3"	1
3	HOME DEPOT	CASEMENT	2' - 3"	4' - 3"	3
4	HOME DEPOT	FIXED	1' - 11"	6' - 8"	4



KEY PLAN

NO.	DESCRIPTION	DA <sup>*</sup>

NOTE:

LEGEND:

PROJECT

161 HAVEN 733 2Bd 1Ba RANCH 550

DRAWING NAME

### ARCHITECTURAL ELEVATIONS

CLIENT NAME:	Client Name
PROJECT NUMBER:	0061_12
DATE:	4/2/2025 2:33:38 PM
DESIGNED BY:	Designer
DRAWN BY:	Author
CHECKED BY:	Checker

A201

### **ABOUT WALL FINISHING**

### **CORRUGATED IRON SHEET**

CORRUGATED IRON IS A FINISHING MATERIAL MADE FROM STEEL THAT HAS BEEN GALVANIZED (COATED WITH A THIN LAYER OF ZINC) TO PROTECT IT FROM CORROSION AND RUST.

IN THIS SPECIFIC PROJECT, THE CORRUGATED IRON SHEETS ARE INSTALLED HORIZONTALLY ON VERTICAL FURRING STRIPS THAT ARE DIRECTLY ATTACHED ONTO THE PROPERLY INSTALLED AND SEALED HOME WRAP, USING SELF-DRILLING SCREWS THAT ARE DRIVEN THROUGH THE RIDGES OR VALLEYS OF THE CORRUGATIONS.

### STUCCO FINISH

STUCCO IS A CEMENT-BASED EXTERIOR WALL FINISH THAT OFFERS A DURABLE, WEATHER-RESISTANT, AND CUSTOMIZABLE CLADDING SOLUTION FOR BUILDINGS.

IN THIS SPECIFIC PROJECT, AMERICAN STUCCO SYSTEMS IS USED AS A FINISH MATERIAL BECAUSE IT IS GENERALLY CONSIDERED A WATER-RESISTANT EXTERIOR FINISH AND USES A THREE-COAT APPLICATION PROCESS.

3/8-INCH OF IT IS APPLIED AS AN EXTERNAL WALL FINISH AS IT IS THE MOST COMMON AND WIDELY ACCEPTED STANDARD THICKNESS FOR STUCCO EXTERIOR WALL FINISHES. THIS MULTI-LAYER APPROACH ALSO HELPS CREATE A STRONG, CRACK-RESISTANT STUCCO SURFACE.

THIS STANDARD STUCCO IS APPLIED OVER OSB SHEATHINGS (FOR COLD FORMED STRUCTURE CONSTRUCTION).


IT IS NOT DIRECTLY TROWELED OVER THE OSB BUT OVER A WATER-RESISTANT BARRIER (HOMEWRAP) AND METAL/PLASTIC LATH THAT ARE INSTALLED ON TOP SURFACE OF THE OSB TO PROVIDE AN ADDITIONAL LAYER OF PROTECTION AGAINST MOISTURE INTRUSION.

REGULAR INSPECTION AND PROMPT REPAIR OF ANY CRACKS, CHIPS, OR DAMAGE TO THE STUCCO FINISH IS IMPORTANT. THIS MAINTAINS THE STUCCO'S WATER-RESISTANT PROPERTIES OVER THE BUILDING'S LIFE SPAN.


### **CEDAR WOOD**

CEDAR WOOD REFERS TO THE WOOD FROM VARIOUS SPECIES OF CEDAR TREES, WHICH ARE CONIFEROUS EVERGREEN TREES KNOWN FOR THEIR DISTINCT AROMA AND NATURAL RESISTANCE TO DECAY AND INSECTS.

IN THIS SPECIFIC PROJECT, CEDAR WOOD IS USED A FINISH MATERIAL ON BEAMS AND COLUMNS.

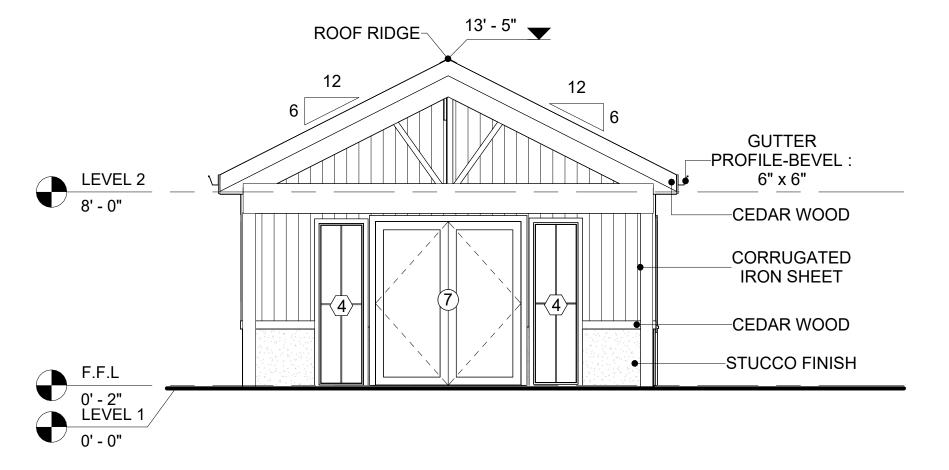

1 REAR ELEVATION
1/4" = 1'-0"

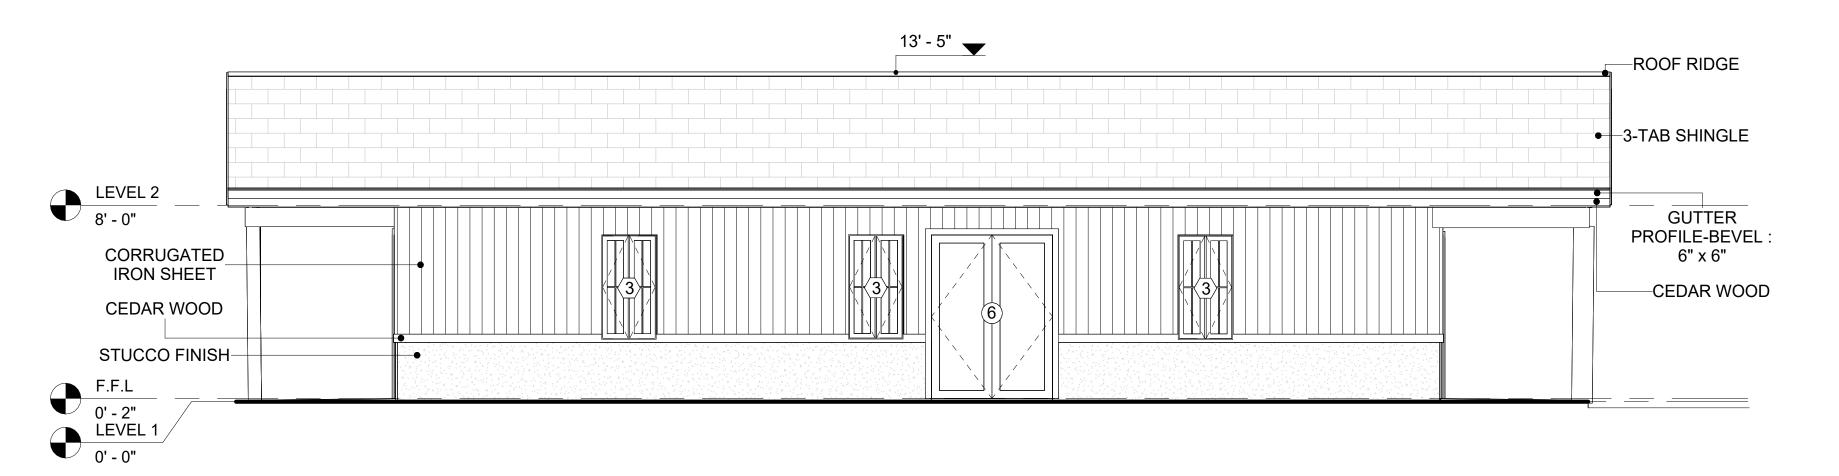

2 LEFT SIDE ELEVATION
1/4" = 1'-0"



KEY PLAN

1

2

NO.	DESCRIPTION	DATE

NOTE:

LEGEND:

PROJECT

161 HAVEN 733 2Bd 1Ba RANCH 550

DRAWING NAME

ARCHITECTURAL ELEVATIONS

CLIENT NAME:

PROJECT NUMBER:

0061\_12

DATE:

4/2/2025 2:33:41 PM


DESIGNED BY:


DRAWN BY:

CHECKED BY:

Checker

A202

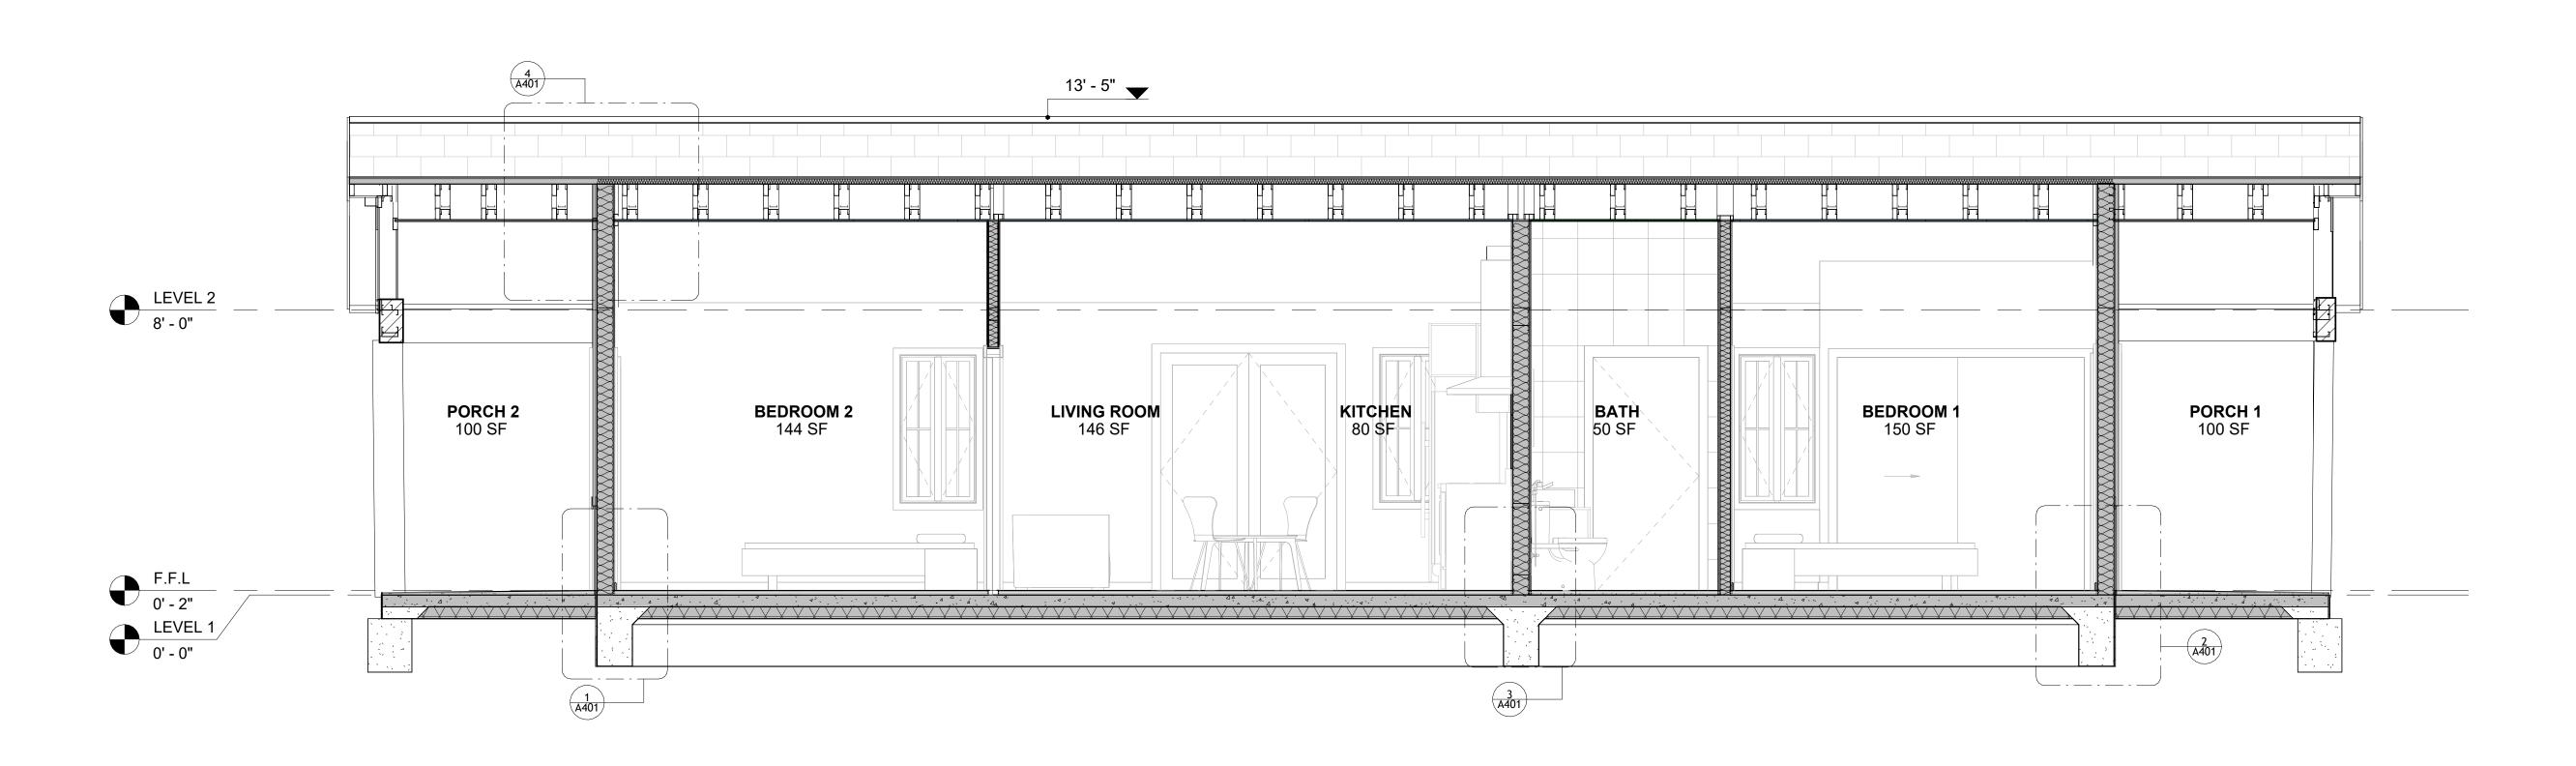


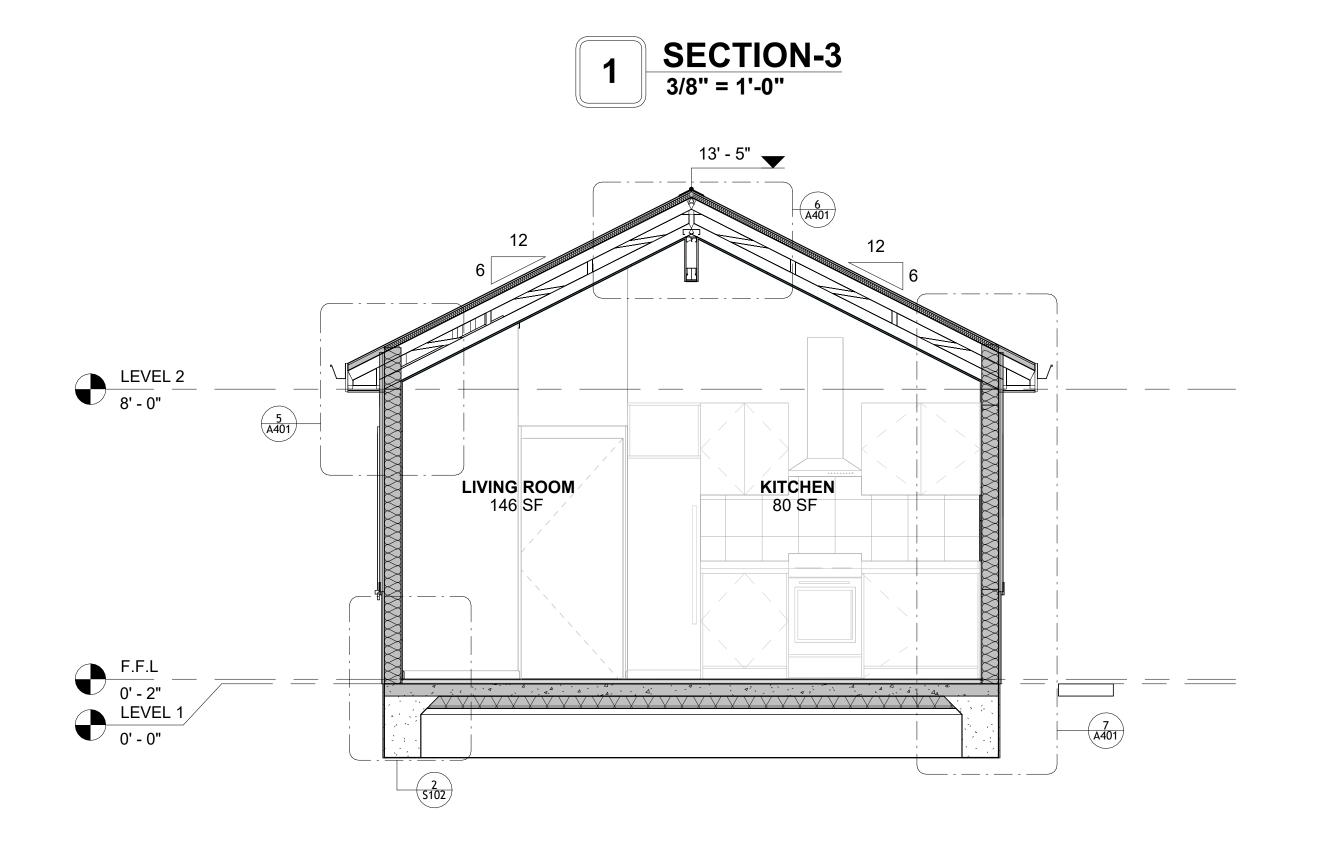

2 SECTION-2 3/8" = 1'-0"



**KEY PLAN** 

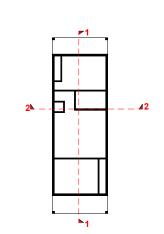

NO.	DESCRIPTION	DAT

NOTE:

LEGEND:

PROJECT


161 HAVEN 733 2Bd 1Ba RANCH 550


DRAWING NAME


ARCHITECTURAL SECTIONS


	Client Name
	0061_12
4/2	
	Designer
	Author
	Checker


A301

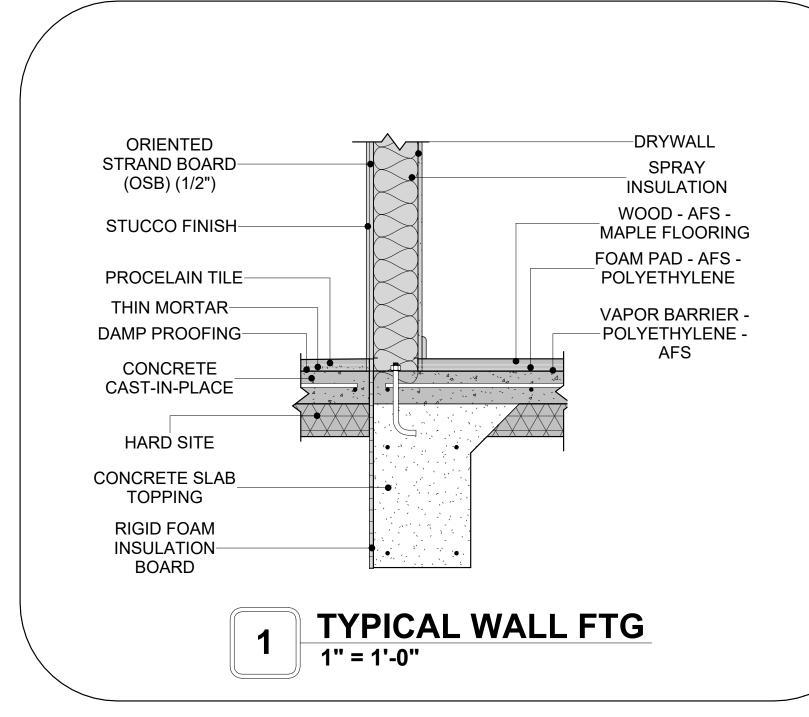


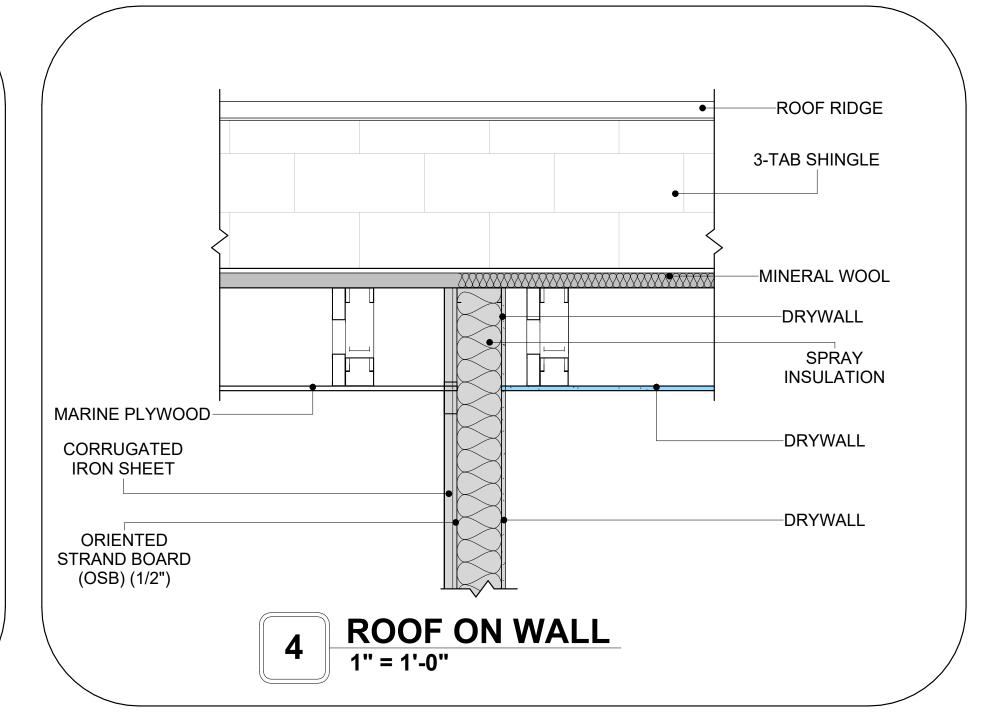


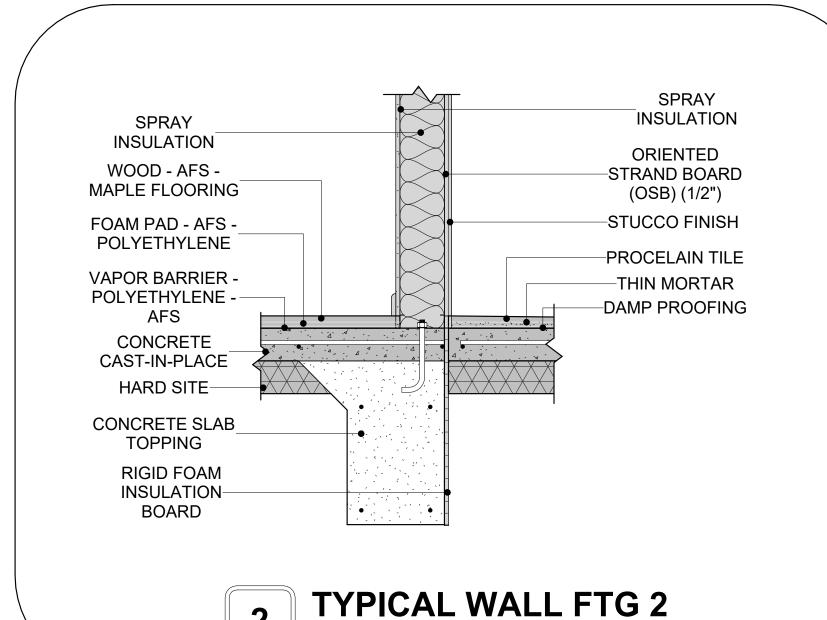


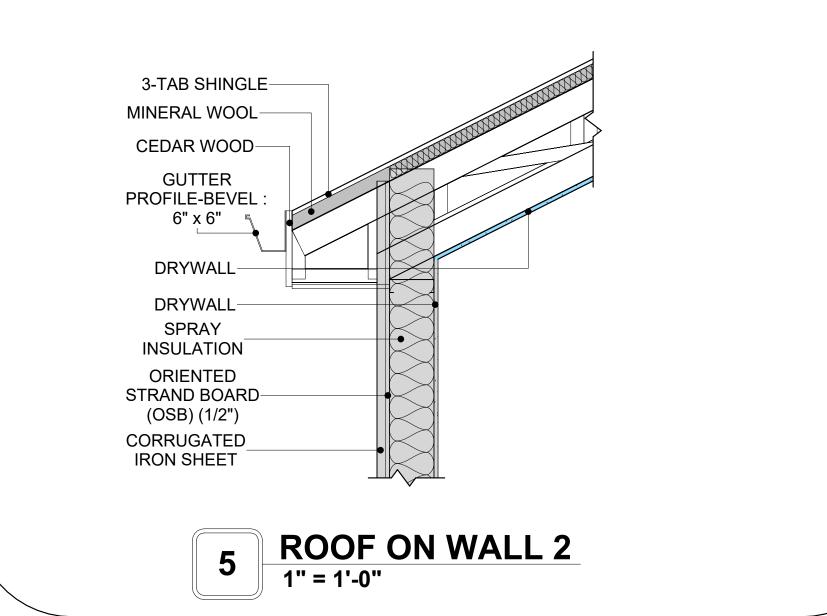

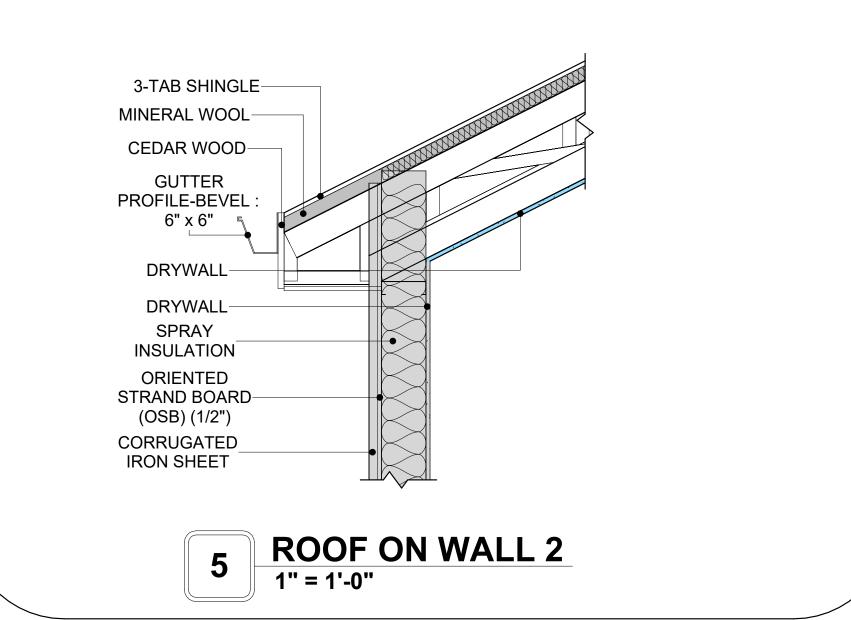

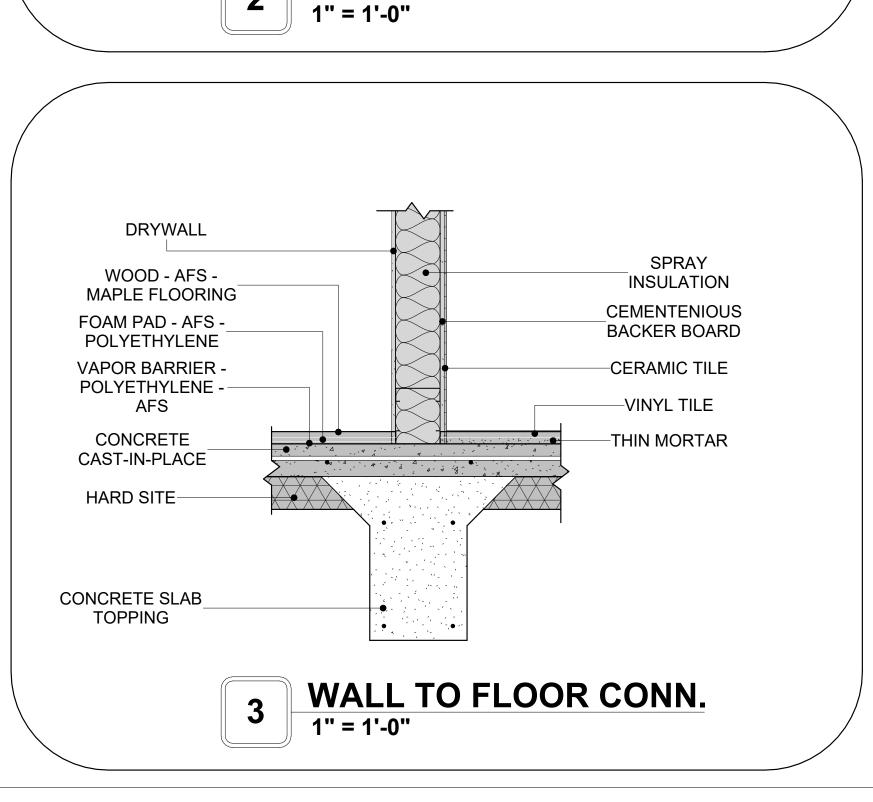

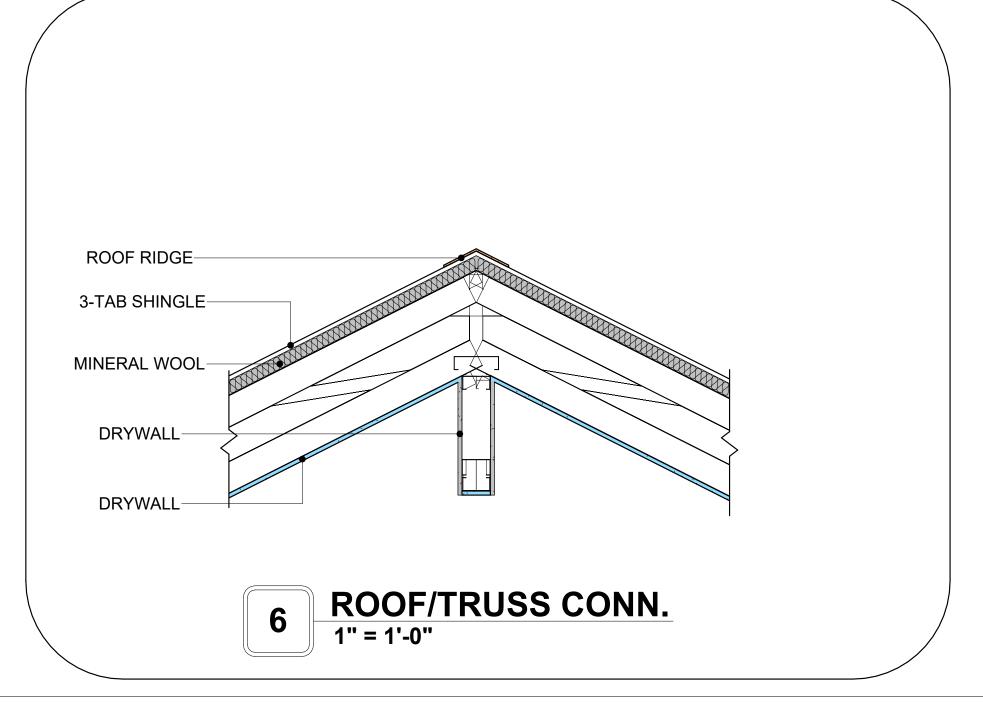

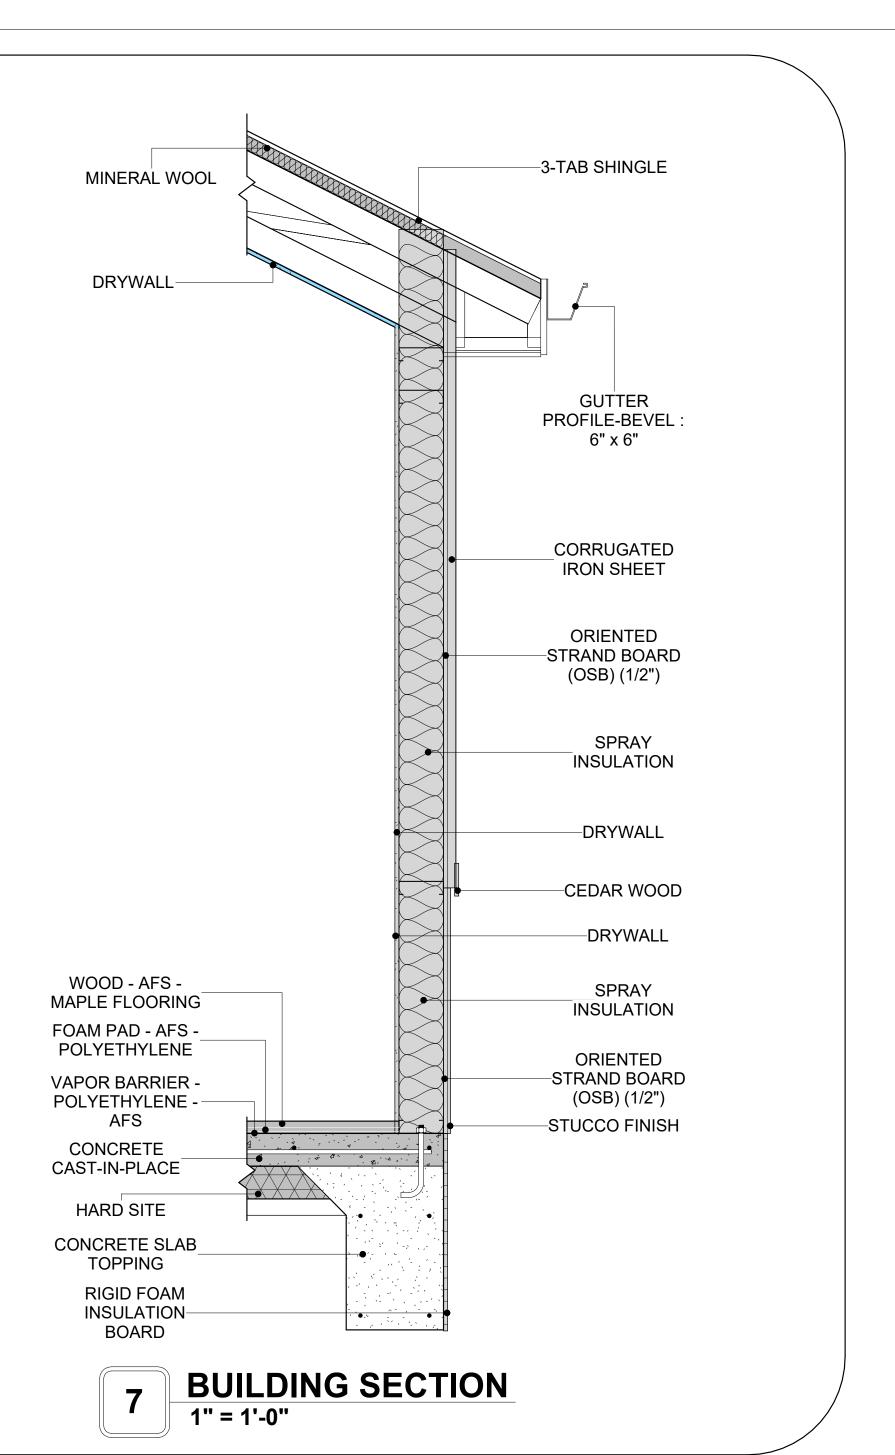



**KEY PLAN** 

NO.	DESCRIPTION	DATE

NOTE:

LEGEND:

PROJECT

161 HAVEN 733 2Bd 1Ba **RANCH 550** 

DRAWING NAME

ARCHITECTURAL DETAILS

CLIENT NAME:	Client Name
PROJECT NUMBER:	0061_12
DATE:	4/2/2025 2:33:45 PM
DESIGNED BY:	Designer
DRAWN BY:	Author
CHECKED BY:	Checker

A401


SCALE: 1" = 1'-0"


# **CASEWORK GENERAL NOTES**


- ALL CABINET HEIGHTS INCLUDE COUNTERTOPS. DIMENSIONS ARE TO THE NEAREST INCH. DIVISIONS IN CASEWORK ARE SHOWN FOR CLARITY AND DO NOT REPRESENT BREAKS IN THE COUNTERTOP.
- PROVIDE CONTINUOUS COUNTERTOP OVER ALL SIMILAR HEIGHT CASEWORK, UNLESS AND OTHERWISE NOTED.
- MANUFACTURER AND CATALOG NUMBERS ARE FOR REFERENCE AND ILLUSTRATION PURPOSES
- DOTTED LINES INDICATE WALL HUNG CABINETS, DIVISIONS OF BASE CABINETS BELOW THE
- COUNTERTOP, FURNITURE NOT IN THE CONTRACT OR PROJECTION SCREENS -SEE CASEWORK KEY AND SPECIFICATIONS.
- ALL CABINETS AND DRAWERS TO HAVE CAM LOCKS EXCEPT FOR SINK BASE CABINETS.
  ALL EXPOSED SURFACES (EXPOSED TO VIEW FROM ANY PERSPECTIVE) TO BE COVERED WITH
- LAMINATE.
- ALL CASEWORK WHICH MEETS A WALL AT ONE OR BOTH ENDS, TO BE PROVIDED WITH FILLER PANELS AND SCRIBED TO THE WALL(S) AS REQUIRED.
- 10. ALL CABINETS AND DRAWERS ARE PROVIDED WITH RECESSED HANDLES.
- 11. CONTRACTOR TO FIELD VERIFY ALL CLEAR OPENINGS PRIOR TO MILLWORK OR CASEWORK FABRICATION.
- 12. CASEWORK DRAWINGS ARE DIAGRAMMATIC IN NATURE TO SHOW DESIGN INTENT.

	CASEWORK SCHEDULE						
TYPE MAR K	TYPE	COUN T	HEIGHT	WIDTH	DEPTH	AREA	
01	L-SHAPE COUNTER TOP 158	1	0' - 4"	7' - 0"	7' - 0"	2 SF	
02	BASE CABINET DOUBLE DOOR 2	1	2' - 11"	3' - 1"	2' - 0"	9 SF	
03	BASE CABINET L-SHAPED	1	2' - 11"	3' - 3"	3' - 3"	9 SF	
04	WALL CABINET DOUBLE DOOR 2 158	1	2' - 6"	3' - 3"	1' - 0"	8 SF	
05	WALL CABINET DOUBLE DOOR 3 159.186 2	1	2' - 6"	2' - 5"	1' - 0"	6 SF	
06	LINEAR COUNTER TOP 2 159.186 2	1	0' - 4"	2' - 5"	2' - 1"	1 SF	
07	BASE_CABINET_DOUBLE_DOOR	1	2' - 11"	2' - 5"	2' - 0"	7 SF	
08	LAUNDRY OPEN CABINET	1	1' - 6"	2' - 0"	2' - 4"	3 SF	
09	RECESSED_MED_CABINET	1	2' - 0"	1' - 6"	0' - 3"	3 SF	
10	VANITY 2	1	2' - 4"	3' - 0"	1' - 8"	7 SF	
11	LAUNDRY OPEN CABINET 3 159.186	1	1' - 1"	2' - 3"	3' - 0"	2 SF	
12	CLOSET_3	1	5' - 11"	7' - 6"	1' - 4"	44 SF	
13	CLOSET_4	1	5' - 11"	10' - 6"	1' - 4"	62 SF	
GRAND	TOTAL	13					


SPECIALTY EQUIPMENT SCHEDULE				
TYPE MARK	TYPE	COUNT		
01	WASHER-FRONT-LOAD	1		
02	REFRIGERATOR	1		
03	RANGE	1		
04	DRYER-FRONT-LOAD	1		
05	DISHWASHER	1		
GRAND TOTAL: 5	·			

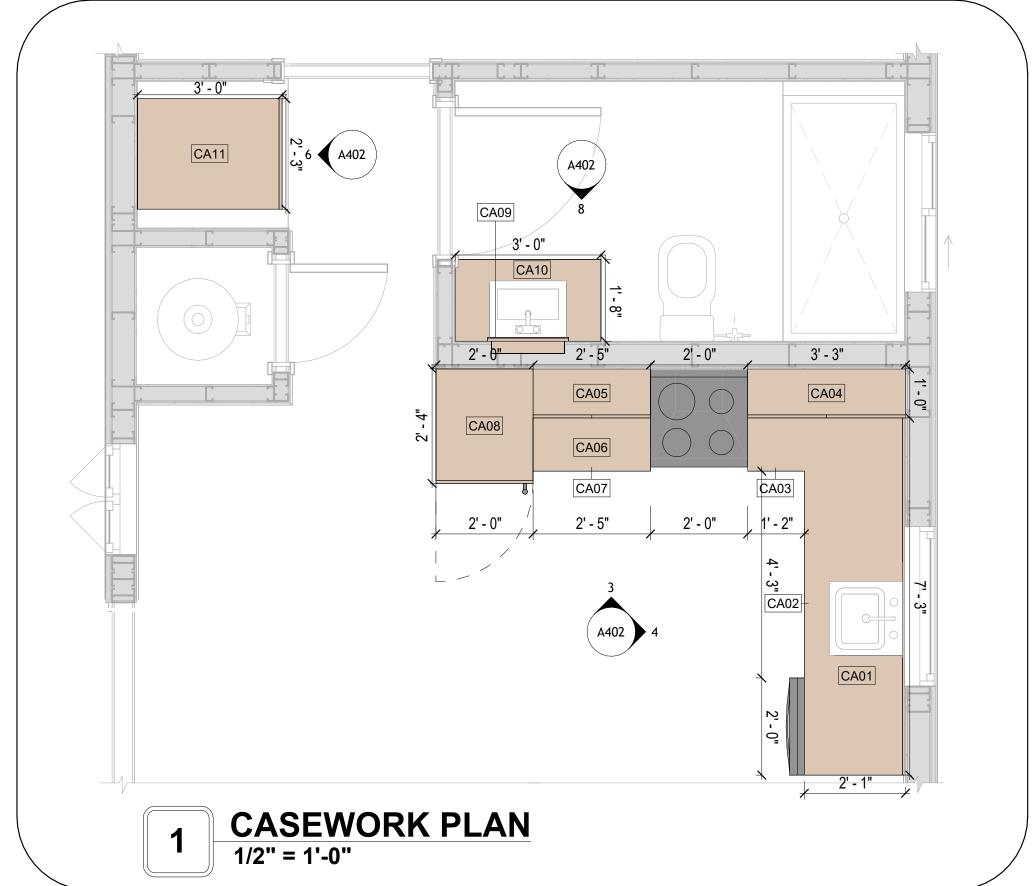

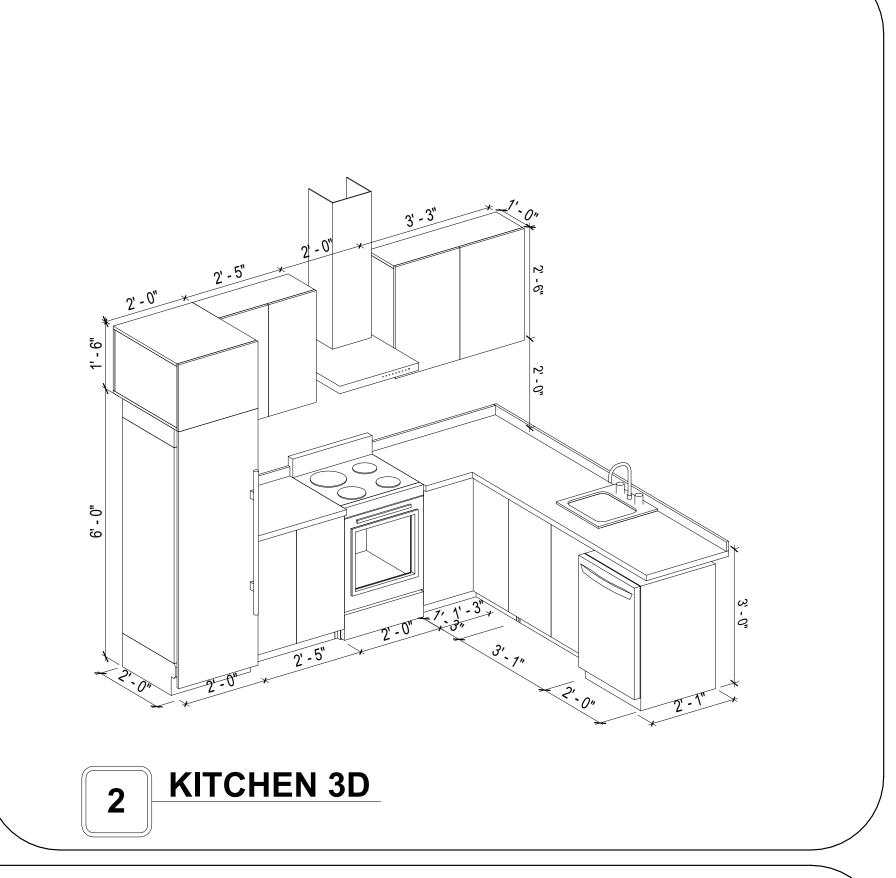

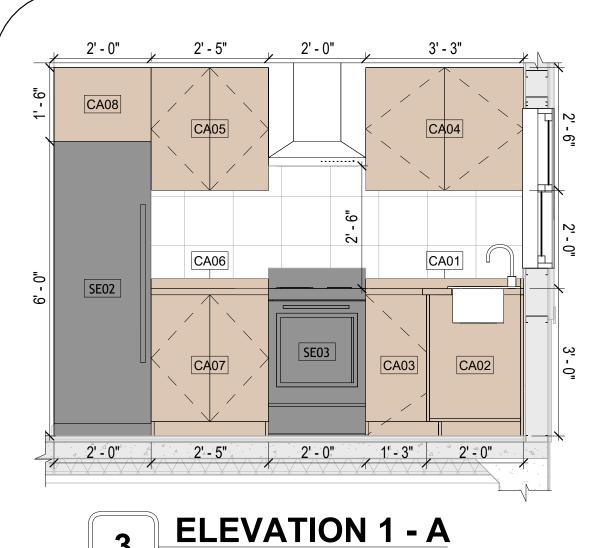



1/2" = 1'-0"

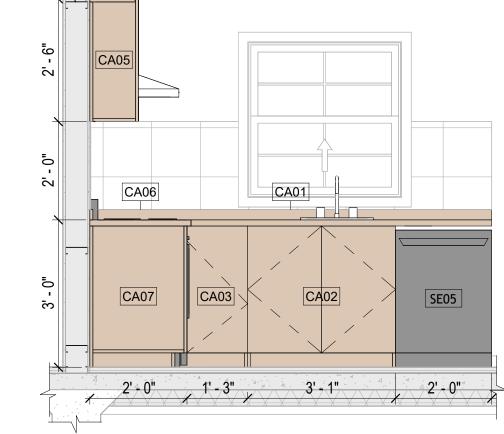

1/2" = 1'-0"


**ELEVATION 1 - B** 

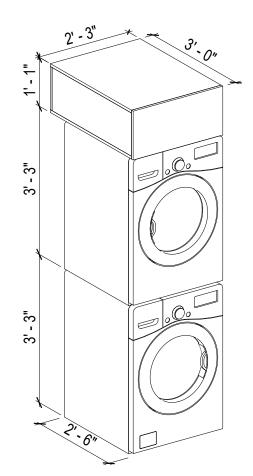


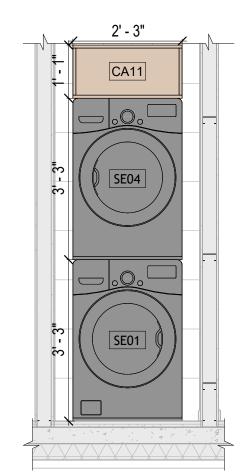

5 LAUNDRY 3D


**ELEVATION 1 - C** 1/2" = 1'-0"

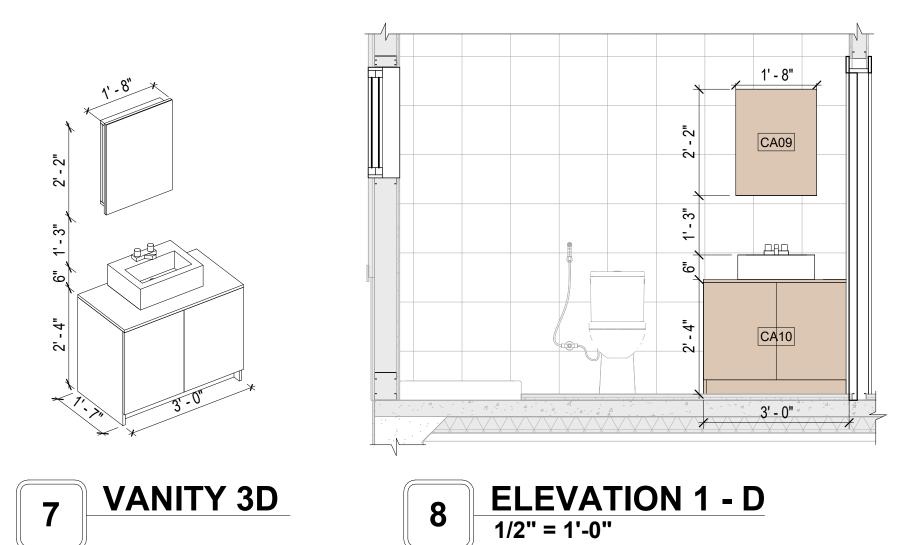

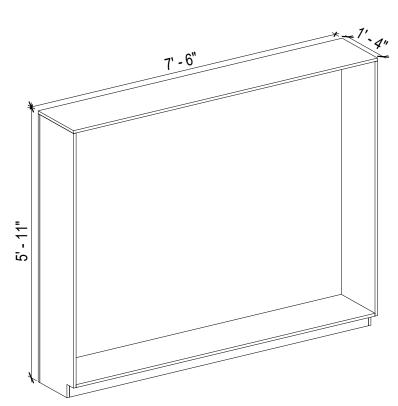

9 CLOSET 3D



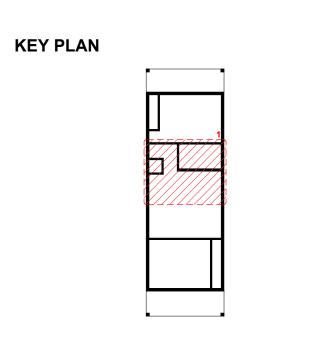

NO.	DESCRIPTION	DATE

NOTE:

LEGEND:

PROJECT

161 HAVEN 733 2Bd 1Ba RANCH 550

DRAWING NAME

ARCHITECTURAL CASEWORK

CLIENT NAME:	Client Name
PROJECT NUMBER:	0061_12
DATE:	4/2/2025 2:33:47 PM
DESIGNED BY:	Designer
DRAWN BY:	Author
CHECKED BY:	Checker

A402

SCALE: As indicated

### **GENERAL NOTES**

T1. THIS DRAWING DEPICTS THE HVAC (HEATING, VENTILATION, AND AIR CONDITIONING) SYSTEM FOR THE HAVEN 2BD1BA RANCH. IT PROVIDES A VISUATION OF THE HAVEN 2BD1BA RANCH. IT PROVIDES A VISUATION OF THE HAVEN 2BD1BA RANCH. REPRESENTATION OF THE SYSTEM LAYOUT AND COMPONENTS.

2.THE HVAC SYSTEM IS DESIGNED TO MEET THE SPECIFIC REQUIREMENTS OF THE BUILDING, INCLUDING HEATING, COOLING, AND VENTILATION NEEDS AS PER THE PROJECT SPECIFICATIONS AND APPLICABLE CODES AND STANDARDS.

3. THE HVAC SYSTEM INSTALLATION SHALL COMPLY WITH THE LATEST EDITION OF THE INTERNATIONAL MECHANICAL CODE (IMC), INTERNATIONAL RESIDENTIAL CODE (IRC), AND ALL OTHER APPLICABLE LOCAL, STATE, AND NATIONAL CODES AND REGULATIONS.

4. THE EQUIPMENT SHOWN ON THIS DRAWING INCLUDES BUT IS NOT LIMITED TO AIR HANDLING UNITS (AHUS), CHILLERS, BOILERS, COOLING TOWERS, PUMPS, DUCTWORK, DIFFUSERS, GRILLES, AND CONTROL DEVICES.

5. ALL EQUIPMENT, DUCTWORK, AND PIPING SHALL BE INSTALLED IN ACCORDANCE WITH MANUFACTURER'S SPECIFICATIONS, LOCAL CODES, AND INDUSTRY BEST PRACTICES.

6. ALL DUCTWORK SHALL BE SIZED, FABRICATED, AND INSTALLED IN ACCORDANCE WITH THE LATEST EDITION OF THE ACCA MANUAL D AND THE SMACNA HVAC DUCT CONSTRUCTION STANDARDS. DUCTWORK SHALL BE INSTALLED IN A NEAT AND WORKMANLIKE MANNER, PROPERLY SUPPORTED AND BRACED TO PREVENT SAGGING, AIR LEAKAGE, OR VIBRATION.

7. CONDENSATE DRAINAGE PIPING SHALL BE PROPERLY PITCHED TO ENSURE POSITIVE DRAINAGE TO AN APPROVED DISPOSAL LOCATION, SUCH AS A FLOOR DRAIN, SUMP PUMP, OR EXTERIOR GRADE. CONDENSATE LINES SHALL BE INSULATED TO PREVENT SWEATING.

8. THE LOCATION OF CONTROL PANELS AND SENSORS INDICATED ON THIS DRAWING CAN BEMODIFY with THE SPECIFIC LOCATIONS AND WIRING DETAILS WILL BE DETERMINED DURING THE CONTROL SYSTEM DESIGN AND INSTALLATION.

9. THE HVAC SYSTEM DESIGN CONSIDER ENERGY EFFICIENCY, INDOOR AIR QUALITY, OCCUPANT COMFORT, AND NOISE CONTROL, FOLLOWING APPLICABLE GUIDELINES AND REGULATIONS.

WITH THE LOCAL BUILDING DEPARTMENT AND UTILITY PROVIDERS TO ENSURE A TIMELY AND COMPLIANT INSTALLATION.

10. COORDINATION WITH OTHER TREADS HAS BEEN DONE ON A DESIGN LEVEL. THIS DRAWING SHALL BE READ TOGETHER WITH THE AR, EL AND SN DESIGN DRAWINGS TO ENSURE PROPER INSTALLATION AND INTEGRATION OF THE HVAC SYSTEMS.

11. THE HVAC CONTRACTOR IS RESPONSIBLE FOR OBTAINING ALL NECESSARY PERMITS AND LICENSES, AND FOR SCHEDULING AND COORDINATING

12. ALL DUCTWORK PENETRATIONS THROUGH WALLS, FLOORS, OR CEILINGS SHALL BE PROPERLY SEALED AND FIRE-STOPPED USING APPROVED METHODS AND MATERIALS TO MAINTAIN THE INTEGRITY OF THE BUILDING'S FIRE-RESISTANCE RATINGS.

13. HVAC EQUIPMENT SHALL BE INSTALLED LEVEL AND PLUMB. AND IN STRICT ACCORDANCE WITH THE MANUFACTURER'S INSTALLATION INSTRUCTIONS AND RECOMMENDATIONS. PROVIDE ADEQUATE CLEARANCES AROUND EQUIPMENT FOR PROPER AIRFLOW, SERVICE ACCESS, AND CODE COMPLIANCE.


14. ALL HVAC EQUIPMENT AND COMPONENTS, INCLUDING THERMOSTATS, DAMPERS, AND ACCESS PANELS, SHALL BE LOCATED IN ACCESSIBLE AREAS FOR EASY SERVICING AND MAINTENANCE. PROVIDE ADEQUATE SPACE AROUND EQUIPMENT FOR PROPER AIRFLOW AND SERVICE ACCESS.


15. THE HVAC SYSTEM SHALL BE BALANCED AND ADJUSTED TO ENSURE PROPER AIRFLOW, TEMPERATURE DISTRIBUTION, AND SYSTEM PERFORMANC THROUGHOUT THE RESIDENCE. PROVIDE A WRITTEN REPORT DOCUMENTING THE FINAL SYSTEM BALANCE.

16. ANY DEVIATIONS OR MODIFICATIONS TO THE HVAC SYSTEM DESIGN SHALL BE REVIEWED AND APPROVED BY THE RESPONSIBLE DESIGN

PROFESSIONALS AND COMMUNICATED TO ALL RELEVANT PARTIES INVOLVED IN THE CONSTRUCTION PROCESS.

17. FOR ANY INQUIRIES OR CLARIFICATIONS REGARDING THE HVAC SYSTEM DESIGN, PLEASE CONSULT THE RESPONSIBLE DESIGN PROFESSIONALS OR THE PROJECT MANAGEMENT TEAM.

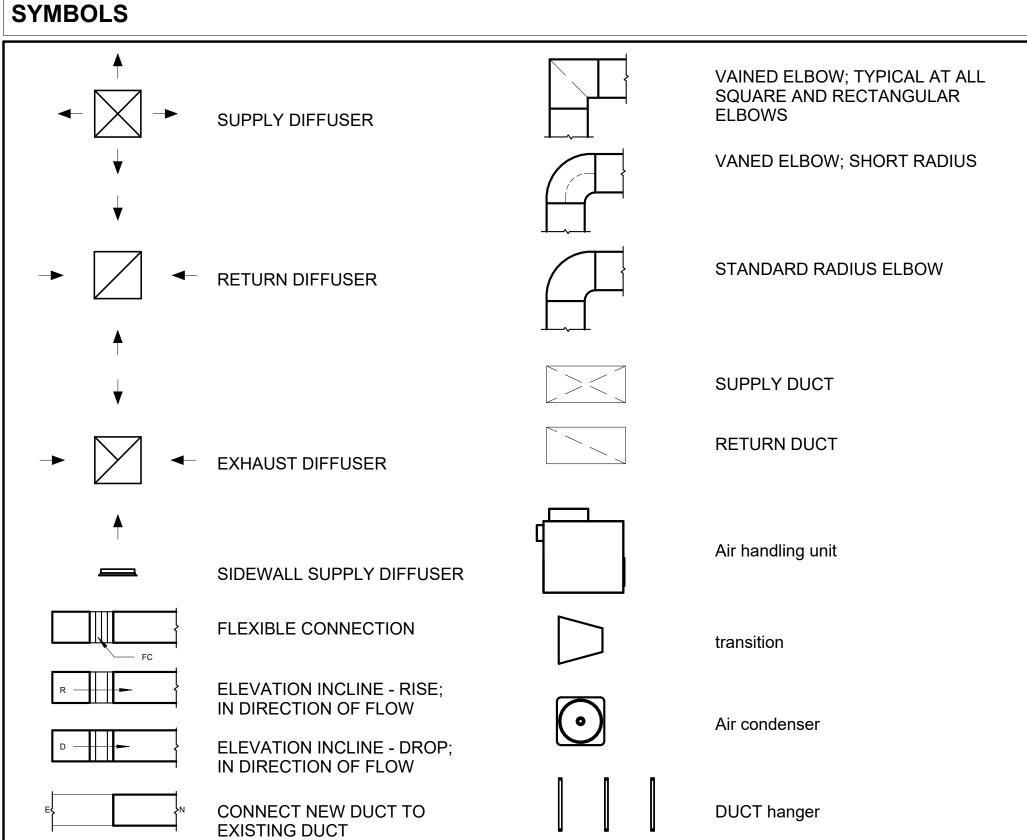

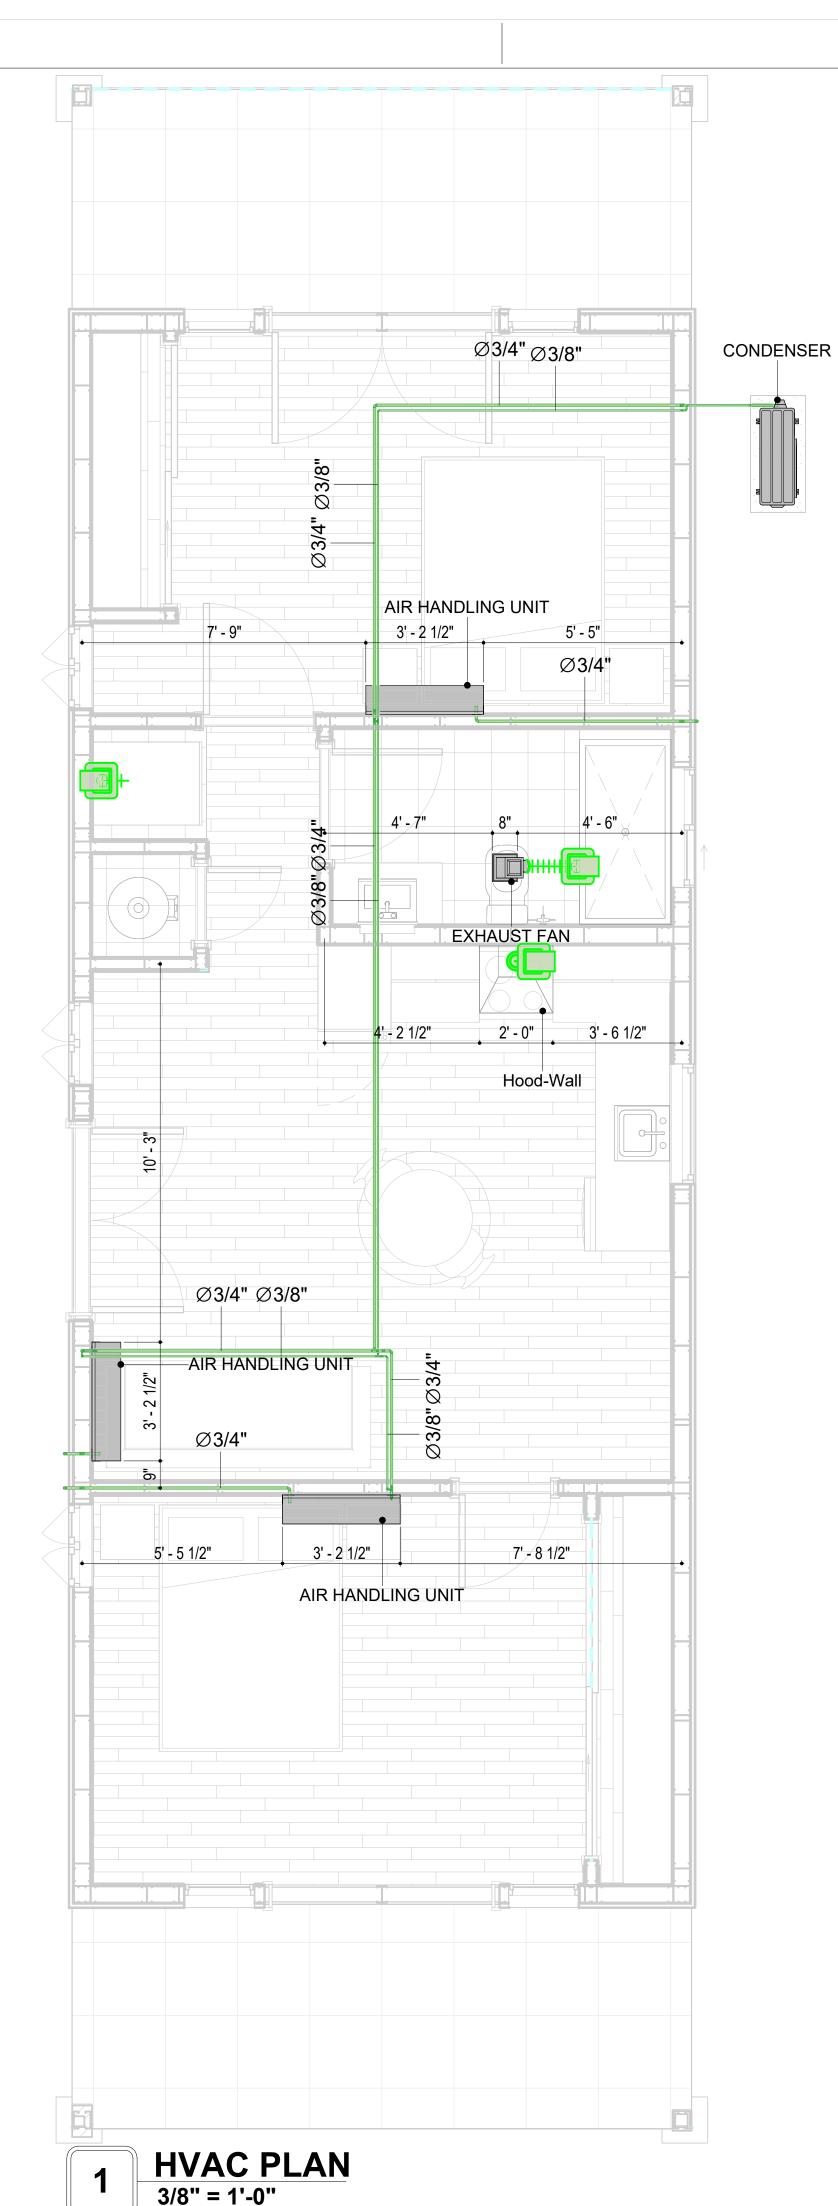



air conditioning pipe line

REFRIGERANT LINE SCHEDULE					
CATAGORY DESCRIPTION DIAMETER LENGT					
Pipe Types	Copper	3/8"	70.91		
Pipe Types	Copper	3/4"	103.60		

REFRIGERANT LINE FITTING SCHEDULE					
CATAGORY	DESCRIPTION	Size	Count		
Elbow - Generic	Elbow - Generic: Standard/HVAC	3/4"ø-3/4"ø	25		
Elbow - Generic	Elbow - Generic: Standard/HVAC	3/8"ø-3/8"ø	21		
Tee - Generic	Tee - Generic: Standard	3/4"ø-3/4"ø-3/ 4"ø	2		
Tee - Generic	Tee - Generic: Standard	3/8"ø-3/8"ø-3/ 8"ø	2		
Transition - Generic	Transition - Generic: Standard	3/4"ø-1/2"ø	4		
Transition - Generic	Transition - Generic: Standard	3/4"ø-3/4"ø	1		
Transition - Generic	Transition - Generic: Standard	3/4"ø-5/8"ø	3		
Transition - Generic	Transition - Generic: Standard	3/8"ø-1/4"ø	1		

MECHANICAL EQUIPMENT SCHEDULE				
CATAGORY DESCRIPTION CO				
AIR HANDLING UNIT	AIR HANDLING UNIT: WALL MOUNTED	3		
	CONDENSER: OUT DOOR 1			
CONDENSER	CONDENSER: OUT DOOR	1		
CONDENSER Exhaust Fan	CONDENSER: OUT DOOR  EXHAUST FAN: 75 CFM	1		

DUCT FITTING SCHEDULE				
CATAGORY	DESCRIPTION	COUNT		
Round Transition - Angle	45 Degree	5		

DUCT ACCESSORY SCHEDULE			
CATAGORY	DESCRIPTION	COUNT	
ROOF VENT	3" DIAMETER	3	

FLEX DUCT SCHEDULE					
DESCRIPTION	DESCRIPTION	LENGTH	DIAMETER	COUNT	
Flex Duct Round	FLEX-ROUND	11.23	4"	3	
Grand total: 3		11 23		•	



### **KEY PLAN**

NO.	DESCRIPTION	DATE

NOTE:

LEGEND:

PROJECT

161-Haven-733 2Bd1Ba-Ranch-550

DRAWING NAME

# **HVAC PLAN**

CLIENT NAME:	Owner
PROJECT NUMBER:	15_0001
DATE:	4/2/2025 3:21:13 AM
DESIGNED BY:	Designer
DRAWN BY:	Author
CHECKED BY:	Checker

M101

SCALE: As indicated

### **ELECTRICAL NOTES**

- 1. THIS DRAWING DEPICTS THE ELECTRICAL SYSTEM FOR THE 161-Haven-733-2Bd 1Ba Ranch-550. IT PROVIDES A VISUAL REPRESENTATION OF THE ELECTRICAL LAYOUT AND COMPONENTS, INCLUDING POWER DISTRIBUTION, LIGHTING, AND CONTROL SYSTEMS.
- 2. THE ELECTRICAL SYSTEM IS DESIGNED TO MEET THE SPECIFIC REQUIREMENTS OF THE BUILDING, INCLUDING POWER DISTRIBUTION, LIGHTING, AND SPECIALIZED ELECTRICAL EQUIPMENT NEEDS, AS PER THE PROJECT SPECIFICATIONS AND APPLICABLE CODES AND STANDARDS.
- 3. THE ELECTRICAL SYSTEM INSTALLATION SHALL COMPLY WITH THE LATEST EDITION OF THE NATIONAL ELECTRICAL CODE (NEC), INTERNATIONAL BUILDING CODE (IBC), AND ALL OTHER APPLICABLE LOCAL, STATE, AND NATIONAL CODES AND REGULATIONS.
- 4. LOCATIONS AS NEEDED, DEVICES ARE SHOWN ON PLANS IN APPROXIMATE IDEAL LOCATIONS, UNLESS SPECIFICALLY DIMMENSIONED.
- 5. OPEN WALLS AS NEEDED TO ALLOW FOR NEW ELECTRICAL INSTALLATIONS.
- 6. LABEL ALL CIRCUITS ON JUNCTION BOXES, RECEPTACLES, DATA, SMOKE DETECTOR, AND EQUIPMENT IN PANEL BOX.
- 7. INSTALL RACEWAY AS NEEDED FOR DDC, ACCESS CONTROL, LOW VOLTAGE WIRING & DATA.
- 8. RELABEL POWER, DATA & FIRE ALARM FOR ROOM #CHANGES.
- 9. VERIFY ALL CIRCUITS LABELED ON PRINT ARE CORRECT BEFORE WORKING ON THEM.
   10. NOTE ON SITE PLAN ALL CHANGES OR MISSING DETAIL TO BE INCORPORATED INTO THE MASTER PLAN.
- 11. DRAWINGS ARE DIAGRAMMATIC ONLY FOR THE PURPOSE OF SHOWING FIXTURE AND OUTLET LOCATIONS.
- 12. ELECTRICAL CONTRACTOR TO VERIFY SERVICE SIZE BY CALCULATION BASED UPON ACTUAL NAME
- PLATE RATINGS OF SELECTED EQUIPMENT.
- 13. VERIFY LOCATION OF SERVICE ENTRANCE WITH POWER COMPANY. PROVIDE UFER GROUND IN
- BUILDING FOUNDATION AT SERVICE ENTRANCE LOCATION.

  14. PROVIDE A MIN. OF 20 FEET OF ONE \*4 BARE COPPER UFER WIRE EMBEDDED IN CONCRETE FOOTING AT THE SERVICE ENTRANCE LOCATION WHERE APPROVED BY LOCAL SERVICE PROVIDER.
- 15. PROVIDE WATERPROOF FIXTURES IN ALL HIGH MOISTURE AREAS (EXTERIOR, SHOWER AND TUB
- CEILINGS ETC.)
- 16. PROVIDE DEDICATED CIRCUITS TO EACH BATH, DEN, FAMILY ROOM, BEDROOM, LOFT, KITCHEN REFRIGERATOR, KITCHEN FREEZER DISHWASHER, AND ANY AREA/ITEM SPECIFIED BY OWNER.
- 17. INCANDESCENT FIXTURES WITH OPEN OR PARTIALLY ENCLOSED LAMPS, PENDANT FIXTURES, AND
- LAMP HOLDERS ARE NOT PERMITTED IN CLOSETS.

  18. ALL WORKMANSHIP AND MATERIALS TO CONFORM WITH THE 2015 IRC.
- 19. PROVIDE A MIN. OF 20 FEET OF ONE \*4 BARE COPPER UFER WIRE EMBEDDED IN CONCRETE FOOTING AT THE SERVICE ENTRANCE LOCATION WHERE APPROVED BY LOCAL SERVICE PROVIDER.
- 20. PROVIDE A BONDING CONDUCTOR CONSISTING OF A MINIMUM OF ONE \*4 BARE COPPER WIRE CONNECTING THE BUILDING'S METAL WATER PIPING SYSTEM TO THE SERVICE EQUIPMENT ENCLOSURE GROUNDING.

### MAIN PANEL CALCS

ELECTRICAL CALCS	
LIGHT AND OUTLETS 733 @ 3W	2,199 W
3 APPLIANCE CIRCUITS	4,500 W
DRYER	2,000 W
WASHER	2,000 W
RANGE	5,000 W
WATER HEATER	5,000 W
REFRIG.	1,800 W
DISHWASHER & DISPOSAL	3000 W
TOTAL	25,499 W
FRIST 10,000 @ 100% REMAINDER @ 40% MINI. SPLIT UNITS	10,000 W 6,200W 10,000W
TOTAL	26,200 W

26,200 W DIVIDED BY 240V = 110 AMPS TOTAL

(USE 200 AMP SERVICE)

# **ELECTRICAL ABBREVIATIONS LIST**

1P	1 POLE (2P, 3P, 4P, ETC.)	CTR	CENTER	HT	HEIGHT
A	AMPERE	CU	COPPER	HTG	HEATING
AC	ABOVE COUNTER OR AIR CONDITIONER	DCP	DOMESTIC WATER CIRCULATING PUMP	HTR	HEATER
	ABOVE COUNTER OR AIR CONDITIONER ABOVE CEILING	DEPT	DEPARTMENT	HV	HIGH VOLTAGE
ACLG					
ADO	AUTOMATIC DOOR OPENER	DET	DETAIL	HVAC	HEATING, VENTILATING AND AIR
AF	AMP FRAME	DIA	DIAMETER	CONDITIONING	CONDITIONING
AFF	ABOVE FINISHED FLOOR	DISC	DISCONNECT	HWP	HYDRONIC WATER PUMP
AFG	ABOVE FINISHED GRADE	DIST	DISTRIBUTION	IC	INTERRUPTING CAPACITY
AFI	ARC FAULT CIRCUIT INTERRUPTER	DN	DOWN	IG	ISOLATED GROUND
AHU	AIR HANDLING UNIT	DPR	DAMPER	IMC	INTERMEDIATE METAL CONDUIT
AL	ALUMINUM	DS	SAFETY DISCONNECT SWITCH	INCAND	INCANDESCENT
ALT	ALTERNATE	DT	DOUBLE THROW	IR	INFRARED
AMP	AMPERE	DWG	DRAWING	I/W	INTERLOCK WITH
AMPL	AMPLIFIER	DDC	DIRECT DIGITAL CONTROL	J-BOX	JUNCTION BOX
ANNUN	ANNUNCIATOR APPROX APPROXIMATELY		ELECTRICAL CONTRACTOR	KV	KILOVOLT
AQ-STAT	AQUASTAT	ELEC	ELECTRIC, ELECTRICAL	KVA	KILOVOLT-AMPERE
ARCH	ARCHITECT, ARCHITECTURAL	ELEV	ELEVATOR	KVAR	KILOVOLT-AMPERE REACTIVE
AS	AMP SWITCH	EM	EMERGENCY	KW	KILOWATT
AT	AMP TRIP	EMS	ENERGY MANAGEMENT SYSTEM	KWH	KILOWATT HOUR
ATS	AUTOMATIC TRANSFER SWITCH	EMT	ELECTRICAL METALLIC TUBING	LOC	LOCATE OR LOCATION
AUTO	AUTOMATIC	EP	ELECTRIC PNEUMATIC	LT	LIGHT
AUX	AUXILIARY	EQUIP	EQUIPMENT	LTG	LIGHTING
AV	AUDIO VISUAL	EWC	ELECTRIC WATER COOLER	LTNG	LIGHTNING
AWG	AMERICAN WIRE GAUGE	EXIST	EXISTING	LV	LOW VOLTAGE
BATT	BATTERY	EXH	EXHAUST	MAX	MAXIMUM
BD	BOARD	EXP	EXPLOSION PROOF	MAG.S	MAGNETIC STARTER
BLDG	BUILDING	FA	FIRE ALARM	M/C	MOMENTARY CONTACT
BMS	BUILDING MANAGEMENT SYSTEM	FABP	FIRE ALARM BOOSTER POWER	MC	MECHANICAL CONTRACTOR
C	CONDUIT	SUPPLY PANEL	SUPPLY PANEL	MCB	MAIN CIRCUIT BREAKER
CAB	CABINET	FACP	FIRE ALARM CONTROL PANEL	MCC	MOTOR CONTROL CENTER
CAT	CATALOG	FCU	FAN COIL UNIT	MDC	MAIN DISTRIBUTION CENTER
CATV	CABLE TELEVISION	FIXT	FIXTURE	MDP	MAIN DISTRIBUTION PANEL
СВ	CIRCUIT BREAKER	FLR	FLOOR	MFR	MANUFACTURERMAIN FUSED
CCTV	CLOSED CIRCUIT TELEVISION	FLUOR	FLUORESCENT		DISCONNECT SWITCH
CKT	CIRCUIT	FU	FUSE	MH	MANHOLE
CLG	CEILING	FUDS	FUSED SAFETY DISCONNECT SWITCH	MIC	MICROPHONE
COMB	COMBINATION	GA	GAUGE	MIN	MINIMUM
CMPR	COMPRESSOR	GAL	GALLON	MISC	MISCELLANEOUS
CONN	CONNECTION	GALV	GALVANIZED	MLO	MAIN LUGS ONLY
CONST	CONSTRUCTION	GC	GENERAL CONTRACTOR	MMS	MANUAL MOTOR STARTER
CONT	CONTINUATION OR CONTINUOUS	GEN	GENERATOR	MOA	MULTIOUTLET ASSEMBLY
CONTR	CONTRACTOR	GFI	GROUND FAULT CIRCUIT INTERRUPTER	MSP	MOTOR STARTER PANELBOARD
CONV	CONVECTOR	GFP	GROUND FAULT PROTECTOR	MSBD	MAIN SWITCHBOARD
CP	CIRCULATING PUMP	GND	GROUND	MT	MOUNT
CRT	CATHODE-RAY TUBE	GRS	GALVANIZED RIGID STEEL (CONDUIT)	MT.C	EMPTY CONDUIT
CT	CURRENT TRANSFORMER	GYP BD	GYPSUM BOARD	UL	UNDERWRITERS LABORATORIES
		0 55			

### **Branch Panel:**

Location: KITCHEN 02
Supply From:
Mounting: Recessed

Enclosure: Type 1

Volts: 120/240 Single
Phases: 1
Wires: 3

A.I.C. Rating:
Mains Type:
Mains Rating: 200 A
MCB Rating: 1 A

### Notes

Circuit Numb er		Number of Elements	Rating	Length	Wire Size	A		ı	3	Wire Size	Length	Rating	Number of Elements	Circuit Description	Circuit Numb er
1	BED 1 LIGHT	9	15 A	33' - 7 15/16"	1-#14, 1-#14, 1-#14	568 VA	576 VA			1-#12, 1-#12, 1-#12	31' - 11 5/32"	20 A	7	BATH GFCI	2
3	KITCHEN & HALL LIGHT	11	15 A	39' - 6 7/8"	1-#14, 1-#14, 1-#14			456 VA	237 VA	1-#14, 1-#14, 1-#14	35' - 3 31/32"	15 A	9	LIVING LIGHT	4
5	BED 2 LIGHT	9	20 A	39' - 7 29/32"	1-#12, 1-#12, 1-#12	568 VA	600 VA			1-#14, 1-#14, 1-#14	46' - 2 29/32"	15 A	9	OUTDOOR LIGHT	6
7	KITCHEN GFCI	3	20 A	16' - 7 9/32"	1-#12, 1-#12, 1-#12			540 VA	180 VA	1-#12, 1-#12, 1-#12	9' - 2 31/32"	20 A	1	OVENHOOD	8
9	RANGE	1	50 A	15' - 2 7/16"	2-#8, 1-#8, 1-#10	2500 VA	1800 VA			1-#12, 1-#12, 1-#12	19' - 2 31/32"	20 A	1	REFRIGERATOR	10
11								2500 VA	2500 VA	2-#10, 1-#10, 1-#10	31' - 3 27/32"	30 A	1	DRYER	12
13	WATER HEATER	1	30 A	30' - 0 31/32"	2-#10, 1-#10, 1-#10	2250 VA	2500 VA								14
15								2250 VA	1200 VA	1-#12, 1-#12, 1-#12	34' - 3 7/32"	20 A	1	WASHEIN MASHEIN	16
17	BED 1 RECEPTACLE	6	20 A	42' - 3 1/8"	1-#12, 1-#12, 1-#12	1080 VA	900 VA			1-#12, 1-#12, 1-#12	37' - 4 7/8"	20 A	5	LIVING RECEPTACLE	18
19	BED 2 RECEPTACLE	5	20 A	49' - 1 11/16"	1-#12, 1-#12, 1-#12			900 VA	720 VA	1-#12, 1-#12, 1-#12	37' - 4 7/16"	20 A	4	OUTDOOR RECEPTACLE	20
21															22
23															24
25															26
						13312	2 VA	1148	0 VA			·			
						111	Α	96	6 A						

### Legend:

Load Classification	Connected Load	<b>Demand Factor</b>	Estimated Demand	Panel	Totals
LIGHTING - DWELLING UNIT	800 VA	100.00%	800 VA		
OTHER	1564 VA	100.00%	1564 VA	Total Conn. Load:	24791 VA
RECEPTACLE	5880 VA	100.00%	5880 VA	Total Est. Demand:	23791 VA
LIGHTING	300 VA	100.00%	300 VA	Total Conn.:	103 A
WATER HEATER	4500 VA	100.00%	4500 VA	Total Est. Demand:	99 A
RANGE	5000 VA	80.00%	4000 VA		
DRYER	5000 VA	100.00%	5000 VA		
REFRIGERATOR	1800 VA	100.00%	1800 VA		



**KEY PLAN** 

NO. DESCRIPTION DATE

NOTE:

LEGEND:

PROJECT

161-Haven-733-2Bd 1Ba Ranch-550

DRAWING NAME

# **SCHEDULE**

CLIENT NAME:

PROJECT NUMBER:

0384\_13

DATE:

4/2/2025 3:44:51 PM

DESIGNED BY:

DRAWN BY:

CHECKED BY:

Checker

E101

SCALE: 1/4" = 1'-0"

# **ELECTRICAL NOTE**

- A. PROVIDE INTERCONNECTED SMOKE ALARMS IN EACH SLEEPING ROOMS, OUTSIDE EACH SLEEPING ROOM, ON EACH STORY, IN THE HALL OR ADJACENT ROOM LUHERE THE CEILING HEIGHT OF A ROOM OPEN TO THE HALL EXCEEDS THE HALL BY 24'. SMOKE ALARMS SHALL BE PERMANENTLY HARD WIRED WITH BATTERY BACKUP.
- B. RECEPTACLE OUTLETS FOR RANGES AND CLOTHES DRYERS SHALL BE A THREE POLE WITH GROUND TYPE. FOUR WIRE GROUNDING-TYPE FLEXIBLE CORDS WILL BE REQUIRED FOR CONNECTION OF RANGES AND CLOTHES DRYERS. THE BONDING JUMPER SHALL NOT BE CONNECTED BETWEEN NEUTRAL TERMINAL AND THE FRAME OF THE APPLIANCE.
- C. TWO OR MORE 20 AMP SMALL APPLIANCE CIRCUITS SHALL BE PROVIDED TO SERVE THE KITCHEN, BREAKFAST NOOK, AND DINING ROOM. SUCH CIRCUITS SHALL HAVE NO OTHER OUTLETS.
- D. AT LEAST ONE 20 AMP BRANCH CIRCUIT SHALL BE PROVIDED TO SERVICE THE LAUNDRY ROOM. THIS CIRCUIT SHALL HAVE NO OTHER OUTLETS.
- E. ALL RECEPTACLES WITH IN 6' OF A WET BAR SINK OR KITCHEN SINK TO SERVE COUNTER TOP SURFACES MUST BE GFCI. ON KITCHEN COUNTERS 12' OR WIDER NO POINT ALONG THE WALL SHALL BE MORE THAN 2' FROM A RECEPTACLE. ALL RECEPTACLES WITH IN 6' OF KITCHEN SINK MUST BE GFCI. AT LEAST ONE GFCI RECEPTACLE SHALL
- BE INSTALLED IN THE BATHROOM ADJACENT TO EACH BASIN.

  F. FIXTURES INCLUDING CEILING FANS THAT ARE LOCATED IN DAMP LOCATIONS SHALL BE LISTED TO BE SUITABLE FOR
- SUCH LOCATIONS PER 2012 IRC
- G. PROVIDE ONE (1) SWITCHED OUTLET @ ALL BEDROOMS AND DEN
- H. CEILING FANS NOT EXCEEDING 35 LBS. (WITH OR WITHOUT ACCESSORIES MAY BE SUPPORTED BY OUTLET BOXES PROVIDED THE OUTLET BOXES ARE IDENTIFIED FOR SUCH USE PER 2012 IRC
- I. ELECTRICAL OUTLET BOXES ON OPPOSITE SIDES OF FIRE RATED WALLS SHALL BE SEPARATED BY A HORIZONTAL DISTANCE OF NOT LESS THAN 24".
- J. OUTLET BOXES IN THE WALLS BETWEEN THE GARAGE AND DWELLING SHALL BE METAL OR U.L. APPROVED FIRE RESISTIVE PLASTIC. BOXES IN GARAGE CEILING SHALL BE METAL.
- K. ALL BRANCH CIRCUITS THAT SUPPLY 120 VOLTS SINGLE PHASE 15 AND 20 AMPS RECEPTACLE OUTLETS INSTALLED IN THE DWELLING SHALL BE PROTECTED BY AN ARC FAULT CIRCUIT INTERRUPTER, EXCEPT GFCI RECEPTICLES.

### NOTE:

A. RECEPTACLES MUST BE PROVIDED IN HALLWAYS 10'-0" OR MORE IN LENGTH. FOR A ONE FAMILY DWELLINGS AND EACH OF A TWO FAMILY DWELLING THAT IS AT GRADE LEVEL, AT LEAST ONE WP-GFCI RECEPTACLE OUTLET ACCESSIBLE AT GRADE LEVEL AND NOT MORE THAN 6'-6" ABOVE GRADE SHALL BE INSTALLED AT THE FRONT AND BACK OF THE DWELLING.

### **NOTE: APPLIANCE DISCONNECT**

### **E4001.5 GROUNDING OF ENCLOSURES.**

METAL ENCLOSURES FOR SWITCHES OR CIRCUIT BREAKERS SHALL BE CONNECTED TO AN

EQUIPMENT GROUNDING CONDUCTOR.

METAL ENCLOSURES FOR SWITCHES OR CIRCUIT BREAKERS USED AS SERVICE

EQUIPMENT SHALL COMPLY WITH THE PROVISIONS OF SECTION E3609.4. WHERE


NONMETALLIC ENCLOSURES ARE USED WITH METAL RACEWAYS OR METAL-ARMORED

CABLES, PROVISIONS SHALL BE MADE FOR CONNECTING THE EQUIPMENT GROUNDING CONDUCTOR.


NONMETALLIC BOXES FOR SWITCHES SHALL BE INSTALLED WITH A WIRING METHOD THAT

PROVIDES OR INCLUDES AN EQUIPMENT GROUNDING CONDUCTOR. (404.12)

ELECTRICAL LEGEND			
	Electrical Lights With Fan		
0	Waterproof Recessed Can Light		
	Pendant Light		
0	Recessed Can Light		
<b>–</b> □	Wall Lamp		
	Standalone linear		
<b>⊬</b> 13	Single Switch		
₩	Three way Switch		
₩	Fan Switch		
	Duplex Receptacle		
	Triplex Receptacle		
⊕ GFCI	GFCI Receptacle		
	Exhaust Fan		
•	Smoke and heat detector		

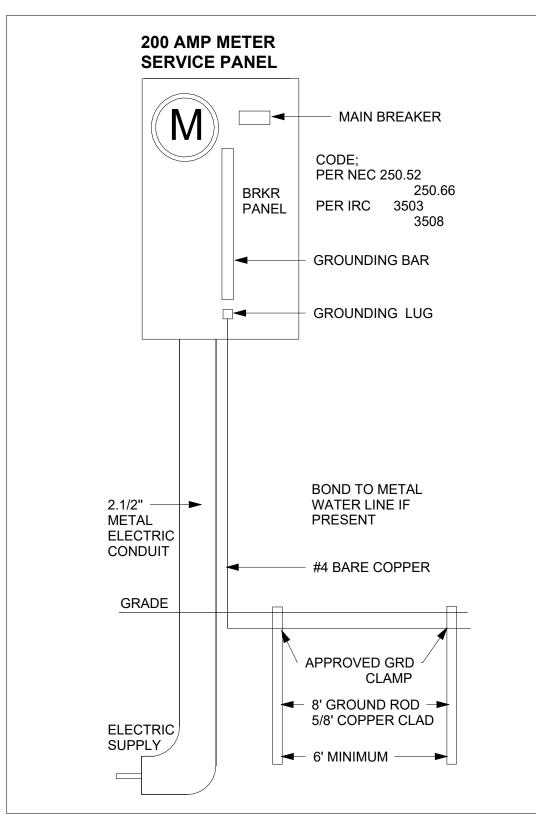



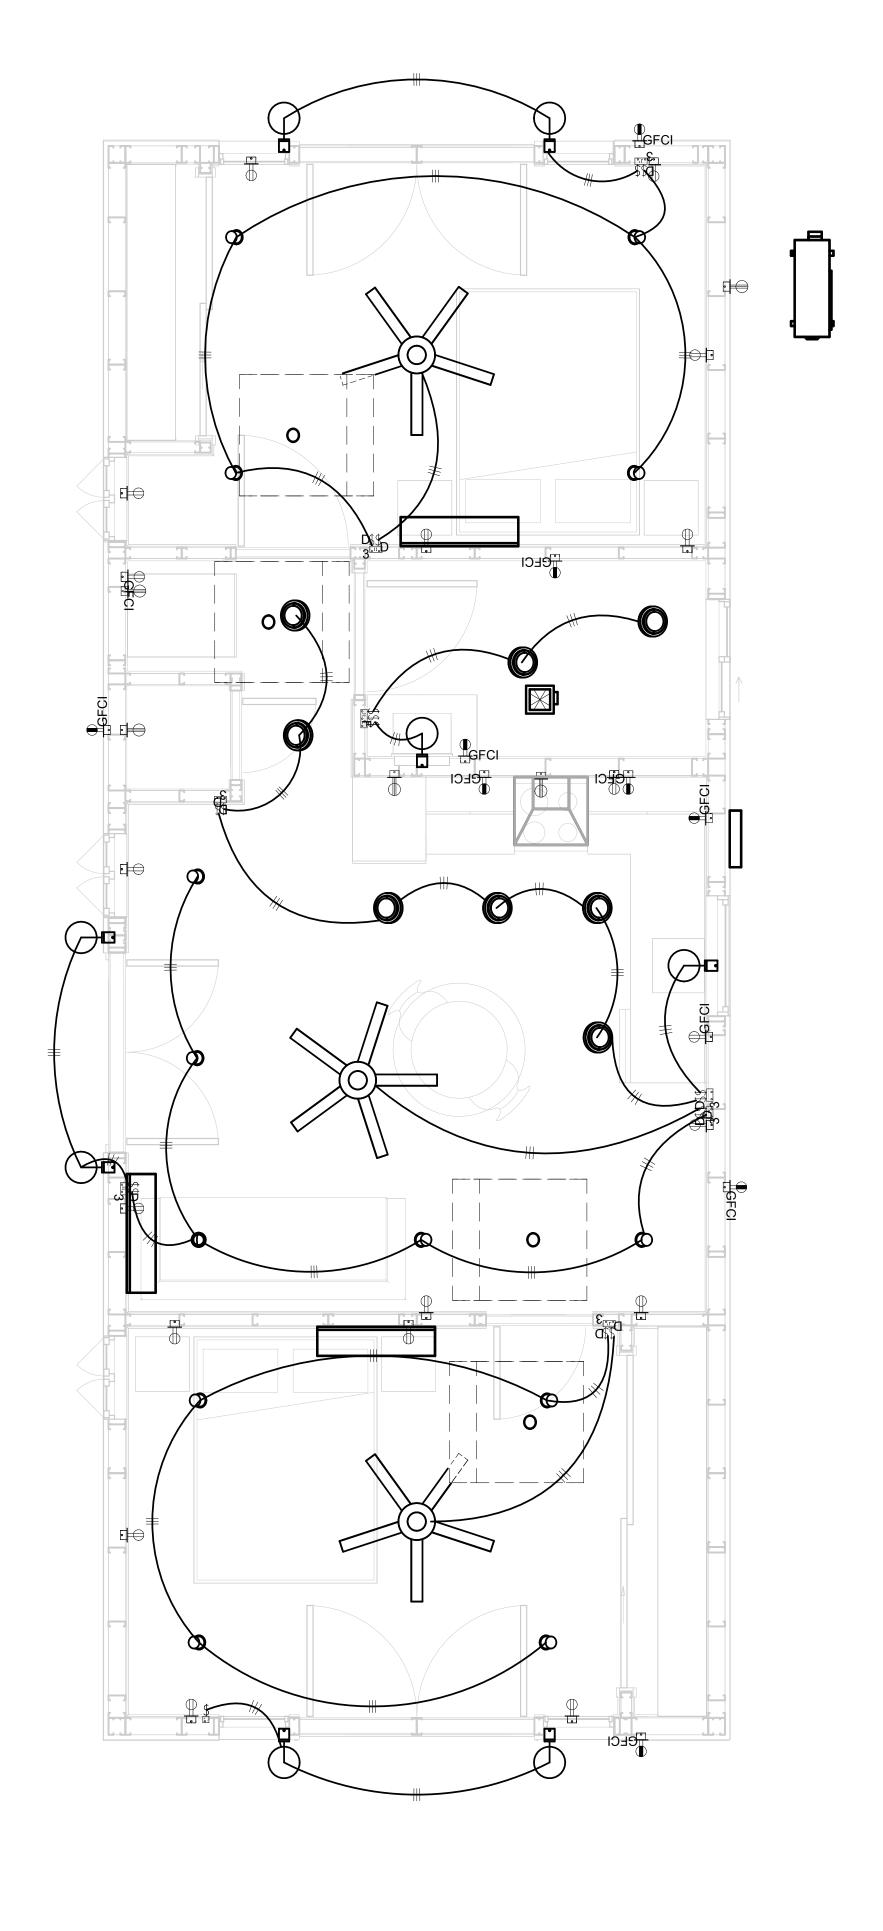





**KEY PLAN** 

NO.	DESCRIPTION	DATE

NOTE:

LEGEND:

PROJECT

161-Haven-733-2Bd 1Ba Ranch-550

DRAWING NAME


# LIGHTING

CLIENT NAME:	Owner
PROJECT NUMBER:	0384_13
DATE:	4/2/2025 3:44:54 PM
DESIGNED BY:	Designer
DRAWN BY:	Author
CHECKED BY:	Checker


E102

# **NOTES: CONDUIT, CABLE AND WIRING**


- Use Metalic Conduits (IMC) for cables running under concrete slabs.
   Use IMC for circuits with high voltage appliances (240 volts and above)
   For circuits with 120 volts consider using EMT or PVC conduits if needed.
   For Low voltage applications up to 50 volts consider using non metalic conduits.
   All conduits to be used in the project must conform to the latest National Electrical Code (NEC),
- All conduits to be used in the project must also conform to the latest National Electrical Code (NEC), 2015.
  All cables and wires used should be rated for their respective loading and should be gauged and

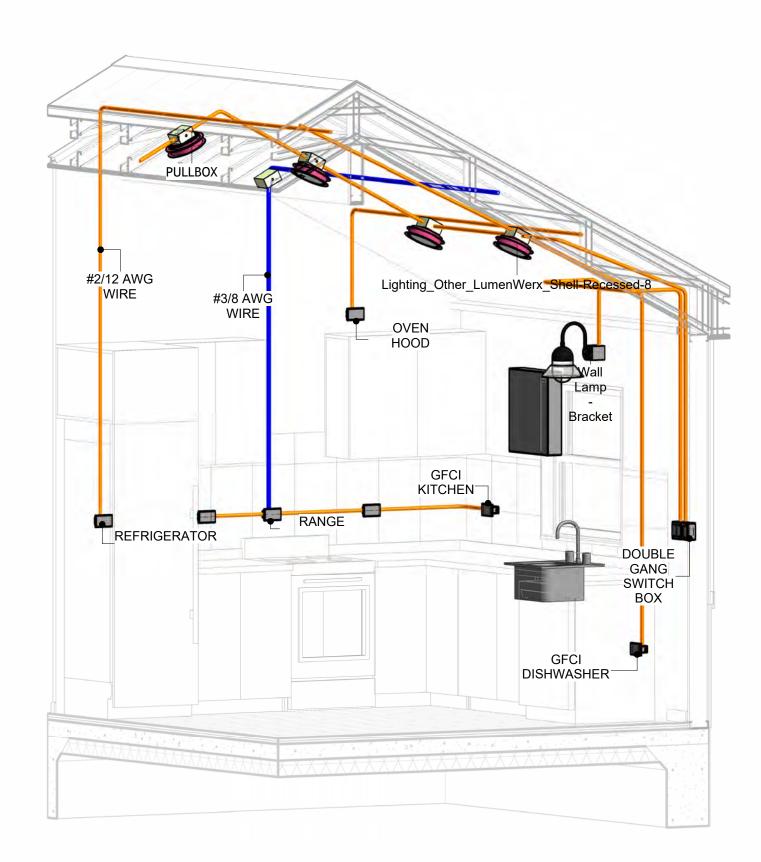


**3D-KITCHEN** 

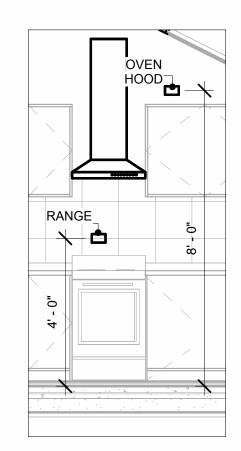


Range & OvenHood
3/8" = 1'-0"

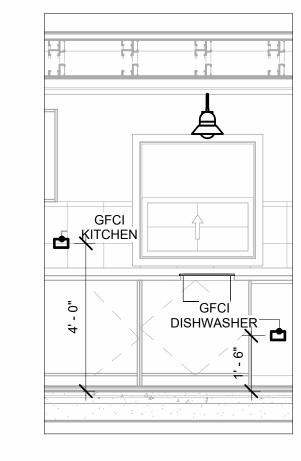

**Gfci** 3/8" = 1'-0"

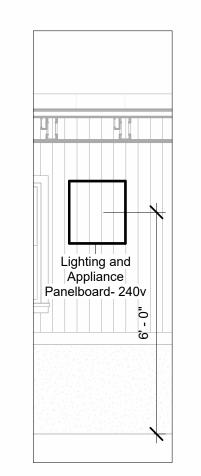

Panel 3/8" = 1'-0"

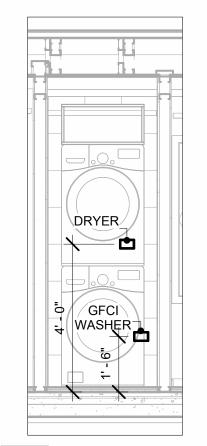

**Dryer & Washer** 3/8" = 1'-0"



KEY F	PLAN I I	
	<b>├</b>	
NO.	DESCRIPTION	DATE

NOTE:

LEGEND:

PROJECT

161-Haven-733-2Bd 1Ba Ranch-550

DRAWING NAME

# **POWER**

CLIENT NAME:	Owner
PROJECT NUMBER:	0384_13
DATE:	4/2/2025 3:45:18 PM
DESIGNED BY:	Designer
DRAWN BY:	Author
CHECKED BY:	Checker

E103

SCALE: As indicated

# **NOTES: LIGHT**

- 1. LIGHT FIXTURES AND LUMINARIES SHALL CONFORM TO THE NEC, THE IRC AND LOCAL SAFETY & BUILDING CODE.
- 2. ALL LIGHTING FIXTURES SHOULD CONFORM TO THE DESIGN ELECTRICAL LOAD AND SHALL BE PROPERLY WIRED AND MOUNTED BY QUALIFIED ELECTRICIAN FOLLOWING MANUFACTURERS SPECIFICATIONS.
- 3. CEILING FANS AND FANS WITH LIGHT WITH WEIGHT EXCEEDING 35 LBS SHOULD BE PROVIDED WITH STRUCTURAL BACKING FOR SUPPORT AND SHALL BE FIXED AS PER MANUFACTURERS SPECIFICATIONS.
  4. EXTERIOR LIGHTS SHALL CONFORM TO LOCAL BUILDING CODE AND GUIDELINES.

# **NOTES: SWITCH JUNCTION BOX**


- 1. THE MINIMUM SIZE OF JUCTION BOX TO BE USED IS 2"X4"X(1.5" OR 3.5" DEEP) THIS ARE TO BE USED FOR SINGLE GANG SWITCH OR OUTLETS.
- 2. FOR DOUBLE GANG (2 GANG) OUTLETS AND SWITCHS THE MINIMUM SIZE OF THE
- JUCTION BOX TO BE PROVIDED SHALL NOT BE LESS THAN 4"X4"X(1.5" OR 3.5" DEEP)
- 3. FOR THREE GANG (3 GANG) OUTLETS AND SWITCHS THE MINIMUM SIZE OF THE JUCTION BOX SHALL NOT BE LESS THAN 6"X4"X(1.5" OR 3.5" DEEP).

FITTING SCHEDULE(PULL BOX)						
FAMILY COUNT DESCRIPTION						
PULLBOX1	28	#1/4 PULLBOX				

ELECTRICAL FIXTURE SCHEDULE (SWITCH BOX)		
TYPE COUNT		
DOUBLE GANG SWITCH BOX	7	
SINGLE GANG SWITCH BOX	1	
TRIPLE GANG SWITCH BOX	1	

LIGHT	ING DEVICE
TYPE	COUNT
DIMMER	4
FAN SWITCH	1
SINGLE POLE	6
THREE WAY WITH DIMMER	7

LIGHTING FIXTURE			
LIGHTING FIXTURE TYPE	VOLTAGE	ELECTRICAL LOAD	COUNT
ELECTRICAL_LIGHTS_FAN-LIGHT1	120 V/1-100 VA- 120 V/1-100 VA	200 A, 120 V/240 V, SINGLE PHASE, 3 WIRES	3
LIGHTING_OTHER_LUMENWE RX_SHELL-RECESSED-8	120 V/1-60 VA	200 A, 120 V/240 V, SINGLE PHASE, 3 WIRES	8
SASSO 100 ROUND WALLWASHER TRIM	120 V/1-28 VA	200 A, 120 V/240 V, SINGLE PHASE, 3 WIRES	13
WALL LAMP - BRACKET	120 V/1-100 VA	200 A, 120 V/240 V, SINGLE PHASE, 3 WIRES	8

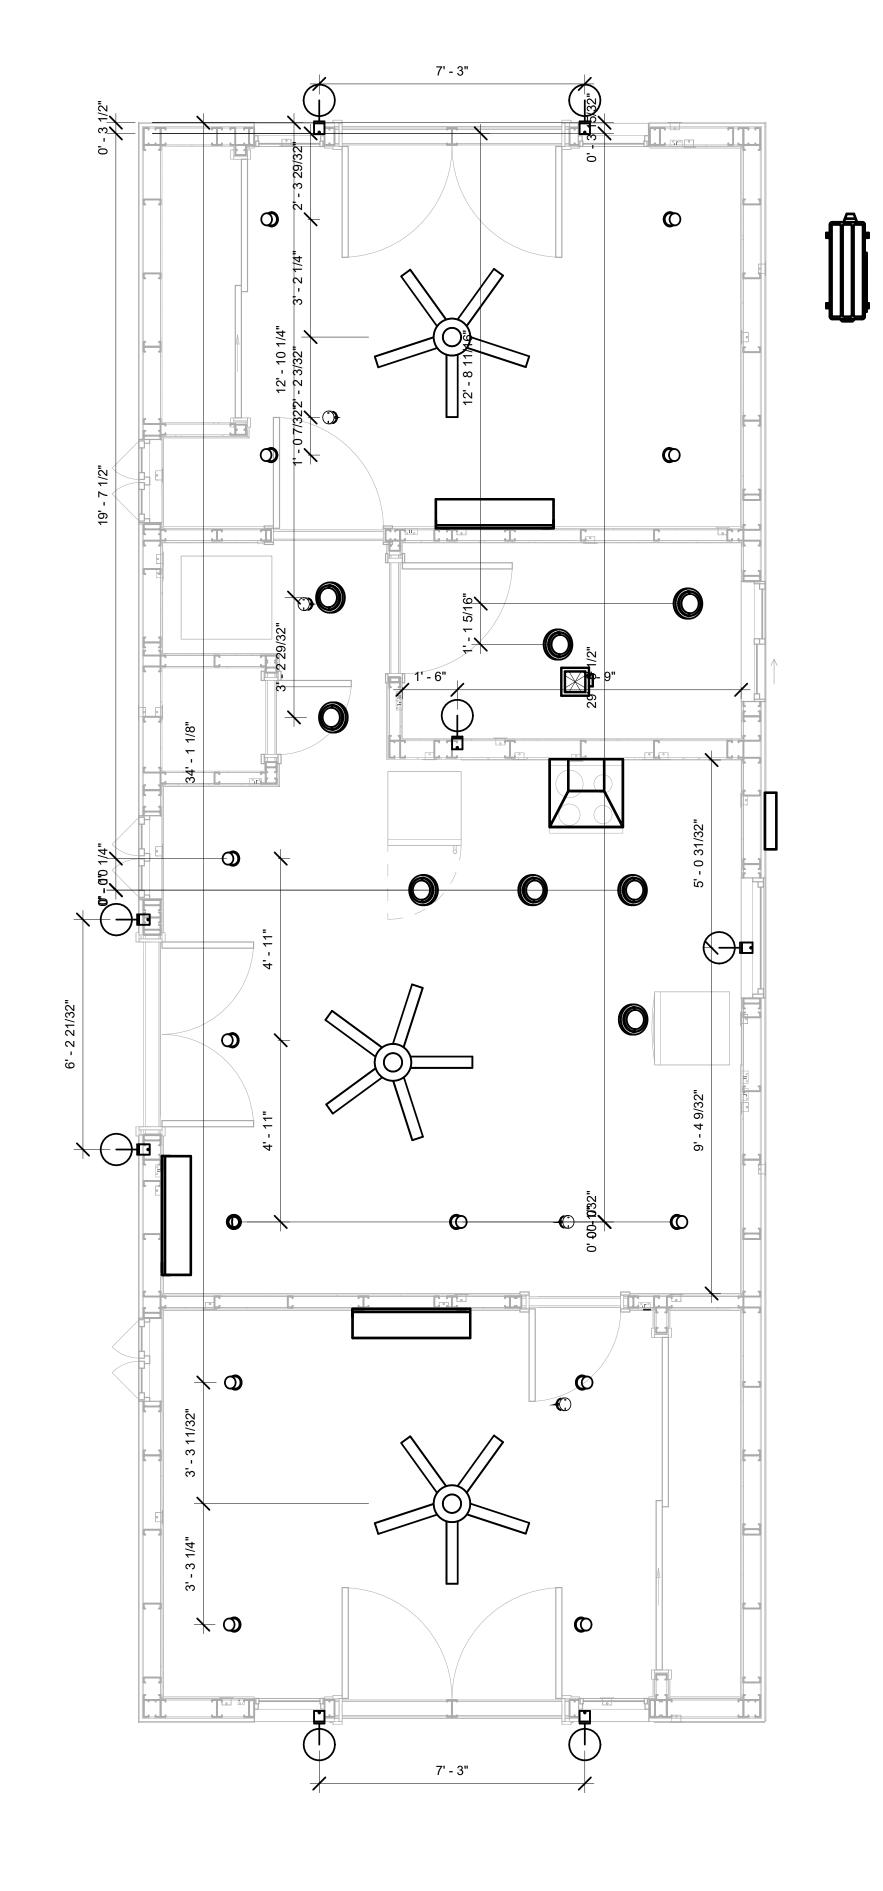





**KEY PLAN** 

10.	DESCRIPTION	DATE

NOTE:

LEGEND:

PROJECT

161-Haven-733-2Bd 1Ba Ranch-550

DRAWING NAME

# **DIMENSION PLAN** FOR LIGHT FIXTURES

Owner	CLIENT NAME:
0384_13	PROJECT NUMBER:
4/2/2025 3:45:20 PM	DATE:
Designer	DESIGNED BY:
Author	DRAWN BY:
Checker	CHECKED BY:


E104

# NOTES;

- 1. VERIFY EQUIPMENT PLUG CONFIGURATION BEFORE PURCHASING RECEPTACLES
- 2. FOR ALL EQUIPMENT.
- 3. COORDINATE EXACT LOCATION OF LIGHT FIXTURES, WALL SWITCHES, RECEPTACLES AND OTHER DEVICES WITH ARCHITECTURAL DRAWINGS.
- 4. USE METALLIC JUNCTION BOX WITH THE GFCI RECEPTACLES, WITH HIGHT VOLTAGE.

ELECTRICAL FIXTURE SCHEDULE (RECEPTACLE)		
TYPE	COUNT	
CONDENSER	1	
DRYER	1	
DUPLEX RECEPTACLE	16	
GFCI BATH ROOM	2	
GFCI DISHWASHER	1	
GFCI KITCHEN	3	
GFCI OUT DOOR	4	
GFCI WASHER	1	
OVEN HOOD	1	
RANGE	1	
REFRIGERATOR	1	
WATER HEATER	1	

ELECTRICAL OUTLET SCHEDULE			
TYPE	CIRCUIT NUMBER	ELECTRICAL DATA	COUNT
CONDENSER		120 V/1-1500 VA	1
GFCI DISHWASHER		120 V/1-1200 VA	1
GFCI BATH ROOM	2	120 V/1-180 VA	2
GFCI KITCHEN	7	120 V/1-180 VA	3
OVEN HOOD	8	120 V/1-180 VA	1
RANGE	9,11	240 V/2-5000 VA	1
REFRIGERATOR	10	120 V/1-1800 VA	1
DRYER	12,14	240 V/2-5000 VA	1
WATER HEATER	13,15	240 V/2-4500 VA	1
GFCI WASHER	16	120 V/1-1200 VA	1
DUPLEX RECEPTACLE	17	120 V/1-180 VA	6
DUPLEX RECEPTACLE	18	120 V/1-180 VA	5
DUPLEX RECEPTACLE	19	120 V/1-180 VA	5
GFCI OUT DOOR	20	120 V/1-180 VA	4

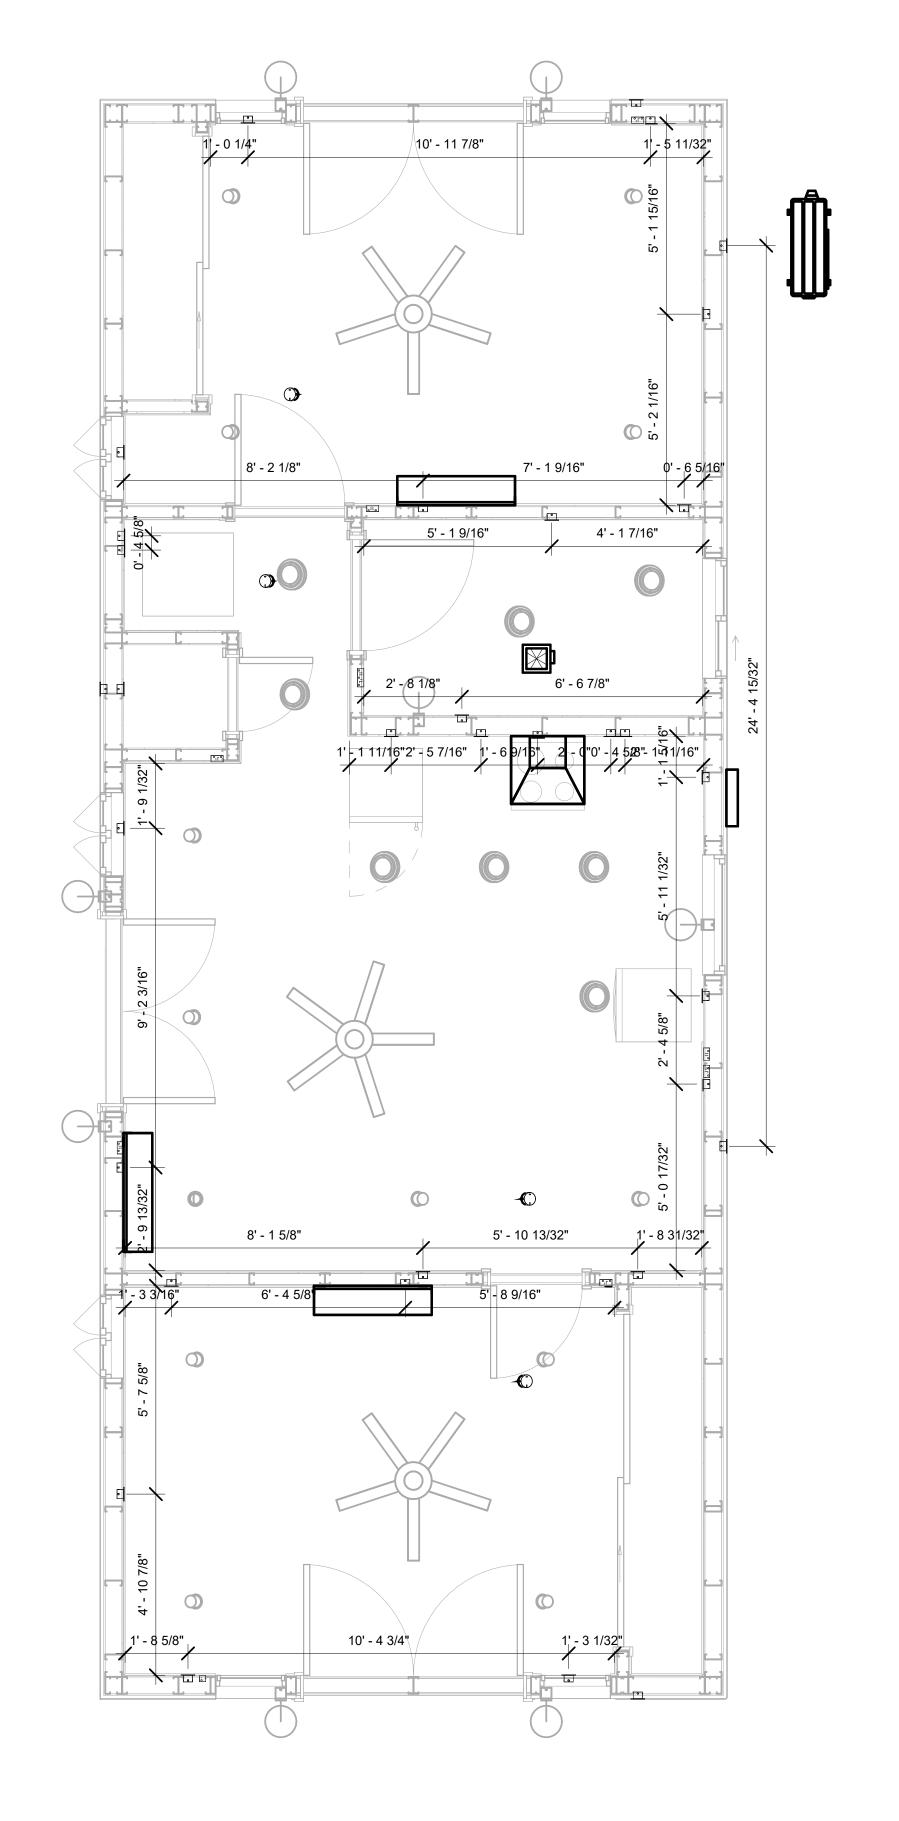





**KEY PLAN** 

NO.	DESCRIPTION	DATE

NOTE:

LEGEND:

PROJECT

161-Haven-733-2Bd 1Ba Ranch-550

DRAWING NAME

# DIMENSION PLAN FOR FITTINGS

Owner
0384_13
4/2/2025 3:45:21 PM
Designer
Author
Checker

E105

SCALE: 3/8" = 1'-0"

# SHEET LIST

SHEET NUMBER SHEET NAME

P101 NOTE AND SCHEDULE
P102 WATER SUPPLY AND SEWAGE
SYSTEM

PIPE COL	OR SCHEME
	<ul> <li>DOMESTIC COLD WATE</li> </ul>
	<ul> <li>DOMESTIC HOT WATER</li> </ul>
	<ul><li>SANITARY VENT</li></ul>
	SANITARY SEWER
	<ul> <li>STORM DRAINAGE</li> </ul>
	GRAY WATER
	GAS LINE

### PLUMBING NOTES

- THE PLUMBING SYSTEM IS DESIGNED TO MEET THE BUILDING'S DOMESTIC WATER SUPPLY, SANITARY DRAINAGE, AND STORM DRAINAGE REQUIREMENTS, AS PER PROJECT SPECIFICATIONS AND APPLICABLE CODES.
- THE SYSTEM INSTALLATION SHALL COMPLY WITH THE LATEST INTERNATIONAL PLUMBING CODE (IPC), INTERNATIONAL RESIDENTIAL CODE (IRC), AND ALL OTHER RELEVANT LOCAL, STATE, AND NATIONAL REGULATIONS.
- 3. ALL PLUMBING WORK SHALL COMPLY WITH THE LATEST EDITION OF THE INTERNATIONAL PLUMBING CODE (IPC) AND THE LOCAL PLUMBING CODE.
- 4. PLUMBING SYSTEMS SHALL BE TESTED AND INSPECTED IN ACCORDANCE WITH THE LOCAL PLUMBING CODE REQUIREMENTS.
- 5. PLUMBING FIXTURES SHALL BE INSTALLED WITH THE APPROPRIATE TRIM, FITTINGS, AND ACCESSORIES, AS RECOMMENDED BY THE MANUFACTURER.
- 6. PIPING SHALL BE PROPERLY SUPPORTED AND SECURED TO PREVENT SAGGING, MOVEMENT, AND VIBRATION.
- 7. SHUT-OFF VALVES SHALL BE PROVIDED AT ALL BRANCH CONNECTIONS AND AT THE INLET AND OUTLET OF EACH PIECE OF EQUIPMENT.
- 8. BACKFLOW PREVENTION DEVICES SHALL BE INSTALLED AS REQUIRED BY THE LOCAL
- PLUMBING CODE TO PROTECT THE POTABLE WATER SYSTEM.

  9. PLUMBING FIXTURES AND EQUIPMENT SHALL BE ACCESSIBLE FOR MAINTENANCE AND SERVICING
- 10. EXPOSED PLUMBING PIPING AND FIXTURES SHALL BE INSULATED TO PREVENT CONDENSATION AND ENERGY LOSS.
- 11. DEAD ENDS IN THE DRAINAGE SYSTEM MUST BE AVOIDED, EXCEPT WHERE NECESSARY TO INSTALL A CLEANOUT IN AN ACCESSIBLE LOCATION, AND MUST HAVE A VENTED CONNECTION TO THE OUTSIDE ATMOSPHERE.
- 12. THE VERTICAL DEFLECTION OF PVC PIPE MUST NOT EXCEED 5%, AND NO DEFLECTION IS PERMITTED FOR IRON PIPE.
- 13. WORK MUST BE PROPERLY COORDINATED WITH OTHER TRADES TO AVOID CONFLICTS, REFERRING TO THE ARCHITECTURAL AND STRUCTURAL DRAWINGS FOR INFORMATION REGARDING CEILING ELEVATIONS, SPACE CLEARANCES, WALL AND PARTITION LOCATIONS, ETC.
- 14. ALL FIXTURES SHALL HAVE ACCESSIBLE STOPS.
- 15. DOMESTIC WATER PIPING SHALL BE PEX, AND PVC PIPING IS NOT ACCEPTABLE FOR INTERIOR USE.
- 16. VENT TERMINATIONS SHALL BE LOCATED AT LEAST 10 FEET FROM OR 3 FEET ABOVE ANY OPERABLE WINDOW, DOOR OPENING, AIR INTAKE, OR VENT SHAFT, AND AT LEAST 3 FEET IN EVERY DIRECTION FROM ANY LOT LINE, ALLEY, OR STREET.
- 17. PIPE AND FITTINGS UTILIZED IN THE WATER SUPPLY SYSTEM SHALL HAVE A MAXIMUM OF 8 PERCENT LEAD.
- 18. ACRYLONITRILE BUTADIENE STYRENE (ABS) SHALL BE USED FOR THE SEWERAGE AND VENTILATION SYSTEM.
- 19. CROSS-LINKED POLYETHYLENE (PEX) SHALL BE USED FOR THE WATER SUPPLY SYSTEM.
- 20. POLYVINYL CHLORIDE (PVC) SHALL BE USED FOR THE RAIN WATER SYSTEM.
- 21. THE MIMIMUM WATER SUPPLY DEPTH UNDER FLOOR FINISH SHOUD BE 1/2".
  22. ANY PIPE INSTALLED UNDERGROUND MUST HAVE AT LEAST 12 INCHES OF CLEARANCE
- BETWEEN THE OUTSIDE OF THE PIPE AND ANY OTHER UNDERGROUND STRUCTURE.
- 23. THE MINIMUM CLEARANCE BETWEEN COLD AND HOT WATER LINES IN RESIDENTIAL HOMES MAINTAIN A MINIMUM DISTANCE OF 6 INCHES.
- 24. HORIZONTAL SEPARATION BETWEEN WATER AND SEWER LINES: A MINIMUM OF 12 INCHES BETWEEN POTABLE WATER SUPPLY LINES (COLD AND HOT WATER) AND SANITARY SEWER LINES.

# **ABBREVIATIONS**

Ø	DIAMETER
ABS	ACRYLONITRILE BUTADIENE STYRENE
ABV	ABOVE
AD	AREA DRAIN
AFF	ABOVE FINISHED FLOOR
ALT	ALTERNATE
BFF	BELOW FINISHED FLOOR
BLW	BELOW
CO	CLEAN OUT
CW	COLD WATER
D	DEGREE
DFU	DRANAGE FIXTURE UNIT
DIA	DIAMETER
DN	DOWN
FCO	FLOOR CLEAN OUT
FD	FLOOR DRAIN
FL	FLOOR
FS	FLOOR SINK
FT	FOOT/FEET
НВ	HOSE BIB
HW	HOT WATER
IN	INCH
MIN	MINIMUM
NO	NUMBER
NTS	NOT TO SCALE
PEX	CROSS-LINKED POLYETHYLENE
PLBG	PLUMBING
PVC	POLYVINYL CHLORIDE
QTY	QUANTITY
RD	ROOF DRAIN
RED	REDUCER
RM	ROOM
RW	RAIN WATER
SF	SQUARE FOOT
V	VENT
VTR	VENT THROUGH ROOF
W	WASTE
WCO	WALL CLEAN OUT
WSFU	WATER SUPPLY FIXTURE UNIT

# PLUMBING LEGEND

D	CAP
	BEND 45 DEG
B	BEND 90 DEG
	TEE REDUCING
	TEE
	CLEAN TWO-WAY
	WYE 45 DEG
	WYE 45 DEG DOUBLE
	WYE COMBINATION
	P-TRAP

PIPE SCHEDULE							
MATERIAL	DIAMETER	LENGTH					
ACRYLONITRILE BUTADIENE STYRENE (ABS)	1 1/2"	23 FT					
ACRYLONITRILE BUTADIENE STYRENE (ABS)	2"	40 FT					
ACRYLONITRILE BUTADIENE STYRENE (ABS)	3"	23 FT					
CROSS-LINKED POLYETHYLENE (PEX)	1/2"	94 FT					
CROSS-LINKED POLYETHYLENE (PEX)	3/4"	20 FT					
CROSS-LINKED POLYETHYLENE (PEX)	1"	1 FT					
POLYVINYL CHLORIDE - RIGID	2"	58 FT					

FITTING SCHEDULE						
FITTING	SIZE	QTY				
DOMESTIC COLD WATER						
PEX 90 DEGREE ELBOW	1/2"ø-1/2"ø	14				
PEX 90 DEGREE ELBOW	3/4"ø-3/4"ø	1				
PEX TEE ELBOW	1/2"ø-1/2"ø-1/2"ø	5				
PEX TEE ELBOW	3/4"ø-3/4"ø-3/4"ø	2				
PEX TRANSITION ELBOW	1"ø-3/4"ø	1				
PEX TRANSITION ELBOW	3/4"ø-1/2"ø	1				
DOMESTIC HOT WATER						
PEX 90 DEGREE ELBOW	1/2"ø-1/2"ø	12				
PEX 90 DEGREE ELBOW	3/4"ø-3/4"ø	2				
PEX TEE ELBOW	1/2"ø-1/2"ø-1/2"ø	4				
PEX TRANSITION ELBOW	3/4"ø-1/2"ø	1				
RAIN WATER PVC 90 DEG BEND ELBOW PVC 90 DEGREE BEND ELBOW	2"ø-2"ø 2"ø-2"ø	8 16				
SEWAGE						
ABS 90 DEGREE BEND ELBOW	1 1/2"ø-1 1/2"ø	1				
ABS 90 DEGREE BEND ELBOW	2"ø-2"ø	3				
ABS 90 DEGREE BEND ELBOW	3"ø-3"ø	1				
ABS P-TRAP	1 1/2"ø-1 1/2"ø	3				
ABS P-TRAP	2"ø-2"ø	2				
ABS REDUCER ELBOW	2"ø-1 1/2"ø	1				
ABS REDUCER ELBOW	3"ø-2"ø	1				
ABS TEE ELBOW	1 1/2"ø-1 1/2"ø-1 1/2"ø	1				
ABS TEE ELBOW	2"ø-2"ø-2"ø	1				
ABS TEE ELBOW	3"ø-3"ø-3"ø	2				
ABS TEE REDUCER ELBOW	3"ø-3"ø-1 1/2"ø	2				
ABS TEE REDUCER ELBOW	3"ø-3"ø-2"ø	1				
WASTE DOUBLE TEE	2"ø-2"ø-2"ø	1				
VENT						
ABS VENT CAP ELBOW	1 1/2"ø	1				
ABS VENT CAP ELBOW	2"ø	2				
ABS VENT CAP ELBOW	3"ø	1				

FIXTURE CONNECTION SCHEDULE											
FAMILY	W	V	TRAP	CW	HW	QTY	DFU	TOT.	WFU	TOT.	NOTES
DISHWASHER	2"	1-1/2"	1-1/2"	1/2"	1/2"	1		0			DRAIN TO SEWER SEE PLANS
DRYER	N/A	N/A	N/A	N/A	N/A	1		0			
HANGING PIPES CLAMP						16		0			
SHOWER TRAY	2"	1-1/2"	1-1/2"	1/2"	1/2"	1		0			
SHOWER TRIM	-	-	-	1/2"	1/2"	1		0			
SINK ISLAND SINGLE	2"	1-1/2"	1-1/2"	1/2"	1/2"	1		0			
VANITY SINK	2"	1-1/2"	1-1/2"	1/2"	1/2"	1		0			
WASHER	2"	1-1/2"	2"	1/2"	1/2"	1		0			DRAINS TO GRAY WATER OR SEWER SEE PLANS
WATER CLOSET						1		0			
WATER HEATER	N/A	N/A	N/A	3/4"	3/4"	1		0			

FIXTURE SCHEDULE								
FIXTURE	QTY	DESCRIPTION						
DISHWASHER	1	DRAIN TO SEWER SEE PLANS						
DRYER	1							
HANGING PIPES CLAMP	16							
SHOWER TRAY	1							
SHOWER TRIM	1							
SINK ISLAND SINGLE	1							
VANITY SINK	1							
WASHER	1	DRAINS TO GRAY WATER OR SEWER SEE PLANS						
WATER CLOSET	1							
WATER HEATER	1							

ACCESSORIES & FITTINGS SCHEDULE								
FIXTURE	FIXTURE QTY DESCRIPTIONS							
DISHWASHER CONNECTOR	2							
HOSE BIB	1							
SHUTOFF VALVE	6							

PLUMBING SCHEDULE									
FIXTURE	TRAP	WASTE	VENT	C.W	H.W				
DISHWASHER	1-1/2"	2"	1-1/2"	1/2"	1/2"				
DRYER	N/A	N/A	N/A	N/A	N/A				
SHOWER TRAY	1-1/2"	2"	1-1/2"	1/2"	1/2"				
SHOWER TRIM	-	-	-	1/2"	1/2"				
SINK ISLAND SINGLE	1-1/2"	2"	1-1/2"	1/2"	1/2"				
VANITY SINK	1-1/2"	2"	1-1/2"	1/2"	1/2"				
WASHER	2"	2"	1-1/2"	1/2"	1/2"				
WATER CLOSET									
WATER HEATER	N/A	N/A	N/A	3/4"	3/4"				

WATER FIXTURE UNIT SCHEDULE									
FAMILY	QTY	UNIT VALUE	TOTAL						
DISHWASHER 1 0									
DRYER	1		0						
HANGING PIPES CLAMP	16		0						
SHOWER TRAY	1		0						
SHOWER TRIM	1		0						
SINK ISLAND SINGLE	1		0						
VANITY SINK	1		0						
WASHER	1		0						
WATER CLOSET	1		0						
WATER HEATER	1		0						

1	WASTE FIXTURE UNIT SCHEDULE								
FAMILY QTY DFU VALUES TOTAL									
DISHWASHER	1		0						
DRYER	1		0						
HANGING PIPES CLAMP	16		0						
SHOWER TRAY	1		0						
SHOWER TRIM	1		0						
SINK ISLAND SINGLE	1		0						
VANITY SINK	1		0						
WASHER	1		0						
WATER CLOSET	1		0						
WATER HEATER	1		0						



**KEY PLAN** 

NO.	DESCRIPTION	DATE
·		

NOTE:

LEGEND:

PROJECT

161-Haven-733 2Bd/1Ba Ranch-550

DRAWING NAME

NOTE AND SCHEDULE

 CLIENT NAME:

 PROJECT NUMBER:
 0384\_12

 DATE:
 3/26/2025 11:23:57 AM


 DESIGNED BY:
 Designer

 DRAWN BY:
 Author

 CHECKED BY:
 Checker

P101

SCALE: 1/2" = 1'-0"

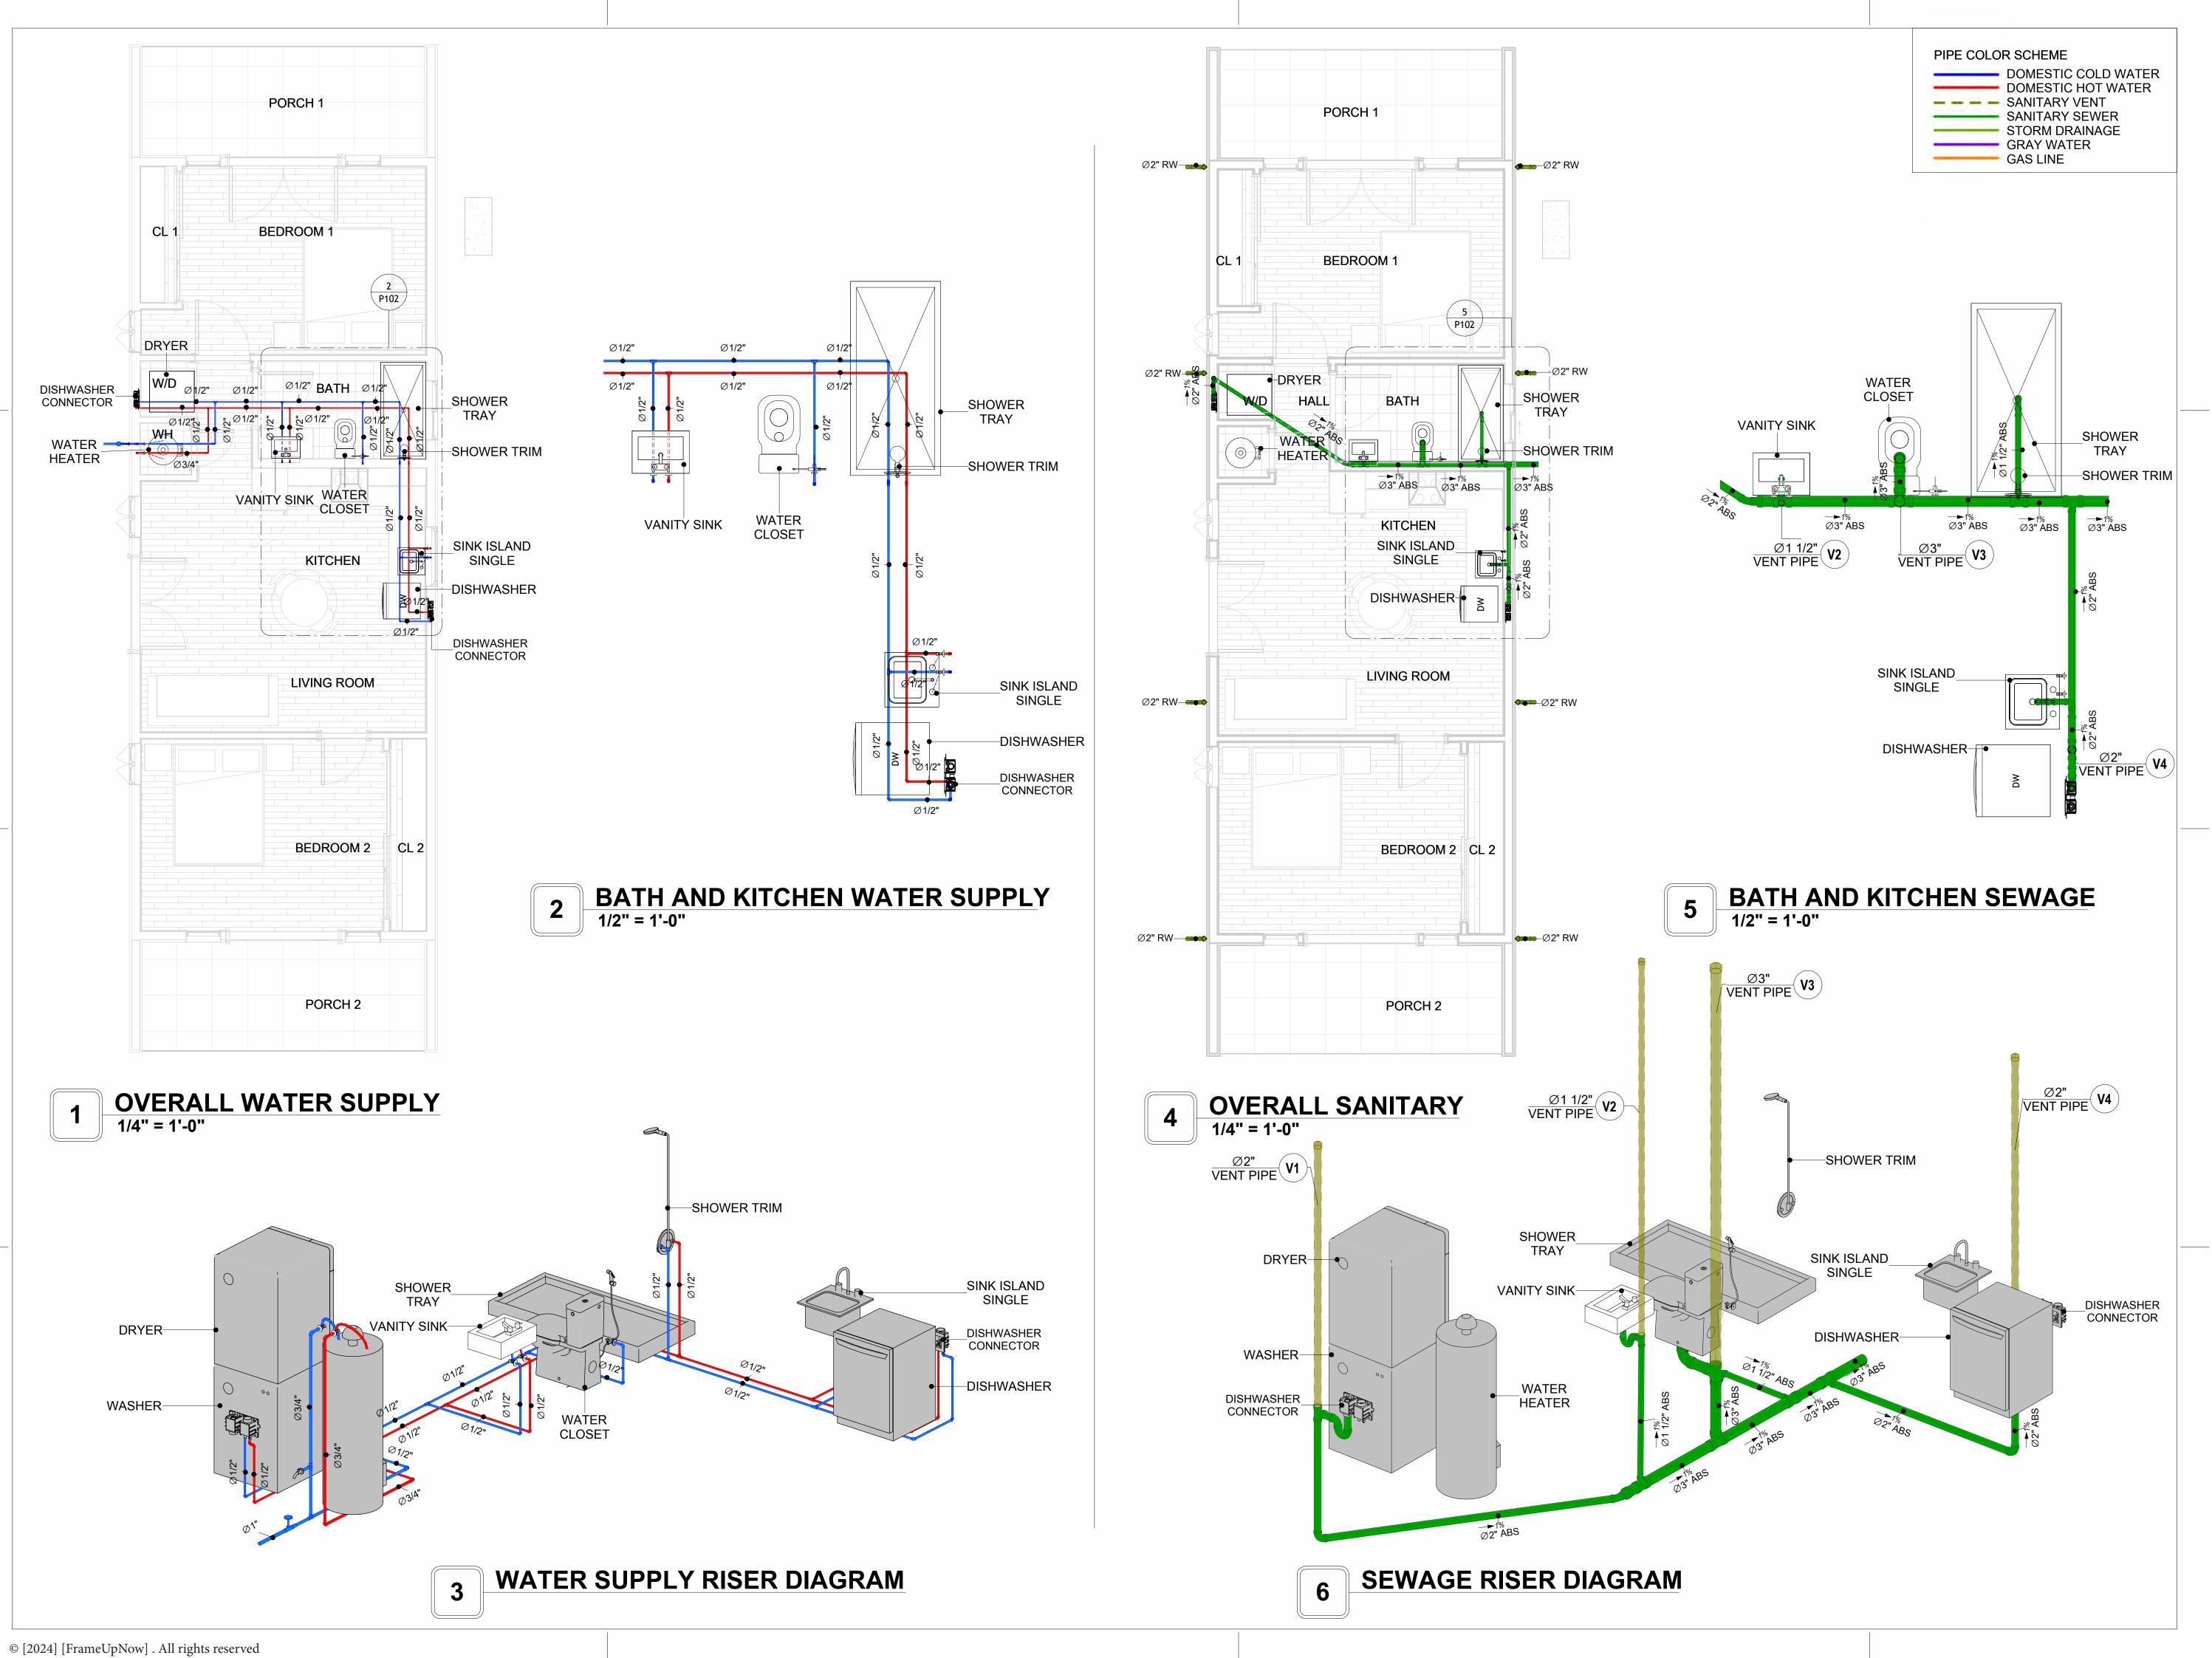



**KEY PLAN** 

DATE

DESCRIPTION

NOTE:

LEGEND:

PROJECT

161-Haven-733 2Bd/1Ba Ranch-550

DRAWING NAME

# WATER SUPPLY AND SEWAGE SYSTEM

CLIENT NAME:

PROJECT NUMBER:

DATE:

3/26/2025 11:24:26 AM

DESIGNED BY:

DRAWN BY:

CHECKED BY:

Checker

P102

# Materials Shopping List

Please print and take this Materials Shopping List to your favorite Home Depot and ask for assistance in selecting the materials, fixtures and fittings to complete your new home.

Record your selection and the price of the item. Then do the math to determine the cost for your selections and the total cost of finishing your home.

#### **Have It Your Way!**

The material types listed in this document were selected based on personal preferences. The Customer is encouraged to make changes to the material types in accordance with local customs, regulations, and personal preferences.

Have It Your Way!



# 20 good reasons to frame a home with metal and not wood



Why build your ADU with metal vs wood	Wood	Metal	Explanation
1 DIY Construction Benefit		<b>~</b>	The wall frames, trusses and beams can be erected in a just a few days
2 Minimal Construction Skills Required		<b>~</b>	Pre-assembled walls and trusses require no specialized skills to errect
3 Build as DIY, Hybrid or by a General Contractor		<b>✓</b>	Do it yourself, Hybrid (involve special contractors) or hire a General Contractor
4 Build It As You Can Afford It		$\checkmark$	Impervious to Weather - build as you have the time and money
5 Up Front Cost of Framing Materials	<b>~</b>		As to only the framing material, wood is less expensive
6 Total Cost To Build		<b>~</b>	Savings in time, labor, and other areas make light gauge steel LESS expensive
7 Termites and wood boring insects		<b>Y</b>	Termites, carpenter ants and wood boring insects eat wood, not metal
8 Mold resistant		<b>~</b>	Metal does not attract mold
9 Damage caused by exterior and interior flooding		<b>~</b>	Metal needs no reconditioning after a flood
10 Fire Resistant		<b>~</b>	Non-combustible
11 Lower insurance rates		<b>Y</b>	Many insurance underwriters now provide lower rates for metal framed homes
12 Walls, trusses, and beams retain their original form		<b>~</b>	Perfectly straight walls - no shimming of drywall
13 Corners are 90 degrees		<b>✓</b>	No need for templating of countertops to adjust for out of square corners
14 Strength and weight		<b>✓</b>	Metal is stronger than wood and weighs less - no need for crane to lift ADU trusses
15 IBC Engineered Stamp		<b>✓</b>	If an engineering stamp is necessary, months of waiting are saved
16 Complete BOM (Materials Shopping List)		<b>~</b>	Take the materials shopping list to Home Depot and start shopping/pricing
17 Flexible in Seismic Areas - Won't Fracture		<b>~</b>	Light gauge steel is flexible and won't fracture when the earth moves
18 No Waste At Job Site		~	Steel is the most recycled material in the world. A typical wood home has 20-30% waste
19 Environmentally Friendly		<b>~</b>	Trees don't have to be destroyed and the source of most metal is from recycling
20 How-To Videos Included		<b>~</b>	How-to videos provide simple assembly instructions
21 Relationship Counselor		<b>~</b>	Eliminate emotional uphevels - save time, money, and preserve the relationship

#### Universal Requirements - some or all may be required

- 1 Site plan
- 2 Electrical Supply Connection
- 3 Sewer Connection
- 4 Fresh Water Supply Connection
- 5 Set Backs
- 6 Soils Evaluation

- 7 Earthquake (fault) evaluation
- 8 Foundation Plan subject to soils
- 9 Compliance with local energy codes: insulation home wrap and flashing
- 10 Engineering for wind speed and snow load.
- 11 State and Local ordinances regarding ADUs
- 12 Local Architect and/or Engineer may be necessary





### Haven-2Bd1Ba-Ranch MATERIAL SHOPPING LIST

#### **Have It Your Way!**

The material types listed in this document were selected based on personal preferences. The Customer is encouraged to make changes to the material types in accordance with local customs, regulations, and personal preferences. Have It Your Way!

### TOC

Name



#### Link Page No Cover Page TOC 2

#### 1 Cover Page 2 TOC 3 ELECTRICAL BOM **ELECTRICAL BOM** 3 5 HVAC BOM **HVAC BOM** 7 PLUMBING BOM 4 PLUMBING BOM 10 6 ARCHITECTURAL BOM ARCHITECTURAL BOM 15

**Table Of Content** 

#### Have It Your Way!

The material types listed in this document were selected based on personal preferences. The Customer is encouraged to make changes to the material types in accordance with local customs, regulations, and personal preferences. Have It Your Way!

#### **GENERAL NOTES**

- 1 This BOM (Bill of Materials) is prepared as a Materials Shopping List to help builders and DIYers gain a complete understanding of most if not all elements required for the complete construction of this structure, according to the original design documents provided by FrameUpNow.
- 2 All quantities and specifications are subject to change based on the final design, field measurements, availability of products and customer preferences. The customer should verify all information prior to purchasing materials.
- 3 All products and elements in the list shall conform to the International Residential Code (IRC), or any other local and international building codes, safety regulations, and standards that are applicable to the location of the structure.
- 4 If any changes are made by the customer to the list of materials specified in this document, the customer is responsible for assuring that the correct type and quantity of materials are utilized in accordance with local building
- 5 FrameUpNow, will not be held responsible for any misuse of this document, the products listed, or for deviations from the content that are made due to changes in specifications, pricing, availability, or customer preferences.
- 6 The customer is advised to consult a qualified professional or technician prior to purchasing materials for specialized construction system items. Some items including but not limited to caseworks, doors and windows may require as built measurements prior to purchase to confirmation of final dimensions.
- If there are additional trim elements or specific installation methods, the total amount of materials needed might vary. Consider any additional trim required for corners, intersections, or other architectural details that might cause this variations before procedding to purchase and construction.

### **ARCHITECTURAL BOM**



			aven-2Bd1				
	lu u	ARCHITECT				Tatal	Descri "
۱o.	APPLIANCES	Туре	Unit	Quantity	Unit Price	Total	Description
<u> </u>		I	PCS	1			
	Refrigerator		PCS	1			
3	Range		PCS	1			
	Washer						
4	Dryer		PCS	1			
5	Dish Washer		PCS	1			
6	Oven		PCS	0			
	Microwave		PCS	0			
<u> </u>	CASEWORKS	I	le T	45.00			
	Kitchen Cabinet		FT	15.82			
	Laundry Cabinet		FT	2.25			
3	Vanity Cabinet		FT	3			
	Medicine Cabinet		PCS	1			
	Kitchen countertop		SF	24.56			
	Laundry Countertop		PCS	0			
7	Bathroom Countertop		SF	0			
8	Island		FT	0			
9	Peninsula		FT	0			
10	Closets		SF	106.37			
Δ	CEILING						
1	Ceiling Board	Dry Wall	SF	650			
2	Dry Wall Fastener	Screw	PCS	1137.5			
3	Vapor Retarder	Polyethylene film	SF	954			
4	Vapor Retarder Fastener	Nails with washer heads	PCS	2862			
	Ceiling Board (MRD)	Moisture resistant drywall	SF	57			
	MRD Fastener		PCS	99.75			
	Ceiling Board	Marine Plywood	SF	247			
	Marine Plywood Fastener	Screw	PCS	432.25			
	Dry Wall Tape	0.0.0.0	FT	477			
	FLOORING			1771			
	Main Living Space		SF	248.65			
2	Bathroom		SF	55.05			
3	Bedroom		SF	333.11			
	Porch		SF	204.72			
	STRUCTURE		31	204.72			
<u> </u>	Foundation	I	SF	928.55			
1	WALLS EXTERIOR		31	920.00			
1	Stucco Finish	I	SF	22/			
	1			236			
	Exterior-Grade Plywood	0.15.1.111. (400.1.1.)	SF	691			
		Self-drilling screws(100/pkt)	PKT	6.91			
	Wall Shteathing (OSB)		SF	927			
	Shteathing Fastener	Self-drilling screws(100/pkt)	PKT	9.27			
6	Wall Homewrap		SF	927			
	Homewrap Fastener	Stapled fastener (200/pkt)	PKT	3.5226			
	Furring Strip		PCS	86.375			
	Furring Strip Fastener	Self-drilling screws(100/pkt)	PKT	6.91			
	Wall Paint		SF	927			
	Stone Copping	Masonry stone	SF	0			
	Stone Veneer	Masonry stone	SF	0			
	Mortar for Stone Veneer		SF	0			
	Wall Insulation		SF	2956			
	WALLS INTERIOR						
	Cementitious Backer Board		SF	368			
	Kerdi membrane		SF	368			
	Kerdi membrane Fastener		SF	368			
	Wall Ceramic Tile		SF	368			
	Drywall Board		SF	1559			
	Drywall Fastener	Self-drilling screws(100/pkt)	PKT	15.59			
•	Wall Paint	Son drining sorews (100/pht)	SF	1559			
						1	
	Drywall Tape		FT	293			

### **ARCHITECTURAL BOM**



	DOORS				
1	Interior Swinging	2' - 6" X 6'-8"	PCS	1	
2	Interior Swinging	3' - 0" X 6'-8"	PCS	1	
3	Interior Sliding	9' - 0" X 6'- 8"	PCS	1	
4	Interior Swinging	3' - 0" X 6'- 8"	PCS	1	
5	Interior Sliding	7' - 0" X 6'- 8"	PCS	1	
6	Exterior Swinging	5' - 0" X 6'- 8"		1	
7	Exterior Swinging	6' - 0" X 6'- 8"		2	
8	Interior Swinging	3' - 0" X 6'-8"	PCS	1	
9	Exterior Door Trim		FT	57	
10	Interior Door Trim		FT	272	
11	Entry Lock set			3	
	Privacy Lock set			3	
13	Passage Lock set			3	
Δ	WINDOWS				
1	Single Hung	3' - 3" X 3'-3"	PCS	1	
2	Sliding	3' - 3" X 2'-3"	PCS	1	
3	Casment	2' - 3" X 4'-3"	PCS	3	
4	Fixed	1' - 11" X 6'-8"	PCS	4	
5	Exterior Window Trim		FT	133	
6	Interior Window Trim		FT	133	
	ROOF				
1	Roof Covering		SF	1200	
2	Roof Covering Fastener		PCS	600	
3	Roof Felt Paper		SF	1200	
4	Roof Felt Paper Fastener		PCS	3600	
5	Roof Sheathing		SF	1200	
6	Roof Sheathing Fastener		PCS	9600	
7	Batten		FT	0	
8	Batten Fastener		PCS	0	
9	Soffit		SF	152	
10	Soffit Fastener		PCS	76	
11	Fascia		FT	156	
12	Fascia board fastener		PCS	78	
13	Roof Insulation		SF	1200	



	ŀ	Haven-2Bd1Ba-Ran	ch					
ELECTRICAL MATERIAL SHOPPING LIST								
No.	Item	Type	Unit	Quantity	Description			
	LIGHTING FIXTURES			-				
1	Kitchen Ceiling Light		PCS	4				
2	Kitchen Wall Mounted Light		PCS	1				
3	Exterior Wall Mounted Light		PCS	6				
4	Livingroom Ceiling Light With Fan		PCS	1				
5	Bedroom Ceiling Light With Fan		PCS	2				
6	Dining Ceiling Light		PCS	0				
7	Bath Wall Mounted Light		PCS	1				
8	Bathroom Ceiling Light		PCS	2				
9	Livingroom Ceiling Light		PCS	6				
10	Bedroom Ceiling Light		PCS	8				
11	Hall & Entry Ceiling Light		PCS	2				
12	Closet Ceiling Light		PCS	0				
	Smoke Detector		PCS	4				
			1 03	4				
1/	ELECTRICAL FITTINGS Standard Receptacle 120V	20A	PCS	16				
14	·	20 A	PCS					
15	GFCI Receptacle 120V	30 A		13				
16	GFCI Receptacle 240V	1 * *	PCS	2				
17	GFCI Receptacle 240V	50 A	PCS	1				
18	GFCI Receptacle 240V	60 A	PCS	1				
19	Fan Switch		PCS	1				
20	Single Pole Switch		PCS	6				
21	Three Way Switch		PCS	7				
22	Dimmer Switch		PCS	4				
	ELECTRICAL CONDUITS & WIRING							
	ROMEX 14 AWG	14/3/W/ground	FT	155				
	ROMEX 12 AWG	12/3/W/ground	FT	317				
25	ROMEX 12 AWG	12/2/W/ground	FT	0				
26	ROMEX 10 AWG	10/3/W/ground	FT	0				
27	ROMEX 10 AWG	10/2/W/ground	FT	62				
28	Romex 8 AWG	8/3/W/ground	FT	0				
29	Romex 8 AWG	8/2/W/ground	FT	15				
	ROMEX 6 AWG	6/3/W/ground	FT	26				
31	Bare Copper Ground Wire 6 AWG	Ŭ Ü	FT					
	ELECTRICAL BOXES & CIRCUTES							
	Panelboard -240V 1 Phase MLO	200 AMP	PCS	1				
	Circuit breaker	15 A	PCS	4				
	Circuit breaker	20 A	PCS	10				
	Circuit breaker	30 A	PCS	2				
	Circuit breaker	50 A	PCS	1				
	Circuit breaker	60 A	PCS	1				
	Single Gang Switch Box	00 A	PCS	1				
			PCS	7				
	Double Gang Switch Box		PCS	1				
	Triple Gang Switch Box	<u> </u>	PCS					
	Pull Box	#1/4		28				
44	Receptacle Box		PCS	33				

#### PLUMBING BOM

16 PEX 90 Degree Elbow

17 PEX 90 Degree Elbow

20 PEX Transition Elbow

21 PEX Transition Elbow

23 WASTE DOUBLE TEE

22 PVC 90 Deg Bend Elbow

18 PEX Tee Elbow

19 PEX Tee Elbow



#### Haven-2Bd1Ba-Ranch PLUMBING SYSTEM MATERIAL SHOPPING LIST Item Unit Quantity Unit Price Total Description 1 Bath Tub (Alcove Tub) PCS 2 Kitchen Sink PCS 1 3 Kitchen Faucets PCS 4 Vanity Sink PCS 1 5 Bath room Faucets PCS 6 Water Closet PCS 7 Shower Trim PCS 8 Shower Tray PCS 9 Water Heater PCS 10 Hose Bib PCS 1 11 Shutoff Valve PCS 12 Hanging pipe clamp PCS 19 13 Gate Valve PCS 14 Dishwasher Supply Single Connector PCS 1 15 Dishwasher Sewage Single Connector PCS 16 Laundry Sweat Connector PCS 1 △ SANITARY & PLUMBING PIPE 1 ABS (Acrylonitrile Butadiene Styrene) Pipes 2 ABS (Acrylonitrile Butadiene Styrene) Pipes ø 1" FT 0 ø 1 1/2 FT 23 3 ABS (Acrylonitrile Butadiene Styrene) Pipes ø 2" FT 40 4 ABS (Acrylonitrile Butadiene Styrene) Pipes ø 3" FT 23 5 PEX (Cross-linked polyethylene) Pipes ø 1/2' FT 94 6 PEX (Cross-linked polyethylene) Pipes ø 3/4" FT 20 7 PEX (Cross-linked polyethylene) Pipes ø 1" FT 1 8 PVC Pipes Sch.80 - Rigid ø 1 1/2" FT 0 9 PVC Pipes Sch.80 - Rigid ø 2" FT 58 10 PVC Pipes Sch.80 - Rigid ø 3" FT 0 11 Flex Pipe Round ø 1/2" PCS 8 1 ABS 90 Degree Bend Elbow 1 1/2"ø-1 1/2"ø PCS 2 ABS 90 Degree Bend Elbow 2"a-2"a PCS 3 3 ABS 90 Degree Bend Elbow 3"ø-3"ø PCS 4 ABS P-Trap 1 1/2"ø-1 1/2"ø PCS 3 5 ABS P-Trap 2"ø-2"ø PCS 6 ABS Reducer Elbow 2"ø-1 1/2"ø **PCS** 7 ABS Reducer Elbow PCS 3"ø-2"ø 8 ABS TEE Elbow 1 1/2"ø-1 1/2"ø-1 1/2"ø PCS 1 9 ABS TEE Elbow 2"ø-2"ø-2"ø PCS 10 ABS TEE Elbow 3"ø-3"ø-3"ø PCS 11 ABS Tee Reducer Elbow 3"ø-3"ø-1 1/2"ø PCS 12 ABS Tee Reducer Elbow PCS 3"ø-3"ø-2"ø 13 ABS Vent Cap Elbow 1 1/2"ø PCS 14 ABS Vent Cap Elbow PCS 2"ø 2 15 ABS Vent Cap Elbow PCS 3"ø

PCS

PCS

PCS

PCS

PCS

PCS

PCS

PCS

26

3

9

2

1

16

1

1/2"ø-1/2"ø

3/4"ø-3/4"ø

1"ø-3/4"ø

2"ø-2"ø

3/4"ø-1/2"ø

1/2"ø-1/2"ø-1/2"ø

3/4"ø-3/4"ø-3/4"ø

2"ø-2"ø-2"ø-2"ø

		Haven	-2Bd1Ba-	Ranch			
		HVAC SYSTEM N	/ATERIAL	SHOPP	ING LIST		
No.	Item	Туре	Unit	Quantity	Unit Price	Total	Description
	HVAC_DUCTS						
1	PIPE (REFRIGERANT LINE)	3/8" (Ø)	FT	70.91			
2	PIPE (REFRIGERANT LINE)	3/4''' (Ø)	FT	103.6			
3	DRAYER HOSE	4" (Ø)	FT	5			
4	FLEX DUCT ROUND	4" (Ø)	FT	6.23			
$\triangle$	<b>DUCT FITTINGS &amp; ACCESSORIES</b>						
	ELBOW (REFRIGERANT LINE)	3/4" (Ø)-3/4" (Ø)	PCS	25			
6	ELBOW (REFRIGERANT LINE)	3/8" (Ø)-3/8" (Ø)	PCS	21			
7	TEE (REFRIGERANT LINE)	3/4" (Ø)-3/4" (Ø)-3/4" (Ø)	PCS	2			
8	TEE (REFRIGERANT LINE)	3/8" (Ø)-3/8" (Ø))-3/8" (Ø)	PCS	2			
9	TRANSITION (REFRIGERANT	3/4" (Ø)-1/2" (Ø)	PCS	4			
10	TRANSITION (REFRIGERANT	3/4" (Ø)-3/4" (Ø)	PCS	1			
11	TRANSITION (REFRIGERANT	3/4" (Ø)-5/8" (Ø)	PCS	3			
12	TRANSITION (REFRIGERANT	3/8" (Ø)-1/4" (Ø)	PCS	1			
<u></u>	HVAC_EQUIPMENTS						
13	AIR HANDLING UNIT	WALL MOUNTED	PCS	3			
14	CONDENSER	OUTDOOR UNIT	PCS	1			
15	EXHAUST FAN	75 CFM	PCS	1			
16	EXHAUST HOOD	WALL MOUNTED	PCS	1			
17	HOOD-WALL: VENT	HOOD-WALL: VENT	PCS	1			
18	DRAYER: VENT	DRAYER: VENT	PCS	1			
19	ROOF VENT	3"(Ø)	PCS	1			



#### **Table Of Content**

#	Name	Link	Page No
1	Cover Page	<u>Cover Page</u>	1
2	TOC	TOC	2
3	ELECTRICAL BOM	ELECTRICAL BOM	3
5	HVAC BOM	HVAC BOM	7
4	PLUMBING BOM	PLUMBING BOM	10
6	ARCHITECTURAL BOM	ARCHITECTURAL BOM_	15

#### **Have It Your Way!**

The material types listed in this document were selected based on personal preferences. The Customer is encouraged to make changes to the material types in accordance with local customs, regulations, and personal preferences. Have It Your Way!

#### **GENERAL NOTES**

- 1 This BOM (Bill of Materials) is prepared as a Materials Shopping List to help builders and DIYers gain a complete understanding of most if not all elements required for the complete construction of this structure, according to the original design documents provided by FrameUpNow.
- 2 All quantities and specifications are subject to change based on the final design, field measurements, availability of products and customer preferences. The customer should verify all information prior to purchasing materials.
- 3 All products and elements in the list shall conform to the International Residential Code (IRC), or any other local and international building codes, safety regulations, and standards that are applicable to the location of the structure.
- 4 If any changes are made by the customer to the list of materials specified in this document, the customer is responsible for assuring that the correct type and quantity of materials are utilized in accordance with local building codes.
- 5 FrameUpNow, will not be held responsible for any misuse of this document, the products listed, or for deviations from the content that are made due to changes in specifications, pricing, availability, or customer preferences.
- 6 The customer is advised to consult a qualified professional or technician prior to purchasing materials for specialized construction system items. Some items including but not limited to caseworks, doors and windows may require as built measurements prior to purchase to confirmation of final dimensions.
- 7 If there are additional trim elements or specific installation methods, the total amount of materials needed might vary. Consider any additional trim required for corners, intersections, or other architectural details that might cause this variations before procedding to purchase and construction.



			LIGHTING FIXTURES				
#	Item	Туре	Description, Manufacturer, SKU	Unit	Quantity	Unit Price	Total
1	Kitchen Ceiling Light			PCS	4		
3	Kitchen Wall Mounted Light			PCS	1		
4	Exterior Wall Mounted Light			PCS	6		
5	Livingroom Ceiling Light With Fan			PCS	1		
6	Bedroom Ceiling Light With Fan			PCS	2		
7	Dining Ceiling Light			PCS	0		
8	Bath Wall Mounted Light			PCS	1		
9	Bathroom Ceiling Light			PCS	2		
10	Livingroom Ceiling Light			PCS	6		
11	Bedroom Ceiling Light			PCS	8		
12	Hall & Entry Ceiling Light			PCS	2		
12	Closet Ceiling Light			PCS	0		
13	Smoke Detector			PCS	4		
14							
15							



			ELECTRICAL FITTINGS				
#	Item	Туре	Description, Manufacturer, SKU	Unit	Quantity	Unit Price	Total
1	Standard Receptacle 120V	20A		PCS	16		
2	GFCI Receptacle 120V	20 A		PCS	13		
3	GFCI Receptacle 240V	30 A		PCS	2		
1	GFCI Receptacle 240V	50 A		PCS	1		
j	GFCI Receptacle 240V	60 A		PCS	1		
j	Fan Switch			PCS	1		
•	Single Pole Switch			PCS	6		
}	Three Way Switch			PCS	7		
	Dimmer Switch			PCS	4		
.0							
1							
2							
.3							
.4							
5							



		ELECTR	ICAL CONDUITS & WIRING				
#	Item	Туре	Description, Manufacturer, SKU	Unit	Quantity	Unit Price	Total
1	ROMEX 14 AWG	14/3/W/ground		FT	155		
3	ROMEX 12 AWG	12/3/W/ground		FT	317		
4	ROMEX 12 AWG	12/2/W/ground		FT	0		
6	ROMEX 10 AWG	10/3/W/ground		FT	0		
8	ROMEX 10 AWG	10/2/W/ground		FT	62		
9	Romex 8 AWG	8/3/W/ground		FT	0		
10	Romex 8 AWG	8/2/W/ground		FT	15		
11	ROMEX 6 AWG	6/3/W/ground		FT	26		
12	Bare Copper Ground Wire 6 AWG			FT			
13							
14							
15							
16							



		ELEC	CTRICAL BOXES & CIRCUTES				
#	Item	Туре	Description, Manufacturer, SKU	Unit	Quantity	Unit Price	Total
1	Panelboard -240V 1 Phase MLO	200 AMP		PCS	1		
2	Circuit breaker	15 A		PCS	4		
3	Circuit breaker	20 A		PCS	10		
4	Circuit breaker	30 A		PCS	2		
5	Circuit breaker	50 A		PCS	1		
6	Circuit breaker	60 A		PCS	1		
7	Single Gang Switch Box			PCS	1		
8	Double Gang Switch Box			PCS	7		
9	Triple Gang Switch Box			PCS	1		
10	Pull Box	#1/4		PCS	28		
11	Receptacle Box			PCS	33		
12							
13							
14							
15							

			HVAC_DUCTS 01				
#	Item	Туре	Description, Manufacturer, SKU	Unit	Quantity	Unit Price	Total
1	PIPE (REFRIGERANT LINE)			FT	50.2`		
2	PIPE (REFRIGERANT LINE)	3/4''' (Ø)		FT	88.33		
3	DRAYER HOSE	4" (Ø)		FT	6.3		
4	FLEX DUCT ROUND	4" (Ø)		FT	7.12		
5							
6							
7							
8							
9							
10							
11							
12							
13							
14							
15							
16							

			DUCT FITTINGS & ACCESSORIES				
#	Item	Туре	Description, Manufacturer, SKU	Unit	Quantity	Unit Price	Total
1	ELBOW (REFRIGERANT LINE)	3/4" (Ø)-3/4" (Ø)		PCS	25		
2	ELBOW (REFRIGERANT LINE)	3/8" (Ø)-3/8" (Ø)		PCS	21		
3	TEE (REFRIGERANT LINE)	3/4" (Ø)-3/4" (Ø)-3/4" (Ø)		PCS	2		
1	TEE (REFRIGERANT LINE)	3/8" (Ø)-3/8" (Ø))-3/8" (Ø)		PCS	2		
5	TRANSITION (REFRIGERANT LINE)	3/4" (Ø)-1/2" (Ø)		PCS	4		
5	TRANSITION (REFRIGERANT LINE)	3/4" (Ø)-3/4" (Ø)		PCS	1		
7	TRANSITION (REFRIGERANT LINE)	3/4" (Ø)-5/8" (Ø)		PCS	3		
8	TRANSITION (REFRIGERANT LINE)	3/8" (Ø)-1/4" (Ø)		PCS	1		
9							
10							
11							
12							
13							
14							
15							
16							

			HVAC_EQUIPMENTS				
#	Item	Туре	Description, Manufacturer, SKU	Unit	Quantity	<b>Unit Price</b>	Total
1	AIR HANDLING UNIT	WALL MOUNTED		PCS	3		
2	CONDENSER	OUTDOOR UNIT		PCS	1		
3	EXHAUST FAN	75 CFM		PCS	1		
1	EXHAUST HOOD	WALL MOUNTED		PCS	1		
5	HOOD-WALL: VENT	HOOD-WALL: VENT		PCS	1		
5	DRAYER: VENT	DRAYER: VENT		PCS	1		
7	ROOF VENT	3"(Ø)		PCS	1		
8							
9							
10							
11							
12							
13							
14							



	PLUMBING FIXTURES & ACCESSORIES								
#	Item	Туре	Description, Manufacturer, SKU	Unit	Quantity	Unit Price	Total		
1	Bath Tub (Alcove Tub)			PCS	0				
2	Kitchen Sink			PCS	1				
3	Kitchen faucets			PCS	1				
4	Vanity Sink			PCS	1				
5	Bath room faucets			PCS	1				
6	Water Closet			PCS	1				
7	Shower Trim			PCS	1				
8	Shower Tray			PCS	1				
9	Water Heater			PCS	1				
10	Hose Bib			PCS	1				
11	Shutoff Valve			PCS	6				
12	Hanging pipe clamp			PCS	16				
13	Gate Valve			PCS	1				
14	Dishwasher Supply Single Connector			PCS	1				
15	Dishwasher Sewage Single Connector			PCS	1				
16	Laundry Sweat Connector			PCS	1				



		SANI	TARY & PLUMBING PIPES				
#	Item	Туре	Description, Manufacturer, SKU	Unit	Quantity	Unit Price	Total
1	ABS (Acrylonitrile Butadiene Styrene) Pipes	ø 1"		FT	0		
2	ABS (Acrylonitrile Butadiene Styrene) Pipes	ø 1 1/2"		FT	23		
3	ABS (Acrylonitrile Butadiene Styrene) Pipes	ø 2"		FT	40		
4	ABS (Acrylonitrile Butadiene Styrene) Pipes	ø 3"		FT	23		
5	PEX (Cross-linked polyethylene) Pipes	ø 1/2"		FT	94		
6	PEX (Cross-linked polyethylene) Pipes	ø 3/4"		FT	20		
7	PEX (Cross-linked polyethylene) Pipes	ø 1"		FT	1		
8	PVC Pipes Sch.80 - Rigid	ø 1 1/2"		FT	0		
9	PVC Pipes Sch.80 - Rigid	ø 2"		FT	58		
10	PVC Pipes Sch.80 - Rigid	ø 3"		FT	0		
11	Flex Pipe Round	ø 1/2"		PCS	8		
12							
13							
14							
15							



	PIPE FITTINGS 01								
#	Item	Туре	Description, Manufacturer, SKU	Unit	Quantity	Unit Price	Total		
	ABS 90 Degree Bend Elbow	1 1/2"ø-1 1/2"ø		PCS	1				
	ABS 90 Degree Bend Elbow	2"ø-2"ø		PCS	3				
	ABS 90 Degree Bend Elbow	3"ø-3"ø		PCS	1				
	ABS P-Trap	1 1/2"ø-1 1/2"ø		PCS	3				
	ABS P-Trap	2"ø-2"ø		PCS	2				
	ABS Reducer Elbow	2"ø-1 1/2"ø		PCS	1				
	ABS Reducer Elbow	3"ø-2"ø		PCS	1				
	ABS TEE Elbow	1 1/2"ø-1 1/2"ø-1 1/2"ø		PCS	1				
	ABS TEE Elbow	2"ø-2"ø		PCS	1				
)	ABS TEE Elbow	3"ø-3"ø-3"ø		PCS	2				
l	ABS Tee Reducer Elbow	3"ø-3"ø-1 1/2"ø		PCS	2				
2	ABS Tee Reducer Elbow	3"ø-3"ø-2"ø		PCS	1				
3	ABS Vent Cap Elbow	1 1/2"ø		PCS	1				
1	ABS Vent Cap Elbow	2"ø		PCS	2				
5	ABS Vent Cap Elbow	3"ø		PCS	1				



		PII	PE FITTINGS 02				
#	Item	Туре	Description, Manufacturer, SKU	Unit	Quantity	Unit Price	Total
1	PEX 90 Degree Elbow	1/2"ø-1/2"ø		PCS	26		
2	PEX 90 Degree Elbow	3/4"ø-3/4"ø		PCS	3		
3	PEX Tee Elbow	1/2"ø-1/2"ø-1/2"ø		PCS	9		
4	PEX Tee Elbow	3/4"ø-3/4"ø-3/4"ø		PCS	2		
5	PEX Transition Elbow	1"ø-3/4"ø		PCS	1		
6	PEX Transition Elbow	3/4"ø-1/2"ø		PCS	2		
7	PVC 90 Deg Bend Elbow	2"ø-2"ø		PCS	16		
8	WASTE DOUBLE TEE	2"ø-2"ø-2"ø		PCS	1		
9							
10							
11							
12							
13							
14							
15							



			APPLIANCES				
#	Item	Туре	Description, Manufacturer, SKU	Unit	Quantity	Unit Price	Total
1	Refrigerator			PCS			
2	Range			PCS			
3	Washer Front Load	Stackable		PCS			
4	Dryer Front Load	Stackable		PCS			
5	Dish Washer			PCS			
6	Oven			PCS	(		
7	Microwave			PCS	(		
8							
9							
10							
11							
12							
13							
14							
15							
16							



			CASEWORKS 01				
#	Item	Туре	Description, Manufacturer, SKU	Unit	Quantity	Unit Price	Total
1	Kitchen Cabinet			FT	15.82		
2	Laundry Cabinet			FT	2.25		
3	Vanity Cabinet			FT	3		
4	Medicine Cabinet			PCS	1		
5	Kitchen countertop			SF	24.56		
6	Laundry Countertop			PCS	0		
7	Bathroom Countertop			SF	0		
8	Island			FT	0		
9	Peninsula			FT	0		
10	Closets			SF	106.37		
11							
12							
13							
14							
15							



	1		CEILING 01				
ŧ	Item	Туре	Description, Manufacturer, SKU	Unit	Quantity	Unit Price	Total
	LIVING ROOM + KITCHEN			SF	257.0		
L	Ceiling Board	Drywall		SF	257		
	Drywall Fastener	Screw		PCS	450		
	Vapor Retarder	Polyethylene film		SF	257		
	Vapor Retarder Fastener	Nails with washer heads		PCS	771		
	BATH ROOM			SF	57.0		
,	Ceiling Board	MRD (Moisture resistant drywall)		SF	57		
	MRD Fastener	Screw		PCS	100		
	HALL + WD			SF	21.0		
•	Ceiling Board	Drywall		SF	21		
	Drywall Fastener	Screw		PCS	37		
	Vapor Retarder	Polyethylene film		SF	21		
0	Vapor Retarder Fastener	Nails with washer heads		PCS	63		
	SHADE			SF	40.0		
.1	Ceiling Board	Marine Plywood		SF	40		
L2	Exterior Grade Plywood	Screw		PCS	70		



	1		CEILING 02				
#	Item	Туре	Description, Manufacturer, SKU	Unit	Quantity	Unit Price	Total
	CLOSET 1			SF	17.0		
13	Ceiling Board	Drywall		SF	17		
14	Drywall Fastener	Screw		PCS	30		
15	Vapor Retarder	Polyethylene film		SF	17		
16	Vapor Retarder Fastener	Nails with washer heads		PCS	51		
	CLOSET 2			SF	21.0		
17	Ceiling Board	Drywall		SF	21		
18	Drywall Fastener	Screw		PCS	37		
19	Vapor Retarder	Polyethylene film		SF	21		
20	Vapor Retarder Fastener	Nails with washer heads		PCS	63		
	WH			SF	9.0		
21	Ceiling Board	Drywall		SF	9		
22	Drywall Fastener	Screw		PCS	16		
23	Vapor Retarder	Polyethylene film		SF	9		
24	Vapor Retarder Fastener	Nails with washer heads		PCS	27		



			CEILING 03				
#	Item	Туре	Description, Manufacturer, SKU	Unit	Quantity	Unit Price	Total
	BED ROOM 1			SF	165.0		
25	Ceiling Board	Drywall		SF	165		
26	Drywall Fastener	Screw		PCS	289		
27	Vapor Retarder	Polyethylene film		SF	165		
28	Vapor Retarder Fastener	Nails with washer heads		PCS	495		
	BED ROOM 2			SF	160.0		
29	Ceiling Board	Drywall		SF	160		
60	Drywall Fastener	Screw		PCS	280		
61	Vapor Retarder	Polyethylene film		SF	160		
62	Vapor Retarder Fastener	Nails with washer heads		PCS	480		
	PORCH 1			SF	103.0		
63	Ceiling Board	Marine Plywood		SF	103		
64	Exterior Grade Plywood	Screw		PCS	180		
	PORCH 2			SF	104.0		
65	Ceiling Board	Marine Plywood		SF	104		
66	Exterior Grade Plywood	Screw		PCS	182		



			FLOORING INTERIOR 01				
#	Item	Туре	Description, Manufacturer, SKU	Unit	Quantity	Unit Price	Total
	BEDROOM 1						
1	Bedroom Flooring			SF	150		
2	Wood underlay	Foam Pad Polyethylene		SF	150		
3	Vapor Retarder	Vapor Barrier Polyethylene		SF	150		
	BEDROOM 2						
4	Bedroom Flooring			SF	146		
5	Wood underlay	Foam Pad Polyethylene		SF	146		
6	Vapor Retarder	Vapor Barrier Polyethylene		SF	146		
	CLOSET 1	:					
7	Closet Flooring			SF	15		
8	Wood underlay	Foam Pad Polyethylene		SF	15		
9	Vapor Retarder	Vapor Barrier Polyethylene		SF	15		
	CLOSET 2						
10	Closet Flooring			SF	22		
11	Wood underlay	Foam Pad Polyethylene		SF	22		
12	Vapor Retarder	Vapor Barrier Polyethylene		SF	22		



			FLOORING INTERIOR 02				
#	Item	Туре	Description, Manufacturer, SKU	Unit	Quantity	Unit Price	Total
	LIVING ROOM AND KITCH	EN					
13	Living Area Flooring			SF	249		
14	Wood underlay	Foam Pad Polyethylene		SF	249		
15	Vapor Retarder	Vapor Barrier Polyethylene		SF	249		
	BATHROOM						
16	Tile Finish			SF	37		
17	Adhesive	1/2" Thin set Mortar		SF	37		
18	Vapor Retarder	Vapor Barrier Polyethylene		SF	37		
	W/D						
19	Tile Finish			SF	10		
20	Adhesive	1/2" Thin set Mortar		SF	10		
21	Vapor Retarder	Vapor Barrier Polyethylene		SF	10		
	BOILER ROOM						
22	Tile Finish			SF	8		
23	Adhesive	1/2" Thin set Mortar		SF	8		
24	Vapor Retarder	Vapor Barrier Polyethylene		SF	8		



	<u>1</u>		FLOORING EXTERIOR			
#	Item	Туре	Description, Manufacturer, SKU	Unit	Quantity	Unit Price
	STRUCTURE			SF	928.55	
1	Concrete Slab	4"concrete cast in situ		CF	300.04	
2	Insulation	Rigid insulation		SF	287.04	
3	Hard core	Compacted soil		CF	230.12	
4	Re-bar	#4 re-bar		Ton	0.92	
5	Concrete Pad	4"concrete cast in situ		CF	2	
6	Slab edge	Turndown		CF	255.32	
7	Footing	Cast-in-place concrete		CF	9.36	
	PORCH FRONT					
8	Tile Finish			SF	102.12	
9	Adhesive	1/2" Thin set Mortar		SF	102.12	
10	Vapor Retarder	Vapor Barrier Polyethylene		SF	102.12	
	PORCH BACK					
11	Tile Finish			SF	102.6	
12	Adhesive	1/2" Thin set Mortar		SF	102.6	
13	Vapor Retarder	Vapor Barrier Polyethylene		SF	102.6	



			WALLS: EXTERIOR				
#	Item	Туре	Description, Manufacturer, SKU	Unit	Quantity	Unit Price	Total
1	Stucco Finish			SF	236		
2	Exterior-Grade Plywood Horizontal Siding			SF	691		
3	8/panel	Self-drilling screws(100/pkt)		PKT	6.91		
4	Wall Shteathing (OSB)			SF	927		
5	Shteathing Fastener	Self-drilling screws(100/pkt)		PKT	9.27		
6	Wall Homewrap			SF	927.00		
7	Homewrap Fastener	Stapled fastener (200/pkt)		PKT	3.52		
8	Furring Strip			PCS	86.375		
9	Furring Strip Fastener	Self-drilling screws(100/pkt)		PKT	6.91		
10	Wall Paint			SF	927		
11	Stone Copping	Masonry stone		SF	0		
12	Stone Veneer	Masonry stone		SF	0		
13	Mortar for Stone Veneer			SF	0		
14	Wall Insulation			SF	2956		
15							



			WALLS: INTERIOR 01				
#	Item	Туре	Description, Manufacturer, SKU	Unit	Quantity	Unit Price	Total
	BATHROOM			SF	50.0		
1	Cementitious Backer Board			SF	268		
2	Kerdi membrane			SF	268		
3	Kerdi membrane Fastener			SF	268		
4	Wall Ceramic Tile			SF	268		
	BEDROOM 1			SF	150.0		
5	Drywall Board			SF	363		
6	Drywall Fastener	Self-drilling screws(100/pkt)		PKT	3.63		
7	Wall Paint			SF	363		
8	Drywall Tape			FT	68.1		
	BEDROOM 2			SF	144.0		
9	Drywall Board			SF	318		
10	Drywall Fastener	Self-drilling screws(100/pkt)		PKT	3.18		
11	Wall Paint			SF	318		
12	Drywall Tape			FT	59.6		



			WALLS: INTERIOR 02				
#	Item	Туре	Description, Manufacturer, SKU	Unit	Quantity	Unit Price	Total
	LIVING ROOM			SF	147.0		
13	Drywall Board			SF	296		
14	Drywall Fastener	Self-drilling screws(100/pkt)		PKT	2.96		
15	Wall Paint			SF	296		
16	Drywall Tape			FT	55.5		
	KITCHEN			SF	80.0		
17	Cementitious Backer Board			SF	24		
18	Drywall Board			SF	150		
19	Drywall Fastener	Self-drilling screws(100/pkt)		PKT	1.5		
20	Kerdi membrane			SF	24		
21	Kerdi membrane Fastener			SF	24		
22	Wall Ceramic Tile			SF	24		
23	Wall Paint			SF	150		
24	Drywall Tape			FT	28.3		



			WALLS: INTERIOR 03				
#	Item	Туре	Description, Manufacturer, SKU	Unit	Quantity	Unit Price	Total
	CL 1			SF	16.0		
25	Drywall Board			SF	116		
26	Drywall Fastener	Self-drilling screws(100/pkt)		PKT	1.16		
27	Wall Paint			SF	116		
28	Drywall Tape			FT	21.8		
	CL 2			SF	23.0		
29	Drywall Board			SF	157		
30	Drywall Fastener	Self-drilling screws(100/pkt)		PKT	1.57		
31	Wall Paint			SF	157		
32	Drywall Tape			FT	29.4		



			WALLS: INTERIOR 04				
#	Item	Туре	Description, Manufacturer, SKU	Unit	Quantity	Unit Price	Total
	WD			SF	9.0		
33	Cementitious Backer Board			SF	76		
34	Kerdi membrane			SF	76		
35	Kerdi membrane Fastener			SF	76		
36	Wall Ceramic Tile			SF	76		
	WH			SF	8.0		
37	Drywall Board			SF	84		
38	Drywall Fastener	Self-drilling screws(100/pkt)		PKT	0.84		
39	Wall Paint			SF	84		
40	Drywall Tape			FT	16		
	HALL			SF	22.0		
41	Drywall Board			SF	75		
42	Drywall Fastener	Self-drilling screws(100/pkt)		PKT	0.75		
43	Wall Paint			SF	75		
44	Drywall Tape			FT	14		
1	Wall Skirting	Ceramic		FT	127	'	



		DOORS							
#	Item	Туре	Description, Manufacturer, SKU	Unit	Quantity	Unit Price	Total		
1	Interior Swinging	2' - 6" X 6'-8"		PCS	1				
	Interior Swinging	3' - 0" X 6'-8"		PCS	1				
	Interior Sliding	9' - 0" X 6'- 8"		PCS	1				
	Interior Swinging	3' - 0" X 6'- 8"		PCS	1				
,	Interior Sliding	7' - 0" X 6'- 8"		PCS	1				
j	Exterior Swinging	5' - 0" X 6'- 8"		PCS	1				
'	Exterior Swinging	6' - 0" X 6'- 8"		PCS	2	2			
3	Interior Swinging	3' - 0" X 6'-8"		PCS	1				
	Exterior Door Trim			FT	57	7			
0	Interior Door Trim			FT	272	2			
1	Entry Lock set			PCS	3				
2	Privacy Lock set			PCS	3				
.3	Passage Lock set			PCS	3				
.4				. 33					
.5									



			WINDOWS				
#	Item	Туре	Description, Manufacturer, SKU	Unit	Quantity	Unit Price	Total
1	Single Hung	3' - 3" X 3'-3"		PCS	1		
2	Sliding	3' - 3" X 2'-3"		PCS	1		
3	Casment	2' - 3" X 4'-3"		PCS	3		
4	Fixed	1' - 11" X 6'-8"		PCS	4		
5	Exterior Window Trim			FT	133		
6	Interior Window Trim			FT	133		
7							
8							
9							
10							
11							
12							
13							
14							
15							



		ROOF 01							
#	Item	Туре	Description, Manufacturer, SKU	Unit	Quantity	Unit Price	Total		
1	Roof Covering			SF	1200.0				
2	Roof Covering Fastener			PCS	600				
3	Roof Felt Paper			SF	1200.0				
4	Roof Felt Paper Fastener			PCS	3600.0				
5	Roof Sheathing			SF	1200.0				
6	Roof Sheathing Fastener			PCS	9600				
7	Batten			FT	0.0				
8	Batten Fastener			PCS	0.0				
9	Soffit			SF	152.0				
10	Soffit Fastener			PCS	76.0				
11	Fascia			FT	156.0				
12	Fascia board fastener			PCS	78				
13	Roof Insulation			SF	1200.0				
14									
15									