

# ORCHARD

The Orchard is a charming Craftsman-style onebedroom, one-bathroom home designed for comfortable and efficient living. The walls are finished with horizontal siding in a warm, earthy tone, creating a clean and traditional aesthetic. The gable end features wood shingles, adding a touch of natural texture and visual interest. A prominent covered porch spans the front of the home, supported by substantial stone-clad pillars and a decorative pergola, creating a welcoming outdoor space.

Inside, the Orchard features a simple rectangular layout. The living, dining, and kitchen spaces are seamlessly merged into a single room at one end of the plan while the bedroom is thoughtfully located on the other end of the plan, offering a private and quiet retreat. Functional spaces, such as the bathroom and laundry, are strategically placed between the living and sleeping areas, creating a clear separation and enhancing overall functionality.

## Materials Shopping List

Please print and take this Materials Shopping List to your favorite Home Depot and ask for assistance in selecting the materials, fixtures and fittings to complete your new home.

Record your selection and the price of the item. Then do the math to determine the cost for your selections and the total cost of finishing your home.

## < CLICK HERE >

To Go To Materials Shopping List






## **FLOOR PLAN**

495 SF

1 Bed Room

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# **ABOUT**

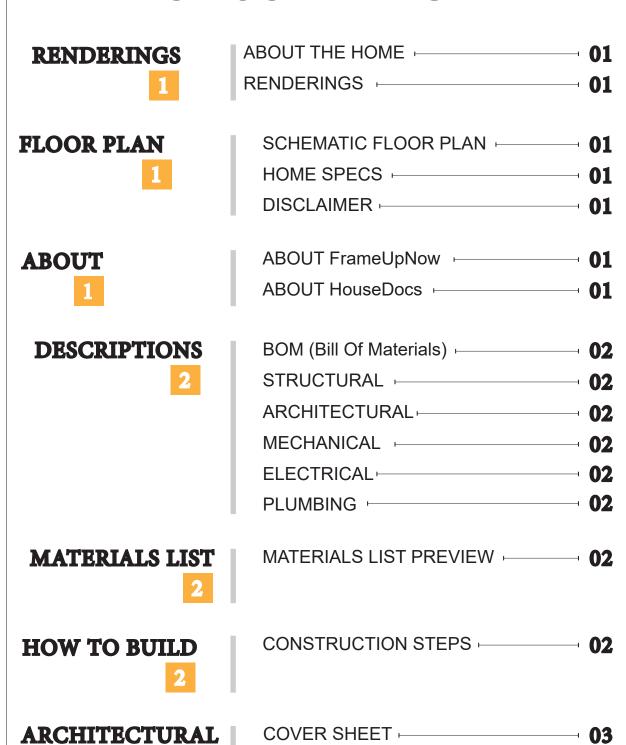

FrameUpNow is a design and manufacturing company providing precision-engineered home framing solutions. We offer a catalog of Affordable Homes, Tiny Homes, Garages, Shops and Barndominiums. FrameUpNow manufactures cold-formed steel (CFS) also known as Light Gauge Steel (LGS) framing components that conform to our engineered metal house frame plans or can be purchased as DIY skeleton kits.

The CFS/LGS framing is lightweight, easily assembled, and does not require heavy equipment or specialized labor, enabling homeowners to erect the frame themselves in just a few days. Unlike wood, the steel framing is impervious termites and bores, warping, expansion, and fire.

Our home plans come complete with a structural engineered stamp for permit approvals. Customers receive a full BOM also known as a Materials Shopping List to purchase finish materials from a Building Materials retailer. FrameUpNow prides itself on the quality and efficiency of our precision-engineered home framing solutions for construction professionals and DIY homeowners.



**KEY PLAN** 

NO.	DESCRIPTION	DATE

NOTE:

LEGEND:

PROJECT

181-Orchard-495-1Bd1Ba-Craftsman-550

DRAWING NAME

## INTRODUCTION

CLIENT NAME:
PROJECT NUMBER:
DATE:
DESIGNED BY:
DRAWN BY:
CHECKED BY:

**I101** 

SCALE:

# **DISCLAIMER**

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## **DESCRIPTIONS**

## MATERIALS LIST

The BOM (Bill Of Materials) package, known as the Materials Shopping List document, provides:

Comprehensive Inventory: Detailed lists of essential materials sourced from architectural, mechanical, HVAC, electrical, and plumbing design drawing sets.

Precise Curation: Each item meticulously selected and organized for accuracy and efficiency in project planning.

Customizable Options: Customers can modify listed items to their preferences and calculate costs accordingly, ensuring alignment with personal project needs and budget.

Dedicated Space for Details: Includes tables for customers to note Home Depot SKU numbers or product descriptions for selected items,

facilitating seamless purchasing and coordination with suppliers.

Customer Convenience: Take the list to Home Depot or preferred suppliers for accurate pricing, helping align the total home budget with personal financial plans.

Simplify your construction journey with our Materials Shopping List document, where detailed preparation meets streamlined implementation for your dream home.

## STRUCTURAL

The structural drawings package provides an exhaustive set of detailed plans essential for the precise assembly of your building. This comprehensive package includes:

Framing Plans: Detailed layouts for all framing components. Truss Layouts: Clear instructions for truss placement and

Panel Length Plans: Specifications for panel dimensions. Framing Elevations and Sections: Precise elevation and sectional views for accurate construction.

Truss and Wall Blocking Plans: Plans for truss and wall blocking to ensure structural integrity.

Hold-Down Plan: Detailed hold-down requirements for stability. Snap Sheet: Reference sheet for quick identification of components

Structural Details and Bracing Plans: Complete details and bracing plans for all structural elements.

Accompanying these plans is a comprehensive Bill of Materials (BOM) that lists every necessary building component, from cold formed steel (CFS) frames to fasteners.

## ARCHITECTURAL

With the comprehensive architectural package, both builders and DIY homeowners can confidently execute the construction.

The architectural package includes:

Furnished Floor Plans: Complete with furniture layouts for a clear understanding of space utilization.

Detailed Dimension Plans: Ensures precise measurements, from the overall footprint down to the exact placement of windows and

Foundation Plan: Detailed plan to establish a solid foundation.

Wall Framing and Truss Layout: Comprehensive plans for wall framing and truss placement.

Architectural Elevations: Exterior views showcasing the design.

Strategic Building Sections: Critical cross-sectional details for a thorough understanding of the build.

Casework Drawings and Diagrams: Suggested designs for built-in caseworks, such as kitchen cabinets.

## **MECHANICAL**

The mechanical package includes everything needed to guide HVAC

Detailed HVAC Floor Plan: Precisely maps out the placement of air handlers, ductwork, and vents throughout the home's layout.

HVAC Sections and Riser Diagrams: Technical drawings offering critical cross-sectional details and piping schematics, ensuring proper integration of the heating and cooling system into the home's structure.

Bill of Materials: A complete list of all necessary HVAC components.

## **ELECTRICAL**

The electrical package includes all the plans and documentation needed to guide the installation of your home's electrical system:

Detailed Power Plan: Precisely maps out the placement of outlets, switches, and other power components throughout the layout.

Comprehensive Lighting Plan: Shows the optimal locations for lighting fixtures, sconces, and other illumination sources to create a well-lit, functional interior.

Dimensioned Electrical Layout: Provides exact dimensions and measurements to ensure proper placement of all electrical elements.

Bill of Materials: A complete list of every component needed, from circuit breakers to wiring.

Detailed Water Supply System Plan: Precisely maps out the placement of pipes, valves, and plumbing fixtures throughout the

Comprehensive Sewage System Plan: Shows the optimal routing and sizing of drain lines to effectively remove waste and ensure

Detailed Riser Diagrams: Provide information needed to properly

## **PLUMBING**


The plumbing package includes everything needed to guide the installation of your home's water supply and drainage systems:

proper drainage.

install all vertical plumbing risers and vent stacks.

Bill of Materials: A complete list of every component needed, from pipes to fixtures.


# BOM (Bill Of Materials) (Separately Attached)

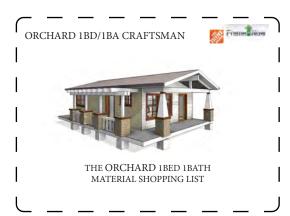



The Bill of Materials (BOM) is a crucial document that compiles the material requirements from different disciplines into a centralized inventory, enabling efficient procurement, inventory management, and cost estimation for a specified project or

### **ELECTRICAL BOM**



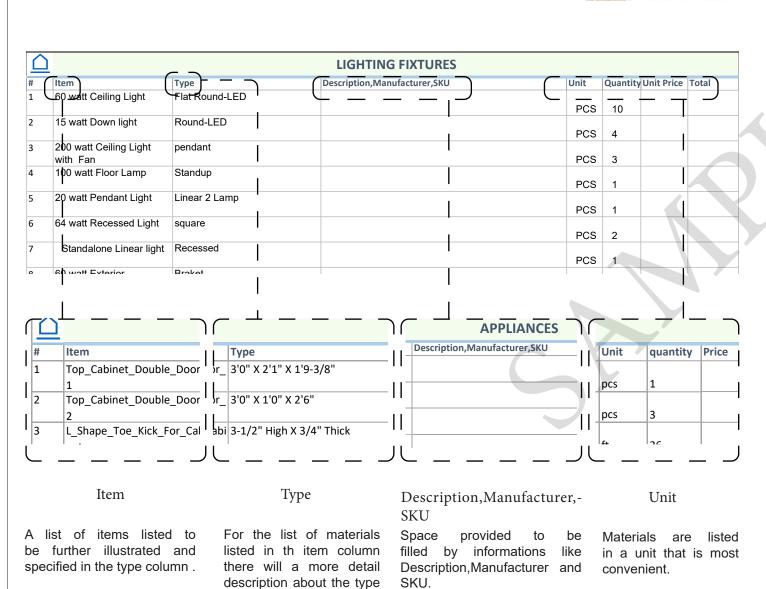

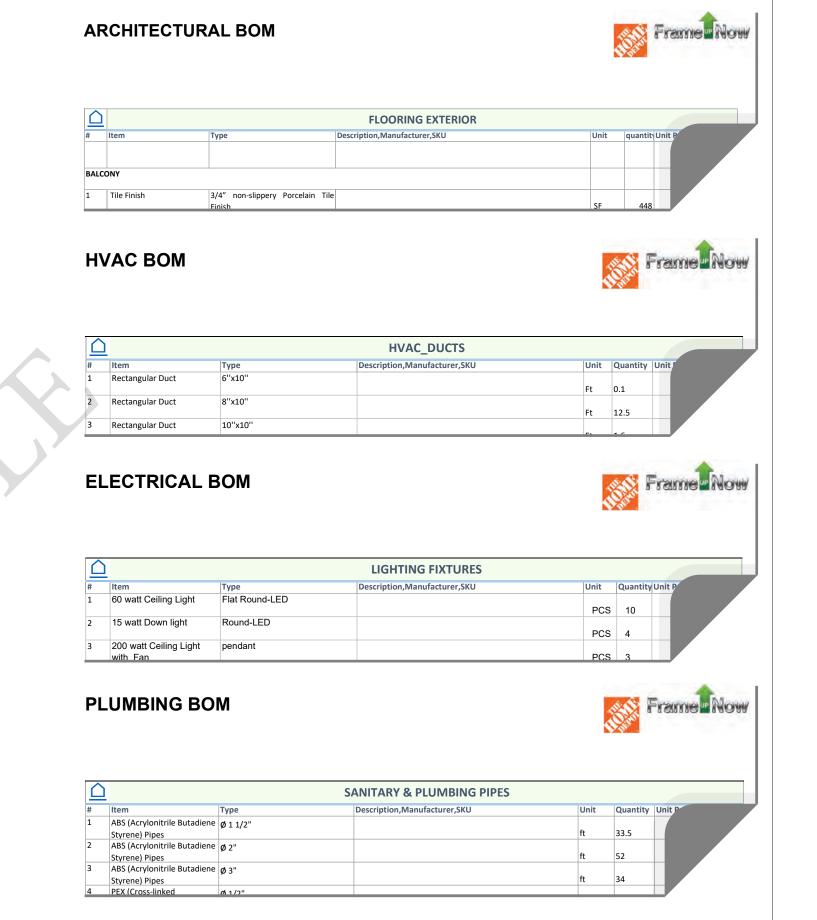

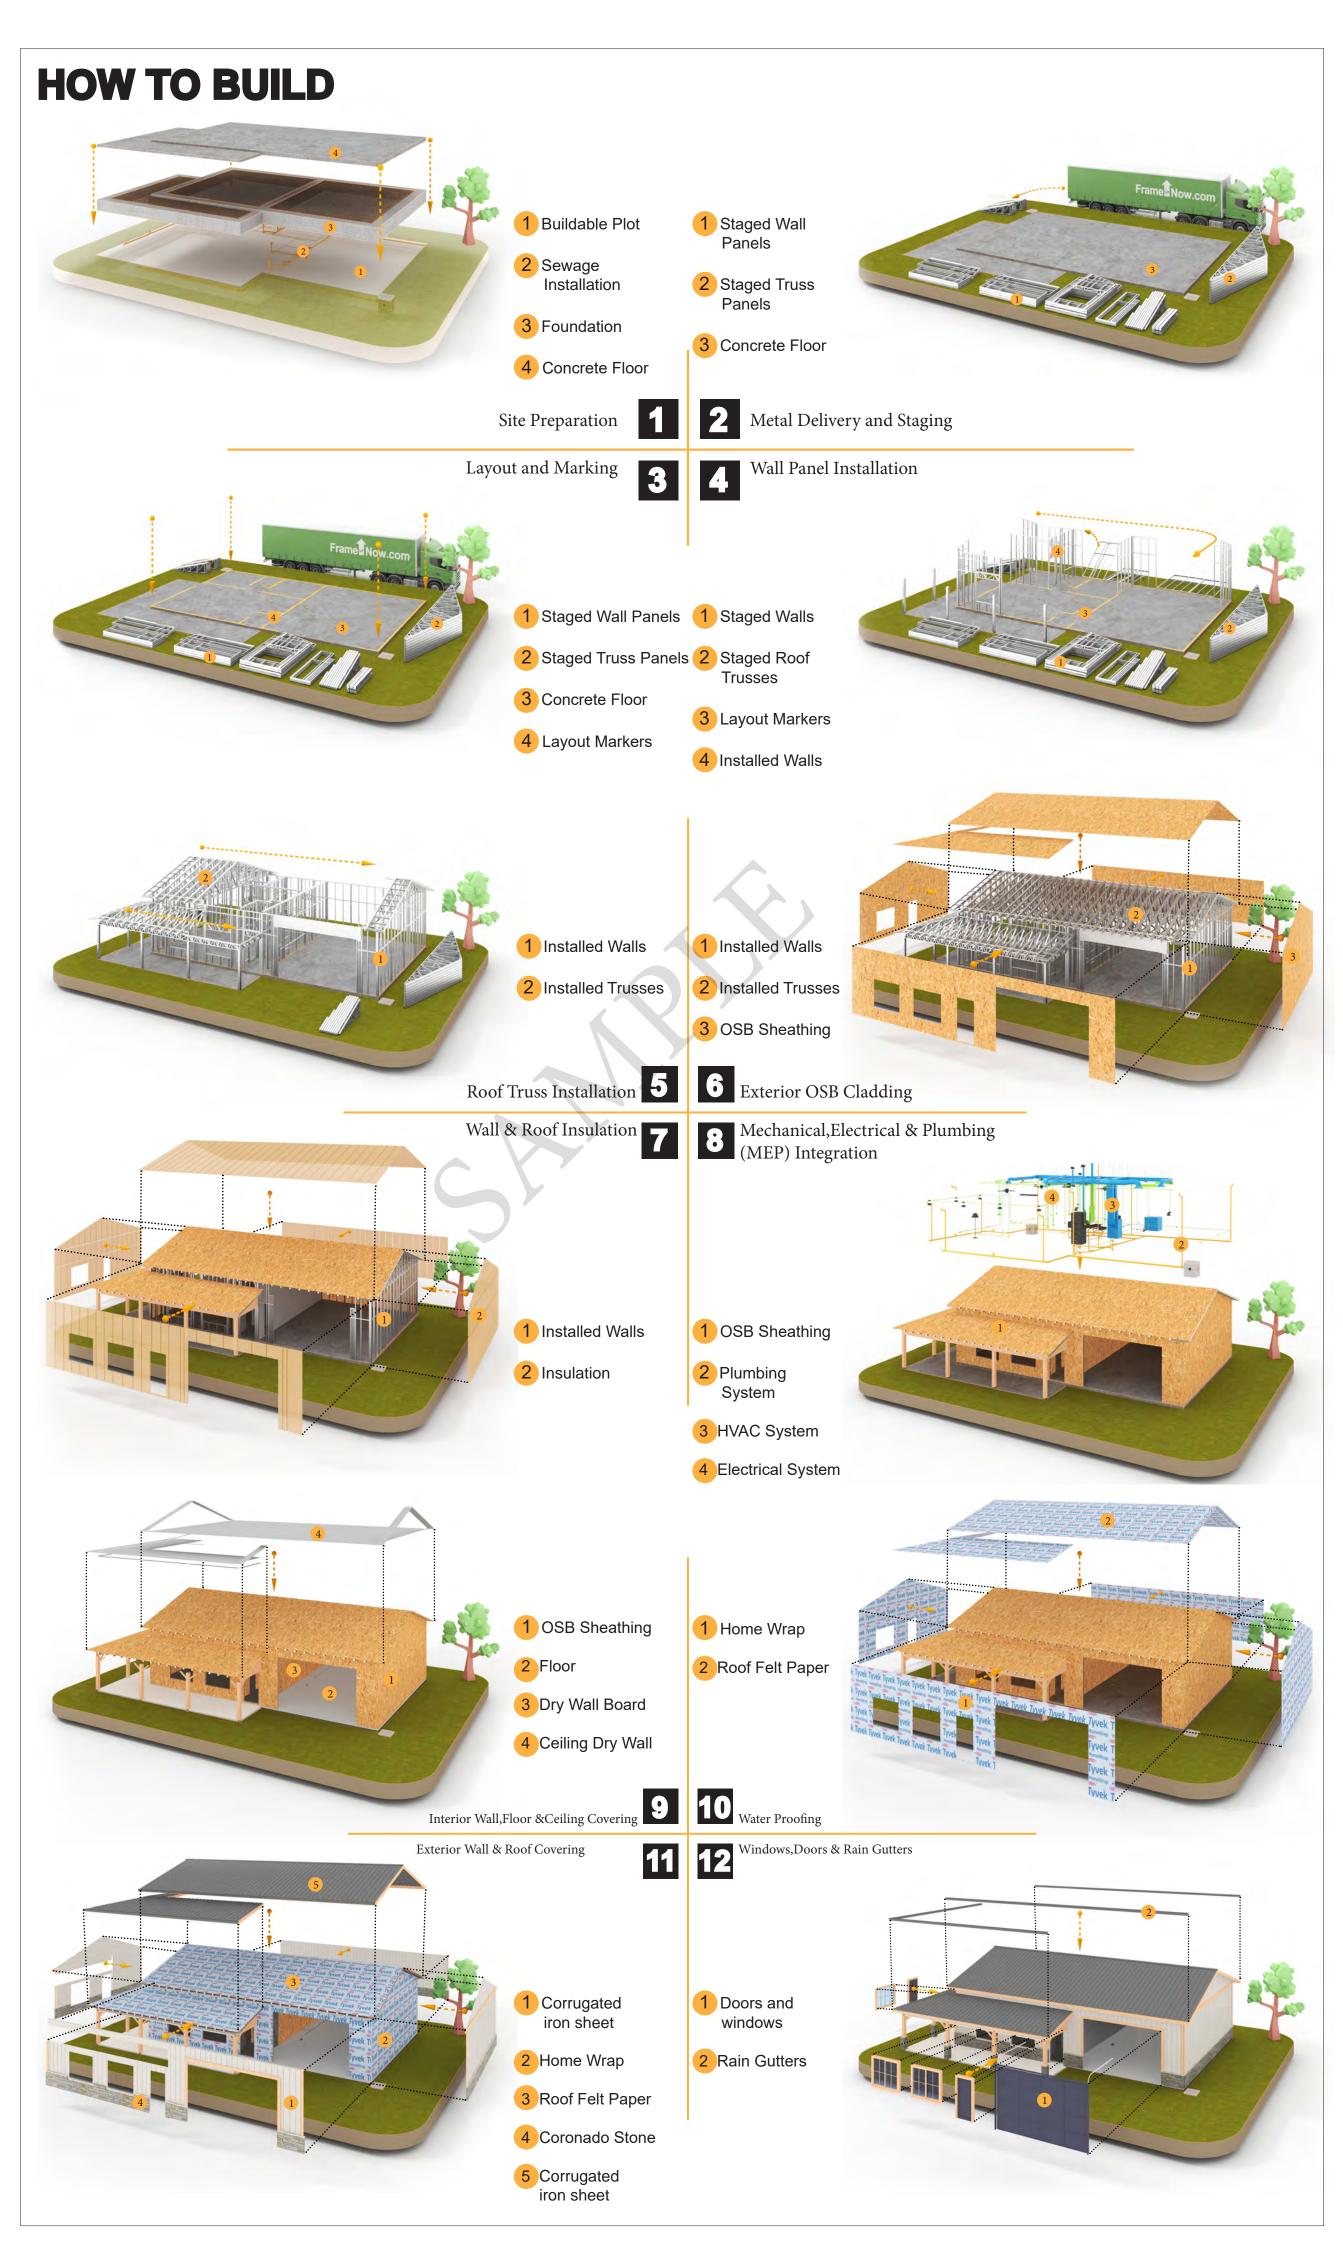



**KEY PLAN** 

NO.	DESCRIPTION	DATE

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181-Orchard-495-1Bd1Ba-Craftsman-550

DRAWING NAME


INTRODUCTION

CLIENT NAME: PROJECT NUMBER: DATE: **DESIGNED BY** DRAWN BY: CHECKED BY:

1102

SCALE:

of the Material.

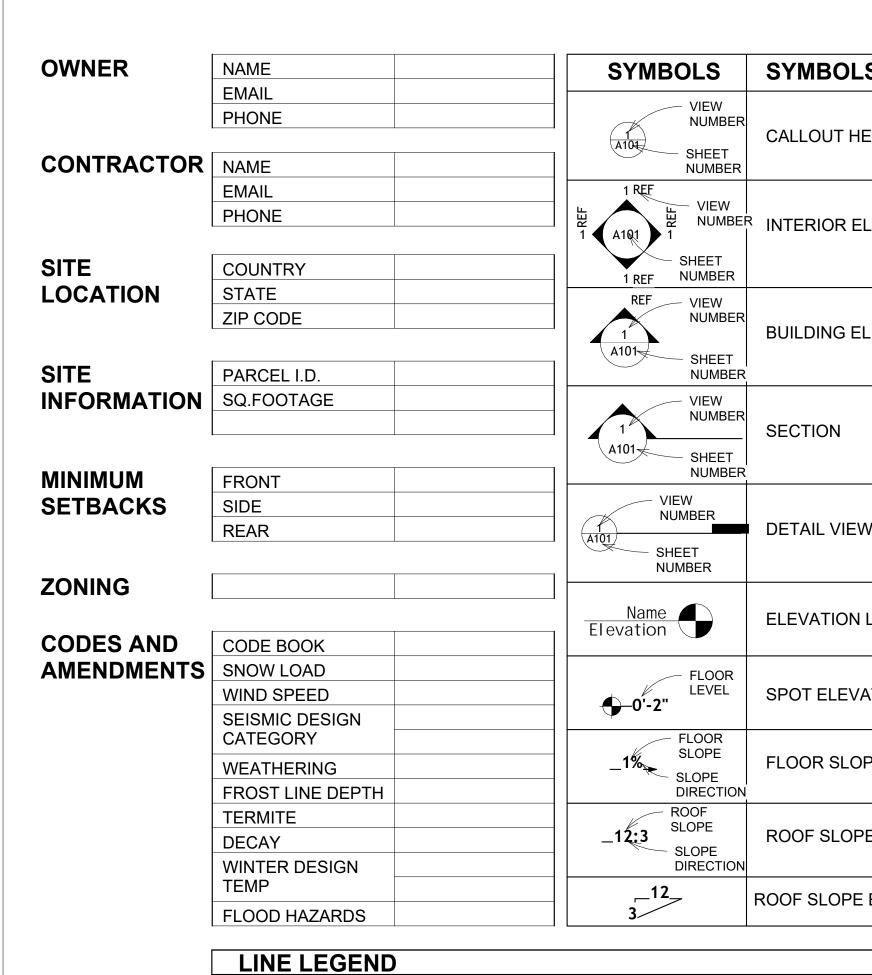

HIDDEN LINE

OVER HEAD

ROOM SEPARATOR

DOOR OPENING DIRECTION

SYMBOLS NAME		PAGE INDEX
	G101	COVER SHEET
	A101	FLOOR PLAN
CALLOUT HEAD	A102	DIMENSION PLAN
	S101	FOUNDATION PLAN
	S102	STRUCTURAL FLOOR PLAN
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INTERNOTE ELEVATION	S104	ROOF TRUSS LAYOUT
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FLOOR SLOPE		

TAG'S NAME

CASEWORK TAG

FURNITURE TAG

PE01 PLUMBING EQUIPMENT TAG

SPECIALTY EQUIPMENT TAG

MECHANICAL EQUIPMENT TAG

WINDOW TAG

DOOR TAG

	I
NO.	NUMBER
O.C	ON CENTER
OSB	ORIENTED STRAND BOARD
PL	PLUMBING
PSI	POUNDS PER SQUARE INCH
PVC	POLYVINYL CHLORIDE
REF	REFERENCE
RG	RIGHT GARAGE
SE	SPECIAL EQUIPMENT
SF	SQUARE FEET
SIMP. STHD8	SIMPSON STRAP THE HOLDDOWN
SIMP. ABE66	SIMPSON ANCHOR BOLT EDGE
TV	TELEVISION
UNO	UNLESS NOTED OTHERWISE
W/	WITH
W/D	WASHER/DRYER
AC	AIR CONDITIONING UNIT
ACC	AIR COOLED CONDENSER
ACCU	AIR COOLED CONDSENSING UNIT
AHU	AIR HANDLING UNIT
CC	COOLING COIL
CD	CEILING DIFFUSER
CFm	Cubic Feet Per Minute
CR	CEILING REGISTER
CU	CONDENSING UNIT
CW	COLD WATER
E/A	EXHAUST AIR
EF	EXHAUST FAN
ET	EXPANSION TANK
EX.	EXISTING
FC	FLEXIBLE CONNECTION
FCU	FAN COIL UNIT
FLR.	FLOOR
HC	HEATING COIL
HE	AIR TO AIR HEAT EXCHANGER
HV	HEATING AND VENTILATING UNIT
IV	INLET VANES
MER	MECHANICAL ROOM
MAX.	MAXIMUM
MIN.	MINIMUM
R/A	RETURN AIR
RCU	RECIPROCATING CHILLER UNIT
RF	RETURN FAN
S/A	SUPPLY AIR
SCD	SMOKE CONTROL DAMPER
SP	STATIC PRESSURE

**ABBREVIATION** 

CASEWORK

**ELECTRICAL** 

FOOTINGS

MAXIMUM

MINIMUM

**MECHANICAL** 


F.F.L

ACTION FLOOR SYSTEMS

AMERICAN SOCIETY FOR

**TESTING AND MATERIAL** 

FINISHED FLOOR LEVEL

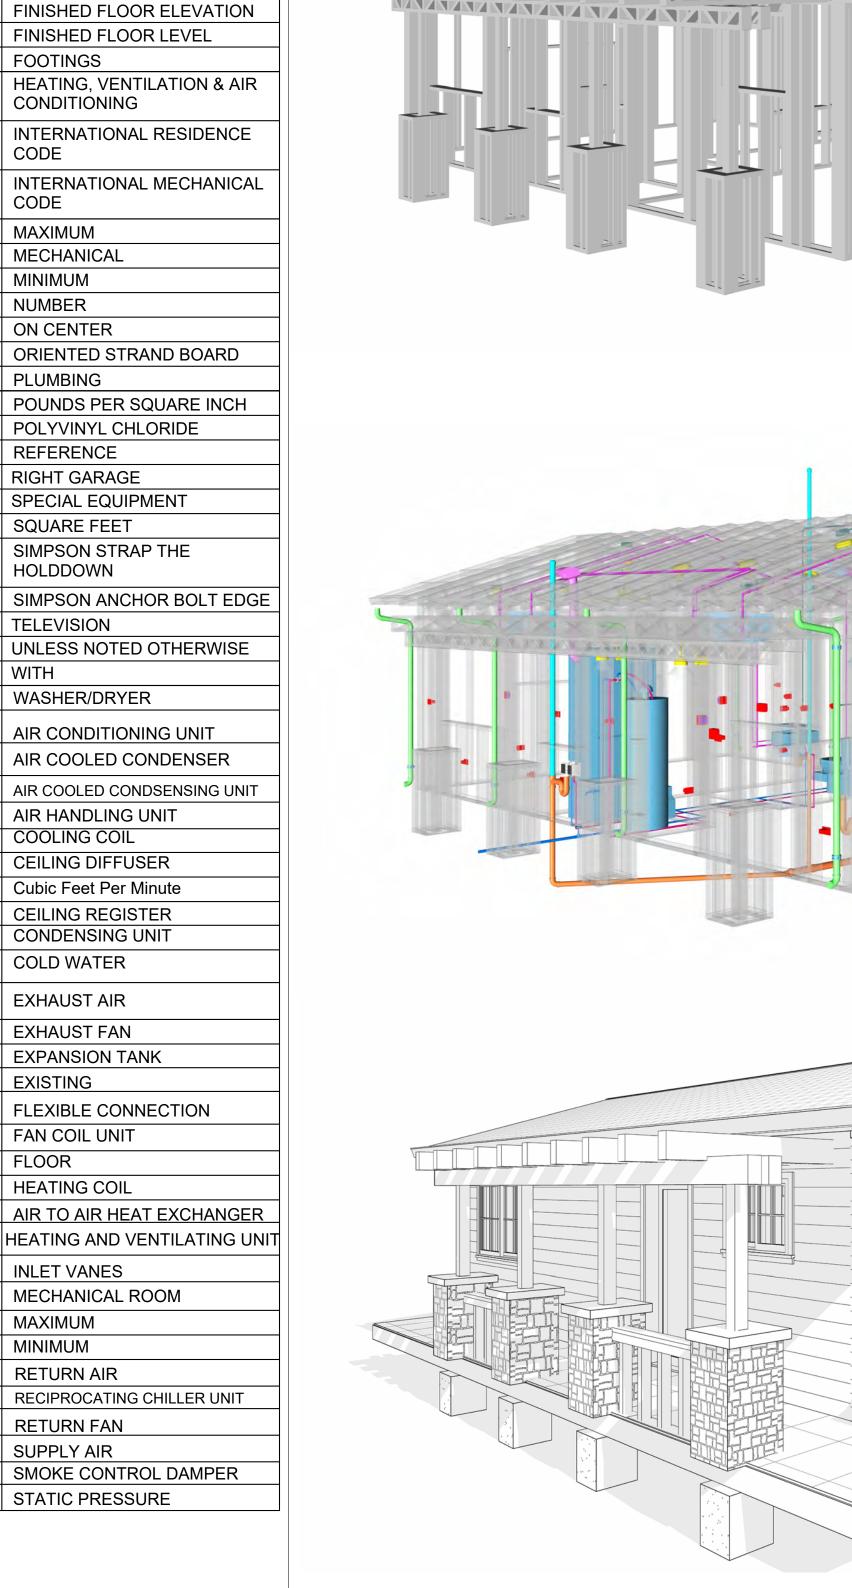



181-ORCHARD-495-1Bd1Ba-**CRAFTSMAN-550** 

SQUARE FO	OTAGE
LIVING	495
PORCH	153
TOTAL	648



**KEY PLAN** 

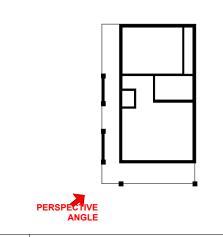

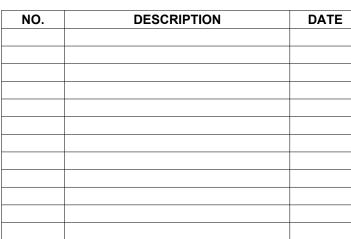

NOTE:

LEGEND:

PROJECT

181-ORCHARD-495-1Bd1Ba-**CRAFTSMAN-550** 

DRAWING NAME

**COVER SHEET** 

CLIENT NAME:	Client Name
PROJECT NUMBER:	0061_12
DATE:	5/6/2025 10:19:31 AM
DESIGNED BY:	Designer
DRAWN BY:	Author
CHECKED BY:	Checker

G101

SCALE: As indicated



**ROOF SLOPE** 

CALL OUT BOUNDRY — — — — —

ROOF SLOPE ELEVATION

### **GENERAL NOTES**

- THIS DRAWING DEPICTS THE ARCHITECTURAL (SPACE LAYOUT, FURNISHING, FLOOR, WALLS, ROOFS, FOUNDATION, WINDOWS AND DOORS) SYSTEMS. IT PROVIDES A VISUAL REPRESENTATION OF THE ARCHITECTURAL LAYOUT AND COMPONENTS.
- THE ARCHITECTURAL DRAWINGS ARE PREPARED TO MEET THE SPECIFIC REQUIREMENTS OF THE BUILDING, AS PER THE PROJECT SPECIFICATIONS AND APPLICABLE CODES AND STANDARDS.
- THE CONSTRUCTION OF THIS HOME SHALL COMPLY WITH THE LATEST EDITION OF THE INTERNATIONAL RESIDENTIAL CODE (IRC), INTERNATIONAL MECHANICAL CODE (IMC), THE INTERNATIONAL PLUMBING STANDARD, THE NATIONAL ELECTRICAL STANDARD AND ALL OTHER APPLICABLE LOCAL, STATE, AND NATIONAL CODES AND REGULATIONS.
- COORDINATION WITH OTHER TRADES HAS BEEN DONE ON A DESIGN LEVEL. THIS DRAWING SHALL BE READ TOGETHER WITH THE ME, EL AND PL DESIGN DRAWINGS TO ENSURE PROPER CONSTRUCTION AND INTEGRATION OF THE BUILDING SYSTEMS.

#### ABOUT WALLS:


- SHOWER WALL COVERING
- BATHTUB AND SHOWER SPACES (WALLS AND FLOORS) WITH INSTALLED SHOWER HEADS AND IN SHOWER COMPARTMENTS SHALL BE FINISHED WITH A NON-ABSORBENT SURFACE.
- 2. WALL PAINT (INTERNAL) THE TYPICAL THICKNESS OF LATEX WALL PAINT IS 1/32 OF AN INCH FOR A SINGLE COAT. AND
- DOUBLE COAT (1/16") SHALL BE APPLIED FOR DURABILITY.
- 3. ADHESIVES:

THE ADVISABLE TYPE OF ADHESIVE FOR THIS PROJECT IS **EPOXY ADHESIVES**BECAUSE THEY ARE KNOWN FOR THEIR HIGH STRENGTH, DURABILITY, AND RESISTANCE TO MOISTURE, CHEMICALS AND

REFER TO SHEETS A201 & A202 FOR GENERAL NOTES ON EXTERNAL FINISHING MATERIALS

#### ABOUT FLOORS:


- THE SPOT ELEVATION INDICATES THE FINISHED FLOOR ELEVATION.
- FINISHED FLOORS PER PLANS.
- FIELD VERIFY FOR DIMENSION DROP 4" FOR SHOWER AND BATHTUB USE.
- 1% SLOPE ON OUTDOOR BALCONIES FOR WATER RUN OFF.
- 2% SLOPE TOWARDS THE SHOWER DRAIN FOR SUFFICIENT DRAINAGE.
- 4" DROP AT THE DOOR LEADING TO EXTERIOR BALCONY FROM THE MAIN LIVING AREA.
- 5% SLOPE FOR GARAGE IS USED, WHICH SHOULD BE CHECKED WITH THE LOCAL GARAGING
- ZONING LAWS.

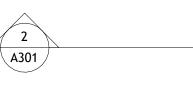





FURNITURE SCHEDULE				
TYPE MARK	TYF	E	COUNT	
01	KING SIZE BED	1		
02	TWO SEAT SOFA	1		

	ROOM FINISH SCHEDULE						
ROOM NUMBE R	ROOM NAME	FLOOR FINISH	BASE FINISH	WALL FINISH	CEILING FINISH	CEILING HEIGHT	COM MEN TS
01	LIVING ROOM	HARDWOOD	CONCRETE	WALL PAINT	DRY WALL	8' - 0"	
02	KITCHEN	HARDWOOD	CONCRETE	WALL PAINT + CERAMIC	DRY WALL	8' - 0"	
03	BEDROOM	HARDWOOD	CONCRETE	WALL PAINT	DRY WALL	8' - 0"	
04	BATH	VINYL TILES	CONCRETE	CERAMIC TILE	MRD	8' - 0"	
05	CL	HARDWOOD	CONCRETE	WALL PAINT	DRY WALL	8' - 0"	
06	WD	HARDWOOD	CONCRETE	WALL PAINT	DRY WALL	8' - 0"	
07	WH	HARDWOOD	CONCRETE	WALL PAINT	DRY WALL	8' - 0"	
08	HALL	HARDWOOD	CONCRETE	WALL PAINT	DRY WALL	8' - 0"	
09	PORCH	PROCELAIN TILE	CONCRETE	EXTERIOR-GRADE PLYWOOD	PLYWOOD	8' - 0"	

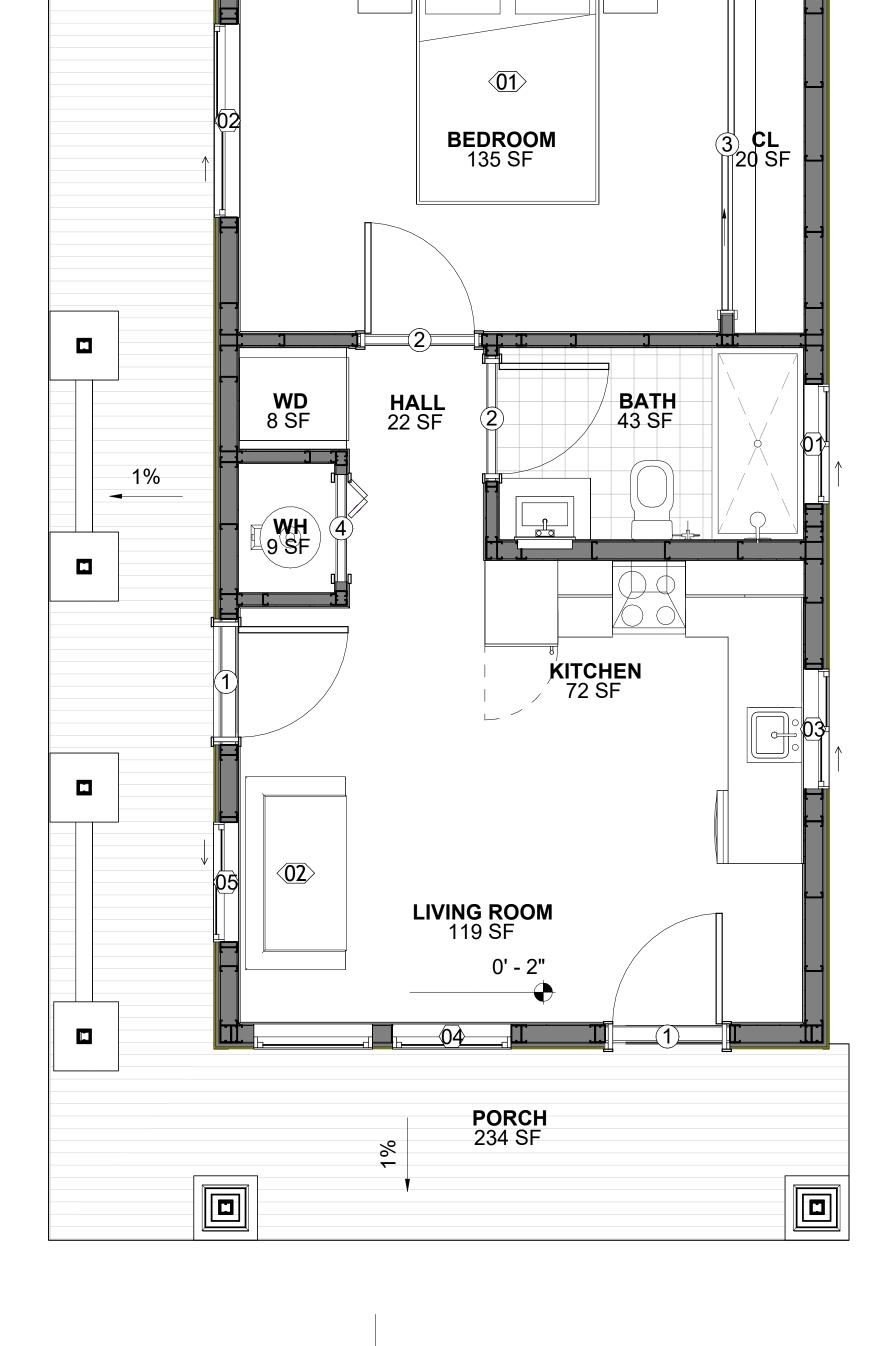

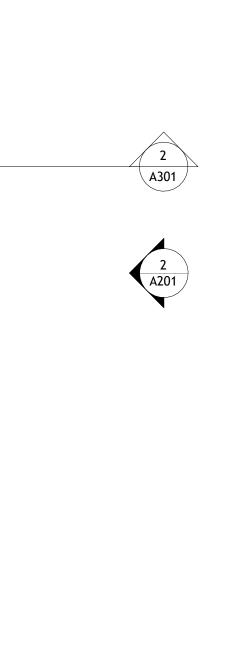

**FLOOR PLAN** 3/8" = 1'-0"

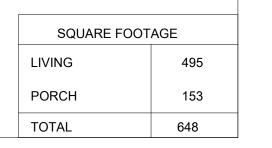



**KEY PLAN** 

NO.	DESCRIPTION	DATE

NOTE:

LEGEND:

PROJECT


181-ORCHARD-495-1Bd1Ba-**CRAFTSMAN-550** 

DRAWING NAME

**FLOOR PLAN** 

CLIENT NAME:	Client Name
PROJECT NUMBER:	0061_12
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DESIGNED BY:	Designer
DRAWN BY:	Author
CHECKED BY:	Checker
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**KEY PLAN** 

	NO.	DESCRIPTION	DATE
-			

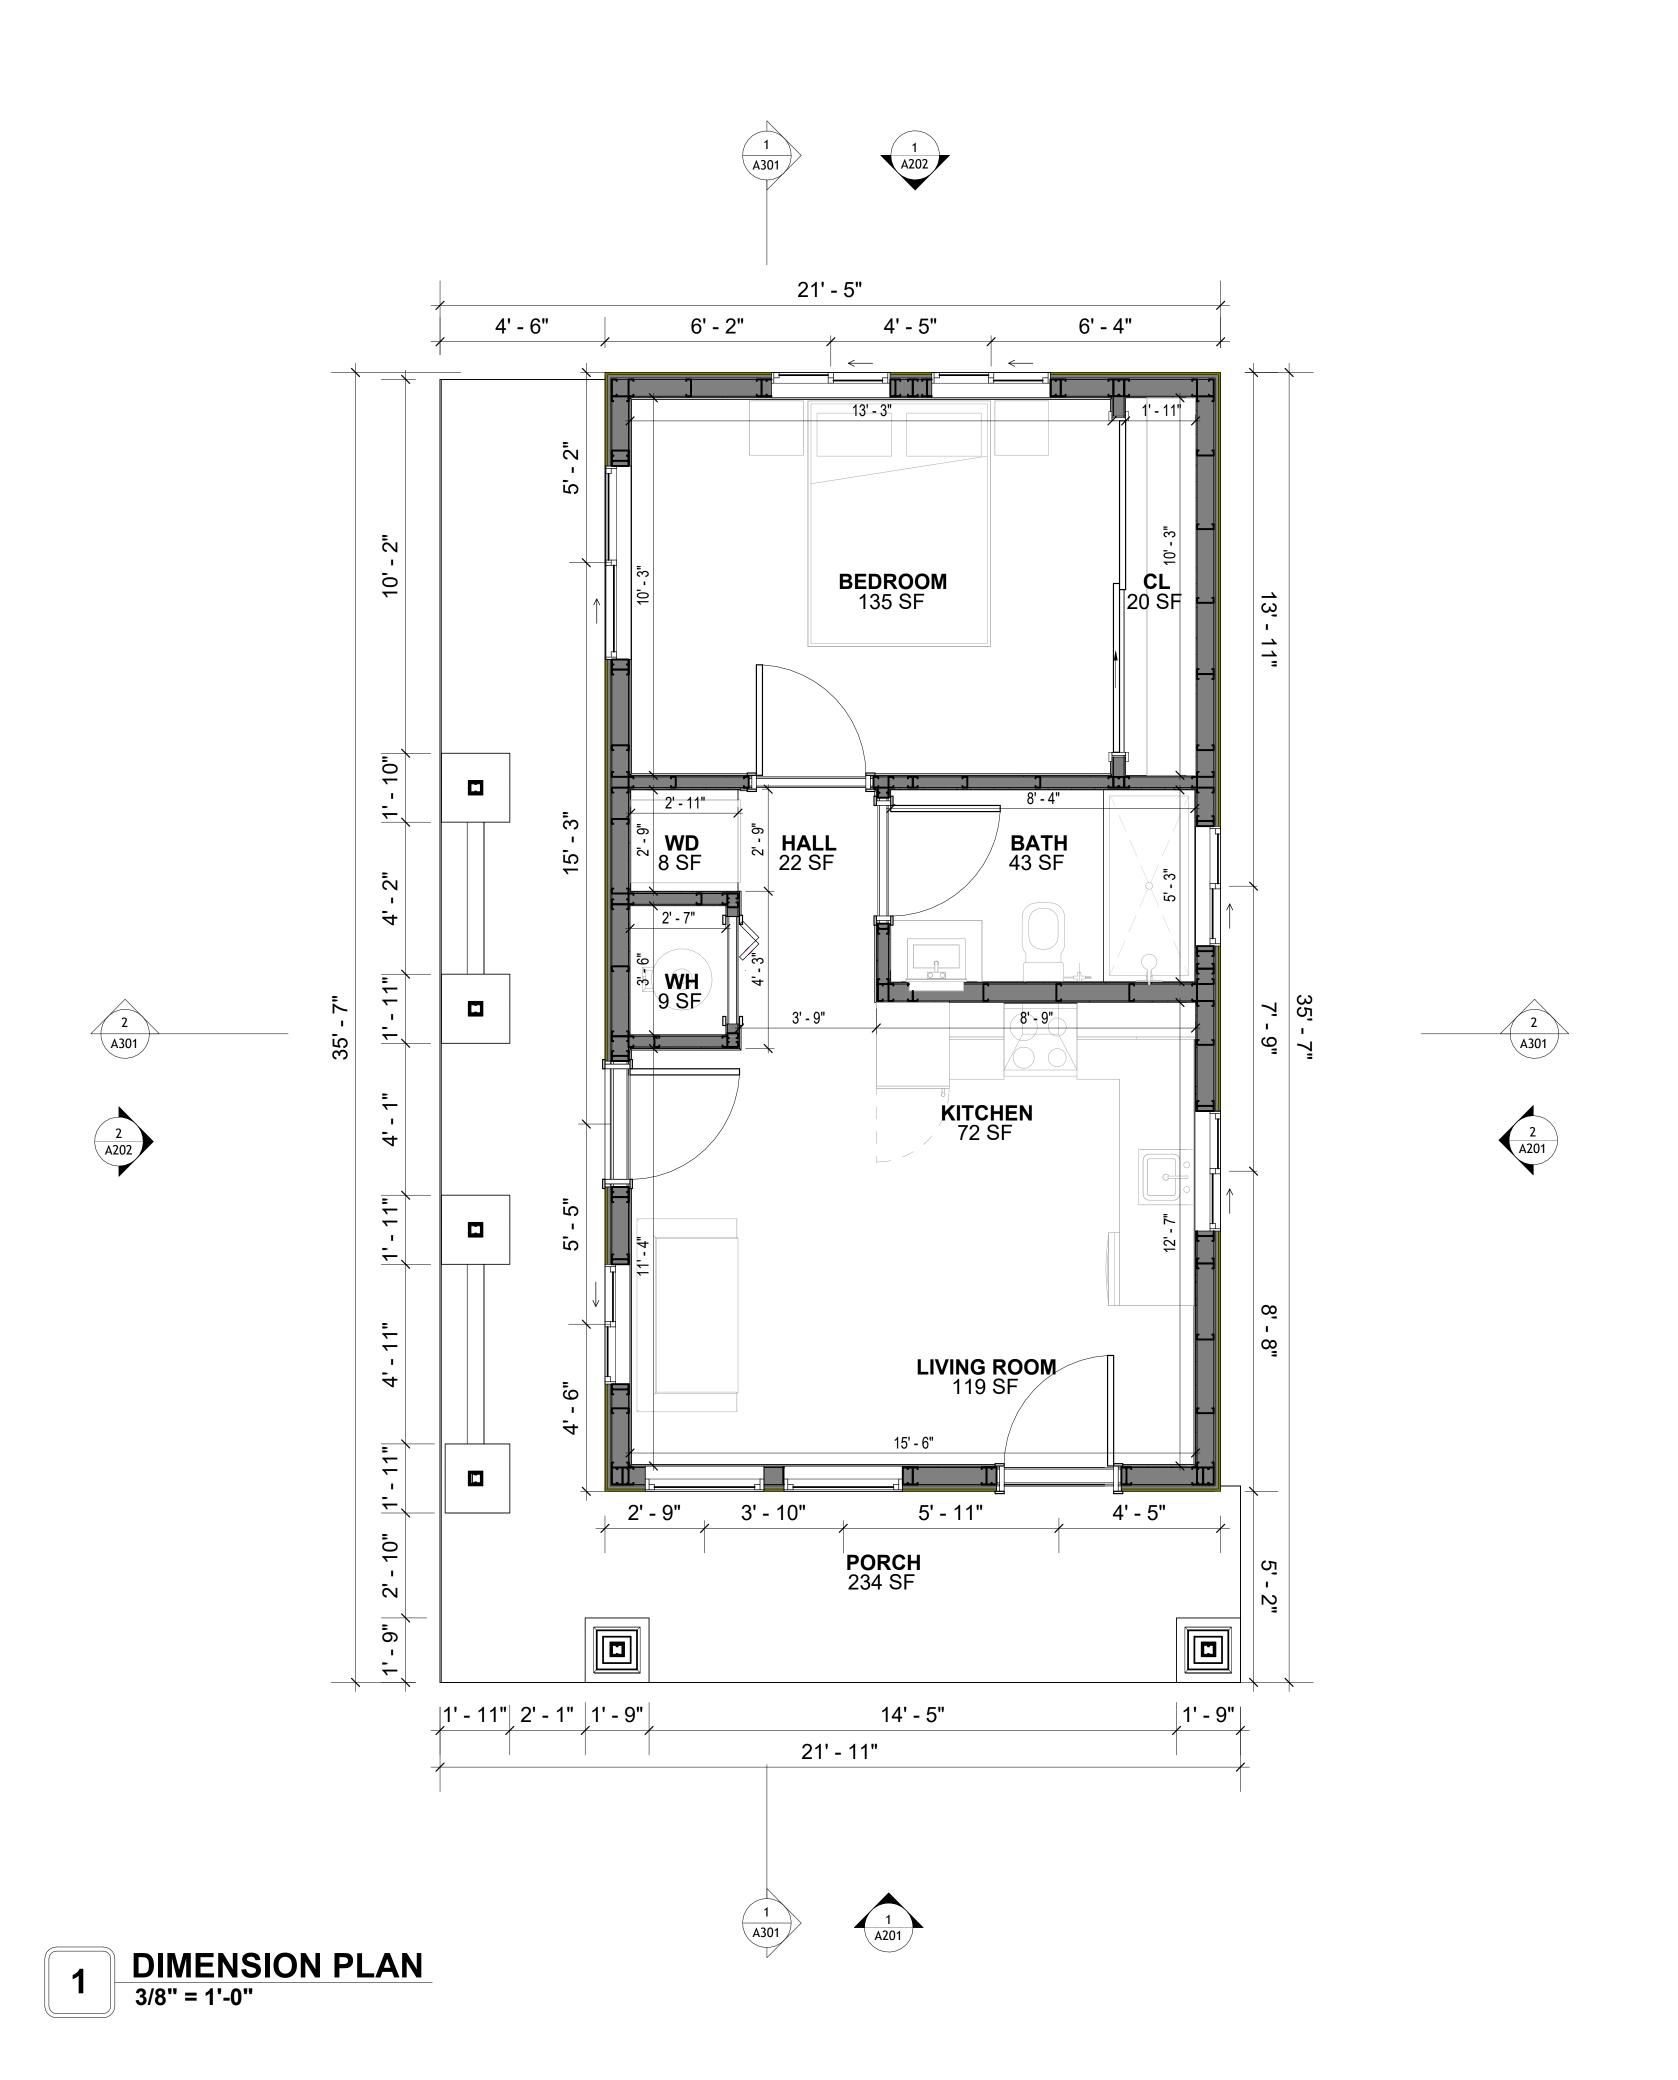NOTE:

LEGEND:

PROJECT

181-ORCHARD-495-1Bd1Ba-CRAFTSMAN-550

DRAWING NAME

DIMENSION PLAN

CLIENT NAME:	Client Name
PROJECT NUMBER:	0061_12
DATE:	5/6/2025 10:19:33 AM
DESIGNED BY:	Designer
DRAWN BY:	Author
CHECKED BY:	Checker

SQUARE FOOTAGE

PORCH

TOTAL

495

153

648

SCALE: 3/8" = 1'-0"

A102

DIMENSIONS IN THE ARCHITECTURAL DRAWINGS CONSIDER FINISHING MATERIALS. FOR PRECISE MEASUREMENTS OF THE STRUCTUAL FRAMING, REFER TO THE ATTACHED STRUCTURAL PLAN SET.

#### **FOUNDATION NOTES**

#### **NOTES:**

TERMITES PRETREATMENT BY LICENSED CONTRACTOR UNDER SLAB AND AROUND FOOTINGS. ALL AREAS BELOW SLABS SHALL BE TREATED NO MORE THAN 24 HOURS PRIOR TO CONCRETE POUR. EVIDENCE OF TREATMENT MUST BE PROVIDED PRIOR TO PLACING OF CONCRETE.

#### 1. MATERIALS:

ALL INTERIOR CONCRETE SLABS SHALL BE A MIN. OF 4" THICK CONCRETE OVER 4" COMPACTED AGGREGATE BASE (ASTM D698), FINISH ELEVATIONS AS NOTED ON DRAWINGS, 6" ABOVE ADJACENT GRADE, LEVEL SLABS TO 1/8"-10' MAX.. CONCRETE SLABS SHALL BE 2500# PSI AT 28 DAYS, A 4" ALLOWABLE SLUMP.

#### 2. PAD PREPARATION:

EXCAVATION FOR FOOTING SHALL BE NEAT.

FOOTINGS SHALL BE POURED IMMEDIATELY AFTER EXCAVATION AND APPROPRIATE

INSPECTION.
- ALL REINFORCING STEEL MARKED "CONTINUOUS" SHALL BE LAPPED 36 BAR DIAMETERS AT SPLICES AND AROUND CORNERS OR INTERSECTIONS WITH A STANDARD 90 DEGREE BEND ON CORNER BARS. LAP WIRE MESH ONE FULL MESH AT SIDE AND END LAPS.

- ALL HARDWARE TO BE SIMPSON OR EQUIVALENT.

- EXTERIOR FRAME WALL TO BE SECURED WITH 1/2"X10" ANCHOR BOLTS 4'-0" O.C. FOR 1-STORY AND 2'-8" O.C. FOR 2-STORY. BOLTS SHALL BE LOCATED WITHIN 1'-0" OF EACH END PIECE AND SHALL HAVE A MIN. OF TWO BOLTS PER PIECE.

-FOUNDATION ANCHOR STRAPS SHALL BE PERMITTED, ACCORDING TO RESIDENTIAL CODE 2021

- ALL INTERIOR WALLS TO BE SECURED WITH POWER DRIVEN PINS PER MANUFACTURER SPECIFICATION USE PIN SPACING EQUIVALENT TO 1/2" ANCHOR BOLTS.

- ALL CONSTRUCTION TO CONFORM TO THE 2012 IRC

R-10 RIGID INSULATION OUTSIDE OF EXTERIOR FOUNDATION WALLS UNDER LIVING AREA.
 CONCRETE PAD FOR CONDENSER THICKNESS IS 4" MIN UNLESS OTHERWISE NOTED.

#### 3. CONCRETE CONSTRUCTION:

- THE SLAB SHALL BE UNDERLAIN BY A VAPOR BARRIER/RETARDER IN THE LIVING AREA (TYPICALLY POLYETHYLENE, UNLESS MORE STRINGENT PROTECTION REQUIRED BY THE ARCHITECT, ENGINEER, FLOOR COVERING MANUFACTURER, OR ACCEPTED PRACTICE). UNLESS OTHERWISE REQUIRED, BARRIER MAY BE OMITTED AT GARAGES, PORCHES AND PATIOS WITHOUT FLOOR COVERINGS. IT IS BEYOND THE SCOPE OF THESE PLANS TO DETERMINE THE APPLICABILITY OF THESE MORE STRINGENT REQUIREMENTS. BUILDER SHALL VERIFY PRIOR TO CONSTRUCTION.

#### 4. REINFORCEMENT:

- IF CONSTRUCTED ON ACTIVE SOILS, THE LONG TERM PERFORMANCE OF THE FOUNDATION IS DEPENDENT ON MAINTENANCE BY THE OWNER. THUS THE BUILDER SHALL ADVISE THE OWNER OF THE FOLLOWING:

1. DRAINAGE MUST BE MAINTAINED. WATER SHALL NEVER BE ALLOWED TO POND NEAR THE FOUNDATION.

2. THE SOIL AROUND THE FOUNDATION SHALL BE MAINTAINED IN A RELATIVELY DAMP CONDITION, SUCH AS THAT REQUIRED TO KEEP A LAWN GREEN. IF IT DRIES OUT IT WILL

SHRINK. IF IT GETS WET, IT WILL HEAVE UPWARD.

3. SLABS ON THE SHORTER SIDE USES MAIN BARS ARE USED IN THIS DIRECTION ONLY WITH SMALLER DIAMETER DISTRIBUTION BARS ARE PLACED, FORMING A MAT OR GRID.

4. ALL REINFORCEMENT BARS SIZE 10MM OR LARGER IN ACCORDANCE TO ASTM

3. ANCHOR BOLTS AT ALL EXTERIOR WALLS SHALL BE MINIMUM 1/2 INCH DIAMETER WITH A

MAXIMUM SPACING OF 6'-0" ON CENTER, UNLESS NOTED OTHERWISE.

4. ANCHOR BOLTS SHALL BE INSTALLED WITHIN 12 INCHES OF EACH END OF EACH SILL PLATE LONG.

PLATE WITH AT LEAST TWO ANCHOR BOLTS FOR EACH BOLTS FOR EACH SILL PLATE LONGER THAN 12 INCHES.

5. SIMPSONS SILL ANCHORS MAYBE SUBSTITUTED FOR ANCHOR BOLTS AT THE SAME

5. SIMPSONS SILL ANCHORS MAYBE SUBSTITUTED FOR ANCHOR BOLTS AT THE SAME SPACING.


6. EXTERIOR CONCRETE SLABS WHICH ARE NOT PART OF THE MAIN SLAB SHALL BE MINIMUM 4 INCHES THICK WITH NO STEEL REINFORCING BARS REQUIRED, UNLESS NOTED OTHERWISE ON FOUNDATION PLAN.

### **VERIFY THE FOLLOWING PRIOR TO POURING:**

- 1. ALL HOLDDOWNS , STRAP, AND POST LOCATIONS.
- ALL HOLDDOWNS, STRAP, AND FOST LOCATIONS.
   CONCRETE FINISHES. PANEL RISER LOCATION WHERE APPLICABLE.
- 3. UNDERSLAB MECHANICAL REQUIREMENTS.
- 4. STEM WALL BLOCKOUTS.
- 5. UNDERSLAB ELECTRICAL REQUIREMENTS AND PANEL RISER LOCATION. WHERE
- APPLICABLE.
- PROVIDE THE FOLLOWING:- PVC SLEEVES THROUGH FTG IF REQUIRED
- 20' #4 COPPER GROUND BAR.

7. SLOPE FINISH GRADE AWAY FROM FOOTING.

**NOTE**: FIELD VERIFY ALL DIMENSIONS SEE DIMENSIONED ARCHITECTURAL DRAWINGS

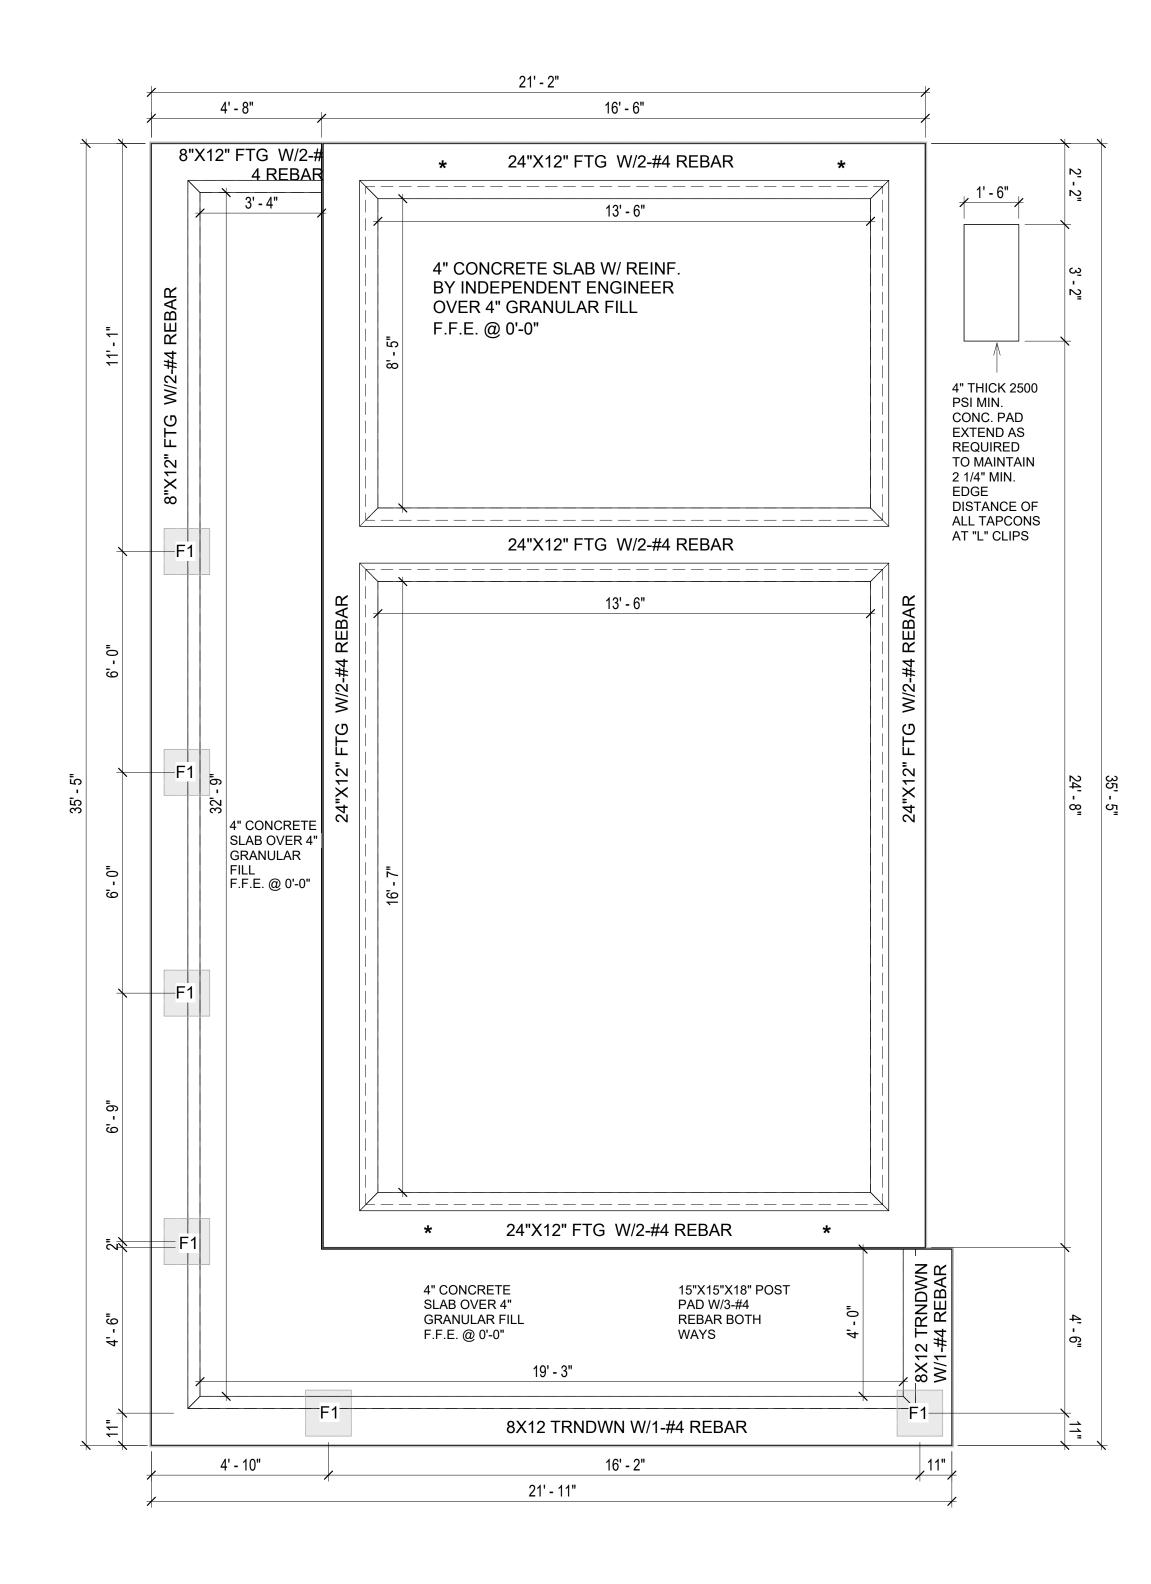

FOUNDATION PLAN
3/8" = 1'-0"

SQUARE FOOTAGE

LIVING 495

PORCH 153

TOTAL 648



**KEY PLAN** 

NO.	DESCRIPTION	DATE

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181-ORCHARD-495-1Bd1Ba-CRAFTSMAN-550

DRAWING NAME

**FOUNDATION PLAN** 

CLIENT NAME:

PROJECT NUMBER:

0061\_12

DATE:

5/6/2025 10:19:34 AM

DESIGNED BY:

DRAWN BY:

CHECKED BY:

Checker

**S101** 

SCALE: 3/8" = 1'-0"

#### **GENERAL NOTES**

#### **NOTES:**

-ALL BEARING WALLS SHOULD HAVE A THICKENED SLAB PER SECTION PER DETAIL A401/5.

#### A) FOUNDATION PLAN NOTES:

- CONCRETE SLAB SHALL BE 6" THICK WITH 1/2" DIAMETER TENDONS PER LAYOUT PLAN, CENTERED IN SLAB THICKNESS, OVER APPROVED SUBBASE PER GENERAL STRUCTURE
- 2. TERMITE PROTECTION SHALL BE PROVIDED PER IRC SECTION R318.1 NONE TYPICAL ANCHOR BOLT SPACING AT SHEAR WALL AND HOLD DOWN
- SPECIFICATIONS PER APPROVED ARCHITECTURAL PLANS. 4. INSTALL HOLDOWNS BEFORE CONCRETE SLAB POUR.
- EXISTING FILL ON-SITE SHALL BE COMPACTED IN ACCORDANCE WITH THE
- REQUIREMENTS IN THE GEOTECHNICAL REPORT.
- 6. ALL FLOOR SLABS ARE REINFORCED ON CONCRETE SLABS.

#### SPECIAL INSPECTION IS REQUIRED FOR THICKENED FOUNDATION CONSTRUCTION

- 1. REINFORCEMENT
- 2. 2300 PSI CONCRETE POUR


#### B) **REINFORCEMENT FOR CONCRETE**:


1. ALL REINFORCING SLABS BARS SIZE 10MM OR LARGER SHALL BE DEFORMED IN ACCORDANCE TO ASTM-A706, AND BARS SMALLER THAN 10 MM MAYBE PLAIN. 2. UNLESS OTHERWISE NOTED IN PLANS, THE YIELD STRENGTH OF REINFORCING BARS SHALL BE:


> A) FOOTING = 40,000 PSI B) NON-LOAD BEARING WALLS AND PARAPETS= 40,000 PSI

- 3. SPLICES SHALL BE SECURELY WIRED TOGETHER AND SHALL LAP OR EXTEND
- GRADE OF STEEL FOR RCC WORKS SHALL BE GRADE 4 10.
- BAR NOTATIONS GIVES INFORMATION
- A) BAR SIZE
- B) SPACING(IF REQUIRED)
- 6. LAP REINFORCEMENT ONLY AT LOCATION SHOWN IN THE DRAWINGS
- REINFORCEMENT SHALL NOT BE CUT, VENT OR HEATED ON SITE WITHOUT ENGINEERS' APPROVAL.
- C) **CONCRETE SLAB NOTES**
- 1. ALL SLAB REINFORCEMENT SHALL BE 20MM CLEAR MINIMUM FROM BOTTOM AND FROM TOP OF SLAB.
- 2. REINFORCEMENT IN CONTINUOUS ELEVATED SLAB SHALL BE CUT AS FOLLOWS.

- THIS IS A SCHEMATIC PLAN FOR THE PURPOSE OF LOCATING AND IDENTIFYING FOUNDATION REINFORCING ELEMENTS ONLY, VERIFY ALL DIMENSIONS, DROPS OFFSETS AND FEATURES WITH THE ARCHITECTURAL PLANS BEFORE FORMING THE FOUNDATION.

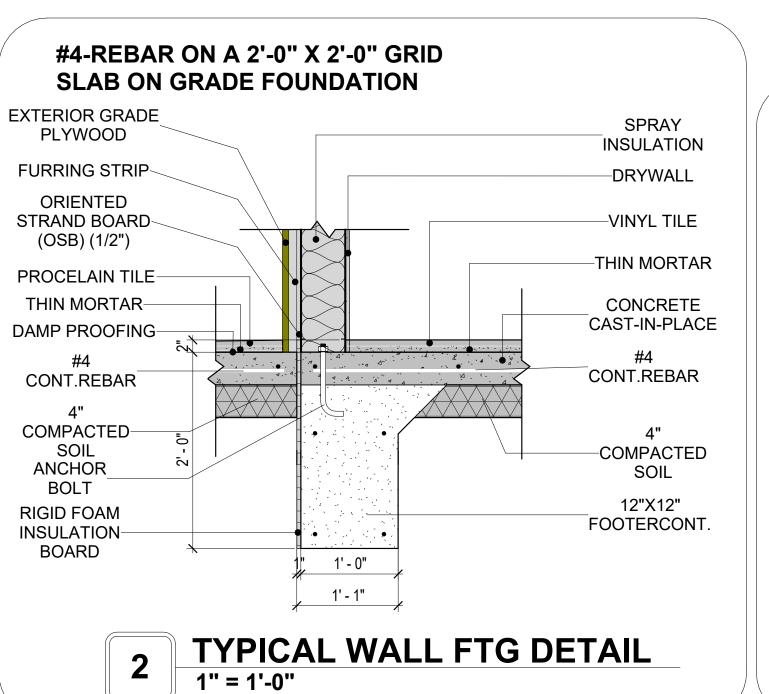

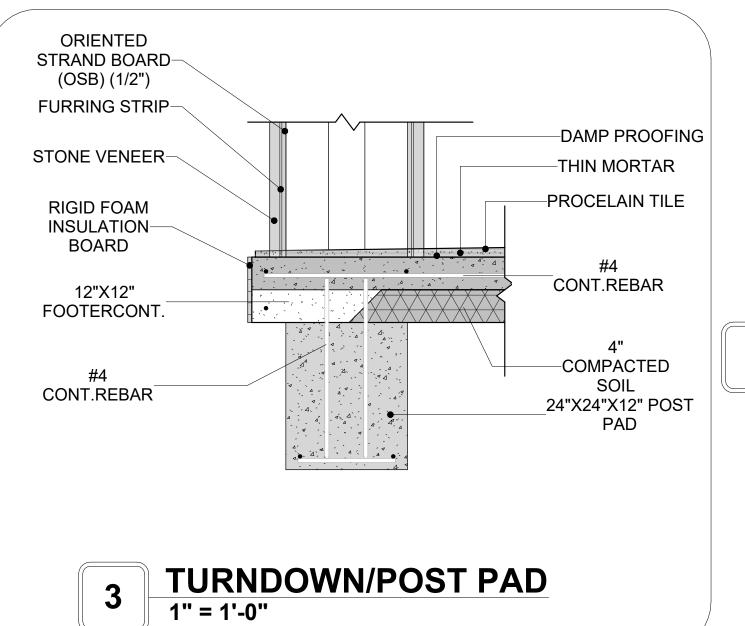

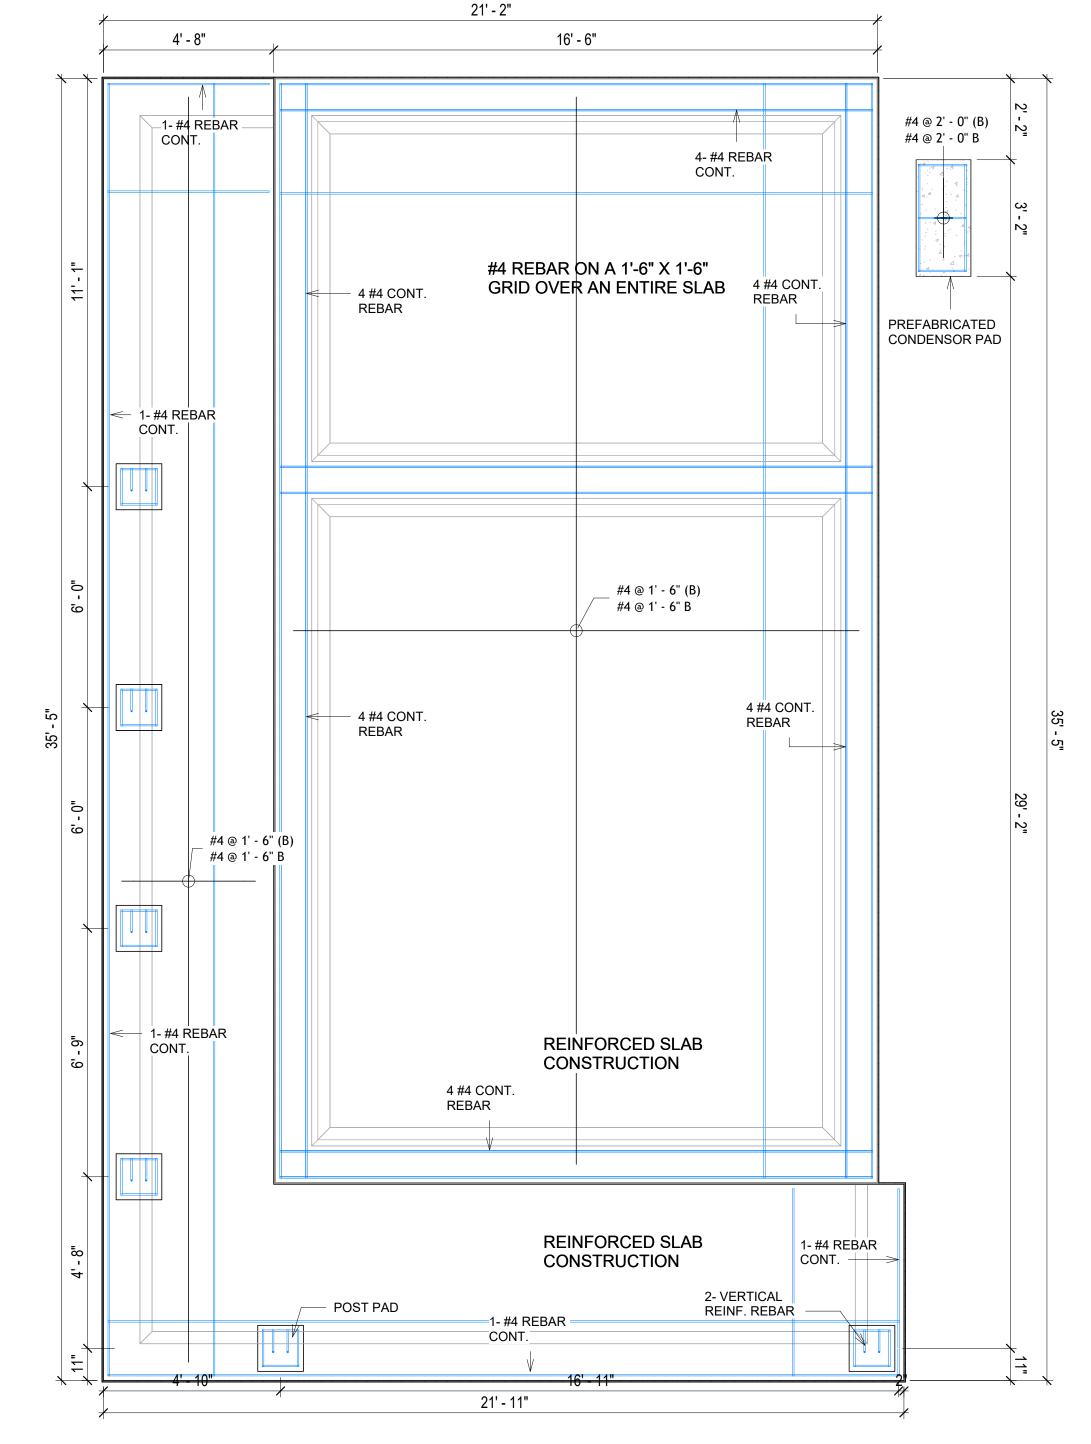

## FOUNDATION REBAR PLAN 3/8" = 1'-0"



**KEY PLAN** 

NO.	DESCRIPTION	DATE

NOTE:

LEGEND:

PROJECT

181-ORCHARD-495-1Bd1Ba-**CRAFTSMAN-550** 

DRAWING NAME

STRUCTURAL FLOOR PLAN


CLIENT NAME:	Client Name
PROJECT NUMBER:	0061_12
DATE:	5/6/2025 10:19:35 AM
DESIGNED BY:	Designer
DRAWN BY:	Author
CHECKED BY:	Checker

**S102** 


## **ROOF NOTES**

- ROOFING COMPOSITION ROOFING PER OWNERS/BUILDERS
   SPECIFICATIONS INSTALL PER MANUFACTURE SPECIFICATIONS ON 1/2"
   ORIENTED STRAND BOARD ON PRE-ENGINEERED TRUSS @ 24" O.C. (UNO.)
   73" OVERHANG AT EAVES (UNO.)
- 3. ENDS OF ALL TRUSSES AND JOISTS TO BE FULLY BLOCKED. PROVIDE SOLID
- BLOCKING AT ALL RIDGES AND VALLEYS

  SHEATHING TO BE 1/2" 2/8" OSB SHEAD DANEL AND EQUIVALENT
- 4. SHEATHING TO BE 1/2", 3/8" OSB SHEAR PANEL AND EQUIVALENT. UNDERSIDE OF PORCH TRUSSES TO BE FINISHED WITH MOISTURE RESISTANT DRYWALL, TAPED AND TEXTURED.
- 5. EXPOSED EAVES AND OTHER WEATHER EXPOSED AREAS TO BE SHEATHED WITH EXTERIOR GRADE PLYWOOD.
- 6. ALL MATERIALS THICKNESS AND SIZE ARE THE MINIMUM. Refer TO LOCAL STANDARDS FOR ACTUAL THICKNESS AND LAYERING OF MATERIALS.
- 7. ENGINEERED TRUSS CALCULATIONS TO BE SUBMITTED TO BUILDING DEPARTMENT PRIOR TO FABRICATION AND INSTALLATION.
- 8. TRUSS MANUFACTURER TO SPECIFY HANGER CONNECTORS FOR TRUSS COMPONENTS (TYPICAL)
- 9. DESIGNER ASSUMES THAT TRUSSES BEAR ON ALL EXTERIOR PERIMETER
- WALLS (TYPICAL) OR BEAMS.
- 10. PROVIDE GALVANIZED STEEL FLASHING WITH A LENGTH OF 10 FEET, WIDTH OF 12 INCHES, AND THICKNESS OF 24 GAUGE.

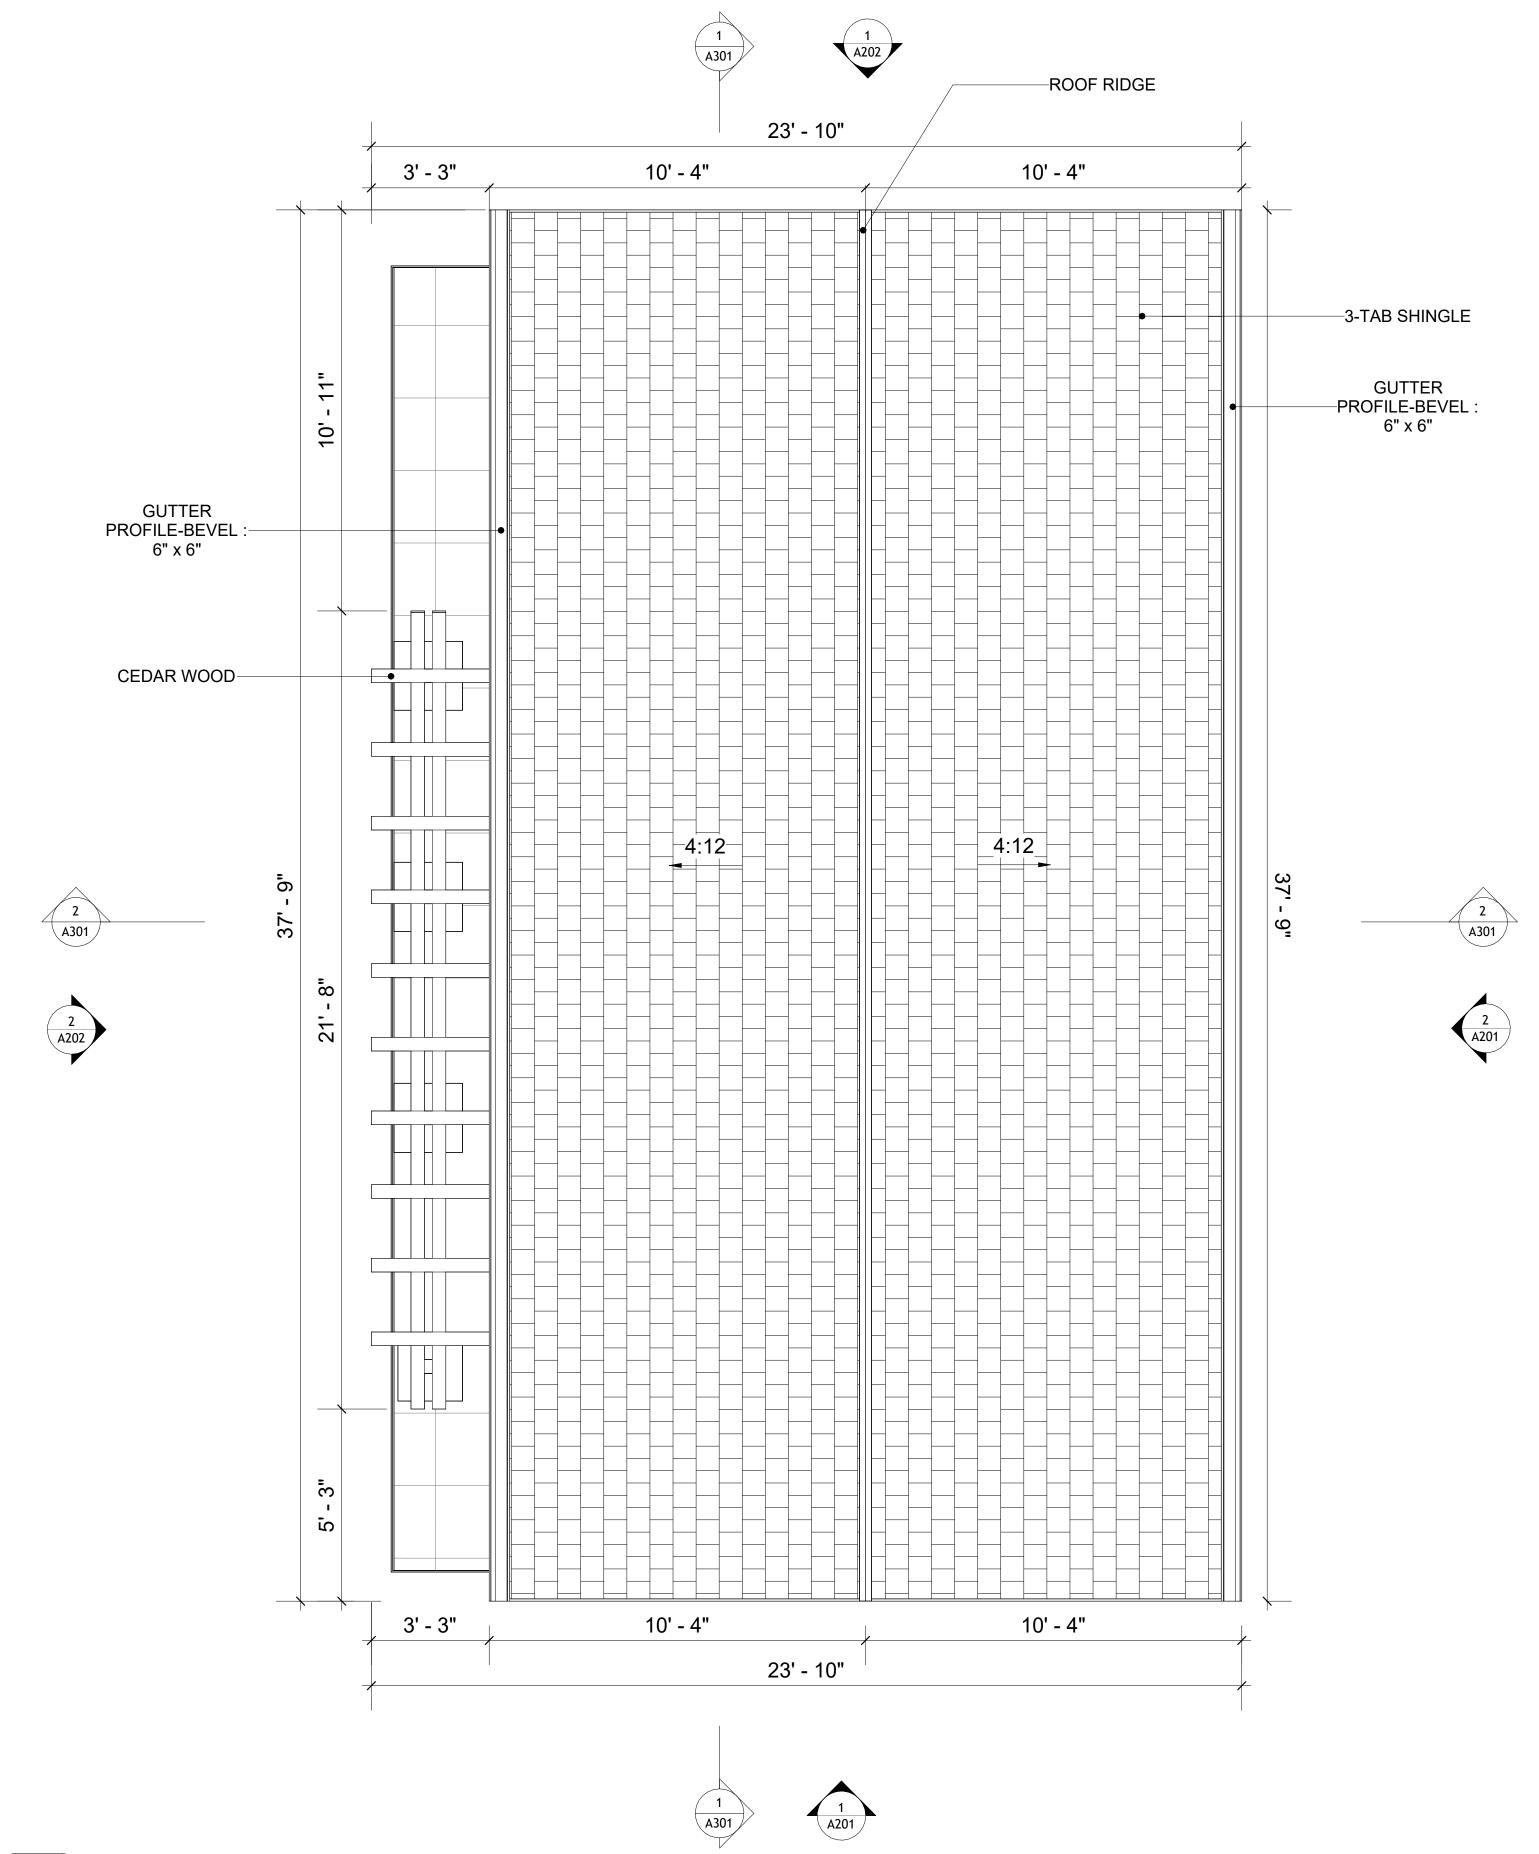



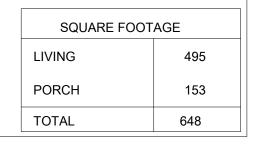



**KEY PLAN** 

NO.	DESCRIPTION	DATE

NOTE:

LEGEND:

PROJECT

181-ORCHARD-495-1Bd1Ba-CRAFTSMAN-550

DRAWING NAME

**ROOF PLAN** 

CLIENT NAME:	Client Name
PROJECT NUMBER:	0061_12
DATE:	5/6/2025 10:19:37 AM
DESIGNED BY:	Designer
DRAWN BY:	Author
CHECKED BY:	Checker

A103

### **ABOUT WALL FINISHING**

#### **CEDAR WOOD**

CEDAR WOOD REFERS TO THE WOOD FROM VARIOUS SPECIES OF CEDAR TREES, WHICH ARE CONIFEROUS EVERGREEN TREES KNOWN FOR THEIR DISTINCT AROMA AND NATURAL RESISTANCE TO DECAY AND INSECTS.

IN THIS SPECIFIC PROJECT, CEDAR WOOD IS USED A FINISH MATERIAL ON BEAMS AND COLUMNS.

#### STONE VENEER

STONE VENEER REFERS TO THIN LAYERS OF NATURAL OR MANUFACTURED STONE APPLIED TO A STRUCTURAL WALL, KNOWN FOR THEIR REALISTIC APPEARANCE AND RELATIVE LIGHTNESS. THESE VENEERS PROVIDE THE AESTHETIC OF STONE WITHOUT THE COST AND WEIGHT OF FULL STONE CONSTRUCTION, CONTRIBUTING TO A BEAUTIFUL AND COST-EFFECTIVE EXTERIOR FINISH.

IN THIS SPECIFIC PROJECT, STONE VENEER IS USED A FINISH MATERIAL ON EXTERIOR FINISH.

#### **GRANITE COPPING**

GRANITE COPPING REFERS TO A STONE, TYPICALLY GRANITE, USED TO COVER THE TOP EDGE OR CAP OF A WALL, PARAPET, OR OTHER ARCHITECTURAL FEATURE, PROVIDING PROTECTION AND A FINISHED LOOK.


IN THIS PROJECT, GRANITE COPPING IS USED AS THE COPING MATERIAL, PROVIDING A DURABLE AND AESTHETIC FINISH THAT MIMICS THE APPEARANCE OF NATURAL STONE.

#### PLYWOOD WALL SIDING

WALL SIDING IS AN EXTERIOR CLADDING MATERIAL USED TO COVER AND PROTECT THE WALLS OF A BUILDING, PROVIDING BOTH FUNCTIONAL AND AESTHETIC BENEFITS.

IN THIS SPECIFIC PROJECT, PLYWOOD WALL PANELS ARE USED AS A FINISH SIDING BECAUSE THIS TYPE OF SIDING PROVIDES A DURABLE, COST-EFFECTIVE, AND VERSATILE EXTERIOR CLADDING THAT CAN BE EASILY INSTALLED, FINISHED, AND MAINTAINED TO ENHANCE THE AESTHETIC AND PROTECTIVE QUALITIES OF A BUILDING'S EXTERIOR.

STANDARD SIZES OF 1' X 8' EXTERIOR-GRADE PLYWOOD PANELS ARE INSTALLED ON THE FURRING STRIPS USING GALVANIZED STEEL SELF-DRILLING SCREWS.

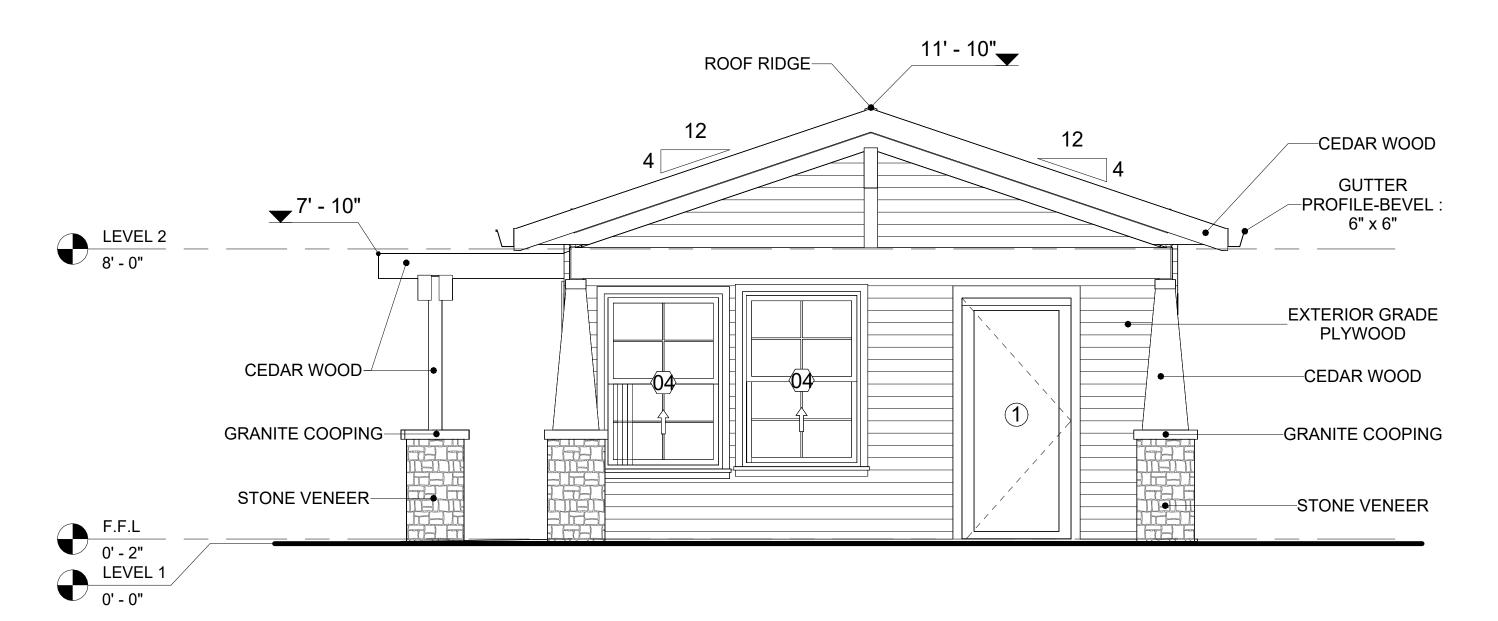






# 2 RIGHT SIDE ELEVATION 3/8" = 1'-0"

DOOR SCHEDULE						
TYPE				9	SIZE	
MAR K	SUPPLIER	DOOR TYPE	LOCATIO	WIDTH	HEIGHT	COUNT
1	HOME DEPOT	EXTERIOR SINGLE PANEL SWINGING	INTERIOR	3' - 0"	6' - 8"	2
2	HOME DEPOT	INTERIOR SINGLE PANEL SWINGING	INTERIOR	3' - 0"	6' - 8"	2
3	HOME DEPOT	INTERIOR DOUBLE PANEL SLIDING	INTERIOR	9' - 0"	6' - 8"	1
4	HOME DEPOT	SINGLE FOLD 2	INTERIOR	2' - 6"	6' - 8"	1

WINDOW SCHEDULE					
			SIZE		
<b>TYPE MARK</b>	SUPPLIER	WINDOW TYPE	WIDTH	HEIGHT	COUNT
01	HOME DEPOT	SLIDING	3' - 3"	1' - 9"	1
02	HOME DEPOT	SLIDING	5' - 3"	3' - 7"	1
03	HOME DEPOT	SLIDING	3' - 3"	3' - 3"	1
04	HOME DEPOT	SINGLE HUNG	3' - 3"	4' - 9"	2
05	HOME DEPOT	SLIDING	3' - 3"	2' - 3"	3

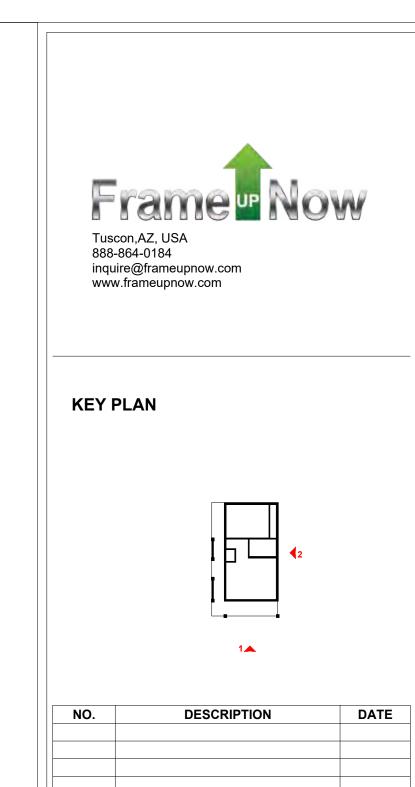

NOTE:

LEGEND:

PROJECT

181-ORCHARD-495-1Bd1Ba-CRAFTSMAN-550

DRAWING NAME

**ARCHITECTURAL ELEVATIONS** 

CLIENT NAME:	Client Name
PROJECT NUMBER:	0061_12
DATE:	5/6/2025 10:19:39 AM
DESIGNED BY:	Designer
DRAWN BY:	Author
CHECKED BY:	Checker

A201

### **ABOUT WALL FINISHING**

#### **CEDAR WOOD**

CEDAR WOOD REFERS TO THE WOOD FROM VARIOUS SPECIES OF CEDAR TREES, WHICH ARE CONIFEROUS EVERGREEN TREES KNOWN FOR THEIR DISTINCT AROMA AND NATURAL RESISTANCE TO DECAY AND INSECTS.

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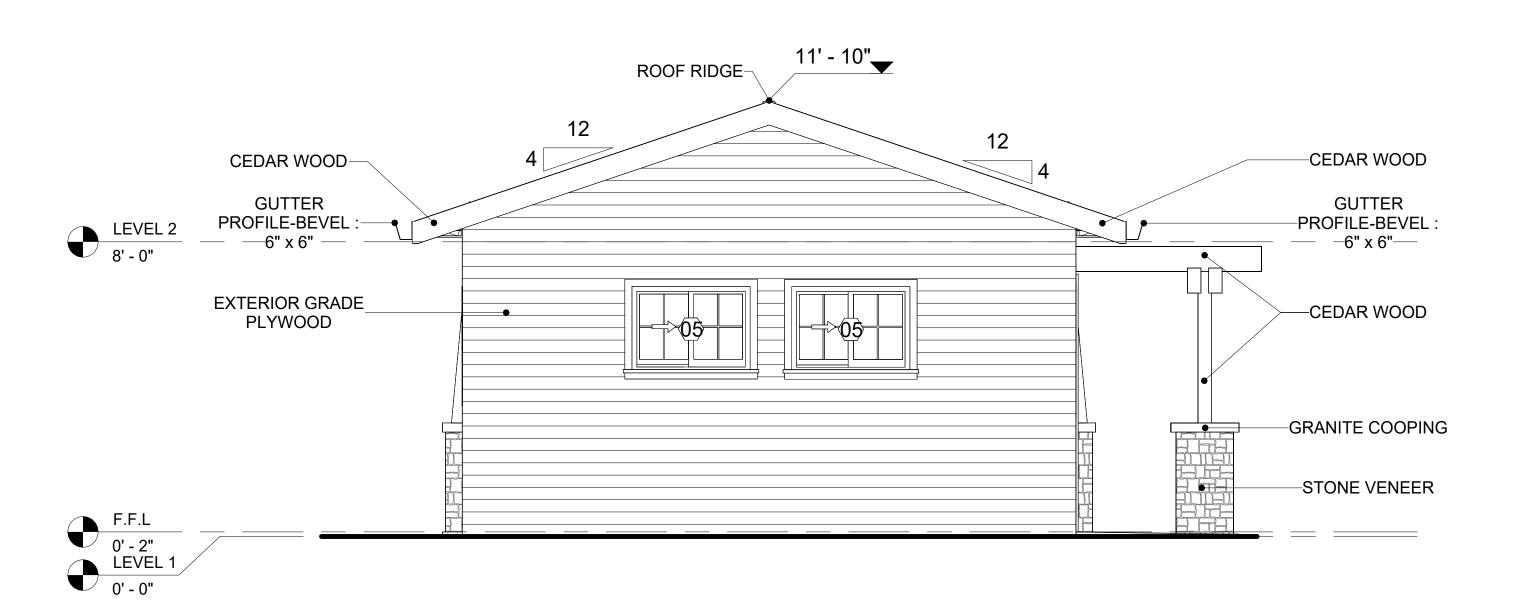
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STANDARD SIZES OF 1' X 8' EXTERIOR-GRADE PLYWOOD PANELS ARE INSTALLED ON THE FURRING STRIPS USING GALVANIZED STEEL SELF-DRILLING SCREWS.




1 REAR ELEVATION
3/8" = 1'-0"



2 LEFT SIDE ELEVATION
3/8" = 1'-0"

Tuscon,AZ, USA 888-864-0184 inquire@frameupnow.com www.frameupnow.com

KEY PLAN

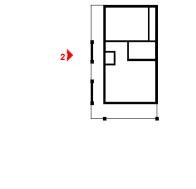

NO.	DESCRIPTION	DESCRIPTION DATE	

NOTE:

LEGEND:

PROJECT

181-ORCHARD-495-1Bd1Ba-CRAFTSMAN-550

DRAWING NAME

ARCHITECTURAL ELEVATIONS

CLIENT NAME:

PROJECT NUMBER:

DATE:

5/6/2025 10:19:42 AM


DESIGNED BY:

DRAWN BY:

CHECKED BY:


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A202



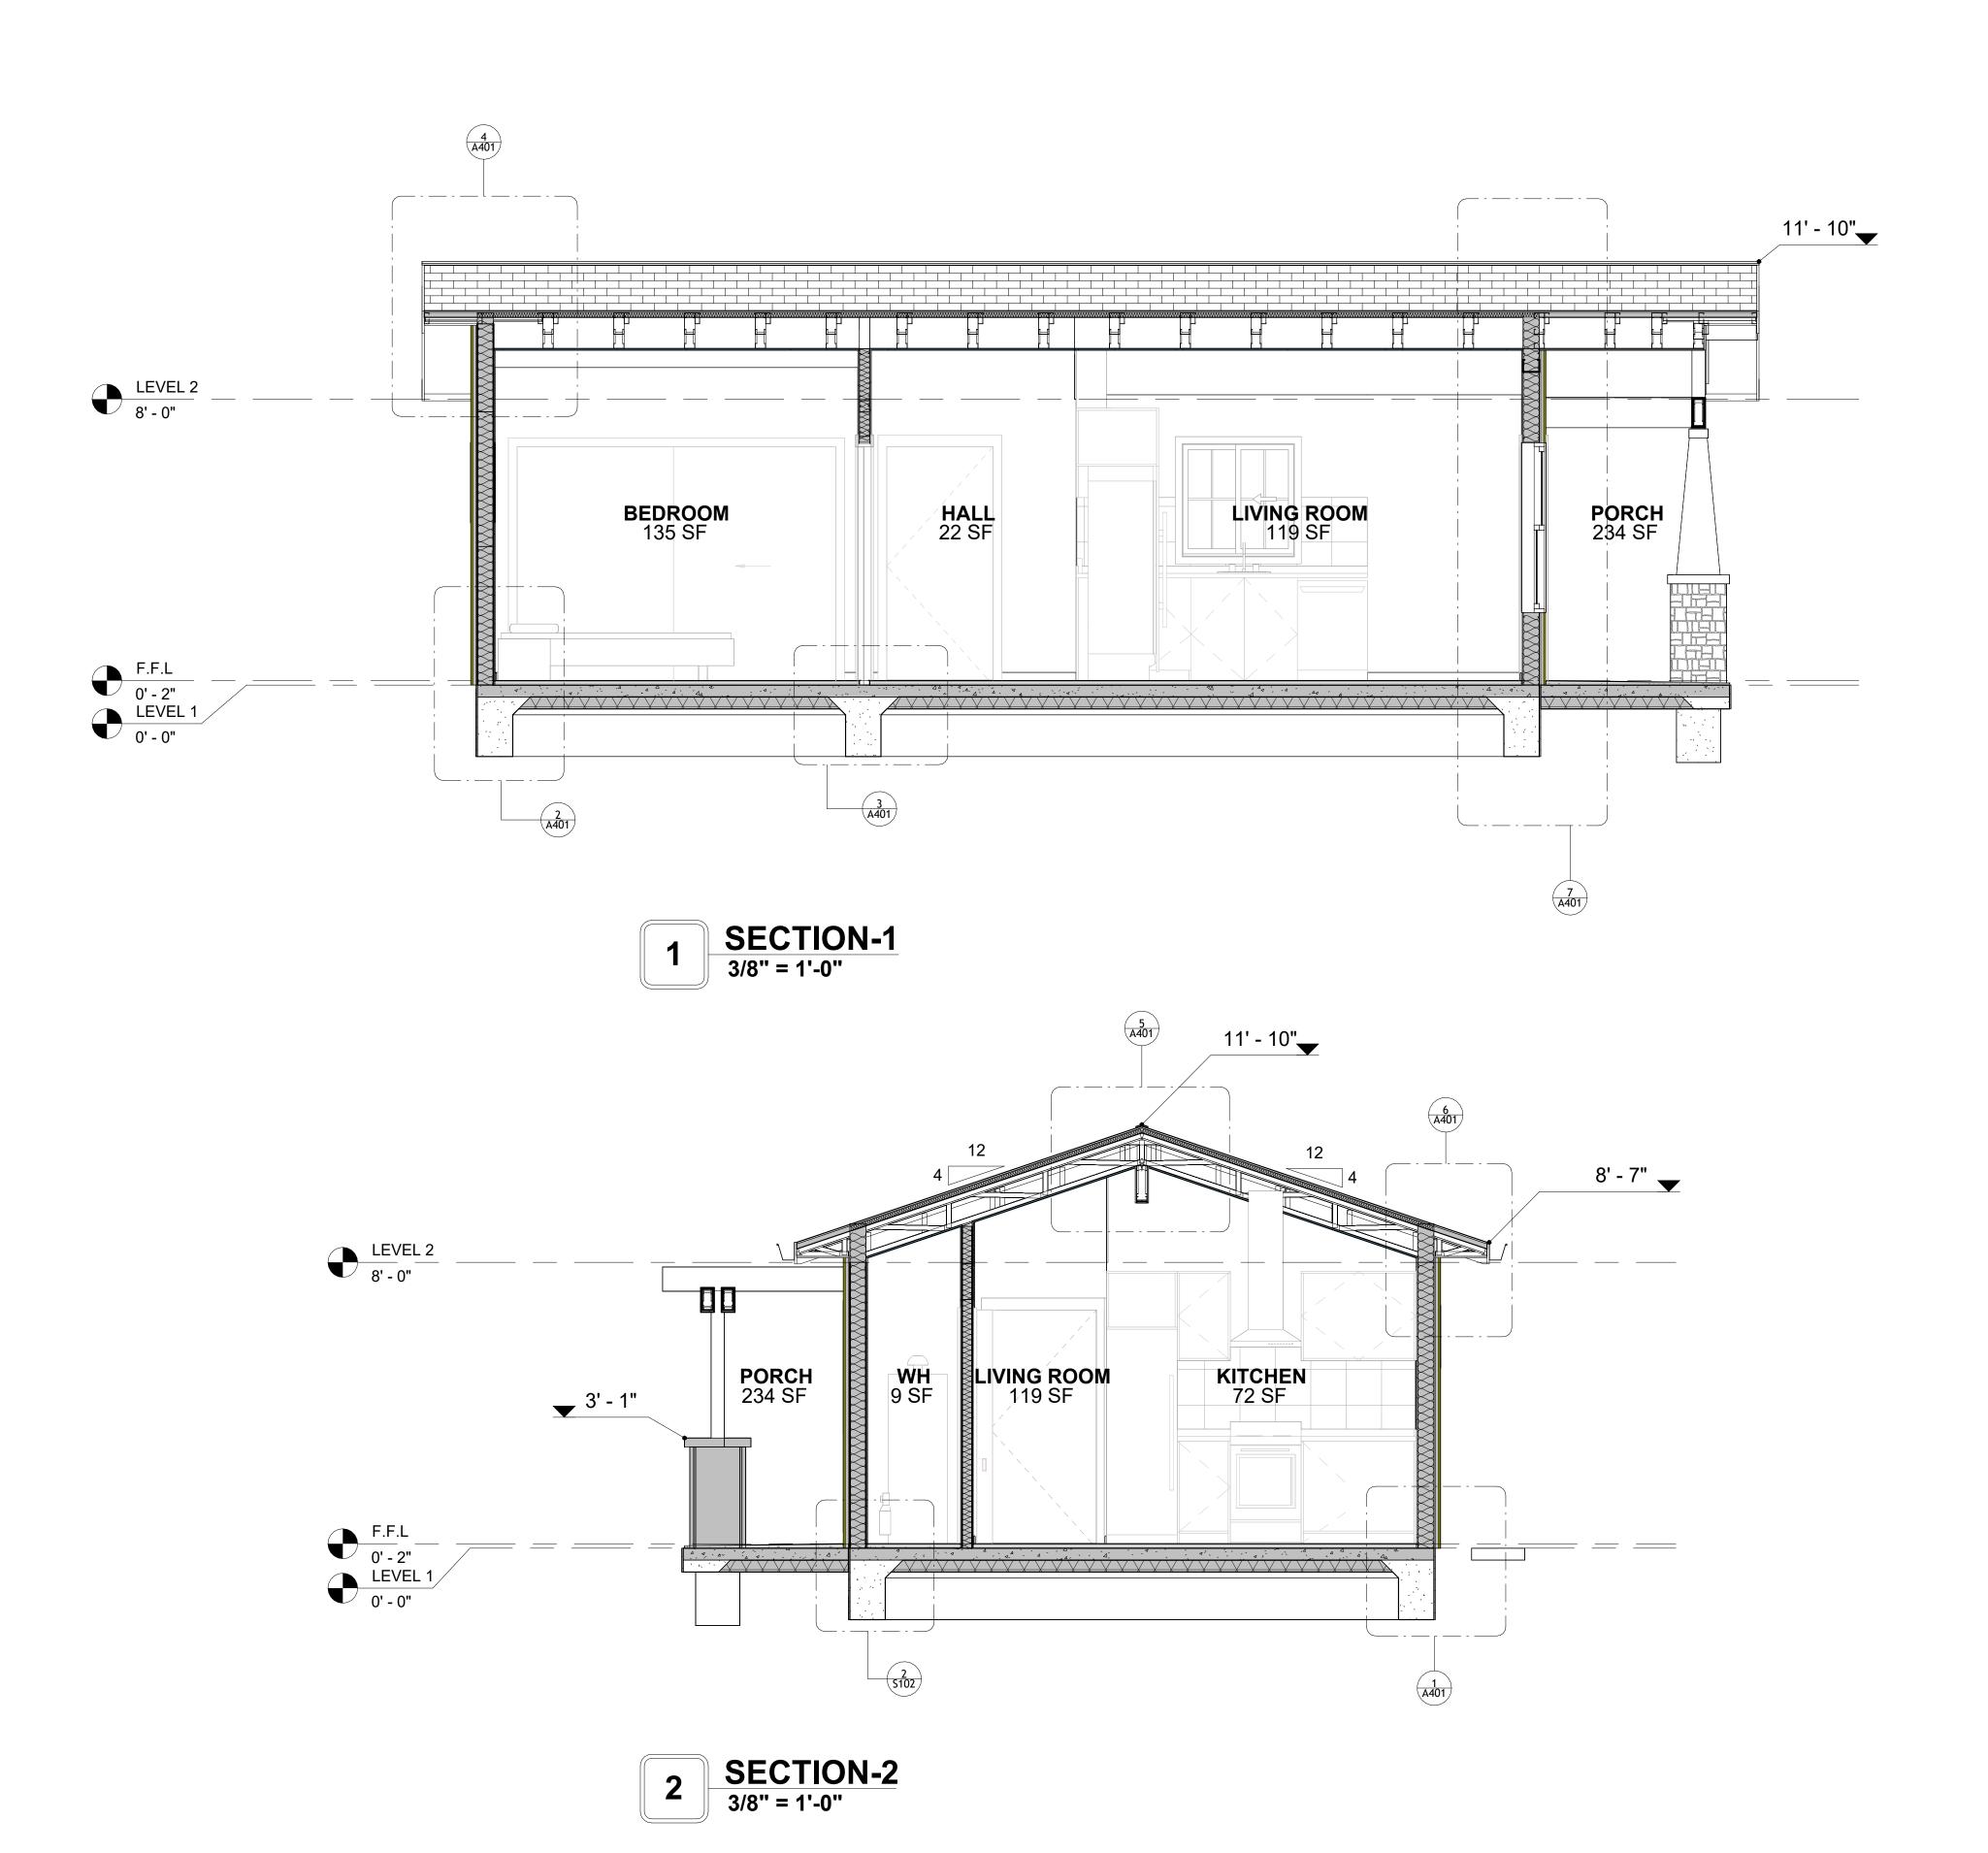

**KEY PLAN** 

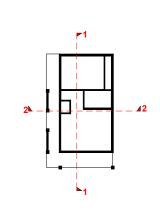

NO.	DESCRIPTION	DATE	

NOTE:

LEGEND:

PROJECT


181-ORCHARD-495-1Bd1Ba-CRAFTSMAN-550

DRAWING NAME

ARCHITECTURAL SECTIONS


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ER:	0061_12
5	/6/2025 10:19:43 AM
	Designer
	Author
	Checker


A301

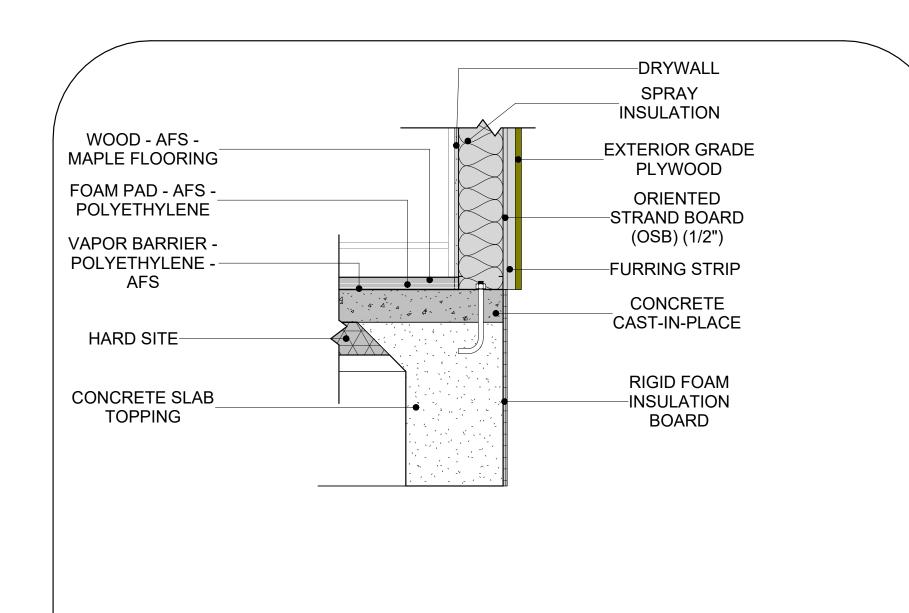



**TYPICAL WALL FTG** 


1" = 1'-0"

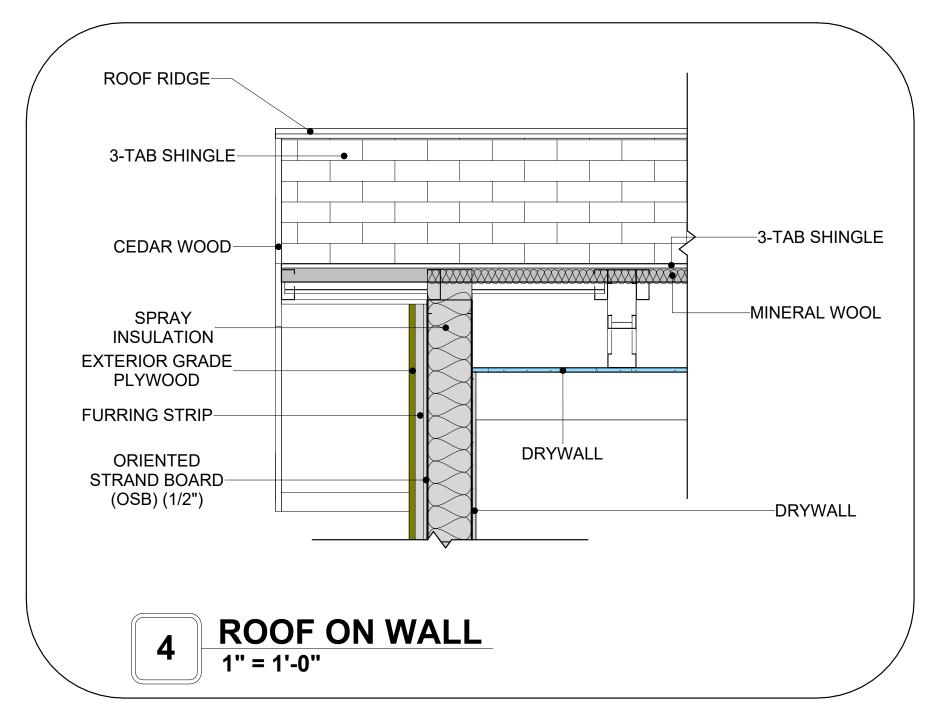


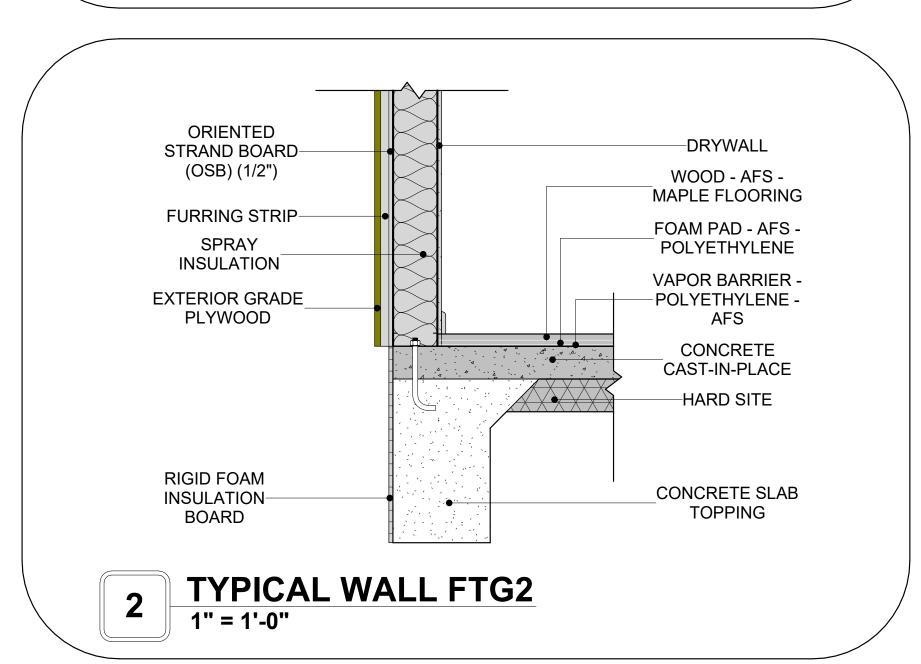

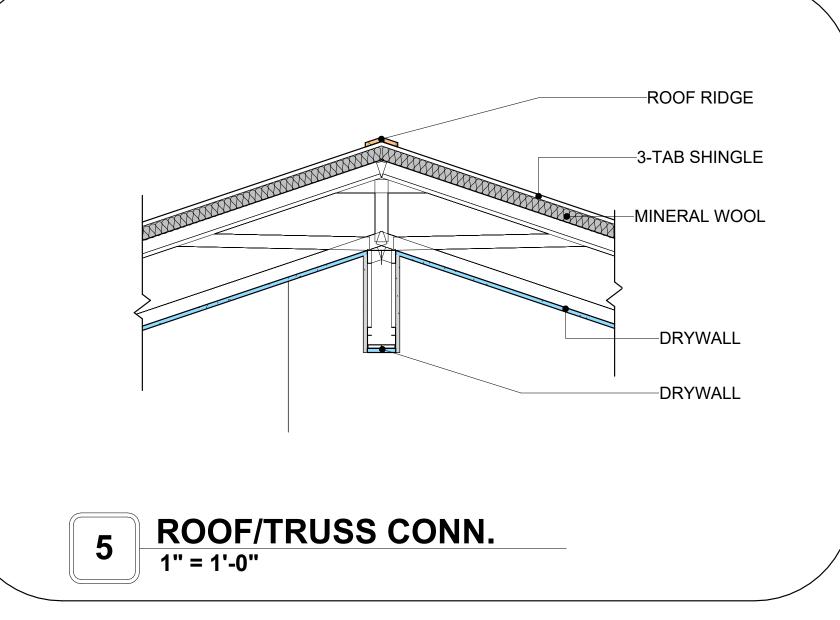

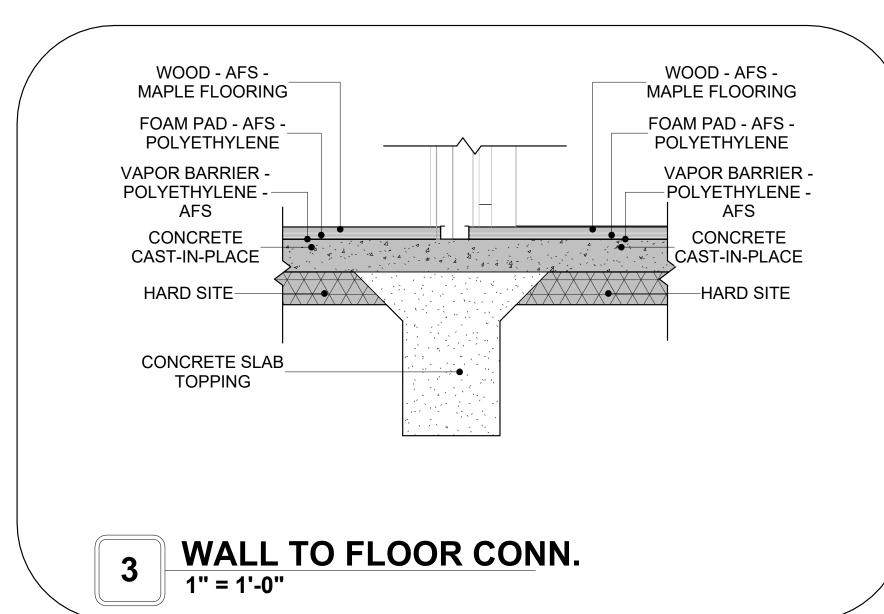

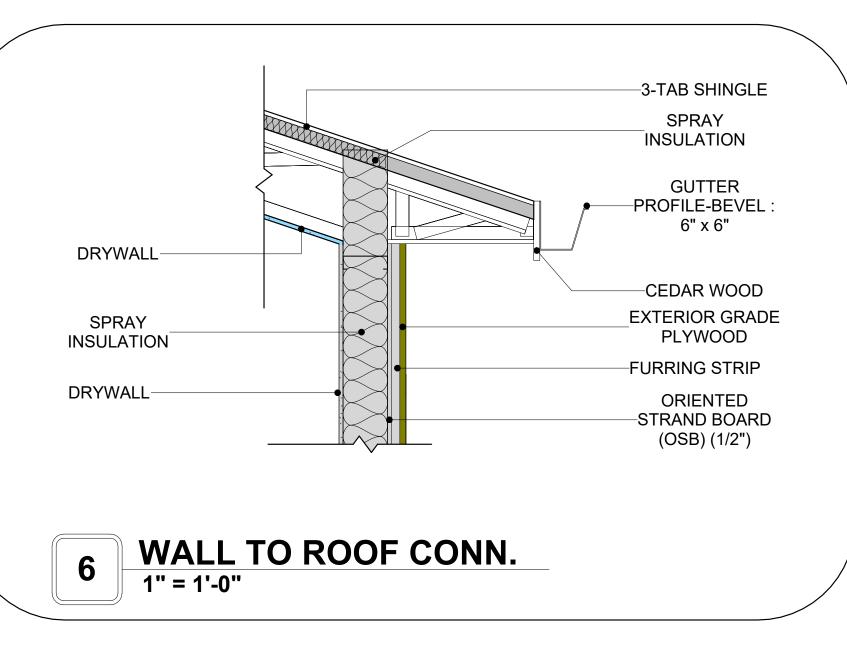

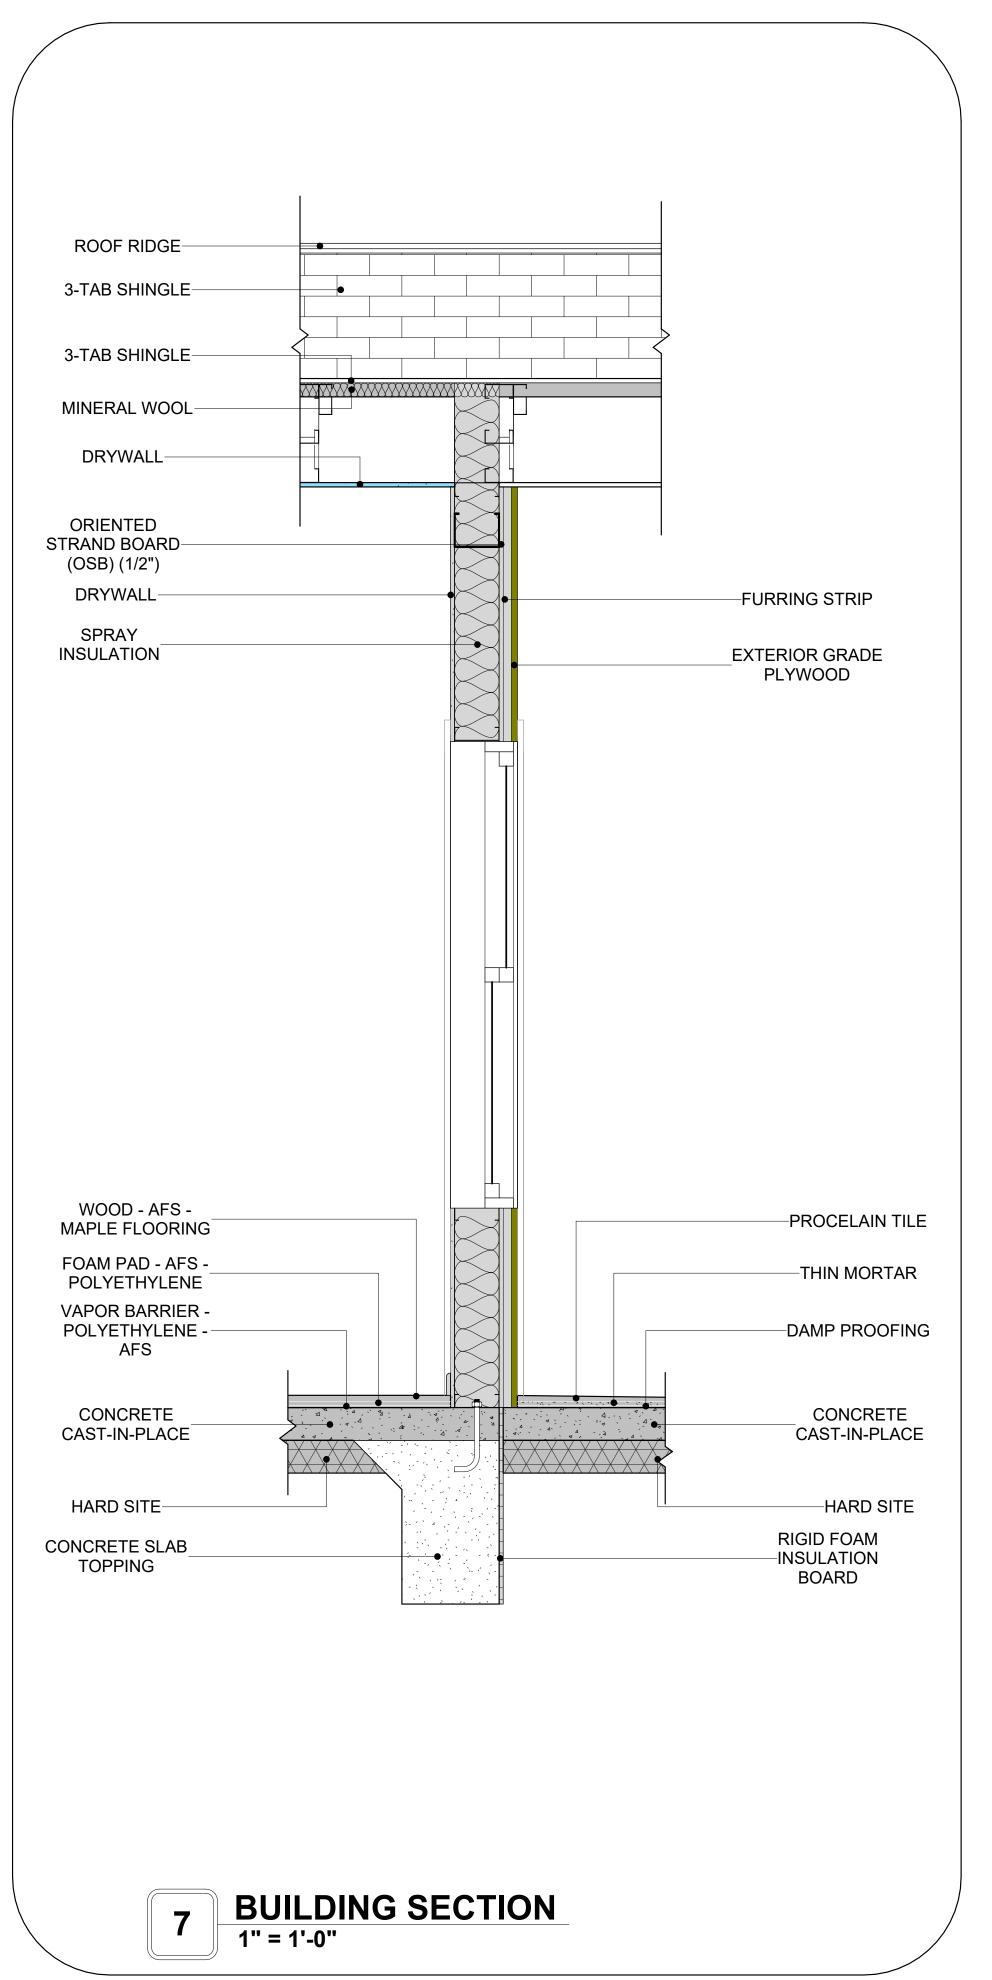



**KEY PLAN** 

NO.	DESCRIPTION	DATE	

NOTE:

LEGEND:

PROJECT

181-ORCHARD-495-1Bd1Ba-CRAFTSMAN-550

DRAWING NAME

ARCHITECTURAL DETAILS

CLIENT NAME:	Client Name
PROJECT NUMBER:	0061_12
DATE:	5/6/2025 10:19:45 AM
DESIGNED BY:	Designer
DRAWN BY:	Author
CHECKED BY:	Checker

A401

SCALE: 1" = 1'-0"

## **CASEWORK GENERAL NOTES**


- ALL CABINET HEIGHTS INCLUDE COUNTERTOPS. DIMENSIONS ARE TO THE NEAREST INCH.
   DIVISIONS IN CASEWORK ARE SHOWN FOR CLARITY AND DO NOT REPRESENT BREAKS IN THE COUNTERTOP.
- 3. PROVIDE CONTINUOUS COUNTERTOP OVER ALL SIMILAR HEIGHT CASEWORK, UNLESS AND OTHERWISE NOTED.
- 4. MANUFACTURER AND CATALOG NUMBERS ARE FOR REFERENCE AND ILLUSTRATION PURPOSES
- 5. DOTTED LINES INDICATE WALL HUNG CABINETS, DIVISIONS OF BASE CABINETS BELOW THE
- 6. COUNTERTOP, FURNITURE NOT IN THE CONTRACT OR PROJECTION SCREENS -SEE CASEWORK KEY AND SPECIFICATIONS.
- 7. ALL CABINETS AND DRAWERS TO HAVE CAM LOCKS EXCEPT FOR SINK BASE CABINETS.
  8. ALL EXPOSED SURFACES (EXPOSED TO VIEW FROM ANY PERSPECTIVE) TO BE COVERED WITH
- LAMINATE.

  9. ALL CASEWORK WHICH MEETS A WALL AT ONE OR BOTH ENDS, TO BE PROVIDED WITH FILLER
- PANELS AND SCRIBED TO THE WALL(S) AS REQUIRED.

  10. ALL CABINETS AND DRAWERS ARE PROVIDED WITH RECESSED HANDLES.
- 11. CONTRACTOR TO FIELD VERIFY ALL CLEAR OPENINGS PRIOR TO MILLWORK OR CASEWORK FABRICATION.
- 12. CASEWORK DRAWINGS ARE DIAGRAMMATIC IN NATURE TO SHOW DESIGN INTENT.

	CASEWORK SCHEDULE						
TYPE MAR K	TYPE	COUN	HEIGHT	WIDTH	DEPTH	AREA	
01	WALL CABINET SINGLE DOOR	1	2' - 6"	1' - 6"	1' - 0"	4 SF	
02	LINEAR COUNTER TOP 2	1	0' - 4"	3' - 0"	2' - 1"	1 SF	
03	RECESSED MED CABINET	1	2' - 0"	1' - 6"	0' - 3"	3 SF	
04	CLOSET 4	1	6' - 0"	10' - 3"	1' - 4"	61 SF	
05	BASE_CABINET_SINGLE_DOOR	1	2' - 7"	1' - 6"	2' - 0"	4 SF	
06	REFRIGERATOR TOP	1	1' - 8"	2' - 0"	2' - 4"	3 SF	
07	VANITY	1	2' - 4"	2' - 6"	1' - 8"	6 SF	
08	WALL_CABINET_DOUBLE_DOOR 2	1	2' - 6"	3' - 3"	1' - 0"	8 SF	
09	HD_L-SHAPE_COUNTER_TOP W SINK HOLE 2	1	0' - 4"	4' - 6"	8' - 1"	1 SF	
10	BASE_CABINET_DOUBLE_DOOR	1	2' - 11"	3' - 0"	2' - 0"	9 SF	
11	LAUNDRY OPEN CABINET 2	1	1' - 2"	2' - 3"	3' - 0"	3 SF	
12	BASE_CABINET_L-SHAPED	1	2' - 11"	3' - 3"	3' - 3"	9 SF	
GRAND	TOTAL	12					

SPECIALTY EQUIPMENT SCHEDULE				
TYPE MARK	TYPE	COUNT		
01	WASHER-FRONT-LOAD	1		
02	REFRIGERATOR	1		
03	RANGE	1		
04	DRYER-FRONT-LOAD	1		
05	DISHWASHER	1		
GRAND TOTAL: 5				

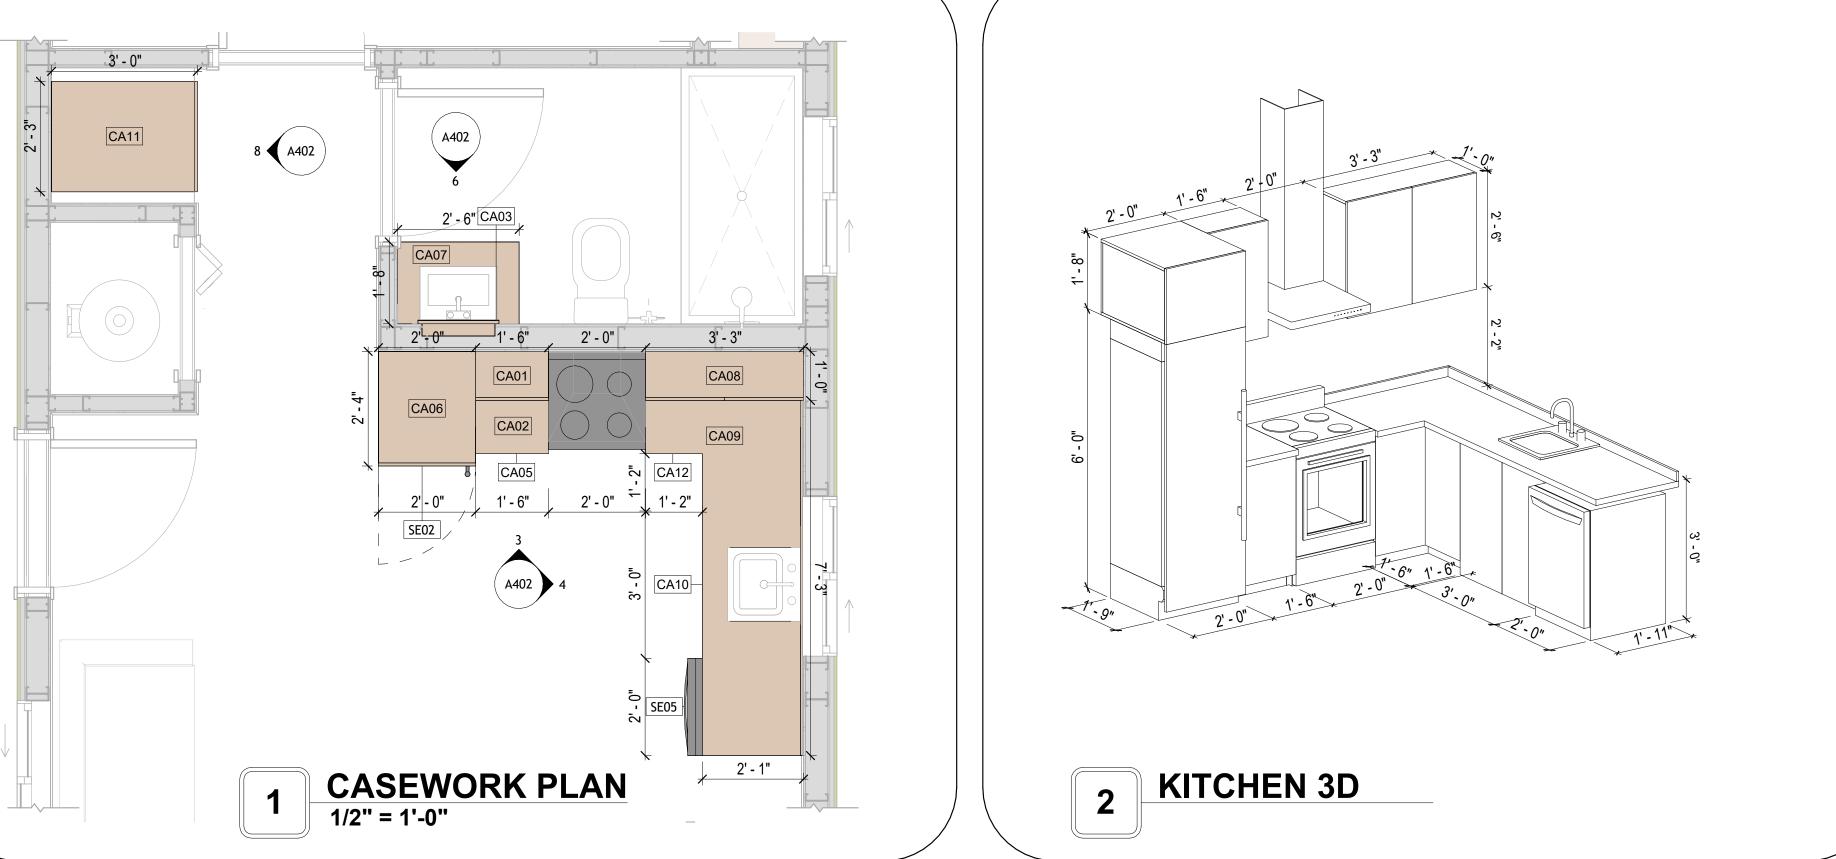




**ELEVATION** 1 - E

**LAUNDRY 3D** 

9 CLOSET 3D



**KEY PLAN** 

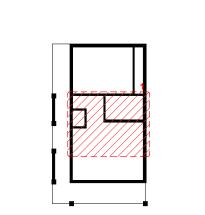

NO.	DESCRIPTION	DATE
	·	

NOTE:

LEGEND:

PROJECT

181-ORCHARD-495-1Bd1Ba-CRAFTSMAN-550

DRAWING NAME

ARCHITECTURAL CASEWORK

CLIENT NAME:	Client Name
PROJECT NUMBER:	0061_12
DATE:	5/6/2025 10:19:47 AM
DESIGNED BY:	Designer
DRAWN BY:	Author
CHECKED BY:	Checker

A402

#### **GENERAL NOTES**

1. THIS DRAWING DEPICTS THE HVAC (HEATING, VENTILATION, AND AIR CONDITIONING) SYSTEM FOR THE ORCHARD 1BD1BA CRAFTSMAN. IT PROVIDES A VISUAL REPRESENTATION OF THE SYSTEM LAYOUT AND COMPONENTS.

2.THE HVAC SYSTEM IS DESIGNED TO MEET THE SPECIFIC REQUIREMENTS OF THE BUILDING, INCLUDING HEATING, COOLING, AND VENTILATION NEEDS, AS PER THE PROJECT SPECIFICATIONS AND APPLICABLE CODES AND STANDARDS.

3. THE HVAC SYSTEM INSTALLATION SHALL COMPLY WITH THE LATEST EDITION OF THE INTERNATIONAL MECHANICAL CODE (IMC), INTERNATIONAL RESIDENTIAL CODE (IRC), AND ALL OTHER APPLICABLE LOCAL, STATE, AND NATIONAL CODES AND REGULATIONS.

4. THE EQUIPMENT SHOWN ON THIS DRAWING INCLUDES BUT IS NOT LIMITED TO AIR HANDLING UNITS (AHUS), CHILLERS, BOILERS, COOLING TOWERS, PUMPS, DUCTWORK, DIFFUSERS, GRILLES, AND CONTROL DEVICES.

5. ALL EQUIPMENT, DUCTWORK, AND PIPING SHALL BE INSTALLED IN ACCORDANCE WITH MANUFACTURER'S SPECIFICATIONS, LOCAL CODES, AND

6. ALL DUCTWORK SHALL BE SIZED, FABRICATED, AND INSTALLED IN ACCORDANCE WITH THE LATEST EDITION OF THE ACCA MANUAL D AND THE SMACNA HVAC DUCT CONSTRUCTION STANDARDS. DUCTWORK SHALL BE INSTALLED IN A NEAT AND WORKMANLIKE MANNER, PROPERLY SUPPORTED

AND BRACED TO PREVENT SAGGING, AIR LEAKAGE, OR VIBRATION. 7. CONDENSATE DRAINAGE PIPING SHALL BE PROPERLY PITCHED TO ENSURE POSITIVE DRAINAGE TO AN APPROVED DISPOSAL LOCATION, SUCH AS A

8. THE LOCATION OF CONTROL PANELS AND SENSORS INDICATED ON THIS DRAWING CAN BEMODIFY WITH THE SPECIFIC LOCATIONS AND WIRING

DETAILS WILL BE DETERMINED DURING THE CONTROL SYSTEM DESIGN AND INSTALLATION.

9. THE HVAC SYSTEM DESIGN CONSIDER ENERGY EFFICIENCY, INDOOR AIR QUALITY, OCCUPANT COMFORT, AND NOISE CONTROL, FOLLOWING APPLICABLE GUIDELINES AND REGULATIONS.

FLOOR DRAIN, SUMP PUMP, OR EXTERIOR GRADE. CONDENSATE LINES SHALL BE INSULATED TO PREVENT SWEATING.

10. COORDINATION WITH OTHER TREADS HAS BEEN DONE ON A DESIGN LEVEL. THIS DRAWING SHALL BE READ TOGETHER WITH THE AR, EL AND SN DESIGN DRAWINGS TO ENSURE PROPER INSTALLATION AND INTEGRATION OF THE HVAC SYSTEMS.

11. THE HVAC CONTRACTOR IS RESPONSIBLE FOR OBTAINING ALL NECESSARY PERMITS AND LICENSES, AND FOR SCHEDULING AND COORDINATING WITH THE LOCAL BUILDING DEPARTMENT AND UTILITY PROVIDERS TO ENSURE A TIMELY AND COMPLIANT INSTALLATION.

12. ALL DUCTWORK PENETRATIONS THROUGH WALLS, FLOORS, OR CEILINGS SHALL BE PROPERLY SEALED AND FIRE-STOPPED USING APPROVED METHODS AND MATERIALS TO MAINTAIN THE INTEGRITY OF THE BUILDING'S FIRE-RESISTANCE RATINGS.

13. HVAC EQUIPMENT SHALL BE INSTALLED LEVEL AND PLUMB, AND IN STRICT ACCORDANCE WITH THE MANUFACTURER'S INSTALLATION INSTRUCTIONS AND RECOMMENDATIONS. PROVIDE ADEQUATE CLEARANCES AROUND EQUIPMENT FOR PROPER AIRFLOW, SERVICE ACCESS, AND

CODE COMPLIANCE. 14. ALL HVAC EQUIPMENT AND COMPONENTS, INCLUDING THERMOSTATS, DAMPERS, AND ACCESS PANELS, SHALL BE LOCATED IN ACCESSIBLE AREAS

15. THE HVAC SYSTEM SHALL BE BALANCED AND ADJUSTED TO ENSURE PROPER AIRFLOW, TEMPERATURE DISTRIBUTION, AND SYSTEM


PERFORMANCE THROUGHOUT THE RESIDENCE. PROVIDE A WRITTEN REPORT DOCUMENTING THE FINAL SYSTEM BALANCE.


FOR EASY SERVICING AND MAINTENANCE. PROVIDE ADEQUATE SPACE AROUND EQUIPMENT FOR PROPER AIRFLOW AND SERVICE ACCESS.

16. ANY DEVIATIONS OR MODIFICATIONS TO THE HVAC SYSTEM DESIGN SHALL BE REVIEWED AND APPROVED BY THE RESPONSIBLE DESIGN PROFESSIONALS AND COMMUNICATED TO ALL RELEVANT PARTIES INVOLVED IN THE CONSTRUCTION PROCESS.

17. FOR ANY INQUIRIES OR CLARIFICATIONS REGARDING THE HVAC SYSTEM DESIGN, PLEASE CONSULT THE RESPONSIBLE DESIGN PROFESSIONALS OR THE PROJECT MANAGEMENT TEAM.

## SYMBOLS

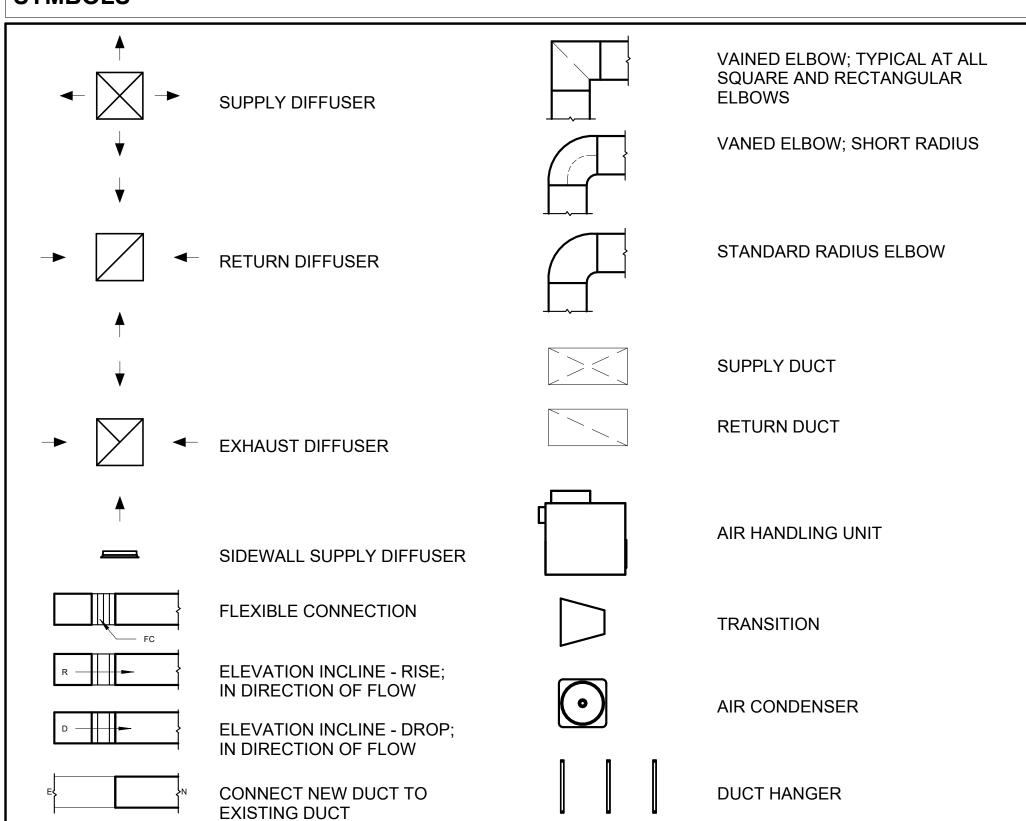

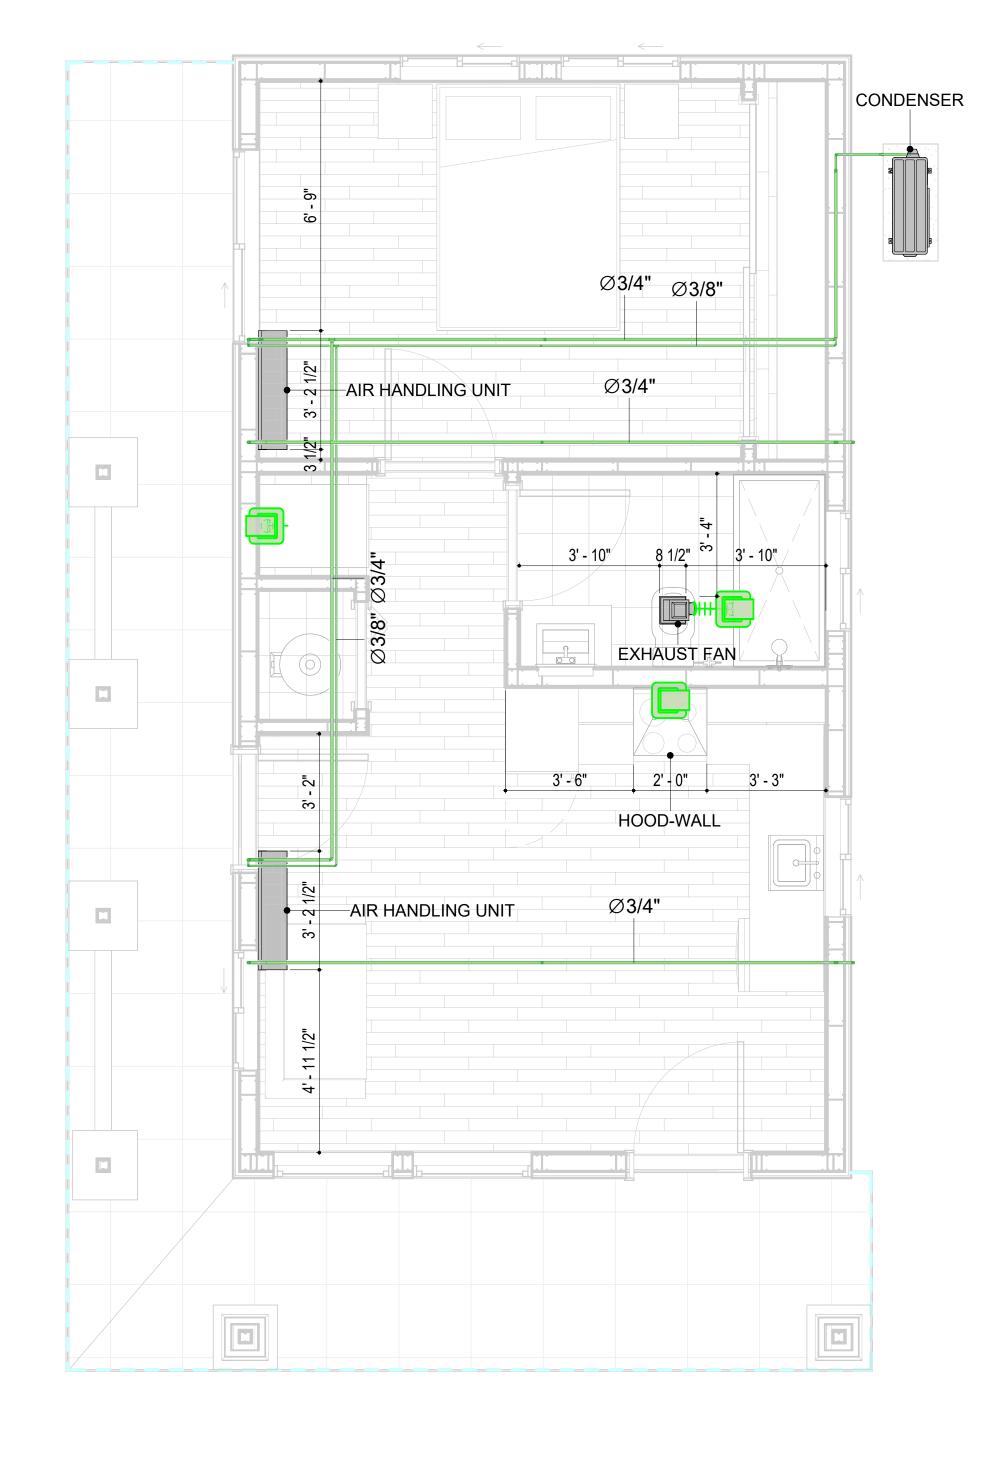

**HVAC PLAN** 3/8" = 1'-0"

HVAC COLOR SCHEME

AIR CONDITIONING PIPE LINE

REFRIGERANT LINE SCHEDULE					
CATAGORY	DESCRIPTION	DIAMETER	LENGTH		
PIPE TYPES	COPPER	3/8"	52.11		
PIPE TYPES	COPPER	3/4"	105.48		

REFRIGERANT LINE FITTING SCHEDULE						
CATAGORY	DESCRIPTION	Size	Count			
ELBOW - GENERIC	ELBOW - GENERIC: STANDARD/HVAC	3/4"ø-3/4"ø	25			
ELBOW - GENERIC	ELBOW - GENERIC: STANDARD/HVAC	3/8"ø-3/8"ø	14			
TEE - GENERIC	TEE - GENERIC: STANDARD	3/4"ø-3/4"ø-3/ 4"ø	1			
TEE - GENERIC	TEE - GENERIC: STANDARD	3/8"ø-3/8"ø-3/ 8"ø	1			
TRANSITION - GENERIC	TRANSITION - GENERIC: STANDARD	3/4"ø-1/2"ø	3			
TRANSITION - GENERIC	TRANSITION - GENERIC: STANDARD	3/4"ø-5/8"ø	2			
TRANSITION - GENERIC	TRANSITION - GENERIC: STANDARD	3/8"ø-1/4"ø	1			

MECHANICAL EQUIPMENT SCHEDULE					
CATAGORY DESCRIPTION COUNT					
AIR HANDLING UNIT	AIR HANDLING UNIT: WALL MOUNTED	2			
CONDENSER	CONDENSER: OUT DOOR	1			
EXHAUST FAN	EXHAUST FAN: 75 CFM	1			
	HOOD-WALL: VENT	1			

DUCT FITTING SCHEDULE				
CATAGORY DESCRIPTION COUNT				
ROUND TRANSITION - ANGLE	45 DEGREE	4		

DUCT ACCESSORY SCHEDULE				
CATAGORY DESCRIPTION COUNT				
		1-		
ROOF VENT	3" DIAMETER	3		

FLEX DUCT SCHEDULE						
DESCRIPTION DESCRIPTION LENGTH DIAMETER COUNT						
FLEX DUCT ROUND	FLEX-ROUND	9.19	4"	3		
GRAND TOTAL: 3		9.19				



**KEY PLAN** 

NO.	DESCRIPTION	DATE

NOTE:

LEGEND:

PROJECT

181-ORCHARD-495-1Bd1Ba **CRAFTSMAN-550** 

DRAWING NAME

**HVAC PLAN** 

CLIENT NAME:	Owner
PROJECT NUMBER:	15_0001
DATE:	5/6/2025 1:15:54 AM
DESIGNED BY:	Designer
DRAWN BY:	Author
CHECKED BY:	Checker

M101

SCALE: As indicated

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### **ELECTRICAL NOTES**

- 1. THIS DRAWING DEPICTS THE ELECTRICAL SYSTEM FOR THE181-ORCHARD-495-1Bd 1Ba CRAFTSMAN-550 . IT PROVIDES A VISUAL REPRESENTATION OF THE ELECTRICAL LAYOUT AND COMPONENTS, INCLUDING POWER DISTRIBUTION, LIGHTING, AND CONTROL SYSTEMS.
- 2. THE ELECTRICAL SYSTEM IS DESIGNED TO MEET THE SPECIFIC REQUIREMENTS OF THE BUILDING, INCLUDING POWER DISTRIBUTION, LIGHTING, AND SPECIALIZED ELECTRICAL EQUIPMENT NEEDS, AS PER THE PROJECT SPECIFICATIONS AND APPLICABLE CODES AND STANDARDS.
- 3. THE ELECTRICAL SYSTEM INSTALLATION SHALL COMPLY WITH THE LATEST EDITION OF THE NATIONAL ELECTRICAL CODE (NEC), INTERNATIONAL BUILDING CODE (IBC), AND ALL OTHER APPLICABLE LOCAL, STATE, AND NATIONAL CODES AND REGULATIONS.
- 4. LOCATIONS AS NEEDED, DEVICES ARE SHOWN ON PLANS IN APPROXIMATE IDEAL LOCATIONS, UNLESS SPECIFICALLY DIMMENSIONED.
- OPEN WALLS AS NEEDED TO ALLOW FOR NEW ELECTRICAL INSTALLATIONS.
- 6. LABEL ALL CIRCUITS ON JUNCTION BOXES, RECEPTACLES, DATA, SMOKE DETECTOR, AND EQUIPMENT IN PANEL BOX.
- 7. INSTALL RACEWAY AS NEEDED FOR DDC, ACCESS CONTROL, LOW VOLTAGE WIRING & DATA.
- 8. RELABEL POWER, DATA & FIRE ALARM FOR ROOM #CHANGES.
- 9. VERIFY ALL CIRCUITS LABELED ON PRINT ARE CORRECT BEFORE WORKING ON THEM. 10. NOTE ON SITE PLAN – ALL CHANGES OR MISSING DETAIL TO BE INCORPORATED INTO THE MASTER PLAN.
- 11. DRAWINGS ARE DIAGRAMMATIC ONLY FOR THE PURPOSE OF SHOWING FIXTURE AND OUTLET LOCATIONS.
- 12. ELECTRICAL CONTRACTOR TO VERIFY SERVICE SIZE BY CALCULATION BASED UPON ACTUAL NAME
- PLATE RATINGS OF SELECTED EQUIPMENT.
- 13. VERIFY LOCATION OF SERVICE ENTRANCE WITH POWER COMPANY. PROVIDE UFER GROUND IN BUILDING FOUNDATION AT SERVICE ENTRANCE LOCATION.
- 14. PROVIDE A MIN. OF 20 FEET OF ONE \*4 BARE COPPER UFER WIRE EMBEDDED IN CONCRETE FOOTING
- AT THE SERVICE ENTRANCE LOCATION WHERE APPROVED BY LOCAL SERVICE PROVIDER. 15. PROVIDE WATERPROOF FIXTURES IN ALL HIGH MOISTURE AREAS (EXTERIOR, SHOWER AND TUB
- CEILINGS ETC.)
- 16. PROVIDE DEDICATED CIRCUITS TO EACH BATH, DEN, FAMILY ROOM, BEDROOM, LOFT, KITCHEN
- REFRIGERATOR, KITCHEN FREEZER DISHWASHER, AND ANY AREA/ITEM SPECIFIED BY OWNER. 17. INCANDESCENT FIXTURES WITH OPEN OR PARTIALLY ENCLOSED LAMPS, PENDANT FIXTURES, AND
- LAMP HOLDERS ARE NOT PERMITTED IN CLOSETS. 18. ALL WORKMANSHIP AND MATERIALS TO CONFORM WITH THE 2015 IRC.
- 19. PROVIDE A MIN. OF 20 FEET OF ONE \*4 BARE COPPER UFER WIRE EMBEDDED IN CONCRETE FOOTING AT THE SERVICE ENTRANCE LOCATION WHERE APPROVED BY LOCAL SERVICE PROVIDER.
- 20. PROVIDE A BONDING CONDUCTOR CONSISTING OF A MINIMUM OF ONE \*4 BARE COPPER WIRE CONNECTING THE BUILDING'S METAL WATER PIPING SYSTEM TO THE SERVICE EQUIPMENT ENCLOSURE GROUNDING.

### MAIN PANEL CALCS

ELECTRICAL CALCS	
LIGHT AND OUTLETS 495 @ 3W	1,485 W
3 APPLIANCE CIRCUITS	4,500 W
DRYER	2,000 W
WASHER	2,000 W
RANGE	5,000 W
WATER HEATER	5,000 W
REFRIG.	1,800 W
DISHWASHER & DISPOSAL	3000 W
TOTAL	24,785W
FRIST 10,000 @ 100% REMAINDER @ 40% MINI. SPLIT UNITS	10,000 W 5,914W 10,000 W
TOTAL	25,914 W

25,914 W DIVIDED BY 240V = 108 AMPS TOTAL

(USE 200 AMP SERVICE)

## **ELECTRICAL ABBREVIATIONS LIST**

	1P	1 POLE (2P, 3P, 4P, ETC.)	CTR	CENTER	нт	HEIGHT
		AMPERE	CU	COPPER	HTG	HEATING
	A		I I			
	AC	ABOVE COUNTER OR AIR CONDITIONER	DCP	DOMESTIC WATER CIRCULATING PUMP	HTR	HEATER
	ACLG	ABOVE CEILING	DEPT	DEPARTMENT	HV	HIGH VOLTAGE
	ADO	AUTOMATIC DOOR OPENER	DET	DETAIL	HVAC	HEATING, VENTILATING AND AIR
	AF	AMP FRAME	DIA	DIAMETER	CONDITIONING	CONDITIONING
	AFF	ABOVE FINISHED FLOOR	DISC	DISCONNECT	HWP	HYDRONIC WATER PUMP
	AFG	ABOVE FINISHED GRADE	DIST	DISTRIBUTION	IC	INTERRUPTING CAPACITY
	AFI	ARC FAULT CIRCUIT INTERRUPTER	DN	DOWN	IG	ISOLATED GROUND
	AHU	AIR HANDLING UNIT	DPR	DAMPER	IMC	INTERMEDIATE METAL CONDUIT
	AL	ALUMINUM	DS	SAFETY DISCONNECT SWITCH	INCAND	INCANDESCENT
	ALT	ALTERNATE	DT	DOUBLE THROW	IR	INFRARED
	AMP	AMPERE	DWG	DRAWING	I/W	INTERLOCK WITH
			I I	DIRECT DIGITAL CONTROL		
	AMPL	AMPLIFIER  ANNUMENT OF A PROCESS ASSESSMENT OF A PROCE	DDC		J-BOX	JUNCTION BOX
	ANNUN	ANNUNCIATOR APPROX APPROXIMATELY	EC	ELECTRICAL CONTRACTOR	KV	KILOVOLT
	AQ-STAT	AQUASTAT	ELEC	ELECTRIC, ELECTRICAL	KVA	KILOVOLT-AMPERE
	ARCH	ARCHITECT, ARCHITECTURAL	ELEV	ELEVATOR	KVAR	KILOVOLT-AMPERE REACTIVE
	AS	AMP SWITCH	EM	EMERGENCY	KW	KILOWATT
	AT	AMP TRIP	EMS	ENERGY MANAGEMENT SYSTEM	KWH	KILOWATT HOUR
	ATS	AUTOMATIC TRANSFER SWITCH	EMT	ELECTRICAL METALLIC TUBING	LOC	LOCATE OR LOCATION
	AUTO	AUTOMATIC	EP	ELECTRIC PNEUMATIC	LT	LIGHT
	AUX	AUXILIARY	EQUIP	EQUIPMENT	LTG	LIGHTING
	AV	AUDIO VISUAL	EWC	ELECTRIC WATER COOLER	LTNG	LIGHTNING
	AWG	AMERICAN WIRE GAUGE	EXIST	EXISTING	LV	LOW VOLTAGE
	BATT	BATTERY	EXH	EXHAUST	MAX	MAXIMUM
	BD	BOARD	EXP	EXPLOSION PROOF	MAG.S	MAGNETIC STARTER
					1	
	BLDG	BUILDING	FA	FIRE ALARM	M/C	MOMENTARY CONTACT
	BMS	BUILDING MANAGEMENT SYSTEM	FABP	FIRE ALARM BOOSTER POWER	MC	MECHANICAL CONTRACTOR
	С	CONDUIT	SUPPLY PANEL	SUPPLY PANEL	MCB	MAIN CIRCUIT BREAKER
	CAB	CABINET	FACP	FIRE ALARM CONTROL PANEL	MCC	MOTOR CONTROL CENTER
	CAT	CATALOG	FCU	FAN COIL UNIT	MDC	MAIN DISTRIBUTION CENTER
	CATV	CABLE TELEVISION	FIXT	FIXTURE	MDP	MAIN DISTRIBUTION PANEL
	СВ	CIRCUIT BREAKER	FLR	FLOOR	MFR	MANUFACTURERMAIN FUSED
	CCTV	CLOSED CIRCUIT TELEVISION	FLUOR	FLUORESCENT		DISCONNECT SWITCH
	CKT	CIRCUIT	FU	FUSE	MH	MANHOLE
	CLG	CEILING	FUDS	FUSED SAFETY DISCONNECT SWITCH	MIC	MICROPHONE
	COMB	COMBINATION	GA	GAUGE	MIN	MINIMUM
	CMPR	COMPRESSOR	GAL	GALLON	MISC	MISCELLANEOUS
	CONN	CONNECTION	GALV	GALVANIZED	MLO	MAIN LUGS ONLY
	CONST	CONSTRUCTION		GENERAL CONTRACTOR	MMS	MANUAL MOTOR STARTER
			GC			
	CONTR	CONTINUATION OR CONTINUOUS	GEN	GENERATOR	MOA	MULTIOUTLET ASSEMBLY
	CONTR	CONTRACTOR	GFI	GROUND FAULT CIRCUIT INTERRUPTER	MSP	MOTOR STARTER PANELBOARD
	CONV	CONVECTOR	GFP	GROUND FAULT PROTECTOR	MSBD	MAIN SWITCHBOARD
	CP	CIRCULATING PUMP	GND	GROUND	MT	MOUNT
	CRT	CATHODE-RAY TUBE	GRS	GALVANIZED RIGID STEEL (CONDUIT)	MT.C	EMPTY CONDUIT
	CT	CURRENT TRANSFORMER	GYP BD	GYPSUM BOARD	UL	UNDERWRITERS LABORATORIES
L						

### **Branch Panel:**

Location: LIVING ROOM 01 **Supply From:** Mounting: Recessed

Enclosure: Type 1

Volts: 120/240 Single Phases: 1 Wires: 3

A.I.C. Rating: Mains Type: Mains Rating: 200 A MCB Rating: 1 A

Circuit Numb er	Circuit Description	Number of Elements	Rating	Length	Wire Size	A			3	Wire Size	Length	Rating	Number of Elements	Circuit Description	Circui Numb er
1	BED LIGHT	8	15 A	42' - 0 13/16"	1-#14, 1-#14, 1-#14	209 VA	576 VA			1-#12, 1-#12, 1-#12	29' - 1 5/16"	20 A	7	BATH GFCI	2
3	HALL & KITCHEN LIGHT	10	20 A	29' - 2 7/8"	1-#12, 1-#12, 1-#12			396 VA	237 VA	1-#12, 1-#12, 1-#12	28' - 9 19/32"	20 A	9	LIVING LIGHT	4
5	OUTDOOR LIGHT	6	15 A	33' - 2 1/16"	1-#14, 1-#14, 1-#14	400 VA	2500 VA			2-#10, 1-#10, 1-#10	39' - 6 1/4"	30 A	1	DRYER	6
7	WASHER	1	20 A	41' - 8 3/8"	1-#12, 1-#12, 1-#12			1200 VA	2500 VA						8
9	RANGE	1	50 A	23' - 1 1/4"	2-#8, 1-#8, 1-#10	2500 VA	1800 VA			1-#12, 1-#12, 1-#12	26' - 8 1/16"	20 A	1	REFRIGERATOR	10
11								2500 VA	720 VA	1-#12, 1-#12, 1-#12	24' - 11"	20 A	4	KITCHEN GFCI	12
13	OVENHOOD	1	20 A	17' - 0 13/16"	1-#12, 1-#12, 1-#12	180 VA	1200 VA			1-#12, 1-#12, 1-#12	13' - 11 11/16"	20 A	1	DISHWASHER	14
15	LIVING RECEPTACLE	5	20 A	34' - 2"	1-#12, 1-#12, 1-#12			900 VA	2250 VA	2-#10, 1-#10, 1-#10	35' - 6 1/2"	30 A	1	WATER HEATER	16
17	BED RECEPTACLE	5	20 A	50' - 0 15/32"	1-#12, 1-#12, 1-#12	900 VA	2250 VA								18
	OUTDOOR RECEPTACLE	5	20 A	50' - 1 3/8"	1-#12, 1-#12, 1-#12			900 VA	2500 VA	2-#6, 1-#6, 1-#10	30' - 11 5/8"	60 A	1	CONDENSER	20
21							2500 VA								22
23															24
25															26
						14993	3 VA	1410	0 VA						1

100.00% 100.00% 100.00%	600 VA 672 VA 6360 VA	Total Conn. Load: Total Est. Demand:	
100.00%			
	6360 VA	Total Est. Demand:	00000 \ / 4
400.000/			28093 VA
100.00%	200 VA	Total Conn.:	121 A
100.00%	5000 VA	Total Est. Demand:	117 A
100.00%	4500 VA		
80.00%	4000 VA		
100.00%	5000 VA		
	1800 VA		
	100.00% 100.00%		



**KEY PLAN** 

NO.	DESCRIPTION	DATE

NOTE:

LEGEND:

PROJECT

181-ORCHARD-495-1Bd 1Ba **CRAFTSMAN-550** 

DRAWING NAME

## **SCHEDULE**

CLIENT NAME: Owner PROJECT NUMBER 0267\_12 3/28/2025 3:32:56 PM Designer DESIGNED BY: DRAWN BY: CHECKED BY: Checker

E101

SCALE: 1/4" = 1'-0"

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### **ELECTRICAL NOTE**

- A. PROVIDE INTERCONNECTED SMOKE ALARMS IN EACH SLEEPING ROOMS, OUTSIDE EACH SLEEPING ROOM, ON EACH STORY, IN THE HALL OR ADJACENT ROOM LUHERE THE CEILING HEIGHT OF A ROOM OPEN TO THE HALL EXCEEDS THE HALL BY 24'. SMOKE ALARMS SHALL BE PERMANENTLY HARD WIRED WITH BATTERY BACKUP.
- B. RECEPTACLE OUTLETS FOR RANGES AND CLOTHES DRYERS SHALL BE A THREE POLE WITH GROUND TYPE. FOUR WIRE GROUNDING-TYPE FLEXIBLE CORDS WILL BE REQUIRED FOR CONNECTION OF RANGES AND CLOTHES DRYERS. THE BONDING JUMPER SHALL NOT BE CONNECTED BETWEEN NEUTRAL TERMINAL AND THE FRAME OF THE APPLIANCE.
- C. TWO OR MORE 20 AMP SMALL APPLIANCE CIRCUITS SHALL BE PROVIDED TO SERVE THE KITCHEN, BREAKFAST NOOK, AND DINING ROOM. SUCH CIRCUITS SHALL HAVE NO OTHER OUTLETS.
- D. AT LEAST ONE 20 AMP BRANCH CIRCUIT SHALL BE PROVIDED TO SERVICE THE LAUNDRY ROOM. THIS CIRCUIT SHALL HAVE NO OTHER OUTLETS.
- E. ALL RECEPTACLES WITH IN 6' OF A WET BAR SINK OR KITCHEN SINK TO SERVE COUNTER TOP SURFACES MUST BE GFCI. ON KITCHEN COUNTERS 12' OR WIDER NO POINT ALONG THE WALL SHALL BE MORE THAN 2' FROM A RECEPTACLE. ALL RECEPTACLES WITH IN 6' OF KITCHEN SINK MUST BE GFCI. AT LEAST ONE GFCI RECEPTACLE SHALL BE INSTALLED IN THE BATHROOM ADJACENT TO EACH BASIN.
- F. FIXTURES INCLUDING CEILING FANS THAT ARE LOCATED IN DAMP LOCATIONS SHALL BE LISTED TO BE SUITABLE FOR
- SUCH LOCATIONS PER 2012 IRC
- G. PROVIDE ONE (1) SWITCHED OUTLET @ ALL BEDROOMS AND DEN
- H. CEILING FANS NOT EXCEEDING 35 LBS. (WITH OR WITHOUT ACCESSORIES MAY BE SUPPORTED BY OUTLET BOXES PROVIDED THE OUTLET BOXES ARE IDENTIFIED FOR SUCH USE PER 2012 IRC
- I. ELECTRICAL OUTLET BOXES ON OPPOSITE SIDES OF FIRE RATED WALLS SHALL BE SEPARATED BY A HORIZONTAL DISTANCE OF NOT LESS THAN 24".
- J. OUTLET BOXES IN THE WALLS BETWEEN THE GARAGE AND DWELLING SHALL BE METAL OR U.L. APPROVED FIRE RESISTIVE PLASTIC. BOXES IN GARAGE CEILING SHALL BE METAL.
- K. ALL BRANCH CIRCUITS THAT SUPPLY 120 VOLTS SINGLE PHASE 15 AND 20 AMPS RECEPTACLE OUTLETS INSTALLED IN THE DWELLING SHALL BE PROTECTED BY AN ARC FAULT CIRCUIT INTERRUPTER, EXCEPT GFCI RECEPTICLES.

#### NOTE:

A. RECEPTACLES MUST BE PROVIDED IN HALLWAYS 10'-0" OR MORE IN LENGTH. FOR A ONE FAMILY DWELLINGS AND EACH OF A TWO FAMILY DWELLING THAT IS AT GRADE LEVEL, AT LEAST ONE WP-GFCI RECEPTACLE OUTLET ACCESSIBLE AT GRADE LEVEL AND NOT MORE THAN 6'-6" ABOVE GRADE SHALL BE INSTALLED AT THE FRONT AND BACK OF THE DWELLING.

#### **NOTE: APPLIANCE DISCONNECT**

#### **E4001.5 GROUNDING OF ENCLOSURES.**

METAL ENCLOSURES FOR SWITCHES OR CIRCUIT BREAKERS SHALL BE CONNECTED TO AN

EQUIPMENT GROUNDING CONDUCTOR.

METAL ENCLOSURES FOR SWITCHES OR CIRCUIT BREAKERS USED AS SERVICE EQUIPMENT SHALL COMPLY WITH THE PROVISIONS OF SECTION E3609.4. WHERE


NONMETALLIC ENCLOSURES ARE USED WITH METAL RACEWAYS OR METAL-ARMORED

CABLES, PROVISIONS SHALL BE MADE FOR CONNECTING THE EQUIPMENT GROUNDING CONDUCTOR.


NONMETALLIC BOXES FOR SWITCHES SHALL BE INSTALLED WITH A WIRING METHOD THAT


PROVIDES OR INCLUDES AN EQUIPMENT GROUNDING CONDUCTOR. (404.12)

ELECTRIC	CAL LEGEND
	Electrical Lights With Fan
0	Waterproof Recessed Can Light
	Pendant Light
0	Recessed Can Light
<b>-</b> ₫ <b>)</b>	Wall Lamp
	Standalone linear
<b>⊬1</b> 3	Single Switch
₩	Three way Switch
<b>₩</b>	Fan Switch
⊖□	Duplex Receptacle
	Triplex Receptacle
⊕ GFCI	GFCI Receptacle
	Exhaust Fan
•	Smoke and heat detector

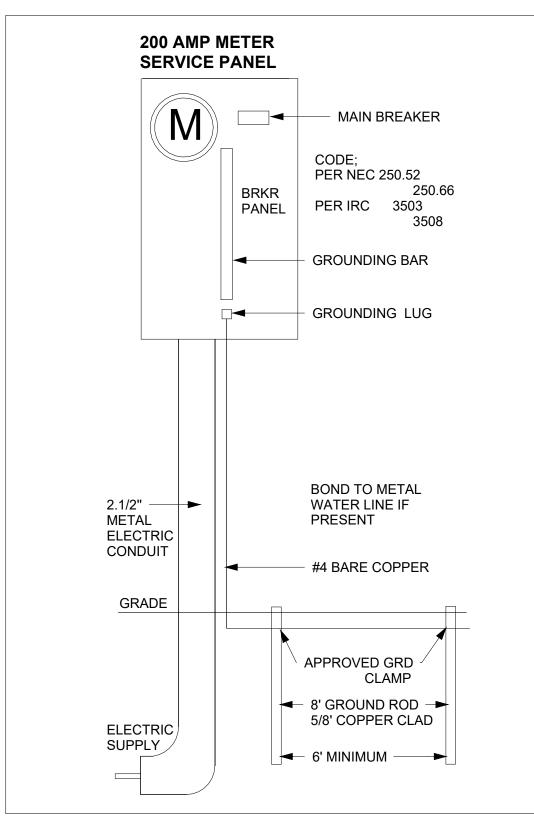



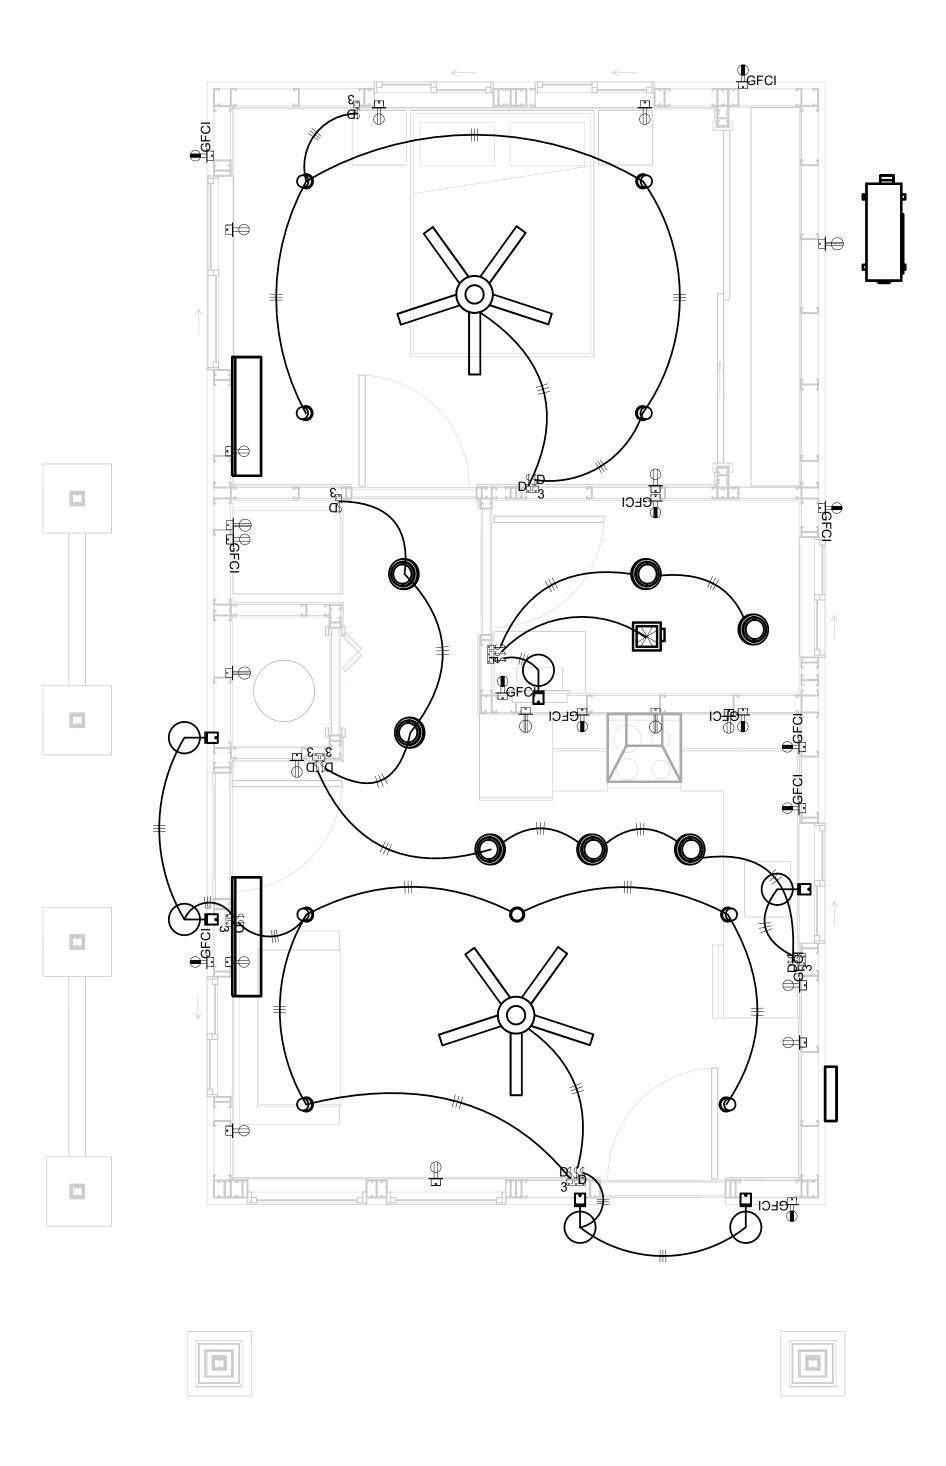

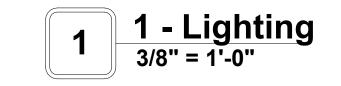



**KEY PLAN** 

NO.	DESCRIPTION	DATE

NOTE:

LEGEND:

PROJECT

181-ORCHARD-495-1Bd 1Ba CRAFTSMAN-550

DRAWING NAME


## LIGHTING

CLIENT NAME:	Owner
PROJECT NUMBER:	0267_12
DATE:	3/28/2025 3:32:58 PM
DESIGNED BY:	Designer
DRAWN BY:	Author
CHECKED BY:	Checker
CHECKED BY:	Check


E102

## **NOTES: CONDUIT, CABLE AND WIRING**


- Use Metalic Conduits (IMC) for cables running under concrete slabs.
   Use IMC for circuits with high voltage appliances (240 volts and above)
   For circuits with 120 volts consider using EMT or PVC conduits if needed.
   For Low voltage applications up to 50 volts consider using non metalic conduits.
   All conduits to be used in the project must conform to the latest National Electrical Code (NEC),
- All wiring and cables to be used in the project must also conform to the latest National Electrical Code (NEC), 2015.
- 7. All cables and wires used should be rated for their respective loading and should be gauged and conform to the NEC.

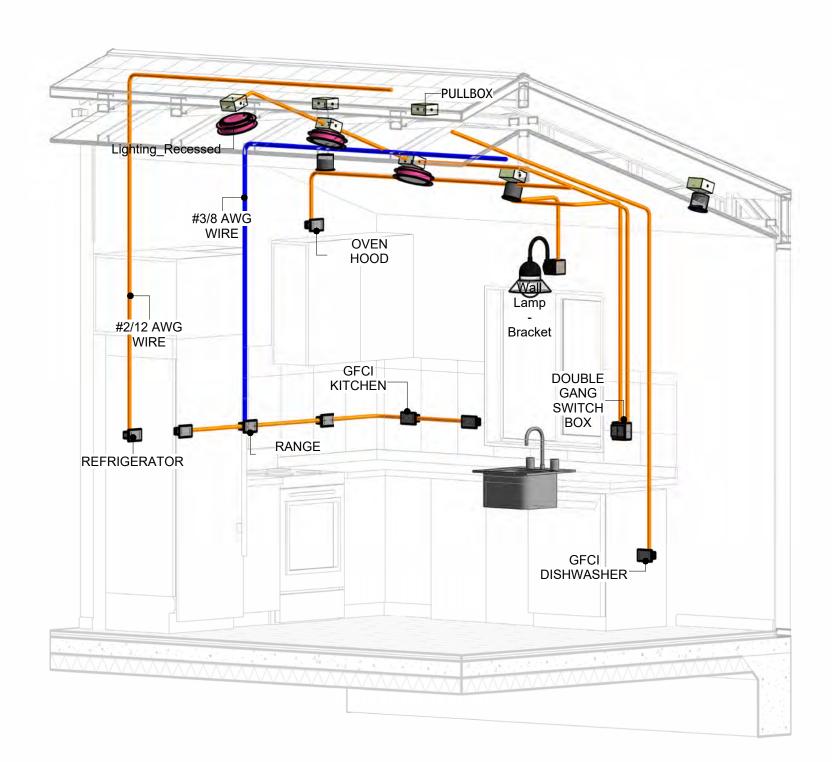


**3D-KITCHEN** 

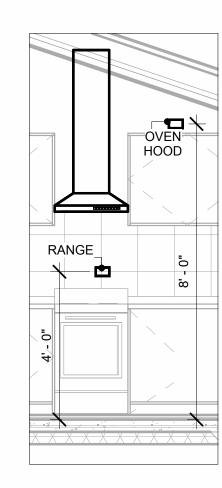


**RANGE & OVENHOOD** 3/8" = 1'-0"

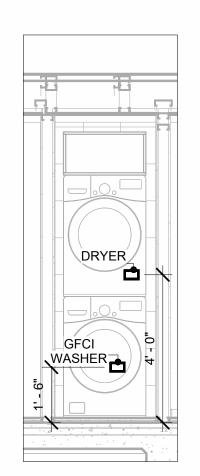

DRYER & WASHER
3/8" = 1'-0"

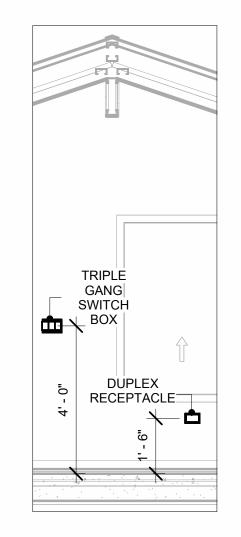

**SWITCH & RECEPTACLE** 3/8" = 1'-0"

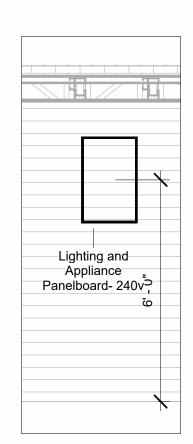

**PANEL** 3/8" = 1'-0"



**KEY PLAN** 

NO.	DESCRIPTION	DATE

NOTE:

LEGEND:

PROJECT

181-ORCHARD-495-1Bd 1Ba **CRAFTSMAN-550** 

DRAWING NAME

## **POWER**

CLIENT NAME:	Owner
PROJECT NUMBER:	0267_12
DATE:	3/28/2025 3:33:22 PM
DESIGNED BY:	Designer
DRAWN BY:	Author
CHECKED BY:	Checker

E103

## **NOTES: LIGHT**

- 1. LIGHT FIXTURES AND LUMINARIES SHALL CONFORM TO THE NEC, THE IRC AND LOCAL SAFETY & BUILDING CODE.
- 2. ALL LIGHTING FIXTURES SHOULD CONFORM TO THE DESIGN ELECTRICAL LOAD AND SHALL BE PROPERLY WIRED AND MOUNTED BY QUALIFIED ELECTRICIAN FOLLOWING MANUFACTURERS SPECIFICATIONS.
- 3. CEILING FANS AND FANS WITH LIGHT WITH WEIGHT EXCEEDING 35 LBS SHOULD BE PROVIDED WITH STRUCTURAL BACKING FOR SUPPORT AND SHALL BE FIXED AS PER MANUFACTURERS SPECIFICATIONS.
- 4. EXTERIOR LIGHTS SHALL CONFORM TO LOCAL BUILDING CODE AND GUIDELINES.

## **NOTES: SWITCH JUNCTION BOX**


- 1. THE MINIMUM SIZE OF JUCTION BOX TO BE USED IS 2"X4"X(1.5" OR 3.5" DEEP) THIS ARE TO BE USED FOR SINGLE GANG SWITCH OR OUTLETS.
- 2. FOR DOUBLE GANG (2 GANG) OUTLETS AND SWITCHS THE MINIMUM SIZE OF THE
- JUCTION BOX TO BE PROVIDED SHALL NOT BE LESS THAN 4"X4"X(1.5" OR 3.5" DEEP)
- 3. FOR THREE GANG (3 GANG) OUTLETS AND SWITCHS THE MINIMUM SIZE OF THE JUĆTION BOX SHALL NOT BE LESS THAN 6"X4"X(1.5" OR 3.5" DEEP).

FITTING SCHEDULE(PULL BOX)			
FAMILY COUNT DESCRIPTION			
PULLBOX1 20 #1/4 PULLBOX			

ELECTRICAL FIXTURE SCHEDULE (SWITCH BOX)		
TYPE	COUNT	
DOUBLE GANG SWITCH BOX	4	
SINGLE GANG SWITCH BOX	2	
TRIPLE GANG SWITCH BOX	2	

LIGHTING DEVICE		
TYPE	COUNT	
DIMMER	2	
FAN SWITCH	1	
SINGLE POLE	5	
THREE WAY WITH DIMMER	8	

LIGHTING FIXTURE			
LIGHTING FIXTURE TYPE	VOLTAGE	ELECTRICAL LOAD	COUNT
ELECTRICAL_LIGHTS_FAN-LIGHT1	120 V/1-100 VA- 120 V/1-100 VA	200 A, 120 V/240 V, SINGLE PHASE, 3 WIRES	2
LIGHTING_RECESSED	120 V/1-60 VA	200 A, 120 V/240 V, SINGLE PHASE, 3 WIRES	7
SASSO 100 ROUND WALLWASHER TRIM	120 V/1-28 VA	200 A, 120 V/240 V, SINGLE PHASE, 3 WIRES	9
WALL LAMP - BRACKET	120 V/1-100 VA	200 A, 120 V/240 V, SINGLE PHASE, 3 WIRES	6

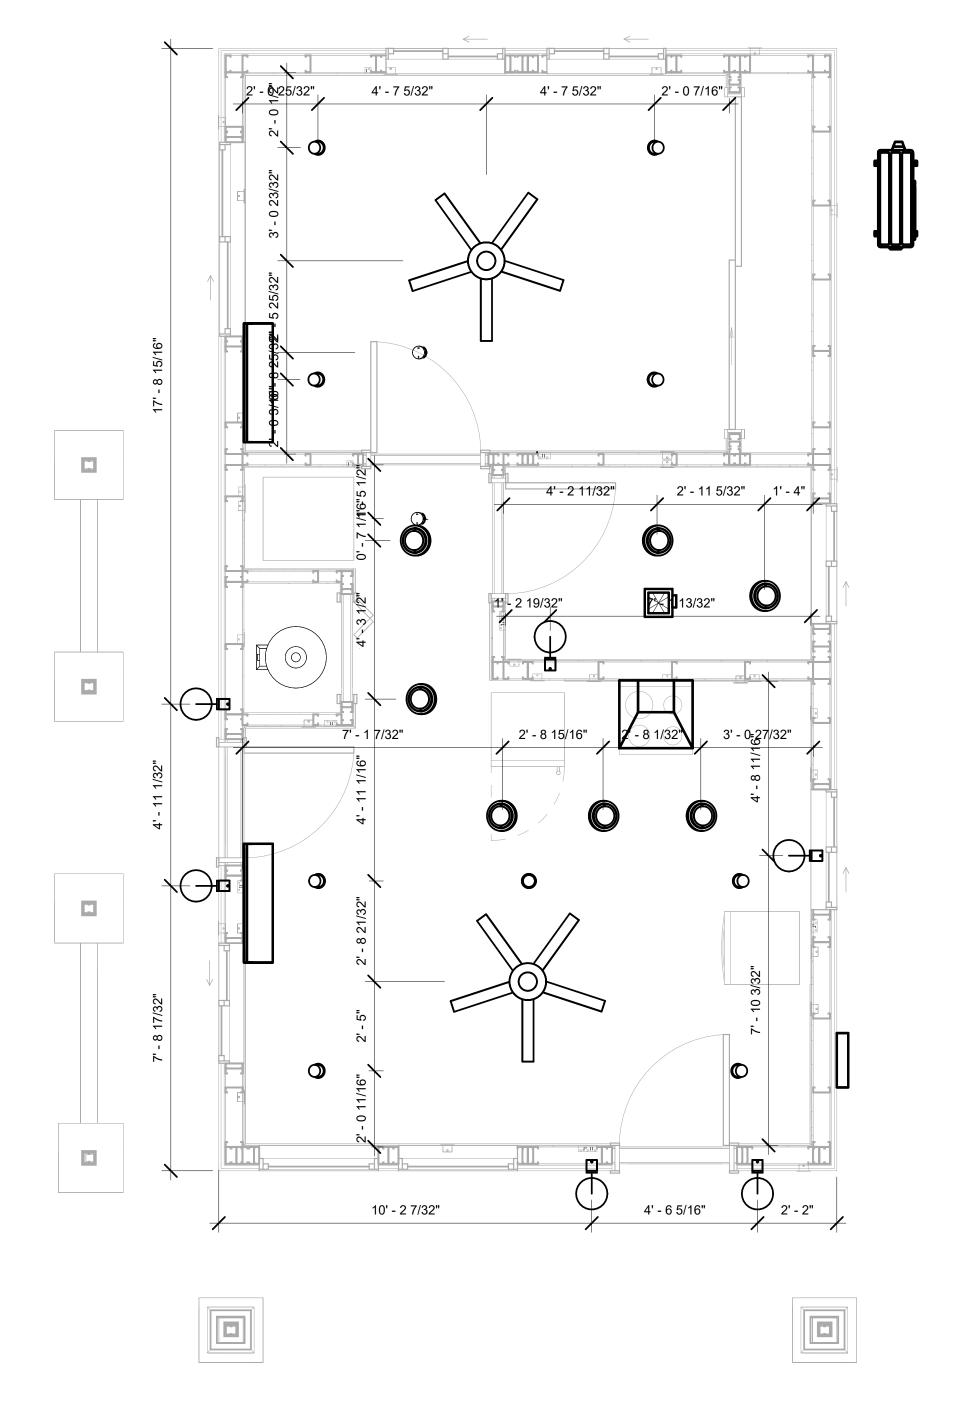





**KEY PLAN** 

NO.	DESCRIPTION	DATE

NOTE:

LEGEND:

PROJECT

181-ORCHARD-495-1Bd 1Ba **CRAFTSMAN-550** 

DRAWING NAME

## **DIMENSION PLAN** FOR LIGHT FIXTURES

CLIENT NAME:	Owner
PROJECT NUMBER:	0267_12
DATE:	3/28/2025 3:33:23 PM
DESIGNED BY:	Designer
DRAWN BY:	Author
CHECKED BY:	Checker


E104

## NOTES;

- 1. VERIFY EQUIPMENT PLUG CONFIGURATION BEFORE PURCHASING RECEPTACLES
- 2. FOR ALL EQUIPMENT.
- 3. COORDINATE EXACT LOCATION OF LIGHT FIXTURES, WALL SWITCHES, RECEPTACLES AND OTHER DEVICES WITH ARCHITECTURAL DRAWINGS.
- 4. USE METALLIC JUNCTION BOX WITH THE GFCI RECEPTACLES, WITH HIGHT VOLTAGE.

ELECTRICAL FIXTURE SCHEDULE (RECEPTACLE)		
TYPE	COUNT	
CONDENSER	1	
DRYER	1	
DUPLEX RECEPTACLE	1	
GFCI BATH ROOM	2	
GFCI DISHWASHER	1	
GFCI KITCHEN	4	
GFCI OUT DOOR	5	
GFCI WASHER	1	
OVEN HOOD	1	
RANGE	1	
REFRIGERATOR	1	
STANDARD	9	
WATER HEATER	1	

ELECTRICAL OUTLET SCHEDULE			
TYPE	CIRCUIT NUMBER	ELECTRICAL DATA	COUNT
GFCI BATH ROOM	2	120 V/1-180 VA	2
DRYER	6,8	240 V/2-5000 VA	1
GFCI WASHER	7	120 V/1-1200 VA	1
RANGE	9,11	240 V/2-5000 VA	1
REFRIGERATOR	10	120 V/1-1800 VA	1
GFCI KITCHEN	12	120 V/1-180 VA	4
OVEN HOOD	13	120 V/1-180 VA	1
GFCI DISHWASHER	14	120 V/1-1200 VA	1
DUPLEX RECEPTACLE	15	120 V/1-180 VA	1
STANDARD	15	120 V/1-180 VA	4
WATER HEATER	16,18	240 V/2-4500 VA	1
STANDARD	17	120 V/1-180 VA	5
GFCI OUT DOOR	19	120 V/1-180 VA	5
CONDENSER	20,22	240 V/2-5000 VA	1

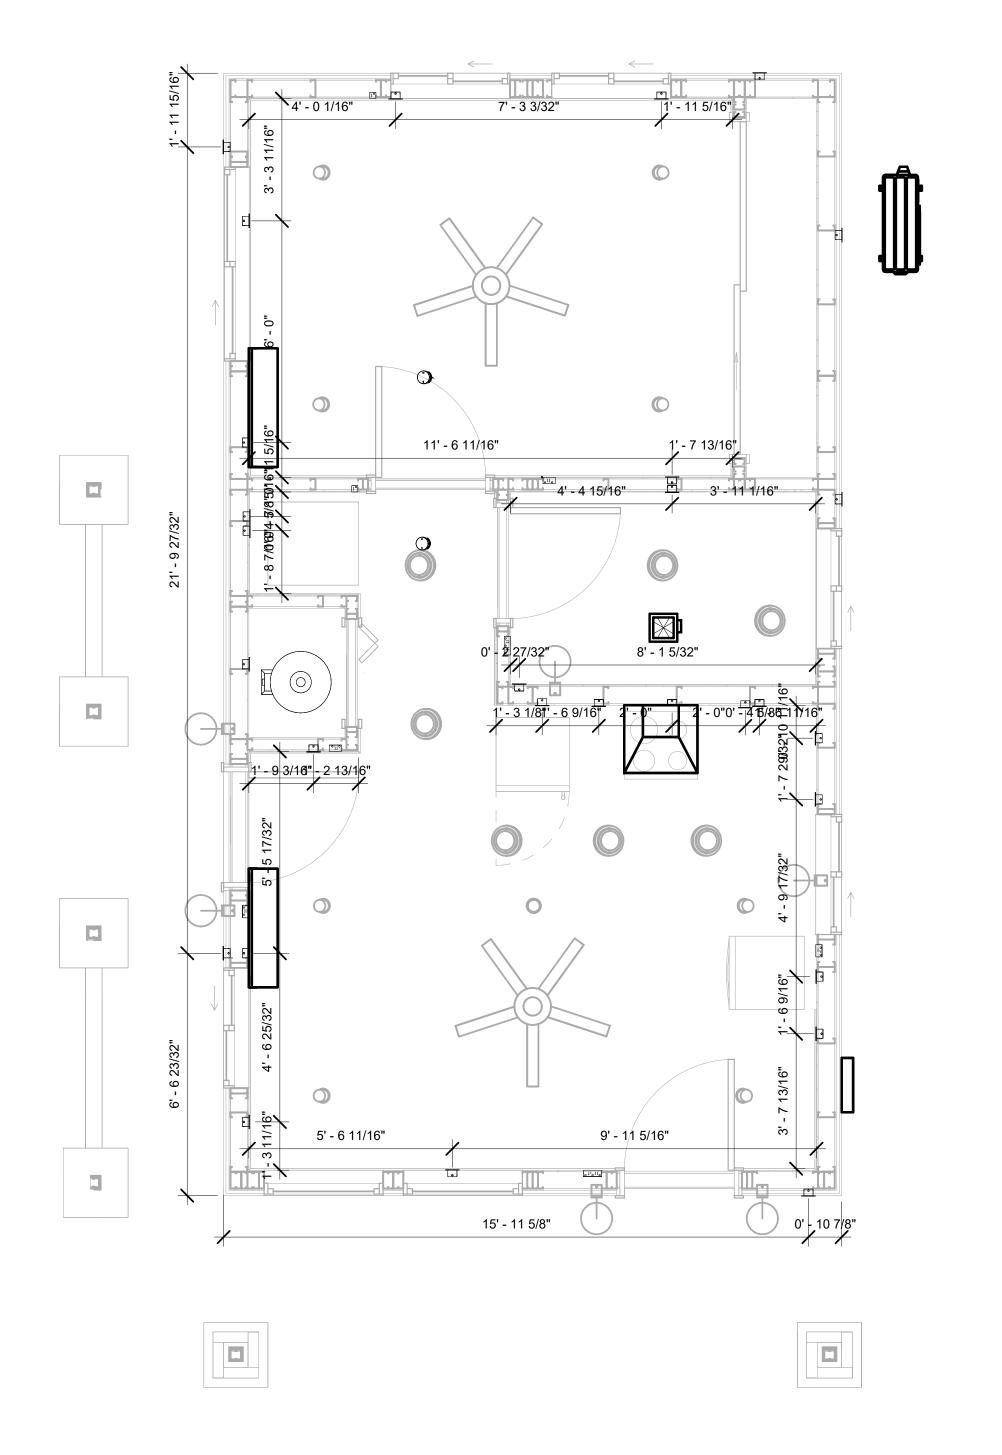





**KEY PLAN** 

NO.	DESCRIPTION	DATE

NOTE:

LEGEND:

PROJECT

181-ORCHARD-495-1Bd 1Ba CRAFTSMAN-550

DRAWING NAME

## DIMENSION PLAN FOR FITTINGS

Owner		CLIENT NAME:
0267_12		PROJECT NUMBER:
3:33:24 PM	3/28/	DATE:
Designer		DESIGNED BY:
Author		DRAWN BY:
Checker		CHECKED BY:

E105

## SHEET LIST

Sheet Number Sheet Name

P101 NOTE AND SCHEDULE
P102 WATER SUPPLY AND SEWAGE
SYSTEM

PIPe Color SCHEME		
	DOMESTIC COLD WATE DOMESTIC HOT WATER SANITARY VENT SANITARY SEWER STORM DRAINAGE Gray Water GAS LINE	

### **PLUMBING NOTES**

- I. The plumbing system is designed to meet the building's domestic water supply, sanitary drainage, and storm drainage requirements, as per project specifications and applicable codes.
- The system installation shall comply with the latest International Plumbing Code (IPC), International Residential Code (IRC), and all other relevant local, state, and national regulations.
- 3. ALL PLUMBING WORK SHALL COMPLY WITH THE LATEST EDITION OF THE INTERNATIONAL PLUMBING CODE (IPC) AND THE LOCAL PLUMBING CODE.
- 4. PLUMBING SYSTEMS SHALL BE TESTED AND INSPECTED IN ACCORDANCE WITH THE LOCAL PLUMBING CODE REQUIREMENTS.
- 5. PLUMBING FIXTURES SHALL BE INSTALLED WITH THE APPROPRIATE TRIM, FITTINGS, AND ACCESSORIES, AS RECOMMENDED BY THE MANUFACTURER.
- 6. PIPING SHALL BE PROPERLY SUPPORTED AND SECURED TO PREVENT SAGGING, MOVEMENT, AND VIBRATION.
- 7. SHUT-OFF VALVES SHALL BE PROVIDED AT ALL BRANCH CONNECTIONS AND AT THE
- INLET AND OUTLET OF EACH PIECE OF EQUIPMENT.

  8. BACKFLOW PREVENTION DEVICES SHALL BE INSTALLED AS REQUIRED BY THE LOCAL
- PLUMBING CODE TO PROTECT THE POTABLE WATER SYSTEM.

  9. PLUMBING FIXTURES AND EQUIPMENT SHALL BE ACCESSIBLE FOR MAINTENANCE AND
- SERVICING.

  10. EXPOSED PLUMBING PIPING AND FIXTURES SHALL BE INSULATED TO PREVENT
- 10. EXPOSED PLUMBING PIPING AND FIXTURES SHALL BE INSULATED TO PREVENT CONDENSATION AND ENERGY LOSS.
- 11. DEAD ENDS IN THE DRAINAGE SYSTEM MUST BE AVOIDED, EXCEPT WHERE NECESSARY TO INSTALL A CLEANOUT IN AN ACCESSIBLE LOCATION, AND MUST HAVE A VENTED CONNECTION TO THE OUTSIDE ATMOSPHERE.
- 12. THE VERTICAL DEFLECTION OF PVC PIPE MUST NOT EXCEED 5%, AND NO DEFLECTION IS PERMITTED FOR IRON PIPE.
- 13. WORK MUST BE PROPERLY COORDINATED WITH OTHER TRADES TO AVOID CONFLICTS, REFERRING TO THE ARCHITECTURAL AND STRUCTURAL DRAWINGS FOR INFORMATION REGARDING CEILING ELEVATIONS, SPACE CLEARANCES, WALL AND PARTITION LOCATIONS, ETC.
- 14. ALL FIXTURES SHALL HAVE ACCESSIBLE STOPS.
- 15. DOMESTIC WATER PIPING SHALL BE PEX, AND PVC PIPING IS NOT ACCEPTABLE FOR INTERIOR USE.
- 16. VENT TERMINATIONS SHALL BE LOCATED AT LEAST 10 FEET FROM OR 3 FEET ABOVE ANY OPERABLE WINDOW, DOOR OPENING, AIR INTAKE, OR VENT SHAFT, AND AT LEAST 3 FEET IN EVERY DIRECTION FROM ANY LOT LINE. ALLEY, OR STREET.
- 17. PIPE AND FITTINGS UTILIZED IN THE WATER SUPPLY SYSTEM SHALL HAVE A MAXIMUM OF 8 PERCENT LEAD.
- 18. ACRYLONITRILE BUTADIENE STYRENE (ABS) SHALL BE USED FOR THE SEWERAGE AND VENTILATION SYSTEM.
- 19. CROSS-LINKED POLYETHYLENE (PEX) SHALL BE USED FOR THE WATER SUPPLY SYSTEM.
- 20. POLYVINYL CHLORIDE (PVC) SHALL BE USED FOR THE RAIN WATER SYSTEM.
- 21. THE MIMIMUM WATER SUPPLY DEPTH UNDER FLOOR FINISH SHOUD BE 1/2".
   22. ANY PIPE INSTALLED UNDERGROUND MUST HAVE AT LEAST 12 INCHES OF CLEARANCE
- BETWEEN THE OUTSIDE OF THE PIPE AND ANY OTHER UNDERGROUND STRUCTURE.
- 23. THE MINIMUM CLEARANCE BETWEEN COLD AND HOT WATER LINES IN RESIDENTIAL
- HOMES MAINTAIN A MINIMUM DISTANCE OF 6 INCHES.

  24. HORIZONTAL SEPARATION BETWEEN WATER AND SEWER LINES: A MINIMUM OF 12 INCHES BETWEEN POTABLE WATER SUPPLY LINES (COLD AND HOT WATER) AND SANITARY SEWER LINES.

## **ABBREVIATIONS**

Ø	Diameter						
ABS	ACRYLONITRILE BUTADIENE STYRENE						
ABV	ABOVE						
AD	AREA DRAIN						
AFF	ABOVE FINISHED FLOOR						
ALT	ALTERNATE						
BFF	BELOW FINISHED FLOOR						
BLW	BELOW						
CO	CLEAN OUT						
CW	COLD WATER						
D	DEGREE						
DFU	Dranage FIXTURE UNIT						
DIA	DIAMETER						
DN	DOWN						
FCO	FLOOR CLEAN OUT						
FD	FLOOR DRAIN						
FL	FLOOR						
FS	FLOOR SINK						
FT	FOOT/FEET						
HB	HOSE BIB						
HW	HOT WATER						
IN	INCH						
MIN	MINIMUM						
NO	NUMBER						
NTS	NOT TO SCALE						
PEX	CROSS-LINKED POLYETHYLENE						
PLBG	PLUMBING						
PVC	POLYVINYL CHLORIDE						
QTY	Quantity						
RD	ROOF DRAIN						
RED	REDUCER						
RM	ROOM						
RW	RAIN WATER						
SF	SQUARE FOOT						
V	VENT						
VTR	VENT THROUGH ROOF						
W	WASTE						
WCO	WALL CLEAN OUT						
WSFU	WATER SUPPLY FIXTURE UNIT						

## PLUMBING LEGEND

D	Сар
	Bend 45 Deg
$\Box$	Bend 90 Deg
	Tee Reducing
	Tee
	Clean Two-Way
	Wye 45 Deg
	Wye 45 Deg Double
	Wye Combination
	P-Trap

PIPE SCHEDULE								
Material Diameter Length								
Acrylonitrile Butadiene Styrene (ABS)	1 1/2"	23 ft						
Acrylonitrile Butadiene Styrene (ABS)	2"	46 ft						
Acrylonitrile Butadiene Styrene (ABS)	3"	16 ft						
Cross-linked polyethylene (PEX)	1/2"	94 ft						
Cross-linked polyethylene (PEX)	3/4"	21 ft						
Cross-linked polyethylene (PEX)	1"	3 ft						
Polyvinyl Chloride - Rigid	2"	61 ft						

FITTING SCHEDULE						
FITTING	Size	QTY				
Domestic Cold Water						
PEX 90 Degree Elbow	1/2"ø-1/2"ø	12				
PEX 90 Degree Elbow	3/4"ø-3/4"ø	1				
PEX Tee Elbow	1/2"ø-1/2"ø	5				
PEX Tee Elbow	3/4"ø-3/4"ø-3/4"ø	2				
PEX Transition Elbow	1"ø-3/4"ø	1				
PEX Transition Elbow	3/4"ø-1/2"ø	1				
Domestic Hot Water						
PEX 90 Degree Elbow	1/2"ø-1/2"ø	12				
PEX 90 Degree Elbow	3/4"ø-3/4"ø	2				
PEX Tee Elbow	1/2"ø-1/2"ø	4				
PEX Transition Elbow	3/4"ø-1/2"ø	1				
Sewage						
Sewage						
ABS 90 Degree Bend Elbow	1 1/2"ø-1 1/2"ø	1				
ABS 90 Degree Bend Elbow	2"ø-2"ø	2				
ABS 90 Degree Bend Elbow	3"ø-3"ø	1				
ABS P-Trap	1 1/2"ø-1 1/2"ø	3				
ABS P-Trap	2"ø-2"ø	2				
ABS P-Trap	3"ø-3"ø	1				
ABS Reducer Elbow	2"ø-1 1/2"ø	1				
ABS Reducer Elbow	3"ø-2"ø	3				
ABS TEE Elbow	1 1/2"ø-1 1/2"ø-1 1/2"ø	1				
ABS TEE Elbow	2"ø-2"ø-2"ø	1				
ABS TEE Elbow	3"ø-3"ø	2				
ABS Tee Reducer Elbow	3"ø-3"ø-1 1/2"ø	2				
ABS Tee Reducer Elbow	3"ø-3"ø	1				
WASTE DOUBLE TEE	2"ø-2"ø-2"ø	1				
Vent						
ABS Vent Cap Elbow	1 1/2"ø	1				
ABS Vent Cap Elbow	2"ø	3				

	FIXTURE CONNECTION SCHEDULE										
Family	W	V	Trap	cw	HW	QT Y	DFU	тот.	WF U	TOT	NOTES
Dishwasher	2"	1-1/2"	1-1/2"	1/2"	1/2"	1		0			Drain to sewer see plans
Dryer	N/A	N/A	N/A	N/A	N/A	1		0			
Hanging pipes clamp1						16		0			
Shower Tray1	2"	1-1/2"	1-1/2"	1/2"	1/2"	1		0			
Shower Trim	-	-	-	1/2"	1/2"	1		0			
Sink Island Single	2"	1-1/2"	1-1/2"	1/2"	1/2"	1		0			
VANITY SINK1						1		0			
Washer	2"	1-1/2"	2"	1/2"	1/2"	1		0			DRAINS TO GRAY WATE OR SEWER SEE PLANS
Water Closet1						1		0			
Water Heater	N/A	N/A	N/A	3/4"	3/4"	1		0			

FIXTURE SCHEDULE					
fixture	QTY	Description			
Dishwasher	1	Drain to sewer see plans			
Dryer	1				
Hanging pipes clamp1	16				
Shower Tray1	1				
Shower Trim	1				
Sink Island Single	1				
VANITY SINK1	1				
Washer	1	DRAINS TO GRAY WATER OR SEWER SEE PLANS			
Water Closet1	1				
Water Heater	1				

ACCESSORIES & FITTINGS SCHEDULE							
fixture QTY Descriptions							
DISHWASHER CONNECTOR	2						
Hose Bib	1						
Shutoff Valve	6						

PLUMBING SCHEDULE							
FIXTURE	Trap	Vent	C.W	H.W			
Dishwasher	1-1/2"	2"	1-1/2"	1/2"	1/2"		
Dryer	N/A	N/A	N/A	N/A	N/A		
Globe Valve							
Shower Tray1	1-1/2"	2"	1-1/2"	1/2"	1/2"		
Shower Trim	-	-	-	1/2"	1/2"		
Shutoff Valve							
Sink Island Single	1-1/2"	2"	1-1/2"	1/2"	1/2"		
VANITY SINK1							
Washer	2"	2"	1-1/2"	1/2"	1/2"		
Water Closet1							
Water Heater	N/A	N/A	N/A	3/4"	3/4"		

WATER FIXTURE UNIT SCHEDULE									
Family	QTY	UNIT VALUE	TOTAL						
Dishwasher 1 0									
Dryer	1		0						
Hanging pipes clamp1	16		0						
Shower Tray1	1		0						
Shower Trim	1		0						
Sink Island Single	1		0						
VANITY SINK1	1		0						
Washer	1		0						
Water Closet1	1		0						
Water Heater	1		0						

WASTE FIXTURE UNIT SCHEDULE						
Family	QTY	DFU Values	TOTAL			
	1		)			
Dryer	1					
Hanging pipes clamp1	16	0				
Shower Tray1	1		)			
Shower Trim	1		)			
Sink Island Single	1		)			
VANITY SINK1	1		)			
Washer	1		)			
Water Closet1	1		)			
Water Heater	1		)			



**KEY PLAN** 

IO. DESCRIPTION DATE

NOTE:

LEGEND:

PROJECT

181-ORCHARD-495-1Bd1Ba CRAFTSMAN-550

DRAWING NAME

NOTE AND SCHEDULE

CLIENT NAME:

 PROJECT NUMBER:
 0267\_12

 DATE:
 3/26/2025 11:55:39 PM


 DESIGNED BY:
 Designer

 DRAWN BY:
 Author

 CHECKED BY:
 Checker

P101

SCALE: 1/2" = 1'-0"

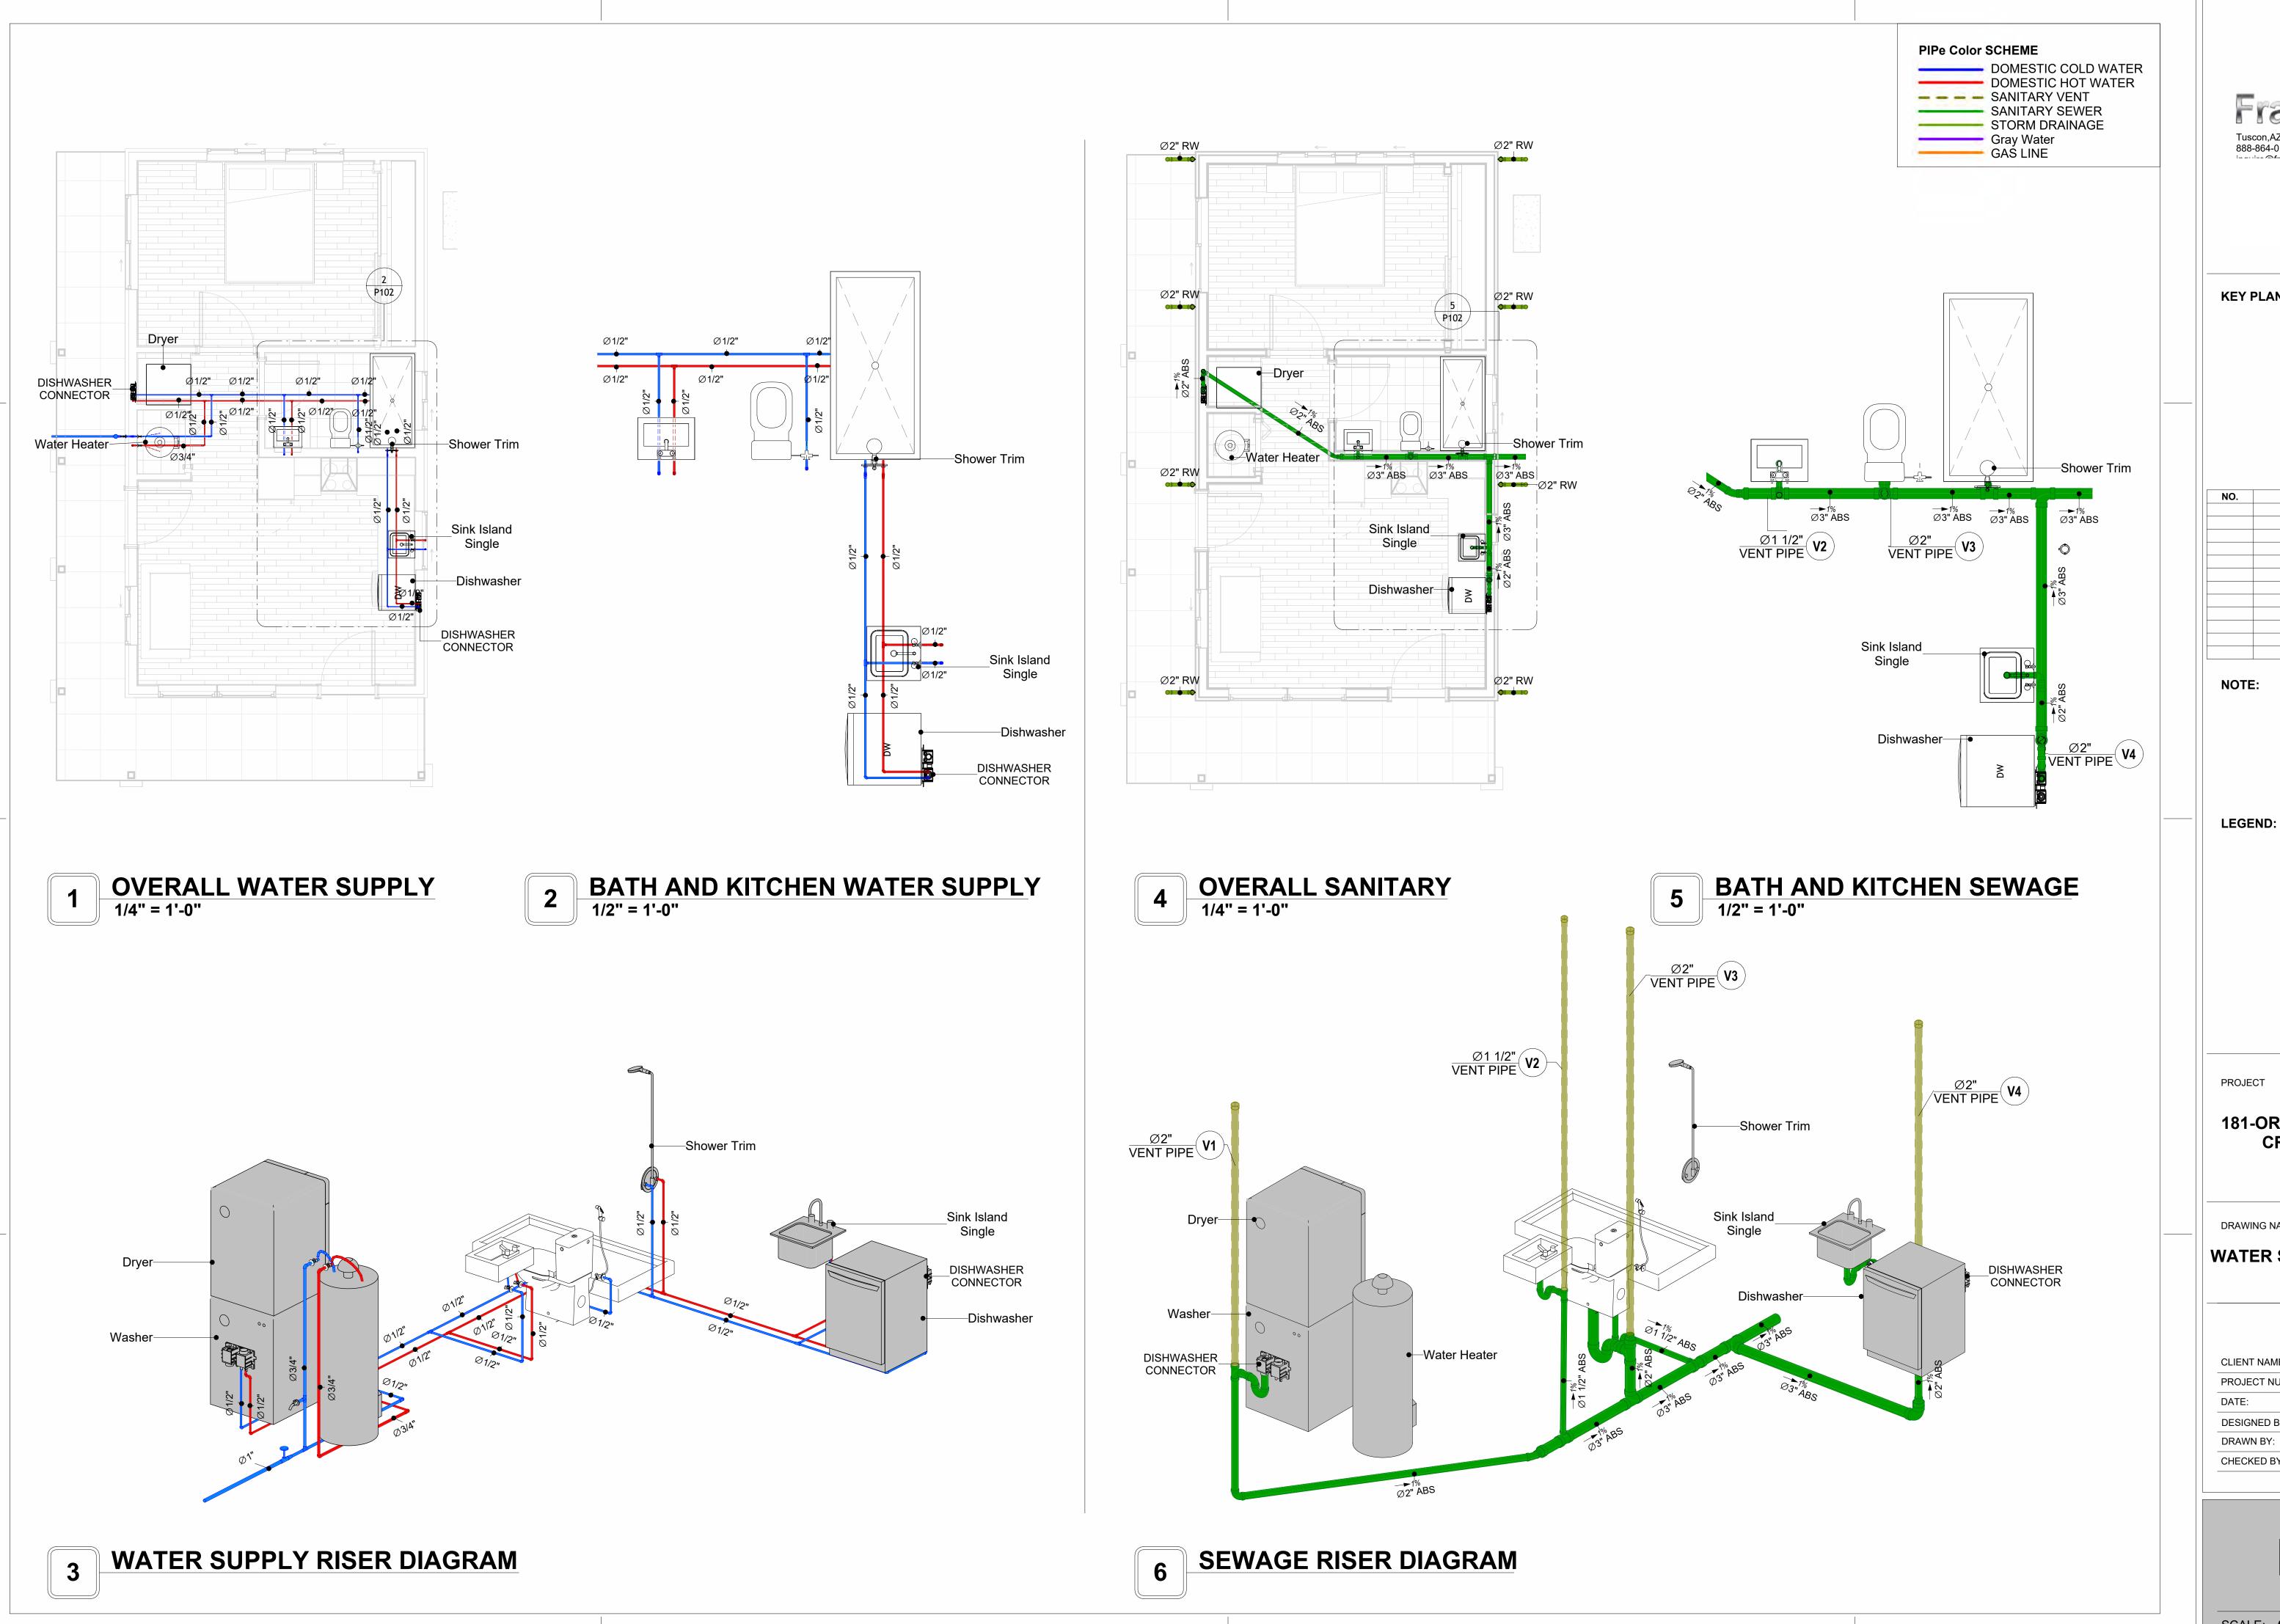



**KEY PLAN** 

DESCRIPTION DATE

181-ORCHARD-495-1Bd1Ba **CRAFTSMAN-550** 

DRAWING NAME

WATER SUPPLY AND SEWAGE SYSTEM

CLIENT NAME: 0267\_12 PROJECT NUMBER: 3/26/2025 11:56:03 PM Designer DESIGNED BY: DRAWN BY: CHECKED BY: Checker

P102

# Materials Shopping List

Please print and take this Materials Shopping List to your favorite Home Depot and ask for assistance in selecting the materials, fixtures and fittings to complete your new home.

Record your selection and the price of the item. Then do the math to determine the cost for your selections and the total cost of finishing your home.

#### **Have It Your Way!**

The material types listed in this document were selected based on personal preferences. The Customer is encouraged to make changes to the material types in accordance with local customs, regulations, and personal preferences.

Have It Your Way!



## 20 good reasons to frame a home with metal and not wood



Why build your ADU with metal vs wood	Wood N	Metal	Explanation
1 DIY Construction Benefit		<b>~</b>	The wall frames, trusses and beams can be erected in a just a few days
2 Minimal Construction Skills Required		<b>~</b>	Pre-assembled walls and trusses require no specialized skills to errect
3 Build as DIY, Hybrid or by a General Contractor		<b>~</b>	Do it yourself, Hybrid (involve special contractors) or hire a General Contractor
4 Build It As You Can Afford It		<b>~</b>	Impervious to Weather - build as you have the time and money
5 Up Front Cost of Framing Materials	<b>~</b>		As to only the framing material, wood is less expensive
6 Total Cost To Build		$\checkmark$	Savings in time, labor, and other areas make light gauge steel LESS expensive
7 Termites and wood boring insects		<b>~</b>	Termites, carpenter ants and wood boring insects eat wood, not metal
8 Mold resistant		$\checkmark$	Metal does not attract mold
9 Damage caused by exterior and interior flooding		<b>~</b>	Metal needs no reconditioning after a flood
10 Fire Resistant		<b>~</b>	Non-combustible
11 Lower insurance rates		<b>~</b>	Many insurance underwriters now provide lower rates for metal framed homes
12 Walls, trusses, and beams retain their original form		<b>~</b>	Perfectly straight walls - no shimming of drywall
13 Corners are 90 degrees		$\checkmark$	No need for templating of countertops to adjust for out of square corners
14 Strength and weight		<b>~</b>	Metal is stronger than wood and weighs less - no need for crane to lift ADU trusses
15 IBC Engineered Stamp		<b>~</b>	If an engineering stamp is necessary, months of waiting are saved
16 Complete BOM (Materials Shopping List)		<b>~</b>	Take the materials shopping list to Home Depot and start shopping/pricing
17 Flexible in Seismic Areas - Won't Fracture		<b>~</b>	Light gauge steel is flexible and won't fracture when the earth moves
18 No Waste At Job Site		<b>~</b>	Steel is the most recycled material in the world. A typical wood home has 20-30% waste
19 Environmentally Friendly		<b>~</b>	Trees don't have to be destroyed and the source of most metal is from recycling
20 How-To Videos Included		<b>Y</b>	How-to videos provide simple assembly instructions
21 Relationship Counselor		<b>~</b>	Eliminate emotional uphevels - save time, money, and preserve the relationship

#### Universal Requirements - some or all may be required

- 1 Site plan
- 2 Electrical Supply Connection
- 3 Sewer Connection
- 4 Fresh Water Supply Connection
- 5 Set Backs
- 6 Soils Evaluation

- 7 Earthquake (fault) evaluation
- 8 Foundation Plan subject to soils
- 9 Compliance with local energy codes: insulation home wrap and flashing
- 10 Engineering for wind speed and snow load.
- 11 State and Local ordinances regarding ADUs
- 12 Local Architect and/or Engineer may be necessary







#### Orchard-1Bd1Ba-Craftsman MATERIAL SHOPPING LIST

#### **Have It Your Way!**

The material types listed in this document were selected based on personal preferences. The Customer is encouraged to make changes to the material types in accordance with local customs, regulations, and personal preferences. Have It Your Way!

#### TOC



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#### Have It Your Way!

The material types listed in this document were selected based on personal preferences. The Customer is encouraged to make changes to the material types in accordance with local customs, regulations, and personal preferences. Have It Your Way!

#### **GENERAL NOTES**

- 1 This BOM (Bill of Materials) is prepared as a Materials Shopping List to help builders and DIYers gain a complete understanding of most if not all elements required for the complete construction of this structure, according to the original design documents provided by FrameUpNow.
- 2 All quantities and specifications are subject to change based on the final design, field measurements, availability of products and customer preferences. The customer should verify all information prior to purchasing materials.
- 3 All products and elements in the list shall conform to the International Residential Code (IRC), or any other local and international building codes, safety regulations, and standards that are applicable to the location of the structure.
- 4 If any changes are made by the customer to the list of materials specified in this document, the customer is responsible for assuring that the correct type and quantity of materials are utilized in accordance with local building
- 5 FrameUpNow, will not be held responsible for any misuse of this document, the products listed, or for deviations from the content that are made due to changes in specifications, pricing, availability, or customer preferences.
- 6 The customer is advised to consult a qualified professional or technician prior to purchasing materials for specialized construction system items. Some items including but not limited to caseworks, doors and windows may require as built measurements prior to purchase to confirmation of final dimensions.
- If there are additional trim elements or specific installation methods, the total amount of materials needed might vary. Consider any additional trim required for corners, intersections, or other architectural details that might cause this variations before procedding to purchase and construction.

#### **ARCHITECTURAL BOM**



				Ba-Craftsma			
		ARCHITECTU				T	
No.	Item	Туре	Unit	Quantity	Unit Price	Total	Description
1	APPLIANCES  Defrigarator	T.	PCS	1	1		
2	Refrigerator		PCS	1 1			
3	Range		PCS	1			
	Washer		PCS	1			
4	Dryer Dish Washer		PCS				
5	Dish Washer			1			
6	Oven		PCS	0			
7	Microwave		PCS	0			
<u>∩</u>	CASEWORKS	I	let.	14.05	1		
1	Kitchen Cabinet		FT	14.85			
2	Laundry Cabinet		FT	2.25			
3	Vanity Cabinet		FT	2.5			
4	Medicine Cabinet		PCS	1			
5	Kitchen countertop		SF	22.61			
6	Laundry Countertop		PCS	0			
7	Bathroom Countertop		SF	0			
8	Island		FT	0			
9	Peninsula		FT	0			
10	Closets		SF	61.49			
△	CEILING						
1	Ceiling Board	Dry Wall	SF	413			
2	Dry Wall Fastener	Screw	PCS	722.75			
3	Vapor Retarder	Polyethylene film	SF	537			
4	Vapor Retarder Fastener	Nails with washer heads	PCS	1611			
5	Ceiling Board (MRD)	Moisture resistant drywall	SF	47			
6	MRD Fastener		PCS	82.25			
7	Ceiling Board	Marine Plywood	SF	77			
8	Marine Plywood Fastener	Screw	PCS	134.75			
9	Dry Wall Tape		FT	268.5			
Δ	FLOORING	!		200.0			
1	Main Living Space		SF	215.9			
2	Bathroom		SF	49.7			
3	Bedroom		SF	161			
4	Porch		SF	215.5			
△	STRUCTURE	l	51	213.3	I		
	Foundation		SF	710.4	1		
	WALLS EXTERIOR	1	51	710.4			
1	Exterior-Grade Plywood Horizonta	LSiding	SF	673	1		
	Exterior-Grade Plywood Fastener		PKT	6.73			
3	Wall Shteathing (OSB)	Sell-milling screws (100/pkt)	SF	673			
4	Shteathing Fastener	Self-drilling screws(100/pkt)	PKT				
	Wall Homewrap	Sell-drilling screws (100/pkt)		6.73			
5		Ctopled feetener (200/-1.4)	SF	673			
	Homewrap Fastener	Stapled fastener (200/pkt)	PKT	2.5574			
7	Furring Strip	0 15 1 1111	PCS	84.125			
8	Furring Strip Fastener	Self-drilling screws(100/pkt)	PKT	6.73			
9	Wall Paint		SF	673			
10	Stone Copping	Masonry stone	SF	0			
	Stone Veneer	Masonry stone	SF	0			
	Mortar for Stone Veneer		SF	0			
	Wall Insulation		SF	2195.0			
△	WALLS INTERIOR						
	Cementitious Backer Board		SF	326			
	Kerdi membrane		SF	326			
3	Kerdi membrane Fastener		SF	326			
4	Wall Ceramic Tile		SF	326			
5	Drywall Board		SF	962			
	Drywall Fastener	Self-drilling screws(100/pkt)	PKT	9.62			
7	Wall Paint		SF	962			
8	Drywall Tape	İ	FT	181			
9	Wall Sweep		FT	95			

#### **ARCHITECTURAL BOM**



Δ	DOORS				
1	Exterior Swinging	3' - 0" X 6'-8"	PCS	2	
2	Interior Swinging	3' - 0" X 6'-8"	PCS	2	
3	Interior Sliding	9' - 0" X 6'-8"	PCS	1	
_	Folding	2' - 6" X 6'-8"	PCS	1	
5	Exterior Door Trim	2 - 0 X 0 - 8	FT	33	
_			FT	175	
6	Interior Door Trim		FI		
/	Entry Lock set			2	
8	Privacy Lock set			2	
9	Passage Lock set			2	
△	WINDOWS				
1	Sliding	3' - 3" X 3'-3"	PCS	1	
2	Sliding	3' - 3" X 2'-3"	PCS	3	
3	Sliding	3' - 3" X 1'-9"	PCS	1	
4	Sliding	5' - 3" X 3'-7"	PCS	1	
5	Single Hung	3' - 3" X 4'-9"	PCS	2	
6	Exterior Window Trim		FT	107	
7	Interior Window Trim		FT	107	
△	ROOF				
1	Roof Covering		SF	774	
2	Roof Covering Fastener		PCS	387	
3	Roof Felt Paper		SF	774	
4	Roof Felt Paper Fastener		PCS	2322	
5	Roof Sheathing		SF	774	
6	Roof Sheathing Fastener		PCS	6192	
7	Batten		FT	0	
8	Batten Fastener		PCS	0	
9	Soffit		SF	166	
10	Soffit Fastener		PCS	83	
11	Fascia		FT	116	
	Fascia board fastener		PCS	58	
13	Roof Insulation		SF	774	
_					



	Orc	hard-1Bd1Ba-Crafts	sman		
	FLECTRIC	AL MATERIAL SHO	PPING LIST	-	
No.	Item	Type		Quantity	Description
	LIGHTING FIXTURES	71			
1	Kitchen Ceiling Light		PCS	3	
2	Kitchen Wall Mounted Light		PCS	1	
	Exterior Wall Mounted Light		PCS	4	
4	Livingroom Ceiling Light With Fan		PCS	1	
5	Bedroom Ceiling Light With Fan		PCS	1	
6	Dining Ceiling Light		PCS	0	
7	Bath Wall Mounted Light		PCS	1	
8	Bathroom Ceiling Light		PCS	2	
9	Livingroom Ceiling Light		PCS	5	
	Bedroom Ceiling Light		PCS	4	
	Hall & Entry Ceiling Light		PCS	2	
	Closet Ceiling Light		PCS	0	
	Smoke Detector		PCS	2	
	ELECTRICAL FITTINGS		1 03		
	Standard Receptacle 120V	20A	PCS	10	
	GFCI Receptacle 120V	20 A	PCS	14	
_	·	30 A	PCS	2	
16	·	50 A	PCS	1	
17		60 A	PCS		
18	GFCI Receptacle 240V Fan Switch	00 A	PCS	1	
			PCS	1	
	Single Pole Switch			5	
	Three Way Switch		PCS	8	
	Dimmer Switch		PCS	2	
	ELECTRICAL CONDUITS & WIRING		F.T.		
	ROMEX 14 AWG	14/3/W/ground	FT	75	
	ROMEX 12 AWG	12/3/W/ground	FT	346	
	ROMEX 12 AWG	12/2/W/ground	FT	0	
	ROMEX 10 AWG	10/3/W/ground	FT	0	
	ROMEX 10 AWG	10/2/W/ground	FT	75	
	Romex 8 AWG	8/3/W/ground	FT	0	
	Romex 8 AWG	8/2/W/ground	FT	23	
	ROMEX 6 AWG	6/3/W/ground	FT	31	
	Bare Copper Ground Wire 6 AWG		FT		
	ELECTRICAL BOXES & CIRCUTES				
32	Panelboard -240V 1 Phase MLO	200 AMP	PCS	1	
33	Circuit breaker	15 A	PCS	2	
34	Circuit breaker	20 A	PCS	11	
35	Circuit breaker	30 A	PCS	2	
36	Circuit breaker	50 A	PCS	1	
37	Circuit breaker	60 A	PCS	1	
	Single Gang Switch Box		PCS	2	
	Double Gang Switch Box		PCS	4	
	Triple Gang Switch Box		PCS	2	
	Pull Box	#1/4	PCS	20	
	Receptacle Box		PCS	29	



#### Orchard-1Bd1Ba-Craftsman PLUMBING SYSTEM MATERIAL SHOPPING LIST Item Unit Quantity Unit Price Total Description 1 Bath Tub (Alcove Tub) PCS 2 Kitchen Sink PCS 1 3 Kitchen Faucets PCS 4 Vanity Sink PCS 1 5 Bath room Faucets PCS 6 Water Closet PCS 7 Shower Trim PCS 8 Shower Tray PCS 9 Water Heater PCS 10 Hose Bib PCS 1 11 Shutoff Valve PCS 12 Hanging pipe clamp PCS 16 13 Gate Valve PCS 14 Dishwasher Supply Single Connector PCS 1 15 Dishwasher Sewage Single Connector PCS 16 Laundry Sweat Connector PCS 1 △ SANITARY & PLUMBING PIPE 1 ABS (Acrylonitrile Butadiene Styrene) Pipes ø 1" FT 0 2 ABS (Acrylonitrile Butadiene Styrene) Pipes ø 1 1/2 FT 23 3 ABS (Acrylonitrile Butadiene Styrene) Pipes ø 2" FT 46 4 ABS (Acrylonitrile Butadiene Styrene) Pipes ø 3" FT 25 5 PEX (Cross-linked polyethylene) Pipes ø 1/2' FT 94 6 PEX (Cross-linked polyethylene) Pipes ø 3/4" FT 21 7 PEX (Cross-linked polyethylene) Pipes ø 1" FT 3 8 PVC Pipes Sch.80 - Rigid ø 1 1/2" FT 0 9 PVC Pipes Sch.80 - Rigid ø 2" FT 61 10 PVC Pipes Sch.80 - Rigid ø 3" FT 0 11 Flex Pipe Round ø 1/2" PCS 6 12 Flex Pipe Round ø 3/4" **PCS** 0 13 Flex Pipe Round ø 1" PCS 0 1 PEX 90 Degree Elbow 1/2"ø-1/2"ø PCS 12 PCS 2 PEX 90 Degree Elbow 3/4"ø-3/4"ø 1 3 PEX Tee Elbow 1/2"ø-1/2"ø-1/2"ø PCS 4 PEX Tee Elbow 3/4"ø-3/4"ø-3/4"ø **PCS** 5 PEX Transition Elbow 1"ø-3/4"ø PCS 6 PEX Transition Elbow 3/4"ø-1/2"ø PCS 1 7 PEX 90 Degree Elbow 1/2"ø-1/2"ø PCS 12 8 PEX 90 Degree Elbow 3/4"ø-3/4"ø PCS 2 9 PEX Tee Elbow 1/2"ø-1/2"ø-1/2"ø PCS 10 PEX Transition Elbow 3/4"ø-1/2"ø **PCS** 11 PVC 90 Deg Bend Elbow 2"ø-2"ø PCS 24 12 ABS 90 Degree Bend Elbow 1 1/2"ø-1 1/2"ø PCS 1 13 ABS 90 Degree Bend Elbow 2"ø-2"ø PCS 14 ABS 90 Degree Bend Elbow PCS 3"ø-3"ø 15 ABS P-Trap 1 1/2"ø-1 1/2"ø PCS 16 ABS P-Trap PCS 2"ø-2"ø 17 ABS P-Trap 3"ø-3"ø PCS 18 ABS Reducer Elbow 2"ø-1 1/2"ø PCS 19 ABS Reducer Elbow 3"ø-2"ø PCS 20 ABS TEE Elbow 1 1/2"ø-1 1/2"ø-1 1/2"ø PCS 21 ABS TEE Elbow PCS 2"ø-2"ø-2"ø 22 ABS TEE Elbow PCS 3"ø-3"ø-3"ø 2 23 ABS Tee Reducer Elbow 3"ø-3"ø-1 1/2"ø PCS 24 ABS Tee Reducer Elbow PCS 3"ø-3"ø-3"ø 25 WASTE DOUBLE TEE 2"ø-2"ø-2"ø-2"ø PCS 26 ABS Vent Cap Elbow 1 1/2"ø PCS 27 ABS Vent Cap Elbow PCS

3

2"ø

		Orchard-1B	d1Ba-C	raftsmar	1		
		HVAC SYSTEM MA	TERIAL	SHOPP	ING LIST		
No.	Item	Туре	Unit	Quantity	Unit Price	Total	Description
$\triangle$	HVAC_DUCTS						
1	PIPE (REFRIGERANT LINE)	3/8" (Ø)	FT	52.11			
2	PIPE (REFRIGERANT LINE)	3/4''' (Ø)	FT	105.48			
3	DRAYER HOSE	4" (Ø)	FT	3.6			
4	FLEX DUCT ROUND	4" (Ø)	FT	5.59			
	DUCT FITTINGS & ACCESSORIES						
5	ELBOW (REFRIGERANT LINE)	3/4" (Ø)-3/4" (Ø)	PCS	25			
6	ELBOW (REFRIGERANT LINE)	3/8" (Ø)-3/8" (Ø)	PCS	14			
7	TEE (REFRIGERANT LINE)	3/4" (Ø)-3/4" (Ø)-3/4" (Ø)	PCS	1			
8	TEE (REFRIGERANT LINE)	3/8" (Ø)-3/8" (Ø))-3/8" (Ø)	PCS	1			
9	TRANSITION (REFRIGERANT	3/4" (Ø)-1/2" (Ø)	PCS	3			
10	TRANSITION (REFRIGERANT	3/4" (Ø)-5/8" (Ø)	PCS	2			
11	TRANSITION (REFRIGERANT	3/8" (Ø)-1/4" (Ø)	PCS	1			
	HVAC_EQUIPMENTS						
12	AIR HANDLING UNIT	WALL MOUNTED	PCS	2			
13	CONDENSER	OUTDOOR UNIT	PCS	1			
14	EXHAUST FAN	75 CFM	PCS	1			
15	EXHAUST HOOD	WALL MOUNTED	PCS	1			
16	HOOD-WALL: VENT	HOOD-WALL: VENT	PCS	1			
17	DRAYER: VENT	DRAYER: VENT	PCS	1			
18	ROOF VENT	3"(Ø)	PCS	1			



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#### **Have It Your Way!**

The material types listed in this document were selected based on personal preferences. The Customer is encouraged to make changes to the material types in accordance with local customs, regulations, and personal preferences. Have It Your Way!

#### **GENERAL NOTES**

- This BOM (Bill of Materials) is prepared as a Materials Shopping List to help builders and DIYers gain a complete understanding of most if not all elements required for the complete construction of this structure, according to the original design documents provided by FrameUpNow.
- 2 All quantities and specifications are subject to change based on the final design, field measurements, availability of products and customer preferences. The customer should verify all information prior to purchasing materials.
- 3 All products and elements in the list shall conform to the International Residential Code (IRC), or any other local and international building codes, safety regulations, and standards that are applicable to the location of the structure.
- 4 If any changes are made by the customer to the list of materials specified in this document, the customer is responsible for assuring that the correct type and quantity of materials are utilized in accordance with local building codes.
- 5 FrameUpNow, will not be held responsible for any misuse of this document, the products listed, or for deviations from the content that are made due to changes in specifications, pricing, availability, or customer preferences.
- The customer is advised to consult a qualified professional or technician prior to purchasing materials for specialized construction system items. Some items including but not limited to caseworks, doors and windows may require as built measurements prior to purchase to confirmation of final dimensions.
- 7 If there are additional trim elements or specific installation methods, the total amount of materials needed might vary. Consider any additional trim required for corners, intersections, or other architectural details that might cause this variations before procedding to purchase and construction.



			LIGHTING FIXTURES				
#	Item	Туре	Description, Manufacturer, SKU	Unit	Quantity	Unit Price	Total
1	Kitchen Ceiling Light			PCS	3		
3	Kitchen Wall Mounted Light			PCS	1		
4	Exterior Wall Mounted Light			PCS	4		
5	Livingroom Ceiling Light With Fan			PCS	1		
6	Bedroom Ceiling Light With Fan			PCS	1		
7	Dining Ceiling Light			PCS	0		
8	Bath Wall Mounted Light			PCS	1		
9	Bathroom Ceiling Light			PCS	2		
10	Livingroom Ceiling Light			PCS	5		
11	Bedroom Ceiling Light			PCS	4		
12	Hall & Entry Ceiling Light			PCS	2		
12	Closet Ceiling Light			PCS	0		
13	Smoke Detector			PCS	2		
14							
15							



			ELECTRICAL FITTINGS				
#	Item	Туре	Description, Manufacturer, SKU	Unit	Quantity	Unit Price	Total
1	Standard Receptacle 120V	20A		PCS	10		
2	GFCI Receptacle 120V	20 A		PCS	14		
3	GFCI Receptacle 240V	30 A		PCS	2		
4	GFCI Receptacle 240V	50 A		PCS	1		
5	GFCI Receptacle 240V	60 A		PCS	1		
6	Fan Switch			PCS	1		
7	Single Pole Switch			PCS	5		
8	Three Way Switch			PCS	8		
9	Dimmer Switch			PCS	2		
10							
11							
12							
13							
14							
15							



		ELECTR	ICAL CONDUITS & WIRING			
#	Item	Туре	Description, Manufacturer, SKU	Unit	Quantity Unit	Price   Total
1	ROMEX 14 AWG	14/3/W/ground		FT	75	
3	ROMEX 12 AWG	12/3/W/ground		FT	346	
4	ROMEX 12 AWG	12/2/W/ground		FT	0	
6	ROMEX 10 AWG	10/3/W/ground		FT	0	
8	ROMEX 10 AWG	10/2/W/ground		FT	75	
9	Romex 8 AWG	8/3/W/ground		FT	0	
10	Romex 8 AWG	8/2/W/ground		FT	23	
11	ROMEX 6 AWG	6/2/W/ground		FT	31	
12	Bare Copper Ground Wire 6 AWG			FT		
13						
14						
15						
16						



		ELEC	TRICAL BOXES & CIRCUTES				
#	Item	Туре	Description, Manufacturer, SKU	Unit	Quantity	Unit Price	Total
1	Panelboard -240V 1 Phase MLO	200 AMP		PCS	1		
2	Circuit breaker	15 A		PCS	2		
3	Circuit breaker	20 A		PCS	11		
4	Circuit breaker	30 A		PCS	2		
5	Circuit breaker	50 A		PCS	1		
6	Circuit breaker	60 A		PCS	1		
7	Single Gang Switch Box			PCS	2		
8	Double Gang Switch Box			PCS	4		
9	Triple Gang Switch Box			PCS	2		
10	Pull Box	#1/4		PCS	20		
11	Receptacle Box			PCS	29		
12							
13							
14							
15							

			HVAC_DUCTS 01				
#		Туре	Description, Manufacturer, SKU	Unit	Quantity	Unit Price	Total
1	PIPE (REFRIGERANT LINE)			FT	52.11		
2	PIPE (REFRIGERANT LINE)	3/4''' (Ø)		FT	105.48		
3	DRAYER HOSE	4" (Ø)		FT	3.6		
4	FLEX DUCT ROUND	4" (Ø)		FT	5.59		

		C	OUCT FITTINGS & ACCESSORIES				
#	Item	Туре	Description, Manufacturer, SKU	Unit	Quantity	Unit Price	Total
1	ELBOW (REFRIGERANT LINE)	3/4" (Ø)-3/4" (Ø)		PCS	25		
2	ELBOW (REFRIGERANT LINE)	3/8" (Ø)-3/8" (Ø)		PCS	14		
3	TEE (REFRIGERANT LINE)	3/4" (Ø)-3/4" (Ø)-3/4" (Ø)		PCS	1		
4	TEE (REFRIGERANT LINE)	3/8" (Ø)-3/8" (Ø))-3/8" (Ø)		PCS	1		
5	TRANSITION (REFRIGERANT LINE)	3/4" (Ø)-1/2" (Ø)		PCS	3		
6	TRANSITION (REFRIGERANT LINE)	3/4" (Ø)-5/8" (Ø)		PCS	2		
7	TRANSITION (REFRIGERANT LINE)	3/8" (Ø)-1/4" (Ø)		PCS	1		

			HVAC_EQUIPMENTS				
#	Item	Туре	Description, Manufacturer, SKU	Unit	Quantity	<b>Unit Price</b>	Total
1	AIR HANDLING UNIT	WALL MOUNTED		PCS	2		
2	CONDENSER	OUTDOOR UNIT		PCS	1		
3	EXHAUST FAN	75 CFM		PCS	1		
4	EXHAUST HOOD	WALL MOUNTED		PCS	1		
5	HOOD-WALL: VENT	HOOD-WALL: VENT		PCS	1		
6	DRAYER: VENT	DRAYER: VENT		PCS	1		
7	ROOF VENT	3"(Ø)		PCS	1		
8							
9							
10							
11							
12							
13							
14							



		PLUMBI	NG FIXTURES & ACCESSORIES				
#	Item	Туре	Description, Manufacturer, SKU	Unit	Quantity	Unit Price	Total
1	Bath Tub (Alcove Tub)			PCS	0		
2	Kitchen Sink			PCS	1		
3	Kitchen faucets			PCS	1		
4	Vanity Sink			PCS	1		
5	Bath room faucets			PCS	1		
6	Water Closet			PCS	1		
7	Shower Trim			PCS	1		
8	Shower Tray			PCS	1		
9	Water Heater			PCS	1		
10	Hose Bib			PCS	1		
11	Shutoff Valve			PCS	6		
12	Hanging pipe clamp			PCS	16		
13	Globe Valve			PCS	1		
14	Dishwasher Supply Single Connector			PCS	1		
15	Dishwasher Sewage Single Connector			PCS	1		
16	Laundry Sweat Connector			PCS	1		



		SANI	ITARY & PLUMBING PIPES				
#	Item	Туре	Description, Manufacturer, SKU	Unit	Quantity	Unit Price	Total
1	ABS (Acrylonitrile Butadiene Styrene) Pipes	ø 1"		FT	C		
2	ABS (Acrylonitrile Butadiene Styrene) Pipes	ø 1 1/2"		FT	23		
3	ABS (Acrylonitrile Butadiene Styrene) Pipes	ø 2"		FT	46		
4	ABS (Acrylonitrile Butadiene Styrene) Pipes	ø 3"		FT	25		
5	PEX (Cross-linked polyethylene) Pipes	ø 1/2"		FT	94		
6	PEX (Cross-linked polyethylene) Pipes	ø 3/4"		FT	21		
7	PEX (Cross-linked polyethylene) Pipes	ø 1"		FT	3		
8	PVC Pipes Sch.80 - Rigid	ø 1 1/2"		FT	C		
9	PVC Pipes Sch.80 - Rigid	ø 2"		FT	61		
10	PVC Pipes Sch.80 - Rigid	ø 3"		FT	0		
11	Flex Pipe Round	ø 1/2"		FT	6		
12	Flex Pipe Round	ø 3/4"		FT	C		
13	Flex Pipe Round	ø 1"		FT	C		
14							
15							



		PI	PE FITTINGS 01				
#	Item	Туре	Description, Manufacturer, SKU	Unit	Quantity	Unit Price	Total
1	PEX 90 Degree Elbow	1/2"ø-1/2"ø		PCS	12		
2	PEX 90 Degree Elbow	3/4"ø-3/4"ø		PCS	1		
3	PEX Tee Elbow	1/2"ø-1/2"ø-1/2"ø		PCS	5		
4	PEX Tee Elbow	3/4"ø-3/4"ø-3/4"ø		PCS	2		
5	PEX Transition Elbow	1"ø-3/4"ø		PCS	1		
6	PEX Transition Elbow	3/4"ø-1/2"ø		PCS	1		
7	PEX 90 Degree Elbow	1/2"ø-1/2"ø		PCS	12		
8	PEX 90 Degree Elbow	3/4"ø-3/4"ø		PCS	2		
9	PEX Tee Elbow	1/2"ø-1/2"ø-1/2"ø		PCS	4		
10	PEX Transition Elbow	3/4"ø-1/2"ø		PCS	1		
11	PVC 90 Deg Bend Elbow	2"ø-2"ø		PCS	24		
12	ABS 90 Degree Bend Elbow	1 1/2"ø-1 1/2"ø		PCS	1		
13	ABS 90 Degree Bend Elbow	2"ø-2"ø		PCS	2		
14	ABS 90 Degree Bend Elbow	3"ø-3"ø		PCS	1		
15	ABS P-Trap	1 1/2"ø-1 1/2"ø		PCS	3		



		PIPE	FITTINGS 02				
#	Item	Туре	Description, Manufacturer, SKU	Unit	Quantity	Unit Price	Total
1	ABS P-Trap	2"Ø-2"Ø		PCS	2		
2	ABS P-Trap	3"ø-3"ø		PCS	1		
3	ABS Reducer Elbow	2"ø-1 1/2"ø		PCS	1		
4	ABS Reducer Elbow	3"ø-2"ø		PCS	3		
5	ABS TEE Elbow	1 1/2"ø-1 1/2"ø-1 1/2"ø		PCS	1		
6	ABS TEE Elbow	2"Ø-2"Ø-2"Ø		PCS	1		
7	ABS TEE Elbow	3"ø-3"ø-3"ø		PCS	2		
8	ABS Tee Reducer Elbow	3"ø-3"ø-1 1/2"ø		PCS	2		
9	ABS Tee Reducer Elbow	3"ø-3"ø-3"ø		PCS	1		
10	WASTE DOUBLE TEE	2"Ø-2"Ø-2"Ø		PCS	1		
11	ABS Vent Cap Elbow	1 1/2"ø		PCS	1		
12	ABS Vent Cap Elbow	2"Ø		PCS	3		
13							
14							
15							



			APPLIANCES				
#	Item	Туре	Description, Manufacturer, SKU	Unit	Quantity	Unit Price	Total
1	Refrigerator			PCS			
2	Range			PCS			
3	Washer Front Load	Stackable		PCS			
4	Dryer Front Load	Stackable		PCS			
5	Dish Washer			PCS			
6	Oven			PCS	(		
7	Microwave			PCS	(		
8							
9							
10							
11							
12							
13							
14							
15							
16							



			CASEWORKS 01				
#	Item	Туре	Description, Manufacturer, SKU	Unit	Quantity	Unit Price	Total
1	Kitchen Cabinet			FT	14.85		
2	Laundry Cabinet			FT	2.25		
3	Vanity Cabinet			FT	2.5		
4	Medicine Cabinet			PCS	1		
5	Kitchen countertop			SF	22.61		
6	Laundry Countertop			PCS	0		
7	Bathroom Countertop			SF	0		
8	Island			FT	0		
9	Peninsula			FT	0		
10	Closets			SF	61.49		
11							
12							
13							
14							
15							



	1		CEILING 01				
#	Item	Туре	Description, Manufacturer, SKU	Unit	Quantity	Unit Price	Total
	LIVING ROOM AND KITCHEN	<b>I</b>		SF	204.0		
1	Ceiling Board	Drywall		SF	204		
<u>)</u>	Drywall Fastener	Screw		PCS	357		
3	Vapor Retarder	Polyethylene film		SF	204		
1	Vapor Retarder Fastener	Nails with washer heads		PCS	612		
	BATHROOM			SF	47.0		
5	Ceiling Board	MRD (Moisture resistant drywall)		SF	47		
5	MRD Fastener	Screw		PCS	82		
	BEDROOM			SF	145.0		
7	Ceiling Board	Drywall		SF	145		
3	Drywall Fastener	Screw		PCS	254		
)	Vapor Retarder	Polyethylene film		SF	145		
10	Vapor Retarder Fastener	Nails with washer heads		PCS	435		
	PORCH			SF	77.0		
11	Ceiling Board	Marine Plywood		SF	77		
12	Exterior Grade Plywood	Screw		PCS	135		



			CEILING 02				
#	Item	Туре	Description, Manufacturer, SKU	Unit	Quantity	Unit Price	Total
	CLOSET			SF	22.0		
13	Ceiling Board	Drywall		SF	22		
14	Drywall Fastener	Screw		PCS	39		
15	Vapor Retarder	Polyethylene film		SF	22		
16	Vapor Retarder Fastener	Nails with washer heads		PCS	66		
	HALL	'		SF	32.0		
17	Ceiling Board	Drywall		SF	32		
18	Drywall Fastener	Screw		PCS	56		
19	Vapor Retarder	Polyethylene film		SF	32		
20	Vapor Retarder Fastener	Nails with washer heads		PCS	96		
	WH			SF	10.0		
21	Ceiling Board	Drywall		SF	10		
22	Drywall Fastener	Screw		PCS	18		
23	Vapor Retarder	Polyethylene film		SF	10		
24	Vapor Retarder Fastener	Nails with washer heads		PCS	30		



	<u>1</u>		FLOORING INTERIOR 01				
#	Item	Туре	Description, Manufacturer, SKU	Unit	Quantity	Unit Price	Total
	CLOSET						
1	Closet Flooring			SF	21		
2	Wood underlay	Foam Pad Polyethylene		SF	21		
3	Vapor Retarder	Vapor Barrier Polyethylene		SF	21		
	BEDROOM						
4	Living Area Flooring			SF	140		
5	Wood underlay	Foam Pad Polyethylene		SF	140		
6	Vapor Retarder	Vapor Barrier Polyethylene		SF	140		
	LIVING ROOM AND KITCHI	EN					
7	Tile Finish			SF	216		
8	Adhesive	1/2" Thin set Mortar		SF	216		
9	Vapor Retarder	Vapor Barrier Polyethylene		SF	216		
	BATHROOM						
10	Tile Finish			SF	31		
11	Adhesive	1/2" Thin set Mortar		SF	31		
12	Vapor Retarder	Vapor Barrier Polyethylene		SF	31		



			FLOORING INTERIOR 02				
#	Item	Туре	Description, Manufacturer, SKU	Unit	Quantity	Unit Price	Total
	W/D						
13	Tile Finish			SF	9		
14	Adhesive	1/2" Thin set Mortar		SF	9		
15	Vapor Retarder	Vapor Barrier Polyethylene		SF	9		
	BOILER ROOM	·					
16	Tile Finish			SF	10		
17	Adhesive	1/2" Thin set Mortar		SF	10		
18	Vapor Retarder	Vapor Barrier Polyethylene		SF	10		



			FLOORING EXTERIOR			
#	Item	Туре	Description, Manufacturer, SKU	Unit	Quantity	Unit Price
	STRUCTURE			SF	710.4	
1	Concrete Slab	4"concrete cast in situ		CF	237	
2	Insulation	Rigid insulation		SF	229	
3	Hard core	Compacted soil		CF	166.7	
4	Re-bar	#4 re-bar		Ton	0.70	
5	Concrete Pad	4"concrete cast in situ		CF	1.58	
6	Slab edge	Turndown		CF	209.7	
7	Footing	Cast-in-place concrete		CF	14.04	
	PORCH					
8	Tile Finish			SF	215.5	
9	Adhesive	1/2" Thin set Mortar		SF	215.5	
10	Vapor Retarder	Vapor Barrier Polyethylene		SF	215.5	



			WALLS: EXTERIOR				
#	Item	Туре	Description, Manufacturer, SKU	Unit	Quantity	Unit Price	Total
1	Exterior-Grade Plywood Horizonta	l Siding		SF	673		
2	Exterior-Grade Plywood Fastener 8/panel	Self-drilling screws(100/pkt)		PKT	6.73		
3	Wall Shteathing (OSB)			SF	673		
4	Shteathing Fastener	Self-drilling screws(100/pkt)		PKT	6.7		
5	Wall Homewrap			SF	673.0		
6	Homewrap Fastener	Stapled fastener (200/pkt)		PKT	3		
7	Furring Strip			PCS	84.125		
8	Furring Strip Fastener	Self-drilling screws(100/pkt)		PKT	6.73		
9	Wall Paint			SF	673		
10	Stone Copping	Masonry stone		SF	0		
11	Stone Veneer	Masonry stone		SF	0		
12	Mortar for Stone Veneer			SF	0		
13	Wall Insulation			SF	2195		
14							
15							



			WALLS: INTERIOR 01				
#	Item	Туре	Description, Manufacturer, SKU	Unit	Quantity	Unit Price	Total
	BATHROOM			SF	45.0		
1	Cementitious Backer Board			SF	228		
2	Kerdi membrane			SF	228		
3	Kerdi membrane Fastener			SF	228		
4	Wall Ceramic Tile			SF	228		
	BEDROOM			SF	136.0		
5	Drywall Board			SF	309		
6	Drywall Fastener	Self-drilling screws(100/pkt)		PKT	3.09		
7	Wall Paint			SF	309		
8	Drywall Tape			FT	57.9		
	HALL			SF	25.0		
9	Drywall Board			SF	69		
10	Drywall Fastener	Self-drilling screws(100/pkt)		PKT	0.69		
11	Wall Paint			SF	69		
12	Drywall Tape			FT	13		



			WALLS: INTERIOR 02				
#	Item	Туре	Description, Manufacturer, SKU	Unit	Quantity	Unit Price	Total
	LIVING ROOM			SF	121.0		
13	Drywall Board			SF	214		
14	Drywall Fastener	Self-drilling screws(100/pkt)		PKT	2.14		
15	Wall Paint			SF	214		
16	Drywall Tape			FT	40.2		
	KITCHEN			SF	72.0		
17	Cementitious Backer Board			SF	23		
18	Drywall Board			SF	139		
19	Drywall Fastener	Self-drilling screws(100/pkt)		PKT	1.39		
20	Kerdi membrane			SF	23		
21	Kerdi membrane Fastener			SF	23		
22	Wall Ceramic Tile			SF	23		
23	Wall Paint			SF	139		
24	Drywall Tape			FT	26.2		



			WALLS: INTERIOR 03				
#	Item	Туре	Description, Manufacturer, SKU	Unit	Quantity	Unit Price	Total
	CL			SF	20.0		
25	Drywall Board			SF	144		
26	Drywall Fastener	Self-drilling screws(100/pkt)		PKT	1.44		
27	Wall Paint			SF	144		
28	Drywall Tape			FT	27		
	WD			SF	9.0		
37	Cementitious Backer Board			SF	75		
38	Kerdi membrane			SF	75		
39	Kerdi membrane Fastener			SF	75		
40	Wall Ceramic Tile			SF	75		
	WH	'		SF	9.0		
41	Drywall Board			SF	87		
42	Drywall Fastener	Self-drilling screws(100/pkt)		PKT	0.87		
43	Wall Paint			SF	87		
44	Drywall Tape			FT	16		
1	Wall Skirting	Ceramic		FT	95		



			DOORS				
#	Item	Туре	Description, Manufacturer, SKU	Unit	Quantity	Unit Price	Total
1	Exterior Swinging	3' - 0" X 6'-8"		PCS	2		
2	Interior Swinging	3' - 0" X 6'-8"		PCS	2		
3	Interior Sliding	9' - 0" X 6'-8"		PCS	1		
4	Folding	2' - 6" X 6'-8"		PCS	1		
5	Exterior Door Trim			FT	33		
6	Interior Door Trim			FT	175		
7	Entry Lock set			PCS	2		
8	Privacy Lock set			PCS	2		
9	Passage Lock set			PCS	2		



			WINDOWS				
#	Item	Туре	Description, Manufacturer, SKU	Unit	Quantity	Unit Price	Total
1	Sliding	3' - 3" X 3'-3"		PCS	1		
2	Sliding	3' - 3" X 2'-3"		PCS	3		
3	Sliding	3' - 3" X 1'-9"		PCS	1		
4	Sliding	5' - 3" X 3'-7"		PCS	1		
5	Single Hung	3' - 3" X 4'-9"		PCS	2		
6	Exterior Window Trim			FT	107		
7	Interior Window Trim			FT	107		



			ROOF 01				
#	Item	Туре	Description, Manufacturer, SKU	Unit	Quantity	Unit Price	Total
1	Roof Covering			SF	774.0		
2	Roof Covering Fastener			PCS	387		
3	Roof Felt Paper			SF	774.0		
4	Roof Felt Paper Fastener			PCS	2322.0		
5	Roof Sheathing			SF	774.0		
6	Roof Sheathing Fastener			PCS	6192		
7	Batten			FT	0.0		
8	Batten Fastener			PCS	0.0		
9	Soffit			SF	166.0		
10	Soffit Fastener			PCS	83.0		
11	Fascia			FT	116.0		
12	Fascia board fastener			PCS	58		
13	Roof Insulation			SF	774.0		
14					17.110		
15							