

ORCHARD

The Orchard is a charming Craftsman-style onebedroom, one-bathroom home designed for efficient and comfortable living. The walls are finished with horizontal siding in a warm, earthy tone, creating a clean and traditional aesthetic. The gable end features exposed framing and a decorative truss detail, adding architectural interest. A prominent covered porch spans the front of the home, supported by substantial stoneclad pillars, creating a welcoming outdoor space.

Inside, the Orchard features a simple rectangular plan. The kitchen, dining, and living areas are seamlessly merged together on one end of the plan, creating a spacious and versatile living space. The bedroom and bathroom are located side by side at the other end of the plan, offering a private and convenient layout.

Materials Shopping List

Please print and take this Materials Shopping List to your favorite Home Depot and ask for assistance in selecting the materials, fixtures and fittings to complete your new home.

Record your selection and the price of the item. Then do the math to determine the cost for your selections and the total cost of finishing your home.

< CLICK HERE >

To Go To Materials Shopping List



20' - 0" BEDROOM 115 SF LIVING ROOM 164 SF


FLOOR PLAN

553 SF

1 Bed Room




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MATERIALS SHOPPING LIST

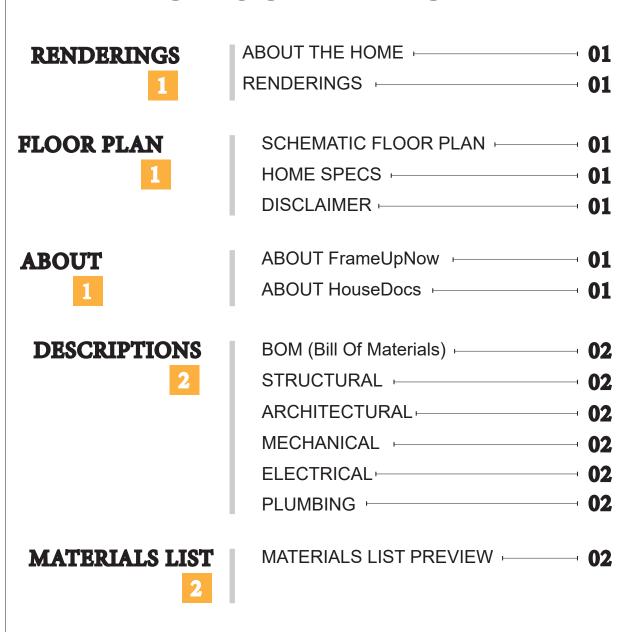ABOUT



FrameUpNow is a design and manufacturing company providing precision-engineered home framing solutions. We offer a catalog of Affordable Homes, Tiny Homes, Garages, Shops and Barndominiums. FrameUpNow manufactures cold-formed steel (CFS) also known as Light Gauge Steel (LGS) framing components that conform to our engineered metal house frame plans or can be purchased as DIY skeleton kits.

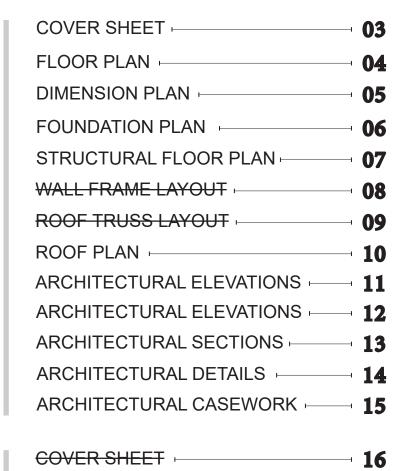The CFS/LGS framing is lightweight, easily assembled, and does not require heavy equipment or specialized labor, enabling homeowners to erect the frame themselves in just a few days. Unlike wood, the steel framing is impervious termites and bores, warping, expansion, and fire.

Our home plans come complete with a structural engineered stamp for permit approvals. Customers receive a full BOM also known as a Materials Shopping List to purchase finish materials from a Building Materials retailer. FrameUpNow prides itself on the quality and efficiency of our precision-engineered home framing solutions for construction professionals and DIY homeowners.



KEY PLAN

NO.	DESCRIPTION	DATE

NOTE:

LEGEND:

PROJECT

185-Orchard-553-1Bd1Ba-Craftsman-550

DRAWING NAME

INTRODUCTION

CLIENT NAME:
PROJECT NUMBER:
DATE:
DESIGNED BY:
DRAWN BY:
CHECKED BY:

I101

SCALE:

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DISCLAIMER

marketing content.

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DESCRIPTIONS

MATERIALS LIST

The BOM (Bill Of Materials) package, known as the Materials Shopping List document, provides:

Comprehensive Inventory: Detailed lists of essential materials sourced from architectural, mechanical, HVAC, electrical, and plumbing design drawing sets.

Precise Curation: Each item meticulously selected and organized for accuracy and efficiency in project planning.

Customizable Options: Customers can modify listed items to their preferences and calculate costs accordingly, ensuring alignment with personal project needs and budget.

Dedicated Space for Details: Includes tables for customers to note Home Depot SKU numbers or product descriptions for selected items, facilitating seamless purchasing and coordination with suppliers.

Customer Convenience: Take the list to Home Depot or preferred suppliers for accurate pricing, helping align the total home budget with personal financial plans.

Simplify your construction journey with our Materials Shopping List document, where detailed preparation meets streamlined implementation for your dream home.

STRUCTURAL

The structural drawings package provides an exhaustive set of detailed plans essential for the precise assembly of your building. This comprehensive package includes:

Framing Plans: Detailed layouts for all framing components. Truss Layouts: Clear instructions for truss placement and

Panel Length Plans: Specifications for panel dimensions. Framing Elevations and Sections: Precise elevation and sectional views for accurate construction.

Truss and Wall Blocking Plans: Plans for truss and wall blocking to ensure structural integrity.

Hold-Down Plan: Detailed hold-down requirements for stability. Snap Sheet: Reference sheet for quick identification of components

Structural Details and Bracing Plans: Complete details and bracing plans for all structural elements.

Accompanying these plans is a comprehensive Bill of Materials (BOM) that lists every necessary building component, from cold formed steel (CFS) frames to fasteners.

ARCHITECTURAL

With the comprehensive architectural package, both builders and DIY homeowners can confidently execute the construction.

HOW TO BUILD

The architectural package includes:

Furnished Floor Plans: Complete with furniture layouts for a clear understanding of space utilization.

Detailed Dimension Plans: Ensures precise measurements, from the overall footprint down to the exact placement of windows and

Foundation Plan: Detailed plan to establish a solid foundation.

Wall Framing and Truss Layout: Comprehensive plans for wall framing and truss placement.

Architectural Elevations: Exterior views showcasing the design.

Strategic Building Sections: Critical cross-sectional details for a thorough understanding of the build.

Casework Drawings and Diagrams: Suggested designs for built-in caseworks, such as kitchen cabinets.

MECHANICAL

The mechanical package includes everything needed to guide HVAC

Detailed HVAC Floor Plan: Precisely maps out the placement of air handlers, ductwork, and vents throughout the home's layout.

HVAC Sections and Riser Diagrams: Technical drawings offering critical cross-sectional details and piping schematics, ensuring proper integration of the heating and cooling system into the home's structure.

Bill of Materials: A complete list of all necessary HVAC components.

ELECTRICAL

The electrical package includes all the plans and documentation needed to guide the installation of your home's electrical system:

Detailed Power Plan: Precisely maps out the placement of outlets, switches, and other power components throughout the layout.

Comprehensive Lighting Plan: Shows the optimal locations for lighting fixtures, sconces, and other illumination sources to create a well-lit, functional interior.

Dimensioned Electrical Layout: Provides exact dimensions and measurements to ensure proper placement of all electrical elements.

Bill of Materials: A complete list of every component needed, from circuit breakers to wiring.

PLUMBING


The plumbing package includes everything needed to guide the installation of your home's water supply and drainage systems:

Detailed Water Supply System Plan: Precisely maps out the placement of pipes, valves, and plumbing fixtures throughout the

Comprehensive Sewage System Plan: Shows the optimal routing and sizing of drain lines to effectively remove waste and ensure proper drainage.

Detailed Riser Diagrams: Provide information needed to properly install all vertical plumbing risers and vent stacks.

Bill of Materials: A complete list of every component needed, from pipes to fixtures.

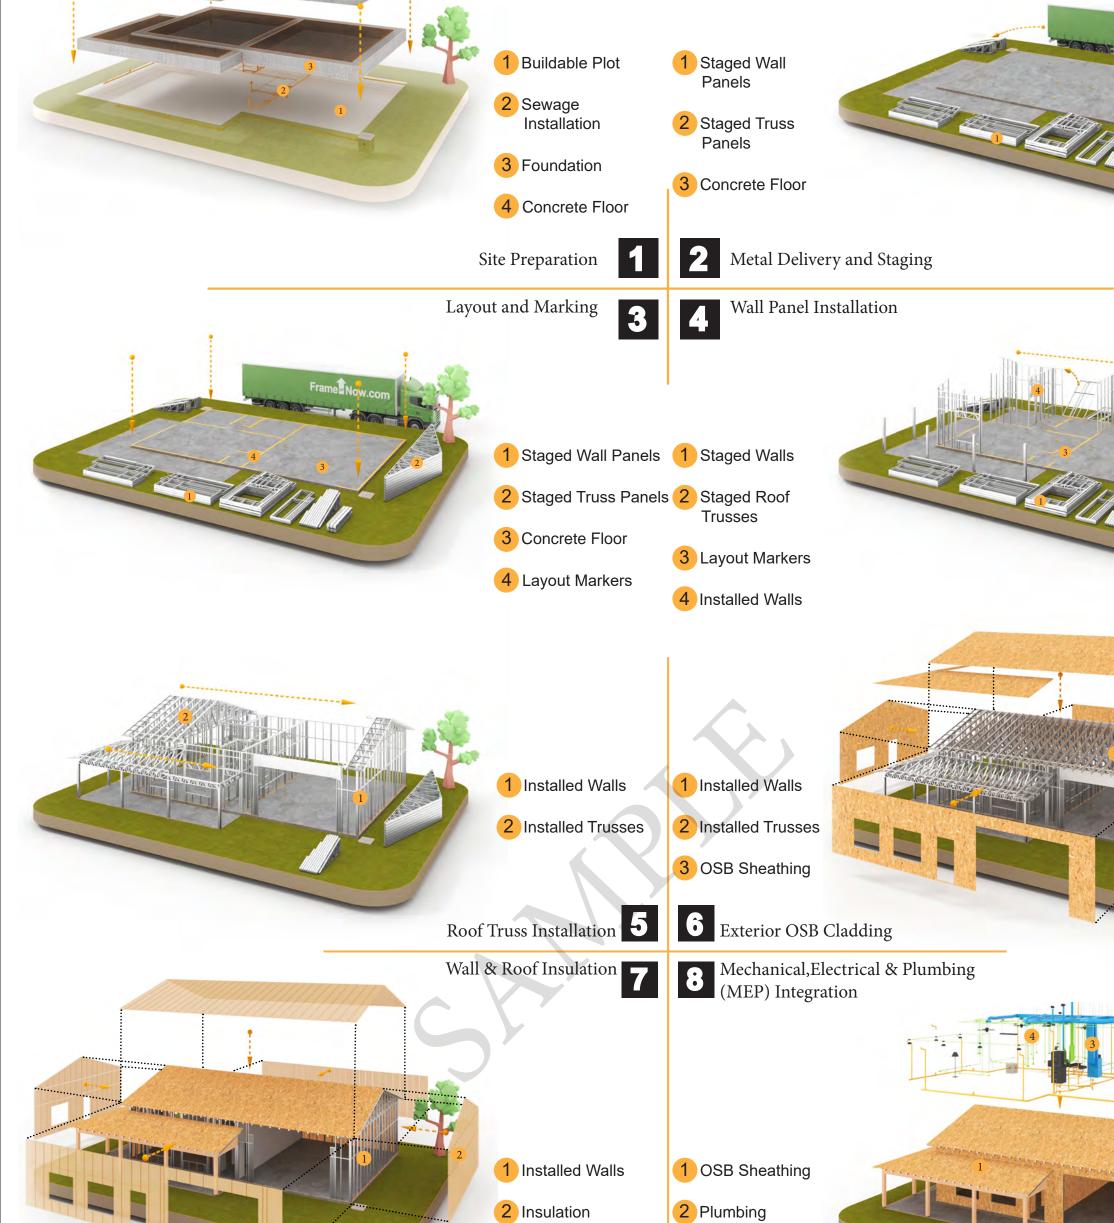

1 OSB Sheathing

3 Dry Wall Board

4 Ceiling Dry Wall

Corrugated

iron sheet

2 Home Wrap

3 Roof Felt Paper

4 Coronado Stone

5 Corrugated

iron sheet

2 Floor

Exterior Wall & Roof Covering

System

3 HVAC System

Home Wrap

Doors and

windows

2 Rain Gutters

2 Roof Felt Paper

ndows,Doors & Rain Gutters

4 Electrical System



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185-Orchard-553-1Bd1Ba-Craftsman-550

DRAWING NAME

SCALE:

INTRODUCTION

CLIENT NAME: PROJECT NUMBER: DATE: **DESIGNED BY** DRAWN BY: CHECKED BY:

1102


BOM (Bill Of Materials) (Separately Attached)




The Bill of Materials (BOM) is a crucial document that compiles the material requirements from different disciplines into a centralized inventory, enabling efficient procurement, inventory management, and cost estimation for a specified project or


ELECTRICAL BOM



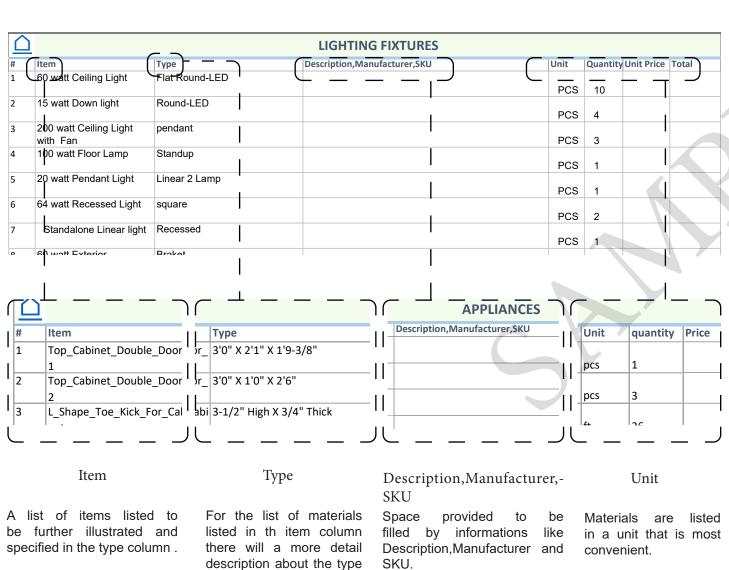

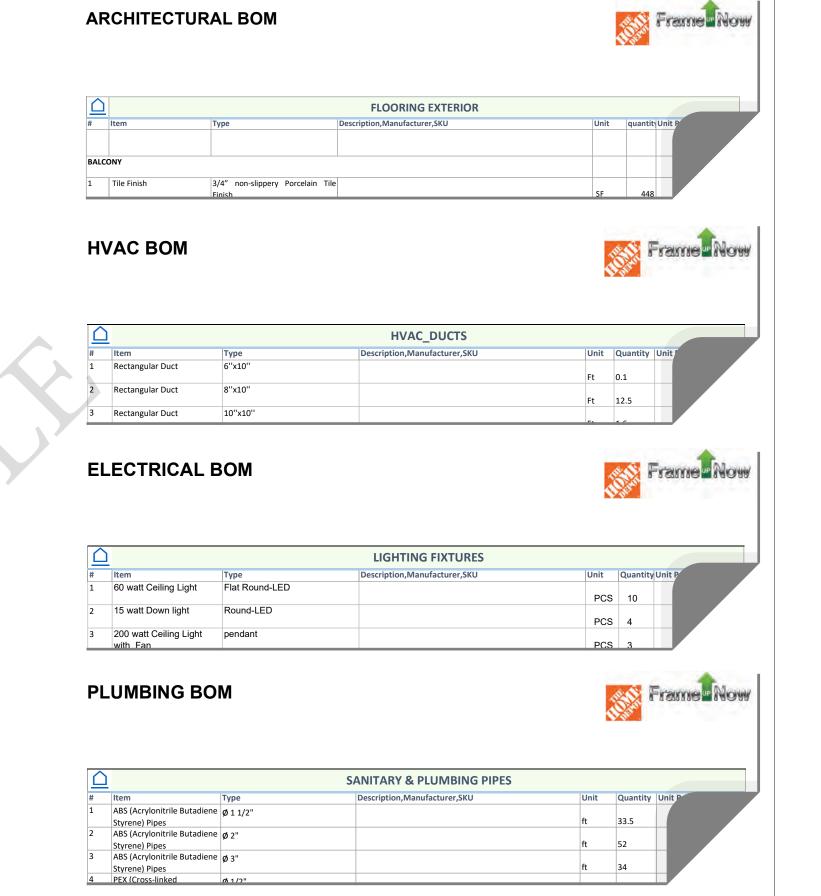

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PAGE INDEX	Α	BBREVIATION
COVER SHEET	AFS	ACTION FLOOR SYSTEMS
FLOOR PLAN	ASTM D698	AMERICAN SOCIETY FOR
DIMENSION PLAN		TESTING AND MATERIAL
FOUNDATION PLAN	CA	CASEWORK
STRUCTURAL FLOOR PLAN	EL	ELECTRICAL
FRAME LAYOUT	F.F.E	FINISHED FLOOR ELEVATION
ROOF TRUSS LAYOUT	F.F.L	FINISHED FLOOR LEVEL
ROOF PLAN	FTG	FOOTINGS
ELEVATIONS	HVAC	HEATING, VENTILATION & A
ELEVATIONS		CONDITIONING
SECTIONS	IRC	INTERNATIONAL RESIDENC
DETAILS		CODE
CASEWORK DETAILS	IMC	INTERNATIONAL MECHANI
CASEWORK DETAILS		CODE
SCHEDULE	MAX.	MAXIMUM
LIGHTING PLAN	ME	MECHANICAL
POWER PLAN	MIN.	MINIMUM
DIMENSION PLAN FOR LIGHT FIXTURE	NO.	NUMBER
DIMENSION PLAN FOR FITTING	O.C	ON CENTER
COVER SHEET	OSB	ORIENTED STRAND BOARD
WATER SUPPLY SYSTEM	PL	PLUMBING
SEWAGE SYSTEM	PSI	POUNDS PER SQUARE INC
RISER DIAGRAM	PVC	POLYVINYL CHLORIDE
HVAC PLAN	REF	REFERENCE
HVAC SECTION	RG	RIGHT GARAGE
RISER DIAGRAM	SE	SPECIAL EQUIPMENT
	SF	SQUARE FEET
	SIMP. STHD8	SIMPSON STRAP THE
TAG'S NAME		HOLDDOWN
	SIMP. ABE66	SIMPSON ANCHOR BOLT E
CASEWORK TAG	TV	TELEVISION
DOOR TAG	UNO	UNLESS NOTED OTHERWIS
 FUDAUTURE TAO	W/	WITH
FURNITURE TAG	W/D	WASHER/DRYER
WINDOW TAG	AC	AIR CONDITIONING UNIT
SPECIALTY EQUIPMENT TAG	ACC	AIR COOLED CONDENSER
MECHANICAL FOLUDIMENT TAG	ACCU	AIR COOLED CONDSENSING U
MECHANICAL EQUIPMENT TAG	AHU	AIR HANDLING UNIT

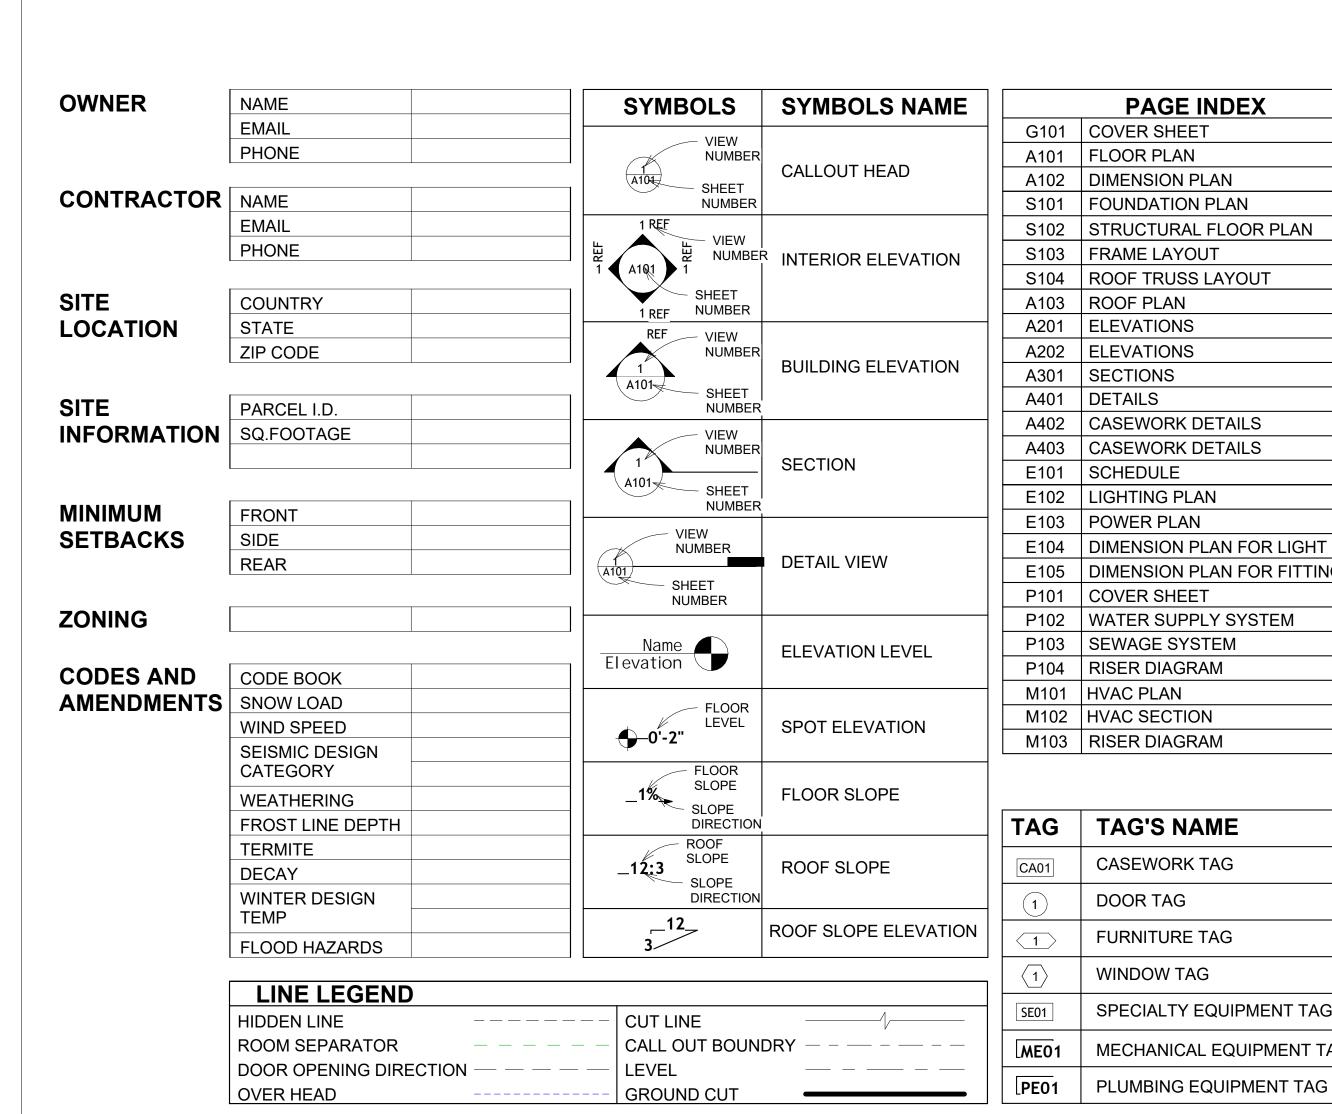


	CODE CODE		
MAX.	MAXIMUM		
ME	MECHANICAL		
MIN.	MINIMUM		
NO.	NUMBER		
O.C	ON CENTER		
OSB	ORIENTED STRAND BOARD		
PL	PLUMBING		
PSI	POUNDS PER SQUARE INCH		
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SF STUDS	SQUARE FEET		
SIMP. STHD8	SIMPSON STRAP THE HOLDDOWN		
SIMP. ABE66	SIMPSON ANCHOR BOLT EDGE		
TV	TELEVISION		
UNO	UNLESS NOTED OTHERWISE		
W/	WITH		
W/D	WASHER/DRYER		
AC	AIR CONDITIONING UNIT		
ACC	AIR COOLED CONDENSER		
ACCU	AIR COOLED CONDSENSING UNIT		
AHU	AIR HANDLING UNIT		
CC	COOLING COIL		
CD	CEILING DIFFUSER		
CFm	Cubic Feet Per Minute		
CR	CEILING REGISTER		
CU	CONDENSING UNIT		
CW	COLD WATER		
E/A	EXHAUST AIR		
EF	EXHAUST FAN		
ET	EXPANSION TANK		
EX.	EXISTING		
FC	FLEXIBLE CONNECTION		
FCU	FAN COIL UNIT		
FLR.	FLOOR		
HC			
	HEATING COIL		
HE	AIR TO AIR HEAT EXCHANGER		
HV	HEATING AND VENTILATING UNIT		
IV	INLET VANES		
MER	R MECHANICAL ROOM		
MAX.	MAXIMUM		
MIN.	MINIMUM		
R/A	RETURN AIR		
RCU	RECIPROCATING CHILLER UNIT		
RF C/A	RETURN FAN		
S/A	SUPPLY AIR		
SCD	SMOKE CONTROL DAMPER		

FINISHED FLOOR ELEVATION

HEATING, VENTILATION & AIR

INTERNATIONAL RESIDENCE

INTERNATIONAL MECHANICAL

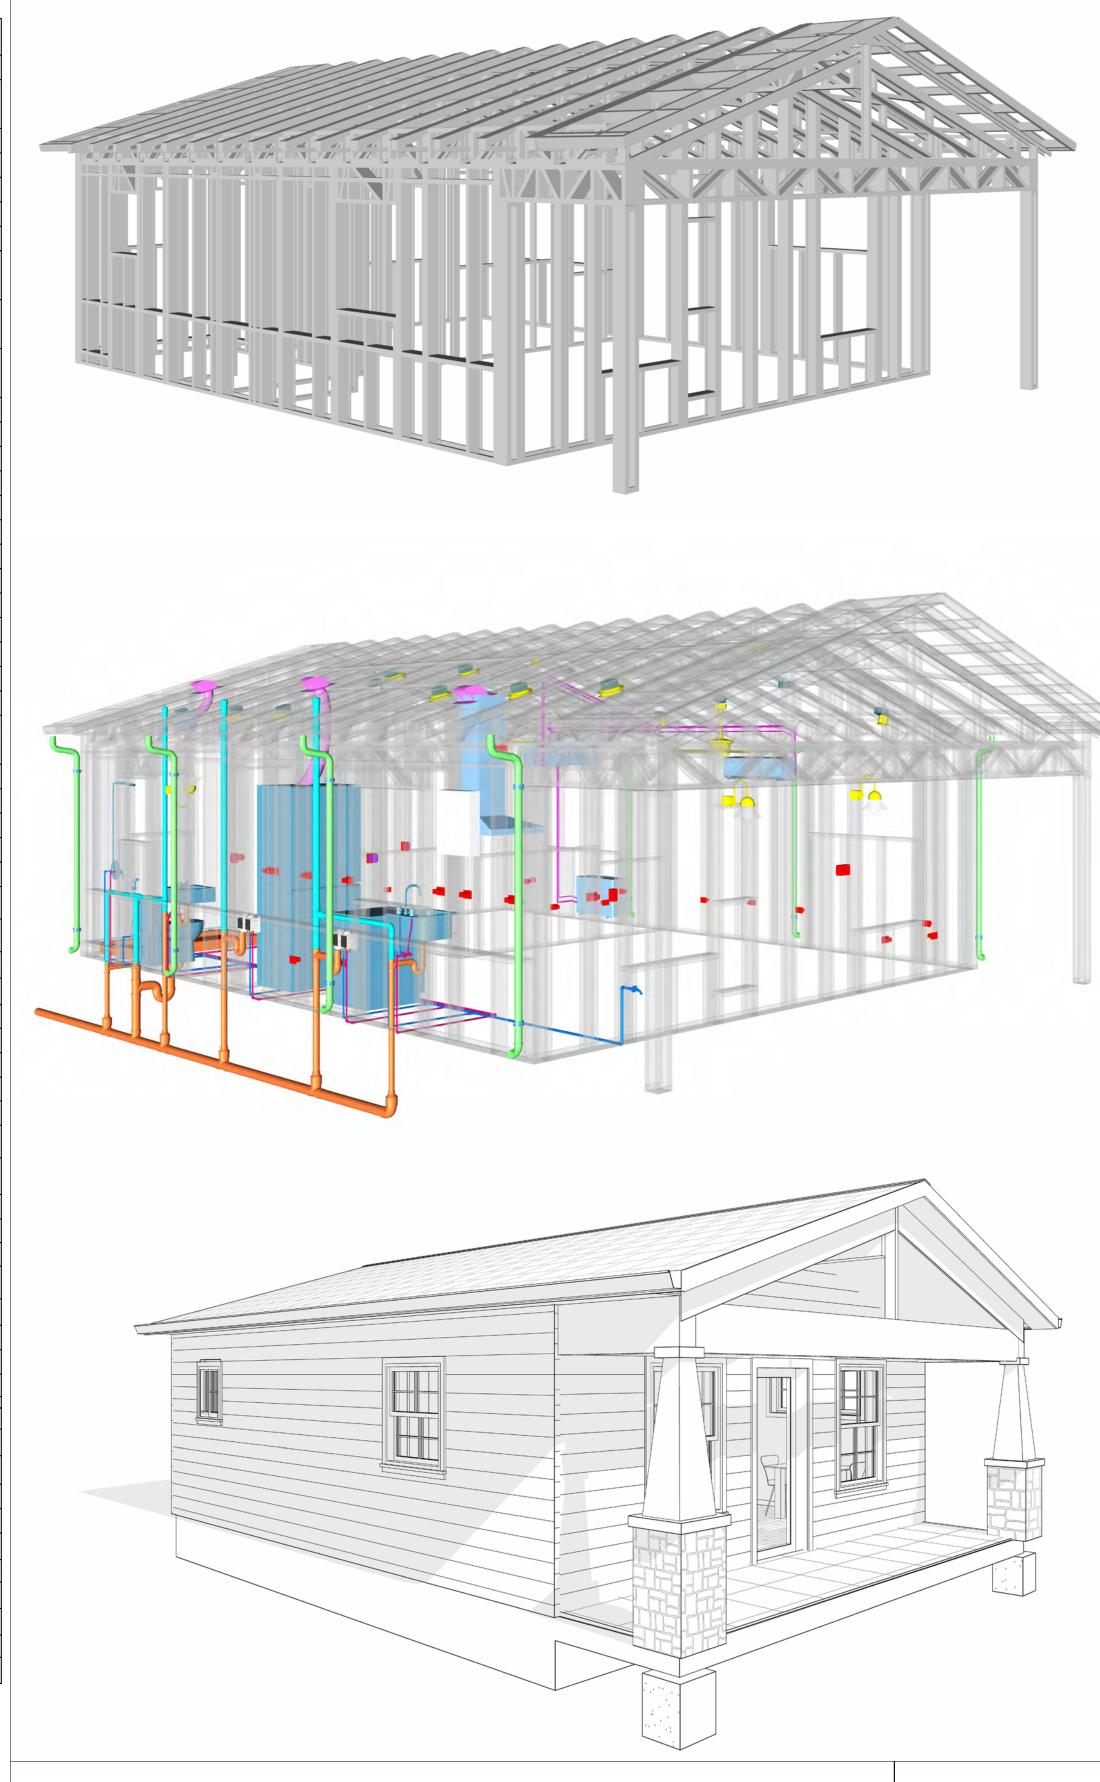


185-ORCHARD-553 1Bd1Ba-CRAFTSMAN-550

SQUARE FOOTAGE			
LIVING	553		
PORCH	92		
TOTAL	645		



KEY PLAN

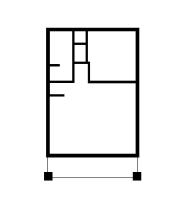

RSPECTIVE ANGLE			
NO.	DESCRIPTION	DAT	

NOTE:

LEGEND:

185-ORCHARD-553 1Bd1Ba-CRAFTSMAN-550

DRAWING NAME

COVER SHEET

CLIENT NAME:	Client Name
PROJECT NUMBER:	0061_12
DATE:	5/6/2025 10:28:07 AM
DESIGNED BY:	Designer
DRAWN BY:	Author
CHECKED BY:	Checker
-	

G101

GENERAL NOTES

- THIS DRAWING DEPICTS THE ARCHITECTURAL (SPACE LAYOUT, FURNISHING, FLOOR, WALLS, ROOFS, FOUNDATION, WINDOWS AND DOORS) SYSTEMS. IT PROVIDES A VISUAL REPRESENTATION OF THE ARCHITECTURAL LAYOUT AND COMPONENTS.
- THE ARCHITECTURAL DRAWINGS ARE PREPARED TO MEET THE SPECIFIC REQUIREMENTS OF THE BUILDING, AS PER THE PROJECT SPECIFICATIONS AND APPLICABLE CODES AND STANDARDS.
- THE CONSTRUCTION OF THIS HOME SHALL COMPLY WITH THE LATEST EDITION OF THE INTERNATIONAL RESIDENTIAL CODE (IRC), INTERNATIONAL MECHANICAL CODE (IMC), THE INTERNATIONAL PLUMBING STANDARD, THE NATIONAL ELECTRICAL STANDARD AND ALL OTHER APPLICABLE LOCAL, STATE, AND NATIONAL CODES AND REGULATIONS.
- COORDINATION WITH OTHER TRADES HAS BEEN DONE ON A DESIGN LEVEL. THIS DRAWING SHALL BE READ TOGETHER WITH THE ME, EL AND PL DESIGN DRAWINGS TO ENSURE PROPER CONSTRUCTION AND INTEGRATION OF THE BUILDING SYSTEMS.

ABOUT WALLS:

SHOWER WALL COVERING

BATHTUB AND SHOWER SPACES (WALLS AND FLOORS) WITH INSTALLED SHOWER HEADS AND IN SHOWER COMPARTMENTS SHALL BE FINISHED WITH A NON-ABSORBENT SURFACE.

2. WALL PAINT (INTERNAL)

THE TYPICAL THICKNESS OF LATEX WALL PAINT IS 1/32 OF AN INCH FOR A SINGLE COAT. AND DOUBLE COAT (1/16") SHALL BE APPLIED FOR DURABILITY.

3. ADHESIVES:


THE ADVISABLE TYPE OF ADHESIVE FOR THIS PROJECT IS **EPOXY ADHESIVES**BECAUSE THEY ARE KNOWN FOR THEIR HIGH STRENGTH, DURABILITY, AND RESISTANCE TO MOISTURE, CHEMICALS AND

REFER TO SHEETS A201 & A202 FOR GENERAL NOTES ON EXTERNAL FINISHING MATERIALS

ABOUT FLOORS:

- THE SPOT ELEVATION INDICATES THE FINISHED FLOOR ELEVATION.
- FINISHED FLOORS PER PLANS.
- FIELD VERIFY FOR DIMENSION DROP 4" FOR SHOWER AND BATHTUB USE.
- 1% SLOPE ON OUTDOOR BALCONIES FOR WATER RUN OFF.
- 2% SLOPE TOWARDS THE SHOWER DRAIN FOR SUFFICIENT DRAINAGE.
- 4" DROP AT THE DOOR LEADING TO EXTERIOR BALCONY FROM THE MAIN LIVING AREA.
- 5% SLOPE FOR GARAGE IS USED, WHICH SHOULD BE CHECKED WITH THE LOCAL GARAGING ZONING LAWS.



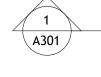




	FURNITURE SCHEDULE				
	TYPE MARK	T	/PE	COUNT	
01		KING SIZE BED	1		
02		DINING CHAIR	2		
03		25" X 60" DINING 2	1		
04		FOUR SIT 65" X 95"	1		

	ROOM FINISH SCHEDULE						
ROOM NUMBE R	ROOM NAME	FLOOR FINISH	BASE FINISH	WALL FINISH	CEILING FINISH	CEILING HEIGHT	COM MEN TS
01	BATH 1	VINYL TILES	CONCRETE	CERAMIC TILE	MRD	8' - 0"	
02	LIVING ROOM	HARDWOOD	CONCRETE	WALL PAINT	DRY WALL	8' - 0"	
03	PORCH	PROCELAIN TILE	CONCRETE	EXTERIOR-GRADE PLYWOOD	PLYWOOD	8' - 0"	
04	HALL	HARDWOOD	CONCRETE	WALL PAINT	DRY WALL	8' - 0"	
05	KITCHEN	HARDWOOD	CONCRETE	WALL PAINT + CERAMIC	DRY WALL	8' - 0"	
06	WD	HARDWOOD	CONCRETE	WALL PAINT	DRY WALL	8' - 0"	
07	BEDROOM	HARDWOOD	CONCRETE	WALL PAINT	DRY WALL	8' - 0"	
08	CL	HARDWOOD	CONCRETE	WALL PAINT	DRY WALL	8' - 0"	
09	WH	HARDWOOD	CONCRETE	WALL PAINT	DRY WALL	8' - 0"	



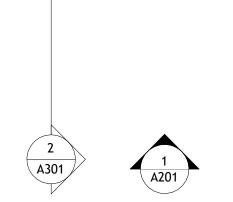



SQUARE FOOTAGE			
LIVING	553		
PORCH	92		
TOTAL	645		



KEY PLAN

NO.	DESCRIPTION	DATE	

NOTE:

LEGEND:

PROJECT


185-ORCHARD-553 1Bd1Ba-CRAFTSMAN-550


DRAWING NAME

FLOOR PLAN

Client Name
0061_12
5/6/2025 10:28:08 AM
Designer
Author
Checker

A101

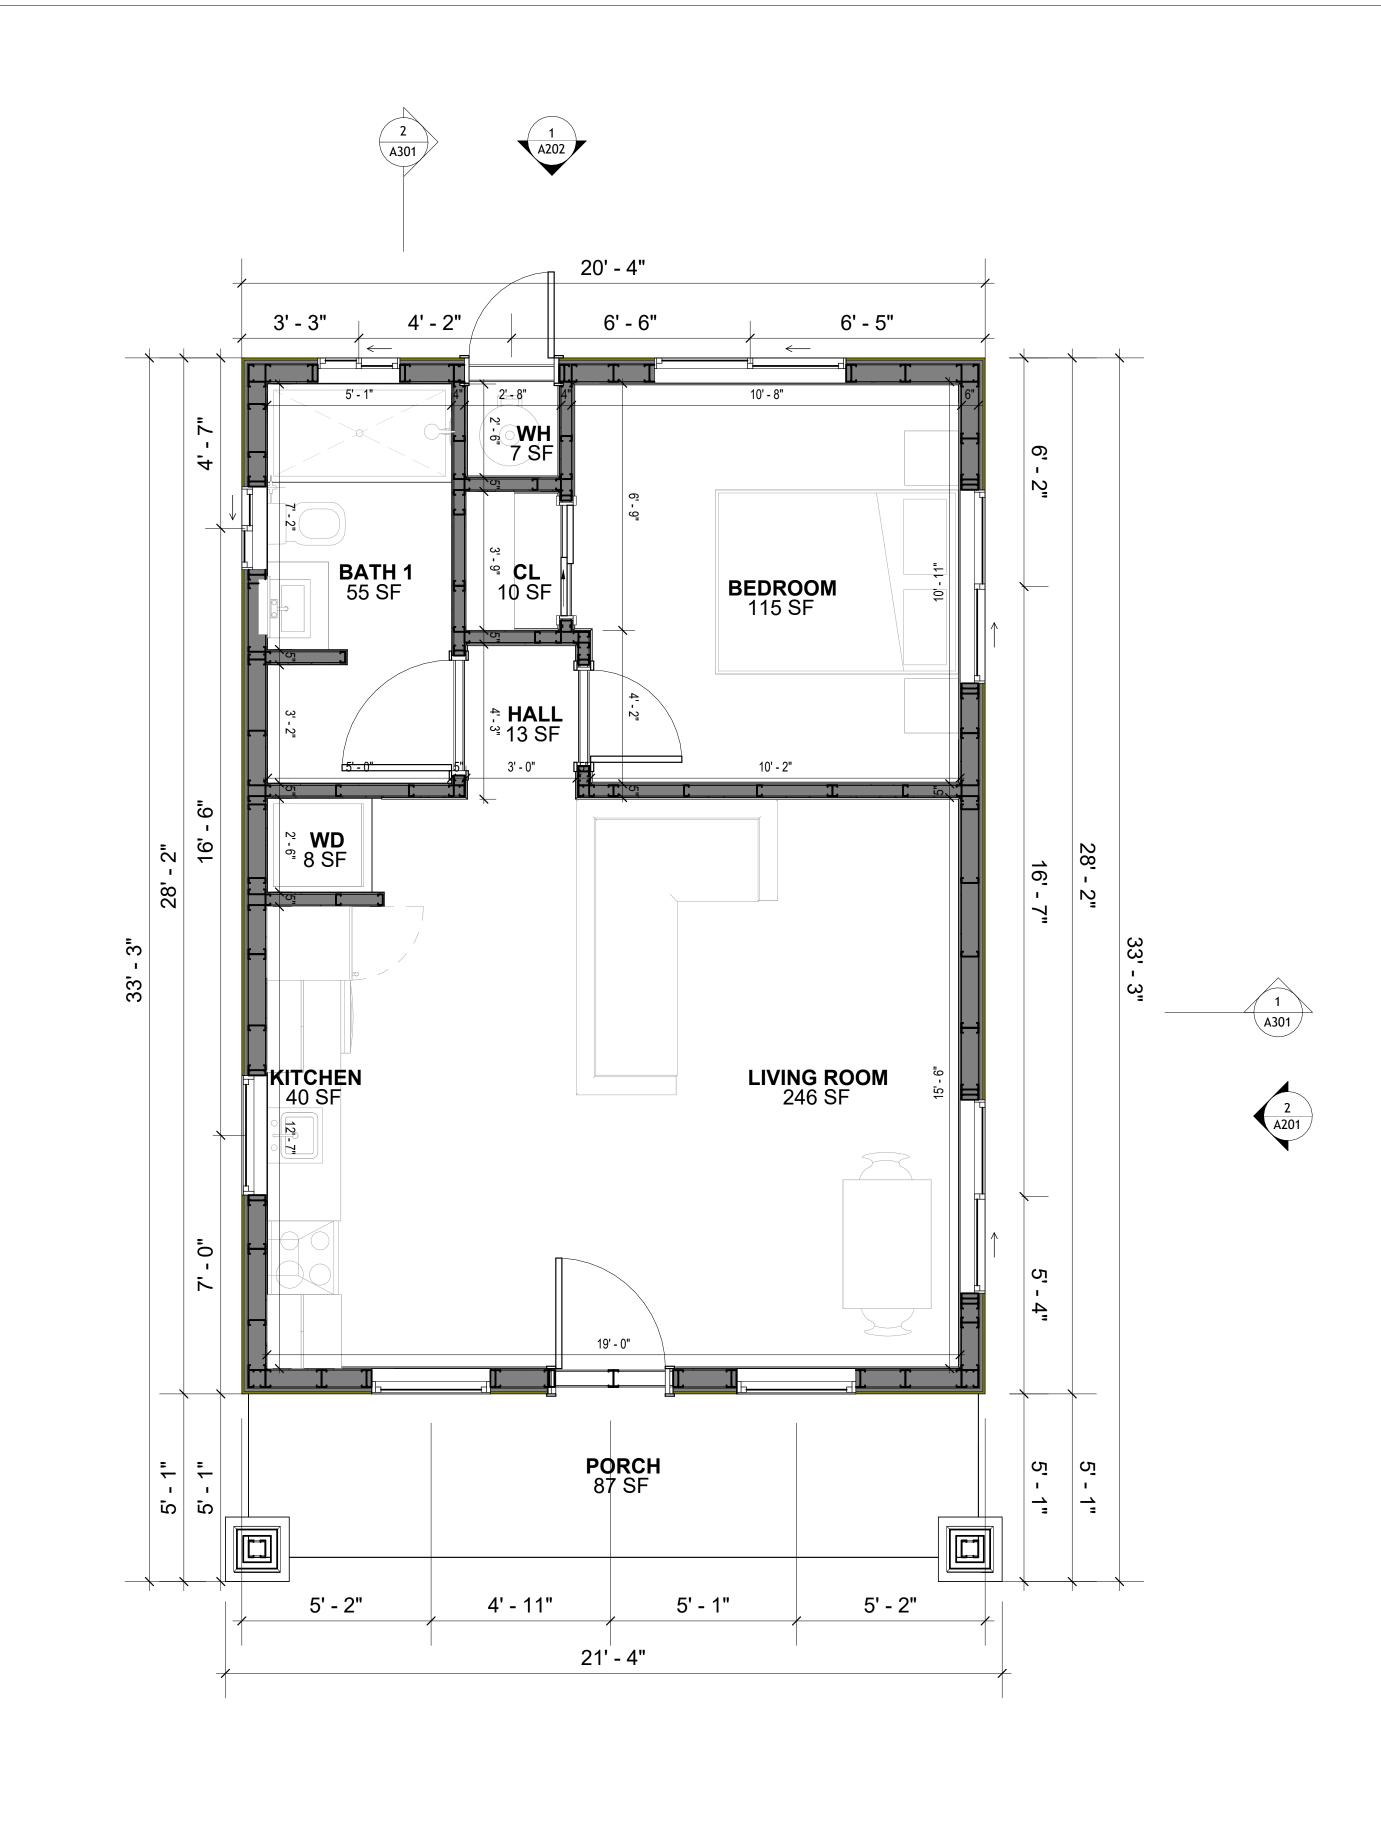

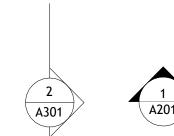

1 DIMENSION PLAN 3/8" = 1'-0"

DIMENSIONS IN THE ARCHITECTURAL DRAWINGS CONSIDER FINISHING MATERIALS. FOR PRECISE MEASUREMENTS OF THE STRUCTUAL FRAMING, REFER TO THE ATTACHED STRUCTURAL PLAN SET.

SQUARE FOOTAGE

LIVING 553

PORCH 92

TOTAL 645



KEY PLAN

NO.	DESCRIPTION	DATE	

NOTE:

LEGEND:

PROJECT

185-ORCHARD-553 1Bd1Ba-CRAFTSMAN-550

DRAWING NAME

DIMENSION PLAN

CLIENT NAME:	Client Name
PROJECT NUMBER:	0061_12
DATE:	5/6/2025 10:28:10 AM
DESIGNED BY:	Designer
DRAWN BY:	Author
CHECKED BY:	Checker

A102

SCALE: 3/8" = 1'-0"

FOUNDATION NOTES

NOTES:

TERMITES PRETREATMENT BY LICENSED CONTRACTOR UNDER SLAB AND AROUND FOOTINGS. ALL AREAS BELOW SLABS SHALL BE TREATED NO MORE THAN 24 HOURS PRIOR TO CONCRETE POUR. EVIDENCE OF TREATMENT MUST BE PROVIDED PRIOR TO PLACING OF CONCRETE.

1. MATERIALS:

ALL INTERIOR CONCRETE SLABS SHALL BE A MIN. OF 4" THICK CONCRETE OVER 4" COMPACTED AGGREGATE BASE (ASTM D698), FINISH ELEVATIONS AS NOTED ON DRAWINGS, 6" ABOVE ADJACENT GRADE, LEVEL SLABS TO 1/8"-10' MAX.. CONCRETE SLABS SHALL BE 2500# PSI AT 28 DAYS. A 4" ALLOWABLE SLUMP.

2. PAD PREPARATION:

EXCAVATION FOR FOOTING SHALL BE NEAT.

FOOTINGS SHALL BE POURED IMMEDIATELY AFTER EXCAVATION AND APPROPRIATE

INSPECTION.
- ALL REINFORCING STEEL MARKED "CONTINUOUS" SHALL BE LAPPED 36 BAR DIAMETERS AT SPLICES AND AROUND CORNERS OR INTERSECTIONS WITH A STANDARD 90 DEGREE BEND ON

CORNER BARS. LAP WIRE MESH ONE FULL MESH AT SIDE AND END LAPS. - ALL HARDWARE TO BE SIMPSON OR EQUIVALENT.

- EXTERIOR FRAME WALL TO BE SECURED WITH 1/2"X10" ANCHOR BOLTS 4'-0" O.C. FOR 1-STORY AND 2'-8" O.C. FOR 2-STORY. BOLTS SHALL BE LOCATED WITHIN 1'-0" OF EACH END PIECE AND SHALL HAVE A MIN. OF TWO BOLTS PER PIECE.

-FOUNDATION ANCHOR STRAPS SHALL BE PERMITTED, ACCORDING TO RESIDENTIAL CODE 2021

- ALL INTERIOR WALLS TO BE SECURED WITH POWER DRIVEN PINS PER MANUFACTURER SPECIFICATION USE PIN SPACING EQUIVALENT TO 1/2" ANCHOR BOLTS.

- ALL CONSTRUCTION TO CONFORM TO THE 2012 IRC

- R-10 RIGID INSULATION OUTSIDE OF EXTERIOR FOUNDATION WALLS UNDER LIVING AREA.
- CONCRETE PAD FOR CONDENSER THICKNESS IS 4" MIN UNLESS OTHERWISE NOTED.

3. CONCRETE CONSTRUCTION:

- THE SLAB SHALL BE UNDERLAIN BY A VAPOR BARRIER/RETARDER IN THE LIVING AREA (TYPICALLY POLYETHYLENE, UNLESS MORE STRINGENT PROTECTION REQUIRED BY THE ARCHITECT, ENGINEER, FLOOR COVERING MANUFACTURER, OR ACCEPTED PRACTICE). UNLESS OTHERWISE REQUIRED, BARRIER MAY BE OMITTED AT GARAGES, PORCHES AND PATIOS WITHOUT FLOOR COVERINGS. IT IS BEYOND THE SCOPE OF THESE PLANS TO DETERMINE THE APPLICABILITY OF THESE MORE STRINGENT REQUIREMENTS. BUILDER SHALL VERIFY PRIOR TO CONSTRUCTION.

4. REINFORCEMENT:

- IF CONSTRUCTED ON ACTIVE SOILS, THE LONG TERM PERFORMANCE OF THE FOUNDATION IS DEPENDENT ON MAINTENANCE BY THE OWNER. THUS THE BUILDER SHALL ADVISE THE OWNER OF THE FOLLOWING:

1. DRAINAGE MUST BE MAINTAINED. WATER SHALL NEVER BE ALLOWED TO POND NEAR THE

FOUNDATION.

2. THE SOIL AROUND THE FOUNDATION SHALL BE MAINTAINED IN A RELATIVELY DAMP CONDITION, SUCH AS THAT REQUIRED TO KEEP A LAWN GREEN. IF IT DRIES OUT IT WILL

SHRINK. IF IT GETS WET, IT WILL HEAVE UPWARD.

3. SLABS ON THE SHORTER SIDE USES MAIN BARS ARE USED IN THIS DIRECTION ONLY

WITH SMALLER DIAMETER DISTRIBUTION BARS ARE PLACED, FORMING A MAT OR GRID.

4. ALL REINFORCEMENT BARS SIZE 10MM OR LARGER IN ACCORDANCE TO ASTM

3. ANCHOR BOLTS AT ALL EXTERIOR WALLS SHALL BE MINIMUM 1/2 INCH DIAMETER WITH A

MAXIMUM SPACING OF 6'-0" ON CENTER, UNLESS NOTED OTHERWISE.

4. ANCHOR BOLTS SHALL BE INSTALLED WITHIN 12 INCHES OF EACH END OF EACH SILL PLATE WITH AT LEAST TWO ANCHOR BOLTS FOR EACH BOLTS FOR EACH SILL PLATE LONGER THAN 12 INCHES.


5. SIMPSONS SILL ANCHORS MAYBE SUBSTITUTED FOR ANCHOR BOLTS AT THE SAME SPACING.

6. EXTERIOR CONCRETE SLABS WHICH ARE NOT PART OF THE MAIN SLAB SHALL BE MINIMUM 4 INCHES THICK WITH NO STEEL REINFORCING BARS REQUIRED, UNLESS NOTED OTHERWISE ON FOUNDATION PLAN.

VERIFY THE FOLLOWING PRIOR TO POURING:

- 1. ALL HOLDDOWNS , STRAP, AND POST LOCATIONS.
- 2. CONCRETE FINISHES. PANEL RISER LOCATION WHERE APPLICABLE.
- 3. UNDERSLAB MECHANICAL REQUIREMENTS.
- 4. STEM WALL BLOCKOUTS.
- 5. UNDERSLAB ELECTRICAL REQUIREMENTS AND PANEL RISER LOCATION. WHERE APPLICABLE.
- 6. PROVIDE THE FOLLOWING:
- PVC SLEEVES THROUGH FTG IF REQUIRED
 20' #4 COPPER GROUND BAR.
- 7. SLOPE FINISH GRADE AWAY FROM FOOTING.

NOTE: FIELD VERIFY ALL DIMENSIONS SEE DIMENSIONED ARCHITECTURAL DRAWINGS

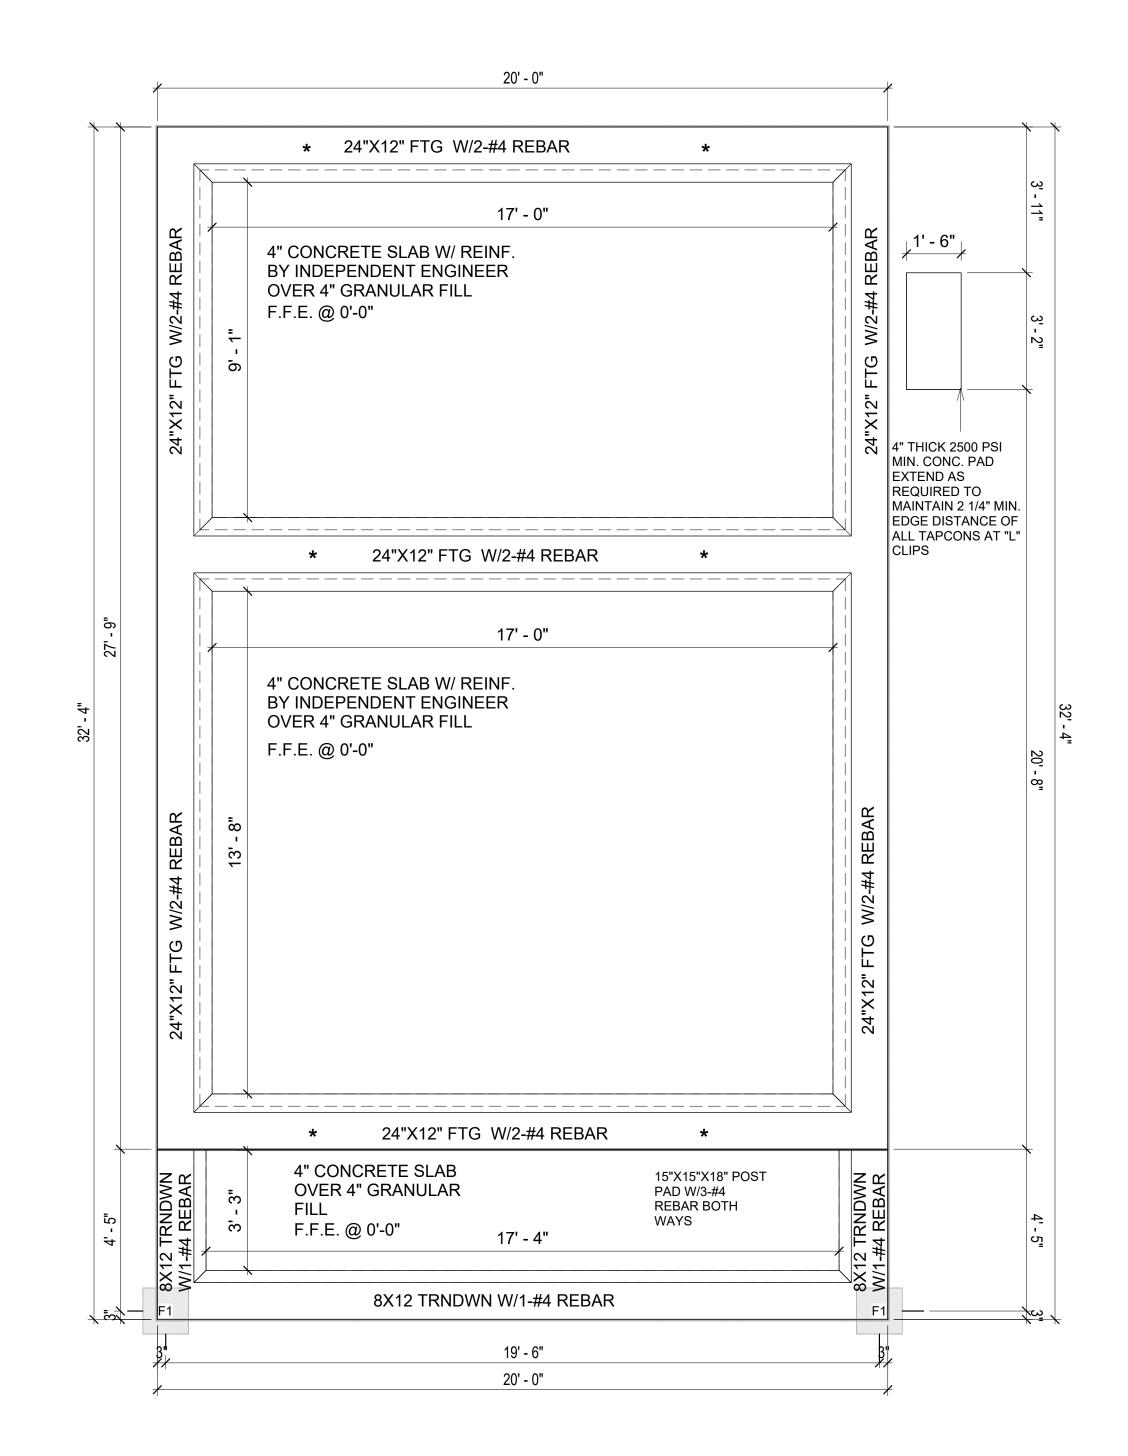

1 FOUNDATION PLAN
3/8" = 1'-0"

SQUARE FOOTAGE		
LIVING	553	
PORCH	92	
TOTAL	645	



KEY PLAN

NO.	DESCRIPTION	DATE

NOTE:

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185-ORCHARD-553 1Bd1Ba-CRAFTSMAN-550

DRAWING NAME

FOUNDATION PLAN

CLIENT NAME:	Client Name
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DATE:	5/6/2025 10:28:11 AM
DESIGNED BY:	Designer
DRAWN BY:	Author
CHECKED BY:	Checker

S101

SCALE: 3/8" = 1'-0"

GENERAL NOTES

NOTES:

-ALL BEARING WALLS SHOULD HAVE A THICKENED SLAB PER SECTION PER DETAIL A401/5.

A) **FOUNDATION PLAN NOTES**:

- CONCRETE SLAB SHALL BE 6" THICK WITH 1/2" DIAMETER TENDONS PER LAYOUT PLAN, CENTERED IN SLAB THICKNESS, OVER APPROVED SUBBASE PER GENERAL STRUCTURE NOTES.
- 2. TERMITE PROTECTION SHALL BE PROVIDED PER IRC SECTION R318.1 NONE TYPICAL ANCHOR BOLT SPACING AT SHEAR WALL AND HOLD DOWN
- SPECIFICATIONS PER APPROVED ARCHITECTURAL PLANS. 4. INSTALL HOLDOWNS BEFORE CONCRETE SLAB POUR.
- EXISTING FILL ON-SITE SHALL BE COMPACTED IN ACCORDANCE WITH THE
- REQUIREMENTS IN THE GEOTECHNICAL REPORT.
- 6. ALL FLOOR SLABS ARE REINFORCED ON CONCRETE SLABS.

SPECIAL INSPECTION IS REQUIRED FOR THICKENED FOUNDATION CONSTRUCTION

- 1. REINFORCEMENT
- 2. 2300 PSI CONCRETE POUR


B) **REINFORCEMENT FOR CONCRETE**:


1. ALL REINFORCING SLABS BARS SIZE 10MM OR LARGER SHALL BE DEFORMED IN ACCORDANCE TO ASTM-A706, AND BARS SMALLER THAN 10 MM MAYBE PLAIN. 2. UNLESS OTHERWISE NOTED IN PLANS, THE YIELD STRENGTH OF REINFORCING BARS SHALL BE:

> A) FOOTING = 40,000 PSI B) NON-LOAD BEARING WALLS AND PARAPETS= 40,000 PSI

- 3. SPLICES SHALL BE SECURELY WIRED TOGETHER AND SHALL LAP OR EXTEND
- 4. GRADE OF STEEL FOR RCC WORKS SHALL BE GRADE 4 10.
- BAR NOTATIONS GIVES INFORMATION
- A) BAR SIZE
- B) SPACING(IF REQUIRED)
- 6. LAP REINFORCEMENT ONLY AT LOCATION SHOWN IN THE DRAWINGS REINFORCEMENT SHALL NOT BE CUT, VENT OR HEATED ON SITE WITHOUT ENGINEERS'
- APPROVAL.
- C) **CONCRETE SLAB NOTES**
- 1. ALL SLAB REINFORCEMENT SHALL BE 20MM CLEAR MINIMUM FROM BOTTOM AND FROM TOP OF SLAB.
- 2. REINFORCEMENT IN CONTINUOUS ELEVATED SLAB SHALL BE CUT AS FOLLOWS.

- THIS IS A SCHEMATIC PLAN FOR THE PURPOSE OF LOCATING AND IDENTIFYING FOUNDATION REINFORCING ELEMENTS ONLY. VERIFY ALL DIMENSIONS, DROPS, OFFSETS AND FEATURES WITH THE ARCHITECTURAL PLANS BEFORE FORMING THE FOUNDATION.

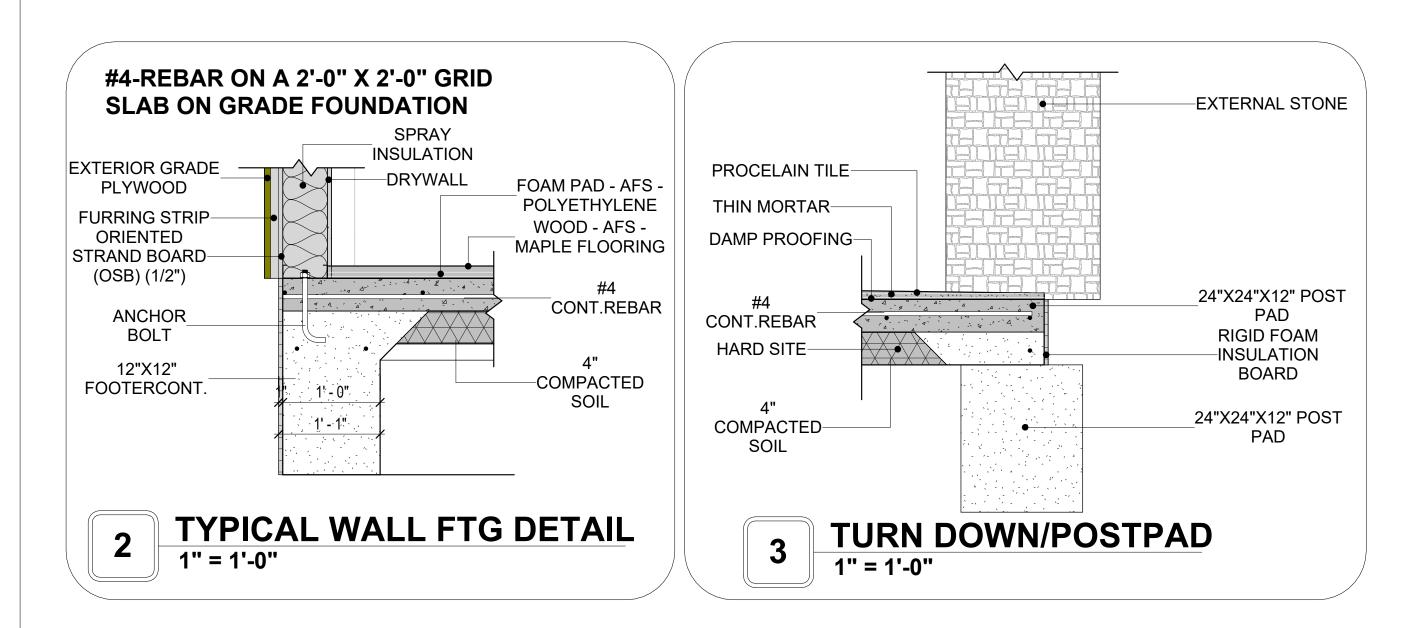

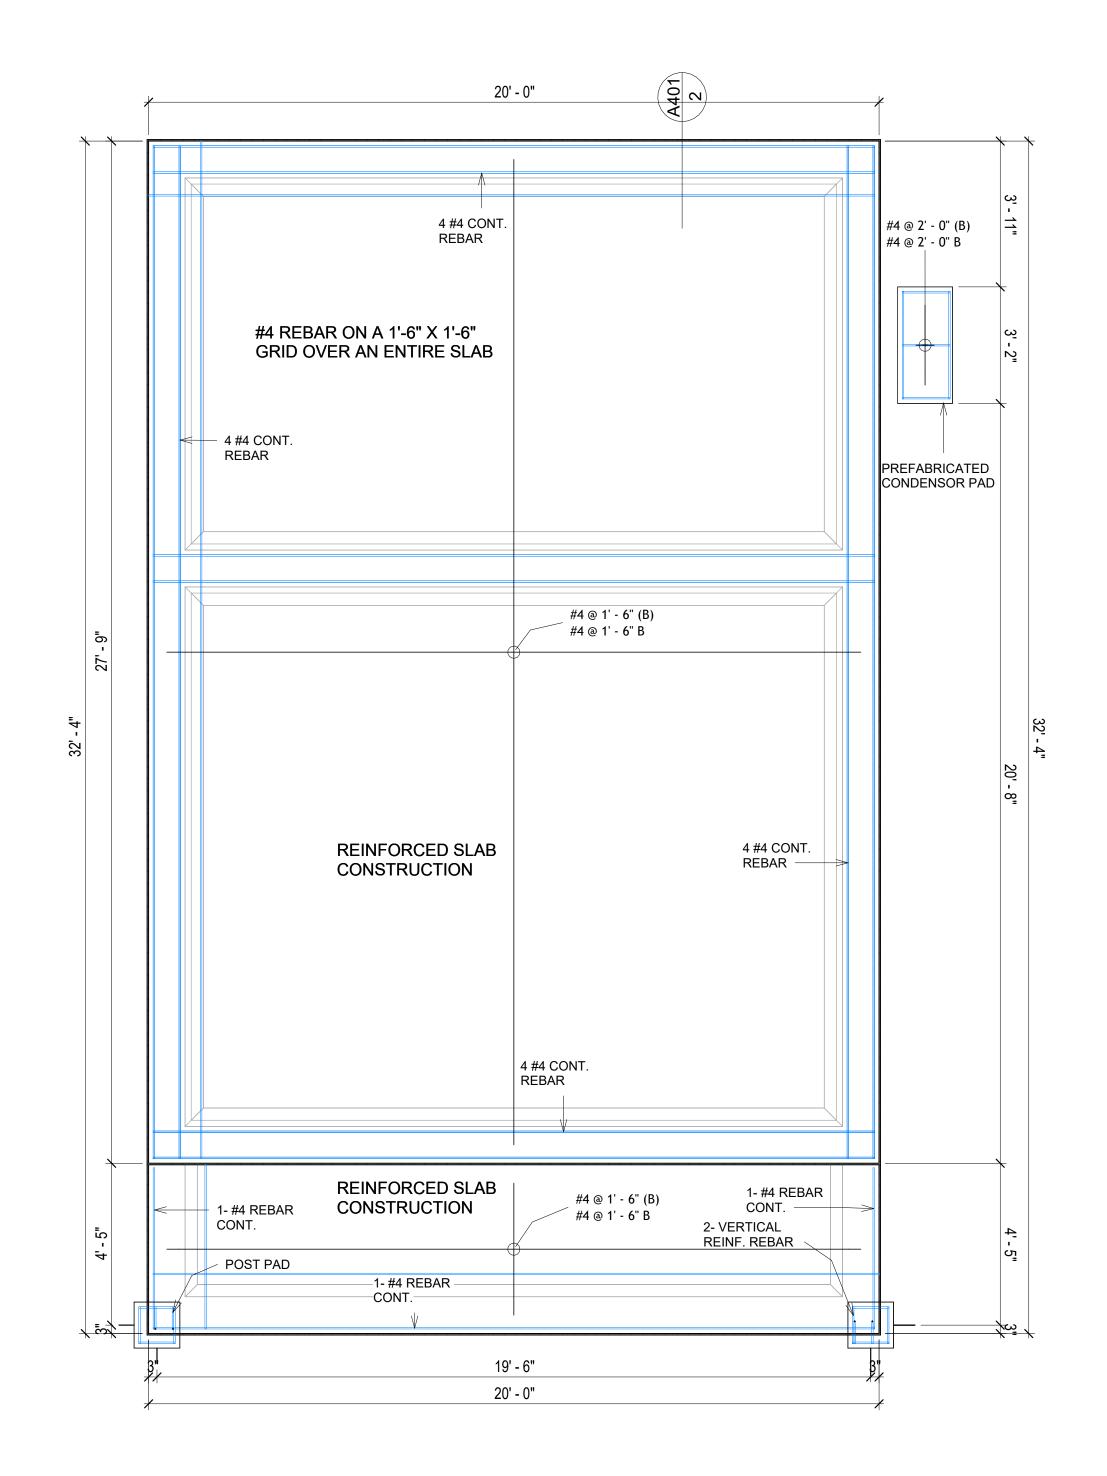

FOUNDATION REBAR PLAN 3/8" = 1'-0"



KEY PLAN

NO.	DESCRIPTION	DATE

NOTE:

LEGEND:

PROJECT

185-ORCHARD-553 1Bd1Ba-CRAFTSMAN-550

DRAWING NAME


STRUCTURAL FLOOR PLAN

CLIENT NAME: **Client Name** PROJECT NUMBER: 0061_12 5/6/2025 10:28:12 AM Designer **DESIGNED BY:** DRAWN BY: **Author** CHECKED BY: Checker


S102

ROOF NOTES

- 1. ROOFING COMPOSITION ROOFING PER OWNERS/BUILDERS SPECIFICATIONS INSTALL PER MANUFACTURE SPECIFICATIONS ON 1/2" ORIENTED STRAND BOARD ON PRE-ENGINEERED TRUSS @ 24" O.C. (UNO.)
- 73" OVERHANG AT EAVES (UNO.)
 ENDS OF ALL TRUSSES AND JOISTS TO BE FULLY BLOCKED. PROVIDE SOLID
- BLOCKING AT ALL RIDGES AND VALLEYS
- 4. SHEATHING TO BE 1/2", 3/8" OSB SHEAR PANEL AND EQUIVALENT. UNDERSIDE OF PORCH TRUSSES TO BE FINISHED WITH MOISTURE RESISTANT DRYWALL, TAPED AND TEXTURED.
- 5. EXPOSED EAVES AND OTHER WEATHER EXPOSED AREAS TO BE SHEATHED WITH EXTERIOR GRADE PLYWOOD.
- 6. ALL MATERIALS THICKNESS AND SIZE ARE THE MINIMUM. Refer TO LOCAL STANDARDS FOR ACTUAL THICKNESS AND LAYERING OF MATERIALS.
- 7. ENGINEERED TRUSS CALCULATIONS TO BE SUBMITTED TO BUILDING
- DEPARTMENT PRIOR TO FABRICATION AND INSTALLATION.
 8. TRUSS MANUFACTURER TO SPECIFY HANGER CONNECTORS FOR TRUSS
- COMPONENTS (TYPICAL)
- 9. DESIGNER ASSUMES THAT TRUSSES BEAR ON ALL EXTERIOR PERIMETER WALLS (TYPICAL) OR BEAMS.
- 10. PROVIDE GALVANIZED STEEL FLASHING WITH A LENGTH OF 10 FEET, WIDTH
- OF 12 INCHES, AND THICKNESS OF 24 GAUGE.

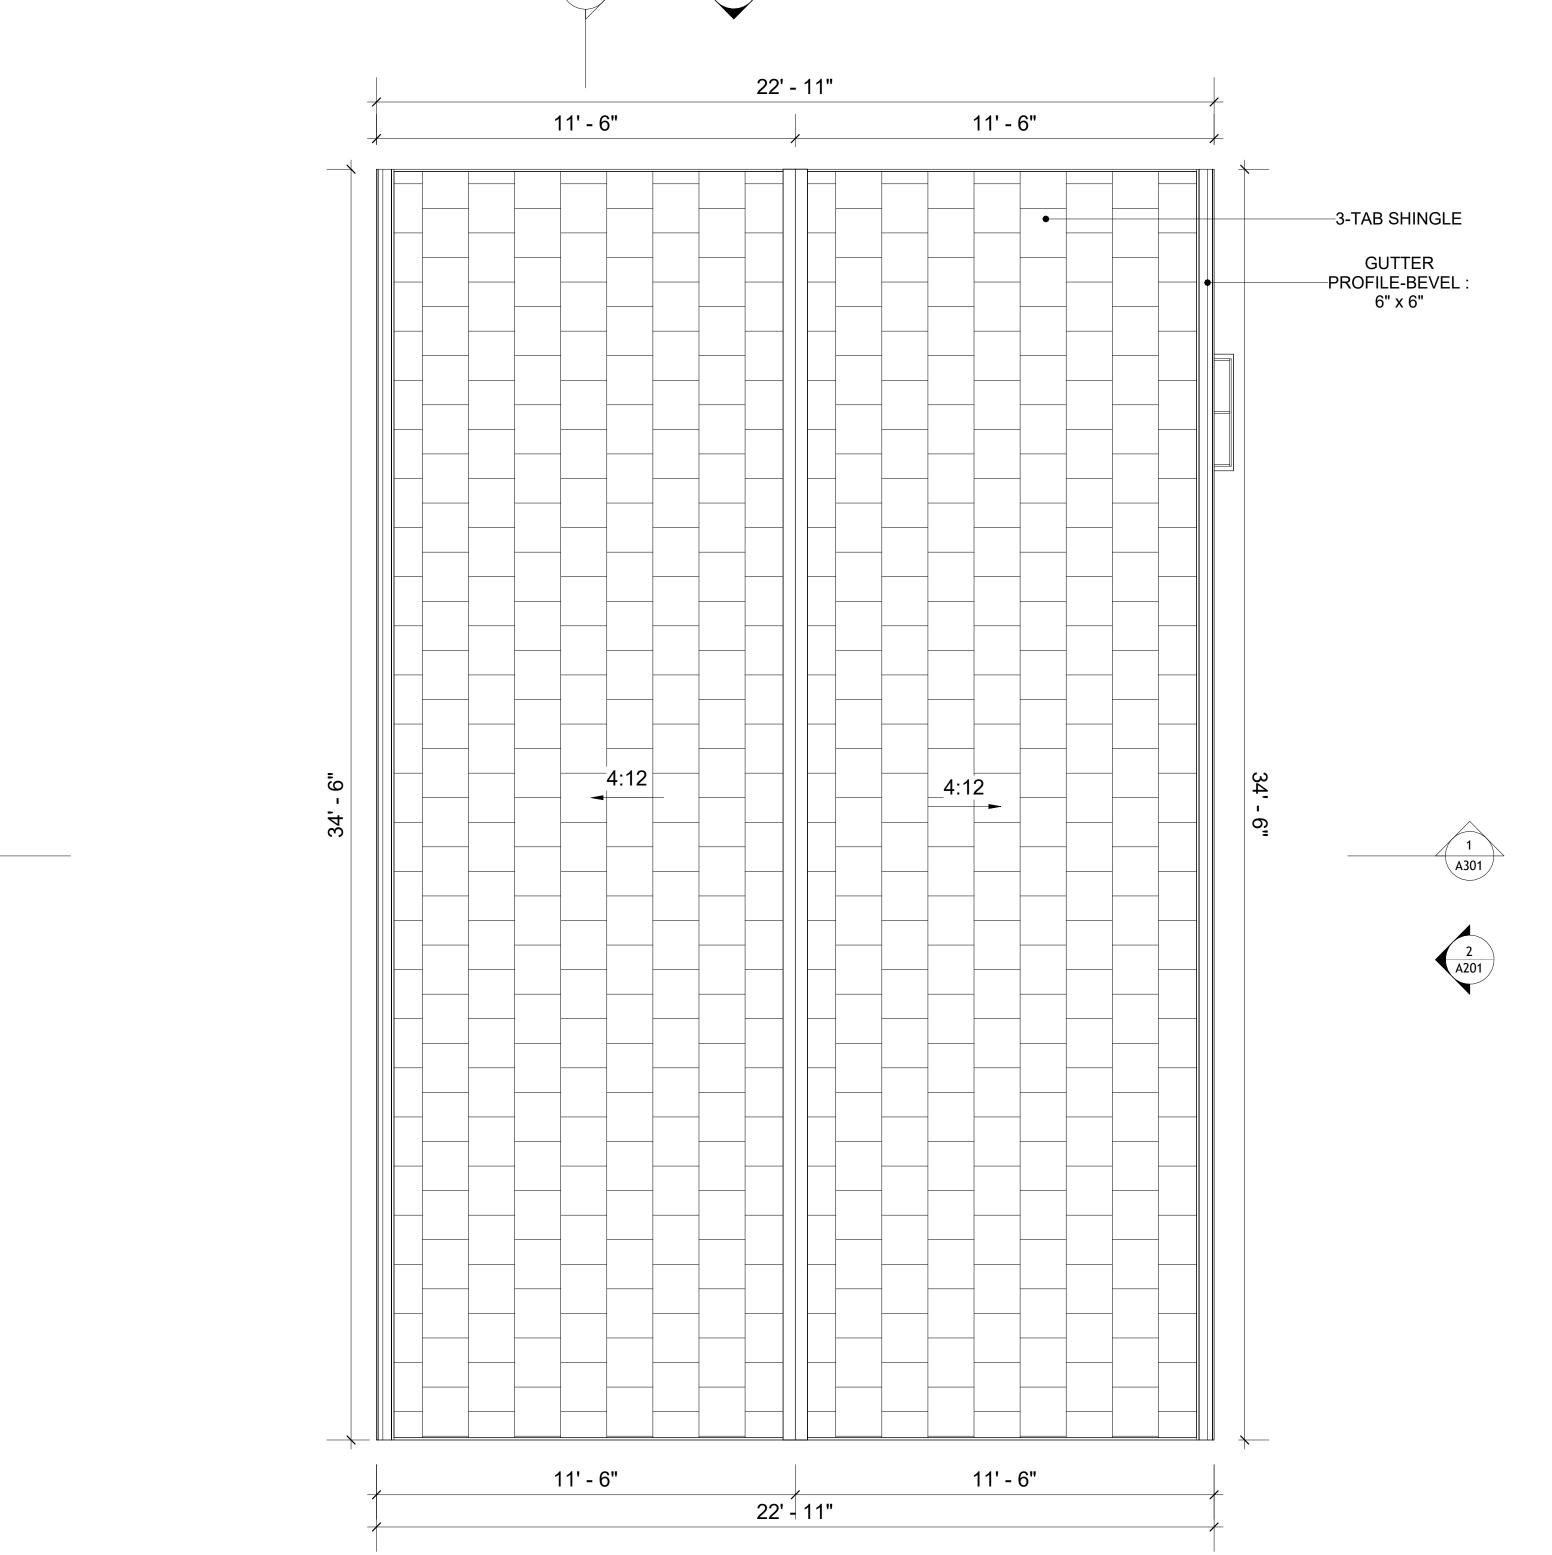



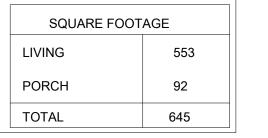



KEY PLAN

NO.	DESCRIPTION	DATE

NOTE:

LEGEND:

PROJECT

185-ORCHARD-553 1Bd1Ba-CRAFTSMAN-550

DRAWING NAME

ROOF PLAN

Client Name
0061_12
5/6/2025 10:28:14 AM
Designer
Author
Checker

A103

ABOUT WALL FINISHING

PLYWOOD WALL SIDING

WALL SIDING IS AN EXTERIOR CLADDING MATERIAL USED TO COVER AND PROTECT THE WALLS OF A BUILDING, PROVIDING BOTH FUNCTIONAL AND AESTHETIC BENEFITS.

IN THIS SPECIFIC PROJECT, PLYWOOD WALL PANELS ARE USED AS A FINISH SIDING BECAUSE THIS TYPE OF SIDING PROVIDES A DURABLE, COST-EFFECTIVE, AND VERSATILE EXTERIOR CLADDING THAT CAN BE EASILY INSTALLED, FINISHED, AND MAINTAINED TO ENHANCE THE AESTHETIC AND PROTECTIVE QUALITIES OF A BUILDING'S EXTERIOR.

STANDARD SIZES OF 1' X 8' EXTERIOR-GRADE PLYWOOD PANELS ARE INSTALLED ON THE FURRING STRIPS USING GALVANIZED STEEL SELF-DRILLING SCREWS.

EXTERNAL STONE


THESE STONE PRODUCTS ARE MADE FROM A BLEND OF NATURAL AGGREGATES, CEMENT, AND OTHER PROPRIETARY MATERIALS.


THE STONE FINISH IS DIRECTLY ATTACHED TO COLD-FORMED STEEL (CS) FRAMING. (FOR COLUMN FINISH) EXTERNAL STONE CAN BE AN EXCELLENT EXTERIOR CLADDING OPTION FOR CS-FRAMED BUILDINGS. IN THIS SCENARIO, THE EXTERNAL STONE WOULD BE ADHERED TO THE CS FRAME USING A SCRATCH COAT AND MORTAR-BASED ADHESIVE.

CEDAR WOOD

CEDAR WOOD REFERS TO THE WOOD FROM VARIOUS SPECIES OF CEDAR TREES, WHICH ARE CONIFEROUS EVERGREEN TREES KNOWN FOR THEIR DISTINCT AROMA AND NATURAL RESISTANCE TO DECAY AND INSECTS.

IN THIS SPECIFIC PROJECT, CEDAR WOOD IS USED A FINISH MATERIAL ON BEAMS AND COLUMNS.

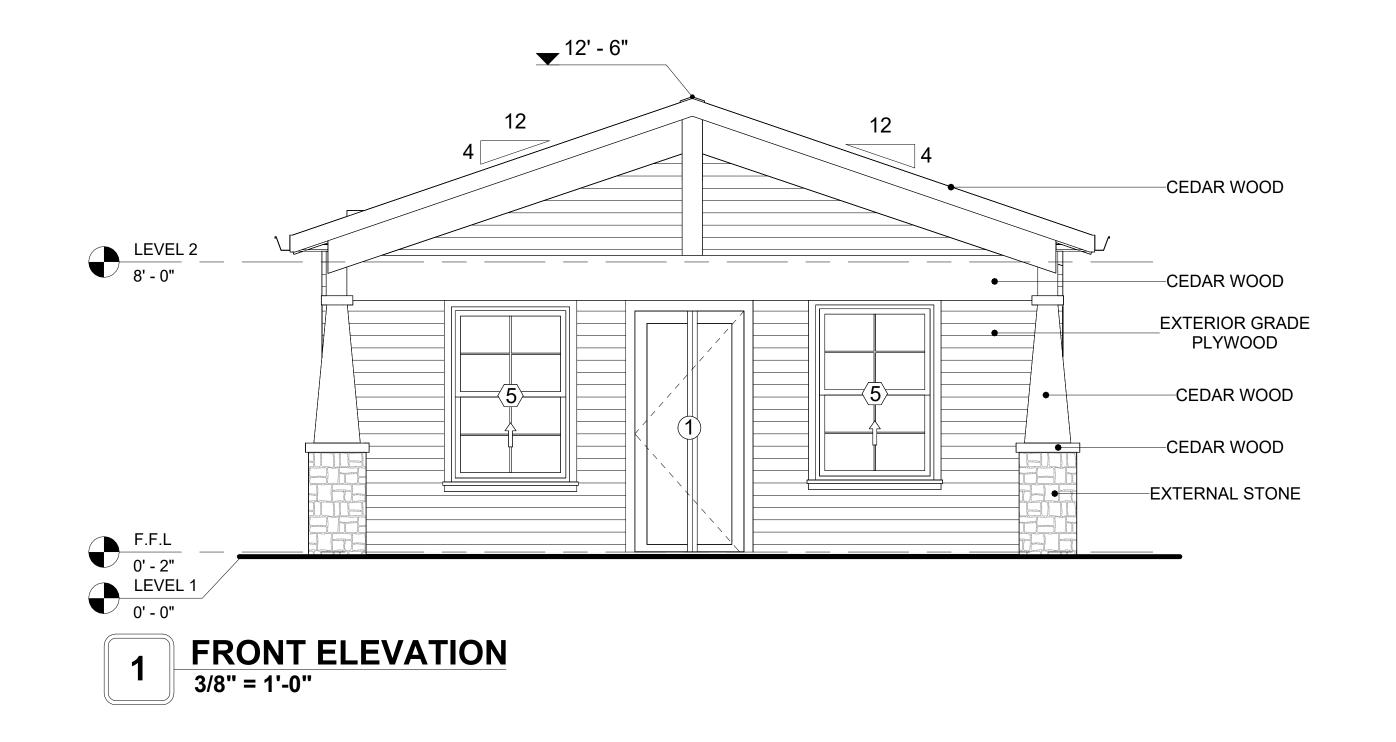

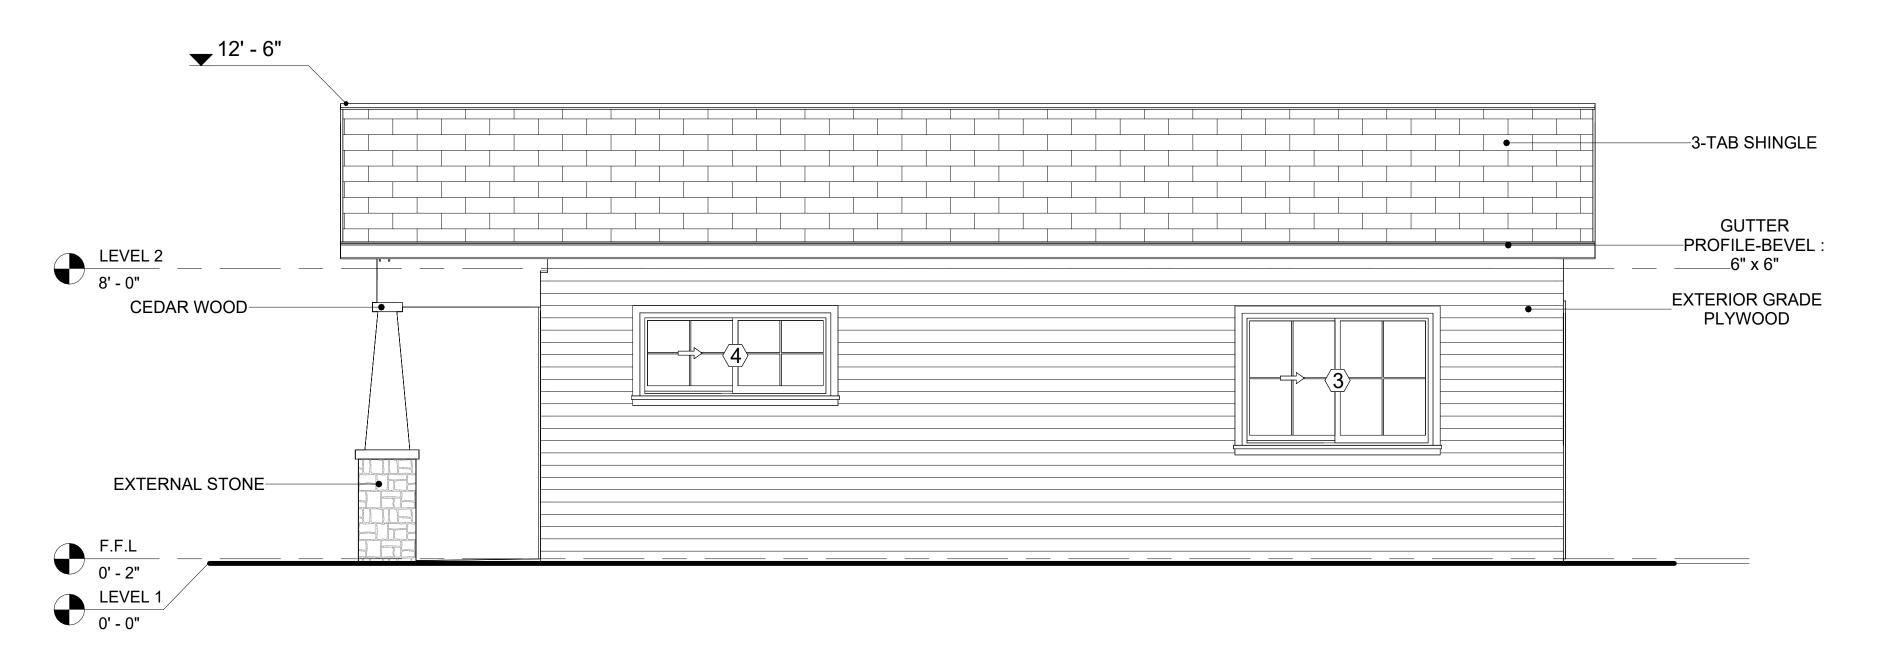




	DOOR SCHEDULE						
TYPE				SIZE			
MAR K	SUPPLIER	DOOR TYPE	LOCATIO N	WIDTH	HEIGHT	COUNT	
1	HOME DEPOT	EXTERIOR SINGLE PANEL SWINGING	INTERIOR	3' - 0"	6' - 8"	1	
2	HOME DEPOT	INTERIOR SINGLE PANEL SWINGING	INTERIOR	2' - 6"	6' - 8"	1	
3	HOME DEPOT	INTERIOR SINGLE PANEL SWINGING	INTERIOR	3' - 0"	6' - 8"	1	
4	HOME DEPOT	EXTERIOR SINGLE PANEL SWINGING	INTERIOR	2' - 4"	6' - 8"	1	
5	HOME DEPOT	INTERIOR DOUBLE PANEL SLIDING	INTERIOR	3' - 0"	6' - 8"	1	

WINDOW SCHEDULE						
				SIZE		
TYPE MARK	SUPPLIER	WINDOW TYPE	WIDTH	HEIGHT	COUNT	
1	HOME DEPOT	SINGLE HUNG	3' - 3"	3' - 3"	1	
2	HOME DEPOT	SLIDING	2' - 3"	2' - 3"	2	
3	HOME DEPOT	SLIDING	5' - 3"	3' - 7"	2	
4	HOME DEPOT	SLIDING	5' - 3"	2' - 3"	1	
5	HOME DEPOT	SINGLE HUNG	3' - 3"	4' - 9"	2	



KEY PLAN

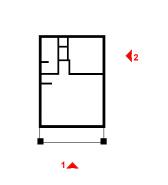

NO.	DESCRIPTION	DATE

NOTE:

LEGEND:

PROJECT

185-ORCHARD-553 1Bd1Ba-CRAFTSMAN-550

DRAWING NAME

ARCHITECTURAL ELEVATIONS

CLIENT NAME:	Client Name
PROJECT NUMBER:	0061_12
DATE:	5/6/2025 10:28:17 AM
DESIGNED BY:	Designer
DRAWN BY:	Author
CHECKED BY:	Checker

A201

ABOUT WALL FINISHING

PLYWOOD WALL SIDING

WALL SIDING IS AN EXTERIOR CLADDING MATERIAL USED TO COVER AND PROTECT THE WALLS OF A BUILDING, PROVIDING BOTH FUNCTIONAL AND AESTHETIC BENEFITS.

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STANDARD SIZES OF 1' X 8' EXTERIOR-GRADE PLYWOOD PANELS ARE INSTALLED ON THE FURRING STRIPS USING GALVANIZED STEEL SELF-DRILLING SCREWS.

EXTERNAL STONE


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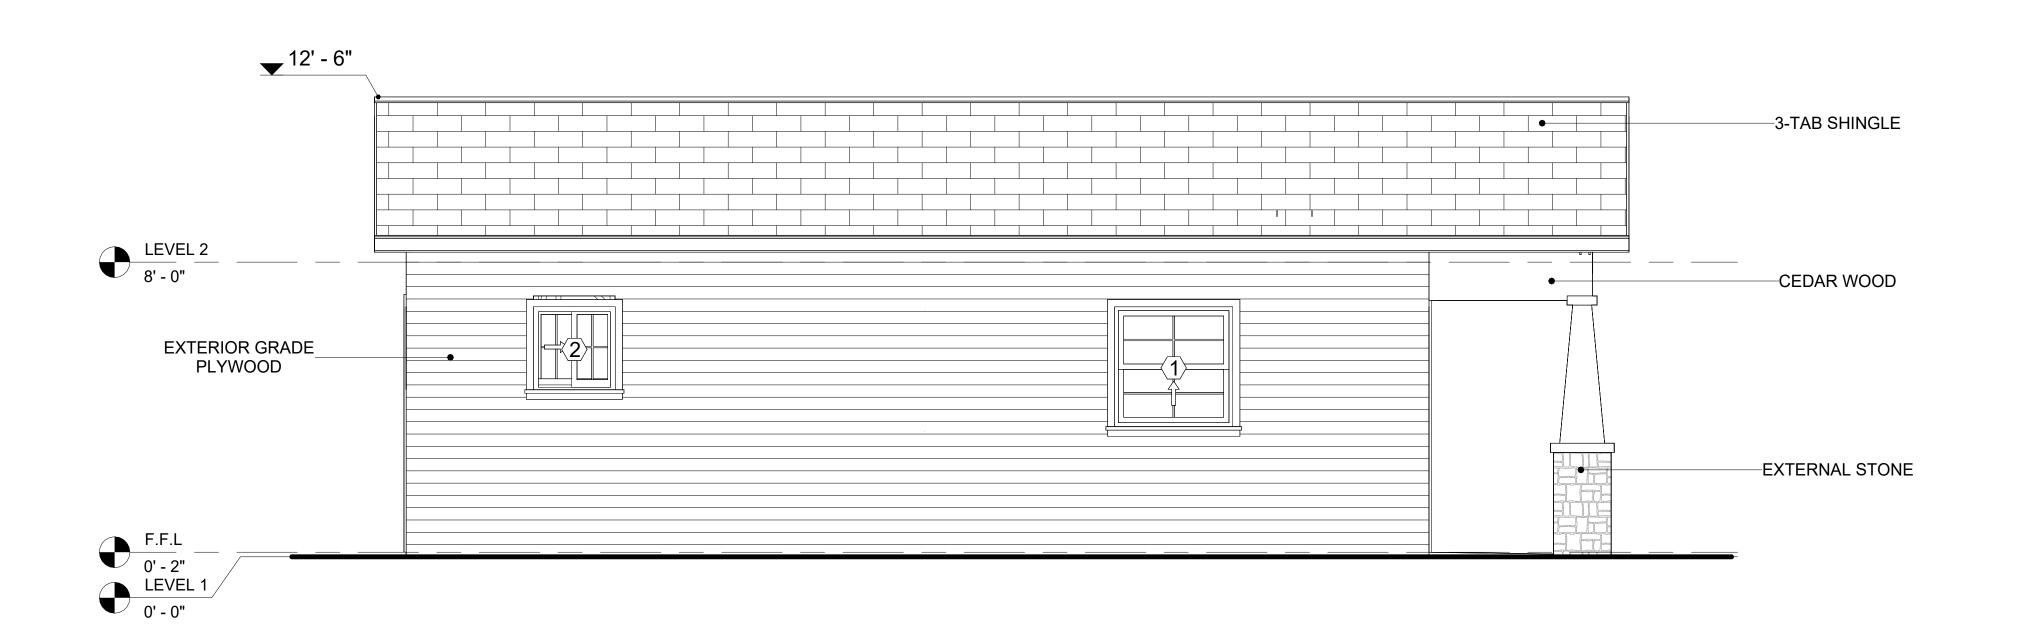
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IN THIS SPECIFIC PROJECT, CEDAR WOOD IS USED A FINISH MATERIAL ON BEAMS AND COLUMNS.




1 REAR ELEVATION 3/8" = 1'-0"



2 LEFT SIDE ELEVATION
3/8" = 1'-0"

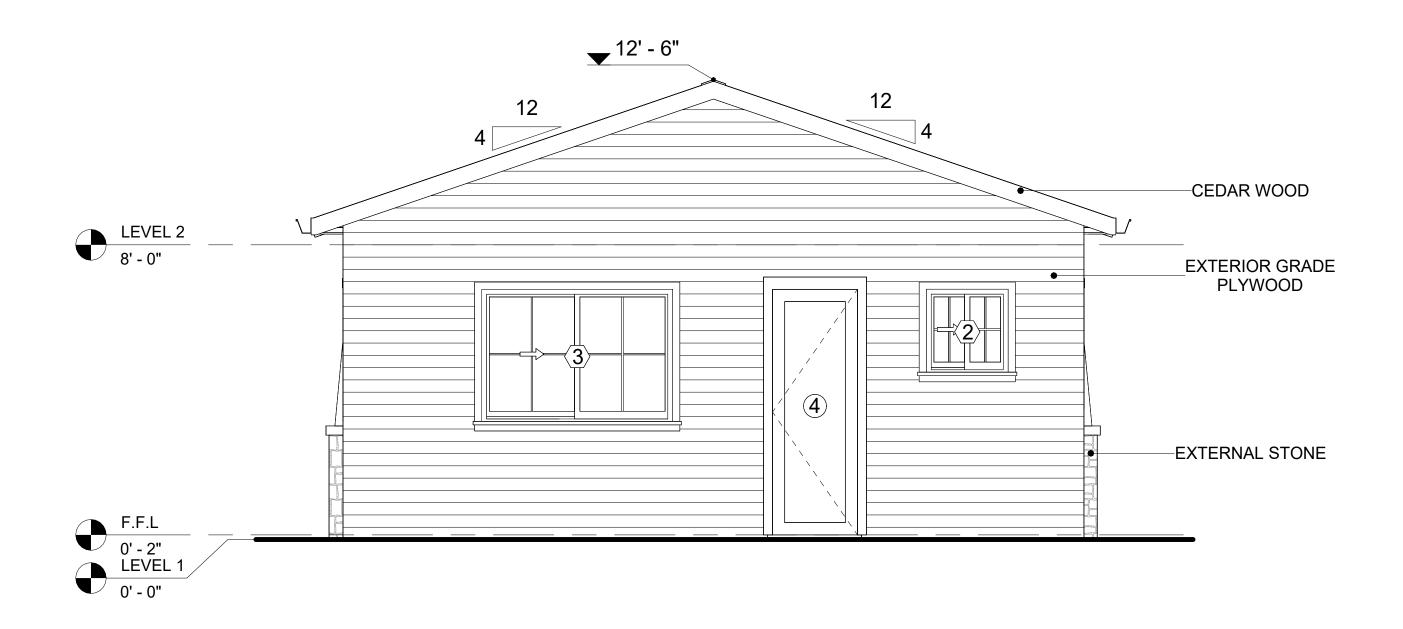

KEY PLAN

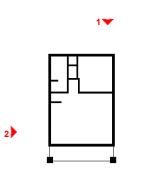

NO.	DESCRIPTION	DAT

NOTE:

LEGEND:

PROJECT

185-ORCHARD-553 1Bd1Ba-CRAFTSMAN-550

DRAWING NAME

ARCHITECTURAL ELEVATIONS

CLIENT NAME:

PROJECT NUMBER:

0061_12

DATE:

5/6/2025 10:28:20 AM


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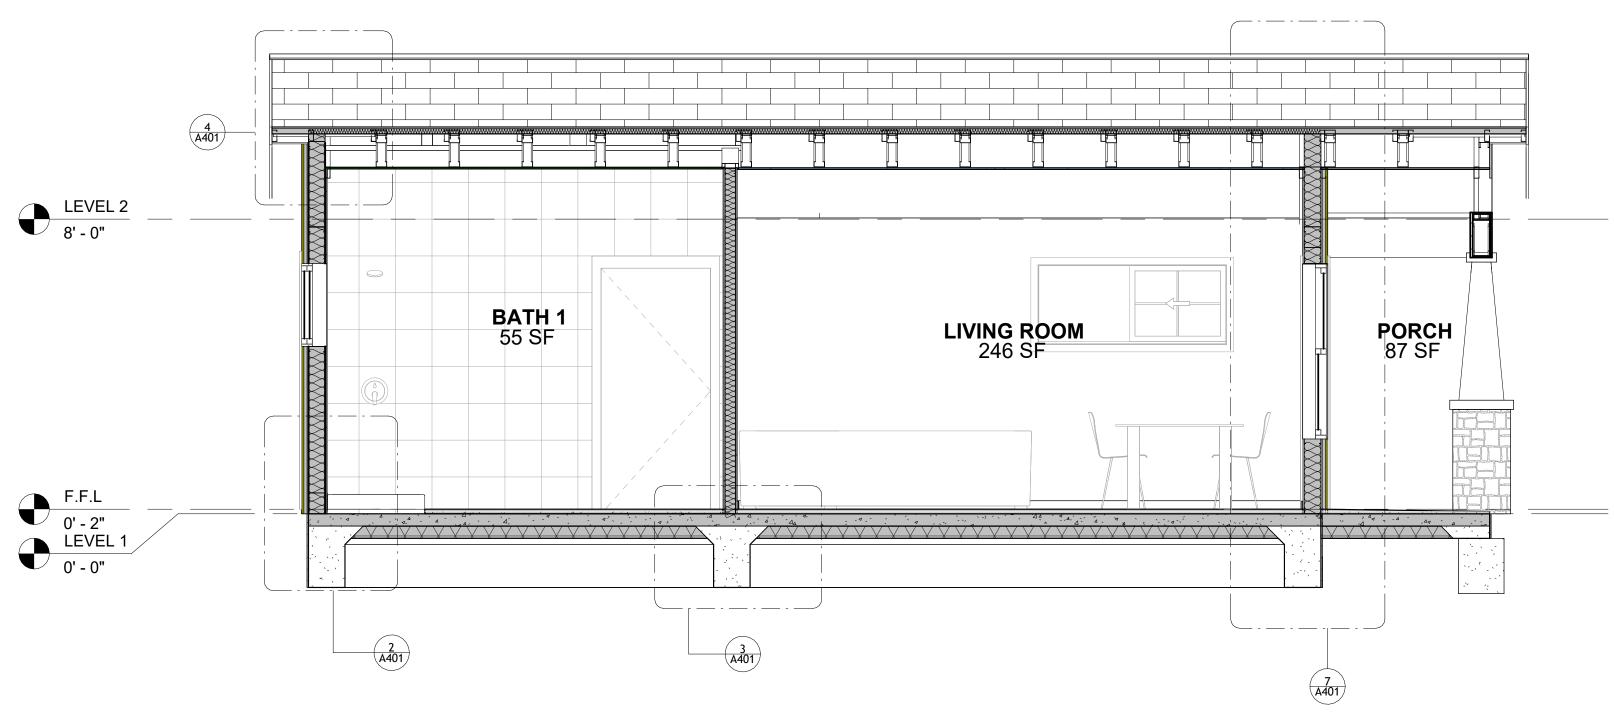
DRAWN BY:

CHECKED BY:

Checker

A202




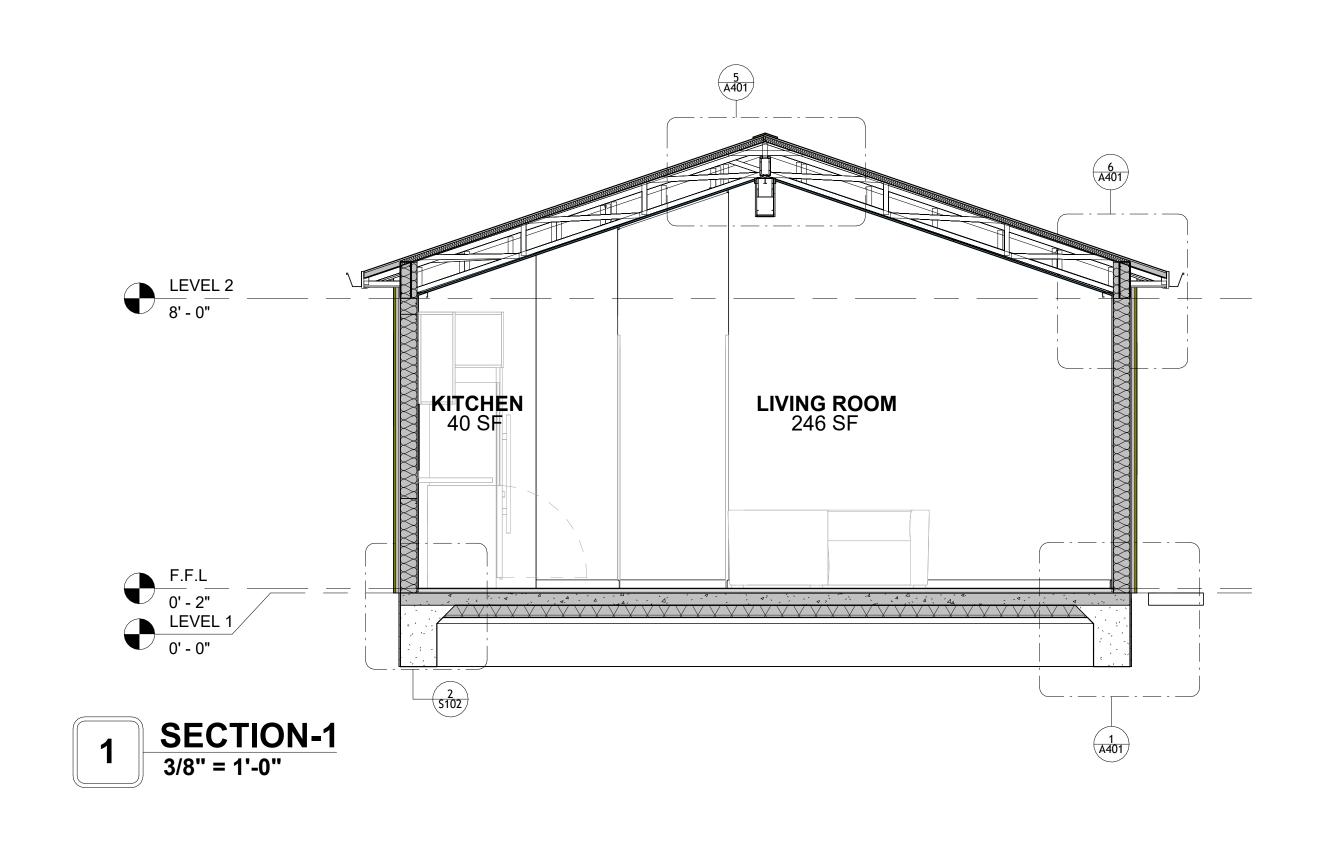

2 SECTION-2 3/8" = 1'-0"



KEY PLAN

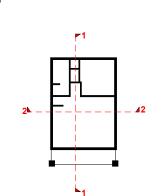

NO.	DESCRIPTION	DATE

NOTE:

LEGEND:

PROJECT


185-ORCHARD-553 1Bd1Ba-CRAFTSMAN-550


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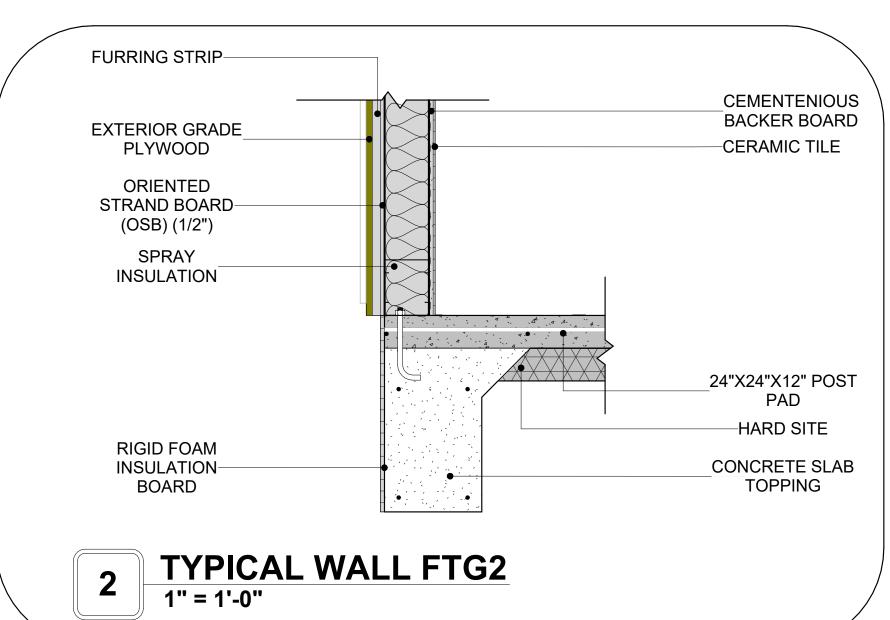
ARCHITECTURAL SECTIONS


CLIENT NAME:	Client Name
PROJECT NUMBER:	0061_12
DATE:	5/6/2025 10:28:22 AM
DESIGNED BY:	Designer
DRAWN BY:	Author
CHECKED BY:	Checker


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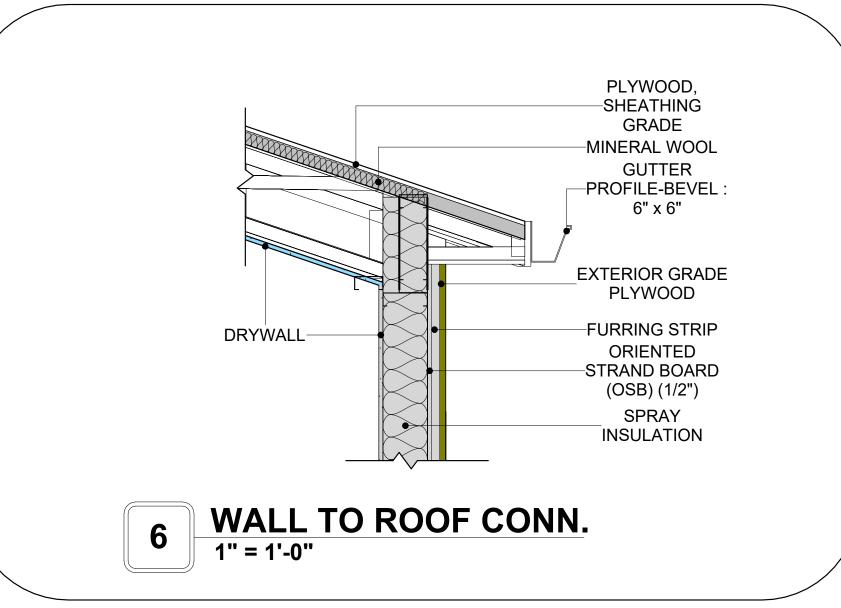





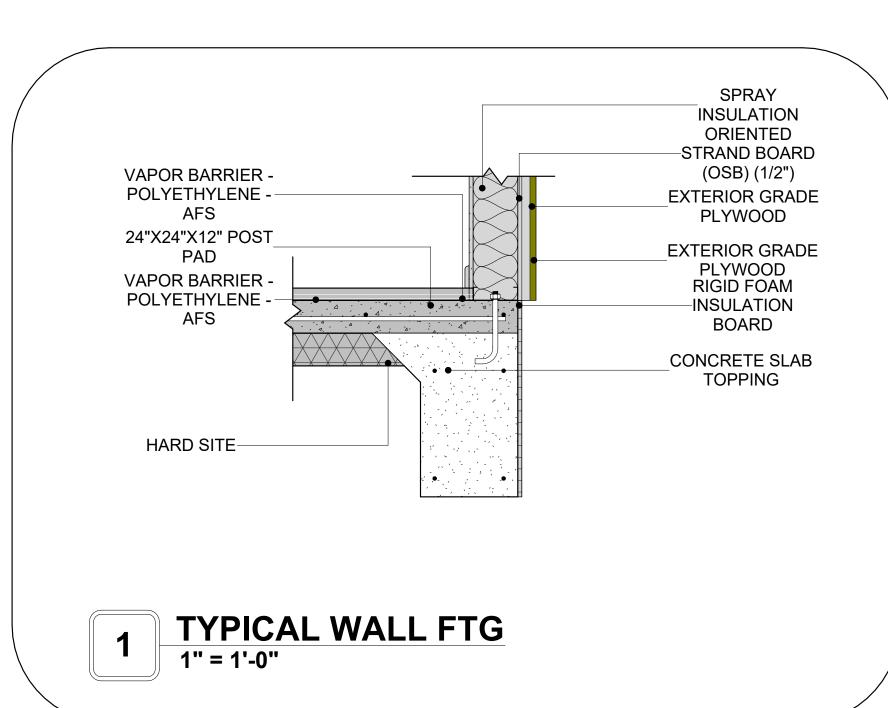

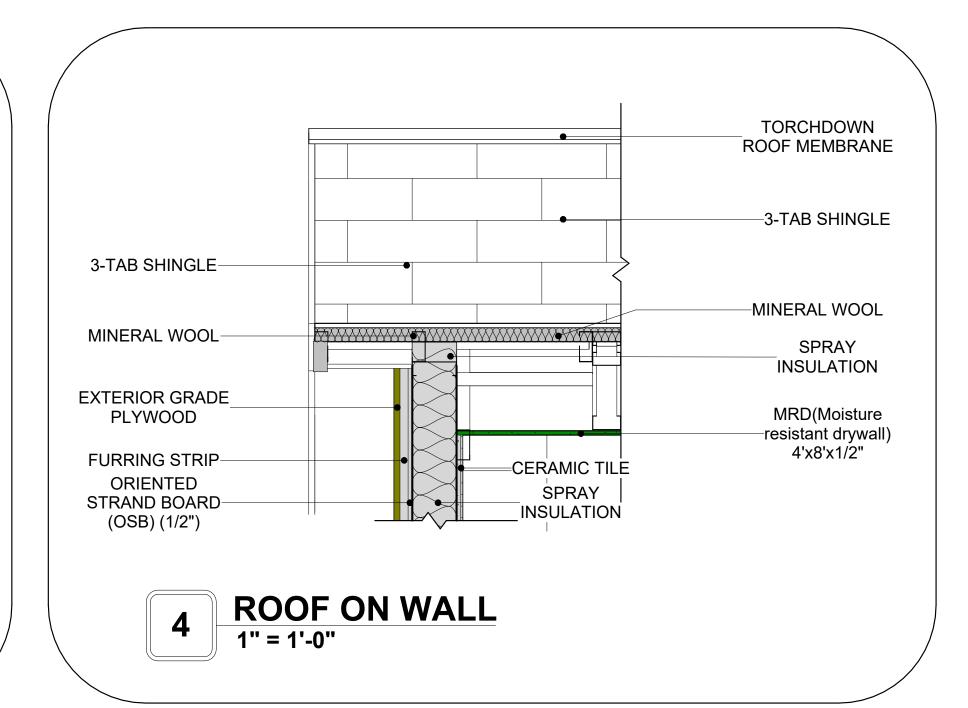

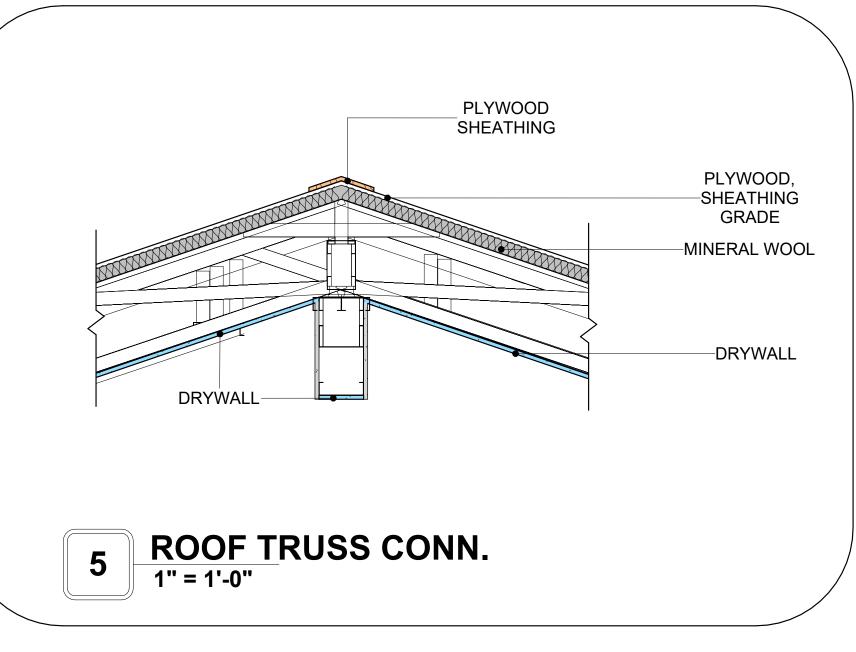

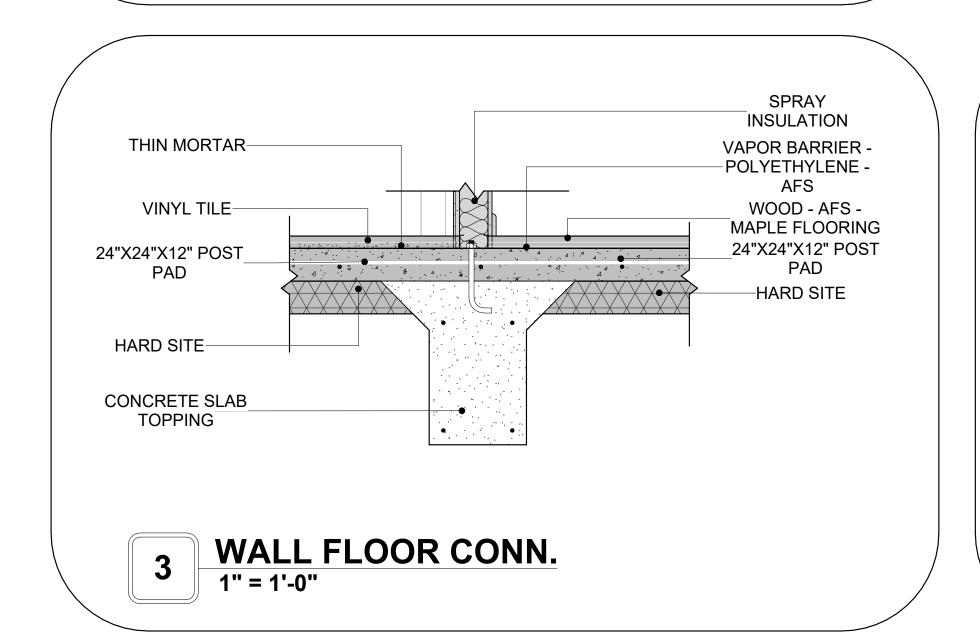

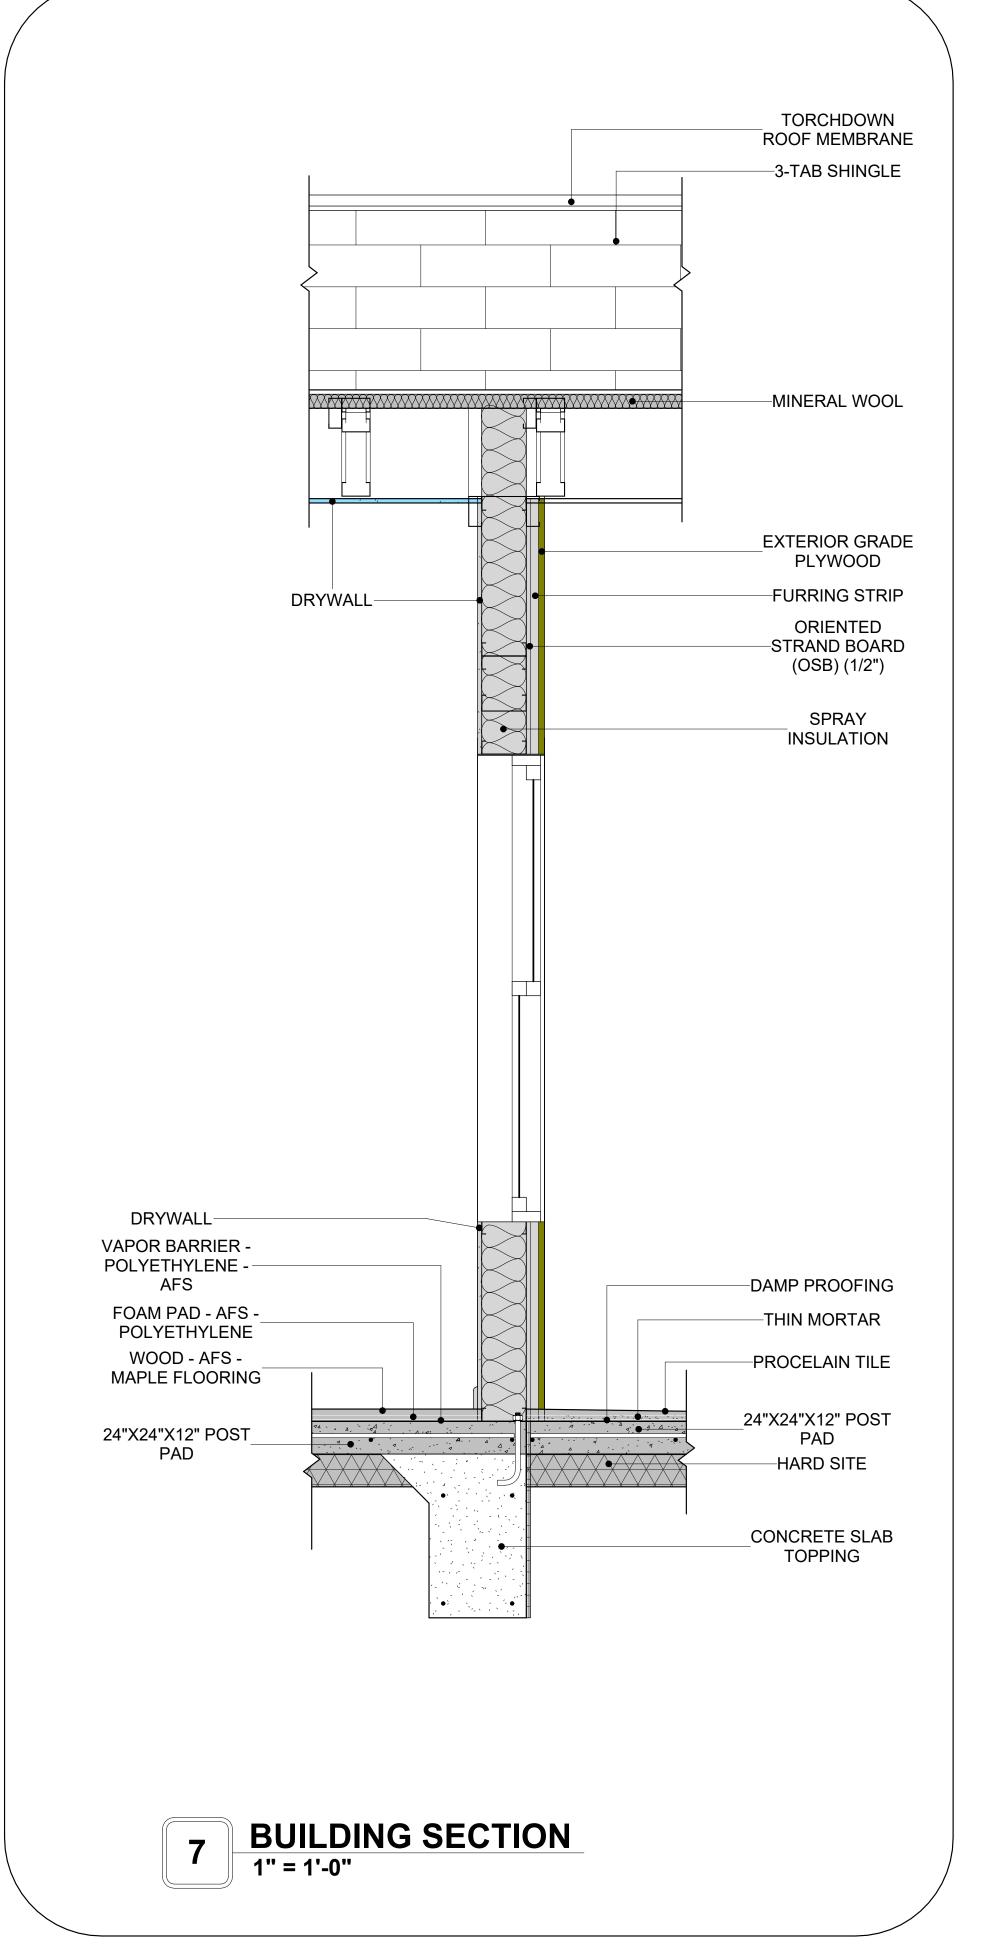



KEY PLAN

NO.	DESCRIPTION	DATE

NOTE:

LEGEND:

PROJECT

185-ORCHARD-553 1Bd1Ba-CRAFTSMAN-550

DRAWING NAME

ARCHITECTURAL DETAILS

Client Name
0061_12
5/6/2025 10:28:24 AM
Designer
Author
Checker

A401


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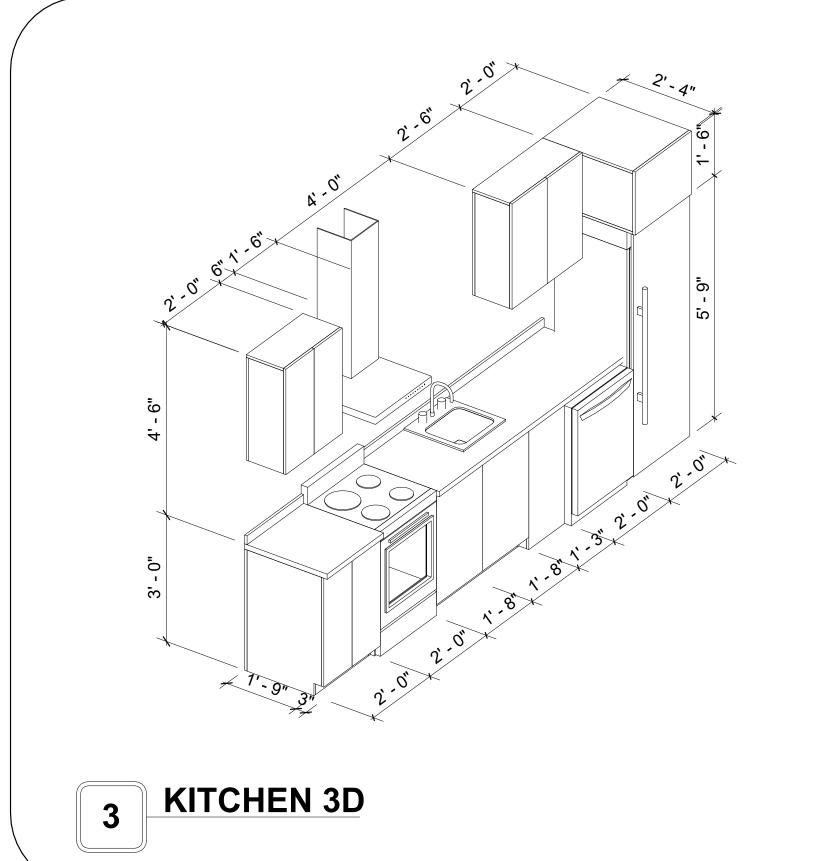
CASEWORK GENERAL NOTES


- ALL CABINET HEIGHTS INCLUDE COUNTERTOPS. DIMENSIONS ARE TO THE NEAREST INCH. DIVISIONS IN CASEWORK ARE SHOWN FOR CLARITY AND DO NOT REPRESENT BREAKS IN THE COUNTERTOP.
- PROVIDE CONTINUOUS COUNTERTOP OVER ALL SIMILAR HEIGHT CASEWORK, UNLESS AND OTHERWISE NOTED.
- MANUFACTURER AND CATALOG NUMBERS ARE FOR REFERENCE AND ILLUSTRATION PURPOSES
- DOTTED LINES INDICATE WALL HUNG CABINETS, DIVISIONS OF BASE CABINETS BELOW THE
- COUNTERTOP, FURNITURE NOT IN THE CONTRACT OR PROJECTION SCREENS -SEE CASEWORK KEY AND SPECIFICATIONS.
- ALL CABINETS AND DRAWERS TO HAVE CAM LOCKS EXCEPT FOR SINK BASE CABINETS. ALL EXPOSED SURFACES (EXPOSED TO VIEW FROM ANY PERSPECTIVE) TO BE COVERED WITH
- LAMINATE.
- ALL CASEWORK WHICH MEETS A WALL AT ONE OR BOTH ENDS, TO BE PROVIDED WITH FILLER PANELS AND SCRIBED TO THE WALL(S) AS REQUIRED.
- 10. ALL CABINETS AND DRAWERS ARE PROVIDED WITH RECESSED HANDLES.
- 11. CONTRACTOR TO FIELD VERIFY ALL CLEAR OPENINGS PRIOR TO MILLWORK OR CASEWORK FABRICATION.
- 12. CASEWORK DRAWINGS ARE DIAGRAMMATIC IN NATURE TO SHOW DESIGN INTENT.


	CASEWORK SCHEDULE					
TYPE MAR K	TYPE	COUN	HEIGHT	WIDTH	DEPTH	AREA
01	RECESSED_MED_CABINET 2	1	2' - 0"	1' - 6"	0' - 3"	3 SF
02	WALL CABINET DOUBLE DOOR 2 158	1	2' - 6"	2' - 0"	1' - 0"	5 SF
03	LAUNDRY OPEN CABINET	1	1' - 6"	2' - 0"	2' - 4"	3 SF
04	LAUNDRY OPEN CABINET 3	1	1' - 2"	2' - 3"	2' - 6"	3 SF
05	VANITY	1	2' - 4"	2' - 6"	1' - 8"	6 SF
06	CLOSET 3	1	6' - 0"	3' - 9"	1' - 4"	23 SF
07	WALL CABINET DOUBLE DOOR 2 159	1	2' - 6"	2' - 6"	1' - 0"	6 SF
80	HD_LINEAR_COUNTER_TOP 2	1	0' - 4"	1' - 9"	2' - 1"	1 SF
09	BASE_CABINET_DOUBLE_DOOR 3	1	2' - 11"	2' - 0"	2' - 0"	6 SF
10	HD_LINEAR_COUNTER_TOP 2	1	0' - 4"	6' - 10"	2' - 1"	2 SF
11	BASE CABINET DOUBLE DOOR 2	1	2' - 11"	3' - 3"	2' - 0"	9 SF
12	BASE_CABINET_SINGLE_DOOR	1	2' - 11"	1' - 3"	2' - 0"	4 SF
GRAND	TOTAL	12				


SPECIALTY EQUIPMENT SCHEDULE			
TYPE MARK	TYPE	COUNT	
01	WASHER-FRONT-LOAD	1	
02	REFRIGERATOR	1	
03	RANGE	1	
04	DRYER-FRONT-LOAD	1	
05	DISHWASHER	1	
GRAND TOTAL · 5	·		



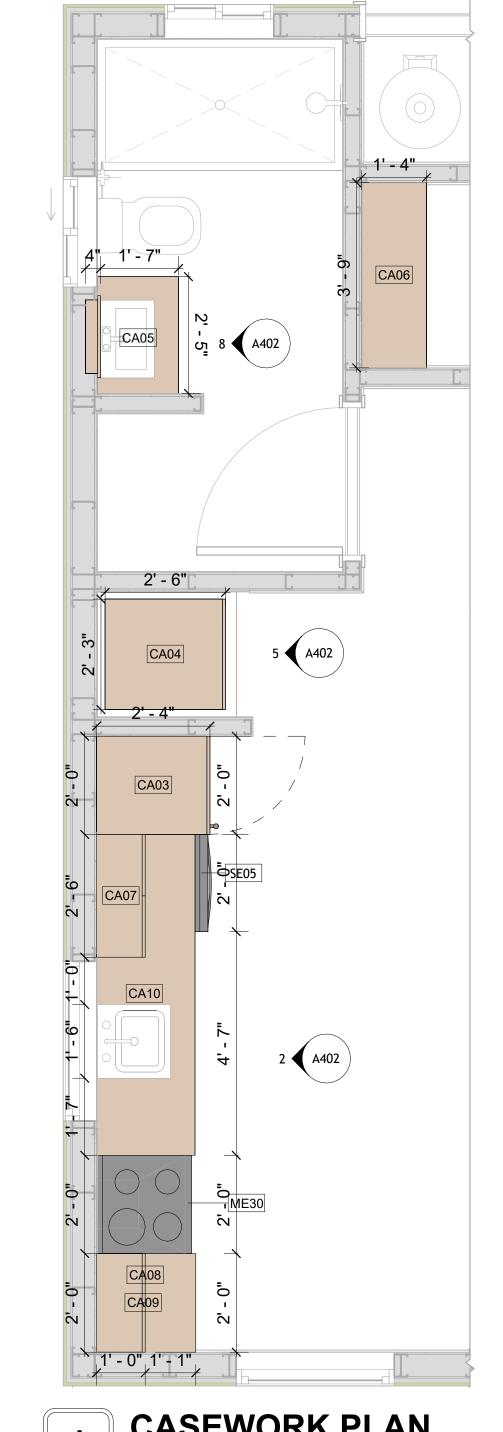

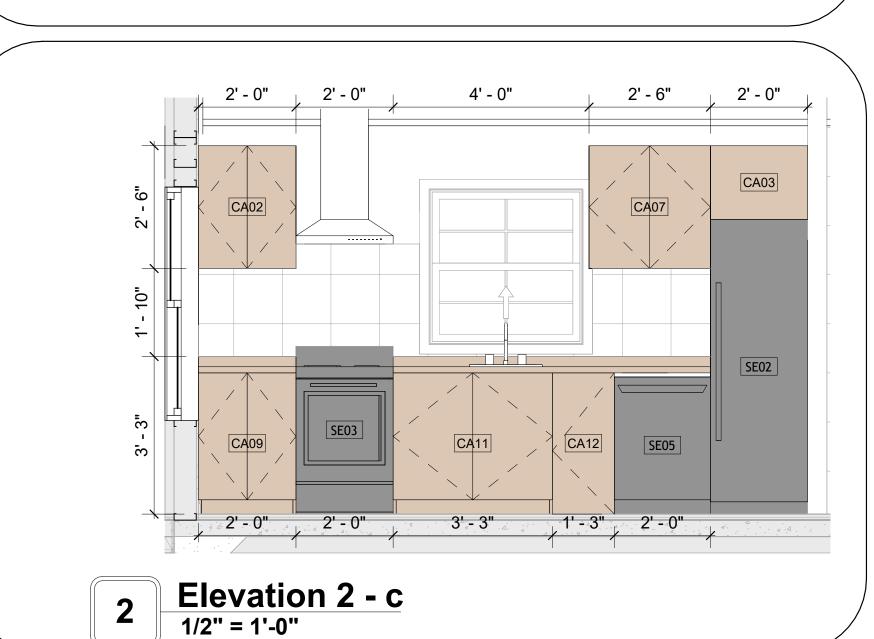

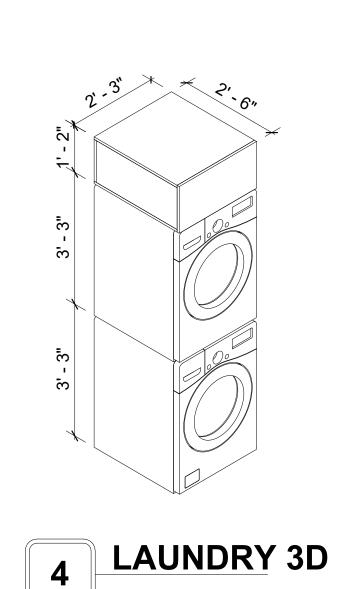

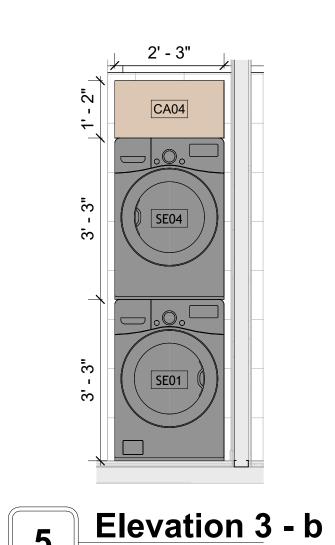

1/2" = 1'-0"

PROJECT

185-ORCHARD-553 1Bd1Ba-CRAFTSMAN-550

DRAWING NAME

Tuscon,AZ, USA 888-864-0184

KEY PLAN

NO.

NOTE:

LEGEND:

inquire@frameupnow.com www.frameupnow.com

DESCRIPTION

DATE


ARCHITECTURAL CASEWORK

CLIENT NAME:	Client Name
PROJECT NUMBER:	0061_12
DATE:	5/6/2025 10:28:27 AM
DESIGNED BY:	Designer
DRAWN BY:	Author
CHECKED BY:	Checker


A402


SCALE: As indicated

ELEVATION 1 - E 1/2" = 1'-0"

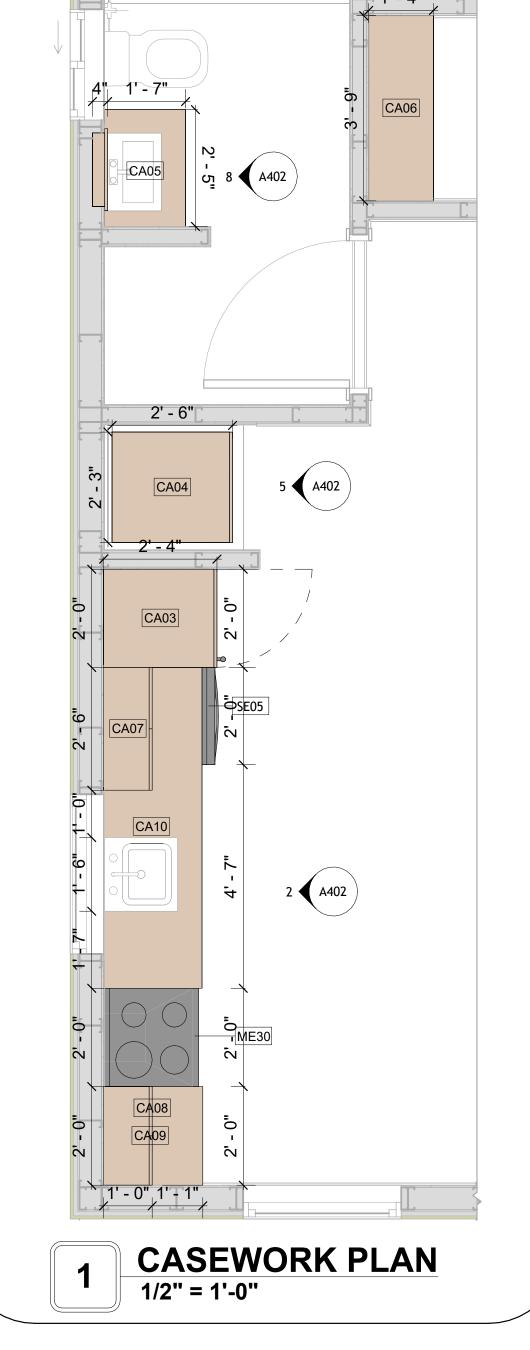

CLOSET 3D

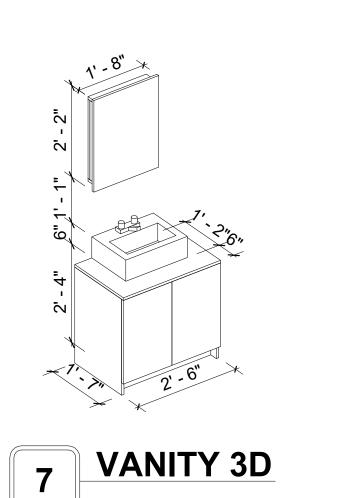

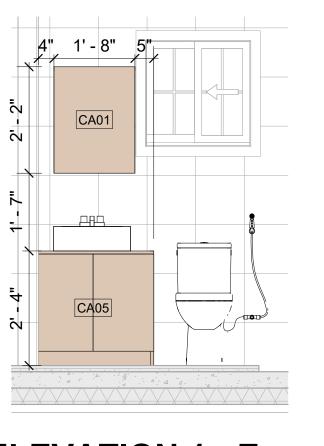

air conditioning pipe line

1. THIS DRAWING DEPICTS THE HVAC (HEATING, VENTILATION, AND AIR CONDITIONING) SYSTEM FOR THEORCHARD 1Bd1Ba CRAFTSMAN IT PROVIDES A VISUAL REPRESENTATION OF THE SYSTEM LAYOUT AND COMPONENTS.

2.THE HVAC SYSTEM IS DESIGNED TO MEET THE SPECIFIC REQUIREMENTS OF THE BUILDING, INCLUDING HEATING, COOLING, AND VENTILATION NEEDS AS PER THE PROJECT SPECIFICATIONS AND APPLICABLE CODES AND STANDARDS.

3. THE HVAC SYSTEM INSTALLATION SHALL COMPLY WITH THE LATEST EDITION OF THE INTERNATIONAL MECHANICAL CODE (IMC), INTERNATIONAL RESIDENTIAL CODE (IRC), AND ALL OTHER APPLICABLE LOCAL, STATE, AND NATIONAL CODES AND REGULATIONS.

4. THE EQUIPMENT SHOWN ON THIS DRAWING INCLUDES BUT IS NOT LIMITED TO AIR HANDLING UNITS (AHUS), CHILLERS, BOILERS, COOLING TOWERS, PUMPS, DUCTWORK, DIFFUSERS, GRILLES, AND CONTROL DEVICES.

5. ALL EQUIPMENT, DUCTWORK, AND PIPING SHALL BE INSTALLED IN ACCORDANCE WITH MANUFACTURER'S SPECIFICATIONS, LOCAL CODES, AND INDUSTRY BEST PRACTICES.

6. ALL DUCTWORK SHALL BE SIZED, FABRICATED, AND INSTALLED IN ACCORDANCE WITH THE LATEST EDITION OF THE ACCA MANUAL D AND THE SMACNA HVAC DUCT CONSTRUCTION STANDARDS. DUCTWORK SHALL BE INSTALLED IN A NEAT AND WORKMANLIKE MANNER, PROPERLY SUPPORTED AND BRACED TO PREVENT SAGGING, AIR LEAKAGE, OR VIBRATION.

7. CONDENSATE DRAINAGE PIPING SHALL BE PROPERLY PITCHED TO ENSURE POSITIVE DRAINAGE TO AN APPROVED DISPOSAL LOCATION, SUCH AS A FLOOR DRAIN, SUMP PUMP, OR EXTERIOR GRADE. CONDENSATE LINES SHALL BE INSULATED TO PREVENT SWEATING.

8. THE LOCATION OF CONTROL PANELS AND SENSORS INDICATED ON THIS DRAWING CAN BEMODIFY with THE SPECIFIC LOCATIONS AND WIRING DETAILS WILL BE DETERMINED DURING THE CONTROL SYSTEM DESIGN AND INSTALLATION.

9. THE HVAC SYSTEM DESIGN CONSIDER ENERGY EFFICIENCY, INDOOR AIR QUALITY, OCCUPANT COMFORT, AND NOISE CONTROL, FOLLOWING APPLICABLE GUIDELINES AND REGULATIONS.

10. COORDINATION WITH OTHER TREADS HAS BEEN DONE ON A DESIGN LEVEL. THIS DRAWING SHALL BE READ TOGETHER WITH THE AR, EL AND SN DESIGN DRAWINGS TO ENSURE PROPER INSTALLATION AND INTEGRATION OF THE HVAC SYSTEMS.

11. THE HVAC CONTRACTOR IS RESPONSIBLE FOR OBTAINING ALL NECESSARY PERMITS AND LICENSES, AND FOR SCHEDULING AND COORDINATING WITH THE LOCAL BUILDING DEPARTMENT AND UTILITY PROVIDERS TO ENSURE A TIMELY AND COMPLIANT INSTALLATION.

12. ALL DUCTWORK PENETRATIONS THROUGH WALLS, FLOORS, OR CEILINGS SHALL BE PROPERLY SEALED AND FIRE-STOPPED USING APPROVED METHODS AND MATERIALS TO MAINTAIN THE INTEGRITY OF THE BUILDING'S FIRE-RESISTANCE RATINGS.

13. HVAC EQUIPMENT SHALL BE INSTALLED LEVEL AND PLUMB, AND IN STRICT ACCORDANCE WITH THE MANUFACTURER'S INSTALLATION INSTRUCTIONS AND RECOMMENDATIONS. PROVIDE ADEQUATE CLEARANCES AROUND EQUIPMENT FOR PROPER AIRFLOW, SERVICE ACCESS, AND CODE COMPLIANCE.

FOR EASY SERVICING AND MAINTENANCE. PROVIDE ADEQUATE SPACE AROUND EQUIPMENT FOR PROPER AIRFLOW AND SERVICE ACCESS.


14. ALL HVAC EQUIPMENT AND COMPONENTS, INCLUDING THERMOSTATS, DAMPERS, AND ACCESS PANELS, SHALL BE LOCATED IN ACCESSIBLE AREAS


15. THE HVAC SYSTEM SHALL BE BALANCED AND ADJUSTED TO ENSURE PROPER AIRFLOW, TEMPERATURE DISTRIBUTION, AND SYSTEM PERFORMANC THROUGHOUT THE RESIDENCE. PROVIDE A WRITTEN REPORT DOCUMENTING THE FINAL SYSTEM BALANCE.

16. ANY DEVIATIONS OR MODIFICATIONS TO THE HVAC SYSTEM DESIGN SHALL BE REVIEWED AND APPROVED BY THE RESPONSIBLE DESIGN PROFESSIONALS AND COMMUNICATED TO ALL RELEVANT PARTIES INVOLVED IN THE CONSTRUCTION PROCESS.

17. FOR ANY INQUIRIES OR CLARIFICATIONS REGARDING THE HVAC SYSTEM DESIGN, PLEASE CONSULT THE RESPONSIBLE DESIGN PROFESSIONALS OR THE PROJECT MANAGEMENT TEAM.

SYMBOLS

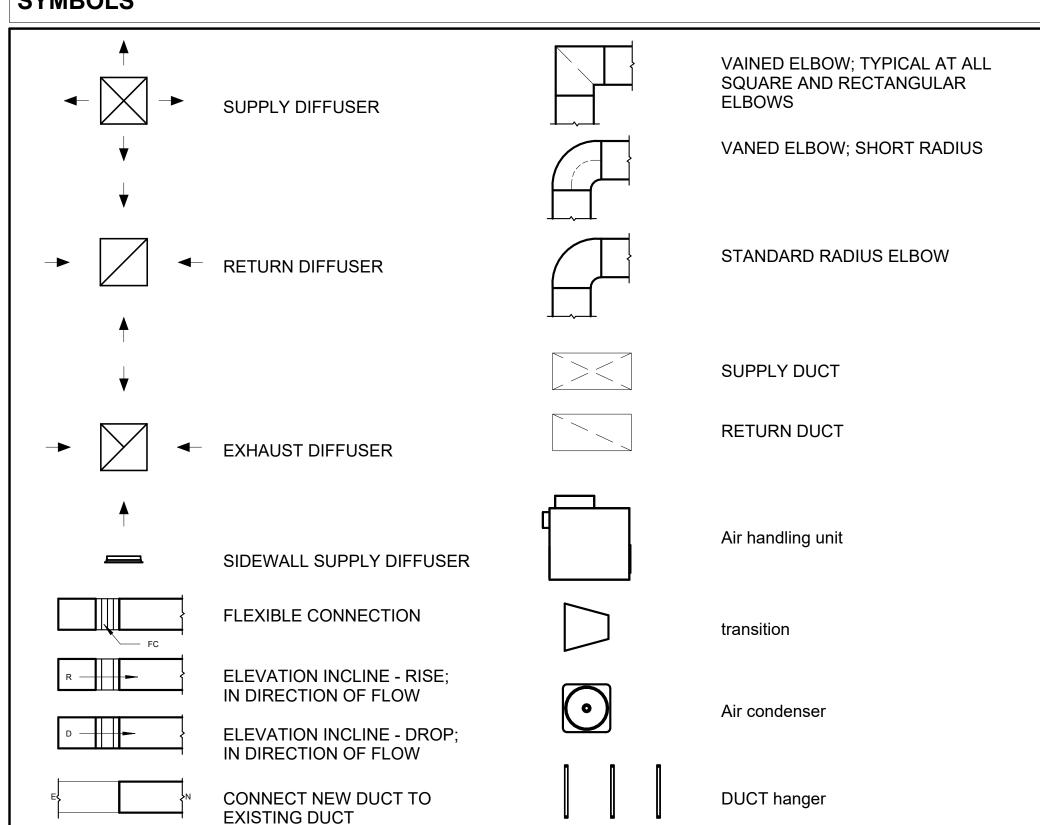

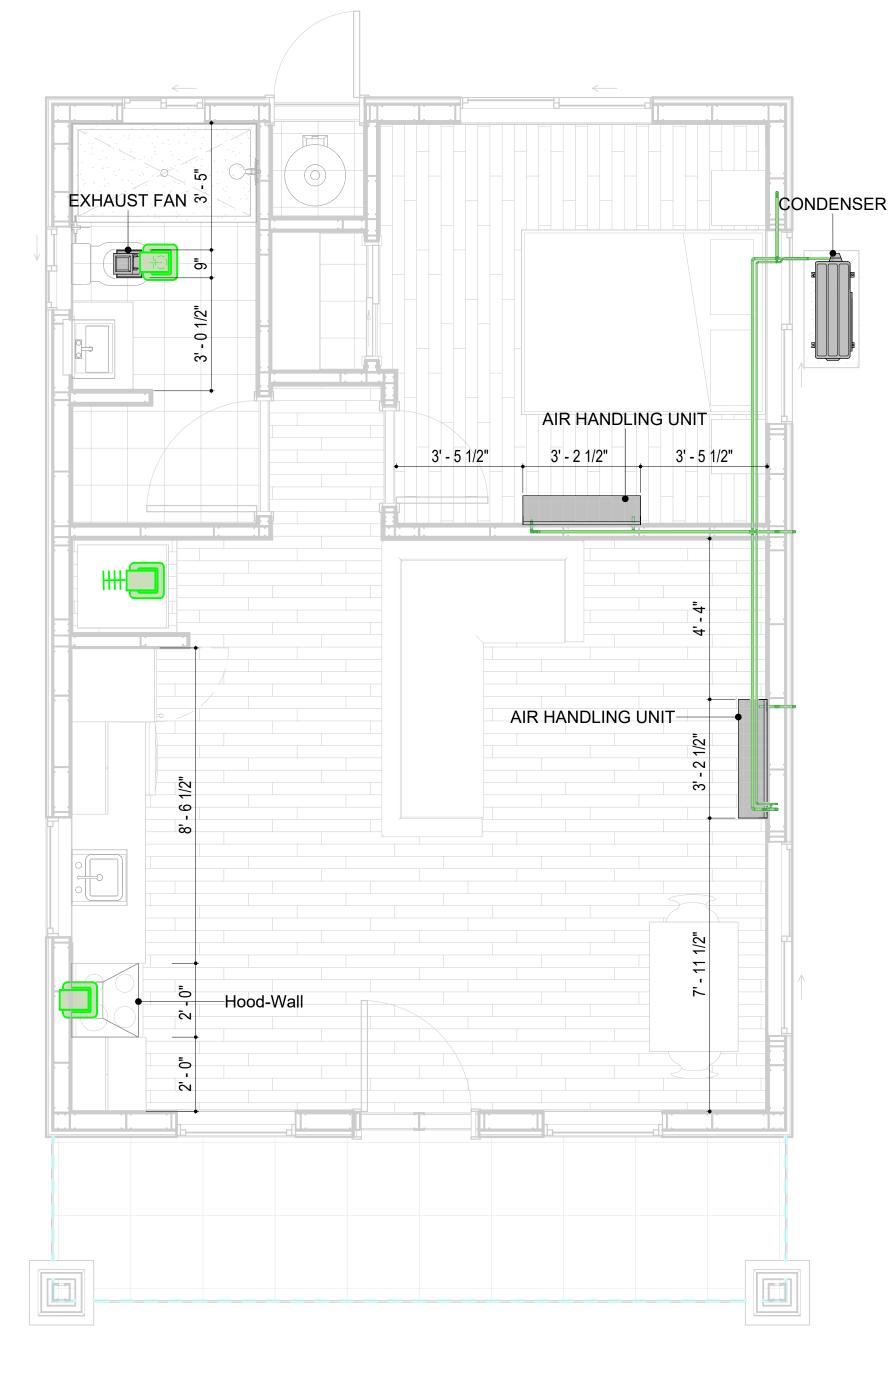



REFRIGERANT LINE SCHEDULE				
CATAGORY	DESCRIPTION	DIAMETER	LENGTH	
Pipe Types	Copper	3/8"	39.55	
Pipe Types	Copper	3/4"	58.47	

Hvac Color scheme

REFRIG	ERANT LINE FITTING S	CHEDULE	
CATAGORY	DESCRIPTION	Size	Count
Elbow - Generic	Elbow - Generic: Standard/HVAC	3/4"ø-3/4"ø	23
Elbow - Generic	Elbow - Generic: Standard/HVAC	3/8"ø-3/8"ø	21
Tee - Generic	Tee - Generic: Standard	3/4"ø-3/4"ø-3/ 4"ø	1
Tee - Generic	Tee - Generic: Standard	3/8"ø-3/8"ø-3/ 8"ø	1
Transition - Generic	Transition - Generic: Standard	3/4"ø-1/2"ø	3
Transition - Generic	Transition - Generic: Standard	3/4"ø-5/8"ø	2
Transition - Generic	Transition - Generic: Standard	3/8"ø-1/4"ø	1

MECHANICAL EQUIPMENT SCHEDULE					
CATAGORY DESCRIPTION COUNT					
AIR HANDLING UNIT	AIR HANDLING UNIT: WALL MOUNTED	2			
CONDENSER	CONDENSER: OUT DOOR 1				
Exhaust Fan	EXHAUST FAN: 75 CFM 1				
	Hood-Wall: VENT	1			

DUCT FITTING SCHEDULE					
CATAGORY DESCRIPTION COUNT					
Round Transition - Angle	45 Degree	5			

DUCT ACCESSORY SCHEDULE				
CATAGORY	DESCRIPTION	COUNT		
ROOF VENT	3" DIAMETER	3		

	FLEX DU	JCT SCHEDULE		
DESCRIPTION	DESCRIPTION	LENGTH	DIAMETER	COUNT
Flex Duct Round	FLEX-ROUND	3.52	4"	2
Flex Duct Round	FLEX-ROUND	4.03	6"	1
Grand total: 3		7.55		



KEY PLAN

NO.	DESCRIPTION	DATE

NOTE:

LEGEND:

PROJECT

185-ORCHARD-553-1Bd1Ba **CRAFTSMAN-550**

DRAWING NAME

HVAC PLAN

CLIENT NAME: Owner PROJECT NUMBER 15_0001 DATE: 5/6/2025 1:19:11 AM Designer DESIGNED BY: DRAWN BY: Author CHECKED BY: Checker

M101

SCALE: As indicated

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ELECTRICAL NOTES

- 1. THIS DRAWING DEPICTS THE ELECTRICAL SYSTEM FOR THE 1185-ORCHARD-553-1Bd1Ba CRAFTSMAN-550. IT PROVIDES A VISUAL REPRESENTATION OF THE ELECTRICAL LAYOUT AND COMPONENTS, INCLUDING POWER DISTRIBUTION, LIGHTING, AND CONTROL SYSTEMS.
- 2. THE ELECTRICAL SYSTEM IS DESIGNED TO MEET THE SPECIFIC REQUIREMENTS OF THE BUILDING, INCLUDING POWER DISTRIBUTION, LIGHTING, AND SPECIALIZED ELECTRICAL EQUIPMENT NEEDS, AS PER THE PROJECT SPECIFICATIONS AND APPLICABLE CODES AND STANDARDS.
- 3. THE ELECTRICAL SYSTEM INSTALLATION SHALL COMPLY WITH THE LATEST EDITION OF THE NATIONAL ELECTRICAL CODE (NEC), INTERNATIONAL BUILDING CODE (IBC), AND ALL OTHER APPLICABLE LOCAL, STATE, AND NATIONAL CODES AND REGULATIONS.
- 4. LOCATIONS AS NEEDED, DEVICES ARE SHOWN ON PLANS IN APPROXIMATE IDEAL LOCATIONS, UNLESS SPECIFICALLY DIMMENSIONED.
- 5. OPEN WALLS AS NEEDED TO ALLOW FOR NEW ELECTRICAL INSTALLATIONS.
- 6. LABEL ALL CIRCUITS ON JUNCTION BOXES, RECEPTACLES, DATA, SMOKE DETECTOR, AND EQUIPMENT IN PANEL BOX.
- 7. INSTALL RACEWAY AS NEEDED FOR DDC, ACCESS CONTROL, LOW VOLTAGE WIRING & DATA.
- 8. RELABEL POWER, DATA & FIRE ALARM FOR ROOM #CHANGES.
- VERIFY ALL CIRCUITS LABELED ON PRINT ARE CORRECT BEFORE WORKING ON THEM.
 NOTE ON SITE PLAN ALL CHANGES OR MISSING DETAIL TO BE INCORPORATED INTO THE MASTER PLAN.
- 11. DRAWINGS ARE DIAGRAMMATIC ONLY FOR THE PURPOSE OF SHOWING FIXTURE AND OUTLET LOCATIONS.
- 12. ELECTRICAL CONTRACTOR TO VERIFY SERVICE SIZE BY CALCULATION BASED UPON ACTUAL NAME PLATE RATINGS OF SELECTED FOLIPMENT
- PLATE RATINGS OF SELECTED EQUIPMENT.

 13. VERIEV LOCATION OF SERVICE ENTRANCE WITH POWER COMPANY PROVIDE LIFER GROUND IN
- 13. VERIFY LOCATION OF SERVICE ENTRANCE WITH POWER COMPANY. PROVIDE UFER GROUND IN BUILDING FOUNDATION AT SERVICE ENTRANCE LOCATION.
- 14. PROVIDE A MIN. OF 20 FEET OF ONE *4 BARE COPPER UFER WIRE EMBEDDED IN CONCRETE FOOTING AT THE SERVICE ENTRANCE LOCATION WHERE APPROVED BY LOCAL SERVICE PROVIDER.
- 15. PROVIDE WATERPROOF FIXTURES IN ALL HIGH MOISTURE AREAS (EXTERIOR, SHOWER AND TUB
- CEILINGS ETC.)

 16. PROVIDE DEDICATED CIRCUITS TO EACH BATH, DEN, FAMILY ROOM, BEDROOM, LOFT, KITCHEN
- REFRIGERATOR, KITCHEN FREEZER DISHWASHER, AND ANY AREA/ITEM SPECIFIED BY OWNER.
- 17. INCANDESCENT FIXTURES WITH OPEN OR PARTIALLY ENCLOSED LAMPS, PENDANT FIXTURES, AND LAMP HOLDERS ARE NOT PERMITTED IN CLOSETS.
- 18. ALL WORKMANSHIP AND MATERIALS TO CONFORM WITH THE 2015 IRC.
- 19. PROVIDE A MIN. OF 20 FEET OF ONE *4 BARE COPPER UFER WIRE EMBEDDED IN CONCRETE FOOTING AT THE SERVICE ENTRANCE LOCATION WHERE APPROVED BY LOCAL SERVICE PROVIDER.
- 20. PROVIDE A BONDING CONDUCTOR CONSISTING OF A MINIMUM OF ONE *4 BARE COPPER WIRE CONNECTING THE BUILDING'S METAL WATER PIPING SYSTEM TO THE SERVICE EQUIPMENT ENCLOSURE GROUNDING.

MAIN PANEL CALCS

ELECTRICAL CALCS				
LIGHT AND OUTLETS 533 @ 3W	1,659 W			
3 APPLIANCE CIRCUITS	4,500 W			
DRYER	2,000 W			
WASHER	2,000 W			
RANGE	5,000 W			
WATER HEATER	5,000 W			
REFRIG.	1,800 W			
DISHWASHER & DISPOSAL	3000 W			
TOTAL	24,959 W			
FRIST 10,000 @ 100% REMAINDER @ 40% MINI. SPLIT UNITS	10,000 W 5,954 W 10,000 W			
TOTAL	25,954 W			

25,954 W DIVIDED BY 240V = 108 AMPS TOTAL

(USE 200 AMP SERVICE)

ELECTRICAL ABBREVIATIONS LIST

1P	1 POLE (2P, 3P, 4P, ETC.)	CTR	CENTER	HT	HEIGHT
A	AMPERE	CU	COPPER	HTG	HEATING
AC	ABOVE COUNTER OR AIR CONDITIONER	DCP	DOMESTIC WATER CIRCULATING PUMP	HTR	HEATER
ACLG	ABOVE CEILING	DEPT	DEPARTMENT	HV	HIGH VOLTAGE
ADO	AUTOMATIC DOOR OPENER	DET	DETAIL	HVAC	HEATING, VENTILATING AND AIR
AF	AMP FRAME	DIA	DIAMETER	CONDITIONING	CONDITIONING
AFF	ABOVE FINISHED FLOOR	DISC	DISCONNECT	HWP	HYDRONIC WATER PUMP
AFG	ABOVE FINISHED GRADE	DIST	DISTRIBUTION	IC	INTERRUPTING CAPACITY
AFI	ARC FAULT CIRCUIT INTERRUPTER	DN	DOWN	IG	ISOLATED GROUND
AHU	AIR HANDLING UNIT	DPR	DAMPER	IMC	INTERMEDIATE METAL CONDUIT
AL	ALUMINUM	DS	SAFETY DISCONNECT SWITCH	INCAND	INCANDESCENT
ALT	ALTERNATE	DT	DOUBLE THROW	IR	INFRARED
AMP	AMPERE	DWG	DRAWING	I/W	INTERLOCK WITH
AMPL	AMPLIFIER	DDC	DIRECT DIGITAL CONTROL	J-BOX	JUNCTION BOX
ANNUN	ANNUNCIATOR APPROX APPROXIMATELY	EC	ELECTRICAL CONTRACTOR	KV	KILOVOLT
AQ-STAT	AQUASTAT	ELEC	ELECTRIC, ELECTRICAL	KVA	KILOVOLT-AMPERE
ARCH	ARCHITECT, ARCHITECTURAL	ELEV	ELEVATOR	KVAR	KILOVOLT-AMPERE REACTIVE
AS	AMP SWITCH	EM	EMERGENCY	KW	KILOWATT
AT	AMP TRIP	EMS	ENERGY MANAGEMENT SYSTEM	KWH	KILOWATT HOUR
ATS	AUTOMATIC TRANSFER SWITCH	EMT	ELECTRICAL METALLIC TUBING	LOC	LOCATE OR LOCATION
AUTO	AUTOMATIC	EP	ELECTRIC PNEUMATIC	LT	LIGHT
AUX	AUXILIARY	EQUIP	EQUIPMENT	LTG	LIGHTING
AV	AUDIO VISUAL	EWC	ELECTRIC WATER COOLER	LTNG	LIGHTNING
AWG	AMERICAN WIRE GAUGE	EXIST	EXISTING	LV	LOW VOLTAGE
BATT	BATTERY	EXH	EXHAUST	MAX	MAXIMUM
BD	BOARD	EXP	EXPLOSION PROOF	MAG.S	MAGNETIC STARTER
BLDG	BUILDING	FA	FIRE ALARM	M/C	MOMENTARY CONTACT
BMS	BUILDING MANAGEMENT SYSTEM	FABP	FIRE ALARM BOOSTER POWER	MC	MECHANICAL CONTRACTOR
C	CONDUIT	SUPPLY PANEL	SUPPLY PANEL	MCB	MAIN CIRCUIT BREAKER
CAB	CABINET	FACP	FIRE ALARM CONTROL PANEL	MCC	MOTOR CONTROL CENTER
CAT	CATALOG	FCU	FAN COIL UNIT	MDC	MAIN DISTRIBUTION CENTER
CATV	CABLE TELEVISION	FIXT	FIXTURE	MDP	MAIN DISTRIBUTION PANEL
CB	CIRCUIT BREAKER	FLR	FLOOR	MFR	MANUFACTURERMAIN FUSED
CCTV	CLOSED CIRCUIT TELEVISION	FLUOR	FLUORESCENT	IVII IX	DISCONNECT SWITCH
CKT	CIRCUIT	FU	FUSE	MH	MANHOLE
CLG	CEILING	FUDS	FUSED SAFETY DISCONNECT SWITCH	MIC	MICROPHONE
COMB	COMBINATION	GA	GAUGE	MIN	MINIMUM
CMPR	COMPRESSOR	GAL	GALLON	MISC	MISCELLANEOUS
	CONNECTION	GALV	GALVANIZED	MLO	MAIN LUGS ONLY
CONN CONST	CONSTRUCTION	GC		MMS	MANUAL MOTOR STARTER
			GENERAL CONTRACTOR		
CONT	CONTINUATION OR CONTINUOUS	GEN	GENERATOR	MOA	MULTIOUTLET ASSEMBLY
CONTR	CONTRACTOR	GFI	GROUND FAULT CIRCUIT INTERRUPTER	MSP	MOTOR STARTER PANELBOARD
CONV	CONVECTOR	GFP	GROUND FAULT PROTECTOR	MSBD	MAIN SWITCHBOARD
CP	CIRCULATING PUMP	GND	GROUND	MT	MOUNT
CRT	CATHODE-RAY TUBE	GRS	GALVANIZED RIGID STEEL (CONDUIT)	MT.C	EMPTY CONDUIT
CT	CURRENT TRANSFORMER	GYP BD	GYPSUM BOARD	UL	UNDERWRITERS LABORATORIES
1		1		1	I and the second

Branch Panel:

Location: KITCHEN 05
Supply From:
Mounting: Recessed

Enclosure: Type 1

Volts: 120/240 Single
Phases: 1
Wires: 3

A.I.C. Rating:
Mains Type:
Mains Rating: 200 A
MCB Rating: 1 A

Notes

Circuit Numb er		Number of Elements	Rating	Length	Wire Size	A		i i	3	Wire Size	Length	Rating	Number of Elements	Circuit Description	Circuit Numb er
1	BED LIGHT	9	15 A	49' - 8 25/32"	1-#14, 1-#14, 1-#14	568 VA	636 VA			1-#12, 1-#12, 1-#12	29' - 5 1/4"	20 A	9	BATH GFCI	2
3	KITCHEN GFCI	3	20 A	15' - 3 7/8"	1-#12, 1-#12, 1-#12			540 VA	1800 VA	1-#12, 1-#12, 1-#12	17' - 8 9/16"	20 A	1	REFRIGERATOR	4
5	RANGE	1	50 A	9' - 5 5/16"	2-#8, 1-#8, 1-#10	2500 VA	180 VA			1-#12, 1-#12, 1-#12	5' - 6 5/8"	20 A	1	OVENHOOD	6
7								2500 VA	1200 VA	1-#12, 1-#12, 1-#12	18' - 2 1/2"	20 A	1	DISHWASHER	8
9	LIVING LIGHT	7	20 A	32' - 2 9/32"	1-#12, 1-#12, 1-#12	209 VA	396 VA			1-#14, 1-#14, 1-#14	44' - 3 11/32"	15 A	9	KITCHEN & HALL LIGHT	10
11	OUTDOOR LIGHT	2	15 A	22' - 9 5/32"	1-#14, 1-#14, 1-#14			200 VA	540 VA	1-#12, 1-#12, 1-#12	39' - 7 5/8"	20 A	3	OUTDOOR GFCI	12
13	WASHER	1	20 A	22' - 2 3/4"	1-#12, 1-#12, 1-#12	1200 VA	2500 VA			2-#10, 1-#10, 1-#10	20' - 0 1/2"	30 A	1	DRYER	14
15	CONDENSER	1	60 A	53' - 10 13/16"	2-#6, 1-#6, 1-#10			2500 VA	2500 VA						16
17						2500 VA	2250 VA			2-#10, 1-#10, 1-#10	40' - 3 9/16"	30 A	1	WATER HEATER	18
19	BED RECEPTACLE	5	20 A	53' - 1 7/16"	1-#12, 1-#12, 1-#12			900 VA	2250 VA						20
21	LIVING RECEPTACLE	5	20 A	41' - 2 1/4"	1-#12, 1-#12, 1-#12	900 VA									22
23															24
25															26
	•					13835	VA	1492	0 VA						-
						115	Α	12	4 A						

	Legen	
--	-------	--

Load Classification	Connected Load	Demand Factor	Estimated Demand	Panel	Totals
LIGHTING - DWELLING UNIT	400 VA	100.00%	400 VA		
OTHER	1064 VA	100.00%	1064 VA	Total Conn. Load:	28755 VA
RECEPTACLE	5820 VA	100.00%	5820 VA	Total Est. Demand:	27755 VA
LIGHTING	200 VA	100.00%	200 VA	Total Conn.:	120 A
CONDENSER	5000 VA	100.00%	5000 VA	Total Est. Demand:	116 A
WATER HEATER	4500 VA	100.00%	4500 VA		
RANGE	5000 VA	80.00%	4000 VA		
DRYER	5000 VA	100.00%	5000 VA		
REFRIGERATOR	1800 VA	100.00%	1800 VA		

Tuscon,AZ, USA 888-864-0184 inquire@frameupnow.com

www.frameupnow.com

KEY PLAN

NO.	DESCRIPTION	DATE

NOTE:

LEGEND:

PROJECT

185-ORCHARD-553-1Bd1Ba CRAFTSMAN-550

DRAWING NAME

SCHEDULE

CLIENT NAME:	Owner
PROJECT NUMBER:	0275_12
DATE:	4/12/2025 2:00:45 PM
DESIGNED BY:	Designer
DRAWN BY:	Author
CHECKED BY:	Checker

E101

SCALE: 1/4" = 1'-0"

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ELECTRICAL NOTE

- PROVIDE INTERCONNECTED SMOKE ALARMS IN EACH SLEEPING ROOMS, OUTSIDE EACH SLEEPING ROOM, ON EACH STORY, IN THE HALL OR ADJACENT ROOM LUHERE THE CEILING HEIGHT OF A ROOM OPEN TO THE HALL EXCEEDS THE HALL BY 24'. SMOKE ALARMS SHALL BE PERMANENTLY HARD WIRED WITH BATTERY BACKUP.
- B. RECEPTACLE OUTLETS FOR RANGES AND CLOTHES DRYERS SHALL BE A THREE POLE WITH GROUND TYPE. FOUR WIRE GROUNDING-TYPE FLEXIBLE CORDS WILL BE REQUIRED FOR CONNECTION OF RANGES AND CLOTHES DRYERS. THE BONDING JUMPER SHALL NOT BE CONNECTED BETWEEN NEUTRAL TERMINAL AND THE FRAME OF THE **APPLIANCE**
- C. TWO OR MORE 20 AMP SMALL APPLIANCE CIRCUITS SHALL BE PROVIDED TO SERVE THE KITCHEN, BREAKFAST NOOK, AND DINING ROOM. SUCH CIRCUITS SHALL HAVE NO OTHER OUTLETS.
- D. AT LEAST ONE 20 AMP BRANCH CIRCUIT SHALL BE PROVIDED TO SERVICE THE LAUNDRY ROOM. THIS CIRCUIT SHALL HAVE NO OTHER OUTLETS.
- E. ALL RECEPTACLES WITH IN 6' OF A WET BAR SINK OR KITCHEN SINK TO SERVE COUNTER TOP SURFACES MUST BE GFCI. ON KITCHEN COUNTERS 12' OR WIDER NO POINT ALONG THE WALL SHALL BE MORE THAN 2' FROM A RECEPTACLE. ALL RECEPTACLES WITH IN 6' OF KITCHEN SINK MUST BE GFCI. AT LEAST ONE GFCI RECEPTACLE SHALL
- BE INSTALLED IN THE BATHROOM ADJACENT TO EACH BASIN. FIXTURES INCLUDING CEILING FANS THAT ARE LOCATED IN DAMP LOCATIONS SHALL BE LISTED TO BE SUITABLE FOR
- SUCH LOCATIONS PER 2012 IRC
- G. PROVIDE ONE (1) SWITCHED OUTLET @ ALL BEDROOMS AND DEN
- H. CEILING FANS NOT EXCEEDING 35 LBS. (WITH OR WITHOUT ACCESSORIES MAY BE SUPPORTED BY OUTLET BOXES PROVIDED THE OUTLET BOXES ARE IDENTIFIED FOR SUCH USE PER 2012 IRC
- ELECTRICAL OUTLET BOXES ON OPPOSITE SIDES OF FIRE RATED WALLS SHALL BE SEPARATED BY A HORIZONTAL DISTANCE OF NOT LESS THAN 24".
- OUTLET BOXES IN THE WALLS BETWEEN THE GARAGE AND DWELLING SHALL BE METAL OR U.L. APPROVED FIRE RESISTIVE PLASTIC. BOXES IN GARAGE CEILING SHALL BE METAL.
- K. ALL BRANCH CIRCUITS THAT SUPPLY 120 VOLTS SINGLE PHASE 15 AND 20 AMPS RECEPTACLE OUTLETS INSTALLED IN THE DWELLING SHALL BE PROTECTED BY AN ARC FAULT CIRCUIT INTERRUPTER, EXCEPT GFCI RECEPTICLES.

NOTE:

RECEPTACLES MUST BE PROVIDED IN HALLWAYS 10'-0" OR MORE IN LENGTH. FOR A ONE FAMILY DWELLINGS AND EACH OF A TWO FAMILY DWELLING THAT IS AT GRADE LEVEL, AT LEAST ONE WP-GFCI RECEPTACLE OUTLET ACCESSIBLE AT GRADE LEVEL AND NOT MORE THAN 6'-6" ABOVE GRADE SHALL BE INSTALLED AT THE FRONT AND BACK OF THE DWELLING.

NOTE: APPLIANCE DISCONNECT

E4001.5 GROUNDING OF ENCLOSURES.

METAL ENCLOSURES FOR SWITCHES OR CIRCUIT BREAKERS SHALL BE CONNECTED TO AN

EQUIPMENT GROUNDING CONDUCTOR.

METAL ENCLOSURES FOR SWITCHES OR CIRCUIT BREAKERS USED AS SERVICE


EQUIPMENT SHALL COMPLY WITH THE PROVISIONS OF SECTION E3609.4. WHERE


NONMETALLIC ENCLOSURES ARE USED WITH METAL RACEWAYS OR METAL-ARMORED CABLES, PROVISIONS SHALL BE MADE FOR CONNECTING THE EQUIPMENT GROUNDING

CONDUCTOR.


NONMETALLIC BOXES FOR SWITCHES SHALL BE INSTALLED WITH A WIRING METHOD THAT


PROVIDES OR INCLUDES AN EQUIPMENT GROUNDING CONDUCTOR. (404.12)

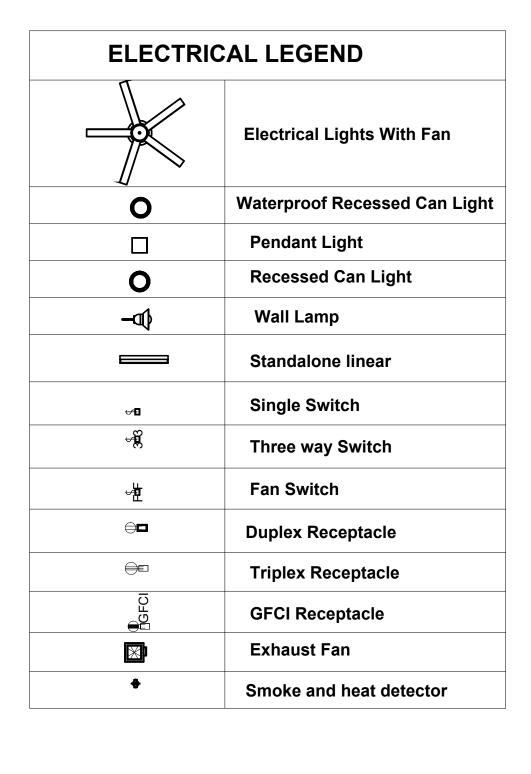

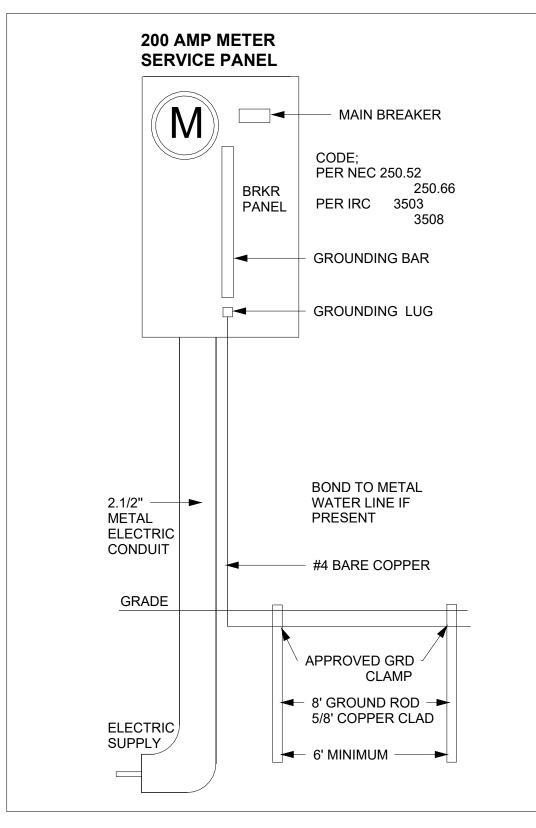



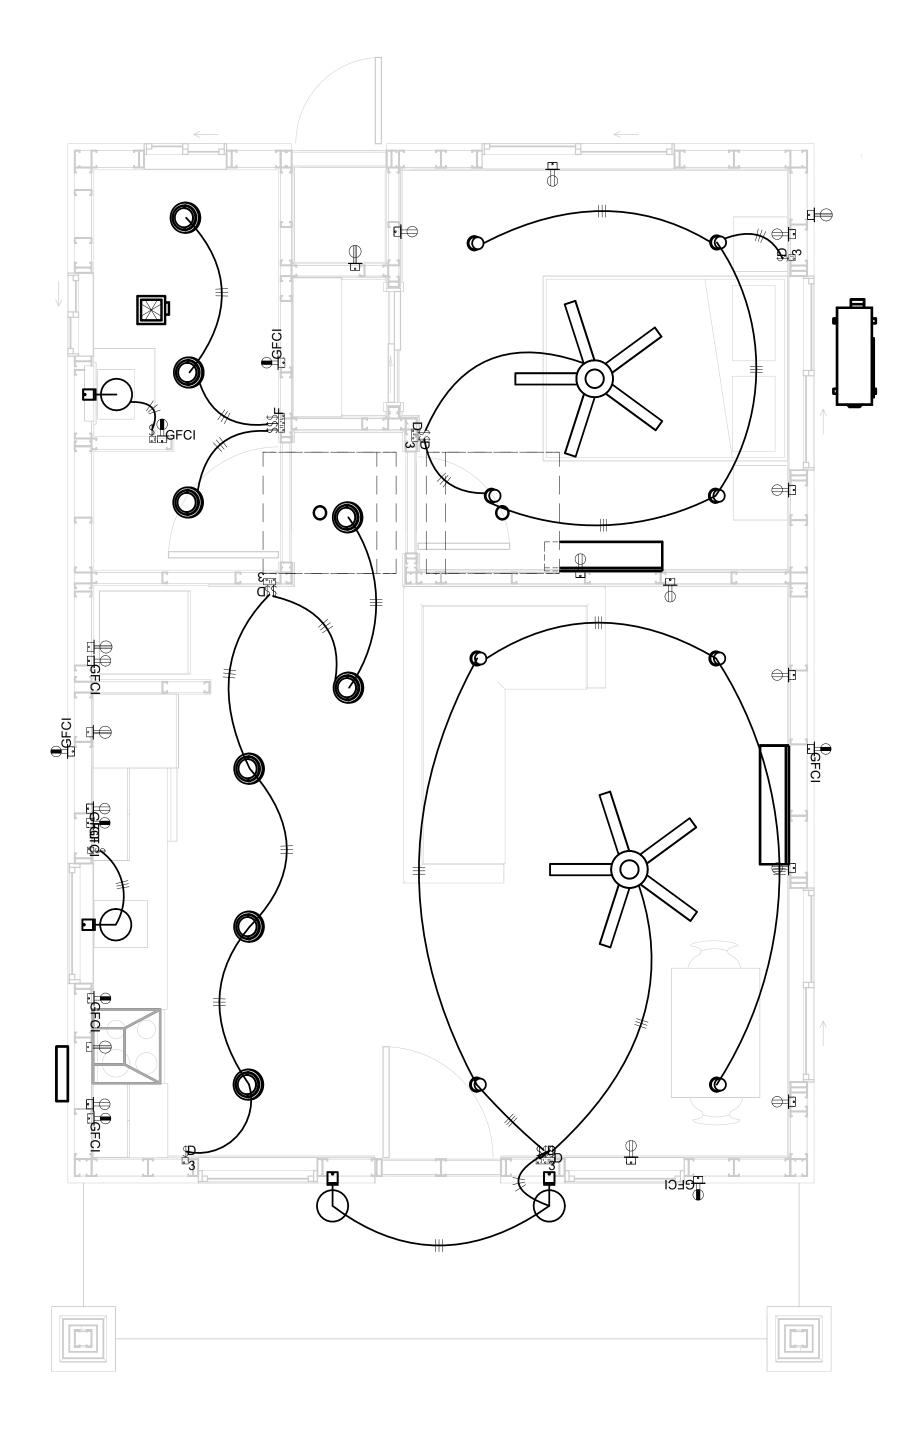

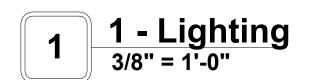



KEY PLAN

DESCRIPTION DATE

NOTE:

LEGEND:

PROJECT

185-ORCHARD-553-1Bd1Ba **CRAFTSMAN-550**

DRAWING NAME


LIGHTING

CLIENT NAME: Owner PROJECT NUMBER 0275_12 DATE: 4/12/2025 2:00:47 PM Designer **DESIGNED BY** DRAWN BY: **Author** CHECKED BY: Checker


E102

NOTES: CONDUIT, CABLE AND WIRING


- Use Metalic Conduits (IMC) for cables running under concrete slabs.
 Use IMC for circuits with high voltage appliances (240 volts and above)
 For circuits with 120 volts consider using EMT or PVC conduits if needed.
 For Low voltage applications up to 50 volts consider using non metalic conduits.
 All conduits to be used in the project must conform to the latest National Electrical Code (NEC),
- 6. All wiring and cables to be used in the project must also conform to the latest National Electrical Code (NEC), 2015.
 7. All cables and wires used should be rated for their respective loading and should be gauged and
- conform to the NEC.

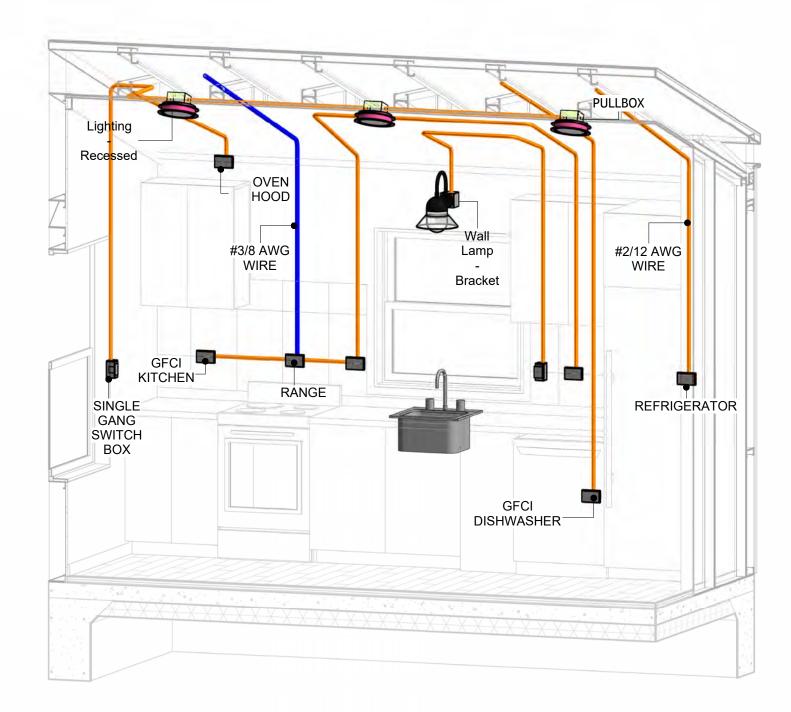


3D-KITCHEN

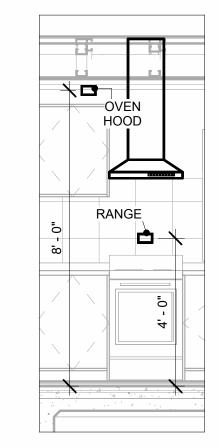


RANGE & OVENHOOD

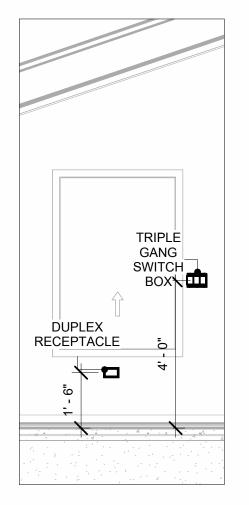

SWITCH & RECEPTACLE 3/8" = 1'-0"

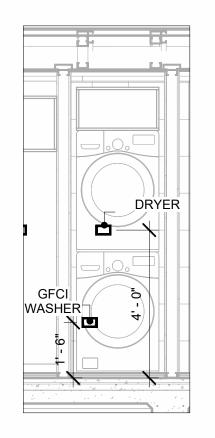


DRYER & WASHER 3/8" = 1'-0"

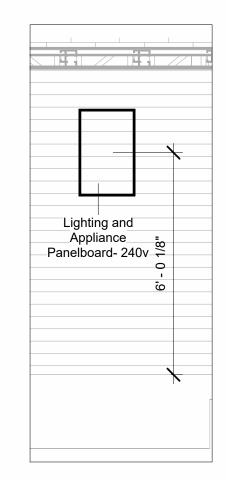

PANEL 3/8" = 1'-0"



KEY PLAN

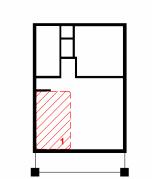

NO.	DESCRIPTION	DATE

NOTE:

LEGEND:

PROJECT

185-ORCHARD-553-1Bd1Ba **CRAFTSMAN-550**

DRAWING NAME

POWER

CLIENT NAME:	Owner
PROJECT NUMBER:	0275_12
DATE:	4/12/2025 2:01:12 PM
DESIGNED BY:	Designer
DRAWN BY:	Author
CHECKED BY:	Checker

E103

SCALE: As indicated

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NOTES: LIGHT

- 1. LIGHT FIXTURES AND LUMINARIES SHALL CONFORM TO THE NEC, THE IRC AND LOCAL SAFETY & BUILDING CODE.
- 2. ALL LIGHTING FIXTURES SHOULD CONFORM TO THE DESIGN ELECTRICAL LOAD AND SHALL BE PROPERLY WIRED AND MOUNTED BY QUALIFIED ELECTRICIAN FOLLOWING MANUFACTURERS SPECIFICATIONS.
- 3. CEILING FANS AND FANS WITH LIGHT WITH WEIGHT EXCEEDING 35 LBS SHOULD BE PROVIDED WITH STRUCTURAL BACKING FOR SUPPORT AND SHALL BE FIXED AS PER MANUFACTURERS SPECIFICATIONS.
- 4. EXTERIOR LIGHTS SHALL CONFORM TO LOCAL BUILDING CODE AND GUIDELINES.

NOTES: SWITCH JUNCTION BOX


- 1. THE MINIMUM SIZE OF JUCTION BOX TO BE USED IS 2"X4"X(1.5" OR 3.5" DEEP) THIS ARE TO BE USED FOR SINGLE GANG SWITCH OR OUTLETS.
- 2. FOR DOUBLE GANG (2 GANG) OUTLETS AND SWITCHS THE MINIMUM SIZE OF THE
- JUCTION BOX TO BE PROVIDED SHALL NOT BE LESS THAN 4"X4"X(1.5" OR 3.5" DEEP)
- 3. FOR THREE GANG (3 GANG) OUTLETS AND SWITCHS THE MINIMUM SIZE OF THE JUĆTION BOX SHALL NOT BE LESS THAN 6"X4"X(1.5" OR 3.5" DEEP).

FITTING SCHEDULE(PULL BOX)			
FAMILY	COUNT	DESCRIPTION	
PULLBOX1	20	#1/4 PULLBOX	

ELECTRICAL FIXTURE SCHEDULE (SWITCH BOX)			
TYPE	COUNT		
DOUBLE GANG SWITCH BOX	2		
SINGLE GANG SWITCH BOX	4		
TRIPLE GANG SWITCH BOX	2		

LIGHTING DEVICE		
TYPE	COUNT	
DIMMER	2	
FAN SWITCH	1	
SINGLE POLE	6	
THREE WAY WITH DIMMER	5	

LIGHTING FIXTURE				
LIGHTING FIXTURE TYPE	VOLTAGE	ELECTRICAL LOAD	COUNT	
ELECTRICAL_LIGHTS_FAN-LIGHT1	120 V/1-100 VA- 120 V/1-100 VA	200 A, 120 V/240 V, SINGLE PHASE, 3 WIRES	2	
LIGHTING - RECESSED	120 V/1-60 VA	200 A, 120 V/240 V, SINGLE PHASE, 3 WIRES	8	
SASSO 100 ROUND WALLWASHER TRIM	120 V/1-28 VA	200 A, 120 V/240 V, SINGLE PHASE, 3 WIRES	8	
WALL LAMP - BRACKET	120 V/1-100 VA	200 A, 120 V/240 V, SINGLE PHASE, 3 WIRES	4	

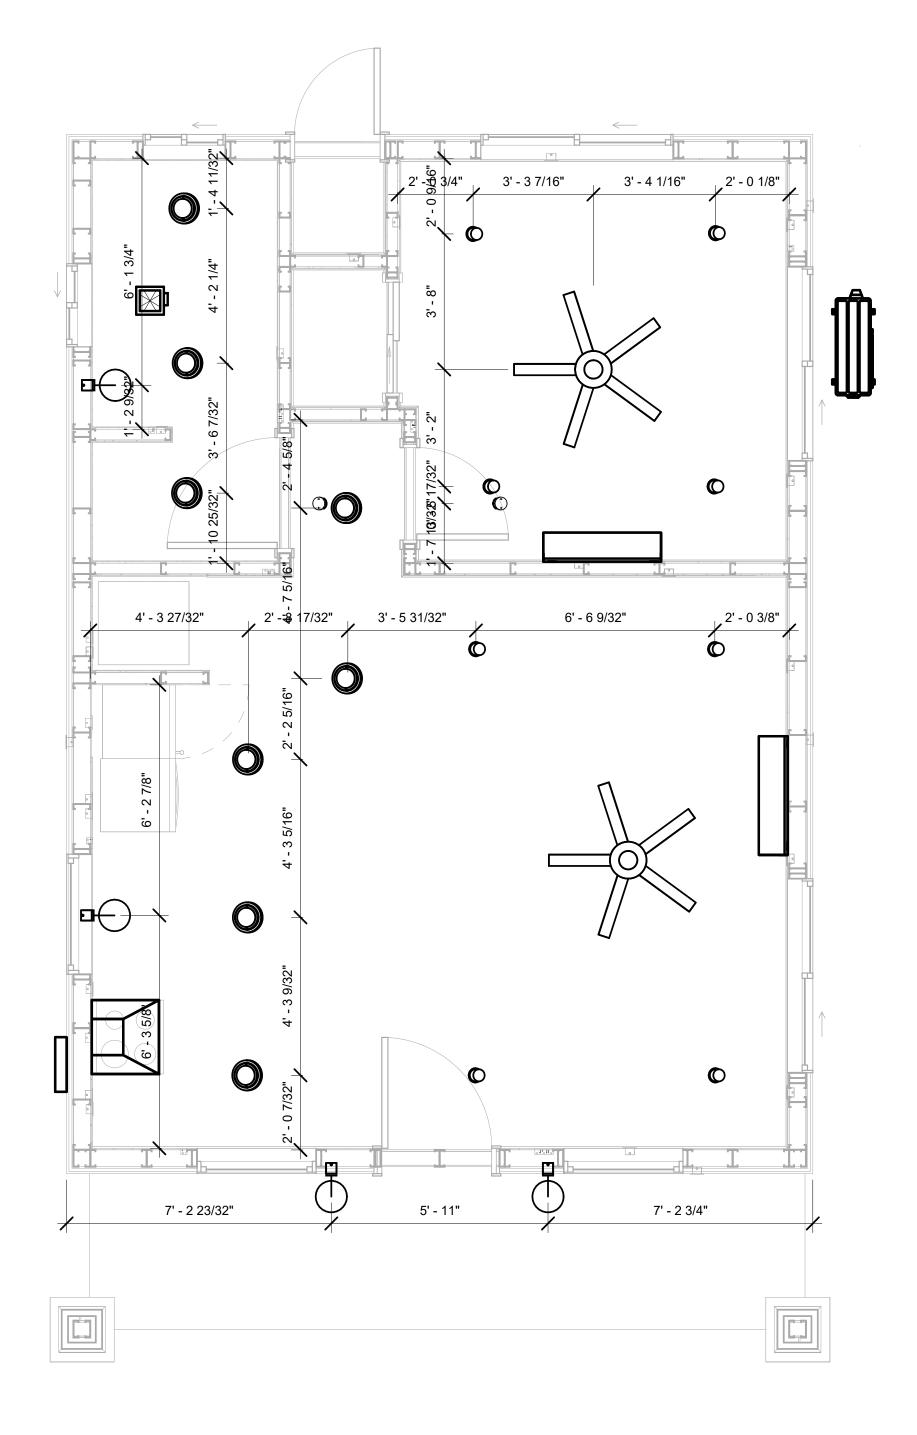





KEY PLAN

NO.	DESCRIPTION	DATE

NOTE:

LEGEND:

PROJECT

185-ORCHARD-553-1Bd1Ba **CRAFTSMAN-550**

DRAWING NAME

DIMENSION PLAN FOR LIGHT FIXTURES

CLIENT NAME:	Owner
PROJECT NUMBER:	0275_12
DATE:	4/12/2025 2:01:13 PM
DESIGNED BY:	Designer
DRAWN BY:	Author
CHECKED BY:	Checker


E104

NOTES;

- 1. VERIFY EQUIPMENT PLUG CONFIGURATION BEFORE PURCHASING RECEPTACLES
- 2. FOR ALL EQUIPMENT.
- 3. COORDINATE EXACT LOCATION OF LIGHT FIXTURES, WALL SWITCHES, RECEPTACLES AND OTHER DEVICES WITH ARCHITECTURAL DRAWINGS.
- 4. USE METALLIC JUNCTION BOX WITH THE GFCI RECEPTACLES, WITH HIGHT VOLTAGE.

ELECTRICAL FIXTURE SCHEDULE (RECEPTACLE) TYPE COUNT CONDENSER DRYER 1 DUPLEX RECEPTACLE GFCI BATH ROOM GFCI DISHWASHER GFCI KITCHEN 3			
CONDENSER 1 DRYER 1 DUPLEX RECEPTACLE 10 GFCI BATH ROOM 2 GFCI DISHWASHER 1 GFCI KITCHEN 3	ELECTRICAL FIXTURE SCHEDULE (RECEPTACLE)		
DRYER 1 DUPLEX RECEPTACLE 10 GFCI BATH ROOM 2 GFCI DISHWASHER 1 GFCI KITCHEN 3	TYPE	COUNT	
DRYER 1 DUPLEX RECEPTACLE 10 GFCI BATH ROOM 2 GFCI DISHWASHER 1 GFCI KITCHEN 3			
DUPLEX RECEPTACLE 10 GFCI BATH ROOM 2 GFCI DISHWASHER 1 GFCI KITCHEN 3	CONDENSER	1	
GFCI BATH ROOM 2 GFCI DISHWASHER 1 GFCI KITCHEN 3	DRYER	1	
GFCI DISHWASHER 1 GFCI KITCHEN 3	DUPLEX RECEPTACLE	10	
GFCI KITCHEN 3	GFCI BATH ROOM	2	
	GFCI DISHWASHER	1	
	GFCI KITCHEN	3	
GFCI OUT DOOR 3	GFCI OUT DOOR	3	
GFCI WASHER 1	GFCI WASHER	1	
OVEN HOOD 1	OVEN HOOD	1	
RANGE 1	RANGE	1	
REFRIGERATOR 1	REFRIGERATOR	1	
WATER HEATER 1	WATER HEATER	1	

ELECTRICAL OUTLET SCHEDULE				
TYPE	CIRCUIT NUMBER	ELECTRICAL DATA	COUNT	
GFCI BATH ROOM	2	120 V/1-180 VA	2	
GFCI KITCHEN	3	120 V/1-180 VA	3	
REFRIGERATOR	4	120 V/1-1800 VA	1	
RANGE	5,7	240 V/2-5000 VA	1	
OVEN HOOD	6	120 V/1-180 VA	1	
GFCI DISHWASHER	8	120 V/1-1200 VA	1	
GFCI OUT DOOR	12	120 V/1-180 VA	3	
GFCI WASHER	13	120 V/1-1200 VA	1	
DRYER	14,16	240 V/2-5000 VA	1	
CONDENSER	15,17	240 V/2-5000 VA	1	
WATER HEATER	18,20	240 V/2-4500 VA	1	
DUPLEX RECEPTACLE	19	120 V/1-180 VA	5	
DUPLEX RECEPTACLE	21	120 V/1-180 VA	5	

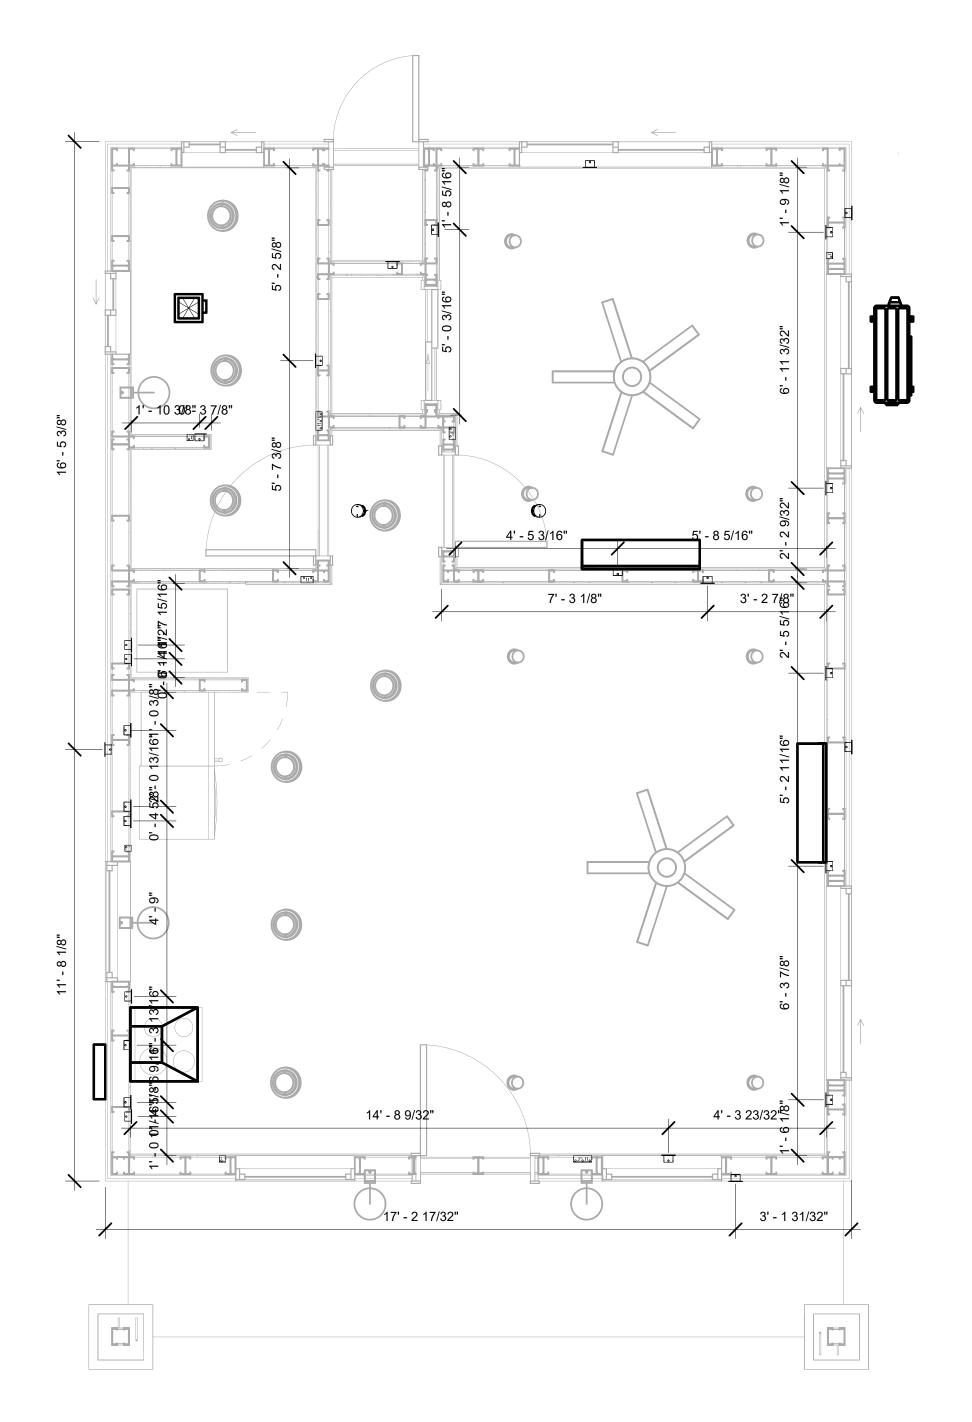

1 DIMENSION FOR FITTINGS 3/8" = 1'-0"



KEY PLAN

NO.	DESCRIPTION	DATE

NOTE:

LEGEND:

PROJECT

185-ORCHARD-553-1Bd1Ba CRAFTSMAN-550

DRAWING NAME

DIMENSION PLAN FOR FITTINGS

er
12
PM
er
or
er

E105

SHEET LIST

Sheet Name Sheet Number

P101 NOTE AND SCHEDULE P102 WATER SUPPLY AND SEWAGE SYSTEM

PIPe Color	SCHEME
	 DOMESTIC COLD WATE DOMESTIC HOT WATEF SANITARY VENT
	SANITARY SEWER STORM DRAINAGE
	Gray Water GAS LINE

PLUMBING NOTES

- The plumbing system is designed to meet the building's domestic water supply, sanitary drainage, and storm drainage requirements, as per project specifications and applicable codes.
- The system installation shall comply with the latest International Plumbing Code (IPC), International Residential Code (IRC), and all other relevant local, state, and national regulations.
- ALL PLUMBING WORK SHALL COMPLY WITH THE LATEST EDITION OF THE INTERNATIONAL PLUMBING CODE (IPC) AND THE LOCAL PLUMBING CODE.
- PLUMBING SYSTEMS SHALL BE TESTED AND INSPECTED IN ACCORDANCE WITH THE LOCAL PLUMBING CODE REQUIREMENTS.
- PLUMBING FIXTURES SHALL BE INSTALLED WITH THE APPROPRIATE TRIM, FITTINGS, AND ACCESSORIES, AS RECOMMENDED BY THE MANUFACTURER.
- 6. PIPING SHALL BE PROPERLY SUPPORTED AND SECURED TO PREVENT SAGGING,
- MOVEMENT, AND VIBRATION. SHUT-OFF VALVES SHALL BE PROVIDED AT ALL BRANCH CONNECTIONS AND AT THE
- INLET AND OUTLET OF EACH PIECE OF EQUIPMENT. BACKFLOW PREVENTION DEVICES SHALL BE INSTALLED AS REQUIRED BY THE LOCAL
- PLUMBING CODE TO PROTECT THE POTABLE WATER SYSTEM. PLUMBING FIXTURES AND EQUIPMENT SHALL BE ACCESSIBLE FOR MAINTENANCE AND
- SERVICING.
- EXPOSED PLUMBING PIPING AND FIXTURES SHALL BE INSULATED TO PREVENT CONDENSATION AND ENERGY LOSS.
- 11. DEAD ENDS IN THE DRAINAGE SYSTEM MUST BE AVOIDED, EXCEPT WHERE NECESSARY TO INSTALL A CLEANOUT IN AN ACCESSIBLE LOCATION, AND MUST HAVE A VENTED CONNECTION TO THE OUTSIDE ATMOSPHERE.
- 12. THE VERTICAL DEFLECTION OF PVC PIPE MUST NOT EXCEED 5%, AND NO DEFLECTION IS PERMITTED FOR IRON PIPE.
- 13. WORK MUST BE PROPERLY COORDINATED WITH OTHER TRADES TO AVOID CONFLICTS, REFERRING TO THE ARCHITECTURAL AND STRUCTURAL DRAWINGS FOR INFORMATION REGARDING CEILING ELEVATIONS, SPACE CLEARANCES, WALL AND PARTITION LOCATIONS, ETC.
- 14. ALL FIXTURES SHALL HAVE ACCESSIBLE STOPS.
- 15. DOMESTIC WATER PIPING SHALL BE PEX, AND PVC PIPING IS NOT ACCEPTABLE FOR INTERIOR USE
- 16. VENT TERMINATIONS SHALL BE LOCATED AT LEAST 10 FEET FROM OR 3 FEET ABOVE ANY OPERABLE WINDOW, DOOR OPENING, AIR INTAKE, OR VENT SHAFT, AND AT LEAST 3 FEET IN EVERY DIRECTION FROM ANY LOT LINE, ALLEY, OR STREET.
- 17. PIPE AND FITTINGS UTILIZED IN THE WATER SUPPLY SYSTEM SHALL HAVE A MAXIMUM OF 8 PERCENT LEAD.
- 18. ACRYLONITRILE BUTADIENE STYRENE (ABS) SHALL BE USED FOR THE SEWERAGE AND
- VENTILATION SYSTEM. 19. CROSS-LINKED POLYETHYLENE (PEX) SHALL BE USED FOR THE WATER SUPPLY SYSTEM.
- 20. POLYVINYL CHLORIDE (PVC) SHALL BE USED FOR THE RAIN WATER SYSTEM.
- 21. THE MIMIMUM WATER SUPPLY DEPTH UNDER FLOOR FINISH SHOUD BE 1/2".
- ANY PIPE INSTALLED UNDERGROUND MUST HAVE AT LEAST 12 INCHES OF CLEARANCE BETWEEN THE OUTSIDE OF THE PIPE AND ANY OTHER UNDERGROUND STRUCTURE.
- 23. THE MINIMUM CLEARANCE BETWEEN COLD AND HOT WATER LINES IN RESIDENTIAL
- HOMES MAINTAIN A MINIMUM DISTANCE OF 6 INCHES.
- 24. HORIZONTAL SEPARATION BETWEEN WATER AND SEWER LINES: A MINIMUM OF 12 INCHES BETWEEN POTABLE WATER SUPPLY LINES (COLD AND HOT WATER) AND SANITARY SEWER LINES.

Ø	Diameter
ABS	ACRYLONITRILE BUTADIENE STYRENE
ABV	ABOVE
AD	AREA DRAIN
AFF	ABOVE FINISHED FLOOR
ALT	ALTERNATE
BFF	BELOW FINISHED FLOOR
BLW	BELOW
CO	CLEAN OUT
CW	COLD WATER
D	DEGREE
DFU	Dranage FIXTURE UNIT
DIA	DIAMETER
DN	DOWN
FCO	FLOOR CLEAN OUT
FD	FLOOR DRAIN
FL	FLOOR
FS	FLOOR SINK
FT	FOOT/FEET
HB	HOSE BIB
HW	HOT WATER
IN	INCH
MIN	MINIMUM
NO	NUMBER
NTS	NOT TO SCALE
PEX	CROSS-LINKED POLYETHYLENE
PLBG	PLUMBING
PVC	POLYVINYL CHLORIDE
QTY	Quantity
RD	ROOF DRAIN
RED	REDUCER
RM	ROOM
RW	RAIN WATER
SF	SQUARE FOOT
V	VENT
VTR	VENT THROUGH ROOF
W	WASTE
WCO	WALL CLEAN OUT
WSFU	WATER SUPPLY FIXTURE UNIT

PLUMBING LEGEND

D	Сар
	Bend 45 Deg
B	Bend 90 Deg
	Tee Reducing
	Tee
	Clean Two-Way
	Wye 45 Deg
	Wye 45 Deg Double
	Wye Combination
	P-Trap

PIPE SCHEDULE					
Material	Diameter	Length			
Acrylonitrile Butadiene Styrene (ABS)	1 1/2"	30 ft			
Acrylonitrile Butadiene Styrene (ABS)	2"	25 ft			
Acrylonitrile Butadiene Styrene (ABS)	3"	24 ft			
Cross-linked polyethylene (PEX)	1/2"	48 ft			
Cross-linked polyethylene (PEX)	3/4"	79 ft			
Cross-linked polyethylene (PEX)	1"	1 ft			
Polyvinyl Chloride - Rigid	2"	60 ft			

F	FITTING SCHEDULE					
FITTING	Size	QTY				
Domestic Cold Water						
PEX 90 Degree Elbow	1/2"ø-1/2"ø	9				
PEX 90 Degree Elbow	3/4"ø-3/4"ø	5				
PEX Tee Elbow	3/4"ø-3/4"ø	7				
PEX Transition Elbow	1"ø-3/4"ø	1				
PEX Transition Elbow	3/4"ø-1/2"ø	6				
Domestic Hot Water						
PEX 90 Degree Elbow	1/2"ø-1/2"ø	9				
PEX 90 Degree Elbow	3/4"ø-3/4"ø	5				
PEX Tee Elbow	3/4"ø-3/4"ø	4				
PEX Transition Elbow	3/4"ø-1/2"ø	5				
PVC 90 Deg Bend Elbow Sewage	2"ø-2"ø	24				
ABS 90 Degree Bend Elbow	3"ø-3"ø	1				
ABS P-Trap	1 1/2"ø-1 1/2"ø	3				
ABS P-Trap	2"ø-2"ø	2				
ABS P-Trap	3"ø-3"ø	1				
ABS Reducer Elbow	3"ø-1 1/2"ø	3				
ABS Reducer Elbow	3"ø-2"ø	3				
ABS TEE Elbow	1 1/2"ø-1 1/2"ø-1 1/2"ø	3				
ABS TEE Elbow	2"ø-2"ø	2				
ABS TEE Elbow	3"ø-3"ø	6				
122 2.501						
Vent ABS 90 Degree Bend Flbow	1 1/2"ø-1 1/2"ø	2				
ABS 90 Degree Bend Elbow	1 1/2"ø-1 1/2"ø 2"ø-1 1/2"ø	2				
ABS 90 Degree Bend Elbow ABS Reducer Elbow	2"ø-1 1/2"ø	3				
ABS 90 Degree Bend Elbow ABS Reducer Elbow ABS TEE Elbow	2"ø-1 1/2"ø 1 1/2"ø-1 1/2"ø-1 1/2"ø	3				
ABS 90 Degree Bend Elbow ABS Reducer Elbow	2"ø-1 1/2"ø	3				

FIXTURE CONNECTION SCHEDULE											
Family	w	V	Trap	cw	HW	QT Y	DFU	тот.	WF U	TOT	NOTES
D: 1	0"	4 4 (011	4 4 (0)	4 /0"	4 (011						.
Dishwasher	2"	1-1/2"	1-1/2"	1/2"	1/2"	1		0			Drain to sewer see plans
Dryer	N/A	N/A	N/A	N/A	N/A	1		0			
Hanging pipes clamp						16		0			
Shower Tray						1		0			
Shower Trim	-	-	-	1/2"	1/2"	1		0			
Sink Island Single	2"	1-1/2"	1-1/2"	1/2"	1/2"	1		0			
Vanity Sink	2"	1-1/2"	1-1/2"	1/2"	1/2"	1		0			
Washer	2"	1-1/2"	2"	1/2"	1/2"	1		0			DRAINS TO GRAY WATE OR SEWER SEE PLANS
Water Closet	3"	2"	3"	1/2"	1/2"	1		0			
Water Heater	N/A	N/A	N/A	3/4"	3/4"	1		0			

FIXTURE SCHEDULE					
fixture	QTY	Description			
Dishwasher	1	Drain to sewer see plans			
Dryer	1	·			
Hanging pipes clamp	16				
Shower Tray	1				
Shower Trim	1				
Sink Island Single	1				
Vanity Sink	1				
Washer	1	DRAINS TO GRAY WATER OR SEWER SEE PLANS			
Water Closet	1				
Water Heater	1				

ACCESSORIES & FITTINGS SCHEDULE						
fixture	QTY	Descriptions				
DISHWASHER CONNECTOR	1					
Hose Bib	1					
LAUNDRY SWEAT CONNECTOR	1					
Shutoff Valve	6					

PLUMBING SCHEDULE						
FIXTURE	Trap	Waste	Vent	C.W	H.W	
Dishwasher	1-1/2"	2"	1-1/2"	1/2"	1/2"	
Dryer	N/A	N/A	N/A	N/A	N/A	
Shower Tray						
Shower Trim	-	-	-	1/2"	1/2"	
Sink Island Single	1-1/2"	2"	1-1/2"	1/2"	1/2"	
Vanity Sink	1-1/2"	2"	1-1/2"	1/2"	1/2"	
Washer	2"	2"	1-1/2"	1/2"	1/2"	
Water Closet	3"	3"	2"	1/2"	1/2"	
Water Heater	N/A	N/A	N/A	3/4"	3/4"	

WATER FIXTURE UNIT SCHEDULE						
Family	QTY	UNIT VALUE	TOTAL			
Dishwasher	1		0			
Dryer	1		0			
Shower Tray	1		0			
Shower Trim	1		0			
Sink Island Single	1		0			
Vanity Sink	1		0			
Washer	1		0			
Water Closet	1		0			
Water Heater	1		0			

WASTE FIXTURE UNIT SCHEDULE						
Family	QTY	DFU Values	TOTAL			
Dishwasher	1		0			
Dryer	1		0			
Hanging pipes clamp	16		0			
Shower Tray	1		0			
Shower Trim	1		0			
Sink Island Single	1		0			
Vanity Sink	1		0			
Washer	1		0			
Water Closet	1		0			
Water Heater	1		0			



KEY PLAN

DESCRIPTION DATE

NOTE:

LEGEND:

PROJECT

185-ORCHARD-553-1Bd1Ba **CRAFTSMAN-550**

DRAWING NAME


NOTE AND SCHEDULE

CLIENT NAME:

PROJECT NUMBER: 0275_12 4/8/2025 7:17:50 AM DATE: Designer DESIGNED BY: DRAWN BY: CHECKED BY: Checker


P101

SCALE: 1/2" = 1'-0"

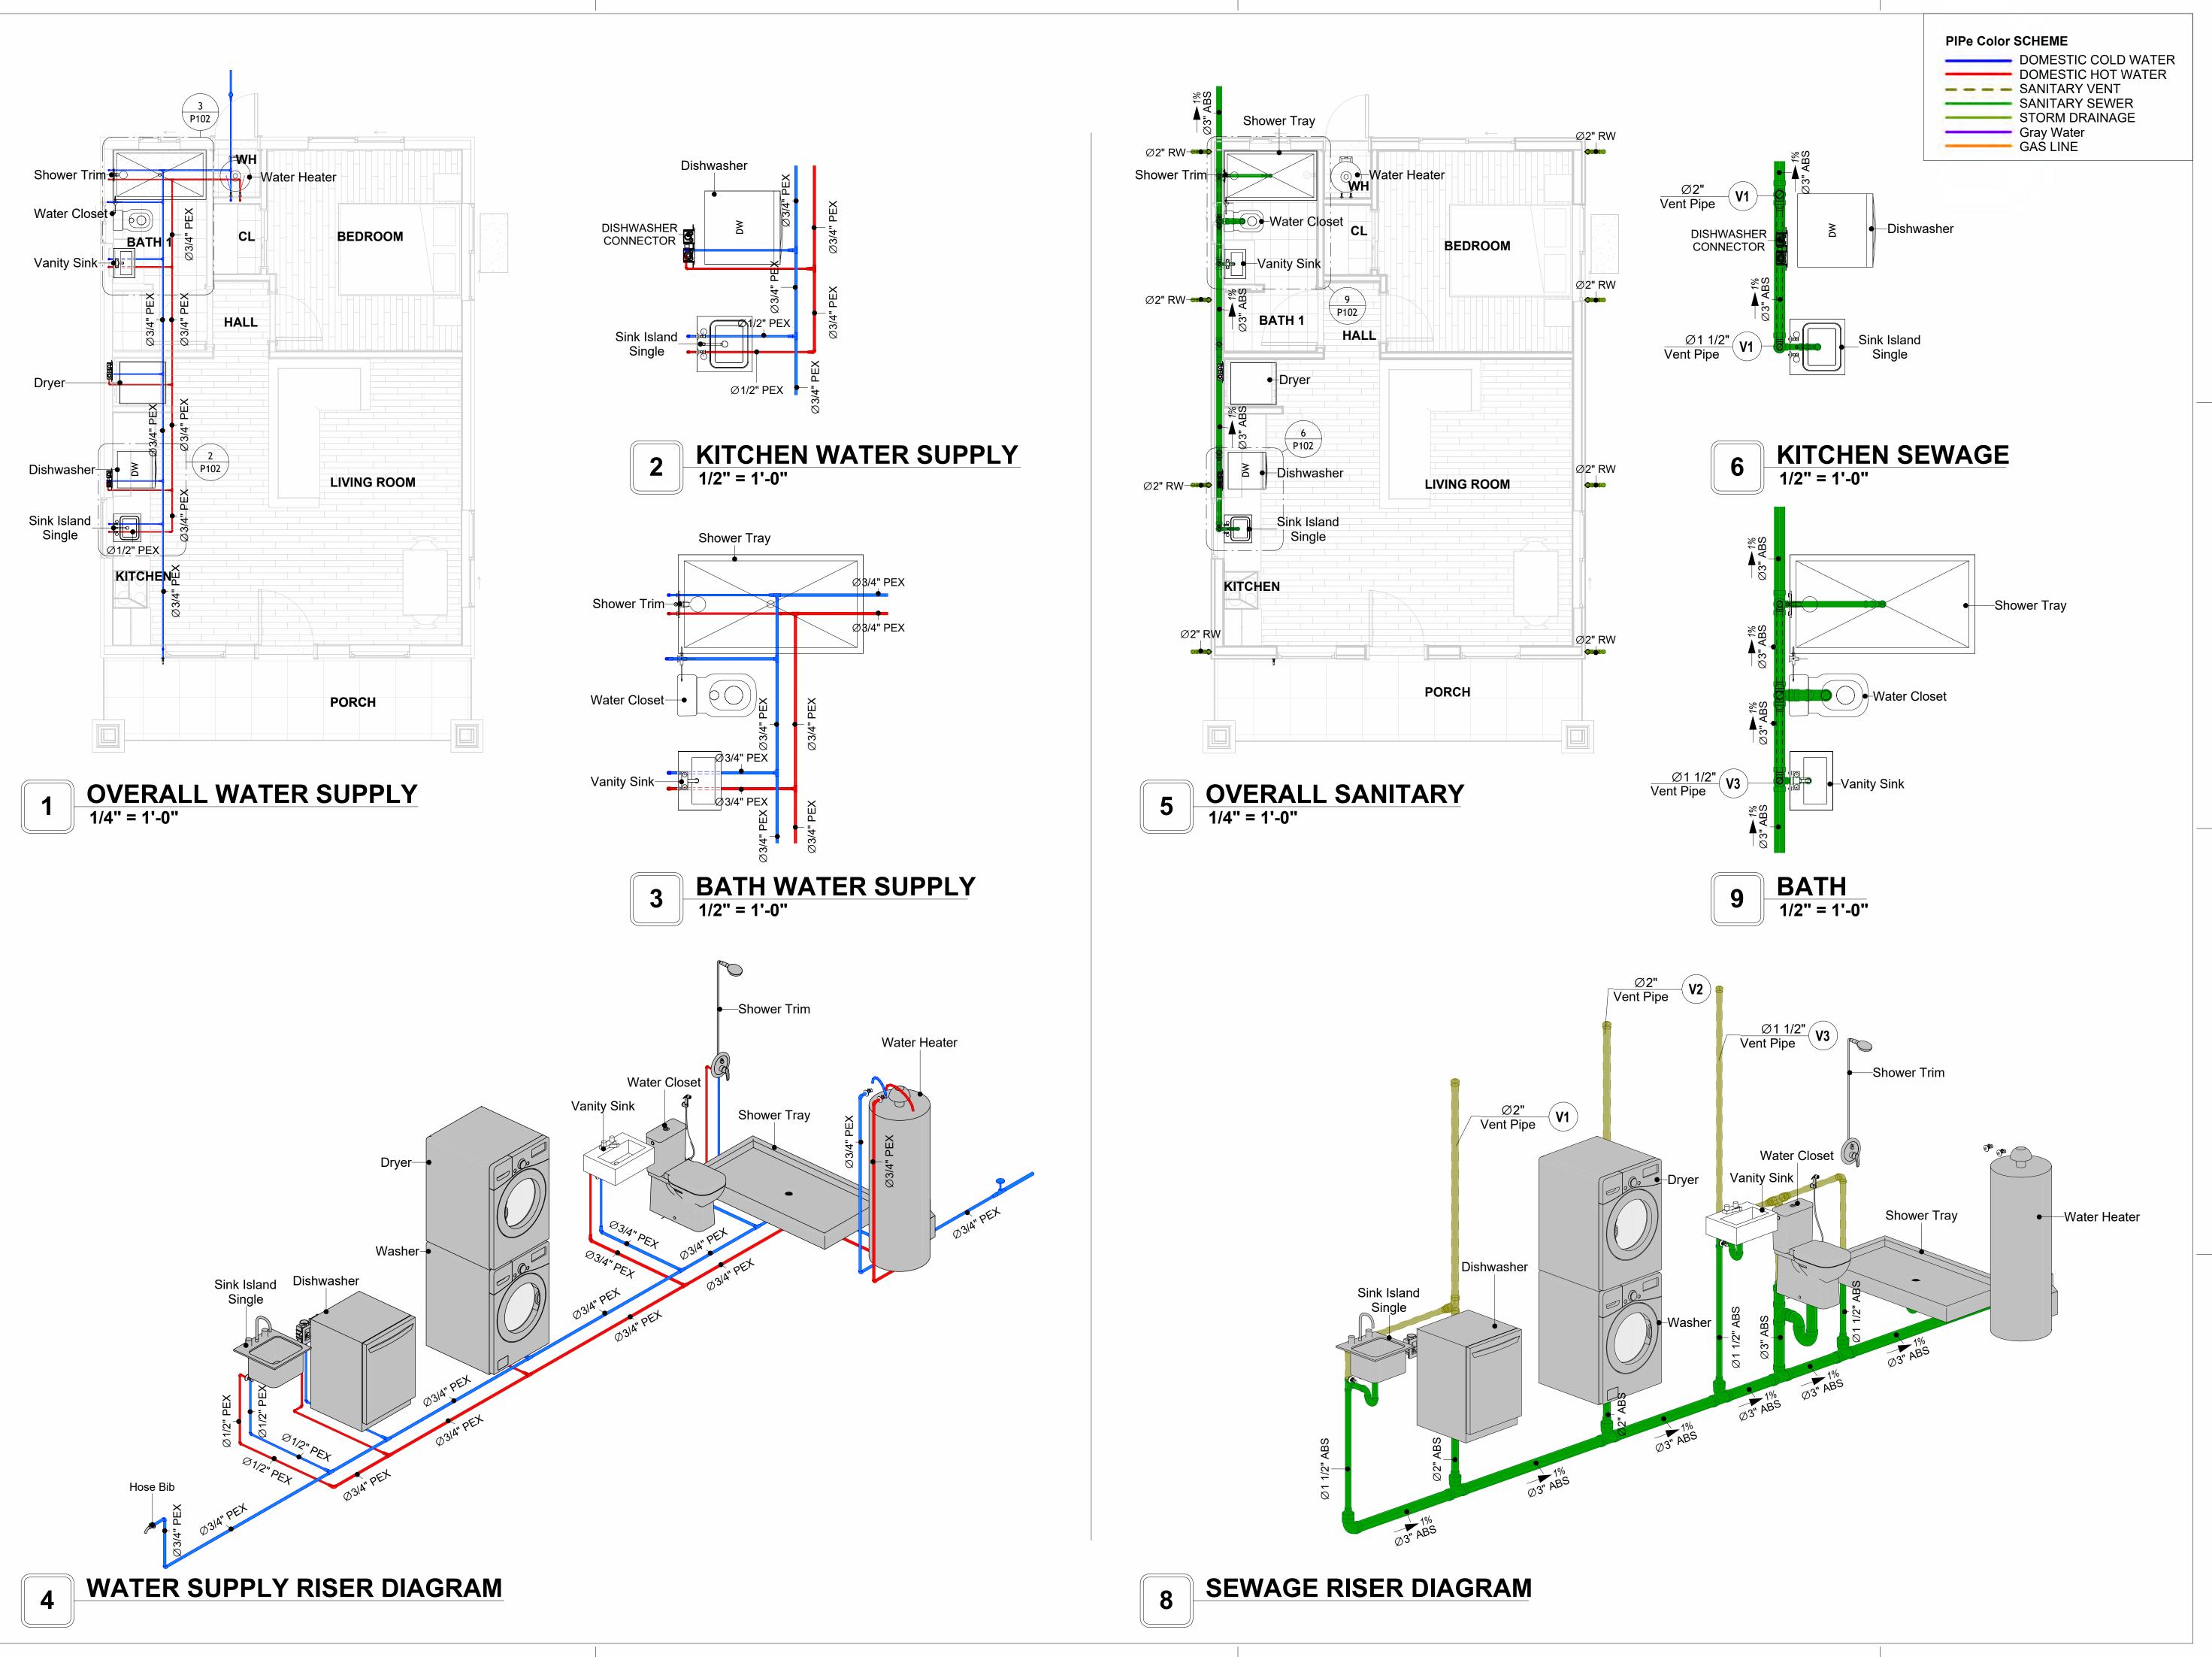



KEY PLAN

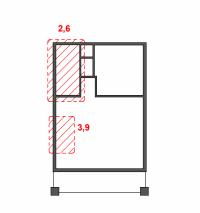

NO.	DESCRIPTION	DATE

NOTE:

LEGEND:

PROJECT

185-ORCHARD-553-1Bd1Ba **CRAFTSMAN-550**

DRAWING NAME

WATER SUPPLY AND **SEWAGE SYSTEM**

CLIENT NAME:	
PROJECT NUMBER:	0275_12
DATE:	4/8/2025 7:18:15 AM
DESIGNED BY:	Designer
DRAWN BY:	Author
CHECKED BY:	Checker
	011001

P102

Materials Shopping List

Please print and take this Materials Shopping List to your favorite Home Depot and ask for assistance in selecting the materials, fixtures and fittings to complete your new home.

Record your selection and the price of the item. Then do the math to determine the cost for your selections and the total cost of finishing your home.

Have It Your Way!

The material types listed in this document were selected based on personal preferences. The Customer is encouraged to make changes to the material types in accordance with local customs, regulations, and personal preferences.

Have It Your Way!



20 good reasons to frame a home with metal and not wood



Why build your ADU with metal vs wood	Wood N	Metal	Explanation
1 DIY Construction Benefit		\checkmark	The wall frames, trusses and beams can be erected in a just a few days
2 Minimal Construction Skills Required		~	Pre-assembled walls and trusses require no specialized skills to errect
3 Build as DIY, Hybrid or by a General Contractor		~	Do it yourself, Hybrid (involve special contractors) or hire a General Contractor
4 Build It As You Can Afford It		\checkmark	Impervious to Weather - build as you have the time and money
5 Up Front Cost of Framing Materials	~		As to only the framing material, wood is less expensive
6 Total Cost To Build		\checkmark	Savings in time, labor, and other areas make light gauge steel LESS expensive
7 Termites and wood boring insects		~	Termites, carpenter ants and wood boring insects eat wood, not metal
8 Mold resistant		\checkmark	Metal does not attract mold
9 Damage caused by exterior and interior flooding		~	Metal needs no reconditioning after a flood
10 Fire Resistant		~	Non-combustible
11 Lower insurance rates		~	Many insurance underwriters now provide lower rates for metal framed homes
12 Walls, trusses, and beams retain their original form		~	Perfectly straight walls - no shimming of drywall
13 Corners are 90 degrees		\checkmark	No need for templating of countertops to adjust for out of square corners
14 Strength and weight		~	Metal is stronger than wood and weighs less - no need for crane to lift ADU trusses
15 IBC Engineered Stamp		~	If an engineering stamp is necessary, months of waiting are saved
16 Complete BOM (Materials Shopping List)		~	Take the materials shopping list to Home Depot and start shopping/pricing
17 Flexible in Seismic Areas - Won't Fracture		~	Light gauge steel is flexible and won't fracture when the earth moves
18 No Waste At Job Site		~	Steel is the most recycled material in the world. A typical wood home has 20-30% waste
19 Environmentally Friendly		✓	Trees don't have to be destroyed and the source of most metal is from recycling
20 How-To Videos Included		~	How-to videos provide simple assembly instructions
21 Relationship Counselor		~	Eliminate emotional uphevels - save time, money, and preserve the relationship

Universal Requirements - some or all may be required

- 1 Site plan
- 2 Electrical Supply Connection
- 3 Sewer Connection
- 4 Fresh Water Supply Connection
- 5 Set Backs
- 6 Soils Evaluation

- 7 Earthquake (fault) evaluation
- 8 Foundation Plan subject to soils
- 9 Compliance with local energy codes: insulation home wrap and flashing
- 10 Engineering for wind speed and snow load.
- 11 State and Local ordinances regarding ADUs
- 12 Local Architect and/or Engineer may be necessary

Orchard-1Bd1Ba-Craftsman





Orchard-1Bd1Ba-Craftsman MATERIAL SHOPPING LIST

Have It Your Way!

The material types listed in this document were selected based on personal preferences. The Customer is encouraged to make changes to the material types in accordance with local customs, regulations, and personal preferences. Have It Your Way!

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Have It Your Way!

ARCHITECTURAL BOM

The material types listed in this document were selected based on personal preferences. The Customer is encouraged to make changes to the material types in accordance with local customs, regulations, and personal preferences. Have It Your Way!

GENERAL NOTES

6 ARCHITECTURAL BOM

- 1 This BOM (Bill of Materials) is prepared as a Materials Shopping List to help builders and DIYers gain a complete understanding of most if not all elements required for the complete construction of this structure, according to the original design documents provided by FrameUpNow.
- 2 All quantities and specifications are subject to change based on the final design, field measurements, availability of products and customer preferences. The customer should verify all information prior to purchasing materials.
- 3 All products and elements in the list shall conform to the International Residential Code (IRC), or any other local and international building codes, safety regulations, and standards that are applicable to the location of the structure.
- 4 If any changes are made by the customer to the list of materials specified in this document, the customer is responsible for assuring that the correct type and quantity of materials are utilized in accordance with local building codes.
- 5 FrameUpNow, will not be held responsible for any misuse of this document, the products listed, or for deviations from the content that are made due to changes in specifications, pricing, availability, or customer preferences.
- 6 The customer is advised to consult a qualified professional or technician prior to purchasing materials for specialized construction system items. Some items including but not limited to caseworks, doors and windows may require as built measurements prior to purchase to confirmation of final dimensions.
- 7 If there are additional trim elements or specific installation methods, the total amount of materials needed might vary. Consider any additional trim required for corners, intersections, or other architectural details that might cause this variations before proceeding to purchase and construction.

ARCHITECTURAL BOM



		Orchard	-1Bd 1E	Ba-Craftsm	an		
		ARCHITECTURA					
No.	Item	Туре	Unit	Quantity	Unit Price	Total	Description
	APPLIANCES		200				
1	Refrigerator		PCS	1			
2	Range		PCS	1			
3	Washer		PCS	1			
4	Dryer		PCS	1			
5	Dish Washer		PCS	1			
6	Oven		PCS	0			
7	Microwave		PCS	0			
\triangle	CASEWORKS						
1	Kitchen Cabinet		FT	12.54			
2	Laundry Cabinet		FT	2.25			
3	Vanity Cabinet		FT	2.5			
4	Medicine Cabinet		PCS	1			
5	Kitchen countertop		SF	17.34			
6	Laundry Countertop		PCS	1			
7	Bathroom Countertop		SF	0			
8	Island		FT	0			
9	Peninsula		FT	0			
	Closets		SF	22.62			
	CEILING		<u> </u>	22.02			
1	Ceiling Board	Dry Wall	SF	465	1		
	Dry Wall Fastener	Screw	PCS	813.75			
3			SF	615.75			
_	Vapor Retarder						
4	Vapor Retarder Fastener	Nails with washer heads	PCS	1845			
	Ceiling Board (MRD)	Moisture resistant drywall	SF	59			
	MRD Fastener		PCS	103.25			
7	Ceiling Board	Marine Plywood	SF	91			
	Marine Plywood Fastener	Screw	PCS	159.25			
	Dry Wall Tape		FT	307.5			
	FLOORING						
1	Main Living Space		SF	301.68			
2	Bathroom		SF	56.66			
3	Bedroom		SF	125.32			
4	Porch		SF	92.48			
Δ	STRUCTURE						
1	Foundation		SF	647.48			
	WALLS EXTERIOR						
1	Exterior-Grade Plywood		SF	722			
	Exterior-Grade Plywood Fastener		PKT	7.22			
	Wall Shteathing (OSB)		SF	722			
4	Shteathing Fastener		PKT	7.22			
5	Wall Homewrap		SF	7.22			
	Homewrap Fastener		PKT	2.7436			
7	Furring Strip		PCS	90.25			
	Furring Strip Fastener	Self-drilling screws(100/pkt)	PKT	7.22			
9	Wall Paint		SF	722			
	Stone Copping	Masonry stone	SF	0			
	Stone Veneer		SF	0			
	Mortar for Stone Veneer		SF	0			
	Wall Insulation		SF	2312.0			
	WALLS INTERIOR						
	Cementitious Backer Board		SF	381			
	Kerdi membrane		SF	381			
3	Kerdi membrane Fastener		SF	381			
	Wall Ceramic Tile		SF	381			
	Drywall Board		SF	1104			
	Drywall Fastener		PKT	11.04			
	Wall Paint		SF	1104			
	Drywall Tape		FT	208			
U	Wall Sweep		FT	125			

ARCHITECTURAL BOM



	DOORS				
1	Exterior Swinging	3' - 0" X 6'-8"	PCS	1	
2	Interior Swinging	2' - 6" X 6'-8"	PCS	1	
3	Interior Swinging	3' - 0" X 6'-8"	PCS	1	
4	Exterior Swinging	2' - 4" X 6'-8"	PCS	1	
5	Interior Sliding	3' - 0" X 6'-8"	PCS	1	
6	Exterior Door Trim		FT	32	
7	Interior Door Trim		FT	129	
8	Entry Lock set			2	
9	Privacy Lock set			2	
10	Passage Lock set			2	
	WINDOWS				'
1	Single Hung	3' - 3" X 3'-3"	PCS	1	
2	Sliding	2' - 3" X 2'-3"	PCS	2	
3	Sliding	5' - 3" X 3'-7"	PCS	2	
4	Sliding	5' - 3" X 2'-3"	PCS	1	
5	Single Hung	3' - 3" X 4'-9"	PCS	2	
6	Exterior Window Trim		FT	115	
7	Interior Window Trim		FT	115	
△	ROOF				
1	Roof Covering		SF	798	
2	Roof Covering Fastener		PCS	399	
3	Roof Felt Paper		SF	798	
4	Roof Felt Paper Fastener		PCS	2394	
5	Roof Sheathing		SF	798	
6	Roof Sheathing Fastener		PCS	6384	
7	Batten		FT	0	
8	Batten Fastener		PCS	0	
9	Soffit		SF	111	
10	Soffit Fastener		PCS	55.5	
11	Fascia		FT	115	
12	Fascia board fastener		PCS	57.5	
13	Roof Insulation		SF	798	



	Orchard-1Bd 1	Ba-Craftsr	man			
FI	ECTRICAL MATER	IAL SHOP	PING LI	ST		
No. Item	Type	Unit		Unit Price	Total	Description
	71:-					
1 Kitchen Ceiling Light		PCS	3			
2 Kitchen Wall Mounted Light		PCS	1			
3 Exterior Wall Mounted Light		PCS	2			
4 Livingroom Ceiling Light With Fan		PCS	1			
5 Bedroom Ceiling Light With Fan		PCS	1			
6 Dining Ceiling Light		PCS	0			
7 Bath Wall Mounted Light		PCS	1			
8 Bathroom Ceiling Light		PCS	3			
9 Livingroom Ceiling Light		PCS	5			
		PCS	4			
10 Bedroom Ceiling Light		PCS	1			
11 Hall & Entry Ceiling Light		PCS	0			
12 Closet Ceiling Light		PCS				
13 Smoke Detector		PC5	2			
	Tana.	1===				
14 Standard Receptacle 120V	20A	PCS	10			
15 GFCI Receptacle 120V	20 A	PCS	13			
16 GFCI Receptacle 240V	30 A	PCS	2			
17 GFCI Receptacle 240V	50 A	PCS	1			
18 GFCI Receptacle 240V	60 A	PCS	1			
19 Fan Switch		PCS	1			
20 Single Pole Switch		PCS	6			
21 Three Way Switch		PCS	5			
22 Dimmer Switch		PCS	2			
23 ROMEX 14 AWG	14/3/W/ground	FT	117			
24 ROMEX 12 AWG	12/3/W/ground	FT	275			
25 ROMEX 12 AWG	12/2/W/ground	FT	0			
26 ROMEX 10 AWG	10/3/W/ground	FT	0			
27 ROMEX 10 AWG	10/2/W/ground	FT	60			
28 Romex 8 AWG	8/3/W/ground	FT	0			
29 Romex 8 AWG	8/2/W/ground	FT	10			
30 ROMEX 6 AWG	6/3/W/ground	FT	54			
31 Bare Copper Ground Wire 6 AWG	0/3/vv/ground	FT	34			
		ГІ				
ELECTRICAL BOXES & CIRCUTES	200 AMD	DCC	1			
32 Panelboard -240V 1 Phase MLO	200 AMP	PCS	1			
33 Circuit breaker	15 A	PCS	3			
34 Circuit breaker	20 A	PCS	10			
36 Circuit breaker	30 A	PCS	2			
37 Circuit breaker	50 A	PCS	1			
39 Circuit breaker	60 A	PCS	1			
40 Single Gang Switch Box		PCS	4			
41 Double Gang Switch Box		PCS	2			
42 Triple Gang Switch Box		PCS	2			
43 Pull Box	#1/4	PCS	20			
44 Receptacle Box		PCS	26			

PLUMBING BOM

25 ABS Vent Cap Elbow



Orchard-1Bd 1Ba-Craftsman PLUMBING SYSTEM MATERIAL SHOPPING LIST Item Unit Quantity Unit Price Total Description 1 Bath Tub (Alcove Tub) PCS 2 Kitchen Sink PCS 1 3 Kitchen Faucets PCS 4 Vanity Sink PCS 1 5 Bath room Faucets PCS 6 Water Closet PCS 7 Shower Trim PCS 8 Shower Tray PCS 9 Water Heater PCS 10 Hose Bib PCS 1 11 Shutoff Valve PCS 12 Hanging pipe clamp PCS 19 13 Gate Valve PCS 14 Dishwasher Supply Single Connector PCS 1 15 Dishwasher Sewage Single Connector PCS 16 Laundry Sweat Connector PCS 1 △ SANITARY & PLUMBING PIPE 1 ABS (Acrylonitrile Butadiene Styrene) Pipes ø 1" FT 0 2 ABS (Acrylonitrile Butadiene Styrene) Pipes ø 1 1/2 FT 33 3 ABS (Acrylonitrile Butadiene Styrene) Pipes ø 2" FT 25 4 ABS (Acrylonitrile Butadiene Styrene) Pipes ø 3" FT 24 5 PEX (Cross-linked polyethylene) Pipes ø 1/2' FT 48 6 PEX (Cross-linked polyethylene) Pipes ø 3/4" FT 79 7 PEX (Cross-linked polyethylene) Pipes ø 1" FT 1 8 PVC Pipes Sch.80 - Rigid ø 1 1/2" FT 0 9 PVC Pipes Sch.80 - Rigid ø 2" FT 60 10 PVC Pipes Sch.80 - Rigid ø 3" FT 0 11 Flex Pipe Round ø 1/2" PCS 6 12 Flex Pipe Round ø 3/4" **PCS** 0 13 Flex Pipe Round ø 1" PCS 0 1 PEX 90 Degree Elbow 1/2"ø-1/2"ø PCS PCS 2 PEX 90 Degree Elbow 3/4"ø-3/4"ø 5 3 PEX Tee Elbow 3/4"ø-3/4"ø-3/4"ø PCS 4 PEX Transition Elbow 1"ø-3/4"ø **PCS** 5 PEX Transition Elbow 3/4"ø-1/2"ø PCS 6 6 PEX 90 Degree Elbow 1/2"ø-1/2"ø PCS 9 7 PEX 90 Degree Elbow 3/4"ø-3/4"ø PCS 5 8 PEX Tee Elbow 3/4"ø-3/4"ø-3/4"ø PCS 4 9 PEX Transition Elbow 3/4"ø-1/2"ø PCS 10 PVC 90 Deg Bend Elbow PCS 2"ø-2"ø 24 11 ABS 90 Degree Bend Elbow 3"ø-3"ø PCS 12 ABS P-Trap 1 1/2"ø-1 1/2"ø PCS 3 13 ABS P-Trap 2"ø-2"ø PCS 14 ABS P-Trap PCS 3"ø-3"ø 15 ABS Reducer Elbow 3"ø-1 1/2"ø PCS 16 ABS Reducer Elbow PCS 3"ø-2"ø 3 17 ABS TEE Elbow 1 1/2"ø-1 1/2"ø-1 1/2"ø PCS 3 18 ABS TEE Elbow PCS 2"ø-2"ø-2"ø 19 ABS TEE Elbow 3"ø-3"ø-3"ø PCS 6 20 ABS 90 Degree Bend Elbow PCS 1 1/2"ø-1 1/2"ø 21 ABS Reducer Elbow 2"ø-1 1/2"ø PCS 2 22 ABS TEE Elbow 1 1/2"ø-1 1/2"ø-1 1/2"ø PCS 1 23 ABS TEE Elbow 2"ø-2"ø-2"ø PCS 24 ABS Vent Cap Elbow PCS 1 1/2"ø 2

PCS

2"ø

		Orchard-	·1Bd 1Ba-(Craftsma	n		
		HVAC SYSTEM I	MATERIAL	SHOPP	ING LIST		
No.	Item	Туре	Unit	Quantity	Unit Price	Total	Description
	HVAC_DUCTS						
1	PIPE (REFRIGERANT LINE)	3/8" (Ø)	FT	38.09			
2	PIPE (REFRIGERANT LINE)	3/4''' (Ø)	FT	55.55			
3	DRAYER HOSE	4" (Ø)	FT	4			
4	FLEX DUCT ROUND	4" (Ø)	FT	3.52			
	DUCT FITTINGS & ACCESSORIES						
5	ELBOW (REFRIGERANT LINE)	3/4" (Ø)-3/4" (Ø)	PCS	20			
6	ELBOW (REFRIGERANT LINE)	3/8" (Ø)-3/8" (Ø)	PCS	16			
7	TEE (REFRIGERANT LINE)	3/4" (Ø)-3/4" (Ø)-3/4" (Ø)	PCS	1			
8	TEE (REFRIGERANT LINE)	3/8" (Ø)-3/8" (Ø)-3/8" (Ø)	PCS	1			
9	TRANSITION (REFRIGERANT	3/4" (Ø)-1/2" (Ø)	PCS	3			
10	TRANSITION (REFRIGERANT	3/4" (Ø)-5/8" (Ø)	PCS	2			
11	TRANSITION (REFRIGERANT	3/8" (Ø)-1/4" (Ø)	PCS	1			
Δ	HVAC_EQUIPMENTS						
12	AIR HANDLING UNIT	WALL MOUNTED	PCS	2			
13	CONDENSER	OUTDOOR UNIT	PCS	1			
14	EXHAUST FAN	75 CFM	PCS	1			
15	EXHAUST HOOD	WALL MOUNTED	PCS	1			
16	HOOD-WALL: VENT	HOOD-WALL: VENT	PCS	1			
17	DRAYER: VENT	DRAYER: VENT	PCS	1			
18	ROOF VENT	3"(Ø)	PCS	1			



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Have It Your Way!

The material types listed in this document were selected based on personal preferences. The Customer is encouraged to make changes to the material types in accordance with local customs, regulations, and personal preferences. Have It Your Way!

GENERAL NOTES

- This BOM (Bill of Materials) is prepared as a Materials Shopping List to help builders and DIYers gain a complete understanding of most if not all elements required for the complete construction of this structure, according to the original design documents provided by FrameUpNow.
- 2 All quantities and specifications are subject to change based on the final design, field measurements, availability of products and customer preferences. The customer should verify all information prior to purchasing materials.
- 3 All products and elements in the list shall conform to the International Residential Code (IRC), or any other local and international building codes, safety regulations, and standards that are applicable to the location of the structure.
- 4 If any changes are made by the customer to the list of materials specified in this document, the customer is responsible for assuring that the correct type and quantity of materials are utilized in accordance with local building codes.
- 5 FrameUpNow, will not be held responsible for any misuse of this document, the products listed, or for deviations from the content that are made due to changes in specifications, pricing, availability, or customer preferences.
- The customer is advised to consult a qualified professional or technician prior to purchasing materials for specialized construction system items. Some items including but not limited to caseworks, doors and windows may require as built measurements prior to purchase to confirmation of final dimensions.
- 7 If there are additional trim elements or specific installation methods, the total amount of materials needed might vary. Consider any additional trim required for corners, intersections, or other architectural details that might cause this variations before procedding to purchase and construction.



			LIGHTING FIXTURES				
#	Item	Туре	Description, Manufacturer, SKU	Unit	Quantity	Unit Price	Total
1	Kitchen Ceiling Light			PCS	3		
3	Kitchen Wall Mounted Light			PCS	1		
4	Exterior Wall Mounted Light			PCS	2		
5	Livingroom Ceiling Light With Fan			PCS	1		
6	Bedroom Ceiling Light With Fan			PCS	1		
7	Dining Ceiling Light			PCS	0		
8	Bath Wall Mounted Light			PCS	1		
9	Bathroom Ceiling Light			PCS	3		
10	Livingroom Ceiling Light			PCS	5		
11	Bedroom Ceiling Light			PCS	4		
12	Hall & Entry Ceiling Light			PCS	1		
12	Closet Ceiling Light			PCS	0		
13	Smoke Detector			PCS	2		
14							
15							



			ELECTRICAL FITTINGS			
#	Item	Туре	Description, Manufacturer, SKU	Unit	Quantity Unit P	rice Total
1	Standard Receptacle 120V	20A		PCS	10	
2	GFCI Receptacle 120V	20 A		PCS	13	
1	GFCI Receptacle 240V	30 A		PCS	2	
	GFCI Receptacle 240V	50 A		PCS	1	
i	GFCI Receptacle 240V	60 A		PCS	1	
5	Fan Switch			PCS	1	
,	Single Pole Switch			PCS	6	
}	Three Way Switch			PCS	5	
١	Dimmer Switch			PCS	2	
0		,		'		
1						
2						
.3						
.4						
.5						



		ELECTR	ICAL CONDUITS & WIRING				
#	Item	Туре	Description, Manufacturer, SKU	Unit	Quantity	Unit Price	Total
1	ROMEX 14 AWG	14/3/W/ground		FT	117		
3	ROMEX 12 AWG	12/3/W/ground		FT	275		
4	ROMEX 12 AWG	12/2/W/ground		FT	0		
6	ROMEX 10 AWG	10/3/W/ground		FT	0		
8	ROMEX 10 AWG	10/2/W/ground		FT	60		
9	Romex 8 AWG	8/3/W/ground		FT	0		
10	Romex 8 AWG	8/2/W/ground		FT	10		
11	ROMEX 6 AWG	6/2/W/ground		FT	54		
12	Bare Copper Ground Wire 6 AWG			FT			
13							
14							
15							
16							



		ELEC	TRICAL BOXES & CIRCUTES				
#	Item	Туре	Description, Manufacturer, SKU	Unit	Quantity	Unit Price	Total
1	Panelboard -240V 1 Phase MLO	200 AMP		PCS	1		
2	Circuit breaker	15 A		PCS	3		
3	Circuit breaker	20 A		PCS	10		
4	Circuit breaker	30 A		PCS	2		
5	Circuit breaker	50 A		PCS	1		
6	Circuit breaker	60 A		PCS	1		
7	Single Gang Switch Box			PCS	4		
8	Double Gang Switch Box			PCS	2		
9	Triple Gang Switch Box			PCS	2		
10	Pull Box	#1/4		PCS	20		
11	Receptacle Box			PCS	26		
12							
13							
14							
15							

			HVAC_DUCTS 01				
#		Туре	Description, Manufacturer, SKU	Unit	Quantity	Unit Price	Total
1	PIPE (REFRIGERANT LINE)			FT	38.09		
2	PIPE (REFRIGERANT LINE)	3/4''' (Ø)		FT	55.55		
3	DRAYER HOSE	4" (Ø)		FT	4		
4	FLEX DUCT ROUND	4" (Ø)		FT	3.52		
5							
6							
7							
8							
9							
10							
11							
12							
13							
14							
15							
16							

			DUCT FITTINGS & ACCESSORIES				
#	Item	Туре	Description, Manufacturer, SKU	Unit	Quantity	Unit Price	Total
1	ELBOW (REFRIGERANT LINE)	3/4" (Ø)-3/4" (Ø)		PCS	20		
2	ELBOW (REFRIGERANT LINE)	3/8" (Ø)-3/8" (Ø)		PCS	16		
3	TEE (REFRIGERANT LINE)	3/4" (Ø)-3/4" (Ø)-3/4" (Ø)		PCS	1		
4	TEE (REFRIGERANT LINE)	3/8" (Ø)-3/8" (Ø)-3/8" (Ø)		PCS	1		
5	TRANSITION (REFRIGERANT LINE)	3/4" (Ø)-1/2" (Ø)		PCS	3		
6	TRANSITION (REFRIGERANT LINE)	3/4" (Ø)-5/8" (Ø)		PCS	2		
7	TRANSITION (REFRIGERANT LINE)	3/8" (Ø)-1/4" (Ø)		PCS	1		
8							
9							
10							
11							
12							
13							
14							
15							
16							

			HVAC_EQUIPMENTS				
#	Item	Туре	Description, Manufacturer, SKU	Unit	Quantity	Unit Price	Total
1	AIR HANDLING UNIT	WALL MOUNTED		PCS	2		
2	CONDENSER	OUTDOOR UNIT		PCS	1		
3	EXHAUST FAN	75 CFM		PCS	1		
1	EXHAUST HOOD	WALL MOUNTED		PCS	1		
5	HOOD-WALL: VENT	HOOD-WALL: VENT		PCS	1		
5	DRAYER: VENT	DRAYER: VENT		PCS	1		
7	ROOF VENT	3"(Ø)		PCS	1		
8							
9							
10							
11							
12							
13							
14							



		PLUMBIN	NG FIXTURES & ACCESSORIES				
#	Item	Туре	Description, Manufacturer, SKU	Unit	Quantity	Unit Price	Total
1	Bath Tub (Alcove Tub)			PCS	0		
2	Kitchen Sink			PCS	1		
3	Kitchen faucets			PCS	1		
4	Vanity Sink			PCS	1		
5	Bath room faucets			PCS	1		
6	Water Closet			PCS	1		
7	Shower Trim			PCS	1		
8	Shower Tray			PCS	1		
9	Water Heater			PCS	1		
10	Hose Bib			PCS	1		
11	Shutoff Valve			PCS	6		
12	Hanging pipe clamp			PCS	16		
13	Gate Valve			PCS	1		
14	Dishwasher Supply Single Connector			PCS	1		
15	Dishwasher Sewage Single Connector			PCS	1		
16	Laundry Sweat Connector			PCS	1		



		SANI	TARY & PLUMBING PIPES				
#	Item	Туре	Description, Manufacturer, SKU	Unit	Quantity	Unit Price	Total
1	ABS (Acrylonitrile Butadiene Styrene) Pipes	ø 1"		FT	0		
2	ABS (Acrylonitrile Butadiene Styrene) Pipes	ø 1 1/2"		FT	33		
3	ABS (Acrylonitrile Butadiene Styrene) Pipes	ø 2"		FT	25		
4	ABS (Acrylonitrile Butadiene Styrene) Pipes	ø 3"		FT	24		
5	PEX (Cross-linked polyethylene) Pipes	ø 1/2"		FT	48		
6	PEX (Cross-linked polyethylene) Pipes	ø 3/4"		FT	79		
7	PEX (Cross-linked polyethylene) Pipes	ø 1"		FT	1		
8	PVC Pipes Sch.80 - Rigid	ø 1 1/2"		FT	0		
9	PVC Pipes Sch.80 - Rigid	ø 2"		FT	60		
10	PVC Pipes Sch.80 - Rigid	ø 3"		FT	0		
11	Flex Pipe Round	ø 1/2"		FT	6		
12	Flex Pipe Round	ø 3/4"		FT	0		
13	Flex Pipe Round	ø 1"		FT	0		
14							
15							



		PI	PE FITTINGS 01				
ŧ	Item	Туре	Description, Manufacturer, SKU	Unit	Quantity	Unit Price	Total
	PEX 90 Degree Elbow	1/2"ø-1/2"ø		PCS	9		
	PEX 90 Degree Elbow	3/4"ø-3/4"ø		PCS	5		
	PEX Tee Elbow	3/4"ø-3/4"ø-3/4"ø		PCS	7		
	PEX Transition Elbow	1"ø-3/4"ø		PCS	1		
	PEX Transition Elbow	3/4"ø-1/2"ø		PCS	6		
	PEX 90 Degree Elbow	1/2"ø-1/2"ø		PCS	9		
	PEX 90 Degree Elbow	3/4"ø-3/4"ø		PCS	5		
	PEX Tee Elbow	3/4"ø-3/4"ø-3/4"ø		PCS	4		
	PEX Transition Elbow	3/4"ø-1/2"ø		PCS	5		
0	PVC 90 Deg Bend Elbow	2"ø-2"ø		PCS	24		
1	ABS 90 Degree Bend Elbow	3"ø-3"ø		PCS	1		
2	ABS P-Trap	1 1/2"ø-1 1/2"ø		PCS	3		
3	ABS P-Trap	2"ø-2"ø		PCS	2		
4	ABS P-Trap	3"ø-3"ø		PCS	1		
5	ABS Reducer Elbow	3"ø-1 1/2"ø		PCS	3		



		PIPE	FITTINGS 02				
# 1	tem	Туре	Description, Manufacturer, SKU	Unit	Quantity	Unit Price	Total
P	ABS Reducer Elbow	3"ø-2"ø		PCS	3		
A	ABS TEE Elbow	1 1/2"ø-1 1/2"ø-1 1/2"ø		PCS	3		
P	ABS TEE Elbow	2"ø-2"ø-2"ø		PCS	2		
F	ABS TEE Elbow	3"ø-3"ø-3"ø		PCS	6		
F	ABS 90 Degree Bend Elbow	1 1/2"ø-1 1/2"ø		PCS	1		
A	ABS Reducer Elbow	2"ø-1 1/2"ø		PCS	2		
A	ABS TEE Elbow	1 1/2"ø-1 1/2"ø-1 1/2"ø		PCS	1		
A	ABS TEE Elbow	2"ø-2"ø-2"ø		PCS	1		
P	ABS Vent Cap Elbow	1 1/2"ø		PCS	2		
0 /	ABS Vent Cap Elbow	2"ø		PCS	2		
1							
2							
3							
4							
5							



			APPLIANCES				
#	Item	Туре	Description, Manufacturer, SKU	Unit	Quantity	Unit Price	Total
1	Refrigerator			PCS			
2	Range			PCS			
3	Washer Front Load	Stackable		PCS			
4	Dryer Front Load	Stackable		PCS			
5	Dish Washer			PCS			
6	Oven			PCS	(
7	Microwave			PCS	(
8							
9							
10							
11							
12							
13							
14							
15							
16							



			CASEWORKS 01				
#	Item	Туре	Description, Manufacturer, SKU	Unit	Quantity	Unit Price	Total
1	Kitchen Cabinet			FT	12.54		
2	Laundry Cabinet			FT	2.25		
3	Vanity Cabinet			FT	2.5		
4	Medicine Cabinet			PCS	1		
5	Kitchen countertop			SF	17.34		
6	Laundry Countertop			PCS	1		
7	Bathroom Countertop			SF	0		
8	Island			FT	0		
9	Peninsula			FT	0		
10	Closets			SF	22.62		
11							
12							
13							
14							
15							



	1		CEILING 01				
ŧ	Item	Туре	Description, Manufacturer, SKU	Unit	Quantity	Unit Price	Total
	LIVING ROOM AND KITCHEN	I		SF	312.0		
	Ceiling Board	Drywall		SF	312		
	Drywall Fastener	Screw		PCS	546		
	Vapor Retarder	Polyethylene film		SF	312		
	Vapor Retarder Fastener	Nails with washer heads		PCS	936		
	BATHROOM			SF	59.0		
	Ceiling Board	MRD (Moisture resistant drywall)		SF	59		
	MRD Fastener	Screw		PCS	103		
	BEDROOM	.		SF	121.0		
	Ceiling Board	Drywall		SF	121		
	Drywall Fastener	Screw		PCS	212		
	Vapor Retarder	Polyethylene film		SF	121		
0	Vapor Retarder Fastener	Nails with washer heads		PCS	363		
	PORCH	!		SF	91.0		
.1	Ceiling Board	Marine Plywood		SF	91		
.2	Exterior Grade Plywood	Screw		PCS	159		



			CEILING 02				
#	Item	Туре	Description, Manufacturer, SKU	Unit	Quantity	Unit Price	Total
	CLOSET			SF	11.0		
13	Ceiling Board	Drywall		SF	11		
14	Drywall Fastener	Screw		PCS	19		
15	Vapor Retarder	Polyethylene film		SF	11		
16	Vapor Retarder Fastener	Nails with washer heads		PCS	33		
	HALL			SF	14.0		
17	Ceiling Board	Drywall		SF	14		
18	Drywall Fastener	Screw		PCS	25		
19	Vapor Retarder	Polyethylene film		SF	14		
20	Vapor Retarder Fastener	Nails with washer heads		PCS	42		
	WH			SF	7.0		
21	Ceiling Board	Drywall		SF	7		
22	Drywall Fastener	Screw		PCS	12		
23	Vapor Retarder	Polyethylene film		SF	7		
24	Vapor Retarder Fastener	Nails with washer heads		PCS	21		



			FLOORING INTERIOR 01				
#	Item	Туре	Description, Manufacturer, SKU	Unit	Quantity	Unit Price	Total
	CLOSET						
1	Closet Flooring			SF	10		
2	Wood underlay	Foam Pad Polyethylene		SF	10		
3	Vapor Retarder	Vapor Barrier Polyethylene		SF	10		
	BEDROOM	·					
4	Living Area Flooring			SF	115		
5	Wood underlay	Foam Pad Polyethylene		SF	115		
6	Vapor Retarder	Vapor Barrier Polyethylene		SF	115		
	LIVING ROOM AND KITCHE	EN					
7	Tile Finish			SF	302		
8	Adhesive	1/2" Thin set Mortar		SF	302		
9	Vapor Retarder	Vapor Barrier Polyethylene		SF	302		
	BATHROOM						
10	Tile Finish			SF	42		
11	Adhesive	1/2" Thin set Mortar		SF	42		
12	Vapor Retarder	Vapor Barrier Polyethylene		SF	42		



			FLOORING INTERIOR 02				
#	Item	Туре	Description, Manufacturer, SKU	Unit	Quantity	Unit Price	Total
	W/D						
13	Tile Finish			SF	8		
14	Adhesive	1/2" Thin set Mortar		SF	8		
15	Vapor Retarder	Vapor Barrier Polyethylene		SF	8		
	BOILER ROOM						
16	Tile Finish			SF	7		
17	Adhesive	1/2" Thin set Mortar		SF	7		
18	Vapor Retarder	Vapor Barrier Polyethylene		SF	7		



			FLOORING EXTERIOR			
#	Item	Туре	Description, Manufacturer, SKU	Unit	Quantity	Unit Price
	STRUCTURE			SF	647.48	
1	Concrete Slab	4"concrete cast in situ		CF	215.82	
2	Insulation	Rigid insulation		SF	210.86	
3	Hard core	Compacted soil		CF	155.68	
4	Re-bar	#4 re-bar		Ton	0.67	
5	Concrete Pad	4"concrete cast in situ		CF	2	
6	Slab edge	Turndown		CF	207.81	
7	Footing	Cast-in-place concrete		CF	4.68	
	PORCH					
8	Tile Finish			SF	92	
9	Adhesive	1/2" Thin set Mortar		SF	92	
10	Vapor Retarder	Vapor Barrier Polyethylene		SF	92	



			WALLS: EXTERIOR				
#	Item	Туре	Description, Manufacturer, SKU	Unit	Quantity	Unit Price	Total
1	Exterior-Grade Plywood Horizontal Siding			SF	722		
2	Exterior-Grade Plywood Fastener 8/panel	Self-drilling screws(100/pkt)		PKT	7.22		
3	Wall Shteathing (OSB)			SF	722		
4	Shteathing Fastener	Self-drilling screws(100/pkt)		PKT	7.22		
5	Wall Homewrap			SF	722		
6	Homewrap Fastener	Stapled fastener (200/pkt)		PKT	2.74		
7	Furring Strip			PCS	90.25		
8	Furring Strip Fastener	Self-drilling screws(100/pkt)		PKT	7.22		
9	Wall Paint			SF	722		
10	Stone Copping	Masonry stone		SF	0		
11	Stone Veneer	Masonry stone		SF	0		
12	Mortar for Stone Veneer			SF	0		
13	Wall Insulation			SF	2312		



			WALLS: INTERIOR 01				
#	Item	Туре	Description, Manufacturer, SKU	Unit	Quantity	Unit Price	Total
	BATHROOM			SF	55.0		
1	Cementitious Backer Board			SF	291		
2	Kerdi membrane			SF	291		
3	Kerdi membrane Fastener			SF	291		
4	Wall Ceramic Tile			SF	291		
	BEDROOM			SF	121.0		
5	Drywall Board			SF	337		
6	Drywall Fastener	Self-drilling screws(100/pkt)		PKT	3.37		
7	Wall Paint			SF	337		
8	Drywall Tape			FT	63.2		
	HALL			SF	13.0		
9	Drywall Board			SF	78		
10	Drywall Fastener	Self-drilling screws(100/pkt)		PKT	0.78		
11	Wall Paint			SF	78		
12	Drywall Tape			FT	15		



			WALLS: INTERIOR 02				
#	Item	Туре	Description, Manufacturer, SKU	Unit	Quantity	Unit Price	Total
	LIVING ROOM			SF	245.0		
13	Drywall Board			SF	238		
14	Drywall Fastener	Self-drilling screws(100/pkt)		PKT	2.38		
15	Wall Paint			SF	238		
16	Drywall Tape			FT	44.7		
	KITCHEN			SF	40.0		
17	Cementitious Backer Board			SF	14		
18	Drywall Board			SF	249		
19	Drywall Fastener	Self-drilling screws(100/pkt)		PKT	2.49		
20	Kerdi membrane			SF	14		
21	Kerdi membrane Fastener			SF	14		
22	Wall Ceramic Tile			SF	14		
23	Wall Paint			SF	249		
24	Drywall Tape			FT	47.0		



			WALLS: INTERIOR 03				
#	Item	Туре	Description, Manufacturer, SKU	Unit	Quantity	Unit Price	Total
	CL			SF	12.0		
25	Drywall Board			SF	110		
26	Drywall Fastener	Self-drilling screws(100/pkt)		PKT	1.1		
27	Wall Paint			SF	110		
28	Drywall Tape			FT	20.6		
	WD			SF	8.0		
29	Cementitious Backer Board			SF	76		
30	Kerdi membrane			SF	76		
31	Kerdi membrane Fastener			SF	76		
32	Wall Ceramic Tile			SF	76		
	WH	'		SF	7.0		
33	Drywall Board			SF	92		
34	Drywall Fastener	Self-drilling screws(100/pkt)		PKT	0.92		
35	Wall Paint			SF	92		
36	Drywall Tape			FT	17		
1	Wall Skirting	Ceramic		FT	125		



			DOORS				
#	Item	Туре	Description, Manufacturer, SKU	Unit	Quantity	Unit Price	Total
1	Exterior Swinging	3' - 0" X 6'-8"		PCS	1		
2	Interior Swinging	2' - 6" X 6'-8"		PCS	1		
3	Interior Swinging	3' - 0" X 6'-8"		PCS	1		
4	Exterior Swinging	2' - 4" X 6'-8"		PCS	1		
5	Interior Sliding	3' - 0" X 6'-8"		PCS	1		
6	Exterior Door Trim			FT	32		
7	Interior Door Trim			FT	129		
8	Entry Lock set			PCS	2		
9	Privacy Lock set			PCS	2		
10	Passage Lock set			PCS	2		



			WINDOWS				
#	Item	Туре	Description, Manufacturer, SKU	Unit	Quantity	Unit Price	Total
1	Single Hung	3' - 3" X 3'-3"		PCS	1		
2	Sliding	2' - 3" X 2'-3"		PCS	2		
3	Sliding	5' - 3" X 3'-7"		PCS	2		
4	Sliding	5' - 3" X 2'-3"		PCS	1		
5	Single Hung	3' - 3" X 4'-9"		PCS	2		
6	Exterior Window Trim			FT	115		
7	Interior Window Trim			FT	115		
8							
9							
10							
11							
12							
13							
14							
15							



			ROOF 01				
#	Item	Туре	Description, Manufacturer, SKU	Unit	Quantity	Unit Price	Total
1	Roof Covering			SF	798.0		
2	Roof Covering Fastener			PCS	399		
3	Roof Felt Paper			SF	798.0		
4	Roof Felt Paper Fastener			PCS	2394.0		
5	Roof Sheathing			SF	798.0		
6	Roof Sheathing Fastener			PCS	6384		
7	Batten			FT	0.0		
8	Batten Fastener			PCS	0.0		
9	Soffit			SF	111.0		
10	Soffit Fastener			PCS	55.5		
11	Fascia			FT	115.0		
12	Fascia board fastener			PCS	58		
13	Roof Insulation			SF	798.0		
14					7616		
15							