

# **ORCHARD**

The Orchard is a charming Craftsman-style 2 bedroom, 1 bathroom home designed for comfortable and efficient living. The walls are finished with horizontal siding in a warm, earthy tone, creating a clean and traditional aesthetic. The simple gable roof with decorative truss details provides shelter and complements the overall design. A prominent covered porch spans the front of the home, supported by substantial stoneclad pillars, creating a welcoming outdoor space.

Inside, the Orchard features a simple L-shaped layout. The living, kitchen, and dining areas are merged into a single space, creating a spacious living area. The two bedrooms are thoughtfully located at the back of the house, offering private and quiet retreats. Functional spaces, such as the bathroom and laundry, are strategically placed between the living area and the bedrooms, creating a clear separation.




Please print and take this Materials Shopping List to your favorite Home Depot and ask for assistance in selecting the materials, fixtures and fittings to complete your new home.

Record your selection and the price of the item. Then do the math to determine the cost for your selections and the total cost of finishing your home.



To Go To Materials Shopping List



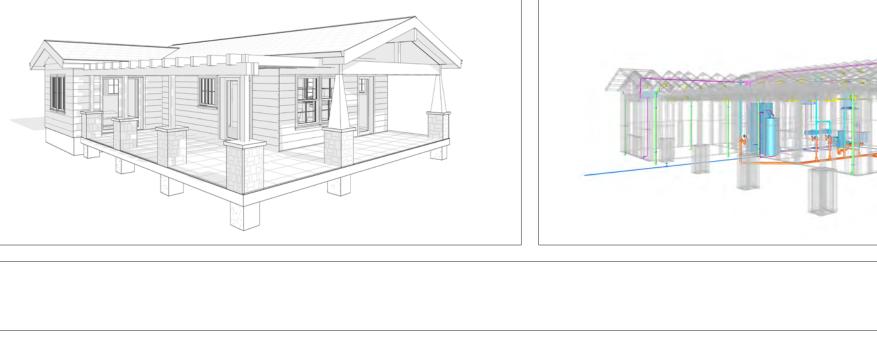

# **FLOOR PLAN**

746 SF

2 Bed Rooms



# **MATERIALS LIST** MATERIALS LIST PREVIEW -

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MATERIALS SHOPPING LIST

# **ABOUT**

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FrameUpNow is a design and manufacturing company providing precision-engineered home framing solutions. We offer a catalog of Affordable Homes, Tiny Homes, Garages, Shops and Barndominiums. FrameUpNow manufactures cold-formed steel (CFS) also known as Light Gauge Steel (LGS) framing components that conform to our engineered metal house frame plans or can be purchased as DIY skeleton kits.

The CFS/LGS framing is lightweight, easily assembled, and does not require heavy equipment or specialized labor, enabling homeowners to erect the frame themselves in just a few days. Unlike wood, the steel framing is impervious termites and bores, warping, expansion, and fire.

Our home plans come complete with a structural engineered stamp for permit approvals. Customers receive a full BOM also known as a Materials Shopping List to purchase finish materials from a Building Materials retailer. FrameUpNow prides itself on the quality and efficiency of our precision-engineered home framing solutions for construction professionals and DIY homeowners.



**KEY PLAN** 

NO.	DESCRIPTION	DATE

NOTE:

LEGEND:

PROJECT

189-Orchard-746-2Bd1Ba-Craftsman-550

DRAWING NAME

# INTRODUCTION

CLIENT NAME:
PROJECT NUMBER:
DATE:
DESIGNED BY:
DRAWN BY:
CHECKED BY:

**I101** 

SCALE:

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**DISCLAIMER** 

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## **DESCRIPTIONS**

## MATERIALS LIST

The BOM (Bill Of Materials) package, known as the Materials Shopping List document, provides:

Comprehensive Inventory: Detailed lists of essential materials sourced from architectural, mechanical, HVAC, electrical, and plumbing design drawing sets.

Precise Curation: Each item meticulously selected and organized for accuracy and efficiency in project planning.

Customizable Options: Customers can modify listed items to their preferences and calculate costs accordingly, ensuring alignment with personal project needs and budget.

Dedicated Space for Details: Includes tables for customers to note Home Depot SKU numbers or product descriptions for selected items, facilitating seamless purchasing and coordination with suppliers.

Customer Convenience: Take the list to Home Depot or preferred suppliers for accurate pricing, helping align the total home budget with personal financial plans.

Simplify your construction journey with our Materials Shopping List document, where detailed preparation meets streamlined implementation for your dream home.

## STRUCTURAL

The structural drawings package provides an exhaustive set of detailed plans essential for the precise assembly of your building. This comprehensive package includes:

Framing Plans: Detailed layouts for all framing components. Truss Layouts: Clear instructions for truss placement and

Panel Length Plans: Specifications for panel dimensions. Framing Elevations and Sections: Precise elevation and sectional views for accurate construction.

Truss and Wall Blocking Plans: Plans for truss and wall blocking to ensure structural integrity.

Hold-Down Plan: Detailed hold-down requirements for stability. Snap Sheet: Reference sheet for quick identification of components

Structural Details and Bracing Plans: Complete details and bracing plans for all structural elements.

Accompanying these plans is a comprehensive Bill of Materials (BOM) that lists every necessary building component, from cold formed steel (CFS) frames to fasteners.

## ARCHITECTURAL

With the comprehensive architectural package, both builders and DIY homeowners can confidently execute the construction.

The architectural package includes:

Furnished Floor Plans: Complete with furniture layouts for a clear understanding of space utilization.

Detailed Dimension Plans: Ensures precise measurements, from the overall footprint down to the exact placement of windows and

Foundation Plan: Detailed plan to establish a solid foundation.

Wall Framing and Truss Layout: Comprehensive plans for wall framing and truss placement.

Architectural Elevations: Exterior views showcasing the design.

Strategic Building Sections: Critical cross-sectional details for a thorough understanding of the build.

Casework Drawings and Diagrams: Suggested designs for built-in caseworks, such as kitchen cabinets.

# **MECHANICAL**

The mechanical package includes everything needed to guide HVAC

Detailed HVAC Floor Plan: Precisely maps out the placement of air handlers, ductwork, and vents throughout the home's layout.

HVAC Sections and Riser Diagrams: Technical drawings offering critical cross-sectional details and piping schematics, ensuring proper integration of the heating and cooling system into the home's structure.

Bill of Materials: A complete list of all necessary HVAC components.

## **ELECTRICAL**

The electrical package includes all the plans and documentation needed to guide the installation of your home's electrical system:

Detailed Power Plan: Precisely maps out the placement of outlets, switches, and other power components throughout the layout.

Comprehensive Lighting Plan: Shows the optimal locations for lighting fixtures, sconces, and other illumination sources to create a well-lit, functional interior.

Dimensioned Electrical Layout: Provides exact dimensions and measurements to ensure proper placement of all electrical elements.

Bill of Materials: A complete list of every component needed, from circuit breakers to wiring.

The plumbing package includes everything needed to guide the

Detailed Water Supply System Plan: Precisely maps out the placement of pipes, valves, and plumbing fixtures throughout the

Comprehensive Sewage System Plan: Shows the optimal routing and sizing of drain lines to effectively remove waste and ensure

Detailed Riser Diagrams: Provide information needed to properly

# **PLUMBING**

installation of your home's water supply and drainage systems:

proper drainage.

install all vertical plumbing risers and vent stacks.

Bill of Materials: A complete list of every component needed, from pipes to fixtures.


# BOM (Bill Of Materials) (Separately Attached)





The Bill of Materials (BOM) is a crucial document that compiles the material requirements from different disciplines into a centralized inventory, enabling efficient procurement, inventory management, and cost estimation for a specified project or

**ELECTRICAL BOM** 



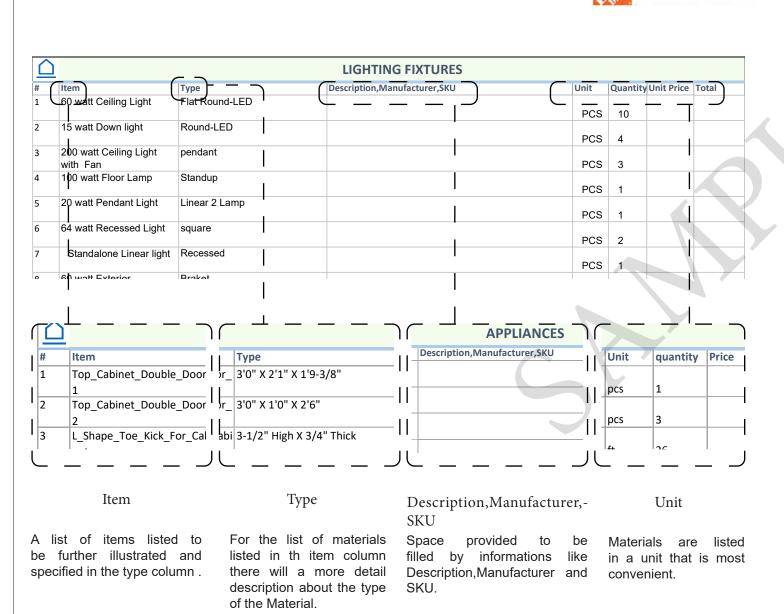

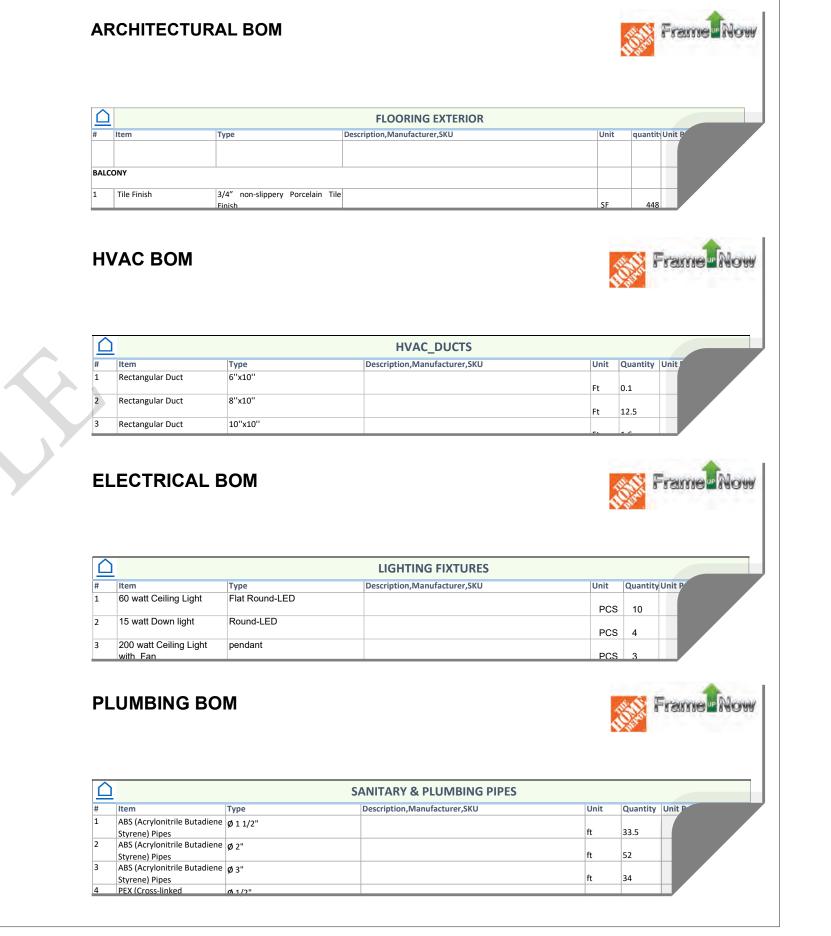

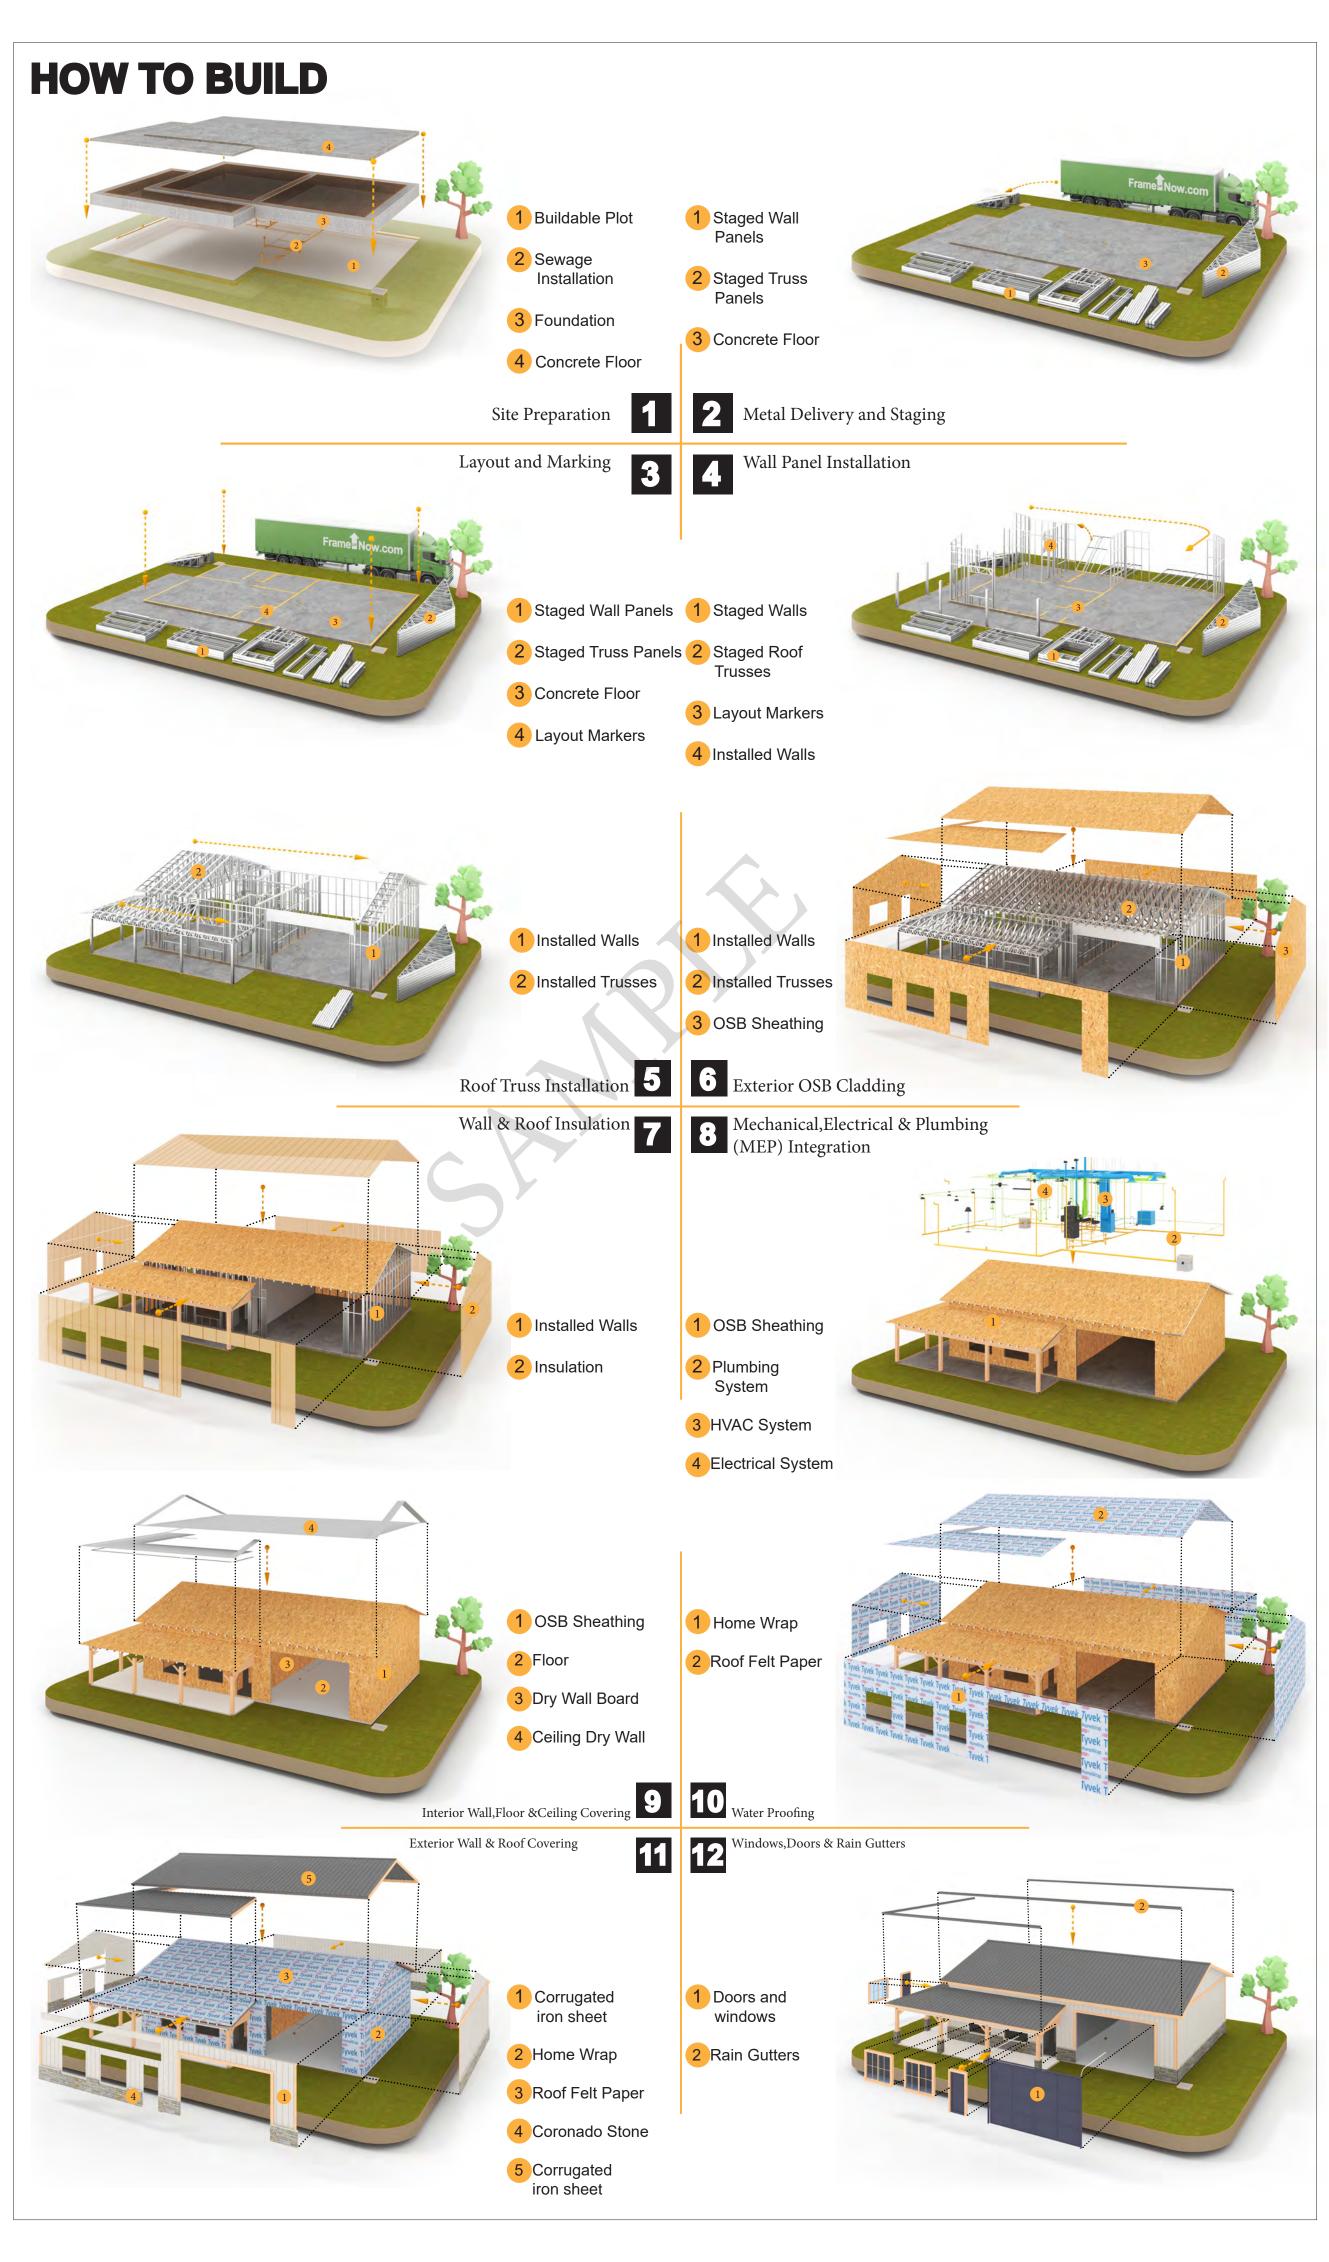



**KEY PLAN** 

NO.	DESCRIPTION	DATE

NOTE:

LEGEND:

PROJECT

189-Orchard-746-2Bd1Ba-Craftsman-550


DRAWING NAME

# INTRODUCTION

CLIENT NAME: PROJECT NUMBER: DATE: **DESIGNED BY** DRAWN BY: CHECKED BY:

1102

SCALE:

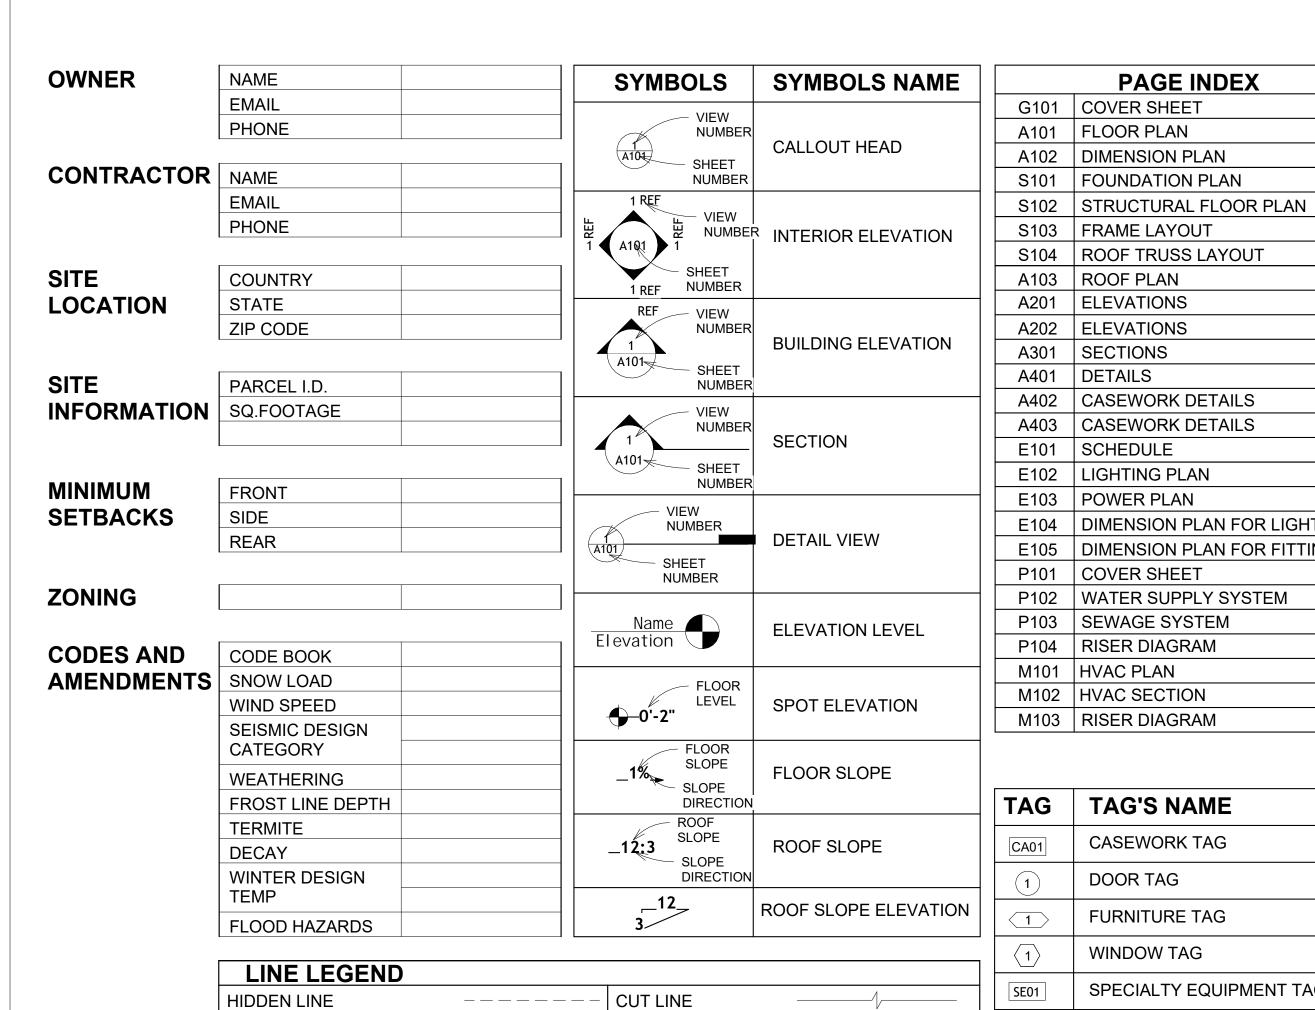

**ROOM SEPARATOR** 

OVER HEAD

DOOR OPENING DIRECTION

ELEVATIONS	
SECTIONS	IRC
DETAILS	
CASEWORK DETAILS	IMC
CASEWORK DETAILS	livio
SCHEDULE	MAX
LIGHTING PLAN	ME
POWER PLAN	MIN.
DIMENSION PLAN FOR LIGHT FIXTURE	NO.
DIMENSION PLAN FOR FITTING	O.C
COVER SHEET	OSB
WATER SUPPLY SYSTEM	PL
SEWAGE SYSTEM	PSI
RISER DIAGRAM	PVC
HVAC PLAN	REF
HVAC SECTION	RG
RISER DIAGRAM	SE
	SF
	SIMF
TAG'S NAME	
CASEWORK TAG	SIMF
CASEWORKTAG	TV
DOOR TAG	UNO
FURNITURE TAG	W/ W/D
WINDOW TAG	AC
SPECIALTY EQUIPMENT TAG	ACC
or zon zer egon werve into	ACCI
MECHANICAL EQUIPMENT TAG	AHL
PLUMBING EQUIPMENT TAG	
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ELEVATIONS

SECTIONS

SCHEDULE


SEWAGE SYSTEM

TAG'S NAME

PE01 PLUMBING EQUIPMENT




CALL OUT BOUNDRY

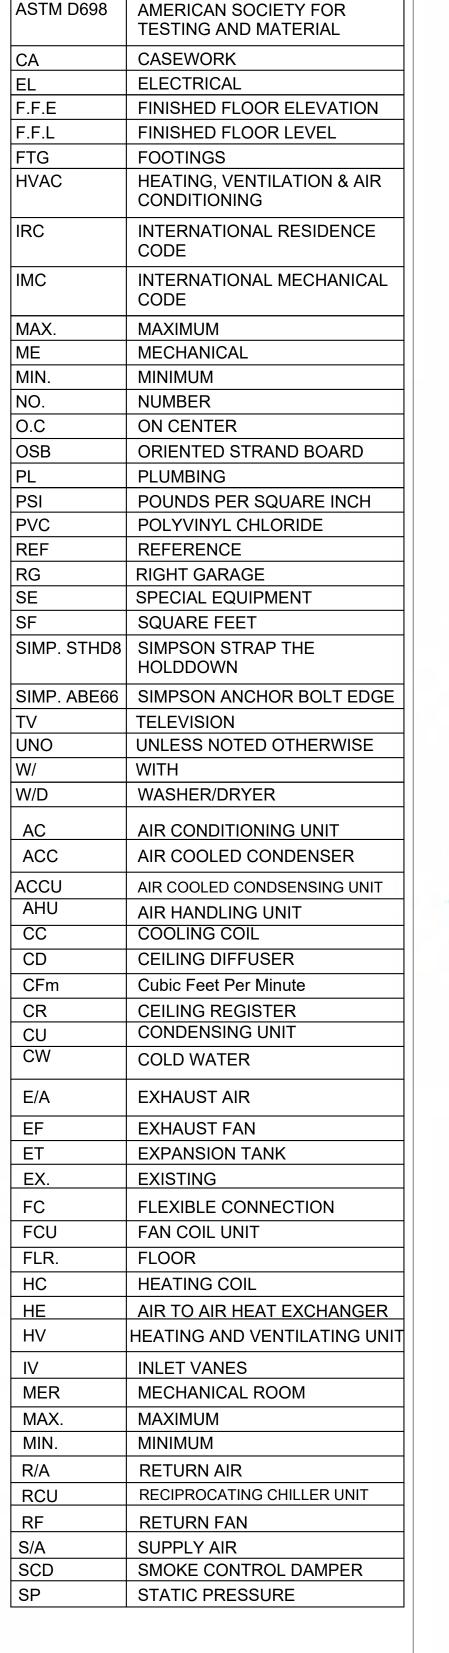

**ABBREVIATION** 

ACTION FLOOR SYSTEMS


AFS

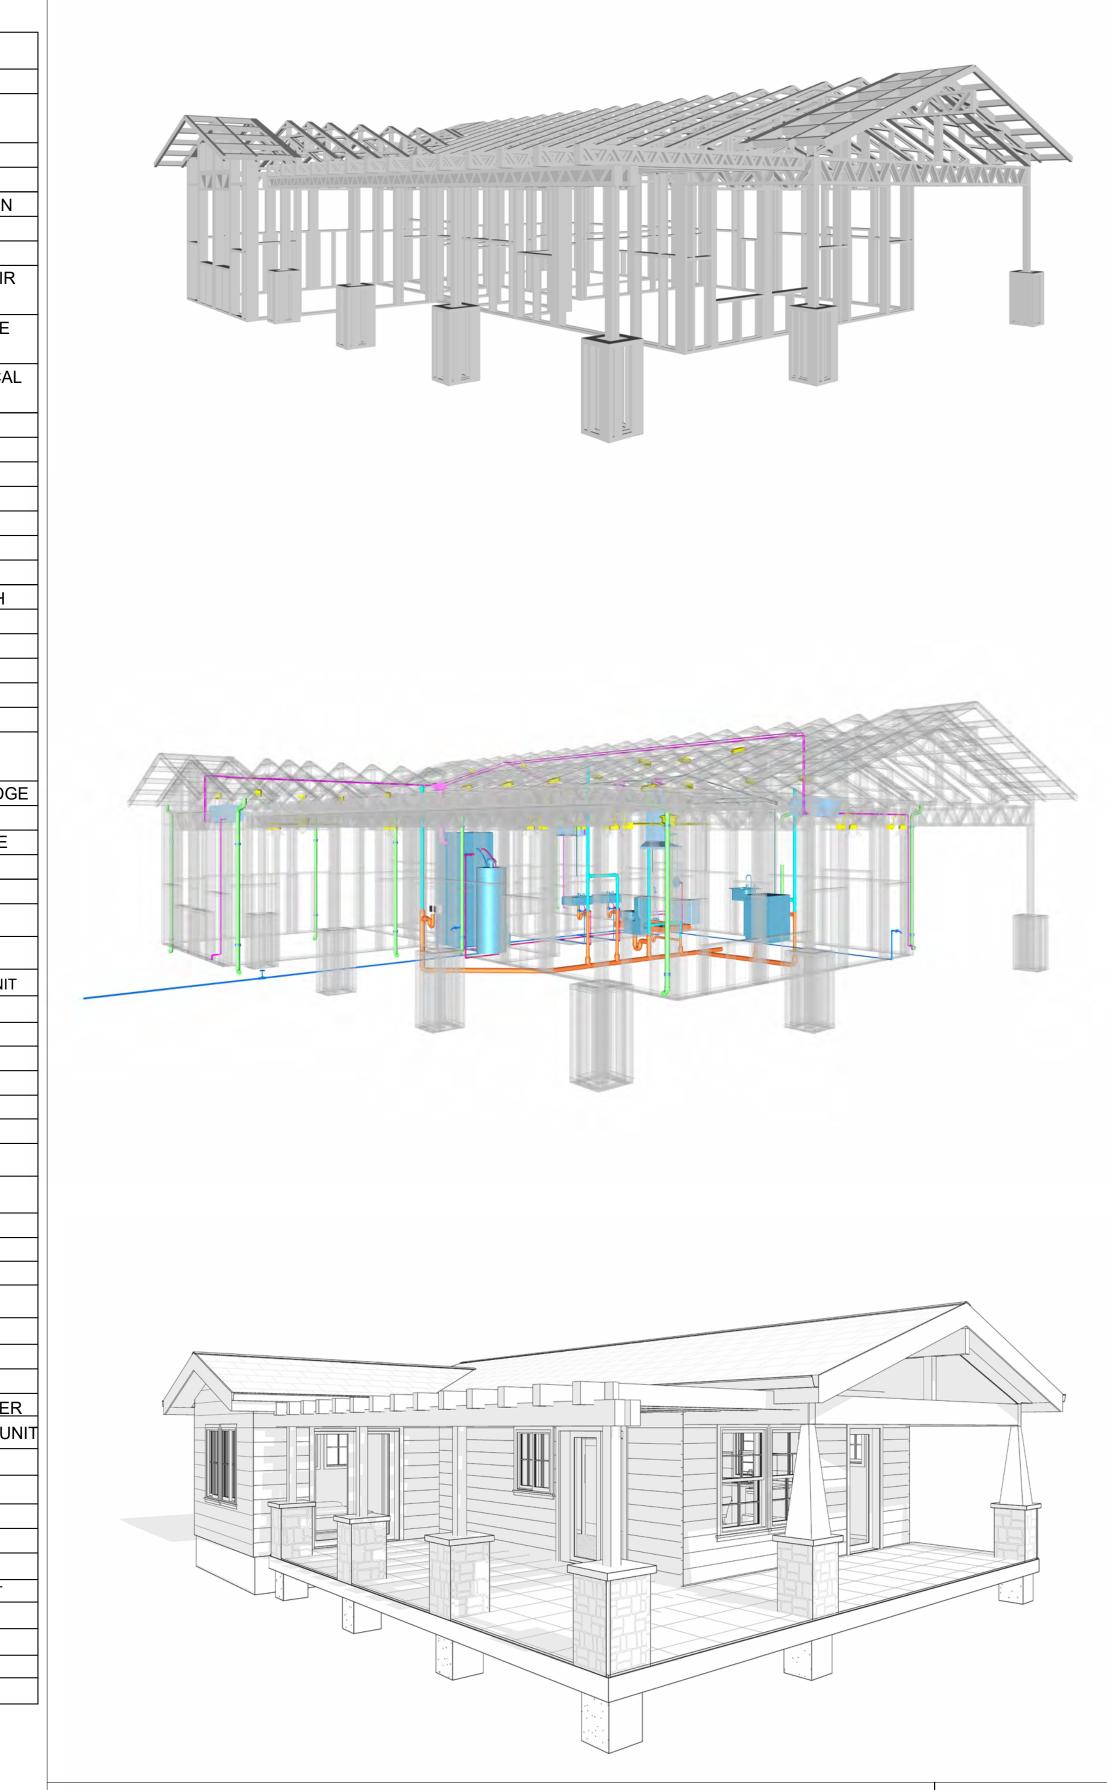

189-ORCHARD-746-2Bd1Ba-**CRAFTSMAN-550** 

SQUARE FOOTAGE		
LIVING	746	
PORCH	394	
TOTAL	1140	



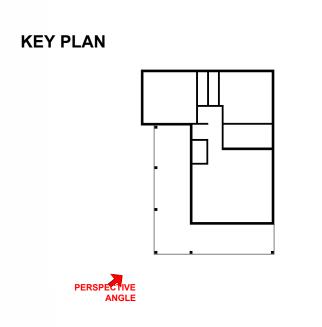

	NO.	DESCRIPTION	DATE
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NOTE:

LEGEND:

**PROJECT** 

189-ORCHARD-746-2Bd1Ba-CRAFTSMAN-550

DRAWING NAME

**COVER SHEET** 

CLIENT NAME:	Client Name
PROJECT NUMBER:	0061_12
DATE:	4/23/2025 12:21:06 PM
DESIGNED BY:	Designer
DRAWN BY:	Author
CHECKED BY:	Checker

G101

## **GENERAL NOTES**

- THIS DRAWING DEPICTS THE ARCHITECTURAL (SPACE LAYOUT, FURNISHING, FLOOR, WALLS, ROOFS, FOUNDATION, WINDOWS AND DOORS) SYSTEMS. IT PROVIDES A VISUAL REPRESENTATION OF THE ARCHITECTURAL LAYOUT AND COMPONENTS.
- THE ARCHITECTURAL DRAWINGS ARE PREPARED TO MEET THE SPECIFIC REQUIREMENTS OF THE BUILDING, AS PER THE PROJECT SPECIFICATIONS AND APPLICABLE CODES AND STANDARDS. THE CONSTRUCTION OF THIS HOME SHALL COMPLY WITH THE LATEST EDITION OF THE INTERNATIONAL RESIDENTIAL CODE (IRC), INTERNATIONAL MECHANICAL CODE (IMC), THE
- INTERNATIONAL PLUMBING STANDARD, THE NATIONAL ELECTRICAL STANDARD AND ALL OTHER APPLICABLE LOCAL, STATE, AND NATIONAL CODES AND REGULATIONS. COORDINATION WITH OTHER TRADES HAS BEEN DONE ON A DESIGN LEVEL. THIS DRAWING SHALL BE READ TOGETHER WITH THE ME, EL AND PL DESIGN DRAWINGS TO ENSURE PROPER

#### **ABOUT WALLS:**

- SHOWER WALL COVERING
- BATHTUB AND SHOWER SPACES (WALLS AND FLOORS) WITH INSTALLED SHOWER HEADS AND IN SHOWER COMPARTMENTS SHALL BE FINISHED WITH A NON-ABSORBENT SURFACE.
- WALL PAINT (INTERNAL)
  - THE TYPICAL THICKNESS OF LATEX WALL PAINT IS 1/32 OF AN INCH FOR A SINGLE COAT. AND DOUBLE COAT (1/16") SHALL BE APPLIED FOR DURABILITY.

THE ADVISABLE TYPE OF ADHESIVE FOR THIS PROJECT IS EPOXY ADHESIVES BECAUSE THEY ARE KNOWN FOR THEIR HIGH STRENGTH, DURABILITY, AND RESISTANCE TO MOISTURE, CHEMICALS AND

REFER TO SHEETS A201 & A202 FOR GENERAL NOTES ON EXTERNAL FINISHING MATERIALS

### ABOUT FLOORS:


THE SPOT ELEVATION INDICATES THE FINISHED FLOOR ELEVATION.

CONSTRUCTION AND INTEGRATION OF THE BUILDING SYSTEMS.

- FINISHED FLOORS PER PLANS.
- FIELD VERIFY FOR DIMENSION DROP 4" FOR SHOWER AND BATHTUB USE.
- 1% SLOPE ON OUTDOOR BALCONIES FOR WATER RUN OFF.
- 2% SLOPE TOWARDS THE SHOWER DRAIN FOR SUFFICIENT DRAINAGE.
- 4" DROP AT THE DOOR LEADING TO EXTERIOR BALCONY FROM THE MAIN LIVING AREA. 5% SLOPE FOR GARAGE IS USED, WHICH SHOULD BE CHECKED WITH THE LOCAL GARAGING
- ZONING LAWS.

	FURNITURE SCHEDULE				
	TYPE MARK	TYPE	COUNT		
01		KING SIZE BED	2		
02		THREE SEAT SOFA	1		
03		DINING CHAIR	2		
04		25" X 60" DINING 2	1		

	ROOM FINISH SCHEDULE						
ROOM NUMBE R	ROOM NAME	FLOOR FINISH	BASE FINISH	WALL FINISH	CEILING FINISH	CEILING HEIGHT	COM MEN TS
01	LIVING ROOM	HARDWOOD	CONCRETE	WALL PAINT	DRY WALL	8' - 0"	
02	KITCHEN	HARDWOOD	CONCRETE	WALL PAINT + CERAMIC	DRY WALL	8' - 0"	
03	BEDROOM 1	HARDWOOD	CONCRETE	WALL PAINT	DRY WALL	8' - 0"	
04	BEDROOM 2	HARDWOOD	CONCRETE	WALL PAINT	DRY WALL	8' - 0"	
05	BATH	VINYL TILES	CONCRETE	CERAMIC TILE	MRD	8' - 0"	
06	CL 1	HARDWOOD	CONCRETE	WALL PAINT	DRY WALL	8' - 0"	
07	CL 2	HARDWOOD	CONCRETE	WALL PAINT	DRY WALL	8' - 0"	
08	WH	HARDWOOD	CONCRETE	WALL PAINT	DRY WALL	8' - 0"	
09	WD	HARDWOOD	CONCRETE	CERAMIC TILE	DRY WALL	8' - 0"	
10	HALL	HARDWOOD	CONCRETE	WALL PAINT	DRY WALL	8' - 0"	
11	PORCH	PROCELAIN TILE	CONCRETE	CORRUGATED IRON	PLYWOOD	8' - 0"	

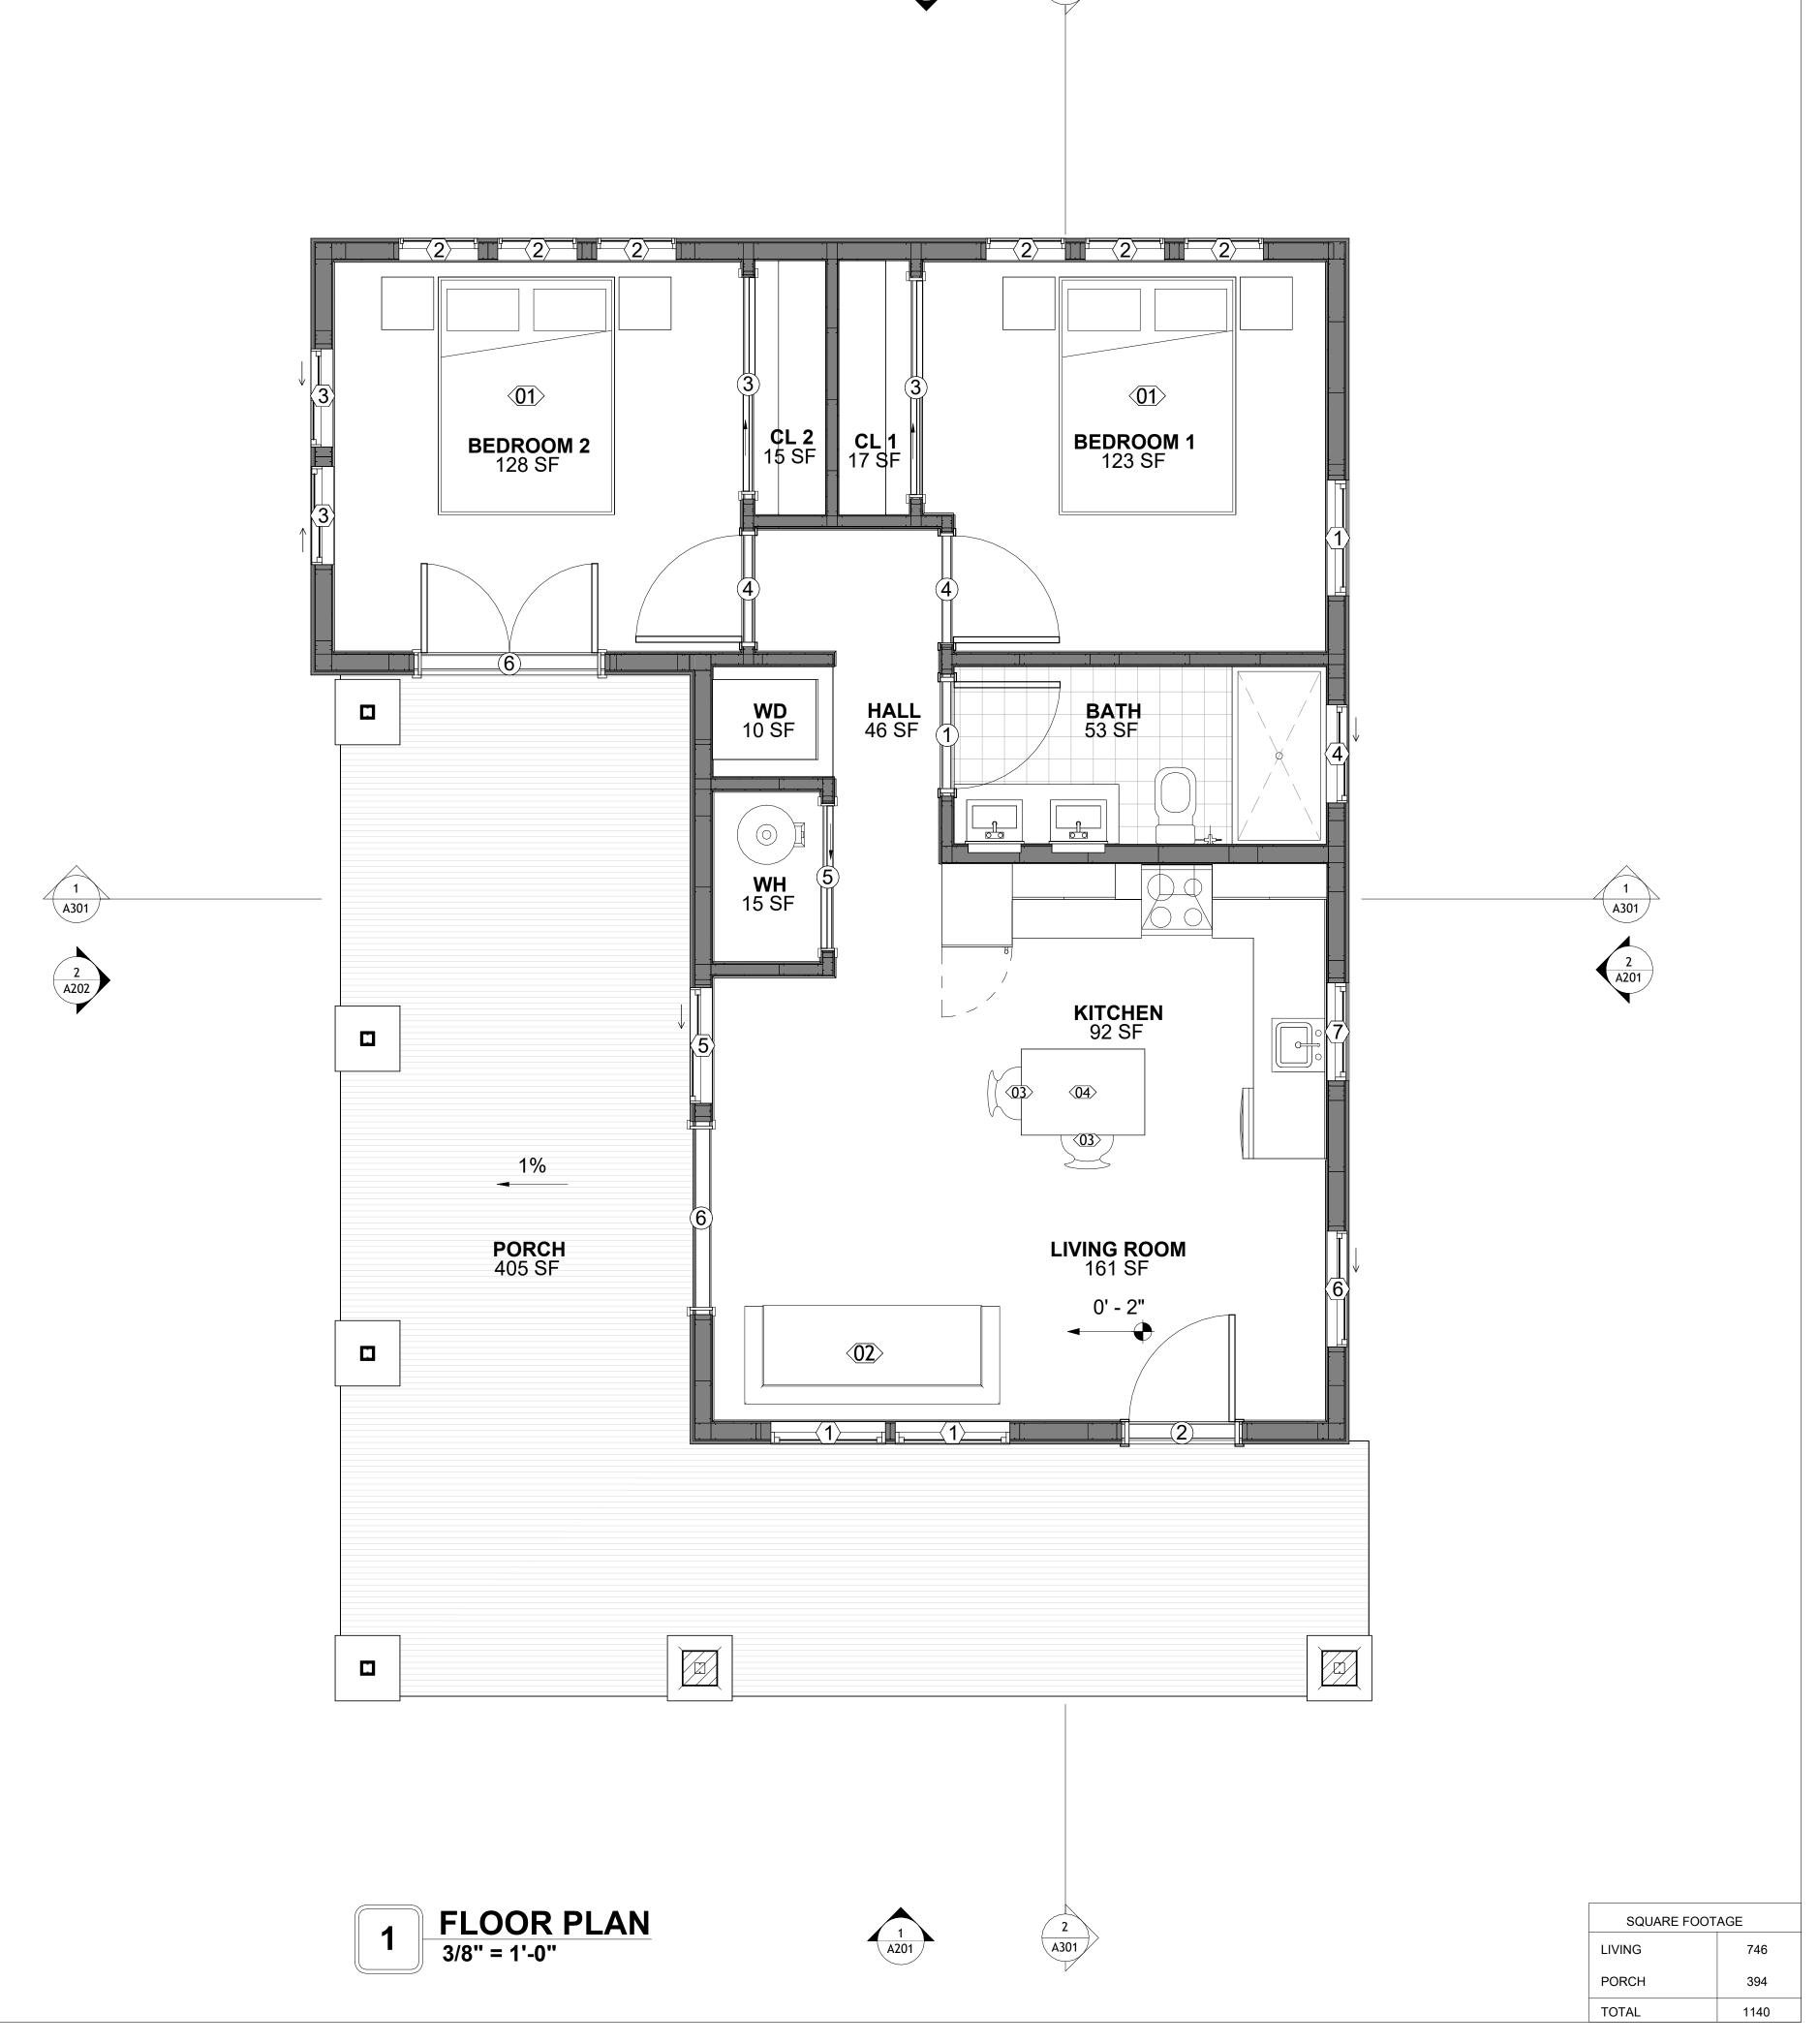



**KEY PLAN** 

NO.	DESCRIPTION	DATE

NOTE:

LEGEND:

PROJECT


189-ORCHARD-746-2Bd1Ba-CRAFTSMAN-550

DRAWING NAME

**FLOOR PLAN** 

CLIENT NAME:	Client Name
PROJECT NUMBER:	0061_12
DATE:	4/23/2025 12:21:06 PM
DESIGNED BY:	Designer
DRAWN BY:	Author
CHECKED BY:	Checker

A101

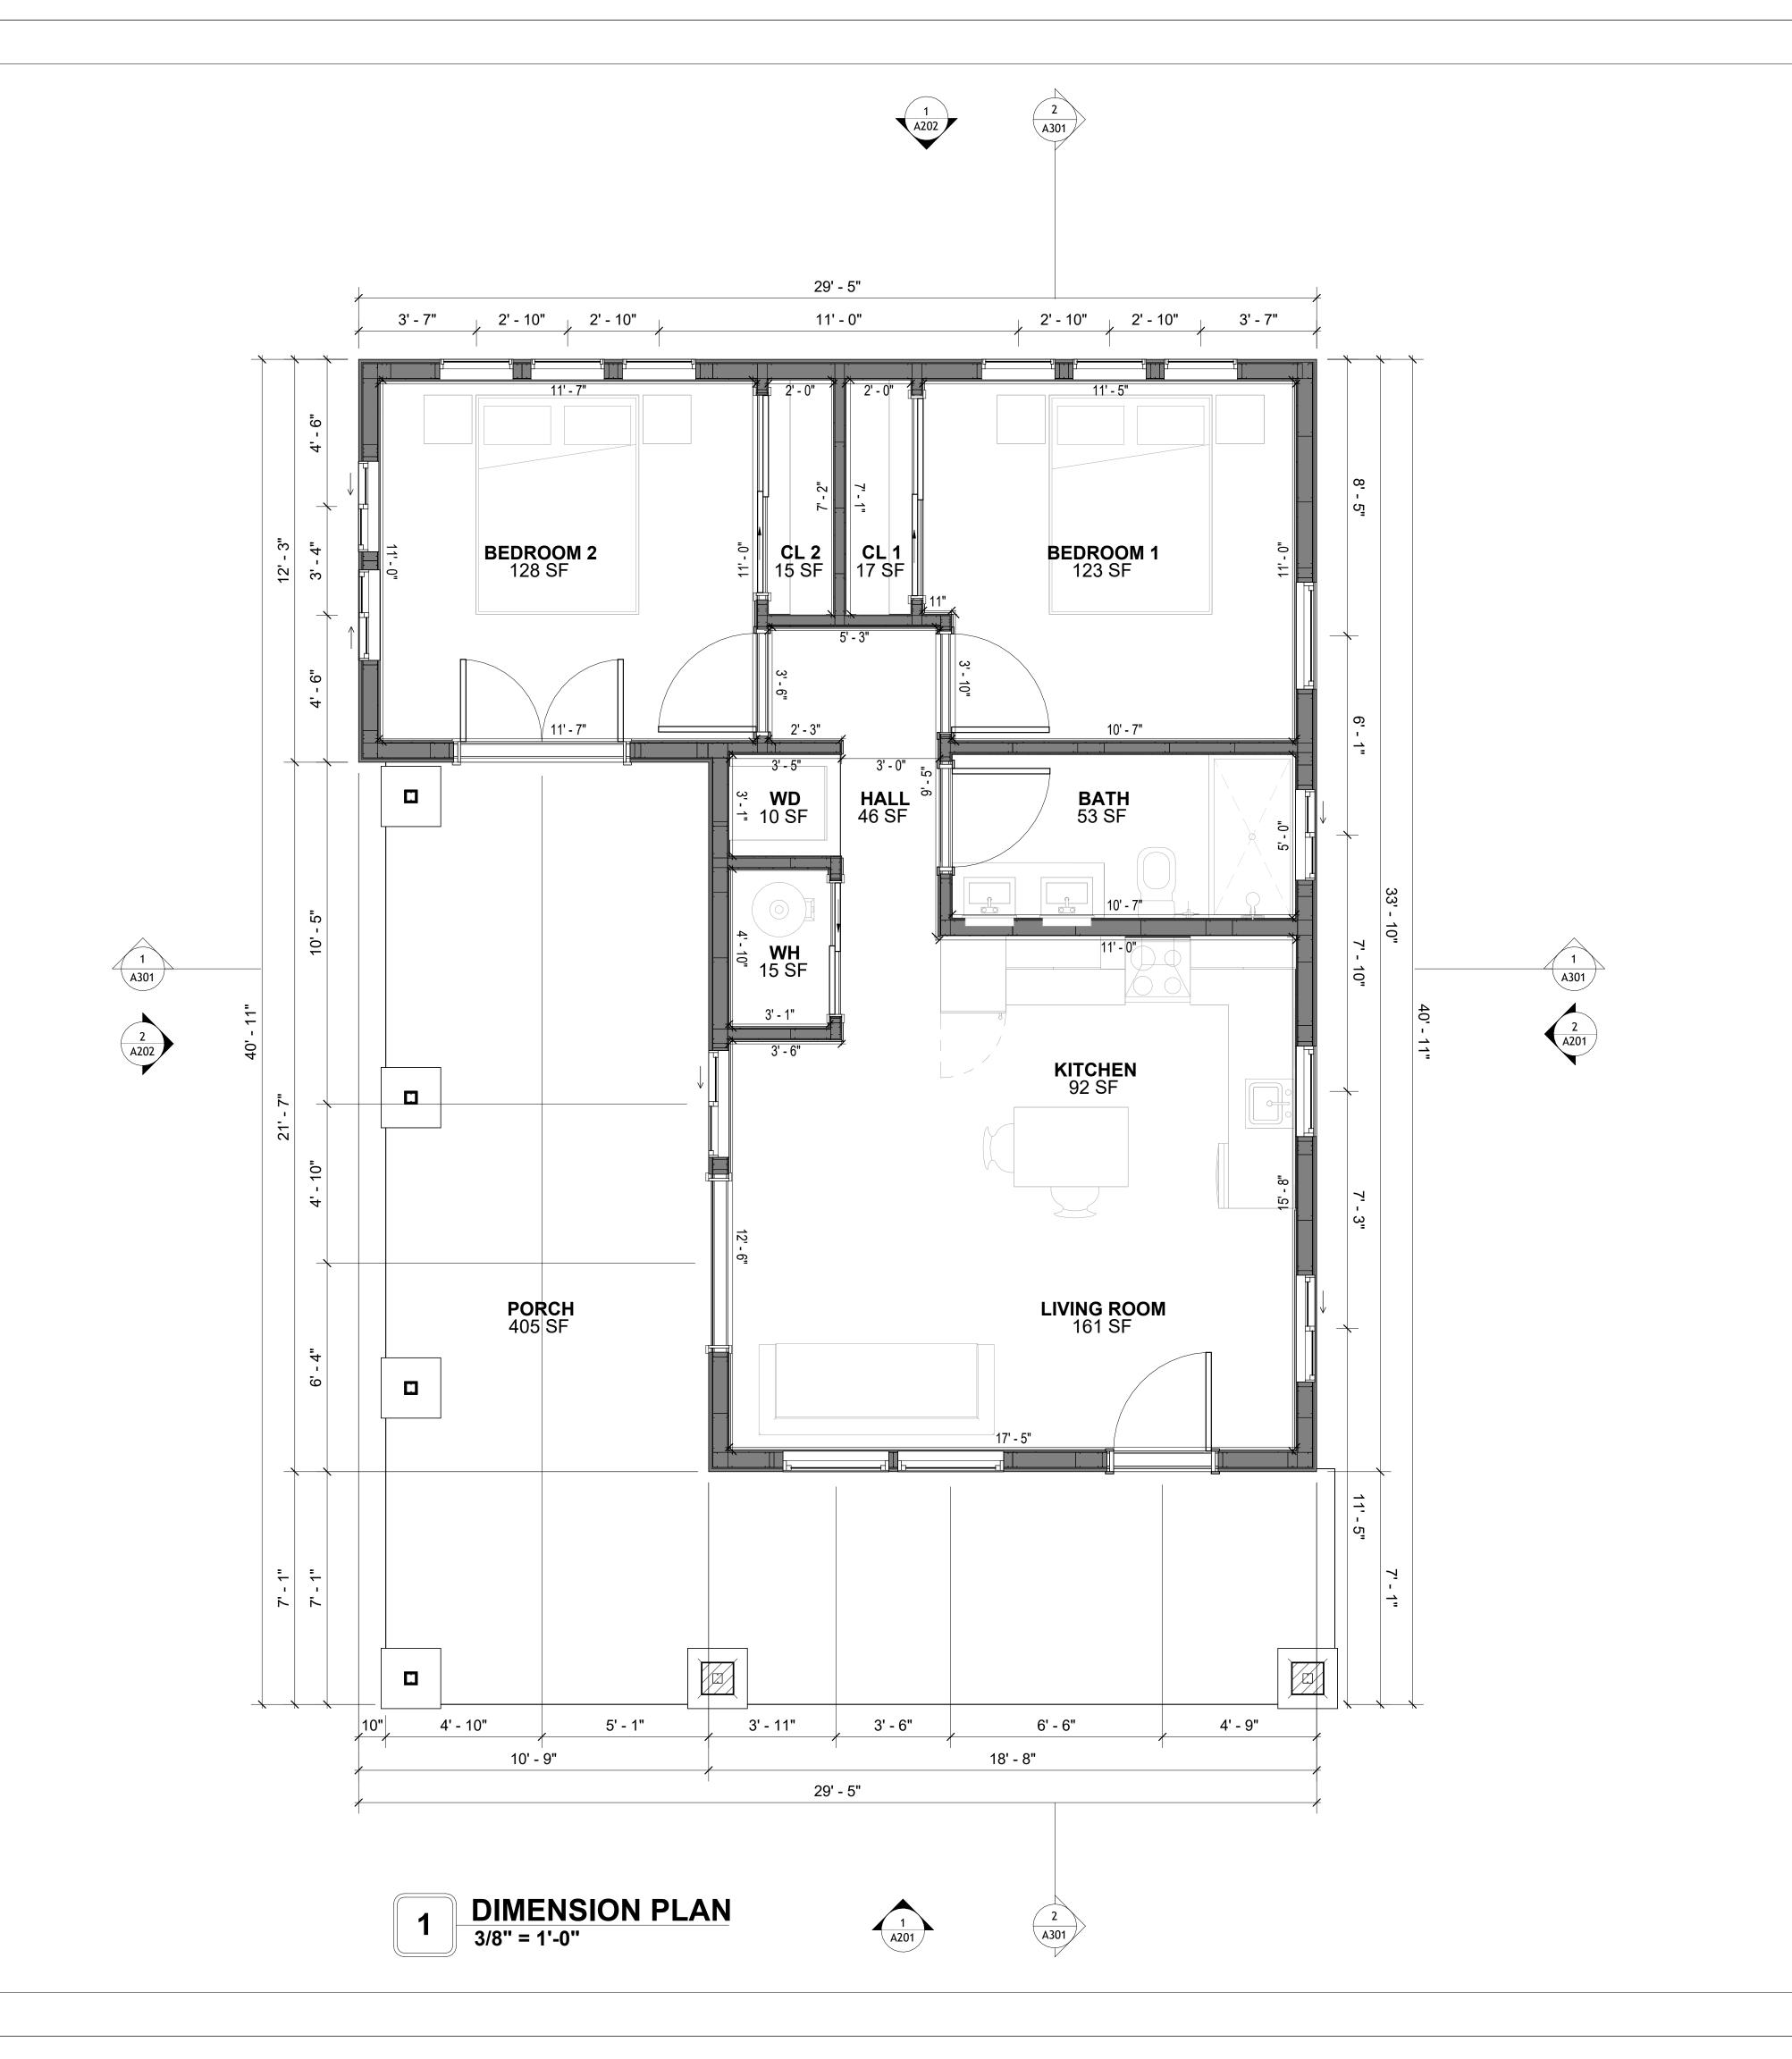



**KEY PLAN** 

NO.	DESCRIPTION	DATE

NOTE:

LEGEND:

PROJECT

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DRAWING NAME

DIMENSION PLAN

CLIENT NAME:	Client Name
PROJECT NUMBER:	0061_12
DATE:	4/23/2025 12:21:08 PM
DESIGNED BY:	Designer
DRAWN BY:	Author
CHECKED BY:	Checker

A102

2015 20" - 410"

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DIMENSIONS IN THE ARCHITECTURAL DRAWINGS CONSIDER FINISHING MATERIALS. FOR PRECISE MEASUREMENTS OF THE STRUCTUAL FRAMING, REFER TO THE ATTACHED STRUCTURAL PLAN SET.

SCALE: 3/8" = 1'-0"

SQUARE FOOTAGE

PORCH

TOTAL

746

394

1140

### **FOUNDATION NOTES**

#### NOTES:

TERMITES PRETREATMENT BY LICENSED CONTRACTOR UNDER SLAB AND AROUND FOOTINGS. ALL AREAS BELOW SLABS SHALL BE TREATED NO MORE THAN 24 HOURS PRIOR TO CONCRETE POUR. EVIDENCE OF TREATMENT MUST BE PROVIDED PRIOR TO PLACING OF CONCRETE.

#### MATERIALS:

ALL INTERIOR CONCRETE SLABS SHALL BE A MIN. OF 4" THICK CONCRETE OVER 4" COMPACTED AGGREGATE BASE (ASTM D698), FINISH ELEVATIONS AS NOTED ON DRAWINGS, 6" ABOVE ADJACENT GRADE, LEVEL SLABS TO 1/8"-10' MAX.. CONCRETE SLABS SHALL BE 2500# PSI AT 28 DAYS. A 4" ALLOWABLE SLUMP.

#### 2. PAD PREPARATION:

EXCAVATION FOR FOOTING SHALL BE NEAT.

- FOOTINGS SHALL BE POURED IMMEDIATELY AFTER EXCAVATION AND APPROPRIATE INSPECTION.

- ALL REINFORCING STEEL MARKED "CONTINUOUS" SHALL BE LAPPED 36 BAR DIAMETERS AT SPLICES AND AROUND CORNERS OR INTERSECTIONS WITH A STANDARD 90 DEGREE BEND ON CORNER BARS. LAP WIRE MESH ONE FULL MESH AT SIDE AND END LAPS.

- ALL HARDWARE TO BE SIMPSON OR EQUIVALENT.
- EXTERIOR FRAME WALL TO BE SECURED WITH 1/2"X10" ANCHOR BOLTS 4'-0" O.C. FOR 1-STORY AND 2'-8" O.C. FOR 2-STORY. BOLTS SHALL BE LOCATED WITHIN 1'-0" OF EACH END

PIECE AND SHALL HAVE A MIN. OF TWO BOLTS PER PIECE.
-FOUNDATION ANCHOR STRAPS SHALL BE PERMITTED, ACCORDING TO RESIDENTIAL CODE

- ALL INTERIOR WALLS TO BE SECURED WITH POWER DRIVEN PINS PER MANUFACTURER

SPECIFICATION USE PIN SPACING EQUIVALENT TO 1/2" ANCHOR BOLTS.
- ALL CONSTRUCTION TO CONFORM TO THE 2012 IRC

- ALL CONSTRUCTION TO CONFORM TO THE 2012 IRC
- R-10 RIGID INSULATION OUTSIDE OF EXTERIOR FOUNDATION WALLS UNDER LIVING AREA.
- CONCRETE PAD FOR CONDENSER THICKNESS IS 4" MIN UNLESS OTHERWISE NOTED.

#### 3. CONCRETE CONSTRUCTION:

- THE SLAB SHALL BE UNDERLAIN BY A VAPOR BARRIER/RETARDER IN THE LIVING AREA (TYPICALLY POLYETHYLENE, UNLESS MORE STRINGENT PROTECTION REQUIRED BY THE ARCHITECT, ENGINEER, FLOOR COVERING MANUFACTURER, OR ACCEPTED PRACTICE). UNLESS OTHERWISE REQUIRED, BARRIER MAY BE OMITTED AT GARAGES, PORCHES AND PATIOS WITHOUT FLOOR COVERINGS. IT IS BEYOND THE SCOPE OF THESE PLANS TO DETERMINE THE APPLICABILITY OF THESE MORE STRINGENT REQUIREMENTS. BUILDER SHALL VERIFY PRIOR TO CONSTRUCTION.

#### 4. REINFORCEMENT:

- IF CONSTRUCTED ON ACTIVE SOILS, THE LONG TERM PERFORMANCE OF THE FOUNDATION IS DEPENDENT ON MAINTENANCE BY THE OWNER. THUS THE BUILDER SHALL ADVISE THE OWNER OF THE FOLLOWING:
- 1. DRAINAGE MUST BE MAINTAINED. WATER SHALL NEVER BE ALLOWED TO POND NEAR THE FOUNDATION.
- 2. THE SOIL AROUND THE FOUNDATION SHALL BE MAINTAINED IN A RELATIVELY DAMP CONDITION, SUCH AS THAT REQUIRED TO KEEP A LAWN GREEN. IF IT DRIES OUT IT WILL
- SHRINK. IF IT GETS WET, IT WILL HEAVE UPWARD.

  3. SLABS ON THE SHORTER SIDE USES MAIN BARS ARE USED IN THIS DIRECTION ONLY
- WITH SMALLER DIAMETER DISTRIBUTION BARS ARE PLACED, FORMING A MAT OR GRID.

  4. ALL REINFORCEMENT BARS SIZE 10MM OR LARGER IN ACCORDANCE TO ASTM


  3. ANCHOR BOLTS AT ALL EXTERIOR WALLS SHALL BE MINIMUM 1/2 INCH DIAMETER WITH A
- MAXIMUM SPACING OF 6'-0" ON CENTER, UNLESS NOTED OTHERWISE.

  4. ANCHOR BOLTS SHALL BE INSTALLED WITHIN 12 INCHES OF EACH END OF EACH SILL
  PLATE WITH AT LEAST TWO ANCHOR BOLTS FOR EACH BOLTS FOR EACH SILL PLATE LONGER
- 5. SIMPSONS SILL ANCHORS MAYBE SUBSTITUTED FOR ANCHOR BOLTS AT THE SAME SPACING.
- 6. EXTERIOR CONCRETE SLABS WHICH ARE NOT PART OF THE MAIN SLAB SHALL BE MINIMUM 4 INCHES THICK WITH NO STEEL REINFORCING BARS REQUIRED, UNLESS NOTED OTHERWISE ON FOUNDATION PLAN.

## VERIFY THE FOLLOWING PRIOR TO POURING:

- 1. ALL HOLDDOWNS , STRAP, AND POST LOCATIONS.
- 2. CONCRETE FINISHES. PANEL RISER LOCATION WHERE APPLICABLE.
- 3. UNDERSLAB MECHANICAL REQUIREMENTS.
- 4. STEM WALL BLOCKOUTS.
- 5. UNDERSLAB ELECTRICAL REQUIREMENTS AND PANEL RISER LOCATION. WHERE APPLICABLE.
- 6. PROVIDE THE FOLLOWING:
- PVC SLEEVES THROUGH FTG IF REQUIRED
   20' #4 COPPER GROUND BAR.
- 20 #4 COPPER GROUND BAR.7. SLOPE FINISH GRADE AWAY FROM FOOTING.

**NOTE**: FIELD VERIFY ALL DIMENSIONS SEE DIMENSIONED ARCHITECTURAL DRAWINGS

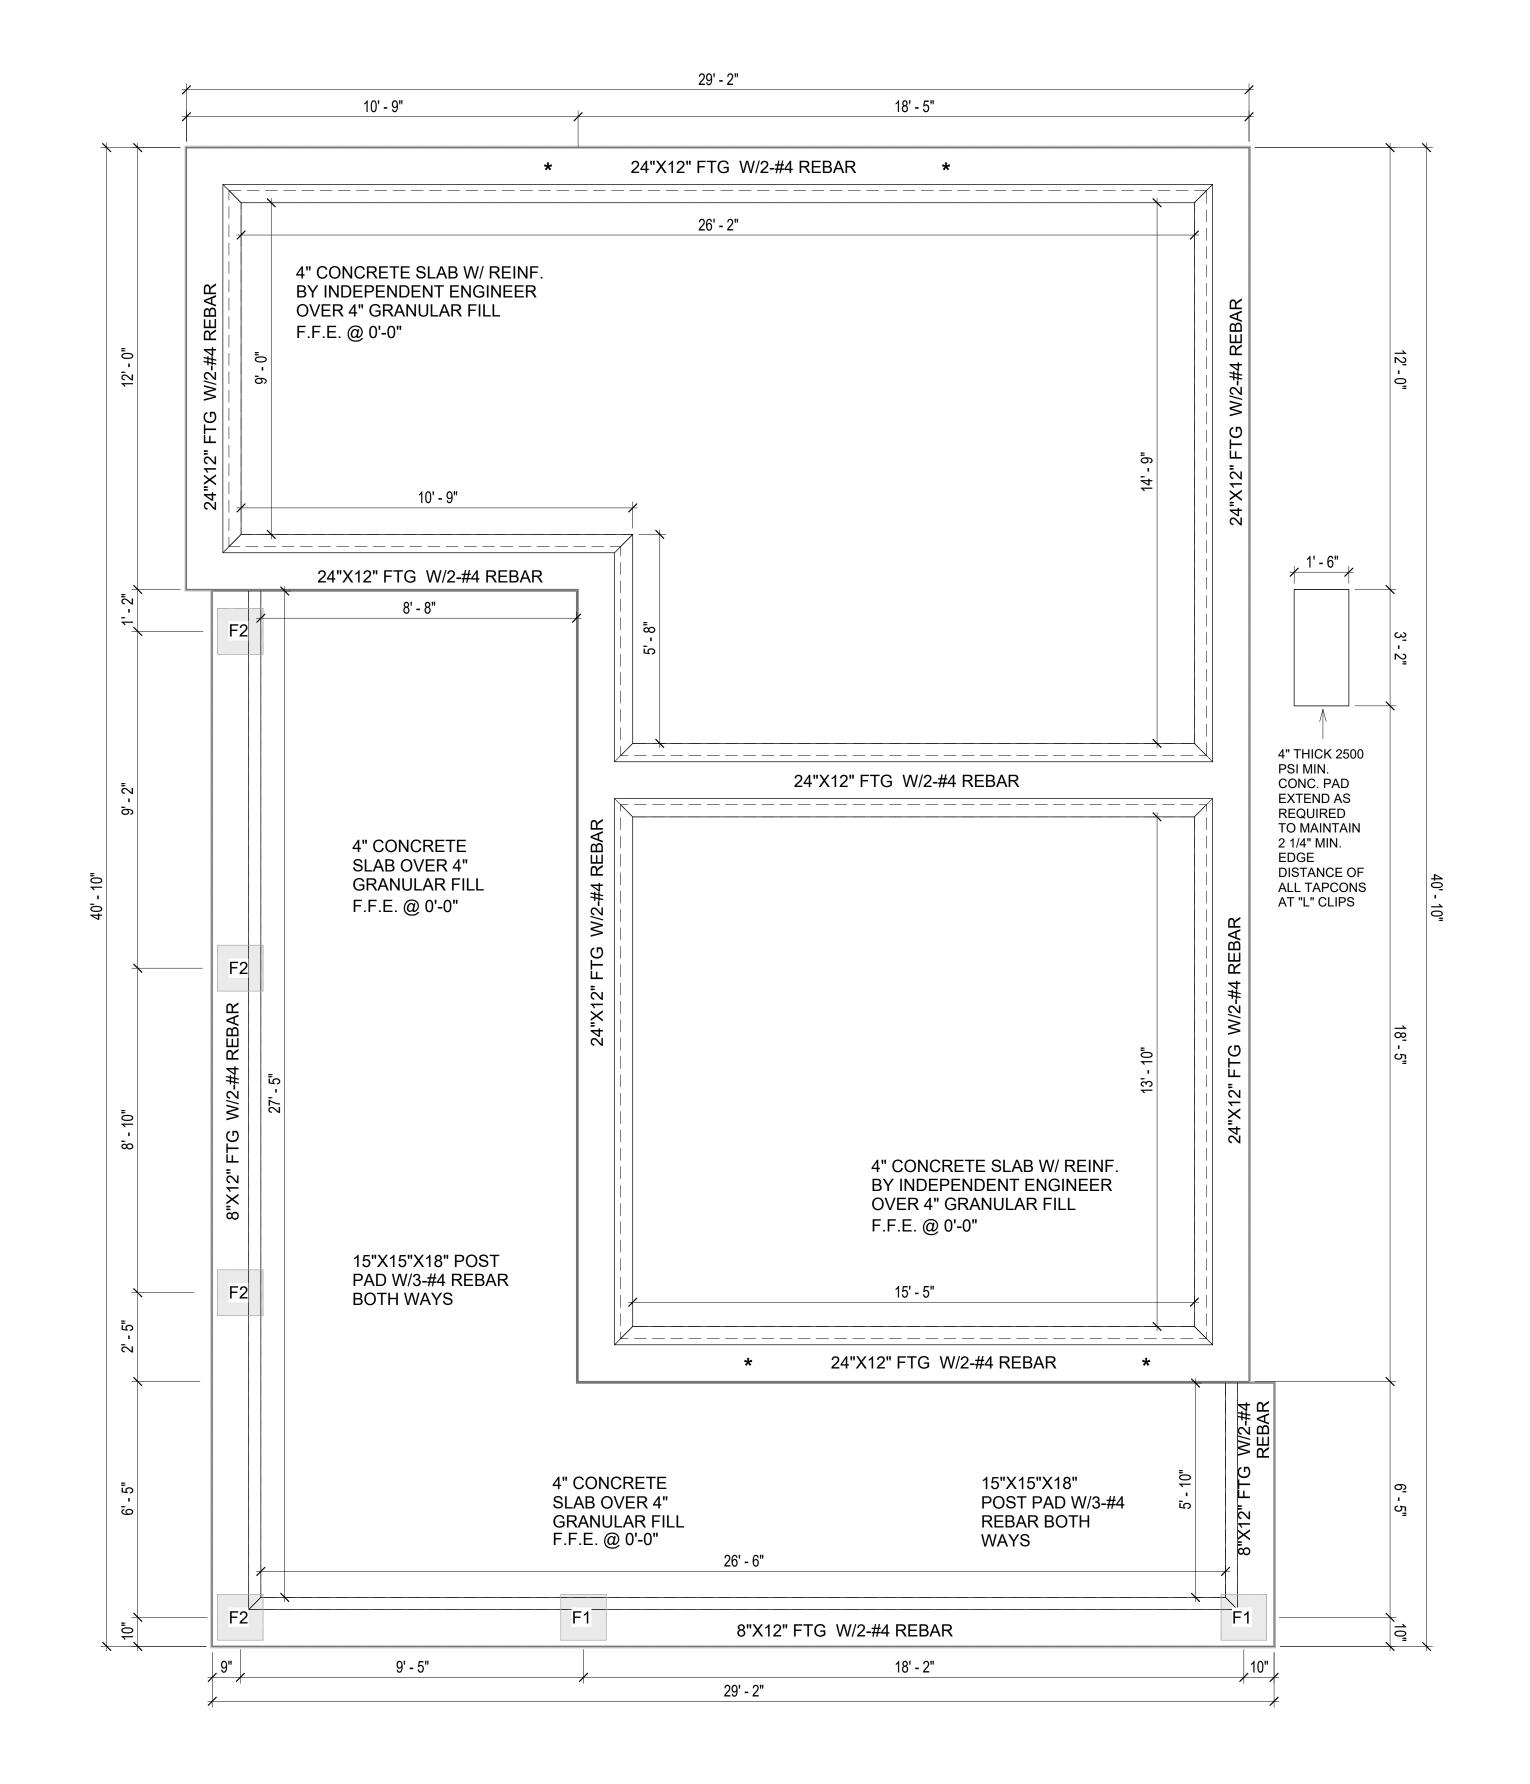

1 FOUNDATION PLAN
3/8" = 1'-0"

SQUARE FOOTAGE

LIVING 746

PORCH 394

TOTAL 1140



**KEY PLAN** 

NO. DESCRIPTION DATE

NOTE:

LEGEND:

PROJECT

189-ORCHARD-746-2Bd1Ba-CRAFTSMAN-550

DRAWING NAME

FOUNDATION PLAN

CLIENT NAME: Client Name
PROJECT NUMBER: 0061\_12

DATE: 4/23/2025 12:21:09 PM
DESIGNED BY: Designer
DRAWN BY: Author
CHECKED BY: Checker

**S101** 

SCALE: 3/8" = 1'-0"

### **GENERAL NOTES**

#### **NOTES:**

-ALL BEARING WALLS SHOULD HAVE A THICKENED SLAB PER SECTION PER DETAIL A401/5.

#### A) FOUNDATION PLAN NOTES:

- 1. CONCRETE SLAB SHALL BE 6" THICK WITH 1/2" DIAMETER TENDONS PER LAYOUT PLAN, CENTERED IN SLAB THICKNESS, OVER APPROVED SUBBASE PER GENERAL STRUCTURE NOTES.
- TERMITE PROTECTION SHALL BE PROVIDED PER IRC SECTION R318.1
   NONE TYPICAL ANCHOR BOLT SPACING AT SHEAR WALL AND HOLD DOWN
- SPECIFICATIONS PER APPROVED ARCHITECTURAL PLANS.
- INSTALL HOLDOWNS BEFORE CONCRETE SLAB POUR.
   EXISTING FILL ON-SITE SHALL BE COMPACTED IN ACCORDANCE WITH THE
- REQUIREMENTS IN THE GEOTECHNICAL REPORT.
- 6. ALL FLOOR SLABS ARE REINFORCED ON CONCRETE SLABS.

#### SPECIAL INSPECTION IS REQUIRED FOR THICKENED FOUNDATION CONSTRUCTION

- 1. REINFORCEMENT
- 2. 2300 PSI CONCRETE POUR

#### B) REINFORCEMENT FOR CONCRETE:


 ALL REINFORCING SLABS BARS SIZE 10MM OR LARGER SHALL BE DEFORMED IN ACCORDANCE TO ASTM-A706, AND BARS SMALLER THAN 10 MM MAYBE PLAIN.
 UNLESS OTHERWISE NOTED IN PLANS, THE YIELD STRENGTH OF REINFORCING BARS SHALL BE:


> A) FOOTING = 40,000 PSI B) NON-LOAD BEARING WALLS AND PARAPETS= 40,000 PSI

- 3. SPLICES SHALL BE SECURELY WIRED TOGETHER AND SHALL LAP OR EXTEND
- 4. GRADE OF STEEL FOR RCC WORKS SHALL BE GRADE 4 10.
- 5. BAR NOTATIONS GIVES INFORMATION
- A) BAR SIZE
- B) SPACING(IF REQUIRED)
- 6. LAP REINFORCEMENT ONLY AT LOCATION SHOWN IN THE DRAWINGS
- 7. REINFORCEMENT SHALL NOT BE CUT, VENT OR HEATED ON SITE WITHOUT ENGINEERS' APPROVAL.
- C) CONCRETE SLAB NOTES
- 1. ALL SLAB REINFORCEMENT SHALL BE 20MM CLEAR MINIMUM FROM BOTTOM AND FROM TOP OF SLAB.
- 2. REINFORCEMENT IN CONTINUOUS ELEVATED SLAB SHALL BE CUT AS FOLLOWS.

#### NOTE

- THIS IS A SCHEMATIC PLAN FOR THE PURPOSE OF LOCATING AND IDENTIFYING FOUNDATION REINFORCING ELEMENTS ONLY. VERIFY ALL DIMENSIONS, DROPS, OFFSETS AND FEATURES WITH THE ARCHITECTURAL PLANS BEFORE FORMING THE FOUNDATION.

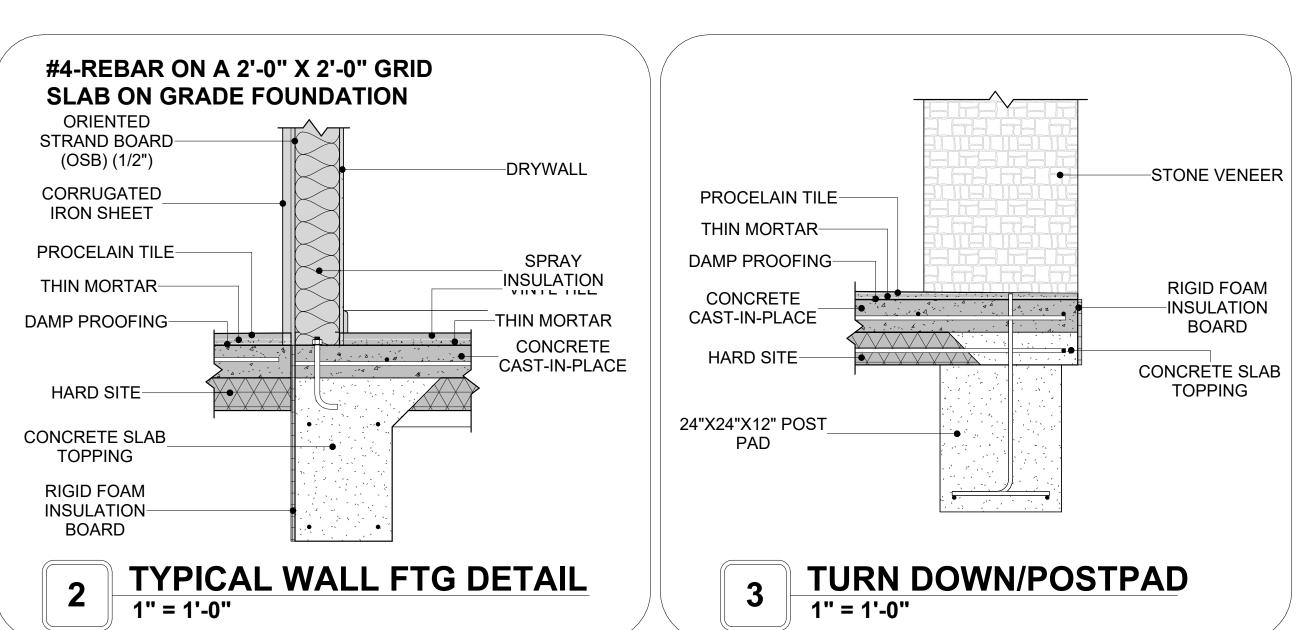

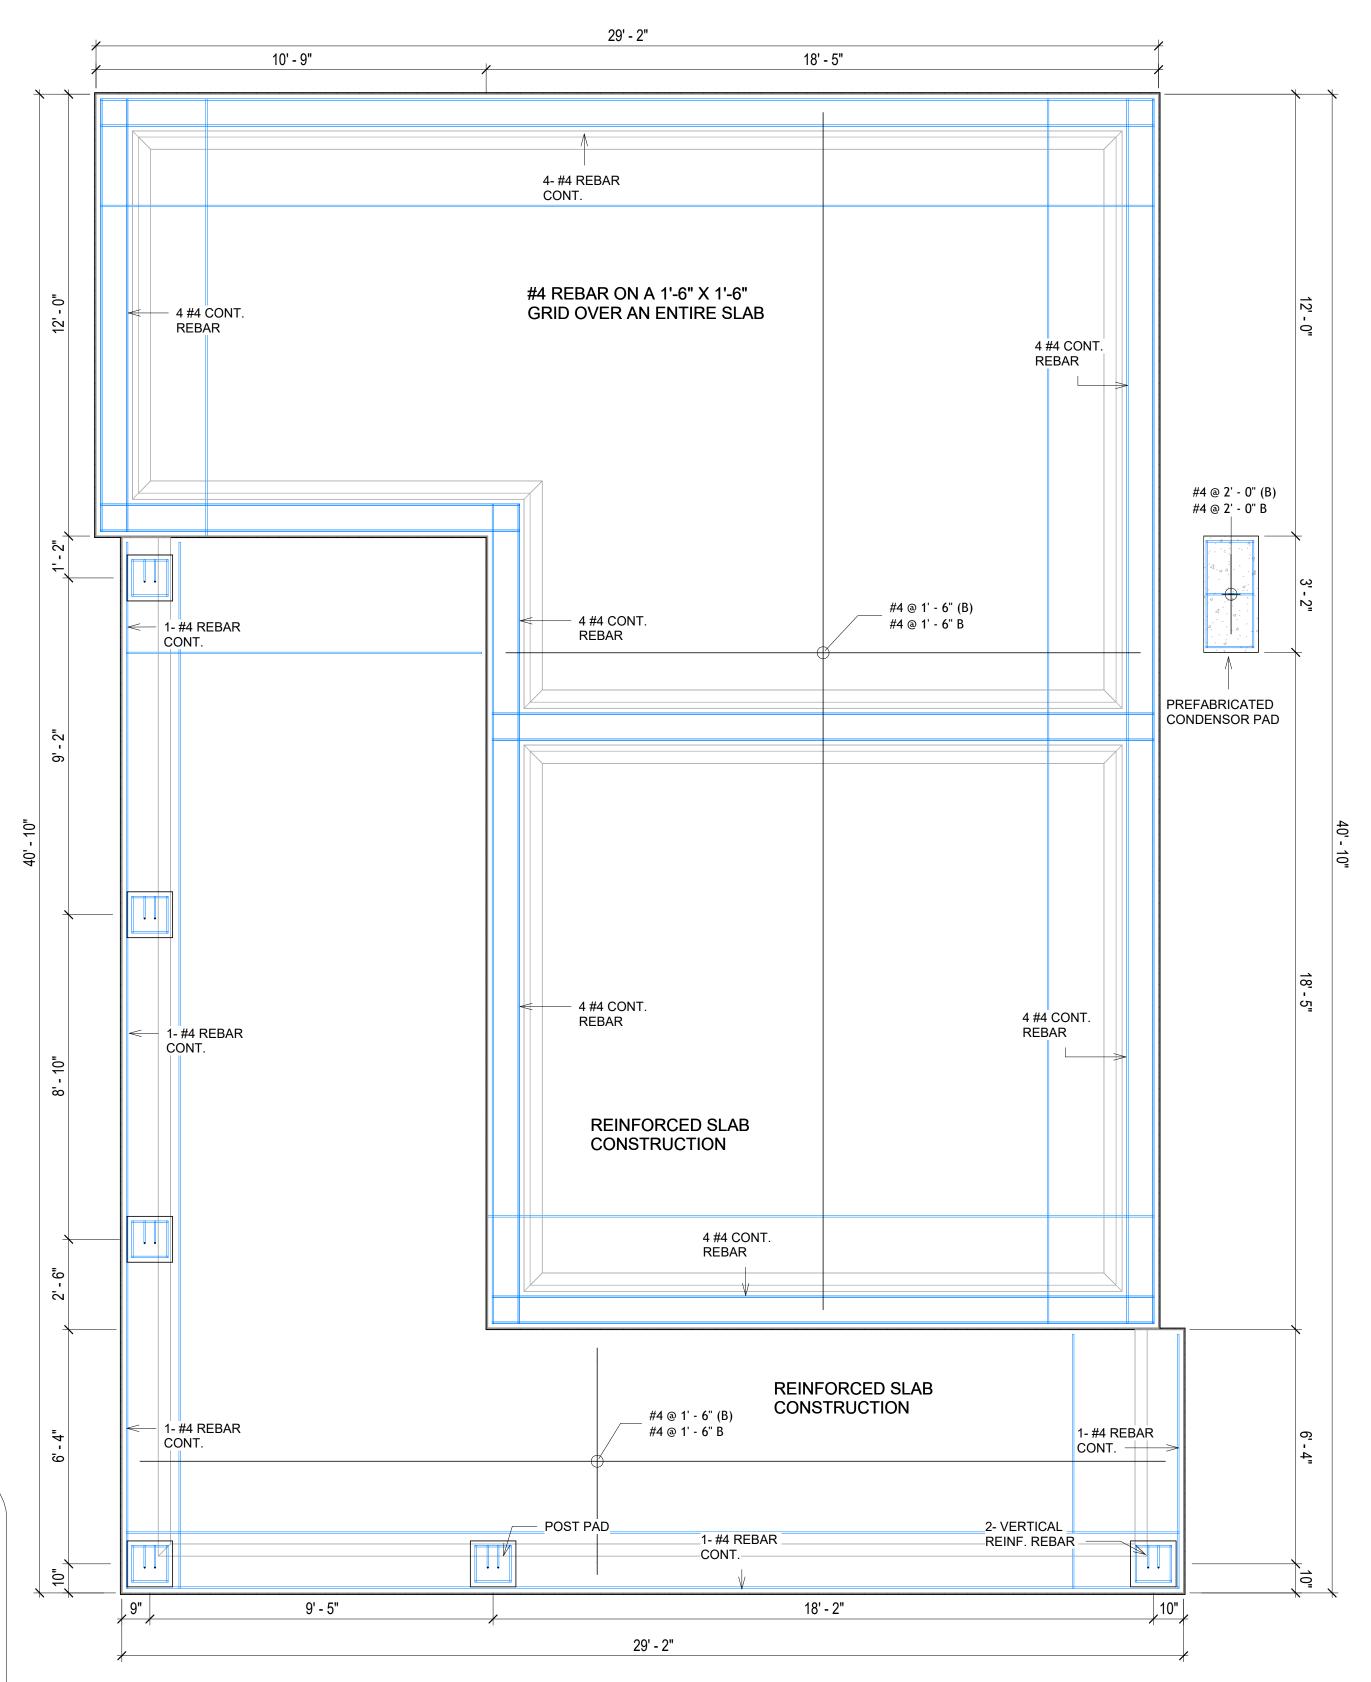

1 FOUNDATION REBAR PLAN
3/8" = 1'-0"



**KEY PLAN** 

NO.	DESCRIPTION	DATE

NOTE:

LEGEND:

PROJECT

189-ORCHARD-746-2Bd1Ba-CRAFTSMAN-550

DRAWING NAME


STRUCTURAL FLOOR PLAN

Client Name	CLIENT NAME:
0061_12	PROJECT NUMBER:
4/23/2025 12:21:10 PM	DATE:
Designer	DESIGNED BY:
Author	DRAWN BY:
Checker	CHECKED BY:

**S102** 

## **ROOF NOTES**

- 1. ROOFING COMPOSITION ROOFING PER OWNERS/BUILDERS SPECIFICATIONS INSTALL PER MANUFACTURE SPECIFICATIONS ON 1/2" ORIENTED STRAND BOARD ON PRE-ENGINEERED TRUSS @ 24" O.C. (UNO.)
- 73" OVERHANG AT EAVES (UNO.)
   ENDS OF ALL TRUSSES AND JOISTS TO BE FULLY BLOCKED. PROVIDE SOLID BLOCKING AT ALL RIDGES AND VALLEYS
- 4. SHEATHING TO BE 1/2", 3/8" OSB SHEAR PANEL AND EQUIVALENT. UNDERSIDE OF PORCH TRUSSES TO BE FINISHED WITH MOISTURE RESISTANT DRYWALL, TAPED AND TEXTURED.
- EXPOSED EAVES AND OTHER WEATHER EXPOSED AREAS TO BE SHEATHED WITH EXTERIOR GRADE PLYWOOD.
- 6. ALL MATERIALS THICKNESS AND SIZE ARE THE MINIMUM. Refer TO LOCAL STANDARDS FOR ACTUAL THICKNESS AND LAYERING OF MATERIALS.
- 7. ENGINEERED TRUSS CALCULATIONS TO BE SUBMITTED TO BUILDING DEPARTMENT PRIOR TO FABRICATION AND INSTALLATION.
- 8. TRUSS MANUFACTURER TO SPECIFY HANGER CONNECTORS FOR TRUSS COMPONENTS (TYPICAL)
- DESIGNER ASSUMES THAT TRUSSES BEAR ON ALL EXTERIOR PERIMETER WALLS (TYPICAL) OR BEAMS.
- 10. PROVIDE GALVANIZED STEEL FLASHING WITH A LENGTH OF 10 FEET, WIDTH OF 12 INCHES, AND THICKNESS OF 24 GAUGE.

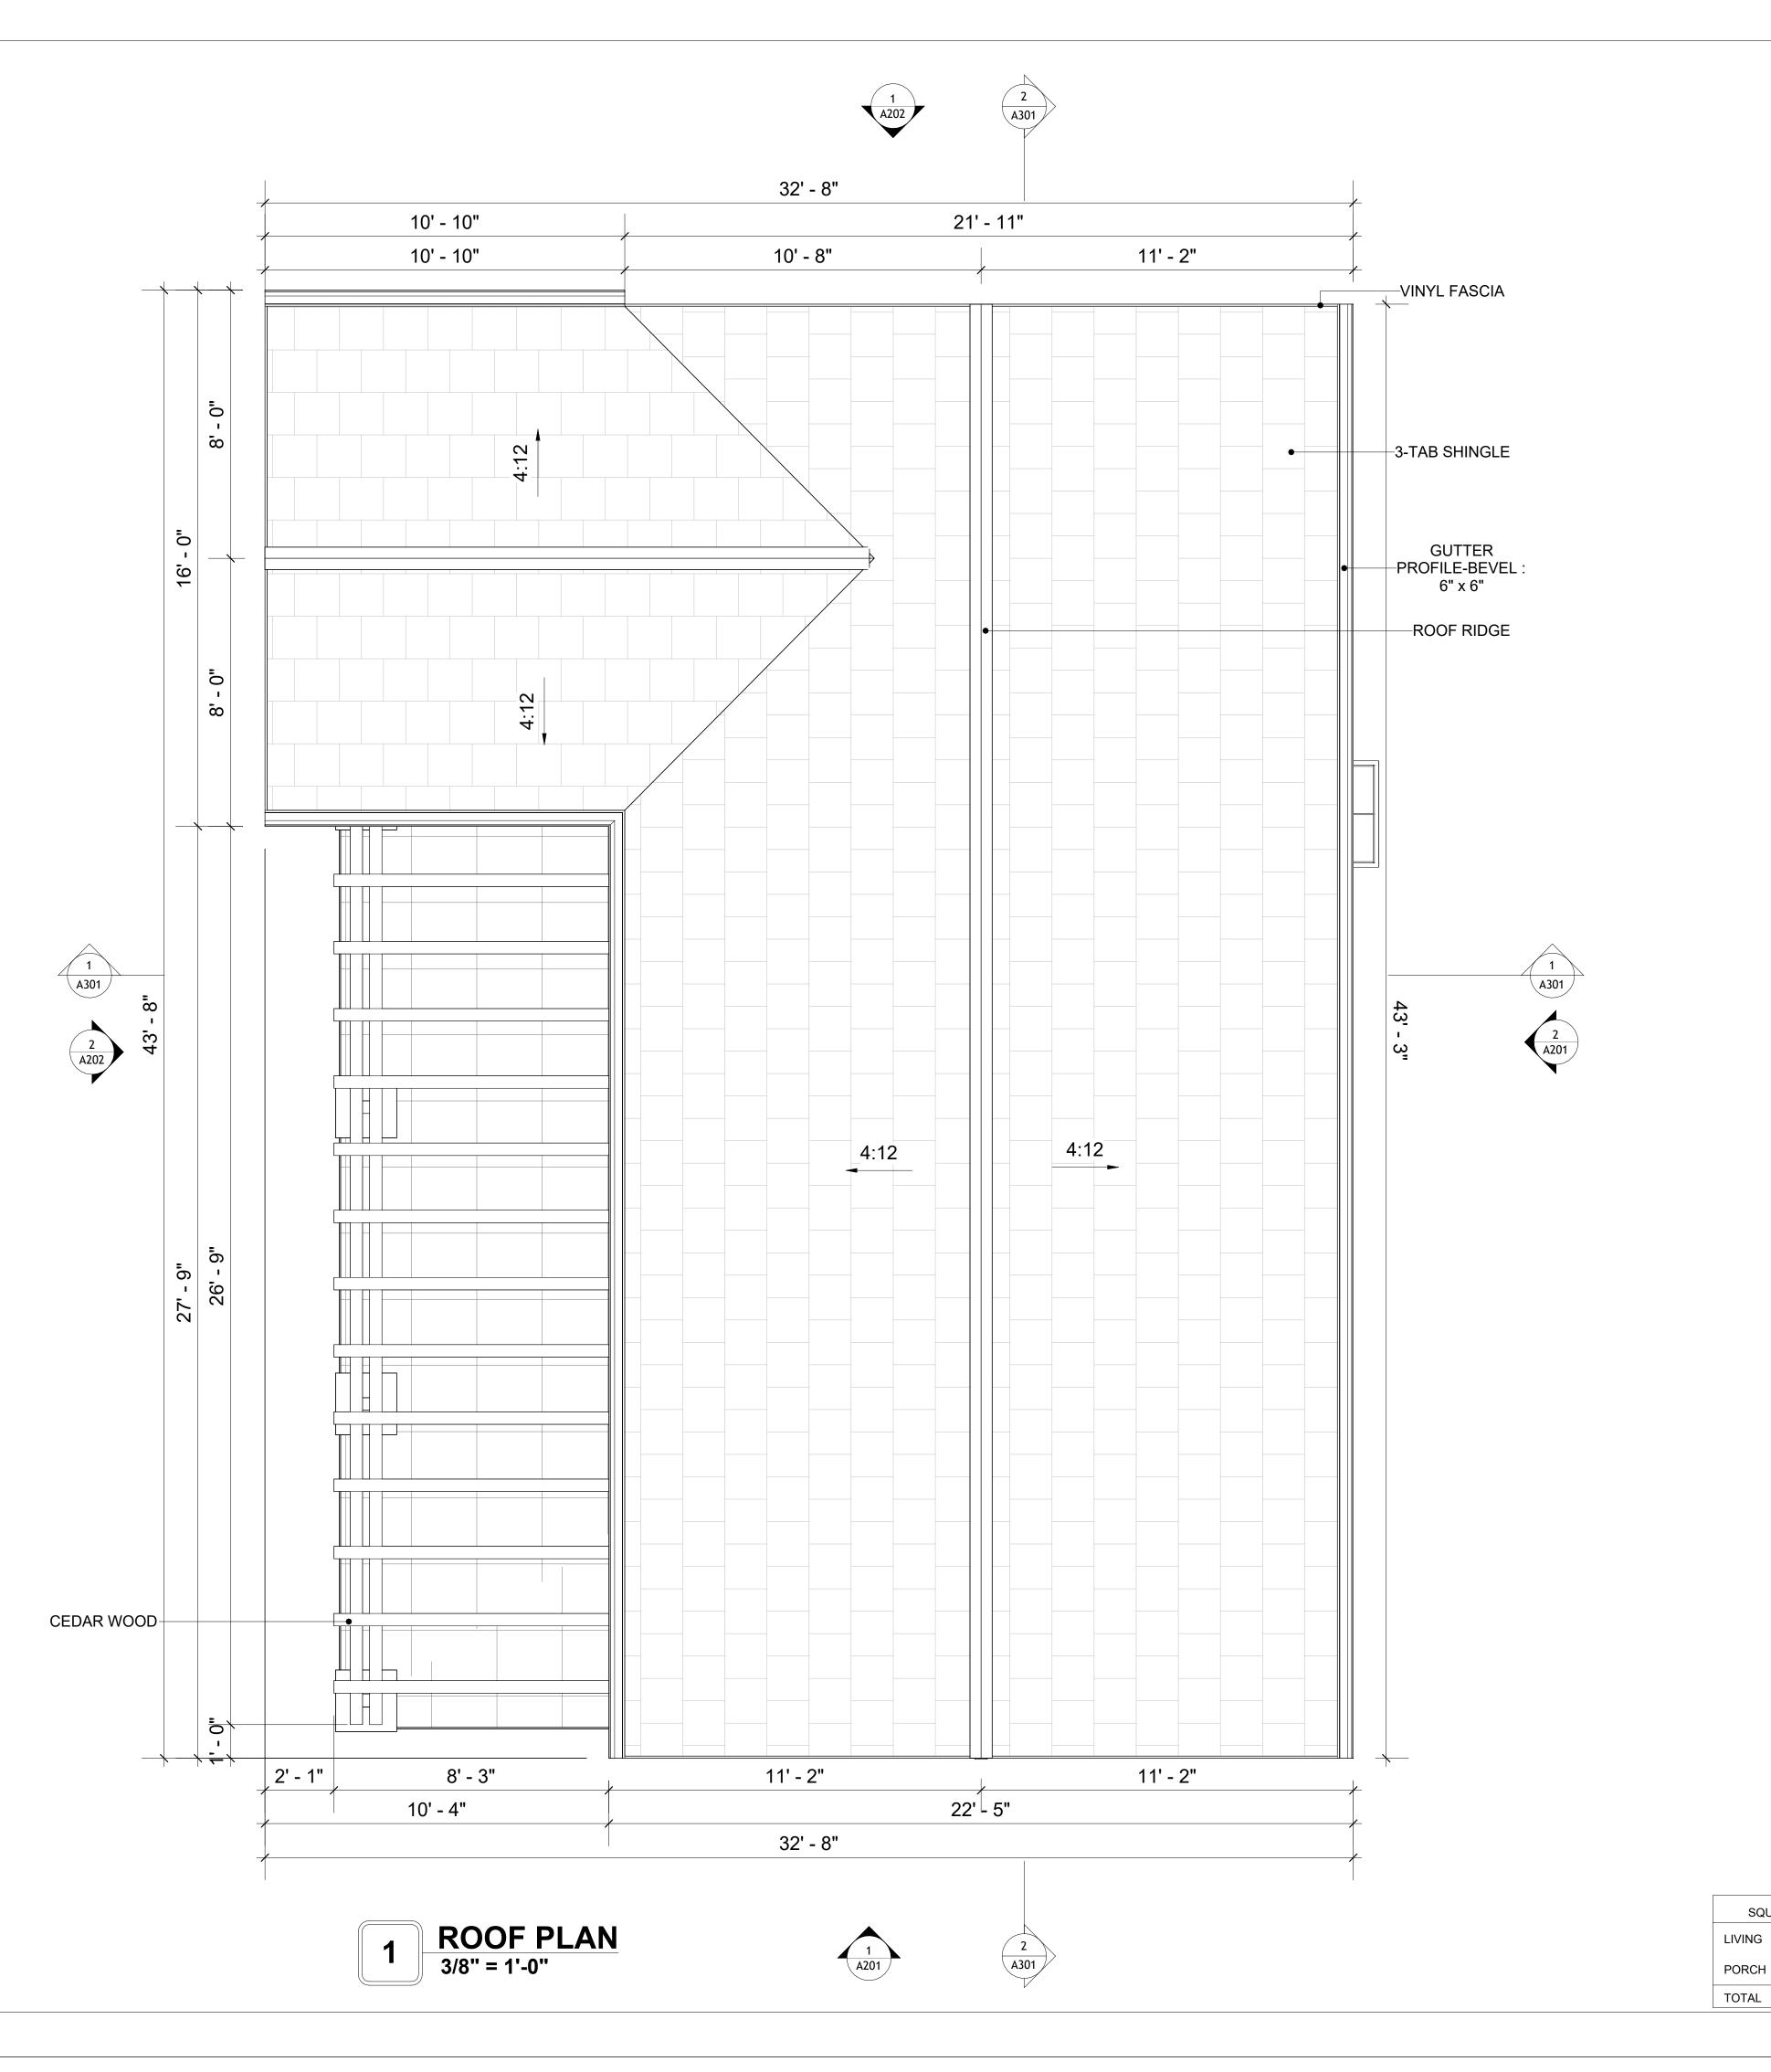



**KEY PLAN** 

NO.	DESCRIPTION	DATE	

NOTE:

LEGEND:

PROJECT

189-ORCHARD-746-2Bd1Ba-CRAFTSMAN-550

DRAWING NAME

ROOF PLAN

CLIENT NAME:	Client Name
PROJECT NUMBER:	0061_12
DATE:	4/23/2025 12:21:12 PM
DESIGNED BY:	Designer
DRAWN BY:	Author
CHECKED BY:	Checker

A103

SCALE: As indicated

SQUARE FOOTAGE

746

394

1140

## **ABOUT WALL FINISHING**

#### **CORRUGATED IRON SHEET**

CORRUGATED IRON IS A FINISHING MATERIAL MADE FROM STEEL THAT HAS BEEN GALVANIZED (COATED WITH A THIN LAYER OF ZINC) TO PROTECT IT FROM CORROSION AND RUST.

IN THIS SPECIFIC PROJECT, THE CORRUGATED IRON SHEETS ARE INSTALLED HORIZONTALLY ON VERTICAL FURRING STRIPS THAT ARE DIRECTLY ATTACHED ONTO THE PROPERLY INSTALLED AND SEALED HOME WRAP, USING SELF-DRILLING SCREWS THAT ARE DRIVEN THROUGH THE RIDGES OR VALLEYS OF THE CORRUGATIONS.

#### **CEDAR WOOD**


CEDAR WOOD REFERS TO THE WOOD FROM VARIOUS SPECIES OF CEDAR TREES, WHICH ARE CONIFEROUS EVERGREEN TREES KNOWN FOR THEIR DISTINCT AROMA AND NATURAL RESISTANCE TO DECAY AND INSECTS. IN THIS SPECIFIC PROJECT, CEDAR WOOD IS USED AS A FURRING STRIP AND A FINISH MATERIAL ON BEAMS AND COLUMNS.

CEDAR WOOD AS A FURRING STRIPS PROVIDE THERMAL INSULATION, MOISTURE MANAGEMENT, AND AN AESTHETICALLY PLEASING, VERSATILE FRAMING SOLUTION WHEN INTEGRATED WITH CORONADO STONE AND CORRUGATED IRON SHEET CLADDING.
THE VERTICAL CEDAR WOOD FURRING STRIPS ARE ATTACHED TO HOME WRAP USING CORROSION-RESISTANT FASTENERS (HOT DIP GALVANIZED SCREWS), ENSURING PROPER PENETRATION INTO THE WALL FRAMING


#### STONE VENEER

STONE VENEER REFERS TO THIN LAYERS OF NATURAL OR MANUFACTURED STONE APPLIED TO A STRUCTURAL WALL, KNOWN FOR THEIR REALISTIC APPEARANCE AND RELATIVE LIGHTNESS. THESE VENEERS PROVIDE THE AESTHETIC OF STONE WITHOUT THE COST AND WEIGHT OF FULL STONE CONSTRUCTION, CONTRIBUTING TO A BEAUTIFUL AND COSTEFFECTIVE EXTERIOR FINISH.

IN THIS SPECIFIC PROJECT, STONE VENEER IS USED A FINISH MATERIAL ON EXTERIOR FINISH.

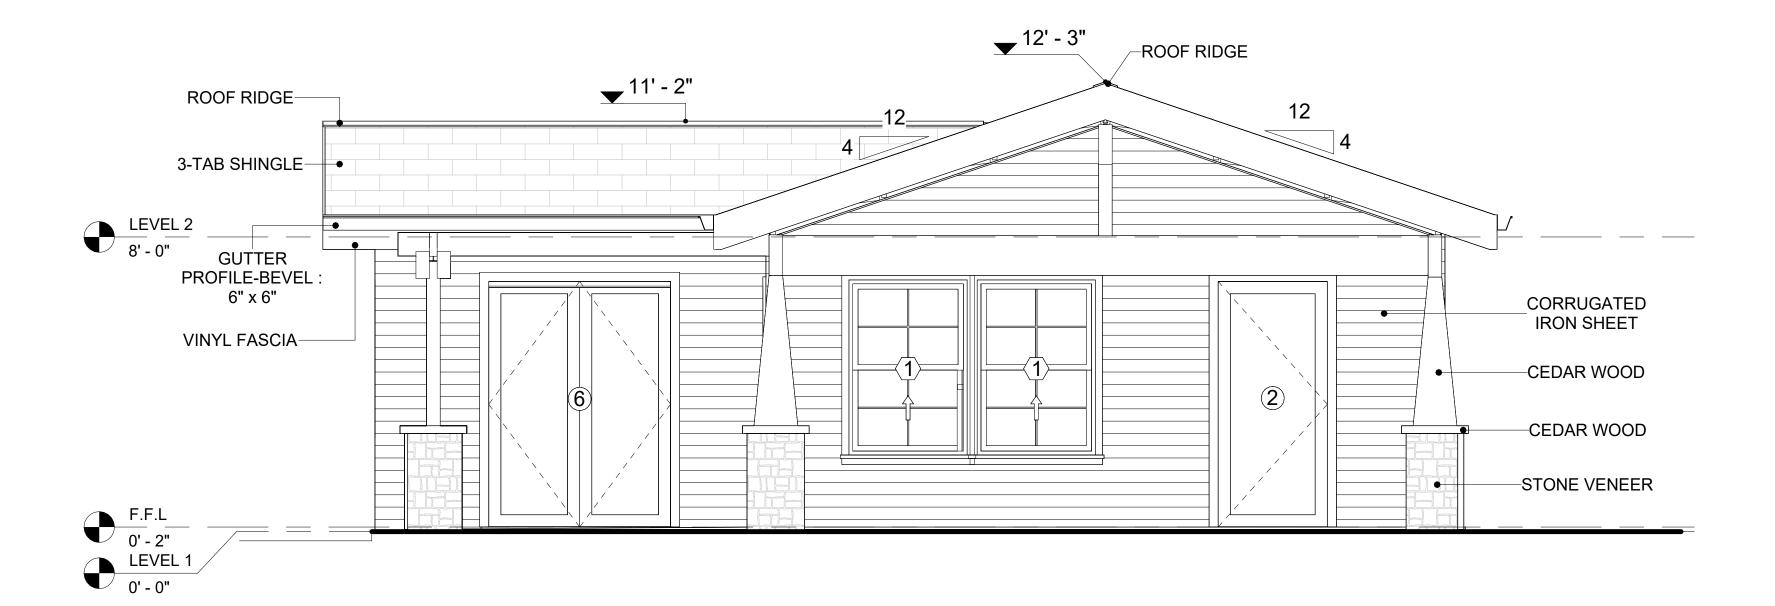

1 FRONT ELEVATION
3/8" = 1'-0"

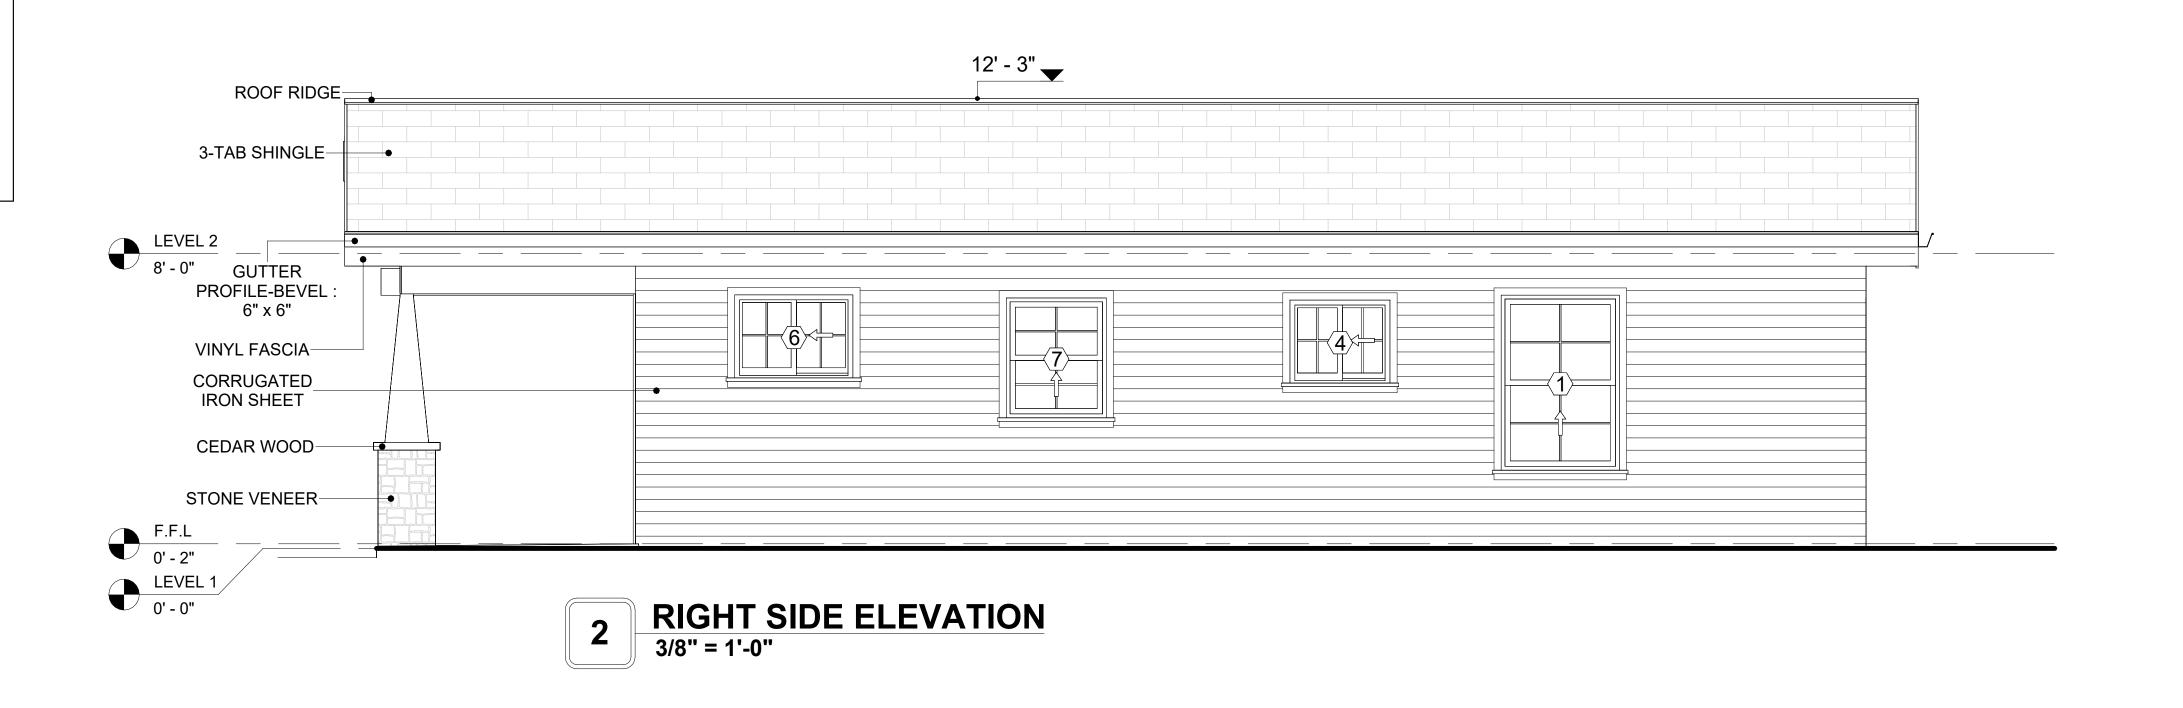


DOOR SCHEDULE						
TYPE			5			
MAR			LOCATIO			
K	SUPPLIER	DOOR TYPE	N	WIDTH	HEIGHT	COUNT
			·			
1	HOME DEPOT	INTERIOR SINGLE PANEL SWINGING	INTERIOR	3' - 0"	6' - 8"	1
2	HOME DEPOT	EXTERIOR SINGLE PANEL SWINGING	INTERIOR	3' - 0"	6' - 8"	1
3	HOME DEPOT	INTERIOR DOUBLE PANEL SLIDING	INTERIOR	6' - 0"	6' - 8"	2
4	HOME DEPOT	INTERIOR SINGLE PANEL SWINGING	INTERIOR	3' - 0"	6' - 8"	2
5	HOME DEPOT	INTERIOR DOUBLE PANEL SLIDING	INTERIOR	4' - 0"	6' - 8"	1
6	HOME DEPOT	EXTERIOR DOUBLE PANEL SWINGING	INTERIOR	5' - 0"	6' - 8"	2

WINDOW SCHEDULE					
				SIZE	
TYPE MARK	SUPPLIER	WINDOW TYPE	WIDTH	HEIGHT	COUNT
1	HOME DEPOT	SINGLE HUNG	3' - 3"	4' - 9"	3
2	HOME DEPOT	FIXED	2' - 3"	2' - 9"	6
3	HOME DEPOT	SLIDING	2' - 9"	4' - 3"	2
4	HOME DEPOT	SLIDING	2' - 9"	2' - 3"	1
5	HOME DEPOT	SLIDING	3' - 3"	3' - 3"	1
6	HOME DEPOT	SLIDING	3' - 3"	2' - 3"	1
7	HOME DEPOT	SINGLE HUNG	2' - 9"	3' - 3"	1



KEY PLAN

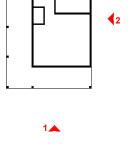

NO. DESCRIPTION DATE

NOTE:

LEGEND:

PROJECT

189-ORCHARD-746-2Bd1Ba-CRAFTSMAN-550

DRAWING NAME

ARCHITECTURAL ELEVATIONS

CLIENT NAME:

PROJECT NUMBER:

0061\_12

DATE:

4/23/2025 12:21:16 PM

DESIGNED BY:

DRAWN BY:

CHECKED BY:

Checker

A201

## **ABOUT WALL FINISHING**

#### **CORRUGATED IRON SHEET**

CORRUGATED IRON IS A FINISHING MATERIAL MADE FROM STEEL THAT HAS BEEN GALVANIZED (COATED WITH A THIN LAYER OF ZINC) TO PROTECT IT FROM CORROSION AND RUST.

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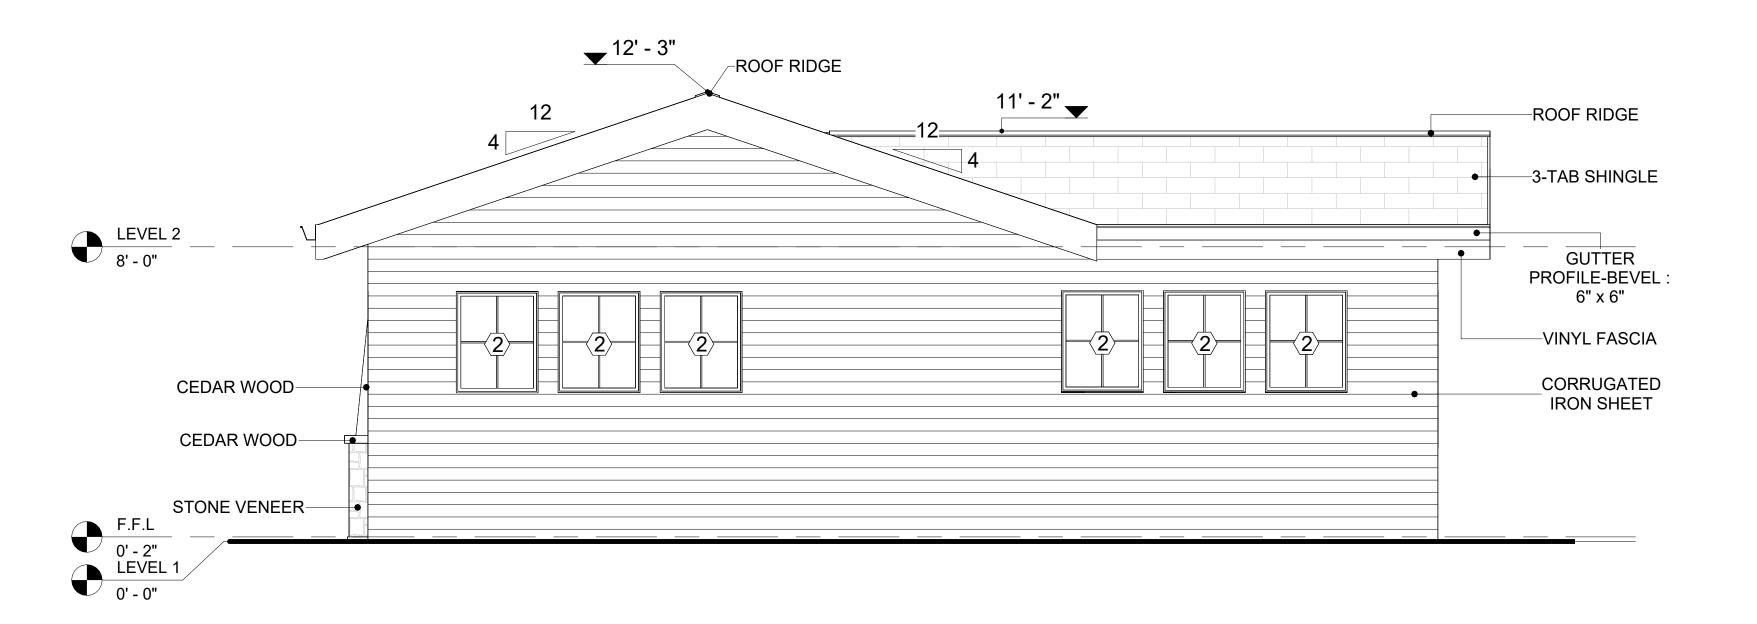
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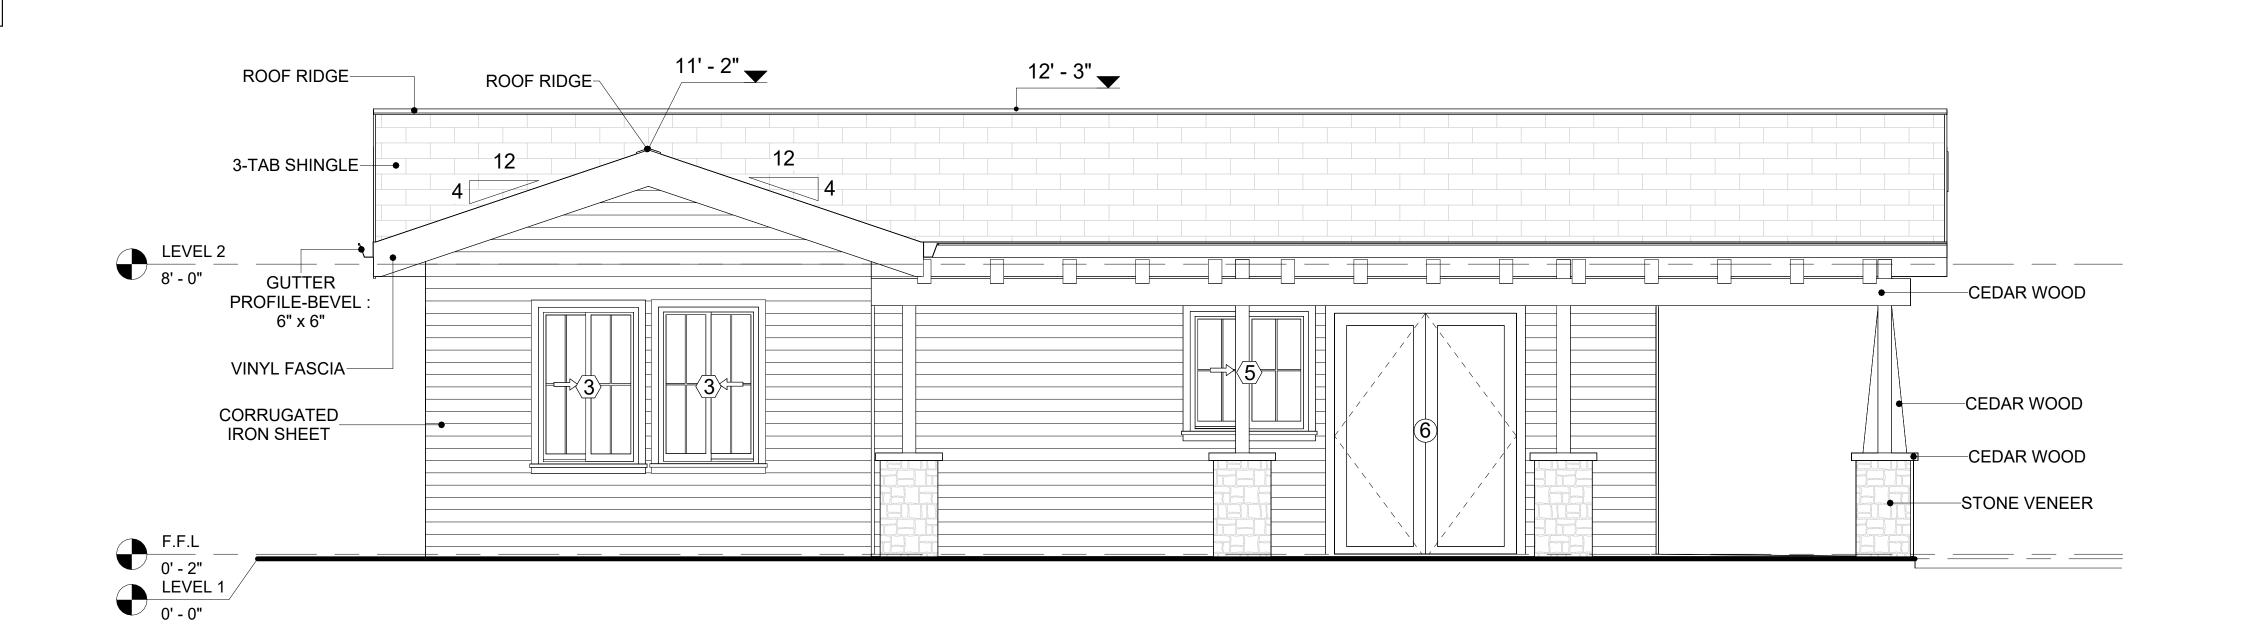
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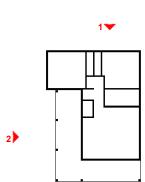
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2 LEFT SIDE ELEVATION
3/8" = 1'-0"



KEY PLAN



NO.	DESCRIPTION	DATE

NOTE:

LEGEND:

PROJECT

189-ORCHARD-746-2Bd1Ba-CRAFTSMAN-550

DRAWING NAME

ARCHITECTURAL ELEVATIONS

CLIENT NAME:

PROJECT NUMBER:

0061\_12

DATE:

4/23/2025 12:21:19 PM


DESIGNED BY:

DRAWN BY:


CHECKED BY:

Checker

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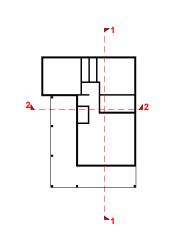
1 SECTION-1 3/8" = 1'-0"

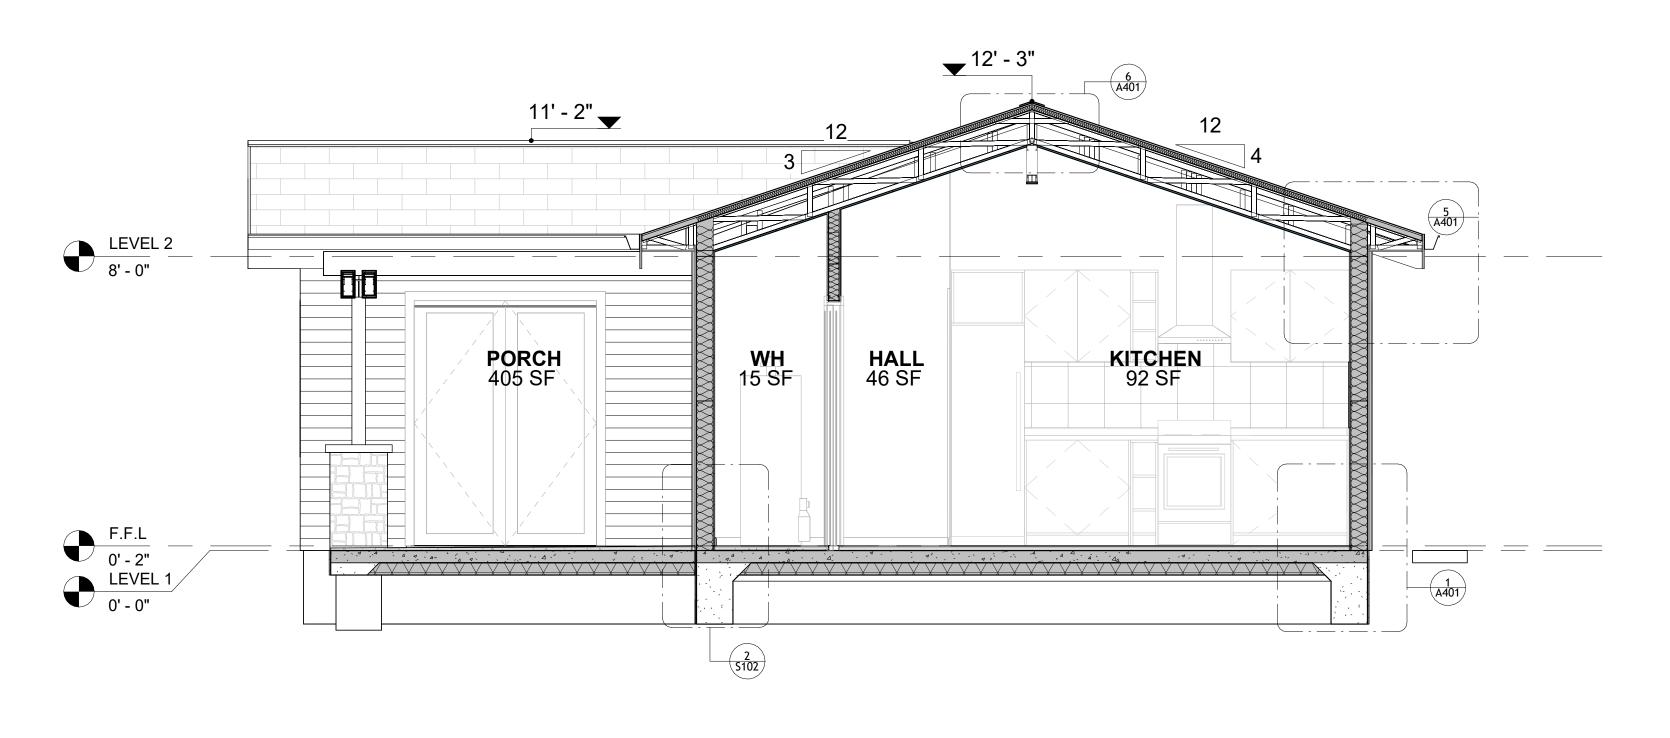

2 SECTION-2 3/8" = 1'-0"

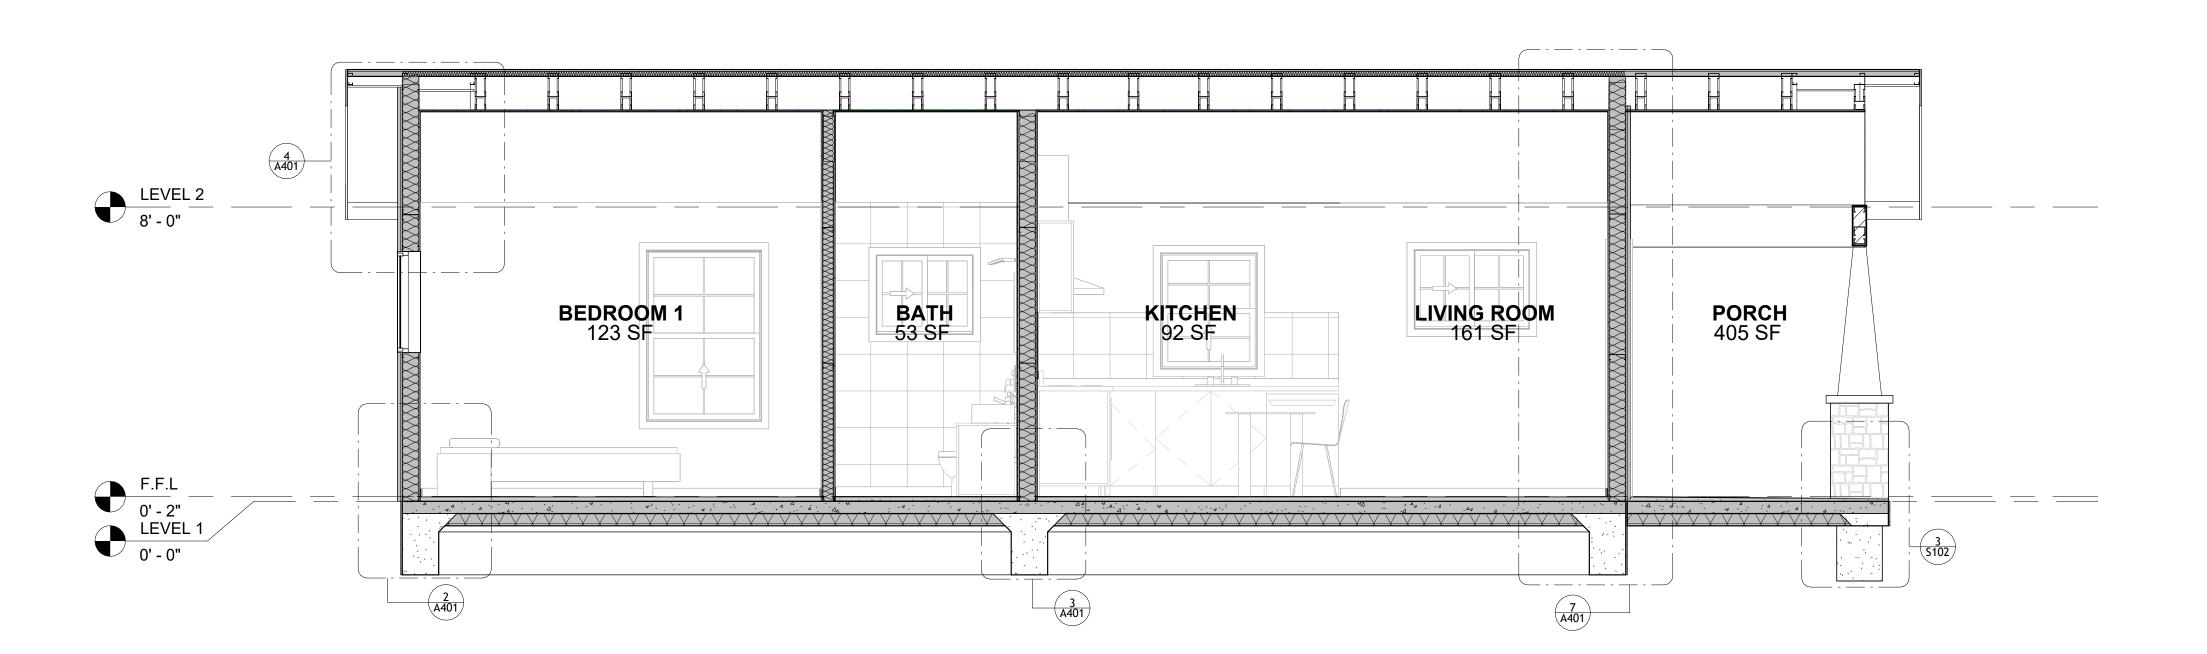

**KEY PLAN** 



NO.	DESCRIPTION	DATE

NOTE:

LEGEND:

PROJECT


189-ORCHARD-746-2Bd1Ba-CRAFTSMAN-550


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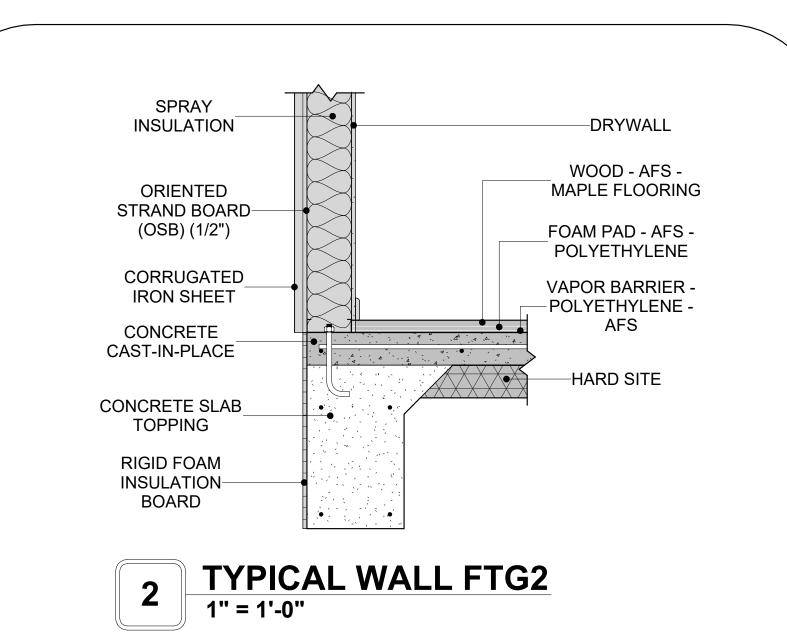
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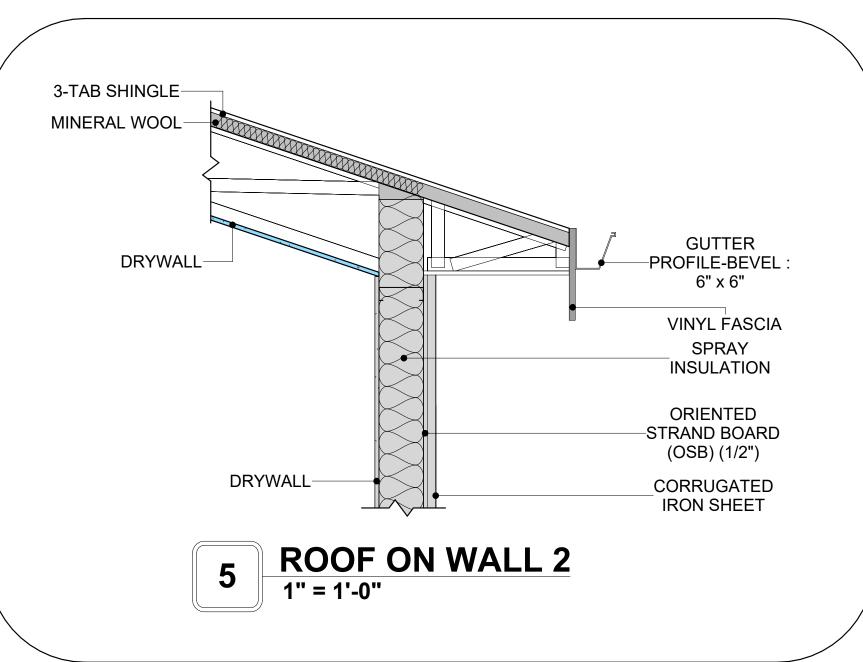
CLIENT NAME:	Client Name
PROJECT NUMBER:	0061_12
DATE:	4/23/2025 12:21:21 PM
DESIGNED BY:	Designer
DRAWN BY:	Author
CHECKED BY:	Checker


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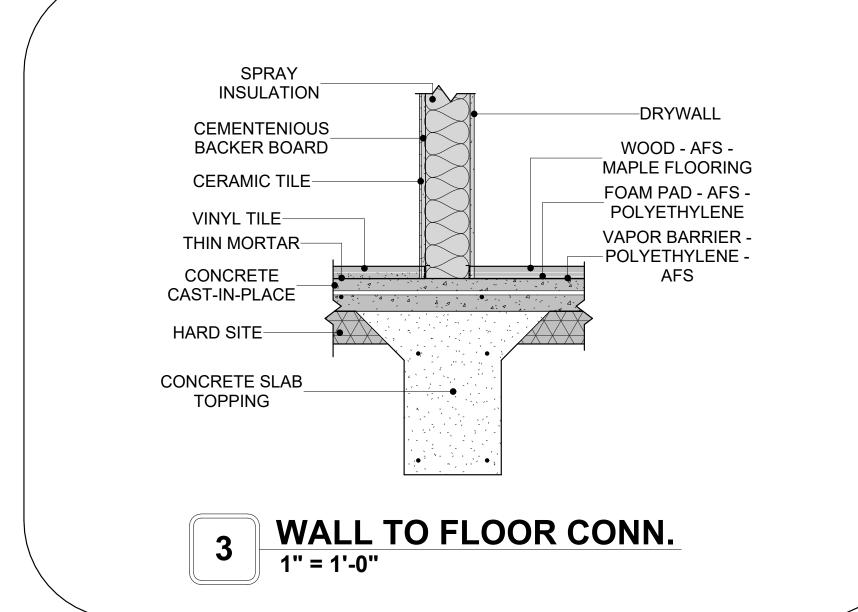







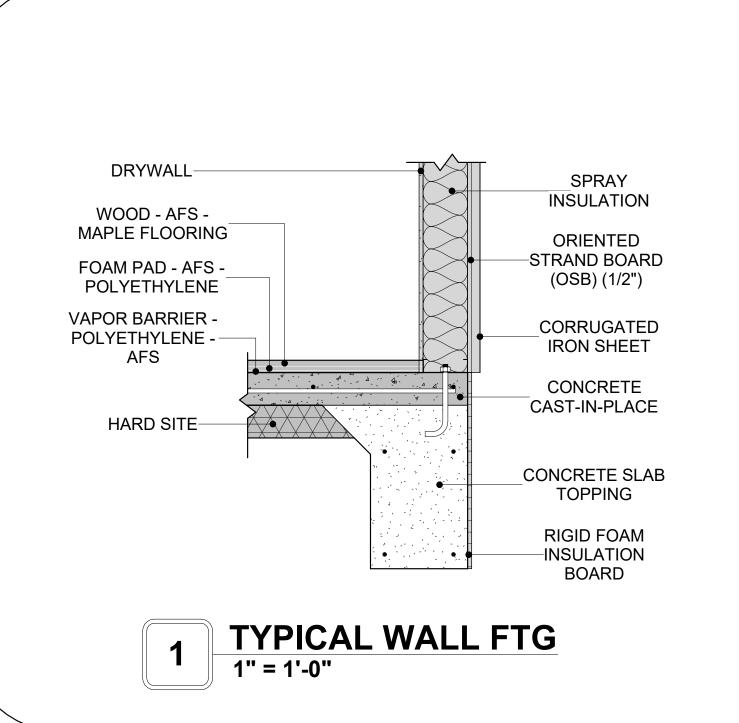

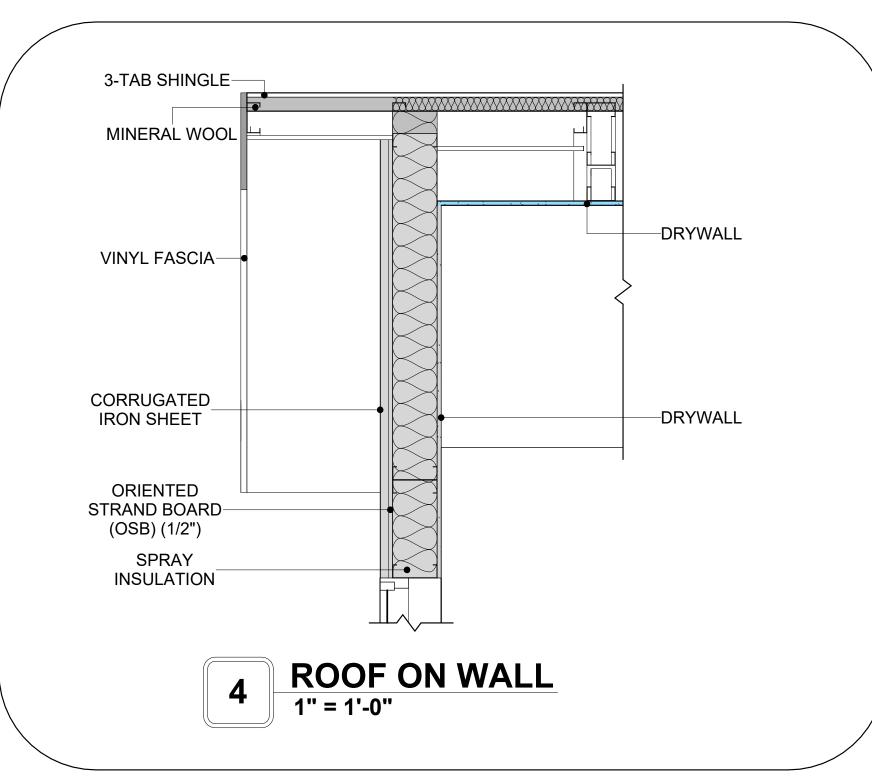

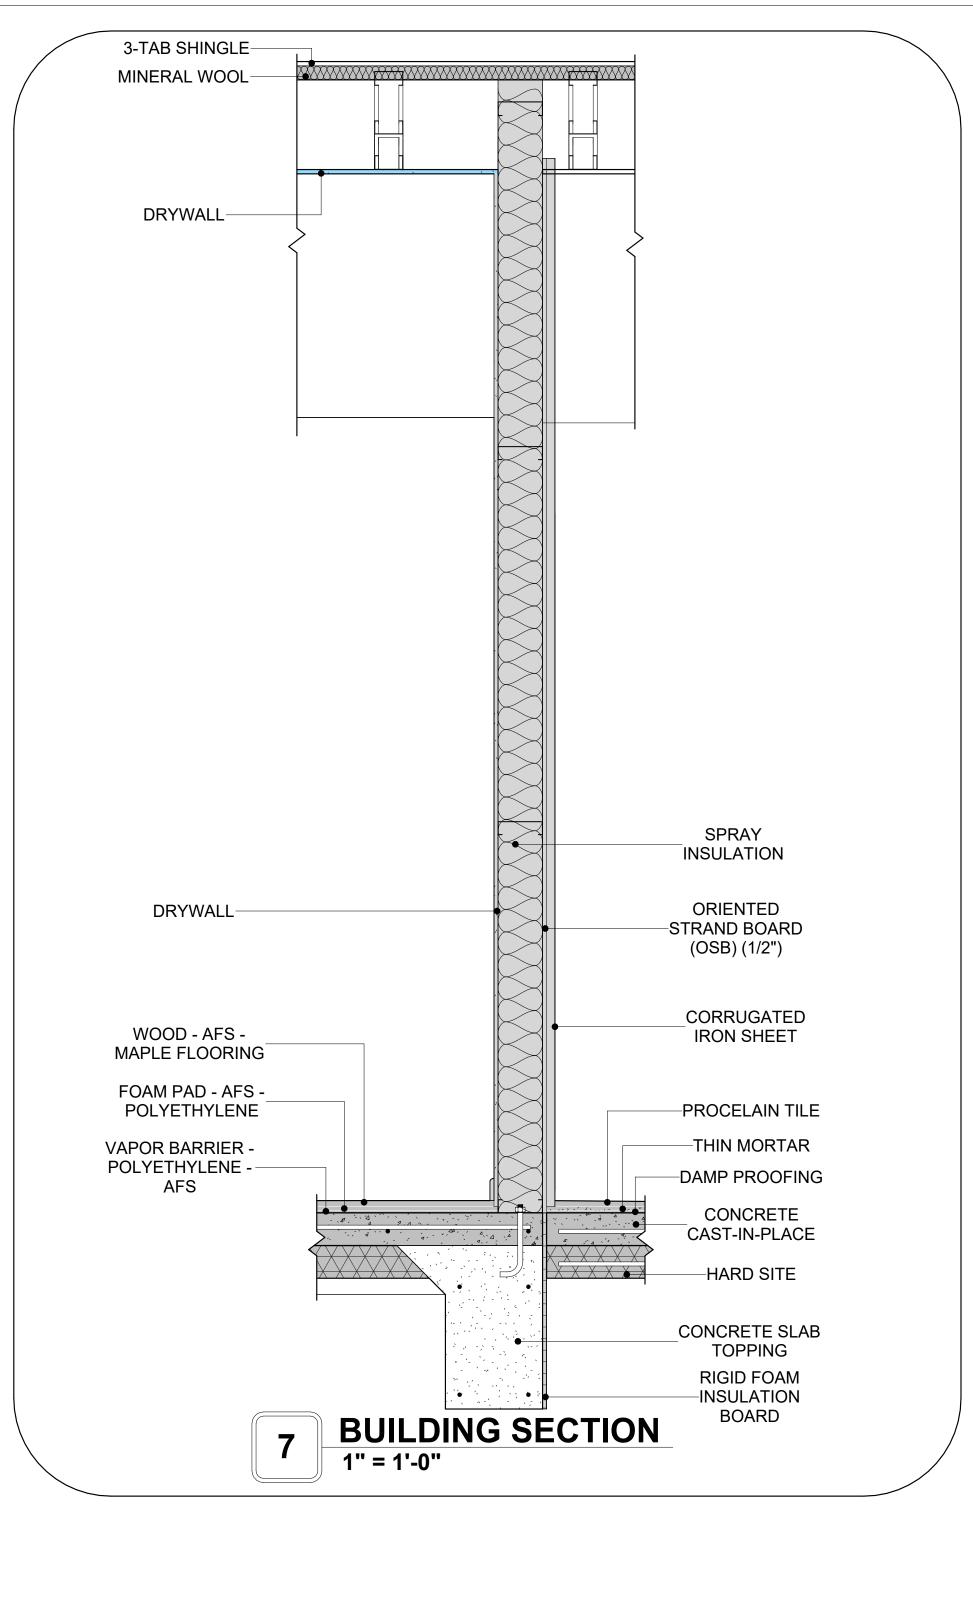

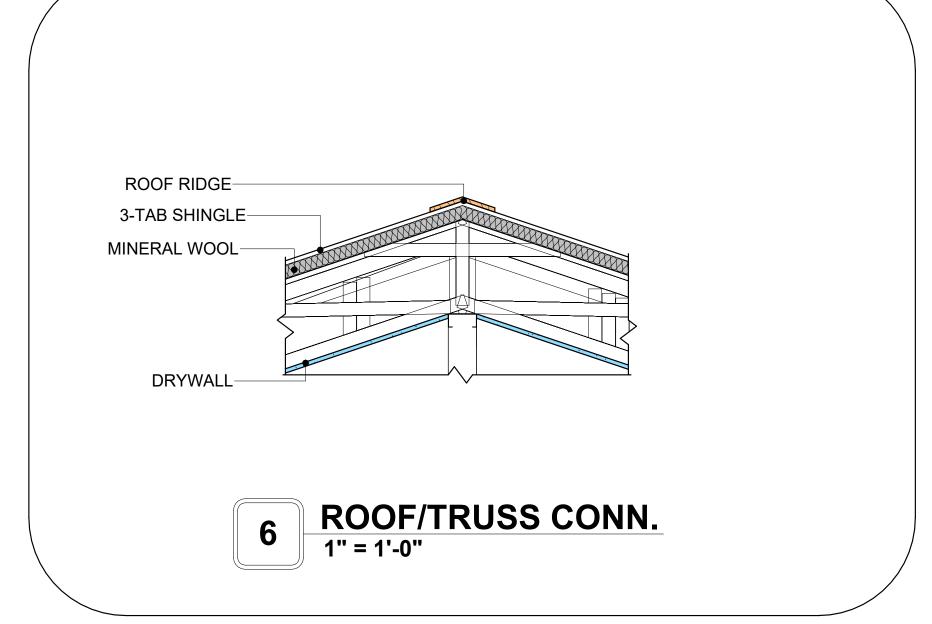



**KEY PLAN** 

NO.	DESCRIPTION	DATE

NOTE:

LEGEND:

PROJECT

189-ORCHARD-746-2Bd1Ba-CRAFTSMAN-550

DRAWING NAME

ARCHITECTURAL DETAILS

CLIENT NAME:	Client Name
PROJECT NUMBER:	0061_12
DATE:	4/23/2025 12:21:22 PM
DESIGNED BY:	Designer
DRAWN BY:	Author
CHECKED BY:	Checker

A401


SCALE: 1" = 1'-0"


## **CASEWORK GENERAL NOTES**


- ALL CABINET HEIGHTS INCLUDE COUNTERTOPS. DIMENSIONS ARE TO THE NEAREST INCH. DIVISIONS IN CASEWORK ARE SHOWN FOR CLARITY AND DO NOT REPRESENT BREAKS IN THE COUNTERTOP.
- PROVIDE CONTINUOUS COUNTERTOP OVER ALL SIMILAR HEIGHT CASEWORK, UNLESS AND OTHERWISE NOTED.
- MANUFACTURER AND CATALOG NUMBERS ARE FOR REFERENCE AND ILLUSTRATION PURPOSES
- DOTTED LINES INDICATE WALL HUNG CABINETS, DIVISIONS OF BASE CABINETS BELOW THE
- COUNTERTOP, FURNITURE NOT IN THE CONTRACT OR PROJECTION SCREENS -SEE CASEWORK KEY AND SPECIFICATIONS.
- ALL CABINETS AND DRAWERS TO HAVE CAM LOCKS EXCEPT FOR SINK BASE CABINETS. ALL EXPOSED SURFACES (EXPOSED TO VIEW FROM ANY PERSPECTIVE) TO BE COVERED WITH
- LAMINATE.
- ALL CASEWORK WHICH MEETS A WALL AT ONE OR BOTH ENDS, TO BE PROVIDED WITH FILLER PANELS AND SCRIBED TO THE WALL(S) AS REQUIRED.
- 10. ALL CABINETS AND DRAWERS ARE PROVIDED WITH RECESSED HANDLES.
- 11. CONTRACTOR TO FIELD VERIFY ALL CLEAR OPENINGS PRIOR TO MILLWORK OR CASEWORK FABRICATION.
- 12. CASEWORK DRAWINGS ARE DIAGRAMMATIC IN NATURE TO SHOW DESIGN INTENT.

	CASI	EWOR	K SCHEDU	LE		
TYPE MAR K	TYPE	COUN T	HEIGHT	WIDTH	DEPTH	AREA
01	L-SHAPE COUNTER TOP 158	1	0' - 4"	7' - 0"	7' - 0"	2 SF
02	BASE CABINET DOUBLE DOOR 2	1	2' - 11"	3' - 1"	2' - 0"	9 SF
03	BASE_CABINET_L-SHAPED	1	2' - 11"	3' - 3"	3' - 3"	9 SF
04	WALL CABINET DOUBLE DOOR 2 158	1	2' - 6"	3' - 3"	1' - 0"	8 SF
05	WALL FILLER	1	2' - 6"	0' - 9"	1' - 0"	2 SF
06	WALL CABINET DOUBLE DOOR 3 159.186 2	1	2' - 6"	2' - 11"	1' - 0"	7 SF
07	LINEAR COUNTER TOP 2 159.186 2	1	0' - 4"	3' - 8"	2' - 1"	1 SF
80	BASE_FILLER_18	1	2' - 11"	0' - 9"	2' - 0"	2 SF
09	BASE_CABINET_DOUBLE_DOOR	1	2' - 11"	2' - 11"	2' - 0"	8 SF
10	LAUNDRY OPEN CABINET	1	1' - 6"	2' - 0"	2' - 4"	3 SF
11	DOUBLE SINK VANITY 2	1	3' - 0"	4' - 8"	1' - 8"	14 SF
12	RECESSED_MED_CABINET	2	2' - 0"	1' - 6"	0' - 3"	3 SF
13	LAUNDRY OPEN CABINET 2	1	1' - 2"	2' - 3"	3' - 0"	3 SF
14	CLOSET 4	2	6' - 0"	7' - 2"	1' - 4"	43 SF
GRAND	TOTAL	16				

SPECIALTY EQUIPMENT SCHEDULE				
TYPE MARK TYPE COUNT				
01	WASHER-FRONT-LOAD	1		
02	REFRIGERATOR	1		
03	RANGE	1		
04	DRYER-FRONT-LOAD	1		
05	DISHWASHER	1		
GRAND TOTAL: 5	DISHWASHER	1		

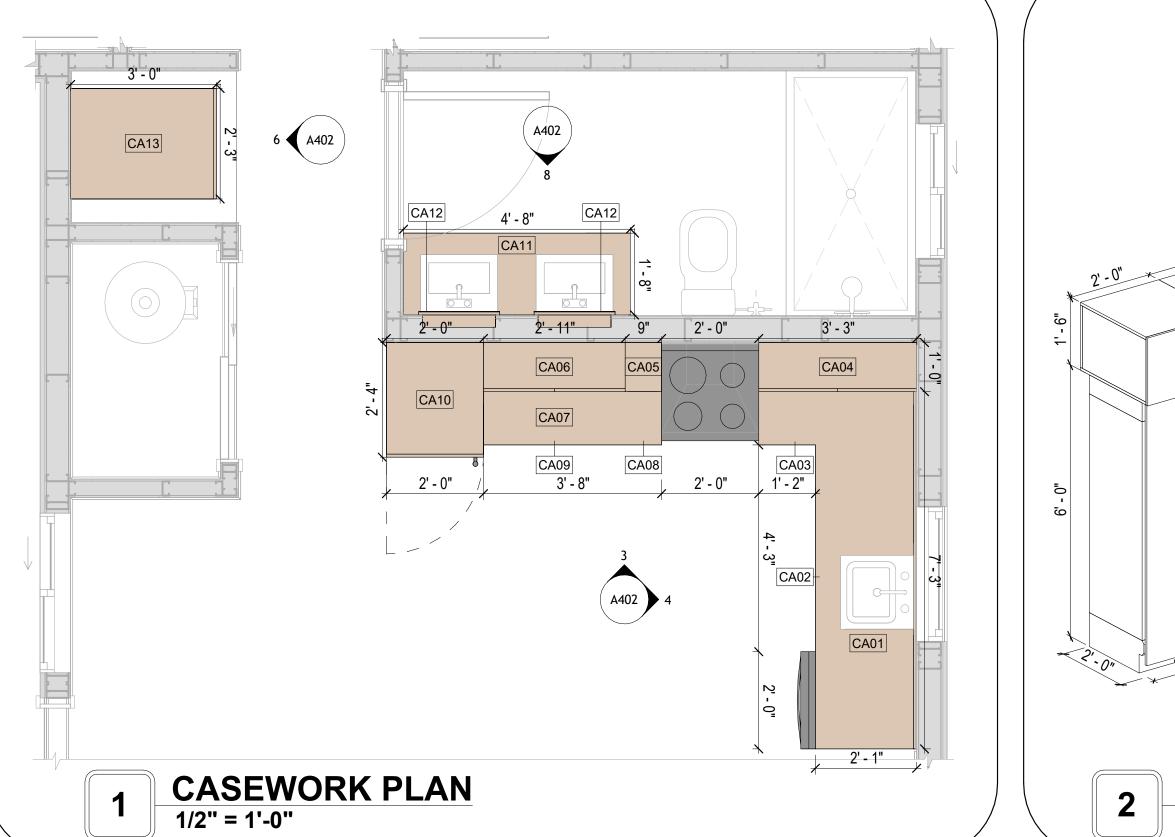

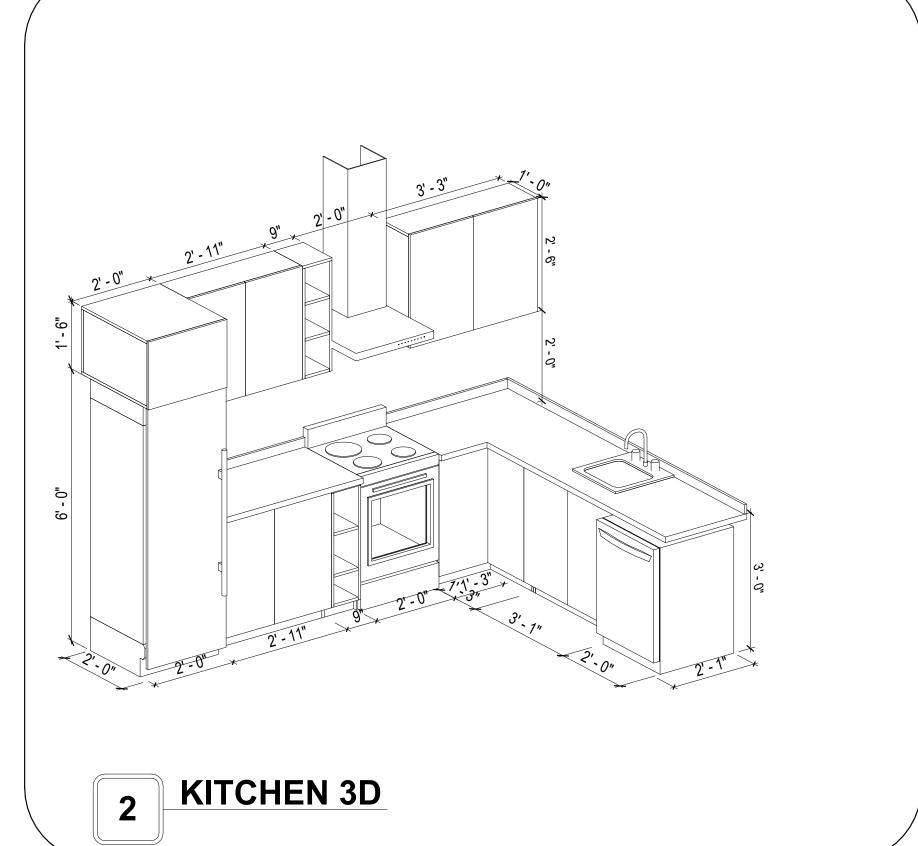


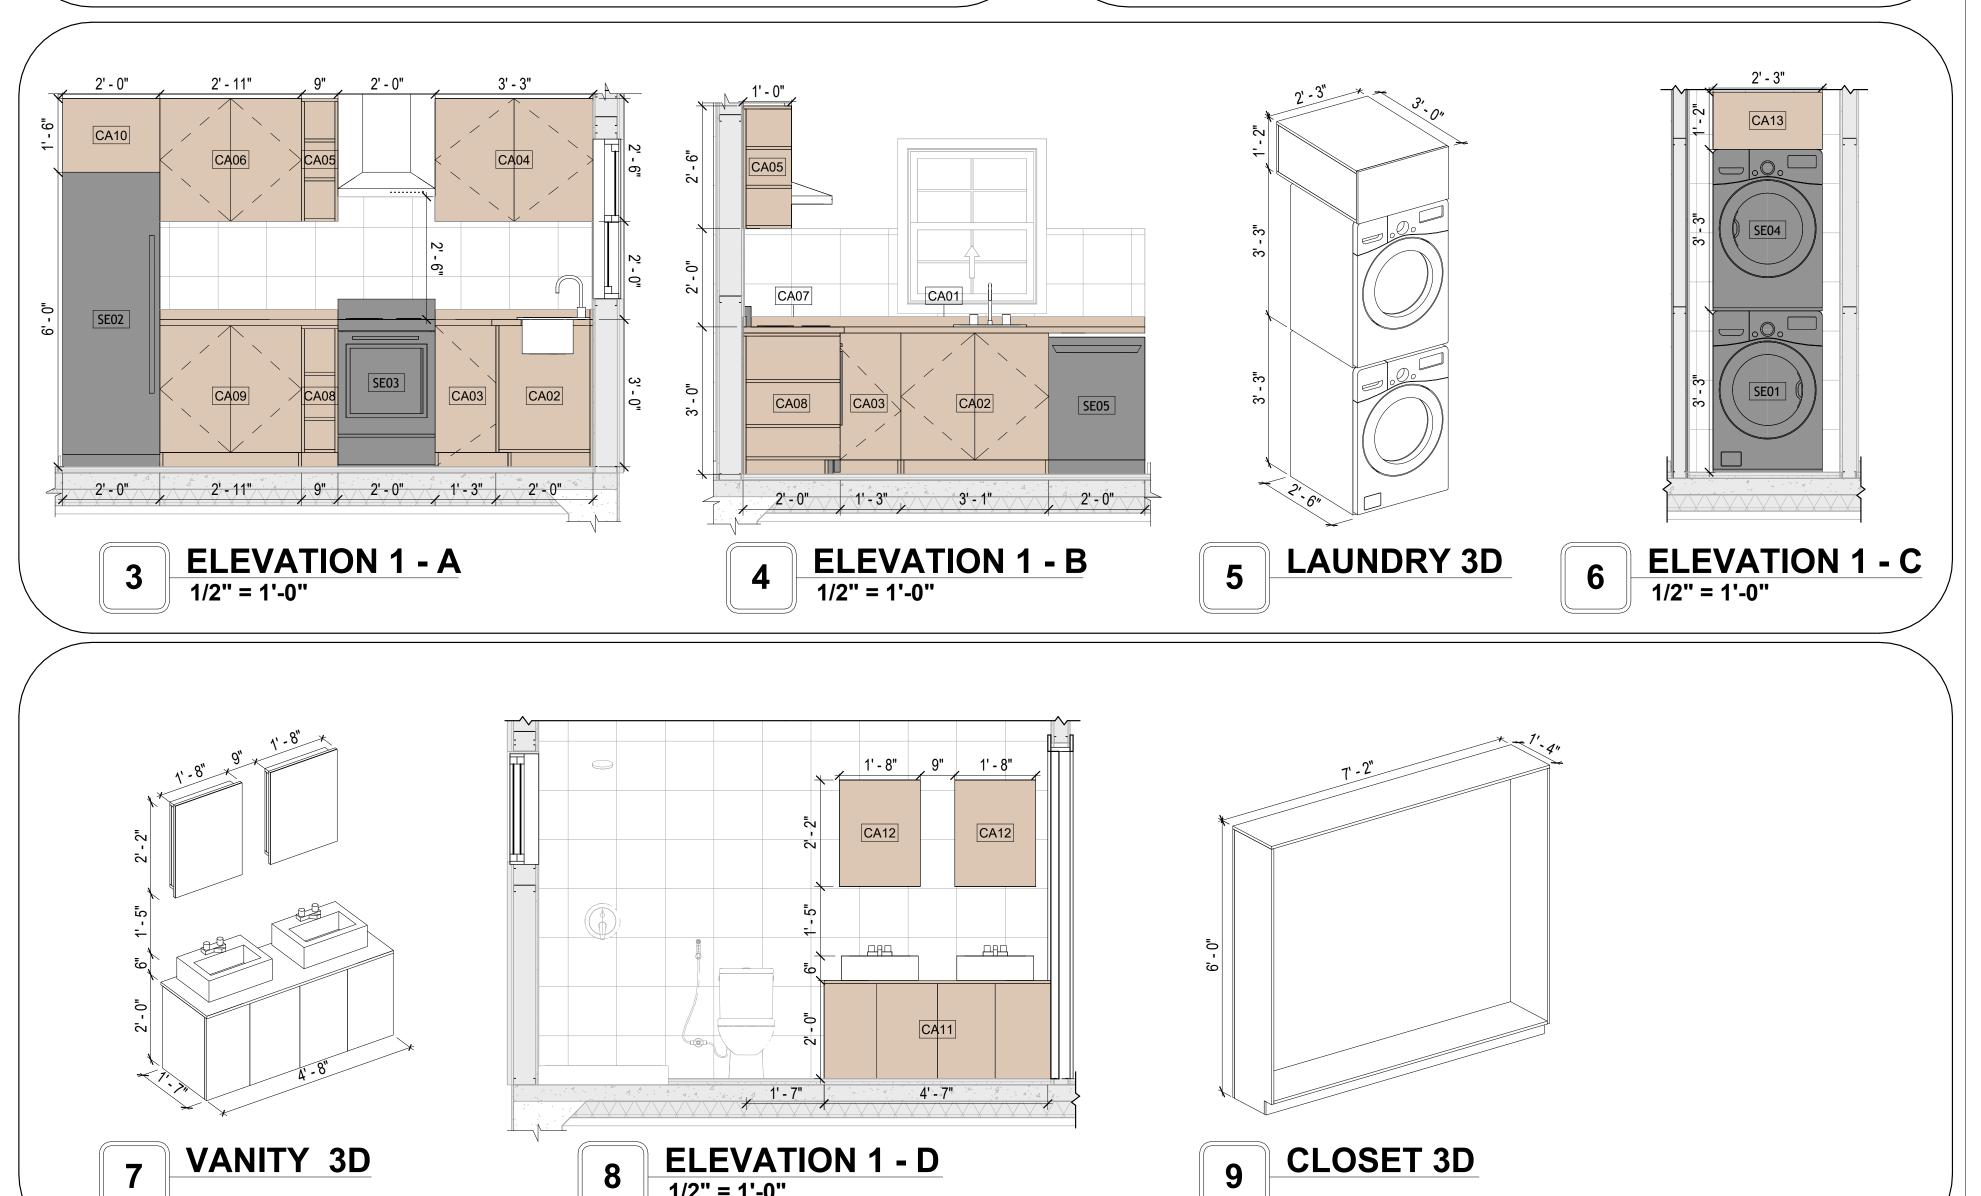

1/2" = 1'-0"



**KEY PLAN** 

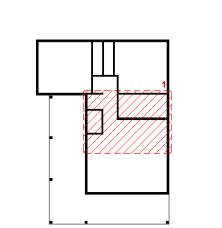

NO.	DESCRIPTION	DATE

NOTE:

LEGEND:

PROJECT

189-ORCHARD-746-2Bd1Ba-CRAFTSMAN-550

DRAWING NAME

ARCHITECTURAL CASEWORK

Client Name
0061_12
4/23/2025 12:21:23 PM
Designer
Author
Checker

A402

## **GENERAL NOTES**

1. THIS DRAWING DEPICTS THE HVAC (HEATING, VENTILATION, AND AIR CONDITIONING) SYSTEM FOR THE ORCHARD 2BD1BA CRAFTSMAN IT PROVIDES A VISUAL REPRESENTATION OF THE SYSTEM LAYOUT AND COMPONENTS.

2.THE HVAC SYSTEM IS DESIGNED TO MEET THE SPECIFIC REQUIREMENTS OF THE BUILDING, INCLUDING HEATING, COOLING, AND VENTILATION NEEDS, AS PER THE PROJECT SPECIFICATIONS AND APPLICABLE CODES AND STANDARDS.

3. THE HVAC SYSTEM INSTALLATION SHALL COMPLY WITH THE LATEST EDITION OF THE INTERNATIONAL MECHANICAL CODE (IMC), INTERNATIONAL RESIDENTIAL CODE (IRC), AND ALL OTHER APPLICABLE LOCAL, STATE, AND NATIONAL CODES AND REGULATIONS.

4. THE EQUIPMENT SHOWN ON THIS DRAWING INCLUDES BUT IS NOT LIMITED TO AIR HANDLING UNITS (AHUS), CHILLERS, BOILERS, COOLING TOWERS, PUMPS, DUCTWORK, DIFFUSERS, GRILLES, AND CONTROL DEVICES.

5. ALL EQUIPMENT, DUCTWORK, AND PIPING SHALL BE INSTALLED IN ACCORDANCE WITH MANUFACTURER'S SPECIFICATIONS, LOCAL CODES, AND

6. ALL DUCTWORK SHALL BE SIZED, FABRICATED, AND INSTALLED IN ACCORDANCE WITH THE LATEST EDITION OF THE ACCA MANUAL D AND THE SMACNA HVAC DUCT CONSTRUCTION STANDARDS. DUCTWORK SHALL BE INSTALLED IN A NEAT AND WORKMANLIKE MANNER, PROPERLY SUPPORTED AND BRACED TO PREVENT SAGGING, AIR LEAKAGE, OR VIBRATION.

7. CONDENSATE DRAINAGE PIPING SHALL BE PROPERLY PITCHED TO ENSURE POSITIVE DRAINAGE TO AN APPROVED DISPOSAL LOCATION, SUCH AS A FLOOR DRAIN, SUMP PUMP, OR EXTERIOR GRADE. CONDENSATE LINES SHALL BE INSULATED TO PREVENT SWEATING.

8. THE LOCATION OF CONTROL PANELS AND SENSORS INDICATED ON THIS DRAWING CAN BEMODIFY WITH THE SPECIFIC LOCATIONS AND WIRING DETAILS WILL BE DETERMINED DURING THE CONTROL SYSTEM DESIGN AND INSTALLATION.

9. THE HVAC SYSTEM DESIGN CONSIDER ENERGY EFFICIENCY, INDOOR AIR QUALITY, OCCUPANT COMFORT, AND NOISE CONTROL, FOLLOWING APPLICABLE GUIDELINES AND REGULATIONS.

10. COORDINATION WITH OTHER TREADS HAS BEEN DONE ON A DESIGN LEVEL. THIS DRAWING SHALL BE READ TOGETHER WITH THE AR, EL AND SN DESIGN DRAWINGS TO ENSURE PROPER INSTALLATION AND INTEGRATION OF THE HVAC SYSTEMS.

11. THE HVAC CONTRACTOR IS RESPONSIBLE FOR OBTAINING ALL NECESSARY PERMITS AND LICENSES, AND FOR SCHEDULING AND COORDINATING WITH THE LOCAL BUILDING DEPARTMENT AND UTILITY PROVIDERS TO ENSURE A TIMELY AND COMPLIANT INSTALLATION.

12. ALL DUCTWORK PENETRATIONS THROUGH WALLS, FLOORS, OR CEILINGS SHALL BE PROPERLY SEALED AND FIRE-STOPPED USING APPROVED METHODS AND MATERIALS TO MAINTAIN THE INTEGRITY OF THE BUILDING'S FIRE-RESISTANCE RATINGS.

13. HVAC EQUIPMENT SHALL BE INSTALLED LEVEL AND PLUMB, AND IN STRICT ACCORDANCE WITH THE MANUFACTURER'S INSTALLATION INSTRUCTIONS AND RECOMMENDATIONS. PROVIDE ADEQUATE CLEARANCES AROUND EQUIPMENT FOR PROPER AIRFLOW, SERVICE ACCESS, AND


14. ALL HVAC EQUIPMENT AND COMPONENTS, INCLUDING THERMOSTATS, DAMPERS, AND ACCESS PANELS, SHALL BE LOCATED IN ACCESSIBLE AREAS FOR EASY SERVICING AND MAINTENANCE. PROVIDE ADEQUATE SPACE AROUND EQUIPMENT FOR PROPER AIRFLOW AND SERVICE ACCESS.

15. THE HVAC SYSTEM SHALL BE BALANCED AND ADJUSTED TO ENSURE PROPER AIRFLOW, TEMPERATURE DISTRIBUTION, AND SYSTEM PERFORMANCE THROUGHOUT THE RESIDENCE. PROVIDE A WRITTEN REPORT DOCUMENTING THE FINAL SYSTEM BALANCE.

16. ANY DEVIATIONS OR MODIFICATIONS TO THE HVAC SYSTEM DESIGN SHALL BE REVIEWED AND APPROVED BY THE RESPONSIBLE DESIGN PROFESSIONALS AND COMMUNICATED TO ALL RELEVANT PARTIES INVOLVED IN THE CONSTRUCTION PROCESS.

17. FOR ANY INQUIRIES OR CLARIFICATIONS REGARDING THE HVAC SYSTEM DESIGN, PLEASE CONSULT THE RESPONSIBLE DESIGN PROFESSIONALS OR THE PROJECT MANAGEMENT TEAM.


CODE COMPLIANCE.

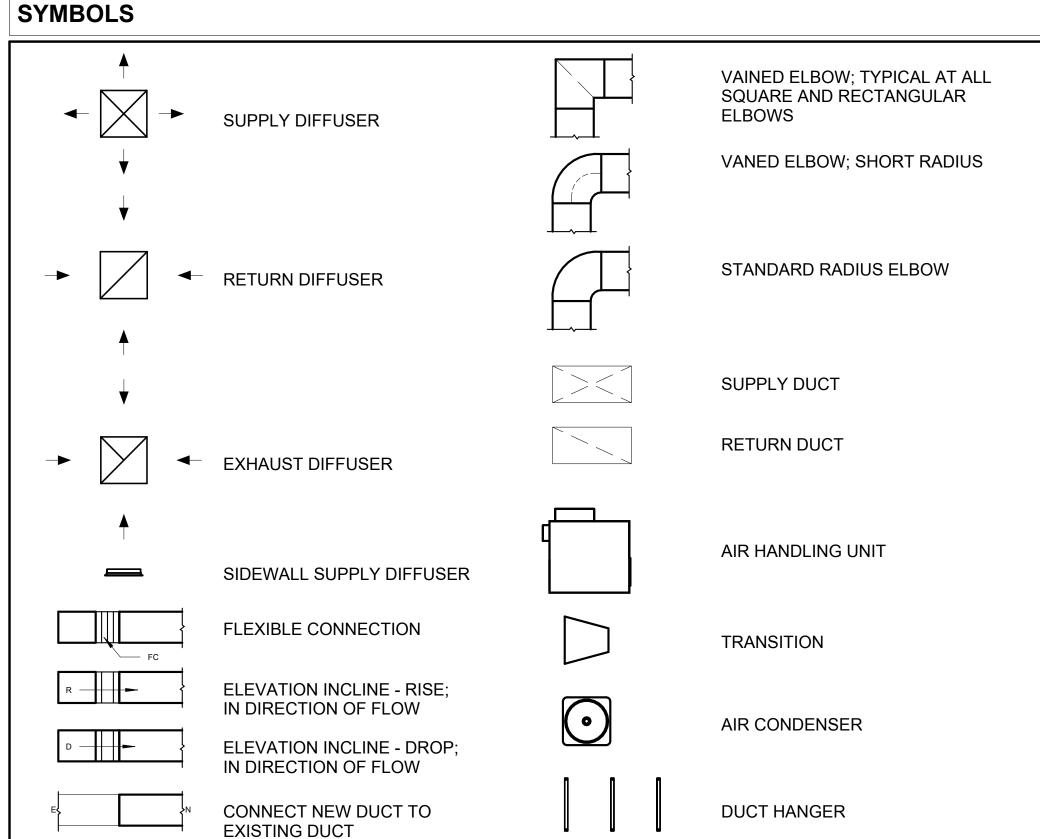



AIR CONDITIONING PIPE LINE

REFRIGERANT LINE SCHEDULE				
CATAGORY	DESCRIPTION	DIAMETER	LENGTH	
DIDE T. (DEC	00000	0.404		
PIPE TYPES	COPPER	3/8"	82.68	
PIPE TYPES	COPPER	3/4"	110.07	

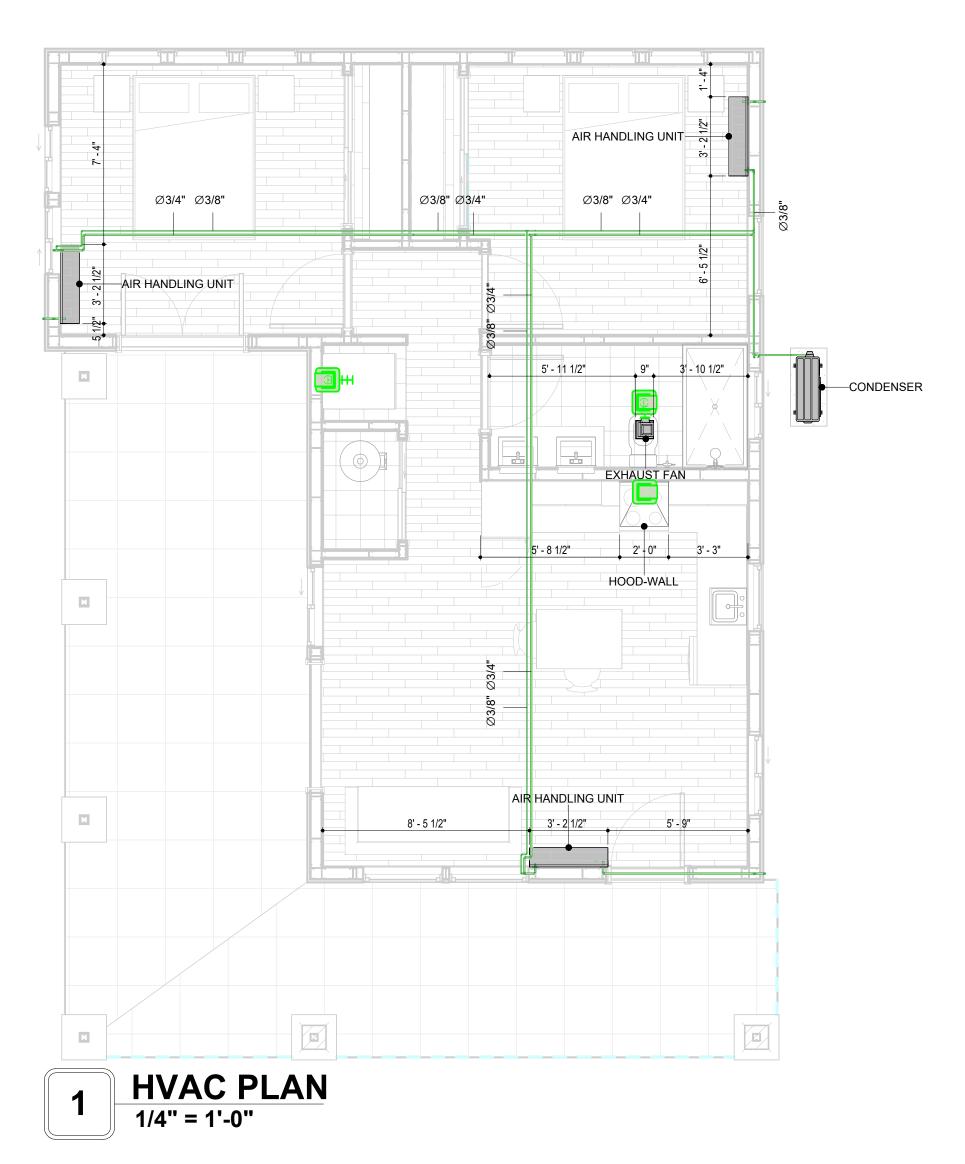

CATAGORY	DESCRIPTION	Size	Count
CATAGORT	DESCRIPTION	Size	Count
ELBOW - GENERIC	ELBOW - GENERIC: STANDARD/HVAC	3/4"ø-3/4"ø	29
ELBOW - GENERIC	ELBOW - GENERIC: STANDARD/HVAC	3/8"ø-3/8"ø	23
TEE - GENERIC	TEE - GENERIC: STANDARD	3/4"ø-3/4"ø-3/ 4"ø	2
TEE - GENERIC	TEE - GENERIC: STANDARD	3/8"ø-3/8"ø-3/ 8"ø	2
TRANSITION - GENERIC	TRANSITION - GENERIC: STANDARD	3/4"ø-1/2"ø	5
TRANSITION - GENERIC	TRANSITION - GENERIC: STANDARD	3/4"ø-5/8"ø	3
TRANSITION - GENERIC	TRANSITION - GENERIC: STANDARD	3/8"ø-1/4"ø	2

MECHANICAL EQUIPMENT SCHEDULE				
CATAGORY DESCRIPTION COUN				
		·		
AIR HANDLING UNIT	AIR HANDLING UNIT: WALL MOUNTED	3		
CONDENSER	CONDENSER: OUT DOOR			
EXHAUST FAN EXHAUST FAN: 75 CFM 1				
	HOOD-WALL: VENT	1		

DUCT FITTING SCHEDULE				
CATAGORY	DESCRIPTION	COUNT		
ROUND TRANSITION - ANGLE 45 DEGREE 5				

DUCT ACCESSORY SCHEDULE			
CATAGORY	DESCRIPTION	COUNT	
ROOF VENT	3" DIAMETER	3	

FLEX DUCT SCHEDULE				
DESCRIPTION	DESCRIPTION	LENGTH	DIAMETER	COUNT
FLEX DUCT ROUND	FLEX-ROUND	7.79	4"	3
GRAND TOTAL: 3	T ELX TOOTED	7.79	1	



**KEY PLAN** 

NO.	DESCRIPTION	DATE

NOTE:

LEGEND:

PROJECT

189-ORCHARD-746-2Bd1Ba **CRAFTSMAN-550** 

DRAWING NAME

**HVAC PLAN** 

CLIENT NAME: Owner PROJECT NUMBER: 15\_0001 DATE: 4/16/2025 12:06:16 AM Designer DESIGNED BY: DRAWN BY: Author CHECKED BY: Checker

M101

SCALE: As indicated

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#### **ELECTRICAL NOTES**

- 1. THIS DRAWING DEPICTS THE ELECTRICAL SYSTEM FOR THE 189\_ORCHARD\_746\_2Bd1Ba\_Craftsman\_550. IT PROVIDES A VISUAL REPRESENTATION OF THE ELECTRICAL LAYOUT AND COMPONENTS, INCLUDING POWER DISTRIBUTION, LIGHTING, AND CONTROL SYSTEMS.
- 2. THE ELECTRICAL SYSTEM IS DESIGNED TO MEET THE SPECIFIC REQUIREMENTS OF THE BUILDING, INCLUDING POWER DISTRIBUTION, LIGHTING, AND SPECIALIZED ELECTRICAL EQUIPMENT NEEDS, AS PER THE PROJECT SPECIFICATIONS AND APPLICABLE CODES AND STANDARDS.
- 3. THE ELECTRICAL SYSTEM INSTALLATION SHALL COMPLY WITH THE LATEST EDITION OF THE NATIONAL ELECTRICAL CODE (NEC), INTERNATIONAL BUILDING CODE (IBC), AND ALL OTHER APPLICABLE LOCAL, STATE, AND NATIONAL CODES AND REGULATIONS.
- 4. LOCATIONS AS NEEDED, DEVICES ARE SHOWN ON PLANS IN APPROXIMATE IDEAL LOCATIONS, UNLESS SPECIFICALLY DIMMENSIONED.
- 5. OPEN WALLS AS NEEDED TO ALLOW FOR NEW ELECTRICAL INSTALLATIONS.
- 6. LABEL ALL CIRCUITS ON JUNCTION BOXES, RECEPTACLES, DATA, SMOKE DETECTOR, AND EQUIPMENT IN PANEL BOX.
- 7. INSTALL RACEWAY AS NEEDED FOR DDC, ACCESS CONTROL, LOW VOLTAGE WIRING & DATA.
- 8. RELABEL POWER, DATA & FIRE ALARM FOR ROOM #CHANGES.
  9. VERIFY ALL CIRCUITS LABELED ON PRINT ARE CORRECT BEFORE WORKING ON THEM.
- 10. NOTE ON SITE PLAN ALL CHANGES OR MISSING DETAIL TO BE INCORPORATED INTO THE MASTER PLAN.
- 11. DRAWINGS ARE DIAGRAMMATIC ONLY FOR THE PURPOSE OF SHOWING FIXTURE AND OUTLET LOCATIONS.
- 12. ELECTRICAL CONTRACTOR TO VERIFY SERVICE SIZE BY CALCULATION BASED UPON ACTUAL NAME PLATE RATINGS OF SELECTED EQUIPMENT.
- PLATE RATINGS OF SELECTED EQUIPMENT.

  13. VERIFY LOCATION OF SERVICE ENTRANCE WITH POWER COMPANY. PROVIDE UFER GROUND IN
- BUILDING FOUNDATION AT SERVICE ENTRANCE LOCATION.

  14. PROVIDE A MIN. OF 20 FEET OF ONE \*4 BARE COPPER UFER WIRE EMBEDDED IN CONCRETE FOOTING
- AT THE SERVICE ENTRANCE LOCATION WHERE APPROVED BY LOCAL SERVICE PROVIDER.
- 15. PROVIDE WATERPROOF FIXTURES IN ALL HIGH MOISTURE AREAS (EXTERIOR, SHOWER AND TUB CEILINGS ETC.)
- 16. PROVIDE DEDICATED CIRCUITS TO EACH BATH, DEN, FAMILY ROOM, BEDROOM, LOFT, KITCHEN
- REFRIGERATOR, KITCHEN FREEZER DISHWASHER, AND ANY AREA/ITEM SPECIFIED BY OWNER.

  17. INCANDESCENT FIXTURES WITH OPEN OR PARTIALLY ENCLOSED LAMPS, PENDANT FIXTURES, AND
- LAMP HOLDERS ARE NOT PERMITTED IN CLOSETS.

  18. ALL WORKMANSHIP AND MATERIALS TO CONFORM WITH THE 2015 IRC.
- 19. PROVIDE A MIN. OF 20 FEET OF ONE \*4 BARE COPPER UFER WIRE EMBEDDED IN CONCRETE FOOTING
- AT THE SERVICE ENTRANCE LOCATION WHERE APPROVED BY LOCAL SERVICE PROVIDER.

  20. PROVIDE A BONDING CONDUCTOR CONSISTING OF A MINIMUM OF ONE \*4 BARE COPPER WIRE CONNECTING THE BUILDING'S METAL WATER PIPING SYSTEM TO THE SERVICE EQUIPMENT ENCLOSURE GROUNDING.

MAIN	<b>PANEL</b>	CALCS
		UALUU

ELECTRICAL CALCS	
LIGHT AND OUTLETS 746 @ 3W	2,238 W
3 APPLIANCE CIRCUITS	4,500 W
DRYER	2,000 W
WASHER	2,000 W
RANGE	5,000 W
WATER HEATER	5,000 W
REFRIG.	1,800 W
DISHWASHER & DISPOSAL	3,000 W
TOTAL	25,538 W
FRIST 10,000 @ 100% REMAINDER @ 40% MINI. SPLIT UNITS	10,000 W 6,215 W 10,000 W
TOTAL	26,215 W

26,215 W DIVIDED BY 240V = 109 AMPS TOTAL

(USE 200 AMP SERVICE)

## **ELECTRICAL ABBREVIATIONS LIST**

1P	1 POLE (2P, 3P, 4P, ETC.)	CTR	CENTER	HT	HEIGHT
A	AMPERE	CU	COPPER	HTG	HEATING
AC	ABOVE COUNTER OR AIR CONDITIONER	DCP	DOMESTIC WATER CIRCULATING PUMP	HTR	HEATER
ACLG	ABOVE CEILING	DEPT	DEPARTMENT	HV	HIGH VOLTAGE
ADO	AUTOMATIC DOOR OPENER	DET	DETAIL	HVAC	HEATING, VENTILATING AND AIR
AF	AMP FRAME	DIA	DIAMETER	CONDITIONING	CONDITIONING
AFF	ABOVE FINISHED FLOOR	DISC	DISCONNECT	HWP	HYDRONIC WATER PUMP
AFG	ABOVE FINISHED GRADE	DIST	DISTRIBUTION	IC	INTERRUPTING CAPACITY
AFI	ARC FAULT CIRCUIT INTERRUPTER	DN	DOWN	IG	ISOLATED GROUND
AHU	AIR HANDLING UNIT	DPR	DAMPER	IMC	INTERMEDIATE METAL CONDUIT
AL	ALUMINUM	DS	SAFETY DISCONNECT SWITCH	INCAND	INCANDESCENT
ALT	ALTERNATE	DT	DOUBLE THROW	IR	INFRARED
AMP	AMPERE	DWG	DRAWING	I/W	INTERLOCK WITH
AMPL	AMPLIFIER	DDC	DIRECT DIGITAL CONTROL	J-BOX	JUNCTION BOX
ANNUN	ANNUNCIATOR APPROX APPROXIMATELY	EC	ELECTRICAL CONTRACTOR	KV	KILOVOLT
AQ-STAT	AQUASTAT	ELEC	ELECTRIC, ELECTRICAL	KVA	KILOVOLT-AMPERE
ARCH	ARCHITECT, ARCHITECTURAL	ELEV	ELEVATOR	KVAR	KILOVOLT-AMPERE REACTIVE
AS	AMP SWITCH	EM	EMERGENCY	KW	KILOWATT
AT	AMP TRIP	EMS	ENERGY MANAGEMENT SYSTEM	KWH	KILOWATT HOUR
ATS	AUTOMATIC TRANSFER SWITCH	EMT	ELECTRICAL METALLIC TUBING	LOC	LOCATE OR LOCATION
AUTO	AUTOMATIC	EP	ELECTRIC PNEUMATIC	LT	LIGHT
AUX	AUXILIARY	EQUIP	EQUIPMENT	LTG	LIGHTING
AV	AUDIO VISUAL	EWC	ELECTRIC WATER COOLER	LTNG	LIGHTNING
AWG	AMERICAN WIRE GAUGE	EXIST	EXISTING	LV	LOW VOLTAGE
BATT	BATTERY	EXH	EXHAUST	MAX	MAXIMUM
BD	BOARD	EXP	EXPLOSION PROOF	MAG.S	MAGNETIC STARTER
BLDG	BUILDING	FA	FIRE ALARM	M/C	MOMENTARY CONTACT
BMS	BUILDING MANAGEMENT SYSTEM	FABP	FIRE ALARM BOOSTER POWER	MC	MECHANICAL CONTRACTOR
C	CONDUIT	SUPPLY PANEL	SUPPLY PANEL	MCB	MAIN CIRCUIT BREAKER
CAB	CABINET	FACP	FIRE ALARM CONTROL PANEL	MCC	MOTOR CONTROL CENTER
CAT	CATALOG	FCU	FAN COIL UNIT	MDC	MAIN DISTRIBUTION CENTER
CATV	CABLE TELEVISION	FIXT	FIXTURE	MDP	MAIN DISTRIBUTION PANEL
СВ	CIRCUIT BREAKER	FLR	FLOOR	MFR	MANUFACTURERMAIN FUSED
CCTV	CLOSED CIRCUIT TELEVISION	FLUOR	FLUORESCENT		DISCONNECT SWITCH
CKT	CIRCUIT	FU	FUSE	MH	MANHOLE
CLG	CEILING	FUDS	FUSED SAFETY DISCONNECT SWITCH	MIC	MICROPHONE
COMB	COMBINATION	GA	GAUGE	MIN	MINIMUM
CMPR	COMPRESSOR	GALY	GALLON	MISC	MISCELLANEOUS
CONN	CONNECTION	GALV	GALVANIZED	MLO	MAIN LUGS ONLY
CONST	CONSTRUCTION	GC	GENERAL CONTRACTOR	MMS	MANUAL MOTOR STARTER
CONT	CONTINUATION OR CONTINUOUS	GEN	GENERATOR	MOA	MULTIOUTLET ASSEMBLY
CONTR	CONTRACTOR	GFI	GROUND FAULT CIRCUIT INTERRUPTER	MSP	MOTOR STARTER PANELBOARD
CONV	CONVECTOR	GFP	GROUND FAULT PROTECTOR	MSBD	MAIN SWITCHBOARD
CP	CIRCULATING PUMP	GND	GROUND	MT	MOUNT
CRT	CATHODE-RAY TUBE	GRS	GALVANIZED RIGID STEEL (CONDUIT)	MT.C	EMPTY CONDUIT
CT	CURRENT TRANSFORMER	GYP BD	GYPSUM BOARD	UL	UNDERWRITERS LABORATORIES

## **Branch Panel:**

Location: KITCHEN 02
Supply From:
Mounting: Recessed

Enclosure: Type 1

Volts: 120/240 Single
Phases: 1
Wires: 3

A.I.C. Rating: Mains Type: Mains Rating: 200 A MCB Rating: 1 A

Notes

Circuit Description	Number of Elements	Rating	Length	Wire Size	_A		E	3	Wire Size	Length	Rating	Number of Elements		Circu Numl er
CONDENCER	1	60 A	21' - 11 5/16"	2-#6, 1-#6, 1-#10	750 VA	900 VA			1-#12, 1-#12, 1-#12	50' - 11 3/16"	20 A	5	OUTDOOR GFCI RECEPTACLES	2
							750 VA	600 VA	1-#12, 1-#12, 1-#12	44' - 7 5/16"	20 A	9	OUTDOOR LIGHT POINTS	4
RANGE	1	50 A	20' - 4 1/2"	2-#8, 1-#8, 1-#10	750 VA	336 VA			1-#12, 1-#12, 1-#12	24' - 3 1/16"	20 A	9	LIVING ROOM LIGHT POINTS	6
							750 VA	613 VA	1-#12, 1-#12, 1-#12	28' - 2 31/32"	20 A	8	BATHROOM UNITS	8
KITCHEN GFCI RECEPTACLES	5	20 A	24' - 6 27/32"	1-#12, 1-#12, 1-#12	900 VA	1200 VA			1-#10, 1-#10, 1-#10	10' - 9 21/32"	30 A	1	GFCI DISH WASHER	10
REFRIGERATOR	1	20 A	26' - 8 1/32"	1-#12, 1-#12, 1-#12			1500 VA	420 VA	1-#12, 1-#12, 1-#12	32' - 7 5/8"	20 A	10	KITCHEN AND HALL LIGHT POINTS	12
WATER HEATER	1	30 A	35' - 7 29/32"	2-#10, 1-#10, 1-#10	750 VA	1080 VA			1-#12, 1-#12, 1-#12	38' - 7 15/32"	20 A	6	LIVING AND HALL RECEPTACLES	14
							750 VA	750 VA	2-#10, 1-#10, 1-#10	37' - 1 29/32"	30 A	1	DRYER	16
GFCI WASHER	1	20 A	39' - 4 1/32"	1-#12, 1-#12, 1-#12	1200 VA	750 VA								18
BEDROOM 1 RECEPTAC LES	4	20 A	62' - 0 15/32"	1-#12, 1-#12, 1-#12			720 VA	900 VA	1-#12, 1-#12, 1-#12	44' - 10 1/32"	20 A	5	BEDROOM 2 RECEPTACLES	20
BEDROOM 1 LIGHT POINTS	10	20 A	52' - 5 13/32"	1-#12, 1-#12, 1-#12	568 VA	388 VA			1-#12, 1-#12, 1-#12	52' - 7 11/32"	20 A	9	BEDROOM 2 LIGHT POINTS	22
														24
														26
					9569	VA	772	1 VA						
	Circuit Description  CONDENCER   RANGE   KITCHEN GFCI RECEPTACLES  REFRIGERATOR  WATER HEATER   GFCI WASHER  BEDROOM 1 RECEPTAC LES  BEDROOM 1 LIGHT	Circuit Description  CONDENCER  1   RANGE  1  KITCHEN GFCI RECEPTACLES  REFRIGERATOR  1  WATER HEATER  1  GFCI WASHER  1  BEDROOM 1 LIGHT  BEDROOM 1 LIGHT	Circuit Description         Number of Elements         Rating           CONDENCER         1         60 A                RANGE         1         50 A                KITCHEN GFCI RECEPTACLES         5         20 A           REFRIGERATOR         1         20 A           WATER HEATER         1         30 A                GFCI WASHER         1         20 A           BEDROOM 1 RECEPTACLES         4         20 A	Circuit Description         Number of Elements         Rating           CONDENCER         1         60 A         21' - 11 5/16"                 RANGE         1         50 A         20' - 4 1/2"                 KITCHEN GFCI RECEPTACLES         5         20 A         24' - 6 27/32"           REFRIGERATOR         1         20 A         26' - 8 1/32"           WATER HEATER         1         30 A         35' - 7 29/32"                 GFCI WASHER         1         20 A         39' - 4 1/32"           BEDROOM 1 RECEPTAC LES         4         20 A         62' - 0 15/32"	Circuit Description         Number of Elements         Rating         Length         Wire Size           CONDENCER         1         60 A         21' - 11 5/16"         2-#6, 1-#6, 1-#10                  RANGE         1         50 A         20' - 4 1/2"         2-#8, 1-#8, 1-#10                  KITCHEN GFCI RECEPTACLES         5         20 A         24' - 6 27/32"         1-#12, 1-#12, 1-#12           REFRIGERATOR         1         20 A         26' - 8 1/32"         1-#12, 1-#12, 1-#12           WATER HEATER         1         30 A         35' - 7 29/32"         1-#10, 1-#10, 1-#10                  GFCI WASHER         1         20 A         39' - 4 1/32"         1-#12,	Circuit Description         Number of Elements         Rating         Length         Wire Size         A           CONDENCER         1         60 A         21' - 11 5/16"         2-#6, 1-#6, 1-#10, 1-#10         750 VA                    RANGE         1         50 A         20' - 4 1/2"         2-#8, 1-#8, 1-#8, 1-#10, 1-#10         750 VA                   KITCHEN GFCI RECEPTACLES         5         20 A         24' - 6 27/32"         1-#12, 1-#12, 1-#12, 1-#12, 1-#12, 1-#12, 1-#12         900 VA           REFRIGERATOR         1         20 A         26' - 8 1/32"         1-#12, 1-#12, 1-#12, 1-#12, 1-#10, 1-#10         750 VA   <	Circuit Description         Number of Elements         Rating         Length         Wire Size         A           CONDENCER         1         60 A         21' - 11 5/16"         2-#6, 1-#6, 1-#6, 1-#10, 750 VA         900 VA                    RANGE         1         50 A         20' - 4 1/2"         2-#8, 1-#8, 1-#8, 1-#10, 1-#10, 1-#10, 1-#10         750 VA         336 VA   <	Circuit Description         Number of Elements         Rating         Length         Wire Size         A         E           CONDENCER         1         60 A         21' - 11 5/16"         2-#6, 1-#6, 1-#6, 1-#10.         750 VA         900 VA                 750 VA           RANGE         1         50 A         20' - 4 1/2"         2-#8, 1-#8, 1-#8, 1-#10, 1-#10, 750 VA         336 VA                 750 VA           KITCHEN GFCI RECEPTACLES         5         20 A         24' - 6 27/32"         1-#12, 1-#1	Circuit Description   Circuit Description	Number of Elements   Rating   Rating	Circuit Description   Elements   Rating   Condender   Rating   Rating   Rating   Condender   Rating   R	Circuit Description   Elements   Rating   Condense   Rating   Condense   Co	Circuit Description   Elements   Rating   Condense   Condense	Number of Elements   Rating   Selection   Number of Elements   Rating   Selection   Selection   Rating   Selecti

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Load Classification	Connected Load	Demand Factor	Estimated Demand	Panel Totals
Lighting - Dwelling Unit	800 VA	100.00%	800 VA	
Other	1484 VA	100.00%	1484 VA	Total Conn. Load: 17292 VA
Receptacle	14760 VA	83.88%	12380 VA	Total Est. Demand: 14913 VA
Lighting	300 VA	100.00%	300 VA	Total Conn.: 72 A
				Total Est. Demand: 62 A

PROJECT

NOTE:

LEGEND:

**KEY PLAN** 

DESCRIPTION

DATE

189-ORCHARD-746-2Bd1Ba CRAFTSMAN-550

DRAWING NAME

## SCHEDULE

CLIENT NAME:	Owner
PROJECT NUMBER:	0283_13
DATE:	4/15/2025 7:23:14 AM
DESIGNED BY:	Designer
DRAWN BY:	Author
CHECKED BY:	Checker

E101

SCALE: 1/4" = 1'-0"

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## **ELECTRICAL NOTE**

- PROVIDE INTERCONNECTED SMOKE ALARMS IN EACH SLEEPING ROOMS, OUTSIDE EACH SLEEPING ROOM, ON EACH STORY, IN THE HALL OR ADJACENT ROOM LUHERE THE CEILING HEIGHT OF A ROOM OPEN TO THE HALL EXCEEDS THE HALL BY 24'. SMOKE ALARMS SHALL BE PERMANENTLY HARD WIRED WITH BATTERY BACKUP.
- B. RECEPTACLE OUTLETS FOR RANGES AND CLOTHES DRYERS SHALL BE A THREE POLE WITH GROUND TYPE. FOUR WIRE GROUNDING-TYPE FLEXIBLE CORDS WILL BE REQUIRED FOR CONNECTION OF RANGES AND CLOTHES DRYERS. THE BONDING JUMPER SHALL NOT BE CONNECTED BETWEEN NEUTRAL TERMINAL AND THE FRAME OF THE **APPLIANCE**
- C. TWO OR MORE 20 AMP SMALL APPLIANCE CIRCUITS SHALL BE PROVIDED TO SERVE THE KITCHEN, BREAKFAST NOOK, AND DINING ROOM. SUCH CIRCUITS SHALL HAVE NO OTHER OUTLETS.
- D. AT LEAST ONE 20 AMP BRANCH CIRCUIT SHALL BE PROVIDED TO SERVICE THE LAUNDRY ROOM. THIS CIRCUIT SHALL HAVE NO OTHER OUTLETS.
- E. ALL RECEPTACLES WITH IN 6' OF A WET BAR SINK OR KITCHEN SINK TO SERVE COUNTER TOP SURFACES MUST BE GFCI. ON KITCHEN COUNTERS 12' OR WIDER NO POINT ALONG THE WALL SHALL BE MORE THAN 2' FROM A RECEPTACLE. ALL RECEPTACLES WITH IN 6' OF KITCHEN SINK MUST BE GFCI. AT LEAST ONE GFCI RECEPTACLE SHALL BE INSTALLED IN THE BATHROOM ADJACENT TO EACH BASIN.
- FIXTURES INCLUDING CEILING FANS THAT ARE LOCATED IN DAMP LOCATIONS SHALL BE LISTED TO BE SUITABLE FOR
- SUCH LOCATIONS PER 2012 IRC
- G. PROVIDE ONE (1) SWITCHED OUTLET @ ALL BEDROOMS AND DEN
- H. CEILING FANS NOT EXCEEDING 35 LBS. (WITH OR WITHOUT ACCESSORIES MAY BE SUPPORTED BY OUTLET BOXES PROVIDED THE OUTLET BOXES ARE IDENTIFIED FOR SUCH USE PER 2012 IRC
- ELECTRICAL OUTLET BOXES ON OPPOSITE SIDES OF FIRE RATED WALLS SHALL BE SEPARATED BY A HORIZONTAL DISTANCE OF NOT LESS THAN 24".
- OUTLET BOXES IN THE WALLS BETWEEN THE GARAGE AND DWELLING SHALL BE METAL OR U.L. APPROVED FIRE RESISTIVE PLASTIC. BOXES IN GARAGE CEILING SHALL BE METAL.
- K. ALL BRANCH CIRCUITS THAT SUPPLY 120 VOLTS SINGLE PHASE 15 AND 20 AMPS RECEPTACLE OUTLETS INSTALLED IN THE DWELLING SHALL BE PROTECTED BY AN ARC FAULT CIRCUIT INTERRUPTER, EXCEPT GFCI RECEPTICLES.

#### NOTE:

RECEPTACLES MUST BE PROVIDED IN HALLWAYS 10'-0" OR MORE IN LENGTH. FOR A ONE FAMILY DWELLINGS AND EACH OF A TWO FAMILY DWELLING THAT IS AT GRADE LEVEL, AT LEAST ONE WP-GFCI RECEPTACLE OUTLET ACCESSIBLE AT GRADE LEVEL AND NOT MORE THAN 6'-6" ABOVE GRADE SHALL BE INSTALLED AT THE FRONT AND BACK OF THE DWELLING.

#### NOTE: APPLIANCE DISCONNECT

#### **E4001.5 GROUNDING OF ENCLOSURES.**

METAL ENCLOSURES FOR SWITCHES OR CIRCUIT BREAKERS SHALL BE CONNECTED TO AN

**EQUIPMENT GROUNDING CONDUCTOR.** 

METAL ENCLOSURES FOR SWITCHES OR CIRCUIT BREAKERS USED AS SERVICE

EQUIPMENT SHALL COMPLY WITH THE PROVISIONS OF SECTION E3609.4. WHERE NONMETALLIC ENCLOSURES ARE USED WITH METAL RACEWAYS OR METAL-ARMORED


CABLES, PROVISIONS SHALL BE MADE FOR CONNECTING THE EQUIPMENT GROUNDING

CONDUCTOR.


NONMETALLIC BOXES FOR SWITCHES SHALL BE INSTALLED WITH A WIRING METHOD THAT


PROVIDES OR INCLUDES AN EQUIPMENT GROUNDING CONDUCTOR. (404.12)

ELECTRICAL LEGEND			
	Electrical Lights With Fan		
0	Waterproof Recessed Can Light		
	Pendant Light		
0	Recessed Can Light		
<b>-</b> □	Wall Lamp		
	Standalone linear		
<b>⊬</b> 1	Single Switch		
₩	Three way Switch		
<b>₩</b>	Fan Switch		
	Duplex Receptacle		
	Triplex Receptacle		
⊕ □GFCI	GFCI Receptacle		
	Exhaust Fan		
•	Smoke and heat detector		
	.1		

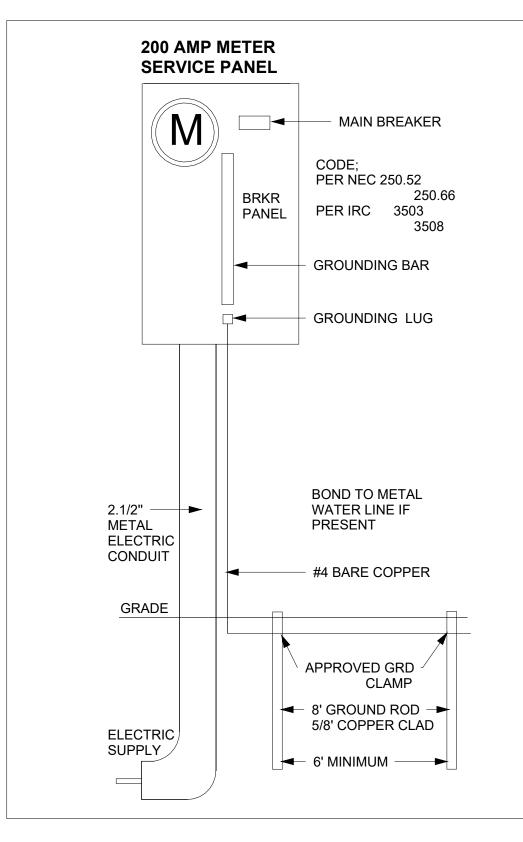



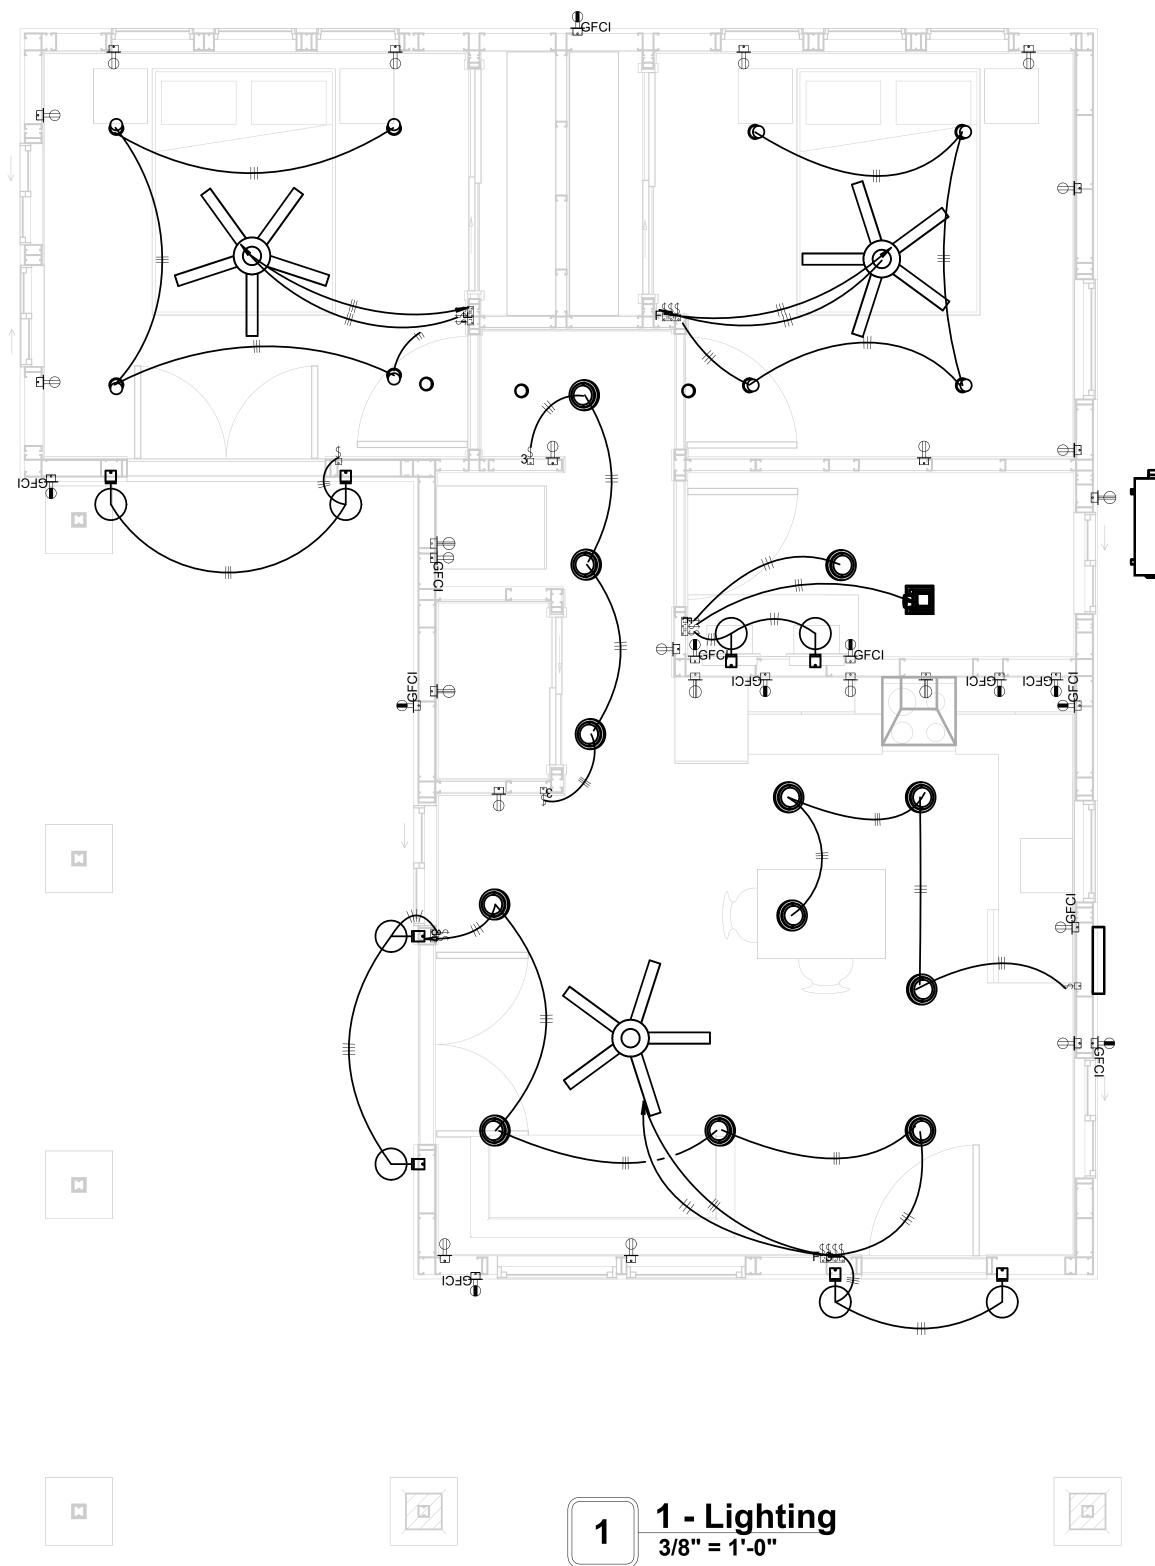

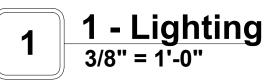



**KEY PLAN** 

NO.	DESCRIPTION	DATE

NOTE:

LEGEND:

PROJECT

189-ORCHARD-746-2Bd1Ba **CRAFTSMAN-550** 

DRAWING NAME


LIGHTING


CLIENT NAME:	Owner
PROJECT NUMBER:	0283_13
DATE:	4/15/2025 7:23:17 AM
DESIGNED BY:	Designer
DRAWN BY:	Author
CHECKED BY:	Checker


E102


## **NOTES: CONDUIT, CABLE AND WIRING**

- Use Metalic Conduits (IMC) for cables running under concrete slabs.
   Use IMC for circuits with high voltage appliances (240 volts and above)
   For circuits with 120 volts consider using EMT or PVC conduits if needed.
   For Low voltage applications up to 50 volts consider using non metalic conduits.
   All conduits to be used in the project must conform to the latest National Electrical Code (NEC),
- 6. All wiring and cables to be used in the project must also conform to the latest National Electrical Code (NEC), 2015.
  7. All cables and wires used should be rated for their respective loading and should be gauged and
- conform to the NEC.

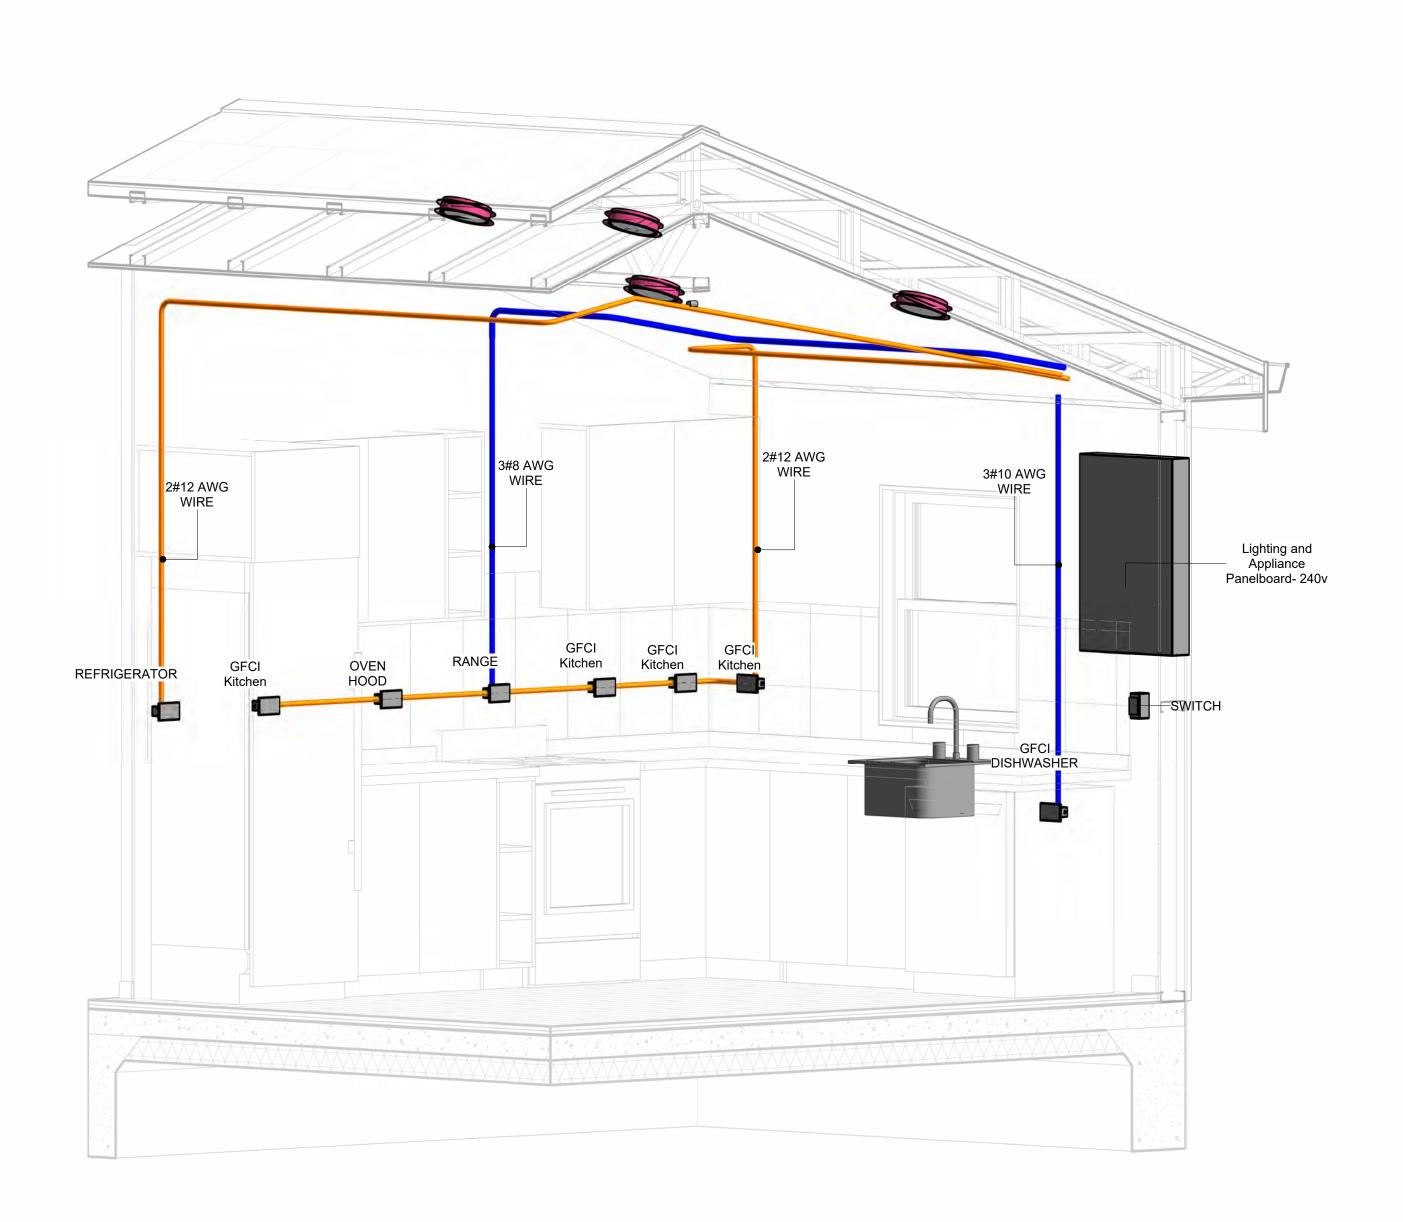


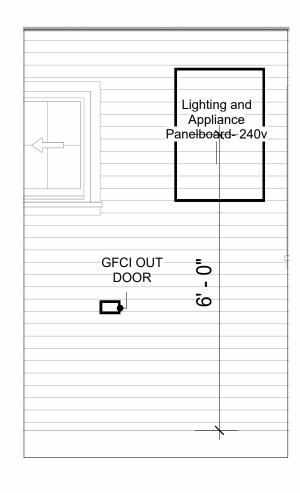

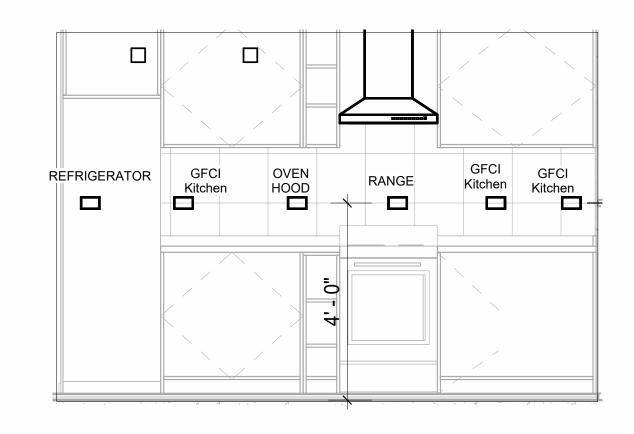

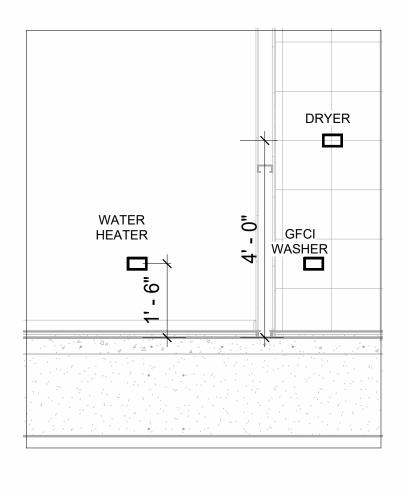

4 Section 3 1/2" = 1'-0"

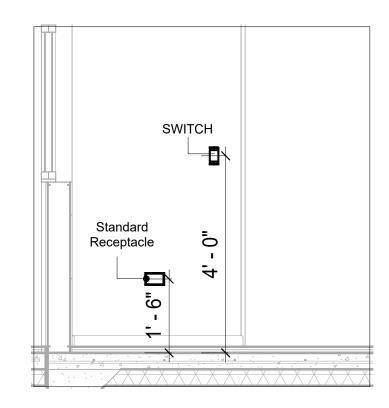


6 Section 4 1/2" = 1'-0"

**3D-KITCHEN** 



**KEY PLAN** 

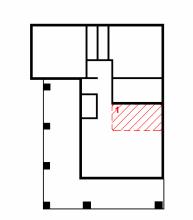

NO.	DESCRIPTION	DATE

NOTE:

LEGEND:

PROJECT

189-ORCHARD-746-2Bd1Ba **CRAFTSMAN-550** 

DRAWING NAME

**POWER** 

CLIENT NAME:	Owner
PROJECT NUMBER:	0283_13
DATE:	4/15/2025 7:23:42 AM
DESIGNED BY:	Designer
DRAWN BY:	Author
CHECKED BY:	Checker

E103

## **NOTES: LIGHT**

- 1. LIGHT FIXTURES AND LUMINARIES SHALL CONFORM TO THE NEC, THE IRC AND LOCAL SAFETY & BUILDING CODE.
- 2. ALL LIGHTING FIXTURES SHOULD CONFORM TO THE DESIGN ELECTRICAL LOAD AND SHALL BE PROPERLY WIRED AND MOUNTED BY QUALIFIED ELECTRICIAN FOLLOWING MANUFACTURERS SPECIFICATIONS.
- 3. CEILING FANS AND FANS WITH LIGHT WITH WEIGHT EXCEEDING 35 LBS SHOULD BE PROVIDED WITH STRUCTURAL BACKING FOR SUPPORT AND SHALL BE FIXED AS PER MANUFACTURERS SPECIFICATIONS.
- 4. EXTERIOR LIGHTS SHALL CONFORM TO LOCAL BUILDING CODE AND GUIDELINES.

## **NOTES: SWITCH JUNCTION BOX**


- 1. THE MINIMUM SIZE OF JUCTION BOX TO BE USED IS 2"X4"X(1.5" OR 3.5" DEEP) THIS ARE TO BE USED FOR SINGLE GANG SWITCH OR OUTLETS.
- 2. FOR DOUBLE GANG (2 GANG) OUTLETS AND SWITCHS THE MINIMUM SIZE OF THE
- JUCTION BOX TO BE PROVIDED SHALL NOT BE LESS THAN 4"X4"X(1.5" OR 3.5" DEEP)

  3. FOR THREE GANG (3 GANG) OUTLETS AND SWITCHS THE MINIMUM SIZE OF THE JUCTION
- BOX SHALL NOT BE LESS THAN 6"X4"X(1.5" OR 3.5" DEEP).

Electrical Fixture Schedule (SWITCH BOX)			
Type	Count		
Double Gang Switch Box	1		
Single Gang Switch Box	5		
Triple Gang Switch Box	4		

Lighting Device		
Type Count		
Fan switch	4	
Single Pole	11	
Single Pole Three Way	4	

Lighting Fixture					
Lighting Fixture Type Voltage Electrical Load Count					
Electrical_Lights_Fan-Light1	120 V/1-100 VA- 120 V/1-100 VA	200 A, 120 V/240 V, Single Phase, 3 Wires	3		
Lighting - Recessed	120 V/1-60 VA	200 A, 120 V/240 V, Single Phase, 3 Wires	12		
SASSO 100 round wallwasher trim	120 V/1-28 VA	200 A, 120 V/240 V, Single Phase, 3 Wires	8		
Wall Lamp - Bracket	120 V/1-100 VA	200 A, 120 V/240 V, Single Phase, 3 Wires	8		

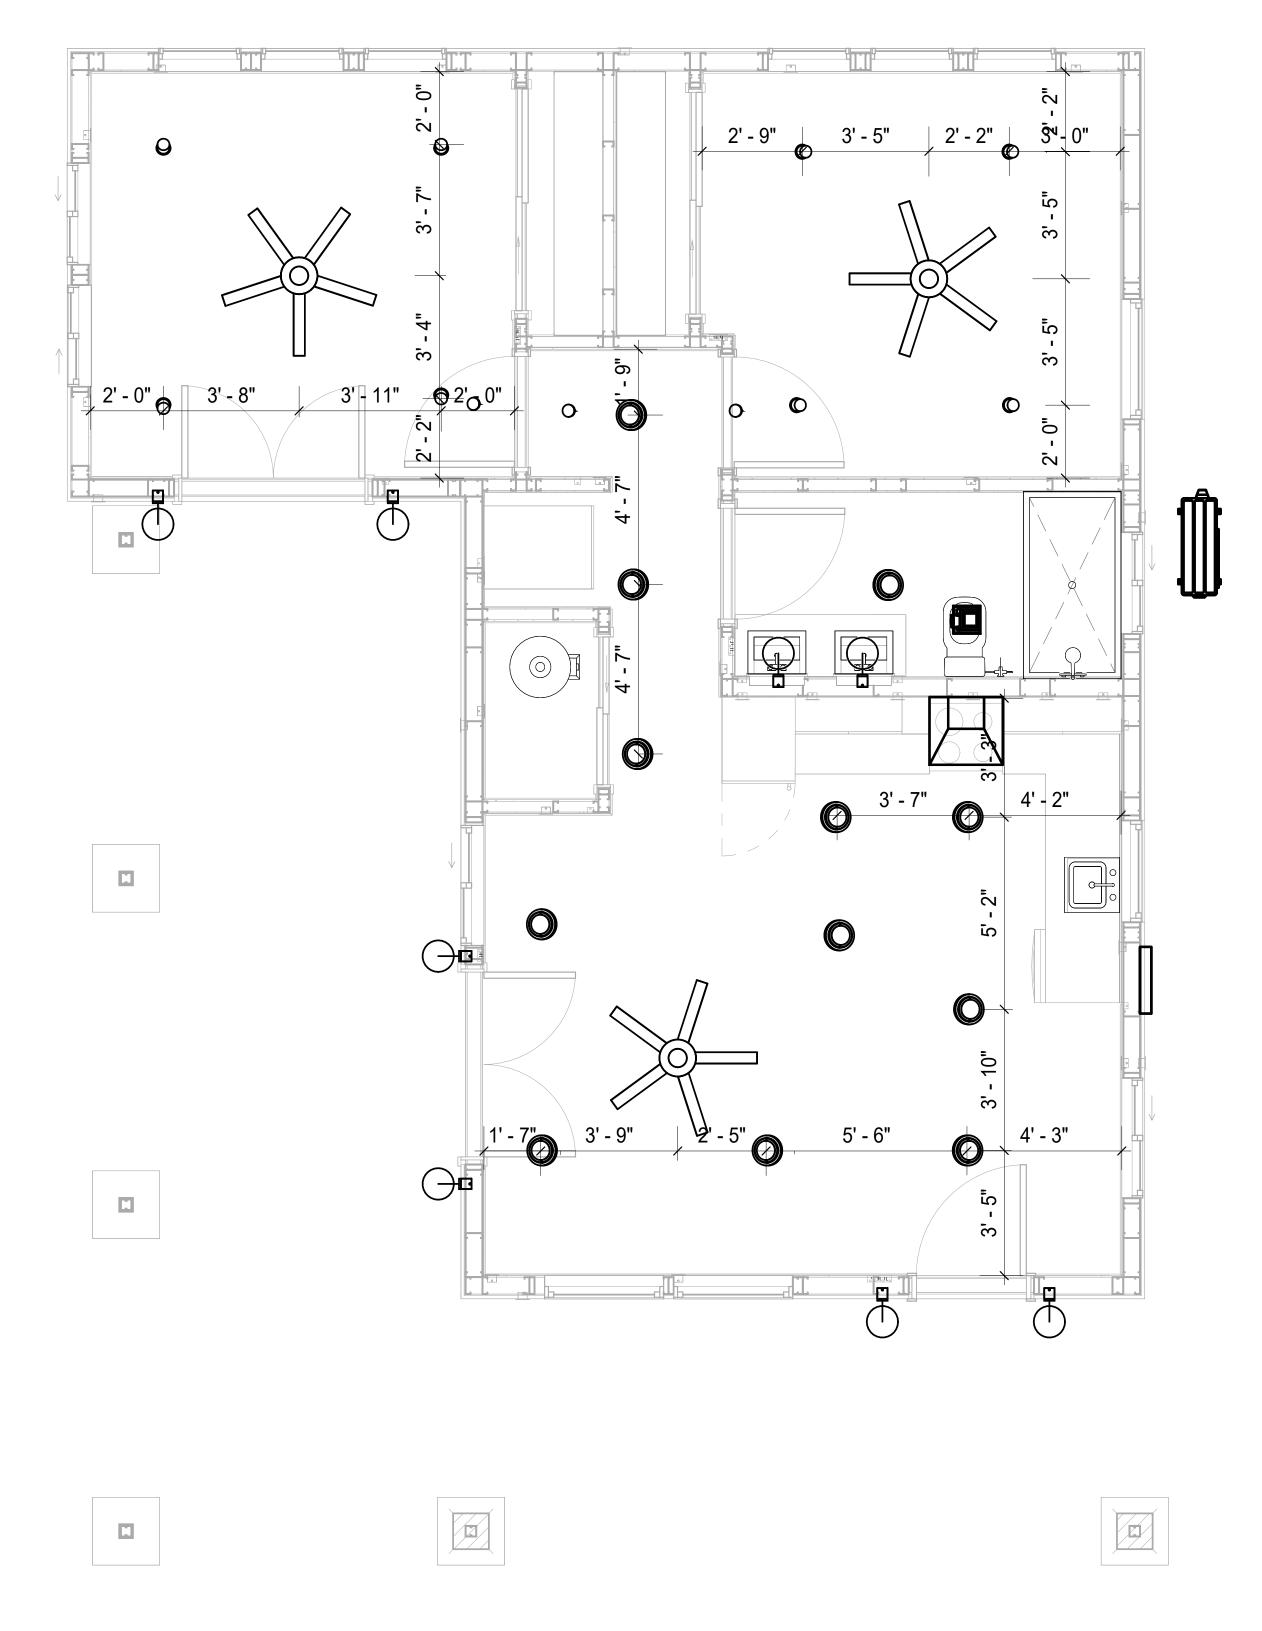





**KEY PLAN** 

NO. DESCRIPTION DATE

NOTE:

LEGEND:

PROJECT

189-ORCHARD-746-2Bd1Ba CRAFTSMAN-550

DRAWING NAME

# DIMENSION PLAN FOR LIGHT FIXTURES

CLIENT NAME:	Owner
PROJECT NUMBER:	0283_13
DATE:	4/15/2025 7:23:43 AM
DESIGNED BY:	Designer
DRAWN BY:	Author
CHECKED BY:	Checker

E104


SCALE: 3/8" = 1'-0"

## NOTES;

- 1. VERIFY EQUIPMENT PLUG CONFIGURATION BEFORE PURCHASING RECEPTACLES
- 2. FOR ALL EQUIPMENT.
- 3. COORDINATE EXACT LOCATION OF LIGHT FIXTURES, WALL SWITCHES, RECEPTACLES AND OTHER DEVICES WITH ARCHITECTURAL DRAWINGS.
- 4. USE METALLIC JUNCTION BOX WITH THE GFCI RECEPTACLES, WITH HIGHT VOLTAGE.

Electrical Fixture Schedule (Receptacle)		
Type Count		
CONDENSER	1	
DRYER	1	
GFCI BATH ROOM	2	
GFCI DISHWASHER	1	
GFCI Kitchen	4	
GFCI OUT DOOR	5	
GFCI WASHER	1	
OVEN HOOD	1	
RANGE	1	
REFRIGERATOR	1	
Standard Receptacle	15	
WATER HEATER	1	

Electrical Outlet Schedule			
Туре	Circuit Number	Electrical Data	Count
CONDENSER	1,3	240 V/2-1500 VA	1
GFCI OUT DOOR	2	120 V/1-180 VA	5
RANGE	5,7	240 V/2-1500 VA	1
GFCI BATH ROOM	8	120 V/1-180 VA	2
GFCI Kitchen	9	120 V/1-180 VA	4
OVEN HOOD	9	120 V/1-180 VA	1
GFCI DISHWASHER	10	120 V/1-1200 VA	1
REFRIGERATOR	11	120 V/1-1500 VA	1
WATER HEATER	13,15	240 V/2-1500 VA	1
Standard Receptacle	14	120 V/1-180 VA	6
DRYER	16,18	240 V/2-1500 VA	1
GFCI WASHER	17	120 V/1-1200 VA	1
Standard Receptacle	19	120 V/1-180 VA	4
Standard Receptacle	20	120 V/1-180 VA	5

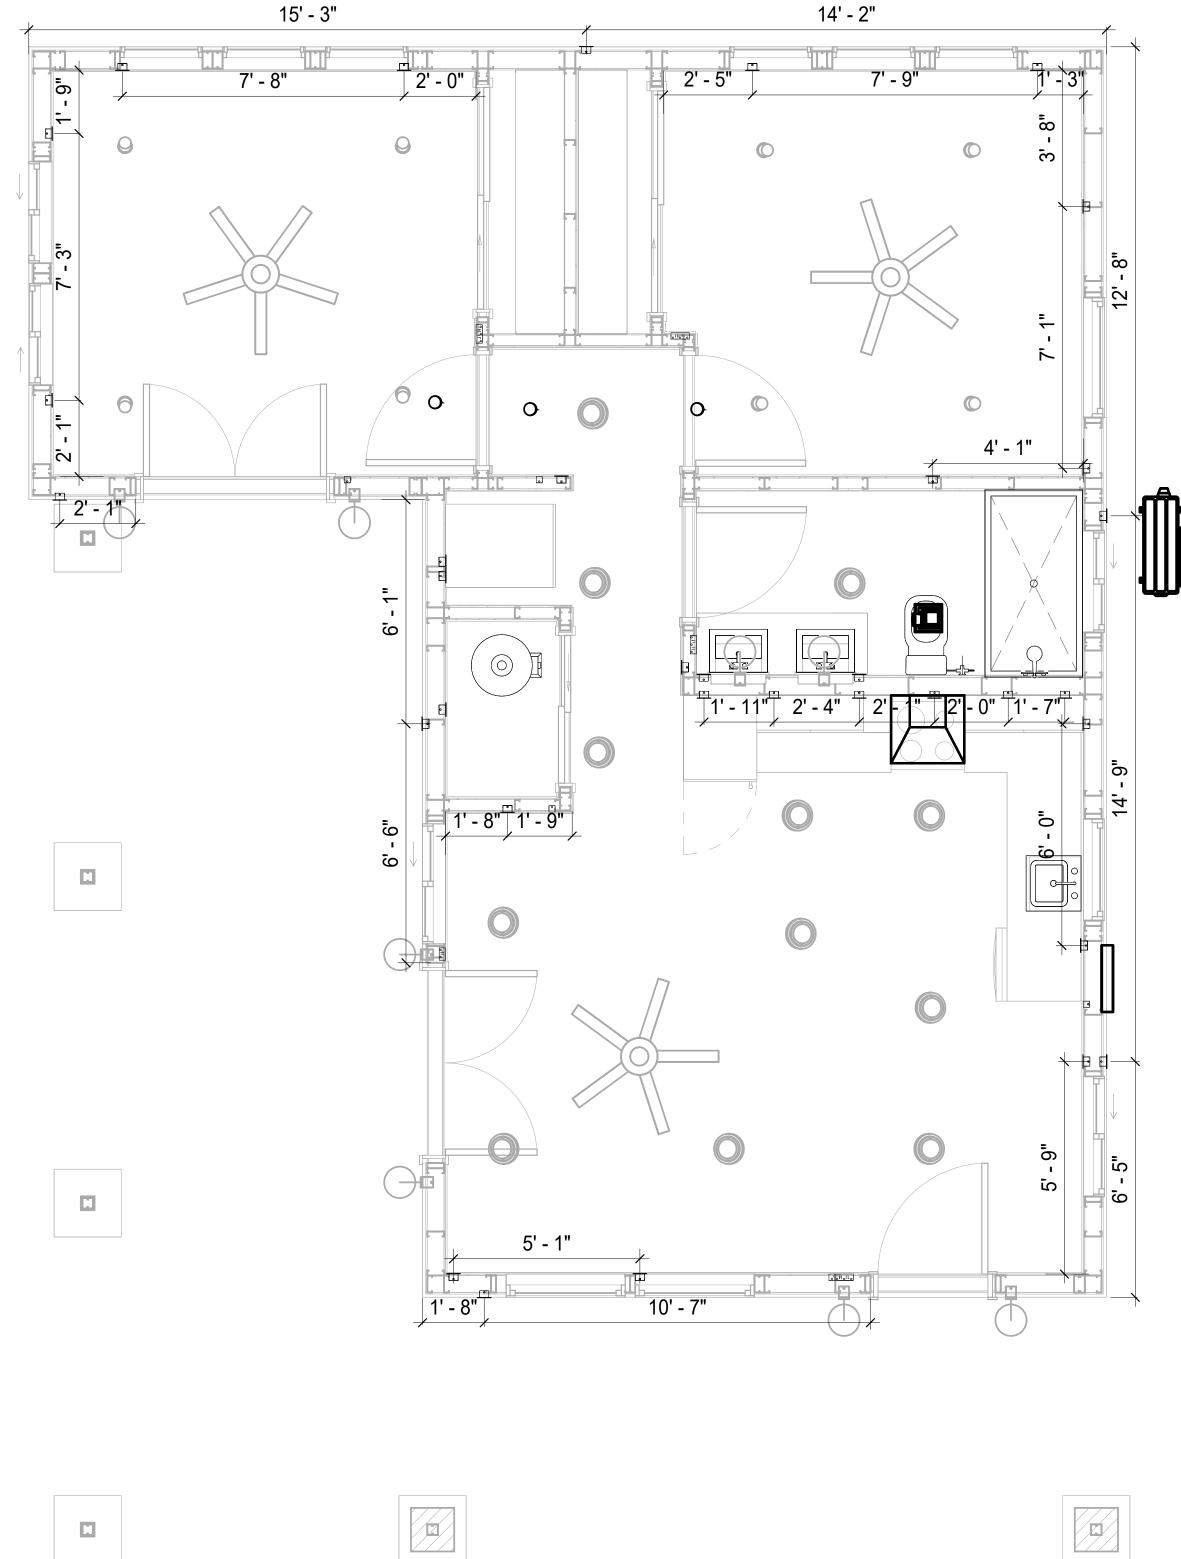

DIMENSION FOR FITTINGS
3/8" = 1'-0"

**KEY PLAN** 

DESCRIPTION DATE

NOTE:

LEGEND:

PROJECT

189-ORCHARD-746-2Bd1Ba CRAFTSMAN-550

DRAWING NAME

## **DIMENSION PLAN** FOR FITTINGS

CLIENT NAME:	Owner
PROJECT NUMBER:	0283_13
DATE:	4/15/2025 7:23:44 AM
DESIGNED BY:	Designer
DRAWN BY:	Author
CHECKED BY:	Checker

E105

SCALE: 3/8" = 1'-0"

## SHEET LIST

**Sheet Name** Sheet Number

P101	NOTE AND SCHEDULE
P102	WATER SUPPLY AND SEWAGE
	SYSTEM

#### PIPe Color SCHEME DOMESTIC COLD WATER DOMESTIC HOT WATER - - - SANITARY VENT SANITARY SEWER STORM DRAINAGE Gray Water GAS LINE

## **PLUMBING NOTES**

- The plumbing system is designed to meet the building's domestic water supply, sanitary drainage, and storm drainage requirements, as per project specifications and applicable codes.
- The system installation shall comply with the latest International Plumbing Code (IPC), International Residential Code (IRC), and all other relevant local, state, and national regulations.
- ALL PLUMBING WORK SHALL COMPLY WITH THE LATEST EDITION OF THE INTERNATIONAL PLUMBING CODE (IPC) AND THE LOCAL PLUMBING CODE.
- PLUMBING SYSTEMS SHALL BE TESTED AND INSPECTED IN ACCORDANCE WITH THE LOCAL PLUMBING CODE REQUIREMENTS.
- PLUMBING FIXTURES SHALL BE INSTALLED WITH THE APPROPRIATE TRIM, FITTINGS, AND ACCESSORIES, AS RECOMMENDED BY THE MANUFACTURER.
- 6. PIPING SHALL BE PROPERLY SUPPORTED AND SECURED TO PREVENT SAGGING,
- MOVEMENT, AND VIBRATION. SHUT-OFF VALVES SHALL BE PROVIDED AT ALL BRANCH CONNECTIONS AND AT THE
- INLET AND OUTLET OF EACH PIECE OF EQUIPMENT. BACKFLOW PREVENTION DEVICES SHALL BE INSTALLED AS REQUIRED BY THE LOCAL
- PLUMBING CODE TO PROTECT THE POTABLE WATER SYSTEM.
- PLUMBING FIXTURES AND EQUIPMENT SHALL BE ACCESSIBLE FOR MAINTENANCE AND SERVICING.
- EXPOSED PLUMBING PIPING AND FIXTURES SHALL BE INSULATED TO PREVENT
- CONDENSATION AND ENERGY LOSS. 11. DEAD ENDS IN THE DRAINAGE SYSTEM MUST BE AVOIDED, EXCEPT WHERE NECESSARY TO INSTALL A CLEANOUT IN AN ACCESSIBLE LOCATION, AND MUST HAVE A VENTED CONNECTION TO THE OUTSIDE ATMOSPHERE.
- 12. THE VERTICAL DEFLECTION OF PVC PIPE MUST NOT EXCEED 5%, AND NO DEFLECTION IS PERMITTED FOR IRON PIPE.
- 13. WORK MUST BE PROPERLY COORDINATED WITH OTHER TRADES TO AVOID CONFLICTS, REFERRING TO THE ARCHITECTURAL AND STRUCTURAL DRAWINGS FOR INFORMATION REGARDING CEILING ELEVATIONS, SPACE CLEARANCES, WALL AND PARTITION LOCATIONS, ETC.
- 14. ALL FIXTURES SHALL HAVE ACCESSIBLE STOPS.
- 15. DOMESTIC WATER PIPING SHALL BE PEX, AND PVC PIPING IS NOT ACCEPTABLE FOR INTERIOR USE
- 16. VENT TERMINATIONS SHALL BE LOCATED AT LEAST 10 FEET FROM OR 3 FEET ABOVE ANY OPERABLE WINDOW, DOOR OPENING, AIR INTAKE, OR VENT SHAFT, AND AT LEAST 3 FEET IN EVERY DIRECTION FROM ANY LOT LINE, ALLEY, OR STREET,
- 17. PIPE AND FITTINGS UTILIZED IN THE WATER SUPPLY SYSTEM SHALL HAVE A MAXIMUM OF 8 PERCENT LEAD.
- 18. ACRYLONITRILE BUTADIENE STYRENE (ABS) SHALL BE USED FOR THE SEWERAGE AND VENTILATION SYSTEM.
- 19. CROSS-LINKED POLYETHYLENE (PEX) SHALL BE USED FOR THE WATER SUPPLY SYSTEM.
- 20. POLYVINYL CHLORIDE (PVC) SHALL BE USED FOR THE RAIN WATER SYSTEM.
- 21. THE MIMIMUM WATER SUPPLY DEPTH UNDER FLOOR FINISH SHOUD BE 1/2".
- ANY PIPE INSTALLED UNDERGROUND MUST HAVE AT LEAST 12 INCHES OF CLEARANCE BETWEEN THE OUTSIDE OF THE PIPE AND ANY OTHER UNDERGROUND STRUCTURE.
- 23. THE MINIMUM CLEARANCE BETWEEN COLD AND HOT WATER LINES IN RESIDENTIAL
- HOMES MAINTAIN A MINIMUM DISTANCE OF 6 INCHES.
- 24. HORIZONTAL SEPARATION BETWEEN WATER AND SEWER LINES: A MINIMUM OF 12 INCHES BETWEEN POTABLE WATER SUPPLY LINES (COLD AND HOT WATER) AND SANITARY SEWER LINES.

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ABS ACRYLONITRILE BUTADIENE STYRENE ABV ABOVE AD AREA DRAIN AFF ABOVE FINISHED FLOOR ALT ALTERNATE BFF BELOW FINISHED FLOOR BLW BELOW CO CLEAN OUT CW COLD WATER D DEGREE DFU Dranage FIXTURE UNIT DIA DIAMETER DN DOWN FCO FLOOR CLEAN OUT FD FLOOR DRAIN FL FLOOR FS FLOOR SINK FT FOOT/FEET HB HOSE BIB HW HOT WATER IN INCH MIN MINIMUM NO NUMBER NTS NOT TO SCALE PEX CROSS-LINKED POLYETHYLENE PLBG PLUMBING PVC POLYVINYL CHLORIDE QTY Quantity RD ROOF DRAIN RED REDUCER RM ROOM RW RAIN WATER SF SQUARE FOOT V VENT VTR VENT THROUGH ROOF W WASTE WCO WALL CLEAN OUT WSFU WATER SUPPLY FIXTURE UNIT		
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FT FOOT/FEET  HB HOSE BIB  HW HOT WATER  IN INCH  MIN MINIMUM  NO NUMBER  NTS NOT TO SCALE  PEX CROSS-LINKED POLYETHYLENE  PLBG PLUMBING  PVC POLYVINYL CHLORIDE  QTY Quantity  RD ROOF DRAIN  RED REDUCER  RM ROOM  RW RAIN WATER  SF SQUARE FOOT  V VENT  VTR VENT THROUGH ROOF  W WASTE  WCO WALL CLEAN OUT	FL	FLOOR
HB HOSE BIB HW HOT WATER IN INCH MIN MINIMUM NO NUMBER NTS NOT TO SCALE PEX CROSS-LINKED POLYETHYLENE PLBG PLUMBING PVC POLYVINYL CHLORIDE QTY Quantity RD ROOF DRAIN RED REDUCER RM ROOM RW RAIN WATER SF SQUARE FOOT V VENT VTR VENT THROUGH ROOF W WASTE WCO WALL CLEAN OUT	FS	FLOOR SINK
HW HOT WATER IN INCH MIN MINIMUM NO NUMBER NTS NOT TO SCALE PEX CROSS-LINKED POLYETHYLENE PLBG PLUMBING PVC POLYVINYL CHLORIDE QTY Quantity RD ROOF DRAIN RED REDUCER RM ROOM RW RAIN WATER SF SQUARE FOOT V VENT VTR VENT THROUGH ROOF W WASTE WCO WALL CLEAN OUT	FT	FOOT/FEET
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NO NUMBER  NTS NOT TO SCALE  PEX CROSS-LINKED POLYETHYLENE  PLBG PLUMBING  PVC POLYVINYL CHLORIDE  QTY Quantity  RD ROOF DRAIN  RED REDUCER  RM ROOM  RW RAIN WATER  SF SQUARE FOOT  V VENT  VTR VENT THROUGH ROOF  W WASTE  WCO WALL CLEAN OUT	IN	INCH
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PVC POLYVINYL CHLORIDE QTY Quantity  RD ROOF DRAIN  RED REDUCER  RM ROOM  RW RAIN WATER  SF SQUARE FOOT  V VENT  VTR VENT THROUGH ROOF  W WASTE  WCO WALL CLEAN OUT	PEX	CROSS-LINKED POLYETHYLENE
QTY Quantity  RD ROOF DRAIN  RED REDUCER  RM ROOM  RW RAIN WATER  SF SQUARE FOOT  V VENT  VTR VENT THROUGH ROOF  W WASTE  WCO WALL CLEAN OUT	PLBG	PLUMBING
RD ROOF DRAIN RED REDUCER RM ROOM RW RAIN WATER SF SQUARE FOOT V VENT VTR VENT THROUGH ROOF W WASTE WCO WALL CLEAN OUT	PVC	POLYVINYL CHLORIDE
RED REDUCER  RM ROOM  RW RAIN WATER  SF SQUARE FOOT  V VENT  VTR VENT THROUGH ROOF  W WASTE  WCO WALL CLEAN OUT	QTY	Quantity
RM ROOM RW RAIN WATER SF SQUARE FOOT V VENT VTR VENT THROUGH ROOF W WASTE WCO WALL CLEAN OUT	RD	ROOF DRAIN
RW RAIN WATER SF SQUARE FOOT V VENT VTR VENT THROUGH ROOF W WASTE WCO WALL CLEAN OUT	RED	REDUCER
SF SQUARE FOOT  V VENT  VTR VENT THROUGH ROOF  W WASTE  WCO WALL CLEAN OUT	RM	ROOM
V VENT VTR VENT THROUGH ROOF W WASTE WCO WALL CLEAN OUT	RW	RAIN WATER
VTR VENT THROUGH ROOF W WASTE WCO WALL CLEAN OUT	SF	SQUARE FOOT
W WASTE WCO WALL CLEAN OUT	V	VENT
WCO WALL CLEAN OUT	VTR	VENT THROUGH ROOF
	W	WASTE
WSFU WATER SUPPLY FIXTURE UNIT	WCO	WALL CLEAN OUT
	WSFU	WATER SUPPLY FIXTURE UNIT

## **PLUMBING LEGEND**

D	Сар
	Bend 45 Deg
B	Bend 90 Deg
	Tee Reducing
	Tee
	Clean Two-Way
	Wye 45 Deg
	Wye 45 Deg Double
	Wye Combination
	P-Trap

PIPE SCHEDULE		
Material	Diameter	Length
Acrylonitrile Butadiene Styrene (ABS)	1 1/2"	14 ft
Acrylonitrile Butadiene Styrene (ABS)	2"	43 ft
Acrylonitrile Butadiene Styrene (ABS)	3"	29 ft
Cross-linked polyethylene (PEX)	1/2"	67 ft
Cross-linked polyethylene (PEX)	3/4"	83 ft
Polyvinyl Chloride - Rigid	2"	79 ft

	FITTING SCHEDULE	
FITTING	Size	QTY
Domestic Cold Water		
PEX 90 Degree Elbow	1/2"ø-1/2"ø	12
PEX 90 Degree Elbow	3/4"ø-3/4"ø	4
PEX Tee Elbow	1/2"ø-1/2"ø	3
PEX Tee Elbow	3/4"ø-3/4"ø	6
PEX Transition Elbow	3/4"ø-1/2"ø	7
Domestic Hot Water		
PEX 90 Degree Elbow	1/2"ø-1/2"ø	12
PEX 90 Degree Elbow	3/4"ø-3/4"ø	4
PEX Tee Elbow	1/2"ø-1/2"ø	2
PEX Tee Elbow	3/4"ø-3/4"ø	3
PEX Transition Elbow	3/4"ø-1/2"ø	5
PVC 90 Degree Bend Elbow	2"ø-2"ø	2
Sewage		
ABS 90 Degree Bend Elbow	3"ø-3"ø	3
ABS P-Trap	1 1/2"ø-1 1/2"ø	4
ABS P-Trap	2"ø-2"ø	2
ABS P-Trap	3"ø-3"ø	1
ABS Reducer Elbow	2"ø-1 1/2"ø	2
ABS Reducer Elbow	3"ø-1 1/2"ø	2
ABS Reducer Elbow	3"ø-2"ø	6
ABS TEE Elbow	1 1/2"ø-1 1/2"ø-1 1/2"ø	2
ABS TEE Elbow	2"ø-2"ø-2"ø	3
ABS TEE Elbow	3"ø-3"ø-3"ø	8
Vent		
ABS 90 Degree Bend Elbow	1 1/2"ø-1 1/2"ø	2
ABS 90 Degree Bend Elbow	2"ø-2"ø	1
ABS Reducer Elbow	2"ø-1 1/2"ø	2
ABS TEE Elbow	2"ø-2"ø	3
ABS Vent Cap Elbow	2"ø	4

	FIXTURE CONNECTION SCHEDULE										
Family	W	V	Trap	cw	HW	QT Y	DFU	тот.	WF U	TOT	NOTES
Dishwasher 2" 1-1/2" 1-1/2" 1/2" 1 0 Drain to sewer see plans											
Dryer	N/A	N/A	N/A	N/A	N/A	1		0			·
Hanging pipes clamp						20		0			
Shower Tray						1		0			
Shower Trim		-	-	1/2"	1/2"	1		0			
Sink Island Single	2"	1-1/2"	1-1/2"	1/2"	1/2"	1		0			
Vanity Sink	2"	1-1/2"	1-1/2"	1/2"	1/2"	2		0			
Washer	2"	1-1/2"	2"	1/2"	1/2"	1		0			DRAINS TO GRAY WATER OR SEWER SEE PLANS
Water Closet	3"	2"	3"	1/2"	1/2"	1		0			
Water Heater	N/A	N/A	N/A	3/4"	3/4"	1		0			

	FIXTURE SCHEDULE								
fixture	QTY	Description							
Dishwasher	1	Drain to sower see plans							
Dryer	1	Drain to sewer see plans							
Hanging pipes clamp	20								
Shower Tray	1								
Shower Trim	1								
Sink Island Single	1								
Vanity Sink	2								
Washer	1	DRAINS TO GRAY WATER OR SEWER SEE PLANS							
Water Closet	1								
Water Heater	1								

ACCESSORIES & FITTINGS SCHEDULE								
fixture	QTY	Descriptions						
DISHWASHER CONNECTOR	1							
Hose Bib	2							
LAUNDRY SWEAT CONNECTOR	1							
Shutoff Valve	8							

PLUMBING SCHEDULE										
FIXTURE Trap Waste Vent C.W H.W										
Dishwasher	1-1/2"	2"	1-1/2"	1/2"	1/2"					
Dryer	N/A	N/A	N/A	N/A	N/A					
Shower Tray										
Shower Trim	-	-	-	1/2"	1/2"					
Sink Island Single	1-1/2"	2"	1-1/2"	1/2"	1/2"					
Vanity Sink	1-1/2"	2"	1-1/2"	1/2"	1/2"					
Washer	2"	2"	1-1/2"	1/2"	1/2"					
Water Closet	3"	3"	2"	1/2"	1/2"					
Water Heater	N/A	N/A	N/A	3/4"	3/4"					

WATER FIXTURE UNIT SCHEDULE								
Family	QTY	UNIT VALUE	TOTAL					
Dishwasher	1		0					
Dryer	1		0					
Shower Tray	1		0					
Shower Trim	1		0					
Sink Island Single	1		0					
Vanity Sink	2		0					
Washer	1		0					
Water Closet	1		0					
Water Heater	1		0					

WASTE FIXTURE UNIT SCHEDULE								
Family	QTY	DFU Values	TOTAL					
Dishwasher	1		0					
Dryer	1		0					
Hanging pipes clamp	20		0					
Shower Tray	1		0					
Shower Trim	1		0					
Sink Island Single	1		0					
Vanity Sink	2		0					
Washer	1		0					
Water Closet	1		0					
Water Heater	1		0					



**KEY PLAN** 

DESCRIPTION DATE

NOTE:

LEGEND:

PROJECT

189-ORCHARD-746-2Bd1Ba **CRAFTSMAN-550** 

DRAWING NAME


CHECKED BY:

## **NOTE AND SCHEDULE**

CLIENT NAME: PROJECT NUMBER: 0283\_13 5/5/2025 11:17:25 PM Designer DESIGNED BY: DRAWN BY: Author


P101

Checker

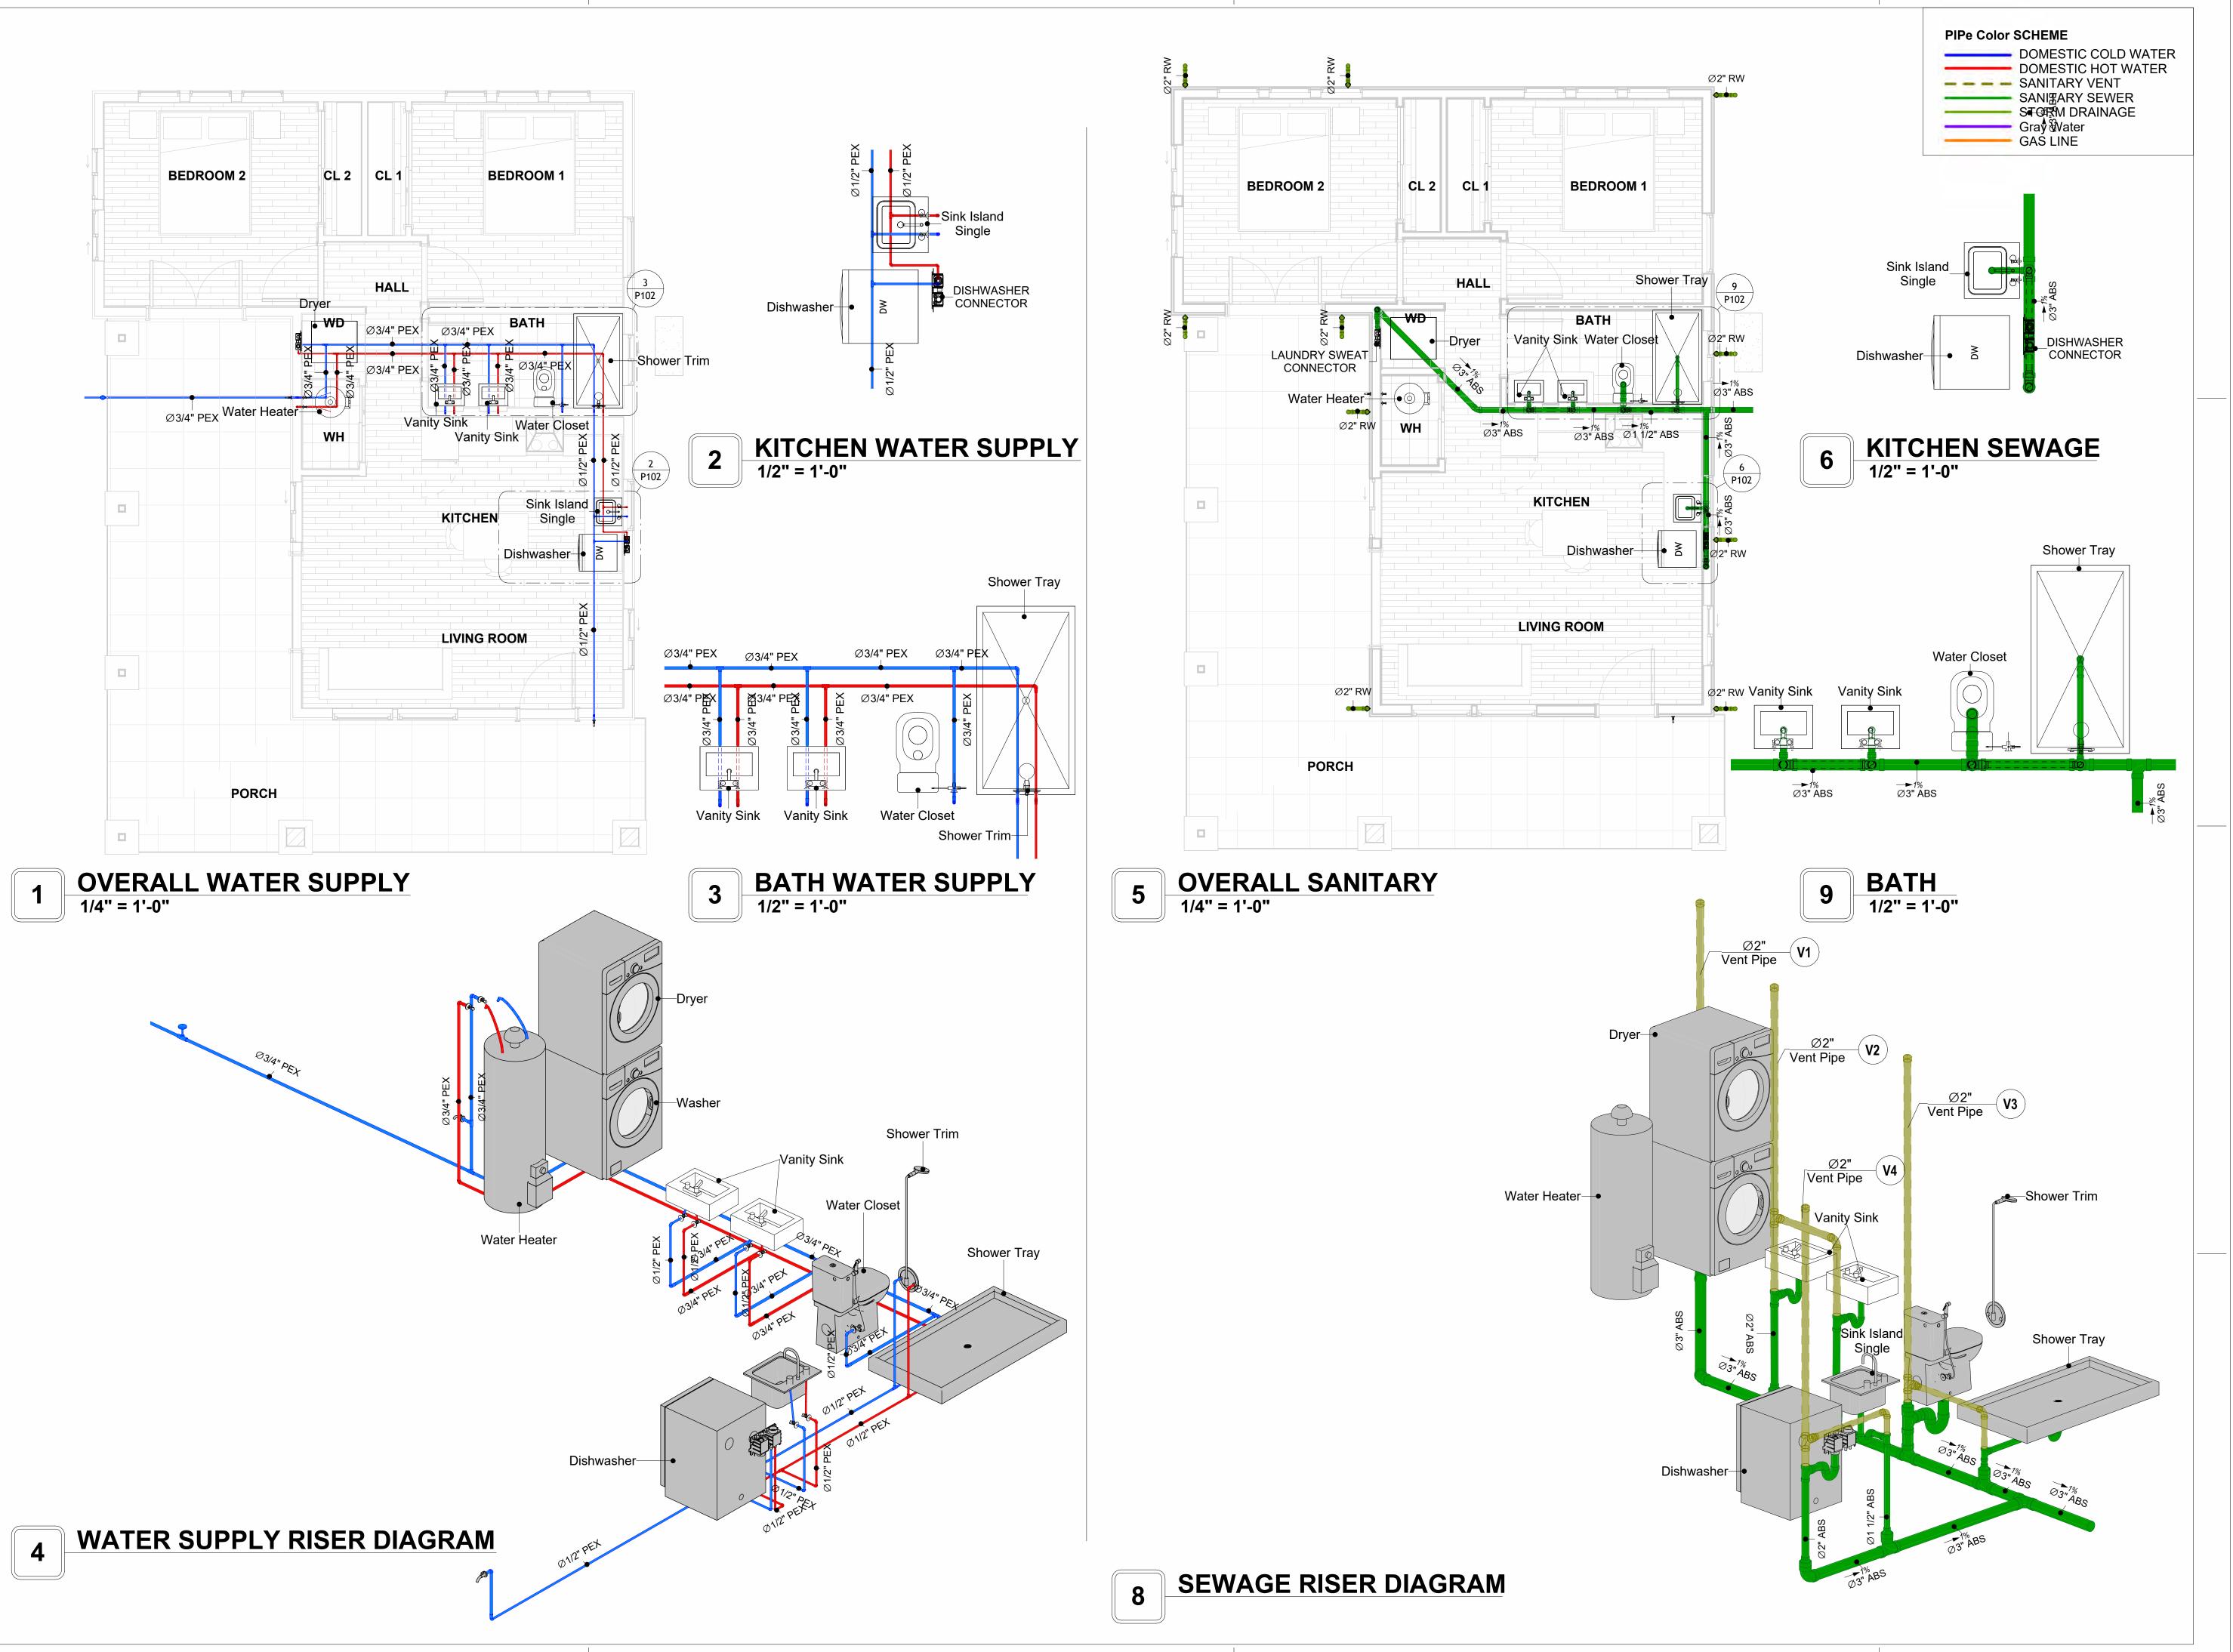



KEY PLAN

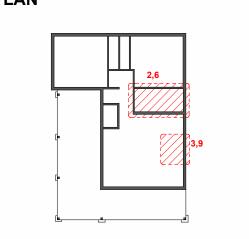

DATE

DESCRIPTION

NOTE:

LEGEND:

PROJECT

189-ORCHARD-746-2Bd1Ba CRAFTSMAN-550

DRAWING NAME

# WATER SUPPLY AND SEWAGE SYSTEM

 CLIENT NAME:

 PROJECT NUMBER:
 0283\_13

 DATE:
 5/5/2025 11:17:51 PM

 DESIGNED BY:
 Designer

 DRAWN BY:
 Author

 CHECKED BY:
 Checker

P102

# Materials Shopping List

Please print and take this Materials Shopping List to your favorite Home Depot and ask for assistance in selecting the materials, fixtures and fittings to complete your new home.

Record your selection and the price of the item. Then do the math to determine the cost for your selections and the total cost of finishing your home.

#### **Have It Your Way!**

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Have It Your Way!



# 20 good reasons to frame a home with metal and not wood



Why build your ADU with metal vs wood	Wood	Metal	Explanation
1 DIY Construction Benefit		<b>~</b>	The wall frames, trusses and beams can be erected in a just a few days
2 Minimal Construction Skills Required		<b>~</b>	Pre-assembled walls and trusses require no specialized skills to errect
3 Build as DIY, Hybrid or by a General Contractor		<b>~</b>	Do it yourself, Hybrid (involve special contractors) or hire a General Contractor
4 Build It As You Can Afford It		<b>~</b>	Impervious to Weather - build as you have the time and money
5 Up Front Cost of Framing Materials	~		As to only the framing material, wood is less expensive
6 Total Cost To Build		<b>~</b>	Savings in time, labor, and other areas make light gauge steel LESS expensive
7 Termites and wood boring insects		<b>~</b>	Termites, carpenter ants and wood boring insects eat wood, not metal
8 Mold resistant		<b>~</b>	Metal does not attract mold
9 Damage caused by exterior and interior flooding		<b>~</b>	Metal needs no reconditioning after a flood
10 Fire Resistant		<b>~</b>	Non-combustible
11 Lower insurance rates		<b>~</b>	Many insurance underwriters now provide lower rates for metal framed homes
12 Walls, trusses, and beams retain their original form		<b>~</b>	Perfectly straight walls - no shimming of drywall
13 Corners are 90 degrees		<b>~</b>	No need for templating of countertops to adjust for out of square corners
14 Strength and weight		<b>~</b>	Metal is stronger than wood and weighs less - no need for crane to lift ADU trusses
15 IBC Engineered Stamp		<b>~</b>	If an engineering stamp is necessary, months of waiting are saved
16 Complete BOM (Materials Shopping List)		<b>~</b>	Take the materials shopping list to Home Depot and start shopping/pricing
17 Flexible in Seismic Areas - Won't Fracture		<b>~</b>	Light gauge steel is flexible and won't fracture when the earth moves
18 No Waste At Job Site		<b>~</b>	Steel is the most recycled material in the world. A typical wood home has 20-30% waste
19 Environmentally Friendly		<b>~</b>	Trees don't have to be destroyed and the source of most metal is from recycling
20 How-To Videos Included		<b>~</b>	How-to videos provide simple assembly instructions
21 Relationship Counselor		<b>~</b>	Eliminate emotional uphevels - save time, money, and preserve the relationship

#### Universal Requirements - some or all may be required

- 1 Site plan
- 2 Electrical Supply Connection
- 3 Sewer Connection
- 4 Fresh Water Supply Connection
- 5 Set Backs
- 6 Soils Evaluation

- 7 Earthquake (fault) evaluation
- 8 Foundation Plan subject to soils
- 9 Compliance with local energy codes: insulation home wrap and flashing
- 10 Engineering for wind speed and snow load.
- 11 State and Local ordinances regarding ADUs
- 12 Local Architect and/or Engineer may be necessary

#### Orchard-2Bd1Ba-Craftsman





# Orchard-2Bd1Ba-Craftsman MATERIAL SHOPPING LIST

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#### TOC



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#### **GENERAL NOTES**

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- 6 The customer is advised to consult a qualified professional or technician prior to purchasing materials for specialized construction system items. Some items including but not limited to caseworks, doors and windows may require as built measurements prior to purchase to confirmation of final dimensions.
- 7 If there are additional trim elements or specific installation methods, the total amount of materials needed might vary. Consider any additional trim required for corners, intersections, or other architectural details that might cause this variations before procedding to purchase and construction.

#### **ARCHITECTURAL BOM**



	Orchard-2Bd1Ba-Craftsman								
ARCHITECTURAL MATERIAL SHOPPING LIST									
No.	Item	Туре	Unit	Quantity	Unit Price	Total	Description		
	APPLIANCES								
	Refrigerator		PCS	1					
2	Range		PCS	1					
3	Washer		PCS	1					
4	Dryer		PCS	1					
5	Dish Washer		PCS	1					
6	Oven		PCS	0					
	Microwave		PCS	0					
<u> </u>	CASEWORKS								
	Kitchen Cabinet		FT	17.08					
2	Laundry Cabinet		FT	2.25					
3	Vanity Cabinet		FT	4.6					
4	Medicine Cabinet		PCS	2					
	Kitchen countertop		SF	27.16					
	Laundry Countertop		PCS	0					
7	Bathroom Countertop		SF	0					
8	Island		FT	0					
9	Peninsula		FT	0					
	Closets		SF	85.9					
	CEILING								
	Ceiling Board	Dry Wall	SF	643					
2	Dry Wall Fastener	Screw	PCS	1125					
3	Vapor Retarder	Polyethylene film	SF	817					
4	Vapor Retarder Fastener	Nails with washer heads	PCS	2451					
5	Ceiling Board (MRD)	Moisture resistant drywall	SF	55					
6	MRD Fastener		PCS	96					
7	Ceiling Board	Marine Plywood	SF	119					
8	Marine Plywood Fastener	Screw	PCS	208					
	Dry Wall Tape		FT	409					
	FLOORING	•			-				
1	Main Living Space		SF	301.7					
2	Bathroom		SF	66.9					
3	Bedroom		SF	284.4					
4	Porch		SF	424.5					
	STRUCTURE					-			
	Foundation		SF	1172.2					
	WALLS EXTERIOR	·							
1	Siding		SF	868					
2	Siding Fastener	Self-drilling screws(100/pkt)	PKT	8.68					
3	Stone Veneer	J , , ,	SF	91					
4	Mortar Stone Veneer		SF	91					
5	Wall Homewrap		SF	961					
	Homewrap Fastener	Stapled fastener (200/pkt)	PKT	3.7					
	Furring Strip		PCS	120					
	Furring Strip Fastner	Self-drilling screws(100/pkt)	PKT	9.6					
	Wall Shteathing (OSB)	2 2	SF	961					
	Shteathing Fastener	Self-drilling screws(100/pkt)	PKT	9.61					
	Wall Paint	Con drining Screws(100/pkt/)	SF	961					
	Wall Insulation		FT	1436					
	WALLS INTERIOR	1	i i	1 1730					
	Cementitious Backer Board		SF	387	1				
	Kerdi membrane		SF	387					
	Kerdi membrane Fastener		SF	387					
	Wall Ceramic Tile		SF	387					
	Drywall Board		SF	1583					
	Drywall Fastener	Self-drilling screws(100/pkt)	PKT	15.83					
	Wall Paint	Sell-utilling Screws(100/pkt)							
			SF	1583					
	Drywall Tape		FT	299					
9	Wall Sweep		FT	185					

#### **ARCHITECTURAL BOM**



	DOORS				
	Exterior Swinging	5' - 0" X 6'-8"	PCS	2	
	Exterior Swinging	3' - 0" X 6'-8"	PCS	1	
3	Interior Swinging	3' - 0" X 6'-8"	PCS	3	
4	Interior Sliding	4' - 0" X 6'- 8"	PCS	1	
5	Interior Sliding	6' - 0" X 6'-8"	PCS	2	
6	Exterior Door Trim		FT	53.02	
7	Interior Door Trim		FT	263.1	
8	Entry Lock set		PCS	3	
9	Privacy Lock set		PCS	3	
10	Passage Lock set		PCS	3	
	WINDOWS		1. 22		'
1	Single Hung	3' - 3" X 4'-9"	PCS	3	
2	Fixed	2' - 3" X 2'-9"	PCS	6	
3	Sliding	2' - 9" X 4'-3"	PCS	2	
4	Sliding	3' - 3" X 3'-3"	PCS	1	
5	Sliding	3' - 3" X 3'-3"	PCS	1	
6	Sliding	2' - 9" X 2'-3"	PCS	1	
7	Single Hung	2' - 9" X 3'-3"	PCS	1	
8	Sliding	3' - 3" X 2'-3"	PCS	1	
9	Exterior Window Trim		FT	179	
10	Interior Window Trim		FT	179	
	ROOF				·
1	Roof Covering		SF	1025	
2	Roof Covering Fastener		PCS	512.5	
3	Roof Felt Paper		SF	1025	
4	Roof Felt Paper Fastener		PCS	3075	
5	Roof Sheathing		SF	1025	
6	Roof Sheathing Fastener		PCS	8200	
7	Batten		FT	0	
8	Batten Fastener		PCS	0	
9	Soffit		SF	143	
10	Soffit Fastener		PCS	71.5	
	Fascia		FT	147	
	Fascia board fastener		PCS	73.5	
13	Roof Insulation		SF	1025	



	Orchard-2Bd1Ba-Craftsman								
	FI	ECTRICAL MATER	ΙΔΙ SHΩΡ	PING LI	TZ				
No.	Item	Type	Unit		Unit Price	Total	Description		
	LIGHTING FIXTURES	. , , , , ,	, C		0	. ota.	2 000		
1	Kitchen Ceiling Light		PCS	3					
	Kitchen Wall Mounted Light		PCS	0					
	Exterior Wall Mounted Light		PCS	6					
4	Livingroom Ceiling Light With Fan		PCS	1					
5	Bedroom Ceiling Light With Fan		PCS	2					
	Dining Ceiling Light		PCS	2					
	Bath Wall Mounted Light		PCS	2					
	Bathroom Ceiling Light		PCS	1					
	Livingroom Ceiling Light		PCS	3					
	Bedroom Ceiling Light		PCS	8					
	Hall & Entry Ceiling Light		PCS	3					
	Closet Ceiling Light		PCS	0					
	Smoke Detector		PCS	3					
	ELECTRICAL FITTINGS		. 00						
	Standard Receptacle 120V	20A	PCS	16					
	GFCI Receptacle 120V	20 A	PCS	19					
16	GFCI Receptacle 240V	30 A	PCS	3					
17	GFCI Receptacle 240V	50 A	PCS	1					
18	GFCI Receptacle 240V	60 A	PCS	1					
	Fan Switch	00 A	PCS	3					
_	Single Pole Switch		PCS	9					
	Three Way Switch		PCS	4					
	Dimmer Switch		PCS						
			PCS	0					
	ELECTRICAL CONDUITS & WIRING	4.4/2/\41/	FT	0	1				
	ROMEX 14 AWG	14/3/W/ground		0					
	ROMEX 12 AWG	12/2/W/ground	FT	453					
_	ROMEX 10 AWG	10/3/W/ground	FT	63					
	Romex 8 AWG	8/3/W/ground	FT	10					
	ROMEX 6 AWG	6/3/W/ground	FT	16					
	Bare Copper Ground Wire 6 AWG		FT	0					
_	ELECTRICAL BOXES & CIRCUTES	000 1115	D00						
	Panelboard -240V 1 Phase MLO	200 AMP	PCS	1					
	Circuit breaker	15 A	PCS	0					
-	Circuit breaker	20 A	PCS	12					
	Circuit breaker	30 A	PCS	3					
	Circuit breaker	50 A	PCS	1					
	Circuit breaker	60 A	PCS	1					
	Single Gang Switch Box		PCS	7					
	Double Gang Switch Box		PCS	1					
	Triple Gang Switch Box		PCS	2					
	Pull Box	#1/4	PCS	22					
39	Receptacle Box		PCS	40					



		Orchard-2B	d1Ba-Cra	ftsman			
	P	LUMBING SYSTEM M	IATERIAL				
Vo.	Item	Туре	Unit	Quantity	Unit Price	Total	Description
Δ	PLUMBING FIXTURES & ACCESSORIES						
1	Bath Tub (Alcove Tub)		PCS	0			
2	Kitchen Sink		PCS	1			
3	Kitchen Faucets		PCS	1			
4	Vanity Sink		PCS	2			
5	Bath room Faucets		PCS	2			
6	Water Closet		PCS	1			
7	Shower Trim		PCS	1			
8	Shower Tray		PCS	1			
9	Water Heater		PCS	1			
10	Hose Bib		PCS	2			
11	Shutoff Valve		PCS	8			
	Hanging pipe clamp		PCS	20			
	Gate Valve		PCS	1			
	Dishwasher Supply Single Connector		PCS	1			
	Dishwasher Sewage Single Connector		PCS	1			
16	Laundry Sweat Connector		PCS	1			
$\triangle$	SANITARY & PLUMBING PIPES						
	ABS (Acrylonitrile Butadiene Styrene) Pipes	ø 1"	FT	0			
	ABS (Acrylonitrile Butadiene Styrene) Pipes	ø 1 1/2"	FT	14			
	ABS (Acrylonitrile Butadiene Styrene) Pipes	ø 2"	FT	43			
	ABS (Acrylonitrile Butadiene Styrene) Pipes	ø 3"	FT	29			
	PEX (Cross-linked polyethylene) Pipes	ø 1/2"	FT	67			
6	PEX (Cross-linked polyethylene) Pipes	ø 3/4"	FT	85			
	PEX (Cross-linked polyethylene) Pipes	ø 1"	FT	0			
8	PVC Pipes Sch.80 - Rigid	ø 1 1/2"	FT	0			
9	PVC Pipes Sch.80 - Rigid	ø 2"	FT	123			
10	PVC Pipes Sch.80 - Rigid	ø 3"	FT	0			
11	Flex Pipe Round	ø 1/2"	PCS	8			
12	Flex Pipe Round	ø 3/4"	PCS	0			
	Flex Pipe Round	ø 1"	PCS	0			
	PIPE FITTINGS						
1	PEX 90 Degree Elbow	1/2"ø-1/2"ø	PCS	12			
2	PEX 90 Degree Elbow	3/4"ø-3/4"ø	PCS	4			
3	PEX Tee Elbow	1/2"ø-1/2"ø-1/2"ø	PCS	3			
4	PEX Tee Elbow	3/4"ø-3/4"ø-3/4"ø	PCS	6			
5	PEX Transition Elbow	3/4"ø-1/2"ø	PCS	8			
6	PEX 90 Degree Elbow	1/2"ø-1/2"ø	PCS	12			
	PEX 90 Degree Elbow	3/4"ø-3/4"ø	PCS	4			
	PEX Tee Elbow	1/2"ø-1/2"ø-1/2"ø	PCS	2			
9	PEX Tee Elbow	3/4"ø-3/4"ø-3/4"ø	PCS	3			
10	PEX Transition Elbow	3/4"ø-1/2"ø	PCS	6			
	PVC 90 Deg Bend Elbow	2"ø-2"ø	PCS	26			
	PVC 90 Degree Bend Elbow	2"ø-2"ø	PCS	2			
	PVC TEE Elbow	2"ø-2"ø-2"ø	PCS	3			
	ABS 90 Degree Bend Elbow	3"ø-3"ø	PCS	3			
	ABS P-Trap	1 1/2"ø-1 1/2"ø	PCS	4			
	ABS P-Trap	2"ø-2"ø	PCS	2			
	ABS P-Trap	3"ø-3"ø	PCS	1			
	ABS Reducer Elbow	2"ø-1 1/2"ø	PCS	2			
	ABS Reducer Elbow	3"ø-1 1/2"ø	PCS	2			
	ABS Reducer Elbow	3"ø-2"ø	PCS	6			
	ABS TEE Elbow	1 1/2"ø-1 1/2"ø-1 1/2"ø	PCS	2			
	ABS TEE Elbow	2"ø-2"ø-2"ø	PCS	3			
	ABS TEE Elbow	3"ø-3"ø-3"ø	PCS				
	ABS 90 Degree Bend Elbow	1 1/2"ø-1 1/2"ø	PCS	8			
	ABS 90 Degree Bend Elbow		PCS	1			
	ABS Reducer Elbow	2"ø-2"ø					
		2"ø-1 1/2"ø	PCS	2			
27	ABS TEE Elbow ABS Vent Cap Elbow	2"ø-2"ø-2"ø 2"ø	PCS PCS	3			

		Orchard	-2Bd1Ba-0	Craftsma	n		
		HVAC SYSTEM I	MATERIAL	SHOPP	ING LIST		
No.	Item	Туре	Unit	Quantity	Unit Price	Total	Description
	HVAC_DUCTS						
1	PIPE (REFRIGERANT LINE)	3/8" (Ø)	FT	79.45			
2	PIPE (REFRIGERANT LINE)	3/4" (Ø)	FT	92.17			
3	DRAYER HOSE	4" (Ø)	FT	4			
4	FLEX DUCT ROUND	4" (Ø)	FT	3.9			
	<b>DUCT FITTINGS &amp; ACCESSORIES</b>						
5	ELBOW (REFRIGERANT LINE)	3/4" (Ø)-3/4" (Ø)	PCS	20			
6	ELBOW (REFRIGERANT LINE)	3/8" (Ø)-3/8" (Ø)	PCS	19			
7	TRANSITION (REFRIGERANT	3/4" (Ø)-1/2" (Ø)	PCS	3			
8	TRANSITION (REFRIGERANT	3/4" (Ø)-3/8" (Ø)	PCS	3			
9	TRANSITION (REFRIGERANT	3/8" (Ø)-1/4" (Ø)	PCS	2			
10	TEE (REFRIGERANT LINE)	3/4" (Ø)-3/4" (Ø)-3/4" (Ø)	PCS	2			
11	TEE (REFRIGERANT LINE)	3/8" (Ø)-3/8" (Ø)-3/8" (Ø)	PCS	2			
12	ROUND TRANSITION(ANGLE)	45 DEGREE	PCS	5			
	HVAC_EQUIPMENTS						
13	AIR HANDLING UNIT	WALL MOUNTED	PCS	3			
14	CONDENSER	OUTDOOR UNIT	PCS	1			
15	EXHAUST FAN	75 CFM	PCS	1			
16	EXHAUST HOOD	WALL MOUNTED	PCS	1			
17	HOOD-WALL: VENT	HOOD-WALL: VENT	PCS	1			
18	DRAYER: VENT	DRAYER: VENT	PCS	1			
19	ROOF VENT	3"(Ø)	PCS	1			



#### **Table Of Content**

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			LIGHTING FIXTURES				
#	Item	Туре	Description, Manufacturer, SKU	Unit	Quantity	Unit Price	Total
1	Kitchen Ceiling Light			PCS	3		
3	Kitchen Wall Mounted Light			PCS	0		
4	Exterior Wall Mounted Light			PCS	6		
5	Livingroom Ceiling Light With Fan			PCS	1		
6	Bedroom Ceiling Light With Fan			PCS	2		
7	Dining Ceiling Light			PCS	2		
8	Bath Wall Mounted Light			PCS	2		
9	Bathroom Ceiling Light			PCS	1		
10	Livingroom Ceiling Light			PCS	3		
11	Bedroom Ceiling Light			PCS	8		
12	Hall & Entry Ceiling Light			PCS	3		
12	Closet Ceiling Light			PCS	0		
13	Smoke Detector			PCS	3		
14							
15							



			ELECTRICAL FITTINGS				
#	Item	Туре	Description, Manufacturer, SKU	Unit	Quantity	Unit Price	Total
1	Standard Receptacle 120V	20A		PCS	16		
2	GFCI Receptacle 120V	20 A		PCS	19		
3	GFCI Receptacle 240V	30 A		PCS	3		
1	GFCI Receptacle 240V	50 A		PCS	1		
5	GFCI Receptacle 240V	60 A		PCS	1		
6	Fan Switch			PCS	3		
7	Single Pole Switch			PCS	9		
8	Three Way Switch			PCS	4		
9	Dimmer Switch			PCS	0		
10		,	·	'			
11							
12							
13							
14							
15							



		ELECTR	ICAL CONDUITS & WIRING				
#	Item	Туре	Description, Manufacturer, SKU	Unit	Quantity	Unit Price	Total
1	ROMEX 14 AWG	14/3/W/ground		FT	0		
3	ROMEX 12 AWG	12/2/W/ground		FT	453		
4	ROMEX 10 AWG	10/3/W/ground		FT	63		
6	Romex 8 AWG	8/3/W/ground		FT	10		
8	ROMEX 6 AWG	6/3/W/ground		FT	16		
9	Bare Copper Ground Wire 6 AWG			FT			
10							
11							
12							
13							
14							
15							
16							



		ELEC	TRICAL BOXES & CIRCUTES				
#	Item	Туре	Description, Manufacturer, SKU	Unit	Quantity	Unit Price	Total
1	Panelboard -240V 1 Phase MLO	200 AMP		PCS	1		
2	Circuit breaker	15 A		PCS	0		
3	Circuit breaker	20 A		PCS	12		
4	Circuit breaker	30 A		PCS	3		
5	Circuit breaker	50 A		PCS	1		
6	Circuit breaker	60 A		PCS	1		
7	Single Gang Switch Box			PCS	7		
8	Double Gang Switch Box			PCS	1		
9	Triple Gang Switch Box			PCS	2		
10	Pull Box	#1/4		PCS	22		
11	Receptacle Box			PCS	40		
12							
13							
14							
15							

			HVAC_DUCTS 01				
#	Item	Туре	Description, Manufacturer, SKU	Unit	Quantity	Unit Price	Total
1	PIPE (REFRIGERANT LINE)	3/8" (Ø)		FT	79.45		
2	PIPE (REFRIGERANT LINE)	3/4" (Ø)		FT	92.17		
3	DRAYER HOSE	4" (Ø)		FT	4		
4	FLEX DUCT ROUND	4" (Ø)		FT	3.9		
5							
6							
7							
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			DUCT FITTINGS & ACCESSORIES				
#	Item	Туре	Description, Manufacturer, SKU	Unit	Quantity	Unit Price	Total
1	ELBOW (REFRIGERANT LINE)	3/4" (Ø)-3/4" (Ø)		PCS	20		
2	ELBOW (REFRIGERANT LINE)	3/8" (Ø)-3/8" (Ø)		PCS	19		
3	TRANSITION (REFRIGERANT LINE)	3/4" (Ø)-1/2" (Ø)		PCS	3		
4	TRANSITION (REFRIGERANT LINE)	3/4" (Ø)-3/8" (Ø)		PCS	3		
5	TRANSITION (REFRIGERANT LINE)	3/8" (Ø)-1/4" (Ø)		PCS	2		
6	TEE (REFRIGERANT LINE)	3/4" (Ø)-3/4" (Ø)-3/4" (Ø)		PCS	2		
7	TEE (REFRIGERANT LINE)	3/8" (Ø)-3/8" (Ø)-3/8" (Ø)		PCS	2		
8	ROUND TRANSITION(ANGLE)	45 DEGREE		PCS	5		
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			HVAC_EQUIPMENTS				
#	Item	Туре	Description, Manufacturer, SKU	Unit	Quantity	<b>Unit Price</b>	Total
1	AIR HANDLING UNIT	WALL MOUNTED		PCS	3		
2	CONDENSER	OUTDOOR UNIT		PCS	1		
3	EXHAUST FAN	75 CFM		PCS	1		
1	EXHAUST HOOD	WALL MOUNTED		PCS	1		
5	HOOD-WALL: VENT	HOOD-WALL: VENT		PCS	1		
5	DRAYER: VENT	DRAYER: VENT		PCS	1		
7	ROOF VENT	3"(Ø)		PCS	1		
8							
9							
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12							
13							
14							



PLUMBING FIXTURES & ACCESSORIES								
#	Item	Туре	Description, Manufacturer, SKU	Unit	Quantity	Unit Price	Total	
1	Bath Tub (Alcove Tub)			PCS	C			
2	Kitchen Sink			PCS	1			
3	Kitchen faucets			PCS	1			
4	Vanity Sink			PCS	2			
5	Bath room faucets			PCS	2			
6	Water Closet			PCS	1			
7	Shower Trim			PCS	1			
8	Shower Tray			PCS	1			
9	Water Heater			PCS	1			
10	Hose Bib			PCS	2			
11	Shutoff Valve			PCS	8			
12	Hanging pipe clamp			PCS	20			
13	Globe Valve			PCS	1			
14	Dishwasher Supply Single Connector			PCS	1			
15	Dishwasher Sewage Single Connector			PCS	1			
16	Laundry Sweat Connector			PCS	1			



		SANI	TARY & PLUMBING PIPES				
#	Item	Туре	Description, Manufacturer, SKU	Unit	Quantity	Unit Price	Total
1	ABS (Acrylonitrile Butadiene Styrene) Pipes	ø 1"		FT	0		
2	ABS (Acrylonitrile Butadiene Styrene) Pipes	ø 1 1/2"		FT	14		
3	ABS (Acrylonitrile Butadiene Styrene) Pipes	ø 2"		FT	43		
4	ABS (Acrylonitrile Butadiene Styrene) Pipes	ø 3"		FT	29		
5	PEX (Cross-linked polyethylene) Pipes	ø 1/2"		FT	67		
6	PEX (Cross-linked polyethylene) Pipes	ø 3/4"		FT	85		
7	PEX (Cross-linked polyethylene) Pipes	ø 1"		FT	0		
8	PVC Pipes Sch.80 - Rigid	ø 1 1/2"		FT	0		
9	PVC Pipes Sch.80 - Rigid	ø 2"		FT	123		
10	PVC Pipes Sch.80 - Rigid	ø 3"		FT	0		
11	Flex Pipe Round	ø 1/2"		FT	8		
12	Flex Pipe Round	ø 3/4"		FT	0		
13	Flex Pipe Round	ø 1"		FT	0		
14							
15							



		PI	PE FITTINGS 01				
#	Item	Туре	Description, Manufacturer, SKU	Unit	Quantity	Unit Price	Total
1	PEX 90 Degree Elbow	1/2"ø-1/2"ø		PCS	12		
2	PEX 90 Degree Elbow	3/4"ø-3/4"ø		PCS	4		
3	PEX Tee Elbow	1/2"ø-1/2"ø-1/2"ø		PCS	3		
4	PEX Tee Elbow	3/4"ø-3/4"ø-3/4"ø		PCS	6		
5	PEX Transition Elbow	3/4"ø-1/2"ø		PCS	8		
6	PEX 90 Degree Elbow	1/2"ø-1/2"ø		PCS	12		
7	PEX 90 Degree Elbow	3/4"ø-3/4"ø		PCS	4		
8	PEX Tee Elbow	1/2"ø-1/2"ø-1/2"ø		PCS	2		
9	PEX Tee Elbow	3/4"ø-3/4"ø-3/4"ø		PCS	3		
10	PEX Transition Elbow	3/4"ø-1/2"ø		PCS	6		
11	PVC 90 Deg Bend Elbow	2"ø-2"ø		PCS	26		
12	PVC 90 Degree Bend Elbow	2"ø-2"ø		PCS	2		
13	PVC TEE Elbow	2"ø-2"ø-2"ø		PCS	3		
14	ABS 90 Degree Bend Elbow	3"ø-3"ø		PCS	3		
15	ABS P-Trap	1 1/2"ø-1 1/2"ø		PCS	4		



		PIPE	FITTINGS 02				
#	Item	Туре	Description, Manufacturer, SKU	Unit	Quantity	Unit Price	Total
1	ABS P-Trap	2"ø-2"ø		PCS	2		
2	ABS P-Trap	3"ø-3"ø		PCS	1		
3	ABS Reducer Elbow	2"ø-1 1/2"ø		PCS	2		
4	ABS Reducer Elbow	3"ø-1 1/2"ø		PCS	2		
5	ABS Reducer Elbow	3"Ø-2"Ø		PCS	6		
6	ABS TEE Elbow	1 1/2"ø-1 1/2"ø-1 1/2"ø		PCS	2		
7	ABS TEE Elbow	2"ø-2"ø-2"ø		PCS	3		
8	ABS TEE Elbow	3"ø-3"ø-3"ø		PCS	8		
9	ABS 90 Degree Bend Elbow	1 1/2"ø-1 1/2"ø		PCS	2		
10	ABS 90 Degree Bend Elbow	2"Ø-2"Ø		PCS	1		
11	ABS Reducer Elbow	2"ø-1 1/2"ø		PCS	2		
12	ABS TEE Elbow	2"Ø-2"Ø-2"Ø		PCS	3		
13	ABS Vent Cap Elbow	2"Ø		PCS	4		
14							
15							



			APPLIANCES				
#	Item	Туре	Description, Manufacturer, SKU	Unit	Quantity	Unit Price	Total
1	Refrigerator			PCS			
2	Range			PCS			
3	Washer Front Load	Stackable		PCS			
4	Dryer Front Load	Stackable		PCS			
5	Dish Washer			PCS			
6	Oven			PCS	(		
7	Microwave			PCS	(		
8							
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			CASEWORKS 01				
#	Item	Туре	Description, Manufacturer, SKU	Unit	Quantity	Unit Price	Total
1	Kitchen Cabinet			FT	17.08		
2	Laundry Cabinet			FT	2.25		
3	Vanity Cabinet			FT	4.6		
4	Medicine Cabinet			PCS	2		
5	Kitchen countertop			SF	27.16		
6	Laundry Countertop			PCS	0		
7	Bathroom Countertop			SF	0		
8	Island			FT	0		
9	Peninsula			FT	0		
10	Closets			SF	85.9		
11							
12							
13							
14							
15							



	<u>1</u>		CEILING 01				
	Item	Туре	Description, Manufacturer, SKU	Unit	Quantity	Unit Price	Total
	LIVING ROOM AND KITCHEN	I		SF	275.0		
	Ceiling Board	Drywall		SF	275		
	Drywall Fastener	Screw		PCS	481		
	Vapor Retarder	Polyethylene film		SF	275		
	Vapor Retarder Fastener	Nails with washer heads		PCS	825		
	BATHROOM	,		SF	55.0		
	Ceiling Board	MRD (Moisture resistant drywall)		SF	55		
	MRD Fastener	Screw		PCS	96		
	HALL			SF	42.0		
	Ceiling Board	Drywall		SF	42		
	Drywall Fastener	Screw		PCS	74		
	Vapor Retarder	Polyethylene film		SF	42		
)	Vapor Retarder Fastener	Nails with washer heads		PCS	126		
	PORCH			SF	119.0		
1	Ceiling Board	Marine Plywood		SF	119		
2	Exterior Grade Plywood	Screw		PCS	208		



			CEILING 02				
#	Item	Туре	Description, Manufacturer, SKU	Unit	Quantity	Unit Price	Total
	BEDROOM 1			SF	126.0		
13	Ceiling Board	Drywall		SF	126		
14	Drywall Fastener	Screw		PCS	221		
15	Vapor Retarder	Polyethylene film		SF	126		
16	Vapor Retarder Fastener	Nails with washer heads		PCS	378		
	BEDROOM 2			SF	127.0		
17	Ceiling Board	Drywall		SF	127		
18	Drywall Fastener	Screw		PCS	222		
19	Vapor Retarder	Polyethylene film		SF	127		
20	Vapor Retarder Fastener	Nails with washer heads		PCS	381		
	CLOSET 1			SF	15.0		
21	Ceiling Board	Drywall		SF	15		
22	Drywall Fastener	Screw		PCS	26		
23	Vapor Retarder	Polyethylene film		SF	15		
24	Vapor Retarder Fastener	Nails with washer heads		PCS	45		



			CEILING 03				
#	Item	Туре	Description, Manufacturer, SKU	Unit	Quantity	Unit Price	Total
	CLOSET 2			SF	16.0		
25	Ceiling Board	Drywall		SF	16		
26	Drywall Fastener	Screw		PCS	28		
27	Vapor Retarder	Polyethylene film		SF	16		
28	Vapor Retarder Fastener	Nails with washer heads		PCS	48		
	W/D			SF	42.0		
29	Ceiling Board	Drywall		SF	42		
30	Drywall Fastener	Screw		PCS	74		
31	Vapor Retarder	Polyethylene film		SF	42		
32	Vapor Retarder Fastener	Nails with washer heads		PCS	126		



			FLOORING INTERIOR 01				
#	Item	Туре	Description, Manufacturer, SKU	Unit	Quantity	Unit Price	Total
	BEDROOM 1						
1	Bedroom Flooring			SF	125		
2	Wood underlay	Foam Pad Polyethylene		SF	125		
3	Vapor Retarder	Vapor Barrier Polyethylene		SF	125		
	BEDROOM 2						
4	Bedroom Flooring			SF	130		
5	Wood underlay	Foam Pad Polyethylene		SF	130		
6	Vapor Retarder	Vapor Barrier Polyethylene		SF	130		
	CLOSET 1						
7	Closet Flooring			SF	15		
8	Wood underlay	Foam Pad Polyethylene		SF	15		
9	Vapor Retarder	Vapor Barrier Polyethylene		SF	15		
	CLOSET 2						
10	Closet Flooring			SF	15		
11	Wood underlay	Foam Pad Polyethylene		SF	15		
12	Vapor Retarder	Vapor Barrier Polyethylene		SF	15		



			FLOORING INTERIOR 02				
#	Item	Туре	Description, Manufacturer, SKU	Unit	Quantity	Unit Price	Total
	LIVING ROOM AND KITCHEN						
13	Living Area Flooring			SF	302		
14	Wood underlay	Foam Pad Polyethylene		SF	302		
15	Vapor Retarder	Vapor Barrier Polyethylene		SF	302		
	BATHROOM						
16	Tile Finish			SF	40		
17	Adhesive	1/2" Thin set Mortar		SF	40		
18	Vapor Retarder	Vapor Barrier Polyethylene		SF	40		
	W/D						
19	Tile Finish			SF	11		
20	Adhesive	1/2" Thin set Mortar		SF	11		
21	Vapor Retarder	Vapor Barrier Polyethylene		SF	11		
	BOILER ROOM						
22	Tile Finish			SF	16		
23	Adhesive	1/2" Thin set Mortar		SF	16		
24	Vapor Retarder	Vapor Barrier Polyethylene		SF	16		



			FLOORING EXTERIOR			
#	Item	Туре	Description, Manufacturer, SKU	Unit	Quantity	Unit Price
	STRUCTURE			SF	1172.2	
1	Concrete Slab	4"concrete cast in situ		CF	391	
2	Insulation	Rigid insulation		SF	295	
3	Hard core	Compacted soil		CF	304.2	
4	Re-bar	#4 re-bar		Ton	1.07	
5	Concrete Pad	4"concrete cast in situ		CF	2	
6	Slab edge	Turndown		CF	272.5	
7	Footing	Cast-in-place concrete		CF	14.04	
	PORCH					
8	Tile Finish			SF	425	
9	Adhesive	1/2" Thin set Mortar		SF	425	
10	Vapor Retarder	Vapor Barrier Polyethylene		SF	425	



	WALLS: EXTERIOR							
#	Item	Туре	Description, Manufacturer, SKU	Unit	Quantity	Unit Price	Total	
1	Horizontal Siding			SF	868			
2	Horizontal Siding Fastner	Self-drilling screws(100/pkt)		PKT	8.68			
3	Stone Veneer			SF	91			
4	Mortar Stone Veneer			SF	91			
5	Wall Homewrap			SF	961			
6	Homewrap Fastener	Stapled fastener (200/pkt)		PKT	3.65			
7	Furring Strip			PCS	120.13			
8	Furring Strip Fastner	Self-drilling screws(100/pkt)		PKT	9.61			
9	Wall Shteathing (OSB)			SF	961			
10	Shteathing Fastener	Self-drilling screws(100/pkt)		PKT	9.61			
11	Wall Paint			SF	961			
12	Wall Insulation			FT	1436			



			WALLS: INTERIOR 01				
#	Item	Туре	Description, Manufacturer, SKU	Unit	Quantity	Unit Price	Total
	BATHROOM			SF	53.0		
1	Cementitious Backer Board			SF	270		
2	Kerdi membrane			SF	270		
3	Kerdi membrane Fastener			SF	270		
4	Wall Ceramic Tile			SF	270		
	BEDROOM 1			SF	123.0		
5	Drywall Board			SF	330		
6	Drywall Fastener	Self-drilling screws(100/pkt)		PKT	3.3		
7	Wall Paint			SF	330		
8	Drywall Tape			FT	61.9		
	BEDROOM 2			SF	128.0		
9	Drywall Board			SF	235		
10	Drywall Fastener	Self-drilling screws(100/pkt)		PKT	2.35		
11	Wall Paint			SF	235		
12	Drywall Tape			FT	44.1		



			WALLS: INTERIOR 02				
#	Item	Туре	Description, Manufacturer, SKU	Unit	Quantity	Unit Price	Total
	LIVING ROOM			SF	161.0		
13	Drywall Board			SF	248		
14	Drywall Fastener	Self-drilling screws(100/pkt)		PKT	2.48		
15	Wall Paint			SF	248		
16	Drywall Tape			FT	46.5		
	KITCHEN			SF	92.0		
17	Cementitious Backer Board			SF	31		
18	Drywall Board			SF	165		
19	Drywall Fastener	Self-drilling screws(100/pkt)		PKT	1.65		
20	Kerdi membrane			SF	31		
21	Kerdi membrane Fastener			SF	31		
22	Wall Ceramic Tile			SF	31		
23	Wall Paint			SF	165		
24	Drywall Tape			FT	31.1		



	WALLS: INTERIOR 03							
#	Item	Туре	Description, Manufacturer, SKU	Unit	Quantity	Unit Price	Total	
	CLOSET 1			SF	15.0			
25	Drywall Board			SF	121			
26	Drywall Fastener	Self-drilling screws(100/pkt)		PKT	1.21			
27	Wall Paint			SF	121			
28	Drywall Tape			FT	22.7			
	CLOSET 2			SF	15.0			
29	Drywall Board			SF	112			
30	Drywall Fastener	Self-drilling screws(100/pkt)		PKT	1.12			
31	Wall Paint			SF	112			
32	Drywall Tape			FT	21.0			
	WD			SF	10.0			
33	Cementitious Backer Board			SF	86			
34	Kerdi membrane			SF	86			
35	Kerdi membrane Fastener			SF	86			
36	Wall Ceramic Tile			SF	86			



	△ WALLS: INTERIOR 04						
#	Item	Туре	Description, Manufacturer, SKU	Unit	Quantity	Unit Price	Total
	WH			SF	15.0		
37	Drywall Board			SF	111		
38	Drywall Fastener	Self-drilling screws(100/pkt)		PKT	1.11		
39	Wall Paint			SF	111		
40	Drywall Tape			FT	21		
	HALL			SF	46.0		
41	Drywall Board			SF	149		
42	Drywall Fastener	Self-drilling screws(100/pkt)		PKT	1.49		
43	Wall Paint			SF	149		
44	Drywall Tape			FT	28		
1	Wall Skirting	Ceramic		FT	185		



			DOORS				
#	Item	Туре	Description, Manufacturer, SKU	Unit	Quantity	Unit Price	Total
1	Exterior Swinging	5' - 0" X 6'-8"		PCS	2		
2	Exterior Swinging	3' - 0" X 6'-8"		PCS	1		
3	Interior Swinging	3' - 0" X 6'-8"		PCS	3		
4	Interior Sliding	4' - 0" X 6'- 8"		PCS	1		
5	Interior Sliding	6' - 0" X 6'-8"		PCS	2		
6	Exterior Door Trim			FT	53.02		
7	Interior Door Trim			FT	263.1		
8	Entry Lock set			PCS	3		
9	Privacy Lock set			PCS	3		
10	Passage Lock set			PCS	3		



			WINDOWS				
#	Item	Туре	Description, Manufacturer, SKU	Unit	Quantity	Unit Price	Total
1	Single Hung	3' - 3" X 4'-9"		PCS	3		
2	Fixed	2' - 3" X 2'-9"		PCS	6		
3	Sliding	2' - 9" X 4'-3"		PCS	2		
4	Sliding	3' - 3" X 3'-3"		PCS	1		
5	Sliding	3' - 3" X 3'-3"		PCS	1		
6	Sliding	2' - 9" X 2'-3"		PCS	1		
7	Single Hung	2' - 9" X 3'-3"		PCS	1		
8	Sliding	3' - 3" X 2'-3"		PCS	1		
9	Exterior Window Trim			FT	179		
10	Interior Window Trim			FT	179		
11							
12							
13							
14							
15							



			ROOF 01				
#	Item	Туре	Description, Manufacturer, SKU	Unit	Quantity	Unit Price	Total
1	Roof Covering			SF	1025.0		
2	Roof Covering Fastener			PCS	513		
3	Roof Felt Paper			SF	1025.0		
4	Roof Felt Paper Fastener			PCS	3075.0		
5	Roof Sheathing			SF	1025.0		
6	Roof Sheathing Fastener			PCS	8200		
7	Batten			FT	0.0		
8	Batten Fastener			PCS	0.0		
9	Soffit			SF	143.0		
10	Soffit Fastener			PCS	71.5		
11	Fascia			FT	147.0		
12	Fascia board fastener			PCS	74		
13	Roof Insulation			SF	1025.0		
14							
15							