


ORCHARD

The Orchard is a Craftsman-style two-bedroom, two-bathroom home designed for comfortable living. The walls are finished with horizontal siding in a warm, earthy tone, creating a clean and traditional aesthetic. The simple gable roof, with ends featuring wood shingles, provides shelter and complements the overall design. A prominent covered porch spans the front of the home, supported by substantial stone-clad pillars, creating a welcoming outdoor space.


Inside, the house features a simple rectangular layout with the living, dining, and kitchen areas merged into a single open space. The two bedrooms are thoughtfully located on either side of the living area, offering privacy and quiet retreats.

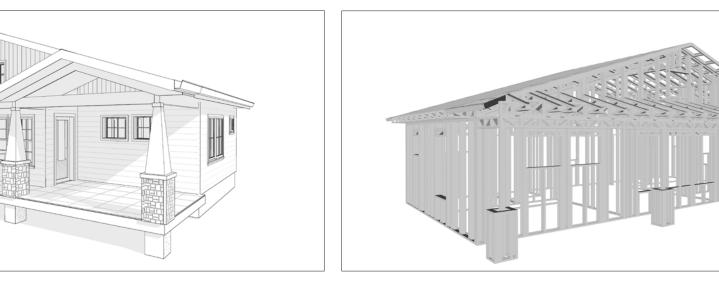



Please print and take this Materials Shopping List to your favorite Home Depot and ask for assistance in selecting the materials, fixtures and fittings to complete your new home.

Record your selection and the price of the item. Then do the math to determine the cost for your selections and the total cost of finishing your home.

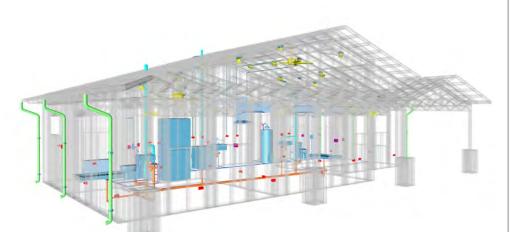

< CLICK HERE >

To Go To Materials Shopping List






FLOOR PLAN



2 Bed Rooms



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ROOF PLAN — 10
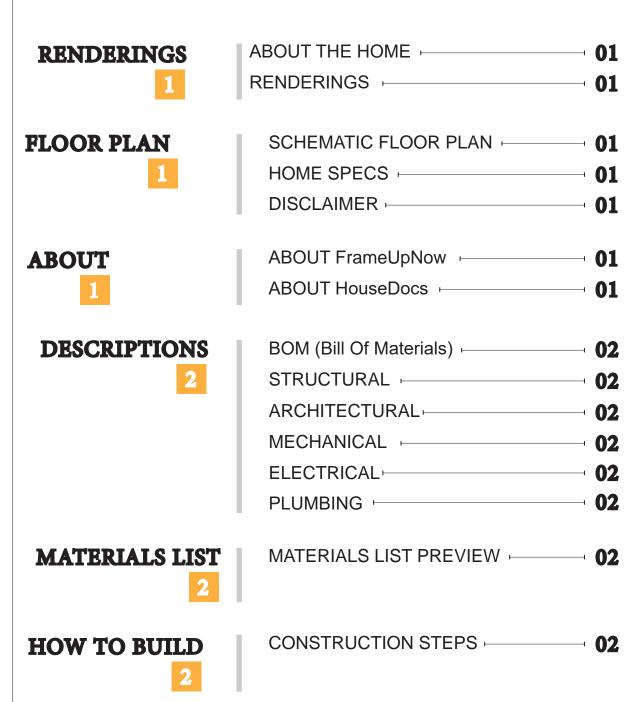
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03

ARCHITECTURAL CASEWORK **COVER SHEET GENERAL NOTES** WALL FRAME LAYOUT WALL PANEL & LAYOUT PLAN 19 20 ROOF TRUSS LAYOUT **STRUCTURAL SECTIONS** -21 WALL BRACING LAYOUT HOLD-DOWN PLAN **STRUCTURAL DETAILS 1 STRUCTURAL DETAILS 2 STRUCTURAL DETAILS 3 27** TRUSS BLOCKING LAYOUT 28 SHEETROCK BACKING

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ABOUT



FrameUpNow is a design and manufacturing company providing precision-engineered home framing solutions. We offer a catalog of Affordable Homes, Tiny Homes, Garages, Shops and Barndominiums. FrameUpNow manufactures cold-formed steel (CFS) also known as Light Gauge Steel (LGS) framing components that conform to our engineered metal house frame plans or can be purchased as DIY skeleton kits.

The CFS/LGS framing is lightweight, easily assembled, and does not require heavy equipment or specialized labor, enabling homeowners to erect the frame themselves in just a few days. Unlike wood, the steel framing is impervious termites and bores, warping, expansion, and fire.

Our home plans come complete with a structural engineered stamp for permit approvals. Customers receive a full BOM also known as a Materials Shopping List to purchase finish materials from a Building Materials retailer. FrameUpNow prides itself on the quality and efficiency of our precision-engineered home framing solutions for construction professionals and DIY homeowners.



KEY PLAN

NO.	DESCRIPTION	DATE

NOTE:

LEGEND:

PROJECT

193-Orchard-749-2Bd2Ba-Craftsman-550

DRAWING NAME

INTRODUCTION

CLIEN	IT NAME:		
PROJ	ECT NUMBER:		
DATE	:		
DESI	GNED BY:		
DRAV	VN BY:		
CHEC	KED BY:		

1101

SCALE:

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DISCLAIMER

marketing content.

DESCRIPTIONS

MATERIALS LIST

The BOM (Bill Of Materials) package, known as the Materials Shopping List document, provides:

Comprehensive Inventory: Detailed lists of essential materials sourced from architectural, mechanical, HVAC, electrical, and plumbing design drawing sets.

Precise Curation: Each item meticulously selected and organized for accuracy and efficiency in project planning.

Customizable Options: Customers can modify listed items to their preferences and calculate costs accordingly, ensuring alignment with personal project needs and budget.

Dedicated Space for Details: Includes tables for customers to note Home Depot SKU numbers or product descriptions for selected items,

facilitating seamless purchasing and coordination with suppliers.

Customer Convenience: Take the list to Home Depot or preferred suppliers for accurate pricing, helping align the total home budget with personal financial plans.

Simplify your construction journey with our Materials Shopping List document, where detailed preparation meets streamlined implementation for your dream home.

STRUCTURAL

The structural drawings package provides an exhaustive set of detailed plans essential for the precise assembly of your building. This comprehensive package includes:

Framing Plans: Detailed layouts for all framing components. Truss Layouts: Clear instructions for truss placement and

Panel Length Plans: Specifications for panel dimensions. Framing Elevations and Sections: Precise elevation and sectional views for accurate construction.

Truss and Wall Blocking Plans: Plans for truss and wall blocking to ensure structural integrity.

Hold-Down Plan: Detailed hold-down requirements for stability. Snap Sheet: Reference sheet for quick identification of components

Structural Details and Bracing Plans: Complete details and bracing plans for all structural elements.

Accompanying these plans is a comprehensive Bill of Materials (BOM) that lists every necessary building component, from cold formed steel (CFS) frames to fasteners.

ARCHITECTURAL

With the comprehensive architectural package, both builders and DIY homeowners can confidently execute the construction.

The architectural package includes:

Furnished Floor Plans: Complete with furniture layouts for a clear understanding of space utilization.

Detailed Dimension Plans: Ensures precise measurements, from the overall footprint down to the exact placement of windows and

Foundation Plan: Detailed plan to establish a solid foundation.

Wall Framing and Truss Layout: Comprehensive plans for wall framing and truss placement.

Architectural Elevations: Exterior views showcasing the design.

Strategic Building Sections: Critical cross-sectional details for a thorough understanding of the build.

Casework Drawings and Diagrams: Suggested designs for built-in caseworks, such as kitchen cabinets.

MECHANICAL

The mechanical package includes everything needed to guide HVAC

Detailed HVAC Floor Plan: Precisely maps out the placement of air handlers, ductwork, and vents throughout the home's layout.

HVAC Sections and Riser Diagrams: Technical drawings offering critical cross-sectional details and piping schematics, ensuring proper integration of the heating and cooling system into the home's structure.

Bill of Materials: A complete list of all necessary HVAC components.

ELECTRICAL

The electrical package includes all the plans and documentation needed to guide the installation of your home's electrical system:

Detailed Power Plan: Precisely maps out the placement of outlets, switches, and other power components throughout the layout.

Comprehensive Lighting Plan: Shows the optimal locations for lighting fixtures, sconces, and other illumination sources to create a well-lit, functional interior.

Dimensioned Electrical Layout: Provides exact dimensions and measurements to ensure proper placement of all electrical elements.

ARCHITECTURAL BOM

Styrene) Pipes

Bill of Materials: A complete list of every component needed, from circuit breakers to wiring.

The plumbing package includes everything needed to guide the

Detailed Water Supply System Plan: Precisely maps out the placement of pipes, valves, and plumbing fixtures throughout the

Comprehensive Sewage System Plan: Shows the optimal routing and sizing of drain lines to effectively remove waste and ensure

Detailed Riser Diagrams: Provide information needed to properly

pipes to fixtures.


PLUMBING


installation of your home's water supply and drainage systems:

proper drainage.

install all vertical plumbing risers and vent stacks.

Bill of Materials: A complete list of every component needed, from

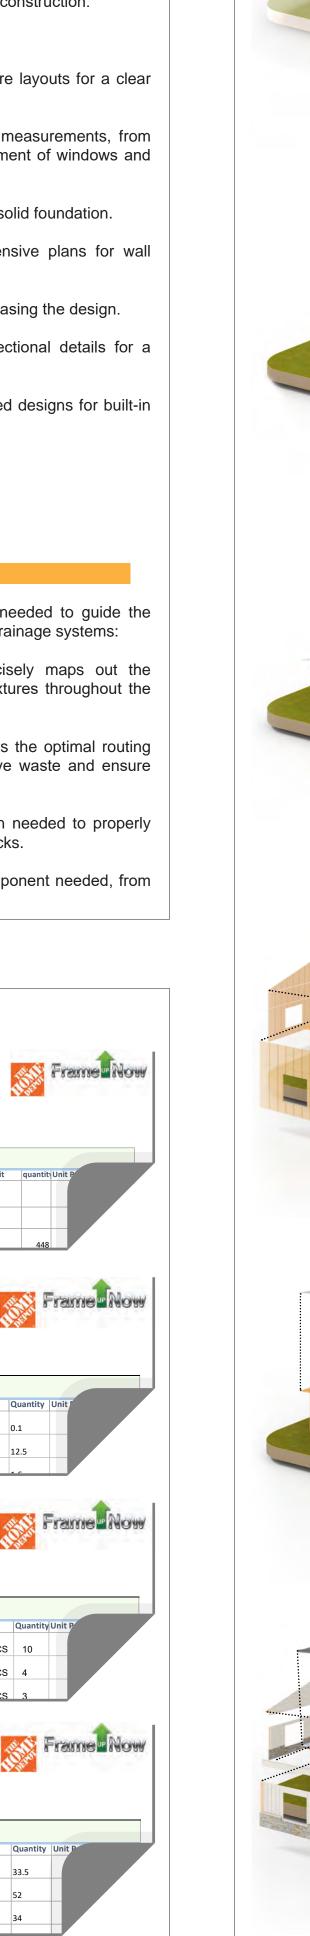

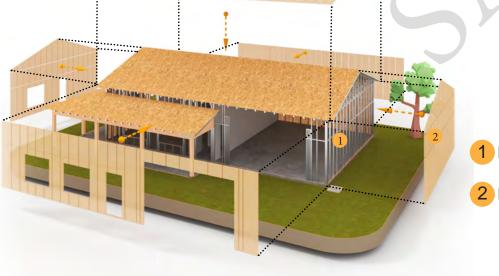

HOW TO BUILD





1 Staged Wall

Panels

2 Staged Truss

3 Concrete Floor

3 Layout Markers

4 Installed Walls

1 Installed Walls

2 Installed Trusses

OSB Sheathing

Mechanical, Electrica (MEP) Integration

Mechanical, Electrical & Plumbing

Roof Truss Installation **5** Exterior OSB Cladding

Metal Delivery and Staging

Wall Panel Installation

2 Sewage

Installation

4 Concrete Floor

3 Concrete Floor

4 Layout Markers

1 Installed Walls

Wall & Roof Insulation

2 Installed Trusses

1 Staged Wall Panels 1 Staged Walls


2 Staged Truss Panels 2 Staged Roof

3 Foundation

Layout and Marking



1 Home Wrap

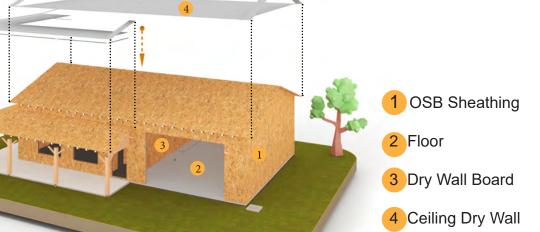

Exterior Wall & Roof Covering

Corrugated

iron sheet

2 Home Wrap

3 Roof Felt Paper

4 Coronado Stone

5 Corrugated


iron sheet









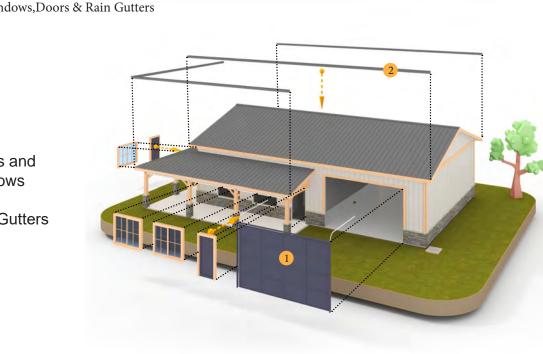



KEY PLAN

DESCRIPTION DATE

NOTE:

LEGEND:

PROJECT

193-Orchard-749-2Bd2Ba-Craftsman-550

DRAWING NAME

INTRODUCTION

CLIENT NAME: PROJECT NUMBER: DATE: **DESIGNED BY** DRAWN BY: CHECKED BY:

1102

SCALE:


BOM (Bill Of Materials) (Separately Attached)




The Bill of Materials (BOM) is a crucial document that compiles the material requirements from different disciplines into a centralized inventory, enabling efficient procurement, inventory management, and cost estimation for a specified project or

ELECTRICAL BOM




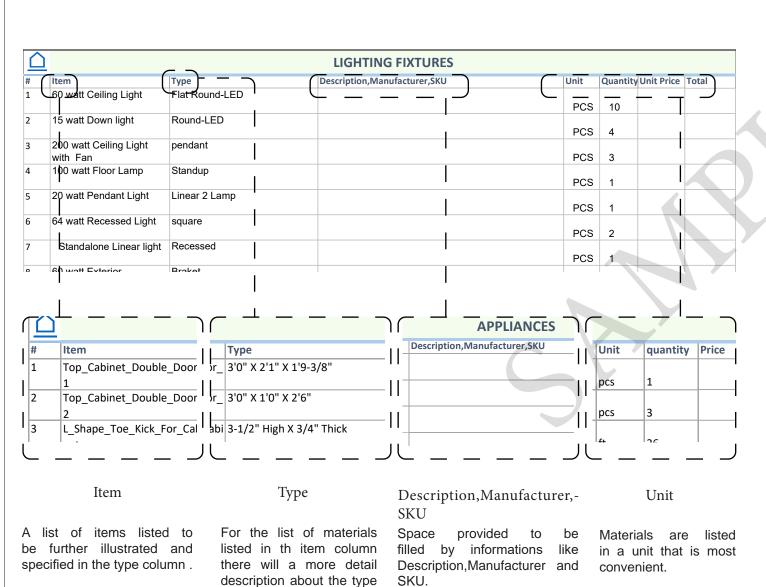

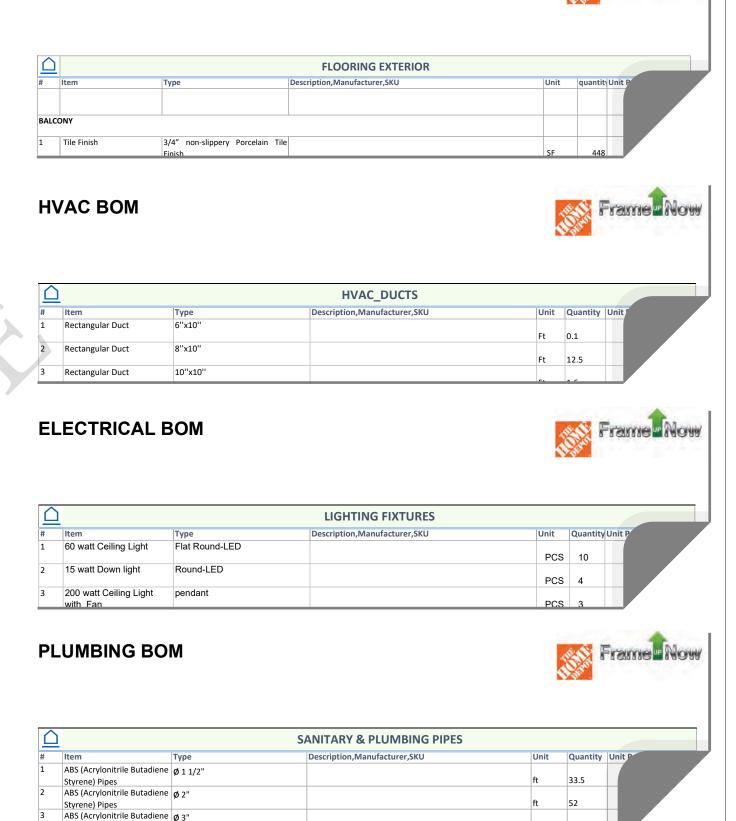

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of the Material.

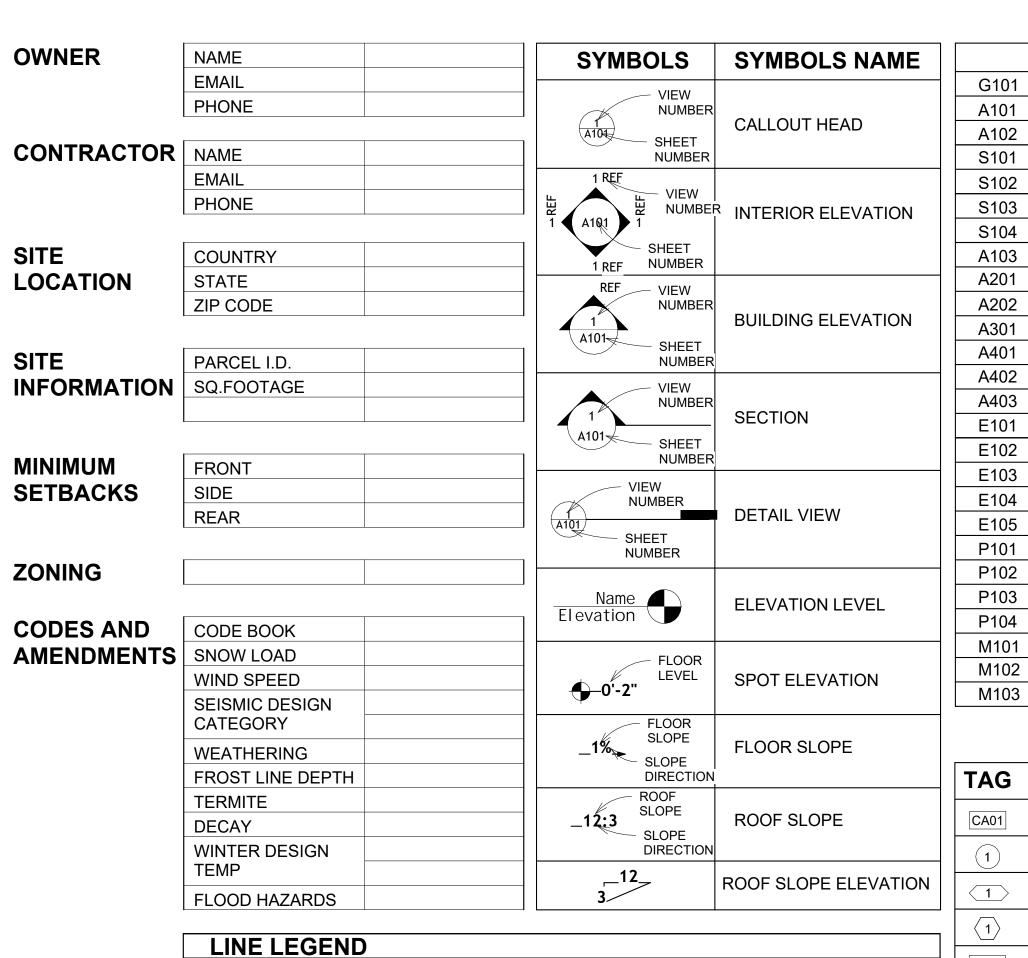

- CUT LINE

HIDDEN LINE

OVER HEAD

ROOM SEPARATOR

DOOR OPENING DIRECTION -

	PAGE INDEX	Α	BBREVIATION
G101	COVER SHEET	AFS	ACTION FLOOR SYSTEMS
A101	FLOOR PLAN	ASTM D698	AMERICAN SOCIETY FOR
A102	DIMENSION PLAN		TESTING AND MATERIAL
S101	FOUNDATION PLAN	CA	CASEWORK
S102	STRUCTURAL FLOOR PLAN	EL	ELECTRICAL
S103	FRAME LAYOUT	F.F.E	FINISHED FLOOR ELEVATION
S104	ROOF TRUSS LAYOUT	F.F.L	FINISHED FLOOR LEVEL
A103	ROOF PLAN	FTG	FOOTINGS
A201	ELEVATIONS	HVAC	HEATING, VENTILATION & A
A202	ELEVATIONS		CONDITIONING
A301	SECTIONS	IRC	INTERNATIONAL RESIDENC
A401	DETAILS		CODE
A402	CASEWORK DETAILS	IMC	INTERNATIONAL MECHANIC
A403	CASEWORK DETAILS		CODE
E101	SCHEDULE	MAX.	MAXIMUM
E102	LIGHTING PLAN	ME	MECHANICAL
E103	POWER PLAN	MIN.	MINIMUM
E104	DIMENSION PLAN FOR LIGHT FIXTURE	NO.	NUMBER
E105	DIMENSION PLAN FOR FITTING	O.C	ON CENTER
P101	COVER SHEET	OSB	ORIENTED STRAND BOARD
P102	WATER SUPPLY SYSTEM	PL	PLUMBING
P103	SEWAGE SYSTEM	PSI	POUNDS PER SQUARE INC
P104	RISER DIAGRAM	PVC	POLYVINYL CHLORIDE
M101	HVAC PLAN	REF	REFERENCE
M102	HVAC SECTION	RG	RIGHT GARAGE
M103	RISER DIAGRAM	SE	SPECIAL EQUIPMENT
		SF	SQUARE FEET
		SIMP. STHD8	SIMPSON STRAP THE
	Ţ	1 2	

TAG'S NAME

CASEWORK TAG

FURNITURE TAG

SPECIALTY EQUIPMENT TAG


MECHANICAL EQUIPMENT TAG

WINDOW TAG

PE01 PLUMBING EQUIPMENT TAG

DOOR TAG

111	INLILINOL
RG	RIGHT GARAGE
SE	SPECIAL EQUIPMENT
SF	SQUARE FEET
SIMP. STHD8	SIMPSON STRAP THE HOLDDOWN
SIMP. ABE66	SIMPSON ANCHOR BOLT EDGE
TV	TELEVISION
UNO	UNLESS NOTED OTHERWISE
W/	WITH
W/D	WASHER/DRYER
AC	AIR CONDITIONING UNIT
ACC	AIR COOLED CONDENSER
ACCU	AIR COOLED CONDSENSING UNIT
AHU	AIR HANDLING UNIT
CC	COOLING COIL
CD	CEILING DIFFUSER
CFm	Cubic Feet Per Minute
CR	CEILING REGISTER
CU	CONDENSING UNIT
CW	COLD WATER
E/A	EXHAUST AIR
EF	EXHAUST FAN
ET	EXPANSION TANK
EX.	EXISTING
FC	FLEXIBLE CONNECTION
FCU	FAN COIL UNIT
FLR.	FLOOR
HC	HEATING COIL
HE	AIR TO AIR HEAT EXCHANGER
HV	HEATING AND VENTILATING UNIT
IV	INLET VANES
MER	MECHANICAL ROOM
MAX.	MAXIMUM
MIN.	MINIMUM
R/A	RETURN AIR
RCU	RECIPROCATING CHILLER UNIT
RF	RETURN FAN
S/A	SUPPLY AIR
SCD	SMOKE CONTROL DAMPER
SP	STATIC PRESSURE

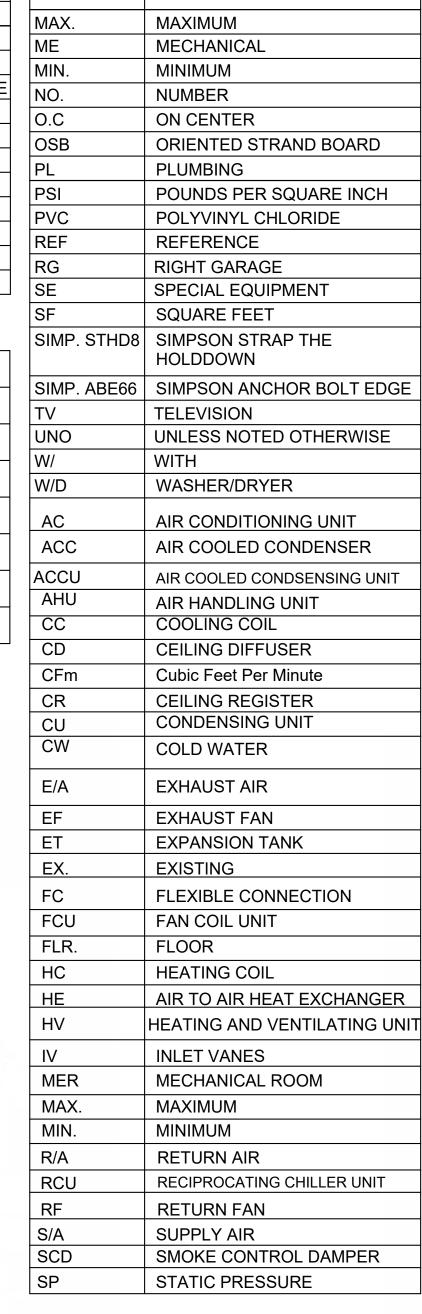



FINISHED FLOOR ELEVATION

HEATING, VENTILATION & AIR

INTERNATIONAL RESIDENCE

INTERNATIONAL MECHANICAL

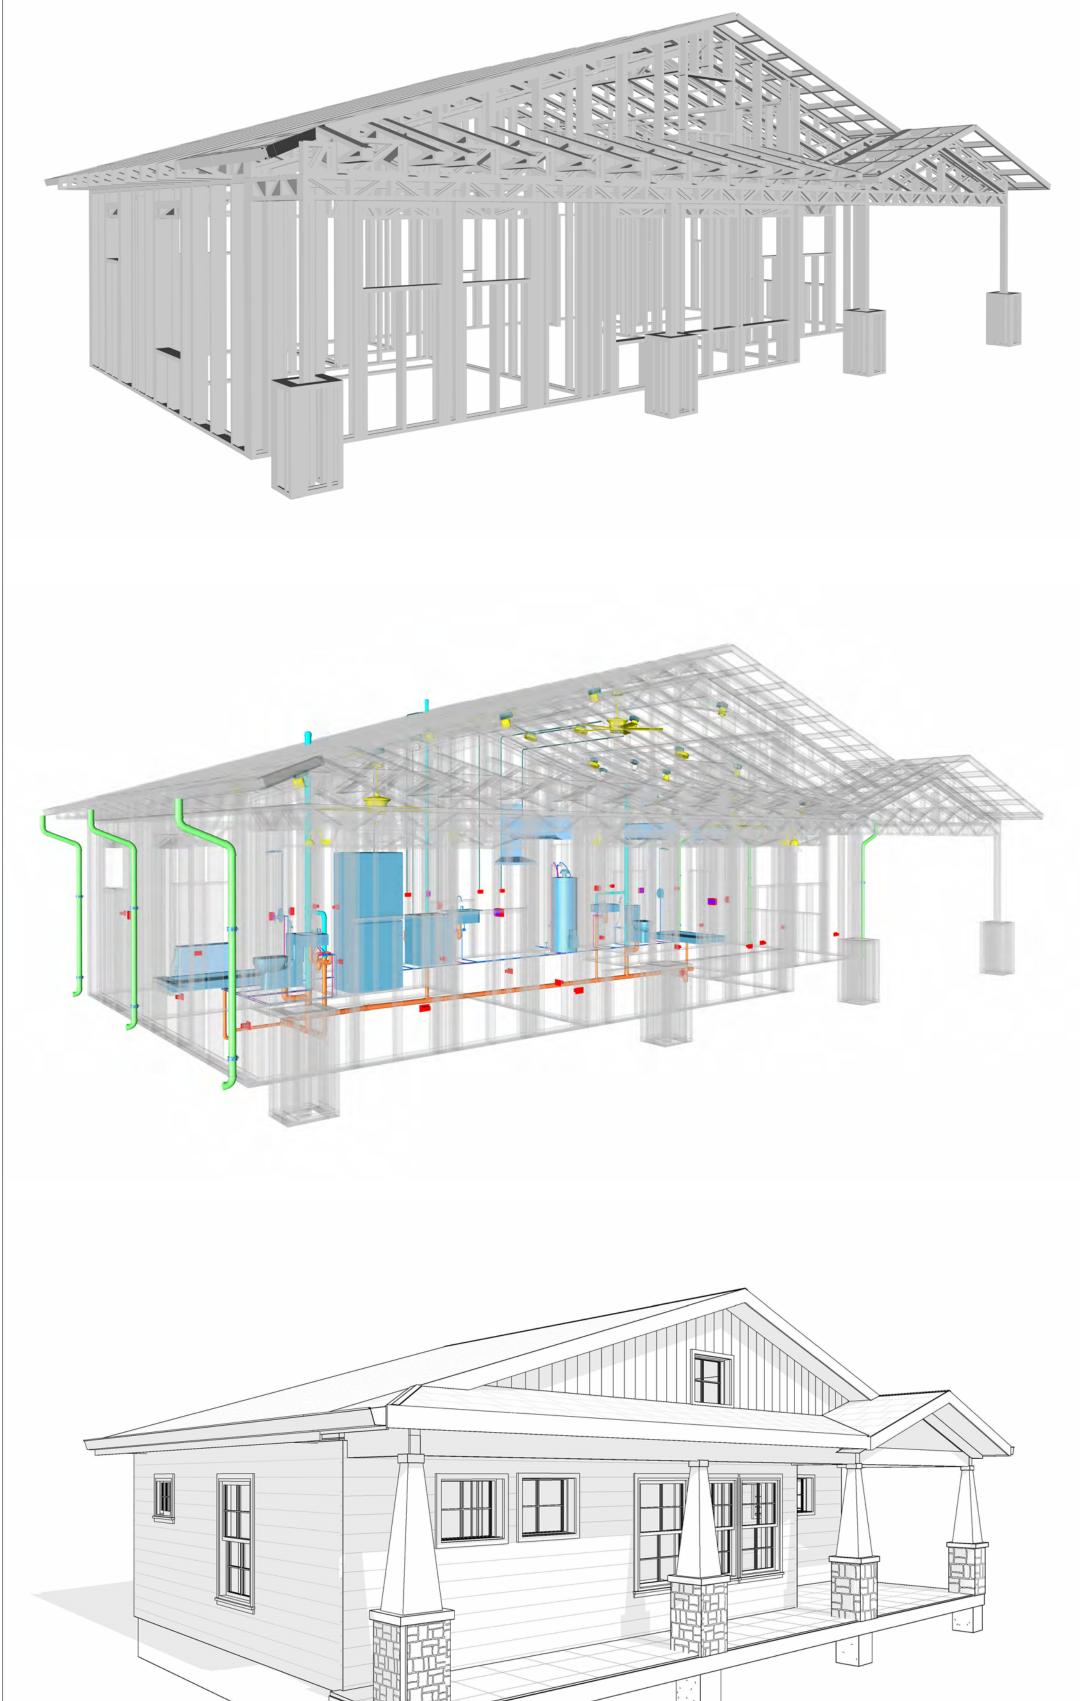

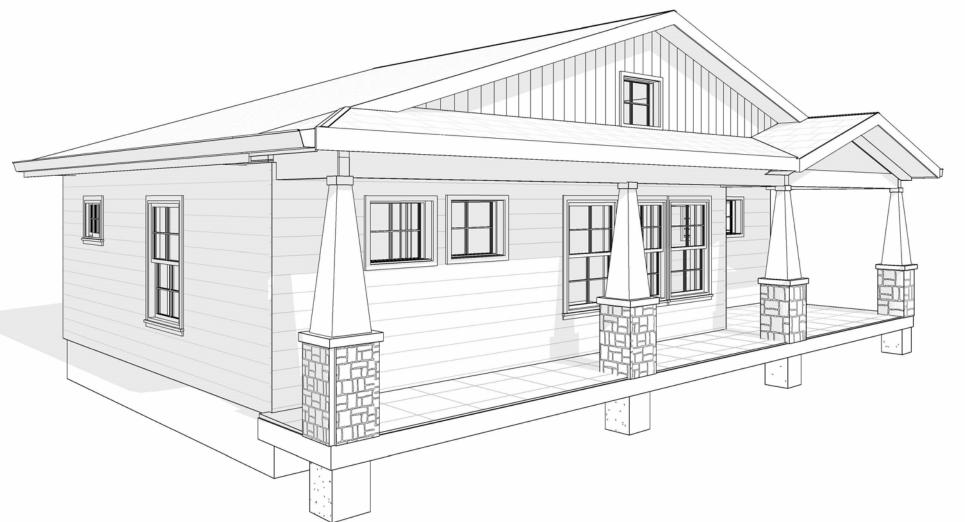



193-ORCHARD-749 2Bd2Ba-**CRAFTSMAN-550**

SQUARE FOOTAGE			
LIVING	749		
PORCH	213		
TOTAL	962		



KEY PLAN

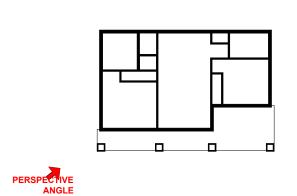

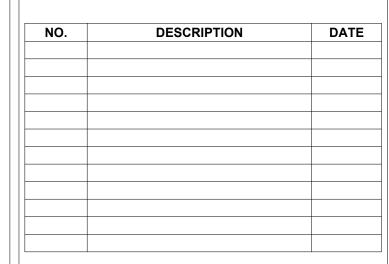

NOTE:

LEGEND:

PROJECT

193-ORCHARD-749 2Bd2Ba-CRAFTSMAN-550

DRAWING NAME

COVER SHEET

CLIENT NAME:	Client Name
PROJECT NUMBER:	0061_12
DATE:	5/6/2025 11:30:31 AM
DESIGNED BY:	Designer
DRAWN BY:	Author
CHECKED BY:	Checker

G101

SCALE: As indicated

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GENERAL NOTES

- THIS DRAWING DEPICTS THE ARCHITECTURAL (SPACE LAYOUT, FURNISHING, FLOOR, WALLS, ROOFS, FOUNDATION, WINDOWS AND DOORS) SYSTEMS. IT PROVIDES A VISUAL REPRESENTATION OF THE ARCHITECTURAL LAYOUT AND COMPONENTS.
- THE ARCHITECTURAL DRAWINGS ARE PREPARED TO MEET THE SPECIFIC REQUIREMENTS OF THE BUILDING, AS PER THE PROJECT SPECIFICATIONS AND APPLICABLE CODES AND STANDARDS.
- THE CONSTRUCTION OF THIS HOME SHALL COMPLY WITH THE LATEST EDITION OF THE INTERNATIONAL RESIDENTIAL CODE (IRC), INTERNATIONAL MECHANICAL CODE (IMC), THE INTERNATIONAL PLUMBING STANDARD, THE NATIONAL ELECTRICAL STANDARD AND ALL OTHER APPLICABLE LOCAL, STATE, AND NATIONAL CODES AND REGULATIONS.
- COORDINATION WITH OTHER TRADES HAS BEEN DONE ON A DESIGN LEVEL. THIS DRAWING SHALL BE READ TOGETHER WITH THE ME, EL AND PL DESIGN DRAWINGS TO ENSURE PROPER CONSTRUCTION AND INTEGRATION OF THE BUILDING SYSTEMS.

ABOUT WALLS:

SHOWER WALL COVERING

BATHTUB AND SHOWER SPACES (WALLS AND FLOORS) WITH INSTALLED SHOWER HEADS AND IN SHOWER COMPARTMENTS SHALL BE FINISHED WITH A NON-ABSORBENT SURFACE.

2. WALL PAINT (INTERNAL)

THE TYPICAL THICKNESS OF LATEX WALL PAINT IS 1/32 OF AN INCH FOR A SINGLE COAT. AND DOUBLE COAT (1/16") SHALL BE APPLIED FOR DURABILITY.


3. ADHESIVES:

THE ADVISABLE TYPE OF ADHESIVE FOR THIS PROJECT IS **EPOXY ADHESIVES**BECAUSE THEY ARE KNOWN FOR THEIR HIGH STRENGTH, DURABILITY, AND RESISTANCE TO MOISTURE, CHEMICALS AND

REFER TO SHEETS A201 & A202 FOR GENERAL NOTES ON EXTERNAL FINISHING MATERIALS

ABOUT FLOORS:

- THE SPOT ELEVATION INDICATES THE FINISHED FLOOR ELEVATION.
- FINISHED FLOORS PER PLANS.
- FIELD VERIFY FOR DIMENSION DROP 4" FOR SHOWER AND BATHTUB USE.
- 1% SLOPE ON OUTDOOR BALCONIES FOR WATER RUN OFF.
- 2% SLOPE TOWARDS THE SHOWER DRAIN FOR SUFFICIENT DRAINAGE. 4" DROP AT THE DOOR LEADING TO EXTERIOR BALCONY FROM THE MAIN LIVING AREA.
- 5% SLOPE FOR GARAGE IS USED, WHICH SHOULD BE CHECKED WITH THE LOCAL GARAGING
- ZONING LAWS.

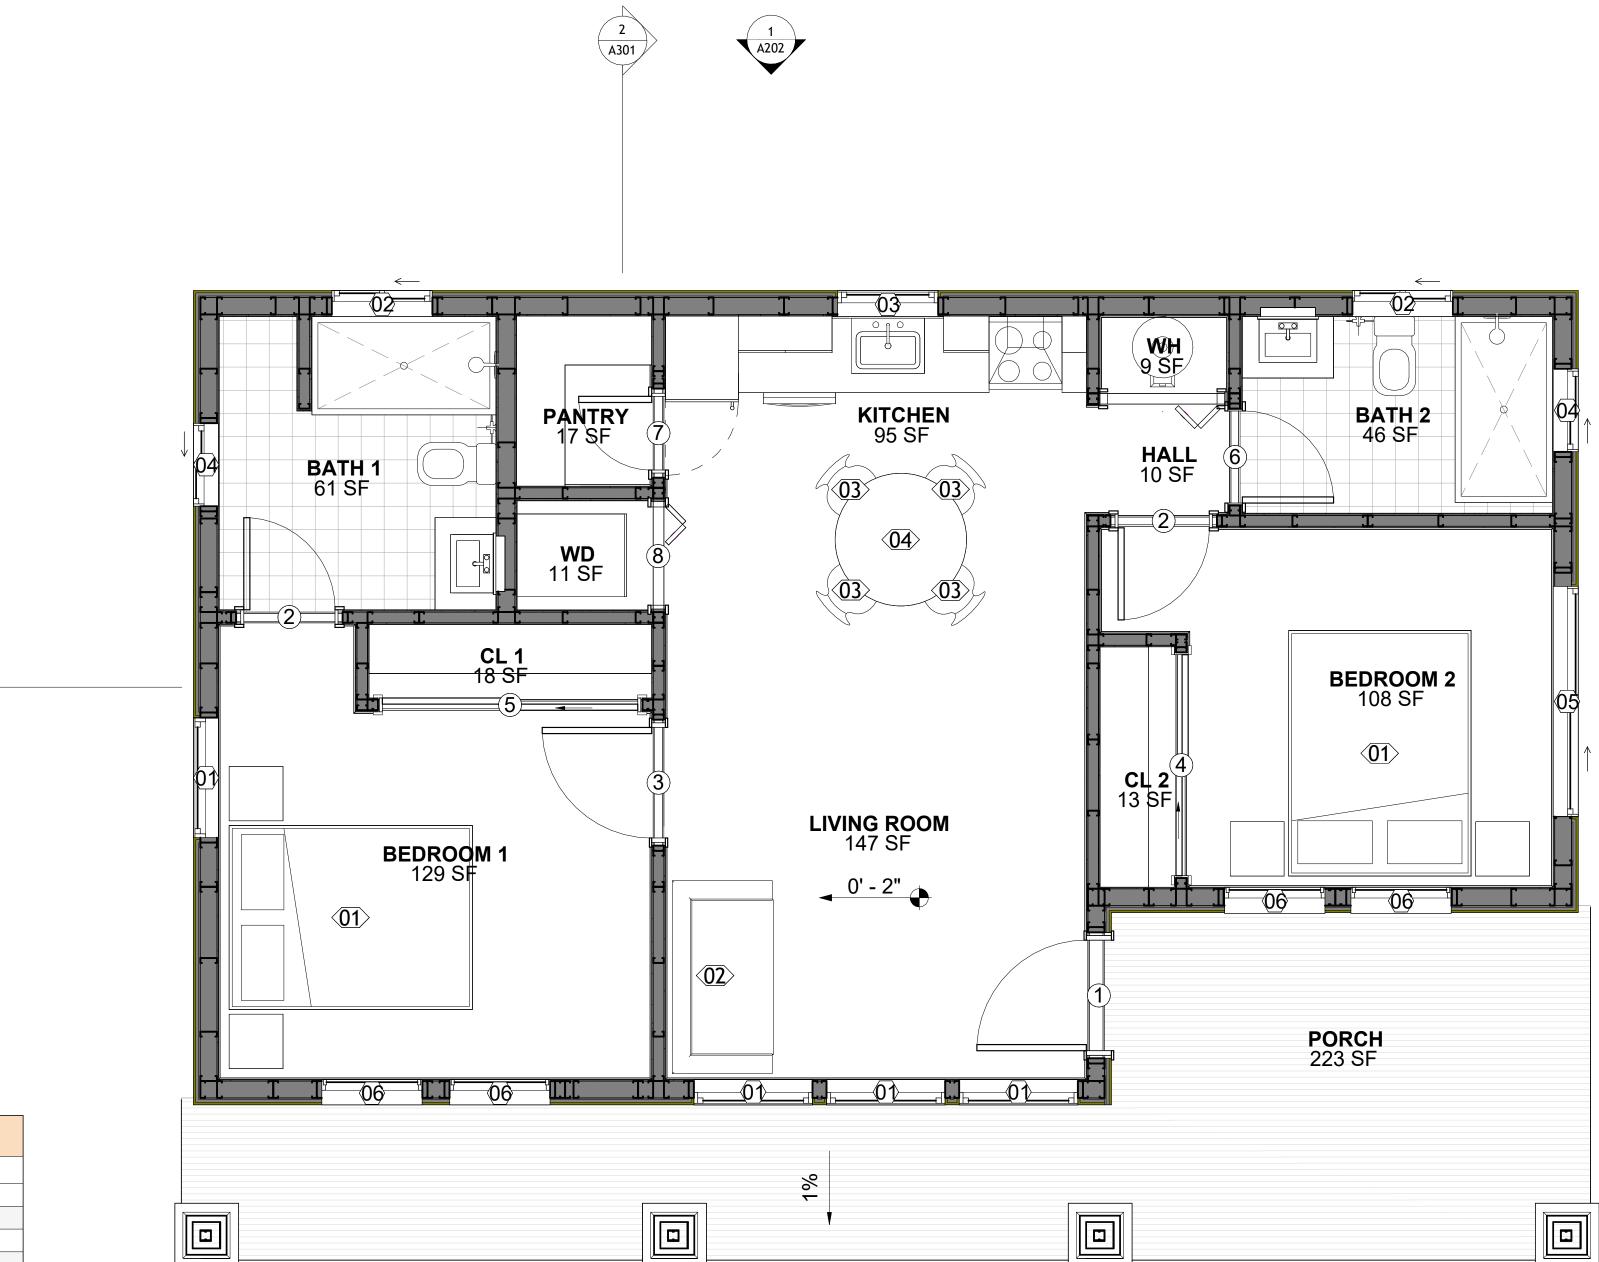


	FURNITURE SCHEDULE		
	TYPE MARK	TYPE	COUNT
01		KING SIZE BED	2
02		TWO SEAT SOFA	1
03		DINING CHAIR	4
04		COFFE TABLE	1

A301

	ROOM FINISH SCHEDULE						
ROOM NUMBE R	ROOM NAME	FLOOR FINISH	BASE FINISH	WALL FINISH	CEILING FINISH	CEILING HEIGHT	COM MEN TS
01	BATH 1	VINYL TILES	CONCRETE	CERAMIC TILE	MRD	8' - 0"	
02	BEDROOM 2	HARDWOOD	CONCRETE	WALL PAINT	DRY WALL	8' - 0"	
03	BATH 2	VINYL TILES	CONCRETE	CERAMIC TILE	MRD	8' - 0"	
04	KITCHEN	HARDWOOD	CONCRETE	WALL PAINTT + CERAMIC	DRY WALL	8' - 0"	
05	LIVING ROOM	HARDWOOD	CONCRETE	WALL PAINT	DRY WALL	8' - 0"	
06	PANTRY	HARDWOOD	CONCRETE	WALL PAINT	DRY WALL	8' - 0"	
07	WD	VINYL TILES	CONCRETE	CERAMIC TILE	DRY WALL	8' - 0"	
08	WH	VINYL TILES	CONCRETE	WALL PAINT	DRY WALL	8' - 0"	
09	CL 2	HARDWOOD	CONCRETE	WALL PAINT	DRY WALL	8' - 0"	
10	CL 1	HARDWOOD	CONCRETE	WALL PAINT	DRY WALL	8' - 0"	
11	BEDROOM 1	HARDWOOD	CONCRETE	WALL PAINT	DRY WALL	8' - 0"	
12	HALL	HARDWOOD	CONCRETE	WALL PAINT	DRY WALL	8' - 0"	
13	PORCH	PROCELAIN TILE	CONCRETE	EXTERIOR-GRADE PLYWOOD	PLYWOOD	8' - 0"	



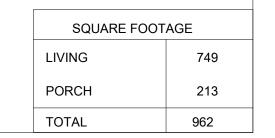



KEY PLAN

NO.	DESCRIPTION	DATE

NOTE:

(1) (A301)

 $\frac{2}{A201}$

LEGEND:

PROJECT


193-ORCHARD-749 2Bd2Ba-CRAFTSMAN-550

DRAWING NAME

FLOOR PLAN

CLIENT NAME:	Client Name
PROJECT NUMBER:	0061 12
DATE:	5/6/2025 11:30:31 AM
DESIGNED BY:	Designer
DRAWN BY:	Author
CHECKED BY:	Checker

A101

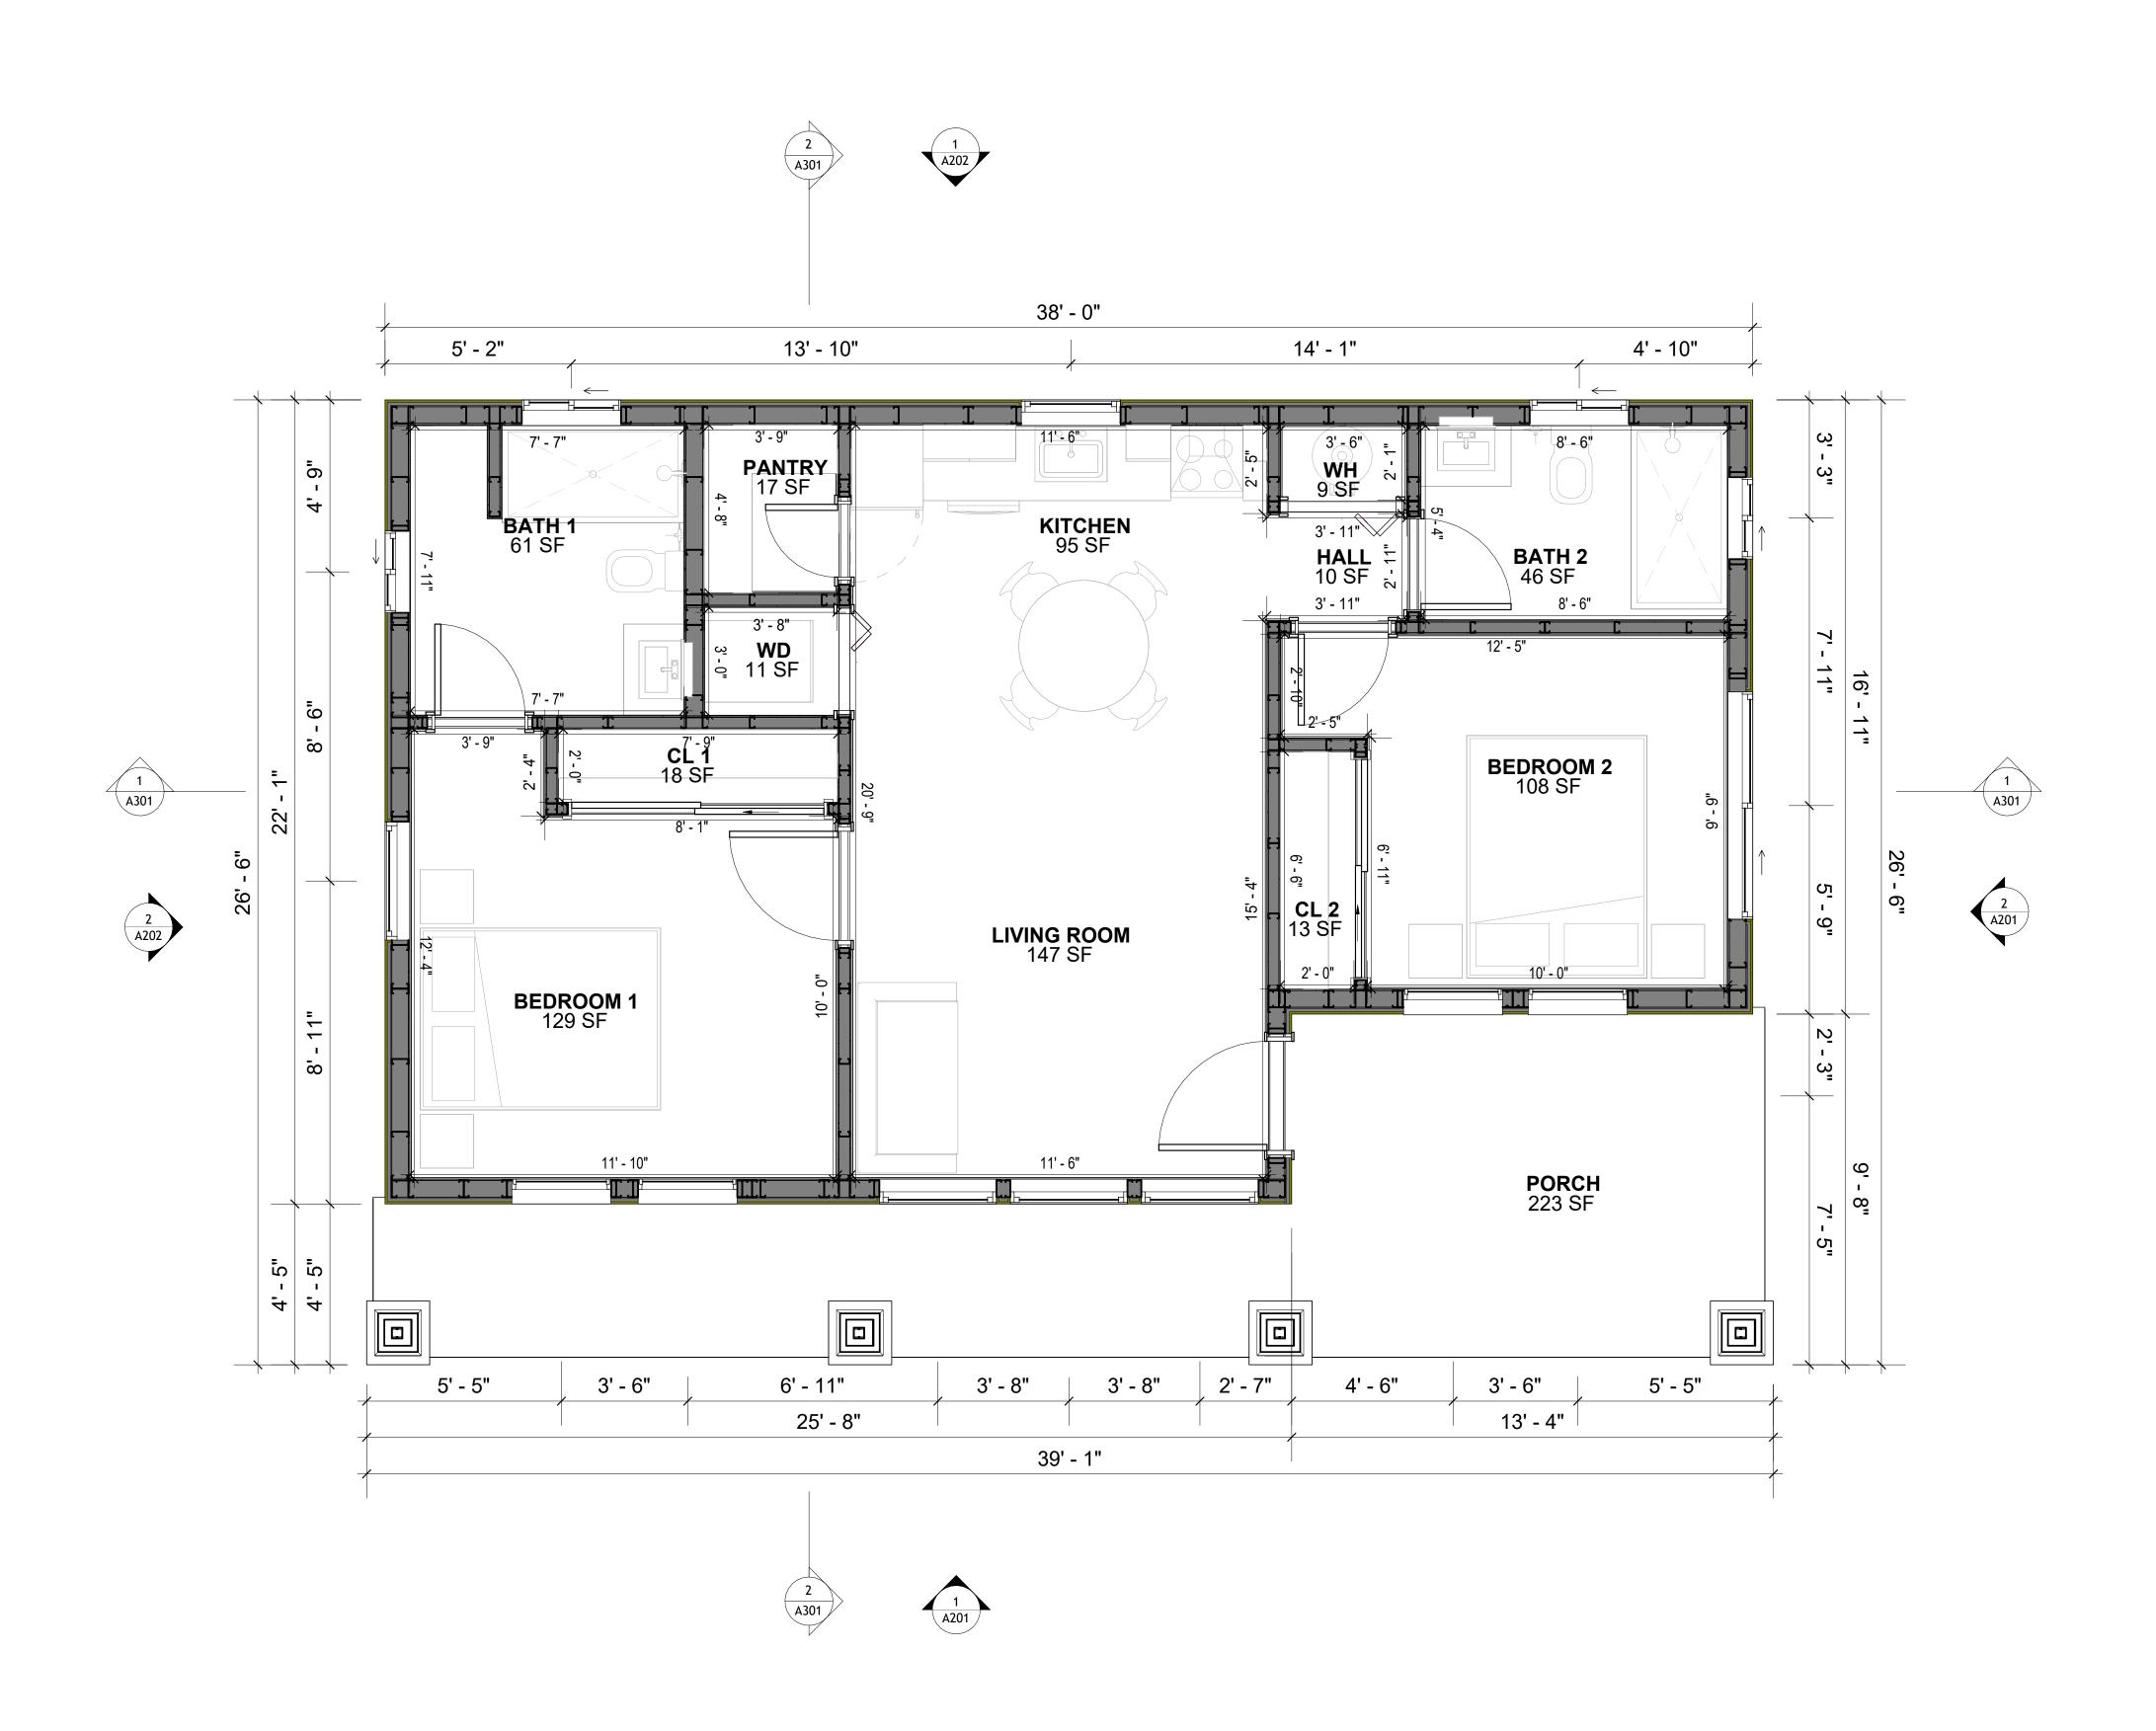

1 DIMENSION PLAN 3/8" = 1'-0"



KEY PLAN

NO.	DESCRIPTION	DATE

NOTE:

LEGEND:

PROJECT

193-ORCHARD-749 2Bd2Ba-CRAFTSMAN-550

DRAWING NAME

DIMENSION PLAN

Client Name
0061_12
5/6/2025 11:30:33 AM
Designer
Author
Checker

49 13 A102

SCALE: 3/8" = 1'-0"

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 LIVING
 749

 PORCH
 213

 TOTAL
 962

SQUARE FOOTAGE

FOUNDATION NOTES

TERMITES PRETREATMENT BY LICENSED CONTRACTOR UNDER SLAB AND AROUND FOOTINGS. ALL AREAS BELOW SLABS SHALL BE TREATED NO MORE THAN 24 HOURS PRIOR TO CONCRETE POUR. EVIDENCE OF TREATMENT MUST BE PROVIDED PRIOR TO PLACING OF CONCRETE.

MATERIALS:

ALL INTERIOR CONCRETE SLABS SHALL BE A MIN. OF 4" THICK CONCRETE OVER 4" COMPACTED AGGREGATE BASE (ASTM D698), FINISH ELEVATIONS AS NOTED ON DRAWINGS, 6" ABOVE ADJACENT GRADE, LEVEL SLABS TO 1/8"-10' MAX.. CONCRETE SLABS SHALL BE 2500# PSI AT 28 DAYS. A 4" ALLOWABLE SLUMP.

2. **PAD PREPARATION:**

EXCAVATION FOR FOOTING SHALL BE NEAT.

FOOTINGS SHALL BE POURED IMMEDIATELY AFTER EXCAVATION AND APPROPRIATE INSPECTION.

ALL REINFORCING STEEL MARKED "CONTINUOUS" SHALL BE LAPPED 36 BAR DIAMETERS AT SPLICES AND AROUND CORNERS OR INTERSECTIONS WITH A STANDARD 90 DEGREE BEND ON CORNER BARS. LAP WIRE MESH ONE FULL MESH AT SIDE AND END LAPS.

ALL HARDWARE TO BE SIMPSON OR EQUIVALENT. EXTERIOR FRAME WALL TO BE SECURED WITH 1/2"X10" ANCHOR BOLTS 4'-0" O.C. FOR 1-STORY AND 2'-8" O.C. FOR 2-STORY. BOLTS SHALL BE LOCATED WITHIN 1'-0" OF EACH END PIECE AND SHALL HAVE A MIN. OF TWO BOLTS PER PIECE.

-FOUNDATION ANCHOR STRAPS SHALL BE PERMITTED, ACCORDING TO RESIDENTIAL CODE

- ALL INTERIOR WALLS TO BE SECURED WITH POWER DRIVEN PINS PER MANUFACTURER SPECIFICATION USE PIN SPACING EQUIVALENT TO 1/2" ANCHOR BOLTS.

ALL CONSTRUCTION TO CONFORM TO THE 2012 IRC · R-10 RIGID INSULATION OUTSIDE OF EXTERIOR FOUNDATION WALLS UNDER LIVING AREA.

CONCRETE PAD FOR CONDENSER THICKNESS IS 4" MIN UNLESS OTHERWISE NOTED.

3. CONCRETE CONSTRUCTION:

- THE SLAB SHALL BE UNDERLAIN BY A VAPOR BARRIER/RETARDER IN THE LIVING AREA (TYPICALLY POLYETHYLENE, UNLESS MORE STRINGENT PROTECTION REQUIRED BY THE ARCHITECT, ENGINEER, FLOOR COVERING MANUFACTURER, OR ACCEPTED PRACTICE). UNLESS OTHERWISE REQUIRED, BARRIER MAY BE OMITTED AT GARAGES, PORCHES AND PATIOS WITHOUT FLOOR COVERINGS. IT IS BEYOND THE SCOPE OF THESE PLANS TO DETERMINE THE APPLICABILITY OF THESE MORE STRINGENT REQUIREMENTS. BUILDER SHALL VERIFY PRIOR TO CONSTRUCTION.

4. REINFORCEMENT:

IF CONSTRUCTED ON ACTIVE SOILS, THE LONG TERM PERFORMANCE OF THE FOUNDATION IS DEPENDENT ON MAINTENANCE BY THE OWNER. THUS THE BUILDER SHALL ADVISE THE OWNER OF THE FOLLOWING:

- DRAINAGE MUST BE MAINTAINED. WATER SHALL NEVER BE ALLOWED TO POND NEAR THE FOUNDATION.
- 2. THE SOIL AROUND THE FOUNDATION SHALL BE MAINTAINED IN A RELATIVELY DAMP CONDITION, SUCH AS THAT REQUIRED TO KEEP A LAWN GREEN. IF IT DRIES OUT IT WILL SHRINK. IF IT GETS WET, IT WILL HEAVE UPWARD.

3. SLABS ON THE SHORTER SIDE USES MAIN BARS ARE USED IN THIS DIRECTION ONLY WITH SMALLER DIAMETER DISTRIBUTION BARS ARE PLACED, FORMING A MAT OR GRID.

- 4. ALL REINFORCEMENT BARS SIZE 10MM OR LARGER IN ACCORDANCE TO ASTM 3. ANCHOR BOLTS AT ALL EXTERIOR WALLS SHALL BE MINIMUM 1/2 INCH DIAMETER WITH A MAXIMUM SPACING OF 6'-0" ON CENTER, UNLESS NOTED OTHERWISE.
- 4. ANCHOR BOLTS SHALL BE INSTALLED WITHIN 12 INCHES OF EACH END OF EACH SILL PLATE WITH AT LEAST TWO ANCHOR BOLTS FOR EACH BOLTS FOR EACH SILL PLATE LONGER THAN 12 INCHES.


5. SIMPSONS SILL ANCHORS MAYBE SUBSTITUTED FOR ANCHOR BOLTS AT THE SAME SPACING.

6. EXTERIOR CONCRETE SLABS WHICH ARE NOT PART OF THE MAIN SLAB SHALL BE MINIMUM 4 INCHES THICK WITH NO STEEL REINFORCING BARS REQUIRED, UNLESS NOTED OTHERWISE ON FOUNDATION PLAN.

VERIFY THE FOLLOWING PRIOR TO POURING:

- ALL HOLDDOWNS, STRAP, AND POST LOCATIONS.
- 2. CONCRETE FINISHES. PANEL RISER LOCATION WHERE APPLICABLE.
- B. UNDERSLAB MECHANICAL REQUIREMENTS.
- STEM WALL BLOCKOUTS.
- 5. UNDERSLAB ELECTRICAL REQUIREMENTS AND PANEL RISER LOCATION. WHERE
- APPLICABLE. PROVIDE THE FOLLOWING:
- PVC SLEEVES THROUGH FTG IF REQUIRED
- 20' #4 COPPER GROUND BAR.
- SLOPE FINISH GRADE AWAY FROM FOOTING.

NOTE: FIELD VERIFY ALL DIMENSIONS SEE DIMENSIONED ARCHITECTURAL DRAWINGS

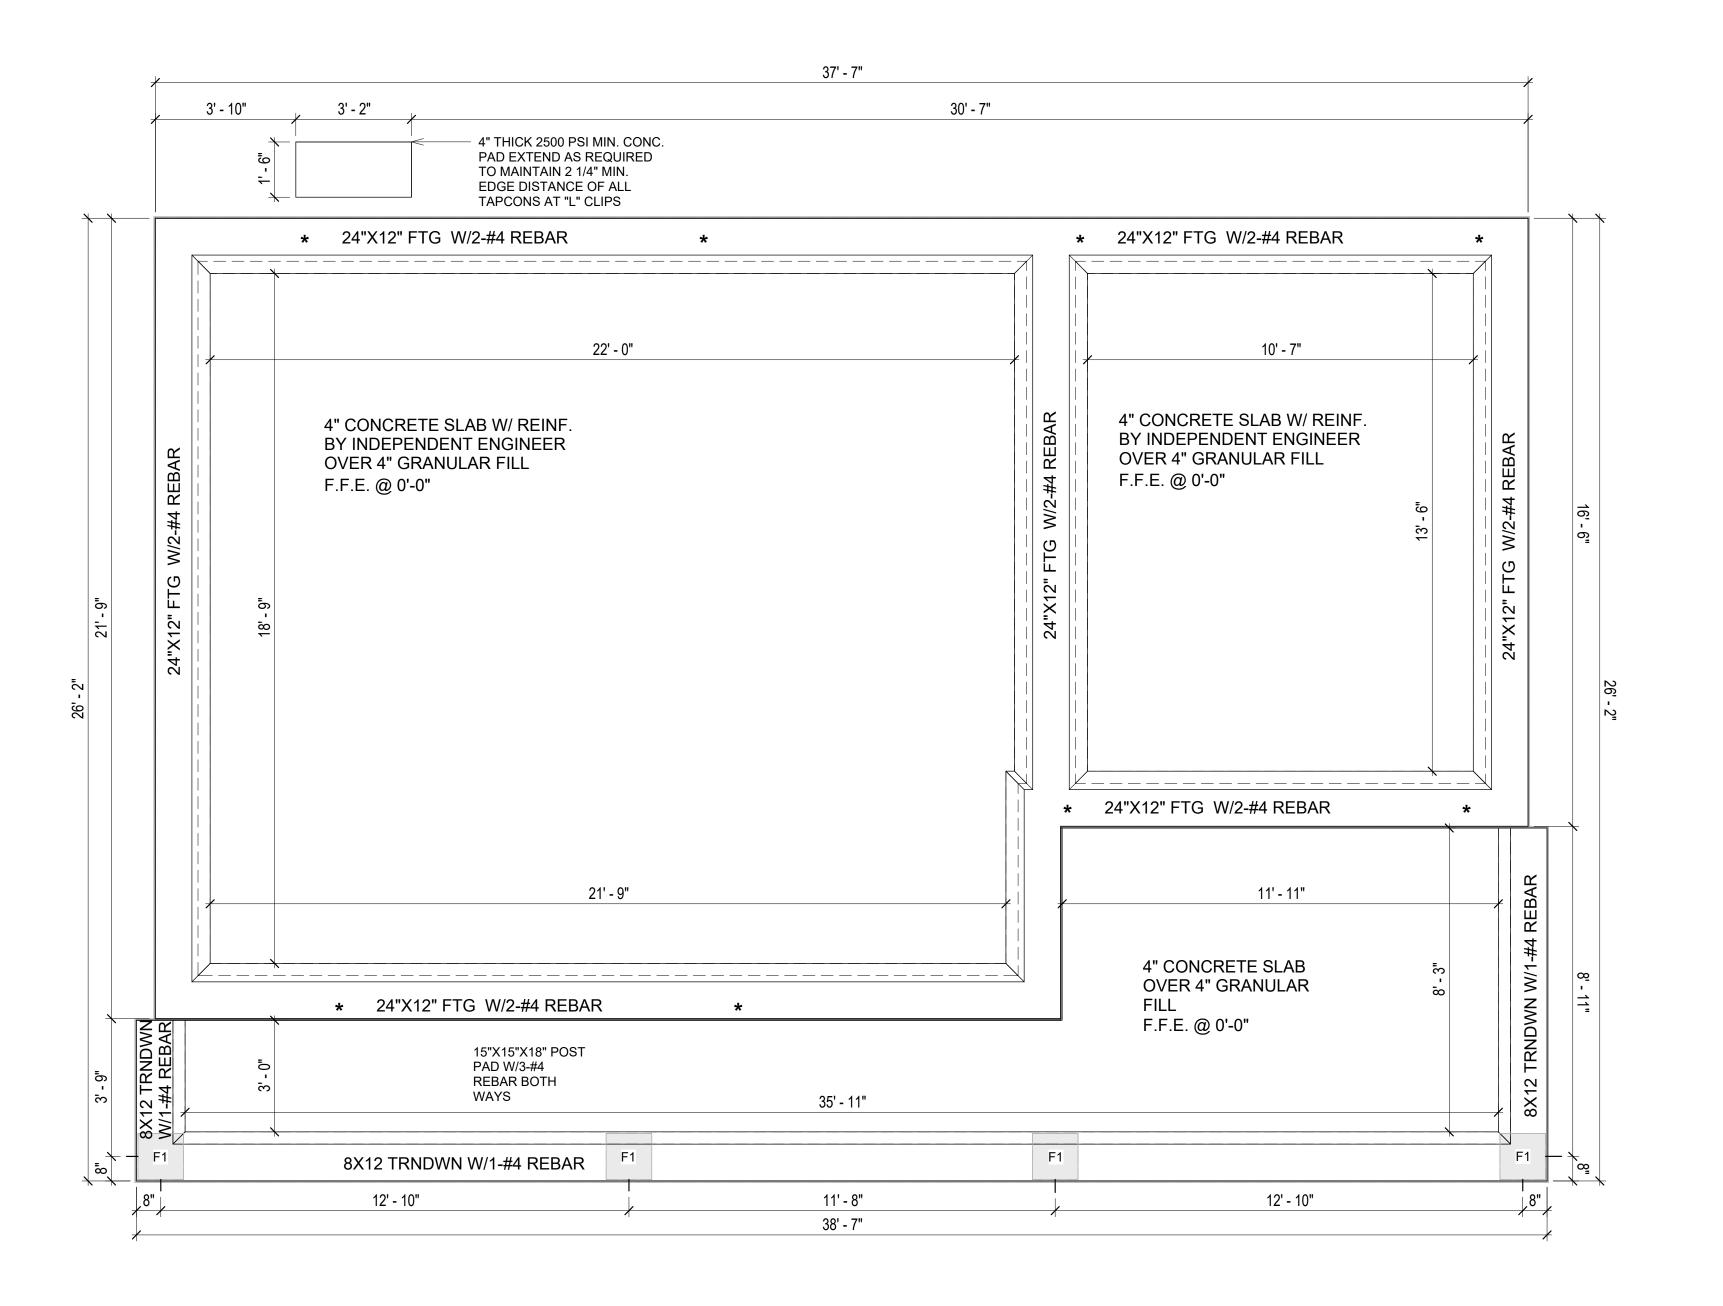

FOUNDATION PLAN 3/8" = 1'-0"

SQUARE FOOT	AGE	
LIVING 749		
PORCH	213	
TOTAL	962	



KEY PLAN

NO.	DESCRIPTION	DATE

NOTE:

LEGEND:

PROJECT

193-ORCHARD-749 2Bd2Ba-CRAFTSMAN-550

DRAWING NAME

FOUNDATION PLAN

CLIENT NAME:	Client Name
PROJECT NUMBER:	0061_12
DATE:	5/6/2025 11:30:33 AM
DESIGNED BY:	Designer
DRAWN BY:	Author
CHECKED BY:	Checker

S101

SCALE: 3/8" = 1'-0"

GENERAL NOTES

NOTES:

-ALL BEARING WALLS SHOULD HAVE A THICKENED SLAB PER SECTION PER DETAIL A401/5.

A) **FOUNDATION PLAN NOTES**:

- CONCRETE SLAB SHALL BE 6" THICK WITH 1/2" DIAMETER TENDONS PER LAYOUT PLAN, CENTERED IN SLAB THICKNESS, OVER APPROVED SUBBASE PER GENERAL STRUCTURE NOTES.
- 2. TERMITE PROTECTION SHALL BE PROVIDED PER IRC SECTION R318.1 NONE TYPICAL ANCHOR BOLT SPACING AT SHEAR WALL AND HOLD DOWN
- SPECIFICATIONS PER APPROVED ARCHITECTURAL PLANS.
- 4. INSTALL HOLDOWNS BEFORE CONCRETE SLAB POUR. EXISTING FILL ON-SITE SHALL BE COMPACTED IN ACCORDANCE WITH THE
- REQUIREMENTS IN THE GEOTECHNICAL REPORT.
- 6. ALL FLOOR SLABS ARE REINFORCED ON CONCRETE SLABS.

SPECIAL INSPECTION IS REQUIRED FOR THICKENED FOUNDATION CONSTRUCTION

- 1. REINFORCEMENT
- 2. 2300 PSI CONCRETE POUR


B) **REINFORCEMENT FOR CONCRETE**:

1. ALL REINFORCING SLABS BARS SIZE 10MM OR LARGER SHALL BE DEFORMED IN ACCORDANCE TO ASTM-A706, AND BARS SMALLER THAN 10 MM MAYBE PLAIN. 2. UNLESS OTHERWISE NOTED IN PLANS, THE YIELD STRENGTH OF REINFORCING BARS SHALL BE:


> A) FOOTING = 40,000 PSI B) NON-LOAD BEARING WALLS AND PARAPETS= 40,000 PSI


- 3. SPLICES SHALL BE SECURELY WIRED TOGETHER AND SHALL LAP OR EXTEND
- 4. GRADE OF STEEL FOR RCC WORKS SHALL BE GRADE 4 10.
- BAR NOTATIONS GIVES INFORMATION
- A) BAR SIZE
- B) SPACING(IF REQUIRED)
- 6. LAP REINFORCEMENT ONLY AT LOCATION SHOWN IN THE DRAWINGS
- REINFORCEMENT SHALL NOT BE CUT, VENT OR HEATED ON SITE WITHOUT ENGINEERS' APPROVAL.
- C) **CONCRETE SLAB NOTES**
- 1. ALL SLAB REINFORCEMENT SHALL BE 20MM CLEAR MINIMUM FROM BOTTOM AND FROM TOP OF SLAB.
- 2. REINFORCEMENT IN CONTINUOUS ELEVATED SLAB SHALL BE CUT AS FOLLOWS.

- THIS IS A SCHEMATIC PLAN FOR THE PURPOSE OF LOCATING AND IDENTIFYING FOUNDATION REINFORCING ELEMENTS ONLY. VERIFY ALL DIMENSIONS, DROPS OFFSETS AND FEATURES WITH THE ARCHITECTURAL PLANS BEFORE FORMING THE FOUNDATION.

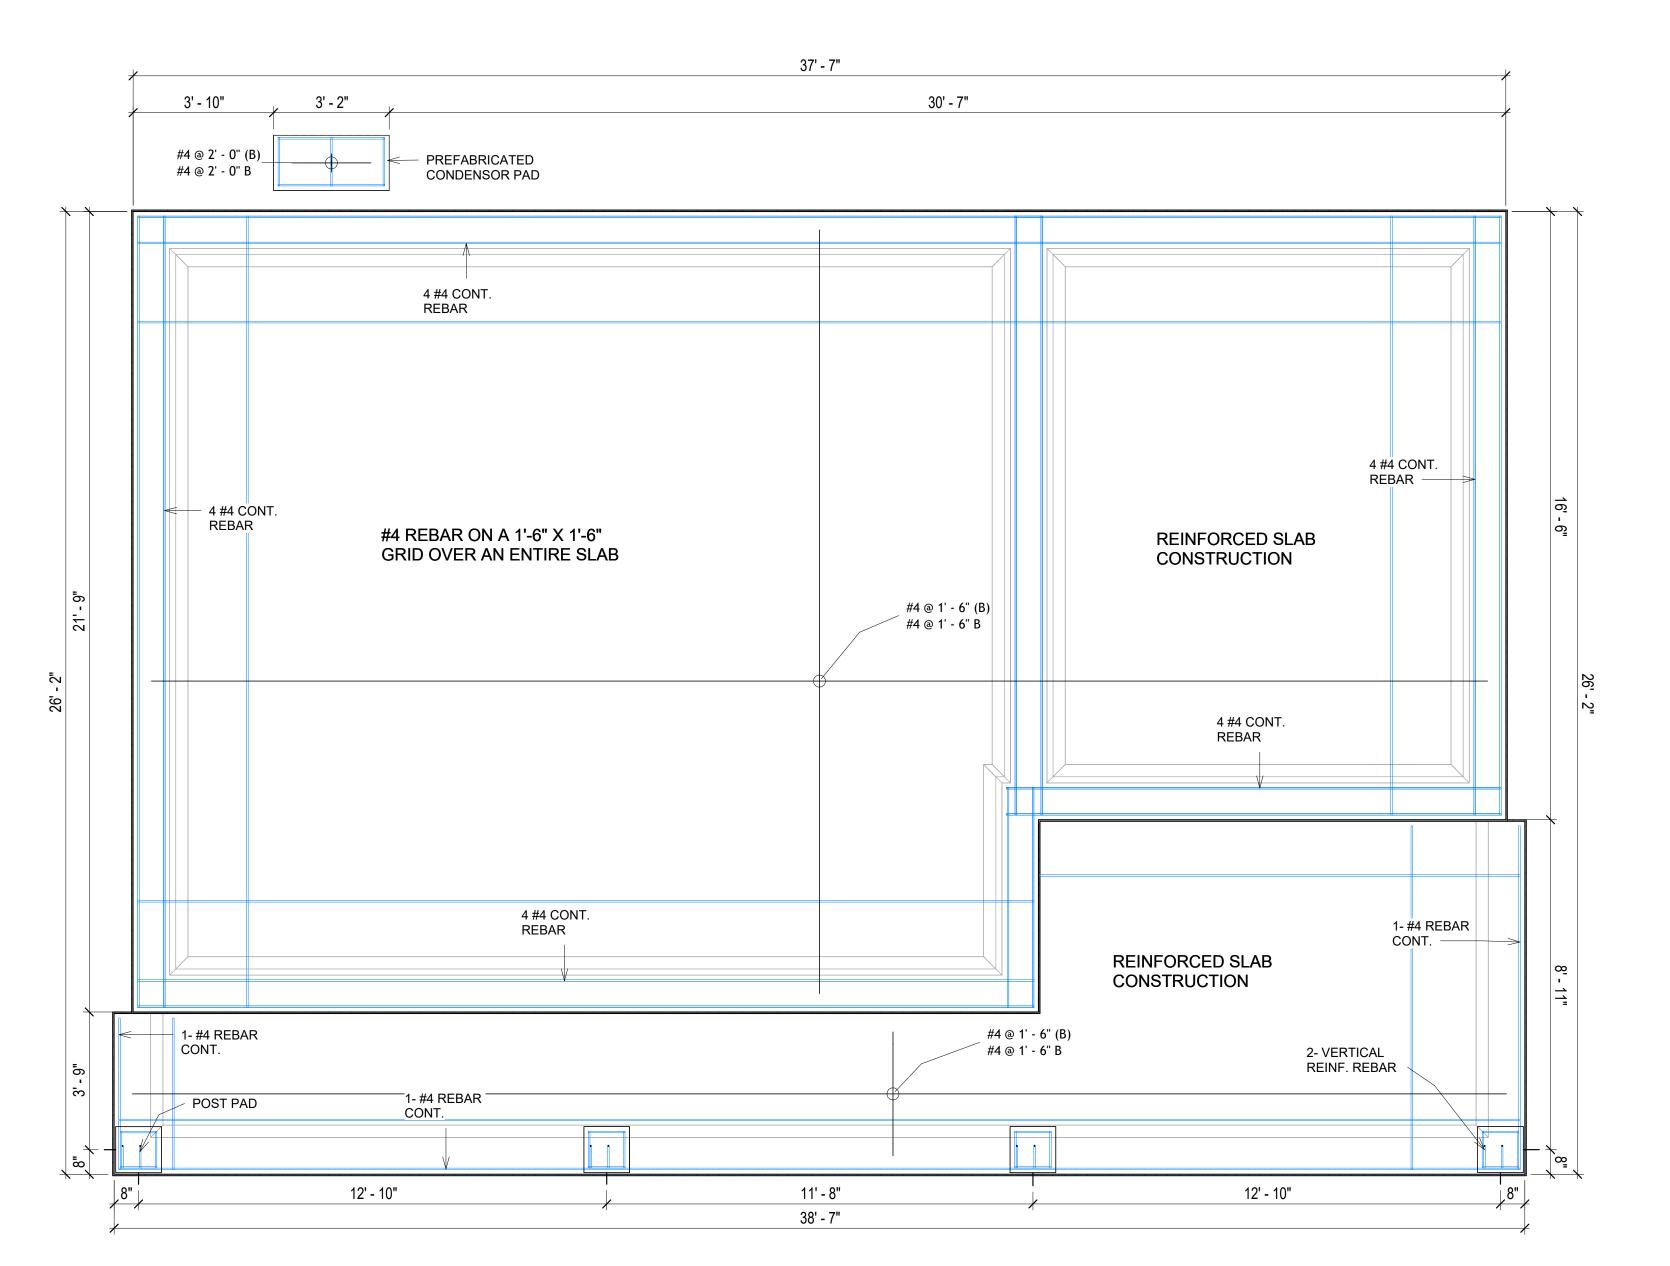

FOUNDATION REBAR PLAN

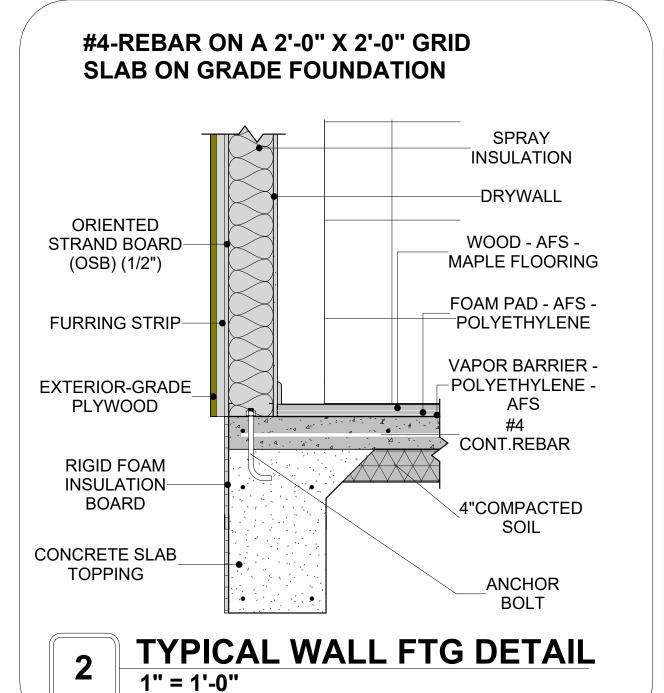

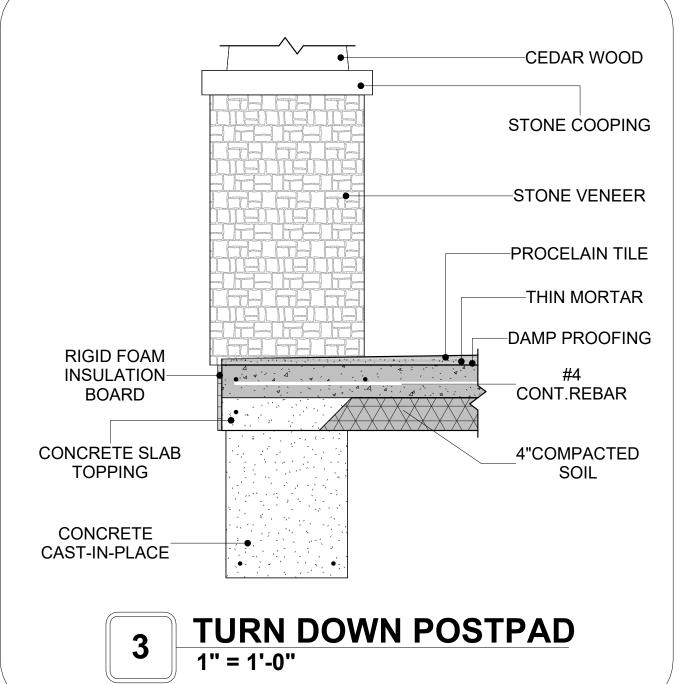

888-864-0184 inquire@frameupnow.com www.frameupnow.com

KEY PLAN

DESCRIPTION DATE

NOTE:

LEGEND:

PROJECT

193-ORCHARD-749 2Bd2Ba-CRAFTSMAN-550

DRAWING NAME


STRUCTURAL FLOOR PLAN

CLIENT NAME: **Client Name** PROJECT NUMBER: 0061_12 5/6/2025 11:30:34 AM Designer **DESIGNED BY:** DRAWN BY: **Author** CHECKED BY: Checker


S102

ROOF NOTES

- ROOFING COMPOSITION ROOFING PER OWNERS/BUILDERS SPECIFICATIONS INSTALL PER MANUFACTURE SPECIFICATIONS ON 1/2" ORIENTED STRAND BOARD ON PRE-ENGINEERED TRUSS @ 24" O.C. (UNO.) 2. 73" OVERHANG AT EAVES (UNO.)
- ENDS OF ALL TRUSSES AND JOISTS TO BE FULLY BLOCKED. PROVIDE SOLID
- BLOCKING AT ALL RIDGES AND VALLEYS 4. SHEATHING TO BE 1/2", 3/8" OSB SHEAR PANEL AND EQUIVALENT. UNDERSIDE OF PORCH TRUSSES TO BE FINISHED WITH MOISTURE
- RESISTANT DRYWALL, TAPED AND TEXTURED. 5. EXPOSED EAVES AND OTHER WEATHER EXPOSED AREAS TO BE SHEATHED WITH EXTERIOR GRADE PLYWOOD.
- 6. ALL MATERIALS THICKNESS AND SIZE ARE THE MINIMUM. Refer TO LOCAL STANDARDS FOR ACTUAL THICKNESS AND LAYERING OF MATERIALS.
- ENGINEERED TRUSS CALCULATIONS TO BE SUBMITTED TO BUILDING DEPARTMENT PRIOR TO FABRICATION AND INSTALLATION.
- TRUSS MANUFACTURER TO SPECIFY HANGER CONNECTORS FOR TRUSS COMPONENTS (TYPICAL)
- 9. DESIGNER ASSUMES THAT TRUSSES BEAR ON ALL EXTERIOR PERIMETER
- WALLS (TYPICAL) OR BEAMS.
- OF 12 INCHES, AND THICKNESS OF 24 GAUGE.
- 10. PROVIDE GALVANIZED STEEL FLASHING WITH A LENGTH OF 10 FEET, WIDTH

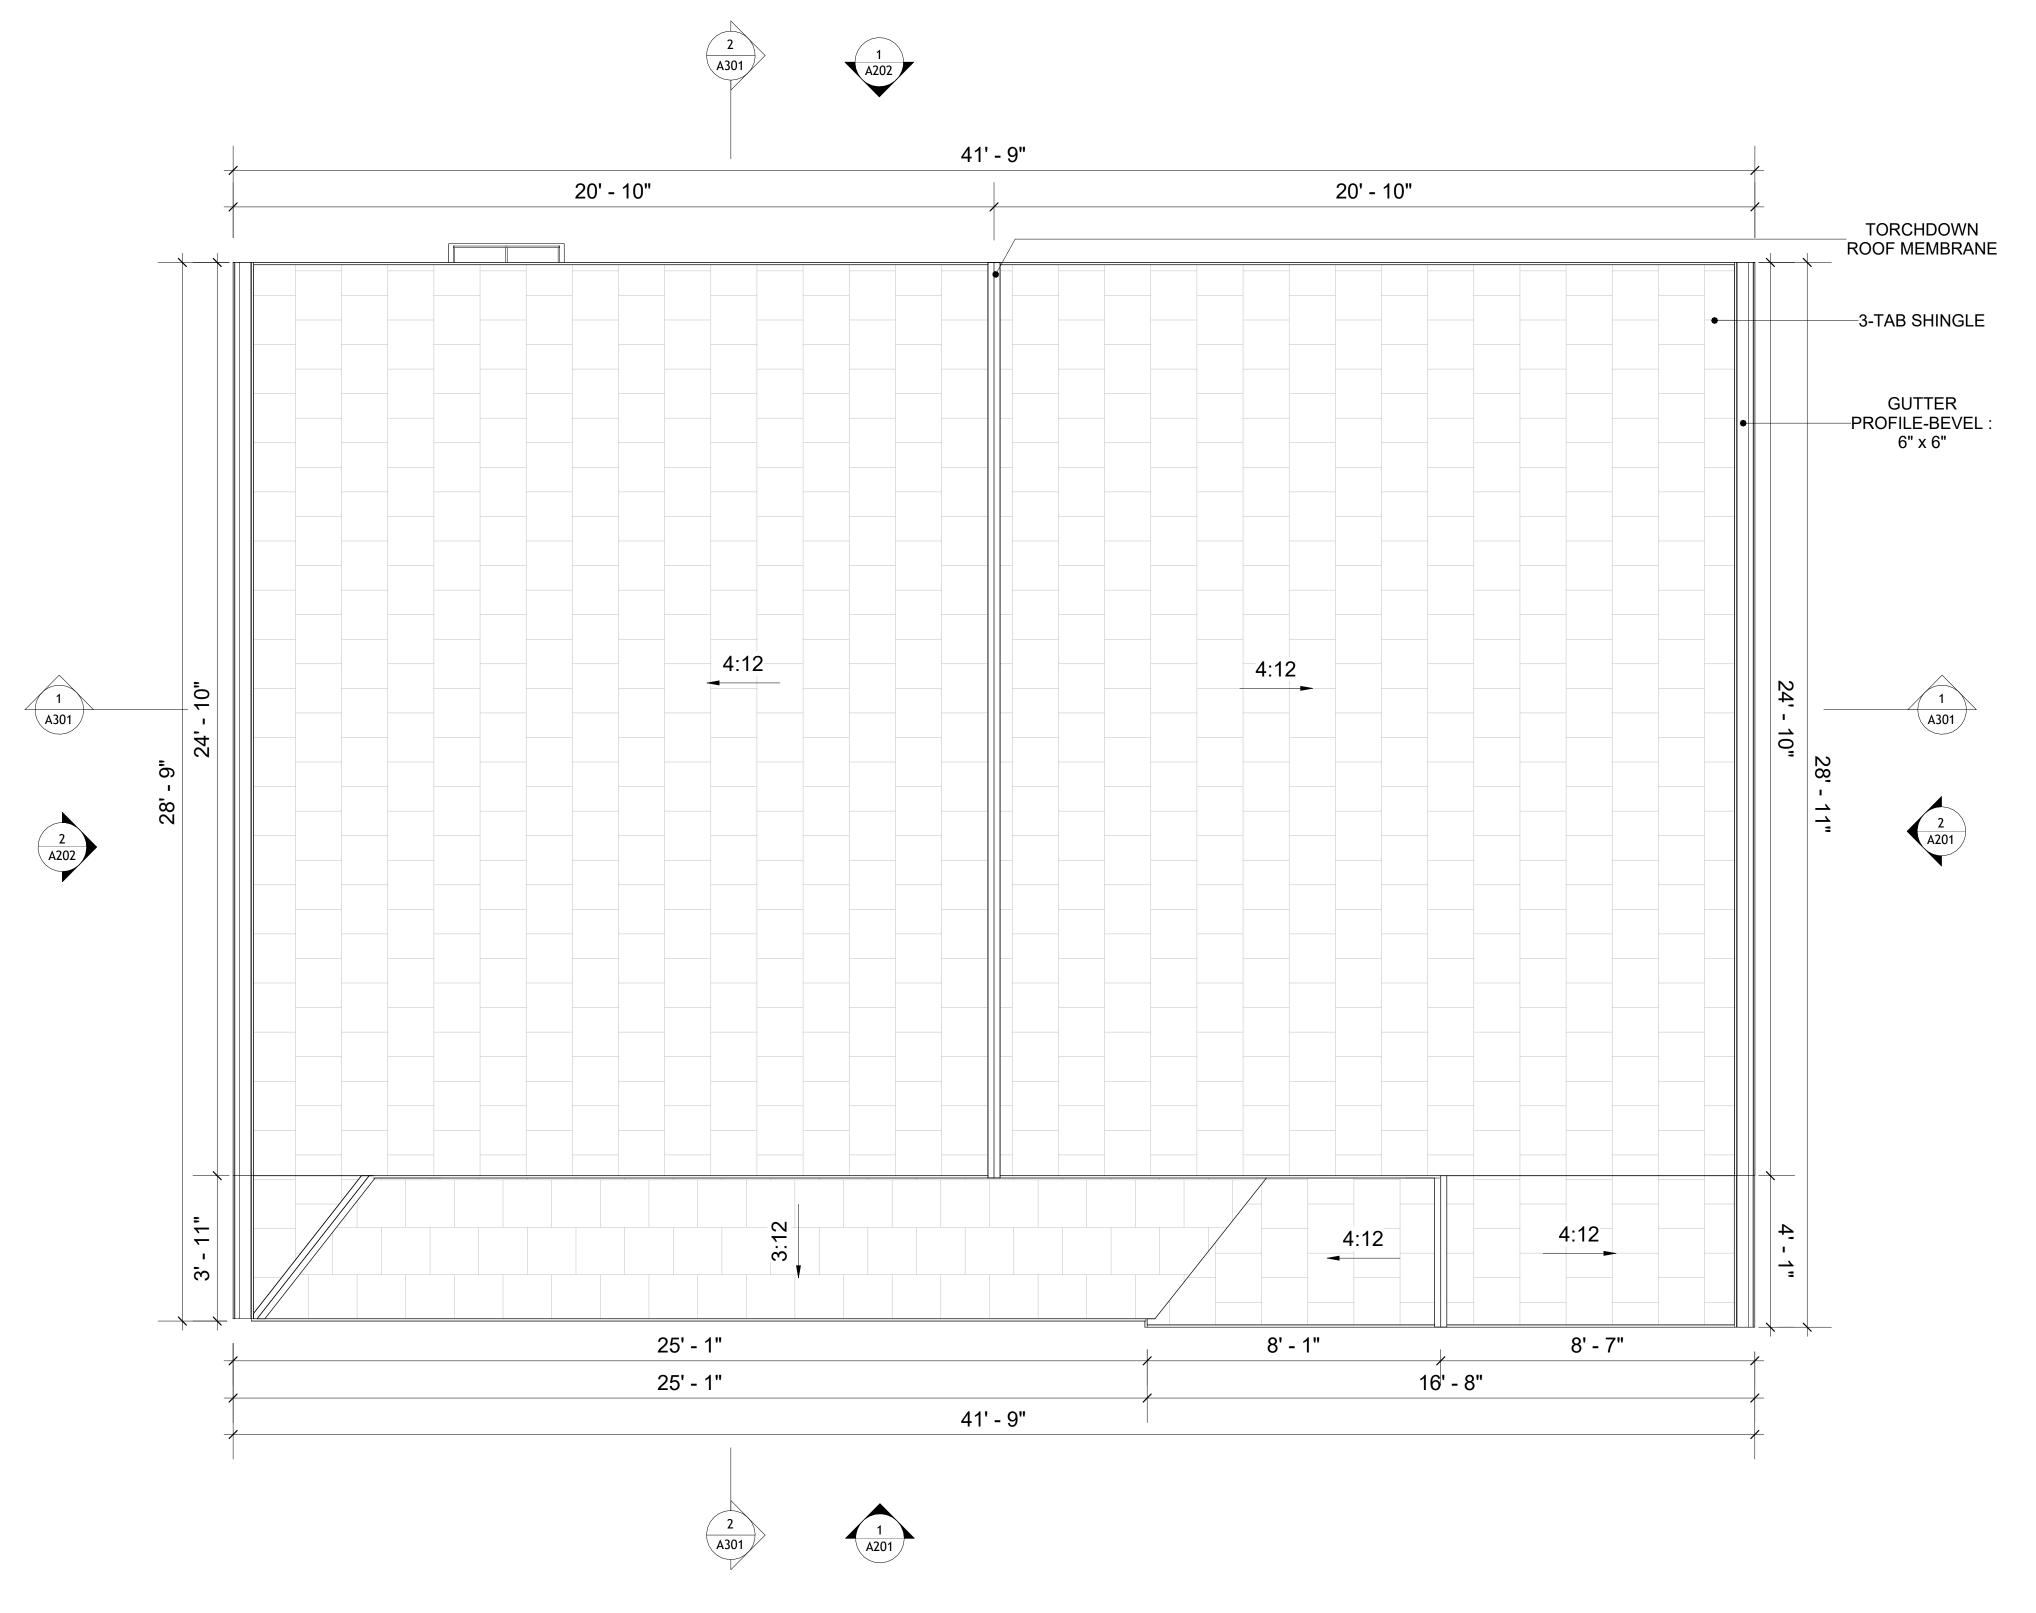

ROOF PLAN 3/8" = 1'-0"

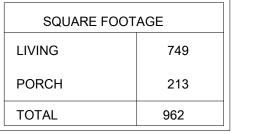



KEY PLAN

NO.	DESCRIPTION	DATE

NOTE:

LEGEND:

PROJECT

193-ORCHARD-749 2Bd2Ba-CRAFTSMAN-550

DRAWING NAME

ROOF PLAN

Client Name	CLIENT NAME:
0061_12	PROJECT NUMBER:
5/6/2025 11:30:37 AM	DATE:
Designer	DESIGNED BY:
Author	DRAWN BY:
Checker	CHECKED BY:

A103

ABOUT WALL FINISHING

PLYWOOD WALL SIDING

WALL SIDING IS AN EXTERIOR CLADDING MATERIAL USED TO COVER AND PROTECT THE WALLS OF A BUILDING, PROVIDING BOTH FUNCTIONAL AND AESTHETIC BENEFITS.

IN THIS SPECIFIC PROJECT, PLYWOOD WALL PANELS ARE USED AS A FINISH SIDING BECAUSE THIS TYPE OF SIDING PROVIDES A DURABLE, COST-EFFECTIVE, AND VERSATILE EXTERIOR CLADDING THAT CAN BE EASILY INSTALLED, FINISHED, AND MAINTAINED TO ENHANCE THE AESTHETIC AND PROTECTIVE QUALITIES OF A BUILDING'S EXTERIOR.

STANDARD SIZES OF 1' X 8' EXTERIOR-GRADE PLYWOOD PANELS ARE INSTALLED ON THE FURRING STRIPS USING GALVANIZED STEEL SELF-DRILLING SCREWS.

STONE VENEER

STONE VENEER REFERS TO THIN LAYERS OF NATURAL OR MANUFACTURED STONE APPLIED TO A STRUCTURAL WALL, KNOWN FOR THEIR REALISTIC APPEARANCE AND RELATIVE LIGHTNESS. THESE VENEERS PROVIDE THE AESTHETIC OF STONE WITHOUT THE COST AND WEIGHT OF FULL STONE CONSTRUCTION, CONTRIBUTING TO A BEAUTIFUL AND COSTEFFECTIVE EXTERIOR FINISH.


IN THIS SPECIFIC PROJECT, STONE VENEER IS USED A FINISH MATERIAL ON EXTERIOR FINISH.

CEDAR WOOD

CEDAR WOOD REFERS TO THE WOOD FROM VARIOUS SPECIES OF CEDAR TREES, WHICH ARE CONIFEROUS EVERGREEN TREES KNOWN FOR THEIR DISTINCT AROMA AND NATURAL RESISTANCE TO DECAY AND INSECTS. IN THIS SPECIFIC PROJECT, CEDAR WOOD IS USED AS A FURRING STRIP AND A FINISH MATERIAL ON BEAMS AND COLUMNS.

CEDAR WOOD AS A FURRING STRIPS PROVIDE THERMAL INSULATION, MOISTURE MANAGEMENT, AND AN AESTHETICALLY PLEASING, VERSATILE FRAMING SOLUTION WHEN INTEGRATED WITH CORONADO STONE AND CORRUGATED IRON SHEET CLADDING.

THE VERTICAL CEDAR WOOD FURRING STRIPS ARE ATTACHED TO HOME WRAP USING CORROSION-RESISTANT FASTENERS (HOT DIP GALVANIZED SCREWS), ENSURING PROPER PENETRATION INTO THE WALL FRAMING.

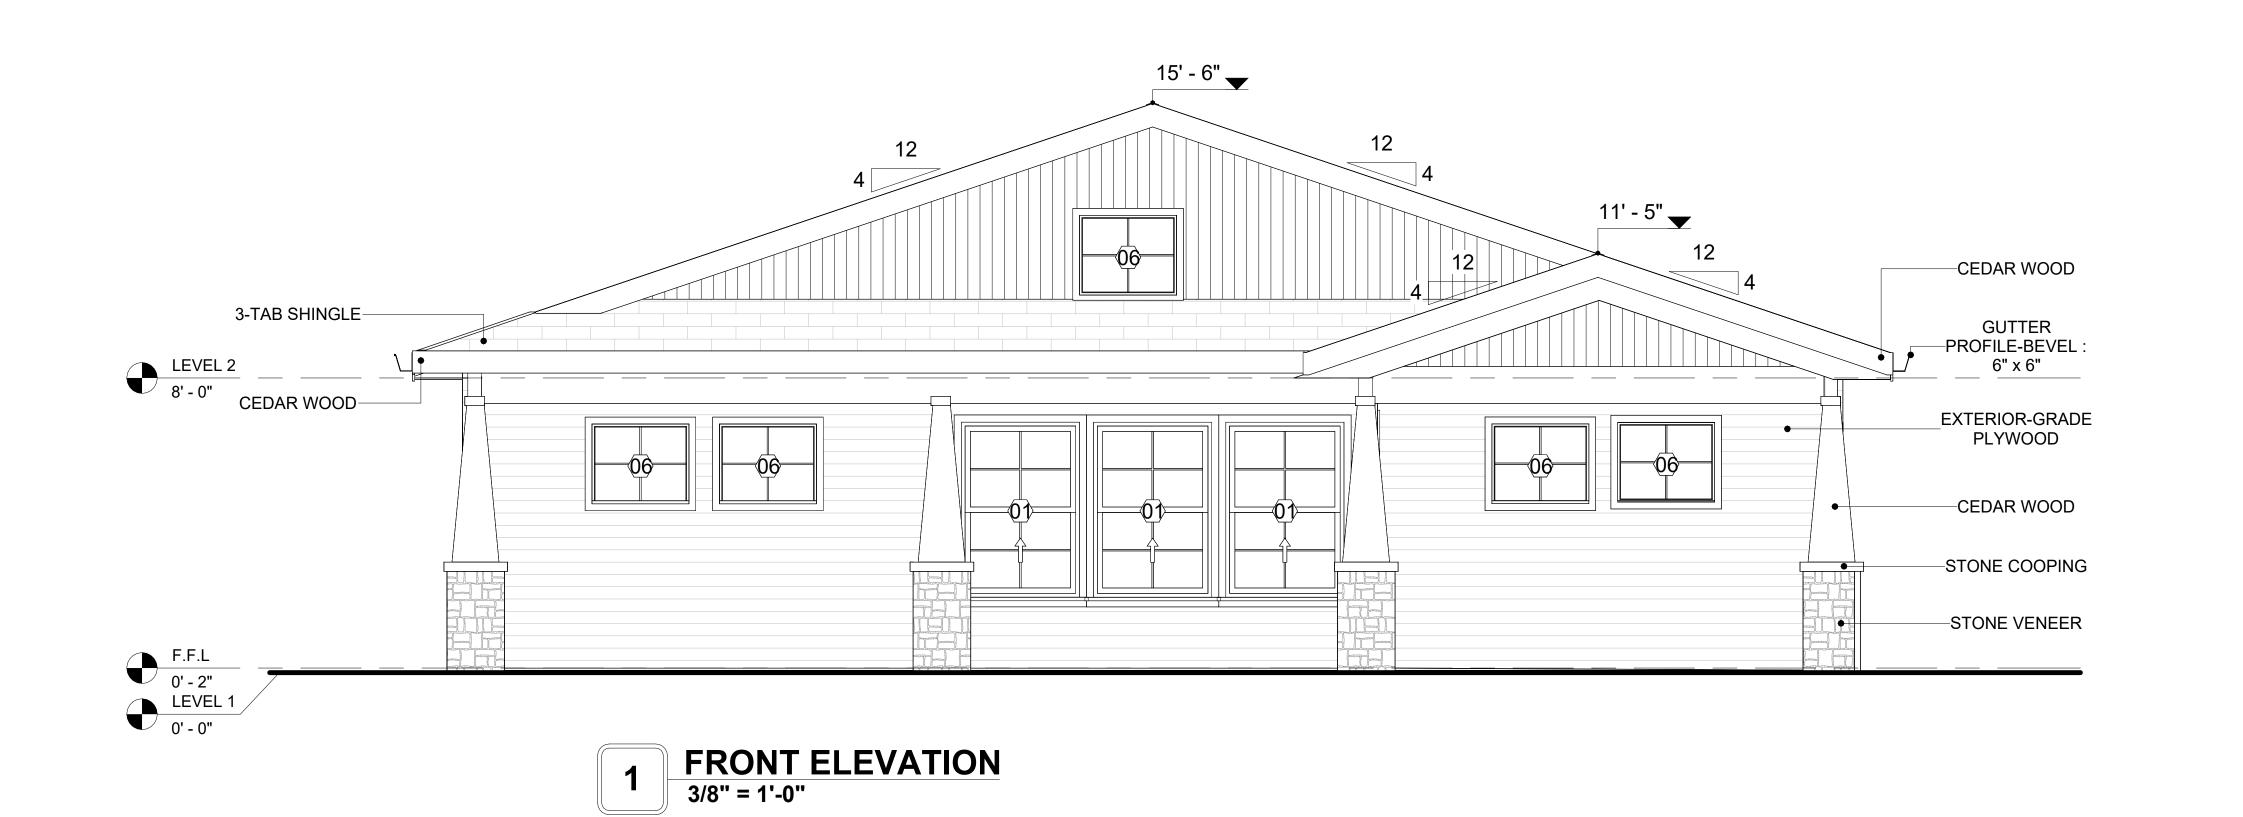




2 RIGHT SIDE ELEVATION 3/8" = 1'-0"

	DOOR SCHEDULE					
TYPE				5	SIZE	
MAR K	SUPPLIER	DOOR TYPE	LOCATIO N	WIDTH	HEIGHT	COUNT
1	HOME DEPOT	EXTERIOR SINGLE PANEL SWINGING	INTERIOR	3' - 0"	6' - 8"	1
2	HOME DEPOT	INTERIOR SINGLE PANEL SWINGING	INTERIOR	2' - 6"	6' - 8"	2
3	HOME DEPOT	INTERIOR SINGLE PANEL SWINGING	INTERIOR	3' - 0"	6' - 8"	1
4	HOME DEPOT	INTERIOR DOUBLE PANEL SLIDING	INTERIOR	6' - 0"	6' - 8"	1
5	HOME DEPOT	INTERIOR DOUBLE PANEL SLIDING	INTERIOR	7' - 0"	6' - 8"	1
6	HOME DEPOT	INTERIOR SINGLE PANEL SWINGING	INTERIOR	2' - 6"	6' - 8"	1
7	HOME DEPOT	INTERIOR SINGLE PANEL SWINGING	INTERIOR	2' - 0"	6' - 8"	1
8	HOME DEPOT	SINGLE FOLD 2	INTERIOR	2' - 8"	6' - 8"	1
9	HOME DEPOT	SINGLE FOLD 2	INTERIOR	3' - 0"	6' - 8"	1

WINDOW SCHEDULE					
				SIZE	
TYPE MARK	SUPPLIER	WINDOW TYPE	WIDTH	HEIGHT	COUNT
01	HOME DEPOT	SINGLE HUNG	3' - 3"	4' - 9"	4
02	HOME DEPOT	SLIDING	2' - 9"	1' - 9"	2
03	HOME DEPOT	SINGLE HUNG	2' - 9"	3' - 3"	1
04	HOME DEPOT	SLIDING	2' - 3"	1' - 9"	2
05	HOME DEPOT	SLIDING	6' - 3"	4' - 3"	1
06	HOME DEPOT	FIXED	2' - 9"	2' - 3"	5



KEY PLAN

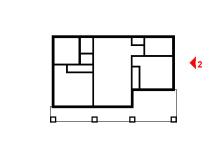

NO.	DESCRIPTION	DATE

NOTE:

LEGEND:

PROJECT

193-ORCHARD-749 2Bd2Ba-CRAFTSMAN-550

DRAWING NAME

ARCHITECTURAL ELEVATIONS

CLIENT NAME:	Client Name
OLIZIVI IV WIZ.	Onent Name
PROJECT NUMBER:	0061_12
DATE:	5/6/2025 11:30:38 AM
DESIGNED BY:	Designer
DRAWN BY:	Author
CHECKED BY:	Checker

A201

ABOUT WALL FINISHING

PLYWOOD WALL SIDING

WALL SIDING IS AN EXTERIOR CLADDING MATERIAL USED TO COVER AND PROTECT THE WALLS OF A BUILDING, PROVIDING BOTH FUNCTIONAL AND AESTHETIC BENEFITS.

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STANDARD SIZES OF 1' X 8' EXTERIOR-GRADE PLYWOOD PANELS ARE INSTALLED ON THE FURRING STRIPS USING GALVANIZED STEEL SELF-DRILLING SCREWS.

STONE VENEER

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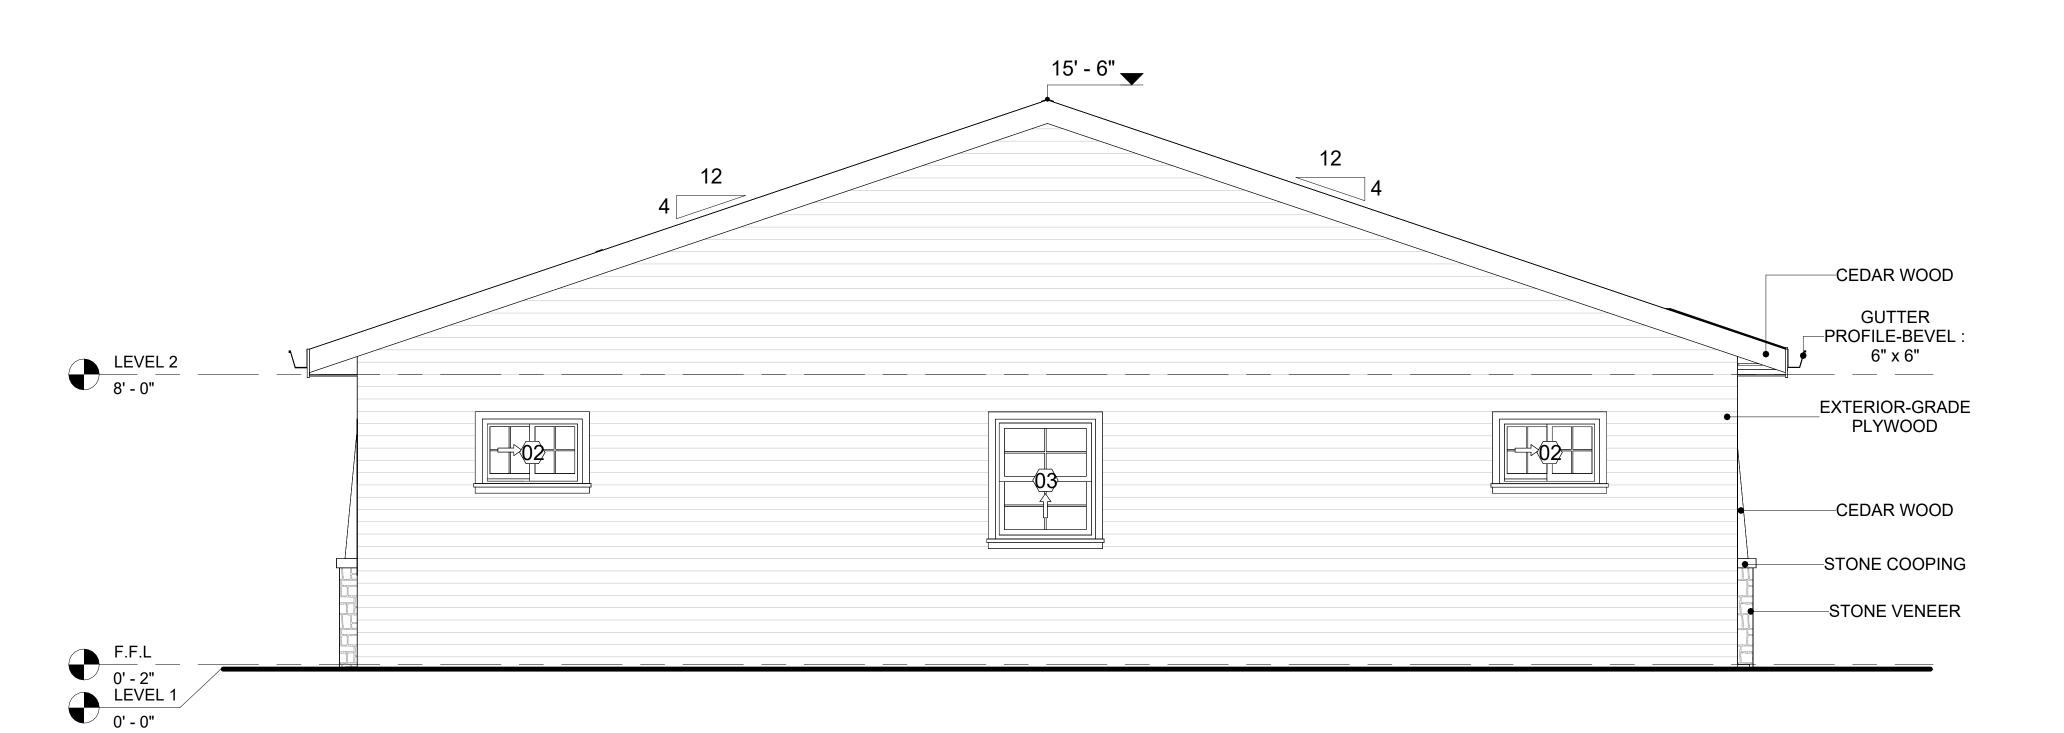
IN THIS SPECIFIC PROJECT, STONE VENEER IS USED A FINISH MATERIAL ON EXTERIOR FINISH.

CEDAR WOOD


CEDAR WOOD REFERS TO THE WOOD FROM VARIOUS SPECIES OF CEDAR TREES, WHICH ARE CONIFEROUS EVERGREEN TREES KNOWN FOR THEIR DISTINCT AROMA AND NATURAL RESISTANCE TO DECAY AND INSECTS. IN THIS SPECIFIC PROJECT, CEDAR WOOD IS USED AS A FURRING STRIP AND A FINISH MATERIAL ON BEAMS AND COLUMNS.

CEDAR WOOD AS A FURRING STRIPS PROVIDE THERMAL INSULATION, MOISTURE MANAGEMENT, AND AN AESTHETICALLY PLEASING, VERSATILE FRAMING SOLUTION WHEN INTEGRATED WITH CORONADO STONE AND CORRUGATED IRON SHEET CLADDING.

THE VERTICAL CEDAR WOOD FURRING STRIPS ARE ATTACHED TO HOME WRAP USING CORROSION-RESISTANT FASTENERS (HOT DIP GALVANIZED SCREWS), ENSURING PROPER PENETRATION INTO THE WALL FRAMING.



1 REAR ELEVATION
3/8" = 1'-0"

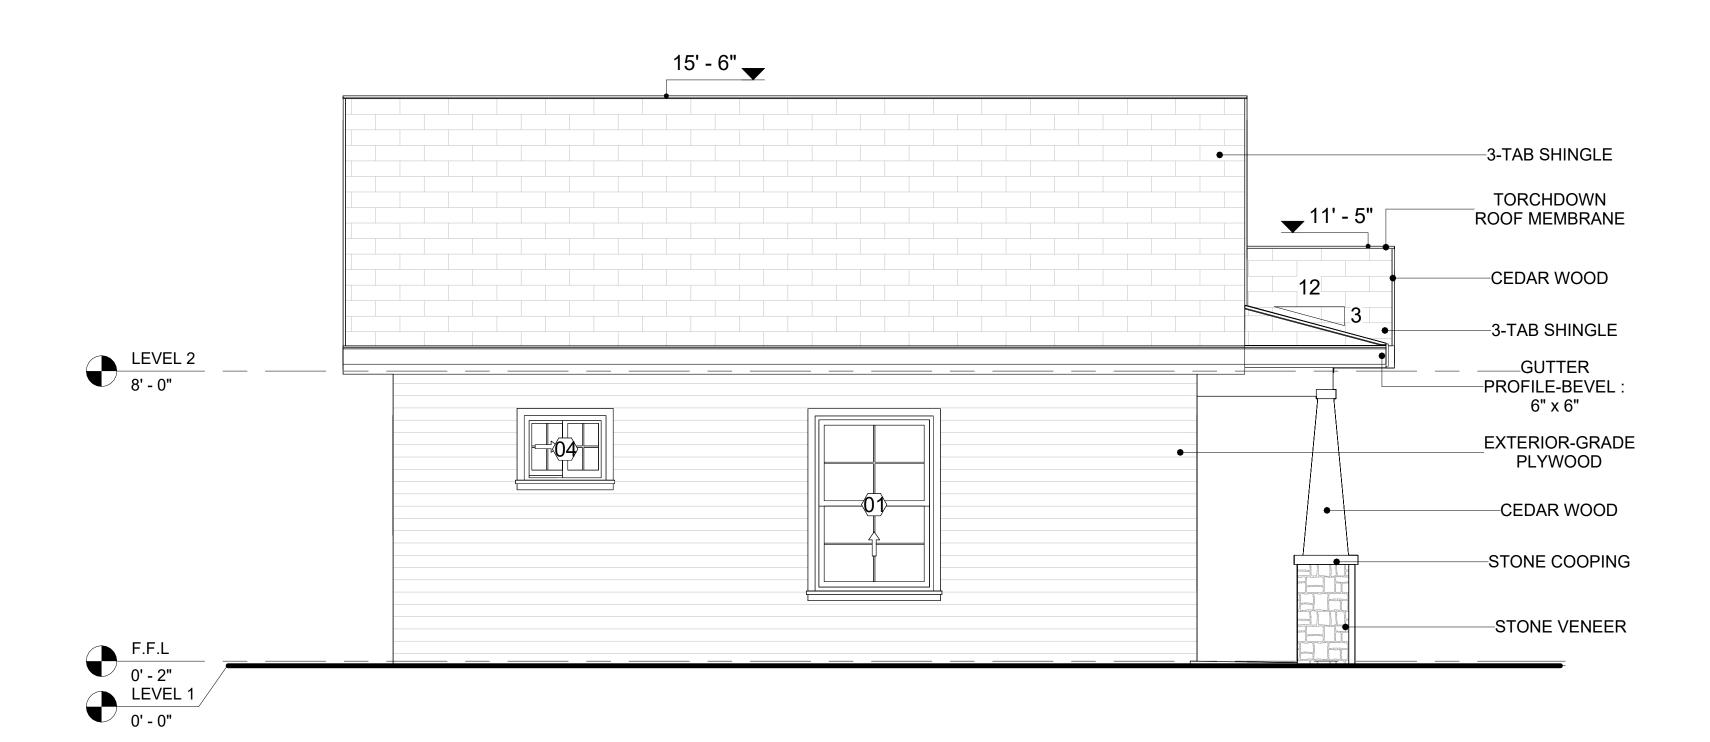

2 LEFT SIDE ELEVATION
3/8" = 1'-0"



KEY PLAN

1

2

NO.	DESCRIPTION	DATI

NOTE:

LEGEND:

PROJECT

193-ORCHARD-749 2Bd2Ba-CRAFTSMAN-550

DRAWING NAME

ARCHITECTURAL ELEVATIONS

CLIENT NAME:

PROJECT NUMBER:

0061_12

DATE:

5/6/2025 11:30:39 AM


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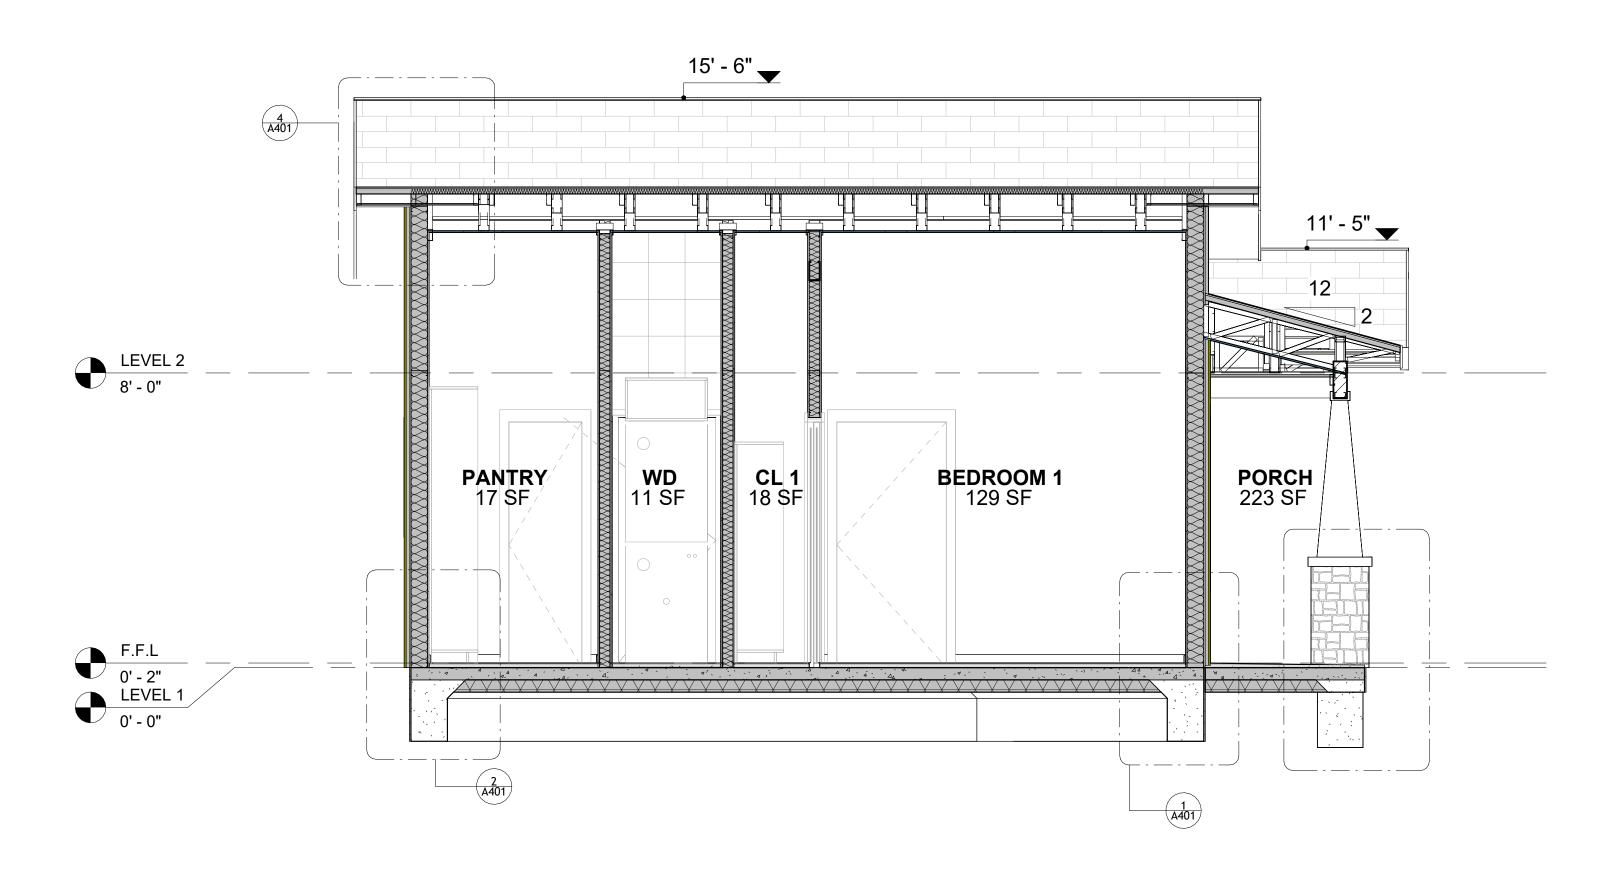
DRAWN BY:

CHECKED BY:

Checker


A202



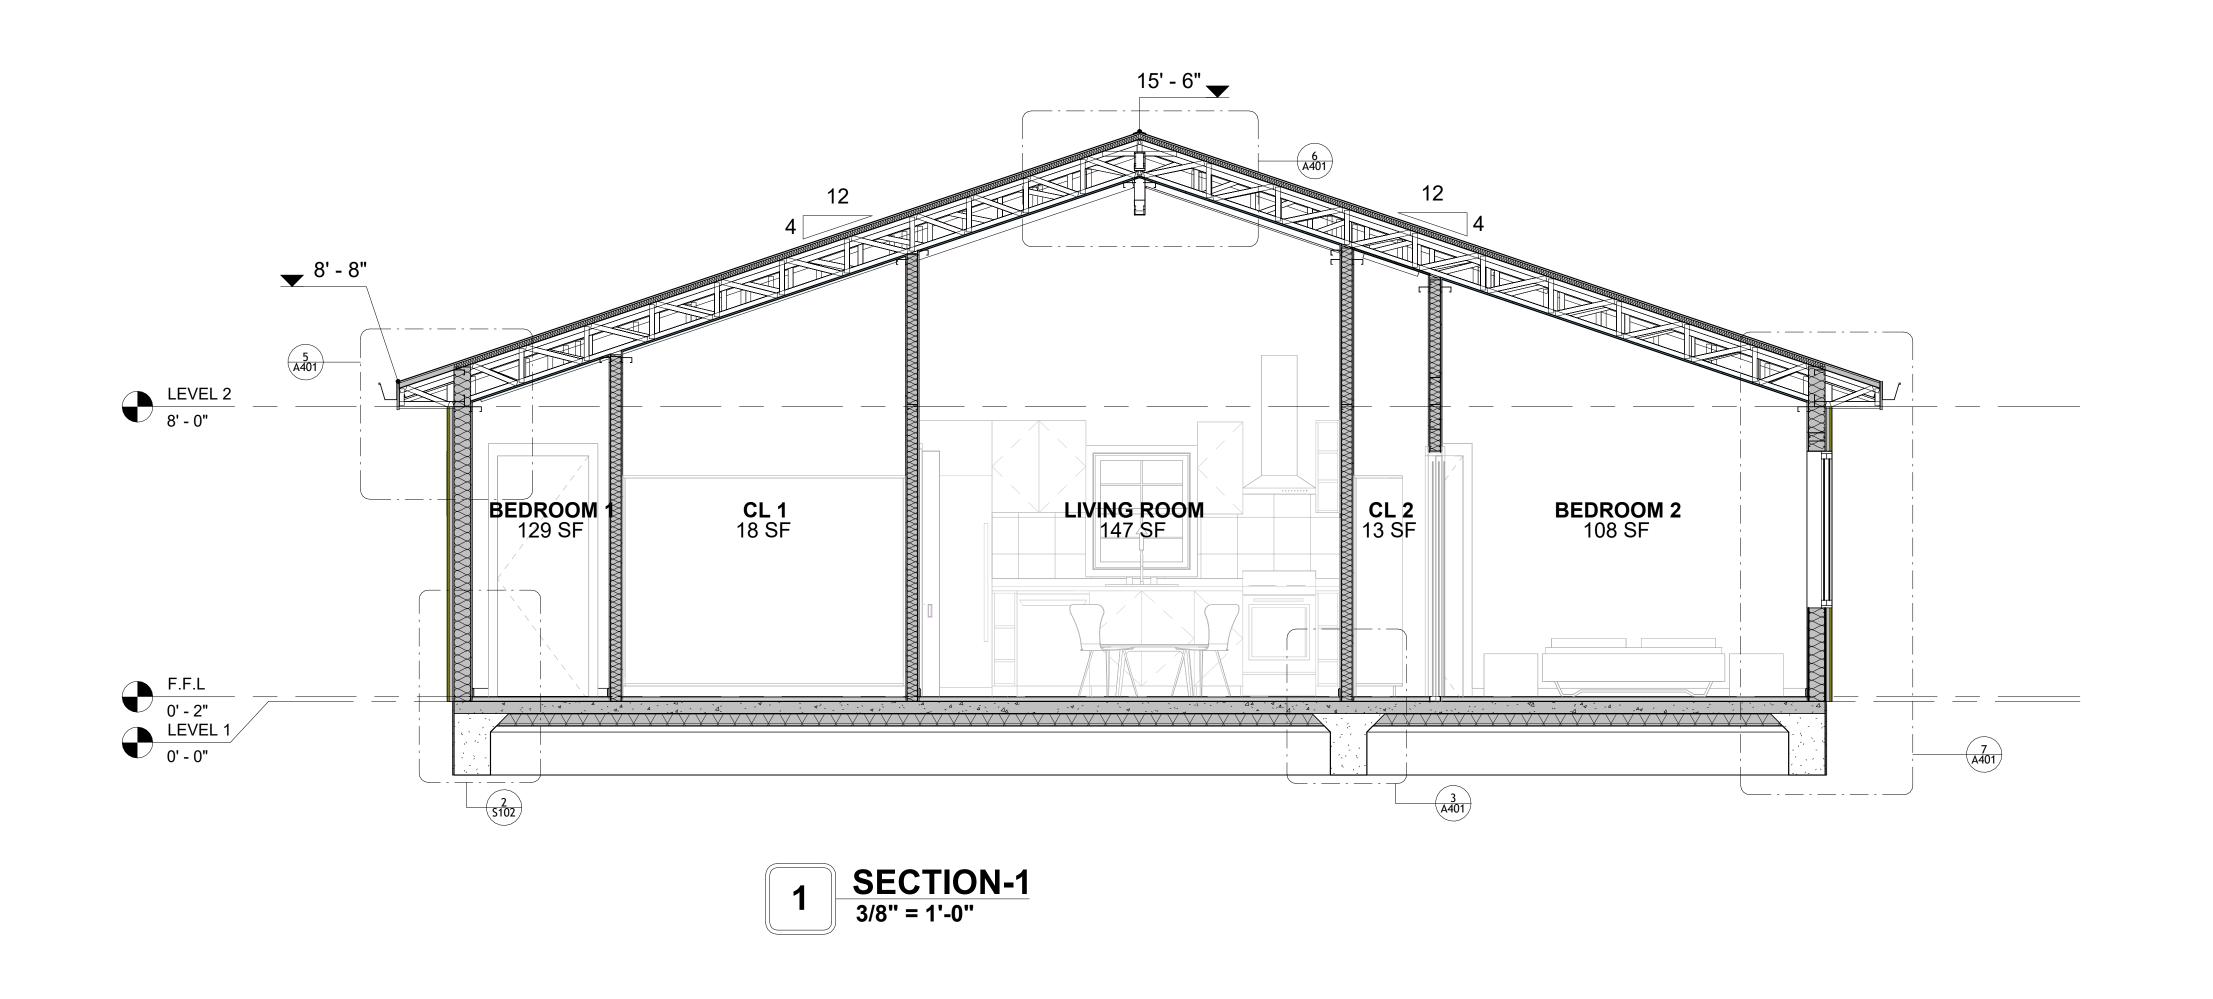

2 SECTION-2 3/8" = 1'-0"



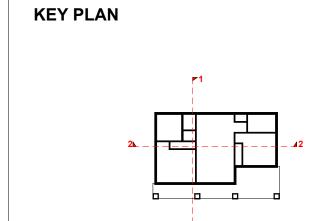

NO.	DESCRIPTION	DATE

NOTE:

LEGEND:

PROJECT


193-ORCHARD-749 2Bd2Ba-CRAFTSMAN-550


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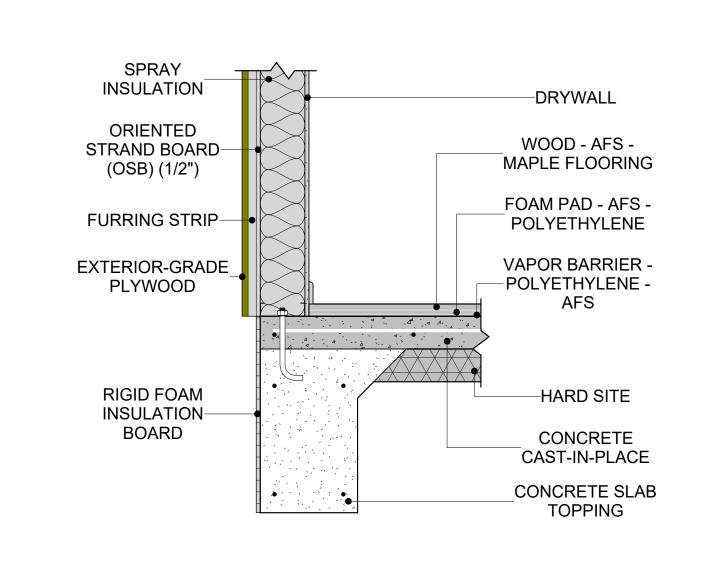
ARCHITECTURAL SECTIONS

CLIENT NAME:	Client Name
PROJECT NUMBER:	0061_12
DATE:	5/6/2025 11:30:41 AM
DESIGNED BY:	Designer
DRAWN BY:	Author
CHECKED BY:	Checker


A301



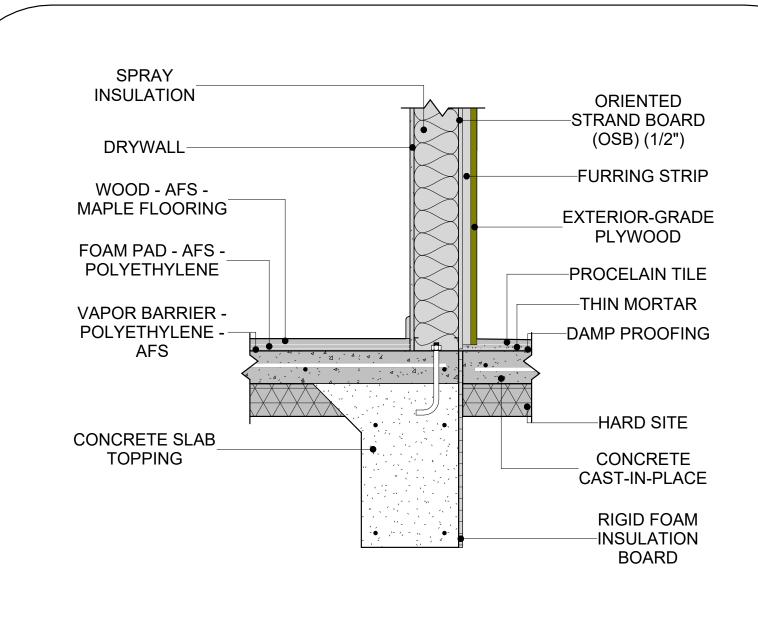

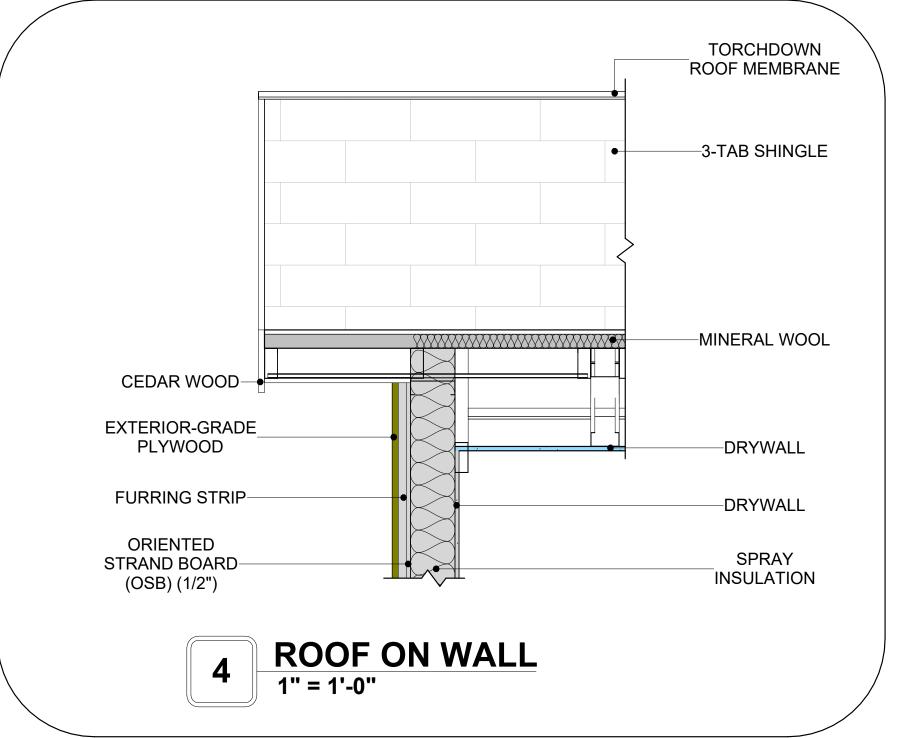

TYPICAL WALL FTG

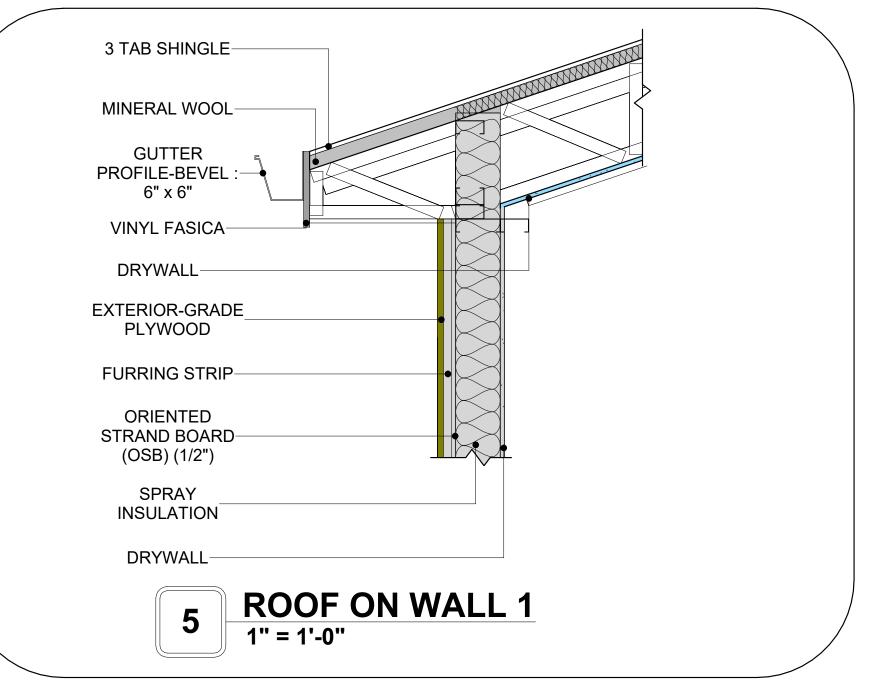



SPRAY

INSULATION

-DRYWALL

WOOD - AFS -

MAPLE FLOORING

FOAM PAD - AFS -

POLYETHYLENE

VAPOR BARRIER --POLYETHYLENE -


HARD SITE


CONCRETE CAST-IN-PLACE


CONCRETE SLAB
TOPPING

WALL TO FLOOR CONN.

1" = 1'-0"

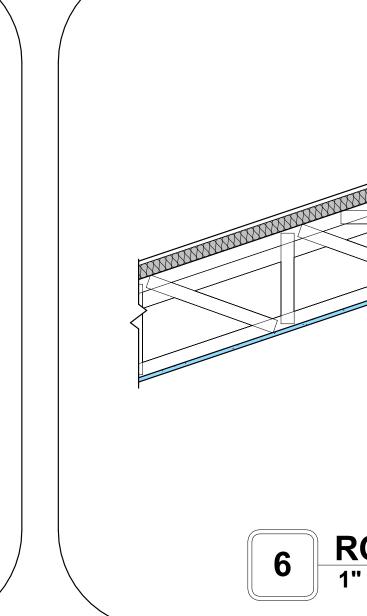

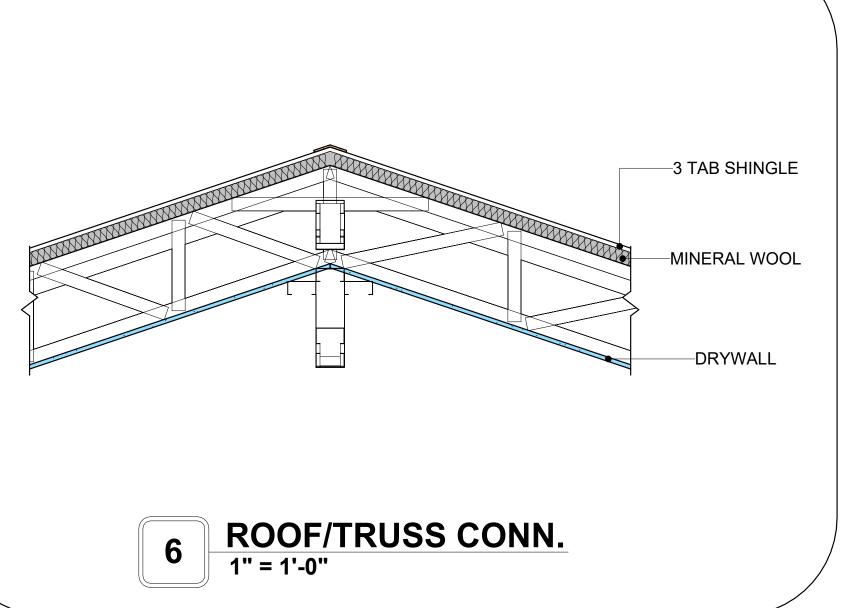

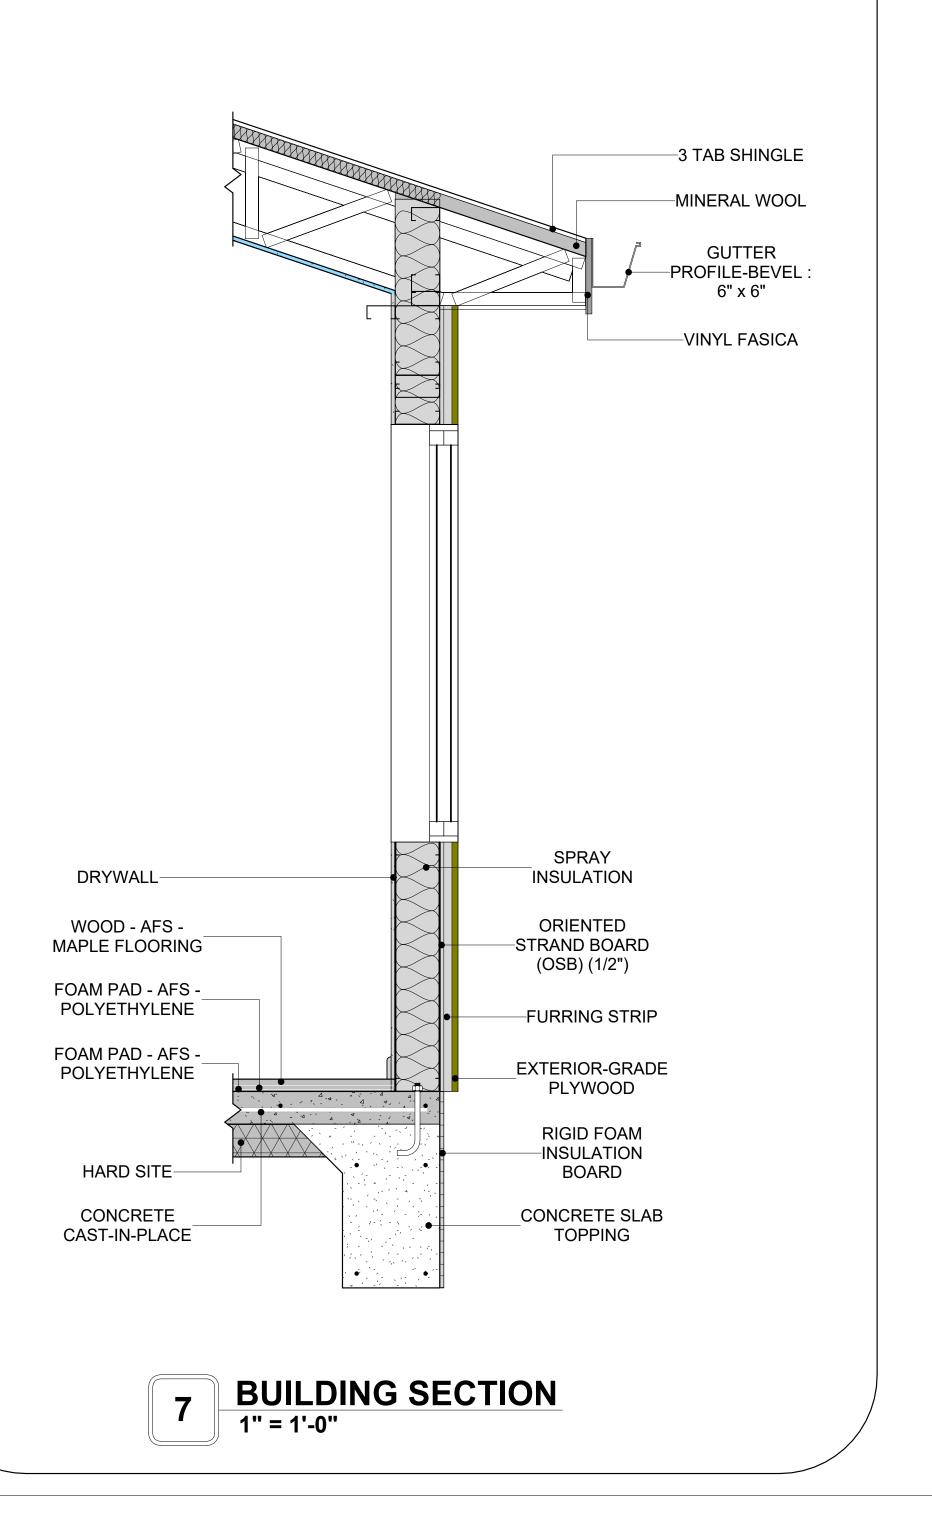



KEY PLAN

NO.	DESCRIPTION	DATE		

NOTE:

LEGEND:

PROJECT

193-ORCHARD-749 2Bd2Ba-CRAFTSMAN-550

DRAWING NAME

ARCHITECTURAL DETAILS

CLIENT NAME:	Client Name
PROJECT NUMBER:	0061_12
DATE:	5/6/2025 11:30:43 AM
DESIGNED BY:	Designer
DRAWN BY:	Author
CHECKED BY:	Checker

A401

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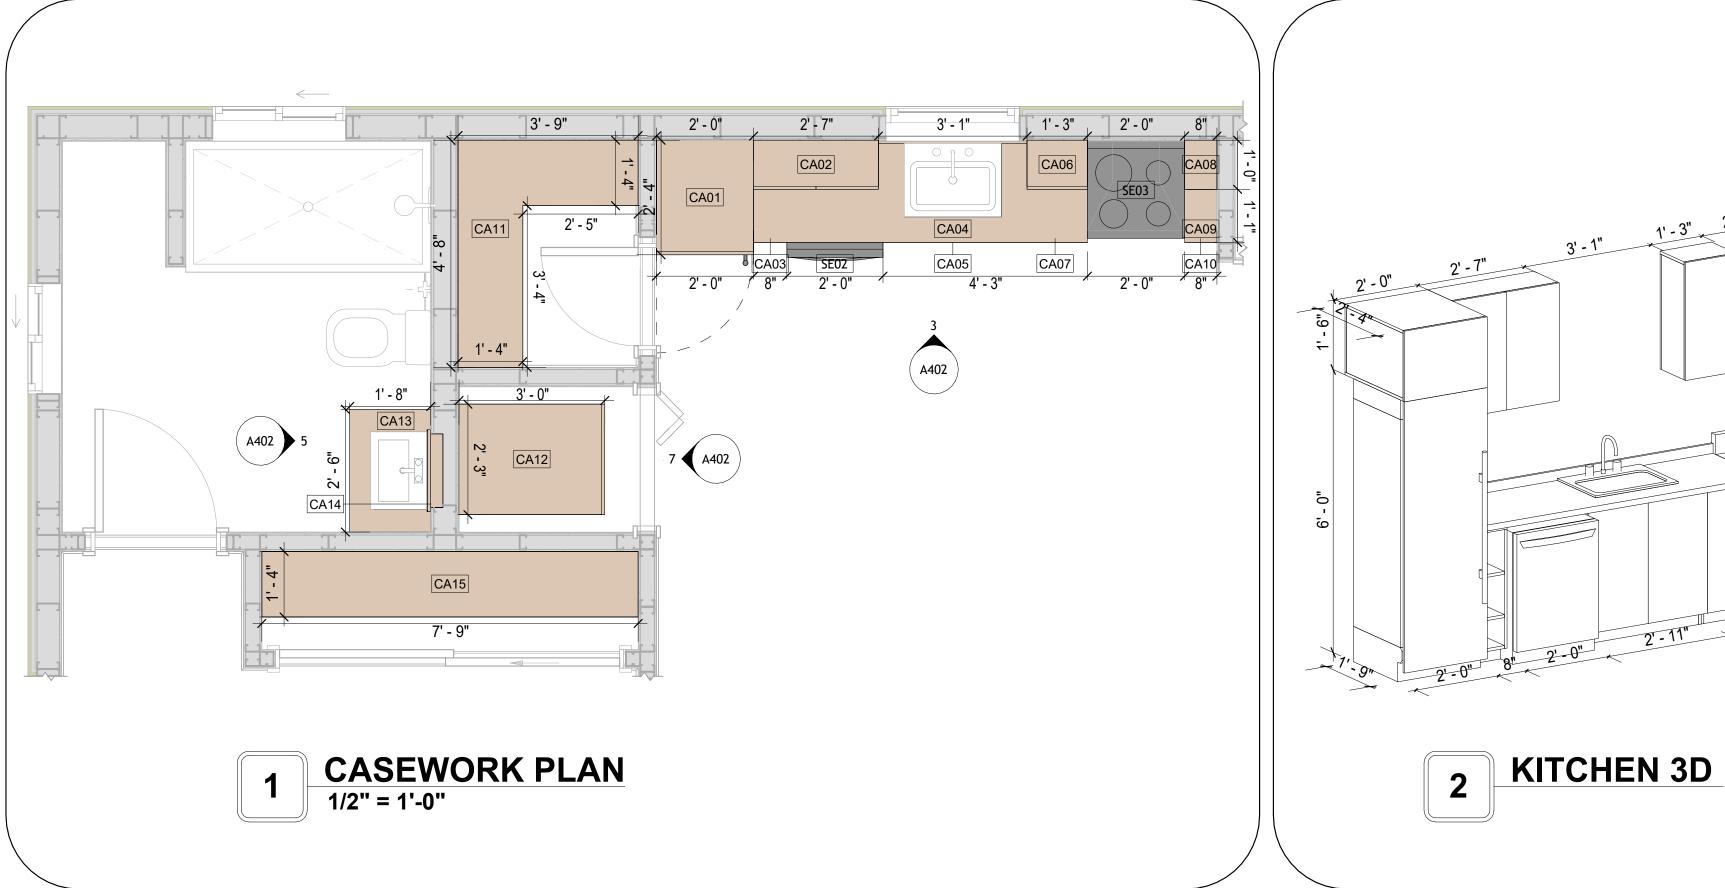
SCALE: 1" = 1'-0"


CASEWORK GENERAL NOTES

- ALL CABINET HEIGHTS INCLUDE COUNTERTOPS. DIMENSIONS ARE TO THE NEAREST INCH. DIVISIONS IN CASEWORK ARE SHOWN FOR CLARITY AND DO NOT REPRESENT BREAKS IN THE COUNTERTOP.
- PROVIDE CONTINUOUS COUNTERTOP OVER ALL SIMILAR HEIGHT CASEWORK, UNLESS AND OTHERWISE NOTED.
- MANUFACTURER AND CATALOG NUMBERS ARE FOR REFERENCE AND ILLUSTRATION PURPOSES
- DOTTED LINES INDICATE WALL HUNG CABINETS, DIVISIONS OF BASE CABINETS BELOW THE
- COUNTERTOP, FURNITURE NOT IN THE CONTRACT OR PROJECTION SCREENS -SEE CASEWORK KEY AND SPECIFICATIONS.
- ALL CABINETS AND DRAWERS TO HAVE CAM LOCKS EXCEPT FOR SINK BASE CABINETS.
 ALL EXPOSED SURFACES (EXPOSED TO VIEW FROM ANY PERSPECTIVE) TO BE COVERED WITH
- LAMINATE.
- ALL CASEWORK WHICH MEETS A WALL AT ONE OR BOTH ENDS, TO BE PROVIDED WITH FILLER PANELS AND SCRIBED TO THE WALL(S) AS REQUIRED.
- 10. ALL CABINETS AND DRAWERS ARE PROVIDED WITH RECESSED HANDLES.
- 11. CONTRACTOR TO FIELD VERIFY ALL CLEAR OPENINGS PRIOR TO MILLWORK OR CASEWORK FABRICATION.
- 12. CASEWORK DRAWINGS ARE DIAGRAMMATIC IN NATURE TO SHOW DESIGN INTENT.


	CAS	SEWOR	K SCHEDU	JLE		
TYPE MAR K	TYPE	COUN	HEIGHT	WIDTH	DEPTH	AREA
01	LAUNDRY OPEN CABINET	1	1' - 6"	2' - 0"	2' - 4"	3 SF
02	WALL_CABINET_DOUBLE_DOOR	1	2' - 6"	2' - 7"	1' - 0"	6 SF
03	BASE_FILLER_2	1	2' - 11"	0' - 8"	2' - 0"	2 SF
04	BASE CABINET DOUBLE DOOR 1	1	2' - 11"	2' - 11"	2' - 0"	8 SF
05	HD_LINEAR_COUNTER_TOP 3	1	0' - 4"	6' - 10"	2' - 1"	2 SF
06	WALL_CABINET_SINGLE_DOOR	1	2' - 6"	1' - 3"	1' - 0"	3 SF
07	BASE_CABINET_SINGLE_DOOR	1	2' - 7"	1' - 4"	2' - 0"	3 SF
08	HD_WALL_FILLER_4' HIGH	1	2' - 6"	0' - 8"	1' - 0"	2 SF
09	LINEAR COUNTER TOP	1	0' - 4"	0' - 8"	2' - 1"	0 SF
10	BASE_FILLER_2 2 2	1	2' - 11"	0' - 8"	2' - 0"	2 SF
11	CLOSET_L_SHAPE 2	1	7' - 6"	3' - 9"	4' - 8"	28 SF
12	LAUNDRY OPEN CABINET 2	1	1' - 2"	2' - 3"	3' - 0"	3 SF
13	VANITY	2	2' - 4"	2' - 6"	1' - 8"	6 SF
14	RECESSED_MED_CABINET	2	2' - 0"	1' - 6"	0' - 3"	3 SF
15	<varies></varies>	2	6' - 0"	<varies></varies>	1' - 4"	<varies></varies>
GRAND	TOTAL	18				

SPECIALTY EQUIPMENT SCHEDULE								
TYPE MARK	TYPE	COUNT						
01	REFRIGERATOR	1						
02	DISHWASHER	1						
03	RANGE	1						
04	DRYER-FRONT-LOAD	1						
05	WASHER-FRONT-LOAD	1						
GRAND TOTAL: 5	j							




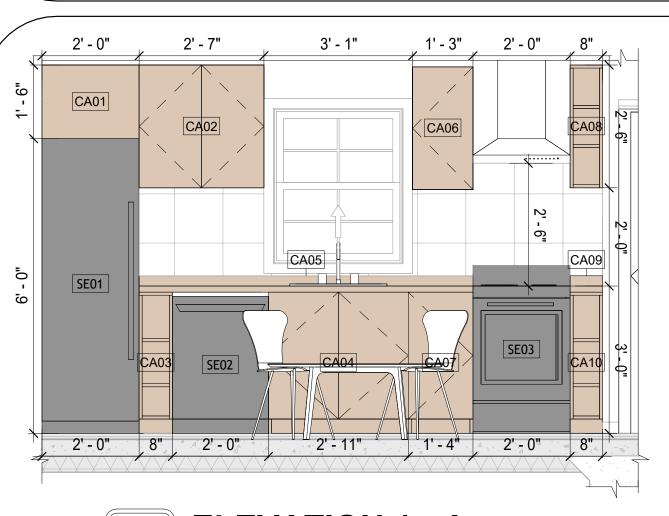




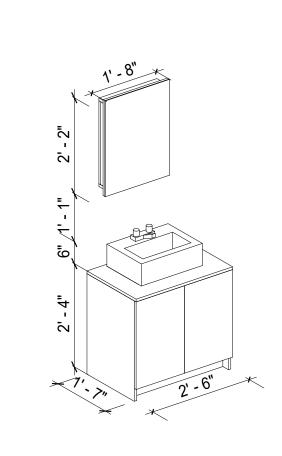




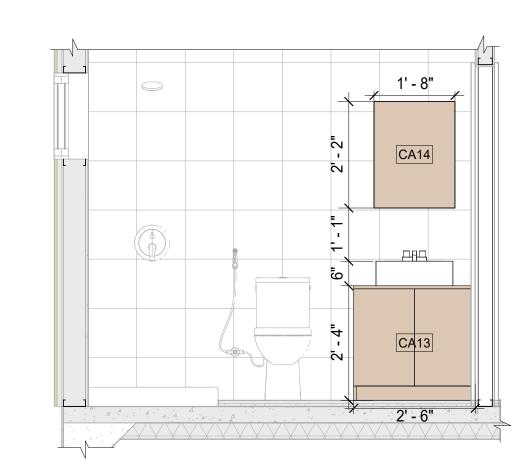


ELEVATION 1 - B 1/2" = 1'-0"

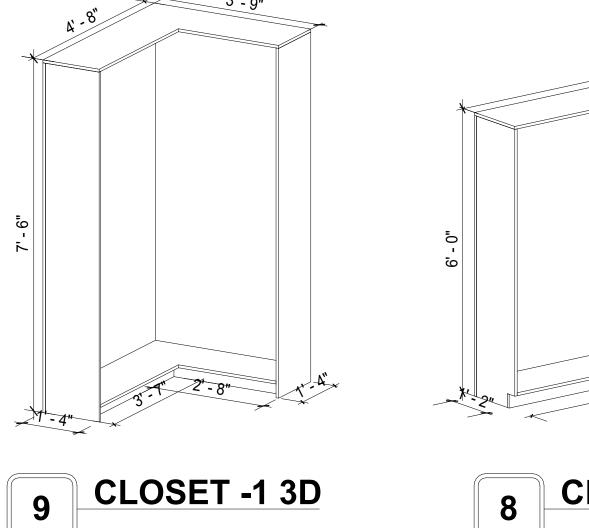

8 CLOSET 3D

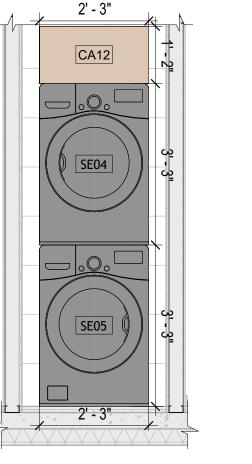


ELEVATION 1 - C 1/2" = 1'-0"

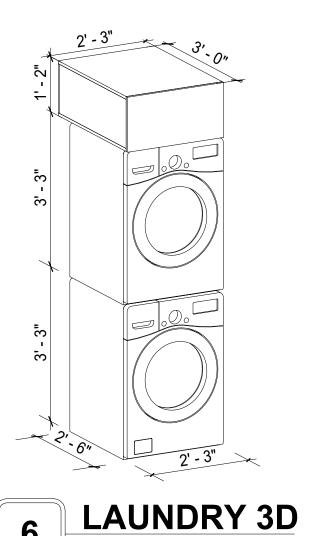

Tuscon,AZ, USA 888-864-0184 inquire@frameupnow.com www.frameupnow.com

KEY PLAN

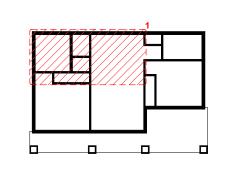

NO.	DESCRIPTION	DATE

NOTE:

LEGEND:

PROJECT

193-ORCHARD-749 2Bd2Ba-CRAFTSMAN-550

DRAWING NAME

ARCHITECTURAL CASEWORK

CLIENT NAME:	Client Name
PROJECT NUMBER:	0061_12
DATE:	5/6/2025 11:30:45 AM
DESIGNED BY:	Designer
DRAWN BY:	Author
CHECKED BY:	Checker

A402

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GENERAL NOTES

APPLICABLE GUIDELINES AND REGULATIONS.

1. THIS DRAWING DEPICTS THE HVAC (HEATING, VENTILATION, AND AIR CONDITIONING) SYSTEM FOR THEORCHARD 2BD2BA CRAFTSMAN. IT PROVIDES A VISUAL REPRESENTATION OF THE SYSTEM LAYOUT AND COMPONENTS.

2.THE HVAC SYSTEM IS DESIGNED TO MEET THE SPECIFIC REQUIREMENTS OF THE BUILDING, INCLUDING HEATING, COOLING, AND VENTILATION NEEDS, AS PER THE PROJECT SPECIFICATIONS AND APPLICABLE CODES AND STANDARDS.

3. THE HVAC SYSTEM INSTALLATION SHALL COMPLY WITH THE LATEST EDITION OF THE INTERNATIONAL MECHANICAL CODE (IMC), INTERNATIONAL RESIDENTIAL CODE (IRC), AND ALL OTHER APPLICABLE LOCAL, STATE, AND NATIONAL CODES AND REGULATIONS.

4. THE EQUIPMENT SHOWN ON THIS DRAWING INCLUDES BUT IS NOT LIMITED TO AIR HANDLING UNITS (AHUS), CHILLERS, BOILERS, COOLING TOWERS, PUMPS, DUCTWORK, DIFFUSERS, GRILLES, AND CONTROL DEVICES.

5. ALL EQUIPMENT, DUCTWORK, AND PIPING SHALL BE INSTALLED IN ACCORDANCE WITH MANUFACTURER'S SPECIFICATIONS, LOCAL CODES, AND

6. ALL DUCTWORK SHALL BE SIZED, FABRICATED, AND INSTALLED IN ACCORDANCE WITH THE LATEST EDITION OF THE ACCA MANUAL D AND THE SMACNA HVAC DUCT CONSTRUCTION STANDARDS. DUCTWORK SHALL BE INSTALLED IN A NEAT AND WORKMANLIKE MANNER, PROPERLY SUPPORTED AND BRACED TO PREVENT SAGGING, AIR LEAKAGE, OR VIBRATION.

7. CONDENSATE DRAINAGE PIPING SHALL BE PROPERLY PITCHED TO ENSURE POSITIVE DRAINAGE TO AN APPROVED DISPOSAL LOCATION, SUCH AS A FLOOR DRAIN, SUMP PUMP, OR EXTERIOR GRADE. CONDENSATE LINES SHALL BE INSULATED TO PREVENT SWEATING.

8. THE LOCATION OF CONTROL PANELS AND SENSORS INDICATED ON THIS DRAWING CAN BEMODIFY WITH THE SPECIFIC LOCATIONS AND WIRING DETAILS WILL BE DETERMINED DURING THE CONTROL SYSTEM DESIGN AND INSTALLATION.

9. THE HVAC SYSTEM DESIGN CONSIDER ENERGY EFFICIENCY, INDOOR AIR QUALITY, OCCUPANT COMFORT, AND NOISE CONTROL, FOLLOWING

10. COORDINATION WITH OTHER TREADS HAS BEEN DONE ON A DESIGN LEVEL. THIS DRAWING SHALL BE READ TOGETHER WITH THE AR, EL AND SN DESIGN DRAWINGS TO ENSURE PROPER INSTALLATION AND INTEGRATION OF THE HVAC SYSTEMS.

11. THE HVAC CONTRACTOR IS RESPONSIBLE FOR OBTAINING ALL NECESSARY PERMITS AND LICENSES, AND FOR SCHEDULING AND COORDINATING WITH THE LOCAL BUILDING DEPARTMENT AND UTILITY PROVIDERS TO ENSURE A TIMELY AND COMPLIANT INSTALLATION.

12. ALL DUCTWORK PENETRATIONS THROUGH WALLS, FLOORS, OR CEILINGS SHALL BE PROPERLY SEALED AND FIRE-STOPPED USING APPROVED METHODS AND MATERIALS TO MAINTAIN THE INTEGRITY OF THE BUILDING'S FIRE-RESISTANCE RATINGS.

13. HVAC EQUIPMENT SHALL BE INSTALLED LEVEL AND PLUMB, AND IN STRICT ACCORDANCE WITH THE MANUFACTURER'S INSTALLATION INSTRUCTIONS AND RECOMMENDATIONS. PROVIDE ADEQUATE CLEARANCES AROUND EQUIPMENT FOR PROPER AIRFLOW, SERVICE ACCESS, AND

CODE COMPLIANCE.

14. ALL HVAC EQUIPMENT AND COMPONENTS, INCLUDING THERMOSTATS, DAMPERS, AND ACCESS PANELS, SHALL BE LOCATED IN ACCESSIBLE AREAS

15. THE HVAC SYSTEM SHALL BE BALANCED AND ADJUSTED TO ENSURE PROPER AIRFLOW, TEMPERATURE DISTRIBUTION, AND SYSTEM


FOR EASY SERVICING AND MAINTENANCE. PROVIDE ADEQUATE SPACE AROUND EQUIPMENT FOR PROPER AIRFLOW AND SERVICE ACCESS.

PERFORMANCE THROUGHOUT THE RESIDENCE. PROVIDE A WRITTEN REPORT DOCUMENTING THE FINAL SYSTEM BALANCE.

16. ANY DEVIATIONS OR MODIFICATIONS TO THE HVAC SYSTEM DESIGN SHALL BE REVIEWED AND APPROVED BY THE RESPONSIBLE DESIGN PROFESSIONALS AND COMMUNICATED TO ALL RELEVANT PARTIES INVOLVED IN THE CONSTRUCTION PROCESS.


17. FOR ANY INQUIRIES OR CLARIFICATIONS REGARDING THE HVAC SYSTEM DESIGN, PLEASE CONSULT THE RESPONSIBLE DESIGN PROFESSIONALS OR THE PROJECT MANAGEMENT TEAM.

SYMBOLS

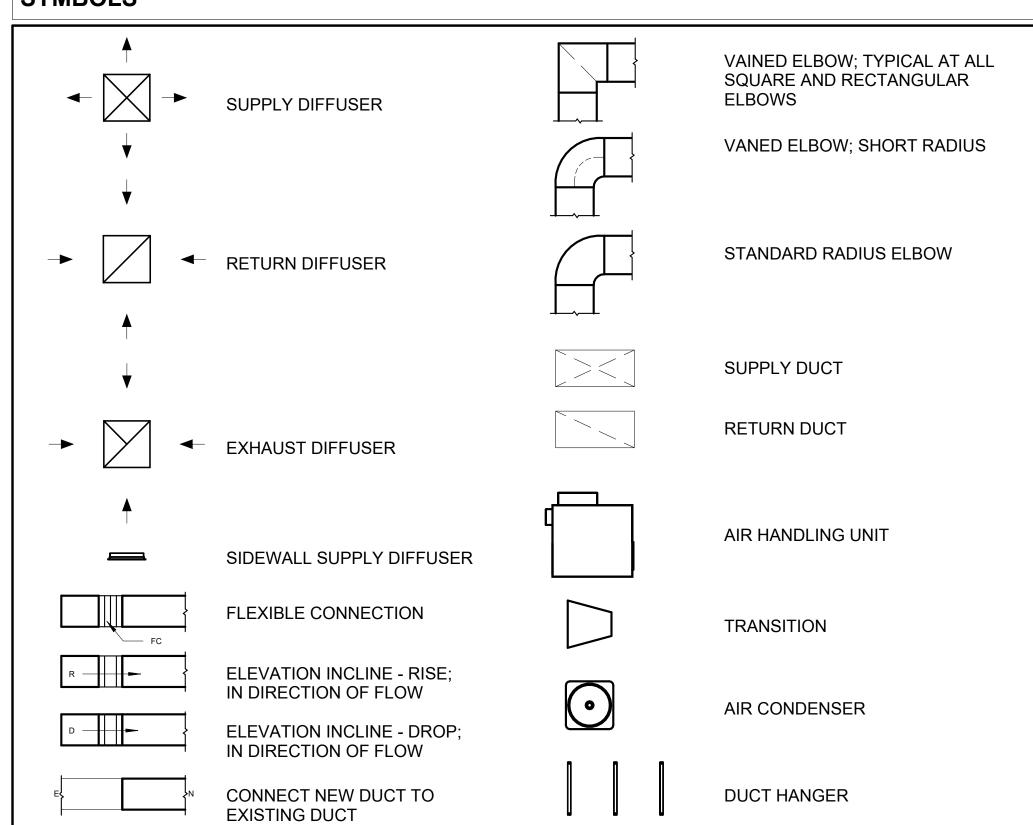



AIR CONDITIONING PIPE LINE

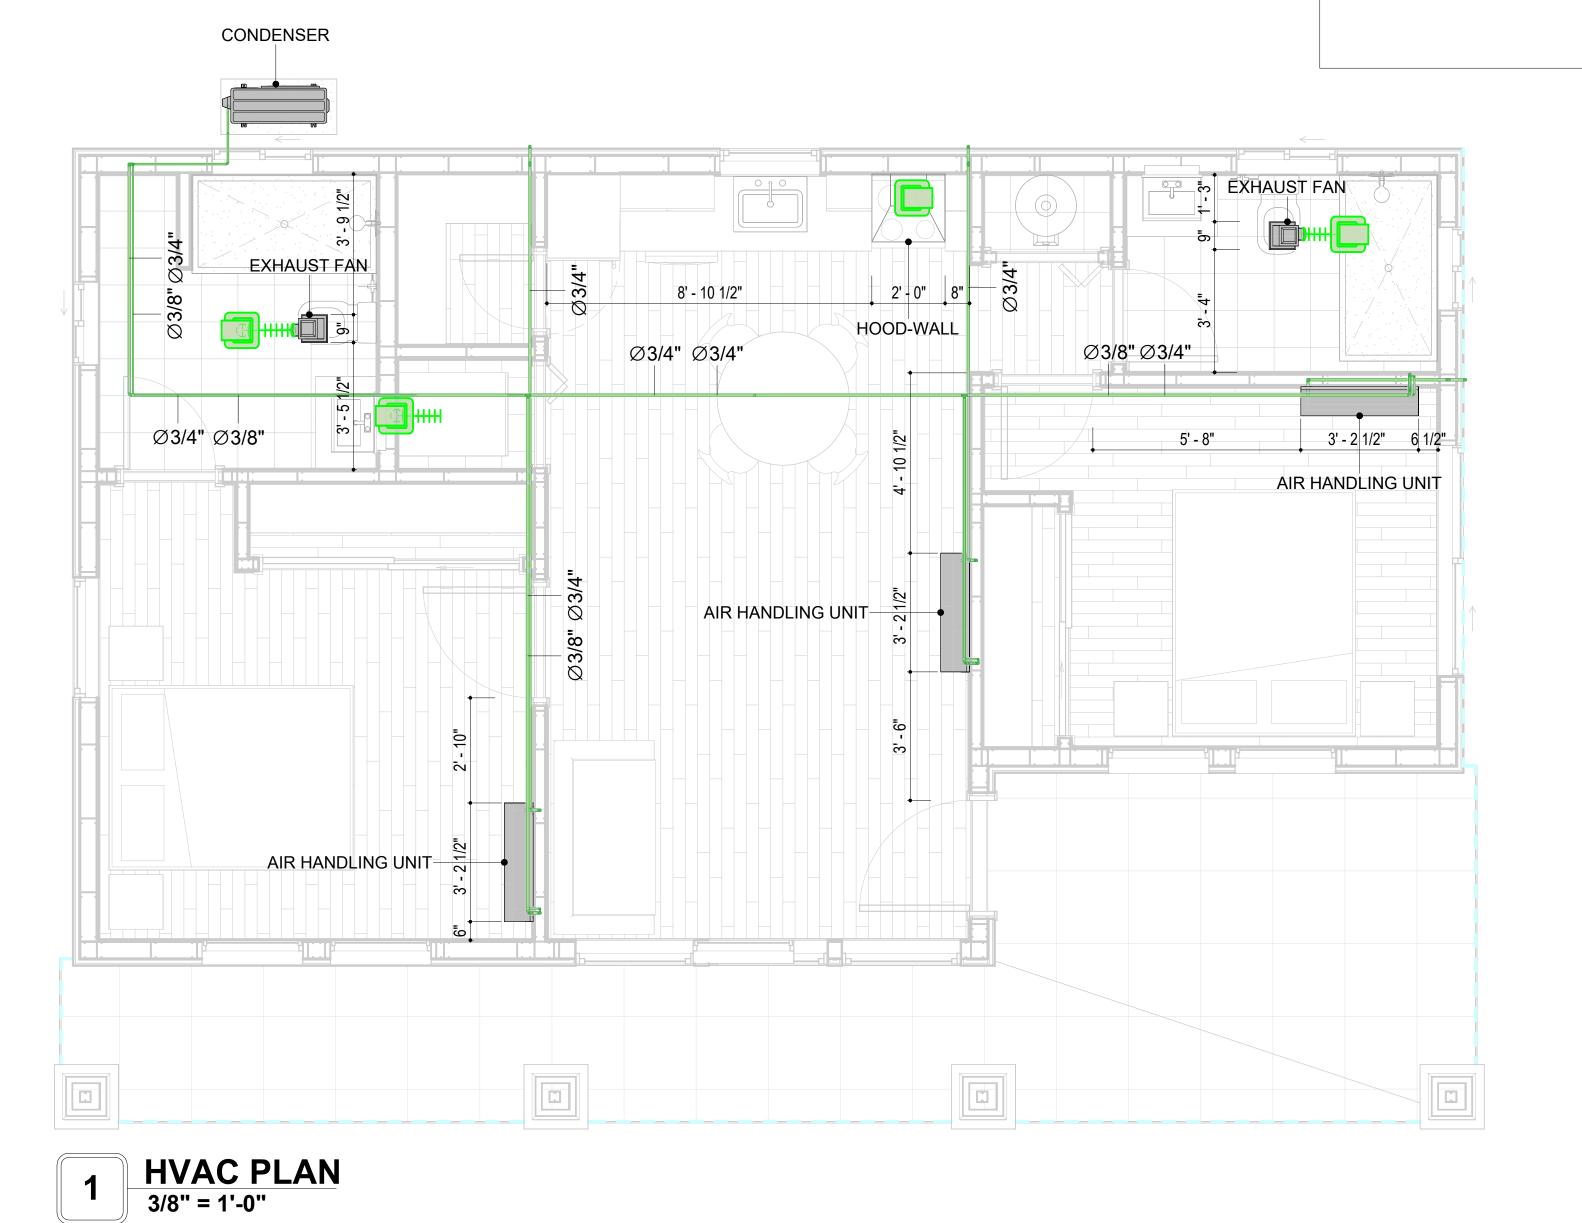

REFRIGERANT LINE SCHEDULE									
CATAGORY DESCRIPTION DIAMETER LENGTH									
PIPE TYPES	COPPER	3/8"	90.77						
PIPE TYPES	COPPER	3/4"	166.47						

CATAGORY	DESCRIPTION	Size	Count
ELBOW - GENERIC	ELBOW - GENERIC:	3/4"ø-3/4"ø	39
ELBOW - GENERIC	STANDARD/HVAC ELBOW - GENERIC: STANDARD/HVAC	3/8"ø-3/8"ø	23
TEE - GENERIC	TEE - GENERIC: STANDARD	3/4"ø-3/4"ø-3/ 4"ø	2
TEE - GENERIC	TEE - GENERIC: STANDARD	3/8"ø-3/8"ø-3/ 8"ø	2
TRANSITION - GENERIC	TRANSITION - GENERIC: STANDARD	3/4"ø-1/2"ø	4
TRANSITION - GENERIC	TRANSITION - GENERIC: STANDARD	3/4"ø-5/8"ø	3
TRANSITION - GENERIC	TRANSITION - GENERIC: STANDARD	3/8"ø-1/4"ø	1

	DU	CT FIT	TING SCH	IEDUL	.E		
CATAGOR	RY		DESCF	RIPTION		COUNT	
ROUND TRANSITION - A	NGLE	45 DEGREE				7	
	DUC1	ACCE	SSORY S	CHED	ULE		
CATAGORY			DESCRIPTI	ON		COUNT	
ROOF VENT	3" DIAMETE	ER .				4	
FLEX DUCT SCHEDULE							
DESCRIPTION	DESCR	RIPTION	LENG	ГН	DIAMETER	COUNT	
FLEX DUCT ROUND	FLEX-ROUN	ND	16.73		4"	4	
GRAND TOTAL: 4	ECHAN	ICAL E	16.73 QUIPMEN	IT CCI	JEDIII E		
	LCHAN	ICAL L	•		ILDULL	0011117	
CATAGORY			DESCRIPTION	ON		COUNT	
AIR HANDLING UNIT			ALL MOUNTED			3	
CONDENSER		R: OUT DOO	DR .			1	
EXHAUST FAN	_	AN: 75 CFM				2	
	∃HOOD-WAI	D-WALL: VENT					



KEY PLAN

NO. DESCRIPTION DATE

NOTE:

LEGEND:

193-ORCHARD-749-2Bd2Ba Craftsman-550

PROJECT

193-ORCHARD-749-2Bd2Ba CRAFTSMAN-550

DRAWING NAME

HVAC PLAN

 CLIENT NAME:
 Owner

 PROJECT NUMBER:
 15_0001

 DATE:
 4/17/2025 3:15:10 AM

 DESIGNED BY:
 Designer

 DRAWN BY:
 Author

 CHECKED BY:
 Checker

M101

SCALE: As indicated

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ELECTRICAL NOTES

- 1. THIS DRAWING DEPICTS THE ELECTRICAL SYSTEM FOR THE 193-ORCHARD-749-2Bd 2Ba-CRAFTSMAN-550. IT PROVIDES A VISUAL REPRESENTATION OF THE ELECTRICAL LAYOUT AND COMPONENTS, INCLUDING POWER DISTRIBUTION, LIGHTING, AND CONTROL SYSTEMS.
- 2. THE ELECTRICAL SYSTEM IS DESIGNED TO MEET THE SPECIFIC REQUIREMENTS OF THE BUILDING, INCLUDING POWER DISTRIBUTION, LIGHTING, AND SPECIALIZED ELECTRICAL EQUIPMENT NEEDS, AS PER THE PROJECT SPECIFICATIONS AND APPLICABLE CODES AND STANDARDS.
- 3. THE ELECTRICAL SYSTEM INSTALLATION SHALL COMPLY WITH THE LATEST EDITION OF THE NATIONAL ELECTRICAL CODE (NEC), INTERNATIONAL BUILDING CODE (IBC), AND ALL OTHER APPLICABLE LOCAL, STATE, AND NATIONAL CODES AND REGULATIONS.
- 4. LOCATIONS AS NEEDED. DEVICES ARE SHOWN ON PLANS IN APPROXIMATE IDEAL LOCATIONS. UNLESS SPECIFICALLY DIMMENSIONED.
- OPEN WALLS AS NEEDED TO ALLOW FOR NEW ELECTRICAL INSTALLATIONS.
- 6. LABEL ALL CIRCUITS ON JUNCTION BOXES, RECEPTACLES, DATA, SMOKE DETECTOR, AND EQUIPMENT IN PANEL BOX.
- 7. INSTALL RACEWAY AS NEEDED FOR DDC, ACCESS CONTROL, LOW VOLTAGE WIRING & DATA. RELABEL
- 8. POWER, DATA & FIRE ALARM FOR ROOM #CHANGES.
- 9. VERIFY ALL CIRCUITS LABELED ON PRINT ARE CORRECT BEFORE WORKING ON THEM. 10. NOTE ON SITE PLAN – ALL CHANGES OR MISSING DETAIL TO BE INCORPORATED INTO THE MASTER PLAN.
- 11. DRAWINGS ARE DIAGRAMMATIC ONLY FOR THE PURPOSE OF SHOWING FIXTURE AND OUTLET LOCATIONS.
- 12. ELECTRICAL CONTRACTOR TO VERIFY SERVICE SIZE BY CALCULATION BASED UPON ACTUAL NAME
- PLATE RATINGS OF SELECTED EQUIPMENT.
- 13. VERIFY LOCATION OF SERVICE ENTRANCE WITH POWER COMPANY. PROVIDE UFER GROUND IN
- BUILDING FOUNDATION AT SERVICE ENTRANCE LOCATION. 14. PROVIDE A MIN. OF 20 FEET OF ONE *4 BARE COPPER UFER WIRE EMBEDDED IN CONCRETE FOOTING AT THE SERVICE ENTRANCE LOCATION WHERE APPROVED BY LOCAL SERVICE PROVIDER.
- 15. PROVIDE WATERPROOF FIXTURES IN ALL HIGH MOISTURE AREAS (EXTERIOR, SHOWER AND TUB
- CEILINGS ETC.) 16. PROVIDE DEDICATED CIRCUITS TO EACH BATH, DEN, FAMILY ROOM, BEDROOM, LOFT, KITCHEN
- REFRIGERATOR, KITCHEN FREEZER DISHWASHER, AND ANY AREA/ITEM SPECIFIED BY OWNER. 17. INCANDESCENT FIXTURES WITH OPEN OR PARTIALLY ENCLOSED LAMPS, PENDANT FIXTURES, AND
- LAMP HOLDERS ARE NOT PERMITTED IN CLOSETS.
- 18. ALL WORKMANSHIP AND MATERIALS TO CONFORM WITH THE 2015 IRC. 19. PROVIDE A MIN. OF 20 FEET OF ONE *4 BARE COPPER UFER WIRE EMBEDDED IN CONCRETE FOOTING AT THE SERVICE ENTRANCE LOCATION WHERE APPROVED BY LOCAL SERVICE PROVIDER.
- 20. PROVIDE A BONDING CONDUCTOR CONSISTING OF A MINIMUM OF ONE *4 BARE COPPER WIRE CONNECTING THE BUILDING'S METAL WATER PIPING SYSTEM TO THE SERVICE EQUIPMENT ENCLOSURE GROUNDING.

MAIN PANEL CALCS

(USE 200 AMP SERVICE)

ELECTRICAL CALCS	
LIGHT AND OUTLETS 749 @ 3W	2,247 W
3 APPLIANCE CIRCUITS	4,500 W
DRYER	2,000 W
WASHER	2,000 W
RANGE	5,000 W
WATER HEATER	5,000 W
REFRIG.	1,800 W
DISHWASHER & DISPOSAL	3000 W
TOTAL	25,547 W
FRIST 10,000 @ 100% REMAINDER @ 40% MINI. SPLIT UNITS	10,000 W 6,219W 10,000 W
TOTAL	26,219 W
26,219 W DIVIDED BY 240V = 1	09 AMPS TOTAL
(,,,,,,,,,,,,,,,,,,,,,,,,,,,,,,,,,,,,,,	

ELECTRICAL ABBREVIATIONS LIST

1P	1 POLE (2P, 3P, 4P, ETC.)	CTR	CENTER	HT	HEIGHT
A	AMPERE	CU	COPPER	HTG	HEATING
AC	ABOVE COUNTER OR AIR CONDITIONER	DCP	DOMESTIC WATER CIRCULATING PUMP	HTR	HEATER
ACLG	ABOVE CEILING	DEPT	DEPARTMENT	HV	HIGH VOLTAGE
ADO	AUTOMATIC DOOR OPENER	DET	DETAIL	HVAC	HEATING, VENTILATING AND AIR
				I .	
AF	AMP FRAME	DIA	DIAMETER	CONDITIONING	CONDITIONING
AFF	ABOVE FINISHED FLOOR	DISC	DISCONNECT	HWP	HYDRONIC WATER PUMP
AFG	ABOVE FINISHED GRADE	DIST	DISTRIBUTION	IC	INTERRUPTING CAPACITY
AFI	ARC FAULT CIRCUIT INTERRUPTER	DN	DOWN	IG	ISOLATED GROUND
AHU	AIR HANDLING UNIT	DPR	DAMPER	IMC	INTERMEDIATE METAL CONDUIT
AL	ALUMINUM	DS	SAFETY DISCONNECT SWITCH	INCAND	INCANDESCENT
ALT	ALTERNATE	DT	DOUBLE THROW	IR	INFRARED
AMP	AMPERE	DWG	DRAWING	I/W	INTERLOCK WITH
AMPL			DIRECT DIGITAL CONTROL	1	
	AMPLIFIER	DDC		J-BOX	JUNCTION BOX
ANNUN	ANNUNCIATOR APPROX APPROXIMATELY		ELECTRICAL CONTRACTOR	KV	KILOVOLT
AQ-STAT	AQUASTAT	ELEC	ELECTRIC, ELECTRICAL	KVA	KILOVOLT-AMPERE
ARCH	ARCHITECT, ARCHITECTURAL	ELEV	ELEVATOR	KVAR	KILOVOLT-AMPERE REACTIVE
AS	AMP SWITCH	EM	EMERGENCY	KW	KILOWATT
AT	AMP TRIP	EMS	ENERGY MANAGEMENT SYSTEM	KWH	KILOWATT HOUR
ATS	AUTOMATIC TRANSFER SWITCH	EMT	ELECTRICAL METALLIC TUBING	LOC	LOCATE OR LOCATION
AUTO	AUTOMATIC	EP	ELECTRIC PNEUMATIC	LT	LIGHT
AUX	AUXILIARY	EQUIP	EQUIPMENT	LTG	LIGHTING
AV	AUDIO VISUAL	EWC	ELECTRIC WATER COOLER	LTNG	LIGHTNING
				I .	
AWG	AMERICAN WIRE GAUGE	EXIST	EXISTING	LV	LOW VOLTAGE
BATT	BATTERY	EXH	EXHAUST	MAX	MAXIMUM
BD	BOARD	EXP	EXPLOSION PROOF	MAG.S	MAGNETIC STARTER
BLDG	BUILDING	FA	FIRE ALARM	M/C	MOMENTARY CONTACT
BMS	BUILDING MANAGEMENT SYSTEM	FABP	FIRE ALARM BOOSTER POWER	MC	MECHANICAL CONTRACTOR
C	CONDUIT	SUPPLY PANEL	SUPPLY PANEL	MCB	MAIN CIRCUIT BREAKER
CAB	CABINET	FACP	FIRE ALARM CONTROL PANEL	MCC	MOTOR CONTROL CENTER
CAT	CATALOG	FCU	FAN COIL UNIT	MDC	MAIN DISTRIBUTION CENTER
CATV	CABLE TELEVISION	FIXT	FIXTURE	MDP	MAIN DISTRIBUTION PANEL
CB	CIRCUIT BREAKER	FLR	FLOOR	MFR	MANUFACTURERMAIN FUSED
				IVIFR	
CCTV	CLOSED CIRCUIT TELEVISION	FLUOR	FLUORESCENT		DISCONNECT SWITCH
CKT	CIRCUIT	FU	FUSE	MH	MANHOLE
CLG	CEILING	FUDS	FUSED SAFETY DISCONNECT SWITCH	MIC	MICROPHONE
COMB	COMBINATION	GA	GAUGE	MIN	MINIMUM
CMPR	COMPRESSOR	GAL	GALLON	MISC	MISCELLANEOUS
CONN	CONNECTION	GALV	GALVANIZED	MLO	MAIN LUGS ONLY
CONST	CONSTRUCTION	GC	GENERAL CONTRACTOR	MMS	MANUAL MOTOR STARTER
CONT	CONTINUATION OR CONTINUOUS	GEN	GENERATOR	MOA	MULTIOUTLET ASSEMBLY
CONTR	CONTRACTOR	GFI	GROUND FAULT CIRCUIT INTERRUPTER	MSP	MOTOR STARTER PANELBOARD
CONV	CONVECTOR	GFP	GROUND FAULT PROTECTOR	MSBD	MAIN SWITCHBOARD
CP	CIRCULATING PUMP	GND	GROUND	MT	MOUNT
CRT	CATHODE-RAY TUBE	GRS	GALVANIZED RIGID STEEL (CONDUIT)	MT.C	EMPTY CONDUIT
CT	CURRENT TRANSFORMER	GYP BD	GYPSUM BOARD	UL	UNDERWRITERS LABORATORIES

Branch Panel:

Location: BATH 1 01 **Supply From:** Mounting: Recessed

Enclosure: Type 1

Volts: 120/240 Single Phases: 1 Wires: 3

A.I.C. Rating: Mains Type: Mains Rating: 200 A MCB Rating: 1 A

Circuit Description	Number of Elements	Rating	Length	Wire Size	A			В	Wire Size	Length	Rating	Number of Elements		Circu Numl er
BATH 1 GFCI	7	20 A	14' - 11 15/32"	1-#12, 1-#12, 1-#12	576 VA	2500 VA			2-#10, 1-#10, 1-#10	17' - 3 27/32"	30 A	1	DRYER	2
WASHER	1	20 A	20' - 0 3/32"	1-#12, 1-#12, 1-#12			1200 VA	2500 VA						4
BED 1 LIGHT	8	15 A	43' - 4 19/32"	1-#14, 1-#14, 1-#14	568 VA	456 VA			1-#12, 1-#12, 1-#12	49' - 3 1/32"	20 A	10	LINEN & KITCHEN LIGHT	6
LIVING LIGHT	7	15 A	53' - 9 3/32"	1-#14, 1-#14, 1-#14			209 VA	628 VA	1-#12, 1-#12, 1-#12	45' - 6"	20 A	11	BED 2 LIGHT	8
BATH 2 GFCI	7	20 A	44' - 0 25/32"	1-#12, 1-#12, 1-#12	576 VA	100 VA			1-#12, 1-#12, 1-#12	45' - 3 7/16"	20 A	2	OUTDOOR LIGHT	10
OVENHOOD	1	20 A	34' - 5 3/4"	1-#12, 1-#12, 1-#12			180 VA	2500 VA	2-#8, 1-#8, 1-#10	36' - 10 1/8"	50 A	1	RANGE	12
KITCHEN GFCI	2	20 A	35' - 4 1/16"	1-#12, 1-#12, 1-#12	360 VA	2500 VA								14
DISHWASHER	1	20 A	33' - 5 1/8"	1-#12, 1-#12, 1-#12			1200 VA	1800 VA	1-#12, 1-#12, 1-#12	28' - 5 3/4"	20 A	1	REFRIGERATOR	16
OUTDOOR GFCI	3	20 A	47' - 6 1/8"	1-#12, 1-#12, 1-#12	540 VA	720 VA			1-#12, 1-#12, 1-#12	55' - 8 13/32"	20 A	4	BED 2 RECEPTACLE	18
LIVING RECEPTACLE	5	20 A	42' - 11 1/4"	1-#12, 1-#12, 1-#12			900 VA	720 VA	1-#12, 1-#12, 1-#12	35' - 9 23/32"	20 A	4	BED 1 RECEPTACLE	20
WATER HEATER	1	30 A	43' - 6 3/32"	2-#10, 1-#10, 1-#10	2250 VA	2500 VA			2-#6, 1-#6, 1-#10	22' - 8 23/32"	60 A	1	CONDENSER	22
							2250 VA	2500 VA						24
														26
					13638	VA	1658	34 VA						1
	BATH 1 GFCI WASHER BED 1 LIGHT LIVING LIGHT BATH 2 GFCI OVENHOOD KITCHEN GFCI DISHWASHER OUTDOOR GFCI LIVING	WASHER 1 BED 1 LIGHT 8 LIVING LIGHT 7 BATH 2 GFCI 7 OVENHOOD 1 KITCHEN GFCI 2 DISHWASHER 1 OUTDOOR GFCI 3 LIVING RECEPTACLE 5 WATER HEATER 1	BATH 1 GFCI 7 20 A WASHER 1 20 A BED 1 LIGHT 8 15 A LIVING LIGHT 7 15 A BATH 2 GFCI 7 20 A OVENHOOD 1 20 A KITCHEN GFCI 2 20 A DISHWASHER 1 20 A OUTDOOR GFCI 3 20 A LIVING RECEPTACLE 5 20 A WATER HEATER 1 30 A	BATH 1 GFCI 7 20 A 14' - 11 15/32" WASHER 1 20 A 20' - 0 3/32" BED 1 LIGHT 8 15 A 43' - 4 19/32" LIVING LIGHT 7 15 A 53' - 9 3/32" BATH 2 GFCI 7 20 A 44' - 0 25/32" OVENHOOD 1 20 A 34' - 5 3/4" KITCHEN GFCI 2 20 A 35' - 4 1/16" DISHWASHER 1 20 A 33' - 5 1/8" OUTDOOR GFCI 3 20 A 47' - 6 1/8" LIVING RECEPTACLE 5 20 A 43' - 6 3/32"	BATH 1 GFCI 7 20 A 14' - 11 15/32" 1-#12, 1-#12	BATH 1 GFCI 7 20 A 14' - 11 15/32" 1.#12, 1.#12, 1.#12 WASHER 1 20 A 20' - 0 3/32" 1.#12, 1.#12, 1.#12, 1.#12, 1.#12 BED 1 LIGHT 8 15 A 43' - 4 19/32" 1.#14, 568 VA LIVING LIGHT 7 15 A 53' - 9 3/32" 1.#14, 1.#14, 1.#14 BATH 2 GFCI 7 20 A 44' - 0 25/32" 1.#12, 1.#12, 1.#12 OVENHOOD 1 20 A 34' - 5 3/4" 1.#12, 1.#12 KITCHEN GFCI 2 20 A 35' - 4 1/16" 1.#12, 1.#12, 1.#12 DISHWASHER 1 20 A 33' - 5 1/8" 1.#12, 1.#12 OUTDOOR GFCI 3 20 A 47' - 6 1/8" 1.#12, 1.#12 LIVING RECEPTACLE 5 20 A 43' - 6 3/32" 1.#12, 1.#12 WATER HEATER 1 30 A 43' - 6 3/32" 1.#12, 1.#12 UNATER HEATER 1 30 A 43' - 6 3/32" 1.#10, 2250 VA 1.#10, 1.#10, 1.#10, 1.#10, 1.#10, 1.#10, 1.#10, 1.#10	BATH 1 GFCI 7 20 A 14' - 11 15/32" 1.#12, 1.#12, 1.#12 WASHER 1 20 A 20' - 0 3/32" 1.#12, 1.#12, 1.#14, 1.#14 BED 1 LIGHT 8 15 A 43' - 4 19/32" 1.#14, 1.#14, 1.#14 LIVING LIGHT 7 15 A 53' - 9 3/32" 1.#14, 1.#14, 1.#14 BATH 2 GFCI 7 20 A 44' - 0 25/32" 1.#12, 1.#12, 1.#12 OVENHOOD 1 20 A 34' - 5 3/4" 1.#12, 1.#12, 1.#12 KITCHEN GFCI 2 20 A 35' - 4 1/16" 1.#12, 1.#12 DISHWASHER 1 20 A 33' - 5 1/8" 1.#12, 1.#12 OUTDOOR GFCI 3 20 A 47' - 6 1/8" 1.#12, 1.#12 LIVING RECEPTACLE 5 20 A 43' - 6 3/32" 1.#12, 1.#12 WATER HEATER 1 30 A 43' - 6 3/32" 1.#10, 2250 VA WATER HEATER 1 30 A 43' - 6 3/32" 1.#10, 1.#10, 2250 VA	BATH 1 GFCI 7 20 A 14' - 11 15/32" 1.#12, 1.#12, 1.#12 576 VA 2500 VA 14' - 11 15/32" 1.#12, 1.#12 576 VA 2500 VA 1200 VA 1.#12, 1.#12, 1.#12, 1.#12, 1.#12, 1.#12, 1.#12, 1.#12, 1.#12, 1.#12, 1.#12, 1.#14, 1.#12,	BATH 1 GFCI 7 20 A 14' - 11 15/32" 1.#12, 1.#12, 576 VA 2500 VA WASHER 1 20 A 20' - 0 3/32" 1.#12, 1.#12, 1.#12, 1.#12 BED 1 LIGHT 8 15 A 43' - 4 19/32" 1.#14, 568 VA 456 VA LIVING LIGHT 7 15 A 53' - 9 3/32" 1.#14, 1.#14, 1.#14 BATH 2 GFCI 7 20 A 44' - 0 25/32" 1.#12, 1.#12, 1.#12 OVENHOOD 1 20 A 34' - 5 3/4" 1.#12, 1.#12, 1.#12 KITCHEN GFCI 2 20 A 35' - 4 1/16" 1.#12, 1.#12, 1.#12 DISHWASHER 1 20 A 33' - 5 1/8" 1.#12, 1.#12 UUTDOOR GFCI 3 20 A 47' - 6 1/8" 1.#12, 1.#12 LIVING RECEPTACLE 5 20 A 43' - 6 3/32" 1.#12, 1.#12 WATER HEATER 1 30 A 43' - 6 3/32" 1.#10, 2250 VA 2500 VA 13638 VA 16584 VA	BATH 1 GFCI 7 20 A 14'-11 15/32" 1-#12, 1-#1	BATH 1 GFCI 7 20 A 14'-11 15/32" 1.#12, 1.#12, 1.#12, 1.#12, 1.#12	BATH 1 GFCI 7 20 A 14'-11 15/32" 1.#12 1.#12 576 VA 2500 VA 2500 VA 1.#10 17'-3 27/32" 30 A 1.#12 1.#1	BATH 1 GFCI 7 20 A 14'-11 15/32' 1-#12 1-#12 576 VA 2500 VA 1-#10 17'-3 27/32'' 30 A 1 WASHER 1 20 A 20'-0 3/32' 1-#12 1-#12 1200 VA 2500 VA	BATH 1 GFCI 7 20 A 14'-11 15/32' 1-812, 1-81

LOAD CLASSIFICATION	Connected Load	Demand Factor	Estimated Demand	Panel Totals
LIGHTING - DWELLING UNIT	400 VA	100.00%	400 VA	
OTHER	1716 VA	100.00%	1716 VA	Total Conn. Load: 30222 VA
RECEPTACLE	6540 VA	100.00%	6540 VA	Total Est. Demand: 29222 VA
LIGHTING	300 VA	100.00%	300 VA	Total Conn.: 126 A
CONDENSER	5000 VA	100.00%	5000 VA	Total Est. Demand: 122 A
WATER HEATER	4500 VA	100.00%	4500 VA	
RANGE	5000 VA	80.00%	4000 VA	
DRYER	5000 VA	100.00%	5000 VA	
REFRIGERATOR	1800 VA	100.00%	1800 VA	



KEY PLAN

NO.	DESCRIPTION	DATE

NOTE:

LEGEND:

PROJECT

193-ORCHARD-749-2Bd 2Ba **CRAFTSMAN-550**

DRAWING NAME

SCHEDULE

Owner CLIENT NAME: PROJECT NUMBER: 0291_13 4/16/2025 9:53:25 AM Designer DESIGNED BY: DRAWN BY: CHECKED BY: Checker

E101

SCALE: 1/4" = 1'-0"

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ELECTRICAL NOTE

- A. PROVIDE INTERCONNECTED SMOKE ALARMS IN EACH SLEEPING ROOMS, OUTSIDE EACH SLEEPING ROOM, ON EACH STORY, IN THE HALL OR ADJACENT ROOM LUHERE THE CEILING HEIGHT OF A ROOM OPEN TO THE HALL EXCEEDS THE HALL BY 24'. SMOKE ALARMS SHALL BE PERMANENTLY HARD WIRED WITH BATTERY BACKUP.
- B. RECEPTACLE OUTLETS FOR RANGES AND CLOTHES DRYERS SHALL BE A THREE POLE WITH GROUND TYPE. FOUR WIRE GROUNDING-TYPE FLEXIBLE CORDS WILL BE REQUIRED FOR CONNECTION OF RANGES AND CLOTHES DRYERS. THE BONDING JUMPER SHALL NOT BE CONNECTED BETWEEN NEUTRAL TERMINAL AND THE FRAME OF THE APPLIANCE.
- C. TWO OR MORE 20 AMP SMALL APPLIANCE CIRCUITS SHALL BE PROVIDED TO SERVE THE KITCHEN, BREAKFAST NOOK, AND DINING ROOM. SUCH CIRCUITS SHALL HAVE NO OTHER OUTLETS.
- D. AT LEAST ONE 20 AMP BRANCH CIRCUIT SHALL BE PROVIDED TO SERVICE THE LAUNDRY ROOM. THIS CIRCUIT SHALL HAVE NO OTHER OUTLETS.
- E. ALL RECEPTACLES WITH IN 6' OF A WET BAR SINK OR KITCHEN SINK TO SERVE COUNTER TOP SURFACES MUST BE GFCI. ON KITCHEN COUNTERS 12' OR WIDER NO POINT ALONG THE WALL SHALL BE MORE THAN 2' FROM A RECEPTACLE. ALL RECEPTACLES WITH IN 6' OF KITCHEN SINK MUST BE GFCI. AT LEAST ONE GFCI RECEPTACLE SHALL BE INSTALLED IN THE BATHROOM ADJACENT TO EACH BASIN.
- F. FIXTURES INCLUDING CEILING FANS THAT ARE LOCATED IN DAMP LOCATIONS SHALL BE LISTED TO BE SUITABLE FOR SUCH LOCATIONS PER 2012 IRC
- G. PROVIDE ONE (1) SWITCHED OUTLET @ ALL BEDROOMS AND DEN
- H. CEILING FANS NOT EXCEEDING 35 LBS. (WITH OR WITHOUT ACCESSORIES MAY BE SUPPORTED BY OUTLET BOXES PROVIDED THE OUTLET BOXES ARE IDENTIFIED FOR SUCH USE PER 2012 IRC
- I. ELECTRICAL OUTLET BOXES ON OPPOSITE SIDES OF FIRE RATED WALLS SHALL BE SEPARATED BY A HORIZONTAL DISTANCE OF NOT LESS THAN 24".
- J. OUTLET BOXES IN THE WALLS BETWEEN THE GARAGE AND DWELLING SHALL BE METAL OR U.L. APPROVED FIRE RESISTIVE PLASTIC. BOXES IN GARAGE CEILING SHALL BE METAL.
- K. ALL BRANCH CIRCUITS THAT SUPPLY 120 VOLTS SINGLE PHASE 15 AND 20 AMPS RECEPTACLE OUTLETS INSTALLED IN THE DWELLING SHALL BE PROTECTED BY AN ARC FAULT CIRCUIT INTERRUPTER, EXCEPT GFCI RECEPTICLES.

NOTE:

A. RECEPTACLES MUST BE PROVIDED IN HALLWAYS 10'-0" OR MORE IN LENGTH. FOR A ONE FAMILY DWELLINGS AND EACH OF A TWO FAMILY DWELLING THAT IS AT GRADE LEVEL, AT LEAST ONE WP-GFCI RECEPTACLE OUTLET ACCESSIBLE AT GRADE LEVEL AND NOT MORE THAN 6'-6" ABOVE GRADE SHALL BE INSTALLED AT THE FRONT AND BACK OF THE DWELLING.

NOTE: APPLIANCE DISCONNECT

E4001.5 GROUNDING OF ENCLOSURES.

METAL ENCLOSURES FOR SWITCHES OR CIRCUIT BREAKERS SHALL BE CONNECTED TO AN

EQUIPMENT GROUNDING CONDUCTOR.

METAL ENCLOSURES FOR SWITCHES OR CIRCUIT BREAKERS USED AS SERVICE

EQUIPMENT SHALL COMPLY WITH THE PROVISIONS OF SECTION E3609.4. WHERE


NONMETALLIC ENCLOSURES ARE USED WITH METAL RACEWAYS OR METAL-ARMORED CABLES, PROVISIONS SHALL BE MADE FOR CONNECTING THE EQUIPMENT GROUNDING

CONDUCTOR.


NONMETALLIC BOXES FOR SWITCHES SHALL BE INSTALLED WITH A WIRING METHOD THAT

PROVIDES OR INCLUDES AN EQUIPMENT GROUNDING CONDUCTOR. (404.12)

ELECTRI	CAL LEGEND
	Electrical Lights With Fan
0	Waterproof Recessed Can Light
	Pendant Light
0	Recessed Can Light
- Ø	Wall Lamp
	Standalone linear
⊬1 0	Single Switch
₩.	Three way Switch
₩.	Fan Switch
	Duplex Receptacle
	Triplex Receptacle
⊕ □GFCI	GFCI Receptacle
	Exhaust Fan
•	Smoke and heat detector

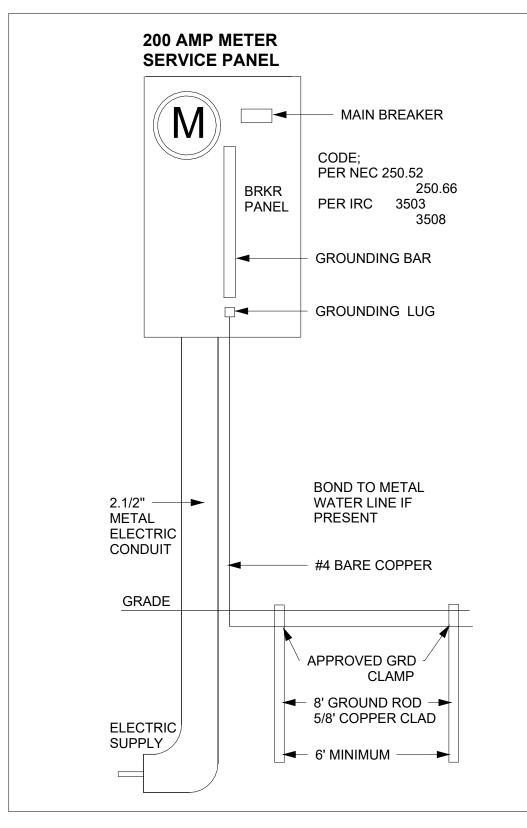



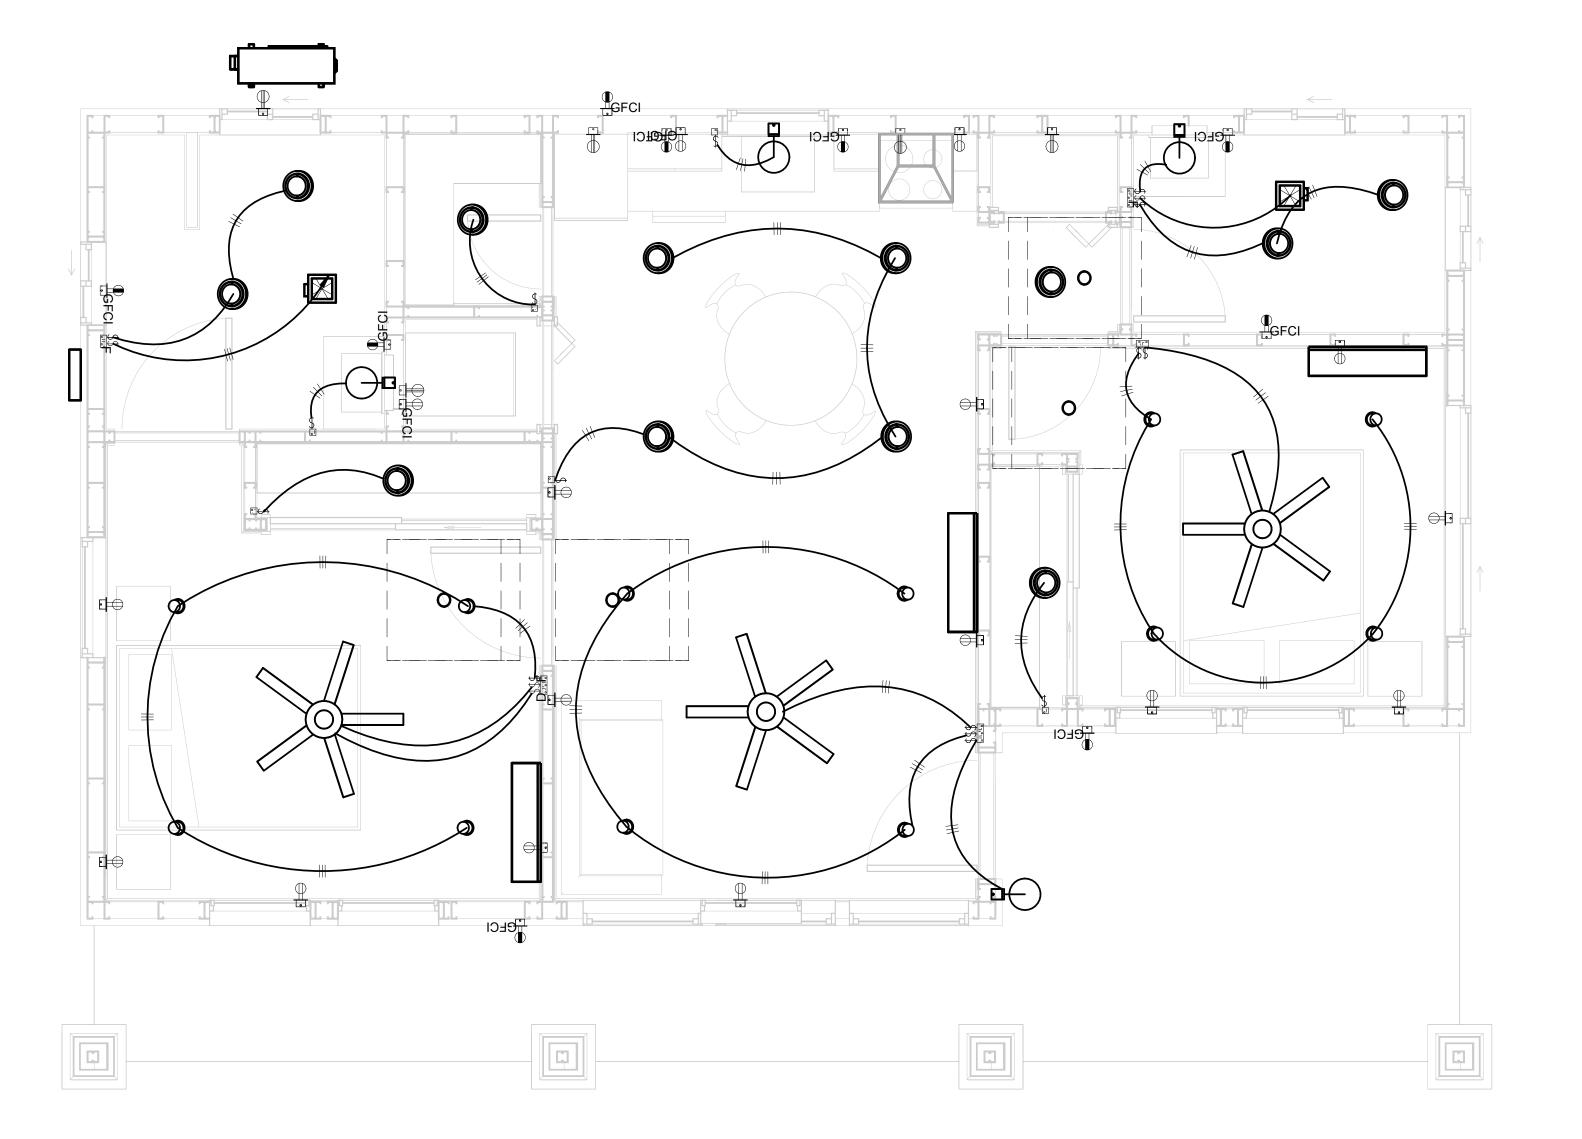

1 - Lighting 3/8" = 1'-0"



KEY PLAN

NO.	DESCRIPTION	DATE

NOTE:

LEGEND:

PROJECT

193-ORCHARD-749-2Bd 2Ba CRAFTSMAN-550

DRAWING NAME


LIGHTING

CLIENT NAME:	Owner
PROJECT NUMBER:	0291_13
DATE:	4/16/2025 9:53:28 AM
DESIGNED BY:	Designer
DRAWN BY:	Author
CHECKED BY:	Checker


E102

NOTES: CONDUIT, CABLE AND WIRING


- Use Metalic Conduits (IMC) for cables running under concrete slabs.
 Use IMC for circuits with high voltage appliances (240 volts and above)
 For circuits with 120 volts consider using EMT or PVC conduits if needed.
 For Low voltage applications up to 50 volts consider using non metalic conduits.
 All conduits to be used in the project must conform to the latest National Electrical Code (NEC),
- All wiring and cables to be used in the project must also conform to the latest National Electrical Code (NEC), 2015.
- 7. All cables and wires used should be rated for their respective loading and should be gauged and conform to the NEC.

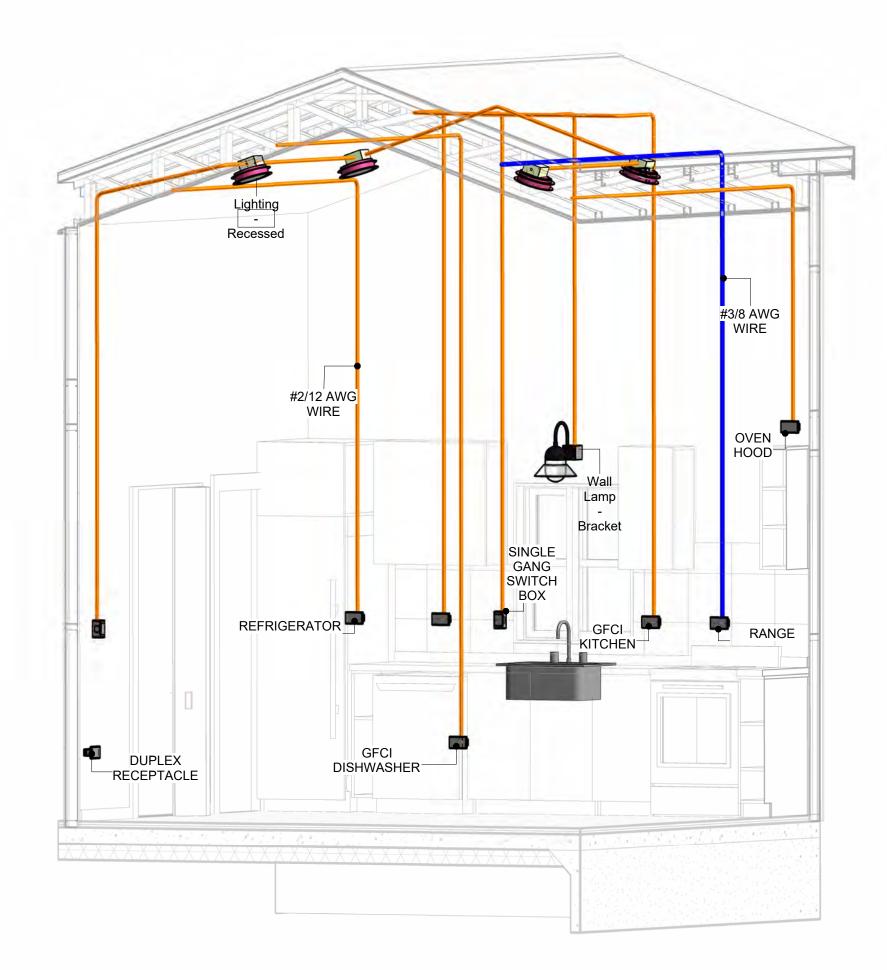




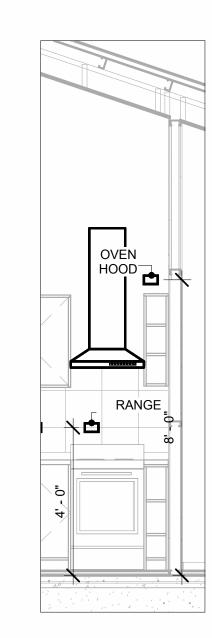


RANGE & OVENHOOD 3/8" = 1'-0"

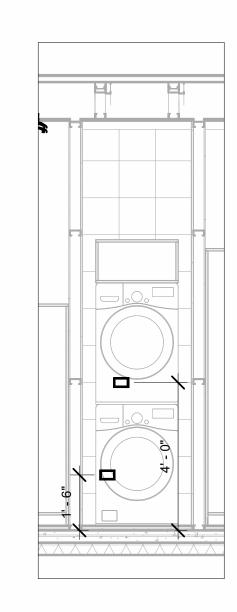

DRYER & WASHER 3/8" = 1'-0"

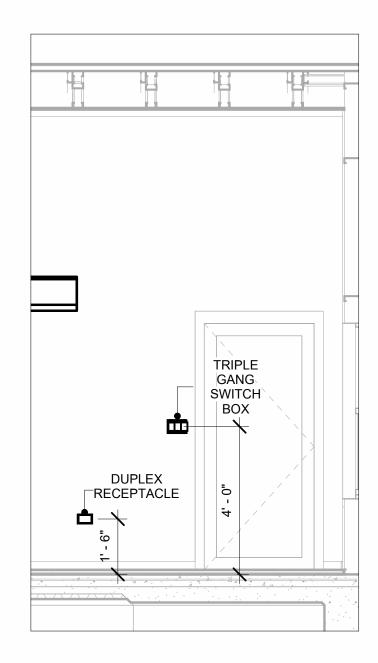


SWITCH & RECEPTACLE 3/8" = 1'-0"

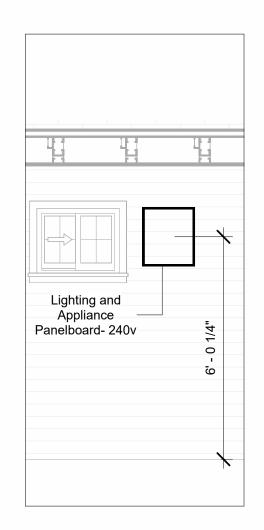

PANEL 3/8" = 1'-0"



KEY PLAN

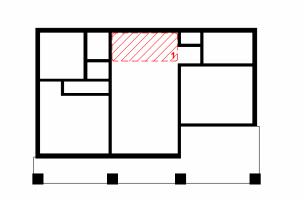

NO.	DESCRIPTION	DATE

NOTE:

LEGEND:

PROJECT

193-ORCHARD-749-2Bd 2Ba CRAFTSMAN-550

DRAWING NAME

POWER

CLIENT NAME:	Owner
PROJECT NUMBER:	0291_13
DATE:	4/16/2025 9:53:54 AM
DESIGNED BY:	Designer
DRAWN BY:	Author
CHECKED BY:	Checker

E103

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NOTES: LIGHT

- 1. LIGHT FIXTURES AND LUMINARIES SHALL CONFORM TO THE NEC, THE IRC AND LOCAL SAFETY & BUILDING CODE.
- 2. ALL LIGHTING FIXTURES SHOULD CONFORM TO THE DESIGN ELECTRICAL LOAD AND SHALL BE PROPERLY WIRED AND MOUNTED BY QUALIFIED ELECTRICIAN FOLLOWING MANUFACTURERS SPECIFICATIONS.
- CEILING FANS AND FANS WITH LIGHT WITH WEIGHT EXCEEDING 35 LBS SHOULD BE PROVIDED WITH STRUCTURAL BACKING FOR SUPPORT AND SHALL BE FIXED AS PER MANUFACTURERS SPECIFICATIONS.
- 4. EXTERIOR LIGHTS SHALL CONFORM TO LOCAL BUILDING CODE AND GUIDELINES.

NOTES: SWITCH JUNCTION BOX


- THE MINIMUM SIZE OF JUCTION BOX TO BE USED IS 2"X4"X(1.5" OR 3.5" DEEP) THIS ARE TO BE USED FOR SINGLE GANG SWITCH OR OUTLETS.
- 2. FOR DOUBLE GANG (2 GANG) OUTLETS AND SWITCHS THE MINIMUM SIZE OF THE
- JUCTION BOX TO BE PROVIDED SHALL NOT BE LESS THAN 4"X4"X(1.5" OR 3.5" DEEP)
- 3. FOR THREE GANG (3 GANG) OUTLETS AND SWITCHS THE MINIMUM SIZE OF THE JUĆTION BOX SHALL NOT BE LESS THAN 6"X4"X(1.5" OR 3.5" DEEP).

FITTING SCHEDULE(PULL BOX)			
FAMILY	COUNT	DESCRIPTION	
PULLBOX1	31	#1/4 PULLBOX	

ELECTRICAL FIXTURE SCHEDULE (SWITCH BOX)			
TYPE	COUNT		
DOUBLE GANG SWITCH BOX	2		
SINGLE GANG SWITCH BOX	6		
TRIPLE GANG SWITCH BOX	3		

LIGHTING DEVICE			
TYPE	COUNT		
DIMMER	1		
FAN SWITCH	3		
SINGLE POLE	15		

LIGHTING FIXTURE					
LIGHTING FIXTURE TYPE	VOLTAGE	ELECTRICAL LOAD	COUNT		
ELECTRICAL_LIGHTS_FAN-LIGHT1	120 V/1-100 VA- 120 V/1-100 VA	200 A, 120 V/240 V, SINGLE PHASE, 3 WIRES	3		
LIGHTING - RECESSED	120 V/1-60 VA	<varies></varies>	12		
SASSO 100 ROUND WALLWASHER TRIM	120 V/1-28 VA	200 A, 120 V/240 V, SINGLE PHASE, 3 WIRES	12		
WALL LAMP - BRACKET	120 V/1-100 VA	200 A, 120 V/240 V, SINGLE PHASE, 3 WIRES	4		

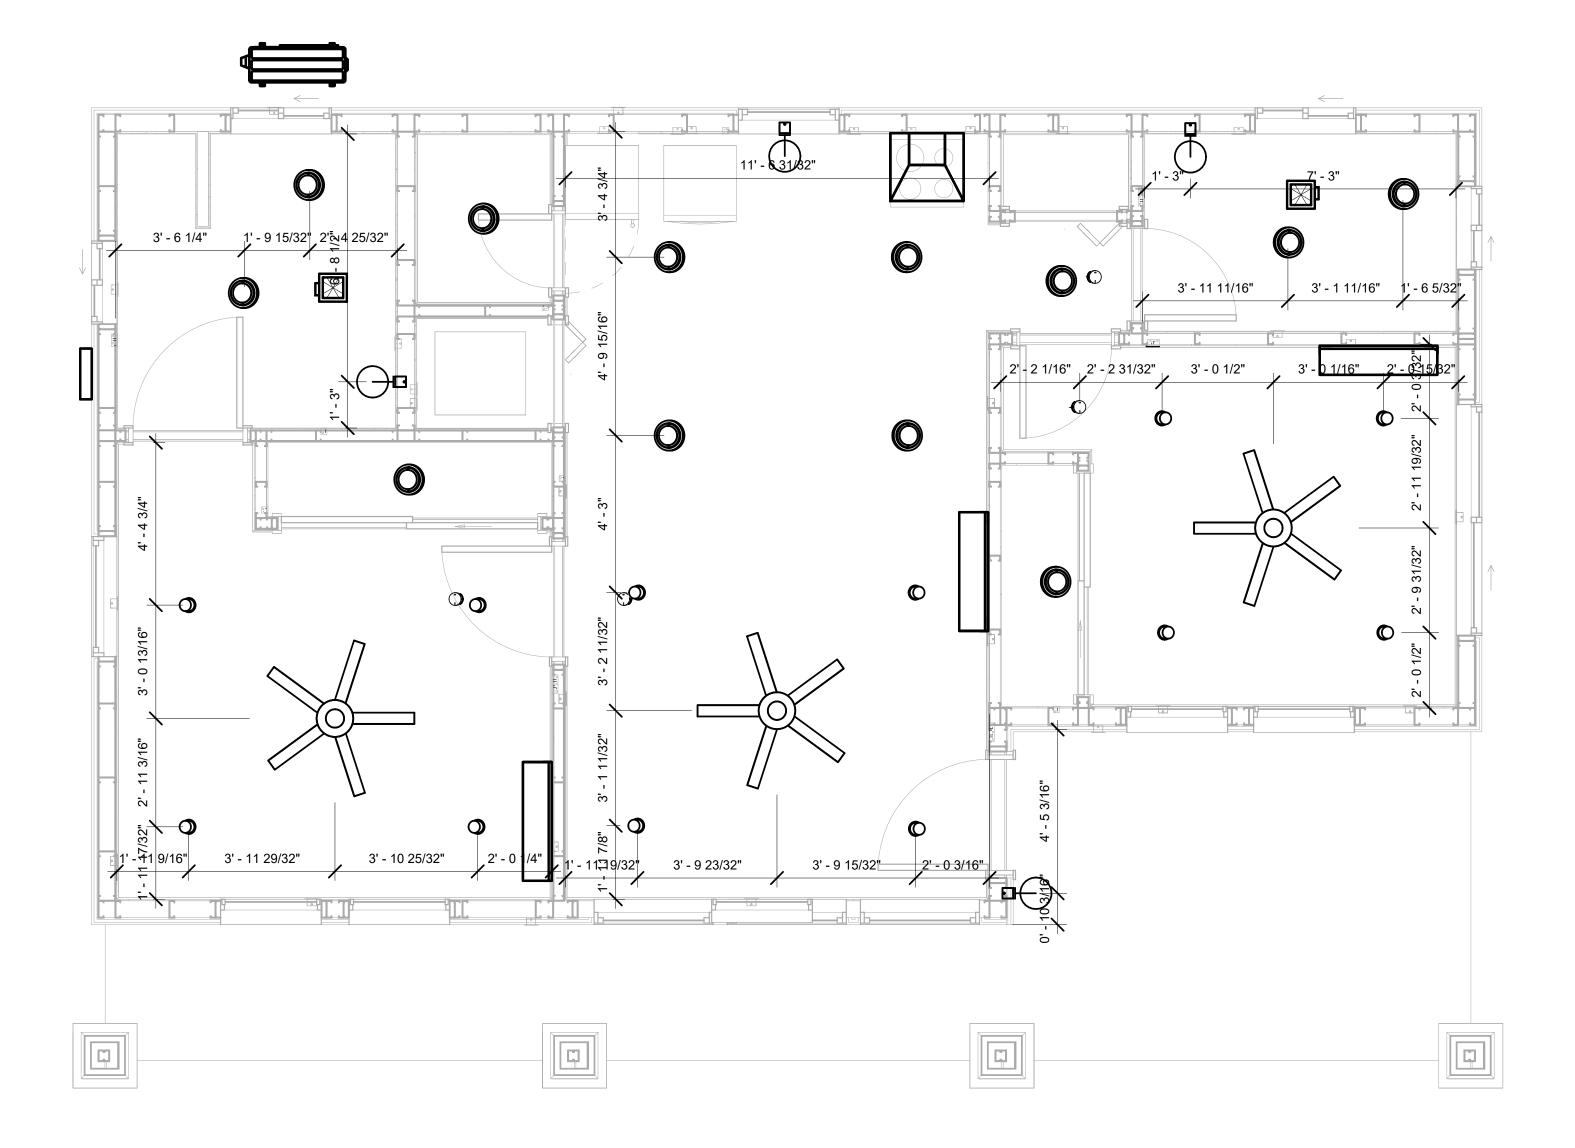

1 DIMENSION FOR LIGHT FIXTURES
3/8" = 1'-0"



KEY PLAN

NO.	DESCRIPTION	DATE

NOTE:

LEGEND:

PROJECT

193-ORCHARD-749-2Bd 2Ba CRAFTSMAN-550

DRAWING NAME

DIMENSION PLAN FOR LIGHT FIXTURES

CLIENT NAME:	Owner
PROJECT NUMBER:	0291_13
DATE:	4/16/2025 9:53:56 AM
DESIGNED BY:	Designer
DRAWN BY:	Author
CHECKED BY:	Checker


E104

NOTES;

- 1. VERIFY EQUIPMENT PLUG CONFIGURATION BEFORE PURCHASING RECEPTACLES
- 2. FOR ALL EQUIPMENT.
- 3. COORDINATE EXACT LOCATION OF LIGHT FIXTURES, WALL SWITCHES, RECEPTACLES AND OTHER DEVICES WITH ARCHITECTURAL DRAWINGS.
- 4. USE METALLIC JUNCTION BOX WITH THE GFCI RECEPTACLES, WITH HIGHT VOLTAGE.

ELECTRICAL FIXTURE SCHEDULE (RECEPTACLE)								
TYPE COUNT								
CONDENSER	1							
DRYER	1							
DUPLEX RECEPTACLE	13							
GFCI BATH ROOM	4							
GFCI DISHWASHER	1							
GFCI KITCHEN	2							
GFCI OUT DOOR	3							
GFCI WASHER	1							
OVEN HOOD	1							
RANGE	1							
REFRIGERATOR	1							
WATER HEATER	1							

ELECTRICAL OUTLET SCHEDULE									
TYPE	CIRCUIT NUMBER	COUNT							
GFCI BATH ROOM	1	120 V/1-180 VA	2						
DRYER	2,4	240 V/2-5000 VA	1						
GFCI WASHER	3	120 V/1-1200 VA	1						
GFCI BATH ROOM	9	120 V/1-180 VA	2						
OVEN HOOD	11	120 V/1-180 VA	1						
RANGE	12,14	240 V/2-5000 VA	1						
GFCI KITCHEN	13	120 V/1-180 VA	2						
GFCI DISHWASHER	15	120 V/1-1200 VA	1						
REFRIGERATOR	16	120 V/1-1800 VA	1						
GFCI OUT DOOR	17	120 V/1-180 VA	3						
DUPLEX RECEPTACLE	18	120 V/1-180 VA	4						
DUPLEX RECEPTACLE	19	120 V/1-180 VA	5						
DUPLEX RECEPTACLE	20	120 V/1-180 VA	4						
WATER HEATER	21,23	240 V/2-4500 VA	1						
CONDENSER	22,24	240 V/2-5000 VA	1						

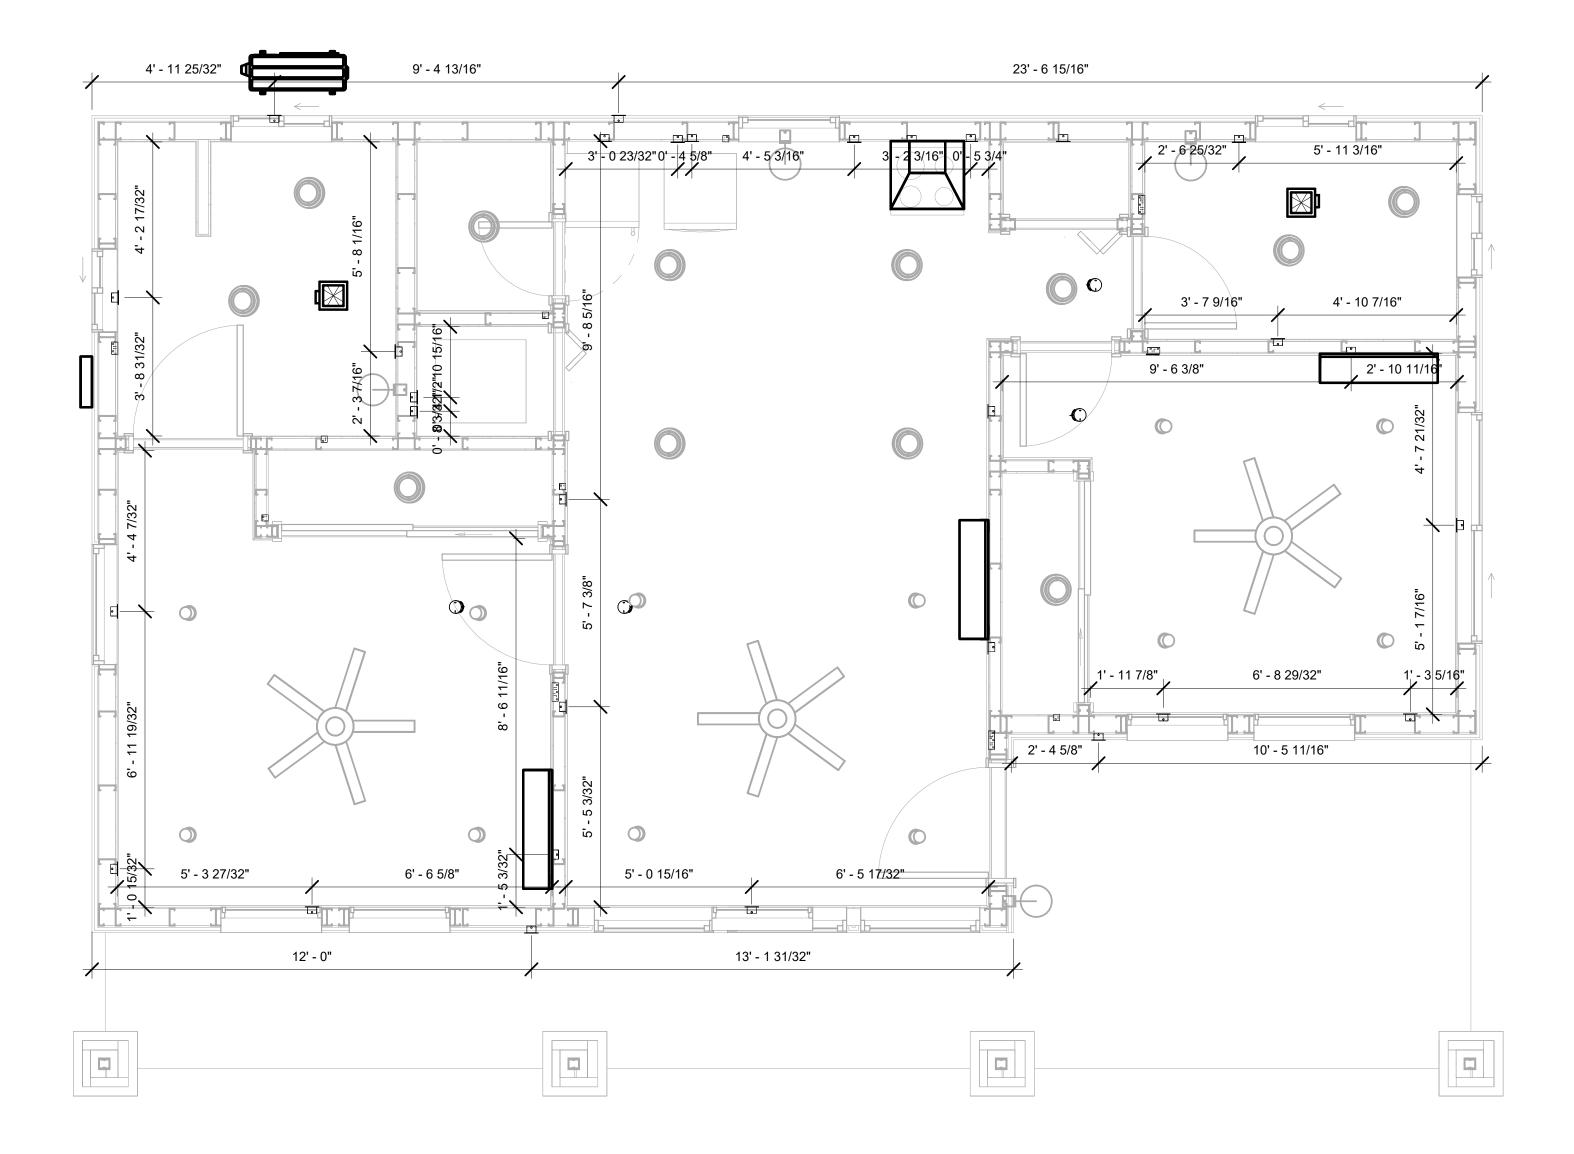

1 DIMENSION FOR FITTINGS
3/8" = 1'-0"



KEY PLAN

NO.	DESCRIPTION	DATE

NOTE:

LEGEND:

PROJECT

193-ORCHARD-749-2Bd 2Ba CRAFTSMAN-550

DRAWING NAME

DIMENSION PLAN FOR FITTINGS

CLIENT NAME:	Owner
PROJECT NUMBER:	0291_13
DATE:	4/16/2025 9:53:59 AM
DESIGNED BY:	Designer
DRAWN BY:	Author
CHECKED BY:	Checker

E105

SHEET LIST

SHEET NUMBER SHEET NAME

P101 NOTE AND SCHEDULE P102 WATER SUPPLY AND SEWAGE SYSTEM

PIPE COLOR	SCHEME
	OOMESTIC COLD WATE OOMESTIC HOT WATER
	SANITARY VENT
_	SANITARY SEWER STORM DRAINAGE
_	GRAY WATER
	SAS LINE

PLUMBING NOTES

- THE PLUMBING SYSTEM IS DESIGNED TO MEET THE BUILDING'S DOMESTIC WATER SUPPLY, SANITARY DRAINAGE, AND STORM DRAINAGE REQUIREMENTS, AS PER PROJECT SPECIFICATIONS AND APPLICABLE CODES.
- THE SYSTEM INSTALLATION SHALL COMPLY WITH THE LATEST INTERNATIONAL PLUMBING CODE (IPC), INTERNATIONAL RESIDENTIAL CODE (IRC), AND ALL OTHER RELEVANT LOCAL, STATE, AND NATIONAL REGULATIONS.
- ALL PLUMBING WORK SHALL COMPLY WITH THE LATEST EDITION OF THE INTERNATIONAL PLUMBING CODE (IPC) AND THE LOCAL PLUMBING CODE.
- PLUMBING SYSTEMS SHALL BE TESTED AND INSPECTED IN ACCORDANCE WITH THE LOCAL PLUMBING CODE REQUIREMENTS.
- 5. PLUMBING FIXTURES SHALL BE INSTALLED WITH THE APPROPRIATE TRIM, FITTINGS, AND ACCESSORIES, AS RECOMMENDED BY THE MANUFACTURER.
- 6. PIPING SHALL BE PROPERLY SUPPORTED AND SECURED TO PREVENT SAGGING,
- MOVEMENT, AND VIBRATION. SHUT-OFF VALVES SHALL BE PROVIDED AT ALL BRANCH CONNECTIONS AND AT THE
- INLET AND OUTLET OF EACH PIECE OF EQUIPMENT. BACKFLOW PREVENTION DEVICES SHALL BE INSTALLED AS REQUIRED BY THE LOCAL
- PLUMBING CODE TO PROTECT THE POTABLE WATER SYSTEM. PLUMBING FIXTURES AND EQUIPMENT SHALL BE ACCESSIBLE FOR MAINTENANCE AND
- 10. EXPOSED PLUMBING PIPING AND FIXTURES SHALL BE INSULATED TO PREVENT CONDENSATION AND ENERGY LOSS.
- 11. DEAD ENDS IN THE DRAINAGE SYSTEM MUST BE AVOIDED, EXCEPT WHERE NECESSARY TO INSTALL A CLEANOUT IN AN ACCESSIBLE LOCATION, AND MUST HAVE A VENTED CONNECTION TO THE OUTSIDE ATMOSPHERE.
- 12. THE VERTICAL DEFLECTION OF PVC PIPE MUST NOT EXCEED 5%, AND NO DEFLECTION IS PERMITTED FOR IRON PIPE.
- 13. WORK MUST BE PROPERLY COORDINATED WITH OTHER TRADES TO AVOID CONFLICTS, REFERRING TO THE ARCHITECTURAL AND STRUCTURAL DRAWINGS FOR INFORMATION REGARDING CEILING ELEVATIONS, SPACE CLEARANCES, WALL AND PARTITION LOCATIONS, ETC.
- 14. ALL FIXTURES SHALL HAVE ACCESSIBLE STOPS.
- 15. DOMESTIC WATER PIPING SHALL BE PEX, AND PVC PIPING IS NOT ACCEPTABLE FOR INTERIOR USE.
- 16. VENT TERMINATIONS SHALL BE LOCATED AT LEAST 10 FEET FROM OR 3 FEET ABOVE ANY OPERABLE WINDOW, DOOR OPENING, AIR INTAKE, OR VENT SHAFT, AND AT LEAST 3 FEET IN EVERY DIRECTION FROM ANY LOT LINE, ALLEY, OR STREET.
- 17. PIPE AND FITTINGS UTILIZED IN THE WATER SUPPLY SYSTEM SHALL HAVE A MAXIMUM OF 8 PERCENT LEAD.
- 18. ACRYLONITRILE BUTADIENE STYRENE (ABS) SHALL BE USED FOR THE SEWERAGE AND VENTILATION SYSTEM.
- 19. CROSS-LINKED POLYETHYLENE (PEX) SHALL BE USED FOR THE WATER SUPPLY SYSTEM.
- POLYVINYL CHLORIDE (PVC) SHALL BE USED FOR THE RAIN WATER SYSTEM.
- 21. THE MIMIMUM WATER SUPPLY DEPTH UNDER FLOOR FINISH SHOUD BE 1/2".
- 22. ANY PIPE INSTALLED UNDERGROUND MUST HAVE AT LEAST 12 INCHES OF CLEARANCE BETWEEN THE OUTSIDE OF THE PIPE AND ANY OTHER UNDERGROUND STRUCTURE.
- 23. THE MINIMUM CLEARANCE BETWEEN COLD AND HOT WATER LINES IN RESIDENTIAL HOMES MAINTAIN A MINIMUM DISTANCE OF 6 INCHES.
- HORIZONTAL SEPARATION BETWEEN WATER AND SEWER LINES: A MINIMUM OF 12
- INCHES BETWEEN POTABLE WATER SUPPLY LINES (COLD AND HOT WATER) AND SANITARY SEWER LINES.

ABBREVIATIONS

Ø	DIAMETER
ABS	ACRYLONITRILE BUTADIENE STYRENE
ABV	ABOVE
AD	AREA DRAIN
AFF	ABOVE FINISHED FLOOR
ALT	ALTERNATE
BFF	BELOW FINISHED FLOOR
BLW	BELOW
CO	CLEAN OUT
CW	COLD WATER
D	DEGREE
DFU	DRANAGE FIXTURE UNIT
DIA	DIAMETER
DN	DOWN
FCO	FLOOR CLEAN OUT
FD	FLOOR DRAIN
FL	FLOOR
FS	FLOOR SINK
FT	FOOT/FEET
НВ	HOSE BIB
HW	HOT WATER
IN	INCH
MIN	MINIMUM
NO	NUMBER
NTS	NOT TO SCALE
PEX	CROSS-LINKED POLYETHYLENE
PLBG	PLUMBING
PVC	POLYVINYL CHLORIDE
QTY	QUANTITY
RD	ROOF DRAIN
RED	REDUCER
RM	ROOM
RW	RAIN WATER
SF	SQUARE FOOT
V	VENT
VTR	VENT THROUGH ROOF
W	WASTE
WCO	WALL CLEAN OUT
WSFU	WATER SUPPLY FIXTURE UNIT

PLUMBING LEGEND

D	CAP
	BEND 45 DEG
B	BEND 90 DEG
	TEE REDUCING
	TEE
	CLEAN TWO-WAY
	WYE 45 DEG
	WYE 45 DEG DOUBLE
	WYE COMBINATION
	P-TRAP

PIPE SCHEDULE										
MATERIAL DIAMETER LENGTH										
ACRYLONITRILE BUTADIENE STYRENE (ABS)	1 1/2"	22 FT								
ACRYLONITRILE BUTADIENE STYRENE (ABS)	2"	25 FT								
ACRYLONITRILE BUTADIENE STYRENE (ABS)	3"	59 FT								
CROSS-LINKED POLYETHYLENE (PEX)	1/2"	121 FT								
CROSS-LINKED POLYETHYLENE (PEX)	3/4"	29 FT								
CROSS-LINKED POLYETHYLENE (PEX)	1"	1 FT								
POLYVINYL CHLORIDE - RIGID	2"	47 FT								

FITTING SCHEDULE								
FITTING	SIZE	QTY						
DOMESTIC COLD WATER								
PEX 90 DEGREE ELBOW	1/2"ø-1/2"ø	18						
PEX 90 DEGREE ELBOW	3/4"ø-3/4"ø	1						
PEX TEE ELBOW	1/2"ø-1/2"ø-1/2"ø	7						
PEX TEE ELBOW	3/4"ø-3/4"ø	3						
PEX TRANSITION ELBOW	1"ø-3/4"ø	1						
PEX TRANSITION ELBOW	3/4"ø-1/2"ø	2						
DOMESTIC HOT WATER								
PEX 90 DEGREE ELBOW	1/2"ø-1/2"ø	18						
PEX 90 DEGREE ELBOW	3/4"ø-3/4"ø	2						
PEX TEE ELBOW	1/2"ø-1/2"ø	5						
PEX TEE ELBOW	3/4"ø-3/4"ø-3/4"ø	1						
PEX TRANSITION ELBOW	3/4"ø-1/2"ø	2						
RAIN WATER PVC 90 DEG BEND ELBOW PVC 90 DEGREE BEND ELBOW	2"ø-2"ø 2"ø-2"ø	6 12						
SEWAGE								
ABS 90 DEGREE BEND ELBOW	1 1/2"ø-1 1/2"ø	3						
ABS 90 DEGREE BEND ELBOW	2"ø-2"ø	1						
ABS 90 DEGREE BEND ELBOW	3"ø-3"ø	4						
ABS P-TRAP	1 1/2"ø-1 1/2"ø	5						
ABS P-TRAP	2"ø-2"ø	2						
ABS REDUCER ELBOW	2"ø-1 1/2"ø	2						
ABS REDUCER ELBOW	3"ø-2"ø	1						
ABS TEE ELBOW	1 1/2"ø-1 1/2"ø-1 1/2"ø	1						
ABS TEE ELBOW	3"ø-3"ø-3"ø	4						
ABS TEE REDUCER ELBOW	3"ø-3"ø-1 1/2"ø	3						
ABS TEE REDUCER ELBOW	3"ø-3"ø-2"ø	1						
WASTE DOUBLE TEE	2"ø-2"ø-2"ø	2						
VENT								
ABS 90 DEGREE BEND ELBOW	1 1/2"ø-1 1/2"ø	1						
ABS 90 DEGREE BEND ELBOW	2"ø-2"ø	1						
ABS TEE REDUCER ELBOW	3"ø-3"ø-1 1/2"ø	1						
ABS TEE REDUCER ELBOW	3"ø-3"ø-2"ø	1						
ABS VENT CAP ELBOW	2"ø	1						
ADO VENT CAD ELDOM	2""	2						

FIXTURE CONNECTION SCHEDULE											
FAMILY	W	V	TRAP	CW	HW	QTY	DFU	TOT.	WFU	TOT.	NOTES
DRAIN TO SEWER SEE											
DISHWASHER	2"	1-1/2"	1-1/2"	1/2"	1/2"	1		0			PLANS
DRYER	N/A	N/A	N/A	N/A	N/A	1		0			
HANGING PIPES CLAMP						12		0			
SHOWER TRAY	2"	1-1/2"	1-1/2"	1/2"	1/2"	2		0			
SHOWER TRIM	-	-	-	1/2"	1/2"	2		0			
SINK ISLAND SINGLE	2"	1-1/2"	1-1/2"	1/2"	1/2"	1		0			
VANITY SINK	2"	1-1/2"	1-1/2"	1/2"	1/2"	2		0			
WASHER	2"	1-1/2"	2"	1/2"	1/2"	1		0			DRAINS TO GRAY WATER OR SEWER SEE PLANS
WATER CLOSET						2		0			
WATER HEATER	N/A	N/A	N/A	3/4"	3/4"	1		0			

3"ø

ABS VENT CAP ELBOW

FIXTURE SCHEDULE							
	TIXTORE SOFIEDOLE						
FIXTURE	QTY	DESCRIPTION					
	1						
DISHWASHER	1	DRAIN TO SEWER SEE PLANS					
DRYER	1						
HANGING PIPES CLAMP	12						
SHOWER TRAY	2						
SHOWER TRIM	2						
SINK ISLAND SINGLE	1						
VANITY SINK	2						
WASHER	1	DRAINS TO GRAY WATER OR SEWER SEE PLANS					
WATER CLOSET	2						
WATER HEATER	1						

ACCESSORIES & FITTINGS SCHEDULE							
FIXTURE	FIXTURE QTY DESCRIPTIONS						
DISHWASHER CONNECTOR	2						
HOSE BIB 1							
SHUTOFF VALVE	8						

PLUMBING SCHEDULE							
FIXTURE	TRAP	WASTE	VENT	C.W	H.W		
DISHWASHER	1-1/2"	2"	1-1/2"	1/2"	1/2"		
DRYER	N/A	N/A	N/A	N/A	N/A		
SHOWER TRAY	1-1/2"	2"	1-1/2"	1/2"	1/2"		
SHOWER TRIM	-	-	-	1/2"	1/2"		
SINK ISLAND SINGLE	1-1/2"	2"	1-1/2"	1/2"	1/2"		
VANITY SINK	1-1/2"	2"	1-1/2"	1/2"	1/2"		
WASHER	2"	2"	1-1/2"	1/2"	1/2"		
WATER CLOSET							
WATER HEATER	N/A	N/A	N/A	3/4"	3/4"		

WATER FIXTURE UNIT SCHEDULE							
FAMILY	QTY	UNIT VALUE	TOTAL				
DICLIMACHED	4						
DISHWASHER	1		0				
DRYER	1		0				
HANGING PIPES CLAMP	12		0				
SHOWER TRAY	2		0				
SHOWER TRIM	2		0				
SINK ISLAND SINGLE	1		0				
VANITY SINK	2		0				
WASHER	1		0				
WATER CLOSET	2		0				
WATER HEATER	1		0				

WASTE FIXTURE UNIT SCHEDULE								
FAMILY QTY DFU VALUES TOTAL								
DISHWASHER	1	0						
DRYER	1	0						
HANGING PIPES CLAMP	12	0						
SHOWER TRAY	2	0						
SHOWER TRIM	2	0						
SINK ISLAND SINGLE	1	0						
VANITY SINK	2	0						
WASHER	1	0						
WATER CLOSET	2	0						
WATER HEATER	1	0						



KEY PLAN

NO.	DESCRIPTION	DATE

NOTE:

LEGEND:

PROJECT

193-ORCHARD-749-2Bd2Ba **CRAFTSMAN-550**

DRAWING NAME


NOTE AND SCHEDULE

CLIENT NAME:

PROJECT NUMBER: 0291_13 DATE: 4/10/2025 11:55:42 AM Designer DESIGNED BY: DRAWN BY: Author CHECKED BY: Checker


P101

SCALE: 1/2" = 1'-0"

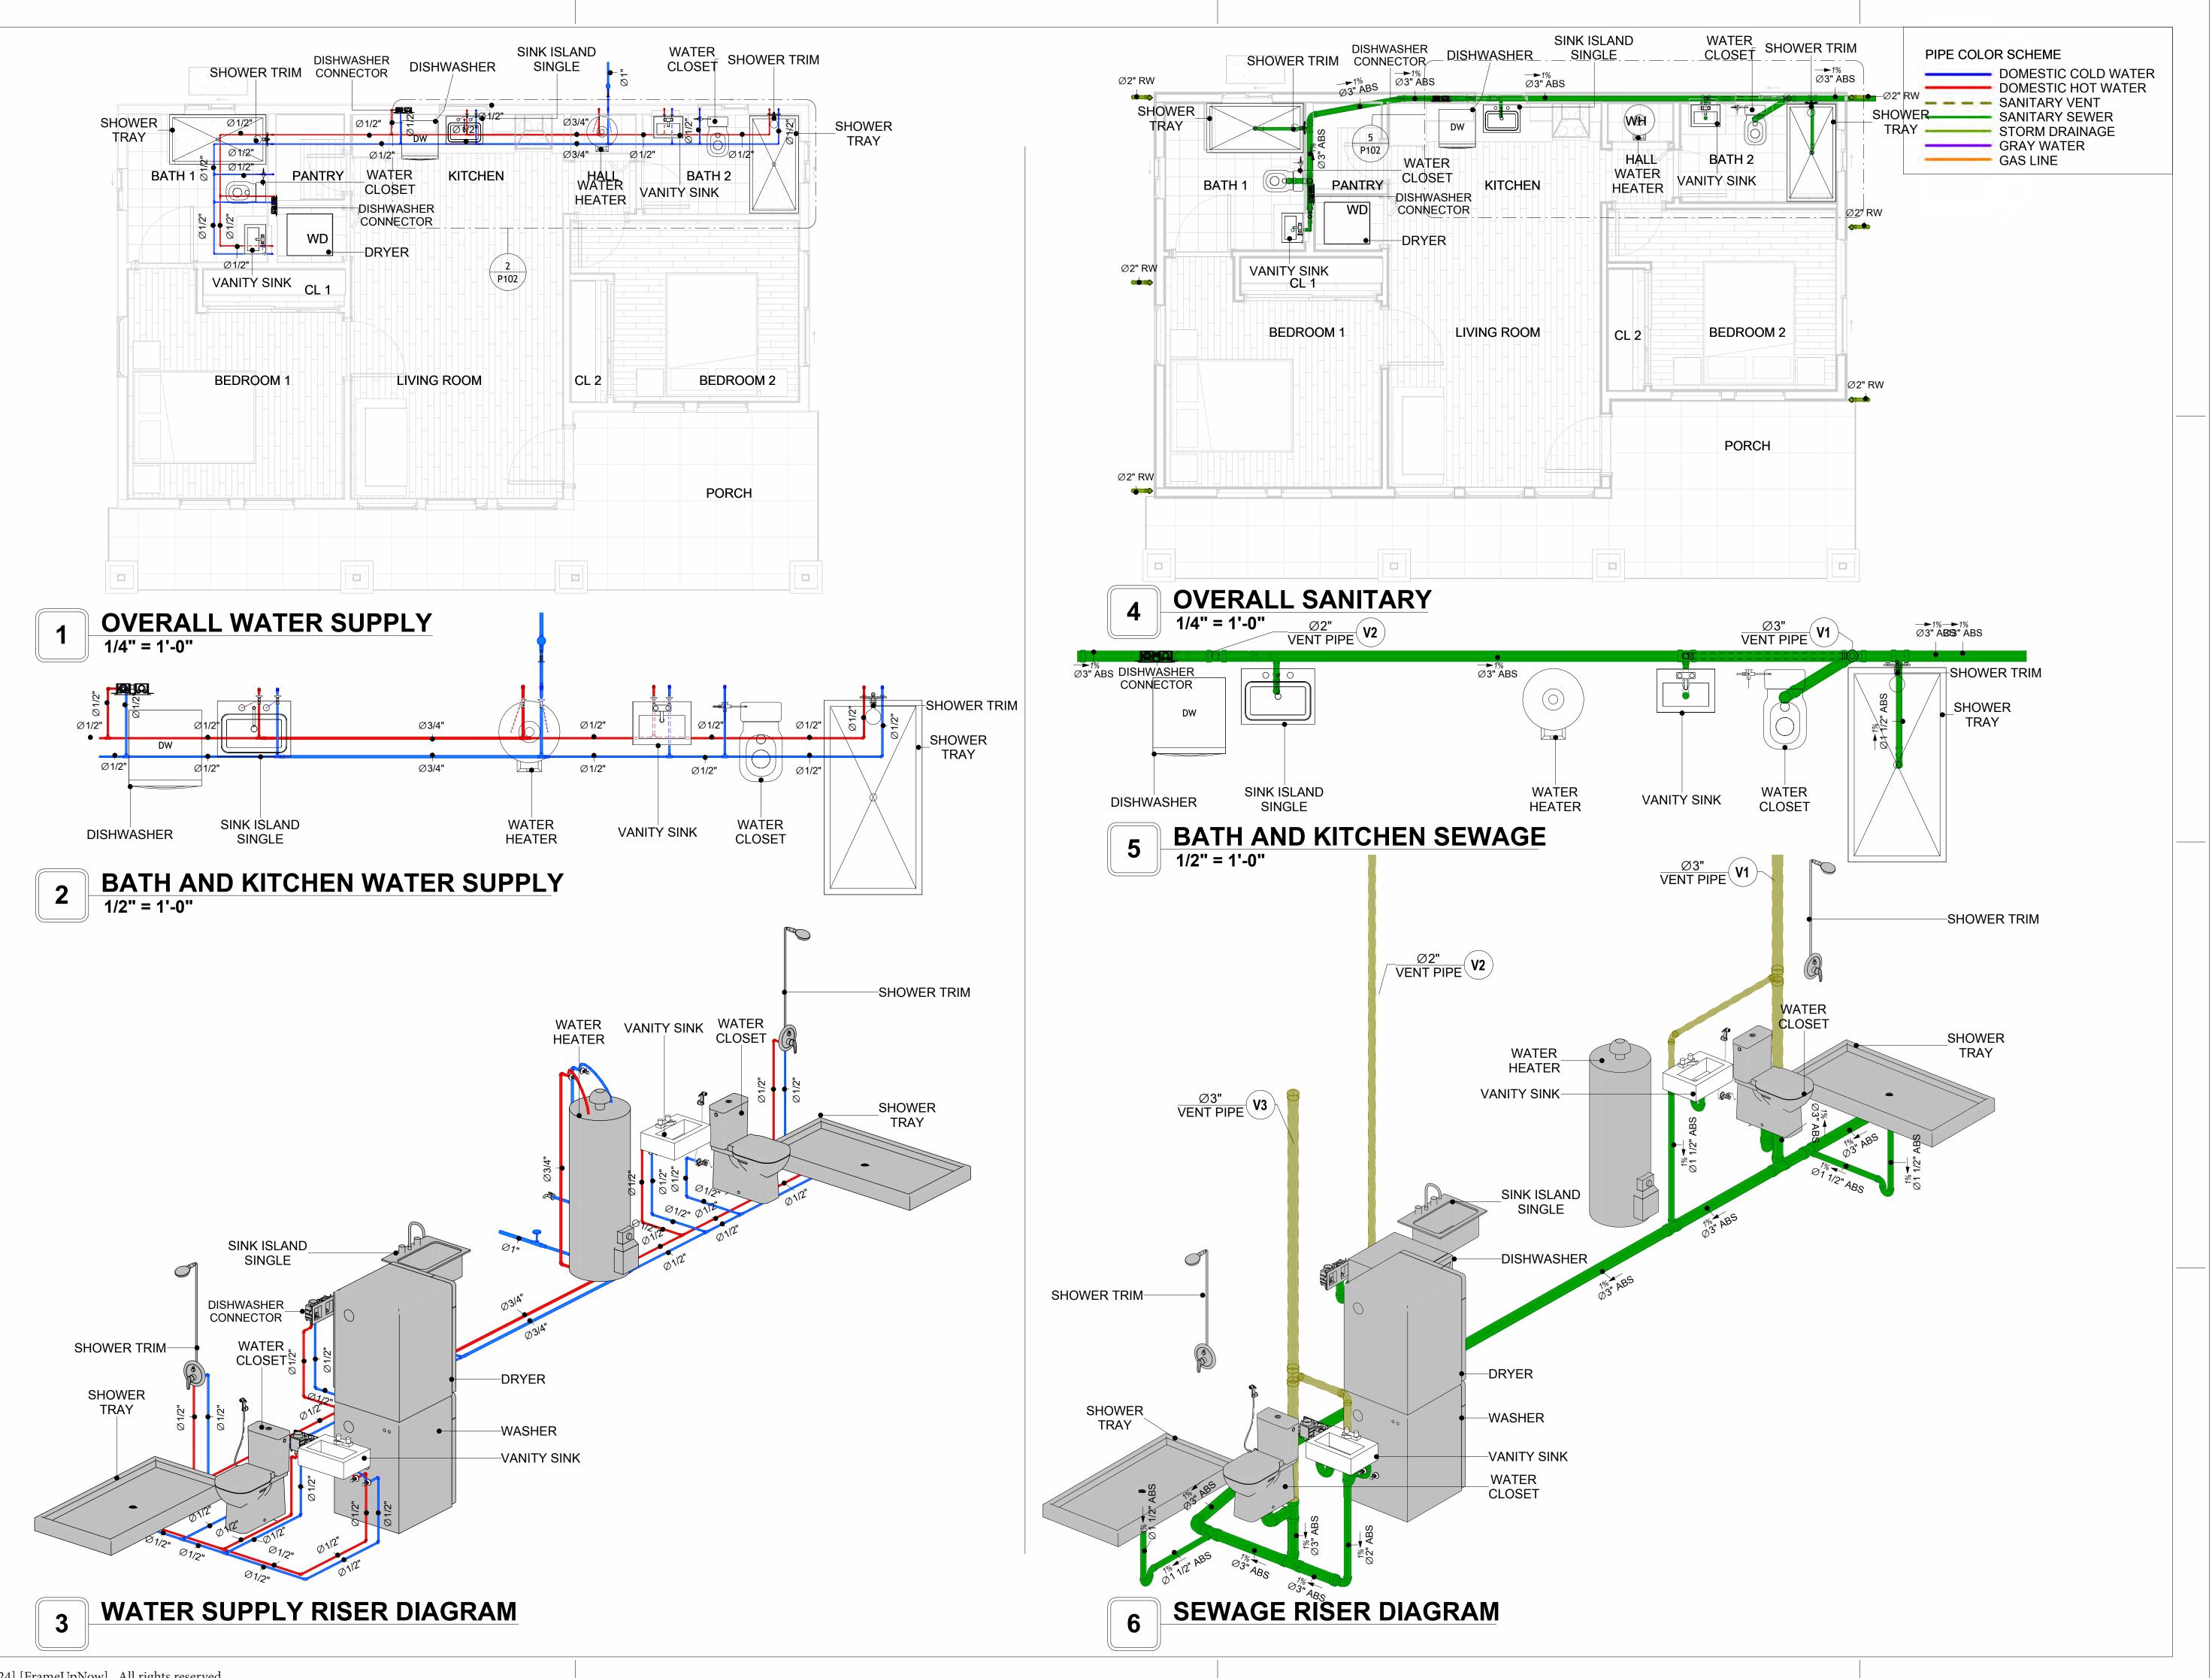



KEY PLAN

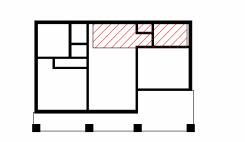

NO.	DESCRIPTION	DATE

NOTE:

LEGEND:

PROJECT

193-ORCHARD-749-2Bd2Ba **CRAFTSMAN-550**

DRAWING NAME

WATER SUPPLY AND **SEWAGE SYSTEM**

0294_13
4/10/2025 11:56:17 AM
Designer
Author
Checker

P102

Materials Shopping List

Please print and take this Materials Shopping List to your favorite Home Depot and ask for assistance in selecting the materials, fixtures and fittings to complete your new home.

Record your selection and the price of the item. Then do the math to determine the cost for your selections and the total cost of finishing your home.

Have It Your Way!

The material types listed in this document were selected based on personal preferences. The Customer is encouraged to make changes to the material types in accordance with local customs, regulations, and personal preferences.

Have It Your Way!



20 good reasons to frame a home with metal and not wood



Why build your ADU with metal vs wood	Wood	Metal	Explanation
1 DIY Construction Benefit		~	The wall frames, trusses and beams can be erected in a just a few days
2 Minimal Construction Skills Required		~	Pre-assembled walls and trusses require no specialized skills to errect
3 Build as DIY, Hybrid or by a General Contractor		✓	Do it yourself, Hybrid (involve special contractors) or hire a General Contractor
4 Build It As You Can Afford It		✓	Impervious to Weather - build as you have the time and money
5 Up Front Cost of Framing Materials	~		As to only the framing material, wood is less expensive
6 Total Cost To Build		~	Savings in time, labor, and other areas make light gauge steel LESS expensive
7 Termites and wood boring insects		Y	Termites, carpenter ants and wood boring insects eat wood, not metal
8 Mold resistant		~	Metal does not attract mold
9 Damage caused by exterior and interior flooding		~	Metal needs no reconditioning after a flood
10 Fire Resistant		~	Non-combustible
11 Lower insurance rates		Y	Many insurance underwriters now provide lower rates for metal framed homes
12 Walls, trusses, and beams retain their original form		~	Perfectly straight walls - no shimming of drywall
13 Corners are 90 degrees		✓	No need for templating of countertops to adjust for out of square corners
14 Strength and weight		✓	Metal is stronger than wood and weighs less - no need for crane to lift ADU trusses
15 IBC Engineered Stamp		✓	If an engineering stamp is necessary, months of waiting are saved
16 Complete BOM (Materials Shopping List)		~	Take the materials shopping list to Home Depot and start shopping/pricing
17 Flexible in Seismic Areas - Won't Fracture		~	Light gauge steel is flexible and won't fracture when the earth moves
18 No Waste At Job Site		~	Steel is the most recycled material in the world. A typical wood home has 20-30% waste
19 Environmentally Friendly		~	Trees don't have to be destroyed and the source of most metal is from recycling
20 How-To Videos Included		~	How-to videos provide simple assembly instructions
21 Relationship Counselor		✓	Eliminate emotional uphevels - save time, money, and preserve the relationship

Universal Requirements - some or all may be required

- 1 Site plan
- 2 Electrical Supply Connection
- 3 Sewer Connection
- 4 Fresh Water Supply Connection
- 5 Set Backs
- 6 Soils Evaluation

- 7 Earthquake (fault) evaluation
- 8 Foundation Plan subject to soils
- 9 Compliance with local energy codes: insulation home wrap and flashing
- 10 Engineering for wind speed and snow load.
- 11 State and Local ordinances regarding ADUs
- 12 Local Architect and/or Engineer may be necessary

Orchard-2Bd2Ba-Craftsman





Orchard-2Bd2Ba-Craftsman MATERIAL SHOPPING LIST

Have It Your Way!

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- 7 If there are additional trim elements or specific installation methods, the total amount of materials needed might vary. Consider any additional trim required for corners, intersections, or other architectural details that might cause this variations before procedding to purchase and construction.

ARCHITECTURAL BOM



	Orchard-2Bd2Ba-Craftsman							
ARCHITECTURAL MATERIAL SHOPPING LIST								
No.	Item	Туре	Unit	Quantity Unit Price	Total	Description		
<u></u>	APPLIANCES							
1	Refrigerator		PCS	1				
2	Range		PCS	1				
3	Washer		PCS	1				
4	Dryer		PCS	1				
5	Dish Washer		PCS	1				
6	Oven		PCS	0				
7	Microwave		PCS	0				
\triangle	CASEWORKS							
1	Kitchen Cabinet		FT	11.5				
2	Laundry Cabinet		FT	2.25				
3	Vanity Cabinet		FT	5				
4	Medicine Cabinet		PCS	2				
5	Kitchen countertop		SF	15.7				
6	Laundry Countertop		PCS	0				
7	Bathroom Countertop		SF	0				
8	Island		FT	0				
9	Peninsula		FT	0				
10	Closets		SF	85.5				
Δ	CEILING		1					
1	Ceiling Board	Dry Wall	SF	578				
2	Dry Wall Fastener	Screw	PCS	1011.5				
3	Vapor Retarder	Polyethylene film	SF	814				
4	Vapor Retarder Fastener	Nails with washer heads	PCS	2442				
5	Ceiling Board (MRD)	Moisture resistant drywall	SF	116				
	MRD Fastener	ivioisture resistant urywan	PCS	203				
6		Mada Dharad						
7	Ceiling Board	Marine Plywood	SF	120				
8	Marine Plywood Fastener	Screw	PCS	210				
9	Dry Wall Tape		FT	407				
<u></u>	FLOORING							
1	Main Living Space		SF	271.48				
2	Bathroom		SF	100.18				
3	Bedroom		SF	266.2				
4	Porch		SF	239.66				
\triangle	STRUCTURE							
1	Foundation		SF	988				
	WALLS EXTERIOR							
1	Siding		SF	958				
2	Siding Fastener	Self-drilling screws(100/pkt)	PKT	9.58				
3	Wall Shteathing (OSB)		SF	958				
4	Shteathing Fastener	Self-drilling screws(100/pkt)	PKT	9.58				
5	Wall Homewrap		SF	958.0				
6	Homewrap Fastener	Stapled fastener (200/pkt)	PKT	3.6				
7	Stone Veneer		SF	0				
8	Mortar for Stone Veneer		SF	0				
9	Wall Paint		SF	958				
	Wall Insulation		SF	3723				
	WALLS INTERIOR		ις.	0.201				
	Cementitious Backer Board		SF	652				
	Kerdi membrane		SF	652				
3	Kerdi membrane Fastener	-	SF	652				
	Wall Ceramic Tile		SF	652				
4								
5	Drywall Board	Colf drilling correct/100/-1-1	SF	2005				
	Drywall Fastener	Self-drilling screws(100/pkt)	PKT	20.05				
7	Wall Paint		SF	2005				
8	Drywall Tape		FT	378				
9	Wall Sweep		FT	181				

ARCHITECTURAL BOM



Δ	DOORS				
_	Exterior Swinging	3' - 0" X 6'-8"	PCS	1	
		3' - 0" X 6'-8"	PCS	2	
2	Interior Swinging		PCS		
3	Interior Swinging	2' - 0" X 6'-8"		1	
4	Interior Sliding	6' - 0" X 6'-8"	PCS	1	
5	Interior Sliding	7' - 0" X 6'-8"	PCS	1	
6	Interior Swinging	2' - 6" X 6'-8"	PCS	2	
7	Bifold Door	2' - 6" X 6'-8"	PCS	1	
8	Bifold Door	2' - 8" X 6'-8"	PCS	1	
9	Exterior Door Trim		FT	16	
10	Interior Door Trim		FT	319	
11	Entry Lock set		PCS	2	
12	Privacy Lock set		PCS	4	
13	Passage Lock set		PCS	3	
Δ	WINDOWS				
1	Hung	3' - 3" X 4'-9"	PCS	4	
2	Sliding	2' - 9" X 1'-9"	PCS	2	
3	Hung	2' - 9" X 3'-3"	PCS	1	
4	Sliding	2' - 3" X 1'-9"	PCS	2	
5	Sliding	6' - 3" X 4'-3"	PCS	1	
6	Fixed	2' - 9" X 2'-3"	PCS	1	
7	Awning	2' - 9" X 2'-3"	PCS	4	
8	Exterior Window Trim		FT	184	
9	Interior Window Trim		FT	184	
Δ	ROOF	1			
1	Roof Covering		SF	1269	
2	Roof Covering Fastener		PCS	634.5	
3	Roof Felt Paper		SF	1269	
4	Roof Felt Paper Fastener		PCS	3807	
5	Roof Sheathing		SF	1269	
6	Roof Sheathing Fastener		PCS	10152	
7	Batten		FT	0	
	Batten Fastener		PCS	0	
9	Soffit		SF	251	
10	Soffit Fastener		PCS	125.5	
11	Fascia		FT	173	
	Fascia board fastener		PCS	86.5	
	Roof Insulation		SF	1269	
13	TOOI IIISUIGIOII		31	1207	



	Orchard-2Bd2	Ba-Craftsr	nan			
FI	LECTRICAL MATER	IAL SHOP	PING LI	ST		
No. Item	Type	Unit		Unit Price	Total	Description
1 Kitchen Ceiling Light		PCS	3			
2 Kitchen Wall Mounted Light		PCS	1			
3 Exterior Wall Mounted Light		PCS	2			
4 Livingroom Ceiling Light With Fan		PCS	1			
5 Bedroom Ceiling Light With Fan		PCS	1			
6 Dining Ceiling Light		PCS	0			
7 Bath Wall Mounted Light		PCS	1			
8 Bathroom Ceiling Light		PCS	2			
9 Livingroom Ceiling Light		PCS	6			
10 Bedroom Ceiling Light		PCS	4			
11 Hall & Entry Ceiling Light		PCS	1			
12 WD Ceiling Light	+	PCS	2			
		PCS	2			
13 Smoke Detector		1.03				
ELECTRICAL FITTINGS 14 Standard Pagantagle 120V	20A	DOC	10		1	
14 Standard Receptacle 120V		PCS	10			
15 GFCI Receptacle 120V	20 A	PCS	13			
16 GFCI Receptacle 240V	30 A	PCS	2			
17 GFCI Receptacle 240V	50 A	PCS	1			
18 GFCI Receptacle 240V	60 A	PCS	1			
19 Fan Switch		PCS	1			
20 Single Pole Switch		PCS	5			
21 Three Way Switch		PCS	3			
22 Dimmer Switch		PCS	5			
23 ROMEX 14 AWG	14/3/W/ground	FT	84			
24 ROMEX 12 AWG	12/3/W/ground	FT	242			
25 ROMEX 12 AWG	12/2/W/ground	FT	0			
26 ROMEX 10 AWG	10/3/W/ground	FT	0			
27 ROMEX 10 AWG	10/2/W/ground	FT	52			
28 Romex 8 AWG	8/3/W/ground	FT	0			
29 Romex 8 AWG	8/2/W/ground	FT	14			
30 ROMEX 6 AWG	6/3/W/ground	FT	26			
31 Bare Copper Ground Wire 6 AWG	Ĭ	FT				
△ ELECTRICAL BOXES & CIRCUTES						
32 Panelboard -240V 1 Phase MLO	200 AMP	PCS	1			
33 Circuit breaker	15 A	PCS	3			
34 Circuit breaker	20 A	PCS	10			
36 Circuit breaker	30 A	PCS	2			
37 Circuit breaker	50 A	PCS	1			
39 Circuit breaker	60 A	PCS	1			
40 Single Gang Switch Box	UU M	PCS	3			
	+	PCS	1			
Double Gang Switch Box		PCS	3			
42 Triple Gang Switch Box	#1/4					
43 Pull Box	#1/4	PCS	22			
44 Receptacle Box		PCS	26			

PLUMBING BOM

23 WASTE DOUBLE TEE



Orchard-2Bd2Ba-Craftsman PLUMBING SYSTEM MATERIAL SHOPPING LIST Item Unit Quantity Unit Price Total Description 1 Bath Tub (Alcove Tub) PCS 2 Kitchen Sink PCS 1 3 Kitchen Faucets PCS 4 Vanity Sink PCS 1 5 Bath room Faucets PCS 6 Water Closet PCS 7 Shower Trim PCS 8 Shower Tray PCS 9 Water Heater PCS 10 Hose Bib PCS 1 11 Shutoff Valve PCS 12 Hanging pipe clamp PCS 19 13 Gate Valve PCS 14 Dishwasher Supply Single Connector PCS 1 15 Dishwasher Sewage Single Connector PCS 16 Laundry Sweat Connector PCS 1 △ SANITARY & PLUMBING PIPE 1 ABS (Acrylonitrile Butadiene Styrene) Pipes 2 ABS (Acrylonitrile Butadiene Styrene) Pipes ø 1" FT 0 ø 1 1/2 FT 23 3 ABS (Acrylonitrile Butadiene Styrene) Pipes ø 2" FT 40 4 ABS (Acrylonitrile Butadiene Styrene) Pipes ø 3" FT 23 5 PEX (Cross-linked polyethylene) Pipes ø 1/2' FT 94 6 PEX (Cross-linked polyethylene) Pipes ø 3/4" FT 20 7 PEX (Cross-linked polyethylene) Pipes ø 1" FT 1 8 PVC Pipes Sch.80 - Rigid ø 1 1/2" FT 0 9 PVC Pipes Sch.80 - Rigid ø 2" FT 58 10 PVC Pipes Sch.80 - Rigid ø 3" FT 0 ø 1/2" 11 Flex Pipe Round PCS 8 1 ABS 90 Degree Bend Elbow 1 1/2"ø-1 1/2"ø PCS 2 ABS 90 Degree Bend Elbow 2"a-2"a PCS 3 3 ABS 90 Degree Bend Elbow 3"ø-3"ø PCS 4 ABS P-Trap 1 1/2"ø-1 1/2"ø PCS 3 5 ABS P-Trap 2"ø-2"ø PCS 6 ABS Reducer Elbow 2"ø-1 1/2"ø **PCS** 7 ABS Reducer Elbow PCS 3"ø-2"ø 8 ABS TEE Elbow 1 1/2"ø-1 1/2"ø-1 1/2"ø PCS 1 9 ABS TEE Elbow 2"ø-2"ø-2"ø PCS 10 ABS TEE Elbow 3"ø-3"ø-3"ø PCS 11 ABS Tee Reducer Elbow 3"ø-3"ø-1 1/2"ø PCS 12 ABS Tee Reducer Elbow PCS 3"ø-3"ø-2"ø 13 ABS Vent Cap Elbow 1 1/2"ø PCS 14 ABS Vent Cap Elbow PCS 2"ø 2 15 ABS Vent Cap Elbow PCS 3"ø 16 PEX 90 Degree Elbow 1/2"ø-1/2"ø PCS 26 17 PEX 90 Degree Elbow 3/4"ø-3/4"ø PCS 18 PEX Tee Elbow 1/2"ø-1/2"ø-1/2"ø PCS 9 19 PEX Tee Elbow 3/4"ø-3/4"ø-3/4"ø PCS 2 20 PEX Transition Elbow 1"ø-3/4"ø PCS 1 21 PEX Transition Elbow 3/4"ø-1/2"ø PCS 22 PVC 90 Deg Bend Elbow PCS 2"ø-2"ø 16

PCS

1

2"ø-2"ø-2"ø-2"ø

		Orchard	-2Bd2Ba-(Craftsma	n		
		HVAC SYSTEM I	MATERIAL	SHOPP	ING LIST		
No.	Item	Туре	Unit	Quantity	Unit Price	Total	Description
	HVAC_DUCTS						
1	PIPE (REFRIGERANT LINE)	3/8" (Ø)	FT	90.79			
2	PIPE (REFRIGERANT LINE)	3/4''' (Ø)	FT	166.26			
3	DRAYER HOSE	4" (Ø)	FT	6.6			
4	FLEX DUCT ROUND	4" (Ø)	FT	10.13			
\triangle	DUCT FITTINGS & ACCESSORIES						
5	ELBOW (REFRIGERANT LINE)	3/4" (Ø)-3/4" (Ø)	PCS	34			
6	ELBOW (REFRIGERANT LINE)	3/8" (Ø)-3/8" (Ø)	PCS	20			
7	TEE (REFRIGERANT LINE)	3/4" (Ø)-3/4" (Ø)-3/4" (Ø)	PCS	2			
8	TEE (REFRIGERANT LINE)	3/8" (Ø)-3/8" (Ø)-3/8" (Ø)	PCS	2			
9	TRANSITION (REFRIGERANT	3/4" (Ø)-1/2" (Ø)	PCS	4			
10	TRANSITION (REFRIGERANT	3/4" (Ø)-5/8" (Ø)	PCS	3			
11	TRANSITION (REFRIGERANT	3/8" (Ø)-1/4" (Ø)	PCS	1			
Δ	HVAC_EQUIPMENTS						
12	AIR HANDLING UNIT	WALL MOUNTED	PCS	2			
13	CONDENSER	OUTDOOR UNIT	PCS	1			
14	EXHAUST FAN	75 CFM	PCS	2			
15	EXHAUST HOOD	WALL MOUNTED	PCS	1			
16	HOOD-WALL: VENT	HOOD-WALL: VENT	PCS	1			
17	DRAYER: VENT	DRAYER: VENT	PCS	1			
18	ROOF VENT	3"(Ø)	PCS	2			



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			LIGHTING FIXTURES				
#	Item	Туре	Description, Manufacturer, SKU	Unit	Quantity	Unit Price	Total
1	Kitchen Ceiling Light			PCS	4		
3	Kitchen Wall Mounted Light			PCS	1		
4	Exterior Wall Mounted Light			PCS	1		
5	Livingroom Ceiling Light With Fan			PCS	1		
6	Bedroom Ceiling Light With Fan			PCS	2		
7	Dining Ceiling Light			PCS	0		
8	Bath Wall Mounted Light			PCS	2		
9	Bathroom Ceiling Light			PCS	4		
10	Livingroom Ceiling Light			PCS	4		
11	Bedroom Ceiling Light			PCS	8		
12	Hall & Linen Ceiling Light			PCS	2		
12	Closet Ceiling Light			PCS	2		
13	Smoke Detector			PCS	4		
14							
15							



			ELECTRICAL FITTINGS				
#	Item	Туре	Description, Manufacturer, SKU	Unit	Quantity	Unit Price	Total
1	Standard Receptacle 120V	20A		PCS	13		
2	GFCI Receptacle 120V	20 A		PCS	13		
3	GFCI Receptacle 240V	30 A		PCS	2		
4	GFCI Receptacle 240V	50 A		PCS	1		
5	GFCI Receptacle 240V	60 A		PCS	1		
6	Fan Switch			PCS	3		
7	Single Pole Switch			PCS	10		
8	Three Way With Dimmer Switch			PCS	5		
9	Dimmer Switch			PCS	3		
10							
11							
12							
13							
14							
15							



		ELECTR	ICAL CONDUITS & WIRING				
#	Item	Туре	Description, Manufacturer, SKU	Unit	Quantity	Unit Price	Total
1	ROMEX 14 AWG	14/3/W/ground		FT	97		
3	ROMEX 12 AWG	12/3/W/ground		FT	0		
4	ROMEX 12 AWG	12/2/W/ground		FT	528		
6	ROMEX 10 AWG	10/3/W/ground		FT	61		
8	ROMEX 10 AWG	10/2/W/ground		FT	0		
9	Romex 8 AWG	8/3/W/ground		FT	37		
10	Romex 8 AWG	8/2/W/ground		FT	0		
11	ROMEX 6 AWG	6/2/W/ground		FT	23		
12	Bare Copper Ground Wire 6 AWG			FT			
13							
14							
15							
16							



		ELEC	CTRICAL BOXES & CIRCUTES				
#	Item	Туре	Description, Manufacturer, SKU	Unit	Quantity	Unit Price	Total
1	Panelboard -240V 1 Phase MLO	200 AMP		PCS	1		
2	Circuit breaker	15 A		PCS	2		
3	Circuit breaker	20 A		PCS	14		
4	Circuit breaker	30 A		PCS	2		
5	Circuit breaker	50 A		PCS	1		
6	Circuit breaker	60 A		PCS	1		
7	Single Gang Switch Box			PCS	8		
8	Double Gang Switch Box			PCS	2		
9	Triple Gang Switch Box			PCS	3		
10	Pull Box	#1/4		PCS	31		
11	Receptacle Box			PCS	30		
12							
13							
14							
15							

			HVAC_DUCTS 01				
#	Item	Туре	Description, Manufacturer, SKU	Unit	Quantity	Unit Price	Total
1	PIPE (REFRIGERANT LINE)			FT	90.79		
2	PIPE (REFRIGERANT LINE)	3/4''' (Ø)		FT	166.26		
3	DRAYER HOSE	4" (Ø)		FT	6.6		
4	FLEX DUCT ROUND	4" (Ø)		FT	10.13		
5							
6							
7							
8							
9							
10							
11							
12							
13							
14							
15							
16							

			DUCT FITTINGS & ACCESSORIES				
#	Item	Туре	Description, Manufacturer, SKU	Unit	Quantity	Unit Price	Total
1	ELBOW (REFRIGERANT LINE)	3/4" (Ø)-3/4" (Ø)		PCS	34		
2	ELBOW (REFRIGERANT LINE)	3/8" (Ø)-3/8" (Ø)		PCS	20		
3	TEE (REFRIGERANT LINE)	3/4" (Ø)-3/4" (Ø)-3/4" (Ø)		PCS	2		
4	TEE (REFRIGERANT LINE)	3/8" (Ø)-3/8" (Ø)-3/8" (Ø)		PCS	2		
5	TRANSITION (REFRIGERANT LINE)	3/4" (Ø)-1/2" (Ø)		PCS	4		
6	TRANSITION (REFRIGERANT LINE)	3/4" (Ø)-5/8" (Ø)		PCS	3		
7	TRANSITION (REFRIGERANT LINE)	3/8" (Ø)-1/4" (Ø)		PCS	1		
8							
9							
10							
11							
12							
13							
14							
15							
16							

			HVAC_EQUIPMENTS				
#	Item	Туре	Description, Manufacturer, SKU	Unit	Quantity	Unit Price	Total
1	AIR HANDLING UNIT	WALL MOUNTED		PCS	2		
2	CONDENSER	OUTDOOR UNIT		PCS	1		
3	EXHAUST FAN	75 CFM		PCS	2		
4	EXHAUST HOOD	WALL MOUNTED		PCS	1		
5	HOOD-WALL: VENT	HOOD-WALL: VENT		PCS	1		
6	DRAYER: VENT	DRAYER: VENT		PCS	1		
7	ROOF VENT	3"(Ø)		PCS	2		
8							
9							
10							
11							
12							
13							
14							



		PLUMBIN	NG FIXTURES & ACCESSORIES				
#	Item	Туре	Description, Manufacturer, SKU	Unit	Quantity	Unit Price	Total
1	Bath Tub (Alcove Tub)			PCS	0		
2	Kitchen Sink			PCS	1		
3	Kitchen faucets			PCS	1		
4	Vanity Sink			PCS	1		
5	Bath room faucets			PCS	1		
6	Water Closet			PCS	1		
7	Shower Trim			PCS	1		
8	Shower Tray			PCS	1		
9	Water Heater			PCS	1		
10	Hose Bib			PCS	1		
11	Shutoff Valve			PCS	6		
12	Hanging pipe clamp			PCS	16		
13	Gate Valve			PCS	1		
14	Dishwasher Supply Single Connector			PCS	1		
15	Dishwasher Sewage Single Connector			PCS	1		
16	Laundry Sweat Connector			PCS	1		



		SANI	TARY & PLUMBING PIPES				
#	Item	Туре	Description, Manufacturer, SKU	Unit	Quantity	Unit Price	Total
1	ABS (Acrylonitrile Butadiene Styrene) Pipes	ø 1"		FT	0		
2	ABS (Acrylonitrile Butadiene Styrene) Pipes	ø 1 1/2"		FT	23		
3	ABS (Acrylonitrile Butadiene Styrene) Pipes	ø 2"		FT	40		
4	ABS (Acrylonitrile Butadiene Styrene) Pipes	ø 3"		FT	23		
5	PEX (Cross-linked polyethylene) Pipes	ø 1/2"		FT	94		
6	PEX (Cross-linked polyethylene) Pipes	ø 3/4"		FT	20		
7	PEX (Cross-linked polyethylene) Pipes	ø 1"		FT	1		
8	PVC Pipes Sch.80 - Rigid	ø 1 1/2"		FT	0		
9	PVC Pipes Sch.80 - Rigid	ø 2"		FT	58		
10	PVC Pipes Sch.80 - Rigid	ø 3"		FT	0		
11	Flex Pipe Round	ø 1/2"		PCS	8		
12							
13							
14							
15							



		PIPE	FITTINGS 01				
#	Item	Туре	Description, Manufacturer, SKU	Unit	Quantity	Unit Price	Total
	ABS 90 Degree Bend Elbow	1 1/2"ø-1 1/2"ø		PCS	1		
	ABS 90 Degree Bend Elbow	2"ø-2"ø		PCS	3		
	ABS 90 Degree Bend Elbow	3"ø-3"ø		PCS	1		
	ABS P-Trap	1 1/2"ø-1 1/2"ø		PCS	3		
	ABS P-Trap	2"ø-2"ø		PCS	2		
	ABS Reducer Elbow	2"ø-1 1/2"ø		PCS	1		
	ABS Reducer Elbow	3"Ø-2"Ø		PCS	1		
	ABS TEE Elbow	1 1/2"ø-1 1/2"ø-1 1/2"ø		PCS	1		
	ABS TEE Elbow	2"ø-2"ø		PCS	1		
)	ABS TEE Elbow	3"ø-3"ø-3"ø		PCS	2		
l	ABS Tee Reducer Elbow	3"ø-3"ø-1 1/2"ø		PCS	2		
2	ABS Tee Reducer Elbow	3"ø-3"ø-2"ø		PCS	1		
3	ABS Vent Cap Elbow	1 1/2"ø		PCS	1		
1	ABS Vent Cap Elbow	2"ø		PCS	2		
5	ABS Vent Cap Elbow	3"ø		PCS	1		



		PII	PE FITTINGS 02				
#	Item	Туре	Description, Manufacturer, SKU	Unit	Quantity	Unit Price	Total
1	PEX 90 Degree Elbow	1/2"ø-1/2"ø		PCS	26		
2	PEX 90 Degree Elbow	3/4"ø-3/4"ø		PCS	3		
3	PEX Tee Elbow	1/2"ø-1/2"ø-1/2"ø		PCS	9		
4	PEX Tee Elbow	3/4"ø-3/4"ø-3/4"ø		PCS	2		
5	PEX Transition Elbow	1"ø-3/4"ø		PCS	1		
6	PEX Transition Elbow	3/4"ø-1/2"ø		PCS	2		
7	PVC 90 Deg Bend Elbow	2"ø-2"ø		PCS	16		
8	WASTE DOUBLE TEE	2"ø-2"ø-2"ø		PCS	1		
9							
10							
11							
12							
13							
14							
15							



			APPLIANCES				
#	Item	Туре	Description, Manufacturer, SKU	Unit	Quantity	Unit Price	Total
1	Refrigerator			PCS			
2	Range			PCS			
3	Washer Front Load	Stackable		PCS			
4	Dryer Front Load	Stackable		PCS			
5	Dish Washer			PCS			
6	Oven			PCS	(
7	Microwave			PCS	(
8							
9							
10							
11							
12							
13							
14							
15							
16							



			CASEWORKS 01				
#	Item	Туре	Description, Manufacturer, SKU	Unit	Quantity	Unit Price	Total
1	Kitchen Cabinet			FT	11.5		
2	Laundry Cabinet			FT	2.25		
3	Vanity Cabinet			FT	5		
4	Medicine Cabinet			PCS	2		
5	Kitchen countertop			SF	15.7		
6	Laundry Countertop			PCS	0		
7	Bathroom Countertop			SF	0		
8	Island			FT	0		
9	Peninsula			FT	0		
10	Closets			SF	85.5		
11							
12							
13							
14							
15							



	1		CEILING 01				
#	Item	Туре	Description, Manufacturer, SKU	Unit	Quantity	Unit Price	Total
	LIVING ROOM + KITCHEN			SF	255.0		
L	Ceiling Board	Drywall		SF	255		
	Drywall Fastener	Screw		PCS	446		
1	Vapor Retarder	Polyethylene film		SF	255		
	Vapor Retarder Fastener	Nails with washer heads		PCS	765		
	BATH 1			SF	66.0		
,	Ceiling Board	MRD (Moisture resistant drywall)		SF	66		
i	MRD Fastener	Screw		PCS	116		
	BATH 2			SF	50.0		
,	Ceiling Board	MRD (Moisture resistant drywall)		SF	50		
3	MRD Fastener	Screw		PCS	88		
	HALL			SF	12.0		
)	Ceiling Board	Drywall		SF	12		
.0	Drywall Fastener	Screw		PCS	21		
1	Vapor Retarder	Polyethylene film		SF	12		
L2	Vapor Retarder Fastener	Nails with washer heads		PCS	36		



			CEILING 02				
#	Item	Туре	Description, Manufacturer, SKU	Unit	Quantity	Unit Price	Total
	BEDROOM 1			SF	136.0		
13	Ceiling Board	Drywall		SF	136		
14	Drywall Fastener	Screw		PCS	238		
15	Vapor Retarder	Polyethylene film		SF	136		
16	Vapor Retarder Fastener	Nails with washer heads		PCS	408		
	BEDROOM 2			SF	112.0		
17	Ceiling Board	Drywall		SF	112		
18	Drywall Fastener	Screw		PCS	196		
19	Vapor Retarder	Polyethylene film		SF	112		
20	Vapor Retarder Fastener	Nails with washer heads		PCS	336		
	PORCH			SF	120.0		
21	Ceiling Board	Marine Plywood		SF	120		
22	Exterior Grade Plywood	Screw		PCS	210		
	CLOSET 1			SF	17.0		
23	Ceiling Board	Drywall		SF	17		
24	Drywall Fastener	Screw		PCS	30		
25	Vapor Retarder	Polyethylene film		SF	17		
26	Vapor Retarder Fastener	Nails with washer heads		PCS	51.0		



			CEILING 03				
#	Item	Туре	Description, Manufacturer, SKU	Unit	Quantity	Unit Price	Total
	CLOSET 2			SF	15.0		
27	Ceiling Board	Drywall		SF	15		
28	Drywall Fastener	Screw		PCS	26)	
29	Vapor Retarder	Polyethylene film		SF	15		
30	Vapor Retarder Fastener	Nails with washer heads		PCS	45		
	WH			SF	8.0		
31	Ceiling Board	Drywall		SF	8		
32	Drywall Fastener	Screw		PCS	14		
33	Vapor Retarder	Polyethylene film		SF	8		
34	Vapor Retarder Fastener	Nails with washer heads		PCS	24		
	PANTRY			SF	19.0		
35	Ceiling Board	Drywall		SF	8		
36	Drywall Fastener	Screw		PCS	14		
37	Vapor Retarder	Polyethylene film		SF	8		
38	Vapor Retarder Fastener	Nails with washer heads		PCS	24		



			CEILING 04				
#	Item	Туре	Description, Manufacturer, SKU	Unit	Quantity	Unit Price	Total
	W/D			SF	15.0		
39	Ceiling Board	Drywall		SF	15		
40	Drywall Fastener	Screw		PCS	26		
41	Vapor Retarder	Polyethylene film		SF	15		
42	Vapor Retarder Fastener	Nails with washer heads		PCS	45		



	<u>1</u>		FLOORING INTERIOR 01				
#	Item	Туре	Description, Manufacturer, SKU	Unit	Quantity	Unit Price	Total
	CLOSET 1						
1	Closet Flooring			SF	16		
2	Wood underlay	Foam Pad Polyethylene		SF	16		
3	Vapor Retarder	Vapor Barrier Polyethylene		SF	16		
	CLOSET 2						
4	Closet Flooring			SF	14		
5	Wood underlay	Foam Pad Polyethylene		SF	14		
6	Vapor Retarder	Vapor Barrier Polyethylene		SF	14		
	PANTRY CL#3						
4	Closet Flooring			SF	18	}	
5	Wood underlay	Foam Pad Polyethylene		SF	18	}	
6	Vapor Retarder	Vapor Barrier Polyethylene		SF	18	3	
	BEDROOM 1						
7	Living Area Flooring			SF	129		
8	Wood underlay	Foam Pad Polyethylene		SF	129		
9	Vapor Retarder	Vapor Barrier Polyethylene		SF	129)	



			FLOORING INTERIOR 02				
#	Item	Туре	Description, Manufacturer, SKU	Unit	Quantity	Unit Price	Total
	BEDROOM 2						
10	Living Area Flooring			SF	106		
11	Wood underlay	Foam Pad Polyethylene		SF	106		
12	Vapor Retarder	Vapor Barrier Polyethylene		SF	106		
	LIVING ROOM AND KITCHI	EN					
13	Tile Finish			SF	254		
14	Adhesive	1/2" Thin set Mortar		SF	254		
15	Vapor Retarder	Vapor Barrier Polyethylene		SF	254		
	BATHROOM 1						
16	Tile Finish			SF	49		
17	Adhesive	1/2" Thin set Mortar		SF	49		
18	Vapor Retarder	Vapor Barrier Polyethylene		SF	49		
	BATHROOM 2	·					
19	Tile Finish			SF	32		
20	Adhesive	1/2" Thin set Mortar		SF	32		
21	Vapor Retarder	Vapor Barrier Polyethylene		SF	32		



			FLOORING INTERIOR 03				
#	Item	Туре	Description, Manufacturer, SKU	Unit	Quantity	Unit Price	Total
	W/D						
1	Tile Finish			SF	12		
2	Adhesive	1/2" Thin set Mortar		SF	12		
3	Vapor Retarder	Vapor Barrier Polyethylene		SF	12		
	BOILER ROOM						
4	Tile Finish			SF	8		
5	Adhesive	1/2" Thin set Mortar		SF	8		
6	Vapor Retarder	Vapor Barrier Polyethylene		SF	3		



			FLOORING EXTERIOR			
#	Item	Туре	Description, Manufacturer, SKU	Unit	Quantity	Unit Price
	STRUCTURE			SF	988.0	
1	Concrete Slab	4"concrete cast in situ		CF	329.34	
2	Insulation	Rigid insulation		SF	273.4	
3	Hard core	Compacted soil		CF	251.78	
4	Re-bar	#4 re-bar		Ton	0.94	
5	Concrete Pad	4"concrete cast in situ		CF	2	
6	Slab edge	Turndown		CF	251.64	
7	Footing	Cast-in-place concrete		CF	9.36	
	PORCH					
8	Tile Finish			SF	240	
9	Adhesive	1/2" Thin set Mortar		SF	240	
10	Vapor Retarder	Vapor Barrier Polyethylene		SF	240	



			WALLS: EXTERIOR				
#	Item	Туре	Description, Manufacturer, SKU	Unit	Quantity	Unit Price	Total
1	Exterior-Grade Plywood Horizontal Siding			SF	958		
2		Self-drilling screws(100/pkt)		PKT	9.58		
3	Wall Shteathing (OSB)			SF	958		
4		Self-drilling screws(100/pkt)		PKT	9.58		
5	Wall Homewrap			SF	958		
6	Homewrap Fastener	Stapled fastener (200/pkt)		PKT	3.64		
7	Stone Veneer			SF	294.00		
8	Mortar for Stone Veneer			SF	294		
9	Wall Paint			SF	958		
10	Wall Insulation			SF	3723		



			WALLS: INTERIOR 01				
#	Item	Туре	Description, Manufacturer, SKU	Unit	Quantity	Unit Price	Total
	BATH 1			SF	40.0		
1	Cementitious Backer Board			SF	262		
2	Kerdi membrane			SF	262		
3	Kerdi membrane Fastener			SF	262		
4	Wall Ceramic Tile			SF	262		
	BATH 2			SF	41.0		
5	Cementitious Backer Board			SF	240		
6	Kerdi membrane			SF	240		
7	Kerdi membrane Fastener			SF	240		
8	Wall Ceramic Tile			SF	240		
	BEDROOM 1			SF	154.0		
9	Drywall Board			SF	361		
10	Drywall Fastener	Self-drilling screws(100/pkt)		PKT	3.61		
11	Wall Paint			SF	361		
12	Drywall Tape			FT	67.7		



			WALLS: INTERIOR 02				
#	Item	Туре	Description, Manufacturer, SKU	Unit	Quantity	Unit Price	Total
	BEDROOM 2			SF	149.0		
13	Drywall Board			SF	348		
14	Drywall Fastener	Self-drilling screws(100/pkt)		PKT	3.48		
15	Wall Paint			SF	348		
16	Drywall Tape			FT	65.3		
	HALL			SF	29.0		
17	Drywall Board			SF	66		
18	Drywall Fastener	Self-drilling screws(100/pkt)		PKT	0.66		
19	Wall Paint			SF	66		
20	Drywall Tape			FT	12		
	LIVING ROOM			SF	152.0		
21	Drywall Board			SF	420		
22	Drywall Fastener	Self-drilling screws(100/pkt)		PKT	4.2		
23	Wall Paint			SF	420		
24	Drywall Tape			FT	78.8		



			WALLS: INTERIOR 03				
#	Item	Туре	Description, Manufacturer, SKU	Unit	Quantity	Unit Price	Total
	KITCHEN			SF	78.0		
25	Cementitious Backer Board			SF	19		
26	Drywall Board			SF	215		
27	Drywall Fastener	Self-drilling screws(100/pkt)		PKT	2.15		
28	Kerdi membrane			SF	19		
29	Kerdi membrane Fastener			SF	19		
30	Wall Ceramic Tile			SF	19		
31	Wall Paint			SF	215		
32	Drywall Tape			FT	40.6		
	CL 1			SF	15.0		
33	Drywall Board			SF	141		
34	Drywall Fastener	Self-drilling screws(100/pkt)		PKT	1.41		
35	Wall Paint			SF	141		
36	Drywall Tape			FT	26.4		



			WALLS: INTERIOR 04				
#	Item	Туре	Description, Manufacturer, SKU	Unit	Quantity	Unit Price	Total
	CL 2			SF	21.0		
37	Drywall Board			SF	165		
38	Drywall Fastener	Self-drilling screws(100/pkt)		PKT	1.65		
39	Wall Paint			SF	165		
40	Drywall Tape			FT	30.9		
	WD			SF	17.0		
41	Cementitious Backer Board			SF	131		
42	Kerdi membrane			SF	131		
43	Kerdi membrane Fastener			SF	131		
44	Wall Ceramic Tile			SF	131		
	WH			SF	6.0		
45	Drywall Board			SF	113		
46	Drywall Fastener	Self-drilling screws(100/pkt)		PKT	1.13		
47	Wall Paint			SF	113		
48	Drywall Tape			FT	21		



			WALLS: INTERIOR 05				
#	Item	Туре	Description, Manufacturer, SKU	Unit	Quantity	Unit Price	Total
	PANTRY			SF	6.0		
49	Drywall Board			SF	176		
50	Drywall Fastener	Self-drilling screws(100/pkt)		PKT	1.76		
51	Wall Paint			SF	176		
52	Drywall Tape			FT	33		
1	Wall Skirting	Ceramic		FT	181		



			DOORS				
:	Item	Туре	Description, Manufacturer, SKU	Unit	Quantity	Unit Price	Total
	Exterior Swinging	3' - 0" X 6'-8"		PCS	1		
	Interior Swinging	3' - 0" X 6'-8"		PCS	2		
	Interior Swinging	2' - 0" X 6'-8"		PCS	1		
	Interior Sliding	6' - 0" X 6'-8"		PCS	1		
	Interior Sliding	7' - 0" X 6'-8"		PCS	1		
	Interior Swinging	2' - 6" X 6'-8"		PCS	2		
	Bifold Door	2' - 6" X 6'-8"		PCS	1		
	Bifold Door	2' - 8" X 6'-8"		PCS	1		
	Exterior Door Trim			FT	16		
)	Interior Door Trim			FT	319		
1	Entry Lock set			PCS	1		
2	Privacy Lock set			PCS	7		
3	Passage Lock set			PCS	2		
4				. 33			
5							



			WINDOWS				
#	Item	Туре	Description, Manufacturer, SKU	Unit	Quantity	Unit Price	Total
1	Hung	3' - 3" X 4'-9"		PCS	4		
2	Sliding	2' - 9" X 1'-9"		PCS	2		
3	Hung	2' - 9" X 3'-3"		PCS	1		
4	Sliding	2' - 3" X 1'-9"		PCS	2		
5	Sliding	6' - 3" X 4'-3"		PCS	1		
6	Fixed	2' - 9" X 2'-3"		PCS	1		
7	Awning	2' - 9" X 2'-3"		PCS	4		
8	Exterior Window Trim			FT	184		
9	Interior Window Trim			FT	184		
10							
11							
12							
13							
14							
15							



			ROOF 01				
#	Item	Туре	Description, Manufacturer, SKU	Unit	Quantity	Unit Price	Total
1	Roof Covering			SF	1269.0		
2	Roof Covering Fastener			PCS	635		
3	Roof Felt Paper			SF	1269.0		
4	Roof Felt Paper Fastener			PCS	3807.0		
5	Roof Sheathing			SF	1269.0		
6	Roof Sheathing Fastener			PCS	10152		
7	Batten			FT	0.0		
8	Batten Fastener			PCS	0.0		
9	Soffit			SF	251.0		
10	Soffit Fastener			PCS	125.5		
11	Fascia			FT	173.0		
12	Fascia board fastener			PCS	87		
13	Roof Insulation			SF	1269.0		
14				0.	1207.0		
15							