


WESTBROOK

The Westbrook is a modern and minimalist onebedroom, one-bathroom home designed for efficient and stylish living. Its exterior showcases clean lines and a contemporary aesthetic. The walls are finished in a smooth, light-colored material, creating a sleek and uncluttered look. The roof is flat, further emphasizing the modern design. A recessed entryway, featuring a darkcolored overhang, provides a touch of architectural detail and shelter.


Inside, the Westbrook features a simple rectangular layout. The living, dining, and kitchen areas are merged into one large room on one side of the plan, creating a spacious and versatile living space. The bedroom is thoughtfully located on the other side of the plan, offering a private and quiet retreat.

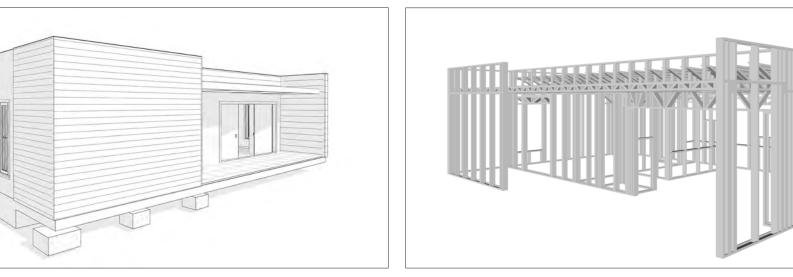



Please print and take this Materials Shopping List to your favorite Home Depot and ask for assistance in selecting the materials, fixtures and fittings to complete your new home.

Record your selection and the price of the item. Then do the math to determine the cost for your selections and the total cost of finishing your home.

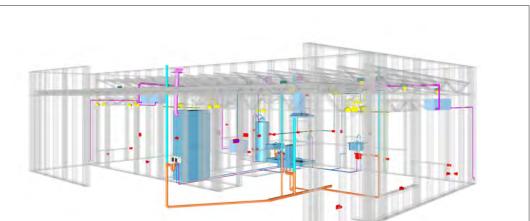

< CLICK HERE >

To Go To Materials Shopping List




PORCH 205 SF

FLOOR PLAN

625 SF

1 Bed Room

TABLE OF CONTENTS

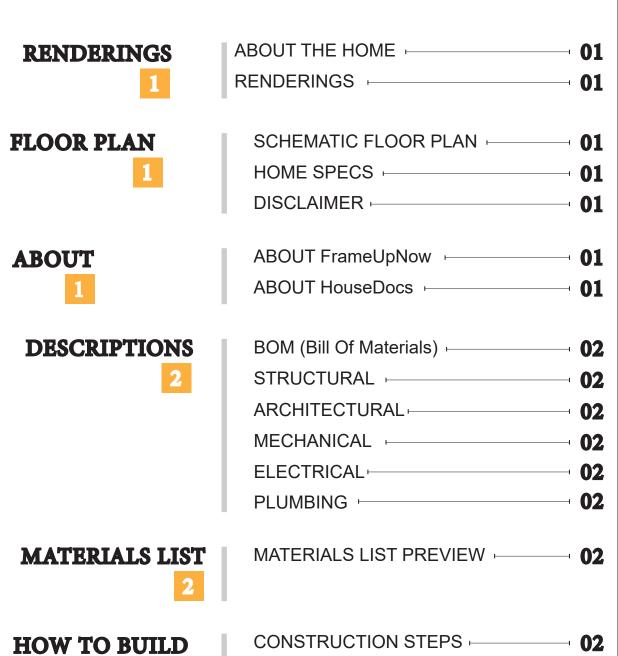

ARCHITECTURAL

COVER SHEET 03 FLOOR PLAN + DIMENSION PLAN + FOUNDATION PLAN STRUCTURAL FLOOR PLAN -WALL FRAME LAYOUT ROOF TRUSS LAYOUT ROOF PLAN + 10 ARCHITECTURAL ELEVATIONS ARCHITECTURAL ELEVATIONS -ARCHITECTURAL SECTIONS -ARCHITECTURAL DETAILS ARCHITECTURAL CASEWORK **COVER SHEET**

STRUCTURAL

MATERIALS

SHOPPING LIST

16	GENERAL NOTES	⊣ 17
_	WALL FRAME LAYOUT	⊣ 18
	WALL PANEL & LAYOUT PLAN	⊣ 19
	ROOF TRUSS LAYOUT	– 20
	STRUCTURAL SECTIONS	□ 21
	WALL BRACING LAYOUT	- 22
	HOLD-DOWN PLAN	⊸ 23
	STRUCTURAL DETAILS 1	⊸ 24
	STRUCTURAL DETAILS 2	□ 25
	STRUCTURAL DETAILS 3	⊸ 26
	TRUSS BLOCKING LAYOUT	⊸ 27
	SHEETROCK BACKING	⊸ 28
	ROOF BRACING LAYOUT	⊸ 29
MECHANICAL	COVER SHEET -	⊣ 31
30	HVAC PLAN -	⊣ 32
ELECTRICAL	SCHEDULE -	⊣ 33
32	LIGHTING -	⊣ 34
	POWER PLAN -	⊣ 35
	DIMENSION FOR LIGHTING -	⊣ 36
	DIMENSION FOR FITTING -	⊣ 37
PLUMBING	NOTES AND SCHEDULES -	⊣ 38
37	WATER SUPPLY & SEWAGE SYSTEM	1 _H 39

MATERIALS SHOPPING LIST

ABOUT



FrameUpNow is a design and manufacturing company providing precision-engineered home framing solutions. We offer a catalog of Affordable Homes, Tiny Homes, Garages, Shops and Barndominiums. FrameUpNow manufactures cold-formed steel (CFS) also known as Light Gauge Steel (LGS) framing components that conform to our engineered metal house frame plans or can be purchased as DIY skeleton kits.

The CFS/LGS framing is lightweight, easily assembled, and does not require heavy equipment or specialized labor, enabling homeowners to erect the frame themselves in just a few days. Unlike wood, the steel framing is impervious termites and bores, warping, expansion, and fire.

Our home plans come complete with a structural engineered stamp for permit approvals. Customers receive a full BOM also known as a Materials Shopping List to purchase finish materials from a Building Materials retailer. FrameUpNow prides itself on the quality and efficiency of our precision-engineered home framing solutions for construction professionals and DIY homeowners.



KEY PLAN

NO.	DESCRIPTION	DATE

NOTE:

LEGEND:

PROJECT

217-Westbrook-625-1Bd1Ba-**Contemporary-550**

DRAWING NAME

INTRODUCTION

CLIENT NAME:	
PROJECT NUMBER:	
DATE:	
DESIGNED BY:	
DRAWN BY:	
CHECKED BY:	

1101

SCALE:

© [2024] [FrameUpNow] . All rights reserved

DISCLAIMER

DISCLAIMER: This documentation and all it's contents are the intellectual property of FrameUpNow. It is provided solely for marketing the services of FrameUpNow. The preliminary information is not approved for actual construction use and is not warranted to be complete or accurate. Unauthorized copying, distribution, or application of these proprietary materials, in any form or format, is strictly prohibited. FrameUpNow assumes no liability for any issues arising from improper use of this marketing content.

DESCRIPTIONS

MATERIALS LIST

The BOM (Bill Of Materials) package, known as the Materials Shopping List document, provides:

Comprehensive Inventory: Detailed lists of essential materials sourced from architectural, mechanical, HVAC, electrical, and plumbing design drawing sets.

Precise Curation: Each item meticulously selected and organized for accuracy and efficiency in project planning.

Customizable Options: Customers can modify listed items to their preferences and calculate costs accordingly, ensuring alignment with personal project needs and budget.

Dedicated Space for Details: Includes tables for customers to note Home Depot SKU numbers or product descriptions for selected items, facilitating seamless purchasing and coordination with suppliers.

Customer Convenience: Take the list to Home Depot or preferred suppliers for accurate pricing, helping align the total home budget with personal financial plans.

Simplify your construction journey with our Materials Shopping List document, where detailed preparation meets streamlined implementation for your dream home.

STRUCTURAL

The structural drawings package provides an exhaustive set of detailed plans essential for the precise assembly of your building. This comprehensive package includes:

Framing Plans: Detailed layouts for all framing components. Truss Layouts: Clear instructions for truss placement and

Panel Length Plans: Specifications for panel dimensions. Framing Elevations and Sections: Precise elevation and sectional views for accurate construction.

Truss and Wall Blocking Plans: Plans for truss and wall blocking to ensure structural integrity.

Hold-Down Plan: Detailed hold-down requirements for stability. Snap Sheet: Reference sheet for quick identification of components

Structural Details and Bracing Plans: Complete details and bracing plans for all structural elements.

Accompanying these plans is a comprehensive Bill of Materials (BOM) that lists every necessary building component, from cold formed steel (CFS) frames to fasteners.

ARCHITECTURAL

With the comprehensive architectural package, both builders and DIY homeowners can confidently execute the construction.

The architectural package includes:

Furnished Floor Plans: Complete with furniture layouts for a clear understanding of space utilization.

Detailed Dimension Plans: Ensures precise measurements, from the overall footprint down to the exact placement of windows and

Foundation Plan: Detailed plan to establish a solid foundation.

Wall Framing and Truss Layout: Comprehensive plans for wall framing and truss placement.

Architectural Elevations: Exterior views showcasing the design.

Strategic Building Sections: Critical cross-sectional details for a thorough understanding of the build.

Casework Drawings and Diagrams: Suggested designs for built-in caseworks, such as kitchen cabinets.

MECHANICAL

The mechanical package includes everything needed to guide HVAC

Detailed HVAC Floor Plan: Precisely maps out the placement of air handlers, ductwork, and vents throughout the home's layout.

HVAC Sections and Riser Diagrams: Technical drawings offering critical cross-sectional details and piping schematics, ensuring proper integration of the heating and cooling system into the home's structure.

Bill of Materials: A complete list of all necessary HVAC components.

ELECTRICAL

The electrical package includes all the plans and documentation needed to guide the installation of your home's electrical system:

Detailed Power Plan: Precisely maps out the placement of outlets, switches, and other power components throughout the layout.

Comprehensive Lighting Plan: Shows the optimal locations for lighting fixtures, sconces, and other illumination sources to create a well-lit, functional interior.

Dimensioned Electrical Layout: Provides exact dimensions and measurements to ensure proper placement of all electrical elements.

Bill of Materials: A complete list of every component needed, from circuit breakers to wiring.

The plumbing package includes everything needed to guide the installation of your home's water supply and drainage systems:

Detailed Water Supply System Plan: Precisely maps out the placement of pipes, valves, and plumbing fixtures throughout the

Comprehensive Sewage System Plan: Shows the optimal routing and sizing of drain lines to effectively remove waste and ensure

Detailed Riser Diagrams: Provide information needed to properly

PLUMBING

proper drainage.

install all vertical plumbing risers and vent stacks.

Bill of Materials: A complete list of every component needed, from pipes to fixtures.


BOM (Bill Of Materials) (Separately Attached)





The Bill of Materials (BOM) is a crucial document that compiles the material requirements from different disciplines into a centralized inventory, enabling efficient procurement, inventory management, and cost estimation for a specified project or

ELECTRICAL BOM



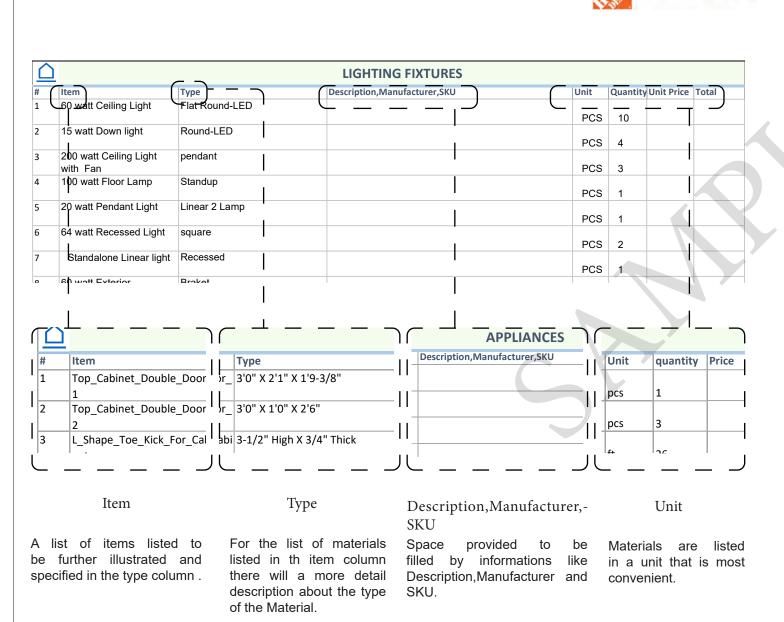

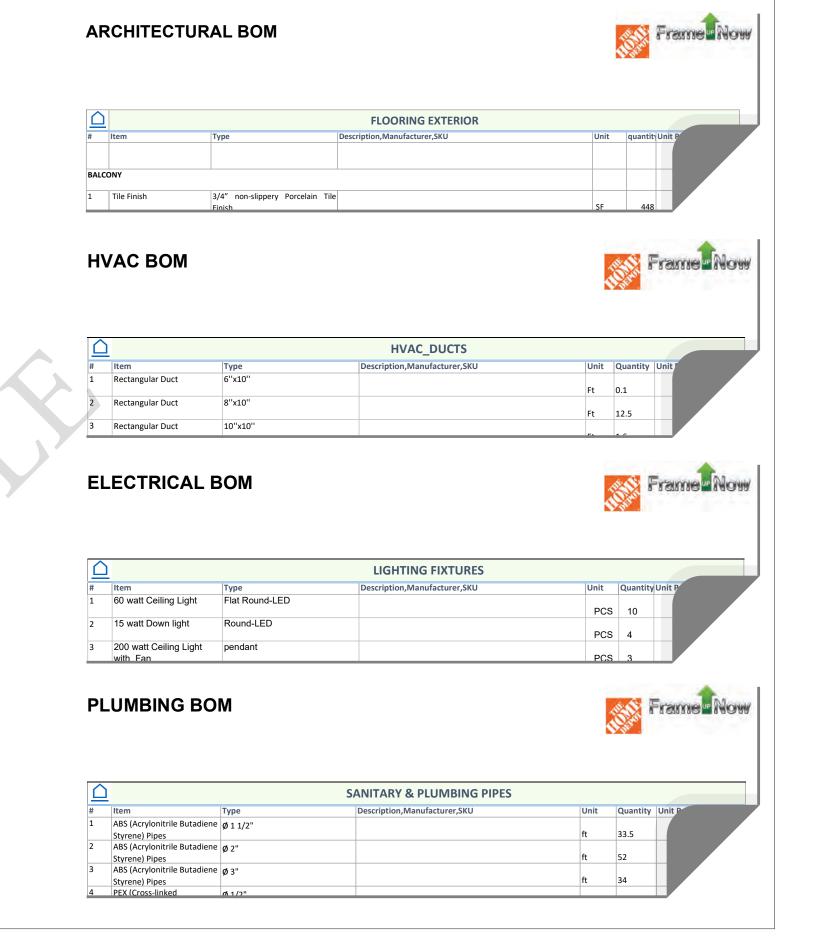

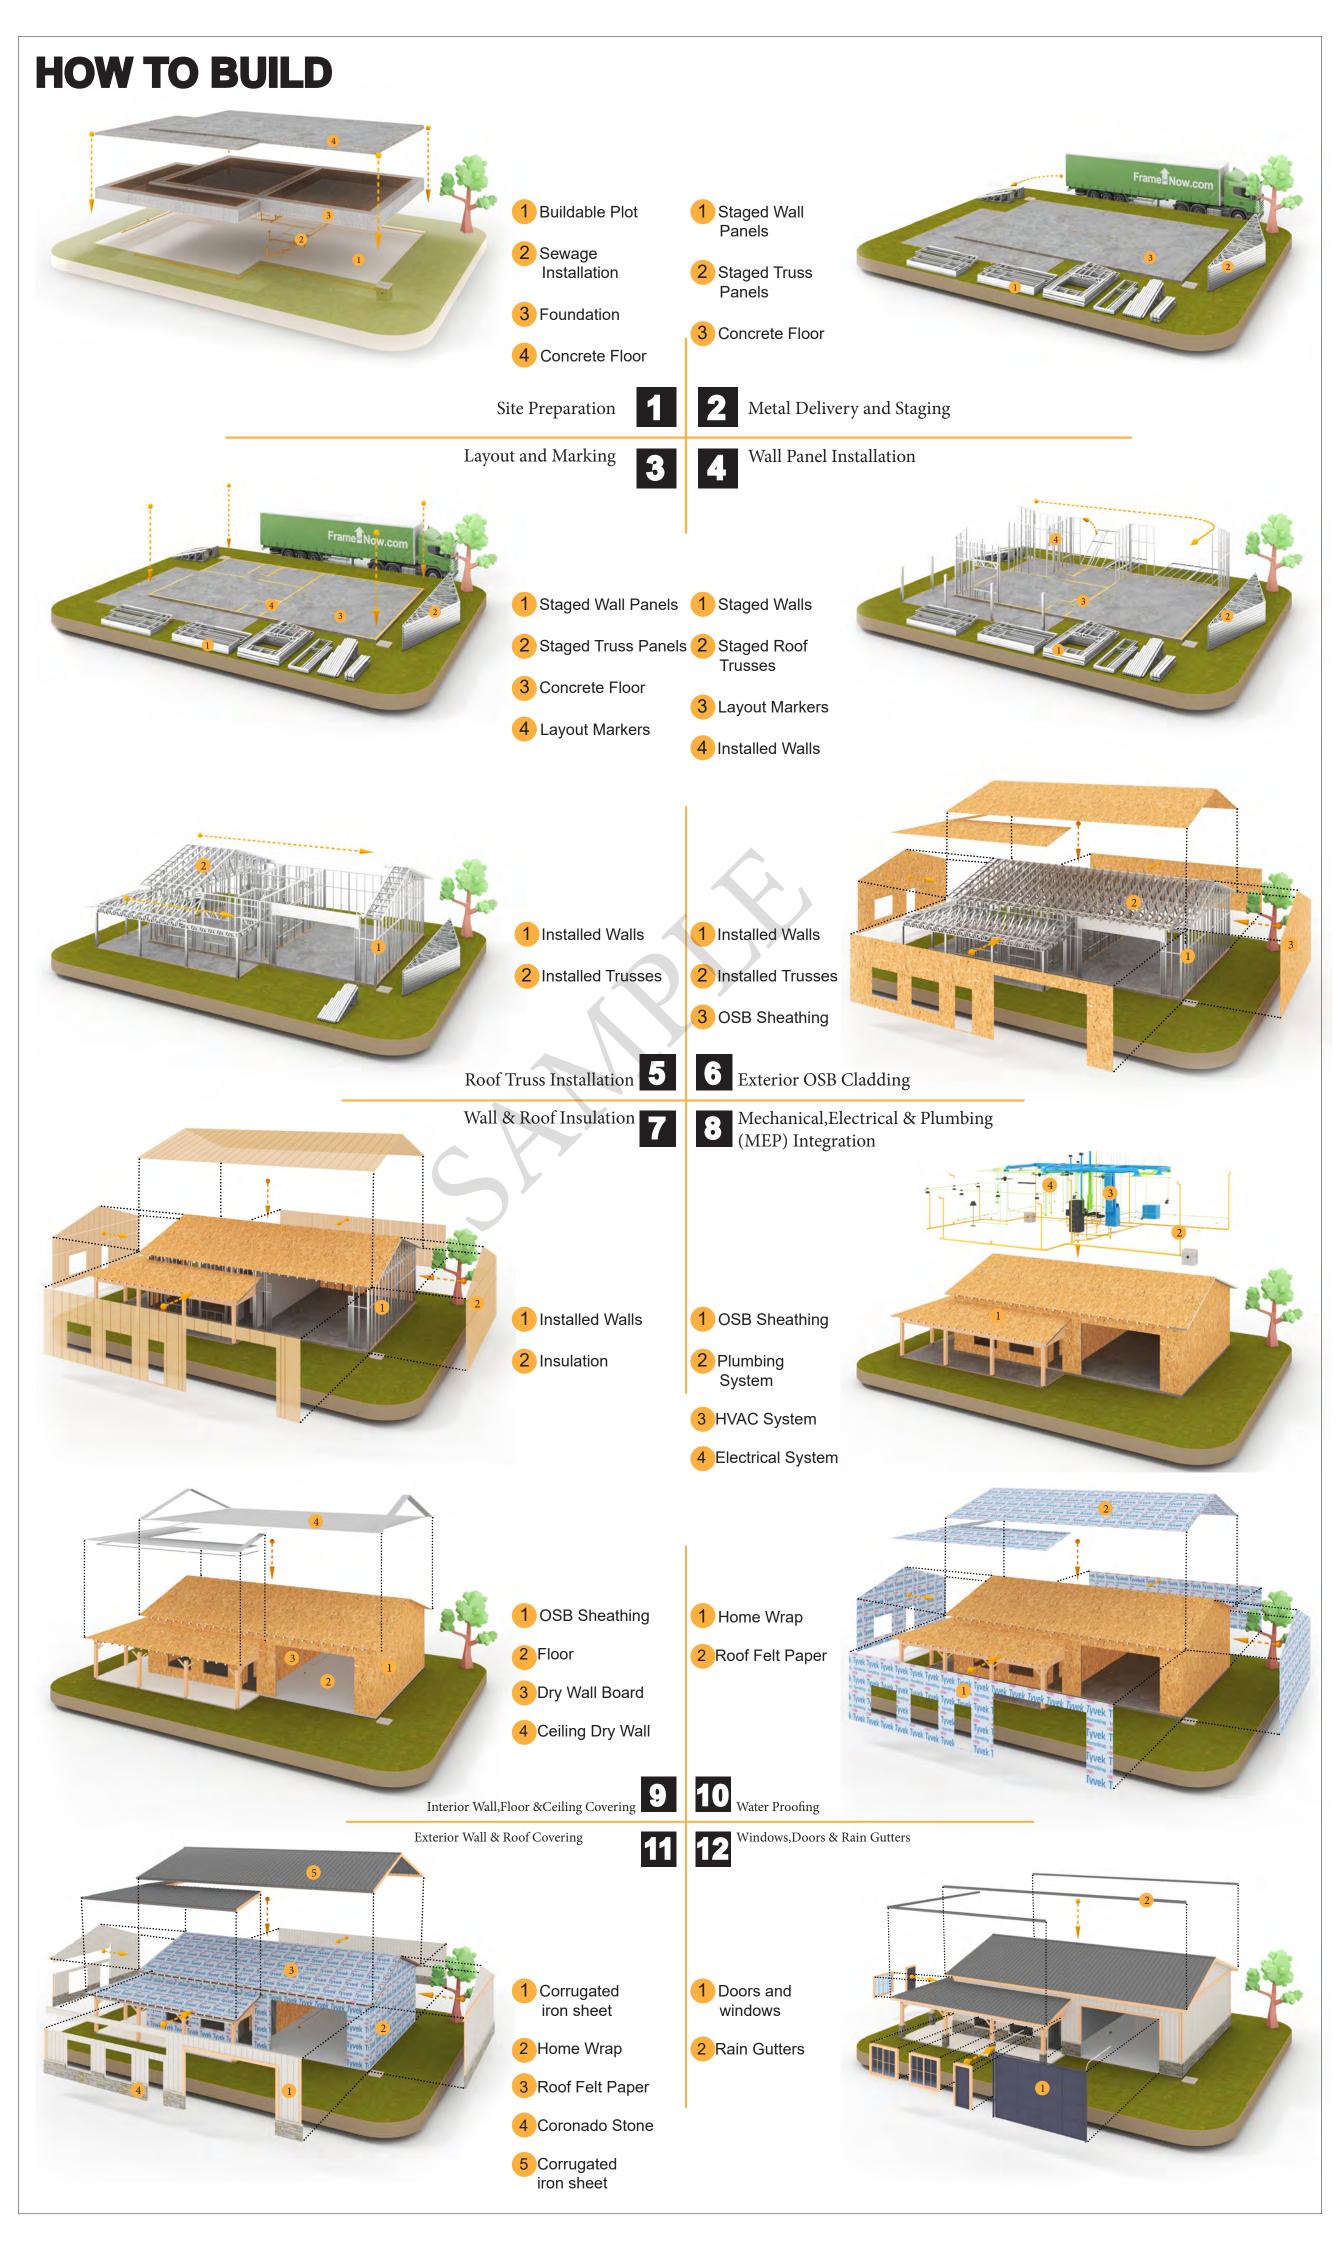



KEY PLAN

NO.	DESCRIPTION	DATE

NOTE:

LEGEND:

PROJECT

217-Westbrook-625-1Bd1Ba-**Contemporary-550**


DRAWING NAME

INTRODUCTION

CLIENT NAME: PROJECT NUMBER: DATE: **DESIGNED BY** DRAWN BY: CHECKED BY:

1102

SCALE:

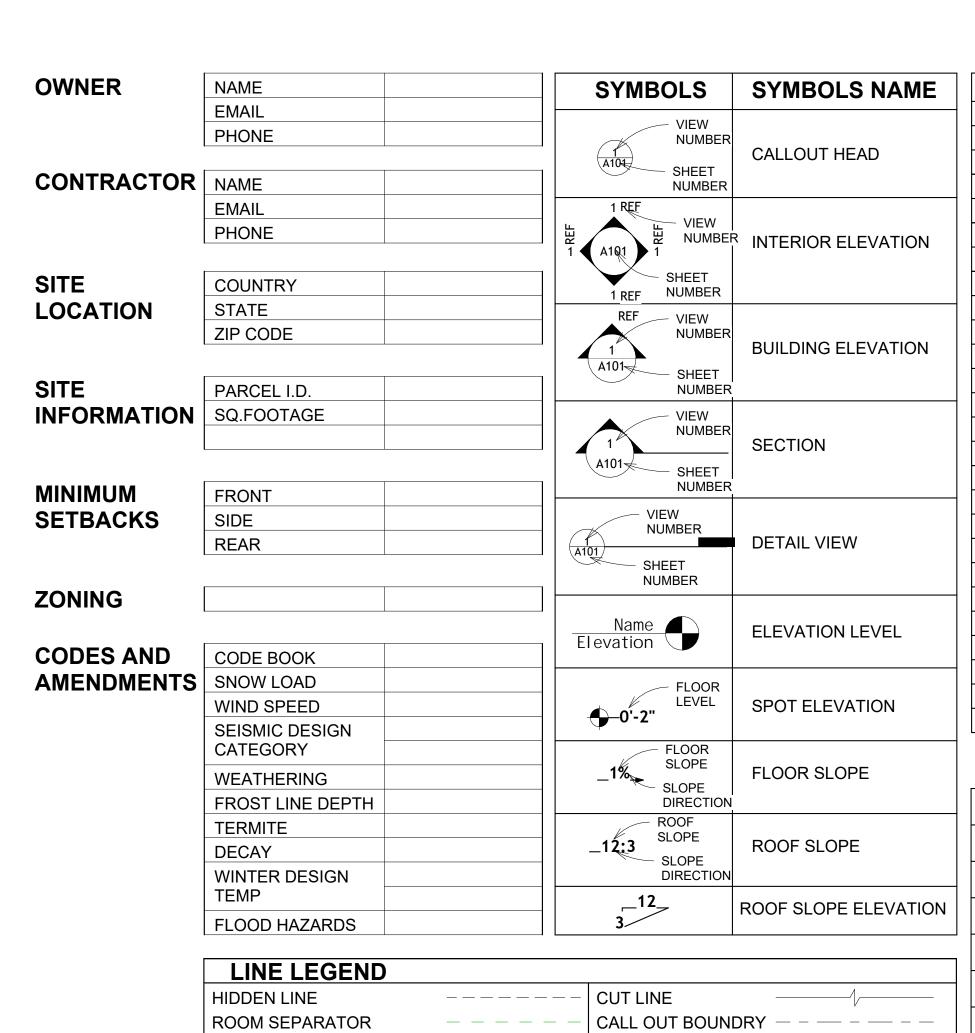

DOOR OPENING DIRECTION

MBOLS NAME		PAGE INDEX	Α
	G101	COVER SHEET	AFS
OUT HEAD	A101	FLOOR PLAN	ASTM D698
OUT READ	A102	DIMENSION PLAN	
	S101	FOUNDATION PLAN	CA
	S102	STRUCTURAL FLOOR PLAN	EL
RIOR ELEVATION	S103	FRAME LAYOUT	F.F.E
	S104	ROOF TRUSS LAYOUT	F.F.L
	A103	ROOF PLAN	FTG
	A201	ELEVATIONS	HVAC
DINIO EL EVATIONI	A202	ELEVATIONS	
DING ELEVATION	A301	SECTIONS	IRC
	A401	DETAILS	
	A402	CASEWORK DETAILS	IMC
-101	A403	CASEWORK DETAILS	
TON	E101	SCHEDULE	MAX.
	E102	LIGHTING PLAN	ME
	E103	POWER PLAN	MIN.
	E104	DIMENSION PLAN FOR LIGHT FIXTURE	NO.
AIL VIEW	E105	DIMENSION PLAN FOR FITTING	O.C
	P101	COVER SHEET	OSB
	P102	WATER SUPPLY SYSTEM	PL
ATION LEVEL	P103	SEWAGE SYSTEM	PSI
711011	P104	RISER DIAGRAM	PVC
	M101	HVAC PLAN	REF
ELEVATION	M102	HVAC SECTION	RG
LLLVATION	M103	RISER DIAGRAM	SE
			SF
R SLOPE			SIMP. STHD8
	TAG	TAG'S NAME	
F SLOPE	CA01	CASEWORK TAG	SIMP. ABE66
323. 2		DOOR TAG	UNO
SLODE ELEVATION	(1)		W/
SLOPE ELEVATION	1	FURNITURE TAG	W/D
	1	WINDOW TAG	AC
	SE01	SPECIALTY EQUIPMENT TAG	ACC
	MEO1	MECHANICAL EQUIPMENT TAG	ACCU AHU
		DI LIMBINIO ECLUBATATA A	CC
	PE01	PLUMBING EQUIPMENT TAG	CD



EL	ELECTRICAL
F.F.E	FINISHED FLOOR ELEVATION
F.F.L	FINISHED FLOOR LEVEL
FTG	FOOTINGS
HVAC	HEATING, VENTILATION & AIR CONDITIONING
IRC	INTERNATIONAL RESIDENCE CODE
IMC	INTERNATIONAL MECHANICAL CODE
MAX.	MAXIMUM
ME	MECHANICAL
MIN.	MINIMUM
NO.	NUMBER
O.C	ON CENTER
OSB	ORIENTED STRAND BOARD
PL	PLUMBING
PSI	POUNDS PER SQUARE INCH
PVC	POLYVINYL CHLORIDE
REF	REFERENCE
RG	RIGHT GARAGE
SE	SPECIAL EQUIPMENT
SF	SQUARE FEET
SIMP. STHD8	SIMPSON STRAP THE
	HOLDDOWN
SIMP. ABE66	
TV UNO	TELEVISION UNLESS NOTED OTHERWISE
W/	WITH
W/D	WASHER/DRYER
AC	AIR CONDITIONING UNIT
ACC	AIR COOLED CONDENSER
ACCU	AIR COOLED CONDSENSING UNIT
AHU	AIR HANDLING UNIT
CC	COOLING COIL
CD	CEILING DIFFUSER
CFm	Cubic Feet Per Minute
CR	CEILING REGISTER
CU	CONDENSING UNIT
CW	COLD WATER
E/A	EXHAUST AIR
EF	EXHAUST FAN
EF ET	EXHAUST FAN EXPANSION TANK
ET	EXPANSION TANK
ET EX.	EXPANSION TANK EXISTING
ET EX. FC FCU	EXPANSION TANK EXISTING FLEXIBLE CONNECTION FAN COIL UNIT
ET EX. FC FCU FLR.	EXPANSION TANK EXISTING FLEXIBLE CONNECTION FAN COIL UNIT FLOOR
ET EX. FC FCU FLR. HC	EXPANSION TANK EXISTING FLEXIBLE CONNECTION FAN COIL UNIT FLOOR HEATING COIL
ET EX. FC FCU FLR. HC	EXPANSION TANK EXISTING FLEXIBLE CONNECTION FAN COIL UNIT FLOOR HEATING COIL AIR TO AIR HEAT EXCHANGER
ET EX. FC FCU FLR. HC HE	EXPANSION TANK EXISTING FLEXIBLE CONNECTION FAN COIL UNIT FLOOR HEATING COIL AIR TO AIR HEAT EXCHANGER HEATING AND VENTILATING UNI
ET EX. FC FCU FLR. HC HE HV	EXPANSION TANK EXISTING FLEXIBLE CONNECTION FAN COIL UNIT FLOOR HEATING COIL AIR TO AIR HEAT EXCHANGER HEATING AND VENTILATING UNI
ET EX. FC FCU FLR. HC HE HV IV MER	EXPANSION TANK EXISTING FLEXIBLE CONNECTION FAN COIL UNIT FLOOR HEATING COIL AIR TO AIR HEAT EXCHANGER HEATING AND VENTILATING UNI
ET EX. FC FCU FLR. HC HE HV IV MER MAX.	EXPANSION TANK EXISTING FLEXIBLE CONNECTION FAN COIL UNIT FLOOR HEATING COIL AIR TO AIR HEAT EXCHANGER HEATING AND VENTILATING UNI INLET VANES MECHANICAL ROOM MAXIMUM
ET EX. FC FCU FLR. HC HE HV IV MER	EXPANSION TANK EXISTING FLEXIBLE CONNECTION FAN COIL UNIT FLOOR HEATING COIL AIR TO AIR HEAT EXCHANGER HEATING AND VENTILATING UNI INLET VANES MECHANICAL ROOM
ET EX. FC FCU FLR. HC HE HV IV MER MAX.	EXPANSION TANK EXISTING FLEXIBLE CONNECTION FAN COIL UNIT FLOOR HEATING COIL AIR TO AIR HEAT EXCHANGER HEATING AND VENTILATING UNI INLET VANES MECHANICAL ROOM MAXIMUM
ET EX. FC FCU FLR. HC HE HV IV MER MAX. MIN.	EXPANSION TANK EXISTING FLEXIBLE CONNECTION FAN COIL UNIT FLOOR HEATING COIL AIR TO AIR HEAT EXCHANGER HEATING AND VENTILATING UNI INLET VANES MECHANICAL ROOM MAXIMUM MINIMUM
ET EX. FC FCU FLR. HC HE HV IV MER MAX. MIN. R/A	EXPANSION TANK EXISTING FLEXIBLE CONNECTION FAN COIL UNIT FLOOR HEATING COIL AIR TO AIR HEAT EXCHANGER HEATING AND VENTILATING UNI INLET VANES MECHANICAL ROOM MAXIMUM MINIMUM RETURN AIR
ET EX. FC FCU FLR. HC HE HV IV MER MAX. MIN. R/A RCU	EXPANSION TANK EXISTING FLEXIBLE CONNECTION FAN COIL UNIT FLOOR HEATING COIL AIR TO AIR HEAT EXCHANGER HEATING AND VENTILATING UNI INLET VANES MECHANICAL ROOM MAXIMUM MINIMUM RETURN AIR RECIPROCATING CHILLER UNIT
ET EX. FC FCU FLR. HC HE HV IV MER MAX. MIN. R/A RCU RF	EXPANSION TANK EXISTING FLEXIBLE CONNECTION FAN COIL UNIT FLOOR HEATING COIL AIR TO AIR HEAT EXCHANGER HEATING AND VENTILATING UNI INLET VANES MECHANICAL ROOM MAXIMUM MINIMUM RETURN AIR RECIPROCATING CHILLER UNIT RETURN FAN

ABBREVIATION


CASEWORK

ELECTRICAL

ACTION FLOOR SYSTEMS

AMERICAN SOCIETY FOR

TESTING AND MATERIAL

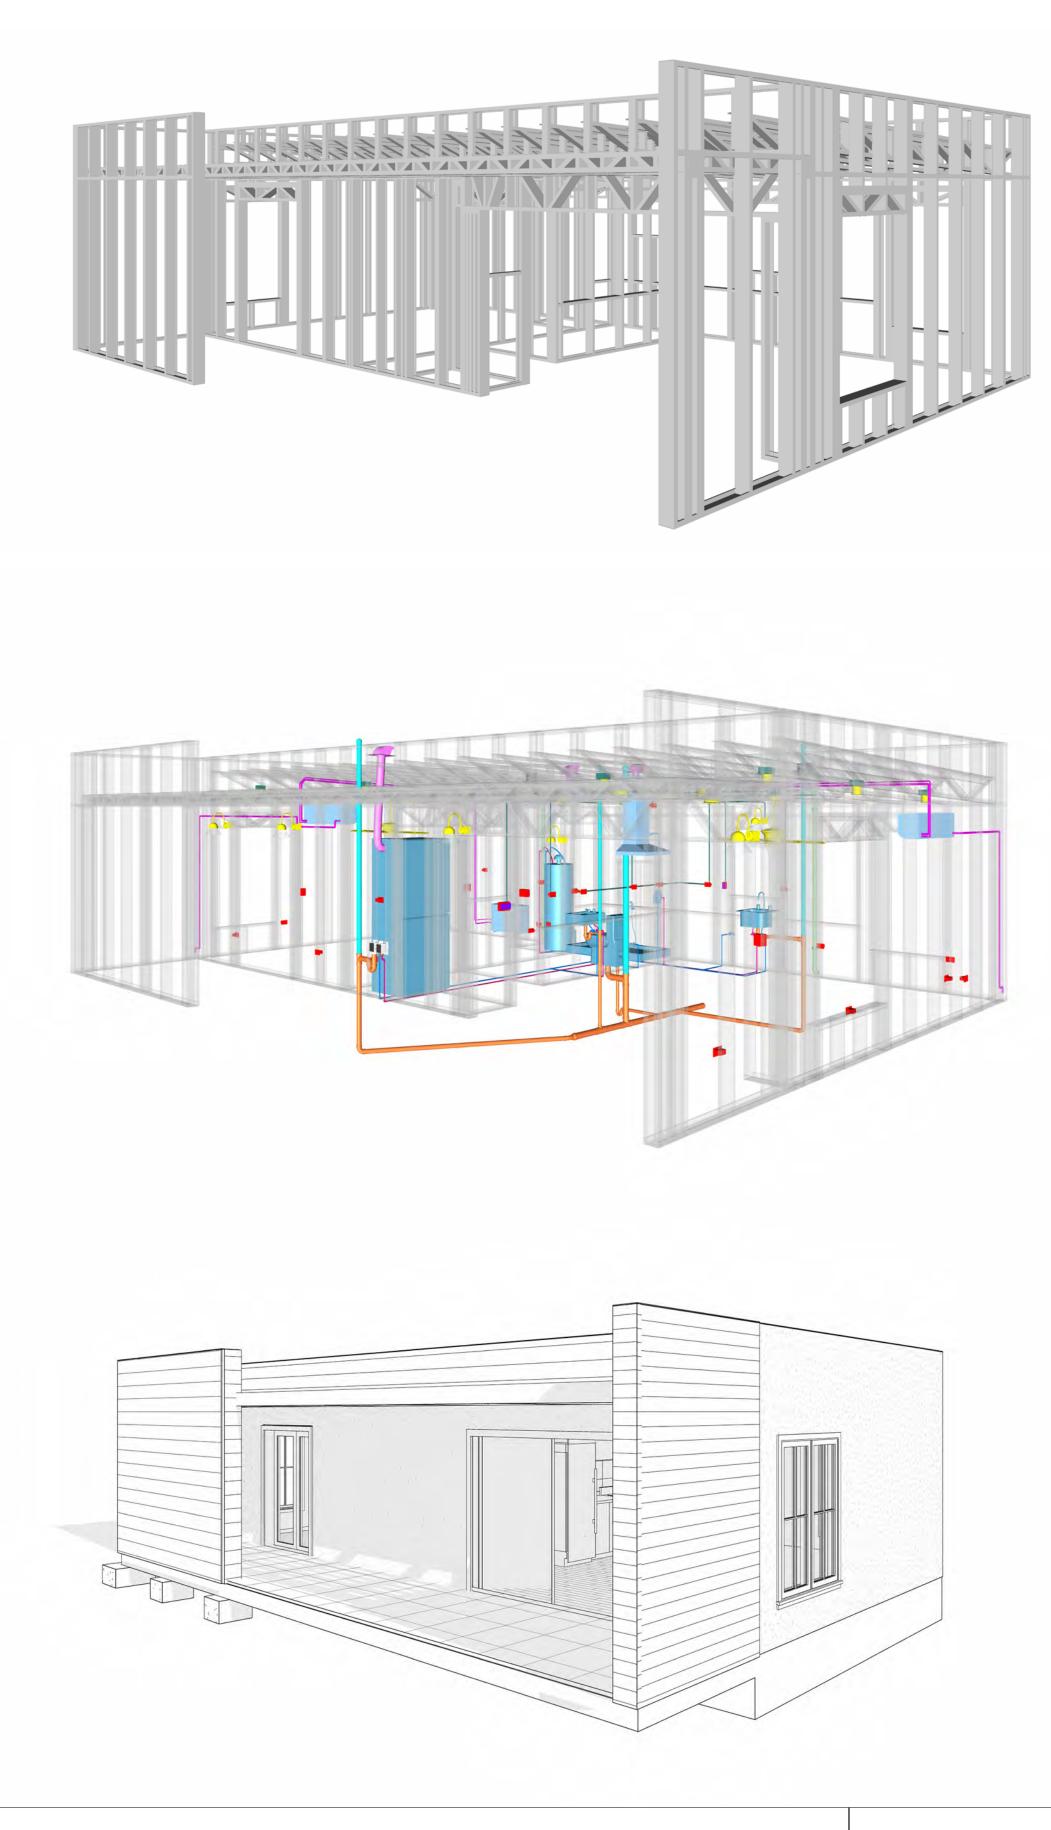


217WESTBROOK-625-1Bd1Ba
-CONTEMPORARY-550

SQUARE FOOT	AGE	
LIVING	625	
PORCH	206	
TOTAL	831	



KEY PLAN

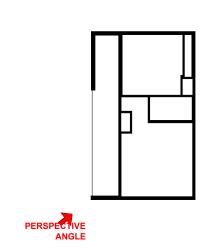

NO.	DESCRIPTION	DATE

NOTE:

LEGEND:

217-WESTBROOK-625-1Bd1Ba-CONTEMPORARY-550

DRAWING NAME

COVER SHEET

CLIENT NAME:	Client Name
PROJECT NUMBER:	0061_12
DATE:	5/6/2025 3:05:32 PM
DESIGNED BY:	Designer
DRAWN BY:	Author
CHECKED BY:	Checker

G101

GENERAL NOTES

- THIS DRAWING DEPICTS THE ARCHITECTURAL (SPACE LAYOUT, FURNISHING, FLOOR, WALLS, ROOFS, FOUNDATION, WINDOWS AND DOORS) SYSTEMS. IT PROVIDES A VISUAL REPRESENTATION OF THE ARCHITECTURAL LAYOUT AND COMPONENTS.
- THE ARCHITECTURAL DRAWINGS ARE PREPARED TO MEET THE SPECIFIC REQUIREMENTS OF THE BUILDING, AS PER THE PROJECT SPECIFICATIONS AND APPLICABLE CODES AND STANDARDS. THE CONSTRUCTION OF THIS HOME SHALL COMPLY WITH THE LATEST EDITION OF THE
- INTERNATIONAL RESIDENTIAL CODE (IRC), INTERNATIONAL MECHANICAL CODE (IMC), THE INTERNATIONAL PLUMBING STANDARD, THE NATIONAL ELECTRICAL STANDARD AND ALL OTHER APPLICABLE LOCAL, STATE, AND NATIONAL CODES AND REGULATIONS.
- COORDINATION WITH OTHER TRADES HAS BEEN DONE ON A DESIGN LEVEL. THIS DRAWING SHALL BE READ TOGETHER WITH THE ME, EL AND PL DESIGN DRAWINGS TO ENSURE PROPER CONSTRUCTION AND INTEGRATION OF THE BUILDING SYSTEMS.

ABOUT WALLS:

SHOWER WALL COVERING

BATHTUB AND SHOWER SPACES (WALLS AND FLOORS) WITH INSTALLED SHOWER HEADS AND IN SHOWER COMPARTMENTS SHALL BE FINISHED WITH A NON-ABSORBENT SURFACE.

WALL PAINT (INTERNAL)

THE TYPICAL THICKNESS OF LATEX WALL PAINT IS 1/32 OF AN INCH FOR A SINGLE COAT. AND DOUBLE COAT (1/16") SHALL BE APPLIED FOR DURABILITY.

THE ADVISABLE TYPE OF ADHESIVE FOR THIS PROJECT IS **EPOXY ADHESIVES**BECAUSE THEY ARE KNOWN FOR THEIR HIGH STRENGTH, DURABILITY, AND RESISTANCE TO MOISTURE, CHEMICALS AND

REFER TO SHEETS A201 & A202 FOR GENERAL NOTES ON EXTERNAL FINISHING MATERIALS

ABOUT FLOORS:

THE SPOT ELEVATION INDICATES THE FINISHED FLOOR ELEVATION.

QUEEN 60" X 79"

FINISHED FLOORS PER PLANS.

FIELD VERIFY FOR DIMENSION DROP 4" FOR SHOWER AND BATHTUB USE.


1% SLOPE ON OUTDOOR BALCONIES FOR WATER RUN OFF.

2% SLOPE TOWARDS THE SHOWER DRAIN FOR SUFFICIENT DRAINAGE.


4" DROP AT THE DOOR LEADING TO EXTERIOR BALCONY FROM THE MAIN LIVING AREA. 5% SLOPE FOR GARAGE IS USED, WHICH SHOULD BE CHECKED WITH THE LOCAL GARAGING

ZONING LAWS.


FURNITURE SCHEDULE			
TYPE MARK	TYPE	COUNT	
01	THREE SEAT SOFA	1	

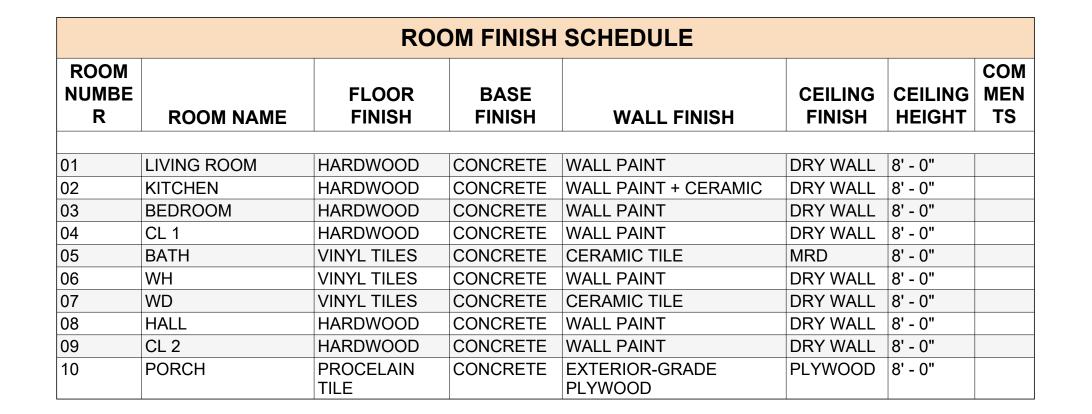



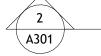



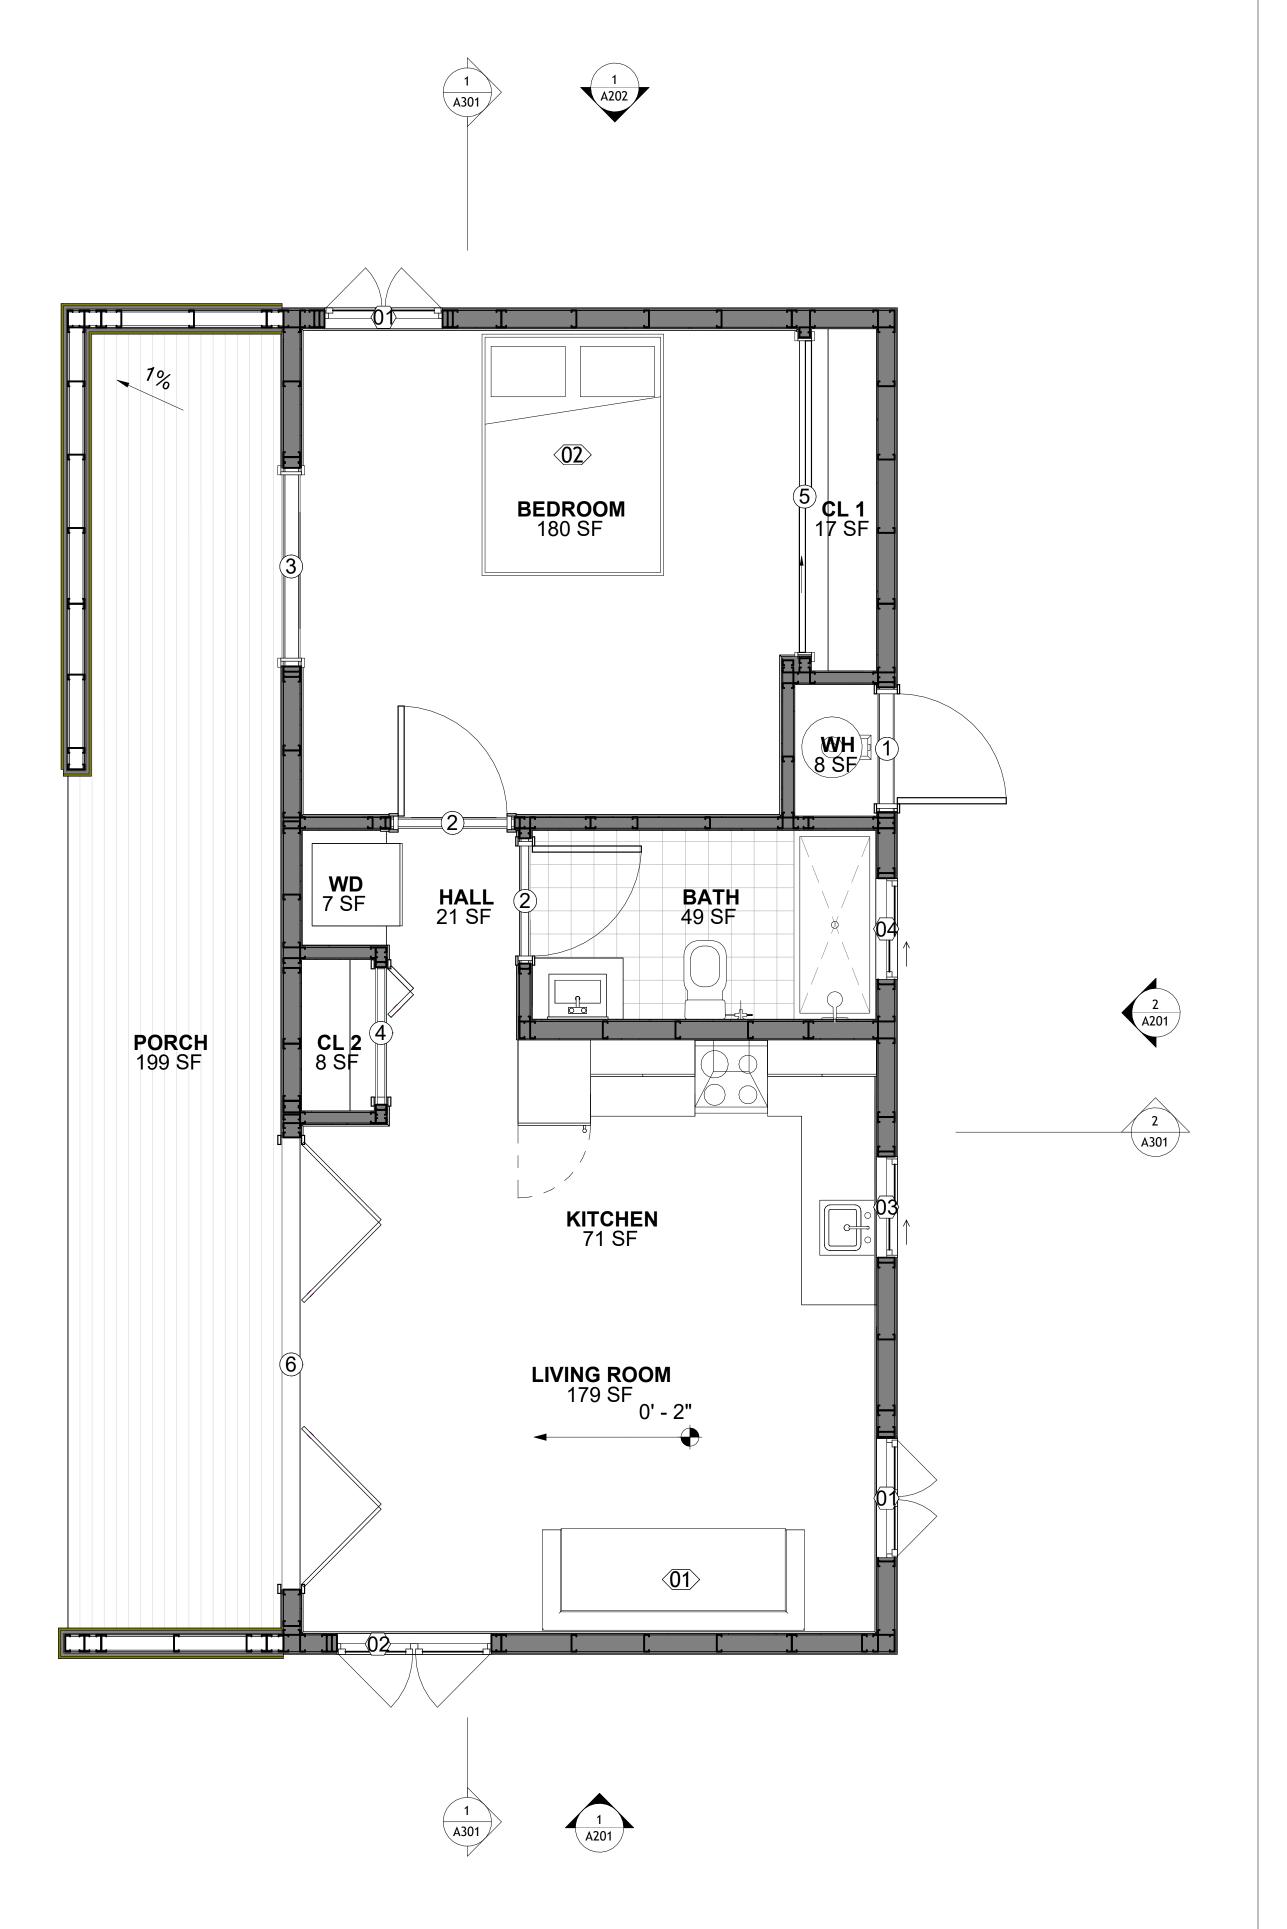

SQUARE FOOT	AGE
LIVING	625
PORCH	206
TOTAL	831



KEY PLAN

NO. DESCRIPTION DATE

NOTE:

LEGEND:

PROJECT


217-WESTBROOK-625-1Bd1Ba-**CONTEMPORARY-550**

DRAWING NAME

FLOOR PLAN

CLIENT NAME: **Client Name** PROJECT NUMBER: 0061_12 5/6/2025 3:05:33 PM Designer DESIGNED BY: **Author** DRAWN BY: CHECKED BY: Checker

A101

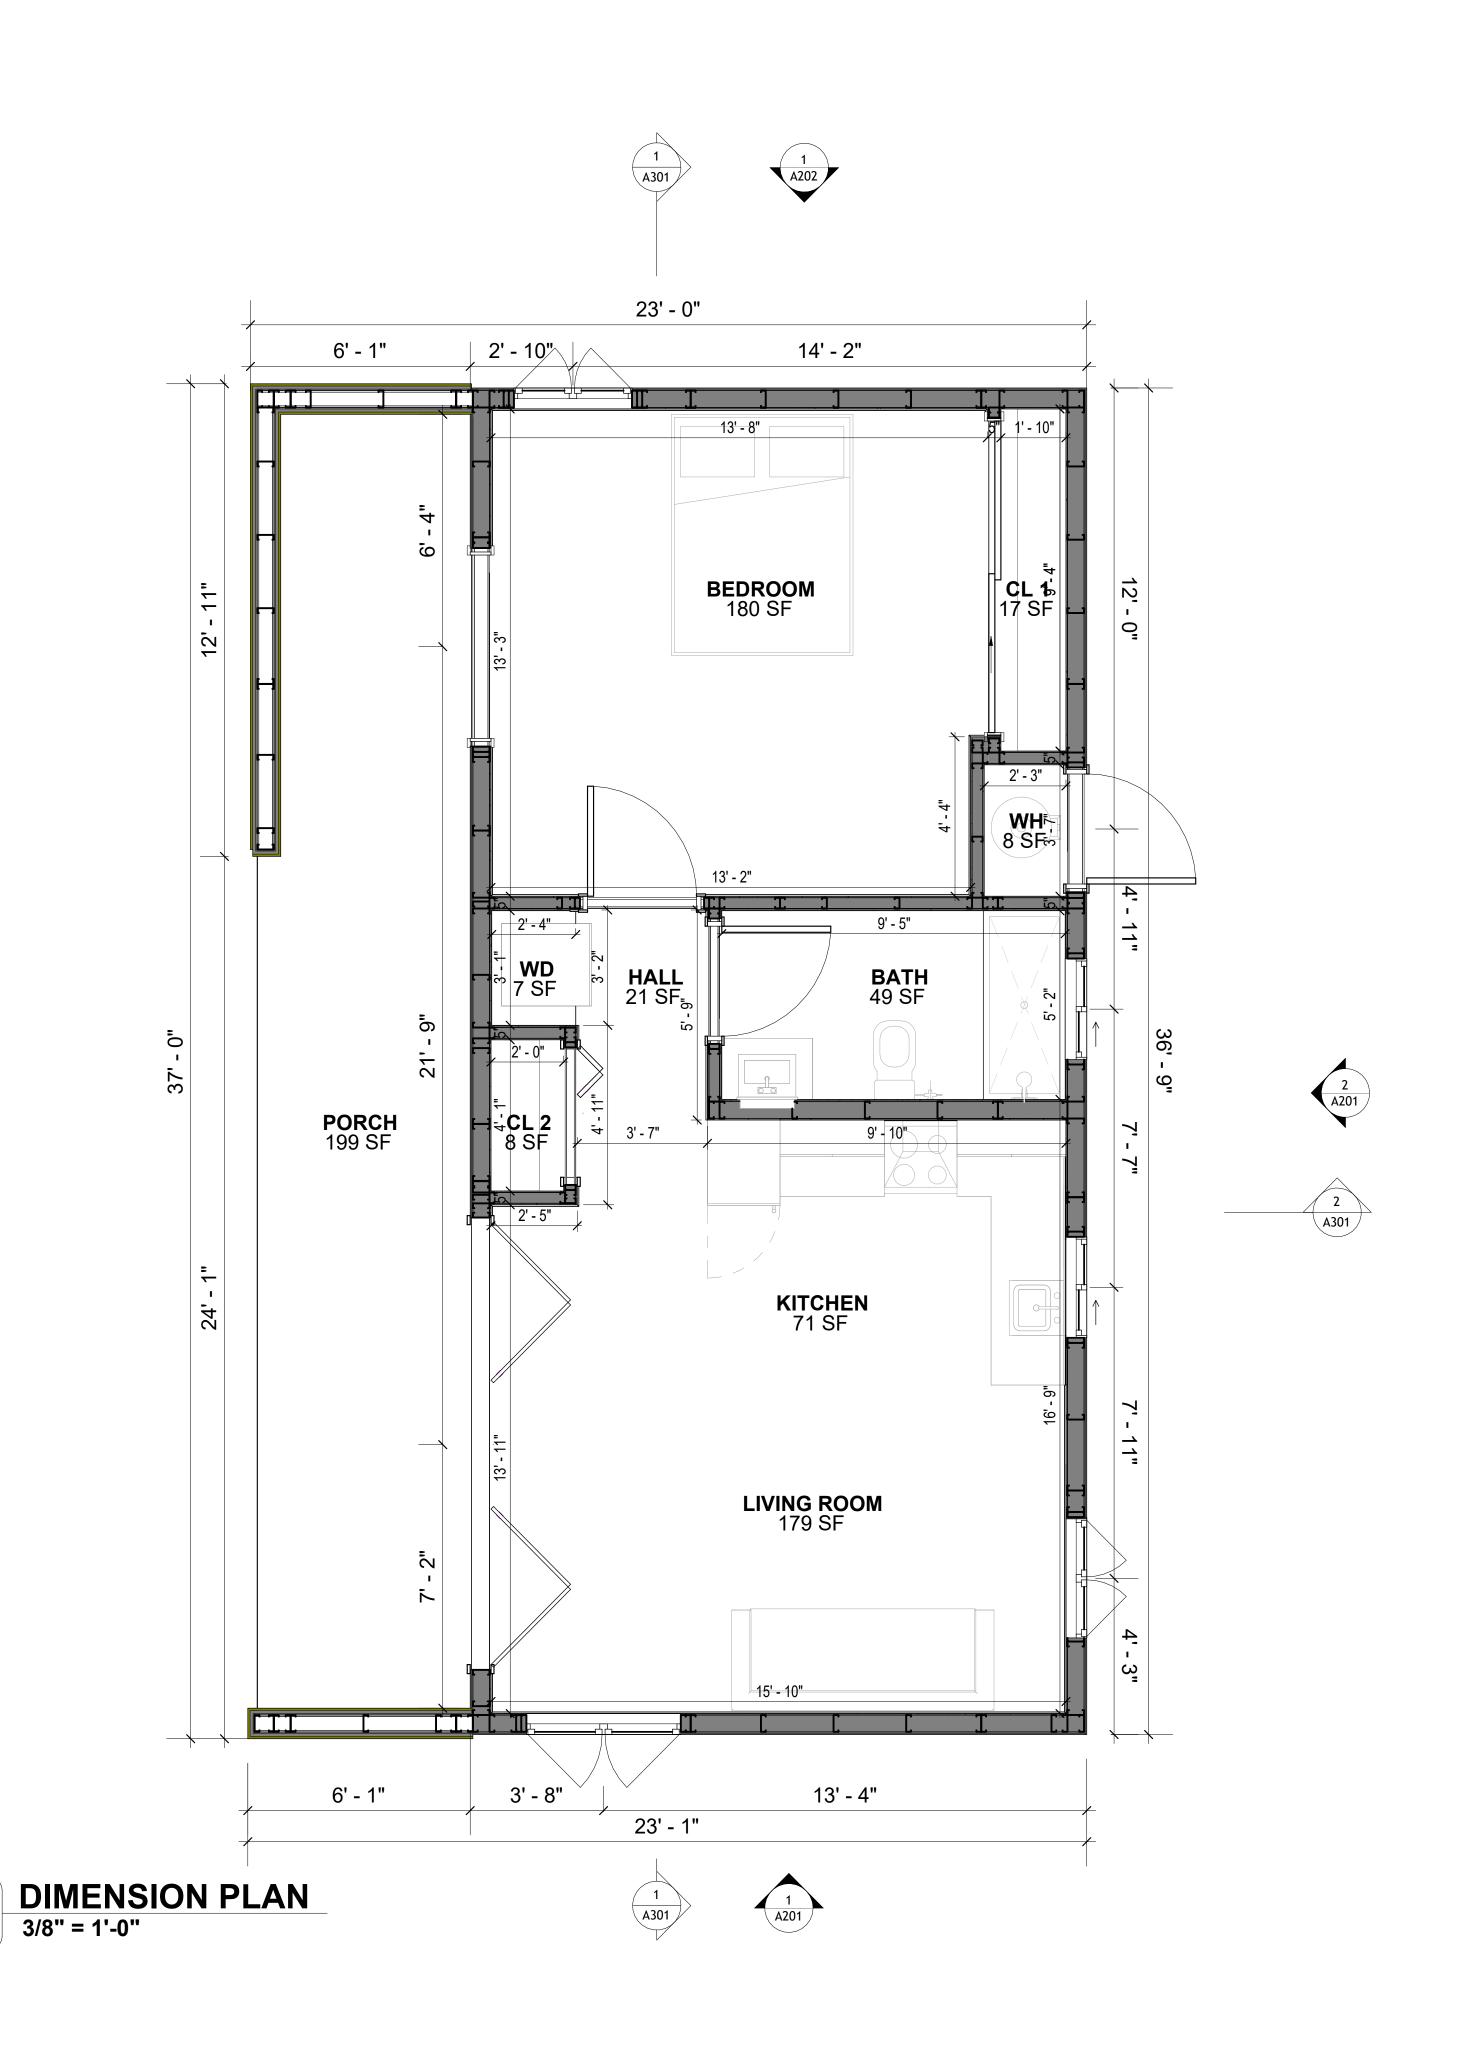



KEY PLAN

NO.	DESCRIPTION	DAIL

NOTE:

LEGEND:

PROJECT

217-WESTBROOK-625-1Bd1Ba-CONTEMPORARY-550

DRAWING NAME

DIMENSION PLAN

CLIENT NAME:	Client Name
PROJECT NUMBER:	0061_12
DATE:	5/6/2025 3:05:34 PM
DESIGNED BY:	Designer
DRAWN BY:	Author
CHECKED BY:	Checker

A102

SCALE: 3/8" = 1'-0"

SQUARE FOOTAGE

206

831

PORCH

TOTAL

DIMENSIONS IN THE ARCHITECTURAL DRAWINGS CONSIDER FINISHING MATERIALS. FOR PRECISE MEASUREMENTS OF THE STRUCTUAL FRAMING, REFER TO THE ATTACHED STRUCTURAL PLAN SET.

FOUNDATION NOTES

NOTES:

TERMITES PRETREATMENT BY LICENSED CONTRACTOR UNDER SLAB AND AROUND FOOTINGS. ALL AREAS BELOW SLABS SHALL BE TREATED NO MORE THAN 24 HOURS PRIOR TO CONCRETE POUR. EVIDENCE OF TREATMENT MUST BE PROVIDED PRIOR TO PLACING OF CONCRETE.

. MATERIALS:

ALL INTERIOR CONCRETE SLABS SHALL BE A MIN. OF 4" THICK CONCRETE OVER 4" COMPACTED AGGREGATE BASE (ASTM D698), FINISH ELEVATIONS AS NOTED ON DRAWINGS, 6" ABOVE ADJACENT GRADE, LEVEL SLABS TO 1/8"-10' MAX.. CONCRETE SLABS SHALL BE 2500# PSI AT 28 DAYS. A 4" ALLOWABLE SLUMP.

2. **PAD PREPARATION:**

- EXCAVATION FOR FOOTING SHALL BE NEAT.
- FOOTINGS SHALL BE POURED IMMEDIATELY AFTER EXCAVATION AND APPROPRIATE INSPECTION.
- ALL REINFORCING STEEL MARKED "CONTINUOUS" SHALL BE LAPPED 36 BAR DIAMETERS AT SPLICES AND AROUND CORNERS OR INTERSECTIONS WITH A STANDARD 90 DEGREE BEND ON CORNER BARS. LAP WIRE MESH ONE FULL MESH AT SIDE AND END LAPS. - ALL HARDWARE TO BE SIMPSON OR EQUIVALENT.
- EXTERIOR FRAME WALL TO BE SECURED WITH 1/2"X10" ANCHOR BOLTS 4'-0" O.C. FOR 1-STORY AND 2'-8" O.C. FOR 2-STORY. BOLTS SHALL BE LOCATED WITHIN 1'-0" OF EACH END PIECE AND SHALL HAVE A MIN. OF TWO BOLTS PER PIECE.
- -FOUNDATION ANCHOR STRAPS SHALL BE PERMITTED, ACCORDING TO RESIDENTIAL CODE
- ALL INTERIOR WALLS TO BE SECURED WITH POWER DRIVEN PINS PER MANUFACTURER SPECIFICATION USE PIN SPACING EQUIVALENT TO 1/2" ANCHOR BOLTS.
- ALL CONSTRUCTION TO CONFORM TO THE 2012 IRC
- R-10 RIGID INSULATION OUTSIDE OF EXTERIOR FOUNDATION WALLS UNDER LIVING AREA. CONCRETE PAD FOR CONDENSER THICKNESS IS 4" MIN UNLESS OTHERWISE NOTED.

3. CONCRETE CONSTRUCTION:

THE SLAB SHALL BE UNDERLAIN BY A VAPOR BARRIER/RETARDER IN THE LIVING AREA (TYPICALLY POLYETHYLENE, UNLESS MORE STRINGENT PROTECTION REQUIRED BY THE ARCHITECT, ENGINEER, FLOOR COVERING MANUFACTURER, OR ACCEPTED PRACTICE). UNLESS OTHERWISE REQUIRED, BARRIER MAY BE OMITTED AT GARAGES, PORCHES AND PATIOS WITHOUT FLOOR COVERINGS. IT IS BEYOND THE SCOPE OF THESE PLANS TO DETERMINE THE APPLICABILITY OF THESE MORE STRINGENT REQUIREMENTS. BUILDER SHALL VERIFY PRIOR TO CONSTRUCTION.


. REINFORCEMENT:

- IF CONSTRUCTED ON ACTIVE SOILS, THE LONG TERM PERFORMANCE OF THE FOUNDATION IS DEPENDENT ON MAINTENANCE BY THE OWNER. THUS THE BUILDER SHALL ADVISE THE OWNER OF THE FOLLOWING:
- 1. DRAINAGE MUST BE MAINTAINED. WATER SHALL NEVER BE ALLOWED TO POND NEAR THE FOUNDATION.
- 2. THE SOIL AROUND THE FOUNDATION SHALL BE MAINTAINED IN A RELATIVELY DAMP CONDITION, SUCH AS THAT REQUIRED TO KEEP A LAWN GREEN. IF IT DRIES OUT IT WILL SHRINK. IF IT GETS WET, IT WILL HEAVE UPWARD.
- . SLABS ON THE SHORTER SIDE USES MAIN BARS ARE USED IN THIS DIRECTION ONLY WITH SMALLER DIAMETER DISTRIBUTION BARS ARE PLACED, FORMING A MAT OR GRID.
- ALL REINFORCEMENT BARS SIZE 10MM OR LARGER IN ACCORDANCE TO ASTM 3. ANCHOR BOLTS AT ALL EXTERIOR WALLS SHALL BE MINIMUM 1/2 INCH DIAMETER WITH A MAXIMUM SPACING OF 6'-0" ON CENTER, UNLESS NOTED OTHERWISE.
- . ANCHOR BOLTS SHALL BE INSTALLED WITHIN 12 INCHES OF EACH END OF EACH SILL PLATE WITH AT LEAST TWO ANCHOR BOLTS FOR EACH BOLTS FOR EACH SILL PLATE LONGER THAN 12 INCHES.
- 5. SIMPSONS SILL ANCHORS MAYBE SUBSTITUTED FOR ANCHOR BOLTS AT THE SAME SPACING.
- 6. EXTERIOR CONCRETE SLABS WHICH ARE NOT PART OF THE MAIN SLAB SHALL BE MINIMUM 4 INCHES THICK WITH NO STEEL REINFORCING BARS REQUIRED, UNLESS NOTED OTHERWISE ON FOUNDATION PLAN.

VERIFY THE FOLLOWING PRIOR TO POURING:

- ALL HOLDDOWNS, STRAP, AND POST LOCATIONS.
- CONCRETE FINISHES. PANEL RISER LOCATION WHERE APPLICABLE.
- UNDERSLAB MECHANICAL REQUIREMENTS. STEM WALL BLOCKOUTS.
- 5. UNDERSLAB ELECTRICAL REQUIREMENTS AND PANEL RISER LOCATION. WHERE APPLICABLE.
- PROVIDE THE FOLLOWING:
- PVC SLEEVES THROUGH FTG IF REQUIRED - 20' #4 COPPER GROUND BAR.
- SLOPE FINISH GRADE AWAY FROM FOOTING.

NOTE: FIELD VERIFY ALL DIMENSIONS SEE DIMENSIONED ARCHITECTURAL DRAWINGS

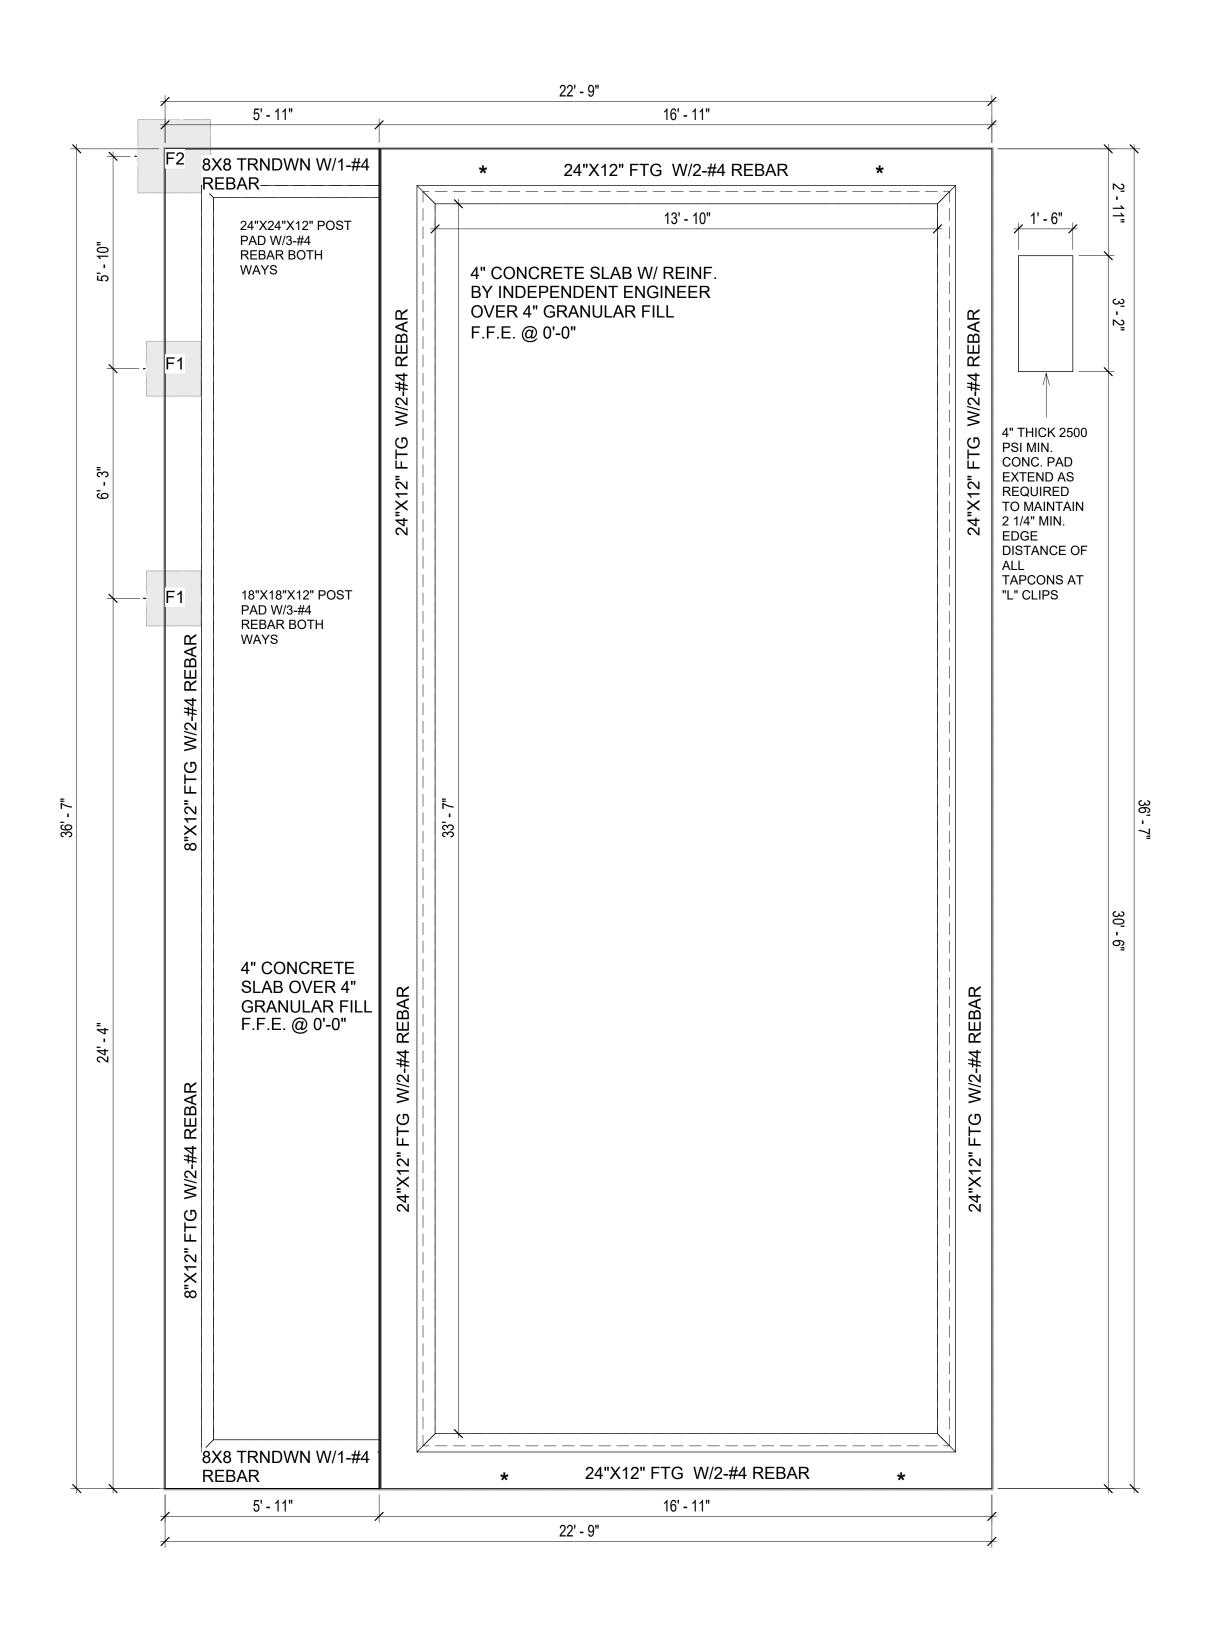

FOUNDATION PLAN

888-864-0184 inquire@frameupnow.com www.frameupnow.com

KEY PLAN

DESCRIPTION

NOTE:

LEGEND:

PROJECT

217-WESTBROOK-625-1Bd1Ba-**CONTEMPORARY-550**

DRAWING NAME

FOUNDATION PLAN

CLIENT NAME: Client Name PROJECT NUMBER: 0061_12 DATE: 5/6/2025 3:05:34 PM DESIGNED BY: Designer Author DRAWN BY: CHECKED BY: Checker

S101

SQUARE FOOTAGE

625

206

831

LIVING

PORCH

TOTAL

© [2024] [FrameUpNow] . All rights reserved

SCALE: 3/8" = 1'-0"

GENERAL NOTES

NOTES:

-ALL BEARING WALLS SHOULD HAVE A THICKENED SLAB PER SECTION PER DETAIL A401/5.

A) **FOUNDATION PLAN NOTES**:

- 1. CONCRETE SLAB SHALL BE 6" THICK WITH 1/2" DIAMETER TENDONS PER LAYOUT PLAN, CENTERED IN SLAB THICKNESS, OVER APPROVED SUBBASE PER GENERAL STRUCTURE NOTES.
- TERMITE PROTECTION SHALL BE PROVIDED PER IRC SECTION R318.1
 NONE TYPICAL ANCHOR BOLT SPACING AT SHEAR WALL AND HOLD DOWN SPECIFICATIONS PER APPROVED ARCHITECTURAL PLANS.
- INSTALL HOLDOWNS BEFORE CONCRETE SLAB POUR.
 EXISTING FILL ON-SITE SHALL BE COMPACTED IN ACCORDANCE WITH:
- 5. EXISTING FILL ON-SITE SHALL BE COMPACTED IN ACCORDANCE WITH THE REQUIREMENTS IN THE GEOTECHNICAL REPORT.
- 6. ALL FLOOR SLABS ARE REINFORCED ON CONCRETE SLABS.

SPECIAL INSPECTION IS REQUIRED FOR THICKENED FOUNDATION CONSTRUCTION

1. REINFORCEMENT

2. 2300 PSI CONCRETE POUR

B) REINFORCEMENT FOR CONCRETE:


 ALL REINFORCING SLABS BARS SIZE 10MM OR LARGER SHALL BE DEFORMED IN ACCORDANCE TO ASTM-A706, AND BARS SMALLER THAN 10 MM MAYBE PLAIN.
 UNLESS OTHERWISE NOTED IN PLANS, THE YIELD STRENGTH OF REINFORCING BARS SHALL BE:


> A) FOOTING = 40,000 PSI B) NON-LOAD BEARING WALLS AND PARAPETS= 40,000 PSI


- 3. SPLICES SHALL BE SECURELY WIRED TOGETHER AND SHALL LAP OR EXTEND
- 4. GRADE OF STEEL FOR RCC WORKS SHALL BE GRADE 4 10.
- 5. BAR NOTATIONS GIVES INFORMATION
- A) BAR SIZE
- B) SPACING(IF REQUIRED)
- 6. LAP REINFORCEMENT ONLY AT LOCATION SHOWN IN THE DRAWINGS
- 7. REINFORCEMENT SHALL NOT BE CUT, VENT OR HEATED ON SITE WITHOUT ENGINEERS' APPROVAL.
- C) CONCRETE SLAB NOTES
- 1. ALL SLAB REINFORCEMENT SHALL BE 20MM CLEAR MINIMUM FROM BOTTOM AND FROM TOP OF SLAB.
- 2. REINFORCEMENT IN CONTINUOUS ELEVATED SLAB SHALL BE CUT AS FOLLOWS.

NOTE

- THIS IS A SCHEMATIC PLAN FOR THE PURPOSE OF LOCATING AND IDENTIFYING FOUNDATION REINFORCING ELEMENTS ONLY. VERIFY ALL DIMENSIONS, DROPS, OFFSETS AND FEATURES WITH THE ARCHITECTURAL PLANS BEFORE FORMING THE FOUNDATION.

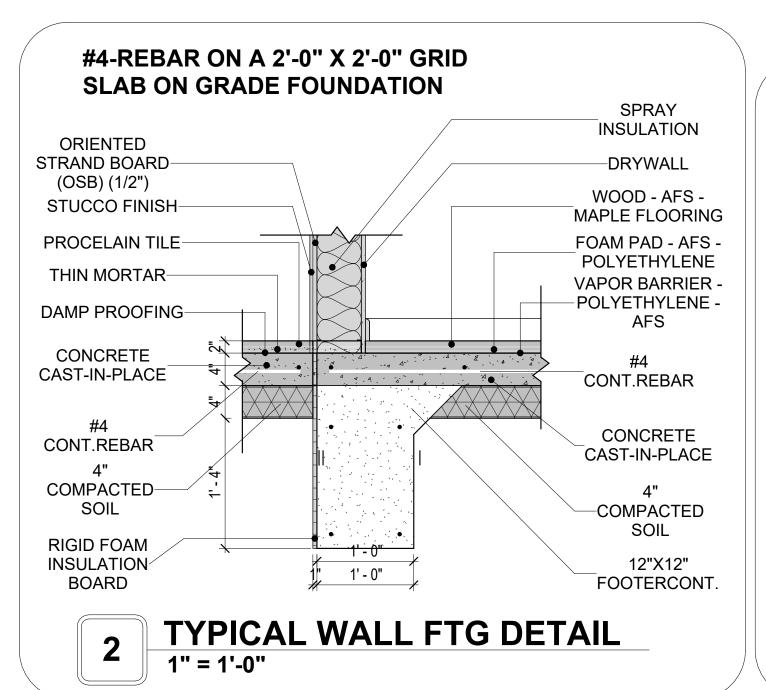

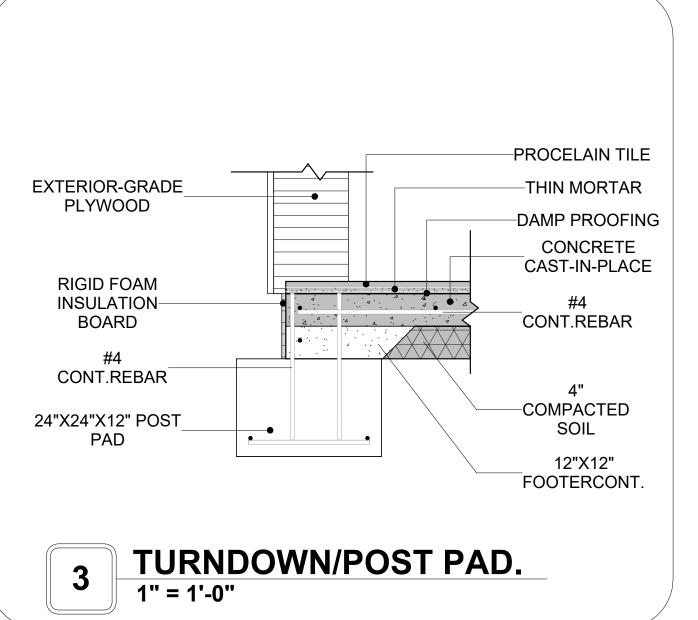

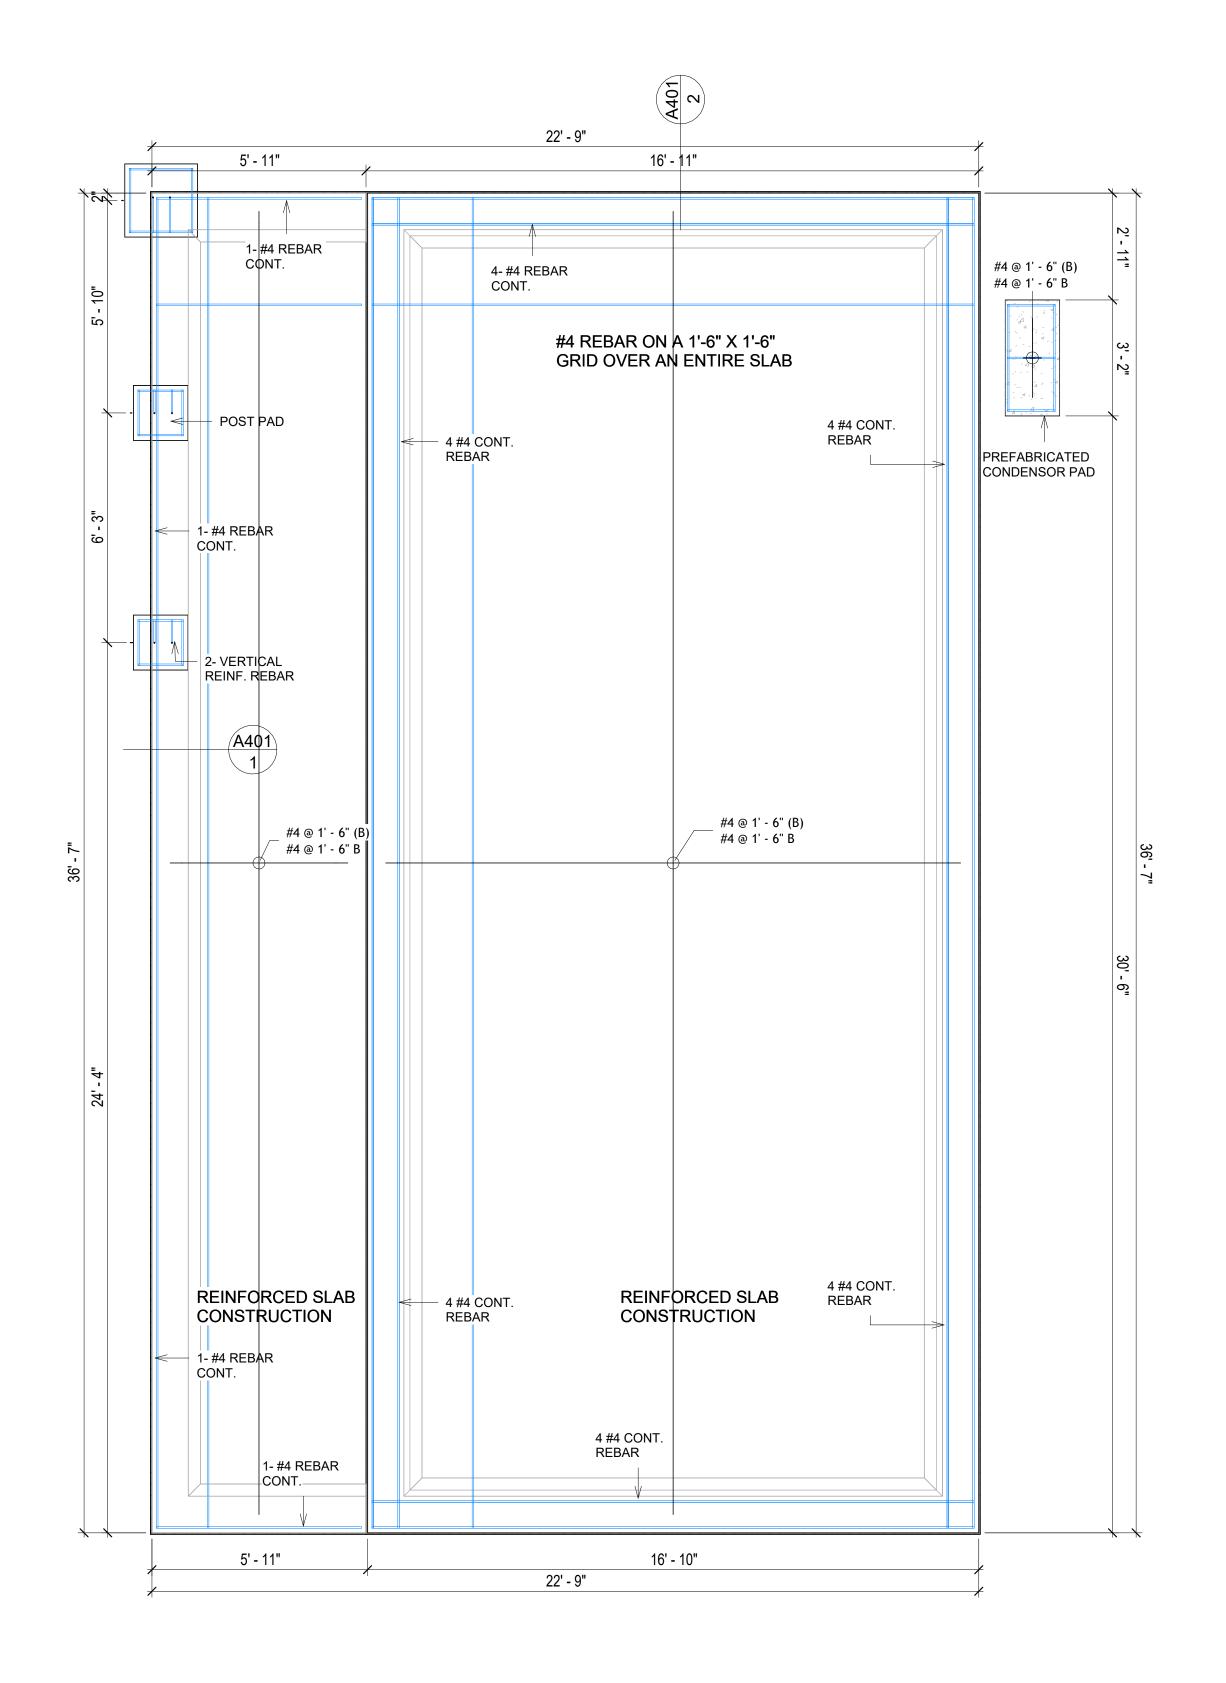

1 FOUNDATION REBAR PLAN
3/8" = 1'-0"



KEY PLAN

NO.	DESCRIPTION	DATE

NOTE:

LEGEND:

PROJECT

217-WESTBROOK-625-1Bd1Ba-CONTEMPORARY-550

DRAWING NAME

STRUCTURAL FLOOR PLAN

 CLIENT NAME:
 Client Name

 PROJECT NUMBER:
 0061_12

 DATE:
 5/6/2025 3:05:35 PM

 DESIGNED BY:
 Designer


 DRAWN BY:
 Author


 CHECKED BY:
 Checker

S102

ROOF NOTES

- ROOFING COMPOSITION ROOFING PER OWNERS/BUILDERS SPECIFICATIONS INSTALL PER MANUFACTURE SPECIFICATIONS ON 1/2" ORIENTED STRAND BOARD ON PRE-ENGINEERED TRUSS @ 24" O.C. (UNO.) 2. 73" OVERHANG AT EAVES (UNO.)
- 3. ENDS OF ALL TRUSSES AND JOISTS TO BE FULLY BLOCKED. PROVIDE SOLID
- BLOCKING AT ALL RIDGES AND VALLEYS 4. SHEATHING TO BE 1/2", 3/8" OSB SHEAR PANEL AND EQUIVALENT.
- UNDERSIDE OF PORCH TRUSSES TO BE FINISHED WITH MOISTURE RESISTANT DRYWALL, TAPED AND TEXTURED.
- 5. EXPOSED EAVES AND OTHER WEATHER EXPOSED AREAS TO BE SHEATHED WITH EXTERIOR GRADE PLYWOOD.
- 6. ALL MATERIALS THICKNESS AND SIZE ARE THE MINIMUM. Refer TO LOCAL STANDARDS FOR ACTUAL THICKNESS AND LAYERING OF MATERIALS.
- ENGINEERED TRUSS CALCULATIONS TO BE SUBMITTED TO BUILDING DEPARTMENT PRIOR TO FABRICATION AND INSTALLATION.
- 8. TRUSS MANUFACTURER TO SPECIFY HANGER CONNECTORS FOR TRUSS COMPONENTS (TYPICAL)
- 9. DESIGNER ASSUMES THAT TRUSSES BEAR ON ALL EXTERIOR PERIMETER WALLS (TYPICAL) OR BEAMS.
- 10. PROVIDE GALVANIZED STEEL FLASHING WITH A LENGTH OF 10 FEET, WIDTH

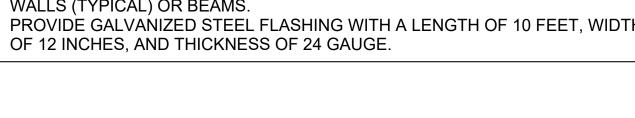

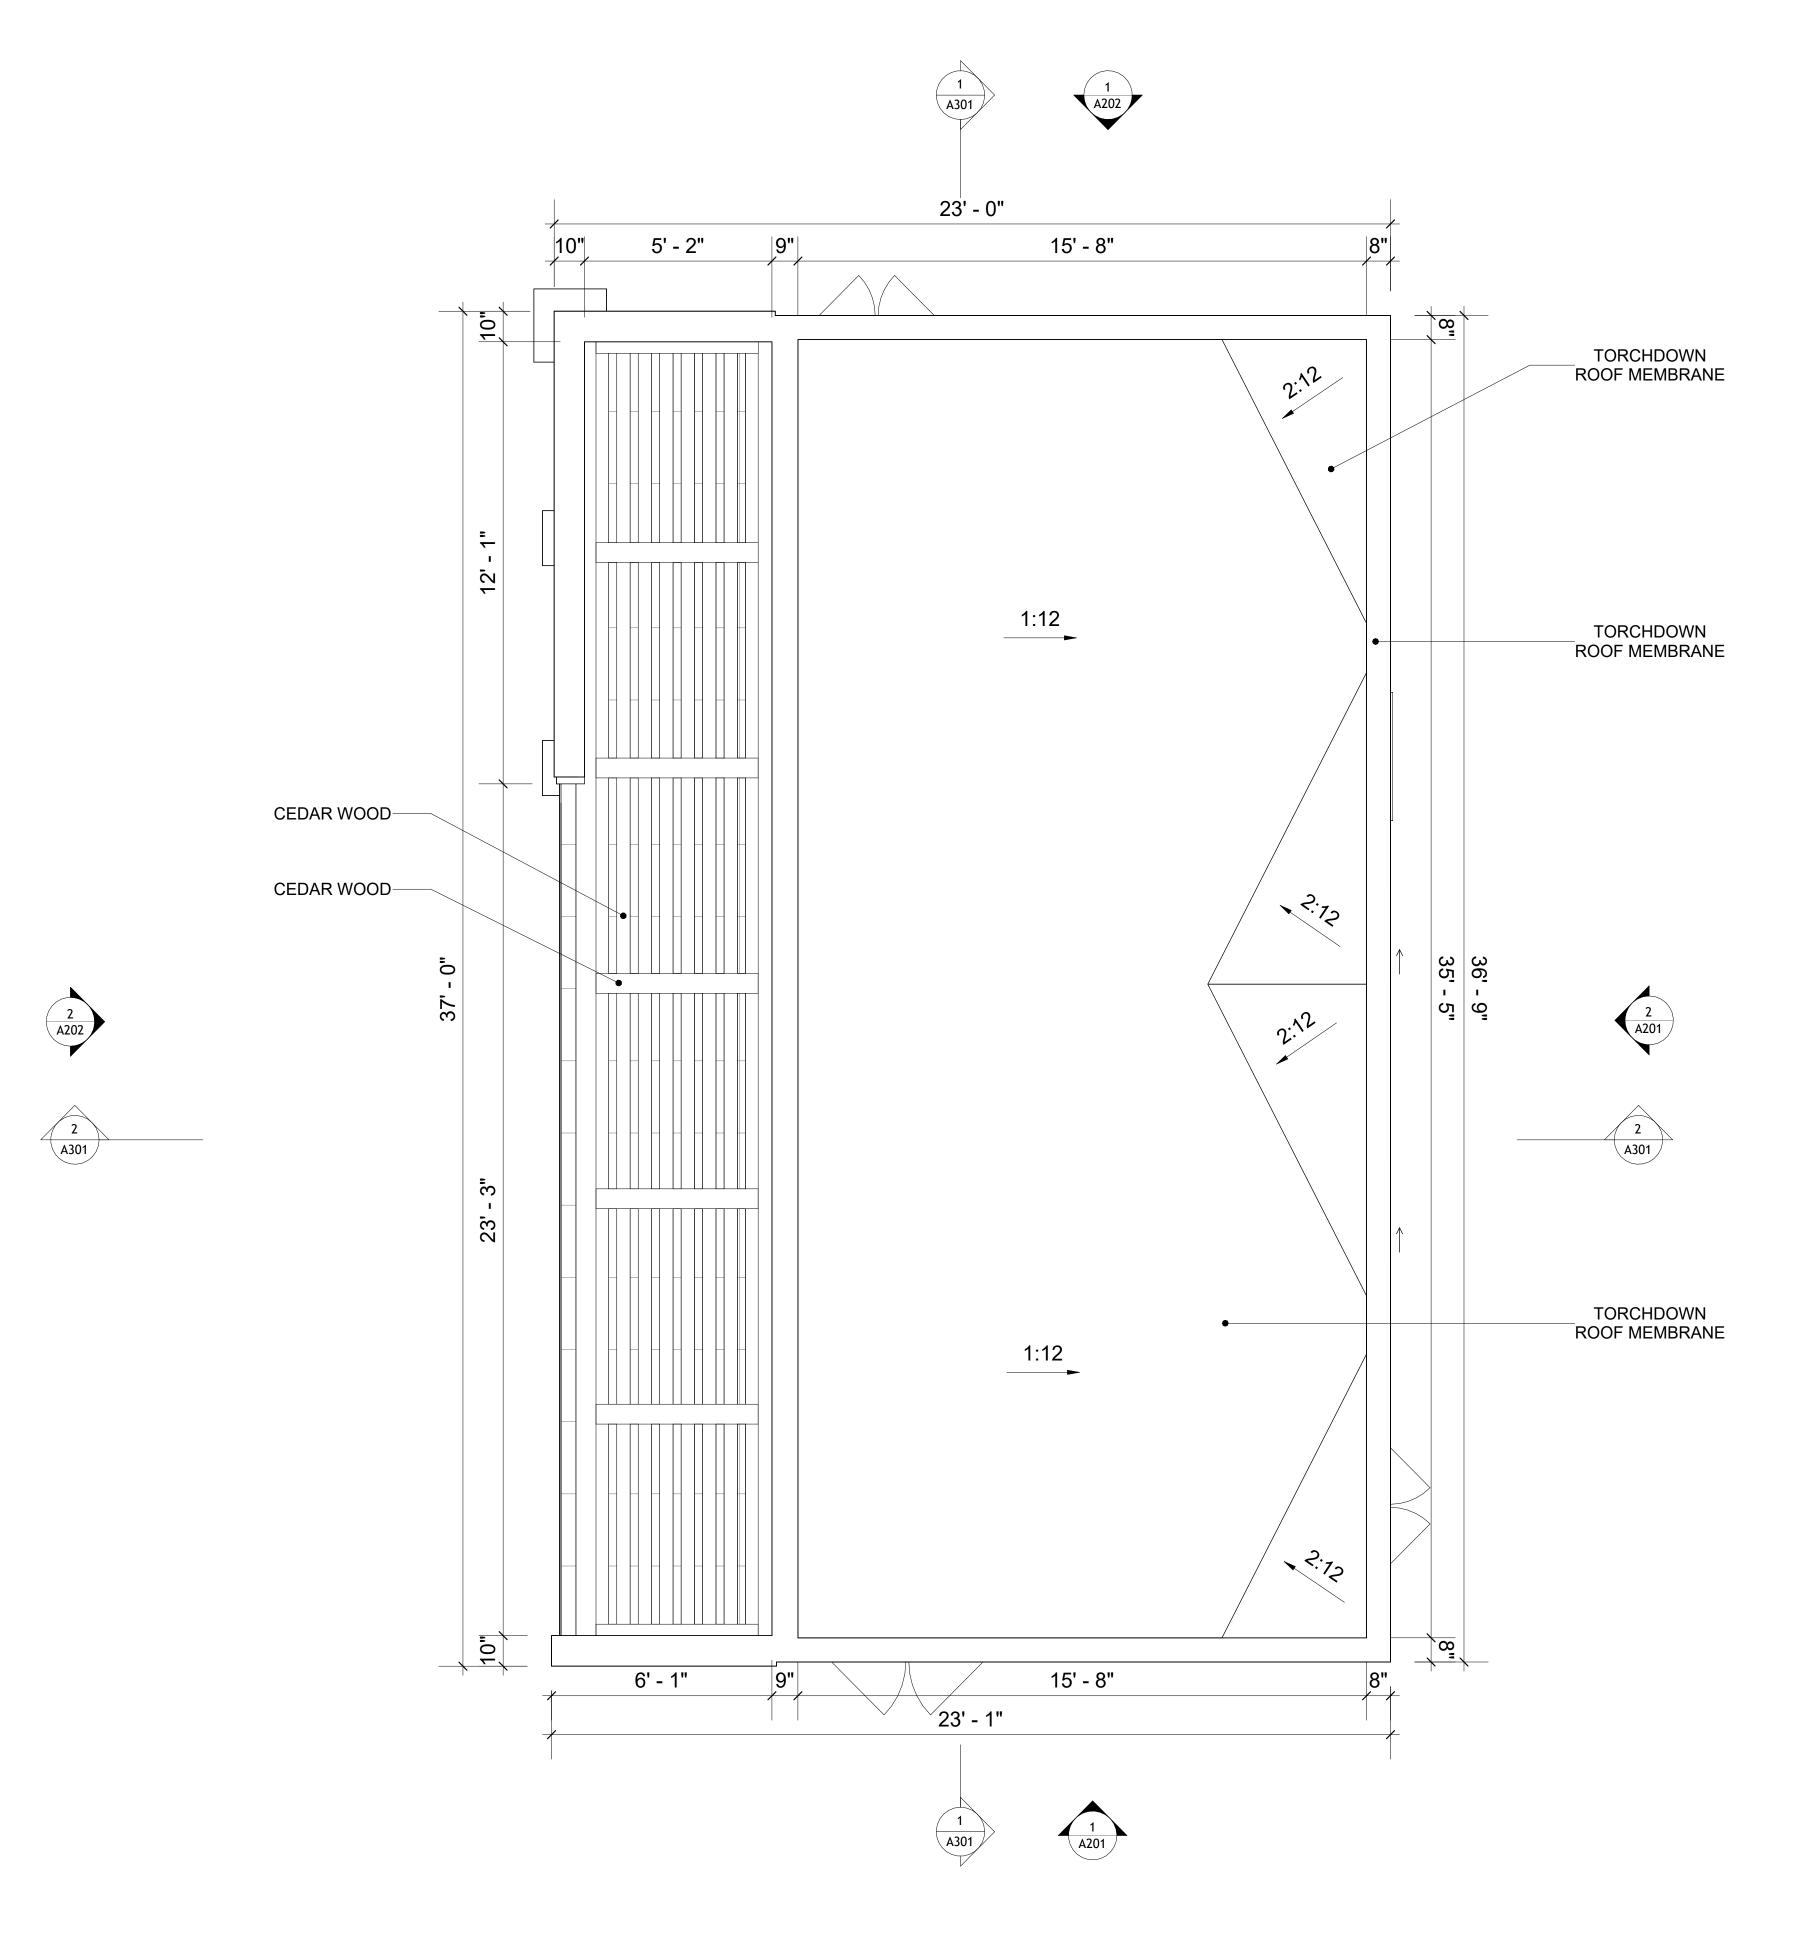



SQUARE FOOTAGE			
LIVING	625		
PORCH	206		
TOTAL	831		



KEY PLAN

NO.	DESCRIPTION	DATE

NOTE:

LEGEND:

PROJECT

217-WESTBROOK-625-1Bd1Ba-**CONTEMPORARY-550**

DRAWING NAME

ROOF PLAN

CLIENT NAME:	Client Name
PROJECT NUMBER:	0061_12
DATE:	5/6/2025 3:05:38 PM
DESIGNED BY:	Designer
DRAWN BY:	Author
CHECKED BY:	Checker

A103

ABOUT WALL FINISHING

STUCCO FINISH

STUCCO IS A CEMENT-BASED EXTERIOR WALL FINISH THAT OFFERS A DURABLE, WEATHER-RESISTANT, AND CUSTOMIZABLE CLADDING SOLUTION FOR BUILDINGS.

IN THIS SPECIFIC PROJECT, AMERICAN STUCCO SYSTEMS IS USED AS A FINISH MATERIAL BECAUSE IT IS GENERALLY CONSIDERED A WATER-RESISTANT EXTERIOR FINISH AND USES A THREE-COAT APPLICATION PROCESS.

3/8-INCH OF IT IS APPLIED AS AN EXTERNAL WALL FINISH AS IT IS THE MOST COMMON AND WIDELY ACCEPTED STANDARD THICKNESS FOR STUCCO EXTERIOR WALL FINISHES. THIS MULTI-LAYER APPROACH ALSO HELPS CREATE A STRONG, CRACK-RESISTANT STUCCO SURFACE.

THIS STANDARD STUCCO IS APPLIED OVER OSB SHEATHINGS (FOR COLD FORMED STRUCTURE CONSTRUCTION).

IT IS NOT DIRECTLY TROWELED OVER THE OSB BUT OVER A WATER-RESISTANT BARRIER (HOMEWRAP) AND METAL/PLASTIC LATH THAT ARE INSTALLED ON TOP SURFACE OF THE OSB TO PROVIDE AN ADDITIONAL LAYER OF PROTECTION AGAINST MOISTURE INTRUSION.


REGULAR INSPECTION AND PROMPT REPAIR OF ANY CRACKS, CHIPS, OR DAMAGE TO THE STUCCO FINISH IS IMPORTANT. THIS MAINTAINS THE STUCCO'S WATER-RESISTANT PROPERTIES OVER THE BUILDING'S LIFE SPAN.

PLYWOOD WALL SIDING


WALL SIDING IS AN EXTERIOR CLADDING MATERIAL USED TO COVER AND PROTECT THE WALLS OF A BUILDING, PROVIDING BOTH FUNCTIONAL AND AESTHETIC BENEFITS.

IN THIS SPECIFIC PROJECT, PLYWOOD WALL PANELS ARE USED AS A FINISH SIDING BECAUSE THIS TYPE OF SIDING PROVIDES A DURABLE, COST-EFFECTIVE, AND VERSATILE EXTERIOR CLADDING THAT CAN BE EASILY INSTALLED, FINISHED, AND MAINTAINED TO ENHANCE THE AESTHETIC AND PROTECTIVE QUALITIES OF A BUILDING'S EXTERIOR.

STANDARD SIZES OF 1' X 8' EXTERIOR-GRADE PLYWOOD PANELS ARE INSTALLED ON THE FURRING STRIPS USING GALVANIZED STEEL SELF-DRILLING SCREWS.

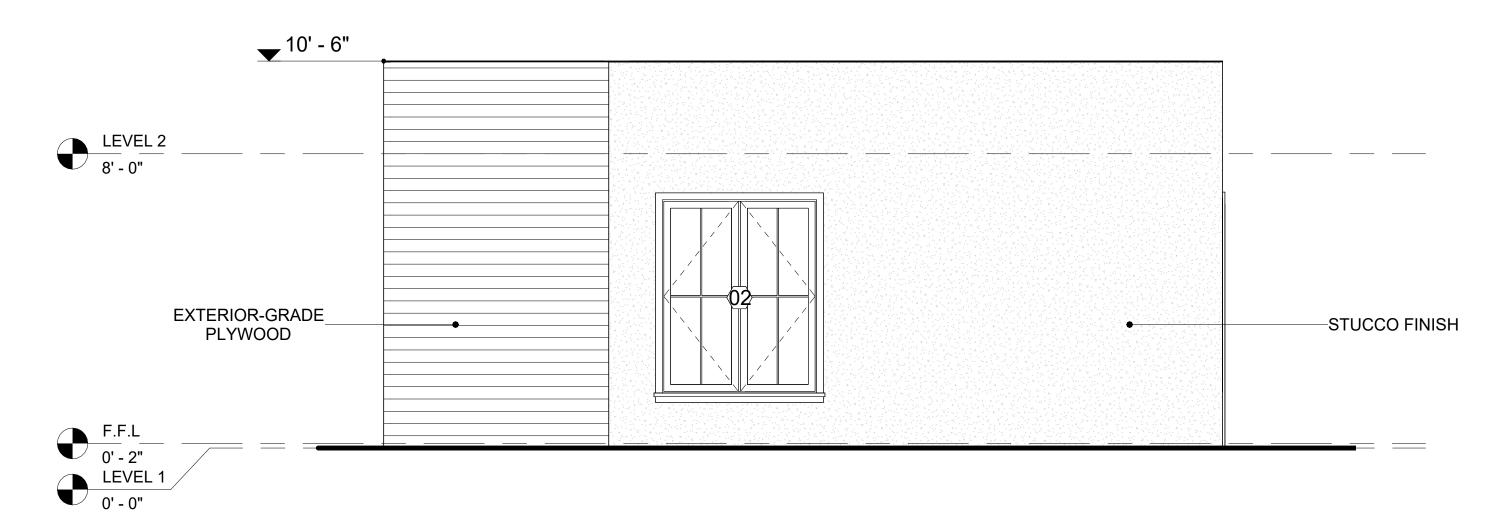



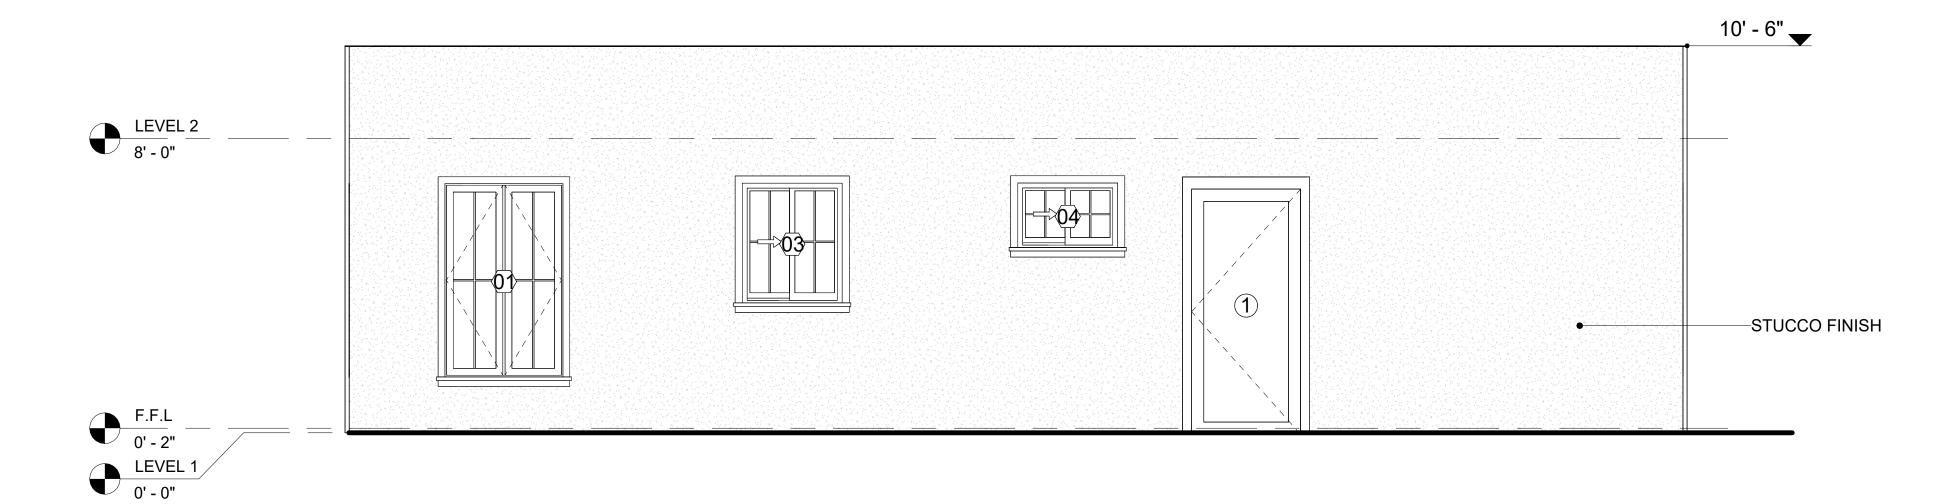


2 RIGHT SIDE ELEVATION
3/8" = 1'-0"

DOOR SCHEDULE						
TYPE				SIZE		
MAR K	SUPPLIER	DOOR TYPE	LOCATIO N	WIDTH	HEIGHT	COUNT
4	LIONAE DEDOT	EVERNOR OINOLE RANEL OWINGING	INITEDIOD	01 011	01 011	
1	HOME DEPOT	EXTERIOR SINGLE PANEL SWINGING	INTERIOR	3' - 0"	6' - 8"	1
2	HOME DEPOT	INTERIOR SINGLE PANEL SWINGING	INTERIOR	3' - 0"	6' - 8"	2
3	HOME DEPOT	EXTERIOR DOUBLE PANEL SWINGING	INTERIOR	5' - 0"	6' - 8"	1
4	HOME DEPOT	SINGLE FOLD 2	INTERIOR	3' - 6"	6' - 8"	1
5	HOME DEPOT	INTERIOR DOUBLE PANEL SLIDING	INTERIOR	8' - 6"	6' - 8"	1
6	HOME DEPOT	DOOR-BIFOLD 9052	INTERIOR	12' - 0"	6' - 8"	1

WINDOW SCHEDULE						
			SIZE			
TYPE MARK	SUPPLIER	WINDOW TYPE	WIDTH	HEIGHT	COUNT	
				,		
01	HOME DEPOT	DOUBLE SWING	3' - 3"	5' - 3"	2	
02	HOME DEPOT	DOUBLE SWING	4' - 3"	5' - 3"	1	
03	HOME DEPOT	SLIDING	2' - 9"	3' - 3"	1	
04	HOME DEPOT	SLIDING	2' - 9"	1' - 9"	1	



KEY PLAN

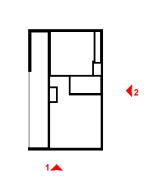

NO.	DESCRIPTION	DATE

NOTE:

LEGEND:

PROJECT

217-WESTBROOK-625-1Bd1Ba-CONTEMPORARY-550

DRAWING NAME

ARCHITECTURAL ELEVATIONS

CLIENT NAME:	Client Name
PROJECT NUMBER:	0061_12
DATE:	5/6/2025 3:05:40 PM
DESIGNED BY:	Designer
DRAWN BY:	Author
CHECKED BY:	Checker

A201

ABOUT WALL FINISHING

STUCCO FINISH

STUCCO IS A CEMENT-BASED EXTERIOR WALL FINISH THAT OFFERS A DURABLE, WEATHER-RESISTANT, AND CUSTOMIZABLE CLADDING SOLUTION FOR BUILDINGS.

IN THIS SPECIFIC PROJECT, AMERICAN STUCCO SYSTEMS IS USED AS A FINISH MATERIAL BECAUSE IT IS GENERALLY CONSIDERED A WATER-RESISTANT EXTERIOR FINISH AND USES A THREE-COAT APPLICATION PROCESS.

3/8-INCH OF IT IS APPLIED AS AN EXTERNAL WALL FINISH AS IT IS THE MOST COMMON AND WIDELY ACCEPTED STANDARD THICKNESS FOR STUCCO EXTERIOR WALL FINISHES. THIS MULTI-LAYER APPROACH ALSO HELPS CREATE A STRONG, CRACK-RESISTANT STUCCO SURFACE.

THIS STANDARD STUCCO IS APPLIED OVER OSB SHEATHINGS (FOR COLD FORMED STRUCTURE CONSTRUCTION).

IT IS NOT DIRECTLY TROWELED OVER THE OSB BUT OVER A WATER-RESISTANT BARRIER (HOMEWRAP) AND METAL/PLASTIC LATH THAT ARE INSTALLED ON TOP SURFACE OF THE OSB TO PROVIDE AN ADDITIONAL LAYER OF PROTECTION AGAINST MOISTURE INTRUSION.

REGULAR INSPECTION AND PROMPT REPAIR OF ANY CRACKS, CHIPS, OR DAMAGE TO THE STUCCO FINISH IS IMPORTANT. THIS MAINTAINS THE STUCCO'S WATER-RESISTANT PROPERTIES OVER THE BUILDING'S LIFE SPAN.

PLYWOOD WALL SIDING


WALL SIDING IS AN EXTERIOR CLADDING MATERIAL USED TO COVER AND PROTECT THE WALLS OF A BUILDING, PROVIDING BOTH FUNCTIONAL AND AESTHETIC BENEFITS.

IN THIS SPECIFIC PROJECT, PLYWOOD WALL PANELS ARE USED AS A FINISH SIDING BECAUSE THIS TYPE OF SIDING PROVIDES A DURABLE, COST-EFFECTIVE, AND VERSATILE EXTERIOR CLADDING THAT CAN BE EASILY INSTALLED, FINISHED, AND MAINTAINED TO ENHANCE THE AESTHETIC AND PROTECTIVE QUALITIES OF A BUILDING'S EXTERIOR.

STANDARD SIZES OF 1' X 8' EXTERIOR-GRADE PLYWOOD PANELS ARE INSTALLED ON THE FURRING STRIPS USING GALVANIZED STEEL SELF-DRILLING SCREWS.




1 REAR ELEVATION 3/8" = 1'-0"

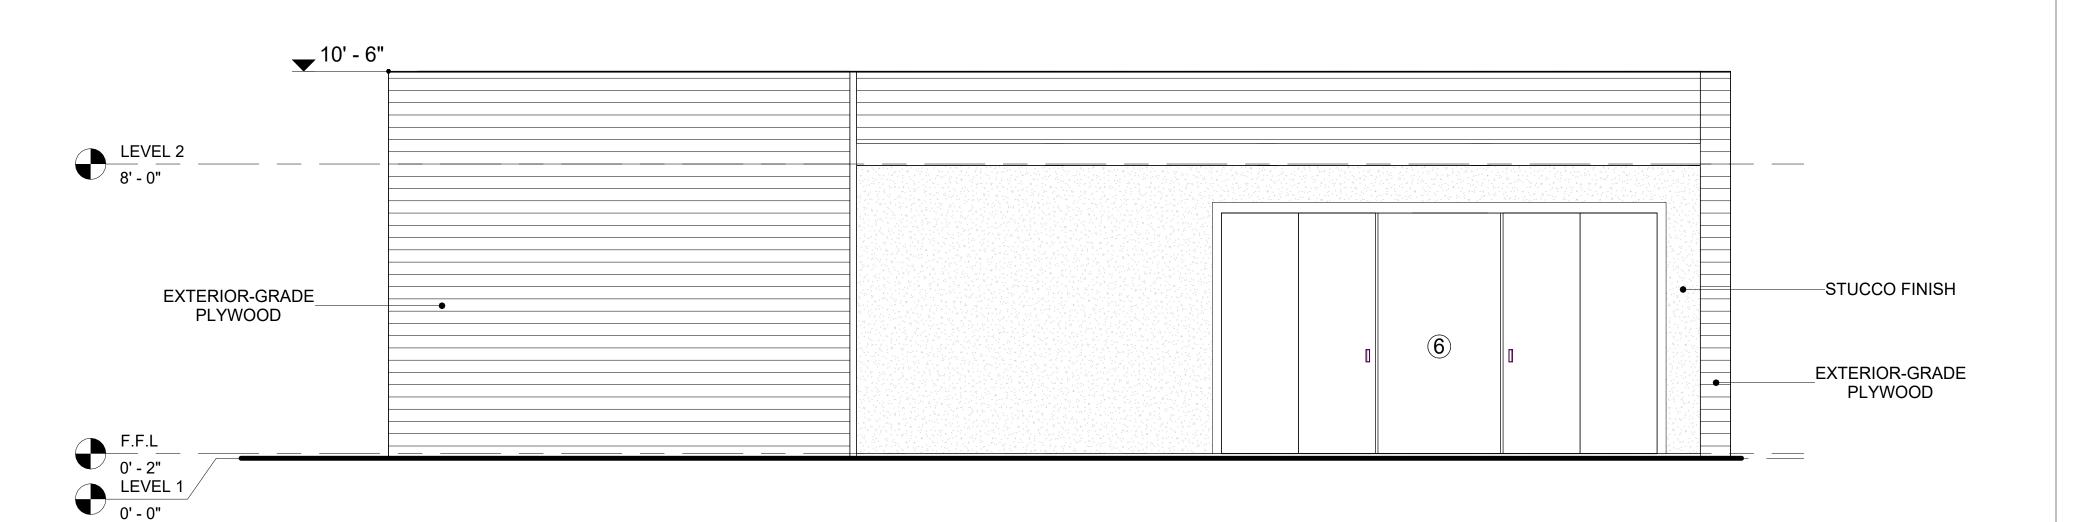

2 LEFT SIDE ELEVATION
3/8" = 1'-0"



KEY PLAN

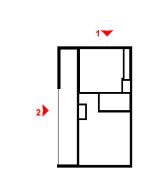

NO.	DESCRIPTION	DATE

NOTE:

LEGEND:

PROJECT


217-WESTBROOK-625-1Bd1Ba-CONTEMPORARY-550

DRAWING NAME


ARCHITECTURAL ELEVATIONS

Client Na	CLIENT NAME:
0061	PROJECT NUMBER:
5/6/2025 3:05:42	DATE:
Desig	DESIGNED BY:
Au	DRAWN BY:
Ched	CHECKED BY:

A202

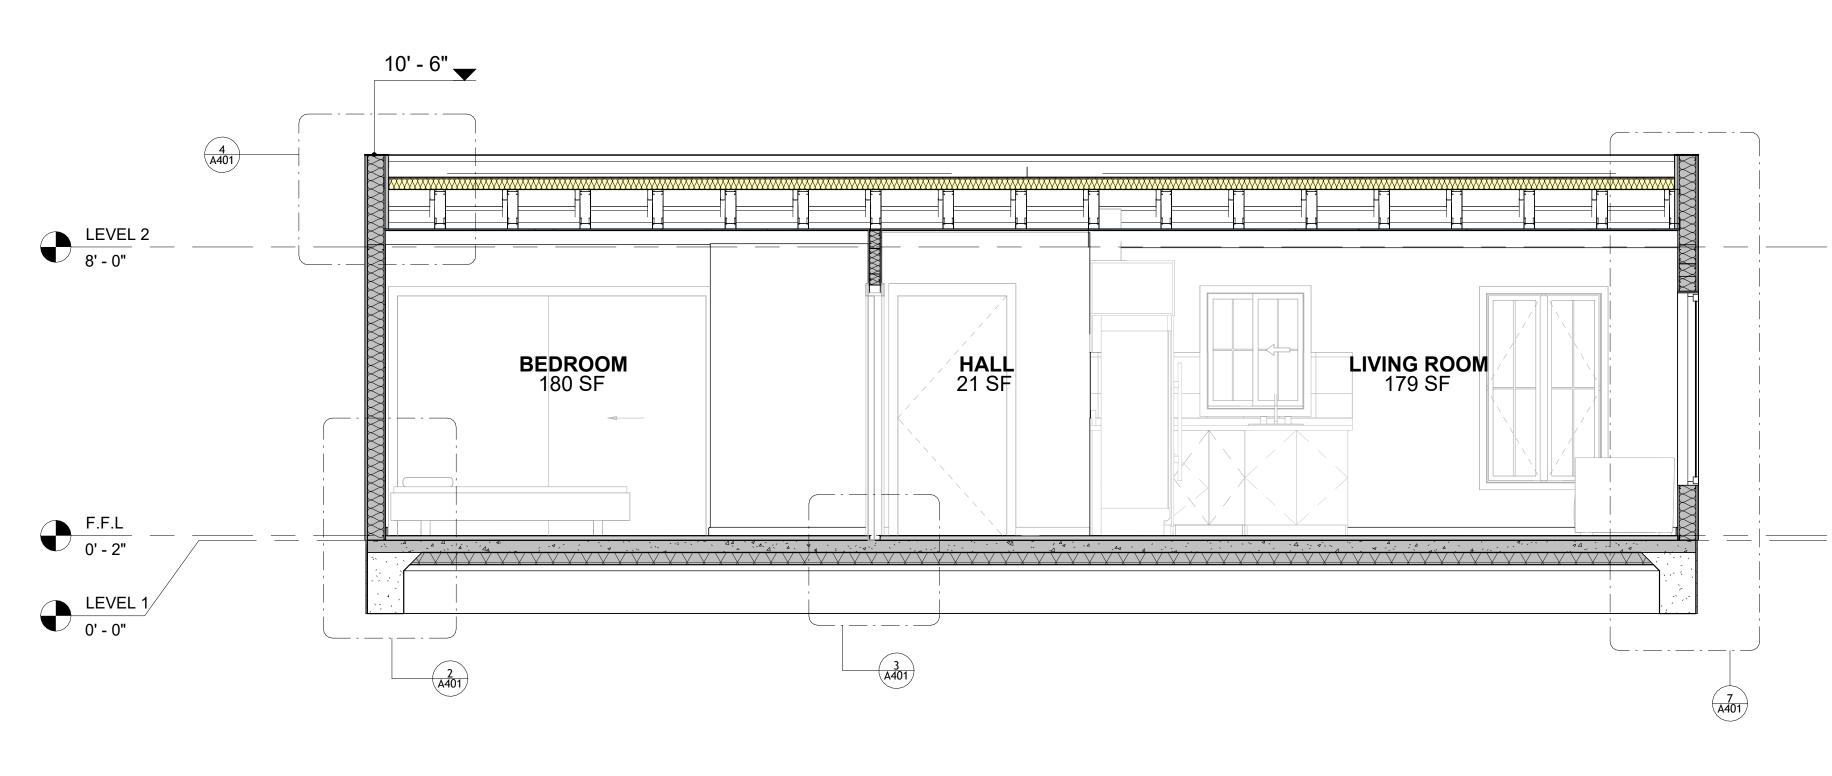




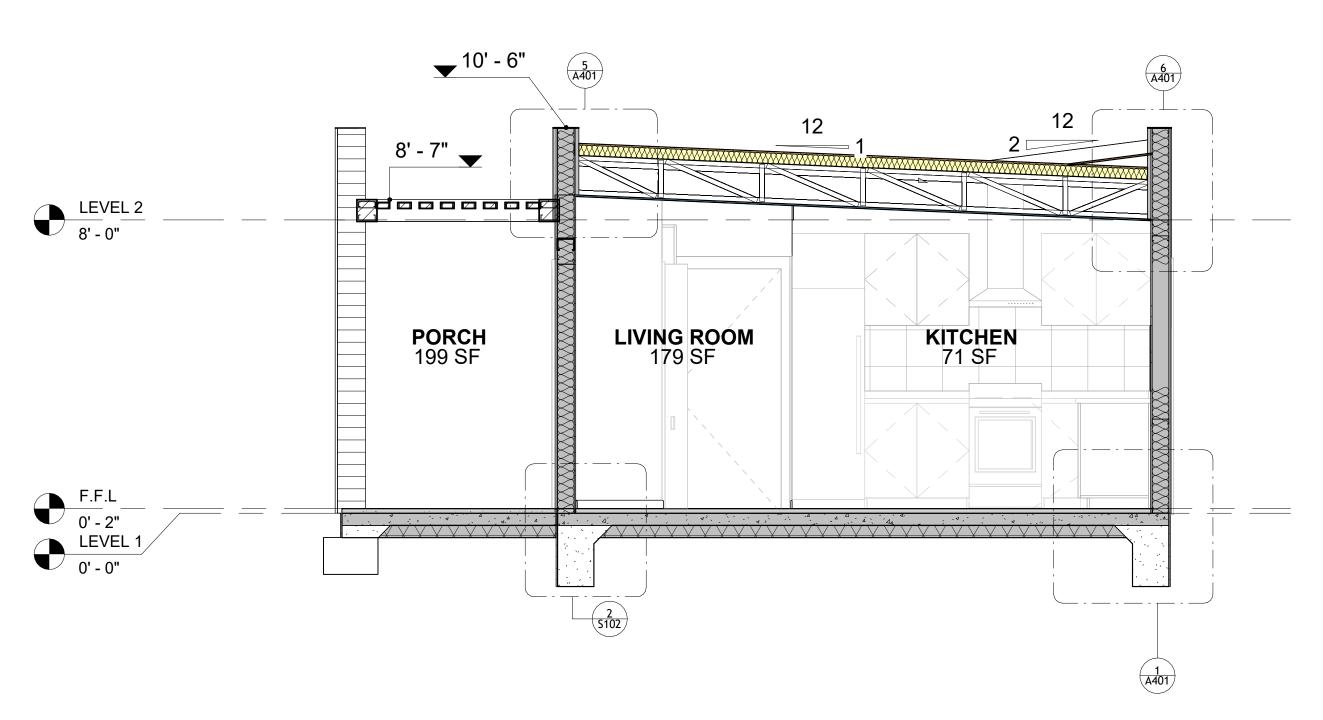

2 SECTION-2 3/8" = 1'-0"



KEY PLAN

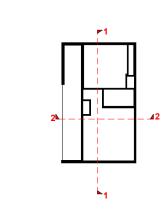

NO.	DESCRIPTION	DATE
	·	

NOTE:

LEGEND:

PROJECT


217-WESTBROOK-625-1Bd1Ba-CONTEMPORARY-550

DRAWING NAME


ARCHITECTURAL SECTIONS


ENT NAME:	Client Name
OJECT NUMBER:	0061_12
TE:	5/6/2025 3:05:44 PM
SIGNED BY:	Designer
AWN BY:	Author
ECKED BY:	Checker


A301

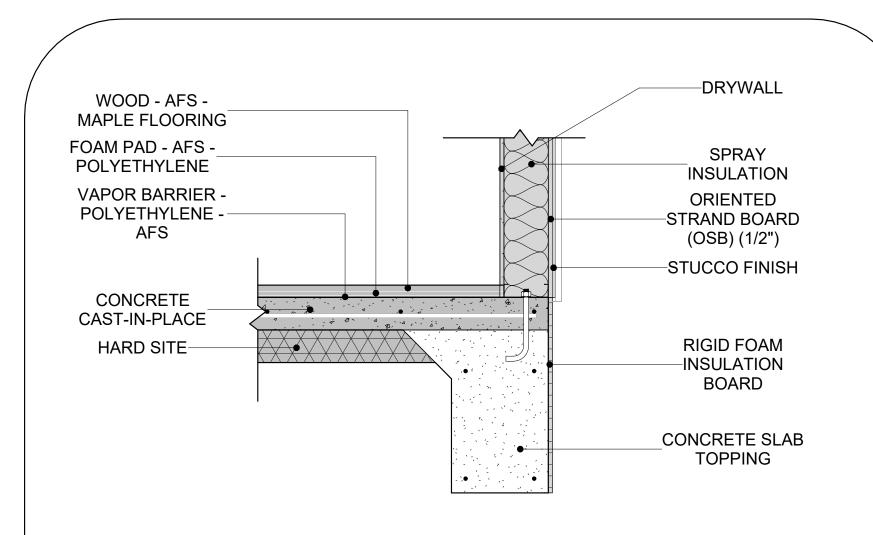


1 TYPICAL WALL FTG

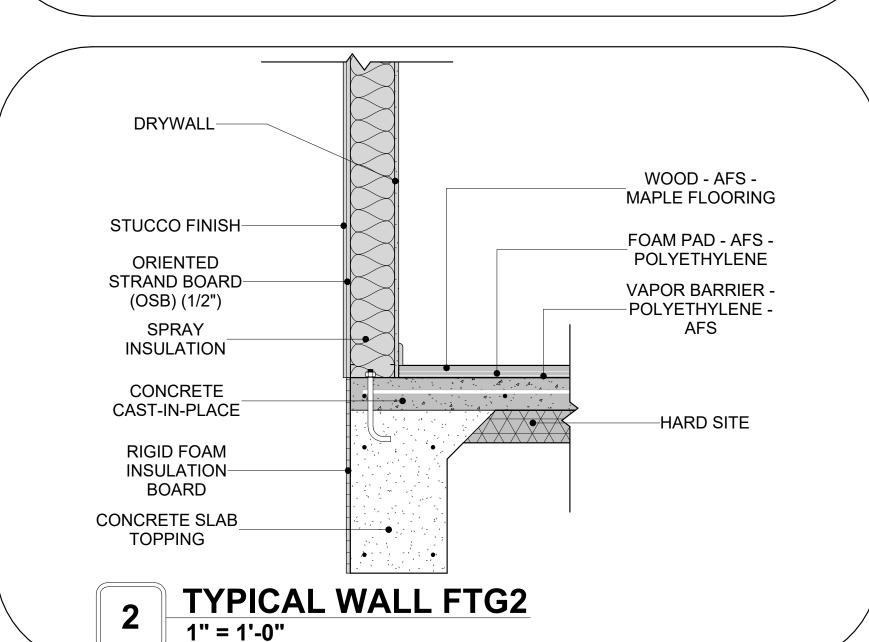

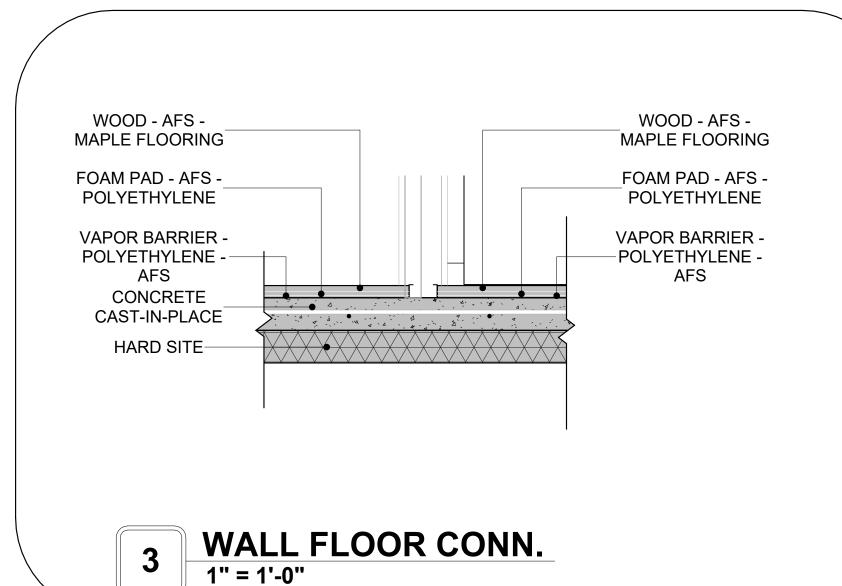

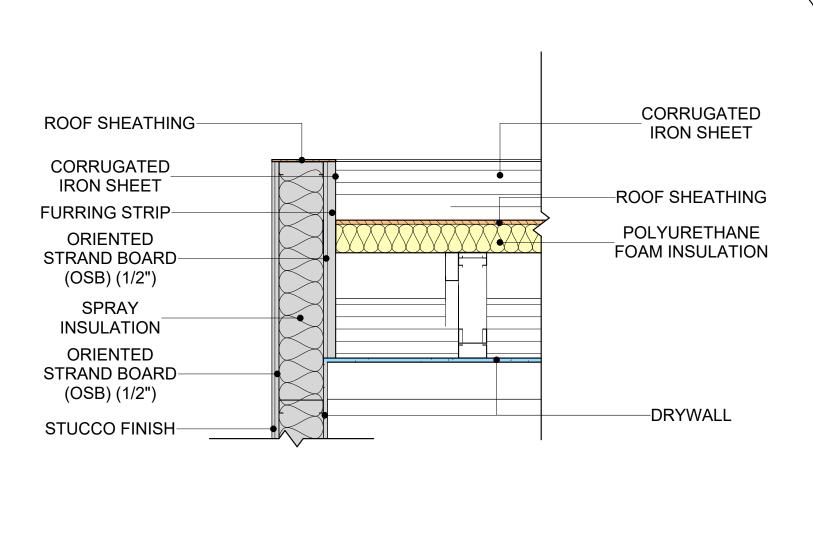


4 ROOF ON WALL
1" = 1'-0"

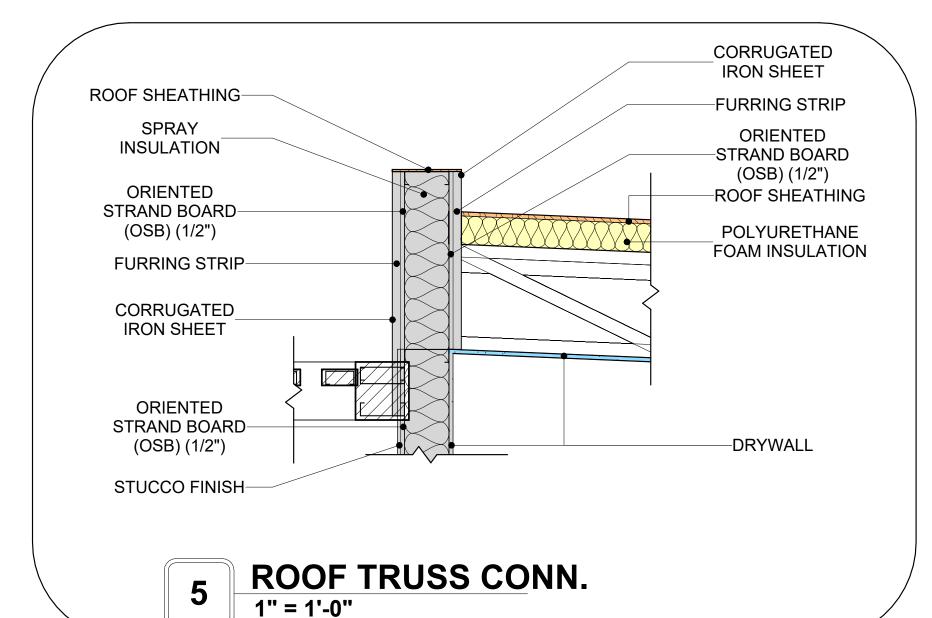

-ROOF SHEATHING SPRAY INSULATION **ROOF SHEATHING-**CORRUGATED IRON SHEET POLYURETHANE FOAM INSULATION -FURRING STRIP ORIENTED -STRAND BOARD (OSB) (1/2") SPRAY INSULATION ORIENTED -STRAND BOARD (OSB) (1/2") DRYWALL-STUCCO FINISH WALL TO ROOF CONN.

1" = 1'-0"

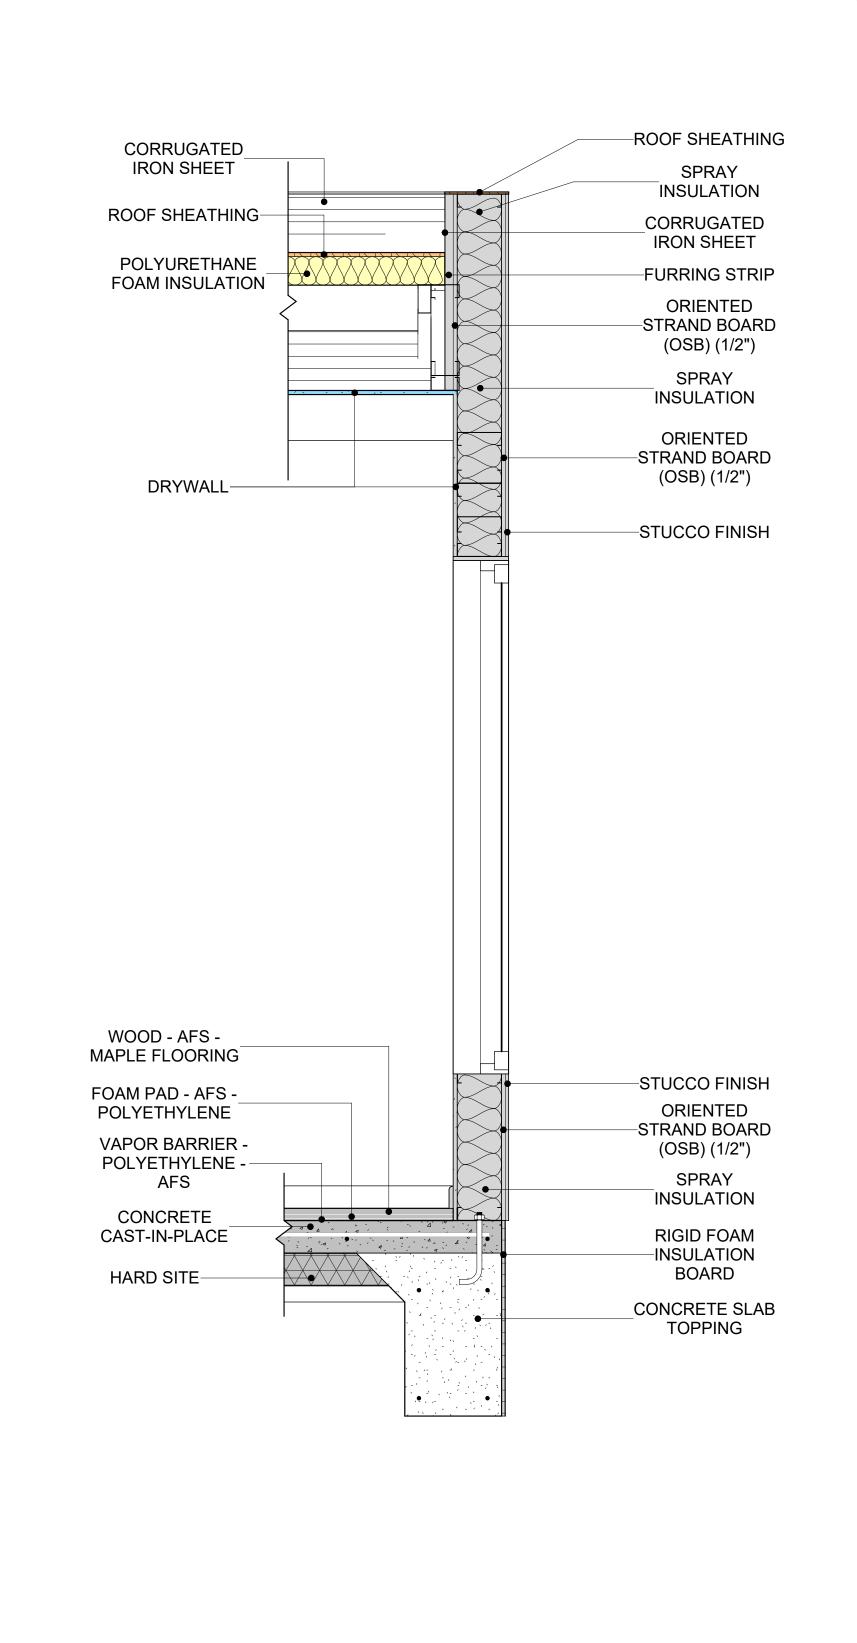

BUILDING SECTION
1" = 1'-0"



KEY PLAN

NO.	DESCRIPTION	DATI

NOTE:

LEGEND:

PROJECT

217-WESTBROOK-625-1Bd1Ba-CONTEMPORARY-550

DRAWING NAME

ARCHITECTURAL DETAILS

CLIENT NAME:	Client Name
PROJECT NUMBER:	0061_12
DATE:	5/6/2025 3:05:46 PM
DESIGNED BY:	Designer
DRAWN BY:	Author
CHECKED BY:	Checker

A401


SCALE: 1" = 1'-0"


CASEWORK GENERAL NOTES

- 1. ALL CABINET HEIGHTS INCLUDE COUNTERTOPS. DIMENSIONS ARE TO THE NEAREST INCH.
- 2. DIVISIONS IN CASEWORK ARE SHOWN FOR CLARITY AND DO NOT REPRESENT BREAKS IN THE COUNTERTOP.
- 3. PROVIDE CONTINUOUS COUNTERTOP OVER ALL SIMILAR HEIGHT CASEWORK, UNLESS AND OTHERWISE NOTED.
- 4. MANUFACTURER AND CATALOG NUMBERS ARE FOR REFERENCE AND ILLUSTRATION PURPOSES
- ONLY.
 5. DOTTED LINES INDICATE WALL HUNG CABINETS, DIVISIONS OF BASE CABINETS BELOW THE
- 6. COUNTERTOP, FURNITURE NOT IN THE CONTRACT OR PROJECTION SCREENS -SEE CASEWORK KEY AND SPECIFICATIONS.
- 7. ALL CABINETS AND DRAWERS TO HAVE CAM LOCKS EXCEPT FOR SINK BASE CABINETS.
 8. ALL EXPOSED SURFACES (EXPOSED TO VIEW FROM ANY PERSPECTIVE) TO BE COVERED WITH
- LAMINATE.
- 9. ALL CASEWORK WHICH MEETS A WALL AT ONE OR BOTH ENDS, TO BE PROVIDED WITH FILLER PANELS AND SCRIBED TO THE WALL(S) AS REQUIRED.
- 10. ALL CABINETS AND DRAWERS ARE PROVIDED WITH RECESSED HANDLES.
- 11. CONTRACTOR TO FIELD VERIFY ALL CLEAR OPENINGS PRIOR TO MILLWORK OR CASEWORK FABRICATION.
- 12. CASEWORK DRAWINGS ARE DIAGRAMMATIC IN NATURE TO SHOW DESIGN INTENT.


	CASEWORK SCHEDULE					
TYPE MAR K	TYPE	COUN T	HEIGHT	WIDTH	DEPTH	AREA
01	L-SHAPE COUNTER TOP	1	0' - 4"	7' - 0"	7' - 0"	2 SF
02	RECESSED_MED_CABINET 2	1	2' - 0"	1' - 6"	0' - 3"	3 SF
03	BASE CABINET L-SHAPED	1	2' - 11"	3' - 3"	3' - 3"	9 SF
05	CLOSET_4	1	6' - 0"	9' - 4"	1' - 4"	56 SF
07	REFRIGERATOR TOP	1	1' - 6"	2' - 0"	2' - 4"	3 SF
80	VANITY	1	2' - 4"	2' - 6"	1' - 8"	6 SF
09	BASE CABINET DOUBLE DOOR 3	1	2' - 11"	2' - 10"	2' - 0"	8 SF
10	LINEAR COUNTER TOP 2	1	0' - 4"	0' - 4"	2' - 1"	0 SF
11	WALL CABINET DOUBLE DOOR 2	1	2' - 6"	2' - 10"	1' - 0"	7 SF
12	LAUNDRY OPEN CABINET 3	1	1' - 2"	2' - 3"	2' - 6"	3 SF
13	BASE CABINET DOUBLE DOOR 5	1	2' - 11"	2' - 0"	2' - 0"	6 SF
14	WALL CABINET DOUBLE DOOR 3	1	2' - 6"	3' - 0"	1' - 0"	8 SF
15	HD_CLOSET_OPEN	1	6' - 0"	4' - 1"	1' - 4"	25 SF
16	BASE CABINET DOUBLE DOOR 2	1	2' - 11"	2' - 10"	2' - 0"	8 SF
GRAND	TOTAL	14				


SPECIALTY EQUIPMENT SCHEDULE			
TYPE MARK	TYPE	COUNT	
01	WASHER-FRONT-LOAD	1	
02	REFRIGERATOR	1	
03	RANGE	1	
04	DRYER-FRONT-LOAD	1	
GRAND TOTAL: 4			

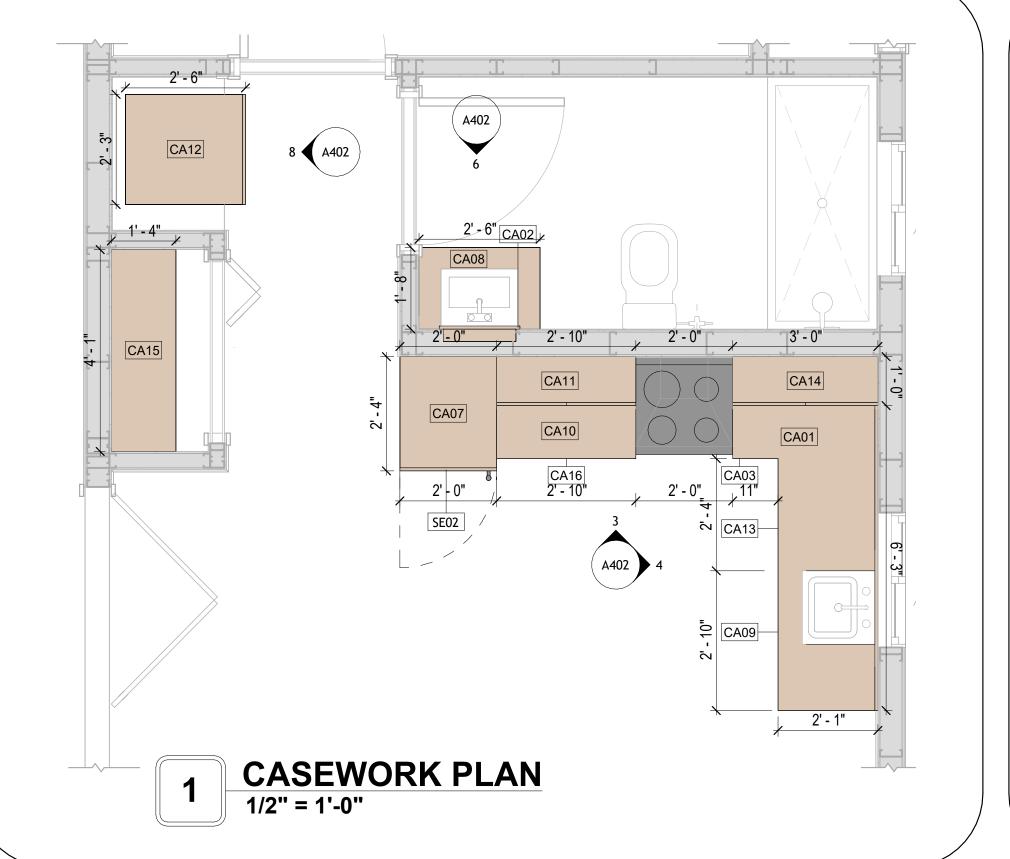

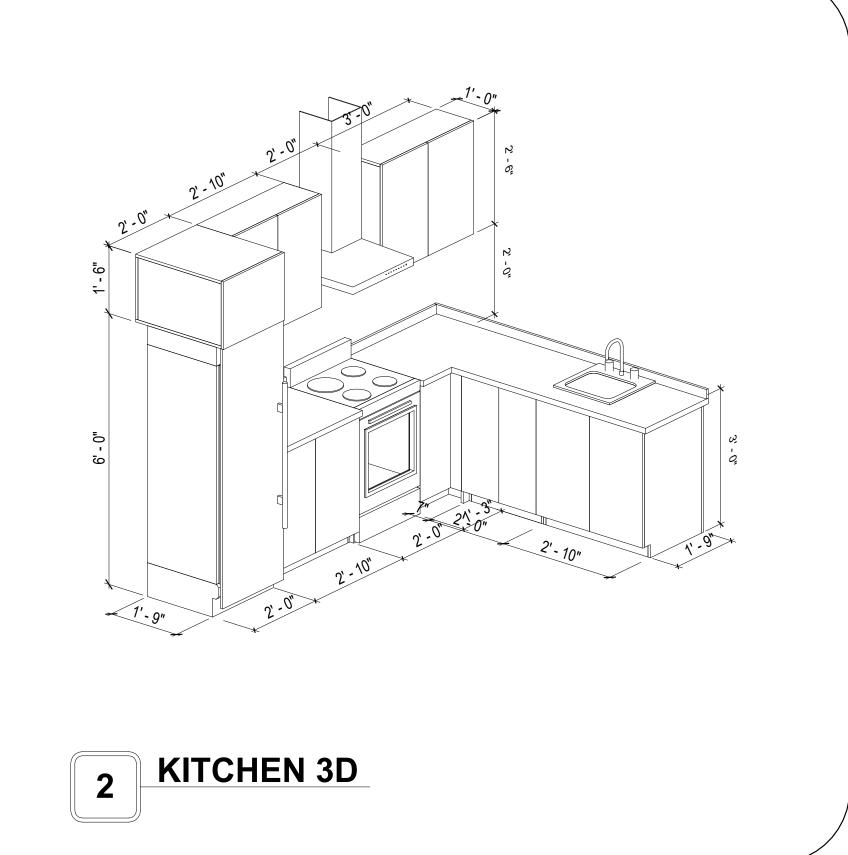


10 CLOSET 3D

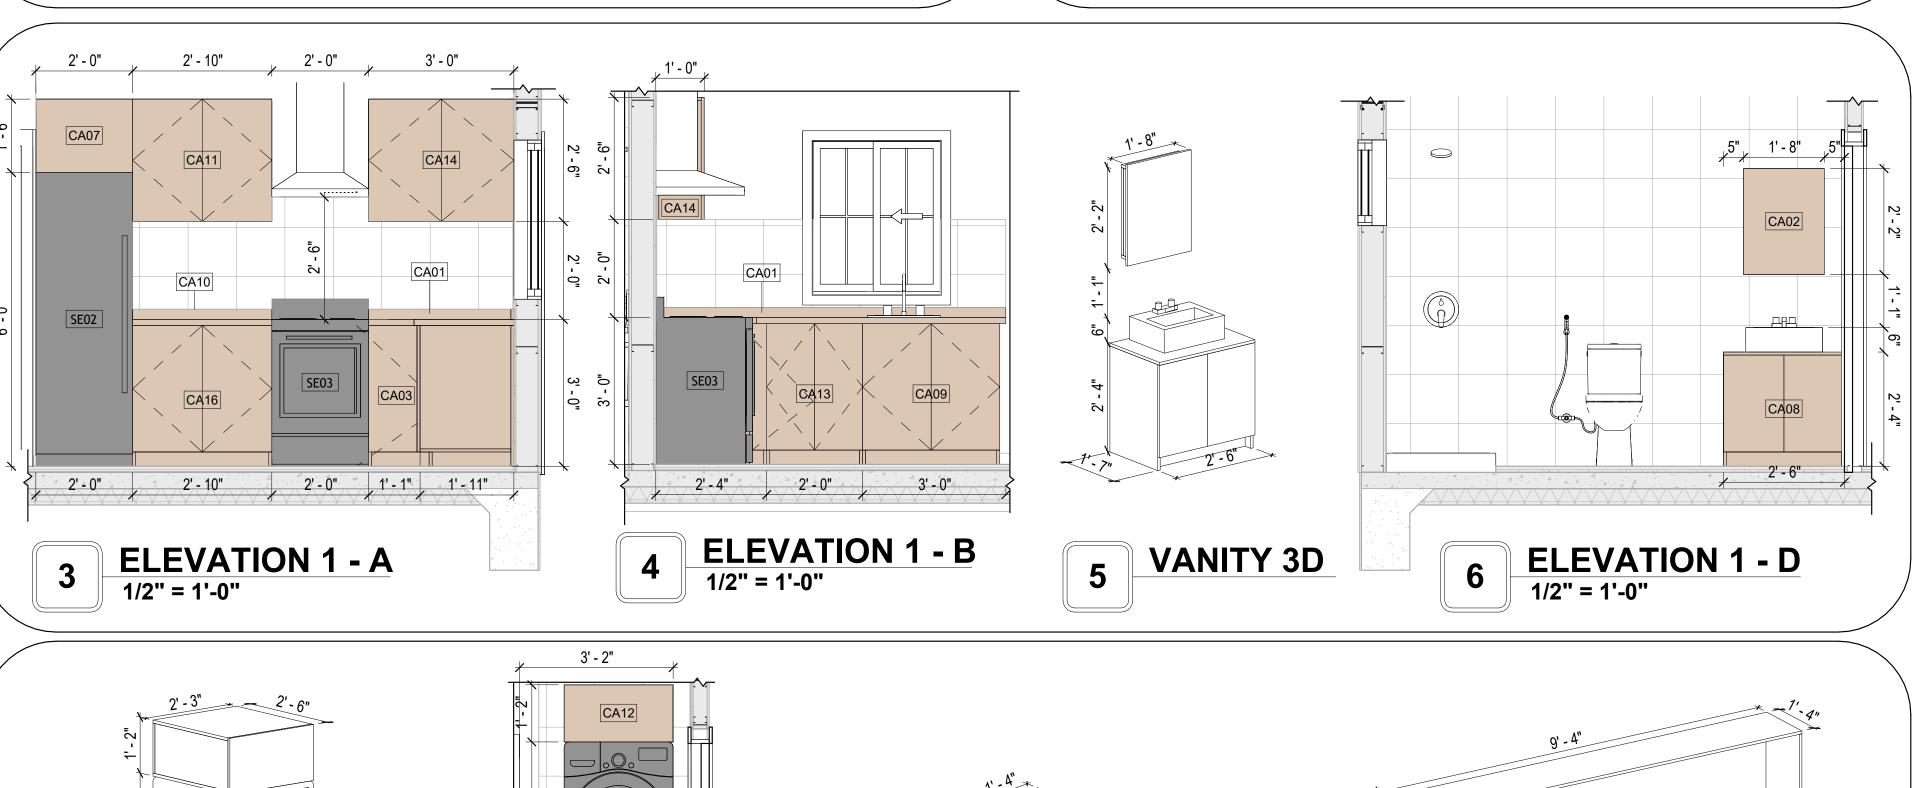

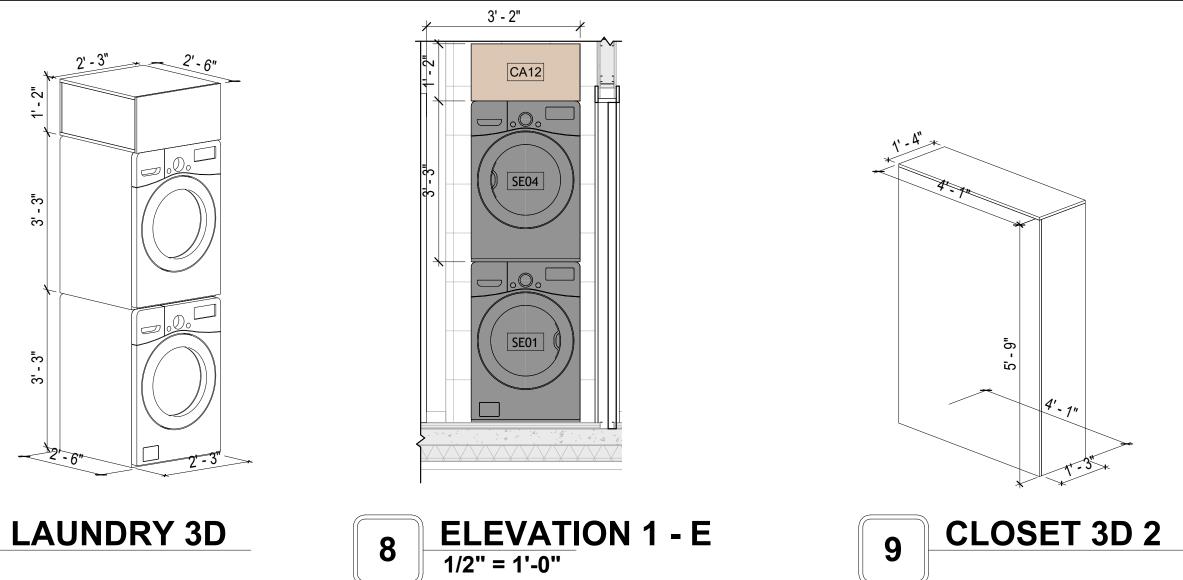



KEY PLAN

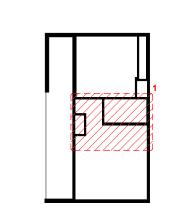

NO.	DESCRIPTION	DATE

NOTE:

LEGEND:

PROJECT

217-WESTBROOK-625-1Bd1Ba-CONTEMPORARY-550

DRAWING NAME

ARCHITECTURAL CASEWORK

CLIENT NAME:	Client Name
PROJECT NUMBER:	0061_12
DATE:	5/6/2025 3:05:48 PM
DESIGNED BY:	Designer
DRAWN BY:	Author
CHECKED BY:	Checker

A402

GENERAL NOTES

1. THIS DRAWING DEPICTS THE HVAC (HEATING, VENTILATION, AND AIR CONDITIONING) SYSTEM FOR WESTBROOK 1BD1BA CONTEMPORARY. IT PROVIDES A VISUAL REPRESENTATION OF THE SYSTEM LAYOUT AND COMPONENTS.

2.THE HVAC SYSTEM IS DESIGNED TO MEET THE SPECIFIC REQUIREMENTS OF THE BUILDING, INCLUDING HEATING, COOLING, AND VENTILATION NEEDS, AS PER THE PROJECT SPECIFICATIONS AND APPLICABLE CODES AND STANDARDS.

3. THE HVAC SYSTEM INSTALLATION SHALL COMPLY WITH THE LATEST EDITION OF THE INTERNATIONAL MECHANICAL CODE (IMC), INTERNATIONAL RESIDENTIAL CODE (IRC), AND ALL OTHER APPLICABLE LOCAL, STATE, AND NATIONAL CODES AND REGULATIONS.

4. THE EQUIPMENT SHOWN ON THIS DRAWING INCLUDES BUT IS NOT LIMITED TO AIR HANDLING UNITS (AHUS), CHILLERS, BOILERS, COOLING TOWERS, PUMPS, DUCTWORK, DIFFUSERS, GRILLES, AND CONTROL DEVICES.

5. ALL EQUIPMENT, DUCTWORK, AND PIPING SHALL BE INSTALLED IN ACCORDANCE WITH MANUFACTURER'S SPECIFICATIONS, LOCAL CODES, AND

6. ALL DUCTWORK SHALL BE SIZED, FABRICATED, AND INSTALLED IN ACCORDANCE WITH THE LATEST EDITION OF THE ACCA MANUAL D AND THE SMACNA HVAC DUCT CONSTRUCTION STANDARDS. DUCTWORK SHALL BE INSTALLED IN A NEAT AND WORKMANLIKE MANNER, PROPERLY SUPPORTED AND BRACED TO PREVENT SAGGING, AIR LEAKAGE, OR VIBRATION.

7. CONDENSATE DRAINAGE PIPING SHALL BE PROPERLY PITCHED TO ENSURE POSITIVE DRAINAGE TO AN APPROVED DISPOSAL LOCATION, SUCH AS A FLOOR DRAIN, SUMP PUMP, OR EXTERIOR GRADE. CONDENSATE LINES SHALL BE INSULATED TO PREVENT SWEATING.

8. THE LOCATION OF CONTROL PANELS AND SENSORS INDICATED ON THIS DRAWING CAN BEMODIFY WITH THE SPECIFIC LOCATIONS AND WIRING DETAILS WILL BE DETERMINED DURING THE CONTROL SYSTEM DESIGN AND INSTALLATION.

9. THE HVAC SYSTEM DESIGN CONSIDER ENERGY EFFICIENCY, INDOOR AIR QUALITY, OCCUPANT COMFORT, AND NOISE CONTROL, FOLLOWING APPLICABLE GUIDELINES AND REGULATIONS.

WITH THE LOCAL BUILDING DEPARTMENT AND UTILITY PROVIDERS TO ENSURE A TIMELY AND COMPLIANT INSTALLATION.

10. COORDINATION WITH OTHER TREADS HAS BEEN DONE ON A DESIGN LEVEL. THIS DRAWING SHALL BE READ TOGETHER WITH THE AR, EL AND SN DESIGN DRAWINGS TO ENSURE PROPER INSTALLATION AND INTEGRATION OF THE HVAC SYSTEMS.

11. THE HVAC CONTRACTOR IS RESPONSIBLE FOR OBTAINING ALL NECESSARY PERMITS AND LICENSES, AND FOR SCHEDULING AND COORDINATING

12. ALL DUCTWORK PENETRATIONS THROUGH WALLS, FLOORS, OR CEILINGS SHALL BE PROPERLY SEALED AND FIRE-STOPPED USING APPROVED

METHODS AND MATERIALS TO MAINTAIN THE INTEGRITY OF THE BUILDING'S FIRE-RESISTANCE RATINGS. 13. HVAC EQUIPMENT SHALL BE INSTALLED LEVEL AND PLUMB, AND IN STRICT ACCORDANCE WITH THE MANUFACTURER'S INSTALLATION

INSTRUCTIONS AND RECOMMENDATIONS. PROVIDE ADEQUATÉ CLEARANCES AROUND EQUIPMENT FOR PROPER AIRFLOW, SERVICE ACCESS, AND CODE COMPLIANCE.


14. ALL HVAC EQUIPMENT AND COMPONENTS, INCLUDING THERMOSTATS, DAMPERS, AND ACCESS PANELS, SHALL BE LOCATED IN ACCESSIBLE AREAS FOR EASY SERVICING AND MAINTENANCE. PROVIDE ADEQUATE SPACE AROUND EQUIPMENT FOR PROPER AIRFLOW AND SERVICE ACCESS.


15. THE HVAC SYSTEM SHALL BE BALANCED AND ADJUSTED TO ENSURE PROPER AIRFLOW, TEMPERATURE DISTRIBUTION, AND SYSTEM PERFORMANCE THROUGHOUT THE RESIDENCE. PROVIDE A WRITTEN REPORT DOCUMENTING THE FINAL SYSTEM BALANCE.


16. ANY DEVIATIONS OR MODIFICATIONS TO THE HVAC SYSTEM DESIGN SHALL BE REVIEWED AND APPROVED BY THE RESPONSIBLE DESIGN PROFESSIONALS AND COMMUNICATED TO ALL RELEVANT PARTIES INVOLVED IN THE CONSTRUCTION PROCESS.

17. FOR ANY INQUIRIES OR CLARIFICATIONS REGARDING THE HVAC SYSTEM DESIGN, PLEASE CONSULT THE RESPONSIBLE DESIGN PROFESSIONALS OR THE PROJECT MANAGEMENT TEAM.

SYMBOLS

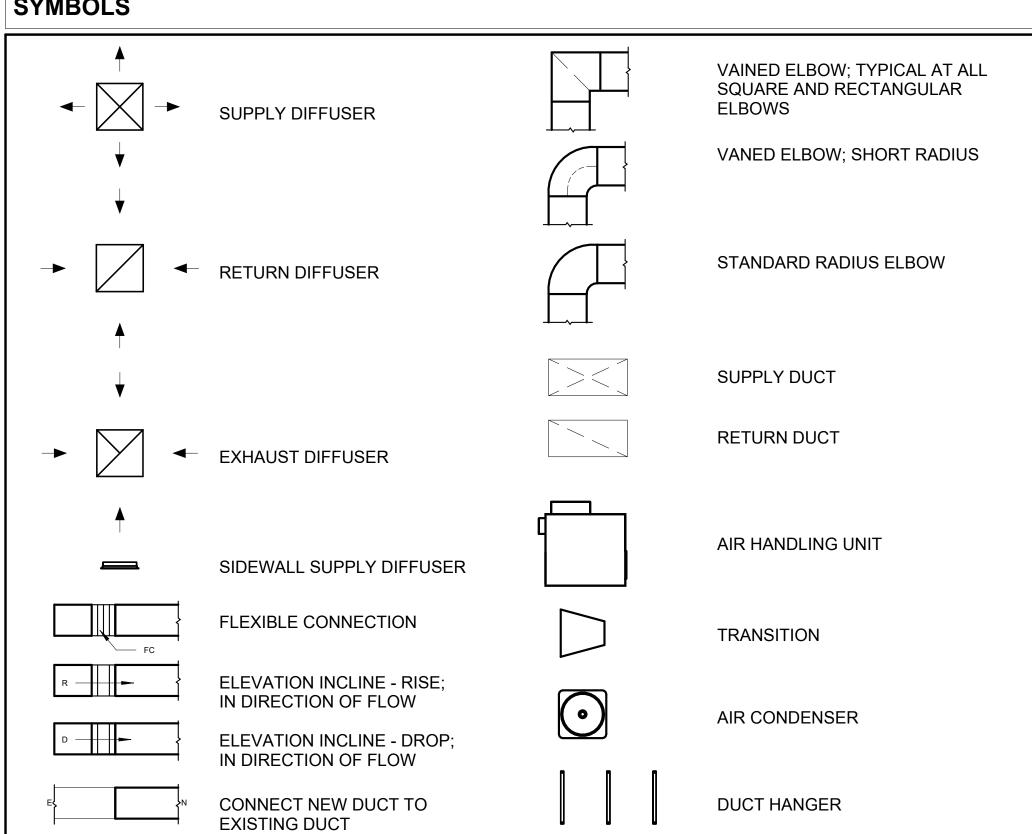

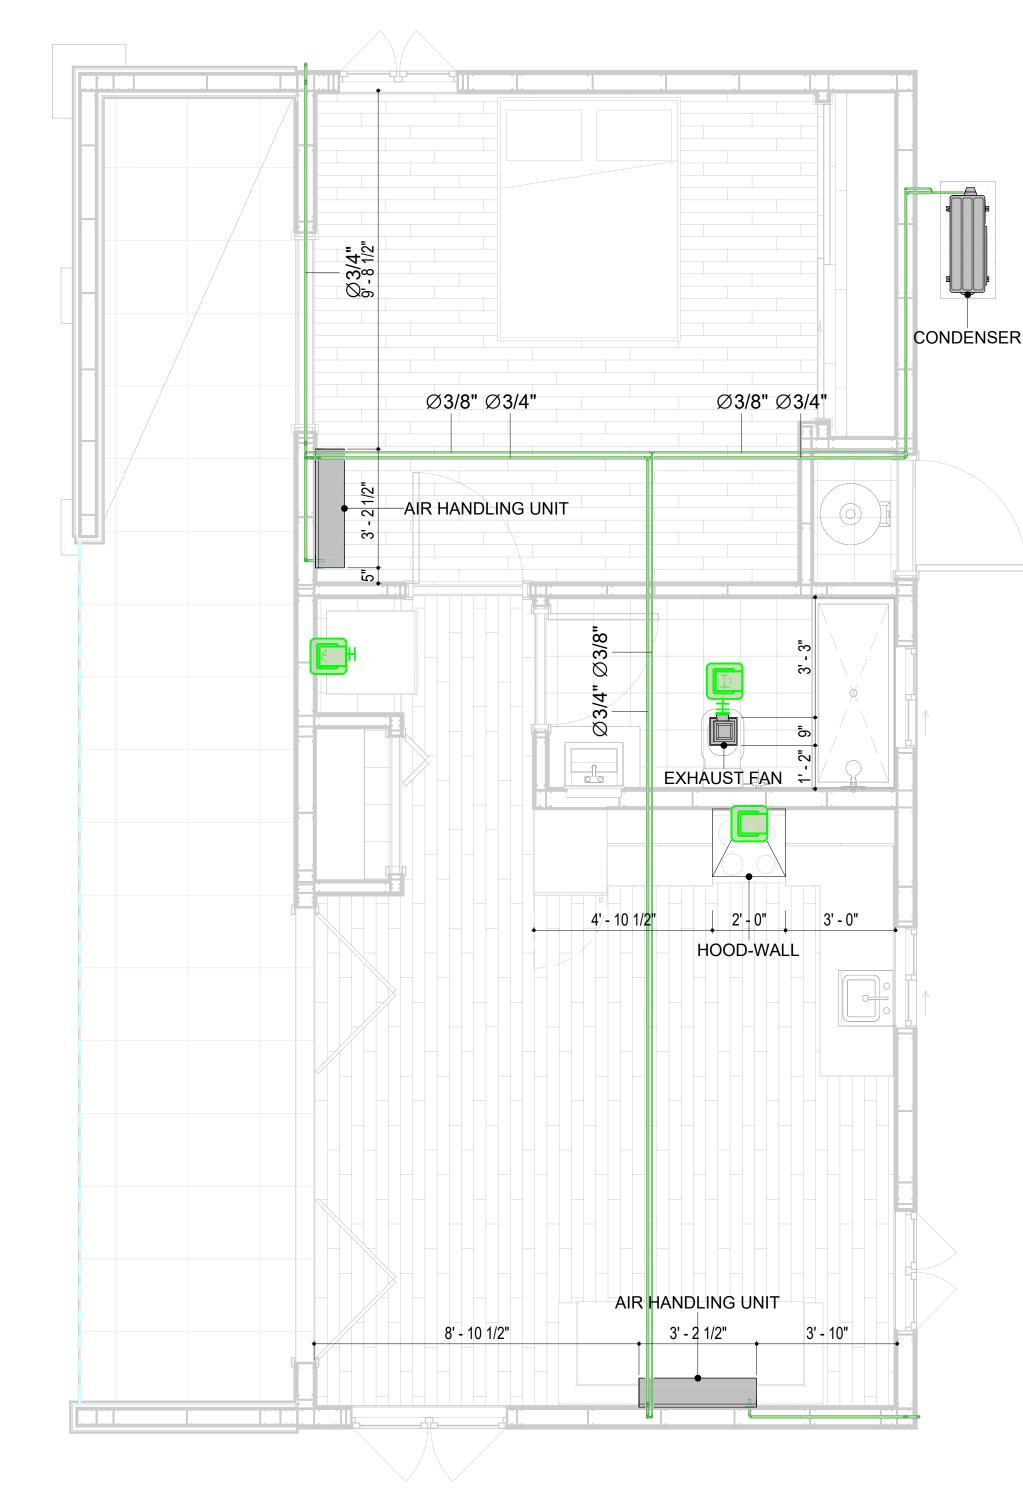

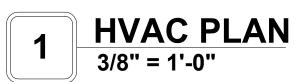



AIR CONDITIONING PIPE

REFRIGERANT LINE SCHEDULE			
CATAGORY	DESCRIPTION	DIAMETER	LENGTH
PIPE TYPES	COPPER	3/8"	63.38
PIPE TYPES	COPPER	3/4"	94.91

REFRIGERANT LINE FITTING SCHEDULE				
CATAGORY	DESCRIPTION	Size	Count	
ELBOW - GENERIC	ELBOW - GENERIC: STANDARD/HVAC	3/4"ø-3/4"ø	23	
ELBOW - GENERIC	ELBOW - GENERIC: STANDARD/HVAC	3/8"ø-3/8"ø	14	
TEE - GENERIC	TEE - GENERIC: STANDARD	3/4"ø-3/4"ø-3/ 4"ø	1	
TEE - GENERIC	TEE - GENERIC: STANDARD	3/8"ø-3/8"ø-3/ 8"ø	1	
TRANSITION - GENERIC	TRANSITION - GENERIC: STANDARD	3/4"ø-1/2"ø	3	
TRANSITION - GENERIC	TRANSITION - GENERIC: STANDARD	3/4"ø-5/8"ø	2	
TRANSITION - GENERIC	TRANSITION - GENERIC: STANDARD	3/8"ø-1/4"ø	1	

MECHANICAL EQUIPMENT SCHEDULE		
CATAGORY	DESCRIPTION	COUNT
AIR HANDLING UNIT	AIR HANDLING UNIT: WALL MOUNTED	2
CONDENSER	CONDENSER: OUT DOOR	1
EXHAUST FAN	EXHAUST FAN: 75 CFM	1
	HOOD-WALL: VENT	1

DUCT FITTING SCHEDULE		
CATAGORY	DESCRIPTI	ON COUNT
ROUND TRANSITION - ANGLE	45 DEGREE	5

DUCT ACCESSORY SCHEDULE		
CATAGORY	DESCRIPTION	COUNT
ROOF VENT	3" DIAMETER	3

FLEX DUCT SCHEDULE						
DESCRIPTION	DESCRIPTION	LENGTH	DIAMETER	COUNT		
FLEX DUCT ROUND	FLEX-ROUND	8.79	4"	3		
GRAND TOTAL: 3		8.79		•		



KEY PLAN

NO.	DESCRIPTION	DATE

NOTE:

LEGEND:

PROJECT

217-WESTBROOK-525-1Bd1Ba **CONTEMPORARY-550**

DRAWING NAME

HVAC PLAN

CLIENT NAME: Owner PROJECT NUMBER: 15_0001 DATE: 4/16/2025 2:49:06 AM Designer DESIGNED BY: DRAWN BY: Author CHECKED BY: Checker

M101

SCALE: As indicated

© [2024] [FrameUpNow] . All rights reserved

ELECTRICAL NOTES

- 1. THIS DRAWING DEPICTS THE ELECTRICAL SYSTEM FOR THE 217-WESTBROOK-525-1Bd1Ba CONTEMPORARY-550. IT PROVIDES A VISUAL REPRESENTATION OF THE ELECTRICAL LAYOUT AND COMPONENTS, INCLUDING POWER DISTRIBUTION, LIGHTING, AND CONTROL SYSTEMS.
- 2. THE ELECTRICAL SYSTEM IS DESIGNED TO MEET THE SPECIFIC REQUIREMENTS OF THE BUILDING, INCLUDING POWER DISTRIBUTION, LIGHTING, AND SPECIALIZED ELECTRICAL EQUIPMENT NEEDS, AS PER THE PROJECT SPECIFICATIONS AND APPLICABLE CODES AND STANDARDS.
- 3. THE ELECTRICAL SYSTEM INSTALLATION SHALL COMPLY WITH THE LATEST EDITION OF THE NATIONAL ELECTRICAL CODE (NEC), INTERNATIONAL BUILDING CODE (IBC), AND ALL OTHER APPLICABLE LOCAL, STATE, AND NATIONAL CODES AND REGULATIONS.
- 4. LOCATIONS AS NEEDED, DEVICES ARE SHOWN ON PLANS IN APPROXIMATE IDEAL LOCATIONS, UNLESS SPECIFICALLY DIMMENSIONED.
- 5. OPEN WALLS AS NEEDED TO ALLOW FOR NEW ELECTRICAL INSTALLATIONS.
- 6. LABEL ALL CIRCUITS ON JUNCTION BOXES, RECEPTACLES, DATA, SMOKE DETECTOR, AND EQUIPMENT IN PANEL BOX.
- 7. INSTALL RACEWAY AS NEEDED FOR DDC, ACCESS CONTROL, LOW VOLTAGE WIRING & DATA.
- 8. RELABEL POWER, DATA & FIRE ALARM FOR ROOM #CHANGES.
 9. VERIFY ALL CIRCUITS LABELED ON PRINT ARE CORRECT BEFORE WORKING ON THEM.
- 10. NOTE ON SITE PLAN ALL CHANGES OR MISSING DETAIL TO BE INCORPORATED INTO THE MASTER PLAN.
- 11. DRAWINGS ARE DIAGRAMMATIC ONLY FOR THE PURPOSE OF SHOWING FIXTURE AND OUTLET LOCATIONS.
- 12. ELECTRICAL CONTRACTOR TO VERIFY SERVICE SIZE BY CALCULATION BASED UPON ACTUAL NAME PLATE RATINGS OF SELECTED FOLIPMENT
- PLATE RATINGS OF SELECTED EQUIPMENT.

 13. VERIEY LOCATION OF SERVICE ENTRANCE WITH POWER COMPANY PROVIDE LIFER GROUND IN
- 13. VERIFY LOCATION OF SERVICE ENTRANCE WITH POWER COMPANY. PROVIDE UFER GROUND IN BUILDING FOUNDATION AT SERVICE ENTRANCE LOCATION.
- 14. PROVIDE A MIN. OF 20 FEET OF ONE *4 BARE COPPER UFER WIRE EMBEDDED IN CONCRETE FOOTING AT THE SERVICE ENTRANCE LOCATION WHERE APPROVED BY LOCAL SERVICE PROVIDER.
- 15. PROVIDE WATERPROOF FIXTURES IN ALL HIGH MOISTURE AREAS (EXTERIOR, SHOWER AND TUB
- CEILINGS ETC.)
 16. PROVIDE DEDICATED CIRCUITS TO EACH BATH, DEN, FAMILY ROOM, BEDROOM, LOFT, KITCHEN
- REFRIGERATOR, KITCHEN FREEZER DISHWASHER, AND ANY AREA/ITEM SPECIFIED BY OWNER.
- 17. INCANDESCENT FIXTURES WITH OPEN OR PARTIALLY ENCLOSED LAMPS, PENDANT FIXTURES, AND LAMP HOLDERS ARE NOT PERMITTED IN CLOSETS.
- 18. ALL WORKMANSHIP AND MATERIALS TO CONFORM WITH THE 2015 IRC.
- 19. PROVIDE A MIN. OF 20 FEET OF ONE *4 BARE COPPER UFER WIRE EMBEDDED IN CONCRETE FOOTING AT THE SERVICE ENTRANCE LOCATION WHERE APPROVED BY LOCAL SERVICE PROVIDER.
- 20. PROVIDE A BONDING CONDUCTOR CONSISTING OF A MINIMUM OF ONE *4 BARE COPPER WIRE CONNECTING THE BUILDING'S METAL WATER PIPING SYSTEM TO THE SERVICE EQUIPMENT ENCLOSURE GROUNDING.

MAIN PANEL CALCS

ELECTRICAL CALCS	
LIGHT AND OUTLETS 525 @ 3W	1,575 W
3 APPLIANCE CIRCUITS	4,500 W
DRYER	2,000 W
WASHER	2,000 W
RANGE	5,000 W
WATER HEATER	5,000 W
REFRIG.	1,800 W
DISHWASHER & DISPOSAL	3000 W
TOTAL	24,875 W
FRIST 10,000 @ 100% REMAINDER @ 40% MINI. SPLIT UNITS	10,000 W 5,950W 10,000 W
TOTAL	25,950 W

25,950 W DIVIDED BY 240V = 108 AMPS TOTAL

(USE 200 AMP SERVICE)

ELECTRICAL ABBREVIATIONS LIST

1P	1 POLE (2P, 3P, 4P, ETC.)	CTR	CENTER	HT	HEIGHT
A	AMPERE	CU	COPPER	HTG	HEATING
AC	ABOVE COUNTER OR AIR CONDITIONER	DCP	DOMESTIC WATER CIRCULATING PUMP	HTR	HEATER
	ABOVE COUNTER OR AIR CONDITIONER ABOVE CEILING	DEPT	DEPARTMENT	HV	
ACLG					HIGH VOLTAGE
ADO	AUTOMATIC DOOR OPENER	DET	DETAIL	HVAC	HEATING, VENTILATING AND AIR
AF	AMP FRAME	DIA	DIAMETER	CONDITIONING	CONDITIONING
AFF	ABOVE FINISHED FLOOR	DISC	DISCONNECT	HWP	HYDRONIC WATER PUMP
AFG	ABOVE FINISHED GRADE	DIST	DISTRIBUTION	IC	INTERRUPTING CAPACITY
AFI	ARC FAULT CIRCUIT INTERRUPTER	DN	DOWN	IG	ISOLATED GROUND
AHU	AIR HANDLING UNIT	DPR	DAMPER	IMC	INTERMEDIATE METAL CONDUIT
AL	ALUMINUM	DS	SAFETY DISCONNECT SWITCH	INCAND	INCANDESCENT
ALT	ALTERNATE	DT	DOUBLE THROW	IR	INFRARED
AMP	AMPERE	DWG	DRAWING	I/W	INTERLOCK WITH
AMPL	AMPLIFIER	DDC	DIRECT DIGITAL CONTROL	J-BOX	JUNCTION BOX
ANNUN	ANNUNCIATOR APPROX APPROXIMATELY		ELECTRICAL CONTRACTOR	KV	KILOVOLT
AQ-STAT	AQUASTAT	ELEC	ELECTRIC, ELECTRICAL	KVA	KILOVOLT-AMPERE
ARCH	ARCHITECT, ARCHITECTURAL	ELEV	ELEVATOR	KVAR	KILOVOLT-AMPERE REACTIVE
AS	AMP SWITCH	EM	EMERGENCY	KW	KILOWATT
AT	AMP TRIP	EMS	ENERGY MANAGEMENT SYSTEM	KWH	KILOWATT HOUR
ATS	AUTOMATIC TRANSFER SWITCH	EMT	ELECTRICAL METALLIC TUBING	LOC	LOCATE OR LOCATION
AUTO	AUTOMATIC	EP	ELECTRIC PNEUMATIC	LT	LIGHT
AUX	AUXILIARY	EQUIP	EQUIPMENT	LTG	LIGHTING
AV	AUDIO VISUAL	EWC	ELECTRIC WATER COOLER	LTNG	LIGHTNING
AWG	AMERICAN WIRE GAUGE	EXIST	EXISTING	LV	LOW VOLTAGE
BATT	BATTERY	EXH	EXHAUST	MAX	MAXIMUM
BD	BOARD	EXP	EXPLOSION PROOF	MAG.S	MAGNETIC STARTER
BLDG	BUILDING	FA	FIRE ALARM	M/C	MOMENTARY CONTACT
BMS	BUILDING MANAGEMENT SYSTEM	FABP	FIRE ALARM BOOSTER POWER	MC	MECHANICAL CONTRACTOR
C	CONDUIT	SUPPLY PANEL	SUPPLY PANEL	MCB	MAIN CIRCUIT BREAKER
CAB	CABINET	FACP	FIRE ALARM CONTROL PANEL	MCC	MOTOR CONTROL CENTER
CAT	CATALOG	FCU	FAN COIL UNIT	MDC	MAIN DISTRIBUTION CENTER
CATV	CABLE TELEVISION	FIXT	FIXTURE	MDP	MAIN DISTRIBUTION PANEL
СВ	CIRCUIT BREAKER	FLR	FLOOR	MFR	MANUFACTURERMAIN FUSED
CCTV	CLOSED CIRCUIT TELEVISION	FLUOR	FLUORESCENT		DISCONNECT SWITCH
CKT	CIRCUIT	FU	FUSE	MH	MANHOLE
CLG	CEILING	FUDS	FUSED SAFETY DISCONNECT SWITCH	MIC	MICROPHONE
COMB	COMBINATION	GA	GAUGE	MIN	MINIMUM
CMPR	COMPRESSOR	GAL	GALLON	MISC	MISCELLANEOUS
CONN	CONNECTION	GALV	GALVANIZED	MLO	MAIN LUGS ONLY
CONST	CONSTRUCTION	GC	GENERAL CONTRACTOR	MMS	MANUAL MOTOR STARTER
CONT	CONTINUATION OR CONTINUOUS	GEN	GENERATOR	MOA	MULTIOUTLET ASSEMBLY
CONTR	CONTRACTOR	GFI	GROUND FAULT CIRCUIT INTERRUPTER	MSP	MOTOR STARTER PANELBOARD
CONV	CONVECTOR	GFP	GROUND FAULT PROTECTOR	MSBD	MAIN SWITCHBOARD
CP	CIRCULATING PUMP	GND	GROUND	MT	MOUNT
CRT	CATHODE-RAY TUBE	GRS	GALVANIZED RIGID STEEL (CONDUIT)	MT.C	EMPTY CONDUIT
CT	CURRENT TRANSFORMER	GYP BD	GYPSUM BOARD	UL	UNDERWRITERS LABORATORIES

Branch Panel:

Location: KITCHEN 02
Supply From:
Mounting: Recessed

Enclosure: Type 1

Volts: 120/240 Single
Phases: 1
Wires: 3

A.I.C. Rating:
Mains Type:
Mains Rating: 200 A
MCB Rating: 1 A

Notes:

Circuit Numb er	Circuit Description	Number of Elements	Rating	Length	Wire Size	A		E	3	Wire Size	Length	Rating	Number of Elements	Circuit Description	Circuit Numb er
1	BED LIGHT	9	15 A	36' - 4"	1-#14, 1-#14, 1-#14	568 VA	576 VA			1-#12, 1-#12, 1-#12	20' - 10 1/8"	20 A	7	BATH GFCI	2
3	WATER HEATER	1	30 A	21' - 9 7/8"	2-#10, 1-#10, 1-#10			2250 VA	900 VA	1-#12, 1-#12, 1-#12	44' - 1 1/8"	20 A	5	BED RECEPTACLE	4
5						2250 VA	2500 VA			2-#10, 1-#10, 1-#10	29' - 1 1/2"	30 A	1	DRYER	6
7	WASHER	1	20 A	32' - 0 13/16"	1-#12, 1-#12, 1-#12			1200 VA	2500 VA						8
9	REFRIGERATOR	1	20 A	19' - 1 5/8"	1-#12, 1-#12, 1-#12	1800 VA	720 VA			1-#12, 1-#12, 1-#12	16' - 11 1/8"	20 A	4	KITCHEN GFCI	10
11	RANGE	1	50 A	13' - 6"	2-#8, 1-#8, 1-#10			2500 VA	180 VA	1-#12, 1-#12, 1-#12	7' - 11 5/8"	20 A	1	OVENHOOD	12
13						2500 VA	396 VA			1-#12, 1-#12, 1-#12	19' - 11 3/8"	20 A	9	KITCHEN & HALL LIGHT	14
15	LIVING LIGHT	9	15 A	38' - 8 1/4"	1-#14, 1-#14, 1-#14			265 VA	400 VA	1-#14, 1-#14, 1-#14	40' - 3 17/32"	15 A	6	OUTDOOR LIGHT	16
17	OUTDOOR GFCI	4	20 A	45' - 1 15/16"	1-#12, 1-#12, 1-#12	720 VA	720 VA			1-#12, 1-#12, 1-#12	38' - 4 7/32"	20 A		LIVING RECEPTACLE	18
19	CONDENSER	1	60 A	25' - 1 7/16"	2-#6, 1-#6, 1-#10			2500 VA							20
21						2500 VA									22
23															24
25															26
	1					15247	'VA	1267	4 VA						1
						127	Α	106	6 A						

Load Classification	Connected Load	Demand Factor	Estimated Demand	Panel Totals
LIGHTING - DWELLING UNIT	600 VA	100.00%	600 VA	
OTHER	1060 VA	100.00%	1060 VA	Total Conn. Load: 27921 VA
RECEPTACLE	4800 VA	100.00%	4800 VA	Total Est. Demand: 26921 VA
LIGHTING	200 VA	100.00%	200 VA	Total Conn.: 116 A
CONDENSER	5000 VA	100.00%	5000 VA	Total Est. Demand: 112 A
WATER HEATER	4500 VA	100.00%	4500 VA	
RANGE	5000 VA	80.00%	4000 VA	
DRYER	5000 VA	100.00%	5000 VA	
REFRIGERATOR	1800 VA	100.00%	1800 VA	



KEY PLAN

NO. DESCRIPTION DATE

NOTE:

LEGEND:

PROJECT

217-WESTBROOK-525-1Bd1Ba CONTEMPORARY-550

DRAWING NAME

SCHEDULE

 CLIENT NAME:
 Owner

 PROJECT NUMBER:
 0308_12

 DATE:
 4/15/2025 12:07:23 PM

 DESIGNED BY:
 Designer

 DRAWN BY:
 Author

 CHECKED BY:
 Checker

E101

SCALE: 1/4" = 1'-0"

© [2024] [FrameUpNow] . All rights reserved

ELECTRICAL NOTE

- PROVIDE INTERCONNECTED SMOKE ALARMS IN EACH SLEEPING ROOMS, OUTSIDE EACH SLEEPING ROOM, ON EACH STORY, IN THE HALL OR ADJACENT ROOM LUHERE THE CEILING HEIGHT OF A ROOM OPEN TO THE HALL EXCEEDS THE HALL BY 24'. SMOKE ALARMS SHALL BE PERMANENTLY HARD WIRED WITH BATTERY BACKUP.
- B. RECEPTACLE OUTLETS FOR RANGES AND CLOTHES DRYERS SHALL BE A THREE POLE WITH GROUND TYPE. FOUR WIRE GROUNDING-TYPE FLEXIBLE CORDS WILL BE REQUIRED FOR CONNECTION OF RANGES AND CLOTHES DRYERS. THE BONDING JUMPER SHALL NOT BE CONNECTED BETWEEN NEUTRAL TERMINAL AND THE FRAME OF THE **APPLIANCE**
- C. TWO OR MORE 20 AMP SMALL APPLIANCE CIRCUITS SHALL BE PROVIDED TO SERVE THE KITCHEN, BREAKFAST NOOK, AND DINING ROOM. SUCH CIRCUITS SHALL HAVE NO OTHER OUTLETS.
- D. AT LEAST ONE 20 AMP BRANCH CIRCUIT SHALL BE PROVIDED TO SERVICE THE LAUNDRY ROOM. THIS CIRCUIT SHALL HAVE NO OTHER OUTLETS.
- E. ALL RECEPTACLES WITH IN 6' OF A WET BAR SINK OR KITCHEN SINK TO SERVE COUNTER TOP SURFACES MUST BE GFCI. ON KITCHEN COUNTERS 12' OR WIDER NO POINT ALONG THE WALL SHALL BE MORE THAN 2' FROM A RECEPTACLE. ALL RECEPTACLES WITH IN 6' OF KITCHEN SINK MUST BE GFCI. AT LEAST ONE GFCI RECEPTACLE SHALL BE INSTALLED IN THE BATHROOM ADJACENT TO EACH BASIN.
- FIXTURES INCLUDING CEILING FANS THAT ARE LOCATED IN DAMP LOCATIONS SHALL BE LISTED TO BE SUITABLE FOR
- SUCH LOCATIONS PER 2012 IRC G. PROVIDE ONE (1) SWITCHED OUTLET @ ALL BEDROOMS AND DEN
- H. CEILING FANS NOT EXCEEDING 35 LBS. (WITH OR WITHOUT ACCESSORIES MAY BE SUPPORTED BY OUTLET BOXES PROVIDED THE OUTLET BOXES ARE IDENTIFIED FOR SUCH USE PER 2012 IRC
- ELECTRICAL OUTLET BOXES ON OPPOSITE SIDES OF FIRE RATED WALLS SHALL BE SEPARATED BY A HORIZONTAL DISTANCE OF NOT LESS THAN 24".
- OUTLET BOXES IN THE WALLS BETWEEN THE GARAGE AND DWELLING SHALL BE METAL OR U.L. APPROVED FIRE RESISTIVE PLASTIC. BOXES IN GARAGE CEILING SHALL BE METAL.
- K. ALL BRANCH CIRCUITS THAT SUPPLY 120 VOLTS SINGLE PHASE 15 AND 20 AMPS RECEPTACLE OUTLETS INSTALLED IN THE DWELLING SHALL BE PROTECTED BY AN ARC FAULT CIRCUIT INTERRUPTER. EXCEPT GFCI RECEPTICLES.

NOTE:

RECEPTACLES MUST BE PROVIDED IN HALLWAYS 10'-0" OR MORE IN LENGTH. FOR A ONE FAMILY DWELLINGS AND EACH OF A TWO FAMILY DWELLING THAT IS AT GRADE LEVEL, AT LEAST ONE WP-GFCI RECEPTACLE OUTLET ACCESSIBLE AT GRADE LEVEL AND NOT MORE THAN 6'-6" ABOVE GRADE SHALL BE INSTALLED AT THE FRONT AND BACK OF THE DWELLING.

NOTE: APPLIANCE DISCONNECT

E4001.5 GROUNDING OF ENCLOSURES.

METAL ENCLOSURES FOR SWITCHES OR CIRCUIT BREAKERS SHALL BE CONNECTED TO AN

EQUIPMENT GROUNDING CONDUCTOR.

METAL ENCLOSURES FOR SWITCHES OR CIRCUIT BREAKERS USED AS SERVICE EQUIPMENT SHALL COMPLY WITH THE PROVISIONS OF SECTION E3609.4. WHERE


NONMETALLIC ENCLOSURES ARE USED WITH METAL RACEWAYS OR METAL-ARMORED

CABLES, PROVISIONS SHALL BE MADE FOR CONNECTING THE EQUIPMENT GROUNDING


NONMETALLIC BOXES FOR SWITCHES SHALL BE INSTALLED WITH A WIRING METHOD THAT

PROVIDES OR INCLUDES AN EQUIPMENT GROUNDING CONDUCTOR. (404.12)

ELECTRICAL LEGEND				
	Electrical Lights With Fan			
0	Waterproof Recessed Can Light			
	Pendant Light			
0	Recessed Can Light			
- □	Wall Lamp			
	Standalone linear			
⊬ 1	Single Switch			
₩.	Three way Switch			
₩.	Fan Switch			
	Duplex Receptacle			
	Triplex Receptacle			
⊕eFC	GFCI Receptacle			
	Exhaust Fan			
•	Smoke and heat detector			

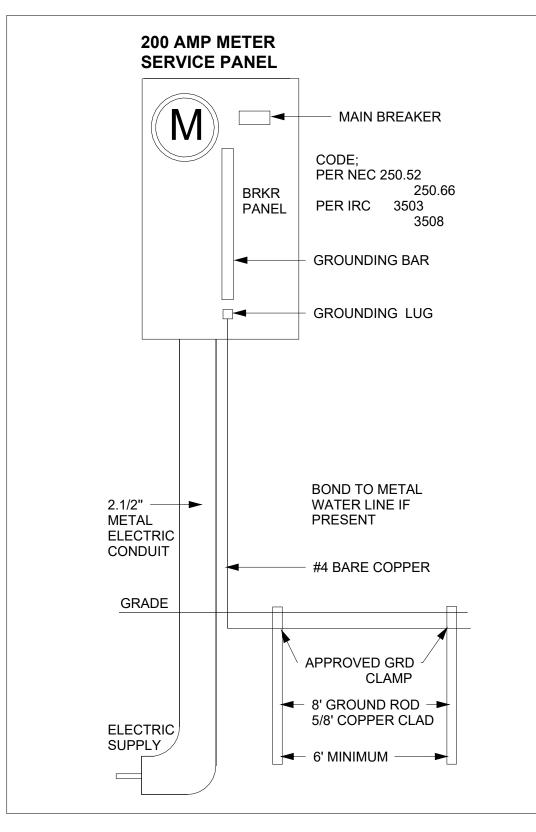



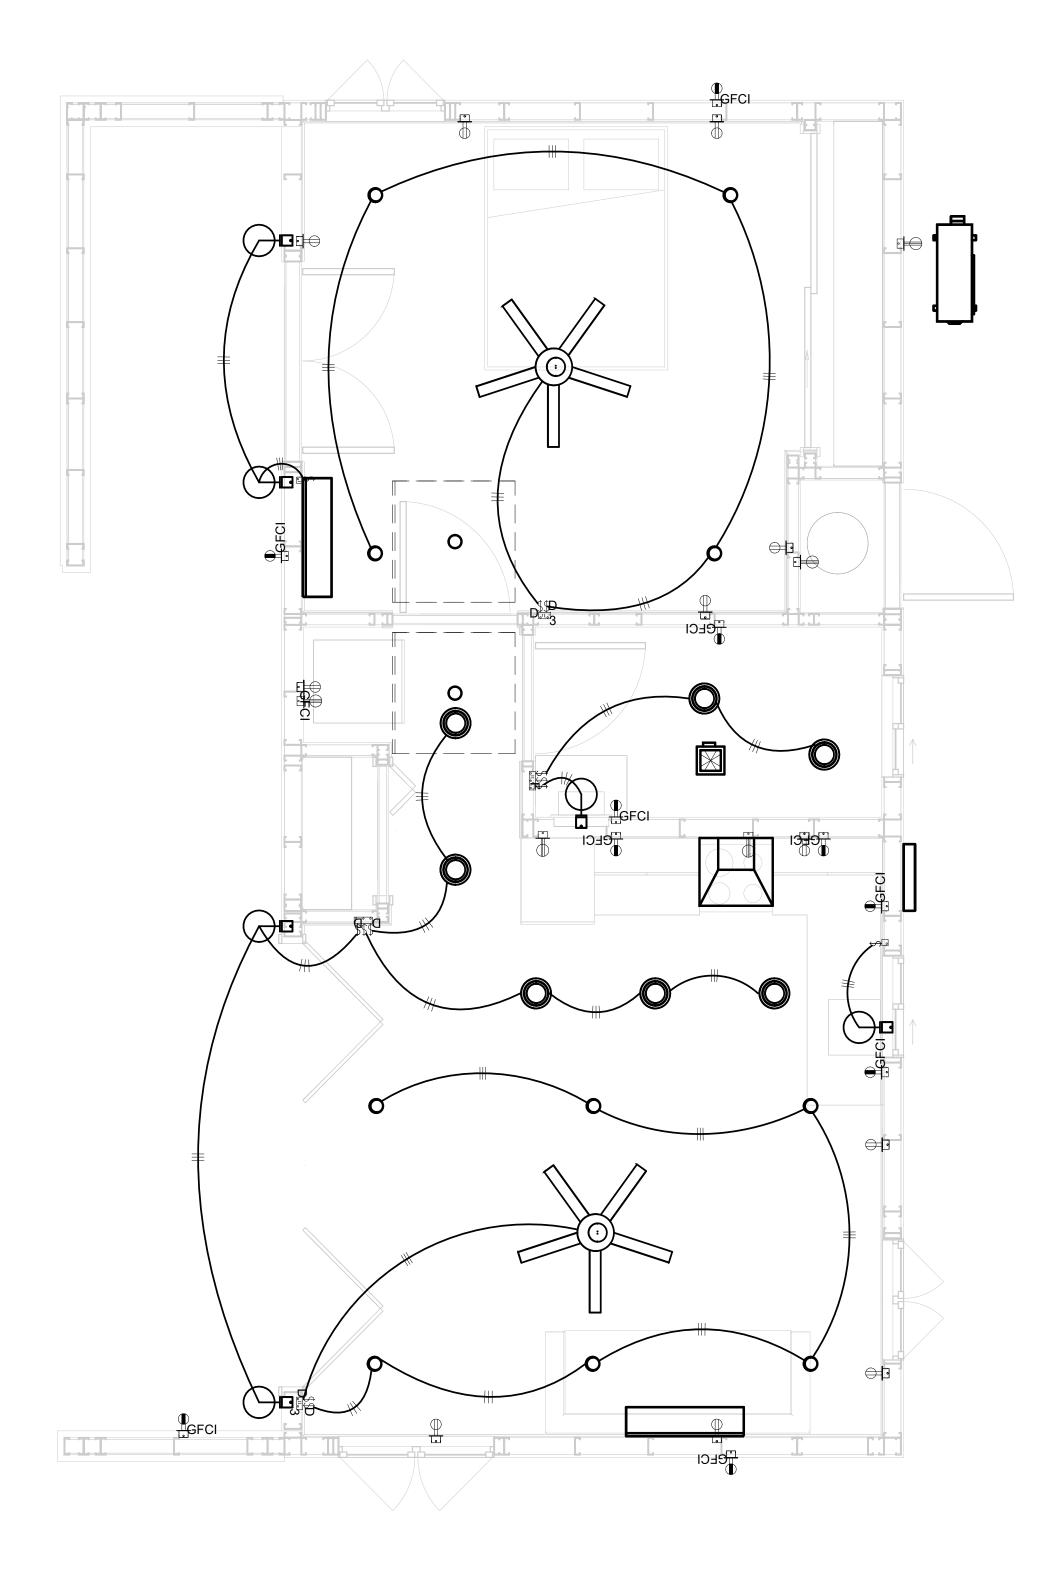

1 - Lighting 3/8" = 1'-0"



KEY PLAN

NO.	DESCRIPTION	DATE

NOTE:

LEGEND:

PROJECT

217-WESTBROOK-525-1Bd1Ba **CONTEMPORARY-550**

DRAWING NAME


LIGHTING

CLIENT NAME: Owner PROJECT NUMBER 0308_12 DATE: 4/15/2025 12:07:25 PM Designer DESIGNED BY DRAWN BY: CHECKED BY: Checker


E102

NOTES: CONDUIT, CABLE AND WIRING


- Use Metalic Conduits (IMC) for cables running under concrete slabs.
 Use IMC for circuits with high voltage appliances (240 volts and above)
 For circuits with 120 volts consider using EMT or PVC conduits if needed.
 For Low voltage applications up to 50 volts consider using non metalic conduits.
 All conduits to be used in the project must conform to the latest National Electrical Code (NEC),
- 6. All wiring and cables to be used in the project must also conform to the latest National Electrical
- 7. All cables and wires used should be rated for their respective loading and should be gauged and conform to the NEC.

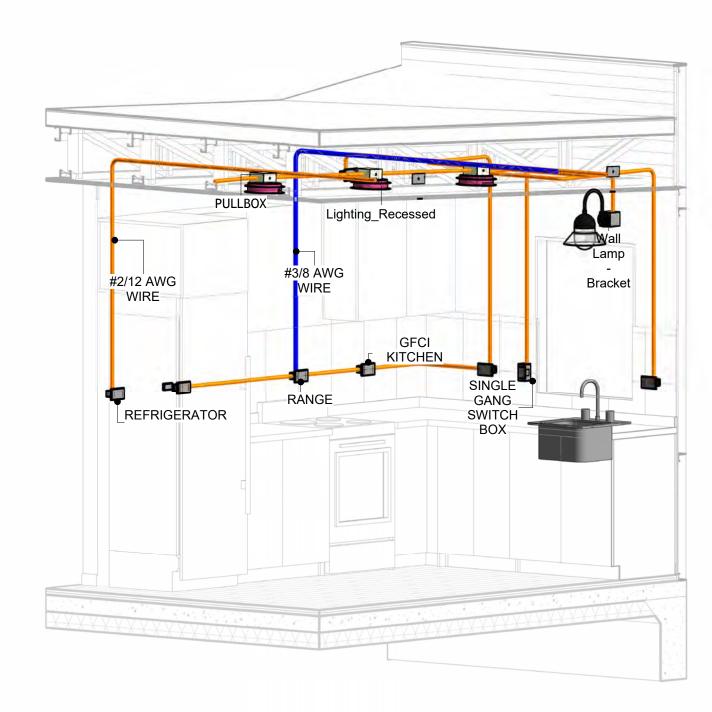


3D-KITCHEN

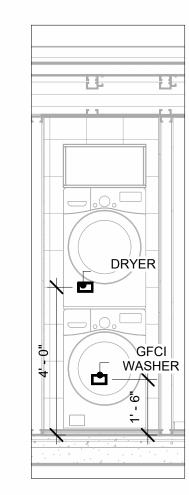


DRYER & WASHER 3/8" = 1'-0"

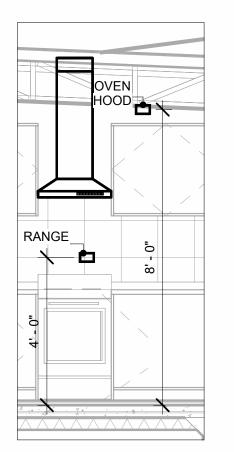

RANGE & OVENHOOD

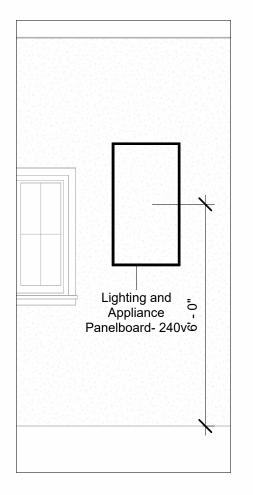


PANEL 3/8" = 1'-0"

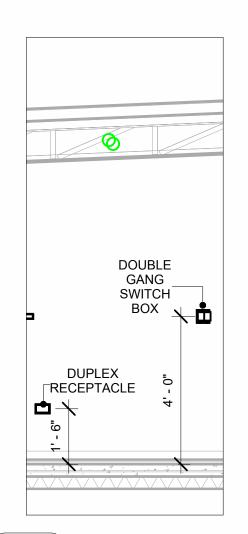

SWITCH & RECEPTACLE



KEY PLAN

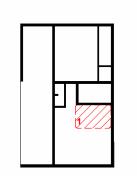

NO.	DESCRIPTION	DATE

NOTE:

LEGEND:

PROJECT

217-WESTBROOK-525-1Bd1Ba **CONTEMPORARY-550**

DRAWING NAME

POWER

Owner CLIENT NAME: 0308_12 PROJECT NUMBER: 4/15/2025 12:07:51 PM DESIGNED BY: DRAWN BY: CHECKED BY: Checker

E103

NOTES: LIGHT

- 1. LIGHT FIXTURES AND LUMINARIES SHALL CONFORM TO THE NEC, THE IRC AND LOCAL SAFETY & BUILDING CODE.
- 2. ALL LIGHTING FIXTURES SHOULD CONFORM TO THE DESIGN ELECTRICAL LOAD AND SHALL BE PROPERLY WIRED AND MOUNTED BY QUALIFIED ELECTRICIAN FOLLOWING MANUFACTURERS SPECIFICATIONS.
- 3. CEILING FANS AND FANS WITH LIGHT WITH WEIGHT EXCEEDING 35 LBS SHOULD BE PROVIDED WITH STRUCTURAL BACKING FOR SUPPORT AND SHALL BE FIXED AS PER MANUFACTURERS SPECIFICATIONS.
- 4. EXTERIOR LIGHTS SHALL CONFORM TO LOCAL BUILDING CODE AND GUIDELINES.

NOTES: SWITCH JUNCTION BOX


- 1. THE MINIMUM SIZE OF JUCTION BOX TO BE USED IS 2"X4"X(1.5" OR 3.5" DEEP) THIS ARE TO BE USED FOR SINGLE GANG SWITCH OR OUTLETS.
- 2. FOR DOUBLE GANG (2 GANG) OUTLETS AND SWITCHS THE MINIMUM SIZE OF THE
- JUCTION BOX TO BE PROVIDED SHALL NOT BE LESS THAN 4"X4"X(1.5" OR 3.5" DEEP)
- 3. FOR THREE GANG (3 GANG) OUTLETS AND SWITCHS THE MINIMUM SIZE OF THE JUĆTION BOX SHALL NOT BE LESS THAN 6"X4"X(1.5" OR 3.5" DEEP).

FITTING SCHEDULE(PULL BOX)				
FAMILY COUNT DESCRIPTION				
PULLBOX1	21	#1/4 PULLBOX		

ELECTRICAL FIXTURE SCHEDULE (SWITCH BOX)						
TYPE	COUNT					
DOUBLE GANG SWITCH BOX	2					
SINGLE GANG SWITCH BOX	2					
TRIPLE GANG SWITCH BOX	2					

LIGHTING DEVICE					
TYPE	COUNT				
DIMMER	4				
FAN SWITCH	1				
SINGLE POLE	5				
THREE WAY WITH DIMMER	2				

LIGHTING FIXTURE			
LIGHTING FIXTURE TYPE	VOLTAGE	ELECTRICAL LOAD	COUNT
ELECTRICAL_LIGHTS_FAN-LIGHT1	120 V/1-100 VA- 120 V/1-100 VA	200 A, 120 V/240 V, SINGLE PHASE, 3 WIRES	2
LIGHTING_RECESSED	120 V/1-60 VA	200 A, 120 V/240 V, SINGLE PHASE, 3 WIRES	7
SASSO 100 ROUND WALLWASHER TRIM	120 V/1-28 VA	200 A, 120 V/240 V, SINGLE PHASE, 3 WIRES	10
WALL LAMP - BRACKET	120 V/1-100 VA	200 A, 120 V/240 V, SINGLE PHASE, 3 WIRES	6

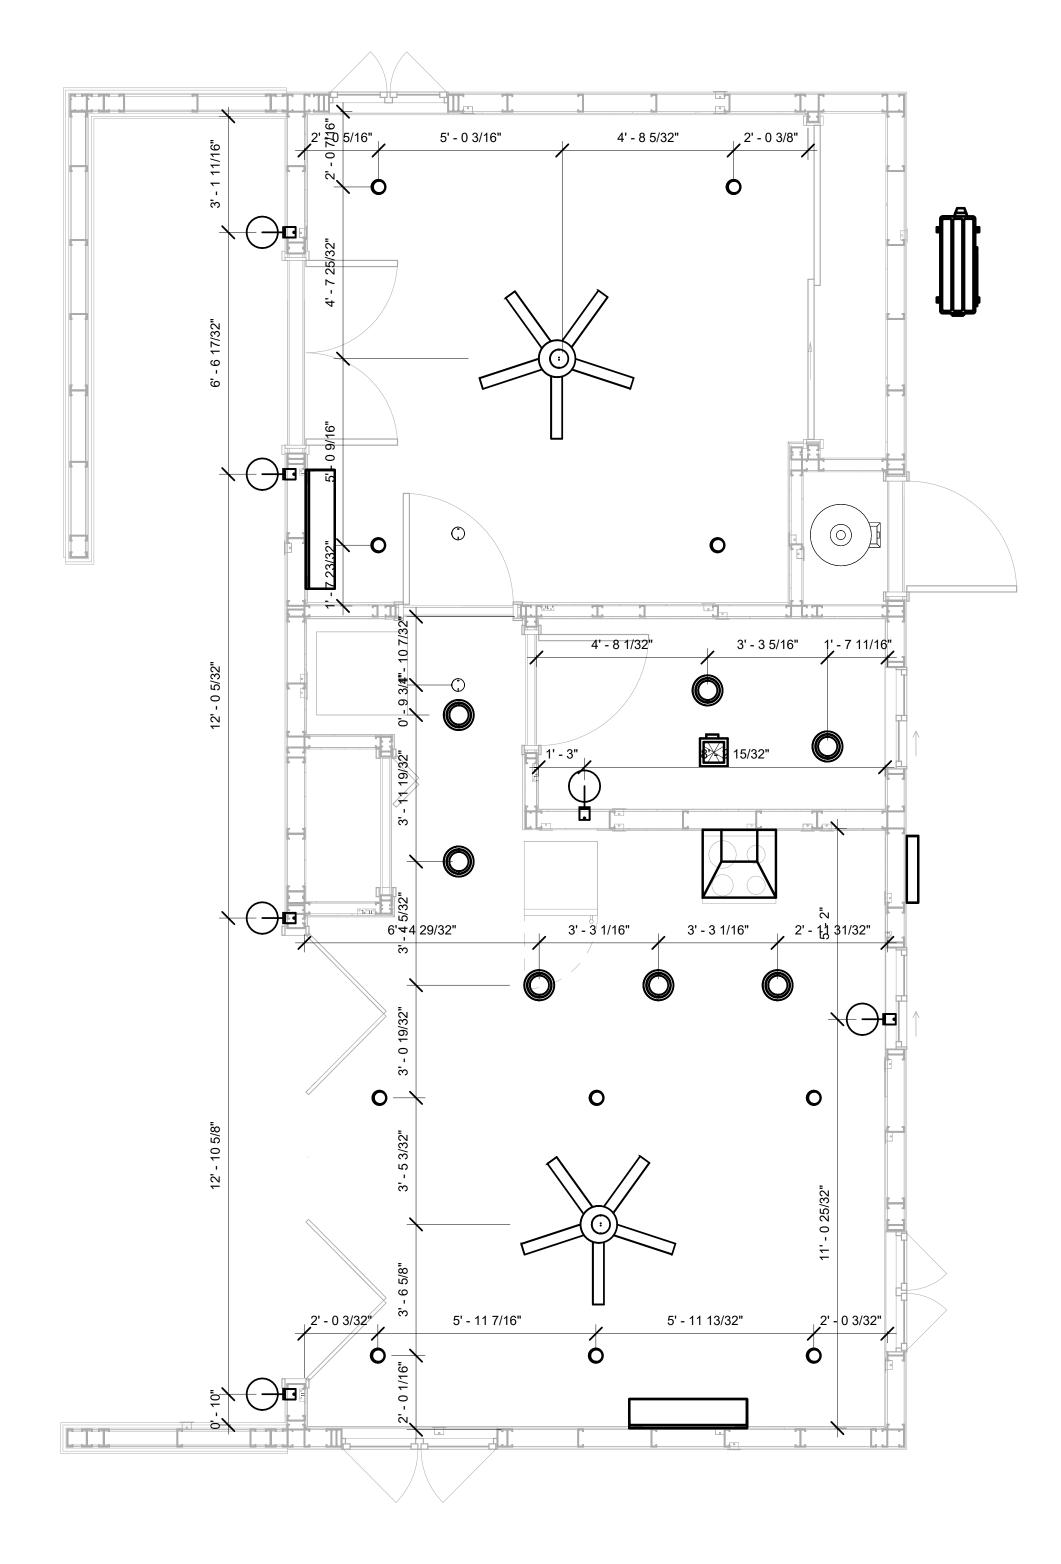

DIMENSION FOR LIGHT FIXTURES 3/8" = 1'-0"



KEY PLAN

NO.	DESCRIPTION	DATE

NOTE:

LEGEND:

PROJECT

217-WESTBROOK-525-1Bd1Ba **CONTEMPORARY-550**

DRAWING NAME

DIMENSION PLAN FOR LIGHT FIXTURES

CLIENT NAME:	Owner
PROJECT NUMBER:	0308_12
DATE:	4/15/2025 12:07:52 PM
DESIGNED BY:	Designer
DRAWN BY:	Author
CHECKED BY:	Checker


E104

NOTES;

- 1. VERIFY EQUIPMENT PLUG CONFIGURATION BEFORE PURCHASING RECEPTACLES
- 2. FOR ALL EQUIPMENT.
- 3. COORDINATE EXACT LOCATION OF LIGHT FIXTURES, WALL SWITCHES, RECEPTACLES AND OTHER DEVICES WITH ARCHITECTURAL DRAWINGS.
- 4. USE METALLIC JUNCTION BOX WITH THE GFCI RECEPTACLES, WITH HIGHT VOLTAGE.

ELECTRICAL FIXTURE SCHEDULE (RECEPTACLE)		
TYPE	COUNT	
CONDENSER	1	
DRYER	1	
DUPLEX RECEPTACLE	1	
GFCI BATH ROOM	2	
GFCI KITCHEN	4	
GFCI OUT DOOR	4	
GFCI WASHER	1	
OVEN HOOD	1	
RANGE	1	
REFRIGERATOR	1	
STANDARD	8	
WATER HEATER	1	

ELECTRICAL OUTLET SCHEDULE			
TYPE	CIRCUIT NUMBER	ELECTRICAL DATA	COUNT
GFCI BATH ROOM	2	120 V/1-180 VA	2
WATER HEATER	3,5	240 V/2-4500 VA	1
DUPLEX RECEPTACLE	4	120 V/1-180 VA	1
STANDARD	4	120 V/1-180 VA	4
DRYER	6,8	240 V/2-5000 VA	1
GFCI WASHER	7	120 V/1-1200 VA	1
REFRIGERATOR	9	120 V/1-1800 VA	1
GFCI KITCHEN	10	120 V/1-180 VA	4
RANGE	11,13	240 V/2-5000 VA	1
OVEN HOOD	12	120 V/1-180 VA	1
GFCI OUT DOOR	17	120 V/1-180 VA	4
STANDARD	18	120 V/1-180 VA	4
CONDENSER	19,21	240 V/2-5000 VA	1

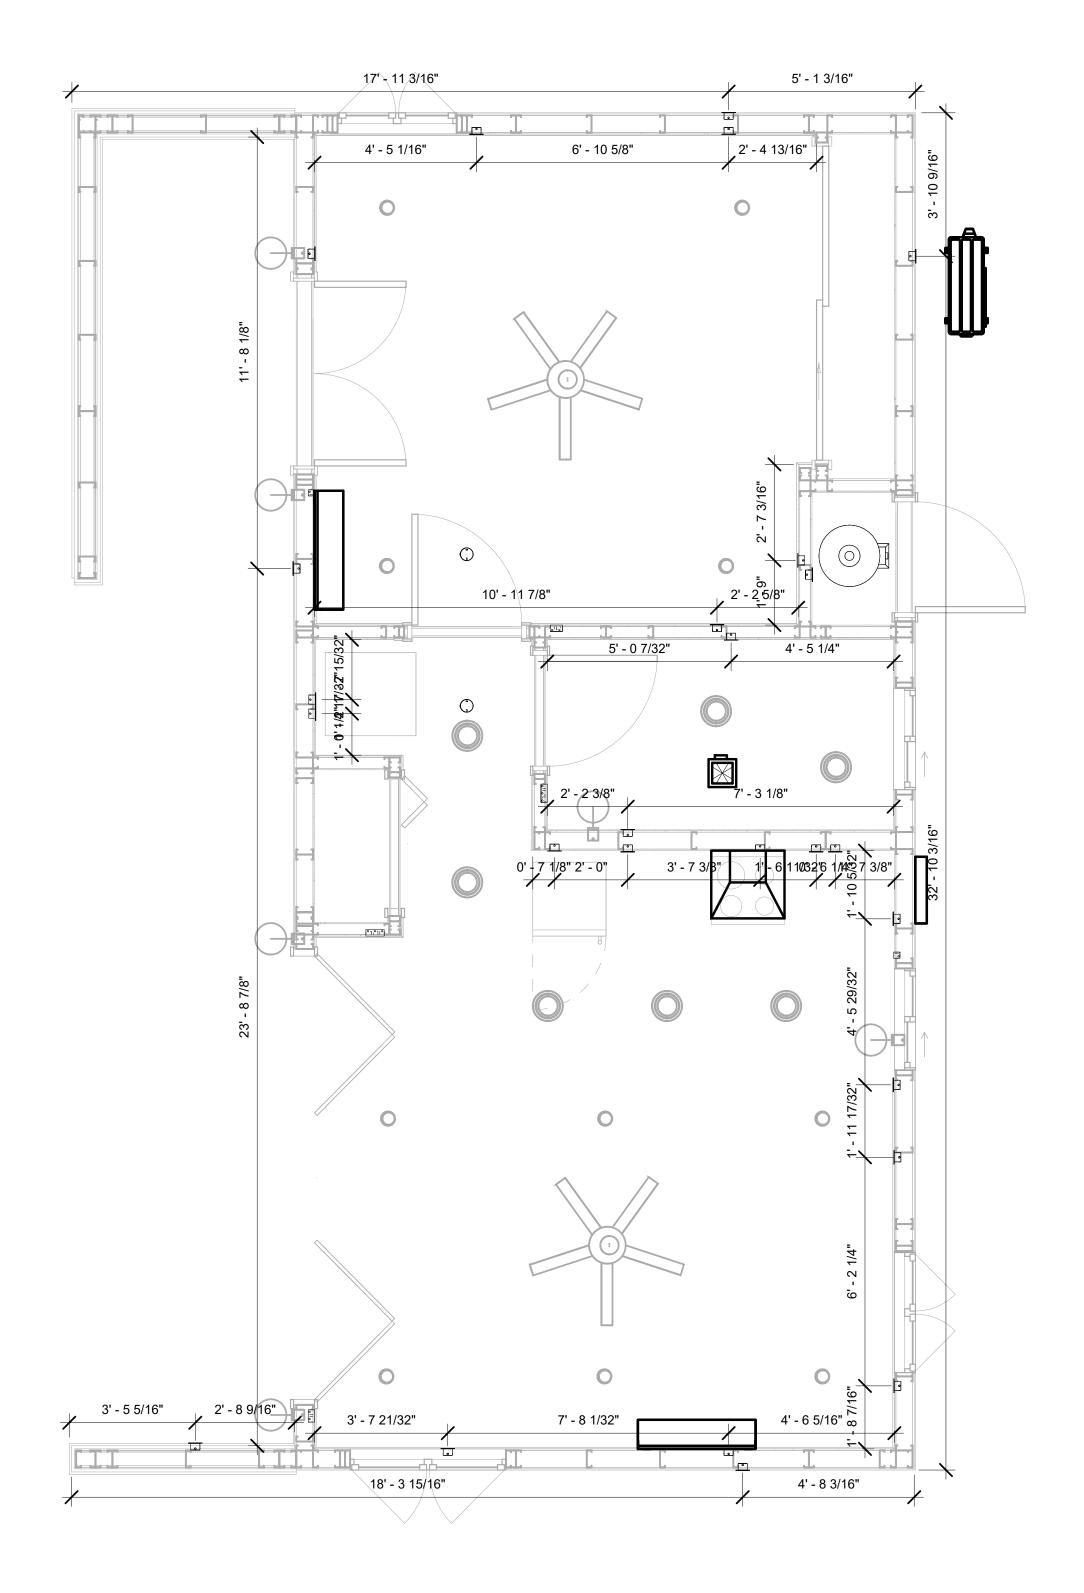

1 DIMENSION FOR FITTINGS
3/8" = 1'-0"



KEY PLAN

NO.	DESCRIPTION	DATE

NOTE:

LEGEND:

PROJECT

217-WESTBROOK-525-1Bd1Ba CONTEMPORARY-550

DRAWING NAME

DIMENSION PLAN FOR FITTINGS

CLIENT NAME:	Owner
PROJECT NUMBER:	0308_12
DATE:	4/15/2025 12:07:53 PM
DESIGNED BY:	Designer
DRAWN BY:	Author
CHECKED BY:	Checker

E105

SHEET LIST

SHEET NUMBER SHEET NAME

P101 NOTE AND SCHEDULE
P102 WATER SUPPLY AND SEWAGE
SYSTEM

PIPE COLOR	SCHEME
	OOMESTIC COLD WATE OOMESTIC HOT WATER SANITARY VENT
S	SANITARY SEWER STORM DRAINAGE
	GRAY WATER GAS LINE

PLUMBING NOTES

- . THE PLUMBING SYSTEM IS DESIGNED TO MEET THE BUILDING'S DOMESTIC WATER SUPPLY, SANITARY DRAINAGE, AND STORM DRAINAGE REQUIREMENTS, AS PER PROJECT SPECIFICATIONS AND APPLICABLE CODES.
- THE SYSTEM INSTALLATION SHALL COMPLY WITH THE LATEST INTERNATIONAL PLUMBING CODE (IPC), INTERNATIONAL RESIDENTIAL CODE (IRC), AND ALL OTHER RELEVANT LOCAL, STATE, AND NATIONAL REGULATIONS.
- ALL PLUMBING WORK SHALL COMPLY WITH THE LATEST EDITION OF THE INTERNATIONAL PLUMBING CODE (IPC) AND THE LOCAL PLUMBING CODE.
- 4. PLUMBING SYSTEMS SHALL BE TESTED AND INSPECTED IN ACCORDANCE WITH THE LOCAL PLUMBING CODE REQUIREMENTS.
- 5. PLUMBING FIXTURES SHALL BE INSTALLED WITH THE APPROPRIATE TRIM, FITTINGS, AND ACCESSORIES, AS RECOMMENDED BY THE MANUFACTURER.
- 6. PIPING SHALL BE PROPERLY SUPPORTED AND SECURED TO PREVENT SAGGING, MOVEMENT, AND VIBRATION.
- 7. SHUT-OFF VALVES SHALL BE PROVIDED AT ALL BRANCH CONNECTIONS AND AT THE
- INLET AND OUTLET OF EACH PIECE OF EQUIPMENT.

 8. BACKFLOW PREVENTION DEVICES SHALL BE INSTALLED AS REQUIRED BY THE LOCAL
- PLUMBING CODE TO PROTECT THE POTABLE WATER SYSTEM.

 9. PLUMBING FIXTURES AND EQUIPMENT SHALL BE ACCESSIBLE FOR MAINTENANCE AND
- 10. EXPOSED PLUMBING PIPING AND FIXTURES SHALL BE INSULATED TO PREVENT CONDENSATION AND ENERGY LOSS.
- 11. DEAD ENDS IN THE DRAINAGE SYSTEM MUST BE AVOIDED, EXCEPT WHERE NECESSARY TO INSTALL A CLEANOUT IN AN ACCESSIBLE LOCATION, AND MUST HAVE A VENTED CONNECTION TO THE OUTSIDE ATMOSPHERE.
- 12. THE VERTICAL DEFLECTION OF PVC PIPE MUST NOT EXCEED 5%, AND NO DEFLECTION IS PERMITTED FOR IRON PIPE.
- 13. WORK MUST BE PROPERLY COORDINATED WITH OTHER TRADES TO AVOID CONFLICTS, REFERRING TO THE ARCHITECTURAL AND STRUCTURAL DRAWINGS FOR INFORMATION REGARDING CEILING ELEVATIONS, SPACE CLEARANCES, WALL AND PARTITION LOCATIONS, ETC.
- 14. ALL FIXTURES SHALL HAVE ACCESSIBLE STOPS.
- 15. DOMESTIC WATER PIPING SHALL BE PEX, AND PVC PIPING IS NOT ACCEPTABLE FOR INTERIOR USE.
- 16. VENT TERMINATIONS SHALL BE LOCATED AT LEAST 10 FEET FROM OR 3 FEET ABOVE ANY OPERABLE WINDOW, DOOR OPENING, AIR INTAKE, OR VENT SHAFT, AND AT LEAST 3 FEET IN EVERY DIRECTION FROM ANY LOT LINE, ALLEY, OR STREET.
- 17. PIPE AND FITTINGS UTILIZED IN THE WATER SUPPLY SYSTEM SHALL HAVE A MAXIMUM OF 8 PERCENT LEAD.
- 18. ACRYLONITRILE BUTADIENE STYRENE (ABS) SHALL BE USED FOR THE SEWERAGE AND VENTILATION SYSTEM.
- 19. CROSS-LINKED POLYETHYLENE (PEX) SHALL BE USED FOR THE WATER SUPPLY SYSTEM.
- 9. CROSS-LINKED POLYETHYLENE (PEX) SHALL BE USED FOR THE WATER SUPPLY SYS 0. POLYVINYL CHLORIDE (PVC) SHALL BE USED FOR THE RAIN WATER SYSTEM.
- 20. POLYVINYL CHLORIDE (PVC) SHALL BE USED FOR THE RAIN WATER SYSTEM.
 21. THE MIMIMUM WATER SUPPLY DEPTH UNDER FLOOR FINISH SHOUD BE 1/2".
- 22. ANY PIPE INSTALLED UNDERGROUND MUST HAVE AT LEAST 12 INCHES OF CLEARANCE BETWEEN THE OUTSIDE OF THE PIPE AND ANY OTHER UNDERGROUND STRUCTURE.
- 23. THE MINIMUM CLEARANCE BETWEEN COLD AND HOT WATER LINES IN RESIDENTIAL
- HOMES MAINTAIN A MINIMUM DISTANCE OF 6 INCHES.

 24. HORIZONTAL SEPARATION BETWEEN WATER AND SEWER LINES: A MINIMUM OF 12 INCHES BETWEEN POTABLE WATER SUPPLY LINES (COLD AND HOT WATER) AND

ABBREVIATIONS

SANITARY SEWER LINES.

Ø	DIAMETER
ABS	ACRYLONITRILE BUTADIENE STYRENE
ABV	ABOVE ABOVE
ADV	AREA DRAIN
AFF	ABOVE FINISHED FLOOR
ALT	ALTERNATE
BFF	BELOW FINISHED FLOOR
BLW	BELOW FINISHED FLOOR
CO	CLEAN OUT
CW	COLD WATER
D	DEGREE
	_
DFU	DRANAGE FIXTURE UNIT DIAMETER
DIA	DOWN
DN	
FCO	FLOOR CLEAN OUT
FD	FLOOR DRAIN
FL	FLOOR FLOOR SINK
FS	
FT	FOOT/FEET
HB	HOSE BIB
HW	HOT WATER
IN	INCH
MIN	MINIMUM
NO	NUMBER
NTS PEX	NOT TO SCALE CROSS-LINKED POLYETHYLENE
PLBG PVC	PLUMBING POLYVINYL CHLORIDE
QTY	QUANTITY
RD	ROOF DRAIN
RED	REDUCER
RM	ROOM
RW	RAIN WATER
SF	SQUARE FOOT
VTD	VENT TUROUGU ROOF
VTR	VENT THROUGH ROOF
W	WASTE
WCO	WALL CLEAN OUT
WSFU	WATER SUPPLY FIXTURE UNIT

PLUMBING LEGEND

D	CAP
⇧	BEND 45 DEG
B	BEND 90 DEG
	TEE REDUCING
	TEE
	CLEAN TWO-WAY
	WYE 45 DEG
	WYE 45 DEG DOUBLE
	WYE COMBINATION
	P-TRAP

PIPE SCHEDULE		
MATERIAL	DIAMETER	LENGTH
ACRYLONITRILE BUTADIENE STYRENE (ABS)	1 1/2"	20 FT
ACRYLONITRILE BUTADIENE STYRENE (ABS)	2"	42 FT
ACRYLONITRILE BUTADIENE STYRENE (ABS)	3"	20 FT
CROSS-LINKED POLYETHYLENE (PEX)	1/2"	79 FT
CROSS-LINKED POLYETHYLENE (PEX)	3/4"	25 FT
POLYVINYL CHLORIDE - RIGID	2"	17 FT

FITTING SCHEDULE			
FITTING	SIZE	QTY	
DOMESTIC COLD WATER			
PEX 90 DEGREE ELBOW	1/2"ø-1/2"ø	11	
PEX 90 DEGREE ELBOW	3/4"ø-3/4"ø	3	
PEX TEE ELBOW	1/2"ø-1/2"ø	5	
PEX TEE ELBOW	3/4"ø-3/4"ø	1	
PEX TRANSITION ELBOW	1"ø-3/4"ø	2	
PEX TRANSITION ELBOW	3/4"ø-1/2"ø	1	
DOMESTIC HOT WATER			
PEX 90 DEGREE ELBOW	1/2"ø-1/2"ø	9	
PEX 90 DEGREE ELBOW	3/4"ø-3/4"ø	3	
PEX TEE ELBOW	1/2"ø-1/2"ø	3	
PEX TRANSITION ELBOW	3/4"ø-1/2"ø	1	
PVC 90 DEG BEND ELBOW PVC 90 DEGREE BEND ELBOW	2"ø-2"ø 2"ø-2"ø	2 4	
PVC 90 DEGREE BEND ELBOW	2"ø-2"ø	4	
SEWAGE			
ABS 90 DEGREE BEND ELBOW	1 1/2"ø-1 1/2"ø	1	
ABS 90 DEGREE BEND ELBOW	2"ø-2"ø	3	
ABS 90 DEGREE BEND ELBOW	3"ø-3"ø	1	
ABS P-TRAP	1 1/2"ø-1 1/2"ø	3	
ABS P-TRAP	2"ø-2"ø	1	
ABS REDUCER ELBOW	2"ø-1 1/2"ø	1	
ABS REDUCER ELBOW	3"ø-2"ø	1	
ABS TEE ELBOW	1 1/2"ø-1 1/2"ø-1 1/2"ø	1	
ABS TEE ELBOW	2"ø-2"ø-2"ø	2	
ABS TEE ELBOW	3"ø-3"ø-3"ø	2	
ABS TEE REDUCER ELBOW	3"ø-3"ø-1 1/2"ø	2	
ABS TEE REDUCER ELBOW	3"ø-3"ø-2"ø	1	
VENT			
ABS VENT CAP ELBOW	1 1/2"ø	1	
ABS VENT CAP ELBOW	2"ø	2	
ABS VENT CAP ELBOW	3"ø	1	

FIXTURE CONNECTION SCHEDULE											
FAMILY	W	V	TRAP	CW	HW	QTY	DFU	TOT.	WFU	TOT.	NOTES
DRYER	N/A	N/A	N/A	N/A	N/A	1		0			
HANGING PIPES CLAMP						4		0			
SHOWER TRAY	2"	1-1/2"	1-1/2"	1/2"	1/2"	1		0			
SHOWER TRIM	-	-	-	1/2"	1/2"	1		0			
SINK ISLAND SINGLE	2"	1-1/2"	1-1/2"	1/2"	1/2"	1		0			
VANITY SINK	2"	1-1/2"	1-1/2"	1/2"	1/2"	1		0			
WASHER	2"	1-1/2"	2"	1/2"	1/2"	1		0			DRAINS TO GRAY WATER OR SEWER SEE PLANS
WATER CLOSET						1		0			
WATER HEATER	N/A	N/A	N/A	3/4"	3/4"	1		0			

FIXTURE SCHEDULE						
FIXTURE	QTY	DESCRIPTION				
	·					
DRYER	1					
HANGING PIPES CLAMP	4					
SHOWER TRAY	1					
SHOWER TRIM	1					
SINK ISLAND SINGLE	1					
VANITY SINK	1					
WASHER	1	DRAINS TO GRAY WATER OR SEWER SEE PLANS				
WATER CLOSET	1					
WATER HEATER	1					

ACCESSORIES & FITTINGS SCHEDULE								
FIXTURE	QTY	DESCRIPTIONS						
DISHWASHER CONNECTOR	1							
HOSE BIB	1							
ROOF DRAIN SCUPPER	2							
SHUTOFF VALVE	6							

PLUMBING SCHEDULE										
FIXTURE	TRAP	WASTE	VENT	C.W	H.W					
DRYER	N/A	N/A	N/A	N/A	N/A					
SHOWER TRAY	1-1/2"	2"	1-1/2"	1/2"	1/2"					
SHOWER TRIM	-	-	-	1/2"	1/2"					
SINK ISLAND SINGLE	1-1/2"	2"	1-1/2"	1/2"	1/2"					
VANITY SINK	1-1/2"	2"	1-1/2"	1/2"	1/2"					
WASHER	2"	2"	1-1/2"	1/2"	1/2"					
WATER CLOSET										
WATER HEATER	N/A	N/A	N/A	3/4"	3/4"					

WATER FIXTURE UNIT SCHEDULE							
FAMILY	QTY	UNIT VALUE	TOTAL				
DRYER	1	0					
HANGING PIPES CLAMP	4	0					
SHOWER TRAY	1	0					
SHOWER TRIM	1	0					
SINK ISLAND SINGLE	1	0					
VANITY SINK	1	0					
WASHER	1	0					
WATER CLOSET	1	0					
WATER HEATER	1	0					

WASTE FIXTURE UNIT SCHEDULE								
FAMILY	QTY	DFU VALUES	TOTAL					
DRYER	1	0						
HANGING PIPES CLAMP	4	0						
SHOWER TRAY	1	0						
SHOWER TRIM	1	0						
SINK ISLAND SINGLE	1	0						
VANITY SINK	1	0						
WASHER	1	0						
WATER CLOSET	1	0						
WATER HEATER	1	0						



KEY PLAN

NO.	DESCRIPTION	DATE
·		•

NOTE:

LEGEND:

PROJECT

217-WESTBROOK-525-1Bd1Ba CONTEMPORARY-550

DRAWING NAME

NOTE AND SCHEDULE

CLIENT NAME:

 PROJECT NUMBER:
 0308_12


 DATE:
 4/11/2025 4:02:45 PM


 DESIGNED BY:
 Designer

 DRAWN BY:
 Author


 CHECKED BY:
 Checker

P101

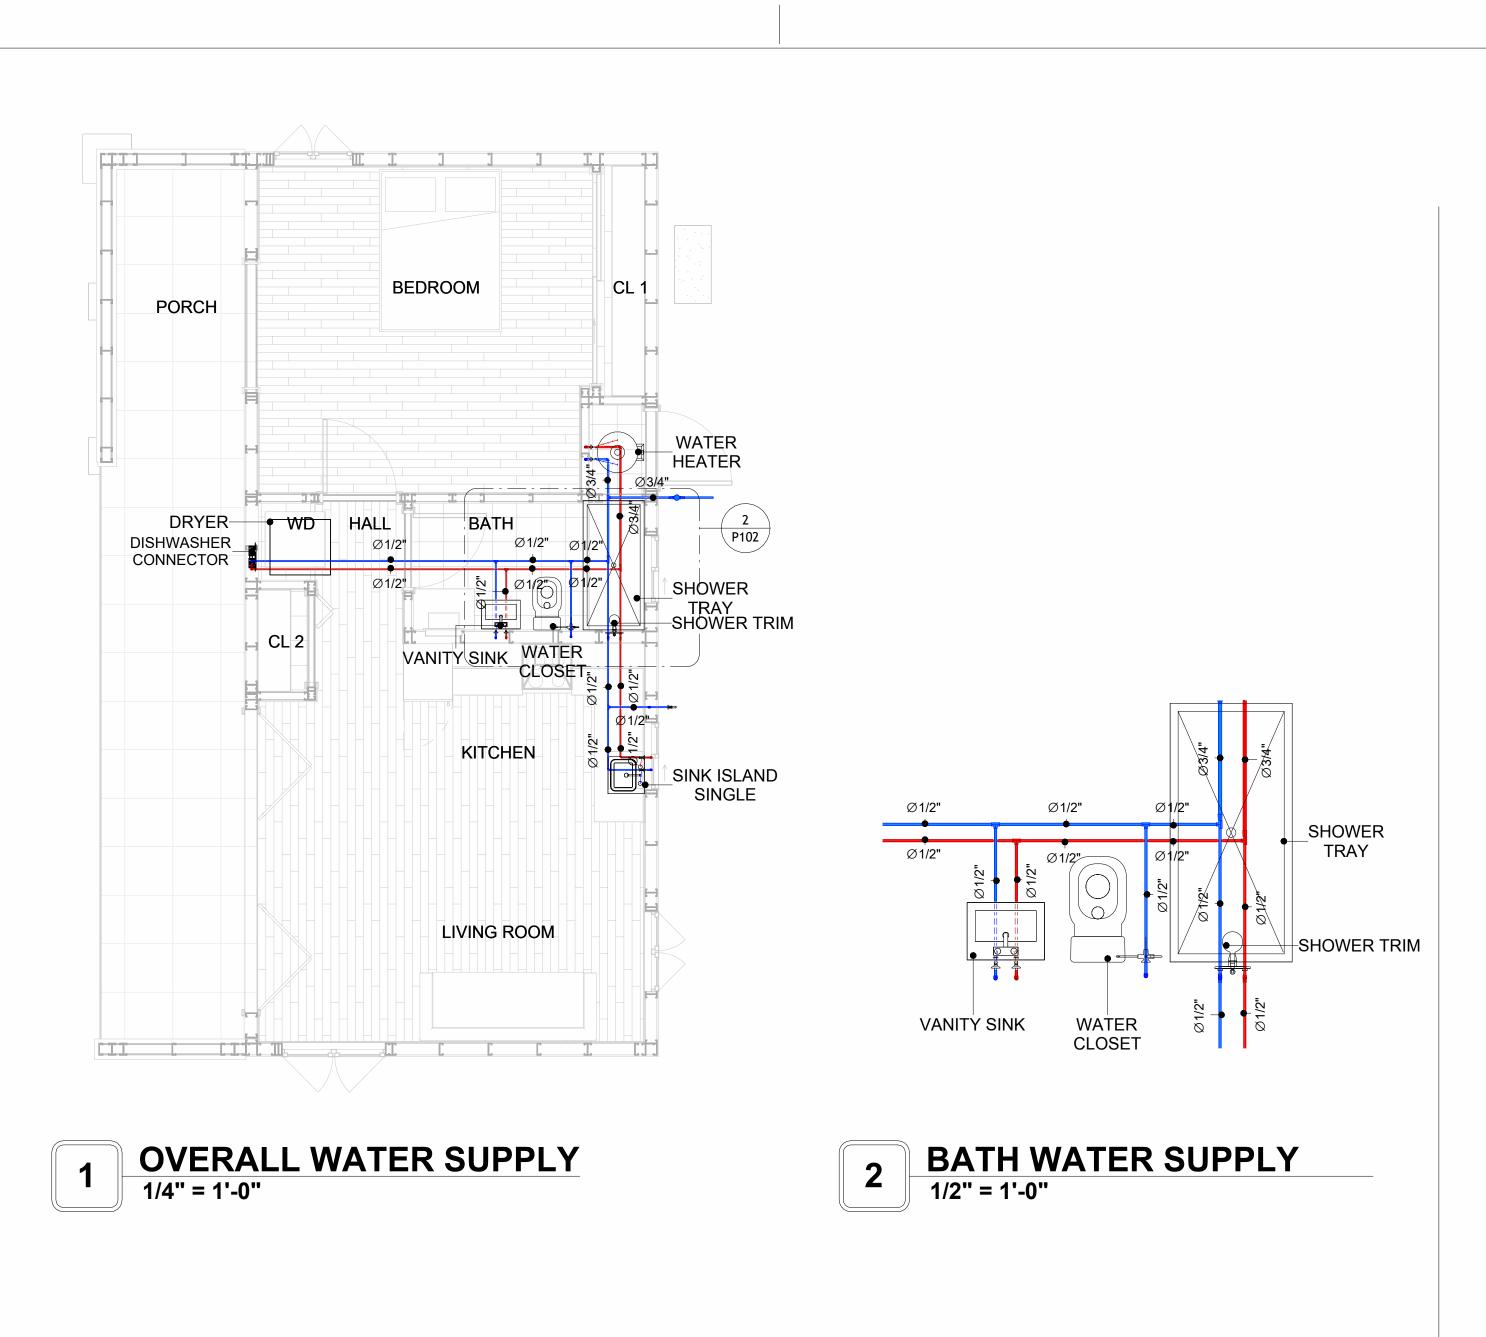


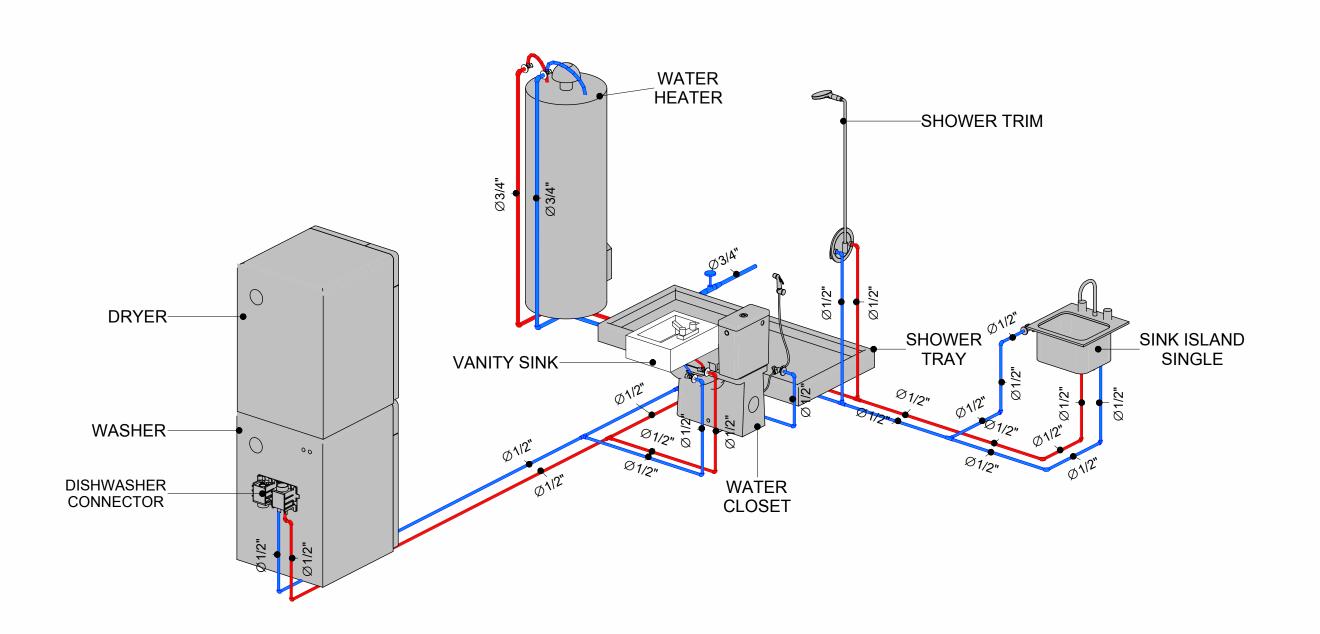

WATER SUPPLY RISER DIAGRAM

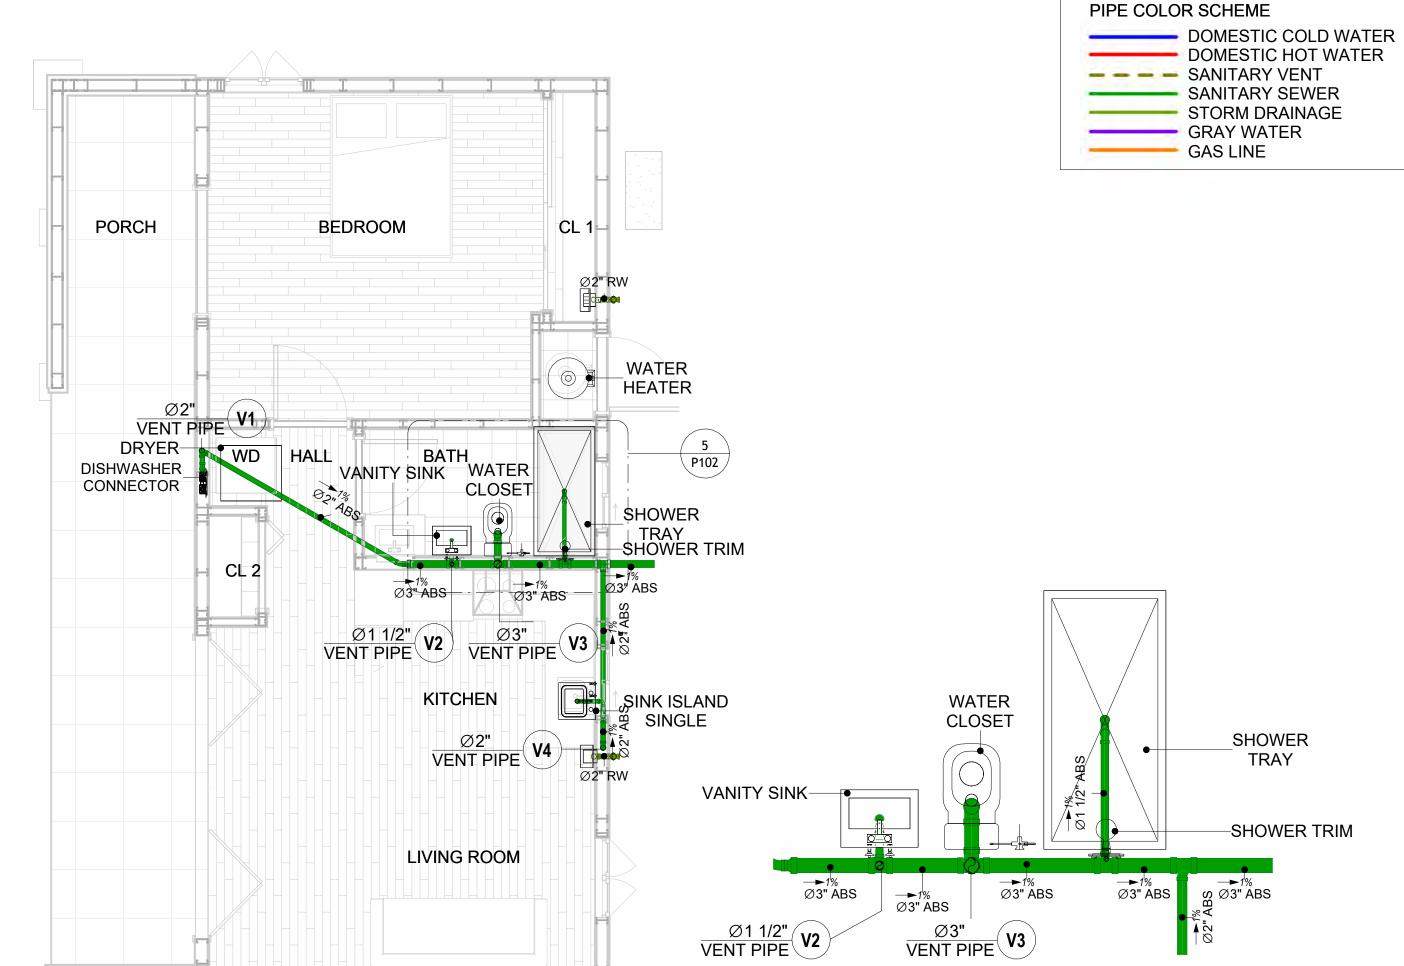

4 OVERALL SANITARY
1/4" = 1'-0"

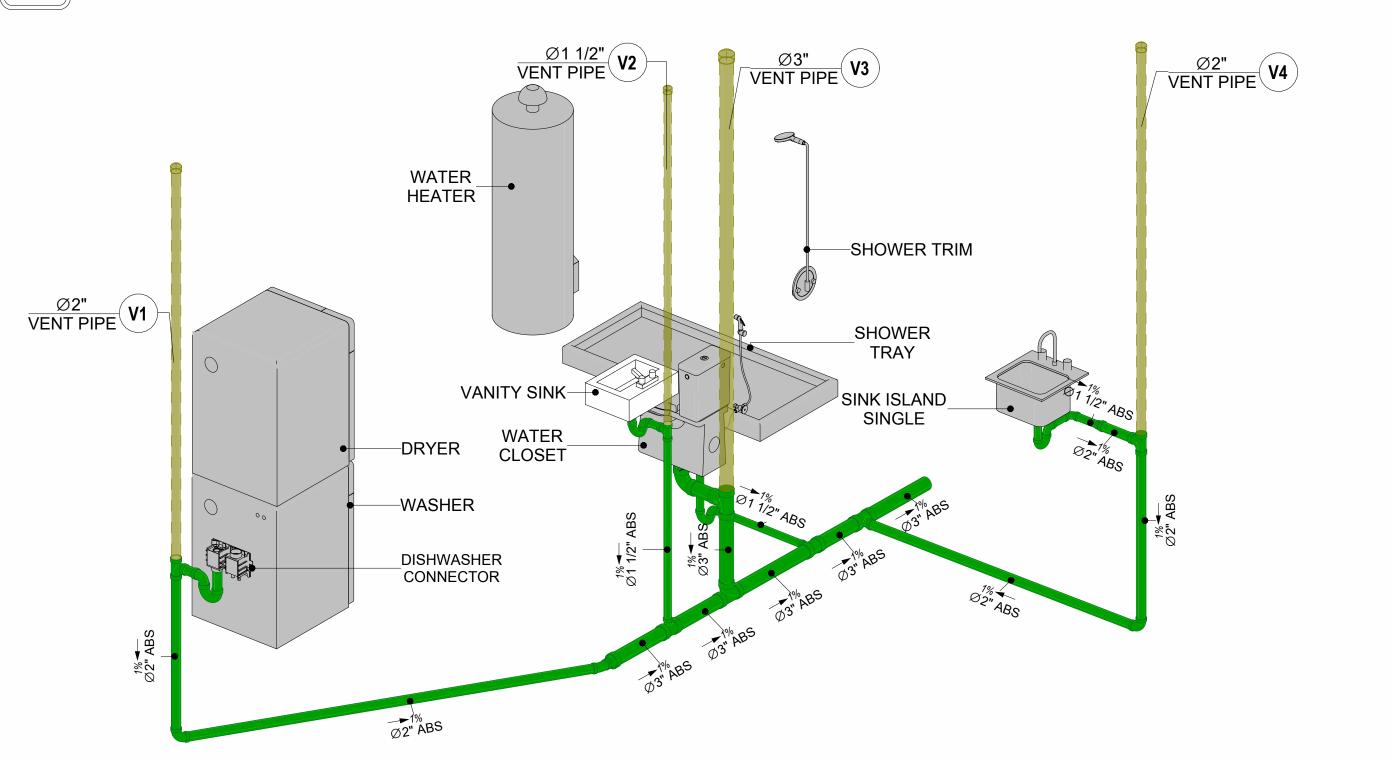


BATH SEWAGE

1/2" = 1'-0"

6 SEWAGE RISER DIAGRAM



KEY PLAN

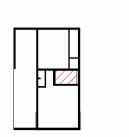

NO.	DESCRIPTION	DATE

NOTE:

LEGEND:

PROJECT

217-WESTBROOK-525-1Bd1Ba CONTEMPORARY-550

DRAWING NAME

WATER SUPPLY AND SEWAGE SYSTEM

	CLIENT NAME:	
	PROJECT NUMBER:	0308_12
	DATE:	4/11/2025 4:03:14 PM
	DESIGNED BY:	Designer
	DRAWN BY:	Author
	CHECKED BY:	Checker
l		

P102

Materials Shopping List

Please print and take this Materials Shopping List to your favorite Home Depot and ask for assistance in selecting the materials, fixtures and fittings to complete your new home.

Record your selection and the price of the item. Then do the math to determine the cost for your selections and the total cost of finishing your home.

Have It Your Way!

The material types listed in this document were selected based on personal preferences. The Customer is encouraged to make changes to the material types in accordance with local customs, regulations, and personal preferences.

Have It Your Way!



20 good reasons to frame a home with metal and not wood



Why build your ADU with metal vs wood	Wood	Metal	Explanation
1 DIY Construction Benefit		~	The wall frames, trusses and beams can be erected in a just a few days
2 Minimal Construction Skills Required		~	Pre-assembled walls and trusses require no specialized skills to errect
3 Build as DIY, Hybrid or by a General Contractor		~	Do it yourself, Hybrid (involve special contractors) or hire a General Contractor
4 Build It As You Can Afford It		~	Impervious to Weather - build as you have the time and money
5 Up Front Cost of Framing Materials	\checkmark		As to only the framing material, wood is less expensive
6 Total Cost To Build		~	Savings in time, labor, and other areas make light gauge steel LESS expensive
7 Termites and wood boring insects		~	Termites, carpenter ants and wood boring insects eat wood, not metal
8 Mold resistant		~	Metal does not attract mold
9 Damage caused by exterior and interior flooding		~	Metal needs no reconditioning after a flood
10 Fire Resistant		~	Non-combustible
11 Lower insurance rates		~	Many insurance underwriters now provide lower rates for metal framed homes
12 Walls, trusses, and beams retain their original form		~	Perfectly straight walls - no shimming of drywall
13 Corners are 90 degrees		~	No need for templating of countertops to adjust for out of square corners
14 Strength and weight		~	Metal is stronger than wood and weighs less - no need for crane to lift ADU trusses
15 IBC Engineered Stamp		~	If an engineering stamp is necessary, months of waiting are saved
16 Complete BOM (Materials Shopping List)		~	Take the materials shopping list to Home Depot and start shopping/pricing
17 Flexible in Seismic Areas - Won't Fracture		~	Light gauge steel is flexible and won't fracture when the earth moves
18 No Waste At Job Site		~	Steel is the most recycled material in the world. A typical wood home has 20-30% waste
19 Environmentally Friendly		~	Trees don't have to be destroyed and the source of most metal is from recycling
20 How-To Videos Included		~	How-to videos provide simple assembly instructions
21 Relationship Counselor		~	Eliminate emotional uphevels - save time, money, and preserve the relationship

Universal Requirements - some or all may be required

- 1 Site plan
- 2 Electrical Supply Connection
- 3 Sewer Connection
- 4 Fresh Water Supply Connection
- 5 Set Backs
- 6 Soils Evaluation

- 7 Earthquake (fault) evaluation
- 8 Foundation Plan subject to soils
- 9 Compliance with local energy codes: insulation home wrap and flashing
- 10 Engineering for wind speed and snow load.
- 11 State and Local ordinances regarding ADUs
- 12 Local Architect and/or Engineer may be necessary





Westbrook-1Ba1Ba-Contemporary MATERIAL SHOPPING LIST

Have It Your Way!

The material types listed in this document were selected based on personal preferences. The Customer is encouraged to make changes to the material types in accordance with local customs, regulations, and personal preferences. Have It Your Way!

TOC



15

#	Name	Link		Page No
1	Cover Page	Cover Page		1
2	TOC	TOC		2
3	ELECTRICAL BOM	ELECTRICAL BOM		3
5	HVAC BOM	HVAC BOM		7
4	PLUMBING BOM	PLUMBING BOM		10

Table Of Content

Have It Your Way!

ARCHITECTURAL BOM

The material types listed in this document were selected based on personal preferences. The Customer is encouraged to make changes to the material types in accordance with local customs, regulations, and personal preferences. Have It Your Way!

GENERAL NOTES

6 ARCHITECTURAL BOM

- 1 This BOM (Bill of Materials) is prepared as a Materials Shopping List to help builders and DIYers gain a complete understanding of most if not all elements required for the complete construction of this structure, according to the original design documents provided by FrameUpNow.
- 2 All quantities and specifications are subject to change based on the final design, field measurements, availability of products and customer preferences. The customer should verify all information prior to purchasing materials.
- 3 All products and elements in the list shall conform to the International Residential Code (IRC), or any other local and international building codes, safety regulations, and standards that are applicable to the location of the structure.
- 4 If any changes are made by the customer to the list of materials specified in this document, the customer is responsible for assuring that the correct type and quantity of materials are utilized in accordance with local building codes.
- 5 FrameUpNow, will not be held responsible for any misuse of this document, the products listed, or for deviations from the content that are made due to changes in specifications, pricing, availability, or customer preferences.
- 6 The customer is advised to consult a qualified professional or technician prior to purchasing materials for specialized construction system items. Some items including but not limited to caseworks, doors and windows may require as built measurements prior to purchase to confirmation of final dimensions.
- 7 If there are additional trim elements or specific installation methods, the total amount of materials needed might vary. Consider any additional trim required for corners, intersections, or other architectural details that might cause this variations before procedding to purchase and construction.

ARCHITECTURAL BOM



	Westbrook-1Ba1Ba-Contemporary								
		ARCHITECTURA							
Vo.	Item	Туре	Unit	Quantity	Unit Price	Total	Description		
	APPLIANCES Defrigerator		PCS	1	1				
1	Refrigerator		PCS PCS	1					
2	Range		PCS	1					
_	Washer								
4	Dryer		PCS	1					
5	Dish Washer		PCS	0					
6	Oven		PCS	0					
	Microwave		PCS	0					
<u> </u>	CASEWORKS		гт	15.00	ı				
1	Kitchen Cabinet		FT	15.03					
	Laundry Cabinet		FT	2.25					
3	Vanity Cabinet		FT	2.5					
	Medicine Cabinet		PCS	1					
5	Kitchen countertop		SF	22.85					
	Laundry Countertop		PCS	0					
7	Bathroom Countertop		SF	0					
8	Island		FT	0					
9	Peninsula		FT	0					
	Closets		SF	62.73					
<u> </u>	CEILING	I=							
	Ceiling Board		SF	500					
	Dry Wall Fastener	Screw	PCS	875					
3	Vapor Retarder		SF	551					
4	Vapor Retarder Fastener	Nails with washer heads	PCS	1653					
5	Ceiling Board (MRD)	Moisture resistant drywall	SF	51					
	MRD Fastener		PCS	89					
	Ceiling Board	Marine Plywood	SF	0					
8	Marine Plywood Fastener	Screw	PCS	0					
	Dry Wall Tape		FT	276					
	FLOORING				· ·				
1	Main Living Space		SF	215.9					
2	Bathroom		SF	66.1					
3	Bedroom		SF	146.1					
4	Porch		SF	204.75					
Δ	STRUCTURE				·				
1	Foundation		SF	831.5					
	WALLS EXTERIOR								
1	Stucco Finish		SF	830					
2	Exterior-Grade Plywood		SF	530					
	Exterior-Grade Plywood Fastener	Self-drilling screws(100/pkt)	PKT	5.3					
	Wall Shteathing (OSB)	3 \ 1 /	SF	1360					
5	Shteathing Fastener		PKT	13.6					
	Wall Homewrap	J (SF	1360					
7	Homewrap Fastener	Stapled fastener (200/pkt)	PKT	5.2					
	Furring Strip		PCS	66.3					
	Furring Strip Fastener	Self-drilling screws(100/pkt)	PKT	5.3					
	Wall Paint	c.i.i.i.g colons(100/pkt/	SF	1360					
	Stone Copping	Masonry stone	SF	0					
	Stone Veneer		SF	0					
	Mortar for Stone Veneer		SF	0					
	Wall Insulation		SF	1877.0					
	WALLS INTERIOR	I .	JI	10//.0					
	Cementitious Backer Board		SF	302	I				
	Kerdi membrane		SF SF	302					
	Kerdi membrane Fastener		SF SF	302					
	Wall Ceramic Tile		SF	302 988					
	Drywall Board		SF						
n	Drywall Fastener		PKT	9.88					
	Mall Dates								
7	Wall Paint Drywall Tape		SF FT	988 186					

ARCHITECTURAL BOM



\cap	DOORS				
1	Exterior Swinging	3' - 0" X 6'-8"	PCS	1	
2	Interior Swinging	3' - 0" X 6'-8"	PCS	2	
3	Exterior Swinging	5' - 0" X 6'-8"	PCS	1	
4	Folding Door	3' - 6" X 6'-8"	PCS	1	
5	Interior Sliding	8' - 6" X 6'-8"	PCS	1	
6	Folding Door	12' - 0" X 6'-8"	PCS	1	
7	Exterior Door Trim	12 0 7 0 0	FT	60	
8	Interior Door Trim		FT	203	
9	Entry Lock set		11	3	
10	Privacy Lock set			2	
11	Passage Lock set			2	
	WINDOWS			2	
1	Casement	3' - 3" X 5'-3"	PCS	2	
2	Casement	4' - 3" X 5'-3"	PCS	1	
3	Sliding	2' - 9" X 3'-3"	PCS	1	
4	Sliding	2' - 9" X 1'-9"	PCS	1	
5	Exterior Window Trim	2 / // /	FT	75	
6	Interior Window Trim		FT	75	
	ROOF			,,,	
1	Roof Covering		SF	568	
2	Roof Covering Fastener		PCS	284	
3	Roof Felt Paper		SF	568	
4	Roof Felt Paper Fastener		PCS	1704	
5	Roof Sheathing		SF	568	
6	Roof Sheathing Fastener		PCS	4544	
7	Batten		FT	0	
8	Batten Fastener		PCS	0	
9	Soffit		SF	0	
10	Soffit Fastener		PCS	0	
11	Fascia		FT	0	
12	Fascia board fastener		PCS	0	
13	Roof Insulation		SF	568	



		Westbrook-1Ba1E	Ba-Contem	porary			
	EL	ECTRICAL MATER	IAL SHOP	PING LI	ST		
No.	ltem	Type	Unit		Unit Price	Total	Description
Δ	LIGHTING FIXTURES		·				
1	Kitchen Ceiling Light		PCS	3			
2	Kitchen Wall Mounted Light		PCS	1			
3	Exterior Wall Mounted Light		PCS	4			
4	Livingroom Ceiling Light With Fan		PCS	1			
5	Bedroom Ceiling Light With Fan		PCS	1			
6	Dining Ceiling Light		PCS	0			
7	Bath Wall Mounted Light		PCS	1			
8	Bathroom Ceiling Light		PCS	2			
	Livingroom Ceiling Light		PCS	6			
	Bedroom Ceiling Light		PCS	4			
	Hall & Entry Ceiling Light		PCS	2			
	WD Ceiling Light		PCS	0			
	Smoke Detector		PCS	4			
	ELECTRICAL FITTINGS		1				
	Standard Receptacle 120V	20A	PCS	9			
	GFCI Receptacle 120V	20 A	PCS	13			
	GFCI Receptacle 240V	30 A	PCS	2			
17	GFCI Receptacle 240V	50 A	PCS	1			
18	GFCI Receptacle 240V	60 A	PCS	1			
	Fan Switch	00 A	PCS	1			
	Single Pole Switch		PCS	5			
	Three Way Switch		PCS	2			
22	Dimmer Switch		PCS	4			
<u> </u>	ELECTRICAL CONDUITS & WIRING		ГТ				
	ROMEX 14 AWG	14/3/W/ground	FT	115			
	ROMEX 12 AWG	12/3/W/ground	FT	245			
	ROMEX 12 AWG	12/2/W/ground	FT	0			
	ROMEX 10 AWG	10/3/W/ground	FT	50			
	ROMEX 10 AWG	10/2/W/ground	FT	78			
	Romex 8 AWG	8/3/W/ground	FT	0			
	Romex 8 AWG	8/2/W/ground	FT	14			
	ROMEX 6 AWG	6/3/W/ground	FT	25			
31	Bare Copper Ground Wire 6 AWG		FT				
\triangle	ELECTRICAL BOXES & CIRCUTES						
32	Panelboard -240V 1 Phase MLO	200 AMP	PCS	1			
33	Circuit breaker	15 A	PCS	3			
34	Circuit breaker	20 A	PCS	9			
36	Circuit breaker	30 A	PCS	2			
37	Circuit breaker	50 A	PCS	1			
	Circuit breaker	60 A	PCS	1			
40	Single Gang Switch Box		PCS	2			
	Double Gang Switch Box		PCS	2			
	Triple Gang Switch Box		PCS	2			
	Pull Box	#1/4	PCS	21			
	Receptacle Box		PCS	26			

PLUMBING BOM

2 ABS 90 Degree Bend Elbow

3 ABS 90 Degree Bend Elbow

4 ABS P-Trap

5 ABS P-Trap

6 ABS Reducer Elbow

7 ABS Reducer Elbow

11 ABS Tee Reducer Elbow

12 ABS Tee Reducer Elbow

13 ABS Vent Cap Elbow

14 ABS Vent Cap Elbow

15 ABS Vent Cap Elbow

16 PEX 90 Degree Elbow

17 PEX 90 Degree Elbow

20 PEX Transition Elbow

21 PEX Transition Elbow

22 PVC 90 Deg Bend Elbow

23 PVC 90 Degree Bend Elbow

18 PEX Tee Elbow

19 PEX Tee Elbow

8 ABS TEE Elbow

9 ABS TEE Elbow

10 ABS TEE Elbow



Westbrook-1Ba1Ba-Contemporary PLUMBING SYSTEM MATERIAL SHOPPING LIST Item Unit Quantity Unit Price Total Description 1 Bath Tub (Alcove Tub) PCS 2 Kitchen Sink PCS 1 3 Kitchen Faucets PCS 4 Vanity Sink PCS 1 5 Bath room Faucets PCS 6 Water Closet PCS 7 Shower Trim PCS 8 Shower Tray PCS 9 Water Heater PCS 10 Hose Bib PCS 1 11 Shutoff Valve PCS 12 Hanging pipe clamp PCS 4 13 Gate Valve PCS 14 Dishwasher Supply Single Connector PCS 0 15 Dishwasher Sewage Single Connector PCS 0 16 Roof Drain Scupper PCS 2 17 Laundry Sweat Connector PCS 1 △ SANITARY & PLUMBING PIPES 1 ABS (Acrylonitrile Butadiene Styrene) Pipes FT 0 2 ABS (Acrylonitrile Butadiene Styrene) Pipes ø 1 1/2' FT 20 3 ABS (Acrylonitrile Butadiene Styrene) Pipes ø 2" FT 42 4 ABS (Acrylonitrile Butadiene Styrene) Pipes ø 3" FT 20 5 PEX (Cross-linked polyethylene) Pipes ø 1/2' FT 79 6 PEX (Cross-linked polyethylene) Pipes ø 3/4" FT 25 7 PEX (Cross-linked polyethylene) Pipes ø 1" FT 1 8 PVC Pipes Sch.80 - Rigid9 PVC Pipes Sch.80 - Rigid ø 1 1/2' FT 0 ø 2" FT 17 10 PVC Pipes Sch.80 - Rigid ø 3" FT 0 11 Flex Pipe Round ø 1/2" **PCS** 6

PCS

PCS

PCS

PCS

PCS

PCS

3

1

20

6

8

2

4

1 1/2"ø-1 1/2"ø

1 1/2"ø-1 1/2"ø

1 1/2"ø-1 1/2"ø-1 1/2"ø

2"ø-2"ø

3"ø-3"ø

2"ø-2"ø

3"ø-2"ø

2"ø-1 1/2"ø

2"ø-2"ø-2"ø

3"ø-3"ø-3"ø

3"ø-3"ø-2"ø

1/2"ø-1/2"ø

3/4"ø-3/4"ø

1"ø-3/4"ø

3/4"ø-1/2"ø

2"ø-2"ø

2"ø-2"ø

1/2"ø-1/2"ø-1/2"ø

3/4"ø-3/4"ø-3/4"ø

1 1/2"ø

2"ø

3"ø

3"ø-3"ø-1 1/2"ø

		Westbrook-	1Ba1Ba-C	ontempo	rary		
		HVAC SYSTEM N	MATERIAL	SHOPP	ING LIST		
No.	Item	Туре	Unit	Quantity	Unit Price	Total	Description
\triangle	HVAC_DUCTS						
1	PIPE (REFRIGERANT LINE)	3/8" (Ø)	FT	63.38			
2	PIPE (REFRIGERANT LINE)	3/4" (Ø)	FT	94.91			
3	DRAYER HOSE	4" (Ø)	FT	5			
4	FLEX DUCT ROUND	4" (Ø)	FT	3.79			
\triangle	DUCT FITTINGS & ACCESSORIES						
	ELBOW (REFRIGERANT LINE)	3/4" (Ø)-3/4" (Ø)	PCS	23			
6	ELBOW (REFRIGERANT LINE)	3/8" (Ø)-3/8" (Ø)	PCS	14			
7	TRANSITION (REFRIGERANT	3/4" (Ø)-1/2" (Ø)	PCS	3			
8	TRANSITION (REFRIGERANT	3/4" (Ø)-3/8" (Ø)	PCS	2			
9	TRANSITION (REFRIGERANT	3/8" (Ø)-1/4" (Ø)	PCS	1			
10	TEE (REFRIGERANT LINE)	3/4" (Ø)-3/4" (Ø)-3/4" (Ø)	PCS	1			
11	TEE (REFRIGERANT LINE)	3/8" (Ø)-3/8" (Ø)-3/8" (Ø)	PCS	1			
12	ROUND TRANSITION(ANGLE)	45 DEGREE	PCS	5			
\Box	HVAC_EQUIPMENTS						
13	AIR HANDLING UNIT	WALL MOUNTED	PCS	2			
14	CONDENSER	OUTDOOR UNIT	PCS	1			
	EXHAUST FAN	75 CFM	PCS	1			
16	EXHAUST HOOD	WALL MOUNTED	PCS	1			
17	HOOD-WALL: VENT	HOOD-WALL: VENT	PCS	1			
18	DRAYER: VENT	DRAYER: VENT	PCS	1			
19	ROOF VENT	3"(Ø)	PCS	1			



Table Of Content

#	Name	Link	Page No
1	Cover Page	<u>Cover Page</u>	1
2	TOC	TOC	2
3	ELECTRICAL BOM	ELECTRICAL BOM	3
5	HVAC BOM	HVAC BOM	7
4	PLUMBING BOM	PLUMBING BOM	10
6	ARCHITECTURAL BOM	ARCHITECTURAL BOM	15

Have It Your Way!

The material types listed in this document were selected based on personal preferences. The Customer is encouraged to make changes to the material types in accordance with local customs, regulations, and personal preferences. Have It Your Way!

GENERAL NOTES

- This BOM (Bill of Materials) is prepared as a Materials Shopping List to help builders and DIYers gain a complete understanding of most if not all elements required for the complete construction of this structure, according to the original design documents provided by FrameUpNow.
- 2 All quantities and specifications are subject to change based on the final design, field measurements, availability of products and customer preferences. The customer should verify all information prior to purchasing materials.
- 3 All products and elements in the list shall conform to the International Residential Code (IRC), or any other local and international building codes, safety regulations, and standards that are applicable to the location of the structure.
- 4 If any changes are made by the customer to the list of materials specified in this document, the customer is responsible for assuring that the correct type and quantity of materials are utilized in accordance with local building codes.
- 5 FrameUpNow, will not be held responsible for any misuse of this document, the products listed, or for deviations from the content that are made due to changes in specifications, pricing, availability, or customer preferences.
- The customer is advised to consult a qualified professional or technician prior to purchasing materials for specialized construction system items. Some items including but not limited to caseworks, doors and windows may require as built measurements prior to purchase to confirmation of final dimensions.
- 7 If there are additional trim elements or specific installation methods, the total amount of materials needed might vary. Consider any additional trim required for corners, intersections, or other architectural details that might cause this variations before procedding to purchase and construction.



			LIGHTING FIXTURES				
#	Item	Туре	Description, Manufacturer, SKU	Unit	Quantity	Unit Price	Total
1	Kitchen Ceiling Light			PCS	3		
3	Kitchen Wall Mounted Light			PCS	1		
4	Exterior Wall Mounted Light			PCS	4		
5	Livingroom Ceiling Light With Fan			PCS	1		
6	Bedroom Ceiling Light With Fan			PCS	1		
7	Dining Ceiling Light			PCS	0		
8	Bath Wall Mounted Light			PCS	1		
9	Bathroom Ceiling Light			PCS	2		
10	Livingroom Ceiling Light			PCS	6		
11	Bedroom Ceiling Light			PCS	4		
12	Hall & Linen Ceiling Light			PCS	2		
12	Closet Ceiling Light			PCS	0		
13	Smoke Detector			PCS	4		
14							
15							



			ELECTRICAL FITTINGS				
#	Item	Туре	Description, Manufacturer, SKU	Unit	Quantity	Unit Price	Total
1	Standard Receptacle 120V	20A		PCS	9		
2	GFCI Receptacle 120V	20 A		PCS	13		
3	GFCI Receptacle 240V	30 A		PCS	2		
1	GFCI Receptacle 240V	50 A		PCS	1		
5	GFCI Receptacle 240V	60 A		PCS	1		
5	Fan Switch			PCS	1		
7	Single Pole Switch			PCS	5		
3	Three Way With Dimmer Switch			PCS	2		
)	Dimmer Switch			PCS	4		
10		,	·	'			
l1							
12							
L3							
14							
15							



		ELECTR	ICAL CONDUITS & WIRING				
#	Item	Туре	Description, Manufacturer, SKU	Unit	Quantity U	nit Price Tot	tal
1	ROMEX 14 AWG	14/3/W/ground		FT	115		
3	ROMEX 12 AWG	12/3/W/ground		FT	245		
4	ROMEX 12 AWG	12/2/W/ground		FT	0		
6	ROMEX 10 AWG	10/3/W/ground		FT	50		
8	ROMEX 10 AWG	10/2/W/ground		FT	78		
9	Romex 8 AWG	8/3/W/ground		FT	0		
10	Romex 8 AWG	8/2/W/ground		FT	14		
11	ROMEX 6 AWG	6/2/W/ground		FT	25		
12	Bare Copper Ground Wire 6 AWG			FT			
13							
14							
15							
16							



		ELEC	CTRICAL BOXES & CIRCUTES				
#	Item	Туре	Description, Manufacturer, SKU	Unit	Quantity	Unit Price	Total
1	Panelboard -240V 1 Phase MLO	200 AMP		PCS	1		
2	Circuit breaker	15 A		PCS	3		
3	Circuit breaker	20 A		PCS	9		
4	Circuit breaker	30 A		PCS	2		
5	Circuit breaker	50 A		PCS	1		
6	Circuit breaker	60 A		PCS	1		
7	Single Gang Switch Box			PCS	2		
8	Double Gang Switch Box			PCS	2		
9	Triple Gang Switch Box			PCS	2		
10	Pull Box	#1/4		PCS	21		
11	Receptacle Box			PCS	26		
12							
13							
14							
15							

			HVAC_DUCTS 01				
#	Item	Туре	Description, Manufacturer, SKU	Unit	Quantity	Unit Price	Total
1	PIPE (REFRIGERANT LINE)			FT	63.38		
2	PIPE (REFRIGERANT LINE)	3/4" (Ø)		FT	94.91		
3	DRAYER HOSE	4" (Ø)		FT	5		
4	FLEX DUCT ROUND	4" (Ø)		FT	3.79		
5							
6							
7							
8							
9							
10							
11							
12							
13							
14							
15							
16							

			DUCT FITTINGS & ACCESSORIES				
#	Item	Туре	Description, Manufacturer, SKU	Unit	Quantity	Unit Price	Total
1	ELBOW (REFRIGERANT LINE)	3/4" (Ø)-3/4" (Ø)		PCS	23		
2	ELBOW (REFRIGERANT LINE)	3/8" (Ø)-3/8" (Ø)		PCS	14		
3	TRANSITION (REFRIGERANT LINE)	3/4" (Ø)-1/2" (Ø)		PCS	3		
4	TRANSITION (REFRIGERANT LINE)	3/4" (Ø)-3/8" (Ø)		PCS	2		
5	TRANSITION (REFRIGERANT LINE)	3/8" (Ø)-1/4" (Ø)		PCS	1		
6	TEE (REFRIGERANT LINE)	3/4" (Ø)-3/4" (Ø)-3/4" (Ø)		PCS	1		
7	TEE (REFRIGERANT LINE)	3/8" (Ø)-3/8" (Ø)-3/8" (Ø)		PCS	1		
8	ROUND TRANSITION(ANGLE)	45 DEGREE		PCS	5		
9							
10							
11							
12							
13							
14							
15							
16							

			HVAC_EQUIPMENTS				
#	Item	Туре	Description, Manufacturer, SKU	Unit	Quantity	Unit Price	Total
1	AIR HANDLING UNIT	WALL MOUNTED		PCS	2		
2	CONDENSER	OUTDOOR UNIT		PCS	1		
3	EXHAUST FAN	75 CFM		PCS	1		
4	EXHAUST HOOD	WALL MOUNTED		PCS	1		
5	HOOD-WALL: VENT	HOOD-WALL: VENT		PCS	1		
6	DRAYER: VENT	DRAYER: VENT		PCS	1		
7	ROOF VENT	3"(Ø)		PCS	1		
8							
9							
10							
11							
12							
13							
14							



PLUMBING FIXTURES & ACCESSORIES								
#	Item	Туре	Description, Manufacturer, SKU	Unit	Quantity	Unit Price	Total	
1	Bath Tub (Alcove Tub)			PCS	0			
2	Kitchen Sink			PCS	1			
3	Kitchen faucets			PCS	1			
4	Vanity Sink			PCS	1			
5	Bath room faucets			PCS	1			
6	Water Closet			PCS	1			
7	Shower Trim			PCS	1			
8	Shower Tray			PCS	1			
9	Water Heater			PCS	1			
10	Hose Bib			PCS	1			
11	Shutoff Valve			PCS	6			
12	Hanging pipe clamp			PCS	4			
13	Gate Valve			PCS	1			
14	Dishwasher Supply Single Connector			PCS	0			
15	Dishwasher Sewage Single Connector			PCS	0			
16	Laundry Sweat Connector			PCS	1			



		SANI	TARY & PLUMBING PIPES				
#	Item	Туре	Description, Manufacturer, SKU	Unit	Quantity	Unit Price	Total
1	ABS (Acrylonitrile Butadiene Styrene) Pipes	ø 1"		FT	C		
2	ABS (Acrylonitrile Butadiene Styrene) Pipes	ø 1 1/2"		FT	20		
3	ABS (Acrylonitrile Butadiene Styrene) Pipes	ø 2"		FT	42		
4	ABS (Acrylonitrile Butadiene Styrene) Pipes	ø 3"		FT	20		
5	PEX (Cross-linked polyethylene) Pipes	ø 1/2"		FT	79		
6	PEX (Cross-linked polyethylene) Pipes	ø 3/4"		FT	25		
7	PEX (Cross-linked polyethylene) Pipes	ø 1"		FT	1		
8	PVC Pipes Sch.80 - Rigid	ø 1 1/2"		FT	C		
9	PVC Pipes Sch.80 - Rigid	ø 2"		FT	17		
10	PVC Pipes Sch.80 - Rigid	ø 3"		FT	О		
11	Flex Pipe Round	ø 1/2"		PCS	6		
12	Roof Drain Scupper	ø 1 1/2"		PCS	2		
13							
14							
15							



	PIPE FITTINGS 01									
#	Item	Туре	Description, Manufacturer, SKU	Unit	Quantity	Unit Price	Total			
1	ABS 90 Degree Bend Elbow	1 1/2"ø-1 1/2"ø		PCS	1					
2	ABS 90 Degree Bend Elbow	2"ø-2"ø		PCS	3					
3	ABS 90 Degree Bend Elbow	3"ø-3"ø		PCS	1					
4	ABS P-Trap	1 1/2"ø-1 1/2"ø		PCS	3					
5	ABS P-Trap	2"ø-2"ø		PCS	1					
6	ABS Reducer Elbow	2"ø-1 1/2"ø		PCS	1					
7	ABS Reducer Elbow	3"ø-2"ø		PCS	1					
8	ABS TEE Elbow	1 1/2"ø-1 1/2"ø-1 1/2"ø		PCS	1					
9	ABS TEE Elbow	2"ø-2"ø-2"ø		PCS	2					
10	ABS TEE Elbow	3"Ø-3"Ø-3"Ø		PCS	2					
11	ABS Tee Reducer Elbow	3"ø-3"ø-1 1/2"ø		PCS	2					
12	ABS Tee Reducer Elbow	3"ø-3"ø-2"ø		PCS	1					
13	ABS Vent Cap Elbow	1 1/2"ø		PCS	1					
14	ABS Vent Cap Elbow	2"Ø		PCS	2					
15	ABS Vent Cap Elbow	3"Ø		PCS	1					



		PIPE FITTINGS 02								
#	Item	Туре	Description, Manufacturer, SKU	Unit	Quantity	Unit Price	Total			
	PEX 90 Degree Elbow	1/2"ø-1/2"ø		PCS	20					
	PEX 90 Degree Elbow	3/4"ø-3/4"ø		PCS	6					
	PEX Tee Elbow	1/2"ø-1/2"ø-1/2"ø		PCS	8					
	PEX Tee Elbow	3/4"ø-3/4"ø-3/4"ø		PCS	1					
	PEX Transition Elbow	1"ø-3/4"ø		PCS	2					
	PEX Transition Elbow	3/4"ø-1/2"ø		PCS	2					
	PVC 90 Deg Bend Elbow	2"ø-2"ø		PCS	2					
	PVC 90 Degree Bend Elbow	2"Ø-2"Ø		PCS	4					
0										
1										
2										
3										
4										
5										



			APPLIANCES				
#	Item	Туре	Description, Manufacturer, SKU	Unit	Quantity	Unit Price	Total
1	Refrigerator			PCS	1		
2	Range			PCS	1		
3	Washer Front Load	Stackable		PCS	1		
4	Dryer Front Load	Stackable		PCS	1		
5	Dish Washer			PCS	()	
6	Oven			PCS	(
7	Microwave			PCS	()	
8							
9							
10							
11							
12							
13							
14							
15							
16							



			CASEWORKS 01				
#	Item	Туре	Description, Manufacturer, SKU	Unit	Quantity	Unit Price	Total
1	Kitchen Cabinet			FT	15.03		
2	Laundry Cabinet			FT	2.25		
3	Vanity Cabinet			FT	2.5		
4	Medicine Cabinet			PCS	1		
5	Kitchen countertop			SF	22.85		
6	Laundry Countertop			PCS	0		
7	Bathroom Countertop			SF	0		
8	Island			FT	0		
9	Peninsula			FT	0		
10	Closets			SF	62.73		
11							
12							
13							
14							
15							



	1		CEILING 01				
‡	Item	Туре	Description, Manufacturer, SKU	Unit	Quantity	Unit Price	Total
	LIVING ROOM + KITCHEN			SF	253.0		
L	Ceiling Board	Drywall		SF	253		
2	Drywall Fastener	Screw		PCS	443		
3	Vapor Retarder	Polyethylene film		SF	253		
l	Vapor Retarder Fastener	Nails with washer heads		PCS	759		
	BATHROOM			SF	51.0		
5	Ceiling Board	MRD (Moisture resistant drywall)		SF	51		
5	MRD Fastener	Screw		PCS	89		
	BEDROOM			SF	182.0		
7	Ceiling Board	Drywall		SF	182		
3	Drywall Fastener	Screw		PCS	319		
)	Vapor Retarder	Polyethylene film		SF	182		
LO	Vapor Retarder Fastener	Nails with washer heads		PCS	546		



			CEILING 02				
#	Item	Туре	Description, Manufacturer, SKU	Unit	Quantity	Unit Price	Total
	HALL+W/D			SF	29.0		
11	Ceiling Board	Drywall		SF	29		
12	Drywall Fastener	Screw		PCS	51		
13	Vapor Retarder	Polyethylene film		SF	29		
14	Vapor Retarder Fastener	Nails with washer heads		PCS	87		
	WH			SF	9.0		
15	Ceiling Board	Drywall		SF	9		
16	Drywall Fastener	Screw		PCS	16		
17	Vapor Retarder	Polyethylene film		SF	9		
18	Vapor Retarder Fastener	Nails with washer heads		PCS	27		
	CLOSET 1			SF	18.0		
19	Ceiling Board	Drywall		SF	18		
20	Drywall Fastener	Screw		PCS	32		
21	Vapor Retarder	Polyethylene film		SF	18		
22	Vapor Retarder Fastener	Nails with washer heads		PCS	54		



			CEILING 03				
#	Item	Туре	Description, Manufacturer, SKU	Unit	Quantity	Unit Price	Total
	CLOSET 2			SF	9.0		
23	Ceiling Board	Drywall		SF	Ç		
24	Drywall Fastener	Screw		PCS	16)	
25	Vapor Retarder	Polyethylene film		SF	Ç)	
26	Vapor Retarder Fastener	Nails with washer heads		PCS	27	,	



	<u>)</u>		FLOORING INTERIOR 01				
#	Item	Туре	Description, Manufacturer, SKU	Unit	Quantity	Unit Price	Total
	CLOSET						
1	Closet Flooring			SF	12		
2	Wood underlay	Foam Pad Polyethylene		SF	12		
3	Vapor Retarder	Vapor Barrier Polyethylene		SF	12		
	BEDROOM						
4	Living Area Flooring			SF	134		
5	Wood underlay	Foam Pad Polyethylene		SF	134		
6	Vapor Retarder	Vapor Barrier Polyethylene		SF	134		
	LIVING ROOM AND KITCH	EN					
7	Tile Finish			SF	208		
8	Adhesive	1/2" Thin set Mortar		SF	208		
9	Vapor Retarder	Vapor Barrier Polyethylene		SF	208		
	BATHROOM						
10	Tile Finish			SF	27		
11	Adhesive	1/2" Thin set Mortar		SF	27		
12	Vapor Retarder	Vapor Barrier Polyethylene		SF	27		



			FLOORING INTERIOR 02				
#	Item	Туре	Description, Manufacturer, SKU	Unit	Quantity	Unit Price	Total
	W/D						
13	Tile Finish			SF	31		
14	Adhesive	1/2" Thin set Mortar		SF	31		
15	Vapor Retarder	Vapor Barrier Polyethylene		SF	31		
	BOILER ROOM						
16	Tile Finish			SF	8		
17	Adhesive	1/2" Thin set Mortar		SF	8		
18	Vapor Retarder	Vapor Barrier Polyethylene		SF	8		



			FLOORING EXTERIOR			
#	Item	Туре	Description, Manufacturer, SKU	Unit	Quantity	Unit Price
	STRUCTURE			SF	831.5	
1	Concrete Slab	4"concrete cast in situ		CF	277	
2	Insulation	Rigid insulation		SF	246	
3	Hard core	Compacted soil		CF	214.2	
4	Re-bar	#4 re-bar		Ton	0.79	
5	Concrete Pad	4"concrete cast in situ		CF	2	
6	Slab edge	Turndown		CF	201.5	
	PORCH					
7	Tile Finish			SF	205	
8	Adhesive	1/2" Thin set Mortar		SF	205	
9	Vapor Retarder	Vapor Barrier Polyethylene		SF	205	



			WALLS: EXTERIOR				
#	Item	Туре	Description, Manufacturer, SKU	Unit	Quantity	Unit Price	Total
1	Stucco Finish			SF	830		
2	Exterior-Grade Plywood Horizontal Siding			SF	530		
3	8/panel	Self-drilling screws(100/pkt)		PKT	5.3		
4	Wall Shteathing (OSB)			SF	1360		
5	Shteathing Fastener	Self-drilling screws(100/pkt)		PKT	13.6		
6	Wall Homewrap			SF	1360.00		
7	Homewrap Fastener	Stapled fastener (200/pkt)		PKT	5.17		
8	Furring Strip			PCS	66.25		
9	Furring Strip Fastener	Self-drilling screws(100/pkt)		PKT	5.3		
10	Wall Paint			SF	1360		
11	Stone Copping	Masonry stone		SF	0		
12	Stone Veneer	Masonry stone		SF	0		
13	Mortar for Stone Veneer			SF	0		
14	Wall Insulation			SF	1877		
15							



			WALLS: INTERIOR 01				
#	Item	Туре	Description, Manufacturer, SKU	Unit	Quantity	Unit Price	Total
	BATHROOM			SF	49.0		
1	Cementitious Backer Board			SF	212		
2	Kerdi membrane			SF	212		
3	Kerdi membrane Fastener			SF	212		
4	Wall Ceramic Tile			SF	212		
	BEDROOM			SF	180.0		
5	Drywall Board			SF	315		
6	Drywall Fastener	Self-drilling screws(100/pkt)		PKT	3.15		
7	Wall Paint			SF	315		
8	Drywall Tape			FT	59.1		
	HALL			SF	21.0		
9	Drywall Board			SF	49		
10	Drywall Fastener	Self-drilling screws(100/pkt)		PKT	0.49		
11	Wall Paint			SF	49		
12	Drywall Tape			FT	9		



			WALLS: INTERIOR 02				
#	Item	Туре	Description, Manufacturer, SKU	Unit	Quantity	Unit Price	Total
	LIVING ROOM			SF	179.0		
13	Drywall Board			SF	229		
14	Drywall Fastener	Self-drilling screws(100/pkt)		PKT	2.29		
15	Wall Paint			SF	229		
16	Drywall Tape			FT	43.0		
	KITCHEN			SF	71.0		
17	Cementitious Backer Board			SF	24		
18	Drywall Board			SF	122		
19	Drywall Fastener	Self-drilling screws(100/pkt)		PKT	1.22		
20	Kerdi membrane			SF	24		
21	Kerdi membrane Fastener			SF	24		
22	Wall Ceramic Tile			SF	24		
23	Wall Paint			SF	122		
24	Drywall Tape			FT	23.0		



			WALLS: INTERIOR 03				
#	Item	Туре	Description, Manufacturer, SKU	Unit	Quantity	Unit Price	Total
	CL 1			SF	17.0		
25	Drywall Board			SF	121		
26	Drywall Fastener	Self-drilling screws(100/pkt)		PKT	1.21		
27	Wall Paint			SF	121		
28	Drywall Tape			FT	22.7		
	CL 2			SF	8.0		
29	Drywall Board			SF	81		
30	Drywall Fastener	Self-drilling screws(100/pkt)		PKT	0.81		
31	Wall Paint			SF	81		
32	Drywall Tape			FT	15.2		



			WALLS: INTERIOR 04				
#	Item	Туре	Description, Manufacturer, SKU	Unit	Quantity	Unit Price	Total
	WD			SF	7.0		
33	Cementitious Backer Board			SF	66		
34	Kerdi membrane			SF	66		
35	Kerdi membrane Fastener			SF	66		
36	Wall Ceramic Tile			SF	66		
	WH			SF	8.0		
37	Drywall Board			SF	71		
38	Drywall Fastener	Self-drilling screws(100/pkt)		PKT	0.71		
39	Wall Paint			SF	71		
40	Drywall Tape			FT	13		
1	Wall Skirting	Ceramic		FT	111		



			DOORS				
#	Item	Туре	Description, Manufacturer, SKU	Unit	Quantity	Unit Price	Total
1	Exterior Swinging	3' - 0" X 6'-8"		PCS	1		
2	Interior Swinging	3' - 0" X 6'-8"		PCS	2		
3	Exterior Swinging	5' - 0" X 6'-8"		PCS	1		
4	Folding Door	3' - 6" X 6'-8"		PCS	1		
5	Interior Sliding	8' - 6" X 6'-8"		PCS	1		
6	Folding Door	12' - 0" X 6'-8"		PCS	1		
7	Exterior Door Trim			FT	60		
8	Interior Door Trim			FT	203		
9	Entry Lock set			PCS	3		
10	Privacy Lock set			PCS	2		
11	Passage Lock set			PCS	2		



			WINDOWS				
#	Item	Туре	Description, Manufacturer, SKU	Unit	Quantity	Unit Price	Total
1	Casement	3' - 3" X 5'-3"		PCS	2		
2	Casement	4' - 3" X 5'-3"		PCS	1		
3	Sliding	2' - 9" X 3'-3"		PCS	1		
4	Sliding	2' - 9" X 1'-9"		PCS	1		
5	Exterior Window Trim			FT	75		
6	Interior Window Trim			FT	75		
7							
8							
9							
10							
11							
12							
13							
14							
15							



			ROOF 01				
#	Item	Туре	Description, Manufacturer, SKU	Unit	Quantity	Unit Price	Total
1	Roof Covering			SF	568.0		
2	Roof Covering Fastener			PCS	284		
3	Roof Felt Paper			SF	568.0		
4	Roof Felt Paper Fastener			PCS	1704.0		
5	Roof Sheathing			SF	568.0		
6	Roof Sheathing Fastener			PCS	4544		
7	Batten			FT	0.0		
8	Batten Fastener			PCS	0.0		
9	Soffit			SF	0.0		
10	Soffit Fastener			PCS	0.0		
11	Fascia			FT	0.0		
12	Fascia board fastener			PCS	0		
13	Roof Insulation			SF	568.0		
14							
15							