


# **WESTBROOK**

The Westbrook is a modern and stylish twobedroom, one-bathroom home with a contemporary barn aesthetic. The main body of the home is clad in dark gray vertical metal siding. A prominent gable end, featuring a large triangular window, adds a touch of rustic charm. Warm-toned wood siding highlights a portion of the wall, adding a natural element and visual contrast.

Inside, the Westbrook features a simple rectangular layout. The two bedrooms are thoughtfully placed on opposite sides of the house, offering privacy and quiet retreats. The living, dining, and kitchen areas are merged into a single open space in the center of the house, creating a spacious and versatile living area.

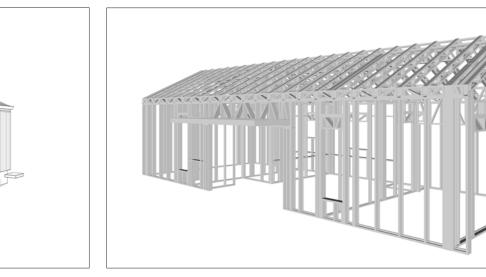

## Materials Shopping List


Please print and take this Materials Shopping List to your favorite Home Depot and ask for assistance in selecting the materials, fixtures and fittings to complete your new home.


Record your selection and the price of the item. Then do the math to determine the cost for your selections and the total cost of finishing your home.



To Go To Materials Shopping List



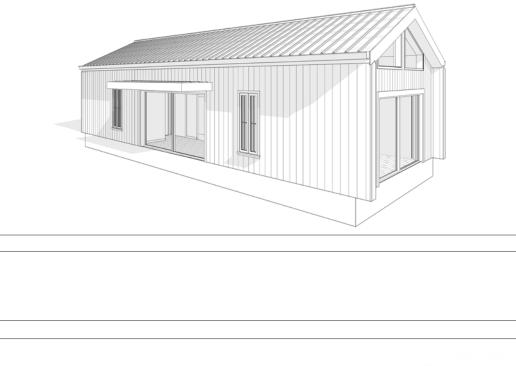

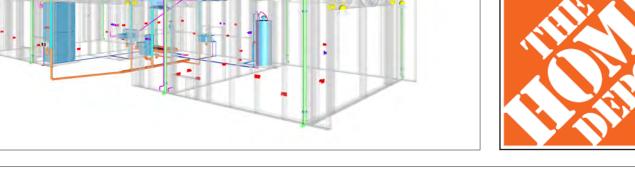


# LIVING ROOM 53 SF

# **FLOOR PLAN**

749 SF

2 Bed Rooms

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# **ABOUT**

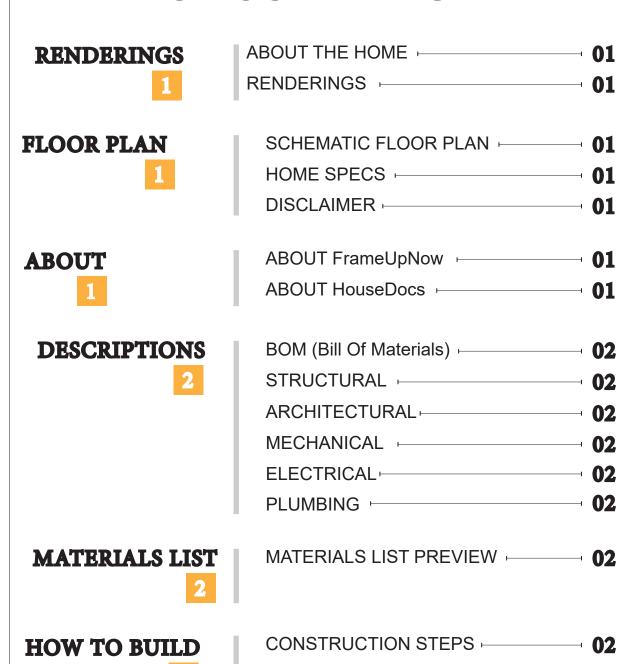

FrameUpNow is a design and manufacturing company providing precision-engineered home framing solutions. We offer a catalog of Affordable Homes, Tiny Homes, Garages, Shops and Barndominiums. FrameUpNow manufactures cold-formed steel (CFS) also known as Light Gauge Steel (LGS) framing components that conform to our engineered metal house frame plans or can be purchased as DIY skeleton kits.

The CFS/LGS framing is lightweight, easily assembled, and does not require heavy equipment or specialized labor, enabling homeowners to erect the frame themselves in just a few days. Unlike wood, the steel framing is impervious termites and bores, warping, expansion, and fire.

Our home plans come complete with a structural engineered stamp for permit approvals. Customers receive a full BOM also known as a Materials Shopping List to purchase finish materials from a Building Materials retailer. FrameUpNow prides itself on the quality and efficiency of our precision-engineered home framing solutions for construction professionals and DIY homeowners.



**KEY PLAN** 

NO.	DESCRIPTION	DATE
NOTE	<b>:</b> :	

LEGEND:

**PROJECT** 

221-Westbrook-749-2Bd1Ba-**Contemporary-Porch-550** 

DRAWING NAME

### INTRODUCTION

CLIENT NAME:	
PROJECT NUMBER:	
DATE:	
DESIGNED BY:	
DRAWN BY:	
CHECKED BY:	

**I101** 

SCALE:

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**DISCLAIMER** 

# **DESCRIPTIONS**

# MATERIALS LIST

The BOM (Bill Of Materials) package, known as the Materials Shopping List document, provides:

Comprehensive Inventory: Detailed lists of essential materials sourced from architectural, mechanical, HVAC, electrical, and plumbing design drawing sets.

Precise Curation: Each item meticulously selected and organized for accuracy and efficiency in project planning.

Customizable Options: Customers can modify listed items to their preferences and calculate costs accordingly, ensuring alignment with personal project needs and budget.

Dedicated Space for Details: Includes tables for customers to note Home Depot SKU numbers or product descriptions for selected items, facilitating seamless purchasing and coordination with suppliers.

Customer Convenience: Take the list to Home Depot or preferred suppliers for accurate pricing, helping align the total home budget with personal financial plans.

Simplify your construction journey with our Materials Shopping List document, where detailed preparation meets streamlined implementation for your dream home.

#### STRUCTURAL

The structural drawings package provides an exhaustive set of detailed plans essential for the precise assembly of your building. This comprehensive package includes:

Framing Plans: Detailed layouts for all framing components. Truss Layouts: Clear instructions for truss placement and

Panel Length Plans: Specifications for panel dimensions. Framing Elevations and Sections: Precise elevation and sectional views for accurate construction.

Truss and Wall Blocking Plans: Plans for truss and wall blocking to ensure structural integrity.

Hold-Down Plan: Detailed hold-down requirements for stability. Snap Sheet: Reference sheet for quick identification of components

Structural Details and Bracing Plans: Complete details and bracing plans for all structural elements.

Accompanying these plans is a comprehensive Bill of Materials (BOM) that lists every necessary building component, from cold formed steel (CFS) frames to fasteners.

# ARCHITECTURAL

With the comprehensive architectural package, both builders and DIY homeowners can confidently execute the construction.

The architectural package includes:

Furnished Floor Plans: Complete with furniture layouts for a clear understanding of space utilization.

Detailed Dimension Plans: Ensures precise measurements, from the overall footprint down to the exact placement of windows and

Foundation Plan: Detailed plan to establish a solid foundation.

Wall Framing and Truss Layout: Comprehensive plans for wall framing and truss placement.

Architectural Elevations: Exterior views showcasing the design.

Strategic Building Sections: Critical cross-sectional details for a thorough understanding of the build.

Casework Drawings and Diagrams: Suggested designs for built-in caseworks, such as kitchen cabinets.

# **MECHANICAL**

The mechanical package includes everything needed to guide HVAC

Detailed HVAC Floor Plan: Precisely maps out the placement of air handlers, ductwork, and vents throughout the home's layout.

HVAC Sections and Riser Diagrams: Technical drawings offering critical cross-sectional details and piping schematics, ensuring proper integration of the heating and cooling system into the home's structure.

Bill of Materials: A complete list of all necessary HVAC components.

# **ELECTRICAL**

The electrical package includes all the plans and documentation needed to guide the installation of your home's electrical system:

Detailed Power Plan: Precisely maps out the placement of outlets, switches, and other power components throughout the layout.

Comprehensive Lighting Plan: Shows the optimal locations for lighting fixtures, sconces, and other illumination sources to create a well-lit, functional interior.

Dimensioned Electrical Layout: Provides exact dimensions and measurements to ensure proper placement of all electrical elements.

Bill of Materials: A complete list of every component needed, from circuit breakers to wiring.

The plumbing package includes everything needed to guide the

Detailed Water Supply System Plan: Precisely maps out the placement of pipes, valves, and plumbing fixtures throughout the

Comprehensive Sewage System Plan: Shows the optimal routing and sizing of drain lines to effectively remove waste and ensure

Detailed Riser Diagrams: Provide information needed to properly

# **PLUMBING**


installation of your home's water supply and drainage systems:

proper drainage.

install all vertical plumbing risers and vent stacks.

Bill of Materials: A complete list of every component needed, from pipes to fixtures.


# BOM (Bill Of Materials) (Separately Attached)

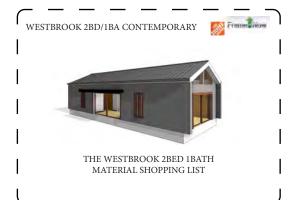



The Bill of Materials (BOM) is a crucial document that compiles the material requirements from different disciplines into a centralized inventory, enabling efficient procurement, inventory management, and cost estimation for a specified project or

#### **ELECTRICAL BOM**



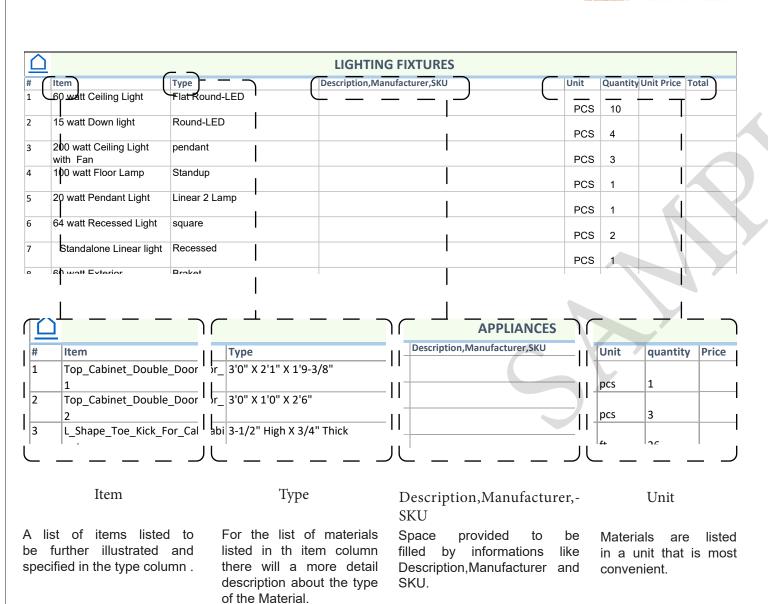

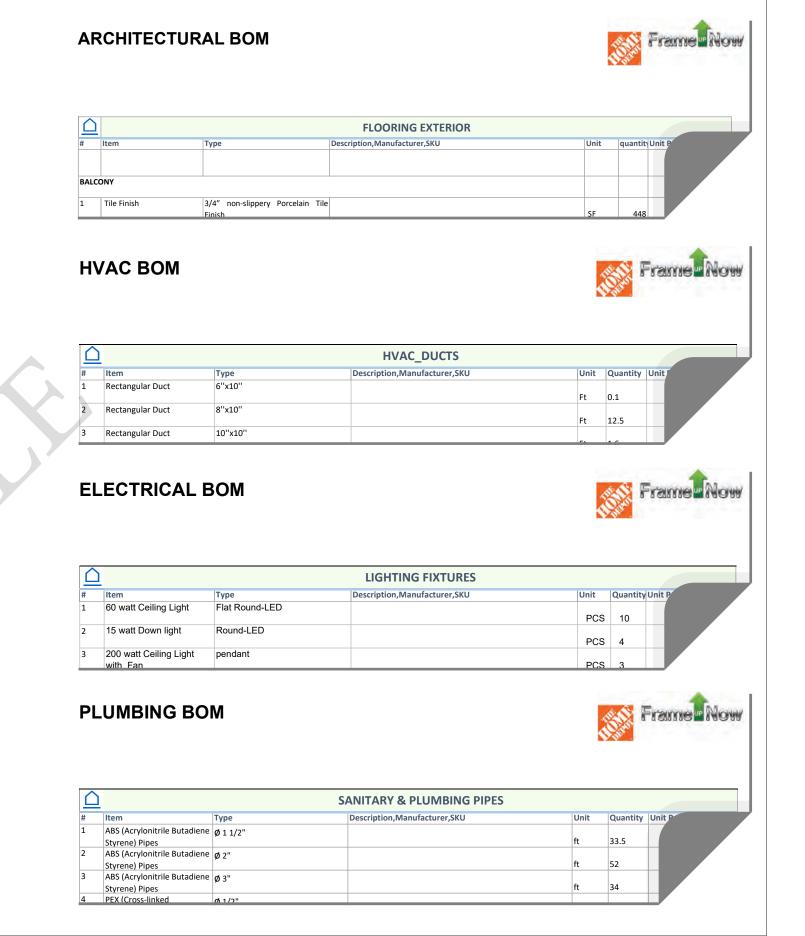

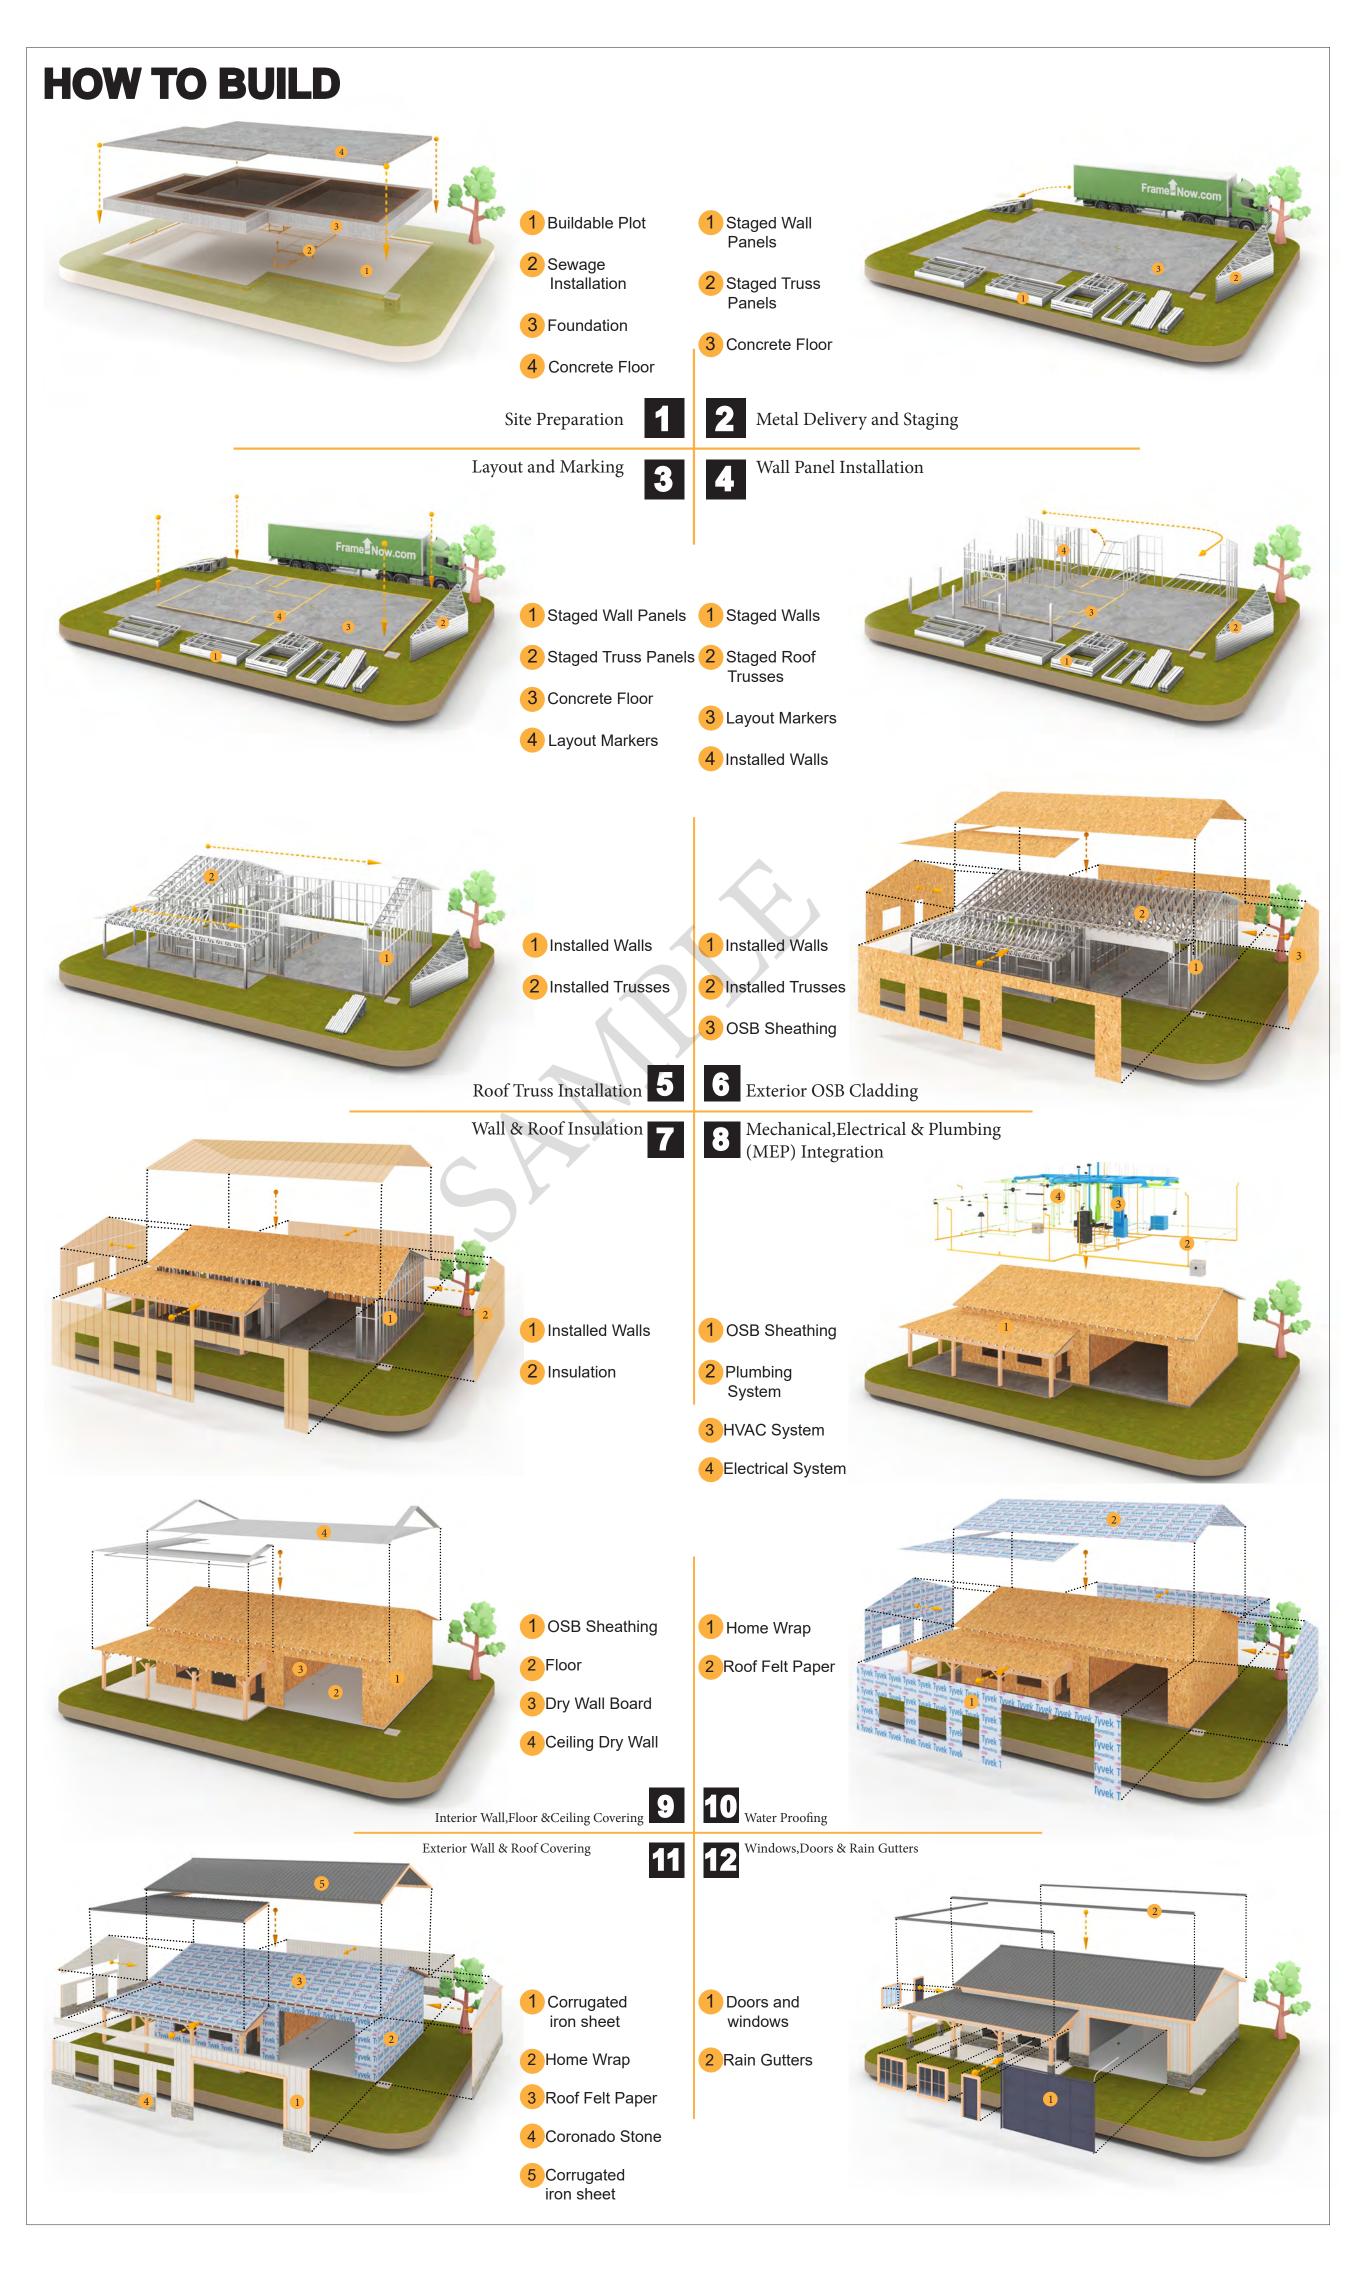



**KEY PLAN** 

DESCRIPTION DATE NOTE:

LEGEND:

PROJECT

221-Westbrook-749-2Bd1Ba-**Contemporary-Porch-550** 


DRAWING NAME

INTRODUCTION

CLIENT NAME: PROJECT NUMBER: DATE: DESIGNED BY DRAWN BY: CHECKED BY:


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SCALE:

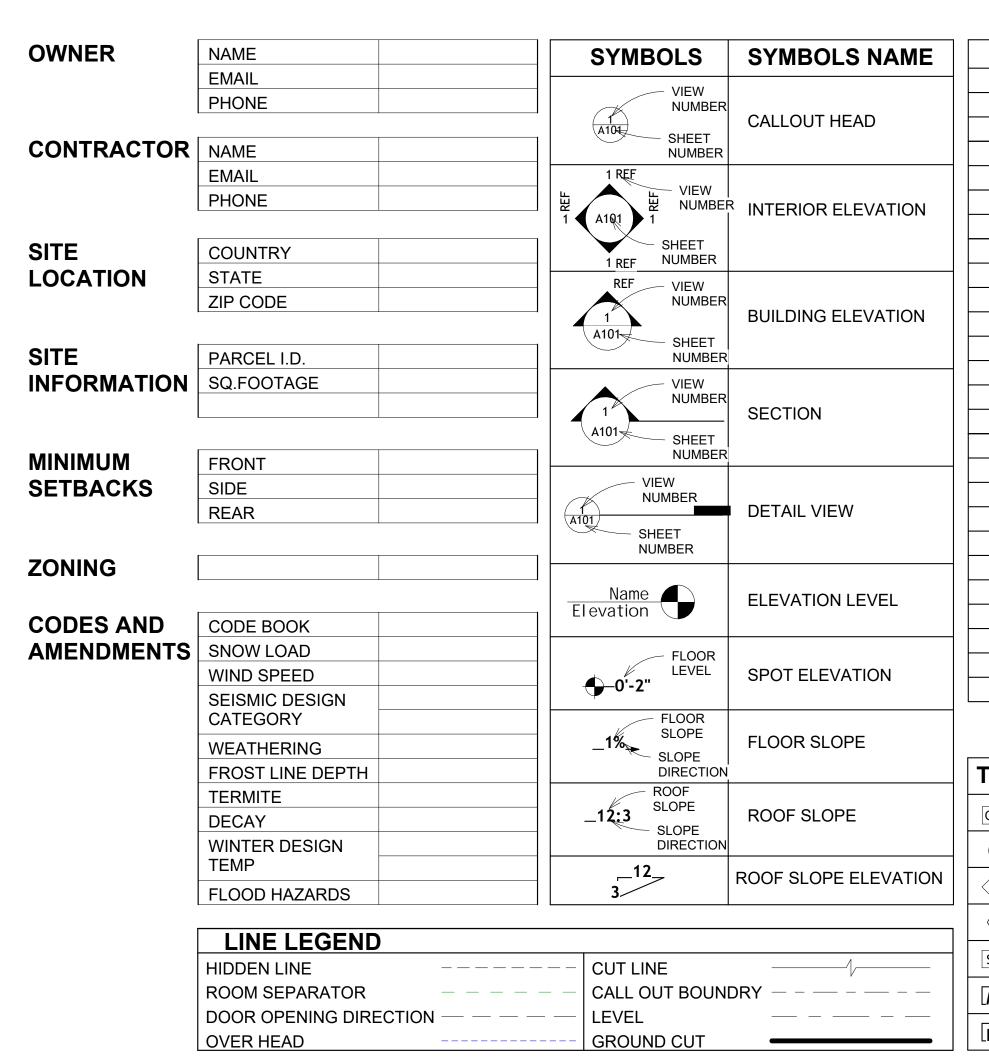


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	T
AG	TAG'S NAME
CA01	CASEWORK TAG
1	DOOR TAG
1	FURNITURE TAG
1	WINDOW TAG
SE01	SPECIALTY EQUIPMENT TAG
MEO1	MECHANICAL EQUIPMENT TAG
PE01	PLUMBING EQUIPMENT TAG




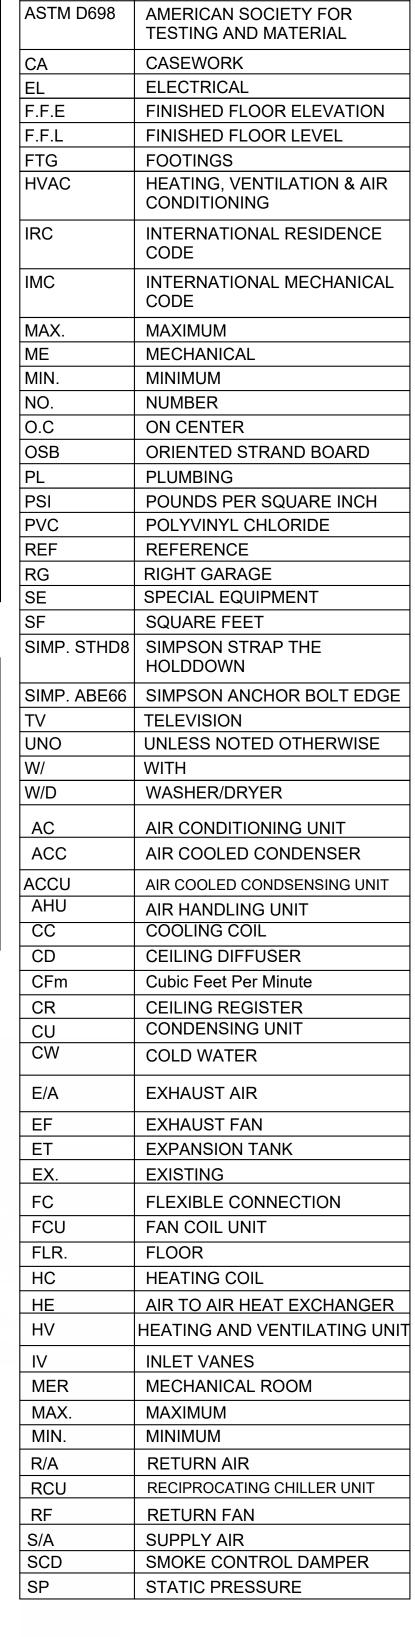

**ABBREVIATION** 

ACTION FLOOR SYSTEMS

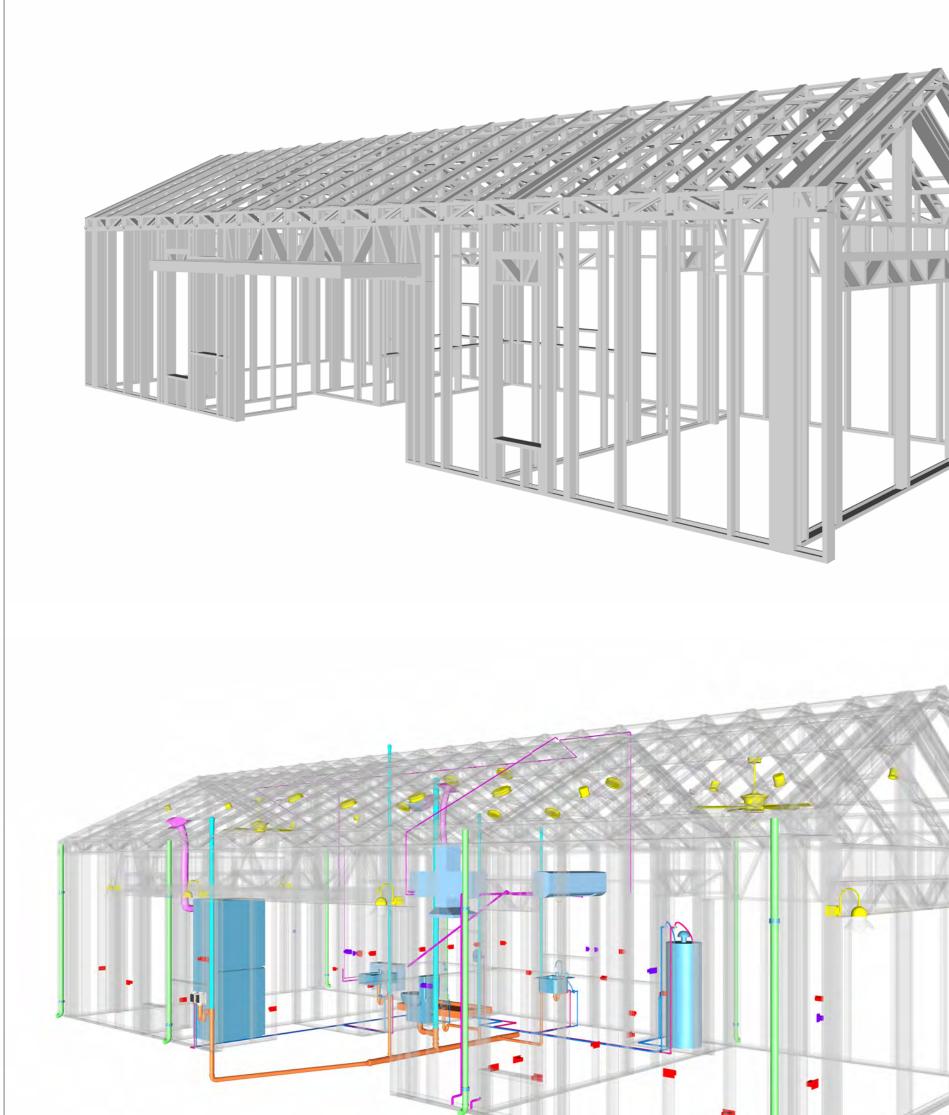


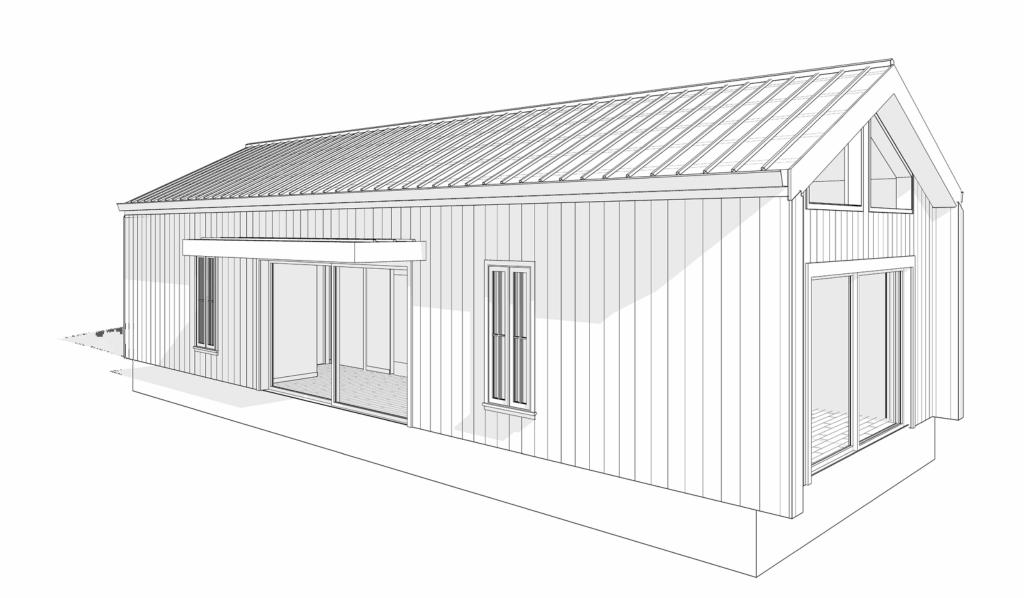

221-WESTBROOK-749 2Bd1Ba-CONTEMPORARY-550

SQUARE FOOTAGE		
LIVING	749	
PORCH	51	
TOTAL	800	



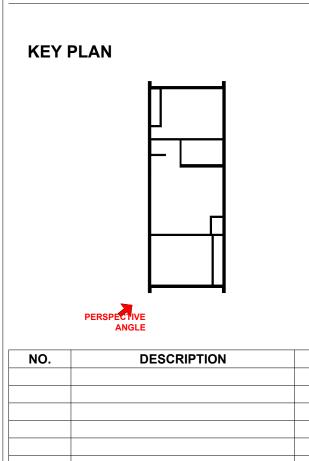

NOTE:

LEGEND:

PROJECT

221-WESTBROOK-749 2Bd1Ba-CONTEMPORARY-550

DRAWING NAME

**COVER SHEET** 

CLIENT NAME:	Client Name
PROJECT NUMBER:	0061_12
DATE:	4/17/2025 10:58:24 AM
DESIGNED BY:	Designer
DRAWN BY:	Author
CHECKED BY:	Checker

G101

#### **GENERAL NOTES**

THIS DRAWING DEPICTS THE ARCHITECTURAL (SPACE LAYOUT, FURNISHING, FLOOR, WALLS, ROOFS, FOUNDATION, WINDOWS AND DOORS) SYSTEMS. IT PROVIDES A VISUAL REPRESENTATION OF THE ARCHITECTURAL LAYOUT AND COMPONENTS.

THE ARCHITECTURAL DRAWINGS ARE PREPARED TO MEET THE SPECIFIC REQUIREMENTS OF THE

- BUILDING, AS PER THE PROJECT SPECIFICATIONS AND APPLICABLE CODES AND STANDARDS. THE CONSTRUCTION OF THIS HOME SHALL COMPLY WITH THE LATEST EDITION OF THE INTERNATIONAL RESIDENTIAL CODE (IRC), INTERNATIONAL MECHANICAL CODE (IMC), THE INTERNATIONAL PLUMBING STANDARD, THE NATIONAL ELECTRICAL STANDARD AND ALL OTHER
- APPLICABLE LOCAL, STATE, AND NATIONAL CODES AND REGULATIONS. COORDINATION WITH OTHER TRADES HAS BEEN DONE ON A DESIGN LEVEL. THIS DRAWING SHALL BE READ TOGETHER WITH THE ME, EL AND PL DESIGN DRAWINGS TO ENSURE PROPER CONSTRUCTION AND INTEGRATION OF THE BUILDING SYSTEMS.

#### ABOUT WALLS:

- BATHTUB AND SHOWER SPACES (WALLS AND FLOORS) WITH INSTALLED SHOWER HEADS AND IN SHOWER COMPARTMENTS SHALL BE FINISHED WITH A NON-ABSORBENT SURFACE.
- WALL PAINT (INTERNAL)
- THE TYPICAL THICKNESS OF LATEX WALL PAINT IS 1/32 OF AN INCH FOR A SINGLE COAT. AND DOUBLE COAT (1/16") SHALL BE APPLIED FOR DURABILITY.

THE ADVISABLE TYPE OF ADHESIVE FOR THIS PROJECT IS EPOXY ADHESIVES BECAUSE THEY ARE KNOWN FOR THEIR HIGH STRENGTH, DURABILITY, AND RESISTANCE TO MOISTURE, CHEMICALS AND


REFER TO SHEETS A201 & A202 FOR GENERAL NOTES ON EXTERNAL FINISHING MATERIALS


#### **ABOUT FLOORS:**

- THE SPOT ELEVATION INDICATES THE FINISHED FLOOR ELEVATION.
- FINISHED FLOORS PER PLANS.
- FIELD VERIFY FOR DIMENSION DROP 4" FOR SHOWER AND BATHTUB USE.
- 1% SLOPE ON OUTDOOR BALCONIES FOR WATER RUN OFF.
- 2% SLOPE TOWARDS THE SHOWER DRAIN FOR SUFFICIENT DRAINAGE. 4" DROP AT THE DOOR LEADING TO EXTERIOR BALCONY FROM THE MAIN LIVING AREA.
- 5% SLOPE FOR GARAGE IS USED, WHICH SHOULD BE CHECKED WITH THE LOCAL GARAGING ZONING LAWS.




	FURNITURE SCHEDULE		
	TYPE MARK	TYPE	COUNT
01		KING SIZE BED	2
02		THREE SEAT SOFA	1
03		DINING CHAIR	2
04		COFFE TABLE	1

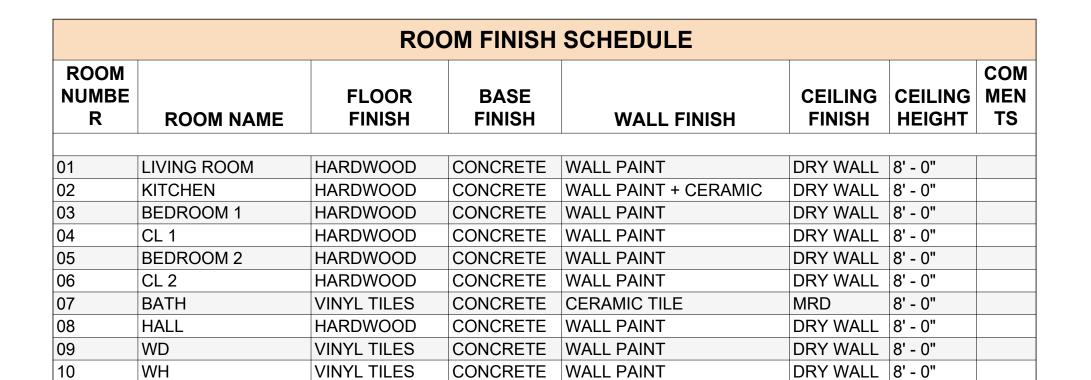

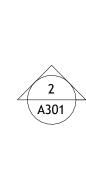



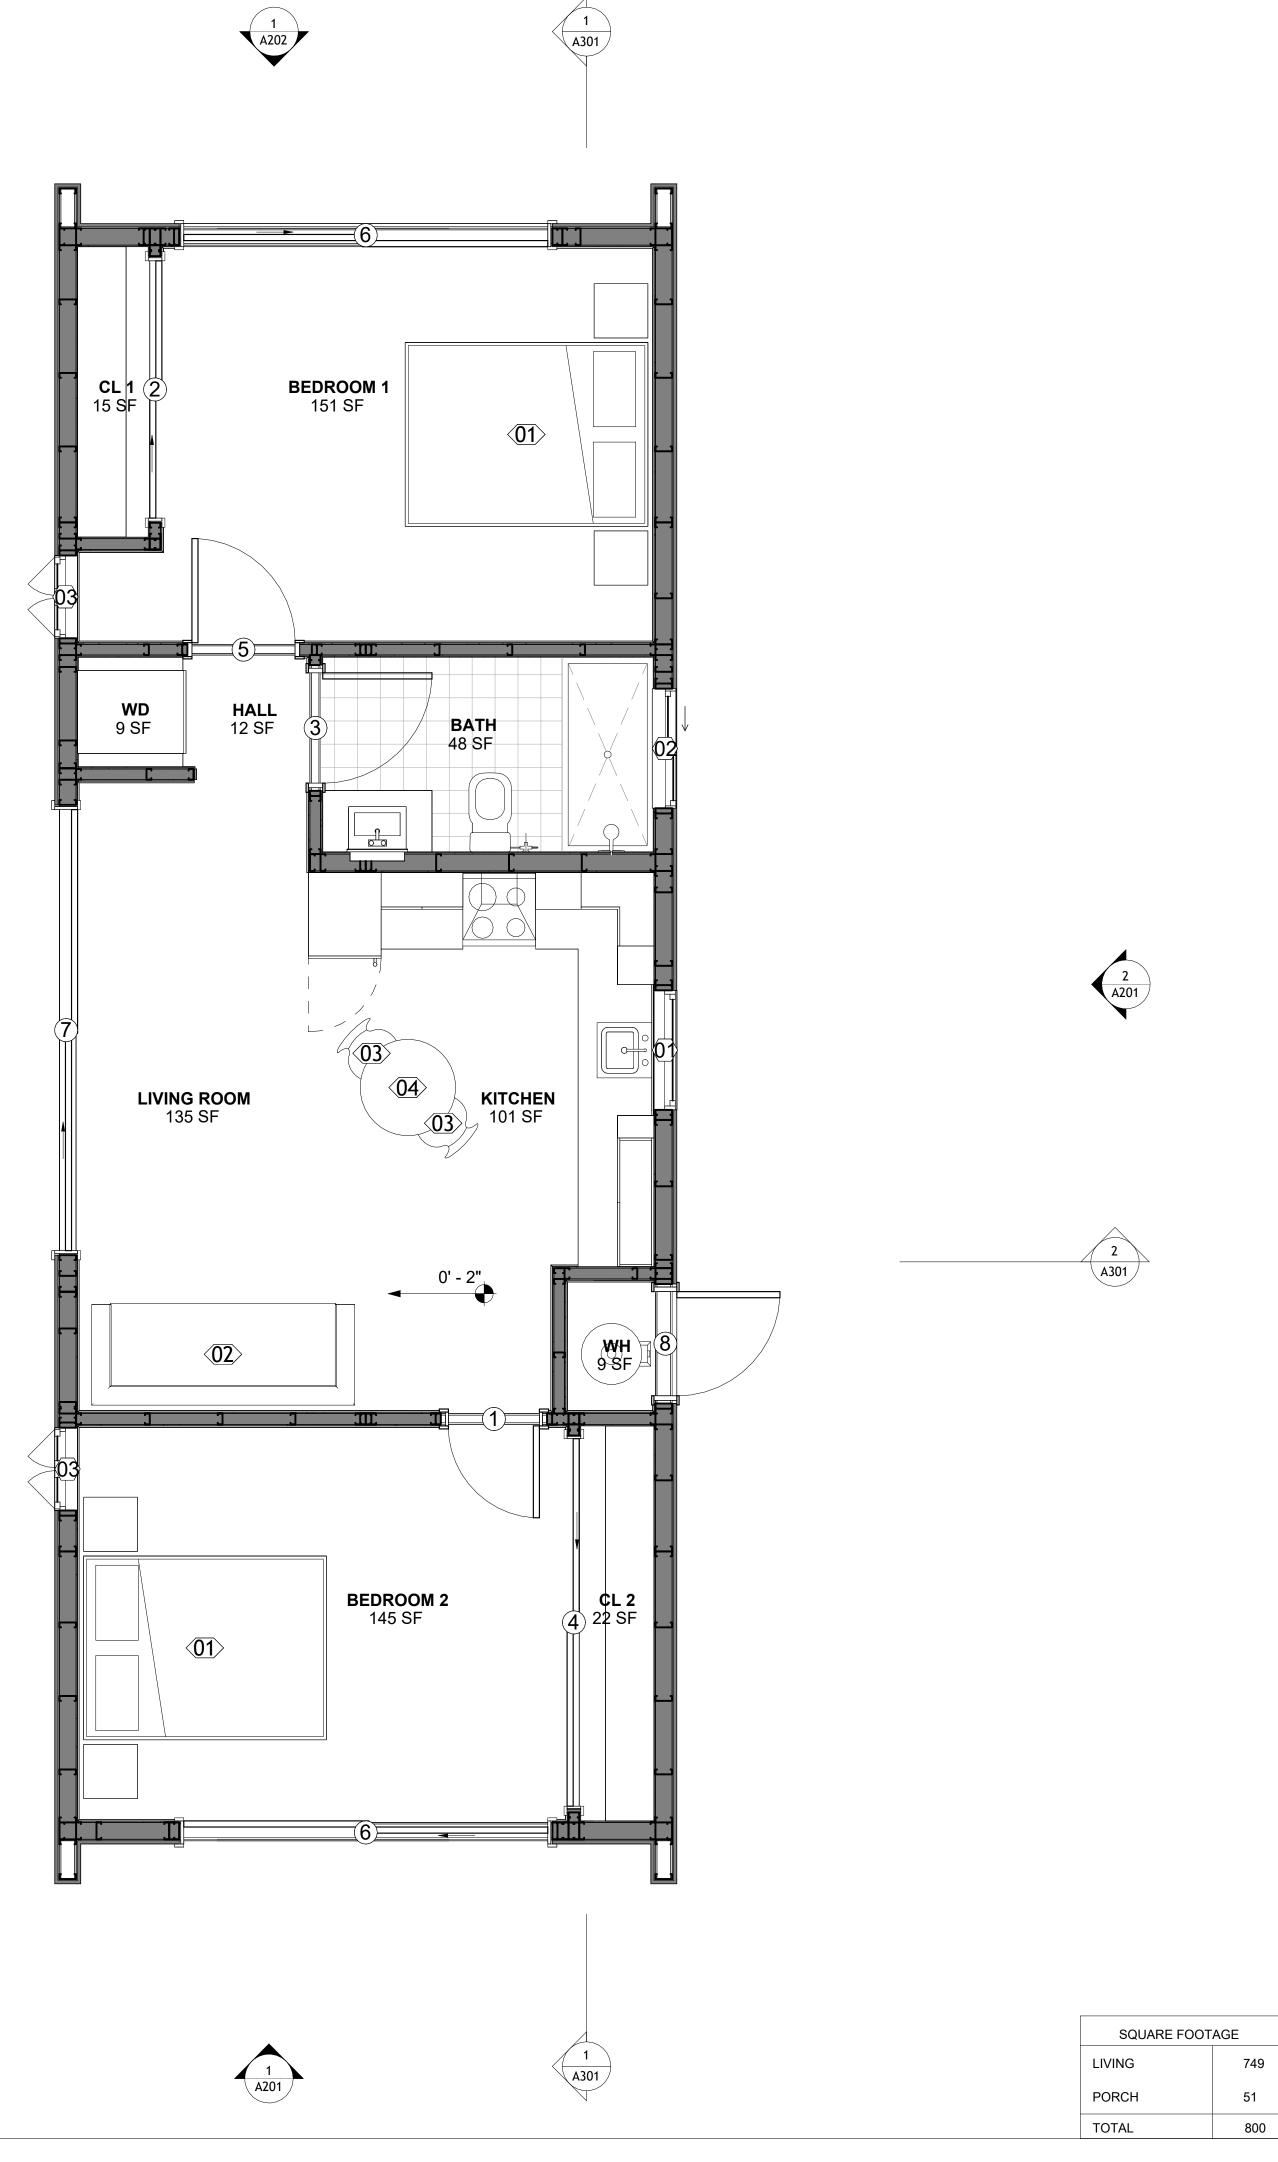



**KEY PLAN** 

NO.	DESCRIPTION	DATE

NOTE:

LEGEND:

PROJECT


**221-WESTBROOK-749** 2Bd1Ba-CONTEMPORARY-550

DRAWING NAME

**FLOOR PLAN** 

CLIENT NAME:	Client Name
PROJECT NUMBER:	0061_12
DATE:	4/17/2025 10:58:24 AM
DESIGNED BY:	Designer
DRAWN BY:	Author
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A101



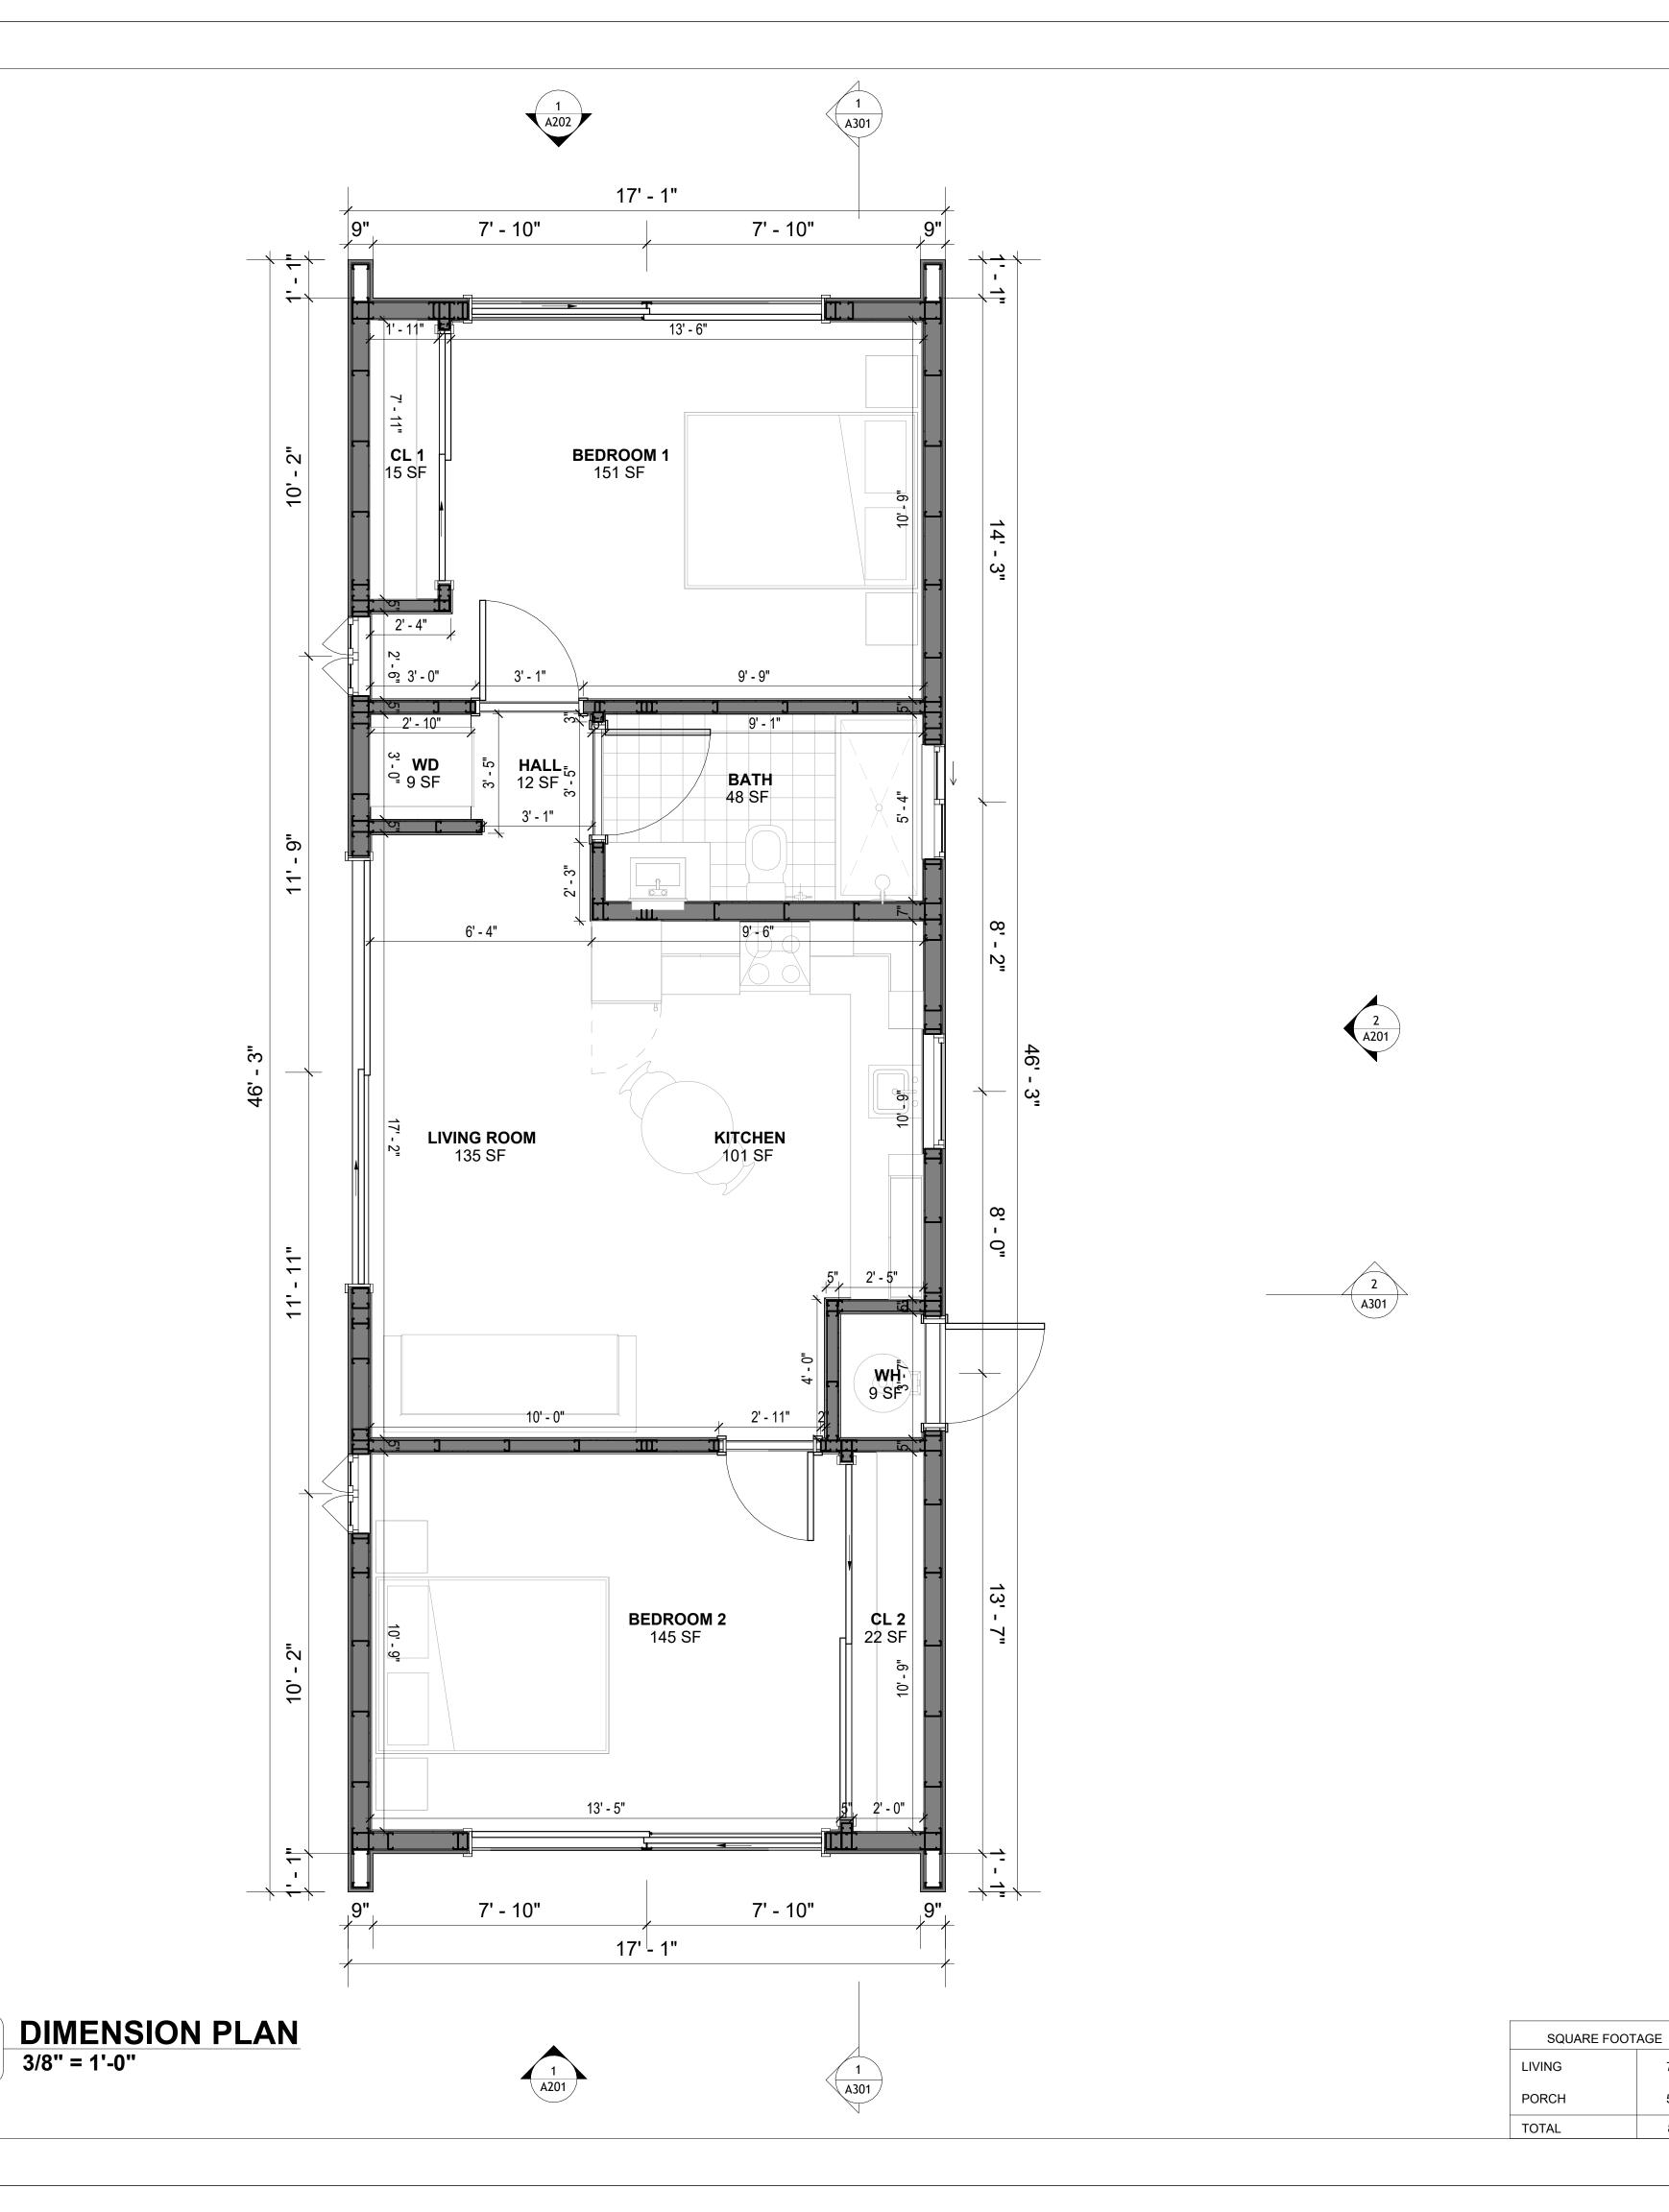

**KEY PLAN** 

NO.	DESCRIPTION	DATE

NOTE:

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PROJECT

221-WESTBROOK-749 2Bd1Ba-CONTEMPORARY-550

DRAWING NAME

**DIMENSION PLAN** 

CLIENT NAME:	Client Name
PROJECT NUMBER:	0061_12
DATE:	4/17/2025 10:58:25 AM
DESIGNED BY:	Designer
DRAWN BY:	Author
CHECKED BY:	Checker

A102

SCALE: 3/8" = 1'-0"

749

800

DIMENSIONS IN THE ARCHITECTURAL DRAWINGS CONSIDER FINISHING MATERIALS. FOR PRECISE MEASUREMENTS OF THE STRUCTUAL FRAMING, REFER TO THE ATTACHED STRUCTURAL PLAN SET.

#### **FOUNDATION NOTES**

TERMITES PRETREATMENT BY LICENSED CONTRACTOR UNDER SLAB AND AROUND FOOTINGS. ALL AREAS BELOW SLABS SHALL BE TREATED NO MORE THAN 24 HOURS PRIOR TO CONCRETE POUR. EVIDENCE OF TREATMENT MUST BE PROVIDED PRIOR TO PLACING OF CONCRETE.

#### . MATERIALS:

ALL INTERIOR CONCRETE SLABS SHALL BE A MIN. OF 4" THICK CONCRETE OVER 4" COMPACTED AGGREGATE BASE (ASTM D698), FINISH ELEVATIONS AS NOTED ON DRAWINGS, 6" ABOVE ADJACENT GRADE, LEVEL SLABS TO 1/8"-10' MAX.. CONCRETE SLABS SHALL BE 2500# PSI AT 28 DAYS. A 4" ALLOWABLE SLUMP.

#### 2. PAD PREPARATION:

#### EXCAVATION FOR FOOTING SHALL BE NEAT.

FOOTINGS SHALL BE POURED IMMEDIATELY AFTER EXCAVATION AND APPROPRIATE INSPECTION.

ALL REINFORCING STEEL MARKED "CONTINUOUS" SHALL BE LAPPED 36 BAR DIAMETERS AT SPLICES AND AROUND CORNERS OR INTERSECTIONS WITH A STANDARD 90 DEGREE BEND ON CORNER BARS. LAP WIRE MESH ONE FULL MESH AT SIDE AND END LAPS. ALL HARDWARE TO BE SIMPSON OR EQUIVALENT.

EXTERIOR FRAME WALL TO BE SECURED WITH 1/2"X10" ANCHOR BOLTS 4'-0" O.C. FOR 1-STORY AND 2'-8" O.C. FOR 2-STORY, BOLTS SHALL BE LOCATED WITHIN 1'-0" OF EACH END PIECE AND SHALL HAVE A MIN. OF TWO BOLTS PER PIECE.

-FOUNDATION ANCHOR STRAPS SHALL BE PERMITTED, ACCORDING TO RESIDENTIAL CODE

- ALL INTERIOR WALLS TO BE SECURED WITH POWER DRIVEN PINS PER MANUFACTURER SPECIFICATION USE PIN SPACING EQUIVALENT TO 1/2" ANCHOR BOLTS.

- ALL CONSTRUCTION TO CONFORM TO THE 2012 IRC

R-10 RIGID INSULATION OUTSIDE OF EXTERIOR FOUNDATION WALLS UNDER LIVING AREA.

CONCRETE PAD FOR CONDENSER THICKNESS IS 4" MIN UNLESS OTHERWISE NOTED.

#### 3. CONCRETE CONSTRUCTION:

THE SLAB SHALL BE UNDERLAIN BY A VAPOR BARRIER/RETARDER IN THE LIVING AREA (TYPICALLY POLYETHYLENE, UNLESS MORE STRINGENT PROTECTION REQUIRED BY THE ARCHITECT, ENGINEER, FLOOR COVERING MANUFACTURER, OR ACCEPTED PRACTICE). UNLESS OTHERWISE REQUIRED, BARRIER MAY BE OMITTED AT GARAGES, PORCHES AND PATIOS WITHOUT FLOOR COVERINGS. IT IS BEYOND THE SCOPE OF THESE PLANS TO DETERMINE THE APPLICABILITY OF THESE MORE STRINGENT REQUIREMENTS. BUILDER SHALL VERIFY PRIOR TO CONSTRUCTION.

#### . REINFORCEMENT:

- IF CONSTRUCTED ON ACTIVE SOILS, THE LONG TERM PERFORMANCE OF THE FOUNDATION IS DEPENDENT ON MAINTENANCE BY THE OWNER. THUS THE BUILDER SHALL ADVISE THE OWNER OF THE FOLLOWING:

. DRAINAGE MUST BE MAINTAINED. WATER SHALL NEVER BE ALLOWED TO POND NEAR THE FOUNDATION.

2. THE SOIL AROUND THE FOUNDATION SHALL BE MAINTAINED IN A RELATIVELY DAMP CONDITION.SUCH AS THAT REQUIRED TO KEEP A LAWN GREEN. IF IT DRIES OUT IT WILL

SHRINK. IF IT GETS WET, IT WILL HEAVE UPWARD. 3. SLABS ON THE SHORTER SIDE USES MAIN BARS ARE USED IN THIS DIRECTION ONLY

WITH SMALLER DIAMETER DISTRIBUTION BARS ARE PLACED, FORMING A MAT OR GRID. 4. ALL REINFORCEMENT BARS SIZE 10MM OR LARGER IN ACCORDANCE TO ASTM

ANCHOR BOLTS AT ALL EXTERIOR WALLS SHALL BE MINIMUM 1/2 INCH DIAMETER WITH A

MAXIMUM SPACING OF 6'-0" ON CENTER, UNLESS NOTED OTHERWISE. ANCHOR BOLTS SHALL BE INSTALLED WITHIN 12 INCHES OF EACH END OF EACH SILL PLATE WITH AT LEAST TWO ANCHOR BOLTS FOR EACH BOLTS FOR EACH SILL PLATE LONGER

THAN 12 INCHES. 5. SIMPSONS SILL ANCHORS MAYBE SUBSTITUTED FOR ANCHOR BOLTS AT THE SAME


SPACING.

6. EXTERIOR CONCRETE SLABS WHICH ARE NOT PART OF THE MAIN SLAB SHALL BE MINIMUM 4 INCHES THICK WITH NO STEEL REINFORCING BARS REQUIRED, UNLESS NOTED OTHERWISE ON FOUNDATION PLAN.

#### **VERIFY THE FOLLOWING PRIOR TO POURING:**

- ALL HOLDDOWNS, STRAP, AND POST LOCATIONS.
- CONCRETE FINISHES. PANEL RISER LOCATION WHERE APPLICABLE.
- . UNDERSLAB MECHANICAL REQUIREMENTS.
- STEM WALL BLOCKOUTS.
- 5. UNDERSLAB ELECTRICAL REQUIREMENTS AND PANEL RISER LOCATION. WHERE APPLICABLE.
- 6. PROVIDE THE FOLLOWING:
- PVC SLEEVES THROUGH FTG IF REQUIRED
- 20' #4 COPPER GROUND BAR.
- SLOPE FINISH GRADE AWAY FROM FOOTING.

**NOTE**: FIELD VERIFY ALL DIMENSIONS SEE DIMENSIONED ARCHITECTURAL DRAWINGS

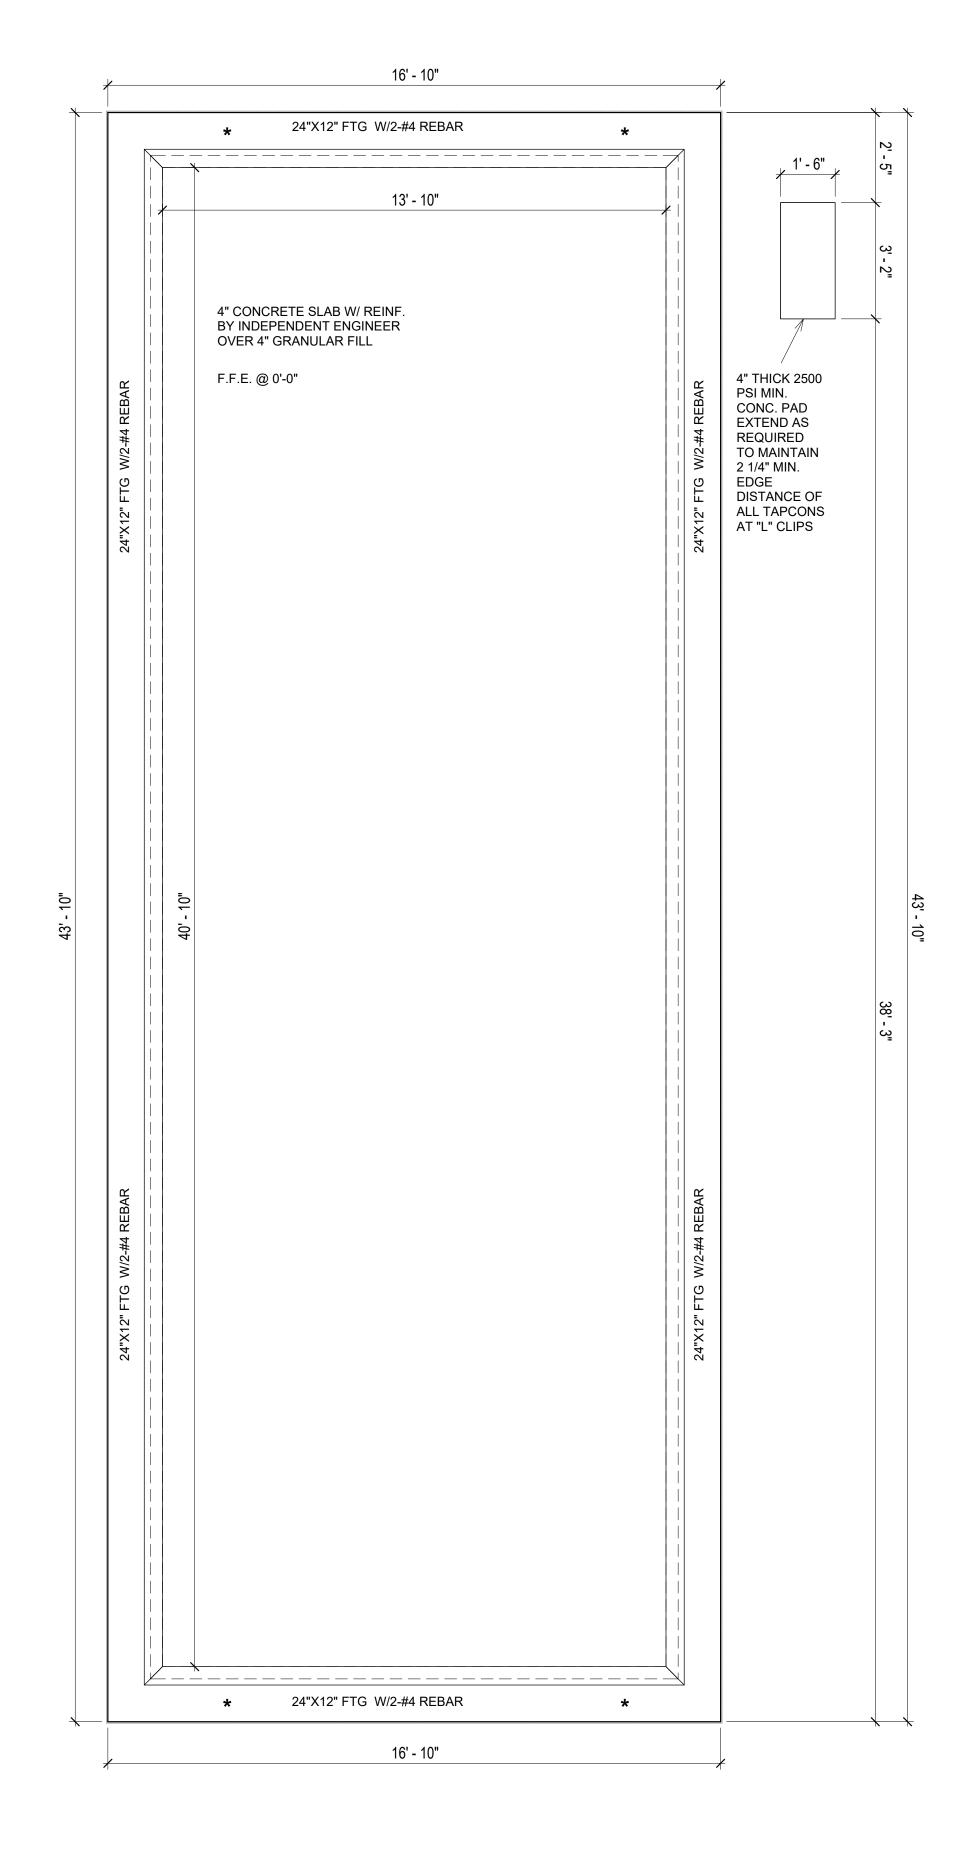

**FOUNDATION PLAN** 3/8" = 1'-0"

SQUARE FOOTAGE LIVING 749 PORCH TOTAL 800



**KEY PLAN** 

NO.	DESCRIPTION	DATE

NOTE:

LEGEND:

PROJECT

**221-WESTBROOK-749** 2Bd1Ba-CONTEMPORARY-550

DRAWING NAME

FOUNDATION PLAN

CLIENT NAME: Client Name PROJECT NUMBER: 0061\_12 DATE: 4/17/2025 10:58:26 AM Designer DESIGNED BY: Author DRAWN BY: CHECKED BY: Checker

**S101** 

SCALE: 3/8" = 1'-0"

#### **GENERAL NOTES**

#### NOTES:

-ALL BEARING WALLS SHOULD HAVE A THICKENED SLAB PER SECTION PER DETAIL A401/5.

#### A) FOUNDATION PLAN NOTES:

- 1. CONCRETE SLAB SHALL BE 6" THICK WITH 1/2" DIAMETER TENDONS PER LAYOUT PLAN, CENTERED IN SLAB THICKNESS, OVER APPROVED SUBBASE PER GENERAL STRUCTURE NOTES.
- TERMITE PROTECTION SHALL BE PROVIDED PER IRC SECTION R318.1
   NONE TYPICAL ANCHOR BOLT SPACING AT SHEAR WALL AND HOLD DOWN
- SPECIFICATIONS PER APPROVED ARCHITECTURAL PLANS.
  4. INSTALL HOLDOWNS BEFORE CONCRETE SLAB POUR.
- 5. EXISTING FILL ON-SITE SHALL BE COMPACTED IN ACCORDANCE WITH THE
- REQUIREMENTS IN THE GEOTECHNICAL REPORT.
- 6. ALL FLOOR SLABS ARE REINFORCED ON CONCRETE SLABS.

#### SPECIAL INSPECTION IS REQUIRED FOR THICKENED FOUNDATION CONSTRUCTION

- 1. REINFORCEMENT
- 2. 2300 PSI CONCRETE POUR

#### B) REINFORCEMENT FOR CONCRETE:


ALL REINFORCING SLABS BARS SIZE 10MM OR LARGER SHALL BE DEFORMED IN ACCORDANCE TO ASTM-A706, AND BARS SMALLER THAN 10 MM MAYBE PLAIN.
 UNLESS OTHERWISE NOTED IN PLANS, THE YIELD STRENGTH OF REINFORCING BARS SHALL BE:


A) FOOTING = 40,000 PSI B) NON-LOAD BEARING WALLS AND PARAPETS= 40,000 PSI

- 3. SPLICES SHALL BE SECURELY WIRED TOGETHER AND SHALL LAP OR EXTEND
- 4. GRADE OF STEEL FOR RCC WORKS SHALL BE GRADE 4 10.
- 5. BAR NOTATIONS GIVES INFORMATION
- A) BAR SIZE
- B) SPACING(IF REQUIRED)
- 6. LAP REINFORCEMENT ONLY AT LOCATION SHOWN IN THE DRAWINGS
- 7. REINFORCEMENT SHALL NOT BE CUT, VENT OR HEATED ON SITE WITHOUT ENGINEERS' APPROVAL.
- C) CONCRETE SLAB NOTES
- 1. ALL SLAB REINFORCEMENT SHALL BE 20MM CLEAR MINIMUM FROM BOTTOM AND FROM TOP OF SLAB.
- 2. REINFORCEMENT IN CONTINUOUS ELEVATED SLAB SHALL BE CUT AS FOLLOWS.

#### NOTE

- THIS IS A SCHEMATIC PLAN FOR THE PURPOSE OF LOCATING AND IDENTIFYING FOUNDATION REINFORCING ELEMENTS ONLY. VERIFY ALL DIMENSIONS, DROPS, OFFSETS AND FEATURES WITH THE ARCHITECTURAL PLANS BEFORE FORMING THE FOUNDATION.

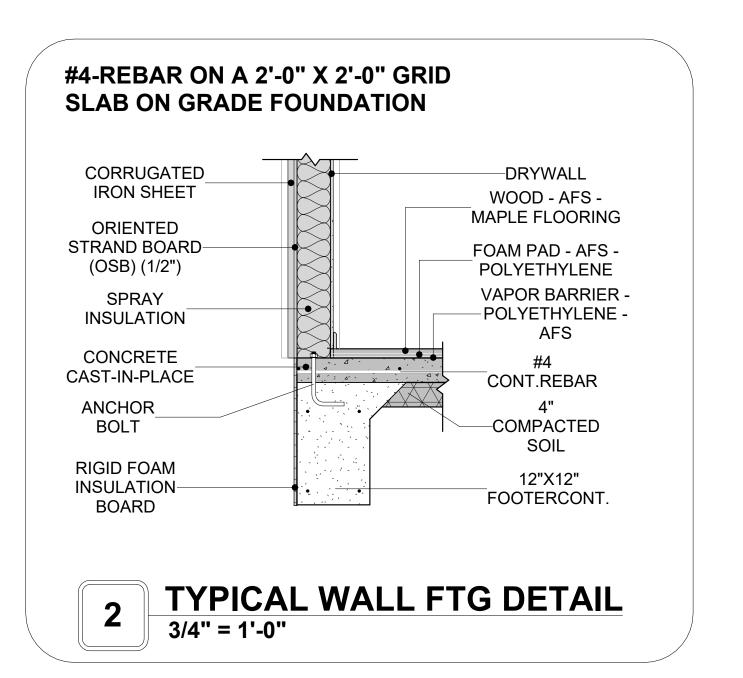

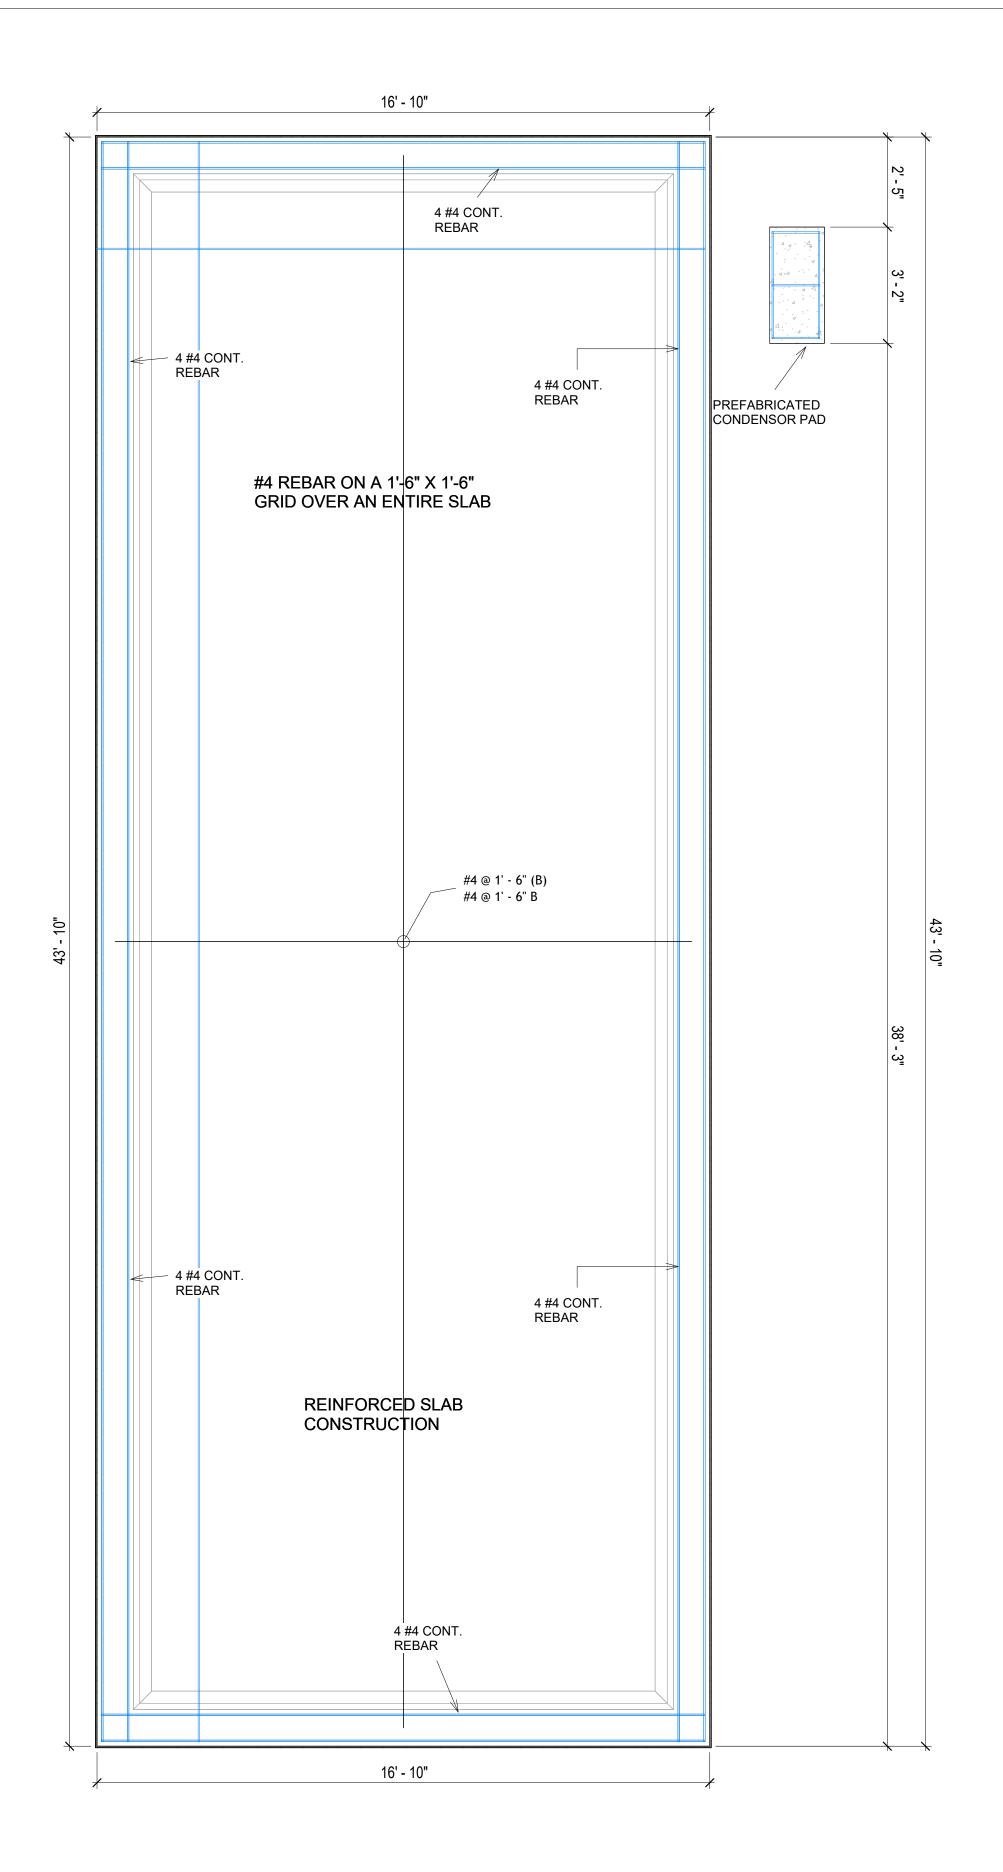

1 FOUNDATION REBAR PLAN
3/8" = 1'-0"



**KEY PLAN** 

NO.	DESCRIPTION	DATE	

NOTE:

LEGEND:

PROJECT

221-WESTBROOK-749 2Bd1Ba-CONTEMPORARY-550

DRAWING NAME

STRUCTURAL FLOOR PLAN

CLIENT NAME:

PROJECT NUMBER:

0061\_12

DATE:

4/17/2025 10:58:26 AM

DESIGNED BY:

DRAWN BY:

CHECKED BY:

Checker


**S102** 

#### **ROOF NOTES**

- 1. ROOFING COMPOSITION ROOFING PER OWNERS/BUILDERS SPECIFICATIONS INSTALL PER MANUFACTURE SPECIFICATIONS ON 1/2" ORIENTED STRAND BOARD ON PRE-ENGINEERED TRUSS @ 24" O.C. (UNO.)
- 73" OVERHANG AT EAVES (UNO.)
   ENDS OF ALL TRUSSES AND JOISTS TO BE FULLY BLOCKED. PROVIDE SOLID
- BLOCKING AT ALL RIDGES AND VALLEYS
  4. SHEATHING TO BE 1/2", 3/8" OSB SHEAR PANEL AND EQUIVALENT.
  UNDERSIDE OF PORCH TRUSSES TO BE FINISHED WITH MOISTURE
- RESISTANT DRYWALL, TAPED AND TEXTURED.
  5. EXPOSED EAVES AND OTHER WEATHER EXPOSED AREAS TO BE SHEATHED WITH EXTERIOR GRADE PLYWOOD.
- 6. ALL MATERIALS THICKNESS AND SIZE ARE THE MINIMUM. Refer TO LOCAL STANDARDS FOR ACTUAL THICKNESS AND LAYERING OF MATERIALS.
- 7. ENGINEERED TRUSS CALCULATIONS TO BE SUBMITTED TO BUILDING
- DEPARTMENT PRIOR TO FABRICATION AND INSTALLATION.

  8. TRUSS MANUFACTURER TO SPECIFY HANGER CONNECTORS FOR TRUSS
- COMPONENTS (TYPICAL)

  9. DESIGNER ASSUMES THAT TRUSSES BEAR ON ALL EXTERIOR PERIMETER
- WALLS (TYPICAL) OR BEAMS.
- 10. PROVIDE GALVANIZED STEEL FLASHING WITH A LENGTH OF 10 FEET, WIDTH OF 12 INCHES, AND THICKNESS OF 24 GAUGE.

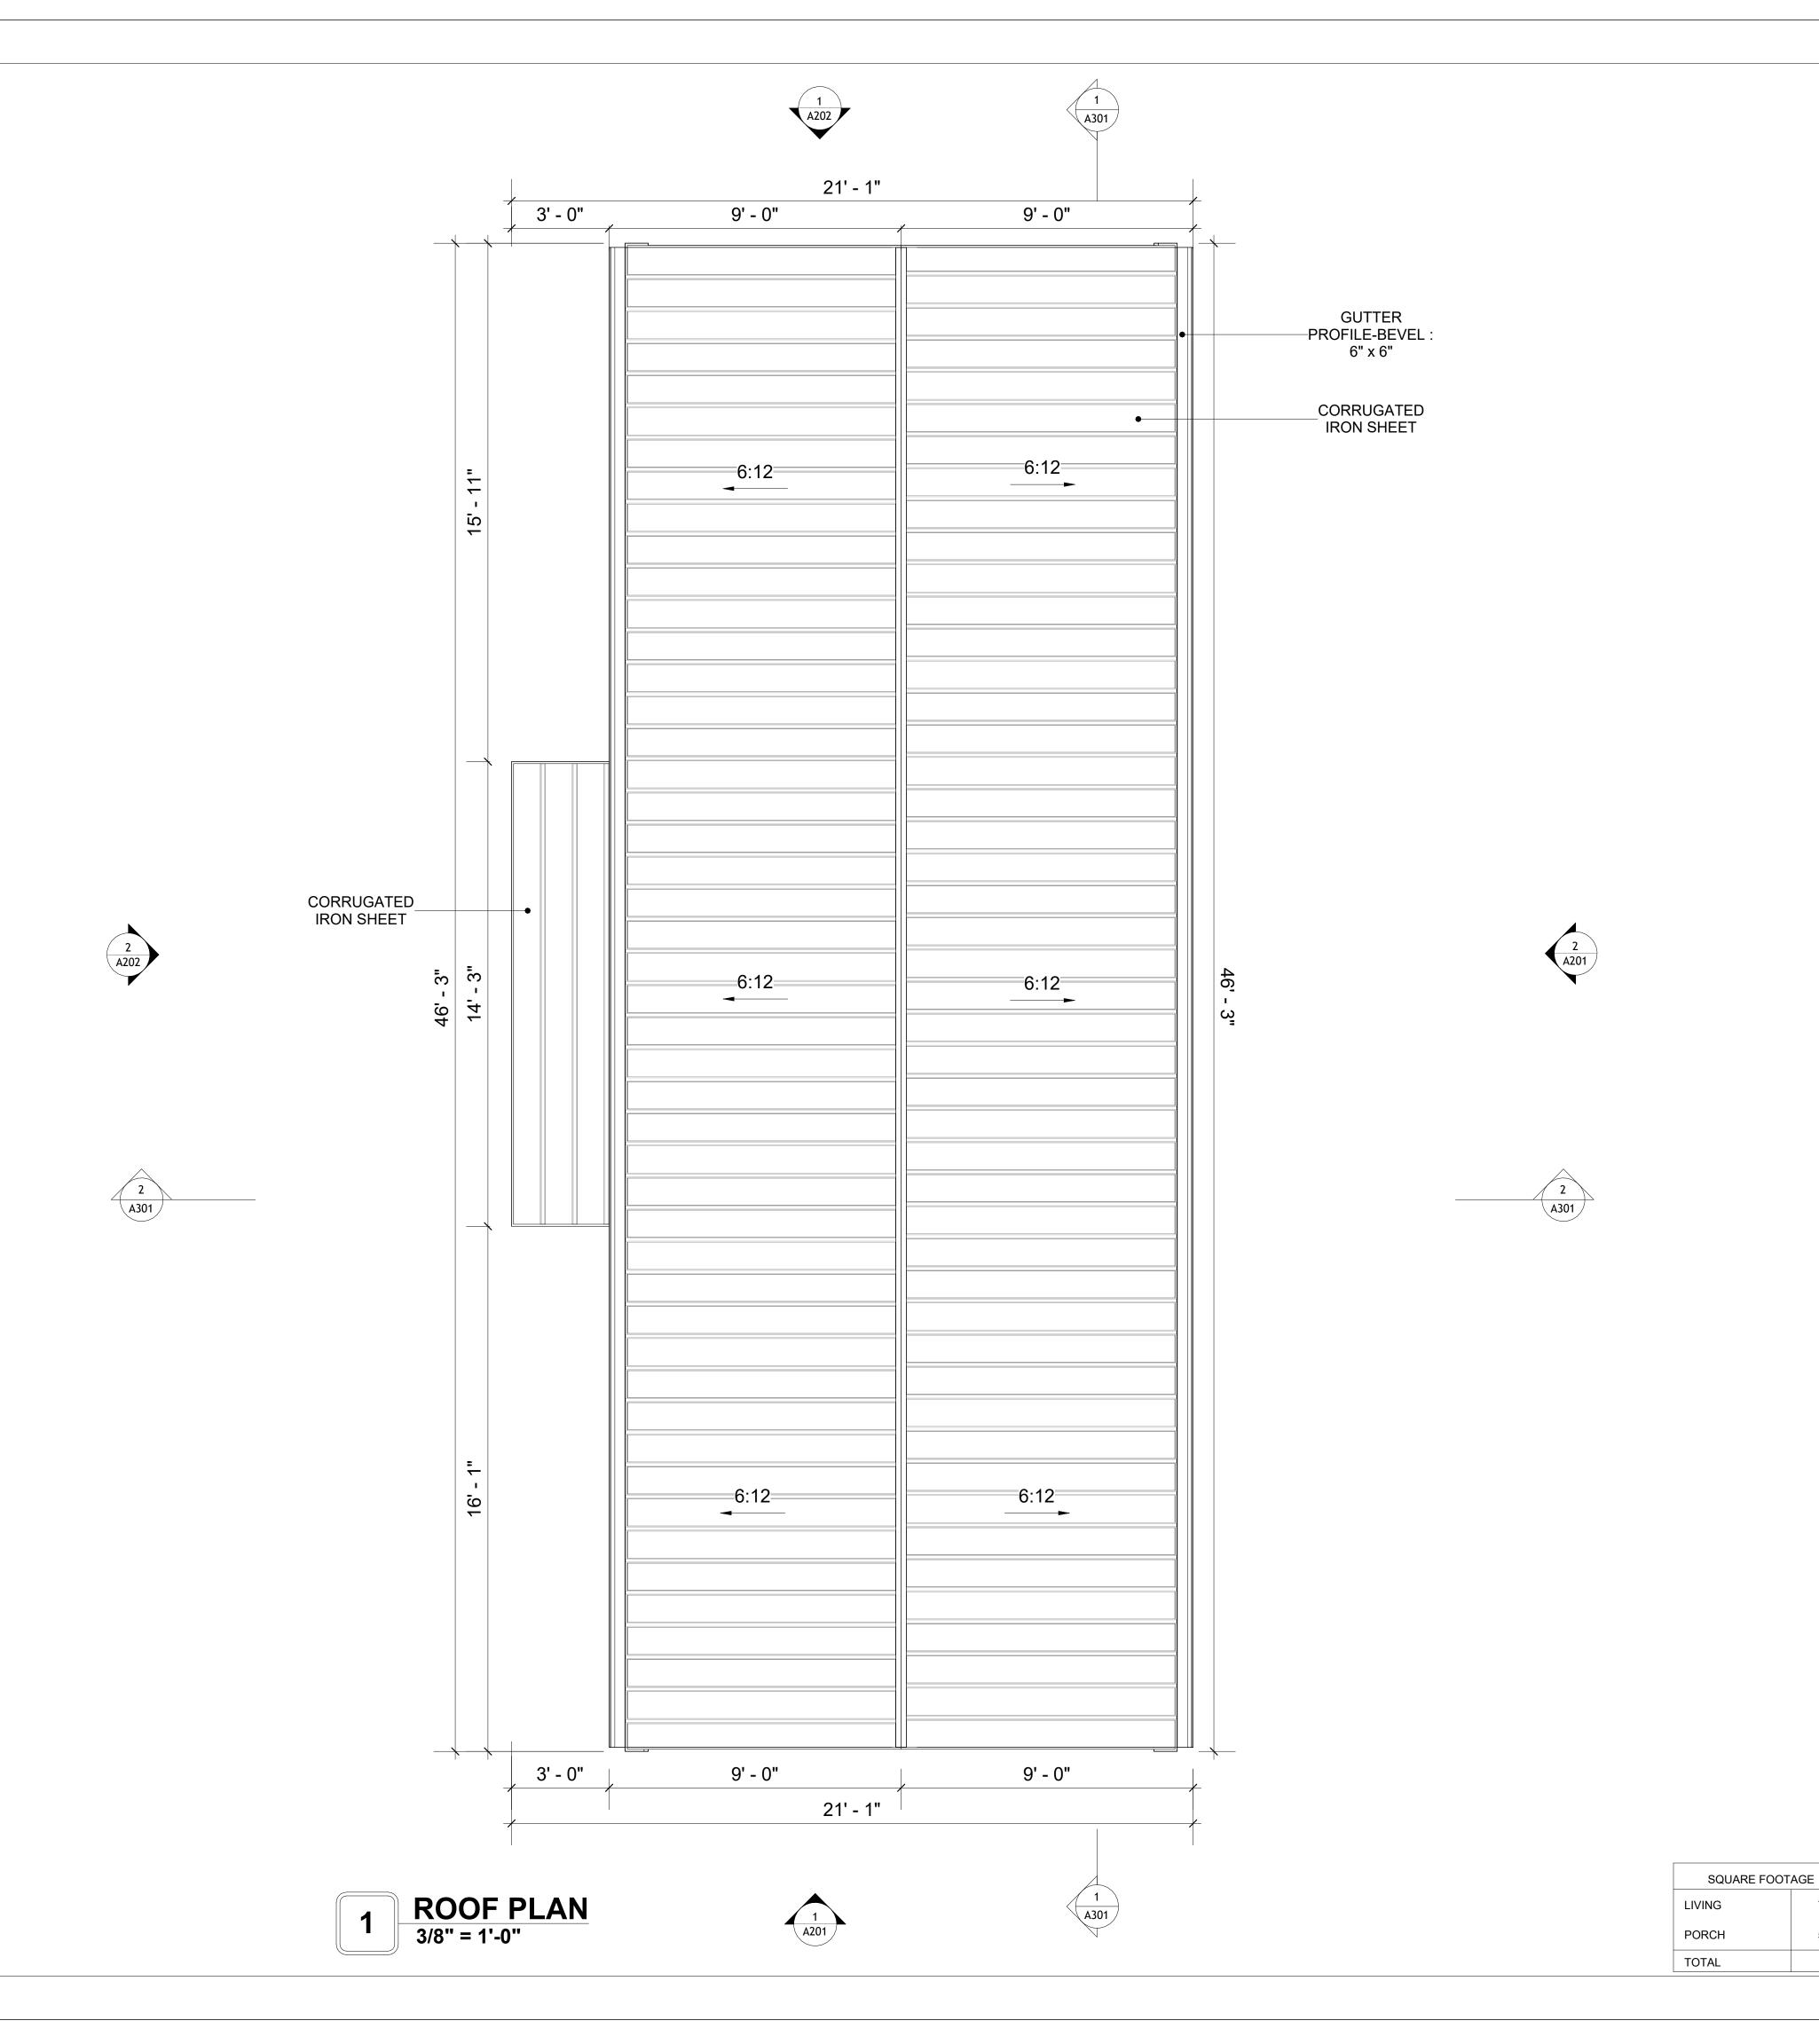



**KEY PLAN** 

NO.	DESCRIPTION	DATE

NOTE:

LEGEND:

221-WESTBROOK-749 2Bd1Ba-CONTEMPORARY-550

DRAWING NAME

ROOF PLAN

CLIENT NAME:	Client Name
CLILIT IVAIVIL.	Cheffi Name
PROJECT NUMBER:	0061_12
DATE:	4/17/2025 10:58:29 AM
DESIGNED BY:	Designer
DRAWN BY:	Author
CHECKED BY:	Checker

A103

SCALE: As indicated

800

#### **ABOUT WALL FINISHING**

#### **CORRUGATED IRON SHEET**


CORRUGATED IRON IS A FINISHING MATERIAL MADE FROM STEEL THAT HAS BEEN GALVANIZED (COATED WITH A THIN LAYER OF ZINC) TO PROTECT IT FROM CORROSION AND RUST.


IN THIS SPECIFIC PROJECT, THE CORRUGATED IRON SHEETS ARE INSTALLED HORIZONTALLY ON VERTICAL FURRING STRIPS THAT ARE DIRECTLY ATTACHED ONTO THE PROPERLY INSTALLED AND SEALED HOME WRAP, USING SELF-DRILLING SCREWS THAT ARE DRIVEN THROUGH THE RIDGES OR VALLEYS OF THE CORRUGATIONS.

#### **CEDAR WOOD**

CEDAR WOOD REFERS TO THE WOOD FROM VARIOUS SPECIES OF CEDAR TREES, WHICH ARE CONIFEROUS EVERGREEN TREES KNOWN FOR THEIR DISTINCT AROMA AND NATURAL RESISTANCE TO DECAY AND INSECTS.

IN THIS SPECIFIC PROJECT, CEDAR WOOD IS USED A FINISH MATERIAL ON BEAMS AND COLUMNS.

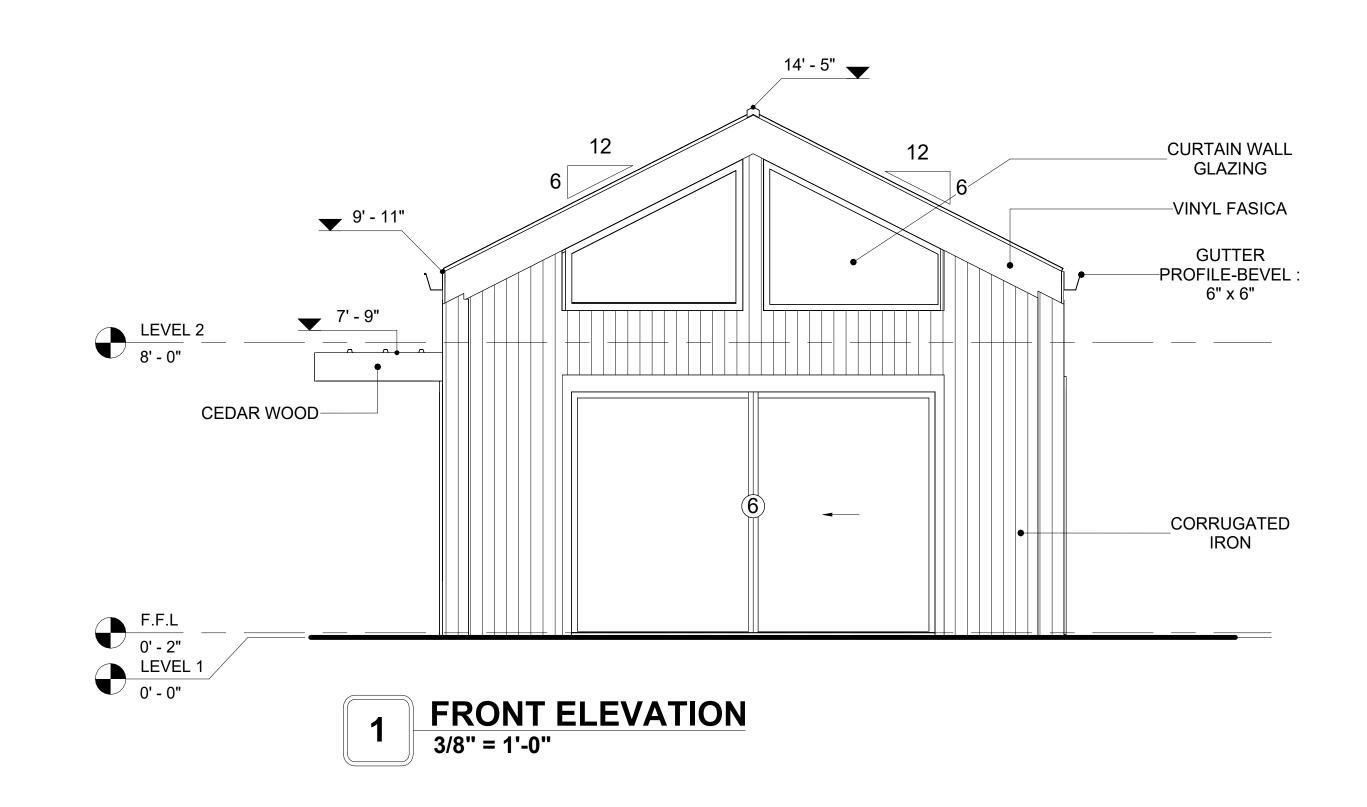

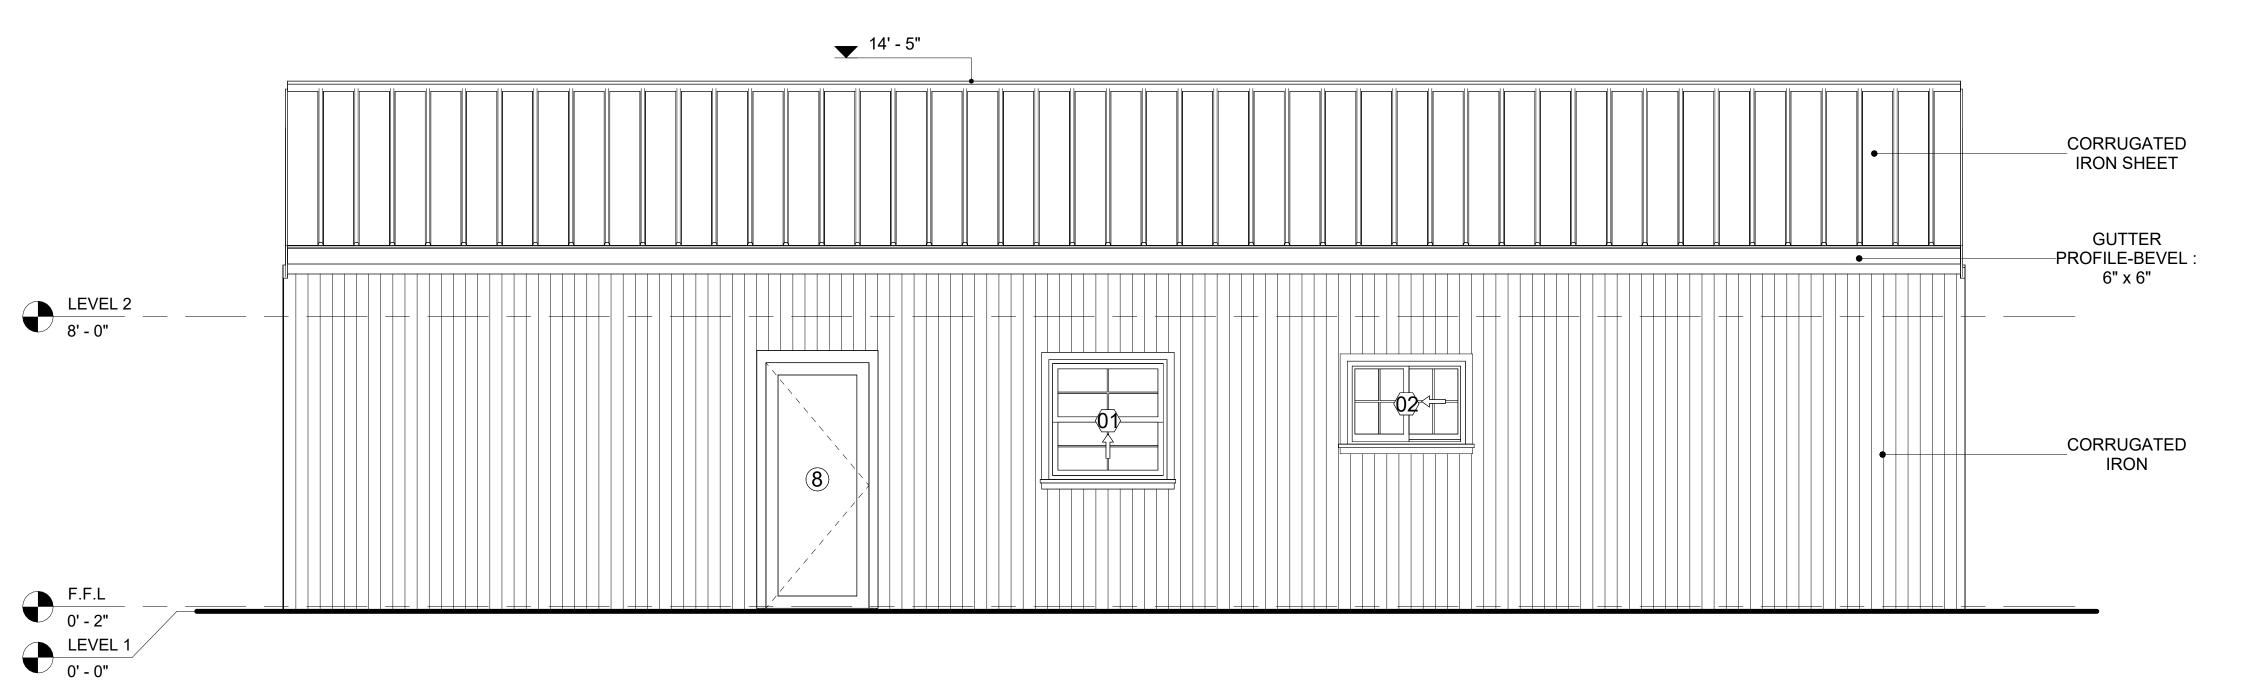

# 2 RIGHT SIDE ELEVATION 3/8" = 1'-0"

DOOR SCHEDULE							
TYPE				SIZE			
MAR K	SUPPLIER	DOOR TYPE	LOCATIO N	WIDTH	HEIGHT	COUNT	
1	HOME DEPOT	INTERIOR SINGLE PANEL SWINGING	INTERIOR	2' - 6"	6' - 8"	1	
2	HOME DEPOT	INTERIOR DOUBLE PANEL SLIDING	INTERIOR	7' - 0"	6' - 8"	1	
3	HOME DEPOT	INTERIOR SINGLE PANEL SWINGING	INTERIOR	3' - 0"	6' - 8"	1	
4	HOME DEPOT	INTERIOR DOUBLE PANEL SLIDING	INTERIOR	10' - 0"	6' - 8"	1	
5	HOME DEPOT	INTERIOR SINGLE PANEL SWINGING	INTERIOR	2' - 10"	6' - 8"	1	
6	HOME DEPOT	PATIO_DOUBLE PANEL_SLIDING	EXTERIOR	10' - 0"	6' - 8"	2	
7	HOME DEPOT	PATIO_DOUBLE PANEL_SLIDING	EXTERIOR	12' - 0"	6' - 8"	1	
8	HOME DEPOT	EXTERIOR SINGLE PANEL SWINGING	INTERIOR	2' - 10"	6' - 8"	1	

WINDOW SCHEDULE						
SIZE						
TYPE MARK	SUPPLIER	WINDOW TYPE	WIDTH	HEIGHT	COUNT	
01	HOME DEPOT	SINGLE HUNG	3' - 3"	3' - 3"	1	
02	HOME DEPOT	SLIDING	3' - 3"	2' - 3"	1	
03	HOME DEPOT	CASEMENT	2' - 3"	5' - 3"	2	



NO.	DESCRIPTION	DAT

NOTE:

LEGEND:

PROJECT

221-WESTBROOK-749 2Bd1Ba-CONTEMPORARY-550

DRAWING NAME

ARCHITECTURAL ELEVATIONS

CLIENT NAME:	Client Name
PROJECT NUMBER:	0061_12
DATE:	4/17/2025 10:58:32 AM
DESIGNED BY:	Designer
DRAWN BY:	Author
CHECKED BY:	Checker

A201

#### **ABOUT WALL FINISHING**

#### **CORRUGATED IRON SHEET**


CORRUGATED IRON IS A FINISHING MATERIAL MADE FROM STEEL THAT HAS BEEN GALVANIZED (COATED WITH A THIN LAYER OF ZINC) TO PROTECT IT FROM CORROSION AND RUST.

IN THIS SPECIFIC PROJECT, THE CORRUGATED IRON SHEETS ARE INSTALLED HORIZONTALLY ON VERTICAL FURRING STRIPS THAT ARE DIRECTLY ATTACHED ONTO THE PROPERLY INSTALLED AND SEALED HOME WRAP, USING SELF-DRILLING SCREWS THAT ARE DRIVEN THROUGH THE RIDGES OR VALLEYS OF THE CORRUGATIONS.


#### **CEDAR WOOD**

CEDAR WOOD REFERS TO THE WOOD FROM VARIOUS SPECIES OF CEDAR TREES, WHICH ARE CONIFEROUS EVERGREEN TREES KNOWN FOR THEIR DISTINCT AROMA AND NATURAL RESISTANCE TO DECAY AND INSECTS.

IN THIS SPECIFIC PROJECT, CEDAR WOOD IS USED A FINISH MATERIAL ON BEAMS AND COLUMNS.

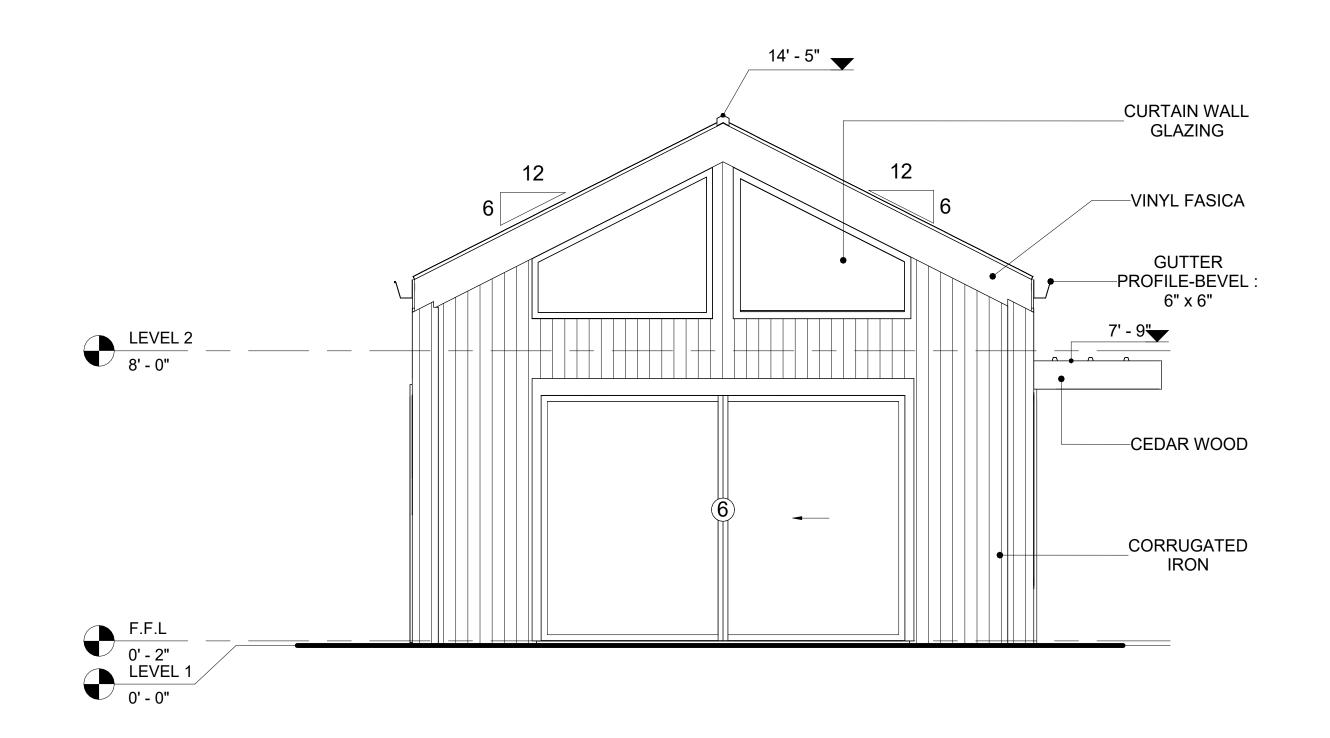


1 REAR ELEVATION 3/8" = 1'-0"

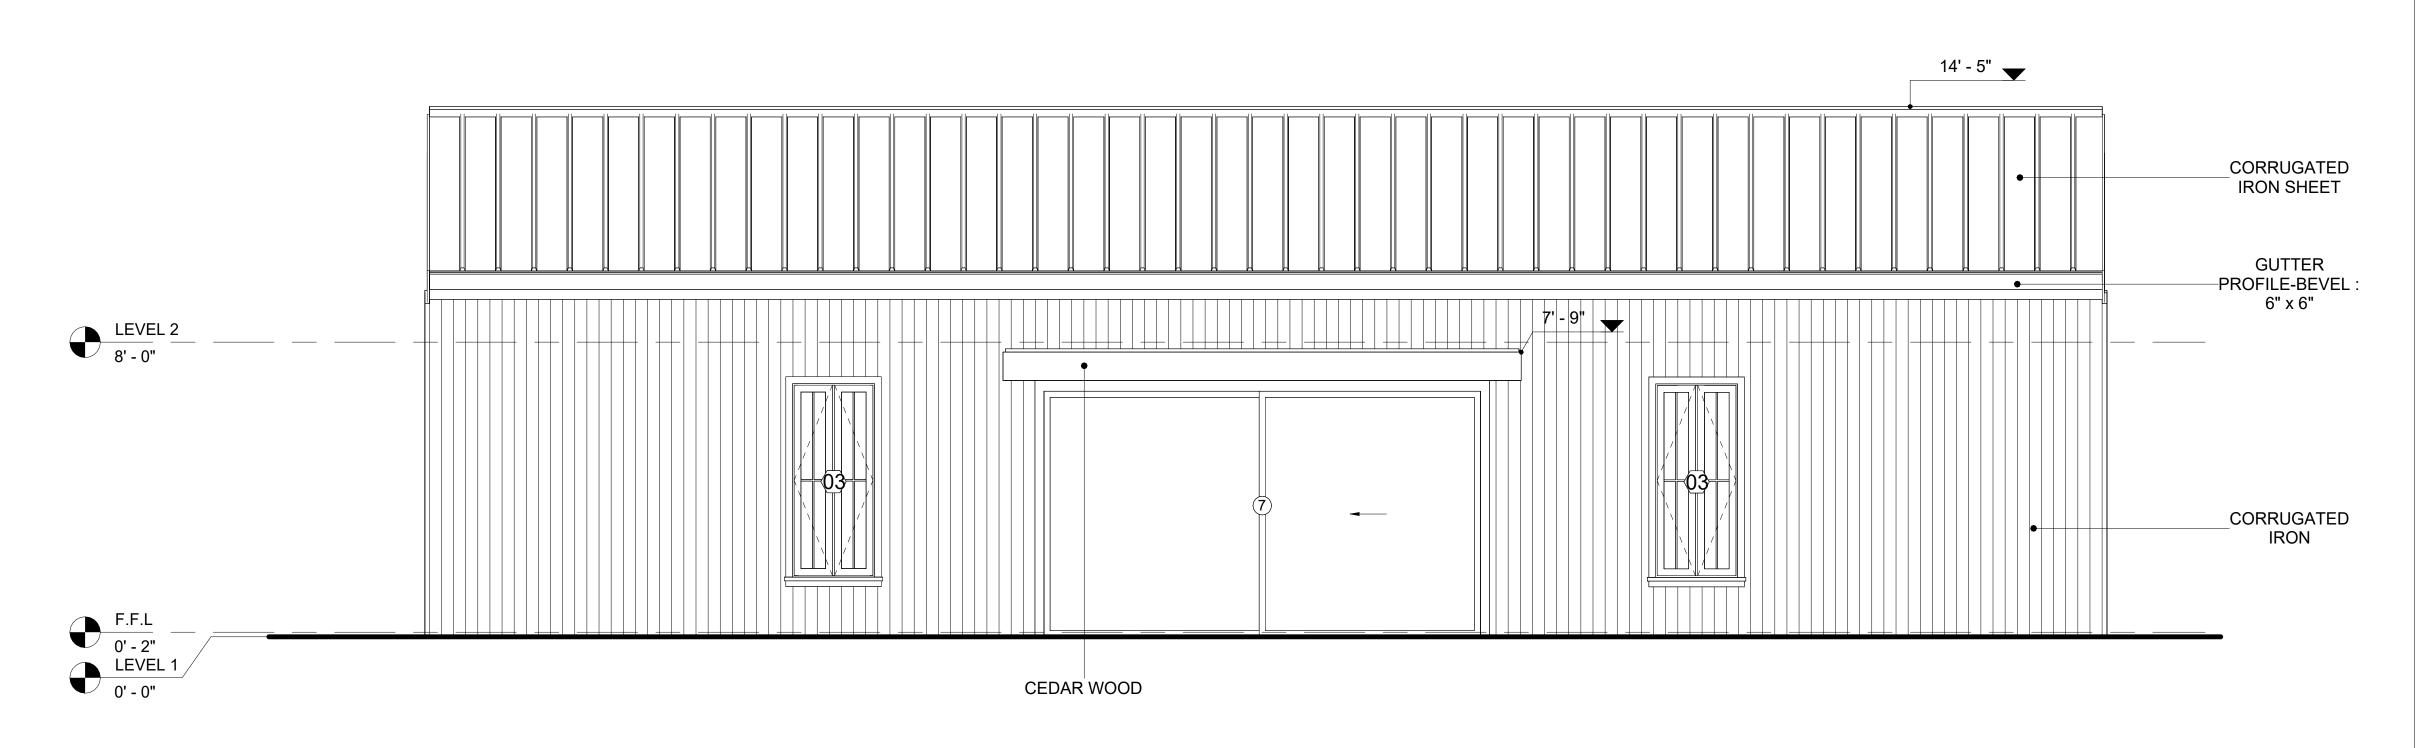

2 LEFT SIDE ELEVATION
3/8" = 1'-0"



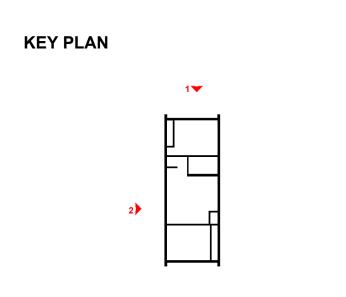

NO.	DESCRIPTION	DATE	

NOTE:

LEGEND:

PROJECT

221-WESTBROOK-749 2Bd1Ba-CONTEMPORARY-550

DRAWING NAME

ARCHITECTURAL ELEVATIONS

CLIENT NAME:

PROJECT NUMBER:

0061\_12

DATE:

4/17/2025 10:58:35 AM


DESIGNED BY:


DRAWN BY:

CHECKED BY:

Checker

A202

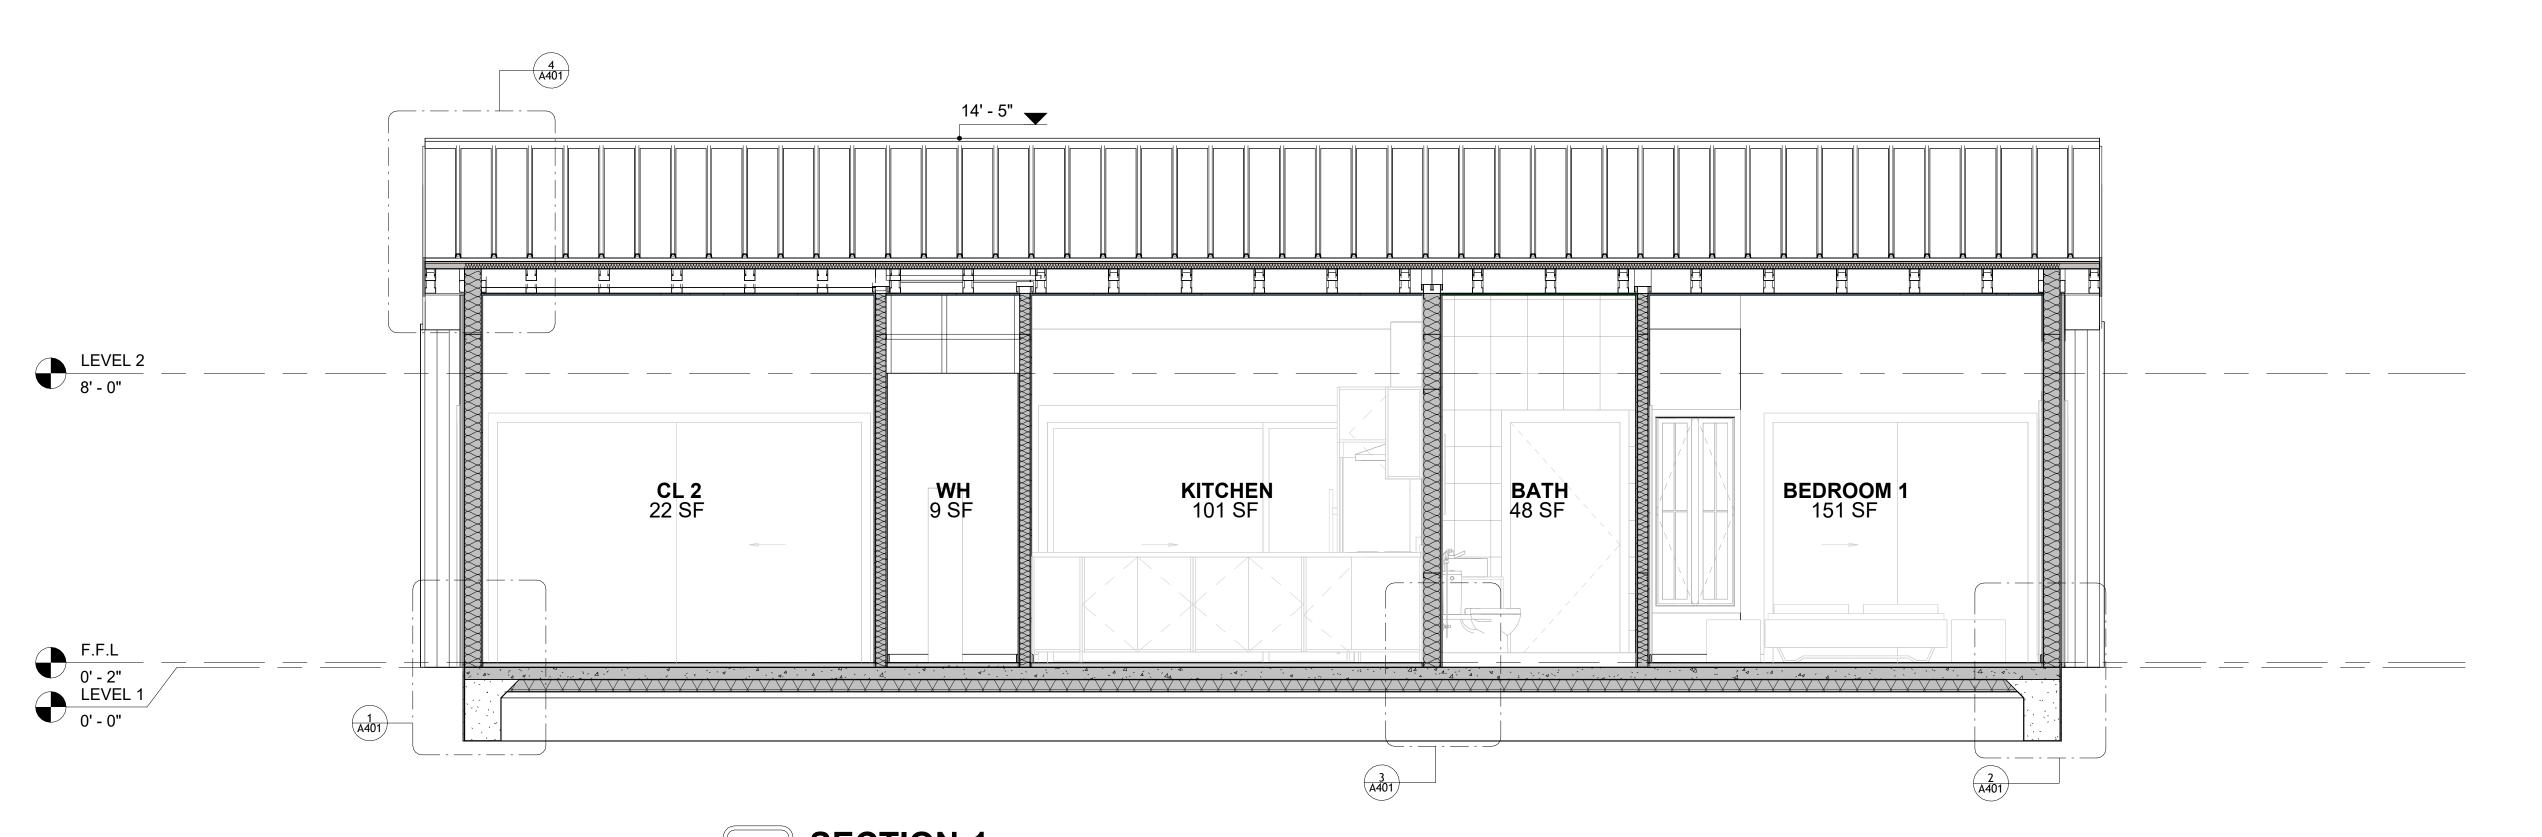


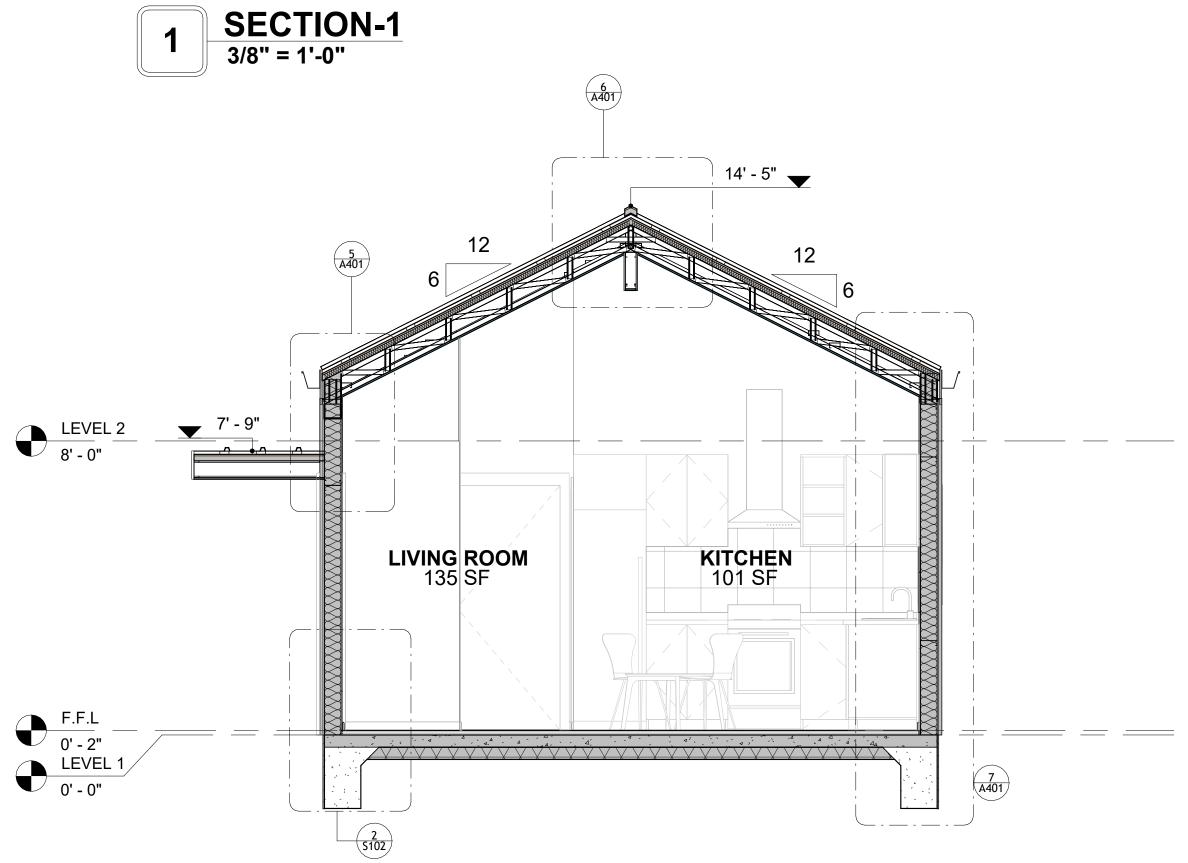

2 SECTION-2 3/8" = 1'-0"



**KEY PLAN** 

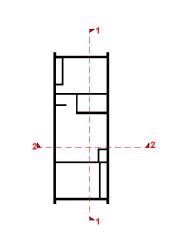

NO.	DESCRIPTION		

NOTE:

LEGEND:

PROJECT


221-WESTBROOK-749 2Bd1Ba-CONTEMPORARY-550


DRAWING NAME


ARCHITECTURAL SECTIONS


Client Name	CLIENT NAME:
0061_12	PROJECT NUMBER:
4/17/2025 10:58:36 AM	DATE:
Designer	DESIGNED BY:
Author	DRAWN BY:
Checker	CHECKED BY:


A301

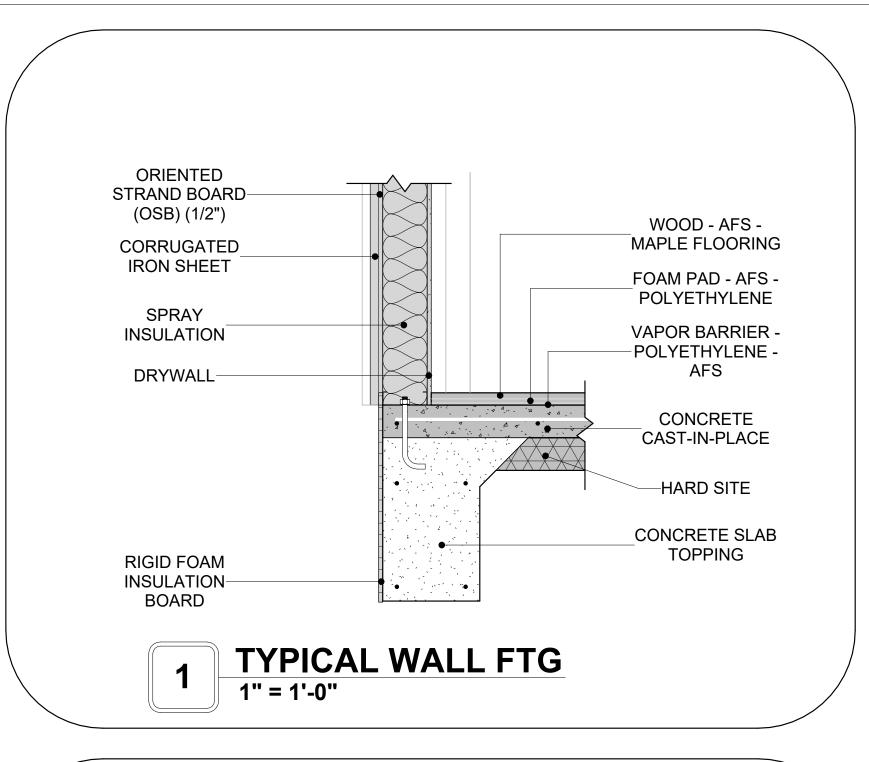


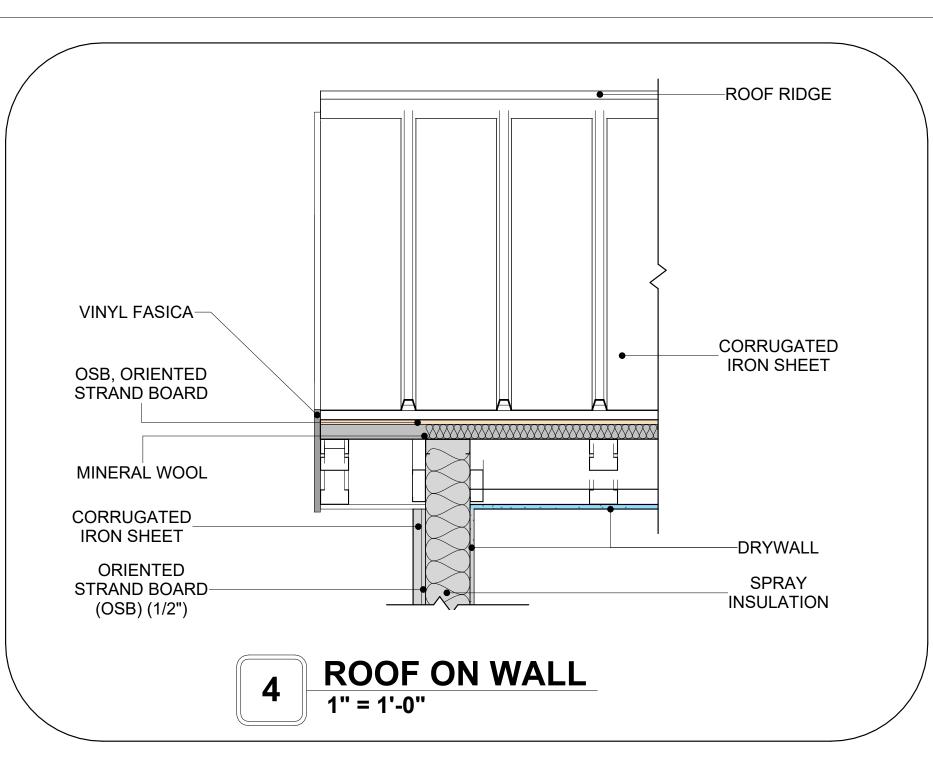


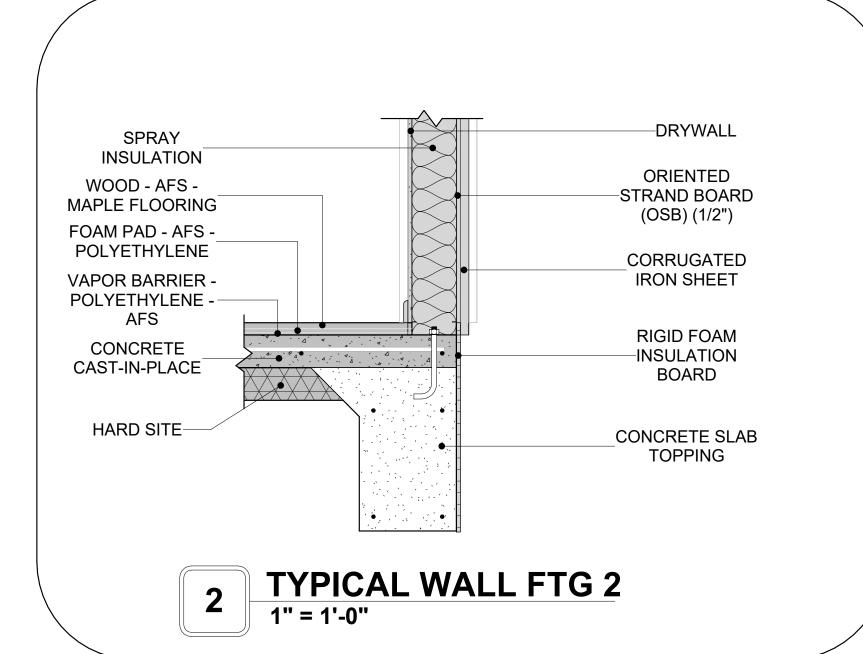

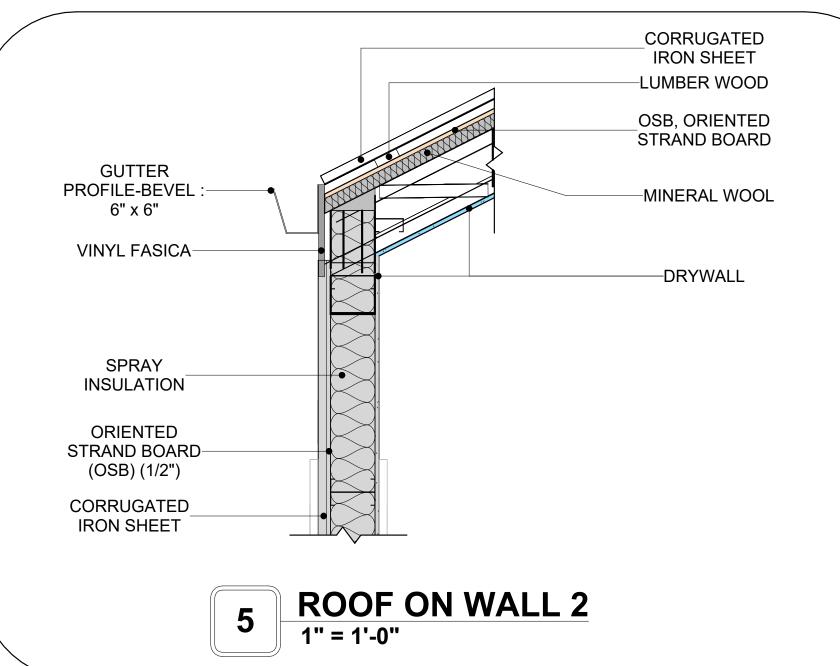

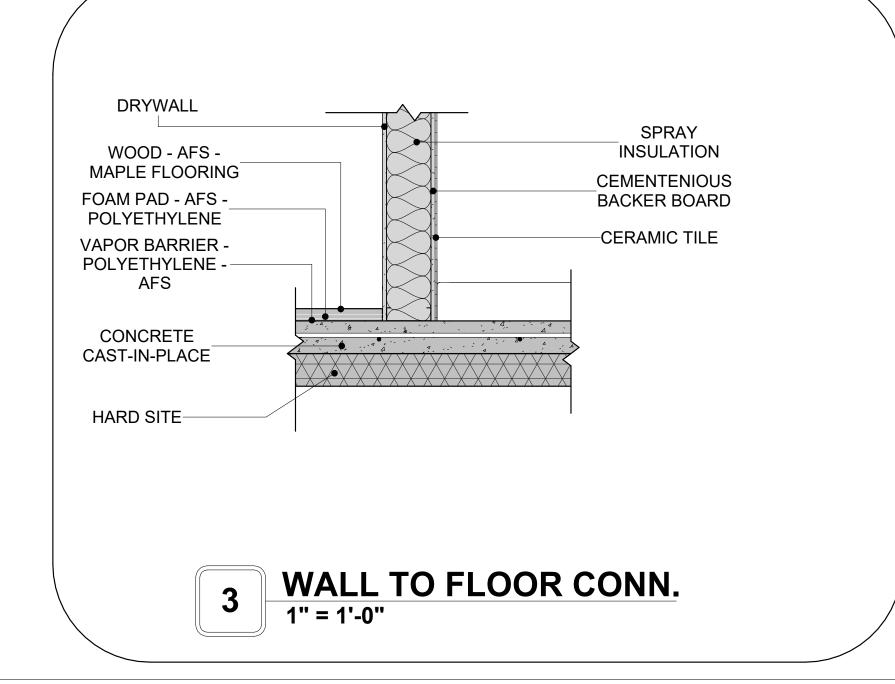

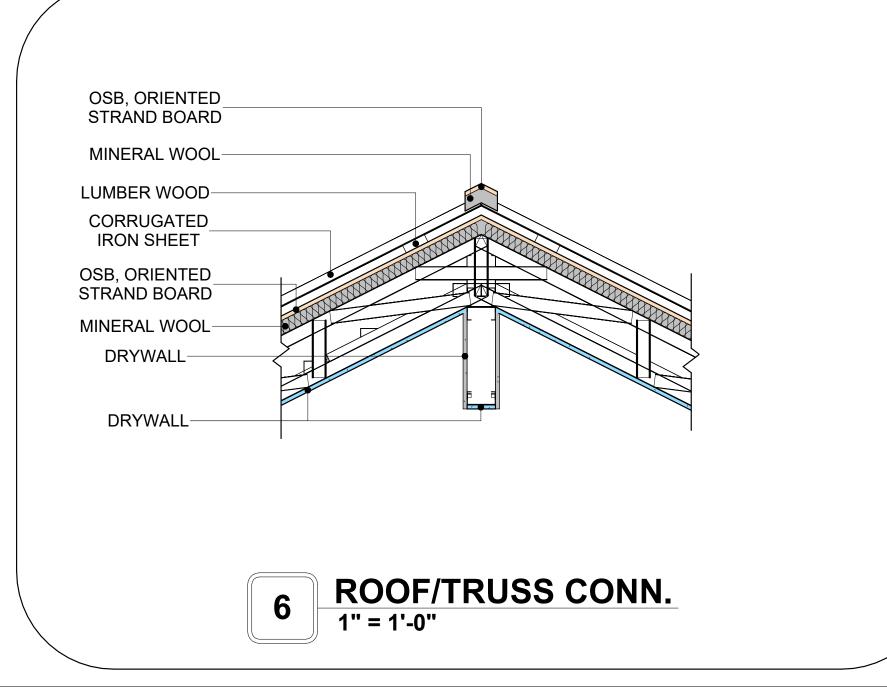

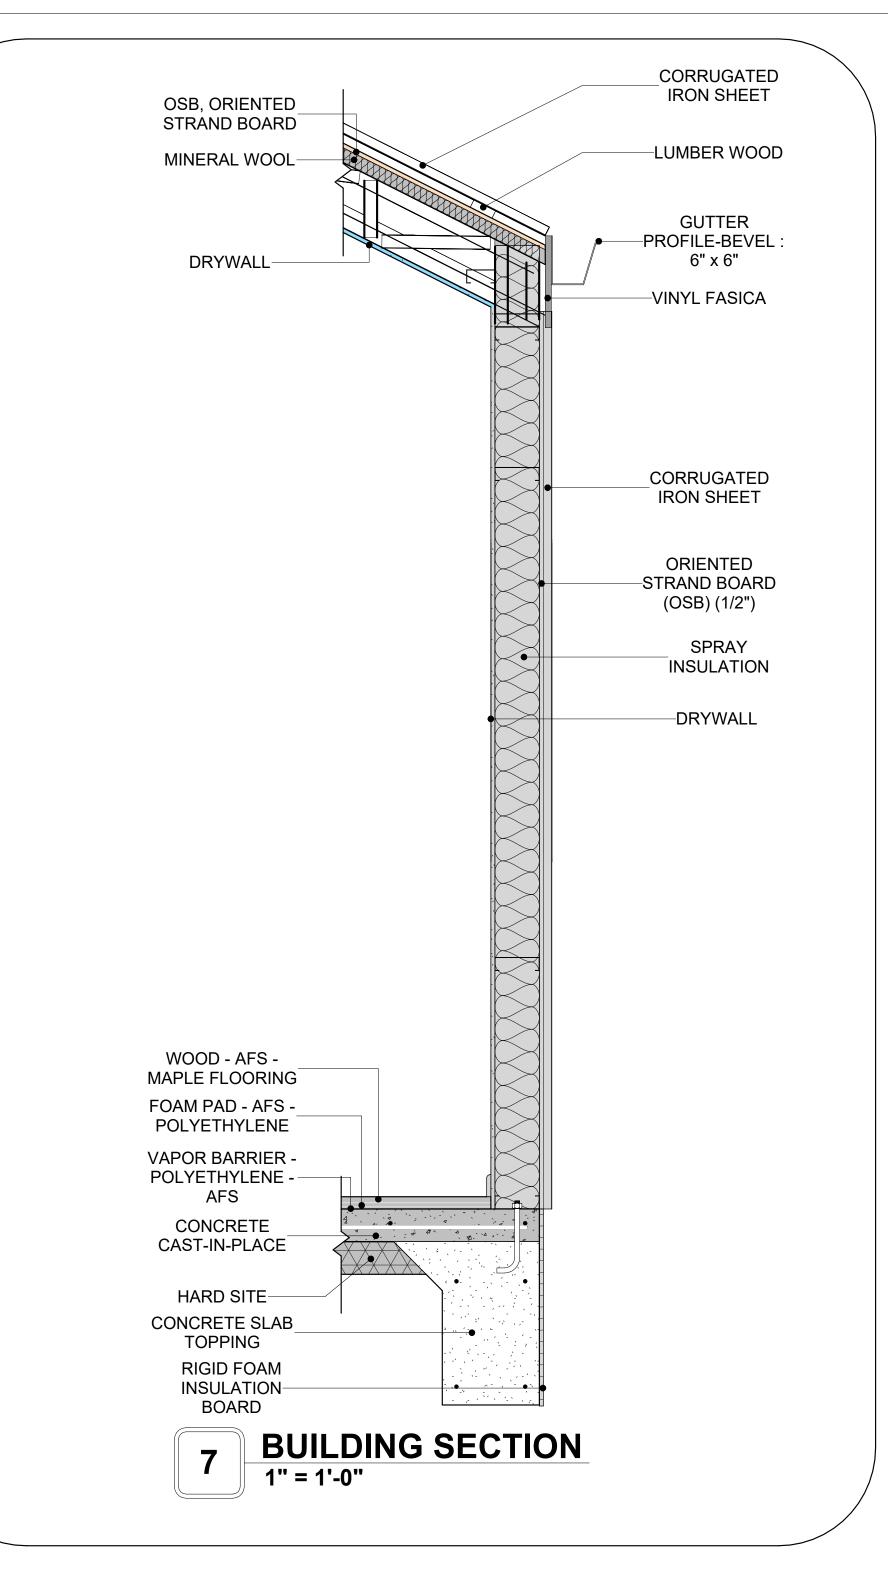



**KEY PLAN** 

NO.	DESCRIPTION	DATE	

NOTE:

LEGEND:

PROJECT

221-WESTBROOK-749 2Bd1Ba-CONTEMPORARY-550

DRAWING NAME

ARCHITECTURAL DETAILS

Client Name
0061_12
4/17/2025 10:58:39 AM
Designer
Author
Checker

A401


SCALE: 1" = 1'-0"


#### **CASEWORK GENERAL NOTES**


- 1. ALL CABINET HEIGHTS INCLUDE COUNTERTOPS. DIMENSIONS ARE TO THE NEAREST INCH.
- 2. DIVISIONS IN CASEWORK ARE SHOWN FOR CLARITY AND DO NOT REPRESENT BREAKS IN THE COUNTERTOP.
- 3. PROVIDE CONTINUOUS COUNTERTOP OVER ALL SIMILAR HEIGHT CASEWORK, UNLESS AND OTHERWISE NOTED.
- 4. MANUFACTURER AND CATALOG NUMBERS ARE FOR REFERENCE AND ILLUSTRATION PURPOSES
- 5. DOTTED LINES INDICATE WALL HUNG CABINETS, DIVISIONS OF BASE CABINETS BELOW THE
- 6. COUNTERTOP, FURNITURE NOT IN THE CONTRACT OR PROJECTION SCREENS -SEE CASEWORK KEY AND SPECIFICATIONS.
- 7. ALL CABINETS AND DRAWERS TO HAVE CAM LOCKS EXCEPT FOR SINK BASE CABINETS.
- 8. ALL EXPOSED SURFACES (EXPOSED TO VIEW FROM ANY PERSPECTIVE) TO BE COVERED WITH LAMINATE.
- 9. ALL CASEWORK WHICH MEETS A WALL AT ONE OR BOTH ENDS, TO BE PROVIDED WITH FILLER
- PANELS AND SCRIBED TO THE WALL(S) AS REQUIRED.
- 10. ALL CABINETS AND DRAWERS ARE PROVIDED WITH RECESSED HANDLES.
- 11. CONTRACTOR TO FIELD VERIFY ALL CLEAR OPENINGS PRIOR TO MILLWORK OR CASEWORK FABRICATION.
- 12. CASEWORK DRAWINGS ARE DIAGRAMMATIC IN NATURE TO SHOW DESIGN INTENT.


	CASEWORK SCHEDULE							
TYPE MAR K	TYPE	COUN	HEIGHT	WIDTH	DEPTH	AREA		
			- 4H	I=1 011	<b></b>	0.05		
01	L-SHAPE COUNTER TOP 158	1	0' - 4"	7' - 0"	7' - 0"	2 SF		
02	BASE CABINET DOUBLE DOOR 2	1	2' - 11"	3' - 1"	2' - 0"	9 SF		
03	BASE_CABINET_L-SHAPED	1	2' - 11"	3' - 3"	3' - 3"	9 SF		
05	WALL CABINET DOUBLE DOOR 3 159.186 2	1	2' - 6"	2' - 3"	1' - 0"	6 SF		
06	LINEAR COUNTER TOP 2 159.186 2 2	1	0' - 4"	1' - 0"	2' - 1"	0 SF		
07	BASE_CABINET_DOUBLE_DOOR	1	2' - 11"	2' - 3"	2' - 0"	6 SF		
08	LAUNDRY OPEN CABINET	1	1' - 6"	2' - 0"	2' - 4"	3 SF		
09	RECESSED_MED_CABINET	1	2' - 0"	1' - 6"	0' - 3"	3 SF		
10	VANITY 2	1	2' - 4"	3' - 0"	1' - 8"	7 SF		
11	LAUNDRY OPEN CABINET 3 159.186	1	1' - 1"	2' - 3"	3' - 0"	2 SF		
12	CLOSET_3	1	6' - 0"	7' - 11"	1' - 4"	47 SF		
13	CLOSET_4	1	6' - 0"	10' - 9"	1' - 4"	64 SF		
14	BASE_CABINET_SINGLE_DOOR	1	2' - 11"	1' - 5"	2' - 0"	4 SF		
15	BASE CABINET DOUBLE DOOR 45	1	2' - 11"	3' - 1"	2' - 0"	9 SF		
16	WALL FILLER	1	2' - 6"	0' - 7"	1' - 0"	2 SF		
17	BASE_CABINET_DOUBLE_DOOR 4	1	2' - 6"	3' - 6"	1' - 0"	9 SF		
18	HD_WALL_FILLER_18	1	2' - 6"	1' - 3"	1' - 0"	3 SF		
19	WALL_CABINET_L-SHAPE 2	1	2' - 6"	2' - 0"	2' - 0"	5 SF		
20	HD_WALL_FILLER_18 2 46	1	2' - 6"	1' - 1"	1' - 0"	3 SF		
GRAND	TOTAL	19			•			

SPECIALTY EQUIPMENT SCHEDULE				
TYPE MARK TYPE COUNT				
01	WASHER-FRONT-LOAD	1		
02	REFRIGERATOR	1		
03	RANGE	1		
04	DRYER-FRONT-LOAD	1		
GRAND TOTAL: 4				

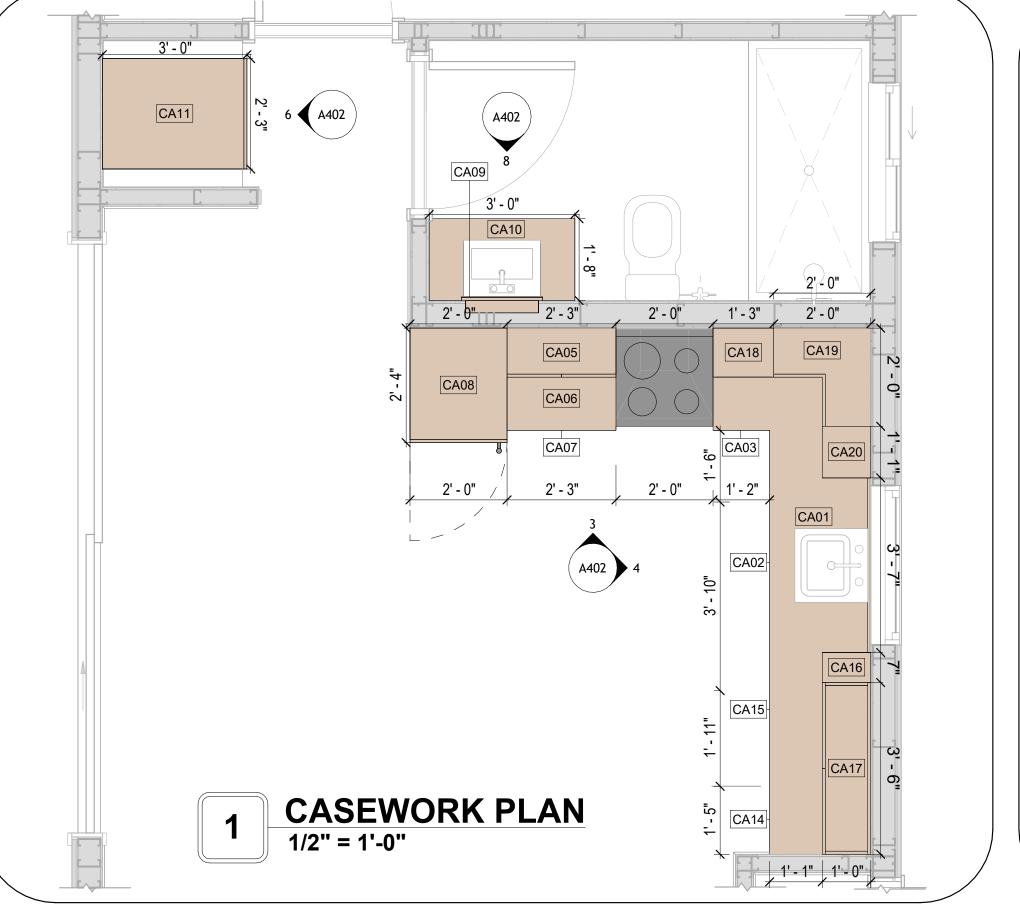

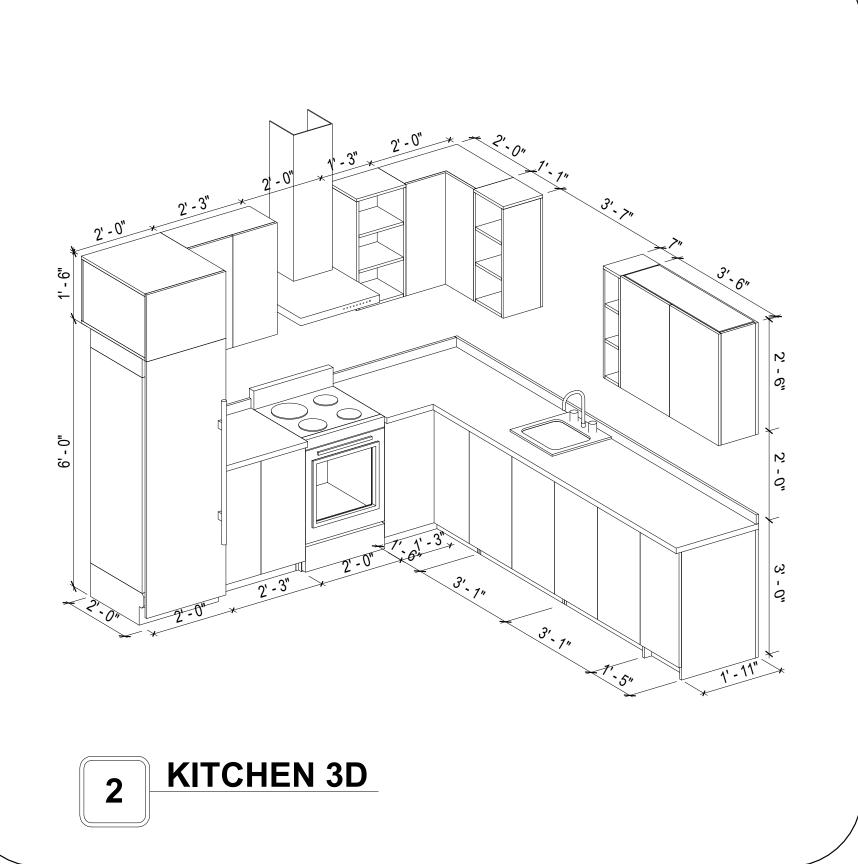


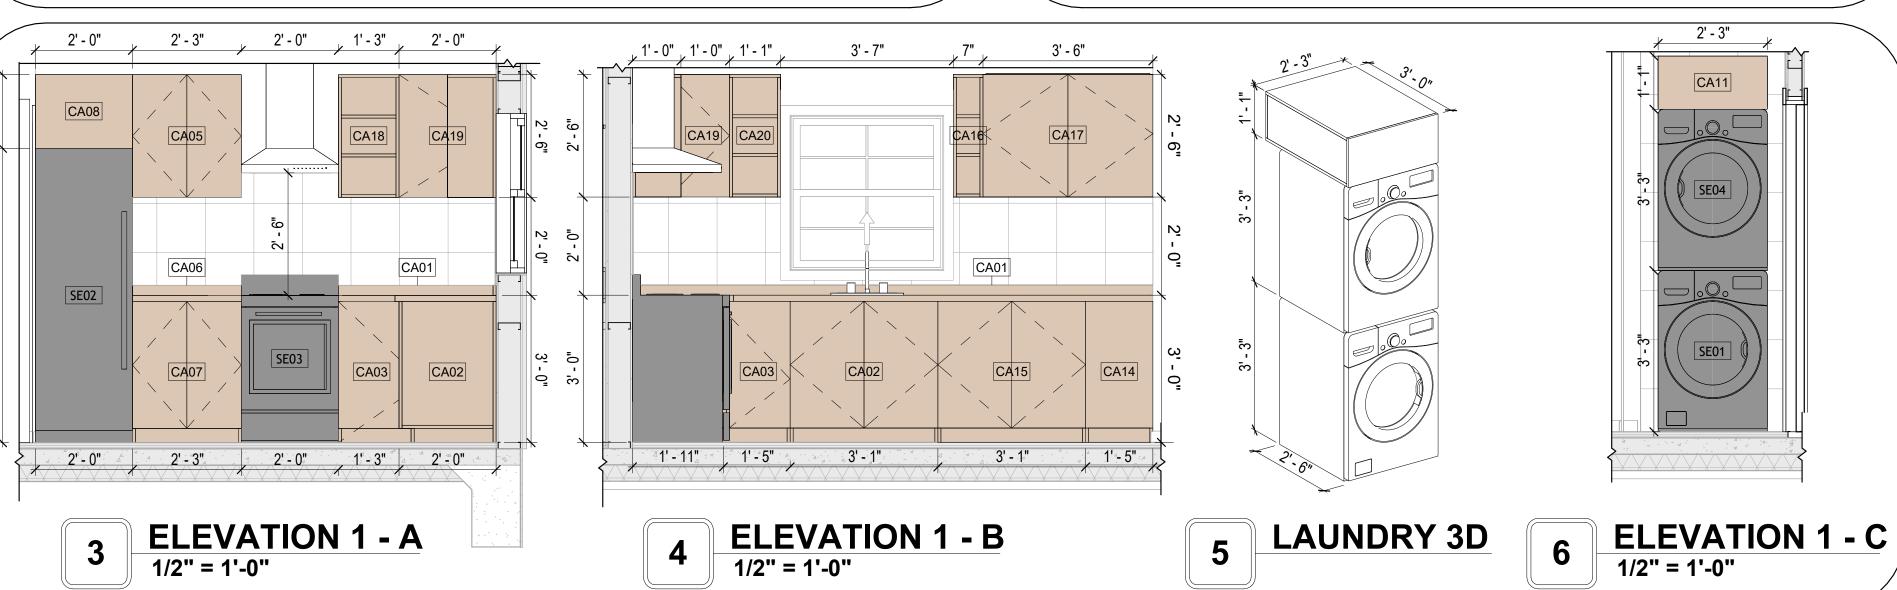

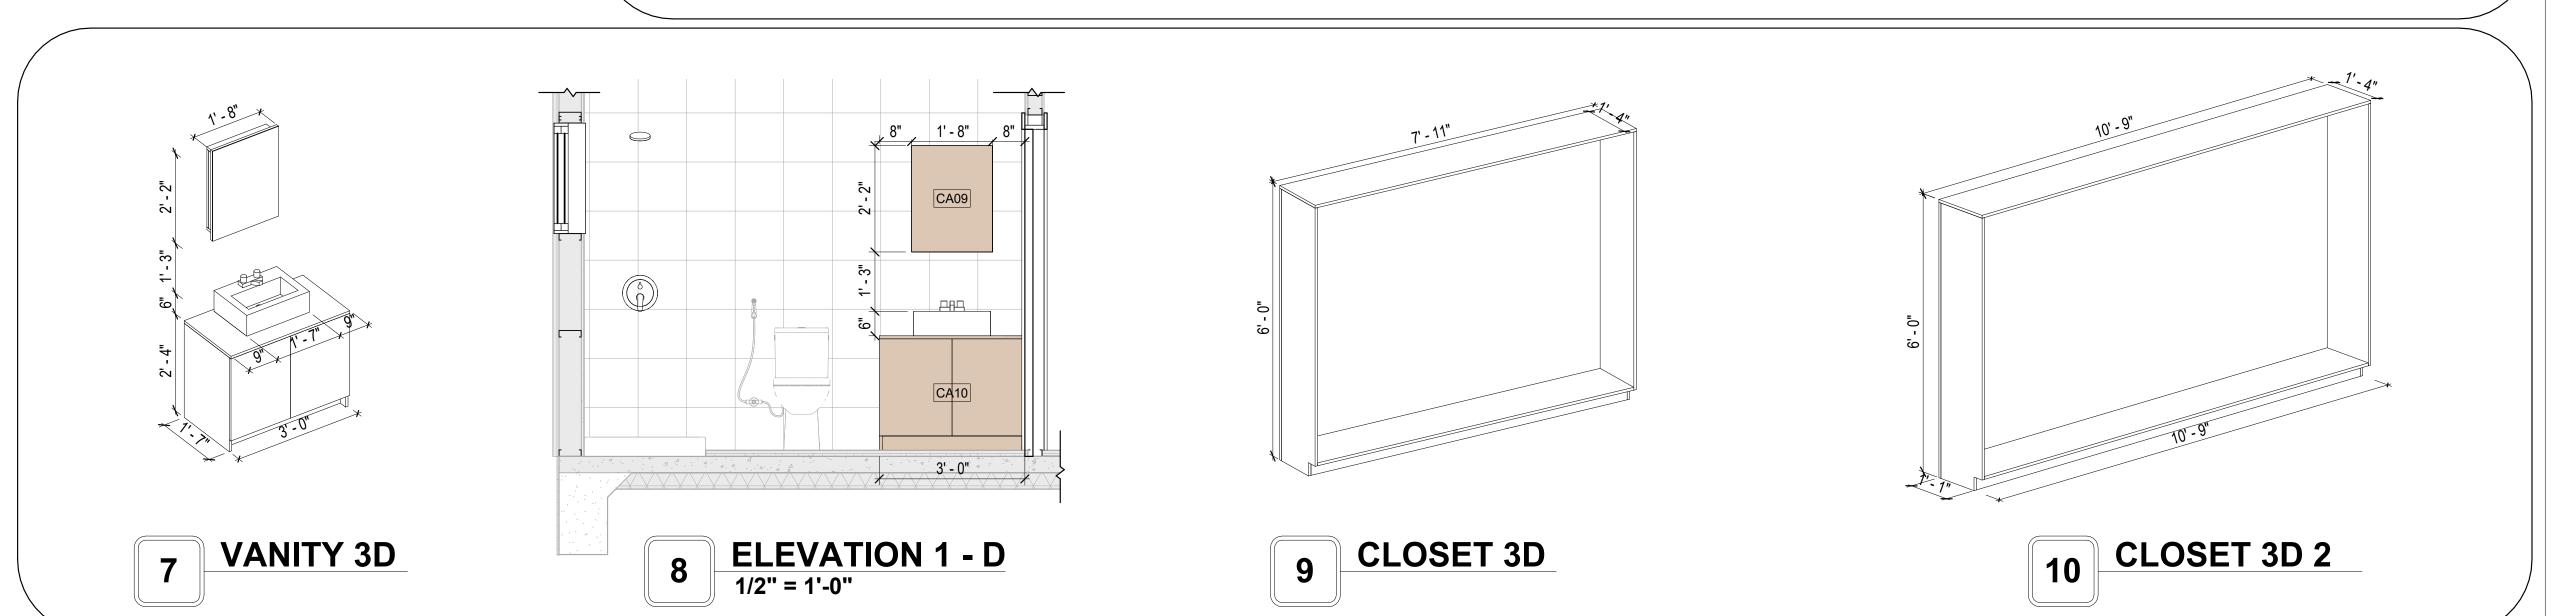



**KEY PLAN** 

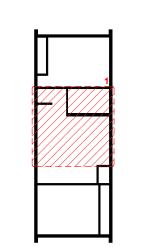

NO.	. DESCRIPTION	

NOTE:

LEGEND:

PROJECT

221-WESTBROOK-749 2Bd1Ba-CONTEMPORARY-550

DRAWING NAME

ARCHITECTURAL CASEWORK

CLIENT NAME:	Client Name
PROJECT NUMBER:	0061_12
DATE:	4/17/2025 10:58:41 AM
DESIGNED BY:	Designer
DRAWN BY:	Author
CHECKED BY:	Checker

A402

#### **GENERAL NOTES**

1. THIS DRAWING DEPICTS THE HVAC (HEATING, VENTILATION, AND AIR CONDITIONING) SYSTEM FOR THE WESTBROOK 2BD1BA CONTEMPORARY. IT PROVIDES A VISUAL REPRESENTATION OF THE SYSTEM LAYOUT AND COMPONENTS.

2.THE HVAC SYSTEM IS DESIGNED TO MEET THE SPECIFIC REQUIREMENTS OF THE BUILDING, INCLUDING HEATING, COOLING, AND VENTILATION NEEDS, AS PER THE PROJECT SPECIFICATIONS AND APPLICABLE CODES AND STANDARDS.

3. THE HVAC SYSTEM INSTALLATION SHALL COMPLY WITH THE LATEST EDITION OF THE INTERNATIONAL MECHANICAL CODE (IMC), INTERNATIONAL RESIDENTIAL CODE (IRC), AND ALL OTHER APPLICABLE LOCAL, STATE, AND NATIONAL CODES AND REGULATIONS.

4. THE EQUIPMENT SHOWN ON THIS DRAWING INCLUDES BUT IS NOT LIMITED TO AIR HANDLING UNITS (AHUS), CHILLERS, BOILERS, COOLING TOWERS, PUMPS, DUCTWORK, DIFFUSERS, GRILLES, AND CONTROL DEVICES.

5. ALL EQUIPMENT, DUCTWORK, AND PIPING SHALL BE INSTALLED IN ACCORDANCE WITH MANUFACTURER'S SPECIFICATIONS, LOCAL CODES, AND

6. ALL DUCTWORK SHALL BE SIZED, FABRICATED, AND INSTALLED IN ACCORDANCE WITH THE LATEST EDITION OF THE ACCA MANUAL D AND THE SMACNA HVAC DUCT CONSTRUCTION STANDARDS. DUCTWORK SHALL BE INSTALLED IN A NEAT AND WORKMANLIKE MANNER, PROPERLY SUPPORTED AND BRACED TO PREVENT SAGGING, AIR LEAKAGE, OR VIBRATION.

7. CONDENSATE DRAINAGE PIPING SHALL BE PROPERLY PITCHED TO ENSURE POSITIVE DRAINAGE TO AN APPROVED DISPOSAL LOCATION, SUCH AS A FLOOR DRAIN, SUMP PUMP, OR EXTERIOR GRADE. CONDENSATE LINES SHALL BE INSULATED TO PREVENT SWEATING.

8. THE LOCATION OF CONTROL PANELS AND SENSORS INDICATED ON THIS DRAWING CAN BEMODIFY WITH THE SPECIFIC LOCATIONS AND WIRING DETAILS WILL BE DETERMINED DURING THE CONTROL SYSTEM DESIGN AND INSTALLATION.

9. THE HVAC SYSTEM DESIGN CONSIDER ENERGY EFFICIENCY, INDOOR AIR QUALITY, OCCUPANT COMFORT, AND NOISE CONTROL, FOLLOWING

APPLICABLE GUIDELINES AND REGULATIONS. 10. COORDINATION WITH OTHER TREADS HAS BEEN DONE ON A DESIGN LEVEL. THIS DRAWING SHALL BE READ TOGETHER WITH THE AR, EL AND SN

DESIGN DRAWINGS TO ENSURE PROPER INSTALLATION AND INTEGRATION OF THE HVAC SYSTEMS.

11. THE HVAC CONTRACTOR IS RESPONSIBLE FOR OBTAINING ALL NECESSARY PERMITS AND LICENSES, AND FOR SCHEDULING AND COORDINATING WITH THE LOCAL BUILDING DEPARTMENT AND UTILITY PROVIDERS TO ENSURE A TIMELY AND COMPLIANT INSTALLATION.

12. ALL DUCTWORK PENETRATIONS THROUGH WALLS, FLOORS, OR CEILINGS SHALL BE PROPERLY SEALED AND FIRE-STOPPED USING APPROVED METHODS AND MATERIALS TO MAINTAIN THE INTEGRITY OF THE BUILDING'S FIRE-RESISTANCE RATINGS.


13. HVAC EQUIPMENT SHALL BE INSTALLED LEVEL AND PLUMB, AND IN STRICT ACCORDANCE WITH THE MANUFACTURER'S INSTALLATION INSTRUCTIONS AND RECOMMENDATIONS. PROVIDE ADEQUATÉ CLEARANCES AROUND EQUIPMENT FOR PROPER AIRFLOW, SERVICE ACCESS, AND CODE COMPLIANCE.


14. ALL HVAC EQUIPMENT AND COMPONENTS, INCLUDING THERMOSTATS, DAMPERS, AND ACCESS PANELS, SHALL BE LOCATED IN ACCESSIBLE AREAS FOR EASY SERVICING AND MAINTENANCE. PROVIDE ADEQUATE SPACE AROUND EQUIPMENT FOR PROPER AIRFLOW AND SERVICE ACCESS.

15. THE HVAC SYSTEM SHALL BE BALANCED AND ADJUSTED TO ENSURE PROPER AIRFLOW, TEMPERATURE DISTRIBUTION, AND SYSTEM PERFORMANCE THROUGHOUT THE RESIDENCE. PROVIDE A WRITTEN REPORT DOCUMENTING THE FINAL SYSTEM BALANCE.

16. ANY DEVIATIONS OR MODIFICATIONS TO THE HVAC SYSTEM DESIGN SHALL BE REVIEWED AND APPROVED BY THE RESPONSIBLE DESIGN PROFESSIONALS AND COMMUNICATED TO ALL RELEVANT PARTIES INVOLVED IN THE CONSTRUCTION PROCESS.

17. FOR ANY INQUIRIES OR CLARIFICATIONS REGARDING THE HVAC SYSTEM DESIGN, PLEASE CONSULT THE RESPONSIBLE DESIGN PROFESSIONALS OR THE PROJECT MANAGEMENT TEAM.

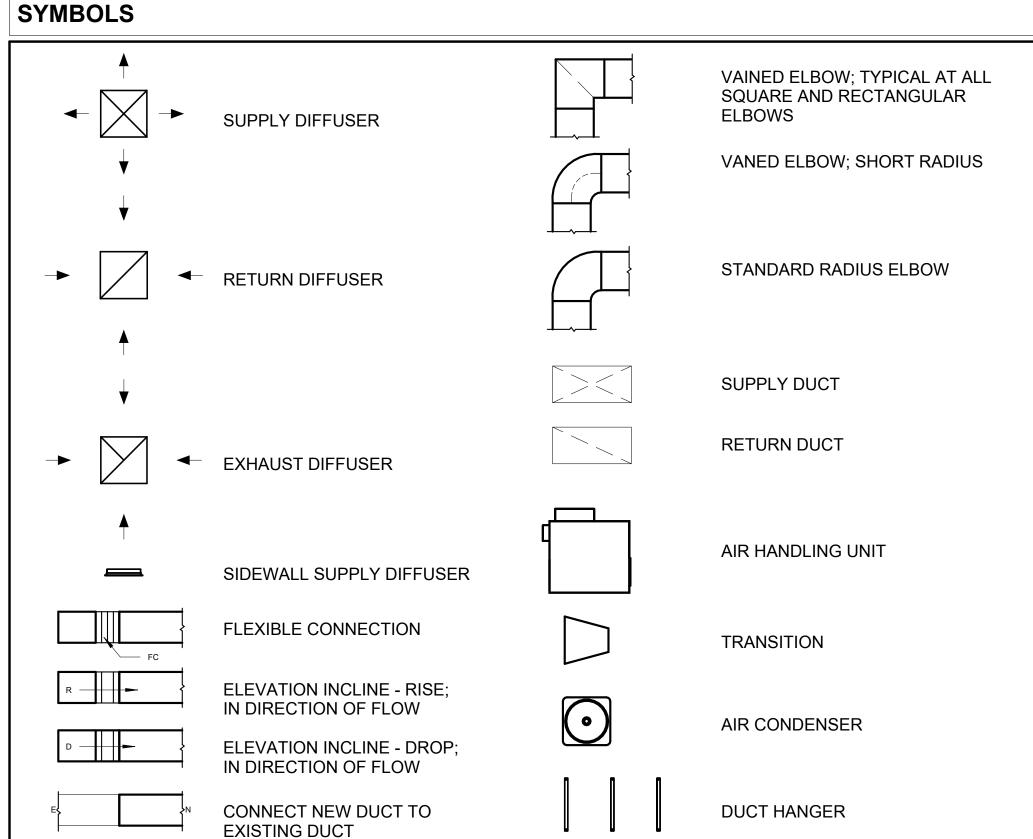

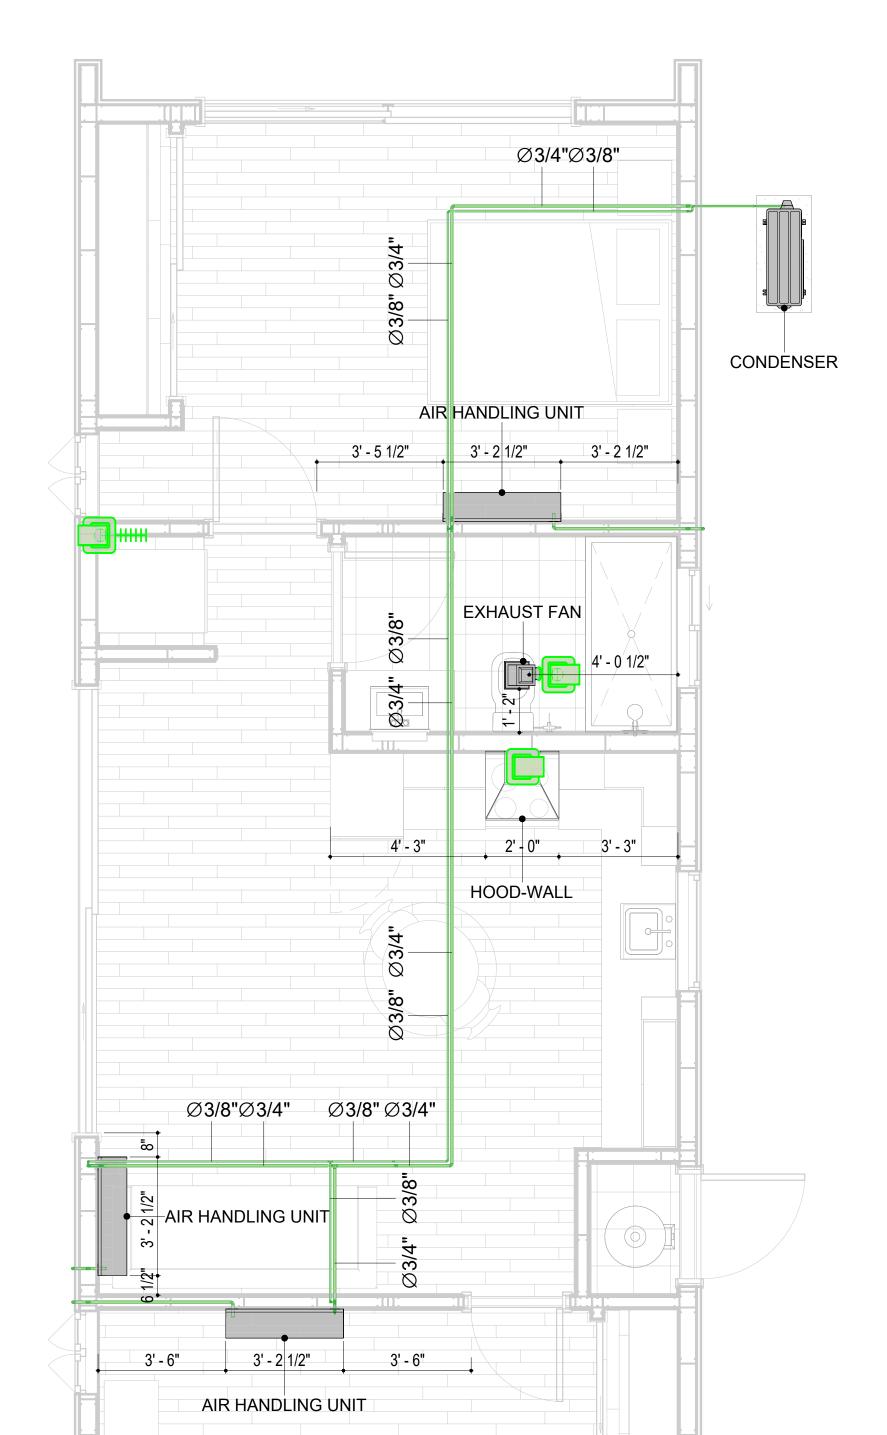

**HVAC PLAN** 3/8" = 1'-0"

HVAC COLOR SCHEME

AIR CONDITIONING PIPE

REFRIGERANT LINE SCHEDULE						
CATAGORY DESCRIPTION DIAMETER LENGTH						
PIPE TYPES	COPPER	3/8"	73.84			
PIPE TYPES	COPPER	1/2"	0.87			
PIPE TYPES	COPPER	3/4"	101.75			

REFRIGERANT LINE FITTING SCHEDULE				
CATAGORY	DESCRIPTION	Size	Count	
ELBOW - GENERIC	ELBOW - GENERIC:	1/2"ø-1/2"ø	1	
ELBOW - GENERIC	STANDARD/HVAC  ELBOW - GENERIC:	3/4"ø-3/4"ø	25	
ELBOW - GENERIC	STANDARD/HVAC  ELBOW - GENERIC: STANDARD/HVAC	3/8"ø-3/8"ø	21	
TEE - GENERIC	TEE - GENERIC: STANDARD	3/4"ø-3/4"ø-3/ 4"ø	2	
TEE - GENERIC	TEE - GENERIC: STANDARD	3/8"ø-3/8"ø-3/ 8"ø	2	
TRANSITION - GENERIC	TRANSITION - GENERIC: STANDARD	3/4"ø-1/2"ø	4	
TRANSITION - GENERIC	TRANSITION - GENERIC: STANDARD	3/4"ø-5/8"ø	3	
TRANSITION - GENERIC	TRANSITION - GENERIC: STANDARD	3/8"ø-1/4"ø	1	

MECHANICAL EQUIPMENT SCHEDULE				
CATAGORY DESCRIPTION				
AIR HANDLING UNIT	AIR HANDLING UNIT: WALL MOUNTED	3		
CONDENSER	CONDENSER: OUT DOOR	1		
EXHAUST FAN	EXHAUST FAN: 75 CFM	1		
	HOOD-WALL: VENT	1		

DUCT FITTING SCHEDULE			
CATAGORY DESCRIPTION COUNT			
ROUND TRANSITION - ANGLE	45 DEGREE	5	

DUCT ACCESSORY SCHEDULE			
CATAGORY	DESCRIPTION	COUNT	
ROOF VENT	3" DIAMETER	2	

FLEX DUCT SCHEDULE				
DESCRIPTION	DESCRIPTION	LENGTH	DIAMETER	COUNT
FLEX DUCT ROUND	FLEX-ROUND	11.03	4"	3
GRAND TOTAL: 3		11.03		



**KEY PLAN** 

NO.	DESCRIPTION	DATE

NOTE:

LEGEND:

PROJECT

221-WESTBROOK-749-2Bd1Ba **CONTEMPORARY-550** 

DRAWING NAME

**HVAC PLAN** 

CLIENT NAME: Owner PROJECT NUMBER 15\_0001 4/17/2025 1:59:27 AM DATE: Designer DESIGNED BY: DRAWN BY: Author CHECKED BY: Checker

M101

SCALE: As indicated

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#### **ELECTRICAL NOTES**

- 1. THIS DRAWING DEPICTS THE ELECTRICAL SYSTEM FOR THE 221\_WestBrook\_749\_2Bd1Ba\_Contemporary\_ 550. IT PROVIDES A VISUAL REPRESENTATION OF THE ELECTRICAL LAYOUT AND COMPONENTS, INCLUDING POWER DISTRIBUTION, LIGHTING, AND CONTROL SYSTEMS.
- 2. THE ELECTRICAL SYSTEM IS DESIGNED TO MEET THE SPECIFIC REQUIREMENTS OF THE BUILDING, INCLUDING POWER DISTRIBUTION, LIGHTING, AND SPECIALIZED ELECTRICAL EQUIPMENT NEEDS, AS PER THE PROJECT SPECIFICATIONS AND APPLICABLE CODES AND STANDARDS.
- 3. THE ELECTRICAL SYSTEM INSTALLATION SHALL COMPLY WITH THE LATEST EDITION OF THE NATIONAL ELECTRICAL CODE (NEC), INTERNATIONAL BUILDING CODE (IBC), AND ALL OTHER APPLICABLE LOCAL, STATE, AND NATIONAL CODES AND REGULATIONS.
- 4. LOCATIONS AS NEEDED, DEVICES ARE SHOWN ON PLANS IN APPROXIMATE IDEAL LOCATIONS, UNLESS SPECIFICALLY DIMMENSIONED.
- OPEN WALLS AS NEEDED TO ALLOW FOR NEW ELECTRICAL INSTALLATIONS.
- 6. LABEL ALL CIRCUITS ON JUNCTION BOXES, RECEPTACLES, DATA, SMOKE DETECTOR, AND EQUIPMENT IN PANEL BOX.
- 7. INSTALL RACEWAY AS NEEDED FOR DDC, ACCESS CONTROL, LOW VOLTAGE WIRING & DATA.
- RELABEL POWER, DATA & FIRE ALARM FOR ROOM #CHANGES.
- 9. VERIFY ALL CIRCUITS LABELED ON PRINT ARE CORRECT BEFORE WORKING ON THEM. 10. NOTE ON SITE PLAN – ALL CHANGES OR MISSING DETAIL TO BE INCORPORATED INTO THE MASTER PLAN.
- 11. DRAWINGS ARE DIAGRAMMATIC ONLY FOR THE PURPOSE OF SHOWING FIXTURE AND OUTLET LOCATIONS.
- 12. ELECTRICAL CONTRACTOR TO VERIFY SERVICE SIZE BY CALCULATION BASED UPON ACTUAL NAME
- PLATE RATINGS OF SELECTED EQUIPMENT. 13. VERIFY LOCATION OF SERVICE ENTRANCE WITH POWER COMPANY. PROVIDE UFER GROUND IN
- BUILDING FOUNDATION AT SERVICE ENTRANCE LOCATION. 14. PROVIDE A MIN. OF 20 FEET OF ONE \*4 BARE COPPER UFER WIRE EMBEDDED IN CONCRETE FOOTING
- AT THE SERVICE ENTRANCE LOCATION WHERE APPROVED BY LOCAL SERVICE PROVIDER. 15. PROVIDE WATERPROOF FIXTURES IN ALL HIGH MOISTURE AREAS (EXTERIOR, SHOWER AND TUB
- CEILINGS ETC.)
- 16. PROVIDE DEDICATED CIRCUITS TO EACH BATH, DEN, FAMILY ROOM, BEDROOM, LOFT, KITCHEN REFRIGERATOR, KITCHEN FREEZER DISHWASHER, AND ANY AREA/ITEM SPECIFIED BY OWNER.
- 17. INCANDESCENT FIXTURES WITH OPEN OR PARTIALLY ENCLOSED LAMPS, PENDANT FIXTURES, AND LAMP HOLDERS ARE NOT PERMITTED IN CLOSETS.
- 18. ALL WORKMANSHIP AND MATERIALS TO CONFORM WITH THE 2015 IRC.
- 19. PROVIDE A MIN. OF 20 FEET OF ONE \*4 BARE COPPER UFER WIRE EMBEDDED IN CONCRETE FOOTING AT THE SERVICE ENTRANCE LOCATION WHERE APPROVED BY LOCAL SERVICE PROVIDER.
- 20. PROVIDE A BONDING CONDUCTOR CONSISTING OF A MINIMUM OF ONE \*4 BARE COPPER WIRE CONNECTING THE BUILDING'S METAL WATER PIPING SYSTEM TO THE SERVICE EQUIPMENT ENCLOSURE GROUNDING.

#### MAIN PANEL CALCS

ELECTRICAL CALCS			
LIGHT AND OUTLETS 749 @ 3W	2,247 W		
3 APPLIANCE CIRCUITS	4,500 W		
DRYER	2,000 W		
WASHER	2,000 W		
RANGE	5,000 W		
WATER HEATER	5,000 W		
REFRIG.	1,800 W		
DISHWASHER & DISPOSAL	3000 W		
TOTAL	25,547 W		
FRIST 10,000 @ 100% REMAINDER @ 40% MINI. SPLIT UNITS	10,000 W 6,219 W 10,000 W		
TOTAL	26,219 W		
26,219 W DIVIDED BY 240V = 1	09 AMPS TOTAL		

(USE 200 AMP SERVICE)

#### **ELECTRICAL ABBREVIATIONS LIST**

1P A CLG ACLG ADO AFF AFF AFF AFF AFF AFF AFF AFF AFF AF	1 POLE (2P, 3P, 4P, ETC.) AMPERE ABOVE COUNTER OR AIR CONDITIONER ABOVE CEILING AUTOMATIC DOOR OPENER AMP FRAME ABOVE FINISHED FLOOR ABOVE FINISHED GRADE ARC FAULT CIRCUIT INTERRUPTER AIR HANDLING UNIT ALUMINUM ALTERNATE AMPERE AMPLIFIER ANNUNCIATOR APPROX APPROXIMATELY AQUASTAT ARCHITECT, ARCHITECTURAL AMP SWITCH AMP TRIP AUTOMATIC TRANSFER SWITCH AUTOMATIC AUXILIARY AUDIO VISUAL AMERICAN WIRE GAUGE BATTERY BOARD BUILDING BUILDING BUILDING BUILDING MANAGEMENT SYSTEM CONDUIT CABINET CATALOG CABLE TELEVISION CIRCUIT BREAKER CLOSED CIRCUIT TELEVISION CIRCUIT CEILING COMBINATION COMPRESSOR CONNECTION CONSTRUCTION CONSTRUCTION CONTRACTOR CIRCULATING PUMP CATHODE-RAY TUBE	CTR CU DCP DET DIA DIST DWG DEC ELEV EMS E PE EXIST EXP FANEL FLOR FLU FU GALV GEN GEN GROWN GRO	CENTER COPPER DOMESTIC WATER CIRCULATING PUMP DEPARTMENT DETAIL DIAMETER DISCONNECT DISTRIBUTION DOWN DAMPER SAFETY DISCONNECT SWITCH DOUBLE THROW DRAWING DIRECT DIGITAL CONTROL ELECTRICAL CONTRACTOR ELECTRIC, ELECTRICAL ELEVATOR EMERGENCY ENERGY MANAGEMENT SYSTEM ELECTRIC PNEUMATIC EQUIPMENT ELECTRIC WATER COOLER EXISTING EXHAUST EXPLOSION PROOF FIRE ALARM FIRE ALARM BOOSTER POWER SUPPLY PANEL FIRE ALARM CONTROL PANEL FAN COIL UNIT FIXTURE FLOOR FLUORESCENT FUSE GALLON GALVANIZED GENERATOR GROUND GALVANIZED RIGID STEEL (CONDUIT)	HT HTG HTR HVAC HVAC HVAC IMC IMC IMC IMC IMC IMC IMC IMC IMC IM	HEIGHT HEATING HEATER HIGH VOLTAGE HEATING, VENTILATING AND AIR CONDITIONING HYDRONIC WATER PUMP INTERRUPTING CAPACITY ISOLATED GROUND INTERMEDIATE METAL CONDUIT INCANDESCENT INFRARED INTERLOCK WITH JUNCTION BOX KILOVOLT KILOVOLT-AMPERE KILOVOLT-AMPERE REACTIVE KILOWATT KILOWATT HOUR LOCATE OR LOCATION LIGHT LIGHTING LIGHTNING LOW VOLTAGE MAXIMUM MAGNETIC STARTER MOMENTARY CONTACT MECHANICAL CONTRACTOR MAIN CIRCUIT BREAKER MOTOR CONTROL CENTER MAIN DISTRIBUTION CENTER MAIN DISTRIBUTION PANEL MANUFACTURERMAIN FUSED DISCONNECT SWITCH MANHOLE MICROPHONE MINIMUM MISCELLANEOUS MAIN LUGS ONLY MANUAL MOTOR STARTER MULTIOUTLET ASSEMBLY MOTOR STARTER PANELBOARD MAIN SWITCHBOARD MOUNT EMPTY CONDUIT
CRT CT	CATHODE-RAY TUBE CURRENT TRANSFORMER	GRS GYP BD	GALVANIZED RIGID STEEL (CONDUIT) GYPSUM BOARD	MT.C UL	EMPTY CONDUIT UNDERWRITERS LABORATORIES

#### **Branch Panel:**

Location: KITCHEN 02 Supply From: Mounting: Recessed Enclosure: Type 1

Volts: 120/240 Single Phases: 1 Wires: 3

A.I.C. Rating: Mains Type: Mains Rating: 200 A MCB Rating: 1 A

Circuit Numb er		Number of Elements	Rating	Length	Wire Size	A		ı	3	Wire Size	Length	Rating	Number of Elements	Circuit Description	Circu Num er
1	CONDENCER	1	60 A	24' - 4 1/4"	2-#6, 1-#6, 1-#10	750 VA	600 VA			1-#12, 1-#12, 1-#12	46' - 5 9/16"	20 A	9	OUTDOOR LIGHT POINTS	2
3								750 VA	1080 VA	1-#12, 1-#12, 1-#12	49' - 11 23/32"	20 A	6	OUTDOOR GFCI RECEPTACLES	4
5	BEDROOM 1 LIGHT POINTS	10	20 A	49' - 0 7/8"	1-#12, 1-#12, 1-#12	568 VA	300 VA			1-#12, 1-#12, 1-#12	34' - 9 3/32"	20 A	7	LIVING ROOM AND HALL RECEPTACLES	6
7	BEDROOM 1 RECEPTACLES	4	20 A	35' - 8 13/32"	1-#12, 1-#12, 1-#12			720 VA	750 VA	2-#10, 1-#10, 1-#10	29' - 3 1/32"	30 A	1	DRYER	8
9	BATH UNITS	6	20 A	30' - 4 1/16"	1-#12, 1-#12, 1-#12	336 VA	750 VA								10
11	REFRIGERATOR	1	20 A	19' - 2 13/16"	1-#12, 1-#12, 1-#12			1500 VA	720 VA	1-#12, 1-#12, 1-#12	16' - 0 3/16"	20 A	4	KITCHEN GFCI RECEPTACLES	1:
13	RANGE	1	50 A	14' - 0 3/16"	2-#8, 1-#8, 1-#10	750 VA	1200 VA			1-#12, 1-#12, 1-#12	10' - 9 15/16"	20 A	1	GFCI DISH WASHER	1
15								750 VA	336 VA	1-#12, 1-#12, 1-#12	31' - 11"	20 A	7	KITCHEN LIGHT POINTS	1
17	WATER HEATER	1	30 A	24' - 1 7/16"	2-#10, 1-#10, 1-#10	750 VA	568 VA			1-#12, 1-#12, 1-#12	58' - 10 17/32"	20 A	10	BEDROOM 2 LIGHT POINTS	1
19								750 VA	720 VA	1-#12, 1-#12, 1-#12	49' - 11 9/16"	20 A	4	BEDROOM 2 RECEPTACLES	2
21	LIVING ROOM RECEPTACLES	4	20 A	38' - 4 11/16"	1-#12, 1-#12, 1-#12	720 VA	1200 VA			1-#12, 1-#12, 1-#12	33' - 9 25/32"	20 A	1	GFCI WASHER	2
23															2
25															2
						8464	VA	807	5 VA						

	Legend
--	--------

Load Classification	Connected Load	Demand Factor	Estimated Demand	Panel	Totals
Lighting - Dwelling Unit	800 VA	100.00%	800 VA		
Other	1544 VA	100.00%	1544 VA	Total Conn. Load:	16537 VA
Receptacle	14040 VA	85.61%	12020 VA	Total Est. Demand:	14517 VA
Lighting	200 VA	100.00%	200 VA	Total Conn.:	69 A
				Total Est. Demand:	60 A

**KEY PLAN** 

DESCRIPTION DATE

NOTE:

LEGEND:

PROJECT

221-WESTBROOK-749 2Bd1Ba-**CONTEMPORARY-550** 

DRAWING NAME

**SCHEDULE** 

CLIENT NAME: Owner PROJECT NUMBER: 0316\_13 4/16/2025 6:10:36 AM DESIGNED BY: DRAWN BY: CHECKED BY: Checker

E101

SCALE: 1/4" = 1'-0"

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#### **ELECTRICAL NOTE**

- PROVIDE INTERCONNECTED SMOKE ALARMS IN EACH SLEEPING ROOMS, OUTSIDE EACH SLEEPING ROOM, ON EACH STORY, IN THE HALL OR ADJACENT ROOM LUHERE THE CEILING HEIGHT OF A ROOM OPEN TO THE HALL EXCEEDS THE HALL BY 24'. SMOKE ALARMS SHALL BE PERMANENTLY HARD WIRED WITH BATTERY BACKUP.
- B. RECEPTACLE OUTLETS FOR RANGES AND CLOTHES DRYERS SHALL BE A THREE POLE WITH GROUND TYPE. FOUR WIRE GROUNDING-TYPE FLEXIBLE CORDS WILL BE REQUIRED FOR CONNECTION OF RANGES AND CLOTHES DRYERS. THE BONDING JUMPER SHALL NOT BE CONNECTED BETWEEN NEUTRAL TERMINAL AND THE FRAME OF THE **APPLIANCE**
- C. TWO OR MORE 20 AMP SMALL APPLIANCE CIRCUITS SHALL BE PROVIDED TO SERVE THE KITCHEN, BREAKFAST NOOK, AND DINING ROOM. SUCH CIRCUITS SHALL HAVE NO OTHER OUTLETS.
- D. AT LEAST ONE 20 AMP BRANCH CIRCUIT SHALL BE PROVIDED TO SERVICE THE LAUNDRY ROOM. THIS CIRCUIT SHALL HAVE NO OTHER OUTLETS.
- E. ALL RECEPTACLES WITH IN 6' OF A WET BAR SINK OR KITCHEN SINK TO SERVE COUNTER TOP SURFACES MUST BE GFCI. ON KITCHEN COUNTERS 12' OR WIDER NO POINT ALONG THE WALL SHALL BE MORE THAN 2' FROM A RECEPTACLE. ALL RECEPTACLES WITH IN 6' OF KITCHEN SINK MUST BE GFCI. AT LEAST ONE GFCI RECEPTACLE SHALL
- BE INSTALLED IN THE BATHROOM ADJACENT TO EACH BASIN. FIXTURES INCLUDING CEILING FANS THAT ARE LOCATED IN DAMP LOCATIONS SHALL BE LISTED TO BE SUITABLE FOR
- SUCH LOCATIONS PER 2012 IRC
- G. PROVIDE ONE (1) SWITCHED OUTLET @ ALL BEDROOMS AND DEN
- H. CEILING FANS NOT EXCEEDING 35 LBS. (WITH OR WITHOUT ACCESSORIES MAY BE SUPPORTED BY OUTLET BOXES PROVIDED THE OUTLET BOXES ARE IDENTIFIED FOR SUCH USE PER 2012 IRC
- ELECTRICAL OUTLET BOXES ON OPPOSITE SIDES OF FIRE RATED WALLS SHALL BE SEPARATED BY A HORIZONTAL DISTANCE OF NOT LESS THAN 24".
- OUTLET BOXES IN THE WALLS BETWEEN THE GARAGE AND DWELLING SHALL BE METAL OR U.L. APPROVED FIRE RESISTIVE PLASTIC. BOXES IN GARAGE CEILING SHALL BE METAL.
- K. ALL BRANCH CIRCUITS THAT SUPPLY 120 VOLTS SINGLE PHASE 15 AND 20 AMPS RECEPTACLE OUTLETS INSTALLED IN THE DWELLING SHALL BE PROTECTED BY AN ARC FAULT CIRCUIT INTERRUPTER, EXCEPT GFCI RECEPTICLES.

#### NOTE:

RECEPTACLES MUST BE PROVIDED IN HALLWAYS 10'-0" OR MORE IN LENGTH. FOR A ONE FAMILY DWELLINGS AND EACH OF A TWO FAMILY DWELLING THAT IS AT GRADE LEVEL, AT LEAST ONE WP-GFCI RECEPTACLE OUTLET ACCESSIBLE AT GRADE LEVEL AND NOT MORE THAN 6'-6" ABOVE GRADE SHALL BE INSTALLED AT THE FRONT AND BACK OF THE DWELLING.

#### NOTE: APPLIANCE DISCONNECT

#### **E4001.5 GROUNDING OF ENCLOSURES.**

METAL ENCLOSURES FOR SWITCHES OR CIRCUIT BREAKERS SHALL BE CONNECTED TO AN

EQUIPMENT GROUNDING CONDUCTOR.

METAL ENCLOSURES FOR SWITCHES OR CIRCUIT BREAKERS USED AS SERVICE EQUIPMENT SHALL COMPLY WITH THE PROVISIONS OF SECTION E3609.4. WHERE

NONMETALLIC ENCLOSURES ARE USED WITH METAL RACEWAYS OR METAL-ARMORED


CABLES, PROVISIONS SHALL BE MADE FOR CONNECTING THE EQUIPMENT GROUNDING

CONDUCTOR.


NONMETALLIC BOXES FOR SWITCHES SHALL BE INSTALLED WITH A WIRING METHOD THAT

PROVIDES OR INCLUDES AN EQUIPMENT GROUNDING CONDUCTOR. (404.12)

#### **ELECTRICAL LEGEND Electrical Lights With Fan Waterproof Recessed Can Light** 0 Pendant Light **Recessed Can Light** 0 **−**Ø **Wall Lamp Standalone linear** Single Switch ₩ ₩ **Three way Switch** Fan Switch ₩ $\ominus \Box$ **Duplex Receptacle** Triplex Receptacle **GFCI Receptacle** $\mathbb{X}$ Exhaust Fan Smoke and heat detector

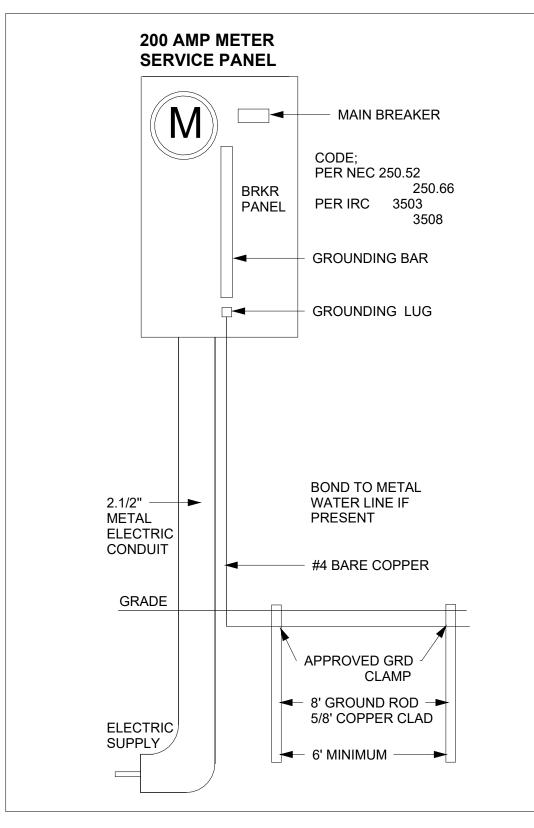



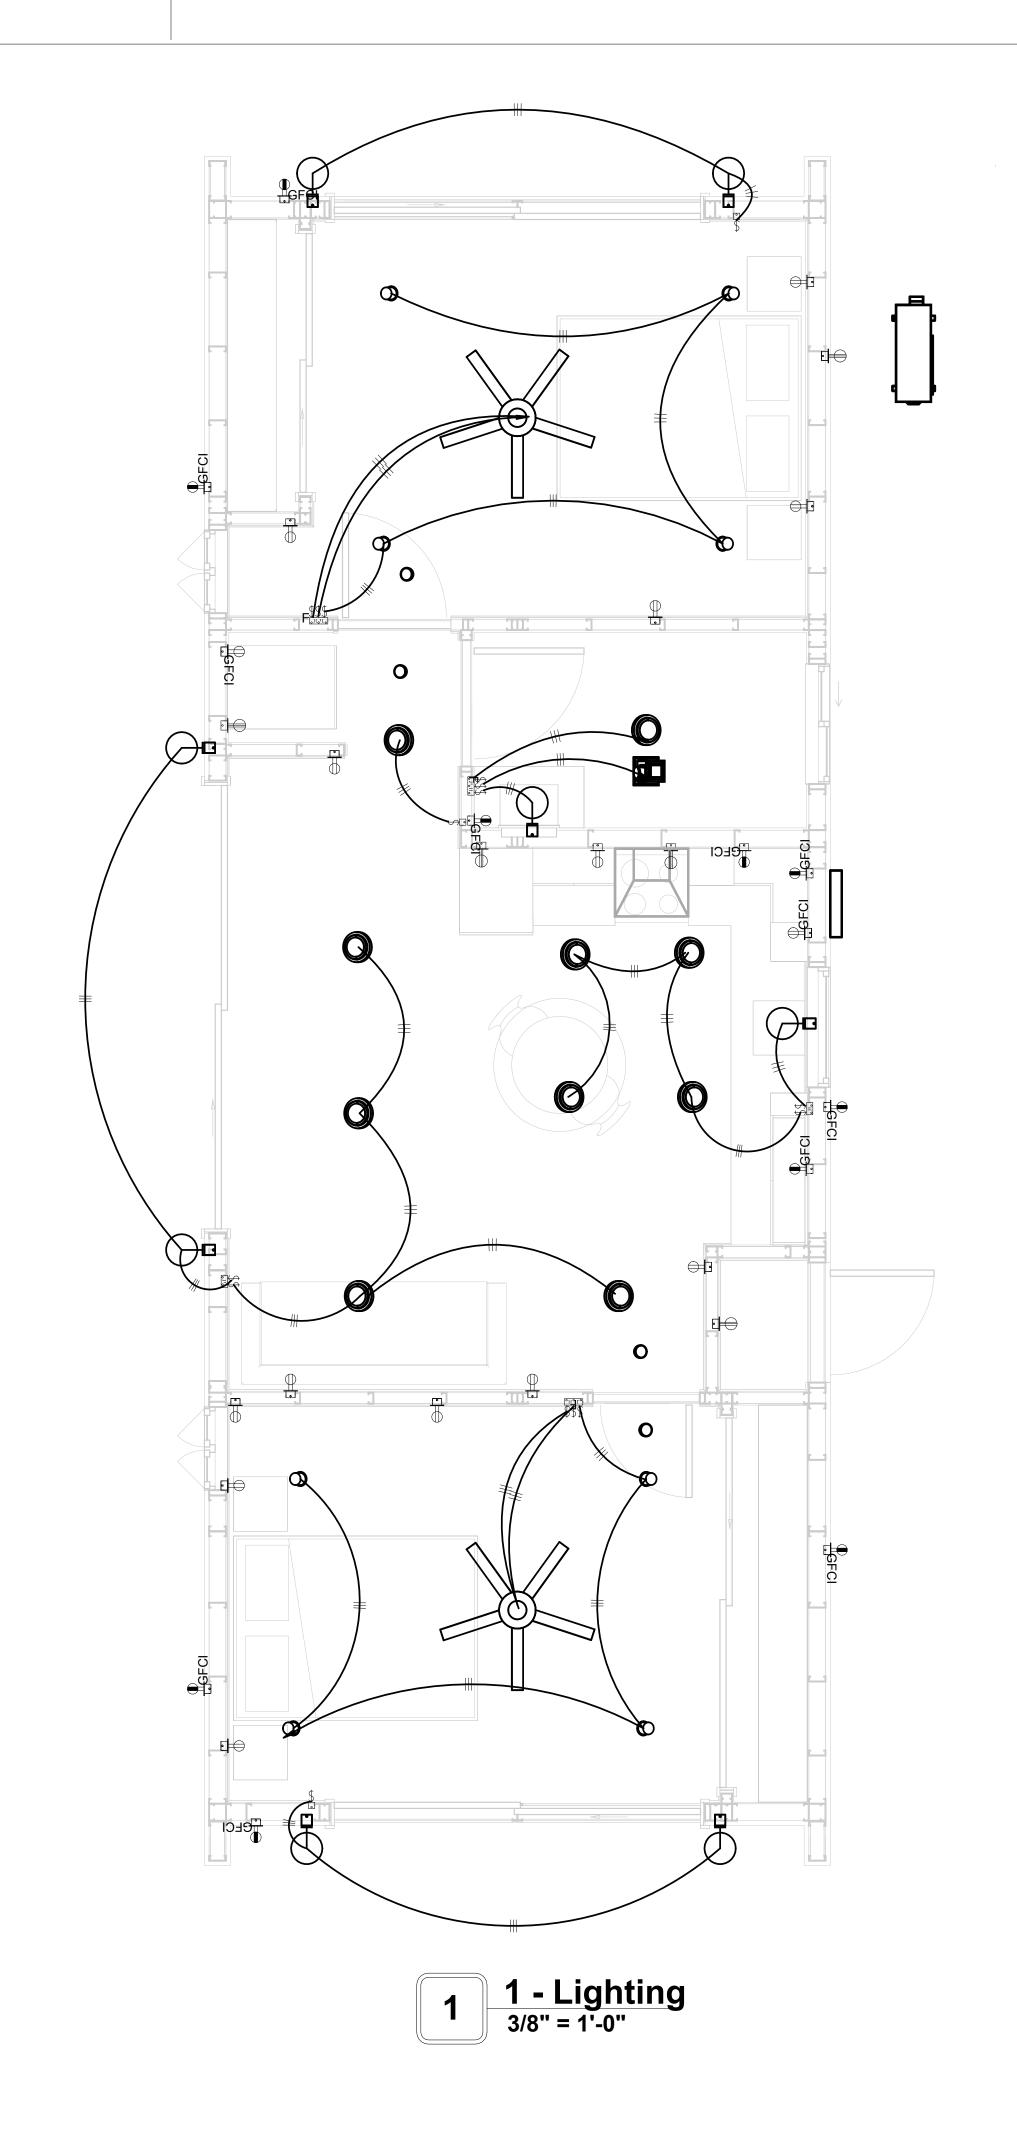



**KEY PLAN** 

NOTE:

LEGEND:

PROJECT

221-WESTBROOK-749 2Bd1Ba-**CONTEMPORARY-550** 

DRAWING NAME


LIGHTING


CLIENT NAME:	Owner
PROJECT NUMBER:	0316_13
DATE:	4/16/2025 6:10:38 AM
DESIGNED BY:	Designer
DRAWN BY:	Author
CHECKED BY:	Checker


E102


#### **NOTES: CONDUIT, CABLE AND WIRING**


- Use Metalic Conduits (IMC) for cables running under concrete slabs.
   Use IMC for circuits with high voltage appliances (240 volts and above)
   For circuits with 120 volts consider using EMT or PVC conduits if needed.
   For Low voltage applications up to 50 volts consider using non metalic conduits.
   All conduits to be used in the project must conform to the latest National Electrical Code (NEC),
- 5. All conduits to be used in the project must comorn to the latest National Electrical Code (NEC), 2015.
  6. All wiring and cables to be used in the project must also conform to the latest National Electrical Code (NEC), 2015.
  7. All cables and wires used should be rated for their respective loading and should be gauged and conform to the NEC.

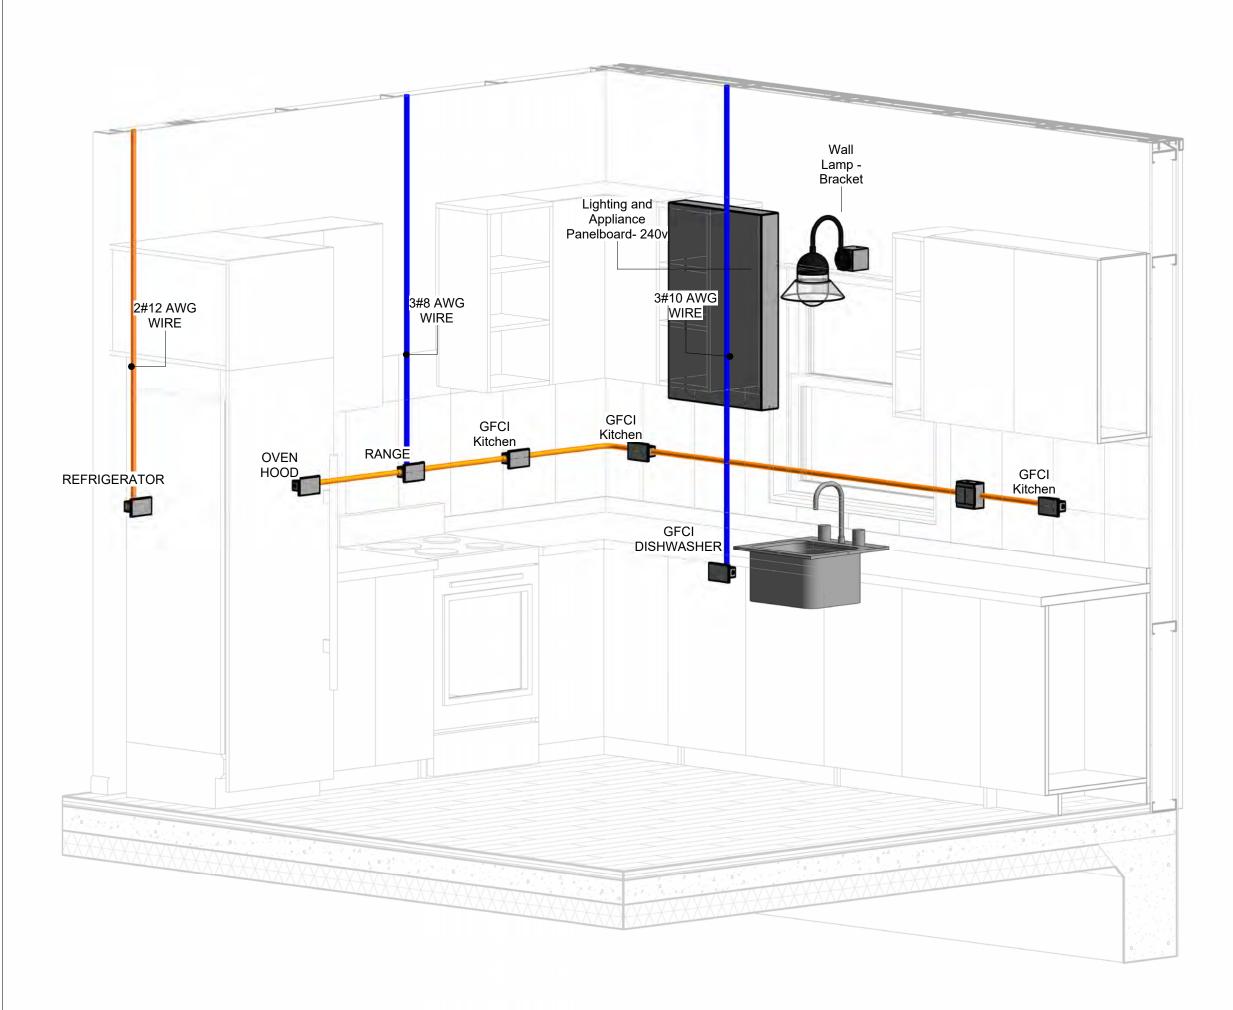


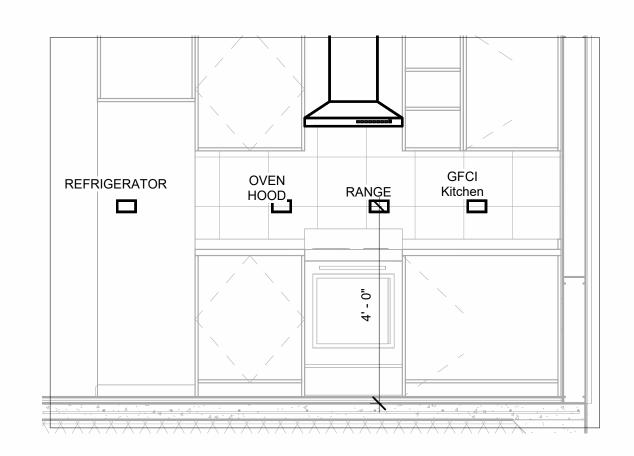


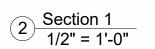

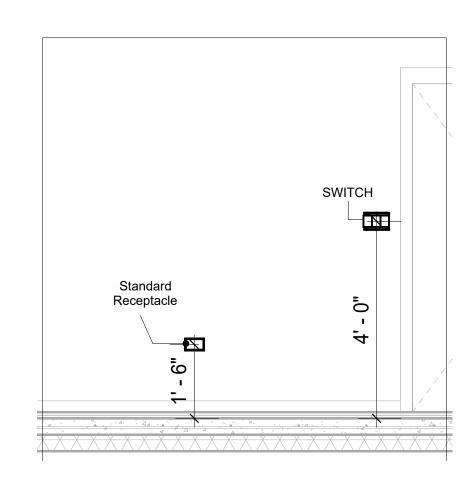


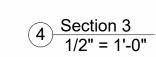

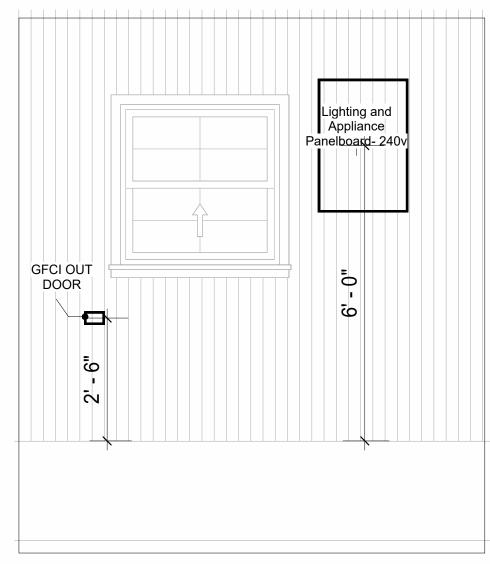

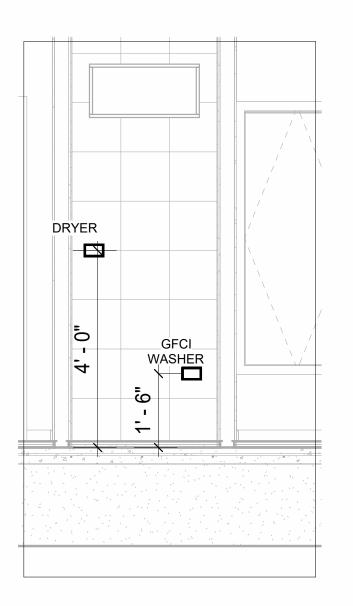

6 Section 4 1/2" = 1'-0"

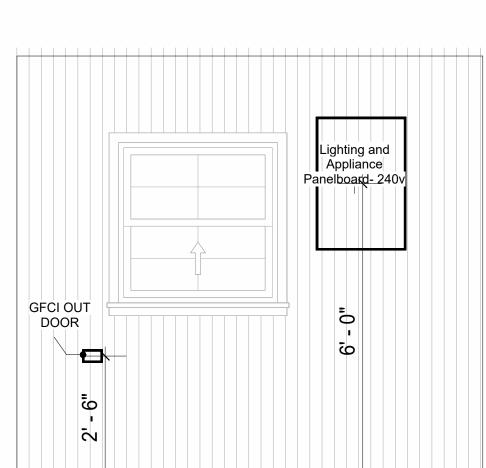

PROJECT

NOTE:

LEGEND:

**KEY PLAN** 

PERSPECTIVE ANGLE

DESCRIPTION

DATE

221-WESTBROOK-749 2Bd1Ba-**CONTEMPORARY-550** 

DRAWING NAME

**POWER** 

Owner	CLIENT NAME:
0316_13	PROJECT NUMBER:
4/16/2025 6:11:04 AN	DATE:
Designer	DESIGNED BY:
Author	DRAWN BY:
Checker	CHECKED BY:

E103

SCALE: As indicated

**3D-KITCHEN** 

#### **NOTES: LIGHT**

- 1. LIGHT FIXTURES AND LUMINARIES SHALL CONFORM TO THE NEC, THE IRC AND LOCAL SAFETY & BUILDING CODE.
- 2. ALL LIGHTING FIXTURES SHOULD CONFORM TO THE DESIGN ELECTRICAL LOAD AND SHALL BE PROPERLY WIRED AND MOUNTED BY QUALIFIED ELECTRICIAN FOLLOWING MANUFACTURERS SPECIFICATIONS.
- 3. CEILING FANS AND FANS WITH LIGHT WITH WEIGHT EXCEEDING 35 LBS SHOULD BE PROVIDED WITH STRUCTURAL BACKING FOR SUPPORT AND SHALL BE FIXED AS PER MANUFACTURERS SPECIFICATIONS.
- 4. EXTERIOR LIGHTS SHALL CONFORM TO LOCAL BUILDING CODE AND GUIDELINES.

#### **NOTES: SWITCH JUNCTION BOX**


- THE MINIMUM SIZE OF JUCTION BOX TO BE USED IS 2"X4"X(1.5" OR 3.5" DEEP) THIS ARE TO BE USED FOR SINGLE GANG SWITCH OR OUTLETS.
- 2. FOR DOUBLE GANG (2 GANG) OUTLETS AND SWITCHS THE MINIMUM SIZE OF THE
- JUCTION BOX TO BE PROVIDED SHALL NOT BE LESS THAN 4"X4"X(1.5" OR 3.5" DEEP)
- 3. FOR THREE GANG (3 GANG) OUTLETS AND SWITCHS THE MINIMUM SIZE OF THE JUĆTION BOX SHALL NOT BE LESS THAN 6"X4"X(1.5" OR 3.5" DEEP).

Conduit Fitting Sc	hedule(junction bo	<b>x</b> )
Family	Count	Description

Electrical Fixture Schedule (SWITCH BOX)		
Туре	Count	
Double Gang Switch Box	2	
Single Gang Switch Box	3	
Triple Gang Switch Box	3	

Lighting Device			
Type	Count		
Fan switch	3		
Single Pole	13		

Lighting Fixture				
Lighting Fixture Type	Voltage	Electrical Load	Count	
			I _	
Electrical_Lights_Fan-Light1	120 V/1-100 VA- 120 V/1-100 VA	200 A, 120 V/240 V, Single Phase, 3 Wires	2	
Lighting_Recessed	120 V/1-60 VA	200 A, 120 V/240 V, Single Phase, 3 Wires	10	
SASSO 100 round wallwasher trim	120 V/1-28 VA	200 A, 120 V/240 V, Single Phase, 3 Wires	8	
Wall Lamp - Bracket	120 V/1-100 VA	200 A, 120 V/240 V, Single Phase, 3 Wires	8	

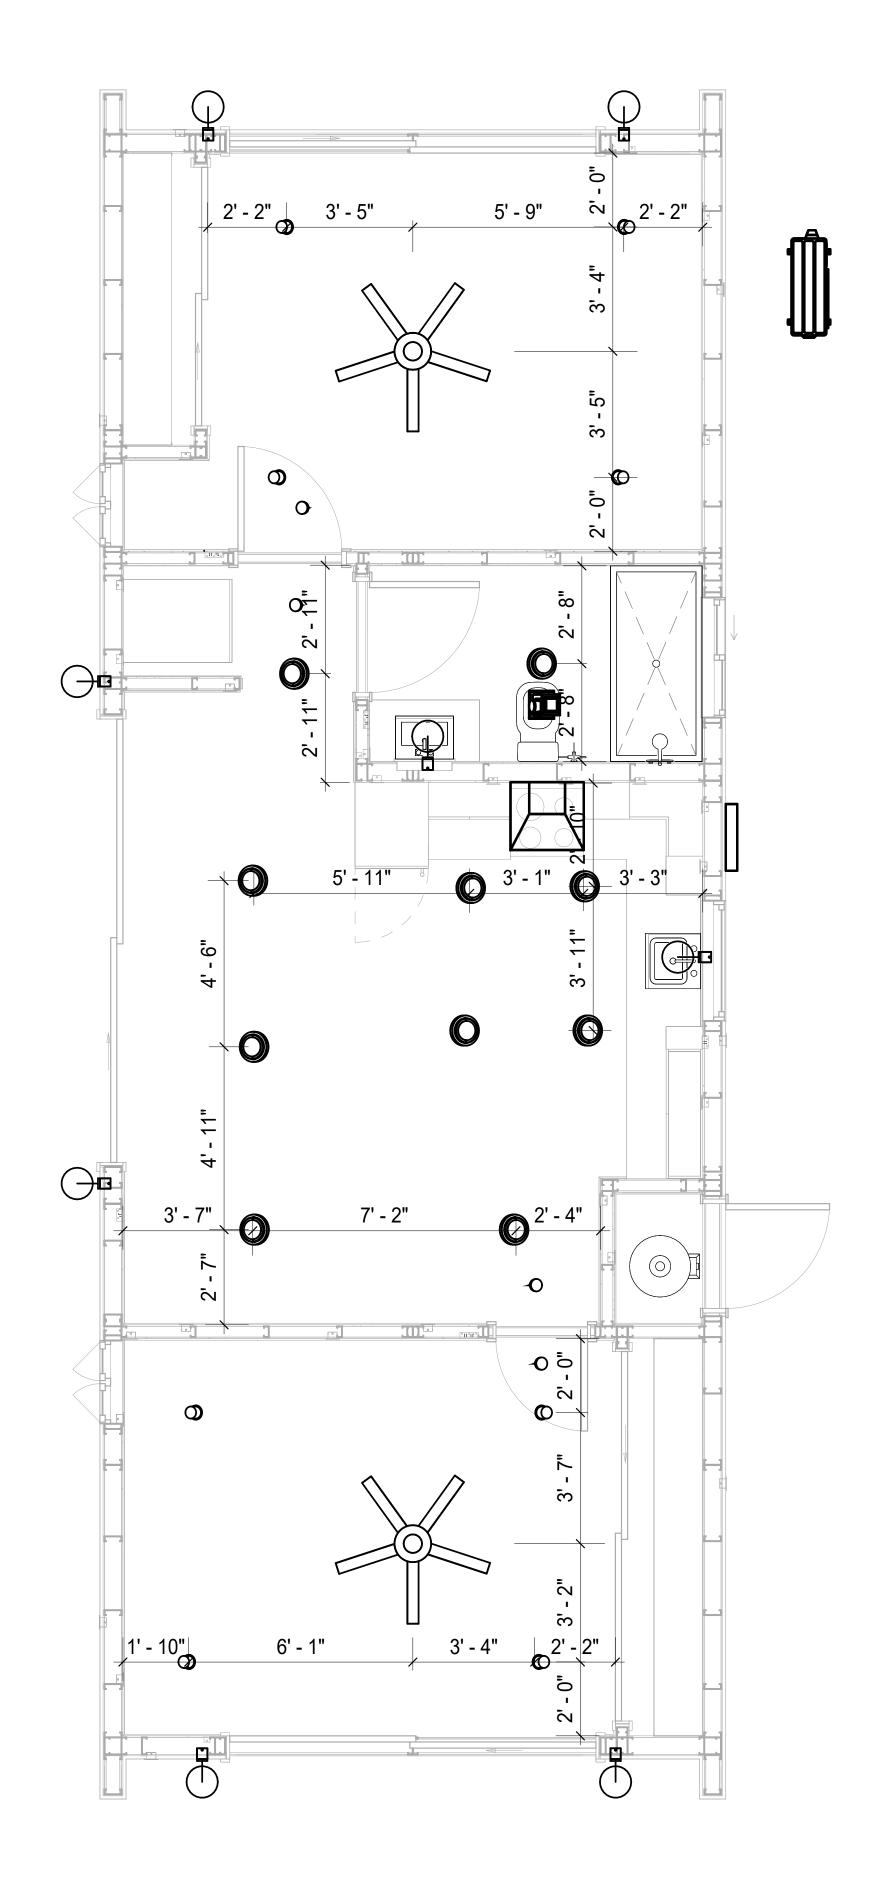

1 DIMENSION FOR LIGHT FIXTURES
3/8" = 1'-0"



**KEY PLAN** 

NO. DESCRIPTION DATE

NOTE:

LEGEND:

PROJECT

221-WESTBROOK-749 2Bd1Ba-CONTEMPORARY-550

DRAWING NAME

# DIMENSION PLAN FOR LIGHT FIXTURES

CLIENT NAME:	Owner
PROJECT NUMBER:	0316_13
DATE:	4/16/2025 6:11:06 AM
DESIGNED BY:	Designer
DRAWN BY:	Author
CHECKED BY:	Checker

E104


SCALE: 3/8" = 1'-0"

#### NOTES;

- 1. VERIFY EQUIPMENT PLUG CONFIGURATION BEFORE PURCHASING RECEPTACLES
- 2. FOR ALL EQUIPMENT.
- 3. COORDINATE EXACT LOCATION OF LIGHT FIXTURES, WALL SWITCHES, RECEPTACLES AND OTHER DEVICES WITH ARCHITECTURAL DRAWINGS.
- 4. USE METALLIC JUNCTION BOX WITH THE GFCI RECEPTACLES, WITH HIGHT VOLTAGE.

Electrical Fixture Schedule (Receptacle)			
Туре	Count		
CONDENSER	1		
DRYER	1		
GFCI BATH ROOM	1		
GFCI DISHWASHER	1		
GFCI Kitchen	3		
GFCI OUT DOOR	6		
GFCI WASHER	1		
OVEN HOOD	1		
RANGE	1		
REFRIGERATOR	1		
Standard	11		
Standard Receptacle	1		
water heater	1		

Electrical Outlet Schedule						
Туре	Circuit Number	Electrical Data	Count			
CONDENSER	1,3	240 V/2-1500 VA	1			
GFCI OUT DOOR	4	120 V/1-180 VA	6			
Standard	7	120 V/1-180 VA	4			
DRYER	8,10	240 V/2-1500 VA	1			
GFCI BATH ROOM	9	120 V/1-180 VA	1			
REFRIGERATOR	11	120 V/1-1500 VA	1			
GFCI Kitchen	12	120 V/1-180 VA	3			
OVEN HOOD	12	120 V/1-180 VA	1			
RANGE	13,15	240 V/2-1500 VA	1			
GFCI DISHWASHER	14	120 V/1-1200 VA	1			
water heater	17,19	240 V/2-1500 VA	1			
Standard	20	120 V/1-180 VA	3			
Standard Receptacle	20	120 V/1-180 VA	1			
Standard	21	120 V/1-180 VA	4			
GFCI WASHER	22	120 V/1-1200 VA	1			

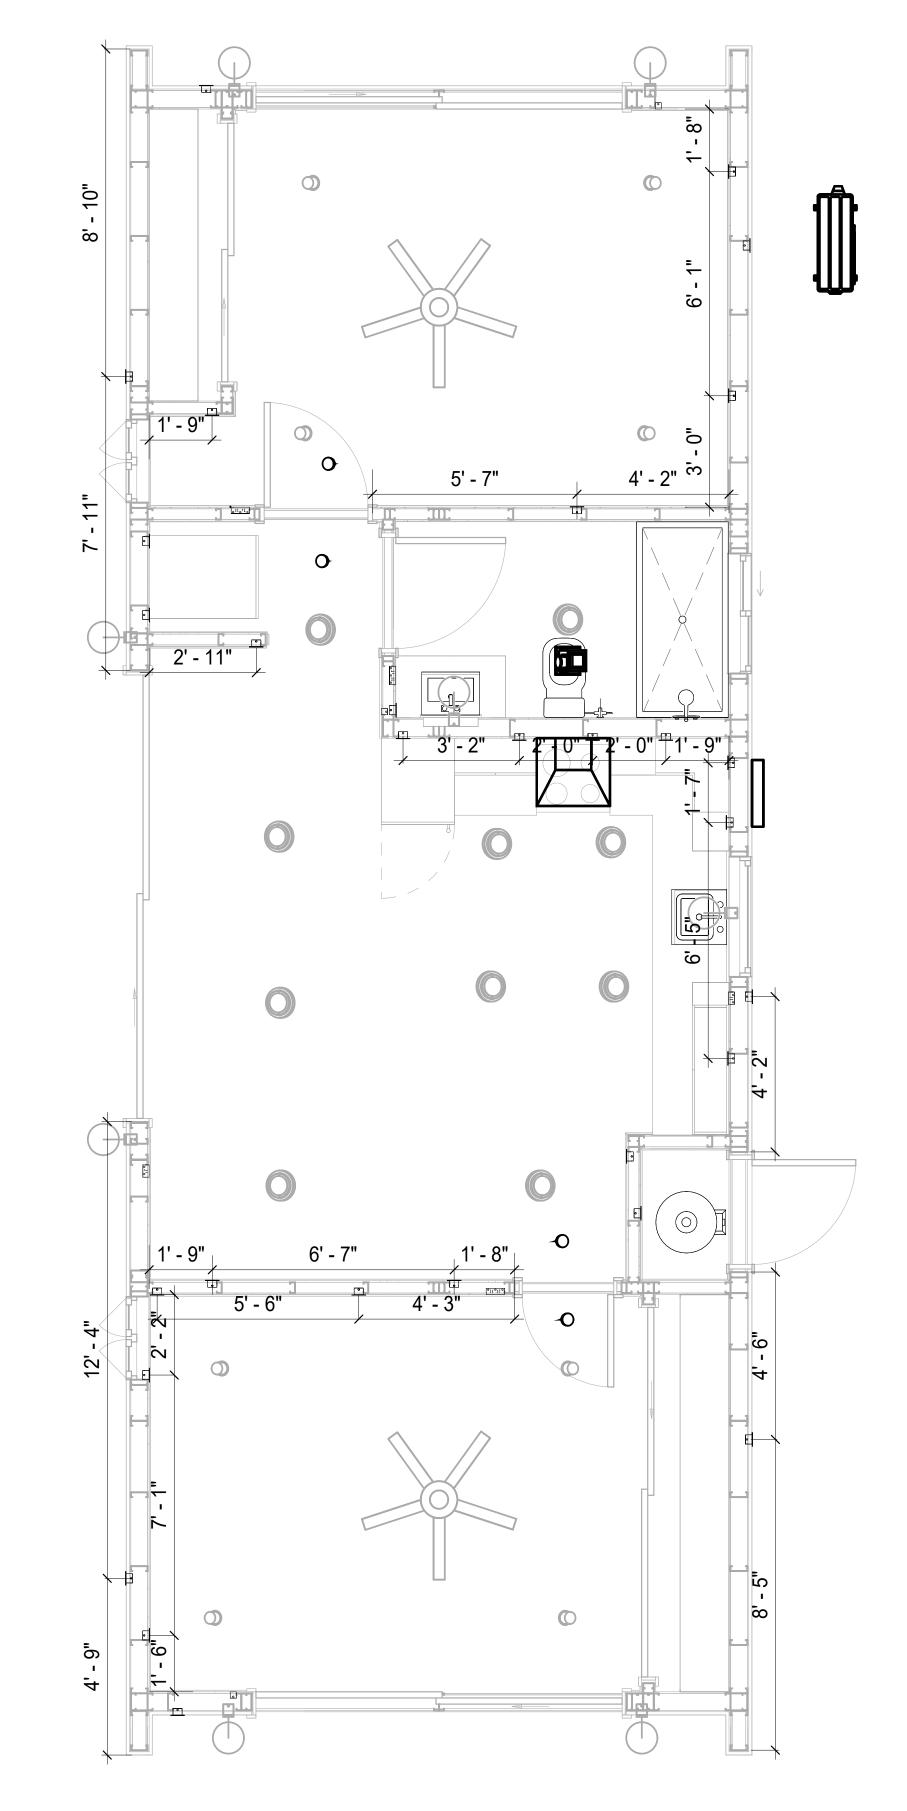

DIMENSION FOR FITTINGS
3/8" = 1'-0"

**KEY PLAN** 

NO. DESCRIPTION DATE

NOTE:

LEGEND:

PROJECT

221-WESTBROOK-749 2Bd1Ba-CONTEMPORARY-550

DRAWING NAME

# DIMENSION PLAN FOR FITTINGS

CLIENT NAME:	Owner
PROJECT NUMBER:	0316_13
DATE:	4/16/2025 6:11:07 AN
DESIGNED BY:	Designer
DRAWN BY:	Author
CHECKED BY:	Checker

E105

SCALE: 3/8" = 1'-0"

#### SHEET LIST

SHEET NUMBER SHEET NAME

P101 NOTE AND SCHEDULE
P102 WATER SUPPLY AND SEWAGE
SYSTEM

# PIPE COLOR SCHEME DOMESTIC COLD WATER DOMESTIC HOT WATER SANITARY VENT SANITARY SEWER STORM DRAINAGE GRAY WATER GAS LINE

#### PLUMBING NOTES

- . THE PLUMBING SYSTEM IS DESIGNED TO MEET THE BUILDING'S DOMESTIC WATER SUPPLY, SANITARY DRAINAGE, AND STORM DRAINAGE REQUIREMENTS, AS PER PROJECT SPECIFICATIONS AND APPLICABLE CODES.
- THE SYSTEM INSTALLATION SHALL COMPLY WITH THE LATEST INTERNATIONAL PLUMBING CODE (IPC), INTERNATIONAL RESIDENTIAL CODE (IRC), AND ALL OTHER RELEVANT LOCAL, STATE, AND NATIONAL REGULATIONS.
- 3. ALL PLUMBING WORK SHALL COMPLY WITH THE LATEST EDITION OF THE INTERNATIONAL PLUMBING CODE (IPC) AND THE LOCAL PLUMBING CODE.
- 4. PLUMBING SYSTEMS SHALL BE TESTED AND INSPECTED IN ACCORDANCE WITH THE LOCAL PLUMBING CODE REQUIREMENTS.
- 5. PLUMBING FIXTURES SHALL BE INSTALLED WITH THE APPROPRIATE TRIM, FITTINGS, AND ACCESSORIES, AS RECOMMENDED BY THE MANUFACTURER.
- 6. PIPING SHALL BE PROPERLY SUPPORTED AND SECURED TO PREVENT SAGGING,
- MOVEMENT, AND VIBRATION.
  7. SHUT-OFF VALVES SHALL BE PROVIDED AT ALL BRANCH CONNECTIONS AND AT THE
- INLET AND OUTLET OF EACH PIECE OF EQUIPMENT.

  8. BACKFLOW PREVENTION DEVICES SHALL BE INSTALLED AS REQUIRED BY THE LOCAL
- PLUMBING CODE TO PROTECT THE POTABLE WATER SYSTEM.

  9. PLUMBING FIXTURES AND EQUIPMENT SHALL BE ACCESSIBLE FOR MAINTENANCE AND
- SERVICING.
- 10. EXPOSED PLUMBING PIPING AND FIXTURES SHALL BE INSULATED TO PREVENT CONDENSATION AND ENERGY LOSS.
- 11. DEAD ENDS IN THE DRAINAGE SYSTEM MUST BE AVOIDED, EXCEPT WHERE NECESSARY TO INSTALL A CLEANOUT IN AN ACCESSIBLE LOCATION, AND MUST HAVE A VENTED CONNECTION TO THE OUTSIDE ATMOSPHERE.
- 12. THE VERTICAL DEFLECTION OF PVC PIPE MUST NOT EXCEED 5%, AND NO DEFLECTION IS PERMITTED FOR IRON PIPE.
- 13. WORK MUST BE PROPERLY COORDINATED WITH OTHER TRADES TO AVOID CONFLICTS, REFERRING TO THE ARCHITECTURAL AND STRUCTURAL DRAWINGS FOR INFORMATION REGARDING CEILING ELEVATIONS, SPACE CLEARANCES, WALL AND PARTITION LOCATIONS, ETC.
- 14. ALL FIXTURES SHALL HAVE ACCESSIBLE STOPS.
- 15. DOMESTIC WATER PIPING SHALL BE PEX, AND PVC PIPING IS NOT ACCEPTABLE FOR INTERIOR USE.
- 16. VENT TERMINATIONS SHALL BE LOCATED AT LEAST 10 FEET FROM OR 3 FEET ABOVE ANY OPERABLE WINDOW, DOOR OPENING, AIR INTAKE, OR VENT SHAFT, AND AT LEAST 3 FEET IN EVERY DIRECTION FROM ANY LOT LINE, ALLEY, OR STREET.
- 17. PIPE AND FITTINGS UTILIZED IN THE WATER SUPPLY SYSTEM SHALL HAVE A MAXIMUM OF 8 PERCENT LEAD.
- 18. ACRYLONITRILE BUTADIENE STYRENE (ABS) SHALL BE USED FOR THE SEWERAGE AND
- VENTILATION SYSTEM.

  19. CROSS-LINKED POLYETHYLENE (PEX) SHALL BE USED FOR THE WATER SUPPLY SYSTEM.
- 0. POLYVINYL CHLORIDE (PVC) SHALL BE USED FOR THE RAIN WATER SYSTEM.
- 21. THE MIMIMUM WATER SUPPLY DEPTH UNDER FLOOR FINISH SHOUD BE 1/2".
- 22. ANY PIPE INSTALLED UNDERGROUND MUST HAVE AT LEAST 12 INCHES OF CLEARANCE BETWEEN THE OUTSIDE OF THE PIPE AND ANY OTHER UNDERGROUND STRUCTURE.
- 23. THE MINIMUM CLEARANCE BETWEEN COLD AND HOT WATER LINES IN RESIDENTIAL HOMES MAINTAIN A MINIMUM DISTANCE OF 6 INCHES.
- 24. HORIZONTAL SEPARATION BETWEEN WATER AND SEWER LINES: A MINIMUM OF 12 INCHES BETWEEN POTABLE WATER SUPPLY LINES (COLD AND HOT WATER) AND SANITARY SEWER LINES.

#### **ABBREVIATIONS**

Ø	DIAMETER
ABS	ACRYLONITRILE BUTADIENE STYRENE
ABV	ABOVE
AD	AREA DRAIN
AFF	ABOVE FINISHED FLOOR
ALT	ALTERNATE
BFF	BELOW FINISHED FLOOR
BLW	BELOW
CO	CLEAN OUT
CW	COLD WATER
D	DEGREE
DFU	DRANAGE FIXTURE UNIT
DIA	DIAMETER
DN	DOWN
FCO	FLOOR CLEAN OUT
FD	FLOOR DRAIN
FL	FLOOR
FS	FLOOR SINK
FT_	FOOT/FEET
HB	HOSE BIB
HW	HOT WATER
IN	INCH
MIN	MINIMUM
NO	NUMBER
NTS	NOT TO SCALE
PEX	CROSS-LINKED POLYETHYLENE
PLBG	PLUMBING
PVC	POLYVINYL CHLORIDE
QTY	QUANTITY
RD	ROOF DRAIN
RED	REDUCER
RM	ROOM
RW	RAIN WATER
SF	SQUARE FOOT
V	VENT
VTR	VENT THROUGH ROOF
W	WASTE
WCO	WALL CLEAN OUT
WSFU	WATER SUPPLY FIXTURE UNIT

#### PLUMBING LEGEND

D	CAP
	BEND 45 DEG
B	BEND 90 DEG
	TEE REDUCING
	TEE
	CLEAN TWO-WAY
	WYE 45 DEG
	WYE 45 DEG DOUBLE
	WYE COMBINATION
	P-TRAP

PIPE SCHEDULE						
MATERIAL	DIAMETER	LENGTH				
ACRYLONITRILE BUTADIENE STYRENE (ABS)	3/4"	5 FT				
ACRYLONITRILE BUTADIENE STYRENE (ABS)	1 1/2"	47 FT				
ACRYLONITRILE BUTADIENE STYRENE (ABS)	2"	18 FT				
ACRYLONITRILE BUTADIENE STYRENE (ABS)	3"	21 FT				
CROSS-LINKED POLYETHYLENE (PEX)	1/2"	73 FT				
CROSS-LINKED POLYETHYLENE (PEX)	3/4"	45 FT				
CROSS-LINKED POLYETHYLENE (PEX)	3"	1 FT				
POLYVINYL CHLORIDE - RIGID	2"	72 FT				

FITTING SCHEDULE					
FITTING	SIZE	QTY			
	,				
ABS 90 DEGREE BEND ELBOW	3/4"ø-3/4"ø	2			
PEX 90 DEGREE ELBOW	1/2"ø-1/2"ø	9			
PEX 90 DEGREE ELBOW	3/4"ø-3/4"ø	5			
PEX TEE ELBOW	1/2"ø-1/2"ø	3			
PEX TEE ELBOW	3/4"ø-3/4"ø-3/4"ø	2			
PEX TRANSITION ELBOW	1"ø-3/4"ø	2			
PEX TRANSITION ELBOW	3/4"ø-1/2"ø	2			
TEE ELBOW	3/4"ø-3/4"ø-3/4"ø	1			
PEX 90 DEGREE ELBOW	1/2"ø-1/2"ø	8			
PEX 90 DEGREE ELBOW	3/4"ø-3/4"ø	4			
PEX TEE ELBOW	1/2"ø-1/2"ø-1/2"ø	2			
PEX TEE ELBOW	3/4"ø-3/4"ø-3/4"ø	1			
PEX TRANSITION ELBOW	3/4"ø-1/2"ø	2			
PVC 90 DEG BEND ELBOW	2"ø-2"ø	8			
ABS 90 DEG BEND ELBOW	3"ø-3"ø	1			
ABS 90 DEGREE BEND ELBOW	1 1/2"ø-1 1/2"ø	2			
ABS 90 DEGREE BEND ELBOW	2"ø-2"ø	2			
ABS P-TRAP	1 1/2"ø-1 1/2"ø	3			
ABS P-TRAP	2"ø-2"ø	1			
ABS REDUCER ELBOW	3"ø-2"ø	1			
ABS TEE ELBOW	1 1/2"ø-1 1/2"ø-1 1/2"ø	3			
ABS TEE ELBOW	2"ø-2"ø	1			
ABS TEE ELBOW	3"ø-3"ø	1			
ABS TEE REDUCER ELBOW	3"ø-3"ø-1 1/2"ø	3			
ABS TEE REDUCER ELBOW	3"ø-3"ø-3"ø	1			
ABS VENT CAP ELBOW	1 1/2"ø	3			
ABS VENT CAP ELBOW	2"ø	1			
ABS VENT CAP ELBOW	3"ø	1			

FIXTURE CONNECTION SCHEDULE											
FAMILY	W	V	TRAP	CW	HW	QTY	DFU	TOT.	WFU	TOT.	NOTES
	•										
DRYER	N/A	N/A	N/A	N/A	N/A	1		0			
HANGING PIPES						16		0			
CLAMP						10		0			
SHOWER TRAY	2"	1-1/2"	1-1/2"	1/2"	1/2"	1		0			
SHOWER TRIM	-	-	-	1/2"	1/2"	1		0			
SINK ISLAND SINGLE	2"	1-1/2"	1-1/2"	1/2"	1/2"	1		0			
VANITY SINK	2"	1-1/2"	1-1/2"	1/2"	1/2"	1		0			
MACHED	2"	1-1/2"	2"	1/2"	1/2"	1		0			DRAINS TO GRAY WATER
WASHER		1-1/2	2	1/2	1/2	ı		U			OR SEWER SEE PLANS
WATER CLOSET	3"	2"	3"	1/2"	1/2"	1		0			
WATER HEATER	N/A	N/A	N/A	3/4"	3/4"	1		0			

FIXTURE SCHEDULE						
FIXTURE	QTY	DESCRIPTION				
DRYER	1					
HANGING PIPES CLAMP	16					
SHOWER TRAY	1					
SHOWER TRIM	1					
SINK ISLAND SINGLE	1					
VANITY SINK	1					
WASHER	1	DRAINS TO GRAY WATER OR SEWER SEE PLANS				
WATER CLOSET	1					
WATER HEATER	1					

ACCESSORIES & FITTINGS SCHEDULE							
FIXTURE	QTY	DESCRIPTIONS					
HOSE BIB	1						
LAUNDRY SWEAT CONNECTOR	1						
SHUTOFF VALVE	6						

PLUMBING SCHEDULE							
FIXTURE	TRAP	WASTE	VENT	C.W	H.W		
DRYER	N/A	N/A	N/A	N/A	N/A		
SHOWER TRAY	1-1/2"	2"	1-1/2"	1/2"	1/2"		
SHOWER TRIM	-	-	-	1/2"	1/2"		
SINK ISLAND SINGLE	1-1/2"	2"	1-1/2"	1/2"	1/2"		
VANITY SINK	1-1/2"	2"	1-1/2"	1/2"	1/2"		
WASHER	2"	2"	1-1/2"	1/2"	1/2"		
WATER CLOSET	3"	3"	2"	1/2"	1/2"		
WATER HEATER	N/A	N/A	N/A	3/4"	3/4"		

WATER FIXTURE UNIT SCHEDULE						
FAMILY	QTY	UNIT VALUE	TOTAL			
DDVED	4	I	0			
DRYER	1		0			
HANGING PIPES CLAMP	16		0			
SHOWER TRAY	1		0			
SHOWER TRIM	1		0			
SINK ISLAND SINGLE	1		0			
VANITY SINK	1		0			
WASHER	1		0			
WATER CLOSET	1		0			
WATER HEATER	1		0			

WASTE FIXTURE UNIT SCHEDULE						
FAMILY	QTY	DFU VALUES	TOTAL			
DRYER	1		0			
HANGING PIPES CLAMP	16		0			
SHOWER TRAY	1		0			
SHOWER TRIM	1		0			
SINK ISLAND SINGLE	1		0			
VANITY SINK	1		0			
WASHER	1		0			
WATER CLOSET	1		0			
WATER HEATER	1		0			



**KEY PLAN** 

NO. DESCRIPTION DATE

NOTE:

LEGEND:

PROJECT

218-WESTBROOK-749-2Bd1Ba CONTEMPORARY-550

DRAWING NAME

NOTE AND SCHEDULE

CLIENT NAME:

 PROJECT NUMBER:
 0316\_13

 DATE:
 4/15/2025 5:12:21 PM


 DESIGNED BY:
 Designer

 DRAWN BY:
 Author

 CHECKED BY:
 Checker

P101

SCALE: 1/2" = 1'-0"

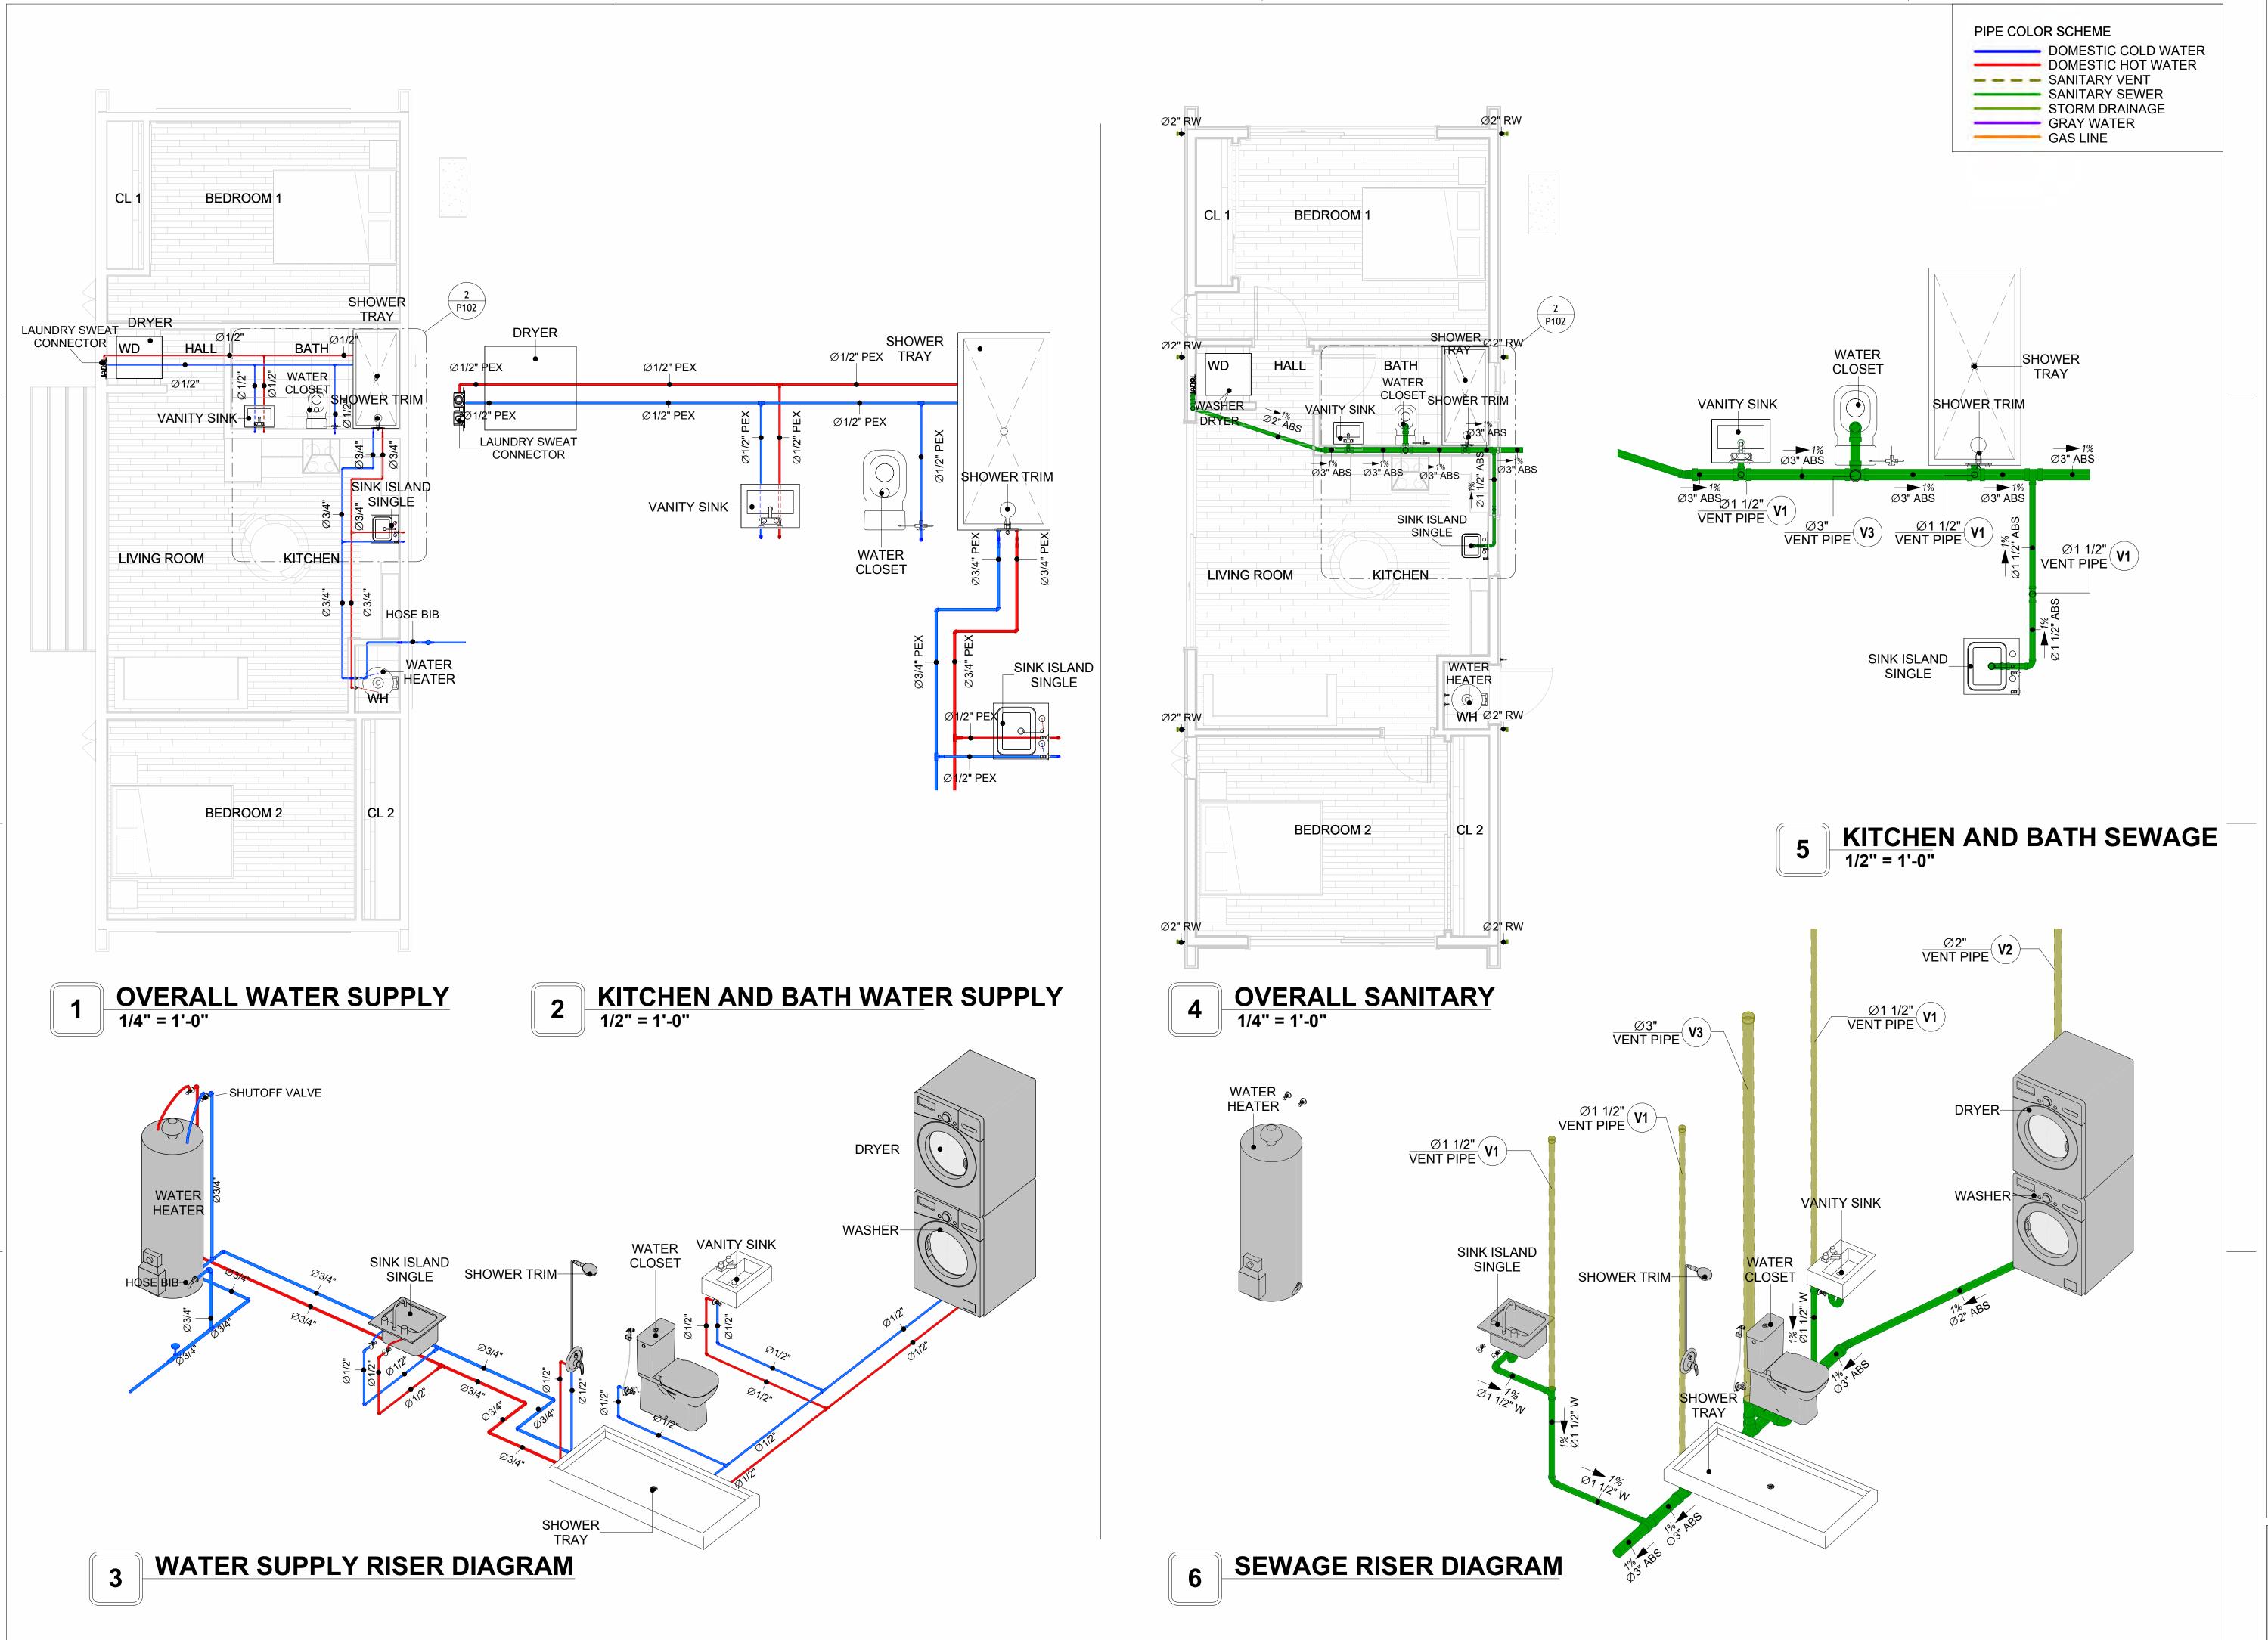



**KEY PLAN** 



NO.	DESCRIPTION	DATE

LEGEND:

NOTE:

PROJECT

218-WESTBROOK-749-2Bd1Ba CONTEMPORARY-550

DRAWING NAME

# WATER SUPPLY AND SEWAGE SYSTEM

 CLIENT NAME:

 PROJECT NUMBER:
 0316\_13

 DATE:
 4/15/2025 5:13:03 PM

 DESIGNED BY:
 Designer

 DRAWN BY:
 Author

 CHECKED BY:
 Checker

P102

# Materials Shopping List

Please print and take this Materials Shopping List to your favorite Home Depot and ask for assistance in selecting the materials, fixtures and fittings to complete your new home.

Record your selection and the price of the item. Then do the math to determine the cost for your selections and the total cost of finishing your home.

#### **Have It Your Way!**

The material types listed in this document were selected based on personal preferences. The Customer is encouraged to make changes to the material types in accordance with local customs, regulations, and personal preferences.

Have It Your Way!



# 20 good reasons to frame a home with metal and not wood



Why build your ADU with metal vs wood	Wood	Metal	Explanation
1 DIY Construction Benefit		~	The wall frames, trusses and beams can be erected in a just a few days
2 Minimal Construction Skills Required		~	Pre-assembled walls and trusses require no specialized skills to errect
Build as DIY, Hybrid or by a General Contractor		~	Do it yourself, Hybrid (involve special contractors) or hire a General Contractor
4 Build It As You Can Afford It		~	Impervious to Weather - build as you have the time and money
5 Up Front Cost of Framing Materials	<b>~</b>		As to only the framing material, wood is less expensive
6 Total Cost To Build		~	Savings in time, labor, and other areas make light gauge steel LESS expensive
7 Termites and wood boring insects		~	Termites, carpenter ants and wood boring insects eat wood, not metal
8 Mold resistant		~	Metal does not attract mold
9 Damage caused by exterior and interior flooding		~	Metal needs no reconditioning after a flood
10 Fire Resistant		~	Non-combustible
11 Lower insurance rates		~	Many insurance underwriters now provide lower rates for metal framed homes
12 Walls, trusses, and beams retain their original form		~	Perfectly straight walls - no shimming of drywall
13 Corners are 90 degrees		~	No need for templating of countertops to adjust for out of square corners
14 Strength and weight		~	Metal is stronger than wood and weighs less - no need for crane to lift ADU trusses
15 IBC Engineered Stamp		~	If an engineering stamp is necessary, months of waiting are saved
16 Complete BOM (Materials Shopping List)		~	Take the materials shopping list to Home Depot and start shopping/pricing
17 Flexible in Seismic Areas - Won't Fracture		~	Light gauge steel is flexible and won't fracture when the earth moves
18 No Waste At Job Site		~	Steel is the most recycled material in the world. A typical wood home has 20-30% waste
19 Environmentally Friendly		~	Trees don't have to be destroyed and the source of most metal is from recycling
20 How-To Videos Included		~	How-to videos provide simple assembly instructions
21 Relationship Counselor		~	Eliminate emotional uphevels - save time, money, and preserve the relationship

#### Universal Requirements - some or all may be required

- 1 Site plan
- 2 Electrical Supply Connection
- 3 Sewer Connection
- 4 Fresh Water Supply Connection
- 5 Set Backs
- 6 Soils Evaluation

- 7 Earthquake (fault) evaluation
- 8 Foundation Plan subject to soils
- 9 Compliance with local energy codes: insulation home wrap and flashing
- 10 Engineering for wind speed and snow load.
- 11 State and Local ordinances regarding ADUs
- 12 Local Architect and/or Engineer may be necessary





# Westbrook-2Bd1Ba-Contemporary MATERIAL SHOPPING LIST

#### **Have It Your Way!**

The material types listed in this document were selected based on personal preferences. The Customer is encouraged to make changes to the material types in accordance with local customs, regulations, and personal preferences. Have It Your Way!

#### TOC



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#### Have It Your Way!

The material types listed in this document were selected based on personal preferences. The Customer is encouraged to make changes to the material types in accordance with local customs, regulations, and personal preferences. Have It Your Way!

#### **GENERAL NOTES**

- 1 This BOM (Bill of Materials) is prepared as a Materials Shopping List to help builders and DIYers gain a complete understanding of most if not all elements required for the complete construction of this structure, according to the original design documents provided by FrameUpNow.
- 2 All quantities and specifications are subject to change based on the final design, field measurements, availability of products and customer preferences. The customer should verify all information prior to purchasing materials.
- 3 All products and elements in the list shall conform to the International Residential Code (IRC), or any other local and international building codes, safety regulations, and standards that are applicable to the location of the structure.
- 4 If any changes are made by the customer to the list of materials specified in this document, the customer is responsible for assuring that the correct type and quantity of materials are utilized in accordance with local building codes.
- 5 FrameUpNow, will not be held responsible for any misuse of this document, the products listed, or for deviations from the content that are made due to changes in specifications, pricing, availability, or customer preferences.
- 6 The customer is advised to consult a qualified professional or technician prior to purchasing materials for specialized construction system items. Some items including but not limited to caseworks, doors and windows may require as built measurements prior to purchase to confirmation of final dimensions.
- 7 If there are additional trim elements or specific installation methods, the total amount of materials needed might vary. Consider any additional trim required for corners, intersections, or other architectural details that might cause this variations before proceeding to purchase and construction.

#### **ARCHITECTURAL BOM**



		Westbrook	-2Bd1B	a-Contemp	orary		
		ARCHITECTURA					
No.	Item	Туре	Unit	Quantity	Unit Price	Total	Description
	APPLIANCES						
	Refrigerator		PCS	1			
2	Range		PCS	1			
3	Washer		PCS	1			
4	Dryer		PCS	1			
5	Dish Washer		PCS	0			
6	Oven		PCS	0			
	Microwave		PCS	0			
<u></u>	CASEWORKS	I	ler.	40.40			
1	Kitchen Cabinet		FT	18.13			
2	Laundry Cabinet		FT	2.25			
3	Vanity Cabinet		FT PCS	3			
4	Medicine Cabinet		SF				
	Kitchen countertop			29.45			
	Laundry Countertop		PCS SF	0			
7 8	Bathroom Countertop Island		FT	0			
9	Peninsula		FT	0			
10	Closets		SF	111.9			
	CEILING	l .	J)I	111.9			
1	Ceiling Board	Dry Wall	SF	680			
	Dry Wall Fastener	Screw	PCS	1190			
3	Vapor Retarder	Polyethylene film	SF	787			
	Vapor Retarder Fastener	Nails with washer heads	PCS	2361			
	Ceiling Board (MRD)	Moisture resistant drywall	SF	56			
	MRD Fastener	Worsture resistant drywan	PCS	98			
	Ceiling Board	Marine Plywood	SF	51			
	Marine Plywood Fastener	Screw	PCS	89.25			
	Dry Wall Tape	Sciew	FT	393.5			
	FLOORING	!	11.1	373.3		<u> </u>	
	Main Living Space		SF	250.8			
2	Bathroom		SF	55.7			
3	Bedroom		SF	344.3			
	STRUCTURE			01110			
	Foundation		SF	737.9			
	WALLS EXTERIOR						
1	Curtain Wall	Glazing	SF	119			
2	Exterior-Grade Plywood		SF	915			
	Exterior-Grade Plywood Fastener	Self-drilling screws(100/pkt)	PKT	9.15			
	Wall Shteathing (OSB)		SF	915			
	Shteathing Fastener	Self-drilling screws(100/pkt)	PKT	9.15			
6	Wall Homewrap		SF	915			
	Homewrap Fastener	Stapled fastener (200/pkt)	PKT	3.477			
8	Furring Strip		PCS	114.375			
9	Furring Strip Fastener	Self-drilling screws(100/pkt)	PKT	9.15			
10	Wall Paint		SF	915			
11	Stone Copping	Masonry stone	SF	0			
12	Stone Veneer	Masonry stone	SF	0			
	Mortar for Stone Veneer		SF	0			
	Wall Insulation		SF	2986			
	WALLS INTERIOR						
	Cementitious Backer Board		SF	410			
	Kerdi membrane		SF	410			
	Kerdi membrane Fastener		SF	410			
	Wall Ceramic Tile		SF	410			
	Drywall Board		SF	1692			
	Drywall Fastener	Self-drilling screws(100/pkt)	PKT	16.92			
	Wall Paint		SF	1692			
	Drywall Tape		FT	318			
9	Wall Sweep		FT	127			

#### **ARCHITECTURAL BOM**



Δ	DOORS				
1	Interior Swinging	2' - 6" X 6'-8"	PCS	1	$\neg$
2	Interior Sliding	7' - 0" X 6'- 8"	PCS	1	$\neg$
3	Interior Swinging	3' - 0" X 6'- 8"	PCS	1	$\neg$
4	Interior Sliding	10' - 0" X 6'- 8"	PCS	1	$\neg$
5	Interior Swinging	2' - 10" X 6'- 8"	PCS	1	$\neg$
6	Patio Sliding	10' - 0" X 6'- 8"	PCS	2	$\neg$
7	Patio Sliding	12' - 0" X 6'- 8"	PCS	1	$\neg$
8	Exterior Swinging	2' - 10" X 6'-8"	PCS	1	$\neg$
	Exterior Door Trim		FT	91	
10	Interior Door Trim		FT	275	$\neg$
11	Entry Lock set			4	
12	Privacy Lock set			3	
13	Passage Lock set			2	
Δ	WINDOWS	·			
1	Single Hung	3' - 3" X 3'-3"	PCS	1	
2	Sliding	3' - 3" X 2'-3"	PCS	1	
3	Casment	2' - 3" X 5'-3"	PCS	2	
4	Exterior Window Trim		FT	55	
5	Interior Window Trim		FT	55	
	ROOF				
1	Roof Covering		SF	940.0	
2	Roof Covering Fastener		PCS	470	
	Roof Felt Paper		SF	940.0	
	Roof Felt Paper Fastener		PCS	2820.0	
5	Roof Sheathing		SF	940	
6	Roof Sheathing Fastener		PCS	7520	
7	Batten		FT	502.0	
8	Batten Fastener		PCS	377.4	
9	Soffit		SF	39.0	
10	Soffit Fastener		PCS	19.5	
	Fascia		FT	151.0	
12	Fascia board fastener		PCS	76	
13	Roof Insulation		SF	940.0	



		Westbrook-2Bd1I	Ba-Conten	porary			
	FI	ECTRICAL MATER	RIAL SHOP	PINGII	ST		
No.	Item	Type	Unit		Unit Price	Total	Description
	LIGHTING FIXTURES	71					
_	Kitchen Ceiling Light		PCS	4			
	Kitchen Wall Mounted Light		PCS	0			
3	Exterior Wall Mounted Light		PCS	6			
	Livingroom Ceiling Light With Fan		PCS	0			
5	Bedroom Ceiling Light With Fan		PCS	2			
6	Dining Ceiling Light		PCS	0			
7	Bath Wall Mounted Light		PCS	1			
_	Bathroom Ceiling Light		PCS	1			
	Livingroom Ceiling Light		PCS	5			
	Bedroom Ceiling Light		PCS	8			
	Hall & Entry Ceiling Light		PCS	1			
		-	PCS	0			
	WD Ceiling Light		PCS	-			
	Smoke Detector		rc3	4			
	ELECTRICAL FITTINGS	004	D00	42			
	Standard Receptacle 120V	20A	PCS	12			
	GFCI Receptacle 120V	20 A	PCS	14			
16	GFCI Receptacle 240V	30 A	PCS	2			
17	GFCI Receptacle 240V	50 A	PCS	1			
18	GFCI Receptacle 240V	60 A	PCS	1			
	Fan Switch		PCS	3			
20	Single Pole Switch		PCS	13			
21	Three Way Switch		PCS	0			
22	Dimmer Switch		PCS	0			
Δ	ELECTRICAL CONDUITS & WIRING						
23	ROMEX 14 AWG	14/3/W/ground	FT	0			
24	ROMEX 12 AWG	12/3/W/ground	FT	505			
25	ROMEX 12 AWG	12/2/W/ground	FT	0			
	ROMEX 10 AWG	10/3/W/ground	FT	0			
	ROMEX 10 AWG	10/2/W/ground	FT	53			
	Romex 8 AWG	8/3/W/ground	FT	0	<u> </u>		
	Romex 8 AWG	8/2/W/ground	FT	14			
	ROMEX 6 AWG	6/3/W/ground	FT	25			
	Bare Copper Ground Wire 6 AWG	0/0/TT/ground	FT				
	ELECTRICAL BOXES & CIRCUTES		- 1 1				
		200 4140	PCS	1			
	Panelboard -240V 1 Phase MLO	200 AMP	PCS	0			
	Circuit breaker	15 A					
	Circuit breaker	20 A	PCS	14			
	Circuit breaker	30 A	PCS	2			
	Circuit breaker	50 A	PCS	1			
	Circuit breaker	60 A	PCS	1			
	Single Gang Switch Box		PCS	3			
	Double Gang Switch Box		PCS	2			
	Triple Gang Switch Box		PCS	3			
	Pull Box	#1/4	PCS	28			
44	Receptacle Box		PCS	30			

#### PLUMBING BOM

21 ABS TEE Elbow

22 ABS TEE Elbow

23 ABS TEE Elbow

24 ABS Tee Reducer Elbow

25 ABS Tee Reducer Elbow

26 ABS Vent Cap Elbow

27 ABS Vent Cap Elbow

28 ABS Vent Cap Elbow



#### Westbrook-2Bd1Ba-Contemporary PLUMBING SYSTEM MATERIAL SHOPPING LIST Item Unit Quantity Unit Price Total Description 1 Bath Tub (Alcove Tub) PCS 2 Kitchen Sink PCS 1 3 Kitchen Faucets PCS 4 Vanity Sink PCS 1 5 Bath room Faucets PCS 6 Water Closet PCS 7 Shower Trim PCS 8 Shower Tray PCS 9 Water Heater PCS 10 Hose Bib PCS 1 11 Shutoff Valve PCS 12 Hanging pipe clamp PCS 19 13 Gate Valve PCS 14 Dishwasher Supply Single Connector PCS 0 15 Dishwasher Sewage Single Connector PCS 0 16 Laundry Sweat Connector PCS 1 △ SANITARY & PLUMBING PIPE 1 ABS (Acrylonitrile Butadiene Styrene) Pipes ø 1" FT 0 2 ABS (Acrylonitrile Butadiene Styrene) Pipes ø 1 1/2 FT 47 3 ABS (Acrylonitrile Butadiene Styrene) Pipes ø 2" FT 18 4 ABS (Acrylonitrile Butadiene Styrene) Pipes ø 3" FT 21 5 PEX (Cross-linked polyethylene) Pipes ø 1/2' FT 73 6 PEX (Cross-linked polyethylene) Pipes ø 3/4" FT 45 7 PEX (Cross-linked polyethylene) Pipes ø 1" FT 0 8 PVC Pipes Sch.80 - Rigid ø 1 1/2" FT 1 9 PVC Pipes Sch.80 - Rigid ø 2" FT 0 10 PVC Pipes Sch.80 - Rigid ø 3" FT 72 11 Flex Pipe Round ø 1/2" PCS 0 1 ABS 90 Degree Bend Elbow 3/4"ø-3/4"ø PCS 2 PEX 90 Degree Elbow 1/2"a-1/2"a PCS 9 3 PEX 90 Degree Elbow 3/4"ø-3/4"ø PCS 5 4 PEX Tee Elbow 1/2"ø-1/2"ø-1/2"ø PCS 3 5 PEX Tee Elbow 3/4"ø-3/4"ø-3/4"ø PCS 6 PEX Transition Elbow 1"ø-3/4"ø **PCS** 7 PEX Transition Elbow 3/4"ø-1/2"ø PCS 2 8 Tee Elbow 3/4"ø-3/4"ø-3/4"ø PCS 9 PEX 90 Degree Elbow 1/2"ø-1/2"ø PCS 8 10 PEX 90 Degree Elbow 3/4"ø-3/4"ø PCS 4 1/2"ø-1/2"ø-1/2"ø 11 PEX Tee Elbow PCS 12 PEX Tee Elbow 3/4"ø-3/4"ø-3/4"ø PCS 13 PEX Transition Elbow 3/4"ø-1/2"ø PCS 14 PVC 90 Deg Bend Elbow PCS 2"ø-2"ø 8 15 ABS 90 Deg Bend Elbow PCS 3"ø-3"ø 16 ABS 90 Degree Bend Elbow PCS 1 1/2"ø-1 1/2"ø 17 ABS 90 Degree Bend Elbow 2"ø-2"ø PCS 18 ABS P-Trap 1 1/2"ø-1 1/2"ø PCS 3 19 ABS P-Trap 2"ø-2"ø PCS 20 ABS Reducer Elbow PCS 3"ø-2"ø

1 1/2"ø-1 1/2"ø-1 1/2"ø

2"ø-2"ø-2"ø

3"ø-3"ø-3"ø

3"ø-3"ø-3"ø

1 1/2"ø

2"ø

3"ø

3"ø-3"ø-1 1/2"ø

PCS

PCS

PCS

PCS

PCS

PCS

PCS

PCS

3

3

		Westbrook-2	Bd1Ba-C	ontempo	rary		
		HVAC SYSTEM M	ATERIAL	SHOPP	ING LIST		
No.	Item	Туре	Unit	Quantity	Unit Price	Total	Description
	HVAC_DUCTS						
1	PIPE (REFRIGERANT LINE)	3/8" (Ø)	FT	74.26			
2	PIPE (REFRIGERANT LINE)	1/2" (Ø)	FT	0.87			
3	PIPE (REFRIGERANT LINE)	3/4" (Ø)	FT	97.2			
4	DRAYER HOSE	4" (Ø)	FT	4			
5	FLEX DUCT ROUND	4" (Ø)	FT	7			
	<b>DUCT FITTINGS &amp; ACCESSORIES</b>						
6	ELBOW (REFRIGERANT LINE)	1/2" (Ø)-1/2" (Ø)	PCS	1			
7	ELBOW (REFRIGERANT LINE)	3/4" (Ø)-3/4" (Ø)	PCS	24			
8	ELBOW (REFRIGERANT LINE)	3/8" (Ø)-3/8" (Ø)	PCS	19			
9	TRANSITION (REFRIGERANT	3/4" (Ø)-1/2" (Ø)	PCS	4			
10	TRANSITION (REFRIGERANT	3/4" (Ø)-3/8" (Ø)	PCS	3			
11	TRANSITION (REFRIGERANT	3/8" (Ø)-1/4" (Ø)	PCS	1			
12	TEE (REFRIGERANT LINE)	3/4" (Ø)-3/4" (Ø)-3/4" (Ø)	PCS	2			
13	TEE (REFRIGERANT LINE)	3/8" (Ø)-3/8" (Ø)-3/8" (Ø)	PCS	2			
14	ROUND TRANSITION(ANGLE)	45 DEGREE	PCS	5			
	HVAC_EQUIPMENTS						
15	AIR HANDLING UNIT	WALL MOUNTED	PCS	3			
16	CONDENSER	OUTDOOR UNIT	PCS	1			
17	EXHAUST FAN	75 CFM	PCS	1			
18	EXHAUST HOOD	WALL MOUNTED	PCS	1			
19	HOOD-WALL: VENT	HOOD-WALL: VENT	PCS	1			
20	DRAYER: VENT	DRAYER: VENT	PCS	1			
21	ROOF VENT	3"(Ø)	PCS	1			
-							



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#### **Have It Your Way!**

The material types listed in this document were selected based on personal preferences. The Customer is encouraged to make changes to the material types in accordance with local customs, regulations, and personal preferences. Have It Your Way!

#### **GENERAL NOTES**

- This BOM (Bill of Materials) is prepared as a Materials Shopping List to help builders and DIYers gain a complete understanding of most if not all elements required for the complete construction of this structure, according to the original design documents provided by FrameUpNow.
- 2 All quantities and specifications are subject to change based on the final design, field measurements, availability of products and customer preferences. The customer should verify all information prior to purchasing materials.
- 3 All products and elements in the list shall conform to the International Residential Code (IRC), or any other local and international building codes, safety regulations, and standards that are applicable to the location of the structure.
- 4 If any changes are made by the customer to the list of materials specified in this document, the customer is responsible for assuring that the correct type and quantity of materials are utilized in accordance with local building codes.
- 5 FrameUpNow, will not be held responsible for any misuse of this document, the products listed, or for deviations from the content that are made due to changes in specifications, pricing, availability, or customer preferences.
- The customer is advised to consult a qualified professional or technician prior to purchasing materials for specialized construction system items. Some items including but not limited to caseworks, doors and windows may require as built measurements prior to purchase to confirmation of final dimensions.
- 7 If there are additional trim elements or specific installation methods, the total amount of materials needed might vary. Consider any additional trim required for corners, intersections, or other architectural details that might cause this variations before procedding to purchase and construction.



			LIGHTING FIXTURES				
#	Item	Туре	Description, Manufacturer, SKU	Unit	Quantity	Unit Price	Total
1	Kitchen Ceiling Light			PCS	4		
3	Kitchen Wall Mounted Light			PCS	0		
4	Exterior Wall Mounted Light			PCS	6		
5	Livingroom Ceiling Light With Fan			PCS	0		
6	Bedroom Ceiling Light With Fan			PCS	2		
7	Dining Ceiling Light			PCS	0		
8	Bath Wall Mounted Light			PCS	1		
9	Bathroom Ceiling Light			PCS	1		
10	Livingroom Ceiling Light			PCS	5		
11	Bedroom Ceiling Light			PCS	8		
12	Hall & Linen Ceiling Light			PCS	1		
12	Closet Ceiling Light			PCS	0		
13	Smoke Detector			PCS	4		
14							
15							



			ELECTRICAL FITTINGS				
#	Item	Туре	Description, Manufacturer, SKU	Unit	Quantity	Unit Price	Total
1	Standard Receptacle 120V	20A		PCS	12		
2	GFCI Receptacle 120V	20 A		PCS	14		
3	GFCI Receptacle 240V	30 A		PCS	2		
4	GFCI Receptacle 240V	50 A		PCS	1		
5	GFCI Receptacle 240V	60 A		PCS	1		
5	Fan Switch			PCS	3		
7	Single Pole Switch			PCS	13		
3	Three Way With Dimmer Switch			PCS	0		
)	Dimmer Switch			PCS	0		
10		,	·		-		
11							
12							
13							
14							
15							



		ELECTR	ICAL CONDUITS & WIRING				
#	Item	Туре	Description, Manufacturer, SKU	Unit	Quantity	Unit Price	Total
1	ROMEX 14 AWG	14/3/W/ground		FT	0		
3	ROMEX 12 AWG	12/3/W/ground		FT	505		
4	ROMEX 12 AWG	12/2/W/ground		FT	0		
6	ROMEX 10 AWG	10/3/W/ground		FT	0		
8	ROMEX 10 AWG	10/2/W/ground		FT	53		
9	Romex 8 AWG	8/3/W/ground		FT	0		
10	Romex 8 AWG	8/2/W/ground		FT	14		
11	ROMEX 6 AWG	6/2/W/ground		FT	25		
12	Bare Copper Ground Wire 6 AWG			FT			
13							
14							
15							
16							



		ELEC	CTRICAL BOXES & CIRCUTES			
#	Item	Туре	Description, Manufacturer, SKU	Unit	Quantity Unit Price	e Total
1	Panelboard -240V 1 Phase MLO	200 AMP		PCS	1	
2	Circuit breaker	15 A		PCS	0	
3	Circuit breaker	20 A		PCS	14	
4	Circuit breaker	30 A		PCS	2	
5	Circuit breaker	50 A		PCS	1	
6	Circuit breaker	60 A		PCS	1	
7	Single Gang Switch Box			PCS	3	
8	Double Gang Switch Box			PCS	2	
9	Triple Gang Switch Box			PCS	3	
10	Pull Box	#1/4		PCS	28	
11	Receptacle Box			PCS	30	
12						
13						
14						
15						

	HVAC_DUCTS 01						
#	Item	Туре	Description, Manufacturer, SKU	Unit	Quantity	Unit Price	Total
1	PIPE (REFRIGERANT LINE)	3/8" (Ø)		FT	74.26		
2	PIPE (REFRIGERANT LINE)	1/2" (Ø)		FT	0.87		
3	PIPE (REFRIGERANT LINE)	3/4" (Ø)		FT	97.2		
4	DRAYER HOSE	4" (Ø)		FT	4		
5	FLEX DUCT ROUND	4" (Ø)		FT	7		
6							
7							
8							
9							
10							
11							
12							
13							
14							
15							
16							

			DUCT FITTINGS & ACCESSORIES				
#	Item	Туре	Description, Manufacturer, SKU	Unit	Quantity	Unit Price	Total
1	ELBOW (REFRIGERANT LINE)	1/2" (Ø)-1/2" (Ø)		PCS	1		
2	ELBOW (REFRIGERANT LINE)	3/4" (Ø)-3/4" (Ø)		PCS	24		
}	ELBOW (REFRIGERANT LINE)	3/8" (Ø)-3/8" (Ø)		PCS	19		
	TRANSITION (REFRIGERANT LINE)	3/4" (Ø)-1/2" (Ø)		PCS	4		
i	TRANSITION (REFRIGERANT LINE)	3/4" (Ø)-3/8" (Ø)		PCS	3		
5	TRANSITION (REFRIGERANT LINE)	3/8" (Ø)-1/4" (Ø)		PCS	1		
,	TEE (REFRIGERANT LINE)	3/4" (Ø)-3/4" (Ø)-3/4" (Ø)		PCS	2		
3	TEE (REFRIGERANT LINE)	3/8" (Ø)-3/8" (Ø)-3/8" (Ø)		PCS	2		
)	ROUND TRANSITION(ANGLE)	45 DEGREE		PCS	5		
.0							
.1							
.2							
.3							
L4							
L5							
16							

			HVAC_EQUIPMENTS				
#	Item	Туре	Description, Manufacturer, SKU	Unit	Quantity	<b>Unit Price</b>	Total
1	AIR HANDLING UNIT	WALL MOUNTED		PCS	3		
2	CONDENSER	OUTDOOR UNIT		PCS	1		
3	EXHAUST FAN	75 CFM		PCS	1		
1	EXHAUST HOOD	WALL MOUNTED		PCS	1		
5	HOOD-WALL: VENT	HOOD-WALL: VENT		PCS	1		
5	DRAYER: VENT	DRAYER: VENT		PCS	1		
7	ROOF VENT	3"(Ø)		PCS	1		
8							
9							
10							
11							
12							
13							
14							



		PLUMBIN	NG FIXTURES & ACCESSORIES				
#	Item	Туре	Description, Manufacturer, SKU	Unit	Quantity	Unit Price	Total
1	Bath Tub (Alcove Tub)			PCS	0		
2	Kitchen Sink			PCS	1		
3	Kitchen faucets			PCS	1		
4	Vanity Sink			PCS	1		
5	Bath room faucets		'	PCS	1		
6	Water Closet			PCS	1		
7	Shower Trim			PCS	1		
8	Shower Tray			PCS	1		
9	Water Heater			PCS	1		
10	Hose Bib			PCS	1		
11	Shutoff Valve			PCS	6		
12	Hanging pipe clamp			PCS	16		
13	Gate Valve			PCS	1		
14	Dishwasher Supply Single Connector			PCS	0		
15	Dishwasher Sewage Single Connector			PCS	0		
16	Laundry Sweat Connector			PCS	1		



		SANI	TARY & PLUMBING PIPES				
#	Item	Туре	Description, Manufacturer, SKU	Unit	Quantity	Unit Price	Total
1	ABS (Acrylonitrile Butadiene Styrene) Pipes	ø 1"		FT	C		
2	ABS (Acrylonitrile Butadiene Styrene) Pipes	ø 1 1/2"		FT	47	,	
3	ABS (Acrylonitrile Butadiene Styrene) Pipes	ø 2"		FT	18		
4	ABS (Acrylonitrile Butadiene Styrene) Pipes	ø 3"		FT	21		
5	PEX (Cross-linked polyethylene) Pipes	ø 1/2"		FT	73		
6	PEX (Cross-linked polyethylene) Pipes	ø 3/4"		FT	45		
7	PEX (Cross-linked polyethylene) Pipes	ø 1"		FT	C		
8	PEX (Cross-linked polyethylene) Pipes	ø 3"		FT	1		
9	PVC Pipes Sch.80 - Rigid	ø 1 1/2"		FT	C		
10	PVC Pipes Sch.80 - Rigid	ø 2"		FT	72		
11	PVC Pipes Sch.80 - Rigid	ø 3"		FT	C		
12	Flex Pipe Round	ø 1/2"		PCS	6		
13							
14							
15							



		PI	PE FITTINGS 01				
#	Item	Туре	Description, Manufacturer, SKU	Unit	Quantity	Unit Price	Total
1	ABS 90 Degree Bend Elbow	3/4"ø-3/4"ø			2		
2	PEX 90 Degree Elbow	1/2"ø-1/2"ø			9		
3	PEX 90 Degree Elbow	3/4"ø-3/4"ø			5		
4	PEX Tee Elbow	1/2"ø-1/2"ø-1/2"ø			3	3	
5	PEX Tee Elbow	3/4"ø-3/4"ø-3/4"ø			2	2	
6	PEX Transition Elbow	1"ø-3/4"ø			2		
7	PEX Transition Elbow	3/4"ø-1/2"ø			2	2	
8	Tee Elbow	3/4"ø-3/4"ø-3/4"ø			1		
9	PEX 90 Degree Elbow	1/2"ø-1/2"ø			8	3	
10	PEX 90 Degree Elbow	3/4"ø-3/4"ø			4		
11	PEX Tee Elbow	1/2"ø-1/2"ø-1/2"ø			2		
12	PEX Tee Elbow	3/4"ø-3/4"ø-3/4"ø			1		
13	PEX Transition Elbow	3/4"ø-1/2"ø			2		
14	PVC 90 Deg Bend Elbow	2"ø-2"ø			8	3	
15	ABS 90 Deg Bend Elbow	3"ø-3"ø			1		



		PIPE	FITTINGS 02				
#	Item	Туре	Description, Manufacturer, SKU	Unit	Quantity	Unit Price	Total
1	ABS 90 Degree Bend Elbow	1 1/2"ø-1 1/2"ø			2		
2	ABS 90 Degree Bend Elbow	2"ø-2"ø			2		
3	ABS P-Trap	1 1/2"ø-1 1/2"ø			3		
4	ABS P-Trap	2"Ø-2"Ø			1		
5	ABS Reducer Elbow	3"ø-2"ø			1		
6	ABS TEE Elbow	1 1/2"ø-1 1/2"ø-1 1/2"ø			3		
7	ABS TEE Elbow	2"ø-2"ø-2"ø			1		
8	ABS TEE Elbow	3"ø-3"ø-3"ø			1		
9	ABS Tee Reducer Elbow	3"ø-3"ø-1 1/2"ø			3		
10	ABS Tee Reducer Elbow	3"ø-3"ø-3"ø			1		
11	ABS Vent Cap Elbow	1 1/2"ø			3		
12	ABS Vent Cap Elbow	2"ø			1		
13	ABS Vent Cap Elbow	3"ø			1		
14					<u> </u>		
15							



			APPLIANCES				
#	Item	Туре	Description, Manufacturer, SKU	Unit	Quantity	Unit Price	Total
1	Refrigerator			PCS	1		
2	Range			PCS	1		
3	Washer Front Load	Stackable		PCS	1		
4	Dryer Front Load	Stackable		PCS	1		
5	Dish Washer			PCS	C		
6	Oven			PCS	C		
7	Microwave			PCS	C		
8							
9							
10							
11							
12							
13							
14							
15							
16							



			CASEWORKS 01				
#	Item	Туре	Description, Manufacturer, SKU	Unit	Quantity	Unit Price	Total
1	Kitchen Cabinet			FT	18.13		
2	Laundry Cabinet			FT	2.25		
3	Vanity Cabinet			FT	3		
4	Medicine Cabinet			PCS	1		
5	Kitchen countertop			SF	29.45		
6	Laundry Countertop			PCS	0		
7	Bathroom Countertop			SF	0		
8	Island			FT	0		
9	Peninsula			FT	0		
10	Closets			SF	111.9		
11							
12							
13							
14							
15							



			CEILING 01				
‡	Item	Туре	Description, Manufacturer, SKU	Unit	Quantity	Unit Price	Total
	LIVING ROOM + KITCHEN			SF	259.0		
	Ceiling Board	Drywall		SF	259		
	Drywall Fastener	Screw		PCS	453		
	Vapor Retarder	Polyethylene film		SF	259		
	Vapor Retarder Fastener	Nails with washer heads		PCS	777		
	BATH 1			SF	56.0		
•	Ceiling Board	MRD (Moisture resistant drywall)		SF	56		
i	MRD Fastener	Screw		PCS	98		
	SHADE			SF	51.0		
,	Ceiling Board	Marine Plywood		SF	51		
3	Exterior Grade Plywood	Screw		PCS	89		
	HALL+W/D			SF	33.0		
)	Ceiling Board	Drywall		SF	33		
.0	Drywall Fastener	Screw		PCS	58		
1	Vapor Retarder	Polyethylene film		SF	33		
L2	Vapor Retarder Fastener	Nails with washer heads		PCS	99		



			CEILING 02				
#	Item	Туре	Description, Manufacturer, SKU	Unit	Quantity	Unit Price	Total
	BED ROOM 1			SF	171.0		
13	Ceiling Board	Drywall		SF	171		
14	Drywall Fastener	Screw		PCS	299		
15	Vapor Retarder	Polyethylene film		SF	171		
16	Vapor Retarder Fastener	Nails with washer heads		PCS	513		
	BED ROOM 2			SF	164.0		
17	Ceiling Board	Drywall		SF	164		
18	Drywall Fastener	Screw		PCS	287		
19	Vapor Retarder	Polyethylene film		SF	164		
20	Vapor Retarder Fastener	Nails with washer heads		PCS	492		
	CLOSET 1			SF	18.0		
21	Ceiling Board	Drywall		SF	18		
22	Drywall Fastener	Screw		PCS	32		
23	Vapor Retarder	Polyethylene film		SF	18		
24	Vapor Retarder Fastener	Nails with washer heads		PCS	54		



			CEILING 03				
#	Item	Туре	Description, Manufacturer, SKU	Unit	Quantity	Unit Price	Total
	CLOSET 2			SF	25.0		
25	Ceiling Board	Drywall		SF	25		
26	Drywall Fastener	Screw		PCS	44		
27	Vapor Retarder	Polyethylene film		SF	25		
28	Vapor Retarder Fastener	Nails with washer heads		PCS	75		
	WH			SF	10.0		
29	Ceiling Board	Drywall		SF	10		
30	Drywall Fastener	Screw		PCS	18		
31	Vapor Retarder	Polyethylene film		SF	10		
32	Vapor Retarder Fastener	Nails with washer heads		PCS	30		



			FLOORING INTERIOR 01				
#	Item	Туре	Description, Manufacturer, SKU	Unit	Quantity	Unit Price	Total
	BEDROOM #1						
1	Bedroom Flooring			SF	156		
2	Wood underlay	Foam Pad Polyethylene		SF	156		
3	Vapor Retarder	Vapor Barrier Polyethylene		SF	156		
	BEDROOM #2						
4	Bedroom Flooring			SF	150		
5	Wood underlay	Foam Pad Polyethylene		SF	150		
6	Vapor Retarder	Vapor Barrier Polyethylene		SF	150		
	CLOSET 1						
7	Closet Flooring			SF	16		
8	Wood underlay	Foam Pad Polyethylene		SF	16		
9	Vapor Retarder	Vapor Barrier Polyethylene		SF	16		
	CLOSET 2						
10	Closet Flooring			SF	23		
11	Wood underlay	Foam Pad Polyethylene		SF	23		
12	Vapor Retarder	Vapor Barrier Polyethylene		SF	23		



	1		FLOORING INTERIOR 02				
#	Item	Туре	Description, Manufacturer, SKU	Unit	Quantity	Unit Price	Total
	LIVING ROOM AND KITCH	EN					
13	Living Area Flooring			SF	251		
14	Wood underlay	Foam Pad Polyethylene		SF	251		
15	Vapor Retarder	Vapor Barrier Polyethylene		SF	251		
	BATHROOM	·					
16	Tile Finish			SF	37		
17	Adhesive	1/2" Thin set Mortar		SF	37		
18	Vapor Retarder	Vapor Barrier Polyethylene		SF	37		
	W/D	<del></del>					
19	Tile Finish			SF	10		
20	Adhesive	1/2" Thin set Mortar		SF	10		
21	Vapor Retarder	Vapor Barrier Polyethylene		SF	10		
	BOILER ROOM	·					
22	Tile Finish			SF	9		
23	Adhesive	1/2" Thin set Mortar		SF	9		
24	Vapor Retarder	Vapor Barrier Polyethylene		SF	9		



			FLOORING EXTERIOR			
#	Item	Туре	Description, Manufacturer, SKU	Unit	Quantity	Unit Price
	STRUCTURE			SF	737.9	
1	Concrete Slab	4"concrete cast in situ		CF	246	
2	Insulation	Rigid insulation		SF	248	
3	Hard core	Compacted soil		CF	194.4	
4	Re-bar	#4 re-bar		Ton	0.71	
5	Concrete Pad	4"concrete cast in situ		CF	2	
6	Slab edge	Turndown		CF	209.6	



			WALLS: EXTERIOR				
#	Item	Туре	Description, Manufacturer, SKU	Unit	Quantity	Unit Price	Total
1	Curtain Wall	Glazing		SF	119		
2	Exterior-Grade Plywood Siding			SF	915		
3	Exterior-Grade Plywood Fastener 8/panel	Self-drilling screws(100/pkt)		PKT	9.15		
4	Wall Shteathing (OSB)			SF	915		
5	Shteathing Fastener	Self-drilling screws(100/pkt)		PKT	9.15		
6	Wall Homewrap			SF	915.0		
7	Homewrap Fastener	Stapled fastener (200/pkt)		PKT	3.5		
8	Furring Strip			PCS	114.375		
9	Furring Strip Fastener	Self-drilling screws(100/pkt)		PKT	9.15		
10	Wall Paint			SF	915		
11	Stone Copping	Masonry stone		SF	0		
12	Stone Veneer	Masonry stone		SF	0		
13	Mortar for Stone Veneer			SF	0		
14	Wall Insulation			SF	2986		
15							



			WALLS: INTERIOR 01				
#	Item	Туре	Description, Manufacturer, SKU	Unit	Quantity	Unit Price	Total
	BATHROOM			SF	48.0		
1	Cementitious Backer Board			SF	293		
2	Kerdi membrane			SF	293		
3	Kerdi membrane Fastener			SF	293		
4	Wall Ceramic Tile			SF	293		
	BEDROOM 1			SF	151.0		
5	Drywall Board			SF	383		
6	Drywall Fastener	Self-drilling screws(100/pkt)		PKT	3.83		
7	Wall Paint			SF	383		
8	Drywall Tape			FT	71.8		
	BEDROOM 2			SF	145.0		
9	Drywall Board			SF	333		
10	Drywall Fastener	Self-drilling screws(100/pkt)		PKT	3.33		
11	Wall Paint			SF	333		
12	Drywall Tape			FT	62.4		



			WALLS: INTERIOR 02				
#	Item	Туре	Description, Manufacturer, SKU	Unit	Quantity	Unit Price	Total
	LIVING ROOM			SF	135.0		
13	Drywall Board			SF	283		
14	Drywall Fastener	Self-drilling screws(100/pkt)		PKT	2.83		
15	Wall Paint			SF	283		
16	Drywall Tape			FT	53.1		
	KITCHEN			SF	101.0	ı	
17	Cementitious Backer Board			SF	28		
18	Drywall Board			SF	225		
19	Drywall Fastener	Self-drilling screws(100/pkt)		PKT	2.25		
20	Kerdi membrane			SF	28		
21	Kerdi membrane Fastener			SF	28		
22	Wall Ceramic Tile			SF	28		
23	Wall Paint			SF	225		
24	Drywall Tape			FT	42.5		



		WALLS: INTERIOR 03							
#	Item	Туре	Description, Manufacturer, SKU	Unit	Quantity	Unit Price	Total		
	CL 1			SF	15.0	l			
25	Drywall Board			SF	143				
26	Drywall Fastener	Self-drilling screws(100/pkt)		PKT	1.43				
27	Wall Paint			SF	143				
28	Drywall Tape			FT	26.8				
	CL 2			SF	22.0	l			
29	Drywall Board			SF	180				
30	Drywall Fastener	Self-drilling screws(100/pkt)		PKT	1.8				
31	Wall Paint			SF	180				
32	Drywall Tape			FT	33.8				
	WD			SF	9.0				
33	Cementitious Backer Board			SF	89				
34	Kerdi membrane			SF	89				
35	Kerdi membrane Fastener			SF	89				
36	Wall Ceramic Tile			SF	89				



		WALLS: INTERIOR 04							
#	Item	Туре	Description, Manufacturer, SKU	Unit	Quantity	Unit Price	Total		
	WH			SF	9.0				
37	Drywall Board			SF	75				
38	Drywall Fastener	Self-drilling screws(100/pkt)		PKT	0.75				
39	Wall Paint			SF	75				
40	Drywall Tape			FT	14				
	HALL			SF	12.0				
41	Drywall Board			SF	70				
42	Drywall Fastener	Self-drilling screws(100/pkt)		PKT	0.7				
43	Wall Paint			SF	70				
44	Drywall Tape			FT	13				
1	Wall Skirting	Ceramic		FT	127				



			DOORS				
#	Item	Туре	Description, Manufacturer, SKU	Unit	Quantity	Unit Price	Total
1	Interior Swinging	2' - 6" X 6'-8"		PCS		1	
2	Interior Sliding	7' - 0" X 6'- 8"		PCS		1	
3	Interior Swinging	3' - 0" X 6'- 8"		PCS		1	
4	Interior Sliding	10' - 0" X 6'- 8"		PCS		1	
5	Interior Swinging	2' - 10" X 6'- 8"		PCS		1	
6	Patio Sliding	10' - 0" X 6'- 8"		PCS		2	
7	Patio Sliding	12' - 0" X 6'- 8"		PCS		1	
8	Exterior Swinging	2' - 10" X 6'-8"		PCS		1	
9	Exterior Door Trim			FT	9	1	
10	Interior Door Trim			FT	27	5	
11	Entry Lock set			PCS		1	
12	Privacy Lock set			PCS	:	3	
13	Passage Lock set			PCS		2	
14							
15							



			WINDOWS				
#	Item	Туре	Description, Manufacturer, SKU	Unit	Quantity	Unit Price	Total
1	Single Hung	3' - 3" X 3'-3"		PCS	1		
2	Sliding	3' - 3" X 2'-3"		PCS	1		
3	Casment	2' - 3" X 5'-3"		PCS	2	2	
4	Exterior Window Trim			FT	55		
5	Interior Window Trim			FT	55		
6							
7							
8							
9							
10							
11							
12							
13							
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			ROOF 01				
#	Item	Туре	Description, Manufacturer, SKU	Unit	Quantity	Unit Price	Total
1	Roof Covering			SF	940.0		
2	Roof Covering Fastener			PCS	470		
3	Roof Felt Paper			SF	940.0		
4	Roof Felt Paper Fastener			PCS	2820.0		
5	Roof Sheathing			SF	940.0		
6	Roof Sheathing Fastener			PCS	7520		
7	Batten			FT	502.0		
8	Batten Fastener			PCS	377.4		
9	Soffit			SF	39.0		
10	Soffit Fastener			PCS	19.5		
11	Fascia			FT	151.0		
12	Fascia board fastener			PCS	76		
13	Roof Insulation			SF	940.0		
14					1 1010		
15							