


EMBER

The Ember is a stylish modern studio home. Its exterior showcases walls are clad in dark vertical siding. The roof features a dynamic shed-style design with covered porch extending from the main entrance, supported by simple wooden posts.

Inside, the Ember features a simple rectangular layout. The living and kitchen areas are merged into one large room at the center of the house, creating a spacious and versatile living space. Functional spaces, such as the bathroom and laundry, are conveniently located on one side of the plan.

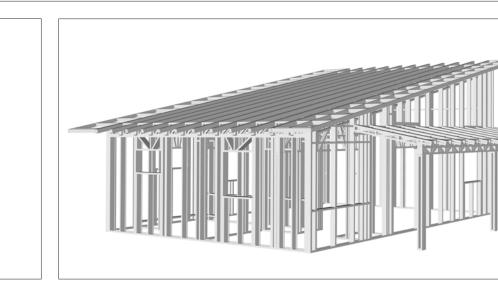


Materials Shopping List


Please print and take this Materials Shopping List to your favorite Home Depot and ask for assistance in selecting the materials, fixtures and fittings to complete your new home.

Record your selection and the price of the item. Then do the math to determine the cost for your selections and the total cost of finishing your home.





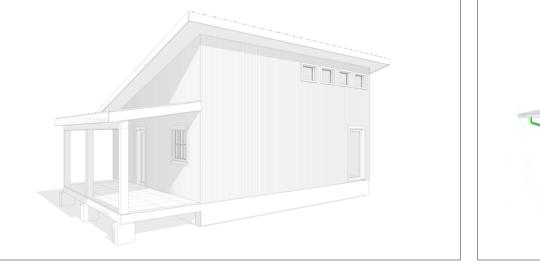

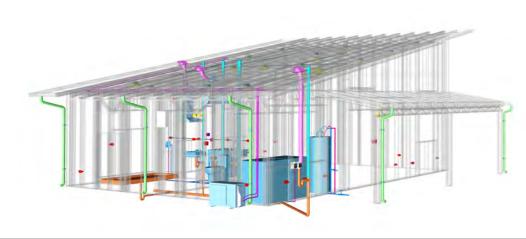


30' - 3" KITCHEN 82 SF PORCH 139 SF STUDIO AREA 295 SF

FLOOR PLAN

624 SF

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STRUCTURAL

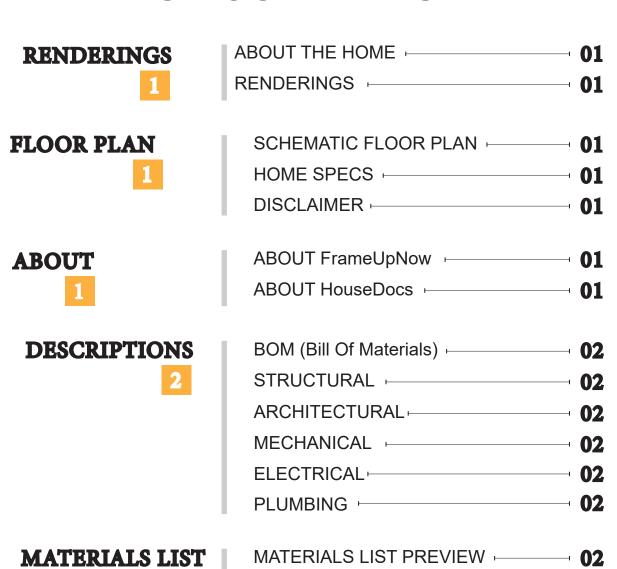MATERIALS

SHOPPING LIST

16	GENERAL NOTES :
_	WALL FRAME LAYOUT
	WALL PANEL & LAYOUT PLAN
	ROOF TRUSS LAYOUT
	STRUCTURAL SECTIONS -
	WALL BRACING LAYOUT
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37	WATER SUPPLY & SEWAGE SYSTEM +

MATERIALS SHOPPING LIST

COVER SHEET

ABOUT



FrameUpNow is a design and manufacturing company providing precision-engineered home framing solutions. We offer a catalog of Affordable Homes, Tiny Homes, Garages, Shops and Barndominiums. FrameUpNow manufactures cold-formed steel (CFS) also known as Light Gauge Steel (LGS) framing components that conform to our engineered metal house frame plans or can be purchased as DIY skeleton kits.

The CFS/LGS framing is lightweight, easily assembled, and does not require heavy equipment or specialized labor, enabling homeowners to erect the frame themselves in just a few days. Unlike wood, the steel framing is impervious termites and bores, warping, expansion, and fire.

Our home plans come complete with a structural engineered stamp for permit approvals. Customers receive a full BOM also known as a Materials Shopping List to purchase finish materials from a Building Materials retailer. FrameUpNow prides itself on the quality and efficiency of our precision-engineered home framing solutions for construction professionals and DIY homeowners.



KEY PLAN

NO.	DESCRIPTION	DATE

NOTE:

LEGEND:

PROJECT

236-Ember-624-Studio-Modern-Base-550

DRAWING NAME

INTRODUCTION

CLIENT NAME:	
PROJECT NUMBER:	
DATE:	
DESIGNED BY:	
DRAWN BY:	
CHECKED BY:	

I101

SCALE:

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DESCRIPTIONS

MATERIALS LIST

The BOM (Bill Of Materials) package, known as the Materials Shopping List document, provides:

Comprehensive Inventory: Detailed lists of essential materials sourced from architectural, mechanical, HVAC, electrical, and plumbing design drawing sets.

Precise Curation: Each item meticulously selected and organized for accuracy and efficiency in project planning.

Customizable Options: Customers can modify listed items to their preferences and calculate costs accordingly, ensuring alignment with personal project needs and budget.

Dedicated Space for Details: Includes tables for customers to note Home Depot SKU numbers or product descriptions for selected items,

facilitating seamless purchasing and coordination with suppliers.

Customer Convenience: Take the list to Home Depot or preferred suppliers for accurate pricing, helping align the total home budget with personal financial plans.

Simplify your construction journey with our Materials Shopping List document, where detailed preparation meets streamlined implementation for your dream home.

MECHANICAL

STRUCTURAL

The structural drawings package provides an exhaustive set of detailed plans essential for the precise assembly of your building. This comprehensive package includes:

Framing Plans: Detailed layouts for all framing components. Truss Layouts: Clear instructions for truss placement and

Panel Length Plans: Specifications for panel dimensions. Framing Elevations and Sections: Precise elevation and sectional views for accurate construction.

Truss and Wall Blocking Plans: Plans for truss and wall blocking to ensure structural integrity.

Hold-Down Plan: Detailed hold-down requirements for stability. Snap Sheet: Reference sheet for quick identification of components

Structural Details and Bracing Plans: Complete details and bracing plans for all structural elements.

Accompanying these plans is a comprehensive Bill of Materials (BOM) that lists every necessary building component, from cold formed steel (CFS) frames to fasteners.

ARCHITECTURAL

With the comprehensive architectural package, both builders and DIY homeowners can confidently execute the construction.

The architectural package includes:

Furnished Floor Plans: Complete with furniture layouts for a clear understanding of space utilization.

Detailed Dimension Plans: Ensures precise measurements, from the overall footprint down to the exact placement of windows and

Foundation Plan: Detailed plan to establish a solid foundation.

Wall Framing and Truss Layout: Comprehensive plans for wall framing and truss placement.

Architectural Elevations: Exterior views showcasing the design.

Strategic Building Sections: Critical cross-sectional details for a thorough understanding of the build.

Casework Drawings and Diagrams: Suggested designs for built-in caseworks, such as kitchen cabinets.

ELECTRICAL

The mechanical package includes everything needed to guide HVAC

Detailed HVAC Floor Plan: Precisely maps out the placement of air handlers, ductwork, and vents throughout the home's layout.

HVAC Sections and Riser Diagrams: Technical drawings offering critical cross-sectional details and piping schematics, ensuring proper integration of the heating and cooling system into the home's structure.

Bill of Materials: A complete list of all necessary HVAC components.

The electrical package includes all the plans and documentation needed to guide the installation of your home's electrical system:

Detailed Power Plan: Precisely maps out the placement of outlets, switches, and other power components throughout the layout.

Comprehensive Lighting Plan: Shows the optimal locations for lighting fixtures, sconces, and other illumination sources to create a well-lit, functional interior.

Dimensioned Electrical Layout: Provides exact dimensions and measurements to ensure proper placement of all electrical elements.

Bill of Materials: A complete list of every component needed, from circuit breakers to wiring.

PLUMBING

The plumbing package includes everything needed to guide the

Detailed Water Supply System Plan: Precisely maps out the placement of pipes, valves, and plumbing fixtures throughout the

and sizing of drain lines to effectively remove waste and ensure proper drainage.

Detailed Riser Diagrams: Provide information needed to properly

Bill of Materials: A complete list of every component needed, from

installation of your home's water supply and drainage systems:

Comprehensive Sewage System Plan: Shows the optimal routing

install all vertical plumbing risers and vent stacks.

pipes to fixtures.


BOM (Bill Of Materials) (Separately Attached)





The Bill of Materials (BOM) is a crucial document that compiles the material requirements from different disciplines into a centralized inventory, enabling efficient procurement, inventory management, and cost estimation for a specified project or

ELECTRICAL BOM



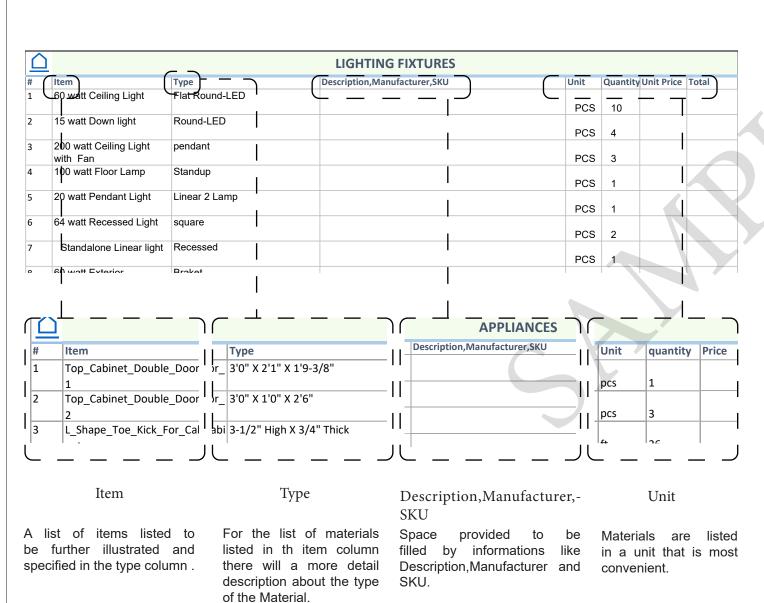

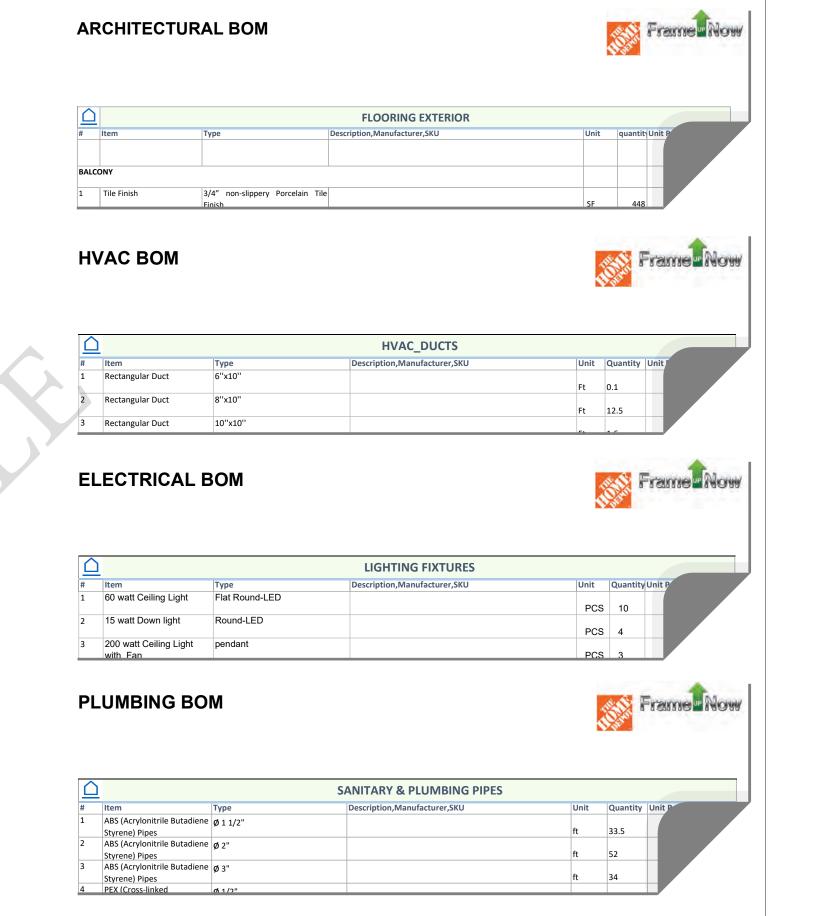

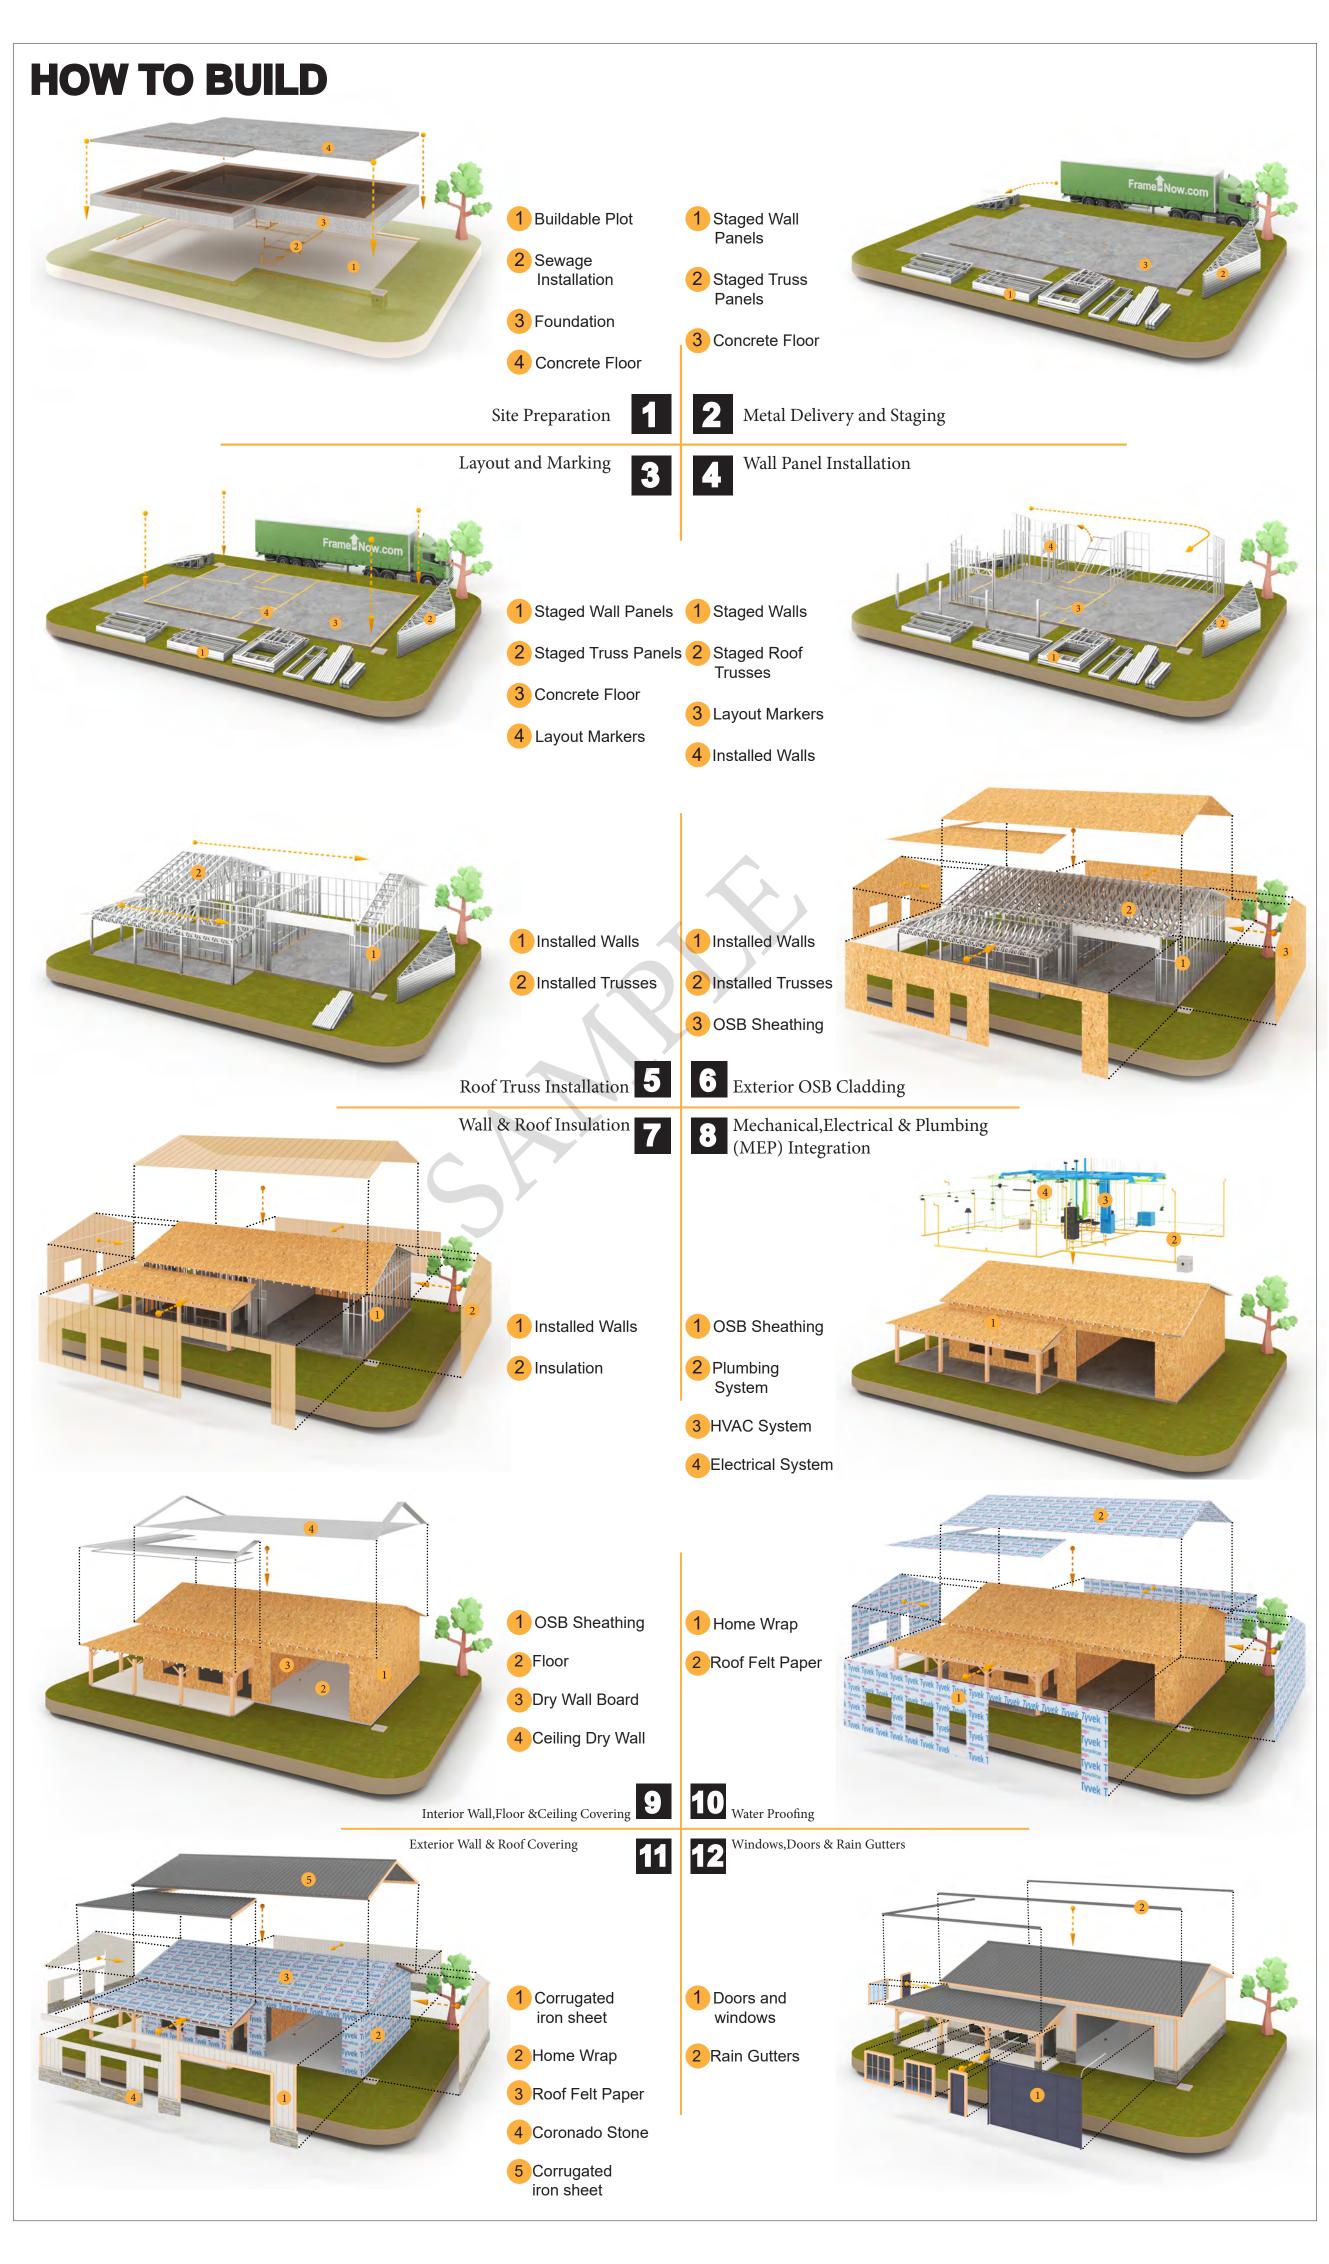



KEY PLAN

NO.	DESCRIPTION	DATE		

NOTE:

LEGEND:

PROJECT

236-Ember-624-Studio-Modern-Base-550


DRAWING NAME

INTRODUCTION

CLIENT NAME: PROJECT NUMBER: DATE: **DESIGNED BY** DRAWN BY: CHECKED BY:

1102

SCALE:

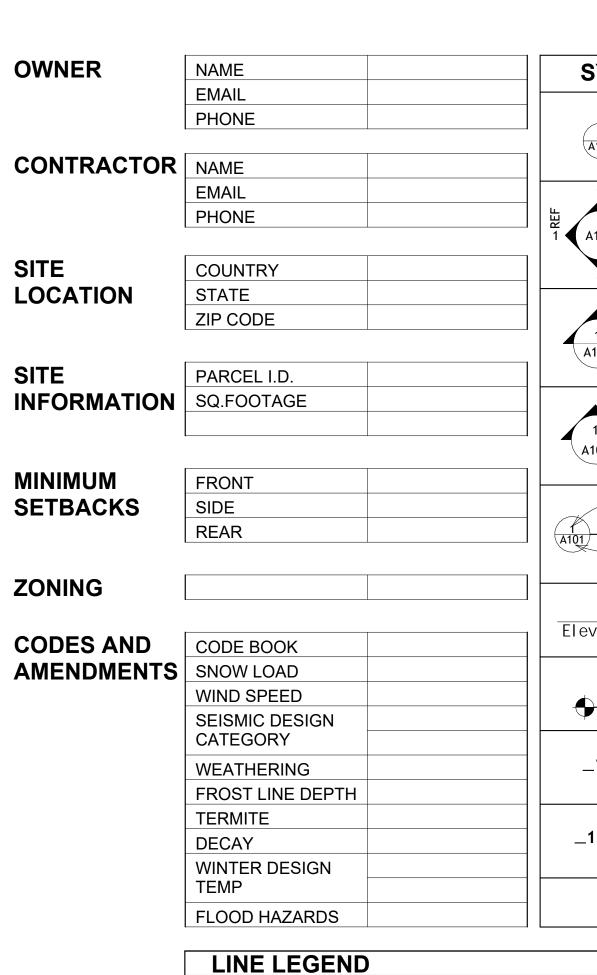

HIDDEN LINE

OVER HEAD

ROOM SEPARATOR

DOOR OPENING DIRECTION

SYMBOLS	SYMBOLS NAME		PAGE INDEX
VIEW		G101	COVER SHEET
NUMBER		A101	FLOOR PLAN
A101 SHEET	CALLOUT HEAD	A102	DIMENSION PLAN
NUMBER		S101	FOUNDATION PLAN
1 REF		S102	STRUCTURAL FLOOR PLAN
NUMBER	R INTERIOR ELEVATION	S103	FRAME LAYOUT
A101 1		S104	ROOF TRUSS LAYOUT
1 REF NUMBER		A103	ROOF PLAN
REF VIEW		A201	ELEVATIONS
NUMBER	DUIL DING ELEVATION	A202	ELEVATIONS
A101	BUILDING ELEVATION	A301	SECTIONS
SHEET NUMBER		A401	DETAILS
VIEW		A402	CASEWORK DETAILS
NUMBER	OFOTION	A403	CASEWORK DETAILS
A101	SECTION	E101	SCHEDULE
SHEET NUMBER		E102	LIGHTING PLAN
VIEW		E103	POWER PLAN
NUMBER	DETAIL MENA	E104	DIMENSION PLAN FOR LIGHT FIXTURE
01 SHEET	DETAIL VIEW	E105	DIMENSION PLAN FOR FITTING
NUMBER		P101	COVER SHEET
		P102	WATER SUPPLY SYSTEM
Name _	ELEVATION LEVEL	P103	SEWAGE SYSTEM
Tevation \		P104	RISER DIAGRAM
ELOOD		M101	HVAC PLAN
FLOOR LEVEL	SPOT ELEVATION	M102	HVAC SECTION
- 0'-2"	O O LLLVATION	M103	DISED DIVCDVM

FLOOR SLOPE

ROOF SLOPE

CALL OUT BOUNDRY — — — — —

ROOF SLOPE ELEVATION

F 102	WATER SUPPLY STSTEW
P103	SEWAGE SYSTEM
P104	RISER DIAGRAM
M101	HVAC PLAN
M102	HVAC SECTION
M103	RISER DIAGRAM
TAG	TAG'S NAME
CA01	CASEWORK TAG
1	DOOR TAG
1	FURNITURE TAG
1	WINDOW TAG
SE01	SPECIALTY EQUIPMENT TAG
ME01	MECHANICAL EQUIPMENT TAG
PE01	PLUMBING EQUIPMENT TAG



- FLOOR SLOPE

SLOPE

ROOF SLOPE

CUT LINE

DIRECTION

SLOPE DIRECTION

MAX.	MAXIMUM
ME	MECHANICAL
MIN.	MINIMUM
NO.	NUMBER
O.C	ON CENTER
OSB	ORIENTED STRAND BOARD
PL	PLUMBING
PSI	POUNDS PER SQUARE INCH
PVC	POLYVINYL CHLORIDE
REF	REFERENCE
RG	RIGHT GARAGE
SE	SPECIAL EQUIPMENT
SF	SQUARE FEET
SIMP. STHD8	SIMPSON STRAP THE HOLDDOWN
SIMP. ABE66	SIMPSON ANCHOR BOLT EDGE
TV	TELEVISION
UNO	UNLESS NOTED OTHERWISE
W/	WITH
W/D	WASHER/DRYER
AC	AIR CONDITIONING UNIT
ACC	AIR COOLED CONDENSER
ACCU AHU	AIR COOLED CONDSENSING UNIT
CC	AIR HANDLING UNIT COOLING COIL
CD	CEILING DIFFUSER
CFm	Cubic Feet Per Minute
CR	CEILING REGISTER
CU	CONDENSING UNIT
CW	COLD WATER
E/A	EXHAUST AIR
EF	EXHAUST FAN
ET	EXPANSION TANK
EX.	EXISTING
FC	FLEXIBLE CONNECTION
FCU	FAN COIL UNIT
FLR.	FLOOR
HC	HEATING COIL
HE	AIR TO AIR HEAT EXCHANGER
HV	HEATING AND VENTILATING UNIT
IV	INLET VANES
MER	MECHANICAL ROOM
MAX.	MAXIMUM
MIN.	MINIMUM
R/A	RETURN AIR
RCU	RECIPROCATING CHILLER UNIT
RF	RETURN FAN
S/A	SUPPLY AIR
SCD	SMOKE CONTROL DAMPER
SP	STATIC PRESSURE

ABBREVIATION

CASEWORK

ELECTRICAL

FOOTINGS

AFS

F.F.L

FTG

HVAC

ACTION FLOOR SYSTEMS

AMERICAN SOCIETY FOR


TESTING AND MATERIAL

FINISHED FLOOR LEVEL

FINISHED FLOOR ELEVATION

HEATING, VENTILATION & AIR CONDITIONING

INTERNATIONAL RESIDENCE

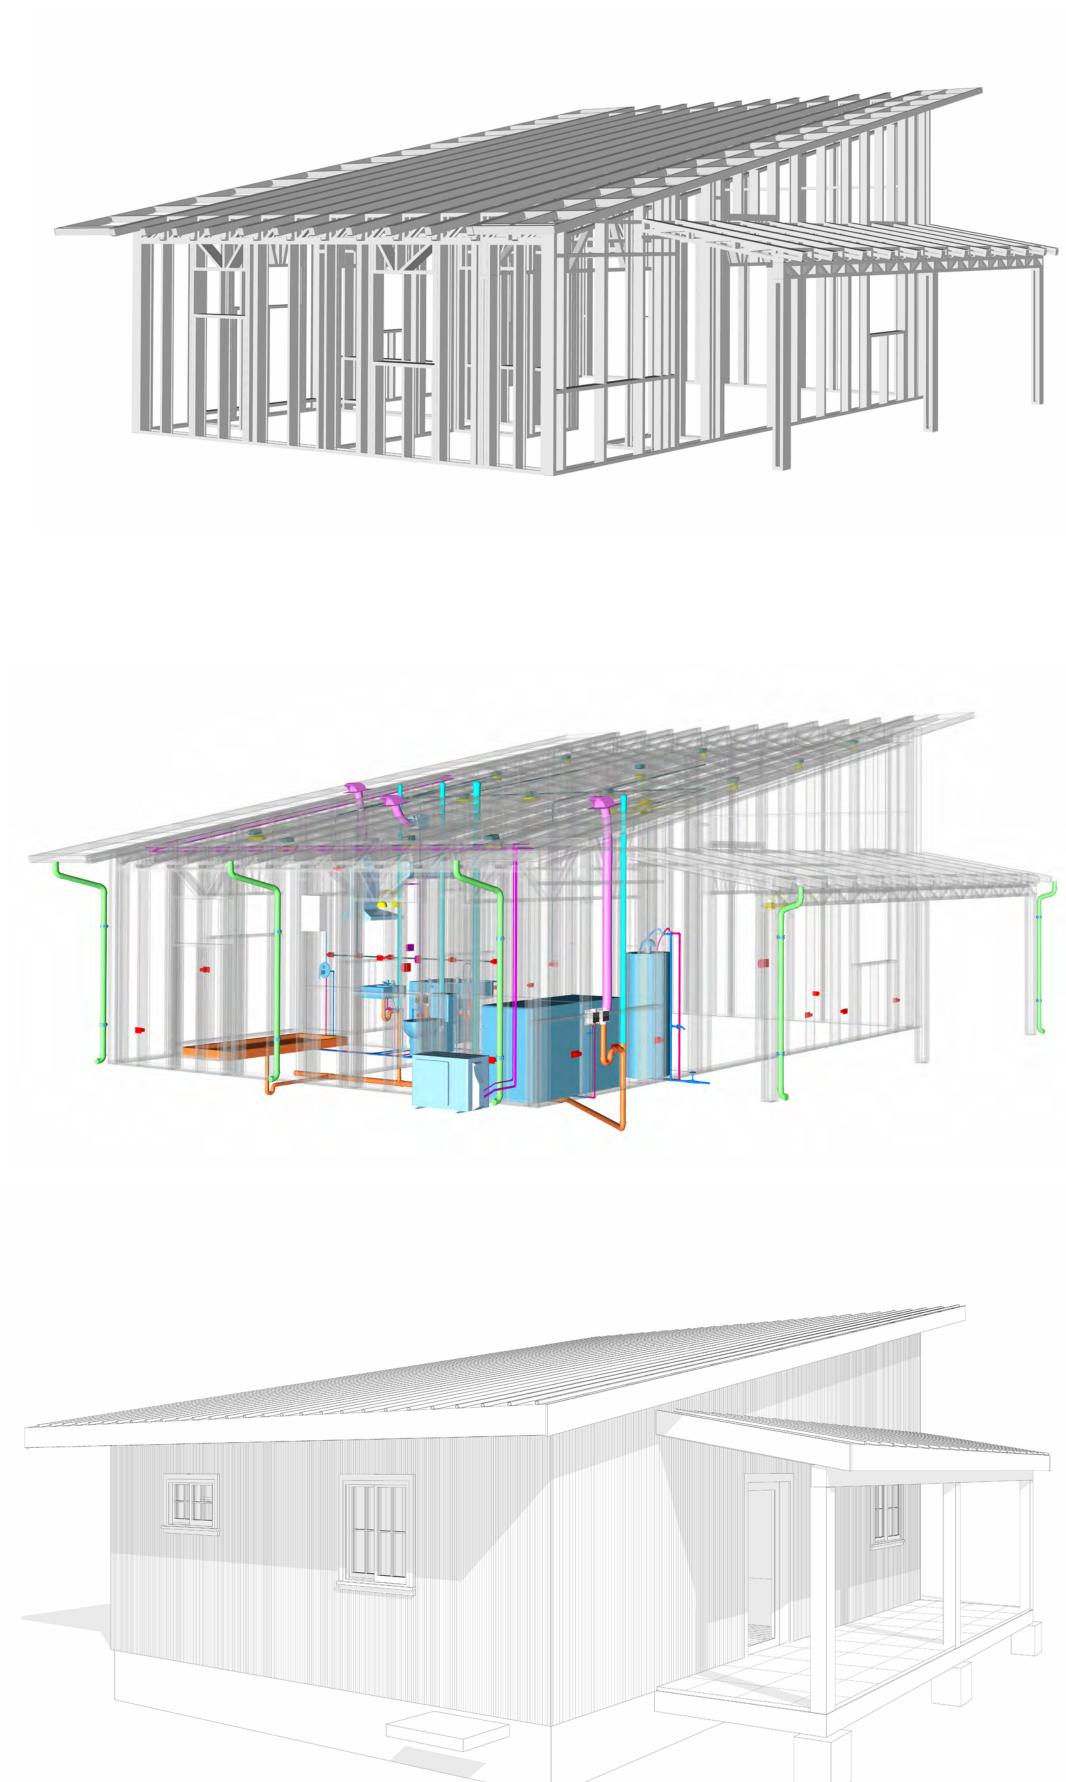


236-EMBER-624-STUDIO MODERN-BASE-550

SQUARE FOOT	AGE
LIVING	616
PORCH	131
TOTAL	755



KEY PLAN

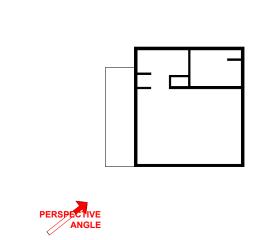

NO.	DESCRIPTION	DATE

NOTE:

LEGEND:

PROJECT

236-EMBER-624-STUDIO MODERN-BASE-550

DRAWING NAME

COVER SHEET

CLIENT NAME:	Client Name
PROJECT NUMBER:	0033_15
DATE:	5/12/2025 3:16:32 PM
DESIGNED BY:	Designer
DRAWN BY:	Author
CHECKED BY:	Checker

G101



- THIS DRAWING DEPICTS THE ARCHITECTURAL (SPACE LAYOUT, FURNISHING, FLOOR, WALLS, ROOFS, FOUNDATION, WINDOWS AND DOORS) SYSTEMS. IT PROVIDES A VISUAL REPRESENTATION OF THE ARCHITECTURAL LAYOUT AND COMPONENTS.
- 2. THE ARCHITECTURAL DRAWINGS ARE PREPARED TO MEET THE SPECIFIC REQUIREMENTS OF THE BUILDING, AS PER THE PROJECT SPECIFICATIONS AND APPLICABLE CODES AND
- 3. THE CONSTRUCTION OF THIS HOME SHALL COMPLY WITH THE LATEST EDITION OF THE INTERNATIONAL RESIDENTIAL CODE (IRC), INTERNATIONAL MECHANICAL CODE (IMC), THE INTERNATIONAL PLUMBING STANDARD, THE NATIONAL ELECTRICAL STANDARD AND ALL OTHER APPLICABLE LOCAL, STATE, AND NATIONAL CODES AND REGULATIONS.
- 4. COORDINATION WITH OTHER TRADES HAS BEEN DONE ON A DESIGN LEVEL. THIS DRAWING SHALL BE READ TOGETHER WITH THE ME, EL AND PL DESIGN DRAWINGS TO ENSURE PROPER CONSTRUCTION AND INTEGRATION OF THE BUILDING SYSTEMS.

ABOUT WALLS:

SHOWER WALL COVERING

BATHTUB AND SHOWER SPACES (WALLS AND FLOORS) WITH INSTALLED SHOWER HEADS AND IN SHOWER COMPARTMENTS SHALL BE FINISHED WITH A NON-ABSORBENT SURFACE.

WALL PAINT (INTERNAL)

THE TYPICAL THICKNESS OF LATEX WALL PAINT IS 1/32 OF AN INCH FOR A SINGLE COAT. AND DOUBLE COAT (1/16") SHALL BE APPLIED FOR DURABILITY.

3. ADHESIVES:

THE ADVISABLE TYPE OF ADHESIVE FOR THIS PROJECT IS **EPOXY ADHESIVES** BECAUSE THEY ARE KNOWN FOR THEIR HIGH STRENGTH, DURABILITY, AND RESISTANCE TO MOISTURE, CHEMICALS AND HEAT.

REFER TO SHEETS A201 & A202 FOR GENERAL NOTES ON EXTERNAL FINISHING MATERIALS

ABOUT FLOORS:


- THE SPOT ELEVATION INDICATES THE FINISHED FLOOR ELEVATION.
- 2. FINISHED FLOORS PER PLANS.
- 3. FIELD VERIFY FOR DIMENSION DROP 4" FOR SHOWER AND BATHTUB USE.
- 4. 1% SLOPE ON OUTDOOR BALCONIES FOR WATER RUN OFF.
- 5. 2% SLOPE TOWARDS THE SHOWER DRAIN FOR SUFFICIENT DRAINAGE.
- 6. 4" DROP AT THE DOOR LEADING TO EXTERIOR BALCONY FROM THE MAIN LIVING AREA.
- 5% SLOPE FOR GARAGE IS USED, WHICH SHOULD BE CHECKED WITH THE LOCAL GARAGING ZONING LAWS.






	FURNITURE SCHEDULE				
	TYPE MARK TYPE COUNT				
01		THREE SEAT SOFA	1		
02		25" X 60" DINING 2	1		
03		DINING CHAIR	2		

	ROOM FINISH SCHEDULE						
ROOM NUMBE R	ROOM NAME	FLOOR FINISH	BASE FINISH	WALL FINISH	CEILING FINISH	CEILING HEIGHT	COMMENT S
01	STUDIO AREA	HARDWOOD	CONCRETE	WALL PAINT	DRY WALL	8' - 0"	
02	KITCHEN	HARDWOOD	CONCRETE	WALL PAINT + CERAMIC	DRY WALL	8' - 0"	
03	BATH	VINYL TILES	CONCRETE	CERAMIC TILE	MRD	8' - 0"	
04	HALL	HARDWOOD	CONCRETE	WALL PAINT	DRY WALL	8' - 0"	
05	CL	HARDWOOD	CONCRETE	WALL PAINT	DRY WALL	8' - 0"	
06	W/D	VINYL TILES	CONCRETE	CERAMIC TILE	DRY WALL	8' - 0"	
07	WH	VINYL TILES	CONCRETE	WALL PAINT	DRY WALL	8' - 0"	
08	PORCH	PROCELAIN TILE	CONCRETE	CORRUGATED IRON	PLYWOOD	8' - 0"	

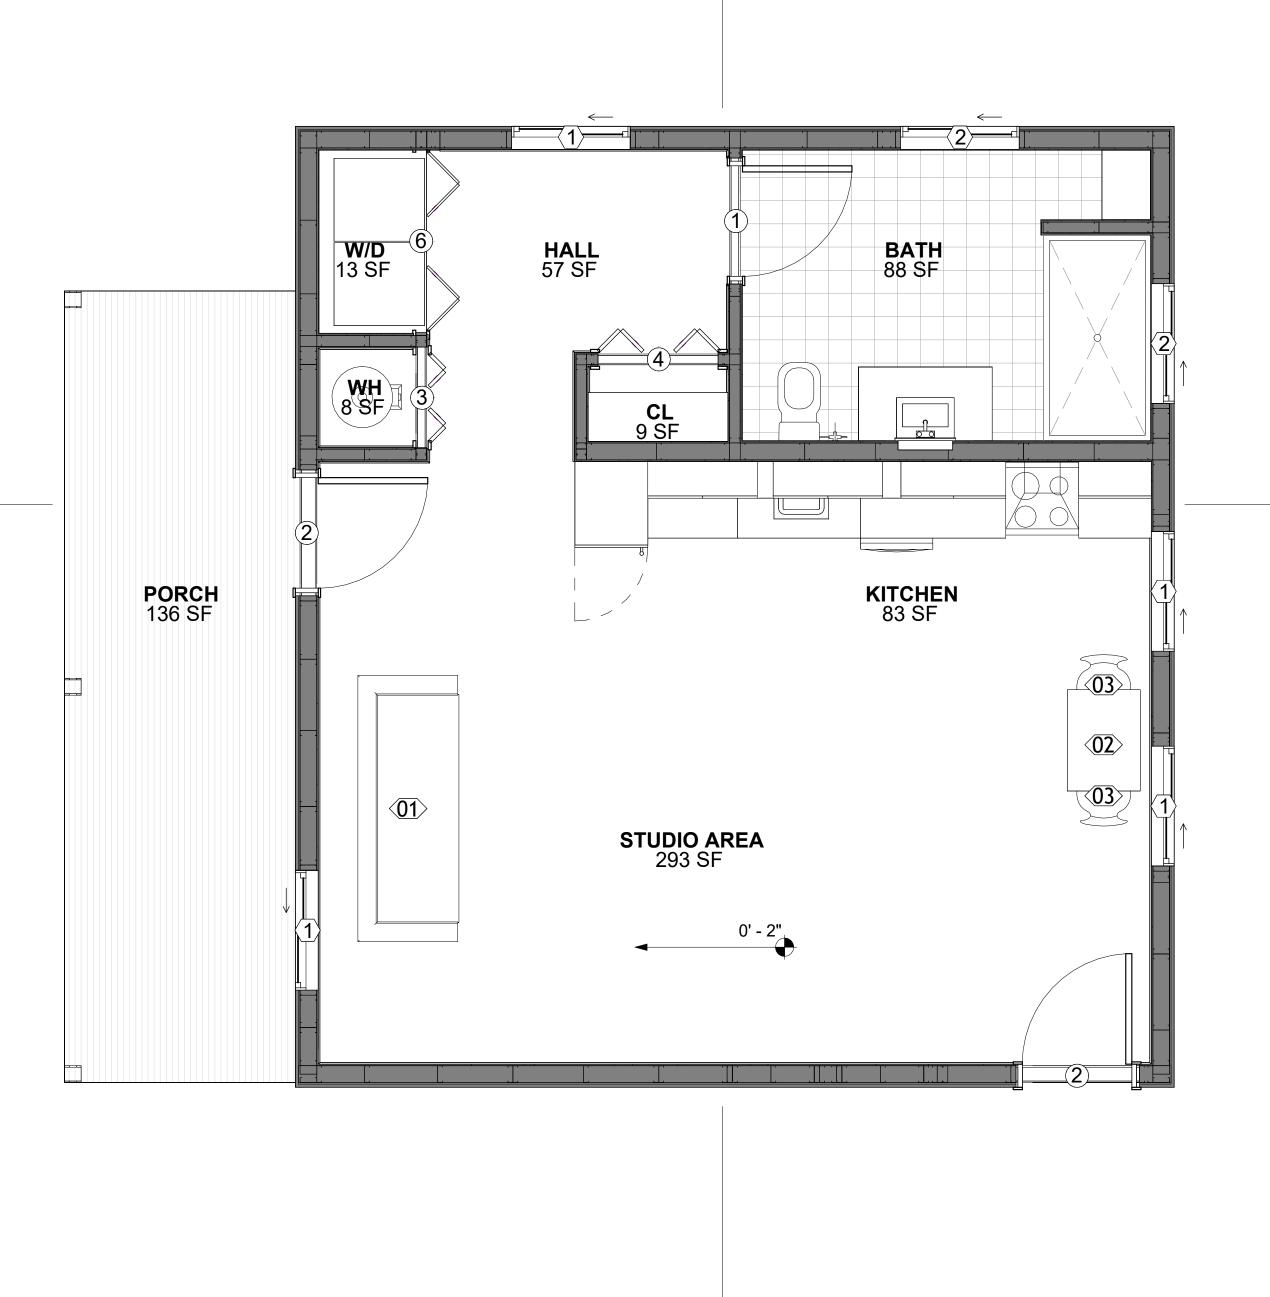

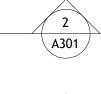



LEGEND:

NOTE:

Tuscon,AZ, USA 888-864-0184

KEY PLAN

inquire@frameupnow.com www.frameupnow.com

DESCRIPTION

DATE

PROJECT

236-EMBER-624-STUDIO MODERN-BASE-550

DRAWING NAME

FLOOR PLAN


CLIENT NAME:	Client Name
PROJECT NUMBER:	0033_15
DATE:	5/12/2025 3:16:33 PM
DESIGNED BY:	Designer
DRAWN BY:	Author
CHECKED BY:	Checker

A101

SCALE: As indicated

ROOM NAME	FINISH	FINISH	WALL FINISH	FINISH	HEIGHT	S
UDIO AREA	HARDWOOD	CONCRETE	WALL PAINT	DRY WALL	8' - 0"	
CHEN	HARDWOOD	CONCRETE	WALL PAINT + CERAMIC	DRY WALL	8' - 0"	
TH	VINYL TILES	CONCRETE	CERAMIC TILE	MRD	8' - 0"	
LL	HARDWOOD	CONCRETE	WALL PAINT	DRY WALL	8' - 0"	

SQUARE FOOTAGE 616 LIVING 131 PORCH TOTAL 755

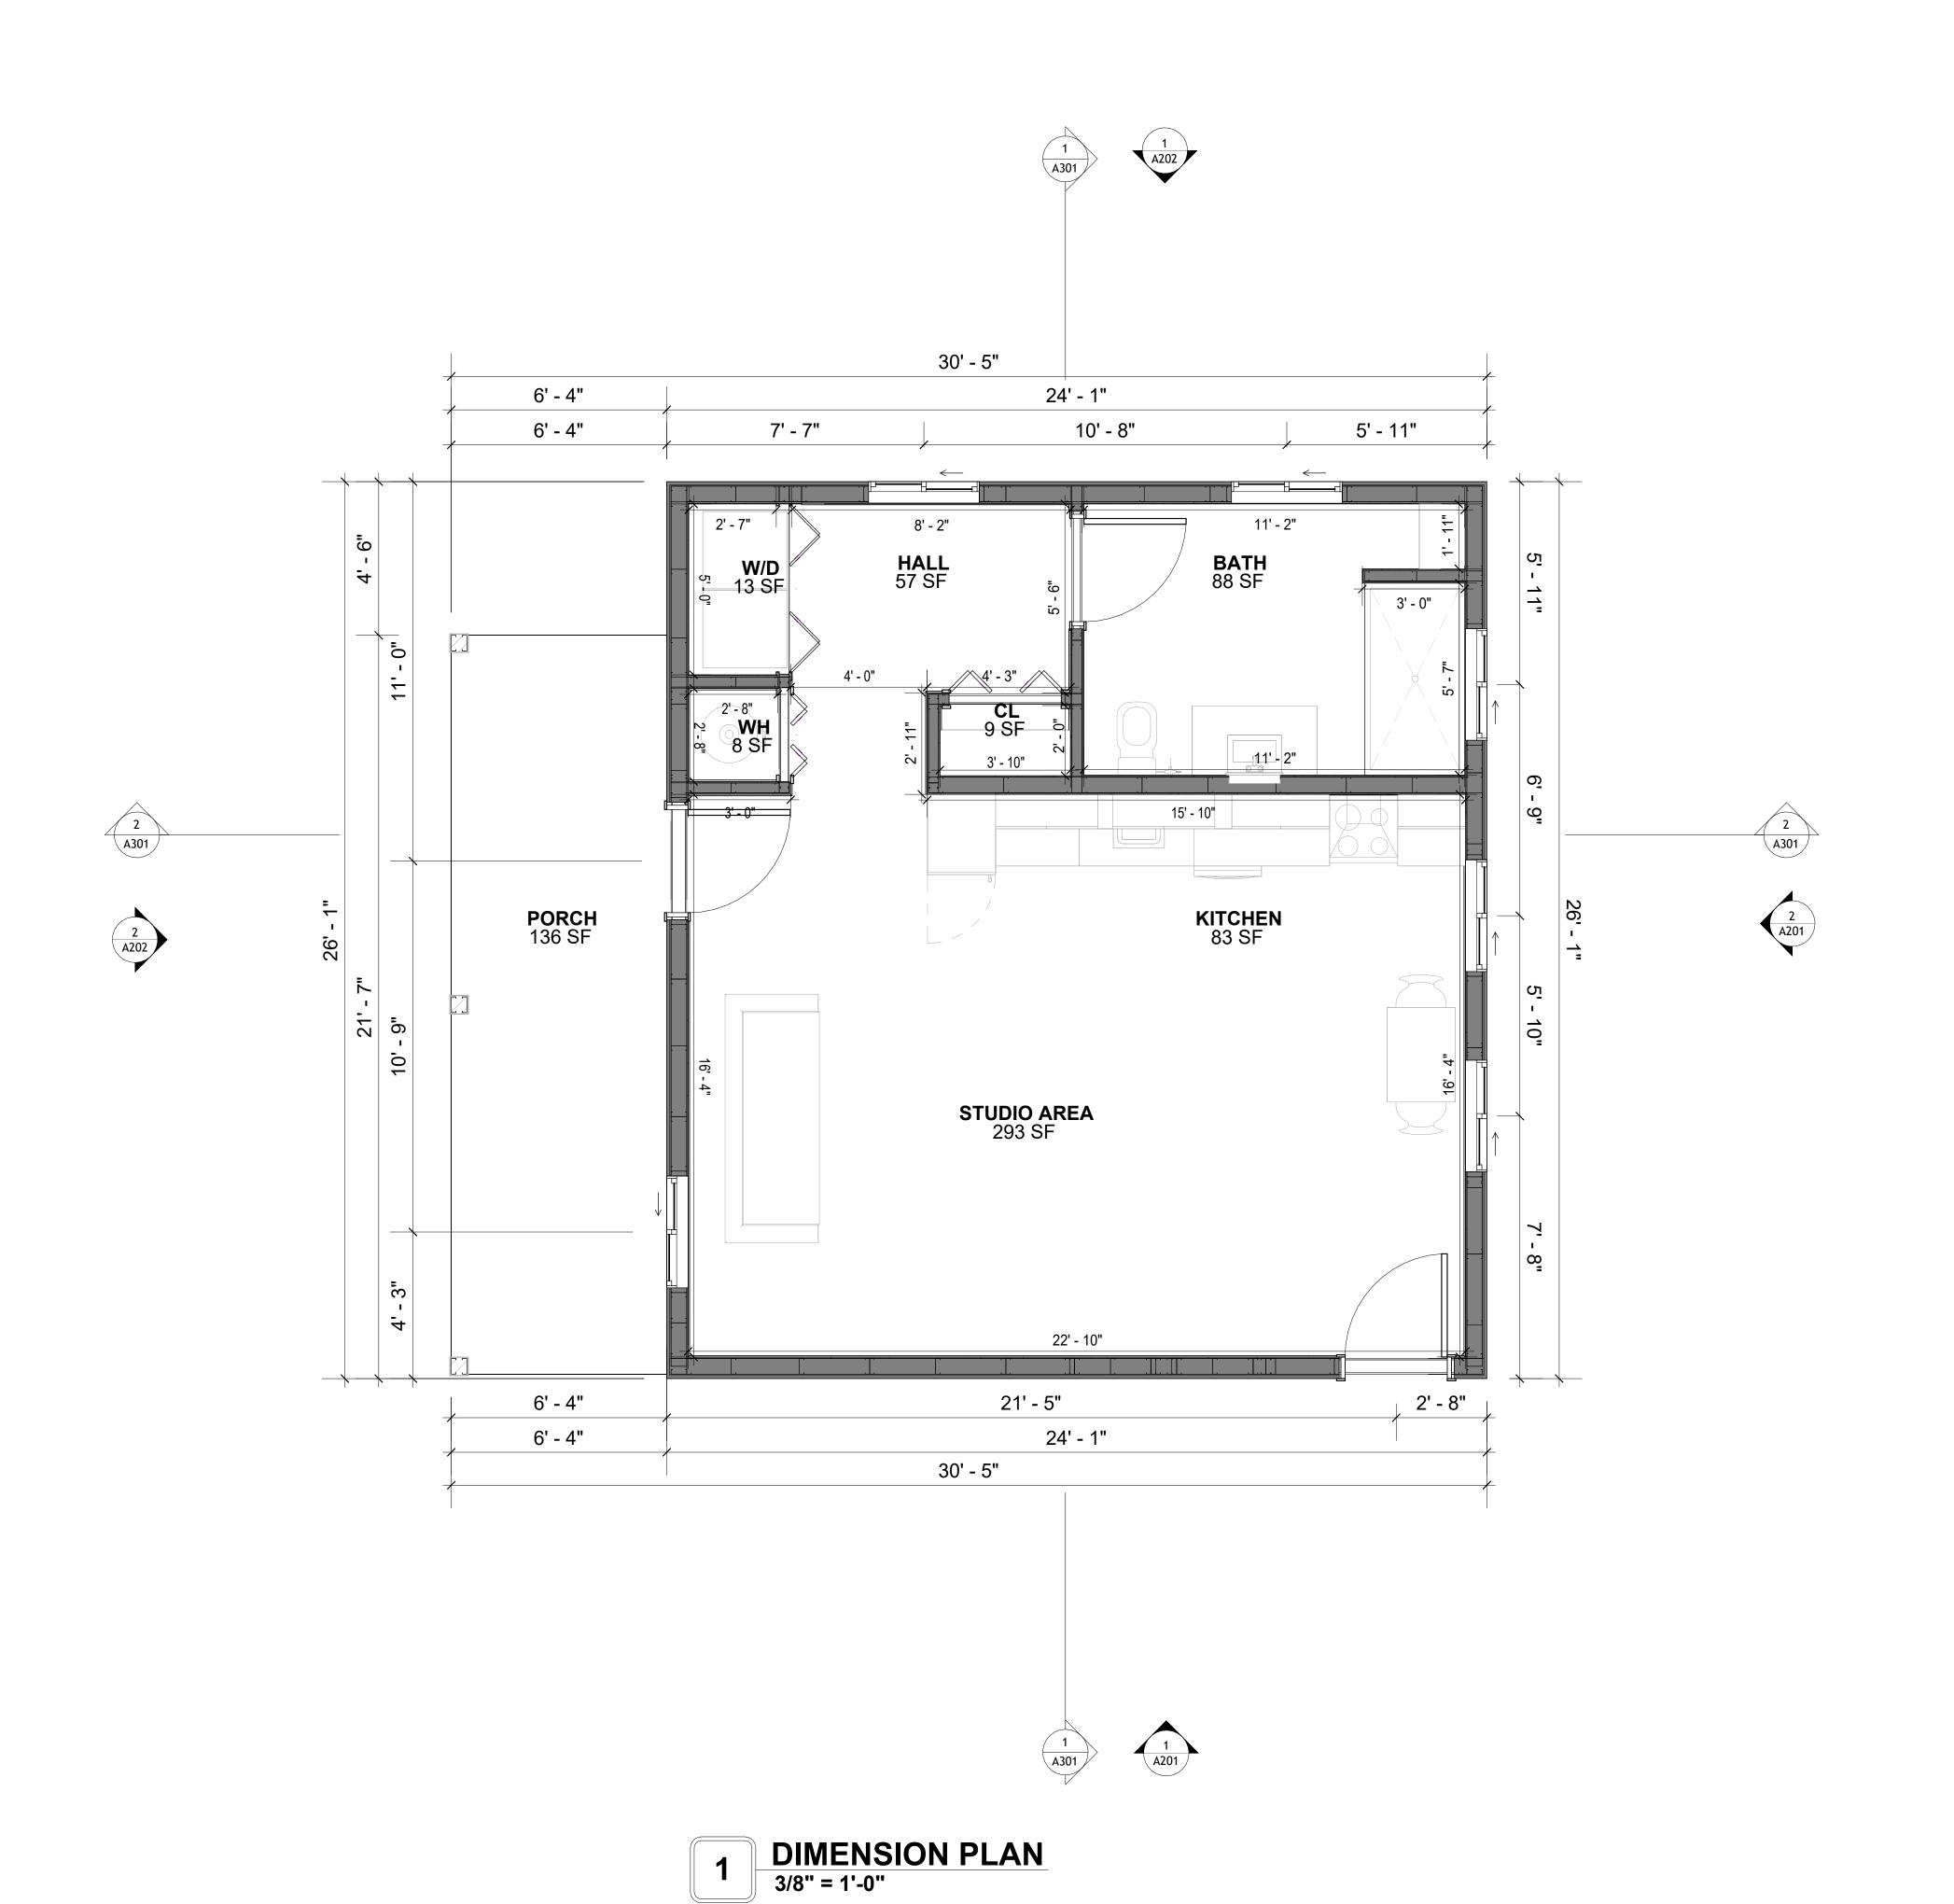



KEY PLAN

NO.	DESCRIPTION	DATE

NOTE:

LEGEND:

PROJECT

236-EMBER-624-STUDIO MODERN-BASE-550

DRAWING NAME

DIMENSION PLAN

CLIENT NAME:	Client Name
PROJECT NUMBER:	0033_15
DATE:	5/12/2025 3:16:34 PM
DESIGNED BY:	Designer
DRAWN BY:	Author
CHECKED BY:	Checker

A102

SCALE: 3/8" = 1'-0"

SQUARE FOOTAGE

PORCH

TOTAL

616

131

755

DIMENSIONS IN THE ARCHITECTURAL DRAWINGS CONSIDER FINISHING MATERIALS. FOR PRECISE MEASUREMENTS OF THE STRUCTUAL FRAMING, REFER TO THE ATTACHED STRUCTURAL PLAN SET.

FOUNDATION NOTES

TERMITES PRETREATMENT BY LICENSED CONTRACTOR UNDER SLAB AND AROUND FOOTINGS. ALL AREAS BELOW SLABS SHALL BE TREATED NO MORE THAN 24 HOURS PRIOR TO CONCRETE POUR. EVIDENCE OF TREATMENT MUST BE PROVIDED PRIOR TO PLACING OF CONCRETE.

. MATERIALS:

ALL INTERIOR CONCRETE SLABS SHALL BE A MIN. OF 4" THICK CONCRETE OVER 4" COMPACTED AGGREGATE BASE (ASTM D698), FINISH ELEVATIONS AS NOTED ON DRAWINGS, 6" ABOVE ADJACENT GRADE, LEVEL SLABS TO 1/8"-10' MAX., CONCRETE SLABS SHALL BE 2500# PSI AT 28 DAYS. A 4" ALLOWABLE SLUMP.

2. **PAD PREPARATION:**

EXCAVATION FOR FOOTING SHALL BE NEAT.

- FOOTINGS SHALL BE POURED IMMEDIATELY AFTER EXCAVATION AND APPROPRIATE

- ALL REINFORCING STEEL MARKED "CONTINUOUS" SHALL BE LAPPED 36 BAR DIAMETERS AT SPLICES AND AROUND CORNERS OR INTERSECTIONS WITH A STANDARD 90 DEGREE BEND ON CORNER BARS. LAP WIRE MESH ONE FULL MESH AT SIDE AND END LAPS. - ALL HARDWARE TO BE SIMPSON OR EQUIVALENT.

EXTERIOR FRAME WALL TO BE SECURED WITH 1/2"X10" ANCHOR BOLTS 4'-0" O.C. FOR 1-

STORY AND 2'-8" O.C. FOR 2-STORY. BOLTS SHALL BE LOCATED WITHIN 1'-0" OF EACH END PIECE AND SHALL HAVE A MIN. OF TWO BOLTS PER PIECE.

-FOUNDATION ANCHOR STRAPS SHALL BE PERMITTED, ACCORDING TO RESIDENTIAL CODE

- ALL INTERIOR WALLS TO BE SECURED WITH POWER DRIVEN PINS PER MANUFACTURER SPECIFICATION USE PIN SPACING EQUIVALENT TO 1/2" ANCHOR BOLTS.

ALL CONSTRUCTION TO CONFORM TO THE 2012 IRC

R-10 RIGID INSULATION OUTSIDE OF EXTERIOR FOUNDATION WALLS UNDER LIVING AREA. CONCRETE PAD FOR CONDENSER THICKNESS IS 4" MIN UNLESS OTHERWISE NOTED.

3. CONCRETE CONSTRUCTION:

THE SLAB SHALL BE UNDERLAIN BY A VAPOR BARRIER/RETARDER IN THE LIVING AREA (TYPICALLY POLYETHYLENE, UNLESS MORE STRINGENT PROTECTION REQUIRED BY THE ARCHITECT, ENGINEER, FLOOR COVERING MANUFACTURER, OR ACCEPTED PRACTICE). UNLESS OTHERWISE REQUIRED, BARRIER MAY BE OMITTED AT GARAGES, PORCHES AND PATIOS WITHOUT FLOOR COVERINGS. IT IS BEYOND THE SCOPE OF THESE PLANS TO DETERMINE THE APPLICABILITY OF THESE MORE STRINGENT REQUIREMENTS. BUILDER SHALL VERIFY PRIOR TO CONSTRUCTION.

4. REINFORCEMENT:

- IF CONSTRUCTED ON ACTIVE SOILS, THE LONG TERM PERFORMANCE OF THE FOUNDATION IS DEPENDENT ON MAINTENANCE BY THE OWNER. THUS THE BUILDER SHALL ADVISE THE OWNER OF THE FOLLOWING:

. DRAINAGE MUST BE MAINTAINED. WATER SHALL NEVER BE ALLOWED TO POND NEAR THE FOUNDATION.

2. THE SOIL AROUND THE FOUNDATION SHALL BE MAINTAINED IN A RELATIVELY DAMP CONDITION, SUCH AS THAT REQUIRED TO KEEP A LAWN GREEN. IF IT DRIES OUT IT WILL

SHRINK. IF IT GETS WET, IT WILL HEAVE UPWARD. 3. SLABS ON THE SHORTER SIDE USES MAIN BARS ARE USED IN THIS DIRECTION ONLY WITH SMALLER DIAMETER DISTRIBUTION BARS ARE PLACED. FORMING A MAT OR GRID.

4. ALL REINFORCEMENT BARS SIZE 10MM OR LARGER IN ACCORDANCE TO ASTM ANCHOR BOLTS AT ALL EXTERIOR WALLS SHALL BE MINIMUM 1/2 INCH DIAMETER WITH A MAXIMUM SPACING OF 6'-0" ON CENTER, UNLESS NOTED OTHERWISE.

. ANCHOR BOLTS SHALL BE INSTALLED WITHIN 12 INCHES OF EACH END OF EACH SILL PLATE WITH AT LEAST TWO ANCHOR BOLTS FOR EACH BOLTS FOR EACH SILL PLATE LONGER THAN 12 INCHES.

5. SIMPSONS SILL ANCHORS MAYBE SUBSTITUTED FOR ANCHOR BOLTS AT THE SAME


SPACING. 6. EXTERIOR CONCRETE SLABS WHICH ARE NOT PART OF THE MAIN SLAB SHALL BE MINIMUM 4 INCHES THICK WITH NO STEEL REINFORCING BARS REQUIRED. UNLESS NOTED OTHERWISE ON FOUNDATION PLAN.

VERIFY THE FOLLOWING PRIOR TO POURING:

- ALL HOLDDOWNS, STRAP, AND POST LOCATIONS.
- CONCRETE FINISHES. PANEL RISER LOCATION WHERE APPLICABLE.
- 3. UNDERSLAB MECHANICAL REQUIREMENTS.
- . STEM WALL BLOCKOUTS.
- 5. UNDERSLAB ELECTRICAL REQUIREMENTS AND PANEL RISER LOCATION. WHERE APPLICABLE.
- 6. PROVIDE THE FOLLOWING:
- PVC SLEEVES THROUGH FTG IF REQUIRED
- 20' #4 COPPER GROUND BAR. SLOPE FINISH GRADE AWAY FROM FOOTING.
- **NOTE**: FIELD VERIFY ALL DIMENSIONS SEE DIMENSIONED ARCHITECTURAL DRAWINGS

30' - 3" 19' - 7" 6' - 3" 3' - 2" 4" THICK 2500 PSI MIN. CONC. PAD EXTEND AS REQUIRED TO MAINTAIN 2 1/4" MIN. EDGE DISTANCE OF ALL TAPCONS AT "L" 24"X12" FTG W/2-#4 REBAR 20' - 10" 8X8 TRNDWN W/1-# 4 REBAR 5' - 1" 4" CONCRETE SLAB W/ REINF. BY INDEPENDENT ENGINEER OVER 4" GRANULAR FILL F.F.E. @ 0'-0" 15"X15"X18" PAD W/3-#4 REBAR BOTI WAYS **(a)** 8X8 TRNDWN W/1-#4 24"X12" FTG W/2-#4 REBAR REBAR 6' - 3" 23' - 10" 30' - 3"



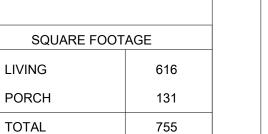



KEY PLAN

NO.	DESCRIPTION	DATE

NOTE:

LEGEND:

PROJECT

236-EMBER-624-STUDIO MODERN-BASE-550

DRAWING NAME

FOUNDATION PLAN

CLIENT NAME:	Client Name
PROJECT NUMBER:	0033_15
DATE:	5/12/2025 3:16:35 PM
DESIGNED BY:	Designer
DRAWN BY:	Author
CHECKED BY:	Checker

S101

SCALE: 3/8" = 1'-0"

GENERAL NOTES

NOTES:

-ALL BEARING WALLS SHOULD HAVE A THICKENED SLAB PER SECTION PER DETAIL A401/5.

A) **FOUNDATION PLAN NOTES**:

- CONCRETE SLAB SHALL BE 6" THICK WITH 1/2" DIAMETER TENDONS PER LAYOUT PLAN, CENTERED IN SLAB THICKNESS, OVER APPROVED SUBBASE PER GENERAL STRUCTURE NOTES.
- 2. TERMITE PROTECTION SHALL BE PROVIDED PER IRC SECTION R318.1 NONE TYPICAL ANCHOR BOLT SPACING AT SHEAR WALL AND HOLD DOWN
- SPECIFICATIONS PER APPROVED ARCHITECTURAL PLANS. 4. INSTALL HOLDOWNS BEFORE CONCRETE SLAB POUR.
- 5. EXISTING FILL ON-SITE SHALL BE COMPACTED IN ACCORDANCE WITH THE
- REQUIREMENTS IN THE GEOTECHNICAL REPORT.
- 6. ALL FLOOR SLABS ARE REINFORCED ON CONCRETE SLABS.

SPECIAL INSPECTION IS REQUIRED FOR THICKENED FOUNDATION CONSTRUCTION

- 1. REINFORCEMENT
- 2. 2300 PSI CONCRETE POUR


B) **REINFORCEMENT FOR CONCRETE**:

1. ALL REINFORCING SLABS BARS SIZE 10MM OR LARGER SHALL BE DEFORMED IN ACCORDANCE TO ASTM-A706, AND BARS SMALLER THAN 10 MM MAYBE PLAIN. 2. UNLESS OTHERWISE NOTED IN PLANS, THE YIELD STRENGTH OF REINFORCING BARS SHALL BE:


> A) FOOTING = 40,000 PSI B) NON-LOAD BEARING WALLS AND PARAPETS= 40,000 PSI

- 3. SPLICES SHALL BE SECURELY WIRED TOGETHER AND SHALL LAP OR EXTEND
- 4. GRADE OF STEEL FOR RCC WORKS SHALL BE GRADE 4 10.
- 5. BAR NOTATIONS GIVES INFORMATION
- A) BAR SIZE
- B) SPACING(IF REQUIRED)
- 6. LAP REINFORCEMENT ONLY AT LOCATION SHOWN IN THE DRAWINGS
- REINFORCEMENT SHALL NOT BE CUT, VENT OR HEATED ON SITE WITHOUT ENGINEERS' APPROVAL.
- C) **CONCRETE SLAB NOTES**
- 1. ALL SLAB REINFORCEMENT SHALL BE 20MM CLEAR MINIMUM FROM BOTTOM AND FROM TOP OF SLAB.
- 2. REINFORCEMENT IN CONTINUOUS ELEVATED SLAB SHALL BE CUT AS FOLLOWS.

- THIS IS A SCHEMATIC PLAN FOR THE PURPOSE OF LOCATING AND IDENTIFYING FOUNDATION REINFORCING ELEMENTS ONLY. VERIFY ALL DIMENSIONS, DROPS, OFFSETS AND FEATURES WITH THE ARCHITECTURAL PLANS BEFORE FORMING THE FOUNDATION.

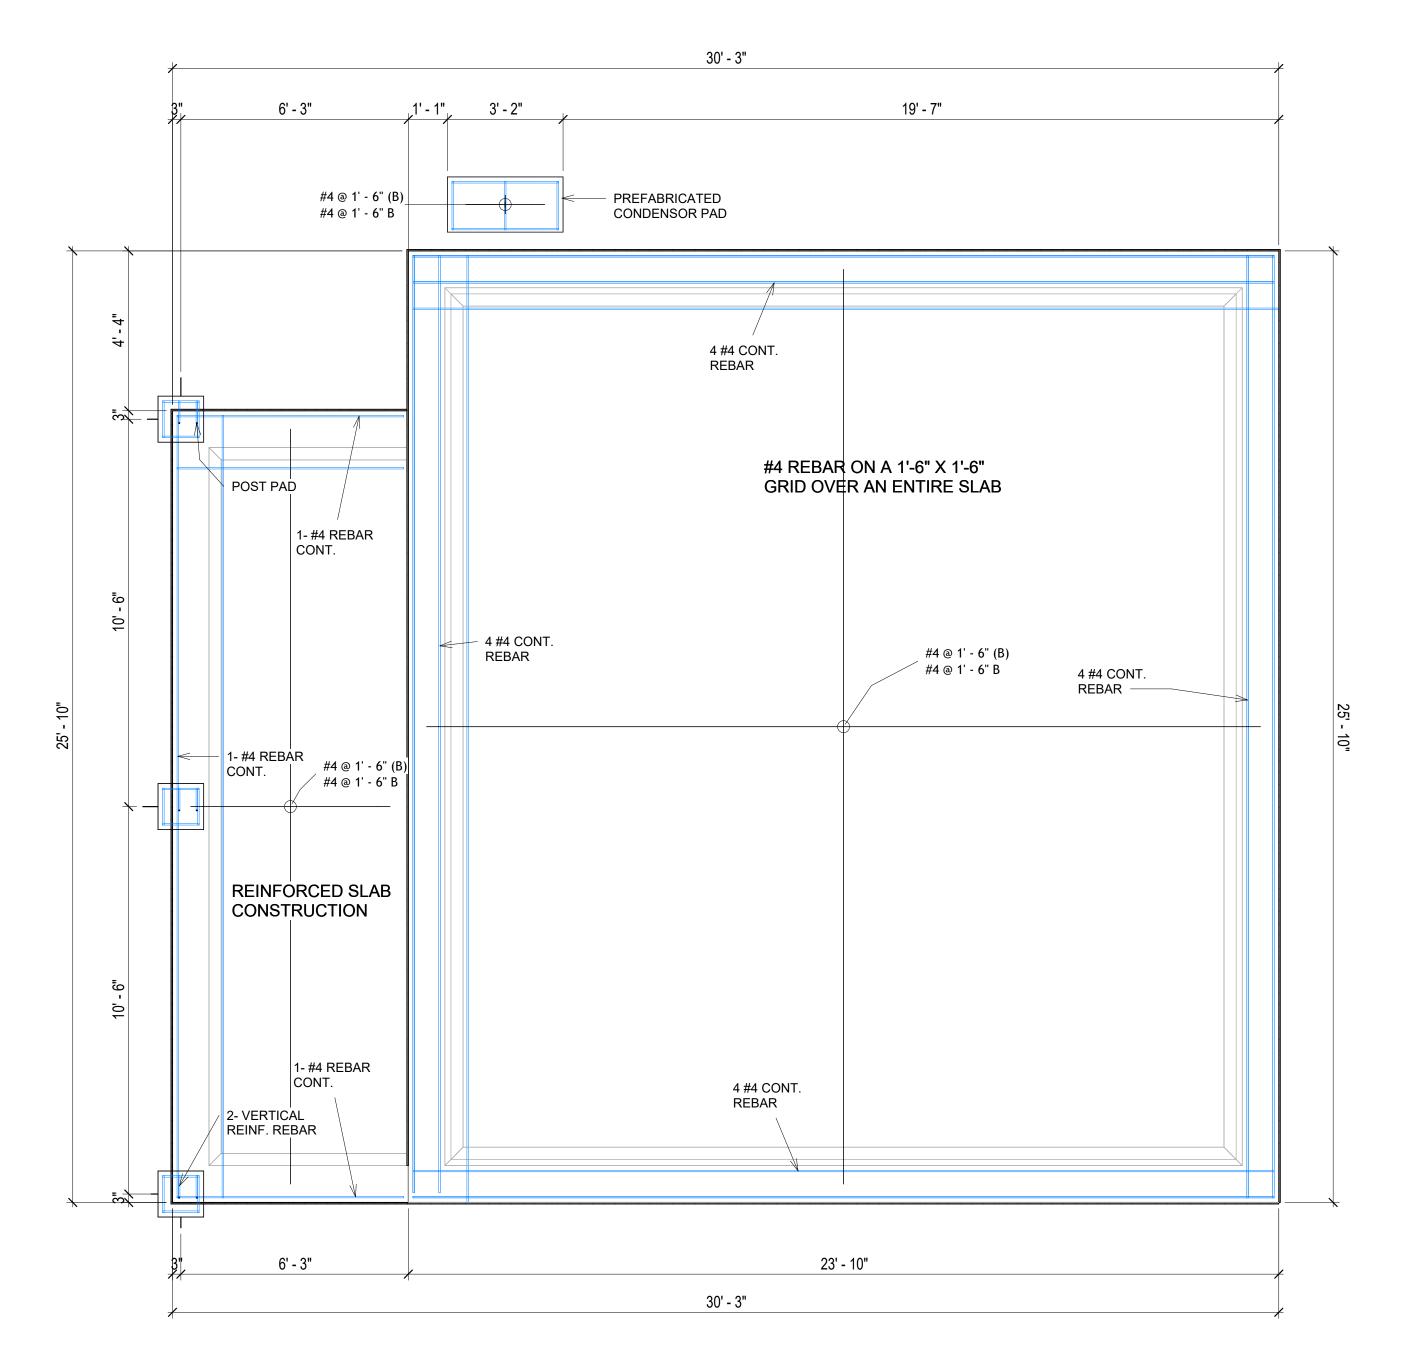

FOUNDATION REBAR PLAN

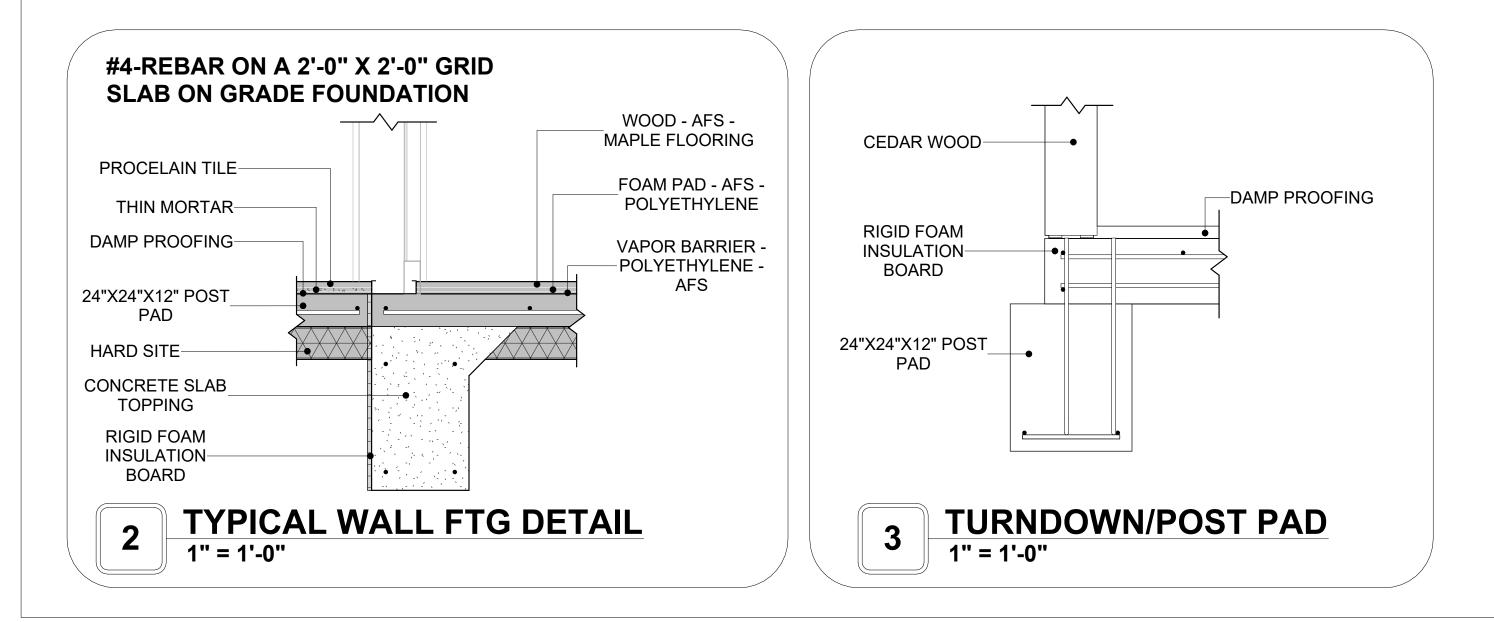



KEY PLAN

DESCRIPTION DATE

NOTE:

LEGEND:

PROJECT

236-EMBER-624-STUDIO MODERN-BASE-550

DRAWING NAME


STRUCTURAL FLOOR PLAN

CLIENT NAME: **Client Name** PROJECT NUMBER: 0033_15 5/12/2025 3:16:36 PM Designer **DESIGNED BY:** DRAWN BY: **Author** CHECKED BY: Checker

S102

ROOF NOTES

- 1. ROOFING COMPOSITION ROOFING PER OWNERS/BUILDERS SPECIFICATIONS INSTALL PER MANUFACTURE SPECIFICATIONS ON 1/2" ORIENTED STRAND BOARD ON PRE-ENGINEERED TRUSS @ 24" O.C. (UNO.)
- 73" OVERHANG AT EAVES (UNO.)
 ENDS OF ALL TRUSSES AND JOISTS TO BE FULLY BLOCKED. PROVIDE SOLID BLOCKING
- 3. ENDS OF ALL TRUSSES AND JOISTS TO BE FULLY BLOCKED. PROVIDE SOLID BLOCKING AT ALL RIDGES AND VALLEYS
- 4. SHEATHING TO BE 1/2", 3/8" OSB SHEAR PANEL AND EQUIVALENT. UNDERSIDE OF PORCH TRUSSES TO BE FINISHED WITH MOISTURE RESISTANT DRYWALL, TAPED AND TEXTURED.
- 5. EXPOSED EAVES AND OTHER WEATHER EXPOSED AREAS TO BE SHEATHED WITH EXTERIOR GRADE PLYWOOD.
- 6. ALL MATERIALS THICKNESS AND SIZE ARE THE MINIMUM. Refer TO LOCAL STANDARDS FOR ACTUAL THICKNESS AND LAYERING OF MATERIALS.
- 7. ENGINEERED TRUSS CALCULATIONS TO BE SUBMITTED TO BUILDING DEPARTMENT PRIOR TO FABRICATION AND INSTALLATION.
- 8. TRUSS MANUFACTURER TO SPECIFY HANGER CONNECTORS FOR TRUSS COMPONENTS (TYPICAL)
- 9. DESIGNER ASSUMES THAT TRUSSES BEAR ON ALL EXTERIOR PERIMETER WALLS (TYPICAL) OR BEAMS.
- 10. PROVIDE GALVANIZED STEEL FLASHING WITH A LENGTH OF 10 FEET, WIDTH OF 12 INCHES, AND THICKNESS OF 24 GAUGE.

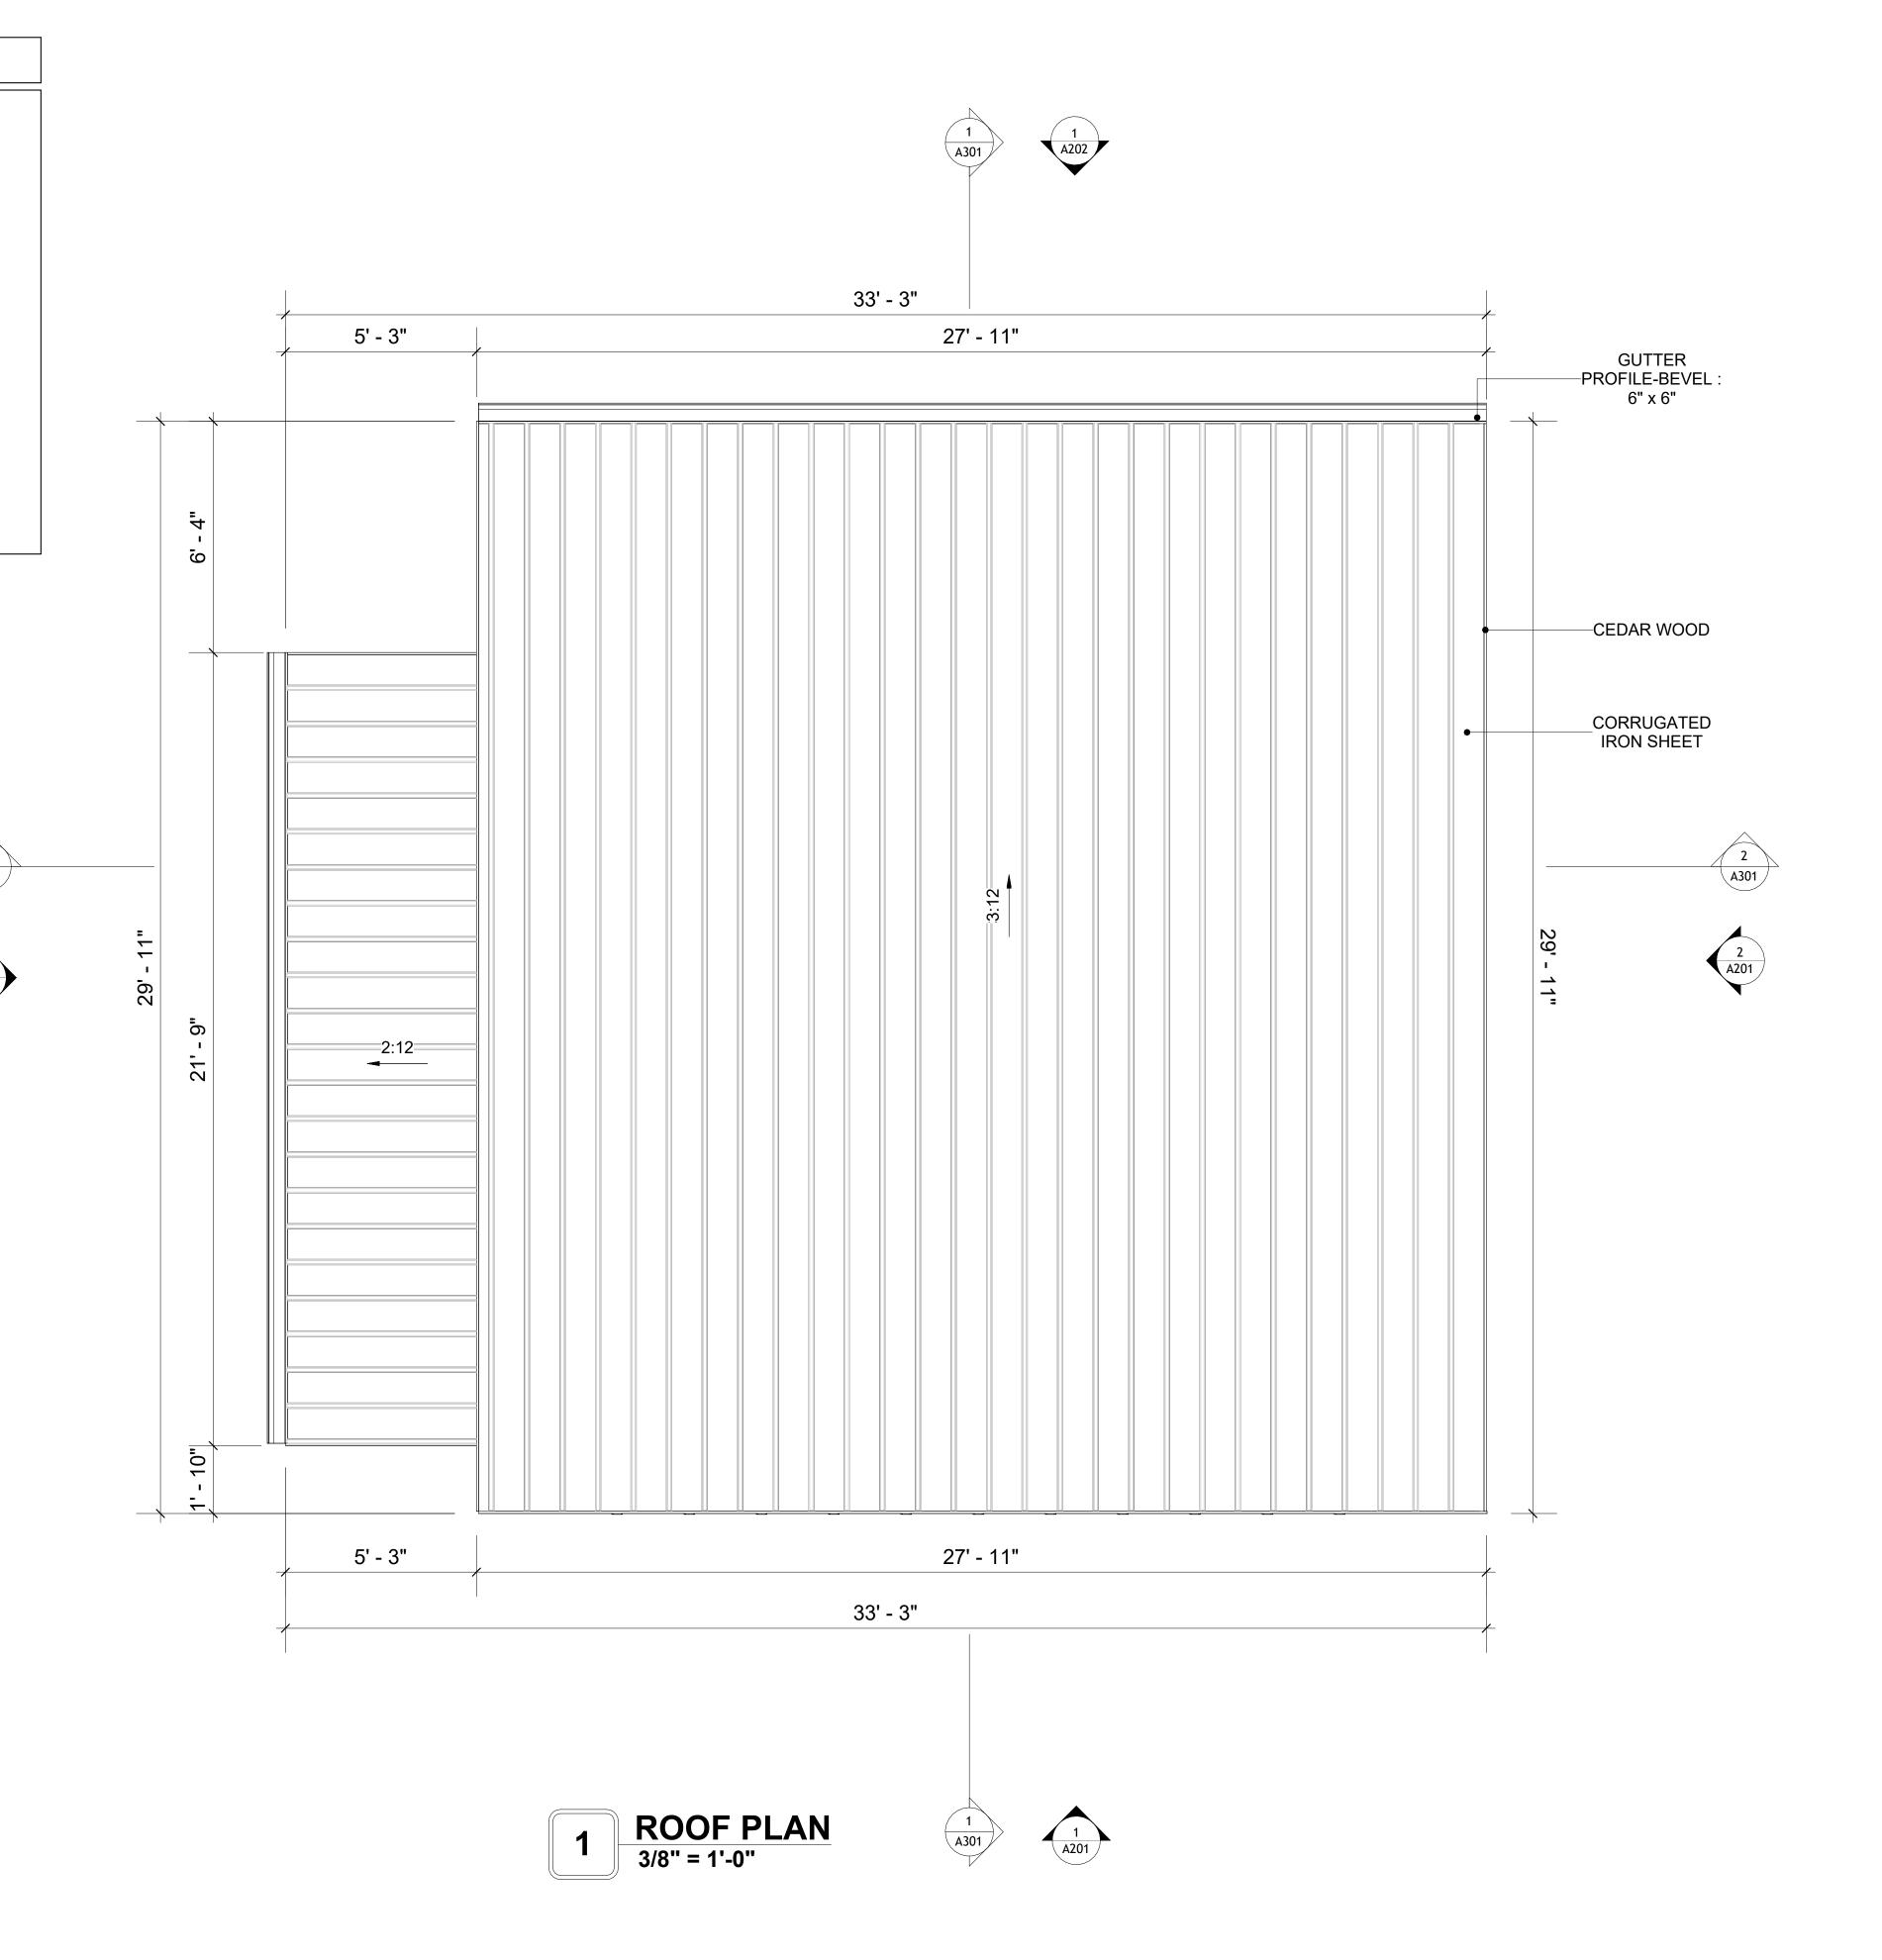

SQUARE FOOT	AGE
LIVING	616
PORCH	131
TOTAL	755



KEY PLAN

NO.	DESCRIPTION	DATE

NOTE:

LEGEND:

PROJECT

236-EMBER-624-STUDIO MODERN-BASE-550

DRAWING NAME

ROOF PLAN

Client Name
Cheffit Name
0033_15
5/12/2025 3:16:38 PM
Designer
Author
Checker

A103

ABOUT WALL FINISHING

CORRUGATED IRON SHEET

CORRUGATED IRON IS A FINISHING MATERIAL MADE FROM STEEL THAT HAS BEEN GALVANIZED (COATED WITH A THIN LAYER OF ZINC) TO PROTECT IT FROM CORROSION AND RUST.


IN THIS SPECIFIC PROJECT, THE CORRUGATED IRON SHEETS ARE INSTALLED HORIZONTALLY ON VERTICAL FURRING STRIPS THAT ARE DIRECTLY ATTACHED ONTO THE PROPERLY INSTALLED AND SEALED HOME WRAP, USING SELF-DRILLING SCREWS THAT ARE DRIVEN THROUGH THE RIDGES OR VALLEYS OF THE CORRUGATIONS.

CEDAR WOOD


CEDAR WOOD REFERS TO THE WOOD FROM VARIOUS SPECIES OF CEDAR TREES, WHICH ARE CONIFEROUS EVERGREEN TREES KNOWN FOR THEIR DISTINCT AROMA AND NATURAL RESISTANCE TO DECAY AND INSECTS.

IN THIS SPECIFIC PROJECT, CEDAR WOOD IS USED AS A FURRING STRIP AND A FINISH MATERIAL ON BEAMS AND COLUMNS.

CEDAR WOOD AS A FURRING STRIPS PROVIDE THERMAL INSULATION AND MOISTURE MANAGEMENT. THE VERTICAL CEDAR WOOD FURRING STRIPS ARE ATTACHED TO HOME WRAP USING CORROSION-RESISTANT FASTENERS (HOT-DIP GALVANIZED SCREWS), ENSURING PROPER PENETRATION INTO THE WALL FRAMING.

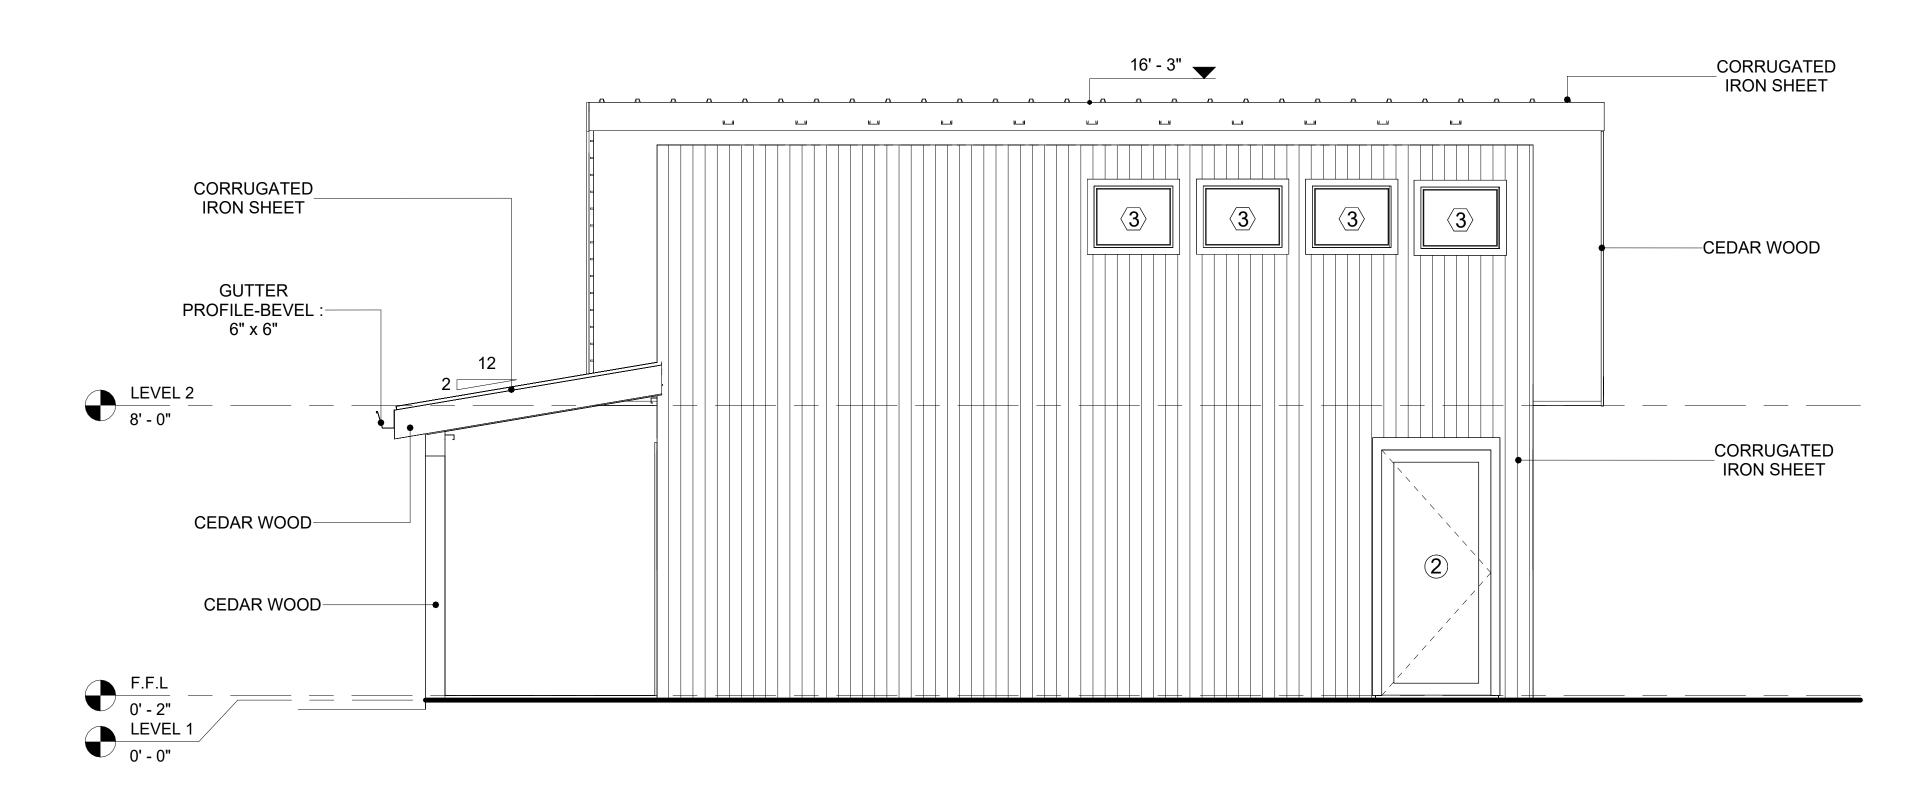

FRONT ELEVATION
3/8" = 1'-0"

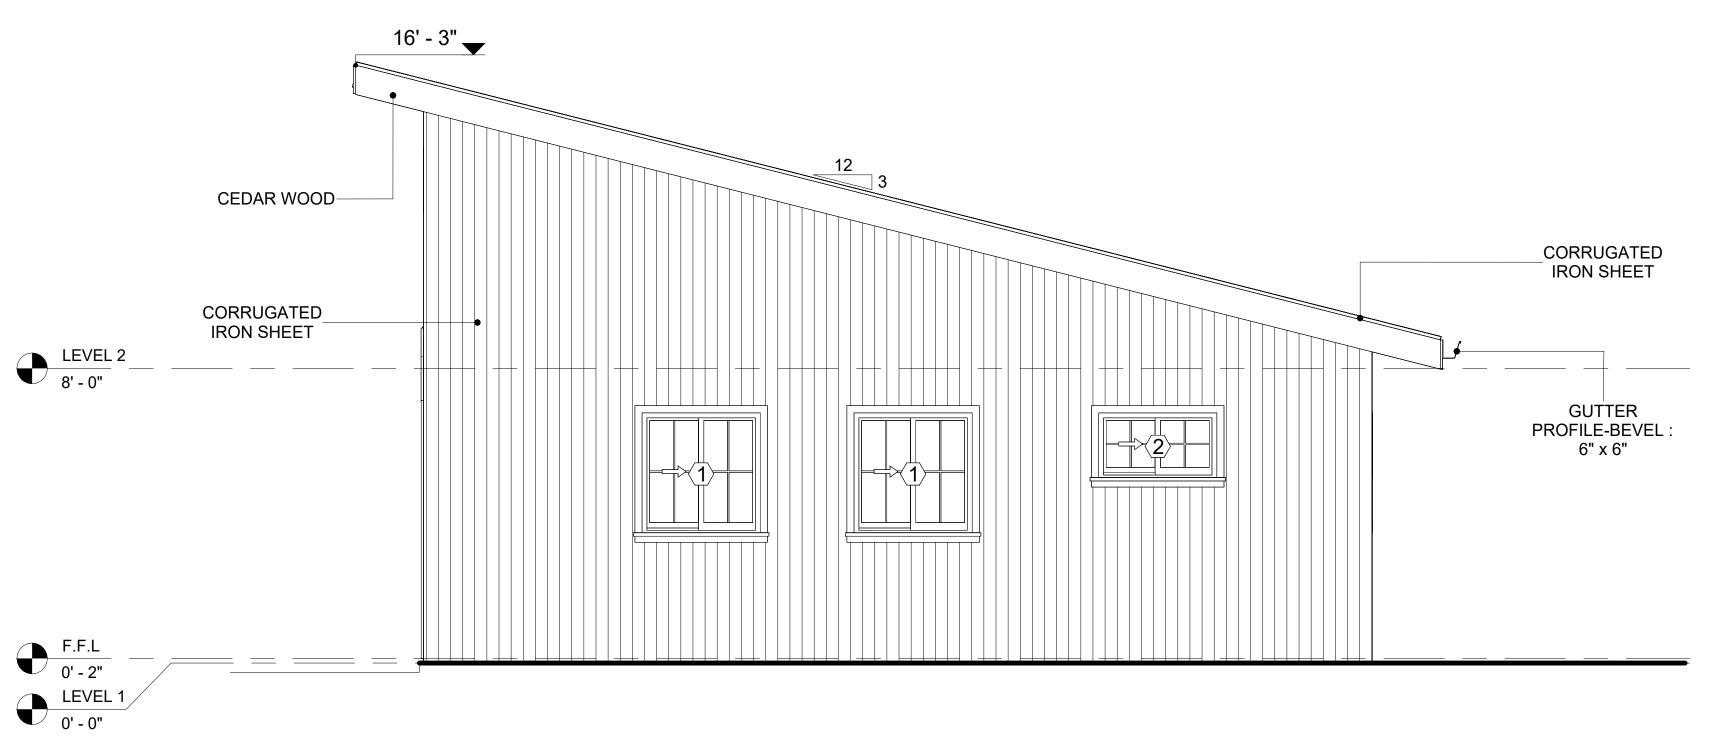


RIGHT SIDE ELEVATION
3/8" = 1'-0"

		DOOR SCHE	DULE			
TYPE MAR				S	SIZE	
K	SUPPLIER	DOOR TYPE	LOCATION	WIDTH	HEIGHT	COUNT
1	HOME DEPOT	INTERIOR SINGLE PANEL SWINGING	INTERIOR	3' - 0"	6' - 8"	1
2	HOME DEPOT	EXTERIOR SINGLE PANEL SWINGING	INTERIOR	3' - 0"	6' - 8"	2
3	HOME DEPOT	DOOR-BIFOLD_9052	INTERIOR	2' - 4"	6' - 8"	1
4	HOME DEPOT	DOOR-BIFOLD_9052	INTERIOR	3' - 3"	6' - 8"	1
6	HOME DEPOT	DOOR-BIFOLD_9052	INTERIOR	4' - 10"	6' - 8"	1

		WINDOW	SCHEDULE		
			S	IZE	
TYPE MARK	SUPPLIER	WINDOW TYPE	WIDTH	HEIGHT	COUNT
1	HOME DEPOT	SLIDING	3' - 3"	3' - 3"	4
2	HOME DEPOT	SLIDING	3' - 3"	1' - 9"	2
3	HOME DEPOT	AWNING	2' - 3"	1' - 9"	4



KEY PLAN

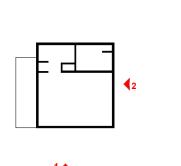

NO.	DESCRIPTION	DATE

NOTE:

LEGEND:

PROJECT

236-EMBER-624-STUDIO MODERN-BASE-550

DRAWING NAME

ARCHITECTURAL ELEVATIONS

CLIENT NAME:	Client Name
PROJECT NUMBER:	0033_15
DATE:	5/12/2025 3:16:41 PM
DESIGNED BY:	Designer
DRAWN BY:	Author
CHECKED BY:	Checker

A201

ABOUT WALL FINISHING

CORRUGATED IRON SHEET

CORRUGATED IRON IS A FINISHING MATERIAL MADE FROM STEEL THAT HAS BEEN GALVANIZED (COATED WITH A THIN LAYER OF ZINC) TO PROTECT IT FROM CORROSION AND RUST.


IN THIS SPECIFIC PROJECT, THE CORRUGATED IRON SHEETS ARE INSTALLED HORIZONTALLY ON VERTICAL FURRING STRIPS THAT ARE DIRECTLY ATTACHED ONTO THE PROPERLY INSTALLED AND SEALED HOME WRAP, USING SELF-DRILLING SCREWS THAT ARE DRIVEN THROUGH THE RIDGES OR VALLEYS OF THE CORRUGATIONS.

CEDAR WOOD


CEDAR WOOD REFERS TO THE WOOD FROM VARIOUS SPECIES OF CEDAR TREES, WHICH ARE CONIFEROUS EVERGREEN TREES KNOWN FOR THEIR DISTINCT AROMA AND NATURAL RESISTANCE TO DECAY AND INSECTS.

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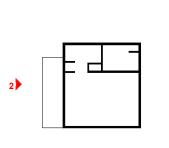
1 REAR ELEVATION 3/8" = 1'-0"

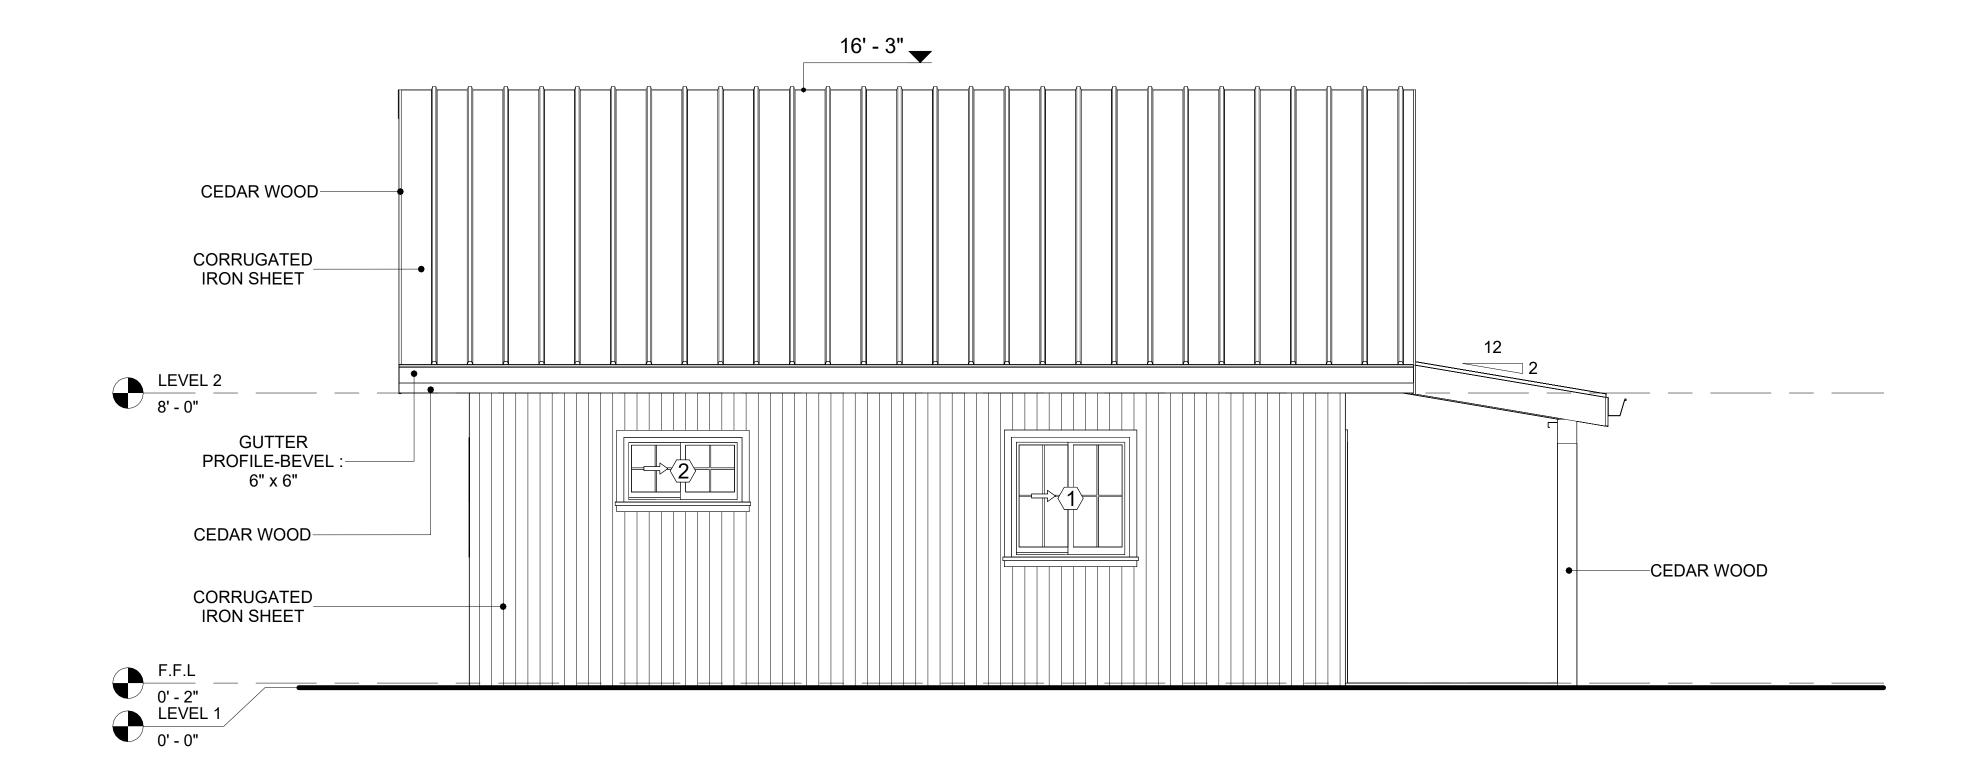

2 LEFT SIDE ELEVATION
3/8" = 1'-0"

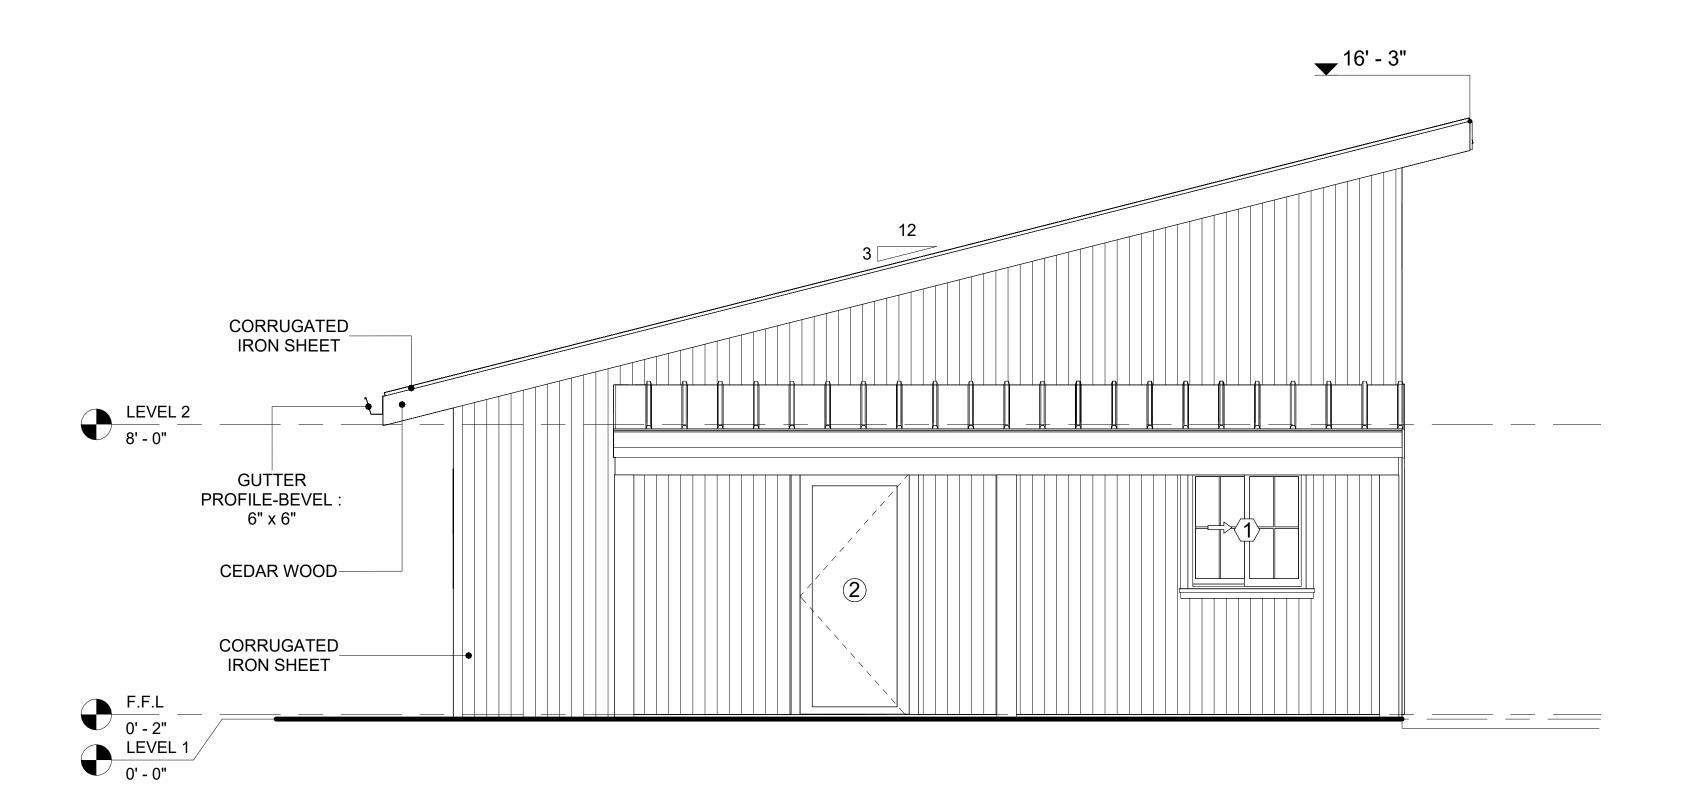

KEY PLAN



NO.	DESCRIPTION	DATE

NOTE:

LEGEND:

PROJECT

236-EMBER-624-STUDIO MODERN-BASE-550

DRAWING NAME

ARCHITECTURAL ELEVATIONS

CLIENT NAME:

PROJECT NUMBER:

0033_15

DATE:

5/12/2025 3:16:43 PM


DESIGNED BY:

DRAWN BY:


CHECKED BY:

Checker

A202

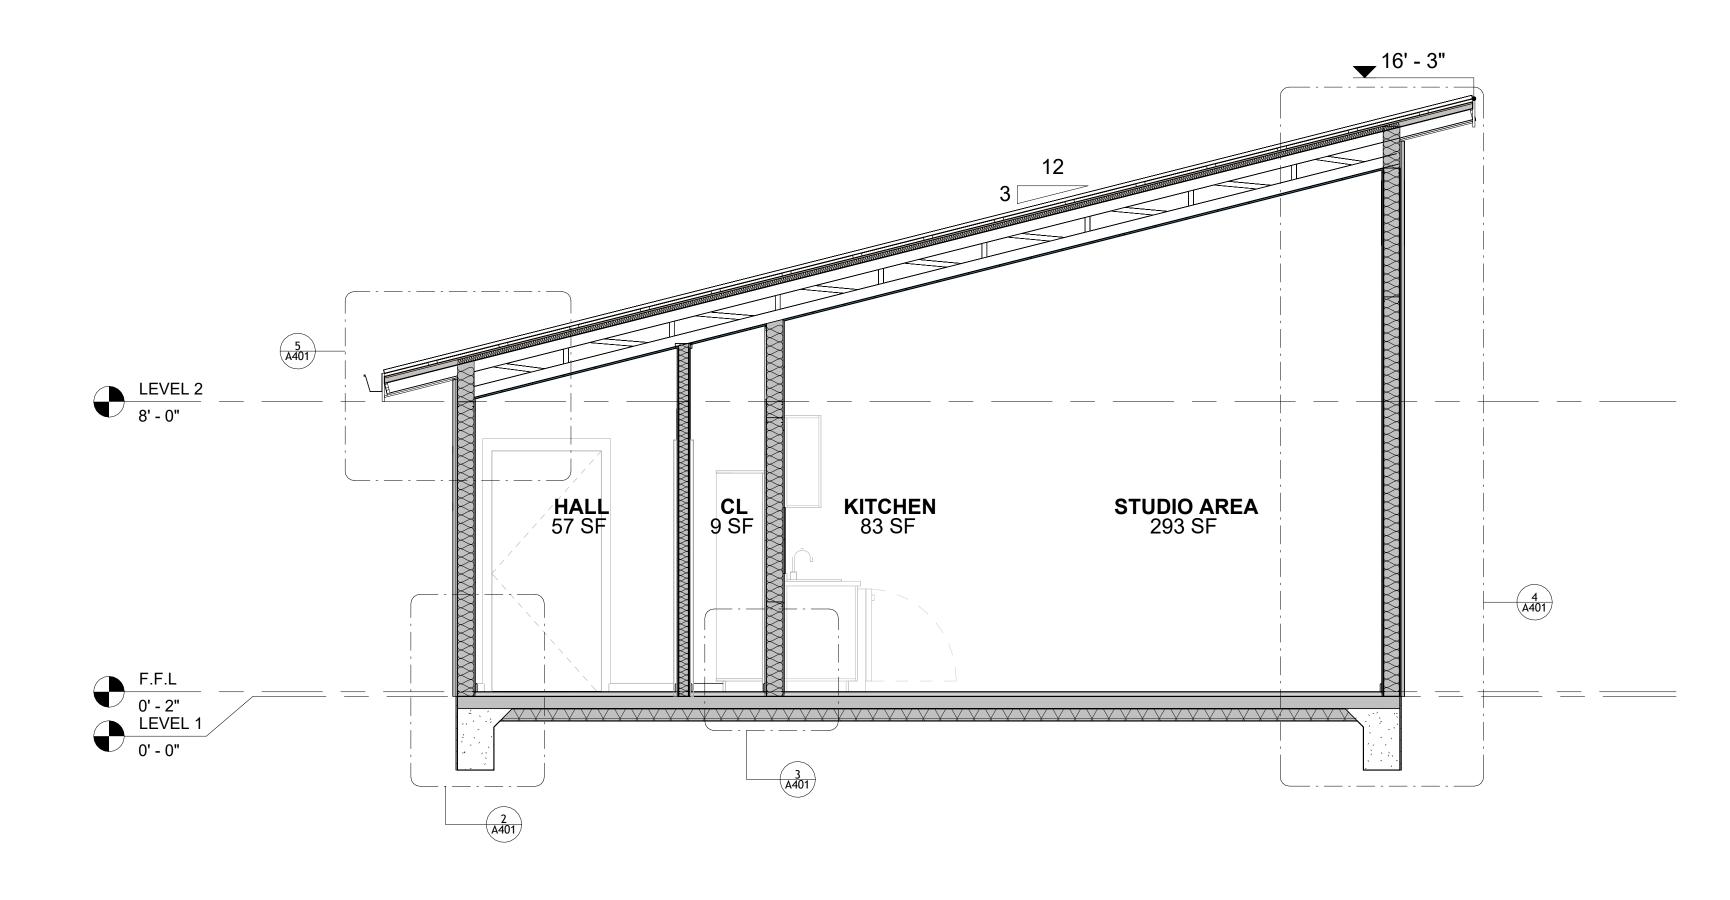


1 SECTION - 1 3/8" = 1'-0"

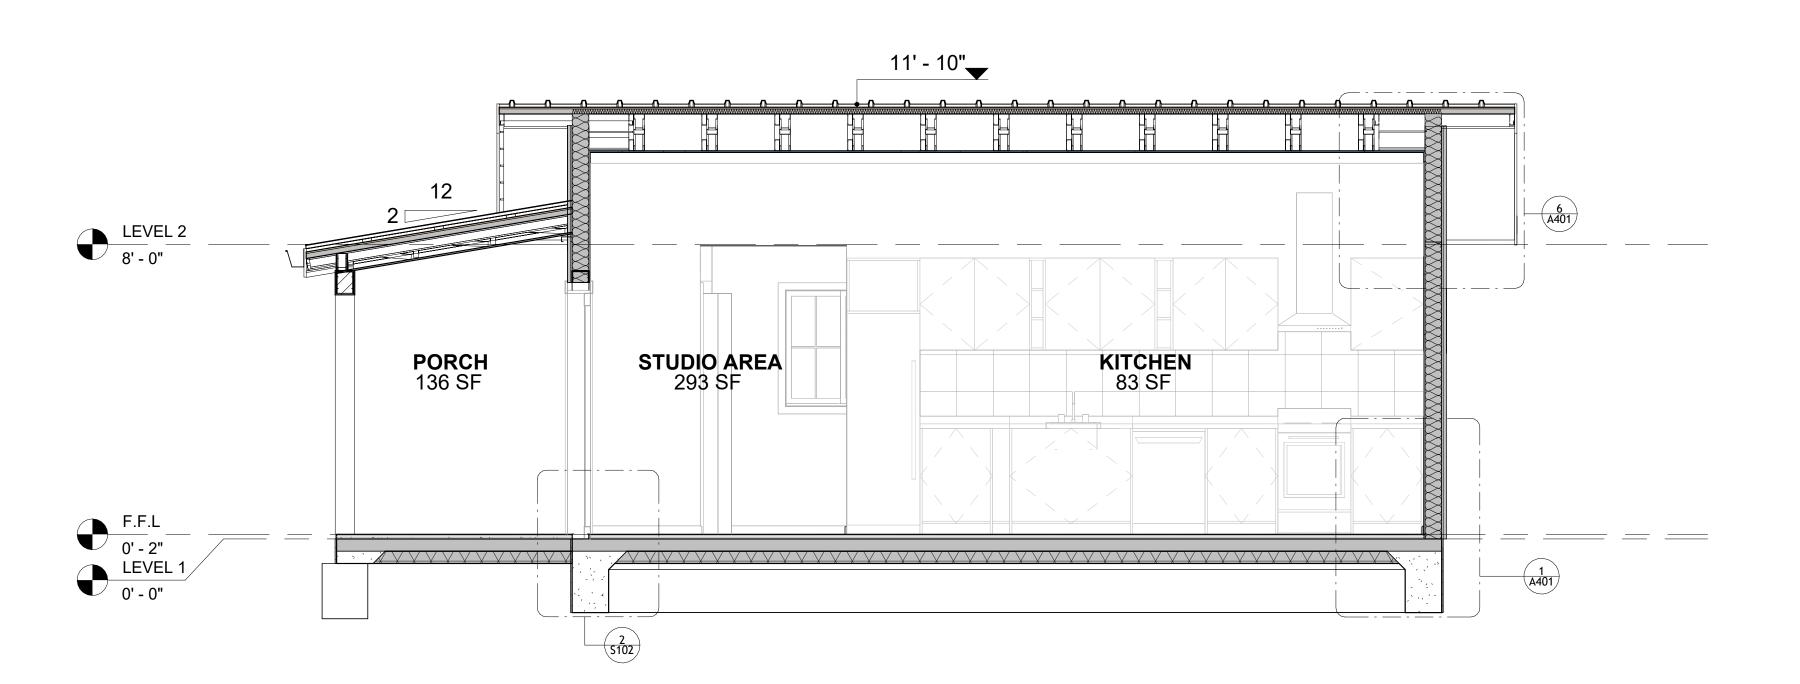

2 SECTION - 2 3/8" = 1'-0"



KEY PLAN

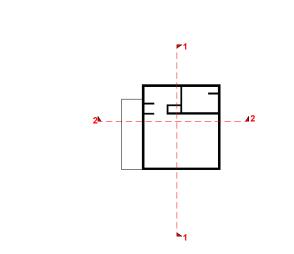

NO.	DESCRIPTION	DATE

NOTI

LEGEND:

PROJECT


236-EMBER-624-STUDIO MODERN-BASE-550


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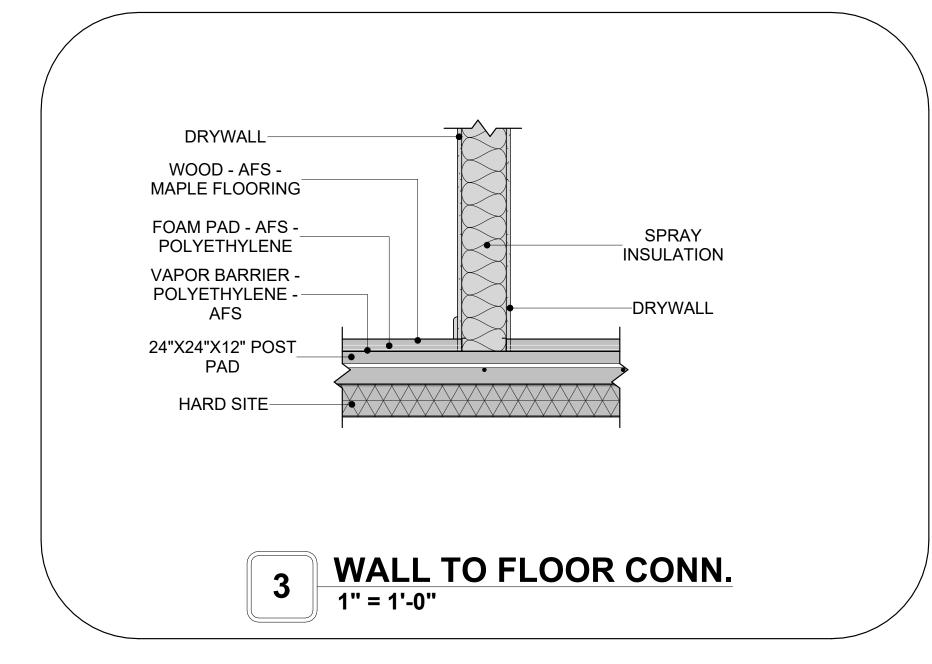
ARCHITECTURAL SECTIONS


CLIENT NAME:	Client Name
PROJECT NUMBER:	0033_15
DATE:	5/12/2025 3:16:44 PM
DESIGNED BY:	Designer
DRAWN BY:	Author
CHECKED BY:	Checker


A301




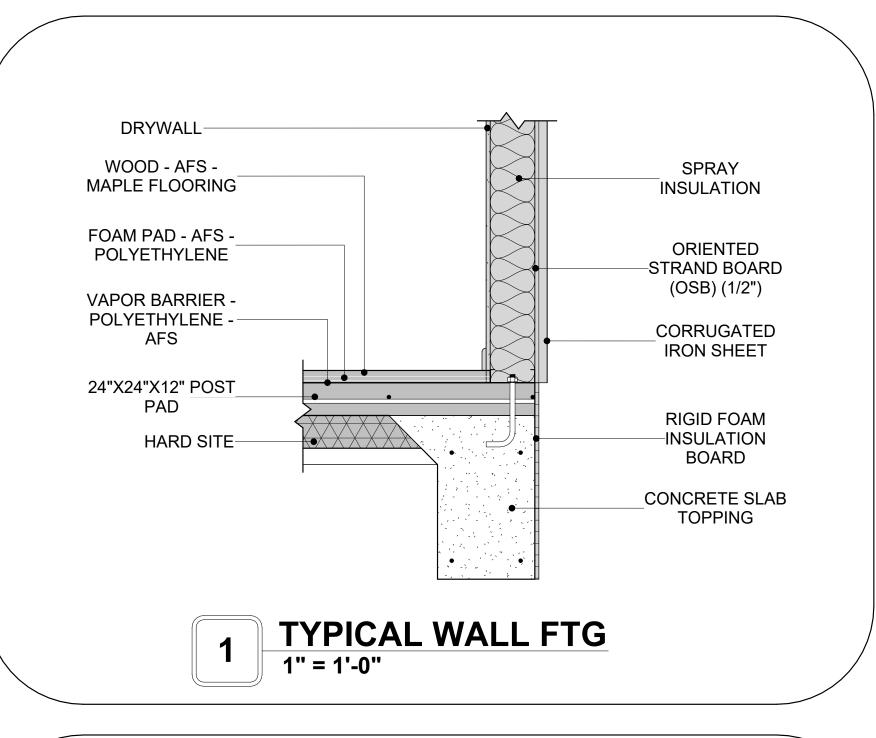

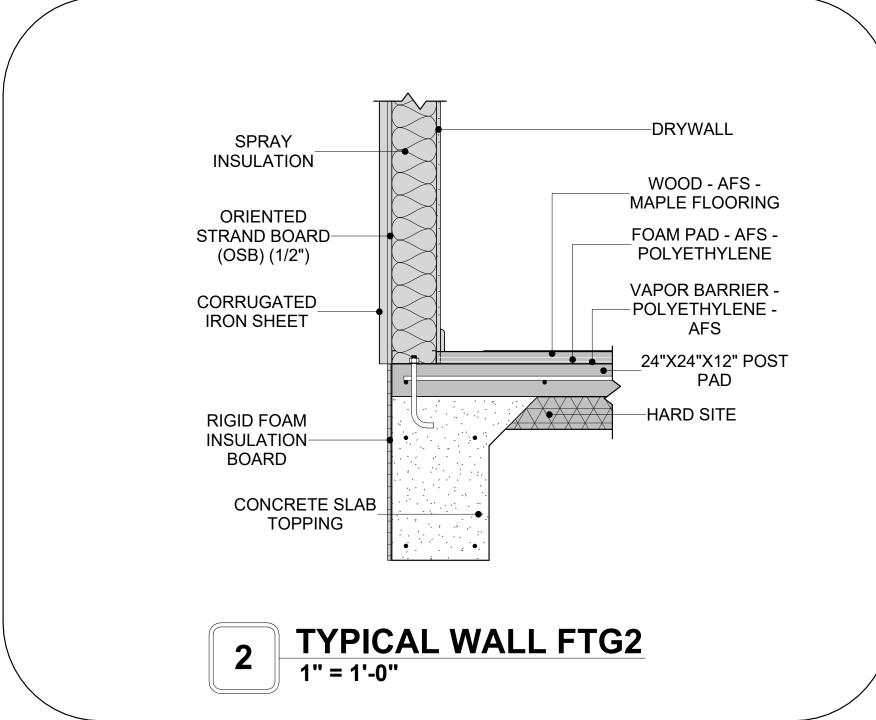

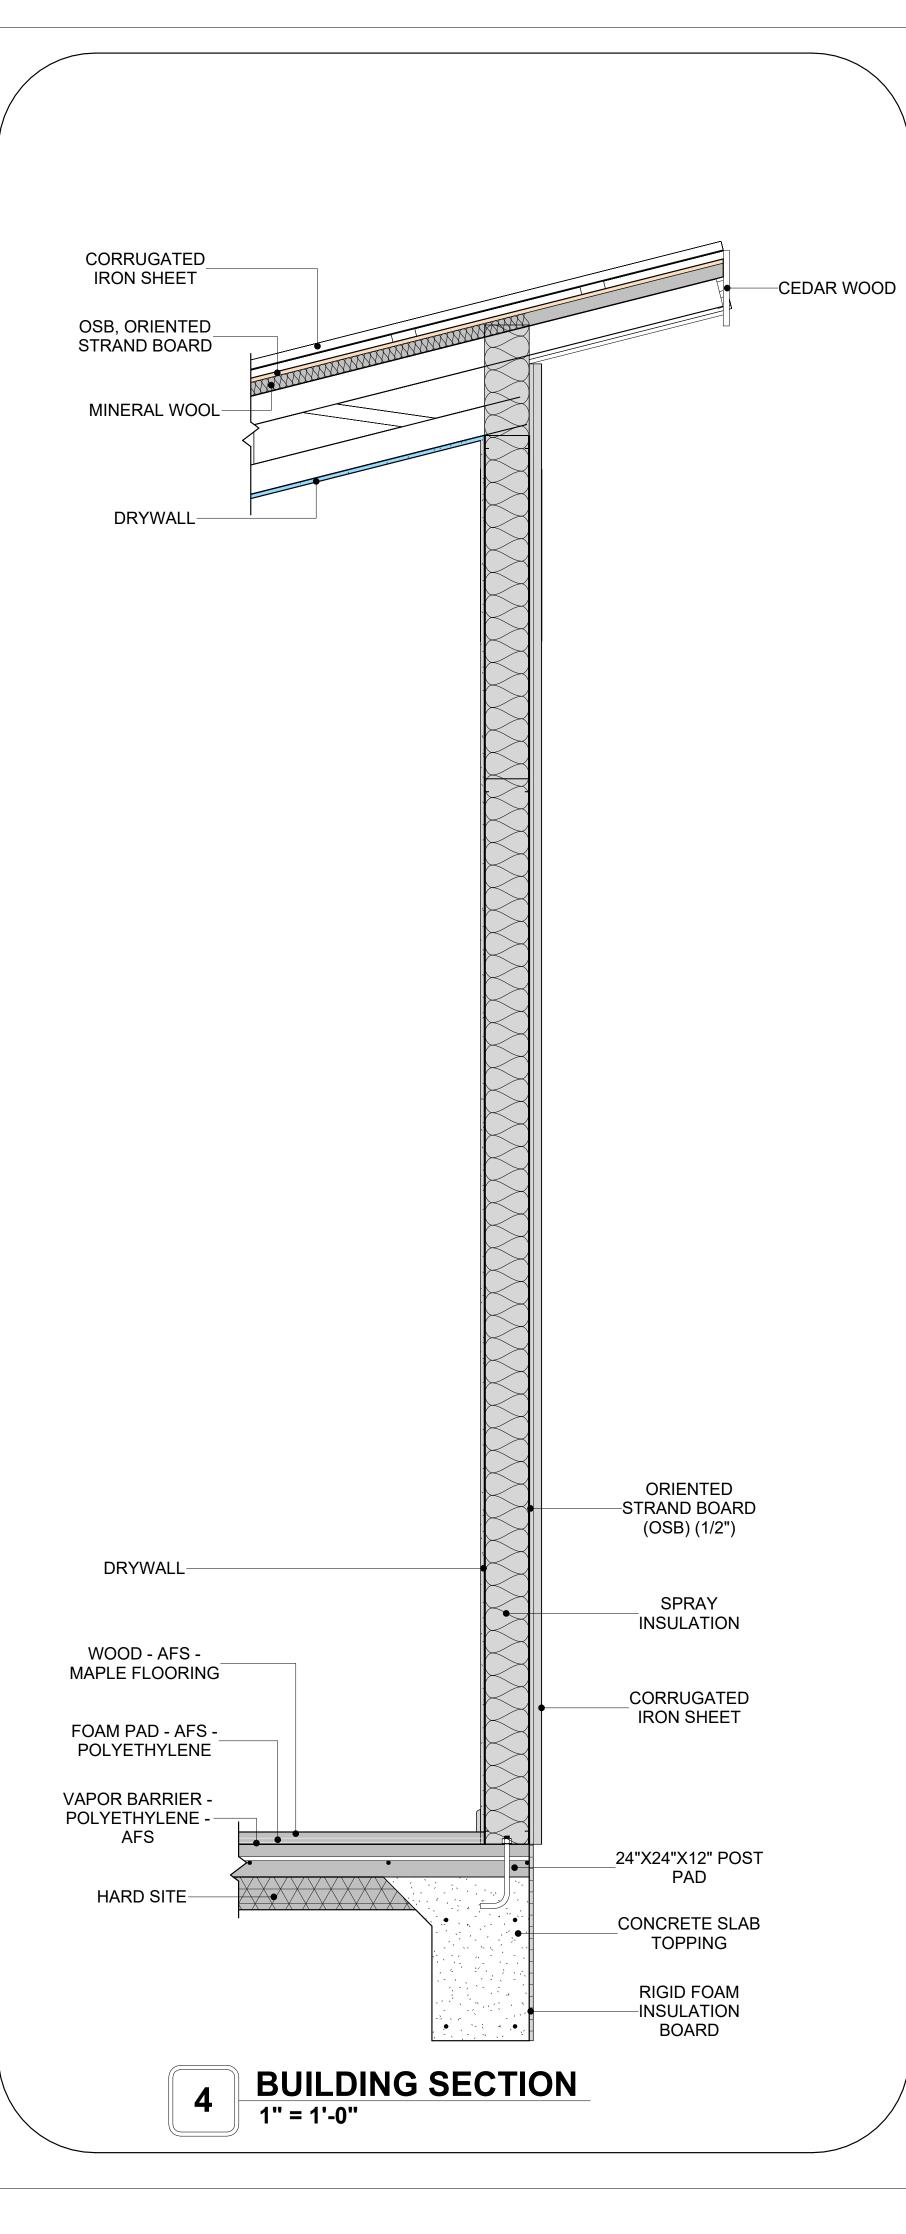

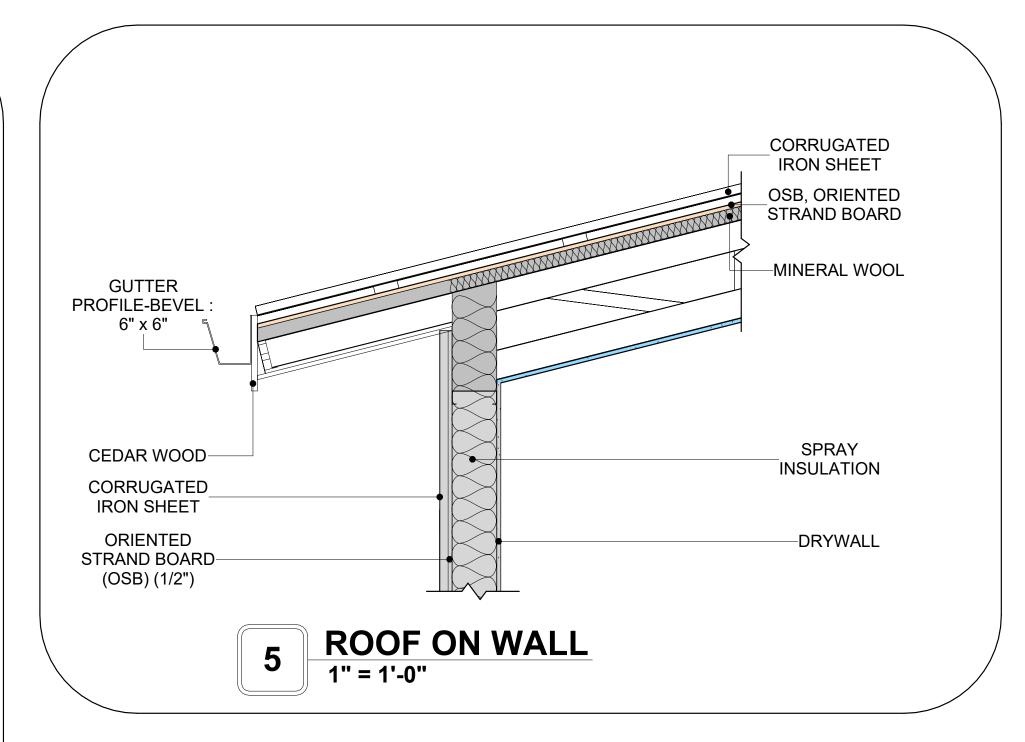

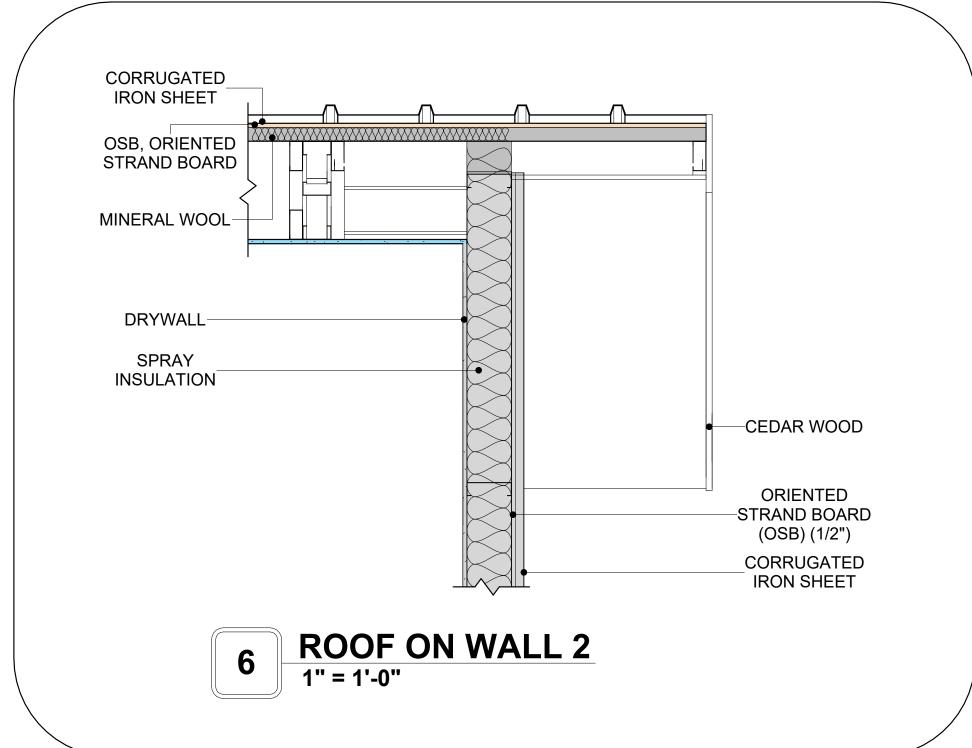



KEY PLAN

NO.	DESCRIPTION	DATE

NOTE:

LEGEND:

PROJECT

236-EMBER-624-STUDIO MODERN-BASE-550

DRAWING NAME

ARCHITECTURAL DETAILS

CLIENT NAME:	Client Name
PROJECT NUMBER:	0033_15
DATE:	5/12/2025 3:16:45 PM
DESIGNED BY:	Designer
DRAWN BY:	Author
CHECKED BY:	Checker

A401


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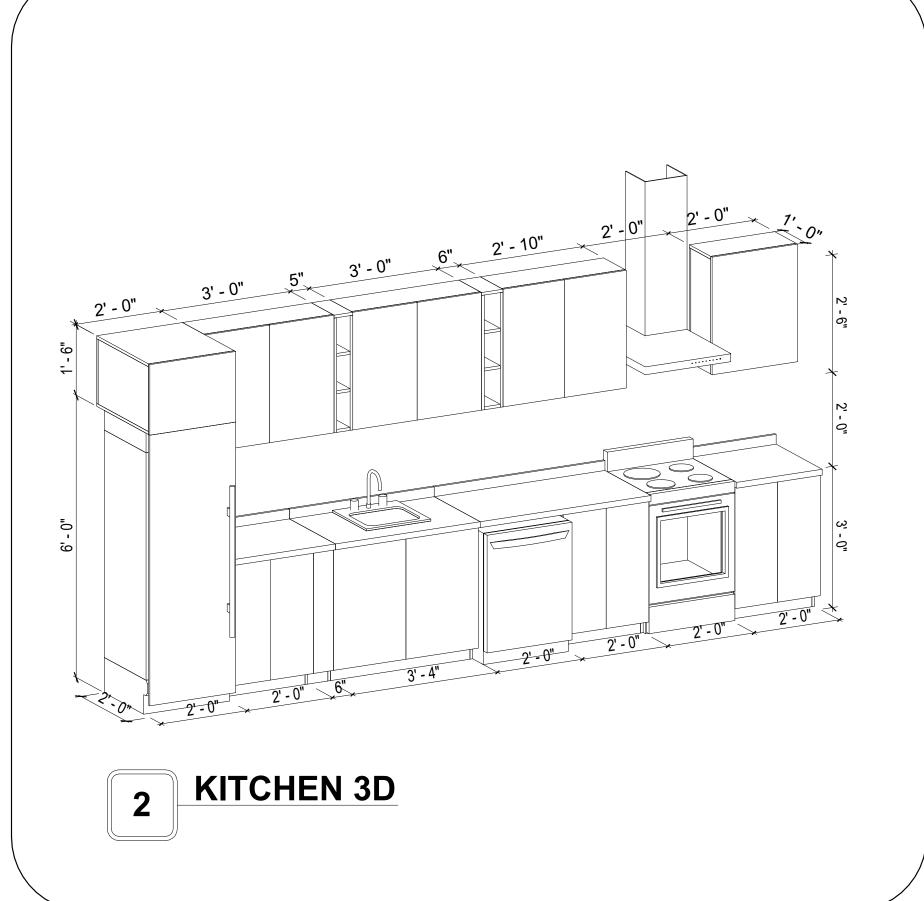
CASEWORK GENERAL NOTES


- ALL CABINET HEIGHTS INCLUDE COUNTERTOPS. DIMENSIONS ARE TO THE NEAREST INCH. DIVISIONS IN CASEWORK ARE SHOWN FOR CLARITY AND DO NOT REPRESENT BREAKS IN THE COUNTERTOP.
- PROVIDE CONTINUOUS COUNTERTOP OVER ALL SIMILAR HEIGHT CASEWORK, UNLESS AND OTHERWISE NOTED.
- MANUFACTURER AND CATALOG NUMBERS ARE FOR REFERENCE AND ILLUSTRATION PURPOSES
- DOTTED LINES INDICATE WALL HUNG CABINETS, DIVISIONS OF BASE CABINETS BELOW THE
- COUNTERTOP, FURNITURE NOT IN THE CONTRACT OR PROJECTION SCREENS -SEE CASEWORK KEY AND SPECIFICATIONS.
- ALL CABINETS AND DRAWERS TO HAVE CAM LOCKS EXCEPT FOR SINK BASE CABINETS.
 ALL EXPOSED SURFACES (EXPOSED TO VIEW FROM ANY PERSPECTIVE) TO BE COVERED WITH LAMINATE.
- ALL CASEWORK WHICH MEETS A WALL AT ONE OR BOTH ENDS, TO BE PROVIDED WITH FILLER
- PANELS AND SCRIBED TO THE WALL(S) AS REQUIRED. 10. ALL CABINETS AND DRAWERS ARE PROVIDED WITH RECESSED HANDLES.
- 11. CONTRACTOR TO FIELD VERIFY ALL CLEAR OPENINGS PRIOR TO MILLWORK OR CASEWORK FABRICATION.
- 12. CASEWORK DRAWINGS ARE DIAGRAMMATIC IN NATURE TO SHOW DESIGN INTENT.


	CAS	EWOR	K SCHEDI	JLE		
TYPE MAR K	TYPE	COUN	HEIGHT	WIDTH	DEPTH	AREA
			1		1	T
01	LINEAR COUNTER TOP 3	1	0' - 4"	2' - 0"	2' - 1"	1 SF
02	BASE CABINET DOUBLE DOOR 1	3	2' - 11"	2' - 0"	2' - 0"	6 SF
03	WALL_CABINET_SINGLE_DOOR	1	2' - 6"	2' - 0"	1' - 0"	5 SF
04	WALL FILLER 2	1	2' - 6"	0' - 5"	1' - 0"	1 SF
05	HD LINEAR COUNTER TOP	1	0' - 4"	3' - 4"	2' - 1"	1 SF
06	LINEAR COUNTER TOP	1	0' - 4"	2' - 6"	2' - 1"	1 SF
07	HD_LINEAR_COUNTER_TOP 2	1	0' - 4"	4' - 0"	2' - 1"	1 SF
08	WALL FILLER	1	2' - 6"	0' - 6"	1' - 0"	1 SF
09	LAUNDRY OPEN CABINET	1	1' - 6"	2' - 0"	2' - 4"	3 SF
10	WALL_CABINET_DOUBLE_DOOR	2	2' - 6"	3' - 0"	1' - 0"	8 SF
11	RECESSED_MED_CABINET	1	2' - 0"	1' - 6"	0' - 3"	3 SF
12	CLOSET 1	1	6' - 0"	3' - 10"	1' - 4"	23 SF
13	WALL_CABINET_DOUBLE_DOOR 3	1	2' - 6"	2' - 10"	1' - 0"	7 SF
14	BASE_CABINET_DOUBLE_DOOR	1	2' - 11"	3' - 4"	2' - 0"	10 SF
15	WALL FILLER 2	1	2' - 11"	0' - 6"	2' - 0"	1 SF
16	LINEN	1	5' - 11"	1' - 11"	1' - 4"	11 SF
17	VANITY_CABINET_3	1	2' - 4"	3' - 8"	2' - 0"	9 SF
GRAND	TOTAL	20				

	SPECIALTY EQUIPMENT SCHEDULE		
TYPE MARK	TYPE	COUNT	
01	WASHER-FRONT-LOAD	1	
02	REFRIGERATOR	1	
03	DISHWASHER	1	
04	DRYER-FRONT-LOAD	1	
05	RANGE	1	
GRAND TOTAL: 5	·		



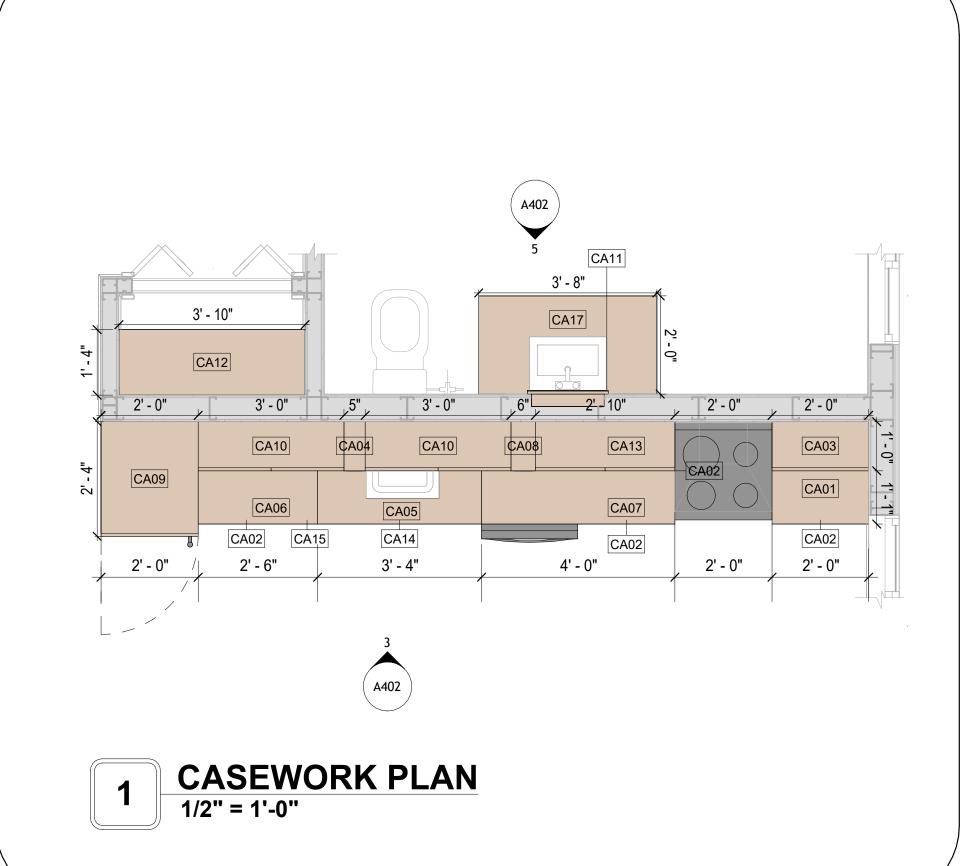


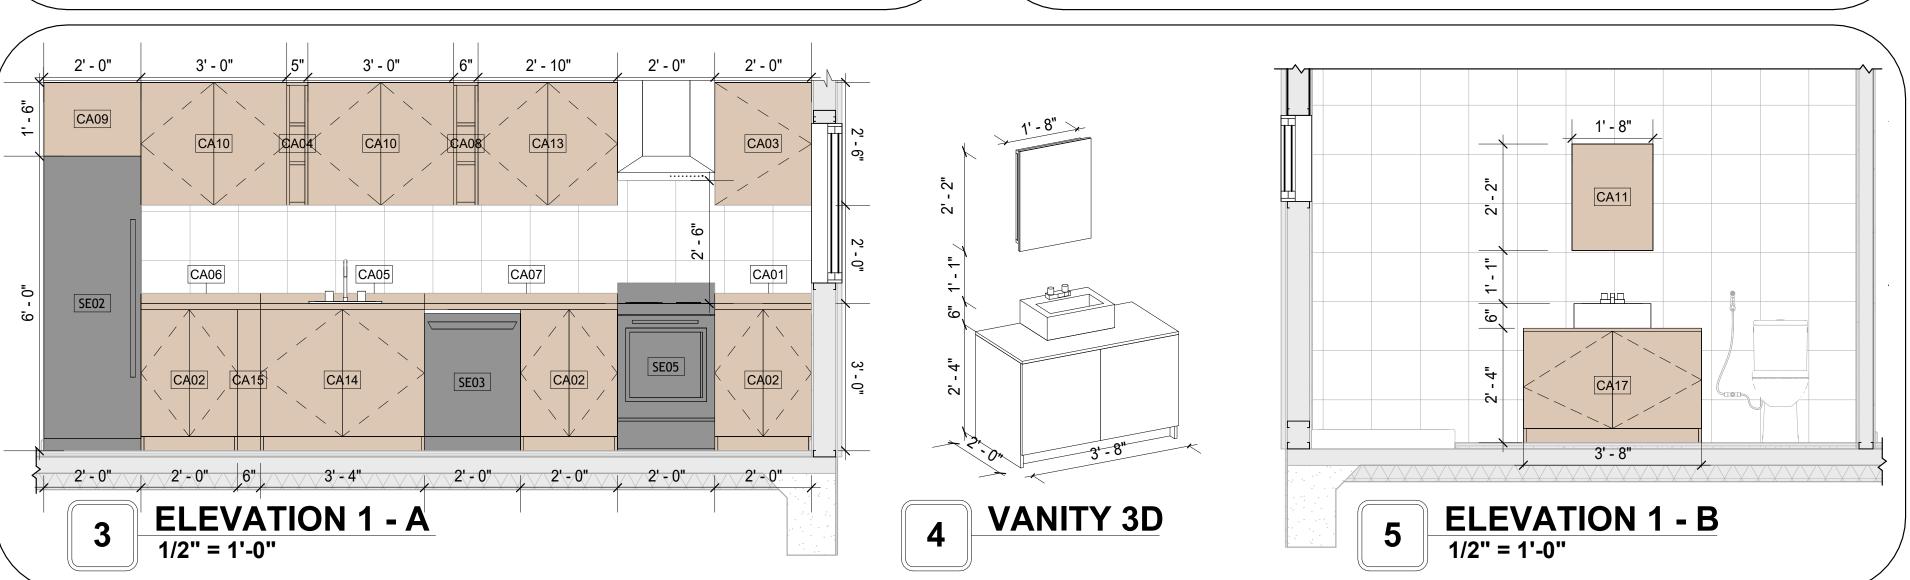

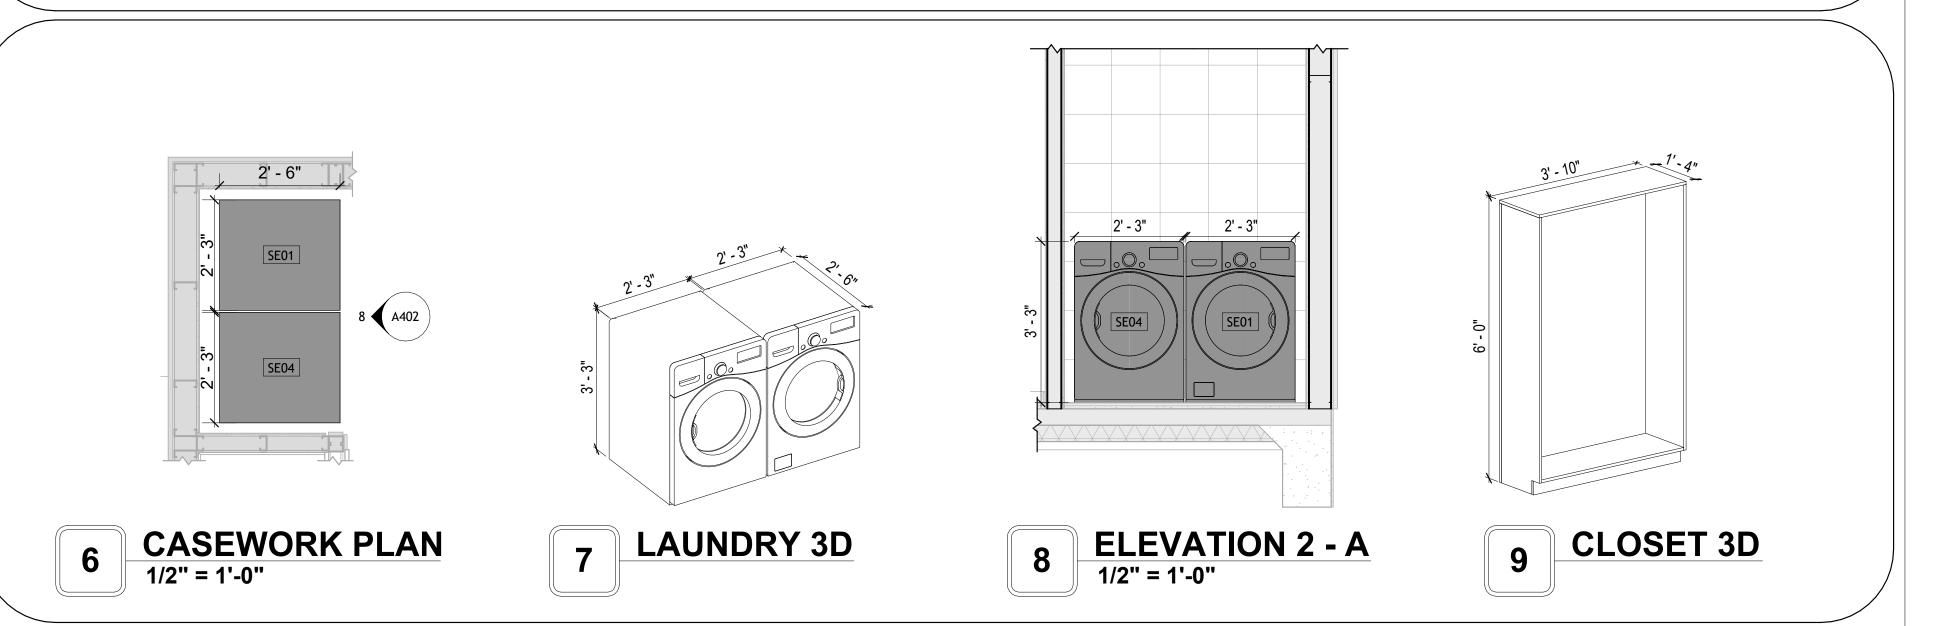



KEY PLAN

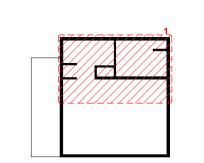

NO.	DESCRIPTION	DATE

NOTE:

LEGEND:

PROJECT

236-EMBER-624-STUDIO MODERN-BASE-550

DRAWING NAME

ARCHITECTURAL CASEWORK

CLIENT NAME:	Client Name
PROJECT NUMBER:	0033_15
DATE:	5/12/2025 3:16:47 PM
DESIGNED BY:	Designer
DRAWN BY:	Author
CHECKED BY:	Checker

A402

GENERAL NOTES

1. THIS DRAWING DEPICTS THE HVAC (HEATING, VENTILATION, AND AIR CONDITIONING) SYSTEM FOR THE EMBER STUDIO MODERN BASE. IT PROVIDES A VISUAL REPRESENTATION OF THE SYSTEM LAYOUT AND COMPONENTS.

2.THE HVAC SYSTEM IS DESIGNED TO MEET THE SPECIFIC REQUIREMENTS OF THE BUILDING, INCLUDING HEATING, COOLING, AND VENTILATION NEEDS, AS PER THE PROJECT SPECIFICATIONS AND APPLICABLE CODES AND STANDARDS.

3. THE HVAC SYSTEM INSTALLATION SHALL COMPLY WITH THE LATEST EDITION OF THE INTERNATIONAL MECHANICAL CODE (IMC), INTERNATIONAL RESIDENTIAL CODE (IRC), AND ALL OTHER APPLICABLE LOCAL, STATE, AND NATIONAL CODES AND REGULATIONS.

4. THE EQUIPMENT SHOWN ON THIS DRAWING INCLUDES BUT IS NOT LIMITED TO AIR HANDLING UNITS (AHUS), CHILLERS, BOILERS, COOLING TOWERS, PUMPS, DUCTWORK, DIFFUSERS, GRILLES, AND CONTROL DEVICES.

5. ALL EQUIPMENT, DUCTWORK, AND PIPING SHALL BE INSTALLED IN ACCORDANCE WITH MANUFACTURER'S SPECIFICATIONS, LOCAL CODES, AND INDUSTRY BEST DRACTICES

6. ALL DUCTWORK SHALL BE SIZED, FABRICATED, AND INSTALLED IN ACCORDANCE WITH THE LATEST EDITION OF THE ACCA MANUAL D AND THE SMACNA HVAC DUCT CONSTRUCTION STANDARDS. DUCTWORK SHALL BE INSTALLED IN A NEAT AND WORKMANLIKE MANNER, PROPERLY SUPPORTED AND BRACED TO PREVENT SAGGING, AIR LEAKAGE, OR VIBRATION.

7. CONDENSATE DRAINAGE PIPING SHALL BE PROPERLY PITCHED TO ENSURE POSITIVE DRAINAGE TO AN APPROVED DISPOSAL LOCATION, SUCH AS A FLOOR DRAIN, SUMP PUMP, OR EXTERIOR GRADE. CONDENSATE LINES SHALL BE INSULATED TO PREVENT SWEATING.

8. THE LOCATION OF CONTROL PANELS AND SENSORS INDICATED ON THIS DRAWING CAN BEMODIFY WITH THE SPECIFIC LOCATIONS AND WIRING DETAILS WILL BE DETERMINED DURING THE CONTROL SYSTEM DESIGN AND INSTALLATION.

9. THE HVAC SYSTEM DESIGN CONSIDER ENERGY EFFICIENCY, INDOOR AIR QUALITY, OCCUPANT COMFORT, AND NOISE CONTROL, FOLLOWING

APPLICABLE GUIDELINES AND REGULATIONS.

10. COORDINATION WITH OTHER TREADS HAS BEEN DONE ON A DESIGN LEVEL. THIS DRAWING SHALL BE READ TOGETHER WITH THE AR, EL AND SN

WITH THE LOCAL BUILDING DEPARTMENT AND UTILITY PROVIDERS TO ENSURE A TIMELY AND COMPLIANT INSTALLATION.

11. THE HVAC CONTRACTOR IS RESPONSIBLE FOR OBTAINING ALL NECESSARY PERMITS AND LICENSES, AND FOR SCHEDULING AND COORDINATING

12. ALL DUCTWORK PENETRATIONS THROUGH WALLS, FLOORS, OR CEILINGS SHALL BE PROPERLY SEALED AND FIRE-STOPPED USING APPROVED

METHODS AND MATERIALS TO MAINTAIN THE INTEGRITY OF THE BUILDING'S FIRE-RESISTANCE RATINGS.

13. HVAC EQUIPMENT SHALL BE INSTALLED LEVEL AND PLUMB, AND IN STRICT ACCORDANCE WITH THE MANUFACTURER'S INSTALLATION

INSTRUCTIONS AND RECOMMENDATIONS. PROVIDE ADEQUATE CLEARANCES AROUND EQUIPMENT FOR PROPER AIRFLOW, SERVICE ACCESS, AND CODE COMPLIANCE.

14. ALL HVAC EQUIPMENT AND COMPONENTS, INCLUDING THERMOSTATS, DAMPERS, AND ACCESS PANELS, SHALL BE LOCATED IN ACCESSIBLE AREAS

15. THE HVAC SYSTEM SHALL BE BALANCED AND ADJUSTED TO ENSURE PROPER AIRFLOW, TEMPERATURE DISTRIBUTION, AND SYSTEM

PERFORMANCE THROUGHOUT THE RESIDENCE. PROVIDE A WRITTEN REPORT DOCUMENTING THE FINAL SYSTEM BALANCE.


FOR EASY SERVICING AND MAINTENANCE. PROVIDE ADEQUATE SPACE AROUND EQUIPMENT FOR PROPER AIRFLOW AND SERVICE ACCESS.

16. ANY DEVIATIONS OR MODIFICATIONS TO THE HVAC SYSTEM DESIGN SHALL BE REVIEWED AND APPROVED BY THE RESPONSIBLE DESIGN

PROFESSIONALS AND COMMUNICATED TO ALL RELEVANT PARTIES INVOLVED IN THE CONSTRUCTION PROCESS.

17. FOR ANY INQUIRIES OR CLARIFICATIONS REGARDING THE HVAC SYSTEM DESIGN, PLEASE CONSULT THE RESPONSIBLE DESIGN PROFESSIONALS OR THE PROJECT MANAGEMENT TEAM.


DESIGN DRAWINGS TO ENSURE PROPER INSTALLATION AND INTEGRATION OF THE HVAC SYSTEMS.

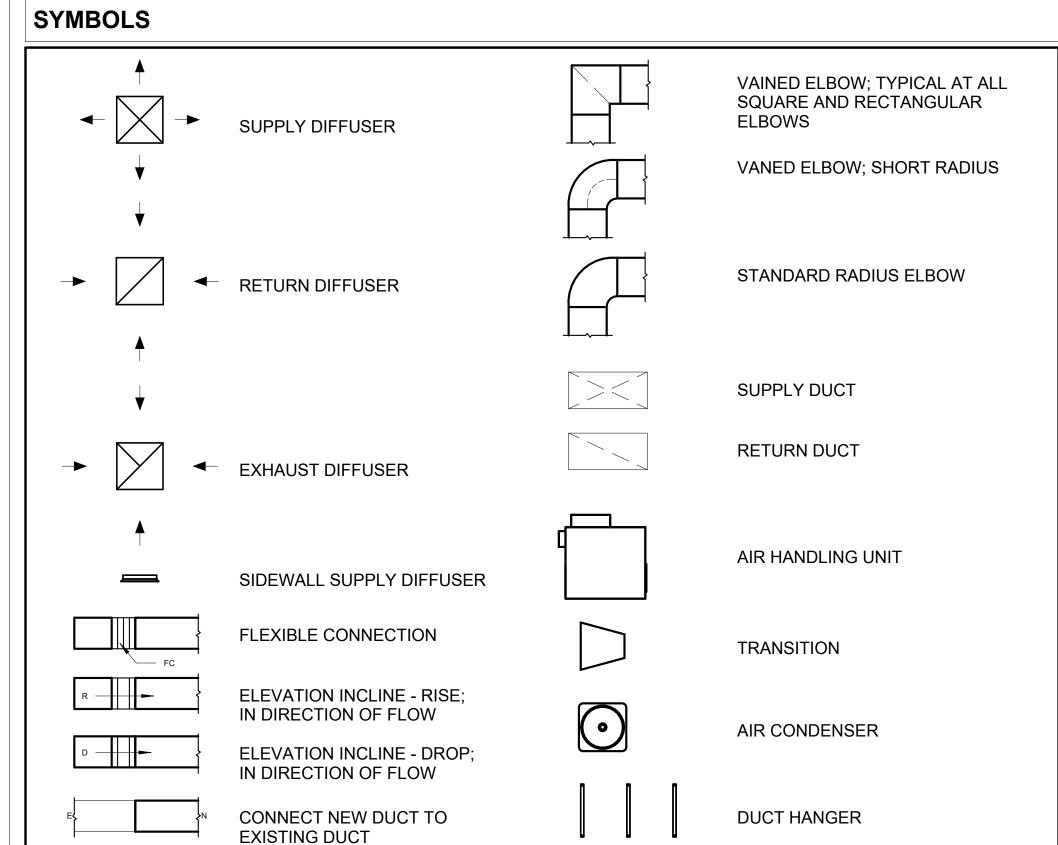

HVAC COLOR SCHEME

AIR CONDITIONING PIPE

	REFRIGERANT L	INE SCHEDULE	
CATAGORY	DESCRIPTION	DIAMETER	LENGTH
PIPE TYPES	COPPER	3/8"	53.89
PIPE TYPES	COPPER	3/4"	62.48

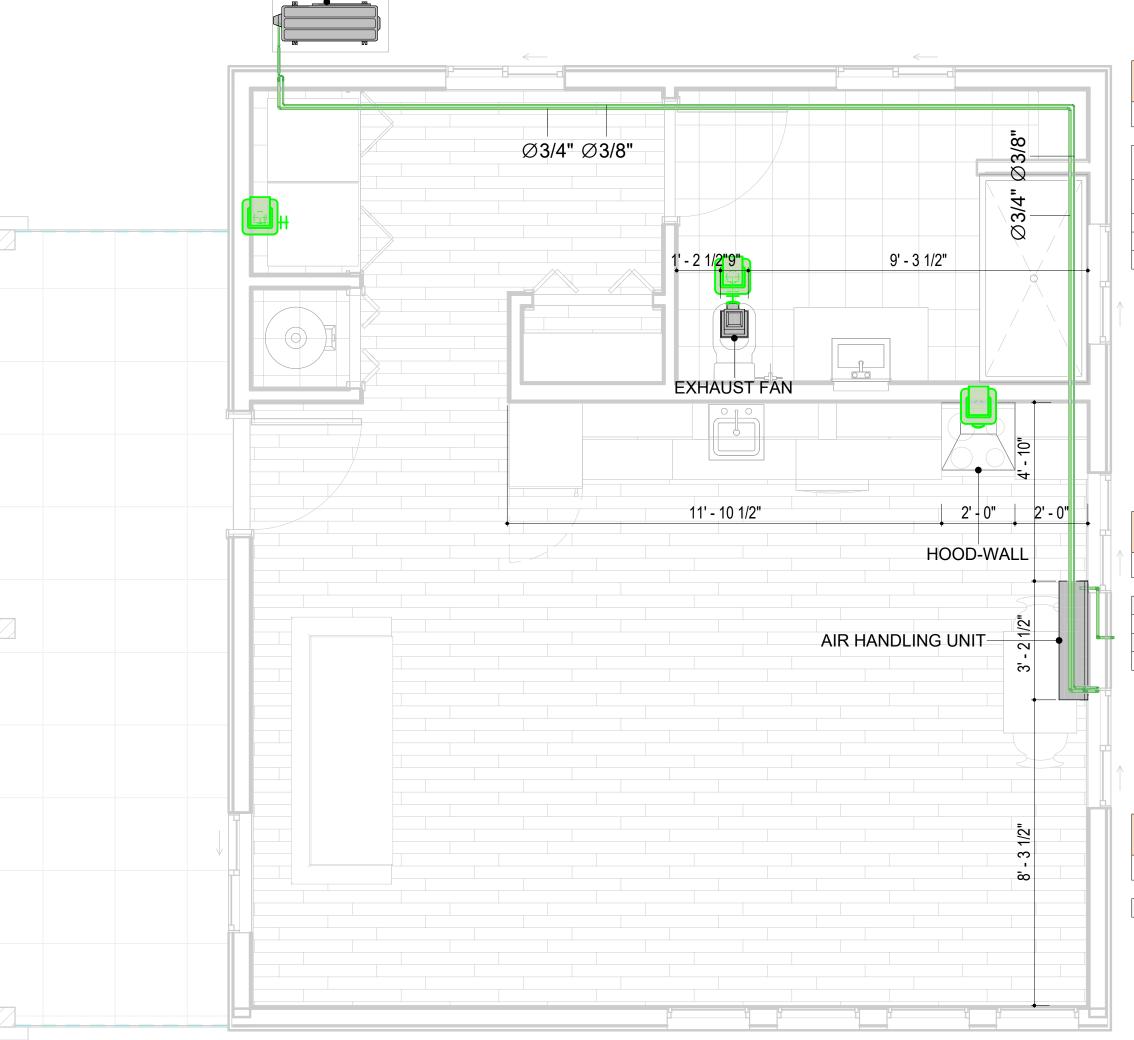

CONDENSER

HVAC PLAN

3/8" = 1'-0"

REFRIGERANT LINE FITTING SCHEDULE				
CATAGORY	DESCRIPTION	Size	Count	
ELBOW - GENERIC	ELBOW - GENERIC: STANDARD/HVAC	3/4"ø-3/4"ø	14	
ELBOW - GENERIC	ELBOW - GENERIC: STANDARD/HVAC	3/8"ø-3/8"ø	12	
TRANSITION - GENERIC	TRANSITION - GENERIC: STANDARD	3/4"ø-1/2"ø	2	
TRANSITION - GENERIC	TRANSITION - GENERIC: STANDARD	3/4"ø-5/8"ø	1	
TRANSITION - GENERIC	TRANSITION - GENERIC: STANDARD	3/8"ø-1/4"ø	1	

MECHANICAL EQUIPMENT SCHEDULE					
CATAGORY	DESCRIPTION	COUNT			
AIR HANDLING UNIT	AIR HANDLING UNIT: WALL MOUNTED	1			
CONDENSER	CONDENSER: OUT DOOR	1			
EXHAUST FAN	EXHAUST FAN: 75 CFM	1			
	HOOD-WALL: VENT	1			

DUCT FITTING SCHEDULE					
CATAGORY	DESCRIPTION	COUNT			
ROUND TRANSITION - ANGLE	45 DEGREE	5			

DUCT ACCESSORY SCHEDULE						
CATAGORY	DESCRIPTION	COUNT				
ROOF VENT	3" DIAMETER	3				

	FLEX DU	JCT SCHEDUL	.E	
DESCRIPTION	DESCRIPTION	LENGTH	DIAMETER	COUNT
FLEX DUCT ROUND	FLEX-ROUND	13.85	4"	3
GRAND TOTAL: 3	•	13.85	•	•



KEY PLAN

NO.	DESCRIPTION	DATE

NOTE:

LEGEND:

PROJECT

236-EMBER-624-STUDIO MODERN-BASE-550

DRAWING NAME

HVAC PLAN

 CLIENT NAME:
 Owner

 PROJECT NUMBER:
 15_0001

 DATE:
 5/10/2025 7:26:00 AM

 DESIGNED BY:
 Designer

 DRAWN BY:
 Author

 CHECKED BY:
 Checker

M101

SCALE: As indicated

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ELECTRICAL NOTES

- 1. THIS DRAWING DEPICTS THE ELECTRICAL SYSTEM FOR THE 236-EMBER-624-STUDIO MODERN-BASE-550. IT PROVIDES A VISUAL REPRESENTATION OF THE ELECTRICAL LAYOUT AND COMPONENTS, INCLUDING POWER DISTRIBUTION, LIGHTING, AND CONTROL SYSTEMS.
- 2. THE ELECTRICAL SYSTEM IS DESIGNED TO MEET THE SPECIFIC REQUIREMENTS OF THE BUILDING, INCLUDING POWER DISTRIBUTION, LIGHTING, AND SPECIALIZED ELECTRICAL EQUIPMENT NEEDS, AS PER THE PROJECT SPECIFICATIONS AND APPLICABLE CODES AND STANDARDS.
- 3. THE ELECTRICAL SYSTEM INSTALLATION SHALL COMPLY WITH THE LATEST EDITION OF THE NATIONAL ELECTRICAL CODE (NEC), INTERNATIONAL BUILDING CODE (IBC), AND ALL OTHER APPLICABLE LOCAL, STATE, AND NATIONAL CODES AND REGULATIONS.
- 4. LOCATIONS AS NEEDED, DEVICES ARE SHOWN ON PLANS IN APPROXIMATE IDEAL LOCATIONS, UNLESS SPECIFICALLY DIMMENSIONED.
- 5. OPEN WALLS AS NEEDED TO ALLOW FOR NEW ELECTRICAL INSTALLATIONS.
- 6. LABEL ALL CIRCUITS ON JUNCTION BOXES, RECEPTACLES, DATA, SMOKE DETECTOR, AND EQUIPMENT IN PANEL BOX.
- 7. INSTALL RACEWAY AS NEEDED FOR DDC, ACCESS CONTROL, LOW VOLTAGE WIRING & DATA.
- 8. RELABEL POWER, DATA & FIRE ALARM FOR ROOM #CHANGES.
 9. VERIFY ALL CIRCUITS LABELED ON PRINT ARE CORRECT BEFORE WORKING ON THEM.
- 10. NOTE ON SITE PLAN ALL CHANGES OR MISSING DETAIL TO BE INCORPORATED INTO THE MASTER PLAN.
- 11. DRAWINGS ARE DIAGRAMMATIC ONLY FOR THE PURPOSE OF SHOWING FIXTURE AND OUTLET LOCATIONS.
- 12. ELECTRICAL CONTRACTOR TO VERIFY SERVICE SIZE BY CALCULATION BASED UPON ACTUAL NAME PLATE RATINGS OF SELECTED EQUIPMENT.
- PLATE RATINGS OF SELECTED EQUIPMENT.

 13. VERIFY LOCATION OF SERVICE ENTRANCE WITH POWER COMPANY. PROVIDE UFER GROUND IN
- 13. VERIFY LOCATION OF SERVICE ENTRANCE WITH POWER COMPANY. PROVIDE UFER GROUND IN BUILDING FOUNDATION AT SERVICE ENTRANCE LOCATION.
- 14. PROVIDE A MIN. OF 20 FEET OF ONE *4 BARE COPPER UFER WIRE EMBEDDED IN CONCRETE FOOTING AT THE SERVICE ENTRANCE LOCATION WHERE APPROVED BY LOCAL SERVICE PROVIDER.
- 15. PROVIDE WATERPROOF FIXTURES IN ALL HIGH MOISTURE AREAS (EXTERIOR, SHOWER AND TUB
- CEILINGS ETC.)
- 16. PROVIDE DEDICATED CIRCUITS TO EACH BATH, DEN, FAMILY ROOM, BEDROOM, LOFT, KITCHEN
- REFRIGERATOR, KITCHEN FREEZER DISHWASHER, AND ANY AREA/ITEM SPECIFIED BY OWNER.

 17. INCANDESCENT FIXTURES WITH OPEN OR PARTIALLY ENCLOSED LAMPS, PENDANT FIXTURES, AND
- LAMP HOLDERS ARE NOT PERMITTED IN CLOSETS.

 18. ALL WORKMANSHIP AND MATERIALS TO CONFORM WITH THE 2015 IRC.
- 19. PROVIDE A MIN. OF 20 FEET OF ONE *4 BARE COPPER UFER WIRE EMBEDDED IN CONCRETE FOOTING AT THE SERVICE ENTRANCE LOCATION WHERE APPROVED BY LOCAL SERVICE PROVIDER.
- 20. PROVIDE A BONDING CONDUCTOR CONSISTING OF A MINIMUM OF ONE *4 BARE COPPER WIRE CONNECTING THE BUILDING'S METAL WATER PIPING SYSTEM TO THE SERVICE EQUIPMENT ENCLOSURE GROUNDING.

MAIN PANEL CALCS	MA	AIN	PAN	EL C	AL	CS
------------------	----	-----	------------	------	----	----

ELECTRICAL CALCS	
LIGHT AND OUTLETS 624 @ 3W	1,872 W
3 APPLIANCE CIRCUITS	4,500 W
DRYER	2,000 W
WASHER	2,000 W
RANGE	5,000 W
WATER HEATER	5,000 W
REFRIG.	1,800 W
DISHWASHER & DISPOSAL	3000 W
TOTAL	25,172 W
FRIST 10,000 @ 100% REMAINDER @ 40% MINI. SPLIT UNITS	10,000 W 6,069W 10,000 W
TOTAL	26,069W
26,069 W DIVIDED BY 240V =	109 AMPS TOTAL

(USE 200 AMP SERVICE)

ELECTRICAL ABBREVIATIONS LIST

1P	1 POLE (2P, 3P, 4P, ETC.)	CTR	CENTER	HT	HEIGHT
A	AMPERE	CU	COPPER	HTG	HEATING
AC	ABOVE COUNTER OR AIR CONDITIONER	DCP	DOMESTIC WATER CIRCULATING PUMP	HTR	HEATER
				HV	HIGH VOLTAGE
ACLG	ABOVE CEILING	DEPT	DEPARTMENT		
ADO	AUTOMATIC DOOR OPENER	DET	DETAIL	HVAC	HEATING, VENTILATING AND AIR
AF	AMP FRAME	DIA	DIAMETER	CONDITIONING	CONDITIONING
AFF	ABOVE FINISHED FLOOR	DISC	DISCONNECT	HWP	HYDRONIC WATER PUMP
AFG	ABOVE FINISHED GRADE	DIST	DISTRIBUTION	IC	INTERRUPTING CAPACITY
AFI	ARC FAULT CIRCUIT INTERRUPTER	DN	DOWN	IG	ISOLATED GROUND
AHU	AIR HANDLING UNIT	DPR	DAMPER	IMC	INTERMEDIATE METAL CONDUIT
AL	ALUMINUM	DS	SAFETY DISCONNECT SWITCH	INCAND	INCANDESCENT
ALT	ALTERNATE	DT	DOUBLE THROW	IR	INFRARED
AMP	AMPERE	DWG	DRAWING	I/W	INTERLOCK WITH
AMPL	AMPLIFIER	DDC	DIRECT DIGITAL CONTROL	J-BOX	JUNCTION BOX
ANNUN	ANNUNCIATOR APPROX APPROXIMATELY		ELECTRICAL CONTRACTOR	KV	KILOVOLT
AQ-STAT	AQUASTAT	ELEC	ELECTRIC, ELECTRICAL	KVA	KILOVOLT-AMPERE
ARCH	ARCHITECT, ARCHITECTURAL	ELEV	ELEVATOR	KVAR	KILOVOLT-AMPERE REACTIVE
AS	AMP SWITCH	EM	EMERGENCY	KW	KILOWATT
AT	AMP TRIP	EMS	ENERGY MANAGEMENT SYSTEM	KWH	KILOWATT HOUR
ATS	AUTOMATIC TRANSFER SWITCH	EMT	ELECTRICAL METALLIC TUBING	LOC	LOCATE OR LOCATION
AUTO	AUTOMATIC	EP	ELECTRIC PNEUMATIC	LT	LIGHT
AUX	AUXILIARY	EQUIP	EQUIPMENT	LTG	LIGHTING
AV	AUDIO VISUAL	EWC	ELECTRIC WATER COOLER	LTNG	LIGHTNING
AWG	AMERICAN WIRE GAUGE	EXIST	EXISTING	LV	LOW VOLTAGE
BATT	BATTERY	EXH	EXHAUST	MAX	MAXIMUM
BD	BOARD	EXP	EXPLOSION PROOF	MAG.S	MAGNETIC STARTER
BLDG	BUILDING	FA	FIRE ALARM	M/C	MOMENTARY CONTACT
	BUILDING MANAGEMENT SYSTEM			MC	
BMS		FABP	FIRE ALARM BOOSTER POWER		MECHANICAL CONTRACTOR
C	CONDUIT	SUPPLY PANEL	SUPPLY PANEL	MCB	MAIN CIRCUIT BREAKER
CAB	CABINET	FACP	FIRE ALARM CONTROL PANEL	MCC	MOTOR CONTROL CENTER
CAT	CATALOG	FCU	FAN COIL UNIT	MDC	MAIN DISTRIBUTION CENTER
CATV	CABLE TELEVISION	FIXT	FIXTURE	MDP	MAIN DISTRIBUTION PANEL
СВ	CIRCUIT BREAKER	FLR	FLOOR	MFR	MANUFACTURERMAIN FUSED
CCTV	CLOSED CIRCUIT TELEVISION	FLUOR	FLUORESCENT		DISCONNECT SWITCH
CKT	CIRCUIT	FU	FUSE	MH	MANHOLE
CLG	CEILING	FUDS	FUSED SAFETY DISCONNECT SWITCH	MIC	MICROPHONE
COMB	COMBINATION	GA	GAUGE	MIN	MINIMUM
CMPR	COMPRESSOR	GAL	GALLON	MISC	MISCELLANEOUS
CONN	CONNECTION	GALV	GALVANIZED	MLO	MAIN LUGS ONLY
CONST	CONSTRUCTION	GC	GENERAL CONTRACTOR	MMS	MANUAL MOTOR STARTER
CONT	CONTINUATION OR CONTINUOUS	GEN	GENERATOR	MOA	MULTIOUTLET ASSEMBLY
				MSP	MOTOR STARTER PANELBOARD
CONTR	CONTRACTOR	GFI	GROUND FAULT DROTTECTOR		
CONV	CONVECTOR	GFP	GROUND FAULT PROTECTOR	MSBD	MAIN SWITCHBOARD
CP	CIRCULATING PUMP	GND	GROUND	MT	MOUNT
CRT	CATHODE-RAY TUBE	GRS	GALVANIZED RIGID STEEL (CONDUIT)	MT.C	EMPTY CONDUIT
CT	CURRENT TRANSFORMER	GYP BD	GYPSUM BOARD	UL	UNDERWRITERS LABORATORIES

Branch Panel:

Location: HALL 04
Supply From:
Mounting: Recessed
Enclosure: Type 1

Volts: 120/240 Single
Phases: 1
Wires: 3

A.I.C. Rating:
Mains Type:
Mains Rating: 200 A
MCB Rating: 1 A

Notes:

Circuit Description	Number of Elements	Rating	Length	Wire Size	Α		E	3	Wire Size	Length	Rating	Number of Elements	Circuit Description	Circu Numb er
BATH GFCI	7	20 A	19' - 6 1/32"	1-#12, 1-#12, 1-#12	576 VA	2500 VA			2-#10, 1-#10, 1-#10	23' - 2 13/16"	30 A	1	DRYER	2
WASHER	1	20 A	25' - 0 9/16"	1-#12, 1-#12, 1-#12			1200 VA	2500 VA						4
WATER HEATER	1	30 A	27' - 6 3/4"	2-#10, 1-#10, 1-#10	2250 VA	420 VA			1-#12, 1-#12, 1-#12	44' - 10 3/32"	20 A	9	HALL & KITCHEN LIGHT	6
							2250 VA	1800 VA	1-#12, 1-#12, 1-#12	19' - 7 21/32"	20 A	1	REFRIGERATOR	8
KITCHEN GFCI	4	20 A	28' - 4 15/32"	1-#12, 1-#12, 1-#12	720 VA	1200 VA			1-#12, 1-#12, 1-#12	24' - 10 15/32"	20 A	1	DISHWASHER	10
RANGE	1	50 A	26' - 4 17/32"	2-#8, 1-#8, 1-#10			2500 VA	2500 VA	2-#6, 1-#6, 1-#10	19' - 0 11/16"	60 A	1	CONDENSER	12
					2500 VA	2500 VA								14
OUTDOOR GFCI	3	20 A	44' - 4 7/32"	1-#12, 1-#12, 1-#12			540 VA							16
LIVING LIGHT	9	15 A	52' - 6 1/2"	1-#14, 1-#14, 1-#14	265 VA	100 VA			1-#12, 1-#12, 1-#12	30' - 6 27/32"	20 A	1	OUTDOOR LIGHT	18
LIV. RECEPATCEL	6	20 A	45' - 10 27/32"	1-#12, 1-#12, 1-#12			1080 VA							20
														22
														24
														26
					13023	VA	1437	0 VA						
	BATH GFCI WASHER WATER HEATER KITCHEN GFCI RANGE OUTDOOR GFCI LIVING LIGHT	Circuit Description Elements BATH GFCI 7 WASHER 1 WATER HEATER 1	Circuit Description Elements Rating BATH GFCI 7 20 A WASHER 1 20 A WATER HEATER 1 30 A KITCHEN GFCI 4 20 A RANGE 1 50 A OUTDOOR GFCI 3 20 A LIVING LIGHT 9 15 A	Circuit Description Number of Elements Rating BATH GFCI 7 20 A 19' - 6 1/32" WASHER 1 20 A 25' - 0 9/16" WATER HEATER 1 30 A 27' - 6 3/4" KITCHEN GFCI 4 20 A 28' - 4 15/32" RANGE 1 50 A 26' - 4 17/32" OUTDOOR GFCI 3 20 A 44' - 4 7/32" LIVING LIGHT 9 15 A 52' - 6 1/2"	Circuit Description Number of Elements Rating 1.#12, 1.#12, 1.#12, 1.#12 BATH GFCI 7 20 A 19' - 6 1/32" 1.#12, 1.#12, 1.#12 WASHER 1 20 A 25' - 0 9/16" 1.#12, 1.#12, 1.#12 WATER HEATER 1 30 A 27' - 6 3/4" 2.#10, 1.#10, 1.#10 KITCHEN GFCI 4 20 A 28' - 4 15/32" 1.#12, 1.#12, 1.#12 RANGE 1 50 A 26' - 4 17/32" 2.#8, 1.#8, 1.#10 OUTDOOR GFCI 3 20 A 44' - 4 7/32" 1.#12, 1.#12, 1.#12, 1.#12, 1.#12, 1.#12 LIVING LIGHT 9 15 A 52' - 6 1/2" 1.#14, 1.#14, 1.#14 LIV. RECEPATCEL 6 20 A 45' - 10 27/32" 1.#12, 1.#12, 1.#12, 1.#12, 1.#12, 1.#12, 1.#12, 1.#12	Circuit Description Elements Rating 1.#12, 1.#10, 1.#10, 1.#10, 1.#10, 1.#10, 1.#10, 1.#10, 1.#12, 1.#12, 1.#12, 1.#12, 1.#12, 1.#12, 1.#12, 1.#12, 1.#14, 1.#10, 1.#14, 1.#14, 1.#14, 1.#14, 1.#14, 1.#14, 1.#14, 1.#14, 1.#14, 1.#14, 1.#12, 1.#12, 1.#12, 1.#12, 1.#12, 1.#12, 1.#14, 1.#14, 1.#14, 1.#14, 1.#14, 1.#14, 1.#14, 1.#12, 1.	Number of Elements Rating A	Rating R	Circuit Description Elements Rating	Circuit Description Climents Rating	Circuit Description Elements Rating	Rating Circuit Description Elements Rating	Circuit Description Circuit Description	A B Circuit Description Circuit Desc

Load Classification	Connected Load	Demand Factor	Estimated Demand	Panel	Totals
LIGHTING - DWELLING UNIT	200 VA	100.00%	200 VA		
OTHER	708 VA	100.00%	708 VA	Total Conn. Load:	27393 VA
RECEPTACLE	5100 VA	100.00%	5100 VA	Total Est. Demand:	26393 VA
LIGHTING	100 VA	100.00%	100 VA	Total Conn.:	114 A
CONDENSER	5000 VA	100.00%	5000 VA	Total Est. Demand:	110 A
WATER HEATER	4500 VA	100.00%	4500 VA		
RANGE	5000 VA	80.00%	4000 VA		
DRYER	5000 VA	100.00%	5000 VA		
REFRIGERATOR	1800 VA	100.00%	1800 VA		

lotes:

Tuscon,AZ, USA 888-864-0184 inquire@frameupnow.com www.frameupnow.com

KEY PLAN

NO. DESCRIPTION DATE

NOTE:

LEGEND:

PROJECT

236-EMBER-624-STUDIO MODERN-BASE-550

DRAWING NAME

SCHEDULE

CLIENT NAME:

PROJECT NUMBER:

0408_11

DATE:

5/12/2025 12:14:40 PM

DESIGNED BY:

DRAWN BY:

CHECKED BY:

Checker

E101

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SCALE: 1/4" = 1'-0"

ELECTRICAL NOTE

- PROVIDE INTERCONNECTED SMOKE ALARMS IN EACH SLEEPING ROOMS, OUTSIDE EACH SLEEPING ROOM, ON EACH STORY, IN THE HALL OR ADJACENT ROOM LUHERE THE CEILING HEIGHT OF A ROOM OPEN TO THE HALL EXCEEDS THE HALL BY 24'. SMOKE ALARMS SHALL BE PERMANENTLY HARD WIRED WITH BATTERY BACKUP.
- B. RECEPTACLE OUTLETS FOR RANGES AND CLOTHES DRYERS SHALL BE A THREE POLE WITH GROUND TYPE. FOUR WIRE GROUNDING-TYPE FLEXIBLE CORDS WILL BE REQUIRED FOR CONNECTION OF RANGES AND CLOTHES DRYERS. THE BONDING JUMPER SHALL NOT BE CONNECTED BETWEEN NEUTRAL TERMINAL AND THE FRAME OF THE **APPLIANCE**
- C. TWO OR MORE 20 AMP SMALL APPLIANCE CIRCUITS SHALL BE PROVIDED TO SERVE THE KITCHEN, BREAKFAST NOOK, AND DINING ROOM. SUCH CIRCUITS SHALL HAVE NO OTHER OUTLETS.
- D. AT LEAST ONE 20 AMP BRANCH CIRCUIT SHALL BE PROVIDED TO SERVICE THE LAUNDRY ROOM. THIS CIRCUIT SHALL HAVE NO OTHER OUTLETS.
- E. ALL RECEPTACLES WITH IN 6' OF A WET BAR SINK OR KITCHEN SINK TO SERVE COUNTER TOP SURFACES MUST BE GFCI. ON KITCHEN COUNTERS 12' OR WIDER NO POINT ALONG THE WALL SHALL BE MORE THAN 2' FROM A RECEPTACLE. ALL RECEPTACLES WITH IN 6' OF KITCHEN SINK MUST BE GFCI. AT LEAST ONE GFCI RECEPTACLE SHALL
- BE INSTALLED IN THE BATHROOM ADJACENT TO EACH BASIN. FIXTURES INCLUDING CEILING FANS THAT ARE LOCATED IN DAMP LOCATIONS SHALL BE LISTED TO BE SUITABLE FOR
- SUCH LOCATIONS PER 2012 IRC G. PROVIDE ONE (1) SWITCHED OUTLET @ ALL BEDROOMS AND DEN
- H. CEILING FANS NOT EXCEEDING 35 LBS. (WITH OR WITHOUT ACCESSORIES MAY BE SUPPORTED BY OUTLET BOXES PROVIDED THE OUTLET BOXES ARE IDENTIFIED FOR SUCH USE PER 2012 IRC
- ELECTRICAL OUTLET BOXES ON OPPOSITE SIDES OF FIRE RATED WALLS SHALL BE SEPARATED BY A HORIZONTAL DISTANCE OF NOT LESS THAN 24".
- OUTLET BOXES IN THE WALLS BETWEEN THE GARAGE AND DWELLING SHALL BE METAL OR U.L. APPROVED FIRE RESISTIVE PLASTIC. BOXES IN GARAGE CEILING SHALL BE METAL.
- K. ALL BRANCH CIRCUITS THAT SUPPLY 120 VOLTS SINGLE PHASE 15 AND 20 AMPS RECEPTACLE OUTLETS INSTALLED IN THE DWELLING SHALL BE PROTECTED BY AN ARC FAULT CIRCUIT INTERRUPTER, EXCEPT GFCI RECEPTICLES.

NOTE:

RECEPTACLES MUST BE PROVIDED IN HALLWAYS 10'-0" OR MORE IN LENGTH. FOR A ONE FAMILY DWELLINGS AND EACH OF A TWO FAMILY DWELLING THAT IS AT GRADE LEVEL, AT LEAST ONE WP-GFCI RECEPTACLE OUTLET ACCESSIBLE AT GRADE LEVEL AND NOT MORE THAN 6'-6" ABOVE GRADE SHALL BE INSTALLED AT THE FRONT AND BACK OF THE DWELLING.

NOTE: APPLIANCE DISCONNECT

E4001.5 GROUNDING OF ENCLOSURES.

METAL ENCLOSURES FOR SWITCHES OR CIRCUIT BREAKERS SHALL BE CONNECTED TO AN

EQUIPMENT GROUNDING CONDUCTOR.

METAL ENCLOSURES FOR SWITCHES OR CIRCUIT BREAKERS USED AS SERVICE

EQUIPMENT SHALL COMPLY WITH THE PROVISIONS OF SECTION E3609.4. WHERE


NONMETALLIC ENCLOSURES ARE USED WITH METAL RACEWAYS OR METAL-ARMORED CABLES, PROVISIONS SHALL BE MADE FOR CONNECTING THE EQUIPMENT GROUNDING

CONDUCTOR.


NONMETALLIC BOXES FOR SWITCHES SHALL BE INSTALLED WITH A WIRING METHOD THAT

PROVIDES OR INCLUDES AN EQUIPMENT GROUNDING CONDUCTOR. (404.12)

ELECTRICAL LEGEND					
	Electrical Lights With Fan				
0	Waterproof Recessed Can Light				
	Pendant Light				
0	Recessed Can Light				
- Φ	Wall Lamp				
	Standalone linear				
√1	Single Switch				
₩	Three way Switch				
₩	Fan Switch				
	Duplex Receptacle				
	Triplex Receptacle				
G FC	GFCI Receptacle				
	Exhaust Fan				
•	Smoke and heat detector				

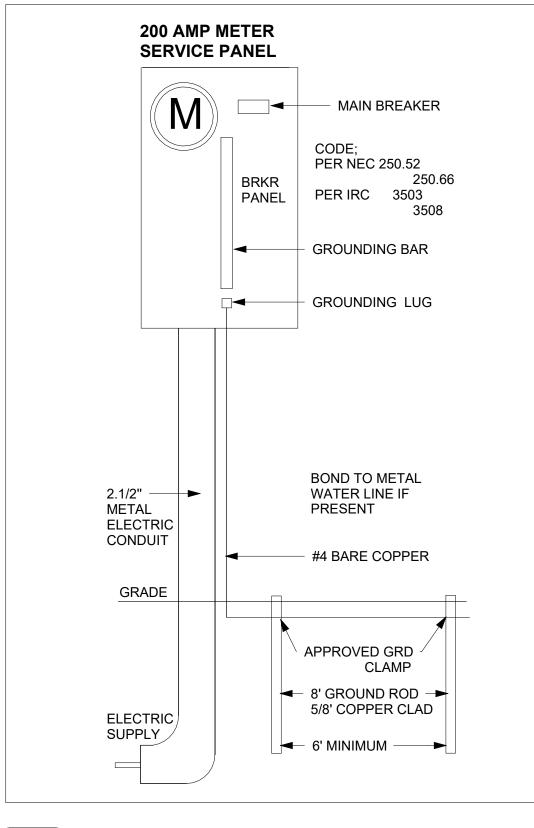



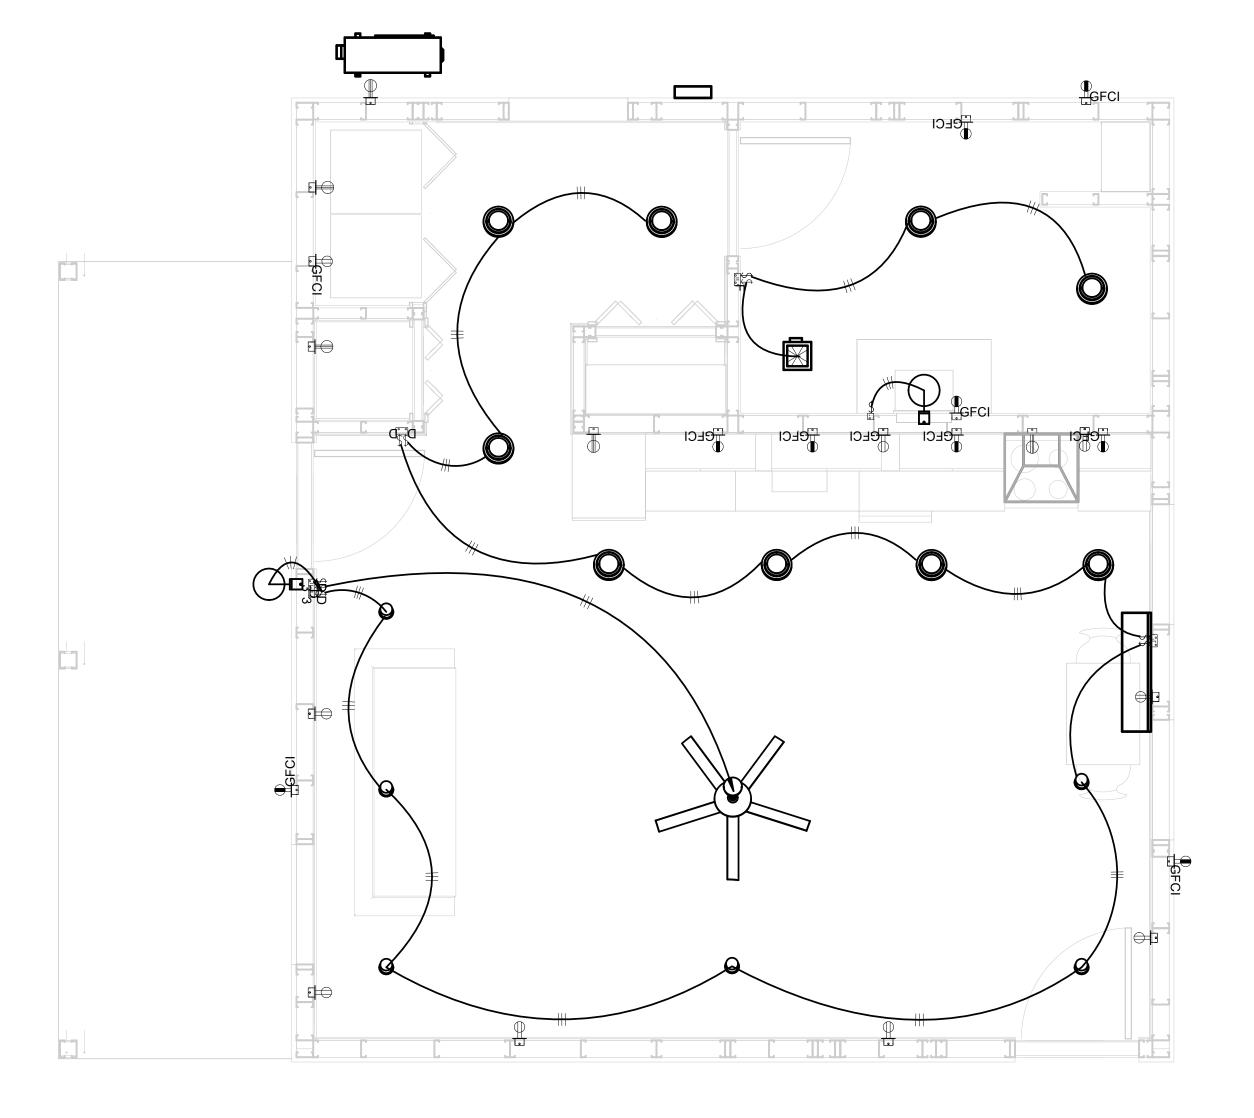



KEY PLAN

NO.	DESCRIPTION	DATE

NOTE:

LEGEND:

PROJECT

236-EMBER-624-STUDIO MODERN-BASE-550

DRAWING NAME


LIGHTING


Owner
0408_11
5/12/2025 12:14:42 PM
Designer
Author
Checker

E102


NOTES: CONDUIT, CABLE AND WIRING

- Use Metalic Conduits (IMC) for cables running under concrete slabs.
 Use IMC for circuits with high voltage appliances (240 volts and above)
 For circuits with 120 volts consider using EMT or PVC conduits if needed.
 For Low voltage applications up to 50 volts consider using non metalic conduits.
 All conduits to be used in the project must conform to the latest National Electrical Code (NEC),
- All wiring and cables to be used in the project must also conform to the latest National Electrical Code (NEC), 2015.
- 7. All cables and wires used should be rated for their respective loading and should be gauged and conform to the NEC.

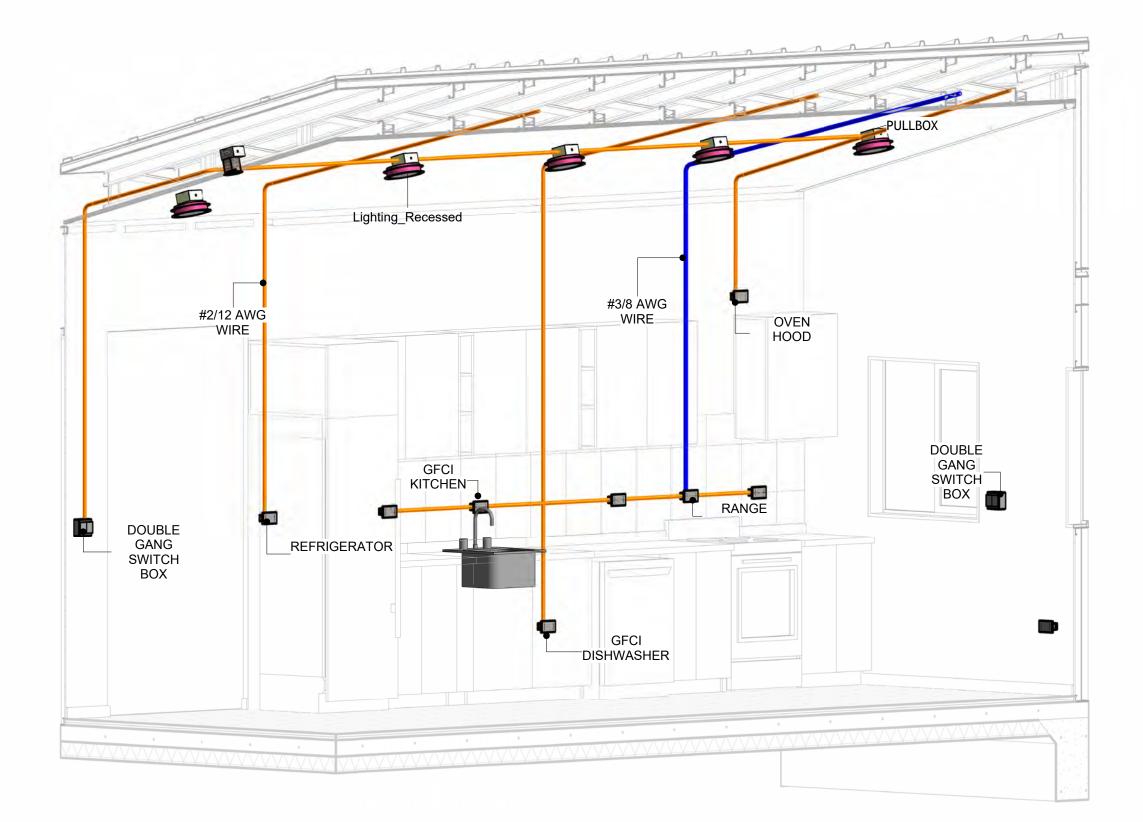


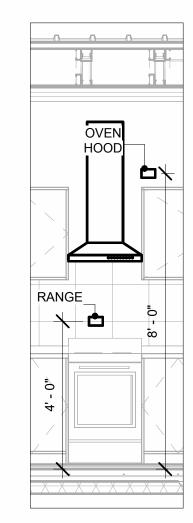


RANGE & OVENHOOD 3/8" = 1'-0"

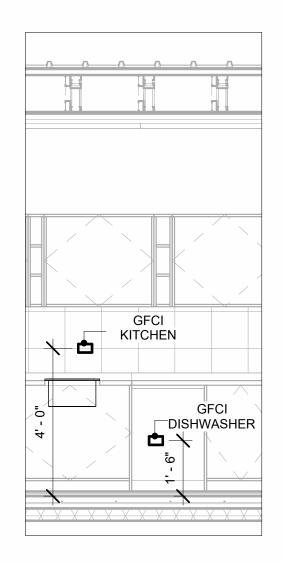

DISHWASHER& GFCI 3/8" = 1'-0"

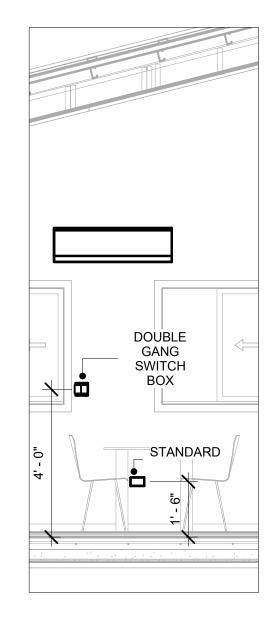


SWITCH & RECEPTACLE
3/8" = 1'-0"

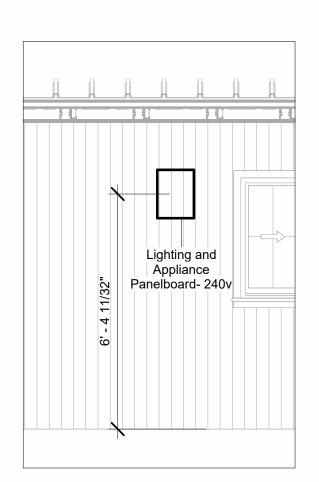

PANEL 3/8" = 1'-0"



KEY PLAN

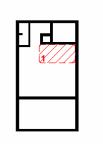

١٥.	DESCRIPTION	DATE

NOTE:

LEGEND:

PROJECT

236-EMBER-624-STUDIO MODERN-BASE-550

DRAWING NAME

POWER

CLIENT NAME:	Owner
PROJECT NUMBER:	0408_11
DATE:	5/12/2025 12:15:07 PM
DESIGNED BY:	Designer
DRAWN BY:	Author
CHECKED BY:	Checker

E103

SCALE: As indicated

3D-KITCHEN

NOTES: LIGHT

- 1. LIGHT FIXTURES AND LUMINARIES SHALL CONFORM TO THE NEC, THE IRC AND LOCAL SAFETY & BUILDING CODE.
- 2. ALL LIGHTING FIXTURES SHOULD CONFORM TO THE DESIGN ELECTRICAL LOAD AND SHALL BE PROPERLY WIRED AND MOUNTED BY QUALIFIED ELECTRICIAN FOLLOWING MANUFACTURERS SPECIFICATIONS.
- 3. CEILING FANS AND FANS WITH LIGHT WITH WEIGHT EXCEEDING 35 LBS SHOULD BE PROVIDED WITH STRUCTURAL BACKING FOR SUPPORT AND SHALL BE FIXED AS PER MANUFACTURERS SPECIFICATIONS.
- 4. EXTERIOR LIGHTS SHALL CONFORM TO LOCAL BUILDING CODE AND GUIDELINES.

NOTES: SWITCH JUNCTION BOX


- THE MINIMUM SIZE OF JUCTION BOX TO BE USED IS 2"X4"X(1.5" OR 3.5" DEEP) THIS ARE TO BE USED FOR SINGLE GANG SWITCH OR OUTLETS.
- 2. FOR DOUBLE GANG (2 GANG) OUTLETS AND SWITCHS THE MINIMUM SIZE OF THE
- JUCTION BOX TO BE PROVIDED SHALL NOT BE LESS THAN 4"X4"X(1.5" OR 3.5" DEEP)
- 3. FOR THREE GANG (3 GANG) OUTLETS AND SWITCHS THE MINIMUM SIZE OF THE JUĆTION BOX SHALL NOT BE LESS THAN 6"X4"X(1.5" OR 3.5" DEEP).

FITTING SCHEDULE(PULL BOX)			
FAMILY COUNT DESCRIPTION			
PULLBOX1 16 #1/4 PULLBOX			

ELECTRICAL FIXTURE SCHEDULE (SWITCH BOX)			
TYPE COUNT			
DOUBLE GANG SWITCH BOX	3		
SINGLE GANG SWITCH BOX 1			
TRIPLE GANG SWITCH BOX	1		

LIGHTING DEVICE			
TYPE	COUNT		
DIMMER	3		
FAN SWITCH	1		
SINGLE POLE	5		
THREE WAY WITH DIMMER	1		

LIGHTING FIXTURE				
LIGHTING FIXTURE TYPE	VOLTAGE	ELECTRICAL LOAD	COUNT	
ELECTRICAL_LIGHTS_FAN-LIGHT1	120 V/1-100 VA- 120 V/1-100 VA	200 A, 120 V/240 V, SINGLE PHASE, 3 WIRES	1	
LIGHTING_RECESSED	120 V/1-60 VA	200 A, 120 V/240 V, SINGLE PHASE, 3 WIRES	9	
SASSO 100 ROUND WALLWASHER TRIM	120 V/1-28 VA	200 A, 120 V/240 V, SINGLE PHASE, 3 WIRES	6	
WALL LAMP - BRACKET	120 V/1-100 VA	200 A, 120 V/240 V, SINGLE PHASE, 3 WIRES	2	

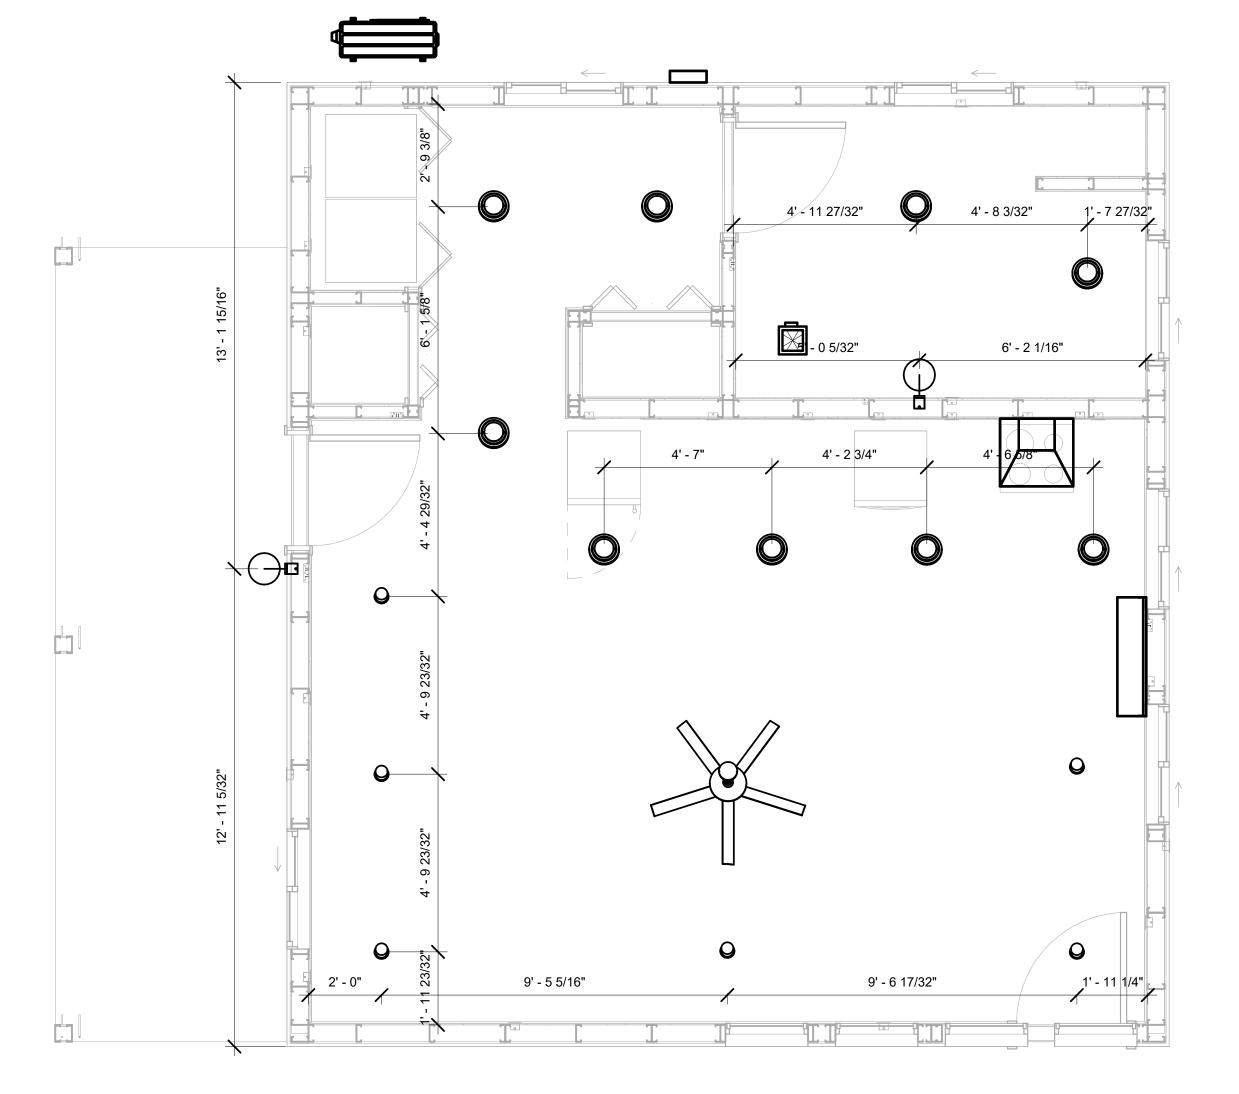

1 DIMENSION FOR LIGHT FIXTURES
3/8" = 1'-0"



KEY PLAN

NO.	DESCRIPTION	DATE

NOTE:

LEGEND:

PROJECT

236-EMBER-624-STUDIO MODERN-BASE-550

DRAWING NAME

DIMENSION PLAN FOR LIGHT FIXTURES

CLIENT NAME:	Owner
PROJECT NUMBER:	0408_11
DATE:	5/12/2025 12:15:07 PM
DESIGNED BY:	Designer
DRAWN BY:	Author
CHECKED BY:	Checker


E104

NOTES;

- 1. VERIFY EQUIPMENT PLUG CONFIGURATION BEFORE PURCHASING RECEPTACLES
- 2. FOR ALL EQUIPMENT.
- 3. COORDINATE EXACT LOCATION OF LIGHT FIXTURES, WALL SWITCHES, RECEPTACLES AND OTHER DEVICES WITH ARCHITECTURAL DRAWINGS.
- 4. USE METALLIC JUNCTION BOX WITH THE GFCI RECEPTACLES, WITH HIGHT VOLTAGE.

ELECTRICAL FIXTURE SCHEDULE (RECEPTACLE)		
TYPE	COUNT	
CONDENSER	1	
DRYER	1	
GFCI BATH ROOM	2	
GFCI DISHWASHER	1	
GFCI KITCHEN	4	
GFCI OUT DOOR	3	
GFCI WASHER	1	
OVEN HOOD	1	
RANGE	1	
REFRIGERATOR	1	
STANDARD	6	
WATER HEATER	1	

ELECTRICAL OUTLET SCHEDULE			
TYPE	COUNT		
OVEN HOOD		120 V/1-180 VA	1
GFCI BATH ROOM	1	120 V/1-180 VA	2
DRYER	2,4	240 V/2-5000 VA	1
GFCI WASHER	3	120 V/1-1200 VA	1
WATER HEATER	5,7	240 V/2-4500 VA	1
REFRIGERATOR	8	120 V/1-1800 VA	1
GFCI KITCHEN	9	120 V/1-180 VA	4
GFCI DISHWASHER	10	120 V/1-1200 VA	1
RANGE	11,13	240 V/2-5000 VA	1
CONDENSER	12,14	240 V/2-5000 VA	1
GFCI OUT DOOR	15	120 V/1-180 VA	3
STANDARD	19	120 V/1-180 VA	6

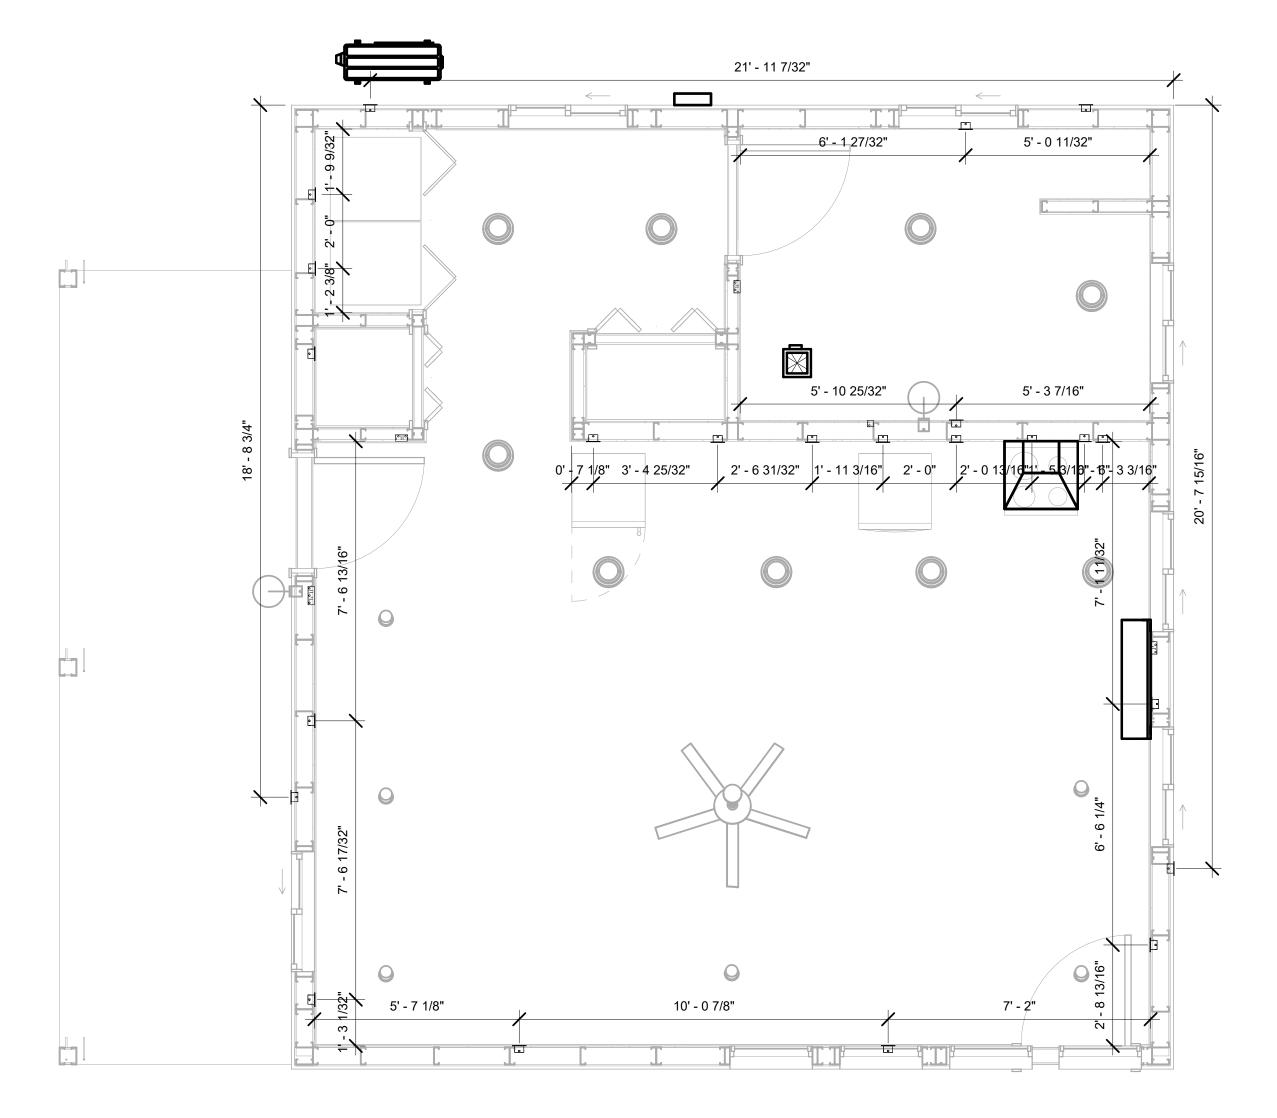

1 DIMENSION FOR FITTINGS 3/8" = 1'-0"



KEY PLAN

NO.	DESCRIPTION	DATE

NOTE:

LEGEND:

PROJECT

236-EMBER-624-STUDIO MODERN-BASE-550

DRAWING NAME

DIMENSION PLAN FOR FITTINGS

CLIENT NAME:	Owner
PROJECT NUMBER:	0408_11
DATE:	5/12/2025 12:15:08 PM
DESIGNED BY:	Designer
DRAWN BY:	Author
CHECKED BY:	Checker

E105

SHEET LIST

SHEET NUMBER SHEET NAME

101	NOTE AND SCHEDULE
=	WATER SUPPLY AND SEWAGE SYSTEM

DOMESTIC COLD WATER DOMESTIC HOT WATER DOMESTIC HOT WATER SANITARY VENT SANITARY SEWER STORM DRAINAGE GRAY WATER GAS LINE

PLUMBING NOTES

- THE PLUMBING SYSTEM IS DESIGNED TO MEET THE BUILDING'S DOMESTIC WATER SUPPLY, SANITARY DRAINAGE, AND STORM DRAINAGE REQUIREMENTS, AS PER PROJECT SPECIFICATIONS AND APPLICABLE CODES.
- THE SYSTEM INSTALLATION SHALL COMPLY WITH THE LATEST INTERNATIONAL PLUMBING CODE (IPC), INTERNATIONAL RESIDENTIAL CODE (IRC), AND ALL OTHER RELEVANT LOCAL, STATE, AND NATIONAL REGULATIONS.
- 3. ALL PLUMBING WORK SHALL COMPLY WITH THE LATEST EDITION OF THE INTERNATIONAL PLUMBING CODE (IPC) AND THE LOCAL PLUMBING CODE.
- 4. PLUMBING SYSTEMS SHALL BE TESTED AND INSPECTED IN ACCORDANCE WITH THE LOCAL PLUMBING CODE REQUIREMENTS.
- 5. PLUMBING FIXTURES SHALL BE INSTALLED WITH THE APPROPRIATE TRIM, FITTINGS, AND ACCESSORIES, AS RECOMMENDED BY THE MANUFACTURER.
- 6. PIPING SHALL BE PROPERLY SUPPORTED AND SECURED TO PREVENT SAGGING, MOVEMENT, AND VIBRATION.
- 7. SHUT-OFF VALVES SHALL BE PROVIDED AT ALL BRANCH CONNECTIONS AND AT THE INLET AND OUTLET OF EACH PIECE OF EQUIPMENT.
- 8. BACKFLOW PREVENTION DEVICES SHALL BE INSTALLED AS REQUIRED BY THE LOCAL PLUMBING CODE TO PROTECT THE POTABLE WATER SYSTEM.
- 9. PLUMBING FIXTURES AND EQUIPMENT SHALL BE ACCESSIBLE FOR MAINTENANCE AND SERVICING.
- 10. EXPOSED PLUMBING PIPING AND FIXTURES SHALL BE INSULATED TO PREVENT CONDENSATION AND ENERGY LOSS.
- 11. DEAD ENDS IN THE DRAINAGE SYSTEM MUST BE AVOIDED, EXCEPT WHERE NECESSARY TO INSTALL A CLEANOUT IN AN ACCESSIBLE LOCATION, AND MUST HAVE A VENTED CONNECTION TO THE OUTSIDE ATMOSPHERE.
- 12. THE VERTICAL DEFLECTION OF PVC PIPE MUST NOT EXCEED 5%, AND NO DEFLECTION IS PERMITTED FOR IRON PIPE.
- 13. WORK MUST BE PROPERLY COORDINATED WITH OTHER TRADES TO AVOID CONFLICTS, REFERRING TO THE ARCHITECTURAL AND STRUCTURAL DRAWINGS FOR INFORMATION REGARDING CEILING ELEVATIONS, SPACE CLEARANCES, WALL AND PARTITION LOCATIONS, ETC.
- 14. ALL FIXTURES SHALL HAVE ACCESSIBLE STOPS.
- 15. DOMESTIC WATER PIPING SHALL BE PEX, AND PVC PIPING IS NOT ACCEPTABLE FOR INTERIOR USE.
- 16. VENT TERMINATIONS SHALL BE LOCATED AT LEAST 10 FEET FROM OR 3 FEET ABOVE ANY OPERABLE WINDOW, DOOR OPENING, AIR INTAKE, OR VENT SHAFT, AND AT LEAST 3 FEET IN EVERY DIRECTION FROM ANY LOT LINE, ALLEY, OR STREET.
- 17. PIPE AND FITTINGS UTILIZED IN THE WATER SUPPLY SYSTEM SHALL HAVE A MAXIMUM OF 8 PERCENT LEAD.
- 18. ACRYLONITRILE BUTADIENE STYRENE (ABS) SHALL BE USED FOR THE SEWERAGE AND VENTILATION SYSTEM.
- 19. CROSS-LINKED POLYETHYLENE (PEX) SHALL BE USED FOR THE WATER SUPPLY SYSTEM.
- 20. POLYVINYL CHLORIDE (PVC) SHÀLL BÉ USED FOR THE RAIN WATER SYSTEM.
- 21. THE MIMIMUM WATER SUPPLY DEPTH UNDER FLOOR FINISH SHOUD BE 1/2".
- 22. ANY PIPE INSTALLED UNDERGROUND MUST HAVE AT LEAST 12 INCHES OF CLEARANCE BETWEEN THE OUTSIDE OF THE PIPE AND ANY OTHER UNDERGROUND STRUCTURE.
- 23. THE MINIMUM CLEARANCE BETWEEN COLD AND HOT WATER LINES IN RESIDENTIAL
- HOMES MAINTAIN A MINIMUM DISTANCE OF 6 INCHES.

 24. HORIZONTAL SEPARATION BETWEEN WATER AND SEWER LINES: A MINIMUM OF 12 INCHES BETWEEN POTABLE WATER SUPPLY LINES (COLD AND HOT WATER) AND

ABBREVIATIONS

SANITARY SEWER LINES.

Ø	DIAMETER
ABS	ACRYLONITRILE BUTADIENE STYRENE
ABV	ABOVE
AD	AREA DRAIN
AFF	ABOVE FINISHED FLOOR
ALT	ALTERNATE
BFF	BELOW FINISHED FLOOR
BLW	BELOW
CO	CLEAN OUT
CW	COLD WATER
D	DEGREE
DFU	DRANAGE FIXTURE UNIT
DIA	DIAMETER
DN	DOWN
FCO	FLOOR CLEAN OUT
FD	FLOOR DRAIN
FL	FLOOR
FS	FLOOR SINK
FT	FOOT/FEET
HB	HOSE BIB
HW	HOT WATER
IN	INCH
MIN	MINIMUM
NO	NUMBER
NTS	NOT TO SCALE
PEX	CROSS-LINKED POLYETHYLENE
PLBG	PLUMBING
PVC	POLYVINYL CHLORIDE
QTY	QUANTITY
RD	ROOF DRAIN
RED	REDUCER
RM	ROOM
RW	RAIN WATER
SF	SQUARE FOOT
V	VENT
VTR	VENT THROUGH ROOF
W	WASTE
WCO	WALL CLEAN OUT
WSFU	WATER SUPPLY FIXTURE UNIT

PLUMBING LEGEND

D	CAP
	BEND 45 DEG
B	BEND 90 DEG
	TEE REDUCING
	TEE
	CLEAN TWO-WAY
	WYE 45 DEG
	WYE 45 DEG DOUBLE
	WYE COMBINATION
Θ	P-TRAP

PIPE SCHEDULE						
MATERIAL	DIAMETER	LENGTH				
ACRYLONITRILE BUTADIENE STYRENE (ABS)	1 1/2"	18 FT				
ACRYLONITRILE BUTADIENE STYRENE (ABS)	2"	33 FT				
ACRYLONITRILE BUTADIENE STYRENE (ABS)	2 1/2"	10 FT				
ACRYLONITRILE BUTADIENE STYRENE (ABS)	3"	18 FT				
CROSS-LINKED POLYETHYLENE (PEX)	1/2"	63 FT				
CROSS-LINKED POLYETHYLENE (PEX)	3/4"	50 FT				
POLYVINYL CHLORIDE - RIGID	2"	38 FT				

FITTING SCHEDULE					
FITTING	SIZE	QTY			
PEX 90 DEG ELBOW	1/2"ø-1/2"ø	3			
PEX 90 DEGREE ELBOW	1/2"ø-1/2"ø	14			
PEX 90 DEGREE ELBOW	3/4"ø-3/4"ø	1			
PEX TEE ELBOW	1/2"ø-1/2"ø	3			
PEX TEE ELBOW	3/4"ø-3/4"ø	4			
PEX TRANSITION ELBOW	1"ø-3/4"ø	2			
PEX TRANSITION ELBOW	3/4"ø-1/2"ø	3			
PEX 90 DEG ELBOW	1/2"ø-1/2"ø	1			
PEX 90 DEGREE ELBOW	1/2"ø-1/2"ø	8			
PEX 90 DEGREE ELBOW	3/4"ø-3/4"ø	4			
PEX TEE ELBOW	1/2"ø-1/2"ø	1			
PEX TEE ELBOW	3/4"ø-3/4"ø	3			
PEX TRANSITION ELBOW	3/4"ø-1/2"ø	6			
PVC 90 DEG BEND ELBOW	2"ø-2"ø	5			
PVC 90 DEGREE BEND ELBOW	2"ø-2"ø	10			
ABS 90 DEGREE BEND ELBOW	1 1/2"ø-1 1/2"ø	1			
ABS 90 DEGREE BEND ELBOW	2"ø-2"ø	2			
ABS 90 DEGREE BEND ELBOW	3"ø-3"ø	1			
ABS P-TRAP	1 1/2"ø-1 1/2"ø	3			
ABS P-TRAP	2"ø-2"ø	1			
ABS REDUCER ELBOW	2"ø-1 1/2"ø	1			
ABS REDUCER ELBOW	3"ø-2"ø	1			
ABS TEE ELBOW	1 1/2"ø-1 1/2"ø-1 1/2"ø	1			
ABS TEE ELBOW	2"ø-2"ø-2"ø	1			
ABS TEE ELBOW	3"ø-3"ø-3"ø	1			
ABS TEE REDUCER ELBOW	2 1/2"ø-2 1/2"ø-1 1/2"ø	2			
ABS TEE REDUCER ELBOW	2 1/2"ø-2 1/2"ø-2"ø	1			
ABS TEE REDUCER ELBOW	3"ø-2 1/2"ø-3"ø	1			
ABS TRAP P	2"ø-2"ø	1			
WASTE DOUBLE TEE	2"ø-2"ø-2"ø	1			
ABS VENT CAP ELBOW	1 1/2"ø	1			
ABS VENT CAP ELBOW	2"ø	2			
ABS VENT CAP ELBOW	3"ø	1			

FIXTURE CONNECTION SCHEDULE											
FAMILY	W	V	TRAP	CW	HW	QTY	DFU	TOT.	WFU	TOT.	NOTES
								ı			
DISHWASHER	2"	1-1/2"	1-1/2"	1/2"	1/2"	1		0			DRAIN TO SEWER SEE PLANS
DRYER	N/A	N/A	N/A	N/A	N/A	1		0			
HANGING PIPES CLAMP						10		0			
SHOWER TRAY	2"	1-1/2"	1-1/2"	1/2"	1/2"	1		0			
SHOWER TRIM	-	-	-	1/2"	1/2"	1		0			
SINK ISLAND SINGLE	2"	1-1/2"	1-1/2"	1/2"	1/2"	1		0			
VANITY SINK	2"	1-1/2"	1-1/2"	1/2"	1/2"	1		0			
WASHER	2"	1-1/2"	2"	1/2"	1/2"	1		0			DRAINS TO GRAY WATER OR SEWER SEE PLANS
WATER CLOSET						1		0			
WATER HEATER	N/A	N/A	N/A	3/4"	3/4"	1		0			

FIXTURE SCHEDULE						
FIXTURE QTY DESCRIPTION						
DISHWASHER	1	DRAIN TO SEWER SEE PLANS				
DRYER	1					
HANGING PIPES CLAMP	10					
SHOWER TRAY	1					
SHOWER TRIM	1					
SINK ISLAND SINGLE	1					
VANITY SINK	1					
WASHER	1	DRAINS TO GRAY WATER OR SEWER SEE PLANS				
WATER CLOSET	1					
WATER HEATER	1					

ACCESSORIES & FITTINGS SCHEDULE							
FIXTURE	QTY	DESCRIPTIONS					
DISHWASHER CONNECTOR	1						
HOSE BIB	1						
LAUNDRY SWEAT CONNECTOR1	1						
SHUTOFF VALVE							

PLUMBING SCHEDULE							
	' =	OWDII TO C	OHLDOLL				
FIXTURE	TRAP	WASTE	VENT	C.W	H.W		
DISHWASHER	1-1/2"	2"	1-1/2"	1/2"	1/2"		
DRYER	N/A	N/A	N/A	N/A	N/A		
SHOWER TRAY	1-1/2"	2"	1-1/2"	1/2"	1/2"		
SHOWER TRIM	-	-	-	1/2"	1/2"		
SINK ISLAND SINGLE	1-1/2"	2"	1-1/2"	1/2"	1/2"		
VANITY SINK	1-1/2"	2"	1-1/2"	1/2"	1/2"		
WASHER	2"	2"	1-1/2"	1/2"	1/2"		
WATER CLOSET							
WATER HEATER	N/A	N/A	N/A	3/4"	3/4"		

WATER FIXTURE UNIT SCHEDULE						
FAMILY	QTY	UNIT VALUE	TOTAL			
DISHWASHER	1		0			
DRYER	1		0			
HANGING PIPES CLAMP	10		0			
SHOWER TRAY	1		0			
SHOWER TRIM	1		0			
SINK ISLAND SINGLE	1		0			
VANITY SINK	1		0			
WASHER	1		0			
WATER CLOSET	1		0			
WATER HEATER	1		0			

WASTE FIXTURE UNIT SCHEDULE							
FAMILY	QTY	DFU VALUES	TOTAL				
DISHWASHER	1	0					
DRYER	1	0					
HANGING PIPES CLAMP	10	0					
SHOWER TRAY	1	0					
SHOWER TRIM	1	0					
SINK ISLAND SINGLE	1	0					
VANITY SINK	1	0					
WASHER	1	0					
WATER CLOSET	1	0					
WATER HEATER	1	0					



inquira@framaunnaw.com

KEY PLAN

NO.	DESCRIPTION	DATE

NOTE:

LEGEND:

PROJECT

236-EMBER-624-STUDIO MODERN-BASE-550

DRAWING NAME

NOTE AND SCHEDULE

CLIENT NAME:

 PROJECT NUMBER:
 0408_11

 DATE:
 5/13/2025 10:46:27 AM

 DESIGNED BY:
 Designer

 DRAWN BY:
 Author

 CHECKED BY:
 Checker

P101

SCALE: 1/2" = 1'-0"

SHEET LIST

SHEET NUMBER SHEET NAME

2101	NOTE AND SCHEDULE
	WATER SUPPLY AND SEWAGE SYSTEM

PIPE C	OLOR SCHEME
	DOMESTIC COLD WATE
	DOMESTIC HOT WATER
	 SANITARY VENT
	SANITARY SEWER
	STORM DRAINAGE
_	GRAY WATER
	GAS LINE

PLUMBING NOTES

- THE PLUMBING SYSTEM IS DESIGNED TO MEET THE BUILDING'S DOMESTIC WATER SUPPLY, SANITARY DRAINAGE, AND STORM DRAINAGE REQUIREMENTS, AS PER PROJECT SPECIFICATIONS AND APPLICABLE CODES.
- 2. THE SYSTEM INSTALLATION SHALL COMPLY WITH THE LATEST INTERNATIONAL PLUMBING CODE (IPC), INTERNATIONAL RESIDENTIAL CODE (IRC), AND ALL OTHER RELEVANT LOCAL, STATE, AND NATIONAL REGULATIONS.
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- 9. PLUMBING FIXTURES AND EQUIPMENT SHALL BE ACCESSIBLE FOR MAINTENANCE AND SERVICING
- 10. EXPOSED PLUMBING PIPING AND FIXTURES SHALL BE INSULATED TO PREVENT CONDENSATION AND ENERGY LOSS.
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- 12. THE VERTICAL DEFLECTION OF PVC PIPE MUST NOT EXCEED 5%, AND NO DEFLECTION IS PERMITTED FOR IRON PIPE.
- 13. WORK MUST BE PROPERLY COORDINATED WITH OTHER TRADES TO AVOID CONFLICTS, REFERRING TO THE ARCHITECTURAL AND STRUCTURAL DRAWINGS FOR INFORMATION REGARDING CEILING ELEVATIONS, SPACE CLEARANCES, WALL AND PARTITION LOCATIONS, ETC.
- 14. ALL FIXTURES SHALL HAVE ACCESSIBLE STOPS.
- 15. DOMESTIC WATER PIPING SHALL BE PEX, AND PVC PIPING IS NOT ACCEPTABLE FOR INTERIOR USE.
- 16. VENT TERMINATIONS SHALL BE LOCATED AT LEAST 10 FEET FROM OR 3 FEET ABOVE ANY OPERABLE WINDOW, DOOR OPENING, AIR INTAKE, OR VENT SHAFT, AND AT LEAST 3 FEET IN EVERY DIRECTION FROM ANY LOT LINE, ALLEY, OR STREET.
- 17. PIPE AND FITTINGS UTILIZED IN THE WATER SUPPLY SYSTEM SHALL HAVE A MAXIMUM OF 8 PERCENT LEAD.
- 18. ACRYLONITRILE BUTADIENE STYRENE (ABS) SHALL BE USED FOR THE SEWERAGE AND VENTILATION SYSTEM.
- 19. CROSS-LINKED POLYETHYLENE (PEX) SHALL BE USED FOR THE WATER SUPPLY SYSTEM.
- 20. POLYVINYL CHLORIDE (PVC) SHALL BE USED FOR THE RAIN WATER SYSTEM.
 21. THE MIMIMUM WATER SUPPLY DEPTH UNDER FLOOR FINISH SHOUD BE 1/2".
- 22. ANY PIPE INSTALLED UNDERGROUND MUST HAVE AT LEAST 12 INCHES OF CLEARANCE
- BETWEEN THE OUTSIDE OF THE PIPE AND ANY OTHER UNDERGROUND STRUCTURE.

 23. THE MINIMUM CLEARANCE BETWEEN COLD AND HOT WATER LINES IN RESIDENTIAL
- HOMES MAINTAIN A MINIMUM DISTANCE OF 6 INCHES.
- 24. HORIZONTAL SEPARATION BETWEEN WATER AND SEWER LINES: A MINIMUM OF 12 INCHES BETWEEN POTABLE WATER SUPPLY LINES (COLD AND HOT WATER) AND SANITARY SEWER LINES.

ABBREVIATIONS

ABS ACRYLONITRILE BUTADIENE STYRENE ABV ABOVE AD AREA DRAIN AFF ABOVE FINISHED FLOOR ALT ALTERNATE BFF BELOW FINISHED FLOOR BLW BELOW CO CLEAN OUT CW COLD WATER D DEGREE DFU DRANAGE FIXTURE UNIT DIA DIAMETER DN DOWN FCO FLOOR CLEAN OUT FD FLOOR DRAIN FL FLOOR FS FLOOR SINK FT FOOT/FEET HB HOSE BIB HW HOT WATER IN INCH MIN MINIMUM NO NUMBER NTS NOT TO SCALE PEX CROSS-LINKED POLYETHYLENE PLBG PLUMBING PVC POLYVINYL CHLORIDE QTY QUANTITY RD ROOF DRAIN RED REDUCER RM ROOM RW RAIN WATER SF SQUARE FOOT	Ø	DIAMETER
AD AREA DRAIN AFF ABOVE FINISHED FLOOR ALT ALTERNATE BFF BELOW FINISHED FLOOR BLW BELOW CO CLEAN OUT CW COLD WATER D DEGREE DFU DRANAGE FIXTURE UNIT DIA DIAMETER DN DOWN FCO FLOOR CLEAN OUT FD FLOOR DRAIN FL FLOOR FS FLOOR SINK FT FOOT/FEET HB HOSE BIB HW HOT WATER IN INCH MIN MINIMUM NO NUMBER NTS NOT TO SCALE PEX CROSS-LINKED POLYETHYLENE PLBG PLUMBING PVC POLYVINYL CHLORIDE QTY QUANTITY RD ROOF DRAIN RED REDUCER RM ROOM RW RAIN WATER	ABS	ACRYLONITRILE BUTADIENE STYRENE
AFF ABOVE FINISHED FLOOR ALT ALTERNATE BFF BELOW FINISHED FLOOR BLW BELOW CO CLEAN OUT CW COLD WATER D DEGREE DFU DRANAGE FIXTURE UNIT DIA DIAMETER DN DOWN FCO FLOOR CLEAN OUT FD FLOOR DRAIN FL FLOOR FS FLOOR SINK FT FOOT/FEET HB HOSE BIB HW HOT WATER IN INCH MIN MINIMUM NO NUMBER NTS NOT TO SCALE PEX CROSS-LINKED POLYETHYLENE PLBG PLUMBING PVC POLYVINYL CHLORIDE QTY QUANTITY RD ROOF DRAIN RED REDUCER RM ROOM RW RAIN WATER	ABV	ABOVE
ALT ALTERNATE BFF BELOW FINISHED FLOOR BLW BELOW CO CLEAN OUT CW COLD WATER D DEGREE DFU DRANAGE FIXTURE UNIT DIA DIAMETER DN DOWN FCO FLOOR CLEAN OUT FD FLOOR DRAIN FL FLOOR FS FLOOR SINK FT FOOT/FEET HB HOSE BIB HW HOT WATER IN INCH MIN MINIMUM NO NUMBER NTS NOT TO SCALE PEX CROSS-LINKED POLYETHYLENE PLBG PLUMBING PVC POLYVINYL CHLORIDE QTY QUANTITY RD ROOF DRAIN RED REDUCER RM ROOM RW RAIN WATER	AD	AREA DRAIN
BFF BELOW FINISHED FLOOR BLW BELOW CO CLEAN OUT CW COLD WATER D DEGREE DFU DRANAGE FIXTURE UNIT DIA DIAMETER DN DOWN FCO FLOOR CLEAN OUT FD FLOOR DRAIN FL FLOOR FS FLOOR SINK FT FOOT/FEET HB HOSE BIB HW HOT WATER IN INCH MIN MINIMUM NO NUMBER NTS NOT TO SCALE PEX CROSS-LINKED POLYETHYLENE PLBG PLUMBING PVC POLYVINYL CHLORIDE QTY QUANTITY RD ROOF DRAIN RED REDUCER RM ROOM RW RAIN WATER	AFF	ABOVE FINISHED FLOOR
BLW BELOW CO CLEAN OUT CW COLD WATER D DEGREE DFU DRANAGE FIXTURE UNIT DIA DIAMETER DN DOWN FCO FLOOR CLEAN OUT FD FLOOR DRAIN FL FLOOR FS FLOOR SINK FT FOOT/FEET HB HOSE BIB HW HOT WATER IN INCH MIN MINIMUM NO NUMBER NTS NOT TO SCALE PEX CROSS-LINKED POLYETHYLENE PLBG PLUMBING PVC POLYVINYL CHLORIDE QTY QUANTITY RD ROOF DRAIN RED REDUCER RM ROOM RW RAIN WATER	ALT	ALTERNATE
CO CLEAN OUT CW COLD WATER D DEGREE DFU DRANAGE FIXTURE UNIT DIA DIAMETER DN DOWN FCO FLOOR CLEAN OUT FD FLOOR DRAIN FL FLOOR FS FLOOR SINK FT FOOT/FEET HB HOSE BIB HW HOT WATER IN INCH MIN MINIMUM NO NUMBER NTS NOT TO SCALE PEX CROSS-LINKED POLYETHYLENE PLBG PLUMBING PVC POLYVINYL CHLORIDE QTY QUANTITY RD ROOF DRAIN RED REDUCER RM ROOM RW RAIN WATER	BFF	BELOW FINISHED FLOOR
CW COLD WATER D DEGREE DFU DRANAGE FIXTURE UNIT DIA DIAMETER DN DOWN FCO FLOOR CLEAN OUT FD FLOOR DRAIN FL FLOOR FS FLOOR SINK FT FOOT/FEET HB HOSE BIB HW HOT WATER IN INCH MIN MINIMUM NO NUMBER NTS NOT TO SCALE PEX CROSS-LINKED POLYETHYLENE PLBG PLUMBING PVC POLYVINYL CHLORIDE QTY QUANTITY RD ROOF DRAIN RED REDUCER RM ROOM RW RAIN WATER	BLW	BELOW
D DEGREE DFU DRANAGE FIXTURE UNIT DIA DIAMETER DN DOWN FCO FLOOR CLEAN OUT FD FLOOR DRAIN FL FLOOR FS FLOOR SINK FT FOOT/FEET HB HOSE BIB HW HOT WATER IN INCH MIN MINIMUM NO NUMBER NTS NOT TO SCALE PEX CROSS-LINKED POLYETHYLENE PLBG PLUMBING PVC POLYVINYL CHLORIDE QTY QUANTITY RD ROOF DRAIN RED REDUCER RM ROOM RW RAIN WATER	CO	CLEAN OUT
DFU DRANAGE FIXTURE UNIT DIA DIAMETER DN DOWN FCO FLOOR CLEAN OUT FD FLOOR DRAIN FL FLOOR FS FLOOR SINK FT FOOT/FEET HB HOSE BIB HW HOT WATER IN INCH MIN MINIMUM NO NUMBER NTS NOT TO SCALE PEX CROSS-LINKED POLYETHYLENE PLBG PLUMBING PVC POLYVINYL CHLORIDE QTY QUANTITY RD ROOF DRAIN RED REDUCER RM ROOM RW RAIN WATER	CW	COLD WATER
DIA DIAMETER DN DOWN FCO FLOOR CLEAN OUT FD FLOOR DRAIN FL FLOOR FS FLOOR SINK FT FOOT/FEET HB HOSE BIB HW HOT WATER IN INCH MIN MINIMUM NO NUMBER NTS NOT TO SCALE PEX CROSS-LINKED POLYETHYLENE PLBG PLUMBING PVC POLYVINYL CHLORIDE QTY QUANTITY RD ROOF DRAIN RED REDUCER RM ROOM RW RAIN WATER	D	DEGREE
DN DOWN FCO FLOOR CLEAN OUT FD FLOOR DRAIN FL FLOOR FS FLOOR SINK FT FOOT/FEET HB HOSE BIB HW HOT WATER IN INCH MIN MINIMUM NO NUMBER NTS NOT TO SCALE PEX CROSS-LINKED POLYETHYLENE PLBG PLUMBING PVC POLYVINYL CHLORIDE QTY QUANTITY RD ROOF DRAIN RED REDUCER RM ROOM RW RAIN WATER	DFU	DRANAGE FIXTURE UNIT
FCO FLOOR CLEAN OUT FD FLOOR DRAIN FL FLOOR FS FLOOR SINK FT FOOT/FEET HB HOSE BIB HW HOT WATER IN INCH MIN MINIMUM NO NUMBER NTS NOT TO SCALE PEX CROSS-LINKED POLYETHYLENE PLBG PLUMBING PVC POLYVINYL CHLORIDE QTY QUANTITY RD ROOF DRAIN RED REDUCER RM ROOM RW RAIN WATER	DIA	DIAMETER
FD FLOOR DRAIN FL FLOOR FS FLOOR SINK FT FOOT/FEET HB HOSE BIB HW HOT WATER IN INCH MIN MINIMUM NO NUMBER NTS NOT TO SCALE PEX CROSS-LINKED POLYETHYLENE PLBG PLUMBING PVC POLYVINYL CHLORIDE QTY QUANTITY RD ROOF DRAIN RED REDUCER RM ROOM RW RAIN WATER	DN	DOWN
FL FLOOR FS FLOOR SINK FT FOOT/FEET HB HOSE BIB HW HOT WATER IN INCH MIN MINIMUM NO NUMBER NTS NOT TO SCALE PEX CROSS-LINKED POLYETHYLENE PLBG PLUMBING PVC POLYVINYL CHLORIDE QTY QUANTITY RD ROOF DRAIN RED REDUCER RM ROOM RW RAIN WATER	FCO	FLOOR CLEAN OUT
FS FLOOR SINK FT FOOT/FEET HB HOSE BIB HW HOT WATER IN INCH MIN MINIMUM NO NUMBER NTS NOT TO SCALE PEX CROSS-LINKED POLYETHYLENE PLBG PLUMBING PVC POLYVINYL CHLORIDE QTY QUANTITY RD ROOF DRAIN RED REDUCER RM ROOM RW RAIN WATER	FD	FLOOR DRAIN
FT FOOT/FEET HB HOSE BIB HW HOT WATER IN INCH MIN MINIMUM NO NUMBER NTS NOT TO SCALE PEX CROSS-LINKED POLYETHYLENE PLBG PLUMBING PVC POLYVINYL CHLORIDE QTY QUANTITY RD ROOF DRAIN RED REDUCER RM ROOM RW RAIN WATER	FL	FLOOR
HB HOSE BIB HW HOT WATER IN INCH MIN MINIMUM NO NUMBER NTS NOT TO SCALE PEX CROSS-LINKED POLYETHYLENE PLBG PLUMBING PVC POLYVINYL CHLORIDE QTY QUANTITY RD ROOF DRAIN RED REDUCER RM ROOM RW RAIN WATER	FS	FLOOR SINK
HW HOT WATER IN INCH MIN MINIMUM NO NUMBER NTS NOT TO SCALE PEX CROSS-LINKED POLYETHYLENE PLBG PLUMBING PVC POLYVINYL CHLORIDE QTY QUANTITY RD ROOF DRAIN RED REDUCER RM ROOM RW RAIN WATER	FT	FOOT/FEET
IN INCH MIN MINIMUM NO NUMBER NTS NOT TO SCALE PEX CROSS-LINKED POLYETHYLENE PLBG PLUMBING PVC POLYVINYL CHLORIDE QTY QUANTITY RD ROOF DRAIN RED REDUCER RM ROOM RW RAIN WATER	HB	HOSE BIB
MIN MINIMUM NO NUMBER NTS NOT TO SCALE PEX CROSS-LINKED POLYETHYLENE PLBG PLUMBING PVC POLYVINYL CHLORIDE QTY QUANTITY RD ROOF DRAIN RED REDUCER RM ROOM RW RAIN WATER	HW	HOT WATER
NO NUMBER NTS NOT TO SCALE PEX CROSS-LINKED POLYETHYLENE PLBG PLUMBING PVC POLYVINYL CHLORIDE QTY QUANTITY RD ROOF DRAIN RED REDUCER RM ROOM RW RAIN WATER	IN	INCH
NTS NOT TO SCALE PEX CROSS-LINKED POLYETHYLENE PLBG PLUMBING PVC POLYVINYL CHLORIDE QTY QUANTITY RD ROOF DRAIN RED REDUCER RM ROOM RW RAIN WATER	MIN	
PEX CROSS-LINKED POLYETHYLENE PLBG PLUMBING PVC POLYVINYL CHLORIDE QTY QUANTITY RD ROOF DRAIN RED REDUCER RM ROOM RW RAIN WATER	NO	NUMBER
PLBG PLUMBING PVC POLYVINYL CHLORIDE QTY QUANTITY RD ROOF DRAIN RED REDUCER RM ROOM RW RAIN WATER	NTS	
PVC POLYVINYL CHLORIDE QTY QUANTITY RD ROOF DRAIN RED REDUCER RM ROOM RW RAIN WATER		CROSS-LINKED POLYETHYLENE
QTY QUANTITY RD ROOF DRAIN RED REDUCER RM ROOM RW RAIN WATER		
RD ROOF DRAIN RED REDUCER RM ROOM RW RAIN WATER		
RED REDUCER RM ROOM RW RAIN WATER	QTY	QUANTITY
RM ROOM RW RAIN WATER		
RW RAIN WATER		
SF SQUARE FOOT		
V VENT		
VTR VENT THROUGH ROOF		
W WASTE		
WCO WALL CLEAN OUT		
WSFU WATER SUPPLY FIXTURE UNIT	WSFU	WATER SUPPLY FIXTURE UNIT

PLUMBING LEGEND

D	CAP
	BEND 45 DEG
a	BEND 90 DEG
	TEE REDUCING
	TEE
	CLEAN TWO-WAY
	WYE 45 DEG
	WYE 45 DEG DOUBLE
	WYE COMBINATION
	P-TRAP

PIPE SCHEDULE							
MATERIAL	DIAMETER	LENGTH					
ACRYLONITRILE BUTADIENE STYRENE (ABS)	1 1/2"	18 FT					
ACRYLONITRILE BUTADIENE STYRENE (ABS)	2"	33 FT					
ACRYLONITRILE BUTADIENE STYRENE (ABS)	2 1/2"	10 FT					
ACRYLONITRILE BUTADIENE STYRENE (ABS)	3"	18 FT					
CROSS-LINKED POLYETHYLENE (PEX)	1/2"	63 FT					
CROSS-LINKED POLYETHYLENE (PEX)	3/4"	50 FT					
POLYVINYL CHLORIDE - RIGID	2"	38 FT					

FITTING	SCHEDULE	
FITTING	SIZE	QTY
PEX 90 DEG ELBOW	1/2"ø-1/2"ø	3
PEX 90 DEGREE ELBOW	1/2"ø-1/2"ø	14
PEX 90 DEGREE ELBOW	3/4"ø-3/4"ø	1
PEX TEE ELBOW	1/2"ø-1/2"ø	3
PEX TEE ELBOW	3/4"ø-3/4"ø	4
PEX TRANSITION ELBOW	1"ø-3/4"ø	2
PEX TRANSITION ELBOW	3/4"ø-1/2"ø	3
PEX 90 DEG ELBOW	1/2"ø-1/2"ø	1
PEX 90 DEGREE ELBOW	1/2"ø-1/2"ø	8
PEX 90 DEGREE ELBOW	3/4"ø-3/4"ø	4
PEX TEE ELBOW	1/2"ø-1/2"ø	1
PEX TEE ELBOW	3/4"ø-3/4"ø-3/4"ø	3
PEX TRANSITION ELBOW	3/4"ø-1/2"ø	6
PVC 90 DEG BEND ELBOW	2"ø-2"ø	5
PVC 90 DEGREE BEND ELBOW	2"ø-2"ø	10
ABS 90 DEGREE BEND ELBOW	1 1/2"ø-1 1/2"ø	1
ABS 90 DEGREE BEND ELBOW	2"ø-2"ø	2
ABS 90 DEGREE BEND ELBOW	3"ø-3"ø	1
ABS P-TRAP	1 1/2"ø-1 1/2"ø	3
ABS P-TRAP	2"ø-2"ø	1
ABS REDUCER ELBOW	2"ø-1 1/2"ø	1
ABS REDUCER ELBOW	3"ø-2"ø	1
ABS TEE ELBOW	1 1/2"ø-1 1/2"ø-1 1/2"ø	1
ABS TEE ELBOW	2"ø-2"ø-2"ø	1
ABS TEE ELBOW	3"ø-3"ø-3"ø	1
ABS TEE REDUCER ELBOW	2 1/2"ø-2 1/2"ø-1 1/2"ø	2
ABS TEE REDUCER ELBOW	2 1/2"ø-2 1/2"ø-2"ø	1
ABS TEE REDUCER ELBOW	3"ø-2 1/2"ø-3"ø	1
ABS TRAP P	2"ø-2"ø	1
WASTE DOUBLE TEE	2"ø-2"ø-2"ø	1
ABS VENT CAP ELBOW	1 1/2"ø	1
ABS VENT CAP ELBOW	2"ø	2
ABS VENT CAP ELBOW	3"ø	1

FIXTURE CONNECTION SCHEDULE											
FAMILY	W	V	TRAP	CW	HW	QTY	DFU	TOT.	WFU	TOT.	NOTES
DISHWASHER	2"	1-1/2"	1-1/2"	1/2"	1/2"	1		0			DRAIN TO SEWER SEE PLANS
DRYER	N/A	N/A	N/A	N/A	N/A	1		0			
HANGING PIPES CLAMP						10		0			
SHOWER TRAY	2"	1-1/2"	1-1/2"	1/2"	1/2"	1		0			
SHOWER TRIM	-	-	-	1/2"	1/2"	1		0			
SINK ISLAND SINGLE	2"	1-1/2"	1-1/2"	1/2"	1/2"	1		0			
VANITY SINK	2"	1-1/2"	1-1/2"	1/2"	1/2"	1		0			
WASHER	2"	1-1/2"	2"	1/2"	1/2"	1		0			DRAINS TO GRAY WATER OR SEWER SEE PLANS
WATER CLOSET						1		0			
WATER HEATER	N/A	N/A	N/A	3/4"	3/4"	1		0			

FIXTURE SCHEDULE							
FIXTURE	QTY	DESCRIPTION					
DISHWASHER	1	DRAIN TO SEWER SEE PLANS					
DRYER	1						
HANGING PIPES CLAMP	10						
SHOWER TRAY	1						
SHOWER TRIM	1						
SINK ISLAND SINGLE	1						
VANITY SINK	1						
WASHER	1	DRAINS TO GRAY WATER OR SEWER SEE PLANS					
WATER CLOSET	1						
WATER HEATER	1						

ACCESSORIES & FITTINGS SCHEDULE							
FIXTURE QTY DESCRIPTIONS							
DISHWASHER CONNECTOR	1						
HOSE BIB	1						
LAUNDRY SWEAT CONNECTOR1	1						

PLUMBING SCHEDULE								
	' =	OWDII TO C	OHLDOLL					
FIXTURE	TRAP	WASTE	VENT	C.W	H.W			
DISHWASHER	1-1/2"	2"	1-1/2"	1/2"	1/2"			
DRYER	N/A	N/A	N/A	N/A	N/A			
SHOWER TRAY	1-1/2"	2"	1-1/2"	1/2"	1/2"			
SHOWER TRIM	-	-	-	1/2"	1/2"			
SINK ISLAND SINGLE	1-1/2"	2"	1-1/2"	1/2"	1/2"			
VANITY SINK	1-1/2"	2"	1-1/2"	1/2"	1/2"			
WASHER	2"	2"	1-1/2"	1/2"	1/2"			
WATER CLOSET								
WATER HEATER	N/A	N/A	N/A	3/4"	3/4"			

WATER FIXTURE UNIT SCHEDULE							
FAMILY	QTY	QTY UNIT VALUE					
DIOLINA OLIED		T					
DISHWASHER	1		0				
DRYER	1		0				
HANGING PIPES CLAMP	10		0				
SHOWER TRAY	1		0				
SHOWER TRIM	1		0				
SINK ISLAND SINGLE	1		0				
VANITY SINK	1		0				
WASHER	1		0				
WATER CLOSET	1		0				
WATER HEATER	1		0				

W	ASTE FIXTURE UI	NIT SCHEDULE	
			TOTAL
FAMILY	QTY	DFU VALUES	TOTAL
DISHWASHER	1		0
DRYER	1		0
HANGING PIPES CLAMP	10		0
SHOWER TRAY	1		0
SHOWER TRIM	1		0
SINK ISLAND SINGLE	1		0
VANITY SINK	1		0
WASHER	1		0
WATER CLOSET	1		0
WATER HEATER	1		0



KEY PLAN

NO.	DESCRIPTION	DATE

NOTE:

LEGEND:

PROJECT

236-EMBER-624-STUDIO MODERN-BASE-550

DRAWING NAME

NOTE AND SCHEDULE

CLIENT NAME:

 PROJECT NUMBER:
 0408_11

 DATE:
 5/13/2025 10:46:27 AM

 DESIGNED BY:
 Designer

 DRAWN BY:
 Author

 CHECKED BY:
 Checker

P101

SCALE: 1/2" = 1'-0"

Materials Shopping List

Please print and take this Materials Shopping List to your favorite Home Depot and ask for assistance in selecting the materials, fixtures and fittings to complete your new home.

Record your selection and the price of the item. Then do the math to determine the cost for your selections and the total cost of finishing your home.

Have It Your Way!

The material types listed in this document were selected based on personal preferences. The Customer is encouraged to make changes to the material types in accordance with local customs, regulations, and personal preferences.

Have It Your Way!



20 good reasons to frame a home with metal and not wood



Why build your ADU with metal vs wood	Wood	Metal	Explanation
1 DIY Construction Benefit		~	The wall frames, trusses and beams can be erected in a just a few days
2 Minimal Construction Skills Required		~	Pre-assembled walls and trusses require no specialized skills to errect
Build as DIY, Hybrid or by a General Contractor		~	Do it yourself, Hybrid (involve special contractors) or hire a General Contractor
4 Build It As You Can Afford It		~	Impervious to Weather - build as you have the time and money
5 Up Front Cost of Framing Materials	~		As to only the framing material, wood is less expensive
6 Total Cost To Build		~	Savings in time, labor, and other areas make light gauge steel LESS expensive
7 Termites and wood boring insects		~	Termites, carpenter ants and wood boring insects eat wood, not metal
8 Mold resistant		~	Metal does not attract mold
9 Damage caused by exterior and interior flooding		~	Metal needs no reconditioning after a flood
10 Fire Resistant		~	Non-combustible
11 Lower insurance rates		~	Many insurance underwriters now provide lower rates for metal framed homes
12 Walls, trusses, and beams retain their original form		~	Perfectly straight walls - no shimming of drywall
13 Corners are 90 degrees		~	No need for templating of countertops to adjust for out of square corners
14 Strength and weight		~	Metal is stronger than wood and weighs less - no need for crane to lift ADU trusses
15 IBC Engineered Stamp		~	If an engineering stamp is necessary, months of waiting are saved
16 Complete BOM (Materials Shopping List)		~	Take the materials shopping list to Home Depot and start shopping/pricing
17 Flexible in Seismic Areas - Won't Fracture		~	Light gauge steel is flexible and won't fracture when the earth moves
18 No Waste At Job Site		~	Steel is the most recycled material in the world. A typical wood home has 20-30% waste
19 Environmentally Friendly		~	Trees don't have to be destroyed and the source of most metal is from recycling
20 How-To Videos Included		~	How-to videos provide simple assembly instructions
21 Relationship Counselor		~	Eliminate emotional uphevels - save time, money, and preserve the relationship

Universal Requirements - some or all may be required

- 1 Site plan
- 2 Electrical Supply Connection
- 3 Sewer Connection
- 4 Fresh Water Supply Connection
- 5 Set Backs
- 6 Soils Evaluation

- 7 Earthquake (fault) evaluation
- 8 Foundation Plan subject to soils
- 9 Compliance with local energy codes: insulation home wrap and flashing
- 10 Engineering for wind speed and snow load.
- 11 State and Local ordinances regarding ADUs
- 12 Local Architect and/or Engineer may be necessary





Ember-Studio-Modern-Base MATERIAL SHOPPING LIST

Have It Your Way!

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TOC



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Name | Link | Page No | 1 | Cover Page | Cover Page | 1 | 2 | TOC | TOC | 2 | 3 | ELECTRICAL BOM | ELECTRICAL BOM | 3 | 5 | HVAC BOM | HVAC BOM | 7 |

PLUMBING BOM

ARCHITECTURAL BOM

Table Of Content

Have It Your Way!

The material types listed in this document were selected based on personal preferences. The Customer is encouraged to make changes to the material types in accordance with local customs, regulations, and personal preferences. Have It Your Way!

GENERAL NOTES

4 PLUMBING BOM

6 ARCHITECTURAL BOM

- 1 This BOM (Bill of Materials) is prepared as a Materials Shopping List to help builders and DIYers gain a complete understanding of most if not all elements required for the complete construction of this structure, according to the original design documents provided by FrameUpNow.
- 2 All quantities and specifications are subject to change based on the final design, field measurements, availability of products and customer preferences. The customer should verify all information prior to purchasing materials.
- 3 All products and elements in the list shall conform to the International Residential Code (IRC), or any other local and international building codes, safety regulations, and standards that are applicable to the location of the structure.
- 4 If any changes are made by the customer to the list of materials specified in this document, the customer is responsible for assuring that the correct type and quantity of materials are utilized in accordance with local building codes.
- 5 FrameUpNow, will not be held responsible for any misuse of this document, the products listed, or for deviations from the content that are made due to changes in specifications, pricing, availability, or customer preferences.
- 6 The customer is advised to consult a qualified professional or technician prior to purchasing materials for specialized construction system items. Some items including but not limited to caseworks, doors and windows may require as built measurements prior to purchase to confirmation of final dimensions.
- 7 If there are additional trim elements or specific installation methods, the total amount of materials needed might vary. Consider any additional trim required for corners, intersections, or other architectural details that might cause this variations before procedding to purchase and construction.

ARCHITECTURAL BOM



		Emb	er-Studio-N	Modern-Bas	se		
		ARCHITECTU	JRAL MATE	RIAL SHOP			
No.	Item	Туре	Unit	Quantity	Unit Price	Total	Description
	APPLIANCES						
	Refrigerator		PCS	1			
2	Range		PCS	1			
3	Washer		PCS	1			
4	Dryer		PCS	1			
5	Dish Washer		PCS	1			
6	Oven		PCS	0			
7	Microwave		PCS	0			
	CASEWORKS						
1	Kitchen Cabinet		FT	15.83			
2	Laundry Cabinet		FT	0			
3	Vanity Cabinet		FT	3.6			
4	Medicine Cabinet		PCS	1			
	Kitchen countertop		SF	24.61			
6	Laundry Countertop		PCS	0			
7	Bathroom Countertop		SF	0			
8	Island		FT	0			
9	Peninsula		FT	0			
10	Closets		SF	34			
<u></u>	CEILING	5 W "	lor.	1 1	-		
1	Ceiling Board	Dry Wall	SF	481			
	Dry Wall Fastener	Screw	PCS	841			
3	Vapor Retarder	Polyethylene film	SF	715			
4	Vapor Retarder Fastener	Nails with washer heads	PCS	2146			
	Ceiling Board (MRD)	Moisture resistant drywall	SF	92			
	MRD Fastener		PCS	162			
7	Ceiling Board	Marine Plywood	SF	142			
8	Marine Plywood Fastener	Screw	PCS	249			
	Dry Wall Tape		FT	358			
<u></u>	FLOORING						
	Main Living Space		SF	443.48			
2	Bathroom		SF	95.57			
3	Porch		SF	138.78			
<u></u>	STRUCTURE						
1	Foundation		SF	754.47			
	WALLS EXTERIOR		1				
	Exterior-Grade Plywood Horizontal Sid		SF	1067			
	Exterior-Grade Plywood Fastener	Self-drilling screws(100/pkt)	PKT	64			
3	Wall Shteathing (OSB)		SF	1067			
4	Shteathing Fastener	Self-drilling screws(100/pkt)	PKT	11			
	Wall Homewrap		SF	1067			
	Homewrap Fastener	Stapled fastener (200/pkt)	PKT	4			
7	Furring Strip	0.15.1.111	PCS	133			
	Furring Strip Fastener	Self-drilling screws(100/pkt)	PKT	11			
9	Wall Paint		SF	1067			
	Stone Copping	Masonry stone	SF	0			
	Stone Veneer	Masonry stone	SF	0			
	Mortar for Stone Veneer		SF	0			
	Wall Insulation		SF	2822.0			
<u></u>	WALLS INTERIOR	T.	lor	1			
	Cementitious Backer Board		SF	485			
	Kerdi membrane		SF	485			
	Kerdi membrane Fastener		SF	485			
	Wall Ceramic Tile		SF	485			
	Drywall Board		SF	1138			
6	Drywall Fastener	Self-drilling screws(100/pkt)	PKT	11.38			
	Wall Paint		SF	1138			
	Drywall Tape		FT	214			
9	Wall Sweep		FT	78			

ARCHITECTURAL BOM



	DOORS				
1	Interior Swinging	3' - 0" X 6'-8"	PCS	1	
2	Exterior Swinging	3' - 0" X 6'-8"	PCS	2	
3	Bifold	2' - 4" X 6'-8"	PCS	1	
4	Bifold	3' - 3" X 6'-8"	PCS	1	
5	Bifold	4' - 10" X 6'-8"	PCS	1	
6	Exterior Door Trim		FT	35	
7	Interior Door Trim		FT	168	
8	Entry Lock set			2	
9	Privacy Lock set			1	
10	Passage Lock set			3	
	WINDOWS				
1	Sliding	3' - 3" X 3'-3"	PCS	4	
2	Sliding	3' - 3" X 1'-9"	PCS	2	
3	Awning	2' - 3" X 1'-9"	PCS	4	
4	Exterior Window Trim		FT	141	
5	Interior Window Trim		FT	141	
Δ	ROOF				
1	Roof Covering		SF	1016.0	
2	Roof Covering Fastener		PCS	508	
3	Roof Felt Paper		SF	1016.0	
4	Roof Felt Paper Fastener		PCS	3048.0	
5	Roof Sheathing		SF	1016	
6	Roof Sheathing Fastener		PCS	8128	
7	Batten		FT	482.0	
8	Batten Fastener		PCS	362.4	
9	Soffit		SF	239.0	
10	Soffit Fastener		PCS	119.5	
	Fascia		FT	154.0	
_	Fascia board fastener		PCS	77	
13	Roof Insulation		SF	1016.0	



Section Sec	Description
No. Item Type Unit Quantity Unit Price Total □ LIGHTING FIXTURES IKitchen Celling Light PCS 4 ■ 2 Kitchen Celling Light PCS 0 ■ 3 Exterior Wall Mounted Light PCS 3 ■ 4 Livingroom Ceiling Light With Fan PCS 0 ■ 5 Bedroom Ceiling Light With Fan PCS 0 ■ 6 Dining Ceiling Light PCS 0 ■ 7 Bath Wall Mounted Light PCS 0 ■ 8 Bathroom Ceiling Light PCS 1 ■ 8 Bathroom Ceiling Light PCS 2 ■ 9 Livingroom Ceiling Light PCS 0 ■ 10 Bedroom Ceiling Light PCS 0 ■ 11 Hall & Entry Ceiling Light PCS 3 ■ 12 Closet Ceiling Light PCS 3 ■	Description
Q LIGHTING FIXTURES 1 Kitchen Ceiling Light PCS 4 2 Kitchen Wall Mounted Light PCS 3 3 Exterior Wall Mounted Light PCS 3 4 Livingroom Ceiling Light With Fan PCS 1 5 Bedroom Ceiling Light With Fan PCS 0 6 Dining Ceiling Light PCS 0 7 Bath Wall Mounted Light PCS 1 8 Bathroom Ceiling Light PCS 2 9 Livingroom Ceiling Light PCS 6 10 Bedroom Ceiling Light PCS 0 11 Hall & Entry Ceiling Light PCS 3 12 Closet Ceiling Light PCS 3 13 Smoke Detector PCS 3 12 Closet Ceiling Light PCS 3 13 Smoke Detector PCS 3 2 Closet Ceiling Light PCS 6 3 TCS 0	
1 Kitchen Ceiling Light PCS 4 2 Kitchen Wall Mounted Light PCS 0 3 Exterior Wall Mounted Light PCS 3 4 Livingroom Ceiling Light With Fan PCS 1 5 Bedroom Ceiling Light With Fan PCS 0 6 Dining Ceiling Light PCS 0 7 Bath Wall Mounted Light PCS 1 8 Bathroom Ceiling Light PCS 2 9 Livingroom Ceiling Light PCS 6 10 Bedroom Ceiling Light PCS 0 11 Hall & Entry Ceiling Light PCS 3 12 Closet Ceiling Light PCS 3 13 Smoke Detector PCS 3 14 Standard Receptacle 240v 20A PCS 6 15 GFCI Receptacle 120v 20A PCS 19 16 GFCI Receptacle 240v 50A PCS 1 17 GFCI Receptacle 240v <td></td>	
2 Kitchen Wall Mounted Light PCS 0 3 Exterior Wall Mounted Light PCS 3 4 Livingroom Ceiling Light With Fan PCS 1 5 Bedroom Ceiling Light With Fan PCS 0 6 Dining Ceiling Light PCS 0 7 Bath Wall Mounted Light PCS 1 8 Bathroom Ceiling Light PCS 2 9 Livingroom Ceiling Light PCS 6 10 Bedroom Ceiling Light PCS 0 11 Hall & Entry Ceiling Light PCS 0 12 Closet Ceiling Light PCS 3 13 Smoke Detector PCS 3 14 Standard Receptacle 240V 20A PCS 6 15 GFCI Receptacle 240V 30 A PCS <td></td>	
3 Exterior Wall Mounted Light PCS 3 4 Livingroom Ceiling Light With Fan PCS 1 5 Bedroom Ceiling Light With Fan PCS 0 6 Dining Ceiling Light PCS 0 7 Bath Wall Mounted Light PCS 1 8 Bathroom Ceiling Light PCS 1 9 Livingroom Ceiling Light PCS 2 9 Livingroom Ceiling Light PCS 6 10 Bedroom Ceiling Light PCS 3 11 Hall & Entry Ceiling Light PCS 3 12 Closet Ceiling Light PCS 3 13 Smoke Detector PCS 0 14 Standard Receptacle 120V 20A PCS 0 15 GFCI Receptacle 120V 20A PCS 19 16 GFCI Receptacle 240V 30 A PCS 2 17 GFCI Receptacle 240V 50 A PCS 1 18 GFCI Receptacle 240V 60 A PCS 1 19 Fan Switch PCS 1 20 Single Pole Switch PCS 1 21 ELECTRICAL CONDUITS & WIRING 23 ROMEX 14 AWG 14/2/W/ground FT 52 24 ROMEX 12 AWG 12/3/Wiground FT 403 25 ROMEX 12 AWG 12/3/Wiground FT 403 25 ROMEX 12 AWG 12/2/W/ground FT 0	
4 Livingroom Ceiling Light With Fan PCS 1 5 Bedroom Ceiling Light With Fan PCS 0 6 Dining Ceiling Light PCS 0 7 Bath Wall Mounted Light PCS 1 8 Bathroom Ceiling Light PCS 2 9 Livingroom Ceiling Light PCS 6 10 Bedroom Ceiling Light PCS 0 11 Hall & Entry Ceiling Light PCS 3 12 Closet Ceiling Light PCS 3 13 Smoke Detector PCS 3 13 Smoke Detector PCS 0 14 Standard Receptacle 120V 20A PCS 6 15 GFCI Receptacle 120V 20 A PCS 19 16 GFCI Receptacle 240V 30 A PCS 2 17 GFCI Receptacle 240V 50 A PCS 1 18 GFCI Receptacle 240V 60 A PCS 1 19	
5 Bedroom Ceiling Light With Fan PCS 0 6 Dining Ceiling Light PCS 0 7 Bath Wall Mounted Light PCS 1 8 Bathroom Ceiling Light PCS 2 9 Livingroom Ceiling Light PCS 6 10 Bedroom Ceiling Light PCS 0 11 Hall & Entry Ceiling Light PCS 3 12 Closet Ceiling Light PCS 3 12	
6 Dining Celling Light PCS 0 7 Bath Wall Mounted Light PCS 1 8 Bathroom Celling Light PCS 2 9 Livingroom Celling Light PCS 6 10 Bedroom Celling Light PCS 0 11 Hall & Entry Celling Light PCS 3 12 Closet Ceiling Light PCS 3 13 Smoke Detector PCS 0 6 FLECTRICAL FITTINGS 14 Standard Receptacle 120V 20A PCS 1 15 GFCI Receptacle 120V 20 A PCS 19 16 GFCI Receptacle 240V 30 A PCS 19 17 GFCI Receptacle 240V 50 A PCS 1 18 GFCI Receptacle 240V 60 A PCS 1 19 Fan Switch PCS 1 20 Single Pole Switch PCS 1 21 Three Way Switch PCS 1 22 Dimmer Switch PCS 4 23 ROMEX 12 AWG 14/2/W/ground FT 403 25 ROMEX 12 AWG 12/2/W/ground FT 403 25 ROMEX 12 AWG 12/2/W/ground FT 403 26 ROMEX 12 AWG 12/2/W/ground FT 403 27 ROMEX 12 AWG 12/2/W/ground FT 403 27 ROMEX 12 AWG 12/2/W/ground FT 403 28 ROMEX 12 AWG 12/2/W/ground FT 403	
7 Bath Wall Mounted Light PCS 1 8 Bathroom Ceiling Light PCS 2 9 Livingroom Ceiling Light PCS 6 10 Bedroom Ceiling Light PCS 0 11 Hall & Entry Ceiling Light PCS 3 12 Closet Ceiling Light PCS 3 13 Smoke Detector PCS 0 □ ELECTRICAL FITTINGS 14 Standard Receptacle 120V 20A PCS 6 15 GFCI Receptacle 120V 20 A PCS 19 16 GFCI Receptacle 240V 30 A PCS 19 16 GFCI Receptacle 240V 50 A PCS 1 18 GFCI Receptacle 240V 60 A PCS 1 19 Fan Switch PCS 1 20 Single Pole Switch PCS 1 21 Three Way Switch PCS 4 22 Dimmer Switch PCS 4 23 ROMEX 14 AWG 14/2/W/ground FT 52	
8 Bathroom Ceiling Light PCS 2 9 Livingroom Ceiling Light PCS 6 10 Bedroom Ceiling Light PCS 0 11 Hall & Entry Ceiling Light PCS 3 12 Closet Ceiling Light PCS 3 13 Smoke Detector PCS 0 △ FLECTRICAL FITTINGS PCS 0 14 Standard Receptacle 120V 20 A PCS 6 15 GFCI Receptacle 120V 20 A PCS 19 16 GFCI Receptacle 240V 30 A PCS 2 17 GFCI Receptacle 240V 50 A PCS 1 18 GFCI Receptacle 240V 60 A PCS 1 19 Fan Switch PCS 1 20 Single Pole Switch PCS 1 21 Three Way Switch PCS 1 22 Dimmer Switch PCS 4 22 Dimmer Switch PCS<	
9 Livingroom Ceiling Light 10 Bedroom Ceiling Light 11 Hall & Entry Ceiling Light 12 Closet Ceiling Light 13 Smoke Detector 14 Standard Receptacle 120V 15 GFCI Receptacle 120V 16 GFCI Receptacle 240V 17 GFCI Receptacle 240V 18 GFCI Receptacle 240V 19 Fan Switch 19 Fan Switch 20 Single Pole Switch 21 Three Way Switch 22 Dimmer Switch 23 ROMEX 14 AWG 25 ROMEX 12 AWG 26 Interval and process of p	
10 Bedroom Ceiling Light PCS 0 11 Hall & Entry Ceiling Light PCS 3 12 Closet Ceiling Light PCS 3 13 Smoke Detector PCS 0 ■ ELECTRICAL FITTINGS 14 Standard Receptacle 120V 20A PCS 6 15 GFCI Receptacle 120V 20 A PCS 19 16 GFCI Receptacle 240V 30 A PCS 2 17 GFCI Receptacle 240V 50 A PCS 1 18 GFCI Receptacle 240V 60 A PCS 1 19 Fan Switch PCS 1 19 Fan Switch PCS 1 20 Single Pole Switch PCS 6 21 Three Way Switch PCS 1 22 Dimmer Switch PCS 4 ■ ELECTRICAL CONDUITS & WIRING PCS 4 24 ROMEX 12 AWG 12/3/W/ground FT 403 25 ROMEX 12 AWG 12/2/W/ground FT 00	
11 Hall & Entry Ceiling Light PCS 3 12 Closet Ceiling Light PCS 3 13 Smoke Detector PCS 0 □ ELECTRICAL FITTINGS 14 Standard Receptacle 120V 20A PCS 19 15 GFCI Receptacle 120V 20 A PCS 19 16 GFCI Receptacle 240V 30 A PCS 2 17 GFCI Receptacle 240V 50 A PCS 1 18 GFCI Receptacle 240V 60 A PCS 1 19 Fan Switch PCS 1 10 Single Pole Switch PCS 1 11 PCS 1 12 Dimmer Switch PCS 1 12 Dimmer Switch PCS 4 1 PCS 1 1 PCS 4 1 PCS 1 1 PCS 5 1 PCS 6 1 PCS 6 1 PCS 1 1	
12 Closet Ceiling Light PCS 3 13 Smoke Detector PCS 0 □ ELECTRICAL FITTINGS 14 Standard Receptacle 120V 20A PCS 19 15 GFCI Receptacle 120V 30 A PCS 19 16 GFCI Receptacle 240V 50 A PCS 1 17 GFCI Receptacle 240V 50 A PCS 1 18 GFCI Receptacle 240V 60 A PCS 1 19 Fan Switch PCS 1 20 Single Pole Switch PCS 6 21 Three Way Switch PCS 6 22 Dimmer Switch PCS 1 23 ROMEX 14 AWG 14/2/W/ground FT 52 24 ROMEX 12 AWG 12/3/W/ground FT 403 25 ROMEX 12 AWG 12/3/W/ground FT 0	
13 Smoke Detector	
☑ ELECTRICAL FITTINGS 14 Standard Receptacle 120V 20 A PCS 6 15 GFCI Receptacle 120V 20 A PCS 19 16 GFCI Receptacle 240V 30 A PCS 2 17 GFCI Receptacle 240V 50 A PCS 1 18 GFCI Receptacle 240V 60 A PCS 1 19 Fan Switch PCS 1 20 Single Pole Switch PCS 1 21 Three Way Switch PCS 6 21 Three Way Switch PCS 1 22 Dimmer Switch PCS 4 ☑ ELECTRICAL CONDUITS & WIRING 23 ROMEX 14 AWG 14/2/W/ground FT 52 24 ROMEX 12 AWG 12/3/W/ground FT 403 25 ROMEX 12 AWG 12/2/W/ground FT 0	
14 Standard Receptacle 120V 20A PCS 6 15 GFCI Receptacle 120V 20 A PCS 19 16 GFCI Receptacle 240V 30 A PCS 2 17 GFCI Receptacle 240V 50 A PCS 1 18 GFCI Receptacle 240V 60 A PCS 1 19 Fan Switch PCS 1 20 Single Pole Switch PCS 1 20 Single Pole Switch PCS 6 21 Three Way Switch PCS 1 22 Dimmer Switch PCS 4 □ ELECTRICAL CONDUITS & WIRING 23 ROMEX 14 AWG 14/2/W/ground FT 52 24 ROMEX 12 AWG 12/3/W/ground FT 403 25 ROMEX 12 AWG 12/2/W/ground FT 0	
15 GFCI Receptacle 120V 20 A PCS 19 16 GFCI Receptacle 240V 30 A PCS 2 17 GFCI Receptacle 240V 50 A PCS 1 18 GFCI Receptacle 240V 60 A PCS 1 19 Fan Switch PCS 1 20 Single Pole Switch PCS 6 21 Three Way Switch PCS 1 22 Dimmer Switch PCS 4 △ ELECTRICAL CONDUITS & WIRING 23 ROMEX 14 AWG 14/2/W/ground FT 52 24 ROMEX 12 AWG 12/3/W/ground FT 403 25 ROMEX 12 AWG 12/2/W/ground FT 0	
16 GFCI Receptacle 240V 30 A PCS 2 17 GFCI Receptacle 240V 50 A PCS 1 18 GFCI Receptacle 240V 60 A PCS 1 19 Fan Switch PCS 1 20 Single Pole Switch PCS 6 21 Three Way Switch PCS 1 22 Dimmer Switch PCS 4 22 Dimmer Switch PCS 4 23 ROMEX 14 AWG 14/2/W/ground FT 52 24 ROMEX 12 AWG 12/3/W/ground FT 403 25 ROMEX 12 AWG 12/2/W/ground FT 0	
17 GFCI Receptacle 240V 50 A PCS 1 18 GFCI Receptacle 240V 60 A PCS 1 19 Fan Switch PCS 1 20 Single Pole Switch PCS 6 21 Three Way Switch PCS 1 22 Dimmer Switch PCS 4 △ ELECTRICAL CONDUITS & WIRING 23 ROMEX 14 AWG 14/2/W/ground FT 52 24 ROMEX 12 AWG 12/3/W/ground FT 403 25 ROMEX 12 AWG 12/2/W/ground FT 0	
18 GFCI Receptacle 240V 60 A PCS 1 19 Fan Switch PCS 1 20 Single Pole Switch PCS 6 21 Three Way Switch PCS 1 22 Dimmer Switch PCS 4 △ ELECTRICAL CONDUITS & WIRING 23 ROMEX 14 AWG 14/2/W/ground FT 52 24 ROMEX 12 AWG 12/3/W/ground FT 403 25 ROMEX 12 AWG 12/2/W/ground FT 0	
19 Fan Switch PCS 1 20 Single Pole Switch PCS 6 21 Three Way Switch PCS 1 22 Dimmer Switch PCS 4 △ ELECTRICAL CONDUITS & WIRING 23 ROMEX 14 AWG 14/2/W/ground FT 52 24 ROMEX 12 AWG 12/3/W/ground FT 403 25 ROMEX 12 AWG 12/2/W/ground FT 0	
20 Single Pole Switch PCS 6 21 Three Way Switch PCS 1 22 Dimmer Switch PCS 4 △ ELECTRICAL CONDUITS & WIRING 23 ROMEX 14 AWG 14/2/W/ground FT 52 24 ROMEX 12 AWG 12/3/W/ground FT 403 25 ROMEX 12 AWG 12/2/W/ground FT 0	
21 Three Way Switch PCS 1 22 Dimmer Switch PCS 4 □ ELECTRICAL CONDUITS & WIRING 23 ROMEX 14 AWG 14/2/W/ground FT 52 24 ROMEX 12 AWG 12/3/W/ground FT 403 25 ROMEX 12 AWG 12/2/W/ground FT 0	
22 Dimmer Switch PCS 4 □ ELECTRICAL CONDUITS & WIRING 23 ROMEX 14 AWG 14/2/W/ground FT 52 24 ROMEX 12 AWG 12/3/W/ground FT 403 25 ROMEX 12 AWG 12/2/W/ground FT 0	
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23 ROMEX 14 AWG 14/2/W/ground FT 52 24 ROMEX 12 AWG 12/3/W/ground FT 403 25 ROMEX 12 AWG 12/2/W/ground FT 0	
24 ROMEX 12 AWG 12/3/W/ground FT 403 25 ROMEX 12 AWG 12/2/W/ground FT 0	
25 ROMEX 12 AWG 12/2/W/ground FT 0	
26 ROMEX 10 AWG 10/3/W/ground FT 0	
27 ROMEX 10 AWG 10/2/W/ground FT 51	
28 Romex 8 AWG 8/3/W/ground FT 0	
29 Romex 8 AWG 8/2/W/ground FT 26	
30 ROMEX 6 AWG 6/3/W/ground FT 19	
31 Bare Copper Ground Wire 6 AWG FT 0	
△ ELECTRICAL BOXES & CIRCUTES	
32 Panelboard -240V 1 Phase MLO 200 AMP PCS 1	
33 Circuit breaker 15 A PCS 2	
34 Circuit breaker 20 A PCS 11	
36 Circuit breaker 30 A PCS 2	
37 Circuit breaker 50 A PCS 1	
39 Circuit breaker 60 A PCS 1	
40 Single Gang Switch Box PCS 1	
41 Double Gang Switch Box PCS 4	
42 Triple Gang Switch Box PCS 1	
43 Pull Box #1/4 PCS 16	
44 Receptacle Box PCS 29	



PLUMBING SYSTEM MATERIAL SHOPPING LIST										
No.	Item	Type	Unit	1	Unit Price	Total	Description			
	PLUMBING FIXTURES & ACCESSORIES									
1	Bath Tub (Alcove Tub)		PCS	0						
2	Kitchen Sink		PCS	1						
3	Kitchen Faucets		PCS	1						
4	Vanity Sink		PCS	2						
5	Bath room Faucets		PCS	2						
6	Water Closet		PCS	1						
7	Shower Trim		PCS	1						
8	Shower Tray		PCS	1						
9	Water Heater		PCS	1						
_	Hose Bib		PCS	2						
11	Shutoff Valve		PCS	8						
	Hanging pipe clamp Globe Valve		PCS PCS	12						
	Dishwasher Supply Single Connector		PCS	1 1						
	Dishwasher Supply Single Connector Dishwasher Sewage Single Connector		PCS	1 1						
	Laundry Sweat Connector		PCS	1						
	SANITARY & PLUMBING PIPES		1 103							
1	ABS (Acrylonitrile Butadiene Styrene) Pipes	ø 1/2"	FT	1 0						
	ABS (Acrylonitrile Butadiene Styrene) Pipes	ø 1 1/2"	FT	18						
3	ABS (Acrylonitrile Butadiene Styrene) Pipes	Ø 2"	FT	33						
4	ABS (Acrylonitrile Butadiene Styrene) Pipes	ø 3"	FT	10						
	PEX (Cross-linked polyethylene) Pipes	ø 1/2"	FT	63						
	PEX (Cross-linked polyethylene) Pipes	ø 3/4"	FT	50						
7	Polyvinyl Chloride - Rigid	1 1/2"	FT	0						
8	Polyvinyl Chloride - Rigid	2"	FT	38						
Δ	PIPE FITTINGS	<u> </u>								
1	ABS 90 Degree Bend Elbow	1 1/2"ø-1 1/2"ø	PCS	1						
2	ABS 90 Degree Bend Elbow	2"ø-2"ø	PCS	2						
3	ABS 90 Degree Bend Elbow	3"ø-3"ø	PCS	1						
4	ABS P-Trap	1 1/2"ø-1 1/2"ø	PCS	3						
5	ABS P-Trap	2"ø-2"ø	PCS	1						
6	ABS Reducer Elbow	2"ø-1 1/2"ø	PCS	1						
7	ABS Reducer Elbow	3"ø-2"ø	PCS	1						
8	ABS TEE Elbow	1 1/2"ø-1 1/2"ø-1 1/2"ø	PCS	1						
9	ABS TEE Elbow	2"ø-2"ø-2"ø	PCS	1						
10	ABS TEE Elbow	3"ø-3"ø-3"ø	PCS	1						
11	ABS Tee Reducer Elbow	2 1/2"ø-2 1/2"ø-1 1/2"ø	PCS	2						
	ABS Tee Reducer Elbow	2 1/2"ø-2 1/2"ø-2"ø	PCS	1						
	ABS Tee Reducer Elbow	3"ø-2 1/2"ø-3"ø	PCS	1						
	ABS Trap P	2"ø-2"ø	PCS	1						
	ABS Vent Cap Elbow	1 1/2"ø	PCS	1						
	ABS Vent Cap Elbow	2"ø	PCS	2						
	ABS Vent Cap Elbow	3"Ø	PCS	1						
	PEX 90 Deg Elbow	1/2"ø-1/2"ø	PCS	3						
	PEX 90 Degree Elbow	1/2"ø-1/2"ø	PCS	14						
	PEX 90 Degree Elbow	3/4"ø-3/4"ø	PCS	1						
	PEX Tee Elbow	1/2"ø-1/2"ø-1/2"ø	PCS	3						
	PEX Tee Elbow	3/4"ø-3/4"ø-3/4"ø	PCS	4						
	PEX Transition Elbow	1"ø-3/4"ø	PCS	2						
	PEX Transition Elbow	3/4"ø-1/2"ø	PCS	3						
	PEX 90 Deg Elbow	1/2"ø-1/2"ø	PCS	1						
	PEX 90 Degree Elbow	1/2"ø-1/2"ø	PCS	8						
	PEX 700 Degree Elbow	3/4"ø-3/4"ø	PCS	4						
	PEX Tee Elbow	1/2"ø-1/2"ø-1/2"ø	PCS	1						
	PEX Tee Elbow PEX Transition Elbow	3/4"ø-3/4"ø-3/4"ø	PCS	3						
		3/4"ø-1/2"ø	PCS	6						
	PVC 90 Deg Bend Elbow	2"ø-2"ø	PCS	5						
32	PVC 90 Degree Bend Elbow WASTE DOUBLE TEE	2"ø-2"ø 2"ø-2"ø-2"ø-2"ø	PCS PCS	10						

		Ember-Stud	dio-Mod	lern-Bas	e		
		HVAC SYSTEM MA	TERIAL	SHOPP	ING LIST		
No.	Item	Туре	Unit	Quantity	Unit Price	Total	Description
	HVAC_DUCTS				·		
1	PIPE (REFRIGERANT LINE)	3/8" (Ø)	FT	53.69			
2	PIPE (REFRIGERANT LINE)	3/4''' (Ø)	FT	62.48			
3	DRAYER HOSE	4" (Ø)	FT	7.6			
4	FLEX DUCT ROUND	4" (Ø)	FT	5.54			
	DUCT FITTINGS & ACCESSORIES						
5	ELBOW (REFRIGERANT LINE)	3/4" (Ø)-3/4" (Ø	PCS	14			
6	ELBOW (REFRIGERANT LINE)	3/8" (Ø)-3/8" (Ø)	PCS	12			
7	TRANSITION (REFRIGERANT	3/4" (Ø)-1/2" (Ø)	PCS	2			
8	TRANSITION (REFRIGERANT	3/4" (Ø)-5/8" (Ø)	PCS	1			
9	TRANSITION (REFRIGERANT	3/8" (Ø)-1/4" (Ø)	PCS	1			
\triangle	HVAC_EQUIPMENTS						
10	AIR HANDLING UNIT	WALL MOUNTED	PCS	1			
11	CONDENSER	OUTDOOR UNIT	PCS	1			
12	EXHAUST FAN	75 CFM	PCS	1			
13	EXHAUST HOOD	WALL MOUNTED	PCS	1			
14	HOOD-WALL: VENT	HOOD-WALL: VENT	PCS	1			
15	DRAYER: VENT	DRAYER: VENT	PCS	1			
16	ROOF VENT	3"(Ø)	PCS	1			



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Have It Your Way!

The material types listed in this document were selected based on personal preferences. The Customer is encouraged to make changes to the material types in accordance with local customs, regulations, and personal preferences. Have It Your Way!

GENERAL NOTES

- 1 This BOM (Bill of Materials) is prepared as a Materials Shopping List to help builders and DIYers gain a complete understanding of most if not all elements required for the complete construction of this structure, according to the original design documents provided by FrameUpNow.
- 2 All quantities and specifications are subject to change based on the final design, field measurements, availability of products and customer preferences. The customer should verify all information prior to purchasing materials.
- 3 All products and elements in the list shall conform to the International Residential Code (IRC), or any other local and international building codes, safety regulations, and standards that are applicable to the location of the structure.
- 4 If any changes are made by the customer to the list of materials specified in this document, the customer is responsible for assuring that the correct type and quantity of materials are utilized in accordance with local building codes.
- FrameUpNow, will not be held responsible for any misuse of this document, the products listed, or for deviations from the content that are made due to changes in specifications, pricing, availability, or customer preferences.
- The customer is advised to consult a qualified professional or technician prior to purchasing materials for specialized construction system items. Some items including but not limited to caseworks, doors and windows may require as built measurements prior to purchase to confirmation of final dimensions.
- 7 If there are additional trim elements or specific installation methods, the total amount of materials needed might vary. Consider any additional trim required for corners, intersections, or other architectural details that might cause this variations before procedding to purchase and construction.



			LIGHTING FIXTURES				
#	Item	Туре	Description, Manufacturer, SKU	Unit	Quantity	Unit Price	Total
1	Kitchen Ceiling Light			PCS	4		
3	Kitchen Wall Mounted Light			PCS	0		
4	Exterior Wall Mounted Light			PCS	1		
5	Livingroom Ceiling Light With Fan			PCS	1		
6	Bedroom Ceiling Light With Fan			PCS	0		
7	Dining Ceiling Light			PCS	0		
8	Bath Wall Mounted Light			PCS	1		
9	Bathroom Ceiling Light			PCS	2		
10	Livingroom Ceiling Light			PCS	6		
11	Bedroom Ceiling Light			PCS	0		
12	Hall & Entry Ceiling Light			PCS	3		
12	Garage Ceiling Light			PCS	0		
13	Smoke Detector			PCS	0		
14							
15							



			ELECTRICAL FITTINGS				
#	Item	Туре	Description, Manufacturer, SKU	Unit	Quantity	Unit Price	Total
1	Standard Receptacle 120V	20A		PCS	6		
2	GFCI Receptacle 120V	20 A		PCS	14		
3	GFCI Receptacle 240V	30 A		PCS	2		
1	GFCI Receptacle 240V	50 A		PCS	1		
5	GFCI Receptacle 240V	60 A		PCS	1		
5	Fan Switch			PCS	1		
7	Single Pole Switch			PCS	5		
3	Three Way Switch			PCS	1		
)	Dimmer Switch			PCS	3		
10		1	'	'			
l1							
12							
13							
14							
15							



		ELECTR	ICAL CONDUITS & WIRING				
#	Item	Туре	Description, Manufacturer, SKU	Unit	Quantity	Unit Price	Total
1	ROMEX 14 AWG	14/2/W/ground		FT	52		
3	ROMEX 12 AWG	12/3/W/ground		FT	297		
4	ROMEX 12 AWG	12/2/W/ground		FT	0		
6	ROMEX 10 AWG	10/3/W/ground		FT	0		
8	ROMEX 10 AWG	10/2/W/ground		FT	51		
9	Romex 8 AWG	8/3/W/ground		FT	0		
10	Romex 8 AWG	8/2/W/ground		FT	26		
11	ROMEX 6 AWG	6/2/W/ground		FT	19		
12	Bare Copper Ground Wire 6 AWG			FT			
13							
14							
15							
16							



		ELEC	CTRICAL BOXES & CIRCUTES			
1	Item	Туре	Description, Manufacturer, SKU	Unit	Quantity Unit F	rice Total
	Panelboard -240V 1 Phase MLO	200 AMP		PCS	1	
	Circuit breaker	15 A		PCS	2	
	Circuit breaker	20 A		PCS	9	
	Circuit breaker	30 A		PCS	2	
	Circuit breaker	50 A		PCS	1	
	Circuit breaker	60 A		PCS	1	
	Single Gang Switch Box			PCS	1	
	Double Gang Switch Box			PCS	3	
	Triple Gang Switch Box			PCS	1	
0	Pull Box	#1/4		PCS	13	
1	Receptacle Box			PCS	24	
2						
3						
4						
.5						

			HVAC_DUCTS 01				
#		Туре	Description, Manufacturer, SKU	Unit	Quantity	Unit Price	Total
1	PIPE (REFRIGERANT LINE)			FT	53.69		
2	PIPE (REFRIGERANT LINE)	3/4''' (Ø)		FT	62.48		
3		4" (Ø)		FT	7.6		
4	FLEX DUCT ROUND	4" (Ø)		FT	5.54		
5							
6							
7							
8							
9							
10							
11							
12							
13							
14							
15							
16							

			DUCT FITTINGS & ACCESSORIES				
#	Item	Туре	Description, Manufacturer, SKU	Unit	Quantity	Unit Price	Total
1	ELBOW (REFRIGERANT LINE)	3/4" (Ø)-3/4" (Ø		PCS	14		
2	ELBOW (REFRIGERANT LINE)	3/8" (Ø)-3/8" (Ø)		PCS	12		
3	TRANSITION (REFRIGERANT LINE)	3/4" (Ø)-1/2" (Ø)		PCS	2		
1	TRANSITION (REFRIGERANT LINE)	3/4" (Ø)-5/8" (Ø)		PCS	1		
5	TRANSITION (REFRIGERANT LINE)	3/8" (Ø)-1/4" (Ø)		PCS	1		
6							
7							
3							
9							
10							
11							
12							
13							
14							
15							
16							

			HVAC_EQUIPMENTS				
#	Item	Туре	Description, Manufacturer, SKU	Unit	Quantity	Unit Price	Total
1	AIR HANDLING UNIT	WALL MOUNTED		PCS	1		
2	CONDENSER	OUTDOOR UNIT		PCS	1		
}	EXHAUST FAN	75 CFM		PCS	1		
1	EXHAUST HOOD	WALL MOUNTED		PCS	1		
5	HOOD-WALL: VENT	HOOD-WALL: VENT		PCS	1		
5	DRAYER: VENT	DRAYER: VENT		PCS	1		
7	ROOF VENT	3"(Ø)		PCS	1		
3							
9							
10							
11							
12							
13							
14							



		PLUMBII	NG FIXTURES & ACCESSORIES				
#	Item	Туре	Description, Manufacturer, SKU	Unit	Quantity	Unit Price	Total
1	Bath Tub (Alcove Tub)			PCS	1		
2	Kitchen Sink			PCS	1		
3	Kitchen faucets			PCS	1		
4	Vanity Sink			PCS	1		
5	Bath room faucets		-	PCS	1		
6	Water Closet			PCS	1		
7	Shower Trim			PCS	1		
8	Shower Tray			PCS	1		
9	Water Heater			PCS	1		
10	Hose Bib			PCS	2		
11	Shutoff Valve			PCS	8		
12	Hanging pipe clamp			PCS	12		
13	Globe Valve			PCS	1		
14	Dishwasher Supply Single Connector			PCS	1		
15	Dishwasher Sewage Single Connector			PCS	1		
16	Laundry Sweat Connector			PCS	1		



		SANI	TARY & PLUMBING PIPES				
#	Item	Туре	Description, Manufacturer, SKU	Unit	Quantity	Unit Price	Total
1	ABS (Acrylonitrile Butadiene Styrene) Pipes	ø 1"		FT	0		
2	ABS (Acrylonitrile Butadiene Styrene) Pipes	ø 1 1/2"		FT	18		
3	ABS (Acrylonitrile Butadiene Styrene) Pipes	ø 2"		FT	33		
4	ABS (Acrylonitrile Butadiene Styrene) Pipes	ø 3"		FT	18		
5	ABS (Acrylonitrile Butadiene Styrene) Pipes	ø 2 1/2"		FT	10		
6	PEX (Cross-linked polyethylene) Pipes	ø 1/2"		FT	63		
7	PEX (Cross-linked polyethylene) Pipes	ø 3/4"		FT	50		
8	PEX (Cross-linked polyethylene) Pipes	ø 1"		FT	0		
9	PVC Pipes Sch.80 - Rigid	ø 1 1/2"		FT	0		
10	PVC Pipes Sch.80 - Rigid	ø 2"		FT	38		
11	PVC Pipes Sch.80 - Rigid	ø 3"		FT	0		
12	Flex Pipe Round	ø 1/2"		FT	8		
13	Flex Pipe Round	ø 3/4"		FT	0		
14	Flex Pipe Round	ø 1"		FT	0		
15							



		PIPE	FITTINGS 01				
#	Item	Туре	Description, Manufacturer, SKU	Unit	Quantity	Unit Price	Total
1	ABS 90 Degree Bend Elbow	1 1/2"ø-1 1/2"ø		PCS	1		
<u>)</u>	ABS 90 Degree Bend Elbow	2"Ø-2"Ø		PCS	2		
}	ABS 90 Degree Bend Elbow	3"ø-3"ø		PCS	1		
	ABS P-Trap	1 1/2"ø-1 1/2"ø		PCS	3		
)	ABS P-Trap	2"ø-2"ø		PCS	1		
,)	ABS Reducer Elbow	2"ø-1 1/2"ø		PCS	1		
1	ABS Reducer Elbow	3"Ø-2"Ø		PCS	1		
}	ABS TEE Elbow	1 1/2"ø-1 1/2"ø-1 1/2"ø		PCS	1		
)	ABS TEE Elbow	2"ø-2"ø-2"ø		PCS	1		
0	ABS TEE Elbow	3"ø-3"ø-3"ø		PCS	1		
1	ABS Tee Reducer Elbow	2 1/2"ø-2 1/2"ø-1 1/2"ø		PCS	2		
2	ABS Tee Reducer Elbow	2 1/2"ø-2 1/2"ø-2"ø		PCS	1		
13	ABS Tee Reducer Elbow	3"ø-2 1/2"ø-3"ø		PCS	1		
4	ABS Trap P	2"Ø-2"Ø		PCS	1		
5	ABS Vent Cap Elbow	1 1/2"ø		PCS	1		
		PIPE	FITTINGS 02				
#	Item	Туре	Description, Manufacturer, SKU	Unit	Quantity	Unit Price	Total
1	ABS Vent Cap Elbow	2"ø		PCS	2		



2	ABS Vent Cap Elbow	3"Ø	PCS 1
3	PEX 90 Deg Elbow	1/2"ø-1/2"ø	PCS 3
4	PEX 90 Degree Elbow	1/2"ø-1/2"ø	PCS 14
5	PEX 90 Degree Elbow	3/4"ø-3/4"ø	PCS 1
6	PEX Tee Elbow	1/2"ø-1/2"ø-1/2"ø	PCS 3
7	PEX Tee Elbow	3/4"ø-3/4"ø-3/4"ø	PCS 4
8	PEX Transition Elbow	1"ø-3/4"ø	PCS 2
9	PEX Transition Elbow	3/4"ø-1/2"ø	PCS 3
10	PEX 90 Deg Elbow	1/2"ø-1/2"ø	PCS 1
11	PEX 90 Degree Elbow	1/2"ø-1/2"ø	PCS 8
12	PEX 90 Degree Elbow	3/4"ø-3/4"ø	PCS 4
13	PEX Tee Elbow	1/2"ø-1/2"ø	PCS 1
14	PEX Tee Elbow	3/4"ø-3/4"ø-3/4"ø	PCS 3
15	PEX Transition Elbow	3/4"ø-1/2"ø	PCS 6



		PIPE FITTINGS 03								
#	Item	Туре	Description, Manufacturer, SKU	Unit	Quantity	Unit Price	Total			
1	PVC 90 Deg Bend Elbow	2"ø-2"ø		PCS	5					
2	PVC 90 Degree Bend Elbow	2"ø-2"ø		PCS	10					
3	WASTE DOUBLE TEE	2"Ø-2"Ø-2"Ø		PCS	1					



			APPLIANCES				
#	Item	Туре	Description, Manufacturer, SKU	Unit	Quantity	Unit Price	Total
1	Refrigerator			PCS	1		
2	Range			PCS	1		
3	Washer Front Load	Stackable		PCS	1		
4	Dryer Front Load	Stackable		PCS	1		
5	Dish Washer			PCS	1		
6	Oven			PCS	(
7	Microwave			PCS	(
8							
9							
10							
11							
12							
13							
14							
15							
16							



			CASEWORKS 01				
#	Item	Туре	Description, Manufacturer, SKU	Unit	Quantity	Unit Price	Total
1	Kitchen Cabinet			FT	15.83		
2	Laundry Cabinet			FT	0		
3	Vanity Cabinet			FT	3.6		
4	Medicine Cabinet			PCS	1		
5	Kitchen countertop			SF	24.61		
6	Laundry Countertop			PCS	0		
7	Bathroom Countertop			SF	0		
8	Island			FT	0		
9	Peninsula			FT	0		
10	Closets			SF	34		
11							
12							
13							
14							
15							



			CEILING 01				
#	Item	Туре	Description, Manufacturer, SKU	Unit	Quantity	Unit Price	Total
	LIVINGROOM + KITCHEN			SF	388.5	i	
1	Ceiling Board	Drywall		SF	389		
2	Drywall Fastener	Screw		PCS	680		
3	Vapor Retarder	Polyethylene film		SF	389		
ļ	Vapor Retarder Fastener	Nails with washer heads		PCS	1166		
	BATHROOM	,		SF	92.5		
5	Ceiling Board	MRD (Moisture resistant drywall)		SF	92		
)	MRD Fastener	Screw		PCS	162		
	PORCH			SF	141.6		
7	Ceiling Board	Marine Plywood		SF	142		
3	Exterior Grade Plywood	Screw		PCS	248		
	WH			SF	7.8		
)	Ceiling Board	Drywall		SF	8		
10	Drywall Fastener	Screw		PCS	14		
l1	Vapor Retarder	Polyethylene film		SF	8		
L2	Vapor Retarder Fastener	Nails with washer heads		PCS	23		



			CEILING 02				
#	Item	Туре	Description, Manufacturer, SKU	Unit	Quantity	Unit Price	Total
	HALL+WD			SF	75.8		
13	Ceiling Board	Drywall		SF	76		
14	Drywall Fastener	Screw		PCS	133		
15	Vapor Retarder	Polyethylene film		SF	76		
16	Vapor Retarder Fastener	Nails with washer heads		PCS	227		
	CLOSET	ı		SF	8.6		
17	Ceiling Board	Drywall		SF	9		
18	Drywall Fastener	Screw		PCS	15		
19	Vapor Retarder	Polyethylene film		SF	9		
20	Vapor Retarder Fastener	Nails with washer heads		PCS	26		



			FLOORING INTERIOR 01				
#	Item	Туре	Description, Manufacturer, SKU	Unit	Quantity	Unit Price	Total
	CLOSET						
1	Closet Flooring			SF	8		
2	Wood underlay	Foam Pad Polyethylene		SF	8		
3	Vapor Retarder	Vapor Barrier Polyethylene		SF	8		
	LIVING ROOM AND KITCH	IEN					
4	Tile Finish			SF	435		
5	Adhesive	1/2" Thin set Mortar		SF	435		
6	Vapor Retarder	Vapor Barrier Polyethylene		SF	435		
	BATHROOM						
7	Tile Finish			SF	73		
8	Adhesive	1/2" Thin set Mortar		SF	73		
9	Vapor Retarder	Vapor Barrier Polyethylene		SF	73		



			FLOORING INTERIOR 02				
#	Item	Туре	Description, Manufacturer, SKU	Unit	Quantity	Unit Price	Total
	W/D						
10	Tile Finish			SF	15		
11	Adhesive	1/2" Thin set Mortar		SF	15		
12	Vapor Retarder	Vapor Barrier Polyethylene		SF	15		
	BOILER ROOM						
13	Tile Finish			SF	8		
14	Adhesive	1/2" Thin set Mortar		SF	8		
15	Vapor Retarder	Vapor Barrier Polyethylene		SF	8		



			FLOORING EXTERIOR			
#	Item	Туре	Description, Manufacturer, SKU	Unit	Quantity	Unit Price
	STRUCTURE			SF	754.47	
1	Concrete Slab	4"concrete cast in situ		CF	251.49	
2	Insulation	Rigid insulation		SF	221.76	
3	Hard core	Compacted soil		CF	207.25	
4	Re-bar	#4 re-bar		Ton	0.72	
5	Concrete Pad	4"concrete cast in situ		CF	2	
6	Slab edge	Turndown		CF	182.61	
7	Footing	Cast-in-place concrete		CF	7.02	
	PORCH					
8	Tile Finish			SF	139	
9	Adhesive	1/2" Thin set Mortar		SF	139	
10	Vapor Retarder	Vapor Barrier Polyethylene		SF	139	



			WALLS: EXTERIOR				
#	Item	Туре	Description, Manufacturer, SKU	Unit	Quantity	Unit Price	Total
1	Exterior-Grade Plywood Vertical Siding			SF	1067		
2	Exterior-Grade Plywood Fastener 8/panel	Self-drilling screws(100/pkt)		PKT	64.02		
3	Wall Shteathing (OSB)			SF	1067		
4	Shteathing Fastener	Self-drilling screws(100/pkt)		PKT	10.67		
5	Wall Homewrap			SF	1067		
6	Homewrap Fastener	Stapled fastener (200/pkt)		PKT	4.05		
7	Furring Strip			PCS	133.38		
8	Furring Strip Fastener	Self-drilling screws(100/pkt)		PKT	10.67		
9	Wall Paint			SF	1067		
10	Stone Copping	Masonry stone		SF	0		
11	Stone Veneer	Masonry stone		SF	0		
12	Mortar for Stone Veneer			SF	0		
13	Wall Insulation			SF	2822		
14							
15							



			WALLS: INTERIOR 01				
#	Item	Туре	Description, Manufacturer, SKU	Unit	Quantity	Unit Price	Total
	BATHROOM			SF	88.0		
1	Cementitious Backer Board			SF	365		
2	Kerdi membrane			SF	365		
3	Kerdi membrane Fastener			SF	365		
4	Wall Ceramic Tile			SF	365		
	CL			SF	9.0		
5	Drywall Board			SF	87		
6	Drywall Fastener	Self-drilling screws(100/pkt)		PKT	0.87		
7	Wall Paint			SF	87		
8	Drywall Tape			FT	16.3		
	HALL			SF	58.0		
9	Drywall Board			SF	148		
10	Drywall Fastener	Self-drilling screws(100/pkt)		PKT	1.48		
11	Wall Paint			SF	148		
12	Drywall Tape			FT	27.8		



			WALLS: INTERIOR 02				
#	Item	Туре	Description, Manufacturer, SKU	Unit	Quantity	Unit Price	Total
	STUDIO			SF	293.0		
13	Drywall Board			SF	665		
14	Drywall Fastener	Self-drilling screws(100/pkt)		PKT	6.65		
15	Wall Paint			SF	665		
16	Drywall Tape			FT	124.8		
	KITCHEN			SF	83.0		
17	Cementitious Backer Board			SF	25		
18	Drywall Board			SF	161		
19	Drywall Fastener	Self-drilling screws(100/pkt)		PKT	1.61		
20	Kerdi membrane			SF	25		
21	Kerdi membrane Fastener			SF	25		
22	Wall Ceramic Tile			SF	25		
23	Wall Paint			SF	161		
24	Drywall Tape			FT	30.4		



			WALLS: INTERIOR 03				
#	Item	Туре	Description, Manufacturer, SKU	Unit	Quantity	Unit Price	Total
	WD			SF	13.0		
25	Cementitious Backer Board			SF	95		
26	Kerdi membrane			SF	95		
27	Kerdi membrane Fastener			SF	95		
28	Wall Ceramic Tile			SF	95		
	WH			SF	8.0		
29	Drywall Board			SF	77		
30	Drywall Fastener	Self-drilling screws(100/pkt)		PKT	0.77		
31	Wall Paint			SF	77		
32	Drywall Tape			FT	15		
1	Wall Sweep			FT	78		



			DOORS				
#	Item	Туре	Description, Manufacturer, SKU	Unit	Quantity	Unit Price	Total
1	Interior Swinging	3' - 0" X 6'-8"		PCS	1		
2	Exterior Swinging	3' - 0" X 6'-8"		PCS	2		
3	Bifold	2' - 4" X 6'-8"		PCS	1		
4	Bifold	3' - 3" X 6'-8"		PCS	1		
5	Bifold	4' - 10" X 6'-8"		PCS	1		
6	Exterior Door Trim			FT	35		
7	Interior Door Trim			FT	168		
8	Entry Lock set			PCS	2		
9	Privacy Lock set			PCS	1		
10	Passage Lock set			PCS	3		
11							
12							
13							
14							
15							



			WINDOWS				
#	Item	Туре	Description, Manufacturer, SKU	Unit	Quantity	Unit Price	Total
1	Sliding	3' - 3" X 3'-3"		PCS	4		
2	Sliding	3' - 3" X 1'-9"		PCS	2		
3	Awning	2' - 3" X 1'-9"		PCS	4		
4	Exterior Window Trim			FT	141		
5	Interior Window Trim			FT	141		
6							
7							
8							
9							
10							
11							
12							
13							
14							
15							



			ROOF 01				
#	Item	Туре	Description, Manufacturer, SKU	Unit	Quantity	Unit Price	Total
1	Roof Covering			SF	1016.0		
2	Roof Covering Fastener			PCS	508		
3	Roof Felt Paper			SF	1016.0		
4	Roof Felt Paper Fastener			PCS	3048.0		
5	Roof Sheathing			SF	1016.0		
6	Roof Sheathing Fastener			PCS	8128		
7	Batten			FT	482.0		
8	Batten Fastener			PCS	362.4		
9	Soffit			SF	239.0		
10	Soffit Fastener			PCS	119.5		
11	Fascia			FT	154.0		
12	Fascia board fastener			PCS	77		
13	Roof Insulation			SF	1016.0		
14							
15							