


EMBER

The Ember is a charming Farmhouse-style studio home. Its exterior showcases walls are finished with horizontal siding in a light, neutral tone. A simple gable roof provides shelter while a covered porch extends from the main entrance, supported by slender white columns creating a welcoming entry way.

Inside, the Ember features a simple rectangular layout. The living and kitchen areas are merged into one large room at the center of the house, creating a spacious and versatile living space. The Bedroom and functional spaces, such as the bathroom and laundry, are conveniently located on one side of the plan, while the one-car garage is situated on the other side.

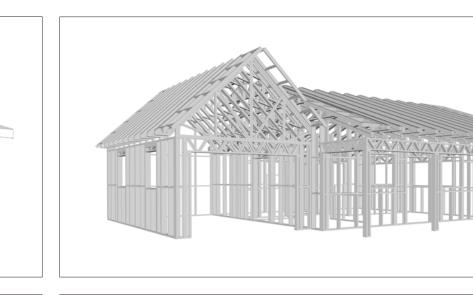

Materials Shopping List

Please print and take this Materials Shopping List to your favorite Home Depot and ask for assistance in selecting the materials, fixtures and fittings to complete your new home.

Record your selection and the price of the item. Then do the math to determine the cost for your selections and the total cost of finishing your home.



< CLICK HERE >

To Go To Materials Shopping List






FLOOR PLAN

624 SF

1 Bed Room




TABLE OF CONTENTS

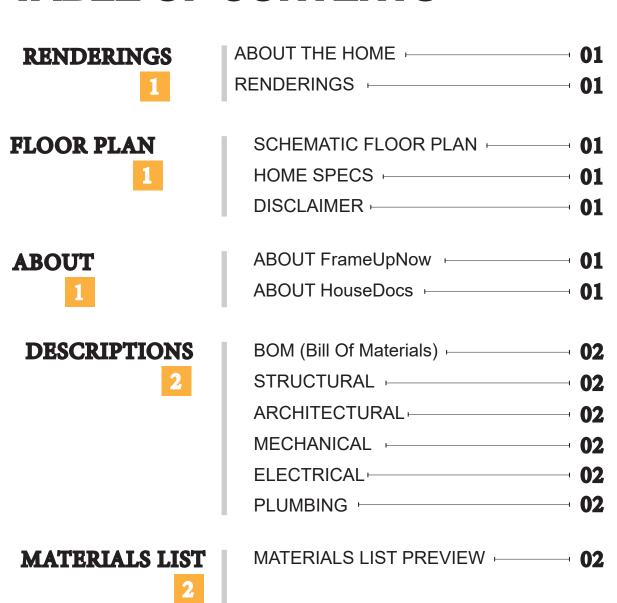

ARCHITECTURAL

HOW TO BUILD

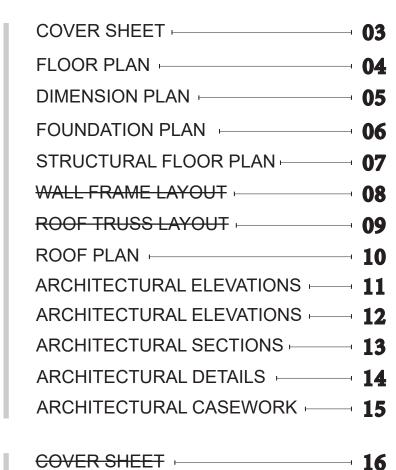

CONSTRUCTION STEPS

STRUCTURAL

MATERIALS

SHOPPING LIST

SIRUCIURAL	OOVER OHEET	1
16	GENERAL NOTES	17
	WALL FRAME LAYOUT	18
	WALL PANEL & LAYOUT PLAN	19
	ROOF TRUSS LAYOUT	20
	STRUCTURAL SECTIONS	2
	WALL BRACING LAYOUT	22
	HOLD-DOWN PLAN	23
	STRUCTURAL DETAILS 1	24
	STRUCTURAL DETAILS 2	2!
	STRUCTURAL DETAILS 3	20
	TRUSS BLOCKING LAYOUT	27
	SHEETROCK BACKING	
	ROOF BRACING LAYOUT	29
MECHANICAL	COVER SHEET -	. 30
30	HVAC PLAN	
ELECTRICAL	SCHEDULE -	. 21
BLECTRICAL	LIGHTING -	
32	POWER PLAN -	
	DIMENSION FOR LIGHTING -	_
	DIMENSION FOR FITTING -	· <i>5</i> (
PLUMBING	NOTES AND SCHEDULES	37
37	WATER SUPPLY & SEWAGE SYSTEM	38
I.		

MATERIALS SHOPPING LIST

ABOUT



FrameUpNow is a design and manufacturing company providing precision-engineered home framing solutions. We offer a catalog of Affordable Homes, Tiny Homes, Garages, Shops and Barndominiums. FrameUpNow manufactures cold-formed steel (CFS) also known as Light Gauge Steel (LGS) framing components that conform to our engineered metal house frame plans or can be purchased as DIY skeleton kits.

The CFS/LGS framing is lightweight, easily assembled, and does not require heavy equipment or specialized labor, enabling homeowners to erect the frame themselves in just a few days. Unlike wood, the steel framing is impervious termites and bores, warping, expansion, and fire.

Our home plans come complete with a structural engineered stamp for permit approvals. Customers receive a full BOM also known as a Materials Shopping List to purchase finish materials from a Building Materials retailer. FrameUpNow prides itself on the quality and efficiency of our precision-engineered home framing solutions for construction professionals and DIY homeowners.



KEY PLAN

NO.	DESCRIPTION	DATE

NOTE:

LEGEND:

PROJECT

238-Ember-624-1Bd 1Ba-Farmhouse-550

DRAWING NAME

INTRODUCTION

CLIENT NAME:
PROJECT NUMBER:
DATE:
DESIGNED BY:
DRAWN BY:
CHECKED BY:

1101

SCALE:

DISCLAIMER

DISCLAIMER: This documentation and all it's contents are the intellectual property of FrameUpNow. It is provided solely for marketing the services of FrameUpNow. The preliminary information is not approved for actual construction use and is not warranted to be complete or accurate. Unauthorized copying, distribution, or application of these proprietary materials, in any form or format, is strictly prohibited. FrameUpNow assumes no liability for any issues arising from improper use of this marketing content.

DESCRIPTIONS

MATERIALS LIST

The BOM (Bill Of Materials) package, known as the Materials Shopping List document, provides:

Comprehensive Inventory: Detailed lists of essential materials sourced from architectural, mechanical, HVAC, electrical, and plumbing design drawing sets.

Precise Curation: Each item meticulously selected and organized for accuracy and efficiency in project planning.

Customizable Options: Customers can modify listed items to their preferences and calculate costs accordingly, ensuring alignment with personal project needs and budget.

Dedicated Space for Details: Includes tables for customers to note Home Depot SKU numbers or product descriptions for selected items, facilitating seamless purchasing and coordination with suppliers.

Customer Convenience: Take the list to Home Depot or preferred suppliers for accurate pricing, helping align the total home budget with personal financial plans.

Simplify your construction journey with our Materials Shopping List document, where detailed preparation meets streamlined implementation for your dream home.

HVAC Sections and Riser Diagrams: Technical drawings offering

critical cross-sectional details and piping schematics, ensuring

proper integration of the heating and cooling system into the home's

Bill of Materials: A complete list of all necessary HVAC components.

MECHANICAL

STRUCTURAL

The structural drawings package provides an exhaustive set of detailed plans essential for the precise assembly of your building. This comprehensive package includes:

Framing Plans: Detailed layouts for all framing components. Truss Layouts: Clear instructions for truss placement and

Panel Length Plans: Specifications for panel dimensions. Framing Elevations and Sections: Precise elevation and sectional views for accurate construction.

Truss and Wall Blocking Plans: Plans for truss and wall blocking to ensure structural integrity.

Hold-Down Plan: Detailed hold-down requirements for stability. Snap Sheet: Reference sheet for quick identification of components

Structural Details and Bracing Plans: Complete details and bracing plans for all structural elements.

Accompanying these plans is a comprehensive Bill of Materials (BOM) that lists every necessary building component, from cold formed steel (CFS) frames to fasteners.

ARCHITECTURAL

With the comprehensive architectural package, both builders and DIY homeowners can confidently execute the construction.

The architectural package includes:

Furnished Floor Plans: Complete with furniture layouts for a clear understanding of space utilization.

Detailed Dimension Plans: Ensures precise measurements, from the overall footprint down to the exact placement of windows and

Foundation Plan: Detailed plan to establish a solid foundation.

Wall Framing and Truss Layout: Comprehensive plans for wall framing and truss placement.

Architectural Elevations: Exterior views showcasing the design.

Strategic Building Sections: Critical cross-sectional details for a thorough understanding of the build.

Casework Drawings and Diagrams: Suggested designs for built-in caseworks, such as kitchen cabinets.

ELECTRICAL

The mechanical package includes everything needed to guide HVAC The electrical package includes all the plans and documentation needed to guide the installation of your home's electrical system:

Detailed HVAC Floor Plan: Precisely maps out the placement of air Detailed Power Plan: Precisely maps out the placement of outlets, handlers, ductwork, and vents throughout the home's layout. switches, and other power components throughout the layout.

> Comprehensive Lighting Plan: Shows the optimal locations for lighting fixtures, sconces, and other illumination sources to create a well-lit, functional interior.

Dimensioned Electrical Layout: Provides exact dimensions and measurements to ensure proper placement of all electrical elements.

Bill of Materials: A complete list of every component needed, from circuit breakers to wiring.

The plumbing package includes everything needed to guide the

Detailed Water Supply System Plan: Precisely maps out the placement of pipes, valves, and plumbing fixtures throughout the

Comprehensive Sewage System Plan: Shows the optimal routing and sizing of drain lines to effectively remove waste and ensure

Detailed Riser Diagrams: Provide information needed to properly

pipes to fixtures.

PLUMBING

installation of your home's water supply and drainage systems:

proper drainage.

install all vertical plumbing risers and vent stacks.

Bill of Materials: A complete list of every component needed, from

BOM (Bill Of Materials) (Separately Attached)





The Bill of Materials (BOM) is a crucial document that compiles the material requirements from different disciplines into a centralized inventory, enabling efficient procurement, inventory management, and cost estimation for a specified project or


ELECTRICAL BOM

structure.



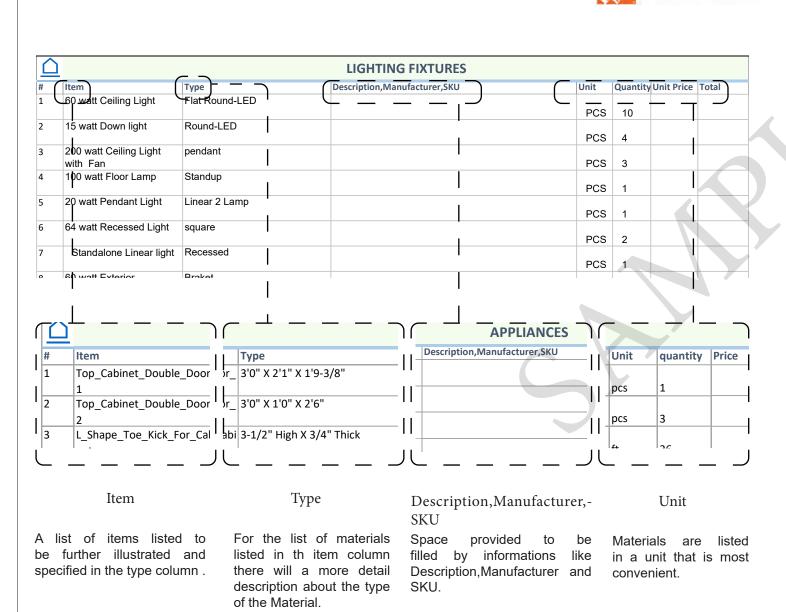

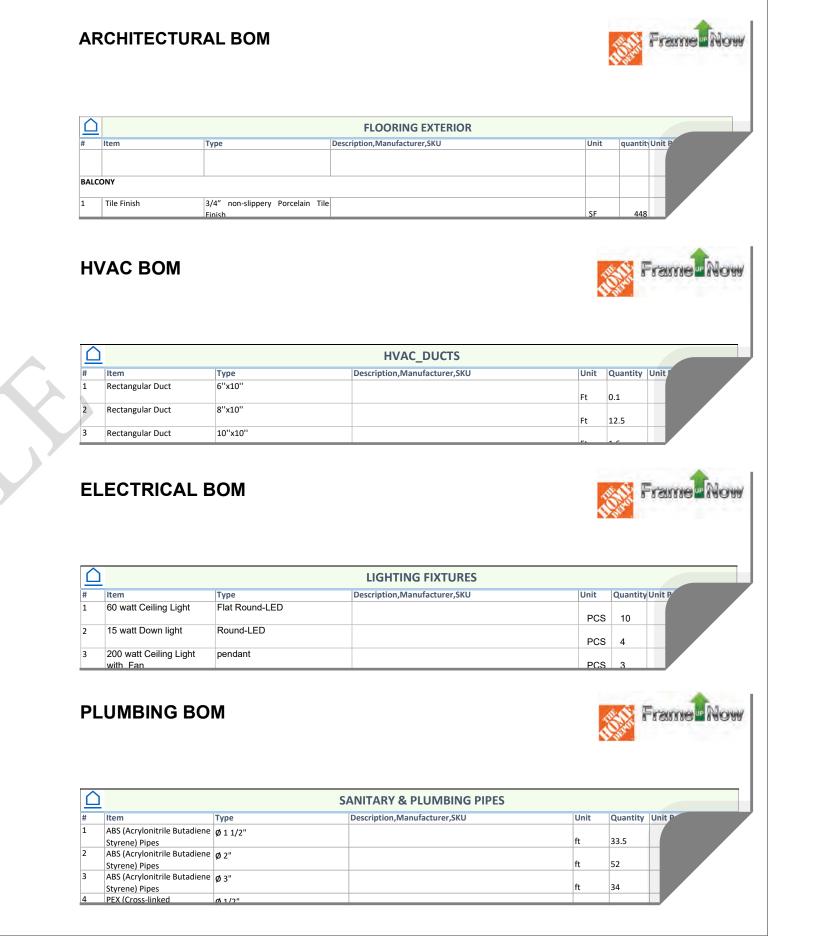

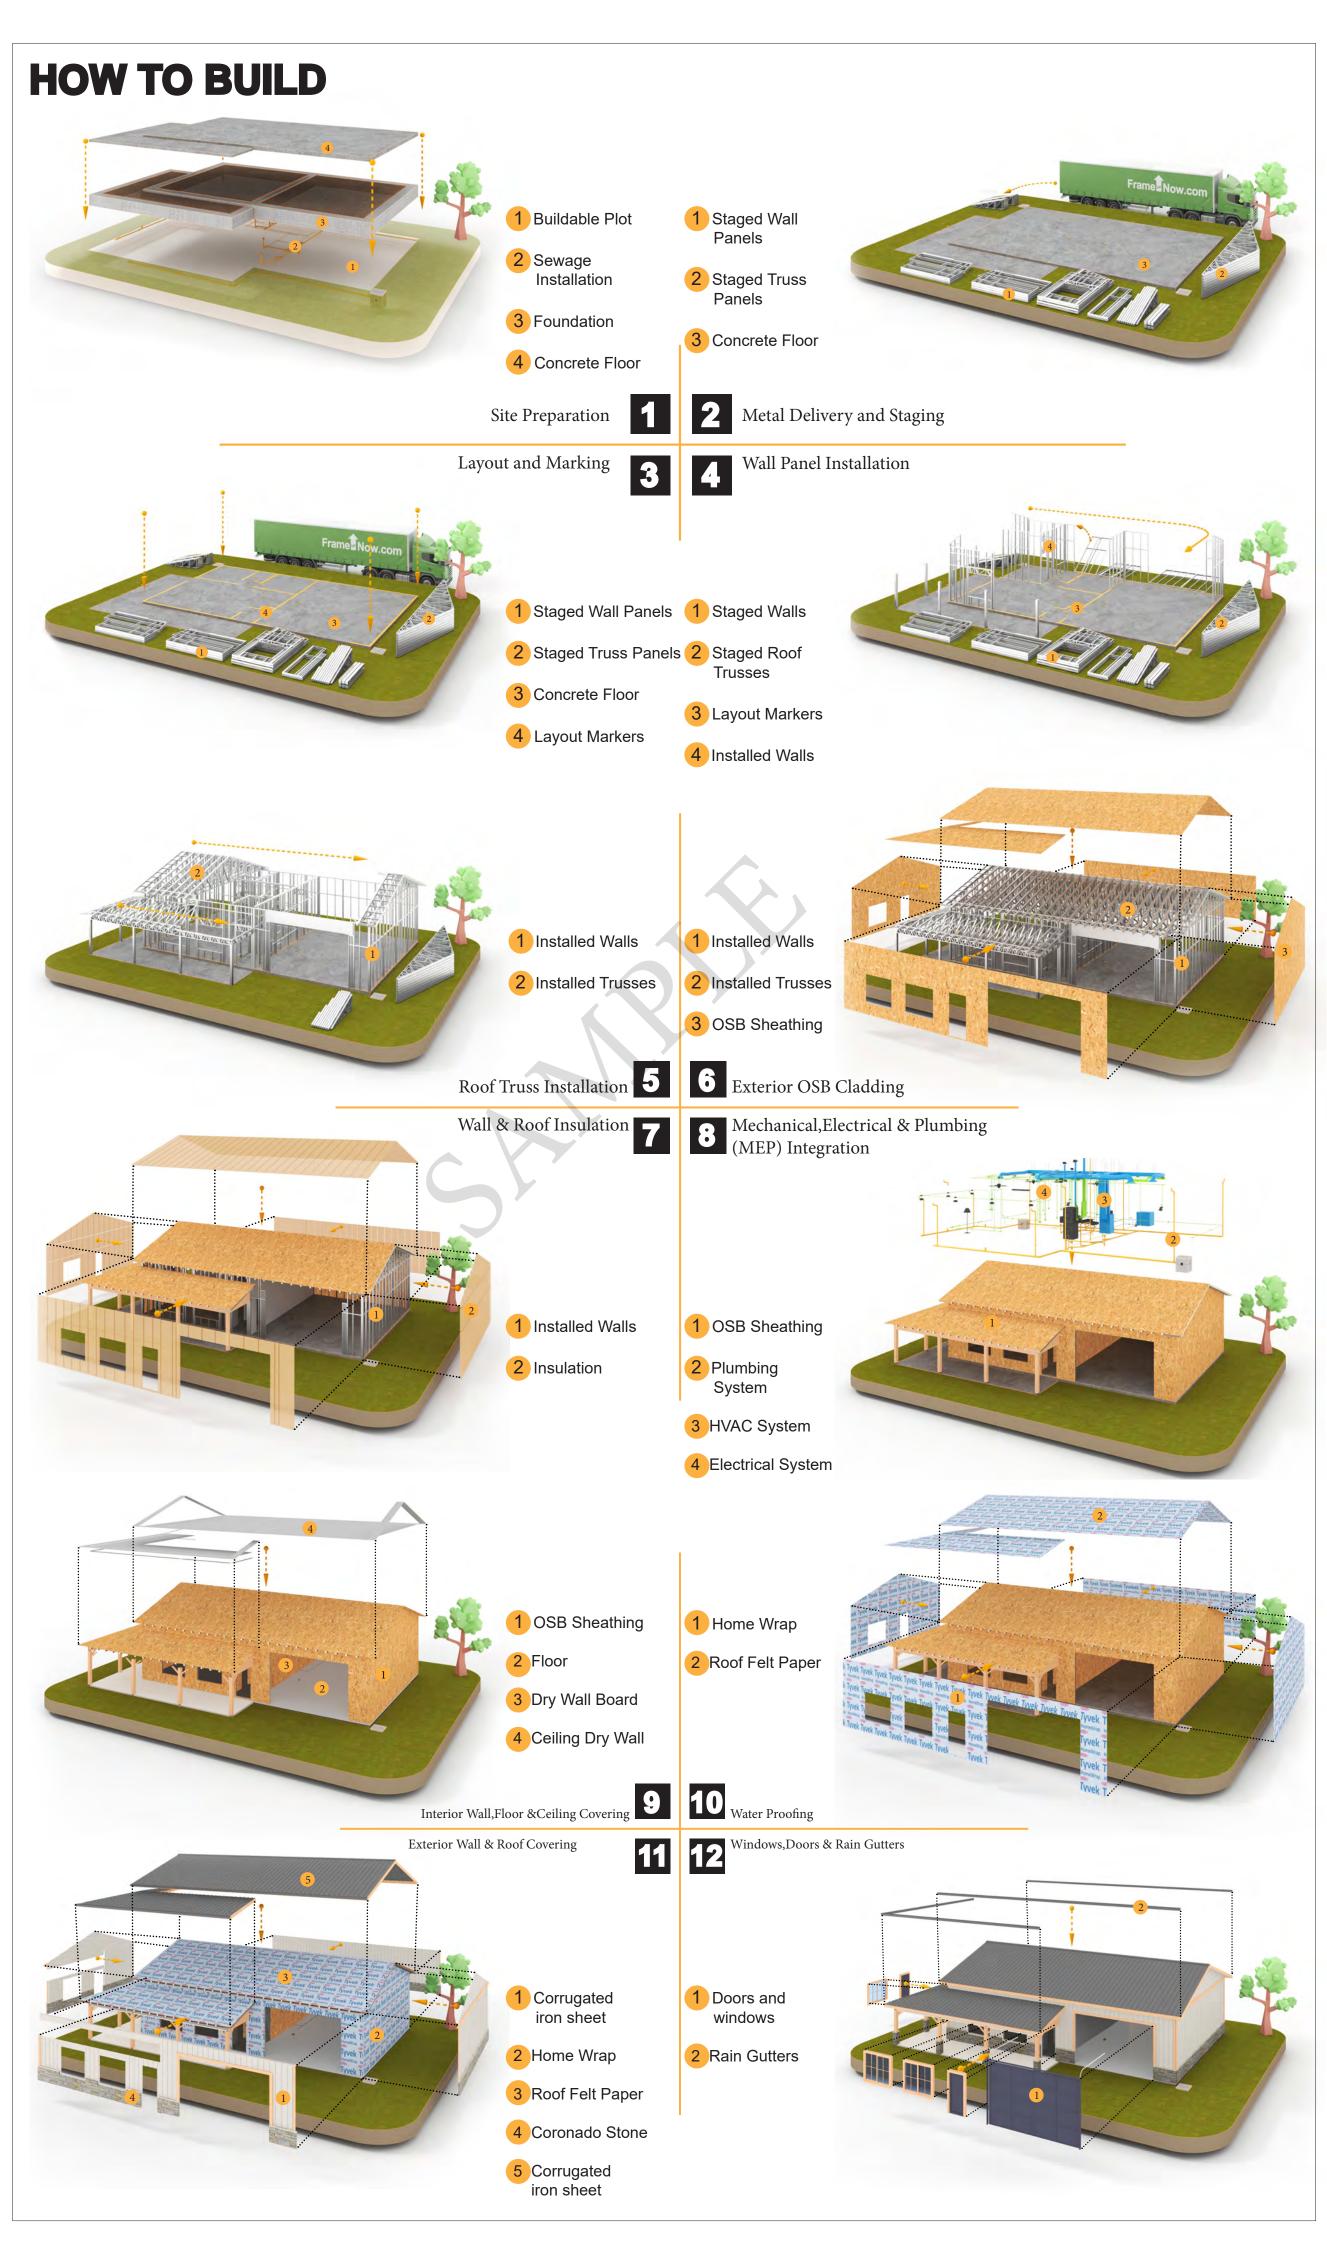



KEY PLAN

NO.	DESCRIPTION	DATE

NOTE:

LEGEND:

PROJECT

238-Ember-624-1Bd 1Ba-Farmhouse-550


DRAWING NAME

INTRODUCTION

CLIENT NAME: PROJECT NUMBER: DATE: **DESIGNED BY** DRAWN BY: CHECKED BY:

1102

SCALE:

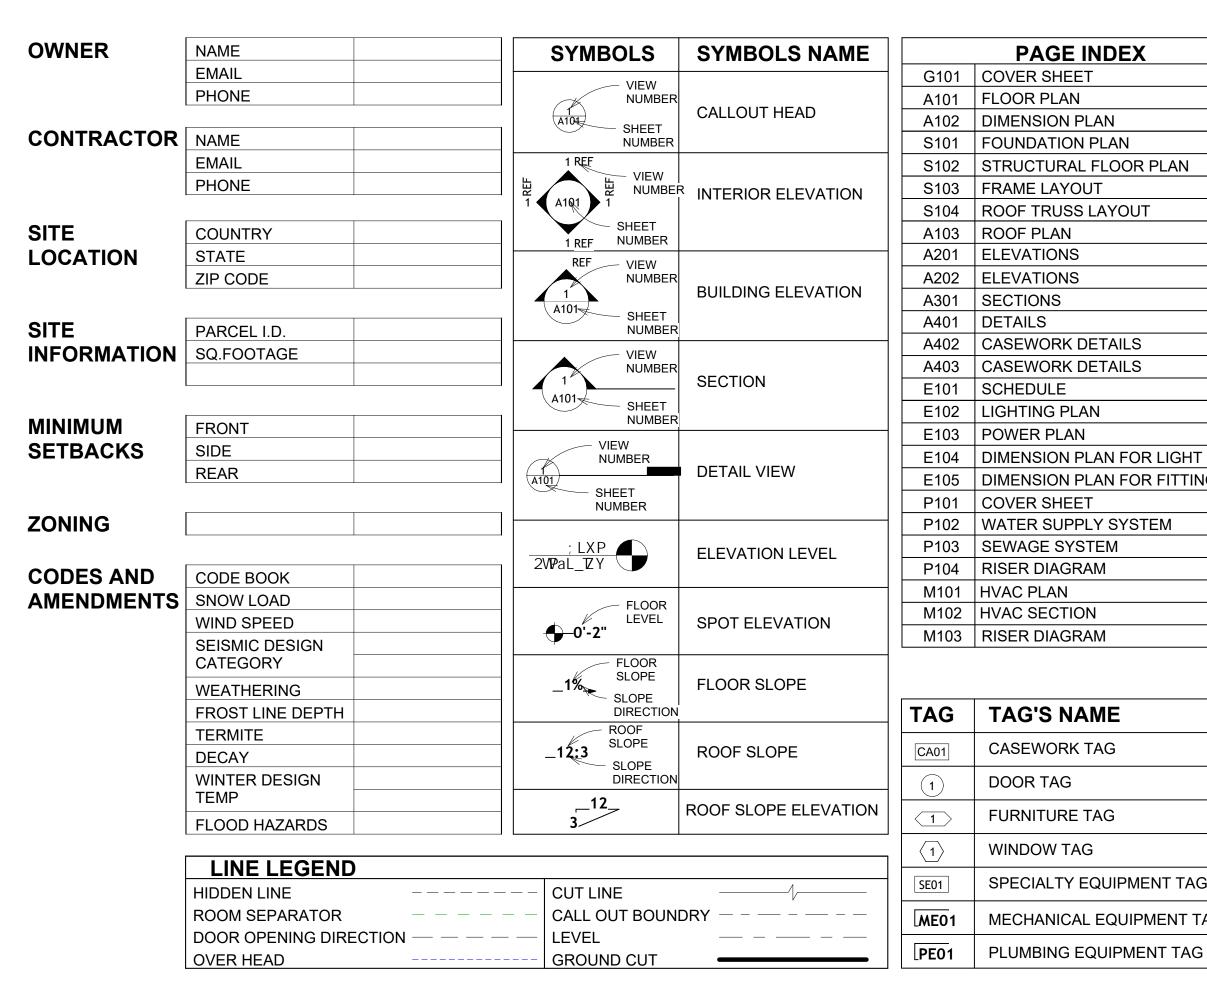

٦		
		PAGE INDEX
	G101	COVER SHEET
	A101	FLOOR PLAN
	A102	DIMENSION PLAN
	S101	FOUNDATION PLAN
	S102	STRUCTURAL FLOOR PLAN
	S103	FRAME LAYOUT
	S104	ROOF TRUSS LAYOUT
	A103	ROOF PLAN
1	A201	ELEVATIONS
	A202	ELEVATIONS
	A301	SECTIONS
	A401	DETAILS
1	A402	CASEWORK DETAILS
	A403	CASEWORK DETAILS
	E101	SCHEDULE
	E102	LIGHTING PLAN
1	E103	POWER PLAN
	E104	DIMENSION PLAN FOR LIGHT FIXTURE
	E105	DIMENSION PLAN FOR FITTING
	P101	COVER SHEET
1	P102	WATER SUPPLY SYSTEM
	P103	SEWAGE SYSTEM
	P104	RISER DIAGRAM
1	M101	HVAC PLAN
	M102	HVAC SECTION
	M103	RISER DIAGRAM

F.F.E

F.F.L

HVAC

MAX.


ME

O.C

TAG'S NAME		HOLDDOWN
	SIMP. ABE66	SIMPSON ANCHOR BOLT EDGE
CASEWORK TAG	TV	TELEVISION
DOOR TAG	UNO	UNLESS NOTED OTHERWISE
	W/	WITH
FURNITURE TAG	W/D	WASHER/DRYER
WINDOW TAG	AC	AIR CONDITIONING UNIT
SPECIALTY EQUIPMENT TAG	ACC	AIR COOLED CONDENSER
MECHANICAL EQUIPMENT TAG	ACCU AHU	AIR COOLED CONDSENSING UNIT
		AIR HANDLING UNIT
PLUMBING EQUIPMENT TAG	CC	COOLING COIL
	CD	CEILING DIFFUSER
	CFm	Cubic Feet Per Minute
	CR	CEILING REGISTER
	CU	CONDENSING UNIT
	CW	COLD WATER
	E/A	EXHAUST AIR
	EF	EXHAUST FAN
	ET	EXPANSION TANK
	EX.	EXISTING
	FC	FLEXIBLE CONNECTION
	FCU	FAN COIL UNIT
	FLR.	FLOOR
	HC	HEATING COIL
	HE	AIR TO AIR HEAT EXCHANGER
	HV	HEATING AND VENTILATING UNI
	IV	INLET VANES
	MER	MECHANICAL ROOM
	MAX.	MAXIMUM
	MIN.	MINIMUM
	R/A	RETURN AIR
	RCU	RECIPROCATING CHILLER UNIT
	RF	RETURN FAN
	S/A	SUPPLY AIR


SMOKE CONTROL DAMPER

STATIC PRESSURE

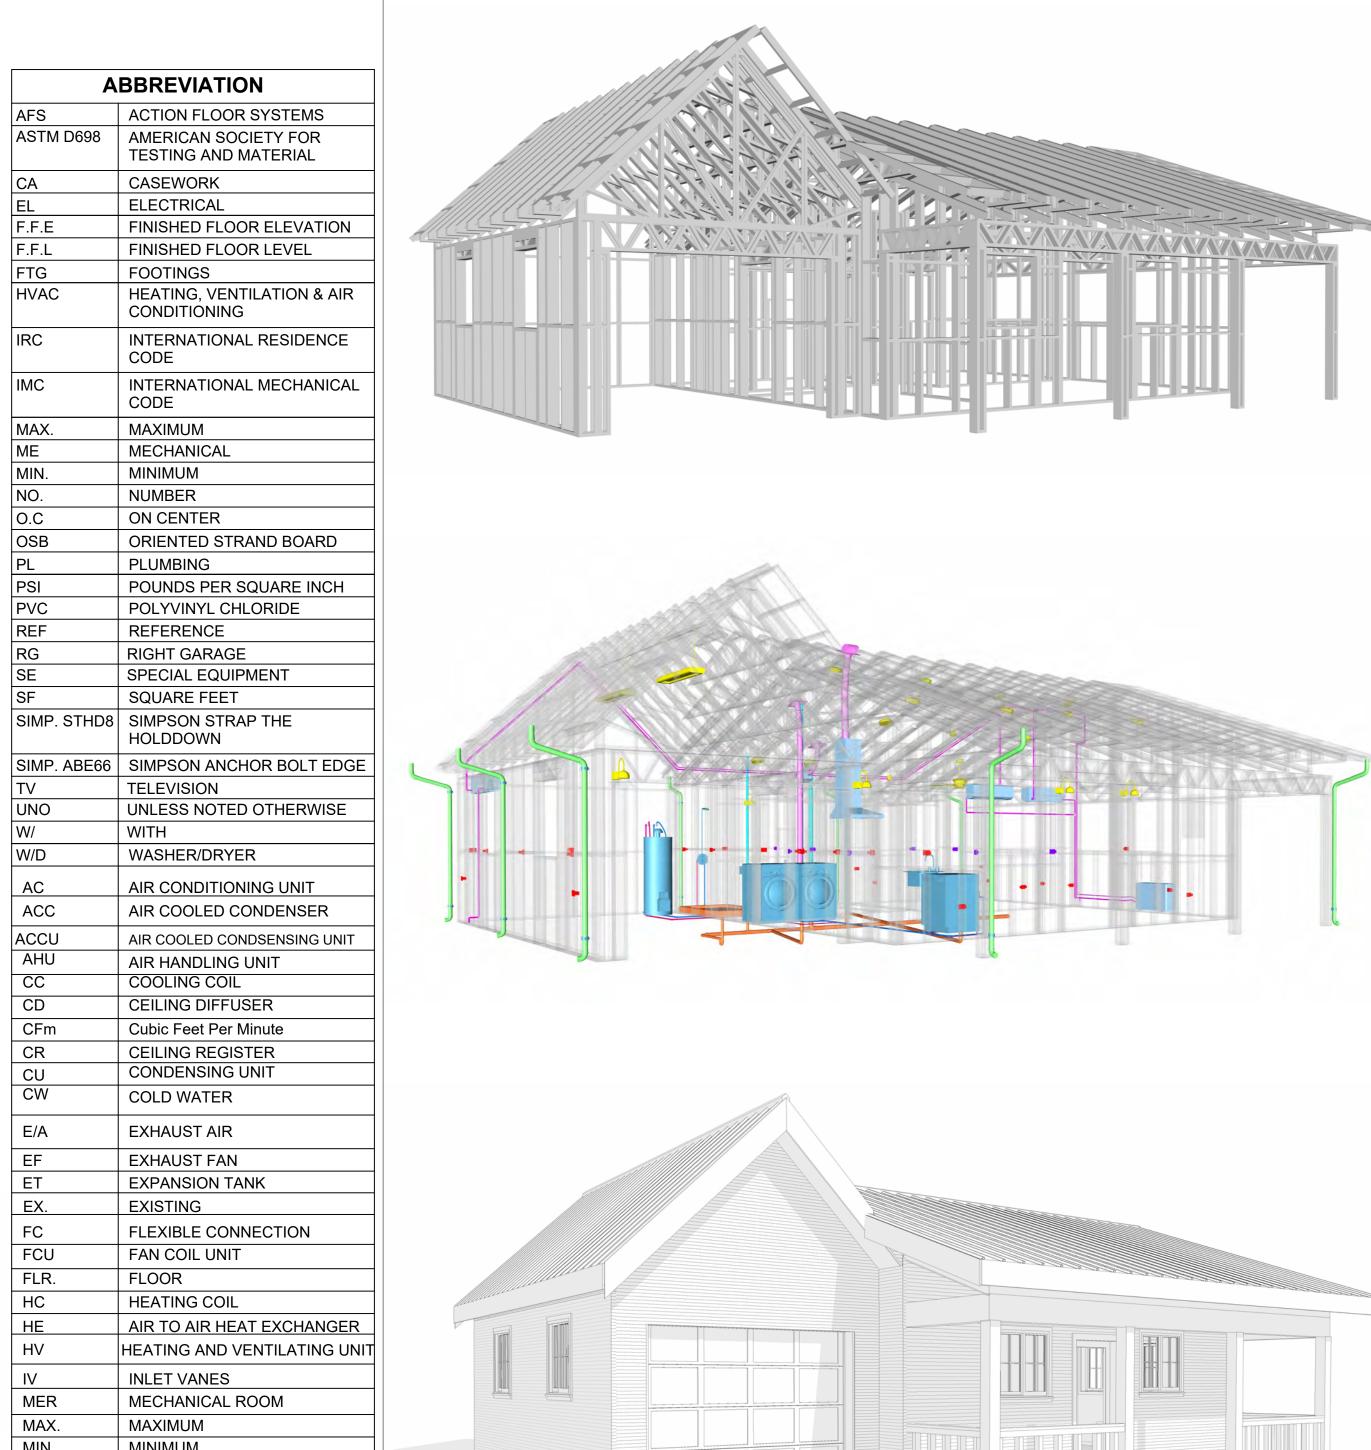

238-EMBER-624-1Bd1Ba **FARMHOUSE-550**

SQUARE FOOTAGE			
LIVING	624		
GARAGE	286		
PORCH	145		
TOTAL	1055		

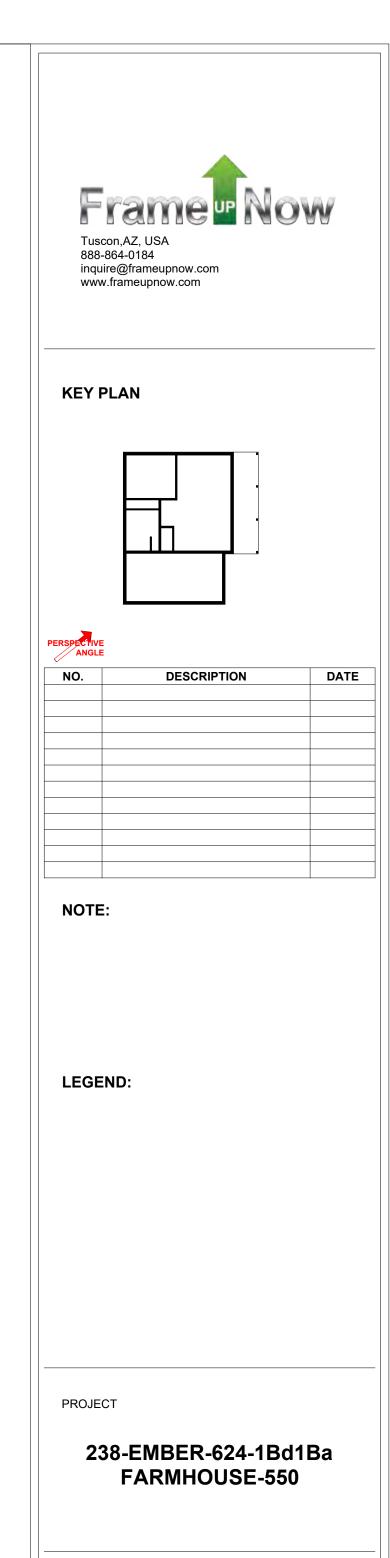

DRAWING NAME

COVER SHEET

Client Nam	CLIENT NAME:	
0033_1	PROJECT NUMBER:	
5/14/2025 11:15:24 A	DATE:	
Designe	DESIGNED BY:	
Autho	DRAWN BY:	
Checke	CHECKED BY:	

GENERAL NOTES

- 1. THIS DRAWING DEPICTS THE ARCHITECTURAL (SPACE LAYOUT, FURNISHING, FLOOR, WALLS, ROOFS, FOUNDATION, WINDOWS AND DOORS) SYSTEMS. IT PROVIDES A VISUAL REPRESENTATION OF THE ARCHITECTURAL LAYOUT AND COMPONENTS.
- 2. THE ARCHITECTURAL DRAWINGS ARE PREPARED TO MEET THE SPECIFIC REQUIREMENTS OF THE BUILDING, AS PER THE PROJECT SPECIFICATIONS AND APPLICABLE CODES AND
- 3. THE CONSTRUCTION OF THIS HOME SHALL COMPLY WITH THE LATEST EDITION OF THE INTERNATIONAL RESIDENTIAL CODE (IRC), INTERNATIONAL MECHANICAL CODE (IMC), THE INTERNATIONAL PLUMBING STANDARD, THE NATIONAL ELECTRICAL STANDARD AND ALL OTHER APPLICABLE LOCAL, STATE, AND NATIONAL CODES AND REGULATIONS.
- 4. COORDINATION WITH OTHER TRADES HAS BEEN DONE ON A DESIGN LEVEL. THIS DRAWING SHALL BE READ TOGETHER WITH THE ME, EL AND PL DESIGN DRAWINGS TO ENSURE PROPER CONSTRUCTION AND INTEGRATION OF THE BUILDING SYSTEMS.

ABOUT WALLS:

. SHOWER WALL COVERING

BATHTUB AND SHOWER SPACES (WALLS AND FLOORS) WITH INSTALLED SHOWER HEADS AND IN SHOWER COMPARTMENTS SHALL BE FINISHED WITH A NON-ABSORBENT SURFACE.

2. WALL PAINT (INTERNAL)

THE TYPICAL THICKNESS OF LATEX WALL PAINT IS 1/32 OF AN INCH FOR A SINGLE COAT. AND DOUBLE COAT (1/16") SHALL BE APPLIED FOR DURABILITY.


3. **ADHESIVES:**

THE ADVISABLE TYPE OF ADHESIVE FOR THIS PROJECT IS **EPOXY ADHESIVES** BECAUSE THEY ARE KNOWN FOR THEIR HIGH STRENGTH, DURABILITY, AND RESISTANCE TO MOISTURE, CHEMICALS AND HEAT.

REFER TO SHEETS A201 & A202 FOR GENERAL NOTES ON EXTERNAL FINISHING MATERIALS

ABOUT FLOORS:

- 1. THE SPOT ELEVATION INDICATES THE FINISHED FLOOR ELEVATION.
- 2. FINISHED FLOORS PER PLANS.
- 3. FIELD VERIFY FOR DIMENSION DROP 4" FOR SHOWER AND BATHTUB USE.
- 4. 1% SLOPE ON OUTDOOR BALCONIES FOR WATER RUN OFF.
- 5. 2% SLOPE TOWARDS THE SHOWER DRAIN FOR SUFFICIENT DRAINAGE.
- 6. 4" DROP AT THE DOOR LEADING TO EXTERIOR BALCONY FROM THE MAIN LIVING AREA.
- 7. 5% SLOPE FOR GARAGE IS USED, WHICH SHOULD BE CHECKED WITH THE LOCAL GARAGING ZONING LAWS.

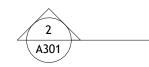



FURNITURE SCHEDULE			
TYPE MARK TYPE COUNT			
1	STOOL-BAR_SMARTBIM	2	
2	FIVE SIT 68" X 126" 2	1	
3	KING SIZE BED	1	

ROOM FINISH SCHEDULE							
ROOM NUMBE R	ROOM NAME	FLOOR FINISH	BASE FINISH	WALL FINISH	CEILING FINISH	CEILING HEIGHT	COMMENT
1	BEDROOM	HARDWOOD	CONCRETE	WALL PAINT	DRY WALL	8' - 0"	
2	KITCHEN	HARDWOOD	CONCRETE	WALL PAINTT + CERAMIC	DRY WALL	8' - 0"	
3	LIVING ROOM	HARDWOOD	CONCRETE	WALL PAINT	DRY WALL	8' - 0"	
4	GARAGE	EPOXY	CONCRETE	WALL PAINT	DRY WALL	8' - 0"	
5	PORCH	HARDWOOD	CONCRETE	EXTERIOR-GRADE PLYWOOD	PLYWOOD	8' - 0"	
6	BATH	VINYL TILES	CONCRETE	CERAMIC	MRD	8' - 0"	
7	WD	HARDWOOD	CONCRETE	WALL PAINT	DRY WALL	8' - 0"	
8	HALL	HARDWOOD	CONCRETE	WALL PAINT	DRY WALL	8' - 0"	
9	CL	HARDWOOD	CONCRETE	WALL PAINT	DRY WALL	8' - 0"	





KEY PLAN

NO.	DESCRIPTION	DATE

NOTE:

LEGEND:

PROJECT

238-EMBER-624-1Bd1Ba **FARMHOUSE-550**

DRAWING NAME

FLOOR PLAN


CLIENT NAME:	Client Name
PROJECT NUMBER:	0033_15
DATE:	5/14/2025 11:15:26 AI
DESIGNED BY:	Designer
DRAWN BY:	Author
CHECKED BY:	Checker

A101

SCALE: As indicated

TOTAL

1055

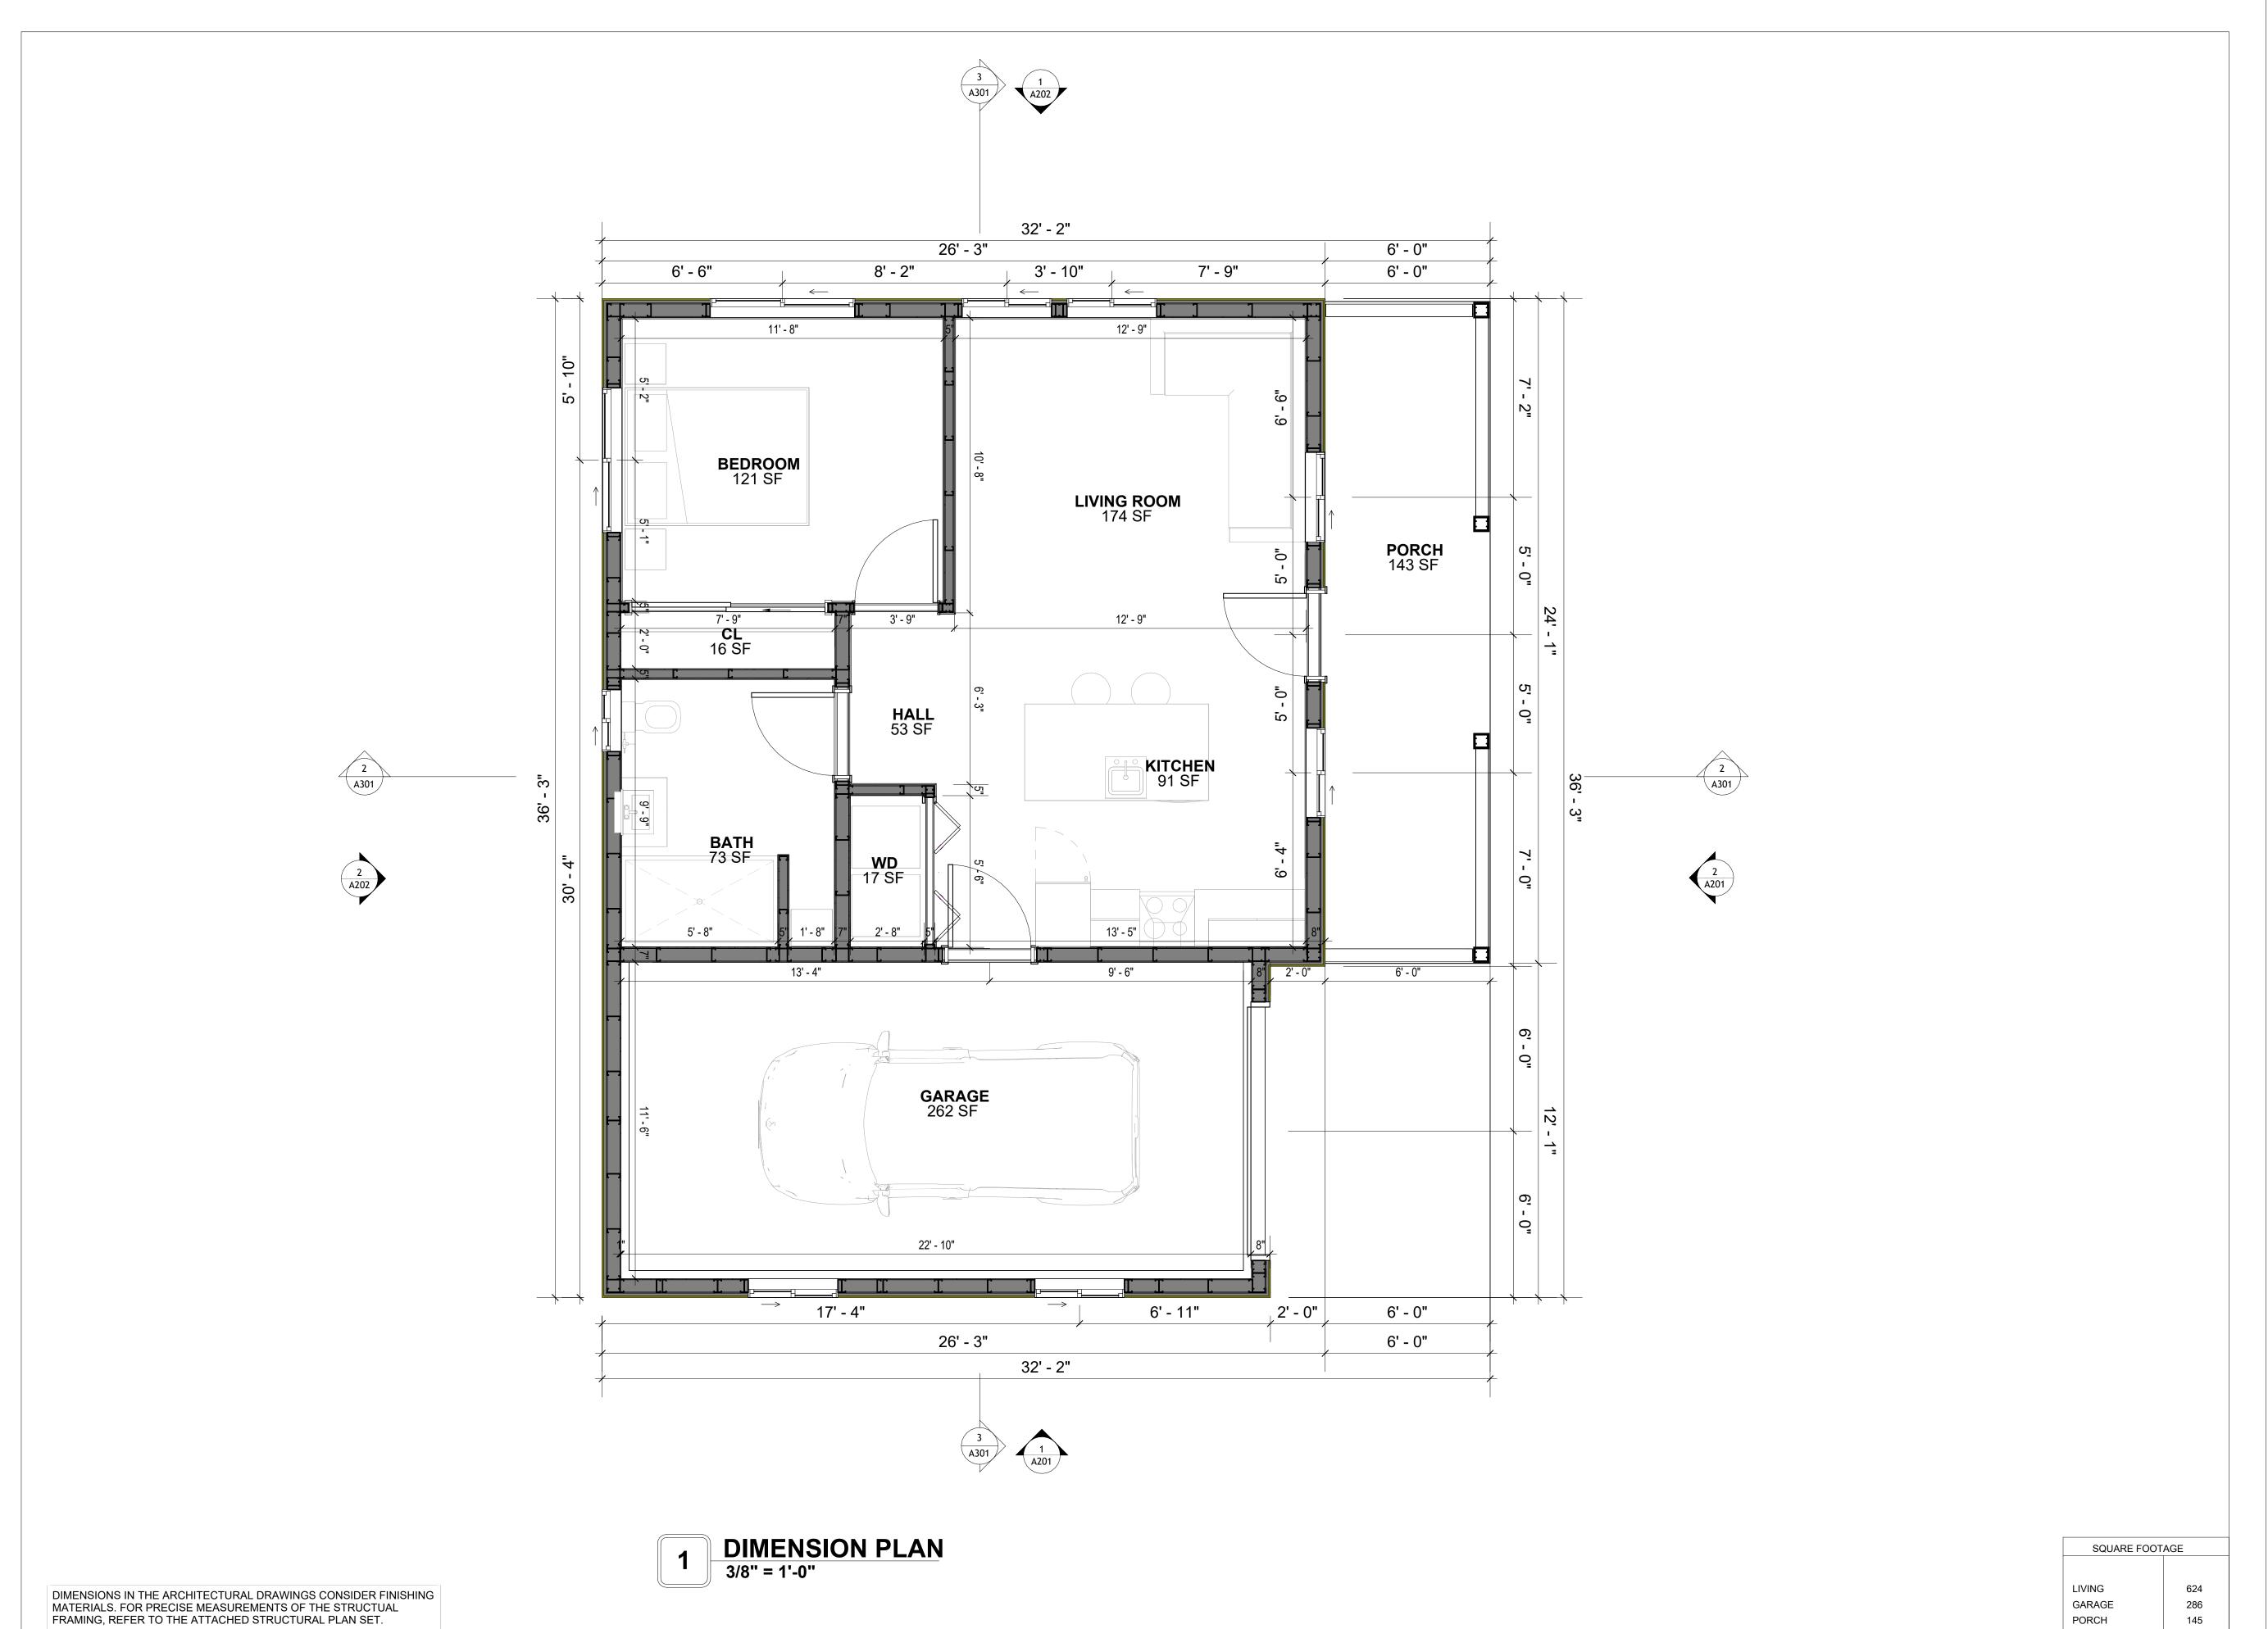



KEY PLAN

NO.	DESCRIPTION	DATE

NOTE:

LEGEND:

PROJECT

238-EMBER-624-1Bd1Ba **FARMHOUSE-550**

DRAWING NAME

DIMENSION PLAN

Client Name	CLIENT NAME:	
0033_15	PROJECT NUMBER:	
5/14/2025 11:15:29 AI	DATE:	
Designe	DESIGNED BY:	
Autho	DRAWN BY:	
Checker	CHECKED BY:	

A103

SCALE: 3/8" = 1'-0"

145

1055

TOTAL

FOUNDATION NOTES

NOTES:

TERMITES PRETREATMENT BY LICENSED CONTRACTOR UNDER SLAB AND AROUND FOOTINGS. ALL AREAS BELOW SLABS SHALL BE TREATED NO MORE THAN 24 HOURS PRIOR TO CONCRETE POUR. EVIDENCE OF TREATMENT MUST BE PROVIDED PRIOR TO PLACING OF CONCRETE.

MATERIALS:

ALL INTERIOR CONCRETE SLABS SHALL BE A MIN. OF 4" THICK CONCRETE OVER 4" COMPACTED AGGREGATE BASE (ASTM D698), FINISH ELEVATIONS AS NOTED ON DRAWINGS, 6" ABOVE ADJACENT GRADE, LEVEL SLABS TO 1/8"-10' MAX.. CONCRETE SLABS SHALL BE 2500# PSI AT 28 DAYS. A 4" ALLOWABLE SLUMP.

2. PAD PREPARATION:

- EXCAVATION FOR FOOTING SHALL BE NEAT.

- FOOTINGS SHALL BE POURED IMMEDIATELY AFTER EXCAVATION AND APPROPRIATE INSPECTION.

- ALL REINFORCING STEEL MARKED "CONTINUOUS" SHALL BE LAPPED 36 BAR DIAMETERS AT SPLICES AND AROUND CORNERS OR INTERSECTIONS WITH A STANDARD 90 DEGREE BEND ON CORNER BARS. LAP WIRE MESH ONE FULL MESH AT SIDE AND END LAPS.

- ALL HARDWARE TO BE SIMPSON OR EQUIVALENT.

- EXTERIOR FRAME WALL TO BE SECURED WITH 1/2"X10" ANCHOR BOLTS 4'-0" O.C. FOR 1-STORY AND 2'-8" O.C. FOR 2-STORY. BOLTS SHALL BE LOCATED WITHIN 1'-0" OF EACH END PIECE AND SHALL HAVE A MIN. OF TWO BOLTS PER PIECE.

-FOUNDATION ANCHOR STRAPS SHALL BE PERMITTED, ACCORDING TO RESIDENTIAL CODE

- ALL INTERIOR WALLS TO BE SECURED WITH POWER DRIVEN PINS PER MANUFACTURER SPECIFICATION USE PIN SPACING EQUIVALENT TO 1/2" ANCHOR BOLTS.

SPECIFICATION USE PIN SPACING EQUIVALENT TO 1/2" ANCHOR BOLTS.
- ALL CONSTRUCTION TO CONFORM TO THE 2012 IRC

R-10 RIGID INSULATION OUTSIDE OF EXTERIOR FOUNDATION WALLS UNDER LIVING AREA.
 CONCRETE PAD FOR CONDENSER THICKNESS IS 4" MIN UNLESS OTHERWISE NOTED.

3. CONCRETE CONSTRUCTION:

- THE SLAB SHALL BE UNDERLAIN BY A VAPOR BARRIER/RETARDER IN THE LIVING AREA (TYPICALLY POLYETHYLENE, UNLESS MORE STRINGENT PROTECTION REQUIRED BY THE ARCHITECT, ENGINEER, FLOOR COVERING MANUFACTURER, OR ACCEPTED PRACTICE). UNLESS OTHERWISE REQUIRED, BARRIER MAY BE OMITTED AT GARAGES, PORCHES AND PATIOS WITHOUT FLOOR COVERINGS. IT IS BEYOND THE SCOPE OF THESE PLANS TO DETERMINE THE APPLICABILITY OF THESE MORE STRINGENT REQUIREMENTS. BUILDER SHALL VERIFY PRIOR TO CONSTRUCTION.

4. REINFORCEMENT:

- IF CONSTRUCTED ON ACTIVE SOILS, THE LONG TERM PERFORMANCE OF THE FOUNDATION IS DEPENDENT ON MAINTENANCE BY THE OWNER. THUS THE BUILDER SHALL ADVISE THE OWNER OF THE FOLLOWING:

1. DRAINAGE MUST BE MAINTAINED. WATER SHALL NEVER BE ALLOWED TO POND NEAR THE FOUNDATION.

2. THE SOIL AROUND THE FOUNDATION SHALL BE MAINTAINED IN A RELATIVELY DAMP CONDITION, SUCH AS THAT REQUIRED TO KEEP A LAWN GREEN. IF IT DRIES OUT IT WILL SHRINK. IF IT GETS WET, IT WILL HEAVE UPWARD.

3. SLABS ON THE SHORTER SIDE USES MAIN BARS ARE USED IN THIS DIRECTION ONLY WITH SMALLER DIAMETER DISTRIBUTION BARS ARE PLACED, FORMING A MAT OR GRID.
4. ALL REINFORCEMENT BARS SIZE 10MM OR LARGER IN ACCORDANCE TO ASTM

3. ANCHOR BOLTS AT ALL EXTERIOR WALLS SHALL BE MINIMUM 1/2 INCH DIAMETER WITH A MAXIMUM SPACING OF 6'-0" ON CENTER, UNLESS NOTED OTHERWISE.

4. ANCHOR BOLTS SHALL BE INSTALLED WITHIN 12 INCHES OF EACH END OF EACH SILL

PLATE WITH AT LEAST TWO ANCHOR BOLTS FOR EACH BOLTS FOR EACH SILL PLATE LONGER THAN 12 INCHES.

5. SIMPSONS SILL ANCHORS MAYBE SUBSTITUTED FOR ANCHOR BOLTS AT THE SAME SPACING.

6. EXTERIOR CONCRETE SLABS WHICH ARE NOT PART OF THE MAIN SLAB SHALL BE MINIMUM 4 INCHES THICK WITH NO STEEL REINFORCING BARS REQUIRED, UNLESS NOTED OTHERWISE ON FOUNDATION PLAN.

VERIFY THE FOLLOWING PRIOR TO POURING:

I. ALL HOLDDOWNS , STRAP, AND POST LOCATIONS.

CONCRETE FINISHES. PANEL RISER LOCATION - WHERE APPLICABLE.

3. UNDERSLAB MECHANICAL REQUIREMENTS.

STEM WALL BLOCKOUTS.
 UNDERSLAB FLECTRICAL REQUIR

5. UNDERSLAB ELECTRICAL REQUIREMENTS AND PANEL RISER LOCATION. WHERE APPLICABLE.


6. PROVIDE THE FOLLOWING:

- PVC SLEEVES THROUGH FTG IF REQUIRED

- 20' #4 COPPER GROUND BAR.

7. SLOPE FINISH GRADE AWAY FROM FOOTING.

NOTE: FIELD VERIFY ALL DIMENSIONS SEE DIMENSIONED ARCHITECTURAL DRAWINGS

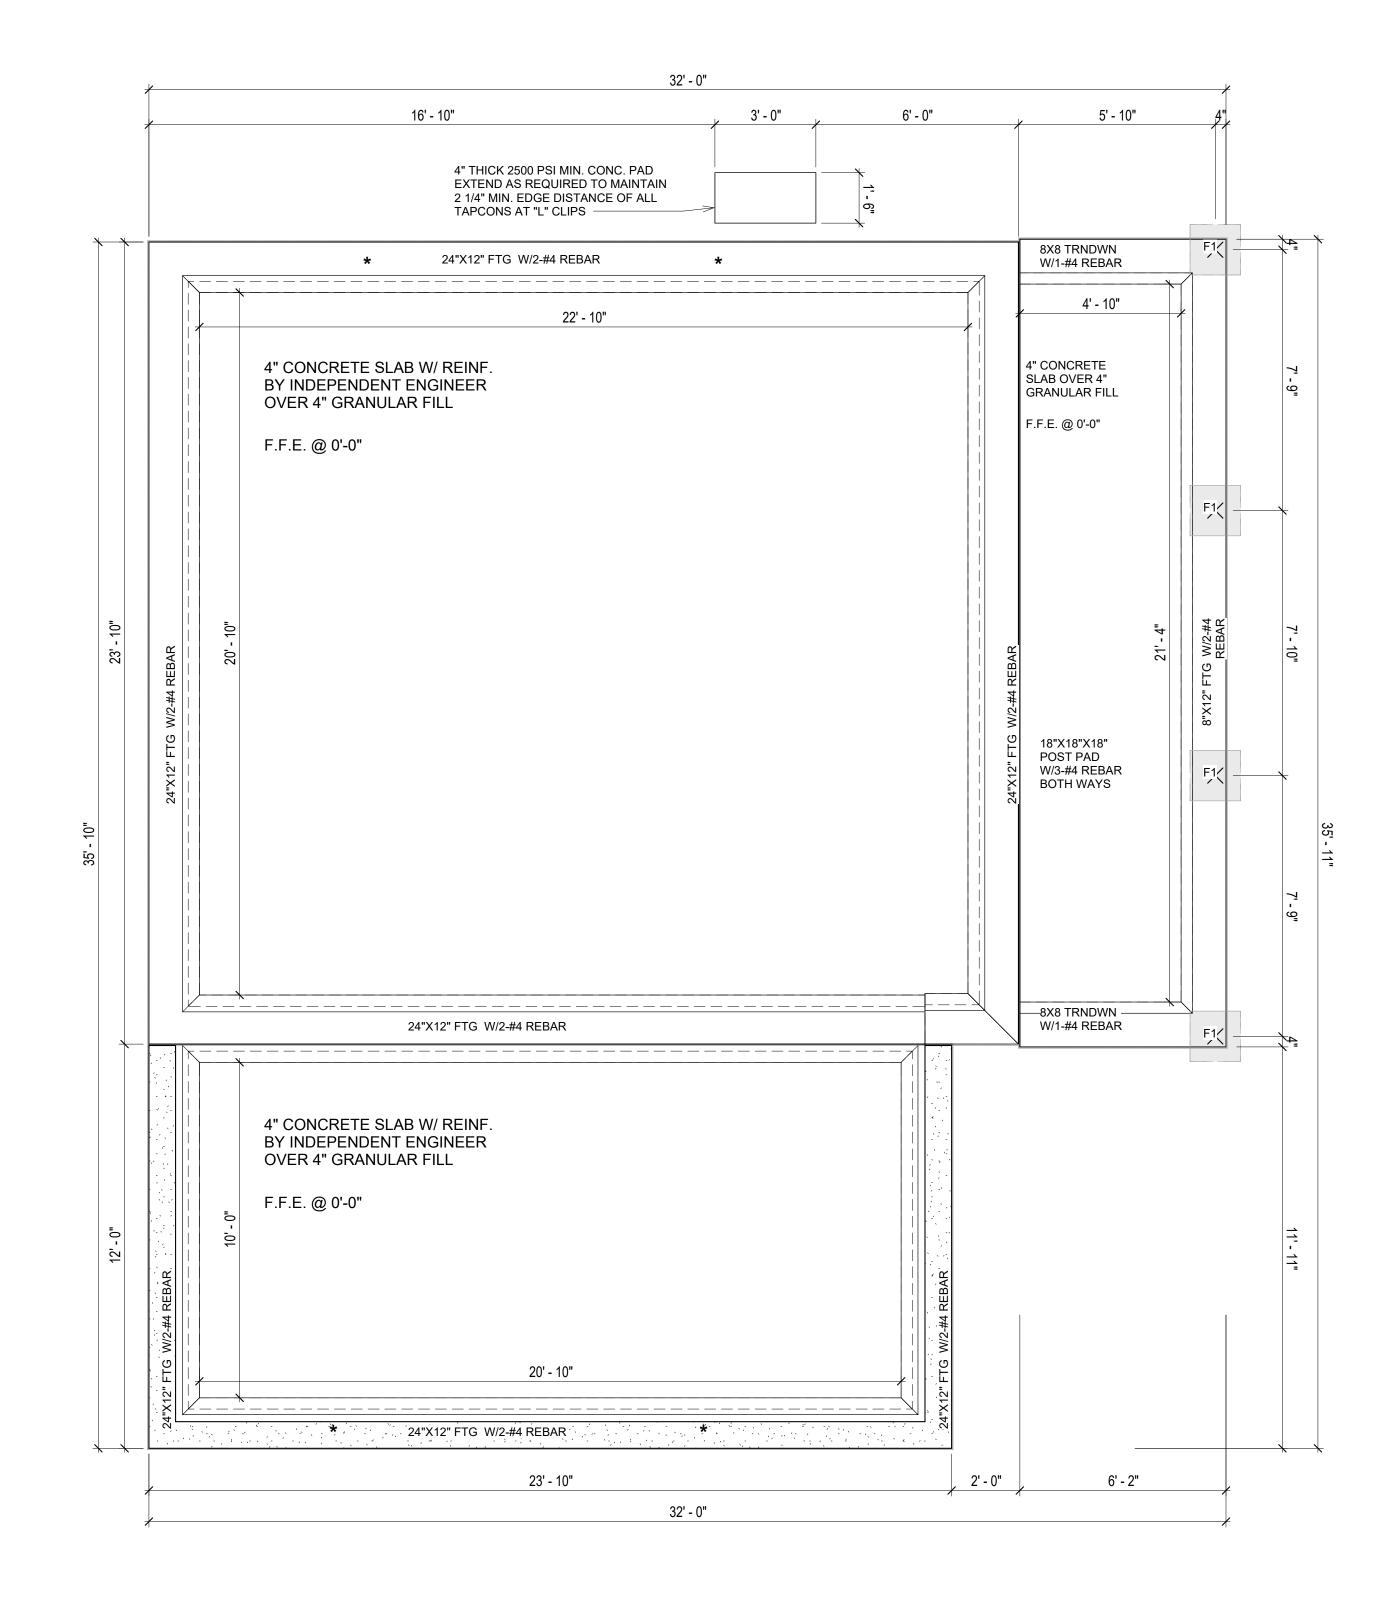

1 FOUNDATION PLAN
3/8" = 1'-0"

SQUARE FOOT	AGE
LIVING	624
GARAGE	286
PORCH	145
TOTAL	1055



KEY PLAN

NO.	DESCRIPTION	DATE

NOTE:

LEGEND:

PROJECT

238-EMBER-624-1Bd1Ba FARMHOUSE-550

DRAWING NAME

FOUNDATION PLAN

CLIENT NAME:	Client Name
PROJECT NUMBER:	0033_15
DATE:	5/14/2025 11:15:30 AM
DESIGNED BY:	Designer
DRAWN BY:	Author
CHECKED BY:	Checker

S101

SCALE: 3/8" = 1'-0"

GENERAL NOTES

-ALL BEARING WALLS SHOULD HAVE A THICKENED SLAB PER SECTION PER DETAIL A401/5.

A) FOUNDATION PLAN NOTES:

- CONCRETE SLAB SHALL BE 6" THICK WITH 1/2" DIAMETER TENDONS PER LAYOUT PLAN, CENTERED IN SLAB THICKNESS, OVER APPROVED SUBBASE PER GENERAL STRUCTURE
- 2. TERMITE PROTECTION SHALL BE PROVIDED PER IRC SECTION R318.1 NONE TYPICAL ANCHOR BOLT SPACING AT SHEAR WALL AND HOLD DOWN
- SPECIFICATIONS PER APPROVED ARCHITECTURAL PLANS.
- 4. INSTALL HOLDOWNS BEFORE CONCRETE SLAB POUR. 5. EXISTING FILL ON-SITE SHALL BE COMPACTED IN ACCORDANCE WITH THE

REQUIREMENTS IN THE GEOTECHNICAL REPORT.

6. ALL FLOOR SLABS ARE REINFORCED ON CONCRETE SLABS.

SPECIAL INSPECTION IS REQUIRED FOR THICKENED FOUNDATION CONSTRUCTION

1. REINFORCEMENT

2. 2300 PSI CONCRETE POUR


B) **REINFORCEMENT FOR CONCRETE**:

1. ALL REINFORCING SLABS BARS SIZE 10MM OR LARGER SHALL BE DEFORMED IN ACCORDANCE TO ASTM-A706, AND BARS SMALLER THAN 10 MM MAYBE PLAIN. 2. UNLESS OTHERWISE NOTED IN PLANS. THE YIELD STRENGTH OF REINFORCING BARS SHALL BE:

> A) FOOTING = 40,000 PSI B) NON-LOAD BEARING WALLS AND PARAPETS= 40,000 PSI

- SPLICES SHALL BE SECURELY WIRED TOGETHER AND SHALL LAP OR EXTEND GRADE OF STEEL FOR RCC WORKS SHALL BE GRADE 4 10.
- 5. BAR NOTATIONS GIVES INFORMATION
 - A) BAR SIZE B) SPACING(IF REQUIRED)
- 6. LAP REINFORCEMENT ONLY AT LOCATION SHOWN IN THE DRAWINGS
- REINFORCEMENT SHALL NOT BE CUT, VENT OR HEATED ON SITE WITHOUT ENGINEERS' APPROVAL.
- C) CONCRETE SLAB NOTES
- 1. ALL SLAB REINFORCEMENT SHALL BE 20MM CLEAR MINIMUM FROM BOTTOM AND FROM
- 2. REINFORCEMENT IN CONTINUOUS ELEVATED SLAB SHALL BE CUT AS FOLLOWS.

- THIS IS A SCHEMATIC PLAN FOR THE PURPOSE OF LOCATING AND IDENTIFYING FOUNDATION REINFORCING ELEMENTS ONLY. VERIFY ALL DIMENSIONS, DROPS, OFFSETS AND FEATURES WITH THE ARCHITECTURAL PLANS BEFORE FORMING THE FOUNDATION.

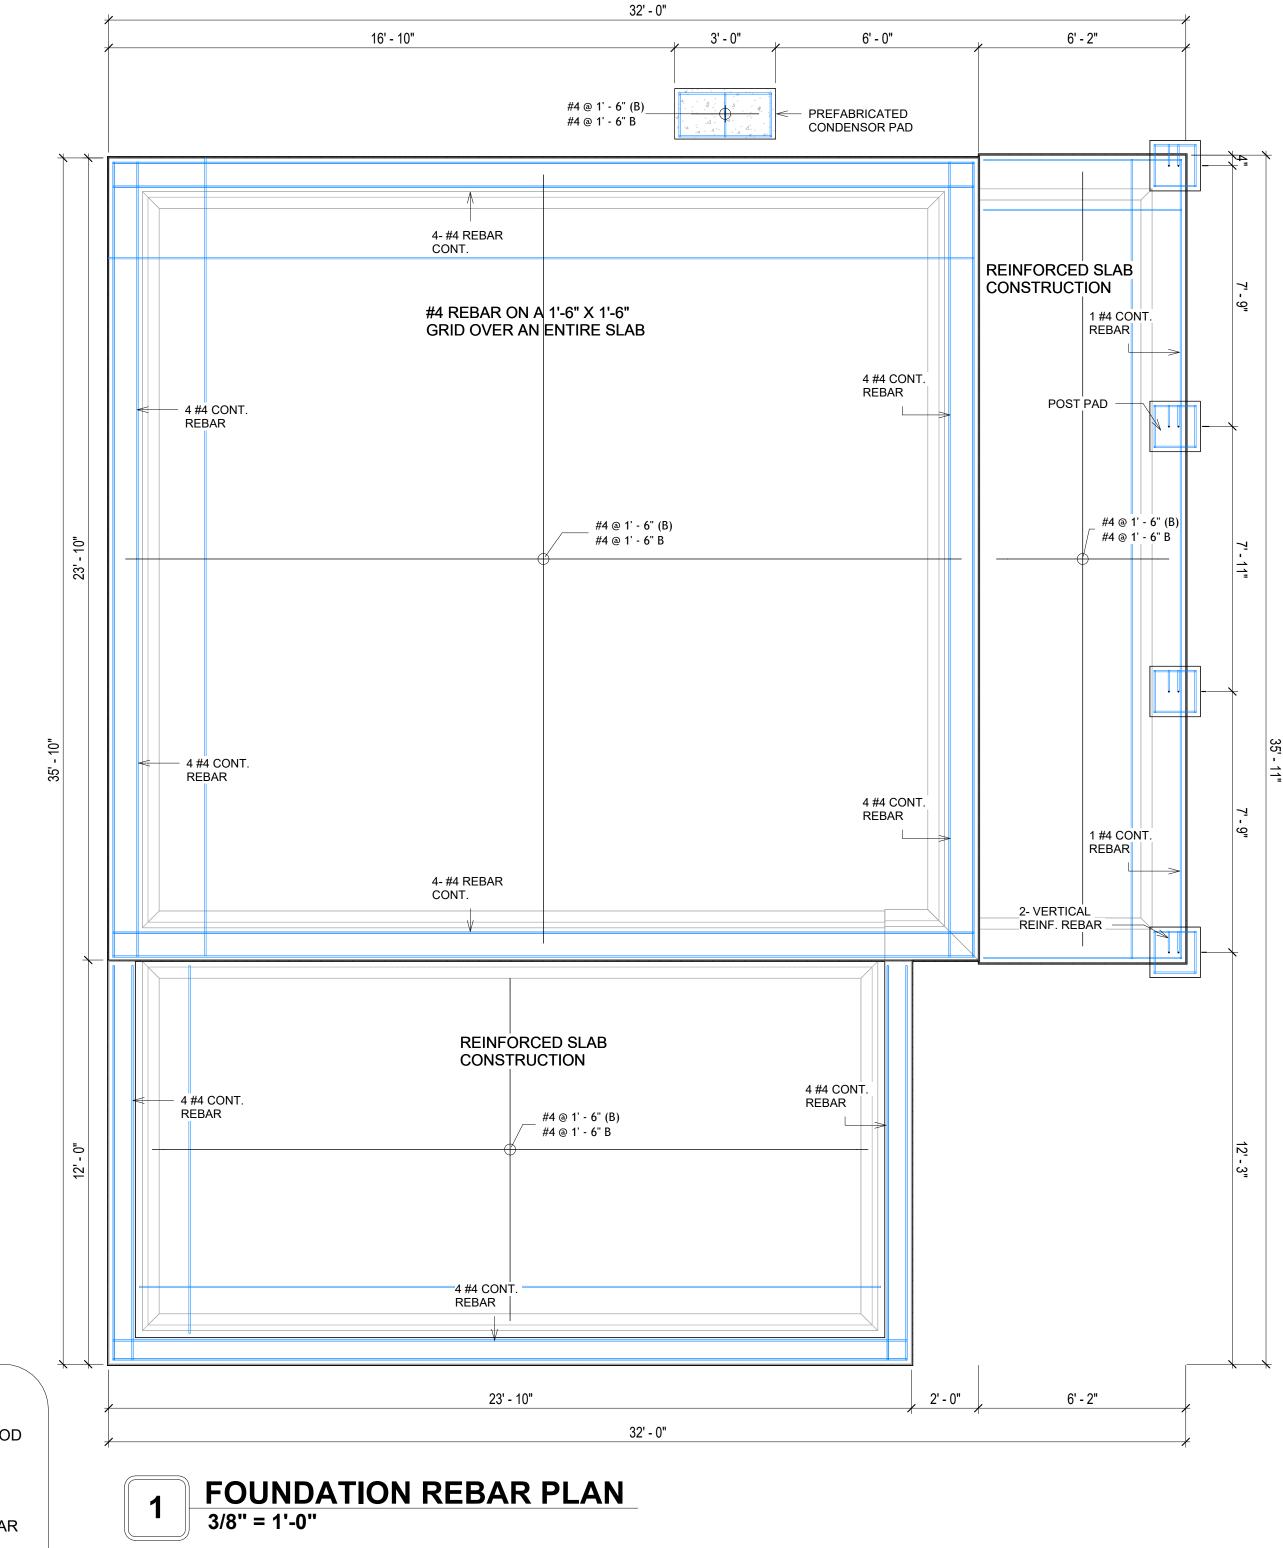

888-864-0184 inquire@frameupnow.com www.frameupnow.com

KEY PLAN

DESCRIPTION DATE NOTE:

LEGEND:

PROJECT


238-EMBER-624-1Bd1Ba **FARMHOUSE-550**


DRAWING NAME


STRUCTURAL FLOOR PLAN

Client Name CLIENT NAME: PROJECT NUMBER: 0033_15 5/14/2025 11:15:31 AM DESIGNED BY: Designer DRAWN BY: **Author** CHECKED BY: Checker

S102

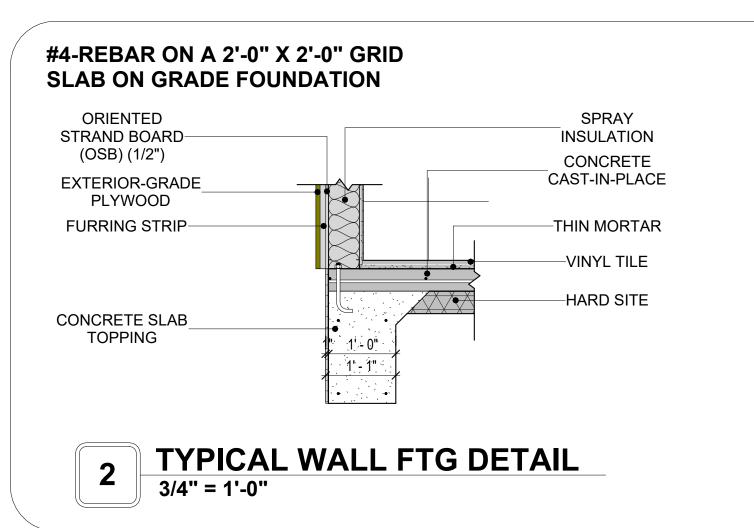

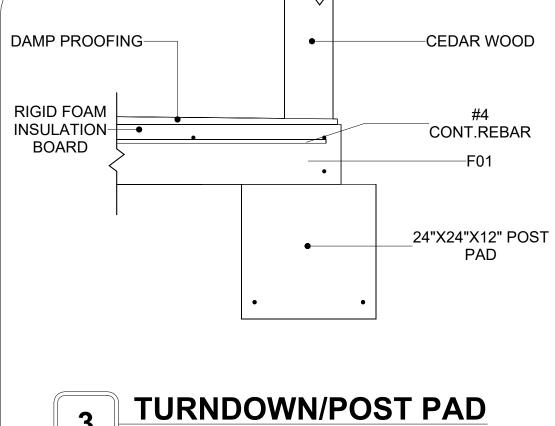

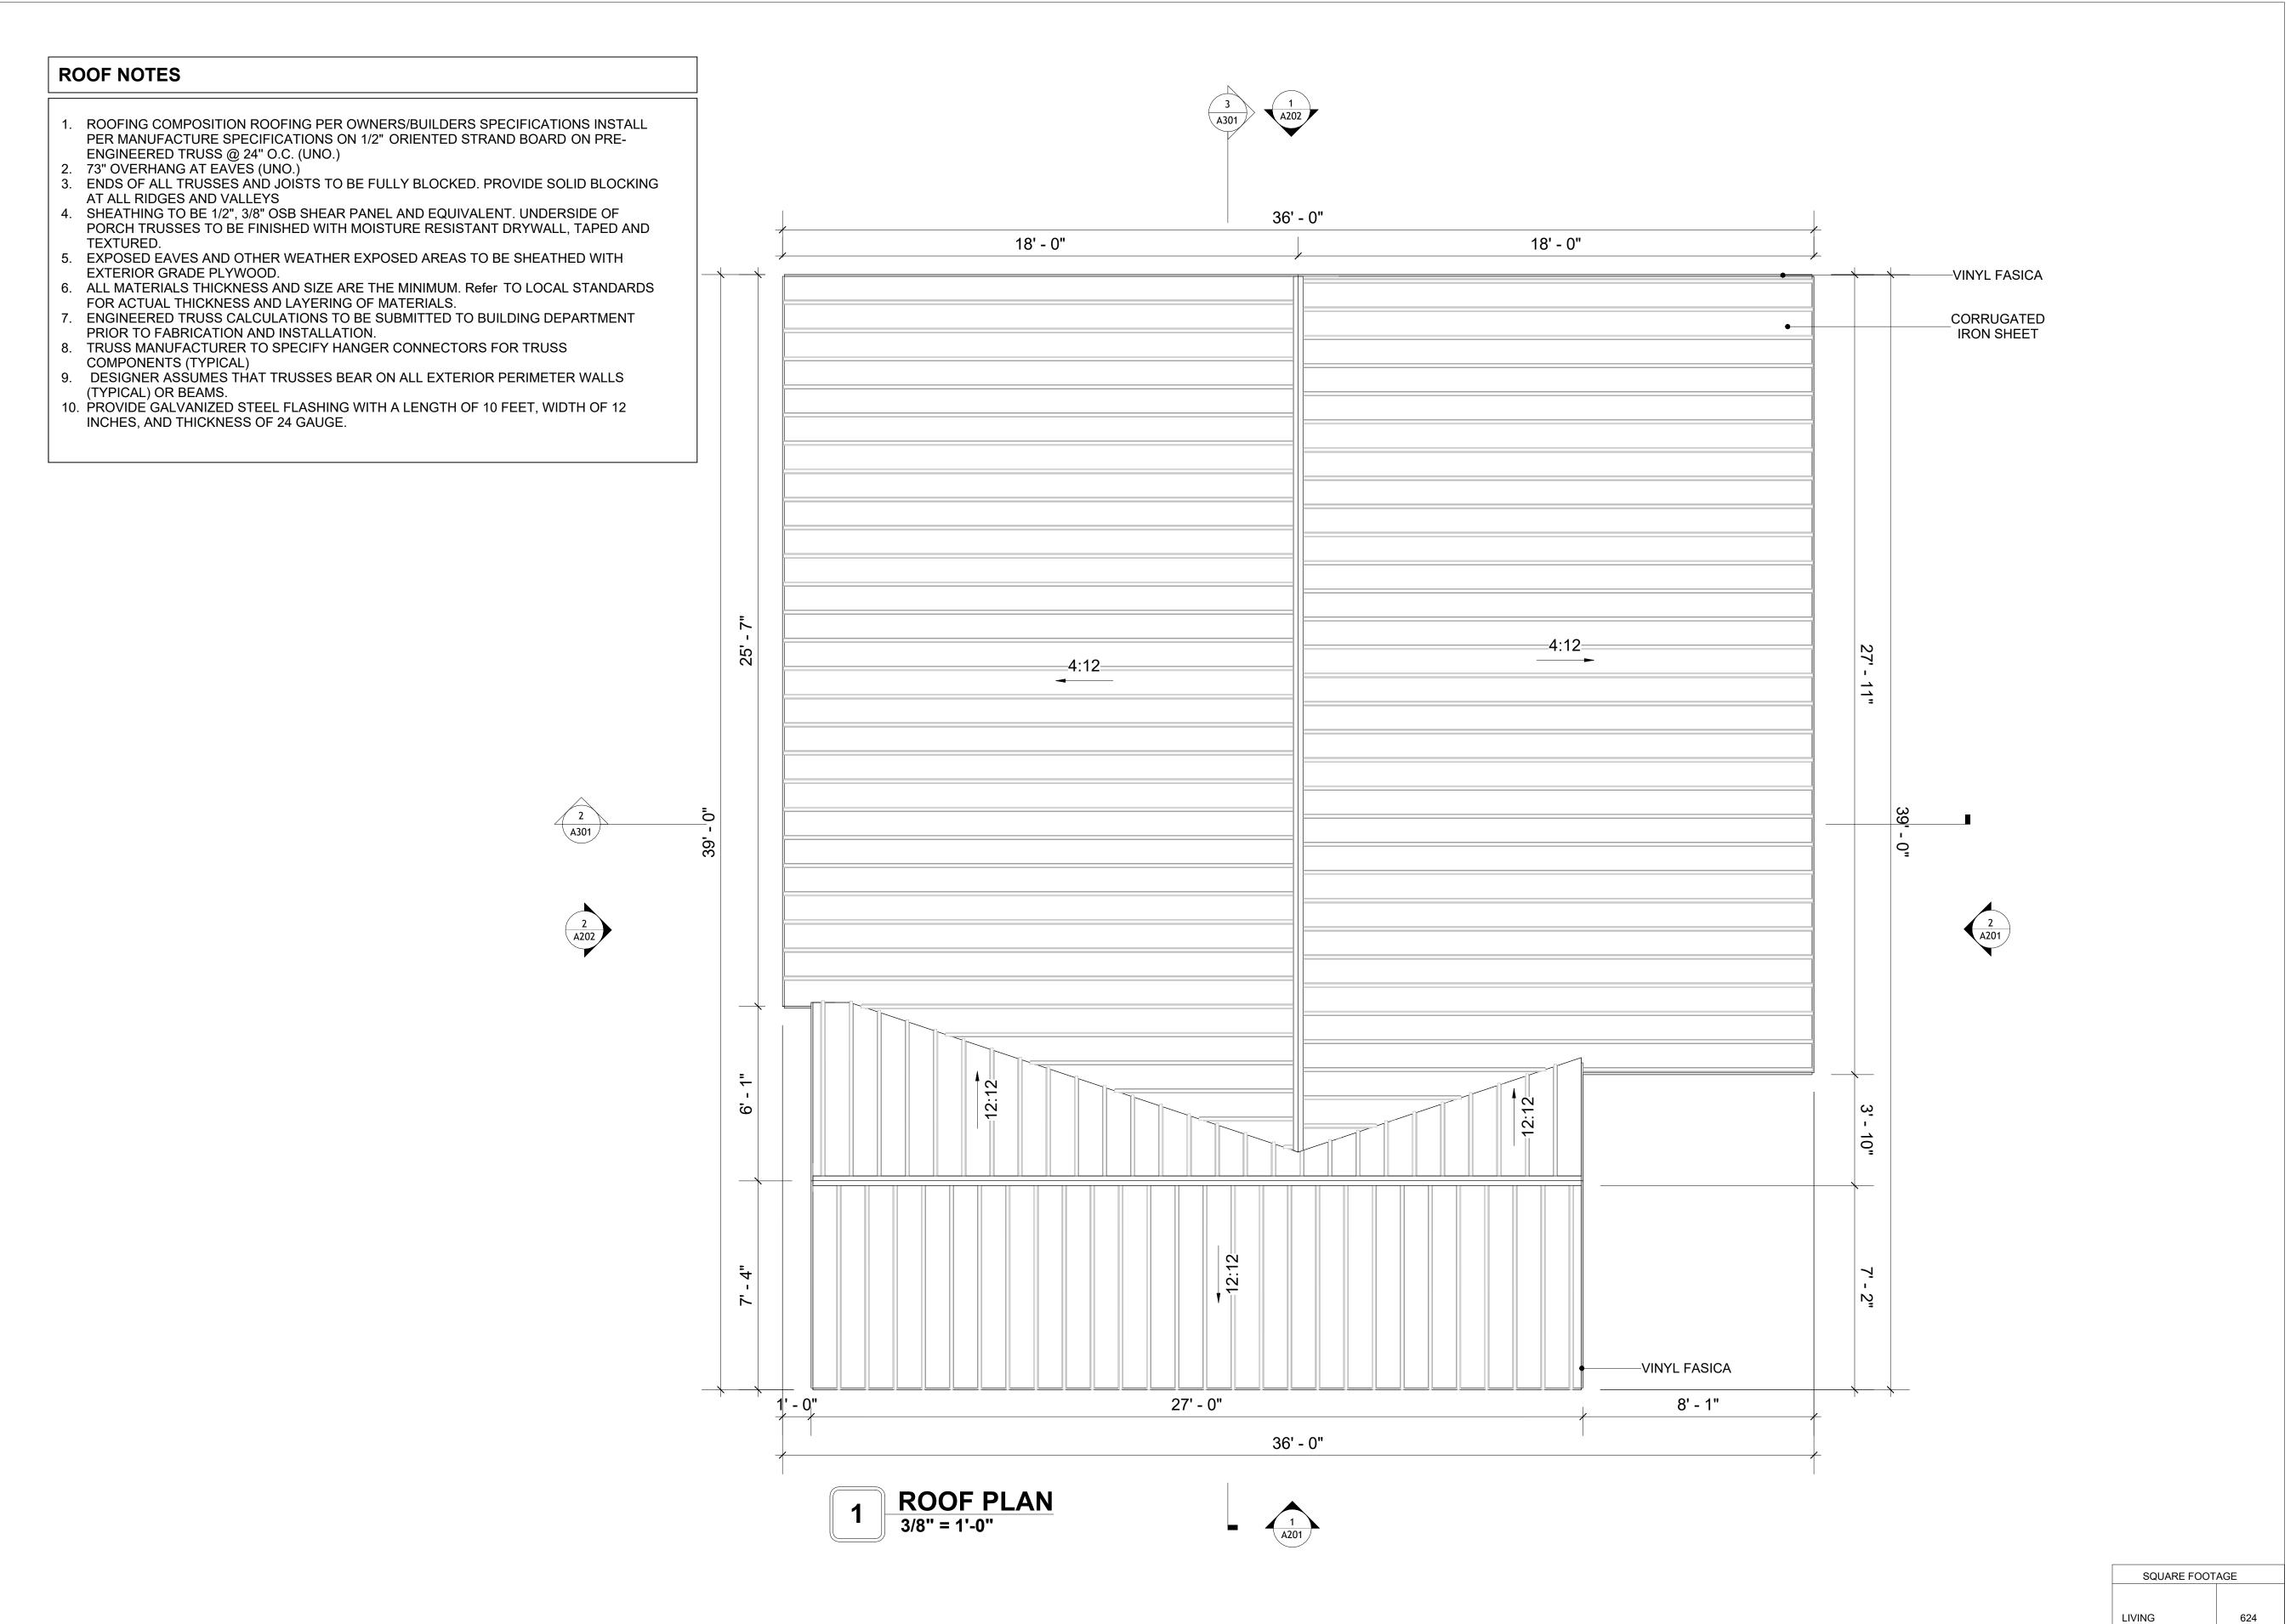



KEY PLAN

NO.	DESCRIPTION	DATE
1	I .	1

NOTE:

LEGEND:

PROJECT

238-EMBER-624-1Bd1Ba FARMHOUSE-550

DRAWING NAME

ROOF PLAN

CLIENT NAME:	Client Name
PROJECT NUMBER:	0033_15
DATE:	5/14/2025 11:15:35 AM
DESIGNED BY:	Designer
DRAWN BY:	Author
CHECKED BY:	Checker

624 286 145

GARAGE

TOTAL

1055

ABOUT WALL FINISHING

PLYWOOD WALL SIDING

WALL SIDING IS AN EXTERIOR CLADDING MATERIAL USED TO COVER AND PROTECT THE WALLS OF A BUILDING, PROVIDING BOTH FUNCTIONAL AND AESTHETIC BENEFITS.

IN THIS SPECIFIC PROJECT, PLYWOOD WALL PANELS ARE USED AS A FINISH SIDING BECAUSE THIS TYPE OF SIDING PROVIDES A DURABLE, COST-EFFECTIVE, AND VERSATILE EXTERIOR CLADDING THAT CAN BE EASILY INSTALLED, FINISHED, AND MAINTAINED TO ENHANCE THE AESTHETIC AND PROTECTIVE QUALITIES OF A BUILDING'S EXTERIOR.


STANDARD SIZES OF 1' X 8' EXTERIOR-GRADE PLYWOOD PANELS ARE INSTALLED ON THE FURRING STRIPS USING GALVANIZED STEEL SELF-DRILLING SCREWS.

CEDAR WOOD

CEDAR WOOD REFERS TO THE WOOD FROM VARIOUS SPECIES OF CEDAR TREES, WHICH ARE CONIFEROUS EVERGREEN TREES KNOWN FOR THEIR DISTINCT AROMA AND NATURAL RESISTANCE TO DECAY AND INSECTS.

IN THIS SPECIFIC PROJECT, CEDAR WOOD IS USED AS A FURRING STRIP AND A FINISH MATERIAL ON BEAMS AND COLUMNS.

CEDAR WOOD AS A FURRING STRIPS PROVIDE THERMAL INSULATION AND MOISTURE MANAGEMENT. THE VERTICAL CEDAR WOOD FURRING STRIPS ARE ATTACHED TO HOME WRAP USING CORROSION-RESISTANT FASTENERS (HOT-DIP GALVANIZED SCREWS), ENSURING PROPER PENETRATION INTO THE WALL FRAMING.

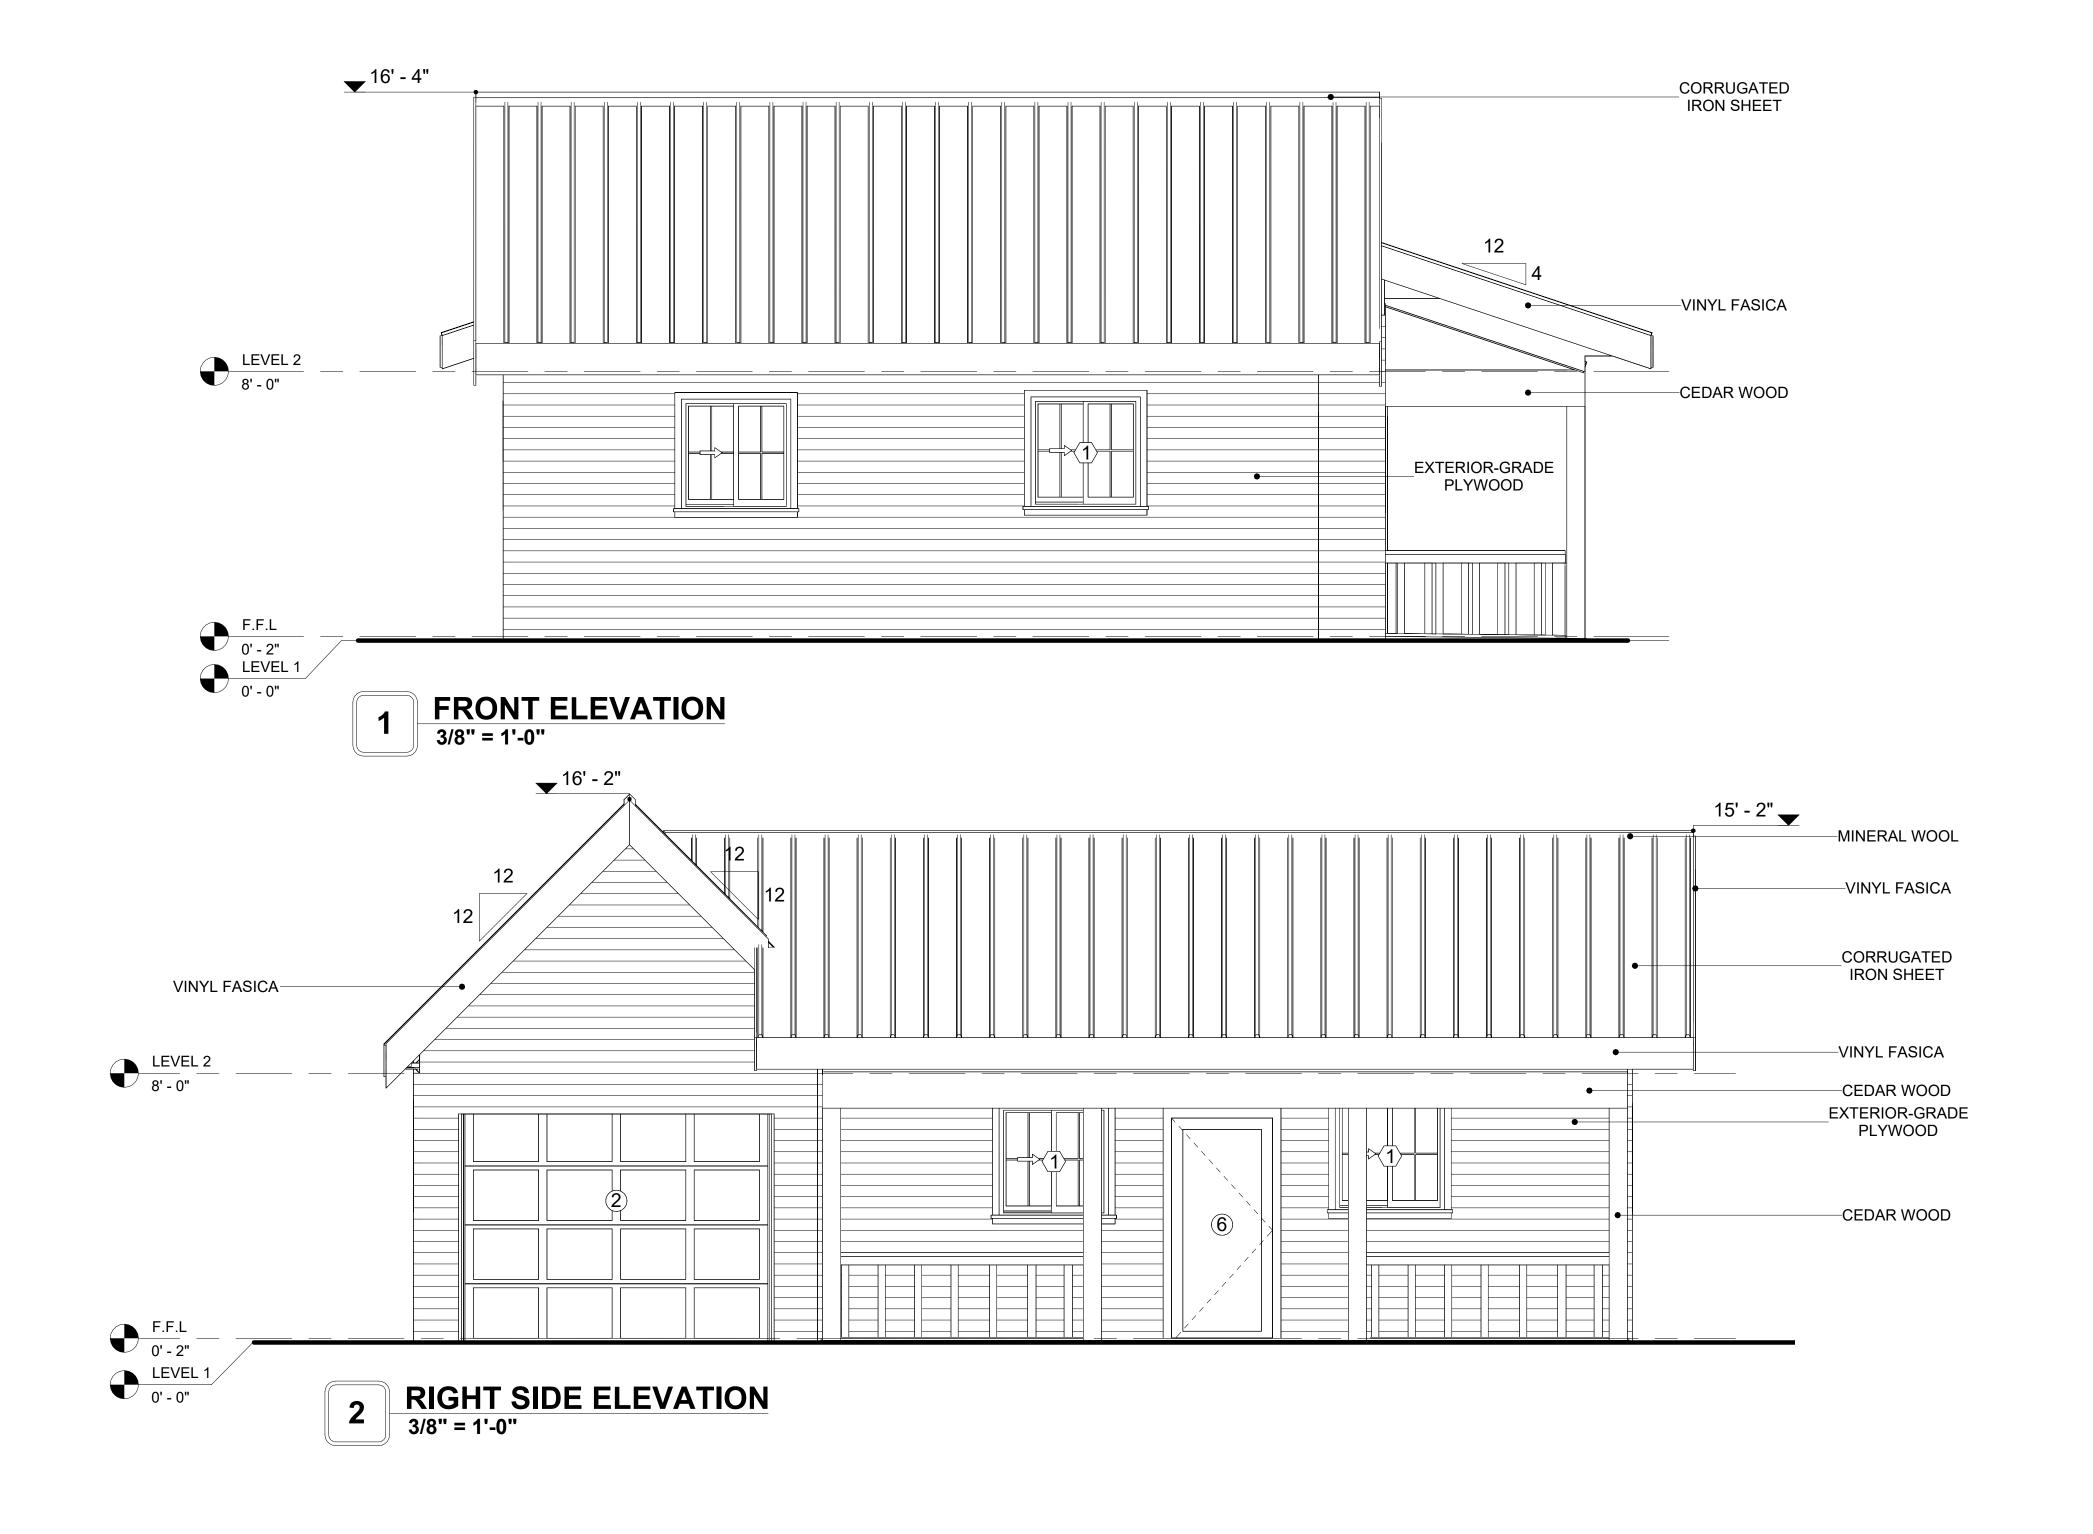


		DOOR SCH	EDULE			
TYPE MAR				S	SIZE	
K	SUPPLIER	DOOR TYPE	LOCATION	WIDTH	HEIGHT	COUNT
1	HOME DEPOT	INTERIOR SINGLE PANEL SWINGING	INTERIOR	3' - 0"	6' - 8"	2
2	HOME DEPOT	DOOR-GARAGE-EMBOSSED_PANEL	EXTERIOR	9' - 0"	7' - 0"	1
3	HOME DEPOT	DOOR-BIFOLD_9052	INTERIOR	5' - 0"	6' - 8"	1
4	HOME DEPOT	INTERIOR DOUBLE PANEL SLIDING	INTERIOR	7' - 0"	6' - 8"	1
5	HOME DEPOT	INTERIOR SINGLE PANEL SWINGING	INTERIOR	3' - 0"	6' - 8"	1
6	HOME DEPOT	EXTERIOR SINGLE PANEL SWINGING	INTERIOR	3' - 0"	6' - 8"	1

		WINDOV	SCHEDULE		
				SIZE	
TYPE MARK	SUPPLIER	WINDOW TYPE	WIDTH	HEIGHT	COUNT
1	HOME DEPOT	SLIDING	3' - 3"	3' - 3"	6
2	HOME DEPOT	SLIDING	5' - 3"	3' - 3"	2
3	HOME DEPOT	SLIDING	2' - 3"	1' - 9"	1



KEY PLAN

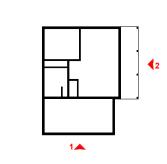

NO.	DESCRIPTION	DATE
	·	

NOTE:

LEGEND:

PROJECT

238-EMBER-624-1Bd1Ba FARMHOUSE-550

DRAWING NAME

ARCHITECTURAL ELEVATIONS

Client Name	CLIENT NAME:
0033_1	PROJECT NUMBER:
5/14/2025 11:15:40 A	DATE:
Designe	DESIGNED BY:
Autho	DRAWN BY:
Checke	CHECKED BY:

A201

ABOUT WALL FINISHING

PLYWOOD WALL SIDING

WALL SIDING IS AN EXTERIOR CLADDING MATERIAL USED TO COVER AND PROTECT THE WALLS OF A BUILDING, PROVIDING BOTH FUNCTIONAL AND AESTHETIC BENEFITS.

IN THIS SPECIFIC PROJECT, PLYWOOD WALL PANELS ARE USED AS A FINISH SIDING BECAUSE THIS TYPE OF SIDING PROVIDES A DURABLE, COST-EFFECTIVE, AND VERSATILE EXTERIOR CLADDING THAT CAN BE EASILY INSTALLED, FINISHED, AND MAINTAINED TO ENHANCE THE AESTHETIC AND PROTECTIVE QUALITIES OF A BUILDING'S EXTERIOR.


STANDARD SIZES OF 1' X 8' EXTERIOR-GRADE PLYWOOD PANELS ARE INSTALLED ON THE FURRING STRIPS USING GALVANIZED STEEL SELF-DRILLING SCREWS.

CEDAR WOOD


CEDAR WOOD REFERS TO THE WOOD FROM VARIOUS SPECIES OF CEDAR TREES, WHICH ARE CONIFEROUS EVERGREEN TREES KNOWN FOR THEIR DISTINCT AROMA AND NATURAL RESISTANCE TO DECAY AND INSECTS.

IN THIS SPECIFIC PROJECT, CEDAR WOOD IS USED AS A FURRING STRIP AND A FINISH MATERIAL ON BEAMS AND COLUMNS.


CEDAR WOOD AS A FURRING STRIPS PROVIDE THERMAL INSULATION AND MOISTURE MANAGEMENT. THE VERTICAL CEDAR WOOD FURRING STRIPS ARE ATTACHED TO HOME WRAP USING CORROSION-RESISTANT FASTENERS (HOT-DIP GALVANIZED SCREWS), ENSURING PROPER PENETRATION INTO THE WALL FRAMING.

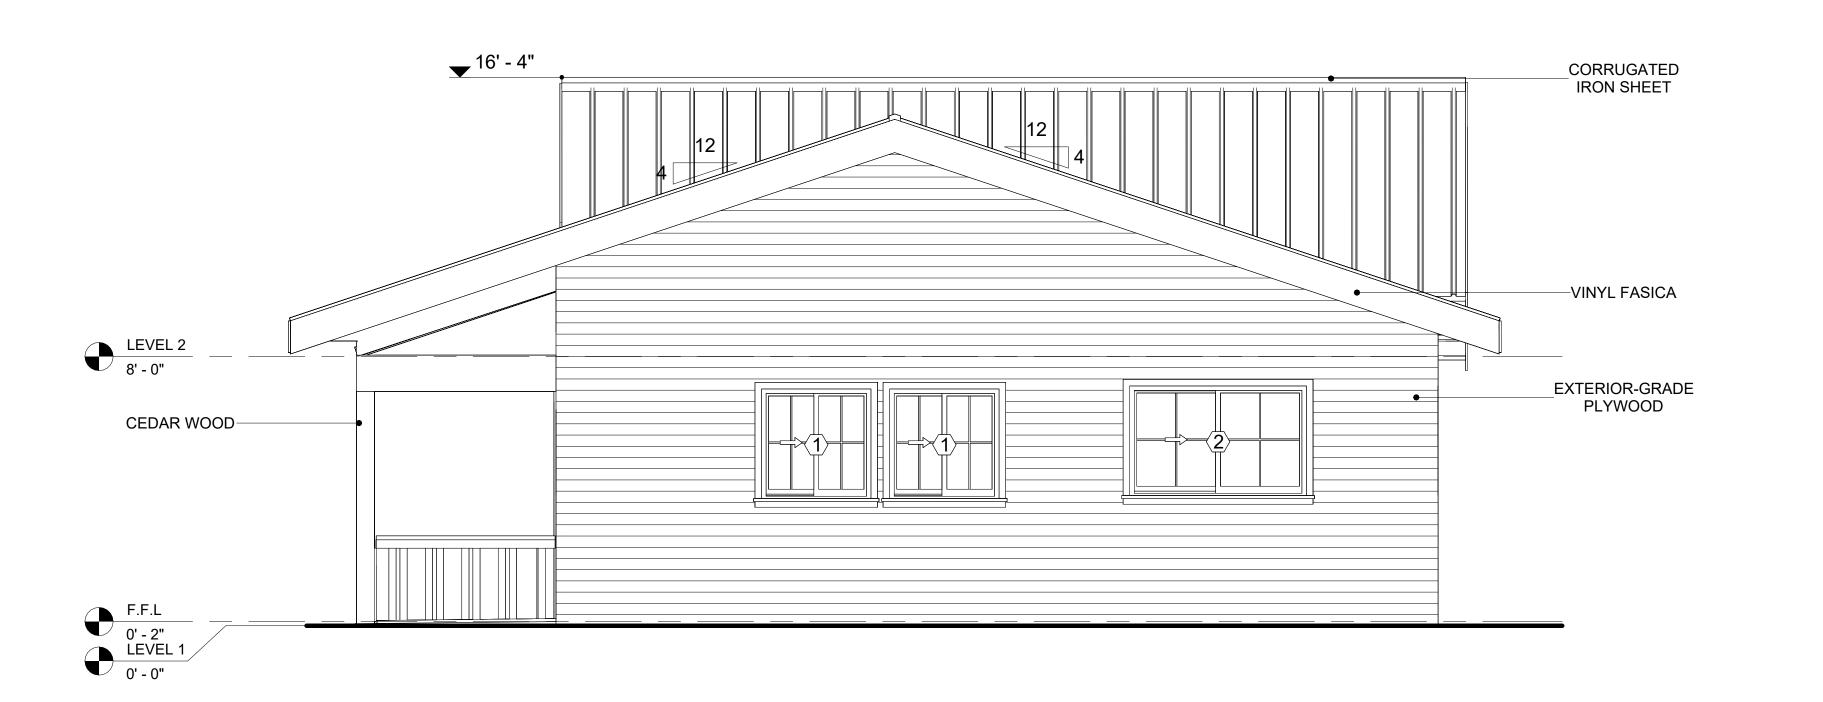

1 REAR ELEVATION 3/8" = 1'-0"

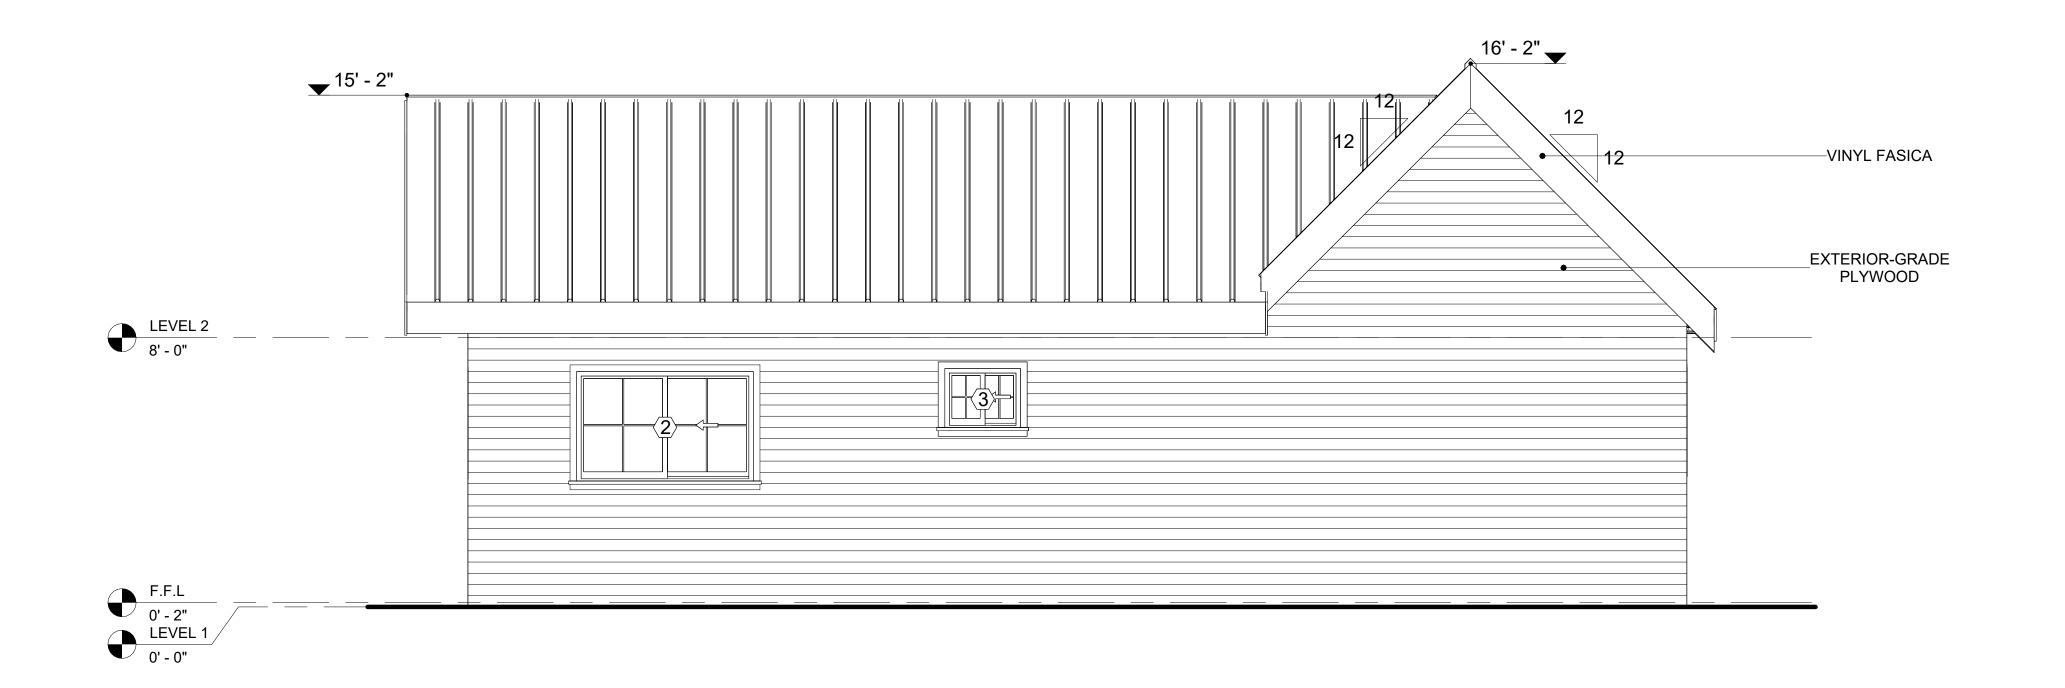

2 LEFT SIDE ELEVATION
3/8" = 1'-0"

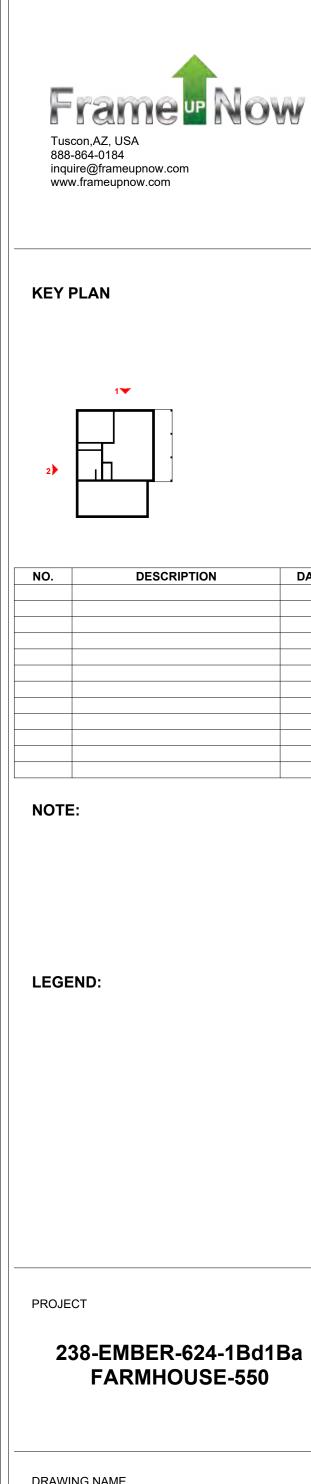



DATE

ARCHITECTURAL ELEVATIONS

Client Name	CLIENT NAME:
0033_15	PROJECT NUMBER:
5/14/2025 11:15:44 AM	DATE:
Designer	DESIGNED BY:
Author	DRAWN BY:
Checker	CHECKED BY:

A202

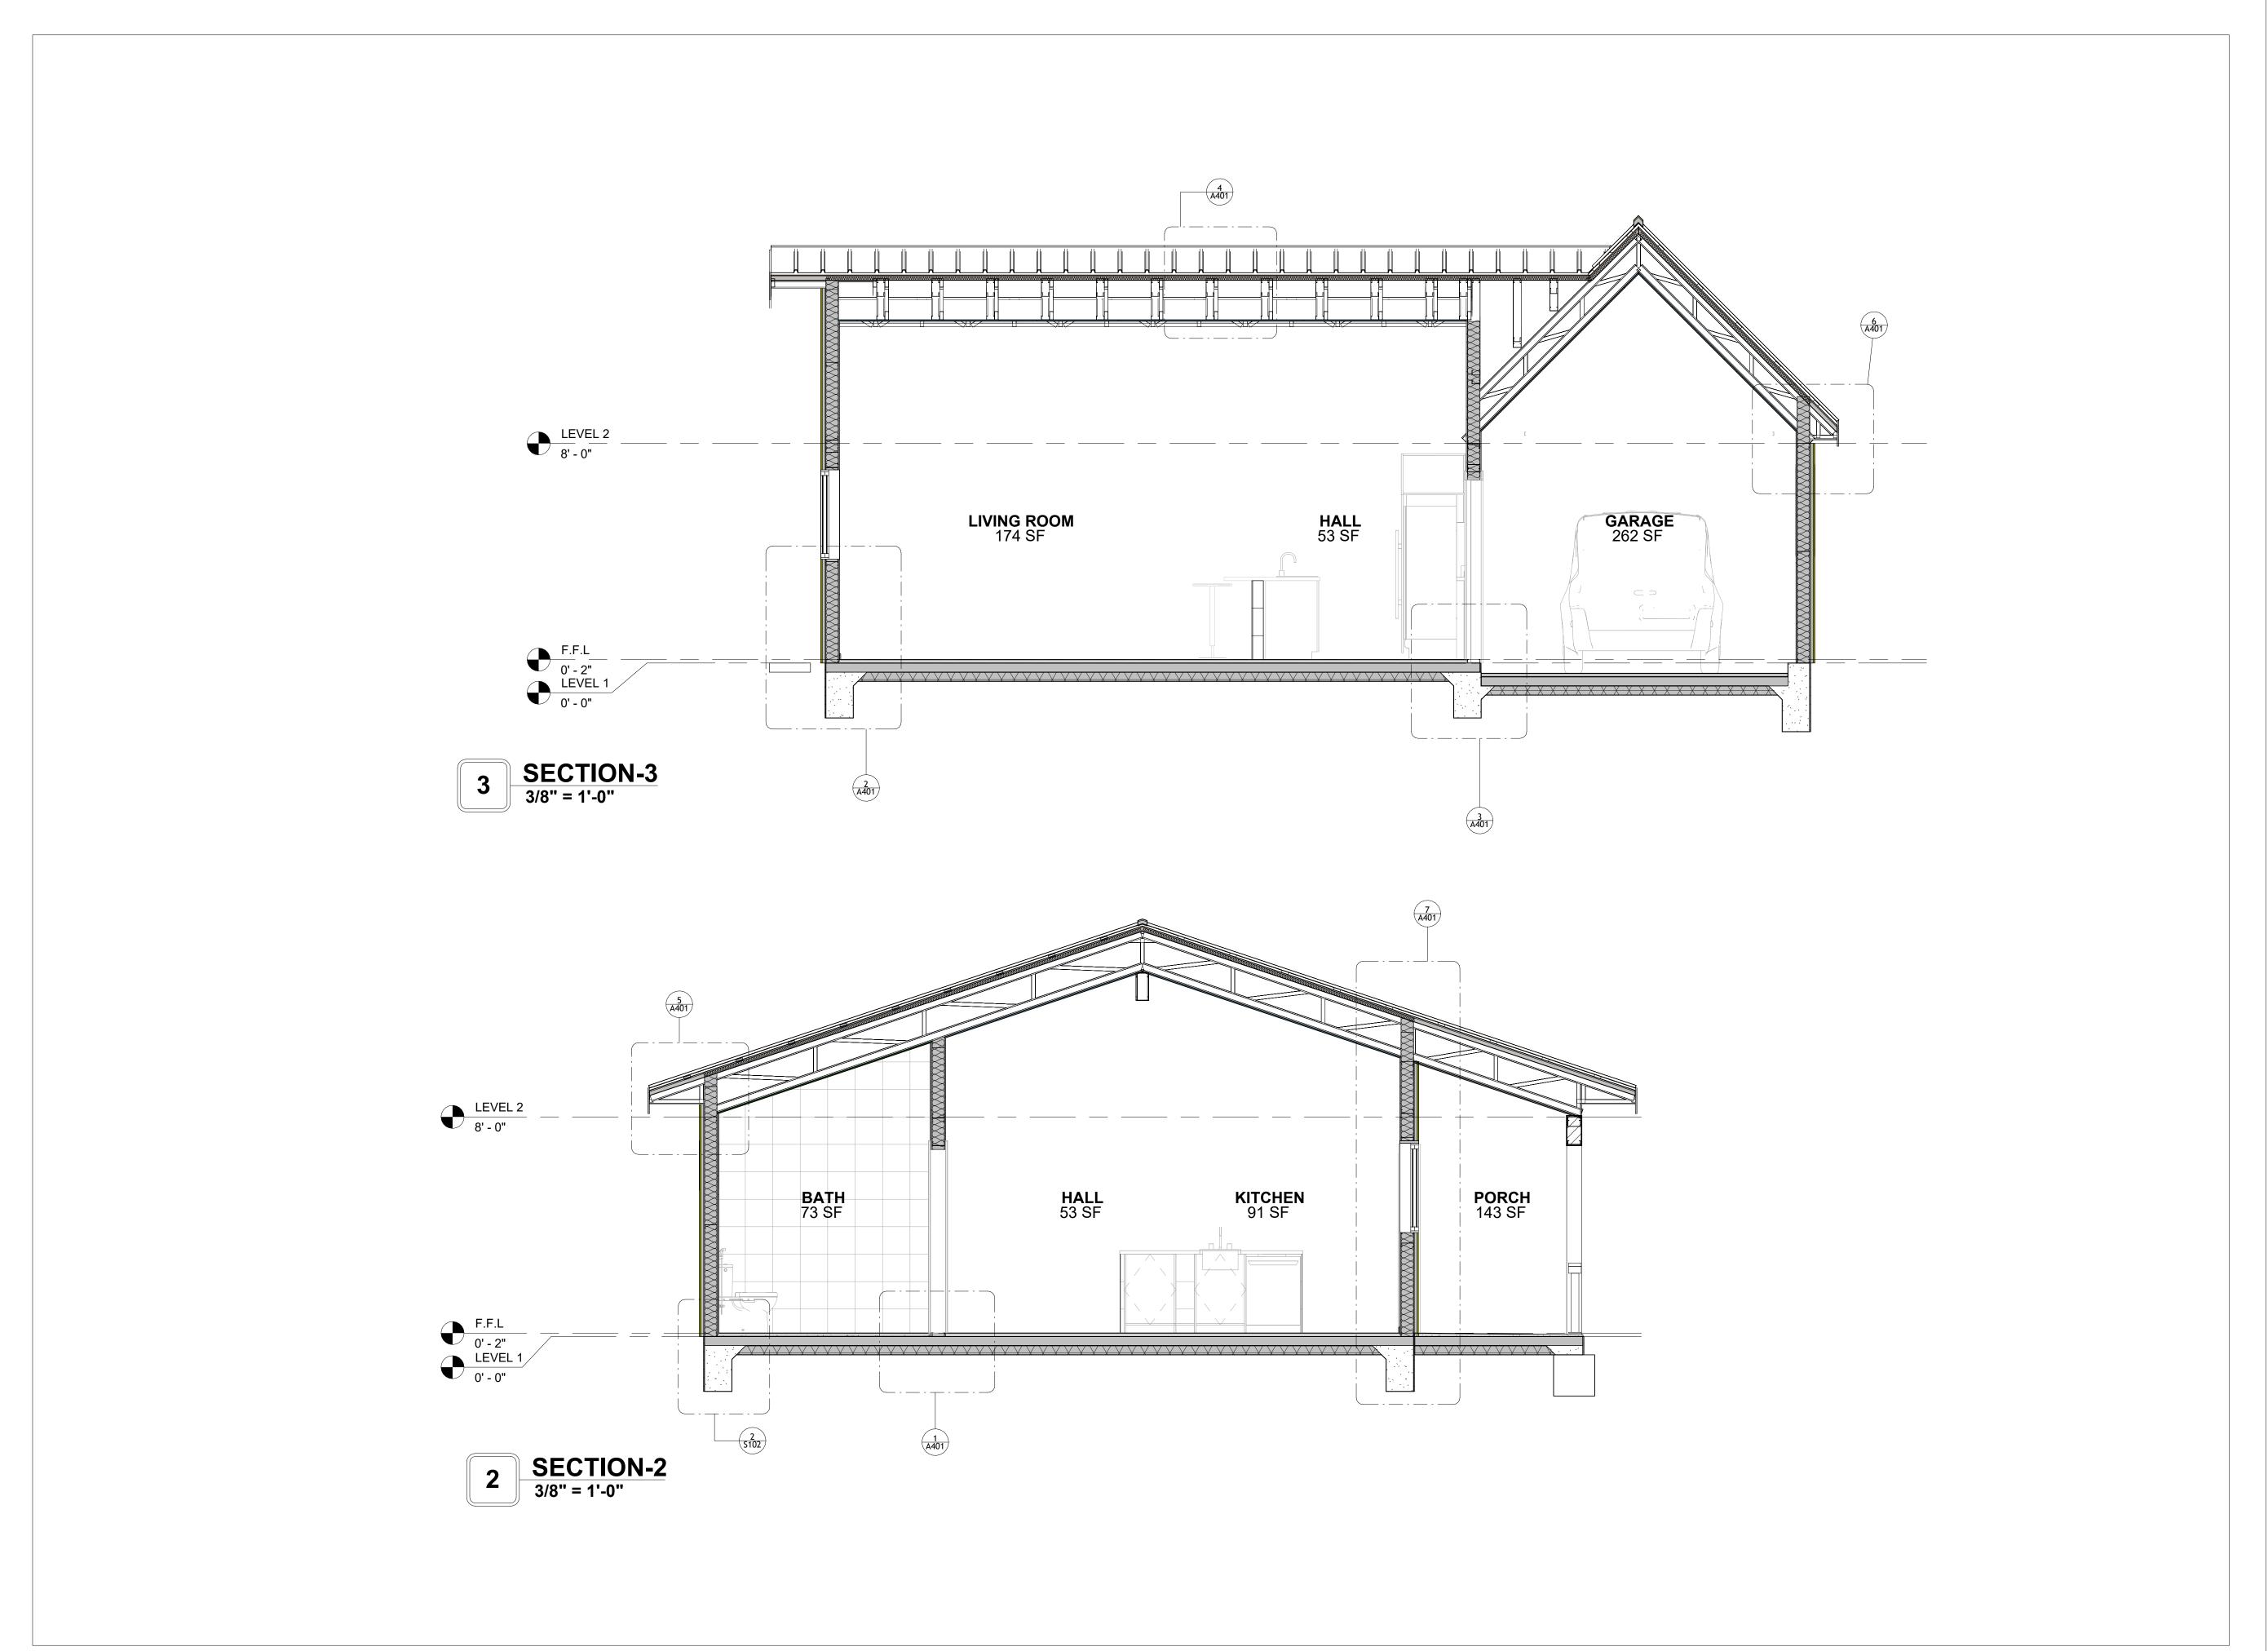

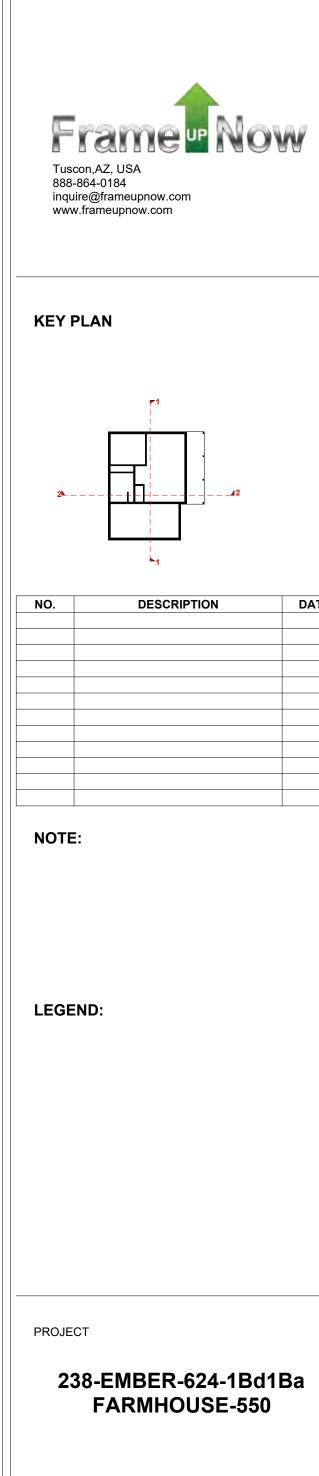


DATE


DRAWING NAME

ARCHITECTURAL SECTIONS

Client Name	CLIENT NAME:	
0033_15	PROJECT NUMBER:	
5/14/2025 11:15:46 AM	DATE:	
Designer	DESIGNED BY:	
Author	DRAWN BY:	
Checker	CHECKED BY:	

A301

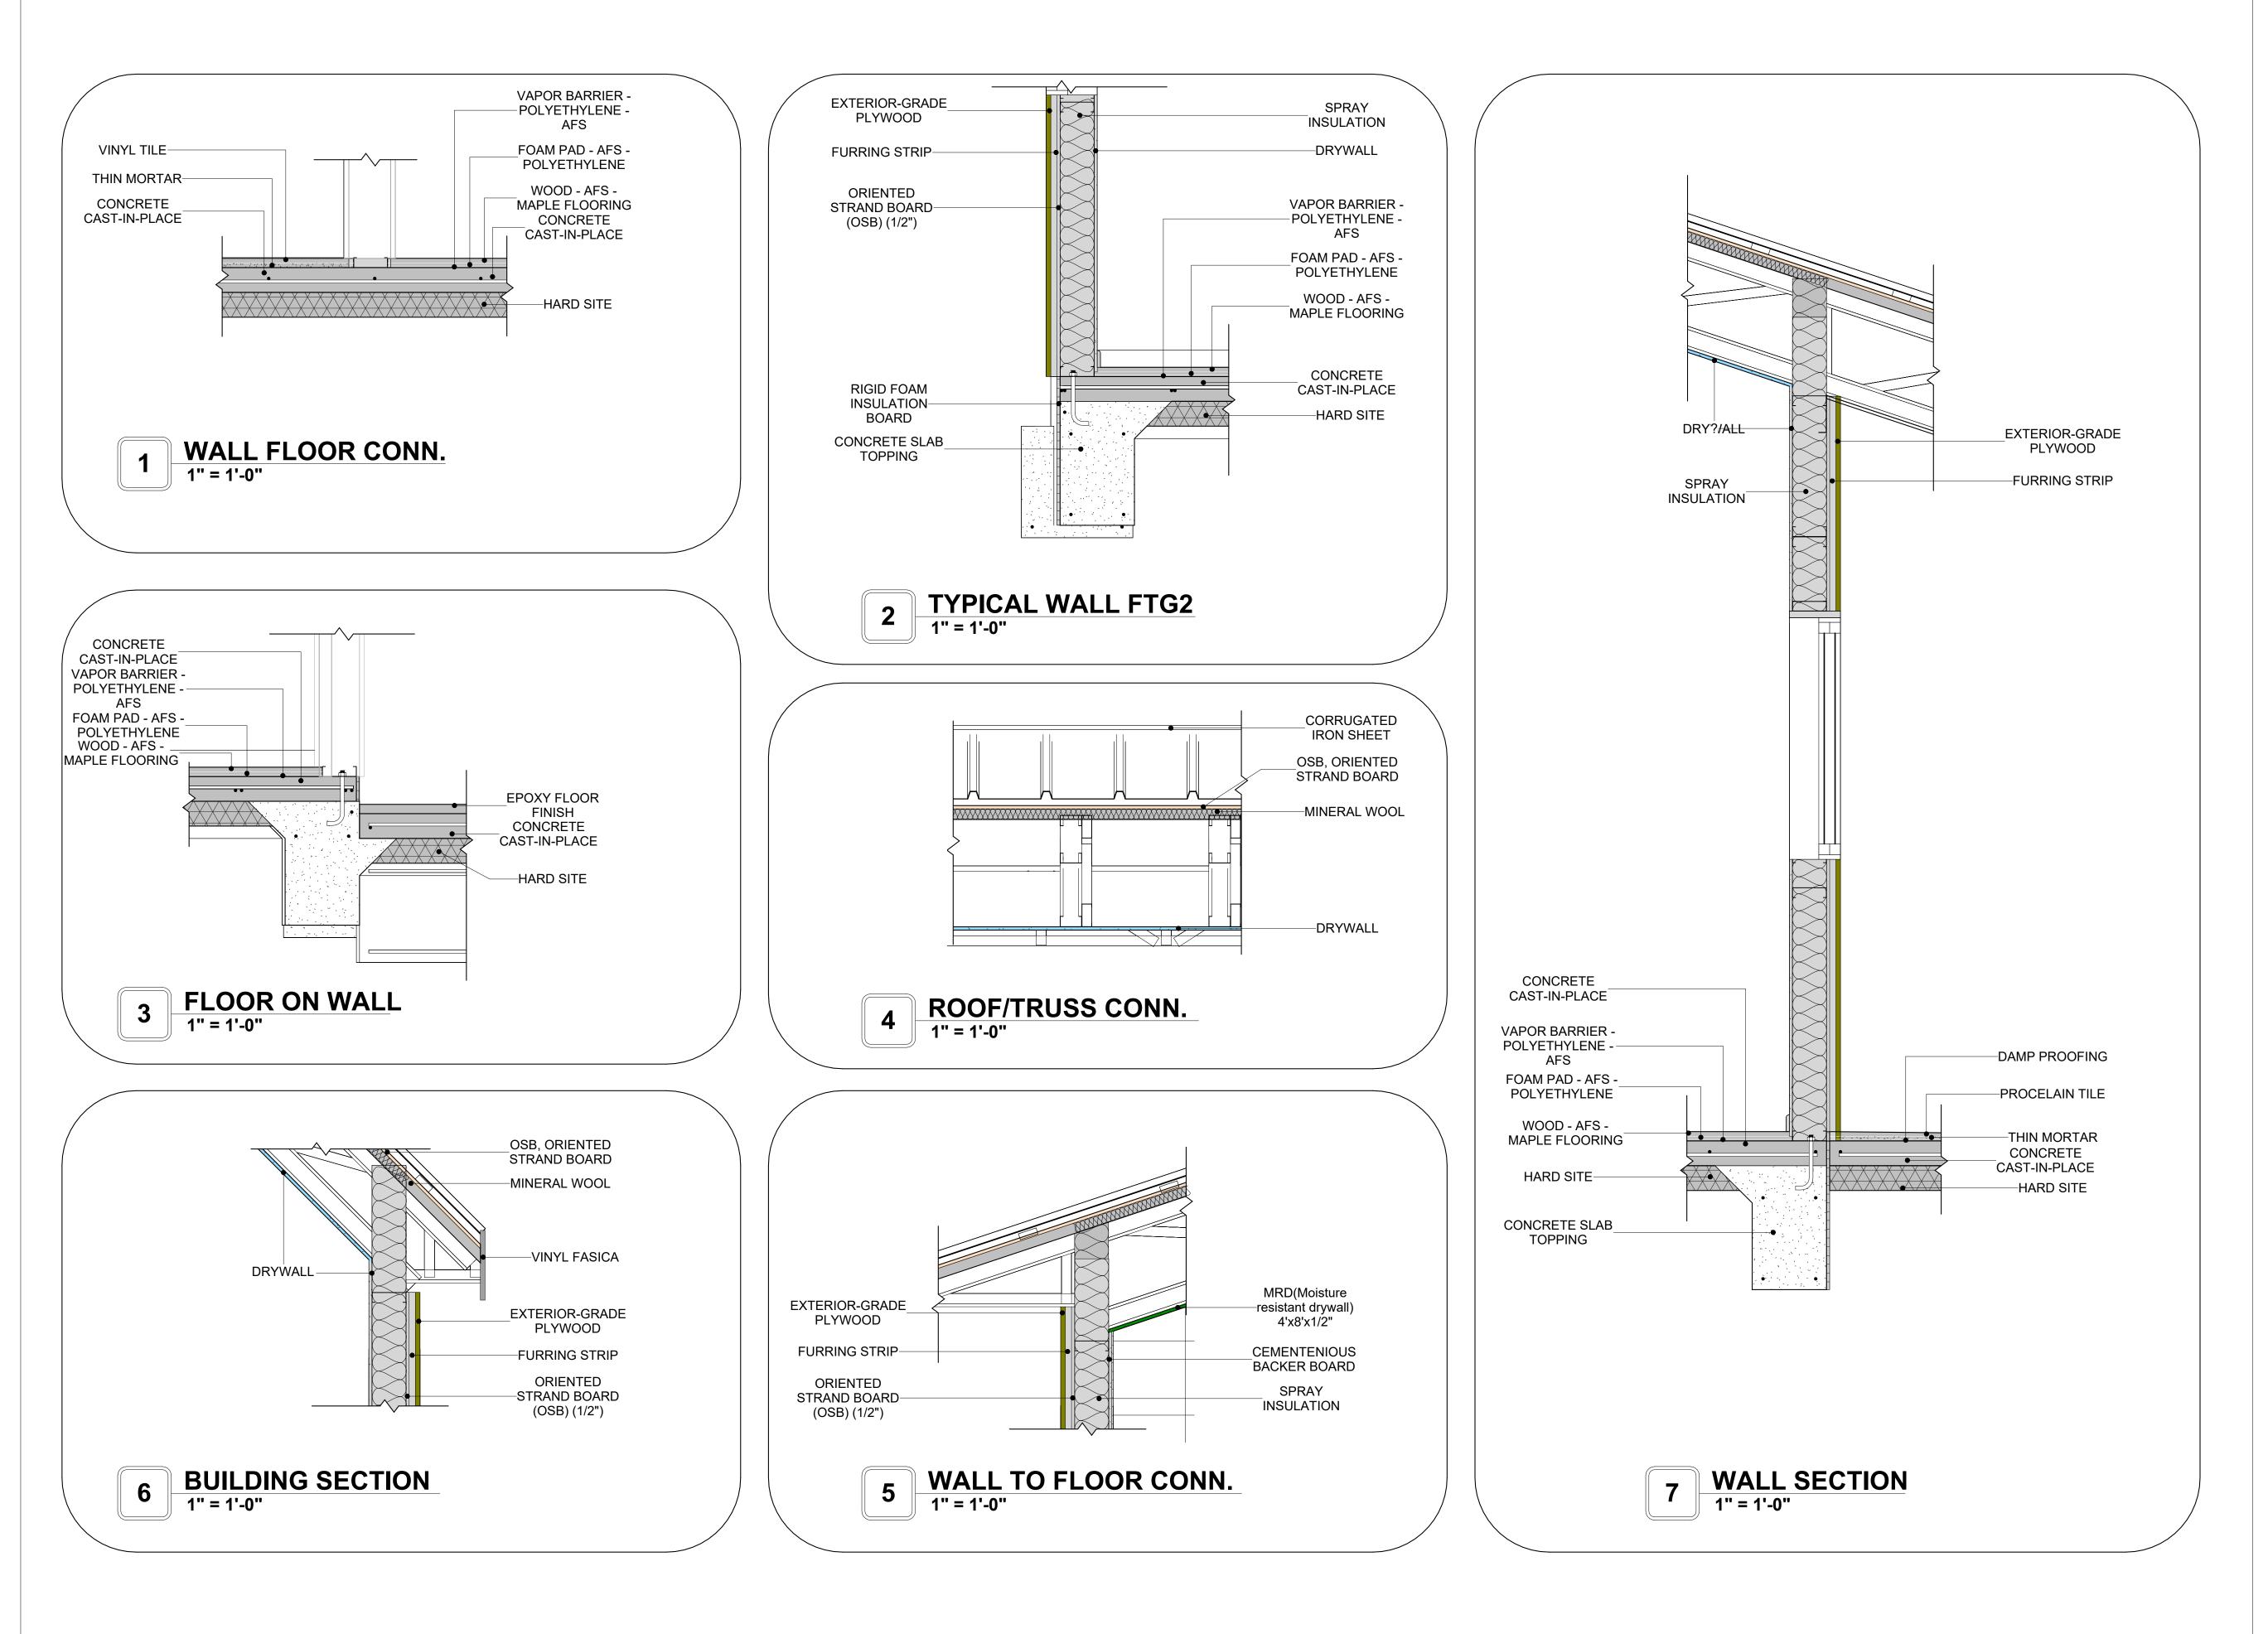

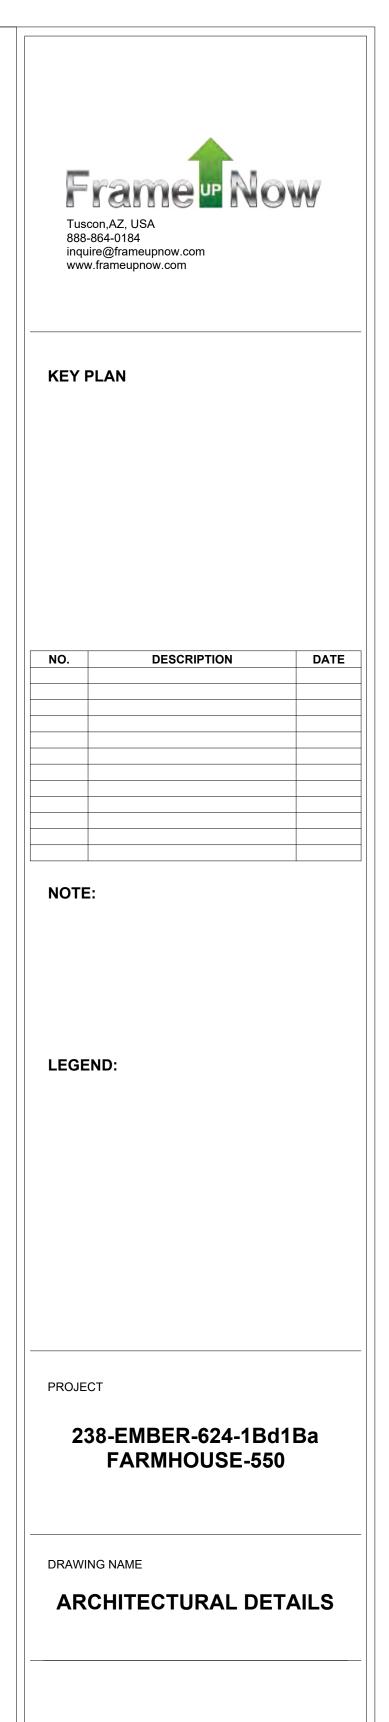

CLIENT NAME:	Client Name
PROJECT NUMBER:	0033_15
DATE:	5/14/2025 11:15:47 AM
DESIGNED BY:	Designer
DRAWN BY:	Author
CHECKED BY:	Checker


A401


SCALE: 1" = 1'-0"


CASEWORK GENERAL NOTES


- ALL CABINET HEIGHTS INCLUDE COUNTERTOPS. DIMENSIONS ARE TO THE NEAREST INCH.
 DIVISIONS IN CASEWORK ARE SHOWN FOR CLARITY AND DO NOT REPRESENT BREAKS IN THE
- COUNTERTOP.
- 3. PROVIDE CONTINUOUS COUNTERTOP OVER ALL SIMILAR HEIGHT CASEWORK, UNLESS AND OTHERWISE NOTED.
- 4. MANUFACTURER AND CATALOG NUMBERS ARE FOR REFERENCE AND ILLUSTRATION PURPOSES
- DOTTED LINES INDICATE WALL HUNG CABINETS, DIVISIONS OF BASE CABINETS BELOW THE
 COUNTERTOP, FURNITURE NOT IN THE CONTRACT OR PROJECTION SCREENS -SEE CASEWORK
- KEY AND SPECIFICATIONS.


 7. ALL CABINETS AND DRAWERS TO HAVE CAM LOCKS EXCEPT FOR SINK BASE CABINETS.
- 8. ALL EXPOSED SURFACES (EXPOSED TO VIEW FROM ANY PERSPECTIVE) TO BE COVERED WITH LAMINATE.
- 9. ALL CASEWORK WHICH MEETS A WALL AT ONE OR BOTH ENDS, TO BE PROVIDED WITH FILLER PANELS AND SCRIBED TO THE WALL(S) AS REQUIRED.
- 10. ALL CABINETS AND DRAWERS ARE PROVIDED WITH RECESSED HANDLES.
- 11. CONTRACTOR TO FIELD VERIFY ALL CLEAR OPENINGS PRIOR TO MILLWORK OR CASEWORK FABRICATION.
- 12. CASEWORK DRAWINGS ARE DIAGRAMMATIC IN NATURE TO SHOW DESIGN INTENT.

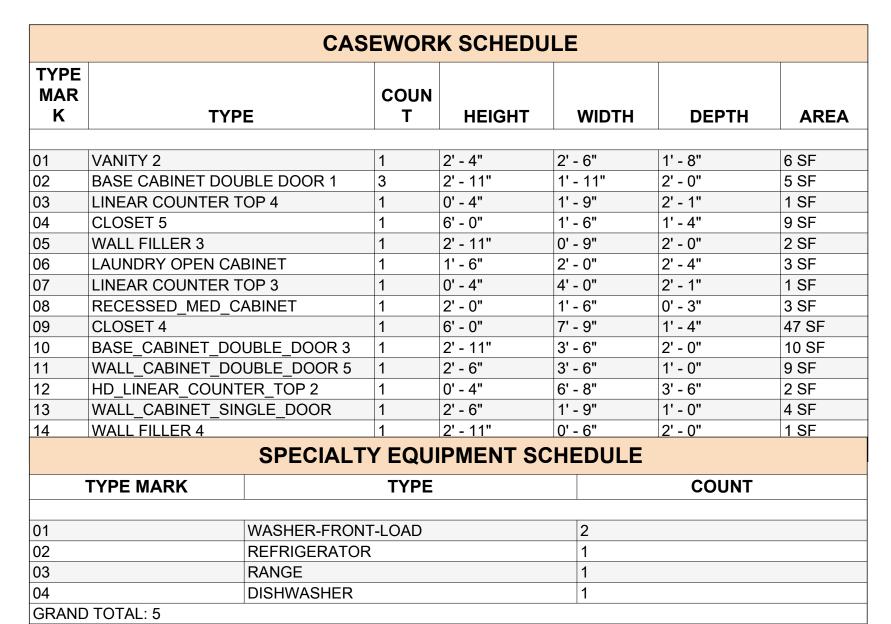


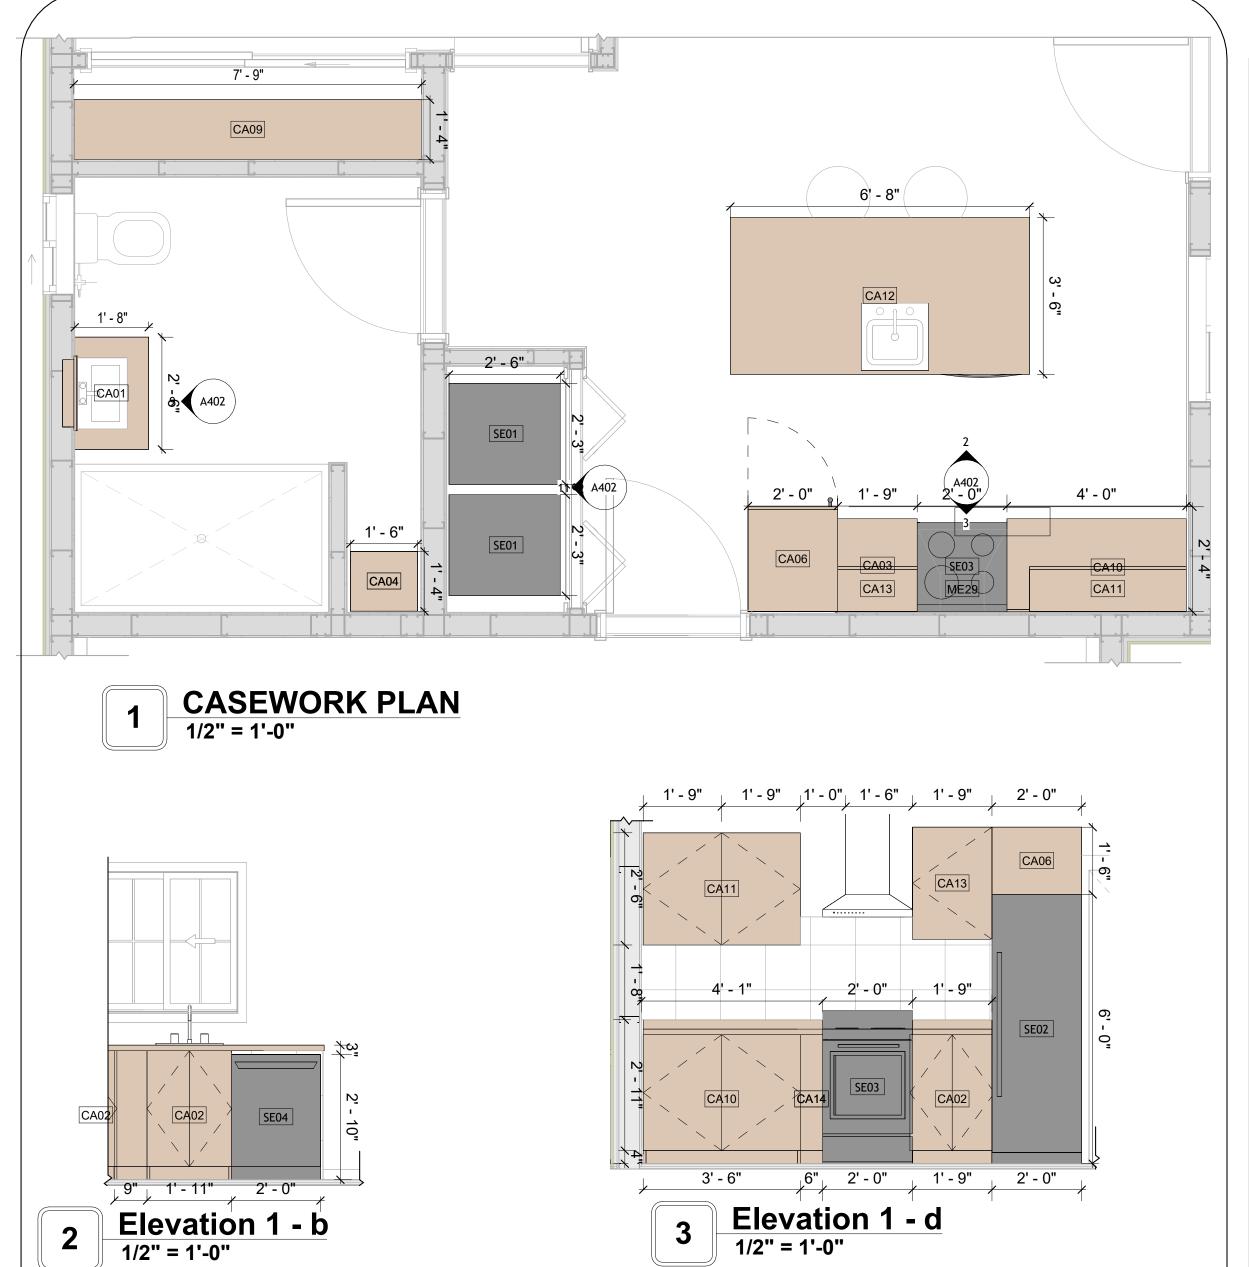


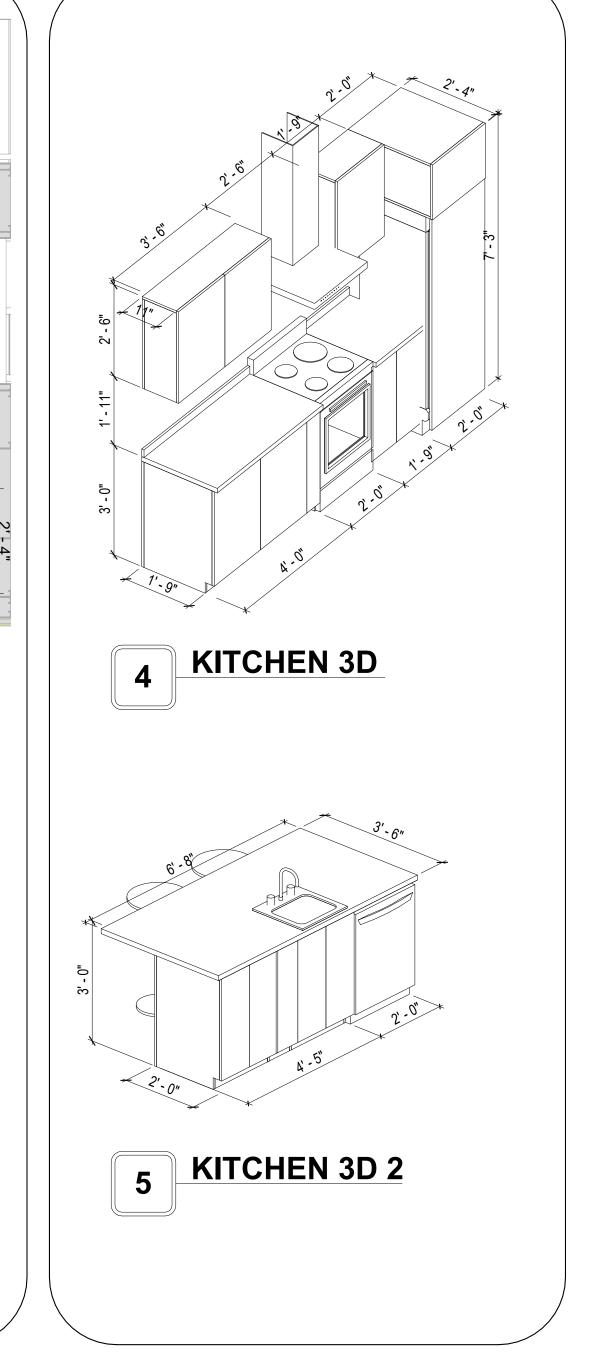


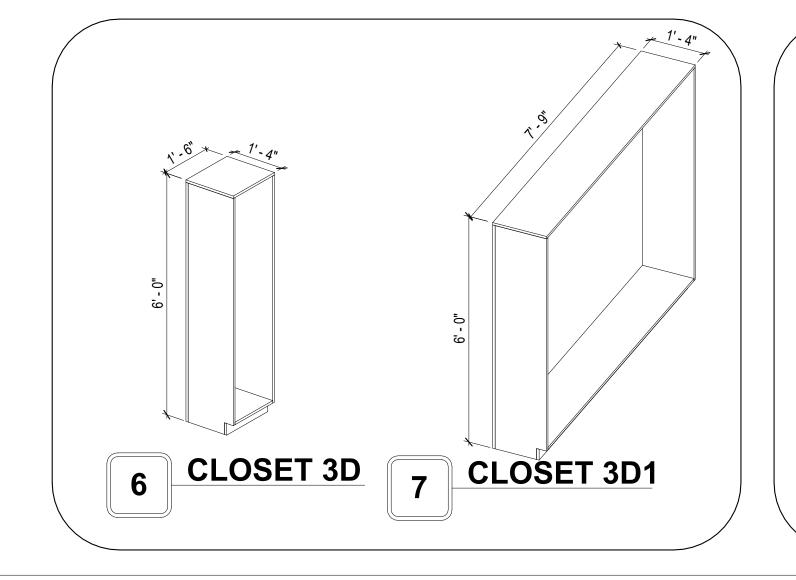


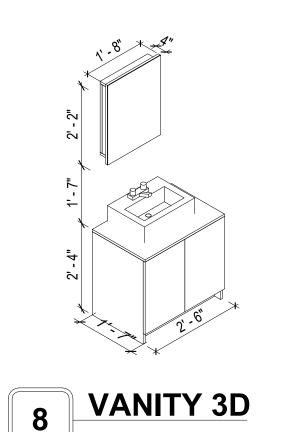

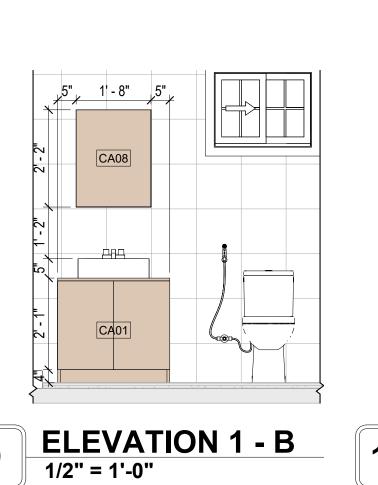

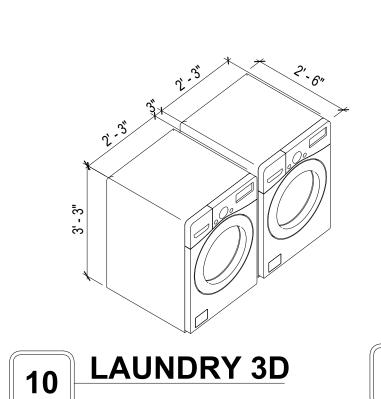

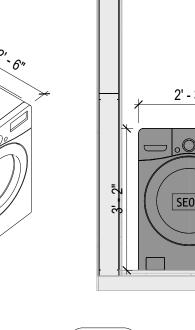


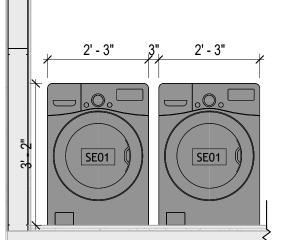

11 Elevation 2 - d

Tuscon,AZ, USA
888-864-0184
inquire@frameupnow.com
www.frameupnow.com

KEY PLAN

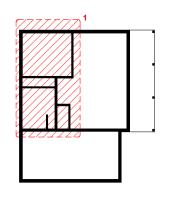

NO.	DESCRIPTION	DATE

NOTE:

LEGEND:

PROJECT

238-EMBER-624-1Bd1Ba FARMHOUSE-550

DRAWING NAME

ARCHITECTURAL CASEWORK

Client Name	CLIENT NAME:
0033_15	PROJECT NUMBER:
5/14/2025 11:15:51 AM	DATE:
Designer	DESIGNED BY:
Author	DRAWN BY:
Checker	CHECKED BY:

A402

GENERAL NOTES

1. THIS DRAWING DEPICTS THE HVAC (HEATING, VENTILATION, AND AIR CONDITIONING) SYSTEM FOR THE EMBER 1BD 1BA FARMHOUSE. IT PROVIDES A VISUAL REPRESENTATION OF THE SYSTEM LAYOUT AND COMPONENTS.

2.THE HVAC SYSTEM IS DESIGNED TO MEET THE SPECIFIC REQUIREMENTS OF THE BUILDING, INCLUDING HEATING, COOLING, AND VENTILATION NEEDS, AS PER THE PROJECT SPECIFICATIONS AND APPLICABLE CODES AND STANDARDS.

3. THE HVAC SYSTEM INSTALLATION SHALL COMPLY WITH THE LATEST EDITION OF THE INTERNATIONAL MECHANICAL CODE (IMC), INTERNATIONAL RESIDENTIAL CODE (IRC), AND ALL OTHER APPLICABLE LOCAL, STATE, AND NATIONAL CODES AND REGULATIONS.

4. THE EQUIPMENT SHOWN ON THIS DRAWING INCLUDES BUT IS NOT LIMITED TO AIR HANDLING UNITS (AHUS), CHILLERS, BOILERS, COOLING TOWERS, PUMPS, DUCTWORK, DIFFUSERS, GRILLES, AND CONTROL DEVICES.

5. ALL EQUIPMENT, DUCTWORK, AND PIPING SHALL BE INSTALLED IN ACCORDANCE WITH MANUFACTURER'S SPECIFICATIONS, LOCAL CODES, AND

6. ALL DUCTWORK SHALL BE SIZED, FABRICATED, AND INSTALLED IN ACCORDANCE WITH THE LATEST EDITION OF THE ACCA MANUAL D AND THE SMACNA HVAC DUCT CONSTRUCTION STANDARDS. DUCTWORK SHALL BE INSTALLED IN A NEAT AND WORKMANLIKE MANNER, PROPERLY SUPPORTED

AND BRACED TO PREVENT SAGGING, AIR LEAKAGE, OR VIBRATION. 7. CONDENSATE DRAINAGE PIPING SHALL BE PROPERLY PITCHED TO ENSURE POSITIVE DRAINAGE TO AN APPROVED DISPOSAL LOCATION, SUCH AS A

8. THE LOCATION OF CONTROL PANELS AND SENSORS INDICATED ON THIS DRAWING CAN BEMODIFY WITH THE SPECIFIC LOCATIONS AND WIRING DETAILS WILL BE DETERMINED DURING THE CONTROL SYSTEM DESIGN AND INSTALLATION.

9. THE HVAC SYSTEM DESIGN CONSIDER ENERGY EFFICIENCY, INDOOR AIR QUALITY, OCCUPANT COMFORT, AND NOISE CONTROL, FOLLOWING APPLICABLE GUIDELINES AND REGULATIONS.

FLOOR DRAIN, SUMP PUMP, OR EXTERIOR GRADE. CONDENSATE LINES SHALL BE INSULATED TO PREVENT SWEATING.

10. COORDINATION WITH OTHER TREADS HAS BEEN DONE ON A DESIGN LEVEL. THIS DRAWING SHALL BE READ TOGETHER WITH THE AR, EL AND SN DESIGN DRAWINGS TO ENSURE PROPER INSTALLATION AND INTEGRATION OF THE HVAC SYSTEMS.

11. THE HVAC CONTRACTOR IS RESPONSIBLE FOR OBTAINING ALL NECESSARY PERMITS AND LICENSES, AND FOR SCHEDULING AND COORDINATING WITH THE LOCAL BUILDING DEPARTMENT AND UTILITY PROVIDERS TO ENSURE A TIMELY AND COMPLIANT INSTALLATION.

12. ALL DUCTWORK PENETRATIONS THROUGH WALLS, FLOORS, OR CEILINGS SHALL BE PROPERLY SEALED AND FIRE-STOPPED USING APPROVED METHODS AND MATERIALS TO MAINTAIN THE INTEGRITY OF THE BUILDING'S FIRE-RESISTANCE RATINGS.

13. HVAC EQUIPMENT SHALL BE INSTALLED LEVEL AND PLUMB, AND IN STRICT ACCORDANCE WITH THE MANUFACTURER'S INSTALLATION INSTRUCTIONS AND RECOMMENDATIONS. PROVIDE ADEQUATE CLEARANCES AROUND EQUIPMENT FOR PROPER AIRFLOW, SERVICE ACCESS, AND


CODE COMPLIANCE. 14. ALL HVAC EQUIPMENT AND COMPONENTS, INCLUDING THERMOSTATS, DAMPERS, AND ACCESS PANELS, SHALL BE LOCATED IN ACCESSIBLE AREAS

15. THE HVAC SYSTEM SHALL BE BALANCED AND ADJUSTED TO ENSURE PROPER AIRFLOW, TEMPERATURE DISTRIBUTION, AND SYSTEM PERFORMANCE THROUGHOUT THE RESIDENCE. PROVIDE A WRITTEN REPORT DOCUMENTING THE FINAL SYSTEM BALANCE.

FOR EASY SERVICING AND MAINTENANCE. PROVIDE ADEQUATE SPACE AROUND EQUIPMENT FOR PROPER AIRFLOW AND SERVICE ACCESS.

16. ANY DEVIATIONS OR MODIFICATIONS TO THE HVAC SYSTEM DESIGN SHALL BE REVIEWED AND APPROVED BY THE RESPONSIBLE DESIGN PROFESSIONALS AND COMMUNICATED TO ALL RELEVANT PARTIES INVOLVED IN THE CONSTRUCTION PROCESS.


17. FOR ANY INQUIRIES OR CLARIFICATIONS REGARDING THE HVAC SYSTEM DESIGN, PLEASE CONSULT THE RESPONSIBLE DESIGN PROFESSIONALS OR THE PROJECT MANAGEMENT TEAM.

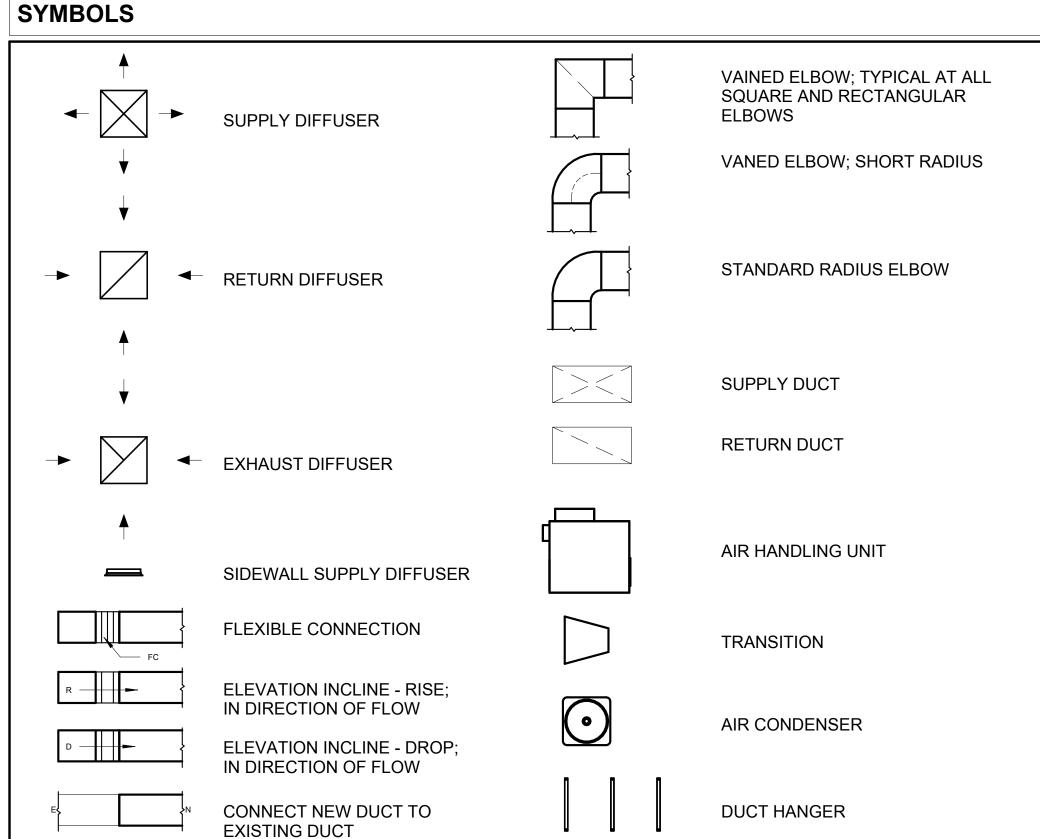



AIR CONDITIONING PIPE

	REFRIGERANT I	INE SCHEDULE	
CATAGORY	DESCRIPTION	DIAMETER	LENGTH
PIPE TYPES	COPPER	3/8"	85.91
PIPE TYPES	COPPER	3/4"	110.95

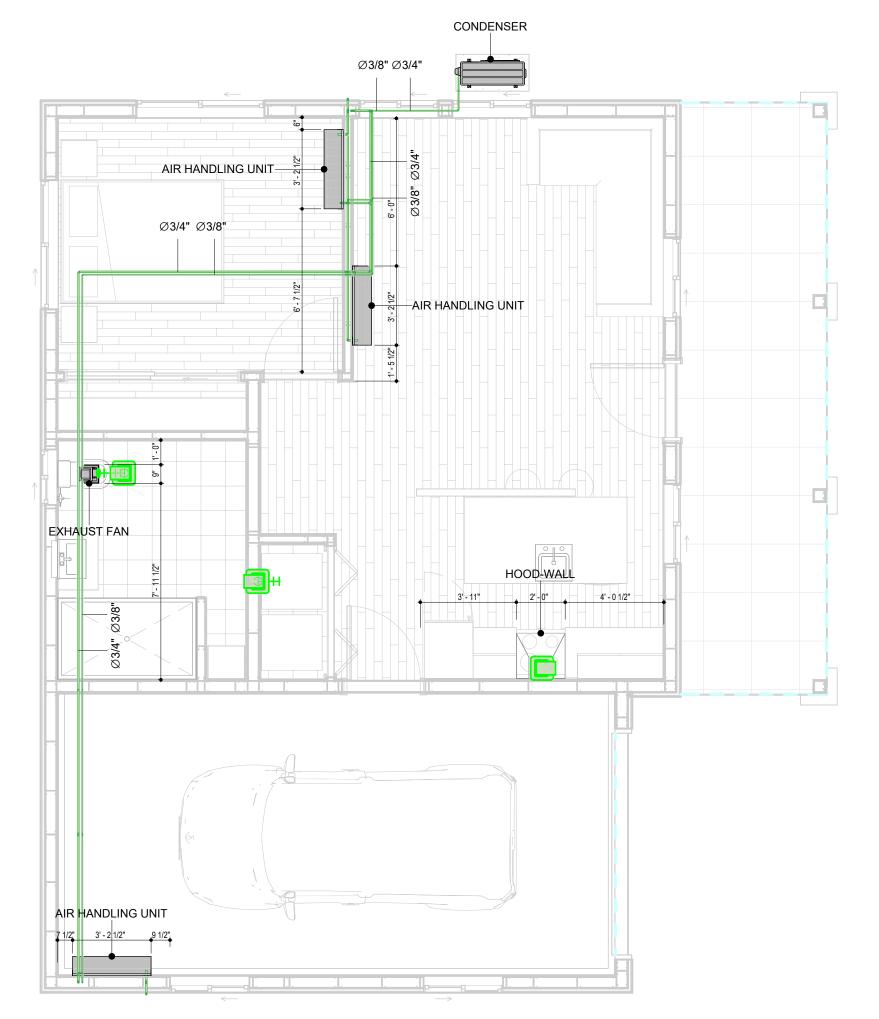

1	HVAC PLAN
	1/4" = 1'-0"

REFRIGERANT LINE FITTING SCHEDULE			
CATAGORY	DESCRIPTION	Size	Count
ELBOW - GENERIC	ELBOW - GENERIC: STANDARD/HVAC	3/4"ø-3/4"ø	27
ELBOW - GENERIC	ELBOW - GENERIC: STANDARD/HVAC	3/8"ø-3/8"ø	21
TEE - GENERIC	TEE - GENERIC: STANDARD	3/4"ø-3/4"ø-3/ 4"ø	3
TEE - GENERIC	TEE - GENERIC: STANDARD	3/8"ø-3/8"ø-3/ 8"ø	2
TRANSITION - GENERIC	TRANSITION - GENERIC: STANDARD	3/4"ø-1/2"ø	4
TRANSITION - GENERIC	TRANSITION - GENERIC: STANDARD	3/4"ø-5/8"ø	3
TRANSITION - GENERIC	TRANSITION - GENERIC: STANDARD	3/8"ø-1/4"ø	1

MECHANICAL EQUIPMENT SCHEDULE		
CATAGORY	DESCRIPTION	COUNT
AIR HANDLING UNIT	AIR HANDLING UNIT: WALL MOUNTED	3
CONDENSER	CONDENSER: OUT DOOR	1
EXHAUST FAN	EXHAUST FAN: 75 CFM	1
	HOOD-WALL: VENT	1

D	JCT FITTING SCHEDULE	
CATAGORY	DESCRIPTION	COUNT
ROUND TRANSITION - ANGLE	45 DEGREE	5

DUCT ACCESSORY SCHEDULE		
CATAGORY	DESCRIPTION	COUNT
ROOF VENT	3" DIAMETER	3

	FLEX DU	JCT SCHEDUL	.E	
DESCRIPTION	DESCRIPTION	LENGTH	DIAMETER	COUNT
FLEX DUCT ROUND	FLEX-ROUND	19.16	4"	3
GRAND TOTAL: 3		19.16	•	•



KEY PLAN

NO.	DESCRIPTION	DATE

NOTE:

LEGEND:

PROJECT

238-Ember-624-1Bd 1Ba Farmhouse-550

DRAWING NAME

HVAC PLAN

CLIENT NAME: Owner PROJECT NUMBER: 15_0001 DATE: 4/28/2025 5:20:24 AM Designer DESIGNED BY: DRAWN BY: Author CHECKED BY: Checker

M101

© [2024] [FrameUpNow] . All rights reserved

ELECTRICAL NOTES

- 1. THIS DRAWING DEPICTS THE ELECTRICAL SYSTEM FOR THE 238_Ember_624_1Bd1Ba_FarmHouse_550. IT PROVIDES A VISUAL REPRESENTATION OF THE ELECTRICAL LAYOUT AND COMPONENTS, INCLUDING POWER DISTRIBUTION, LIGHTING, AND CONTROL SYSTEMS.
- 2. THE ELECTRICAL SYSTEM IS DESIGNED TO MEET THE SPECIFIC REQUIREMENTS OF THE BUILDING, INCLUDING POWER DISTRIBUTION, LIGHTING, AND SPECIALIZED ELECTRICAL EQUIPMENT NEEDS, AS PER THE PROJECT SPECIFICATIONS AND APPLICABLE CODES AND STANDARDS.
- 3. THE ELECTRICAL SYSTEM INSTALLATION SHALL COMPLY WITH THE LATEST EDITION OF THE NATIONAL ELECTRICAL CODE (NEC), INTERNATIONAL BUILDING CODE (IBC), AND ALL OTHER APPLICABLE LOCAL, STATE, AND NATIONAL CODES AND REGULATIONS.
- 4. LOCATIONS AS NEEDED, DEVICES ARE SHOWN ON PLANS IN APPROXIMATE IDEAL LOCATIONS, UNLESS SPECIFICALLY DIMMENSIONED.
- 5. OPEN WALLS AS NEEDED TO ALLOW FOR NEW ELECTRICAL INSTALLATIONS.
- 6. LABEL ALL CIRCUITS ON JUNCTION BOXES, RECEPTACLES, DATA, SMOKE DETECTOR, AND EQUIPMENT IN PANEL BOX.
- 7. INSTALL RACEWAY AS NEEDED FOR DDC, ACCESS CONTROL, LOW VOLTAGE WIRING & DATA.
- 3. RELABEL POWER, DATA & FIRE ALARM FOR ROOM #CHANGES.
- 9. VERIFY ALL CIRCUITS LABELED ON PRINT ARE CORRECT BEFORE WORKING ON THEM.
 10. NOTE ON SITE PLAN ALL CHANGES OR MISSING DETAIL TO BE INCORPORATED INTO THE MASTER PLAN.
- 11. DRAWINGS ARE DIAGRAMMATIC ONLY FOR THE PURPOSE OF SHOWING FIXTURE AND OUTLET LOCATIONS.
- 12. ELECTRICAL CONTRACTOR TO VERIFY SERVICE SIZE BY CALCULATION BASED UPON ACTUAL NAME PLATE RATINGS OF SELECTED FOLIPMENT
- PLATE RATINGS OF SELECTED EQUIPMENT.

 13. VERIFY LOCATION OF SERVICE ENTRANCE WITH POWER COMPANY. PROVIDE UFER GROUND IN
- 13. VERIFY LOCATION OF SERVICE ENTRANCE WITH POWER COMPANY. PROVIDE UFER GROUND IN BUILDING FOUNDATION AT SERVICE ENTRANCE LOCATION.
- 14. PROVIDE A MIN. OF 20 FEET OF ONE *4 BARE COPPER UFER WIRE EMBEDDED IN CONCRETE FOOTING
- AT THE SERVICE ENTRANCE LOCATION WHERE APPROVED BY LOCAL SERVICE PROVIDER.

 15. PROVIDE WATERPROOF FIXTURES IN ALL HIGH MOISTURE AREAS (EXTERIOR, SHOWER AND TUB
- CEILINGS ETC.)
- 16. PROVIDE DEDICATED CIRCUITS TO EACH BATH, DEN, FAMILY ROOM, BEDROOM, LOFT, KITCHEN
- REFRIGERATOR, KITCHEN FREEZER DISHWASHER, AND ANY AREA/ITEM SPECIFIED BY OWNER.

 17. INCANDESCENT FIXTURES WITH OPEN OR PARTIALLY ENCLOSED LAMPS, PENDANT FIXTURES, AND
- LAMP HOLDERS ARE NOT PERMITTED IN CLOSETS.

 18. ALL WORKMANSHIP AND MATERIALS TO CONFORM WITH THE 2015 IRC.
- 19. PROVIDE A MIN. OF 20 FEET OF ONE *4 BARE COPPER UFER WIRE EMBEDDED IN CONCRETE FOOTING AT THE SERVICE ENTRANCE LOCATION WHERE APPROVED BY LOCAL SERVICE PROVIDER.
- 20. PROVIDE A BONDING CONDUCTOR CONSISTING OF A MINIMUM OF ONE *4 BARE COPPER WIRE CONNECTING THE BUILDING'S METAL WATER PIPING SYSTEM TO THE SERVICE EQUIPMENT ENCLOSURE GROUNDING.

MAIN PANEL CALCS

ELECTRICAL CALCS	
LIGHT AND OUTLETS 897 @ 3W	2,691 W
3 APPLIANCE CIRCUITS	4,500 W
DRYER	2,000 W
WASHER	2,000 W
RANGE	5,000 W
WATER HEATER	5,000 W
REFRIG.	1,800 W
DISHWASHER & DISPOSAL	3000 W
TOTAL	25,991 W
FRIST 10,000 @ 100% REMAINDER @ 40% MINI. SPLIT UNITS	10,000 W 6,396 W 10,880 W
TOTAL	26,396 W

26,396 W DIVIDED BY 240V = 110 AMPS TOTAL

(USE 200 AMP SERVICE)

ELECTRICAL ABBREVIATIONS LIST

Г						
	1P	4 DOLE (2D, 2D, 4D, ETC.)	CTD	CENTER	HT	HEIGHT
	A	1 POLE (2P, 3P, 4P, ETC.) AMPERE	CTR CU	COPPER	HTG	HEATING
	AC	ABOVE COUNTER OR AIR CONDITIONER	DCP	DOMESTIC WATER CIRCULATING PUMP	HTR	HEATER
	ACLG	ABOVE COUNTER OR AIR CONDITIONER ABOVE CEILING	DEPT	DEPARTMENT	HV	HIGH VOLTAGE
	ADO	AUTOMATIC DOOR OPENER	DET	DETAIL	HVAC	HEATING, VENTILATING AND AIR
	AF	AMP FRAME	DIA	DIAMETER	CONDITIONING	CONDITIONING
	AFF	ABOVE FINISHED FLOOR	DISC	DISCONNECT	HWP	HYDRONIC WATER PUMP
	AFG	ABOVE FINISHED FLOOR ABOVE FINISHED GRADE	DIST	DISTRIBUTION	IC	INTERRUPTING CAPACITY
	AFI	ARC FAULT CIRCUIT INTERRUPTER	DIST	DOWN	IG	ISOLATED GROUND
	AHU	AIR HANDLING UNIT	DPR	DAMPER	IMC	INTERMEDIATE METAL CONDUIT
	AL	ALUMINUM	DFR	SAFETY DISCONNECT SWITCH	INCAND	INCANDESCENT
	ALT	ALTERNATE	DT	DOUBLE THROW	IR	INFRARED
	AMP	AMPERE	DWG	DRAWING	I/W	INTERLOCK WITH
	AMPL	AMPLIFIER	DDC	DIRECT DIGITAL CONTROL	J-BOX	JUNCTION BOX
	ANNUN	ANNUNCIATOR APPROX APPROXIMATELY	EC	ELECTRICAL CONTRACTOR	KV	KILOVOLT
	AQ-STAT	AQUASTAT	ELEC	ELECTRICAL CONTRACTOR ELECTRIC, ELECTRICAL	KVA	KILOVOLT-AMPERE
	ARCH	ARCHITECT, ARCHITECTURAL	ELEV	ELEVATOR	KVAR	KILOVOLT-AMPERE REACTIVE
	ANOT	AMP SWITCH	EM	EMERGENCY	KW	KILOWATT
	AT	AMP TRIP	EMS	ENERGY MANAGEMENT SYSTEM	KWH	KILOWATT HOUR
	ATS	AUTOMATIC TRANSFER SWITCH	EMT	ELECTRICAL METALLIC TUBING	LOC	LOCATE OR LOCATION
	AUTO	AUTOMATIC	EP	ELECTRIC PNEUMATIC	LT	LIGHT
	AUX	AUXILIARY	EQUIP	EQUIPMENT	LTG	LIGHTING
	AV	AUDIO VISUAL	EWC	ELECTRIC WATER COOLER	LTNG	LIGHTNING
	AWG	AMERICAN WIRE GAUGE	EXIST	EXISTING	LV	LOW VOLTAGE
	BATT	BATTERY	EXH	EXHAUST	MAX	MAXIMUM
	BD	BOARD	EXP	EXPLOSION PROOF	MAG.S	MAGNETIC STARTER
	BLDG	BUILDING	FA	FIRE ALARM	M/C	MOMENTARY CONTACT
	BMS	BUILDING MANAGEMENT SYSTEM	FABP	FIRE ALARM BOOSTER POWER	MC	MECHANICAL CONTRACTOR
	C	CONDUIT	SUPPLY PANEL	SUPPLY PANEL	MCB	MAIN CIRCUIT BREAKER
	CAB	CABINET	FACP	FIRE ALARM CONTROL PANEL	MCC	MOTOR CONTROL CENTER
	CAT	CATALOG	FCU	FAN COIL UNIT	MDC	MAIN DISTRIBUTION CENTER
	CATV	CABLE TELEVISION	FIXT	FIXTURE	MDP	MAIN DISTRIBUTION PANEL
	CB	CIRCUIT BREAKER	FLR	FLOOR	MFR	MANUFACTURERMAIN FUSED
	CCTV	CLOSED CIRCUIT TELEVISION	FLUOR	FLUORESCENT	IVII IX	DISCONNECT SWITCH
	CKT	CIRCUIT	FU	FUSE	MH	MANHOLE
	CLG	CEILING	FUDS	FUSED SAFETY DISCONNECT SWITCH	MIC	MICROPHONE
	COMB	COMBINATION	GA	GAUGE	MIN	MINIMUM
	CMPR	COMPRESSOR	GAL	GALLON	MISC	MISCELLANEOUS
	CONN	CONNECTION	GALV	GALVANIZED	MLO	MAIN LUGS ONLY
	CONST	CONSTRUCTION	GC	GENERAL CONTRACTOR	MMS	MANUAL MOTOR STARTER
	CONT	CONTINUATION OR CONTINUOUS	GEN	GENERATOR	MOA	MULTIOUTLET ASSEMBLY
	CONTR	CONTRACTOR	GFI	GROUND FAULT CIRCUIT INTERRUPTER	MSP	MOTOR STARTER PANELBOARD
	CONV	CONVECTOR	GFP	GROUND FAULT PROTECTOR	MSBD	MAIN SWITCHBOARD
	CP	CIRCULATING PUMP	GND	GROUND	MT	MOUNT
	CRT	CATHODE-RAY TUBE	GRS	GALVANIZED RIGID STEEL (CONDUIT)	MT.C	EMPTY CONDUIT
	CT	CURRENT TRANSFORMER	GYP BD	GYPSUM BOARD	UL	UNDERWRITERS LABORATORIES
		31				

Branch Panel:

Location: LIVING ROOM 3

Supply From:

Mounting: Recessed
Enclosure: Type 1

Volts: 120/240 Single Phases: 1 Wires: 3

A.I.C. Rating: Mains Type: Mains Rating: 200 A MCB Rating: 1 A

Notes

Load Classification

Receptacle

Lighting - Dwelling Unit

Circuit Numb er		Number of Elements	Rating	Length	Wire Size	A		ı	3	Wire Size	Length	Rating	Number of Elements	Circuit Description	Circuit Numb er
1	BEDROOM LIGHT UNITS	7	20 A	31' - 11 1/8"	1-#12, 1-#12, 1-#12	568 VA	900 VA			1-#12, 1-#12, 1-#12	41' - 5 1/32"	20 A	5	BEDROOM RECEPTACLES	2
3	OUTDOOR GFCI RECEPTACLES	4	20 A	65' - 7 9/16"	1-#12, 1-#12, 1-#12			720 VA	750 VA	2-#6, 1-#6, 1-#10	14' - 11 15/16"	60 A	1	CONDENCER	4
5	LIVINGROOM RECEPTACLES	6	20 A	33' - 5 11/16"	1-#12, 1-#12, 1-#12	1080 VA	750 VA								6
7	LIVINGROOM LIGHT POINTS	4	20 A	35' - 3 29/32"	1-#12, 1-#12, 1-#12			240 VA	300 VA	1-#12, 1-#12, 1-#12	46' - 4 5/16"	20 A	5	KITCHEN AND HALL LIGHT POINTS	8
9	BATHROOM UNITS	4	20 A	50' - 2 1/2"	1-#12, 1-#12, 1-#12	396 VA	1200 VA			1-#12, 1-#12, 1-#12	40' - 10 7/8"	20 A	1	GFCI WASHER	10
11	DRYER	1	30 A	43' - 5 3/4"	2-#10, 1-#10, 1-#10			750 VA	1500 VA	1-#12, 1-#12, 1-#12	37' - 6 19/32"	20 A	1	REFRIGERATOR	12
13						750 VA	750 VA			2-#8, 1-#8, 1-#10	33' - 11 23/32"	50 A	1	RANGE	14
15	GFCI KITCHEN RECEPTACLES	3	20 A	33' - 0 13/32"	1-#12, 1-#12, 1-#12			540 VA	750 VA						16
17	DISH WASHER	1	30 A	26' - 7 1/4"	1-#10, 1-#10, 1-#10	1200 VA	750 VA			2-#10, 1-#10, 1-#10	53' - 1 23/32"	30 A	1	WATER HEATER	18
19	GARAGE GFCI RECEPTACLES	7	20 A	66' - 7 15/16"	1-#10, 1-#10, 1-#10			1260 VA	750 VA						20
21	GARAGE LIGHT POINTS	3	15 A	64' - 5 19/32"	1-#14, 1-#14, 1-#14	128 VA	400 VA			1-#12, 1-#12, 1-#12	43' - 1 1/8"	20 A	4	OUTDOOR LIGHT POINTS	22
23															24
25															26
	1					8847	VA	756	VA						-
						74	Α	63	A						

Demand Factor

100.00%

100.00%

84.29%

Estimated Demand

628 VA

1132 VA

12290 VA

Panel Totals

Total Conn. Load: 16405 VA

Total Est. Demand: 14115 VA

Total Est. Demand: 59 A

Connected Load

1132 VA

14580 VA



KEY PLAN

NO. DESCRIPTION DATE

NOTE:

LEGEND:

PROJECT

238-EMBER-624-1Bd1Ba FARMHOUSE-550

DRAWING NAME

SCHEDULE

 CLIENT NAME:
 Owner

 PROJECT NUMBER:
 0126_12

 DATE:
 5/1/2025 2:10:33 AM

 DESIGNED BY:
 Designer

 DRAWN BY:
 Author

 CHECKED BY:
 Checker

E101

SCALE: 1/4" = 1'-0"

© [2024] [FrameUpNow] . All rights reserved

ELECTRICAL NOTE

- PROVIDE INTERCONNECTED SMOKE ALARMS IN EACH SLEEPING ROOMS, OUTSIDE EACH SLEEPING ROOM, ON EACH STORY, IN THE HALL OR ADJACENT ROOM LUHERE THE CEILING HEIGHT OF A ROOM OPEN TO THE HALL EXCEEDS THE HALL BY 24'. SMOKE ALARMS SHALL BE PERMANENTLY HARD WIRED WITH BATTERY BACKUP.
- B. RECEPTACLE OUTLETS FOR RANGES AND CLOTHES DRYERS SHALL BE A THREE POLE WITH GROUND TYPE. FOUR WIRE GROUNDING-TYPE FLEXIBLE CORDS WILL BE REQUIRED FOR CONNECTION OF RANGES AND CLOTHES DRYERS. THE BONDING JUMPER SHALL NOT BE CONNECTED BETWEEN NEUTRAL TERMINAL AND THE FRAME OF THE **APPLIANCE**
- C. TWO OR MORE 20 AMP SMALL APPLIANCE CIRCUITS SHALL BE PROVIDED TO SERVE THE KITCHEN, BREAKFAST NOOK, AND DINING ROOM. SUCH CIRCUITS SHALL HAVE NO OTHER OUTLETS.
- D. AT LEAST ONE 20 AMP BRANCH CIRCUIT SHALL BE PROVIDED TO SERVICE THE LAUNDRY ROOM. THIS CIRCUIT SHALL HAVE NO OTHER OUTLETS.
- E. ALL RECEPTACLES WITH IN 6' OF A WET BAR SINK OR KITCHEN SINK TO SERVE COUNTER TOP SURFACES MUST BE GFCI. ON KITCHEN COUNTERS 12' OR WIDER NO POINT ALONG THE WALL SHALL BE MORE THAN 2' FROM A RECEPTACLE. ALL RECEPTACLES WITH IN 6' OF KITCHEN SINK MUST BE GFCI. AT LEAST ONE GFCI RECEPTACLE SHALL BE INSTALLED IN THE BATHROOM ADJACENT TO EACH BASIN.
- FIXTURES INCLUDING CEILING FANS THAT ARE LOCATED IN DAMP LOCATIONS SHALL BE LISTED TO BE SUITABLE FOR
- SUCH LOCATIONS PER 2012 IRC
- G. PROVIDE ONE (1) SWITCHED OUTLET @ ALL BEDROOMS AND DEN
- H. CEILING FANS NOT EXCEEDING 35 LBS. (WITH OR WITHOUT ACCESSORIES MAY BE SUPPORTED BY OUTLET BOXES PROVIDED THE OUTLET BOXES ARE IDENTIFIED FOR SUCH USE PER 2012 IRC
- ELECTRICAL OUTLET BOXES ON OPPOSITE SIDES OF FIRE RATED WALLS SHALL BE SEPARATED BY A HORIZONTAL DISTANCE OF NOT LESS THAN 24".
- OUTLET BOXES IN THE WALLS BETWEEN THE GARAGE AND DWELLING SHALL BE METAL OR U.L. APPROVED FIRE RESISTIVE PLASTIC. BOXES IN GARAGE CEILING SHALL BE METAL.
- K. ALL BRANCH CIRCUITS THAT SUPPLY 120 VOLTS SINGLE PHASE 15 AND 20 AMPS RECEPTACLE OUTLETS INSTALLED IN THE DWELLING SHALL BE PROTECTED BY AN ARC FAULT CIRCUIT INTERRUPTER, EXCEPT GFCI RECEPTICLES.

NOTE:

RECEPTACLES MUST BE PROVIDED IN HALLWAYS 10'-0" OR MORE IN LENGTH. FOR A ONE FAMILY DWELLINGS AND EACH OF A TWO FAMILY DWELLING THAT IS AT GRADE LEVEL, AT LEAST ONE WP-GFCI RECEPTACLE OUTLET ACCESSIBLE AT GRADE LEVEL AND NOT MORE THAN 6'-6" ABOVE GRADE SHALL BE INSTALLED AT THE FRONT AND BACK OF THE DWELLING.

NOTE: APPLIANCE DISCONNECT

E4001.5 GROUNDING OF ENCLOSURES.

METAL ENCLOSURES FOR SWITCHES OR CIRCUIT BREAKERS SHALL BE CONNECTED TO AN

EQUIPMENT GROUNDING CONDUCTOR.

METAL ENCLOSURES FOR SWITCHES OR CIRCUIT BREAKERS USED AS SERVICE


EQUIPMENT SHALL COMPLY WITH THE PROVISIONS OF SECTION E3609.4. WHERE NONMETALLIC ENCLOSURES ARE USED WITH METAL RACEWAYS OR METAL-ARMORED


CABLES, PROVISIONS SHALL BE MADE FOR CONNECTING THE EQUIPMENT GROUNDING CONDUCTOR.


NONMETALLIC BOXES FOR SWITCHES SHALL BE INSTALLED WITH A WIRING METHOD THAT


PROVIDES OR INCLUDES AN EQUIPMENT GROUNDING CONDUCTOR. (404.12)

ELECTRIC	CAL LEGEND
	Electrical Lights With Fan
0	Waterproof Recessed Can Light
	Pendant Light
0	Recessed Can Light
-	Wall Lamp
	Standalone linear
√1 0	Single Switch
₩	Three way Switch
₽ ₽	Fan Switch
	Duplex Receptacle
	Triplex Receptacle
⊕ ⊞GFCI	GFCI Receptacle
	Exhaust Fan
•	Smoke and heat detector

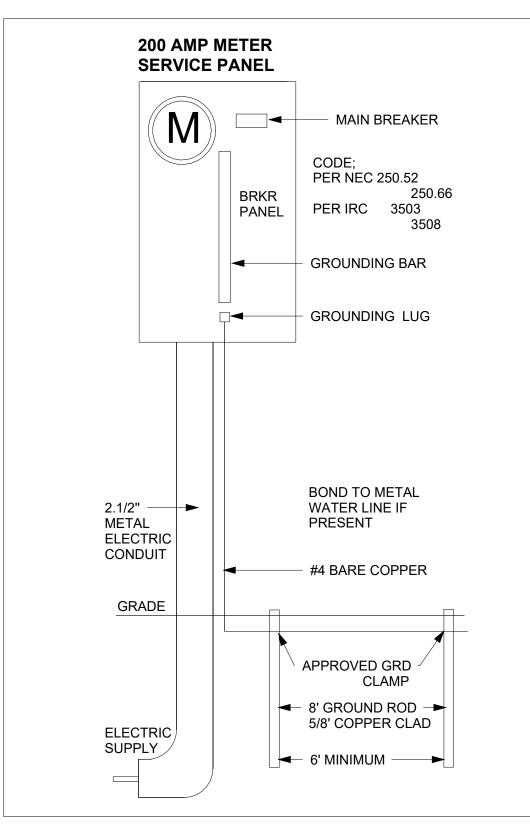

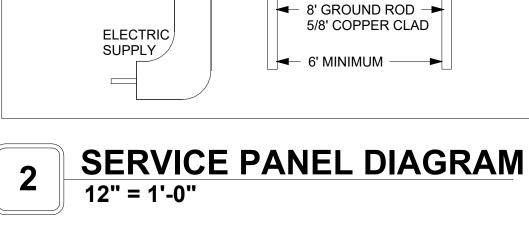

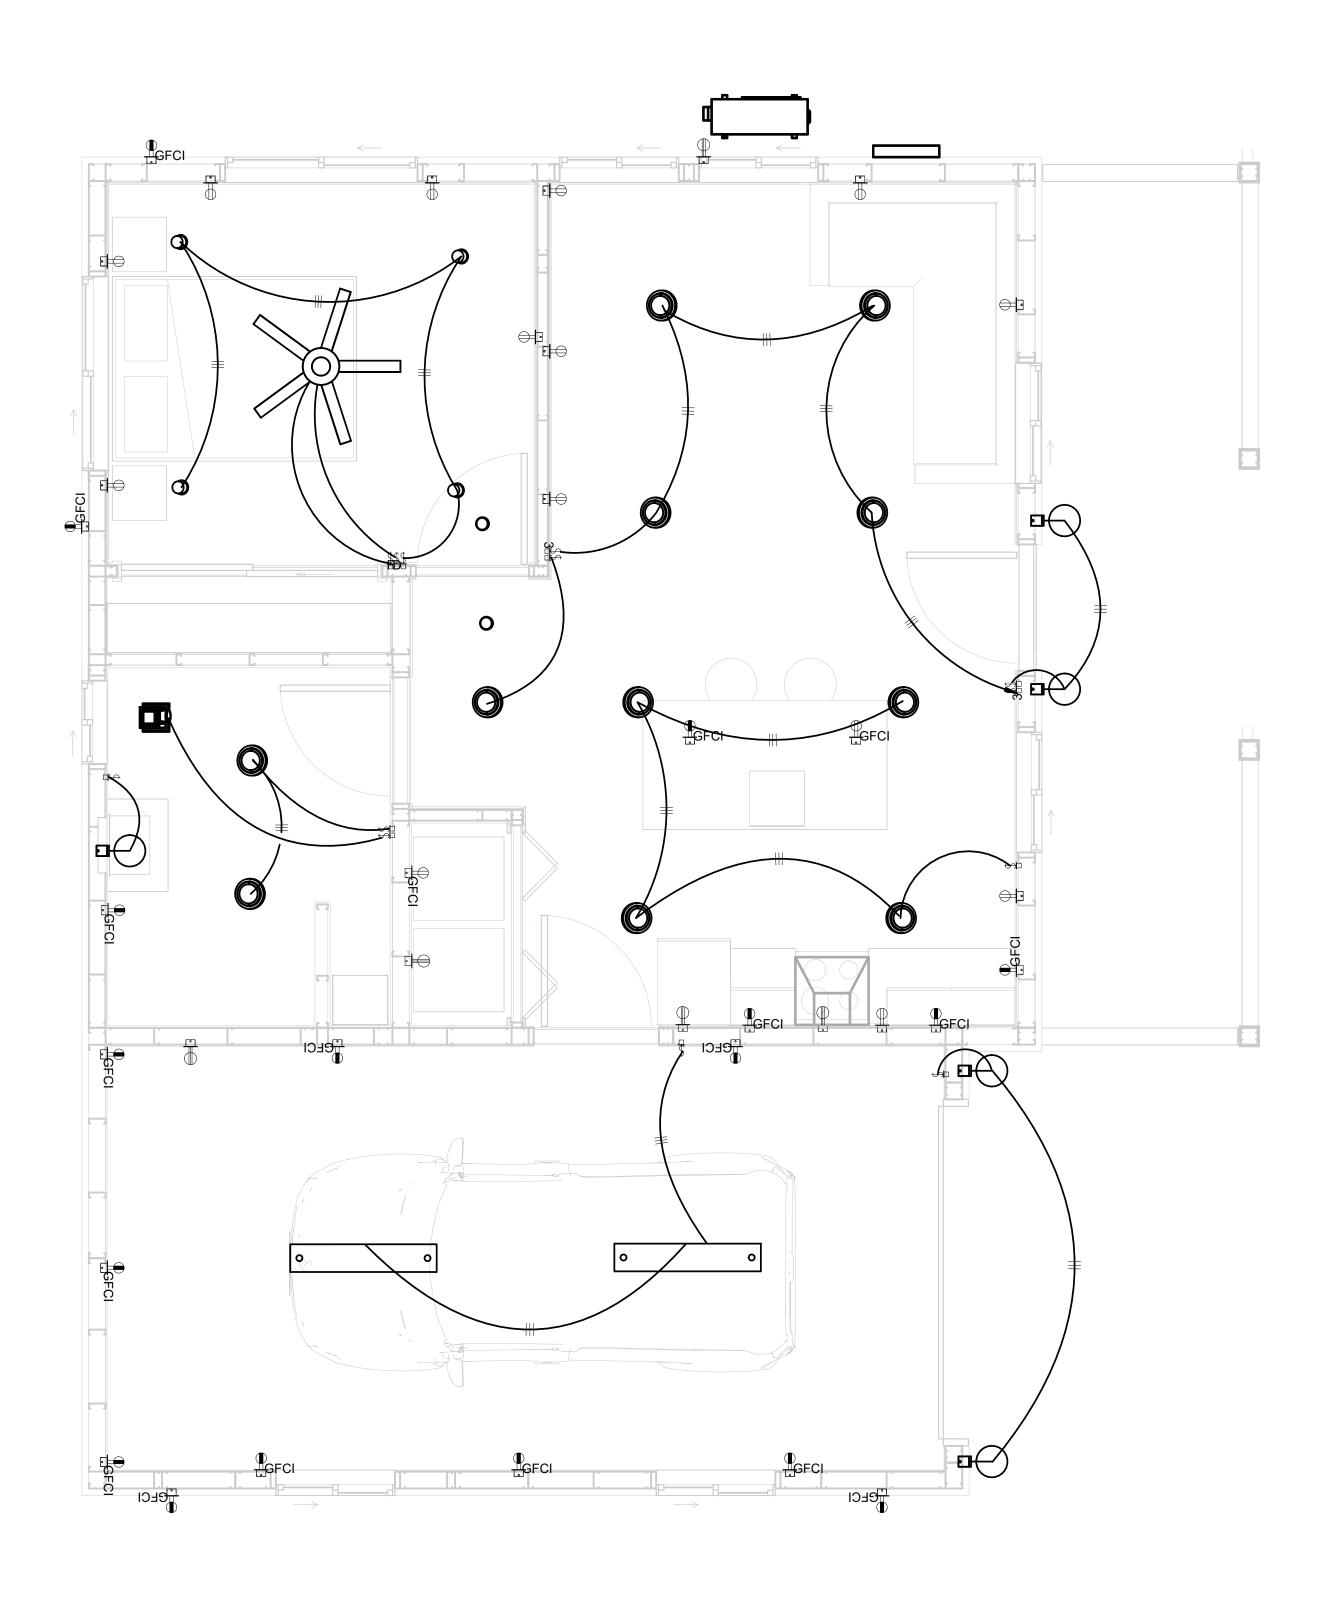

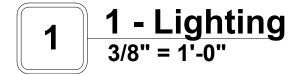



KEY PLAN

NO.	DESCRIPTION	DATE

NOTE:

LEGEND:

PROJECT

238-EMBER-624-1Bd1Ba **FARMHOUSE-550**

DRAWING NAME


LIGHTING

Owner	CLIENT NAME:
0126_12	PROJECT NUMBER:
5/1/2025 2:10:35 AM	DATE:
Designer	DESIGNED BY:
Author	DRAWN BY:
Checker	CHECKED BY:


E102

NOTES: CONDUIT, CABLE AND WIRING


- Use Metalic Conduits (IMC) for cables running under concrete slabs.
 Use IMC for circuits with high voltage appliances (240 volts and above)
 For circuits with 120 volts consider using EMT or PVC conduits if needed.
 For Low voltage applications up to 50 volts consider using non metalic conduits.
 All conduits to be used in the project must conform to the latest National Electrical Code (NEC),
- 5. All conduits to be used in the project must also conform to the latest National Electrical Code (NEC), 2015.
 6. All wiring and cables to be used in the project must also conform to the latest National Electrical Code (NEC), 2015.
 7. All cables and wires used should be rated for their respective loading and should be gauged and

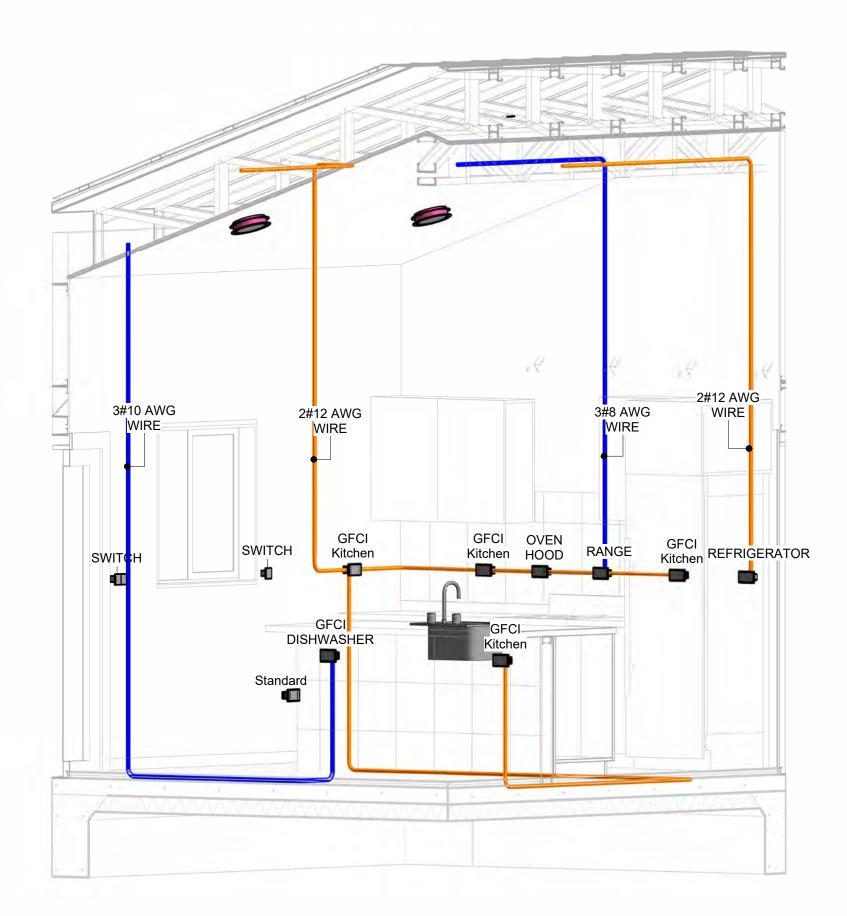




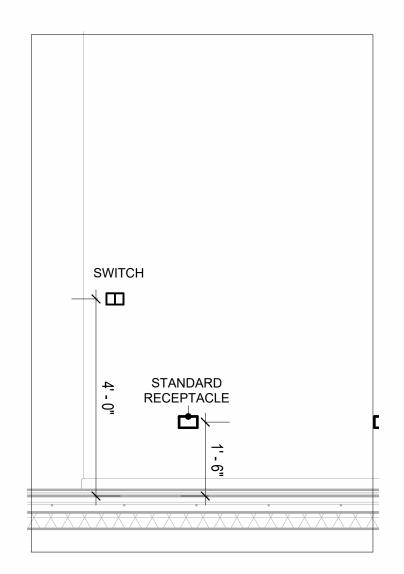


2 Section 1 1/2" = 1'-0"

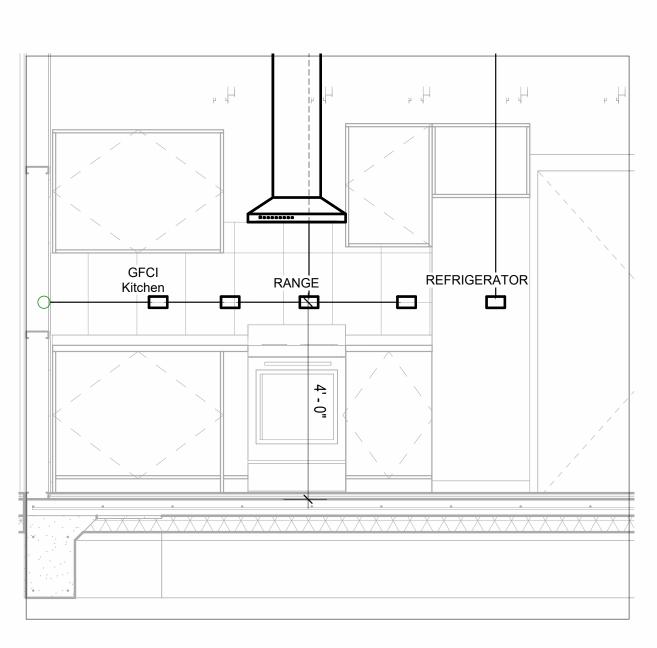


4 Section 3 1/2" = 1'-0"

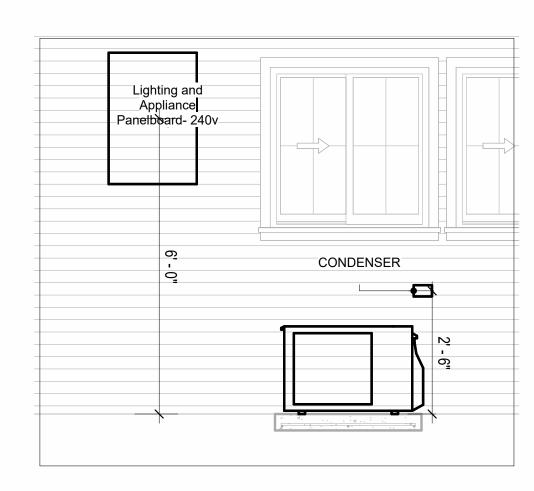


3 Section 2 1/2" = 1'-0"

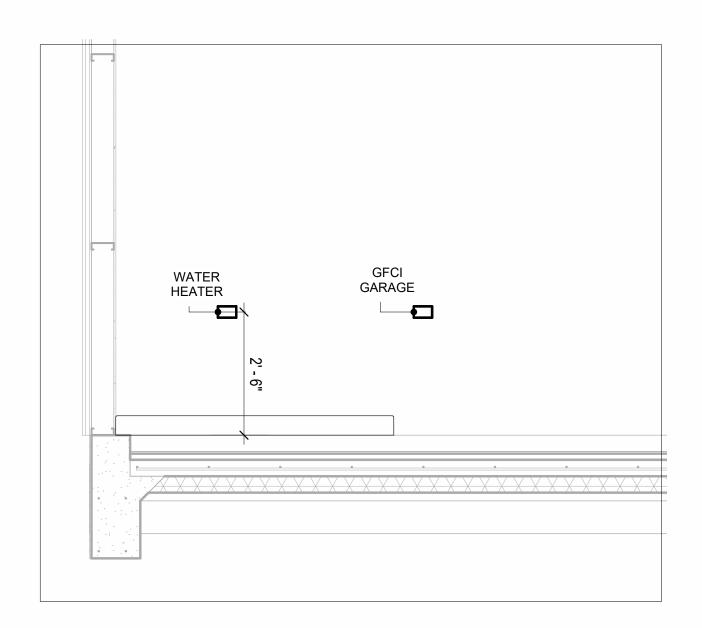

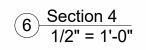



KEY PLAN

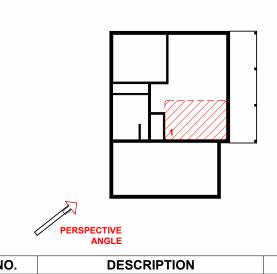

DATE

NOTE:

LEGEND:

PROJECT

238-EMBER-624-1Bd1Ba **FARMHOUSE-550**

DRAWING NAME

POWER

CLIENT NAME:	Owner
PROJECT NUMBER:	0126_12
DATE:	5/1/2025 2:11:00 AM
DESIGNED BY:	Designer
DRAWN BY:	Author
CHECKED BY:	Checker

E103

SCALE: As indicated

© [2024] [FrameUpNow] . All rights reserved

NOTES: LIGHT


- 1. LIGHT FIXTURES AND LUMINARIES SHALL CONFORM TO THE NEC, THE IRC AND LOCAL SAFETY & BUILDING CODE.
- 2. ALL LIGHTING FIXTURES SHOULD CONFORM TO THE DESIGN ELECTRICAL LOAD AND SHALL BE PROPERLY WIRED AND MOUNTED BY QUALIFIED ELECTRICIAN FOLLOWING MANUFACTURERS SPECIFICATIONS.
- 3. CEILING FANS AND FANS WITH LIGHT WITH WEIGHT EXCEEDING 35 LBS SHOULD BE PROVIDED WITH STRUCTURAL BACKING FOR SUPPORT AND SHALL BE FIXED AS PER MANUFACTURERS SPECIFICATIONS.
- 4. EXTERIOR LIGHTS SHALL CONFORM TO LOCAL BUILDING CODE AND GUIDELINES.

NOTES: SWITCH JUNCTION BOX

- 1. THE MINIMUM SIZE OF JUCTION BOX TO BE USED IS 2"X4"X(1.5" OR 3.5" DEEP) THIS ARE TO BE USED FOR SINGLE GANG SWITCH OR OUTLETS.
- 2. FOR DOUBLE GANG (2 GANG) OUTLETS AND SWITCHS THE MINIMUM SIZE OF THE
- JUCTION BOX TO BE PROVIDED SHALL NOT BE LESS THAN 4"X4"X(1.5" OR 3.5" DEEP)
- 3. FOR THREE GANG (3 GANG) OUTLETS AND SWITCHS THE MINIMUM SIZE OF THE JUĆTION BOX SHALL NOT BE LESS THAN 6"X4"X(1.5" OR 3.5" DEEP).

	Ligh	nting Device
	Туре	Count
Dimmer		1
Fan switch		1
Single Pole		9
Three Way		2

	Lighting F	Fixture	
Lighting Fixture Type	Voltage	Electrical Load	Count
Electrical_Lights_Fan-Light1	120 V/1-100 VA- 120 V/1-100 VA	200 A, 120 V/240 V, Single Phase, 3 Wires	1
Lighting_Recessed	120 V/1-60 VA	200 A, 120 V/240 V, Single Phase, 3 Wires	11
Pendant Light - Linear - 2 Lamp	120 V/1-64 VA	200 A, 120 V/240 V, Single Phase, 3 Wires	2
SASSO 100 round wallwasher trim	120 V/1-28 VA	200 A, 120 V/240 V, Single Phase, 3 Wires	4
Wall Lamp - Bracket	120 V/1-100 VA	200 A, 120 V/240 V, Single Phase, 3 Wires	5

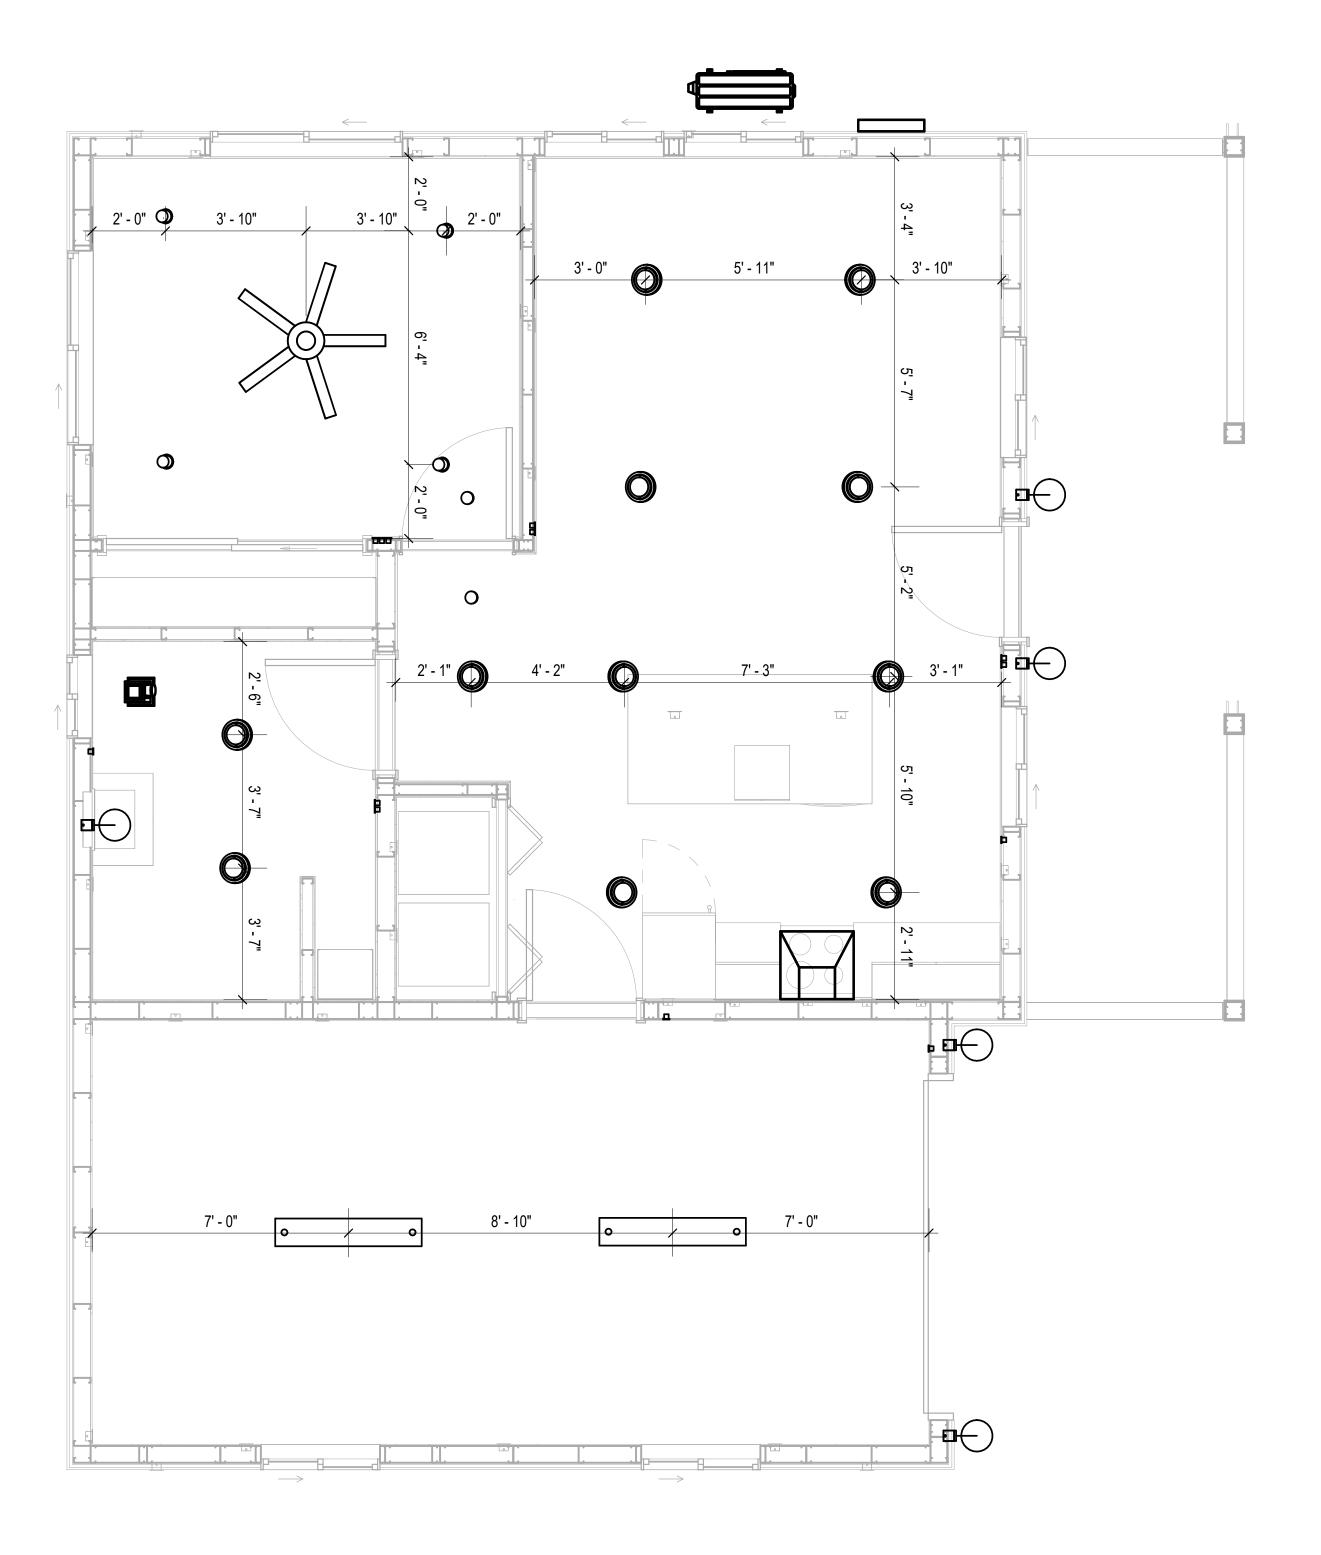

DIMENSION FOR LIGHT FIXTURES 3/8" = 1'-0"



KEY PLAN

DESCRIPTION DATE

NOTE:

LEGEND:

PROJECT

238-EMBER-624-1Bd1Ba **FARMHOUSE-550**

DRAWING NAME

DIMENSION PLAN FOR LIGHT FIXTURES

Owner CLIENT NAME: 0126_12 PROJECT NUMBER: 5/1/2025 2:11:01 AM DATE: Designer DESIGNED BY: DRAWN BY: Checker CHECKED BY:

E104


SCALE: 3/8" = 1'-0"

NOTES;

- 1. VERIFY EQUIPMENT PLUG CONFIGURATION BEFORE PURCHASING RECEPTACLES
- 2. FOR ALL EQUIPMENT.
- 3. COORDINATE EXACT LOCATION OF LIGHT FIXTURES, WALL SWITCHES, RECEPTACLES AND OTHER DEVICES WITH ARCHITECTURAL DRAWINGS.
- 4. USE METALLIC JUNCTION BOX WITH THE GFCI RECEPTACLES, WITH HIGHT VOLTAGE.

Electrica	Fixture Schedule (Receptacle)
Туре	Count
CONDENSER	1
DRYER	1
GFCI BATH ROOM	1
GFCI DISHWASHER	1
GFCI GARAGE	8
GFCI Kitchen	4
GFCI OUT DOOR	4
GFCI WASHER	1
OVEN HOOD	1
RANGE	1
REFRIGERATOR	1
Standard	10
STANDARD RECEPTACLE	1
WATER HEATER	1

	Electric	cal Outlet Schedu	le
Туре	Circuit Number	Electrical Data	Count
GFCI GARAGE		120 V/1-180 VA	1
GFCI Kitchen		120 V/1-180 VA	1
OVEN HOOD		120 V/1-180 VA	1
Standard	2	120 V/1-180 VA	5
GFCI OUT DOOR	3	120 V/1-180 VA	4
CONDENSER	4,6	240 V/2-1500 VA	1
Standard	5	120 V/1-180 VA	5
STANDARD RECEPTACLE	5	120 V/1-180 VA	1
GFCI BATH ROOM	9	120 V/1-180 VA	1
GFCI WASHER	10	120 V/1-1200 VA	1
DRYER	11,13	240 V/2-1500 VA	1
REFRIGERATOR	12	120 V/1-1500 VA	1
RANGE	14,16	240 V/2-1500 VA	1
GFCI Kitchen	15	120 V/1-180 VA	3
GFCI DISHWASHER	17	120 V/1-1200 VA	1
WATER HEATER	18,20	240 V/2-1500 VA	1
GFCI GARAGE	19	120 V/1-180 VA	7

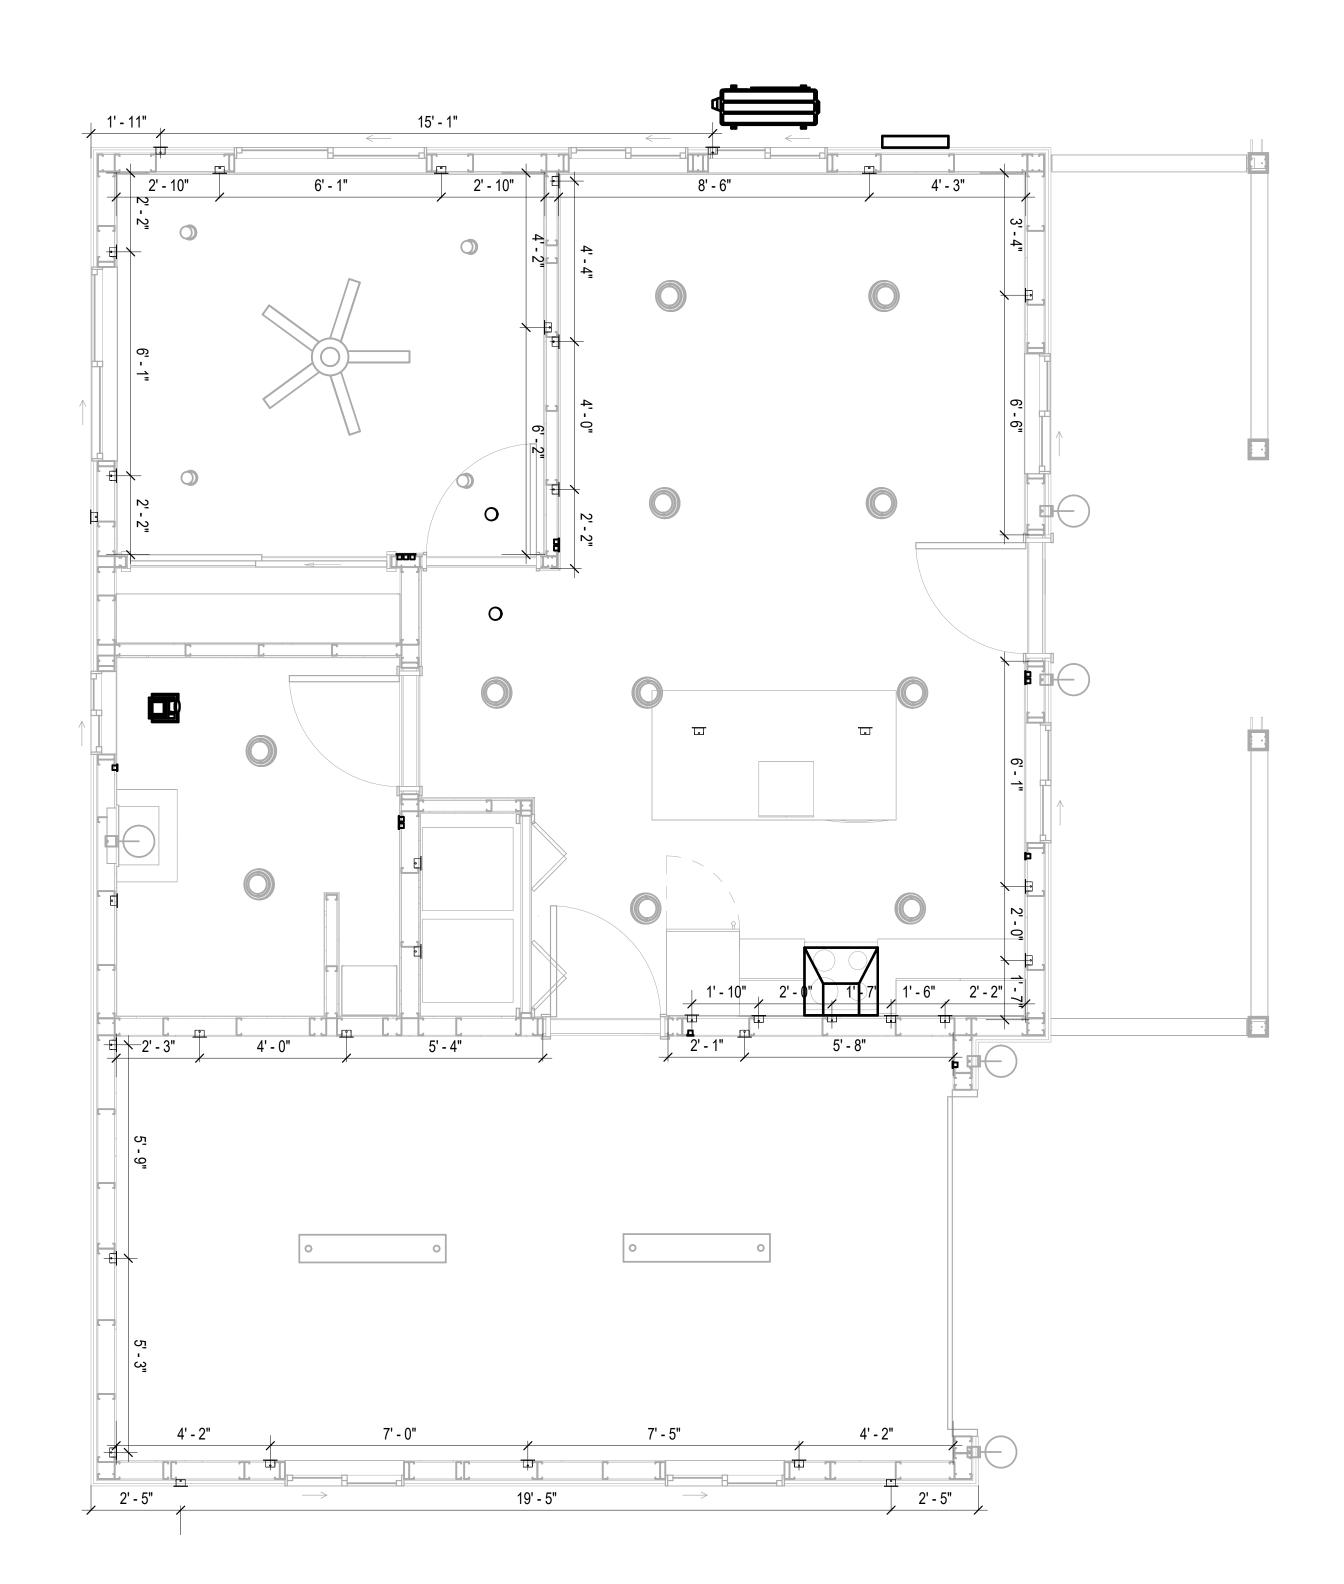

1 DIMENSION FOR FITTINGS 3/8" = 1'-0" 4

KEY PLAN

NO. DESCRIPTION DATE

NOTE:

LEGEND:

PROJECT

238-EMBER-624-1Bd1Ba FARMHOUSE-550

DRAWING NAME

DIMENSION PLAN FOR FITTINGS

Owner	CLIENT NAME:
0126_12	PROJECT NUMBER:
5/1/2025 2:11:03 AM	DATE:
Designer	DESIGNED BY:
Author	DRAWN BY:
Checker	CHECKED BY:

E105

SCALE: 3/8" = 1'-0"

SHEET LIST

SHEET NUMBER SHEET NAME

P101 NOTE AND SCHEDULE P102 WATER SUPPLY AND SEWAGE SYSTEM

PIPE C	OLOR SCHEME
	DOMESTIC COLD WATE
	DOMESTIC HOT WATER
	 SANITARY VENT
_	SANITARY SEWER
	STORM DRAINAGE
_	GRAY WATER
	GAS LINE

PLUMBING NOTES

- THE PLUMBING SYSTEM IS DESIGNED TO MEET THE BUILDING'S DOMESTIC WATER SUPPLY, SANITARY DRAINAGE, AND STORM DRAINAGE REQUIREMENTS, AS PER PROJECT SPECIFICATIONS AND APPLICABLE CODES.
- THE SYSTEM INSTALLATION SHALL COMPLY WITH THE LATEST INTERNATIONAL PLUMBING CODE (IPC), INTERNATIONAL RESIDENTIAL CODE (IRC), AND ALL OTHER RELEVANT LOCAL, STATE, AND NATIONAL REGULATIONS.
- ALL PLUMBING WORK SHALL COMPLY WITH THE LATEST EDITION OF THE INTERNATIONAL PLUMBING CODE (IPC) AND THE LOCAL PLUMBING CODE.
- PLUMBING SYSTEMS SHALL BE TESTED AND INSPECTED IN ACCORDANCE WITH THE LOCAL PLUMBING CODE REQUIREMENTS.
- 5. PLUMBING FIXTURES SHALL BE INSTALLED WITH THE APPROPRIATE TRIM, FITTINGS, AND ACCESSORIES, AS RECOMMENDED BY THE MANUFACTURER.
- 6. PIPING SHALL BE PROPERLY SUPPORTED AND SECURED TO PREVENT SAGGING, MOVEMENT, AND VIBRATION.
- SHUT-OFF VALVES SHALL BE PROVIDED AT ALL BRANCH CONNECTIONS AND AT THE INLET AND OUTLET OF EACH PIECE OF EQUIPMENT.
- BACKFLOW PREVENTION DEVICES SHALL BE INSTALLED AS REQUIRED BY THE LOCAL
- PLUMBING CODE TO PROTECT THE POTABLE WATER SYSTEM. PLUMBING FIXTURES AND EQUIPMENT SHALL BE ACCESSIBLE FOR MAINTENANCE AND
- 10. EXPOSED PLUMBING PIPING AND FIXTURES SHALL BE INSULATED TO PREVENT CONDENSATION AND ENERGY LOSS.
- 11. DEAD ENDS IN THE DRAINAGE SYSTEM MUST BE AVOIDED, EXCEPT WHERE NECESSARY TO INSTALL A CLEANOUT IN AN ACCESSIBLE LOCATION, AND MUST HAVE A VENTED CONNECTION TO THE OUTSIDE ATMOSPHERE.
- 12. THE VERTICAL DEFLECTION OF PVC PIPE MUST NOT EXCEED 5%, AND NO DEFLECTION IS PERMITTED FOR IRON PIPE.
- 13. WORK MUST BE PROPERLY COORDINATED WITH OTHER TRADES TO AVOID CONFLICTS, REFERRING TO THE ARCHITECTURAL AND STRUCTURAL DRAWINGS FOR INFORMATION REGARDING CEILING ELEVATIONS, SPACE CLEARANCES, WALL AND PARTITION LOCATIONS, ETC.
- 14. ALL FIXTURES SHALL HAVE ACCESSIBLE STOPS.
- 15. DOMESTIC WATER PIPING SHALL BE PEX, AND PVC PIPING IS NOT ACCEPTABLE FOR INTERIOR USE.
- 16. VENT TERMINATIONS SHALL BE LOCATED AT LEAST 10 FEET FROM OR 3 FEET ABOVE ANY OPERABLE WINDOW, DOOR OPENING, AIR INTAKE, OR VENT SHAFT, AND AT LEAST 3 FEET IN EVERY DIRECTION FROM ANY LOT LINE, ALLEY, OR STREET.
- 17. PIPE AND FITTINGS UTILIZED IN THE WATER SUPPLY SYSTEM SHALL HAVE A MAXIMUM OF 8 PERCENT LEAD.
- 18. ACRYLONITRILE BUTADIENE STYRENE (ABS) SHALL BE USED FOR THE SEWERAGE AND
- **VENTILATION SYSTEM.** 19. CROSS-LINKED POLYETHYLENE (PEX) SHALL BE USED FOR THE WATER SUPPLY SYSTEM.
- POLYVINYL CHLORIDE (PVC) SHALL BE USED FOR THE RAIN WATER SYSTEM.
- 21. THE MIMIMUM WATER SUPPLY DEPTH UNDER FLOOR FINISH SHOUD BE 1/2".
- 22. ANY PIPE INSTALLED UNDERGROUND MUST HAVE AT LEAST 12 INCHES OF CLEARANCE BETWEEN THE OUTSIDE OF THE PIPE AND ANY OTHER UNDERGROUND STRUCTURE.
- 23. THE MINIMUM CLEARANCE BETWEEN COLD AND HOT WATER LINES IN RESIDENTIAL HOMES MAINTAIN A MINIMUM DISTANCE OF 6 INCHES.
- HORIZONTAL SEPARATION BETWEEN WATER AND SEWER LINES: A MINIMUM OF 12 INCHES BETWEEN POTABLE WATER SUPPLY LINES (COLD AND HOT WATER) AND
- SANITARY SEWER LINES.

ABBREVIATIONS

Ø	DIAMETER
ABS	ACRYLONITRILE BUTADIENE STYRENE
ABV	ABOVE
AD	AREA DRAIN
AFF	ABOVE FINISHED FLOOR
ALT	ALTERNATE
BFF	BELOW FINISHED FLOOR
BLW	BELOW
CO	CLEAN OUT
CW	COLD WATER
D	DEGREE
DFU	DRANAGE FIXTURE UNIT
DIA	DIAMETER
DN	DOWN
FCO	FLOOR CLEAN OUT
FD	FLOOR DRAIN
FL	FLOOR
FS	FLOOR SINK
FT_	FOOT/FEET
HB	HOSE BIB
HW	HOT WATER
IN	INCH
MIN	MINIMUM
NO	NUMBER
NTS	NOT TO SCALE
PEX	CROSS-LINKED POLYETHYLENE
PLBG	PLUMBING
PVC	POLYVINYL CHLORIDE
QTY	QUANTITY
RD	ROOF DRAIN
RED	REDUCER
RM	ROOM
RW	RAIN WATER
SF	SQUARE FOOT
V	VENT
VTR	VENT THROUGH ROOF
W	WASTE
WCO	WALL CLEAN OUT
WSFU	WATER SUPPLY FIXTURE UNIT

PLUMBING LEGEND

D	CAP
	BEND 45 DEG
\Box	BEND 90 DEG
	TEE REDUCING
	TEE
	CLEAN TWO-WAY
	WYE 45 DEG
	WYE 45 DEG DOUBLE
	WYE COMBINATION
	P-TRAP

PIPE SCHEDULE					
MATERIAL	DIAMETER	LENGTH			
ACRYLONITRILE BUTADIENE STYRENE (ABS)	1 1/2"	18 FT			
ACRYLONITRILE BUTADIENE STYRENE (ABS)	2"	58 FT			
ACRYLONITRILE BUTADIENE STYRENE (ABS)	2 1/2"	6 FT			
ACRYLONITRILE BUTADIENE STYRENE (ABS)	3"	29 FT			
CROSS-LINKED POLYETHYLENE (PEX)	1/2"	57 FT			
CROSS-LINKED POLYETHYLENE (PEX)	3/4"	72 FT			
POLYVINYL CHLORIDE - RIGID	2"	69 FT			

FITTING SCHEDULE				
FITTING	SIZE	QTY		
PEX 90 DEG ELBOW	1/2"ø-1/2"ø	1		
PEX 90 DEGREE ELBOW	1/2"ø-1/2"ø	12		
PEX 90 DEGREE ELBOW	3/4"ø-3/4"ø	4		
PEX TEE ELBOW	3/4"ø-3/4"ø	7		
PEX TRANSITION ELBOW	1"ø-3/4"ø	2		
PEX TRANSITION ELBOW	3/4"ø-1/2"ø	7		
PEX 90 DEG ELBOW	1/2"ø-1/2"ø	3		
PEX 90 DEGREE ELBOW	1/2"ø-1/2"ø	8		
PEX 90 DEGREE ELBOW	3/4"ø-3/4"ø	4		
PEX TEE ELBOW	3/4"ø-3/4"ø-3/4"ø	4		
PEX TRANSITION ELBOW	3/4"ø-1/2"ø	5		
PVC 90 DEG BEND ELBOW	2"ø-2"ø	8		
PVC 90 DEGREE BEND ELBOW	2"ø-2"ø	16		
ABS 90 DEGREE BEND ELBOW	1 1/2"ø-1 1/2"ø	2		
ABS 90 DEGREE BEND ELBOW	2"ø-2"ø	2		
ABS 90 DEGREE BEND ELBOW	3"ø-3"ø	1		
ABS 90 DEGREE DOUBLE BEND ELBOW	2"ø-2"ø-2"ø	1		
ABS P-TRAP	1 1/2"ø-1 1/2"ø	3		
ABS P-TRAP	2"ø-2"ø	1		
ABS REDUCER ELBOW	2 1/2"ø-1 1/2"ø	1		
ABS REDUCER ELBOW	2"ø-1 1/2"ø	1		
ABS TEE ELBOW	1 1/2"ø-1 1/2"ø-1 1/2"ø	1		
ABS TEE ELBOW	2"ø-2"ø-2"ø	2		
ABS TEE ELBOW	3"ø-3"ø-3"ø	1		
ABS TEE REDUCER ELBOW	2 1/2"ø-2 1/2"ø-1 1/2"ø	1		
ABS TEE REDUCER ELBOW	2 1/2"ø-2 1/2"ø-2"ø	1		
ABS TEE REDUCER ELBOW	3"ø-2 1/2"ø-3"ø	1		
ABS TEE REDUCER ELBOW	3"ø-3"ø-2"ø	1		
ABS TRAP P	2"ø-2"ø	1		
ABS VENT CAP ELBOW	1 1/2"ø	1		
ABS VENT CAP ELBOW	2"ø	2		
ABS VENT CAP ELBOW	3"ø	1		

FIXTURE CONNECTION SCHEDULE											
FAMILY	W	V	TRAP	CW	HW	QTY	DFU	TOT.	WFU	TOT.	NOTES
DISHWASHER	2"	1-1/2"	1-1/2"	1/2"	1/2"	1		0			DRAIN TO SEWER SEE PLANS
DRYER	N/A	N/A	N/A	N/A	N/A	1		0			
HANGING PIPES CLAMP						14		0			
SHOWER TRAY	2"	1-1/2"	1-1/2"	1/2"	1/2"	1		0			
SHOWER TRIM	-	-	-	1/2"	1/2"	1		0			
SINK ISLAND SINGLE	2"	1-1/2"	1-1/2"	1/2"	1/2"	1		0			
VANITY SINK	2"	1-1/2"	1-1/2"	1/2"	1/2"	1		0			
WASHER	2"	1-1/2"	2"	1/2"	1/2"	1		0			DRAINS TO GRAY WATER OR SEWER SEE PLANS
WATER CLOSET						1		0			
WATER HEATER	N/A	N/A	N/A	3/4"	3/4"	1		0			

FIXTURE SCHEDULE				
FIXTURE	QTY	DESCRIPTION		
DISHWASHER	1	DRAIN TO SEWER SEE PLANS		
DRYER	1			
HANGING PIPES CLAMP	14			
SHOWER TRAY	1			
SHOWER TRIM	1			
SINK ISLAND SINGLE	1			
VANITY SINK	1			
WASHER	1	DRAINS TO GRAY WATER OR SEWER SEE PLANS		
WATER CLOSET	1			
WATER HEATER	1			

ACCESSORIES & FITTINGS SCHEDULE				
FIXTURE	QTY	DESCRIPTIONS		
DISHWASHER CONNECTOR	1			
DISTINASTER CONNECTOR	l I			
	1			
HOSE BIB LAUNDRY SWEAT CONNECTOR	1 1			

PLUMBING SCHEDULE							
FIXTURE	TRAP	WASTE	VENT	C.W	H.W		
DISHWASHER	1-1/2"	2"	1-1/2"	1/2"	1/2"		
DRYER	N/A	N/A	N/A	N/A	N/A		
SHOWER TRAY	1-1/2"	2"	1-1/2"	1/2"	1/2"		
SHOWER TRIM	-	-	-	1/2"	1/2"		
SINK ISLAND SINGLE	1-1/2"	2"	1-1/2"	1/2"	1/2"		
VANITY SINK	1-1/2"	2"	1-1/2"	1/2"	1/2"		
WASHER	2"	2"	1-1/2"	1/2"	1/2"		
WATER CLOSET							
WATER HEATER	N/A	N/A	N/A	3/4"	3/4"		

WATER FIXTURE UNIT SCHEDULE					
FAMILY	QTY	UNIT VALUE	TOTAL		
		1			
DISHWASHER	1		0		
DRYER	1		0		
HANGING PIPES CLAMP	14		0		
SHOWER TRAY	1		0		
SHOWER TRIM	1		0		
SINK ISLAND SINGLE	1		0		
VANITY SINK	1		0		
WASHER	1		0		
WATER CLOSET	1		0		
WATER HEATER	1		0		

WASTE FIXTURE UNIT SCHEDULE					
FAMILY	QTY	DFU VALUES	TOTAL		
DISHWASHER	1		0		
DRYER	1		0		
HANGING PIPES CLAMP	14		0		
SHOWER TRAY	1		0		
SHOWER TRIM	1		0		
SINK ISLAND SINGLE	1		0		
VANITY SINK	1		0		
WASHER	1		0		
WATER CLOSET	1		0		
WATER HEATER	1		0		



inquira@framaunnaw.com

KEY PLAN

NO.	DESCRIPTION	DATE

NOTE:

LEGEND:

PROJECT

238-EMBER-624-1Bd1Ba **FARMHOUSE-550**


DRAWING NAME


NOTE AND SCHEDULE

CLIENT NAME:

PROJECT NUMBER: 0126_12 DATE: 4/30/2025 9:19:42 AM Designer DESIGNED BY: DRAWN BY: Author CHECKED BY: Checker

P101

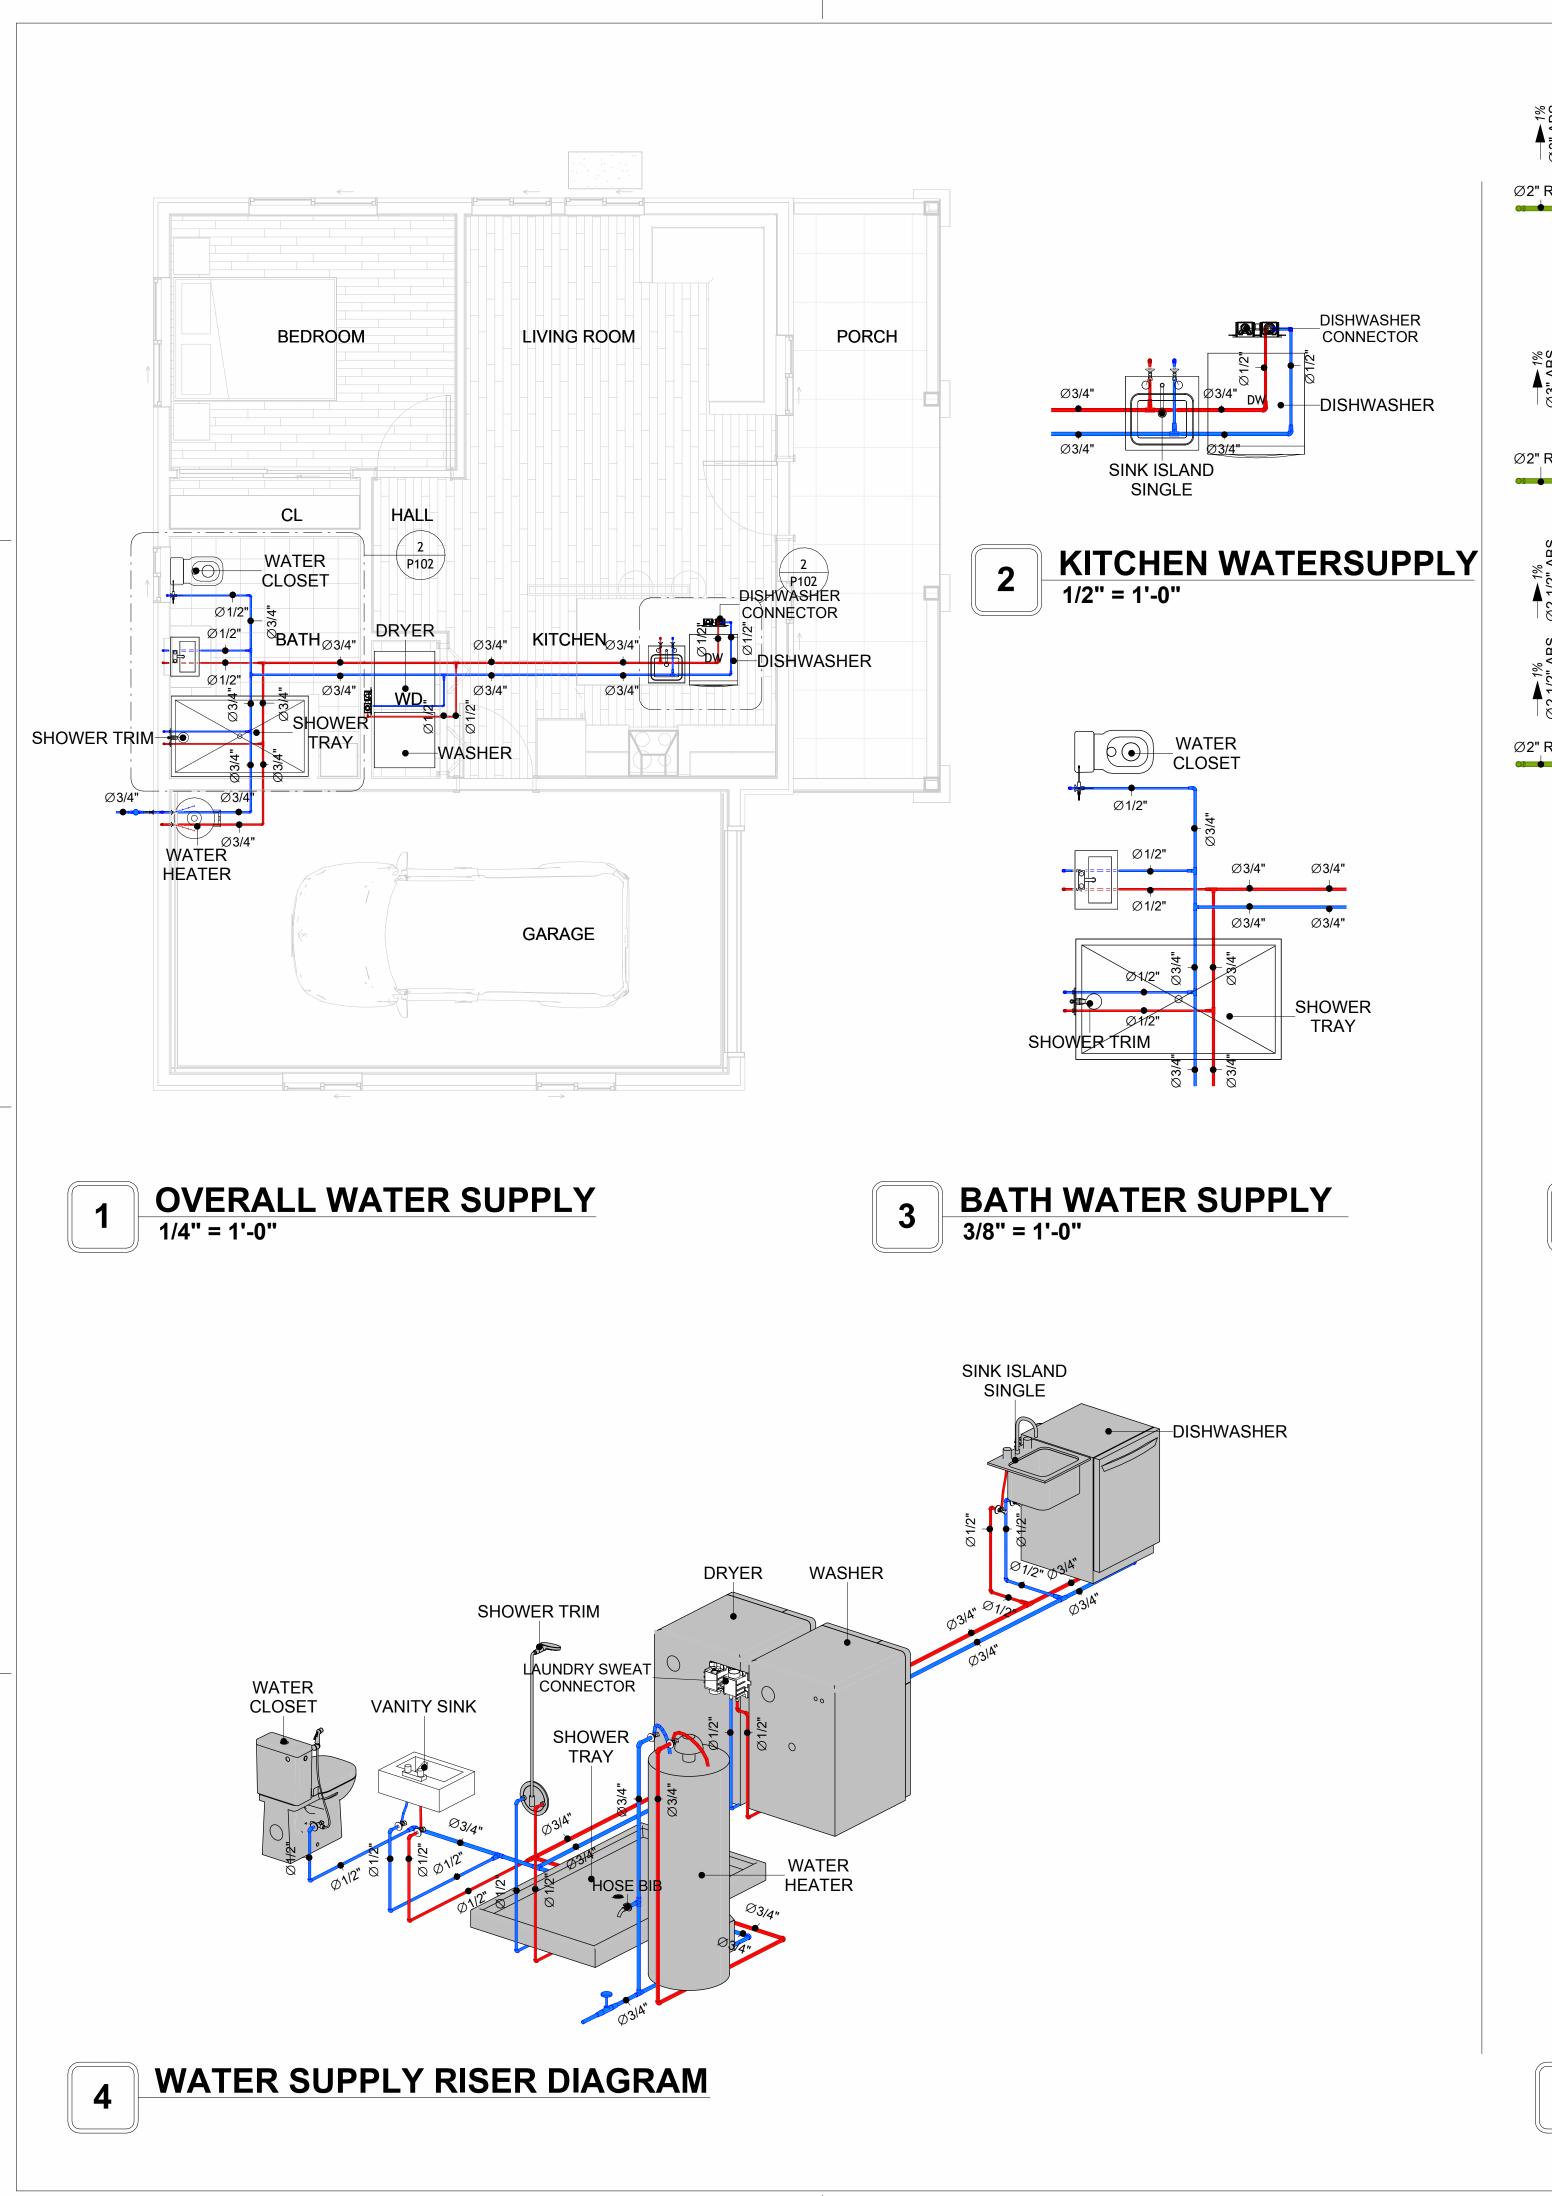


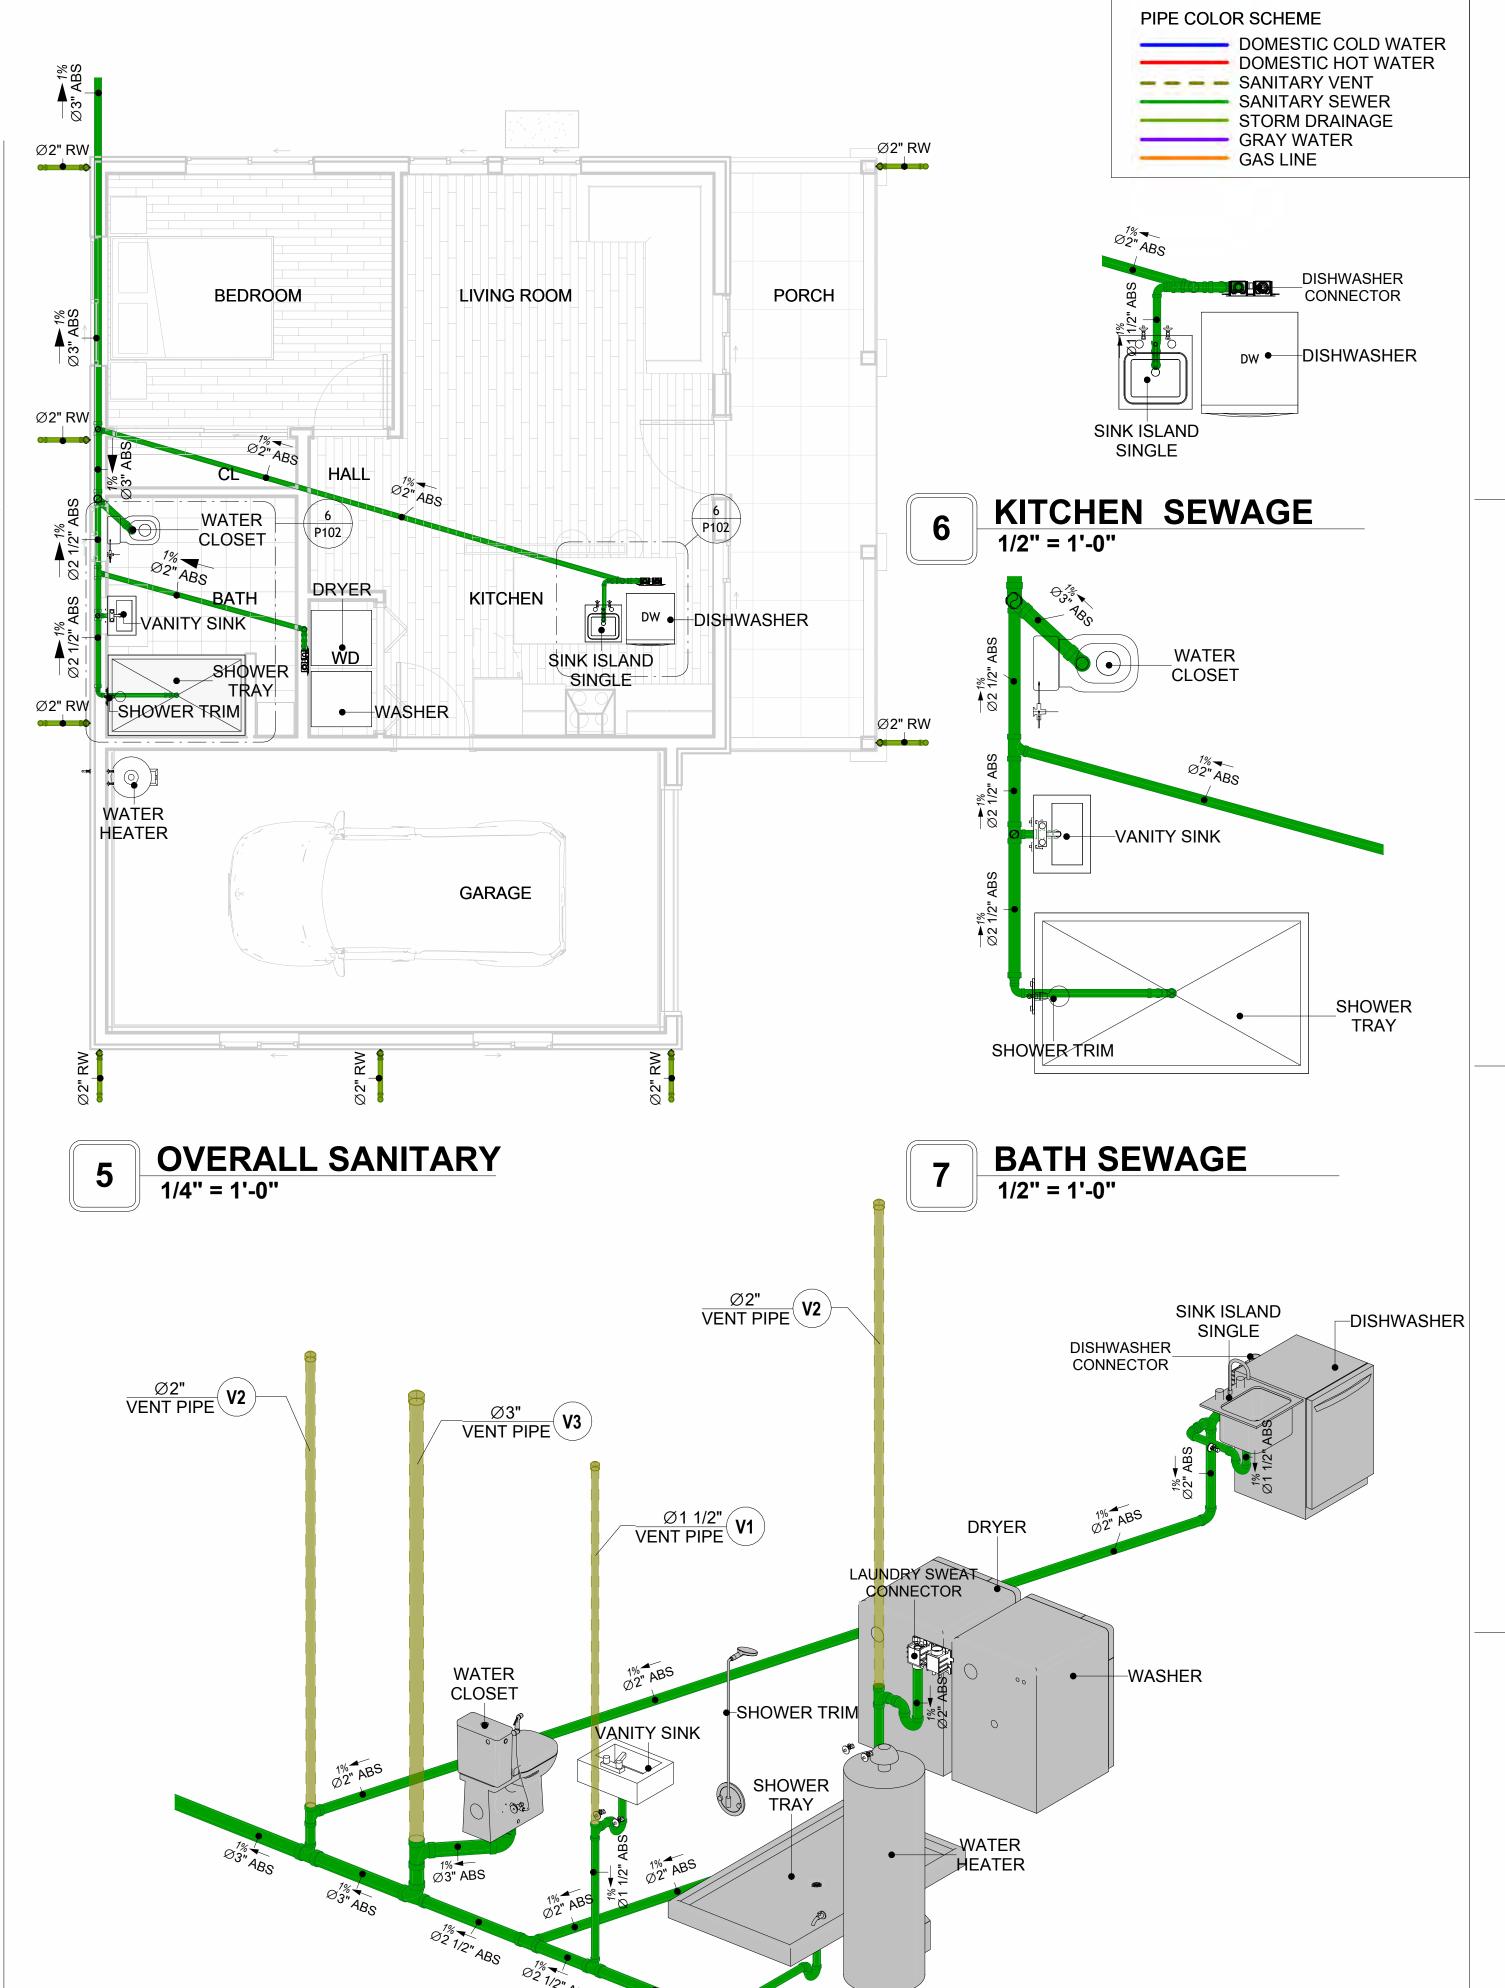

SEWAGE RISER DIAGRAM



KEY PLAN

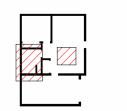

NO.	DESCRIPTION	DATE

NOTE:

LEGEND:

PROJECT

238-EMBER-624-1Bd1Ba FARMHOUSE-550

DRAWING NAME

WATER SUPPLY AND SEWAGE SYSTEM

CLIENT NAME:	
PROJECT NUMBER:	0126_12
DATE:	4/30/2025 9:20:14 AM
DESIGNED BY:	Designer
DRAWN BY:	Author
CHECKED BY:	Checker
	PROJECT NUMBER: DATE: DESIGNED BY: DRAWN BY:

P102

Materials Shopping List

Please print and take this Materials Shopping List to your favorite Home Depot and ask for assistance in selecting the materials, fixtures and fittings to complete your new home.

Record your selection and the price of the item. Then do the math to determine the cost for your selections and the total cost of finishing your home.

Have It Your Way!

The material types listed in this document were selected based on personal preferences. The Customer is encouraged to make changes to the material types in accordance with local customs, regulations, and personal preferences.

Have It Your Way!



20 good reasons to frame a home with metal and not wood



Why build your ADU with metal vs wood	Wood	Metal	Explanation
1 DIY Construction Benefit		~	The wall frames, trusses and beams can be erected in a just a few days
2 Minimal Construction Skills Required		~	Pre-assembled walls and trusses require no specialized skills to errect
Build as DIY, Hybrid or by a General Contractor		~	Do it yourself, Hybrid (involve special contractors) or hire a General Contractor
4 Build It As You Can Afford It		~	Impervious to Weather - build as you have the time and money
5 Up Front Cost of Framing Materials	~		As to only the framing material, wood is less expensive
6 Total Cost To Build		~	Savings in time, labor, and other areas make light gauge steel LESS expensive
7 Termites and wood boring insects		~	Termites, carpenter ants and wood boring insects eat wood, not metal
8 Mold resistant		~	Metal does not attract mold
9 Damage caused by exterior and interior flooding		~	Metal needs no reconditioning after a flood
10 Fire Resistant		~	Non-combustible
11 Lower insurance rates		~	Many insurance underwriters now provide lower rates for metal framed homes
12 Walls, trusses, and beams retain their original form		~	Perfectly straight walls - no shimming of drywall
13 Corners are 90 degrees		~	No need for templating of countertops to adjust for out of square corners
14 Strength and weight		~	Metal is stronger than wood and weighs less - no need for crane to lift ADU trusses
15 IBC Engineered Stamp		~	If an engineering stamp is necessary, months of waiting are saved
16 Complete BOM (Materials Shopping List)		~	Take the materials shopping list to Home Depot and start shopping/pricing
17 Flexible in Seismic Areas - Won't Fracture		~	Light gauge steel is flexible and won't fracture when the earth moves
18 No Waste At Job Site		~	Steel is the most recycled material in the world. A typical wood home has 20-30% waste
19 Environmentally Friendly		~	Trees don't have to be destroyed and the source of most metal is from recycling
20 How-To Videos Included		~	How-to videos provide simple assembly instructions
21 Relationship Counselor		~	Eliminate emotional uphevels - save time, money, and preserve the relationship

Universal Requirements - some or all may be required

- 1 Site plan
- 2 Electrical Supply Connection
- 3 Sewer Connection
- 4 Fresh Water Supply Connection
- 5 Set Backs
- 6 Soils Evaluation

- 7 Earthquake (fault) evaluation
- 8 Foundation Plan subject to soils
- 9 Compliance with local energy codes: insulation home wrap and flashing
- 10 Engineering for wind speed and snow load.
- 11 State and Local ordinances regarding ADUs
- 12 Local Architect and/or Engineer may be necessary





Ember-1Bd1Ba-Farmhouse MATERIAL SHOPPING LIST

Have It Your Way!

The material types listed in this document were selected based on personal preferences. The Customer is encouraged to make changes to the material types in accordance with local customs, regulations, and personal preferences. Have It Your Way!





15

Name Link Page No 1 Cover Page Cover Page 2 TOC TOC 2 3 ELECTRICAL BOM **ELECTRICAL BOM** 3 5 HVAC BOM **HVAC BOM** 7 PLUMBING BOM **4** PLUMBING BOM 10

Table Of Content

Have It Your Way!

ARCHITECTURAL BOM

The material types listed in this document were selected based on personal preferences. The Customer is encouraged to make changes to the material types in accordance with local customs, regulations, and personal preferences. Have It Your Way!

GENERAL NOTES

6 ARCHITECTURAL BOM

- 1 This BOM (Bill of Materials) is prepared as a Materials Shopping List to help builders and DIYers gain a complete understanding of most if not all elements required for the complete construction of this structure, according to the original design documents provided by FrameUpNow.
- 2 All quantities and specifications are subject to change based on the final design, field measurements, availability of products and customer preferences. The customer should verify all information prior to purchasing materials.
- 3 All products and elements in the list shall conform to the International Residential Code (IRC), or any other local and international building codes, safety regulations, and standards that are applicable to the location of the structure.
- 4 If any changes are made by the customer to the list of materials specified in this document, the customer is responsible for assuring that the correct type and quantity of materials are utilized in accordance with local building codes.
- FrameUpNow, will not be held responsible for any misuse of this document, the products listed, or for deviations from the content that are made due to changes in specifications, pricing, availability, or customer preferences.
- 6 The customer is advised to consult a qualified professional or technician prior to purchasing materials for specialized construction system items. Some items including but not limited to caseworks, doors and windows may require as built measurements prior to purchase to confirmation of final dimensions.
- 7 If there are additional trim elements or specific installation methods, the total amount of materials needed might vary. Consider any additional trim required for corners, intersections, or other architectural details that might cause this variations before procedding to purchase and construction.

ARCHITECTURAL BOM



				n-Farmhous			
NI -	lk. m.	ARCHITECTI				Tatal	Diti
lo.	APPLIANCES	Туре	Unit	Quantity	Unit Price	Total	Description
<u>∩</u> 1	Refrigerator		PCS	1			
2	Range		PCS	1			
3	Washer		PCS	2			
4			PCS	1			
_	Dryer Dish Washer		PCS				
5	Dish Washer			0			
6	Oven		PCS	0			
7	Microwave		PCS	0			
<u> </u>	CASEWORKS	I	ГТ	1/ 44			
1	Kitchen Cabinet		FT	16.44			
2	Laundry Cabinet		FT	0			
3	Vanity Cabinet		FT	2.5			
	Medicine Cabinet		PCS	1			
5	Kitchen countertop		SF	35.29			
6	Laundry Countertop		PCS	0			
7	Bathroom Countertop		SF	0			
8	Island		FT	0			
9	Peninsula		FT	0			
10	Closets		SF	55.5			
Δ	CEILING						
1	Ceiling Board	Dry Wall	SF	1463			
2	Dry Wall Fastener	Screw	PCS	2560			
3	Vapor Retarder	Polyethylene film	SF	1682			
4	Vapor Retarder Fastener	Nails with washer heads	PCS	5046			
5	Ceiling Board (MRD)	Moisture resistant drywall	SF	80			
6	MRD Fastener		PCS	140			
7	Ceiling Board	Marine Plywood	SF	139			
8	Marine Plywood Fastener	Screw	PCS	243			
	Dry Wall Tape		FT	841			
Δ	FLOORING	-					
	Main Living Space		SF	322.3			
2	Bathroom		SF	72.3			
3	Bedrooms		SF	139.3			
4	Garage		SF	249			
5	Porch		SF	147			
	STRUCTURE			147	I		
_	Foundation		SF	913.8			
_	WALLS EXTERIOR		51	713.0	I		
1	Exterior-Grade Plywood Horizontal Si	iding	SF	1083			
	Exterior-Grade Plywood Fastener		PKT	10.83			
	Wall Shteathing (OSB)	d Sell-drilling Screws(100/pkt)	SF	10.63			
3		C - 16 - d-1111: (100/-14)					
4	Shteathing Fastener	Self-drilling screws(100/pkt)	PKT	10.83			
5	Wall Homewrap	Charled factors (000/ 11)	SF	1083			
6	Homewrap Fastener	Stapled fastener (200/pkt)	PKT	4.1154			
7	Furring Strip		PCS	135.375			
8	Furring Strip Fastener	Self-drilling screws(100/pkt)	PKT	10.83			
	Wall Paint		SF	1083			
	Stone Copping	Masonry stone	SF	0			
	Stone Veneer	Masonry stone	SF	0			
	Mortar for Stone Veneer		SF	0			
	Wall Insulation		SF	3689.0			
	Cementitious Backer Board		SF	600			
2	Kerdi membrane		SF	600			
3	Kerdi membrane Fastener		SF	600			
	Wall Ceramic Tile		SF	600			
	Drywall Board		SF	1762			
	Drywall Fastener	Self-drilling screws(100/pkt)	PKT	17.62			
7	Wall Paint		SF	1762			
	Drywall Tape		FT	331			
U	Wall Sweep	I .	FT	125			

ARCHITECTURAL BOM



Δ	DOORS				
1	Exterior Swinging	3' - 0" X 6'-8"	PCS	1	
2	Garage Door	9' - 0" X 7'-0"	PCS	1	
3	Bifold	5' - 0" X 6'-8"	PCS	1	
4	Interior Sliding	7' - 0" X 6'-8"	PCS	1	
5	Interior Swinging	3' - 0" X 6'-8"	PCS	3	
6	Exterior Door Trim		FT	40	
7	Interior Door Trim		FT	201	
8	Entry Lock set			2	
9	Privacy Lock set			3	
10	Passage Lock set			2	
Δ	WINDOWS	·			
1	Sliding	3' - 3" X 3'-3"	PCS	6	
2	Sliding	5' - 3" X 3'-3"	PCS	2	
3	Sliding	2' - 3" X 1'-9"	PCS	1	
4	Exterior Window Trim		FT	121	
5	Interior Window Trim		FT	121	
	ROOF				
1	Roof Covering		SF	1480.0	
2	Roof Covering Fastener		PCS	740	
3	Roof Felt Paper		SF	1480.0	
4	Roof Felt Paper Fastener		PCS	4440.0	
5	Roof Sheathing		SF	1480	
6	Roof Sheathing Fastener		PCS	11840	
7	Batten		FT	711.0	
8	Batten Fastener		PCS	534.6	
9	Soffit		SF	267.0	
10	Soffit Fastener		PCS	133.5	
	Fascia		FT	161.0	
	Fascia board fastener		PCS	81	
13	Roof Insulation		SF	1480.0	



		Ember-1Bd1E	Ba-Farmho	use			
	FI	ECTRICAL MATER	PIAL SHOP	PINGLI	ST T2		
No.	Item	Type	Unit		Unit Price	Total	Description
	LIGHTING FIXTURES	71					
1	Kitchen Ceiling Light		PCS	4			
	Kitchen Wall Mounted Light		PCS	0			
3	Exterior Wall Mounted Light		PCS	4			
4	Livingroom Ceiling Light With Fan		PCS	0			
5	Bedroom Ceiling Light With Fan		PCS	1			
6	Dining Ceiling Light		PCS	0			
7	Bath Wall Mounted Light		PCS	1			
8	Bathroom Ceiling Light		PCS	2			
	Livingroom Ceiling Light		PCS	4			
	Bedroom Ceiling Light		PCS	4			
	Hall & Entry Ceiling Light		PCS	1			
			PCS	2			
	Closet Ceiling Light Smoke Detector		PCS	2			
			r\c3	2			
	ELECTRICAL FITTINGS	204	DOC	11		-	
	Standard Receptacle 120V	20A	PCS	11			
	GFCI Receptacle 120V	20 A	PCS	18			
16	GFCI Receptacle 240V	30 A	PCS	3			
17	GFCI Receptacle 240V	50 A	PCS	1			
18	GFCI Receptacle 240V	60 A	PCS	1			
	Fan Switch		PCS	1			
	Single Pole Switch		PCS	9			
	Three Way Switch		PCS	2			
22	Dimmer Switch		PCS	1			
\triangle	ELECTRICAL CONDUITS & WIRING						
23	ROMEX 14 AWG	14/2/W/ground	FT	65			
24	ROMEX 12 AWG	12/3/W/ground	FT	0			
25	ROMEX 12 AWG	12/2/W/ground	FT	459			
26	ROMEX 10 AWG	10/3/W/ground	FT	96.62			
27	ROMEX 10 AWG	10/2/W/ground	FT	93.26			
28	Romex 8 AWG	8/3/W/ground	FT	33.98			
	Romex 8 AWG	8/2/W/ground	FT	0			
	ROMEX 6 AWG	6/3/W/ground	FT	15			
	Bare Copper Ground Wire 6 AWG	- U	FT	0			
	ELECTRICAL BOXES & CIRCUTES		<u> </u>				
	Panelboard -240V 1 Phase MLO	200 AMP	PCS	1	 		
	Circuit breaker	15 A	PCS	1			
	Circuit breaker	20 A	PCS	12			
	Circuit breaker	30 A	PCS	3			
	Circuit breaker	50 A	PCS	1			
	Circuit breaker	60 A	PCS	1			
		UU A	PCS	3			
	Single Gang Switch Box Double Gang Switch Box		PCS	2			
			PCS	1			
	Triple Gang Switch Box	<u>ш</u> 111	PCS	18			
	Pull Box	#1/4					
44	Receptacle Box		PCS	34			



			Ember-1Bd1Ba-Farmhouse									
		LUMBING SYSTEM I				Table	D					
No.	PLUMBING FIXTURES & ACCESSORIES	Туре	Unit	Quantity	Unit Price	Total	Description					
	Bath Tub (Alcove Tub)		PCS	0								
2	Kitchen Sink		PCS	1								
3	Kitchen Faucets		PCS	1								
4	Vanity Sink		PCS	1								
5	Bath room Faucets		PCS	1								
6	Water Closet		PCS	1								
7	Shower Trim		PCS	1								
8	Shower Tray		PCS	1								
9	Water Heater		PCS	1								
	Hose Bib		PCS	1								
11	Shutoff Valve		PCS	6								
	Hanging pipe clamp		PCS	14								
	Globe Valve		PCS	1								
	Dishwasher Supply Single Connector		PCS	1								
	Dishwasher Sewage Single Connector		PCS	1								
	Laundry Sweat Connector		PCS	1								
	SANITARY & PLUMBING PIPES	ı	1 00	<u>'</u>								
	ABS (Acrylonitrile Butadiene Styrene) Pipes	ø 2 1/2"	FT	6								
	ABS (Acrylonitrile Butadiene Styrene) Pipes	ø 1 1/2"	FT	18								
	ABS (Acrylonitrile Butadiene Styrene) Pipes	Ø 2"	FT	58								
	ABS (Acrylonitrile Butadiene Styrene) Pipes	ø 3"	FT	29								
	PEX (Cross-linked polyethylene) Pipes	ø 1/2"	FT	57								
	PEX (Cross-linked polyethylene) Pipes	ø 3/4"	FT	72								
	Polyvinyl Chloride - Rigid	1 1/2"	FT	0								
	Polyvinyl Chloride - Rigid	2"	FT	69								
	PIPE FITTINGS	2	11	07								
	ABS 90 Degree Bend Elbow	1 1/2"ø-1 1/2"ø	PCS	2								
	ABS 90 Degree Bend Elbow	2"ø-2"ø	PCS	2								
	ABS 90 Degree Bend Elbow	3"ø-3"ø	PCS	1								
	ABS 90 Degree Double Bend Elbow	2"ø-2"ø-2"ø	PCS	1								
	ABS P-Trap	1 1/2"ø-1 1/2"ø	PCS	3								
	ABS P-Trap	2"ø-2"ø	PCS	1 1								
7	ABS Reducer Elbow	2 1/2"ø-1 1/2"ø										
8	ABS Reducer Elbow	2"ø-1 1/2"ø	PCS PCS	1 1								
9	ABS TEE Elbow	1 1/2"ø-1 1/2"ø-1 1/2"ø										
			PCS	1								
	ABS TEE Elbow	2"ø-2"ø-2"ø	PCS	2								
	ABS TEE Elbow	3"ø-3"ø-3"ø	PCS	1								
	ABS Tee Reducer Elbow	2 1/2"ø-2 1/2"ø-1 1/2"ø	PCS	1								
_	ABS Tee Reducer Elbow	2 1/2"ø-2 1/2"ø-2"ø	PCS	1								
	ABS Tee Reducer Elbow	3"ø-2 1/2"ø-3"ø	PCS	1								
	ABS Tee Reducer Elbow	3"ø-3"ø-2"ø	PCS	1								
	ABS Trap P	2"ø-2"ø	PCS	1								
	ABS Vent Cap Elbow	1 1/2"ø	PCS	1								
	ABS Vent Cap Elbow	2"ø	PCS	2								
	ABS Vent Cap Elbow	3"ø	PCS	1								
	PEX 90 Deg Elbow	1/2"ø-1/2"ø	PCS	1								
	PEX 90 Degree Elbow	1/2"ø-1/2"ø	PCS	12								
	PEX 90 Degree Elbow	3/4"ø-3/4"ø	PCS	4								
	PEX Tee Elbow	3/4"ø-3/4"ø-3/4"ø	PCS	7								
	PEX Transition Elbow	1"ø-3/4"ø	PCS	2								
	PEX Transition Elbow	3/4"ø-1/2"ø	PCS	7								
	PEX 90 Deg Elbow	1/2"ø-1/2"ø	PCS	3								
	PEX 90 Degree Elbow	1/2"ø-1/2"ø	PCS	8								
	PEX 90 Degree Elbow	3/4"ø-3/4"ø	PCS	4								
29	PEX Tee Elbow	3/4"ø-3/4"ø-3/4"ø	PCS	4								
	PEX Transition Elbow	3/4"ø-1/2"ø	PCS	5								
31	PVC 90 Deg Bend Elbow	2"ø-2"ø	PCS	8								
22	PVC 90 Degree Bend Elbow	2"ø-2"ø	PCS	16								

		Ember-1Bd	11Ba-Fa	rmhouse	9		
		HVAC SYSTEM MA	TERIAL	. SHOPP	ING LIST		
No.	Item	Туре	Unit	Quantity	Unit Price	Total	Description
	HVAC_DUCTS						
1	PIPE (REFRIGERANT LINE)	3/4" (Ø)	FT	85.91			
2	PIPE (REFRIGERANT LINE)	3/8" (Ø)	FT	110.95			
3	DRAYER HOSE	4" (Ø)	FT	9			
4	FLEX DUCT ROUND	4" (Ø)	FT	10			
\triangle	DUCT FITTINGS & ACCESSORIES						
5	ELBOW (REFRIGERANT LINE)	3/4"ø-3/4"ø	PCS	27			
6	ELBOW (REFRIGERANT LINE)	3/8"ø-3/8"ø	PCS	21			
7	TEE (REFRIGERANT LINE)	3/4"ø-3/4"ø-3/4"ø	PCS	3			
8	TEE (REFRIGERANT LINE)	3/8"ø-3/8"ø-3/8"ø	PCS	2			
9	TRANSITION(REFRIGERANT LINE)	3/4"ø-1/2"ø	PCS	4			
10	TRANSITION(REFRIGERANT LINE)	3/4"ø-5/8"ø	PCS	3			
11	TRANSITION(REFRIGERANT LINE)	3/8"ø-1/4"ø	PCS	1			
12	ROUND TRANSITION(ANGLE)	45 DEGREE	PCS	5			
	HVAC_EQUIPMENTS						
13	AIR HANDLING UNIT	WALL MOUNTED	PCS	3			
14	CONDENSER	OUTDOOR UNIT	PCS	1			
15	EXHAUST FAN	75 CFM	PCS	1			
16	ROOF VENT	3"(Ø)	PCS	1			
17	HOOD-WALL: VENT	HOOD-WALL: VENT	PCS	1			
18	DRAYER: VENT	DRAYER: VENT	PCS	1			



Table Of Content

#	Name	Link	Page No
1	Cover Page	<u>Cover Page</u>	1
2	TOC	TOC	2
3	ELECTRICAL BOM	ELECTRICAL BOM	3
5	HVAC BOM	HVAC BOM	7
4	PLUMBING BOM	PLUMBING BOM	10
6	ARCHITECTURAL BOM	ARCHITECTURAL BOM	15

Have It Your Way!

The material types listed in this document were selected based on personal preferences. The Customer is encouraged to make changes to the material types in accordance with local customs, regulations, and personal preferences. Have It Your Way!

GENERAL NOTES

- This BOM (Bill of Materials) is prepared as a Materials Shopping List to help builders and DIYers gain a complete understanding of most if not all elements required for the complete construction of this structure, according to the original design documents provided by FrameUpNow.
- 2 All quantities and specifications are subject to change based on the final design, field measurements, availability of products and customer preferences. The customer should verify all information prior to purchasing materials.
- 3 All products and elements in the list shall conform to the International Residential Code (IRC), or any other local and international building codes, safety regulations, and standards that are applicable to the location of the structure.
- 4 If any changes are made by the customer to the list of materials specified in this document, the customer is responsible for assuring that the correct type and quantity of materials are utilized in accordance with local building codes.
- FrameUpNow, will not be held responsible for any misuse of this document, the products listed, or for deviations from the content that are made due to changes in specifications, pricing, availability, or customer preferences.
- The customer is advised to consult a qualified professional or technician prior to purchasing materials for specialized construction system items. Some items including but not limited to caseworks, doors and windows may require as built measurements prior to purchase to confirmation of final dimensions.
- 7 If there are additional trim elements or specific installation methods, the total amount of materials needed might vary. Consider any additional trim required for corners, intersections, or other architectural details that might cause this variations before procedding to purchase and construction.



			LIGHTING FIXTURES				
#	Item	Туре	Description, Manufacturer, SKU	Unit	Quantity	Unit Price	Total
1	Kitchen Ceiling Light			PCS	4		
3	Kitchen Wall Mounted Light			PCS	0		
4	Exterior Wall Mounted Light			PCS	4		
5	Livingroom Ceiling Light With Fan			PCS	0		
6	Bedroom Ceiling Light With Fan			PCS	1		
7	Dining Ceiling Light			PCS	0		
8	Bath Wall Mounted Light			PCS	1		
9	Bathroom Ceiling Light			PCS	2		
10	Livingroom Ceiling Light			PCS	4		
11	Bedroom Ceiling Light			PCS	4		
12	Hall & Entry Ceiling Light			PCS	1		
12	Garage Ceiling Light			PCS	2		
13	Smoke Detector			PCS	2		
14							
15							



			ELECTRICAL FITTINGS				
#	Item	Туре	Description, Manufacturer, SKU	Unit	Quantity	Unit Price	Total
1	Standard Receptacle 120V	20A		PCS	11		
2	GFCI Receptacle 120V	20 A		PCS	18		
3	GFCI Receptacle 240V	30 A		PCS	3		
1	GFCI Receptacle 240V	50 A		PCS	1		
5	GFCI Receptacle 240V	60 A		PCS	1		
6	Fan Switch			PCS	1		
7	Single Pole Switch			PCS	9		
3	Three Way Switch			PCS	2		
9	Dimmer Switch			PCS	1		
10				'	-		
11							
12							
13							
14							
15							



		ELECTR	ICAL CONDUITS & WIRING				
#	Item	Туре	Description, Manufacturer, SKU	Unit	Quantity	Unit Price	Total
1	ROMEX 14 AWG	14/2/W/ground		FT	65		
3	ROMEX 12 AWG	12/3/W/ground		FT	0		
4	ROMEX 12 AWG	12/2/W/ground		FT	459		
6	ROMEX 10 AWG	10/3/W/ground		FT	96.62		
8	ROMEX 10 AWG	10/2/W/ground		FT	93.26		
9	Romex 8 AWG	8/3/W/ground		FT	33.98		
10	Romex 8 AWG	8/2/W/ground		FT	0		
11	ROMEX 6 AWG	6/3/W/ground		FT	15		
12	Bare Copper Ground Wire 6 AWG			FT			
13							
14							
15							
16							



		ELEC	CTRICAL BOXES & CIRCUTES				
#	Item	Туре	Description, Manufacturer, SKU	Unit	Quantity	Unit Price	Total
1	Panelboard -240V 1 Phase MLO	200 AMP		PCS	1		
2	Circuit breaker	15 A		PCS	1		
3	Circuit breaker	20 A		PCS	12		
4	Circuit breaker	30 A		PCS	3		
5	Circuit breaker	50 A		PCS	1		
6	Circuit breaker	60 A		PCS	1		
7	Single Gang Switch Box			PCS	3		
8	Double Gang Switch Box			PCS	2		
9	Triple Gang Switch Box			PCS	1		
10	Pull Box	#1/4		PCS	18		
11	Receptacle Box			PCS	34		
12							
13							
14							
15							

#	Item	Туре	Description, Manufacturer, SKU	Unit	Quantity	Unit Price	Total
1	PIPE (REFRIGERANT LINE)	3/4" (Ø)		FT	85.91		
2	PIPE (REFRIGERANT LINE)	3/8" (Ø)		FT	110.95		
3	DRAYER HOSE	4" (Ø)		FT	9		
4	FLEX DUCT ROUND	4" (Ø)		FT	10		
5							
6							
7							
8							
9							
10							
11							
12							
13							
14							
15							
16							

			DUCT FITTINGS & ACCESSORIES				
#	Item	Туре	Description, Manufacturer, SKU	Unit	Quantity	Unit Price	Total
1	ELBOW (REFRIGERANT LINE)	3/4"ø-3/4"ø		PCS	27		
2	ELBOW (REFRIGERANT LINE)	3/8"ø-3/8"ø		PCS	21		
3	TEE (REFRIGERANT LINE)	3/4"ø-3/4"ø		PCS	3		
4	TEE (REFRIGERANT LINE)	3/8"ø-3/8"ø-3/8"ø		PCS	2		
5	TRANSITION(REFRIGERA NT LINE)	3/4"ø-1/2"ø		PCS	4		
6		3/4"ø-5/8"ø		PCS	3		
7	TRANSITION(REFRIGERA NT LINE)	3/8"ø-1/4"ø		PCS	1		
8	ROUND TRANSITION(ANGLE)	45 DEGREE		PCS	5		
9							
10							
11							
12							
13							
14							
15							
16							

			HVAC_EQUIPMENTS				
#	Item	Туре	Description, Manufacturer, SKU	Unit	Quantity	Unit Price	Total
1	AIR HANDLING UNIT	WALL MOUNTED		PCS	3		
2	CONDENSER	OUTDOOR UNIT		PCS	1		
3	EXHAUST FAN	75 CFM		PCS	1		
4	ROOF VENT	3"(Ø)		PCS	1		
5	HOOD-WALL: VENT	HOOD-WALL: VENT		PCS	1		
6	DRAYER: VENT	DRAYER: VENT		PCS	1		
7							
8							
9							
10							
11							
12							
13							
14							



		PLUMBI	NG FIXTURES & ACCESSORIES				
#	Item	Туре	Description, Manufacturer, SKU	Unit	Quantity	Unit Price	Total
1	Bath Tub (Alcove Tub)			PCS	0		
2	Kitchen Sink			PCS	1		
3	Kitchen faucets			PCS	1		
4	Vanity Sink			PCS	1		
5	Bath room faucets			PCS	1		
6	Water Closet			PCS	1		
7	Shower Trim			PCS	1		
8	Shower Tray			PCS	1		
9	Water Heater			PCS	1		
10	Hose Bib			PCS	1		
11	Shutoff Valve			PCS	6		
12	Hanging pipe clamp			PCS	16		
13	Globe Valve			PCS	1		
14	Dishwasher Supply Single Connector			PCS	1		
15	Dishwasher Sewage Single Connector			PCS	1		
16	Laundry Sweat Connector			PCS	1		



		SANI	TARY & PLUMBING PIPES				
#	Item	Туре	Description, Manufacturer, SKU	Unit	Quantity	Unit Price	Total
1	ABS (Acrylonitrile Butadiene Styrene) Pipes	ø 2 1/2"		FT	6		
2	ABS (Acrylonitrile Butadiene Styrene) Pipes	ø 1 1/2"		FT	18		
3	ABS (Acrylonitrile Butadiene Styrene) Pipes	ø 2"		FT	58		
4	ABS (Acrylonitrile Butadiene Styrene) Pipes	ø 3"		FT	29		
5	PEX (Cross-linked polyethylene) Pipes	ø 1/2"		FT	57		
6	PEX (Cross-linked polyethylene) Pipes	ø 3/4"		FT	72		
7	PEX (Cross-linked polyethylene) Pipes	ø 1"		FT	0		
8	PVC Pipes Sch.80 - Rigid	ø 1 1/2"		FT	0		
9	PVC Pipes Sch.80 - Rigid	ø 2"		FT	69		
10	PVC Pipes Sch.80 - Rigid	ø 3"		FT	0		
11	Flex Pipe Round	ø 1/2"		FT	6		
12	Flex Pipe Round	ø 3/4"		FT	0		
13	Flex Pipe Round	ø 1"		FT	0		
14							
15							



		PI	PE FITTINGS 01				
#	Item	Туре	Description, Manufacturer, SKU	Unit	Quantity	Unit Price	Total
	PEX 90 Deg Elbow	1/2"ø-1/2"ø		PCS	1		
2	PEX 90 Degree Elbow	1/2"ø-1/2"ø		PCS	12		
	PEX 90 Degree Elbow	3/4"ø-3/4"ø		PCS	4		
	PEX Tee Elbow	3/4"ø-3/4"ø-3/4"ø		PCS	7		
	PEX Transition Elbow	1"ø-3/4"ø		PCS	2		
,	PEX Transition Elbow	3/4"ø-1/2"ø		PCS	7		
	PEX 90 Deg Elbow	1/2"ø-1/2"ø		PCS	3		
	PEX 90 Degree Elbow	1/2"ø-1/2"ø		PCS	8		
	PEX 90 Degree Elbow	3/4"Ø-3/4"Ø		PCS	4		
0	PEX Tee Elbow	3/4"Ø-3/4"Ø-3/4"Ø		PCS	4		
1	PEX Transition Elbow	3/4"ø-1/2"ø		PCS	5		
2	PVC 90 Deg Bend Elbow	2"Ø-2"Ø		PCS	8		
3	PVC 90 Degree Bend Elbow	2"Ø-2"Ø		PCS	16		
4	ABS 90 Degree Bend Elbow	1 1/2"ø-1 1/2"ø		PCS	2		
5	ABS 90 Degree Bend Elbow	2"ø-2"ø		PCS	2		



		PIPE	FITTINGS 02				
#	Item	Туре	Description, Manufacturer, SKU	Unit	Quantity	Unit Price	Total
1	ABS 90 Degree Bend Elbow	3"ø-3"ø		PCS	1		
2	ABS 90 Degree Double Bend Elbow	2"ø-2"ø-2"ø		PCS	1		
3	ABS P-Trap	1 1/2"ø-1 1/2"ø		PCS	3		
4	ABS P-Trap	2"ø-2"ø		PCS	1		
5	ABS Reducer Elbow	2 1/2"ø-1 1/2"ø		PCS	1		
6	ABS Reducer Elbow	2"ø-1 1/2"ø		PCS	1		
7	ABS TEE Elbow	1 1/2"ø-1 1/2"ø-1 1/2"ø		PCS	1		
8	ABS TEE Elbow	2"Ø-2"Ø-2"Ø		PCS	2		
9	ABS TEE Elbow	3"ø-3"ø-3"ø		PCS	1		
10	ABS Tee Reducer Elbow	2 1/2"ø-2 1/2"ø-1 1/2"ø		PCS	1		
11	ABS Tee Reducer Elbow	2 1/2"ø-2 1/2"ø-2"ø		PCS	1		
12	ABS Tee Reducer Elbow	3"ø-2 1/2"ø-3"ø		PCS	1		
13	ABS Tee Reducer Elbow	3"ø-3"ø-2"ø		PCS	1		
14	ABS Trap P	2"ø-2"ø		PCS	1		
15	ABS Vent Cap Elbow	1 1/2"ø		PCS	1		
	ABS Vent Cap Elbow	2"ø		PCS	2		
	ABS Vent Cap Elbow	3"ø		PCS	1		



			APPLIANCES				
#	Item	Туре	Description, Manufacturer, SKU	Unit	Quantity	Unit Price	Total
1	Refrigerator			PCS	1		
2	Range			PCS	1		
3	Washer Front Load	Stackable		PCS	2		
4	Dryer Front Load	Stackable		PCS	1		
5	Dish Washer			PCS	C		
6	Oven			PCS	C		
7	Microwave			PCS	C		
8							
9							
10							
11							
12							
13							
14							
15							
16							



			CASEWORKS 01				
#	Item	Туре	Description, Manufacturer, SKU	Unit	Quantity	Unit Price	Total
1	Kitchen Cabinet			FT	16.44		
2	Laundry Cabinet			FT	0		
3	Vanity Cabinet			FT	2.5		
4	Medicine Cabinet			PCS	1		
5	Kitchen countertop			SF	35.29		
6	Laundry Countertop			PCS	0		
7	Bathroom Countertop			SF	0		
8	Island			FT	0		
9	Peninsula			FT	0		
10	Closets			SF	55.5		
11							
12							
13							
14							
15							



			CEILING 01				
‡	Item	Туре	Description, Manufacturer, SKU	Unit	Quantity	Unit Price	Total
	LIVING ROOM + KITCHEN			SF	1112.0		
L	Ceiling Board	Drywall		SF	1112		
	Drywall Fastener	Screw		PCS	1946		
1	Vapor Retarder	Polyethylene film		SF	1112		
	Vapor Retarder Fastener	Nails with washer heads		PCS	3336		
	BATH ROOM			SF	80.0		
,	Ceiling Board	MRD (Moisture resistant drywall)		SF	80		
i	MRD Fastener	Screw		PCS	140		
	W/D			SF	16.0		
7	Ceiling Board	Drywall		SF	16		
3	Drywall Fastener	Screw		PCS	28		
)	Vapor Retarder	Polyethylene film		SF	16		
.0	Vapor Retarder Fastener	Nails with washer heads		PCS	48		
				SF	8		



			CEILING 02				
#	Item	Туре	Description, Manufacturer, SKU	Unit	Quantity	Unit Price	Total
	BED ROOM 1			SF	129.0		
11	Ceiling Board	Drywall		SF	129		
12	Drywall Fastener	Screw		PCS	226		
13	Vapor Retarder	Polyethylene film		SF	129		
14	Vapor Retarder Fastener	Nails with washer heads		PCS	387		
	GARAGE			SF	189.0		
15	Ceiling Board	Drywall		SF	189		
16	Drywall Fastener	Screw		PCS	331		
17	Vapor Retarder	Polyethylene film		SF	189		
18	Vapor Retarder Fastener	Nails with washer heads		PCS	567		
	CLOSET			SF	17.0		
19	Ceiling Board	Drywall		SF	17		
20	Drywall Fastener	Screw		PCS	30		
21	Vapor Retarder	Polyethylene film		SF	17		
22	Vapor Retarder Fastener	Nails with washer heads		PCS	51		
	PORCH			SF	139.0		
23	Ceiling Board	Marine Plywood		SF	139		
24	Exterior Grade Plywood	Screw		PCS	243.3		



	<u>1</u>		FLOORING INTERIOR 01				
#	Item	Туре	Description, Manufacturer, SKU	Unit	Quantity	Unit Price	Total
	BEDROOM						
1	Bedroom Flooring			SF	123		
2	Wood underlay	Foam Pad Polyethylene		SF	123		
3	Vapor Retarder	Vapor Barrier Polyethylene		SF	123		
	CLOSET						
4	Closet Area Flooring			SF	17		
5	Wood underlay	Foam Pad Polyethylene		SF	17		
6	Vapor Retarder	Vapor Barrier Polyethylene		SF	17		
	LIVING&KITCHEN						
7	Living Area Flooring			SF	322		
8	Wood underlay	Foam Pad Polyethylene		SF	322		
9	Vapor Retarder	Vapor Barrier Polyethylene		SF	322		
	BATHROOM						
10	Tile Finish			SF	57		
11	Adhesive	1/2" Thin set Mortar		SF	57		
12	Vapor Retarder	Vapor Barrier Polyethylene		SF	57		



			FLOORING INTERIOR 02				
#	Item	Туре	Description, Manufacturer, SKU	Unit	Quantity	Unit Price	Total
	W/D						
13	Tile Finish			SF	16		
14	Adhesive	1/2" Thin set Mortar		SF	16		
15	Vapor Retarder	Vapor Barrier Polyethylene		SF	16		
	GARAGE						
16	Epoxy top coat	Sealant high build resin coat		GAL	249		
17	Flake coat	Anti-slip quartz aggregate coat		GAL	249		
18	Primer coat	damp proof membrane		GAL	249		



			FLOORING EXTERIOR				
#	Item	Туре	Description, Manufacturer, SKU	Unit	Quantity	Unit Price	
	STRUCTURE			SF	913.8		
1	Concrete Slab	4"concrete cast in situ		CF	337		
2	Insulation	Rigid insulation		SF	306		
3	Hard core	Compacted soil		CF	272.4		
4	Re-bar	#4 re-bar		Ton	0.97		
5	Concrete Pad	4"concrete cast in situ		CF	1.50		
6	Slab edge	Turndown		CF	294.3		
7	Footing	Cast-in-place concrete		CF	13.5		
	PORCH						
8	Tile Finish			SF	147		
9	Adhesive	1/2" Thin set Mortar		SF	147		
10	Vapor Retarder	Vapor Barrier Polyethylene		SF	147		



			WALLS: EXTERIOR				
#	Item	Туре	Description, Manufacturer, SKU	Unit	Quantity	Unit Price	Total
1	Exterior-Grade Plywood Horizontal						
	Siding			SF	1083		
2	Exterior-Grade Plywood Fastener 8/panel	Self-drilling screws(100/pkt)		PKT	10.83		
3	Wall Shteathing (OSB)			SF	1083		
4	Shteathing Fastener	Self-drilling screws(100/pkt)		PKT	10.83		
5	Wall Homewrap			SF	1083		
6	Homewrap Fastener	Stapled fastener (200/pkt)		PKT	4.12		
7	Furring Strip			PCS	135.38		
8	Furring Strip Fastener	Self-drilling screws(100/pkt)		PKT	10.83		
9	Wall Paint			SF	1083		
10	Stone Copping	Masonry stone		SF	0		
11	Stone Veneer	Masonry stone		SF	0		
12	Mortar for Stone Veneer			SF	0		
13	Wall Insulation			SF	3689		



			WALLS: INTERIOR 01				
#	Item	Туре	Description, Manufacturer, SKU	Unit	Quantity	Unit Price	Total
	BATHROOM			SF	73.0		
1	Cementitious Backer Board			SF	392		
2	Kerdi membrane			SF	392		
3	Kerdi membrane Fastener			SF	392		
4	Wall Ceramic Tile			SF	392		
	BEDROOM			SF	121.0		
5	Drywall Board			SF	342		
6	Drywall Fastener	Self-drilling screws(100/pkt)		PKT	3.42		
7	Wall Paint			SF	342		
8	Drywall Tape			FT	64.1		
	HALL			SF	53.0		
9	Drywall Board			SF	160		
10	Drywall Fastener	Self-drilling screws(100/pkt)		PKT	1.6		
11	Wall Paint			SF	160		
12	Drywall Tape			FT	30		



			WALLS: INTERIOR 02				
#	Item	Туре	Description, Manufacturer, SKU	Unit	Quantity	Unit Price	Total
	LIVING ROOM			SF	174.0		
13	Drywall Board			SF	377		
14	Drywall Fastener	Self-drilling screws(100/pkt)		PKT	3.77		
15	Wall Paint			SF	377		
16	Drywall Tape			FT	70.7		
	KITCHEN			SF	91.0		
17	Cementitious Backer Board			SF	56		
18	Drywall Board			SF	210		
19	Drywall Fastener	Self-drilling screws(100/pkt)		PKT	2.1		
20	Kerdi membrane			SF	56		
21	Kerdi membrane Fastener			SF	56		
22	Wall Ceramic Tile			SF	56		
23	Wall Paint			SF	210		
24	Drywall Tape			FT	39.6		



			WALLS: INTERIOR 03				
#	Item	Туре	Description, Manufacturer, SKU	Unit	Quantity	Unit Price	Total
	CL			SF	16.0		
25	Drywall Board			SF	135		
26	Drywall Fastener	Self-drilling screws(100/pkt)		PKT	1.35		
27	Wall Paint			SF	135		
28	Drywall Tape			FT	25		
	WD			SF	17.0		
29	Cementitious Backer Board			SF	152		
30	Kerdi membrane			SF	152		
31	Kerdi membrane Fastener			SF	152		
32	Wall Ceramic Tile			SF	152		
	GARAGE	'		SF	262.0		
33	Drywall Board			SF	538		
34	Drywall Fastener	Self-drilling screws(100/pkt)		PKT	5.38		
35	Wall Paint			SF	538		
36	Drywall Tape			FT	100.9		
1	Wall Skirting	Ceramic		FT	125.0		



			DOORS				
#	Item	Туре	Description, Manufacturer, SKU	Unit	Quantity	Unit Price	Total
1	Exterior Swinging	3' - 0" X 6'-8"		PCS	1		
2	Garage Door	9' - 0" X 7'-0"		PCS	1		
3	Bifold	5' - 0" X 6'-8"		PCS	1		
4	Interior Sliding	7' - 0" X 6'-8"		PCS	1		
5	Interior Swinging	3' - 0" X 6'-8"		PCS	3		
6	Exterior Door Trim			FT	40		
7	Interior Door Trim			FT	201		
8	Entry Lock set			PCS	2		
9	Privacy Lock set			PCS	3		
10	Passage Lock set			PCS	2		
11							
12							
13							
14							
15							



		WINDOWS						
#	Item	Туре	Description, Manufacturer, SKU	Unit	Quantity	Unit Price	Total	
1	Sliding	3' - 3" X 3'-3"		PCS	6			
2	Sliding	5' - 3" X 3'-3"		PCS	2			
3	Sliding	2' - 3" X 1'-9"		PCS	1			
4	Exterior Window Trim			FT	121			
5	Interior Window Trim			FT	121			
6								
7								
8								
9								
10								
11								
12								
13								
14								
15								



		ROOF 01						
#	Item	Туре	Description, Manufacturer, SKU	Unit	Quantity	Unit Price	Total	
1	Roof Covering			SF	1480.0			
2	Roof Covering Fastener			PCS	740			
3	Roof Felt Paper			SF	1480.0			
4	Roof Felt Paper Fastener			PCS	4440.0			
5	Roof Sheathing			SF	1480.0			
6	Roof Sheathing Fastener			PCS	11840			
7	Batten			FT	711.0			
8	Batten Fastener			PCS	534.6			
9	Soffit			SF	267.0			
10	Soffit Fastener			PCS	133.5			
11	Fascia			FT	161.0			
12	Fascia board fastener			PCS	81			
13	Roof Insulation			SF	1480.0			
14					1.0010			
15								