


EMBER

The Ember is a charming Farmhouse-style 2 bedroom 1 bathroom home. The walls are finished with horizontal siding in a light, neutral tone. Multiple simple gable roofs provide shelter while a welcoming covered porch extends across the front, supported by slender white columns and featuring white railings.


Inside, the Ember features a rectangular layout. The living and kitchen areas are merged into one large room at the center of the house, creating a spacious and versatile living space. The bedrooms and the garage areas are placed on either side of the living area.

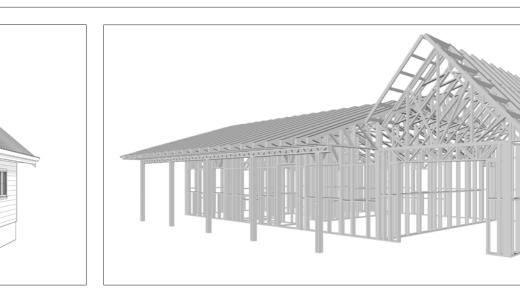

Materials Shopping List

Please print and take this Materials Shopping List to your favorite Home Depot and ask for assistance in selecting the materials, fixtures and fittings to complete your new home.

Record your selection and the price of the item. Then do the math to determine the cost for your selections and the total cost of finishing your home.

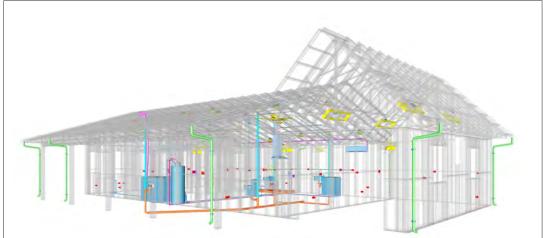

< CLICK HERE >

To Go To Materials Shopping List






FLOOR PLAN

960 SF

2 Bed Rooms



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03

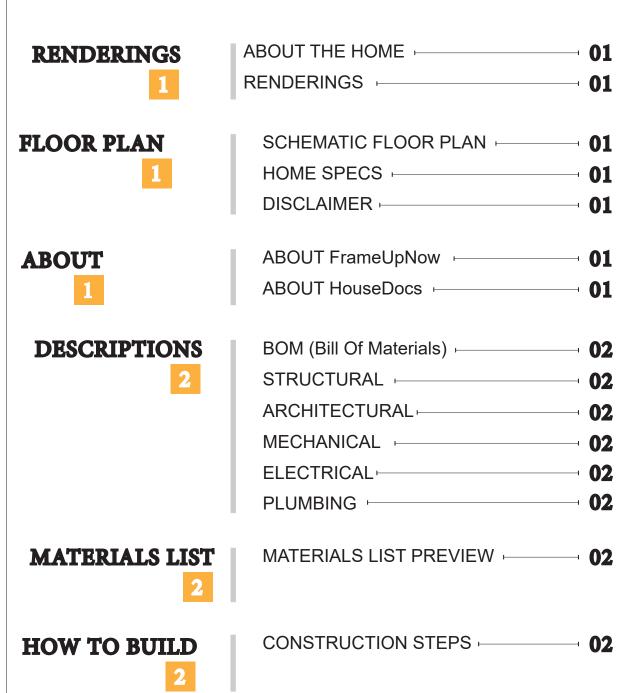COVER SHEET GENERAL NOTES WALL FRAME LAYOUT WALL PANEL & LAYOUT PLAN 19 20 ROOF TRUSS LAYOUT 21 STRUCTURAL SECTIONS WALL BRACING LAYOUT HOLD-DOWN PLAN **STRUCTURAL DETAILS 1 STRUCTURAL DETAILS 2 STRUCTURAL DETAILS 3 27** TRUSS BLOCKING LAYOUT SHEETROCK BACKING 1 **ROOF BRACING LAYOUT** 29 **COVER SHEET**

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DISCLAIMER

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MATERIALS SHOPPING LIST

MATERIALS SHOPPING LIST

DIMENSION FOR FITTING

ABOUT



FrameUpNow is a design and manufacturing company providing precision-engineered home framing solutions. We offer a catalog of Affordable Homes, Tiny Homes, Garages, Shops and Barndominiums. FrameUpNow manufactures cold-formed steel (CFS) also known as Light Gauge Steel (LGS) framing components that conform to our engineered metal house frame plans or can be purchased as DIY skeleton kits.

The CFS/LGS framing is lightweight, easily assembled, and does not require heavy equipment or specialized labor, enabling homeowners to erect the frame themselves in just a few days. Unlike wood, the steel framing is impervious termites and bores, warping, expansion, and fire.

Our home plans come complete with a structural engineered stamp for permit approvals. Customers receive a full BOM also known as a Materials Shopping List to purchase finish materials from a Building Materials retailer. FrameUpNow prides itself on the quality and efficiency of our precision-engineered home framing solutions for construction professionals and DIY homeowners.



KEY PLAN

NO.	DESCRIPTION	DATE

NOTE:

LEGEND:

PROJECT

241-Ember-960-2Bd1Ba-Farmhouse-Garage-550

DRAWING NAME

INTRODUCTION

CLIENT NAME:
PROJECT NUMBER:
DATE:
DESIGNED BY:
DRAWN BY:
CHECKED BY:

I101

SCALE:

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DESCRIPTIONS

MATERIALS LIST

The BOM (Bill Of Materials) package, known as the Materials Shopping List document, provides:

Comprehensive Inventory: Detailed lists of essential materials sourced from architectural, mechanical, HVAC, electrical, and plumbing design drawing sets.

Precise Curation: Each item meticulously selected and organized for accuracy and efficiency in project planning.

Customizable Options: Customers can modify listed items to their preferences and calculate costs accordingly, ensuring alignment with personal project needs and budget.

Dedicated Space for Details: Includes tables for customers to note Home Depot SKU numbers or product descriptions for selected items, facilitating seamless purchasing and coordination with suppliers.

Customer Convenience: Take the list to Home Depot or preferred suppliers for accurate pricing, helping align the total home budget with personal financial plans.

Simplify your construction journey with our Materials Shopping List document, where detailed preparation meets streamlined implementation for your dream home.

STRUCTURAL

The structural drawings package provides an exhaustive set of detailed plans essential for the precise assembly of your building. This comprehensive package includes:

Framing Plans: Detailed layouts for all framing components. Truss Layouts: Clear instructions for truss placement and

Panel Length Plans: Specifications for panel dimensions. Framing Elevations and Sections: Precise elevation and sectional views for accurate construction.

Truss and Wall Blocking Plans: Plans for truss and wall blocking to ensure structural integrity.

Hold-Down Plan: Detailed hold-down requirements for stability. Snap Sheet: Reference sheet for quick identification of components

Structural Details and Bracing Plans: Complete details and bracing plans for all structural elements.

Accompanying these plans is a comprehensive Bill of Materials (BOM) that lists every necessary building component, from cold formed steel (CFS) frames to fasteners.

ARCHITECTURAL

With the comprehensive architectural package, both builders and DIY homeowners can confidently execute the construction.

The architectural package includes:

Furnished Floor Plans: Complete with furniture layouts for a clear understanding of space utilization.

Detailed Dimension Plans: Ensures precise measurements, from the overall footprint down to the exact placement of windows and

Foundation Plan: Detailed plan to establish a solid foundation.

Wall Framing and Truss Layout: Comprehensive plans for wall framing and truss placement.

Architectural Elevations: Exterior views showcasing the design.

Strategic Building Sections: Critical cross-sectional details for a thorough understanding of the build.

Casework Drawings and Diagrams: Suggested designs for built-in caseworks, such as kitchen cabinets.

MECHANICAL

The mechanical package includes everything needed to guide HVAC

Detailed HVAC Floor Plan: Precisely maps out the placement of air handlers, ductwork, and vents throughout the home's layout.

HVAC Sections and Riser Diagrams: Technical drawings offering critical cross-sectional details and piping schematics, ensuring proper integration of the heating and cooling system into the home's structure.

Bill of Materials: A complete list of all necessary HVAC components.

ELECTRICAL

The electrical package includes all the plans and documentation needed to guide the installation of your home's electrical system:

Detailed Power Plan: Precisely maps out the placement of outlets, switches, and other power components throughout the layout.

Comprehensive Lighting Plan: Shows the optimal locations for lighting fixtures, sconces, and other illumination sources to create a well-lit, functional interior.

Dimensioned Electrical Layout: Provides exact dimensions and measurements to ensure proper placement of all electrical elements.

Bill of Materials: A complete list of every component needed, from circuit breakers to wiring.

installation of your home's water supply and drainage systems:

Detailed Water Supply System Plan: Precisely maps out the placement of pipes, valves, and plumbing fixtures throughout the

Comprehensive Sewage System Plan: Shows the optimal routing and sizing of drain lines to effectively remove waste and ensure

Detailed Riser Diagrams: Provide information needed to properly

PLUMBING

The plumbing package includes everything needed to guide the

proper drainage.

install all vertical plumbing risers and vent stacks.

Bill of Materials: A complete list of every component needed, from pipes to fixtures.


BOM (Bill Of Materials) (Separately Attached)





The Bill of Materials (BOM) is a crucial document that compiles the material requirements from different disciplines into a centralized inventory, enabling efficient procurement, inventory management, and cost estimation for a specified project or

ELECTRICAL BOM



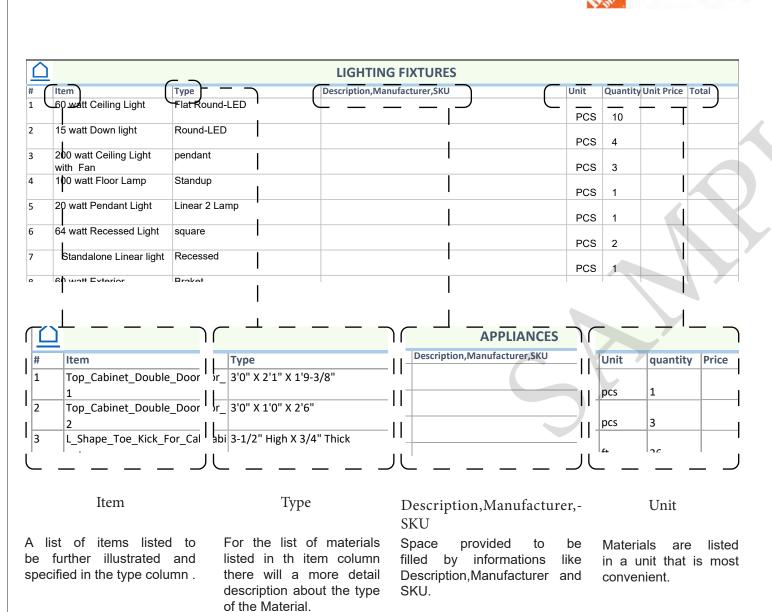

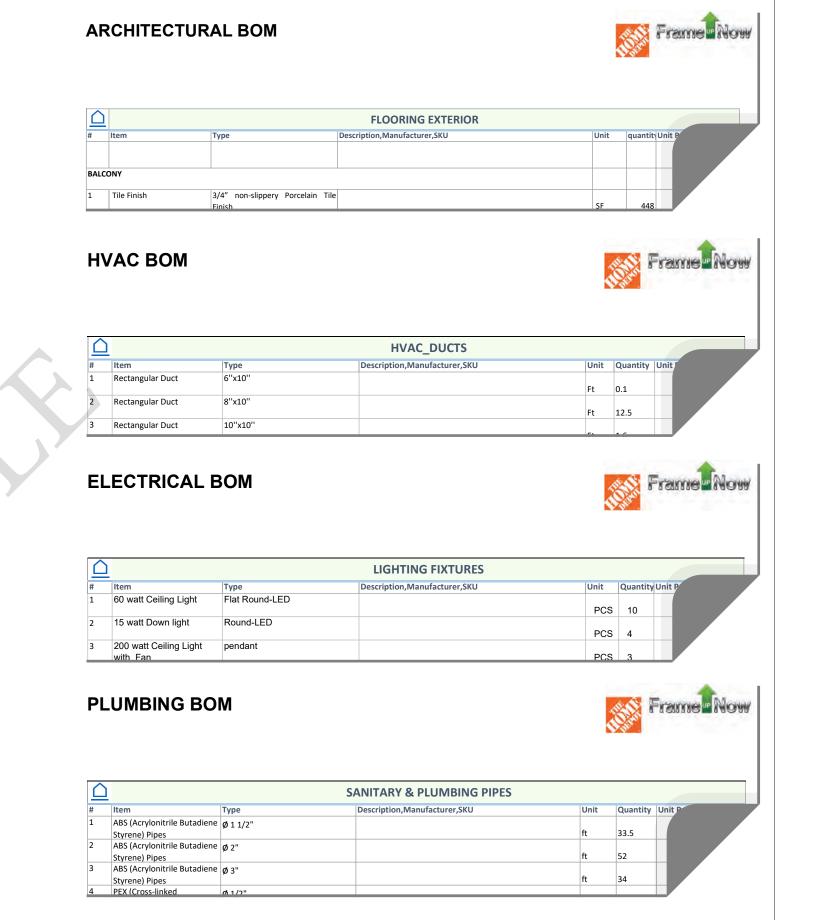

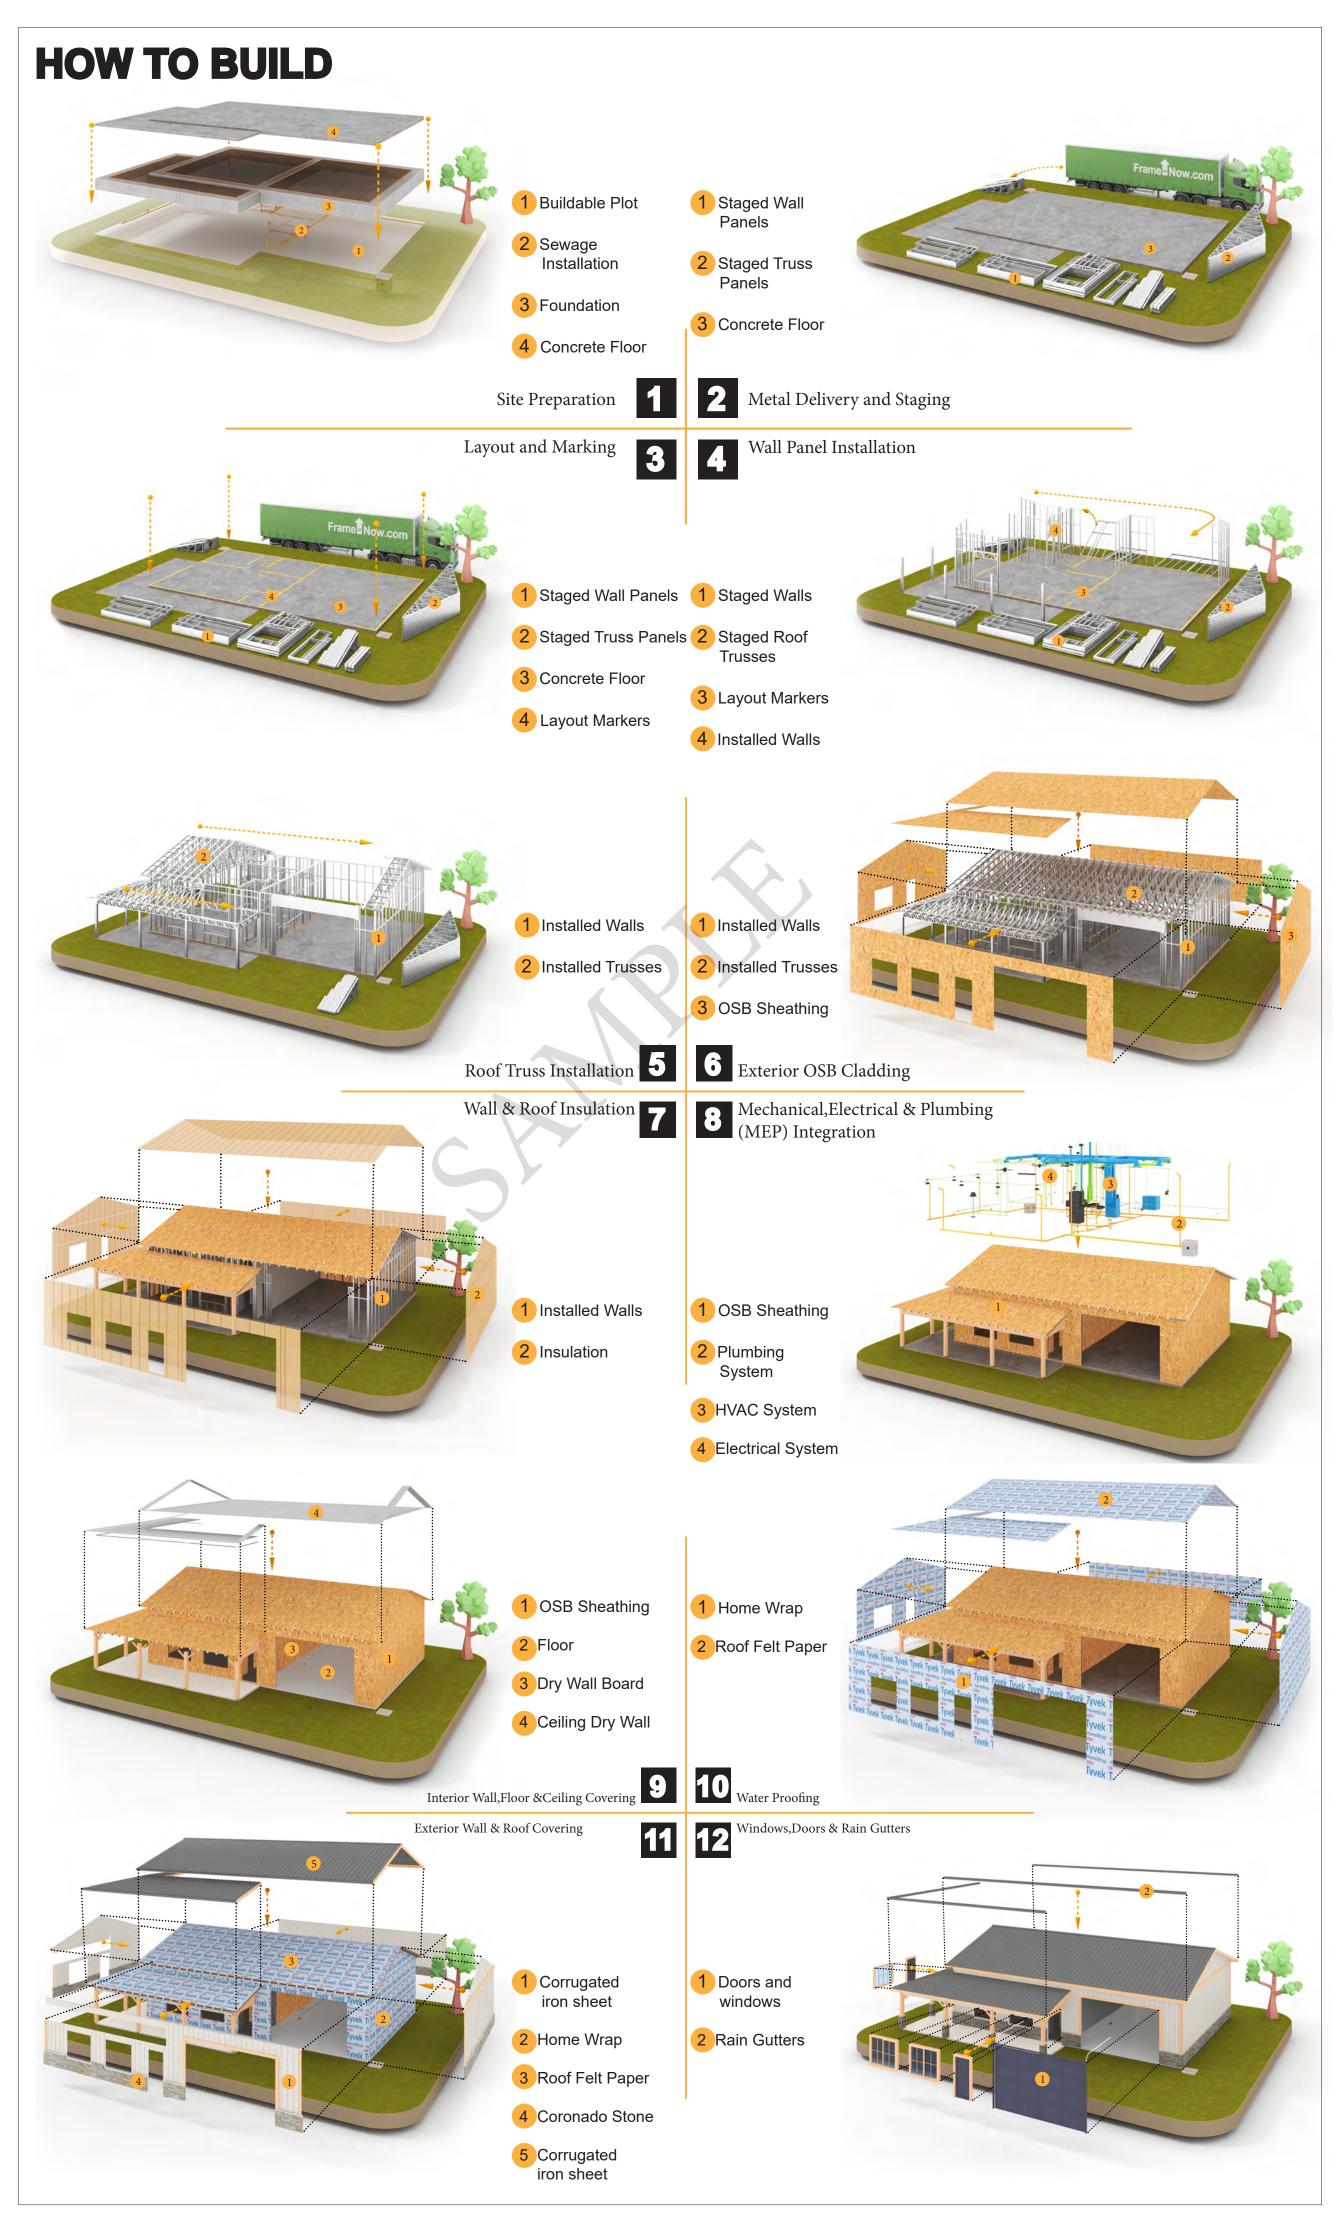



KEY PLAN

DESCRIPTION DATE

NOTE:

LEGEND:

PROJECT

241-Ember-960-2Bd1Ba-Farmhouse-Garage-550


DRAWING NAME

INTRODUCTION

CLIENT NAME: PROJECT NUMBER: DATE: **DESIGNED BY** DRAWN BY: CHECKED BY:

1102

SCALE:

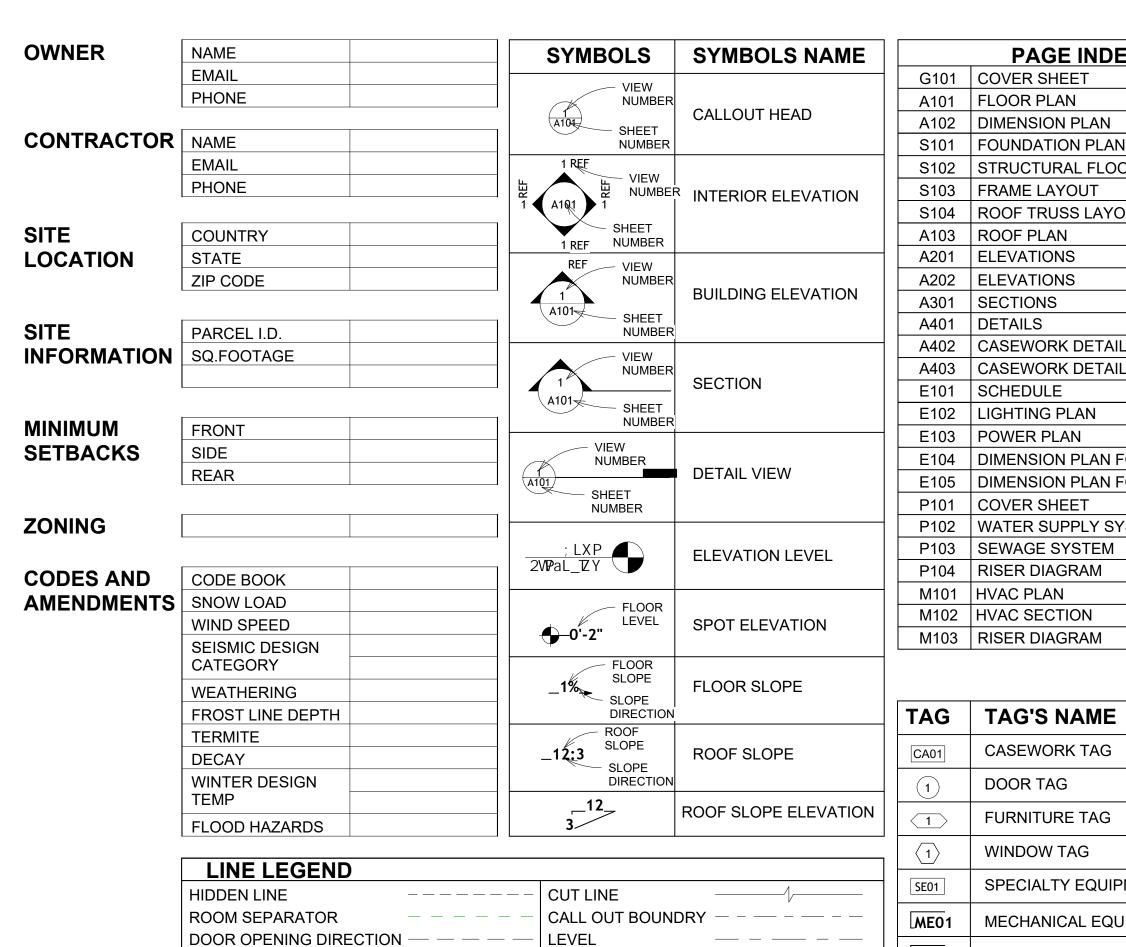

OVER HEAD

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	S101	FOUNDATION PLAN
	S102	STRUCTURAL FLOOR PLAN
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CASEWORK TAG

FURNITURE TAG


SPECIALTY EQUIPMENT TAG

MECHANICAL EQUIPMENT TAG

WINDOW TAG

| LPE01 | PLUMBING EQUIPMENT TAG

DOOR TAG

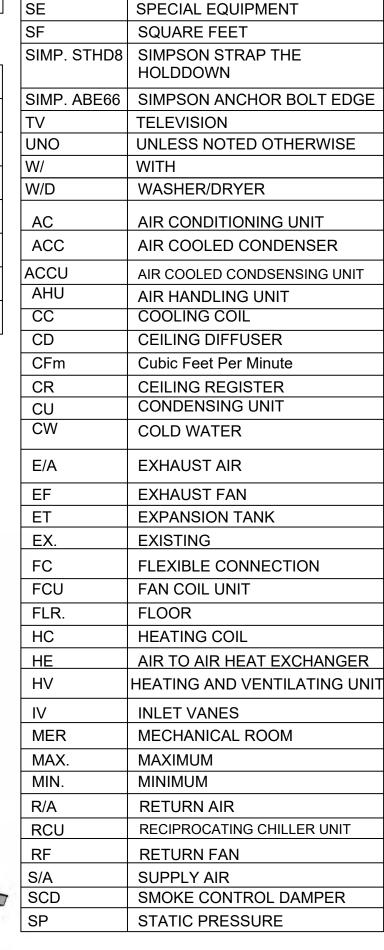

ABBREVIATION

ASTM D698 | AMERICAN SOCIETY FOR

CASEWORK

ELECTRICAL

FOOTINGS

CODE

CODE

MAXIMUM

MINIMUM

NUMBER

ON CENTER

PLUMBING

REFERENCE

RIGHT GARAGE

MECHANICAL

CONDITIONING

F.F.E

F.F.L

HVAC

MAX.

ME

MIN.

O.C

OSB

PVC

REF

RG

ACTION FLOOR SYSTEMS

TESTING AND MATERIAL

FINISHED FLOOR LEVEL

FINISHED FLOOR ELEVATION

HEATING, VENTILATION & AIR


INTERNATIONAL RESIDENCE

INTERNATIONAL MECHANICAL

ORIENTED STRAND BOARD


POUNDS PER SQUARE INCH

POLYVINYL CHLORIDE

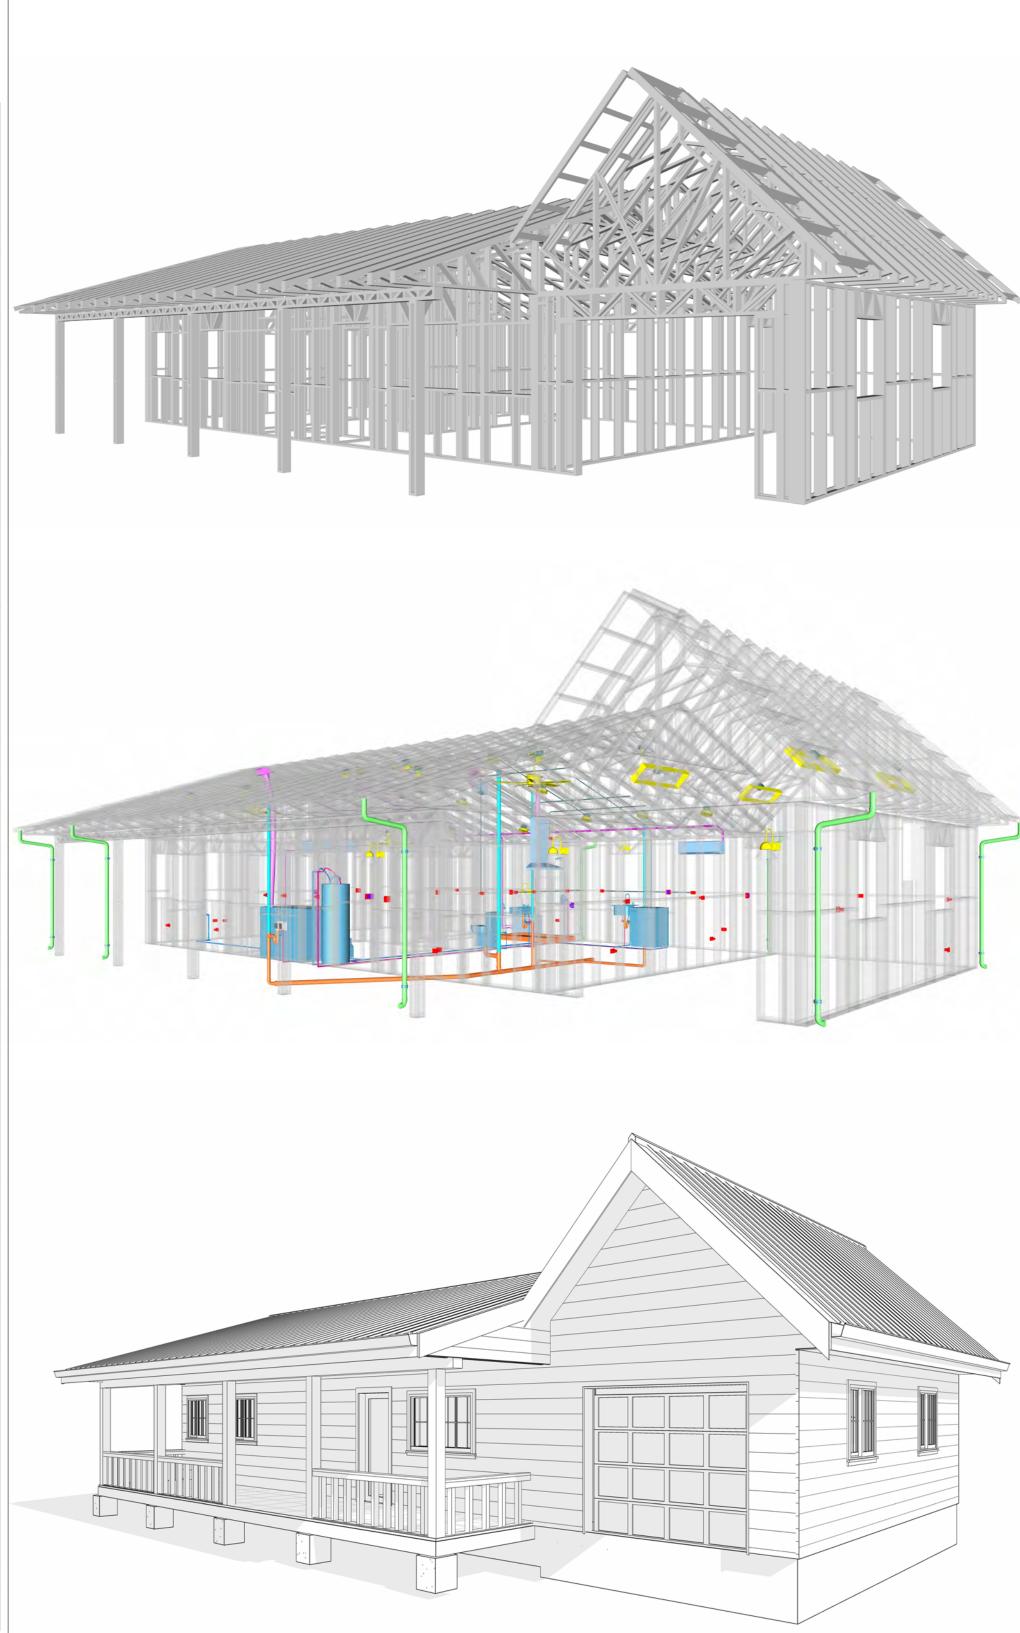

241-EMBER-960-2Bd1Ba **FARMHOUSE-GARAGE-550**

SQUARE FOOT	AGE
LIVING	960
PORCH	288
PORCH	249
TOTAL	1497

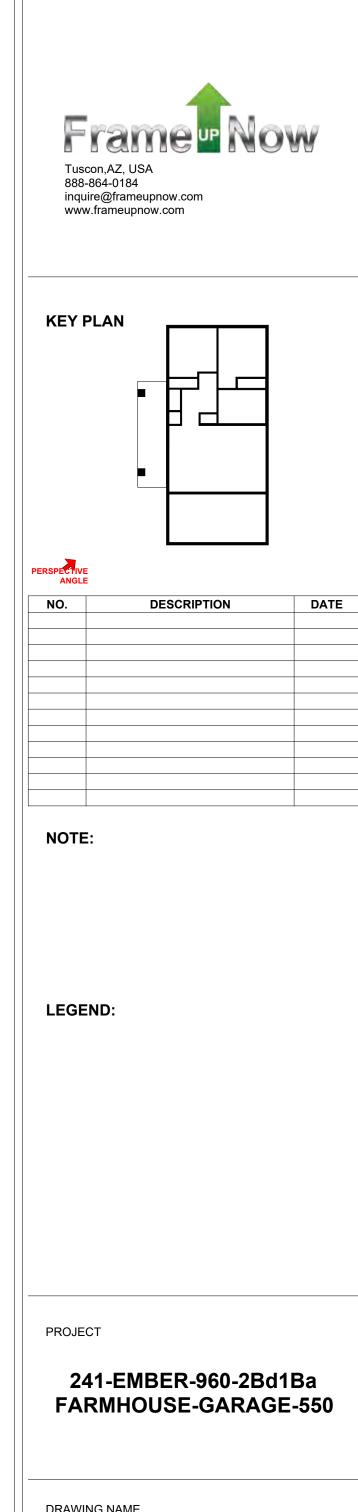

DRAWING NAME

COVER SHEET

CLIENT NAME:	Client Name
PROJECT NUMBER:	0061_12
DATE:	5/13/2025 3:57:32 PM
DESIGNED BY:	Designer
DRAWN BY:	Author
CHECKED BY:	Checker



GENERAL NOTES

- 1. THIS DRAWING DEPICTS THE ARCHITECTURAL (SPACE LAYOUT, FURNISHING, FLOOR, WALLS, ROOFS, FOUNDATION, WINDOWS AND DOORS) SYSTEMS. IT PROVIDES A VISUAL REPRESENTATION OF THE ARCHITECTURAL LAYOUT AND COMPONENTS.
- THE ARCHITECTURAL DRAWINGS ARE PREPARED TO MEET THE SPECIFIC REQUIREMENTS OF THE BUILDING, AS PER THE PROJECT SPECIFICATIONS AND APPLICABLE CODES AND STANDARDS. THE CONSTRUCTION OF THIS HOME SHALL COMPLY WITH THE LATEST EDITION OF THE
- INTERNATIONAL RESIDENTIAL CODE (IRC), INTERNATIONAL MECHANICAL CODE (IMC), THE INTERNATIONAL PLUMBING STANDARD, THE NATIONAL ELECTRICAL STANDARD AND ALL OTHER APPLICABLE LOCAL, STATE, AND NATIONAL CODES AND REGULATIONS.
- COORDINATION WITH OTHER TRADES HAS BEEN DONE ON A DESIGN LEVEL. THIS DRAWING SHALL BE READ TOGETHER WITH THE ME, EL AND PL DESIGN DRAWINGS TO ENSURE PROPER CONSTRUCTION AND INTEGRATION OF THE BUILDING SYSTEMS.

ABOUT WALLS:

SHOWER WALL COVERING

BATHTUB AND SHOWER SPACES (WALLS AND FLOORS) WITH INSTALLED SHOWER HEADS AND IN SHOWER COMPARTMENTS SHALL BE FINISHED WITH A NON-ABSORBENT SURFACE.

WALL PAINT (INTERNAL)

THE TYPICAL THICKNESS OF LATEX WALL PAINT IS 1/32 OF AN INCH FOR A SINGLE COAT. AND DOUBLE COAT (1/16") SHALL BE APPLIED FOR DURABILITY.


ADHESIVES:

THE ADVISABLE TYPE OF ADHESIVE FOR THIS PROJECT IS **EPOXY ADHESIVES**BECAUSE THEY ARE KNOWN FOR THEIR HIGH STRENGTH, DURABILITY, AND RESISTANCE TO MOISTURE, CHEMICALS AND

REFER TO SHEETS A201 & A202 FOR GENERAL NOTES ON EXTERNAL FINISHING MATERIALS


ABOUT FLOORS:

- THE SPOT ELEVATION INDICATES THE FINISHED FLOOR ELEVATION.
- FINISHED FLOORS PER PLANS.
- FIELD VERIFY FOR DIMENSION DROP 4" FOR SHOWER AND BATHTUB USE. 1% SLOPE ON OUTDOOR BALCONIES FOR WATER RUN OFF.
- 2% SLOPE TOWARDS THE SHOWER DRAIN FOR SUFFICIENT DRAINAGE. 4" DROP AT THE DOOR LEADING TO EXTERIOR BALCONY FROM THE MAIN LIVING AREA.
- 5% SLOPE FOR GARAGE IS USED, WHICH SHOULD BE CHECKED WITH THE LOCAL GARAGING ZONING LAWS.

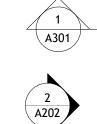

FURNITURE SCHEDULE			
TYPE MARK	TYPE	COUNT	
		·	
01	KING SIZE BED	2	
02	THREE SEAT SOFA	1	
03	DINING CHAIR	2	
04	COFFE TABLE	1	
05	ONE SEAT SOFA	1	

ROOM FINISH SCHEDULE							
ROOM NUMBE R	ROOM NAME	FLOOR FINISH	BASE FINISH	WALL FINISH	CEILING FINISH	CEILING HEIGHT	CON MEN TS
	I				T	T	1
01	BEDROOM 2	HARDWOOD	CONCRETE	WALL PAINT	DRY WALL	8' - 0"	
02	KITCHEN	HARDWOOD	CONCRETE	WALL PAINTT + CERAMIC	DRY WALL	8' - 0"	
03	GARAGE	EPOXY	CONCRETE	WALL PAINT	DRY WALL	8' - 0"	
04	CL 3	HARDWOOD	CONCRETE	WALL PAINT	DRY WALL	8' - 0"	
05	LIVING ROOM	HARDWOOD	CONCRETE	WALL PAINT	DRY WALL	8' - 0"	
06	PORCH	PROCELAIN TILE	CONCRETE	STAINLESS STEEL	PLYWOOD	8' - 0"	
07	WD	HARDWOOD	CONCRETE	WALL PAINT	DRY WALL	8' - 0"	
08	WH	HARDWOOD	CONCRETE	WALL PAINT	DRY WALL	8' - 0"	
09	HALL	HARDWOOD	CONCRETE	WALL PAINT	DRY WALL	8' - 0"	
10	BEDROOM 1	HARDWOOD	CONCRETE	WALL PAINT	DRY WALL	8' - 0"	
11	CL 1	HARDWOOD	CONCRETE	WALL PAINT	DRY WALL	8' - 0"	
12	BATH	VINYL TILES	CONCRETE	CERAMIC TILE	MRD	8' - 0"	
13	CL 2	HARDWOOD	CONCRETE	WALL PAINT	DRY WALL	8' - 0"	

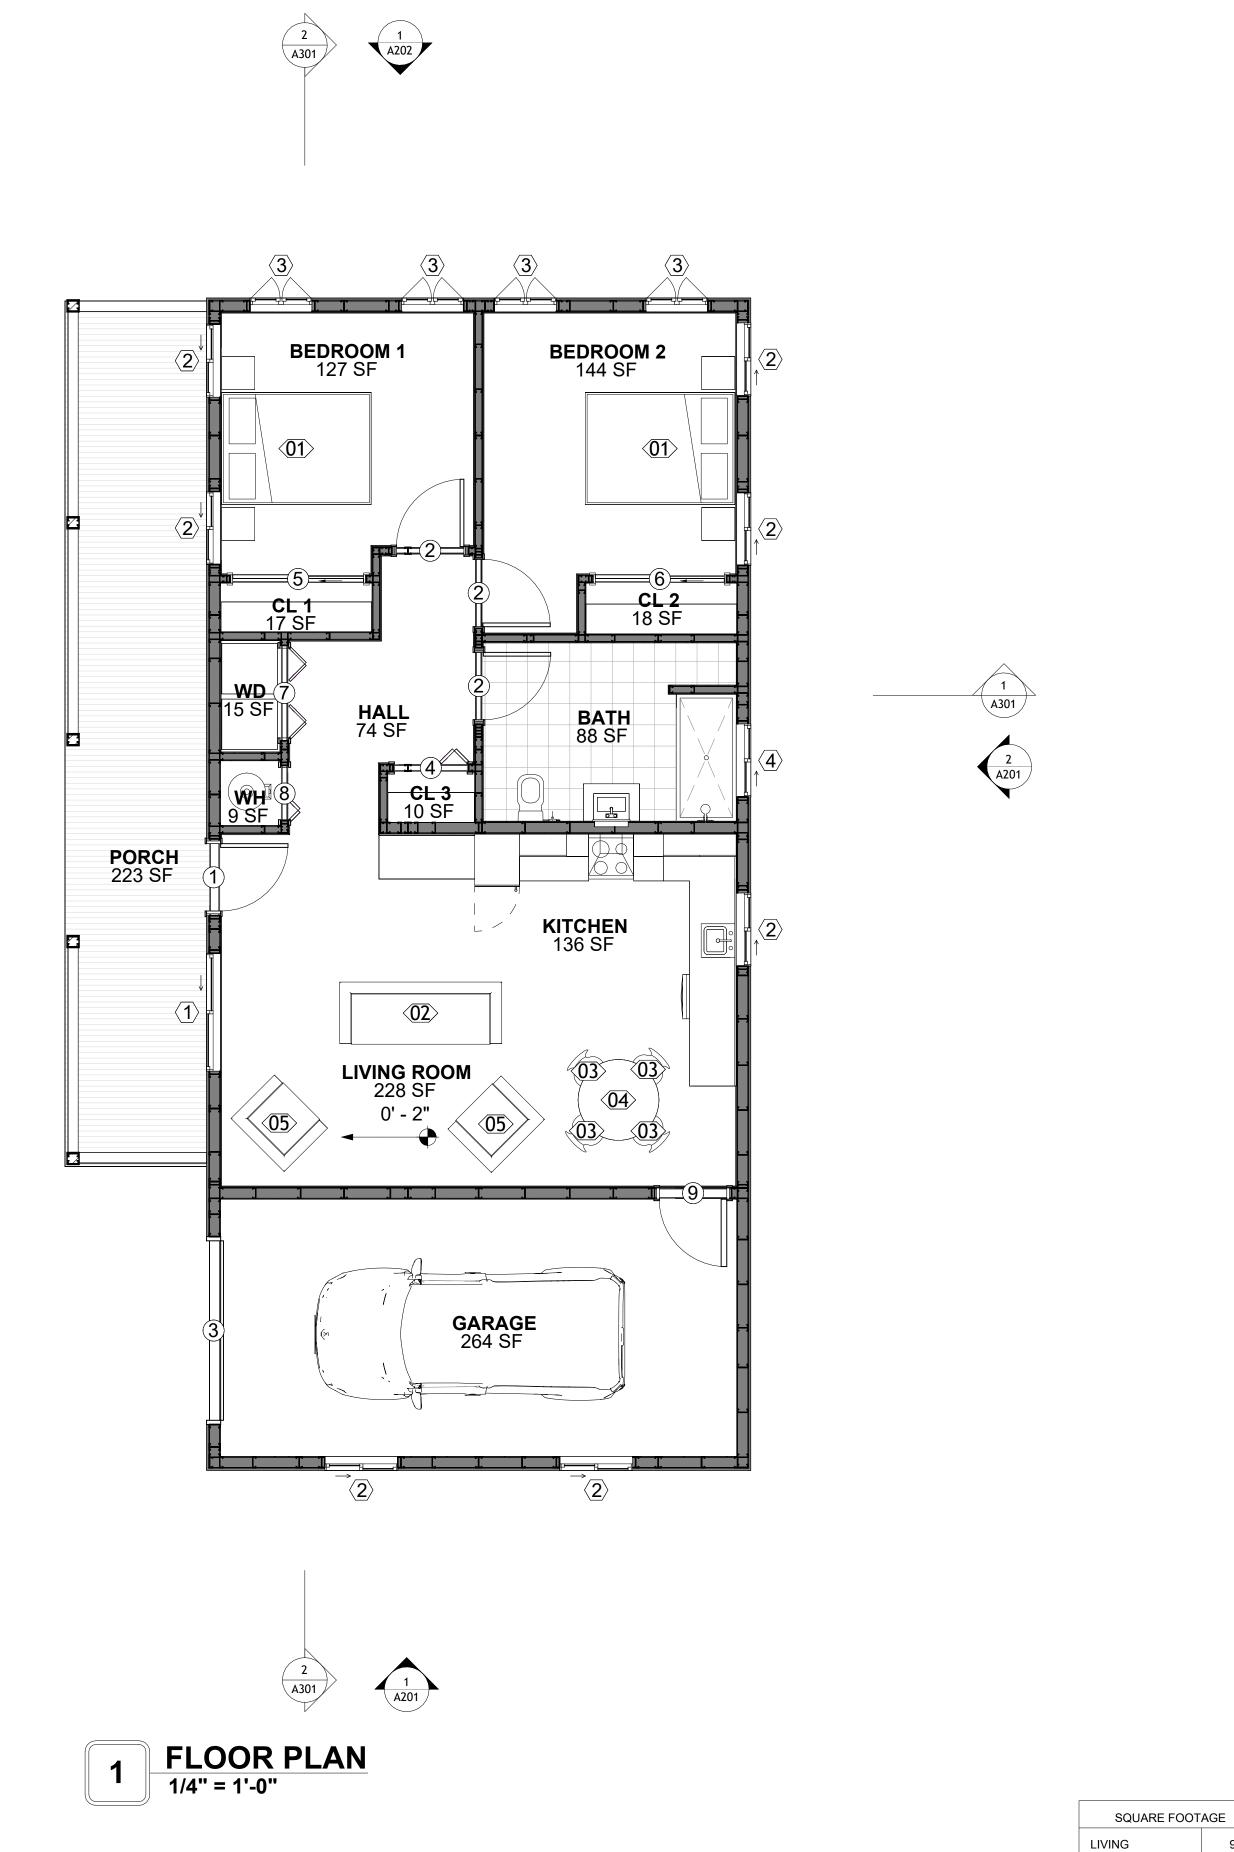



KEY PLAN

NO.	DESCRIPTION	DATE

NOTE:

LEGEND:

PROJECT

241-EMBER-960-2Bd1Ba **FARMHOUSE-GARAGE-550**

DRAWING NAME

FLOOR PLAN

Client Name	CLIENT NAME:
0061_12	PROJECT NUMBER:
5/13/2025 3:57:34 PN	DATE:
Designer	DESIGNED BY:
Author	DRAWN BY:
Checker	CHECKED BY:

A101

SCALE: 1/4" = 1'-0"

960 288


249

1497

PORCH

PORCH

TOTAL

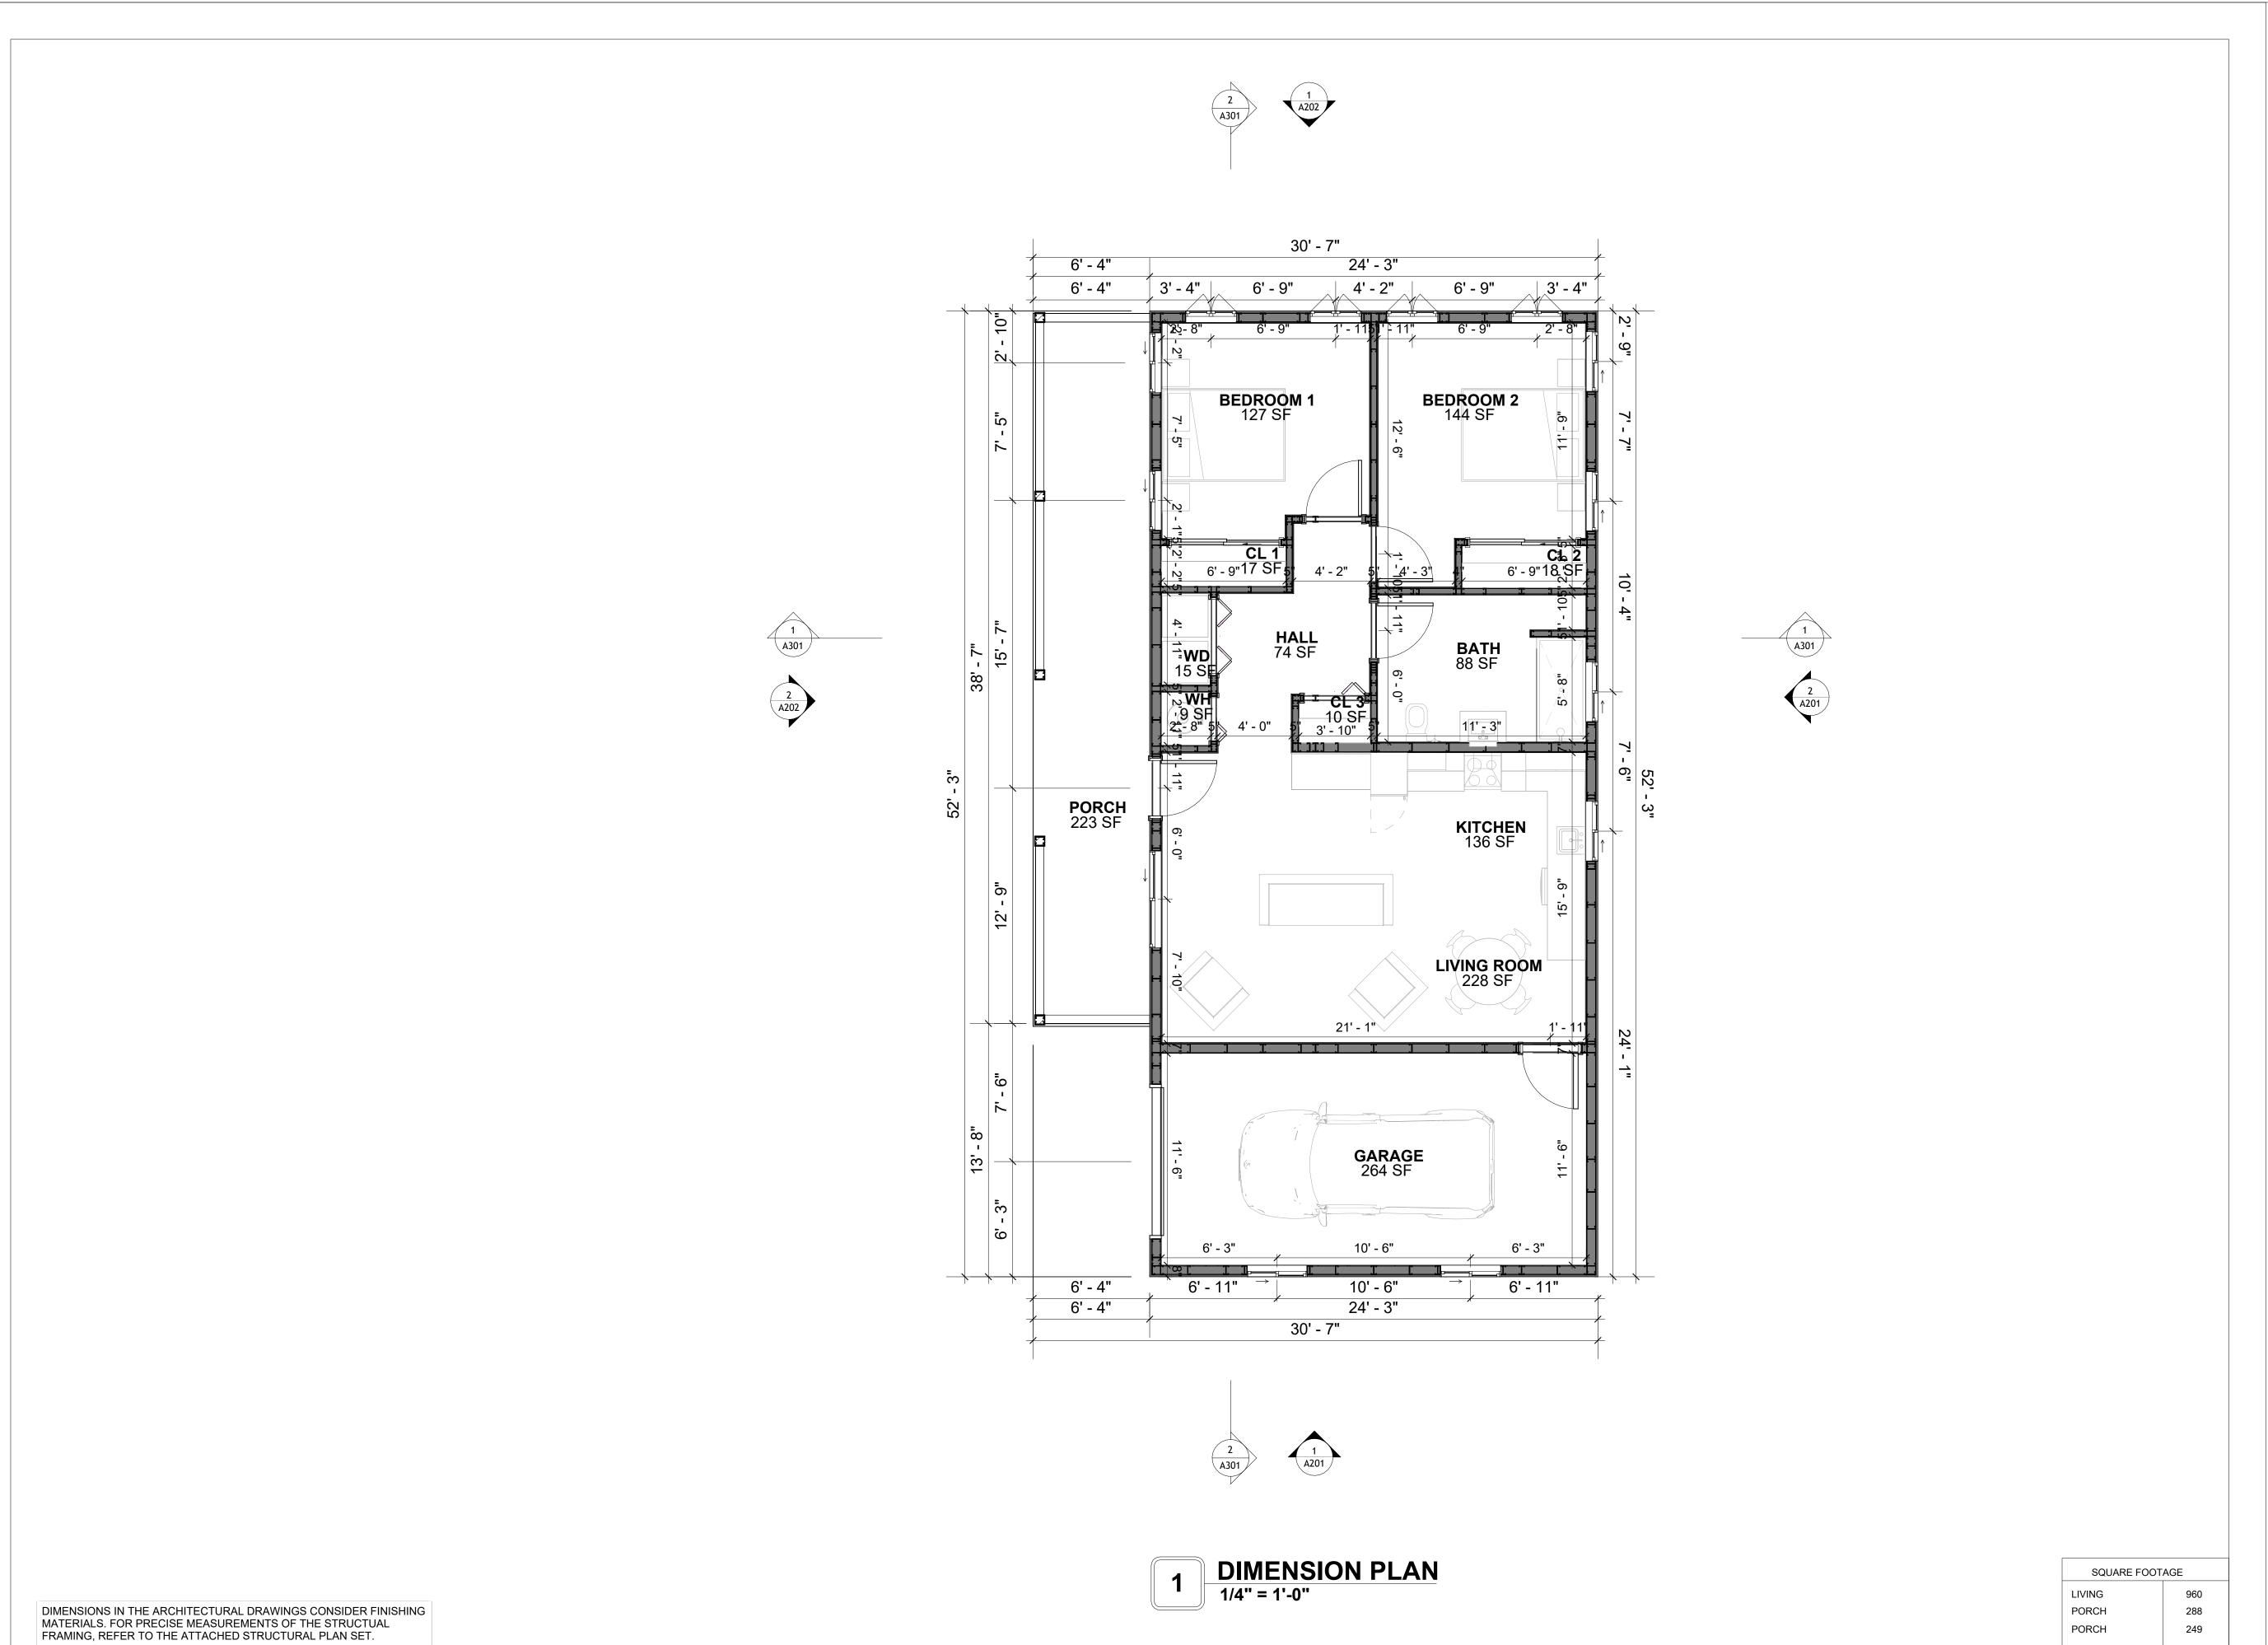



KEY PLAN

NO.	DESCRIPTION	DATE

NOTE:

LEGEND:

PROJECT

241-EMBER-960-2Bd1Ba FARMHOUSE-GARAGE-550

DRAWING NAME

DIMENSION PLAN

CLIENT NAME:	Client Name
PROJECT NUMBER:	0061_12
DATE:	5/13/2025 3:57:36 PM
DESIGNED BY:	Designer
DRAWN BY:	Author
CHECKED BY:	Checker

A102

PORCH

TOTAL

249

1497

SCALE: 1/4" = 1'-0"

FOUNDATION NOTES

TERMITES PRETREATMENT BY LICENSED CONTRACTOR UNDER SLAB AND AROUND FOOTINGS. ALL AREAS BELOW SLABS SHALL BE TREATED NO MORE THAN 24 HOURS PRIOR TO CONCRETE POUR. EVIDENCE OF TREATMENT MUST BE PROVIDED PRIOR TO PLACING OF CONCRETE.

ALL INTERIOR CONCRETE SLABS SHALL BE A MIN. OF 4" THICK CONCRETE OVER 4" COMPACTED AGGREGATE BASE (ASTM D698), FINISH ELEVATIONS AS NOTED ON DRAWINGS, 6" ABOVE ADJACENT GRADE, LEVEL SLABS TO 1/8"-10' MAX.. CONCRETE SLABS SHALL BE 2500# PSI AT 28 DAYS. A 4" ALLOWABLE SLUMP.

2. **PAD PREPARATION:**

- EXCAVATION FOR FOOTING SHALL BE NEAT.

- FOOTINGS SHALL BE POURED IMMEDIATELY AFTER EXCAVATION AND APPROPRIATE

- ALL REINFORCING STEEL MARKED "CONTINUOUS" SHALL BE LAPPED 36 BAR DIAMETERS AT SPLICES AND AROUND CORNERS OR INTERSECTIONS WITH A STANDARD 90 DEGREE BEND ON CORNER BARS. LAP WIRE MESH ONE FULL MESH AT SIDE AND END LAPS. - ALL HARDWARE TO BE SIMPSON OR EQUIVALENT.

- EXTERIOR FRAME WALL TO BE SECURED WITH 1/2"X10" ANCHOR BOLTS 4'-0" O.C. FOR 1-STORY AND 2'-8" O.C. FOR 2-STORY. BOLTS SHALL BE LOCATED WITHIN 1'-0" OF EACH END PIECE AND SHALL HAVE A MIN. OF TWO BOLTS PER PIECE.

-FOUNDATION ANCHOR STRAPS SHALL BE PERMITTED, ACCORDING TO RESIDENTIAL CODE

- ALL INTERIOR WALLS TO BE SECURED WITH POWER DRIVEN PINS PER MANUFACTURER SPECIFICATION USE PIN SPACING EQUIVALENT TO 1/2" ANCHOR BOLTS.

- ALL CONSTRUCTION TO CONFORM TO THE 2012 IRC

- R-10 RIGID INSULATION OUTSIDE OF EXTERIOR FOUNDATION WALLS UNDER LIVING AREA. CONCRETE PAD FOR CONDENSER THICKNESS IS 4" MIN UNLESS OTHERWISE NOTED.

3. CONCRETE CONSTRUCTION:

- THE SLAB SHALL BE UNDERLAIN BY A VAPOR BARRIER/RETARDER IN THE LIVING AREA (TYPICALLY POLYETHYLENE, UNLESS MORE STRINGENT PROTECTION REQUIRED BY THE ARCHITECT, ENGINEER, FLOOR COVERING MANUFACTURER, OR ACCEPTED PRACTICE). UNLESS OTHERWISE REQUIRED, BARRIER MAY BE OMITTED AT GARAGES, PORCHES AND PATIOS WITHOUT FLOOR COVERINGS. IT IS BEYOND THE SCOPE OF THESE PLANS TO DETERMINE THE APPLICABILITY OF THESE MORE STRINGENT REQUIREMENTS. BUILDER SHALL VERIFY PRIOR TO CONSTRUCTION.

4. REINFORCEMENT

- IF CONSTRUCTED ON ACTIVE SOILS, THE LONG TERM PERFORMANCE OF THE FOUNDATION IS DEPENDENT ON MAINTENANCE BY THE OWNER. THUS THE BUILDER SHALL ADVISE THE OWNER OF THE FOLLOWING:

. DRAINAGE MUST BE MAINTAINED. WATER SHALL NEVER BE ALLOWED TO POND NEAR THE FOUNDATION.

2. THE SOIL AROUND THE FOUNDATION SHALL BE MAINTAINED IN A RELATIVELY DAMP CONDITION, SUCH AS THAT REQUIRED TO KEEP A LAWN GREEN. IF IT DRIES OUT IT WILL SHRINK. IF IT GETS WET, IT WILL HEAVE UPWARD.

3. SLABS ON THE SHORTER SIDE USES MAIN BARS ARE USED IN THIS DIRECTION ONLY WITH SMALLER DIAMETER DISTRIBUTION BARS ARE PLACED, FORMING A MAT OR GRID. 4. ALL REINFORCEMENT BARS SIZE 10MM OR LARGER IN ACCORDANCE TO ASTM

3. ANCHOR BOLTS AT ALL EXTERIOR WALLS SHALL BE MINIMUM 1/2 INCH DIAMETER WITH A MAXIMUM SPACING OF 6'-0" ON CENTER, UNLESS NOTED OTHERWISE 4. ANCHOR BOLTS SHALL BE INSTALLED WITHIN 12 INCHES OF EACH END OF EACH SILL

PLATE WITH AT LEAST TWO ANCHOR BOLTS FOR EACH BOLTS FOR EACH SILL PLATE LONGER THAN 12 INCHES.

5. SIMPSONS SILL ANCHORS MAYBE SUBSTITUTED FOR ANCHOR BOLTS AT THE SAME SPACING.

6. EXTERIOR CONCRETE SLABS WHICH ARE NOT PART OF THE MAIN SLAB SHALL BE MINIMUM 4 INCHES THICK WITH NO STEEL REINFORCING BARS REQUIRED, UNLESS NOTED OTHERWISE ON FOUNDATION PLAN.

VERIFY THE FOLLOWING PRIOR TO POURING:

I. ALL HOLDDOWNS, STRAP, AND POST LOCATIONS.

2. CONCRETE FINISHES. PANEL RISER LOCATION - WHERE APPLICABLE.

3. UNDERSLAB MECHANICAL REQUIREMENTS.

4. STEM WALL BLOCKOUTS.

5. UNDERSLAB ELECTRICAL REQUIREMENTS AND PANEL RISER LOCATION. WHERE


APPLICABLE. 6. PROVIDE THE FOLLOWING:

- PVC SLEEVES THROUGH FTG IF REQUIRED

- 20' #4 COPPER GROUND BAR.

. SLOPE FINISH GRADE AWAY FROM FOOTING.

NOTE: FIELD VERIFY ALL DIMENSIONS SEE DIMENSIONED ARCHITECTURAL DRAWINGS

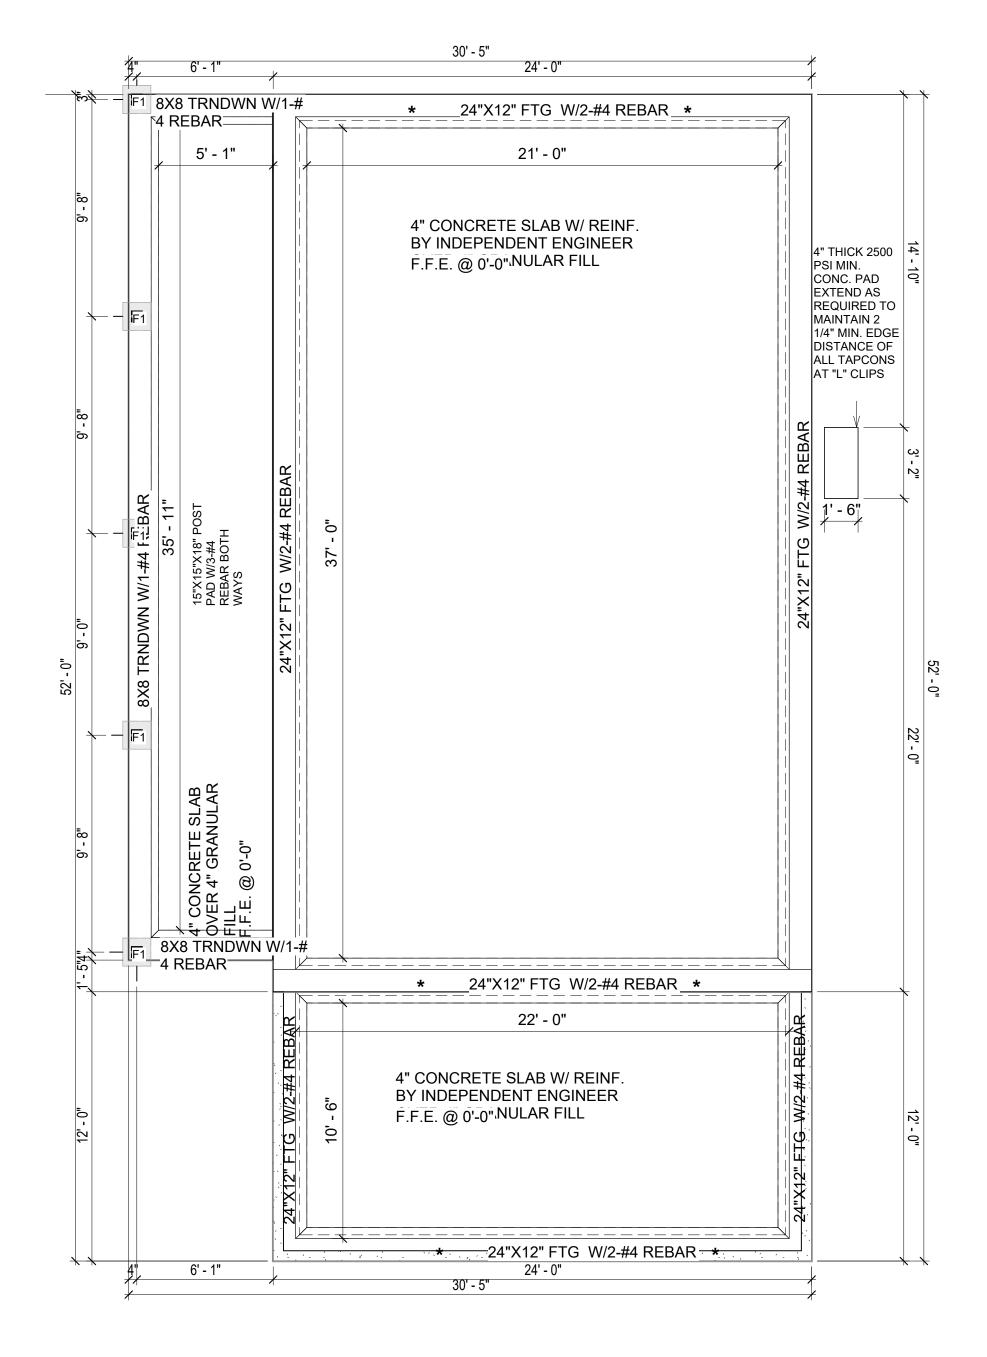

FOUNDATION PLAN 1/4" = 1'-0"



KEY PLAN

NO.	DESCRIPTION	DATE
		•

NOTE:

LEGEND:

PROJECT

241-EMBER-960-2Bd1Ba **FARMHOUSE-GARAGE-550**

DRAWING NAME

FOUNDATION PLAN

Client Name	CLIENT NAME:	
0061_12	PROJECT NUMBER:	
5/13/2025 3:57:37 PM	DATE:	
Designer	DESIGNED BY:	
Author	DRAWN BY:	
Checker	CHECKED BY:	

SQUARE FOOTAGE 960 PORCH 288 PORCH 249 TOTAL 1497

S101

SCALE: 1/4" = 1'-0"

GENERAL NOTES

-ALL BEARING WALLS SHOULD HAVE A THICKENED SLAB PER SECTION PER DETAIL A401/5.

A) FOUNDATION PLAN NOTES:

. CONCRETE SLAB SHALL BE 6" THICK WITH 1/2" DIAMETER TENDONS PER LAYOUT PLAN, CENTERED IN SLAB THICKNESS, OVER APPROVED SUBBASE PER GENERAL STRUCTURE

2. TERMITE PROTECTION SHALL BE PROVIDED PER IRC SECTION R318.1 3. NONE TYPICAL ANCHOR BOLT SPACING AT SHEAR WALL AND HOLD DOWN

SPECIFICATIONS PER APPROVED ARCHITECTURAL PLANS. 4. INSTALL HOLDOWNS BEFORE CONCRETE SLAB POUR.

5. EXISTING FILL ON-SITE SHALL BE COMPACTED IN ACCORDANCE WITH THE

REQUIREMENTS IN THE GEOTECHNICAL REPORT.

6. ALL FLOOR SLABS ARE REINFORCED ON CONCRETE SLABS.

SPECIAL INSPECTION IS REQUIRED FOR THICKENED FOUNDATION CONSTRUCTION

1. REINFORCEMENT

2. 2300 PSI CONCRETE POUR

B) **REINFORCEMENT FOR CONCRETE**:


1. ALL REINFORCING SLABS BARS SIZE 10MM OR LARGER SHALL BE DEFORMED IN ACCORDANCE TO ASTM-A706, AND BARS SMALLER THAN 10 MM MAYBE PLAIN. 2. UNLESS OTHERWISE NOTED IN PLANS, THE YIELD STRENGTH OF REINFORCING BARS SHALL BE:


> A) FOOTING = 40,000 PSI B) NON-LOAD BEARING WALLS AND PARAPETS= 40,000 PSI


- SPLICES SHALL BE SECURELY WIRED TOGETHER AND SHALL LAP OR EXTEND
- GRADE OF STEEL FOR RCC WORKS SHALL BE GRADE 4 10.
- 5. BAR NOTATIONS GIVES INFORMATION
 - A) BAR SIZE B) SPACING(IF REQUIRED)
- 6. LAP REINFORCEMENT ONLY AT LOCATION SHOWN IN THE DRAWINGS
- REINFORCEMENT SHALL NOT BE CUT, VENT OR HEATED ON SITE WITHOUT ENGINEERS' APPROVAL.
- C) CONCRETE SLAB NOTES
- 1. ALL SLAB REINFORCEMENT SHALL BE 20MM CLEAR MINIMUM FROM BOTTOM AND FROM
- 2. REINFORCEMENT IN CONTINUOUS ELEVATED SLAB SHALL BE CUT AS FOLLOWS.

- THIS IS A SCHEMATIC PLAN FOR THE PURPOSE OF LOCATING AND IDENTIFYING FOUNDATION REINFORCING ELEMENTS ONLY. VERIFY ALL DIMENSIONS, DROPS, OFFSETS AND FEATURES WITH THE ARCHITECTURAL PLANS BEFORE FORMING THE FOUNDATION.

#4-REBAR ON A 2'-0" X 2'-0" GRID **SLAB ON GRADE FOUNDATION**

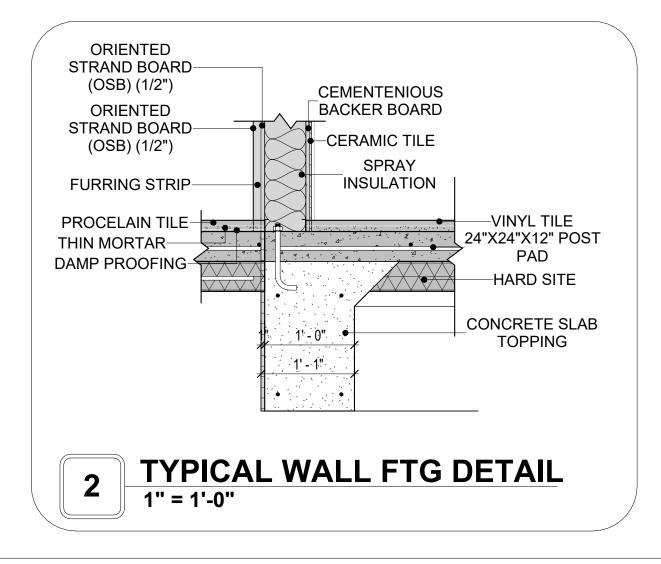

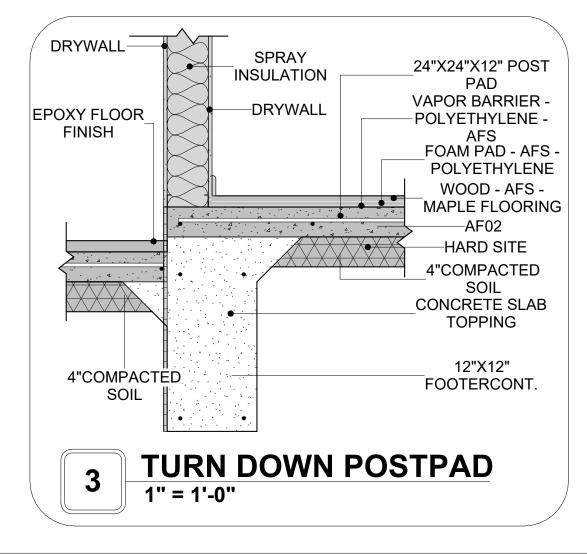

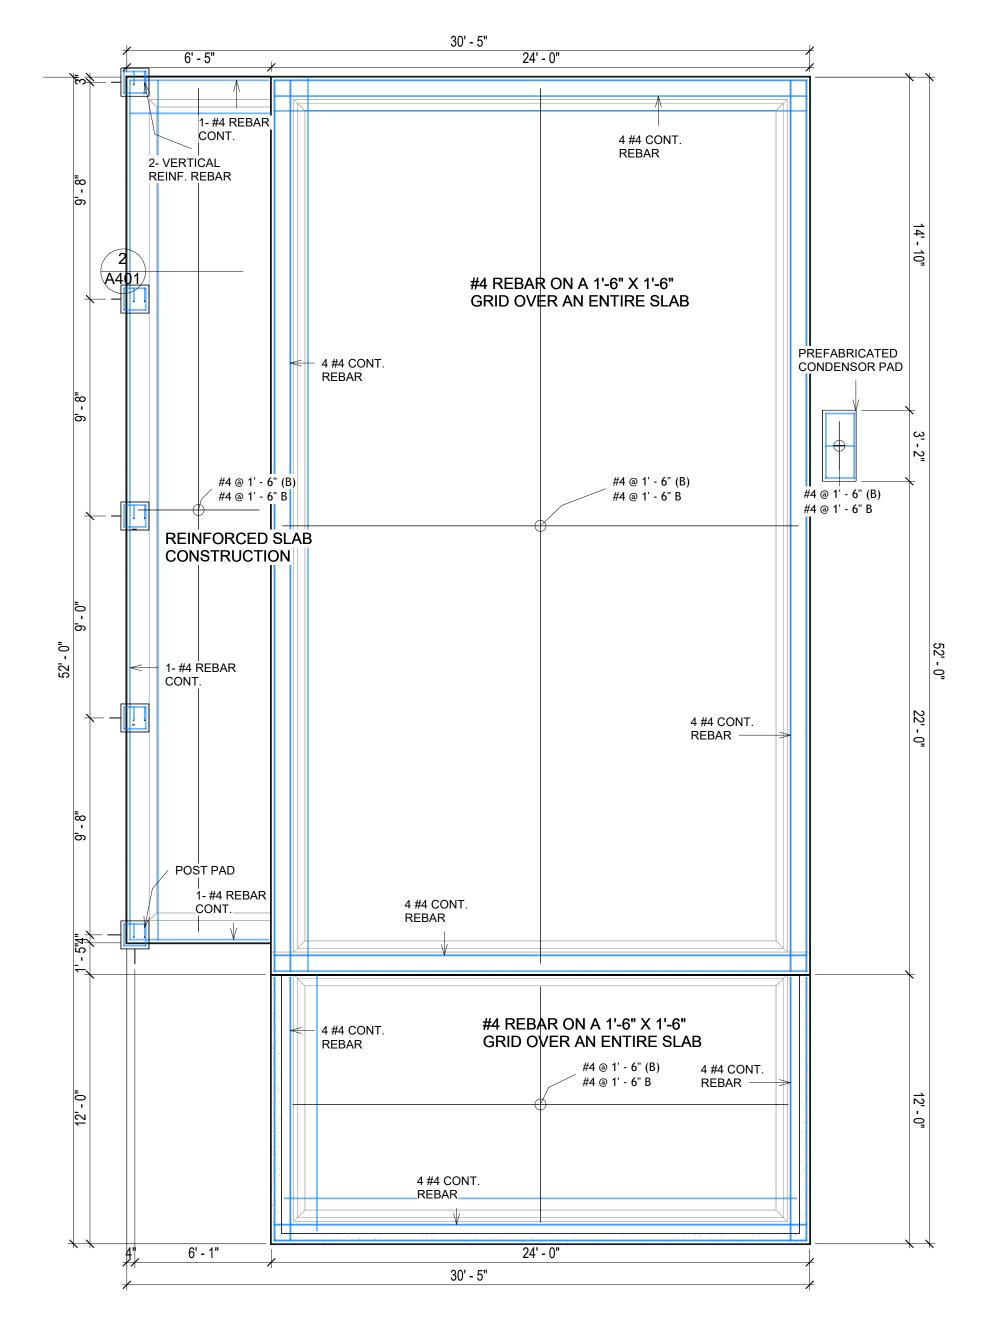

FOUNDATION REBAR PLAN



KEY PLAN

NO.	DESCRIPTION	DATE
		1

NOTE:

LEGEND:

PROJECT

241-EMBER-960-2Bd1Ba **FARMHOUSE-GARAGE-550**

DRAWING NAME

STRUCTURAL FLOOR PLAN


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0061_12	PROJECT NUMBER:
5/13/2025 3:57:38 PM	DATE:
Designer	DESIGNED BY:
Author	DRAWN BY:
Checker	CHECKED BY:


S102

ROOF NOTES

- 1. ROOFING COMPOSITION ROOFING PER OWNERS/BUILDERS SPECIFICATIONS INSTALL PER MANUFACTURE SPECIFICATIONS ON 1/2" ORIENTED STRAND BOARD ON PRE-ENGINEERED TRUSS @ 24" O.C. (UNO.)
- 2. 73" OVERHANG AT EAVES (UNO.)
- 3. ENDS OF ALL TRUSSES AND JOISTS TO BE FULLY BLOCKED. PROVIDE SOLID BLOCKING AT ALL RIDGES AND VALLEYS
- 4. SHEATHING TO BE 1/2", 3/8" OSB SHEAR PANEL AND EQUIVALENT. UNDERSIDE OF PORCH TRUSSES TO BE FINISHED WITH MOISTURE
- RESISTANT DRYWALL, TAPED AND TEXTURED.

 5. EXPOSED EAVES AND OTHER WEATHER EXPOSED AREAS TO BE SHEATHED WITH EXTERIOR GRADE PLYWOOD.
- 6. ALL MATERIALS THICKNESS AND SIZE ARE THE MINIMUM. Refer TO LOCAL STANDARDS FOR ACTUAL THICKNESS AND LAYERING OF MATERIALS.
- 7. ENGINEERED TRUSS CALCULATIONS TO BE SUBMITTED TO BUILDING
- DEPARTMENT PRIOR TO FABRICATION AND INSTALLATION.
- 8. TRUSS MANUFACTURER TO SPECIFY HANGER CONNECTORS FOR TRUSS COMPONENTS (TYPICAL)
- 9. DESIGNER ASSUMES THAT TRUSSES BEAR ON ALL EXTERIOR PERIMETER WALLS (TYPICAL) OR BEAMS.
- 10. PROVIDE GALVANIZED STEEL FLASHING WITH A LENGTH OF 10 FEET, WIDTH OF 12 INCHES, AND THICKNESS OF 24 GAUGE.

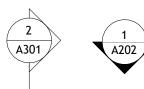

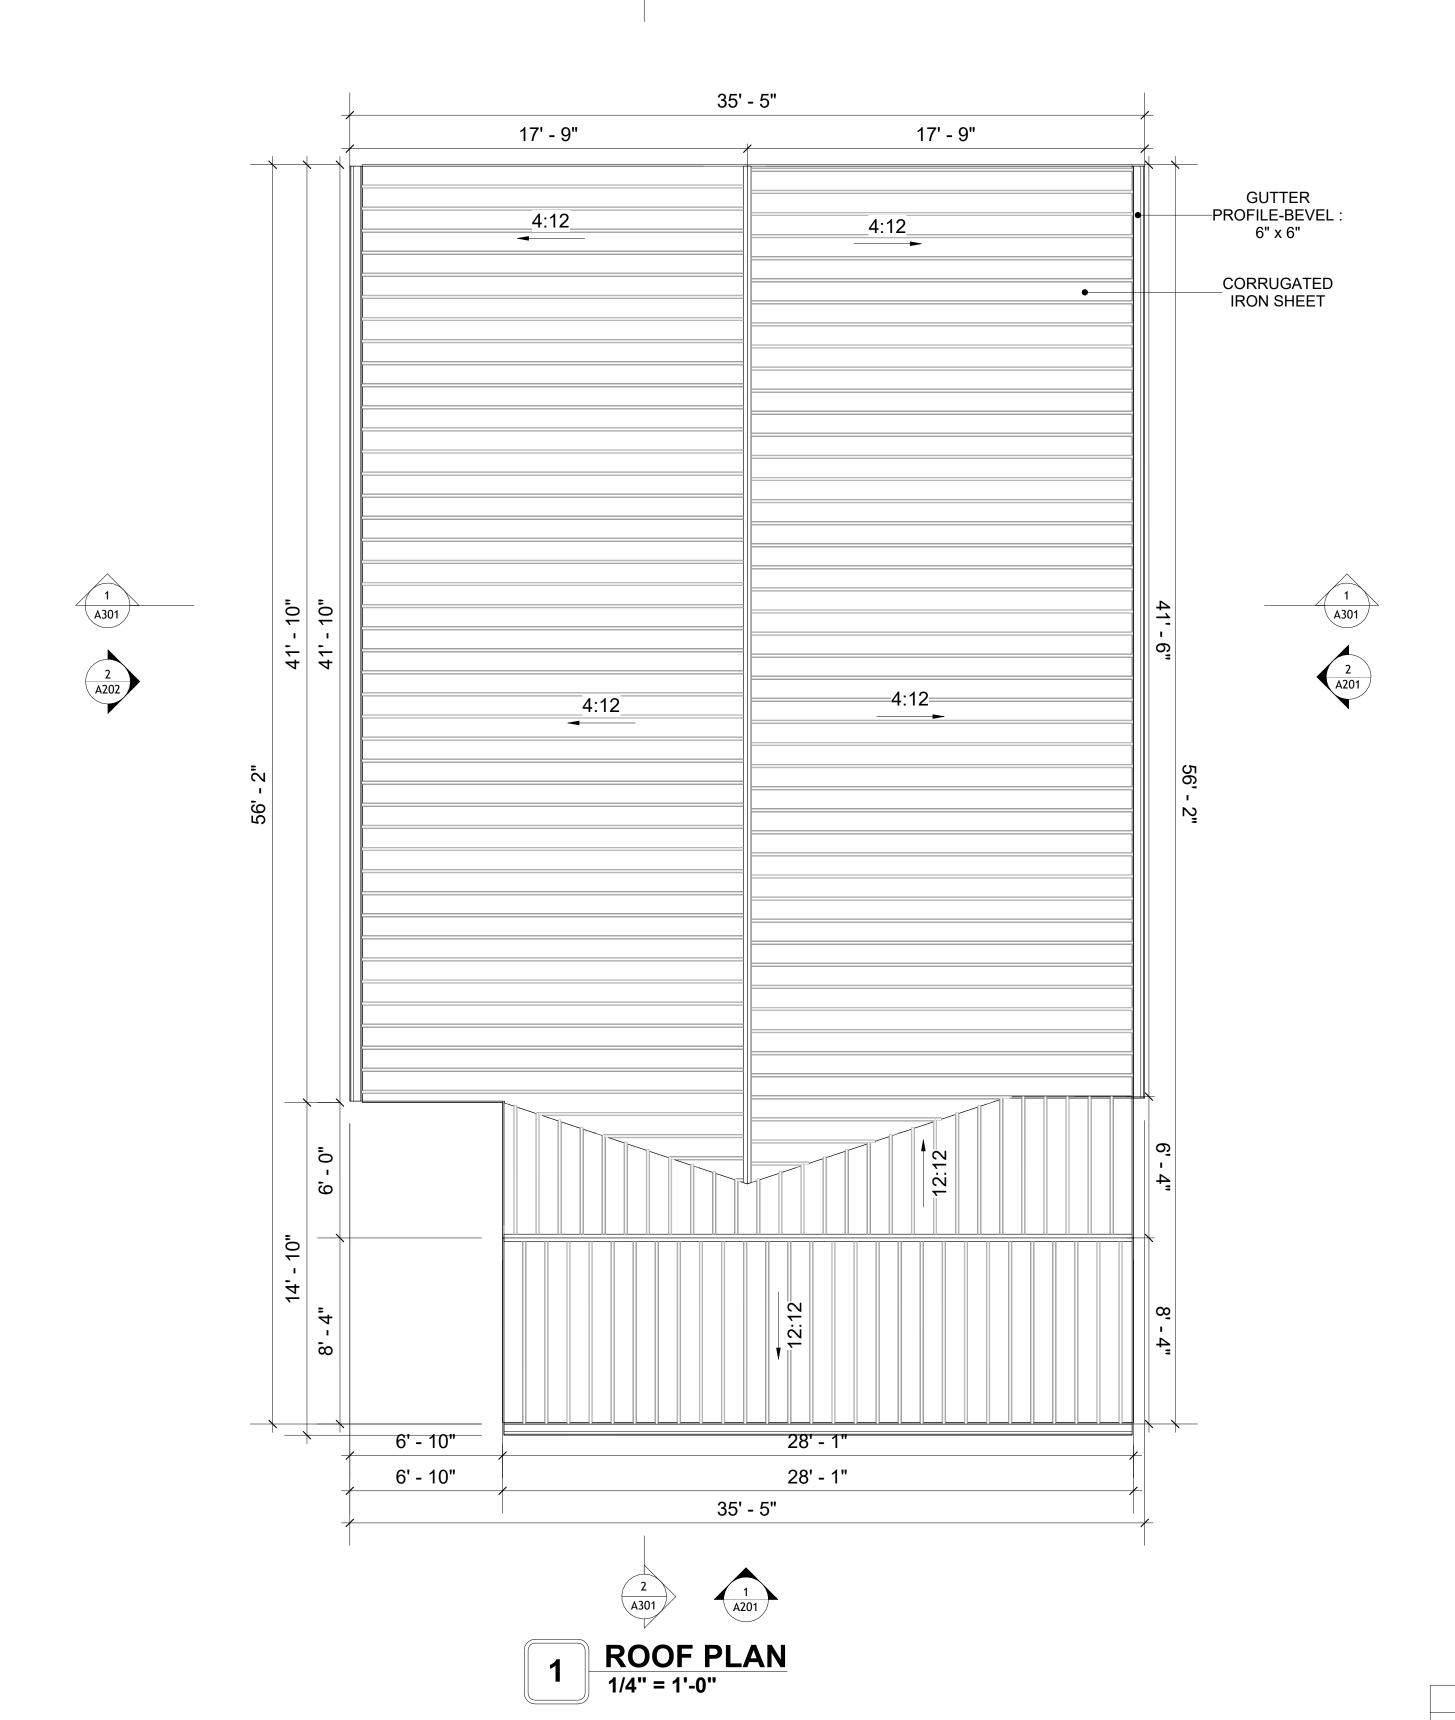



KEY PLAN

NO.	DESCRIPTION	DATE

NOTE:

LEGEND:

PROJE

241-EMBER-960-2Bd1Ba FARMHOUSE-GARAGE-550

DRAWING NAME

ROOF PLAN

Client Name	CLIENT NAME:
0061_1	PROJECT NUMBER:
5/13/2025 3:57:42 P	DATE:
Designe	DESIGNED BY:
Autho	DRAWN BY:
Checke	CHECKED BY:

A103

SCALE: 1/4" = 1'-0"

SQUARE FOOTAGE


249

1497

PORCH

PORCH


TOTAL

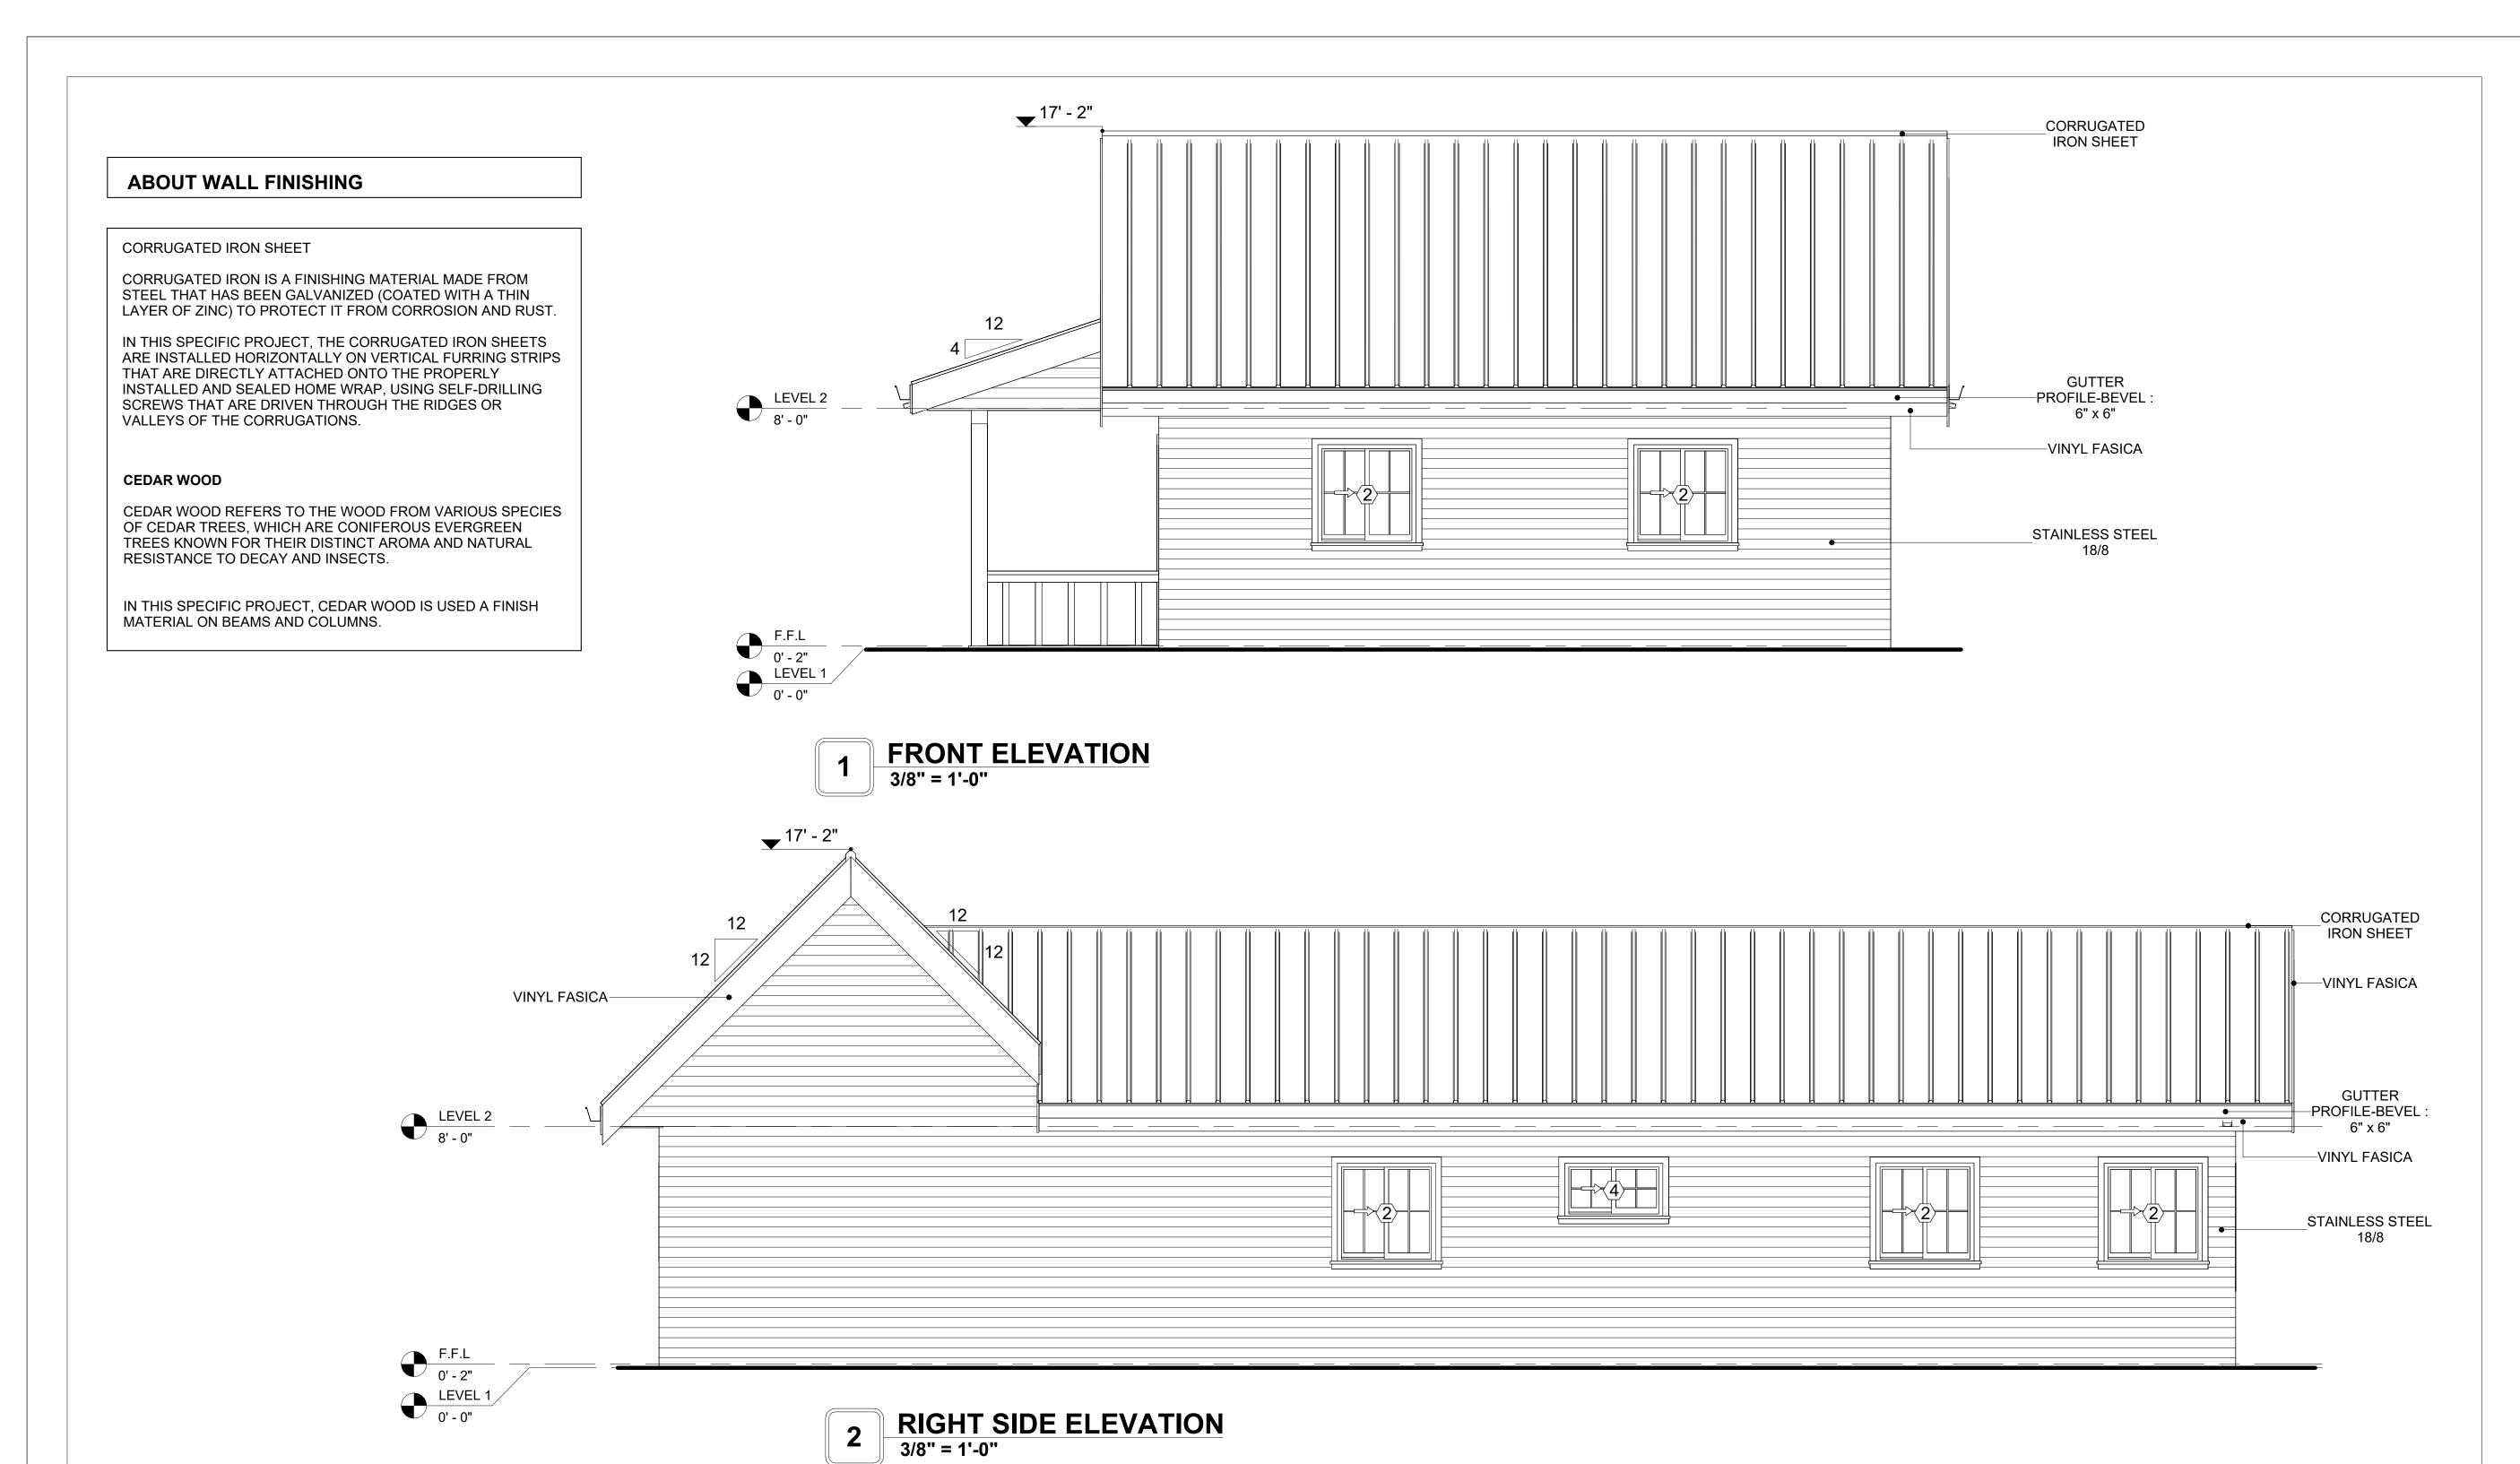

DOOR SCHEDULE						
TYPE			S		SIZE	
MAR K	SUPPLIER	DOOR TYPE	LOCATIO	WIDTH	HEIGHT	COUNT
1	HOME DEPOT	EXTERIOR SINGLE PANEL SWINGING	INTERIOR	3' - 0"	6' - 8"	1
2	HOME DEPOT	INTERIOR SINGLE PANEL SWINGING	INTERIOR	3' - 0"	6' - 8"	3
3	HOME DEPOT	DOOR-GARAGE-EMBOSSED_PANEL	EXTERIOR	8' - 0"	6' - 6"	1
4	HOME DEPOT	SINGLE FOLD 2	INTERIOR	3' - 3"	6' - 8"	1
5	HOME DEPOT	INTERIOR DOUBLE PANEL SLIDING	INTERIOR	5' - 10"	6' - 8"	1
6	HOME DEPOT	INTERIOR DOUBLE PANEL SLIDING	INTERIOR	5' - 9"	6' - 8"	1
7	HOME DEPOT	DOOR-BIFOLD_9052	INTERIOR	4' - 0"	6' - 8"	1
8	HOME DEPOT	SINGLE FOLD 2	INTERIOR	2' - 4"	6' - 8"	1
9	HOME DEPOT	INTERIOR SINGLE PANEL SWINGING	INTERIOR	3' - 0"	6' - 8"	1

WINDOW SCHEDULE						
				SIZE		
TYPE MARK	SUPPLIER	WINDOW TYPE	WIDTH	HEIGHT	COUNT	
1	HOME DEPOT	SLIDING	5' - 3"	3' - 3"	1	
2	HOME DEPOT	SLIDING	3' - 3"	3' - 3"	7	
3	HOME DEPOT	DOUBLE HING	2' - 9"	4' - 3"	4	
4	HOME DEPOT	SLIDING	3' - 3"	1' - 9"	1	



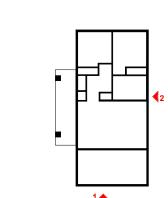

NO.	DESCRIPTION	DATE

NOTE:

LEGEND:

PROJECT

241-EMBER-960-2Bd1Ba FARMHOUSE-GARAGE-550

DRAWING NAME

ARCHITECTURAL ELEVATIONS

CLIENT NAME:	Client Name
PROJECT NUMBER:	0061_12
DATE:	5/13/2025 3:57:47 PM
DESIGNED BY:	Designer
DRAWN BY:	Author
CHECKED BY:	Checker

A201



CORRUGATED IRON SHEET

CORRUGATED IRON IS A FINISHING MATERIAL MADE FROM STEEL THAT HAS BEEN GALVANIZED (COATED WITH A THIN LAYER OF ZINC) TO PROTECT IT FROM CORROSION AND RUST.


IN THIS SPECIFIC PROJECT, THE CORRUGATED IRON SHEETS ARE INSTALLED HORIZONTALLY ON VERTICAL FURRING STRIPS THAT ARE DIRECTLY ATTACHED ONTO THE PROPERLY INSTALLED AND SEALED HOME WRAP, USING SELF-DRILLING SCREWS THAT ARE DRIVEN THROUGH THE RIDGES OR VALLEYS OF THE CORRUGATIONS.

CEDAR WOOD

CEDAR WOOD REFERS TO THE WOOD FROM VARIOUS SPECIES OF CEDAR TREES, WHICH ARE CONIFEROUS EVERGREEN TREES KNOWN FOR THEIR DISTINCT AROMA AND NATURAL RESISTANCE TO DECAY AND INSECTS.

IN THIS SPECIFIC PROJECT, CEDAR WOOD IS USED A FINISH MATERIAL ON BEAMS AND COLUMNS.

F.F.L 0' - 2" LEVEL 1 0' - 0"

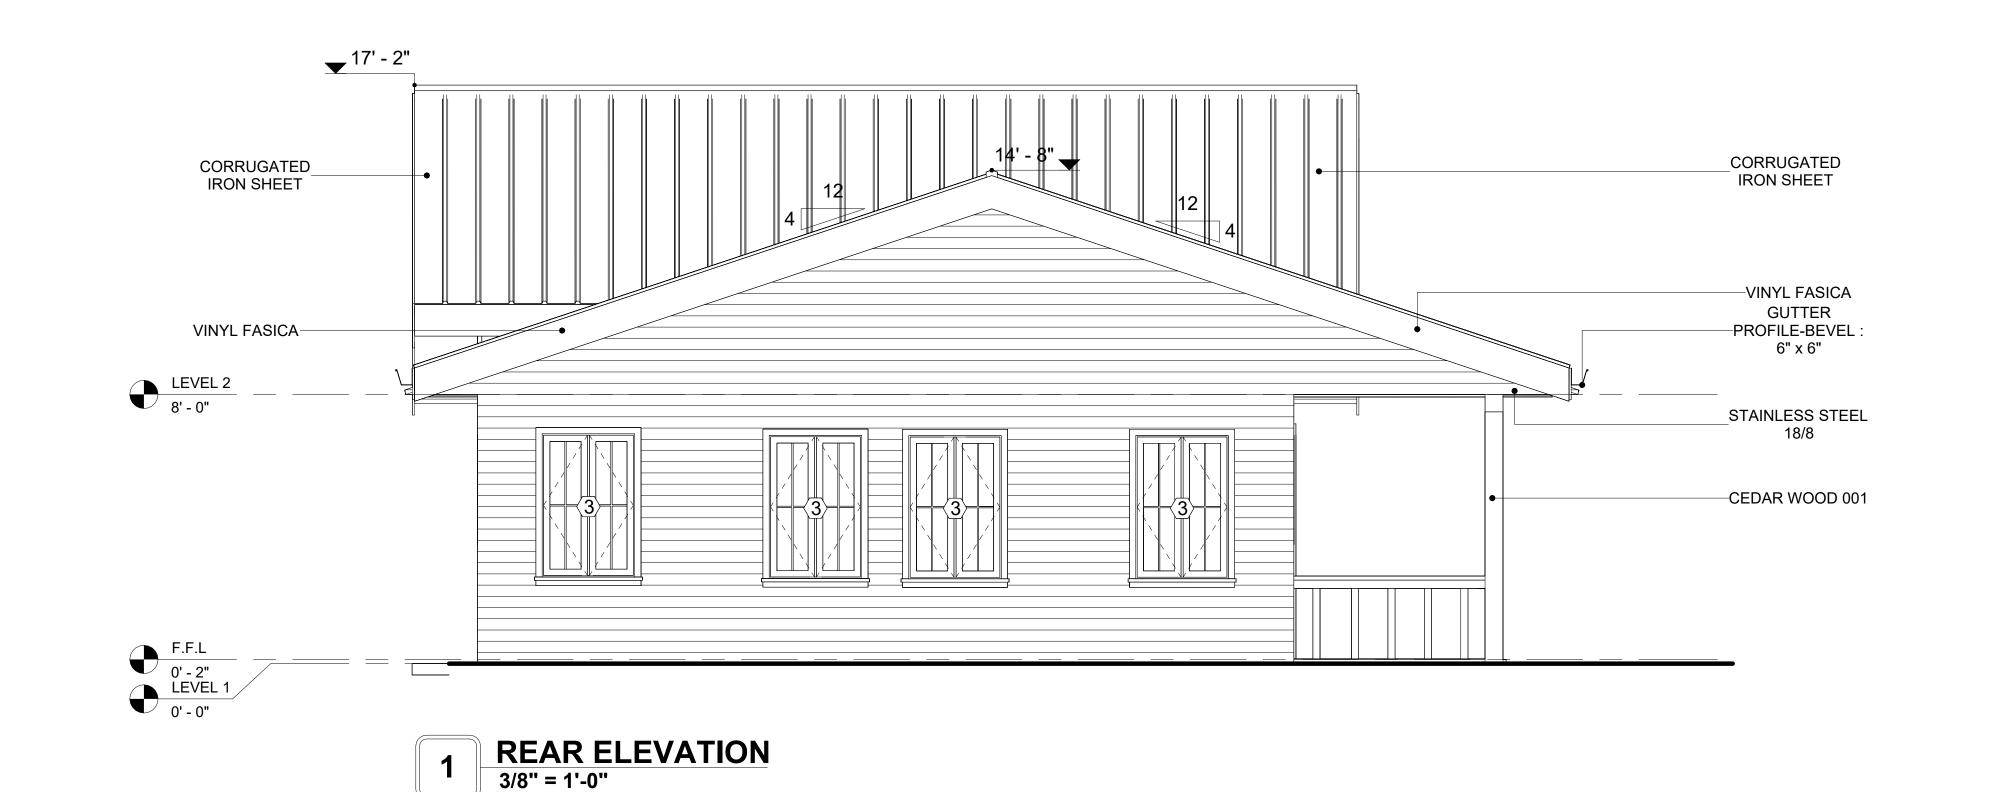

MINERAL WOOL

12

12

CORRUGATED

IRON SHEET


PROFILE-BEVEL:
6'x6'

STAINLESS STEEL

STAINLESS STEEL

2 LEFT SIDE ELEVATION
3/8" = 1'-0"



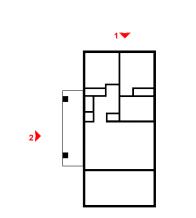

NO. DESCRIPTION		DATE	

NOTE:

LEGEND:

PROJECT


241-EMBER-960-2Bd1Ba FARMHOUSE-GARAGE-550

DRAWING NAME

ARCHITECTURAL ELEVATIONS


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0061_12	PROJECT NUMBER:
5/13/2025 3:57:52 PM	DATE:
Designer	DESIGNED BY:
Author	DRAWN BY:
Checker	CHECKED BY:

A202

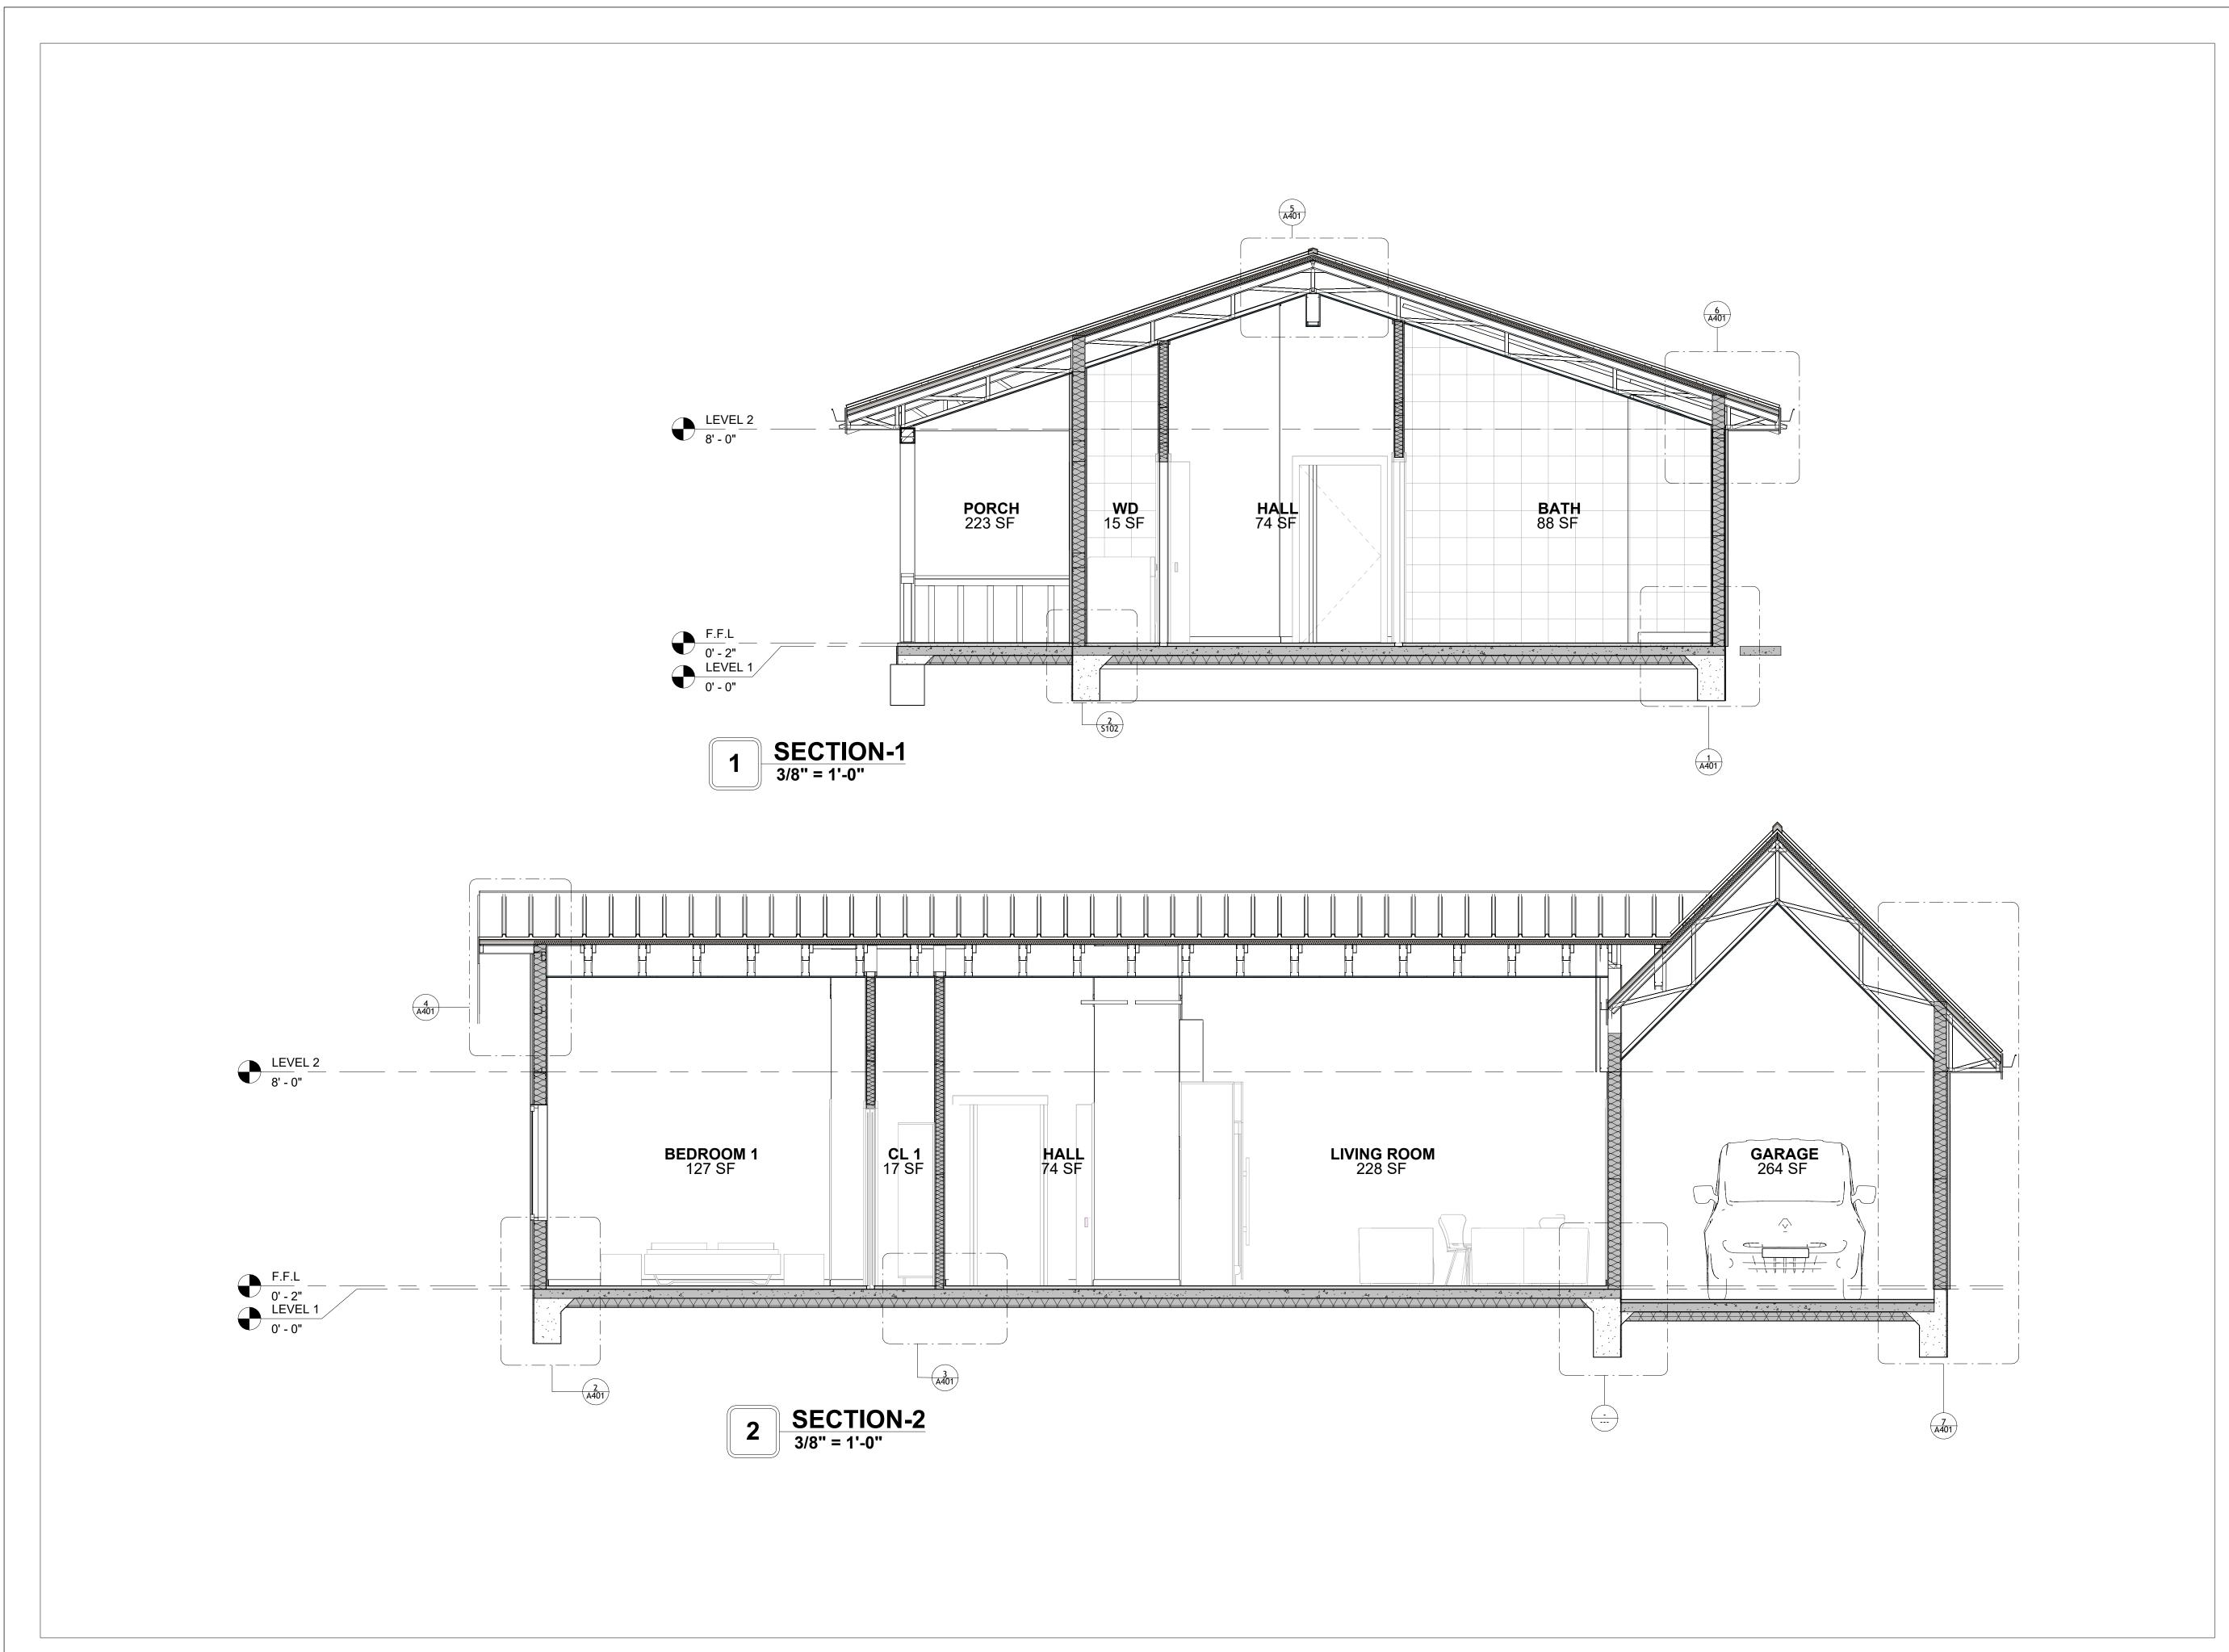



KEY PLAN

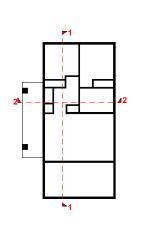

NO.	DESCRIPTION	DATE

NOTE

LEGEND:

PROJECT


241-EMBER-960-2Bd1Ba FARMHOUSE-GARAGE-550


DRAWING NAME

ARCHITECTURAL SECTIONS

CLIENT NAME:
PROJECT NUMBER:
DATE:
DESIGNED BY:
DRAWN BY:
CHECKED BY:
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A301



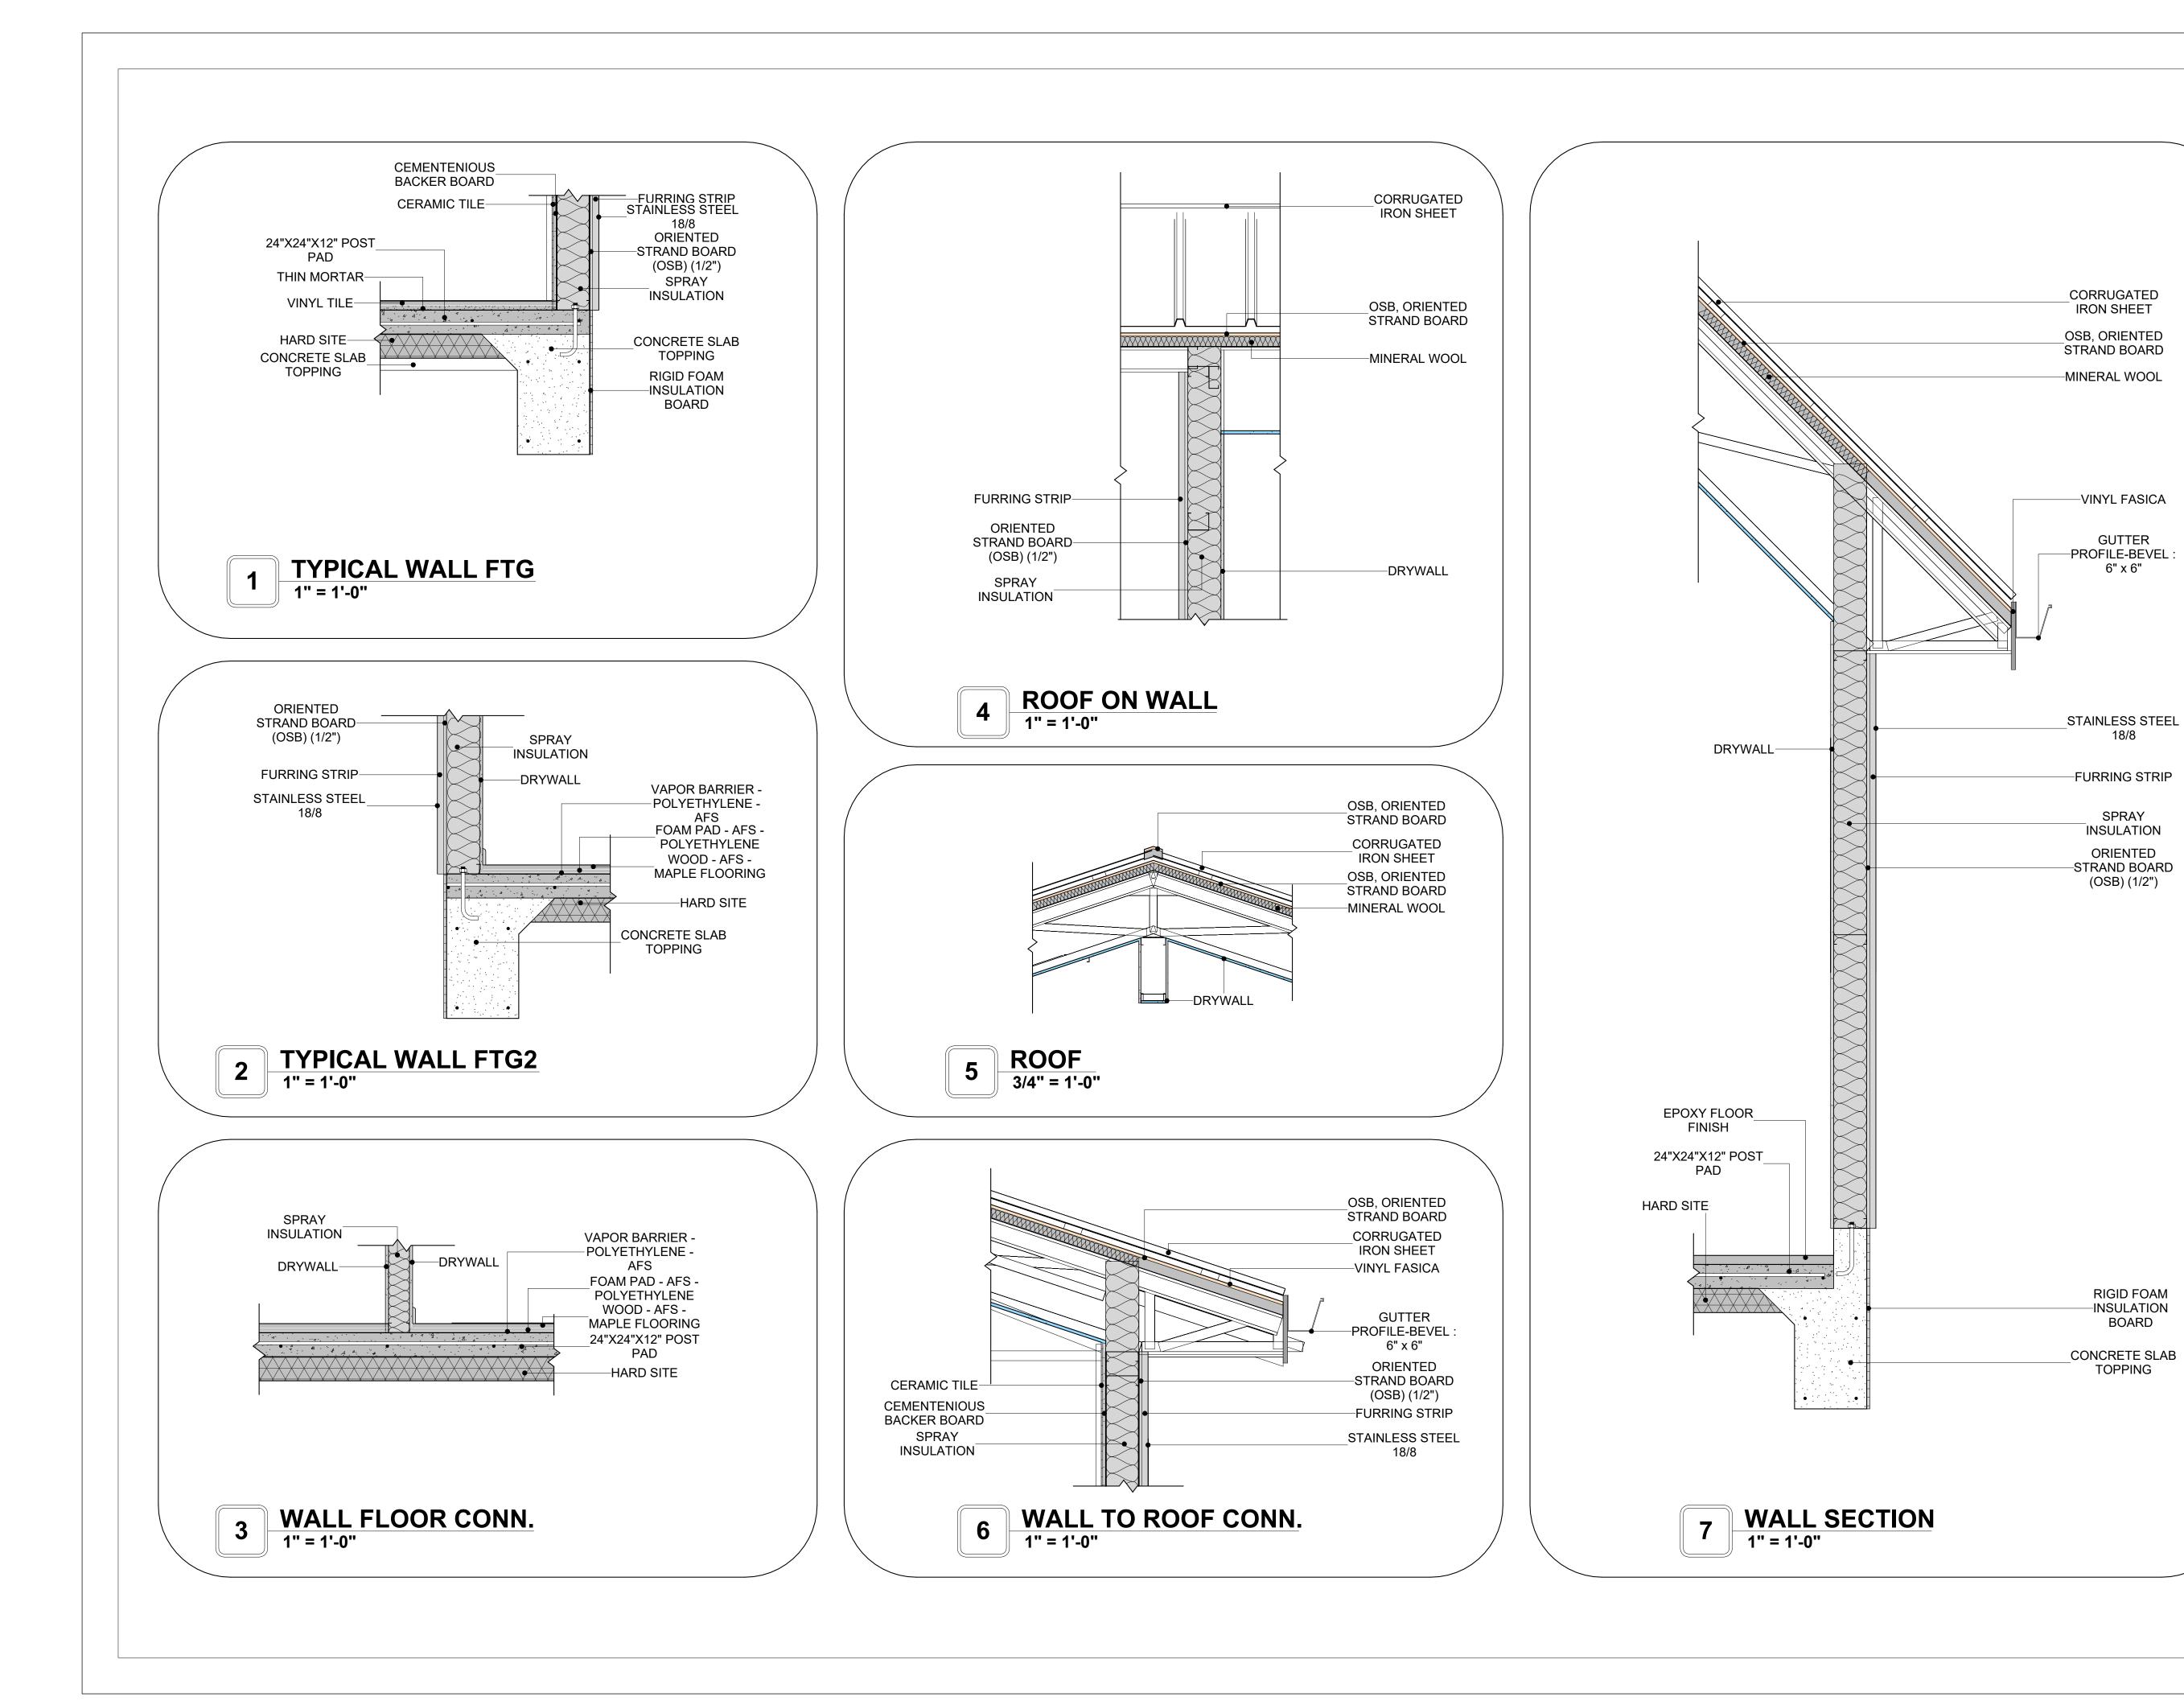

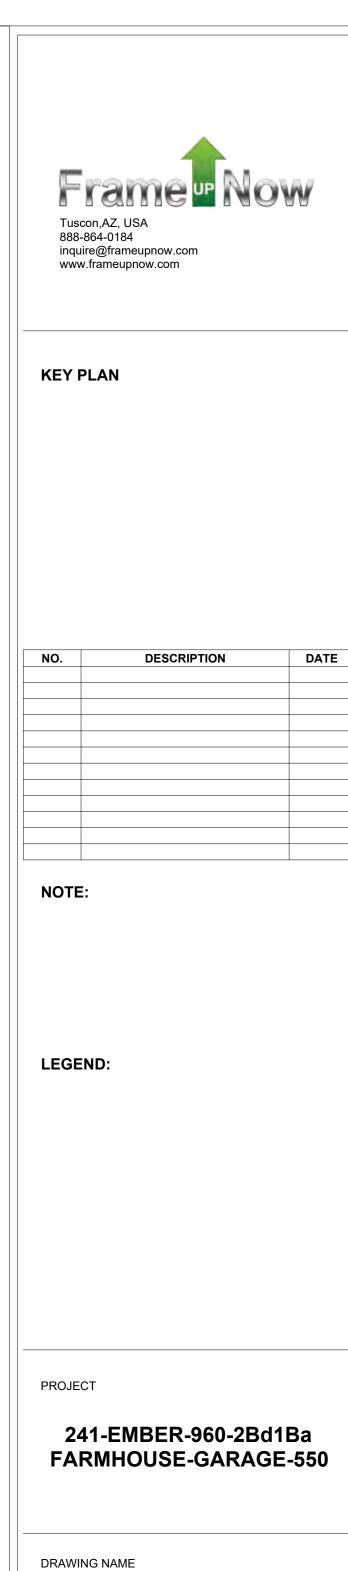DRAWING NAME

ARCHITECTURAL DETAILS

CLIENT NAME:	Client Name
PROJECT NUMBER:	0061_12
DATE:	5/13/2025 3:57:57 PM
DESIGNED BY:	Designer
DRAWN BY:	Author
CHECKED BY:	Checker

A401

CASEWORK GENERAL NOTES

- ALL CABINET HEIGHTS INCLUDE COUNTERTOPS. DIMENSIONS ARE TO THE NEAREST INCH. DIVISIONS IN CASEWORK ARE SHOWN FOR CLARITY AND DO NOT REPRESENT BREAKS IN THE
- PROVIDE CONTINUOUS COUNTERTOP OVER ALL SIMILAR HEIGHT CASEWORK, UNLESS AND
- OTHERWISE NOTED. MANUFACTURER AND CATALOG NUMBERS ARE FOR REFERENCE AND ILLUSTRATION PURPOSES
- DOTTED LINES INDICATE WALL HUNG CABINETS, DIVISIONS OF BASE CABINETS BELOW THE
- COUNTERTOP, FURNITURE NOT IN THE CONTRACT OR PROJECTION SCREENS -SEE CASEWORK KEY AND SPECIFICATIONS.
- ALL CABINETS AND DRAWERS TO HAVE CAM LOCKS EXCEPT FOR SINK BASE CABINETS. 8. ALL EXPOSED SURFACES (EXPOSED TO VIEW FROM ANY PERSPECTIVE) TO BE COVERED WITH
- ALL CASEWORK WHICH MEETS A WALL AT ONE OR BOTH ENDS, TO BE PROVIDED WITH FILLER PANELS AND SCRIBED TO THE WALL(S) AS REQUIRED.
- 10. ALL CABINETS AND DRAWERS ARE PROVIDED WITH RECESSED HANDLES.

WASHER-FRONT-LOAD


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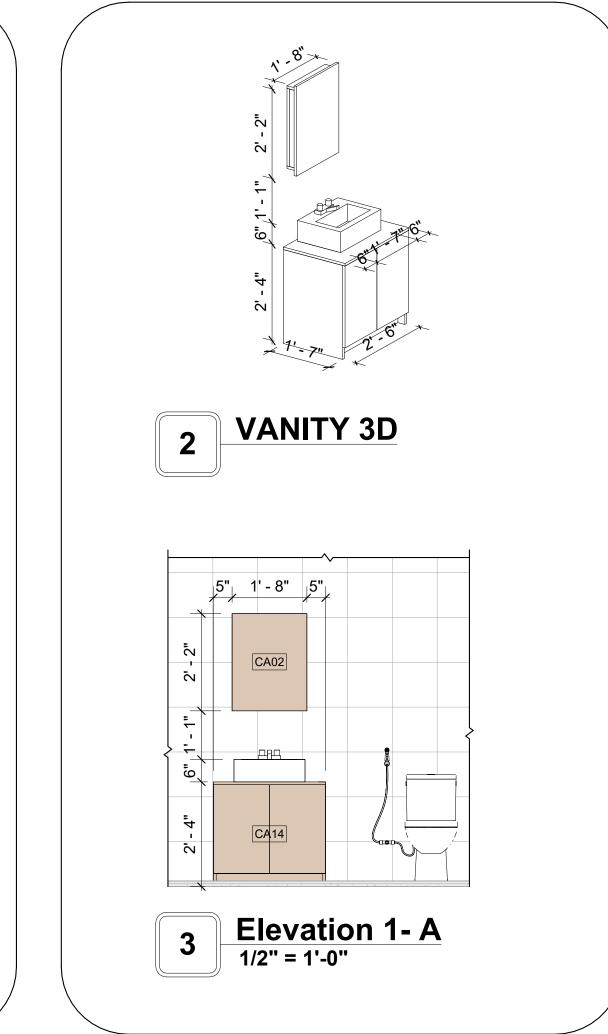
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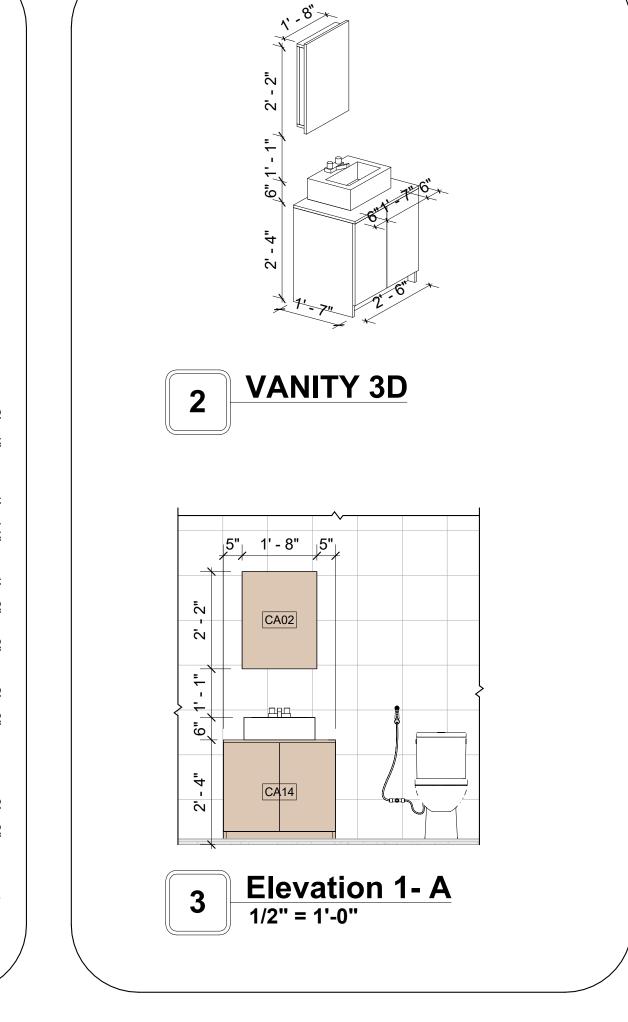
RANGE


- 11. CONTRACTOR TO FIELD VERIFY ALL CLEAR OPENINGS PRIOR TO MILLWORK OR CASEWORK
- 12. CASEWORK DRAWINGS ARE DIAGRAMMATIC IN NATURE TO SHOW DESIGN INTENT.


CASEWORK SCHEDULE						
TYPE MAR K	TYPE	COUN T	HEIGHT	WIDTH	DEPTH	AREA
01	CLOSET 5	2	6' - 0"	6' - 9"	1' - 4"	40 SF
02	RECESSED_MED_CABINET 2	1	2' - 0"	1' - 6"	0' - 3"	3 SF
03	CLOSET 3	1	6' - 0"	3' - 10"	1' - 4"	23 SF
04	HD_L-SHAPE_COUNTER_TOP W SINK HOLE 2	1	0' - 4"	4' - 6"	8' - 1"	1 SF
05	WALL_CABINET_SINGLE_DOOR	1	2' - 6"	2' - 1"	1' - 0"	5 SF
06	BASE_CABINET_SINGLE_DOOR 2	1	2' - 7"	1' - 4"	2' - 0"	3 SF
07	HD_TALL_CABINET_24	1	7' - 6"	4' - 3"	2' - 0"	32 SF
80	WALL FILLER	1	2' - 6"	1' - 4"	1' - 0"	3 SF
09	WALL_CABINET_DOUBLE_DOOR 2	1	2' - 6"	3' - 3"	1' - 0"	8 SF
10	HD_LINEAR_COUNTER_TOP 4	1	0' - 4"	3' - 1"	2' - 1"	1 SF
11	BASE_CABINET_SINGLE_DOOR 3	1	2' - 7"	1' - 0"	2' - 0"	3 SF
12	BASE_CABINET_DOUBLE_DOOR	2	2' - 11"	3' - 0"	2' - 0"	9 SF
13	REFRIGERATOR TOP	1	1' - 6"	2' - 0"	2' - 4"	3 SF
14	VANITY	1	2' - 4"	2' - 6"	1' - 8"	6 SF
15	WALL FILLER 2	1	2' - 6"	1' - 0"	1' - 0"	2 SF
16	BASE_CABINET_L-SHAPED	1	2' - 11"	3' - 3"	3' - 3"	9 SF
17	BASE_CABINET_SINGLE_DOOR	1	2' - 7"	2' - 1"	2' - 0"	5 SF
	SPECIALT	Y EQU	IPMENT S	CHEDULE		
	TYPE MARK	TYPE			COUNT	






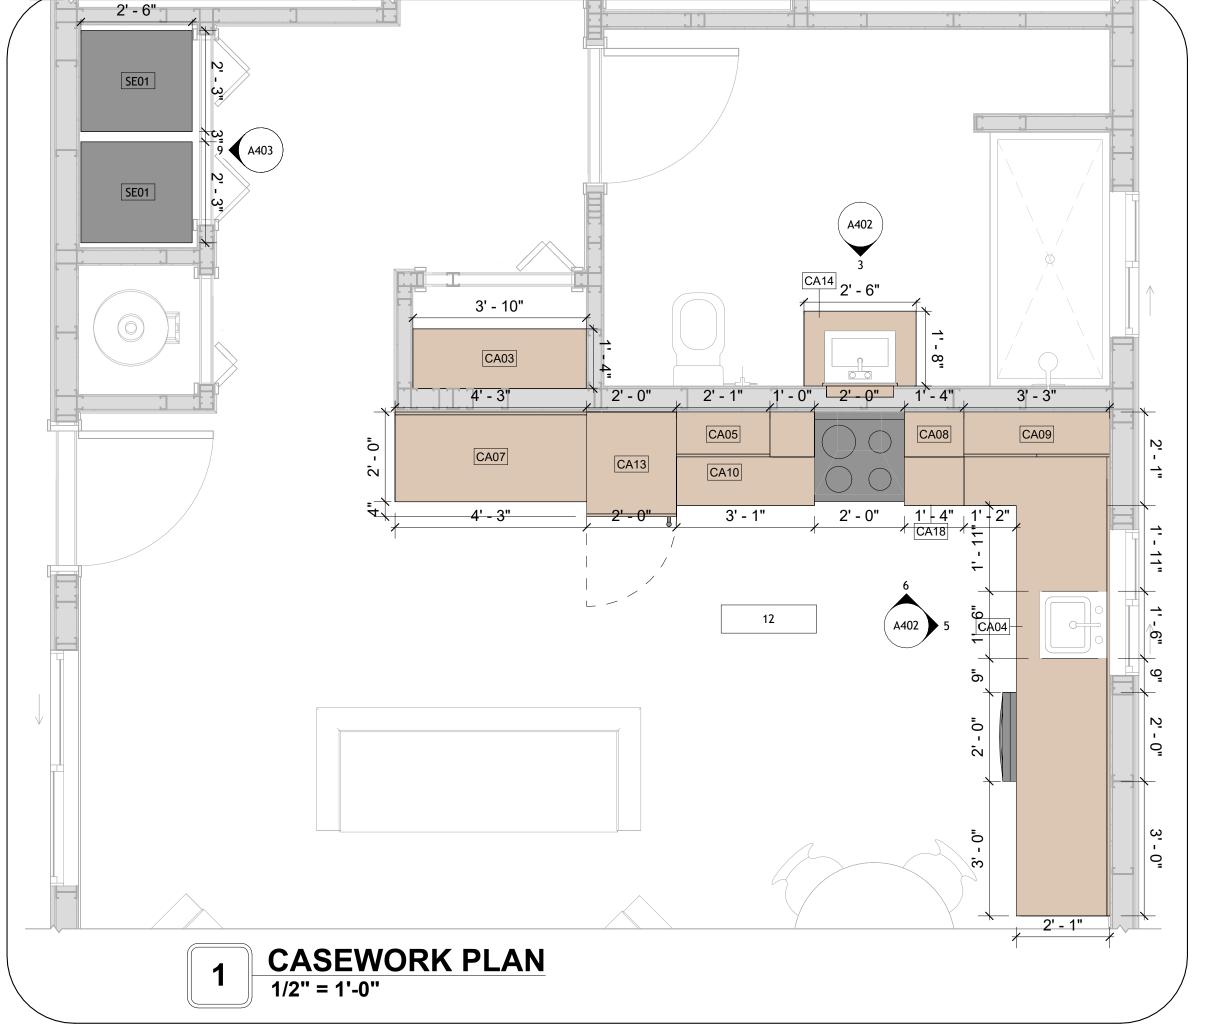


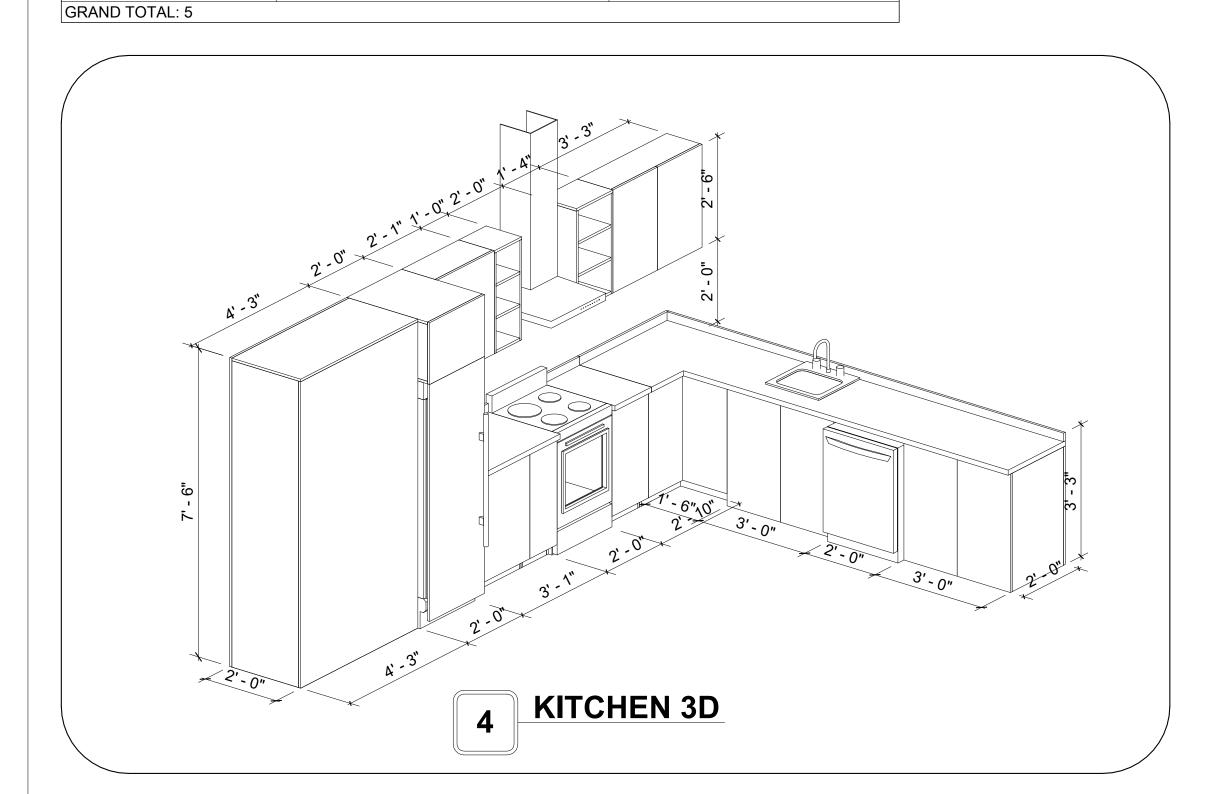

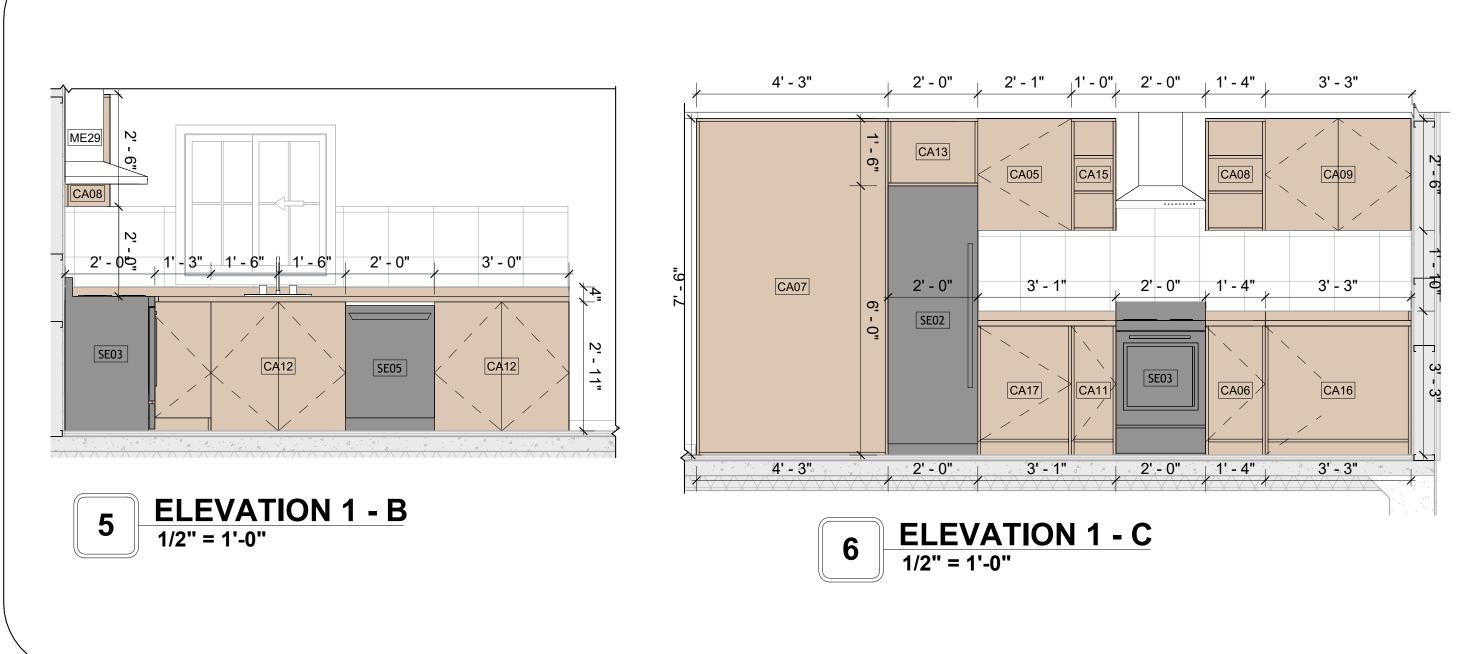



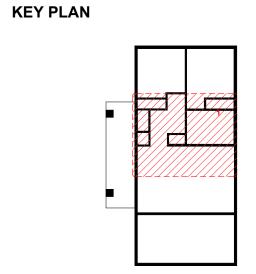

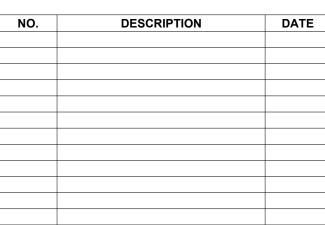

NOTE:

LEGEND:

PROJECT

241-EMBER-960-2Bd1Ba **FARMHOUSE-GARAGE-550**

DRAWING NAME

ARCHITECTURAL CASEWORK

Client Name	CLIENT NAME:
0061_12	PROJECT NUMBER:
5/13/2025 3:58:00 PM	DATE:
Designer	DESIGNED BY:
Author	DRAWN BY:
Checker	CHECKED BY:

A402

CASEWORK GENERAL NOTES

- ALL CABINET HEIGHTS INCLUDE COUNTERTOPS. DIMENSIONS ARE TO THE NEAREST INCH.
 DIVISIONS IN CASEWORK ARE SHOWN FOR CLARITY AND DO NOT REPRESENT BREAKS IN THE
- COUNTERTOP.
- PROVIDE CONTINUOUS COUNTERTOP OVER ALL SIMILAR HEIGHT CASEWORK, UNLESS AND
- OTHERWISE NOTED. MANUFACTURER AND CATALOG NUMBERS ARE FOR REFERENCE AND ILLUSTRATION PURPOSES
- DOTTED LINES INDICATE WALL HUNG CABINETS, DIVISIONS OF BASE CABINETS BELOW THE COUNTERTOP, FURNITURE NOT IN THE CONTRACT OR PROJECTION SCREENS -SEE CASEWORK
- KEY AND SPECIFICATIONS. 7. ALL CABINETS AND DRAWERS TO HAVE CAM LOCKS EXCEPT FOR SINK BASE CABINETS.
 8. ALL EXPOSED SURFACES (EXPOSED TO VIEW FROM ANY PERSPECTIVE) TO BE COVERED WITH
- ALL CASEWORK WHICH MEETS A WALL AT ONE OR BOTH ENDS, TO BE PROVIDED WITH FILLER PANELS AND SCRIBED TO THE WALL(S) AS REQUIRED.
- 10. ALL CABINETS AND DRAWERS ARE PROVIDED WITH RECESSED HANDLES. 11. CONTRACTOR TO FIELD VERIFY ALL CLEAR OPENINGS PRIOR TO MILLWORK OR CASEWORK
- 12. CASEWORK DRAWINGS ARE DIAGRAMMATIC IN NATURE TO SHOW DESIGN INTENT.


CASEWORK SCHEDULE							
TYPE MAR K	TYPE	COUN T	HEIGHT	WIDTH	DEPTH	AREA	
01	CLOSET 5	2	6' - 0"	6' - 9"	1' - 4"	40 SF	
02	RECESSED_MED_CABINET 2	1	2' - 0"	1' - 6"	0' - 3"	3 SF	
03	CLOSET 3	1	6' - 0"	3' - 10"	1' - 4"	23 SF	
04	HD_L-SHAPE_COUNTER_TOP W SINK HOLE 2	1	0' - 4"	4' - 6"	8' - 1"	1 SF	
05	WALL_CABINET_SINGLE_DOOR	1	2' - 6"	2' - 1"	1' - 0"	5 SF	
06	BASE_CABINET_SINGLE_DOOR 2	1	2' - 7"	1' - 4"	2' - 0"	3 SF	
07	HD_TALL_CABINET_24	1	7' - 6"	4' - 3"	2' - 0"	32 SF	
80	WALL FILLER	1	2' - 6"	1' - 4"	1' - 0"	3 SF	
09	WALL_CABINET_DOUBLE_DOOR 2	1	2' - 6"	3' - 3"	1' - 0"	8 SF	
10	HD_LINEAR_COUNTER_TOP 4	1	0' - 4"	3' - 1"	2' - 1"	1 SF	
11	BASE_CABINET_SINGLE_DOOR 3	1	2' - 7"	1' - 0"	2' - 0"	3 SF	
12	BASE_CABINET_DOUBLE_DOOR	2	2' - 11"	3' - 0"	2' - 0"	9 SF	
13	REFRIGERATOR TOP	1	1' - 6"	2' - 0"	2' - 4"	3 SF	
14	VANITY	1	2' - 4"	2' - 6"	1' - 8"	6 SF	
15	WALL FILLER 2	1	2' - 6"	1' - 0"	1' - 0"	2 SF	
16	BASE_CABINET_L-SHAPED	1	2' - 11"	3' - 3"	3' - 3"	9 SF	
17	BASE_CABINET_SINGLE_DOOR	1	2' - 7"	2' - 1"	2' - 0"	5 SF	
	SPECIALT	TY EQU	IPMENT SO	CHEDULE			
	TYPE MARK	TYPE			COUNT		


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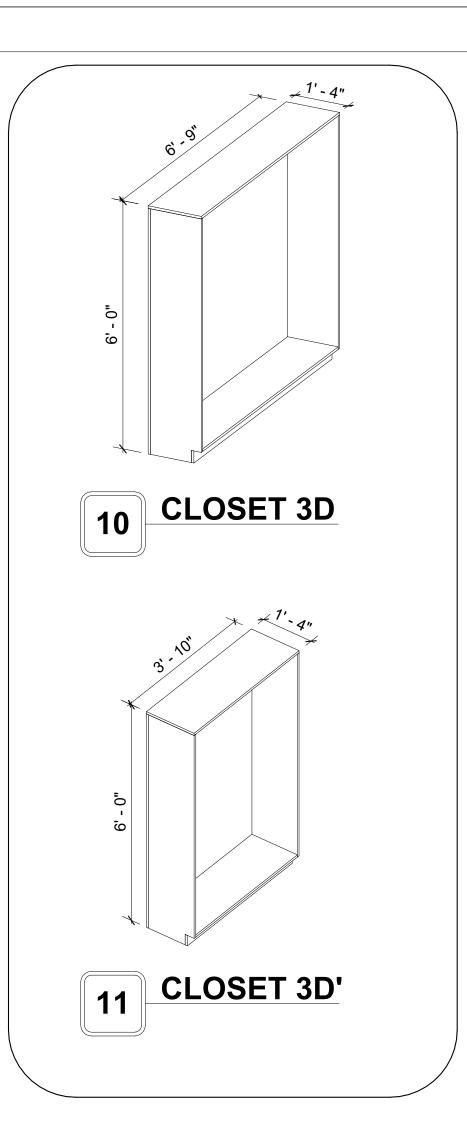
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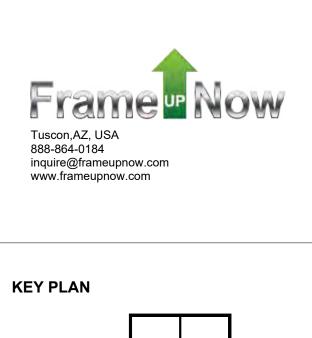
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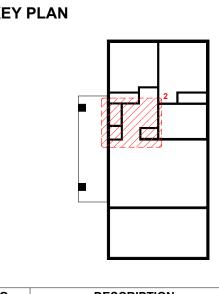
RANGE







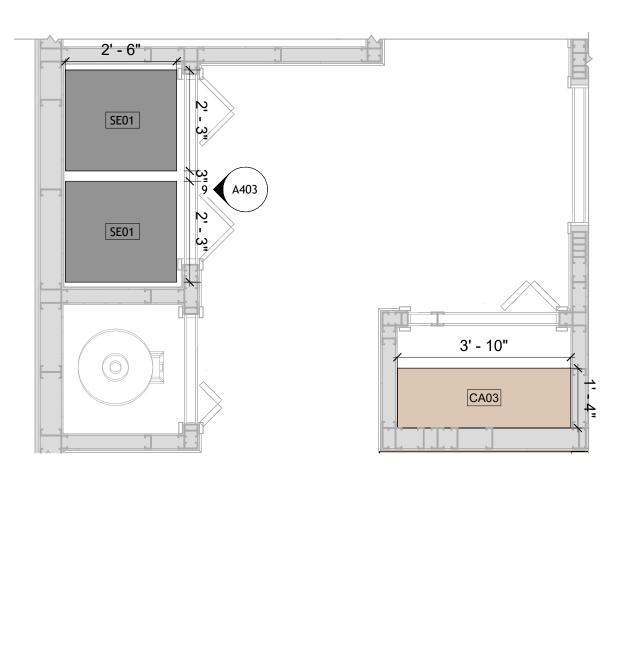

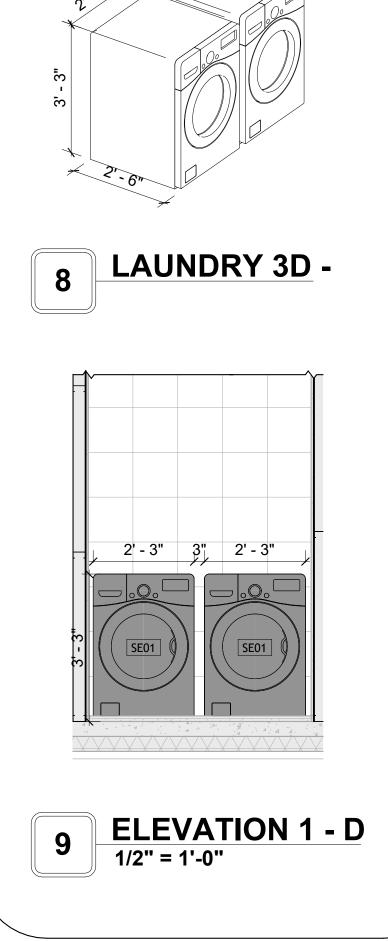

NO.	DESCRIPTION	DATE
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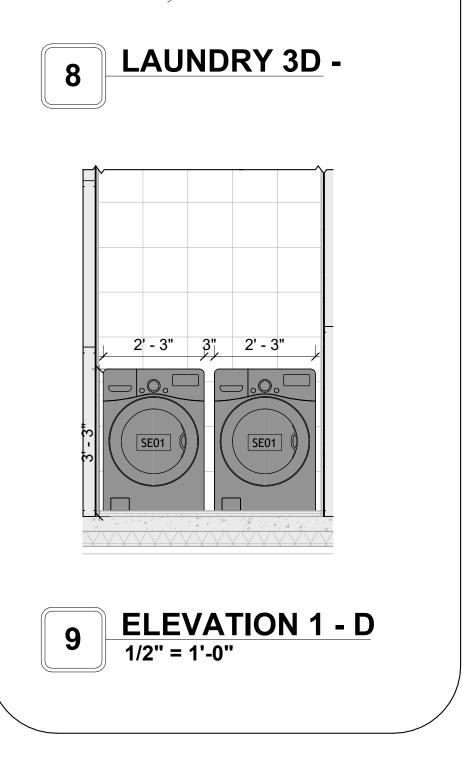
LEGEND:

241-EMBER-960-2Bd1Ba FARMHOUSE-GARAGE-550

ARCHITECTURAL CASEWORK

Client Name	CLIENT NAME:
0061_12	PROJECT NUMBER:
5/13/2025 3:58:02 PM	DATE:
Designer	DESIGNED BY:
Author	DRAWN BY:
Checker	CHECKED BY:

A403



02 03 05

GRAND TOTAL: 5

GENERAL NOTES

T1. THIS DRAWING DEPICTS THE HVAC (HEATING, VENTILATION, AND AIR CONDITIONING) SYSTEM FOR THE EMBER 2BD1BA FARMHOUSE GARAGE. IT VISUAL REPRESENTATION OF THE SYSTEM LAYOUT AND COMPONENTS.

2.THE HVAC SYSTEM IS DESIGNED TO MEET THE SPECIFIC REQUIREMENTS OF THE BUILDING, INCLUDING HEATING, COOLING, AND VENTILATION NEEDS AS PER THE PROJECT SPECIFICATIONS AND APPLICABLE CODES AND STANDARDS.

3. THE HVAC SYSTEM INSTALLATION SHALL COMPLY WITH THE LATEST EDITION OF THE INTERNATIONAL MECHANICAL CODE (IMC), INTERNATIONAL RESIDENTIAL CODE (IRC), AND ALL OTHER APPLICABLE LOCAL, STATE, AND NATIONAL CODES AND REGULATIONS.

4. THE EQUIPMENT SHOWN ON THIS DRAWING INCLUDES BUT IS NOT LIMITED TO AIR HANDLING UNITS (AHUS), CHILLERS, BOILERS, COOLING TOWERS, PUMPS, DUCTWORK, DIFFUSERS, GRILLES, AND CONTROL DEVICES.

5. ALL EQUIPMENT, DUCTWORK, AND PIPING SHALL BE INSTALLED IN ACCORDANCE WITH MANUFACTURER'S SPECIFICATIONS, LOCAL CODES, AND INDUSTRY BEST PRACTICES.

6. ALL DUCTWORK SHALL BE SIZED, FABRICATED, AND INSTALLED IN ACCORDANCE WITH THE LATEST EDITION OF THE ACCA MANUAL D AND THE SMACNA HVAC DUCT CONSTRUCTION STANDARDS. DUCTWORK SHALL BE INSTALLED IN A NEAT AND WORKMANLIKE MANNER, PROPERLY SUPPORTED AND BRACED TO PREVENT SAGGING, AIR LEAKAGE, OR VIBRATION.

7. CONDENSATE DRAINAGE PIPING SHALL BE PROPERLY PITCHED TO ENSURE POSITIVE DRAINAGE TO AN APPROVED DISPOSAL LOCATION, SUCH AS A FLOOR DRAIN, SUMP PUMP, OR EXTERIOR GRADE. CONDENSATE LINES SHALL BE INSULATED TO PREVENT SWEATING.

8. THE LOCATION OF CONTROL PANELS AND SENSORS INDICATED ON THIS DRAWING CAN BEMODIFY with THE SPECIFIC LOCATIONS AND WIRING

9. THE HVAC SYSTEM DESIGN CONSIDER ENERGY EFFICIENCY, INDOOR AIR QUALITY, OCCUPANT COMFORT, AND NOISE CONTROL, FOLLOWING APPLICABLE GUIDELINES AND REGULATIONS.

DETAILS WILL BE DETERMINED DURING THE CONTROL SYSTEM DESIGN AND INSTALLATION.

10. COORDINATION WITH OTHER TREADS HAS BEEN DONE ON A DESIGN LEVEL. THIS DRAWING SHALL BE READ TOGETHER WITH THE AR, EL AND SN DESIGN DRAWINGS TO ENSURE PROPER INSTALLATION AND INTEGRATION OF THE HVAC SYSTEMS.

11. THE HVAC CONTRACTOR IS RESPONSIBLE FOR OBTAINING ALL NECESSARY PERMITS AND LICENSES, AND FOR SCHEDULING AND COORDINATING WITH THE LOCAL BUILDING DEPARTMENT AND UTILITY PROVIDERS TO ENSURE A TIMELY AND COMPLIANT INSTALLATION.

12. ALL DUCTWORK PENETRATIONS THROUGH WALLS, FLOORS, OR CEILINGS SHALL BE PROPERLY SEALED AND FIRE-STOPPED USING APPROVED METHODS AND MATERIALS TO MAINTAIN THE INTEGRITY OF THE BUILDING'S FIRE-RESISTANCE RATINGS.

13. HVAC EQUIPMENT SHALL BE INSTALLED LEVEL AND PLUMB, AND IN STRICT ACCORDANCE WITH THE MANUFACTURER'S INSTALLATION INSTRUCTIONS AND RECOMMENDATIONS. PROVIDE ADEQUATE CLEARANCES AROUND EQUIPMENT FOR PROPER AIRFLOW, SERVICE ACCESS, AND CODE COMPLIANCE.


14. ALL HVAC EQUIPMENT AND COMPONENTS, INCLUDING THERMOSTATS, DAMPERS, AND ACCESS PANELS, SHALL BE LOCATED IN ACCESSIBLE AREAS FOR EASY SERVICING AND MAINTENANCE. PROVIDE ADEQUATE SPACE AROUND EQUIPMENT FOR PROPER AIRFLOW AND SERVICE ACCESS.

15. THE HVAC SYSTEM SHALL BE BALANCED AND ADJUSTED TO ENSURE PROPER AIRFLOW, TEMPERATURE DISTRIBUTION, AND SYSTEM PERFORMANC THROUGHOUT THE RESIDENCE. PROVIDE A WRITTEN REPORT DOCUMENTING THE FINAL SYSTEM BALANCE.

16. ANY DEVIATIONS OR MODIFICATIONS TO THE HVAC SYSTEM DESIGN SHALL BE REVIEWED AND APPROVED BY THE RESPONSIBLE DESIGN PROFESSIONALS AND COMMUNICATED TO ALL RELEVANT PARTIES INVOLVED IN THE CONSTRUCTION PROCESS.


17. FOR ANY INQUIRIES OR CLARIFICATIONS REGARDING THE HVAC SYSTEM DESIGN, PLEASE CONSULT THE RESPONSIBLE DESIGN PROFESSIONALS OR THE PROJECT MANAGEMENT TEAM.

SYMBOLS

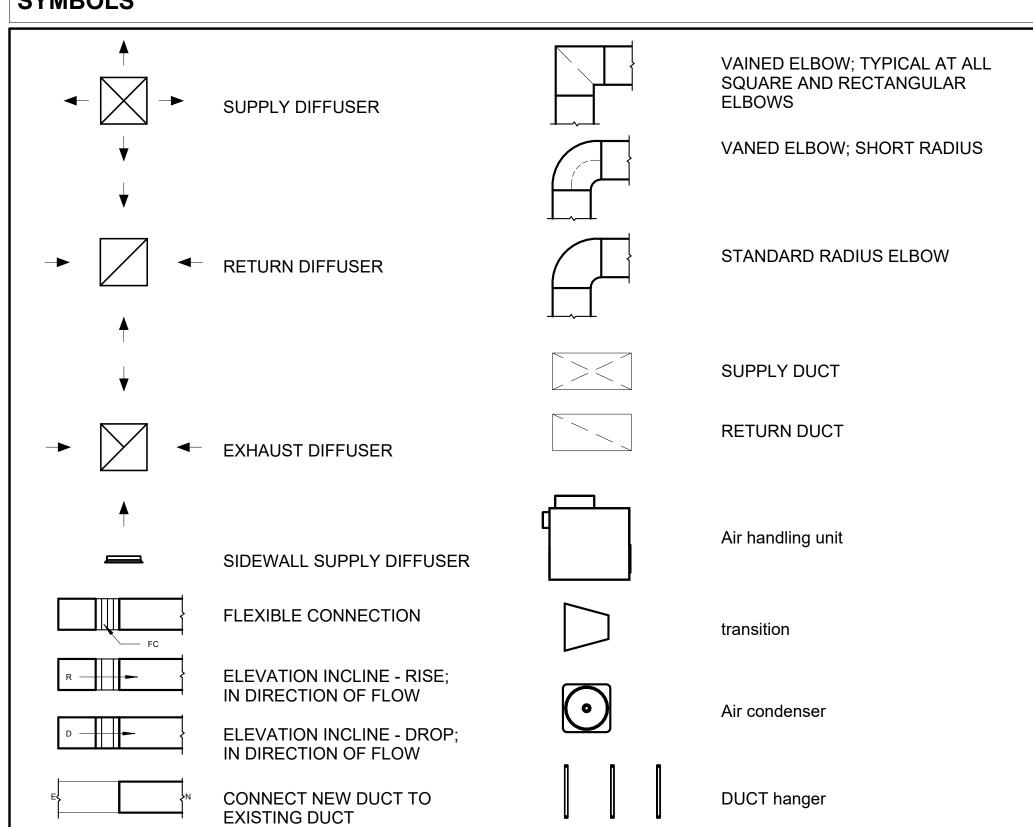



air conditioning pipe line

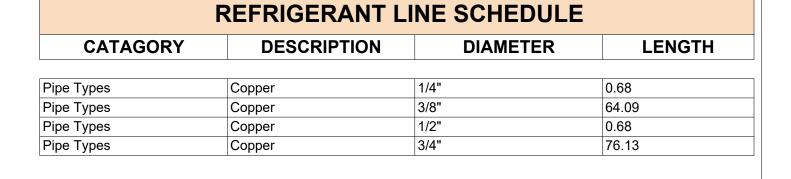

AIR HANDLING UNIT

HVAC PLAN

1/4" = 1'-0"

AIR HANDLING UNIT

EXHAUST FAN

Ø3/8" Ø3/4"

4' - 10"

Hood-Wall

AIR HANDLING UNIT-

-CONDENSER

REFRIGERANT LINE FITTING SCHEDULE					
CATAGORY	DESCRIPTION	Size	Count		
Elbow - Generic	Elbow - Generic: Standard/HVAC	1/2"ø-1/2"ø	1		
Elbow - Generic	Elbow - Generic: Standard/HVAC	1/4"ø-1/4"ø	1		
Elbow - Generic	Elbow - Generic: Standard/HVAC	3/4"ø-3/4"ø	19		
Elbow - Generic	Elbow - Generic: Standard/HVAC	3/8"ø-3/8"ø	20		
Tee - Generic	Tee - Generic: Standard	3/4"ø-3/4"ø-3/ 4"ø	3		
Tee - Generic	Tee - Generic: Standard	3/8"ø-3/8"ø-3/ 8"ø	2		
Transition - Generic	Transition - Generic: Standard	3/4"ø-1/2"ø	3		
Transition - Generic	Transition - Generic: Standard	3/4"ø-5/8"ø	3		
Transition - Generic	Transition - Generic: Standard	3/8"ø-1/4"ø	1		

MECHANICAL EQUIPMENT SCHEDULE				
CATAGORY	COUNT			
AIR HANDLING UNIT	AIR HANDLING UNIT: WALL MOUNTED	3		
CONDENSER CONDENSER: OUT DOOR 1				
Exhaust Fan EXHAUST FAN: 75 CFM 1				
	Hood-Wall: VENT	1		

DUCT FITTING SCHEDULE				
CATAGORY DESCRIPTION				
Round Transition - Angle	45 Degree	5		

DUCT ACCESSORY SCHEDULE			
CATAGORY	DESCRIPTION	COUNT	
ROOF VENT	3" DIAMETER	2	

FLEX DUCT SCHEDULE						
DESCRIPTION DESCRIPTION LENGTH DIAMETER COUNT						
Flex Duct Round FLEX-ROUND 15.59 4" 3						
Grand total: 3	FLEX-ROUND	15.59 15.59	4	3		



KEY PLAN

NO.	DESCRIPTION	DATE

NOTE:

LEGEND:

PROJECT

241-EMBER-960-2Bd1Ba **FARMHOUSE-GARAGE-550**

DRAWING NAME

HVAC PLAN

CLIENT NAME: Owner PROJECT NUMBER: 15_0001 DATE: 5/8/2025 12:06:44 AM Designer DESIGNED BY: DRAWN BY: Author CHECKED BY: Checker

M101

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ELECTRICAL NOTES

- 1. THIS DRAWING DEPICTS THE ELECTRICAL SYSTEM FOR 241-EMBER-960-2Bd1Ba FARMHOUSE-GARAGE-550. IT PROVIDES A VISUAL REPRESENTATION OF THE ELECTRICAL LAYOUT AND COMPONENTS, INCLUDING POWER DISTRIBUTION, LIGHTING, AND CONTROL SYSTEMS.
- 2. THE ELECTRICAL SYSTEM IS DESIGNED TO MEET THE SPECIFIC REQUIREMENTS OF THE BUILDING, INCLUDING POWER DISTRIBUTION, LIGHTING, AND SPECIALIZED ELECTRICAL EQUIPMENT NEEDS, AS PER THE PROJECT SPECIFICATIONS AND APPLICABLE CODES AND STANDARDS.
- 3. THE ELECTRICAL SYSTEM INSTALLATION SHALL COMPLY WITH THE LATEST EDITION OF THE NATIONAL ELECTRICAL CODE (NEC), INTERNATIONAL BUILDING CODE (IBC), AND ALL OTHER APPLICABLE LOCAL, STATE, AND NATIONAL CODES AND REGULATIONS.
- 4. LOCATIONS AS NEEDED, DEVICES ARE SHOWN ON PLANS IN APPROXIMATE IDEAL LOCATIONS, UNLESS SPECIFICALLY DIMMENSIONED.
- OPEN WALLS AS NEEDED TO ALLOW FOR NEW ELECTRICAL INSTALLATIONS.
- 6. LABEL ALL CIRCUITS ON JUNCTION BOXES, RECEPTACLES, DATA, SMOKE DETECTOR, AND EQUIPMENT IN PANEL BOX.
- 7. INSTALL RACEWAY AS NEEDED FOR DDC, ACCESS CONTROL, LOW VOLTAGE WIRING & DATA.
- 8. RELABEL POWER, DATA & FIRE ALARM FOR ROOM #CHANGES. 9. VERIFY ALL CIRCUITS LABELED ON PRINT ARE CORRECT BEFORE WORKING ON THEM.
- 10. NOTE ON SITE PLAN ALL CHANGES OR MISSING DETAIL TO BE INCORPORATED INTO THE MASTER PLAN.
- 11. DRAWINGS ARE DIAGRAMMATIC ONLY FOR THE PURPOSE OF SHOWING FIXTURE AND OUTLET LOCATIONS.
- 12. ELECTRICAL CONTRACTOR TO VERIFY SERVICE SIZE BY CALCULATION BASED UPON ACTUAL NAME
- PLATE RATINGS OF SELECTED EQUIPMENT.
- 13. VERIFY LOCATION OF SERVICE ENTRANCE WITH POWER COMPANY. PROVIDE UFER GROUND IN BUILDING FOUNDATION AT SERVICE ENTRANCE LOCATION.
- 14. PROVIDE A MIN. OF 20 FEET OF ONE *4 BARE COPPER UFER WIRE EMBEDDED IN CONCRETE FOOTING AT THE SERVICE ENTRANCE LOCATION WHERE APPROVED BY LOCAL SERVICE PROVIDER.
- 15. PROVIDE WATERPROOF FIXTURES IN ALL HIGH MOISTURE AREAS (EXTERIOR, SHOWER AND TUB
- CEILINGS ETC.) 16. PROVIDE DEDICATED CIRCUITS TO EACH BATH, DEN, FAMILY ROOM, BEDROOM, LOFT, KITCHEN
- REFRIGERATOR, KITCHEN FREEZER DISHWASHER, AND ANY AREA/ITEM SPECIFIED BY OWNER.
- 17. INCANDESCENT FIXTURES WITH OPEN OR PARTIALLY ENCLOSED LAMPS, PENDANT FIXTURES, AND LAMP HOLDERS ARE NOT PERMITTED IN CLOSETS.
- 18. ALL WORKMANSHIP AND MATERIALS TO CONFORM WITH THE 2015 IRC.
- 19. PROVIDE A MIN. OF 20 FEET OF ONE *4 BARE COPPER UFER WIRE EMBEDDED IN CONCRETE FOOTING AT THE SERVICE ENTRANCE LOCATION WHERE APPROVED BY LOCAL SERVICE PROVIDER.
- 20. PROVIDE A BONDING CONDUCTOR CONSISTING OF A MINIMUM OF ONE *4 BARE COPPER WIRE CONNECTING THE BUILDING'S METAL WATER PIPING SYSTEM TO THE SERVICE EQUIPMENT ENCLOSURE GROUNDING.

MAIN PANEL CALCS

ELECTRICAL CALCS	
LIGHT AND OUTLETS 960 @ 3W	2,880 W
3 APPLIANCE CIRCUITS	4,500 W
DRYER	2,000 W
WASHER	2,000 W
RANGE	5,000 W
WATER HEATER	5,000 W
REFRIG.	1,800 W
DISHWASHER & DISPOSAL	3000 W
TOTAL	26,180 W
FRIST 10,000 @ 100% REMAINDER @ 40% MINI. SPLIT UNITS	10,000 W 6,472 W 10,000 W
TOTAL	26,472 W

26,472 W DIVIDED BY 240V = 110 AMPS TOTAL

(USE 200 AMP SERVICE)

ELECTRICAL ABBREVIATIONS LIST

CB CIRCUIT BREAKER CCTV CLOSED CIRCUIT TELEVISION CKT CIRCUIT CLG CEILING COMB COMBINATION CMPR COMPRESSOR CONN CONNECTION CONST CONSTRUCTION CONT CONTINUATION OR CONTINUOUS CONT CONTINUATION OR CONTINUOUS CONT CONTRACTOR CONT CONTRACTOR CONT CONTRACTOR CONT CONTRACTOR CONT CONVECTOR CONV CONVECTOR CONV CONVECTOR CONV CONVECTOR CONV CONVECTOR CONV CONVECTOR CONC CONVECTOR COND CONVECTOR COND CONVECTOR COND CONVECTOR CONC CONVECTOR COND CONVECTOR CONVEC	1P A AC ACLG ADO AF AFF AFG AFI AHU ALT AMP AMPL ANNUN AQ-STAT ARCH AS AT ATS AUTO AUX AV AWG BATT BD BLDG BMS C CAT CAT	1 POLE (2P, 3P, 4P, ETC.) AMPERE ABOVE COUNTER OR AIR CONDITIONER ABOVE CEILING AUTOMATIC DOOR OPENER AMP FRAME ABOVE FINISHED FLOOR ABOVE FINISHED GRADE ARC FAULT CIRCUIT INTERRUPTER AIR HANDLING UNIT ALUMINUM ALTERNATE AMPERE AMPLIFIER ANNUNCIATOR APPROX APPROXIMATELY AQUASTAT ARCHITECT, ARCHITECTURAL AMP SWITCH AMP TRIP AUTOMATIC TRANSFER SWITCH AUTOMATIC AUXILIARY AUDIO VISUAL AMERICAN WIRE GAUGE BATTERY BOARD BUILDING BUILDING MANAGEMENT SYSTEM CONDUIT CABINET CATALOG	ELEC ELEV EM EMS EMT EP EQUIP EWC EXIST EXH EXP FA FABP SUPPLY PANEL FACP FCU	CENTER COPPER DOMESTIC WATER CIRCULATING PUMP DEPARTMENT DETAIL DIAMETER DISCONNECT DISTRIBUTION DOWN DAMPER SAFETY DISCONNECT SWITCH DOUBLE THROW DRAWING DIRECT DIGITAL CONTROL ELECTRICAL CONTRACTOR ELECTRIC, ELECTRICAL ELEVATOR EMERGENCY ENERGY MANAGEMENT SYSTEM ELECTRICAL METALLIC TUBING ELECTRIC PNEUMATIC EQUIPMENT ELECTRIC WATER COOLER EXISTING EXHAUST EXPLOSION PROOF FIRE ALARM FIRE ALARM BOOSTER POWER SUPPLY PANEL FIRE ALARM CONTROL PANEL FAN COIL UNIT	HT HTG HTR HV HVAC CONDITIONING HWP IC IG IMC INCAND IR I/W J-BOX KV KVAR KWH LOC LT LTG LTNG LTNG LV MAX MAG.S M/C MCB MCC MDC	HEIGHT HEATING HEATER HIGH VOLTAGE HEATING, VENTILATING AND AIR CONDITIONING HYDRONIC WATER PUMP INTERRUPTING CAPACITY ISOLATED GROUND INTERMEDIATE METAL CONDUIT INCANDESCENT INFRARED INTERLOCK WITH JUNCTION BOX KILOVOLT KILOVOLT-AMPERE KILOVOLT-AMPERE REACTIVE KILOWATT KILOWATT HOUR LOCATE OR LOCATION LIGHT LIGHTING LIGHTNING LOW VOLTAGE MAXIMUM MAGNETIC STARTER MOMENTARY CONTACT MECHANICAL CONTRACTOR MAIN CIRCUIT BREAKER MOTOR CONTROL CENTER MAIN DISTRIBUTION CENTER
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CP CIRCULATING PUMP GND GROUND MT MOUNT CATHODE-RAY TUBE GRS GALVANIZED RIGID STEEL (CONDUIT) MT.C EMPTY CONDUIT						MOTOR STARTER PANELBOARD
CRT CATHODE-RAY TUBE GRS GALVANIZED RIGID STEEL (CONDUIT) MT.C EMPTY CONDUIT						
CT CURRENT TRANSFORMER GYP BD GYPSUM BOARD UL UNDERWRITERS LABORATORIE	CT	CURRENT TRANSFORMER	GYP BD	GYPSUM BOARD	UL	UNDERWRITERS LABORATORIES

Branch Panel:

Location: GARAGE 03 **Supply From:**

Mounting: Recessed

Enclosure: Type 1

Volts: 120/240 Single Phases: Wires: 3

A.I.C. Rating: Mains Type: Mains Rating: 200 A MCB Rating: 1 A

-	Elements	Rating	Length	Wire Size	Α		ı	3	Wire Size	Length	Rating	Number of Elements	Circuit Description	Circui Numb er
BED 1&2 LIGHT	17	20 A	79' - 4 27/32"	1-#10, 1-#10, 1-#10	956 VA	576 VA			1-#12, 1-#12, 1-#12	46' - 6 5/16"	20 A	7	BATH GFCI	2
HALL LIGHT	5	20 A	59' - 1 9/16"	1-#12, 1-#12, 1-#12			240 VA	396 VA	1-#12, 1-#12, 1-#12	37' - 5 1/2"	20 A	7	KITCHEN LIGHT	4
LIVING LIGHT	6	20 A	44' - 9 25/32"	1-#12, 1-#12, 1-#12	182 VA	160 VA			1-#12, 1-#12, 1-#12	20' - 6 3/8"	20 A	4	GARAGE LIGHT	6
BED 1 &2 RECEPTACLE	8	20 A	71' - 3 3/32"	1-#10, 1-#10, 1-#10			1440 VA	2500 VA	2-#10, 1-#10, 1-#10	54' - 5 7/8"	30 A	1	DRYER	8
WASHING MASHEIN	1	20 A	52' - 6 5/8"	1-#12, 1-#12, 1-#12	1200 VA	2500 VA								10
WATER HEATER	1	30 A	48' - 11 9/16"	2-#10, 1-#10, 1-#10			2250 VA	1800 VA	1-#12, 1-#12, 1-#12	37' - 7 13/32"	20 A	1	REFRIGERATOR	12
					2250 VA	720 VA			1-#12, 1-#12, 1-#12	46' - 11 27/32"	20 A	4	KITCHEN GFCI	14
RANGE	1	50 A	42' - 11 23/32"	2-#8, 1-#8, 1-#10			2500 VA	180 VA	1-#12, 1-#12, 1-#12	40' - 11 13/32"	20 A	1	OVENHOOD	16
					2500 VA	1200 VA			1-#12, 1-#12, 1-#12	44' - 9 31/32"	20 A	1	DISHWASHER	18
LIVING RECEPTACLE	4	20 A	40' - 10 1/16"	1-#12, 1-#12, 1-#12			720 VA	720 VA	1-#12, 1-#12, 1-#12	69' - 2 13/16"	20 A	4	OUTDOOR GFCI	20
CONDENSER	1	60 A	59' - 2 7/8"	2-#6, 1-#6, 1-#10	2500 VA	900 VA			1-#12, 1-#12, 1-#12	27' - 0 13/32"	20 A	5	GARAGE GFCI	22
-							2500 VA	300 VA	1-#12, 1-#12, 1-#12	41' - 9"	20 A	4	OUTDOOR LIGHT	24
														26
					15631	VA	1553	1 VA						
	IVING LIGHT BED 1 &2 RECEPTACLE VASHING MASHEIN VATER HEATER - RANGE IVING RECEPTACLE CONDENSER	IVING LIGHT 6 BED 1 &2 RECEPTACLE 8 WASHING MASHEIN 1 WATER HEATER 1 RANGE 1 IVING RECEPTACLE 4 CONDENSER 1	IVING LIGHT 6 20 A	ALIVING LIGHT 6 20 A 44' - 9 25/32" 8 ECEPTACLE 8 20 A 71' - 3 3/32" WASHING MASHEIN 1 20 A 52' - 6 5/8" WATER HEATER 1 30 A 48' - 11 9/16"	HALL LIGHT 5 20 A 59' - 1 9/16" 1-#12, 1-#12, 1-#12 INVING LIGHT 6 20 A 44' - 9 25/32" 1-#12, 1-#12 BED 1 &2 RECEPTACLE 8 20 A 71' - 3 3/32" 1-#10, 1-#10 VASHING MASHEIN 1 20 A 52' - 6 5/8" 1-#12, 1-#12 VATER HEATER 1 30 A 48' - 11 9/16" 2-#10, 1-#10 RANGE 1 50 A 42' - 11 23/32" 2-#8, 1-#8, 1-#10 CONDENSER 1 60 A 59' - 2 7/8" 2-#6, 1-#6, 1-#10	HALL LIGHT 5 20 A 59'-19/16" 1.#12, 1.#12, 1.#12 2. 1.#12, 1.#12, 1.#12, 1.#12, 1.#12, 1.#12, 1.#12, 1.#12, 1.#12, 1.#12, 1.#12, 1.#12, 1.#12, 1.#10,	HALL LIGHT 5 20 A 59' - 1 9/16" 1-#12, 1-#12, 1-#12, 1-#12, 1-#12, 1-#12, 1-#12, 1-#12, 1-#12, 1-#12, 1-#12, 1-#12, 1-#10, 1	HALL LIGHT 5 20 A 59'-19/16" 1.#12, 1.#12, 1.#12, 1.#12, 1.#12, 1.#12, 1.#12, 1.#12, 1.#12, 1.#12, 1.#12, 1.#12, 1.#12, 1.#12, 1.#12, 1.#12, 1.#12, 1.#10, 1	HALL LIGHT 5 20 A 59' - 1 9/16" 1.#12, 1.#12, 1.#12 2 240 VA 396 VA 1.#12, 1.#12, 1.#12 1.#12 1.#12 1.#12 1.#12 1.#12 1.#12 1.#12 1.#12 1.#12 1.#12 1.#12 1.#12 1.#12 1.#12 1.#12 1.#12 1.#10 1.	HALL LIGHT 5 20 A 59' - 1 9/16" 1-#12, 1-#12, 1-#12 2 240 VA 396 VA 1-#12, 1-#10, 1-#1	HALL LIGHT 5 20 A 59'-19/16" 1-#12, 1	SALL LIGHT 5	MALL LIGHT 5 20 A 59' - 1 9/16" 1.#12, 1.#10, 1.#10	ALL LIGHT 5 20 A 59'-1 9'16" 1.412, 1.412 240 VA 396 VA 1.412, 1.412 20'-6 3/8" 20 A 7 KITCHEN LIGHT IVING LIGHT 6 20 A 44'-9 25/32" 1.412, 1.410, 1.410, 1.410 IVING LIGHT 8 20 A 71'-3 3/32" 1.410, 1.410, 1.410 IVING LIGHT 8 20 A 71'-3 3/32" 1.410, 1.410, 1.410, 1.410 VASHING ARAHEIN 1 20 A 52'-6 5/8" 1.412, 1.410, 1.410 VASHING ARAHEIN 1 30 A 48'-11 9/16" 1.410, 1.410 VASHING ARAHEIN 1 30 A 48'-11 9/16" 1.410, 1.410 IVING LIGHT 1.410, 1.410 VASHING ARAHEIN 1 30 A 48'-11 9/16" 1.410, 1.410 IVING LIGHT 1.410, 1.410 VASHING ARAHEIN 1 30 A 42'-11 23/32" 2.410, 1.410 IVING LIGHT 1.410, 1.410 IVING LIGHT 1.410, 1.410 IVING LIGHT 1.410, 1.410, 1.410 IVING LIGHT 1.410, 1.

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Load Classification	Connected Load	Demand Factor	Estimated Demand	Panel	Totals
LIGHTING - DWELLING UNIT	660 VA	100.00%	660 VA		
OTHER	1508 VA	100.00%	1508 VA	Total Conn. Load:	31161 VA
RECEPTACLE	7440 VA	100.00%	7440 VA	Total Est. Demand:	30161 VA
LIGHTING	300 VA	100.00%	300 VA	Total Conn.:	130 A
CONDENSER	5000 VA	100.00%	5000 VA	Total Est. Demand:	126 A
WATER HEATER	4500 VA	100.00%	4500 VA		
RANGE	5000 VA	80.00%	4000 VA		
DRYER	5000 VA	100.00%	5000 VA		
REFRIGERATOR	1800 VA	100.00%	1800 VA		



KEY PLAN

NO.	DESCRIPTION	DATE

NOTE:

LEGEND:

PROJECT

241-EMBER-960-2Bd1Ba **FARMHOUSE-GARAGE-550**

DRAWING NAME

SCHEDULE

CLIENT NAME: Owner PROJECT NUMBER 0120_16 5/8/2025 10:42:33 AM Designer DESIGNED BY: DRAWN BY: CHECKED BY: Checker

E101

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SCALE: 1/4" = 1'-0"

ELECTRICAL NOTE

- PROVIDE INTERCONNECTED SMOKE ALARMS IN EACH SLEEPING ROOMS, OUTSIDE EACH SLEEPING ROOM, ON EACH STORY, IN THE HALL OR ADJACENT ROOM LUHERE THE CEILING HEIGHT OF A ROOM OPEN TO THE HALL EXCEEDS THE HALL BY 24'. SMOKE ALARMS SHALL BE PERMANENTLY HARD WIRED WITH BATTERY BACKUP.
- B. RECEPTACLE OUTLETS FOR RANGES AND CLOTHES DRYERS SHALL BE A THREE POLE WITH GROUND TYPE. FOUR WIRE GROUNDING-TYPE FLEXIBLE CORDS WILL BE REQUIRED FOR CONNECTION OF RANGES AND CLOTHES DRYERS. THE BONDING JUMPER SHALL NOT BE CONNECTED BETWEEN NEUTRAL TERMINAL AND THE FRAME OF THE APPLIANCE.
- C. TWO OR MORE 20 AMP SMALL APPLIANCE CIRCUITS SHALL BE PROVIDED TO SERVE THE KITCHEN, BREAKFAST NOOK, AND DINING ROOM. SUCH CIRCUITS SHALL HAVE NO OTHER OUTLETS.
- D. AT LEAST ONE 20 AMP BRANCH CIRCUIT SHALL BE PROVIDED TO SERVICE THE LAUNDRY ROOM. THIS CIRCUIT SHALL HAVE NO OTHER OUTLETS.
- E. ALL RECEPTACLES WITH IN 6' OF A WET BAR SINK OR KITCHEN SINK TO SERVE COUNTER TOP SURFACES MUST BE GFCI. ON KITCHEN COUNTERS 12' OR WIDER NO POINT ALONG THE WALL SHALL BE MORE THAN 2' FROM A RECEPTACLE. ALL RECEPTACLES WITH IN 6' OF KITCHEN SINK MUST BE GFCI. AT LEAST ONE GFCI RECEPTACLE SHALL BE INSTALLED IN THE BATHROOM ADJACENT TO EACH BASIN.
- FIXTURES INCLUDING CEILING FANS THAT ARE LOCATED IN DAMP LOCATIONS SHALL BE LISTED TO BE SUITABLE FOR
- SUCH LOCATIONS PER 2012 IRC
- G. PROVIDE ONE (1) SWITCHED OUTLET @ ALL BEDROOMS AND DEN
- H. CEILING FANS NOT EXCEEDING 35 LBS. (WITH OR WITHOUT ACCESSORIES MAY BE SUPPORTED BY OUTLET BOXES PROVIDED THE OUTLET BOXES ARE IDENTIFIED FOR SUCH USE PER 2012 IRC
- ELECTRICAL OUTLET BOXES ON OPPOSITE SIDES OF FIRE RATED WALLS SHALL BE SEPARATED BY A HORIZONTAL DISTANCE OF NOT LESS THAN 24".
- J. OUTLET BOXES IN THE WALLS BETWEEN THE GARAGE AND DWELLING SHALL BE METAL OR U.L. APPROVED FIRE RESISTIVE PLASTIC. BOXES IN GARAGE CEILING SHALL BE METAL.
- K. ALL BRANCH CIRCUITS THAT SUPPLY 120 VOLTS SINGLE PHASE 15 AND 20 AMPS RECEPTACLE OUTLETS INSTALLED IN THE DWELLING SHALL BE PROTECTED BY AN ARC FAULT CIRCUIT INTERRUPTER. EXCEPT GFCI RECEPTICLES.

NOTE:

RECEPTACLES MUST BE PROVIDED IN HALLWAYS 10'-0" OR MORE IN LENGTH. FOR A ONE FAMILY DWELLINGS AND EACH OF A TWO FAMILY DWELLING THAT IS AT GRADE LEVEL, AT LEAST ONE WP-GFCI RECEPTACLE OUTLET ACCESSIBLE AT GRADE LEVEL AND NOT MORE THAN 6'-6" ABOVE GRADE SHALL BE INSTALLED AT THE FRONT AND BACK OF THE DWELLING.

NOTE: APPLIANCE DISCONNECT

E4001.5 GROUNDING OF ENCLOSURES.

METAL ENCLOSURES FOR SWITCHES OR CIRCUIT BREAKERS SHALL BE CONNECTED TO AN

EQUIPMENT GROUNDING CONDUCTOR.

METAL ENCLOSURES FOR SWITCHES OR CIRCUIT BREAKERS USED AS SERVICE

EQUIPMENT SHALL COMPLY WITH THE PROVISIONS OF SECTION E3609.4. WHERE


NONMETALLIC ENCLOSURES ARE USED WITH METAL RACEWAYS OR METAL-ARMORED CABLES. PROVISIONS SHALL BE MADE FOR CONNECTING THE EQUIPMENT GROUNDING

CONDUCTOR.


NONMETALLIC BOXES FOR SWITCHES SHALL BE INSTALLED WITH A WIRING METHOD THAT

PROVIDES OR INCLUDES AN EQUIPMENT GROUNDING CONDUCTOR. (404.12)

ELECTRICAL LEGEND				
	Electrical Lights With Fan			
0	Waterproof Recessed Can Light			
	Pendant Light			
0	Recessed Can Light			
- □	Wall Lamp			
	Standalone linear			
⊬1 1	Single Switch			
₩	Three way Switch			
₩	Fan Switch			
⊜□	Duplex Receptacle			
	Triplex Receptacle			
⊕ GFCI	GFCI Receptacle			
	Exhaust Fan			
•	Smoke and heat detector			

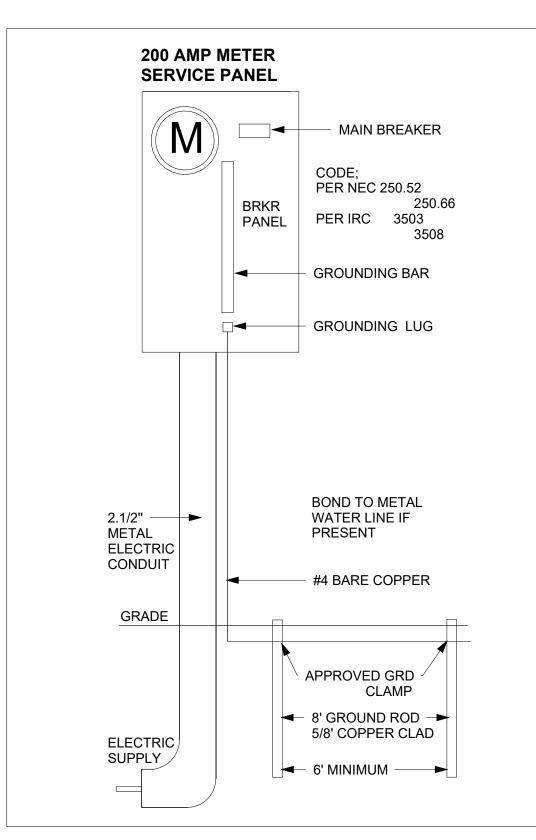



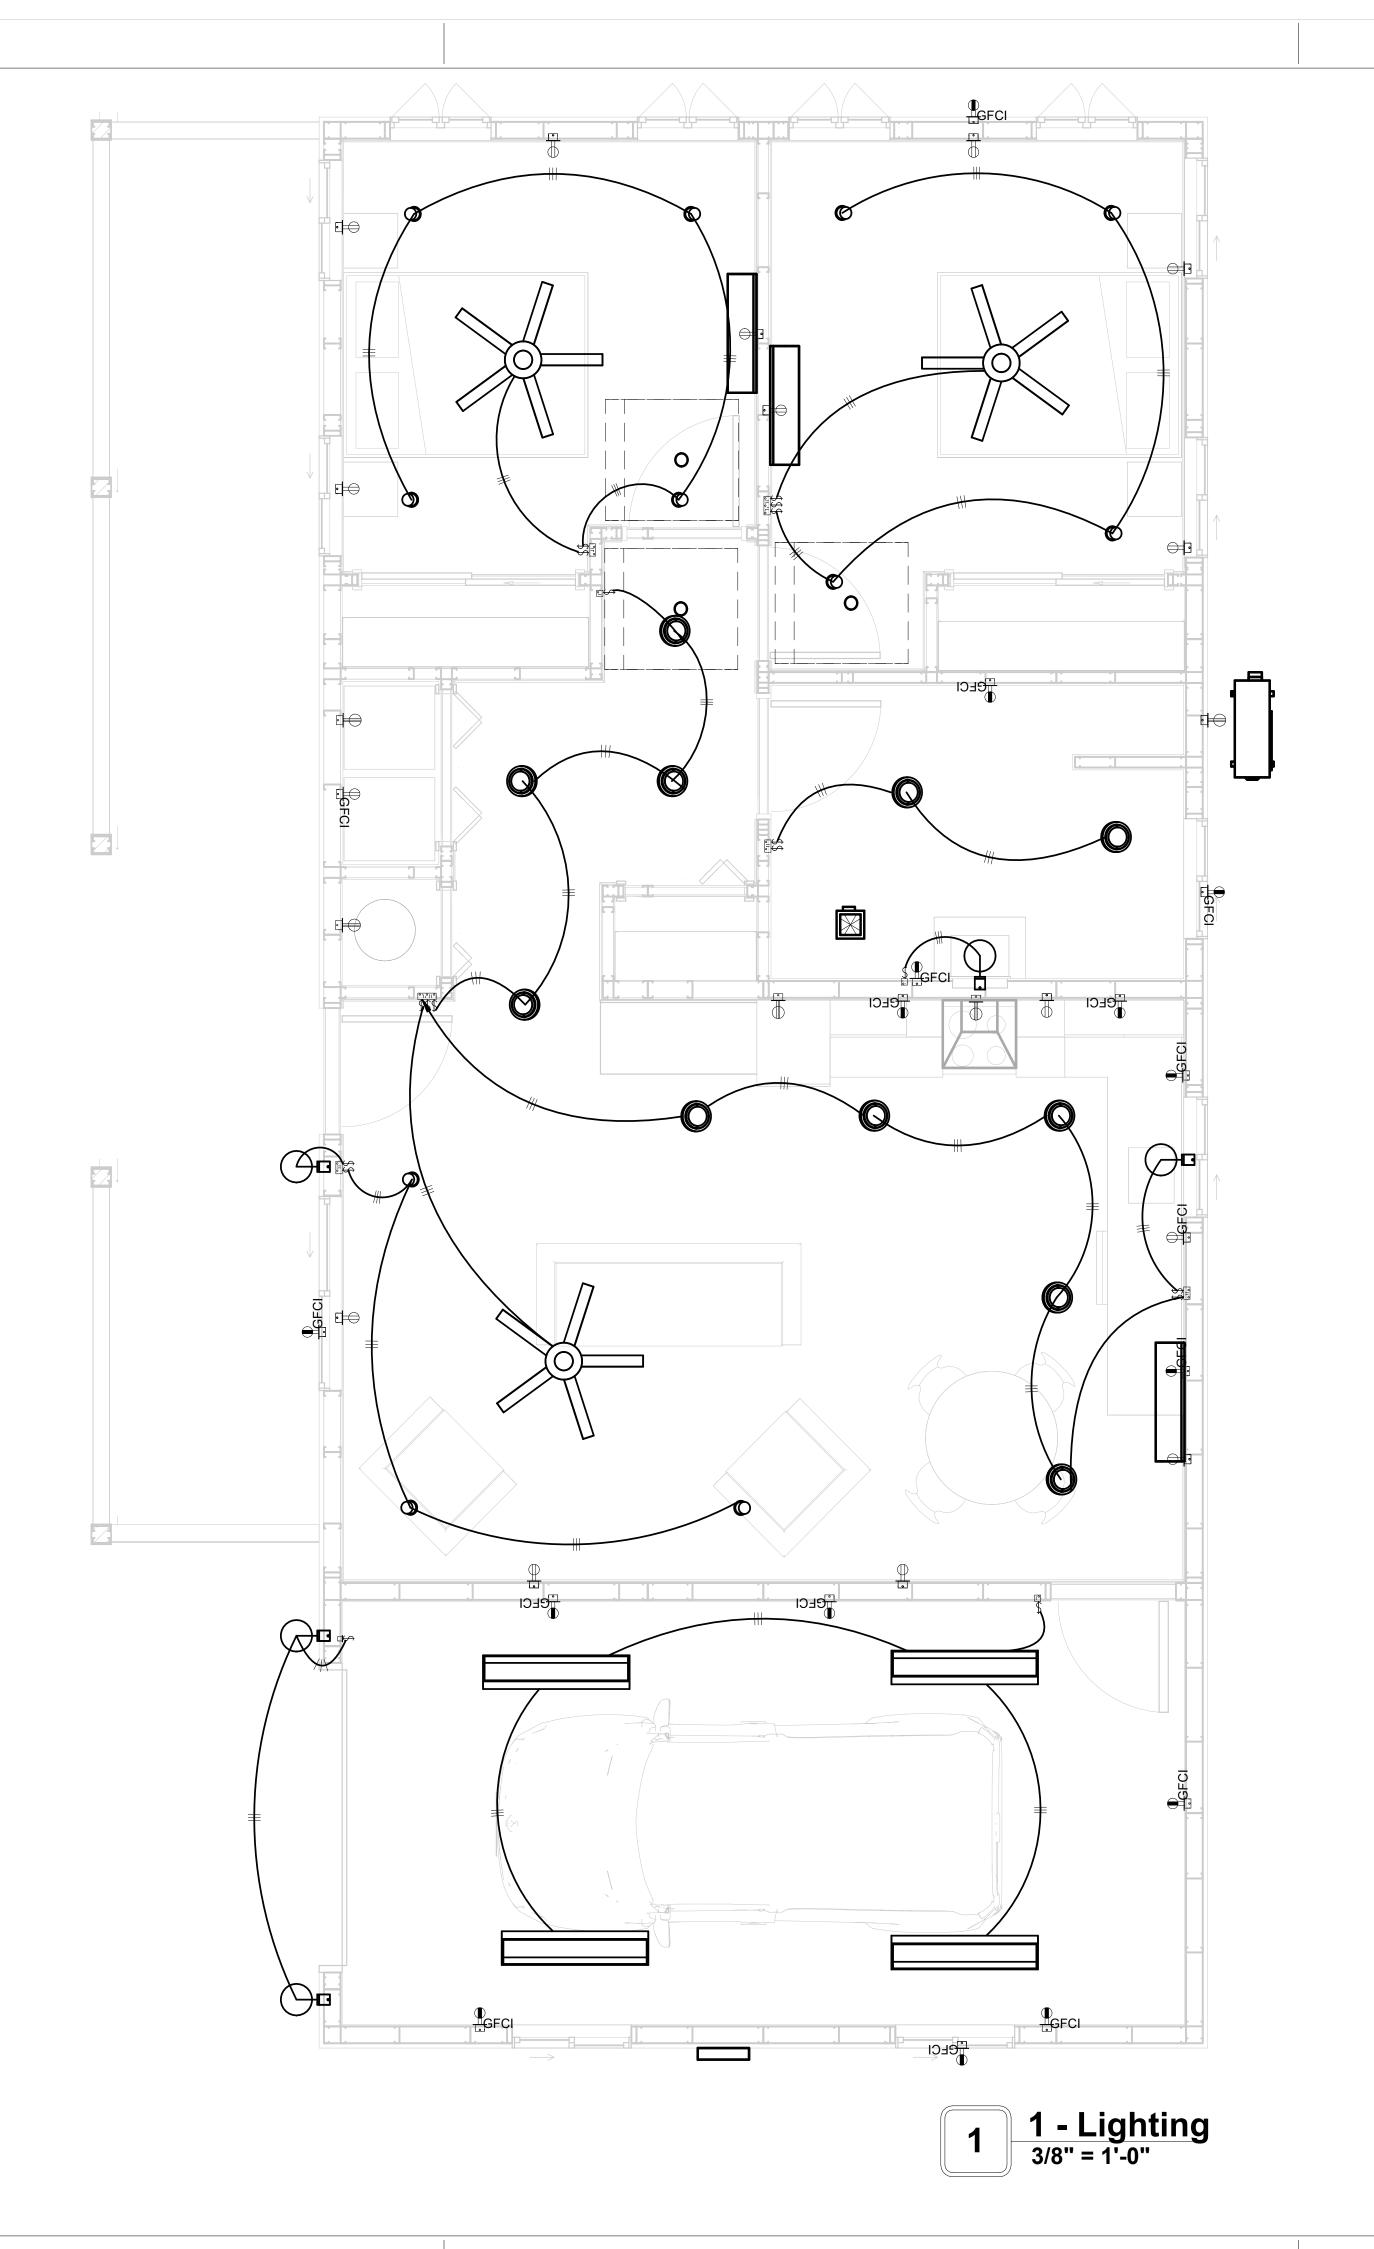



KEY PLAN

NO.	DESCRIPTION	DATE
110.	DECORNI FICIA	DAIL

NOTE:

LEGEND:

PROJECT

241-EMBER-960-2Bd1Ba **FARMHOUSE-GARAGE-550**

DRAWING NAME


LIGHTING

CLIENT NAME:	Owner
PROJECT NUMBER:	0120_16
DATE:	5/8/2025 10:42:36 AM
DESIGNED BY:	Designer
DRAWN BY:	Author
CHECKED BY:	Checker


E102

NOTES: CONDUIT, CABLE AND WIRING


- Use Metalic Conduits (IMC) for cables running under concrete slabs.
 Use IMC for circuits with high voltage appliances (240 volts and above)
 For circuits with 120 volts consider using EMT or PVC conduits if needed.
 For Low voltage applications up to 50 volts consider using non metalic conduits.
 All conduits to be used in the project must conform to the latest National Electrical Code (NEC),
- All wiring and cables to be used in the project must also conform to the latest National Electrical Code (NEC), 2015.
- 7. All cables and wires used should be rated for their respective loading and should be gauged and conform to the NEC.

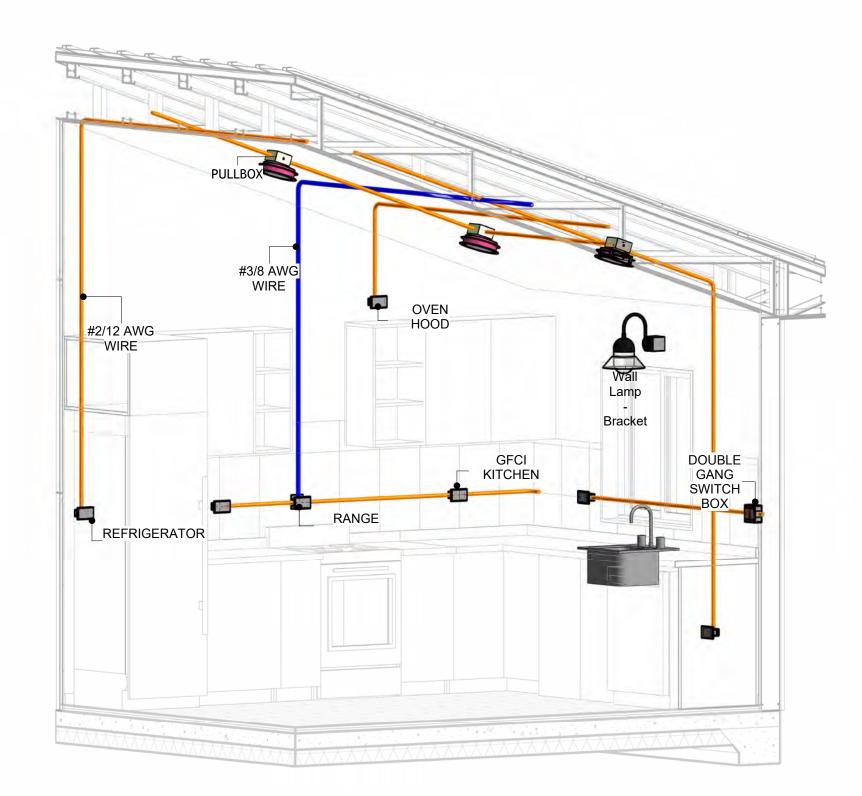


3D-KITCHEN

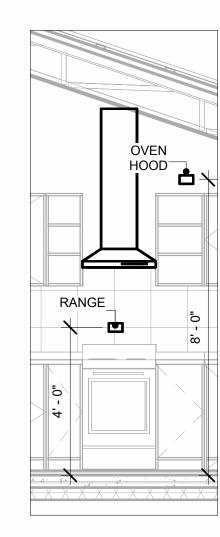


RANGE & OVENHOOD 3/8" = 1'-0"

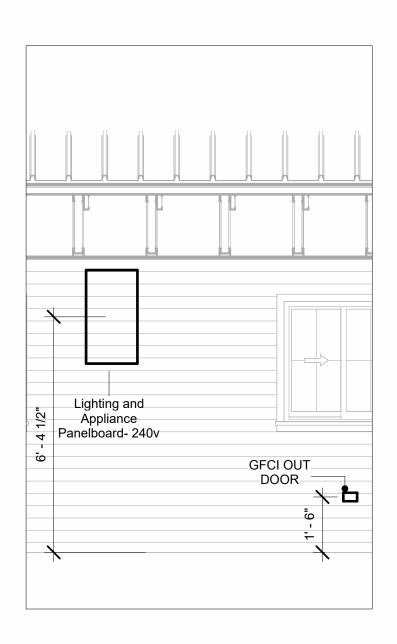

PANEL & GFCI 3/8" = 1'-0"

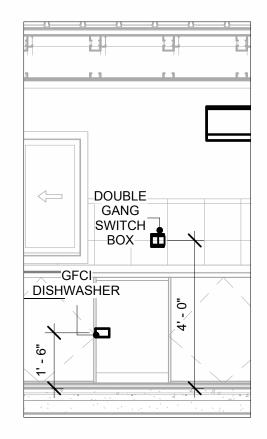


DISHWASHER & SWITCH BOX 3/8" = 1'-0"

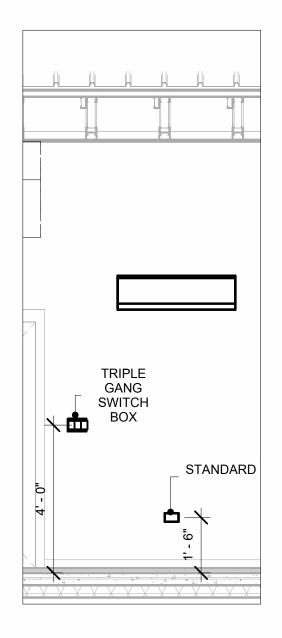

RECEPTACLE & SWITCH



KEY PLAN

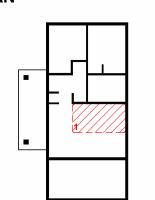

NO.	DESCRIPTION	DATE

NOTE:

LEGEND:

PROJECT

241-EMBER-960-2Bd1Ba FARMHOUSE-GARAGE-550

DRAWING NAME

POWER

CLIE	ENT NAME:	Owner
PRO	DJECT NUMBER:	0120_16
DAT	E:	5/8/2025 10:43:03 AM
DES	SIGNED BY:	Designer
DRA	AWN BY:	Author
СНЕ	ECKED BY:	Checker

E103

SCALE: As indicated

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NOTES: LIGHT

- 1. LIGHT FIXTURES AND LUMINARIES SHALL CONFORM TO THE NEC, THE IRC AND LOCAL SAFETY & BUILDING CODE.
- 2. ALL LIGHTING FIXTURES SHOULD CONFORM TO THE DESIGN ELECTRICAL LOAD AND SHALL BE PROPERLY WIRED AND MOUNTED BY QUALIFIED ELECTRICIAN FOLLOWING MANUFACTURERS SPECIFICATIONS.
- 3. CEILING FANS AND FANS WITH LIGHT WITH WEIGHT EXCEEDING 35 LBS SHOULD BE PROVIDED WITH STRUCTURAL BACKING FOR SUPPORT AND SHALL BE FIXED AS PER MANUFACTURERS SPECIFICATIONS.
- 4. EXTERIOR LIGHTS SHALL CONFORM TO LOCAL BUILDING CODE AND GUIDELINES.

NOTES: SWITCH JUNCTION BOX


- 1. THE MINIMUM SIZE OF JUCTION BOX TO BE USED IS 2"X4"X(1.5" OR 3.5" DEEP) THIS ARE TO BE USED FOR SINGLE GANG SWITCH OR OUTLETS.
- 2. FOR DOUBLE GANG (2 GANG) OUTLETS AND SWITCHS THE MINIMUM SIZE OF THE
- JUCTION BOX TO BE PROVIDED SHALL NOT BE LESS THAN 4"X4"X(1.5" OR 3.5" DEEP)
- 3. FOR THREE GANG (3 GANG) OUTLETS AND SWITCHS THE MINIMUM SIZE OF THE JUĆTION BOX SHALL NOT BE LESS THAN 6"X4"X(1.5" OR 3.5" DEEP).

FITTING SCHEDULE(PULL BOX)		
FAMILY	COUNT	DESCRIPTION
PULLBOX1 32 #1/4 PULLBOX		

ELECTRICAL FIXTURE SCHEDULE (SWITCH BOX)		
TYPE COUNT		
DOUBLE GANG SWITCH BOX	4	
SINGLE GANG SWITCH BOX 3		
TRIPLE GANG SWITCH BOX	RIPLE GANG SWITCH BOX 2	

l	LIGHTING DEVICE
TYPE	COUNT
SINGLE POLE	18

LIGHTING FIXTURE			
LIGHTING FIXTURE TYPE	VOLTAGE	ELECTRICAL LOAD	COUNT
CEILING LIGHT - LINEAR BOX	120 V/1-40 VA	200 A, 120 V/240 V, SINGLE PHASE, 3 WIRES	4
ELECTRICAL_LIGHTS_FAN-LI GHT1	120 V/1-100 VA- 120 V/1-100 VA	200 A, 120 V/240 V, SINGLE PHASE, 3 WIRES	3
LIGHTING_RECESSED	120 V/1-60 VA	200 A, 120 V/240 V, SINGLE PHASE, 3 WIRES	11
SASSO 100 ROUND WALLWASHER TRIM	120 V/1-28 VA	200 A, 120 V/240 V, SINGLE PHASE, 3 WIRES	11
WALL LAMP - BRACKET	120 V/1-100 VA	200 A, 120 V/240 V, SINGLE PHASE, 3 WIRES	5

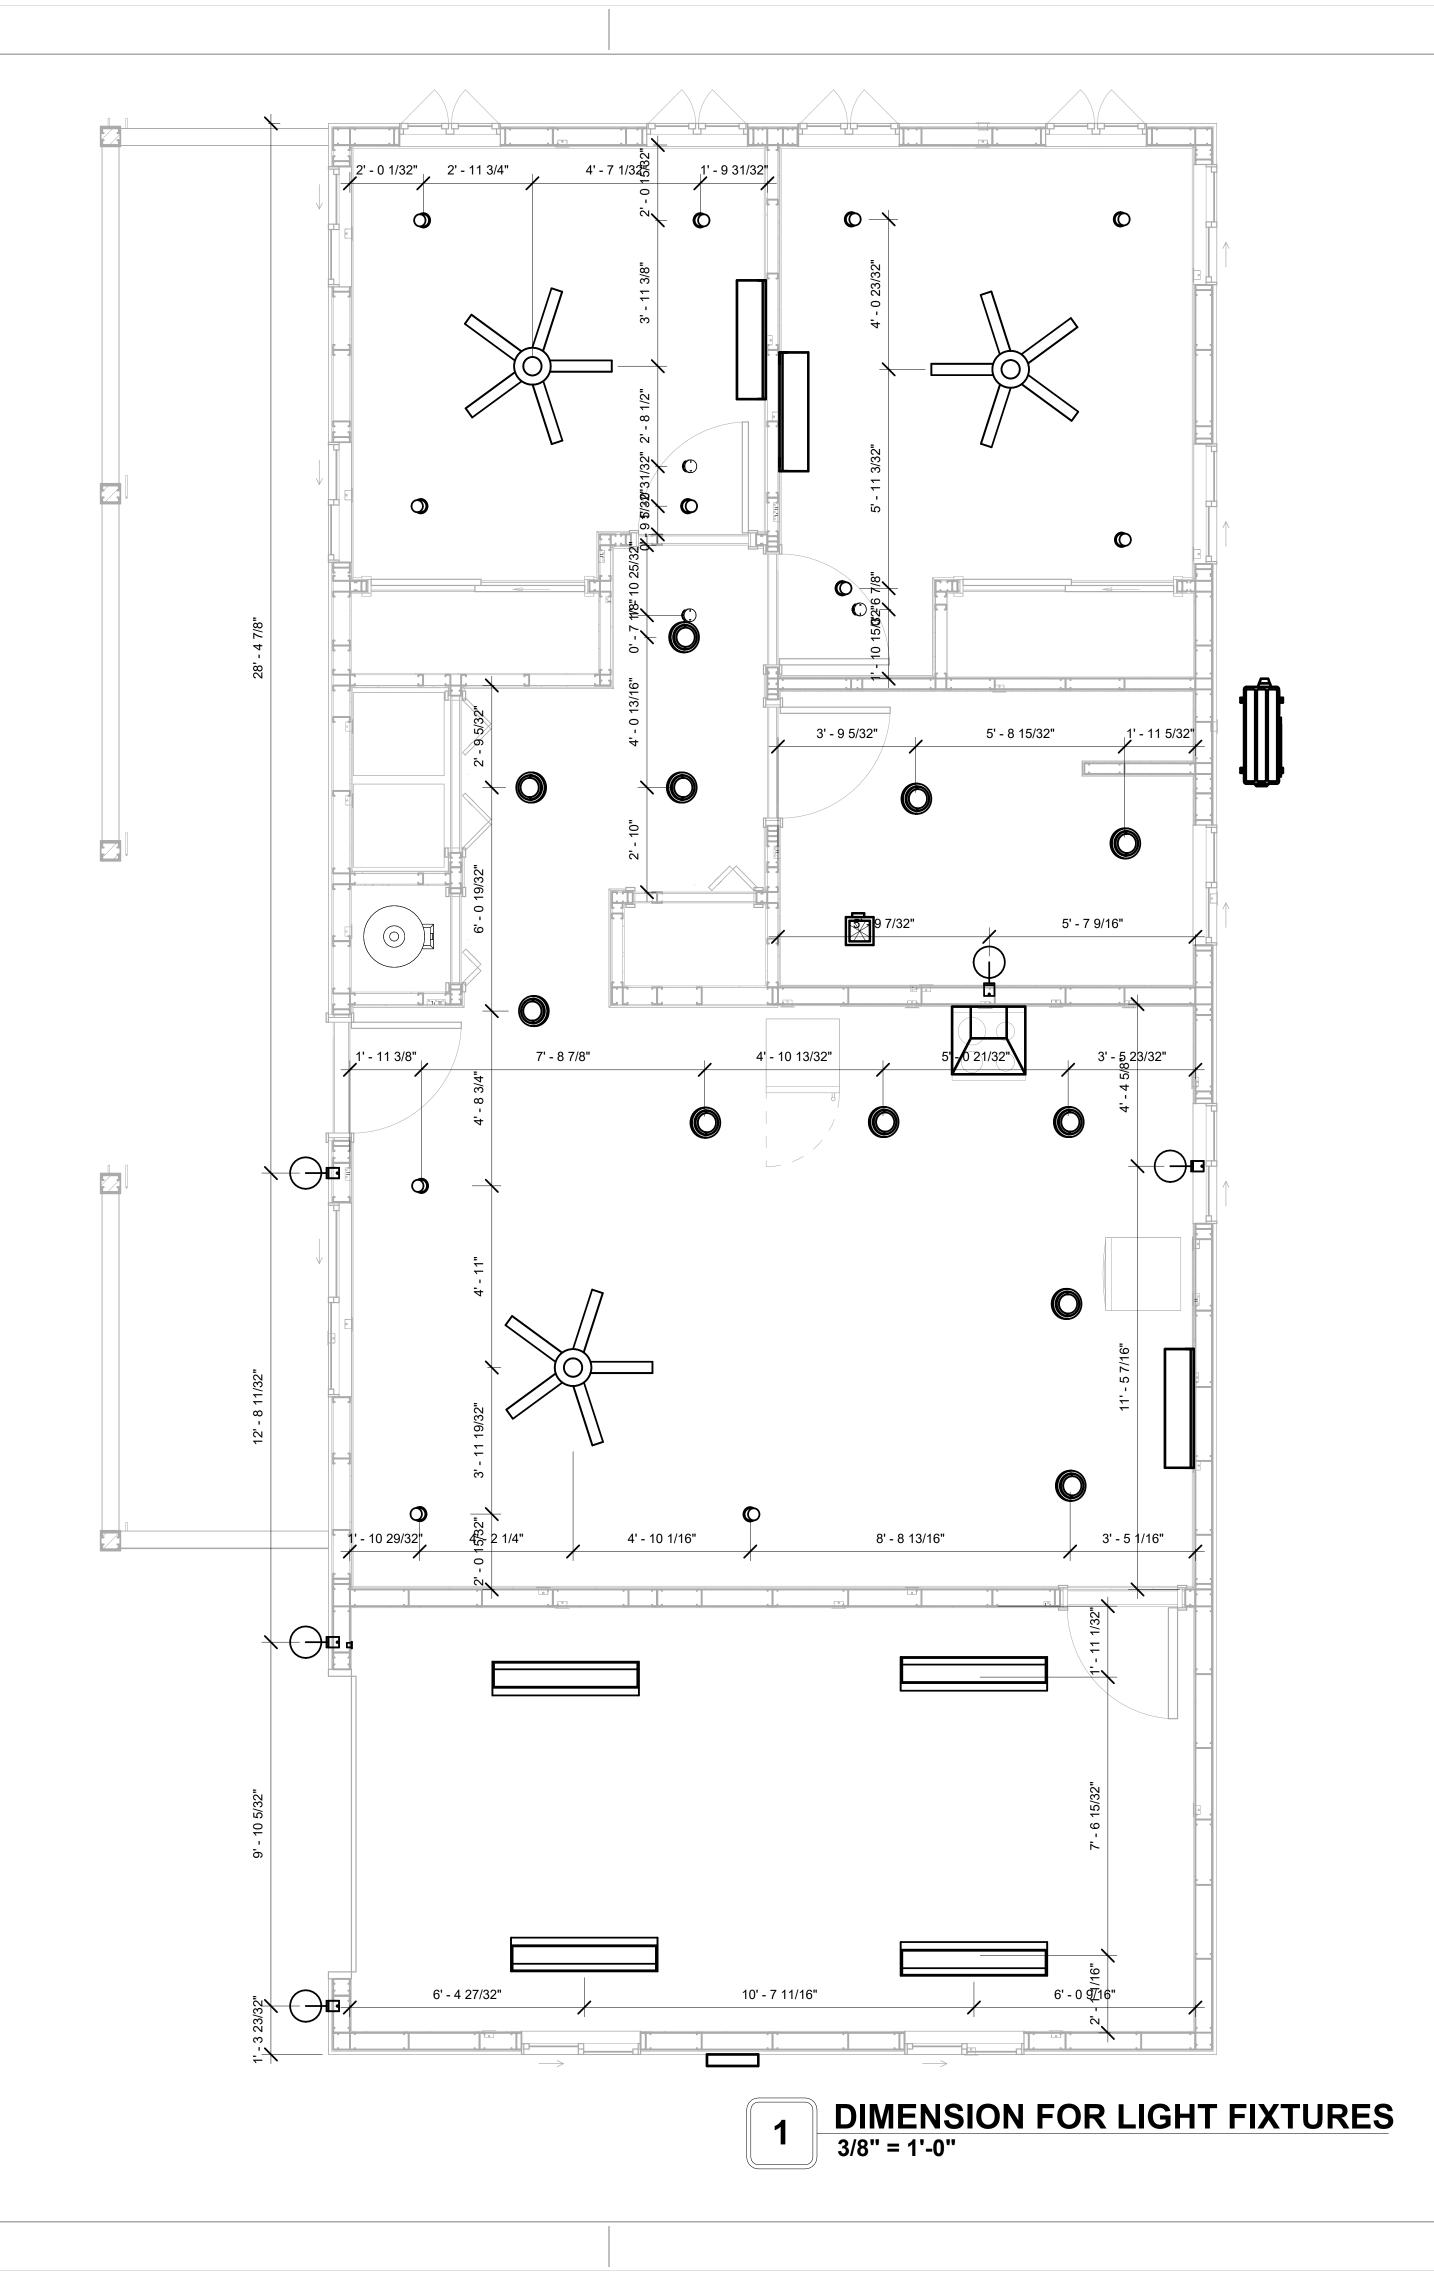



KEY PLAN

NO.	DESCRIPTION	DATE
		+

NOTE:

LEGEND:

PROJECT

241-EMBER-960-2Bd1Ba **FARMHOUSE-GARAGE-550**

DRAWING NAME

DIMENSION PLAN FOR LIGHT FIXTURES

CLIENT NAME:	Owner
PROJECT NUMBER:	0120_16
DATE:	5/8/2025 10:43:04 AM
DESIGNED BY:	Designer
DRAWN BY:	Author
CHECKED BY:	Checker


E104

NOTES;

- 1. VERIFY EQUIPMENT PLUG CONFIGURATION BEFORE PURCHASING RECEPTACLES
- 2. FOR ALL EQUIPMENT.
- 3. COORDINATE EXACT LOCATION OF LIGHT FIXTURES, WALL SWITCHES, RECEPTACLES AND OTHER DEVICES WITH ARCHITECTURAL DRAWINGS.
- 4. USE METALLIC JUNCTION BOX WITH THE GFCI RECEPTACLES, WITH HIGHT VOLTAGE.

ELECTRICAL FIXTURE SCHEDULE (RECEPTACLE)	
TYPE	COUNT
CONDENSER	1
DRYER	1
GFCI BATH ROOM	2
GFCI DISHWASHER	1
GFCI GARAGE	5
GFCI KITCHEN	4
GFCI OUT DOOR	4
GFCI WASHER	1
OVEN HOOD	1
RANGE	1
REFRIGERATOR	1
STANDARD	12
WATER HEATER	1

	ELECTRICAL O	UTLET SCHEDULE	
TYPE	CIRCUIT NUMBER	ELECTRICAL DATA	COUNT
GFCI BATH ROOM	2	120 V/1-180 VA	2
STANDARD	7	120 V/1-180 VA	8
DRYER	8,10	240 V/2-5000 VA	1
GFCI WASHER	9	120 V/1-1200 VA	1
WATER HEATER	11,13	240 V/2-4500 VA	1
REFRIGERATOR	12	120 V/1-1800 VA	1
GFCI KITCHEN	14	120 V/1-180 VA	4
RANGE	15,17	240 V/2-5000 VA	1
OVEN HOOD	16	120 V/1-180 VA	1
GFCI DISHWASHER	18	120 V/1-1200 VA	1
STANDARD	19	120 V/1-180 VA	4
GFCI OUT DOOR	20	120 V/1-180 VA	4
CONDENSER	21,23	240 V/2-5000 VA	1
GFCI GARAGE	22	120 V/1-180 VA	5

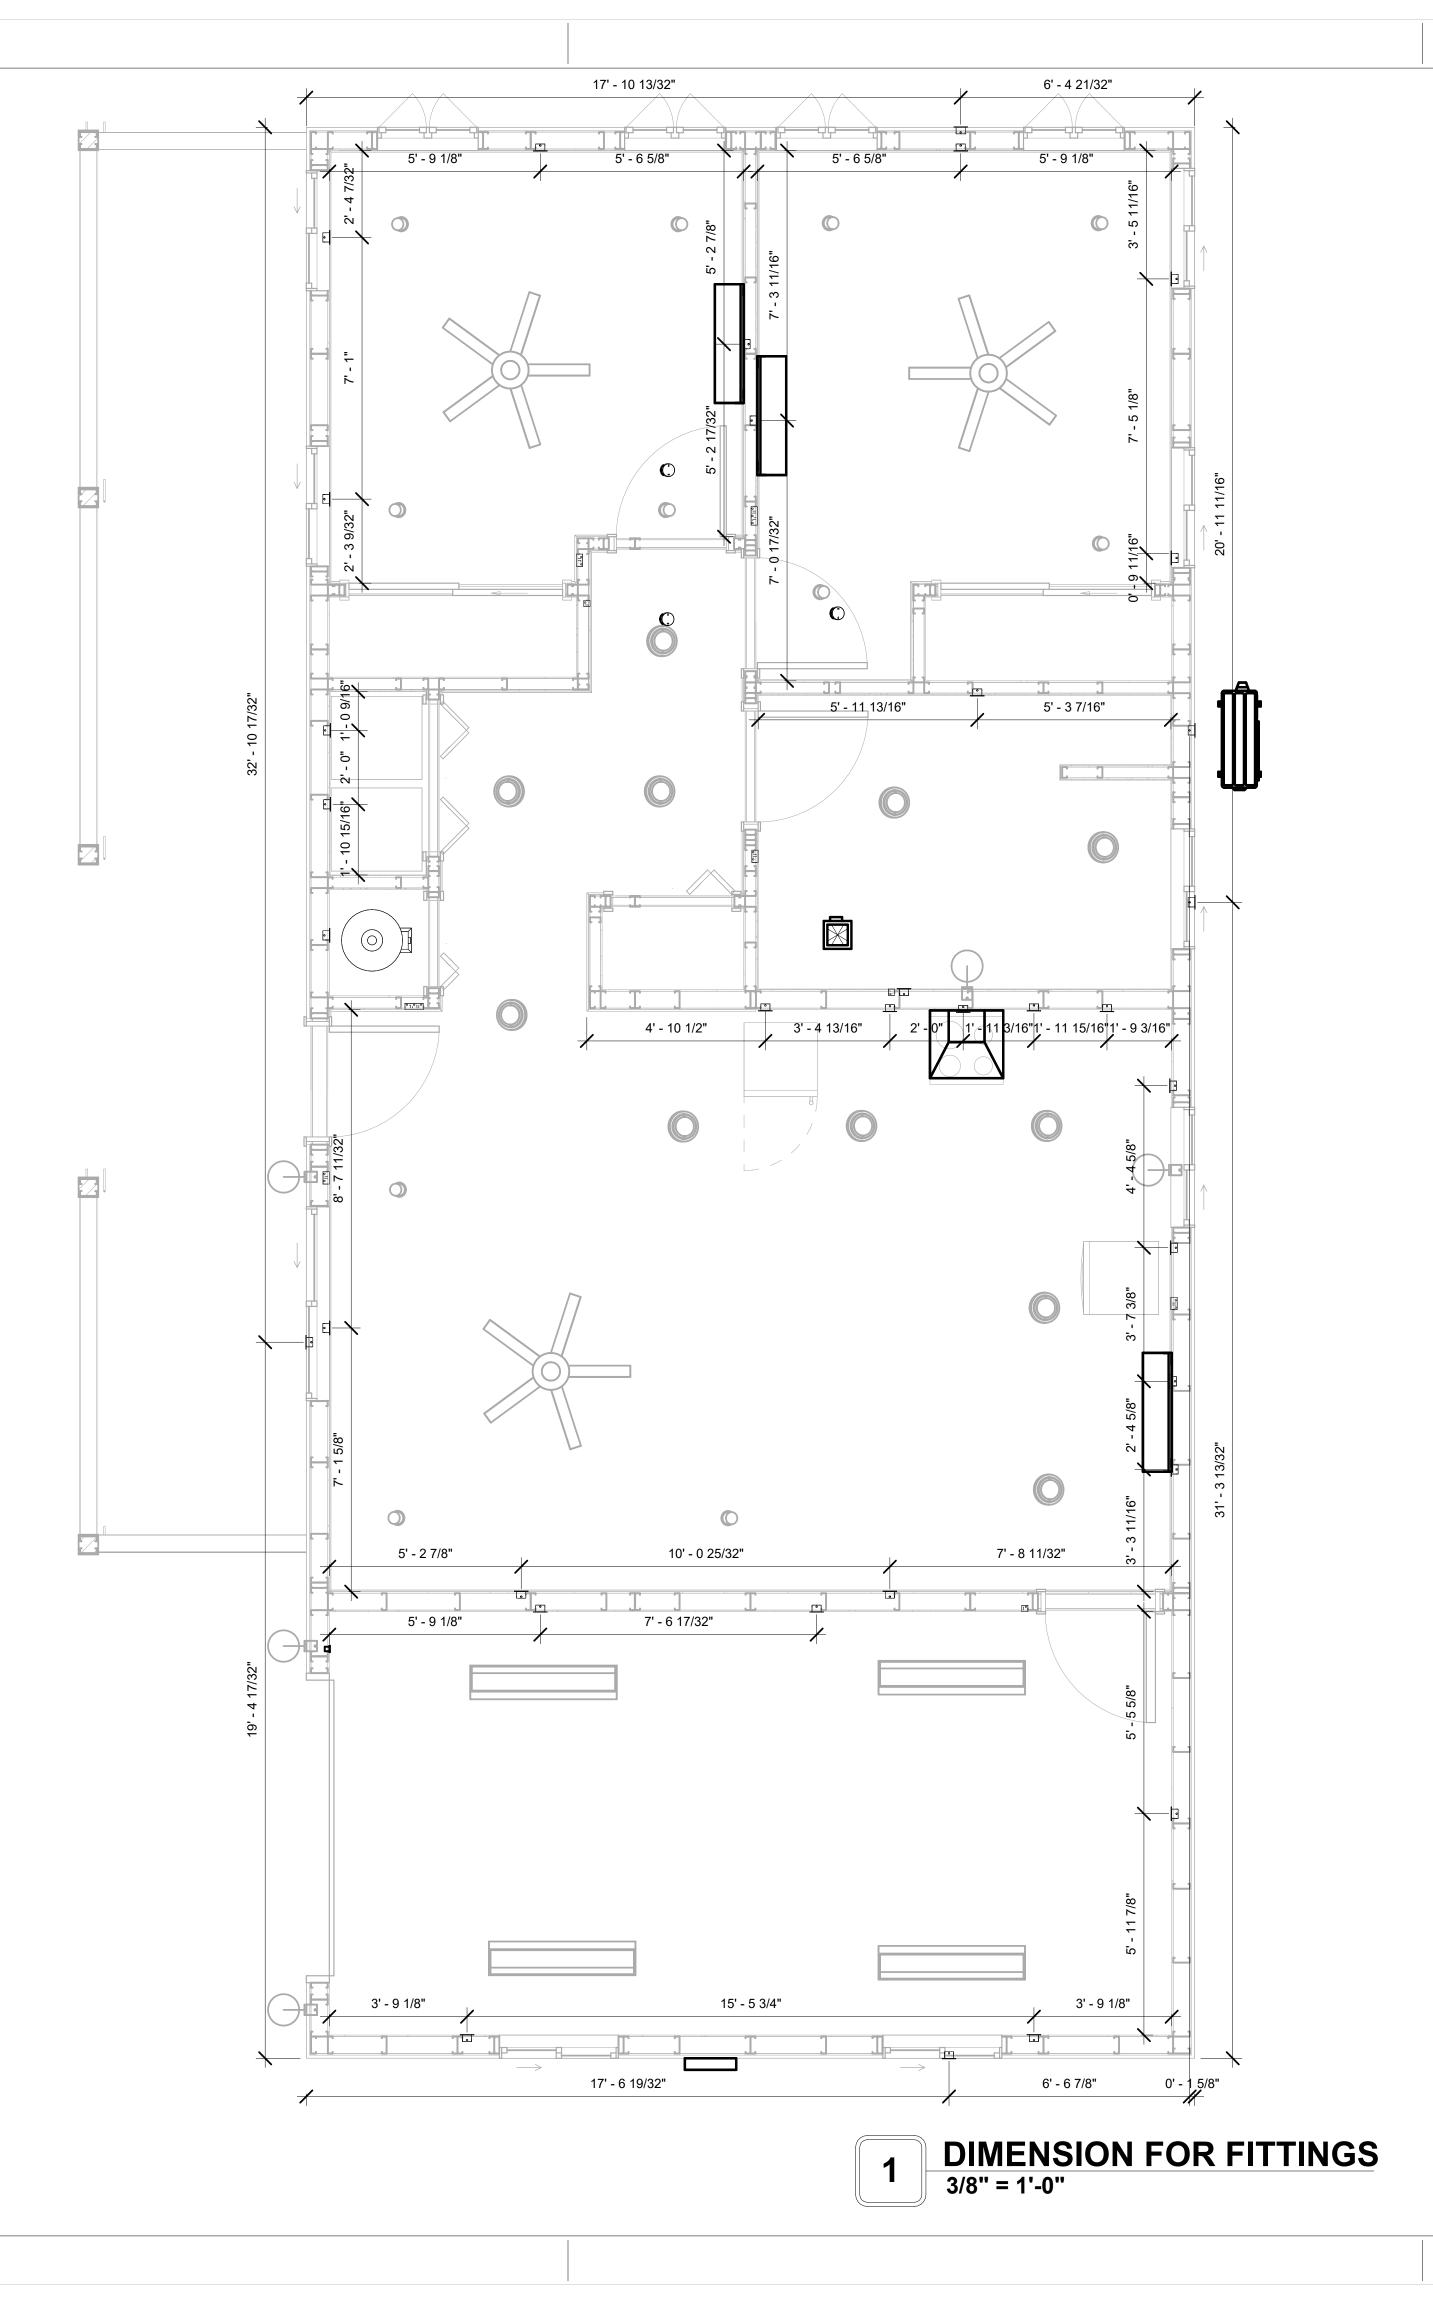



KEY PLAN

NO.	DESCRIPTION	DATE

NOTE:

LEGEND:

PROJECT

241-EMBER-960-2Bd1Ba FARMHOUSE-GARAGE-550

DRAWING NAME

DIMENSION PLAN FOR FITTINGS

CLIENT NAME:	Owner
PROJECT NUMBER:	0120_16
DATE:	5/8/2025 10:43:06 AM
DESIGNED BY:	Designer
DRAWN BY:	Author
CHECKED BY:	Checker

E105

SHEET LIST

SHEET NUMBER SHEET NAME

P101 NOTE AND SCHEDULE
P102 WATER SUPPLY AND SEWAGE
SYSTEM

PIPE CO	OLOR SCHEME
	DOMESTIC COLD WATE
	DOMESTIC HOT WATER
	 SANITARY VENT
_	SANITARY SEWER
_	STORM DRAINAGE
	GRAY WATER
_	GAS LINE

PLUMBING NOTES

- THE PLUMBING SYSTEM IS DESIGNED TO MEET THE BUILDING'S DOMESTIC WATER SUPPLY, SANITARY DRAINAGE, AND STORM DRAINAGE REQUIREMENTS, AS PER PROJECT SPECIFICATIONS AND APPLICABLE CODES.
- THE SYSTEM INSTALLATION SHALL COMPLY WITH THE LATEST INTERNATIONAL PLUMBING CODE (IPC), INTERNATIONAL RESIDENTIAL CODE (IRC), AND ALL OTHER RELEVANT LOCAL, STATE, AND NATIONAL REGULATIONS.
- ALL PLUMBING WORK SHALL COMPLY WITH THE LATEST EDITION OF THE INTERNATIONAL PLUMBING CODE (IPC) AND THE LOCAL PLUMBING CODE.
- 4. PLUMBING SYSTEMS SHALL BE TESTED AND INSPECTED IN ACCORDANCE WITH THE LOCAL PLUMBING CODE REQUIREMENTS.
- 5. PLUMBING FIXTURES SHALL BE INSTALLED WITH THE APPROPRIATE TRIM, FITTINGS, AND ACCESSORIES, AS RECOMMENDED BY THE MANUFACTURER.
- 6. PIPING SHALL BE PROPERLY SUPPORTED AND SECURED TO PREVENT SAGGING,
- MOVEMENT, AND VIBRATION.

 7. SHUT-OFF VALVES SHALL BE PROVIDED AT ALL BRANCH CONNECTIONS AND AT THE
- INLET AND OUTLET OF EACH PIECE OF EQUIPMENT.

 8. BACKFLOW PREVENTION DEVICES SHALL BE INSTALLED AS REQUIRED BY THE LOCAL
- PLUMBING CODE TO PROTECT THE POTABLE WATER SYSTEM.

 9. PLUMBING FIXTURES AND EQUIPMENT SHALL BE ACCESSIBLE FOR MAINTENANCE AND
- SERVICING.

 10. EXPOSED PLUMBING PIPING AND FIXTURES SHALL BE INSULATED TO PREVENT
- CONDENSATION AND ENERGY LOSS.

 11. DEAD ENDS IN THE DRAINAGE SYSTEM MUST BE AVOIDED, EXCEPT WHERE NECESSARY TO INSTALL A CLEANOUT IN AN ACCESSIBLE LOCATION, AND MUST HAVE A VENTED
- CONNECTION TO THE OUTSIDE ATMOSPHERE.

 12. THE VERTICAL DEFLECTION OF PVC PIPE MUST NOT EXCEED 5%, AND NO DEFLECTION IS PERMITTED FOR IRON PIPE.
- 13. WORK MUST BE PROPERLY COORDINATED WITH OTHER TRADES TO AVOID CONFLICTS, REFERRING TO THE ARCHITECTURAL AND STRUCTURAL DRAWINGS FOR INFORMATION REGARDING CEILING ELEVATIONS, SPACE CLEARANCES, WALL AND PARTITION LOCATIONS, ETC.
- 14. ALL FIXTURES SHALL HAVE ACCESSIBLE STOPS.
- 15. DOMESTIC WATER PIPING SHALL BE PEX, AND PVC PIPING IS NOT ACCEPTABLE FOR INTERIOR USE.
- 16. VENT TERMINATIONS SHALL BE LOCATED AT LEAST 10 FEET FROM OR 3 FEET ABOVE ANY OPERABLE WINDOW, DOOR OPENING, AIR INTAKE, OR VENT SHAFT, AND AT LEAST 3 FEET IN EVERY DIRECTION FROM ANY LOT LINE, ALLEY, OR STREET.
- 17. PIPE AND FITTINGS UTILIZED IN THE WATER SUPPLY SYSTEM SHALL HAVE A MAXIMUM OF 8 PERCENT LEAD.
- 18. ACRYLONITRILE BUTADIENE STYRENE (ABS) SHALL BE USED FOR THE SEWERAGE AND
- VENTILATION SYSTEM.

 19. CROSS-LINKED POLYETHYLENE (PEX) SHALL BE USED FOR THE WATER SUPPLY SYSTEM.
- 20. POLYVINYL CHLORIDE (PVC) SHALL BE USED FOR THE RAIN WATER SYSTEM.
 21. THE MIMIMUM WATER SUPPLY DEPTH UNDER FLOOR FINISH SHOUD BE 1/2".
- 22. ANY PIPE INSTALLED UNDERGROUND MUST HAVE AT LEAST 12 INCHES OF CLEARANCE
- BETWEEN THE OUTSIDE OF THE PIPE AND ANY OTHER UNDERGROUND STRUCTURE.

 23. THE MINIMUM CLEARANCE BETWEEN COLD AND HOT WATER LINES IN RESIDENTIAL
- HOMES MAINTAIN A MINIMUM DISTANCE OF 6 INCHES.
- 24. HORIZONTAL SEPARATION BETWEEN WATER AND SEWER LINES: A MINIMUM OF 12 INCHES BETWEEN POTABLE WATER SUPPLY LINES (COLD AND HOT WATER) AND SANITARY SEWER LINES.

ABBREVIATIONS

α	DIAMETER
Ø	DIAMETER
ABS	ACRYLONITRILE BUTADIENE STYRENE
ABV	ABOVE
AD	AREA DRAIN
AFF	ABOVE FINISHED FLOOR
ALT	ALTERNATE
BFF	BELOW FINISHED FLOOR
BLW	BELOW
CO	CLEAN OUT
CW	COLD WATER
D	DEGREE
DFU	DRANAGE FIXTURE UNIT
DIA	DIAMETER
DN	DOWN
FCO	FLOOR CLEAN OUT
FD	FLOOR DRAIN
FL	FLOOR
FS	FLOOR SINK
FT	FOOT/FEET
HB	HOSE BIB
HW	HOT WATER
IN	INCH
MIN	MINIMUM
NO	NUMBER
NTS	NOT TO SCALE
PEX	CROSS-LINKED POLYETHYLENE
PLBG	PLUMBING
PVC	POLYVINYL CHLORIDE
QTY	QUANTITY
RD	ROOF DRAIN
RED	REDUCER
RM	ROOM
RW	RAIN WATER
SF	SQUARE FOOT
V	VENT
VTR	VENT THROUGH ROOF
W	WASTE
WCO	WALL CLEAN OUT
WSFU	WATER SUPPLY FIXTURE UNIT

PLUMBING LEGEND

D	CAP
	BEND 45 DEG
B	BEND 90 DEG
	TEE REDUCING
	TEE
	CLEAN TWO-WAY
	WYE 45 DEG
	WYE 45 DEG DOUBLE
	WYE COMBINATION
Θ	P-TRAP

PIPE SCHEDULE					
MATERIAL	DIAMETER	LENGTH			
ACRYLONITRILE BUTADIENE STYRENE (ABS)	1 1/2"	18 FT			
ACRYLONITRILE BUTADIENE STYRENE (ABS)	2"	28 FT			
ACRYLONITRILE BUTADIENE STYRENE (ABS)	3"	38 FT			
CROSS-LINKED POLYETHYLENE (PEX)	1/2"	62 FT			
CROSS-LINKED POLYETHYLENE (PEX)	3/4"	78 FT			
CROSS-LINKED POLYETHYLENE (PEX)	1"	0 FT			
POLYVINYL CHLORIDE - RIGID	2"	68 FT			

FITTING SCHEDULE				
FITTING	SIZE	QTY		
PEX 90 DEG ELBOW	1/2"ø-1/2"ø	3		
PEX 90 DEGREE ELBOW	1/2"ø-1/2"ø	12		
PEX 90 DEGREE ELBOW	3/4"ø-3/4"ø	5		
PEX TEE ELBOW	1/2"ø-1/2"ø	2		
PEX TEE ELBOW	3/4"ø-3/4"ø	4		
PEX TRANSITION ELBOW	1"ø-3/4"ø	1		
PEX TRANSITION ELBOW	3/4"ø-1/2"ø	4		
TEE ELBOW	3/4"ø-3/4"ø	1		
PEX 90 DEG ELBOW	1/2"ø-1/2"ø	1		
PEX 90 DEGREE ELBOW	1/2"ø-1/2"ø	9		
PEX 90 DEGREE ELBOW	3/4"ø-3/4"ø	2		
PEX TEE ELBOW	1/2"ø-1/2"ø	2		
PEX TEE ELBOW	3/4"ø-3/4"ø	2		
PEX TRANSITION ELBOW	3/4"ø-1/2"ø	3		
PVC 90 DEG BEND ELBOW	2"ø-2"ø	8		
PVC 90 DEGREE BEND ELBOW	2"ø-2"ø	16		
ABS 90 DEGREE BEND ELBOW	1 1/2"ø-1 1/2"ø	1		
ABS 90 DEGREE BEND ELBOW	2"ø-2"ø	2		
ABS 90 DEGREE BEND ELBOW	3"ø-3"ø	2		
ABS P-TRAP	1 1/2"ø-1 1/2"ø	3		
ABS P-TRAP	2"ø-2"ø	1		
ABS REDUCER ELBOW	2"ø-1 1/2"ø	1		
ABS REDUCER ELBOW	3"ø-2"ø	1		
ABS TEE ELBOW	1 1/2"ø-1 1/2"ø-1 1/2"ø	1		
ABS TEE ELBOW	2"ø-2"ø	1		
ABS TEE ELBOW	3"ø-3"ø	1		
ABS TEE REDUCER ELBOW	3"ø-3"ø-1 1/2"ø	2		
ABS TEE REDUCER ELBOW	3"ø-3"ø-2"ø	1		
ABS TEE REDUCER ELBOW	3"ø-3"ø	1		
ABS TRAP P	2"ø-2"ø	1		
WASTE DOUBLE TEE	2"ø-2"ø-2"ø	1		
ABS VENT CAP ELBOW	1 1/2"ø	1		
ABS VENT CAP ELBOW	2"ø	2		
ABS VENT CAP ELBOW	3"ø	1		

FIXTURE CONNECTION SCHEDULE											
FAMILY	W	V	TRAP	CW	HW	QTY	DFU	TOT.	WFU	TOT.	NOTES
								T			
DISHWASHER	2"	1-1/2"	1-1/2"	1/2"	1/2"	1		0			DRAIN TO SEWER SEE PLANS
DRYER	N/A	N/A	N/A	N/A	N/A	1		0			
HANGING PIPES CLAMP						16		0			
SHOWER TRAY	2"	1-1/2"	1-1/2"	1/2"	1/2"	1		0			
SHOWER TRIM	-	-	-	1/2"	1/2"	1		0			
SINK ISLAND SINGLE	2"	1-1/2"	1-1/2"	1/2"	1/2"	1		0			
VANITY SINK	2"	1-1/2"	1-1/2"	1/2"	1/2"	1		0			
WASHER	2"	1-1/2"	2"	1/2"	1/2"	1		0			DRAINS TO GRAY WATER OR SEWER SEE PLANS
WATER CLOSET						1		0			
WATER HEATER	N/A	N/A	N/A	3/4"	3/4"	1		0			

FIXTURE SCHEDULE				
FIXTURE QTY DESCRIPTION				
DISHWASHER	1	DRAIN TO SEWER SEE PLANS		
DRYER	1			
HANGING PIPES CLAMP	16			
SHOWER TRAY	1			
SHOWER TRIM	1			
SINK ISLAND SINGLE	1			
VANITY SINK	1			
WASHER	1	DRAINS TO GRAY WATER OR SEWER SEE PLANS		
WATER CLOSET	1			
WATER HEATER	1			

ACCESSORIES & FITTINGS SCHEDULE					
FIXTURE	QTY	DESCRIPTIONS			
DISHWASHER CONNECTOR	1				
HOSE BIB	1				
LAUNDRY SWEAT CONNECTOR	1				
SHUTOFF VALVE	6				

PLUMBING SCHEDULE					
FIXTURE	TRAP	WASTE	VENT	C.W	H.W
DISHWASHER	1-1/2"	2"	1-1/2"	1/2"	1/2"
DRYER	N/A	N/A	N/A	N/A	N/A
SHOWER TRAY	1-1/2"	2"	1-1/2"	1/2"	1/2"
SHOWER TRIM	-	-	-	1/2"	1/2"
SINK ISLAND SINGLE	1-1/2"	2"	1-1/2"	1/2"	1/2"
VANITY SINK	1-1/2"	2"	1-1/2"	1/2"	1/2"
WASHER	2"	2"	1-1/2"	1/2"	1/2"
WATER CLOSET					
WATER HEATER	N/A	N/A	N/A	3/4"	3/4"

WATER FIXTURE UNIT SCHEDULE				
FAMILY	QTY	UNIT VALUE	TOTAL	
DIOLIMA OLIED	14			
DISHWASHER	1		0	
DRYER	1		0	
HANGING PIPES CLAMP	16		0	
SHOWER TRAY	1		0	
SHOWER TRIM	1		0	
SINK ISLAND SINGLE	1		0	
VANITY SINK	1		0	
WASHER	1		0	
WATER CLOSET	1		0	
WATER HEATER	1		0	

	WASTE FIXTURE UNIT SCHEDULE					
FAMILY	QTY	DFU VALUES	TOTAL			
DICLIMACHED						
DISHWASHER DRYER	1	0				
HANGING PIPES CLAMP	16	0				
SHOWER TRAY	1	0				
SHOWER TRIM	1	0				
SINK ISLAND SINGLE	1	0				
VANITY SINK	1	0				
WASHER	1	0				
WATER CLOSET	1	0				
WATER HEATER	1	0				



KEY PLAN

NO.	DESCRIPTION	DATE

NOTE:

LEGEND:

PROJECT

241-EMBER-960-2Bd1Ba FARMHOUSE-GARAGE-550

DRAWING NAME

NOTE AND SCHEDULE

CLIENT NAME:

 PROJECT NUMBER:
 0120_13

 DATE:
 5/5/2025 2:33:46 PM


 DESIGNED BY:
 Designer

 DRAWN BY:
 Author

 CHECKED BY:
 Checker


P101

SCALE: 1/2" = 1'-0"

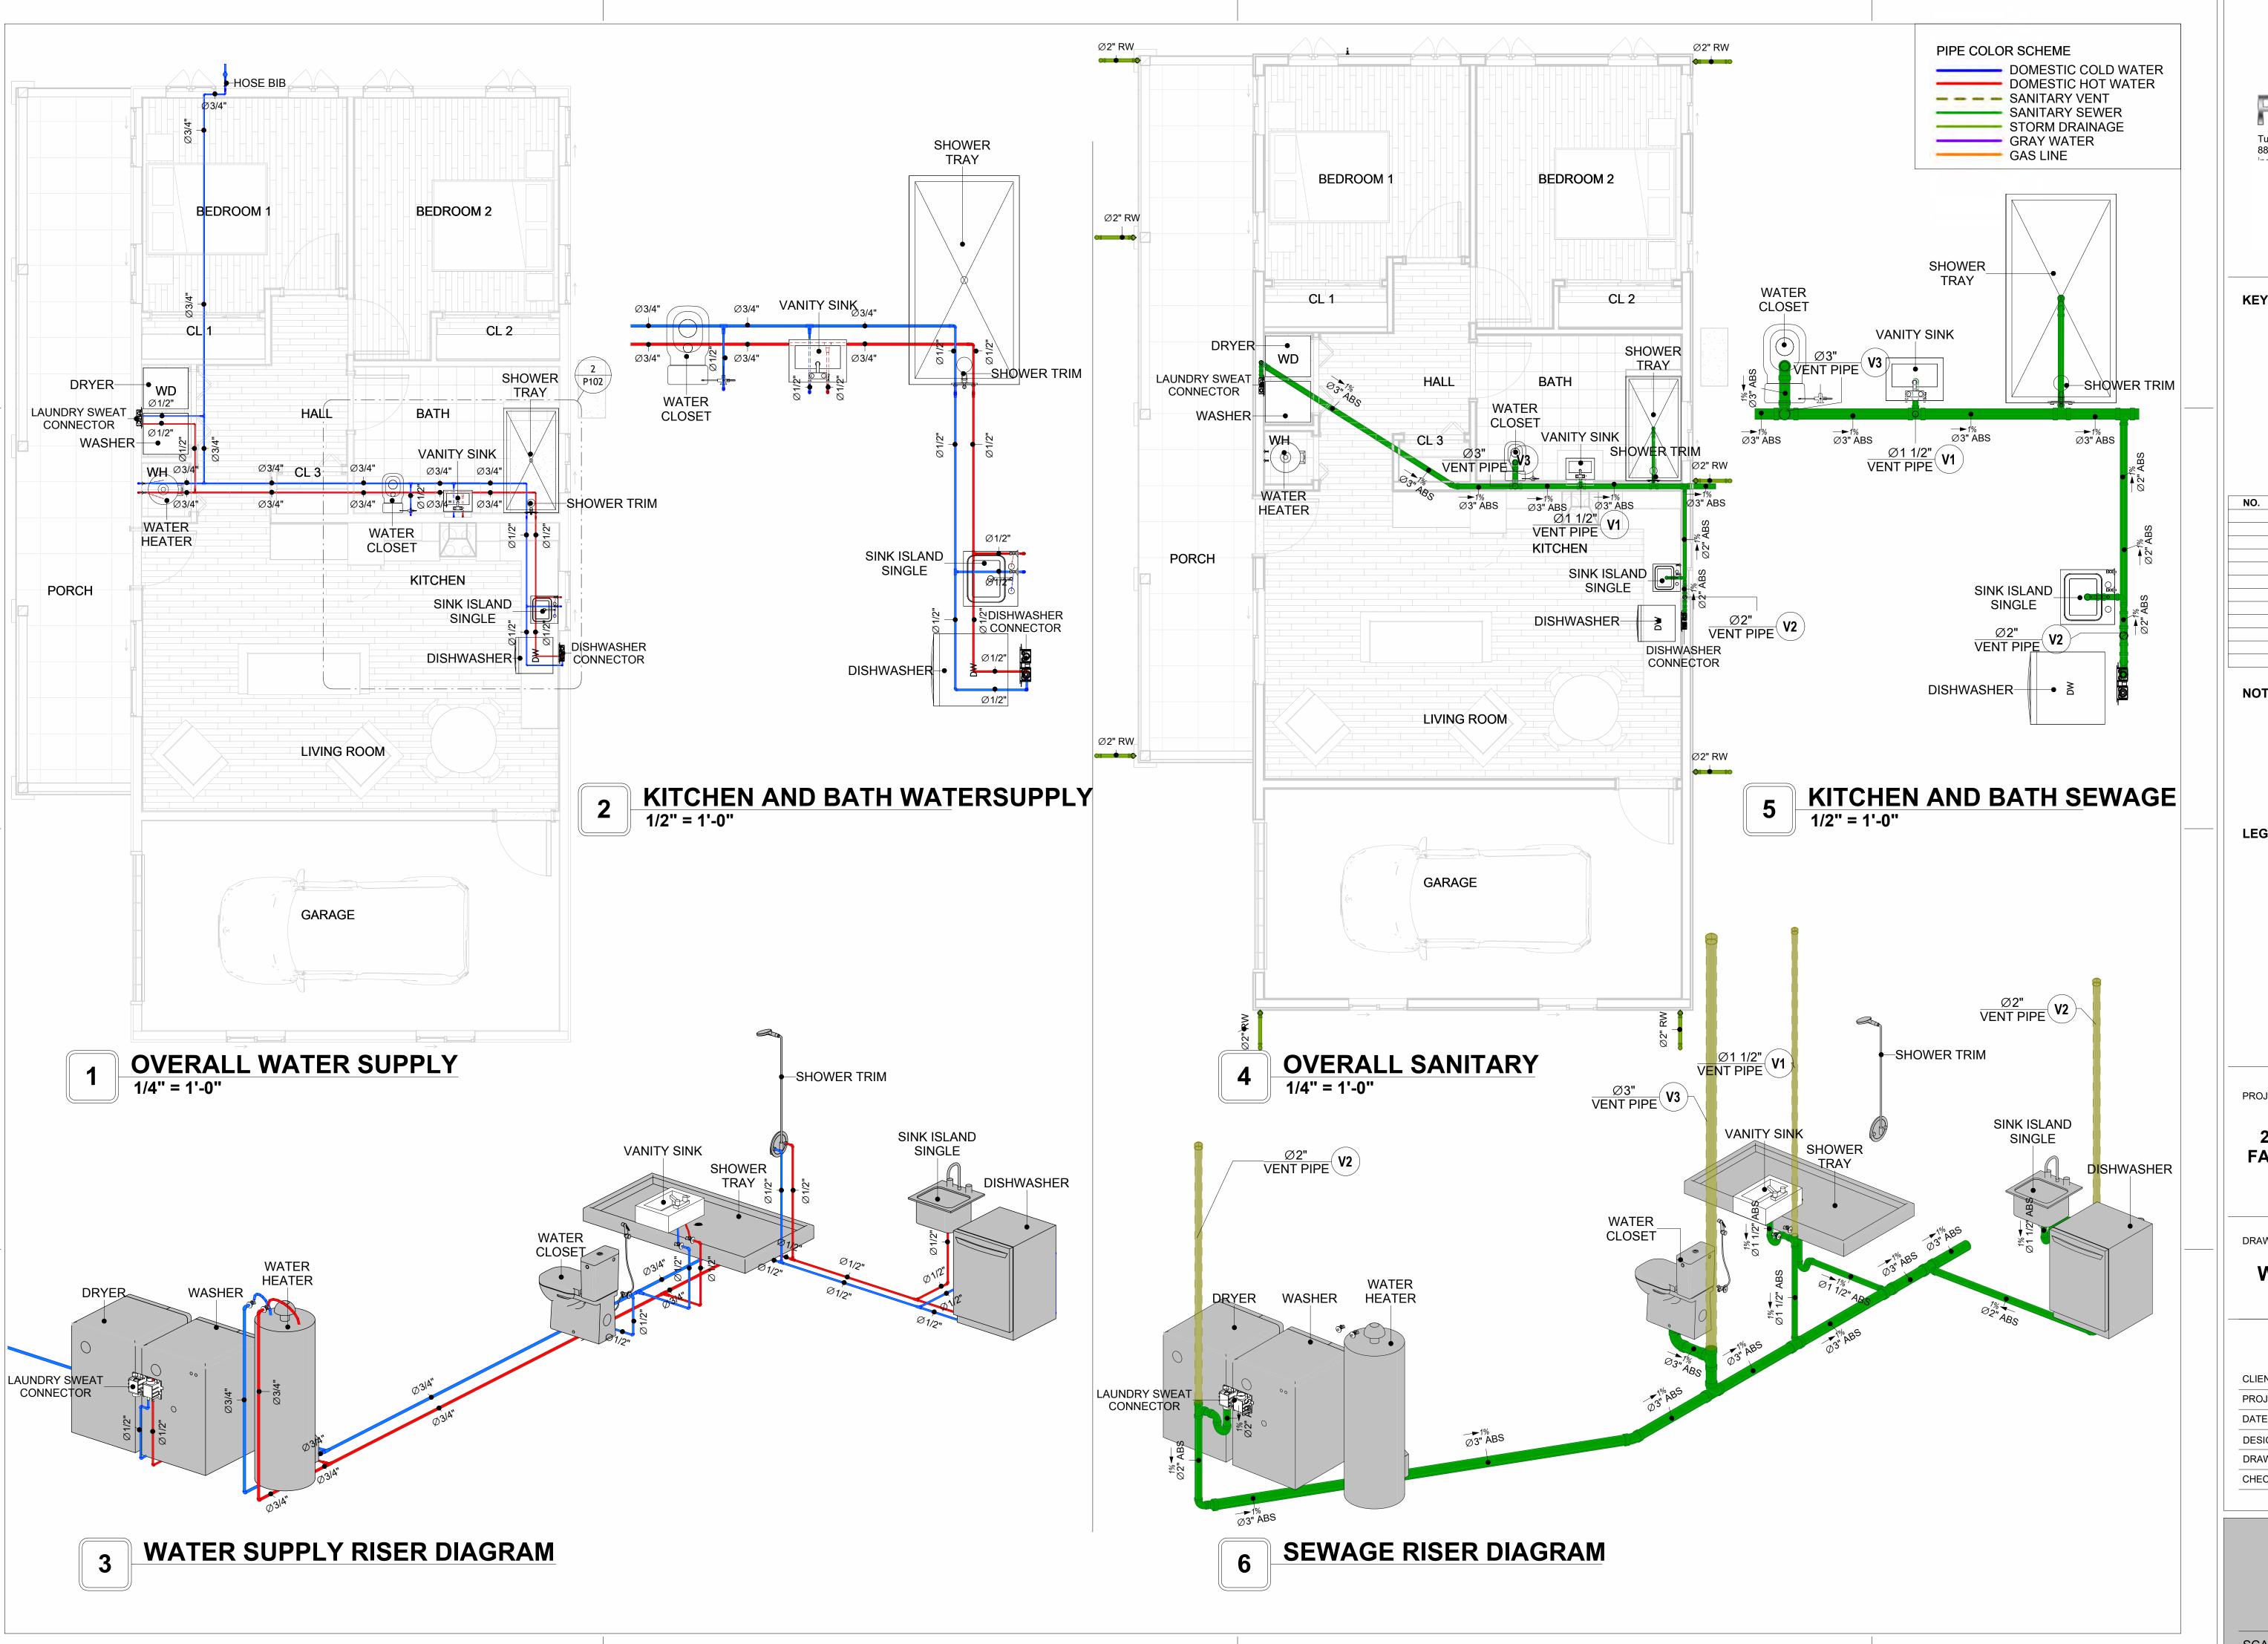



KEY PLAN

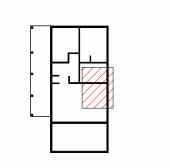

NO.	DESCRIPTION	DATE

LEGEND:

PROJECT

241-EMBER-960-2Bd1Ba **FARMHOUSE-GARAGE-550**

DRAWING NAME

WATER SUPPLY AND SEWAGE SYSTEM

0120_13
5/5/2025 2:34:21 PM
Designer
Author
Checker

P102

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Materials Shopping List

Please print and take this Materials Shopping List to your favorite Home Depot and ask for assistance in selecting the materials, fixtures and fittings to complete your new home.

Record your selection and the price of the item. Then do the math to determine the cost for your selections and the total cost of finishing your home.

Have It Your Way!

The material types listed in this document were selected based on personal preferences. The Customer is encouraged to make changes to the material types in accordance with local customs, regulations, and personal preferences.

Have It Your Way!



20 good reasons to frame a home with metal and not wood



Why build your ADU with metal vs wood	Wood	Metal	Explanation
1 DIY Construction Benefit		~	The wall frames, trusses and beams can be erected in a just a few days
2 Minimal Construction Skills Required		~	Pre-assembled walls and trusses require no specialized skills to errect
Build as DIY, Hybrid or by a General Contractor		~	Do it yourself, Hybrid (involve special contractors) or hire a General Contractor
4 Build It As You Can Afford It		~	Impervious to Weather - build as you have the time and money
5 Up Front Cost of Framing Materials	~		As to only the framing material, wood is less expensive
6 Total Cost To Build		~	Savings in time, labor, and other areas make light gauge steel LESS expensive
7 Termites and wood boring insects		~	Termites, carpenter ants and wood boring insects eat wood, not metal
8 Mold resistant		~	Metal does not attract mold
9 Damage caused by exterior and interior flooding		~	Metal needs no reconditioning after a flood
10 Fire Resistant		~	Non-combustible
11 Lower insurance rates		~	Many insurance underwriters now provide lower rates for metal framed homes
12 Walls, trusses, and beams retain their original form		~	Perfectly straight walls - no shimming of drywall
13 Corners are 90 degrees		~	No need for templating of countertops to adjust for out of square corners
14 Strength and weight		~	Metal is stronger than wood and weighs less - no need for crane to lift ADU trusses
15 IBC Engineered Stamp		~	If an engineering stamp is necessary, months of waiting are saved
16 Complete BOM (Materials Shopping List)		~	Take the materials shopping list to Home Depot and start shopping/pricing
17 Flexible in Seismic Areas - Won't Fracture		~	Light gauge steel is flexible and won't fracture when the earth moves
18 No Waste At Job Site		~	Steel is the most recycled material in the world. A typical wood home has 20-30% waste
19 Environmentally Friendly		~	Trees don't have to be destroyed and the source of most metal is from recycling
20 How-To Videos Included		~	How-to videos provide simple assembly instructions
21 Relationship Counselor		~	Eliminate emotional uphevels - save time, money, and preserve the relationship

Universal Requirements - some or all may be required

- 1 Site plan
- 2 Electrical Supply Connection
- 3 Sewer Connection
- 4 Fresh Water Supply Connection
- 5 Set Backs
- 6 Soils Evaluation

- 7 Earthquake (fault) evaluation
- 8 Foundation Plan subject to soils
- 9 Compliance with local energy codes: insulation home wrap and flashing
- 10 Engineering for wind speed and snow load.
- 11 State and Local ordinances regarding ADUs
- 12 Local Architect and/or Engineer may be necessary

Ember-2Bd1Ba-Farmhouse-Garage





Ember-2Bd1Ba-Farmhouse-Garage MATERIAL SHOPPING LIST

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ARCHITECTURAL BOM



		Ember-2	2Bd1Ba-Fai	rmhouse-G	arage		
		ARCHITECTU	JRAL MATE	RIAL SHOP			
No.	Item	Туре	Unit	Quantity	Unit Price	Total	Description
<u>^</u>	APPLIANCES						
1	Refrigerator		PCS	1			
2	Range		PCS	1			
3	Washer		PCS	1			
4	Dryer		PCS	1			
5	Dish Washer		PCS	1			
6	Oven		PCS	0			
7	Microwave		PCS	0			
<u>_</u>	CASEWORKS		FT	25.07	1		
1	Kitchen Cabinet		FT FT	25.07			
3	Laundry Cabinet Vanity Cabinet		FT	2.5			
4	Medicine Cabinet		PCS	2.5			
_			SF	35			
5	Kitchen countertop Laundry Countertop		PCS	0			
6 7			SF	0			
	Bathroom Countertop		FT	0			
8 9	Island Peninsula		FT	0			
9 10	Closets		SF	105.29			
	CEILING		SF	105.29			
<u>_</u>		Dr. Well	CF	1100			
2	Ceiling Board Dry Wall Fastener	Dry Wall Screw	SF PCS	1199 2098			
3	Vapor Retarder	Polyethylene film	SF	1533			
		Nails with washer heads	PCS	4599			
<u>4</u> 5	Vapor Retarder Fastener Ceiling Board (MRD)	Moisture resistant drywall	SF	96			
		Moisture resistant drywan	PCS	168			
6	MRD Fastener Ceiling Board	Marine Plywood	SF	238			
7	Marine Plywood Fastener	· · · · · · · · · · · · · · · · · · ·	PCS	417			
8	Dry Wall Tape	Screw	FT	767			
9			FI	/0/			
<u> </u>	FLOORING Main Living Space		CF	440.00			
2	Bathroom		SF SF	449.99 100.08			
3	Bedroom		SF	305.71			
4			SF	266.42			
5	Garage Porch		SF SF	248.4			
<u>o</u>	STRUCTURE		ЭГ	240.4			
_	Foundation		SF	1,474.82			
_	WALLS EXTERIOR		SF	1,474.02			
1	Exterior-Grade Plywood Horizontal S	Siding	SF	1309			
2	Exterior-Grade Plywood Fastener		PKT	1307			
3	Wall Shteathing (OSB)	Sell-drilling screws(100/pkt)	SF	1309			
4	Shteathing Fastener	Self-drilling screws(100/pkt)	PKT	1307			
5	Wall Homewrap	John drilling screws(100/pkt)	SF	1309			
6	Homewrap Fastener	Stapled fastener (200/pkt)	PKT	5			
7	Furring Strip	otapica rastorioi (200/pkt)	PCS	164			
8	Furring Strip Fastener	Self-drilling screws(100/pkt)	PKT	13			
9	Wall Paint	John drilling screws(100/pkt)	SF	1309			
	Stone Copping	Masonry stone	SF	0			
	Stone Veneer	Masonry stone	SF	0			
	Mortar for Stone Veneer	imasoni y storic	SF	0			
	Wall Insulation		SF	4946			
	WALLS INTERIOR		Jui	4740	I		
	Cementitious Backer Board		SF	579			
	Kerdi membrane		SF	579			
3	Kerdi membrane Fastener		SF	579			
4	Wall Ceramic Tile		SF	579			
5	Drywall Board		SF	2829			
	Drywall Fastener	Self-drilling screws(100/pkt)	PKT	28.29			
7	Wall Paint	John drilling screws(100/pkt)	SF	2829			
,	Drywall Tape	+	FT	532			
8	IDrwwaii Lane		IE J				

ARCHITECTURAL BOM



1 II 2 (0 3 F	DOORS Interior Swinging Garage Door	3' - 0" X 6'-8"	PCS			
2 (3 F		3 0 X 0 0	IPI \	4		
3 F	Odrage Door	8' - 0" X 6'-6"	PCS	1		
	Folding	3' - 3" X 6'-8"	PCS	1		
4 1	Interior Sliding	5' - 10" X 6'- 8"	PCS	1		
5 1	Interior Sliding	5' - 9" X 6'- 8"	PCS	1		
	Folding	4' - 0" X 6'-8"	PCS	1		
	Folding	2' - 4" X 6'-8"	PCS	1		
	Exterior Swinging	3' - 0" X 6'-8"	PCS	1		
	Exterior Door Trim	3 - 0 × 0 - 8	FT	38		
	Interior Door Trim		FT	344		
_			FI			
	Entry Lock set			2		
	Privacy Lock set					
	Passage Lock set			5		
	WINDOWS	EL OLIVOLOU	200			
_	Sliding	5' - 3" X 3'-3"	PCS	1		
_	Sliding	3' - 3" X 3'-3"	PCS	7		
	Casment	2' - 9" X 4'-3"	PCS	4		
	Sliding	3' - 3" X 1'-9"	PCS	1		
	Exterior Window Trim		FT	177		
	Interior Window Trim		FT	177		
	ROOF					
	Roof Covering		SF	2151.0		
	Roof Covering Fastener		PCS	1076		
	Roof Felt Paper		SF	2151.0		
	Roof Felt Paper Fastener		PCS	6453.0		
5 F	Roof Sheathing		SF	2151		
	Roof Sheathing Fastener		PCS	17208		
7 E	Batten		FT	1013.0		
	Batten Fastener		PCS	761.7	'	
9 5	Soffit		SF	360.0		
10 5	Soffit Fastener		PCS	180.0		
11 F	Fascia		FT	229.0		
12 F	Fascia board fastener		PCS	115		
13 F	Roof Insulation		SF	2151.0		



		Ember-2Bd1Ba-Fa	armhouse-	Garage			
	FI	ECTRICAL MATER	PIAL SHOP	PINGLI	ST T2		
No.	Item	Type	Unit		Unit Price	Total	Description
	LIGHTING FIXTURES	71					
_	Kitchen Ceiling Light		PCS	3			
	Kitchen Wall Mounted Light		PCS	1			
	Exterior Wall Mounted Light		PCS	4			
	Livingroom Ceiling Light With Fan		PCS	1			
5	Bedroom Ceiling Light With Fan		PCS	2			
6	Dining Ceiling Light		PCS	0			
7	Bath Wall Mounted Light		PCS	1			
	Bathroom Ceiling Light		PCS	2			
	Livingroom Ceiling Light		PCS	5			
	Bedroom Ceiling Light		PCS	8			
	Hall & Entry Ceiling Light		PCS	4			
	Garage Ceiling Light		PCS	4			
	Smoke Detector		PCS	3			
			r 03				
_	ELECTRICAL FITTINGS	204	DOC	10		-	
	Standard Receptacle 120V	20A	PCS	12			
	GFCI Receptacle 120V	20 A	PCS	19			
16	GFCI Receptacle 240V	30 A	PCS	2			
17	GFCI Receptacle 240V	50 A	PCS	1			
18	GFCI Receptacle 240V	60 A	PCS	1			
	Fan Switch		PCS	2			
20	Single Pole Switch		PCS	8			
21	Three Way Switch		PCS	5			
22	Dimmer Switch		PCS	3			
Δ	ELECTRICAL CONDUITS & WIRING						
23	ROMEX 14 AWG	14/2/W/ground	FT	183			
24	ROMEX 12 AWG	12/3/W/ground	FT	0			
25	ROMEX 12 AWG	12/2/W/ground	FT	493			
	ROMEX 10 AWG	10/3/W/ground	FT	109			
	ROMEX 10 AWG	10/2/W/ground	FT	71			
	Romex 8 AWG	8/3/W/ground	FT	43			
	Romex 8 AWG	8/2/W/ground	FT	0			
	ROMEX 6 AWG	6/3/W/ground	FT	18			
	Bare Copper Ground Wire 6 AWG	0/0/TT/ground	FT	10			
	ELECTRICAL BOXES & CIRCUTES		- 11				
		200 4140	PCS	1			
	Panelboard -240V 1 Phase MLO	200 AMP	PCS	4			
	Circuit breaker	15 A					
	Circuit breaker	20 A	PCS	12			
	Circuit breaker	30 A	PCS	2			
	Circuit breaker	50 A	PCS	1			
	Circuit breaker	60 A	PCS	1			
	Single Gang Switch Box		PCS	3			
	Double Gang Switch Box		PCS	4			
	Triple Gang Switch Box		PCS	2			
	Pull Box	#1/4	PCS	32			
44	Receptacle Box		PCS	35			



Ember-2Bd1Ba-Farmhouse-Garage										
	P	LUMBING SYSTEM I	MATERIAL	SHOPPII	NG LIST					
Vo.	Item	Туре	Unit	Quantity	Unit Price	Total	Description			
	PLUMBING FIXTURES & ACCESSORIES									
	Bath Tub (Alcove Tub)		PCS	0						
	Kitchen Sink		PCS	1						
3	Kitchen Faucets		PCS	1						
4	Vanity Sink		PCS	1						
	Bath room Faucets		PCS	2						
6	Water Closet		PCS	1						
7	Shower Trim		PCS	1						
	Shower Tray		PCS	1						
9	Water Heater		PCS	1						
	Hose Bib		PCS	1						
	Shutoff Valve		PCS	6						
	Hanging pipe clamp		PCS	16						
	Globe Valve		PCS	1						
	Dishwasher Supply Single Connector		PCS	1						
	Dishwasher Sewage Single Connector		PCS	1						
	Laundry Sweat Connector		PCS	1						
	SANITARY & PLUMBING PIPES									
	ABS (Acrylonitrile Butadiene Styrene) Pipes	ø 1/2"	FT	0						
	ABS (Acrylonitrile Butadiene Styrene) Pipes	ø 1 1/2"	FT	18						
	ABS (Acrylonitrile Butadiene Styrene) Pipes	ø 2"	FT	28						
	ABS (Acrylonitrile Butadiene Styrene) Pipes	ø 3"	FT	38						
	PEX (Cross-linked polyethylene) Pipes	ø 1/2"	FT	78						
	PEX (Cross-linked polyethylene) Pipes	ø 3/4"	FT	54						
	PEX (Cross-linked polyethylene) Pipes	1"	FT	2						
	Polyvinyl Chloride - Rigid	2"	FT	68						
	PIPE FITTINGS									
	PEX 90 Deg Elbow	1/2"ø-1/2"ø	PCS	3						
	PEX 90 Degree Elbow	1/2"ø-1/2"ø	PCS	12						
	PEX 90 Degree Elbow	3/4"ø-3/4"ø	PCS	4						
4	PEX Tee Elbow	1/2"ø-1/2"ø-1/2"ø	PCS	2						
5	PEX Tee Elbow	3/4"ø-3/4"ø-3/4"ø	PCS	6						
6	PEX Transition Elbow	1"ø-3/4"ø	PCS	2						
7	PEX Transition Elbow	3/4"ø-1/2"ø	PCS	4						
	Tee Elbow	3/4"ø-3/4"ø-3/4"ø	PCS	1						
	PEX 90 Deg Elbow	1/2"ø-1/2"ø	PCS	1						
	PEX 90 Degree Elbow	1/2"ø-1/2"ø	PCS	9						
11	PEX 90 Degree Elbow	3/4"ø-3/4"ø	PCS	2						
	PEX Tee Elbow	1/2"ø-1/2"ø-1/2"ø	PCS	2						
13	PEX Tee Elbow	3/4"ø-3/4"ø-3/4"ø	PCS	2						
14	PEX Transition Elbow	3/4"ø-1/2"ø	PCS	3						
15	PVC 90 Deg Bend Elbow	2"ø-2"ø	PCS	8						
16	PVC 90 Degree Bend Elbow	2"ø-2"ø	PCS	16						
17	ABS 90 Degree Bend Elbow	1 1/2"ø-1 1/2"ø	PCS	1						
	ABS 90 Degree Bend Elbow	2"ø-2"ø	PCS	2						
	ABS 90 Degree Bend Elbow	3"ø-3"ø	PCS	2						
	ABS P-Trap	1 1/2"ø-1 1/2"ø	PCS	3						
	ABS P-Trap	2"ø-2"ø	PCS	1						
	ABS Reducer Elbow	2"ø-1 1/2"ø	PCS	1						
	ABS Reducer Elbow	3"ø-2"ø	PCS	1						
	ABS TEE Elbow	1 1/2"ø-1 1/2"ø-1 1/2"ø	PCS	1						
	ABS TEE Elbow	2"ø-2"ø-2"ø	PCS	1						
	ABS TEE Elbow	3"ø-3"ø-3"ø	PCS	1						
	ABS Tee Reducer Elbow	3"ø-3"ø-1 1/2"ø	PCS	2						
	ABS Tee Reducer Elbow	3"ø-3"ø-2"ø	PCS	1						
	ABS Tee Reducer Elbow	3"ø-3"ø-3"ø	PCS	1						
	ABS Trap P	2"ø-2"ø	PCS	1						
	WASTE DOUBLE TEE	2"ø-2"ø-2"ø-2"ø	PCS	1						
	ABS Vent Cap Elbow	1 1/2"ø	PCS	1						
	ABS Vent Cap Elbow	2"ø	PCS	2						
	ABS Vent Cap Elbow	3"Ø	PCS	1						

HVAC BOM

		Ember-2Bd1Ba	a-Farmh	ouse-Ga	rage		
		HVAC SYSTEM MA	TERIAL	SHOPP	ING LIST		
No.	Item	Туре	Unit	Quantity	Unit Price	Total	Description
	HVAC_DUCTS						
	PIPE (REFRIGERANT LINE)	1/4" (Ø)	FT	0.68			
	PIPE (REFRIGERANT LINE)	3/8" (Ø)	FT	64.09			
3	PIPE (REFRIGERANT LINE)	1/2" (Ø)	FT	0.68			
4	PIPE (REFRIGERANT LINE)	3/4''' (Ø)	FT	76.13			
5	DRAYER HOSE	4" (Ø)	FT	9			
_	FLEX DUCT ROUND	4" (Ø)	FT	6.59			
	DUCT FITTINGS & ACCESSORIES						
7	ELBOW (REFRIGERANT LINE)	1/2" (Ø)-1/2" (Ø)	PCS	1			
8	ELBOW (REFRIGERANT LINE)	1/4" (Ø)-1/4" (Ø)	PCS	1			
9	ELBOW (REFRIGERANT LINE)	3/4" (Ø)-3/4" (Ø)	PCS	19			
10	ELBOW (REFRIGERANT LINE)	3/8" (Ø)-3/8" (Ø)	PCS	20			
11	TEE (REFRIGERANT LINE)	3/4" (Ø)-3/4" (Ø)-3/4" (Ø)	PCS	3			
12	TEE (REFRIGERANT LINE)	3/8" (Ø)-3/8" (Ø)-3/8" (Ø)	PCS	2			
13	TRANSITION (REFRIGERANT	3/4" (Ø)-1/2" (Ø)	PCS	3			
14	TRANSITION (REFRIGERANT	3/4" (Ø)-5/8" (Ø)	PCS	3			
15	TRANSITION (REFRIGERANT	3/8" (Ø)-1/4" (Ø)	PCS	1			
16	ROUND TRANSITION(ANGLE)	45 DEGREE	PCS	5			
	HVAC_EQUIPMENTS						
17	AIR HANDLING UNIT	WALL MOUNTED	PCS	3			
18	CONDENSER	OUTDOOR UNIT	PCS	1			
19	EXHAUST FAN	75 CFM	PCS	1			
20	EXHAUST HOOD	WALL MOUNTED	PCS	1			
21	HOOD-WALL: VENT	HOOD-WALL: VENT	PCS	1			
22	DRAYER: VENT	DRAYER: VENT	PCS	1			
23	ROOF VENT	3"(Ø)	PCS	1			



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			LIGHTING FIXTURES				
#	Item	Туре	Description, Manufacturer, SKU	Unit	Quantity	Unit Price	Total
1	Kitchen Ceiling Light			PCS	3		
3	Kitchen Wall Mounted Light			PCS	1		
4	Exterior Wall Mounted Light			PCS	4		
5	Livingroom Ceiling Light With Fan			PCS	1		
6	Bedroom Ceiling Light With Fan			PCS	2		
7	Dining Ceiling Light			PCS	0		
8	Bath Wall Mounted Light			PCS	1		
9	Bathroom Ceiling Light			PCS	2		
10	Livingroom Ceiling Light			PCS	5		
11	Bedroom Ceiling Light			PCS	8		
12	Hall & Entry Ceiling Light			PCS	4		
12	Garage Ceiling Light			PCS	4		
13	Smoke Detector			PCS	3		
14							
15							



			ELECTRICAL FITTINGS				
#	Item	Туре	Description, Manufacturer, SKU	Unit	Quantity	Unit Price	Total
1	Standard Receptacle 120V	20A		PCS	12		
2	GFCI Receptacle 120V	20 A		PCS	19		
3	GFCI Receptacle 240V	30 A		PCS	2		
4	GFCI Receptacle 240V	50 A		PCS	1		
5	GFCI Receptacle 240V	60 A		PCS	1		
6	Fan Switch			PCS	2		
7	Single Pole Switch			PCS	8		
8	Three Way Switch			PCS	5		
9	Dimmer Switch			PCS	3		
10							
11							
12							
13							
14							
15							



		ELECTR	ICAL CONDUITS & WIRING				
#	Item	Туре	Description, Manufacturer, SKU	Unit	Quantity	Unit Price	Total
1	ROMEX 14 AWG	14/2/W/ground		FT	183		
3	ROMEX 12 AWG	12/3/W/ground		FT	0		
4	ROMEX 12 AWG	12/2/W/ground		FT	493		
5	ROMEX 10 AWG	10/3/W/ground		FT	109		
8	ROMEX 10 AWG	10/2/W/ground		FT	71		
9	Romex 8 AWG	8/3/W/ground		FT	43		
10	Romex 8 AWG	8/2/W/ground		FT	0		
11	ROMEX 6 AWG	6/3/W/ground		FT	18		
12	Bare Copper Ground Wire 6 AWG			FT			
13							
14							
15							
16							



		ELEC	CTRICAL BOXES & CIRCUTES				
#	Item	Туре	Description, Manufacturer, SKU	Unit	Quantity	Unit Price	Total
1	Panelboard -240V 1 Phase MLO	200 AMP		PCS	1		
2	Circuit breaker	15 A		PCS	4		
3	Circuit breaker	20 A		PCS	12		
4	Circuit breaker	30 A		PCS	2		
5	Circuit breaker	50 A		PCS	1		
6	Circuit breaker	60 A		PCS	1		
7	Single Gang Switch Box			PCS	3		
8	Double Gang Switch Box			PCS	4		
9	Triple Gang Switch Box			PCS	2		
10	Pull Box	#1/4		PCS	32		
11	Receptacle Box			PCS	35		
12							
13							
14							
15							

HVAC BOM

			HVAC_DUCTS 01				
#	Item	Туре	Description, Manufacturer, SKU	Unit	Quantity	Unit Price	Total
1	PIPE (REFRIGERANT LINE)	1/4" (Ø)		FT	0.68		
2	PIPE (REFRIGERANT LINE)	3/8" (Ø)		FT	64.09		
3	PIPE (REFRIGERANT LINE)	1/2" (Ø)		FT	0.68		
4	PIPE (REFRIGERANT LINE)	3/4"' (Ø)		FT	76.13		
5	DRAYER HOSE	4" (Ø)		FT	9		
6	FLEX DUCT ROUND	4" (Ø)		FT	6.59		
7							
8							
9							
10							
11							
12							
13							
14							
15							
16							

HVAC BOM

		DUCT FITTINGS & ACCESSORIES						
#	Item	Туре	Description, Manufacturer, SKU	Unit	Quantity	Unit Price	Total	
1	ELBOW (REFRIGERANT LINE)	1/2" (Ø)-1/2" (Ø)		PCS	1			
2	ELBOW (REFRIGERANT LINE)	1/4" (Ø)-1/4" (Ø)		PCS	1			
3	ELBOW (REFRIGERANT LINE)	3/4" (Ø)-3/4" (Ø)		PCS	19			
4	ELBOW (REFRIGERANT LINE)	3/8" (Ø)-3/8" (Ø)		PCS	20			
5	TEE (REFRIGERANT LINE)	3/4" (Ø)-3/4" (Ø)-3/4" (Ø)		PCS	3			
6	TEE (REFRIGERANT LINE)	3/8" (Ø)-3/8" (Ø)-3/8" (Ø)		PCS	2			
7	TRANSITION (REFRIGERANT LINE)	3/4" (Ø)-1/2" (Ø)		PCS	3			
8	TRANSITION (REFRIGERANT LINE)	3/4" (Ø)-5/8" (Ø)		PCS	3			
9	TRANSITION (REFRIGERANT LINE)	3/8" (Ø)-1/4" (Ø)		PCS	1			
10	ROUND TRANSITION(ANGLE)	45 DEGREE		PCS	5			
11								
12								
13								
14								
15								
16								

HVAC BOM

			HVAC_EQUIPMENTS				
#	Item	Туре	Description, Manufacturer, SKU	Unit	Quantity	Unit Price	Total
1	AIR HANDLING UNIT	WALL MOUNTED		PCS	3		
2	CONDENSER	OUTDOOR UNIT		PCS	1		
3	EXHAUST FAN	75 CFM		PCS	1		
4	EXHAUST HOOD	WALL MOUNTED		PCS	1		
5	HOOD-WALL: VENT	HOOD-WALL: VENT		PCS	1		
6	DRAYER: VENT	DRAYER: VENT		PCS	1		
7	ROOF VENT	3"(Ø)		PCS	1		
8							
9							
10							
11							
12							
13							
14							



	1	PLUMBII	NG FIXTURES & ACCESSORIES				
#	Item	Туре	Description, Manufacturer, SKU	Unit	Quantity	Unit Price	Total
1	Bath Tub (Alcove Tub)			PCS	1		
2	Kitchen Sink			PCS	1		
3	Kitchen faucets			PCS	1		
4	Vanity Sink			PCS	1		
5	Bath room faucets			PCS	1		
6	Water Closet			PCS	1		
7	Shower Trim			PCS	1		
8	Shower Tray			PCS	1		
9	Water Heater			PCS	1		
10	Hose Bib			PCS	1		
11	Shutoff Valve			PCS	6		
12	Hanging pipe clamp			PCS	16		
13	Globe Valve			PCS	1		
14	Dishwasher Supply Single Connector			PCS	1		
15	Dishwasher Sewage Single Connector			PCS	1		
16	Laundry Sweat Connector			PCS	1		



		SANI	TARY & PLUMBING PIPES				
#	Item	Туре	Description, Manufacturer, SKU	Unit	Quantity	Unit Price	Total
1	ABS (Acrylonitrile Butadiene Styrene) Pipes	ø 1"		FT	0		
2	ABS (Acrylonitrile Butadiene Styrene) Pipes	ø 1 1/2"		FT	18		
3	ABS (Acrylonitrile Butadiene Styrene) Pipes	ø 2"		FT	28		
4	ABS (Acrylonitrile Butadiene Styrene) Pipes	ø 3"		FT	38		
5	PEX (Cross-linked polyethylene) Pipes	ø 1/2"		FT	66		
6	PEX (Cross-linked polyethylene) Pipes	ø 3/4"		FT	54		
7	PEX (Cross-linked polyethylene) Pipes	ø 1"		FT	1		
8	PVC Pipes Sch.80 - Rigid	ø 1 1/2"		FT	0		
9	PVC Pipes Sch.80 - Rigid	ø 2"		FT	66		
10	PVC Pipes Sch.80 - Rigid	ø 3"		FT	0		
11	Flex Pipe Round	ø 1/2"		FT	6		
12	Flex Pipe Round	ø 3/4"		FT	0		
13	Flex Pipe Round	ø 1"		FT	0		
14							
15							



		PII	PE FITTINGS 01				
	Item	Туре	Description, Manufacturer, SKU	Unit	Quantity	Unit Price	Total
	PEX 90 Deg Elbow	1/2"ø-1/2"ø		PCS	3		
<u>)</u>	PEX 90 Degree Elbow	1/2"ø-1/2"ø		PCS	12		
	PEX 90 Degree Elbow	3/4"ø-3/4"ø		PCS	4		
ļ.	PEX Tee Elbow	1/2"ø-1/2"ø-1/2"ø		PCS	2		
5	PEX Tee Elbow	3/4"ø-3/4"ø-3/4"ø		PCS	6		
,)	PEX Transition Elbow	1"ø-3/4"ø		PCS	2		
7	PEX Transition Elbow	3/4"ø-1/2"ø		PCS	4		
3	Tee Elbow	3/4"ø-3/4"ø-3/4"ø		PCS	1		
)	PEX 90 Deg Elbow	1/2"ø-1/2"ø		PCS	1		
10	PEX 90 Degree Elbow	1/2"ø-1/2"ø		PCS	9		
1	PEX 90 Degree Elbow	3/4"ø-3/4"ø		PCS	2		
2	PEX Tee Elbow	1/2"ø-1/2"ø-1/2"ø		PCS	2		
13	PEX Tee Elbow	3/4"ø-3/4"ø-3/4"ø		PCS	2		
14	PEX Transition Elbow	3/4"ø-1/2"ø		PCS	3		
15	PVC 90 Deg Bend Elbow	2"Ø-2"Ø		PCS	8		
		PII	PE FITTINGS 02				
#	Item	Туре	Description, Manufacturer, SKU	Unit	Quantity	Unit Price	Total
1	PVC 90 Degree Bend Elbow	2"ø-2"ø		PCS	16		



2	ABS 90 Degree Bend Elbow	1 1/2"ø-1 1/2"ø		PCS	1		
	ABS 90 Degree Bend Elbow	2"ø-2"ø		PCS	2		
	ABS 90 Degree Bend Elbow	3"Ø-3"Ø		PCS	2		
	ABS P-Trap	1 1/2"ø-1 1/2"ø		PCS	3		
'	ABS P-Trap	2"Ø-2"Ø		PCS	1		
'	ABS Reducer Elbow	2"ø-1 1/2"ø		PCS	1		
	ABS Reducer Elbow	3"ø-2"ø		PCS	1		
)	ABS TEE Elbow	1 1/2"ø-1 1/2"ø-1 1/2"ø		PCS	1		
0	ABS TEE Elbow	2"Ø-2"Ø-2"Ø		PCS	1		
1	ABS TEE Elbow	3"Ø-3"Ø-3"Ø		PCS	1		
2	ABS Tee Reducer Elbow	3"ø-3"ø-1 1/2"ø		PCS	2		
3	ABS Tee Reducer Elbow	3"Ø-3"Ø-2"Ø		PCS	1		
4	ABS Tee Reducer Elbow	3"Ø-3"Ø-3"Ø		PCS	1		
15	ABS Trap P	2"Ø-2"Ø		PCS	1		
		PIPE	FITTINGS 03	-			
#	Item	Туре	Description, Manufacturer, SKU	Unit	Quantity	Unit Price	Total
	WASTE DOUBLE TEE	2"Ø-2"Ø-2"Ø		PCS	1		
)	ABS Vent Cap Elbow	1 1/2"ø		PCS	1		
	ABS Vent Cap Elbow	2"ø		PCS	2		



4	ABS Vent Cap Elbow	3"ø	PCS	1	



			APPLIANCES				
#	Item	Туре	Description, Manufacturer, SKU	Unit	Quantity	Unit Price	Total
1	Refrigerator			PCS			
2	Range			PCS			
3	Washer Front Load	Stackable		PCS			
4	Dryer Front Load	Stackable		PCS			
5	Dish Washer			PCS			
6	Oven			PCS	(
7	Microwave			PCS	(
8							
9							
10							
11							
12							
13							
14							
15							
16							



			CASEWORKS 01				
#	Item	Туре	Description, Manufacturer, SKU	Unit	Quantity	Unit Price	Total
1	Kitchen Cabinet			FT	25.07		
2	Laundry Cabinet			FT	0		
3	Vanity Cabinet			FT	2.5		
4	Medicine Cabinet			PCS	1		
5	Kitchen countertop			SF	35		
6	Laundry Countertop			PCS	0		
7	Bathroom Countertop			SF	0		
8	Island			FT	0		
9	Peninsula			FT	0		
10	Closets			SF	105.29		
11							
12							
13							
14							
15							



			CEILING 01				
#	Item	Туре	Description, Manufacturer, SKU	Unit	Quantity	Unit Price	Total
	LIVINGROOM + KITCHEN			SF	385.0		
1	Ceiling Board	Drywall		SF	385		
2	Drywall Fastener	Screw		PCS	674		
}	Vapor Retarder	Polyethylene film		SF	385		
1	Vapor Retarder Fastener	Nails with washer heads		PCS	1155		
	BATHROOM	,		SF	96.0		
5	Ceiling Board	MRD (Moisture resistant drywall)		SF	96		
j	MRD Fastener	Screw		PCS	168		
	PORCH			SF	238.0		
7	Ceiling Board	Marine Plywood		SF	238		
3	Exterior Grade Plywood	Screw		PCS	417		
	WH			SF	9.0		
)	Ceiling Board	Drywall		SF	9		
10	Drywall Fastener	Screw		PCS	16		
l1	Vapor Retarder	Polyethylene film		SF	9		
12	Vapor Retarder Fastener	Nails with washer heads		PCS	27		



			CEILING 02				
#	Item	Туре	Description, Manufacturer, SKU	Unit	Quantity	Unit Price	Total
	HALL			SF	79.0		
13	Ceiling Board	Drywall		SF	79		
14	Drywall Fastener	Screw		PCS	138		
15	Vapor Retarder	Polyethylene film		SF	79		
16	Vapor Retarder Fastener	Nails with washer heads		PCS	237		
	W/D			SF	15.0		
17	Ceiling Board	Drywall		SF	15		
18	Drywall Fastener	Screw		PCS	26		
19	Vapor Retarder	Polyethylene film		SF	15		
20	Vapor Retarder Fastener	Nails with washer heads		PCS	45		
	GARAGE			SF	380.0		
21	Ceiling Board	Drywall		SF	380		
22	Drywall Fastener	Screw		PCS	665		
23	Vapor Retarder	Polyethylene film		SF	380		
24	Vapor Retarder Fastener	Nails with washer heads		PCS	1140		



			CEILING 03				
#	Item	Туре	Description, Manufacturer, SKU	Unit	Quantity	Unit Price	Total
	CLOSET 1			SF	17.0		
25	Ceiling Board	Drywall		SF	17	,	
26	Drywall Fastener	Screw		PCS	30		
27	Vapor Retarder	Polyethylene film		SF	17	,	
28	Vapor Retarder Fastener	Nails with washer heads		PCS	51		
	CLOSET 2			SF	16.0		
29	Ceiling Board	Drywall		SF	16		
30	Drywall Fastener	Screw		PCS	28	3	
31	Vapor Retarder	Polyethylene film		SF	16		
32	Vapor Retarder Fastener	Nails with washer heads		PCS	48	3	
	CLOSET 3			SF	9.0		
33	Ceiling Board	Drywall		SF	ç)	
34	Drywall Fastener	Screw		PCS	16		
35	Vapor Retarder	Polyethylene film		SF	ç)	
36	Vapor Retarder Fastener	Nails with washer heads		PCS	27	,	



			CEILING 04				
#	Item	Туре	Description, Manufacturer, SKU	Unit	Quantity	Unit Price	Total
	BEDROOM 1			SF	154.0		
37	Ceiling Board	Drywall		SF	154		
38	Drywall Fastener	Screw		PCS	270		
39	Vapor Retarder	Polyethylene film		SF	154		
40	Vapor Retarder Fastener	Nails with washer heads		PCS	462		
	BEDROOM 2			SF	135.0		
41	Ceiling Board	Drywall		SF	135		
42	Drywall Fastener	Screw		PCS	236		
43	Vapor Retarder	Polyethylene film		SF	135		
44	Vapor Retarder Fastener	Nails with washer heads		PCS	405		



	<u>1</u>		FLOORING INTERIOR 01				
#	Item	Туре	Description, Manufacturer, SKU	Unit	Quantity	Unit Price	Total
	CLOSET 1						
1	Closet Flooring			SF	15		
2	Wood underlay	Foam Pad Polyethylene		SF	15		
3	Vapor Retarder	Vapor Barrier Polyethylene		SF	15		
	CLOSET 2						
4	Closet Flooring			SF	16		
5	Wood underlay	Foam Pad Polyethylene		SF	16		
6	Vapor Retarder	Vapor Barrier Polyethylene		SF	16		
	CLOSET 3						
7	Closet Flooring			SF	Ç)	
8	Wood underlay	Foam Pad Polyethylene		SF	Ç)	
9	Vapor Retarder	Vapor Barrier Polyethylene		SF	Ç)	
	BEDROOM 1						
10	Bedroom Flooring			SF	129		
11	Wood underlay	Foam Pad Polyethylene		SF	129		
12	Vapor Retarder	Vapor Barrier Polyethylene		SF	129		



	1		FLOORING INTERIOR 02				
#	Item	Туре	Description, Manufacturer, SKU	Unit	Quantity	Unit Price	Total
	BEDROOM 2						
13	Bedroom Flooring			SF	146		
14	Wood underlay	Foam Pad Polyethylene		SF	146		
15	Vapor Retarder	Vapor Barrier Polyethylene		SF	146		
	LIVING ROOM AND KITC	HEN					
16	Tile Finish			SF	441		
17	Adhesive	1/2" Thin set Mortar		SF	441		
18	Vapor Retarder	Vapor Barrier Polyethylene		SF	441		
	BATHROOM						
19	Tile Finish			SF	78		
20	Adhesive	1/2" Thin set Mortar		SF	78		
21	Vapor Retarder	Vapor Barrier Polyethylene		SF	78		
	GARAGE						
22	Tile Finish			SF	266		
23	Adhesive	1/2" Thin set Mortar		SF	266		
24	Vapor Retarder	Vapor Barrier Polyethylene		SF	266		



			FLOORING INTERIOR 03				
#	Item	Туре	Description, Manufacturer, SKU	Unit	Quantity	Unit Price	Total
	W/D						
25	Tile Finish			SF	14		
26	Adhesive	1/2" Thin set Mortar		SF	14		
27	Vapor Retarder	Vapor Barrier Polyethylene		SF	14		
	BOILER ROOM						
28	Tile Finish			SF	8		
29	Adhesive	1/2" Thin set Mortar		SF	8		
30	Vapor Retarder	Vapor Barrier Polyethylene		SF	8		



			FLOORING EXTERIOR			
#	Item	Туре	Description, Manufacturer, SKU	Unit	Quantity	Unit Price
	STRUCTURE			SF	1,474.82	
1	Concrete Slab	4"concrete cast in situ		CF	491.61	
2	Insulation	Rigid insulation		SF	423.65	
3	Hard core	Compacted soil		CF	415.43	
4	Re-bar	#4 re-bar		Ton	1.34	
5	Concrete Pad	4"concrete cast in situ		CF	2	
6	Slab edge	Turndown		CF	355.33	
7	Footing	Cast-in-place concrete		CF	11.7	
	PORCH					
8	Tile Finish			SF	248	
9	Adhesive	1/2" Thin set Mortar		SF	248	
10	Vapor Retarder	Vapor Barrier Polyethylene		SF	248	



			WALLS: EXTERIOR				
#	Item	Туре	Description, Manufacturer, SKU	Unit	Quantity	Unit Price	Total
1	Exterior-Grade Plywood Horizontal Siding			SF	1309		
2	Exterior-Grade Plywood Fastener 8/panel	Self-drilling screws(100/pkt)		PKT	13.09		
3	Wall Shteathing (OSB)			SF	1309		
4	_	Self-drilling screws(100/pkt)		PKT	13.09		
5	Wall Homewrap			SF	1309		
6	Homewrap Fastener	Stapled fastener (200/pkt)		PKT	4.97		
7	Furring Strip			PCS	163.63		
8	Furring Strip Fastener	Self-drilling screws(100/pkt)		PKT	13.09		
9	Wall Paint			SF	1309		
10		Masonry stone		SF	0		
11		Masonry stone		SF	0		
12	Mortar for Stone Veneer			SF	0		
13	Wall Insulation			SF	4946		



			WALLS: INTERIOR 01				
#	Item	Туре	Description, Manufacturer, SKU	Unit	Quantity	Unit Price	Total
	BATHROOM			SF	88.0		
1	Cementitious Backer Board			SF	410		
2	Kerdi membrane			SF	410		
3	Kerdi membrane Fastener			SF	410		
4	Wall Ceramic Tile			SF	410		
	BEDROOM 1			SF	127.0		
5	Drywall Board			SF	422		
6	Drywall Fastener	Self-drilling screws(100/pkt)		PKT	4.22		
7	Wall Paint			SF	422		
8	Drywall Tape			FT	79.1		
	BEDROOM 2			SF	144.0		
9	Drywall Board			SF	416		
10	Drywall Fastener	Self-drilling screws(100/pkt)		PKT	4.16		
11	Wall Paint			SF	416		
12	Drywall Tape			FT	78.0		



			WALLS: INTERIOR 02				
#	Item	Туре	Description, Manufacturer, SKU	Unit	Quantity	Unit Price	Total
	LIVING ROOM			SF	228.0		
13	Drywall Board			SF	416		
14	Drywall Fastener	Self-drilling screws(100/pkt)		PKT	4.16		
15	Wall Paint			SF	416		
16	Drywall Tape			FT	78.0		
	KITCHEN			SF	136.0		
17	Cementitious Backer Board			SF	33		
18	Drywall Board			SF	155		
19	Drywall Fastener	Self-drilling screws(100/pkt)		PKT	1.55		
20	Kerdi membrane			SF	33		
21	Kerdi membrane Fastener			SF	33		
22	Wall Ceramic Tile			SF	33		
23	Wall Paint			SF	155		
24	Drywall Tape			FT	29.2		



			WALLS: INTERIOR 03				
#	Item	Туре	Description, Manufacturer, SKU	Unit	Quantity	Unit Price	Total
	CL 1			SF	17.0		
25	Drywall Board			SF	164		
26	Drywall Fastener	Self-drilling screws(100/pkt)		PKT	1.64		
27	Wall Paint			SF	164		
28	Drywall Tape			FT	30.8		
	CL 2			SF	18.0		
29	Drywall Board			SF	127		
30	Drywall Fastener	Self-drilling screws(100/pkt)		PKT	1.27		
31	Wall Paint			SF	127		
32	Drywall Tape			FT	23.8		
	CL 3	'		SF	10.0		
33	Drywall Board			SF	130		
34	Drywall Fastener	Self-drilling screws(100/pkt)		PKT	1.3		
35	Wall Paint			SF	130		
36	Drywall Tape			FT	24.4		



			WALLS: INTERIOR 04				
#	Item	Туре	Description, Manufacturer, SKU	Unit	Quantity	Unit Price	Total
	WD			SF	15.0		
37	Cementitious Backer Board			SF	136		
38	Kerdi membrane			SF	136		
39	Kerdi membrane Fastener			SF	136		
40	Wall Ceramic Tile			SF	136		
	WH			SF	9.0		
41	Drywall Board			SF	103		
42	Drywall Fastener	Self-drilling screws(100/pkt)		PKT	1.03		
43	Wall Paint			SF	103		
44	Drywall Tape			FT	19		
	HALL			SF	74.0		
45	Drywall Board			SF	313		
46	Drywall Fastener	Self-drilling screws(100/pkt)		PKT	3.13		
47	Wall Paint			SF	313		
48	Drywall Tape			FT	59		



			WALLS: INTERIOR 05				
#	Item	Туре	Description, Manufacturer, SKU	Unit	Quantity	Unit Price	Total
	GARAGE			SF	264.0		
49	Drywall Board			SF	583		
50	Drywall Fastener	Self-drilling screws(100/pkt)		PKT	5.83		
51	Wall Paint			SF	583		
52	Drywall Tape			FT	110.0		
1	Wall Skirting	Ceramic		FT	191		



			DOORS				
#	Item	Туре	Description, Manufacturer, SKU	Unit	Quantity	Unit Price	Total
1	Interior Swinging	3' - 0" X 6'-8"		PCS	4		
2	Garage Door	8' - 0" X 6'-6"		PCS	1		
3	Folding	3' - 3" X 6'-8"		PCS	1		
4	Interior Sliding	5' - 10" X 6'- 8"		PCS	1		
5	Interior Sliding	5' - 9" X 6'- 8"		PCS	1		
6	Folding	4' - 0" X 6'-8"		PCS	1		
7	Folding	2' - 4" X 6'-8"		PCS	1		
8	Exterior Swinging	3' - 0" X 6'-8"		PCS	1		
9	Exterior Door Trim			FT	38		
10	Interior Door Trim			FT	344		
11	Entry Lock set			PCS	2		
12	Privacy Lock set			PCS	4		
13	Passage Lock set			PCS	5		
14							
15							



			WINDOWS				
#	Item	Туре	Description, Manufacturer, SKU	Unit	Quantity	Unit Price	Total
1	Sliding	5' - 3" X 3'-3"		PCS	1		
2	Sliding	3' - 3" X 3'-3"		PCS	7		
3	Casment	2' - 9" X 4'-3"		PCS	4		
4	Sliding	3' - 3" X 1'-9"		PCS	1		
5	Exterior Window Trim			FT	177		
6	Interior Window Trim			FT	177		
7							
8							
9							
10							
11							
12							
13							
14							
15							



			ROOF 01				
#	Item	Туре	Description, Manufacturer, SKU	Unit	Quantity	Unit Price	Total
1	Roof Covering			SF	2151.0		
2	Roof Covering Fastener			PCS	1076		
3	Roof Felt Paper			SF	2151.0		
4	Roof Felt Paper Fastener			PCS	6453.0		
5	Roof Sheathing			SF	2151.0		
6	Roof Sheathing Fastener			PCS	17208		
7	Batten			FT	1013.0		
8	Batten Fastener			PCS	761.7		
9	Soffit			SF	360.0		
10	Soffit Fastener			PCS	180.0		
11	Fascia			FT	229.0		
12	Fascia board fastener			PCS	115		
13	Roof Insulation			SF	2151.0		
14							
15							