


EMBER

The Ember is a stylish modern 2 bedroom 1 bathroom home. The main body of the home is clad in dark vertical siding and a contrasting section, the garage, features warm-toned horizontal wood siding and stone veneer. The roof features a combination of flat and shed forms while a covered entryway provides shelter and a welcoming point of access.


Inside, the Ember features a rectangular layout. The living and kitchen areas are merged into one large room at the center of the house, creating a spacious and versatile living space. The bedrooms and the garage areas are placed on either side of the living area.

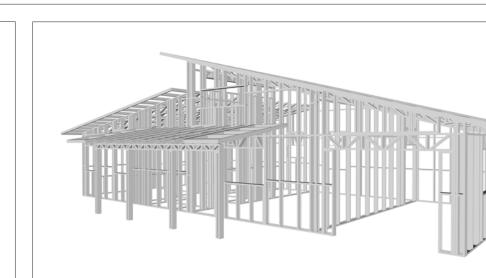

Materials Shopping List

Please print and take this Materials Shopping List to your favorite Home Depot and ask for assistance in selecting the materials, fixtures and fittings to complete your new home.

Record your selection and the price of the item. Then do the math to determine the cost for your selections and the total cost of finishing your home.

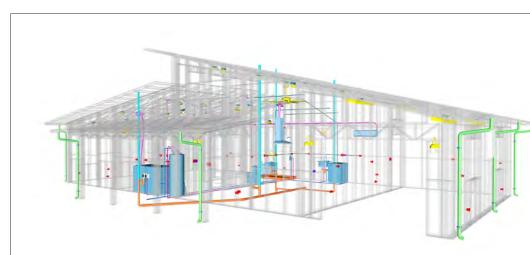

< CLICK HERE >

To Go To Materials Shopping List





FLOOR PLAN

960 SF

2 Bed Rooms

MECHANICAL

ARCHITECTURAL

STRUCTURAL

PLUMBING

SHOPPING LIST

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WALL FRAME LAYOUT ROOF TRUSS LAYOUT ROOF PLAN + ARCHITECTURAL ELEVATIONS -ARCHITECTURAL ELEVATIONS -ARCHITECTURAL SECTIONS -ARCHITECTURAL DETAILS ARCHITECTURAL CASEWORK

COVER SHEET GENERAL NOTES WALL FRAME LAYOUT WALL PANEL & LAYOUT PLAN

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30 HVAC PLAN 31 **ELECTRICAL** SCHEDULE 32

DIMENSION FOR FITTING

LIGHTING POWER PLAN 34 DIMENSION FOR LIGHTING

DISCLAIMER

marketing content.

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NOTES AND SCHEDULES WATER SUPPLY & SEWAGE SYSTEM # 38

MATERIALS MATERIALS SHOPPING LIST

ABOUT



FrameUpNow is a design and manufacturing company providing precision-engineered home framing solutions. We offer a catalog of Affordable Homes, Tiny Homes, Garages, Shops and Barndominiums. FrameUpNow manufactures cold-formed steel (CFS) also known as Light Gauge Steel (LGS) framing components that conform to our engineered metal house frame plans or can be purchased as DIY skeleton kits.

The CFS/LGS framing is lightweight, easily assembled, and does not require heavy equipment or specialized labor, enabling homeowners to erect the frame themselves in just a few days. Unlike wood, the steel framing is impervious termites and bores, warping, expansion, and fire.

Our home plans come complete with a structural engineered stamp for permit approvals. Customers receive a full BOM also known as a Materials Shopping List to purchase finish materials from a Building Materials retailer. FrameUpNow prides itself on the quality and efficiency of our precision-engineered home framing solutions for construction professionals and DIY homeowners.



KEY PLAN

NO.	DESCRIPTION	DATE

NOTE:

LEGEND:

PROJECT

242-Ember-960-2Bd1Ba-**Modern-Garage-550**

DRAWING NAME

INTRODUCTION

CLIENT NAME:
PROJECT NUMBER:
DATE:
DESIGNED BY:
DRAWN BY:
CHECKED BY:

I101

SCALE:

DESCRIPTIONS

MATERIALS LIST

The BOM (Bill Of Materials) package, known as the Materials Shopping List document, provides:

Comprehensive Inventory: Detailed lists of essential materials sourced from architectural, mechanical, HVAC, electrical, and plumbing design drawing sets.

Precise Curation: Each item meticulously selected and organized for accuracy and efficiency in project planning.

Customizable Options: Customers can modify listed items to their preferences and calculate costs accordingly, ensuring alignment with personal project needs and budget.

Dedicated Space for Details: Includes tables for customers to note Home Depot SKU numbers or product descriptions for selected items, facilitating seamless purchasing and coordination with suppliers.

Customer Convenience: Take the list to Home Depot or preferred suppliers for accurate pricing, helping align the total home budget with personal financial plans.

Simplify your construction journey with our Materials Shopping List document, where detailed preparation meets streamlined implementation for your dream home.

STRUCTURAL

The structural drawings package provides an exhaustive set of detailed plans essential for the precise assembly of your building. This comprehensive package includes:

Framing Plans: Detailed layouts for all framing components. Truss Layouts: Clear instructions for truss placement and

Panel Length Plans: Specifications for panel dimensions. Framing Elevations and Sections: Precise elevation and sectional views for accurate construction.

Truss and Wall Blocking Plans: Plans for truss and wall blocking to ensure structural integrity.

Hold-Down Plan: Detailed hold-down requirements for stability. Snap Sheet: Reference sheet for quick identification of components

Structural Details and Bracing Plans: Complete details and bracing plans for all structural elements.

Accompanying these plans is a comprehensive Bill of Materials (BOM) that lists every necessary building component, from cold formed steel (CFS) frames to fasteners.

ARCHITECTURAL

With the comprehensive architectural package, both builders and DIY homeowners can confidently execute the construction.

The architectural package includes:

Furnished Floor Plans: Complete with furniture layouts for a clear understanding of space utilization.

Detailed Dimension Plans: Ensures precise measurements, from the overall footprint down to the exact placement of windows and

Foundation Plan: Detailed plan to establish a solid foundation.

Wall Framing and Truss Layout: Comprehensive plans for wall framing and truss placement.

Architectural Elevations: Exterior views showcasing the design.

Strategic Building Sections: Critical cross-sectional details for a thorough understanding of the build.

Casework Drawings and Diagrams: Suggested designs for built-in caseworks, such as kitchen cabinets.

MECHANICAL

The mechanical package includes everything needed to guide HVAC

Detailed HVAC Floor Plan: Precisely maps out the placement of air handlers, ductwork, and vents throughout the home's layout.

HVAC Sections and Riser Diagrams: Technical drawings offering critical cross-sectional details and piping schematics, ensuring proper integration of the heating and cooling system into the home's structure.

Bill of Materials: A complete list of all necessary HVAC components.

ELECTRICAL

The electrical package includes all the plans and documentation needed to guide the installation of your home's electrical system:

Detailed Power Plan: Precisely maps out the placement of outlets, switches, and other power components throughout the layout.

Comprehensive Lighting Plan: Shows the optimal locations for lighting fixtures, sconces, and other illumination sources to create a well-lit, functional interior.

Dimensioned Electrical Layout: Provides exact dimensions and measurements to ensure proper placement of all electrical elements.

Bill of Materials: A complete list of every component needed, from circuit breakers to wiring.

The plumbing package includes everything needed to guide the

Detailed Water Supply System Plan: Precisely maps out the placement of pipes, valves, and plumbing fixtures throughout the

Comprehensive Sewage System Plan: Shows the optimal routing and sizing of drain lines to effectively remove waste and ensure

Detailed Riser Diagrams: Provide information needed to properly

PLUMBING

installation of your home's water supply and drainage systems:

proper drainage.

install all vertical plumbing risers and vent stacks.

Bill of Materials: A complete list of every component needed, from pipes to fixtures.


BOM (Bill Of Materials) (Separately Attached)





The Bill of Materials (BOM) is a crucial document that compiles the material requirements from different disciplines into a centralized inventory, enabling efficient procurement, inventory management, and cost estimation for a specified project or

ELECTRICAL BOM



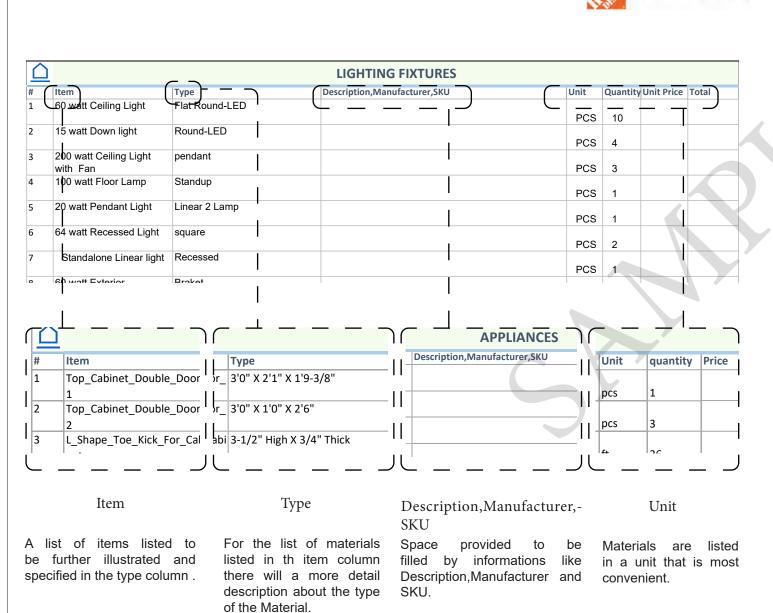

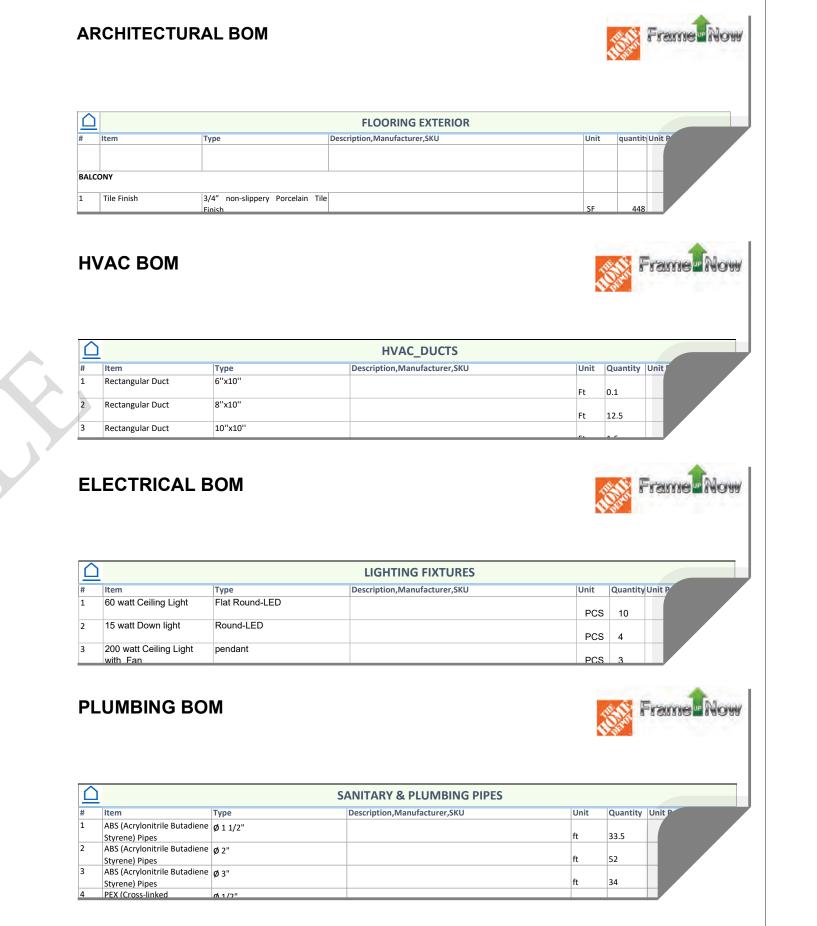

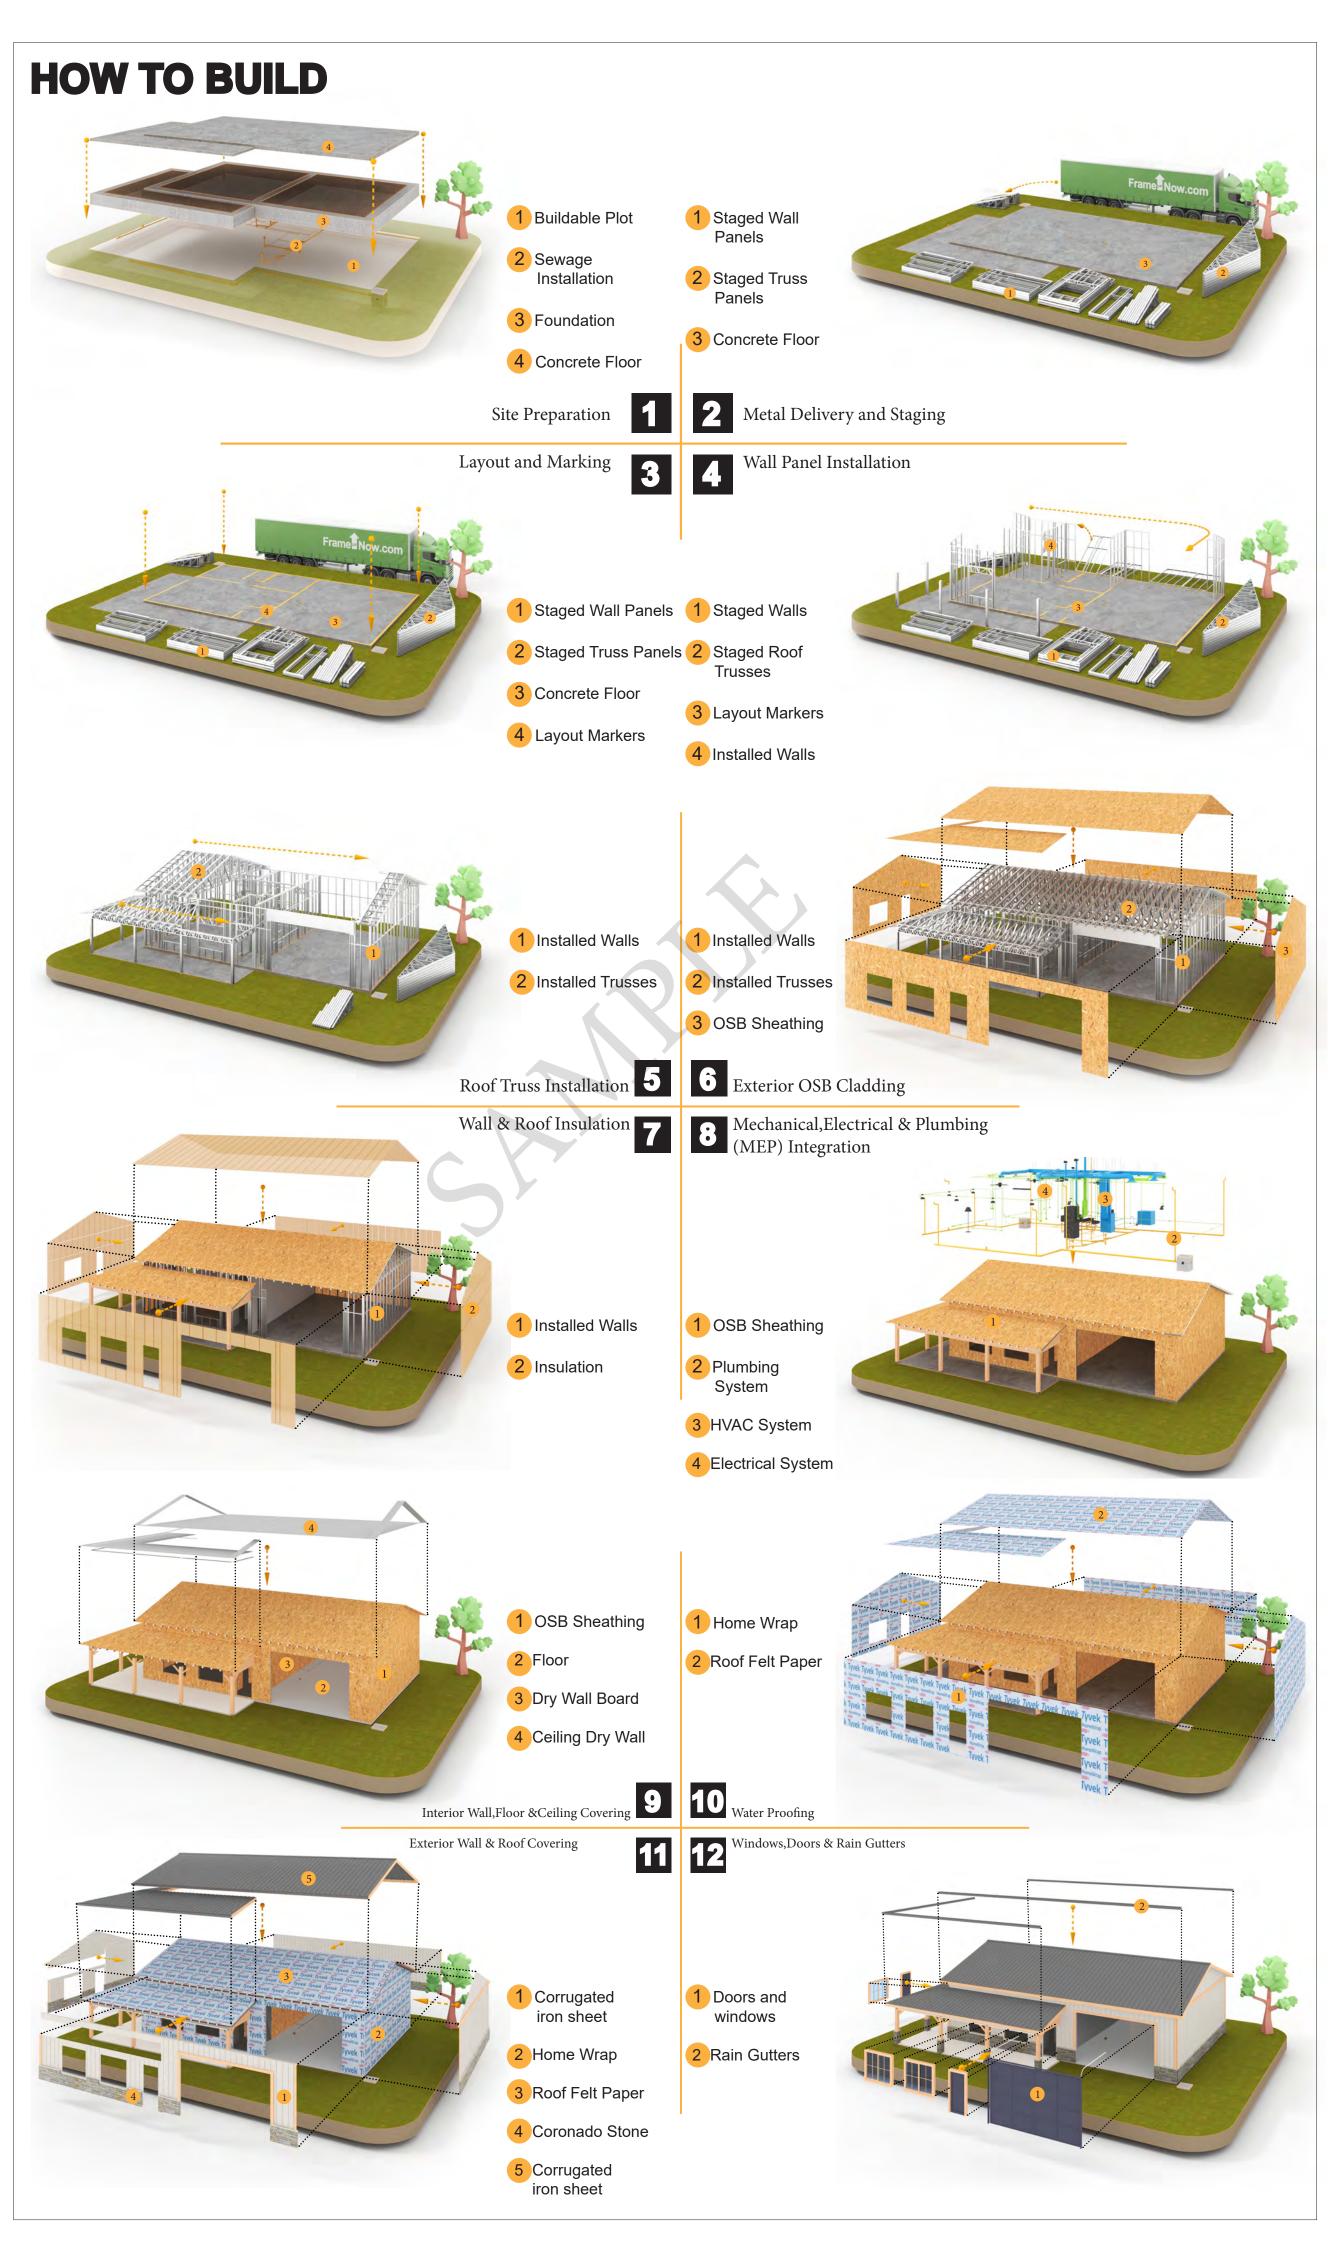



KEY PLAN

NO.	DESCRIPTION	DATE

NOTE:

LEGEND:

PROJECT

242-Ember-960-2Bd1Ba-**Modern-Garage-550**


DRAWING NAME

INTRODUCTION

CLIENT NAME: PROJECT NUMBER: DATE: **DESIGNED BY** DRAWN BY: CHECKED BY:

1102

SCALE:

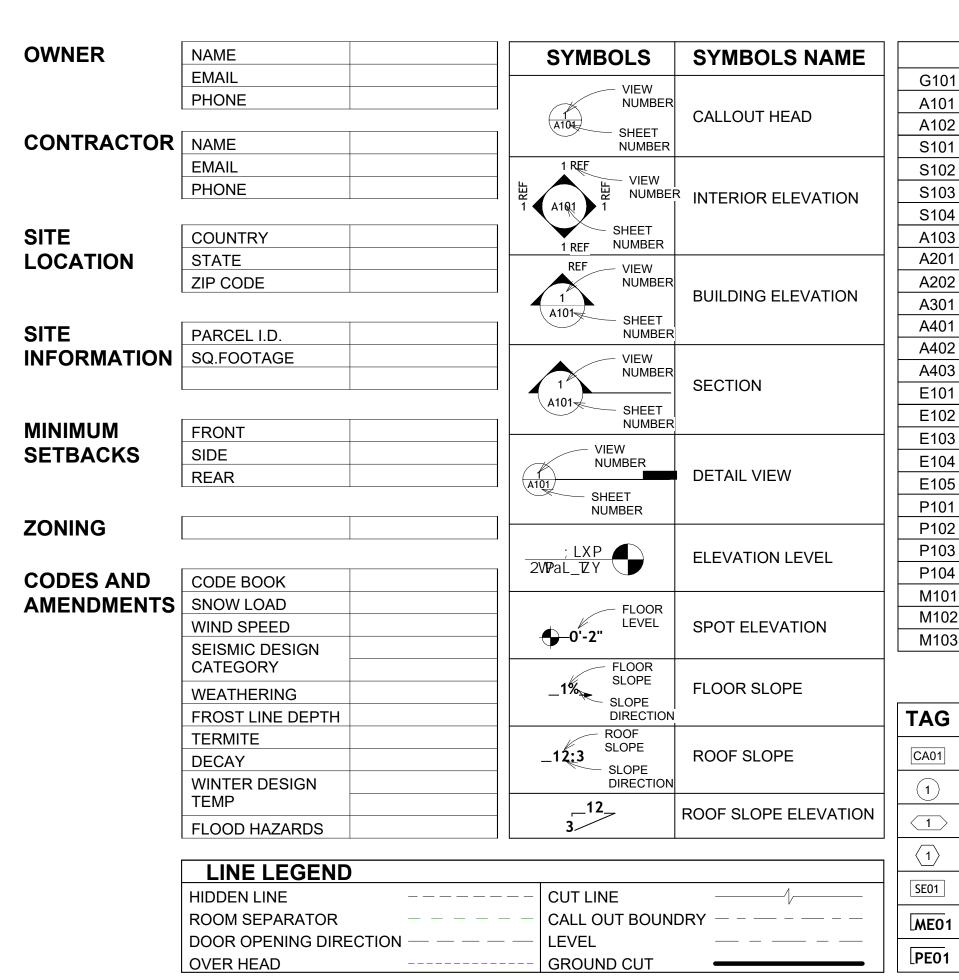

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\dagger	G101	COVER SHEET
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	A102	DIMENSION PLAN
	S101	FOUNDATION PLAN
	S102	STRUCTURAL FLOOR PLAN
	S103	FRAME LAYOUT
	S104	ROOF TRUSS LAYOUT
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	A301	SECTIONS
	A401	DETAILS
\dashv	A402	CASEWORK DETAILS
	A403	CASEWORK DETAILS
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1	E103	POWER PLAN
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TV TELEVISION	R BOLT ED
SIMP. ABE66 SIMPSON ANCHOR TV TELEVISION UNO UNLESS NOTED OT	
OOOR TAG UNO UNLESS NOTED OT	THERWISI
JOSE TAG	THERWISI
W/ WITH	
URNITURE TAG	
W/D WASHER/DRYER	
VINDOW TAG AC AIR CONDITIONING	S UNIT
PECIALTY EQUIPMENT TAG ACC AIR COOLED CONE	DENSER
MECHANICAL EQUIPMENT TAG ALUI ACCU AIR COOLED CONDSI	ENSING UN
AHU AIR HANDLING UNI	Т
PLUMBING EQUIPMENT TAG CC COOLING COIL	
CD CEILING DIFFUSER	₹
CFm Cubic Feet Per Minu	te
CR CEILING REGISTER	?
CU CONDENSING UNIT	Γ
CW COLD WATER	
E/A EXHAUST AIR	
EF EXHAUST FAN	
ET EXPANSION TANK	
EX. EXISTING	
FC FLEXIBLE CONNEC	CTION
FCU FAN COIL UNIT	
FLR. FLOOR	
HC HEATING COIL	
HE AIR TO AIR HEAT E	XCHANG
HV HEATING AND VENT	TILATING I
IV INLET VANES	
MER MECHANICAL ROO	M
MAX. MAXIMUM	
MIN. MINIMUM	
R/A RETURN AIR	
RCU RECIPROCATING CHI	ILLER UNIT

ABBREVIATION

ASTM D698 AMERICAN SOCIETY FOR

CASEWORK

ELECTRICAL

FOOTINGS

CODE

CODE

MAXIMUM

MINIMUM

NUMBER

ON CENTER

PLUMBING

REFERENCE

RIGHT GARAGE

SQUARE FEET

RETURN FAN SUPPLY AIR

STATIC PRESSURE

POLYVINYL CHLORIDE

SPECIAL EQUIPMENT

MECHANICAL

MAX.


ME

CONDITIONING

ACTION FLOOR SYSTEMS


TESTING AND MATERIAL

FINISHED FLOOR LEVEL

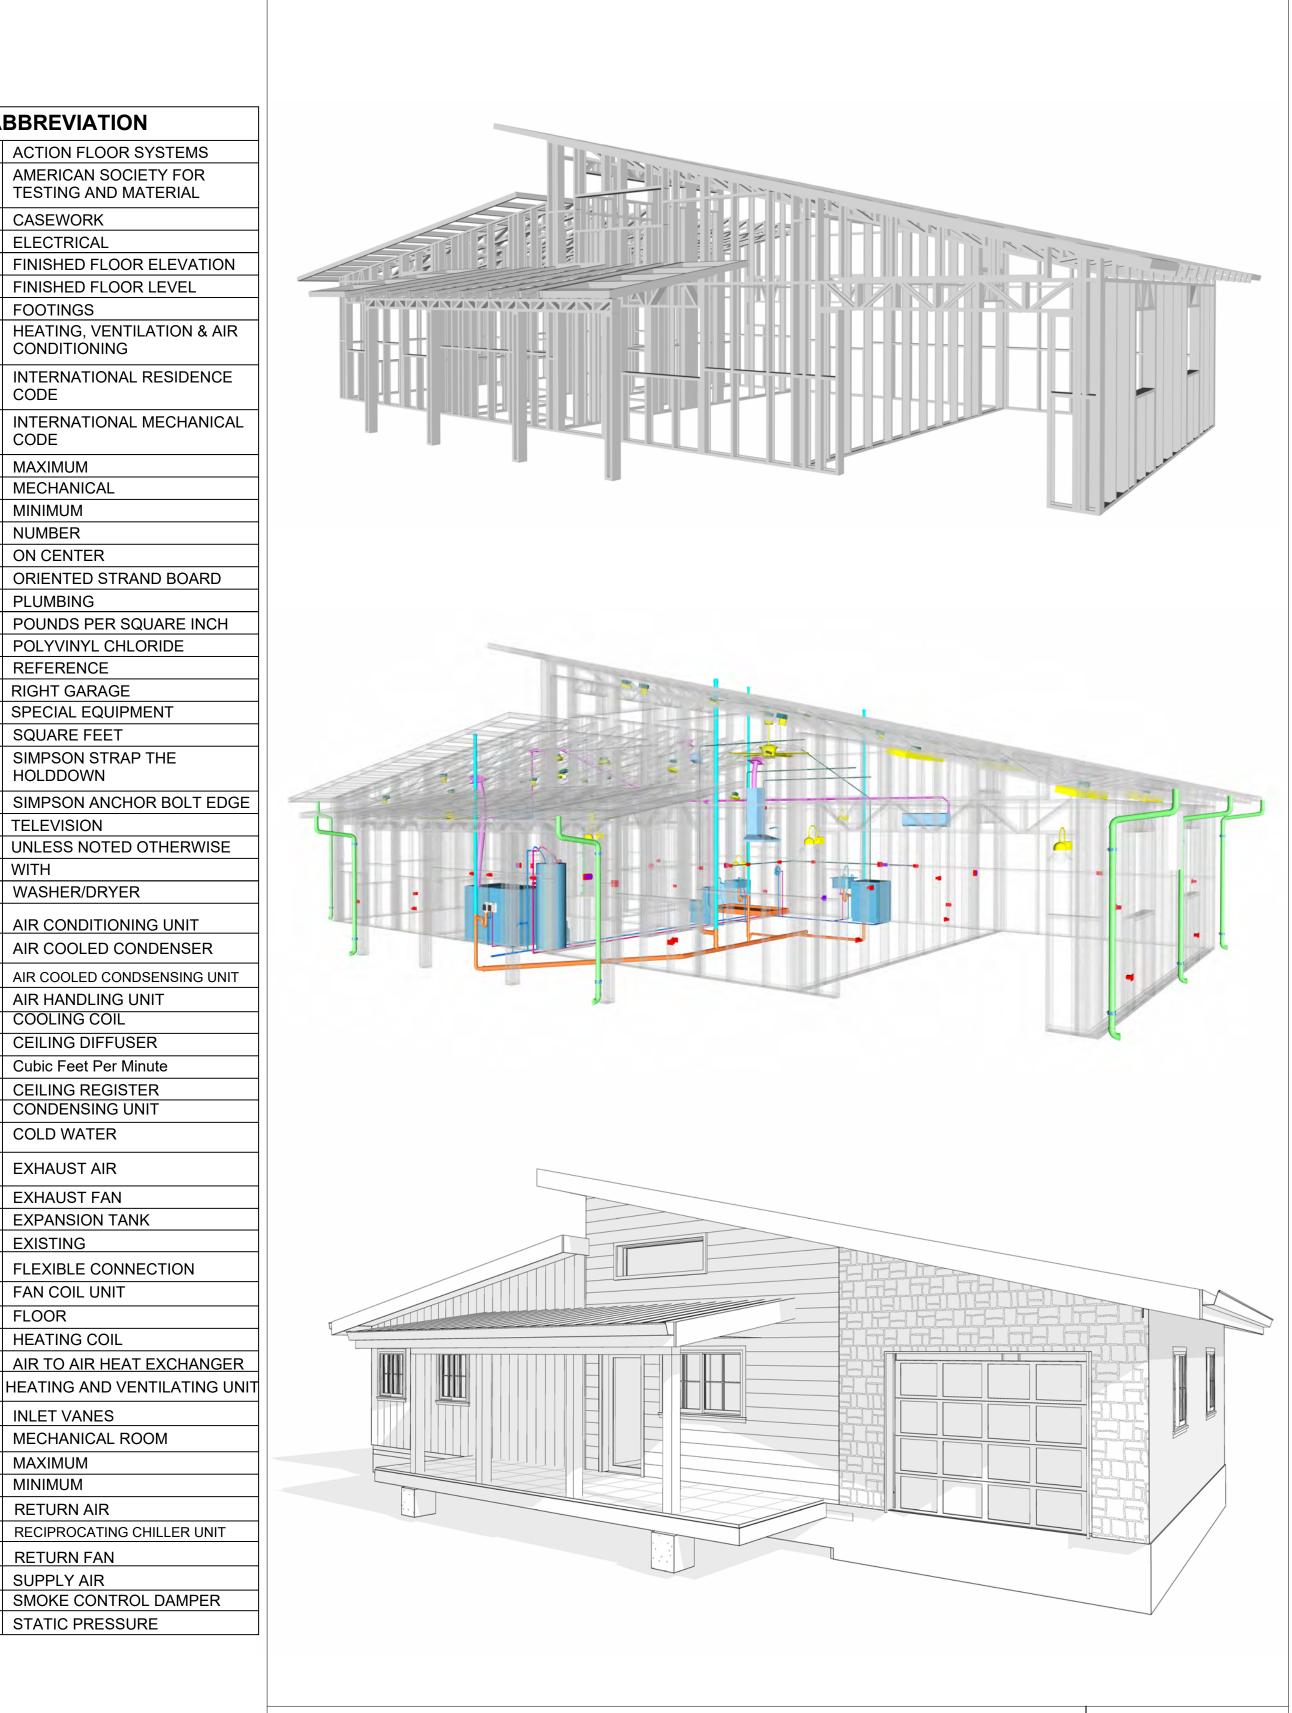

242-EMBER-960-2Bd1Ba-**MODERN-GARAGE-550**

SQUARE FOOT	AGE
LIVING	960
GARAGE	286
PORCH	111
TOTAL	1357

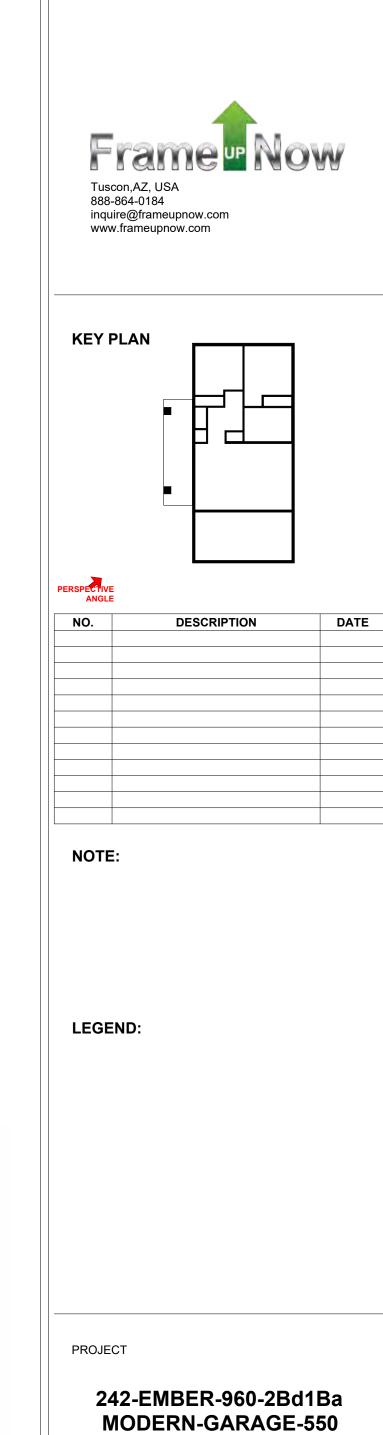

DRAWING NAME

COVER SHEET

Client Name	CLIENT NAME:	
0061_1	PROJECT NUMBER:	
5/13/2025 3:43:44 P	DATE:	
Designe	DESIGNED BY:	
Autho	DRAWN BY:	
Checke	CHECKED BY:	

G101

GENERAL NOTES

- 1. THIS DRAWING DEPICTS THE ARCHITECTURAL (SPACE LAYOUT, FURNISHING, FLOOR, WALLS, ROOFS, FOUNDATION, WINDOWS AND DOORS) SYSTEMS. IT PROVIDES A VISUAL REPRESENTATION OF THE ARCHITECTURAL LAYOUT AND COMPONENTS.
- THE ARCHITECTURAL DRAWINGS ARE PREPARED TO MEET THE SPECIFIC REQUIREMENTS OF THE BUILDING, AS PER THE PROJECT SPECIFICATIONS AND APPLICABLE CODES AND STANDARDS.
- THE CONSTRUCTION OF THIS HOME SHALL COMPLY WITH THE LATEST EDITION OF THE INTERNATIONAL RESIDENTIAL CODE (IRC), INTERNATIONAL MECHANICAL CODE (IMC), THE INTERNATIONAL PLUMBING STANDARD, THE NATIONAL ELECTRICAL STANDARD AND ALL OTHER APPLICABLE LOCAL, STATE, AND NATIONAL CODES AND REGULATIONS.
- COORDINATION WITH OTHER TRADES HAS BEEN DONE ON A DESIGN LEVEL. THIS DRAWING SHALL BE READ TOGETHER WITH THE ME, EL AND PL DESIGN DRAWINGS TO ENSURE PROPER CONSTRUCTION AND INTEGRATION OF THE BUILDING SYSTEMS.

ABOUT WALLS:

SHOWER WALL COVERING

BATHTUB AND SHOWER SPACES (WALLS AND FLOORS) WITH INSTALLED SHOWER HEADS AND IN SHOWER COMPARTMENTS SHALL BE FINISHED WITH A NON-ABSORBENT SURFACE.

WALL PAINT (INTERNAL)

THE TYPICAL THICKNESS OF LATEX WALL PAINT IS 1/32 OF AN INCH FOR A SINGLE COAT. AND DOUBLE COAT (1/16") SHALL BE APPLIED FOR DURABILITY.

ADHESIVES:

THE ADVISABLE TYPE OF ADHESIVE FOR THIS PROJECT IS **EPOXY ADHESIVES**BECAUSE THEY ARE KNOWN FOR THEIR HIGH STRENGTH, DURABILITY, AND RESISTANCE TO MOISTURE, CHEMICALS AND

REFER TO SHEETS A201 & A202 FOR GENERAL NOTES ON EXTERNAL FINISHING MATERIALS

ABOUT FLOORS:

THE SPOT ELEVATION INDICATES THE FINISHED FLOOR ELEVATION.


FINISHED FLOORS PER PLANS.

FIELD VERIFY FOR DIMENSION DROP 4" FOR SHOWER AND BATHTUB USE.

1% SLOPE ON OUTDOOR BALCONIES FOR WATER RUN OFF. 2% SLOPE TOWARDS THE SHOWER DRAIN FOR SUFFICIENT DRAINAGE.


4" DROP AT THE DOOR LEADING TO EXTERIOR BALCONY FROM THE MAIN LIVING AREA.


5% SLOPE FOR GARAGE IS USED, WHICH SHOULD BE CHECKED WITH THE LOCAL GARAGING ZONING LAWS.

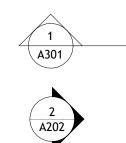


	FURNITURE SCHEDULE	
TYPE MARK	TYPE	COUNT
01	KING SIZE BED	2
02	THREE SEAT SOFA	1
03	DINING CHAIR	2
04	COFFE TABLE	1
05	ONE SEAT SOFA	1

		RO	OM FINISH	SCHEDULE			
ROOM NUMBE R	ROOM NAME	FLOOR FINISH	BASE FINISH	WALL FINISH	CEILING FINISH	CEILING HEIGHT	COM MEN TS
01	BEDROOM 2	HARDWOOD	CONCRETE	WALL PAINT	DRY WALL	8' - 0"	
02	KITCHEN	HARDWOOD	CONCRETE	WALL PAINTT + CERAMIC	DRY WALL	8' - 0"	
03	GARAGE	EPOXY	CONCRETE	WALL PAINT	DRY WALL	8' - 0"	
04	CL 3	HARDWOOD	CONCRETE	WALL PAINT	DRY WALL	8' - 0"	
05	LIVING ROOM	HARDWOOD	CONCRETE	WALL PAINT	DRY WALL	8' - 0"	
06	PORCH	PROCELAIN TILE	CONCRETE	STAINLESS STEEL	PLYWOOD	8' - 0"	
07	WD	HARDWOOD	CONCRETE	WALL PAINT	DRY WALL	8' - 0"	
08	WH	HARDWOOD	CONCRETE	WALL PAINT	DRY WALL	8' - 0"	
09	HALL	HARDWOOD	CONCRETE	WALL PAINT	DRY WALL	8' - 0"	
10	BEDROOM 1	HARDWOOD	CONCRETE	WALL PAINT	DRY WALL	8' - 0"	
11	CL 1	HARDWOOD	CONCRETE	WALL PAINT	DRY WALL	8' - 0"	
12	BATH	VINYL TILES	CONCRETE	CERAMIC TILE	MRD	8' - 0"	
13	CL 2	HARDWOOD	CONCRETE	WALL PAINT	DRY WALL	8' - 0"	

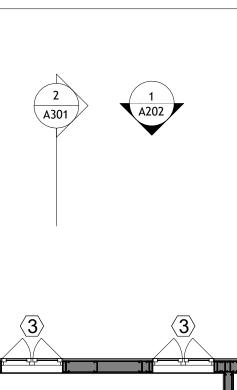

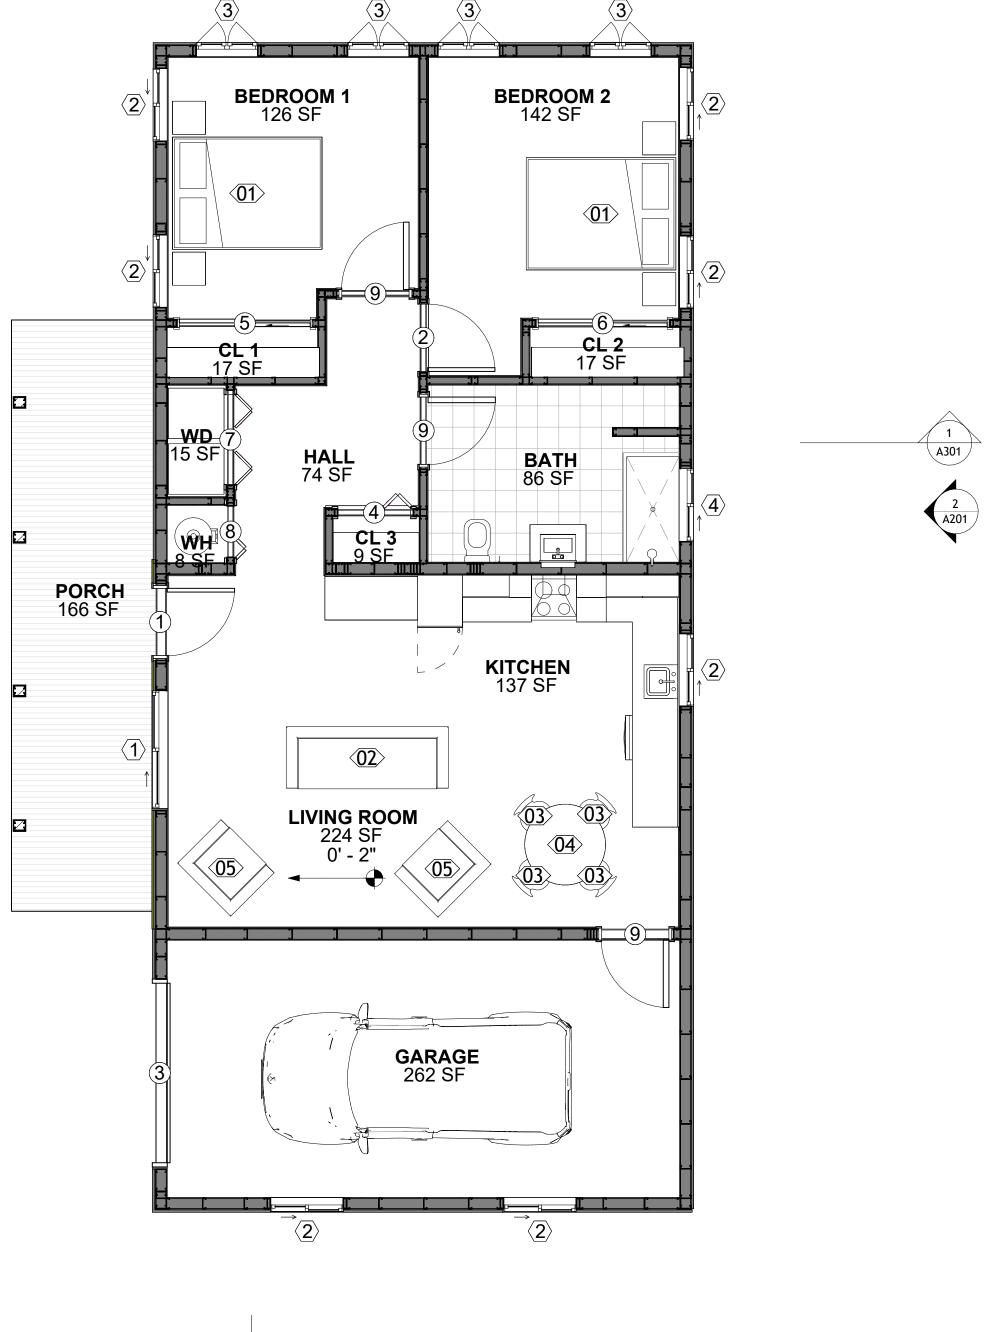

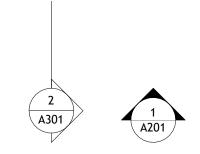





NO.	DESCRIPTION	DATE

NOTE:

LEGEND:

242-EMBER-960-2Bd1Ba **MODERN-GARAGE-550**

DRAWING NAME

FLOOR PLAN

Client Name	CLIENT NAME:
0061_12	PROJECT NUMBER:
5/13/2025 3:43:46 PM	DATE:
Designer	DESIGNED BY:
Author	DRAWN BY:
Checker	CHECKED BY:

A101

SCALE: 1/4" = 1'-0"

SQUARE FOOTAGE

GARAGE


PORCH

TOTAL

960

286

1357

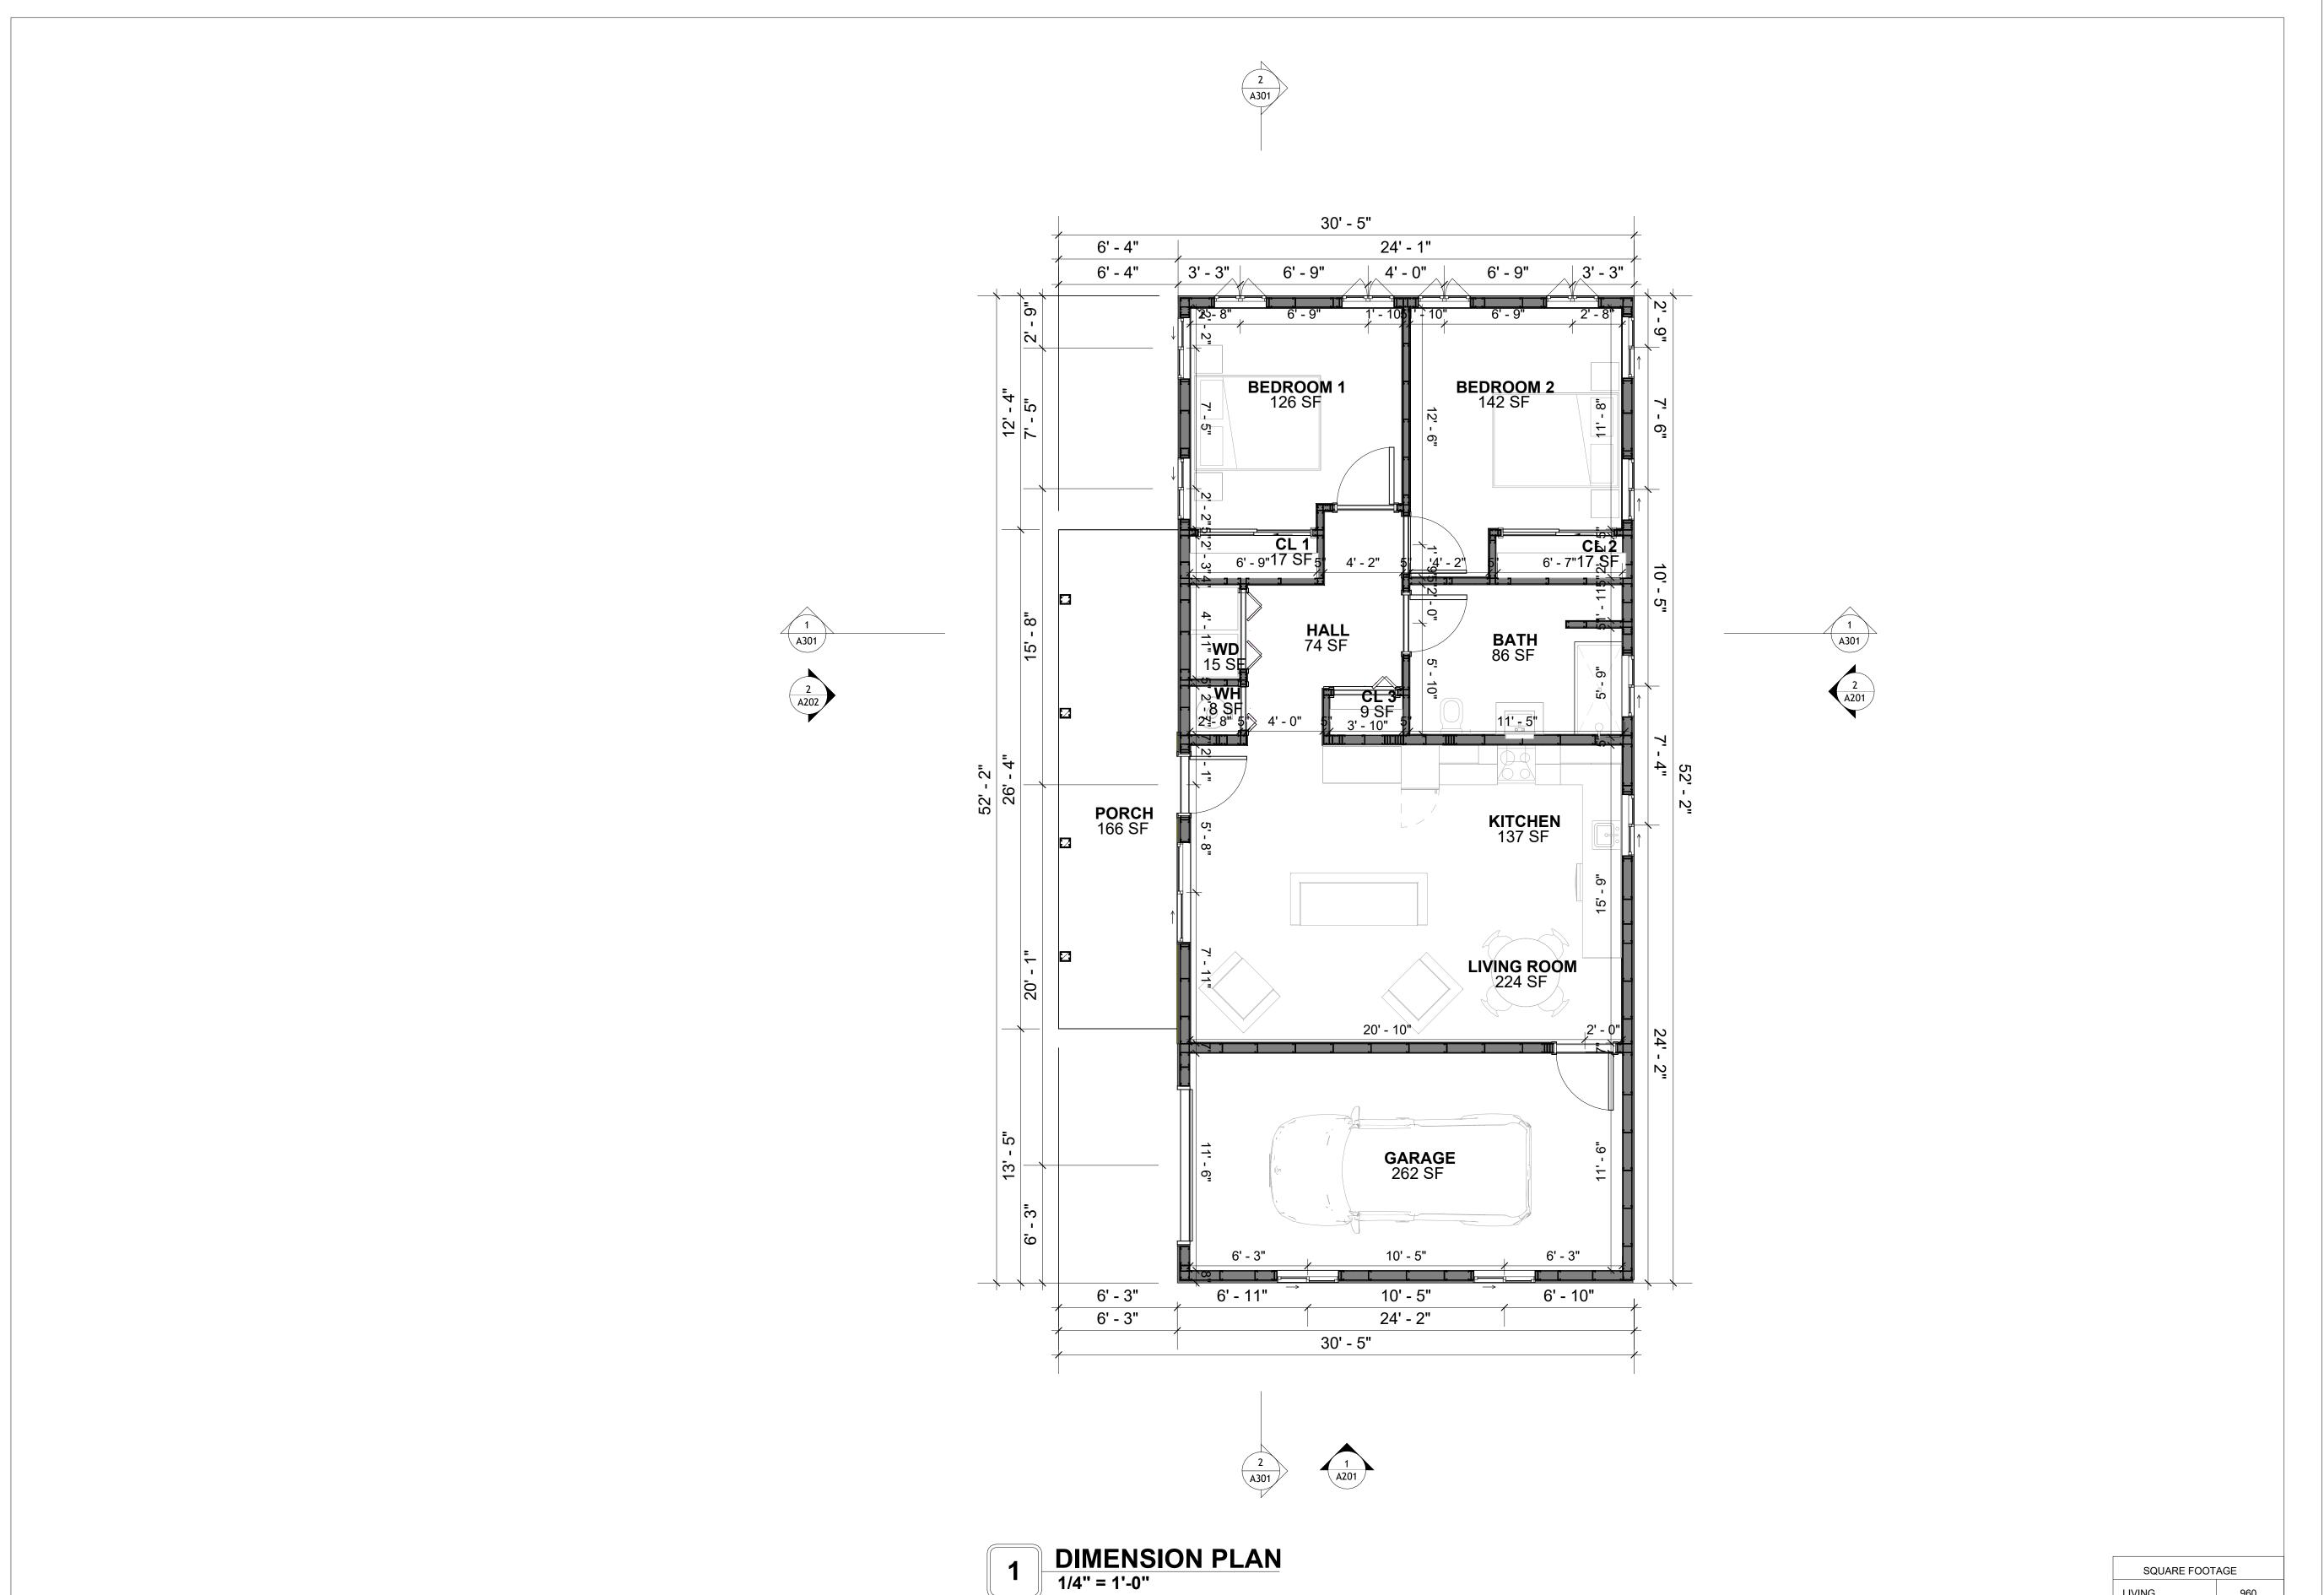



KEY PLAN

NO.	DESCRIPTION	DATE
	<u> </u>	-

NOTE:

LEGEND:

PROJECT

242-EMBER-960-2Bd1Ba **MODERN-GARAGE-550**

DRAWING NAME

DIMENSION PLAN

Client Name	CLIENT NAME:
0061_12	PROJECT NUMBER:
5/13/2025 3:43:48 PM	DATE:
Designer	DESIGNED BY:
Author	DRAWN BY:
Checker	CHECKED BY:

A102

SCALE: 1/4" = 1'-0"

960

286

111

1357

GARAGE

PORCH

TOTAL

DIMENSIONS IN THE ARCHITECTURAL DRAWINGS CONSIDER FINISHING MATERIALS. FOR PRECISE MEASUREMENTS OF THE STRUCTUAL FRAMING, REFER TO THE ATTACHED STRUCTURAL PLAN SET.

FOUNDATION NOTES

TERMITES PRETREATMENT BY LICENSED CONTRACTOR UNDER SLAB AND AROUND FOOTINGS. ALL AREAS BELOW SLABS SHALL BE TREATED NO MORE THAN 24 HOURS PRIOR TO CONCRETE POUR. EVIDENCE OF TREATMENT MUST BE PROVIDED PRIOR TO PLACING OF CONCRETE.

ALL INTERIOR CONCRETE SLABS SHALL BE A MIN. OF 4" THICK CONCRETE OVER 4" COMPACTED AGGREGATE BASE (ASTM D698), FINISH ELEVATIONS AS NOTED ON DRAWINGS, 6" ABOVE ADJACENT GRADE, LEVEL SLABS TO 1/8"-10' MAX.. CONCRETE SLABS SHALL BE 2500# PSI AT 28 DAYS. A 4" ALLOWABLE SLUMP.

2. **PAD PREPARATION:**

- EXCAVATION FOR FOOTING SHALL BE NEAT.

- FOOTINGS SHALL BE POURED IMMEDIATELY AFTER EXCAVATION AND APPROPRIATE

- ALL REINFORCING STEEL MARKED "CONTINUOUS" SHALL BE LAPPED 36 BAR DIAMETERS AT SPLICES AND AROUND CORNERS OR INTERSECTIONS WITH A STANDARD 90 DEGREE BEND ON CORNER BARS. LAP WIRE MESH ONE FULL MESH AT SIDE AND END LAPS. - ALL HARDWARE TO BE SIMPSON OR EQUIVALENT.

- EXTERIOR FRAME WALL TO BE SECURED WITH 1/2"X10" ANCHOR BOLTS 4'-0" O.C. FOR 1-STORY AND 2'-8" O.C. FOR 2-STORY. BOLTS SHALL BE LOCATED WITHIN 1'-0" OF EACH END PIECE AND SHALL HAVE A MIN. OF TWO BOLTS PER PIECE.

-FOUNDATION ANCHOR STRAPS SHALL BE PERMITTED, ACCORDING TO RESIDENTIAL CODE

- ALL INTERIOR WALLS TO BE SECURED WITH POWER DRIVEN PINS PER MANUFACTURER SPECIFICATION USE PIN SPACING EQUIVALENT TO 1/2" ANCHOR BOLTS.

- ALL CONSTRUCTION TO CONFORM TO THE 2012 IRC

- R-10 RIGID INSULATION OUTSIDE OF EXTERIOR FOUNDATION WALLS UNDER LIVING AREA. CONCRETE PAD FOR CONDENSER THICKNESS IS 4" MIN UNLESS OTHERWISE NOTED.

3. CONCRETE CONSTRUCTION:

- THE SLAB SHALL BE UNDERLAIN BY A VAPOR BARRIER/RETARDER IN THE LIVING AREA (TYPICALLY POLYETHYLENE, UNLESS MORE STRINGENT PROTECTION REQUIRED BY THE ARCHITECT, ENGINEER, FLOOR COVERING MANUFACTURER, OR ACCEPTED PRACTICE). UNLESS OTHERWISE REQUIRED, BARRIER MAY BE OMITTED AT GARAGES, PORCHES AND PATIOS WITHOUT FLOOR COVERINGS. IT IS BEYOND THE SCOPE OF THESE PLANS TO DETERMINE THE APPLICABILITY OF THESE MORE STRINGENT REQUIREMENTS. BUILDER SHALL VERIFY PRIOR TO CONSTRUCTION.

4. REINFORCEMENT

- IF CONSTRUCTED ON ACTIVE SOILS, THE LONG TERM PERFORMANCE OF THE FOUNDATION IS DEPENDENT ON MAINTENANCE BY THE OWNER. THUS THE BUILDER SHALL ADVISE THE OWNER OF THE FOLLOWING:

. DRAINAGE MUST BE MAINTAINED. WATER SHALL NEVER BE ALLOWED TO POND NEAR THE FOUNDATION.

2. THE SOIL AROUND THE FOUNDATION SHALL BE MAINTAINED IN A RELATIVELY DAMP CONDITION, SUCH AS THAT REQUIRED TO KEEP A LAWN GREEN. IF IT DRIES OUT IT WILL SHRINK. IF IT GETS WET, IT WILL HEAVE UPWARD.

3. SLABS ON THE SHORTER SIDE USES MAIN BARS ARE USED IN THIS DIRECTION ONLY WITH SMALLER DIAMETER DISTRIBUTION BARS ARE PLACED, FORMING A MAT OR GRID. 4. ALL REINFORCEMENT BARS SIZE 10MM OR LARGER IN ACCORDANCE TO ASTM

3. ANCHOR BOLTS AT ALL EXTERIOR WALLS SHALL BE MINIMUM 1/2 INCH DIAMETER WITH A MAXIMUM SPACING OF 6'-0" ON CENTER, UNLESS NOTED OTHERWISE

ANCHOR BOLTS SHALL BE INSTALLED WITHIN 12 INCHES OF EACH END OF EACH SILL PLATE WITH AT LEAST TWO ANCHOR BOLTS FOR EACH BOLTS FOR EACH SILL PLATE LONGER THAN 12 INCHES.

5. SIMPSONS SILL ANCHORS MAYBE SUBSTITUTED FOR ANCHOR BOLTS AT THE SAME SPACING.

6. EXTERIOR CONCRETE SLABS WHICH ARE NOT PART OF THE MAIN SLAB SHALL BE MINIMUM 4 INCHES THICK WITH NO STEEL REINFORCING BARS REQUIRED, UNLESS NOTED OTHERWISE ON FOUNDATION PLAN.

VERIFY THE FOLLOWING PRIOR TO POURING:

I. ALL HOLDDOWNS, STRAP, AND POST LOCATIONS.

2. CONCRETE FINISHES. PANEL RISER LOCATION - WHERE APPLICABLE.

3. UNDERSLAB MECHANICAL REQUIREMENTS.

4. STEM WALL BLOCKOUTS.

5. UNDERSLAB ELECTRICAL REQUIREMENTS AND PANEL RISER LOCATION. WHERE


APPLICABLE. 6. PROVIDE THE FOLLOWING:

- PVC SLEEVES THROUGH FTG IF REQUIRED


- 20' #4 COPPER GROUND BAR.

. SLOPE FINISH GRADE AWAY FROM FOOTING.

NOTE: FIELD VERIFY ALL DIMENSIONS SEE DIMENSIONED ARCHITECTURAL DRAWINGS

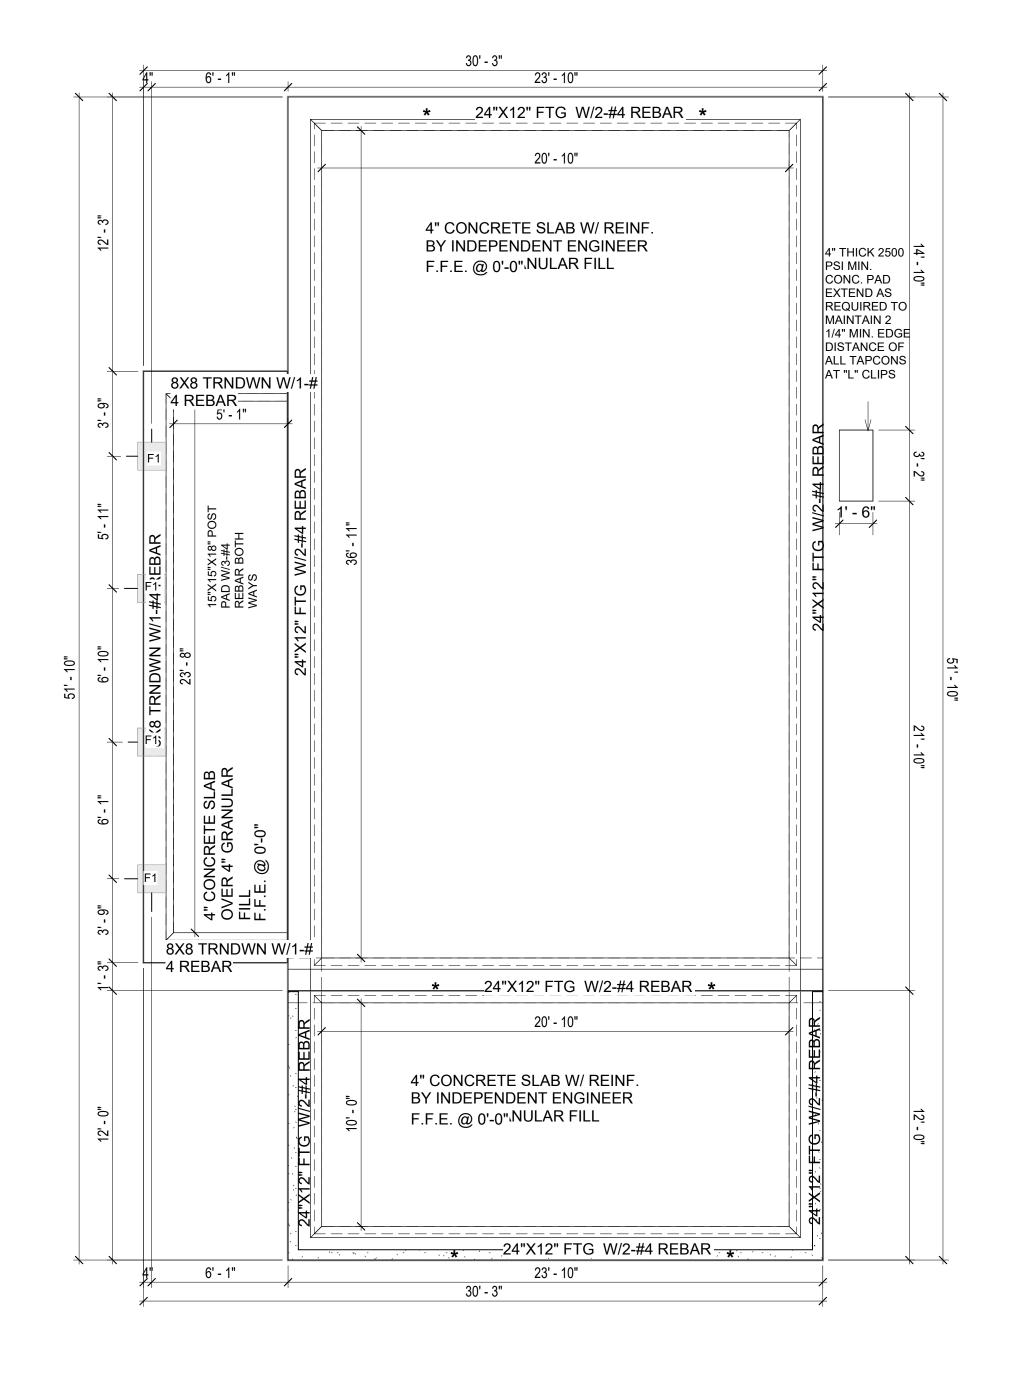

FOUNDATION PLAN 1/4" = 1'-0"

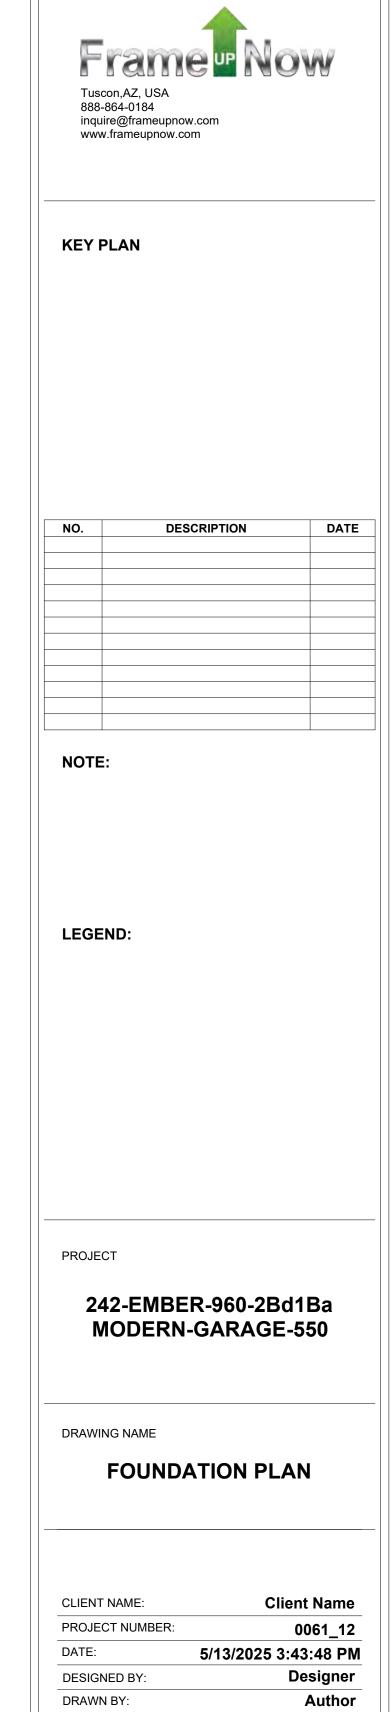

S101 SCALE: 1/4" = 1'-0"

Checker

CHECKED BY:

SQUARE FOOTAGE

286

111

1357

GARAGE

PORCH

TOTAL

GENERAL NOTES

NOTES

-ALL BEARING WALLS SHOULD HAVE A THICKENED SLAB PER SECTION PER DETAIL A401/5.

A) **FOUNDATION PLAN NOTES**:

1. CONCRETE SLAB SHALL BE 6" THICK WITH 1/2" DIAMETER TENDONS PER LAYOUT PLAN, CENTERED IN SLAB THICKNESS, OVER APPROVED SUBBASE PER GENERAL STRUCTURE NOTES.

TERMITE PROTECTION SHALL BE PROVIDED PER IRC SECTION R318.1
 NONE TYPICAL ANCHOR BOLT SPACING AT SHEAR WALL AND HOLD DOWN

SPECIFICATIONS PER APPROVED ARCHITECTURAL PLANS.

INSTALL HOLDOWNS BEFORE CONCRETE SLAB POUR.
 EXISTING FILL ON-SITE SHALL BE COMPACTED IN ACCORDANCE WITH THE

REQUIREMENTS IN THE GEOTECHNICAL REPORT.

6. ALL FLOOR SLABS ARE REINFORCED ON CONCRETE SLABS.

SPECIAL INSPECTION IS REQUIRED FOR THICKENED FOUNDATION CONSTRUCTION

1. REINFORCEMENT

2. 2300 PSI CONCRETE POUR

B) **REINFORCEMENT FOR CONCRETE**:

 ALL REINFORCING SLABS BARS SIZE 10MM OR LARGER SHALL BE DEFORMED IN ACCORDANCE TO ASTM-A706, AND BARS SMALLER THAN 10 MM MAYBE PLAIN.
 UNLESS OTHERWISE NOTED IN PLANS, THE YIELD STRENGTH OF REINFORCING BARS SHALL BE:


> A) FOOTING = 40,000 PSI B) NON-LOAD BEARING WALLS AND PARAPETS= 40,000 PSI


- 3. SPLICES SHALL BE SECURELY WIRED TOGETHER AND SHALL LAP OR EXTEND
- 4. GRADE OF STEEL FOR RCC WORKS SHALL BE GRADE 4 10.
- 5. BAR NOTATIONS GIVES INFORMATION
 - A) BAR SIZE
 B) SPACING(IF REQUIRED)
- 6. LAP REINFORCEMENT ONLY AT LOCATION SHOWN IN THE DRAWINGS
- 7. REINFORCEMENT SHALL NOT BE CUT, VENT OR HEATED ON SITE WITHOUT ENGINEERS' APPROVAL.
- C) CONCRETE SLAB NOTES
- 1. ALL SLAB REINFORCEMENT SHALL BE 20MM CLEAR MINIMUM FROM BOTTOM AND FROM TOP OF SLAB.
- 2. REINFORCEMENT IN CONTINUOUS ELEVATED SLAB SHALL BE CUT AS FOLLOWS.

NOTE:

- THIS IS A SCHEMATIC PLAN FOR THE PURPOSE OF LOCATING AND IDENTIFYING FOUNDATION REINFORCING ELEMENTS ONLY. VERIFY ALL DIMENSIONS, DROPS, OFFSETS AND FEATURES WITH THE ARCHITECTURAL PLANS BEFORE FORMING THE FOUNDATION.

#4-REBAR ON A 2'-0" X 2'-0" GRID SLAB ON GRADE FOUNDATION

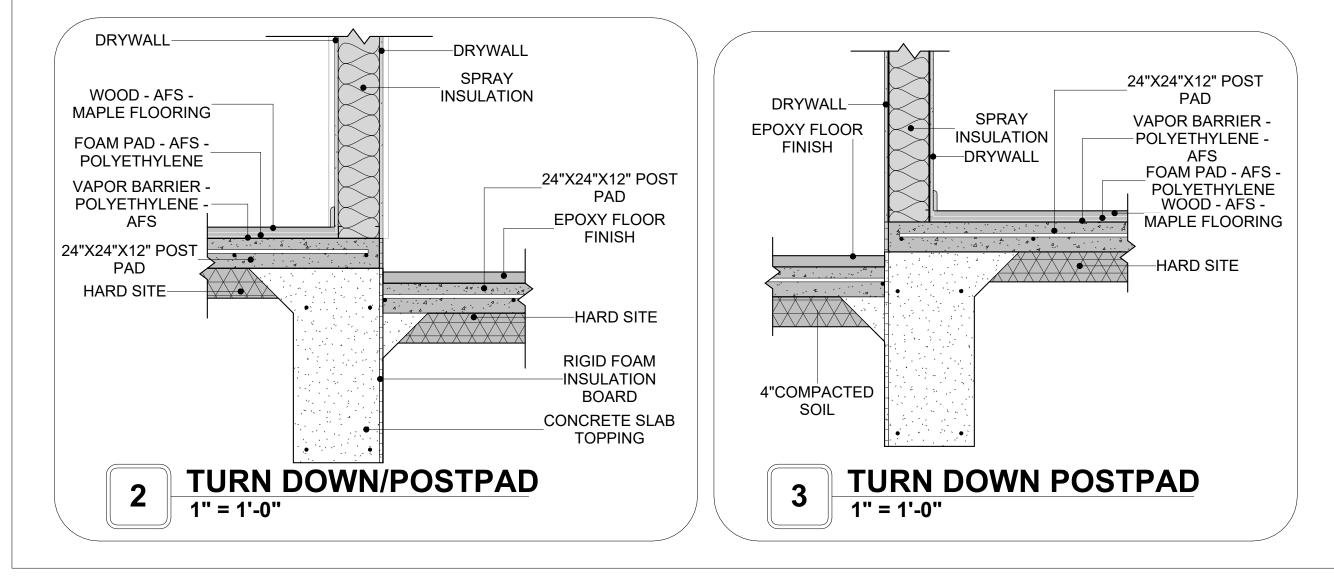

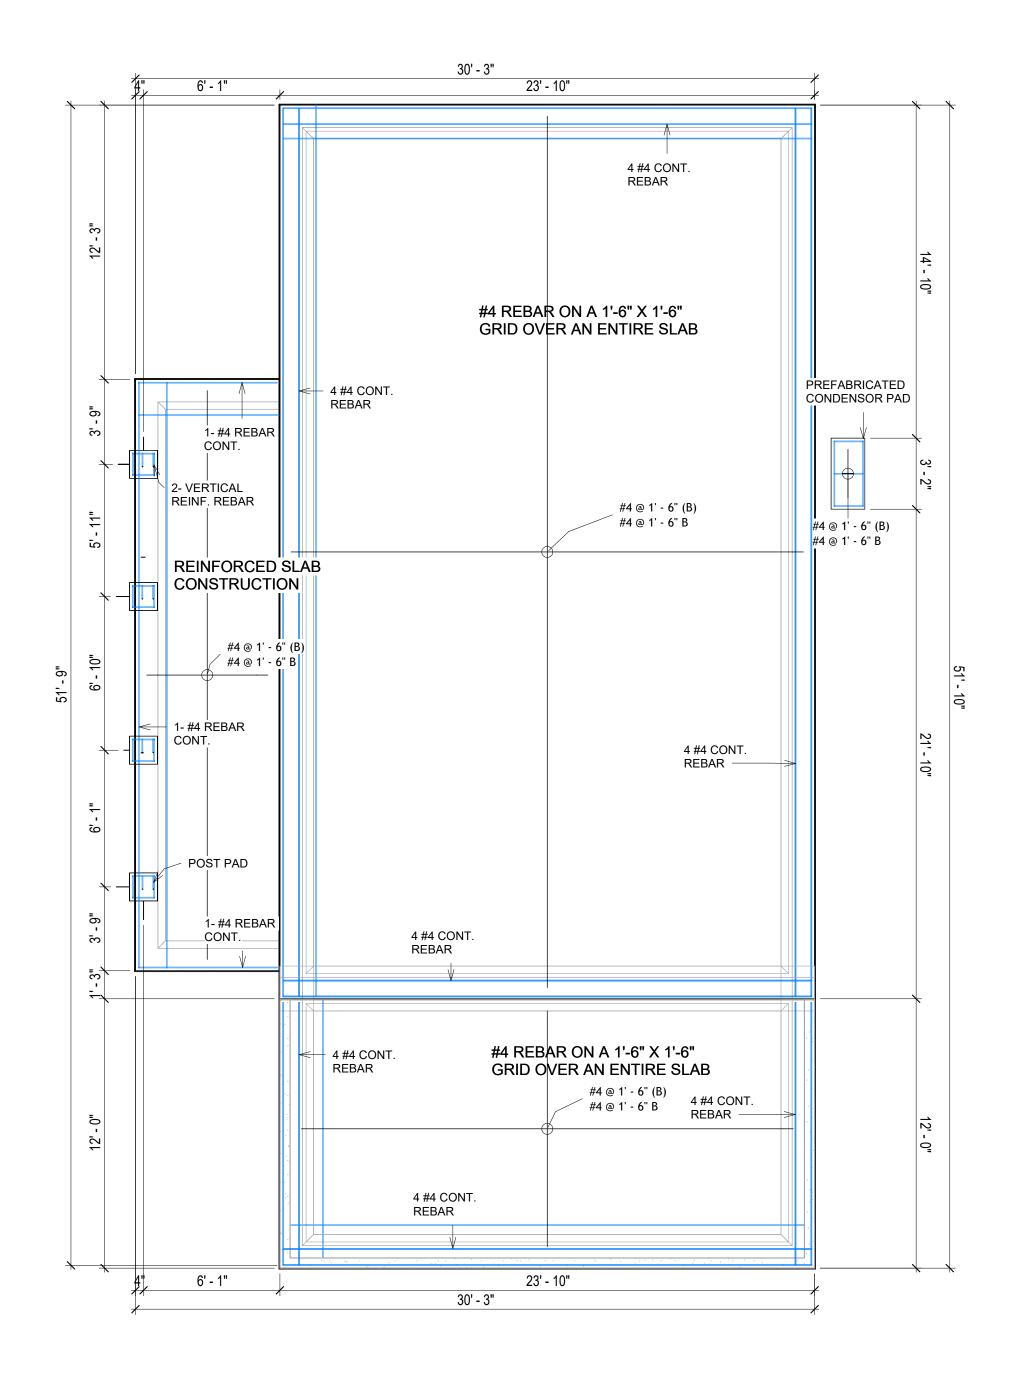

1 FOUNDATION REBAR PLAN
1/4" = 1'-0"



KEY PLAN

NO.	DESCRIPTION	DATE
		'

NOTE:

LEGEND:

PROJECT

242-EMBER-960-2Bd1Ba MODERN-GARAGE-550

DRAWING NAME


STRUCTURAL FLOOR PLAN


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0061_12	PROJECT NUMBER:	
5/13/2025 3:43:50 PN	DATE:	
Designer	DESIGNED BY:	
Author	DRAWN BY:	
Checker	CHECKED BY:	


S102

ROOF NOTES

- ROOFING COMPOSITION ROOFING PER OWNERS/BUILDERS SPECIFICATIONS INSTALL PER MANUFACTURE SPECIFICATIONS ON 1/2" ORIENTED STRAND BOARD ON PRE-ENGINEERED TRUSS @ 24" O.C. (UNO.)
- 2. 73" OVERHANG AT EAVES (UNO.)
- 3. ENDS OF ALL TRUSSES AND JOISTS TO BE FULLY BLOCKED. PROVIDE SOLID BLOCKING AT ALL RIDGES AND VALLEYS
- 4. SHEATHING TO BE 1/2", 3/8" OSB SHEAR PANEL AND EQUIVALENT. UNDERSIDE OF PORCH TRUSSES TO BE FINISHED WITH MOISTURE
- RESISTANT DRYWALL, TAPED AND TEXTURED. 5. EXPOSED EAVES AND OTHER WEATHER EXPOSED AREAS TO BE SHEATHED WITH EXTERIOR GRADE PLYWOOD.
- 6. ALL MATERIALS THICKNESS AND SIZE ARE THE MINIMUM. Refer TO LOCAL STANDARDS FOR ACTUAL THICKNESS AND LAYERING OF MATERIALS.
- 7. ENGINEERED TRUSS CALCULATIONS TO BE SUBMITTED TO BUILDING
- DEPARTMENT PRIOR TO FABRICATION AND INSTALLATION.
- 8. TRUSS MANUFACTURER TO SPECIFY HANGER CONNECTORS FOR TRUSS COMPONENTS (TYPICAL)
- 9. DESIGNER ASSUMES THAT TRUSSES BEAR ON ALL EXTERIOR PERIMETER
- 10. PROVIDE GALVANIZED STEEL FLASHING WITH A LENGTH OF 10 FEET, WIDTH OF 12 INCHES, AND THICKNESS OF 24 GAUGE.
- WALLS (TYPICAL) OR BEAMS.

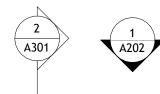

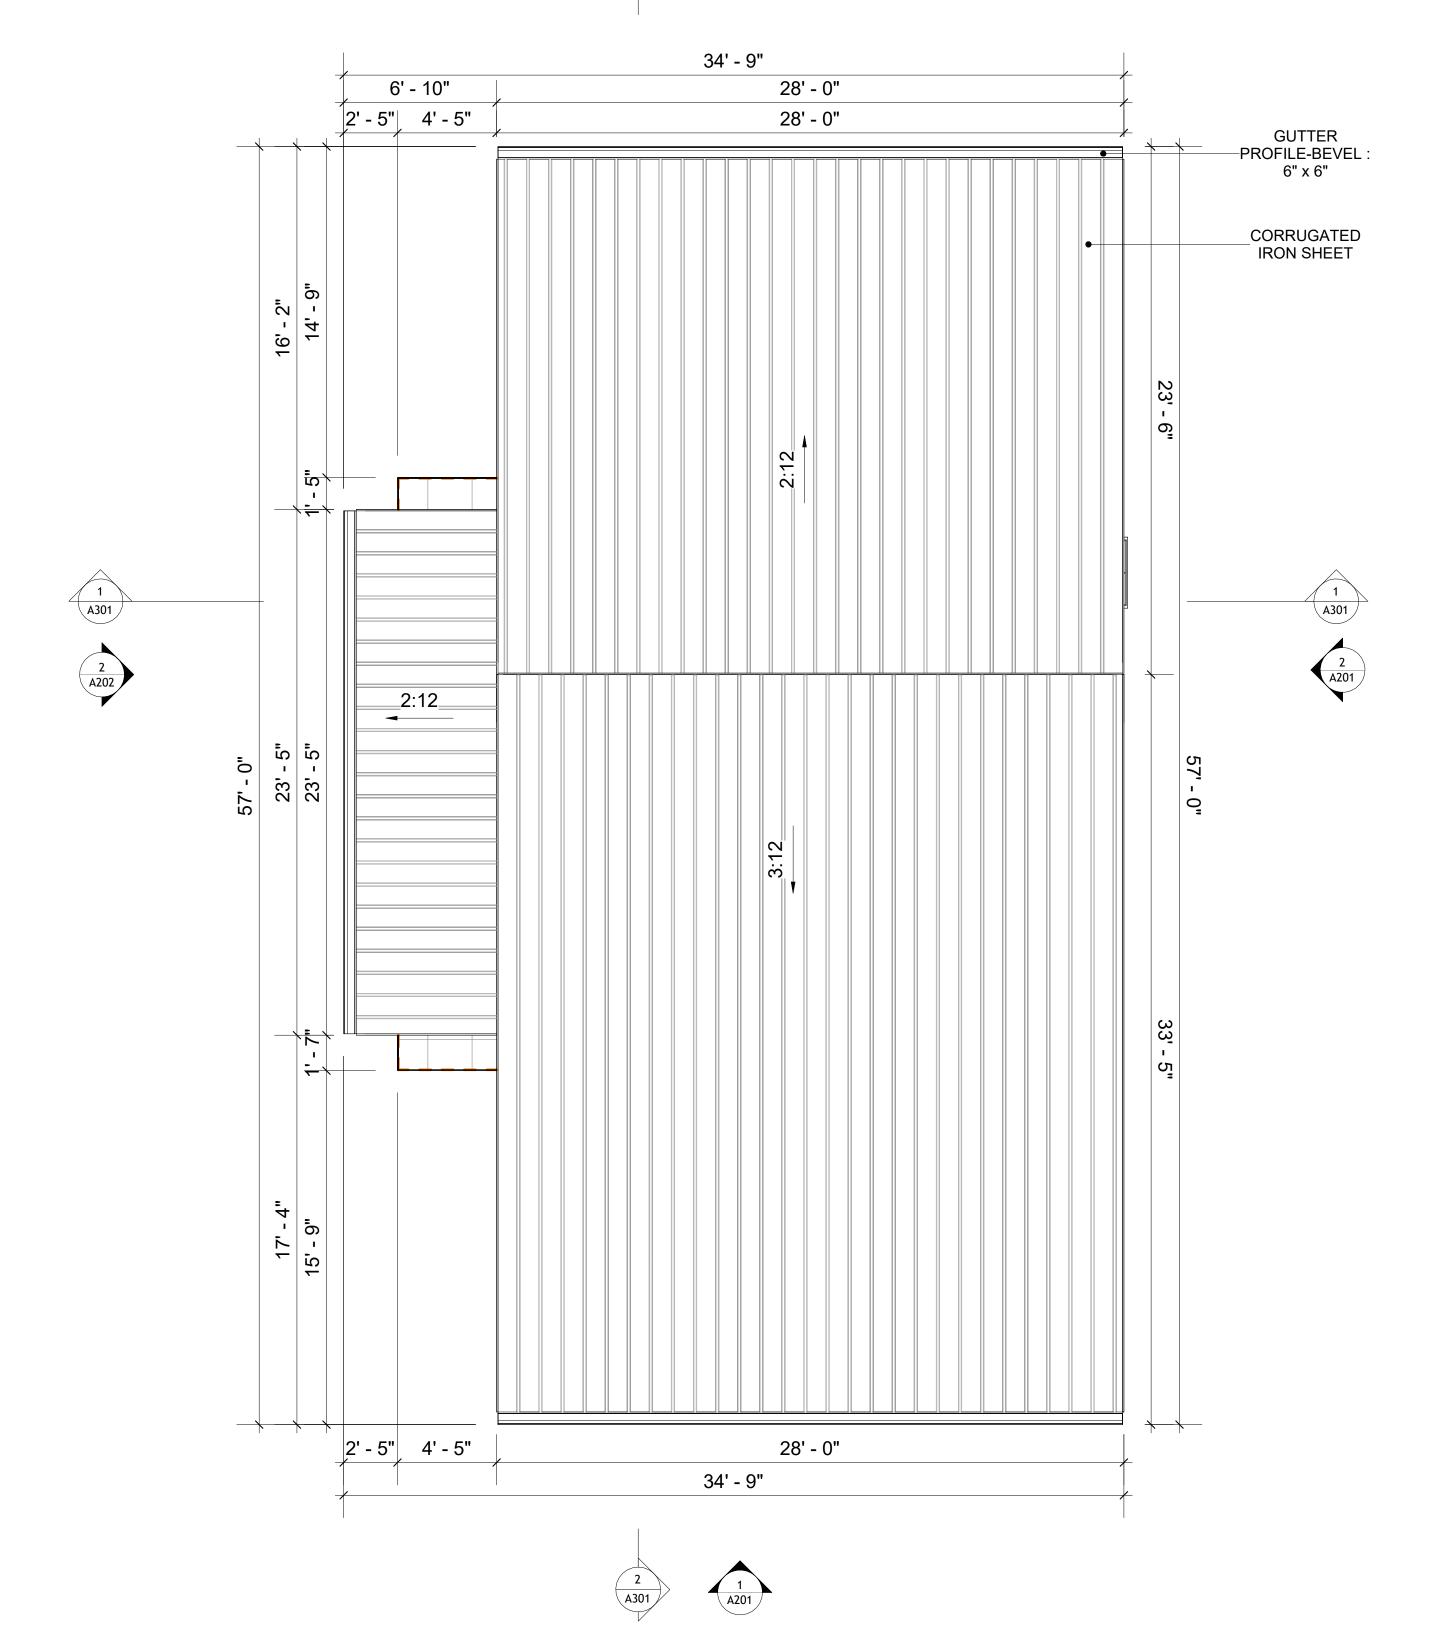

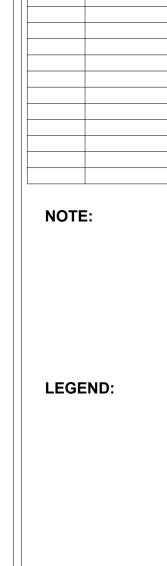

Tuscon,AZ, USA 888-864-0184

KEY PLAN

inquire@frameupnow.com www.frameupnow.com

DESCRIPTION

DATE

PROJECT

242-EMBER-960-2Bd1Ba **MODERN-GARAGE-550**

DRAWING NAME

SQUARE FOOTAGE

286

111

1357

GARAGE

TOTAL

ROOF PLAN

Client Name	CLIENT NAME:
0061_12	PROJECT NUMBER:
5/13/2025 3:43:53 PN	DATE:
Designer	DESIGNED BY:
Author	DRAWN BY:
Checker	CHECKED BY:

A103

SCALE: 1/4" = 1'-0"

1/4" = 1'-0"

ABOUT WALL FINISHING

CORRUGATED IRON SHEET

CORRUGATED IRON IS A FINISHING MATERIAL MADE FROM STEEL THAT HAS BEEN GALVANIZED (COATED WITH A THIN LAYER OF ZINC) TO PROTECT IT FROM CORROSION AND RUST.

IN THIS SPECIFIC PROJECT, THE CORRUGATED IRON SHEETS ARE INSTALLED HORIZONTALLY ON VERTICAL FURRING STRIPS THAT ARE DIRECTLY ATTACHED ONTO THE PROPERLY INSTALLED AND SEALED HOME WRAP, USING SELF-DRILLING SCREWS THAT ARE DRIVEN THROUGH THE RIDGES OR VALLEYS OF THE CORRUGATIONS.

EXTERNAL STONE


THESE STONE PRODUCTS ARE MADE FROM A BLEND OF NATURAL AGGREGATES, CEMENT, AND OTHER PROPRIETARY MATERIALS.


THE STONE FINISH IS DIRECTLY ATTACHED TO COLD-FORMED STEEL (CS) FRAMING. (FOR COLUMN FINISH) EXTERNAL STONE CAN BE AN EXCELLENT EXTERIOR CLADDING OPTION FOR CS-FRAMED BUILDINGS. IN THIS SCENARIO, THE EXTERNAL STONE WOULD BE ADHERED TO THE CS FRAME USING A SCRATCH COAT AND MORTAR-BASED ADHESIVE.

CEDAR WOOD

CEDAR WOOD REFERS TO THE WOOD FROM VARIOUS SPECIES OF CEDAR TREES, WHICH ARE CONIFEROUS EVERGREEN TREES KNOWN FOR THEIR DISTINCT AROMA AND NATURAL RESISTANCE TO DECAY AND INSECTS.


IN THIS SPECIFIC PROJECT, CEDAR WOOD IS USED A FINISH MATERIAL ON BEAMS AND COLUMNS.

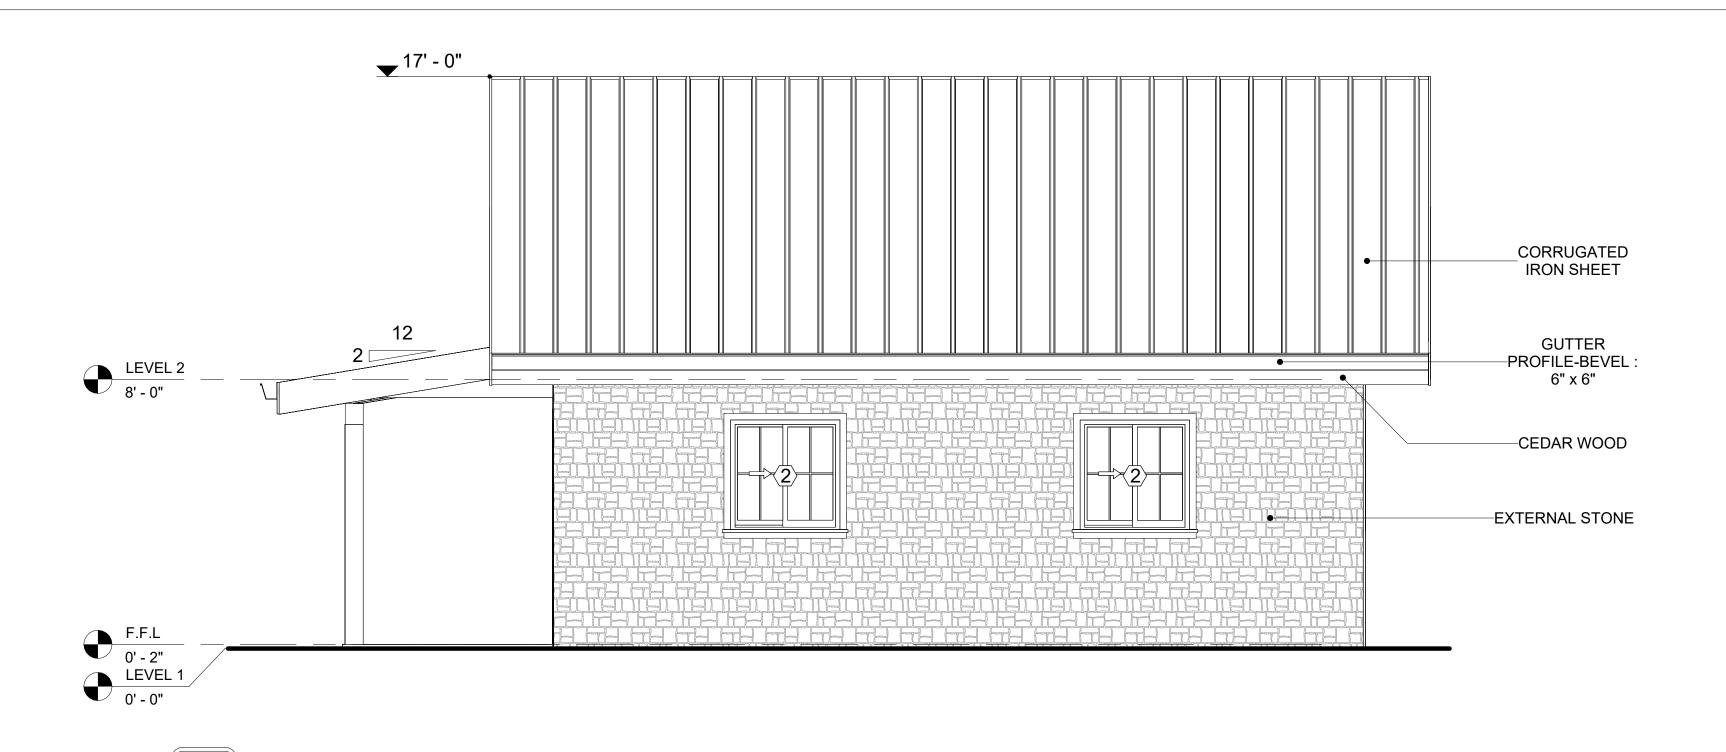

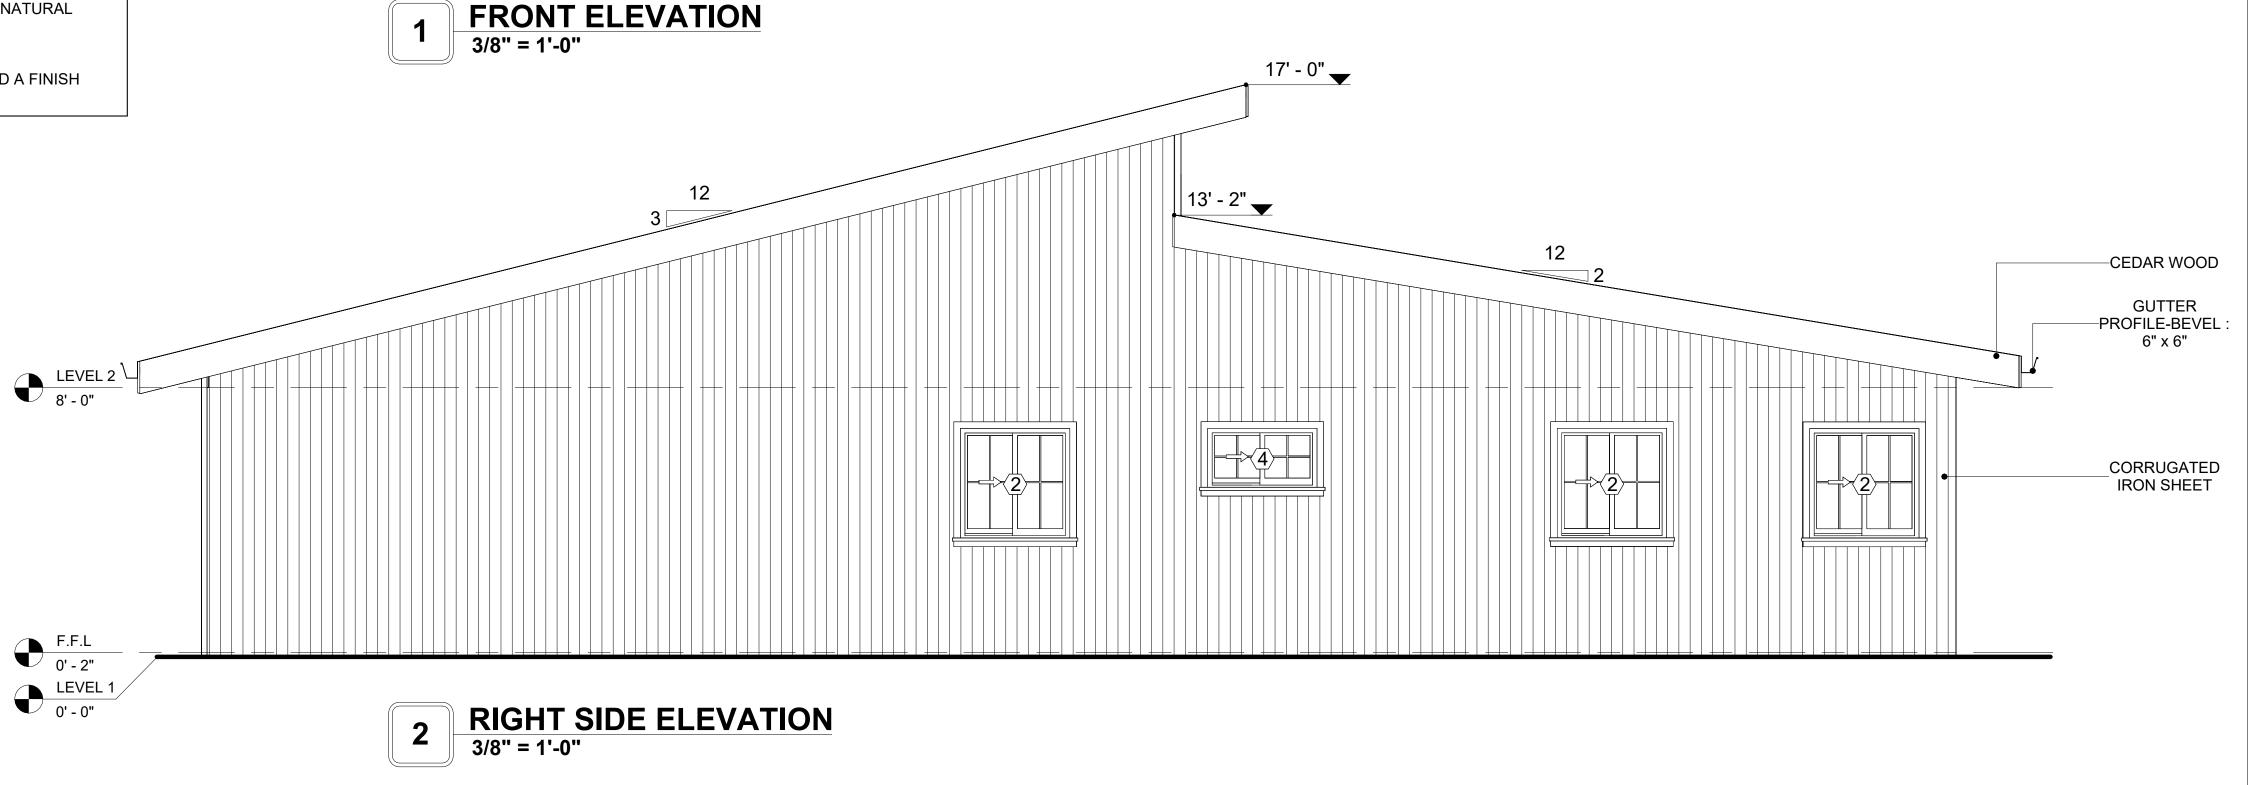

TYPE				5	SIZE	
MAR K	SUPPLIER	DOOR TYPE	LOCATIO N	WIDTH	HEIGHT	COUNT
1	HOME DEPOT	EXTERIOR SINGLE PANEL SWINGING	INTERIOR	3' - 0"	6' - 8"	1
2	HOME DEPOT	INTERIOR SINGLE PANEL SWINGING	INTERIOR	3' - 0"	6' - 8"	1
3	HOME DEPOT	DOOR-GARAGE-EMBOSSED_PANEL	EXTERIOR	8' - 0"	6' - 6"	1
4	HOME DEPOT	SINGLE FOLD 2	INTERIOR	3' - 3"	6' - 8"	1
5	HOME DEPOT	INTERIOR DOUBLE PANEL SLIDING	INTERIOR	5' - 10"	6' - 8"	1
6	HOME DEPOT	INTERIOR DOUBLE PANEL SLIDING	INTERIOR	5' - 9"	6' - 8"	1
7	HOME DEPOT	DOOR-BIFOLD_9052	INTERIOR	4' - 0"	6' - 8"	1
8	HOME DEPOT	SINGLE FOLD 2	INTERIOR	2' - 4"	6' - 8"	1
9	HOME DEPOT	INTERIOR SINGLE PANEL SWINGING	INTERIOR	3' - 0"	6' - 8"	3

		WINDOV	V SCHEDULE		
				SIZE	
TYPE MARK	SUPPLIER	WINDOW TYPE	WIDTH	HEIGHT	COUNT
		·			
1	HOME DEPOT	SLIDING	5' - 3"	3' - 3"	1
2	HOME DEPOT	SLIDING	3' - 3"	3' - 3"	7
3	HOME DEPOT	DOUBLE HING	2' - 9"	4' - 3"	4
4	HOME DEPOT	SLIDING	3' - 3"	1' - 9"	1
5	HOME DEPOT	FIXED	2' - 3"	1' - 3"	4
6	HOME DEPOT	FIXED	6' - 3"	1' - 9"	1

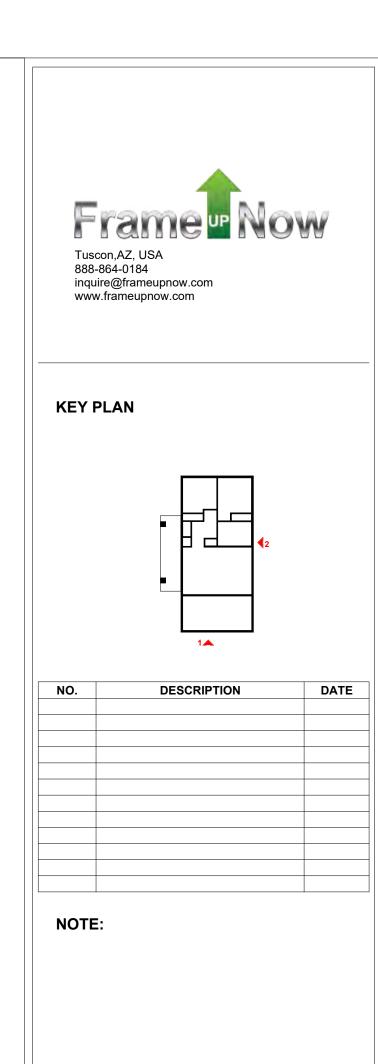

PROJECT

LEGEND:

242-EMBER-960-2Bd1Ba MODERN-GARAGE-550

DRAWING NAME

ARCHITECTURAL ELEVATIONS

CLIENT NAME:	Client Name
PROJECT NUMBER:	0061_12
DATE:	5/13/2025 3:43:57 PM
DESIGNED BY:	Designer
DRAWN BY:	Author
CHECKED BY:	Checker

A201

ABOUT WALL FINISHING

CORRUGATED IRON SHEET

CORRUGATED IRON IS A FINISHING MATERIAL MADE FROM STEEL THAT HAS BEEN GALVANIZED (COATED WITH A THIN LAYER OF ZINC) TO PROTECT IT FROM CORROSION AND RUST.

IN THIS SPECIFIC PROJECT, THE CORRUGATED IRON SHEETS ARE INSTALLED HORIZONTALLY ON VERTICAL FURRING STRIPS THAT ARE DIRECTLY ATTACHED ONTO THE PROPERLY INSTALLED AND SEALED HOME WRAP, USING SELF-DRILLING SCREWS THAT ARE DRIVEN THROUGH THE RIDGES OR VALLEYS OF THE CORRUGATIONS.

EXTERNAL STONE


THESE STONE PRODUCTS ARE MADE FROM A BLEND OF NATURAL AGGREGATES, CEMENT, AND OTHER PROPRIETARY MATERIALS.

THE STONE FINISH IS DIRECTLY ATTACHED TO COLD-FORMED STEEL (CS) FRAMING. (FOR COLUMN FINISH) EXTERNAL STONE CAN BE AN EXCELLENT EXTERIOR CLADDING OPTION FOR CS-FRAMED BUILDINGS. IN THIS SCENARIO, THE EXTERNAL STONE WOULD BE ADHERED TO THE CS FRAME USING A SCRATCH COAT AND MORTAR-BASED ADHESIVE.


CEDAR WOOD

CEDAR WOOD REFERS TO THE WOOD FROM VARIOUS SPECIES OF CEDAR TREES, WHICH ARE CONIFEROUS EVERGREEN TREES KNOWN FOR THEIR DISTINCT AROMA AND NATURAL RESISTANCE TO DECAY AND INSECTS.

IN THIS SPECIFIC PROJECT, CEDAR WOOD IS USED A FINISH MATERIAL ON BEAMS AND COLUMNS.

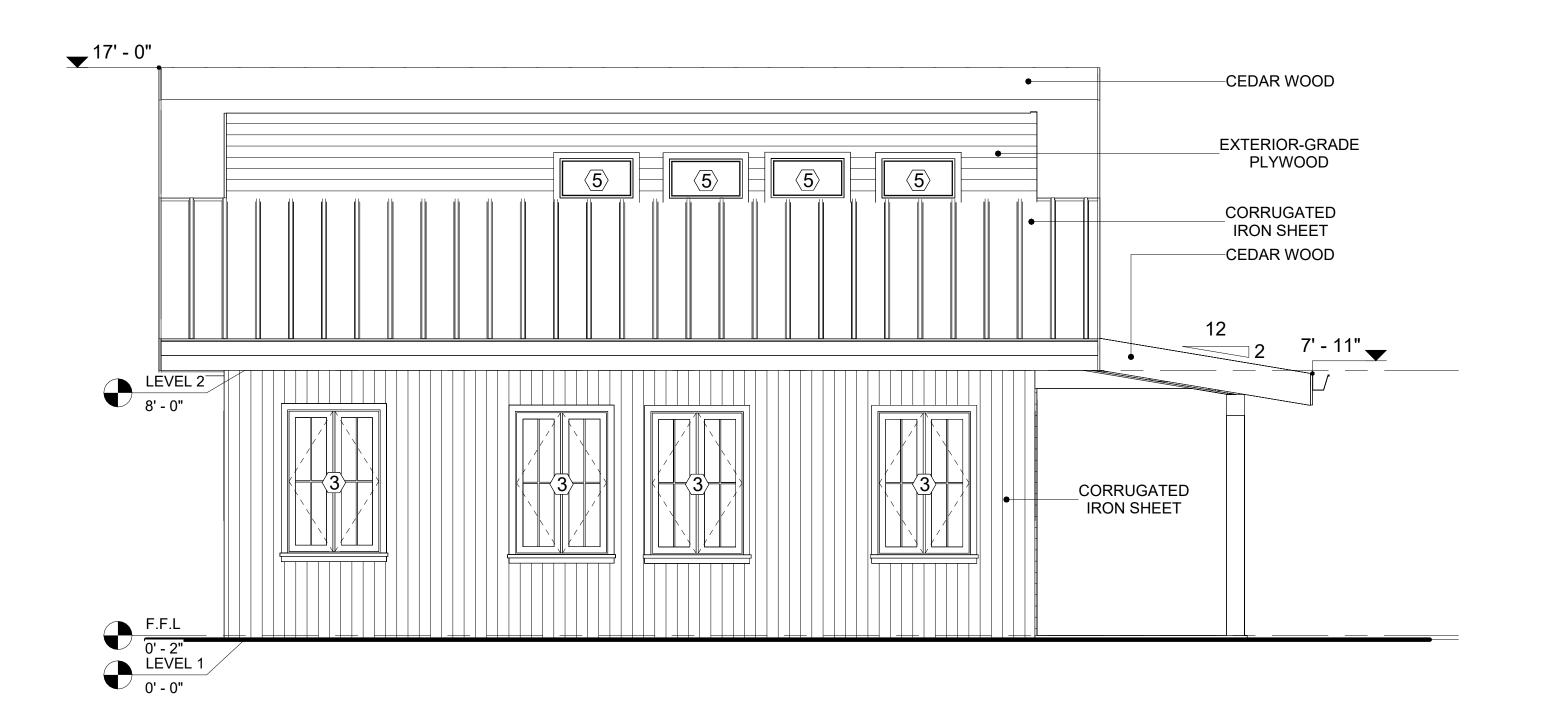


1 REAR ELEVATION 3/8" = 1'-0"

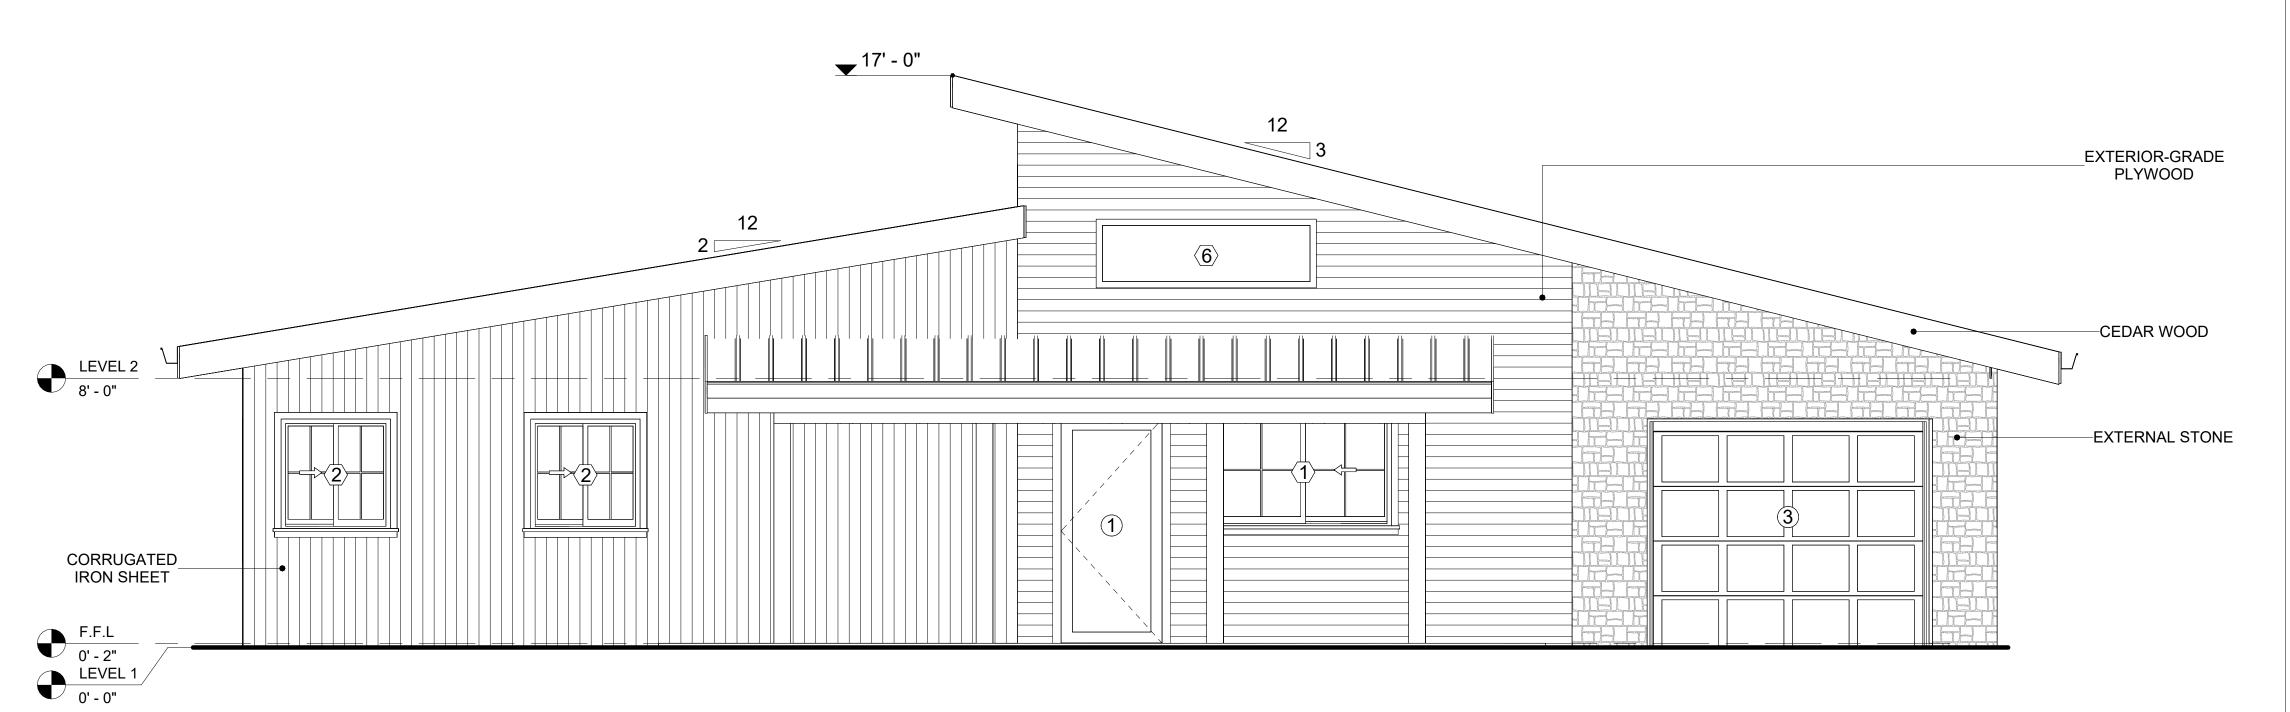

2 LEFT SIDE ELEVATION
3/8" = 1'-0"



KEY PLAN

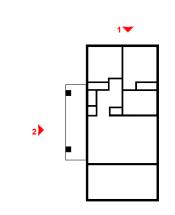

NO.	DESCRIPTION	DA

NOTE:

LEGEND:

PROJECT


242-EMBER-960-2Bd1Ba MODERN-GARAGE-550

DRAWING NAME

ARCHITECTURAL ELEVATIONS


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0061_12	PROJECT NUMBER:
5/13/2025 3:44:01 PM	DATE:
Designer	DESIGNED BY:
Author	DRAWN BY:
Checkei	CHECKED BY:

A202

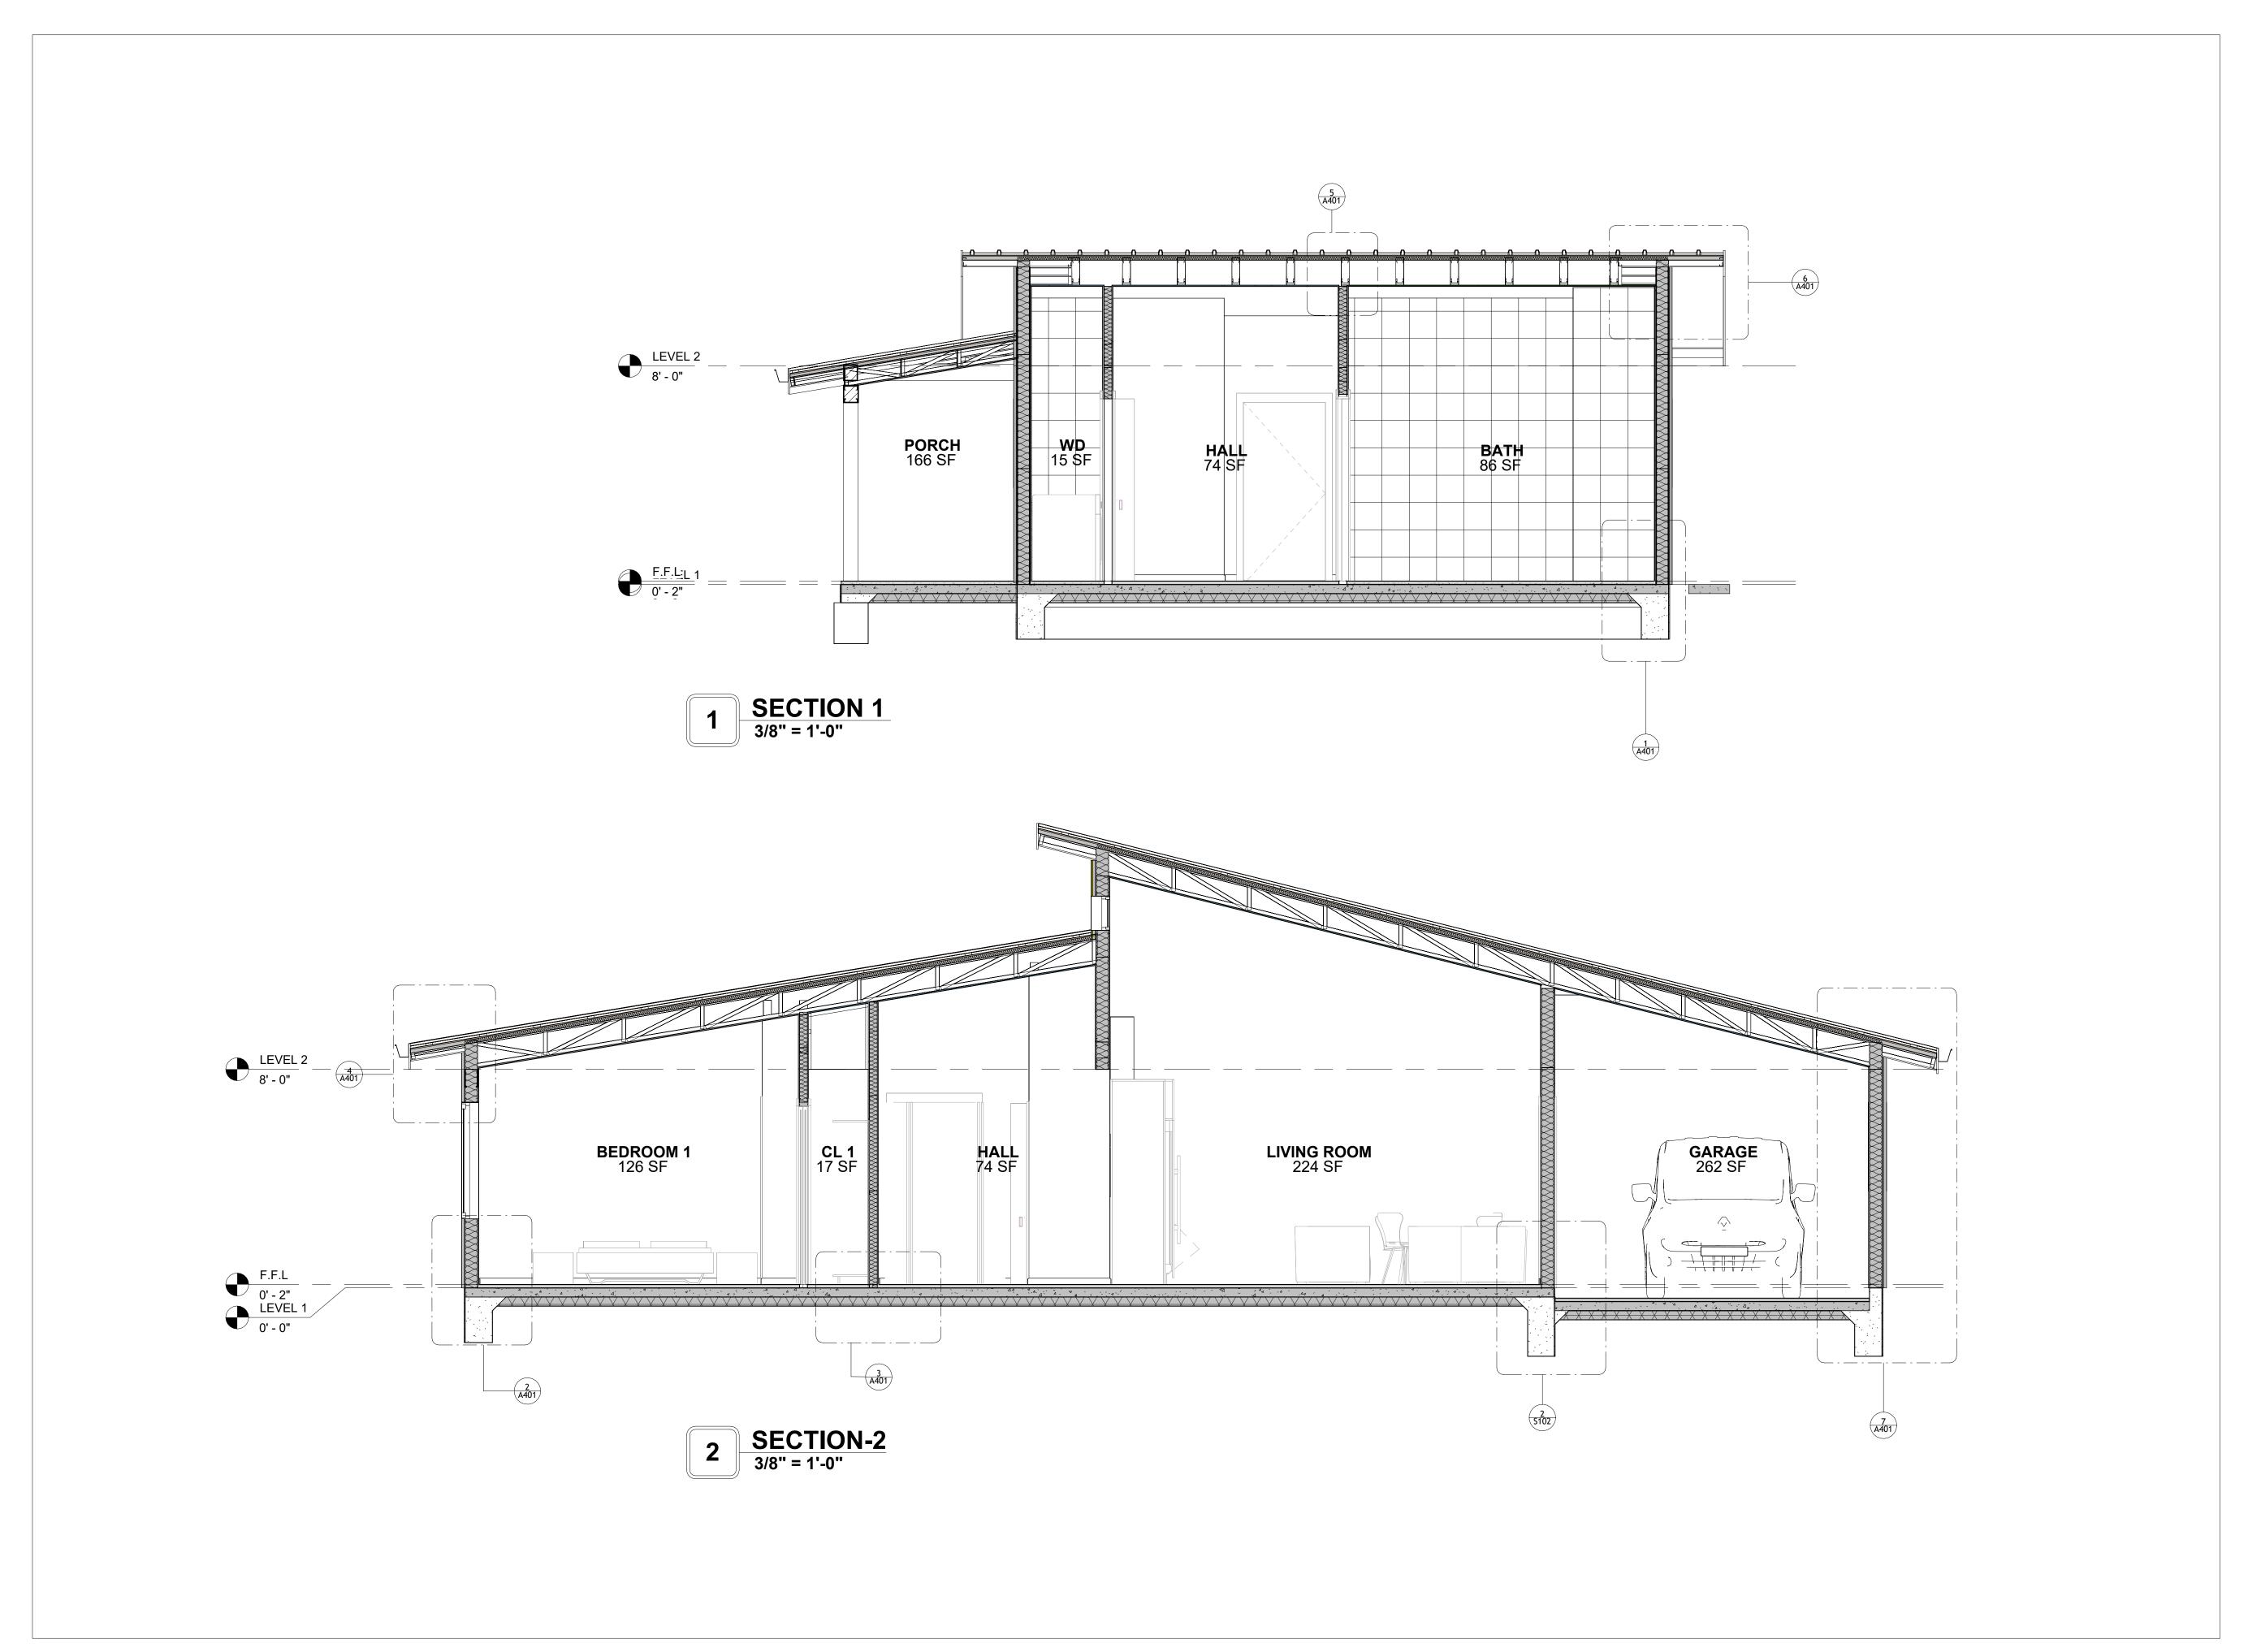



KEY PLAN

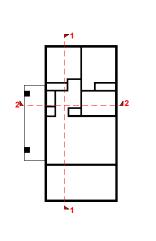

NO.	DESCRIPTION	DAT

NOTE:

LEGEND:

PROJECT


242-EMBER-960-2Bd1Ba MODERN-GARAGE-550


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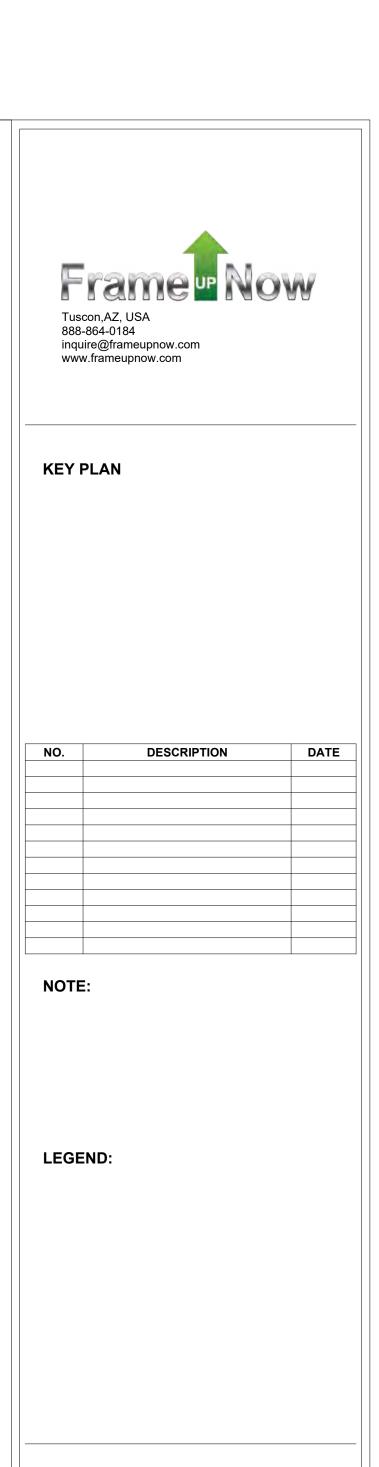
ARCHITECTURAL SECTIONS

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0061_12	PROJECT NUMBER:
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Designer	DESIGNED BY:
Author	DRAWN BY:
Checker	CHECKED BY:

A301



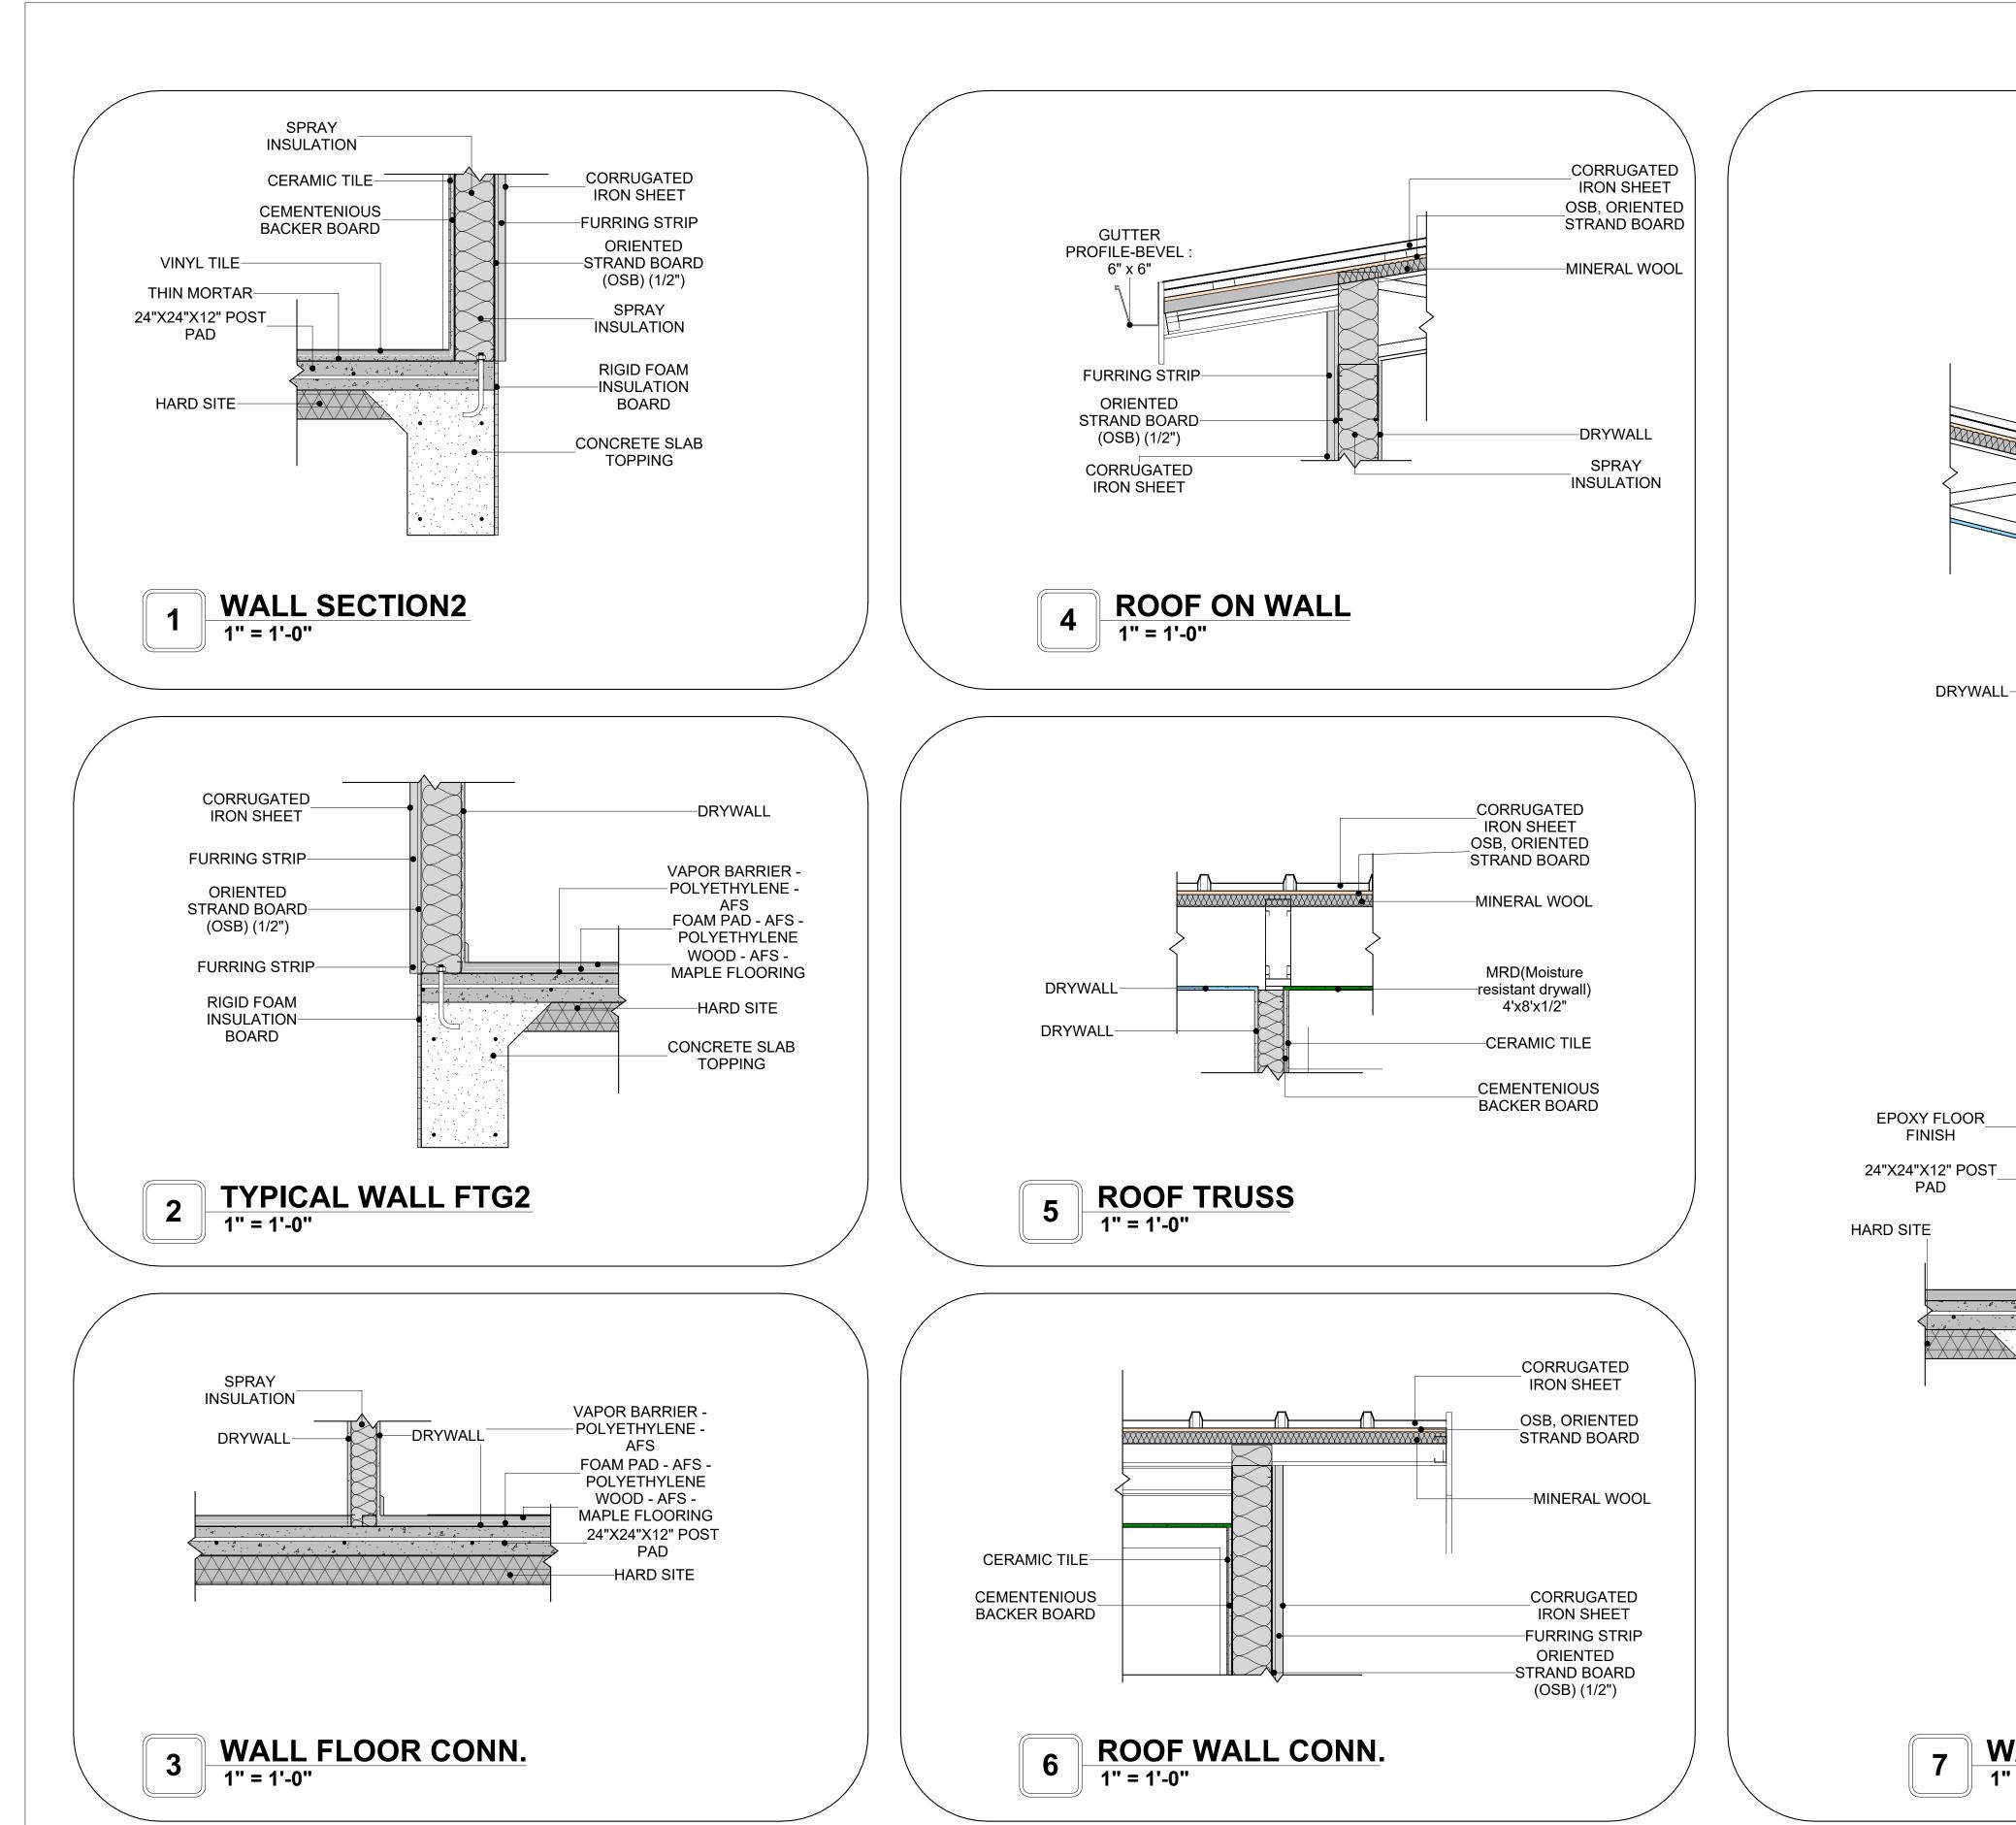

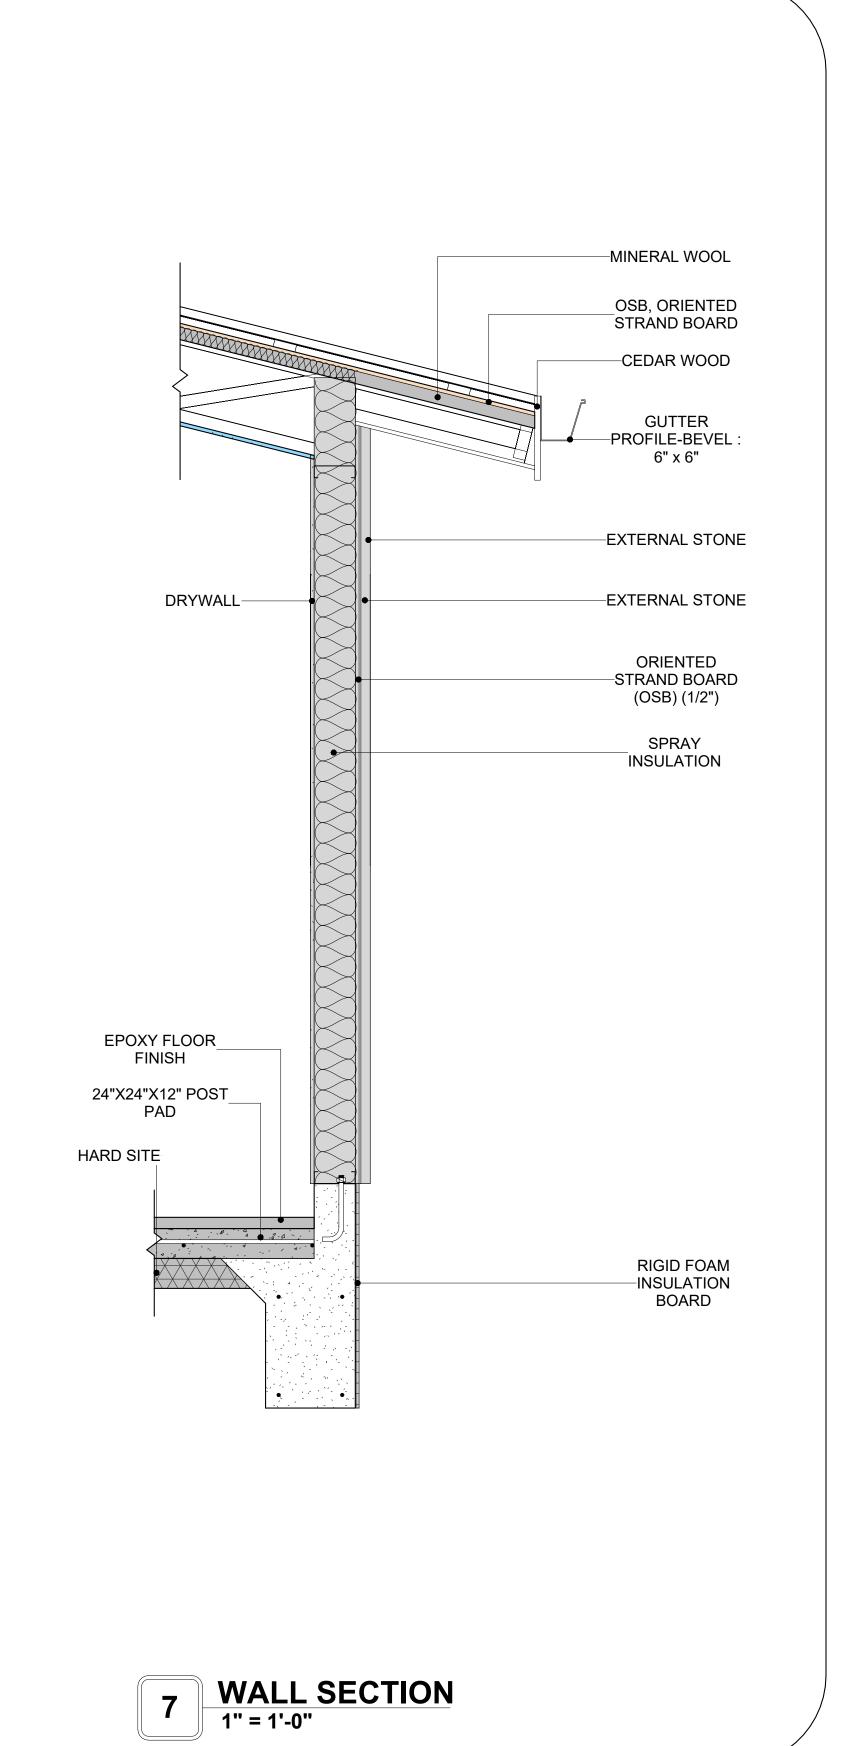

242-EMBER-960-2Bd1Ba MODERN-GARAGE-550

DRAWING NAME

PROJECT

ARCHITECTURAL DETAILS

Client Name	CLIENT NAME:
0061_12	PROJECT NUMBER:
5/13/2025 3:44:03 PM	DATE:
Designer	DESIGNED BY:
Author	DRAWN BY:
Checker	CHECKED BY:

A401


SCALE: 1" = 1'-0"


CASEWORK GENERAL NOTES


- 1. ALL CABINET HEIGHTS INCLUDE COUNTERTOPS. DIMENSIONS ARE TO THE NEAREST INCH.
 2. DIVISIONS IN CASEWORK ARE SHOWN FOR CLARITY AND DO NOT REPRESENT BREAKS IN THE
- COUNTERTOP.
- 3. PROVIDE CONTINUOUS COUNTERTOP OVER ALL SIMILAR HEIGHT CASEWORK, UNLESS AND OTHERWISE NOTED.
- 4. MANUFACTURER AND CATALOG NUMBERS ARE FOR REFERENCE AND ILLUSTRATION PURPOSES ONLY
- DOTTED LINES INDICATE WALL HUNG CABINETS, DIVISIONS OF BASE CABINETS BELOW THE
 COUNTERTOP, FURNITURE NOT IN THE CONTRACT OR PROJECTION SCREENS -SEE CASEWORK KEY AND SPECIFICATIONS.
- 7. ALL CABINETS AND DRAWERS TO HAVE CAM LOCKS EXCEPT FOR SINK BASE CABINETS.
 8. ALL EXPOSED SURFACES (EXPOSED TO VIEW FROM ANY PERSPECTIVE) TO BE COVERED WITH
- LAMINATE.
- ALL CASEWORK WHICH MEETS A WALL AT ONE OR BOTH ENDS, TO BE PROVIDED WITH FILLER PANELS AND SCRIBED TO THE WALL(S) AS REQUIRED.
 ALL CABINETS AND DRAWERS ARE PROVIDED WITH RECESSED HANDLES.
- 11. CONTRACTOR TO FIELD VERIFY ALL CLEAR OPENINGS PRIOR TO MILLWORK OR CASEWORK
- 12. CASEWORK DRAWINGS ARE DIAGRAMMATIC IN NATURE TO SHOW DESIGN INTENT.


	CASEWORK SCHEDULE					
TYPE MAR K	TYPE	COUN	HEIGHT	WIDTH	DEPTH	AREA
01	CLOSET 5	2	6' - 0"	6' - 10"	1' - 4"	41 SF
		1	2' - 0"	1' - 6"	0' - 3"	3 SF
02 03	RECESSED_MED_CABINET 2 CLOSET 3	1	6' - 0"	3' - 10"	1' - 4"	23 SF
04	HD_L-SHAPE_COUNTER_TOP W SINK HOLE 2	1	0' - 4"	4' - 6"	8' - 1"	1 SF
05	WALL_CABINET_SINGLE_DOOR	1	2' - 6"	2' - 1"	1' - 0"	5 SF
06	BASE_CABINET_SINGLE_DOOR 2	1	2' - 7"	1' - 4"	2' - 0"	3 SF
07	HD_TALL_CABINET_24	1	7' - 6"	4' - 2"	2' - 0"	31 SF
08	WALL FILLER	1	2' - 6"	1' - 4"	1' - 0"	3 SF
09	WALL_CABINET_DOUBLE_DOOR 2	1	2' - 6"	3' - 3"	1' - 0"	8 SF
10	HD_LINEAR_COUNTER_TOP 4	1	0' - 4"	3' - 1"	2' - 1"	1 SF
11	BASE_CABINET_SINGLE_DOOR 3	1	2' - 7"	1' - 0"	2' - 0"	3 SF
12	BASE_CABINET_DOUBLE_DOOR	2	2' - 11"	3' - 0"	2' - 0"	9 SF
13	REFRIGERATOR TOP	1	1' - 6"	2' - 0"	2' - 4"	3 SF
14	VANITY	1	2' - 4"	2' - 6"	1' - 8"	6 SF
15	WALL FILLER 2	1	2' - 6"	1' - 0"	1' - 0"	2 SF
16	BASE_CABINET_L-SHAPED	1	2' - 11"	3' - 3"	3' - 3"	9 SF
17	BASE_CABINET_SINGLE_DOOR	1	2' - 7"	2' - 1"	2' - 0"	5 SF
	SPECIALT	Y EQU	IPMENT S	CHEDULE		

	** ** ** *		1 -	1 -		· •	• • •
15	WALL FILLER 2		1	2' - 6"	1' - 0"	1' - 0"	2 SF
16	BASE_CABINET_L-S	HAPED	1	2' - 11"	3' - 3"	3' - 3"	9 SF
17	BASE_CABINET_SIN	IGLE_DOOR	1	2' - 7"	2' - 1"	2' - 0"	5 SF
		SPECIALTY	Y EQU	IPMENT	SCHEDULI		
	TYPE MARK	TYPE COUNT			IT		
01		WASHER-FRONT	-LOAD		2		
02		REFRIGERATOR			1		
03		RANGE			1		
05		DISHWASHER			1		
GRAI	ND TOTAL: 5						

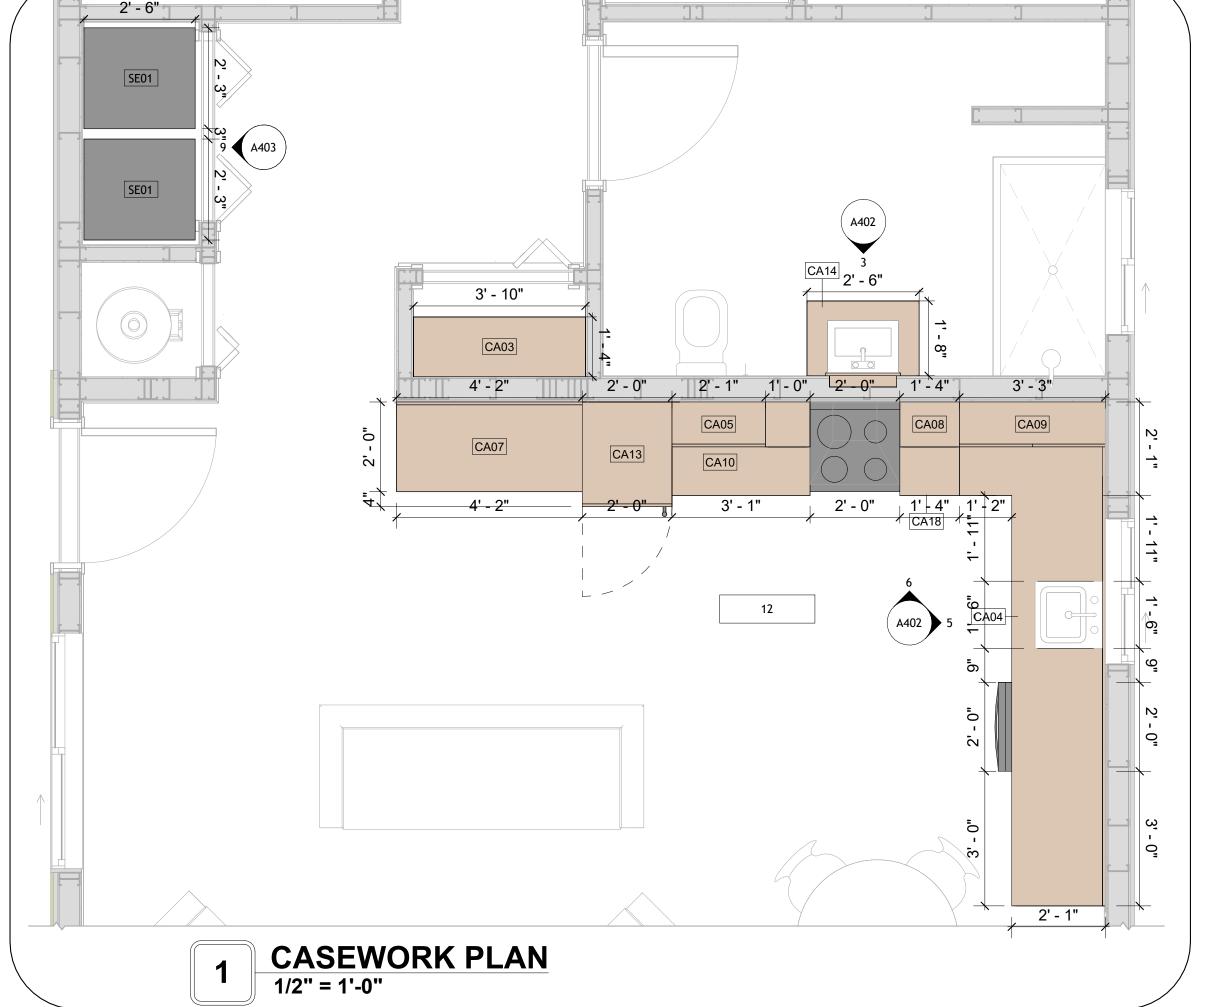


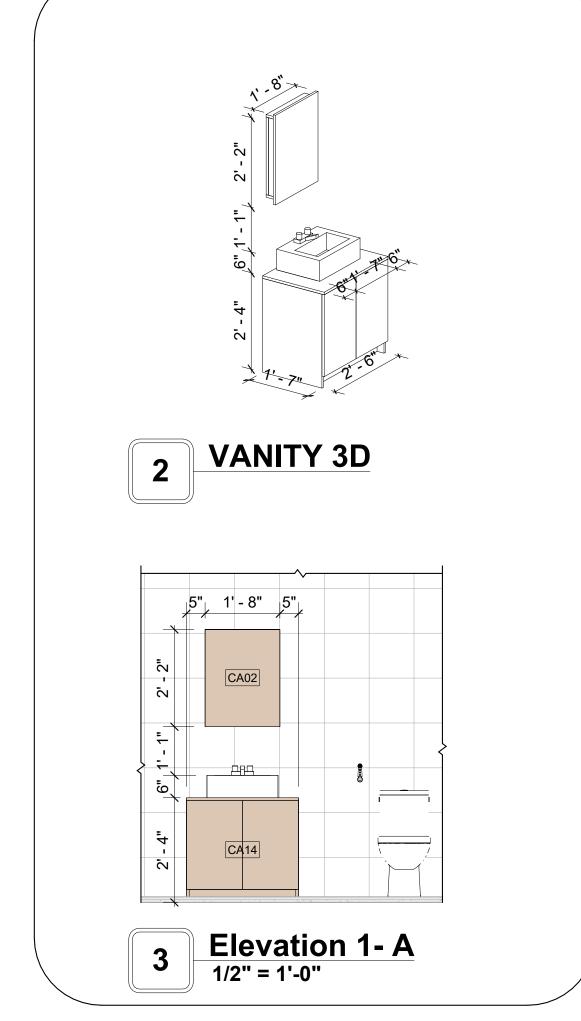

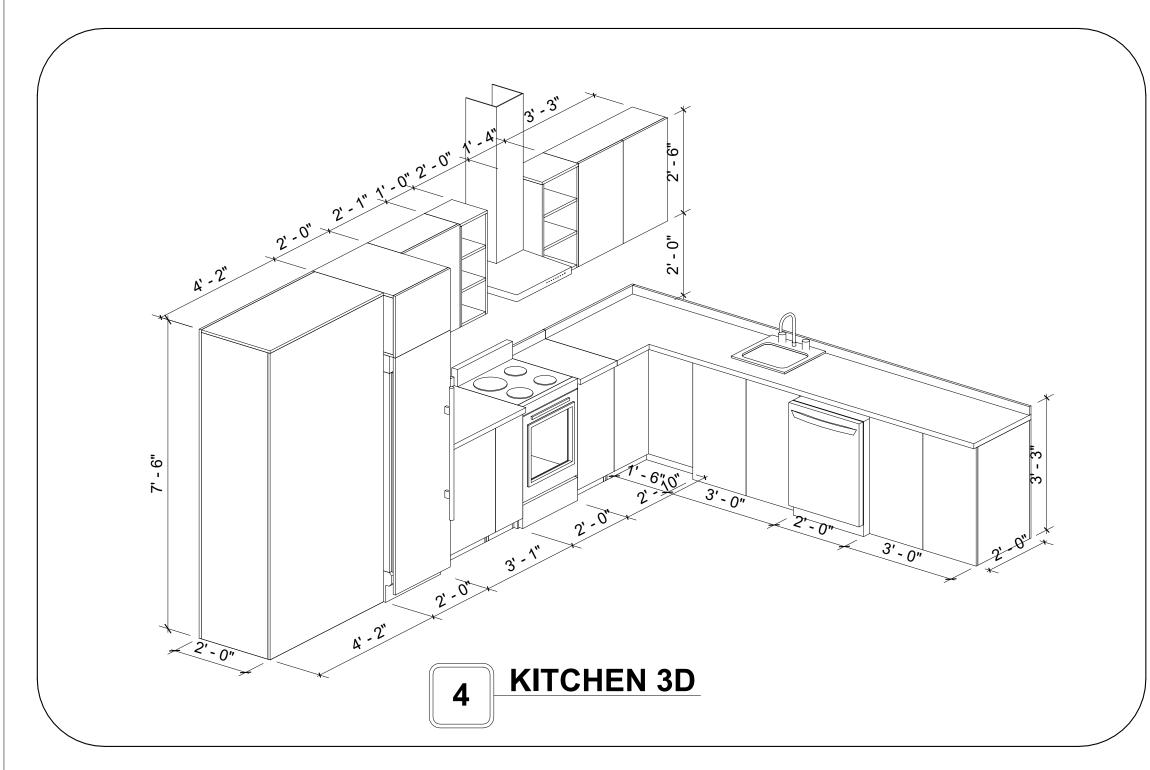

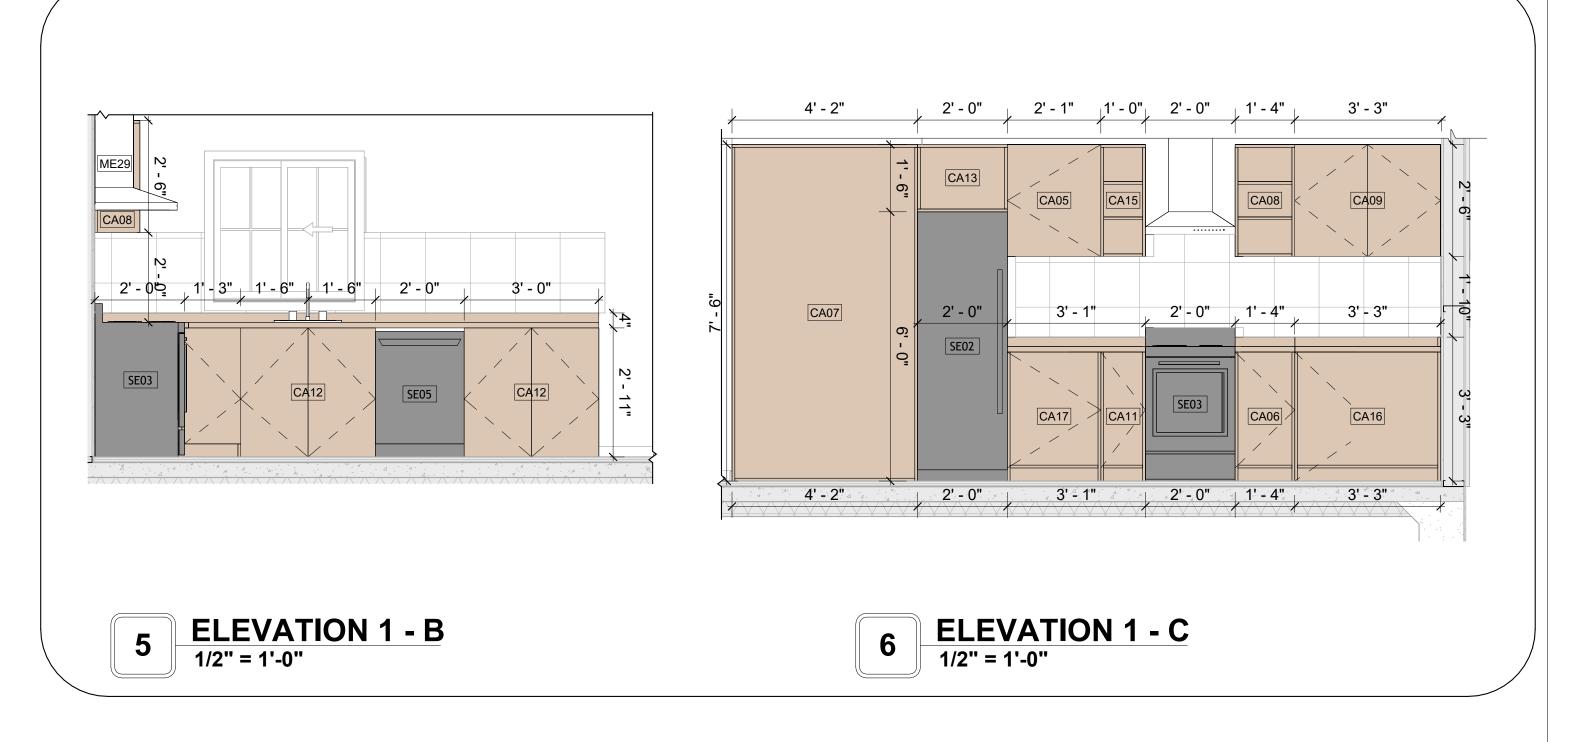



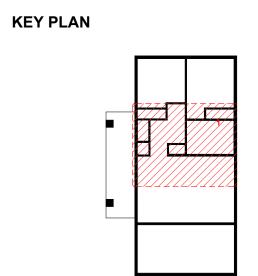

		-
NO.	DESCRIPTION	DAT

NOTE:

LEGEND:

PROJECT

242-EMBER-960-2Bd1Ba MODERN-GARAGE-550

DRAWING NAME

ARCHITECTURAL CASEWORK


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0061_12	PROJECT NUMBER:	
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Author	DRAWN BY:	
Checker	CHECKED BY:	


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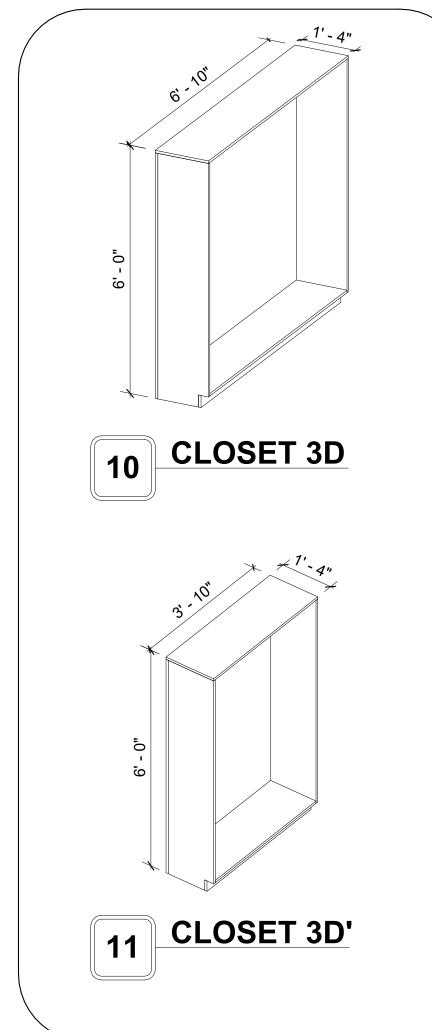
CASEWORK GENERAL NOTES


- ALL CABINET HEIGHTS INCLUDE COUNTERTOPS. DIMENSIONS ARE TO THE NEAREST INCH.
 DIVISIONS IN CASEWORK ARE SHOWN FOR CLARITY AND DO NOT REPRESENT BREAKS IN THE
- PROVIDE CONTINUOUS COUNTERTOP OVER ALL SIMILAR HEIGHT CASEWORK, UNLESS AND OTHERWISE NOTED.
- MANUFACTURER AND CATALOG NUMBERS ARE FOR REFERENCE AND ILLUSTRATION PURPOSES
- DOTTED LINES INDICATE WALL HUNG CABINETS, DIVISIONS OF BASE CABINETS BELOW THE COUNTERTOP, FURNITURE NOT IN THE CONTRACT OR PROJECTION SCREENS -SEE CASEWORK
- KEY AND SPECIFICATIONS.
- 7. ALL CABINETS AND DRAWERS TO HAVE CAM LOCKS EXCEPT FOR SINK BASE CABINETS.
 8. ALL EXPOSED SURFACES (EXPOSED TO VIEW FROM ANY PERSPECTIVE) TO BE COVERED WITH
- ALL CASEWORK WHICH MEETS A WALL AT ONE OR BOTH ENDS, TO BE PROVIDED WITH FILLER PANELS AND SCRIBED TO THE WALL(S) AS REQUIRED.
- 10. ALL CABINETS AND DRAWERS ARE PROVIDED WITH RECESSED HANDLES.
- 11. CONTRACTOR TO FIELD VERIFY ALL CLEAR OPENINGS PRIOR TO MILLWORK OR CASEWORK
- 12. CASEWORK DRAWINGS ARE DIAGRAMMATIC IN NATURE TO SHOW DESIGN INTENT.


		CAS	EWOR	K SCHEDU	JLE		
TYPE MAR K	TYPE		COUN T	HEIGHT	WIDTH	DEPTH	AREA
01	CLOSET 5		2	6' - 0"	6' - 10"	1' - 4"	41 SF
02	RECESSED MED CAI	BINET 2	1	2' - 0"	1' - 6"	0' - 3"	3 SF
03	CLOSET 3		1	6' - 0"	3' - 10"	1' - 4"	23 SF
04	HD_L-SHAPE_COUNT SINK HOLE 2	ER_TOP W	1	0' - 4"	4' - 6"	8' - 1"	1 SF
05	WALL_CABINET_SING	SLE_DOOR	1	2' - 6"	2' - 1"	1' - 0"	5 SF
06	BASE_CABINET_SING	LE_DOOR 2	1	2' - 7"	1' - 4"	2' - 0"	3 SF
07	HD_TALL_CABINET_2	4	1	7' - 6"	4' - 2"	2' - 0"	31 SF
08	WALL FILLER		1	2' - 6"	1' - 4"	1' - 0"	3 SF
09	WALL_CABINET_DOU	BLE_DOOR 2	1	2' - 6"	3' - 3"	1' - 0"	8 SF
10	HD_LINEAR_COUNTE	R_TOP 4	1	0' - 4"	3' - 1"	2' - 1"	1 SF
11	BASE_CABINET_SING	LE_DOOR 3	1	2' - 7"	1' - 0"	2' - 0"	3 SF
12	BASE_CABINET_DOU	BLE_DOOR	2	2' - 11"	3' - 0"	2' - 0"	9 SF
13	REFRIGERATOR TOP		1	1' - 6"	2' - 0"	2' - 4"	3 SF
14	VANITY		1	2' - 4"	2' - 6"	1' - 8"	6 SF
15	WALL FILLER 2		1	2' - 6"	1' - 0"	1' - 0"	2 SF
16	BASE_CABINET_L-SH	APED	1	2' - 11"	3' - 3"	3' - 3"	9 SF
17	BASE_CABINET_SING	LE_DOOR	1	2' - 7"	2' - 1"	2' - 0"	5 SF
		SPECIALT	Y EQU	IPMENT SO	CHEDULE	•	
-	TYPE MARK		TYPE			COUNT	
01	V	VASHER-FRONT	Γ-LOAD		2		
02		REFRIGERATOR			1		



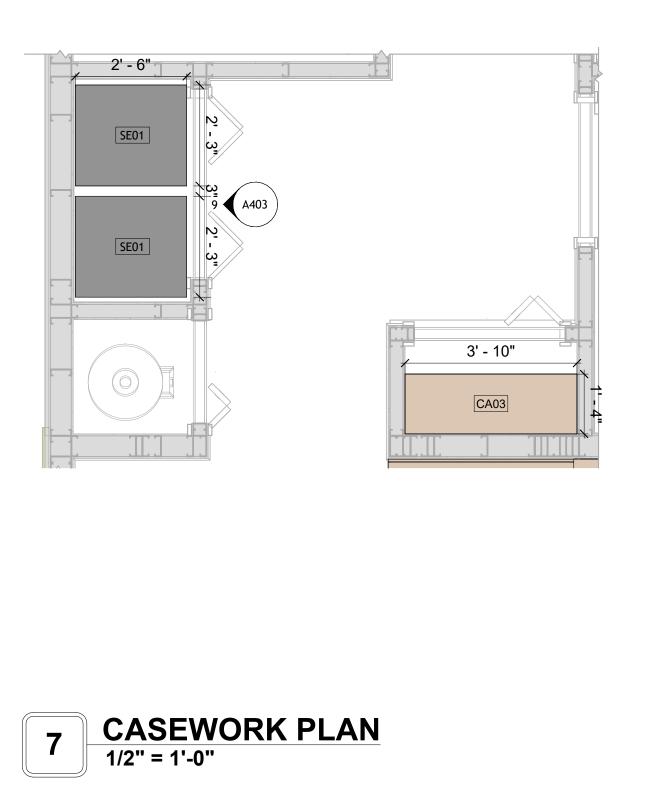

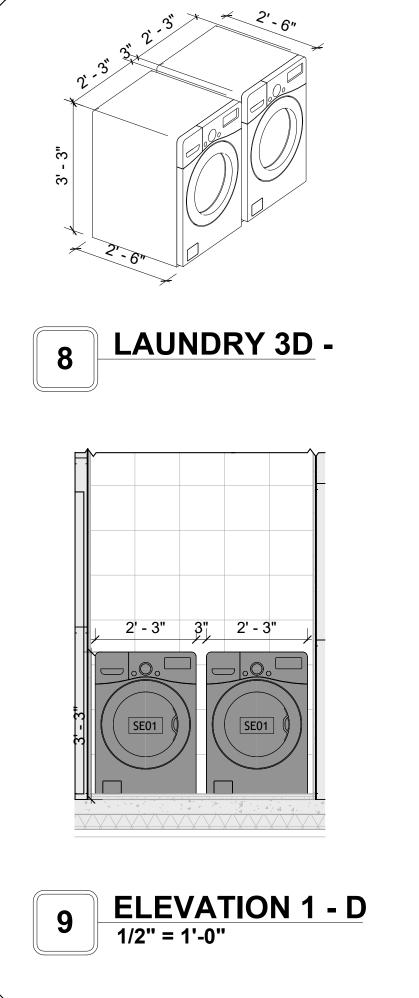

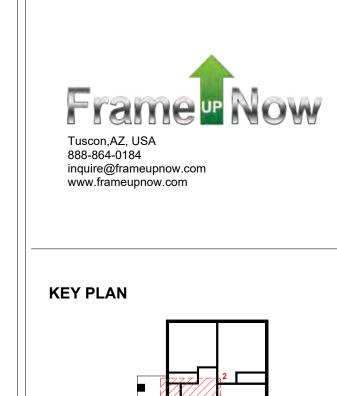

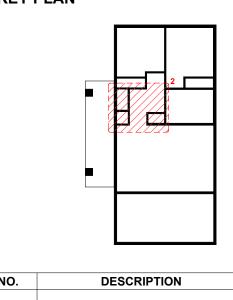

NO.	DESCRIPTION	DATE

NOTE:

LEGEND:

PROJECT

242-EMBER-960-2Bd1Ba **MODERN-GARAGE-550**

DRAWING NAME

ARCHITECTURAL CASEWORK Copy 1

Client Name	CLIENT NAME:
0061_12	PROJECT NUMBER:
5/13/2025 3:44:05 PM	DATE:
Designer	DESIGNED BY:
Author	DRAWN BY:
Checker	CHECKED BY:


A403 SCALE: As indicated


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RANGE

GRAND TOTAL: 5

DISHWASHER



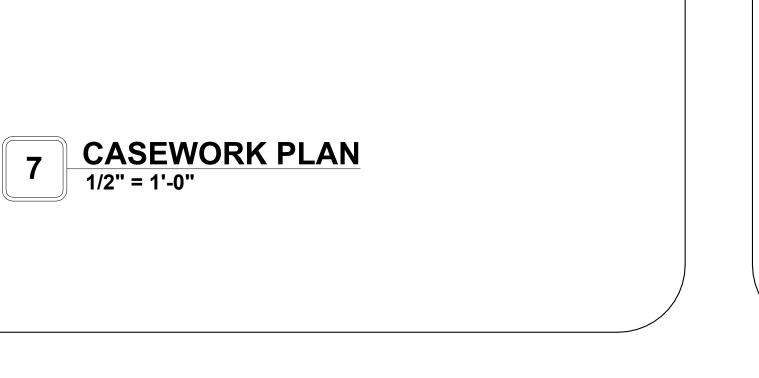

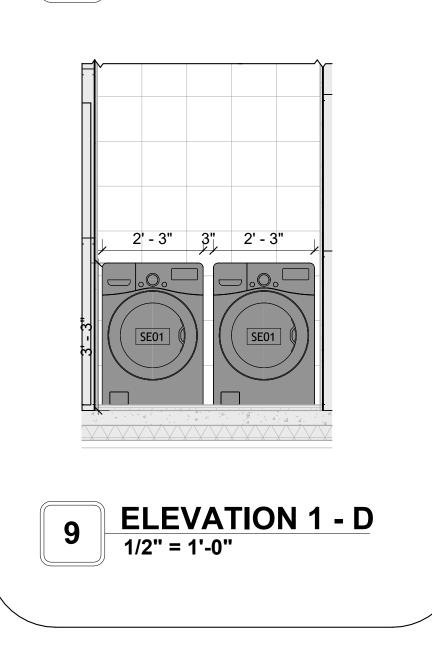GENERAL NOTES

1. THIS DRAWING DEPICTS THE HVAC (HEATING, VENTILATION, AND AIR CONDITIONING) SYSTEM FOR THE EMBER 2BD1BA MODERN GARAGE.IT VISUAL REPRESENTATION OF THE SYSTEM LAYOUT AND COMPONENTS.

2.THE HVAC SYSTEM IS DESIGNED TO MEET THE SPECIFIC REQUIREMENTS OF THE BUILDING, INCLUDING HEATING, COOLING, AND VENTILATION NEEDS AS PER THE PROJECT SPECIFICATIONS AND APPLICABLE CODES AND STANDARDS.

3. THE HVAC SYSTEM INSTALLATION SHALL COMPLY WITH THE LATEST EDITION OF THE INTERNATIONAL MECHANICAL CODE (IMC), INTERNATIONAL RESIDENTIAL CODE (IRC), AND ALL OTHER APPLICABLE LOCAL, STATE, AND NATIONAL CODES AND REGULATIONS.

4. THE EQUIPMENT SHOWN ON THIS DRAWING INCLUDES BUT IS NOT LIMITED TO AIR HANDLING UNITS (AHUS), CHILLERS, BOILERS, COOLING TOWERS, PUMPS, DUCTWORK, DIFFUSERS, GRILLES, AND CONTROL DEVICES.

5. ALL EQUIPMENT, DUCTWORK, AND PIPING SHALL BE INSTALLED IN ACCORDANCE WITH MANUFACTURER'S SPECIFICATIONS, LOCAL CODES, AND INDUSTRY BEST PRACTICES.

6. ALL DUCTWORK SHALL BE SIZED, FABRICATED, AND INSTALLED IN ACCORDANCE WITH THE LATEST EDITION OF THE ACCA MANUAL D AND THE SMACNA HVAC DUCT CONSTRUCTION STANDARDS. DUCTWORK SHALL BE INSTALLED IN A NEAT AND WORKMANLIKE MANNER, PROPERLY SUPPORTED AND BRACED TO PREVENT SAGGING, AIR LEAKAGE, OR VIBRATION.

7. CONDENSATE DRAINAGE PIPING SHALL BE PROPERLY PITCHED TO ENSURE POSITIVE DRAINAGE TO AN APPROVED DISPOSAL LOCATION, SUCH AS A FLOOR DRAIN, SUMP PUMP, OR EXTERIOR GRADE. CONDENSATE LINES SHALL BE INSULATED TO PREVENT SWEATING.

8. THE LOCATION OF CONTROL PANELS AND SENSORS INDICATED ON THIS DRAWING CAN BEMODIFY with THE SPECIFIC LOCATIONS AND WIRING DETAILS WILL BE DETERMINED DURING THE CONTROL SYSTEM DESIGN AND INSTALLATION.

9. THE HVAC SYSTEM DESIGN CONSIDER ENERGY EFFICIENCY, INDOOR AIR QUALITY, OCCUPANT COMFORT, AND NOISE CONTROL, FOLLOWING

APPLICABLE GUIDELINES AND REGULATIONS. 10. COORDINATION WITH OTHER TREADS HAS BEEN DONE ON A DESIGN LEVEL. THIS DRAWING SHALL BE READ TOGETHER WITH THE AR, EL AND SN

WITH THE LOCAL BUILDING DEPARTMENT AND UTILITY PROVIDERS TO ENSURE A TIMELY AND COMPLIANT INSTALLATION.

DESIGN DRAWINGS TO ENSURE PROPER INSTALLATION AND INTEGRATION OF THE HVAC SYSTEMS. 11. THE HVAC CONTRACTOR IS RESPONSIBLE FOR OBTAINING ALL NECESSARY PERMITS AND LICENSES, AND FOR SCHEDULING AND COORDINATING

12. ALL DUCTWORK PENETRATIONS THROUGH WALLS, FLOORS, OR CEILINGS SHALL BE PROPERLY SEALED AND FIRE-STOPPED USING APPROVED METHODS AND MATERIALS TO MAINTAIN THE INTEGRITY OF THE BUILDING'S FIRE-RESISTANCE RATINGS.

13. HVAC EQUIPMENT SHALL BE INSTALLED LEVEL AND PLUMB, AND IN STRICT ACCORDANCE WITH THE MANUFACTURER'S INSTALLATION INSTRUCTIONS AND RECOMMENDATIONS. PROVIDE ADEQUATE CLEARANCES AROUND EQUIPMENT FOR PROPER AIRFLOW, SERVICE ACCESS, AND

14. ALL HVAC EQUIPMENT AND COMPONENTS, INCLUDING THERMOSTATS, DAMPERS, AND ACCESS PANELS, SHALL BE LOCATED IN ACCESSIBLE AREAS FOR EASY SERVICING AND MAINTENANCE. PROVIDE ADEQUATE SPACE AROUND EQUIPMENT FOR PROPER AIRFLOW AND SERVICE ACCESS.


15. THE HVAC SYSTEM SHALL BE BALANCED AND ADJUSTED TO ENSURE PROPER AIRFLOW, TEMPERATURE DISTRIBUTION, AND SYSTEM PERFORMANC THROUGHOUT THE RESIDENCE. PROVIDE A WRITTEN REPORT DOCUMENTING THE FINAL SYSTEM BALANCE.


16. ANY DEVIATIONS OR MODIFICATIONS TO THE HVAC SYSTEM DESIGN SHALL BE REVIEWED AND APPROVED BY THE RESPONSIBLE DESIGN PROFESSIONALS AND COMMUNICATED TO ALL RELEVANT PARTIES INVOLVED IN THE CONSTRUCTION PROCESS.

17. FOR ANY INQUIRIES OR CLARIFICATIONS REGARDING THE HVAC SYSTEM DESIGN, PLEASE CONSULT THE RESPONSIBLE DESIGN PROFESSIONALS OR THE PROJECT MANAGEMENT TEAM.

SYMBOLS

CODE COMPLIANCE.

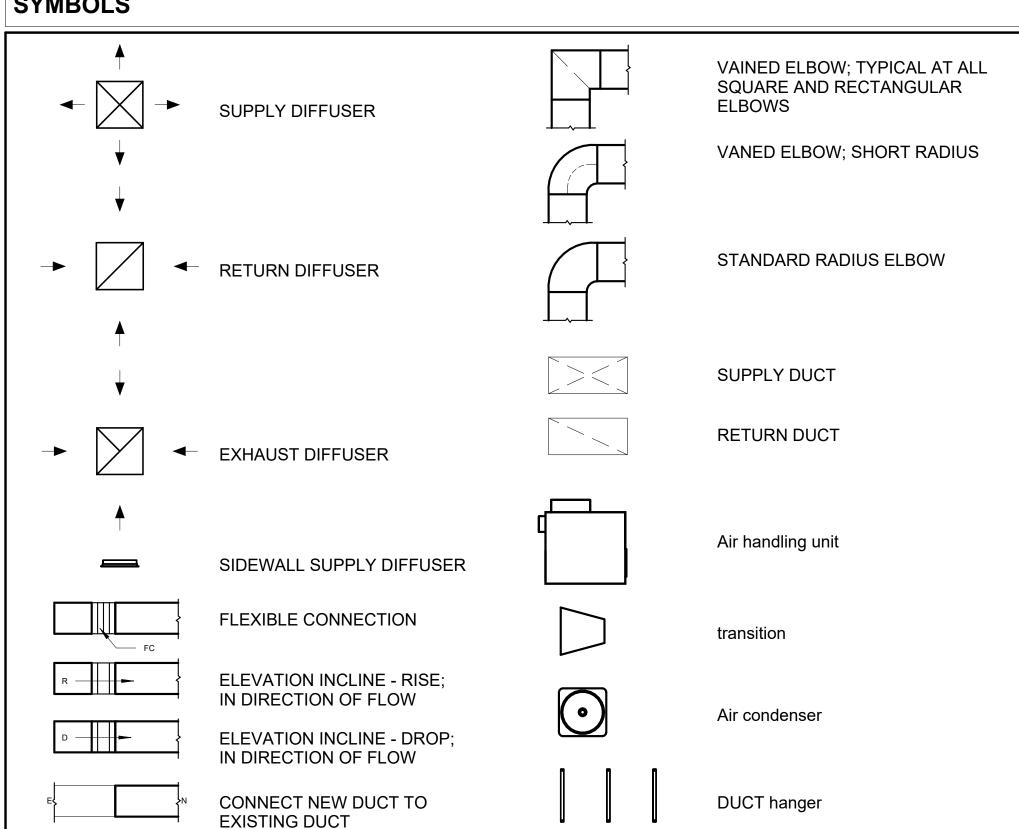

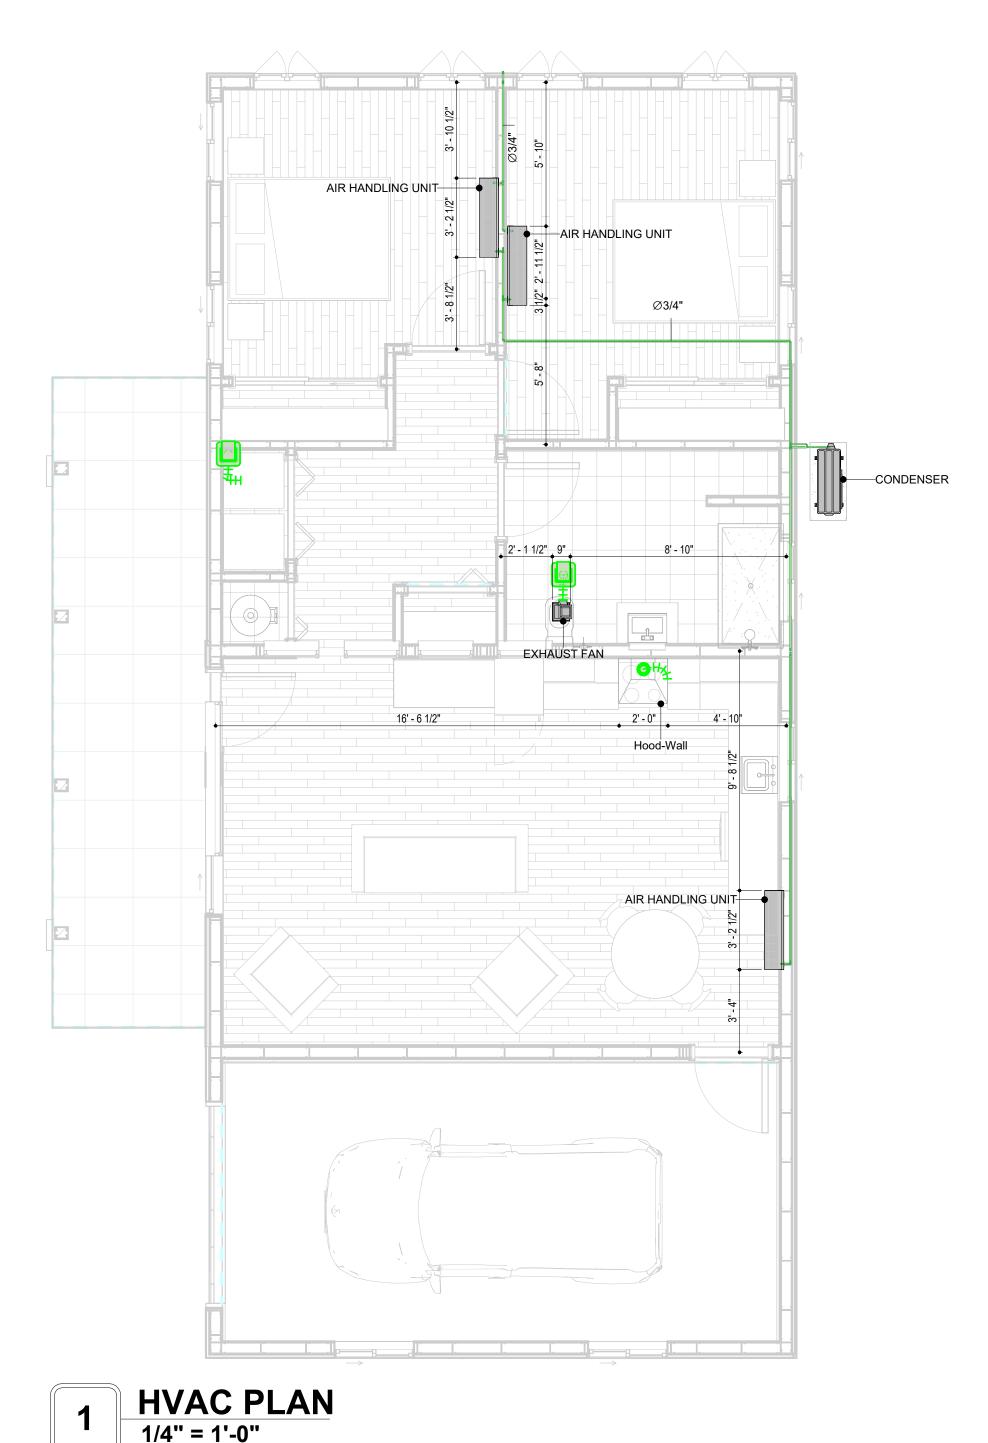

Hvac Color scheme air conditioning pipe line

REFRIGERANT LINE SCHEDULE					
CATAGORY	DESCRIPTION	DIAMETER	LENGTH		
Pipe Types	Copper	1/4"	0.68		
Pipe Types	Copper	3/8"	66.42		
Pipe Types	Copper	1/2"	0.68		
Pipe Types	Copper	3/4"	79.97		

CATAGORY	DESCRIPTION	Size	Count
Elbow - Generic	Elbow - Generic: Standard/HVAC	1/2"ø-1/2"ø	1
Elbow - Generic	Elbow - Generic: Standard/HVAC	1/4"ø-1/4"ø	1
Elbow - Generic	Elbow - Generic: Standard/HVAC	3/4"ø-3/4"ø	19
Elbow - Generic	Elbow - Generic: Standard/HVAC	3/8"ø-3/8"ø	20
Tee - Generic	Tee - Generic: Standard	3/4"ø-3/4"ø-3/ 4"ø	3
Tee - Generic	Tee - Generic: Standard	3/8"ø-3/8"ø-3/ 8"ø	2
Transition - Generic	Transition - Generic: Standard	3/4"ø-1/2"ø	3
Transition - Generic	Transition - Generic: Standard	3/4"ø-5/8"ø	3
Transition - Generic	Transition - Generic: Standard	3/8"ø-1/4"ø	1

MECHANICAL EQUIPMENT SCHEDULE				
CATAGORY	DESCRIPTION	COUNT		
AIR HANDLING UNIT	AIR HANDLING UNIT: WALL MOUNTED	3		
CONDENSER	CONDENSER: OUT DOOR	1		
Endough End	EXHAUST FAN: 75 CFM	1		
Exhaust Fan	EXTAGST FAN. 75 CFM	I.		

DUCT FITTING SCHEDULE				
CATAGORY	DESCRIPTION	COUNT		
Round Transition - Angle	45 Degree	5		

DUCT ACCESSORY SCHEDULE					
CATAGORY	DESCRIPTION	COUNT			
ROOF VENT	3" DIAMETER	3			

FLEX DUCT SCHEDULE							
DESCRIPTION	DESCRIPTION	LENGTH	DIAMETER	COUNT			
Flex Duct Round	FLEX-ROUND	20.30	4"	3			
Grand total: 3		20.30					



KEY PLAN

NO.	DESCRIPTION	DATE	

NOTE:

LEGEND:

PROJECT

242-EMBER-960-2Bd1Ba **MODERN-GARAGE-550**

DRAWING NAME

HVAC PLAN

CLIENT NAME: Owner PROJECT NUMBER: 15_0001 DATE: 5/8/2025 4:36:43 AM Designer DESIGNED BY: DRAWN BY: Author CHECKED BY: Checker

M101

SCALE: As indicated

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ELECTRICAL NOTES

- 1. THIS DRAWING DEPICTS THE ELECTRICAL SYSTEM FOR 242-EMBER-960-2Bd1Ba MODERN-GARAGE-550. IT PROVIDES A VISUAL REPRESENTATION OF THE ELECTRICAL LAYOUT AND COMPONENTS, INCLUDING POWER DISTRIBUTION, LIGHTING, AND CONTROL SYSTEMS.
- 2. THE ELECTRICAL SYSTEM IS DESIGNED TO MEET THE SPECIFIC REQUIREMENTS OF THE BUILDING, INCLUDING POWER DISTRIBUTION, LIGHTING, AND SPECIALIZED ELECTRICAL EQUIPMENT NEEDS, AS PER THE PROJECT SPECIFICATIONS AND APPLICABLE CODES AND STANDARDS.
- 3. THE ELECTRICAL SYSTEM INSTALLATION SHALL COMPLY WITH THE LATEST EDITION OF THE NATIONAL ELECTRICAL CODE (NEC), INTERNATIONAL BUILDING CODE (IBC), AND ALL OTHER APPLICABLE LOCAL, STATE, AND NATIONAL CODES AND REGULATIONS.
- 4. LOCATIONS AS NEEDED, DEVICES ARE SHOWN ON PLANS IN APPROXIMATE IDEAL LOCATIONS, UNLESS SPECIFICALLY DIMMENSIONED.
- 5. OPEN WALLS AS NEEDED TO ALLOW FOR NEW ELECTRICAL INSTALLATIONS.
- 6. LABEL ALL CIRCUITS ON JUNCTION BOXES, RECEPTACLES, DATA, SMOKE DETECTOR, AND EQUIPMENT IN PANEL BOX.
- 7. INSTALL RACEWAY AS NEEDED FOR DDC, ACCESS CONTROL, LOW VOLTAGE WIRING & DATA.
- 8. RELABEL POWER, DATA & FIRE ALARM FOR ROOM #CHANGES.
 9. VERIFY ALL CIRCUITS LABELED ON PRINT ARE CORRECT BEFORE WORKING ON THEM.
- 10. NOTE ON SITE PLAN ALL CHANGES OR MISSING DETAIL TO BE INCORPORATED INTO THE MASTER PLAN.
- 11. DRAWINGS ARE DIAGRAMMATIC ONLY FOR THE PURPOSE OF SHOWING FIXTURE AND OUTLET LOCATIONS.
- 12. ELECTRICAL CONTRACTOR TO VERIFY SERVICE SIZE BY CALCULATION BASED UPON ACTUAL NAME PLATE RATINGS OF SELECTED EQUIPMENT.
- PLATE RATINGS OF SELECTED EQUIPMENT.

 13. VERIFY LOCATION OF SERVICE ENTRANCE WITH POWER COMPANY. PROVIDE UFER GROUND IN
- BUILDING FOUNDATION AT SERVICE ENTRANCE WITH POWER COMPANY. PROVIDE UPER GROUND IN
- 14. PROVIDE A MIN. OF 20 FEET OF ONE *4 BARE COPPER UFER WIRE EMBEDDED IN CONCRETE FOOTING
- AT THE SERVICE ENTRANCE LOCATION WHERE APPROVED BY LOCAL SERVICE PROVIDER.

 15. PROVIDE WATERPROOF FIXTURES IN ALL HIGH MOISTURE AREAS (EXTERIOR, SHOWER AND TUB
- CEILINGS ETC.)

 16. PROVIDE DEDICATED CIRCUITS TO EACH BATH, DEN, FAMILY ROOM, BEDROOM, LOFT, KITCHEN
- REFRIGERATOR, KITCHEN FREEZER DISHWASHER, AND ANY AREA/ITEM SPECIFIED BY OWNER.
- 17. INCANDESCENT FIXTURES WITH OPEN OR PARTIALLY ENCLOSED LAMPS, PENDANT FIXTURES, AND LAMP HOLDERS ARE NOT PERMITTED IN CLOSETS.
- 18. ALL WORKMANSHIP AND MATERIALS TO CONFORM WITH THE 2015 IRC.
- 19. PROVIDE A MIN. OF 20 FEET OF ONE *4 BARE COPPER UFER WIRE EMBEDDED IN CONCRETE FOOTING AT THE SERVICE ENTRANCE LOCATION WHERE APPROVED BY LOCAL SERVICE PROVIDER.
- 20. PROVIDE A BONDING CONDUCTOR CONSISTING OF A MINIMUM OF ONE *4 BARE COPPER WIRE CONNECTING THE BUILDING'S METAL WATER PIPING SYSTEM TO THE SERVICE EQUIPMENT ENCLOSURE GROUNDING.

MAIN PANEL CALCS

ELECTRICAL CALCS	
LIGHT AND OUTLETS 960 @ 3W	2,880 W
3 APPLIANCE CIRCUITS	4,500 W
DRYER	2,000 W
WASHER	2,000 W
RANGE	5,000 W
WATER HEATER	5,000 W
REFRIG.	1,800 W
DISHWASHER & DISPOSAL	3000 W
TOTAL	26,180 W
FRIST 10,000 @ 100% REMAINDER @ 40% MINI. SPLIT UNITS	10,000 W 6,472 W 10,000 W
TOTAL	26,472 W

26,472 W DIVIDED BY 240V = 110 AMPS TOTAL

(USE 200 AMP SERVICE)

ELECTRICAL ABBREVIATIONS LIST

1P	1 POLE (2P, 3P, 4P, ETC.)	CTR	CENTER	HT	HEIGHT
A	AMPERE	CU	COPPER	HTG	HEATING
AC	ABOVE COUNTER OR AIR CONDITIONER	DCP	DOMESTIC WATER CIRCULATING PUMP	HTR	HEATER
ACLG	ABOVE CEILING	DEPT	DEPARTMENT	HV	HIGH VOLTAGE
ADO	AUTOMATIC DOOR OPENER	DET	DETAIL	HVAC	HEATING, VENTILATING AND AIR
AF	AMP FRAME	DIA	DIAMETER	CONDITIONING	CONDITIONING
AFF	ABOVE FINISHED FLOOR	DISC	DISCONNECT	HWP	HYDRONIC WATER PUMP
AFG	ABOVE FINISHED GRADE	DIST	DISTRIBUTION	IC	INTERRUPTING CAPACITY
AFI	ARC FAULT CIRCUIT INTERRUPTER	DN	DOWN	IG	ISOLATED GROUND
AHU	AIR HANDLING UNIT	DPR	DAMPER	IMC	INTERMEDIATE METAL CONDUIT
AL	ALUMINUM	DS	SAFETY DISCONNECT SWITCH	INCAND	INCANDESCENT
ALT	ALTERNATE	DT	DOUBLE THROW	IR	INFRARED
AMP	AMPERE	DWG	DRAWING	I/W	INTERLOCK WITH
AMPL	AMPLIFIER	DDC	DIRECT DIGITAL CONTROL	J-BOX	JUNCTION BOX
ANNUN	ANNUNCIATOR APPROX APPROXIMATELY		ELECTRICAL CONTRACTOR	KV	KILOVOLT
AQ-STAT	AQUASTAT	ELEC	ELECTRICAL CONTRACTOR ELECTRICAL	KVA	KILOVOLT-AMPERE
ARCH	ARCHITECT, ARCHITECTURAL	ELEV	ELEVATOR	KVAR	KILOVOLT-AMPERE REACTIVE
ANCIT	AMP SWITCH	EM	EMERGENCY	KW	KILOVOET-AMII ENE NEACTIVE KILOWATT
AT	AMP TRIP	EMS	ENERGY MANAGEMENT SYSTEM	KWH	KILOWATT HOUR
ATS	AUTOMATIC TRANSFER SWITCH	EMT	ELECTRICAL METALLIC TUBING	LOC	LOCATE OR LOCATION
AUTO	AUTOMATIC	EP	ELECTRICAL METALLIC TOBING ELECTRIC PNEUMATIC	LT	LIGHT
AUX	AUXILIARY	EQUIP	EQUIPMENT	LTG	LIGHTING
AV	AUDIO VISUAL	EWC	ELECTRIC WATER COOLER	LTNG	LIGHTNING
AWG	AMERICAN WIRE GAUGE	EXIST	EXISTING	LV	LOW VOLTAGE
BATT	BATTERY	EXH	EXHAUST	MAX	MAXIMUM
BD	BOARD	EXP	EXPLOSION PROOF	MAG.S	MAGNETIC STARTER
BLDG	BUILDING	FA	FIRE ALARM	M/C	MOMENTARY CONTACT
BEDG	BUILDING MANAGEMENT SYSTEM	FABP	FIRE ALARM BOOSTER POWER	MC	MECHANICAL CONTRACTOR
C	CONDUIT	SUPPLY PANEL	SUPPLY PANEL	MCB	MAIN CIRCUIT BREAKER
CAB	CABINET	FACP	FIRE ALARM CONTROL PANEL	MCC	MOTOR CONTROL CENTER
CAT	CATALOG	FCU	FAN COIL UNIT	MDC	MAIN DISTRIBUTION CENTER
CATV	CABLE TELEVISION	FIXT	FIXTURE	MDP	MAIN DISTRIBUTION CENTER MAIN DISTRIBUTION PANEL
CATV	CIRCUIT BREAKER	FLR	FLOOR	MFR	MANUFACTURERMAIN FUSED
CCTV	CLOSED CIRCUIT TELEVISION	FLUOR	FLUORESCENT	IVII IX	DISCONNECT SWITCH
CKT	CIRCUIT	FU	FUSE	MH	MANHOLE
CLG	CEILING	FUDS	FUSED SAFETY DISCONNECT SWITCH	MIC	MICROPHONE
COMB	COMBINATION	GA	GAUGE	MIN	MINIMUM
CMPR	COMPRESSOR	GAL	GALLON	MISC	MISCELLANEOUS
CONN	CONNECTION		GALVANIZED	MLO	MAIN LUGS ONLY
CONST	CONSTRUCTION	GALV GC	GENERAL CONTRACTOR	MMS	MANUAL MOTOR STARTER
CONST	CONTINUATION OR CONTINUOUS	GEN	GENERATOR	MOA	MULTIOUTLET ASSEMBLY
CONTR	CONTRACTOR	GEN	GROUND FAULT CIRCUIT INTERRUPTER	MSP	MOTOR STARTER PANELBOARD
CONTR	CONVECTOR	GFP	GROUND FAULT CIRCUIT INTERRUPTER GROUND FAULT PROTECTOR	MSBD	MAIN SWITCHBOARD
CONV	CIRCULATING PUMP	GND	GROUND	MT	MOUNT
CRT	CATHODE-RAY TUBE	GRS		MT.C	EMPTY CONDUIT
CRI			GALVANIZED RIGID STEEL (CONDUIT)		
	CURRENT TRANSFORMER	GYP BD	GYPSUM BOARD	UL	UNDERWRITERS LABORATORIES

Branch Panel:

Location: GARAGE 03
Supply From:
Mounting: Recessed

Enclosure: Type 1

Volts: 120/240 Single Phases: 1 Wires: 3 A.I.C. Rating: Mains Type: Mains Rating: 200 A MCB Rating: 1 A

Notes

Circuit Numb er	Circuit Description	Number of Elements	Rating	Length	Wire Size	A			В	Wire Size	Length	Rating	Number of Elements	Circuit Description	Circu Numl er
	BED 1&2 LIGHT	17	20 A	63' - 7 3/32"	1-#12, 1-#12, 1-#12	956 VA	576 VA			1-#12, 1-#12, 1-#12	46' - 4 7/8"	20 A	7	BATH GFCI	2
3	HALL LIGHT	5	20 A	60' - 10 21/32"	1-#12, 1-#12, 1-#12			240 VA	396 VA	1-#12, 1-#12, 1-#12	51' - 10"	20 A	7	KITCHEN LIGHT	4
5	LIVING LIGHT	5	20 A	50' - 5 7/16"	1-#12, 1-#12, 1-#12	182 VA	160 VA			1-#12, 1-#12, 1-#12	38' - 2 1/32"	20 A	4	GARAGE LIGHT	6
	BED 1 &2 RECEPTACLE	8	20 A	70' - 11 5/8"	1-#10, 1-#10, 1-#10			1440 VA	2500 VA	2-#10, 1-#10, 1-#10	54' - 4 13/32"	30 A	1	DRYER	8
	WASHING MASHEIN	1	20 A	52' - 9 1/32"	1-#12, 1-#12, 1-#12	1200 VA	2500 VA								10
11	WATER HEATER	1	30 A	48' - 8 17/32"	2-#10, 1-#10, 1-#10			2250 VA	1800 VA	1-#12, 1-#12, 1-#12	38' - 4 5/16"	20 A	1	REFRIGERATOR	12
13						2250 VA	720 VA			1-#12, 1-#12, 1-#12	46' - 11 1/2"	20 A	4	KITCHEN GFCI	14
15	RANGE	1	50 A	43' - 0 23/32"	2-#8, 1-#8, 1-#10			2500 VA	180 VA	1-#12, 1-#12, 1-#12	41' - 0 31/32"	20 A	1	OVENHOOD	16
17						2500 VA	1200 VA			1-#12, 1-#12, 1-#12	44' - 6 1/4"	20 A	1	DISHWASHER	18
	LIVING RECEPTACLE	4	20 A	40' - 8 3/32"	1-#12, 1-#12, 1-#12			720 VA	720 VA	1-#12, 1-#12, 1-#12	69' - 2 3/16"	20 A	4	OUTDOOR GFCI	20
21	CONDENSER	1	60 A	18' - 0 3/16"	2-#6, 1-#6, 1-#10	2500 VA	900 VA			1-#12, 1-#12, 1-#12	26' - 5 13/32"	20 A	5	GARAGE GFCI	22
23								2500 VA	300 VA	1-#12, 1-#12, 1-#12	42' - 1 23/32"	20 A	4	OUTDOOR LIGHT	24
25															26
						1563 ⁻	1 VA	1553	31 VA						
						130	A	12	9 A						

	Legend
--	--------

Load Classification	Connected Load	Demand Factor	Estimated Demand	Panel Totals
LIGHTING - DWELLING UNIT	660 VA	100.00%	660 VA	
OTHER	1508 VA	100.00%	1508 VA	Total Conn. Load: 31161 VA
RECEPTACLE	7440 VA	100.00%	7440 VA	Total Est. Demand: 30161 VA
LIGHTING	300 VA	100.00%	300 VA	Total Conn.: 130 A
CONDENSER	5000 VA	100.00%	5000 VA	Total Est. Demand: 126 A
WATER HEATER	4500 VA	100.00%	4500 VA	
RANGE	5000 VA	80.00%	4000 VA	
DRYER	5000 VA	100.00%	5000 VA	
REFRIGERATOR	1800 VA	100.00%	1800 VA	



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KEY PLAN

NO. DESCRIPTION DATE

NOTE:

LEGEND:

PROJECT

242-EMBER-960-2Bd1Ba MODERN-GARAGE-550

DRAWING NAME

SCHEDULE

CLIENT NAME:

PROJECT NUMBER:

0119_16

DATE:

5/8/2025 3:00:58 PM

DESIGNED BY:

DRAWN BY:

CHECKED BY:

Checker

E101

SCALE: 1/4" = 1'-0"

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ELECTRICAL NOTE

- A. PROVIDE INTERCONNECTED SMOKE ALARMS IN EACH SLEEPING ROOMS, OUTSIDE EACH SLEEPING ROOM, ON EACH STORY, IN THE HALL OR ADJACENT ROOM LUHERE THE CEILING HEIGHT OF A ROOM OPEN TO THE HALL EXCEEDS THE HALL BY 24'. SMOKE ALARMS SHALL BE PERMANENTLY HARD WIRED WITH BATTERY BACKUP.
- B. RECEPTACLE OUTLETS FOR RANGES AND CLOTHES DRYERS SHALL BE A THREE POLE WITH GROUND TYPE. FOUR WIRE GROUNDING-TYPE FLEXIBLE CORDS WILL BE REQUIRED FOR CONNECTION OF RANGES AND CLOTHES DRYERS. THE BONDING JUMPER SHALL NOT BE CONNECTED BETWEEN NEUTRAL TERMINAL AND THE FRAME OF THE APPLIANCE.
- C. TWO OR MORE 20 AMP SMALL APPLIANCE CIRCUITS SHALL BE PROVIDED TO SERVE THE KITCHEN, BREAKFAST NOOK, AND DINING ROOM. SUCH CIRCUITS SHALL HAVE NO OTHER OUTLETS.
- D. AT LEAST ONE 20 AMP BRANCH CIRCUIT SHALL BE PROVIDED TO SERVICE THE LAUNDRY ROOM. THIS CIRCUIT SHALL HAVE NO OTHER OUTLETS.
- E. ALL RECEPTACLES WITH IN 6' OF A WET BAR SINK OR KITCHEN SINK TO SERVE COUNTER TOP SURFACES MUST BE GFCI. ON KITCHEN COUNTERS 12' OR WIDER NO POINT ALONG THE WALL SHALL BE MORE THAN 2' FROM A RECEPTACLE. ALL RECEPTACLES WITH IN 6' OF KITCHEN SINK MUST BE GFCI. AT LEAST ONE GFCI RECEPTACLE SHALL BE INSTALLED IN THE BATHROOM ADJACENT TO EACH BASIN.
- F. FIXTURES INCLUDING CEILING FANS THAT ARE LOCATED IN DAMP LOCATIONS SHALL BE LISTED TO BE SUITABLE FOR
- SUCH LOCATIONS PER 2012 IRC
- G. PROVIDE ONE (1) SWITCHED OUTLET @ ALL BEDROOMS AND DEN
- H. CEILING FANS NOT EXCEEDING 35 LBS. (WITH OR WITHOUT ACCESSORIES MAY BE SUPPORTED BY OUTLET BOXES PROVIDED THE OUTLET BOXES ARE IDENTIFIED FOR SUCH USE PER 2012 IRC
- I. ELECTRICAL OUTLET BOXES ON OPPOSITE SIDES OF FIRE RATED WALLS SHALL BE SEPARATED BY A HORIZONTAL DISTANCE OF NOT LESS THAN 24".
- J. OUTLET BOXES IN THE WALLS BETWEEN THE GARAGE AND DWELLING SHALL BE METAL OR U.L. APPROVED FIRE RESISTIVE PLASTIC. BOXES IN GARAGE CEILING SHALL BE METAL.
- K. ALL BRANCH CIRCUITS THAT SUPPLY 120 VOLTS SINGLE PHASE 15 AND 20 AMPS RECEPTACLE OUTLETS INSTALLED IN THE DWELLING SHALL BE PROTECTED BY AN ARC FAULT CIRCUIT INTERRUPTER, EXCEPT GFCI RECEPTICLES.

NOTE:

A. RECEPTACLES MUST BE PROVIDED IN HALLWAYS 10'-0" OR MORE IN LENGTH. FOR A ONE FAMILY DWELLINGS AND EACH OF A TWO FAMILY DWELLING THAT IS AT GRADE LEVEL, AT LEAST ONE WP-GFCI RECEPTACLE OUTLET ACCESSIBLE AT GRADE LEVEL AND NOT MORE THAN 6'-6" ABOVE GRADE SHALL BE INSTALLED AT THE FRONT AND BACK OF THE DWELLING.

NOTE: APPLIANCE DISCONNECT

E4001.5 GROUNDING OF ENCLOSURES.

METAL ENCLOSURES FOR SWITCHES OR CIRCUIT BREAKERS SHALL BE CONNECTED TO AN

EQUIPMENT GROUNDING CONDUCTOR.

METAL ENCLOSURES FOR SWITCHES OR CIRCUIT BREAKERS USED AS SERVICE EQUIPMENT SHALL COMPLY WITH THE PROVISIONS OF SECTION E3609.4. WHERE


NONMETALLIC ENCLOSURES ARE USED WITH METAL RACEWAYS OR METAL-ARMORED

CABLES, PROVISIONS SHALL BE MADE FOR CONNECTING THE EQUIPMENT GROUNDING


CONDUCTOR.
NONMETALLIC BOXES FOR SWITCHES SHALL BE INSTALLED WITH A WIRING METHOD THAT

PROVIDES OR INCLUDES AN EQUIPMENT GROUNDING CONDUCTOR. (404.12)

ELECTRI	CAL LEGEND
	Electrical Lights With Fan
0	Waterproof Recessed Can Light
	Pendant Light
0	Recessed Can Light
- □	Wall Lamp
	Standalone linear
⊬ 10	Single Switch
Æ	Three way Switch
₩	Fan Switch
	Duplex Receptacle
	Triplex Receptacle
⊕ □GFCI	GFCI Receptacle
×	Exhaust Fan
•	Smoke and heat detector

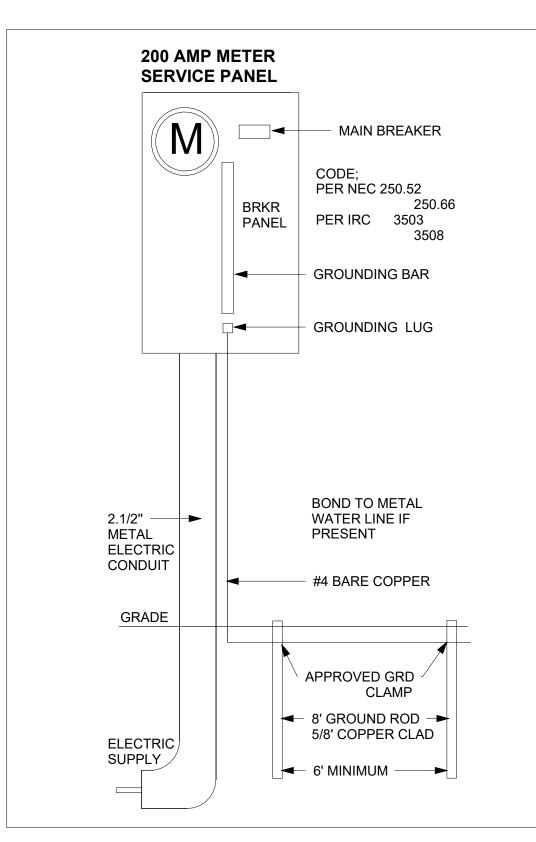



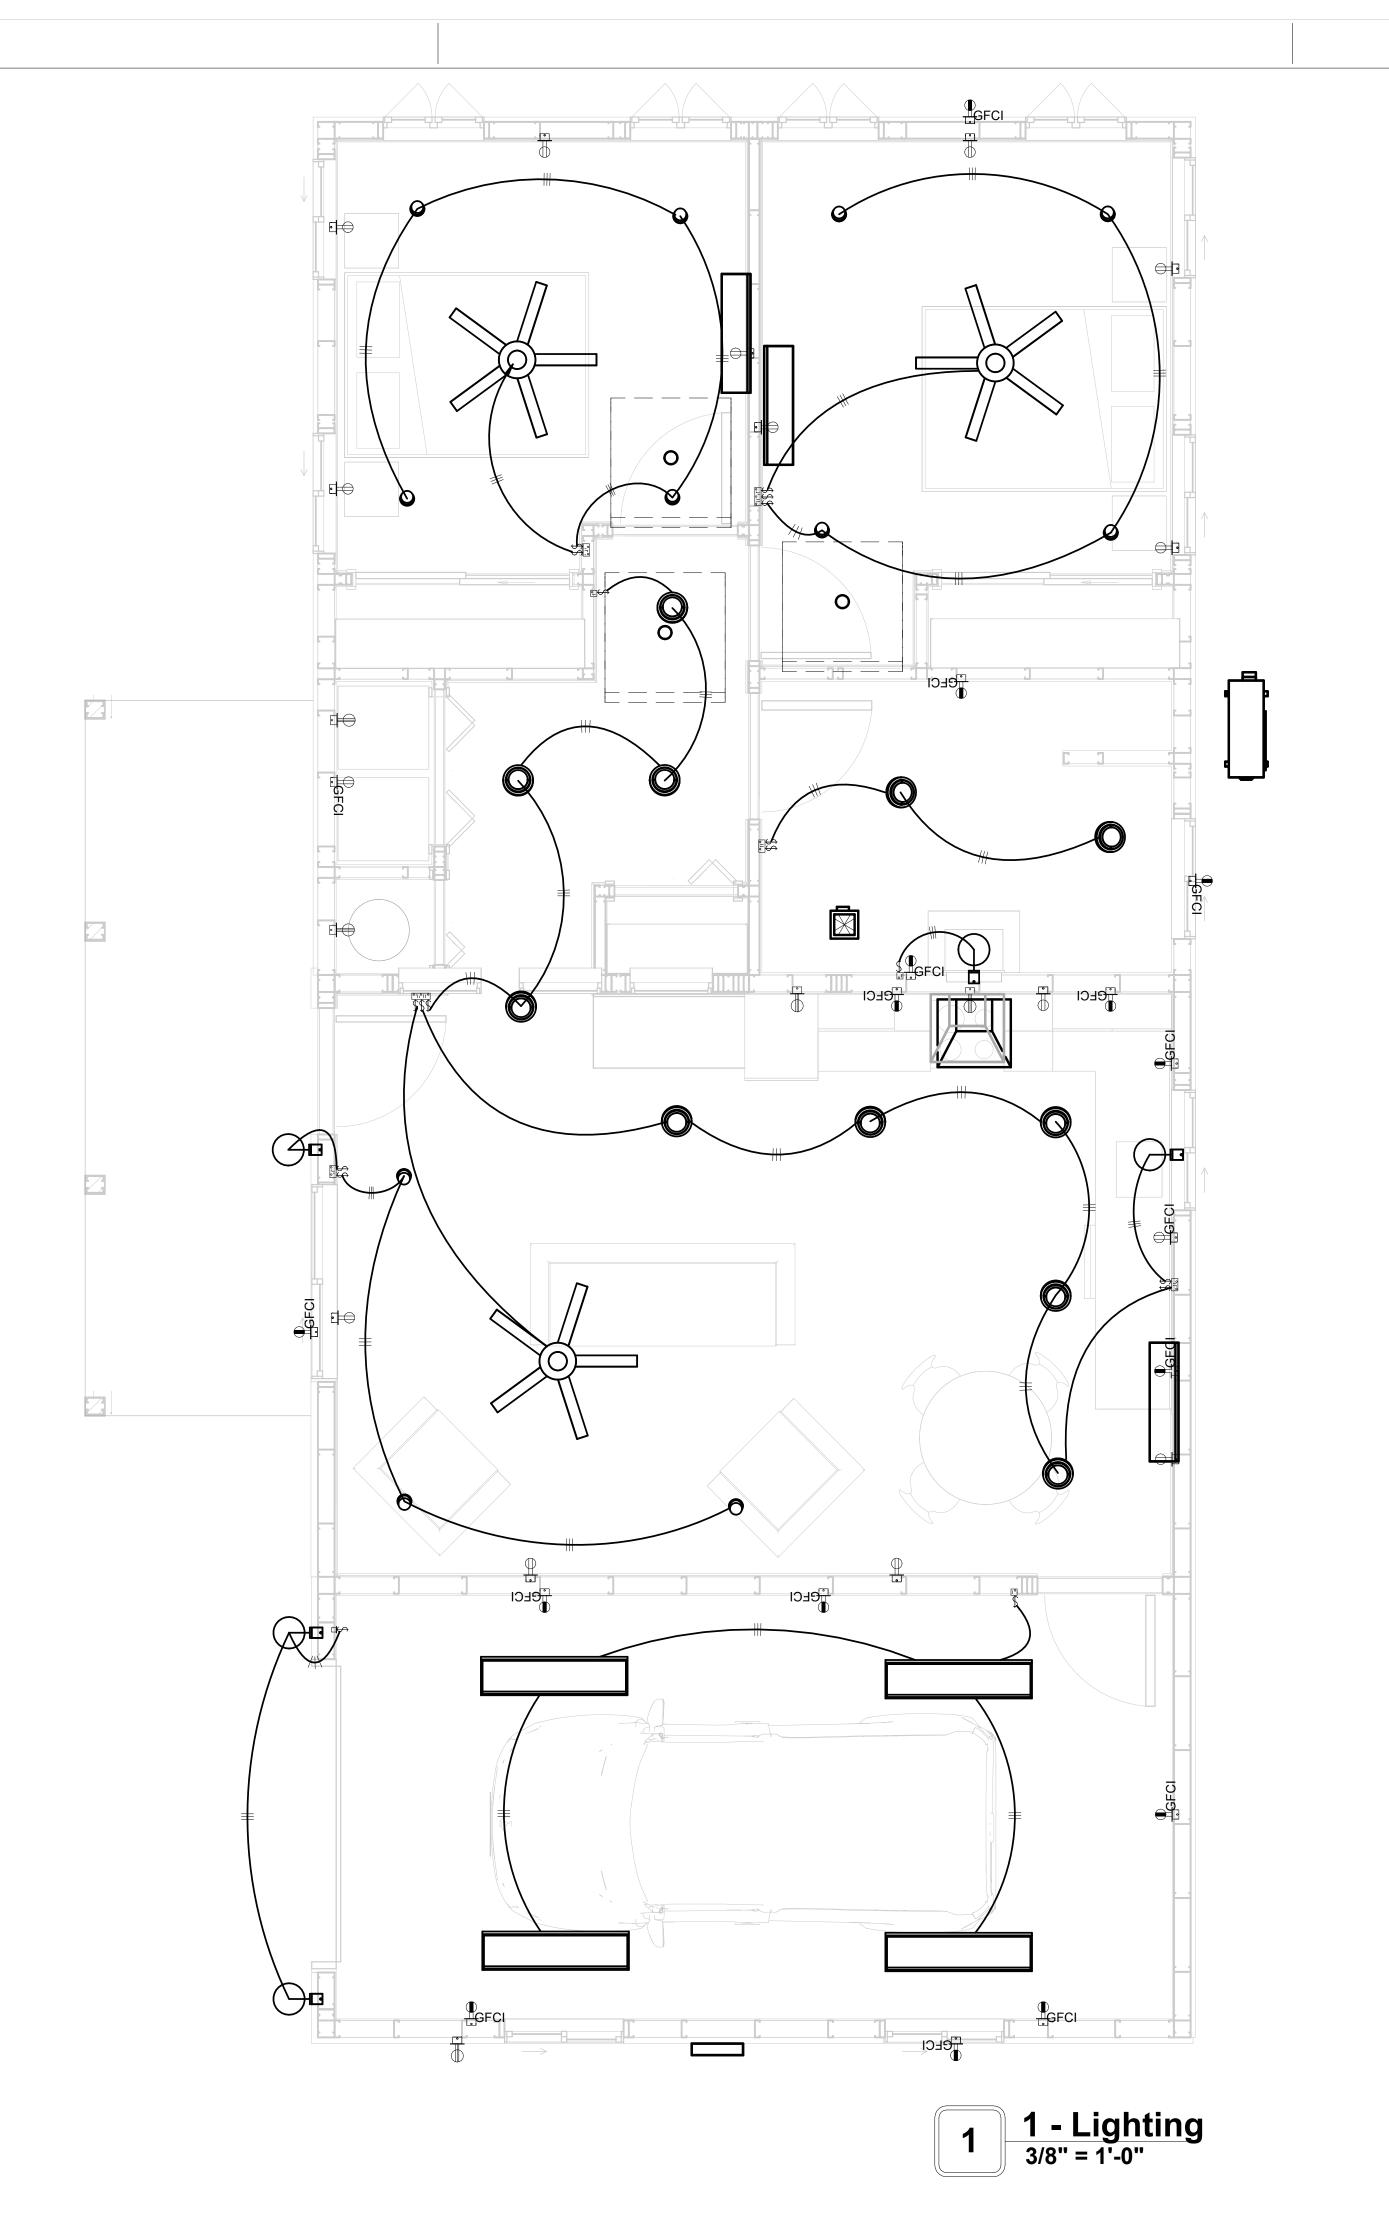



KEY PLAN

NO.	DESCRIPTION	DATE
NO.	DESCRIPTION	DATE

NOTE:

LEGEND:

PROJECT

242-EMBER-960-2Bd1Ba MODERN-GARAGE-550

DRAWING NAME


LIGHTING

CLIENT NAME:	Owner
PROJECT NUMBER:	0119_16
DATE:	5/8/2025 3:01:01 PM
DESIGNED BY:	Designer
DRAWN BY:	Author
CHECKED BY:	Checker


E102

NOTES: CONDUIT, CABLE AND WIRING


- Use Metalic Conduits (IMC) for cables running under concrete slabs.
 Use IMC for circuits with high voltage appliances (240 volts and above)
 For circuits with 120 volts consider using EMT or PVC conduits if needed.
 For Low voltage applications up to 50 volts consider using non metalic conduits.
 All conduits to be used in the project must conform to the latest National Electrical Code (NEC),
- 6. All wiring and cables to be used in the project must also conform to the latest National Electrical
- 7. All cables and wires used should be rated for their respective loading and should be gauged and conform to the NEC.

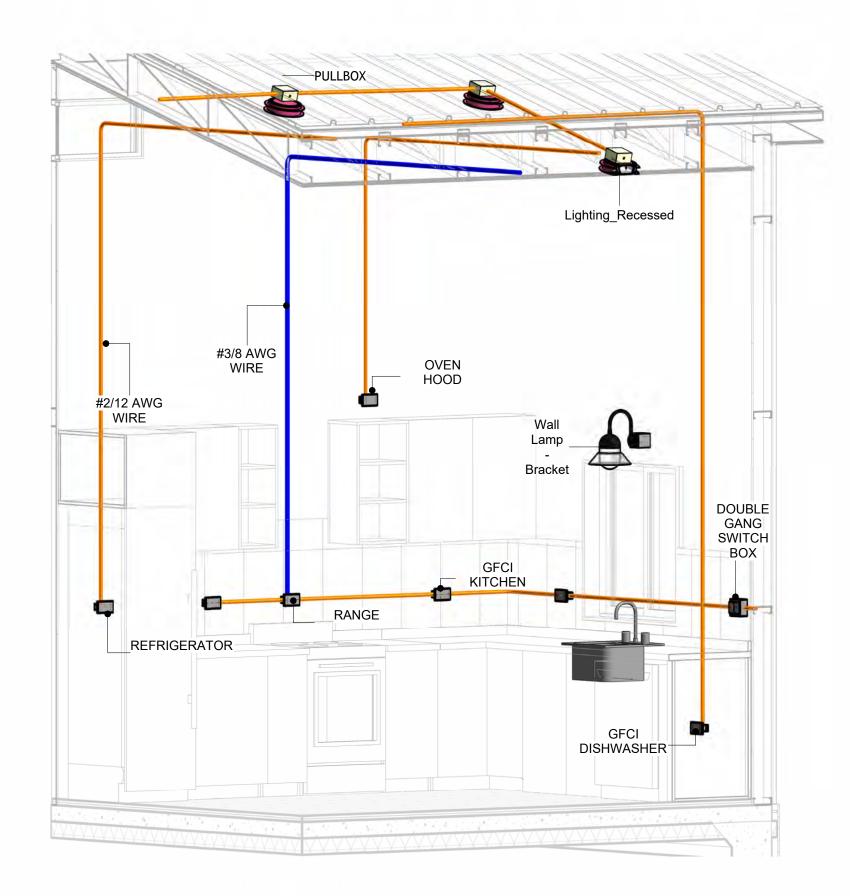


3D-KITCHEN

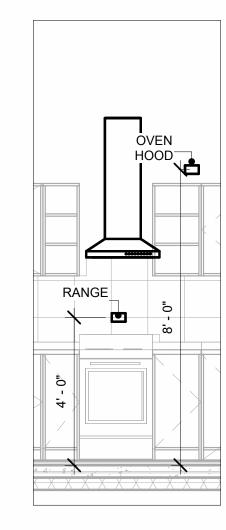


RANGE & OVENHOOD 3/8" = 1'-0"

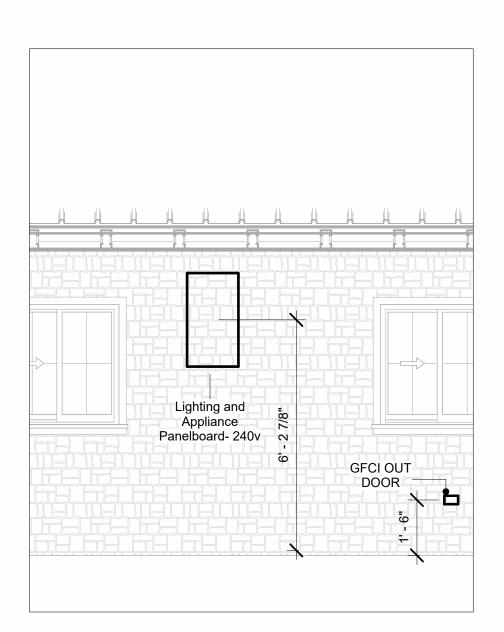

PANEL & GFCI 3/8" = 1'-0"

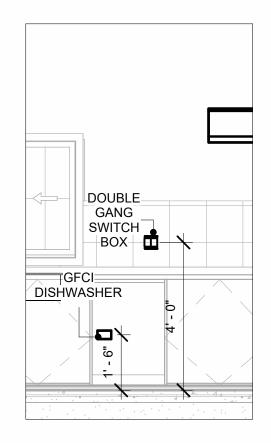


DISHWASHER & SWITCH BOX 3/8" = 1'-0"

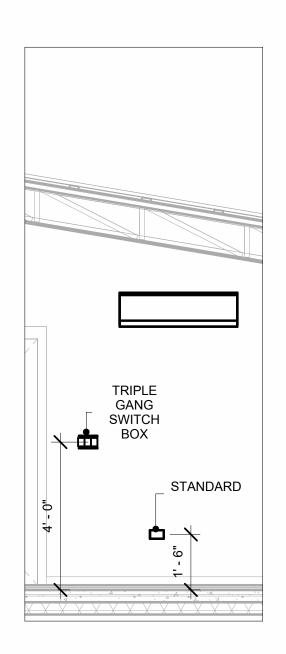

RECEPTACLE & SWITCH



KEY PLAN

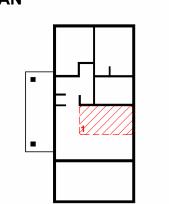

NO.	DESCRIPTION	DATE

NOTE:

LEGEND:

PROJECT

242-EMBER-960-2Bd1Ba **MODERN-GARAGE-550**

DRAWING NAME

POWER

CLIENT NAME:	Owner
PROJECT NUMBER:	0119_16
DATE:	5/8/2025 3:01:26 PM
DESIGNED BY:	Designer
DRAWN BY:	Author
CHECKED BY:	Checker

E103

SCALE: As indicated

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NOTES: LIGHT

- 1. LIGHT FIXTURES AND LUMINARIES SHALL CONFORM TO THE NEC, THE IRC AND LOCAL SAFETY & BUILDING CODE.
- 2. ALL LIGHTING FIXTURES SHOULD CONFORM TO THE DESIGN ELECTRICAL LOAD AND SHALL BE PROPERLY WIRED AND MOUNTED BY QUALIFIED ELECTRICIAN FOLLOWING MANUFACTURERS SPECIFICATIONS.
- 3. CEILING FANS AND FANS WITH LIGHT WITH WEIGHT EXCEEDING 35 LBS SHOULD BE PROVIDED WITH STRUCTURAL BACKING FOR SUPPORT AND SHALL BE FIXED AS PER MANUFACTURERS SPECIFICATIONS.
- 4. EXTERIOR LIGHTS SHALL CONFORM TO LOCAL BUILDING CODE AND GUIDELINES.

NOTES: SWITCH JUNCTION BOX


- 1. THE MINIMUM SIZE OF JUCTION BOX TO BE USED IS 2"X4"X(1.5" OR 3.5" DEEP) THIS ARE TO BE USED FOR SINGLE GANG SWITCH OR OUTLETS.
- 2. FOR DOUBLE GANG (2 GANG) OUTLETS AND SWITCHS THE MINIMUM SIZE OF THE
- JUCTION BOX TO BE PROVIDED SHALL NOT BE LESS THAN 4"X4"X(1.5" OR 3.5" DEEP)
- 3. FOR THREE GANG (3 GANG) OUTLETS AND SWITCHS THE MINIMUM SIZE OF THE JUĆTION BOX SHALL NOT BE LESS THAN 6"X4"X(1.5" OR 3.5" DEEP).

FITTING SCHEDULE(PULL BOX)		
FAMILY COUNT DESCRIPTION		DESCRIPTION
PULLBOX1	32	#1/4 PULLBOX

ELECTRICAL FIXTURE SCHEDULE (SWITCH BOX)		
TYPE	COUNT	
DOUBLE GANG SWITCH BOX	4	
SINGLE GANG SWITCH BOX	3	
TRIPLE GANG SWITCH BOX	2	

LIGHTING DEVICE		
TYPE	COUNT	
SINGLE POLE	18	

LIGHTING FIXTURE			
LIGHTING FIXTURE TYPE	VOLTAGE	ELECTRICAL LOAD	COUNT
CEILING LIGHT - LINEAR BOX	120 V/1-40 VA	200 A, 120 V/240 V, SINGLE PHASE, 3 WIRES	4
ELECTRICAL_LIGHTS_FAN-LI GHT1	120 V/1-100 VA- 120 V/1-100 VA	200 A, 120 V/240 V, SINGLE PHASE, 3 WIRES	3
LIGHTING_RECESSED	120 V/1-60 VA	200 A, 120 V/240 V, SINGLE PHASE, 3 WIRES	11
SASSO 100 ROUND WALLWASHER TRIM	120 V/1-28 VA	200 A, 120 V/240 V, SINGLE PHASE, 3 WIRES	11
WALL LAMP - BRACKET	120 V/1-100 VA	200 A, 120 V/240 V, SINGLE PHASE, 3 WIRES	5

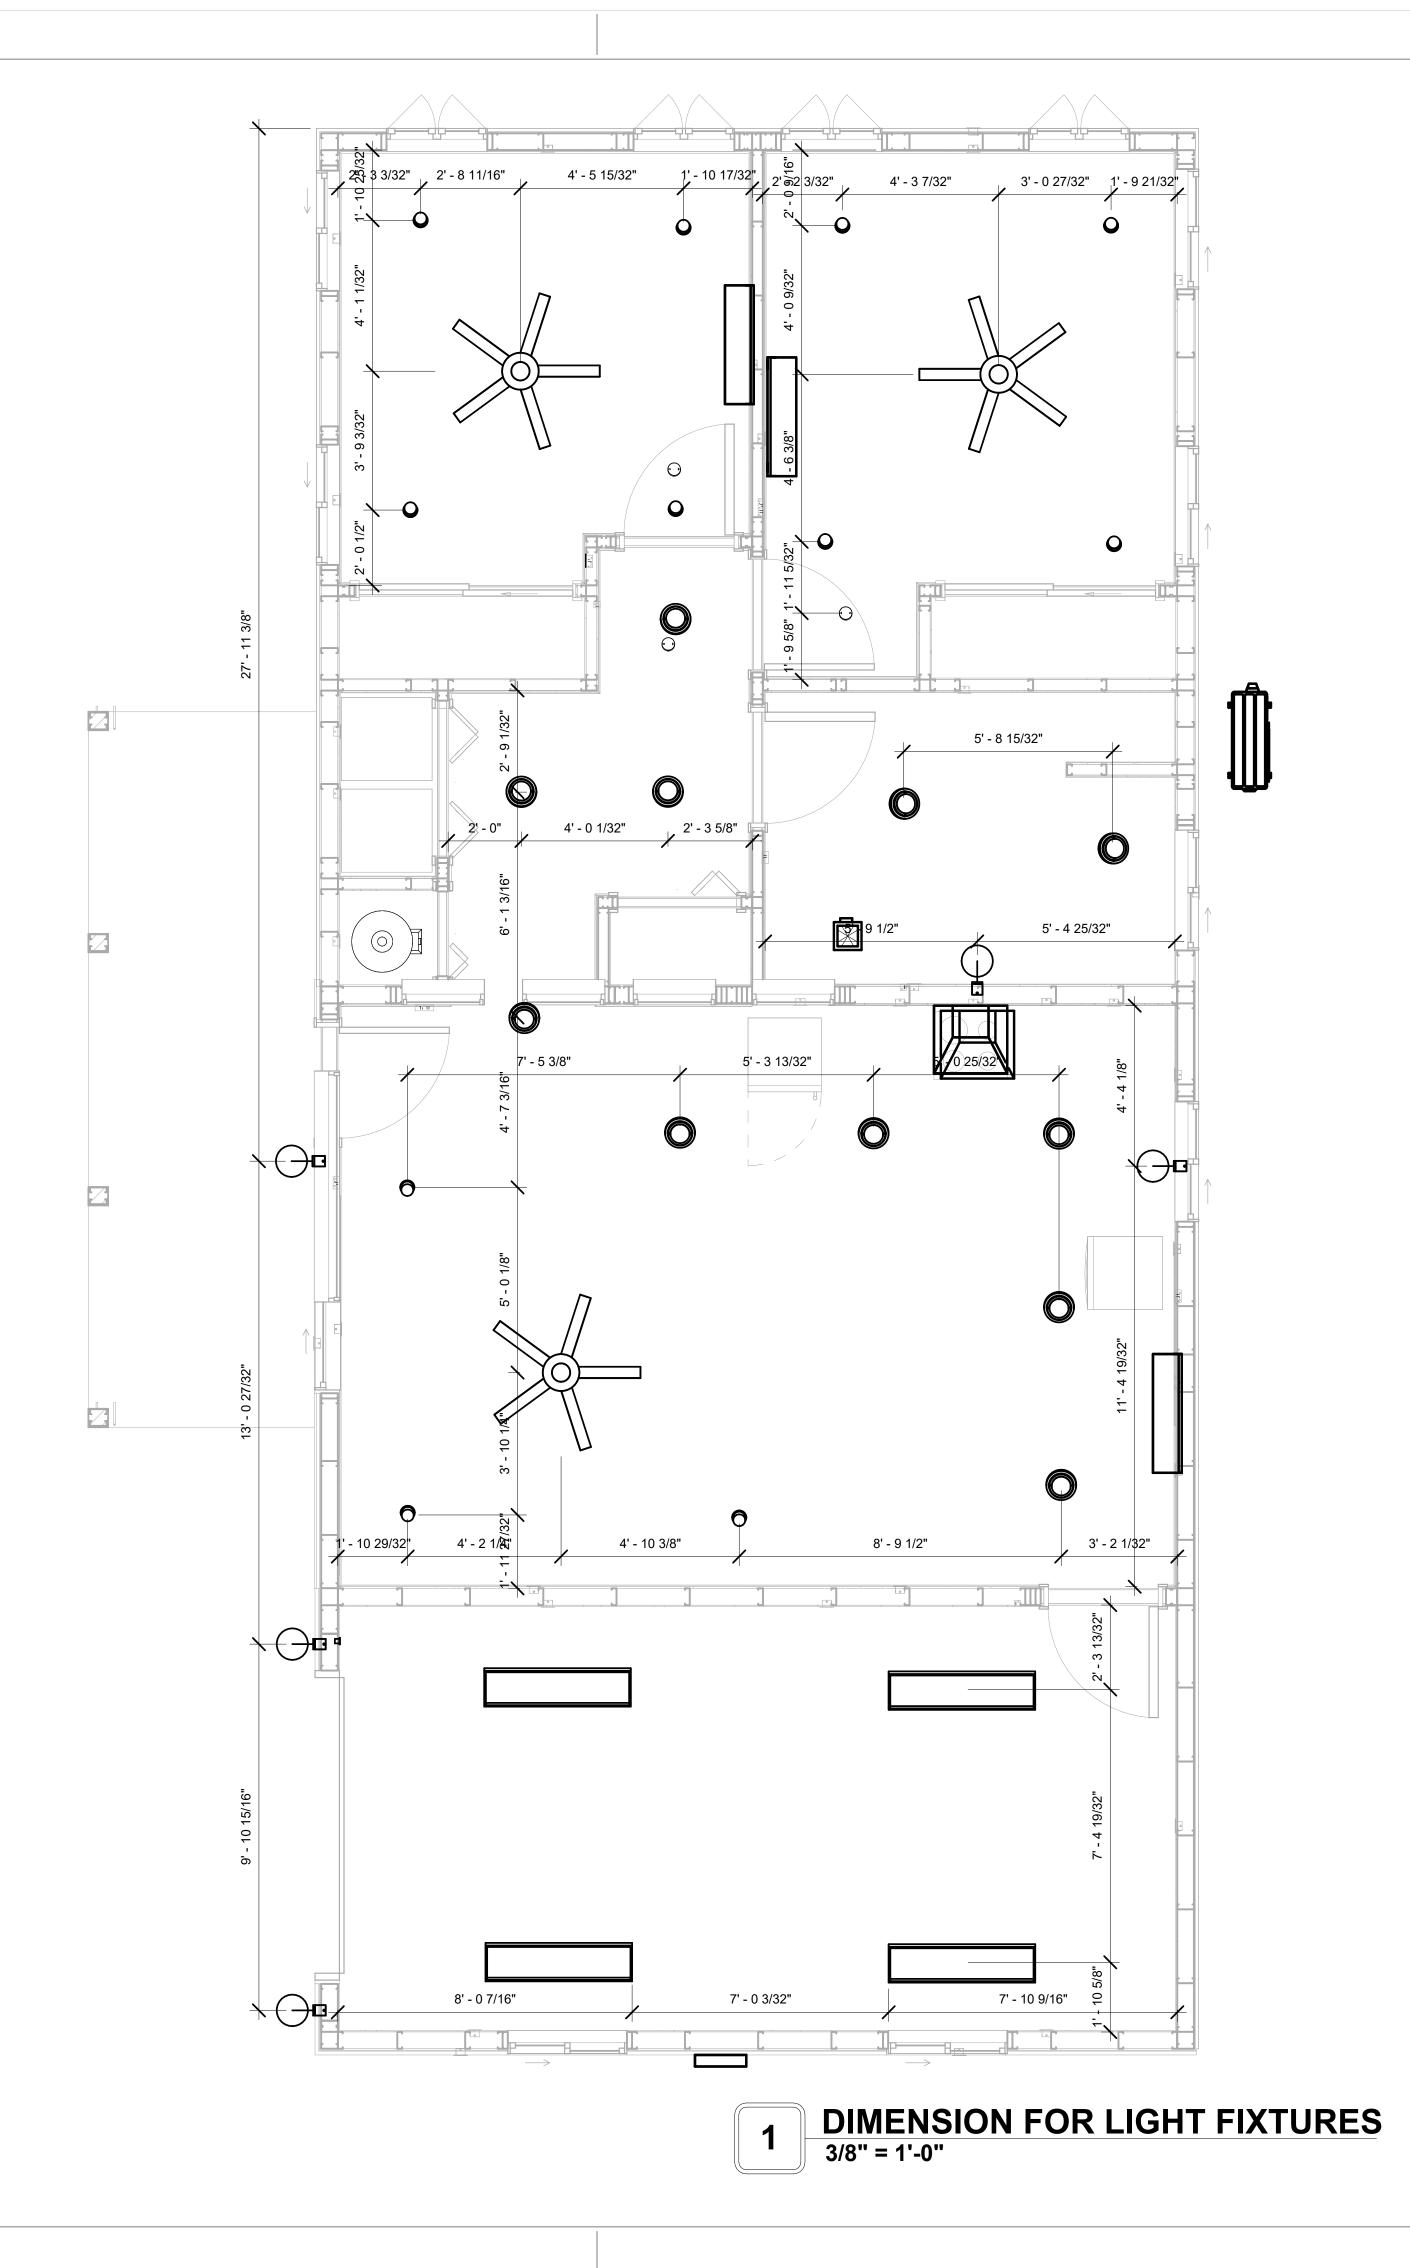



KEY PLAN

NO.	DESCRIPTION	DATE

NOTE:

LEGEND:

PROJECT

242-EMBER-960-2Bd1Ba **MODERN-GARAGE-550**

DRAWING NAME

DIMENSION PLAN FOR LIGHT FIXTURES

CLIENT NAME:	Owner
PROJECT NUMBER:	0119_16
DATE:	5/8/2025 3:01:27 PM
DESIGNED BY:	Designer
DRAWN BY:	Author
CHECKED BY:	Checker


E104

NOTES;

- 1. VERIFY EQUIPMENT PLUG CONFIGURATION BEFORE PURCHASING RECEPTACLES
- 2. FOR ALL EQUIPMENT.
- 3. COORDINATE EXACT LOCATION OF LIGHT FIXTURES, WALL SWITCHES, RECEPTACLES AND OTHER DEVICES WITH ARCHITECTURAL DRAWINGS.
- 4. USE METALLIC JUNCTION BOX WITH THE GFCI RECEPTACLES, WITH HIGHT VOLTAGE.

ELECTRICAL FIXTURE SCHEDULE (RECEPTACLE)		
TYPE	COUNT	
CONDENSER	1	
DRYER	1	
GFCI BATH ROOM	2	
GFCI DISHWASHER	1	
GFCI GARAGE	5	
GFCI KITCHEN	4	
GFCI OUT DOOR	4	
GFCI WASHER	1	
OVEN HOOD	1	
RANGE	1	
REFRIGERATOR	1	
STANDARD	12	
WATER HEATER	1	

ELECTRICAL OUTLET SCHEDULE			
TYPE	CIRCUIT NUMBER	ELECTRICAL DATA	COUNT
GFCI BATH ROOM	2	120 V/1-180 VA	2
STANDARD	7	120 V/1-180 VA	8
DRYER	8,10	240 V/2-5000 VA	1
GFCI WASHER	9	120 V/1-1200 VA	1
WATER HEATER	11,13	240 V/2-4500 VA	1
REFRIGERATOR	12	120 V/1-1800 VA	1
GFCI KITCHEN	14	120 V/1-180 VA	4
RANGE	15,17	240 V/2-5000 VA	1
OVEN HOOD	16	120 V/1-180 VA	1
GFCI DISHWASHER	18	120 V/1-1200 VA	1
STANDARD	19	120 V/1-180 VA	4
GFCI OUT DOOR	20	120 V/1-180 VA	4
CONDENSER	21,23	240 V/2-5000 VA	1
GFCI GARAGE	22	120 V/1-180 VA	5

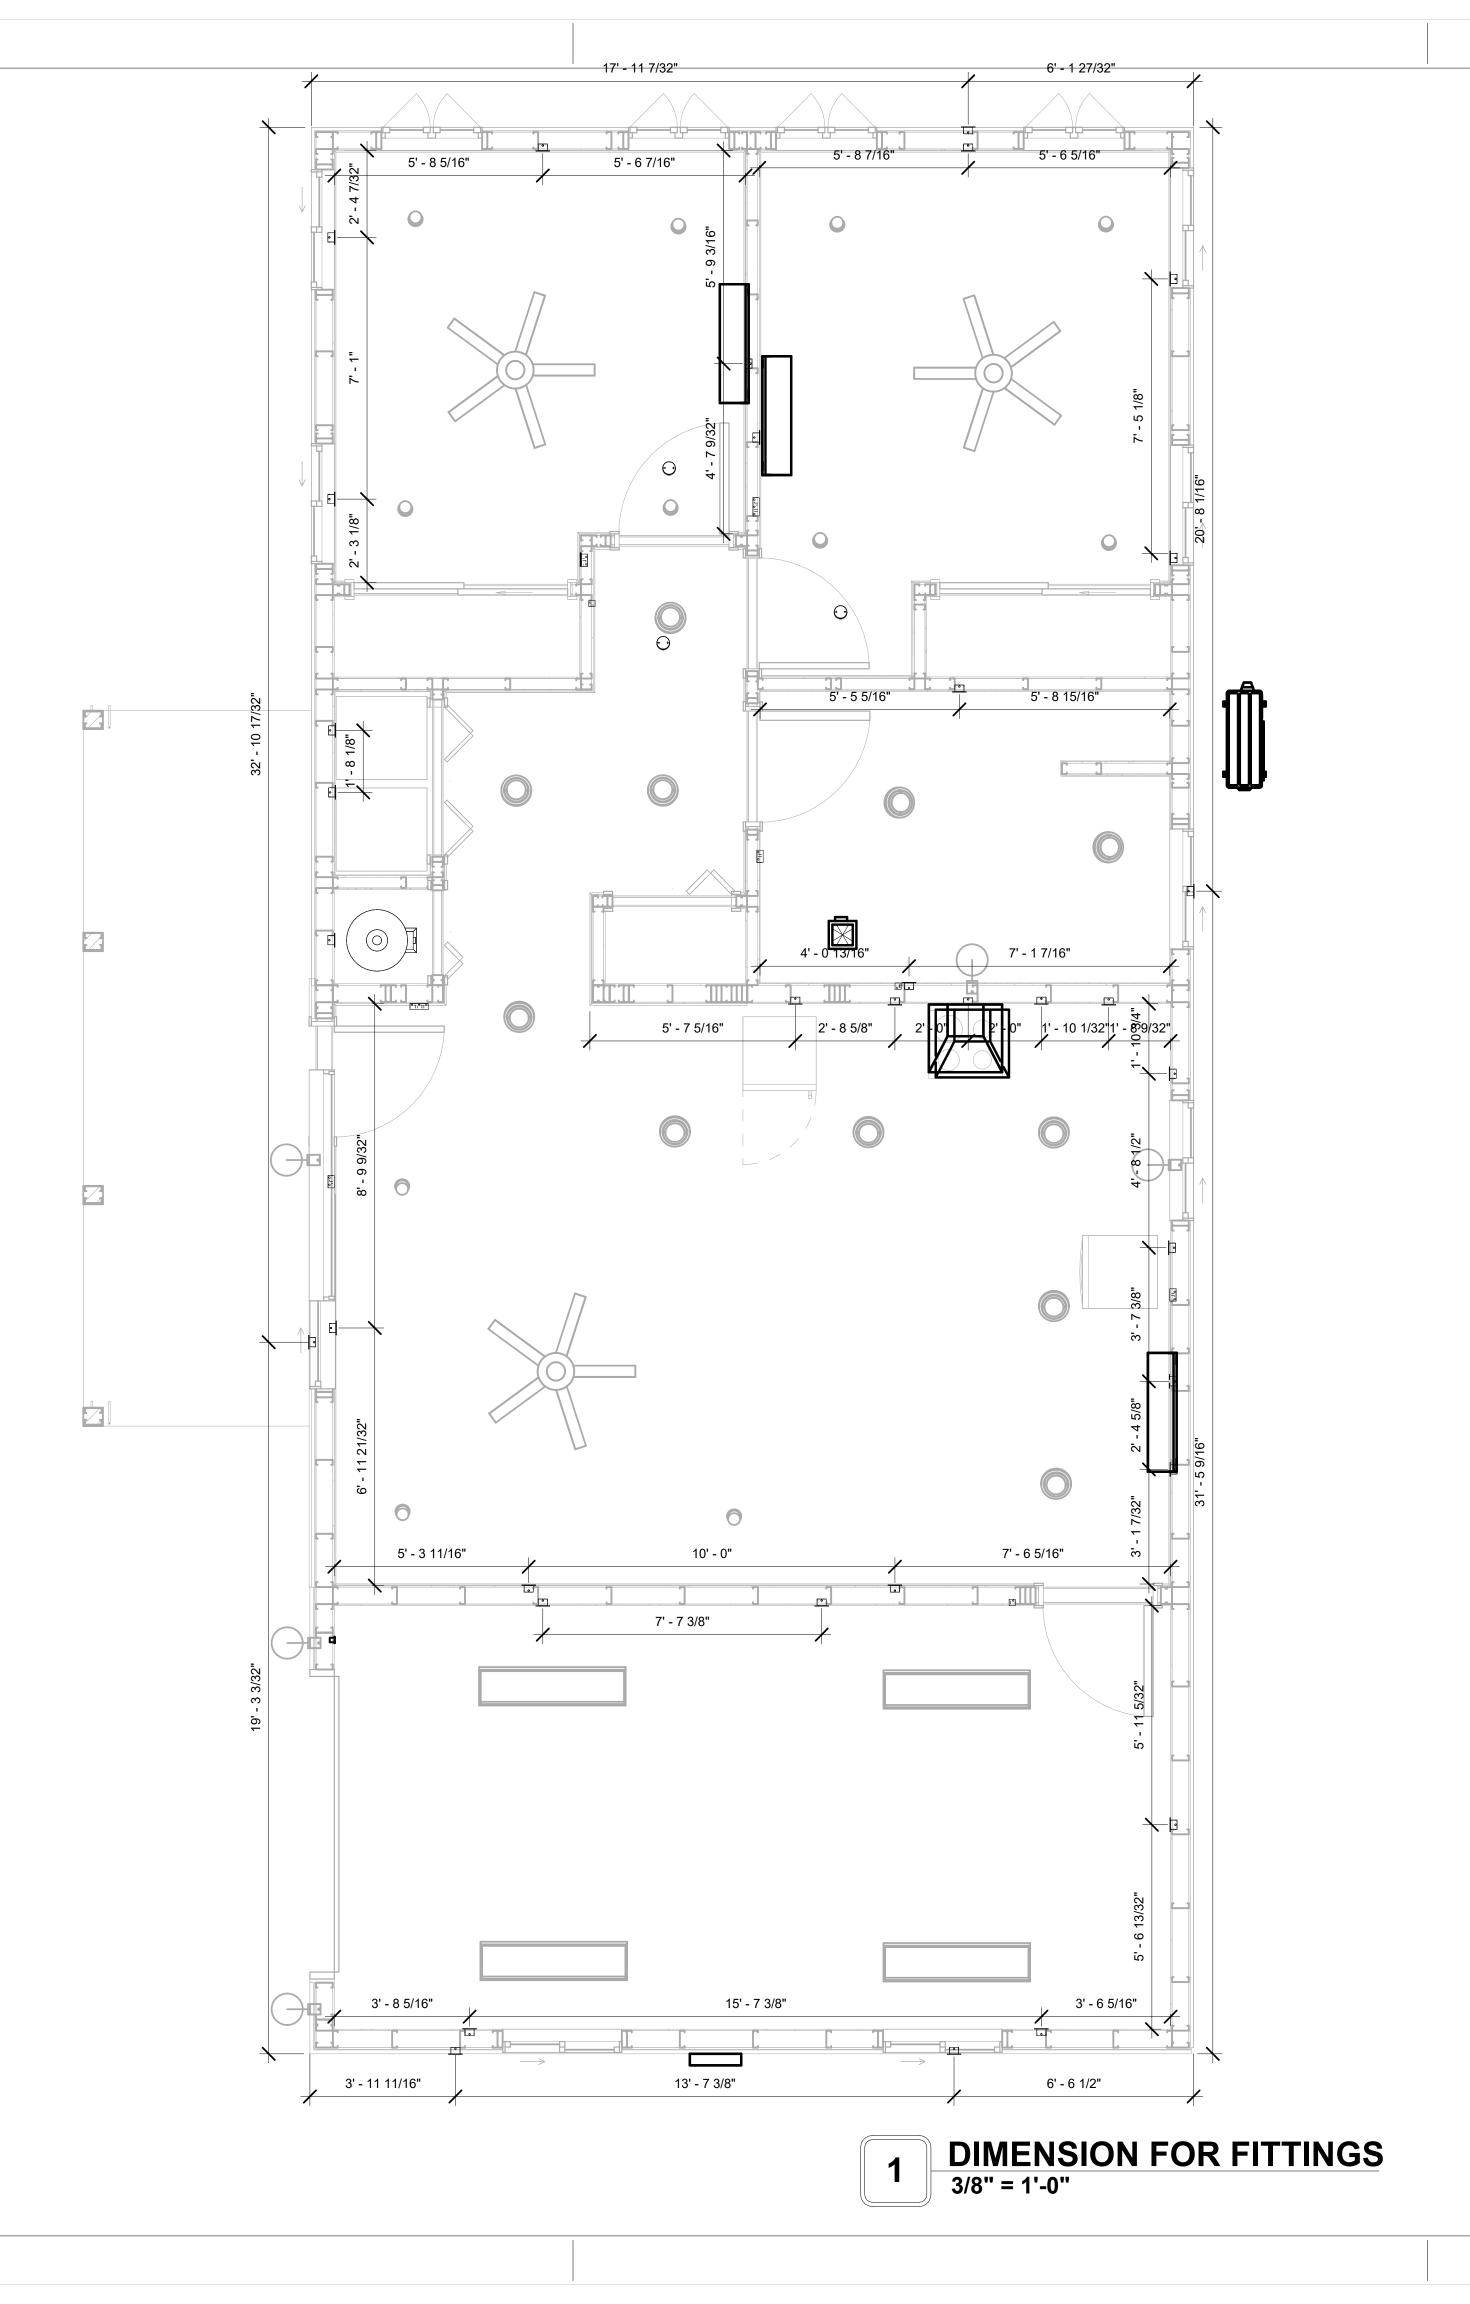



KEY PLAN

NO.	DESCRIPTION	DATE

NOTE:

LEGEND:

PROJECT

242-EMBER-960-2Bd1Ba MODERN-GARAGE-550

DRAWING NAME

DIMENSION PLAN FOR FITTINGS

CLIENT NAME:	Owner
PROJECT NUMBE	R: 0119_16
DATE:	5/8/2025 3:01:28 PM
DESIGNED BY:	Designer
DRAWN BY:	Author
CHECKED BY:	Checker

E105

SHEET LIST

SHEET NUMBER SHEET NAME

P101 NOTE AND SCHEDULE
P102 WATER SUPPLY AND SEWAGE
SYSTEM

PIPE COL	OR SCHEME
	DOMESTIC COLD WATEDOMESTIC HOT WATERSANITARY VENT
	SANITARY SEWER STORM DRAINAGE GRAY WATER
	GAS LINE

PLUMBING NOTES

- THE PLUMBING SYSTEM IS DESIGNED TO MEET THE BUILDING'S DOMESTIC WATER SUPPLY, SANITARY DRAINAGE, AND STORM DRAINAGE REQUIREMENTS, AS PER PROJECT SPECIFICATIONS AND APPLICABLE CODES.
- 2. THE SYSTEM INSTALLATION SHALL COMPLY WITH THE LATEST INTERNATIONAL PLUMBING CODE (IPC), INTERNATIONAL RESIDENTIAL CODE (IRC), AND ALL OTHER RELEVANT LOCAL, STATE, AND NATIONAL REGULATIONS.
- 3. ALL PLUMBING WORK SHALL COMPLY WITH THE LATEST EDITION OF THE INTERNATIONAL PLUMBING CODE (IPC) AND THE LOCAL PLUMBING CODE.
- 4. PLUMBING SYSTEMS SHALL BE TESTED AND INSPECTED IN ACCORDANCE WITH THE LOCAL PLUMBING CODE REQUIREMENTS.
- 5. PLUMBING FIXTURES SHALL BE INSTALLED WITH THE APPROPRIATE TRIM, FITTINGS, AND ACCESSORIES, AS RECOMMENDED BY THE MANUFACTURER.
- 6. PIPING SHALL BE PROPERLY SUPPORTED AND SECURED TO PREVENT SAGGING, MOVEMENT, AND VIBRATION.
- 7. SHUT-OFF VALVES SHALL BE PROVIDED AT ALL BRANCH CONNECTIONS AND AT THE INLET AND OUTLET OF EACH PIECE OF EQUIPMENT.
- 8. BACKFLOW PREVENTION DEVICES SHALL BE INSTALLED AS REQUIRED BY THE LOCAL PLUMBING CODE TO PROTECT THE POTABLE WATER SYSTEM.
- 9. PLUMBING FIXTURES AND EQUIPMENT SHALL BE ACCESSIBLE FOR MAINTENANCE AND SERVICING.
- 10. EXPOSED PLUMBING PIPING AND FIXTURES SHALL BE INSULATED TO PREVENT CONDENSATION AND ENERGY LOSS.
- 11. DEAD ENDS IN THE DRAINAGE SYSTEM MUST BE AVOIDED, EXCEPT WHERE NECESSARY TO INSTALL A CLEANOUT IN AN ACCESSIBLE LOCATION, AND MUST HAVE A VENTED CONNECTION TO THE OUTSIDE ATMOSPHERE.
- 12. THE VERTICAL DEFLECTION OF PVC PIPE MUST NOT EXCEED 5%, AND NO DEFLECTION IS PERMITTED FOR IRON PIPE.
- 13. WORK MUST BE PROPERLY COORDINATED WITH OTHER TRADES TO AVOID CONFLICTS, REFERRING TO THE ARCHITECTURAL AND STRUCTURAL DRAWINGS FOR INFORMATION REGARDING CEILING ELEVATIONS, SPACE CLEARANCES, WALL AND PARTITION LOCATIONS, ETC.
- 14. ALL FIXTURES SHALL HAVE ACCESSIBLE STOPS.
- 15. DOMESTIC WATER PIPING SHALL BE PEX, AND PVC PIPING IS NOT ACCEPTABLE FOR INTERIOR USE.
- 16. VENT TERMINATIONS SHALL BE LOCATED AT LEAST 10 FEET FROM OR 3 FEET ABOVE ANY OPERABLE WINDOW, DOOR OPENING, AIR INTAKE, OR VENT SHAFT, AND AT LEAST 3 FEET IN EVERY DIRECTION FROM ANY LOT LINE, ALLEY, OR STREET.
- 17. PIPE AND FITTINGS UTILIZED IN THE WATER SUPPLY SYSTEM SHALL HAVE A MAXIMUM OF 8 PERCENT LEAD.
- 18. ACRYLONITRILE BUTADIENE STYRENE (ABS) SHALL BE USED FOR THE SEWERAGE AND VENTILATION SYSTEM.
- 19. CROSS-LINKED POLYETHYLENE (PEX) SHALL BE USED FOR THE WATER SUPPLY SYSTEM.
- 20. POLYVINYL CHLORIDE (PVC) SHÀLL BÉ USED FOR THE RAIN WATER SYSTEM.
- 21. THE MIMIMUM WATER SUPPLY DEPTH UNDER FLOOR FINISH SHOUD BE 1/2".
- 22. ANY PIPE INSTALLED UNDERGROUND MUST HAVE AT LEAST 12 INCHES OF CLEARANCE BETWEEN THE OUTSIDE OF THE PIPE AND ANY OTHER UNDERGROUND STRUCTURE.
- 23. THE MINIMUM CLEARANCE BETWEEN COLD AND HOT WATER LINES IN RESIDENTIAL
- HOMES MAINTAIN A MINIMUM DISTANCE OF 6 INCHES.

 24. HORIZONTAL SEPARATION BETWEEN WATER AND SEWER LINES: A MINIMUM OF 12 INCHES BETWEEN POTABLE WATER SUPPLY LINES (COLD AND HOT WATER) AND

ABBREVIATIONS

SANITARY SEWER LINES.

Ø	DIAMETER					
ABS	ACRYLONITRILE BUTADIENE STYRENE					
ABV	ABOVE					
AD	AREA DRAIN					
AFF	ABOVE FINISHED FLOOR					
ALT	ALTERNATE					
BFF	BELOW FINISHED FLOOR					
BLW	BELOW					
CO	CLEAN OUT					
CW	COLD WATER					
D	DEGREE					
DFU	DRANAGE FIXTURE UNIT					
DIA	DIAMETER					
DN	DOWN					
FCO	FLOOR CLEAN OUT					
FD	FLOOR DRAIN					
FL	FLOOR					
FS	FLOOR SINK					
FT	FOOT/FEET					
HB	HOSE BIB					
HW	HOT WATER					
IN	INCH					
MIN	MINIMUM					
NO	NUMBER					
NTS	NOT TO SCALE					
PEX	CROSS-LINKED POLYETHYLENE					
PLBG	PLUMBING					
PVC	POLYVINYL CHLORIDE					
QTY	QUANTITY					
RD	ROOF DRAIN					
RED	REDUCER					
RM	ROOM					
RW	RAIN WATER					
SF	SQUARE FOOT					
V	VENT					
VTR	VENT THROUGH ROOF					
W	WASTE					
WCO	WALL CLEAN OUT					
WSFU	WATER SUPPLY FIXTURE UNIT					

PLUMBING LEGEND

D	CAP
	BEND 45 DEG
B	BEND 90 DEG
	TEE REDUCING
띡	TEE
	CLEAN TWO-WAY
	WYE 45 DEG
	WYE 45 DEG DOUBLE
	WYE COMBINATION
	P-TRAP

PIPE SCHEDULE					
MATERIAL	DIAMETER	LENGTH			
ACRYLONITRILE BUTADIENE STYRENE (ABS)	1 1/2"	24 FT			
ACRYLONITRILE BUTADIENE STYRENE (ABS)	2"	36 FT			
ACRYLONITRILE BUTADIENE STYRENE (ABS)	3"	42 FT			
CROSS-LINKED POLYETHYLENE (PEX)	1/2"	66 FT			
CROSS-LINKED POLYETHYLENE (PEX)	3/4"	54 FT			
CROSS-LINKED POLYETHYLENE (PEX)	1"	1 FT			
POLYVINYL CHLORIDE - RIGID	2"	67 FT			

FI	TTING SCHEDULE	
FITTING	SIZE	QTY
PEX 90 DEG ELBOW	1/2"ø-1/2"ø	3
PEX 90 DEGREE ELBOW	1/2"ø-1/2"ø	13
PEX 90 DEGREE ELBOW	3/4"ø-3/4"ø	1
PEX TEE ELBOW	1/2"ø-1/2"ø-1/2"ø	2
PEX TEE ELBOW	3/4"ø-3/4"ø-3/4"ø	5
PEX TRANSITION ELBOW	1"ø-3/4"ø	1
PEX TRANSITION ELBOW	3/4"ø-1/2"ø	4
PEX 90 DEG ELBOW	1/2"ø-1/2"ø	1
PEX 90 DEGREE ELBOW	1/2"ø-1/2"ø	9
PEX 90 DEGREE ELBOW	3/4"ø-3/4"ø	2
PEX TEE ELBOW	1/2"ø-1/2"ø-1/2"ø	2
PEX TEE ELBOW	3/4"ø-3/4"ø-3/4"ø	2
PEX TRANSITION ELBOW	3/4"ø-1/2"ø	3
PVC 90 DEG BEND ELBOW	2"ø-2"ø	8
PVC 90 DEGREE BEND ELBOW	2"ø-2"ø	16
ABS 90 DEGREE BEND ELBOW	1 1/2"ø-1 1/2"ø	1
ABS 90 DEGREE BEND ELBOW	2"ø-2"ø	2
ABS 90 DEGREE BEND ELBOW	3"ø-3"ø	2
ABS P-TRAP	1 1/2"ø-1 1/2"ø	3
ABS P-TRAP	2"ø-2"ø	1
ABS REDUCER ELBOW	2"ø-1 1/2"ø	1
ABS REDUCER ELBOW	3"ø-2"ø	1
ABS TEE ELBOW	1 1/2"ø-1 1/2"ø-1 1/2"ø	1
ABS TEE ELBOW	2"ø-2"ø-2"ø	1
ABS TEE ELBOW	3"ø-3"ø-3"ø	1
ABS TEE REDUCER ELBOW	3"ø-3"ø-1 1/2"ø	2
ABS TEE REDUCER ELBOW	3"ø-3"ø-2"ø	1
ABS TEE REDUCER ELBOW	3"ø-3"ø-3"ø	1
ABS TRAP P	2"ø-2"ø	1
WASTE DOUBLE TEE	2"ø-2"ø-2"ø	1
ABS VENT CAP ELBOW	1 1/2"ø	1
ABS VENT CAP ELBOW	2"ø	2
ABS VENT CAP ELBOW	3"ø	1

		FIX	ΓURE	CC	NN	ECT	ION	SCH	HEDI	JLE	
FAMILY	W	V	TRAP	CW	HW	QTY	DFU	TOT.	WFU	TOT.	NOTES
					1						
DISHWASHER	2"	1-1/2"	1-1/2"	1/2"	1/2"	1		0			DRAIN TO SEWER SEE PLANS
DRYER	N/A	N/A	N/A	N/A	N/A	1		0			
HANGING PIPES CLAMP						16		0			
SHOWER TRAY	2"	1-1/2"	1-1/2"	1/2"	1/2"	1		0			
SHOWER TRIM	-	-	-	1/2"	1/2"	1		0			
SINK ISLAND SINGLE	2"	1-1/2"	1-1/2"	1/2"	1/2"	1		0			
VANITY SINK	2"	1-1/2"	1-1/2"	1/2"	1/2"	1		0			
WASHER	2"	1-1/2"	2"	1/2"	1/2"	1		0			DRAINS TO GRAY WATER OR SEWER SEE PLANS
WATER CLOSET						1		0			
WATER HEATER	N/A	N/A	N/A	3/4"	3/4"	1		0			

FIXTURE SCHEDULE					
FIXTURE	QTY	DESCRIPTION			
DISHWASHER	1	DRAIN TO SEWER SEE PLANS			
DRYER	1				
HANGING PIPES CLAMP	16				
SHOWER TRAY	1				
SHOWER TRIM	1				
SINK ISLAND SINGLE	1				
VANITY SINK	1				
WASHER	1	DRAINS TO GRAY WATER OR SEWER SEE PLANS			
WATER CLOSET	1				
WATER HEATER	1				

ACCESSORIES & FITTINGS SCHEDULE					
FIXTURE	QTY	DESCRIPTIONS			
DISHWASHER CONNECTOR	1				
HOSE BIB	1				
LAUNDRY SWEAT CONNECTOR	1				

	PL	UMBING S	CHEDULE		
FIXTURE	TRAP	WASTE	VENT	C.W	H.W
DISHWASHER	1-1/2"	2"	1-1/2"	1/2"	1/2"
DRYER	N/A	N/A	N/A	N/A	N/A
SHOWER TRAY	1-1/2"	2"	1-1/2"	1/2"	1/2"
SHOWER TRIM	-	-	-	1/2"	1/2"
SINK ISLAND SINGLE	1-1/2"	2"	1-1/2"	1/2"	1/2"
VANITY SINK	1-1/2"	2"	1-1/2"	1/2"	1/2"
WASHER	2"	2"	1-1/2"	1/2"	1/2"
WATER CLOSET					
WATER HEATER	N/A	N/A	N/A	3/4"	3/4"

WATER FIXTURE UNIT SCHEDULE						
FAMILY	QTY	UNIT VALUE	TOTAL			
DIOLINA OLIED	14					
DISHWASHER	1		0			
DRYER	1		0			
HANGING PIPES CLAMP	16		0			
SHOWER TRAY	1		0			
SHOWER TRIM	1		0			
SINK ISLAND SINGLE	1		0			
VANITY SINK	1		0			
WASHER	1		0			
WATER CLOSET	1		0			
WATER HEATER	1		0			

W	ASTE FIXTURE UI	NIT SCHEDULE	
FAMILY	QTY	DFU VALUES	TOTAL
FAIVIILT	QIT	DFU VALUES	TOTAL
DIOLUMACHED			
DISHWASHER	1		0
DRYER	1		0
HANGING PIPES CLAMP	16		0
SHOWER TRAY	1		0
SHOWER TRIM	1		0
SINK ISLAND SINGLE	1		0
VANITY SINK	1		0
WASHER	1		0
WATER CLOSET	1		0
WATER HEATER	1		0



KEY PLAN

NO. DESCRIPTION DATE

NOTE:

LEGEND:

PROJECT

241-EMBER-960-2Bd1Ba MODERN-GARAGE-550

DRAWING NAME

NOTE AND SCHEDULE

CLIENT NAME:

 PROJECT NUMBER:
 0119_13

 DATE:
 5/6/2025 2:34:57 PM


 DESIGNED BY:
 Designer

 DRAWN BY:
 Author

 CHECKED BY:
 Checker


P101

SCALE: 1/2" = 1'-0"

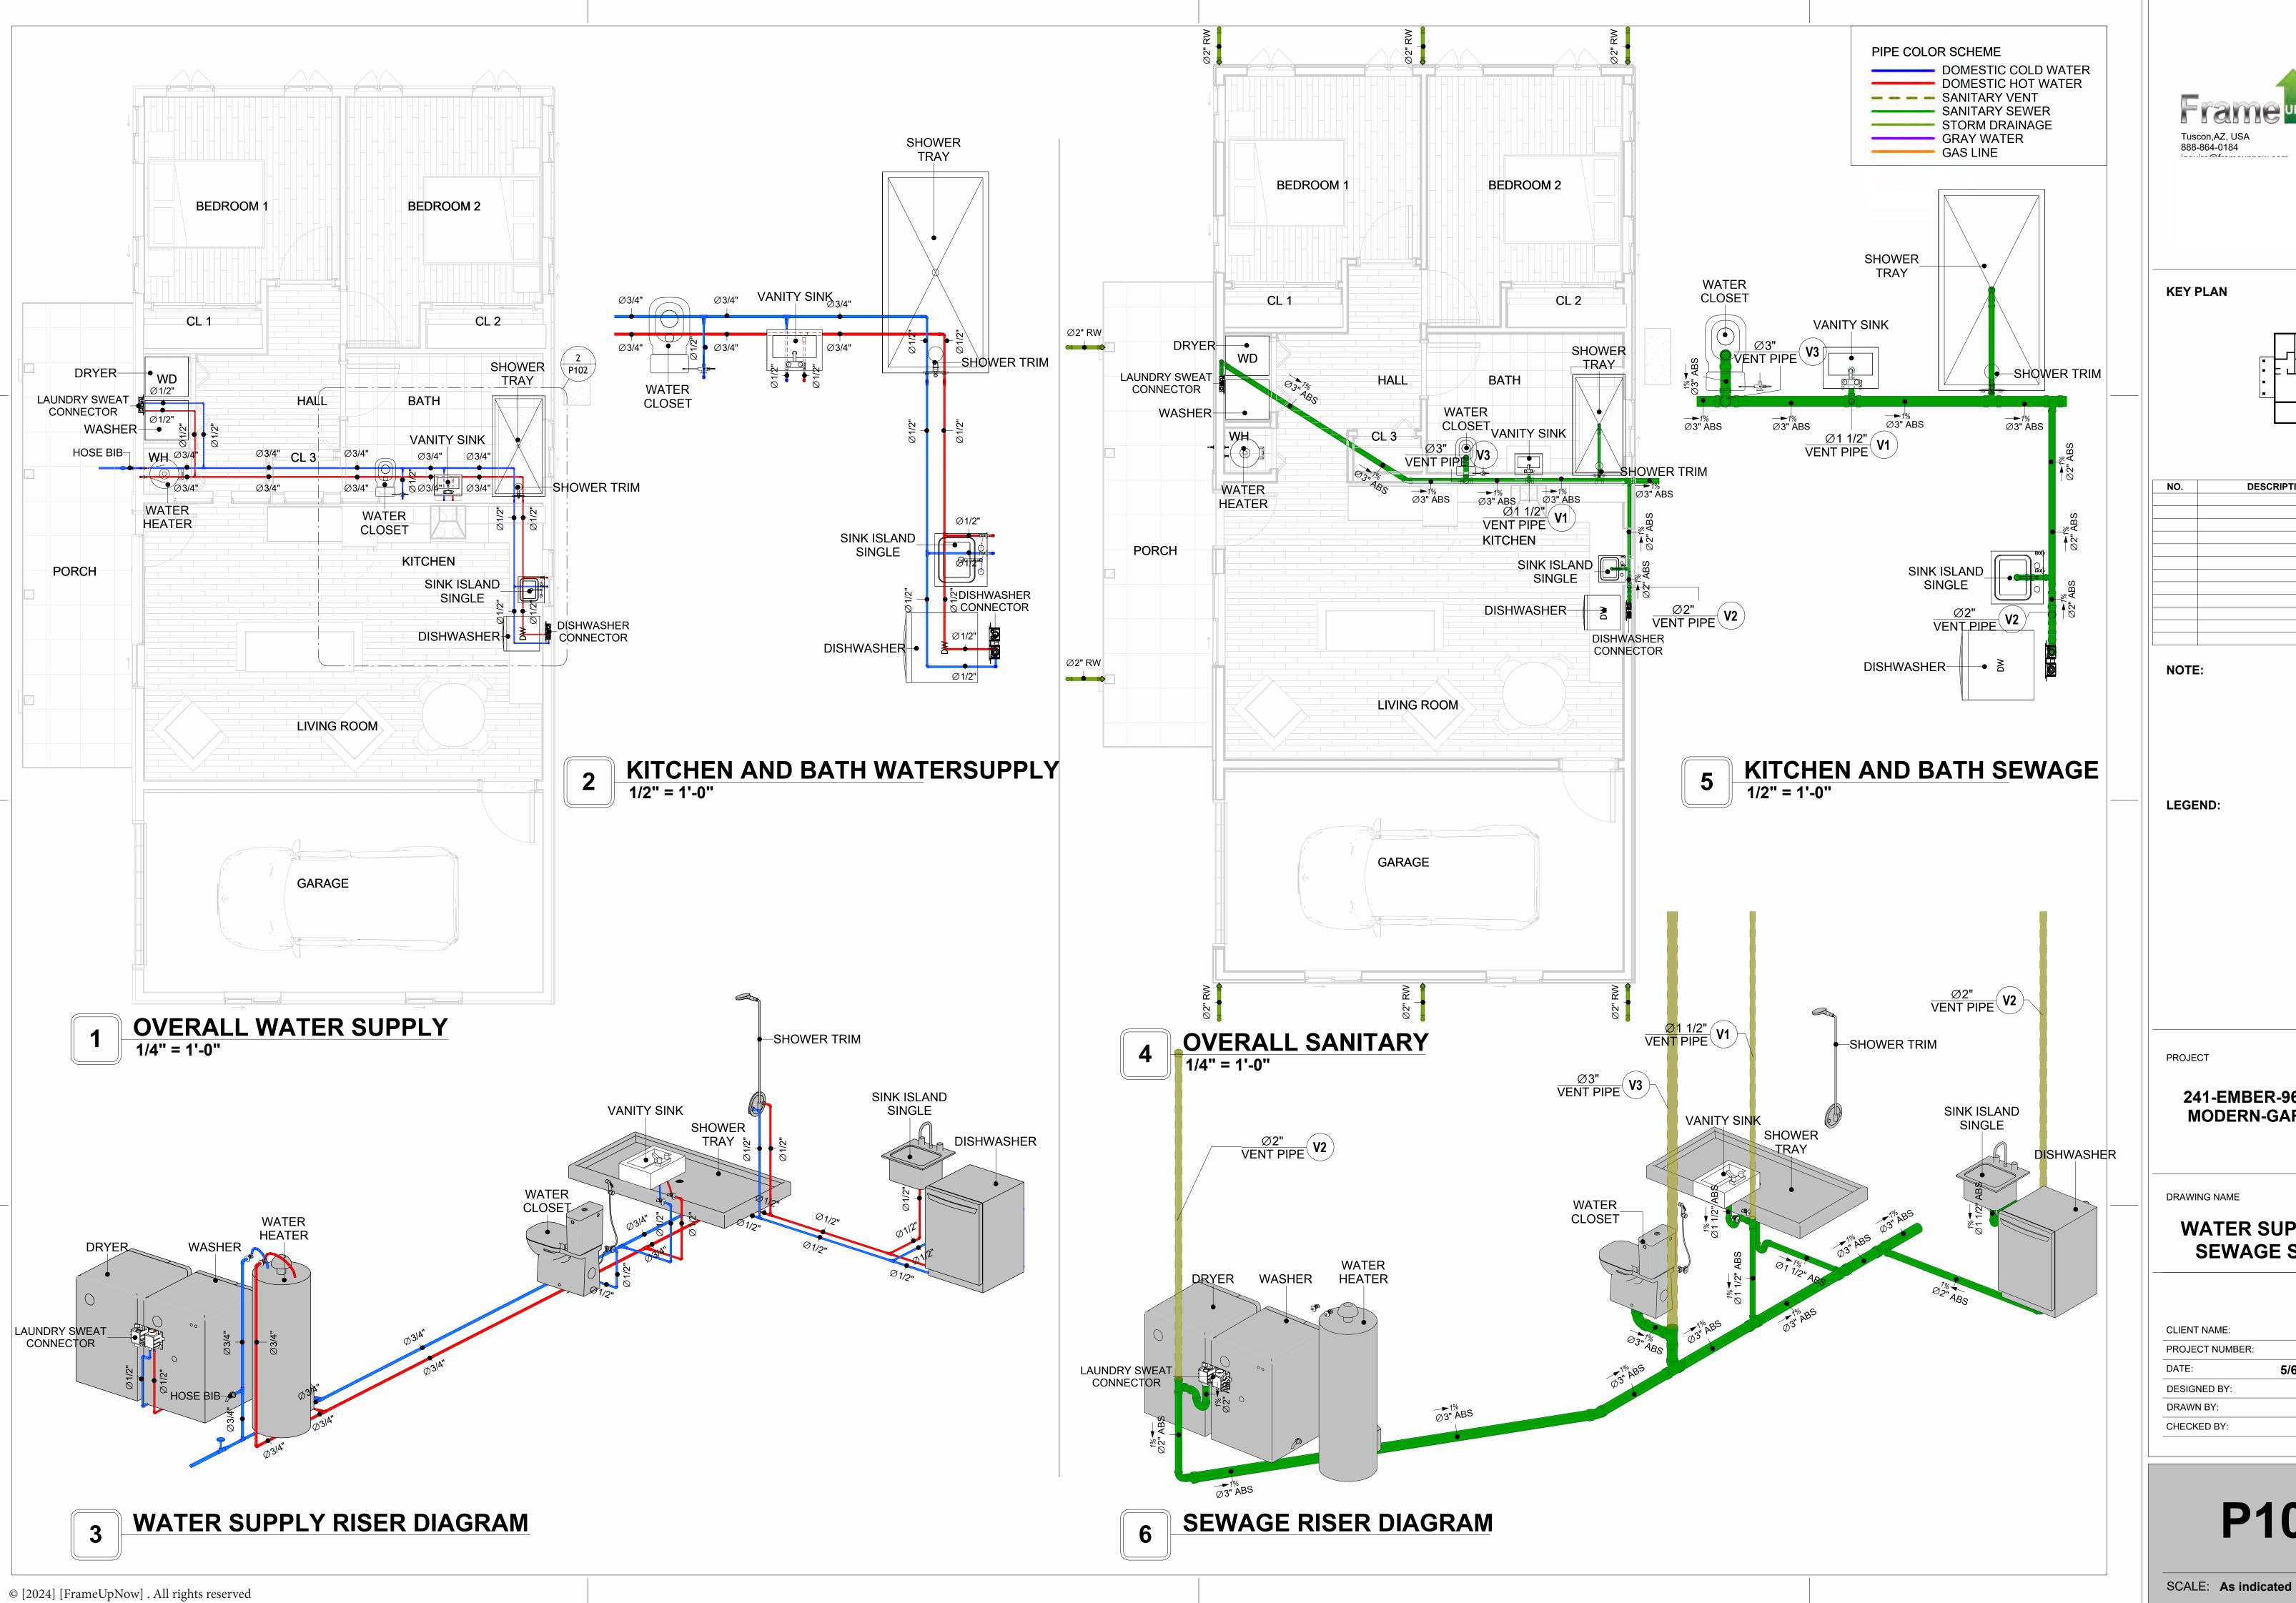



KEY PLAN

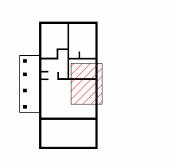

NO.	DESCRIPTION	DAT

LEGEND:

PROJECT

241-EMBER-960-2Bd1Ba **MODERN-GARAGE-550**

DRAWING NAME

WATER SUPPLY AND **SEWAGE SYSTEM**

0119_13
5/6/2025 2:35:41 PM
Designer
Author
Checker

P102

Materials Shopping List

Please print and take this Materials Shopping List to your favorite Home Depot and ask for assistance in selecting the materials, fixtures and fittings to complete your new home.

Record your selection and the price of the item. Then do the math to determine the cost for your selections and the total cost of finishing your home.

Have It Your Way!

The material types listed in this document were selected based on personal preferences. The Customer is encouraged to make changes to the material types in accordance with local customs, regulations, and personal preferences.

Have It Your Way!



20 good reasons to frame a home with metal and not wood



Why build your ADU with metal vs wood	Wood	Metal	Explanation
1 DIY Construction Benefit		~	The wall frames, trusses and beams can be erected in a just a few days
2 Minimal Construction Skills Required		~	Pre-assembled walls and trusses require no specialized skills to errect
Build as DIY, Hybrid or by a General Contractor		~	Do it yourself, Hybrid (involve special contractors) or hire a General Contractor
4 Build It As You Can Afford It		~	Impervious to Weather - build as you have the time and money
5 Up Front Cost of Framing Materials	~		As to only the framing material, wood is less expensive
6 Total Cost To Build		~	Savings in time, labor, and other areas make light gauge steel LESS expensive
7 Termites and wood boring insects		~	Termites, carpenter ants and wood boring insects eat wood, not metal
8 Mold resistant		~	Metal does not attract mold
9 Damage caused by exterior and interior flooding		~	Metal needs no reconditioning after a flood
10 Fire Resistant		~	Non-combustible
11 Lower insurance rates		~	Many insurance underwriters now provide lower rates for metal framed homes
12 Walls, trusses, and beams retain their original form		~	Perfectly straight walls - no shimming of drywall
13 Corners are 90 degrees		~	No need for templating of countertops to adjust for out of square corners
14 Strength and weight		~	Metal is stronger than wood and weighs less - no need for crane to lift ADU trusses
15 IBC Engineered Stamp		~	If an engineering stamp is necessary, months of waiting are saved
16 Complete BOM (Materials Shopping List)		~	Take the materials shopping list to Home Depot and start shopping/pricing
17 Flexible in Seismic Areas - Won't Fracture		~	Light gauge steel is flexible and won't fracture when the earth moves
18 No Waste At Job Site		~	Steel is the most recycled material in the world. A typical wood home has 20-30% waste
19 Environmentally Friendly		~	Trees don't have to be destroyed and the source of most metal is from recycling
20 How-To Videos Included		~	How-to videos provide simple assembly instructions
21 Relationship Counselor		~	Eliminate emotional uphevels - save time, money, and preserve the relationship

Universal Requirements - some or all may be required

- 1 Site plan
- 2 Electrical Supply Connection
- 3 Sewer Connection
- 4 Fresh Water Supply Connection
- 5 Set Backs
- 6 Soils Evaluation

- 7 Earthquake (fault) evaluation
- 8 Foundation Plan subject to soils
- 9 Compliance with local energy codes: insulation home wrap and flashing
- 10 Engineering for wind speed and snow load.
- 11 State and Local ordinances regarding ADUs
- 12 Local Architect and/or Engineer may be necessary





Ember-2Bd1Ba-Modern-Garage MATERIAL SHOPPING LIST

Have It Your Way!

The material types listed in this document were selected based on personal preferences. The Customer is encouraged to make changes to the material types in accordance with local customs, regulations, and personal preferences. Have It Your Way!

TOC



Table Of Content # Name Link Page No 1 Cover Page Cover Page 2 TOC TOC 2 3 ELECTRICAL BOM **ELECTRICAL BOM** 3 5 HVAC BOM **HVAC BOM** 7 PLUMBING BOM 4 PLUMBING BOM 10 6 ARCHITECTURAL BOM ARCHITECTURAL BOM 15

Have It Your Way!

The material types listed in this document were selected based on personal preferences. The Customer is encouraged to make changes to the material types in accordance with local customs, regulations, and personal preferences. Have It Your Way!

GENERAL NOTES

- 1 This BOM (Bill of Materials) is prepared as a Materials Shopping List to help builders and DIYers gain a complete understanding of most if not all elements required for the complete construction of this structure, according to the original design documents provided by FrameUpNow.
- 2 All quantities and specifications are subject to change based on the final design, field measurements, availability of products and customer preferences. The customer should verify all information prior to purchasing materials.
- 3 All products and elements in the list shall conform to the International Residential Code (IRC), or any other local and international building codes, safety regulations, and standards that are applicable to the location of the structure.
- 4 If any changes are made by the customer to the list of materials specified in this document, the customer is responsible for assuring that the correct type and quantity of materials are utilized in accordance with local building codes.
- 5 FrameUpNow, will not be held responsible for any misuse of this document, the products listed, or for deviations from the content that are made due to changes in specifications, pricing, availability, or customer preferences.
- 6 The customer is advised to consult a qualified professional or technician prior to purchasing materials for specialized construction system items. Some items including but not limited to caseworks, doors and windows may require as built measurements prior to purchase to confirmation of final dimensions.
- 7 If there are additional trim elements or specific installation methods, the total amount of materials needed might vary. Consider any additional trim required for corners, intersections, or other architectural details that might cause this variations before proceeding to purchase and construction.

ARCHITECTURAL BOM



				/lodern-Gar			
Me	14	ARCHITECT				Total	Doggeri
lo. ☐	APPLIANCES	Туре	Unit	Quantity	Unit Price	Total	Description
1	Refrigerator	I	PCS	1			
2	Range		PCS	1			
3	Washer		PCS	1			
4			PCS	1			
_	Dryer Dish Washer		PCS				
5	Dish Washer			1			
6	Oven		PCS	0			
7	Microwave	<u> </u>	PCS	0			
<u>^</u>	CASEWORKS	I	FT	25.07			
1	Kitchen Cabinet		FT	25.07			
2	Laundry Cabinet		FT	0			
3	Vanity Cabinet		FT	2.5			
	Medicine Cabinet		PCS	1			
5	Kitchen countertop		SF	35			
6	Laundry Countertop		PCS	0			
7	Bathroom Countertop		SF	0			
8	Island		FT	0			
9	Peninsula		FT	0			
10	Closets		SF	105.29			
Δ	CEILING						
1	Ceiling Board	Dry Wall	SF	1056			
2	Dry Wall Fastener	Screw	PCS	1848			
3	Vapor Retarder	Polyethylene film	SF	1263			
4	Vapor Retarder Fastener	Nails with washer heads	PCS	3789			
5	Ceiling Board (MRD)	Moisture resistant drywall	SF	92			
6	MRD Fastener		PCS	161			
7	Ceiling Board	Marine Plywood	SF	115			
8	Marine Plywood Fastener	Screw	PCS	201			
	Dry Wall Tape		FT	632			
Δ	FLOORING						
	Main Living Space		SF	449.99			
2	Bathroom		SF	100.08			
3	Bedroom		SF	305.71			
4	Garage		SF	266.42			
5	Porch	-	SF	248.4			
	STRUCTURE	I .		240.4			
	Foundation		SF	1396.11			
_	WALLS EXTERIOR	I .	51	1370.11			
1	Exterior-Grade Plywood Siding		SF	1121			
2	Exterior-Grade Plywood Fastener	Solf drilling corous(100/pkt)	PKT	1121			
	Wall Shteathing (OSB)	Sell-drilling sciews(100/pkt)					
3		Colf drilling corous/100/slst\	SF	1121			
4	Shteathing Fastener	Self-drilling screws(100/pkt)	PKT	11			
5	Wall Homewrap	Ctanled factories (200/-1:4)	SF	1121			
6	Homewrap Fastener	Stapled fastener (200/pkt)	PKT	4			
7	Furring Strip	0 15 1 1111 1 1 1 1 1 1 1 1	PCS	140			
8	Furring Strip Fastener	Self-drilling screws(100/pkt)	PKT	11			
	Wall Paint		SF	1121			
	Stone Copping	Masonry stone	SF	0			
	Stone Veneer	Masonry stone	SF	0			
	Mortar for Stone Veneer		SF	252			
	Wall Insulation		SF	5101.0			
	Cementitious Backer Board		SF	634			
2	Kerdi membrane		SF	634			
3	Kerdi membrane Fastener		SF	634			
	Wall Ceramic Tile		SF	634			
	Drywall Board		SF	2760			
	Drywall Fastener	Self-drilling screws(100/pkt)	PKT	27.6			
7	Wall Paint		SF	2760			
	Drywall Tape		FT	519			
-	Wall Sweep		FT	191			

ARCHITECTURAL BOM



Δ	DOORS				
1	Interior Swinging	3' - 0" X 6'-8"	PCS		
2		8' - 0" X 6'-6"	PCS	4	
	Garage Door	3' - 3" X 6'-8"	PCS	1	
_	Folding				
4	Interior Sliding	5' - 10" X 6'- 8"	PCS PCS	1	
5	Interior Sliding	5' - 9" X 6'- 8"			
_	Folding	4' - 0" X 6'-8"	PCS	1	
7	Folding	2' - 4" X 6'-8"	PCS	1	
	Exterior Swinging	3' - 0" X 6'-8"	PCS	1	
	Exterior Door Trim		FT	38	
_	Interior Door Trim		FT	344	
	Entry Lock set			2	
	Privacy Lock set			4	
13	Passage Lock set			5	
	WINDOWS				
1	Sliding	5' - 3" X 3'-3"	PCS	1	
2	Sliding	3' - 3" X 3'-3"	PCS	7	
3	Casment	2' - 9" X 4'-3"	PCS	4	
4	Sliding	3' - 3" X 1'-9"	PCS	1	
5	Awning	2' - 3" X 1'-3"	PCS	1	
6	Awning	6' - 3" X 1'-9"	PCS	1	
7	Exterior Window Trim		FT	222	
8	Interior Window Trim		FT	222	
	ROOF				
1	Roof Covering		SF	1847.0	
	Roof Covering Fastener		PCS	924	
3	Roof Felt Paper		SF	1847.0	
4	Roof Felt Paper Fastener		PCS	5541.0	
	Roof Sheathing		SF	1847	
6	Roof Sheathing Fastener		PCS	14776	
7	Batten		FT	952.0	
8	Batten Fastener		PCS	715.8	
9	Soffit		SF	459.0	
10	Soffit Fastener		PCS	229.5	
11	Fascia		FT	242.0	
12	Fascia board fastener		PCS	121	
13	Roof Insulation		SF	1847.0	
	•	·	-		



		Ember-2Bd1Ba-l	Modern-Ga	arage			
	FI	ECTRICAL MATER	IAL SHOP	PING I I	ST		
No.	Item	Type	Unit		Unit Price	Total	Description
	LIGHTING FIXTURES	71					
1	Kitchen Ceiling Light		PCS	3			
2	Kitchen Wall Mounted Light		PCS	1			
3	Exterior Wall Mounted Light		PCS	4			
4	Livingroom Ceiling Light With Fan		PCS	1			
5	Bedroom Ceiling Light With Fan		PCS	2			
6	Dining Ceiling Light		PCS	0			
7	Bath Wall Mounted Light		PCS	1			
8	Bathroom Ceiling Light		PCS	2			
	Livingroom Ceiling Light		PCS	5			
	Bedroom Ceiling Light		PCS	8			
	Hall & Entry Ceiling Light		PCS	4			
	Garage Ceiling Light		PCS	4			
	Smoke Detector		PCS	3			
	ELECTRICAL FITTINGS		1 00				
	Standard Receptacle 120V	20A	PCS	12		I	
	GFCI Receptacle 120V	20 A	PCS	19			
16	GFCI Receptacle 240V	30 A	PCS	2			
-	GFCI Receptacle 240V	50 A	PCS				
17			PCS	1			
18	GFCI Receptacle 240V	60 A		1			
	Fan Switch		PCS	2			
	Single Pole Switch		PCS	8			
	Three Way Switch		PCS	5			
	Dimmer Switch		PCS	3			
	ELECTRICAL CONDUITS & WIRING	1					
	ROMEX 14 AWG	14/2/W/ground	FT	183			
	ROMEX 12 AWG	12/3/W/ground	FT	0			
	ROMEX 12 AWG	12/2/W/ground	FT	493			
	ROMEX 10 AWG	10/3/W/ground	FT	109			
	ROMEX 10 AWG	10/2/W/ground	FT	71			
	Romex 8 AWG	8/3/W/ground	FT	43			
	Romex 8 AWG	8/2/W/ground	FT	0			
	ROMEX 6 AWG	6/3/W/ground	FT	18			
	Bare Copper Ground Wire 6 AWG		FT				
	ELECTRICAL BOXES & CIRCUTES						
32	Panelboard -240V 1 Phase MLO	200 AMP	PCS	1			
33	Circuit breaker	15 A	PCS	4			
34	Circuit breaker	20 A	PCS	12			
36	Circuit breaker	30 A	PCS	2			
37	Circuit breaker	50 A	PCS	1			
39	Circuit breaker	60 A	PCS	1			
	Single Gang Switch Box		PCS	3			
	Double Gang Switch Box		PCS	4			
	Triple Gang Switch Box		PCS	2			
	Pull Box	#1/4	PCS	32			
	Receptacle Box		PCS	35			



PL	UMBING SYSTEM MA	ALERIAL	SHOPPII	NG LIST
DI I	IMPINIO OVOTENANA	TEDIAL	CHODDI	10 110 7
	Ember-2Bd1Ba	-Modern	-Garage	

	ŀ	LUMBING SYSTEM I	MATERIAL	. SHOPPII	NG LIST		
No.	Item	Туре	Unit	Quantity	Unit Price	Total	Description
Δ	PLUMBING FIXTURES & ACCESSORIES	, ,,		,			·
1	Bath Tub (Alcove Tub)		PCS	0			
2	Kitchen Sink		PCS	1			
3	Kitchen Faucets		PCS	1			
4	Vanity Sink		PCS	1			
			PCS				
5	Bath room Faucets			1			
6	Water Closet		PCS	1			
7	Shower Trim		PCS	1			
8	Shower Tray		PCS	1			
9	Water Heater		PCS	1			
10	Hose Bib		PCS	1			
11	Shutoff Valve		PCS	6			
12	Hanging pipe clamp		PCS	16			
13	Globe Valve		PCS	1			
14	Dishwasher Supply Single Connector		PCS	1			
	Dishwasher Sewage Single Connector		PCS	1			
	Laundry Sweat Connector		PCS	1			
	SANITARY & PLUMBING PIPES		1 03	<u> </u>			
_	ABS (Acrylonitrile Butadiene Styrene) Pipes	ø 1/2"	FT	0		T I	
	ABS (Acrylonitrile Butadiene Styrene) Pipes ABS (Acrylonitrile Butadiene Styrene) Pipes	1.5	_				
	, , , , , , , , , , , , , , , , , , , ,	ø 1 1/2"	FT	24			
	ABS (Acrylonitrile Butadiene Styrene) Pipes	ø 2"	FT	36			
	ABS (Acrylonitrile Butadiene Styrene) Pipes	ø 3"	FT	42			
	PEX (Cross-linked polyethylene) Pipes	ø 1/2"	FT	66			
6	PEX (Cross-linked polyethylene) Pipes	ø 3/4"	FT	54			
7	PEX (Cross-linked polyethylene) Pipes	1"	FT	1			
8	Polyvinyl Chloride - Rigid	2"	FT	67			
Δ	PIPE FITTINGS	·					
1	PEX 90 Deg Elbow	1/2"ø-1/2"ø	PCS	3			
	PEX 90 Degree Elbow	1/2"ø-1/2"ø	PCS	12			
3	PEX 90 Degree Elbow	3/4"ø-3/4"ø	PCS	4			
	PEX Tee Elbow	1/2"ø-1/2"ø-1/2"ø	PCS	2			
5	PEX Tee Elbow		PCS	6			
		3/4"ø-3/4"ø					
6	PEX Transition Elbow	1"ø-3/4"ø	PCS	2			
7	PEX Transition Elbow	3/4"ø-1/2"ø	PCS	4			
8	Tee Elbow	3/4"ø-3/4"ø-3/4"ø	PCS	1			
	PEX 90 Deg Elbow	1/2"ø-1/2"ø	PCS	1			
10	PEX 90 Degree Elbow	1/2"ø-1/2"ø	PCS	9			
11	PEX 90 Degree Elbow	3/4"ø-3/4"ø	PCS	2			
12	PEX Tee Elbow	1/2"ø-1/2"ø-1/2"ø	PCS	2			
13	PEX Tee Elbow	3/4"ø-3/4"ø-3/4"ø	PCS	2			
	PEX Transition Elbow	3/4"ø-1/2"ø	PCS	3			
	PVC 90 Deg Bend Elbow	2"ø-2"ø	PCS	8			
	PVC 90 Degree Bend Elbow	2"ø-2"ø	PCS	16			
	ABS 90 Degree Bend Elbow	1 1/2"ø-1 1/2"ø	PCS	1			
	ABS 90 Degree Bend Elbow	2"ø-2"ø	PCS	2			
	ABS 90 Degree Bend Elbow	3"ø-3"ø	PCS	2			
	ABS P-Trap	1 1/2"ø-1 1/2"ø	PCS	3			
_	ABS P-Trap	2"ø-2"ø	PCS	1			
	ABS Reducer Elbow	2"ø-1 1/2"ø	PCS	1			
	ABS Reducer Elbow	3"ø-2"ø	PCS	1			
24	ABS TEE Elbow	1 1/2"ø-1 1/2"ø-1 1/2"ø	PCS	1			
25	ABS TEE Elbow	2"ø-2"ø-2"ø	PCS	1			
_	ABS TEE Elbow	3"ø-3"ø-3"ø	PCS	1			
	ABS Tee Reducer Elbow	3"ø-3"ø-1 1/2"ø	PCS	2			
	ABS Tee Reducer Elbow	3"ø-3"ø-2"ø	PCS	1			
	ABS Tee Reducer Elbow		_				
		3"ø-3"ø-3"ø	PCS	1			
	ABS Trap P	2"ø-2"ø	PCS	1			
	WASTE DOUBLE TEE	2"ø-2"ø-2"ø	PCS	1			
	ABS Vent Cap Elbow	1 1/2"ø	PCS	1			
	ABS Vent Cap Elbow	2"ø	PCS	2			
	ABS Vent Cap Elbow	3"ø	PCS	1			

HVAC BOM

		Ember-2Bd1	Ba-Mod	ern-Gara	ıge		
		HVAC SYSTEM MA	TERIAL	SHOPP	ING LIST		
No.	Item	Туре	Unit	Quantity	Unit Price	Total	Description
	HVAC_DUCTS						
	PIPE (REFRIGERANT LINE)	1/4" (Ø)	FT	0.68			
	PIPE (REFRIGERANT LINE)	3/8" (Ø)	FT	66.42			
3	PIPE (REFRIGERANT LINE)	1/2" (Ø)	FT	0.68			
4	PIPE (REFRIGERANT LINE)	3/4''' (Ø)	FT	79.97			
5	DRAYER HOSE	4" (Ø)	FT	10			
_	FLEX DUCT ROUND	4" (Ø)	FT	10.3			
	DUCT FITTINGS & ACCESSORIES						
7	ELBOW (REFRIGERANT LINE)	1/2" (Ø)-1/2" (Ø)	PCS	1			
8	ELBOW (REFRIGERANT LINE)	1/4" (Ø)-1/4" (Ø)	PCS	1			
9	ELBOW (REFRIGERANT LINE)	3/4" (Ø)-3/4" (Ø)	PCS	19			
10	ELBOW (REFRIGERANT LINE)	3/8" (Ø)-3/8" (Ø)	PCS	20			
	TEE (REFRIGERANT LINE)	3/4" (Ø)-3/4" (Ø)-3/4" (Ø)	PCS	3			
12	TEE (REFRIGERANT LINE)	3/8" (Ø)-3/8" (Ø)-3/8" (Ø)	PCS	2			
13	TRANSITION (REFRIGERANT	3/4" (Ø)-1/2" (Ø)	PCS	3			
	TRANSITION (REFRIGERANT	3/4" (Ø)-5/8" (Ø)	PCS	3			
15	TRANSITION (REFRIGERANT	3/8" (Ø)-1/4" (Ø)	PCS	1			
16	ROUND TRANSITION(ANGLE)	45 DEGREE	PCS	5			
	HVAC_EQUIPMENTS						
	AIR HANDLING UNIT	WALL MOUNTED	PCS	3			
18	CONDENSER	OUTDOOR UNIT	PCS	1			
19	EXHAUST FAN	75 CFM	PCS	1			
20	EXHAUST HOOD	WALL MOUNTED	PCS	1			
21	HOOD-WALL: VENT	HOOD-WALL: VENT	PCS	1			
22	DRAYER: VENT	DRAYER: VENT	PCS	1			
23	ROOF VENT	3"(Ø)	PCS	1			



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Have It Your Way!

The material types listed in this document were selected based on personal preferences. The Customer is encouraged to make changes to the material types in accordance with local customs, regulations, and personal preferences. Have It Your Way!

GENERAL NOTES

- This BOM (Bill of Materials) is prepared as a Materials Shopping List to help builders and DIYers gain a complete understanding of most if not all elements required for the complete construction of this structure, according to the original design documents provided by FrameUpNow.
- 2 All quantities and specifications are subject to change based on the final design, field measurements, availability of products and customer preferences. The customer should verify all information prior to purchasing materials.
- 3 All products and elements in the list shall conform to the International Residential Code (IRC), or any other local and international building codes, safety regulations, and standards that are applicable to the location of the structure.
- 4 If any changes are made by the customer to the list of materials specified in this document, the customer is responsible for assuring that the correct type and quantity of materials are utilized in accordance with local building codes.
- 5 FrameUpNow, will not be held responsible for any misuse of this document, the products listed, or for deviations from the content that are made due to changes in specifications, pricing, availability, or customer preferences.
- 6 The customer is advised to consult a qualified professional or technician prior to purchasing materials for specialized construction system items. Some items including but not limited to caseworks, doors and windows may require as built measurements prior to purchase to confirmation of final dimensions.
- 7 If there are additional trim elements or specific installation methods, the total amount of materials needed might vary. Consider any additional trim required for corners, intersections, or other architectural details that might cause this variations before procedding to purchase and construction.



			LIGHTING FIXTURES				
#	Item	Туре	Description, Manufacturer, SKU	Unit	Quantity	Unit Price	Total
1	Kitchen Ceiling Light			PCS	3		
3	Kitchen Wall Mounted Light			PCS	1		
4	Exterior Wall Mounted Light			PCS	4		
5	Livingroom Ceiling Light With Fan			PCS	1		
6	Bedroom Ceiling Light With Fan			PCS	2		
7	Dining Ceiling Light			PCS	0		
8	Bath Wall Mounted Light			PCS	1		
9	Bathroom Ceiling Light			PCS	2		
10	Livingroom Ceiling Light			PCS	5		
11	Bedroom Ceiling Light			PCS	8		
12	Hall & Entry Ceiling Light			PCS	4		
12	Garage Ceiling Light			PCS	4		
13	Smoke Detector			PCS	3		
14							
15							



			ELECTRICAL FITTINGS				
#	Item	Туре	Description, Manufacturer, SKU	Unit	Quantity	Unit Price	Total
1	Standard Receptacle 120V	20A		PCS	12		
2	GFCI Receptacle 120V	20 A		PCS	19		
3	GFCI Receptacle 240V	30 A		PCS	2		
4	GFCI Receptacle 240V	50 A		PCS	1		
5	GFCI Receptacle 240V	60 A		PCS	1		
6	Fan Switch			PCS	2		
7	Single Pole Switch			PCS	8		
8	Three Way Switch			PCS	5		
9	Dimmer Switch			PCS	3		
10		'		'			
11							
12							
13							
14							
15							



		ELECTR	ICAL CONDUITS & WIRING				
#	Item	Туре	Description, Manufacturer, SKU	Unit	Quantity	Unit Price	Total
1	ROMEX 14 AWG	14/2/W/ground		FT	183		
3	ROMEX 12 AWG	12/3/W/ground		FT	0		
4	ROMEX 12 AWG	12/2/W/ground		FT	493		
6	ROMEX 10 AWG	10/3/W/ground		FT	109		
8	ROMEX 10 AWG	10/2/W/ground		FT	71		
9	Romex 8 AWG	8/3/W/ground		FT	43		
10	Romex 8 AWG	8/2/W/ground		FT	0		
11	ROMEX 6 AWG	6/3/W/ground		FT	18		
12	Bare Copper Ground Wire 6 AWG			FT			
13							
14							
15							
16							



		ELEC	CTRICAL BOXES & CIRCUTES				
ŧ	Item	Туре	Description, Manufacturer, SKU	Unit	Quantity	Unit Price	Total
L	Panelboard -240V 1 Phase MLO	200 AMP		PCS	1		
	Circuit breaker	15 A		PCS	4		
	Circuit breaker	20 A		PCS	12		
	Circuit breaker	30 A		PCS	2		
	Circuit breaker	50 A		PCS	1		
j	Circuit breaker	60 A		PCS	1		
	Single Gang Switch Box			PCS	3		
3	Double Gang Switch Box			PCS	4		
)	Triple Gang Switch Box			PCS	2		
.0	Pull Box	#1/4		PCS	32		
1	Receptacle Box			PCS	35		
2							
.3							
.4							
L5							

HVAC BOM

	HVAC_DUCTS 01									
#	Item	Туре	Description, Manufacturer, SKU	Unit	Quantity	Unit Price	Total			
1	PIPE (REFRIGERANT LINE)	1/4" (Ø)		FT	0.68					
2	PIPE (REFRIGERANT LINE)	3/8" (Ø)		FT	66.42					
3	PIPE (REFRIGERANT LINE)	1/2" (Ø)		FT	0.68					
4	PIPE (REFRIGERANT LINE)	3/4"' (Ø)		FT	79.97					
5	DRAYER HOSE	4" (Ø)		FT	10					
6	FLEX DUCT ROUND	4" (Ø)		FT	10.3					
7										
8										
9										
10										
11										
12										
13										
14										
15										
16										

HVAC BOM

DUCT FITTINGS & ACCESSORIES										
#	Item	Туре	Description, Manufacturer, SKU	Unit	Quantity	Unit Price	Total			
1	ELBOW (REFRIGERANT LINE)	1/2" (Ø)-1/2" (Ø)		PCS	1					
2	ELBOW (REFRIGERANT LINE)	1/4" (Ø)-1/4" (Ø)		PCS	1					
3	ELBOW (REFRIGERANT LINE)	3/4" (Ø)-3/4" (Ø)		PCS	19					
4	ELBOW (REFRIGERANT LINE)	3/8" (Ø)-3/8" (Ø)		PCS	20					
5	TEE (REFRIGERANT LINE)	3/4" (Ø)-3/4" (Ø)-3/4" (Ø)		PCS	3					
6	TEE (REFRIGERANT LINE)	3/8" (Ø)-3/8" (Ø)-3/8" (Ø)		PCS	2					
7	TRANSITION (REFRIGERANT LINE)	3/4" (Ø)-1/2" (Ø)		PCS	3					
8	TRANSITION (REFRIGERANT LINE)	3/4" (Ø)-5/8" (Ø)		PCS	3					
9	TRANSITION (REFRIGERANT LINE)	3/8" (Ø)-1/4" (Ø)		PCS	1					
10	ROUND TRANSITION(ANGLE)	45 DEGREE		PCS	5					
11	THE WOLLD WANTED									
12										
13										
14										
15										
16										

HVAC BOM

			HVAC_EQUIPMENTS				
#	Item	Туре	Description, Manufacturer, SKU	Unit	Quantity	Unit Price To	otal
1	AIR HANDLING UNIT	WALL MOUNTED		PCS	3		
2	CONDENSER	OUTDOOR UNIT		PCS	1		
3	EXHAUST FAN	75 CFM		PCS	1		
4	EXHAUST HOOD	WALL MOUNTED		PCS	1		
5	HOOD-WALL: VENT	HOOD-WALL: VENT		PCS	1		
6	DRAYER: VENT	DRAYER: VENT		PCS	1		
7	ROOF VENT	3"(Ø)		PCS	1		
8							
9							
10							
11							
12							
13							
14							



	1	PLUMBII	NG FIXTURES & ACCESSORIES				
#	Item	Туре	Description, Manufacturer, SKU	Unit	Quantity	Unit Price	Total
1	Bath Tub (Alcove Tub)			PCS	1		
2	Kitchen Sink			PCS	1		
3	Kitchen faucets			PCS	1		
4	Vanity Sink			PCS	1		
5	Bath room faucets			PCS	1		
6	Water Closet			PCS	1		
7	Shower Trim			PCS	1		
8	Shower Tray			PCS	1		
9	Water Heater			PCS	1		
10	Hose Bib			PCS	1		
11	Shutoff Valve			PCS	6		
12	Hanging pipe clamp			PCS	16		
13	Globe Valve			PCS	1		
14	Dishwasher Supply Single Connector			PCS	1		
15	Dishwasher Sewage Single Connector			PCS	1		
16	Laundry Sweat Connector			PCS	1		



		SANI	TARY & PLUMBING PIPES				
#	Item	Туре	Description, Manufacturer, SKU	Unit	Quantity	Unit Price	Total
1	ABS (Acrylonitrile Butadiene Styrene) Pipes	ø 1"		FT	0		
2	ABS (Acrylonitrile Butadiene Styrene) Pipes	ø 1 1/2"		FT	24		
3	ABS (Acrylonitrile Butadiene Styrene) Pipes	ø 2"		FT	36		
4	ABS (Acrylonitrile Butadiene Styrene) Pipes	ø 3"		FT	42		
5	PEX (Cross-linked polyethylene) Pipes	ø 1/2"		FT	66		
6	PEX (Cross-linked polyethylene) Pipes	ø 3/4"		FT	54		
7	PEX (Cross-linked polyethylene) Pipes	ø 1"		FT	1		
8	PVC Pipes Sch.80 - Rigid	ø 1 1/2"		FT	0		
9	PVC Pipes Sch.80 - Rigid	ø 2"		FT	67		
10	PVC Pipes Sch.80 - Rigid	ø 3"		FT	0		
11	Flex Pipe Round	ø 1/2"		FT	6		
12	Flex Pipe Round	ø 3/4"		FT	0		
13	Flex Pipe Round	ø 1"		FT	0		
14							
15							



		PI	PE FITTINGS 01				
#	Item	Туре	Description, Manufacturer, SKU	Unit	Quantity	Unit Price	Total
1	PEX 90 Deg Elbow	1/2"ø-1/2"ø		PCS	3		
2	PEX 90 Degree Elbow	1/2"ø-1/2"ø		PCS	13		
3	PEX 90 Degree Elbow	3/4"ø-3/4"ø		PCS	1		
4	PEX Tee Elbow	1/2"ø-1/2"ø-1/2"ø		PCS	2		
5	PEX Tee Elbow	3/4"ø-3/4"ø-3/4"ø		PCS	5		
6	PEX Transition Elbow	1"ø-3/4"ø		PCS	1		
7	PEX Transition Elbow	3/4"ø-1/2"ø		PCS	4		
8	Tee Elbow	3/4"ø-3/4"ø-3/4"ø		PCS	1		
9	PEX 90 Deg Elbow	1/2"ø-1/2"ø		PCS	1		
10	PEX 90 Degree Elbow	1/2"ø-1/2"ø		PCS	9		
11	PEX 90 Degree Elbow	3/4"ø-3/4"ø		PCS	2		
12	PEX Tee Elbow	1/2"ø-1/2"ø-1/2"ø		PCS	2		
13	PEX Tee Elbow	3/4"ø-3/4"ø-3/4"ø		PCS	2		
14	PEX Transition Elbow	3/4"ø-1/2"ø		PCS	3		
15	PVC 90 Deg Bend Elbow	2"ø-2"ø		PCS	8		
16	PVC 90 Degree Bend Elbow	2"ø-2"ø		PCS	16		
17	ABS 90 Degree Bend Elbow	1 1/2"ø-1 1/2"ø		PCS	1		



		PIPE	FITTINGS 02				
#	Item	Туре	Description, Manufacturer, SKU	Unit	Quantity	Unit Price	Total
1	ABS 90 Degree Bend Elbow	2"ø-2"ø		PCS	2		
2	ABS 90 Degree Bend Elbow	3"ø-3"ø		PCS	2		
3	ABS P-Trap	1 1/2"ø-1 1/2"ø		PCS	3		
1	ABS P-Trap	2"ø-2"ø		PCS	1		
5	ABS Reducer Elbow	2"ø-1 1/2"ø		PCS	1		
6	ABS Reducer Elbow	3"ø-2"ø		PCS	1		
7	ABS TEE Elbow	1 1/2"ø-1 1/2"ø-1 1/2"ø		PCS	1		
3	ABS TEE Elbow	2"ø-2"ø-2"ø		PCS	1		
9	ABS TEE Elbow	3"ø-3"ø-3"ø		PCS	1		
10	ABS Tee Reducer Elbow	3"ø-3"ø-1 1/2"ø		PCS	2		
11	ABS Tee Reducer Elbow	3"ø-3"ø-2"ø		PCS	1		
12	ABS Tee Reducer Elbow	3"ø-3"ø-3"ø		PCS	1		
13	ABS Trap P	2"ø-2"ø		PCS	1		
14	WASTE DOUBLE TEE	2"Ø-2"Ø-2"Ø		PCS	1		
15	ABS Vent Cap Elbow	1 1/2"ø		PCS	1		
16	ABS Vent Cap Elbow	2"ø		PCS	2		
17	ABS Vent Cap Elbow	3"Ø		PCS	1		



			APPLIANCES				
#	Item	Туре	Description, Manufacturer, SKU	Unit	Quantity	Unit Price	Total
1	Refrigerator			PCS	1		
2	Range			PCS	1		
3	Washer Front Load	Stackable		PCS	1		
4	Dryer Front Load	Stackable		PCS	1		
5	Dish Washer			PCS	1		
6	Oven			PCS	(
7	Microwave			PCS	(
8							
9							
10							
11							
12							
13							
14							
15							
16							



			CASEWORKS 01				
#	Item	Туре	Description, Manufacturer, SKU	Unit	Quantity	Unit Price	Total
1	Kitchen Cabinet			FT	25.07		
2	Laundry Cabinet			FT	0		
3	Vanity Cabinet			FT	2.5		
4	Medicine Cabinet			PCS	1		
5	Kitchen countertop			SF	35		
6	Laundry Countertop			PCS	0		
7	Bathroom Countertop			SF	0		
8	Island			FT	0		
9	Peninsula			FT	0		
10	Closets			SF	105.29		
11							
12							
13							
14							
15							



			CEILING 01				
#	Item	Туре	Description, Manufacturer, SKU	Unit	Quantity	Unit Price	Total
	LIVINGROOM + KITCHEN			SF	374.0		
L	Ceiling Board	Drywall		SF	374		
2	Drywall Fastener	Screw		PCS	655		
3	Vapor Retarder	Polyethylene film		SF	374		
1	Vapor Retarder Fastener	Nails with washer heads		PCS	1122		
	BATHROOM	·		SF	92.0		
5	Ceiling Board	MRD (Moisture resistant drywall)		SF	92		
5	MRD Fastener	Screw		PCS	161		
	PORCH			SF	115.0		
7	Ceiling Board	Marine Plywood		SF	115		
3	Exterior Grade Plywood	Screw		PCS	201		
	WH			SF	7.0		
)	Ceiling Board	Drywall		SF	7		
10	Drywall Fastener	Screw		PCS	12		
l1	Vapor Retarder	Polyethylene film		SF	7		
L2	Vapor Retarder Fastener	Nails with washer heads		PCS	21		



			CEILING 02				
#	Item	Туре	Description, Manufacturer, SKU	Unit	Quantity	Unit Price	Total
	HALL			SF	74.0		
13	Ceiling Board	Drywall		SF	74		
14	Drywall Fastener	Screw		PCS	130		
15	Vapor Retarder	Polyethylene film		SF	74		
16	Vapor Retarder Fastener	Nails with washer heads		PCS	222		
	W/D			SF	14.0		
17	Ceiling Board	Drywall		SF	14		
18	Drywall Fastener	Screw		PCS	25		
19	Vapor Retarder	Polyethylene film		SF	14		
20	Vapor Retarder Fastener	Nails with washer heads		PCS	42		
	GARAGE			SF	273.0		
21	Ceiling Board	Drywall		SF	273		
22	Drywall Fastener	Screw		PCS	478		
23	Vapor Retarder	Polyethylene film		SF	273		
24	Vapor Retarder Fastener	Nails with washer heads		PCS	819		



			CEILING 03				
#	Item	Туре	Description, Manufacturer, SKU	Unit	Quantity	Unit Price	Total
	CLOSET 1			SF	15.0		
25	Ceiling Board	Drywall		SF	15		
26	Drywall Fastener	Screw		PCS	26		
27	Vapor Retarder	Polyethylene film		SF	15		
28	Vapor Retarder Fastener	Nails with washer heads		PCS	45		
	CLOSET 2			SF	16.0		
29	Ceiling Board	Drywall		SF	16		
30	Drywall Fastener	Screw		PCS	28		
31	Vapor Retarder	Polyethylene film		SF	16		
32	Vapor Retarder Fastener	Nails with washer heads		PCS	48		
	CLOSET 3			SF	8.0		
33	Ceiling Board	Drywall		SF	8		
34	Drywall Fastener	Screw		PCS	14		
35	Vapor Retarder	Polyethylene film		SF	8		
36	Vapor Retarder Fastener	Nails with washer heads		PCS	24		



			CEILING 04				
#	Item	Туре	Description, Manufacturer, SKU	Unit	Quantity	Unit Price	Total
	BEDROOM 1			SF	146.0		
37	Ceiling Board	Drywall		SF	146		
38	Drywall Fastener	Screw		PCS	256		
39	Vapor Retarder	Polyethylene film		SF	146		
40	Vapor Retarder Fastener	Nails with washer heads		PCS	438		
	BEDROOM 2			SF	129.0		
41	Ceiling Board	Drywall		SF	129		
42	Drywall Fastener	Screw		PCS	226		
43	Vapor Retarder	Polyethylene film		SF	129		
44	Vapor Retarder Fastener	Nails with washer heads		PCS	387		



			FLOORING INTERIOR 01				
#	Item	Туре	Description, Manufacturer, SKU	Unit	Quantity	Unit Price	Total
	CLOSET 1						
1	Closet Flooring			SF	15		
2	Wood underlay	Foam Pad Polyethylene		SF	15		
3	Vapor Retarder	Vapor Barrier Polyethylene		SF	15		
	CLOSET 2						
4	Closet Flooring			SF	16		
5	Wood underlay	Foam Pad Polyethylene		SF	16		
6	Vapor Retarder	Vapor Barrier Polyethylene		SF	16		
	CLOSET 3						
7	Closet Flooring			SF	Ç		
8	Wood underlay	Foam Pad Polyethylene		SF	ç		
9	Vapor Retarder	Vapor Barrier Polyethylene		SF	ç		
	BEDROOM 1						
10	Bedroom Flooring			SF	129		
11	Wood underlay	Foam Pad Polyethylene		SF	129		
12	Vapor Retarder	Vapor Barrier Polyethylene		SF	129		



	1		FLOORING INTERIOR 02				
#	Item	Туре	Description, Manufacturer, SKU	Unit	Quantity	Unit Price	Total
	BEDROOM 2						
13	Bedroom Flooring			SF	146		
14	Wood underlay	Foam Pad Polyethylene		SF	146		
15	Vapor Retarder	Vapor Barrier Polyethylene		SF	146		
	LIVING ROOM AND KITC	HEN					
16	Tile Finish			SF	441		
17	Adhesive	1/2" Thin set Mortar		SF	441		
18	Vapor Retarder	Vapor Barrier Polyethylene		SF	441		
	BATHROOM						
19	Tile Finish			SF	78		
20	Adhesive	1/2" Thin set Mortar		SF	78		
21	Vapor Retarder	Vapor Barrier Polyethylene		SF	78		
	GARAGE						
22	Tile Finish			SF	266		
23	Adhesive	1/2" Thin set Mortar		SF	266		
24	Vapor Retarder	Vapor Barrier Polyethylene		SF	266		



			FLOORING INTERIOR 03				
#	Item	Туре	Description, Manufacturer, SKU	Unit	Quantity	Unit Price	Total
	W/D						
25	Tile Finish			SF	14		
26	Adhesive	1/2" Thin set Mortar		SF	14		
27	Vapor Retarder	Vapor Barrier Polyethylene		SF	14		
	BOILER ROOM						
28	Tile Finish			SF	8		
29	Adhesive	1/2" Thin set Mortar		SF	8	}	
30	Vapor Retarder	Vapor Barrier Polyethylene		SF	3		



			FLOORING EXTERIOR				
#	Item	Туре	Description, Manufacturer, SKU	Unit	Quantity	Unit Price	
	STRUCTURE			SF	1396.1		
1	Concrete Slab	4"concrete cast in situ		CF	465.37		
2	Insulation	Rigid insulation		SF	415.5		
3	Hard core	Compacted soil		CF	393.95		
4	Re-bar	#4 re-bar		Ton	1.27		
5	Concrete Pad	4"concrete cast in situ		CF	2		
6	Slab edge	Turndown		CF	350.57		
7	Footing	Cast-in-place concrete		CF	4.68		
	PORCH						
8	Tile Finish			SF	170		
9	Adhesive	1/2" Thin set Mortar		SF	170		
10	Vapor Retarder	Vapor Barrier Polyethylene		SF	170		



			WALLS: EXTERIOR				
#	Item	Туре	Description, Manufacturer, SKU	Unit	Quantity	Unit Price	Total
1	Exterior-Grade Plywood Horizontal Siding			SF	177		
2	Exterior-Grade Plywood Vertical Siding			SF	944		
3	Exterior-Grade Plywood Fastener 8/panel	Self-drilling screws(100/pkt)		PKT	11.21		
4	Wall Shteathing (OSB)			SF	1121		
5	Shteathing Fastener	Self-drilling screws(100/pkt)		PKT	11.21		
6	Wall Homewrap			SF	1121.0		
7	Homewrap Fastener	Stapled fastener (200/pkt)		PKT	4.3		
8	Furring Strip			PCS	140		
9	Furring Strip Fastener	Self-drilling screws(100/pkt)		PKT	11.21		
10	Wall Paint			SF	1121		
11	Stone Copping	Masonry stone		SF	0		
12	Stone Veneer	Masonry stone		SF	0		
13	Mortar for Stone Veneer			SF	252		
14	Wall Insulation			SF	5101		



			WALLS: INTERIOR 01				
#	Item	Туре	Description, Manufacturer, SKU	Unit	Quantity	Unit Price	Total
	BATHROOM			SF	86.0		
1	Cementitious Backer Board			SF	463		
2	Kerdi membrane			SF	463		
3	Kerdi membrane Fastener			SF	463		
4	Wall Ceramic Tile			SF	463		
	BEDROOM 1			SF	126.0		
5	Drywall Board			SF	305		
6	Drywall Fastener	Self-drilling screws(100/pkt)		PKT	3.05		
7	Wall Paint			SF	305		
8	Drywall Tape			FT	57.2		
	BEDROOM 2			SF	142.0		
9	Drywall Board			SF	363		
10	Drywall Fastener	Self-drilling screws(100/pkt)		PKT	3.63		
11	Wall Paint			SF	363		
12	Drywall Tape			FT	68.1		



			WALLS: INTERIOR 02				
#	Item	Туре	Description, Manufacturer, SKU	Unit	Quantity	Unit Price	Total
	LIVING ROOM			SF	224.0		
13	Drywall Board			SF	533		
14	Drywall Fastener	Self-drilling screws(100/pkt)		PKT	5.33		
15	Wall Paint			SF	533		
16	Drywall Tape			FT	100		
	KITCHEN			SF	137.0		
17	Cementitious Backer Board			SF	33		
18	Drywall Board			SF	254		
19	Drywall Fastener	Self-drilling screws(100/pkt)		PKT	2.54		
20	Kerdi membrane			SF	33		
21	Kerdi membrane Fastener			SF	33		
22	Wall Ceramic Tile			SF	33		
23	Wall Paint			SF	254		
24	Drywall Tape			FT	47.9		



			WALLS: INTERIOR 03				
#	Item	Туре	Description, Manufacturer, SKU	Unit	Quantity	Unit Price	Total
	CL 1			SF	17.0		
25	Drywall Board			SF	133		
26	Drywall Fastener	Self-drilling screws(100/pkt)		PKT	1.33		
27	Wall Paint			SF	133		
28	Drywall Tape			FT	24.9		
	CL 2			SF	17.0		
29	Drywall Board			SF	138		
30	Drywall Fastener	Self-drilling screws(100/pkt)		PKT	1.38		
31	Wall Paint			SF	138		
32	Drywall Tape			FT	25.9		
	CL 3			SF	9.0		
33	Drywall Board			SF	116		
34	Drywall Fastener	Self-drilling screws(100/pkt)		PKT	1.16		
35	Wall Paint			SF	116		
36	Drywall Tape			FT	21.8		



			WALLS: INTERIOR 04				
#	Item	Туре	Description, Manufacturer, SKU	Unit	Quantity	Unit Price	Total
	WD			SF	15.0		
37	Cementitious Backer Board			SF	138		
38	Kerdi membrane			SF	138		
39	Kerdi membrane Fastener			SF	138		
40	Wall Ceramic Tile			SF	138		
	WH	·		SF	8.0		
41	Drywall Board			SF	106		
42	Drywall Fastener	Self-drilling screws(100/pkt)		PKT	1.06		
43	Wall Paint			SF	106		
44	Drywall Tape			FT	20		
	HALL	'		SF	73.0		
45	Drywall Board			SF	259		
46	Drywall Fastener	Self-drilling screws(100/pkt)		PKT	2.59		
47	Wall Paint			SF	259		
48	Drywall Tape			FT	49		



			WALLS: INTERIOR 05				
#	Item	Туре	Description, Manufacturer, SKU	Unit	Quantity	Unit Price	Total
	GARAGE			SF	262.0		
49	Drywall Board			SF	553		
50	Drywall Fastener	Self-drilling screws(100/pkt)		PKT	5.53		
51	Wall Paint			SF	553		
52	Drywall Tape			FT	104		
1	Wall Skirting	Ceramic		FT	191		



			DOORS				
#	Item	Туре	Description, Manufacturer, SKU	Unit	Quantity	Unit Price	Total
1	Interior Swinging	3' - 0" X 6'-8"		PCS	4		
2	Garage Door	8' - 0" X 6'-6"		PCS	1		
3	Folding	3' - 3" X 6'-8"		PCS	1		
4	Interior Sliding	5' - 10" X 6'- 8"		PCS	1		
5	Interior Sliding	5' - 9" X 6'- 8"		PCS	1		
6	Folding	4' - 0" X 6'-8"		PCS	1		
7	Folding	2' - 4" X 6'-8"		PCS	1		
8	Exterior Swinging	3' - 0" X 6'-8"		PCS	1		
9	Exterior Door Trim			FT	38		
10	Interior Door Trim			FT	344		
11	Entry Lock set			PCS	2		
12	Privacy Lock set			PCS	4		
13	Passage Lock set			PCS	5		
14							
15							



			WINDOWS				
#	Item	Туре	Description, Manufacturer, SKU	Unit	Quantity	Unit Price	Total
1	Sliding	5' - 3" X 3'-3"		PCS	1		
2	Sliding	3' - 3" X 3'-3"		PCS	7		
3	Casment	2' - 9" X 4'-3"		PCS	4		
4	Sliding	3' - 3" X 1'-9"		PCS	1		
5	Awning	2' - 3" X 1'-3"		PCS	4		
6	Awning	6' - 3" X 1'-9"		PCS	1		
7	Exterior Window Trim			FT	222		
8	Interior Window Trim			FT	222		
9							
10							
11							
12							
13							
14							
15							



		ROOF 01				
Item	Туре	Description, Manufacturer, SKU	Unit	Quantity	Unit Price	Total
Roof Covering			SF	1847.0		
Roof Covering Fastener			PCS	924		
Roof Felt Paper			SF	1847.0		
Roof Felt Paper Fastener			PCS	5541.0		
Roof Sheathing			SF	1847.0		
Roof Sheathing Fastener			PCS	14776		
Batten						
Batten Fastener						
Soffit						
Soffit Fastener						
Fascia						
Fascia board fastener						
Roof Insulation						
			31	1017.0		
	Roof Covering Roof Covering Fastener Roof Felt Paper Roof Felt Paper Fastener Roof Sheathing Roof Sheathing Fastener Batten Batten Fastener Soffit Soffit Fastener Fascia Fascia board fastener	Roof Covering Roof Covering Fastener Roof Felt Paper Roof Felt Paper Fastener Roof Sheathing Roof Sheathing Fastener Batten Batten Soffit Soffit Fastener Fascia Fascia board fastener	Item Type Description, Manufacturer, SKU Roof Covering Roof Covering Fastener Roof Felt Paper Roof Felt Paper Fastener Roof Sheathing Roof Sheathing Fastener Batten Batten Fastener Soffit Soffit Fastener Fascia Fascia board fastener	Type Description, Manufacturer, SKU Unit	Item Type Description, Manufacturer, SKU Unit Quantity Roof Covering SF 1847.0 Roof Covering Fastener PCS 924 Roof Felt Paper SF 1847.0 Roof Sheathing Roof Sheathing SF 1847.0 Roof Sheathing Fastener PCS 14776 Batten ST 952.0 Batten Fastener PCS 715.8 Soffit SF 459.0 Soffit Fastener PCS 229.5 Fascia FT 242.0 Fascia board fastener PCS 121	Type