


EMBER

The Ember is a stylish modern 3 bedroom 2 bathroom house design. The main body of the home is clad in dark vertical siding, creating a modern look. A contrasting section, the garage, features warm-toned stone veneer. The roof features a combination of shed and gable forms while a covered entryway provides shelter and a welcoming point of access.

Inside, the Ember features a rectangular layout. The living and kitchen areas are merged into one large room at the center of the house, creating a spacious and versatile living space. The bedrooms and the garage are arranged on either side of the living area.

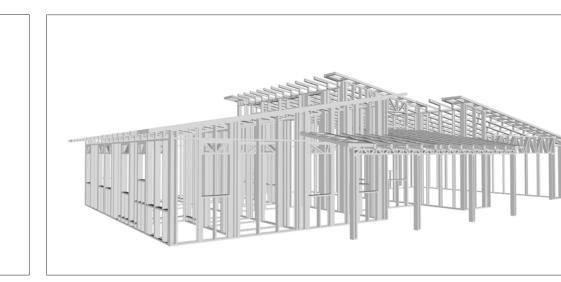


Materials Shopping List

< CLICK HERE >

Please print and take this Materials Shopping List to your favorite Home Depot and ask for assistance in selecting the materials, fixtures and fittings to complete your new home.

Record your selection and the price of the item. Then do the math to determine the cost for your selections and the total cost of finishing your home.

To Go To Materials Shopping List

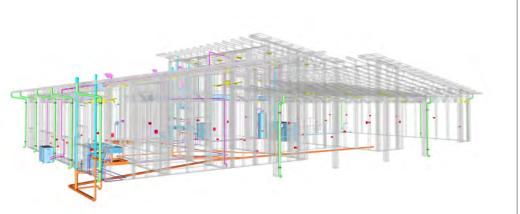


FLOOR PLAN



1396 SF



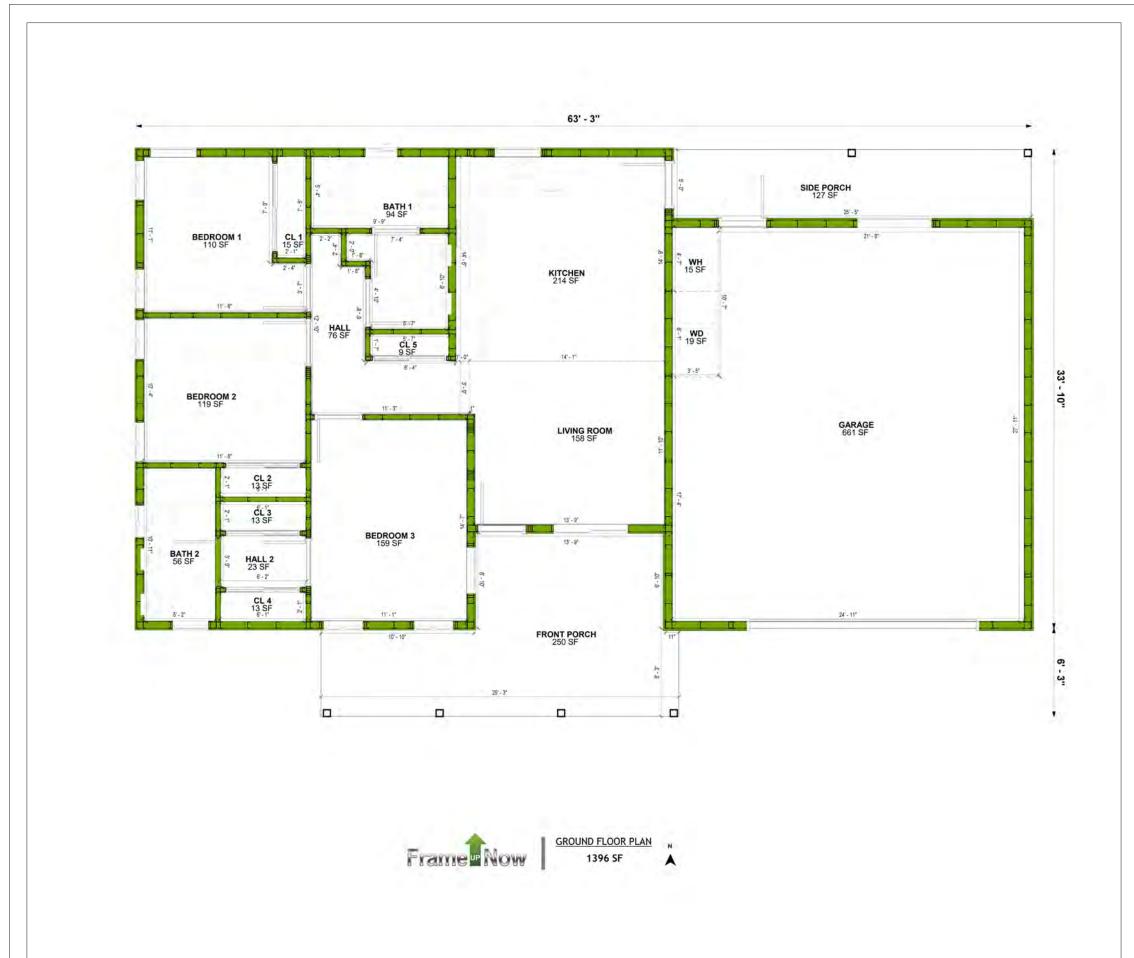

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HOW TO BUILD CONSTRUCTION STEPS

MATERIALS LIST PREVIEW -

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MATERIALS SHOPPING LIST

ABOUT



FrameUpNow is a design and manufacturing company providing precision-engineered home framing solutions. We offer a catalog of Affordable Homes, Tiny Homes, Garages, Shops and Barndominiums. FrameUpNow manufactures cold-formed steel (CFS) also known as Light Gauge Steel (LGS) framing components that conform to our engineered metal house frame plans or can be purchased as DIY skeleton kits.

The CFS/LGS framing is lightweight, easily assembled, and does not require heavy equipment or specialized labor, enabling homeowners to erect the frame themselves in just a few days. Unlike wood, the steel framing is impervious termites and bores, warping, expansion, and fire.

Our home plans come complete with a structural engineered stamp for permit approvals. Customers receive a full BOM also known as a Materials Shopping List to purchase finish materials from a Building Materials retailer. FrameUpNow prides itself on the quality and efficiency of our precision-engineered home framing solutions for construction professionals and DIY homeowners.



KEY PLAN

NO.	DESCRIPTION	DATE

NOTE:

LEGEND:

PROJECT

245-Ember-1396-3Bd2Ba-Modern-550

DRAWING NAME

INTRODUCTION

CLIENT NAME:
PROJECT NUMBER:
DATE:
DESIGNED BY:
DRAWN BY:
CHECKED BY:

I101

SCALE:

DISCLAIMER

DISCLAIMER: This documentation and all it's contents are the intellectual property of FrameUpNow. It is provided solely for marketing the services of FrameUpNow. The preliminary information is not approved for actual construction use and is not warranted to be complete or accurate. Unauthorized copying, distribution, or application of these proprietary materials, in any form or format, is strictly prohibited. FrameUpNow assumes no liability for any issues arising from improper use of this marketing content.

DESCRIPTIONS

MATERIALS LIST

The BOM (Bill Of Materials) package, known as the Materials Shopping List document, provides:

Comprehensive Inventory: Detailed lists of essential materials sourced from architectural, mechanical, HVAC, electrical, and plumbing design drawing sets.

Precise Curation: Each item meticulously selected and organized for accuracy and efficiency in project planning.

Customizable Options: Customers can modify listed items to their preferences and calculate costs accordingly, ensuring alignment with personal project needs and budget.

Dedicated Space for Details: Includes tables for customers to note Home Depot SKU numbers or product descriptions for selected items, facilitating seamless purchasing and coordination with suppliers.

Customer Convenience: Take the list to Home Depot or preferred suppliers for accurate pricing, helping align the total home budget with personal financial plans.

Simplify your construction journey with our Materials Shopping List document, where detailed preparation meets streamlined implementation for your dream home.

STRUCTURAL

The structural drawings package provides an exhaustive set of detailed plans essential for the precise assembly of your building. This comprehensive package includes:

Framing Plans: Detailed layouts for all framing components. Truss Layouts: Clear instructions for truss placement and

Panel Length Plans: Specifications for panel dimensions. Framing Elevations and Sections: Precise elevation and sectional views for accurate construction.

Truss and Wall Blocking Plans: Plans for truss and wall blocking to ensure structural integrity.

Hold-Down Plan: Detailed hold-down requirements for stability. Snap Sheet: Reference sheet for quick identification of components

Structural Details and Bracing Plans: Complete details and bracing plans for all structural elements.

Accompanying these plans is a comprehensive Bill of Materials (BOM) that lists every necessary building component, from cold formed steel (CFS) frames to fasteners.

ARCHITECTURAL

With the comprehensive architectural package, both builders and DIY homeowners can confidently execute the construction.

The architectural package includes:

Furnished Floor Plans: Complete with furniture layouts for a clear understanding of space utilization.

Detailed Dimension Plans: Ensures precise measurements, from the overall footprint down to the exact placement of windows and

Foundation Plan: Detailed plan to establish a solid foundation.

Wall Framing and Truss Layout: Comprehensive plans for wall framing and truss placement.

Architectural Elevations: Exterior views showcasing the design.

Strategic Building Sections: Critical cross-sectional details for a thorough understanding of the build.

Casework Drawings and Diagrams: Suggested designs for built-in caseworks, such as kitchen cabinets.

MECHANICAL

The mechanical package includes everything needed to guide HVAC

Detailed HVAC Floor Plan: Precisely maps out the placement of air handlers, ductwork, and vents throughout the home's layout.

HVAC Sections and Riser Diagrams: Technical drawings offering critical cross-sectional details and piping schematics, ensuring proper integration of the heating and cooling system into the home's structure.

Bill of Materials: A complete list of all necessary HVAC components.

ELECTRICAL

The electrical package includes all the plans and documentation needed to guide the installation of your home's electrical system:

Detailed Power Plan: Precisely maps out the placement of outlets, switches, and other power components throughout the layout.

Comprehensive Lighting Plan: Shows the optimal locations for lighting fixtures, sconces, and other illumination sources to create a well-lit, functional interior.

Dimensioned Electrical Layout: Provides exact dimensions and measurements to ensure proper placement of all electrical elements.

Bill of Materials: A complete list of every component needed, from circuit breakers to wiring.

The plumbing package includes everything needed to guide the

Detailed Water Supply System Plan: Precisely maps out the placement of pipes, valves, and plumbing fixtures throughout the

Comprehensive Sewage System Plan: Shows the optimal routing and sizing of drain lines to effectively remove waste and ensure

Detailed Riser Diagrams: Provide information needed to properly

Bill of Materials: A complete list of every component needed, from

PLUMBING


installation of your home's water supply and drainage systems:

proper drainage.

install all vertical plumbing risers and vent stacks.

pipes to fixtures.


BOM (Bill Of Materials) (Separately Attached)

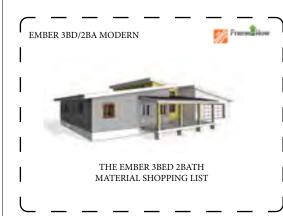



The Bill of Materials (BOM) is a crucial document that compiles the material requirements from different disciplines into a centralized inventory, enabling efficient procurement, inventory management, and cost estimation for a specified project or

ELECTRICAL BOM



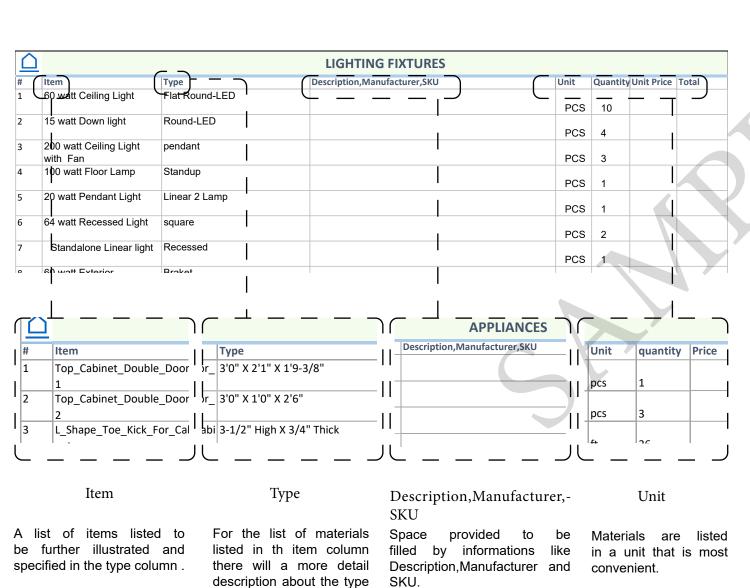

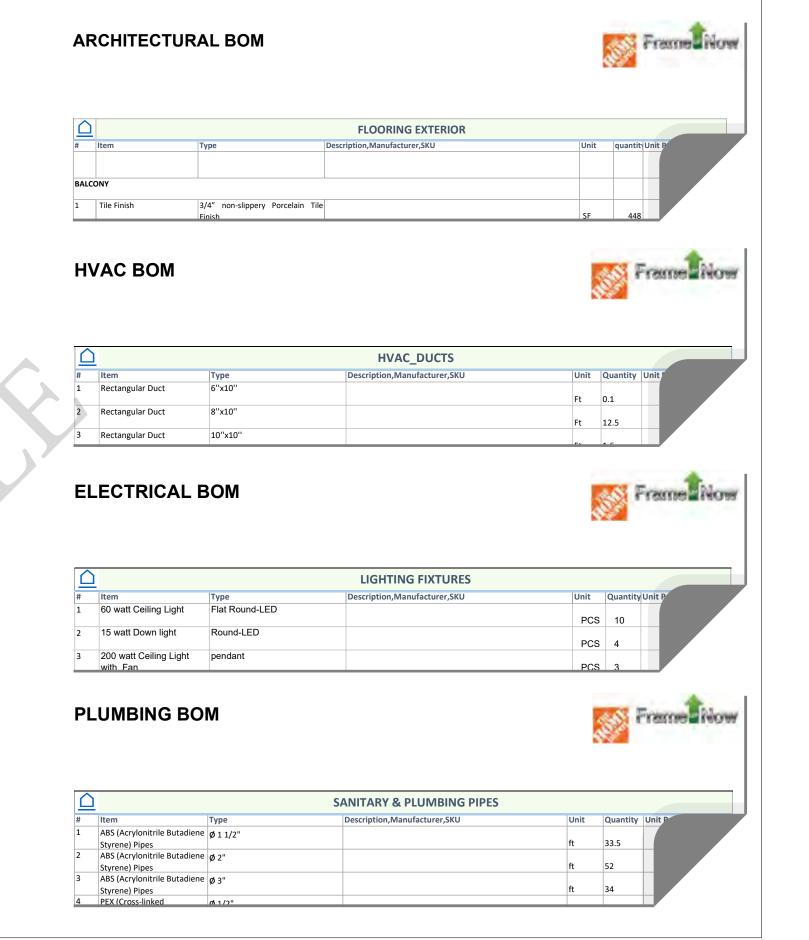

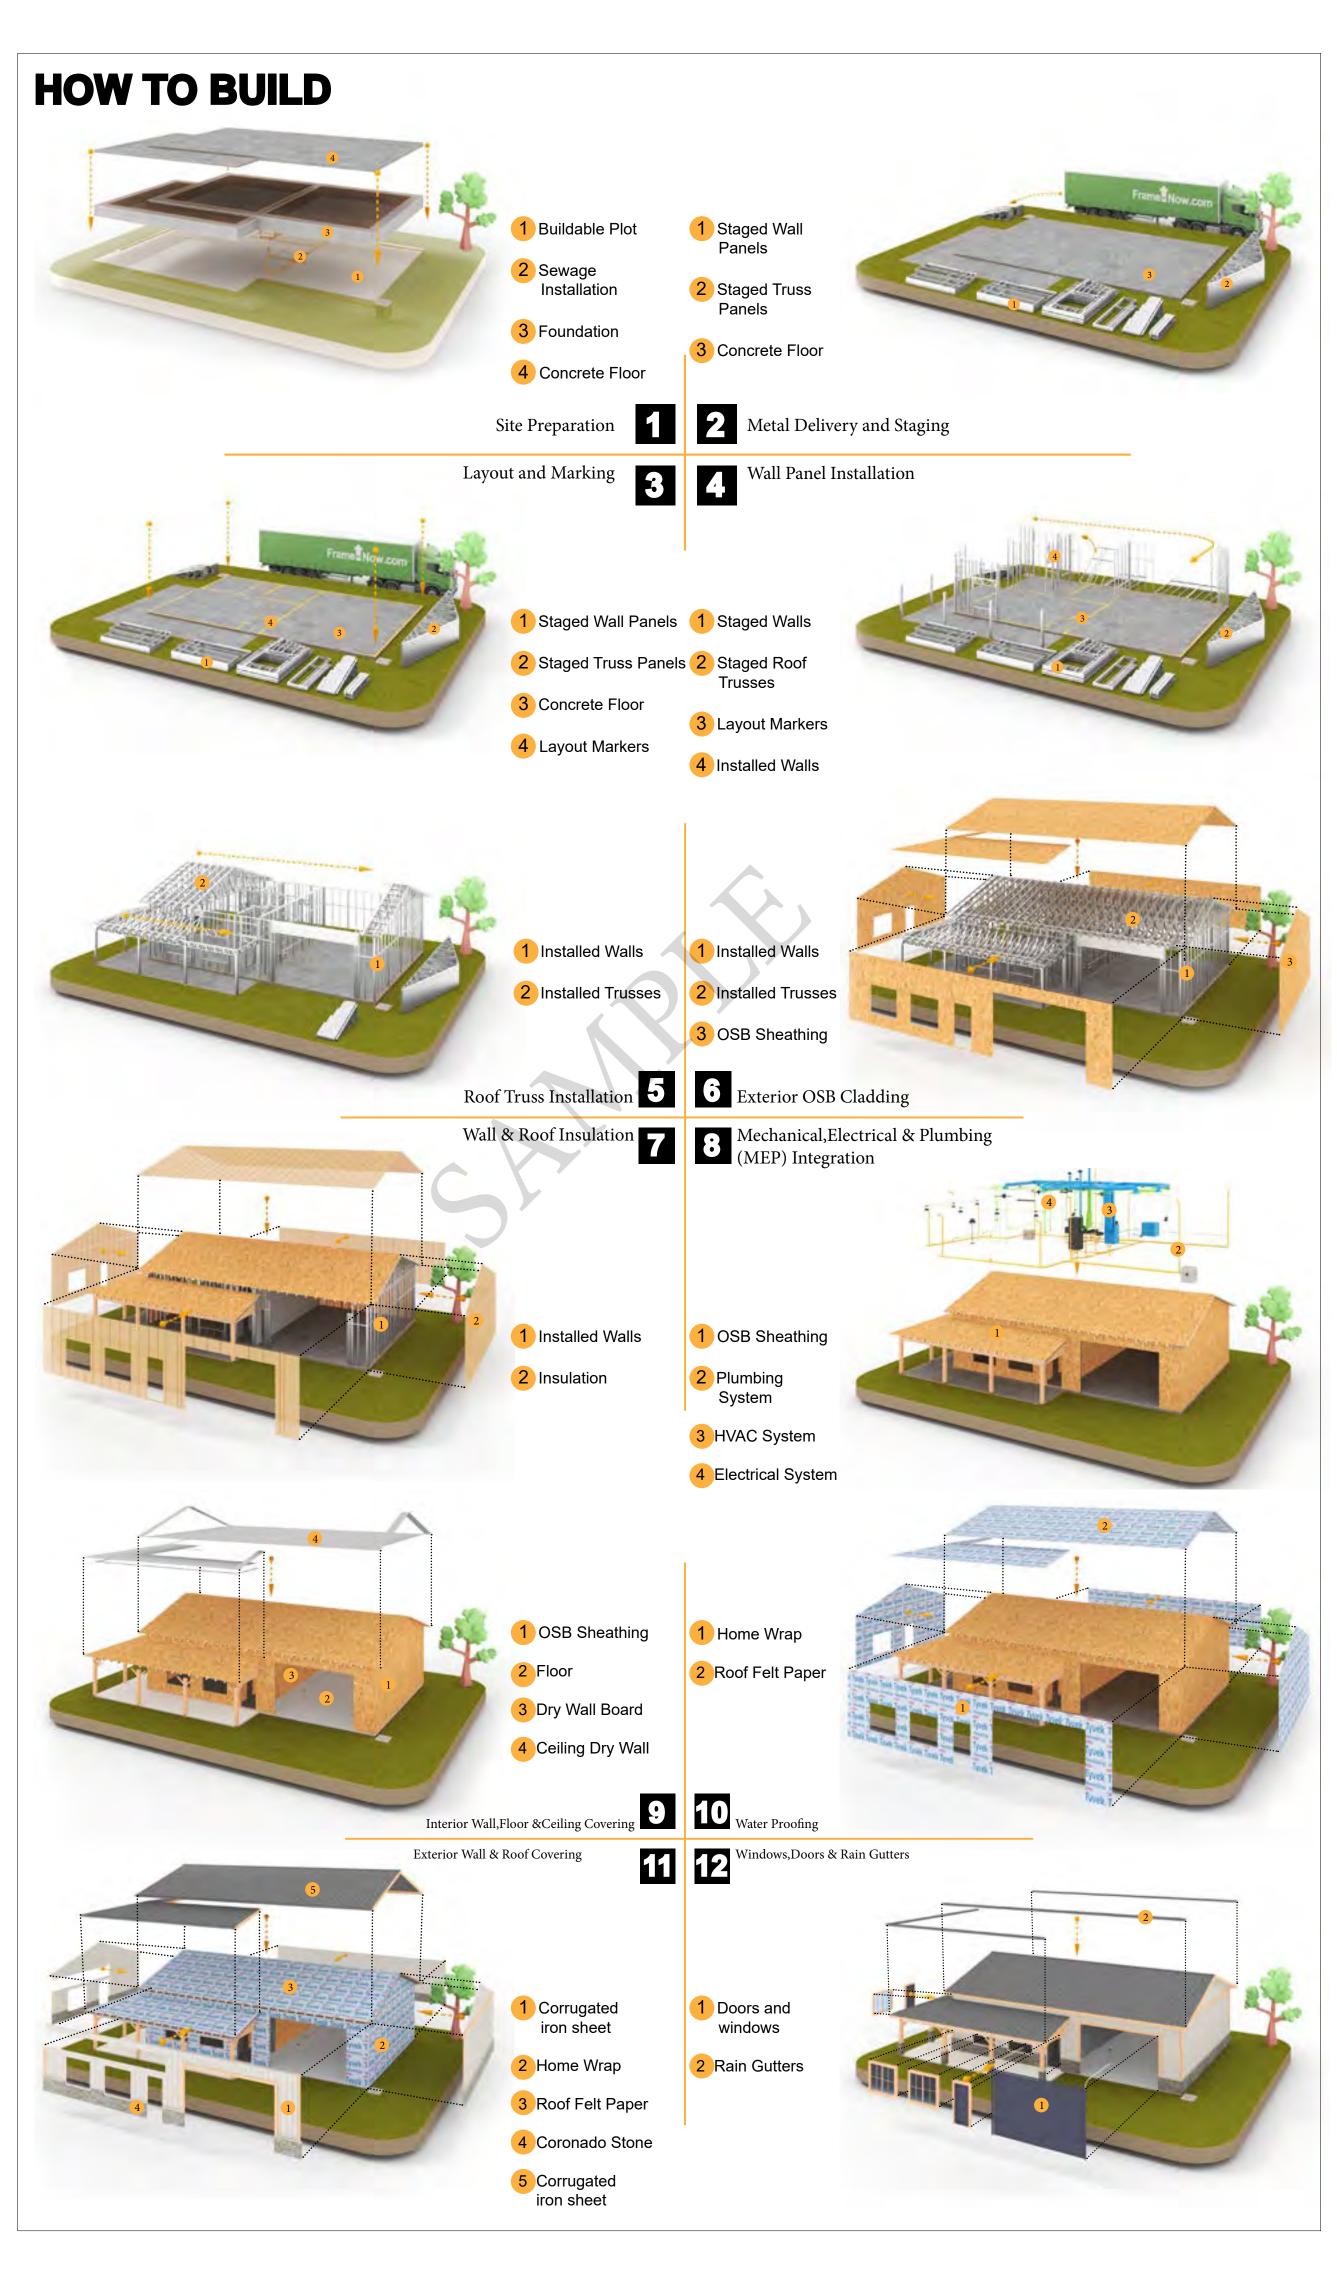



KEY PLAN

NO.	DESCRIPTION	DATE

NOTE:

LEGEND:

PROJECT

245-Ember-1396-3Bd2Ba-Modern-550

DRAWING NAME


INTRODUCTION

CLIENT NAME: DATE: **DESIGNED BY** DRAWN BY: CHECKED BY:

1102

SCALE:

of the Material.

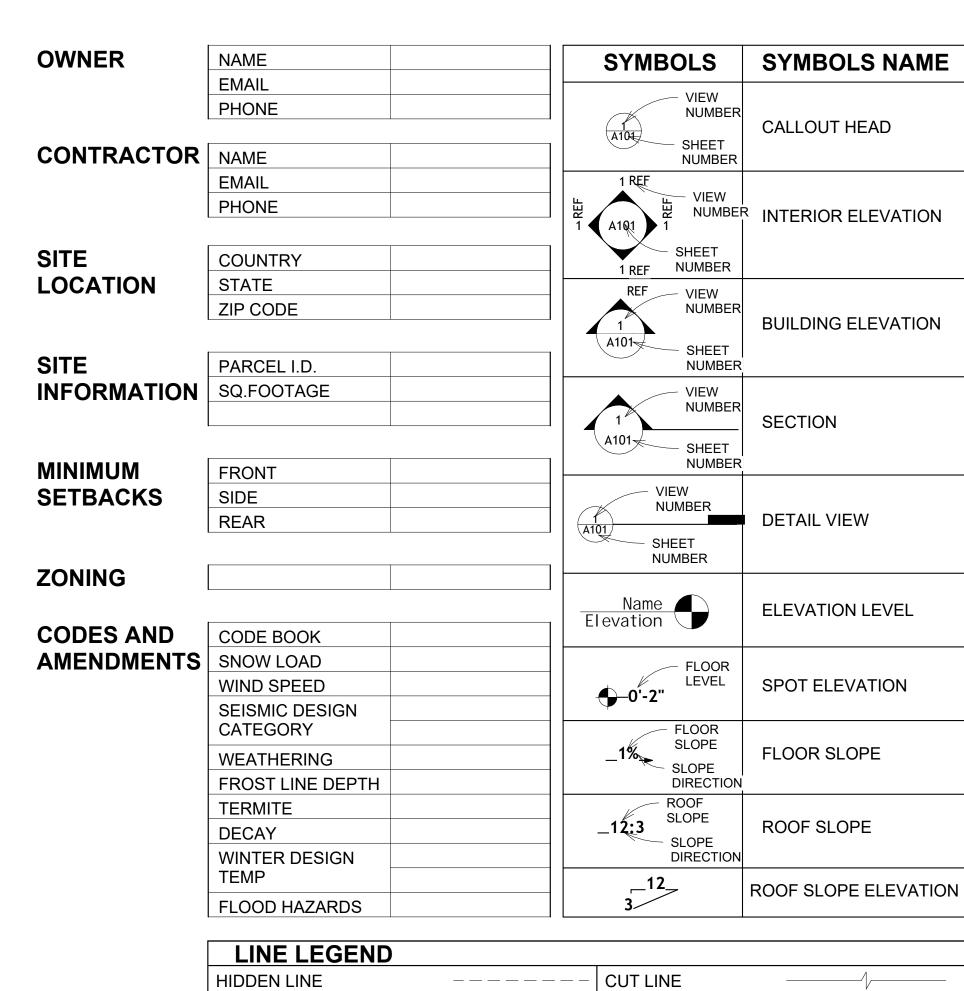

ROOM SEPARATOR

OVER HEAD

DOOR OPENING DIRECTION

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S104	ROOF TRUSS LAYOUT	F.F.L
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M102	HVAC SECTION	RG
M103	RISER DIAGRAM	SE
		SF
		SIMP. S

TAG

CA01

SE01

	ING	RIGHT GARAGE
RISER DIAGRAM	SE	SPECIAL EQUIPMENT
	SF	SQUARE FEET
	SIMP. STHD8	SIMPSON STRAP THE
TAG'S NAME		HOLDDOWN
CASEWORK TAG	SIMP. ABE66	SIMPSON ANCHOR BOLT ED
CASEWORK TAG	TV	TELEVISION
DOOR TAG	UNO	UNLESS NOTED OTHERWISE
FURNITURE TAG	W/	WITH
FUNNITURE TAG	W/D	WASHER/DRYER
WINDOW TAG	AC	AIR CONDITIONING UNIT
SPECIALTY EQUIPMENT TAG	ACC	AIR COOLED CONDENSER
MECHANICAL FOLUDAENT TAC	ACCU	AIR COOLED CONDSENSING UN
MECHANICAL EQUIPMENT TAG	AHU	AIR HANDLING UNIT
PLUMBING EQUIPMENT TAG	CC	COOLING COIL
	CD	CEILING DIFFUSER
	CFm	Cubic Feet Per Minute
	CR	CEILING REGISTER
	CU	CONDENSING UNIT
	CW	COLD WATER
	E/A	EXHAUST AIR
	EF	EXHAUST FAN
	ET	EXPANSION TANK
	EX.	EXISTING
	FC	FLEXIBLE CONNECTION

ABBREVIATION

CASEWORK **ELECTRICAL**

FOOTINGS

MAXIMUM

MINIMUM

NUMBER

ON CENTER

PLUMBING

REFERENCE

RIGHT GARAGE

FAN COIL UNIT

HEATING COIL

INLET VANES

RETURN AIR

RETURN FAN

STATIC PRESSURE

SUPPLY AIR

MAXIMUM

MINIMUM

MECHANICAL ROOM

FLOOR

MER

MAX.

MIN.

S/A

SCD

POLYVINYL CHLORIDE

MECHANICAL

CONDITIONING

ACTION FLOOR SYSTEMS

AMERICAN SOCIETY FOR


TESTING AND MATERIAL

FINISHED FLOOR LEVEL



CALL OUT BOUNDRY — — — — — —

GROUND CUT

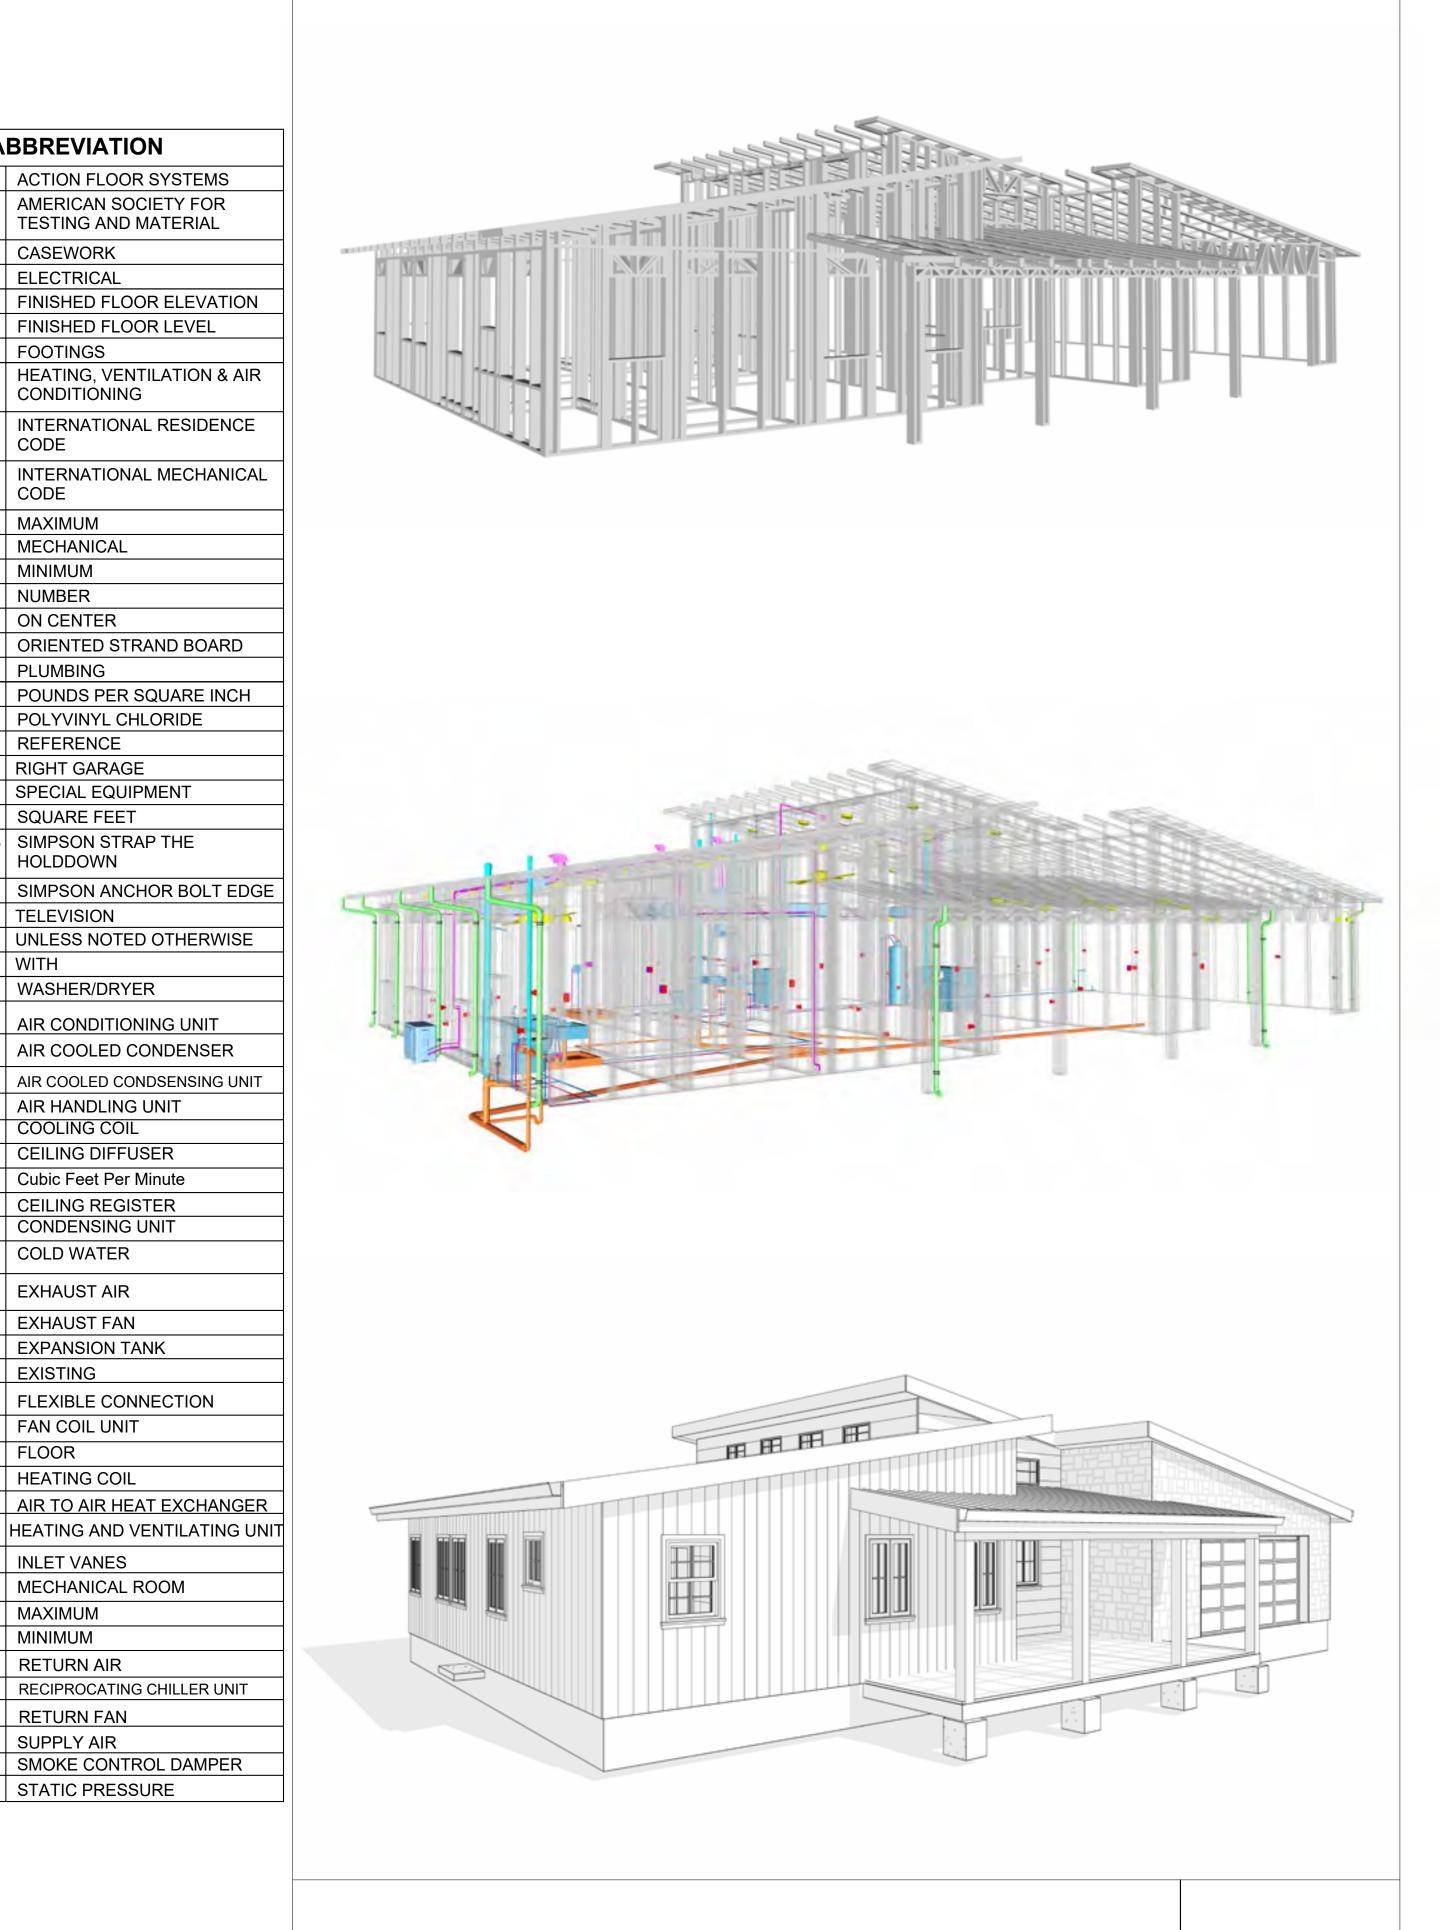

245-EMBER-1396-3Bd2Ba-MODERN-550

SQUARE FOOT	AGE
LIVING	1396
FRONT PORCH	146
SIDE PORCH	127
GARAGE	732
TOTAL	2401



KEY PLAN	

NO.	DESCRIPTION	DATE

NOTE:

LEGEND:

PROJECT

245-EMBER-1396-3Bd2Ba-**MODERN-550**

DRAWING NAME

COVER SHEET

CLIENT NAME:	Client Name
PROJECT NUMBER:	0061_12
DATE:	5/9/2025 3:35:12 PM
DESIGNED BY:	Designer
DRAWN BY:	Author
CHECKED BY:	Checker

G101

GENERAL NOTES

- THIS DRAWING DEPICTS THE ARCHITECTURAL (SPACE LAYOUT, FURNISHING, FLOOR, WALLS, ROOFS, FOUNDATION, WINDOWS AND DOORS) SYSTEMS. IT PROVIDES A VISUAL REPRESENTATION OF THE ARCHITECTURAL LAYOUT AND COMPONENTS.
- THE ARCHITECTURAL DRAWINGS ARE PREPARED TO MEET THE SPECIFIC REQUIREMENTS OF THE BUILDING, AS PER THE PROJECT SPECIFICATIONS AND APPLICABLE CODES AND STANDARDS.
- THE CONSTRUCTION OF THIS HOME SHALL COMPLY WITH THE LATEST EDITION OF THE INTERNATIONAL RESIDENTIAL CODE (IRC), INTERNATIONAL MECHANICAL CODE (IMC), THE INTERNATIONAL PLUMBING STANDARD, THE NATIONAL ELECTRICAL STANDARD AND ALL OTHER APPLICABLE LOCAL, STATE, AND NATIONAL CODES AND REGULATIONS.
- COORDINATION WITH OTHER TRADES HAS BEEN DONE ON A DESIGN LEVEL. THIS DRAWING SHALL BE READ TOGETHER WITH THE ME, EL AND PL DESIGN DRAWINGS TO ENSURE PROPER CONSTRUCTION AND INTEGRATION OF THE BUILDING SYSTEMS.

ABOUT WALLS:

- SHOWER WALL COVERING
- BATHTUB AND SHOWER SPACES (WALLS AND FLOORS) WITH INSTALLED SHOWER HEADS AND IN SHOWER COMPARTMENTS SHALL BE FINISHED WITH A NON-ABSORBENT SURFACE.
- 2. WALL PAINT (INTERNAL)
 - THE TYPICAL THICKNESS OF LATEX WALL PAINT IS 1/32 OF AN INCH FOR A SINGLE COAT. AND DOUBLE COAT (1/16") SHALL BE APPLIED FOR DURABILITY.

3. ADHESIVES: THE ADVISABLE TYPE OF ADHESIVE FOR THIS PROJECT IS **EPOXY ADHESIVES**BECAUSE THEY ARE


KNOWN FOR THEIR HIGH STRENGTH, DURABILITY, AND RESISTANCE TO MOISTURE, CHEMICALS AND

REFER TO SHEETS A201 & A202 FOR GENERAL NOTES ON EXTERNAL FINISHING MATERIALS

ABOUT FLOORS:


- THE SPOT ELEVATION INDICATES THE FINISHED FLOOR ELEVATION.
- FINISHED FLOORS PER PLANS.
- FIELD VERIFY FOR DIMENSION DROP 4" FOR SHOWER AND BATHTUB USE.
- 1% SLOPE ON OUTDOOR BALCONIES FOR WATER RUN OFF.
- 2% SLOPE TOWARDS THE SHOWER DRAIN FOR SUFFICIENT DRAINAGE.
- 4" DROP AT THE DOOR LEADING TO EXTERIOR BALCONY FROM THE MAIN LIVING AREA.
- 5% SLOPE FOR GARAGE IS USED, WHICH SHOULD BE CHECKED WITH THE LOCAL GARAGING ZONING LAWS.



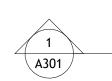

FURNITURE SCHEDULE			
TYPE MARK	TYPE	COUNT	
01	DOUBLE 53" X 74"	3	
02	THREE SEAT SOFA	1	
03	DINING CHAIR	4	
04	COFFE TABLE	1	
05	ONE SEAT SOFA	2	

		ROOM	I FINISH S	CHEDULE			
ROOM NUMBE R	ROOM NAME	FLOOR FINISH	BASE FINISH	WALL FINISH	CEILING FINISH	CEILING HEIGHT	COM MEN TS
01	LIVING ROOM	HARDWOOD	CONCRETE	WALL PAINT	DRY WALL	8' - 0"	
02	KITCHEN	HARDWOOD	CONCRETE	WALL PAINTT + CERAMIC	DRY WALL	8' - 0"	
03	BEDROOM 1	HARDWOOD	CONCRETE	WALL PAINT	DRY WALL	8' - 0"	
04	BEDROOM 2	HARDWOOD	CONCRETE	WALL PAINT	DRY WALL	8' - 0"	
05	BEDROOM 3	HARDWOOD	CONCRETE	WALL PAINT	DRY WALL	8' - 0"	
06	CL 1	HARDWOOD	CONCRETE	WALL PAINT	DRY WALL	8' - 0"	
07	CL 2	HARDWOOD	CONCRETE	WALL PAINT	DRY WALL	8' - 0"	
08	CL 3	HARDWOOD	CONCRETE	WALL PAINT	DRY WALL	8' - 0"	
09	CL 4	HARDWOOD	CONCRETE	WALL PAINT	DRY WALL	8' - 0"	
10	CL 5	HARDWOOD	CONCRETE	WALL PAINT	DRY WALL	8' - 0"	
11	HALL	HARDWOOD	CONCRETE	WALL PAINT	DRY WALL	8' - 0"	
12	WH	EPOXY FLOOR FINISH	CONCRETE	WALL PAINT	DRY WALL	8' - 0"	
13	WD	EPOXY FLOOR FINISH	CONCRETE	WALL PAINT	DRY WALL	8' - 0"	
14	BATH 1	VINYL TILES	CONCRETE	CERAMIC TILE	MRD	8' - 0"	
15	BATH 2	VINYL TILES	CONCRETE	CERAMIC TILE	MRD	8' - 0"	
16	SIDE PORCH	PROCELAIN TILE	CONCRETE	STONE VENEER	PLYWOOD	8' - 0"	
17	FRONT PORCH	PROCELAIN TILE	CONCRETE	CORUGATED IRON	PLYWOOD	8' - 0"	
18	GARAGE	EPOXY FLOOR FINISH	CONCRETE	STONE VENEER	DRY WALL	8' - 0"	

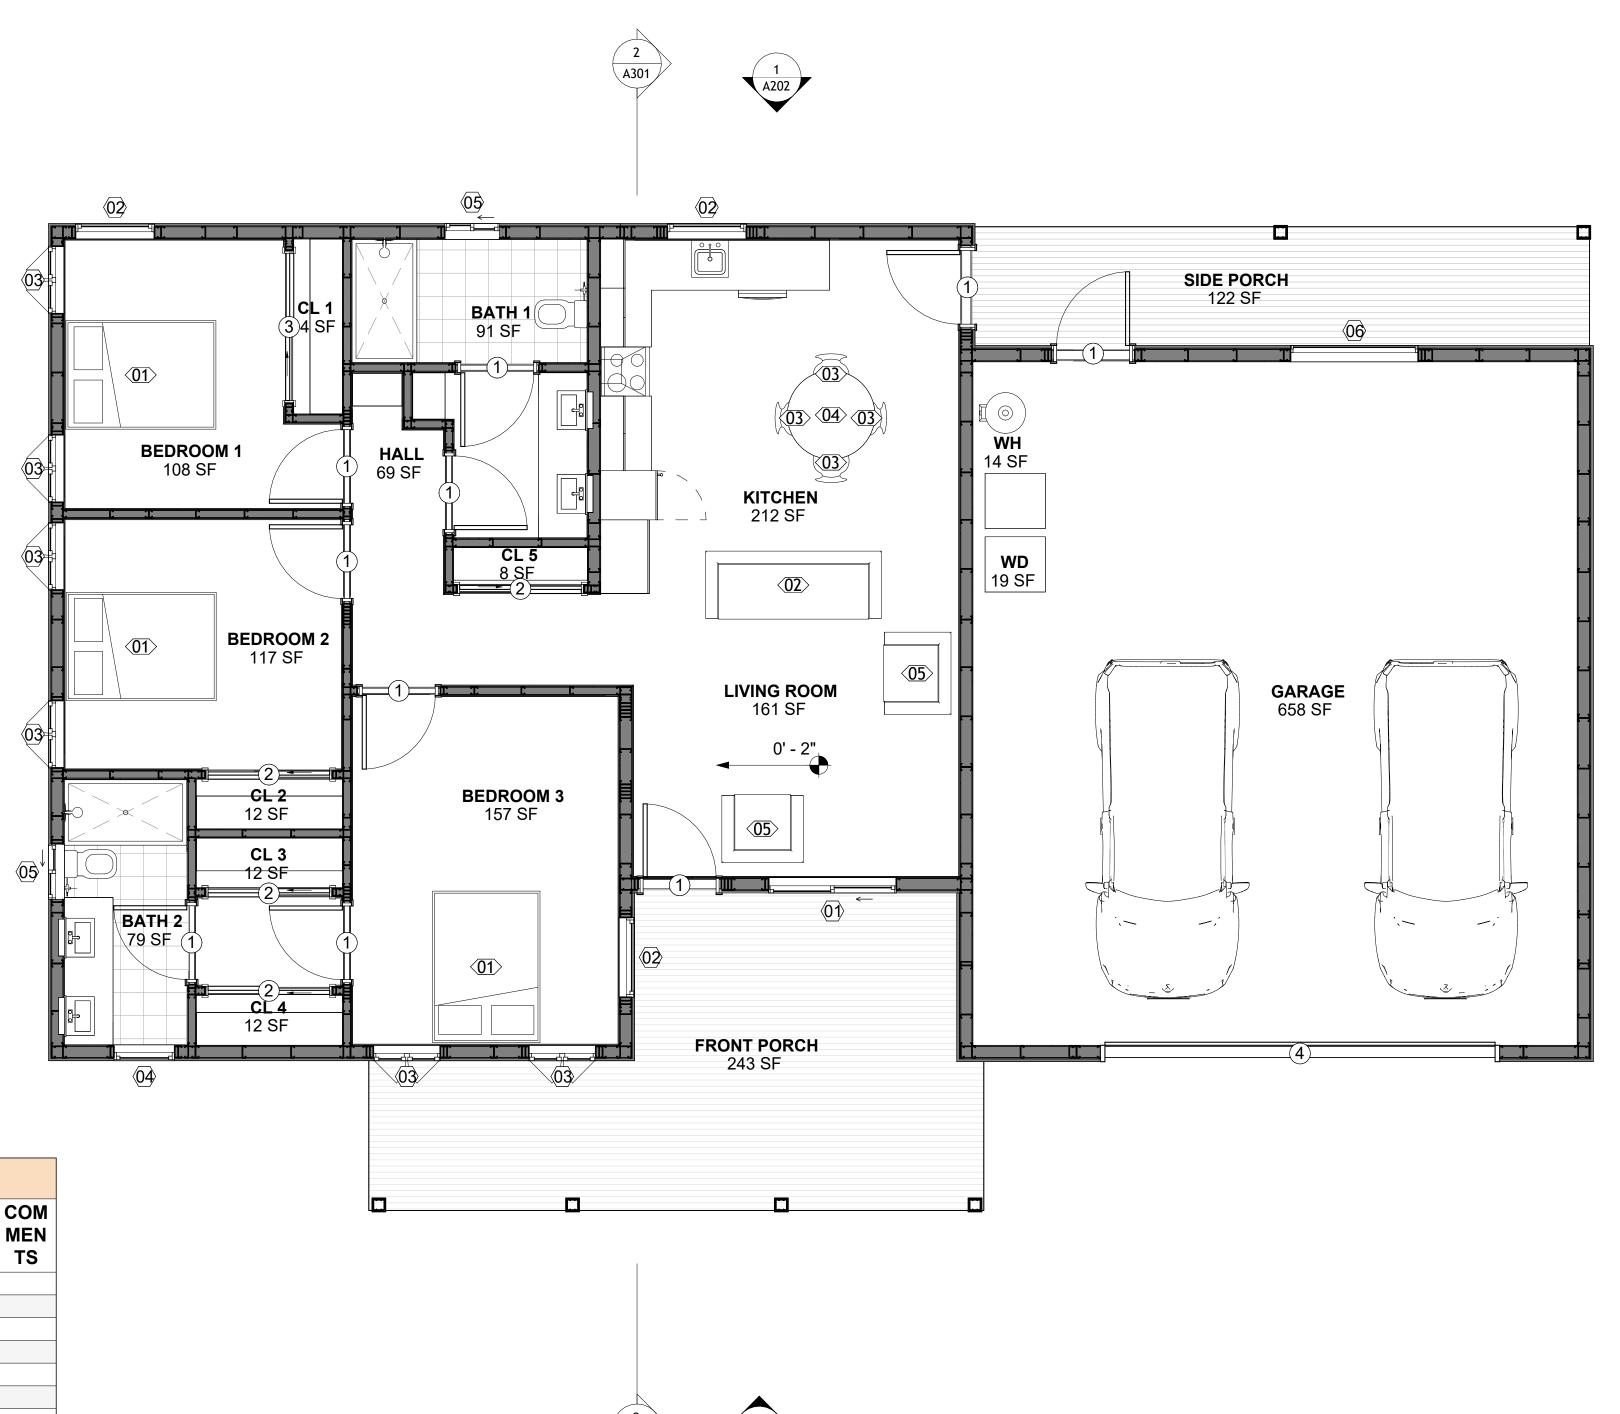

FLOOR PLAN 1/4" = 1'-0"



KEY PLAN

NO. DESCRIPTION DATE

NOTE:

(2 A201

1 A301

SQUARE FOOTAGE

1396

127

732

2401

LIVING

FRONT PORCH

SIDE PORCH

GARAGE

TOTAL

LEGEND:

PROJECT

245-EMBER-1396-3Bd2Ba-**MODERN-550**

DRAWING NAME


FLOOR PLAN

CLIENT NAME: **Client Name** PROJECT NUMBER: 0061_12 5/9/2025 3:35:13 PM Designer **DESIGNED BY:** DRAWN BY: Author CHECKED BY: Checker

A101

SCALE: 1/4" = 1'-0"

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SQUARE FOOTAGE

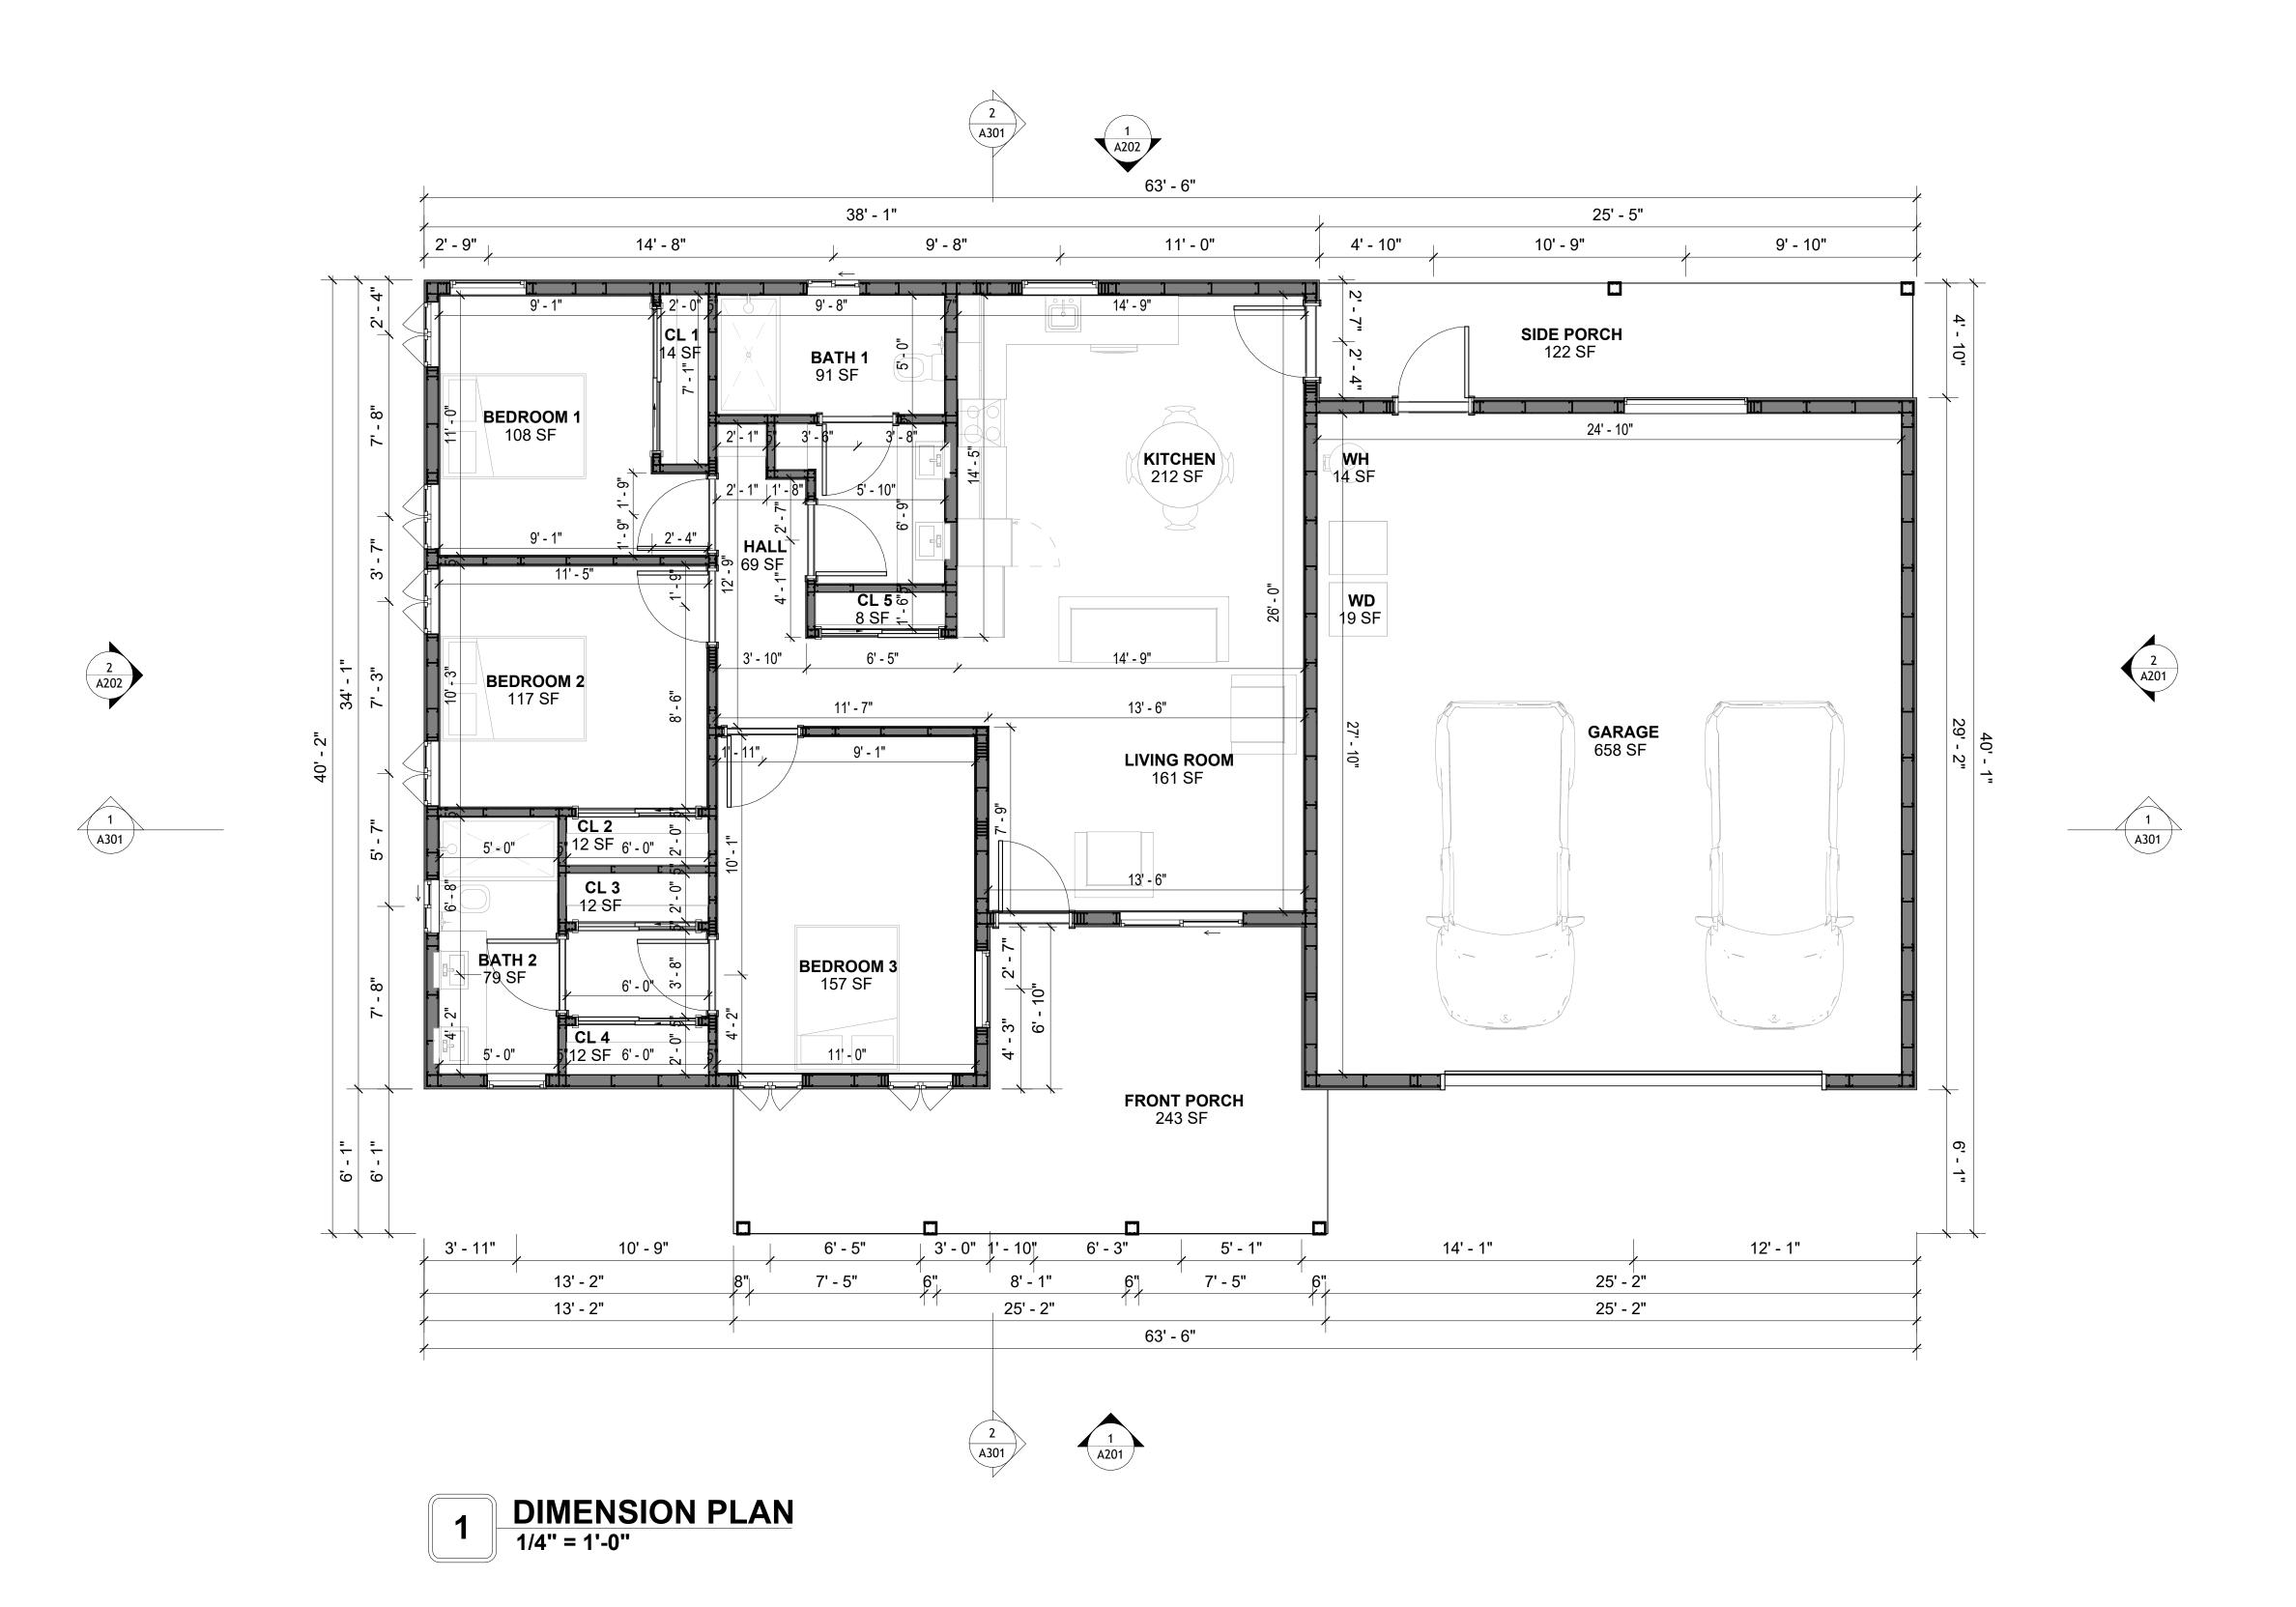LIVING 1396

FRONT PORCH 146

SIDE PORCH 127

GARAGE 732

TOTAL 2401



KEY PLAN

NO.	DESCRIPTION	DATE

NOTE:

LEGEND:

PROJECT

245-EMBER-1396-3Bd2Ba-MODERN-550

DRAWING NAME

DIMENSION PLAN

CLIENT NAME:	Client Name
PROJECT NUMBER:	0061_12
DATE:	5/9/2025 3:35:16 PM
DESIGNED BY:	Designer
DRAWN BY:	Author
CHECKED BY:	Checker

A102

SCALE: 1/4" = 1'-0"

DIMENSIONS IN THE ARCHITECTURAL DRAWINGS CONSIDER FINISHING MATERIALS. FOR PRECISE MEASUREMENTS OF THE STRUCTUAL FRAMING, REFER TO THE ATTACHED STRUCTURAL PLAN SET.

FOUNDATION NOTES

NOTES:

TERMITES PRETREATMENT BY LICENSED CONTRACTOR UNDER SLAB AND AROUND FOOTINGS. ALL AREAS BELOW SLABS SHALL BE TREATED NO MORE THAN 24 HOURS PRIOR TO CONCRETE POUR. EVIDENCE OF TREATMENT MUST BE PROVIDED PRIOR TO PLACING OF CONCRETE.

1. MATERIALS:

ALL INTERIOR CONCRETE SLABS SHALL BE A MIN. OF 4" THICK CONCRETE OVER 4" COMPACTED AGGREGATE BASE (ASTM D698), FINISH ELEVATIONS AS NOTED ON DRAWINGS, 6" ABOVE ADJACENT GRADE, LEVEL SLABS TO 1/8"-10' MAX.. CONCRETE SLABS SHALL BE 2500# PSI AT 28 DAYS. A 4" ALLOWABLE SLUMP.

2. **PAD PREPARATION:**

EXCAVATION FOR FOOTING SHALL BE NEAT.

- FOOTINGS SHALL BE POURED IMMEDIATELY AFTER EXCAVATION AND APPROPRIATE INSPECTION.

- ALL REINFORCING STEEL MARKED "CONTINUOUS" SHALL BE LAPPED 36 BAR DIAMETERS AT SPLICES AND AROUND CORNERS OR INTERSECTIONS WITH A STANDARD 90 DEGREE BEND ON CORNER BARS. LAP WIRE MESH ONE FULL MESH AT SIDE AND END LAPS.

- ALL HARDWARE TO BE SIMPSON OR EQUIVALENT.
- EXTERIOR FRAME WALL TO BE SECURED WITH 1/2"X10" ANCHOR BOLTS 4'-0" O.C. FOR 1-STORY AND 2'-8" O.C. FOR 2-STORY. BOLTS SHALL BE LOCATED WITHIN 1'-0" OF EACH END PIECE AND SHALL HAVE A MIN. OF TWO BOLTS PER PIECE.

-FOUNDATION ANCHOR STRAPS SHALL BE PERMITTED, ACCORDING TO RESIDENTIAL CODE 2021

- ALL INTERIOR WALLS TO BE SECURED WITH POWER DRIVEN PINS PER MANUFACTURER SPECIFICATION USE PIN SPACING EQUIVALENT TO 1/2" ANCHOR BOLTS.

ALL CONSTRUCTION TO CONFORM TO THE 2012 IRC
 R-10 RIGID INSULATION OUTSIDE OF EXTERIOR FOUNDATION WALLS UNDER LIVING AREA.

- R-10 RIGID INSULATION OUTSIDE OF EXTERIOR FOUNDATION WALLS UNDER LIVING ARE - CONCRETE PAD FOR CONDENSER THICKNESS IS 4" MIN UNLESS OTHERWISE NOTED.

3. CONCRETE CONSTRUCTION:

- THE SLAB SHALL BE UNDERLAIN BY A VAPOR BARRIER/RETARDER IN THE LIVING AREA (TYPICALLY POLYETHYLENE, UNLESS MORE STRINGENT PROTECTION REQUIRED BY THE ARCHITECT, ENGINEER, FLOOR COVERING MANUFACTURER, OR ACCEPTED PRACTICE). UNLESS OTHERWISE REQUIRED, BARRIER MAY BE OMITTED AT GARAGES, PORCHES AND PATIOS WITHOUT FLOOR COVERINGS. IT IS BEYOND THE SCOPE OF THESE PLANS TO DETERMINE THE APPLICABILITY OF THESE MORE STRINGENT REQUIREMENTS. BUILDER SHALL VERIFY PRIOR TO CONSTRUCTION.

4. REINFORCEMENT:

- IF CONSTRUCTED ON ACTIVE SOILS, THE LONG TERM PERFORMANCE OF THE FOUNDATION IS DEPENDENT ON MAINTENANCE BY THE OWNER. THUS THE BUILDER SHALL ADVISE THE OWNER OF THE FOLLOWING:

- 1. DRAINAGE MUST BE MAINTAINED. WATER SHALL NEVER BE ALLOWED TO POND NEAR THE FOUNDATION.
- 2. THE SOIL AROUND THE FOUNDATION SHALL BE MAINTAINED IN A RELATIVELY DAMP CONDITION, SUCH AS THAT REQUIRED TO KEEP A LAWN GREEN. IF IT DRIES OUT IT WILL SHRINK. IF IT GETS WET, IT WILL HEAVE UPWARD.

3. SLABS ON THE SHORTER SIDE USES MAIN BARS ARE USED IN THIS DIRECTION ONLY WITH SMALLER DIAMETER DISTRIBUTION BARS ARE PLACED, FORMING A MAT OR GRID.

4. ALL REINFORCEMENT BARS SIZE 10MM OR LARGER IN ACCORDANCE TO ASTM

- ANCHOR BOLTS AT ALL EXTERIOR WALLS SHALL BE MINIMUM 1/2 INCH DIAMETER WITH A MAXIMUM SPACING OF 6'-0" ON CENTER, UNLESS NOTED OTHERWISE.
 ANCHOR BOLTS SHALL BE INSTALLED WITHIN 12 INCHES OF EACH END OF EACH SILL
- 4. ANCHOR BOLTS SHALL BE INSTALLED WITHIN 12 INCHES OF EACH END OF EACH SILL PLATE WITH AT LEAST TWO ANCHOR BOLTS FOR EACH BOLTS FOR EACH SILL PLATE LONGER THAN 12 INCHES.
- 5. SIMPSONS SILL ANCHORS MAYBE SUBSTITUTED FOR ANCHOR BOLTS AT THE SAME SPACING.


6. EXTERIOR CONCRETE SLABS WHICH ARE NOT PART OF THE MAIN SLAB SHALL BE MINIMUM 4 INCHES THICK WITH NO STEEL REINFORCING BARS REQUIRED, UNLESS NOTED OTHERWISE ON FOUNDATION PLAN.

VERIFY THE FOLLOWING PRIOR TO POURING:

- 1. ALL HOLDDOWNS, STRAP, AND POST LOCATIONS.
- 2. CONCRETE FINISHES. PANEL RISER LOCATION WHERE APPLICABLE.
- UNDERSLAB MECHANICAL REQUIREMENTS.
 STEM WALL BLOCKOUTS.
- 5. UNDERSLAB ELECTRICAL REQUIREMENTS AND PANEL RISER LOCATION. WHERE
- APPLICABLE.

 6. PROVIDE THE FOLLOWING:
- PVC SLEEVES THROUGH FTG IF REQUIRED
- 20' #4 COPPER GROUND BAR.
- 7. SLOPE FINISH GRADE AWAY FROM FOOTING.

NOTE: FIELD VERIFY ALL DIMENSIONS SEE DIMENSIONED ARCHITECTURAL DRAWINGS

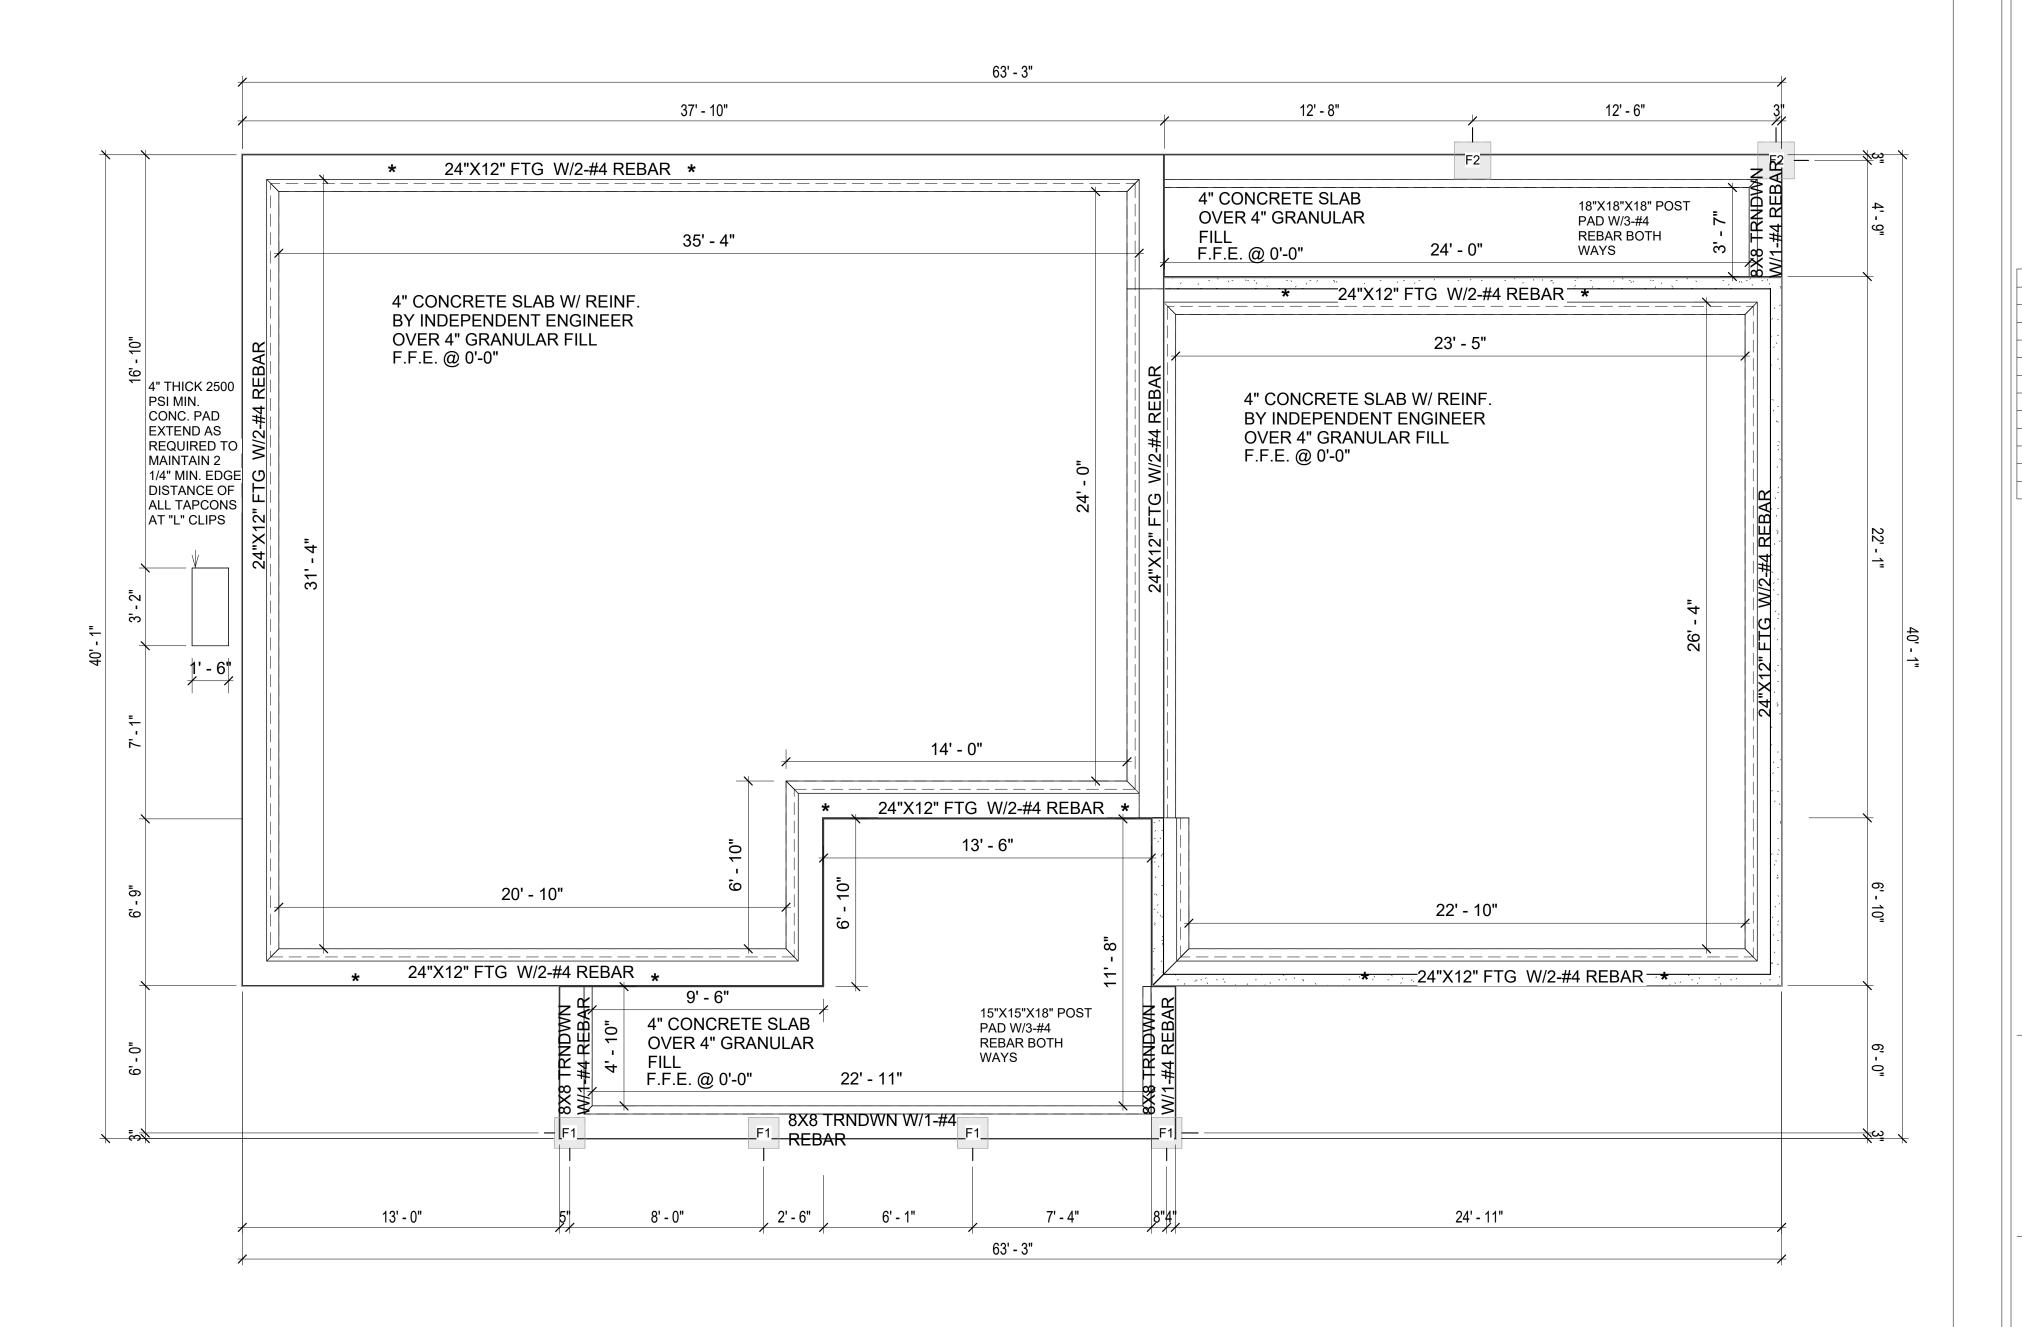

1 FOUNDATION PLAN
1/4" = 1'-0"

SQUARE FOOT	AGE
LIVING	1396
FRONT PORCH	146
SIDE PORCH	127
GARAGE	732
TOTAL	2401



KEY PLAN

NO.	DESCRIPTION	DATE

NOTE:

LEGEND:

PROJECT

245-EMBER-1396-3Bd2Ba-MODERN-550

DRAWING NAME

FOUNDATION PLAN

CLIENT NAME:	Client Name
PROJECT NUMBER:	0061_12
DATE:	5/9/2025 3:35:16 PM
DESIGNED BY:	Designer
DRAWN BY:	Author
CHECKED BY:	Checker

S101

SCALE: 1/4" = 1'-0"

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GENERAL NOTES

NOTES:

-ALL BEARING WALLS SHOULD HAVE A THICKENED SLAB PER SECTION PER DETAIL A401/5.

A) **FOUNDATION PLAN NOTES**:

- CONCRETE SLAB SHALL BE 6" THICK WITH 1/2" DIAMETER TENDONS PER LAYOUT PLAN, CENTERED IN SLAB THICKNESS, OVER APPROVED SUBBASE PER GENERAL STRUCTURE NOTES.
- 2. TERMITE PROTECTION SHALL BE PROVIDED PER IRC SECTION R318.1 NONE TYPICAL ANCHOR BOLT SPACING AT SHEAR WALL AND HOLD DOWN
- SPECIFICATIONS PER APPROVED ARCHITECTURAL PLANS. 4. INSTALL HOLDOWNS BEFORE CONCRETE SLAB POUR.
- EXISTING FILL ON-SITE SHALL BE COMPACTED IN ACCORDANCE WITH THE
- REQUIREMENTS IN THE GEOTECHNICAL REPORT.
- 6. ALL FLOOR SLABS ARE REINFORCED ON CONCRETE SLABS.

SPECIAL INSPECTION IS REQUIRED FOR THICKENED FOUNDATION CONSTRUCTION

- 1. REINFORCEMENT
- 2. 2300 PSI CONCRETE POUR


B) **REINFORCEMENT FOR CONCRETE**:


1. ALL REINFORCING SLABS BARS SIZE 10MM OR LARGER SHALL BE DEFORMED IN ACCORDANCE TO ASTM-A706, AND BARS SMALLER THAN 10 MM MAYBE PLAIN. 2. UNLESS OTHERWISE NOTED IN PLANS, THE YIELD STRENGTH OF REINFORCING BARS SHALL BE:

> A) FOOTING = 40,000 PSI B) NON-LOAD BEARING WALLS AND PARAPETS= 40,000 PSI


- 3. SPLICES SHALL BE SECURELY WIRED TOGETHER AND SHALL LAP OR EXTEND
- 4. GRADE OF STEEL FOR RCC WORKS SHALL BE GRADE 4 10.
- BAR NOTATIONS GIVES INFORMATION
- A) BAR SIZE
- B) SPACING(IF REQUIRED)
- 6. LAP REINFORCEMENT ONLY AT LOCATION SHOWN IN THE DRAWINGS REINFORCEMENT SHALL NOT BE CUT, VENT OR HEATED ON SITE WITHOUT ENGINEERS'
- APPROVAL.
- C) **CONCRETE SLAB NOTES**
- 1. ALL SLAB REINFORCEMENT SHALL BE 20MM CLEAR MINIMUM FROM BOTTOM AND FROM TOP OF SLAB.
- 2. REINFORCEMENT IN CONTINUOUS ELEVATED SLAB SHALL BE CUT AS FOLLOWS.

- THIS IS A SCHEMATIC PLAN FOR THE PURPOSE OF LOCATING AND IDENTIFYING FOUNDATION REINFORCING ELEMENTS ONLY. VERIFY ALL DIMENSIONS, DROPS, OFFSETS AND FEATURES WITH THE ARCHITECTURAL PLANS BEFORE FORMING THE FOUNDATION.

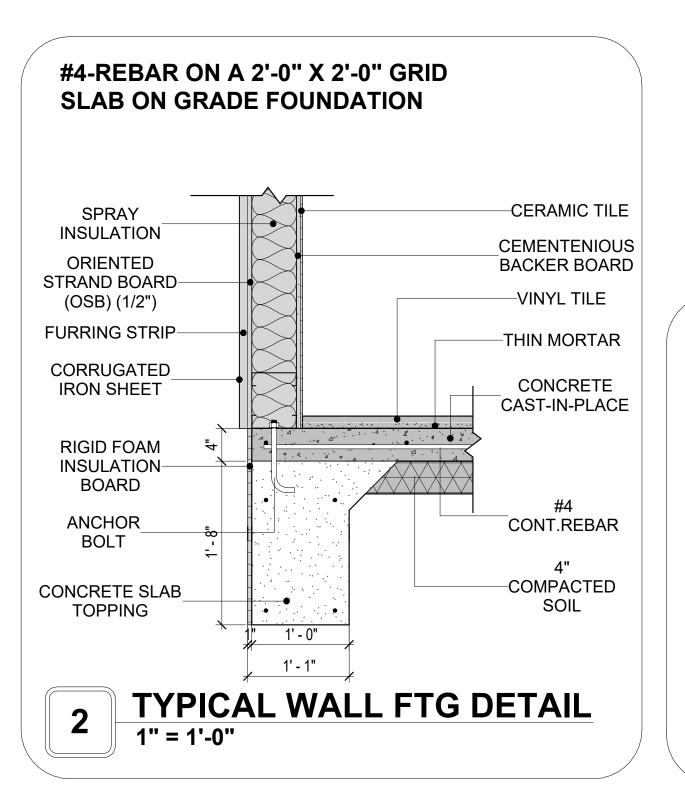

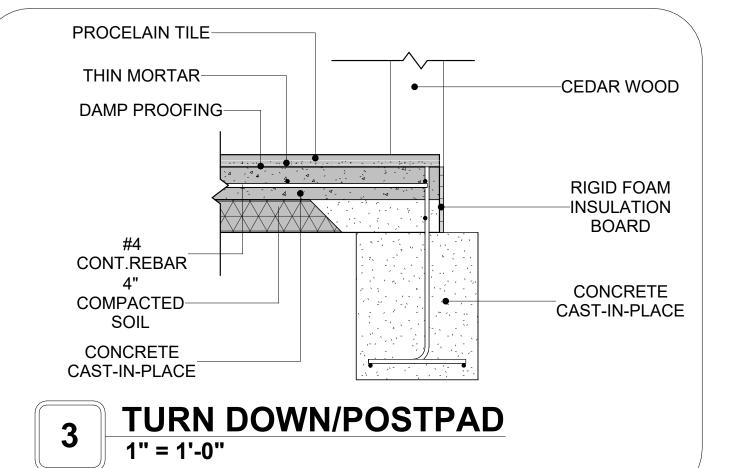

FOUNDATION REBAR PLAN 1/4" = 1'-0"

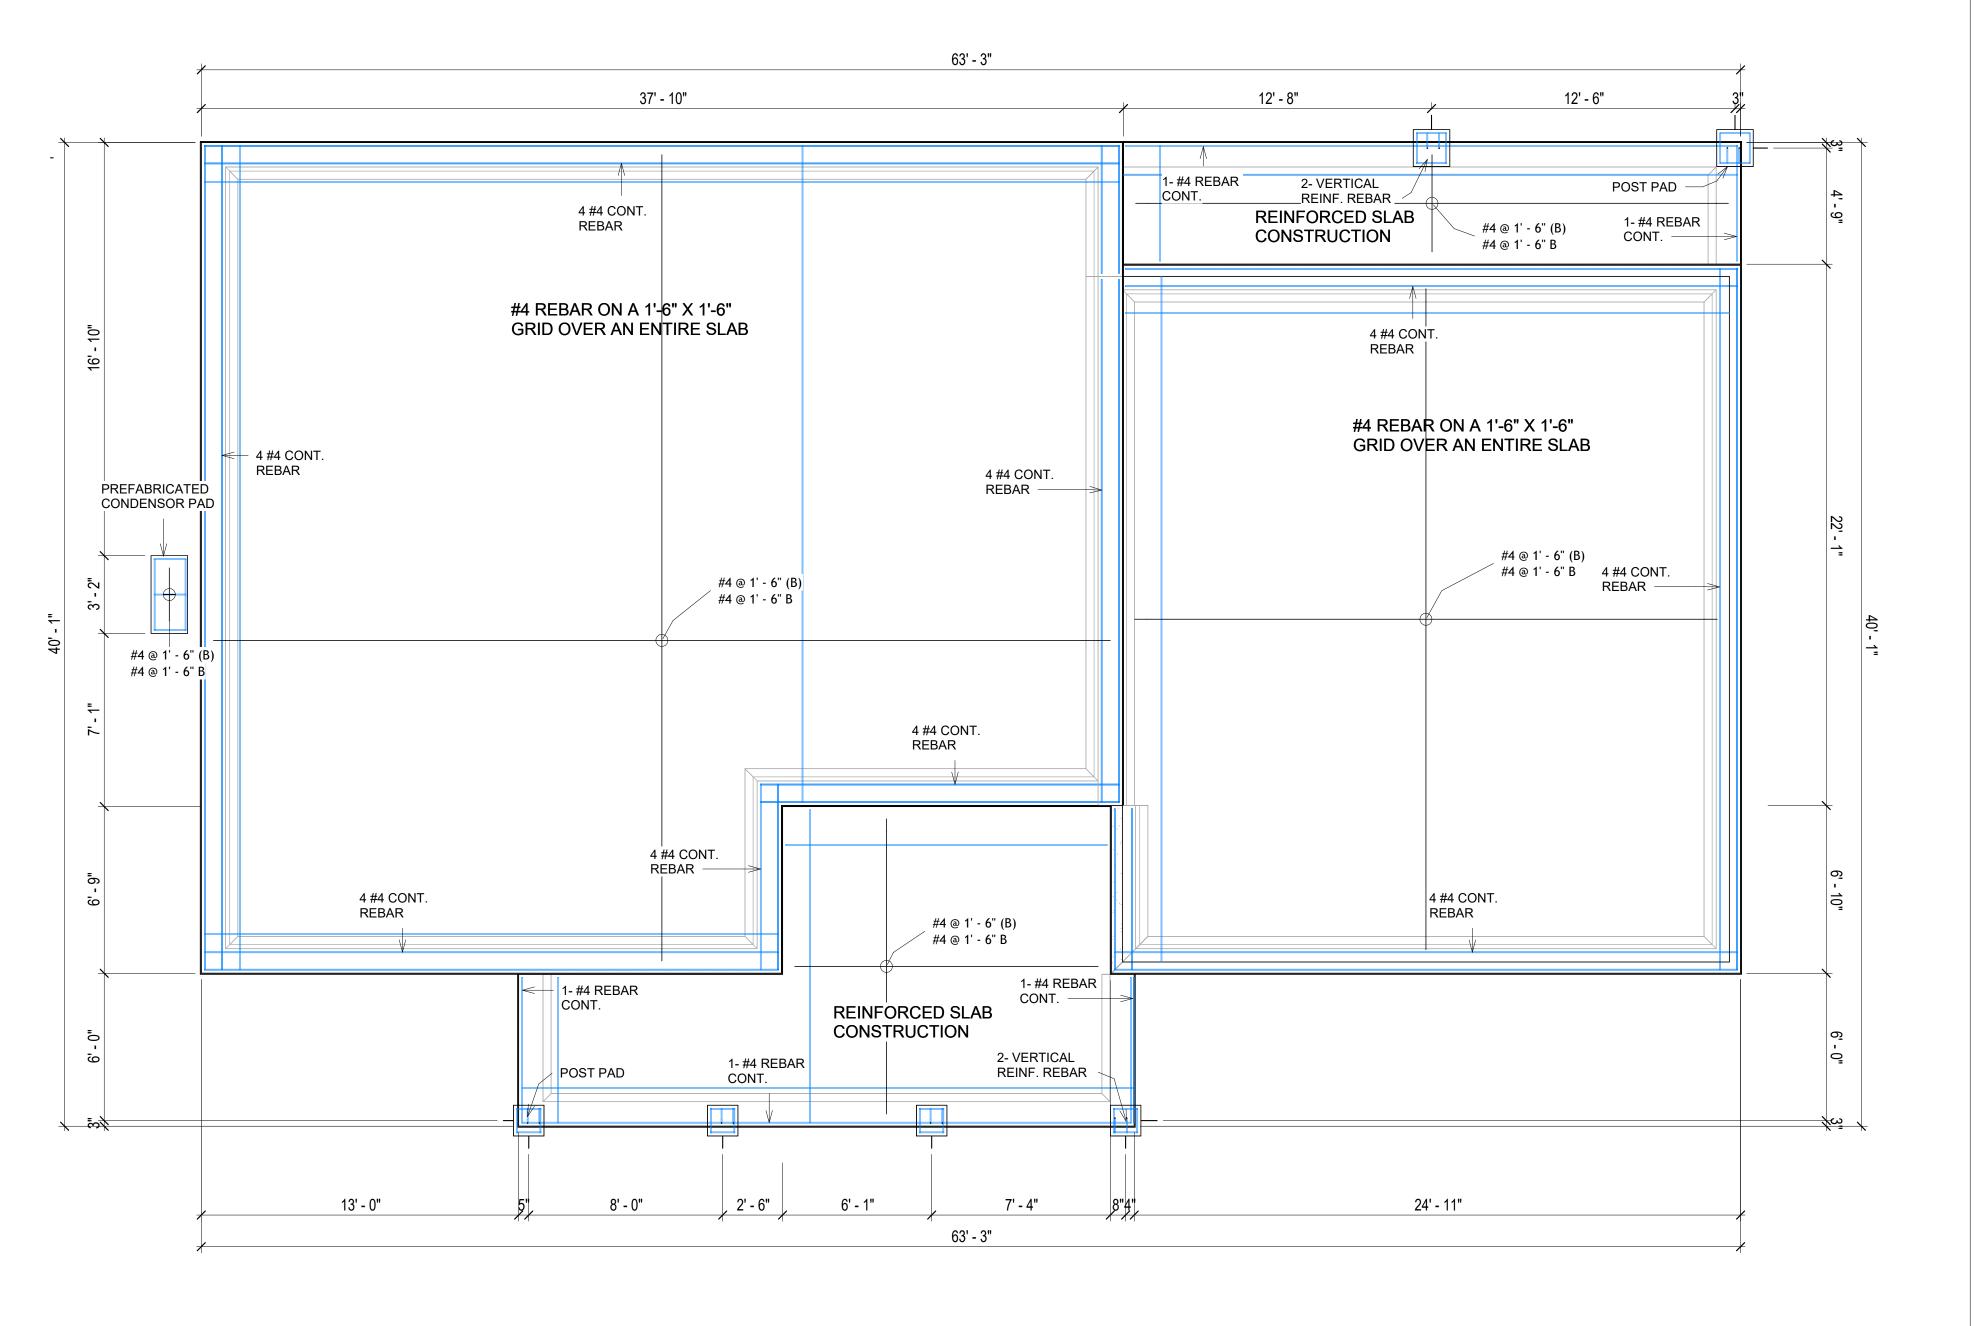



KEY PLAN

DESCRIPTION DATE

NOTE:

LEGEND:

PROJECT

245-EMBER-1396-3Bd2Ba-**MODERN-550**

DRAWING NAME

STRUCTURAL FLOOR PLAN


CLIENT NAME: **Client Name** PROJECT NUMBER: 0061_12 5/9/2025 3:35:17 PM Designer **DESIGNED BY:** DRAWN BY: **Author** CHECKED BY: Checker

S102


ROOF NOTES

- ROOFING COMPOSITION ROOFING PER OWNERS/BUILDERS SPECIFICATIONS INSTALL PER MANUFACTURE SPECIFICATIONS ON 1/2" ORIENTED STRAND BOARD ON PRE-ENGINEERED TRUSS @ 24" O.C. (UNO.) 2. 73" OVERHANG AT EAVES (UNO.)
- ENDS OF ALL TRUSSES AND JOISTS TO BE FULLY BLOCKED. PROVIDE SOLID
- BLOCKING AT ALL RIDGES AND VALLEYS 4. SHEATHING TO BE 1/2", 3/8" OSB SHEAR PANEL AND EQUIVALENT. UNDERSIDE OF PORCH TRUSSES TO BE FINISHED WITH MOISTURE
- RESISTANT DRYWALL, TAPED AND TEXTURED. 5. EXPOSED EAVES AND OTHER WEATHER EXPOSED AREAS TO BE SHEATHED WITH EXTERIOR GRADE PLYWOOD.
- 6. ALL MATERIALS THICKNESS AND SIZE ARE THE MINIMUM. Refer TO LOCAL STANDARDS FOR ACTUAL THICKNESS AND LAYERING OF MATERIALS.
- ENGINEERED TRUSS CALCULATIONS TO BE SUBMITTED TO BUILDING
- DEPARTMENT PRIOR TO FABRICATION AND INSTALLATION. TRUSS MANUFACTURER TO SPECIFY HANGER CONNECTORS FOR TRUSS
- COMPONENTS (TYPICAL) 9. DESIGNER ASSUMES THAT TRUSSES BEAR ON ALL EXTERIOR PERIMETER
- WALLS (TYPICAL) OR BEAMS.

10. PROVIDE GALVANIZED STEEL FLASHING WITH A LENGTH OF 10 FEET, WIDTH OF 12 INCHES, AND THICKNESS OF 24 GAUGE.

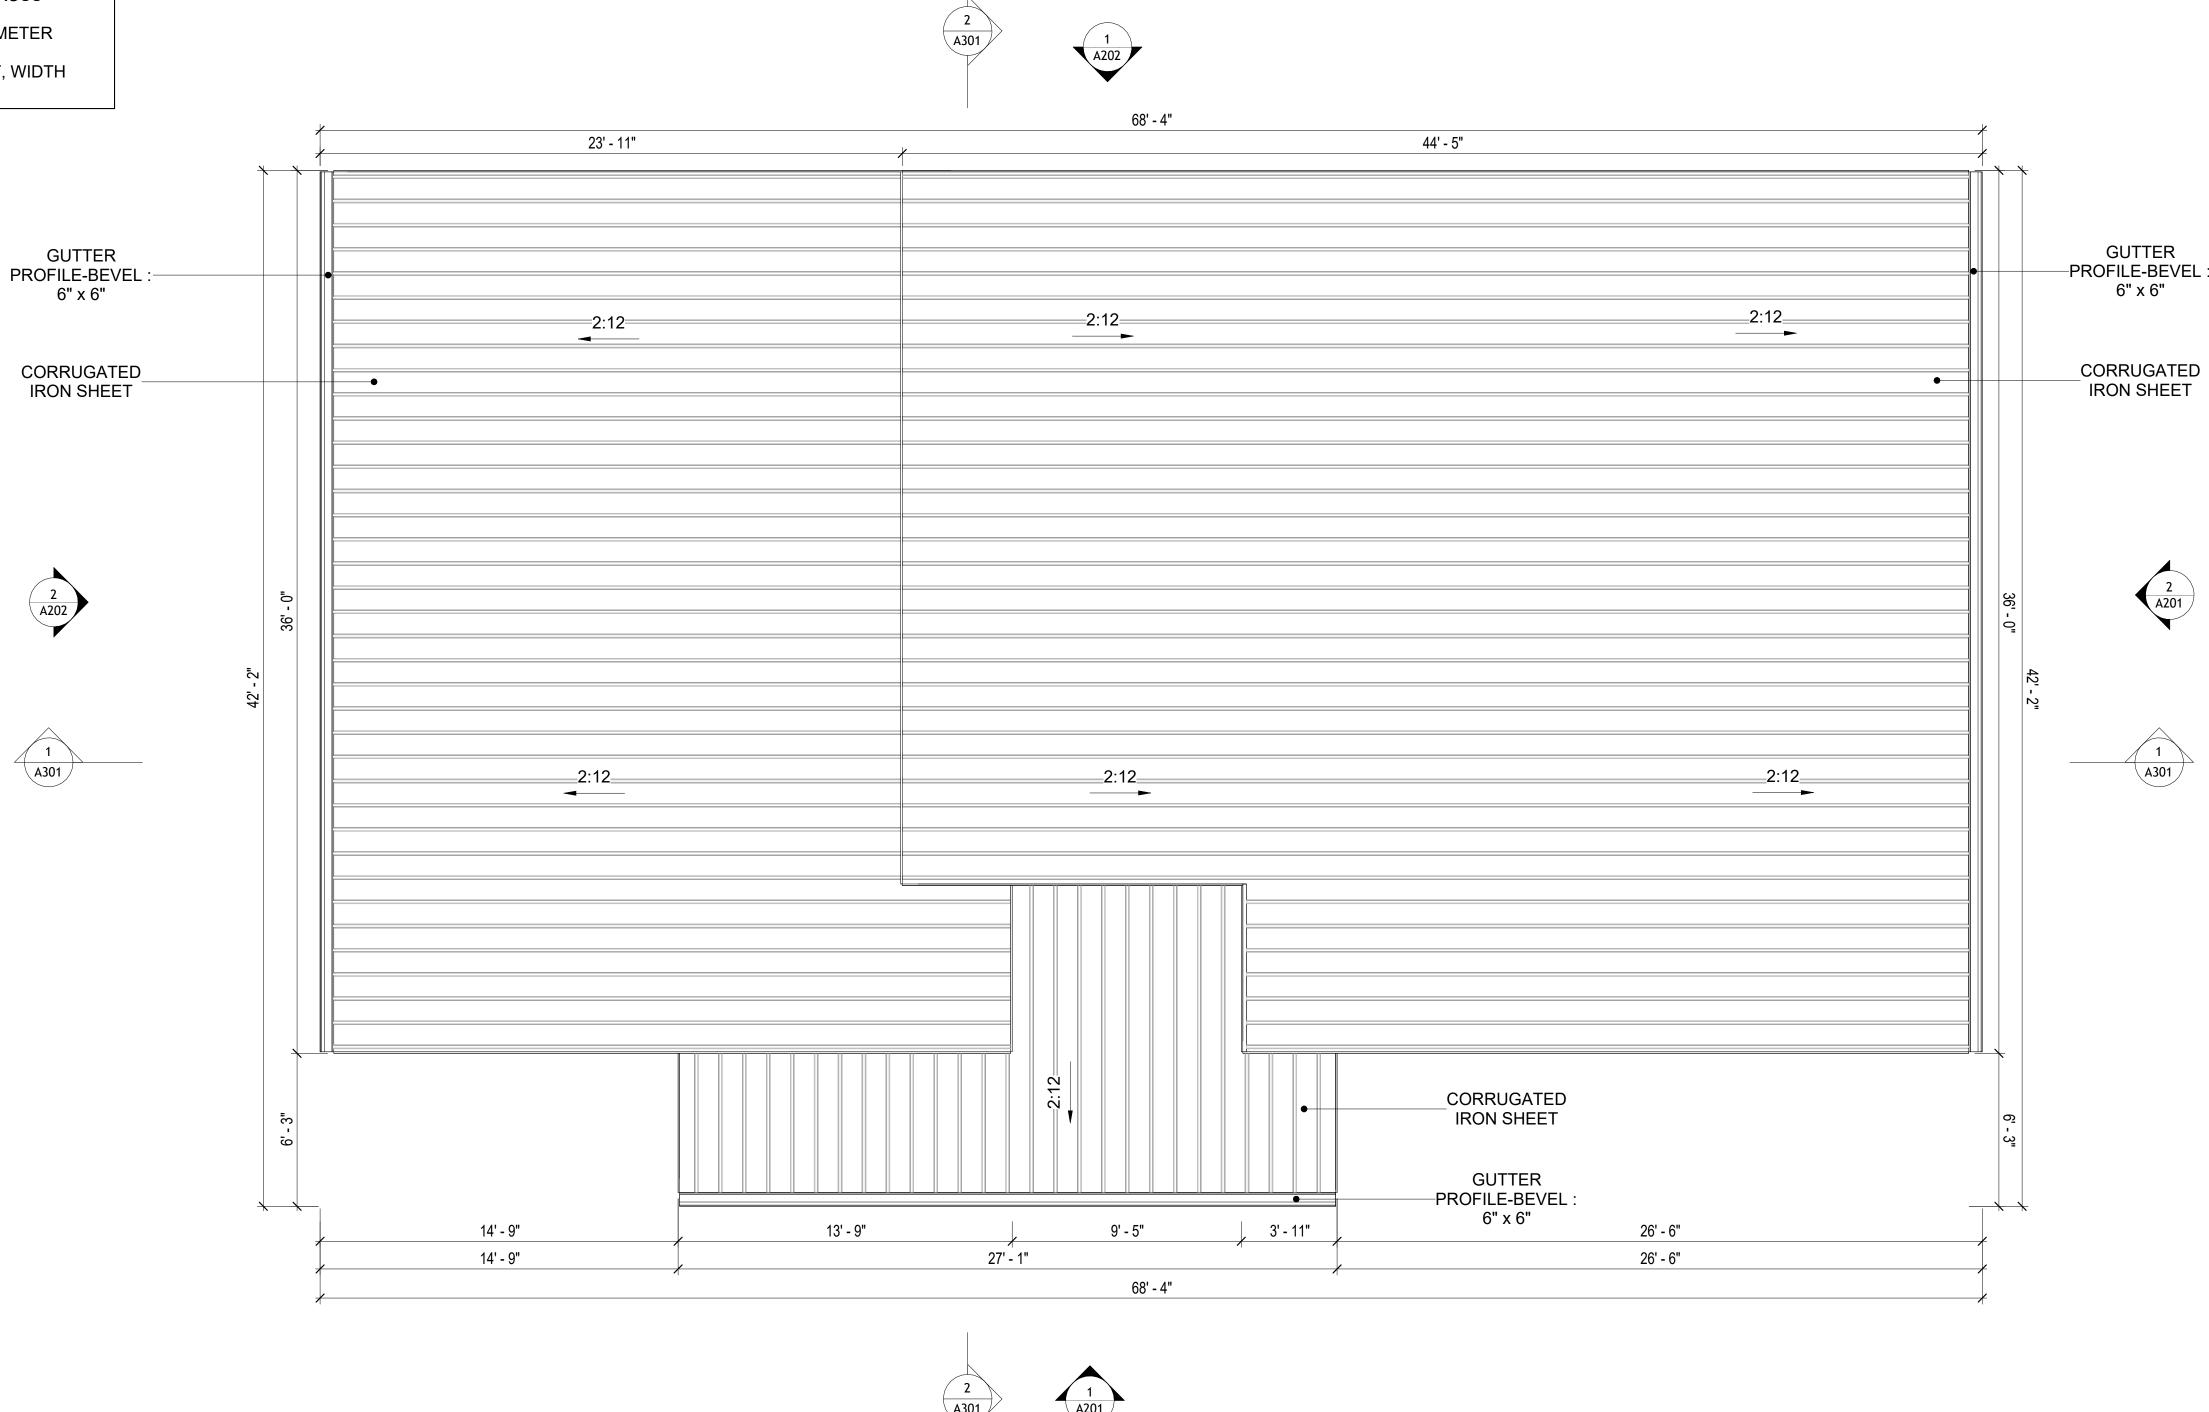

ROOF PLAN 1/4" = 1'-0"

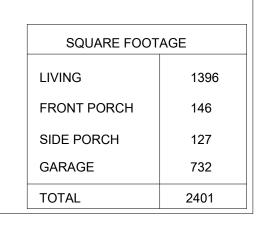



KEY PLAN

NO.	DESCRIPTION	DATE

NOTE:

LEGEND:

PROJECT

245-EMBER-1396-3Bd2Ba-**MODERN-550**

DRAWING NAME

ROOF PLAN

CLIENT NAME:	Client Name
PROJECT NUMBER:	0061_12
DATE:	5/9/2025 3:35:21 PM
DESIGNED BY:	Designer
DRAWN BY:	Author
CHECKED BY:	Checker

A103

SCALE: 1/4" = 1'-0"

ABOUT WALL FINISHING

CORRUGATED IRON SHEET

CORRUGATED IRON IS A FINISHING MATERIAL MADE FROM STEEL THAT HAS BEEN GALVANIZED (COATED WITH A THIN LAYER OF ZINC) TO PROTECT IT FROM CORROSION AND RUST.

IN THIS SPECIFIC PROJECT, THE CORRUGATED IRON SHEETS ARE INSTALLED HORIZONTALLY ON VERTICAL FURRING STRIPS THAT ARE DIRECTLY ATTACHED ONTO THE PROPERLY INSTALLED AND SEALED HOME WRAP, USING SELF-DRILLING SCREWS THAT ARE DRIVEN THROUGH THE RIDGES OR VALLEYS OF THE CORRUGATIONS.

STONE VENEER


STONE VENEER REFERS TO THIN LAYERS OF NATURAL OR MANUFACTURED STONE APPLIED TO A STRUCTURAL WALL, KNOWN FOR THEIR REALISTIC APPEARANCE AND RELATIVE LIGHTNESS. THESE VENEERS PROVIDE THE AESTHETIC OF STONE WITHOUT THE COST AND WEIGHT OF FULL STONE CONSTRUCTION, CONTRIBUTING TO A BEAUTIFUL AND COSTEFFECTIVE EXTERIOR FINISH.


IN THIS SPECIFIC PROJECT, STONE VENEER IS USED A FINISH MATERIAL ON EXTERIOR FINISH.

CEDAR WOOD

CEDAR WOOD REFERS TO THE WOOD FROM VARIOUS SPECIES OF CEDAR TREES, WHICH ARE CONIFEROUS EVERGREEN TREES KNOWN FOR THEIR DISTINCT AROMA AND NATURAL RESISTANCE TO DECAY AND INSECTS.

IN THIS SPECIFIC PROJECT, CEDAR WOOD IS USED A FINISH MATERIAL ON BEAMS AND COLUMNS.

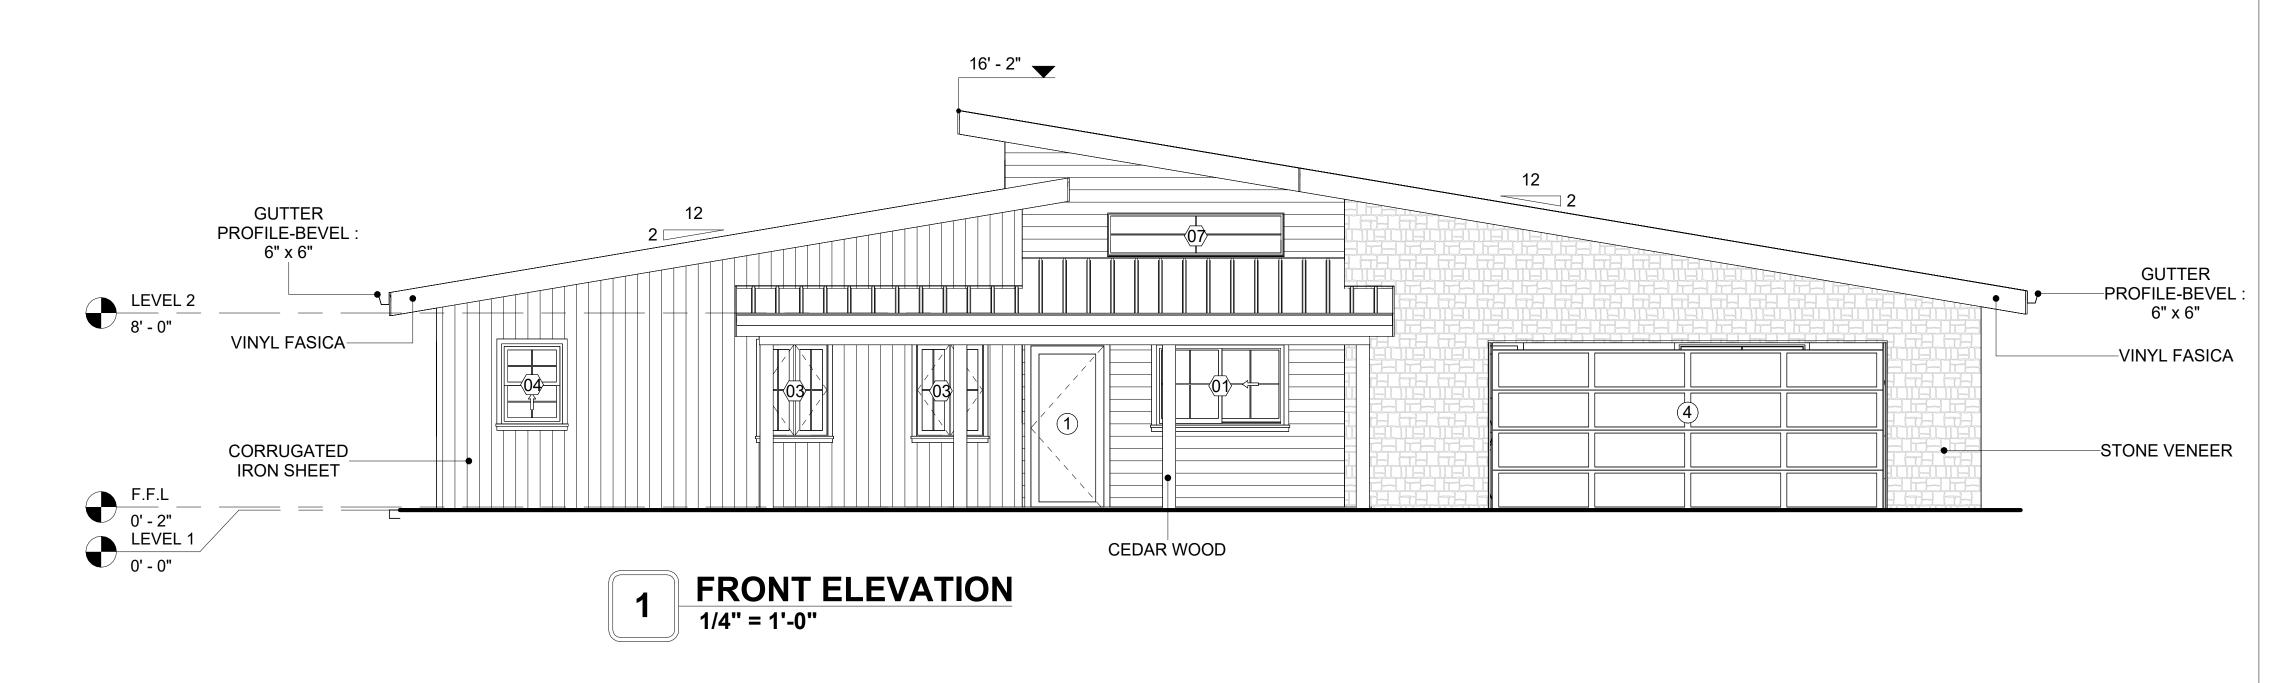

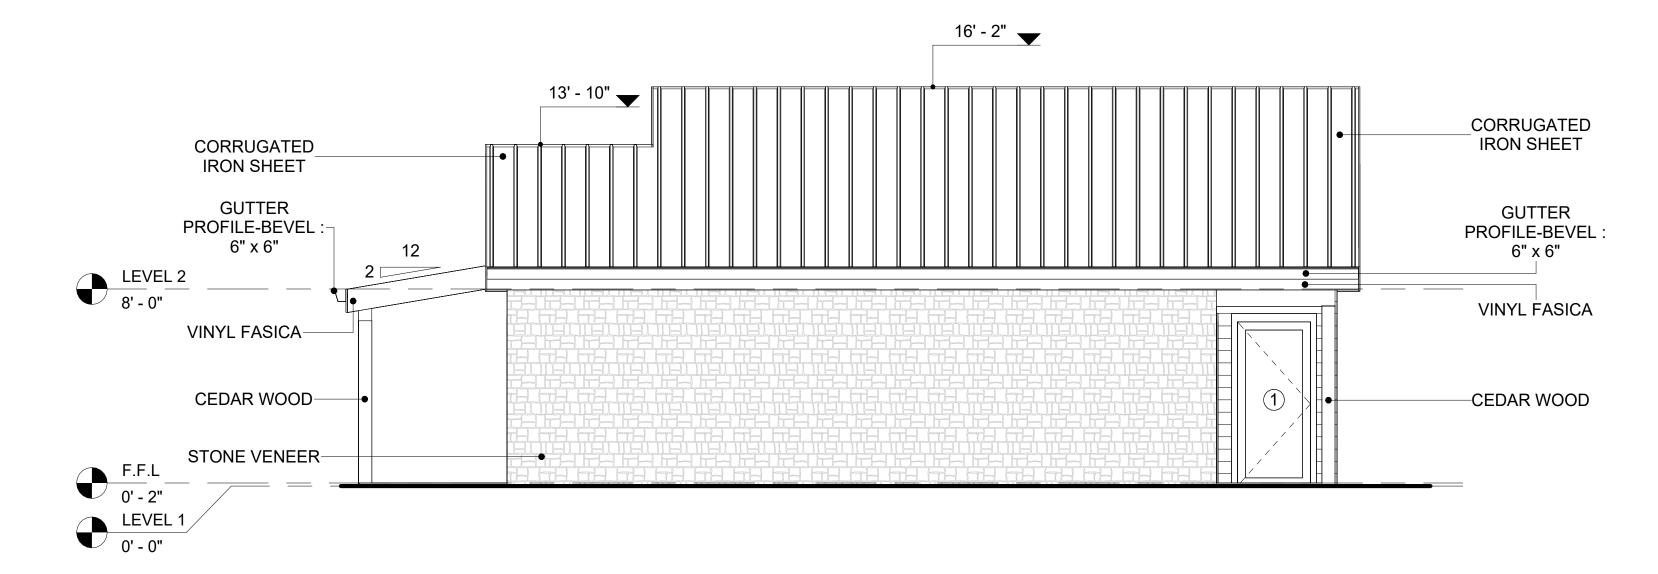


2 RIGHT SIDE ELEVATION 1/4" = 1'-0"

		DOOR SCH	EDULE			
TYPE				5	SIZE	
MAR K	SUPPLIER	DOOR TYPE	LOCATIO	WIDTH	HEIGHT	COUNT
1	HOME DEPOT	EXTERIOR SINGLE PANEL SWINGING	INTERIOR	3' - 0"	6' - 8"	10
2	HOME DEPOT	INTERIOR DOUBLE PANEL SLIDING	INTERIOR	5' - 0"	6' - 8"	4
3	HOME DEPOT	INTERIOR DOUBLE PANEL SLIDING	INTERIOR	6' - 0"	6' - 8"	1
4	HOME DEPOT	DOOR-GARAGE-EMBOSSED_PANEL	EXTERIOR	16' - 1"	6' - 6"	1

		WINDOV	V SCHEDULE		
				SIZE	
TYPE MARK	SUPPLIER	WINDOW TYPE	WIDTH	HEIGHT	COUNT
01	HOME DEPOT	SLIDING	5' - 3"	3' - 3"	1
02	HOME DEPOT	SINGLE HUNG	3' - 3"	3' - 3"	3
03	HOME DEPOT	DOUBLE CASEMENT	2' - 9"	3' - 9"	6
04	HOME DEPOT	SINGLE HUNG	2' - 6"	3' - 3"	1
05	HOME DEPOT	SLIDING	2' - 3"	2' - 3"	2
06	HOME DEPOT	FIXED	5' - 3"	3' - 3"	1
07	HOME DEPOT	FIXED	7' - 3"	1' - 9"	1
08	HOME DEPOT	FIXED	2' - 9"	1' - 3"	4



KEY PLAN

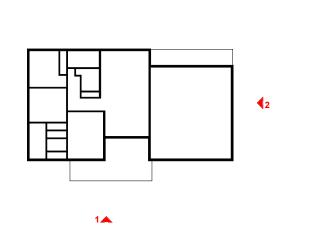

NO.	DESCRIPTION	DATE

NOTE:

LEGEND:

PROJECT

245-EMBER-1396-3Bd2Ba-MODERN-550

DRAWING NAME

ARCHITECTURAL ELEVATIONS

CLIENT NAME:	Client Name
PROJECT NUMBER:	0061_12
DATE:	5/9/2025 3:35:24 PM
DESIGNED BY:	Designer
DRAWN BY:	Author
CHECKED BY:	Checker

A201

ABOUT WALL FINISHING

CORRUGATED IRON SHEET

CORRUGATED IRON IS A FINISHING MATERIAL MADE FROM STEEL THAT HAS BEEN GALVANIZED (COATED WITH A THIN LAYER OF ZINC) TO PROTECT IT FROM CORROSION AND RUST.

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STONE VENEER


STONE VENEER REFERS TO THIN LAYERS OF NATURAL OR MANUFACTURED STONE APPLIED TO A STRUCTURAL WALL, KNOWN FOR THEIR REALISTIC APPEARANCE AND RELATIVE LIGHTNESS. THESE VENEERS PROVIDE THE AESTHETIC OF STONE WITHOUT THE COST AND WEIGHT OF FULL STONE CONSTRUCTION, CONTRIBUTING TO A BEAUTIFUL AND COSTEFFECTIVE EXTERIOR FINISH.

IN THIS SPECIFIC PROJECT, STONE VENEER IS USED A FINISH MATERIAL ON EXTERIOR FINISH.


CEDAR WOOD

CEDAR WOOD REFERS TO THE WOOD FROM VARIOUS SPECIES OF CEDAR TREES, WHICH ARE CONIFEROUS EVERGREEN TREES KNOWN FOR THEIR DISTINCT AROMA AND NATURAL RESISTANCE TO DECAY AND INSECTS.

IN THIS SPECIFIC PROJECT, CEDAR WOOD IS USED A FINISH MATERIAL ON BEAMS AND COLUMNS.

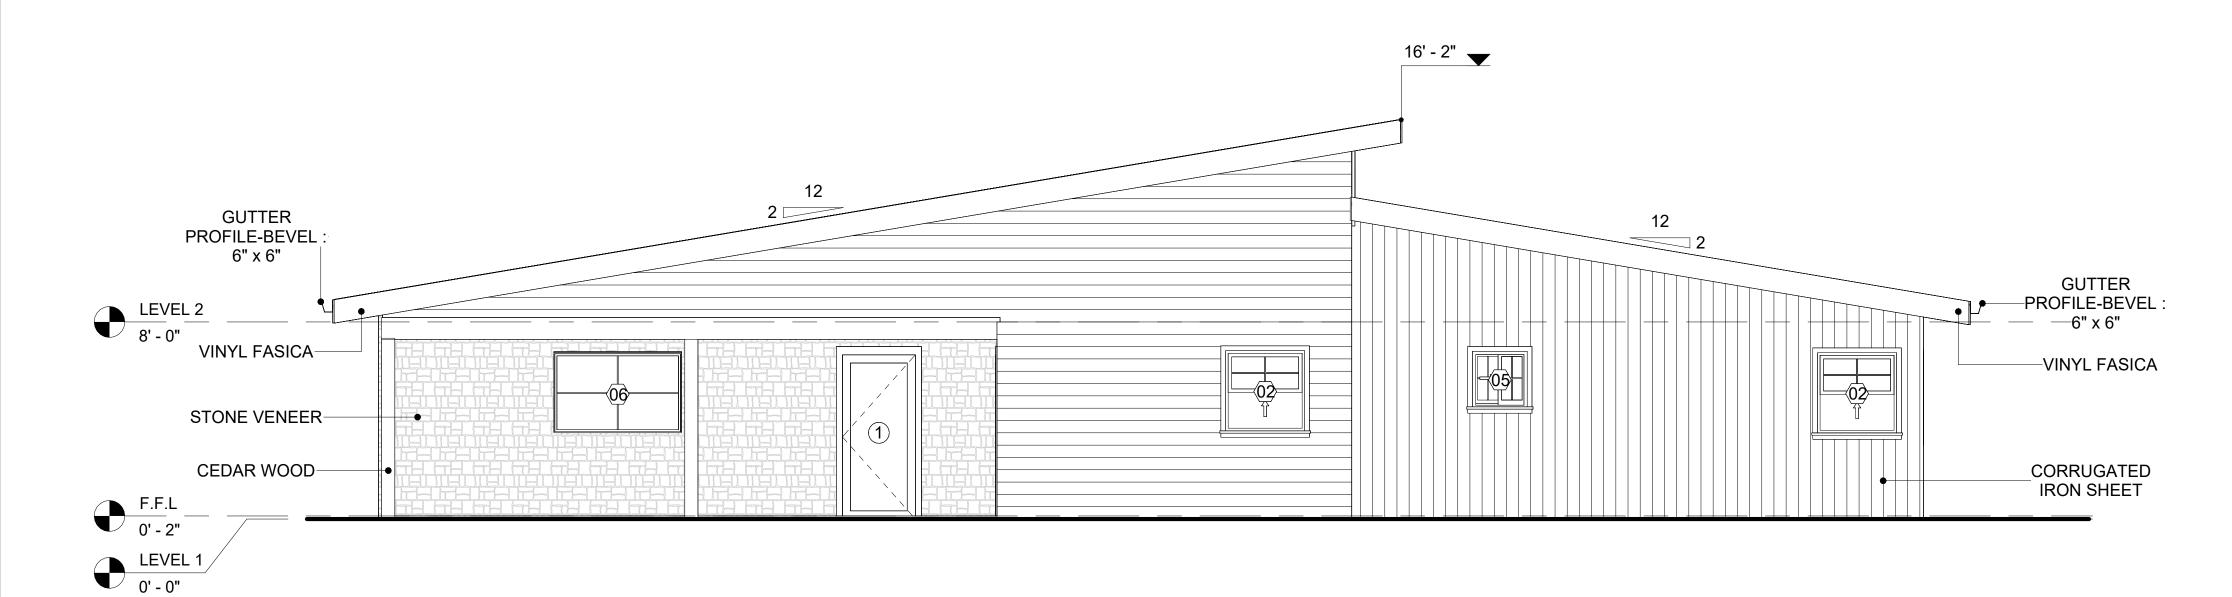


1 REAR ELEVATION
1/4" = 1'-0"

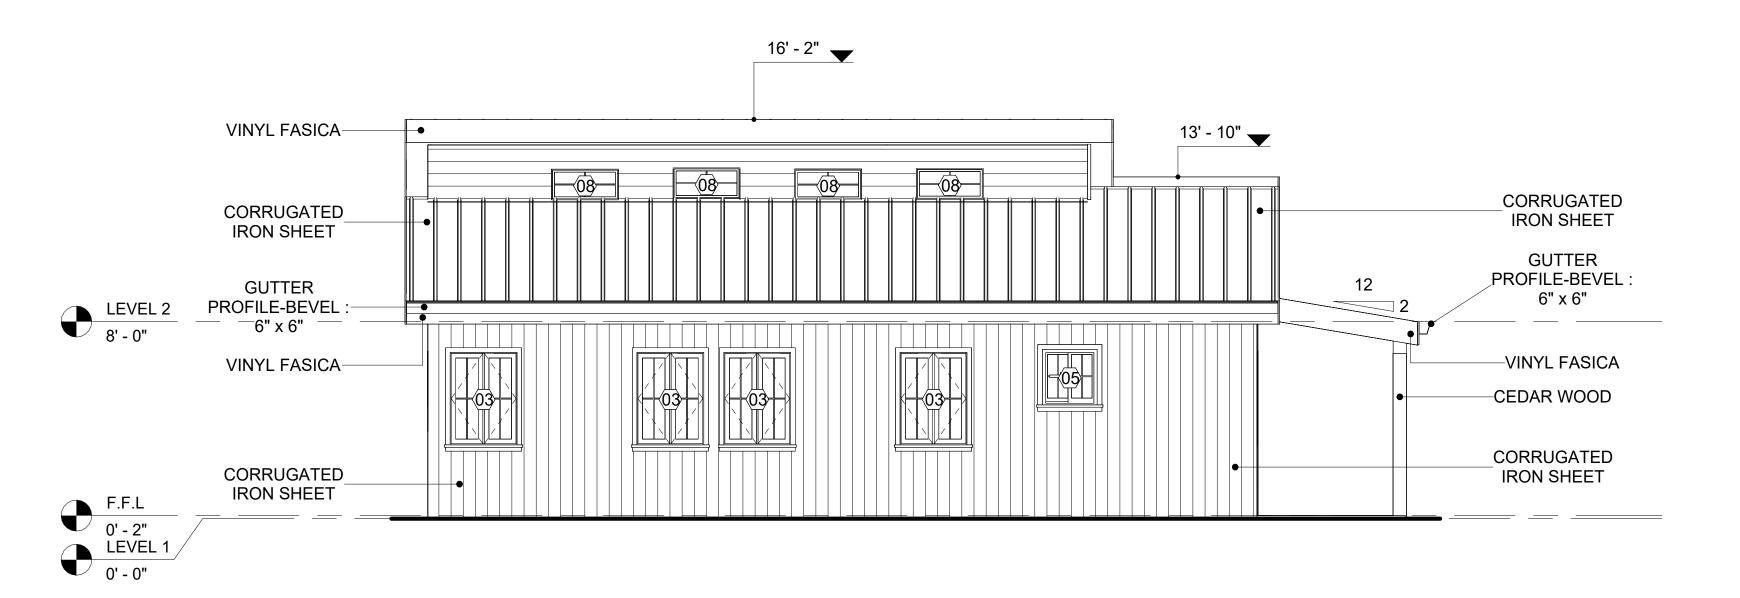

2 LEFT SIDE ELEVATION
1/4" = 1'-0"



KEY PLAN

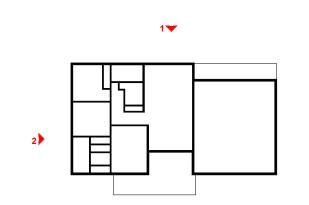

NO.	DESCRIPTION	DATE

NOTE:

LEGEND:

PROJECT


245-EMBER-1396-3Bd2Ba-MODERN-550

DRAWING NAME

ARCHITECTURAL ELEVATIONS


Client Name	CLIENT NAME:
0061_12	PROJECT NUMBER:
5/9/2025 3:35:27 PM	DATE:
Designer	DESIGNED BY:
Author	DRAWN BY:
Checker	CHECKED BY:

A202

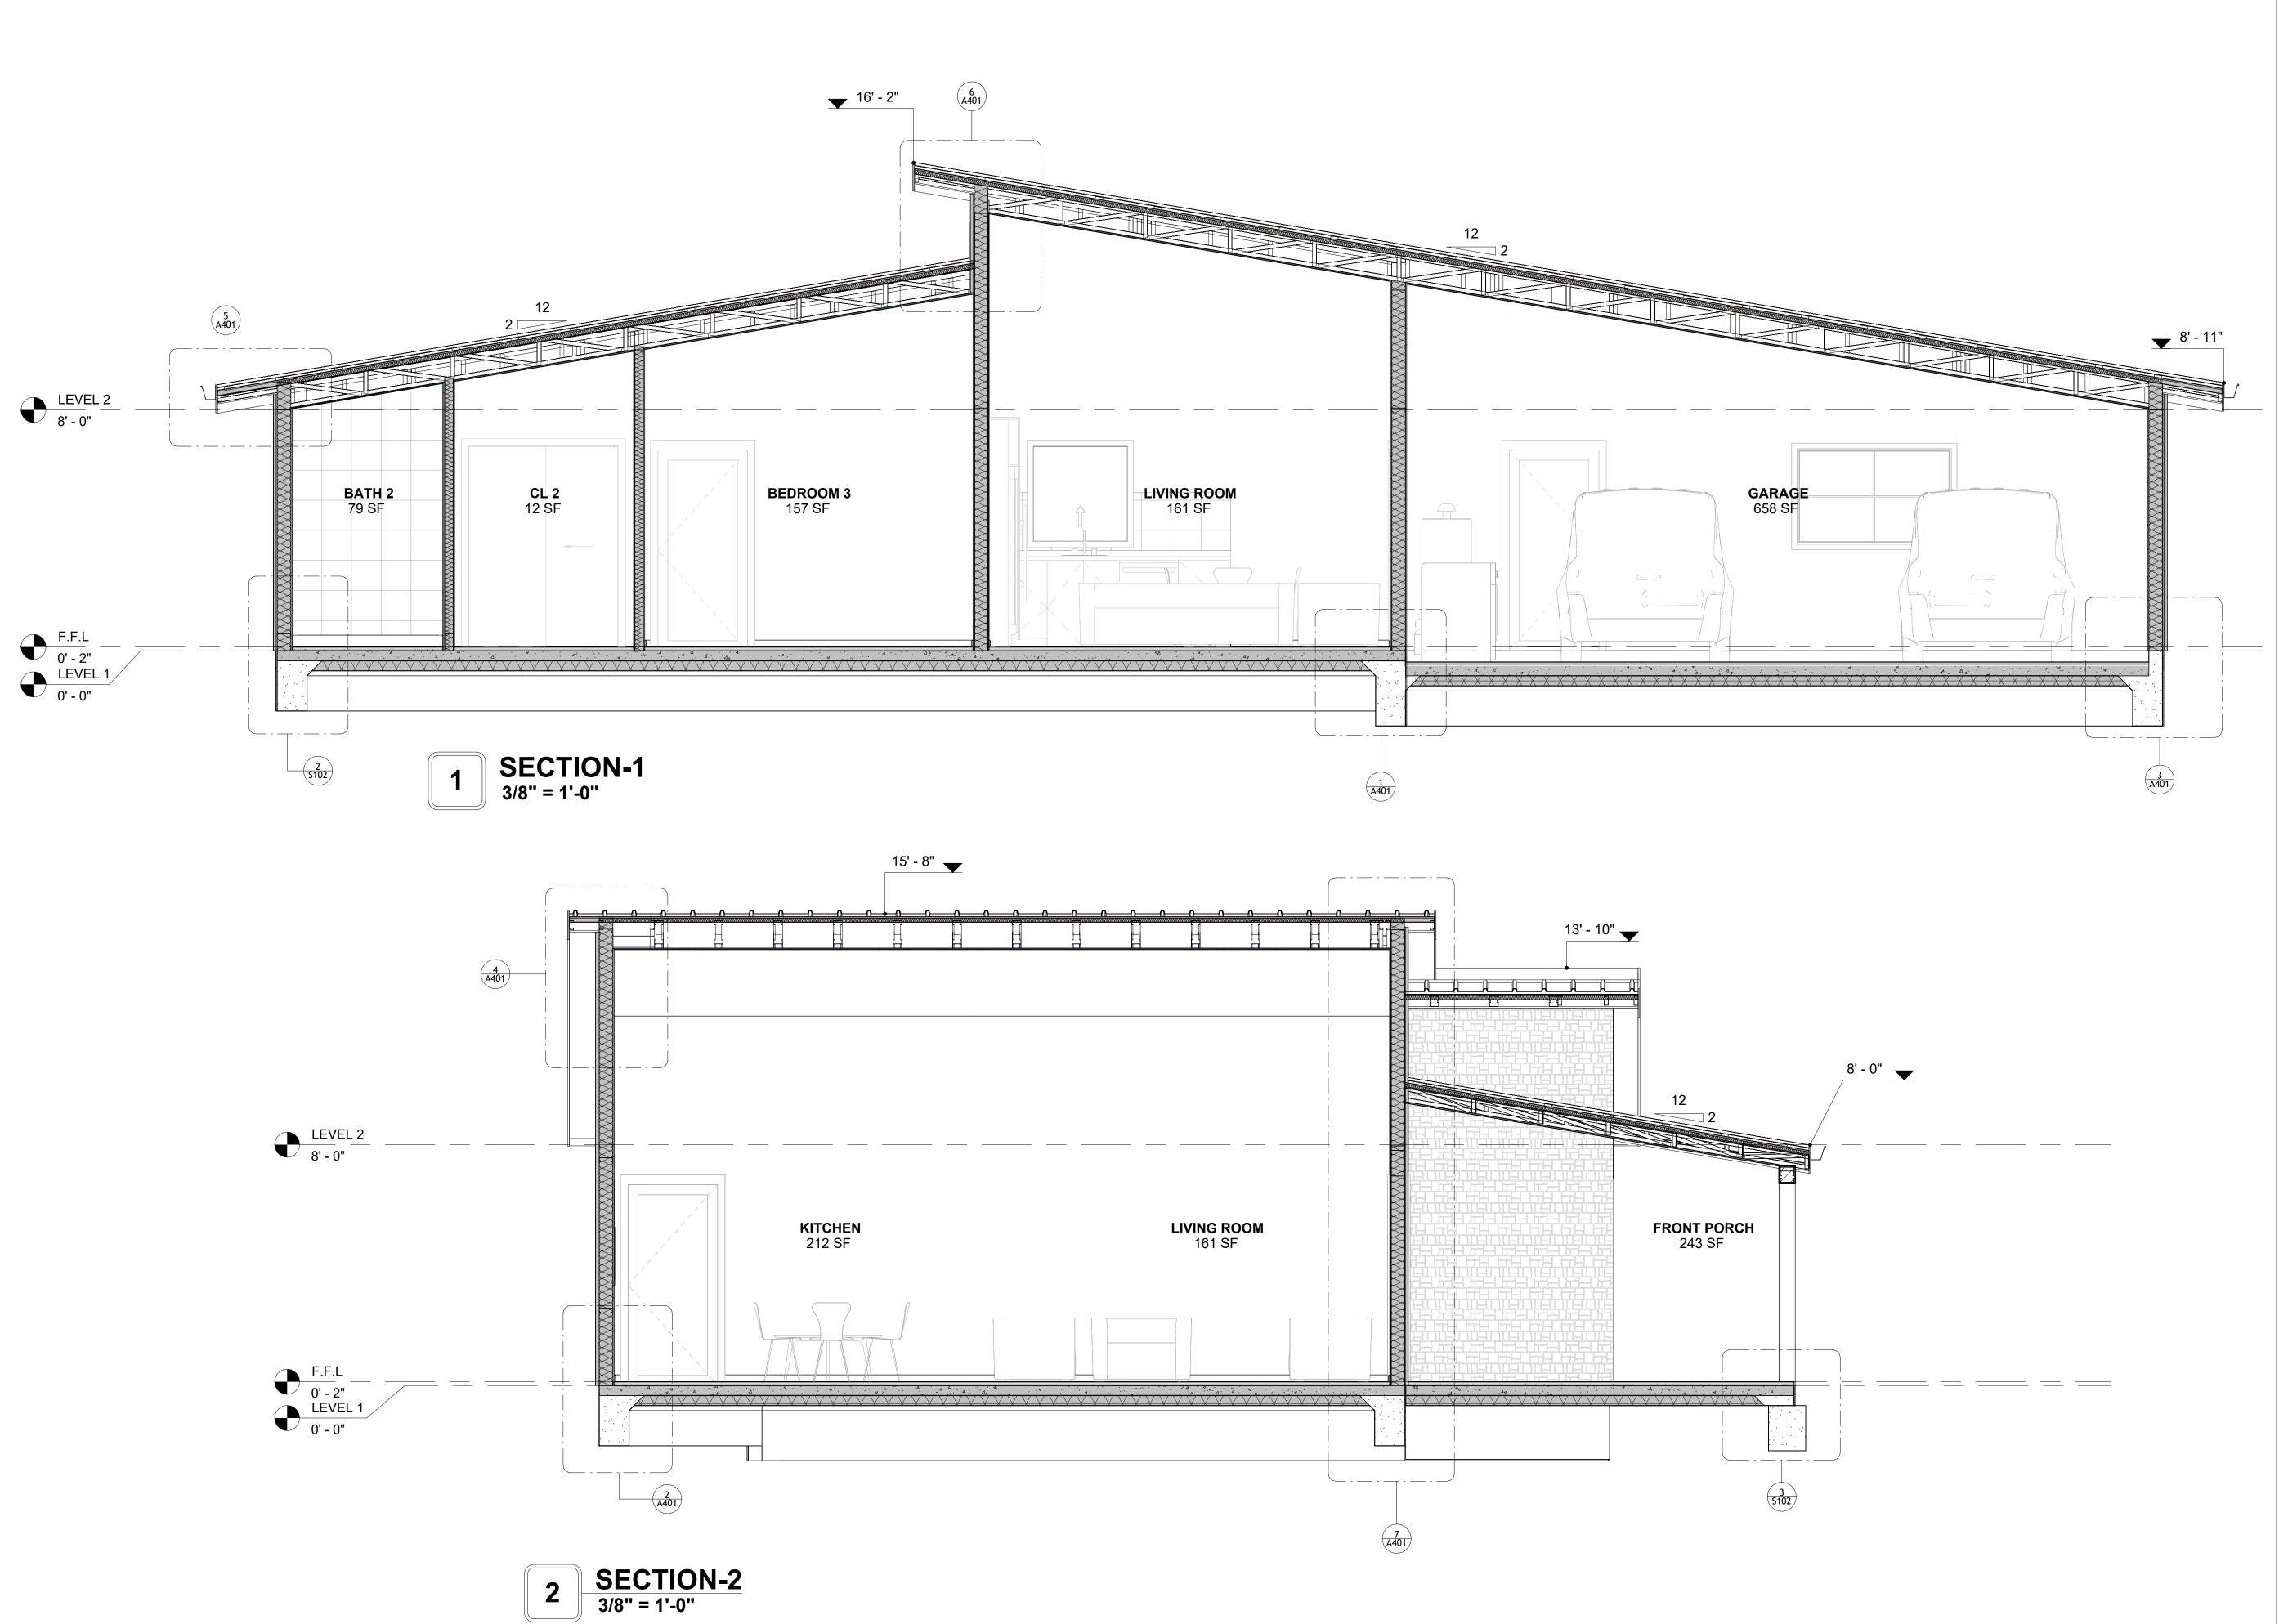



KEY PLAN

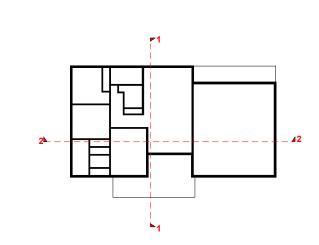

NO.	DESCRIPTION	DATE

NOTE:

LEGEND:

PROJECT


245-EMBER-1396-3Bd2Ba-MODERN-550


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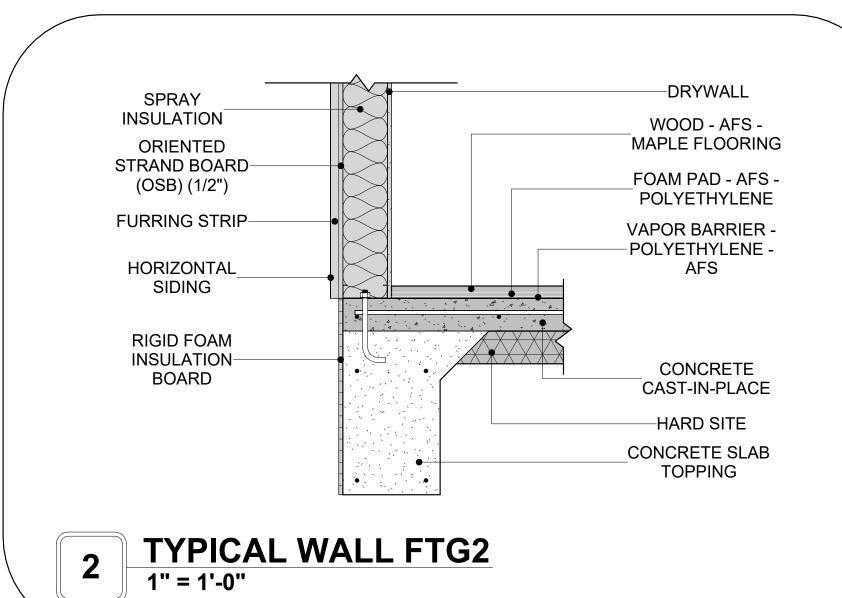
ARCHITECTURAL SECTIONS


Client Name
0061_12
5/9/2025 3:35:31 PM
Designer
Author
Checker


A301




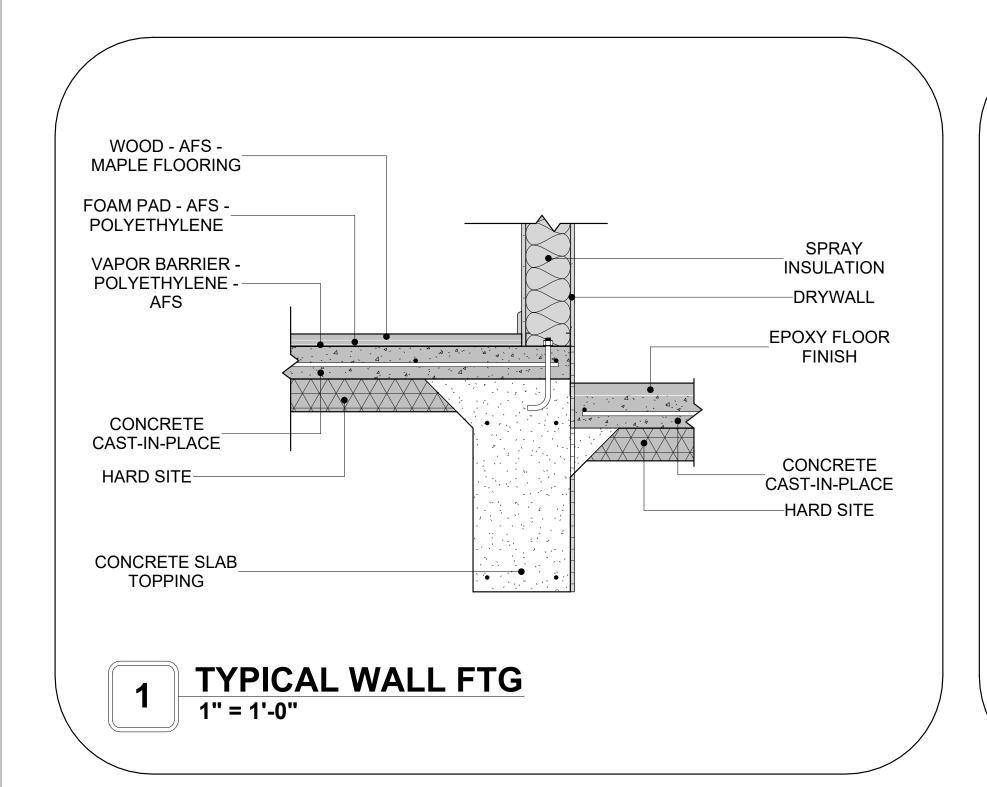


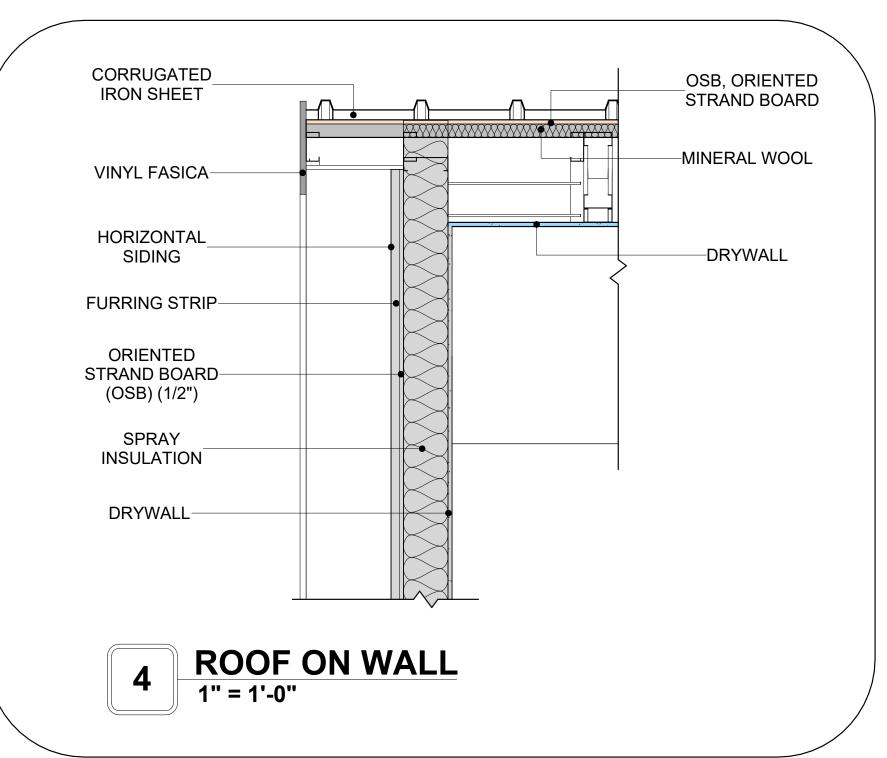

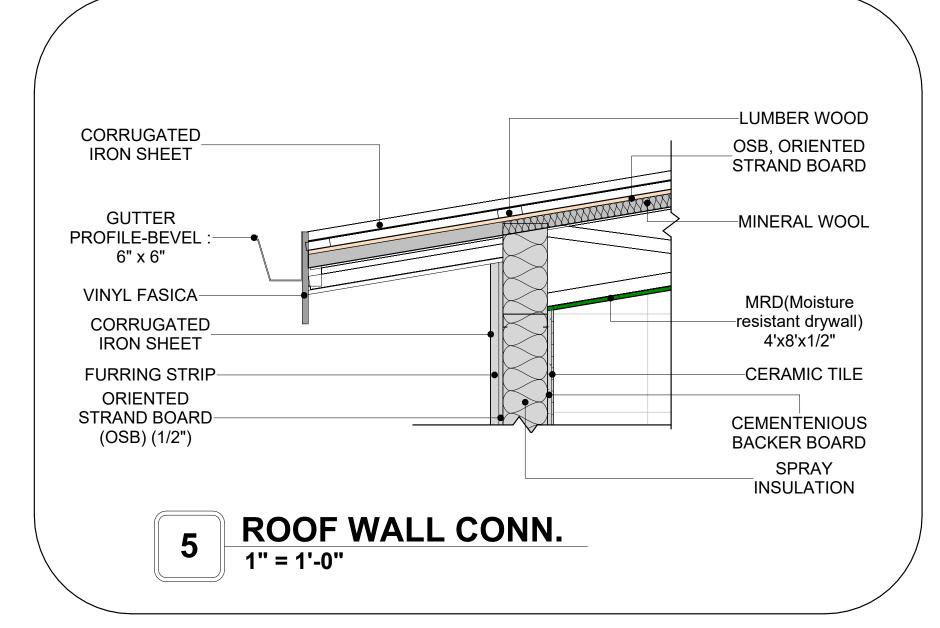

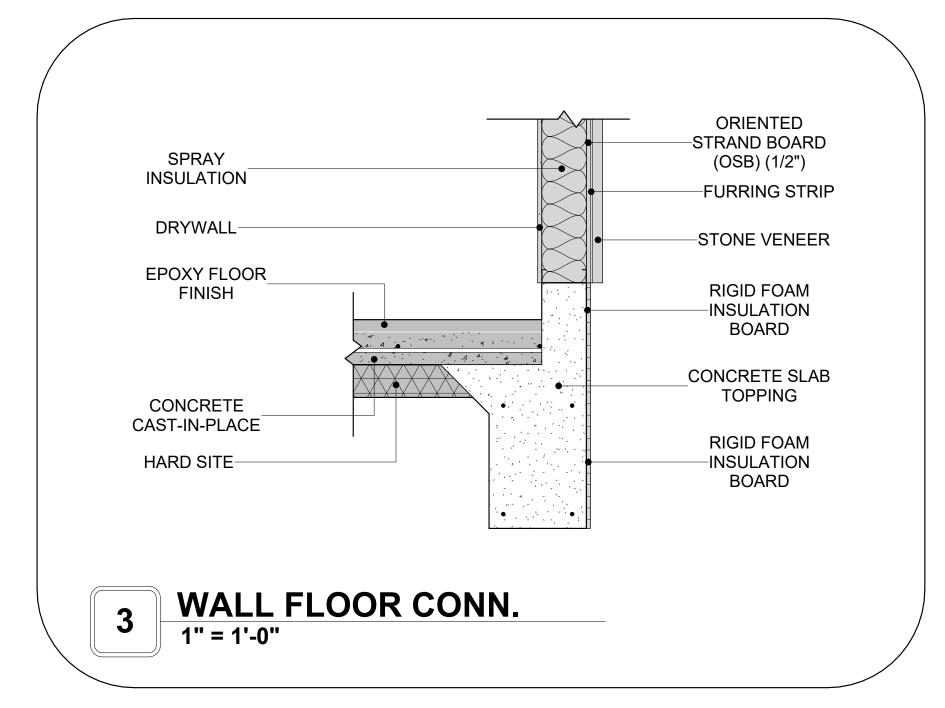

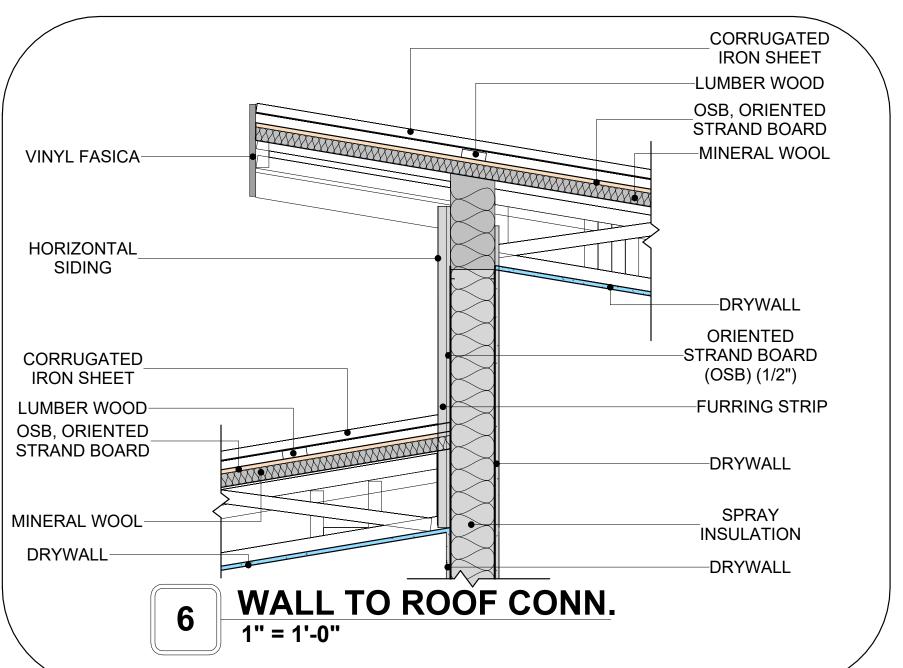

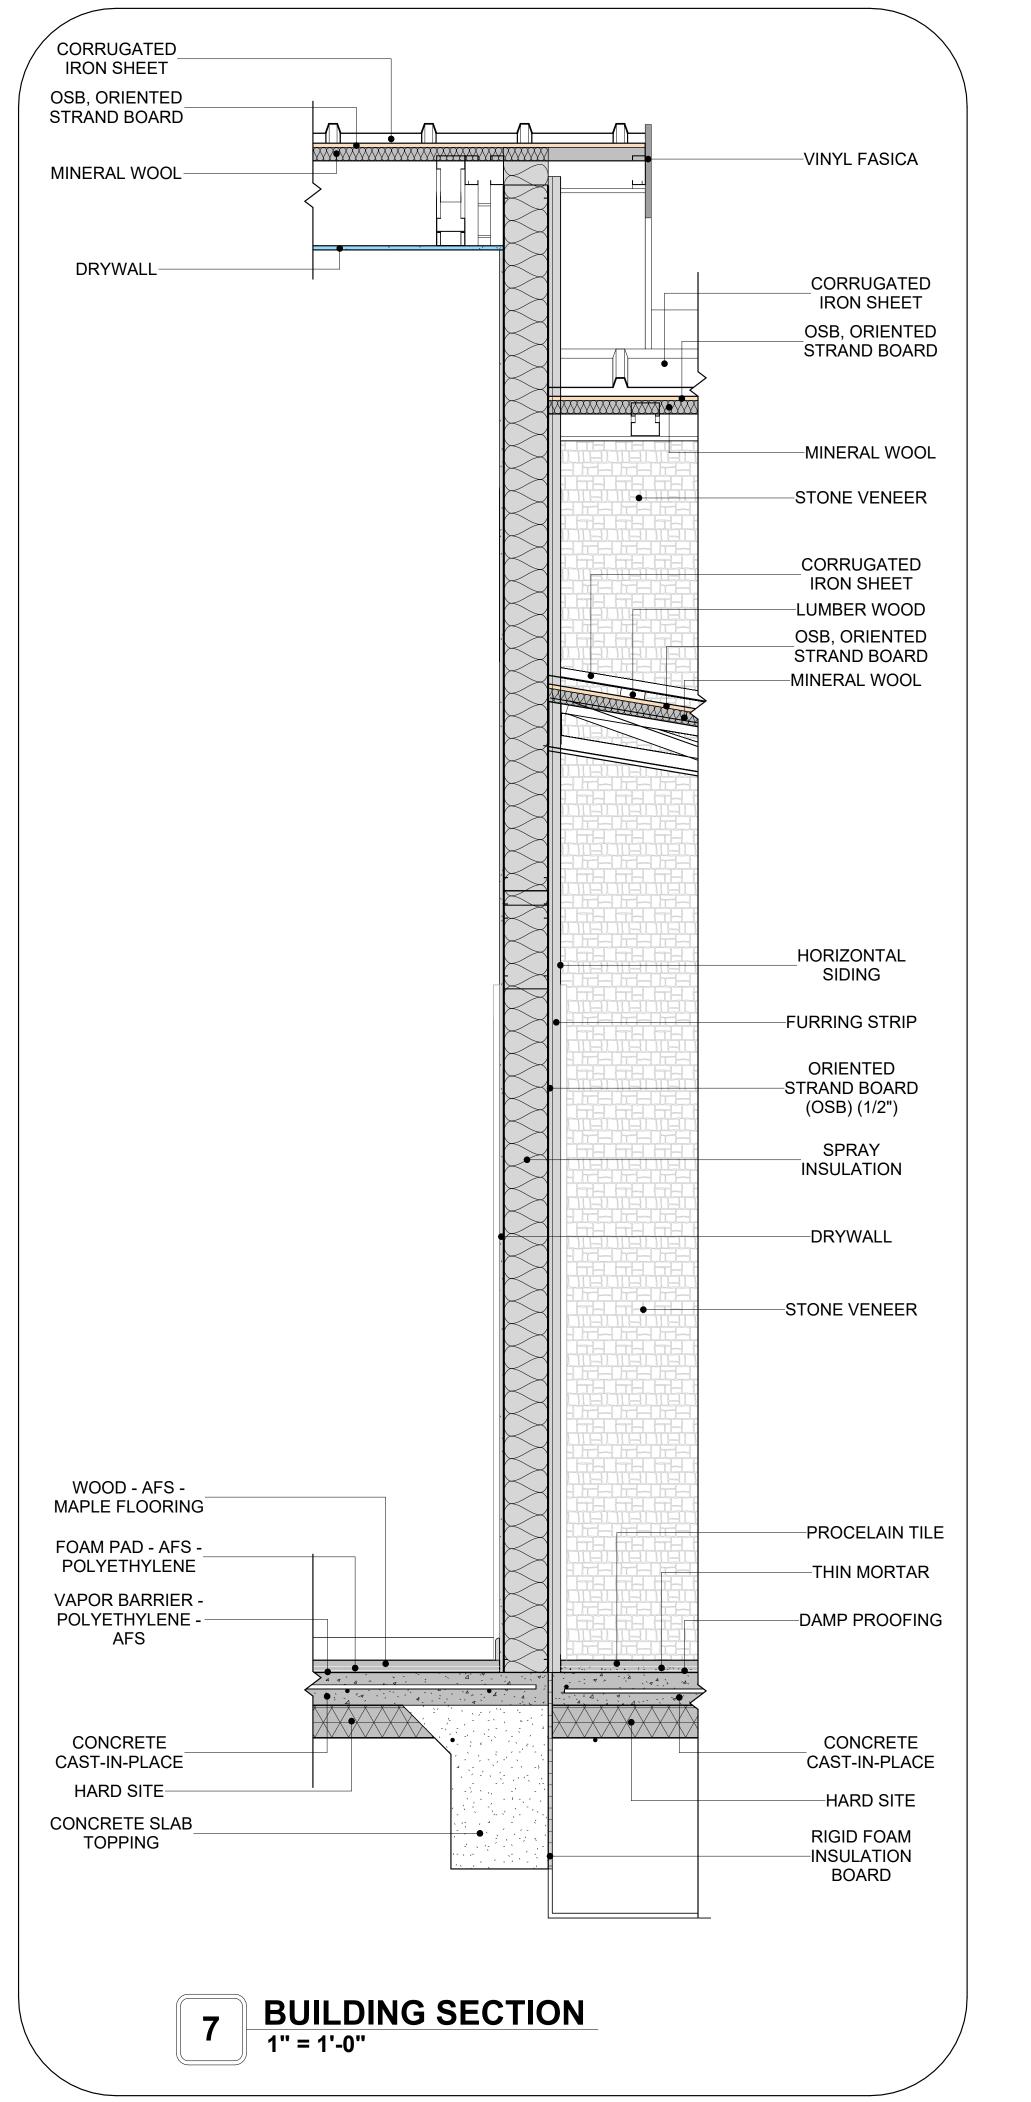



KEY PLAN

NO.	. DESCRIPTION	

NOTE:

LEGEND:

PROJECT

245-EMBER-1396-3Bd2Ba-MODERN-550

DRAWING NAME

ARCHITECTURAL DETAILS

CLIENT NAME:	Client Name
PROJECT NUMBER:	0061_12
DATE:	5/9/2025 3:35:34 PM
DESIGNED BY:	Designer
DRAWN BY:	Author
CHECKED BY:	Checker

A401


SCALE: 1" = 1'-0"


CASEWORK GENERAL NOTES


- ALL CABINET HEIGHTS INCLUDE COUNTERTOPS. DIMENSIONS ARE TO THE NEAREST INCH. DIVISIONS IN CASEWORK ARE SHOWN FOR CLARITY AND DO NOT REPRESENT BREAKS IN THE COUNTERTOP.
- PROVIDE CONTINUOUS COUNTERTOP OVER ALL SIMILAR HEIGHT CASEWORK, UNLESS AND OTHERWISE NOTED.
- MANUFACTURER AND CATALOG NUMBERS ARE FOR REFERENCE AND ILLUSTRATION PURPOSES
- DOTTED LINES INDICATE WALL HUNG CABINETS, DIVISIONS OF BASE CABINETS BELOW THE
- COUNTERTOP, FURNITURE NOT IN THE CONTRACT OR PROJECTION SCREENS -SEE CASEWORK KEY AND SPECIFICATIONS.
- ALL CABINETS AND DRAWERS TO HAVE CAM LOCKS EXCEPT FOR SINK BASE CABINETS.
 ALL EXPOSED SURFACES (EXPOSED TO VIEW FROM ANY PERSPECTIVE) TO BE COVERED WITH
- LAMINATE.
- ALL CASEWORK WHICH MEETS A WALL AT ONE OR BOTH ENDS, TO BE PROVIDED WITH FILLER
- PANELS AND SCRIBED TO THE WALL(S) AS REQUIRED.
- 10. ALL CABINETS AND DRAWERS ARE PRÓVIDED WITH RECESSED HANDLES.
 11. CONTRACTOR TO FIELD VERIFY ALL CLEAR OPENINGS PRIOR TO MILLWORK OR CASEWORK FABRICATION.
- 12. CASEWORK DRAWINGS ARE DIAGRAMMATIC IN NATURE TO SHOW DESIGN INTENT.


	CACEWODY COLEDINE							
	CASEWORK SCHEDULE							
TYPE MAR K	TYPE	COUN	HEIGHT	WIDTH	DEPTH	AREA		
01	WALL_CABINET_DOUBLE_DOOR	1	2' - 6"	2' - 5"	1' - 0"	6 SF		
02	RECESSED_MED_CABINET 2	4	2' - 0"	1' - 6"	0' - 3"	3 SF		
03	WALL_CABINET_SINGLE_DOOR	1	2' - 6"	2' - 0"	1' - 0"	5 SF		
04	HD_L-SHAPE_COUNTER_TOP W SINK HOLE 2	1	0' - 4"	4' - 6"	8' - 1"	1 SF		
05	DOUBLE SINK VANITY	1	3' - 0"	6' - 9"	2' - 0"	20 SF		
06	BASE_CABINET_DOUBLE_DOOR_2	1	2' - 11"	3' - 0"	2' - 0"	9 SF		
07	CLOSET 3	1	6' - 0"	7' - 1"	1' - 4"	43 SF		
08	BASE_CABINET_L-SHAPED	1	2' - 11"	3' - 3"	3' - 3"	9 SF		
09	CLOSET 3	1	7' - 6"	2' - 0"	1' - 4"	15 SF		
10	BASE_CABINET_SINGLE_DOOR	1	2' - 7"	1' - 2"	2' - 0"	3 SF		
11	REFRIGERATOR TOP	1	1' - 8"	2' - 0"	2' - 4"	3 SF		
12	HD_TALL_CABINET_24	1	7' - 8"	3' - 0"	2' - 0"	23 SF		
13	LINEAR COUNTER TOP 2	1	0' - 4"	3' - 0"	2' - 1"	1 SF		
14	BASE_CABINET_DOUBLE_DOOR 2	1	2' - 11"	2' - 5"	2' - 0"	7 SF		
15	BASE_CABINET_SINGLE_DOOR	1	2' - 11"	1' - 9"	2' - 0"	5 SF		
16	WALL CABINET DOUBLE DOOR 211	1	2' - 6"	3' - 0"	1' - 0"	8 SF		
17	CLOSET 6	1	6' - 0"	5' - 6"	1' - 4"	33 SF		
18	CLOSET 4	1	7' - 6"	1' - 11"	1' - 4"	14 SF		
19	CLOSET 5	3	6' - 0"	6' - 0"	1' - 4"	36 SF		
20	DOUBLE SINK VANITY 2	1	3' - 0"	6' - 0"	2' - 0"	18 SF		
GRAND	TOTAL	25						

SPECIALTY EQUIPMENT SCHEDULE				
TYPE MARK	TYPE	COUNT		
)1	WASHER-FRONT-LOAD	1		
)2	REFRIGERATOR	1		
03	RANGE	1		
04	DRYER-FRONT-LOAD	1		
05	DISHWASHER	1		
GRAND TOTAL: 5				

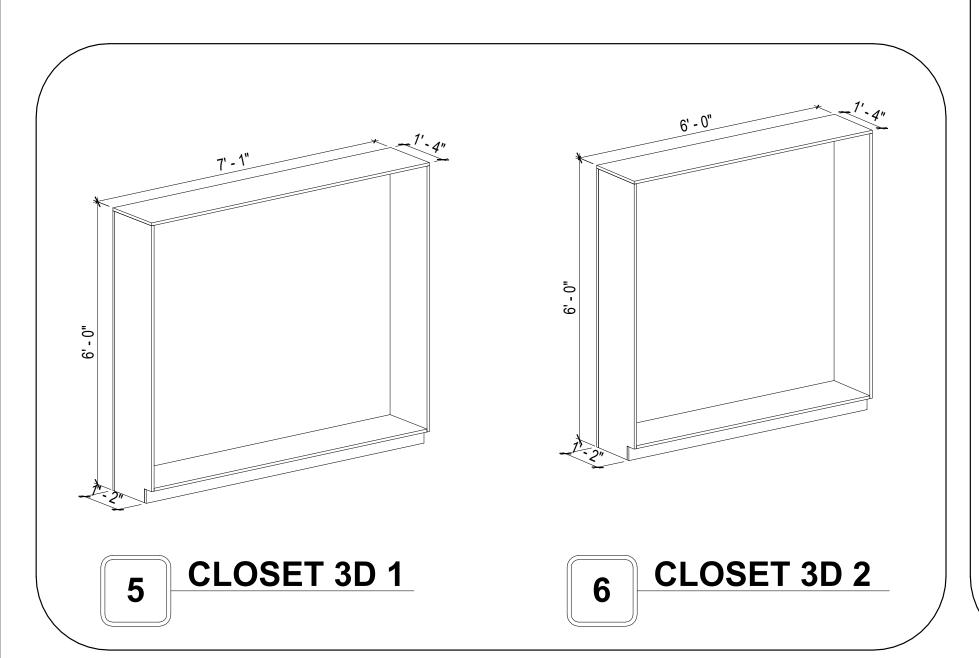

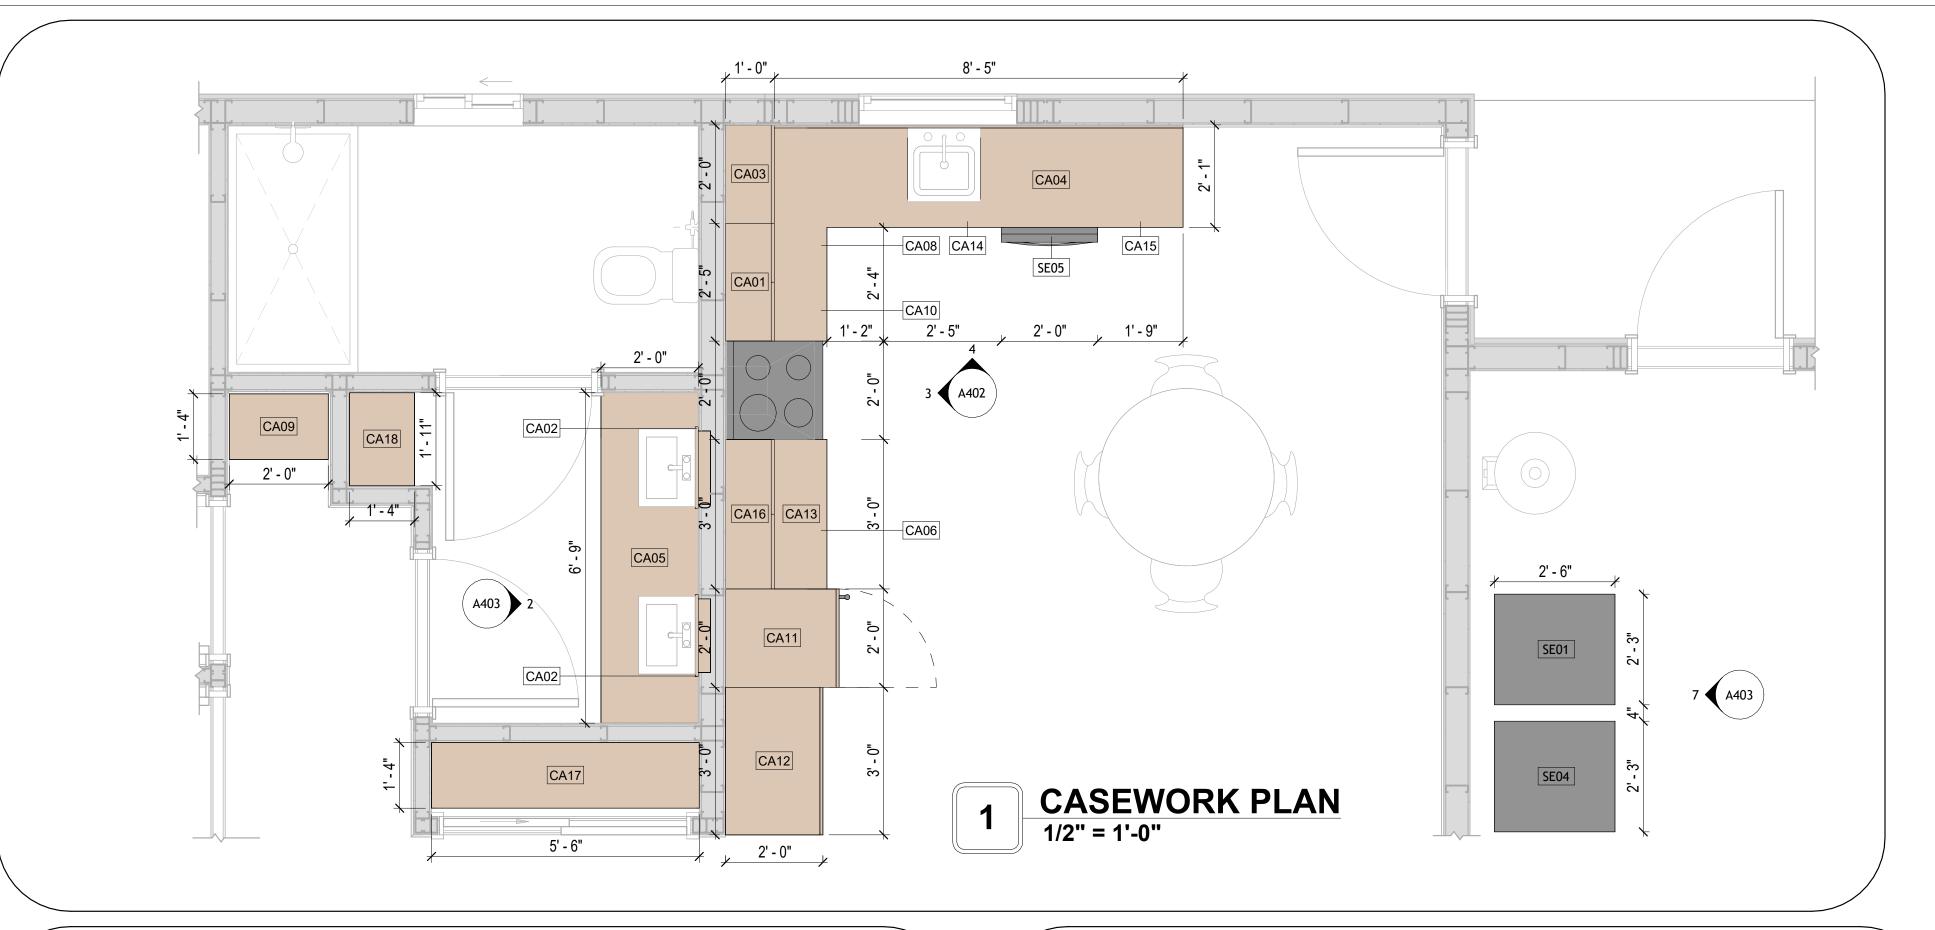

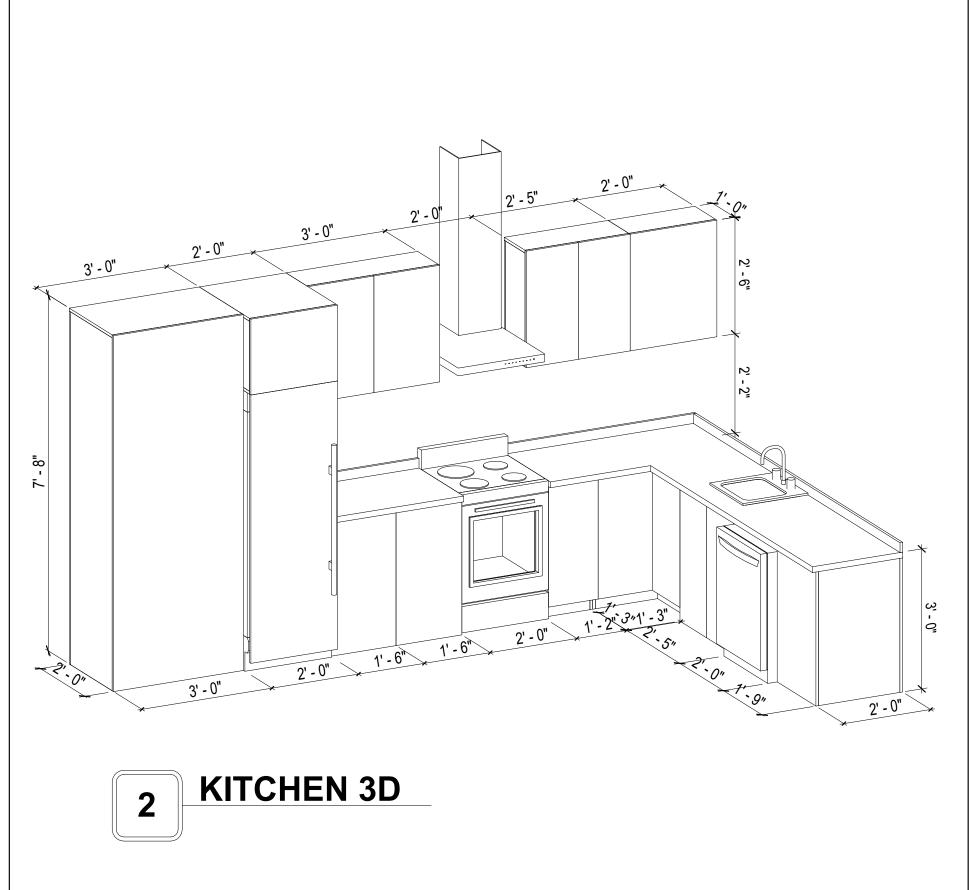

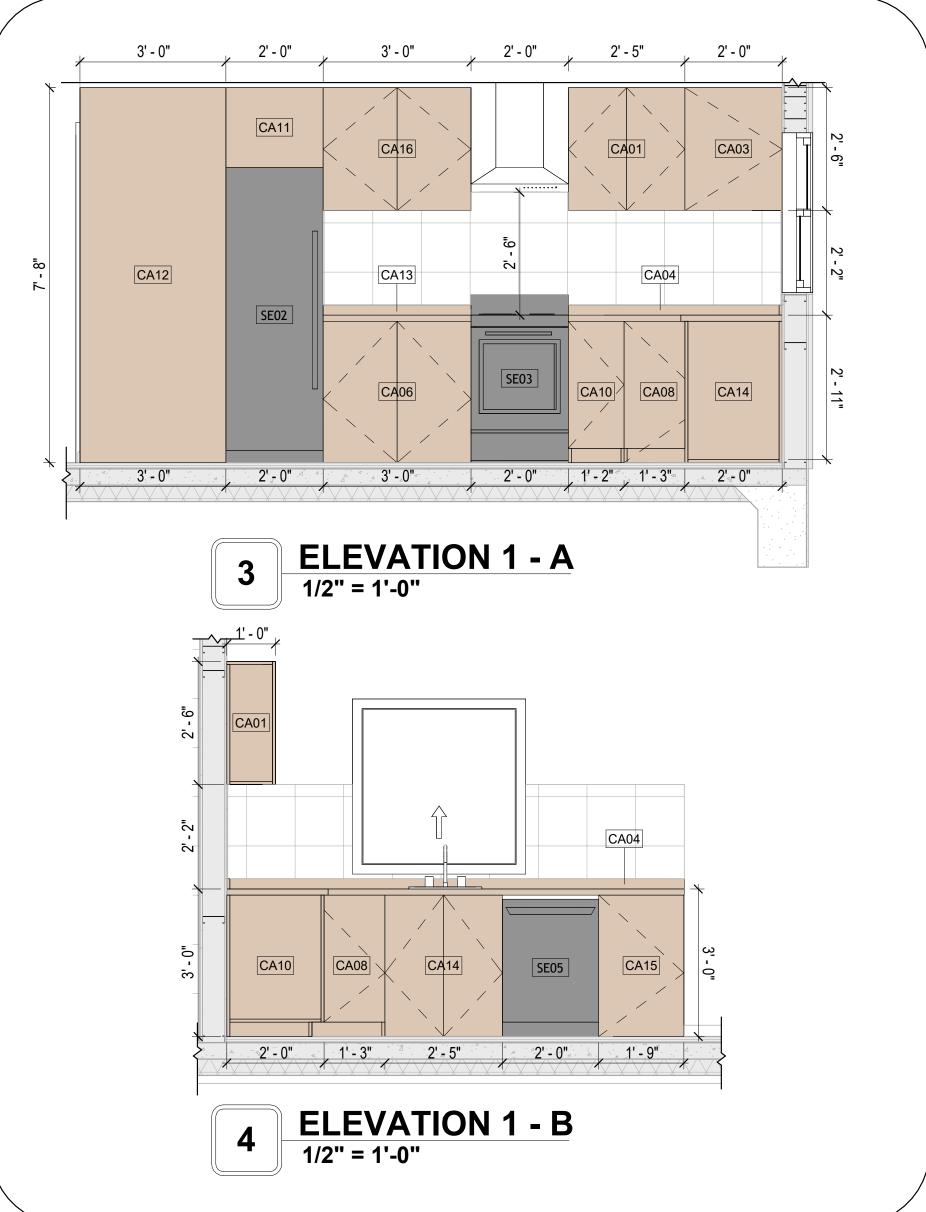



KEY PLAN

NO.	D. DESCRIPTION	

NOTE:

LEGEND:

PROJECT

245-EMBER-1396-3Bd2Ba-**MODERN-550**

DRAWING NAME

ARCHITECTURAL CASEWORK

CLIENT NAME:	Client Name
PROJECT NUMBER:	0061_12
DATE:	5/9/2025 3:35:36 PM
DESIGNED BY:	Designer
DRAWN BY:	Author
CHECKED BY:	Checker
-	

A402

GENERAL NOTES

1. THIS DRAWING DEPICTS THE HVAC (HEATING, VENTILATION, AND AIR CONDITIONING) SYSTEM FOR THE EMBER 3BD2BA MODERN. IT PROVIDES A VISUAL REPRESENTATION OF THE SYSTEM LAYOUT AND COMPONENTS.

2.THE HVAC SYSTEM IS DESIGNED TO MEET THE SPECIFIC REQUIREMENTS OF THE BUILDING, INCLUDING HEATING, COOLING, AND VENTILATION NEEDS AS PER THE PROJECT SPECIFICATIONS AND APPLICABLE CODES AND STANDARDS.

3. THE HVAC SYSTEM INSTALLATION SHALL COMPLY WITH THE LATEST EDITION OF THE INTERNATIONAL MECHANICAL CODE (IMC), INTERNATIONAL RESIDENTIAL CODE (IRC), AND ALL OTHER APPLICABLE LOCAL, STATE, AND NATIONAL CODES AND REGULATIONS.

4. THE EQUIPMENT SHOWN ON THIS DRAWING INCLUDES BUT IS NOT LIMITED TO AIR HANDLING UNITS (AHUS), CHILLERS, BOILERS, COOLING TOWERS, PUMPS, DUCTWORK, DIFFUSERS, GRILLES, AND CONTROL DEVICES.

5. ALL EQUIPMENT, DUCTWORK, AND PIPING SHALL BE INSTALLED IN ACCORDANCE WITH MANUFACTURER'S SPECIFICATIONS, LOCAL CODES, AND

6. ALL DUCTWORK SHALL BE SIZED, FABRICATED, AND INSTALLED IN ACCORDANCE WITH THE LATEST EDITION OF THE ACCA MANUAL D AND THE SMACNA HVAC DUCT CONSTRUCTION STANDARDS. DUCTWORK SHALL BE INSTALLED IN A NEAT AND WORKMANLIKE MANNER, PROPERLY SUPPORTED AND BRACED TO PREVENT SAGGING, AIR LEAKAGE, OR VIBRATION.

7. CONDENSATE DRAINAGE PIPING SHALL BE PROPERLY PITCHED TO ENSURE POSITIVE DRAINAGE TO AN APPROVED DISPOSAL LOCATION, SUCH AS A FLOOR DRAIN, SUMP PUMP, OR EXTERIOR GRADE. CONDENSATE LINES SHALL BE INSULATED TO PREVENT SWEATING.

8. THE LOCATION OF CONTROL PANELS AND SENSORS INDICATED ON THIS DRAWING CAN BEMODIFY with THE SPECIFIC LOCATIONS AND WIRING DETAILS WILL BE DETERMINED DURING THE CONTROL SYSTEM DESIGN AND INSTALLATION.

9. THE HVAC SYSTEM DESIGN CONSIDER ENERGY EFFICIENCY, INDOOR AIR QUALITY, OCCUPANT COMFORT, AND NOISE CONTROL, FOLLOWING

APPLICABLE GUIDELINES AND REGULATIONS. 10. COORDINATION WITH OTHER TREADS HAS BEEN DONE ON A DESIGN LEVEL. THIS DRAWING SHALL BE READ TOGETHER WITH THE AR, EL AND SN

DESIGN DRAWINGS TO ENSURE PROPER INSTALLATION AND INTEGRATION OF THE HVAC SYSTEMS.

11. THE HVAC CONTRACTOR IS RESPONSIBLE FOR OBTAINING ALL NECESSARY PERMITS AND LICENSES, AND FOR SCHEDULING AND COORDINATING WITH THE LOCAL BUILDING DEPARTMENT AND UTILITY PROVIDERS TO ENSURE A TIMELY AND COMPLIANT INSTALLATION.

12. ALL DUCTWORK PENETRATIONS THROUGH WALLS, FLOORS, OR CEILINGS SHALL BE PROPERLY SEALED AND FIRE-STOPPED USING APPROVED METHODS AND MATERIALS TO MAINTAIN THE INTEGRITY OF THE BUILDING'S FIRE-RESISTANCE RATINGS.

13. HVAC EQUIPMENT SHALL BE INSTALLED LEVEL AND PLUMB, AND IN STRICT ACCORDANCE WITH THE MANUFACTURER'S INSTALLATION INSTRUCTIONS AND RECOMMENDATIONS. PROVIDE ADEQUATE CLEARANCES AROUND EQUIPMENT FOR PROPER AIRFLOW, SERVICE ACCESS, AND CODE COMPLIANCE.


14. ALL HVAC EQUIPMENT AND COMPONENTS, INCLUDING THERMOSTATS, DAMPERS, AND ACCESS PANELS, SHALL BE LOCATED IN ACCESSIBLE AREAS FOR EASY SERVICING AND MAINTENANCE. PROVIDE ADEQUATE SPACE AROUND EQUIPMENT FOR PROPER AIRFLOW AND SERVICE ACCESS.

15. THE HVAC SYSTEM SHALL BE BALANCED AND ADJUSTED TO ENSURE PROPER AIRFLOW, TEMPERATURE DISTRIBUTION, AND SYSTEM PERFORMANC THROUGHOUT THE RESIDENCE. PROVIDE A WRITTEN REPORT DOCUMENTING THE FINAL SYSTEM BALANCE.


16. ANY DEVIATIONS OR MODIFICATIONS TO THE HVAC SYSTEM DESIGN SHALL BE REVIEWED AND APPROVED BY THE RESPONSIBLE DESIGN PROFESSIONALS AND COMMUNICATED TO ALL RELEVANT PARTIES INVOLVED IN THE CONSTRUCTION PROCESS.

17. FOR ANY INQUIRIES OR CLARIFICATIONS REGARDING THE HVAC SYSTEM DESIGN, PLEASE CONSULT THE RESPONSIBLE DESIGN PROFESSIONALS OR THE PROJECT MANAGEMENT TEAM.

SYMBOLS

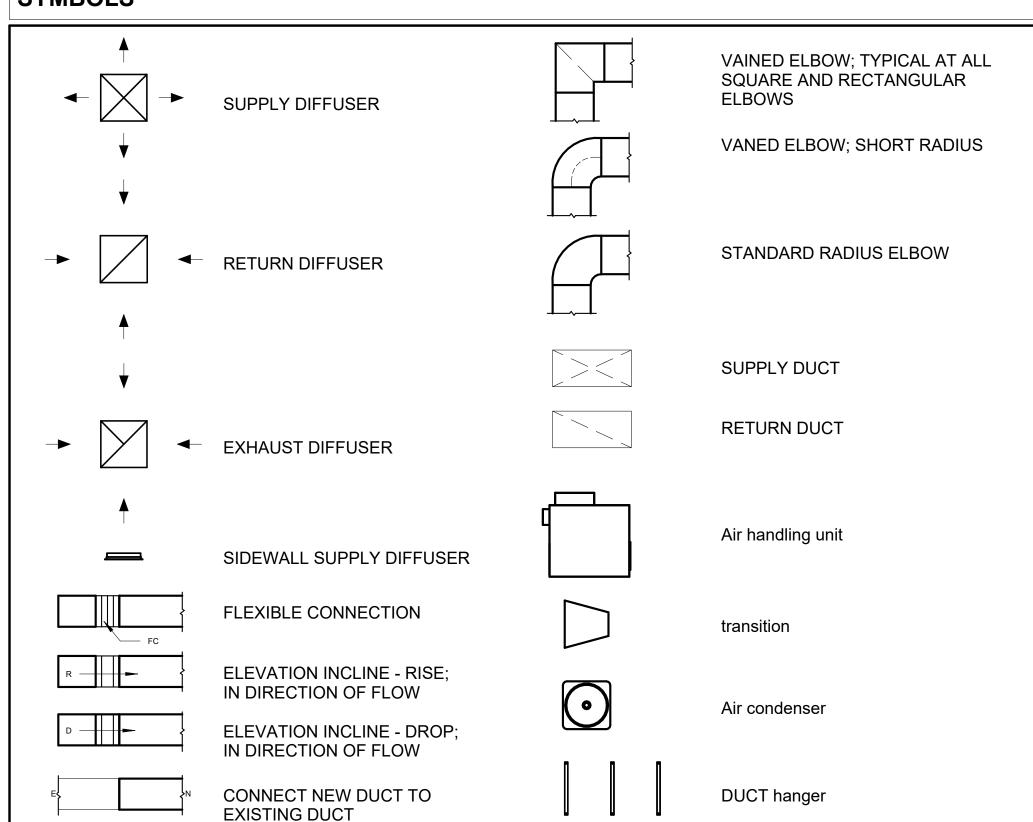



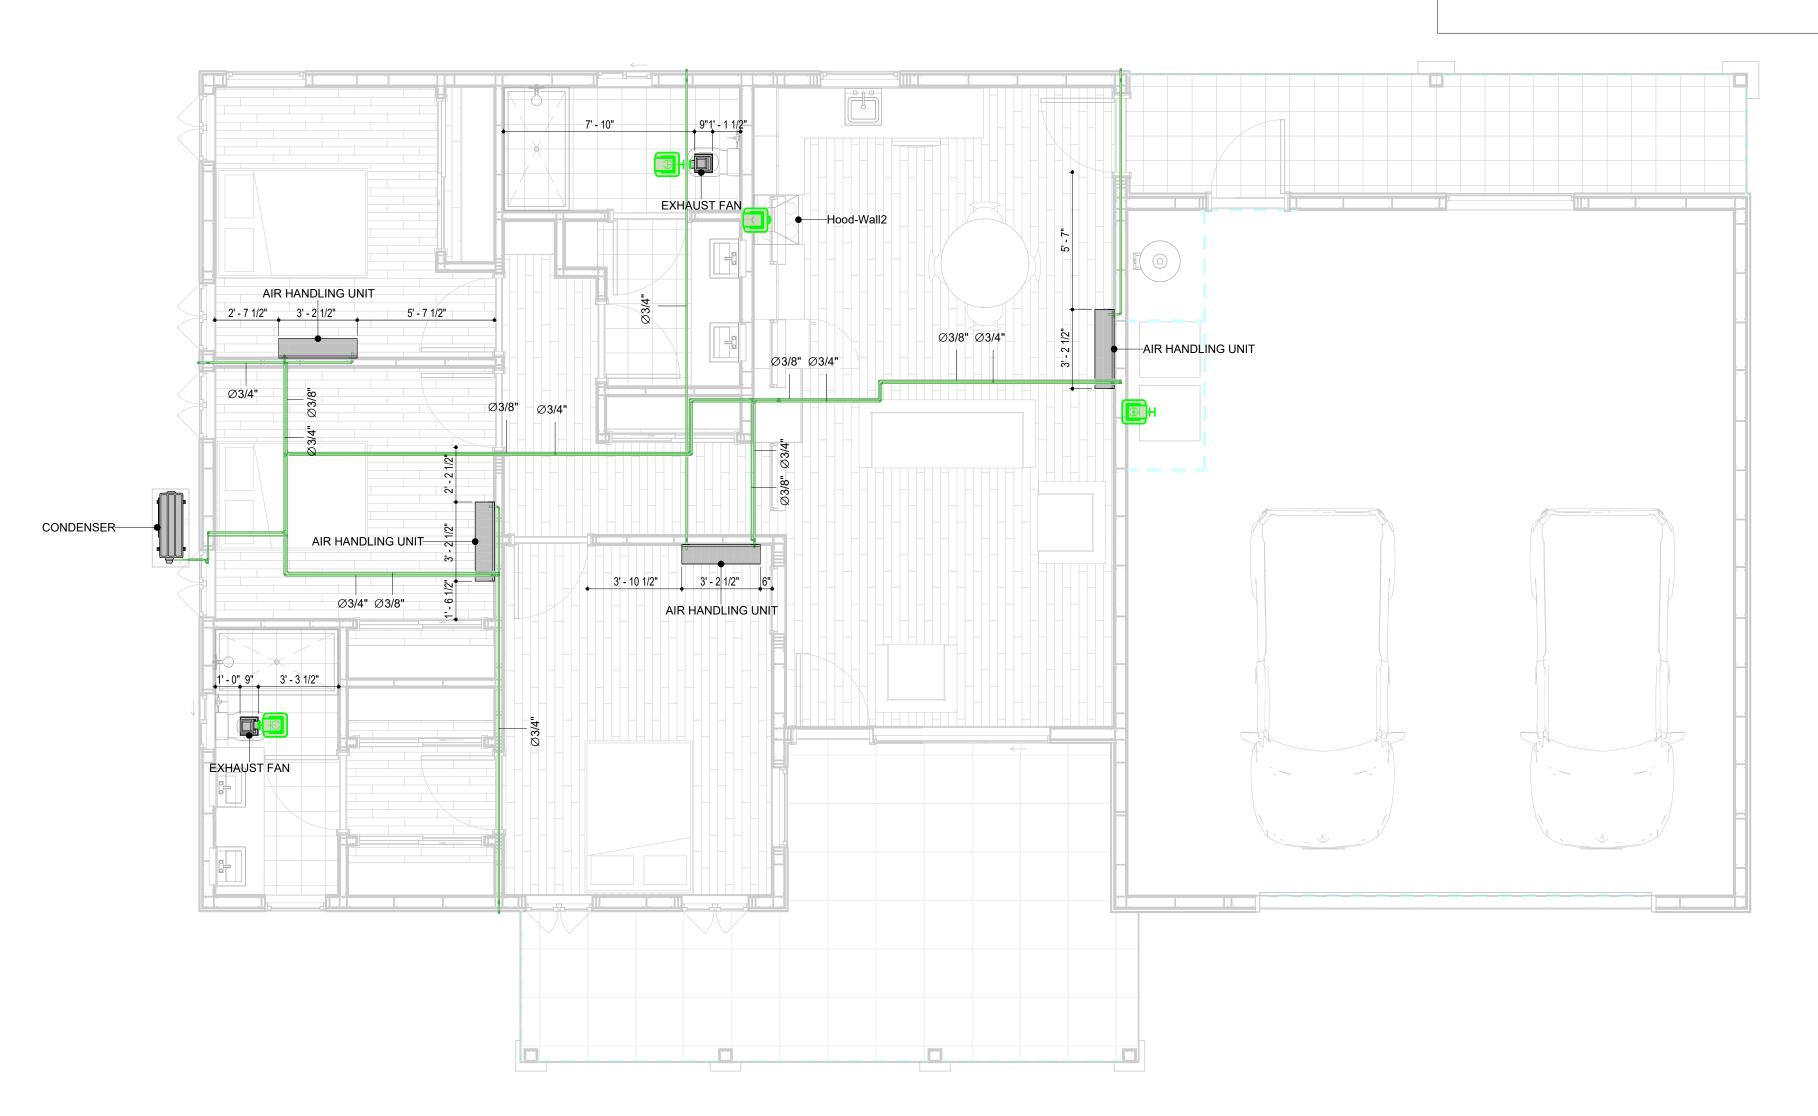



REFRIGERANT LINE SCHEDULE					
CATAGORY	DESCRIPTION	DIAMETER	LENGTH		
Pipe Types	Copper	3/8"	92.60		
Pipe Types	Copper	3/4"	179.30		

REFRIGERANT LINE FITTING SCHEDULE					
CATAGORY	DESCRIPTION	Size	Count		
Elbow - Generic	Elbow - Generic: Standard/HVAC	3/4"ø-3/4"ø	43		
Elbow - Generic	Elbow - Generic: Standard/HVAC	3/8"ø-3/8"ø	32		
Tee - Generic	Tee - Generic: Standard	3/4"ø-3/4"ø-3/ 4"ø	3		
Tee - Generic	Tee - Generic: Standard	3/8"ø-3/8"ø-3/ 8"ø	3		
Transition - Generic	Transition - Generic: Standard	3/4"ø-1/2"ø	5		
Transition - Generic	Transition - Generic: Standard	3/4"ø-5/8"ø	4		
Transition - Generic	Transition - Generic: Standard	3/8"ø-1/4"ø	1		

CONDENSER	CONDENSER: OUT DOOR					1
Exhaust Fan	EXHAUST FAN: 75	EXHAUST FAN: 75 CFM				2
	Hood-Wall2: VENT	Hood-Wall2: VENT 2				1
	DUCT	FITTING	SCHED	ULE		
CATAGOR	RY		DESCRIPTI	ON		COUNT
Round Transition - Angle	45 De	egree				7
	DUCT AC	CCESSO	RY SCHI	EDUI	.E	
CATAGORY	DUCT AC		RY SCHI	EDUL	.E	COUNT
CATAGORY ROOF VENT	DUCT AC			EDUL	.E	COUNT
	3" DIAMETER	DES			_E	
	3" DIAMETER	DES	CRIPTION	LE	DIAMETER	COUNT
ROOF VENT	3" DIAMETER FLEX	DES	CRIPTION	LE		4

MECHANICAL EQUIPMENT SCHEDULE

CATAGORY

AIR HANDLING UNIT AIR HANDLING UNIT: WALL MOUNTED

DESCRIPTION



KEY PLAN

NO.	DESCRIPTION	DATE

NOTE:

LEGEND:

PROJECT

COUNT

245-Ember-1396-3Bd2Ba Modern-550

DRAWING NAME

HVAC PLAN

CLIENT NAME: Owner PROJECT NUMBER: 15_0001 DATE: 5/5/2025 7:03:29 AM Designer DESIGNED BY: DRAWN BY: Author CHECKED BY: Checker

M101

SCALE: As indicated

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ELECTRICAL NOTES

- 1. THIS DRAWING DEPICTS THE ELECTRICAL SYSTEM FOR THE 245_Ember_1396_3Bd2Ba_Modern_550. IT PROVIDES A VISUAL REPRESENTATION OF THE ELECTRICAL LAYOUT AND COMPONENTS, INCLUDING POWER DISTRIBUTION, LIGHTING, AND CONTROL SYSTEMS.
- 2. THE ELECTRICAL SYSTEM IS DESIGNED TO MEET THE SPECIFIC REQUIREMENTS OF THE BUILDING, INCLUDING POWER DISTRIBUTION, LIGHTING, AND SPECIALIZED ELECTRICAL EQUIPMENT NEEDS, AS PER THE PROJECT SPECIFICATIONS AND APPLICABLE CODES AND STANDARDS.
- 3. THE ELECTRICAL SYSTEM INSTALLATION SHALL COMPLY WITH THE LATEST EDITION OF THE NATIONAL ELECTRICAL CODE (NEC), INTERNATIONAL BUILDING CODE (IBC), AND ALL OTHER APPLICABLE LOCAL, STATE, AND NATIONAL CODES AND REGULATIONS.
- 4. LOCATIONS AS NEEDED, DEVICES ARE SHOWN ON PLANS IN APPROXIMATE IDEAL LOCATIONS, UNLESS SPECIFICALLY DIMMENSIONED.
- 6. OPEN WALLS AS NEEDED TO ALLOW FOR NEW ELECTRICAL INSTALLATIONS.
- 6. LABEL ALL CIRCUITS ON JUNCTION BOXES, RECEPTACLES, DATA, SMOKE DETECTOR, AND EQUIPMENT IN PANEL BOX.
- 7. INSTALL RACEWAY AS NEEDED FOR DDC, ACCESS CONTROL, LOW VOLTAGE WIRING & DATA.
- 8. RELABEL POWER, DATA & FIRE ALARM FOR ROOM #CHANGES.
 9. VERIFY ALL CIRCUITS LABELED ON PRINT ARE CORRECT BEFORE WORKING ON THEM.
- 10. NOTE ON SITE PLAN ALL CHANGES OR MISSING DETAIL TO BE INCORPORATED INTO THE MASTER PLAN.
- 11. DRAWINGS ARE DIAGRAMMATIC ONLY FOR THE PURPOSE OF SHOWING FIXTURE AND OUTLET LOCATIONS.
- 12. ELECTRICAL CONTRACTOR TO VERIFY SERVICE SIZE BY CALCULATION BASED UPON ACTUAL NAME PLATE RATINGS OF SELECTED EQUIPMENT.
- PLATE RATINGS OF SELECTED EQUIPMENT.

 13. VERIFY LOCATION OF SERVICE ENTRANCE WITH POWER COMPANY. PROVIDE UFER GROUND IN
- BUILDING FOUNDATION AT SERVICE ENTRANCE LOCATION.

 14. PROVIDE A MIN. OF 20 FEET OF ONE *4 BARE COPPER UFER WIRE EMBEDDED IN CONCRETE FOOTING
- AT THE SERVICE ENTRANCE LOCATION WHERE APPROVED BY LOCAL SERVICE PROVIDER.

 15. PROVIDE WATERPROOF FIXTURES IN ALL HIGH MOISTURE AREAS (EXTERIOR, SHOWER AND TUB
- CEILINGS ETC.)

 16. PROVIDE DEDICATED CIRCUITS TO EACH BATH, DEN, EAMILY ROOM, BEDROOM, LOET, KITCHEN
- 16. PROVIDE DEDICATED CIRCUITS TO EACH BATH, DEN, FAMILY ROOM, BEDROOM, LOFT, KITCHEN REFRIGERATOR, KITCHEN FREEZER DISHWASHER, AND ANY AREA/ITEM SPECIFIED BY OWNER.
- 17. INCANDESCENT FIXTURES WITH OPEN OR PARTIALLY ENCLOSED LAMPS, PENDANT FIXTURES, AND LAMP HOLDERS ARE NOT PERMITTED IN CLOSETS.
- 18. ALL WORKMANSHIP AND MATERIALS TO CONFORM WITH THE 2015 IRC.
- 19. PROVIDE A MIN. OF 20 FEET OF ONE *4 BARE COPPER UFER WIRE EMBEDDED IN CONCRETE FOOTING AT THE SERVICE ENTRANCE LOCATION WHERE APPROVED BY LOCAL SERVICE PROVIDER.
- 20. PROVIDE A BONDING CONDUCTOR CONSISTING OF A MINIMUM OF ONE *4 BARE COPPER WIRE CONNECTING THE BUILDING'S METAL WATER PIPING SYSTEM TO THE SERVICE EQUIPMENT ENCLOSURE GROUNDING.

MAIN PANEL CALCS

ELECTRICAL CALCS	
LIGHT AND OUTLETS 1,950 @ 3W	5,850 W
3 APPLIANCE CIRCUITS	4,500 W
DRYER	2,000 W
WASHER	2,000 W
RANGE	5,000 W
WATER HEATER	5,000 W
REFRIG.	1,800 W
DISHWASHER & DISPOSAL	3000 W
TOTAL	29,150 W
FRIST 10,000 @ 100% REMAINDER @ 40% MINI. SPLIT UNITS	10,000 W 7,660 W 10,000 W
TOTAL	27,660 W

27,660 W DIVIDED BY 240V = 115 AMPS TOTAL

(USE 200 AMP SERVICE)

ELECTRICAL ABBREVIATIONS LIST

1P	1 POLE (2P, 3P, 4P, ETC.)	CTR	CENTER	HT	HEIGHT
Α	AMPERÈ	CU	COPPER	HTG	HEATING
AC	ABOVE COUNTER OR AIR CONDITIONER	DCP	DOMESTIC WATER CIRCULATING PUMP	HTR	HEATER
ACLG	ABOVE CEILING	DEPT	DEPARTMENT	HV	HIGH VOLTAGE
ADO	AUTOMATIC DOOR OPENER	DET	DETAIL	HVAC	HEATING, VENTILATING AND AIR
AF	AMP FRAME	DIA	DIAMETER	CONDITIONING	CONDITIONING
AFF	ABOVE FINISHED FLOOR	DISC	DISCONNECT	HWP	HYDRONIC WATER PUMP
AFG	ABOVE FINISHED GRADE	DIST	DISTRIBUTION	IC	INTERRUPTING CAPACITY
AFI	ARC FAULT CIRCUIT INTERRUPTER	DN	DOWN	İĞ	ISOLATED GROUND
AHU	AIR HANDLING UNIT	DPR	DAMPER	IMC	INTERMEDIATE METAL CONDUIT
AL	ALUMINUM	DS	SAFETY DISCONNECT SWITCH	INCAND	INCANDESCENT
ALT	ALTERNATE	DT	DOUBLE THROW	IR	INFRARED
AMP	AMPERE	DWG	DRAWING	I/W	INTERLOCK WITH
AMPL	AMPLIFIER	DDC	DIRECT DIGITAL CONTROL	J-BOX	JUNCTION BOX
ANNUN	ANNUNCIATOR APPROX APPROXIMATELY	EC	ELECTRICAL CONTRACTOR	KV	KILOVOLT
AQ-STAT	AQUASTAT	ELEC	ELECTRIC, ELECTRICAL	KVA	KILOVOLT-AMPERE
ARCH	ARCHITECT, ARCHITECTURAL	ELEV	ELEVATOR	KVAR	KILOVOLT-AMPERE REACTIVE
AS	AMP SWITCH	EM	EMERGENCY	KW	KILOWATT
AT	AMP TRIP	EMS	ENERGY MANAGEMENT SYSTEM	KWH	KILOWATT HOUR
ATS	AUTOMATIC TRANSFER SWITCH	EMT	ELECTRICAL METALLIC TUBING	LOC	LOCATE OR LOCATION
AUTO	AUTOMATIC	EP	ELECTRIC PNEUMATIC	LT	LIGHT
AUX	AUXILIARY	EQUIP	EQUIPMENT	LTG	LIGHTING
AV	AUDIO VISUAL	EWC	ELECTRIC WATER COOLER	LTNG	LIGHTNING
AWG	AMERICAN WIRE GAUGE	EXIST	EXISTING	LV	LOW VOLTAGE
BATT	BATTERY	EXH	EXHAUST	MAX	MAXIMUM
BD	BOARD	EXP	EXPLOSION PROOF	MAG.S	MAGNETIC STARTER
BLDG	BUILDING	FA	FIRE ALARM	M/C	MOMENTARY CONTACT
BMS	BUILDING MANAGEMENT SYSTEM	FABP	FIRE ALARM BOOSTER POWER	MC	MECHANICAL CONTRACTOR
С	CONDUIT	SUPPLY PANEL	SUPPLY PANEL	MCB	MAIN CIRCUIT BREAKER
CAB	CABINET	FACP	FIRE ALARM CONTROL PANEL	MCC	MOTOR CONTROL CENTER
CAT	CATALOG	FCU	FAN COIL UNIT	MDC	MAIN DISTRIBUTION CENTER
CATV	CABLE TELEVISION	FIXT	FIXTURE	MDP	MAIN DISTRIBUTION PANEL
СВ	CIRCUIT BREAKER	FLR	FLOOR	MFR	MANUFACTURERMAIN FUSED
CCTV	CLOSED CIRCUIT TELEVISION	FLUOR	FLUORESCENT		DISCONNECT SWITCH
CKT	CIRCUIT	FU	FUSE	MH	MANHOLE
CLG	CEILING	FUDS	FUSED SAFETY DISCONNECT SWITCH	MIC	MICROPHONE
COMB	COMBINATION	GA	GAUGE	MIN	MINIMUM
CMPR	COMPRESSOR	GAL	GALLON	MISC	MISCELLANEOUS
CONN	CONNECTION	GALV	GALVANIZED	MLO	MAIN LUGS ONLY
CONST	CONSTRUCTION	GC	GENERAL CONTRACTOR	MMS	MANUAL MOTOR STARTER
CONT	CONTINUATION OR CONTINUOUS	GEN	GENERATOR	MOA	MULTIOUTLET ASSEMBLY
CONTR	CONTRACTOR	GFI	GROUND FAULT CIRCUIT INTERRUPTER	MSP	MOTOR STARTER PANELBOARD
CONV	CONVECTOR	GFP	GROUND FAULT PROTECTOR	MSBD	MAIN SWITCHBOARD
CP	CIRCULATING PUMP	GND	GROUND	MT	MOUNT
CRT	CATHODE-RAY TUBE	GRS	GALVANIZED RIGID STEEL (CONDUIT)	MT.C	EMPTY CONDUIT
CT	CURRENT TRANSFORMER	GYP BD	GYPSUM BOARD	UL	UNDERWRITERS LABORATORIES

Branch Panel:

Location: KITCHEN 02
Supply From:
Mounting: Recessed
Enclosure: Type 1

Volts: 120/240 Single
Phases: 1
Wires: 3

A.I.C. Rating:
Mains Type:
Mains Rating: 200 A
MCB Rating: 1 A

Notes:

Circuit Description	Number of Elements	Rating	Length	Wire Size	Α		E	3	Wire Size	Length	Rating			Circui Numb er
CONDENCER	1	60 A	61' - 7 15/32"	2-#6, 1-#6, 1-#10	750 VA	388 VA			1-#12, 1-#12, 1-#12	45' - 0 19/32"	20 A			2
							750 VA	720 VA	1-#12, 1-#12, 1-#12	64' - 4 1/32"	20 A			4
DRYER	1	30 A	27' - 0 29/32"	2-#10, 1-#10, 1-#10	750 VA	494 VA			1-#12, 1-#12, 1-#12	75' - 0 1/4"	20 A	8	BATHROO 2 UNITS	6
							750 VA	1080 VA	1-#12, 1-#12, 1-#12	61' - 8 7/32"	20 A			8
RANGE	1	50 A	25' - 4 1/4"	2-#8, 1-#8, 1-#10	750 VA	240 VA			1-#12, 1-#12, 1-#12	36' - 9 3/4"	20 A	5	KITCHEN LIGHT UNITS	10
							750 VA	1080 VA	1-#12, 1-#12, 1-#12	28' - 1 5/32"	20 A	6	KITCHEN GFCI RECEPTACLES	12
WATER HEATER	1	30 A	21' - 0 29/32"	2-#10, 1-#10, 1-#10	750 VA	420 VA			1-#12, 1-#12, 1-#12	58' - 5 3/8"	20 A			14
							750 VA	1080 VA	1-#12, 1-#12, 1-#12	43' - 11 5/32"	20 A			16
OUTDOOR GFCI RECEPTACLES	5	20 A	74' - 1 21/32"	1-#12, 1-#12, 1-#12	900 VA	1620 VA			1-#10, 1-#10, 1-#10	64' - 4 3/32"	20 A	9	GARAGE GFCI RECEPTACLES	18
GFCI DISH WASHER	1	30 A	14' - 8 7/16"	1-#10, 1-#10, 1-#10			1200 VA	1200 VA	1-#12, 1-#12, 1-#12	23' - 4 3/32"	20 A	1	GFCI WASHER	20
REFRIGERATOR	1	20 A	31' - 9 31/32"	1-#12, 1-#12, 1-#12	1500 VA	388 VA			1-#12, 1-#12, 1-#12	55' - 7 31/32"	20 A			22
BEDROOM 1 RECEPTACLES	5	20 A	55' - 7 7/8"	1-#12, 1-#12, 1-#12			900 VA	628 VA	1-#12, 1-#12, 1-#12	58' - 0 1/8"	20 A			24
BATHROOM 1 UNITS	10	20 A	45' - 4 1/16"	1-#12, 1-#12, 1-#12	733 VA	192 VA			1-#12, 1-#12, 1-#12	46' - 5 17/32"	20 A			26
OUTDOOR LIGHT POINTS	10	20 A	65' - 10 15/32"	1-#12, 1-#12, 1-#12			592 VA							28
OUTDOOR LIGHT POINTS	7	20 A	29' - 10 9/32"	1-#12, 1-#12, 1-#12	435 VA									30
					10291	VA	1147	3 VA						I.
	CONDENCER DRYER RANGE WATER HEATER OUTDOOR GFCI RECEPTACLES GFCI DISH WASHER REFRIGERATOR BEDROOM 1 RECEPTACLES BATHROOM 1 UNITS OUTDOOR LIGHT POINTS OUTDOOR LIGHT	CIRCUIT Description Elements CONDENCER	Circuit Description Elements Rating CONDENCER 1 60 A DRYER 1 30 A RANGE 1 50 A WATER HEATER 1 30 A OUTDOOR GFCI RECEPTACLES 5 20 A GFCI DISH WASHER 1 30 A REFRIGERATOR 1 20 A BEDROOM 1 RECEPTACLES 5 20 A BATHROOM 1 UNITS 10 20 A OUTDOOR LIGHT POINTS 10 20 A	Circuit Description Elements Rating CONDENCER 1 60 A 61' - 7 15/32" DRYER 1 30 A 27' - 0 29/32" RANGE 1 50 A 25' - 4 1/4" WATER HEATER 1 30 A 21' - 0 29/32" OUTDOOR GFCI RECEPTACLES 5 20 A 74' - 1 21/32" GFCI DISH WASHER 1 30 A 14' - 8 7/16" REFRIGERATOR 1 20 A 31' - 9 31/32" BEDROOM 1 RECEPTACLES 5 20 A 55' - 7 7/8" BATHROOM 1 UNITS 10 20 A 45' - 4 1/16" OUTDOOR LIGHT POINTS 10 20 A 65' - 10 15/32"	Circuit Description Rating CONDENCER 1 60 A 61' - 7 15/32" 2-#6, 1-#6, 1-#10	Circuit Description Number of Elements Rating A CONDENCER 1 60 A 61' - 7 15/32" 2-#6, 1-#6, 1-#6, 1-#10, 1-#10 750 VA	Circuit Description Number of Elements Rating A CONDENCER 1 60 A 61'-715/32" 2#6, 1#6, 1#6, 1#10, 750 VA 388 VA	Circuit Description Reliments Rating A Itements CONDENCER 1 60 A 61' - 7 15/32" 2-#6, 1-#6, 1-#6, 1-#6, 1-#10, 1-#1	Circuit Description Rating A B CONDENCER 1 60 A 61' - 7 15/32" 2#6, 1+6, 1+6, 1+10, 1+	Circuit Description Elements Rating Condended Rating Condended C	Condence Condence	Circuit Description Circuit Description	Circuit Description Elements Rating Elements Rating Elements El	Component Number of Elements Element

egend:	

Load Classification	Connected Load	Demand Factor	Estimated Demand	Panel	Totals
Lighting - Dwelling Unit	1092 VA	100.00%	1092 VA		
Other	2616 VA	100.00%	2616 VA	Total Conn. Load:	21763 VA
Receptacle	17820 VA	78.06%	13910 VA	Total Est. Demand:	17854 VA
Lighting	300 VA	100.00%	300 VA	Total Conn.:	91 A
				Total Est. Demand:	74 A

PROJECT

245-EMBER-1396-3Bd2Ba MODERN-550

DRAWING NAME

SCHEDULE

CLIENT NAME:	Owner
PROJECT NUMBER:	0131_15
DATE:	5/5/2025 6:38:39 AM
DESIGNED BY:	Designer
DRAWN BY:	Author
CHECKED BY:	Checker

E101

SCALE: 1/4" = 1'-0"

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DESCRIPTION

DATE

KEY PLAN

NOTE:

LEGEND:

ELECTRICAL NOTE

- A. PROVIDE INTERCONNECTED SMOKE ALARMS IN EACH SLEEPING ROOMS, OUTSIDE EACH SLEEPING ROOM, ON EACH STORY, IN THE HALL OR ADJACENT ROOM LUHERE THE CEILING HEIGHT OF A ROOM OPEN TO THE HALL EXCEEDS THE HALL BY 24'. SMOKE ALARMS SHALL BE PERMANENTLY HARD WIRED WITH BATTERY BACKUP.
- B. RECEPTACLE OUTLETS FOR RANGES AND CLOTHES DRYERS SHALL BE A THREE POLE WITH GROUND TYPE. FOUR WIRE GROUNDING-TYPE FLEXIBLE CORDS WILL BE REQUIRED FOR CONNECTION OF RANGES AND CLOTHES DRYERS. THE BONDING JUMPER SHALL NOT BE CONNECTED BETWEEN NEUTRAL TERMINAL AND THE FRAME OF THE APPLIANCE.
- C. TWO OR MORE 20 AMP SMALL APPLIANCE CIRCUITS SHALL BE PROVIDED TO SERVE THE KITCHEN, BREAKFAST NOOK, AND DINING ROOM. SUCH CIRCUITS SHALL HAVE NO OTHER OUTLETS.
- D. AT LEAST ONE 20 AMP BRANCH CIRCUIT SHALL BE PROVIDED TO SERVICE THE LAUNDRY ROOM. THIS CIRCUIT SHALL HAVE NO OTHER OUTLETS.
- E. ALL RECEPTACLES WITH IN 6' OF A WET BAR SINK OR KITCHEN SINK TO SERVE COUNTER TOP SURFACES MUST BE GFCI. ON KITCHEN COUNTERS 12' OR WIDER NO POINT ALONG THE WALL SHALL BE MORE THAN 2' FROM A RECEPTACLE. ALL RECEPTACLES WITH IN 6' OF KITCHEN SINK MUST BE GFCI. AT LEAST ONE GFCI RECEPTACLE SHALL
- BE INSTALLED IN THE BATHROOM ADJACENT TO EACH BASIN.

 F. FIXTURES INCLUDING CEILING FANS THAT ARE LOCATED IN DAMP LOCATIONS SHALL BE LISTED TO BE SUITABLE FOR
- SUCH LOCATIONS PER 2012 IRC
- G. PROVIDE ONE (1) SWITCHED OUTLET @ ALL BEDROOMS AND DEN
- H. CEILING FANS NOT EXCEEDING 35 LBS. (WITH OR WITHOUT ACCESSORIES MAY BE SUPPORTED BY OUTLET BOXES PROVIDED THE OUTLET BOXES ARE IDENTIFIED FOR SUCH USE PER 2012 IRC
- I. ELECTRICAL OUTLET BOXES ON OPPOSITE SIDES OF FIRE RATED WALLS SHALL BE SEPARATED BY A HORIZONTAL DISTANCE OF NOT LESS THAN 24".
- J. OUTLET BOXES IN THE WALLS BETWEEN THE GARAGE AND DWELLING SHALL BE METAL OR U.L. APPROVED FIRE RESISTIVE PLASTIC. BOXES IN GARAGE CEILING SHALL BE METAL.
- K. ALL BRANCH CIRCUITS THAT SUPPLY 120 VOLTS SINGLE PHASE 15 AND 20 AMPS RECEPTACLE OUTLETS INSTALLED IN THE DWELLING SHALL BE PROTECTED BY AN ARC FAULT CIRCUIT INTERRUPTER, EXCEPT GFCI RECEPTICLES.

NOTE:

A. RECEPTACLES MUST BE PROVIDED IN HALLWAYS 10'-0" OR MORE IN LENGTH. FOR A ONE FAMILY DWELLINGS AND EACH OF A TWO FAMILY DWELLING THAT IS AT GRADE LEVEL, AT LEAST ONE WP-GFCI RECEPTACLE OUTLET ACCESSIBLE AT GRADE LEVEL AND NOT MORE THAN 6'-6" ABOVE GRADE SHALL BE INSTALLED AT THE FRONT AND BACK OF THE DWELLING.

NOTE: APPLIANCE DISCONNECT

E4001.5 GROUNDING OF ENCLOSURES.

METAL ENCLOSURES FOR SWITCHES OR CIRCUIT BREAKERS SHALL BE CONNECTED TO AN

EQUIPMENT GROUNDING CONDUCTOR.

METAL ENCLOSURES FOR SWITCHES OR CIRCUIT BREAKERS USED AS SERVICE

EQUIPMENT SHALL COMPLY WITH THE PROVISIONS OF SECTION E3609.4. WHERE


NONMETALLIC ENCLOSURES ARE USED WITH METAL RACEWAYS OR METAL-ARMORED

CABLES, PROVISIONS SHALL BE MADE FOR CONNECTING THE EQUIPMENT GROUNDING CONDUCTOR.


NONMETALLIC BOXES FOR SWITCHES SHALL BE INSTALLED WITH A WIRING METHOD THAT


PROVIDES OR INCLUDES AN EQUIPMENT GROUNDING CONDUCTOR. (404.12)

ELECTRI	CAL LEGEND
	Electrical Lights With Fan
0	Waterproof Recessed Can Light
	Pendant Light
0	Recessed Can Light
- •	Wall Lamp
	Standalone linear
√1	Single Switch
-₩	Three way Switch
. . #	Fan Switch
	Duplex Receptacle
	Triplex Receptacle
GFCI	GFCI Receptacle
	Exhaust Fan
•	Smoke and heat detector

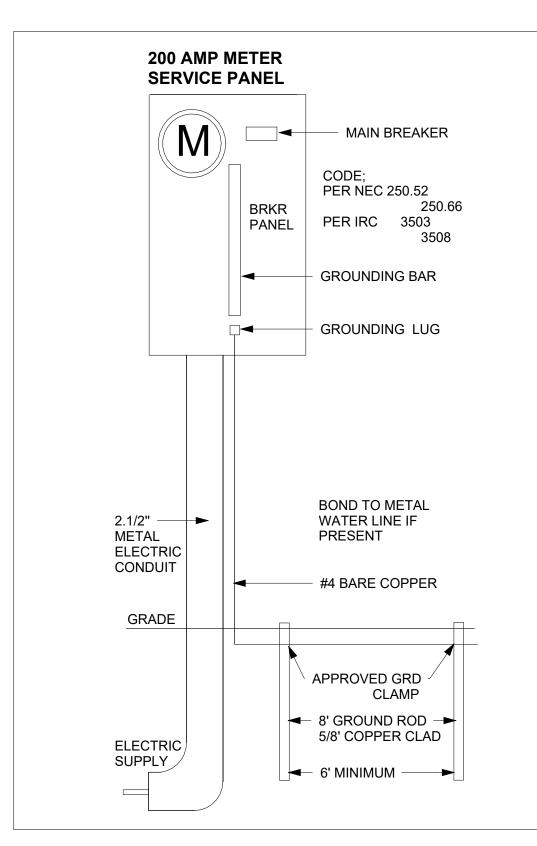



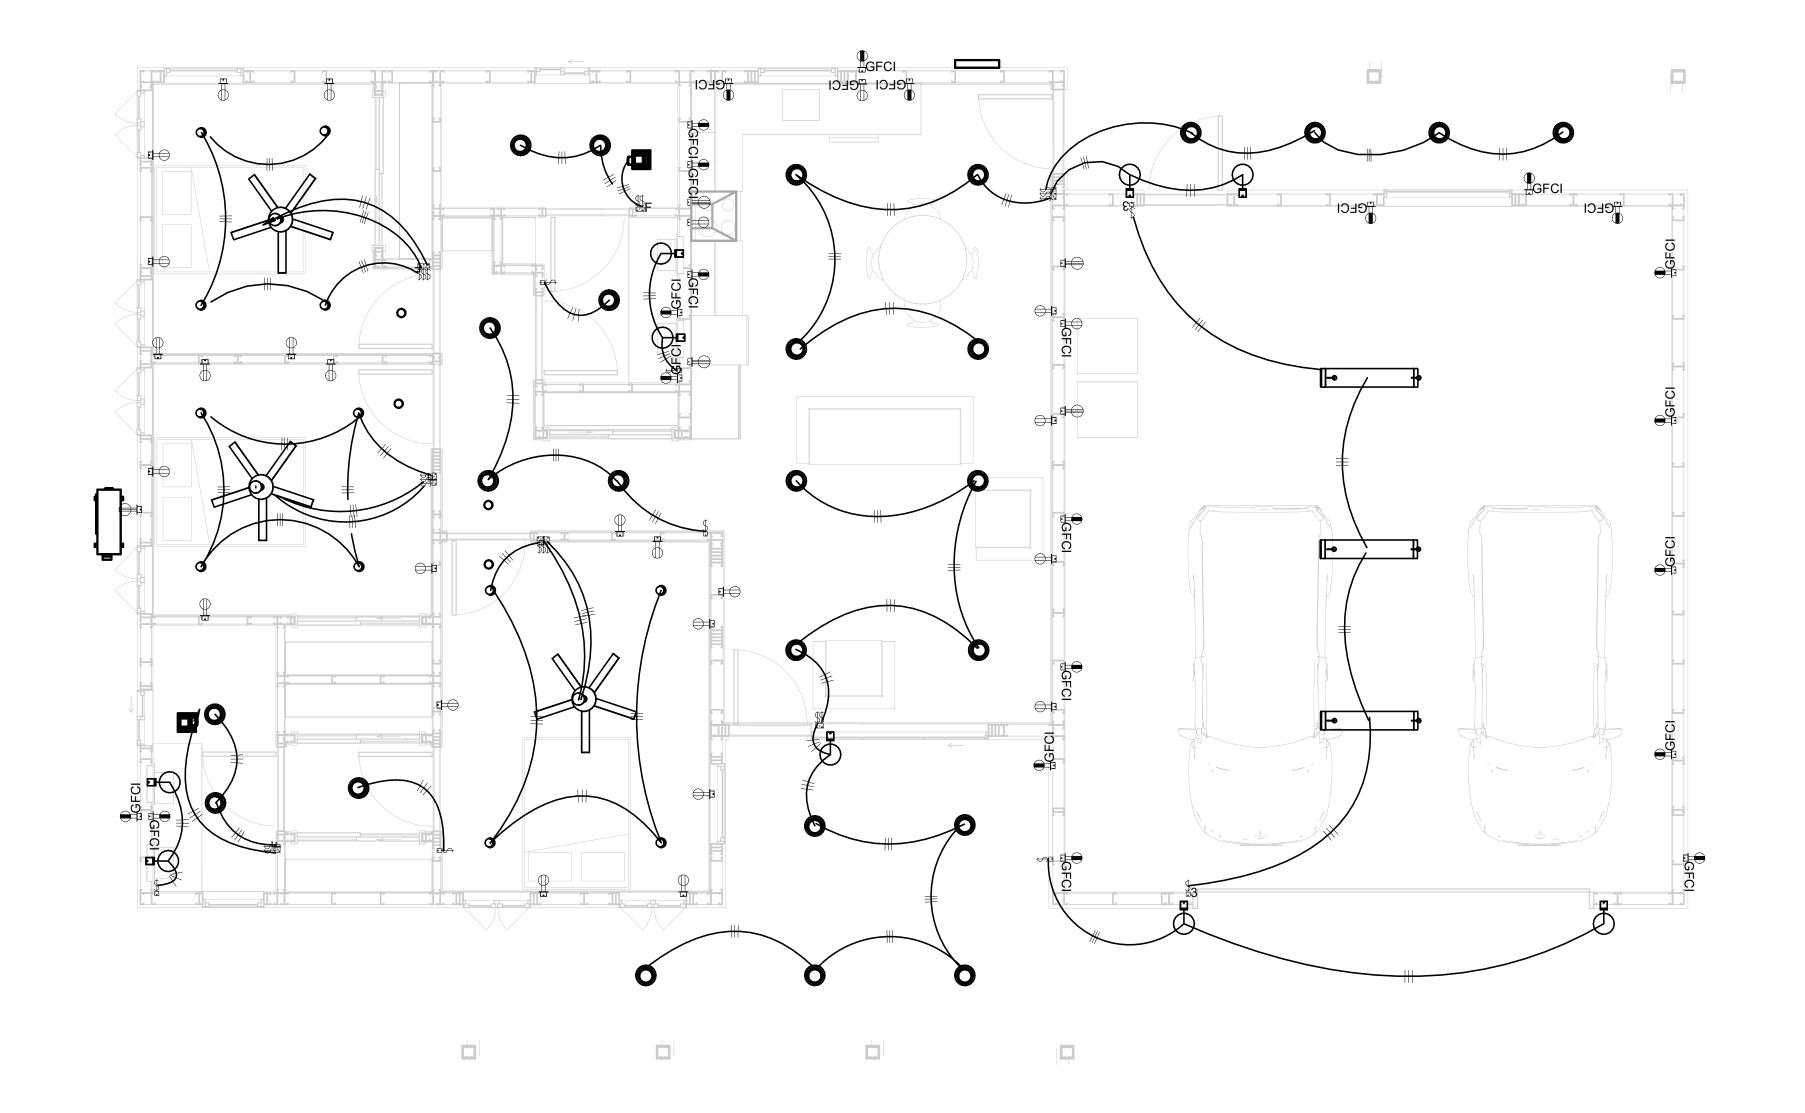

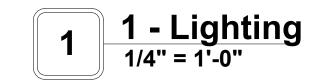



KEY PLAN

NO.	DESCRIPTION	DATE

NOTE:

LEGEND:

PROJECT

245-EMBER-1396-3Bd2Ba MODERN-550

DRAWING NAME


LIGHTING

CLIENT NAME:	Owner
PROJECT NUMBER:	0131_15
DATE:	5/5/2025 6:38:43 AM
DESIGNED BY:	Designer
DRAWN BY:	Author
CHECKED BY:	Checker


E102


NOTES: CONDUIT, CABLE AND WIRING


- Use Metalic Conduits (IMC) for cables running under concrete slabs.
 Use IMC for circuits with high voltage appliances (240 volts and above)
 For circuits with 120 volts consider using EMT or PVC conduits if needed.
 For Low voltage applications up to 50 volts consider using non metalic conduits.
 All conduits to be used in the project must conform to the latest National Electrical Code (NEC),
- 5. All conduits to be used in the project must comorn to the latest National Electrical Code (NEC), 2015.
 6. All wiring and cables to be used in the project must also conform to the latest National Electrical Code (NEC), 2015.
 7. All cables and wires used should be rated for their respective loading and should be gauged and conform to the NEC.

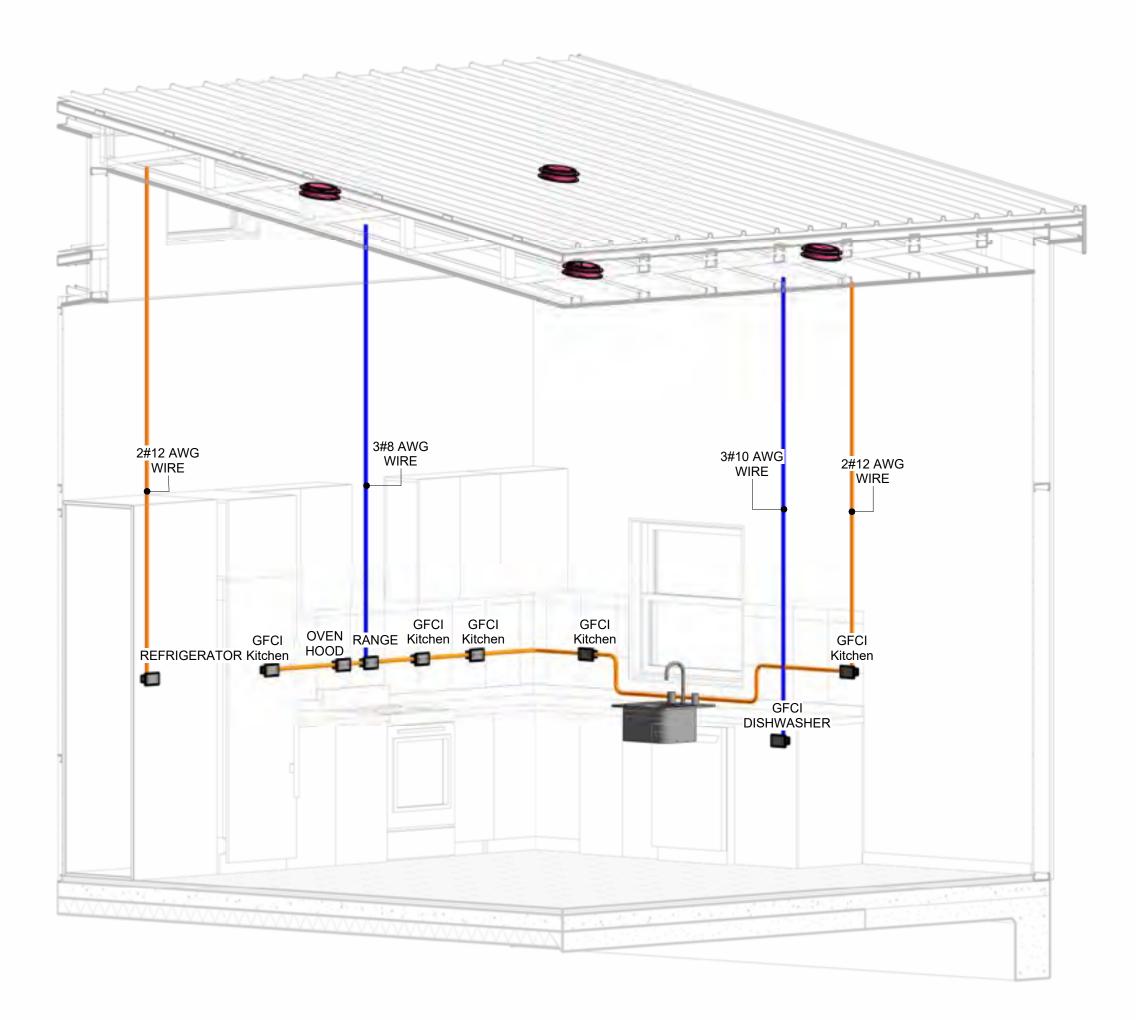




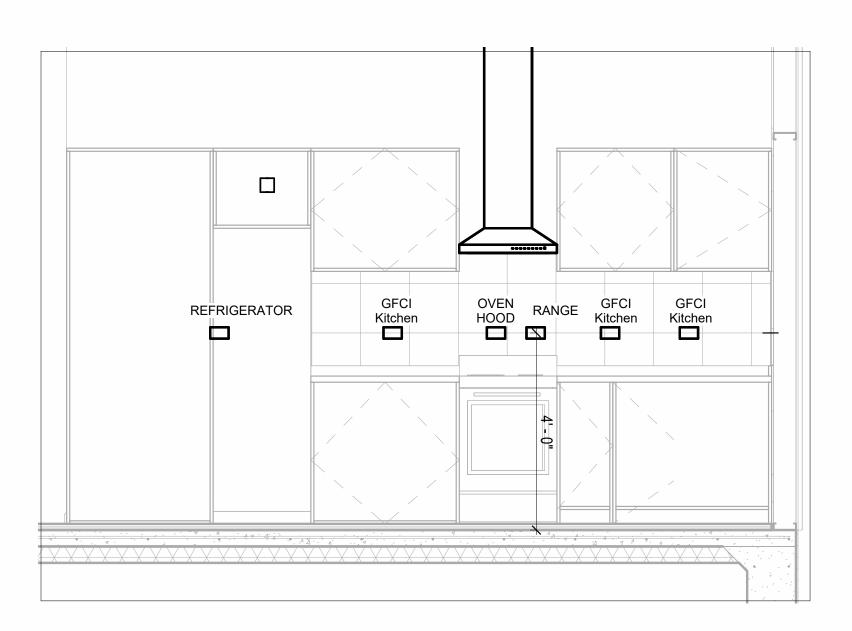


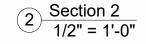


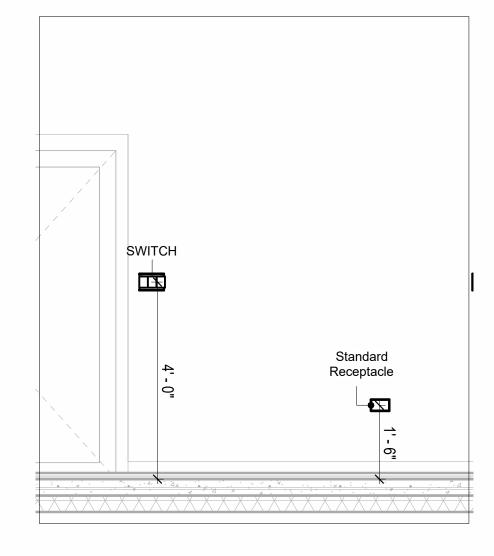

4 Section 4 1/2" = 1'-0"

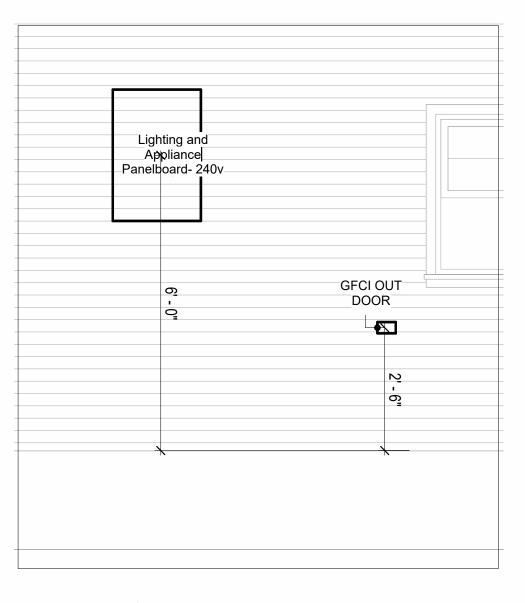

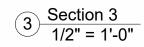

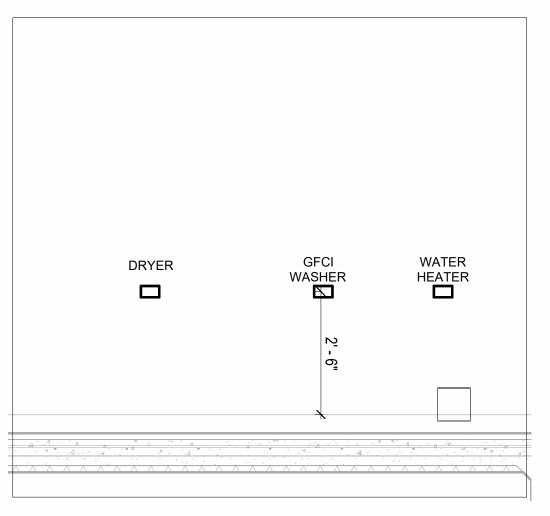

6 Section 5 1/2" = 1'-0"


CLIENT NAME:	Owner
PROJECT NUMBER:	0131_15
DATE:	5/5/2025 6:39:10 AM
DESIGNED BY:	Designer
DRAWN BY:	Author
CHECKED BY:	Checker

E103

SCALE: As indicated

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KEY PLAN

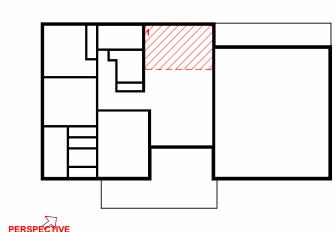

DESCRIPTION DATE

NOTE:

LEGEND:

PROJECT

245-EMBER-1396-3Bd2Ba **MODERN-550**

DRAWING NAME

POWER

NOTES: LIGHT

- 1. LIGHT FIXTURES AND LUMINARIES SHALL CONFORM TO THE NEC, THE IRC AND LOCAL SAFETY & BUILDING CODE.
- 2. ALL LIGHTING FIXTURES SHOULD CONFORM TO THE DESIGN ELECTRICAL LOAD AND SHALL BE PROPERLY WIRED AND MOUNTED BY QUALIFIED ELECTRICIAN FOLLOWING MANUFACTURERS SPECIFICATIONS.
- CEILING FANS AND FANS WITH LIGHT WITH WEIGHT EXCEEDING 35 LBS SHOULD BE PROVIDED WITH STRUCTURAL BACKING FOR SUPPORT AND SHALL BE FIXED AS PER MANUFACTURERS SPECIFICATIONS.
- 4. EXTERIOR LIGHTS SHALL CONFORM TO LOCAL BUILDING CODE AND GUIDELINES.

NOTES: SWITCH JUNCTION BOX


- 1. THE MINIMUM SIZE OF JUCTION BOX TO BE USED IS 2"X4"X(1.5" OR 3.5" DEEP) THIS ARE
- TO BE USED FOR SINGLE GANG SWITCH OR OUTLETS.

 2. FOR DOUBLE GANG (2 GANG) OUTLETS AND SWITCHS THE MINIMUM SIZE OF THE
- JUCTION BOX TO BE PROVIDED SHALL NOT BE LESS THAN 4"X4"X(1.5" OR 3.5" DEEP)
- 3. FOR THREE GANG (3 GANG) OUTLETS AND SWITCHS THE MINIMUM SIZE OF THE JUĆTION BOX SHALL NOT BE LESS THAN 6"X4"X(1.5" OR 3.5" DEEP).

Electrical Fixture Schedule (SWITCH BOX)				
Туре	Count			
Double Gang Switch Box	1			
Double Gang Switch Box	2			
Single Gang Switch Box	8			
Triple Gang Switch Box	4			

Lighting Device				
Туре	Count			
Fan switch	5			
Single Pole	19			
Single Pole Three Way	2			

Lighting Fixture						
Lighting Fixture Type	Voltage	Count				
Electrical_Lights_Fan-Light1	120 V/1-100 VA- 120 V/1-100 VA	200 A, 120 V/240 V, Single Phase, 3 Wires	3			
Lighting_Recessed	120 V/1-60 VA	200 A, 120 V/240 V, Single Phase, 3 Wires	26			
Pendant Light - Linear - 2 Lamp	120 V/1-64 VA	200 A, 120 V/240 V, Single Phase, 3 Wires	3			
SASSO 100 round wallwasher trim	120 V/1-28 VA	200 A, 120 V/240 V, Single Phase, 3 Wires	12			
Wall Lamp - Bracket	120 V/1-100 VA	200 A, 120 V/240 V, Single Phase, 3 Wires	9			

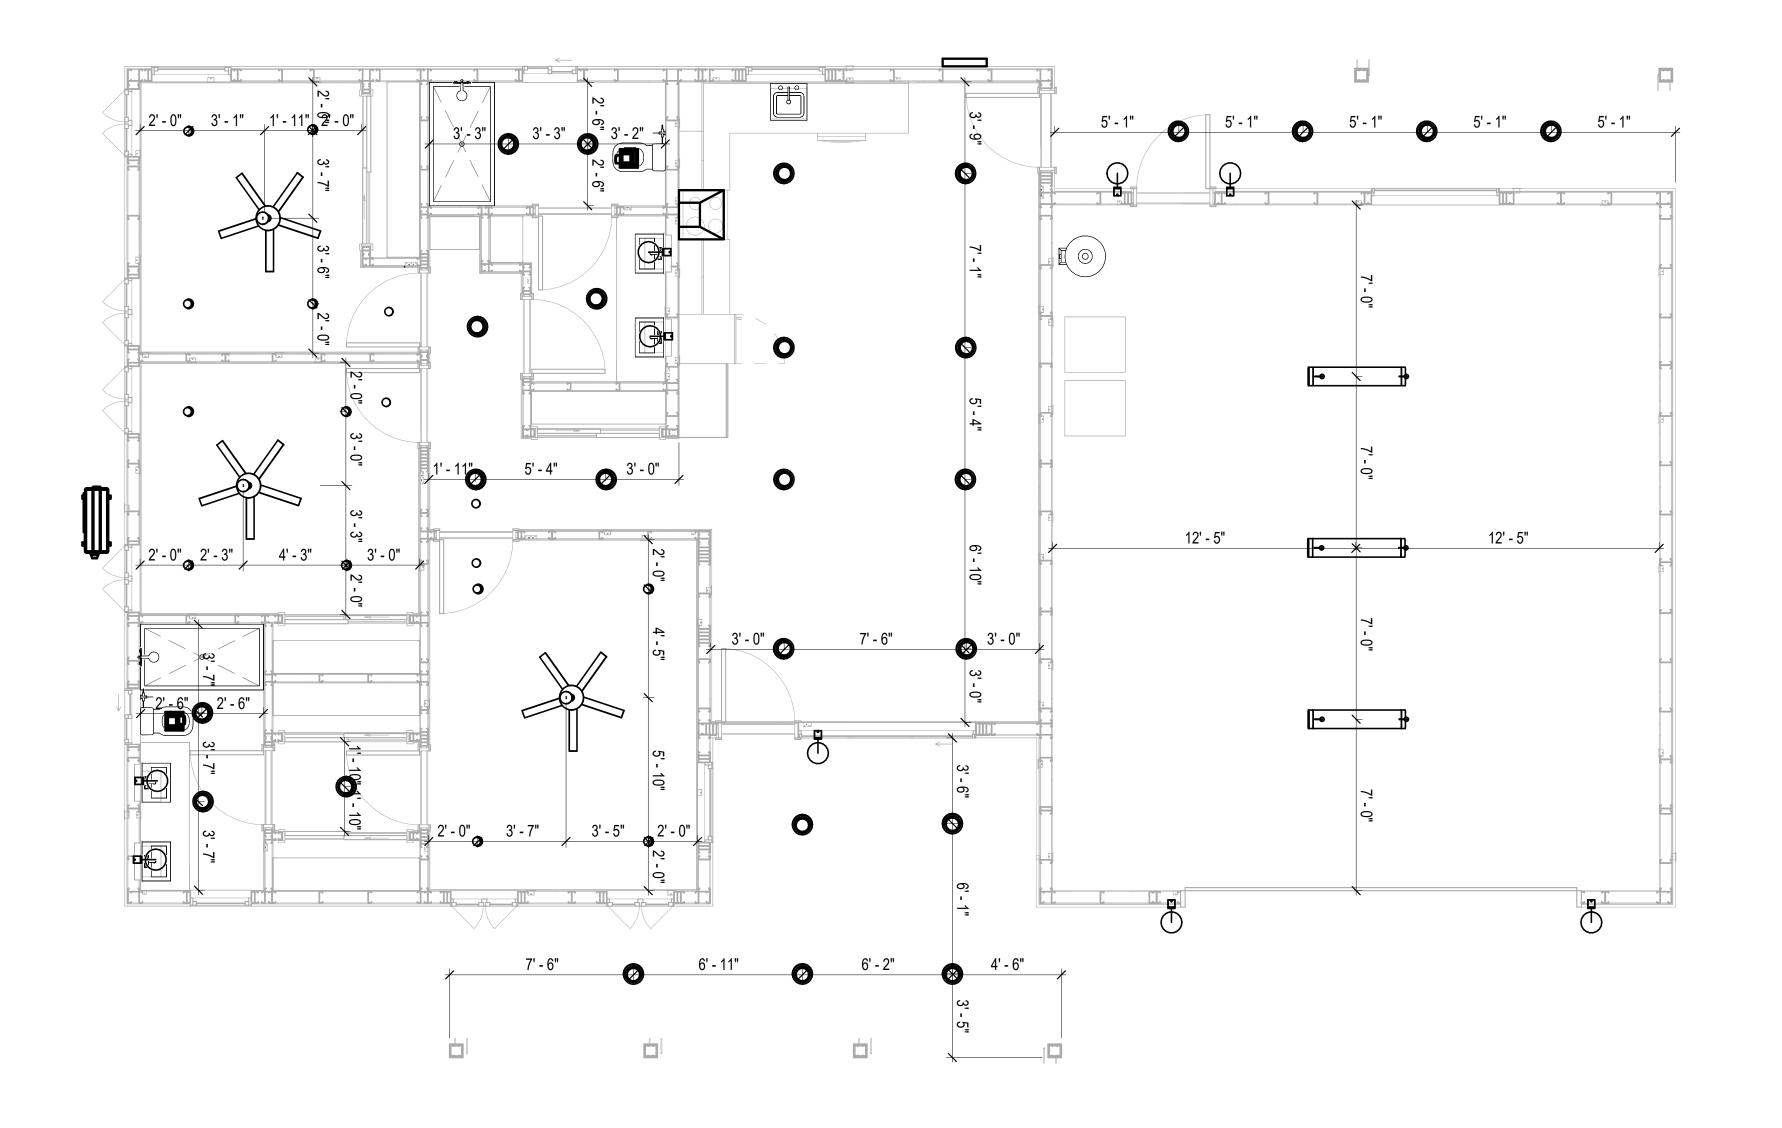

DIMENSION FOR LIGHT FIXTURES
1/4" = 1'-0"

KEY PLAN

NO. DESCRIPTION DATE

NOTE:

LEGEND:

PROJECT

245-EMBER-1396-3Bd2Ba MODERN-550

DRAWING NAME

DIMENSION PLAN FOR LIGHT FIXTURES

CLIENT NAME:	Owner
PROJECT NUMBER:	0131_15
DATE:	5/5/2025 6:39:12 AM
DESIGNED BY:	Designer
DRAWN BY:	Author
CHECKED BY:	Checker

E104


SCALE: 1/4" = 1'-0"

NOTES;

- 1. VERIFY EQUIPMENT PLUG CONFIGURATION BEFORE PURCHASING RECEPTACLES 2. FOR ALL EQUIPMENT.
- 3. COORDINATE EXACT LOCATION OF LIGHT FIXTURES, WALL SWITCHES, RECEPTACLES AND OTHER DEVICES WITH ARCHITECTURAL DRAWINGS.
- 4. USE METALLIC JUNCTION BOX WITH THE GFCI RECEPTACLES, WITH HIGHT VOLTAGE.

Electrical Fixture Schedule (Receptacle)						
Туре	Count					
CONDENSER	1					
DRYER	1					
GFCI BATH ROOM	3					
GFCI DISHWASHER	1					
GFCI GARAGE	9					
GFCI Kitchen	5					
GFCI OUT DOOR	5					
GFCI WASHER	1					
OVEN HOOD	1					
RANGE	1					
REFRIGERATOR	1					
Standard Receptacle	23					
WATER HEATER	1					

Electrical Outlet Schedule						
Туре	Circuit Number	Electrical Data	Count			
Standard Receptacle		120 V/1-180 VA	2			
CONDENSER	1,3	240 V/2-1500 VA	1			
Standard Receptacle	4	120 V/1-180 VA	4			
DRYER	5,7	240 V/2-1500 VA	1			
GFCI BATH ROOM	6	120 V/1-180 VA	1			
Standard Receptacle	8	120 V/1-180 VA	6			
RANGE	9,11	240 V/2-1500 VA	1			
GFCI Kitchen	12	120 V/1-180 VA	5			
OVEN HOOD	12	120 V/1-180 VA	1			
WATER HEATER	13,15	240 V/2-1500 VA	1			
Standard Receptacle	16	120 V/1-180 VA	6			
GFCI OUT DOOR	17	120 V/1-180 VA	5			
GFCI GARAGE	18	120 V/1-180 VA	9			
GFCI DISHWASHER	19	120 V/1-1200 VA	1			
GFCI WASHER	20	120 V/1-1200 VA	1			
REFRIGERATOR	21	120 V/1-1500 VA	1			
Standard Receptacle	23	120 V/1-180 VA	5			
GFCI BATH ROOM	25	120 V/1-180 VA	2			

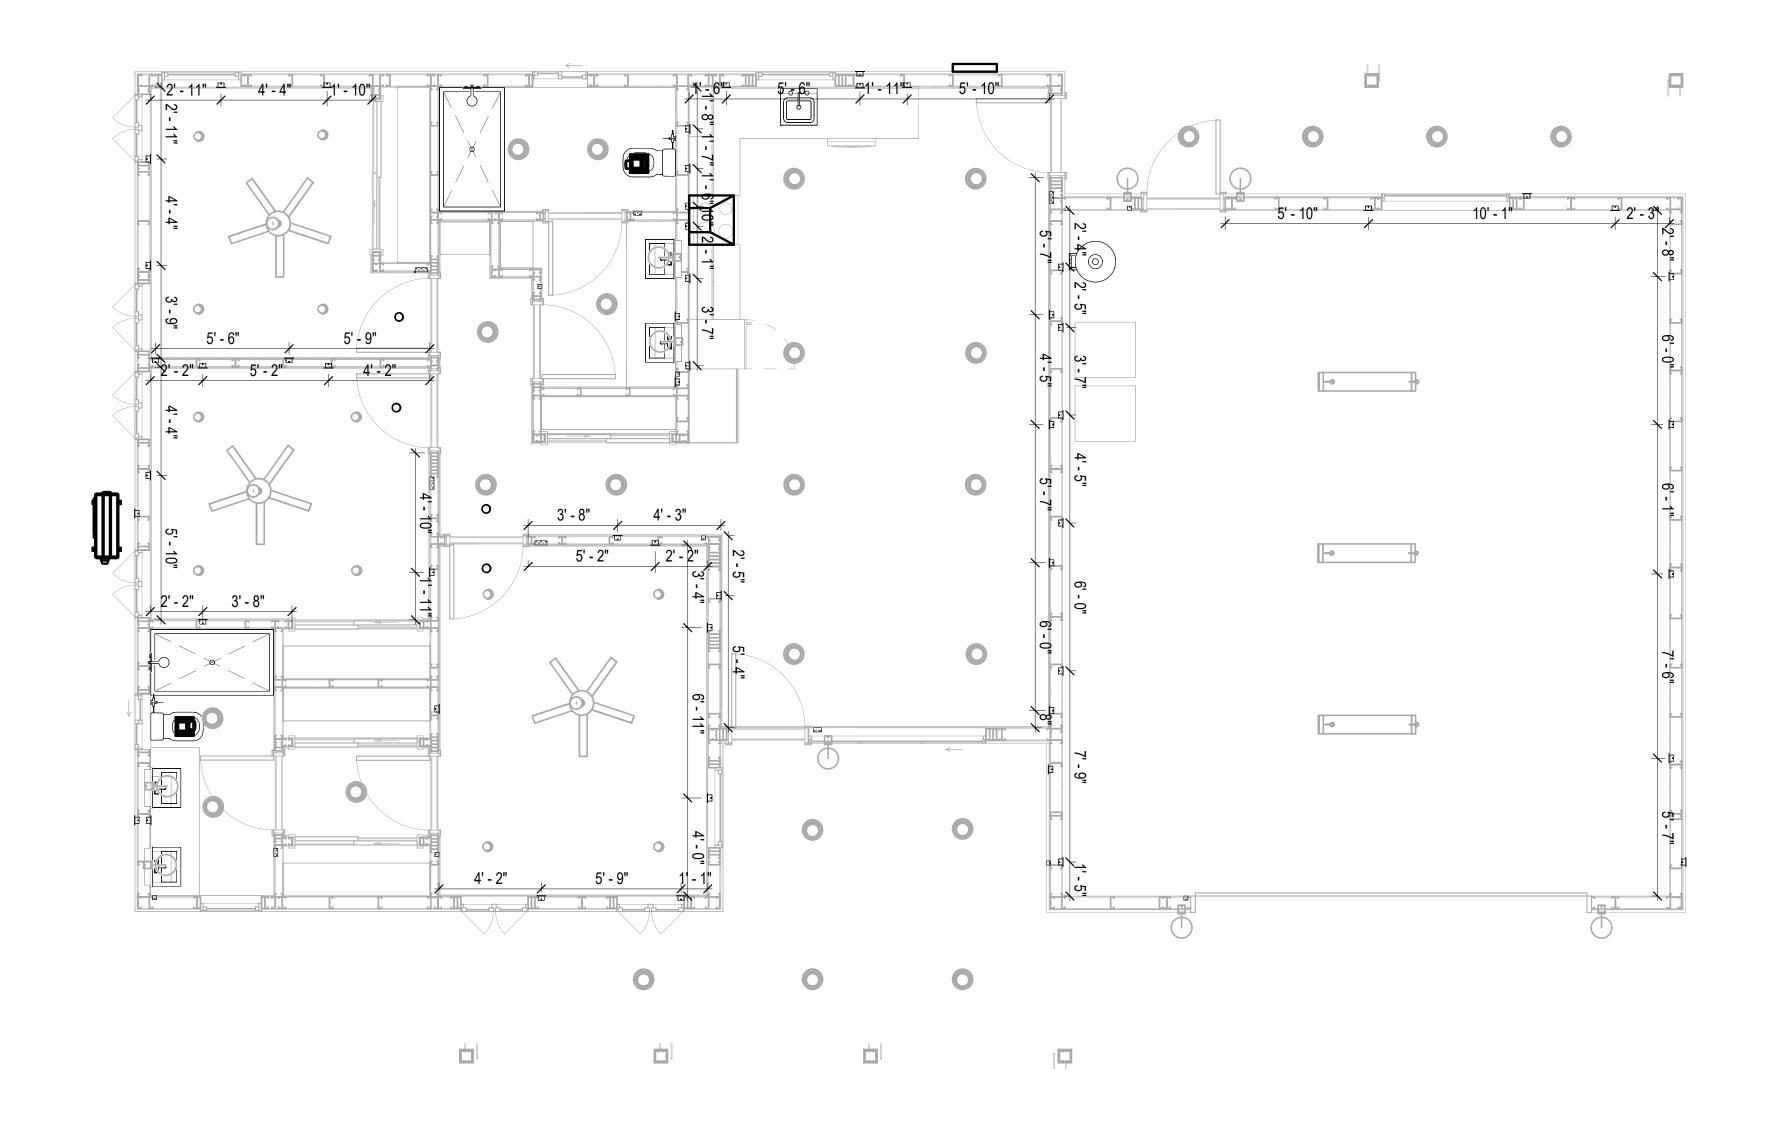

DIMENSION FOR FITTINGS 1/4" = 1'-0"

KEY PLAN

DESCRIPTION

NOTE:

LEGEND:

PROJECT

245-EMBER-1396-3Bd2Ba **MODERN-550**

DRAWING NAME

DIMENSION PLAN FOR FITTINGS

CLIE	NT NAME:	Owner
PRO	JECT NUMBER:	0131_15
DAT	E:	5/5/2025 6:39:14 AM
DES	IGNED BY:	Designer
DRA	WN BY:	Author
CHE	CKED BY:	Checker

E105

SCALE: 1/4" = 1'-0"

SHEET LIST

SHEET NUMBER SHEET NAME

P101	NOTE AND SCHEDULE
P102	WATER SUPPLY
P103	SEWAGE SYSTEM

PIPE COLOR SCHEME DOMESTIC COLD WATER DOMESTIC HOT WATER SANITARY VENT SANITARY SEWER STORM DRAINAGE GRAY WATER GAS LINE

PLUMBING NOTES

- THE PLUMBING SYSTEM IS DESIGNED TO MEET THE BUILDING'S DOMESTIC WATER SUPPLY, SANITARY DRAINAGE, AND STORM DRAINAGE REQUIREMENTS, AS PER PROJECT SPECIFICATIONS AND APPLICABLE CODES.
- THE SYSTEM INSTALLATION SHALL COMPLY WITH THE LATEST INTERNATIONAL PLUMBING CODE (IPC), INTERNATIONAL RESIDENTIAL CODE (IRC), AND ALL OTHER RELEVANT LOCAL, STATE, AND NATIONAL REGULATIONS.
- 3. ALL PLUMBING WORK SHALL COMPLY WITH THE LATEST EDITION OF THE INTERNATIONAL PLUMBING CODE (IPC) AND THE LOCAL PLUMBING CODE.
- 4. PLUMBING SYSTEMS SHALL BE TESTED AND INSPECTED IN ACCORDANCE WITH THE LOCAL PLUMBING CODE REQUIREMENTS.
- 5. PLUMBING FIXTURES SHALL BE INSTALLED WITH THE APPROPRIATE TRIM, FITTINGS, AND ACCESSORIES, AS RECOMMENDED BY THE MANUFACTURER.
- 6. PIPING SHALL BE PROPERLY SUPPORTED AND SECURED TO PREVENT SAGGING,
- MOVEMENT, AND VIBRATION.

 7. SHUT-OFF VALVES SHALL BE PROVIDED AT ALL BRANCH CONNECTIONS AND AT THE
- INLET AND OUTLET OF EACH PIECE OF EQUIPMENT.

 8. BACKFLOW PREVENTION DEVICES SHALL BE INSTALLED AS REQUIRED BY THE LOCAL
- PLUMBING CODE TO PROTECT THE POTABLE WATER SYSTEM.

 PLUMBING FIXTURES AND FOLUPMENT SHALL BE ACCESSIBLE FOR MAINTENANCE AND
- 9. PLUMBING FIXTURES AND EQUIPMENT SHALL BE ACCESSIBLE FOR MAINTENANCE AND SERVICING.
- 10. EXPOSED PLUMBING PIPING AND FIXTURES SHALL BE INSULATED TO PREVENT CONDENSATION AND ENERGY LOSS.
- 11. DEAD ENDS IN THE DRAINAGE SYSTEM MUST BE AVOIDED, EXCEPT WHERE NECESSARY TO INSTALL A CLEANOUT IN AN ACCESSIBLE LOCATION, AND MUST HAVE A VENTED CONNECTION TO THE OUTSIDE ATMOSPHERE.
- 12. THE VERTICAL DEFLECTION OF PVC PIPE MUST NOT EXCEED 5%, AND NO DEFLECTION IS PERMITTED FOR IRON PIPE.
- 13. WORK MUST BE PROPERLY COORDINATED WITH OTHER TRADES TO AVOID CONFLICTS, REFERRING TO THE ARCHITECTURAL AND STRUCTURAL DRAWINGS FOR INFORMATION REGARDING CEILING ELEVATIONS, SPACE CLEARANCES, WALL AND PARTITION LOCATIONS, ETC.
- 14. ALL FIXTURES SHALL HAVE ACCESSIBLE STOPS.
- 15. DOMESTIC WATER PIPING SHALL BE PEX, AND PVC PIPING IS NOT ACCEPTABLE FOR INTERIOR USE.
- 16. VENT TERMINATIONS SHALL BE LOCATED AT LEAST 10 FEET FROM OR 3 FEET ABOVE ANY OPERABLE WINDOW, DOOR OPENING, AIR INTAKE, OR VENT SHAFT, AND AT LEAST 3 FEET IN EVERY DIRECTION FROM ANY LOT LINE, ALLEY, OR STREET.
- 17. PIPE AND FITTINGS UTILIZED IN THE WATER SUPPLY SYSTEM SHALL HAVE A MAXIMUM OF 8 PERCENT LEAD.
- 18. ACRYLONITRILE BUTADIENE STYRENE (ABS) SHALL BE USED FOR THE SEWERAGE AND
- VENTILATION SYSTEM.

 19. CROSS-LINKED POLYETHYLENE (PEX) SHALL BE USED FOR THE WATER SUPPLY SYSTEM.
- 20. POLYVINYL CHLORIDE (PVC) SHALL BE USED FOR THE WATER SUPPL 20. POLYVINYL CHLORIDE (PVC) SHALL BE USED FOR THE RAIN WATER SYSTEM.
- 20. POLYVINYL CHLORIDE (PVC) SHALL BE USED FOR THE RAIN WATER SYSTEM.
 21. THE MIMIMUM WATER SUPPLY DEPTH UNDER FLOOR FINISH SHOUD BE 1/2".
- 22. ANY PIPE INSTALLED UNDERGROUND MUST HAVE AT LEAST 12 INCHES OF CLEARANCE BETWEEN THE OUTSIDE OF THE PIPE AND ANY OTHER UNDERGROUND STRUCTURE.
- 23. THE MINIMUM CLEARANCE BETWEEN COLD AND HOT WATER LINES IN RESIDENTIAL HOMES MAINTAIN A MINIMUM DISTANCE OF 6 INCHES.
- 24. HORIZONTAL SEPARATION BETWEEN WATER AND SEWER LINES: A MINIMUM OF 12
- INCHES BETWEEN POTABLE WATER SUPPLY LINES (COLD AND HOT WATER) AND SANITARY SEWER LINES.

ABBREVIATIONS

Ø DIAMETER ABS ACRYLONITRILE BUTADIENE STYRENE ABV ABOVE AD AREA DRAIN AFF ABOVE FINISHED FLOOR ALT ALTERNATE BFF BELOW FINISHED FLOOR

_	
Τ	ALTERNATE
F	BELOW FINISHED FLOOR
٧	BELOW
0	CLEAN OUT
N	COLD WATER
D	DEGREE
U	DRANAGE FIXTURE UNIT
Α	DIAMETER
N	DOWN
0	FLOOR CLEAN OUT
D	FLOOR DRAIN
L	FLOOR
S	FLOOR SINK
Т	FOOT/FEET
В	HOSE BIB
N	HOT WATER
N	INCH
N	MINIMUM
_	NUMBER
S	NOT TO SCALE
X	CROSS-LINKED POLYETHYLENE
G	PLUMBING
_	POLYVINYL CHLORIDE
Y	QUANTITY
D	ROOF DRAIN
D	REDUCER
M	ROOM
N	RAIN WATER
V	SQUARE FOOT
	FWOWDUANOD:LSTBWNNOSXGCYDDM

PLUMBING LEGEND

CAP
BEND 45 DEG
BEND 90 DEG
TEE REDUCING
TEE
CLEAN TWO-WAY
WYE 45 DEG
WYE 45 DEG DOUBLE
WYE COMBINATION
P-TRAP

PIPE SCHEDULE							
MATERIAL	DIAMETER	LENGTH					
ACRYLONITRILE BUTADIENE STYRENE (ABS)	1 1/2"	92 FT					
ACRYLONITRILE BUTADIENE STYRENE (ABS)	2"	50 FT					
ACRYLONITRILE BUTADIENE STYRENE (ABS)	3"	109 FT					
CROSS-LINKED POLYETHYLENE (PEX)	1/2"	241 FT					
CROSS-LINKED POLYETHYLENE (PEX)	3/4"	58 FT					
POLYVINYL CHLORIDE - RIGID	2"	92 FT					

FITTING SCHEDULE							
FITTING SIZE QTY							
DOMESTIC COLD WATER							
PEX 90 DEG ELBOW	1/2"ø-1/2"ø	3					
PEX 90 DEGREE ELBOW	1/2"ø-1/2"ø	23					
PEX 90 DEGREE ELBOW	3/4"ø-3/4"ø	3					
PEX CROSS ELBOW	1/2"ø-1/2"ø-1/2"ø	1					
PEX TEE ELBOW	1/2"ø-1/2"ø-1/2"ø	7					
PEX TEE ELBOW	3/4"ø-3/4"ø-3/4"ø	3					
PEX TRANSITION ELBOW	1"ø-3/4"ø	2					
PEX TRANSITION ELBOW	3/4"ø-1/2"ø	2					
DOMESTIC HOT WATER							
PEX 90 DEG ELBOW	1/2"ø-1/2"ø	1					
PEX 90 DEGREE ELBOW	1/2"ø-1/2"ø	21					
PEX 90 DEGREE ELBOW	3/4"ø-3/4"ø	3					
PEX CROSS ELBOW	1/2"ø-1/2"ø-1/2"ø	1					
PEX TEE ELBOW	1/2"ø-1/2"ø	5					
PEX TEE ELBOW	3/4"ø-3/4"ø	1					
PEX TRANSITION ELBOW	3/4"ø-1/2"ø	2					
PVC 90 DEG BEND ELBOW	2"ø-2"ø	33					
SEWAGE ABS 90 DEGREE BEND ELBOW	1 1/2"ø-1 1/2"ø	9					
ABS 90 DEGREE BEND ELBOW	2"ø-2"ø	<u> </u>					
ABS 90 DEGREE BEND ELBOW	3"ø-3"ø	5					
ABS P-TRAP	1 1/2"ø-1 1/2"ø						
ABS P-TRAP	2"ø-2"ø						
ABS REDUCER ELBOW	3"ø-1 1/2"ø	1					
ABS TEE ELBOW	1 1/2"ø-1 1/2"ø	2					
ABS TEE ELBOW	2"ø-2"ø	2					
ABS TEE ELBOW	3"ø-3"ø	3					
ABS TEE REDUCER ELBOW	2"ø-1 1/2"ø-2"ø	 1					
ABS TEE REDUCER ELBOW	3"ø-3"ø-1 1/2"ø	2					
ABS TEE REDUCER ELBOW	3"ø-3"ø-2"ø	2					
ABS TEE REDUCER ELBOW	3"ø-3"ø-3"ø	1					
ABS TRAP P	2"ø-2"ø	1					
WASTE DOUBLE TEE	1 1/2"ø-1 1/2"ø-1 1/2"ø	2					
VENT							
ABS VENT CAP ELBOW	1 1/2"ø	3					
ABS VENT CAP ELBOW	2"ø	2					
ABS VENT CAP ELBOW	3"ø	2					
		_					

FIXTURE CONNECTION SCHEDULE

W V TRAP CW HW QTY DFU TOT. WFU TOT.

FAMILY

NOTES

DISHWASHER	2"	1-1/2"	1-1/2"	1/2"	1/2"	1	0	DRAIN TO SEWER SEE PLANS
DRYER	N/A	N/A	N/A	N/A	N/A	1	0	
SHOWER TRAY	2"	1-1/2"	1-1/2"	1/2"	1/2"	2	0	
SHOWER TRIM	-	-	-	1/2"	1/2"	2	0	
SINK ISLAND SINGLE	2"	1-1/2"	1-1/2"	1/2"	1/2"	1	0	
VANITY SINK	2"	1-1/2"	1-1/2"	1/2"	1/2"	4	0	
WASHER	2"	1-1/2"	2"	1/2"	1/2"	1	0	DRAINS TO GRAY WATER OR SEWER SEE PLANS
WATER CLOSET	3"	2"	3"	1/2"	1/2"	2	0	
WATER HEATER	N/A	N/A	N/A	3/4"	3/4"	1	0	

FIXTURE SCHEDULE						
FIXTURE	QTY	DESCRIPTION				
DISHWASHER	1	DRAIN TO SEWER SEE PLANS				
DRYER	1					
SHOWER TRAY	2					
SHOWER TRIM	2					
SINK ISLAND SINGLE	1					
VANITY SINK	4					
WASHER	1	DRAINS TO GRAY WATER OR SEWER SEE PLANS				
WATER CLOSET	2					
WATER HEATER	1					

ACCESSORIES & FITTINGS SCHEDULE							
FIXTURE QTY DESCRIPTIONS							
DISHWASHER CONNECTOR	1						
HANGING PIPES CLAMP	22						
HOSE BIB	1						
LAUNDRY SWEAT CONNECTOR1	1						
SHUTOFF VALVE	12						

	PLUMBING SCHEDULE								
I LOMBING COLLEGE									
FIXTURE	TRAP	WASTE	VENT	C.W	H.W				
DISHWASHER	1-1/2"	2"	1-1/2"	1/2"	1/2"				
DRYER	N/A	N/A	N/A	N/A	N/A				
HANGING PIPES CLAMP									
SHOWER TRAY	1-1/2"	2"	1-1/2"	1/2"	1/2"				
SHOWER TRIM	-	-	-	1/2"	1/2"				
SINK ISLAND SINGLE	1-1/2"	2"	1-1/2"	1/2"	1/2"				
VANITY SINK	1-1/2"	2"	1-1/2"	1/2"	1/2"				
WASHER	2"	2"	1-1/2"	1/2"	1/2"				
WATER CLOSET	3"	3"	2"	1/2"	1/2"				
WATER HEATER	N/A	N/A	N/A	3/4"	3/4"				

WATER FIXTURE UNIT SCHEDULE								
FAMILY QTY UNIT VALUE TOTAL								
DISHWASHER	1		0					
DRYER	1		0					
SHOWER TRAY	2		0					
SHOWER TRIM	2		0					
SINK ISLAND SINGLE	1		0					
VANITY SINK	4		0					
WASHER	1		0					
WATER CLOSET	2		0					
WATER HEATER	1		0					

WASTE FIXTURE UNIT SCHEDULE								
FAMILY	QTY	DFU VALUES	TOTAL					
DISHWASHER	1		0					
DRYER	1		0					
SHOWER TRAY	2		0					
SHOWER TRIM	2		0					
SINK ISLAND SINGLE	1		0					
VANITY SINK	4		0					
WASHER	1		0					
WATER CLOSET	2		0					
WATER HEATER	1		0					



KEY PLAN

IO. DESCRIPTION DATE

NOTE:

LEGEND:

PROJECT

245-EMBER-1396 3Bd2Ba-MODERN-550

DRAWING NAME

NOTE AND SCHEDULE

CLIENT NAME:

 PROJECT NUMBER:
 0131_15

 DATE:
 5/5/2025 2:29:16 PM

 DESIGNED BY:
 Designer

 DRAWN BY:
 Author

 CHECKED BY:
 Checker

P101

SCALE: 1/2" = 1'-0"


V VENT

W WASTE

VTR VENT THROUGH ROOF


WSFU WATER SUPPLY FIXTURE UNIT

WCO WALL CLEAN OUT

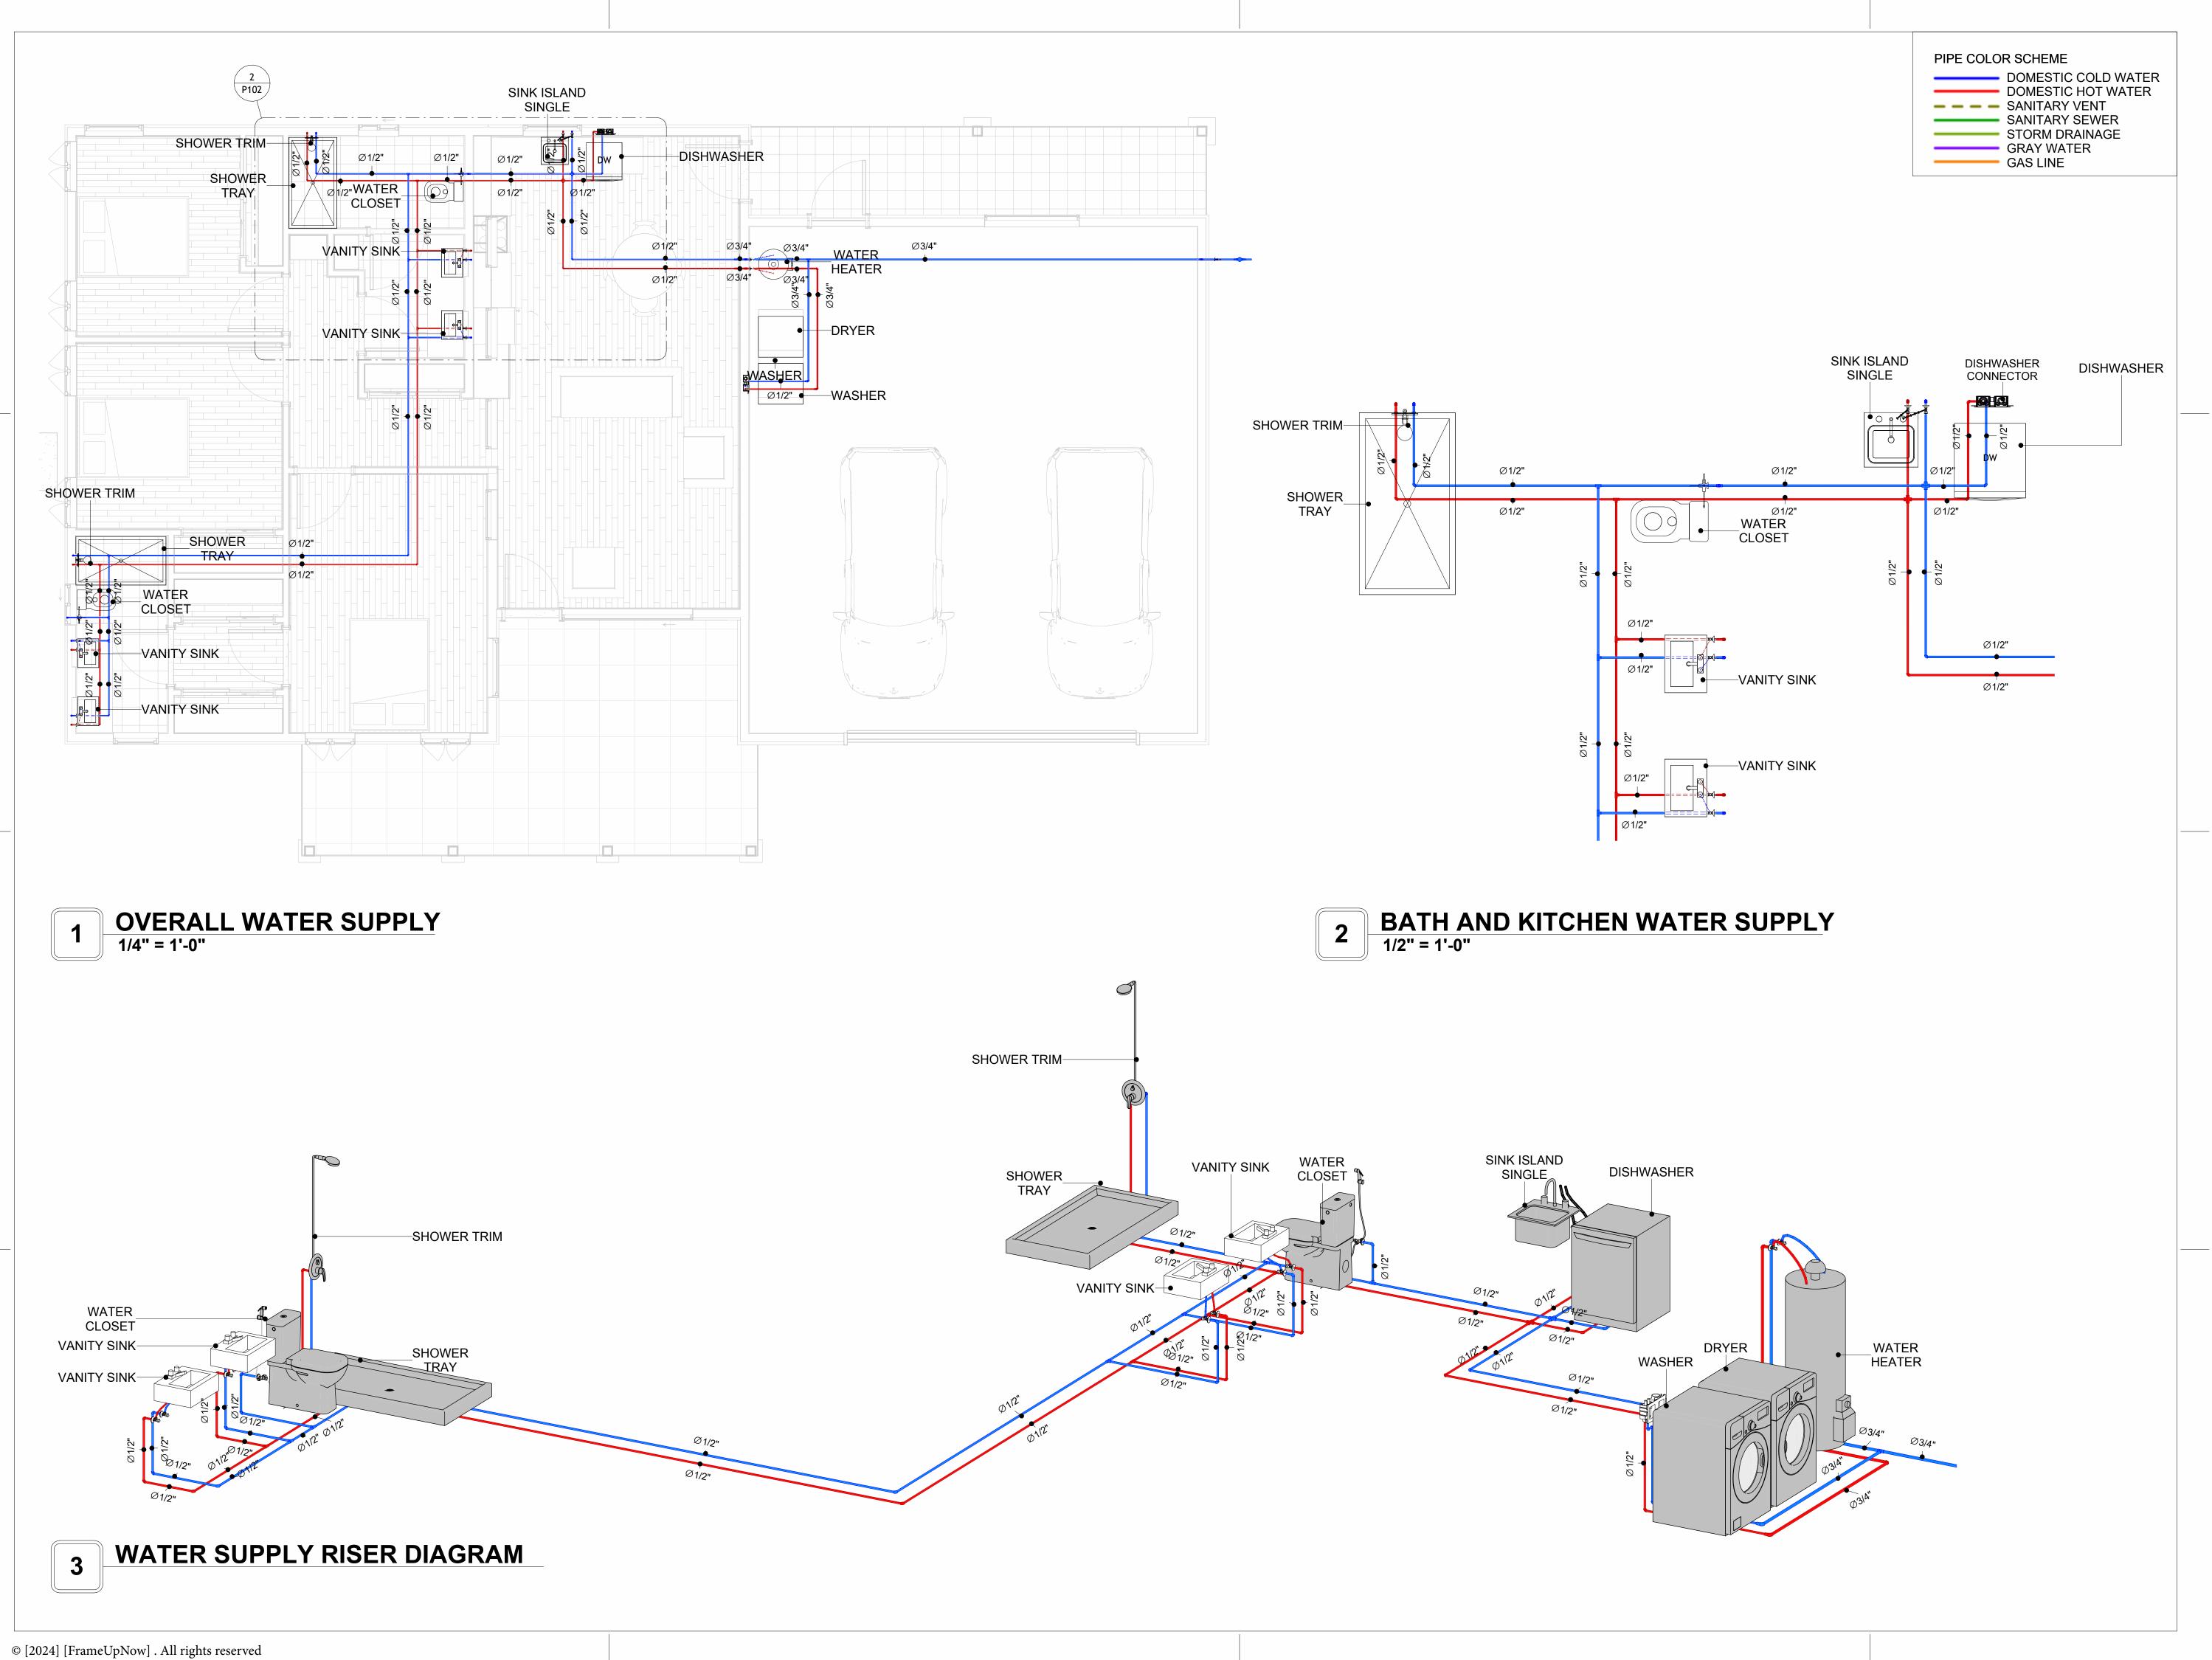



KEY PLAN

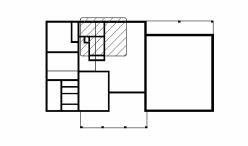

NO.	DESCRIPTION	DATE
•		

NOTE:

LEGEND:

PROJECT

245-EMBER-1396 3Bd2Ba-MODERN-550

DRAWING NAME

WATER SUPPLY

NT NAME:	
JECT NUMBER:	0131_15
E:	5/5/2025 2:29:45 PM
IGNED BY:	Designer
WN BY:	Author
CKED BY:	Checker

P102

Materials Shopping List

Please print and take this Materials Shopping List to your favorite Home Depot and ask for assistance in selecting the materials, fixtures and fittings to complete your new home.

Record your selection and the price of the item. Then do the math to determine the cost for your selections and the total cost of finishing your home.

Have It Your Way!

The material types listed in this document were selected based on personal preferences. The Customer is encouraged to make changes to the material types in accordance with local customs, regulations, and personal preferences.

Have It Your Way!



20 good reasons to frame a home with metal and not wood



Why build your ADU with metal vs wood	Wood	Metal	Explanation
1 DIY Construction Benefit		Y	The wall frames, trusses and beams can be erected in a just a few days
2 Minimal Construction Skills Required		Y	Pre-assembled walls and trusses require no specialized skills to errect
Build as DIY, Hybrid or by a General Contractor		\checkmark	Do it yourself, Hybrid (involve special contractors) or hire a General Contractor
4 Build It As You Can Afford It		\checkmark	Impervious to Weather - build as you have the time and money
5 Up Front Cost of Framing Materials	✓		As to only the framing material, wood is less expensive
6 Total Cost To Build		Y	Savings in time, labor, and other areas make light gauge steel LESS expensive
7 Termites and wood boring insects		Y	Termites, carpenter ants and wood boring insects eat wood, not metal
8 Mold resistant		Y	Metal does not attract mold
9 Damage caused by exterior and interior flooding		Y	Metal needs no reconditioning after a flood
10 Fire Resistant		Y	Non-combustible
11 Lower insurance rates		Y	Many insurance underwriters now provide lower rates for metal framed homes
12 Walls, trusses, and beams retain their original form		Y	Perfectly straight walls - no shimming of drywall
13 Corners are 90 degrees		\checkmark	No need for templating of countertops to adjust for out of square corners
14 Strength and weight		Y	Metal is stronger than wood and weighs less - no need for crane to lift ADU trusses
15 IBC Engineered Stamp		Y	If an engineering stamp is necessary, months of waiting are saved
16 Complete BOM (Materials Shopping List)		Y	Take the materials shopping list to Home Depot and start shopping/pricing
17 Flexible in Seismic Areas - Won't Fracture		Y	Light gauge steel is flexible and won't fracture when the earth moves
18 No Waste At Job Site		Y	Steel is the most recycled material in the world. A typical wood home has $20\text{-}30\%$ waste
19 Environmentally Friendly		Y	Trees don't have to be destroyed and the source of most metal is from recycling
20 How-To Videos Included		Y	How-to videos provide simple assembly instructions
21 Relationship Counselor		V	Eliminate emotional uphevels - save time, money, and preserve the relationship

Universal Requirements - some or all may be required

- 1 Site plan
- 2 Electrical Supply Connection
- 3 Sewer Connection
- 4 Fresh Water Supply Connection
- 5 Set Backs
- 6 Soils Evaluation

- 7 Earthquake (fault) evaluation
- 8 Foundation Plan subject to soils
- 9 Compliance with local energy codes: insulation home wrap and flashing
- 10 Engineering for wind speed and snow load.
- 11 State and Local ordinances regarding ADUs
- 12 Local Architect and/or Engineer may be necessary





Ember-3Bd2Ba-Modern MATERIAL SHOPPING LIST

Have It Your Way!

The material types listed in this document were selected based on personal preferences. The Customer is encouraged to make changes to the material types in accordance with local customs, regulations, and personal preferences. Have It Your Way!

TOC



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	3 ELECTRICAL BOM	ELECTRICAL BOM	3						
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	4 PLUMBING BOM	PLUMBING BOM	10						
	6 ARCHITECTURAL BOM	ARCHITECTURAL BOM	15						

Table Of Content

Have It Your Way!

The material types listed in this document were selected based on personal preferences. The Customer is encouraged to make changes to the material types in accordance with local customs, regulations, and personal preferences. Have It Your Way!

GENERAL NOTES

- 1 This BOM (Bill of Materials) is prepared as a Materials Shopping List to help builders and DIYers gain a complete understanding of most if not all elements required for the complete construction of this structure, according to the original design documents provided by FrameUpNow.
- 2 All quantities and specifications are subject to change based on the final design, field measurements, availability of products and customer preferences. The customer should verify all information prior to purchasing materials.
- 3 All products and elements in the list shall conform to the International Residential Code (IRC), or any other local and international building codes, safety regulations, and standards that are applicable to the location of the structure.
- 4 If any changes are made by the customer to the list of materials specified in this document, the customer is responsible for assuring that the correct type and quantity of materials are utilized in accordance with local building codes
- 5 FrameUpNow, will not be held responsible for any misuse of this document, the products listed, or for deviations from the content that are made due to changes in specifications, pricing, availability, or customer preferences.
- 6 The customer is advised to consult a qualified professional or technician prior to purchasing materials for specialized construction system items. Some items including but not limited to caseworks, doors and windows may require as built measurements prior to purchase to confirmation of final dimensions.
- 7 If there are additional trim elements or specific installation methods, the total amount of materials needed might vary. Consider any additional trim required for corners, intersections, or other architectural details that might cause this variations before proceeding to purchase and construction.

ARCHITECTURAL BOM



	Ember-3Bd2Ba-Modern							
		ARCHITECTI						
No.	Item	Туре	Unit	Quantity	Unit Price	Total	Description	
	APPLIANCES							
1	Refrigerator		PCS	1				
2	Range		PCS	1				
3	Washer		PCS	1				
4	Dryer		PCS	1				
5	Dish Washer		PCS	1				
6	Oven		PCS	0				
7	Microwave		PCS	0				
	CASEWORKS							
1	Kitchen Cabinet		FT	21.75				
2	Laundry Cabinet		FT	0				
3	Vanity Cabinet		FT	12.71				
4	Medicine Cabinet		PCS	4				
5	Kitchen countertop		SF	30.46				
6	Laundry Countertop		PCS	0				
7	Bathroom Countertop		SF	0				
8	Island		FT	0				
9	Peninsula		FT	0				
10	Closets		SF	194.72				
<u></u>	CEILING	Dm. Wall	C.F.	4/00				
1	Ceiling Board	Dry Wall	SF	1639				
2	Dry Wall Fastener	Screw	PCS	2868				
3	Vapor Retarder	Polyethylene film	SF	2128				
4	Vapor Retarder Fastener	Nails with washer heads	PCS	6384				
5	Ceiling Board (MRD)	Moisture resistant drywall	SF	150				
6	MRD Fastener		PCS	263				
7	Ceiling Board	Marine Plywood	SF	339				
8	Marine Plywood Fastener	Screw	PCS	593				
	Dry Wall Tape		FT	1064				
<u></u>	FLOORING							
1	Main Living Space		SF	454.32				
2	Bathroom		SF	147.07				
3	Bedroom		SF	463.06				
4	Garage		SF	695.88				
5	Porch		SF	374.86				
<u></u>	STRUCTURE	1	lo-	005150				
1	Foundation		SF	2254.53				
_	WALLS EXTERIOR	1	CE	1100				
1	Exterior Wall Siding		SF	1198				
2	Wall Paint		SF	1198				
3	Wall Shteathing (OSB)	0.15.1311	SF	1198				
4	Shteathing Fastener	Self-drilling screws(100/pkt)	PKT	12				
5	Wall Insulation		SF	6825				
6	Wall Homewrap	0. 1.15 1. (0.01.13)	SF	1198				
7	Home wrap Fastener	Stapled fastener (200/pkt)	PKT	5				
8	Furring Strip	0.15.1311	PCS	150				
9	Furring Strip Fastener	Self-drilling screws(100/pkt)	PKT	11.98				
	Stone Copping	Masonry stone	SF	0				
	Stone Veneer	Masonry stone	SF	717				
<u></u>	WALLS INTERIOR		lor.	040				
1	Cementitious Backer Board		SF	818				
2	Kerdi membrane		SF	818				
3	Kerdi membrane Fastener		SF	818				
4	Wall Ceramic Tile		SF	818				
5	Drywall Board		SF	3814				
	Drywall Fastener	Self-drilling screws(100/pkt)	PKT	38.14				
7	Wall Paint		SF	3814				
8	Drywall Tape		FT	3814				
9	Wall Skerting		FT	255				

ARCHITECTURAL BOM



	DOORS				
	Exterior Swinging	3' - 0" X 6'-8"	PCS	3	
	Interior Swinging	3' - 0" X 6'-8"	PCS	7	
3	Interior Sliding	5' - 0" X 6'-8"	PCS	4	
4	Interior Sliding	6' - 0" X 6'-8"	PCS	1	
5	Garage Door	16' - 1" X 6'-6"	PCS	1	
6	Exterior Door Trim		FT	109	
7	Interior Door Trim		FT	624	
8	Entry Lock set		PCS	5	
9	Privacy Lock set		PCS	10	
10	Passage Lock set		PCS	7	
Δ	WINDOWS				·
1	Sliding	5' - 3" X 3'-3"	PCS	1	
2	Single Hung	3' - 3" X 3'-3"	PCS	3	
3	Casement	2' - 9" X 3'-9"	PCS	6	
4	Single Hung	2' - 6" X 3'-3"	PCS	1	
5	Sliding	2' - 3" X 2'-3"	PCS	2	
6	Fixed	5' - 3" X 3'-3"	PCS	1	
7	Fixed	7' - 3" X 1'-9"	PCS	1	
8	Fixed	2' - 9" X 1'-3"	PCS	4	
9	Exterior Window Trim		FT	259	
_	Interior Window Trim		FT	259	
	ROOF				
1	Roof Covering		SF	2175.0	
2	Roof Covering Fastener		PCS	1088	
3	Roof Felt Paper		SF	2175.0	
4	Roof Felt Paper Fastener		PCS	6525.0	
5	Roof Sheathing		SF	2175	
6	Roof Sheathing Fastener		PCS	17400	
7	Batten		FT	1321.0	
8	Batten Fastener		PCS	993.2	
9	Soffit		SF	92.0	
10	Soffit Fastener		PCS	46.0	
	Fascia		FT	300.0	
	Fascia board fastener		PCS	150	
13_	Roof Insulation		SF	2175.0	



	Ember-3Bd2Ba-Modern								
	ELECTRICAL MATERIAL SHOPPING LIST								
No.	Item	Type	Unit		Unit Price	Total	Description		
Δ	LIGHTING FIXTURES	· · · · · · · · · · · · · · · · · · ·							
1	Kitchen Ceiling Light		PCS	4					
2	Kitchen Wall Mounted Light		PCS	0					
3	Exterior Wall Mounted Light		PCS	5					
4	Livingroom Ceiling Light With Fan		PCS	0					
5	Bedroom Ceiling Light With Fan		PCS	3					
6	Dining Ceiling Light		PCS	0					
7	Bath Wall Mounted Light		PCS	4					
8	Bathroom Ceiling Light		PCS	5					
	Livingroom Ceiling Light		PCS	4					
	Bedroom Ceiling Light		PCS	12					
	Hall & Entry Ceiling Light		PCS	3					
	Closet Ceiling Light		PCS	1					
	Out Door Ceiling Light		PCS	9					
	Garage Ceiling Light		PCS	3					
	Smoke Detector		PCS	4					
	ELECTRICAL FITTINGS								
_	Standard Receptacle 120V	20A	PCS	23					
	GFCI Receptacle 120V	20 A	PCS	25					
	GFCI Receptacle 240V	30 A	PCS	3					
19	GFCI Receptacle 240V	50 A	PCS	1					
20	GFCI Receptacle 240V	60 A	PCS	1					
	Fan Switch	00 A	PCS	5					
	Single Pole Switch		PCS	19					
	Three Way Switch		PCS	2					
	Dimmer Switch		PCS	0					
24			PU3	0					
<u>□</u>	ROMEX 14 AWG	1.4/2/\4/======	FT	0		1			
	ROMEX 14 AWG	14/3/W/ground	FT	-					
	ROMEX 12 AWG	12/2/W/ground	FT	948					
		10/3/W/ground	FT	65					
	Romex 8 AWG	8/3/W/ground		26					
	ROMEX 6 AWG	6/3/W/ground	FT	62					
	Bare Copper Ground Wire 6 AWG		FT	0					
	ELECTRICAL BOXES & CIRCUTES	000 1115	Doc						
	Panelboard -240V 1 Phase MLO	200 AMP	PCS	1					
	Circuit breaker	15 A	PCS	0					
	Circuit breaker	20 A	PCS	19					
	Circuit breaker	30 A	PCS	3					
	Circuit breaker	50 A	PCS	1					
	Circuit breaker	60 A	PCS	1					
	Single Gang Switch Box		PCS	8					
	Double Gang Switch Box		PCS	4					
	Triple Gang Switch Box		PCS	4					
	Pull Box	#1/4	PCS	49					
41	Receptacle Box		PCS	53					

PLUMBING BOM

27 WASTE DOUBLE TEE



Ember-3Bd2Ba-Modern PLUMBING SYSTEM MATERIAL SHOPPING LIST Item Unit Quantity Unit Price Total Description 1 Bath Tub (Alcove Tub) PCS 2 Kitchen Sink PCS 1 3 Kitchen Faucets PCS 4 Vanity Sink PCS 2 5 Bath room Faucets PCS 6 Water Closet PCS 7 Shower Trim PCS 8 Shower Tray PCS 9 Water Heater PCS 10 Hose Bib PCS 2 11 Shutoff Valve PCS 12 12 Hanging pipe clamp PCS 22 13 Globe Valve PCS 14 Dishwasher Supply Single Connector PCS 1 15 Dishwasher Sewage Single Connector PCS 16 Laundry Sweat Connector PCS 1 △ SANITARY & PLUMBING PIPE 1 ABS (Acrylonitrile Butadiene Styrene) Pipes 2 ABS (Acrylonitrile Butadiene Styrene) Pipes ø 1/2" FT 0 ø 1 1/2 FT 20 3 ABS (Acrylonitrile Butadiene Styrene) Pipes ø 2" FT 47 4 ABS (Acrylonitrile Butadiene Styrene) Pipes ø 3" FT 6 5 PEX (Cross-linked polyethylene) Pipes ø 1/2' FT 91 6 PEX (Cross-linked polyethylene) Pipes ø 3/4" FT 42 7 Polyvinyl Chloride - Rigid 1 1/2" FT 15 8 Polyvinyl Chloride - Rigid 2" FT 59 ☐ PIPE FITTINGS1 ABS 90 Degree Bend Elbow 1 1/2"ø-1 1/2"ø PCS 2 ABS 90 Degree Bend Elbow PCS 2"ø-2"ø 3 ABS 90 Degree Bend Elbow 3"ø-3"ø PCS 5 4 ABS P-Trap 1 1/2"ø-1 1/2"ø PCS 5 ABS P-Trap 2"ø-2"ø PCS 1 6 ABS Reducer Elbow 3"ø-1 1/2"ø PCS 7 ABS TEE Elbow 1 1/2"ø-1 1/2"ø-1 1/2"ø PCS 2 8 ABS TEE Elbow 2"ø-2"ø-2"ø PCS 9 ABS TEE Elbow 3"ø-3"ø-3"ø PCS 10 ABS Tee Reducer Elbow 2"ø-1 1/2"ø-2"ø PCS 11 ABS Tee Reducer Elbow 3"ø-3"ø-1 1/2"ø PCS 2 12 ABS Tee Reducer Elbow 3"ø-3"ø-2"ø PCS 13 ABS Tee Reducer Elbow 3"ø-3"ø-3"ø PCS 14 ABS Trap P 2"ø-2"ø PCS 15 ABS Vent Cap Elbow 1 1/2"ø **PCS** 3 16 ABS Vent Cap Elbow PCS 2"ø 17 ABS Vent Cap Elbow PCS 3"a 2 18 PEX 90 Deg Elbow 1/2"ø-1/2"ø PCS 19 PEX 90 Degree Elbow 1/2"ø-1/2"ø PCS 44 20 PEX 90 Degree Elbow 3/4"ø-3/4"ø PCS 6 21 PEX Cross Elbow 1/2"ø-1/2"ø-1/2"ø PCS 22 PEX Tee Elbow 1/2"ø-1/2"ø-1/2"ø PCS 12 23 PEX Tee Elbow 3/4"ø-3/4"ø-3/4"ø PCS 4 24 PEX Transition Elbow 1"ø-3/4"ø PCS 25 PEX Transition Elbow 3/4"ø-1/2"ø PCS 4 26 PVC 90 Deg Bend Elbow PCS 33 2"ø-2"ø

1 1/2"ø-1 1/2"ø-1 1/2"ø-1

PCS

2

	Ember-3Bd2Ba-Modern								
	HVAC SYSTEM MATERIAL SHOPPING LIST								
No.	Item	Туре	Unit	Quantity	Unit Price	Total	Description		
	HVAC_DUCTS								
1	PIPE (REFRIGERANT LINE)	3/8" (Ø)		FT	92.6				
2	PIPE (REFRIGERANT LINE)	3/4''' (Ø)		FT	179.3				
3	DRAYER HOSE	4" (Ø)		FT	11.8				
4	FLEX DUCT ROUND	4" (Ø)		FT	8.18				
	DUCT FITTINGS & ACCESSORIES								
5	ELBOW (REFRIGERANT LINE)	3/4" (Ø)-3/4" (Ø)		PCS	43				
6	ELBOW (REFRIGERANT LINE)	3/8" (Ø)-3/8" (Ø)		PCS	32				
7	TEE (REFRIGERANT LINE)	3/4" (Ø)-3/4" (Ø)-3/4" (Ø)		PCS	3				
8	TEE (REFRIGERANT LINE)	3/8" (Ø)-3/8" (Ø)-3/8" (Ø)		PCS	3				
9	TRANSITION (REFRIGERANT	3/4" (Ø)-1/2" (Ø)		PCS	5				
10	TRANSITION (REFRIGERANT	3/4" (Ø)-5/8" (Ø)		PCS	4				
11	TRANSITION (REFRIGERANT	3/8" (Ø)-1/4" (Ø)		PCS	1				
	HVAC_EQUIPMENTS								
12	AIR HANDLING UNIT	WALL MOUNTED		PCS	4				
13	CONDENSER	OUTDOOR UNIT		PCS	1				
14	EXHAUST FAN	75 CFM		PCS	2				
15	EXHAUST HOOD	WALL MOUNTED		PCS	1				
16	HOOD-WALL: VENT	HOOD-WALL: VENT		PCS	1				
17	DRAYER: VENT	DRAYER: VENT		PCS	1				
18	ROOF VENT	3"(Ø)		PCS	2				



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Have It Your Way!

The material types listed in this document were selected based on personal preferences. The Customer is encouraged to make changes to the material types in accordance with local customs, regulations, and personal preferences. Have It Your Way!

GENERAL NOTES

- This BOM (Bill of Materials) is prepared as a Materials Shopping List to help builders and DIYers gain a complete understanding of most if not all elements required for the complete construction of this structure, according to the original design documents provided by FrameUpNow.
- 2 All quantities and specifications are subject to change based on the final design, field measurements, availability of products and customer preferences. The customer should verify all information prior to purchasing materials.
- 3 All products and elements in the list shall conform to the International Residential Code (IRC), or any other local and international building codes, safety regulations, and standards that are applicable to the location of the structure.
- 4 If any changes are made by the customer to the list of materials specified in this document, the customer is responsible for assuring that the correct type and quantity of materials are utilized in accordance with local building codes.
- 5 FrameUpNow, will not be held responsible for any misuse of this document, the products listed, or for deviations from the content that are made due to changes in specifications, pricing, availability, or customer preferences.
- The customer is advised to consult a qualified professional or technician prior to purchasing materials for specialized construction system items. Some items including but not limited to caseworks, doors and windows may require as built measurements prior to purchase to confirmation of final dimensions.
- 7 If there are additional trim elements or specific installation methods, the total amount of materials needed might vary. Consider any additional trim required for corners, intersections, or other architectural details that might cause this variations before procedding to purchase and construction.



			LIGHTING FIXTURES				
#	Item	Туре	Description, Manufacturer, SKU	Unit	Quantity	Unit Price	Total
1	Kitchen Ceiling Light			PCS	4		
3	Kitchen Wall Mounted Light			PCS	0		
4	Exterior Wall Mounted Light			PCS	5		
5	Livingroom Ceiling Light With Fan			PCS	0		
6	Bedroom Ceiling Light With Fan			PCS	3		
7	Dining Ceiling Light			PCS	0		
8	Bath Wall Mounted Light			PCS	4		
9	Bathroom Ceiling Light			PCS	5		
10	Livingroom Ceiling Light			PCS	4		
11	Bedroom Ceiling Light			PCS	12		
12	Hall & Entry Ceiling Light			PCS	3		
12	Closet Ceiling Light			PCS	1		
13	Out Door Ceiling Light			PCS	9		
14	Garage Ceiling Light			PCS	3		
15	Smoke Detector			PCS	4		



			ELECTRICAL FITTINGS				
#	Item	Туре	Description, Manufacturer, SKU	Unit	Quantity	Unit Price	Total
1	Standard Receptacle 120V	20A		PCS	23		
2	GFCI Receptacle 120V	20 A		PCS	25		
3	GFCI Receptacle 240V	30 A		PCS	3		
1	GFCI Receptacle 240V	50 A		PCS	1		
5	GFCI Receptacle 240V	60 A		PCS	1		
5	Fan Switch			PCS	5		
7	Single Pole Switch			PCS	19		
3	Three Way Switch			PCS	2		
)	Dimmer Switch			PCS	0		
LO		'		,			
11							
L2							
L3							
14							
15							



		ELECTR	ICAL CONDUITS & WIRING				
#	Item	Туре	Description, Manufacturer, SKU	Unit	Quantity	Unit Price	Total
1	ROMEX 14 AWG	14/3/W/ground		FT	0		
3	ROMEX 12 AWG	12/2/W/ground		FT	948		
1	ROMEX 10 AWG	10/3/W/ground		FT	65		
5	Romex 8 AWG	8/3/W/ground		FT	26		
8	ROMEX 6 AWG	6/3/W/ground		FT	62		
9	Bare Copper Ground Wire 6 AWG			FT			
10							
11							
12							
13							
14							
15							
16							



		ELEC	CTRICAL BOXES & CIRCUTES				
#	Item	Туре	Description, Manufacturer, SKU	Unit	Quantity	Unit Price	Total
L	Panelboard -240V 1 Phase MLO	200 AMP		PCS	1		
	Circuit breaker	15 A		PCS	0		
	Circuit breaker	20 A		PCS	19		
	Circuit breaker	30 A		PCS	3		
	Circuit breaker	50 A		PCS	1		
i	Circuit breaker	60 A		PCS	1		
,	Single Gang Switch Box			PCS	8		
	Double Gang Switch Box			PCS	4		
	Triple Gang Switch Box			PCS	4		
0	Pull Box	#1/4		PCS	49		
1	Receptacle Box			PCS	53		
2							
3							
4							
5							

			HVAC_DUCTS 01				
#	Item	Туре	Description, Manufacturer, SKU	Unit	Quantity	Unit Price	Total
1	PIPE (REFRIGERANT LINE)	3/8" (Ø)		FT	92.6		
2	PIPE (REFRIGERANT LINE)	3/4"' (Ø)		FT	179.3		
3	DRAYER HOSE	4" (Ø)		FT	11.8		
4	FLEX DUCT ROUND	4" (Ø)		FT	8.18		
5							
6							
7							
8							
9							
10							
11							
12							
13							
14							
15							
16							

			DUCT FITTINGS & ACCESSORIES				
#	Item	Туре	Description, Manufacturer, SKU	Unit	Quantity	Unit Price	Total
1	ELBOW (REFRIGERANT LINE)	3/4" (Ø)-3/4" (Ø)		PCS	43		
2	ELBOW (REFRIGERANT LINE)	3/8" (Ø)-3/8" (Ø)		PCS	32		
	TEE (REFRIGERANT LINE)	3/4" (Ø)-3/4" (Ø)-3/4" (Ø)		PCS	3		
	TEE (REFRIGERANT LINE)	3/8" (Ø)-3/8" (Ø)-3/8" (Ø)		PCS	3		
5	TRANSITION (REFRIGERANT LINE)	3/4" (Ø)-1/2" (Ø)		PCS	5		
õ	TRANSITION (REFRIGERANT LINE)	3/4" (Ø)-5/8" (Ø)		PCS	4		
7	TRANSITION (REFRIGERANT LINE)	3/8" (Ø)-1/4" (Ø)		PCS	1		
3							
9							
LO							
1							
L2							
13							
L4							
15							
16							

			HVAC_EQUIPMENTS				
#	Item	Туре	Description, Manufacturer, SKU	Unit	Quantity	Unit Price	Total
1	AIR HANDLING UNIT	WALL MOUNTED		PCS	4		
2	CONDENSER	OUTDOOR UNIT		PCS	1		
1	EXHAUST FAN	75 CFM		PCS	2		
1	EXHAUST HOOD	WALL MOUNTED		PCS	1		
5	HOOD-WALL: VENT	HOOD-WALL: VENT		PCS	1		
5	DRAYER: VENT	DRAYER: VENT		PCS	1		
7	ROOF VENT	3"(Ø)		PCS	2		
3							
9							
10							
11							
12							
13							
14							



		PLUMBIN	NG FIXTURES & ACCESSORIES				
#	Item	Туре	Description, Manufacturer, SKU	Unit	Quantity	Unit Price	Total
1	Bath Tub (Alcove Tub)			PCS	0		
2	Kitchen Sink			PCS	1		
3	Kitchen faucets			PCS	1		
4	Vanity Sink			PCS	4		
5	Bath room faucets			PCS	4		
6	Water Closet			PCS	2		
7	Shower Trim			PCS	2		
8	Shower Tray			PCS	2		
9	Water Heater			PCS	1		
10	Hose Bib			PCS	2		
11	Shutoff Valve			PCS	12		
12	Hanging pipe clamp			PCS	22		
13	Globe Valve			PCS	1		
14	Dishwasher Supply Single Connector			PCS	1		
15	Dishwasher Sewage Single Connector			PCS	1		
16	Laundry Sweat Connector			PCS	1		



		SANIT	TARY & PLUMBING PIPES				
#	Item	Туре	Description, Manufacturer, SKU	Unit	Quantity	Unit Price	Total
1	ABS (Acrylonitrile Butadiene Styrene) Pipes	ø 1"		FT	0		
2	ABS (Acrylonitrile Butadiene Styrene) Pipes	ø 1 1/2"		FT	92		
3	ABS (Acrylonitrile Butadiene Styrene) Pipes	ø 2"		FT	50		
4	ABS (Acrylonitrile Butadiene Styrene) Pipes	ø 3"		FT	109		
5	PEX (Cross-linked polyethylene) Pipes	ø 1/2"		FT	241		
6	PEX (Cross-linked polyethylene) Pipes	ø 3/4"		FT	58		
7	PEX (Cross-linked polyethylene) Pipes	ø 1"		FT	0		
8	PVC Pipes Sch.80 - Rigid	ø 1 1/2"		FT	92		
9	PVC Pipes Sch.80 - Rigid	ø 2"		FT	0		
10	PVC Pipes Sch.80 - Rigid	ø 3"		FT	0		
11	Flex Pipe Round	ø 1/2"		FT	14		
12	Flex Pipe Round	ø 3/4"		FT	0		
13	Flex Pipe Round	ø 1"		FT	0		
14							
15							



		PIPE	FITTINGS 01				
#	Item	Туре	Description, Manufacturer, SKU	Unit	Quantity	Unit Price	Total
	ABS 90 Degree Bend Elbow	1 1/2"ø-1 1/2"ø		PCS	9		
)	ABS 90 Degree Bend Elbow	2"ø-2"ø		PCS	1		
	ABS 90 Degree Bend Elbow	3"ø-3"ø		PCS	5		
	ABS P-Trap	1 1/2"ø-1 1/2"ø		PCS	7		
)	ABS P-Trap	2"ø-2"ø		PCS	1		
)	ABS Reducer Elbow	3"ø-1 1/2"ø		PCS	1		
7	ABS TEE Elbow	1 1/2"ø-1 1/2"ø-1 1/2"ø		PCS	2		
}	ABS TEE Elbow	2"ø-2"ø-2"ø		PCS	2		
)	ABS TEE Elbow	3"ø-3"ø-3"ø		PCS	3		
10	ABS Tee Reducer Elbow	2"ø-1 1/2"ø-2"ø		PCS	1		
1	ABS Tee Reducer Elbow	3"ø-3"ø-1 1/2"ø		PCS	2		
2	ABS Tee Reducer Elbow	3"ø-3"ø-2"ø		PCS	2		
3	ABS Tee Reducer Elbow	3"ø-3"ø-3"ø		PCS	1		
14	ABS Trap P	2"Ø-2"Ø		PCS	1		
15	ABS Vent Cap Elbow	1 1/2"ø		PCS	3		
		PIPE	FITTINGS 02				
#	Item	Туре	Description, Manufacturer, SKU	Unit	Quantity	Unit Price	Total
1	ABS Vent Cap Elbow	2"ø		PCS	2		



2	ABS Vent Cap Elbow	3°Ø	PCS	2	
3	PEX 90 Deg Elbow	1/2"ø-1/2"ø	PCS	4	
4	PEX 90 Degree Elbow	1/2"ø-1/2"ø	PCS	44	
5	PEX 90 Degree Elbow	3/4"ø-3/4"ø	PCS	6	
6	PEX Cross Elbow	1/2"ø-1/2"ø-1/2"ø	PCS	2	
7	PEX Tee Elbow	1/2"ø-1/2"ø	PCS	12	
8	PEX Tee Elbow	3/4"ø-3/4"ø-3/4"ø	PCS	4	
9	PEX Transition Elbow	1"ø-3/4"ø	PCS	2	
10	PEX Transition Elbow	3/4"ø-1/2"ø	PCS	4	
11	PVC 90 Deg Bend Elbow	2"Ø-2"Ø	PCS	33	
12	WASTE DOUBLE TEE	1 1/2"ø-1 1/2"ø-1 1/2"ø	PCS	2	



			APPLIANCES				
#	Item	Туре	Description, Manufacturer, SKU	Unit	Quantity	Unit Price	Total
1	Refrigerator			PCS			
2	Range			PCS			
3	Washer Front Load	Stackable		PCS			
4	Dryer Front Load	Stackable		PCS			
5	Dish Washer			PCS			
6	Oven			PCS	(
7	Microwave			PCS	(
8							
9							
10							
11							
12							
13							
14							
15							
16							



			CASEWORKS 01				
#	Item	Туре	Description, Manufacturer, SKU	Unit	Quantity	Unit Price	Total
1	Kitchen Cabinet			FT	21.75		
2	Laundry Cabinet			FT	0		
3	Vanity Cabinet			FT	12.71		
4	Medicine Cabinet			PCS	4		
5	Kitchen countertop			SF	30.46		
6	Laundry Countertop			PCS	0		
7	Bathroom Countertop			SF	0		
8	Island			FT	0		
9	Peninsula			FT	0		
10	Closets			SF	194.72		
11							
12							
13							
14							
15							



	1		CEILING 01				
Ħ	Item	Туре	Description, Manufacturer, SKU	Unit	Quantity	Unit Price	Total
	LIVING ROOM + KITCHEN			SF	382.0		
1	Ceiling Board	Drywall		SF	382		
2	Drywall Fastener	Screw		PCS	669		
3	Vapor Retarder	Polyethylene film		SF	382		
4	Vapor Retarder Fastener	Nails with washer heads		PCS	1146		
	BATH ROOM 1			SF	93.0		
5	Ceiling Board	MRD (Moisture resistant drywall)		SF	93		
5	MRD Fastener	Screw		PCS	163		
	BATH ROOM 2			SF	57.0		
7	Ceiling Board	MRD (Moisture resistant drywall)		SF	57		
8	MRD Fastener	Screw		PCS	100		
	BED ROOM 1			SF	112.0		
9	Ceiling Board	Drywall		SF	112		
10	Drywall Fastener	Screw		PCS	196		
11	Vapor Retarder	Polyethylene film		SF	112		
12	Vapor Retarder Fastener	Nails with washer heads		PCS	336		



			CEILING 02				
#	Item	Туре	Description, Manufacturer, SKU	Unit	Quantity	Unit Price	Total
	BED ROOM 2			SF	121.0		
13	Ceiling Board	Drywall		SF	121		
14	Drywall Fastener	Screw		PCS	212		
15	Vapor Retarder	Polyethylene film		SF	121		
16	Vapor Retarder Fastener	Nails with washer heads		PCS	363		
	BED ROOM 3			SF	161.0	ı	
17	Ceiling Board	Drywall		SF	161		
18	Drywall Fastener	Screw		PCS	282		
19	Vapor Retarder	Polyethylene film		SF	161		
20	Vapor Retarder Fastener	Nails with washer heads		PCS	483		
	CLOSET 1			SF	15.0		
21	Ceiling Board	Drywall		SF	15		
22	Drywall Fastener	Screw		PCS	26		
23	Vapor Retarder	Polyethylene film		SF	15		
24	Vapor Retarder Fastener	Nails with washer heads		PCS	45		



			CEILING 03				
#	Item	Туре	Description, Manufacturer, SKU	Unit	Quantity	Unit Price	Total
	CLOSET 2			SF	13.0		
25	Ceiling Board	Drywall		SF	13		
26	Drywall Fastener	Screw		PCS	23		
27	Vapor Retarder	Polyethylene film		SF	13		
28	Vapor Retarder Fastener	Nails with washer heads		PCS	39		
	CLOSET 3			SF	13.0		
29	Ceiling Board	Drywall		SF	13		
30	Drywall Fastener	Screw		PCS	23		
31	Vapor Retarder	Polyethylene film		SF	13		
32	Vapor Retarder Fastener	Nails with washer heads		PCS	39		
	CLOSET 4			SF	13.0		
33	Ceiling Board	Drywall		SF	13		
34	Drywall Fastener	Screw		PCS	23		
35	Vapor Retarder	Polyethylene film		SF	13		
36	Vapor Retarder Fastener	Nails with washer heads		PCS	39		



			CEILING 04				
#	Item	Туре	Description, Manufacturer, SKU	Unit	Quantity	Unit Price	Total
	CLOSET 5			SF	9.0		
37	Ceiling Board	Drywall		SF	9		
38	Drywall Fastener	Screw		PCS	16		
39	Vapor Retarder	Polyethylene film		SF	9		
40	Vapor Retarder Fastener	Nails with washer heads		PCS	27		
	GARAGE+WD+WH			SF	705.0		
41	Ceiling Board	Drywall		SF	705		
42	Drywall Fastener	Screw		PCS	1234		
43	Vapor Retarder	Polyethylene film		SF	705		
44	Vapor Retarder Fastener	Nails with washer heads		PCS	2115		
	FRONT PORCH			SF	224.0		
45	Ceiling Board	Marine Plywood		SF	224		
46	Exterior Grade Plywood	Screw		PCS	392		
	BACK PORCH			SF	115.0		
47	Ceiling Board	Marine Plywood		SF	115		
48	Exterior Grade Plywood	Screw		PCS	201		



			CEILING 05				
#	Item	Туре	Description, Manufacturer, SKU	Unit	Quantity	Unit Price	Total
	HALL 1			SF	72.0		
49	Ceiling Board	Drywall		SF	72		
50	Drywall Fastener	Screw		PCS	126		
51	Vapor Retarder	Polyethylene film		SF	72		
52	Vapor Retarder Fastener	Nails with washer heads		PCS	216		
	HALL 2			SF	23.0		
53	Ceiling Board	Drywall		SF	23		
54	Drywall Fastener	Screw		PCS	40		
55	Vapor Retarder	Polyethylene film		SF	23		
56	Vapor Retarder Fastener	Nails with washer heads		PCS	69		



			FLOORING INTERIOR 01				
#	Item	Туре	Description, Manufacturer, SKU	Unit	Quantity	Unit Price	Total
	CLOSET 1						
1	Closet Flooring			SF	15		
2	Wood underlay	Foam Pad Polyethylene		SF	15		
3	Vapor Retarder	Vapor Barrier Polyethylene		SF	15		
	CLOSET 2						
4	Closet Flooring			SF	13		
5	Wood underlay	Foam Pad Polyethylene		SF	13		
6	Vapor Retarder	Vapor Barrier Polyethylene		SF	13		
	CLOSET 3						
7	Closet Flooring			SF	13		
8	Wood underlay	Foam Pad Polyethylene		SF	13		
9	Vapor Retarder	Vapor Barrier Polyethylene		SF	13		
	CLOSET 4	·					
10	Closet Flooring			SF	13		
11	Wood underlay	Foam Pad Polyethylene		SF	13		
12	Vapor Retarder	Vapor Barrier Polyethylene		SF	13		



			FLOORING INTERIOR 02				
#	Item	Туре	Description, Manufacturer, SKU	Unit	Quantity	Unit Price	Total
	CLOSET 5						
13	Closet Flooring			SF	9		
14	Wood underlay	Foam Pad Polyethylene		SF	9		
15	Vapor Retarder	Vapor Barrier Polyethylene		SF	9		
	CLOSET 6	·					
16	Closet Flooring			SF	23		
17	Wood underlay	Foam Pad Polyethylene		SF	23		
18	Vapor Retarder	Vapor Barrier Polyethylene		SF	23		
	BEDROOM 1						
19	Bedroom Flooring			SF	110		
20	Wood underlay	Foam Pad Polyethylene		SF	110		
21	Vapor Retarder	Vapor Barrier Polyethylene		SF	110		
	BEDROOM 2						
22	Bedroom Flooring			SF	119		
23	Wood underlay	Foam Pad Polyethylene		SF	119		
24	Vapor Retarder	Vapor Barrier Polyethylene		SF	119		



	1		FLOORING INTERIOR 03				
#	Item	Туре	Description, Manufacturer, SKU	Unit	Quantity	Unit Price	Total
	BEDROOM 3						
25	Bedroom Flooring			SF	158		
26	Wood underlay	Foam Pad Polyethylene		SF	158		
27	Vapor Retarder	Vapor Barrier Polyethylene		SF	158		
	LIVING ROOM AND KITC	HEN					
28	Tile Finish			SF	445		
29	Adhesive	1/2" Thin set Mortar		SF	445		
30	Vapor Retarder	Vapor Barrier Polyethylene		SF	445		
	BATHROOM 1	·					
31	Tile Finish			SF	55		
32	Adhesive	1/2" Thin set Mortar		SF	55		
33	Vapor Retarder	Vapor Barrier Polyethylene		SF	55		
	BATHROOM 2	·					
34	Tile Finish			SF	42		
35	Adhesive	1/2" Thin set Mortar		SF	42		
36	Vapor Retarder	Vapor Barrier Polyethylene		SF	42		



			FLOORING INTERIOR 04				
#	Item	Туре	Description, Manufacturer, SKU	Unit	Quantity	Unit Price	Total
	BATHROOM 3						
37	Tile Finish			SF	50		
38	Adhesive	1/2" Thin set Mortar		SF	50		
39	Vapor Retarder	Vapor Barrier Polyethylene		SF	50		
	GARAGE						
40	Tile Finish			SF	696		
41	Adhesive	1/2" Thin set Mortar		SF	696		
42	Vapor Retarder	Vapor Barrier Polyethylene		SF	696		



	<u>1</u>		FLOORING EXTERIOR			
#	Item	Туре	Description, Manufacturer, SKU	Unit	Quantity	Unit Price
	STRUCTURE			SF	2254.5	
1	Concrete Slab	4"concrete cast in situ		CF	751.51	
2	Insulation	Rigid insulation		SF	515.41	
3	Hard core	Compacted soil		CF	639.05	
4	Re-bar	#4 re-bar		Ton	1.95	
5	Concrete Pad	4"concrete cast in situ		CF	2	
6	Slab edge	Turndown		CF	469.87	
7	Footing	Cast-in-place concrete		CF	13.86	
	PORCH FRONT					
8	Tile Finish			SF	248	
9	Adhesive	1/2" Thin set Mortar		SF	248	
10	Vapor Retarder	Vapor Barrier Polyethylene		SF	248	
	PORCH BACK					
11	Tile Finish			SF	127	
12	Adhesive	1/2" Thin set Mortar		SF	126.93	
13	Vapor Retarder	Vapor Barrier Polyethylene		SF	126.93	



			WALLS: EXTERIOR				
#	Item	Туре	Description, Manufacturer, SKU	Unit	Quantity	Unit Price	Total
1	Exterior-Grade Plywood Vertical Siding			SF	770		
2	Exterior-Grade Plywood Horizontal Siding			SF	428		
3	8/panel	Self-drilling screws(100/pkt)		PKT	11.98		
4	Wall Shteathing (OSB)			SF	1198		
5	Shteathing Fastener	Self-drilling screws(100/pkt)		PKT	11.98		
6	Wall Homewrap			SF	1198.00		
7	Homewrap Fastener	Stapled fastener (200/pkt)		PKT	4.55		
8	Furring Strip			PCS	149.75		
9	Furring Strip Fastener	Self-drilling screws(100/pkt)		PKT	11.98		
10	Wall Paint			SF	1198		
11	Stone Copping	Masonry stone		SF	0		
12	Stone Veneer	Masonry stone		SF	717		
13	Mortar for Stone Veneer			SF	717		
14	Wall Insulation			SF	6825		



			WALLS: INTERIOR 01				
#	Item	Туре	Description, Manufacturer, SKU	Unit	Quantity	Unit Price	Total
	BATHROOM 1			SF	91.0		
1	Cementitious Backer Board			SF	554		
2	Kerdi membrane			SF	554		
3	Kerdi membrane Fastener			SF	554		
4	Wall Ceramic Tile			SF	554		
	BATHROOM 2			SF	79.0		
5	Cementitious Backer Board			SF	233		
6	Kerdi membrane			SF	233		
7	Kerdi membrane Fastener			SF	233		
8	Wall Ceramic Tile			SF	233		
	BEDROOM 1			SF	108.0		
9	Drywall Board			SF	305		
10	Drywall Fastener	Self-drilling screws(100/pkt)		PKT	3.05		
11	Wall Paint			SF	305		
12	Drywall Tape			FT	57.2		



			WALLS: INTERIOR 02				
#	Item	Туре	Description, Manufacturer, SKU	Unit	Quantity	Unit Price	Total
	BEDROOM 2			SF	117.0		
13	Drywall Board			SF	311		
14	Drywall Fastener	Self-drilling screws(100/pkt)		PKT	3.11		
15	Wall Paint			SF	311		
16	Drywall Tape			FT	58.3		
	KITCHEN			SF	212.0		
17	Cementitious Backer Board			SF	31		
18	Drywall Board			SF	361		
19	Drywall Fastener	Self-drilling screws(100/pkt)		PKT	3.61		
20	Kerdi membrane			SF	31		
21	Kerdi membrane Fastener			SF	31		
22	Wall Ceramic Tile			SF	31		
23	Wall Paint			SF	361		
24	Drywall Tape			FT	68.1		



			WALLS: INTERIOR 03				
#	Item	Туре	Description, Manufacturer, SKU	Unit	Quantity	Unit Price	Total
	BEDROOM 3			SF	157.0		
25	Drywall Board			SF	540		
26	Drywall Fastener	Self-drilling screws(100/pkt)		PKT	5.4		
27	Wall Paint			SF	540		
28	Drywall Tape			FT	101.3		
	LIVING ROOM			SF	161.0	ı	
29	Drywall Board			SF	436		
30	Drywall Fastener	Self-drilling screws(100/pkt)		PKT	4.36		
31	Wall Paint			SF	436		
32	Drywall Tape			FT	81.8		
	CL 1			SF	14.0		
33	Drywall Board			SF	138		
34	Drywall Fastener	Self-drilling screws(100/pkt)		PKT	1.38		
35	Wall Paint			SF	138		
36	Drywall Tape			FT	25.9		



			WALLS: INTERIOR 04				
#	Item	Туре	Description, Manufacturer, SKU	Unit	Quantity	Unit Price	Total
	CL 2			SF	12.0		
37	Drywall Board			SF	118		
38	Drywall Fastener	Self-drilling screws(100/pkt)		PKT	1.18		
39	Wall Paint			SF	118		
40	Drywall Tape			FT	22.1		
	CL 3			SF	12.0		
41	Drywall Board			SF	118		
42	Drywall Fastener	Self-drilling screws(100/pkt)		PKT	1.18		
43	Wall Paint			SF	118		
44	Drywall Tape			FT	22		
	CL 4			SF	12.0		
45	Drywall Board			SF	118		
46	Drywall Fastener	Self-drilling screws(100/pkt)		PKT	1.18		
47	Wall Paint			SF	118		
48	Drywall Tape			FT	22		



			WALLS: INTERIOR 05				
#	Item	Туре	Description, Manufacturer, SKU	Unit	Quantity	Unit Price	Total
	CL 5			SF	8.0		
49	Drywall Board			SF	123		
50	Drywall Fastener	Self-drilling screws(100/pkt)		PKT	1.23		
51	Wall Paint			SF	123		
52	Drywall Tape			FT	23		
	GARAGE			SF	658.0		
53	Drywall Board			SF	915		
54	Drywall Fastener	Self-drilling screws(100/pkt)		PKT	9.15		
55	Wall Paint			SF	915		
56	Drywall Tape			FT	173		
	HALL	<u> </u>		SF	69.0		
57	Drywall Board			SF	331		
58	Drywall Fastener	Self-drilling screws(100/pkt)		PKT	3.31		
59	Wall Paint			SF	331		
60	Drywall Tape			FT	62		
1	Wall Skirting	Ceramic		FT	255		



			DOORS				
#	Item	Туре	Description, Manufacturer, SKU	Unit	Quantity	Unit Price	Total
1	Exterior Swinging	3' - 0" X 6'-8"		PCS	3		
2	Interior Swinging	3' - 0" X 6'-8"		PCS	7		
3	Interior Sliding	5' - 0" X 6'-8"		PCS	4		
4	Interior Sliding	6' - 0" X 6'-8"		PCS	1		
5	Garage Door	16' - 1" X 6'-6"		PCS	1		
6	Exterior Door Trim			FT	79		
7	Interior Door Trim			FT	493		
8	Entry Lock set			PCS	3		
9	Privacy Lock set			PCS	7		
10	Passage Lock set			PCS	6		
11							
12							
13							
14							
15							



			WINDOWS				
#	Item	Туре	Description, Manufacturer, SKU	Unit	Quantity	Unit Price	Total
1	Sliding	5' - 3" X 3'-3"		PCS	1		
2	Single Hung	3' - 3" X 3'-3"		PCS	3		
3	Casement	2' - 9" X 3'-9"		PCS	6		
4	Single Hung	2' - 6" X 3'-3"		PCS	1		
5	Sliding	2' - 3" X 2'-3"		PCS	2		
6	Fixed	5' - 3" X 3'-3"		PCS	1		
7	Fixed	7' - 3" X 1'-9"		PCS	1		
8	Fixed	2' - 9" X 1'-3"		PCS	4		
9	Exterior Window Trim			FT	259		
10	Interior Window Trim			FT	259		
11							
12							
13							
14							
15							



			ROOF 01				
#	Item	Туре	Description, Manufacturer, SKU	Unit	Quantity	Unit Price	Total
1	Roof Covering			SF	2175.0		
2	Roof Covering Fastener			PCS	1088		
3	Roof Felt Paper			SF	2175.0		
4	Roof Felt Paper Fastener			PCS	6525.0		
5	Roof Sheathing			SF	2175.0		
6	Roof Sheathing Fastener			PCS	17400		
7	Batten			FT	1321.0		
8	Batten Fastener			PCS	993.2		
9	Soffit			SF	92.0		
10	Soffit Fastener			PCS	406.0		
11	Fascia			FT	300.0		
12	Fascia board fastener			PCS	150		
13	Roof Insulation			SF	2175.0		
14				0.	2.76.0		
15							