


# **EMBER**

The Ember is a charming Craftsman-style 3 bedroom 2.5 bathroom home design. Its exterior showcases classic Craftsman architectural elements. The walls are finished with horizontal siding in a cool gray tone. The gable ends feature wood shingles, while a simple gable roof with a decorative trim detail at the peak provides shelter.

Inside, the Ember features an L-shape layout. The living and kitchen areas are merged into one large room at the center of the house. The bedrooms are arranged on both sides of the living area, offering privacy. The garage protrudes from the main house, completing the L-shape and providing convenient parking.

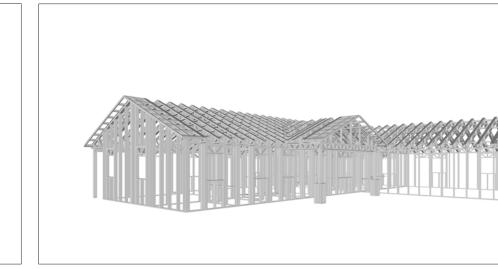

## Materials Shopping List

Please print and take this Materials Shopping List to your favorite Home Depot and ask for assistance in selecting the materials, fixtures and fittings to complete your new home.

Record your selection and the price of the item. Then do the math to determine the cost for your selections and the total cost of finishing your home.



### < CLICK HERE >

To Go To Materials Shopping List





# **FLOOR PLAN**

1650 SF

3 Bed Rooms

# **TABLE OF CONTENTS**

RENDERINGS	ABOUT THE HOME -	
1	RENDERINGS -	— <b>01</b>
FLOOR PLAN	SCHEMATIC FLOOR PLAN	<b>—</b> 01
1	HOME SPECS -	<b></b> 01
	DISCLAIMER -	<b></b> 01
ABOUT	ABOUT FrameUpNow -	<b>—</b> 01
1	ABOUT HouseDocs	<b>—</b> 01
DESCRIPTIONS	BOM (Bill Of Materials) ⊢	<b>—</b> 02
2	STRUCTURAL -	<b>─ 0</b> 2
	ARCHITECTURAL.	
	MECHANICAL -	
	ELECTRICAL-	
	PLUMBING -	
MATERIALS LIST	MATERIALS LIST PREVIEW	<b> 02</b>
HOW TO BUILD	CONSTRUCTION STEPS -	—— <b>02</b>
	1	

**COVER SHEET** 

FLOOR PLAN + DIMENSION PLAN + FOUNDATION PLAN STRUCTURAL FLOOR PLAN -WALL FRAME LAYOUT ROOF TRUSS LAYOUT ROOF PLAN + ARCHITECTURAL ELEVATIONS ARCHITECTURAL ELEVATIONS -ARCHITECTURAL SECTIONS -ARCHITECTURAL DETAILS ARCHITECTURAL CASEWORK

03

**COVER SHEET** GENERAL NOTES WALL FRAME LAYOUT + 19 WALL PANEL & LAYOUT PLAN + 20 ROOF TRUSS LAYOUT -STRUCTURAL SECTIONS -21 WALL BRACING LAYOUT-22 HOLD-DOWN PLAN -STRUCTURAL DETAILS 1 STRUCTURAL DETAILS 2 STRUCTURAL DETAILS 3 **27** TRUSS BLOCKING LAYOUT 28 SHEETROCK BACKING -**ROOF BRACING LAYOUT** 29

**MECHANICAL COVER SHEET** 30 HVAC PLAN 31 **ELECTRICAL** SCHEDULE 32 LIGHTING POWER PLAN 34 DIMENSION FOR LIGHTING

**PLUMBING** 

ARCHITECTURAL

STRUCTURAL

NOTES AND SCHEDULES WATER SUPPLY & SEWAGE SYSTEM # 38

**DISCLAIMER** 

marketing content.

DISCLAIMER: This documentation and all it's contents are the intellectual property of FrameUpNow. It is provided solely for marketing the services of FrameUpNow.

The preliminary information is not approved for actual construction use and is

not warranted to be complete or accurate. Unauthorized copying, distribution, or application of these proprietary materials, in any form or format, is strictly prohibited. FrameUpNow assumes no liability for any issues arising from improper use of this

DIMENSION FOR FITTING -

**MATERIALS SHOPPING LIST** 

MATERIALS SHOPPING LIST

# **ABOUT**



FrameUpNow is a design and manufacturing company providing precision-engineered home framing solutions. We offer a catalog of Affordable Homes, Tiny Homes, Garages, Shops and Barndominiums. FrameUpNow manufactures cold-formed steel (CFS) also known as Light Gauge Steel (LGS) framing components that conform to our engineered metal house frame plans or can be purchased as DIY skeleton kits.

The CFS/LGS framing is lightweight, easily assembled, and does not require heavy equipment or specialized labor, enabling homeowners to erect the frame themselves in just a few days. Unlike wood, the steel framing is impervious termites and bores, warping, expansion, and fire.

Our home plans come complete with a structural engineered stamp for permit approvals. Customers receive a full BOM also known as a Materials Shopping List to purchase finish materials from a Building Materials retailer. FrameUpNow prides itself on the quality and efficiency of our precision-engineered home framing solutions for construction professionals and DIY homeowners.



**KEY PLAN** 

NO.	DESCRIPTION	DATE

NOTE:

LEGEND:

PROJECT

246-Ember-1650-3Bd2.5Ba-Craftsman-550

DRAWING NAME

# INTRODUCTION

CLIENT NAME:
PROJECT NUMBER:
DATE:
DESIGNED BY:
DRAWN BY:
CHECKED BY:

**I101** 

SCALE:

# **DESCRIPTIONS**

# MATERIALS LIST

The BOM (Bill Of Materials) package, known as the Materials Shopping List document, provides:

Comprehensive Inventory: Detailed lists of essential materials sourced from architectural, mechanical, HVAC, electrical, and plumbing design drawing sets.

Precise Curation: Each item meticulously selected and organized for accuracy and efficiency in project planning.

Customizable Options: Customers can modify listed items to their preferences and calculate costs accordingly, ensuring alignment with personal project needs and budget.

Dedicated Space for Details: Includes tables for customers to note Home Depot SKU numbers or product descriptions for selected items,

facilitating seamless purchasing and coordination with suppliers.

Customer Convenience: Take the list to Home Depot or preferred suppliers for accurate pricing, helping align the total home budget with personal financial plans.

Simplify your construction journey with our Materials Shopping List document, where detailed preparation meets streamlined implementation for your dream home.

## STRUCTURAL

The structural drawings package provides an exhaustive set of detailed plans essential for the precise assembly of your building. This comprehensive package includes:

Framing Plans: Detailed layouts for all framing components. Truss Layouts: Clear instructions for truss placement and

Panel Length Plans: Specifications for panel dimensions. Framing Elevations and Sections: Precise elevation and sectional views for accurate construction.

Truss and Wall Blocking Plans: Plans for truss and wall blocking to ensure structural integrity.

Hold-Down Plan: Detailed hold-down requirements for stability. Snap Sheet: Reference sheet for quick identification of components

Structural Details and Bracing Plans: Complete details and bracing plans for all structural elements.

Accompanying these plans is a comprehensive Bill of Materials (BOM) that lists every necessary building component, from cold formed steel (CFS) frames to fasteners.

## ARCHITECTURAL

With the comprehensive architectural package, both builders and DIY homeowners can confidently execute the construction.

The architectural package includes:

Furnished Floor Plans: Complete with furniture layouts for a clear understanding of space utilization.

Detailed Dimension Plans: Ensures precise measurements, from the overall footprint down to the exact placement of windows and

Foundation Plan: Detailed plan to establish a solid foundation.

Wall Framing and Truss Layout: Comprehensive plans for wall framing and truss placement.

Architectural Elevations: Exterior views showcasing the design.

Strategic Building Sections: Critical cross-sectional details for a thorough understanding of the build.

Casework Drawings and Diagrams: Suggested designs for built-in caseworks, such as kitchen cabinets.

# **MECHANICAL**

The mechanical package includes everything needed to guide HVAC

Detailed HVAC Floor Plan: Precisely maps out the placement of air handlers, ductwork, and vents throughout the home's layout.

HVAC Sections and Riser Diagrams: Technical drawings offering critical cross-sectional details and piping schematics, ensuring proper integration of the heating and cooling system into the home's structure.

Bill of Materials: A complete list of all necessary HVAC components.

# **ELECTRICAL**

The electrical package includes all the plans and documentation needed to guide the installation of your home's electrical system:

Detailed Power Plan: Precisely maps out the placement of outlets, switches, and other power components throughout the layout.

Comprehensive Lighting Plan: Shows the optimal locations for lighting fixtures, sconces, and other illumination sources to create a well-lit, functional interior.

Dimensioned Electrical Layout: Provides exact dimensions and measurements to ensure proper placement of all electrical elements.

Bill of Materials: A complete list of every component needed, from circuit breakers to wiring.

The plumbing package includes everything needed to guide the

Detailed Water Supply System Plan: Precisely maps out the placement of pipes, valves, and plumbing fixtures throughout the

Comprehensive Sewage System Plan: Shows the optimal routing and sizing of drain lines to effectively remove waste and ensure

Detailed Riser Diagrams: Provide information needed to properly

# **PLUMBING**


installation of your home's water supply and drainage systems:

proper drainage.

install all vertical plumbing risers and vent stacks.

Bill of Materials: A complete list of every component needed, from pipes to fixtures.


# BOM (Bill Of Materials) (Separately Attached)

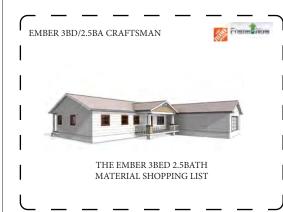



The Bill of Materials (BOM) is a crucial document that compiles the material requirements from different disciplines into a centralized inventory, enabling efficient procurement, inventory management, and cost estimation for a specified project or

**ELECTRICAL BOM** 



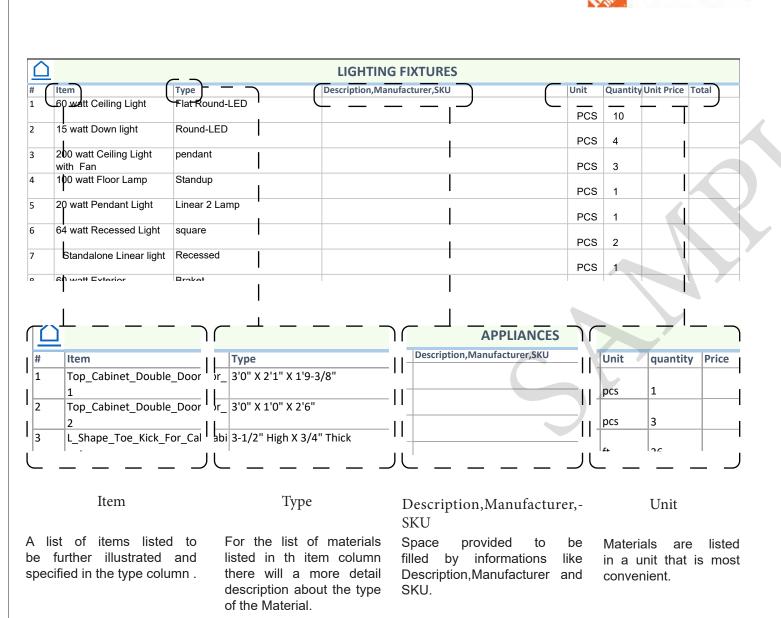

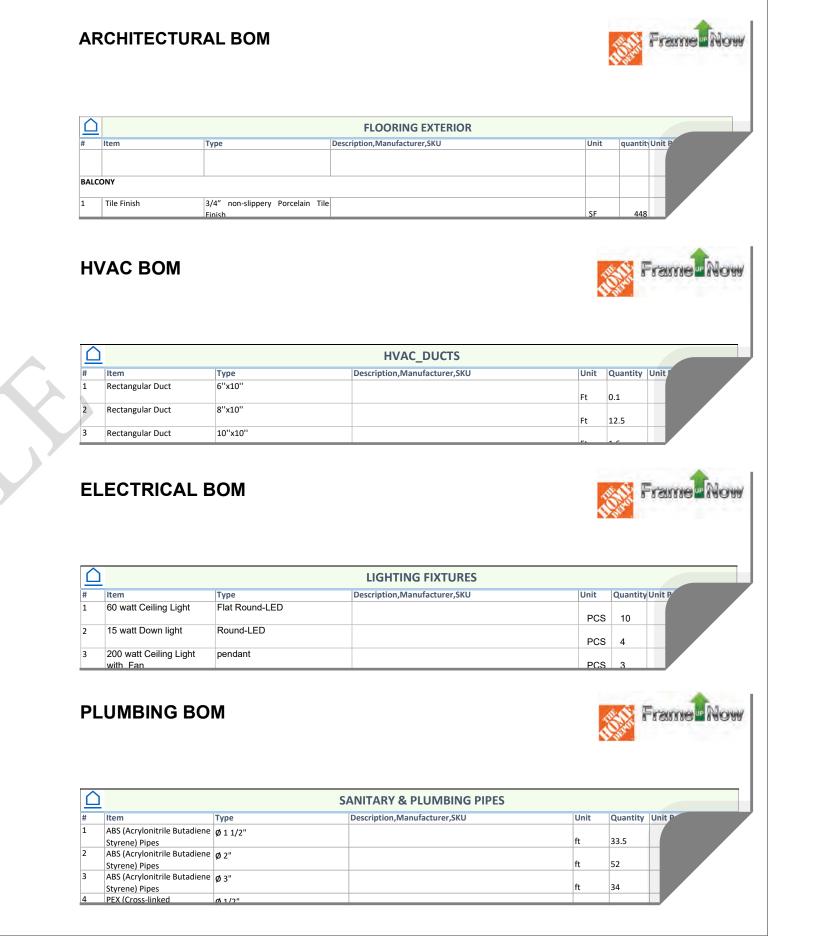

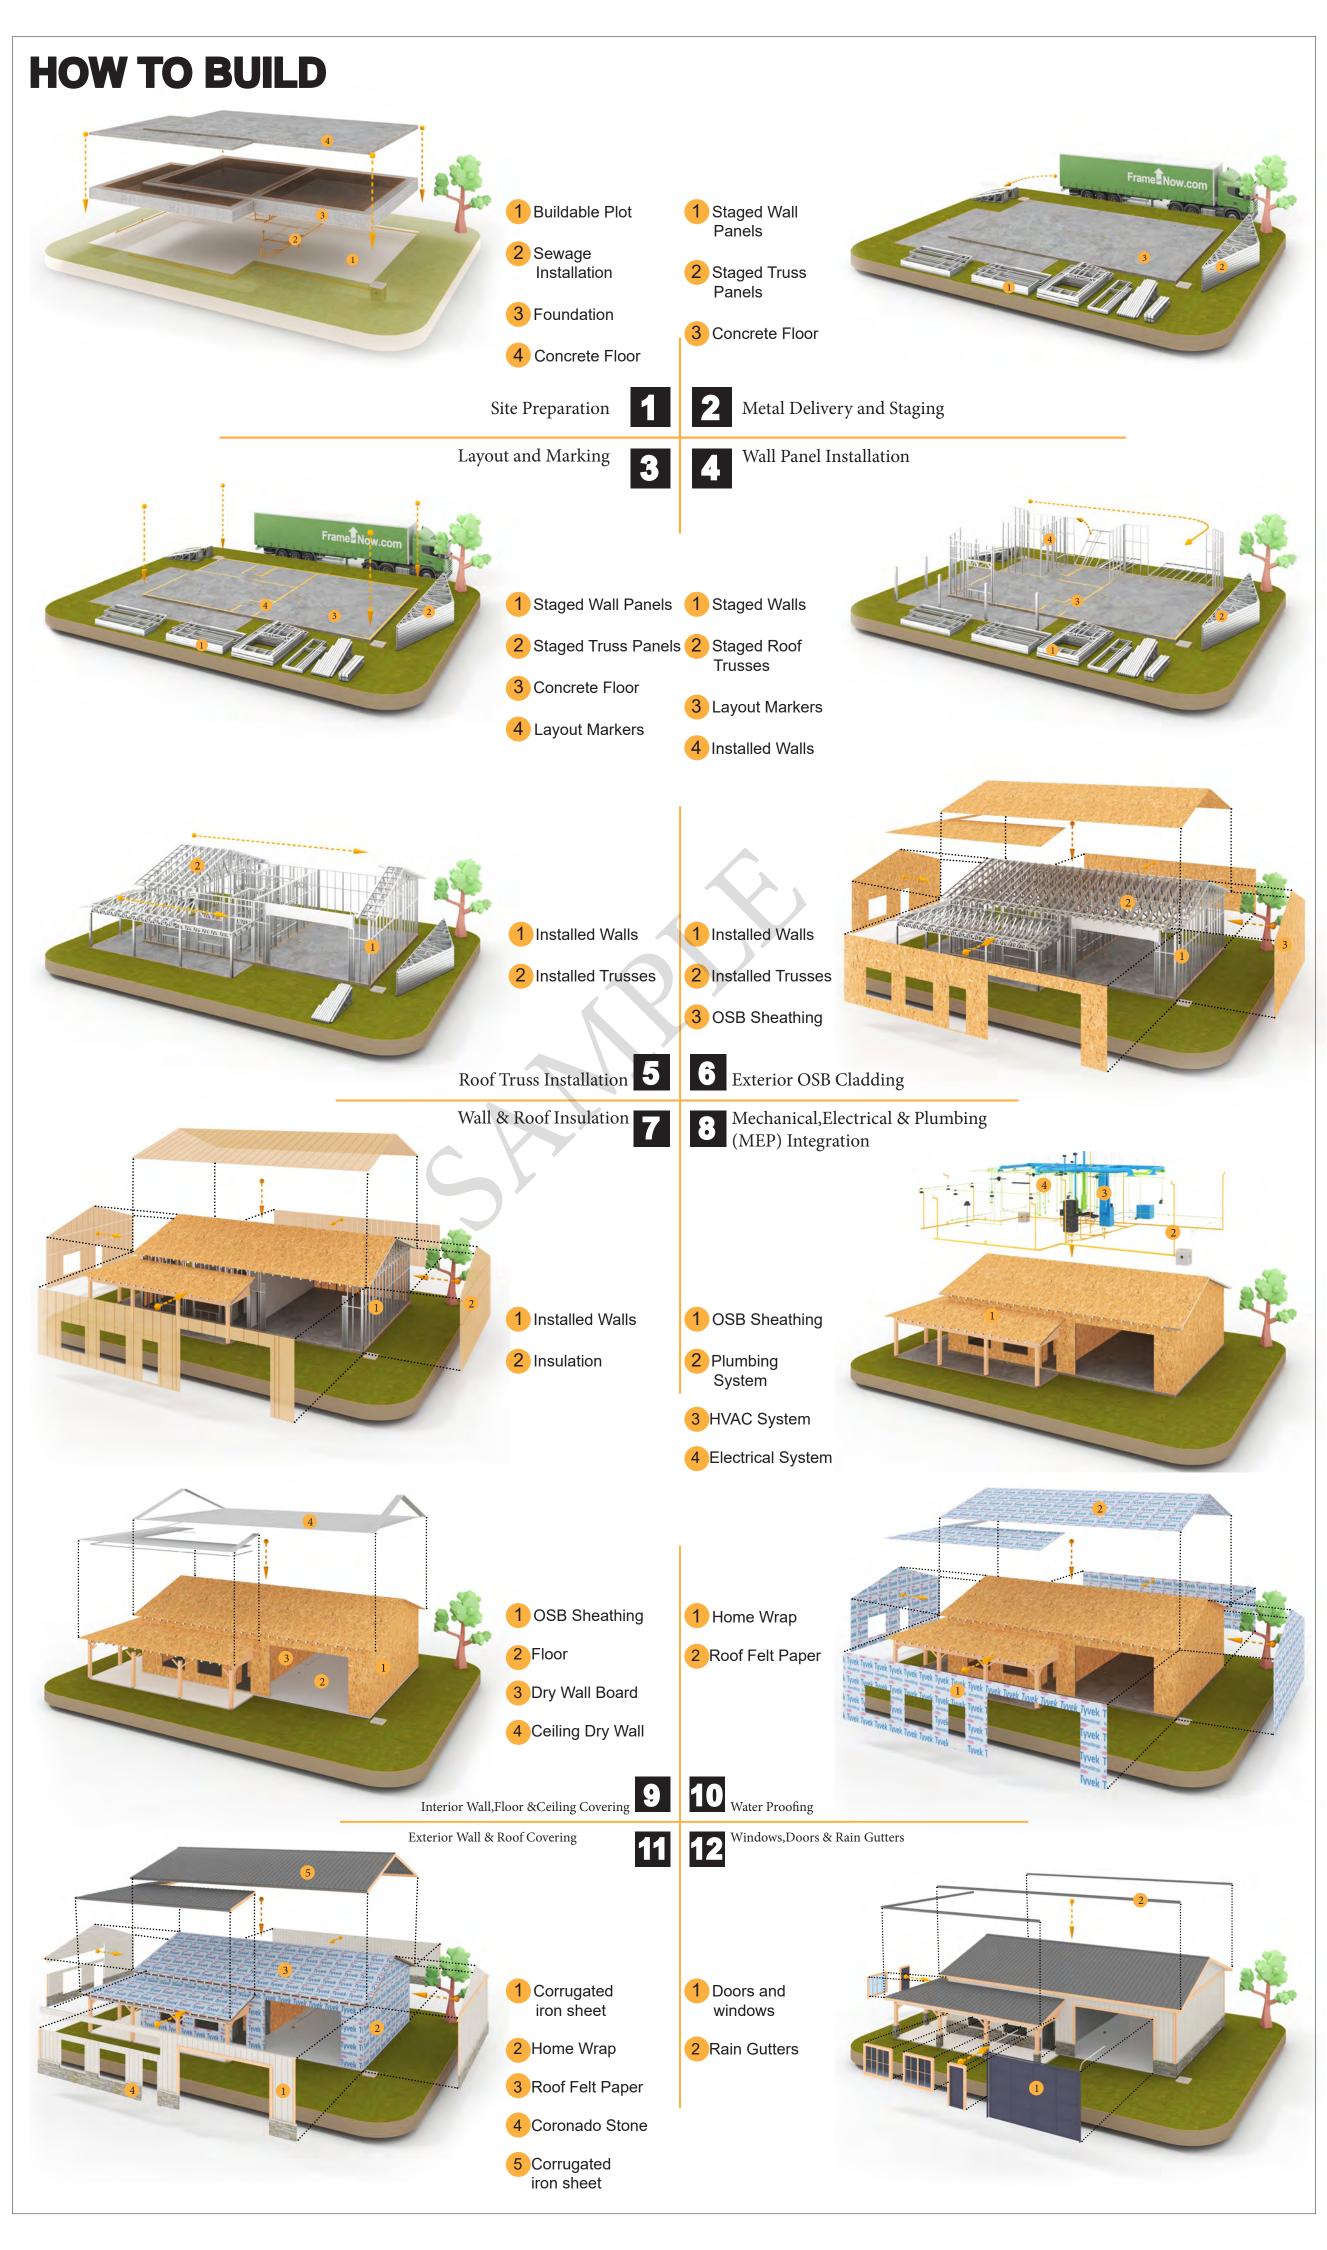



**KEY PLAN** 

NO.	DESCRIPTION	DATE

NOTE:

LEGEND:

**PROJECT** 

246-Ember-1650-3Bd2.5Ba-Craftsman-550


DRAWING NAME

# INTRODUCTION

CLIENT NAME: PROJECT NUMBER: DATE: **DESIGNED BY** DRAWN BY: CHECKED BY:

1102

SCALE:

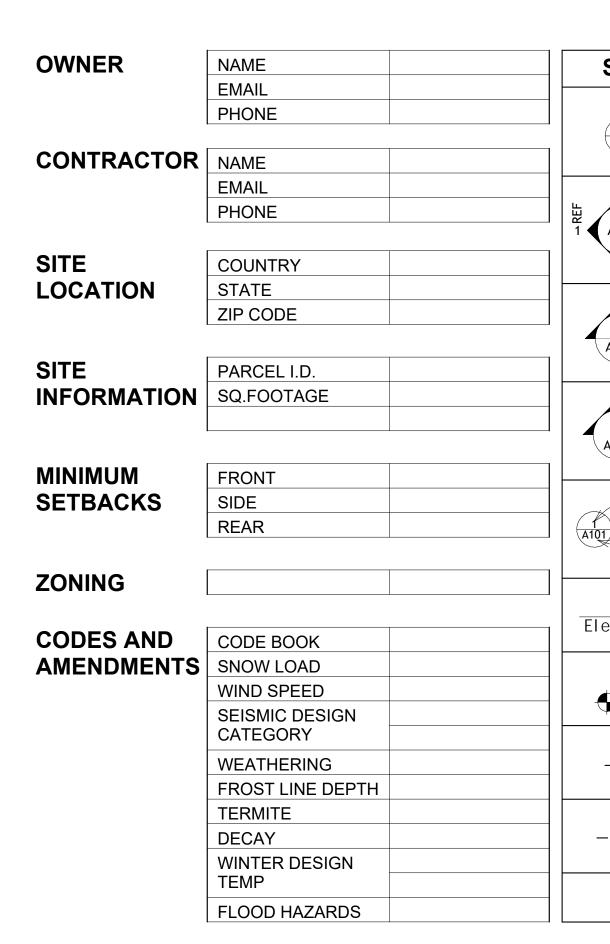

LINE LEGEND

DOOR OPENING DIRECTION

ROOM SEPARATOR

HIDDEN LINE

OVER HEAD

SYMBOLS	SYMBOLS NAME		PAGE INDEX
VIEW		G101	COVER SHEET
NUMBER		A101	FLOOR PLAN
A101 SHEET	CALLOUT HEAD	A102	DIMENSION PLAN
NUMBER		S101	FOUNDATION PLAN
1 REF		S102	STRUCTURAL FLOOR PLAN
NUMBER	R INTERIOR ELEVATION	S103	FRAME LAYOUT
A101 1		S104	ROOF TRUSS LAYOUT
SHEET 1 REF NUMBER		A103	ROOF PLAN
REF VIEW		A201	ELEVATIONS
NUMBER	5. W 5. W 5 5. F. W 5. W 5. W 5. W 5. W	A202	ELEVATIONS
1 A101	BUILDING ELEVATION	A301	SECTIONS
SHEET   NUMBER		A401	DETAILS
· VIEW		A402	CASEWORK DETAILS
NUMBER	05051011	A403	CASEWORK DETAILS
A101 QUEET	SECTION	E101	SCHEDULE
SHEET   NUMBER		E102	LIGHTING PLAN
VIEW		E103	POWER PLAN
NUMBER		E104	DIMENSION PLAN FOR LIGHT FIXTURE
	DETAIL VIEW	E105	DIMENSION PLAN FOR FITTING
SHEET NUMBER		P101	COVER SHEET
		P102	WATER SUPPLY SYSTEM
Name	ELEVATION LEVEL	P103	SEWAGE SYSTEM
evation 📗	LLL VATION LL VLL	P104	RISER DIAGRAM
		M101	HVAC PLAN
FLOOR LEVEL	SPOT ELEVATION	M102	HVAC SECTION
<del>-</del> 0'-2"	OI OI LLLVATION	M103	RISER DIAGRAM
FLOOD			

FLOOR SLOPE

**ROOF SLOPE** 

ROOF SLOPE ELEVATION

SLOPE

ROOF SLOPE

SLOPE

CALL OUT BOUNDRY

CUT LINE

GROUND CUT

DIRECTION


DIRECTION

TAG	TAG'S NAME
CA01	CASEWORK TAG
1	DOOR TAG
<u>1</u>	FURNITURE TAG
1	WINDOW TAG
SE01	SPECIALTY EQUIPMENT TAG
ME01	MECHANICAL EQUIPMENT TAG
PE01	PLUMBING EQUIPMENT TAG






**ABBREVIATION** 

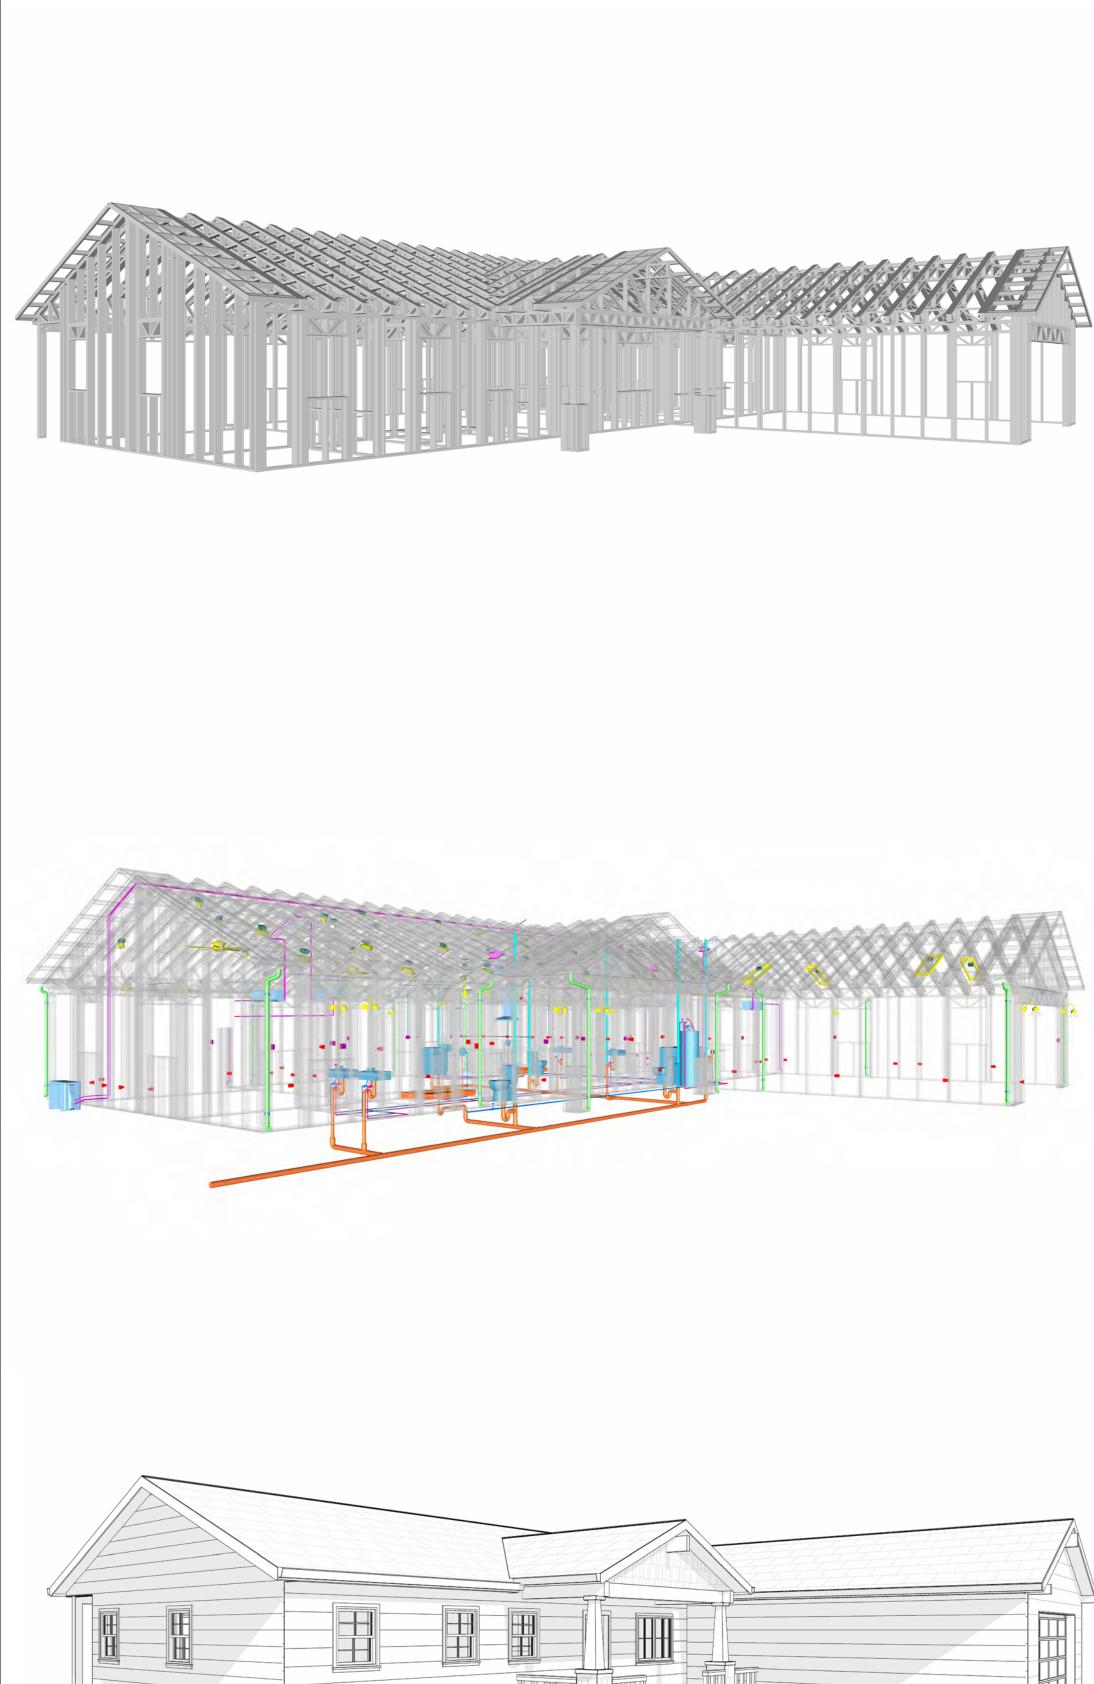

246-EMBER-1650-3Bd2.5Ba-CRAFTSMAN-550

SQUARE FOOT	AGE
LIVING	1650
GARAGE	620
PORCH	254
TOTAL	2524



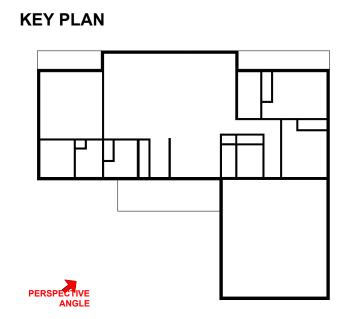

ANGLE	ANGLE				
NO.	DESCRIPTION	DATE			

NOTE:

LEGEND:

PROJECT

246-EMBER-1650-3Bd2.5Ba CRAFTSMAN-550

DRAWING NAME

**COVER SHEET** 

CLIENT NAME:	Client Name
PROJECT NUMBER:	0061_12
DATE:	5/8/2025 2:18:46 PM
DESIGNED BY:	Designer
DRAWN BY:	Author
CHECKED BY:	Checker

G101

### **GENERAL NOTES**

- THIS DRAWING DEPICTS THE ARCHITECTURAL (SPACE LAYOUT, FURNISHING, FLOOR, WALLS, ROOFS, FOUNDATION, WINDOWS AND DOORS) SYSTEMS. IT PROVIDES A VISUAL REPRESENTATION OF THE ARCHITECTURAL LAYOUT AND COMPONENTS.
- THE ARCHITECTURAL DRAWINGS ARE PREPARED TO MEET THE SPECIFIC REQUIREMENTS OF THE BUILDING, AS PER THE PROJECT SPECIFICATIONS AND APPLICABLE CODES AND STANDARDS.
- THE CONSTRUCTION OF THIS HOME SHALL COMPLY WITH THE LATEST EDITION OF THE INTERNATIONAL RESIDENTIAL CODE (IRC), INTERNATIONAL MECHANICAL CODE (IMC), THE INTERNATIONAL PLUMBING STANDARD, THE NATIONAL ELECTRICAL STANDARD AND ALL OTHER APPLICABLE LOCAL, STATE, AND NATIONAL CODES AND REGULATIONS.
- COORDINATION WITH OTHER TRADES HAS BEEN DONE ON A DESIGN LEVEL. THIS DRAWING SHALL BE READ TOGETHER WITH THE ME, EL AND PL DESIGN DRAWINGS TO ENSURE PROPER CONSTRUCTION AND INTEGRATION OF THE BUILDING SYSTEMS.

#### **ABOUT WALLS:**

- SHOWER WALL COVERING
- BATHTUB AND SHOWER SPACES (WALLS AND FLOORS) WITH INSTALLED SHOWER HEADS AND IN SHOWER COMPARTMENTS SHALL BE FINISHED WITH A NON-ABSORBENT SURFACE.
- WALL PAINT (INTERNAL)
  - THE TYPICAL THICKNESS OF LATEX WALL PAINT IS 1/32 OF AN INCH FOR A SINGLE COAT. AND DOUBLE COAT (1/16") SHALL BE APPLIED FOR DURABILITY.

THE ADVISABLE TYPE OF ADHESIVE FOR THIS PROJECT IS **EPOXY ADHESIVES**BECAUSE THEY ARE KNOWN FOR THEIR HIGH STRENGTH, DURABILITY, AND RESISTANCE TO MOISTURE, CHEMICALS AND

REFER TO SHEETS A201 & A202 FOR GENERAL NOTES ON EXTERNAL FINISHING MATERIALS

### ABOUT FLOORS:

- THE SPOT ELEVATION INDICATES THE FINISHED FLOOR ELEVATION.
- FINISHED FLOORS PER PLANS.
- FIELD VERIFY FOR DIMENSION DROP 4" FOR SHOWER AND BATHTUB USE.
- 1% SLOPE ON OUTDOOR BALCONIES FOR WATER RUN OFF.
- 2% SLOPE TOWARDS THE SHOWER DRAIN FOR SUFFICIENT DRAINAGE.
- 4" DROP AT THE DOOR LEADING TO EXTERIOR BALCONY FROM THE MAIN LIVING AREA.
- 5% SLOPE FOR GARAGE IS USED, WHICH SHOULD BE CHECKED WITH THE LOCAL GARAGING
- ZONING LAWS.



A301

	FURNITURE SCHEDULE					
TYPE M	IARK	TYPE		COUNT		
01	KING SIZ	ZE BED		3		
02	FOUR SI	T 85" X 85"		1		
03	ONE SEA	AT SOFA		2		
04	COFFE 1	ABLE		1		
05	DINING (	CHAIR		8		
06	TV STAN	ID		1		

	ROOM FINISH SCHEDULE						
ROOM NUMBE R	ROOM NAME	FLOOR FINISH	BASE FINISH	WALL FINISH	CEILING FINISH	CEILING HEIGHT	COM MEN TS
01	ENTRY	HARDWOOD	CONCRETE	WALL PAINT	DRY WALL		
02	LIVING ROOM	HARDWOOD	CONCRETE	WALL PAINT	DRY WALL	8' - 0"	
03	KITCHEN	HARDWOOD	CONCRETE	WALL PAINT + CERAMIC	DRY WALL	8' - 0"	
04	DINING	HARDWOOD	CONCRETE	WALL PAINT	DRY WALL	8' - 0"	
05	BEDROOM 1	HARDWOOD	CONCRETE	WALL PAINT	DRY WALL	8' - 0"	
06	BEDROOM 2	HARDWOOD	CONCRETE	WALL PAINT	DRY WALL	8' - 0"	
07	BEDROOM 3	HARDWOOD	CONCRETE	WALL PAINT	DRY WALL	8' - 0"	
08	CL 1	HARDWOOD	CONCRETE	WALL PAINT	DRY WALL	8' - 0"	
09	CL 2	HARDWOOD	CONCRETE	WALL PAINT	DRY WALL	8' - 0"	
10	CL 3	HARDWOOD	CONCRETE	WALL PAINT	DRY WALL	8' - 0"	
11	CL 4	HARDWOOD	CONCRETE	WALL PAINT	DRY WALL	8' - 0"	
12	CL 5	HARDWOOD	CONCRETE	WALL PAINT	DRY WALL	8' - 0"	
13	BATH 1	VINYL TILES	CONCRETE	CERAMIC TILE	MRD	8' - 0"	
14	BATH 2	VINYL TILES VINYL TILES	CONCRETE	CERAMIC TILE	MRD	8' - 0"	
15	WC	VINYL TILES  VINYL TILES	CONCRETE	CERAMIC TILE		8' - 0"	
16	W/C	HARDWOOD	CONCRETE	WALL PAINT	DRY WALL	8' - 0"	
		HARDWOOD	CONCRETE	WALL PAINT	DRY WALL	8' - 0"	
17	HALL				DRY WALL		
18	L 1	HARDWOOD	CONCRETE	WALL PAINT	DRY WALL	8' - 0" 8' - 0"	
19		HARDWOOD	CONCRETE	WALL PAINT	DRY WALL		
20	HW	VINYL TILES	CONCRETE	WALL PAINT	DRY WALL	8' - 0"	
21	WD	VINYL TILES	CONCRETE	CERAMIC TILE	DRY WALL		
22	GARAGE	EPOXY	CONCRETE	WALL PAINT	DRY WALL		
23	FRONT PORCH	PROCELAIN TILE	CONCRETE	EXTERIOR-GRADE PLYWOOD	PLYWOOD	8' - 0"	
24	BACK PORCH 1	PROCELAIN TILE	CONCRETE	EXTERIOR-GRADE PLYWOOD	PLYWOOD	8' - 0"	
25	BACK PORCH 2	PROCELAIN TILE	CONCRETE	EXTERIOR-GRADE PLYWOOD	PLYWOOD	8' - 0"	






A301 /

GARAGE

593 SF

FLOOR PLAN 1/4" = 1'-0"



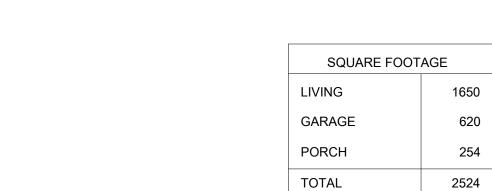



**KEY PLAN** 

NO. DESCRIPTION DATE

NOTE:

LEGEND:

PROJECT

246-EMBER-1650-3Bd2.5Ba **CRAFTSMAN-550** 


DRAWING NAME

**FLOOR PLAN** 

CLIENT NAME: **Client Name** PROJECT NUMBER: 0061\_12 DATE: 5/8/2025 2:18:58 PM **DESIGNED BY:** Designer DRAWN BY: **Author** CHECKED BY: Checker

A101

SCALE: 1/4" = 1'-0"

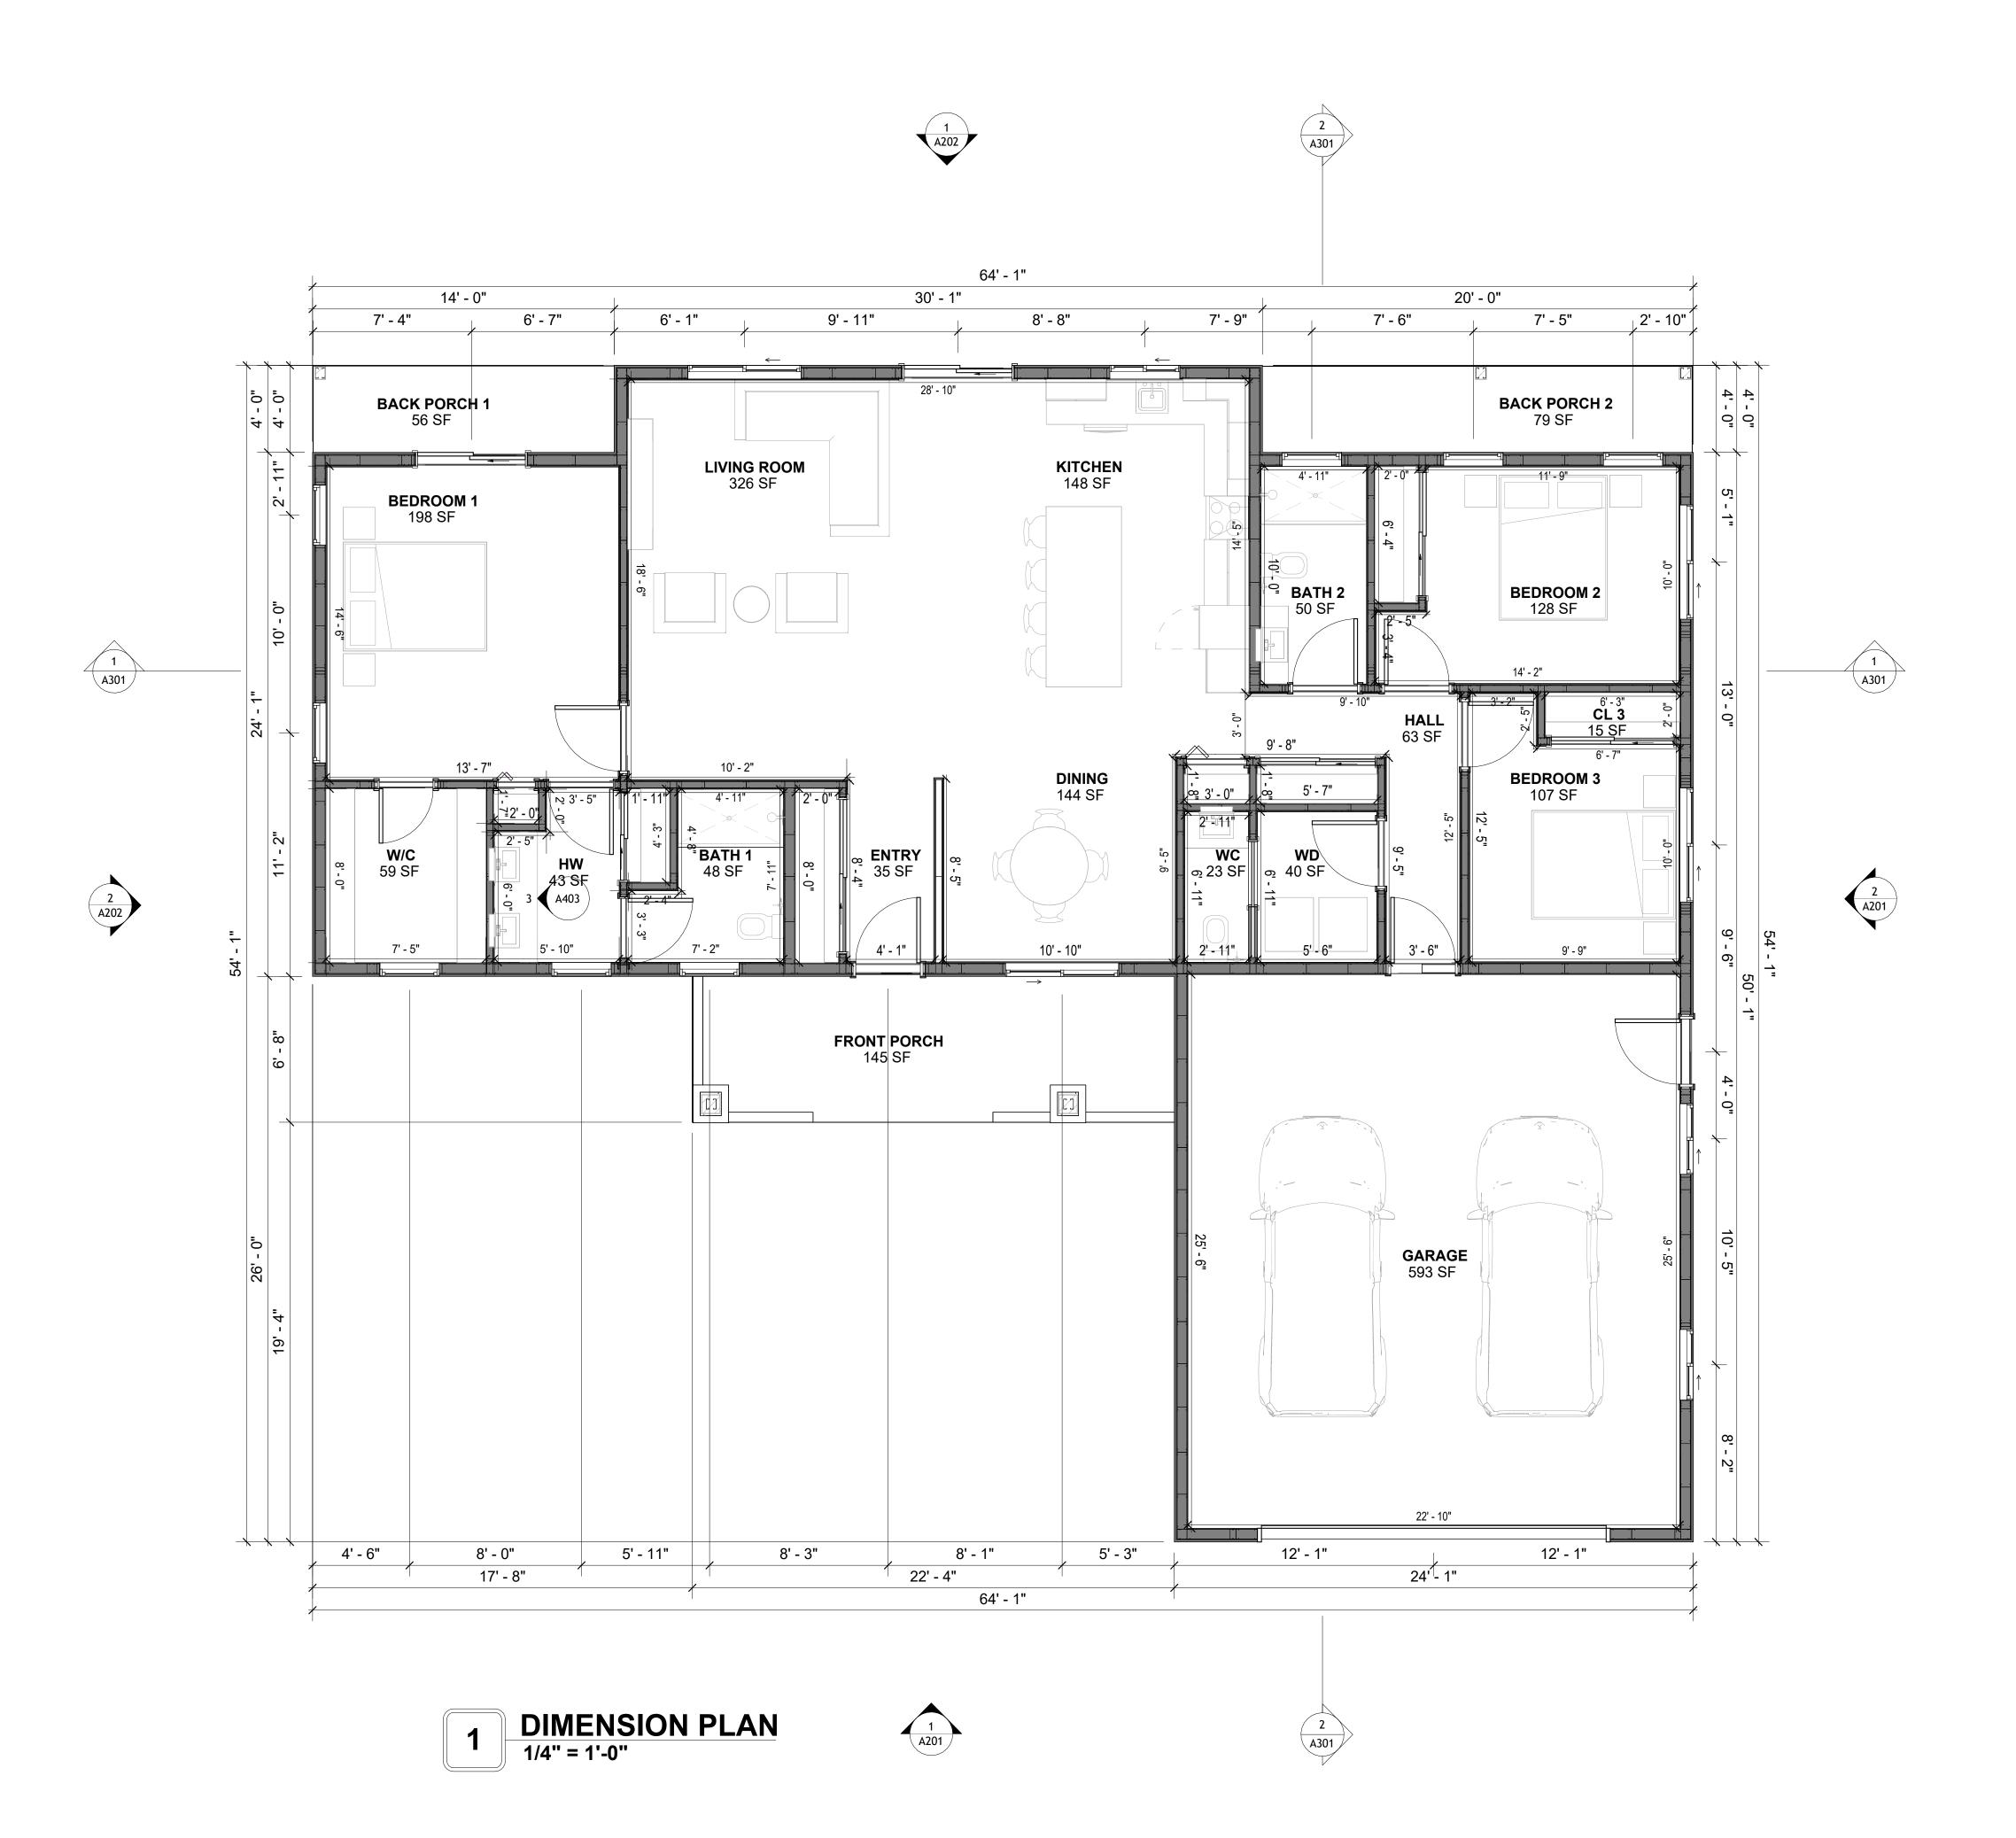



**KEY PLAN** 

NO.	DESCRIPTION	DATE

NOTE:

LEGEND:

PROJECT

246-EMBER-1650-3Bd2.5Ba CRAFTSMAN-550

DRAWING NAME

DIMENSION PLAN

Client Name	CLIENT NAME:
0061_12	PROJECT NUMBER:
5/8/2025 2:19:04 PM	DATE:
Designer	DESIGNED BY:
Author	DRAWN BY:
Checker	CHECKED BY:

A102

SQUARE FOOTAGE

LIVING 1650

GARAGE 620

PORCH 254

TOTAL 2524

DIMENSIONS IN THE ARCHITECTURAL DRAWINGS CONSIDER FINISHING MATERIALS. FOR PRECISE MEASUREMENTS OF THE STRUCTUAL FRAMING, REFER TO THE ATTACHED STRUCTURAL PLAN SET.

SCALE: 1/4" = 1'-0"

### **FOUNDATION NOTES**

TERMITES PRETREATMENT BY LICENSED CONTRACTOR UNDER SLAB AND AROUND FOOTINGS. ALL AREAS BELOW SLABS SHALL BE TREATED NO MORE THAN 24 HOURS PRIOR TO CONCRETE POUR. EVIDENCE OF TREATMENT MUST BE PROVIDED PRIOR TO PLACING OF CONCRETE.

ALL INTERIOR CONCRETE SLABS SHALL BE A MIN. OF 4" THICK CONCRETE OVER 4" COMPACTED AGGREGATE BASE (ASTM D698), FINISH ELEVATIONS AS NOTED ON DRAWINGS, 6" ABOVE ADJACENT GRADE, LEVEL SLABS TO 1/8"-10' MAX.. CONCRETE SLABS SHALL BE 2500# PSI AT 28 DAYS. A 4" ALLOWABLE SLUMP.

#### 2. **PAD PREPARATION:**

- EXCAVATION FOR FOOTING SHALL BE NEAT.

- FOOTINGS SHALL BE POURED IMMEDIATELY AFTER EXCAVATION AND APPROPRIATE INSPECTION.
- ALL REINFORCING STEEL MARKED "CONTINUOUS" SHALL BE LAPPED 36 BAR DIAMETERS AT SPLICES AND AROUND CORNERS OR INTERSECTIONS WITH A STANDARD 90 DEGREE BEND ON CORNER BARS. LAP WIRE MESH ONE FULL MESH AT SIDE AND END LAPS.
- ALL HARDWARE TO BE SIMPSON OR EQUIVALENT. - EXTERIOR FRAME WALL TO BE SECURED WITH 1/2"X10" ANCHOR BOLTS 4'-0" O.C. FOR 1-STORY AND 2'-8" O.C. FOR 2-STORY. BOLTS SHALL BE LOCATED WITHIN 1'-0" OF EACH END
- PIECE AND SHALL HAVE A MIN. OF TWO BOLTS PER PIECE. -FOUNDATION ANCHOR STRAPS SHALL BE PERMITTED.ACCORDING TO RESIDENTIAL CODE
- ALL INTERIOR WALLS TO BE SECURED WITH POWER DRIVEN PINS PER MANUFACTURER SPECIFICATION USE PIN SPACING EQUIVALENT TO 1/2" ANCHOR BOLTS.
- ALL CONSTRUCTION TO CONFORM TO THE 2012 IRC R-10 RIGID INSULATION OUTSIDE OF EXTERIOR FOUNDATION WALLS UNDER LIVING AREA.
- CONCRETE PAD FOR CONDENSER THICKNESS IS 4" MIN UNLESS OTHERWISE NOTED.

### 3. CONCRETE CONSTRUCTION:

- THE SLAB SHALL BE UNDERLAIN BY A VAPOR BARRIER/RETARDER IN THE LIVING AREA (TYPICALLY POLYETHYLENE, UNLESS MORE STRINGENT PROTECTION REQUIRED BY THE ARCHITECT, ENGINEER, FLOOR COVERING MANUFACTURER, OR ACCEPTED PRACTICE). UNLESS OTHERWISE REQUIRED, BARRIER MAY BE OMITTED AT GARAGES, PORCHES AND PATIOS WITHOUT FLOOR COVERINGS. IT IS BEYOND THE SCOPE OF THESE PLANS TO DETERMINE THE APPLICABILITY OF THESE MORE STRINGENT REQUIREMENTS. BUILDER SHALL VERIFY PRIOR TO CONSTRUCTION.

### 4. REINFORCEMENT:


- IF CONSTRUCTED ON ACTIVE SOILS, THE LONG TERM PERFORMANCE OF THE FOUNDATION IS DEPENDENT ON MAINTENANCE BY THE OWNER. THUS THE BUILDER SHALL ADVISE THE OWNER OF THE FOLLOWING:

- 1. DRAINAGE MUST BE MAINTAINED. WATER SHALL NEVER BE ALLOWED TO POND NEAR THE FOUNDATION.
- 2. THE SOIL AROUND THE FOUNDATION SHALL BE MAINTAINED IN A RELATIVELY DAMP CONDITION, SUCH AS THAT REQUIRED TO KEEP A LAWN GREEN. IF IT DRIES OUT IT WILL SHRINK. IF IT GETS WET, IT WILL HEAVE UPWARD.
- SLABS ON THE SHORTER SIDE USES MAIN BARS ARE USED IN THIS DIRECTION ONLY WITH SMALLER DIAMETER DISTRIBUTION BARS ARE PLACED, FORMING A MAT OR GRID. 4. ALL REINFORCEMENT BARS SIZE 10MM OR LARGER IN ACCORDANCE TO ASTM
- ANCHOR BOLTS AT ALL EXTERIOR WALLS SHALL BE MINIMUM 1/2 INCH DIAMETER WITH A MAXIMUM SPACING OF 6'-0" ON CENTER, UNLESS NOTED OTHERWISE.
- 4. ANCHOR BOLTS SHALL BE INSTALLED WITHIN 12 INCHES OF EACH END OF EACH SILL PLATE WITH AT LEAST TWO ANCHOR BOLTS FOR EACH BOLTS FOR EACH SILL PLATE LONGER THAN 12 INCHES.
- 5. SIMPSONS SILL ANCHORS MAYBE SUBSTITUTED FOR ANCHOR BOLTS AT THE SAME SPACING.
- 6. EXTERIOR CONCRETE SLABS WHICH ARE NOT PART OF THE MAIN SLAB SHALL BE MINIMUM 4 INCHES THICK WITH NO STEEL REINFORCING BARS REQUIRED, UNLESS NOTED OTHERWISE ON FOUNDATION PLAN.

### **VERIFY THE FOLLOWING PRIOR TO POURING:**

- ALL HOLDDOWNS, STRAP, AND POST LOCATIONS.
- CONCRETE FINISHES. PANEL RISER LOCATION WHERE APPLICABLE.
- 3. UNDERSLAB MECHANICAL REQUIREMENTS. 4. STEM WALL BLOCKOUTS.
- 5. UNDERSLAB ELECTRICAL REQUIREMENTS AND PANEL RISER LOCATION. WHERE **APPLICABLE**
- 6. PROVIDE THE FOLLOWING:
- PVC SLEEVES THROUGH FTG IF REQUIRED
- 20' #4 COPPER GROUND BAR.
- 7. SLOPE FINISH GRADE AWAY FROM FOOTING.

**NOTE**: FIELD VERIFY ALL DIMENSIONS SEE DIMENSIONED ARCHITECTURAL DRAWINGS

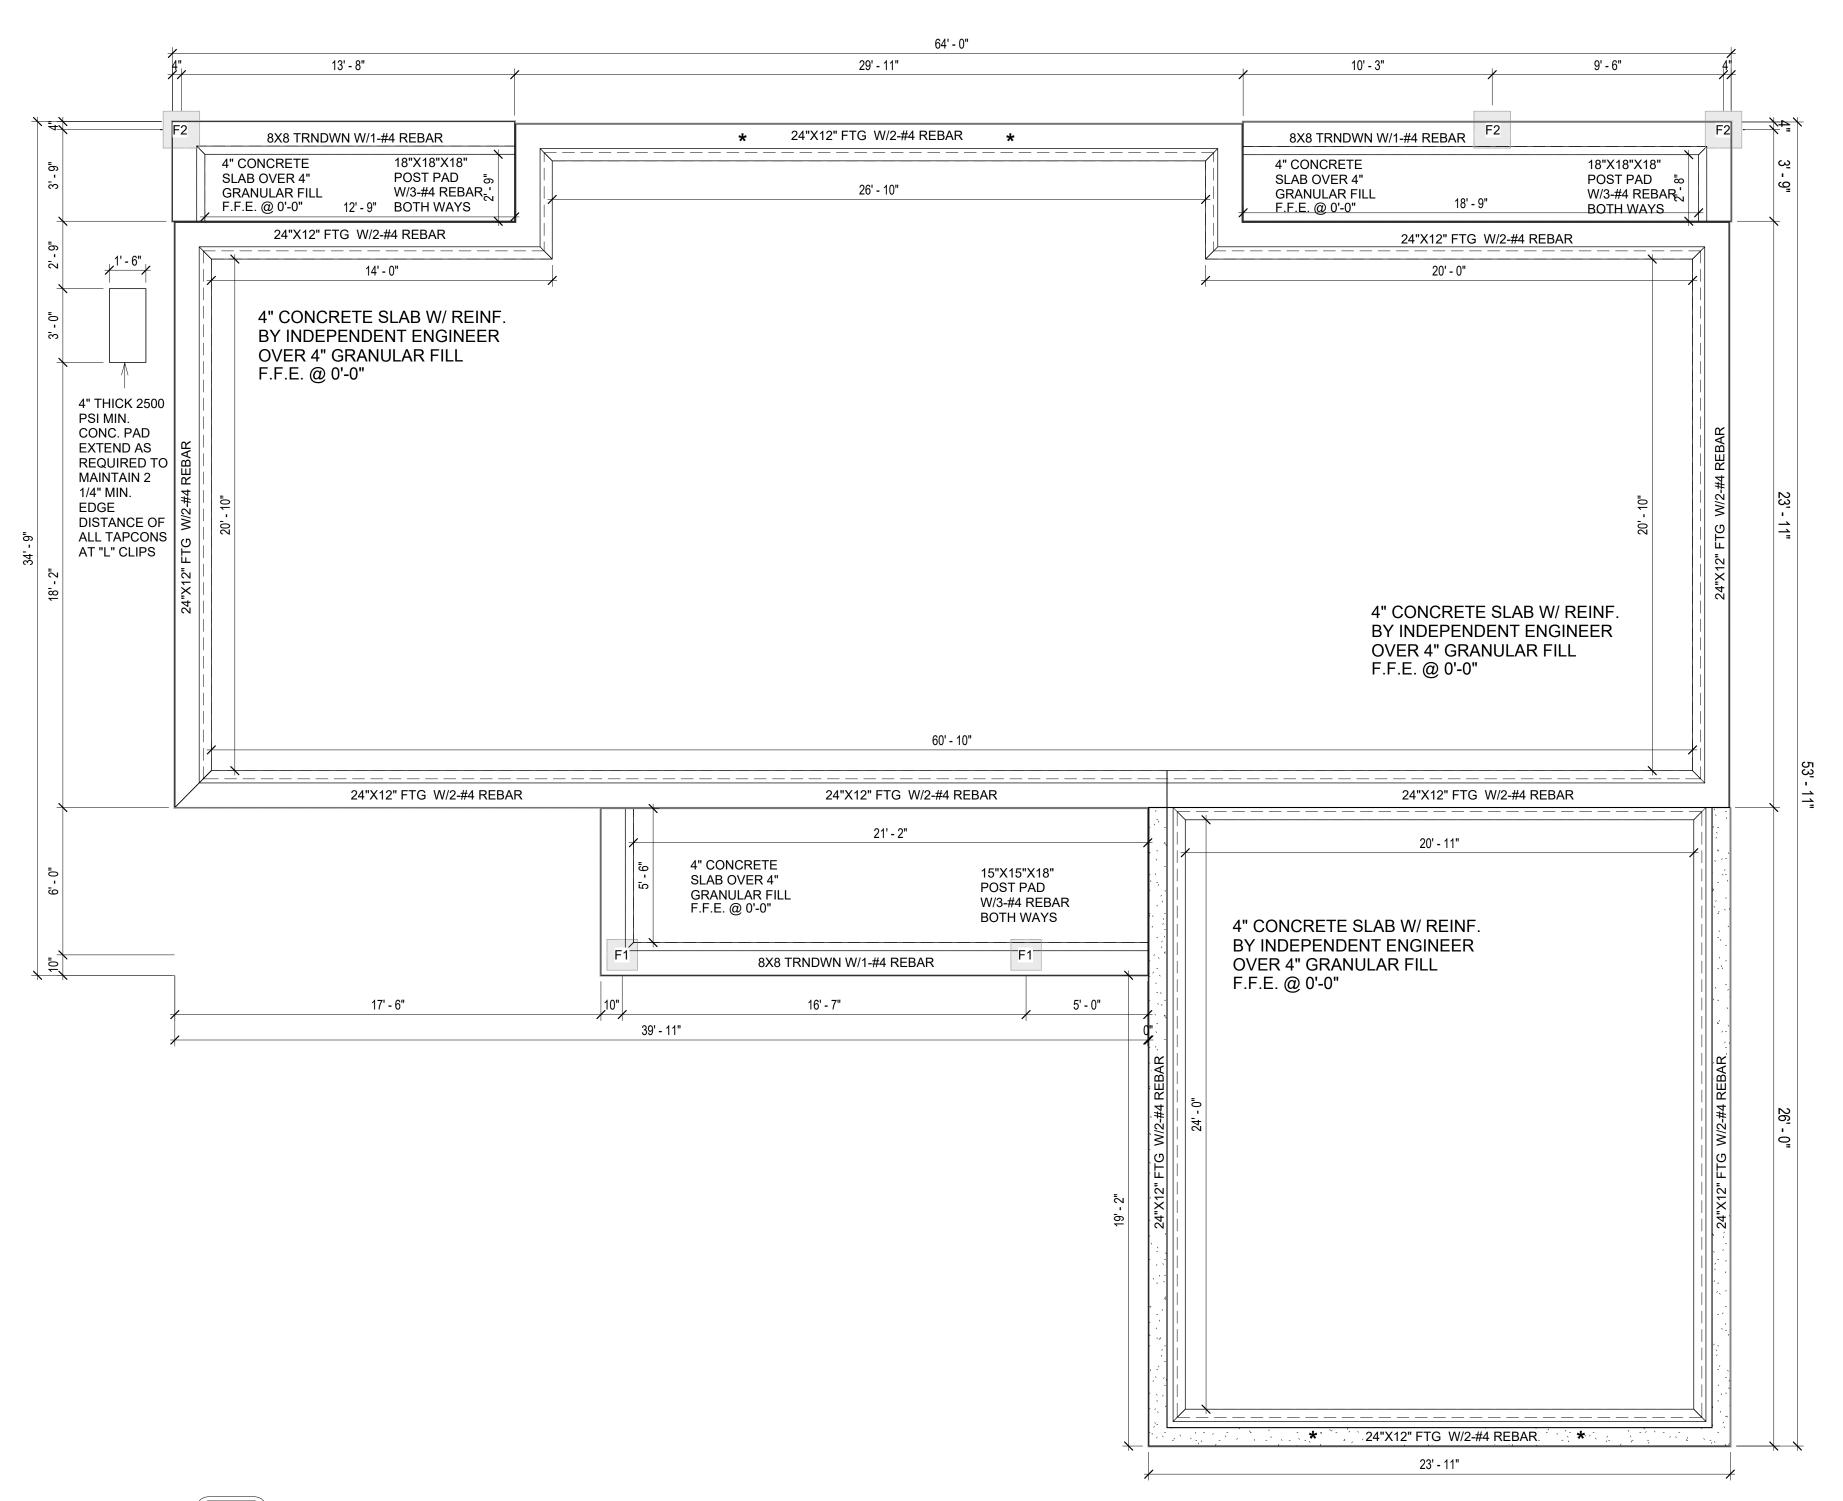

FOUNDATION PLAN 1/4" = 1'-0"

888-864-0184 inquire@frameupnow.com www.frameupnow.com

**KEY PLAN** 

NO.	DESCRIPTION	DATE

NOTE:

LEGEND:

PROJECT

246-EMBER-1650-3Bd2.5Ba **CRAFTSMAN-550** 

DRAWING NAME

FOUNDATION PLAN

Client Name	CLIENT NAME:
0061_12	PROJECT NUMBER:
5/8/2025 2:19:05 PM	DATE:
Designer	DESIGNED BY:
Author	DRAWN BY:
Checker	CHECKED BY:

**S101** 

SCALE: 1/4" = 1'-0"

254 2524

620

SQUARE FOOTAGE

**GARAGE** 

PORCH

TOTAL

### **GENERAL NOTES**

#### **NOTES:**

-ALL BEARING WALLS SHOULD HAVE A THICKENED SLAB PER SECTION PER DETAIL A401/5.

#### A) **FOUNDATION PLAN NOTES**:

- 1. CONCRETE SLAB SHALL BE 6" THICK WITH 1/2" DIAMETER TENDONS PER LAYOUT PLAN, CENTERED IN SLAB THICKNESS, OVER APPROVED SUBBASE PER GENERAL STRUCTURE NOTES.
- TERMITE PROTECTION SHALL BE PROVIDED PER IRC SECTION R318.1
   NONE TYPICAL ANCHOR BOLT SPACING AT SHEAR WALL AND HOLD DOWN
- SPECIFICATIONS PER APPROVED ARCHITECTURAL PLANS.

  4. INSTALL HOLDOWNS BEFORE CONCRETE SLAB POUR.
- 5. EXISTING FILL ON-SITE SHALL BE COMPACTED IN ACCORDANCE WITH THE REQUIREMENTS IN THE GEOTECHNICAL REPORT.
- 6. ALL FLOOR SLABS ARE REINFORCED ON CONCRETE SLABS.

### SPECIAL INSPECTION IS REQUIRED FOR THICKENED FOUNDATION CONSTRUCTION

- 1. REINFORCEMENT
- 2. 2300 PSI CONCRETE POUR

### B) REINFORCEMENT FOR CONCRETE:


 ALL REINFORCING SLABS BARS SIZE 10MM OR LARGER SHALL BE DEFORMED IN ACCORDANCE TO ASTM-A706, AND BARS SMALLER THAN 10 MM MAYBE PLAIN.
 UNLESS OTHERWISE NOTED IN PLANS, THE YIELD STRENGTH OF REINFORCING BARS SHALL BE:


> A) FOOTING = 40,000 PSI B) NON-LOAD BEARING WALLS AND PARAPETS= 40,000 PSI


- 3. SPLICES SHALL BE SECURELY WIRED TOGETHER AND SHALL LAP OR EXTEND
- 4. GRADE OF STEEL FOR RCC WORKS SHALL BE GRADE 4 10.
- 5. BAR NOTATIONS GIVES INFORMATION
- A) BAR SIZE
- B) SPACING(IF REQUIRED)
- LAP REINFORCEMENT ONLY AT LOCATION SHOWN IN THE DRAWINGS
   REINFORCEMENT SHALL NOT BE CUT, VENT OR HEATED ON SITE WITHOUT ENGINEERS' APPROVAL.
- C) CONCRETE SLAB NOTES
- 1. ALL SLAB REINFORCEMENT SHALL BE 20MM CLEAR MINIMUM FROM BOTTOM AND FROM TOP OF SLAB.
- 2. REINFORCEMENT IN CONTINUOUS ELEVATED SLAB SHALL BE CUT AS FOLLOWS.

### NOTE

- THIS IS A SCHEMATIC PLAN FOR THE PURPOSE OF LOCATING AND IDENTIFYING FOUNDATION REINFORCING ELEMENTS ONLY. VERIFY ALL DIMENSIONS, DROPS, OFFSETS AND FEATURES WITH THE ARCHITECTURAL PLANS BEFORE FORMING THE FOUNDATION.

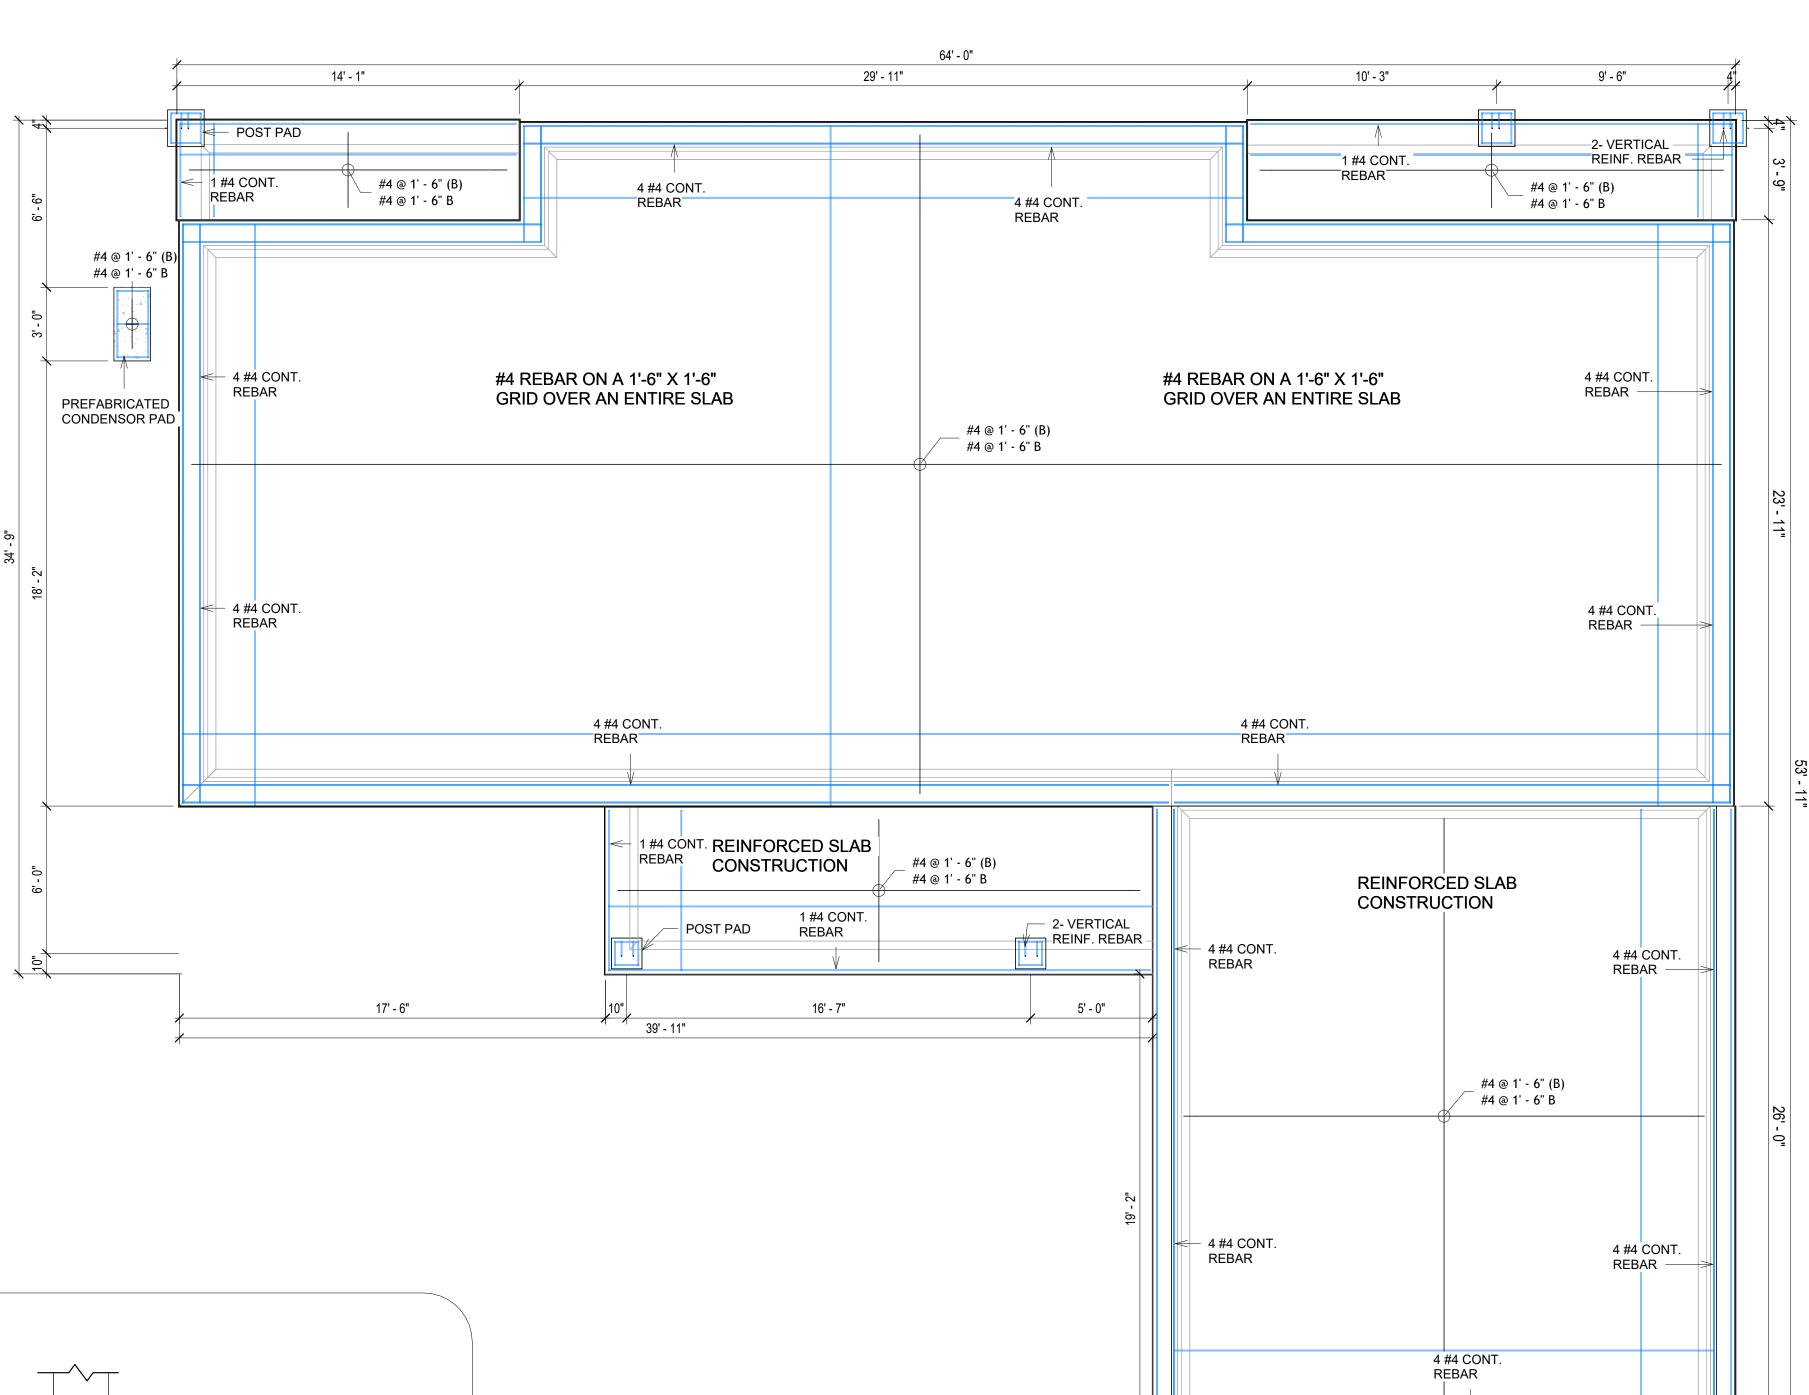

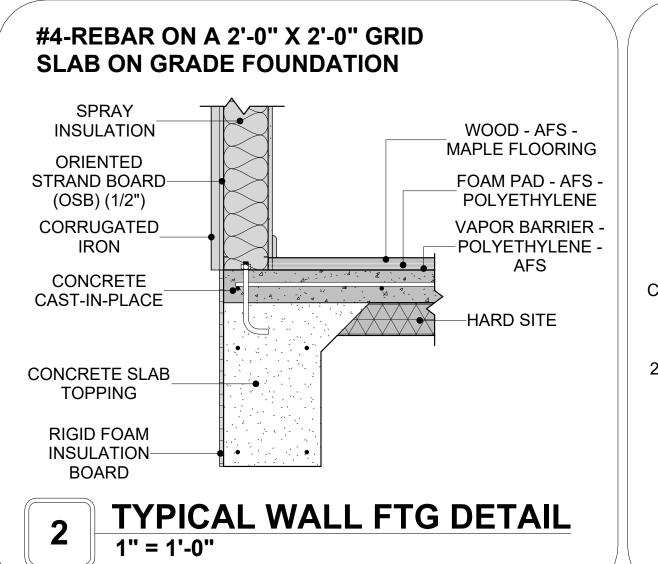

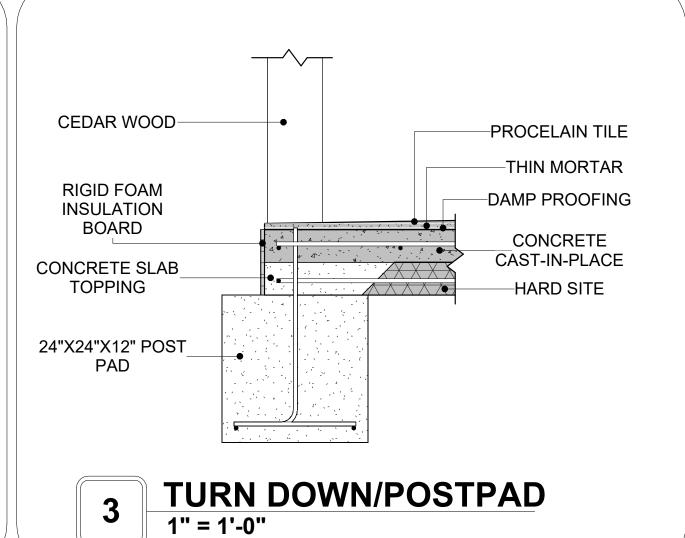

FOUNDATION REBAR PLAN
1/4" = 1'-0"

23' - 11"



**KEY PLAN** 

NO. DESCRIPTION DATE

NOTE:

LEGEND:

PROJECT

246-EMBER-1650-3Bd2.5Ba CRAFTSMAN-550

DRAWING NAME

STRUCTURAL FLOOR PLAN

CLIENT NAME:

PROJECT NUMBER:

0061\_12

DATE:

5/8/2025 2:19:07 PM

DESIGNED BY:

DRAWN BY:

CHECKED BY:

Checker

**S102** 


### LEGEND


LE	Load Bearing External Wall
LI	Load Bearing Internal Wall
NE	Non Load Bearing External Wall
NI	Non Load Bearing Internal Wall
В	Beam
CB	Claded Beam
GB	Glulam Beam

550S 33mil 50ksi	
Single Absolute Stud	Back to Back Stud
15/80   15/80	

350S 33mil 50ksi		
Single Absolute Stud	Back to Back Stud	
158"		

550S 43mil 50ksi		
Single Absolute Stud	Back to Back Stud	
15/8" "Z'-15 "5/8" "15/8" "15/8"		

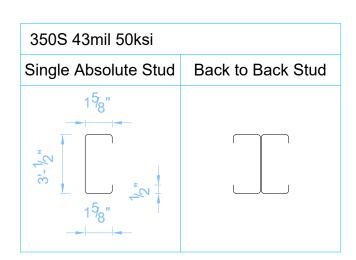

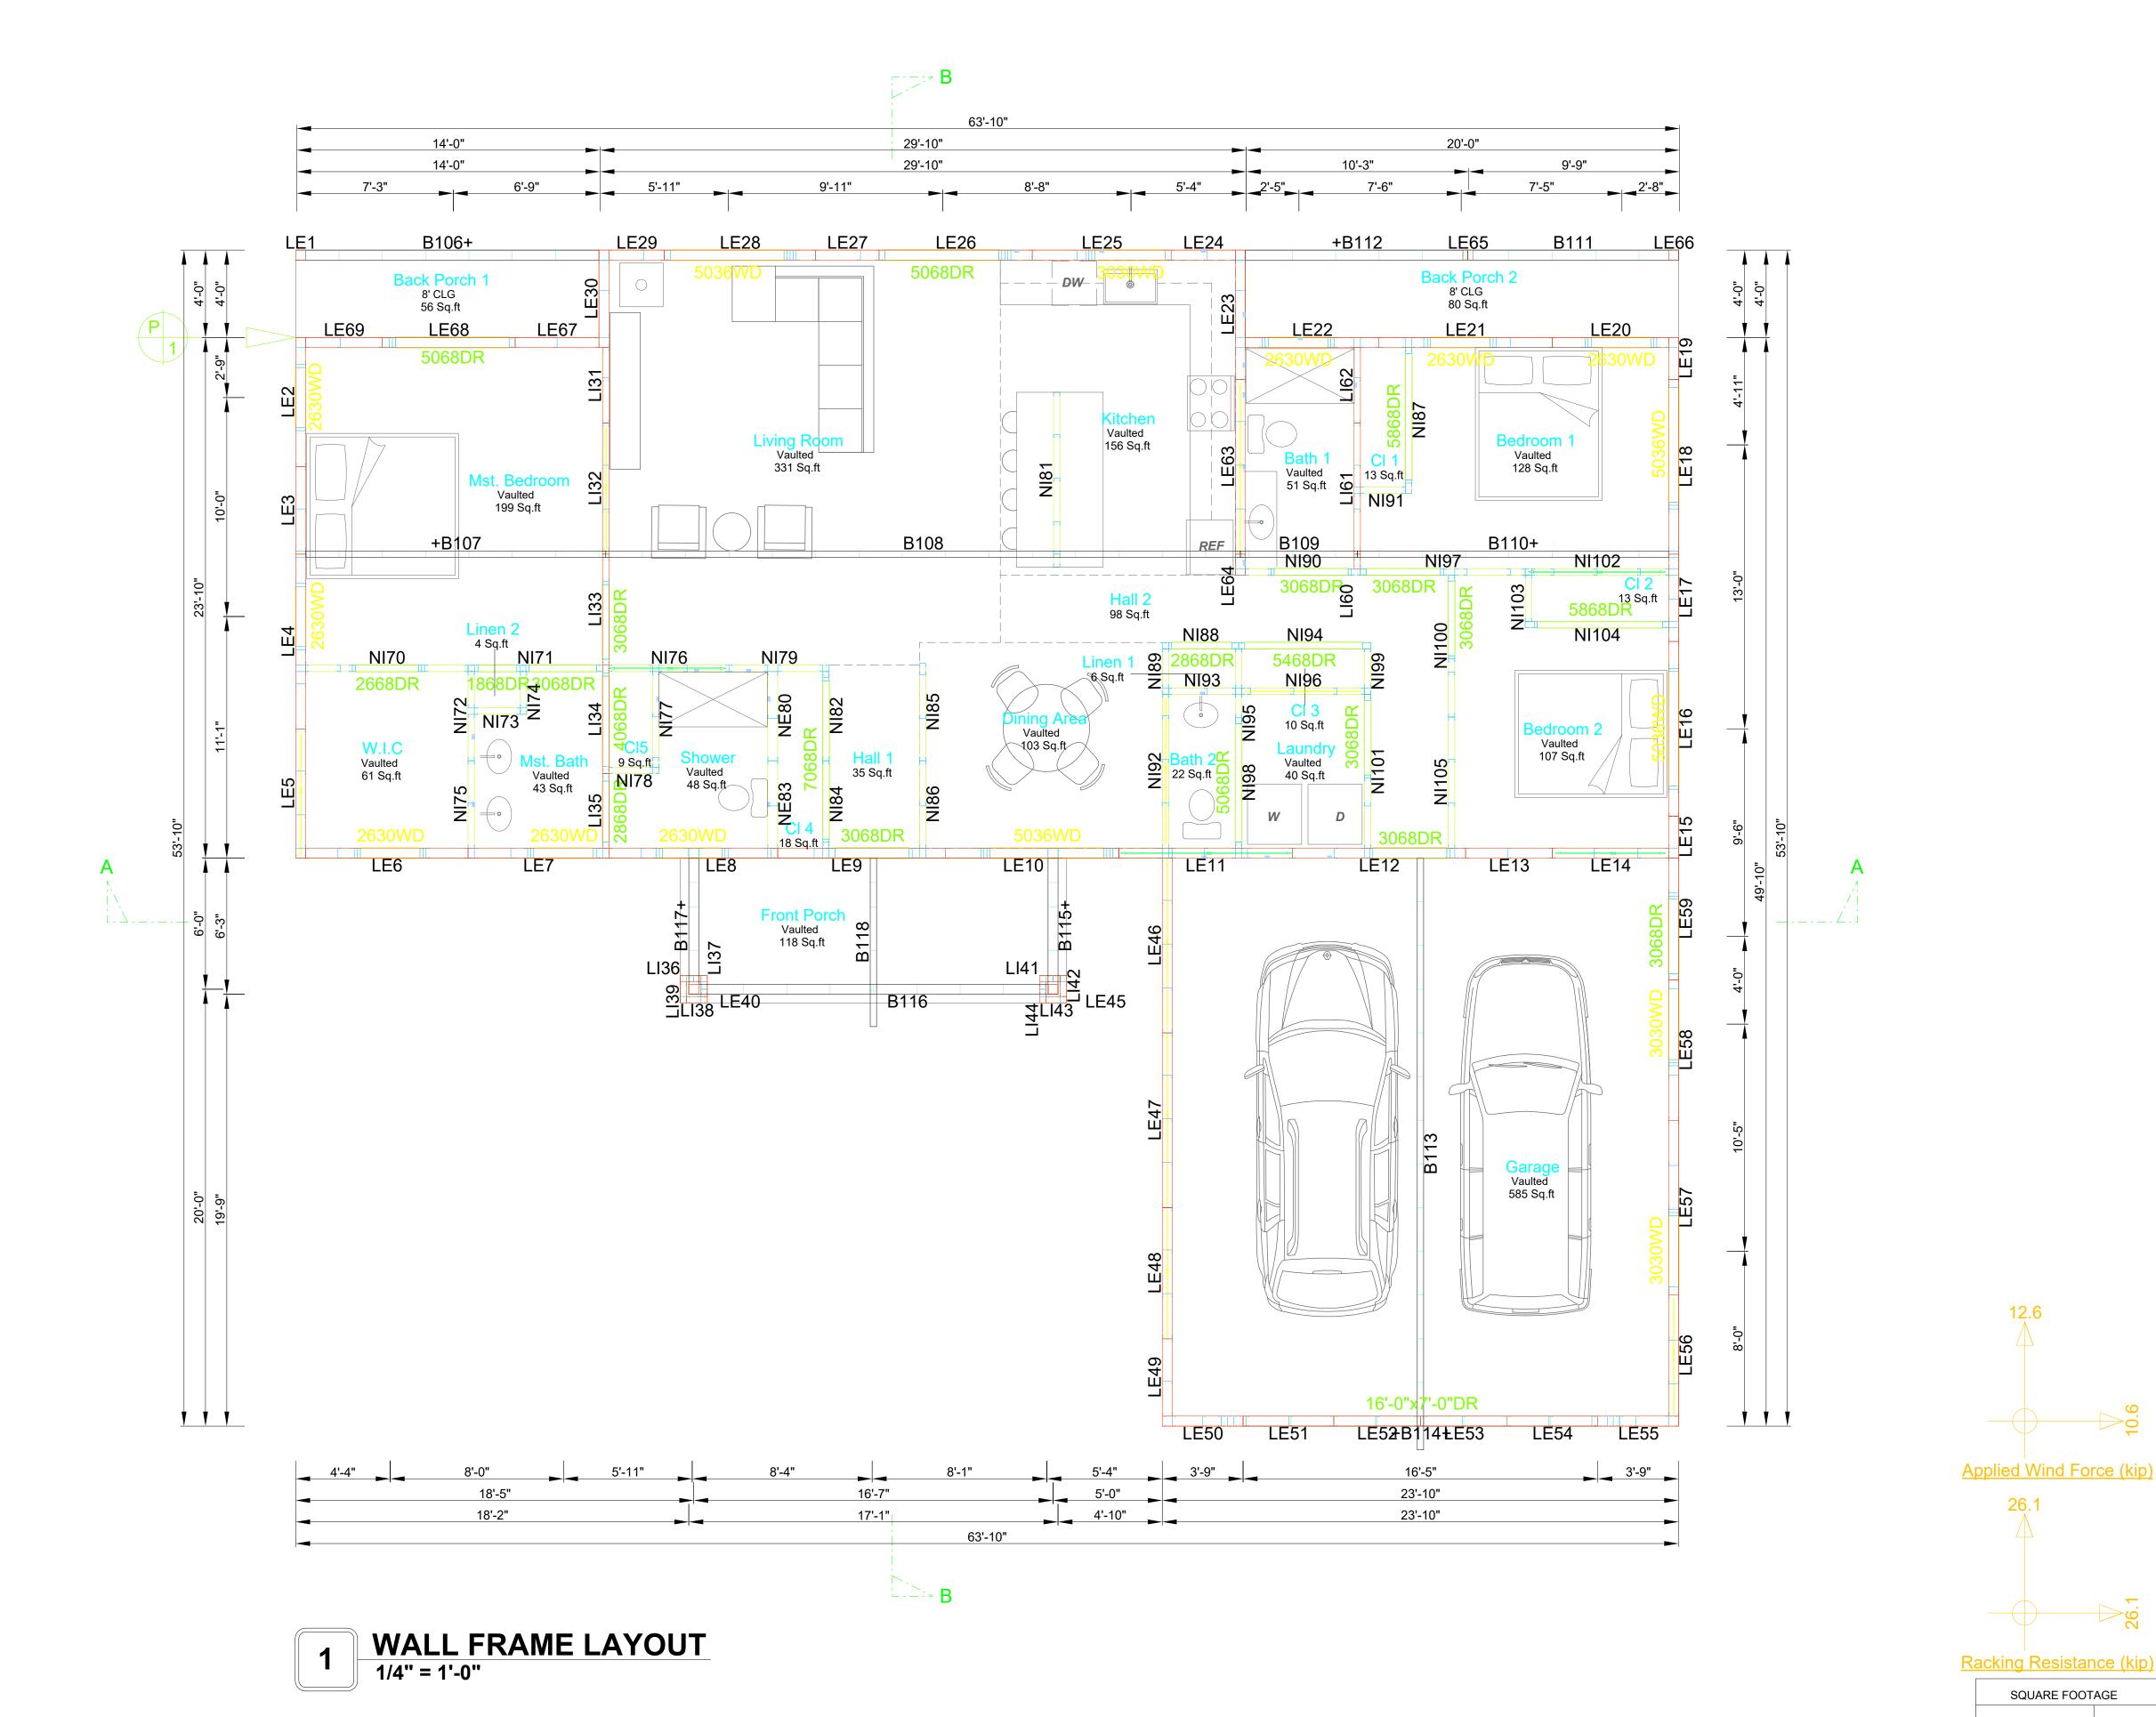



**KEY PLAN** 

NO.	DESCRIPTION	DATE

NOTE:

LEGEND:

PROJECT

12.6

26.1

GARAGE

PORCH

TOTAL

SQUARE FOOTAGE

1650

620

254

2524

0.0

246-EMBER-1650-3Bd2.5Ba **CRAFTSMAN-550** 

DRAWING NAME

WALL FRAME LAYOUT

Client Name
0061_12
5/8/2025 2:19:08 PM
Designer
Author
Checker

**S103** 

SCALE: 1/4" = 1'-0"


© [2024] [FrameUpNow] . All rights reserved

### <u>LEGEND</u>

G	Gable Truss
GI	Girder Truss
GF	Gable Frame
HG	Half Gable Truss
HA	Half Girder Truss
PC	Parallel Truss
Τ	Truncated Truss
S1	Sadel Truss
U	User Truss
V	Rafter

### Roof Design Load

Roof Live Load(psf)	20
Roof Dead load(psf)	14
Celling Dead load(psf)	3
Design Point Load(kip)	0.25
Snow Live Load	<5° = 40 psf
	>5° = 40 psf x slope factor of the Roof

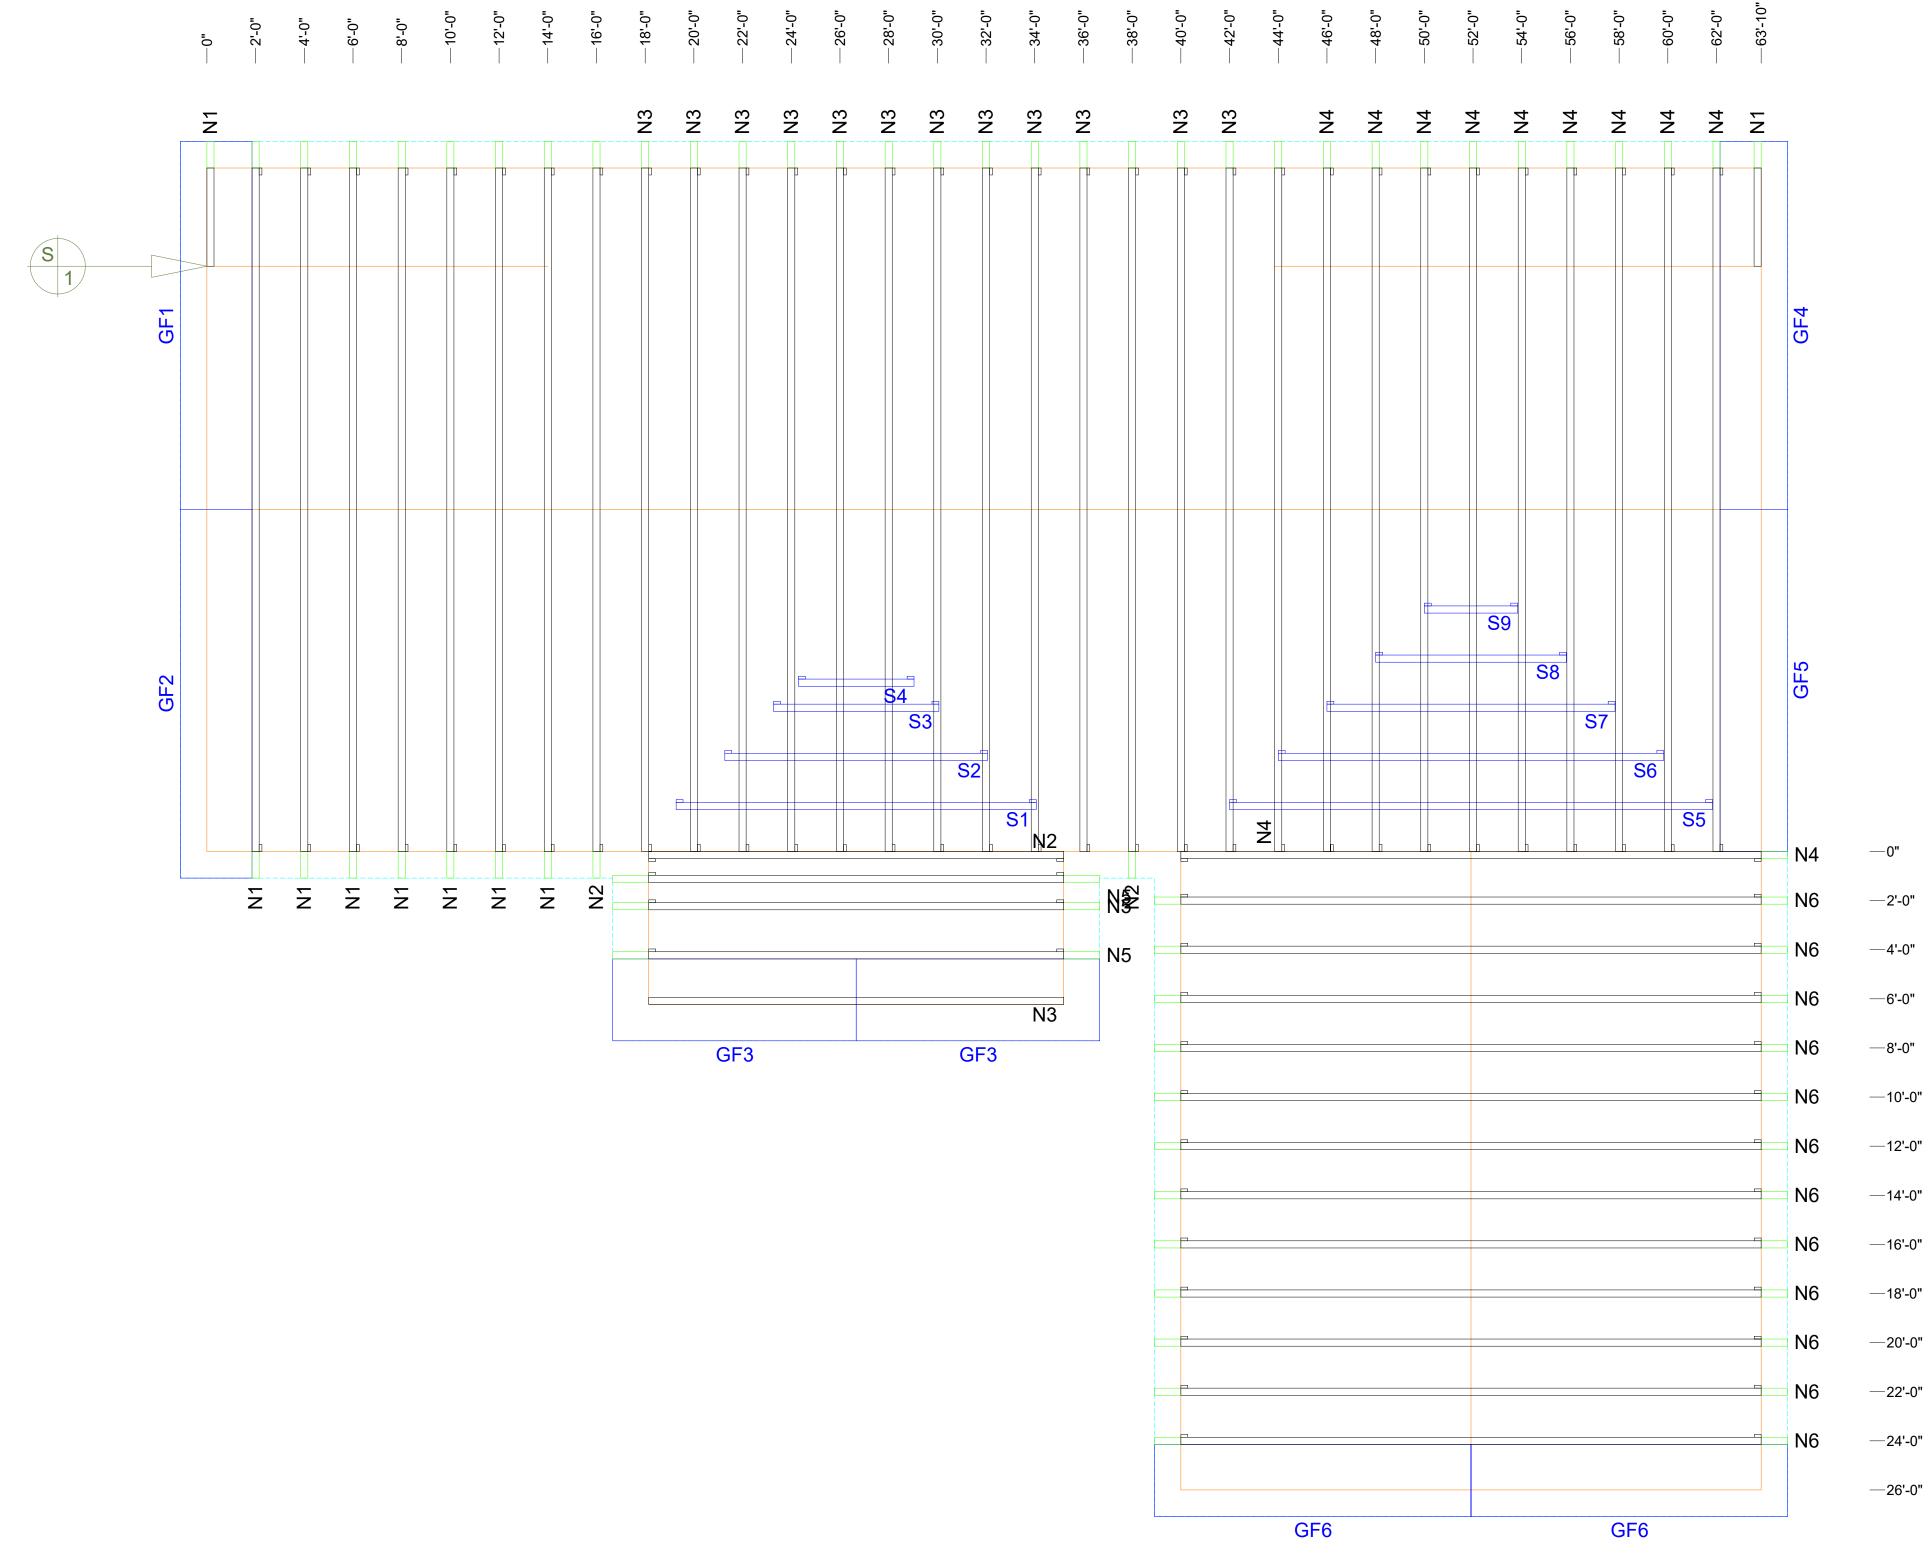

ROOF TRUSS LAYOUT



<b>ROOF TRUS</b>	S LAYOUT
TAVING NAME	

CLIENT NAME:	Client Name
PROJECT NUMBER:	0061_12
DATE:	5/8/2025 2:19:09 PM
DESIGNED BY:	Designer
DRAWN BY:	Author
CHECKED BY:	Checker

SQUARE FOOTAGE 1650 GARAGE 620 PORCH 254 2524 TOTAL

Tuscon,AZ, USA 888-864-0184 inquire@frameupnow.com www.frameupnow.com

**KEY PLAN** 

DESCRIPTION DATE

NOTE:

LEGEND:

PROJECT

246-EMBER-1650-3Bd2.5Ba CRAFTSMAN-550


DRAWING NAME

**S104** 

SCALE: 1/4" = 1'-0"

### **ROOF NOTES**

- ROOFING COMPOSITION ROOFING PER OWNERS/BUILDERS SPECIFICATIONS INSTALL PER MANUFACTURE SPECIFICATIONS ON 1/2" ORIENTED STRAND BOARD ON PRE-ENGINEERED TRUSS @ 24" O.C. (UNO.) 2. 73" OVERHANG AT EAVES (UNO.)
- 3. ENDS OF ALL TRUSSES AND JOISTS TO BE FULLY BLOCKED. PROVIDE SOLID BLOCKING AT ALL RIDGES AND VALLEYS
- 4. SHEATHING TO BE 1/2", 3/8" OSB SHEAR PANEL AND EQUIVALENT. UNDERSIDE OF PORCH TRUSSES TO BE FINISHED WITH MOISTURE RESISTANT DRYWALL, TAPED AND TEXTURED.
- 5. EXPOSED EAVES AND OTHER WEATHER EXPOSED AREAS TO BE SHEATHED WITH EXTERIOR GRADE PLYWOOD.
- 6. ALL MATERIALS THICKNESS AND SIZE ARE THE MINIMUM. Refer TO LOCAL
- STANDARDS FOR ACTUAL THICKNESS AND LAYERING OF MATERIALS. 7. ENGINEERED TRUSS CALCULATIONS TO BE SUBMITTED TO BUILDING
- DEPARTMENT PRIOR TO FABRICATION AND INSTALLATION. 8. TRUSS MANUFACTURER TO SPECIFY HANGER CONNECTORS FOR TRUSS
- COMPONENTS (TYPICAL) 9. DESIGNER ASSUMES THAT TRUSSES BEAR ON ALL EXTERIOR PERIMETER WALLS (TYPICAL) OR BEAMS.
- 10. PROVIDE GALVANIZED STEEL FLASHING WITH A LENGTH OF 10 FEET, WIDTH
- OF 12 INCHES, AND THICKNESS OF 24 GAUGE.

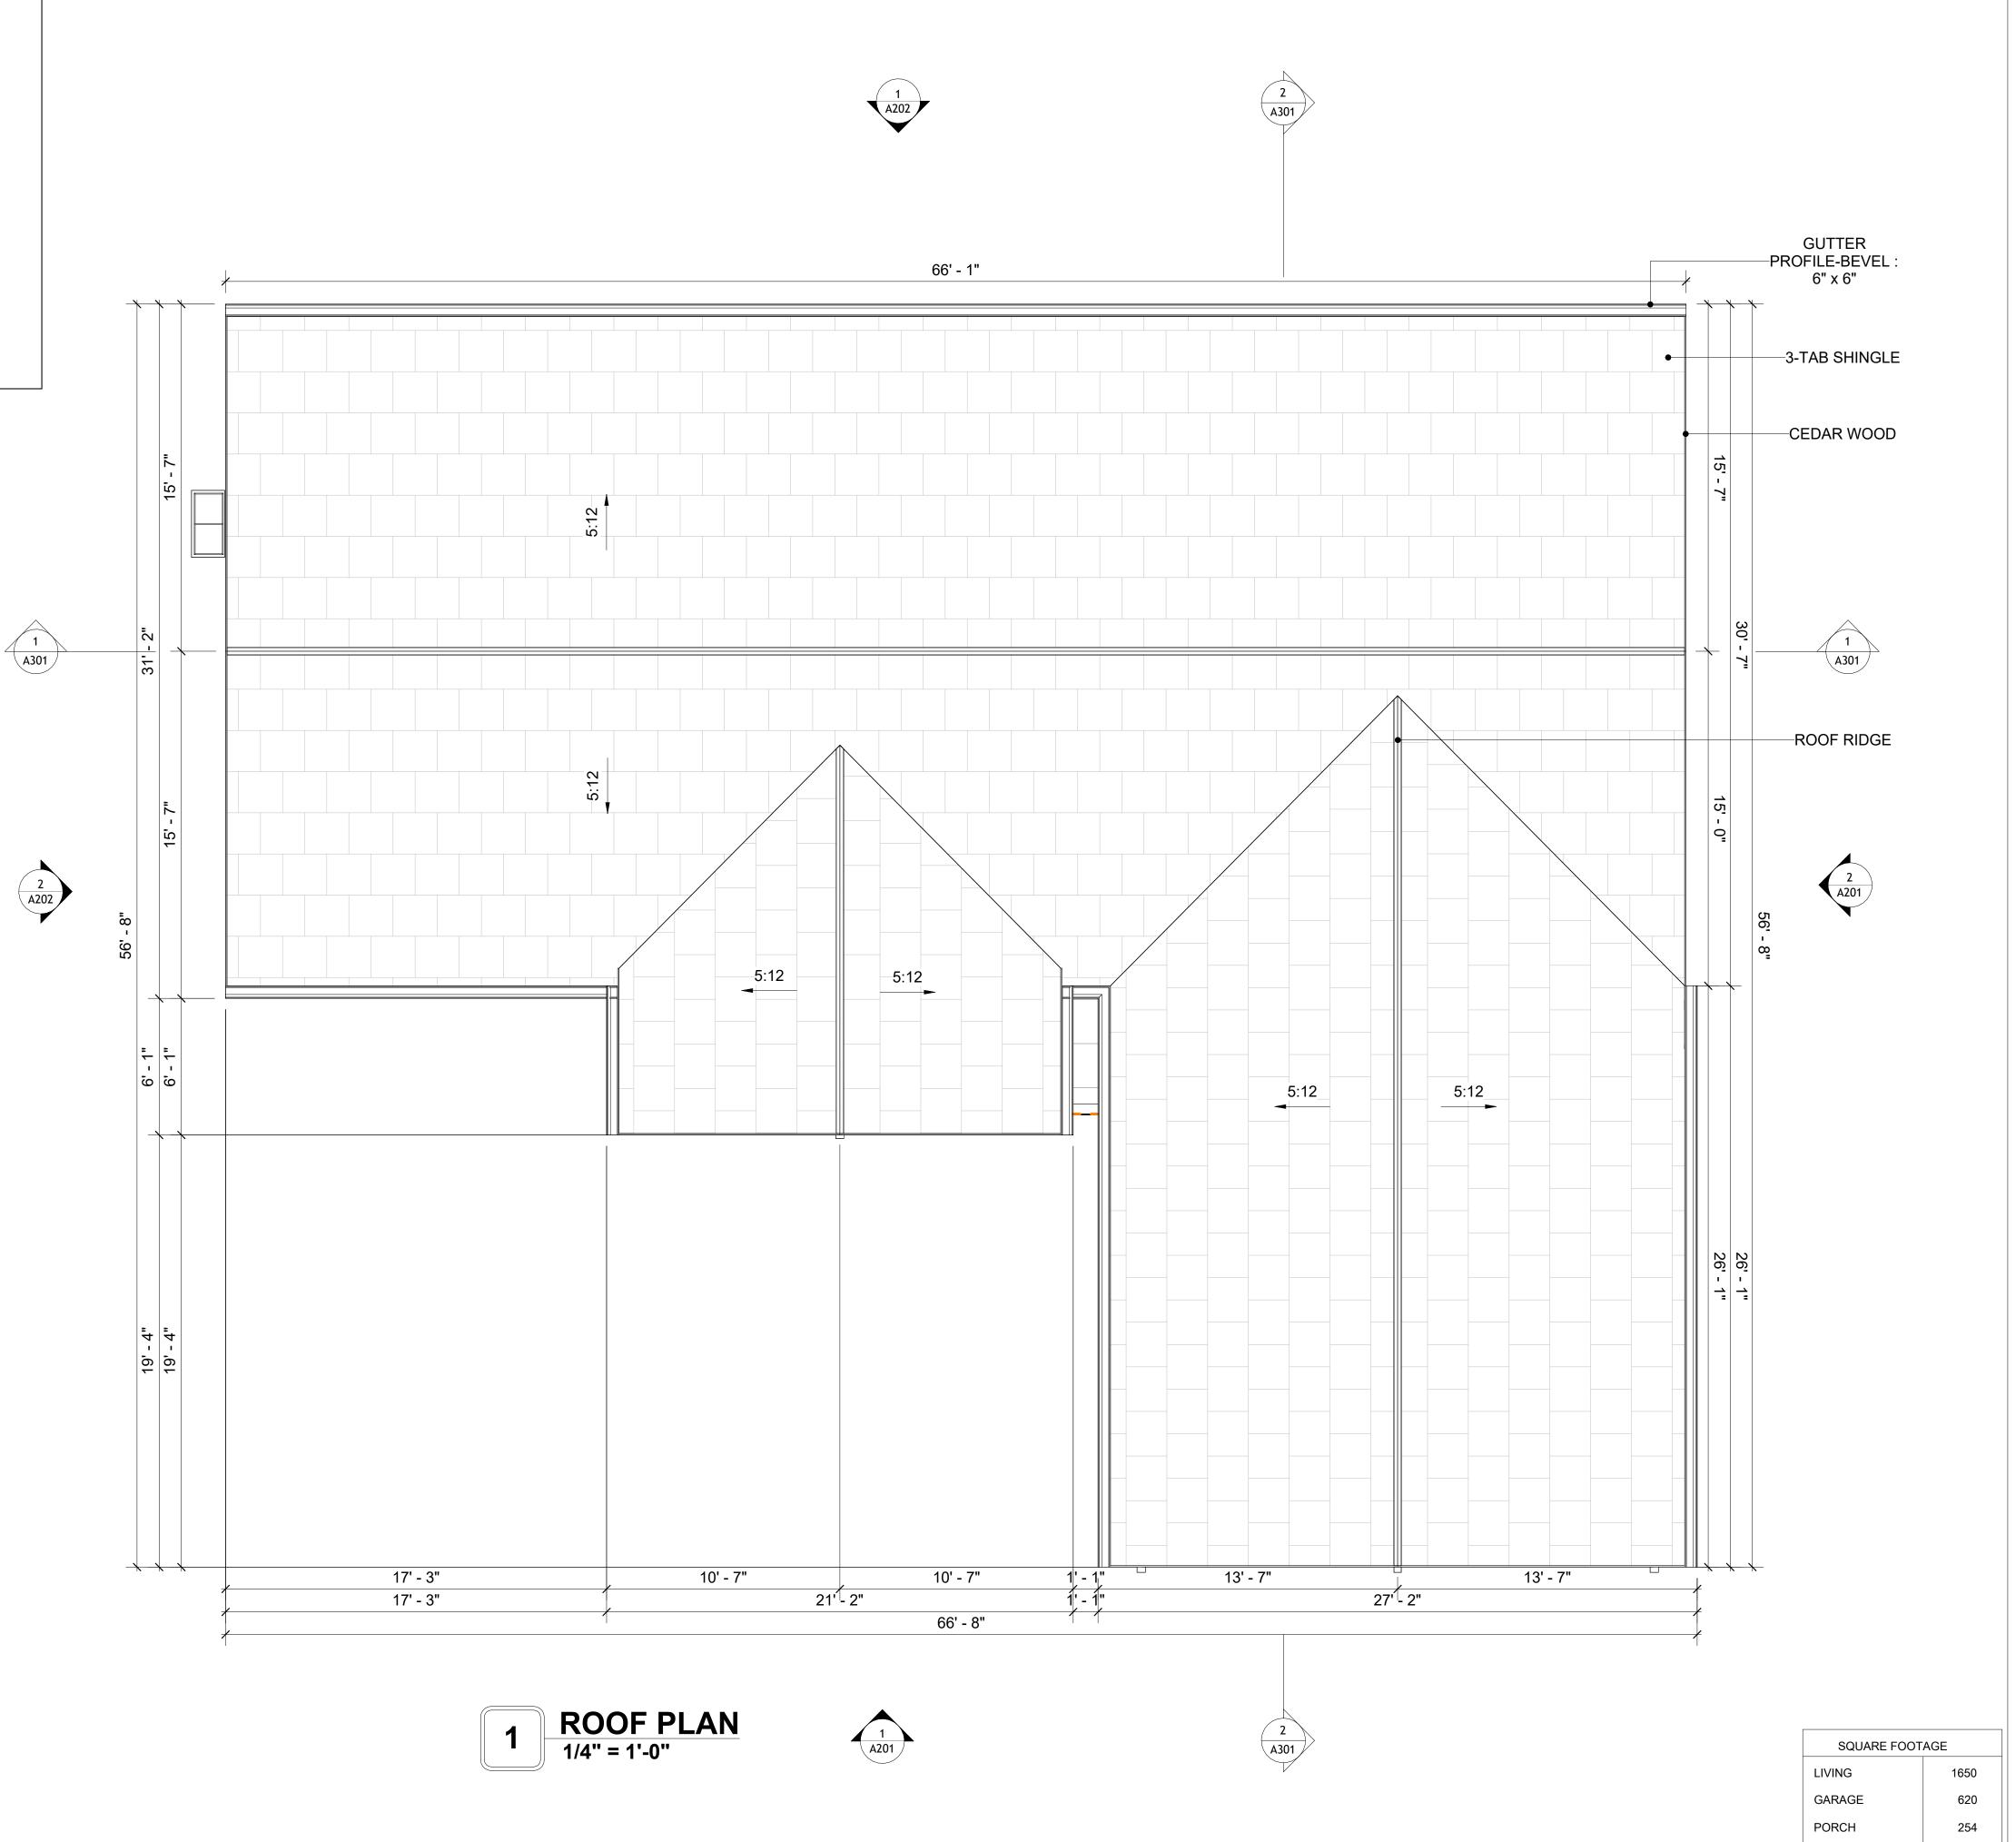



**KEY PLAN** 

NO.	DESCRIPTION	DATE

NOTE:

LEGEND:

PROJECT

246-EMBER-1650-3Bd2.5Ba **CRAFTSMAN-550** 

DRAWING NAME

**ROOF PLAN** 

Client Name	CLIENT NAME:
0061_12	PROJECT NUMBER:
5/8/2025 2:19:14 PM	DATE:
Designer	DESIGNED BY:
Author	DRAWN BY:
Checker	CHECKED BY:

A103

SCALE: 1/4" = 1'-0"

TOTAL

2524

### **ABOUT WALL FINISHING**

### **CORRUGATED IRON SHEET**

CORRUGATED IRON IS A FINISHING MATERIAL MADE FROM STEEL THAT HAS BEEN GALVANIZED (COATED WITH A THIN LAYER OF ZINC) TO PROTECT IT FROM CORROSION AND RUST.

IN THIS SPECIFIC PROJECT, THE CORRUGATED IRON SHEETS ARE INSTALLED HORIZONTALLY ON VERTICAL FURRING STRIPS THAT ARE DIRECTLY ATTACHED ONTO THE PROPERLY INSTALLED AND SEALED HOME WRAP, USING SELF-DRILLING SCREWS THAT ARE DRIVEN THROUGH THE RIDGES OR VALLEYS OF THE CORRUGATIONS.

### STONE VENEER

STONE VENEER REFERS TO THIN LAYERS OF NATURAL OR MANUFACTURED STONE APPLIED TO A STRUCTURAL WALL, KNOWN FOR THEIR REALISTIC APPEARANCE AND RELATIVE LIGHTNESS. THESE VENEERS PROVIDE THE AESTHETIC OF STONE WITHOUT THE COST AND WEIGHT OF FULL STONE CONSTRUCTION, CONTRIBUTING TO A BEAUTIFUL AND COSTEFFECTIVE EXTERIOR FINISH.

IN THIS SPECIFIC PROJECT, STONE VENEER IS USED A FINISH MATERIAL ON EXTERIOR FINISH.

### **CEDAR WOOD**


CEDAR WOOD REFERS TO THE WOOD FROM VARIOUS SPECIES OF CEDAR TREES, WHICH ARE CONIFEROUS EVERGREEN TREES KNOWN FOR THEIR DISTINCT AROMA AND NATURAL RESISTANCE TO DECAY AND INSECTS.

IN THIS SPECIFIC PROJECT, CEDAR WOOD IS USED A FINISH MATERIAL ON BEAMS AND COLUMNS.


### **WOOD SHAKES**

WOOD SHAKES ARE ROUGH-SAWN PIECES OF WOOD,
TYPICALLY MADE FROM CEDAR OR REDWOOD, USED FOR
ROOFING OR WALL CLADDING. THEY OFFER A RUSTIC,
TEXTURED LOOK BUT REQUIRE REGULAR MAINTENANCE FOR
DURABILITY AND PROTECTION AGAINST THE ELEMENTS.

IN THIS SPECIFIC PROJECT, WOOD SHAKES ARE APPLIED AT THE TOP OF THE EXTERNAL WALL, CREATING AN EYE-CATCHING DETAIL THAT COMPLEMENTS THE OVERALL ARCHITECTURE AND ENSURES A STURDY, WEATHER-RESISTANT FINISH.

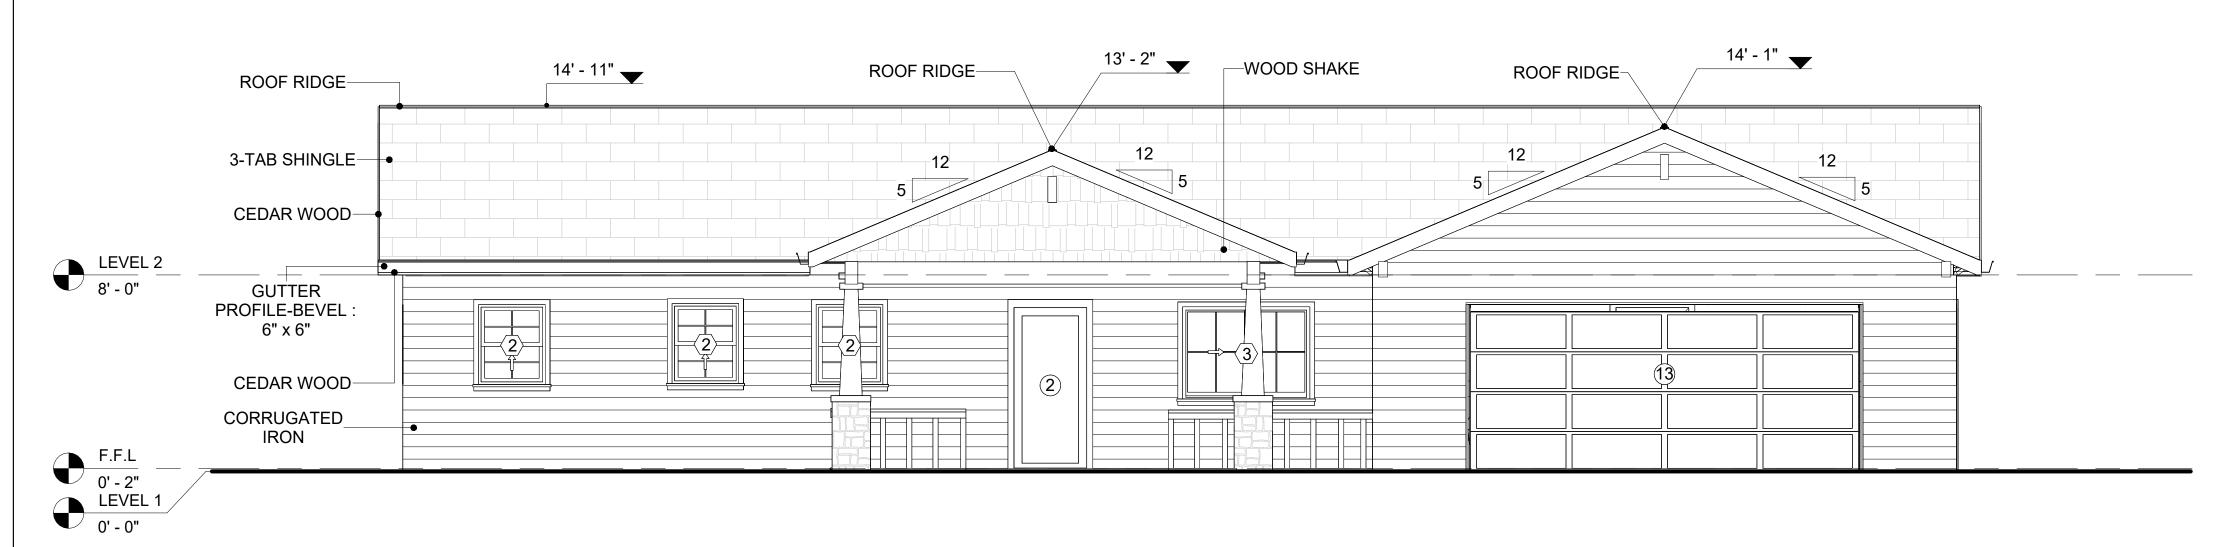



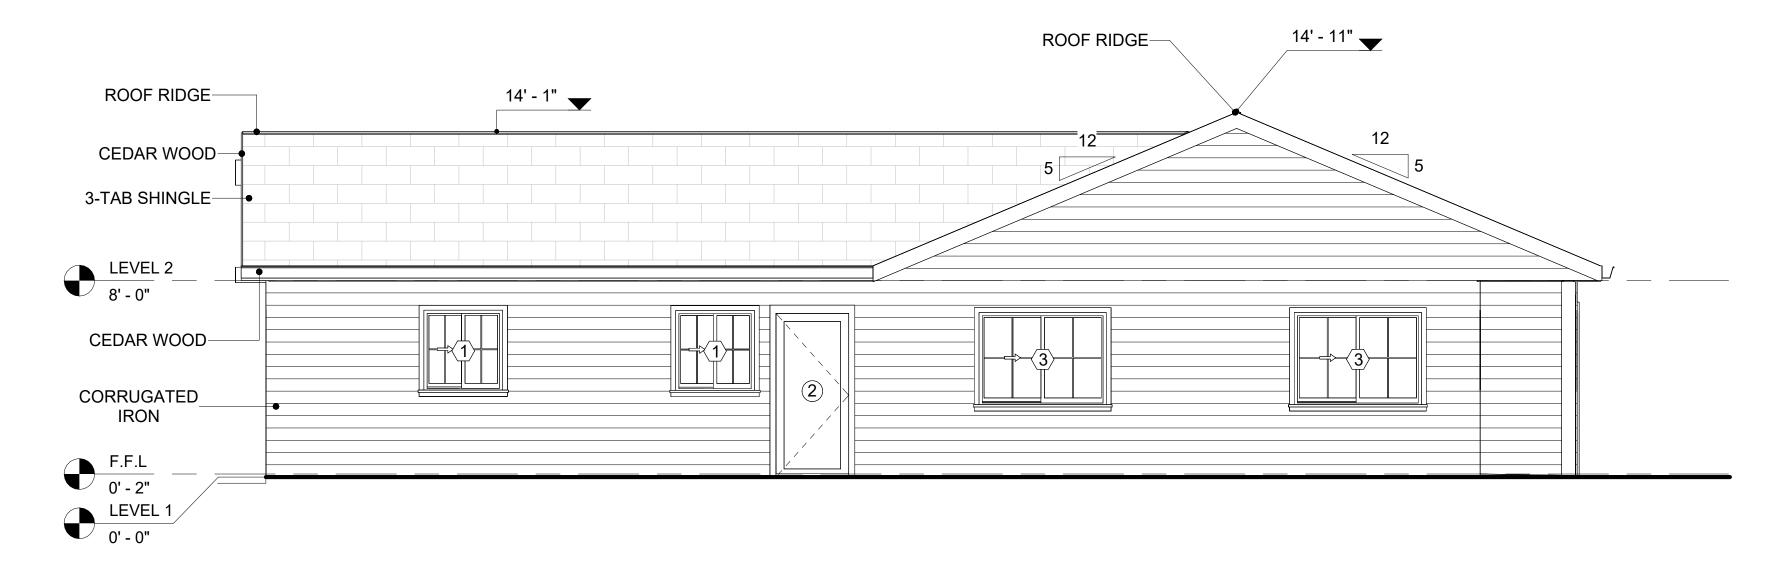

# 2 RIGHT SIDE ELEVATION 1/4" = 1'-0"

DOOR SCHEDULE						
TYPE				SIZE		
MAR K	SUPPLIER	DOOR TYPE	LOCATIO N	WIDTH	HEIGHT	COUNT
4	LIOME DEDOT	INTERIOR CINICI E DANIEL CIVINICINIC	INTEDIOD	21 0"	CI O''	C
۱ ၁	HOME DEPOT	INTERIOR SINGLE PANEL SWINGING EXTERIOR SINGLE PANEL SWINGING	INTERIOR	3' - 0" 3' - 0"	6' - 8" 6' - 8"	2
2	HOME DEPOT	INTERIOR SINGLE PANEL SWINGING	INTERIOR	2' - 6"	6' - 8"	1
3 4	HOME DEPOT	INTERIOR SINGLE PANEL SWINGING	INTERIOR	3' - 0"	6' - 8"	2
<u>.                                      </u>	HOME DEPOT	PATIO DOUBLE PANEL SLIDING	EXTERIOR	5' - 0"	6' - 8"	2
6	HOME DEPOT	INTERIOR DOUBLE PANEL SLIDING	INTERIOR	7' - 0"	6' - 8"	1
7	HOME DEPOT	INTERIOR DOUBLE PANEL SLIDING	INTERIOR	5' - 8"	6' - 8"	2
8	HOME DEPOT	DOOR-INTERIOR-SINGLE-POCKET-2_PANE L-WOOD	INTERIOR	3' - 0"	6' - 9"	1
9	HOME DEPOT	INTERIOR DOUBLE PANEL SLIDING	INTERIOR	5' - 4"	6' - 8"	1
10	HOME DEPOT	SINGLE FOLD 2	INTERIOR	2' - 8"	6' - 8"	1
11	HOME DEPOT	SINGLE FOLD 2	INTERIOR	1' - 8"	6' - 8"	1
12	HOME DEPOT	INTERIOR DOUBLE PANEL SLIDING	INTERIOR	4' - 0"	6' - 8"	1
13	HOME DEPOT	DOOR-GARAGE-EMBOSSED_PANEL	EXTERIOR	16' - 0"	6' - 6"	1

WINDOW SCHEDULE					
SIZE					
TYPE MARK	SUPPLIER	WINDOW TYPE	WIDTH	HEIGHT	COUNT
1	HOME DEPOT	SLIDING	3' - 3"	3' - 3"	3
2	HOME DEPOT	SINGLE HUNG	2' - 9"	3' - 3"	8
3	HOME DEPOT	SLIDING	5' - 3"	3' - 9"	4



KEY PLAN	
	<b>4</b> 2
1_	

NO.	DESCRIPTION	DATE

NOTE:

LEGEND:

PROJECT

246-EMBER-1650-3Bd2.5Ba CRAFTSMAN-550

DRAWING NAME

### ARCHITECTURAL ELEVATIONS

CLIENT NAME:	Client Name
PROJECT NUMBER:	0061_12
DATE:	5/8/2025 2:19:25 PM
DESIGNED BY:	Designer
DRAWN BY:	Author
CHECKED BY:	Checker

A201

### **ABOUT WALL FINISHING**

### **CORRUGATED IRON SHEET**

CORRUGATED IRON IS A FINISHING MATERIAL MADE FROM STEEL THAT HAS BEEN GALVANIZED (COATED WITH A THIN LAYER OF ZINC) TO PROTECT IT FROM CORROSION AND RUST.

IN THIS SPECIFIC PROJECT, THE CORRUGATED IRON SHEETS ARE INSTALLED HORIZONTALLY ON VERTICAL FURRING STRIPS THAT ARE DIRECTLY ATTACHED ONTO THE PROPERLY INSTALLED AND SEALED HOME WRAP, USING SELF-DRILLING SCREWS THAT ARE DRIVEN THROUGH THE RIDGES OR VALLEYS OF THE CORRUGATIONS.

### STONE VENEER

STONE VENEER REFERS TO THIN LAYERS OF NATURAL OR MANUFACTURED STONE APPLIED TO A STRUCTURAL WALL, KNOWN FOR THEIR REALISTIC APPEARANCE AND RELATIVE LIGHTNESS. THESE VENEERS PROVIDE THE AESTHETIC OF STONE WITHOUT THE COST AND WEIGHT OF FULL STONE CONSTRUCTION, CONTRIBUTING TO A BEAUTIFUL AND COST-EFFECTIVE EXTERIOR FINISH.

IN THIS SPECIFIC PROJECT, STONE VENEER IS USED A FINISH MATERIAL ON EXTERIOR FINISH.

### **CEDAR WOOD**

CEDAR WOOD REFERS TO THE WOOD FROM VARIOUS SPECIES OF CEDAR TREES, WHICH ARE CONIFEROUS EVERGREEN TREES KNOWN FOR THEIR DISTINCT AROMA AND NATURAL RESISTANCE TO DECAY AND INSECTS.

IN THIS SPECIFIC PROJECT, CEDAR WOOD IS USED A FINISH MATERIAL ON BEAMS AND COLUMNS.


### **WOOD SHAKES**

WOOD SHAKES ARE ROUGH-SAWN PIECES OF WOOD, TYPICALLY MADE FROM CEDAR OR REDWOOD, USED FOR ROOFING OR WALL CLADDING. THEY OFFER A RUSTIC, TEXTURED LOOK BUT REQUIRE REGULAR MAINTENANCE FOR DURABILITY AND PROTECTION AGAINST THE ELEMENTS.

IN THIS SPECIFIC PROJECT, WOOD SHAKES ARE APPLIED AT THE TOP OF THE EXTERNAL WALL, CREATING AN EYE-CATCHING DETAIL THAT COMPLEMENTS THE OVERALL ARCHITECTURE AND ENSURES A STURDY, WEATHER-RESISTANT FINISH.






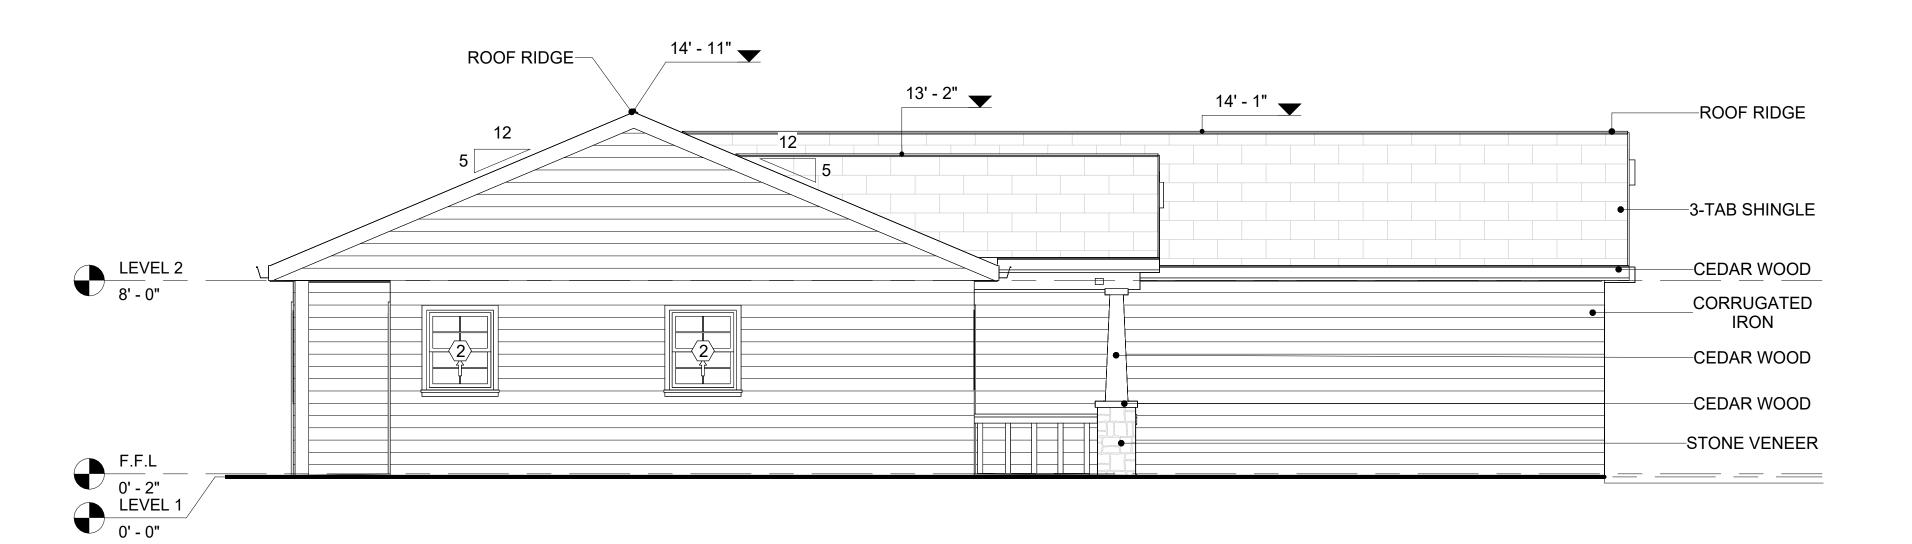

2 LEFT SIDE ELEVATION
1/4" = 1'-0"



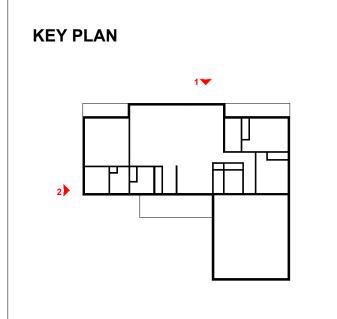

NO.	DESCRIPTION	DATE

NOTE:

LEGEND:

PROJECT

246-EMBER-1650-3Bd2.5Ba CRAFTSMAN-550

DRAWING NAME

ARCHITECTURAL ELEVATIONS

CLIENT NAME:

PROJECT NUMBER:

0061\_12

DATE:

5/8/2025 2:19:34 PM


DESIGNED BY:


DRAWN BY:

CHECKED BY:

Checker


A202

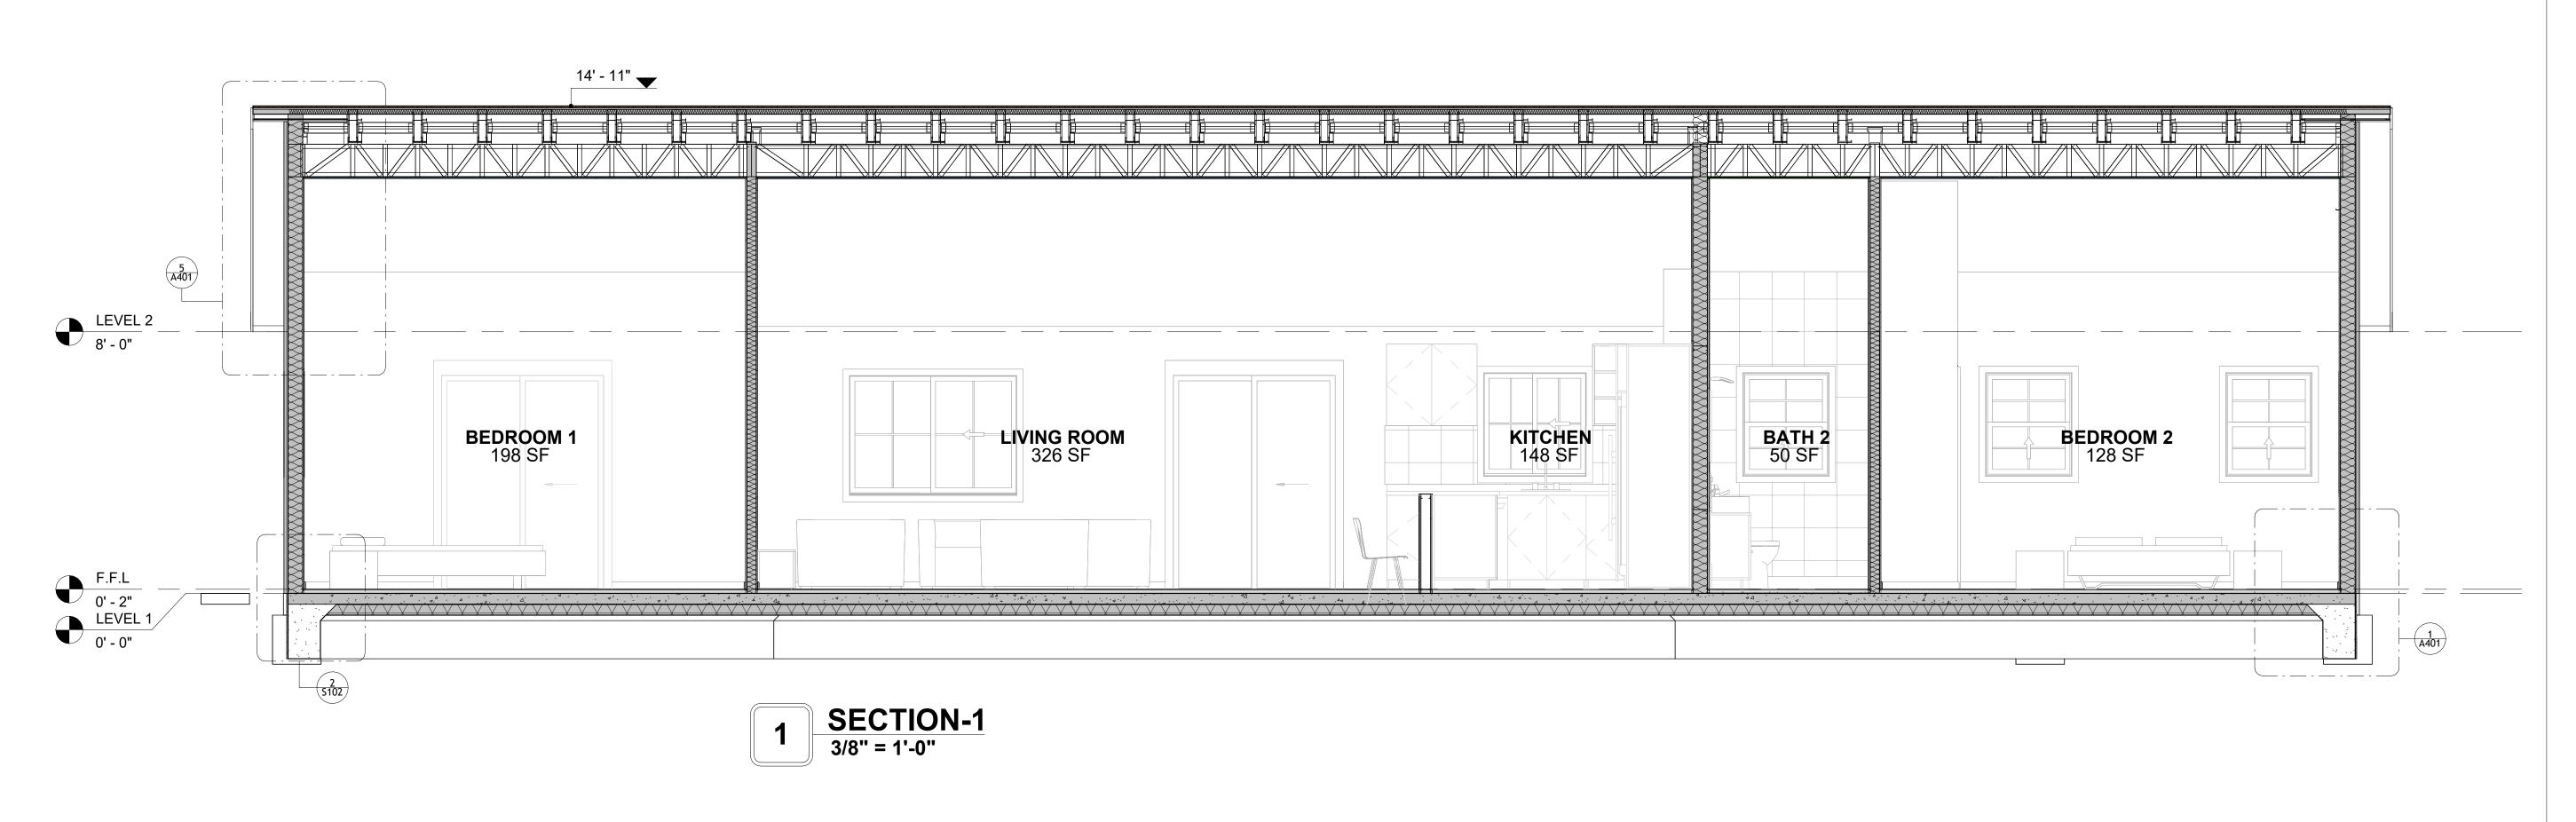

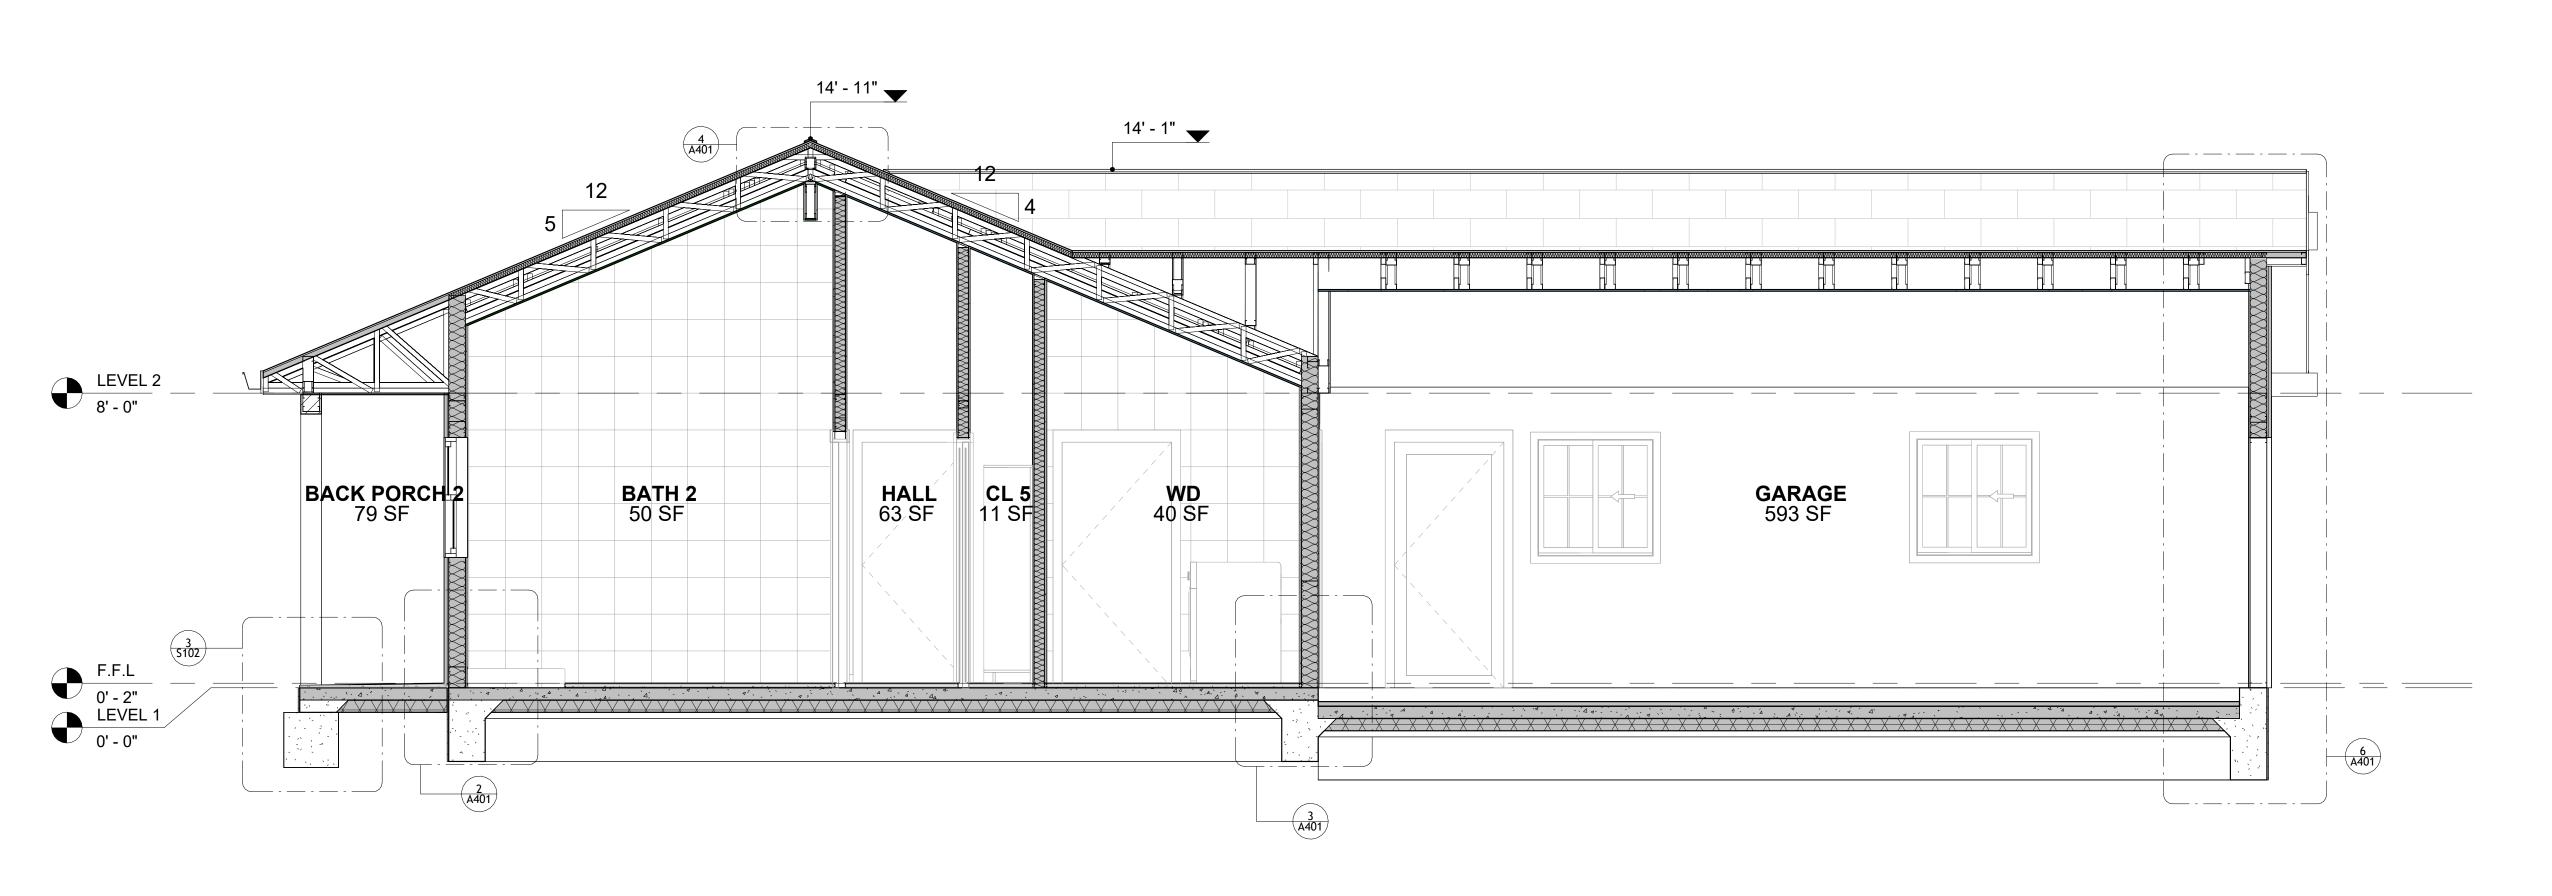

2 SECTION-2 3/8" = 1'-0"



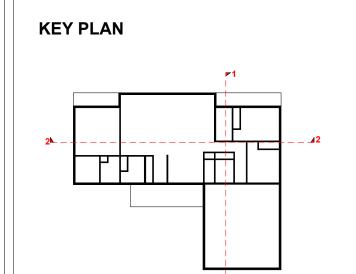

NO.	DESCRIPTION	DATE

NOTE:

LEGEND:

PROJECT


246-EMBER-1650-3Bd2.5Ba CRAFTSMAN-550


DRAWING NAME


ARCHITECTURAL SECTIONS


ENT NAME:	Client Name
OJECT NUMBER:	0061_12
ГЕ:	5/8/2025 2:19:37 PM
SIGNED BY:	Designer
AWN BY:	Author
ECKED BY:	Checker


A301

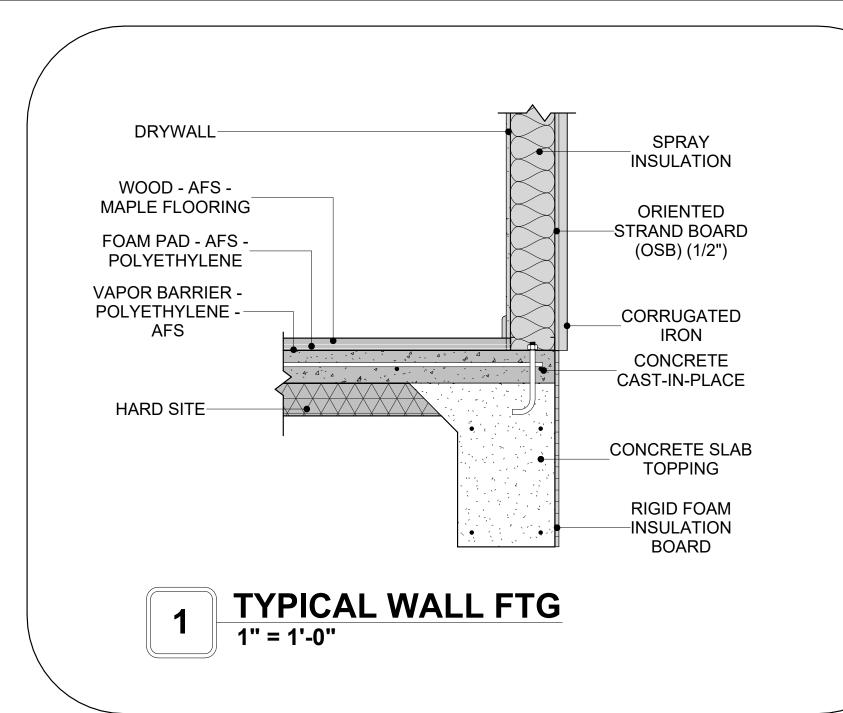


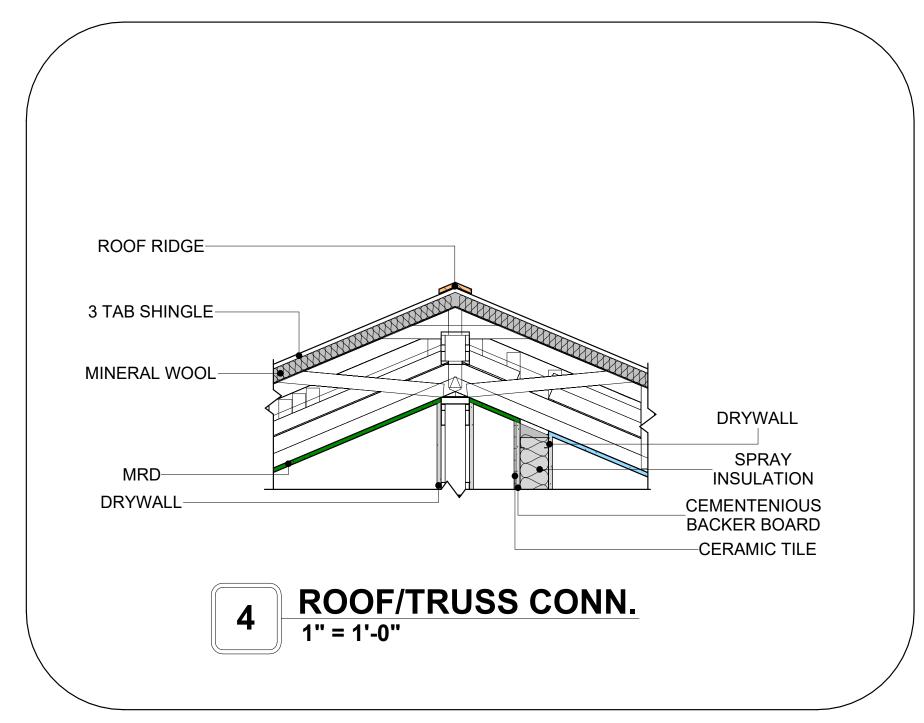

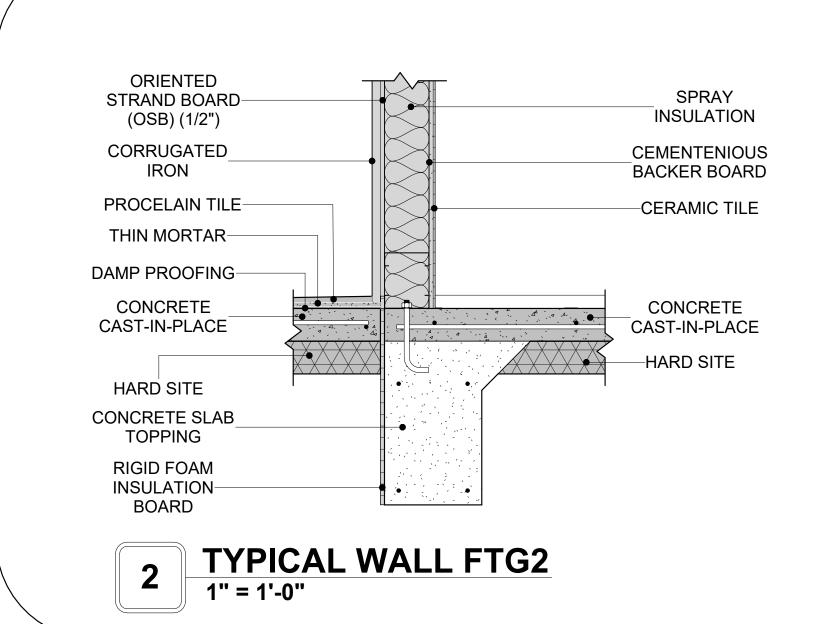

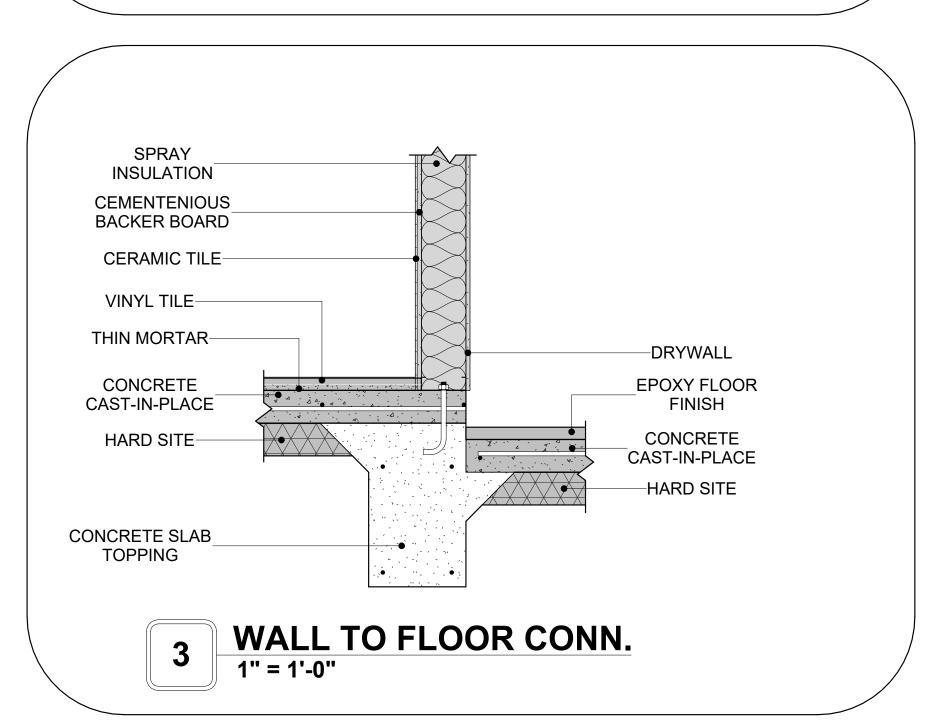

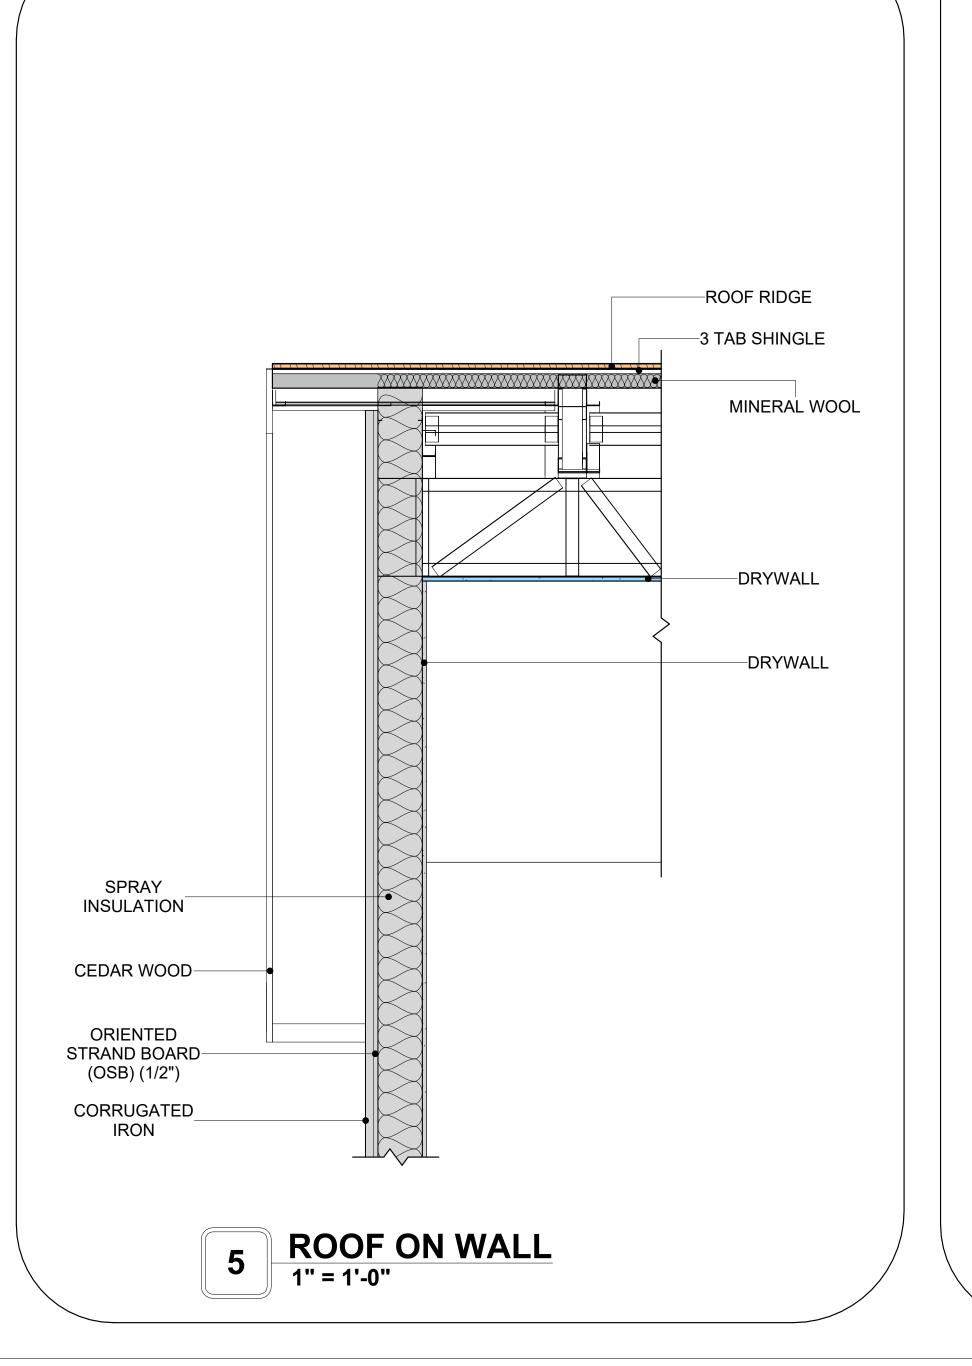

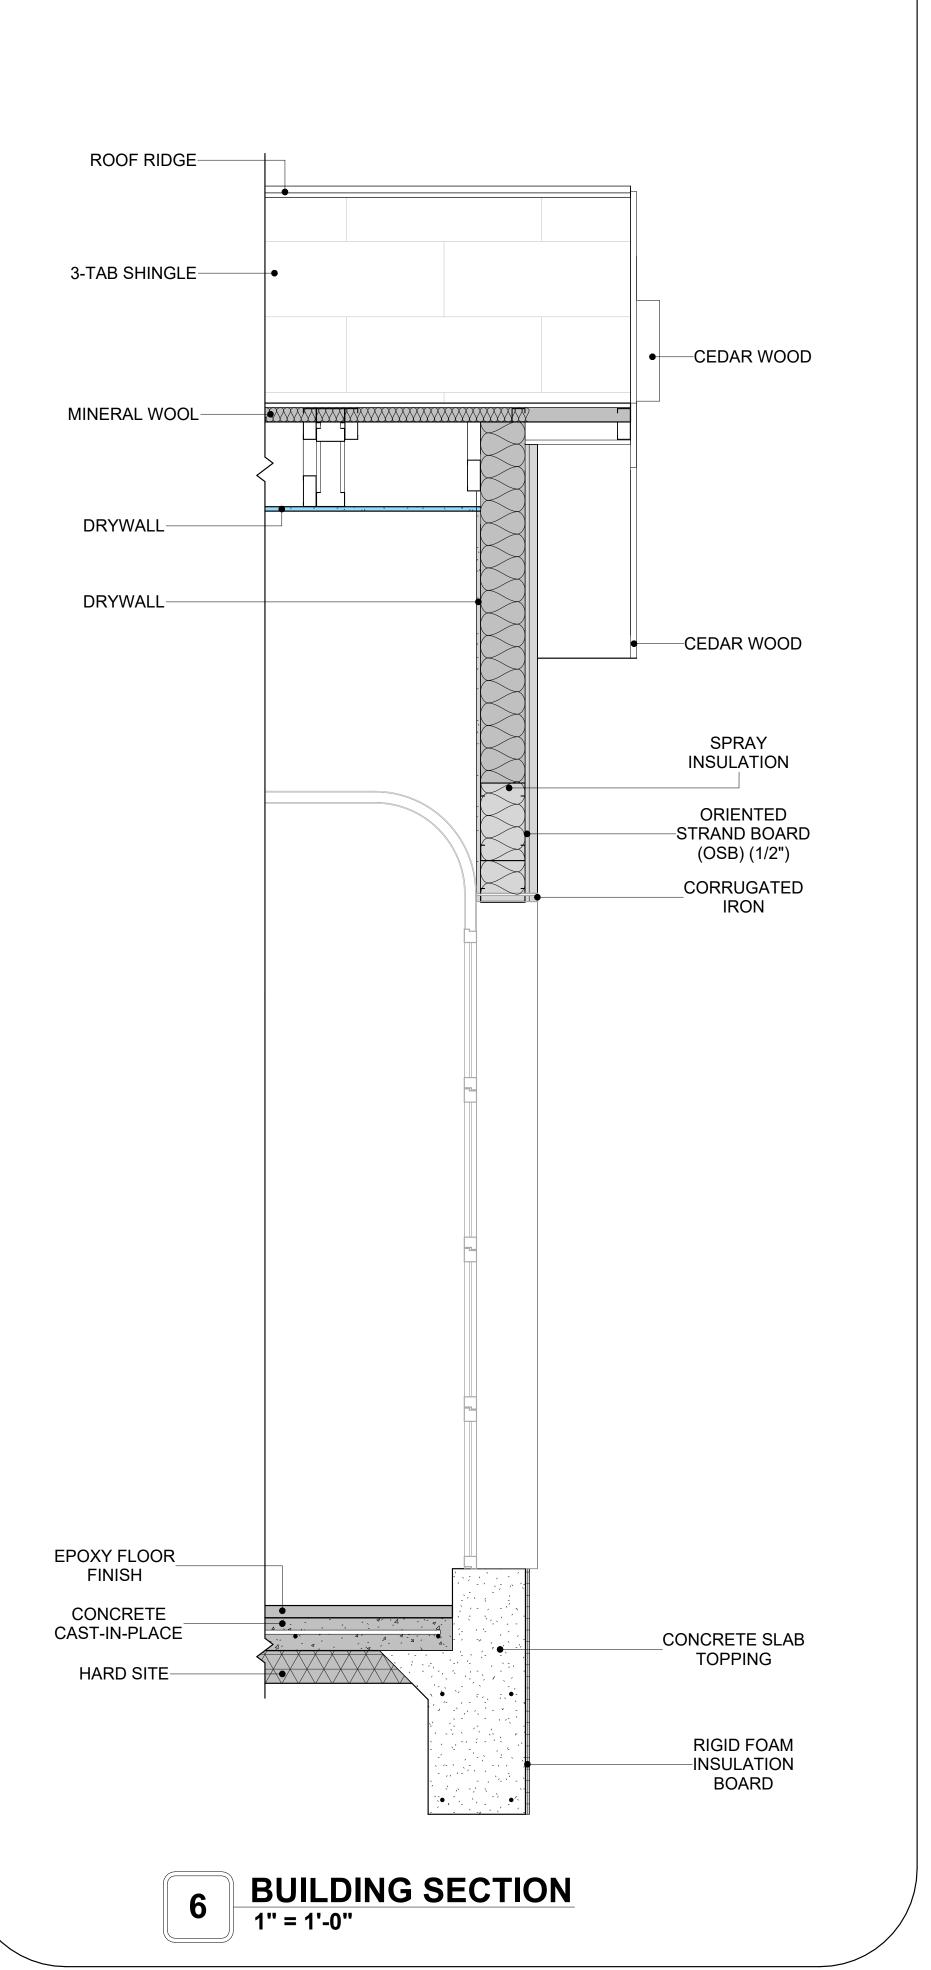



**KEY PLAN** 

NO.	DESCRIPTION	DATE

NOTE:

LEGEND:

PROJECT

246-EMBER-1650-3Bd2.5Ba CRAFTSMAN-550

DRAWING NAME

ARCHITECTURAL DETAILS

CLIENT NAME:	Client Name
PROJECT NUMBER:	0061_12
DATE:	5/8/2025 2:19:39 PM
DESIGNED BY:	Designer
DRAWN BY:	Author
CHECKED BY:	Checker

A401

SCALE: 1" = 1'-0"

### **CASEWORK GENERAL NOTES**

- ALL CABINET HEIGHTS INCLUDE COUNTERTOPS. DIMENSIONS ARE TO THE NEAREST INCH. DIVISIONS IN CASEWORK ARE SHOWN FOR CLARITY AND DO NOT REPRESENT BREAKS IN THE COUNTERTOP.
- PROVIDE CONTINUOUS COUNTERTOP OVER ALL SIMILAR HEIGHT CASEWORK, UNLESS AND OTHERWISE NOTED.
- MANUFACTURER AND CATALOG NUMBERS ARE FOR REFERENCE AND ILLUSTRATION PURPOSES
- DOTTED LINES INDICATE WALL HUNG CABINETS, DIVISIONS OF BASE CABINETS BELOW THE
- COUNTERTOP, FURNITURE NOT IN THE CONTRACT OR PROJECTION SCREENS -SEE CASEWORK KEY AND SPECIFICATIONS.
- ALL CABINETS AND DRAWERS TO HAVE CAM LOCKS EXCEPT FOR SINK BASE CABINETS.
  ALL EXPOSED SURFACES (EXPOSED TO VIEW FROM ANY PERSPECTIVE) TO BE COVERED WITH
- LAMINATE.
- ALL CASEWORK WHICH MEETS A WALL AT ONE OR BOTH ENDS, TO BE PROVIDED WITH FILLER PANELS AND SCRIBED TO THE WALL(S) AS REQUIRED.
- 10. ALL CABINETS AND DRAWERS ARE PROVIDED WITH RECESSED HANDLES.
- 11. CONTRACTOR TO FIELD VERIFY ALL CLEAR OPENINGS PRIOR TO MILLWORK OR CASEWORK FABRICATION.
- 12. CASEWORK DRAWINGS ARE DIAGRAMMATIC IN NATURE TO SHOW DESIGN INTENT.

# CASEWORK SCHEDULE

<b>TYPE</b>						
MAR		COUN				
K	TYPE	T	HEIGHT	WIDTH	DEPTH	AREA
01	HD_TALL_CABINET_24	1	7' - 6"	2' - 0"	2' - 0"	15 SF
02	REFRIGERATOR TOP	1	1' - 6"	2' - 0"	2' - 4"	3 SF
03	WALL CABINET DOUBLE DOOR 211	1	2' - 6"	3' - 0"	1' - 0"	8 SF
04	LINEAR COUNTER TOP 2	1	0' - 4"	3' - 0"	2' - 1"	1 SF
05	BASE_CABINET_DOUBLE_DOOR	1	2' - 11"	3' - 0"	2' - 0"	9 SF
06	WALL FILLER	1	2' - 6"	0' - 9"	1' - 0"	2 SF
07	CLOSET	1	5' - 11"	3' - 0"	1' - 4"	18 SF
08	WALL_CABINET_L-SHAPE 3	1	2' - 6"	2' - 0"	2' - 0"	5 SF
09	WALL FILLER 2	1	2' - 6"	1' - 1"	1' - 0"	3 SF
10	HD_L-SHAPE_COUNTER_TOP W SINK HOLE 3	1	0' - 4"	4' - 6"	8' - 1"	1 SF
11	BASE CABINET DOUBLE DOOR 2	1	2' - 11"	2' - 2"	2' - 0"	6 SF
12	BASE_CABINET_L-SHAPED	1	2' - 11"	3' - 3"	3' - 3"	9 SF
13	BASE CABINET DOUBLE DOOR 2	1	2' - 11"	2' - 5"	2' - 0"	7 SF
14	BASE_CABINET_SINGLE_DOOR	1	2' - 7"	1' - 9"	2' - 0"	5 SF
15	WALL_CABINET_DOUBLE_DOOR	1	2' - 6"	2' - 10"	1' - 0"	7 SF
16	ISLAND_COUNTERTOP FLAT	1	0' - 2"	8' - 4"	3' - 6"	1 SF
17	HD_ISLAND_48X36 2	1	2' - 11"	4' - 1"	2' - 0"	12 SF
18	HD_ISLAND_48X36	1	2' - 11"	4' - 2"	2' - 0"	12 SF
19	VANITY 3	1	2' - 4"	3' - 7"	1' - 3"	8 SF
20	RECESSED_MED_CABINET 2	4	2' - 0"	1' - 6"	0' - 3"	3 SF
21	CLOSET 4	2	6' - 0"	6' - 3"	1' - 4"	37 SF
22	VANITY	1	2' - 4"	2' - 11"	1' - 8"	7 SF
23	LINEN	1	5' - 11"	5' - 7"	1' - 4"	33 SF
24	CLOSET 3	4	6' - 0"	8' - 0"	1' - 4"	48 SF
25	DOUBLE SINK VANITY	1	3' - 0"	6' - 0"	2' - 0"	18 SF
26	CLOSET 2	1	5' - 11"	2' - 0"	1' - 4"	12 SF
27	LINEN 2	1	5' - 11"	4' - 3"	1' - 4"	25 SF
28	WALL_CABINET_DOUBLE_DOOR 6	1	2' - 6"	2' - 7"	1' - 0"	7 SF
GRAND TOTAL 35						

### SPECIALTY EQUIPMENT SCHEDULE

	· · · · · · · · · · · · · · · · · · ·	
TYPE MARK	TYPE	COUNT
1	WASHER-FRONT-LOAD	1
2	REFRIGERATOR	1
3	RANGE	1
4	DRYER-FRONT-LOAD	1
5	DISHWASHER	1

5' - 7"


CA23

2' - 3"

SE01

**CASEWORK PLAN** 

1/2" = 1'-0"

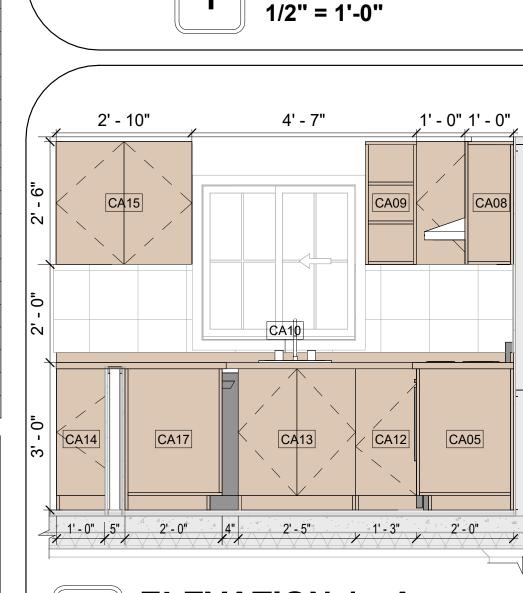

<u>a</u> 2' - 11"

1/2" = 1'-0"

VANITY 1 3D

**ELEVATION 2 - A** 

2' - 10"

CA15

3' - 6"

CA16

\_CA17

-CA18

CASEWORK PLAN


( A402 ) 4

CA10


CA05 CA04 CA03

CA12

CA11

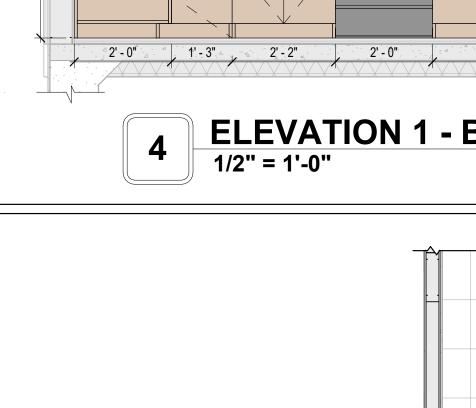


10 LAUNDRY 3D

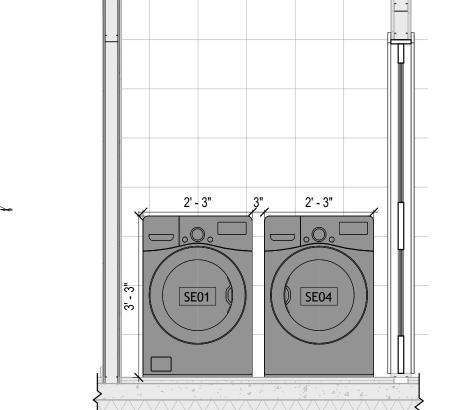

**KITCHEN 3D** 


**ELEVATION 2 - B** 1/2" = 1'-0"

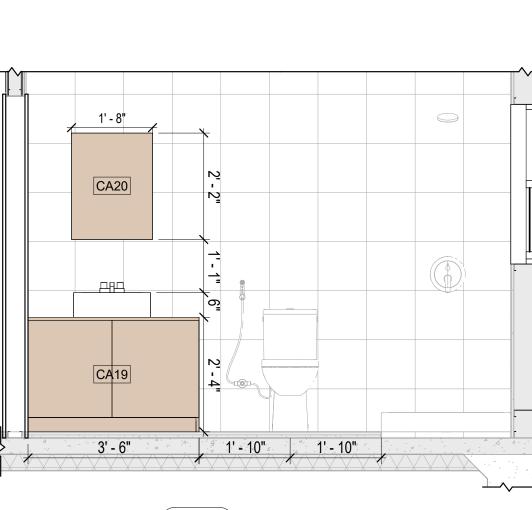

**ELEVATION 1 - C** 1/2" = 1'-0"

VANITY 3D

Tuscon,AZ, USA 888-864-0184 inquire@frameupnow.com www.frameupnow.com

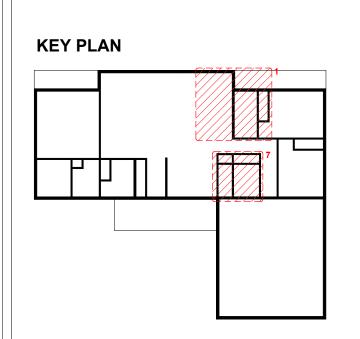

NO.	DESCRIPTION	DATE

NOTE:

LEGEND:

PROJECT

246-EMBER-1650-3Bd2.5Ba **CRAFTSMAN-550** 

DRAWING NAME

**ARCHITECTURAL CASEWORK** 

Client Name	CLIENT NAME:
0061_12	PROJECT NUMBER:
5/8/2025 2:19:41 PM	DATE:
Designer	DESIGNED BY:
Author	DRAWN BY:
Checker	CHECKED BY:

A402

SCALE: As indicated



GRAND TOTAL: 5

3' - 0"

CA07


CA20

A402

	SHEET LIST
Sheet	Sheet Name
Name	Sileet Name
00.4	00/50 0/55
CS-1	COVER SHEET
GN-1	GENERAL NOTE
S1	WALL FRAMING LAYOUT
S2	PANEL LENGTH
S3	ROOF TRUSS LAYOUT
S4	ELEVATION
S5	ELEVATION
S6	SECTIONS VIEW
S7	BRACING PLAN
S8	HOLD-DOWN PLAN
D1	DETAILS
D2	DETAILS
D3	DETAILS
S9	SHEETROCK BACKING
S10	TRUSS BLOCKING LAYOUT
S11	ROOF BRACING

SQUARE FOOTAGE			
ROOM	AREA	RM HEIGHT	
FRONT PORCH	118 SF	Vaulted CLG	
BACK PORCH 1	56 SF	8' CLG	
BACK PORCH 2	80 SF	8' CLG	
GARAGE	585 SF	Vaulted CLG	
HALL 1	35 SF	Vaulted CLG	
LIVING ROOM	331 SF	Vaulted CLG	
CL 4	18 SF	Vaulted CLG	
Mst. BEDROOM	199 SF	Vaulted CLG	
W.I.C	61 SF	Vaulted CLG	
LINEN 2	4 SF	Vaulted CLG	
Mst. BATH	43 SF	Vaulted CLG	
SHOWER	48 SF	Vaulted CLG	
CL 5	9 SF	Vaulted CLG	
KITCHEN	156 SF	Vaulted CLG	
DINING AREA	103 SF	Vaulted CLG	
HALL 2	98 SF	Vaulted CLG	
LINEN 1	6 SF	Vaulted CLG	
CL 3	10 SF	Vaulted CLG	
LAUNDRY	40 SF	Vaulted CLG	
BATH 2	22 SF	Vaulted CLG	
BEDROOM 2	107 SF	Vaulted CLG	
CL 2	13 SF	Vaulted CLG	
BEDROOM 1	128 SF	Vaulted CLG	
CL 1	13 SF	Vaulted CLG	
BATH 1	51 SF	Vaulted CLG	

TOTAL AREA 2524 Sq.ft

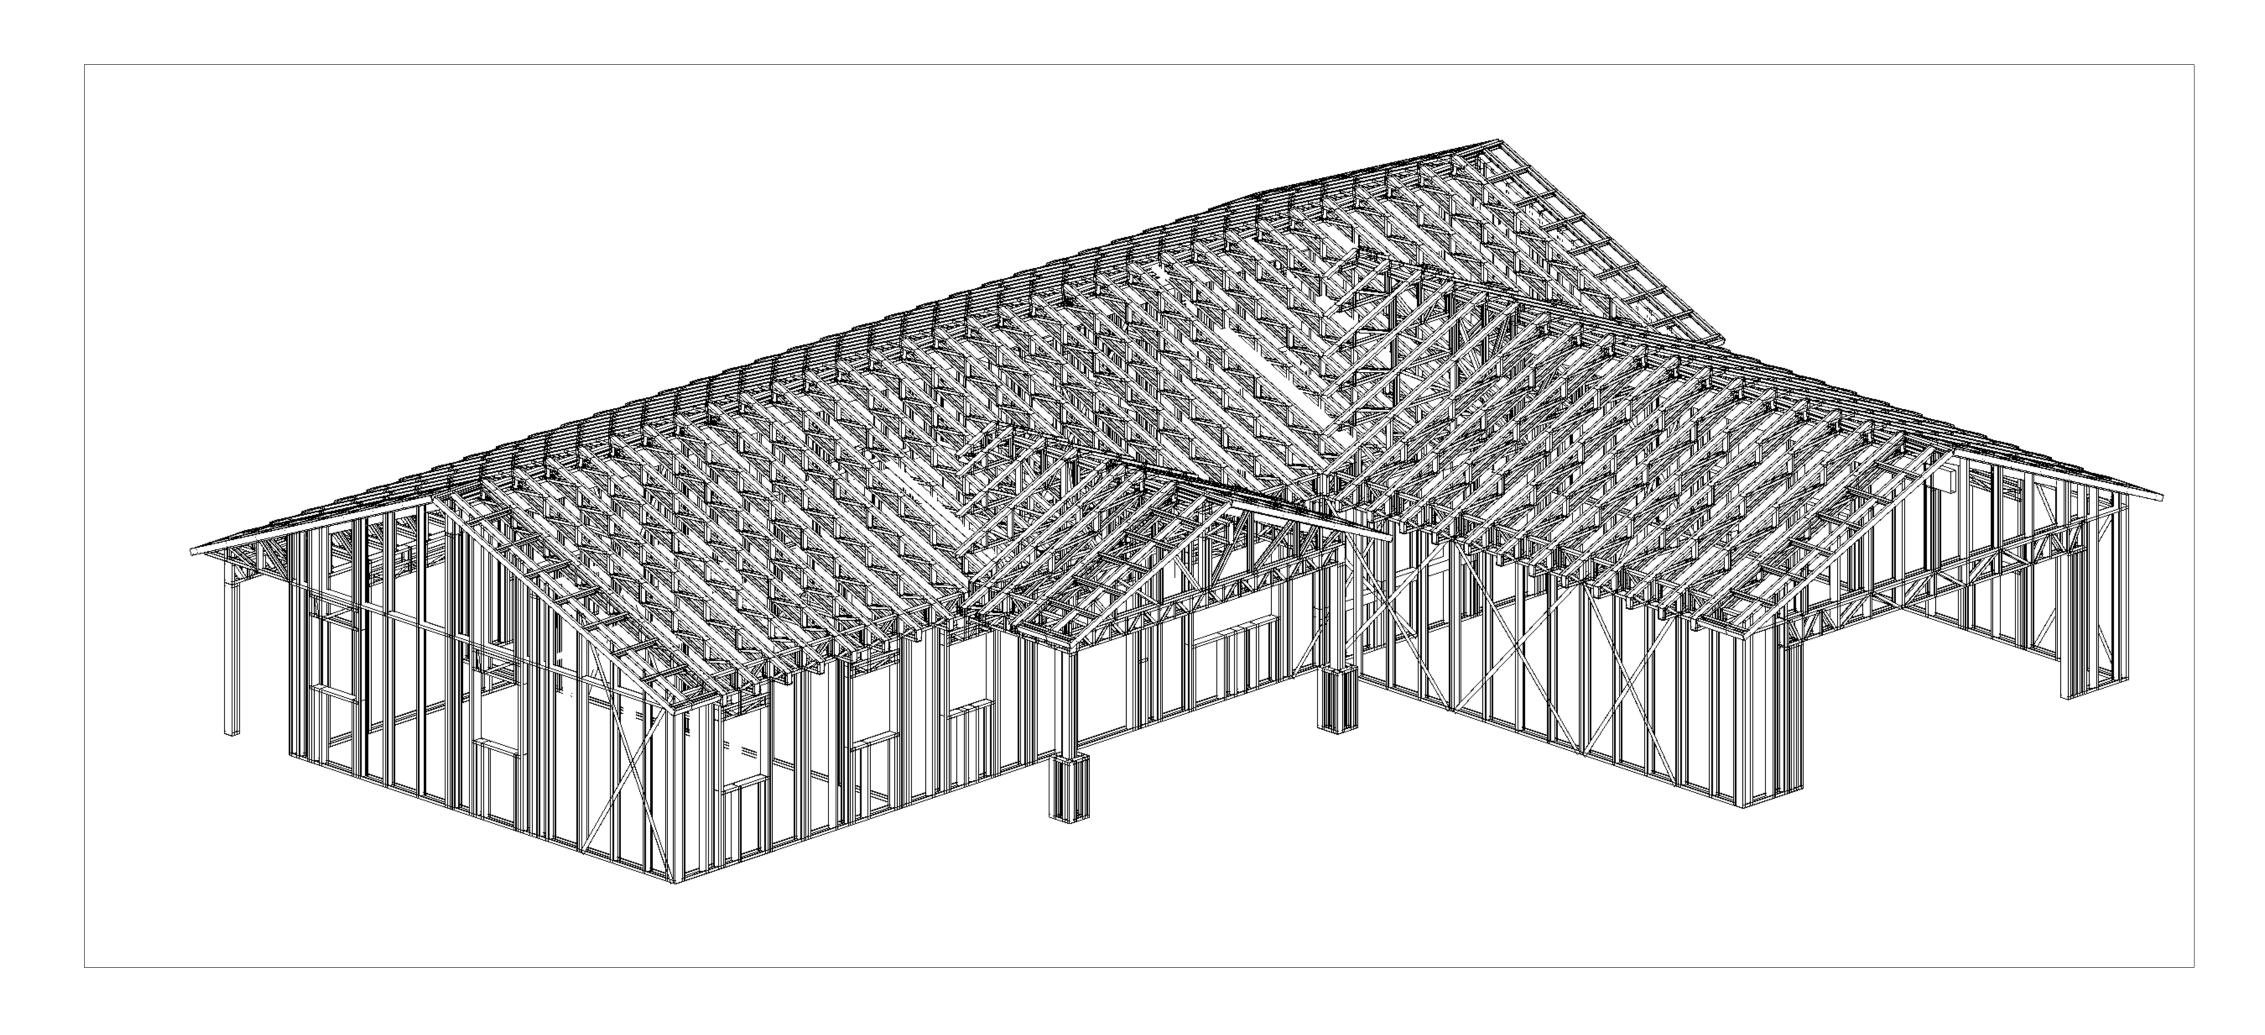

**ISOMETRIC VIEW** 

# 246-Ember-1650-3Bd2.5Ba-Craftsman-550

ON

© [2024] [FrameUpNow] . All rights reserved



JOB DETAILS Ember ADDRESS

DRAWN ВА

DWG FILE 246-Ember-1650-3Bd2.5Ba-Craftsman-550


DATE DRAWN SCALE 04-30-2025 VIEW NAME 1 of 17


1/4" : 1'-0" 36 x 24

JOB REFERENCE

REVISION 500


COLD FORMED STEEL SKELETON ONLY

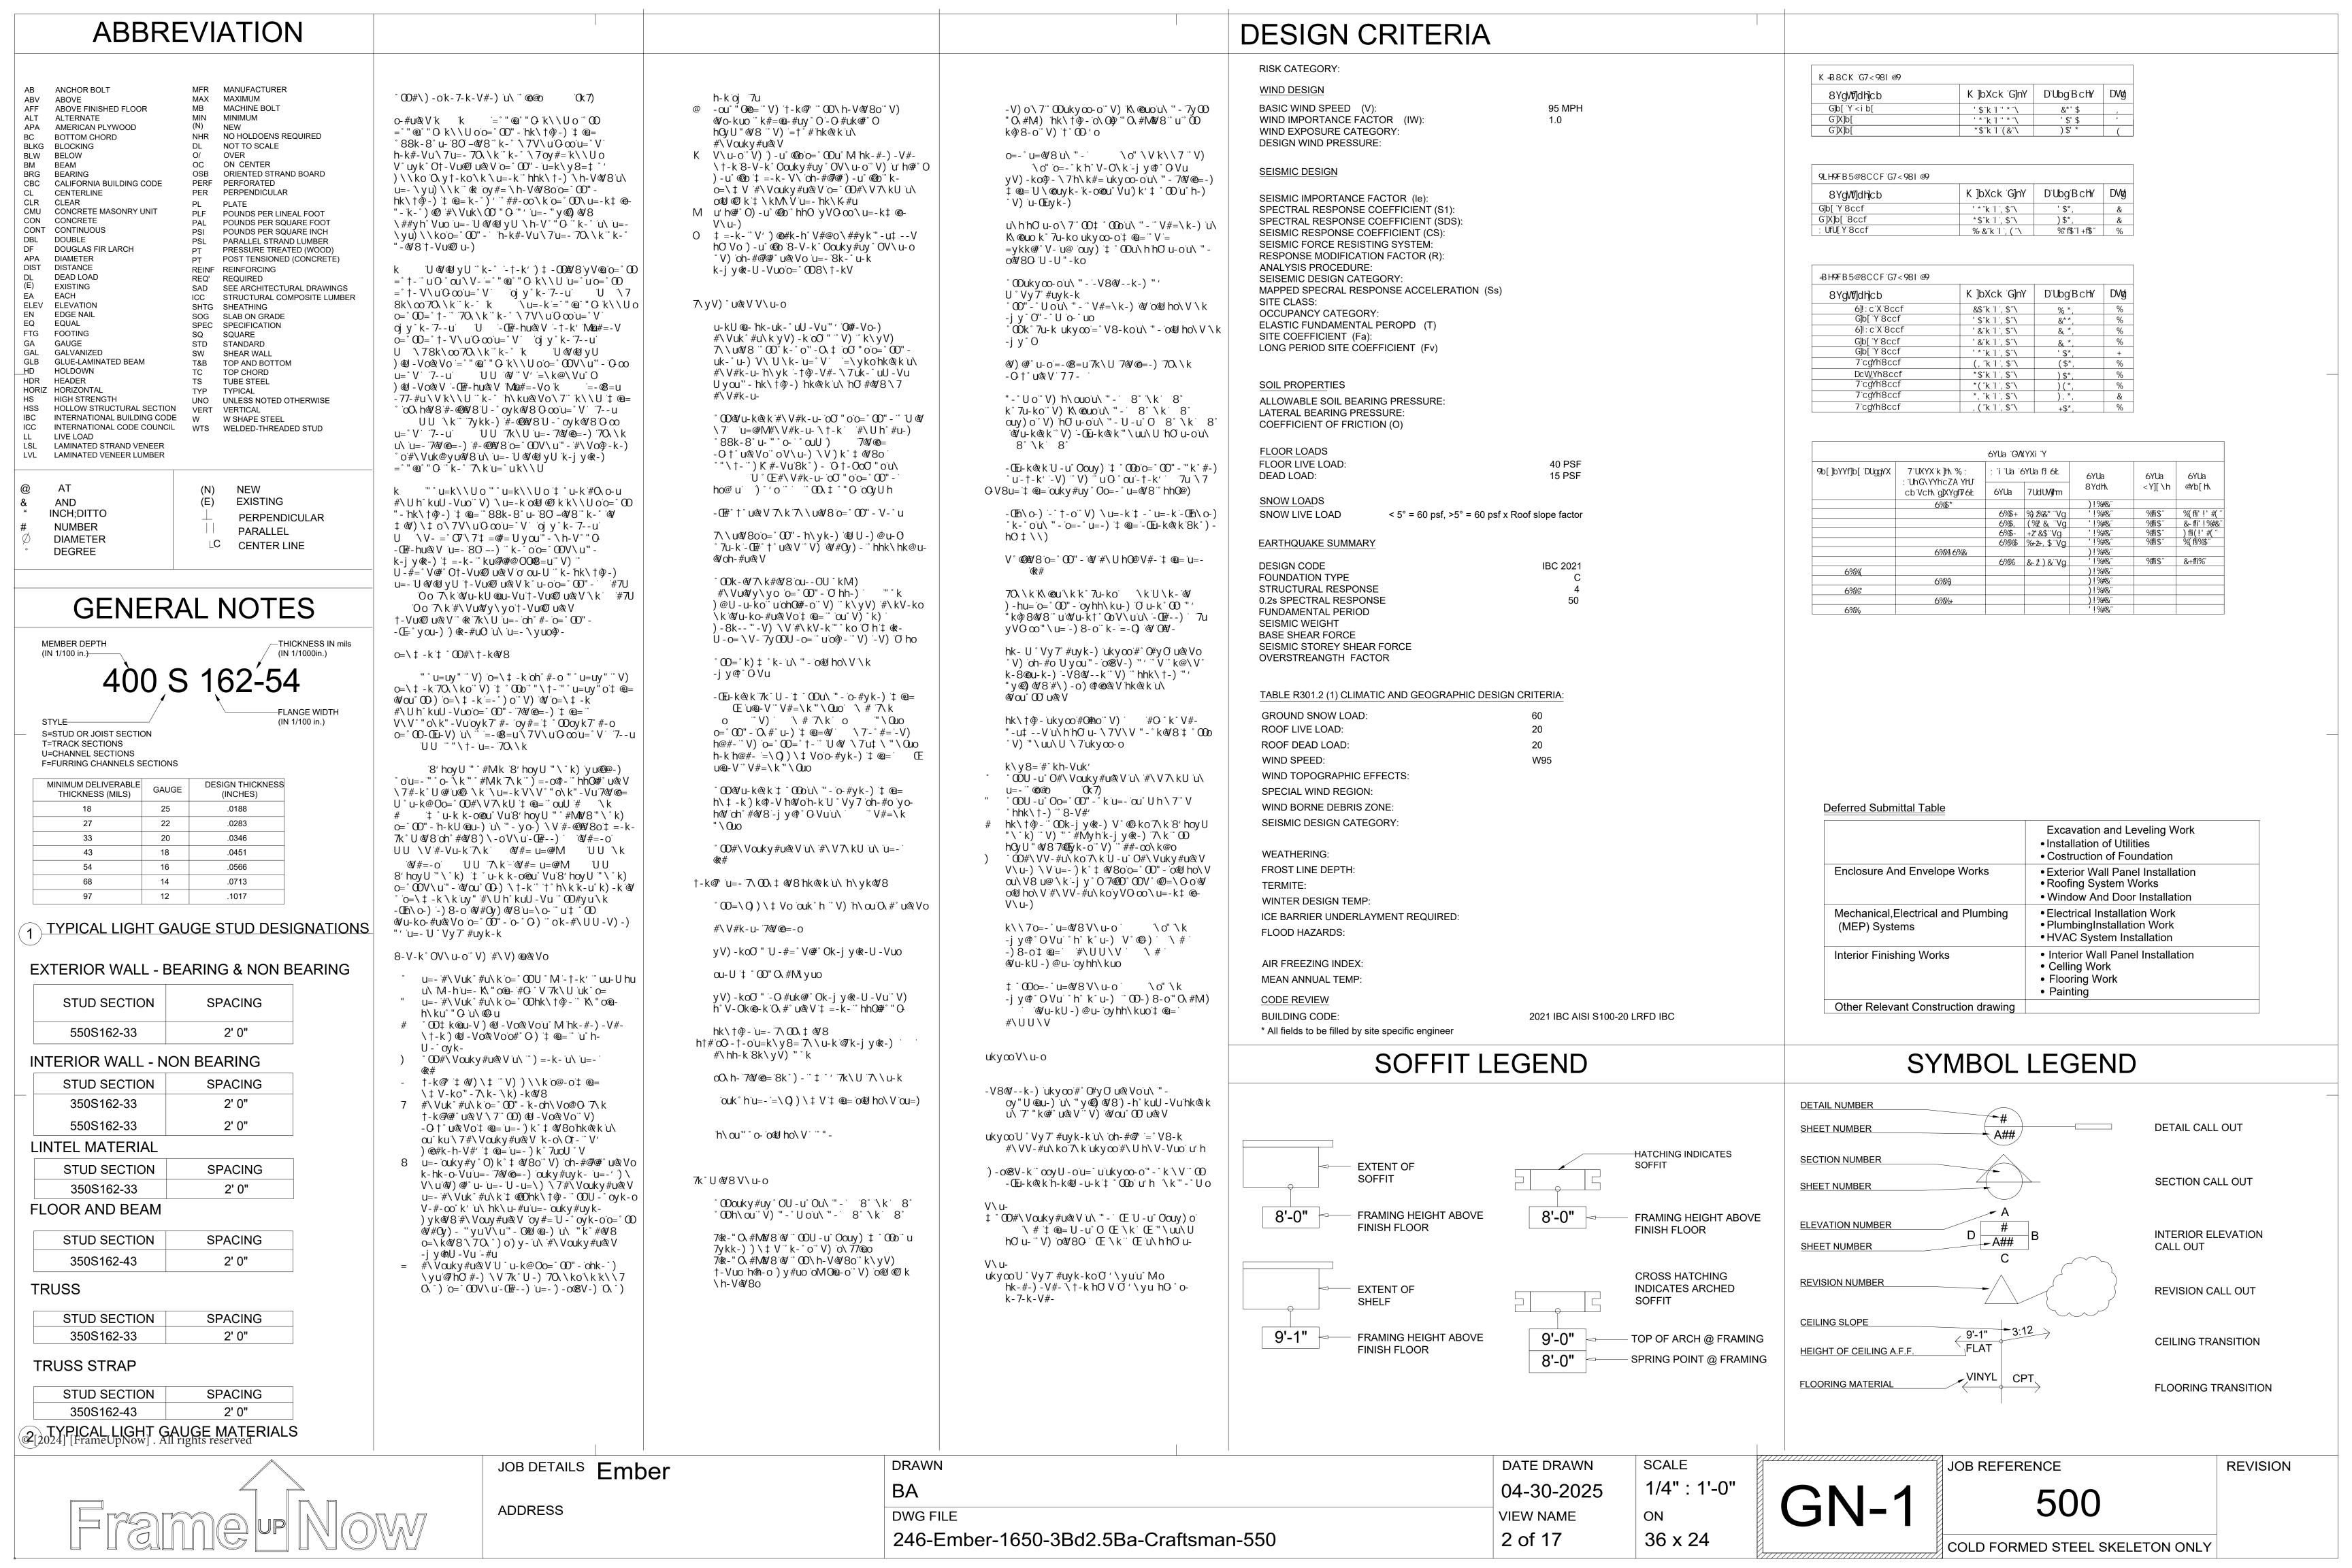

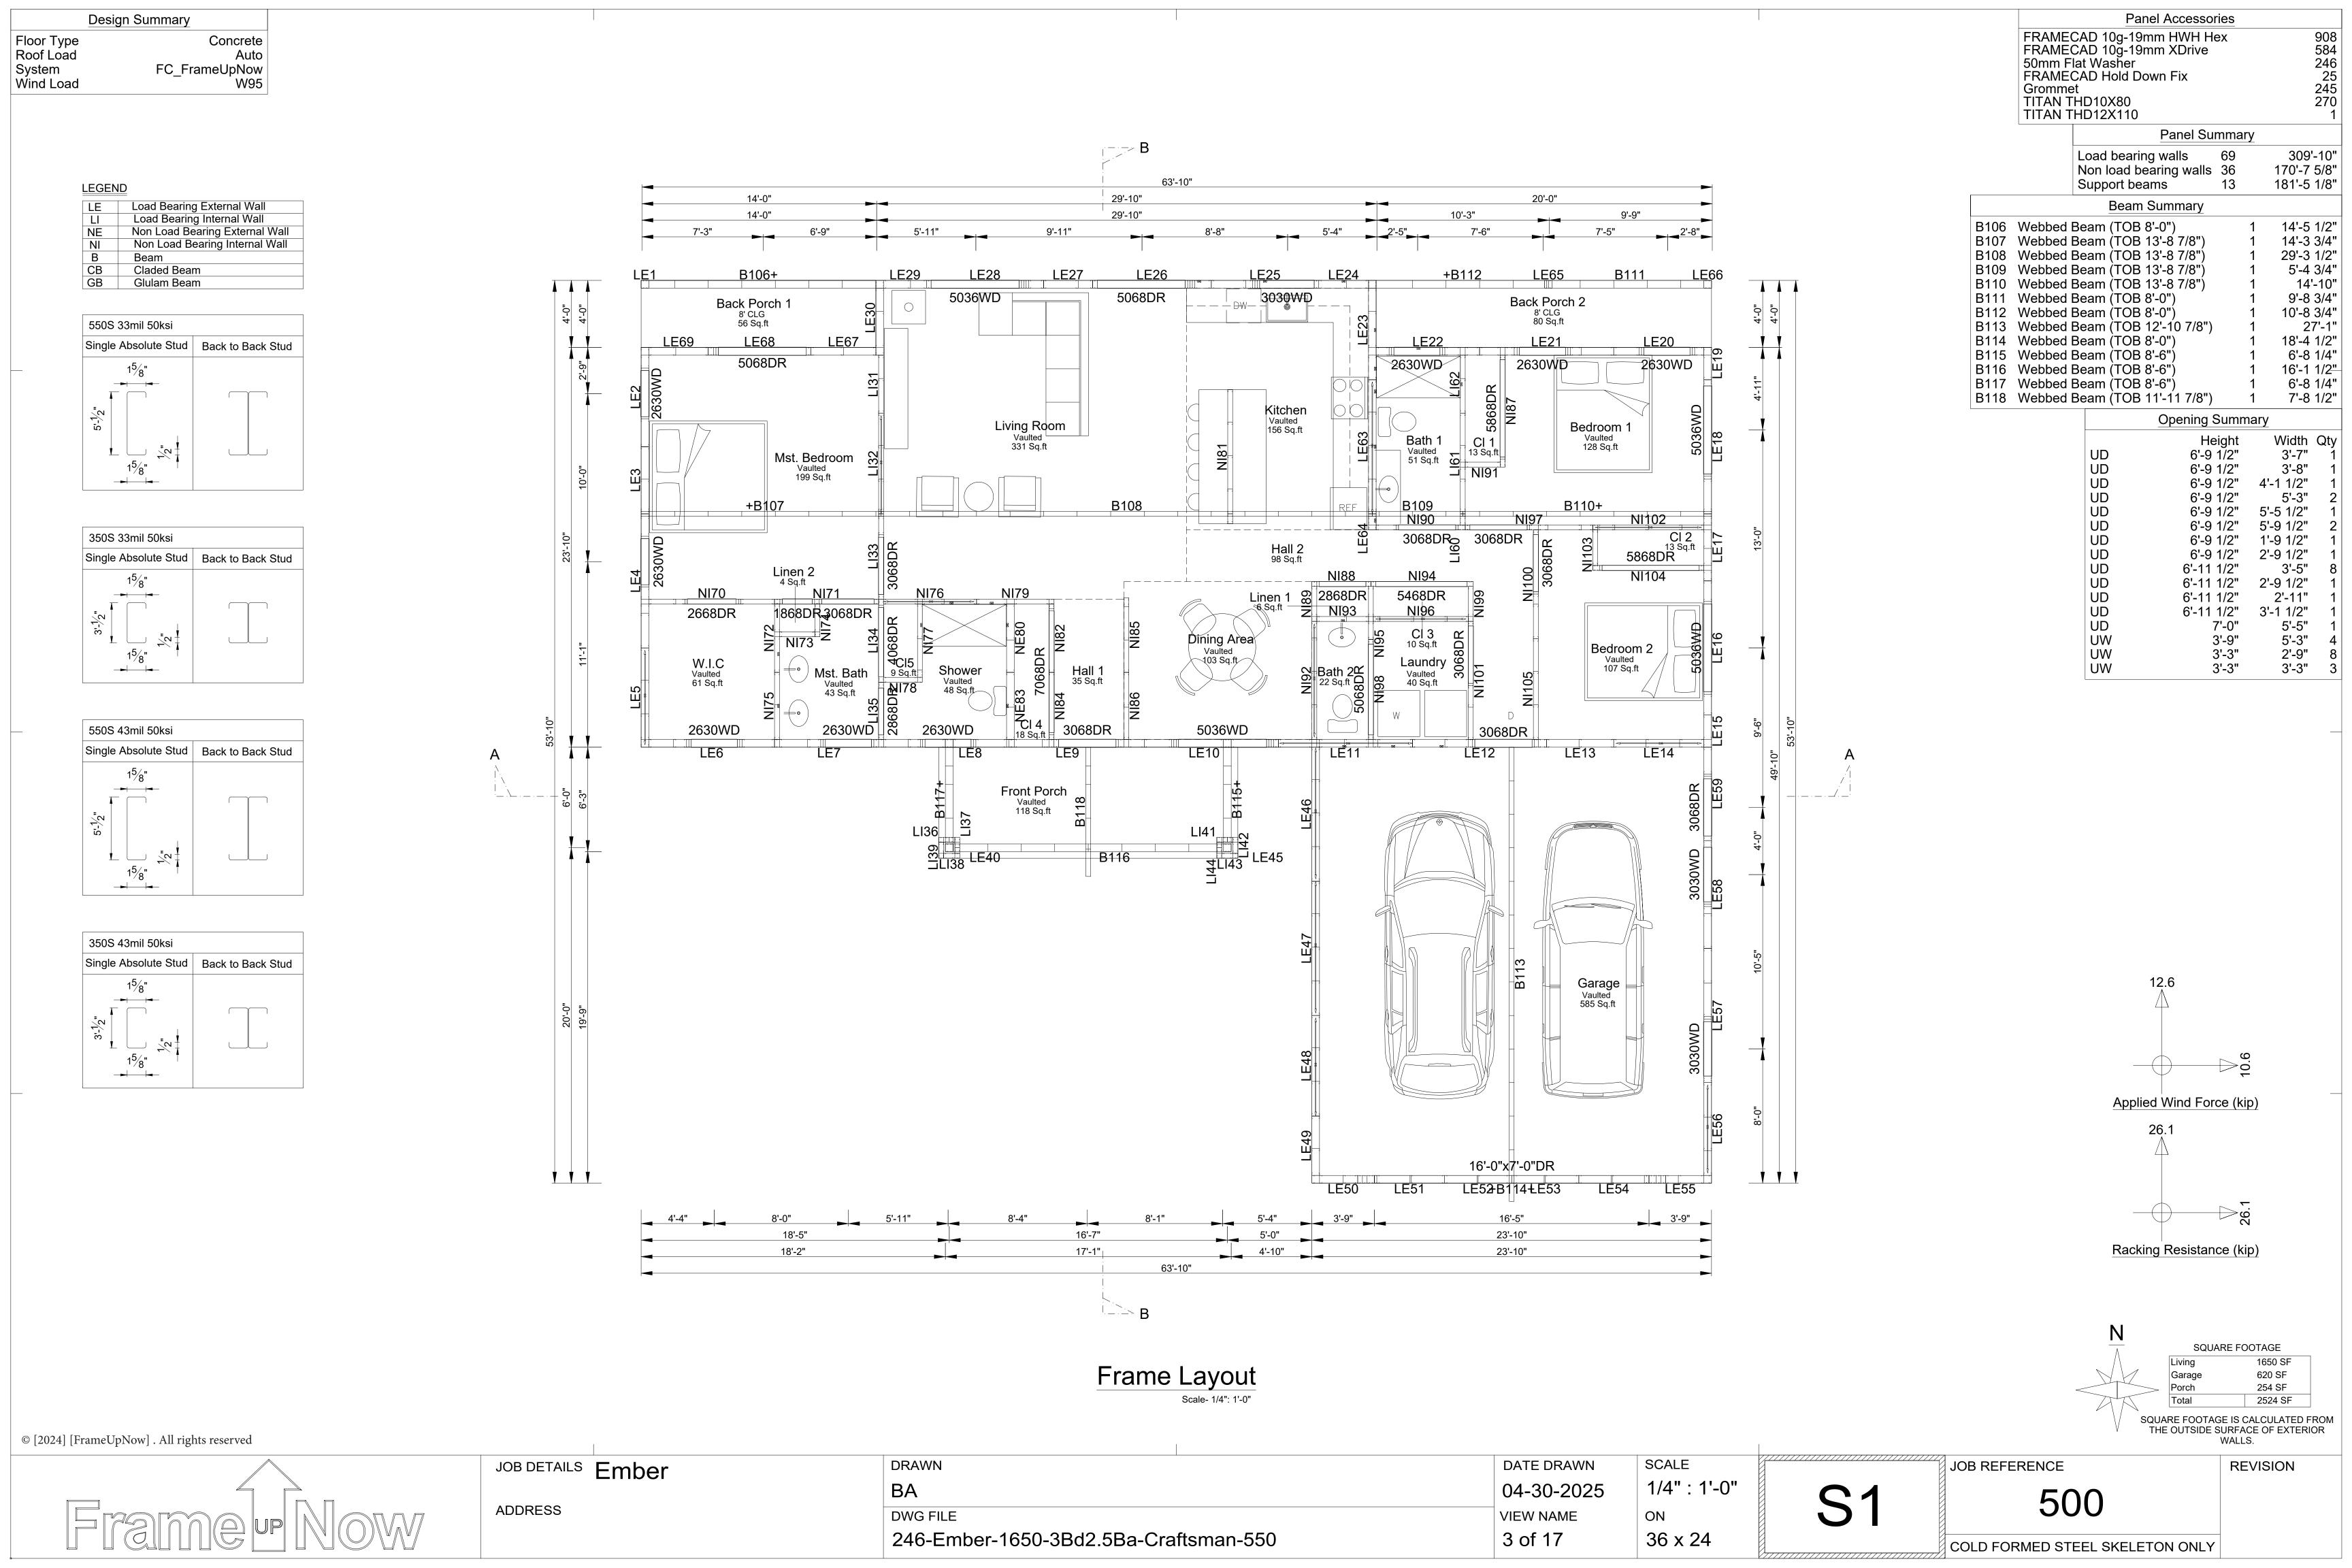


## LEGEND

LE	Load Bearing External Wall
LI	Load Bearing Internal Wall
NE	Non Load Bearing External Wall
NI	Non Load Bearing Internal Wall
В	Beam
СВ	Claded Beam
GB	Glulam Beam

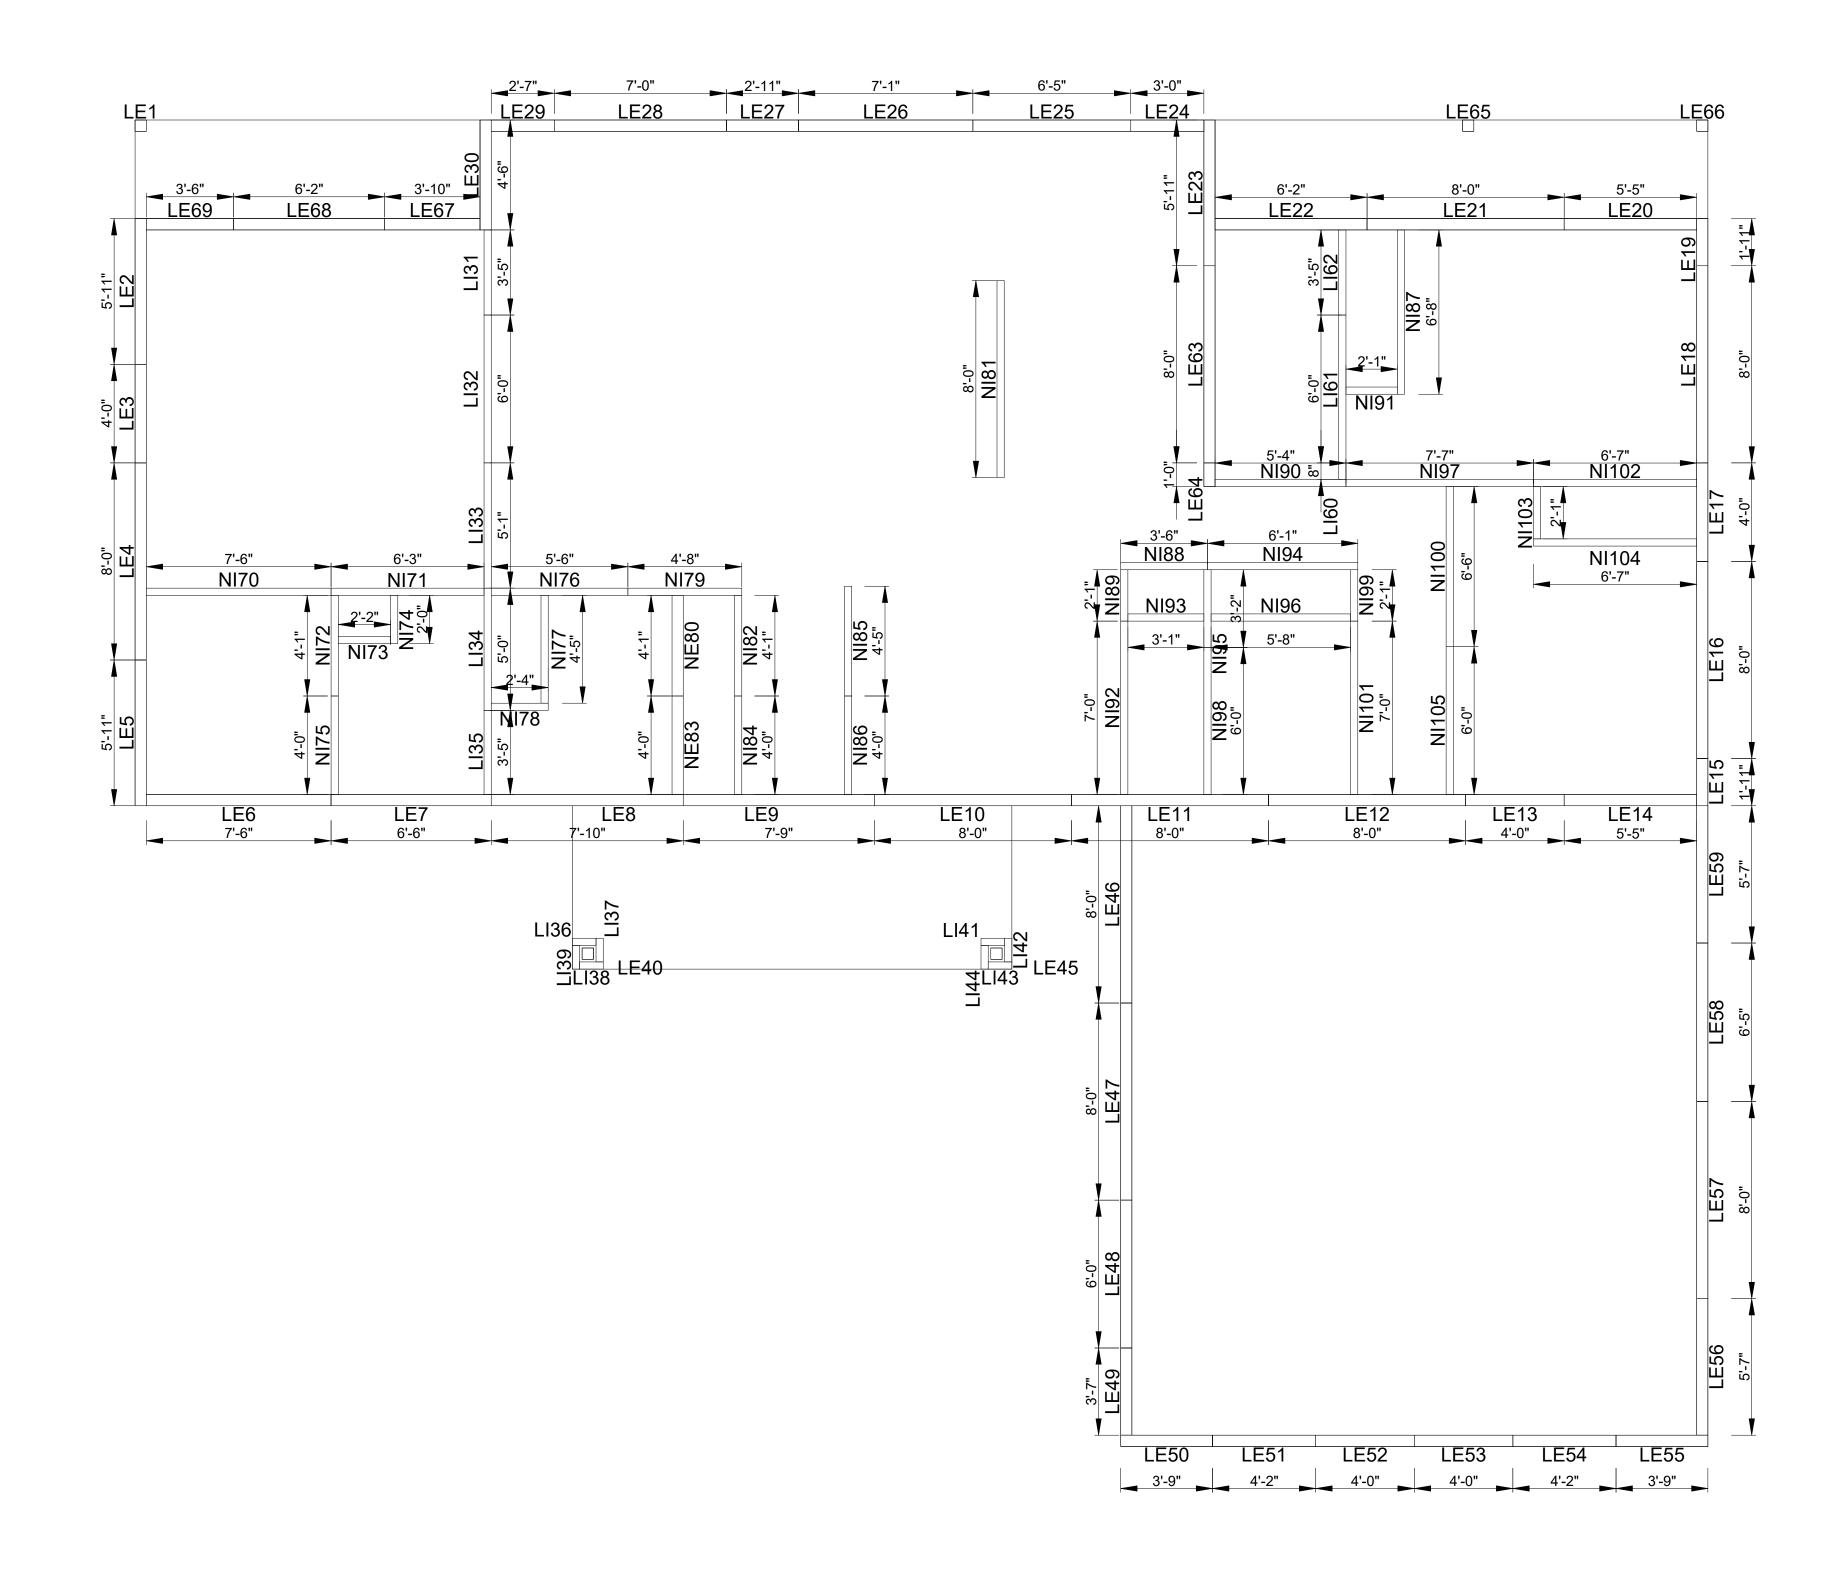

# Panel Length Scale- 1/4": 1'-0"

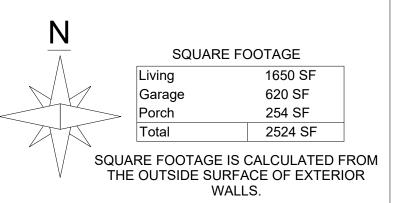

Framelphow

© [2024] [FrameUpNow] . All rights reserved

JOB DETAILS Ember
ADDRESS

 DRAWN
 DATE DRAWN
 SCALE

 BA
 04-30-2025
 1/4": 1'-0"

 DWG FILE
 VIEW NAME
 ON

 246-Ember-1650-3Bd2.5Ba-Craftsman-550
 4 of 17
 36 x 24

2

JOB REFERENCE 500

COLD FORMED STEEL SKELETON ONLY


### Truss Design Summary System Name Design Code Loading Code Roof Load Wind Speed Snow Load Roof Pitch FC\_FrameUpNow AISI S100-20 LRFD IBC 2021 LRFD TILE W95 60.0 22.620 BC Restraints 2'-0"

# LEGEND

G	Gable Truss
GI	Girder Truss
GF	Gable Frame
HG	Half Gable Truss
HA	Half Girder Truss
PC	Parallel Truss
Т	Truncated Truss
S1	Sadel Truss
U	User Truss
V	Rafter

### Roof Design Load

Roof Live Load(psf)	20
Roof Dead load(psf)	19.4
Celling Dead load(psf)	3
Design Point Load(kip)	0.25
Snow Live Load	<5° = 21 psf
	>5° = 21 psf x slope factor of the Roof

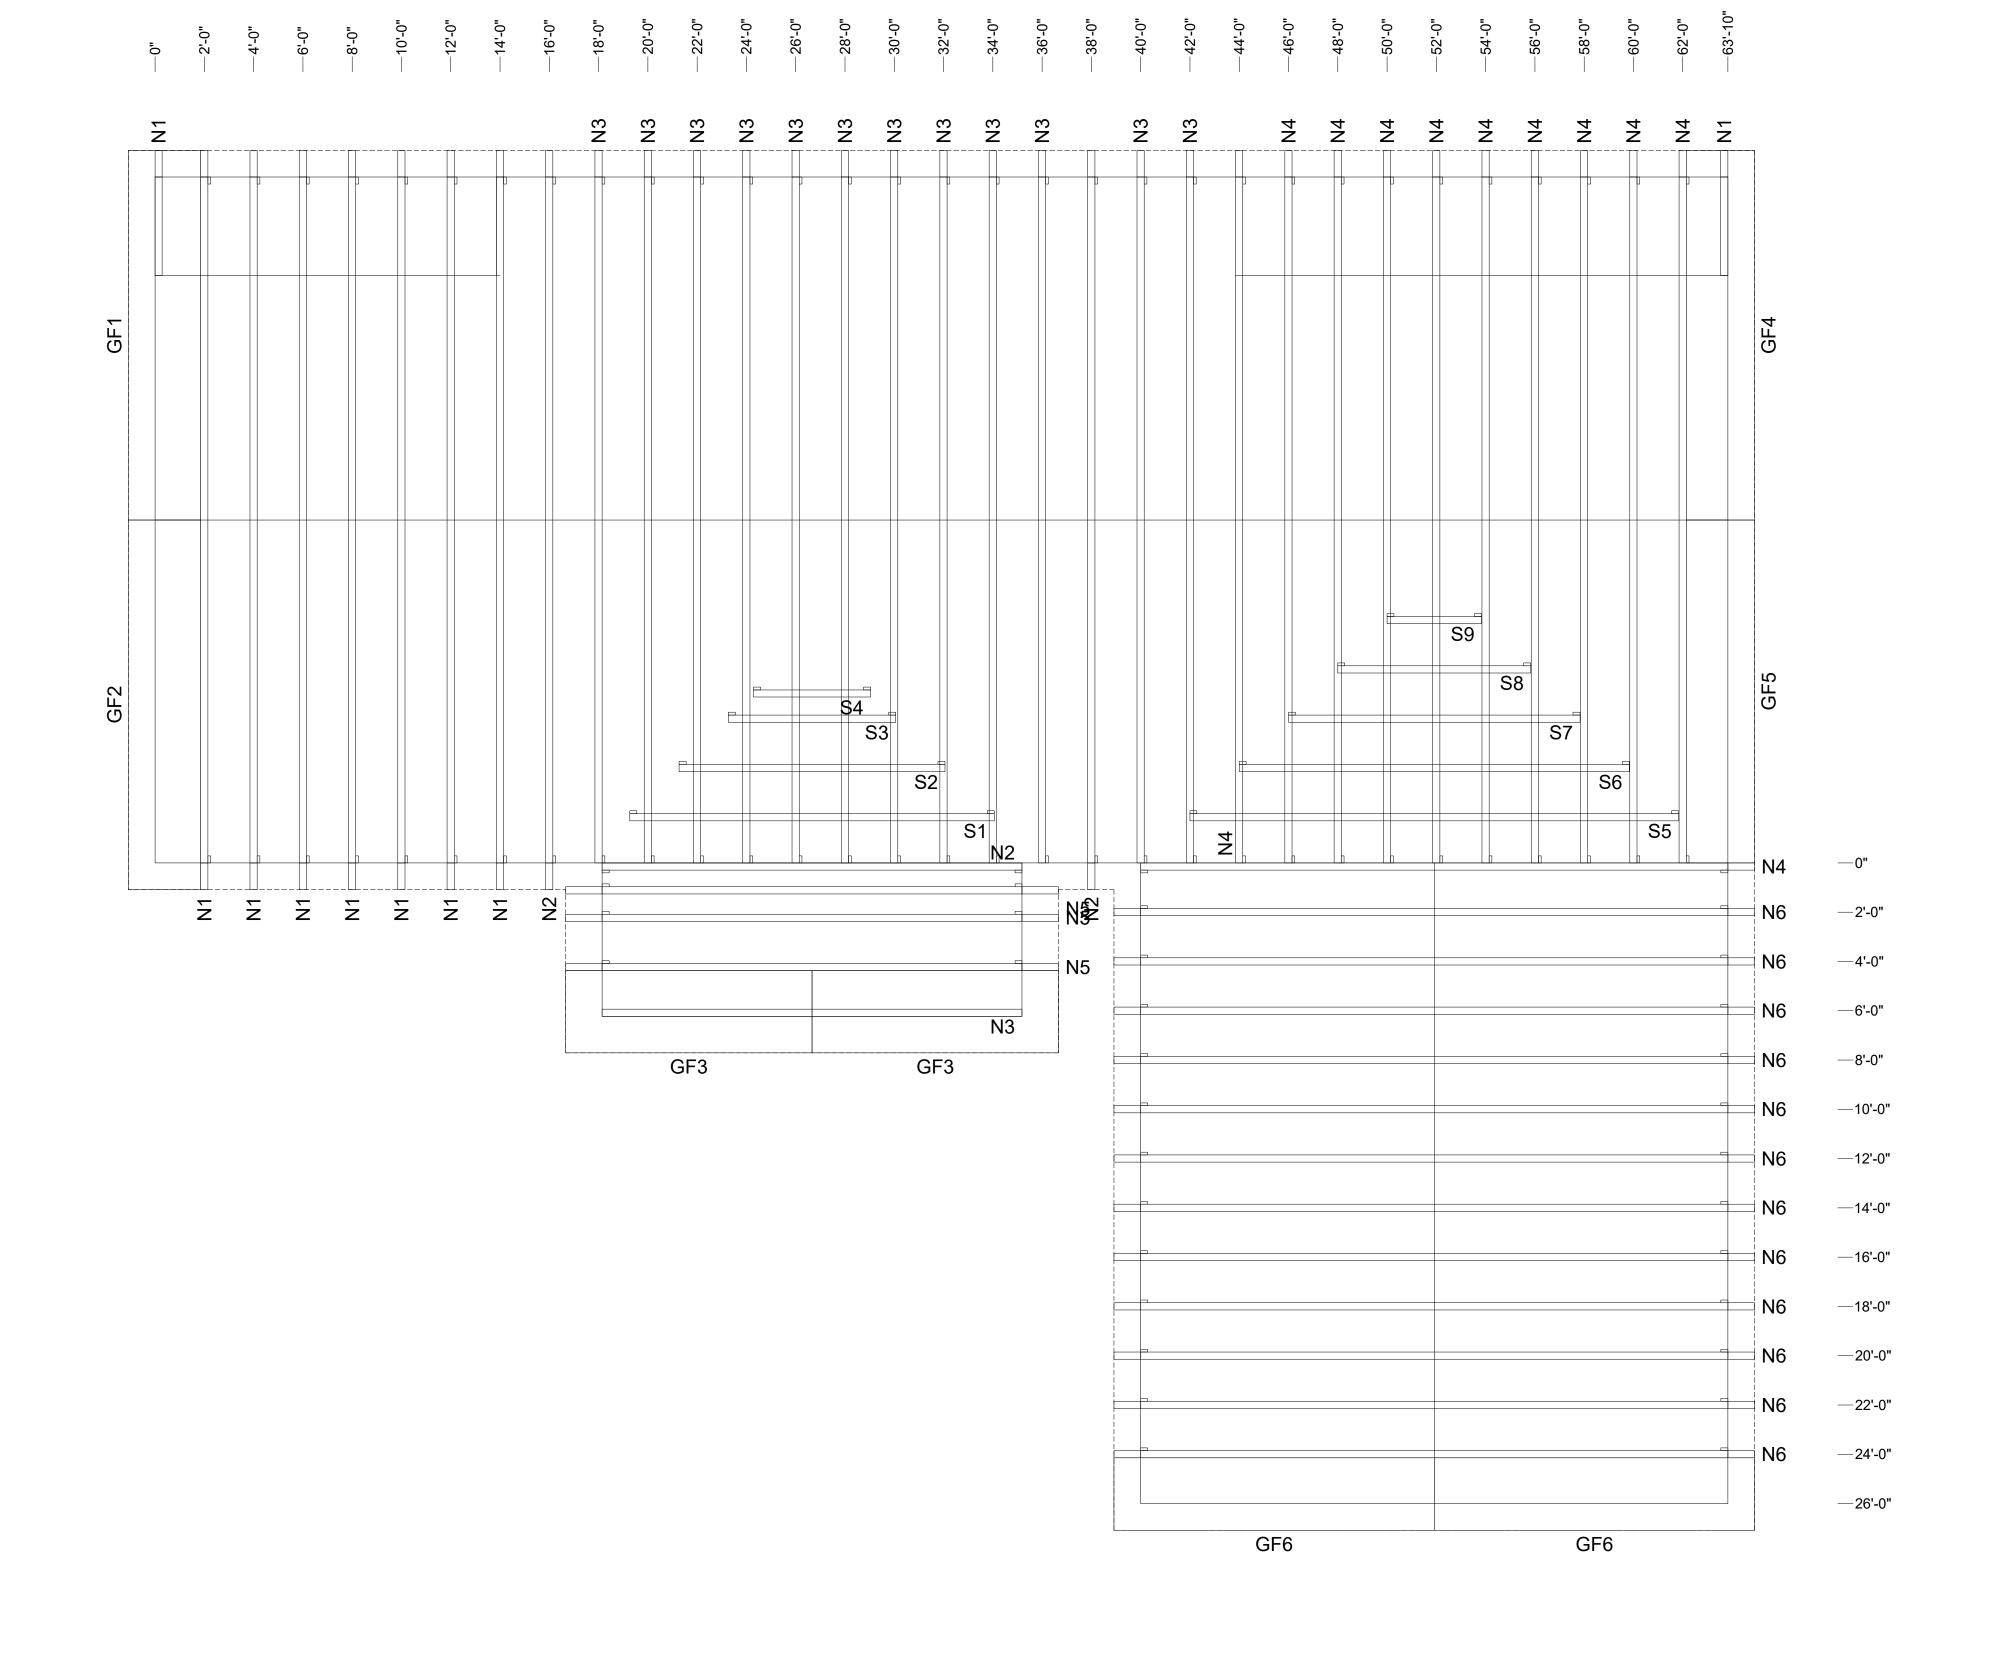

# Roof Truss Layout Scale- 1/4": 1'-0"

© [2024] [FrameUpNow] . All rights reserved

JOB DETAILS Ember ADDRESS

DRAWN BA DWG FILE 246-Ember-1650-3Bd2.5Ba-Craftsman-550

DATE DRAWN 04-30-2025 VIEW NAME ON

5 of 17

SCALE 1/4" : 1'-0" 36 x 24

JOB REFERENCE

SQUARE FOOTAGE 1650 SF 620 SF Garage 254 SF 2524 SF SQUARE FOOTAGE IS CALCULATED FROM THE OUTSIDE SURFACE OF EXTERIOR WALLS.

Truss Accessories

Truss Summary

FRAMECAD Batten 22 FRAMECAD Batten 22

FRAMECAD Tri Fix

FRAMECAD 10g-19mm HWH Hex FRAMECAD Multi Fix

Gable Frame Saddle Truss Standard Truss 87 16'-0" 115 20'-4"


5040


50 137

8 104'-11" 9 96'-3" 51 1265'-11"


500

COLD FORMED STEEL SKELETON ONLY

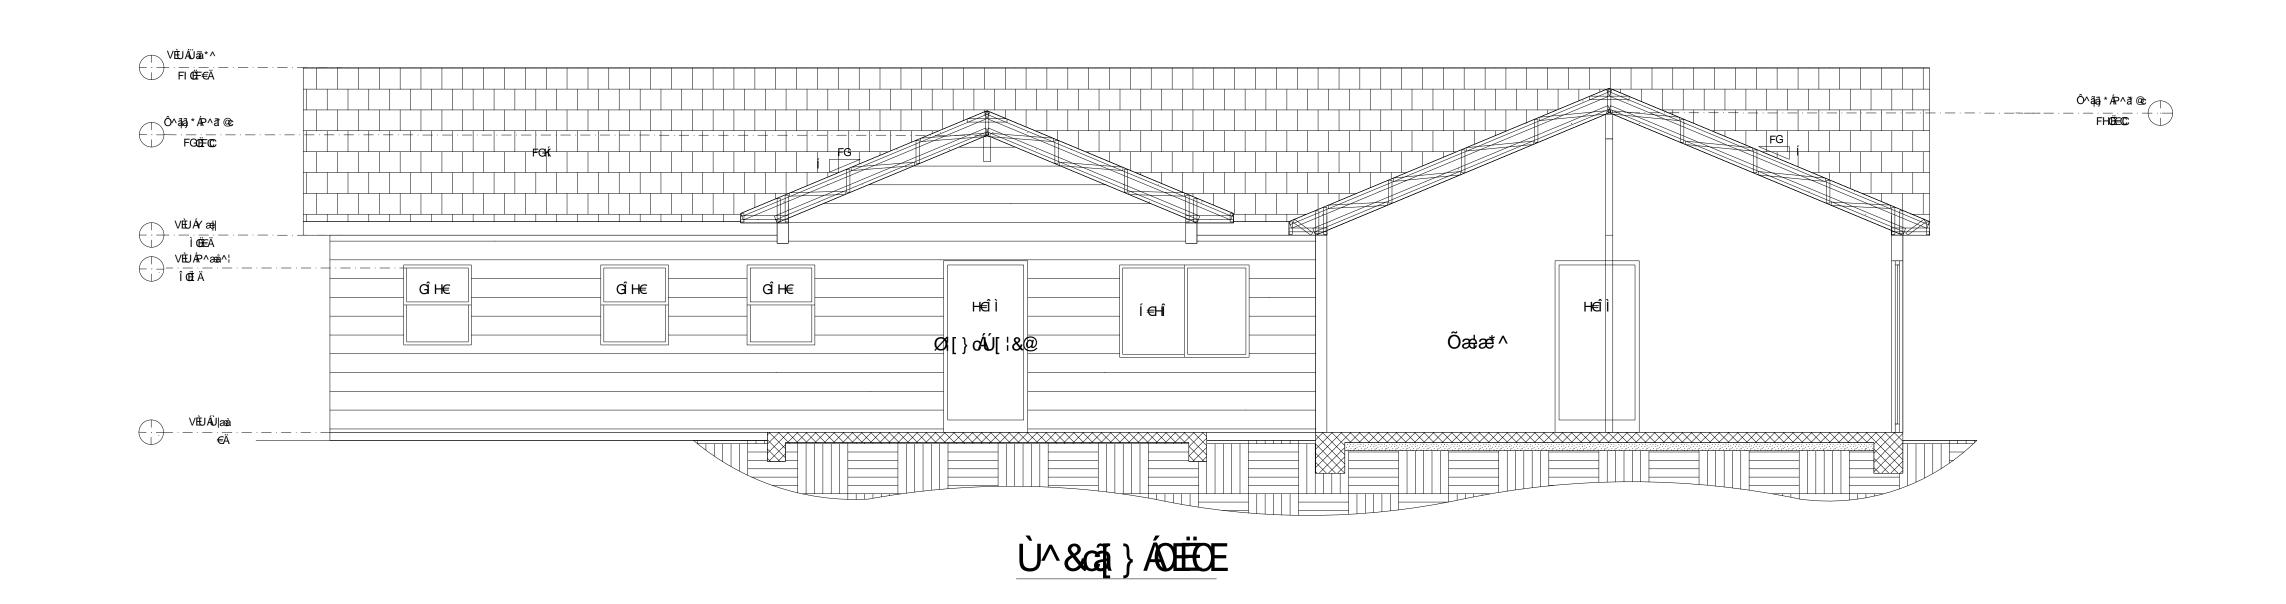

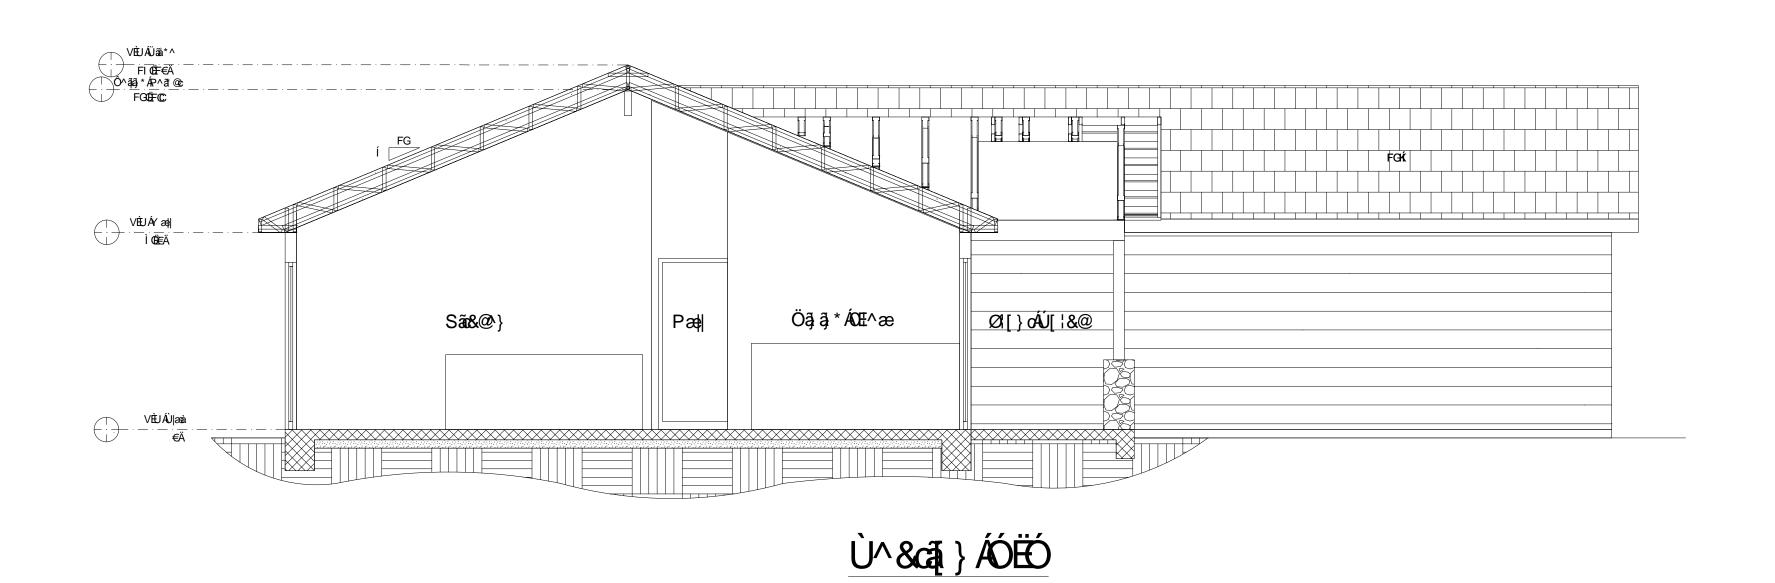

Section View
Scale- 1/4": 1'-0"

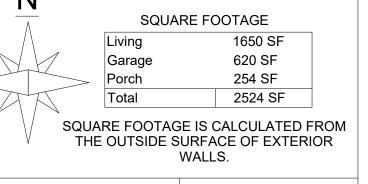

© [2024] [FrameUpNow] . All rights reserved Frame up Now

JOB DETAILS Ember ADDRESS


DRAWN BA DWG FILE 246-Ember-1650-3Bd2.5Ba-Craftsman-550

DATE DRAWN SCALE 1/4" : 1'-0" 04-30-2025 VIEW NAME ON 36 x 24 8 of 17

**S6** 

JOB REFERENCE

COLD FORMED STEEL SKELETON ONLY

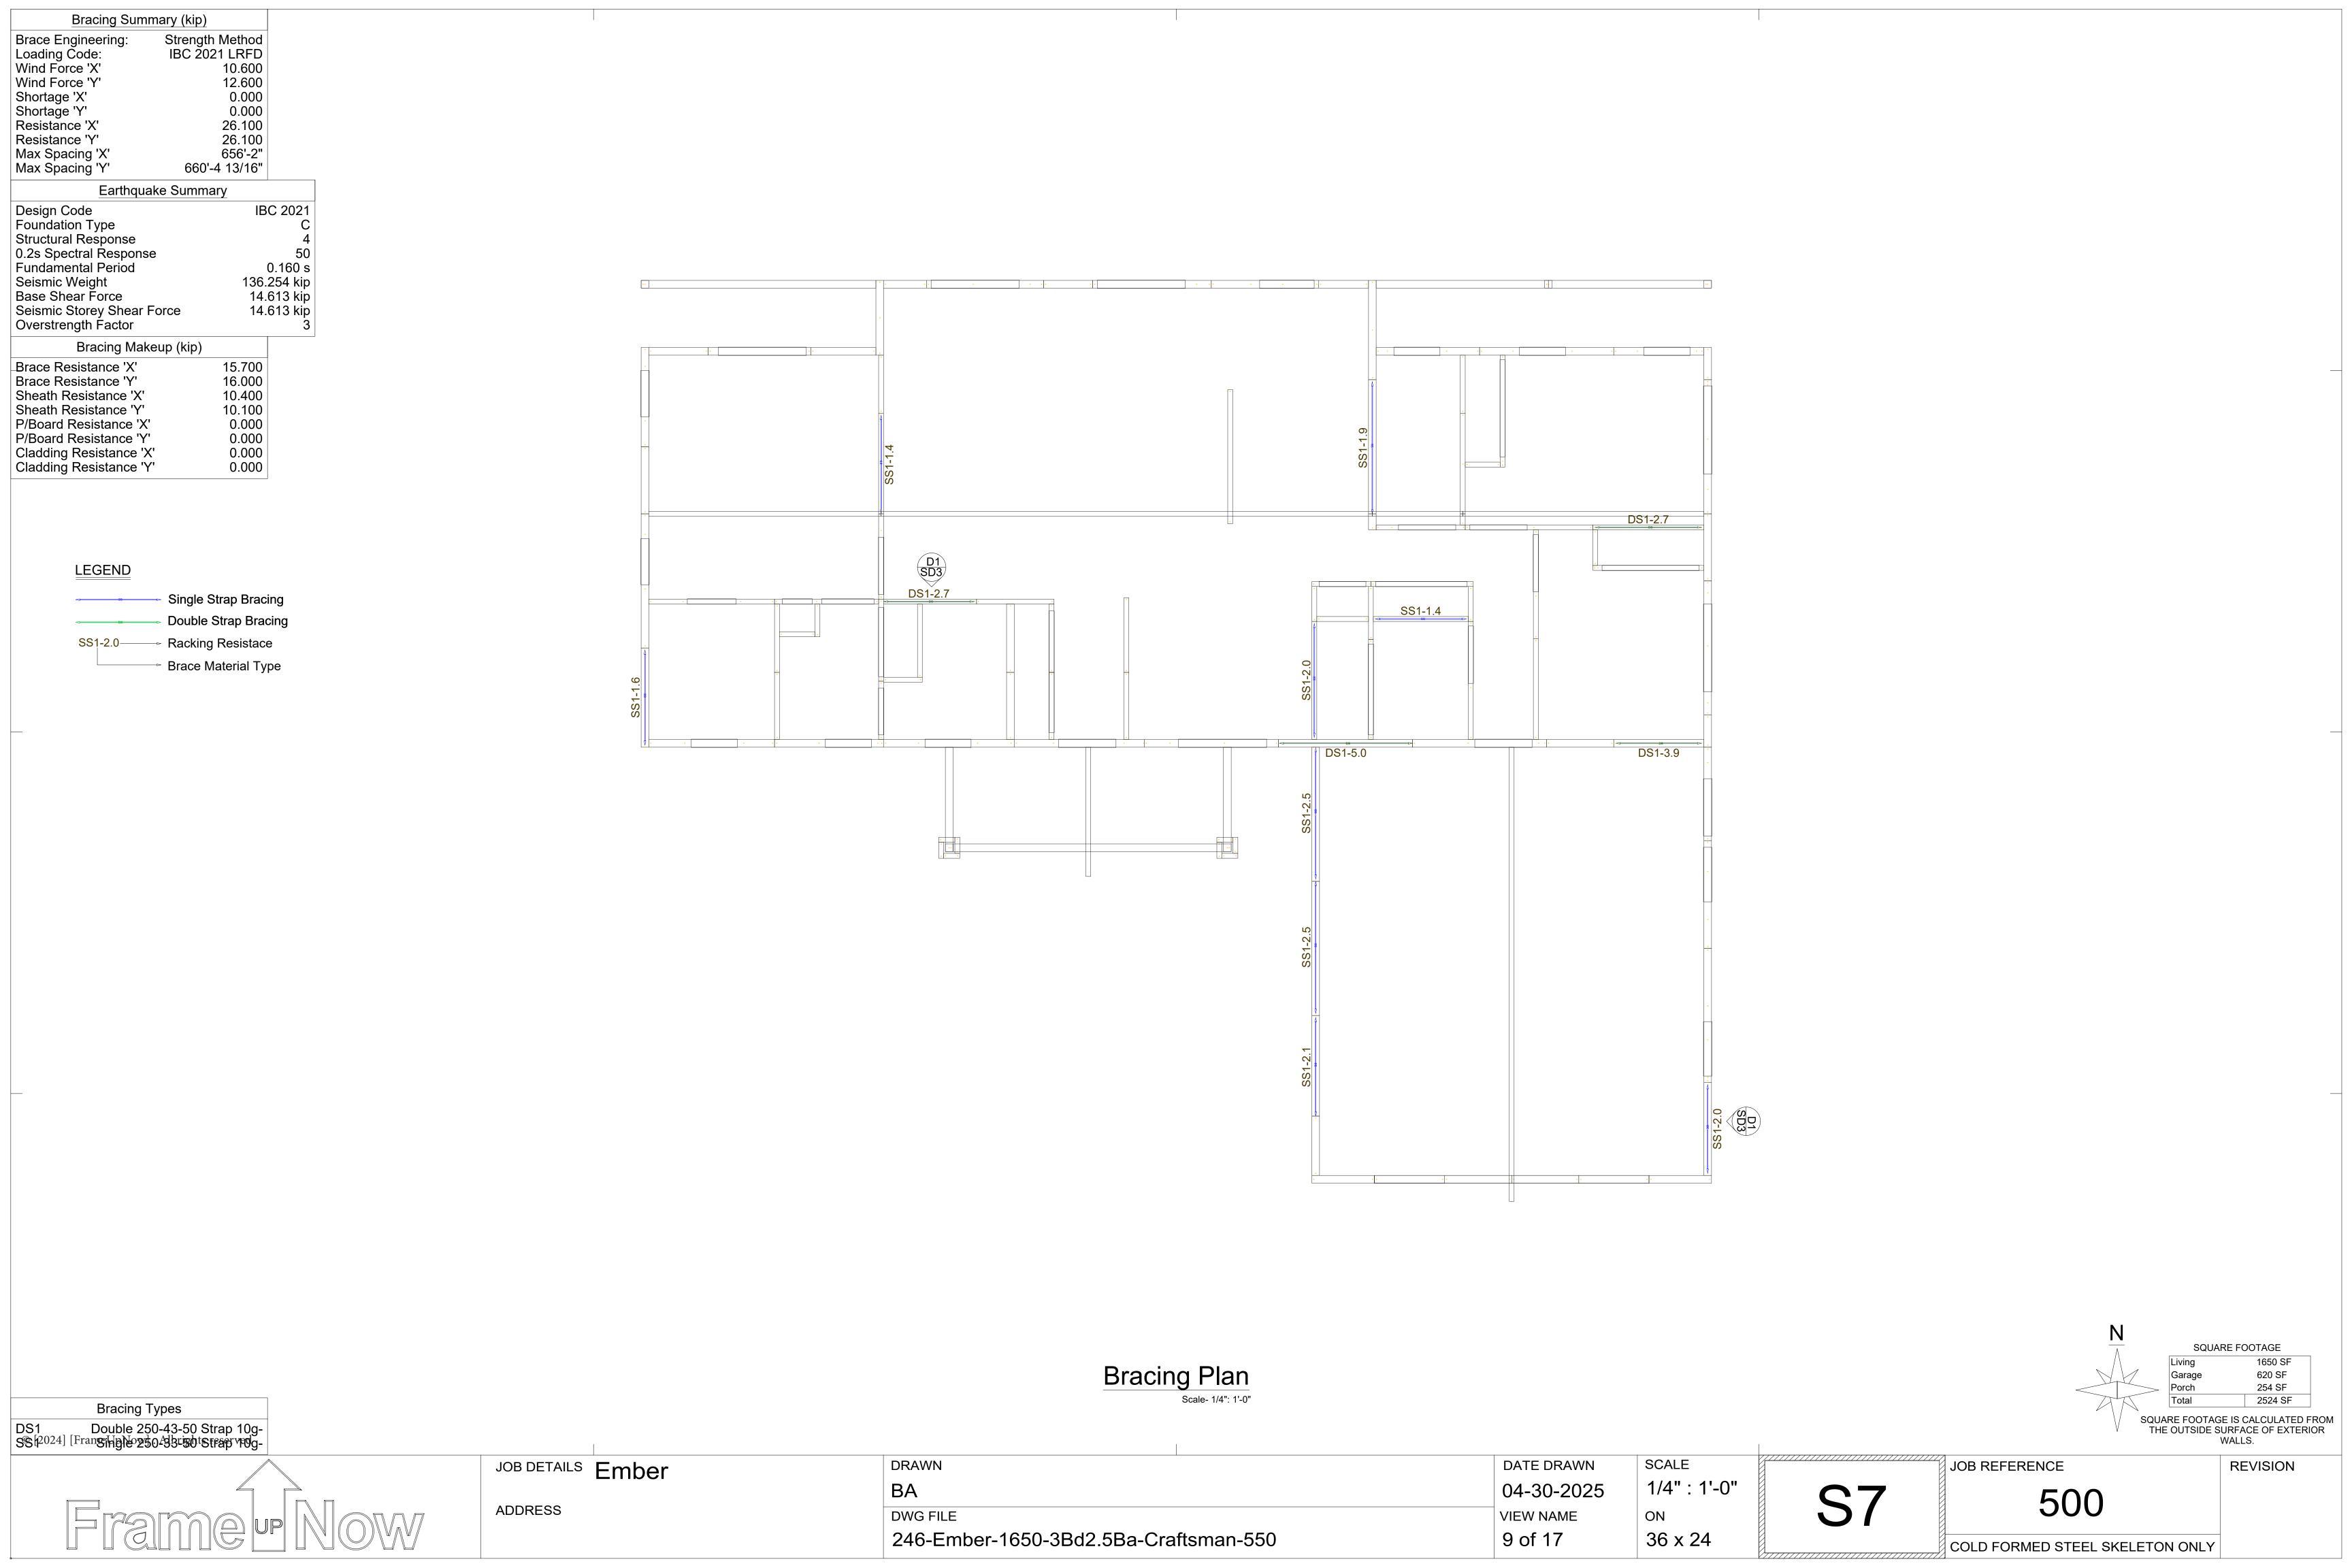

### LEGEND

Titan Bolt with MSSC4 Connector
 For Load Bearing Wall

Titan THD10x80

Shot Pins with WasherFor Non-Load Bearing Wall


Single Strap Bracing

Double Strap Bracing

Racking Resistace

Brace Material Type

Bracing Types
SS1 Single 250-33-50 Strap 10gDS1 Double 250-33-50 Strap 10g-

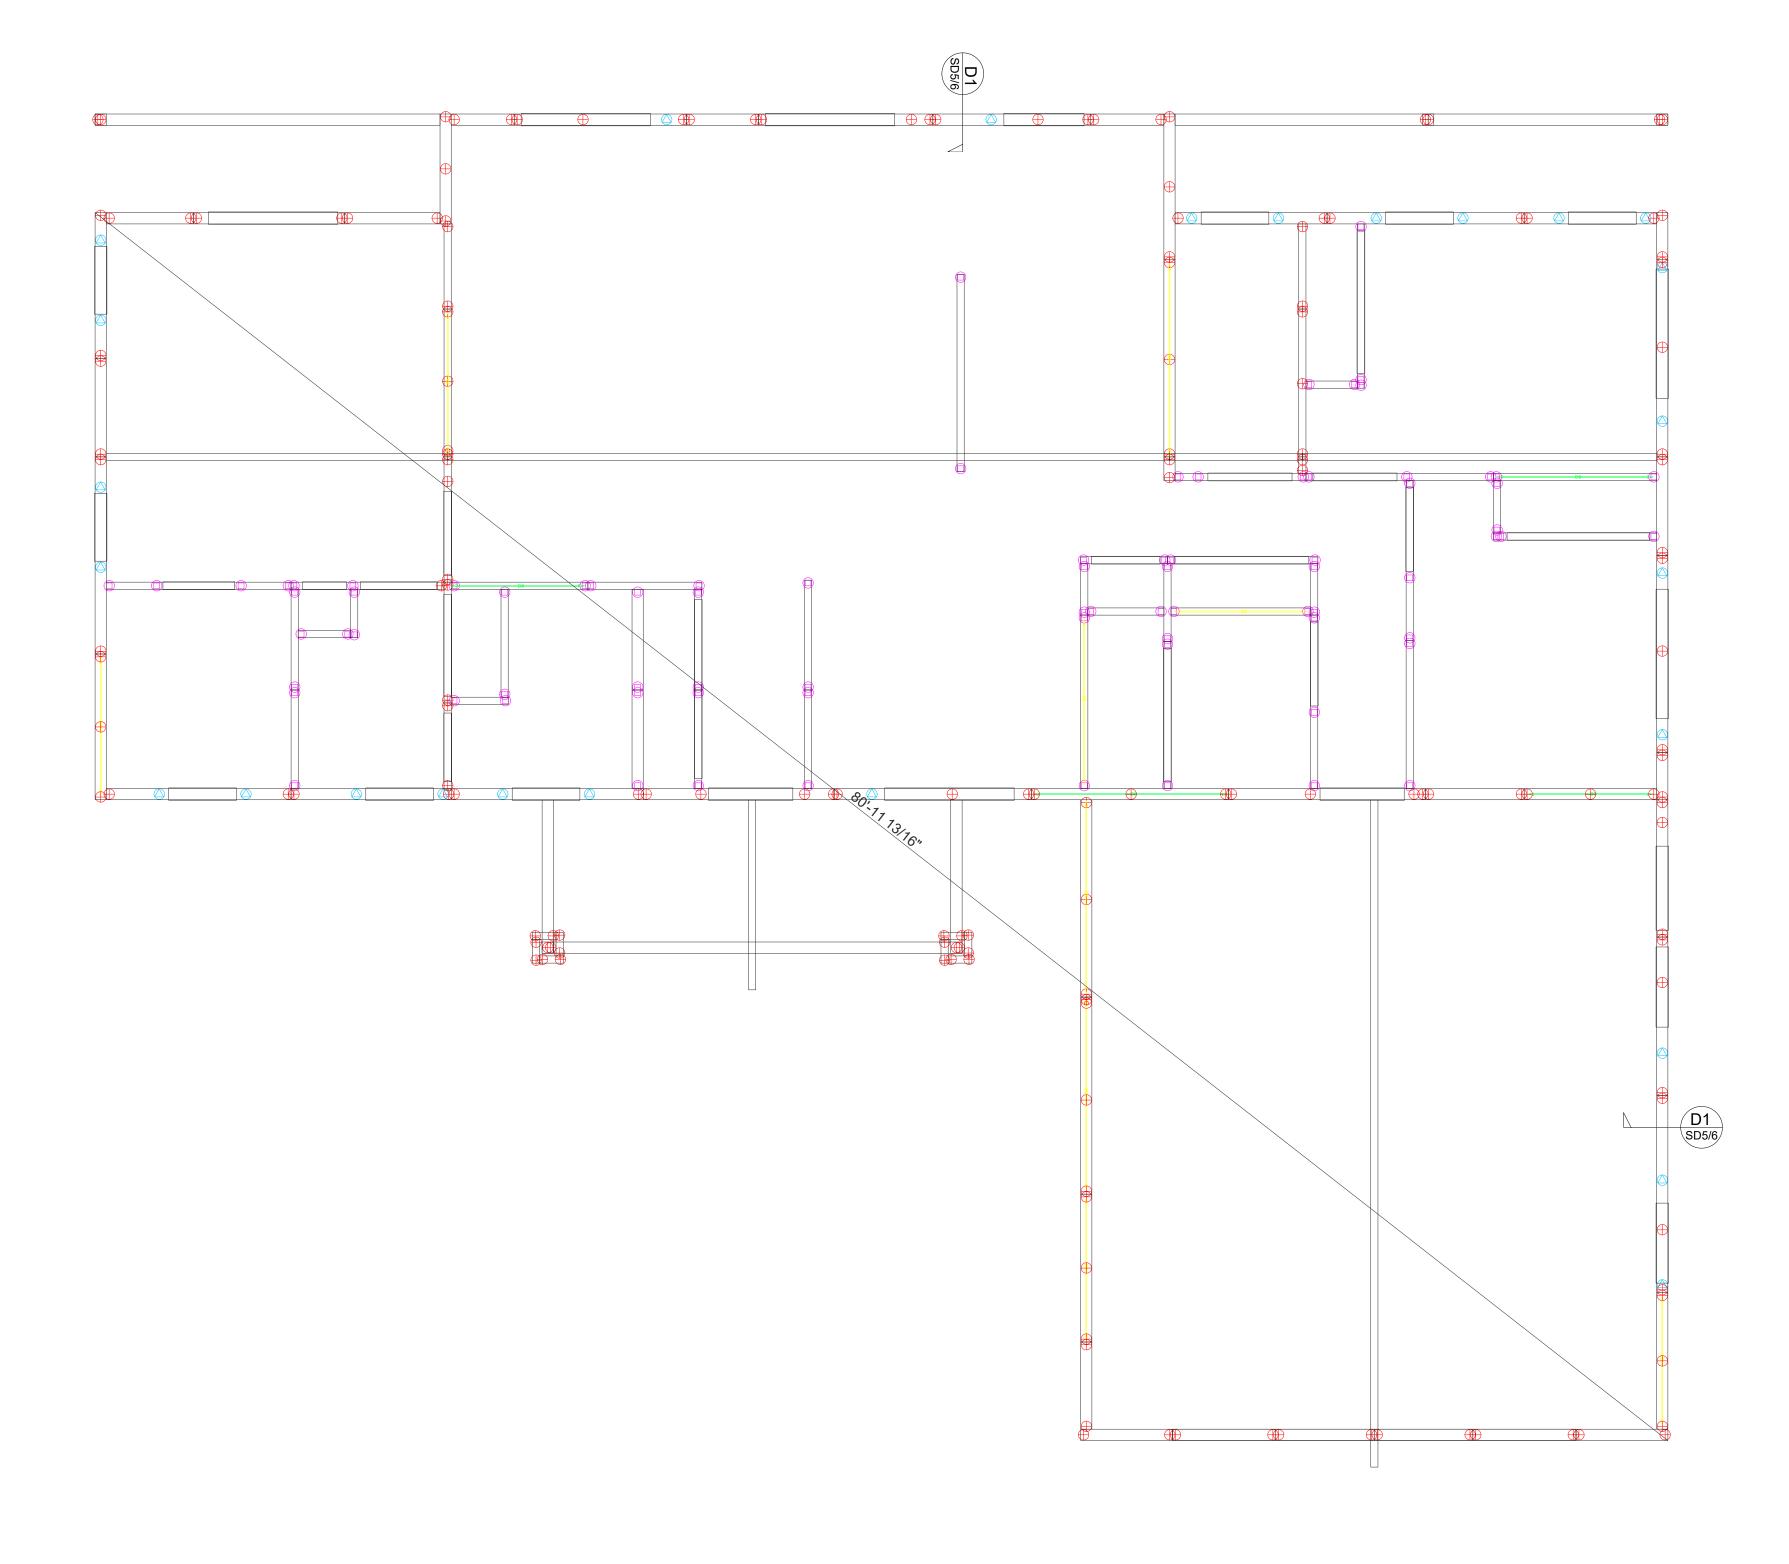

# Hold-down Plan Scale- 1/4": 1'-0"

SQUARE FOOTAGE

Living 1650 SF
Garage 620 SF
Porch 254 SF
Total 2524 SF

SQUARE FOOTAGE IS CALCULATED FROM THE OUTSIDE SURFACE OF EXTERIOR WALLS.

© [2024] [FrameUpNow] . All rights reserved

ADDRESS

JOB DETAILS Ember
ADDRESS

DRAWN
BA

DWG FILE
246-Ember-1650-3Bd2.5Ba-Craftsman-550

DATE DRAWN SCALE

04-30-2025 1/4": 1'-0"


VIEW NAME ON


10 of 17 36 x 24


JOB R

JOB REFERENCE 500


COLD FORMED STEEL SKELETON ONLY

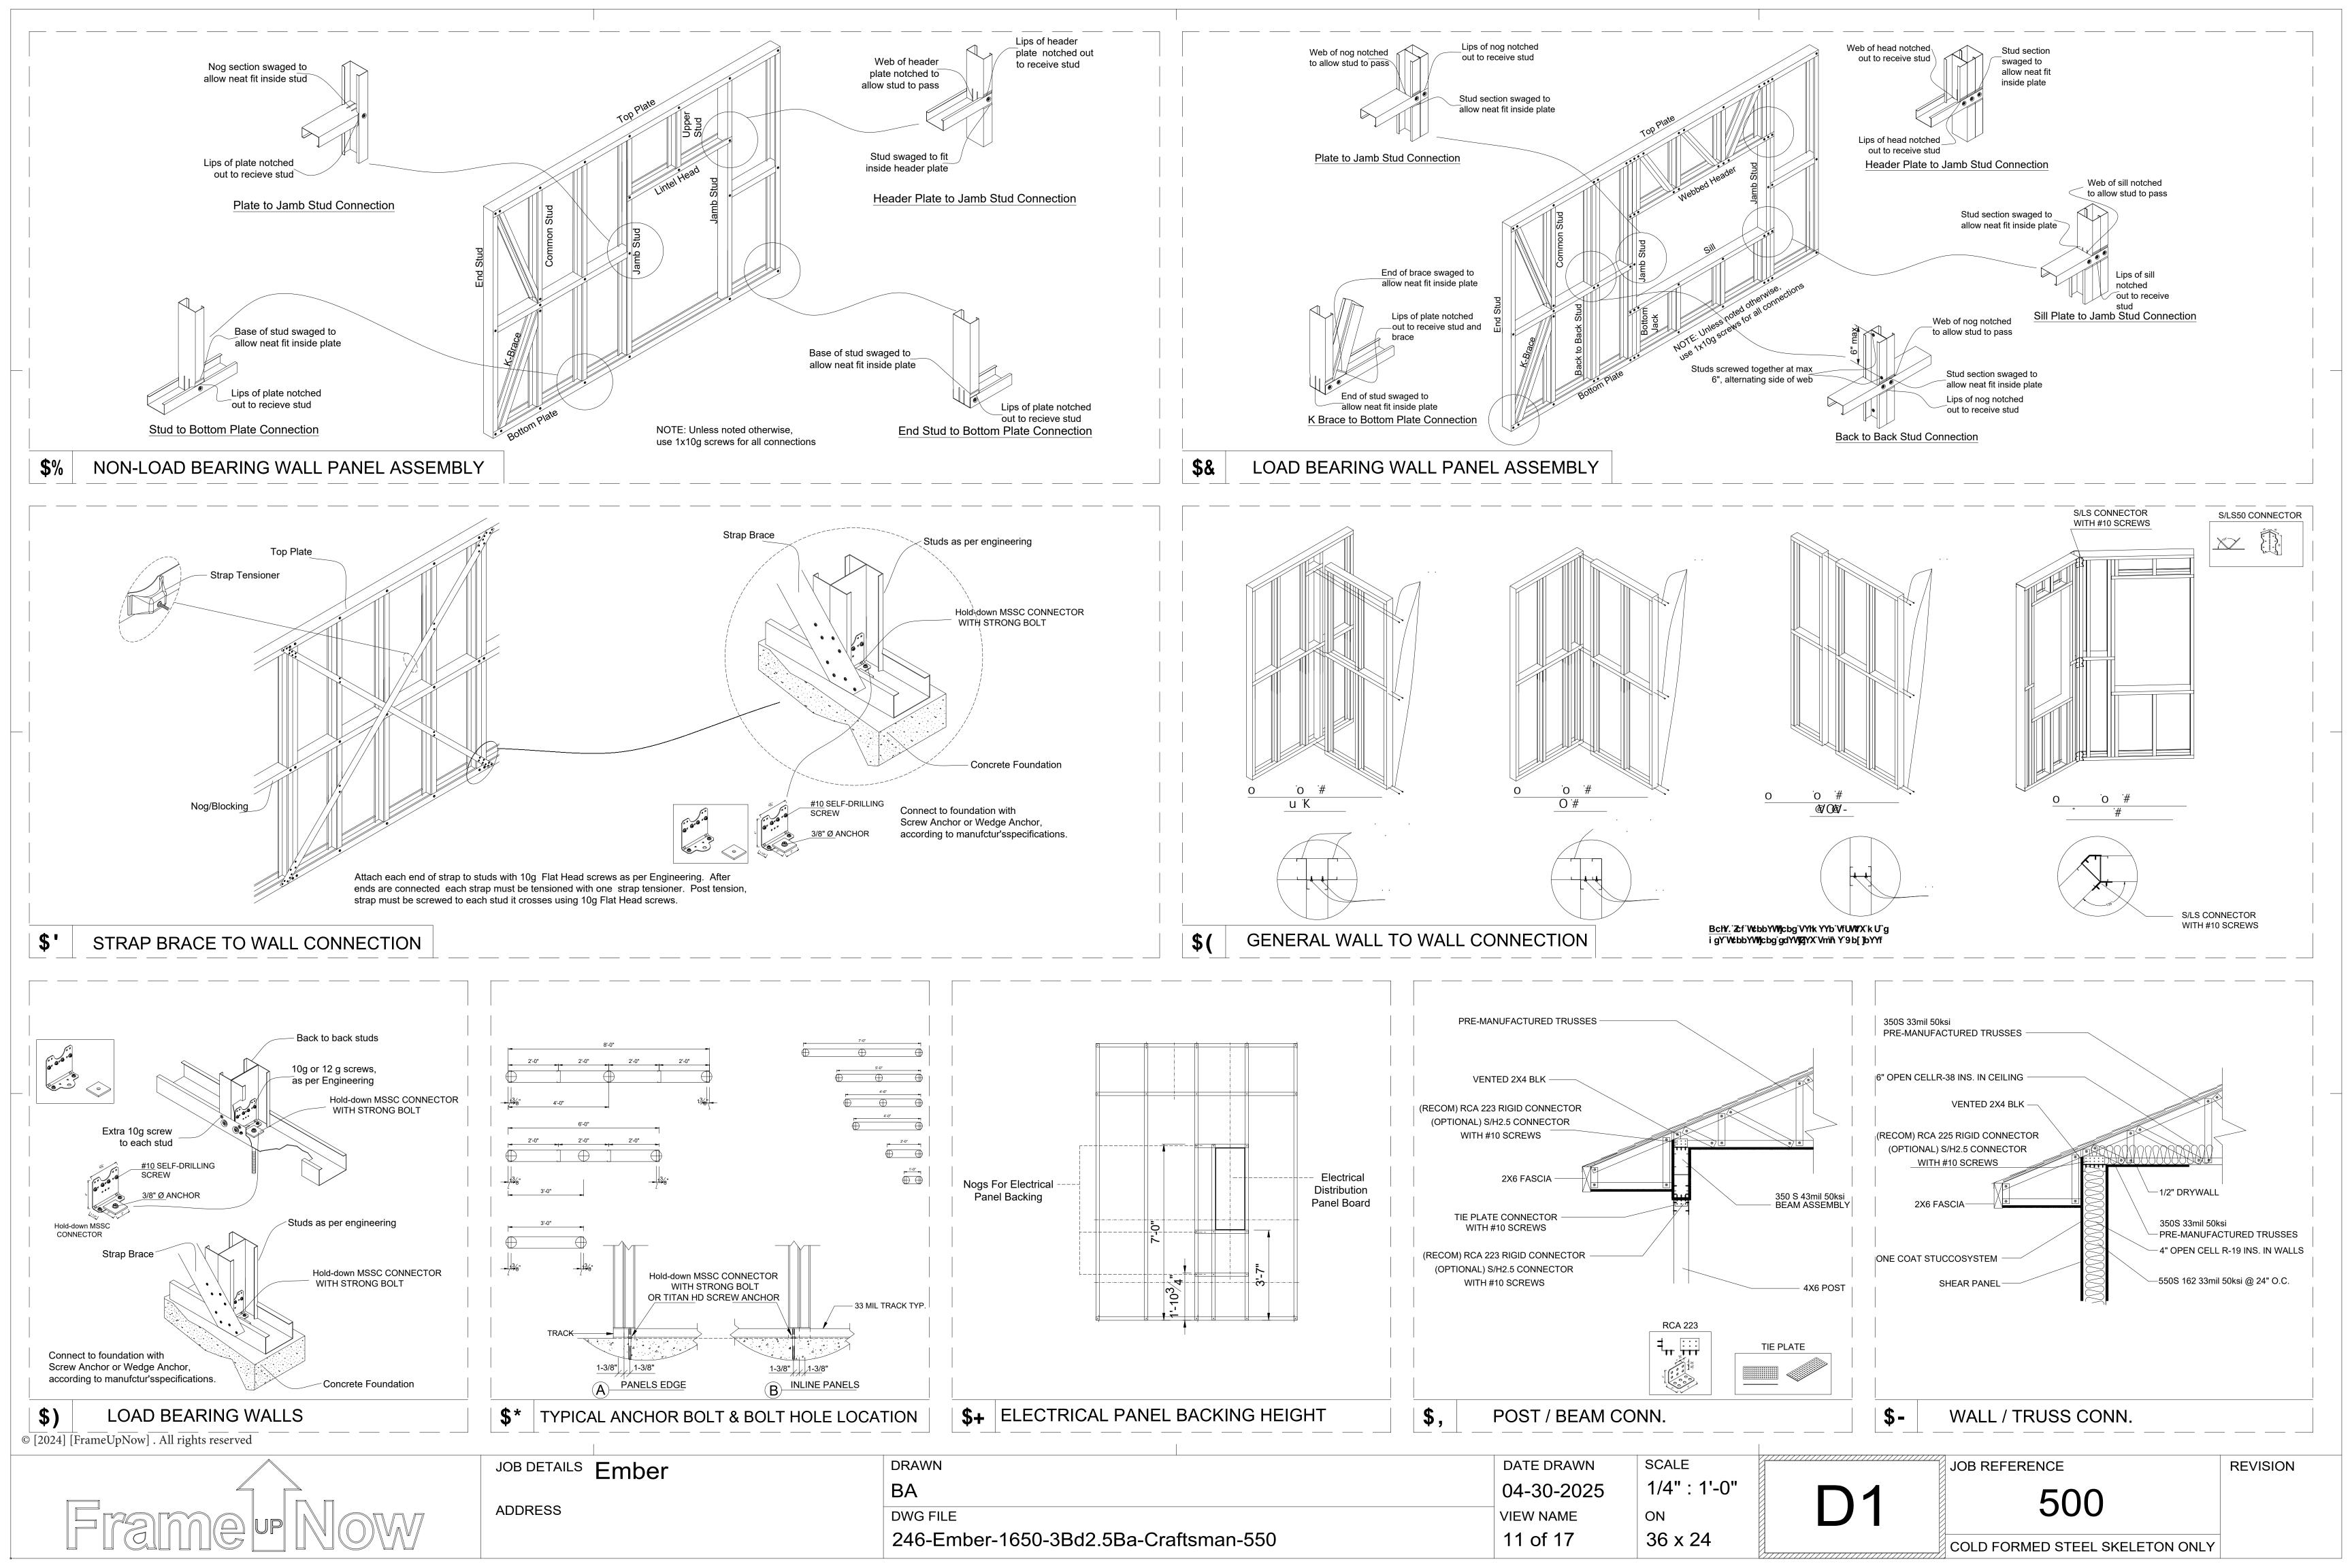

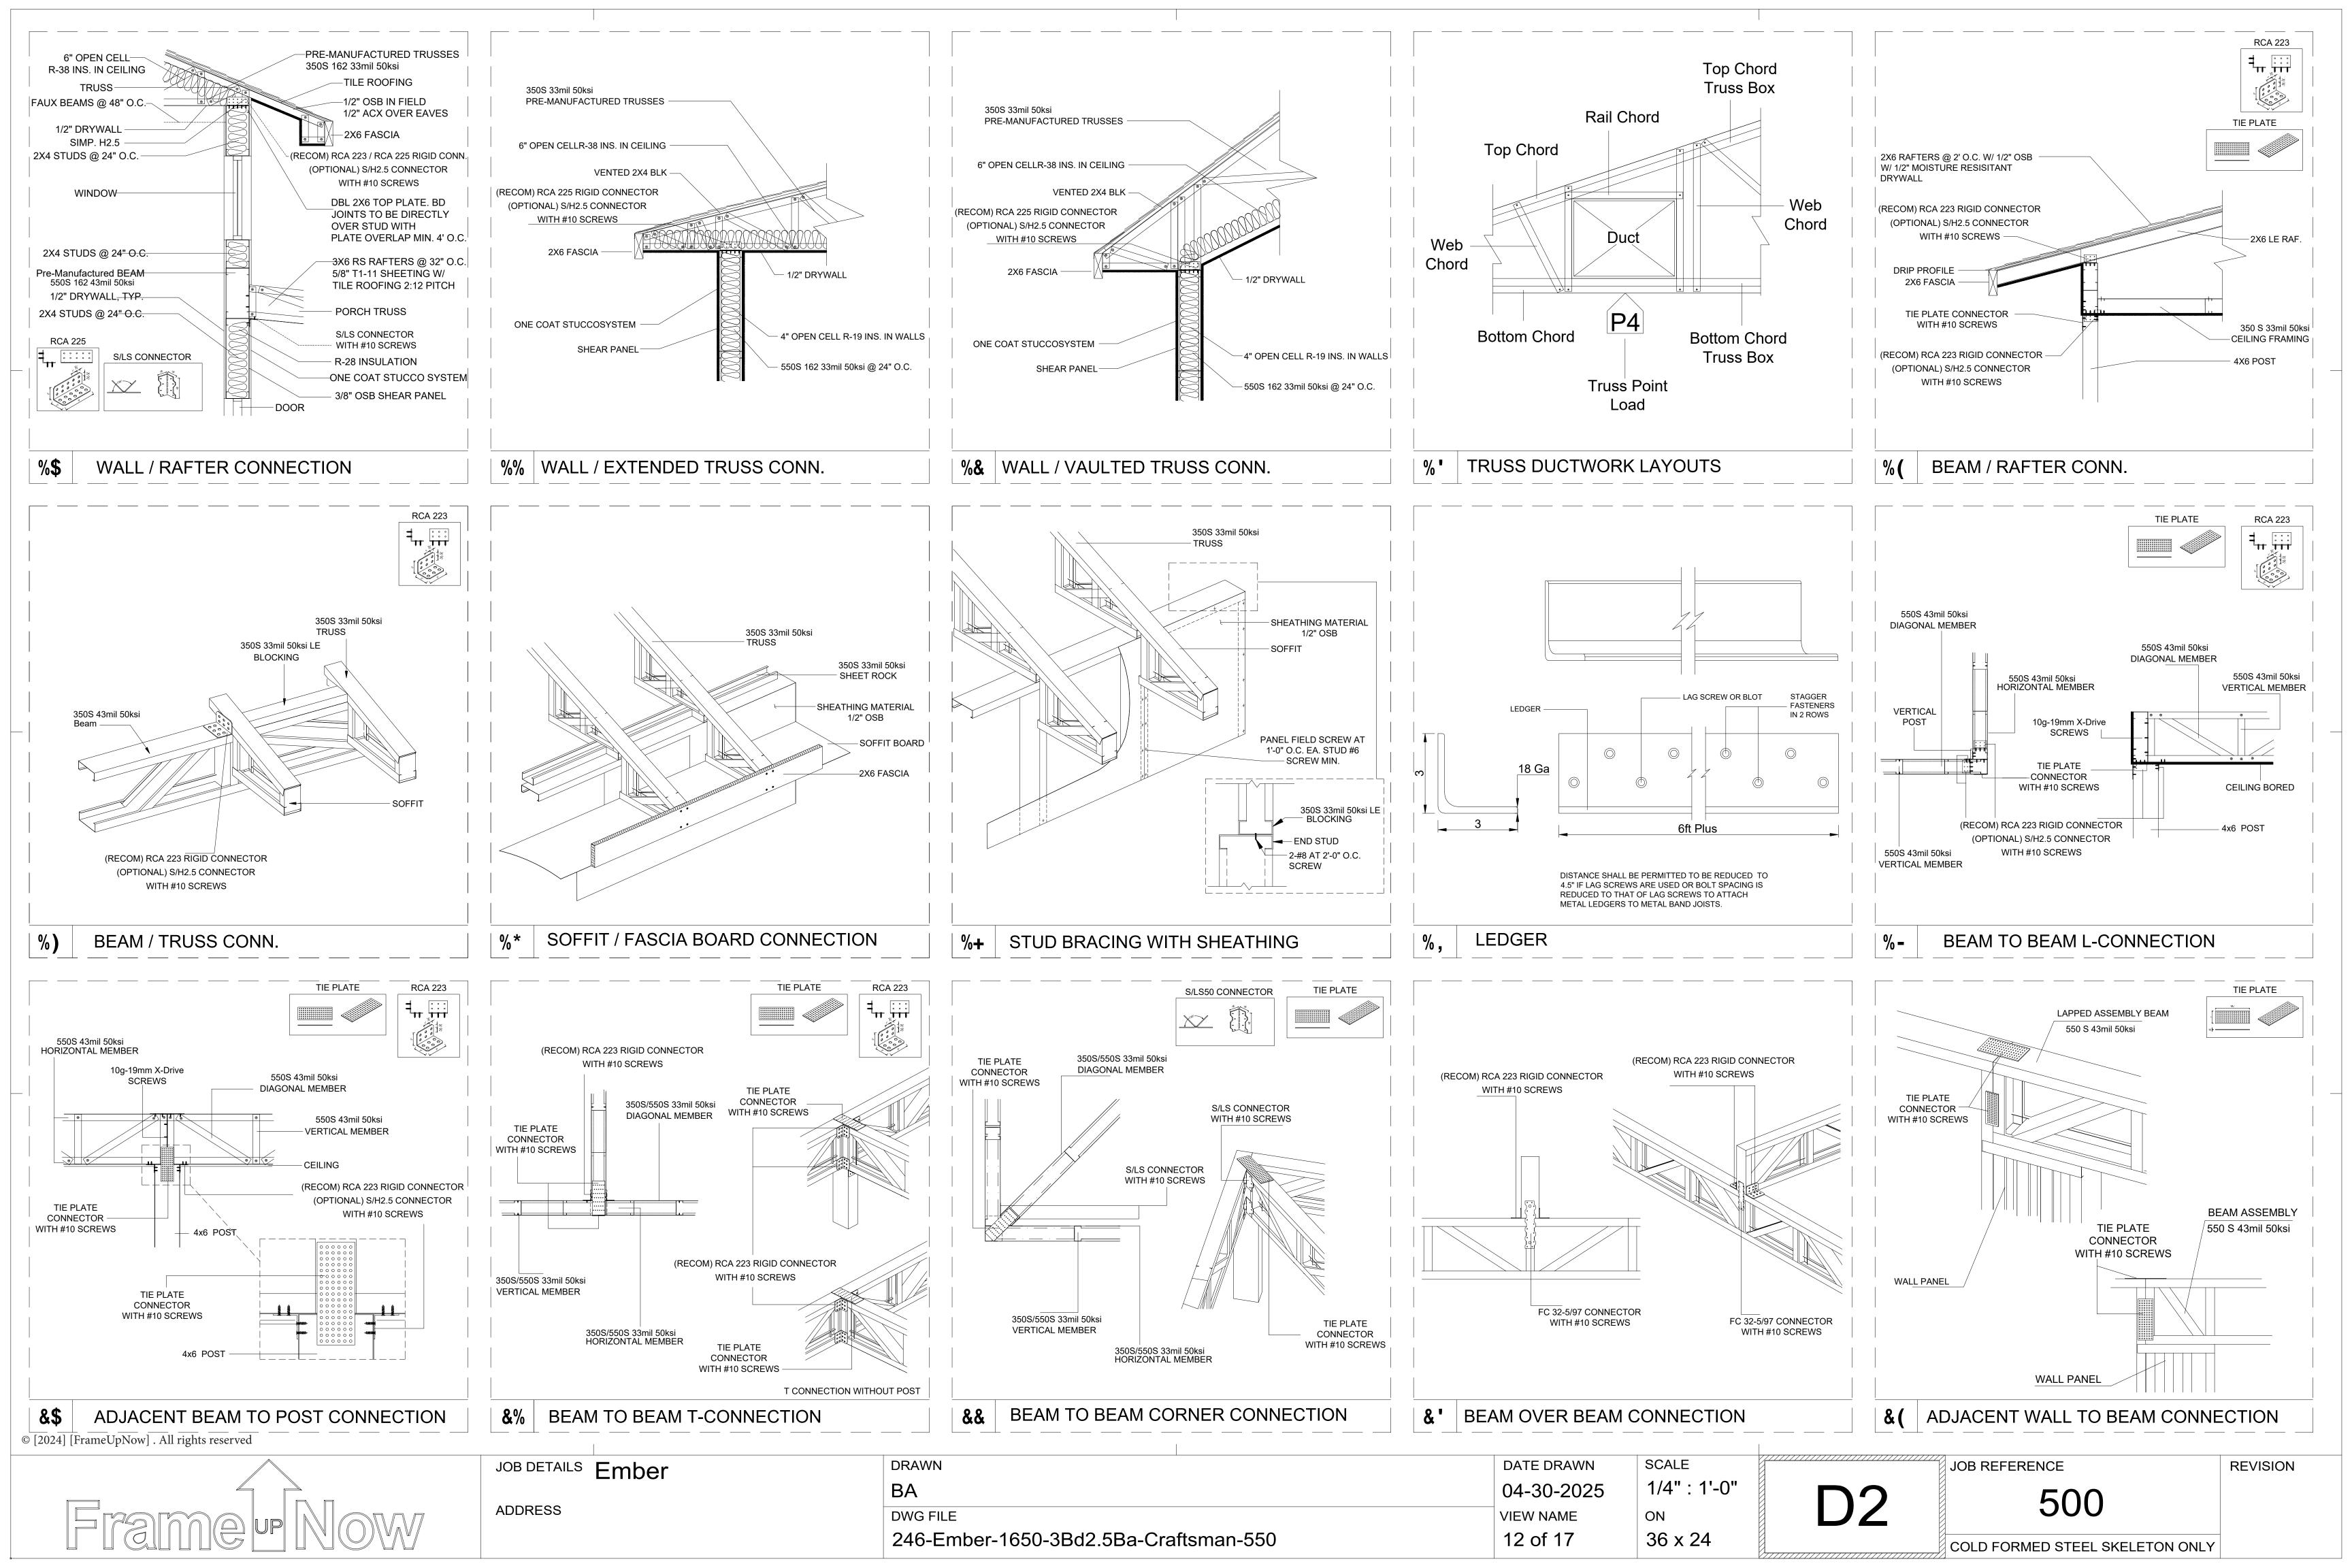

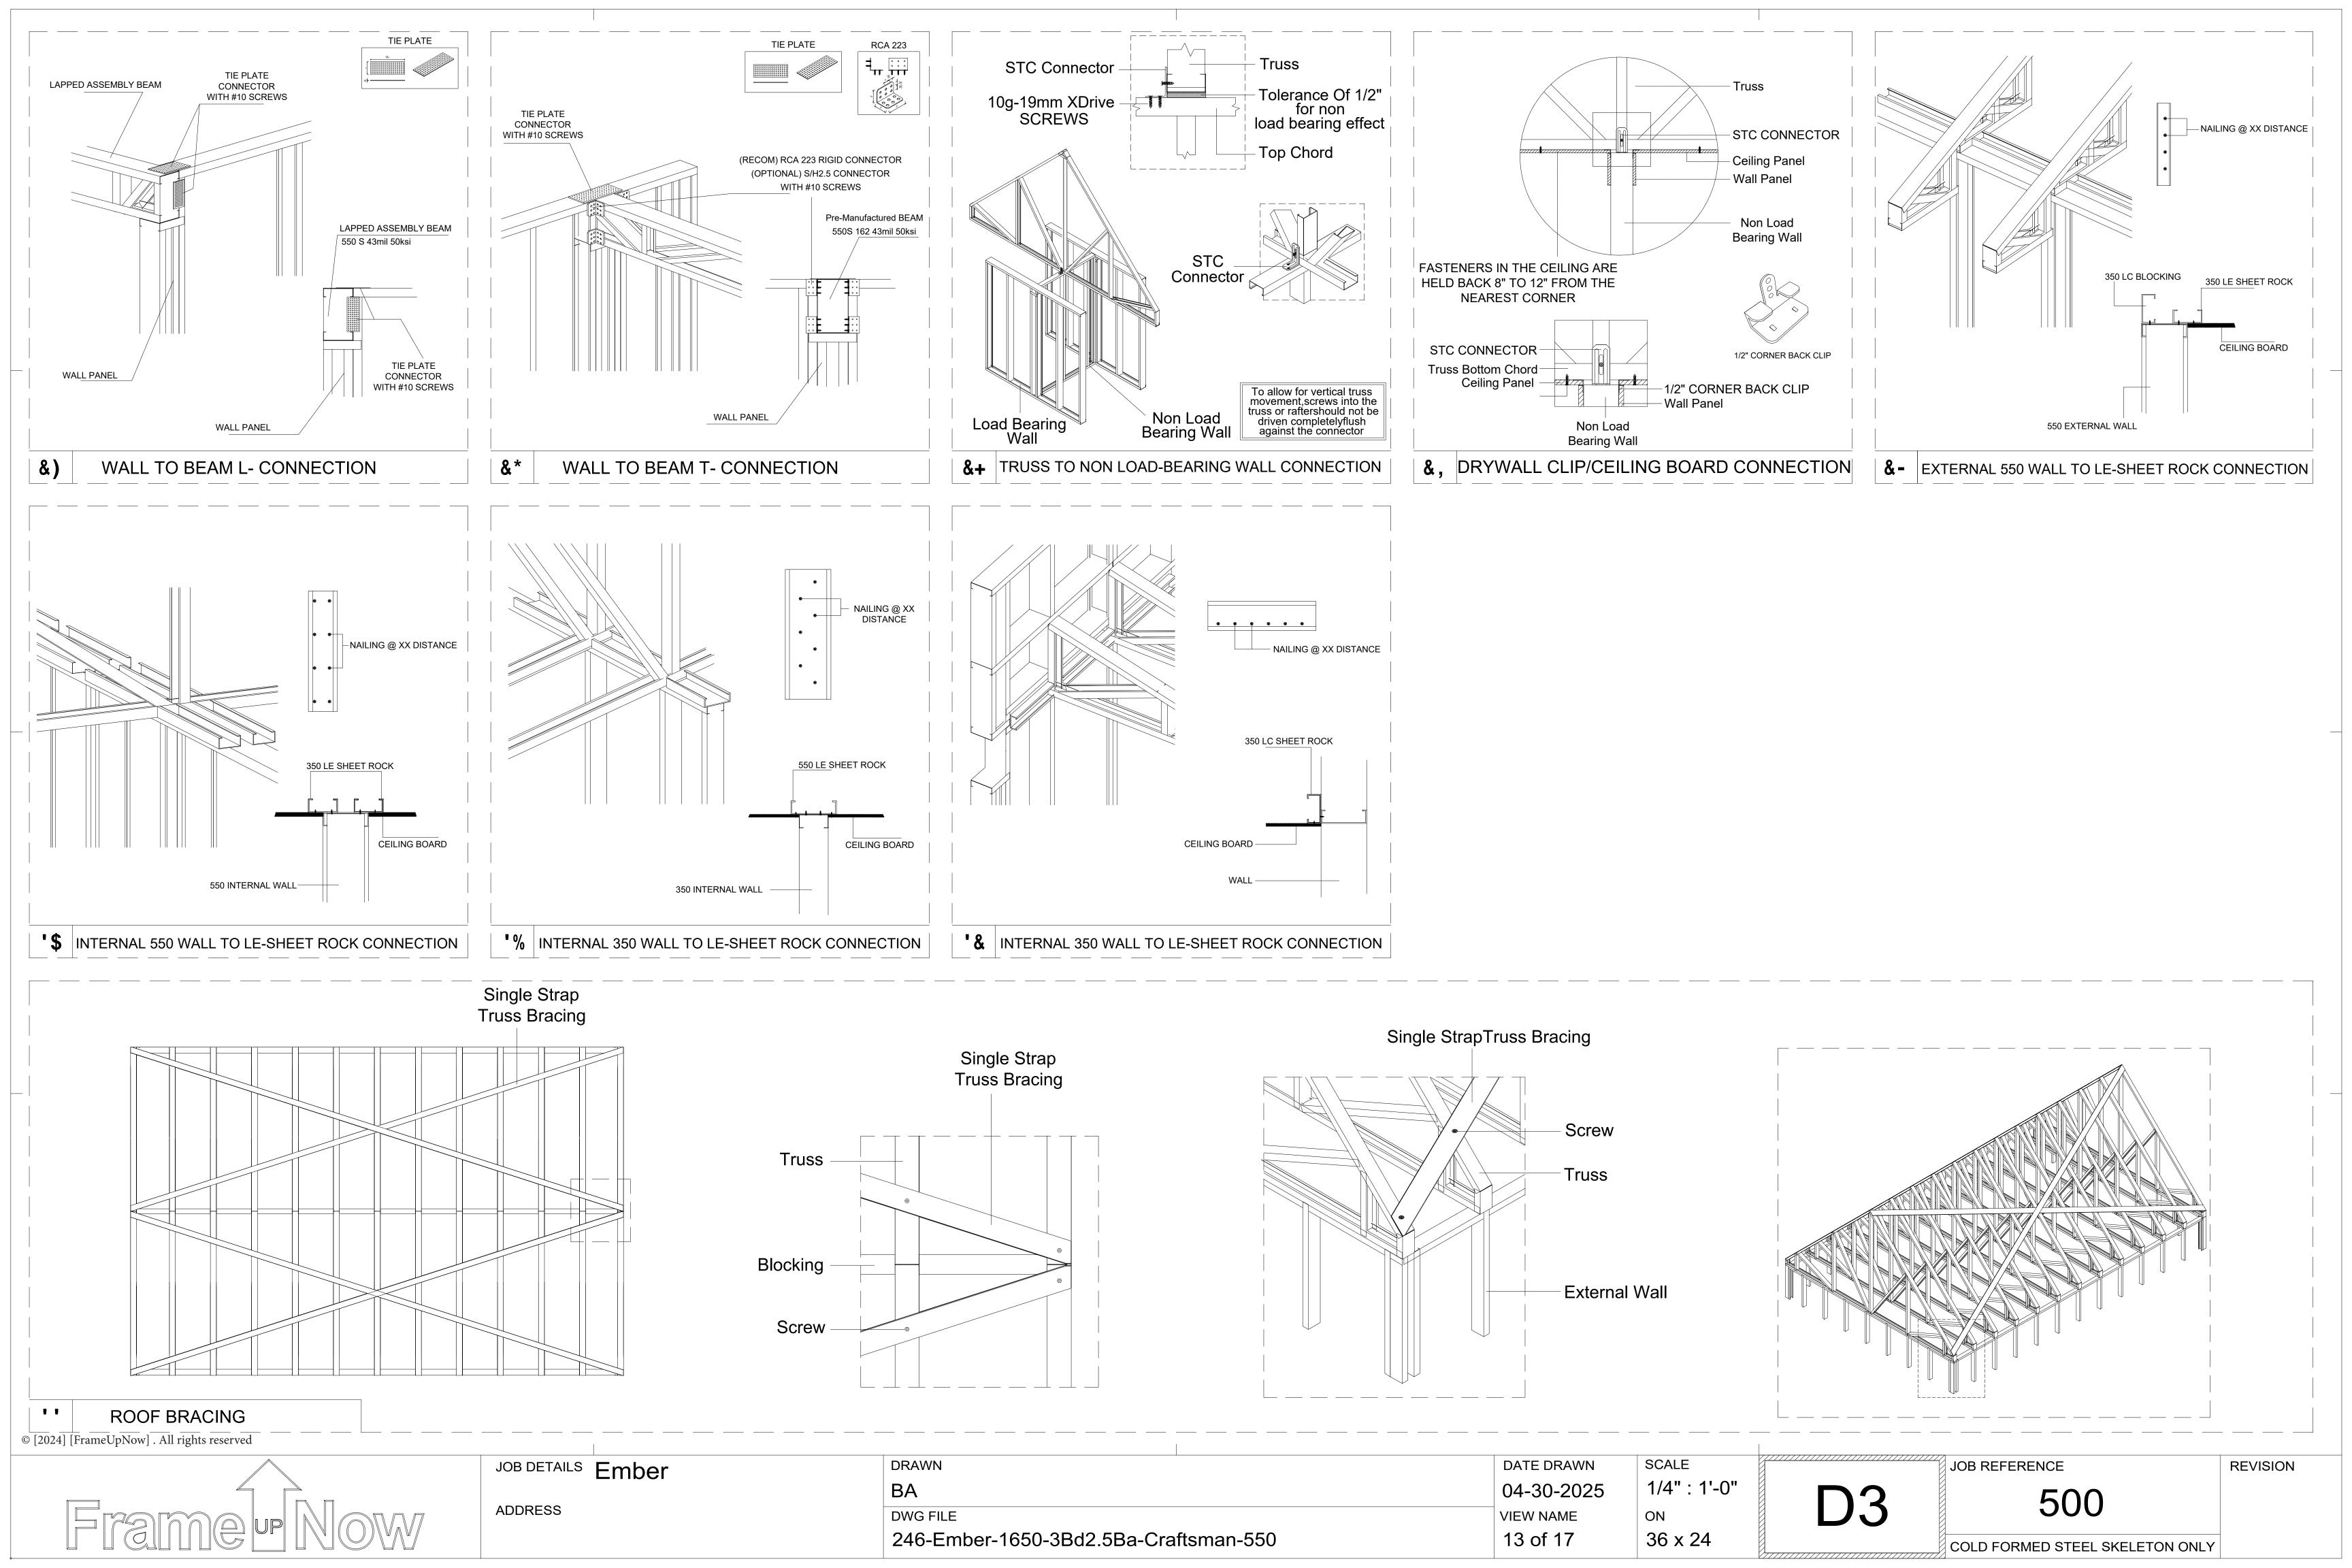

Parallel Truss V Rafter

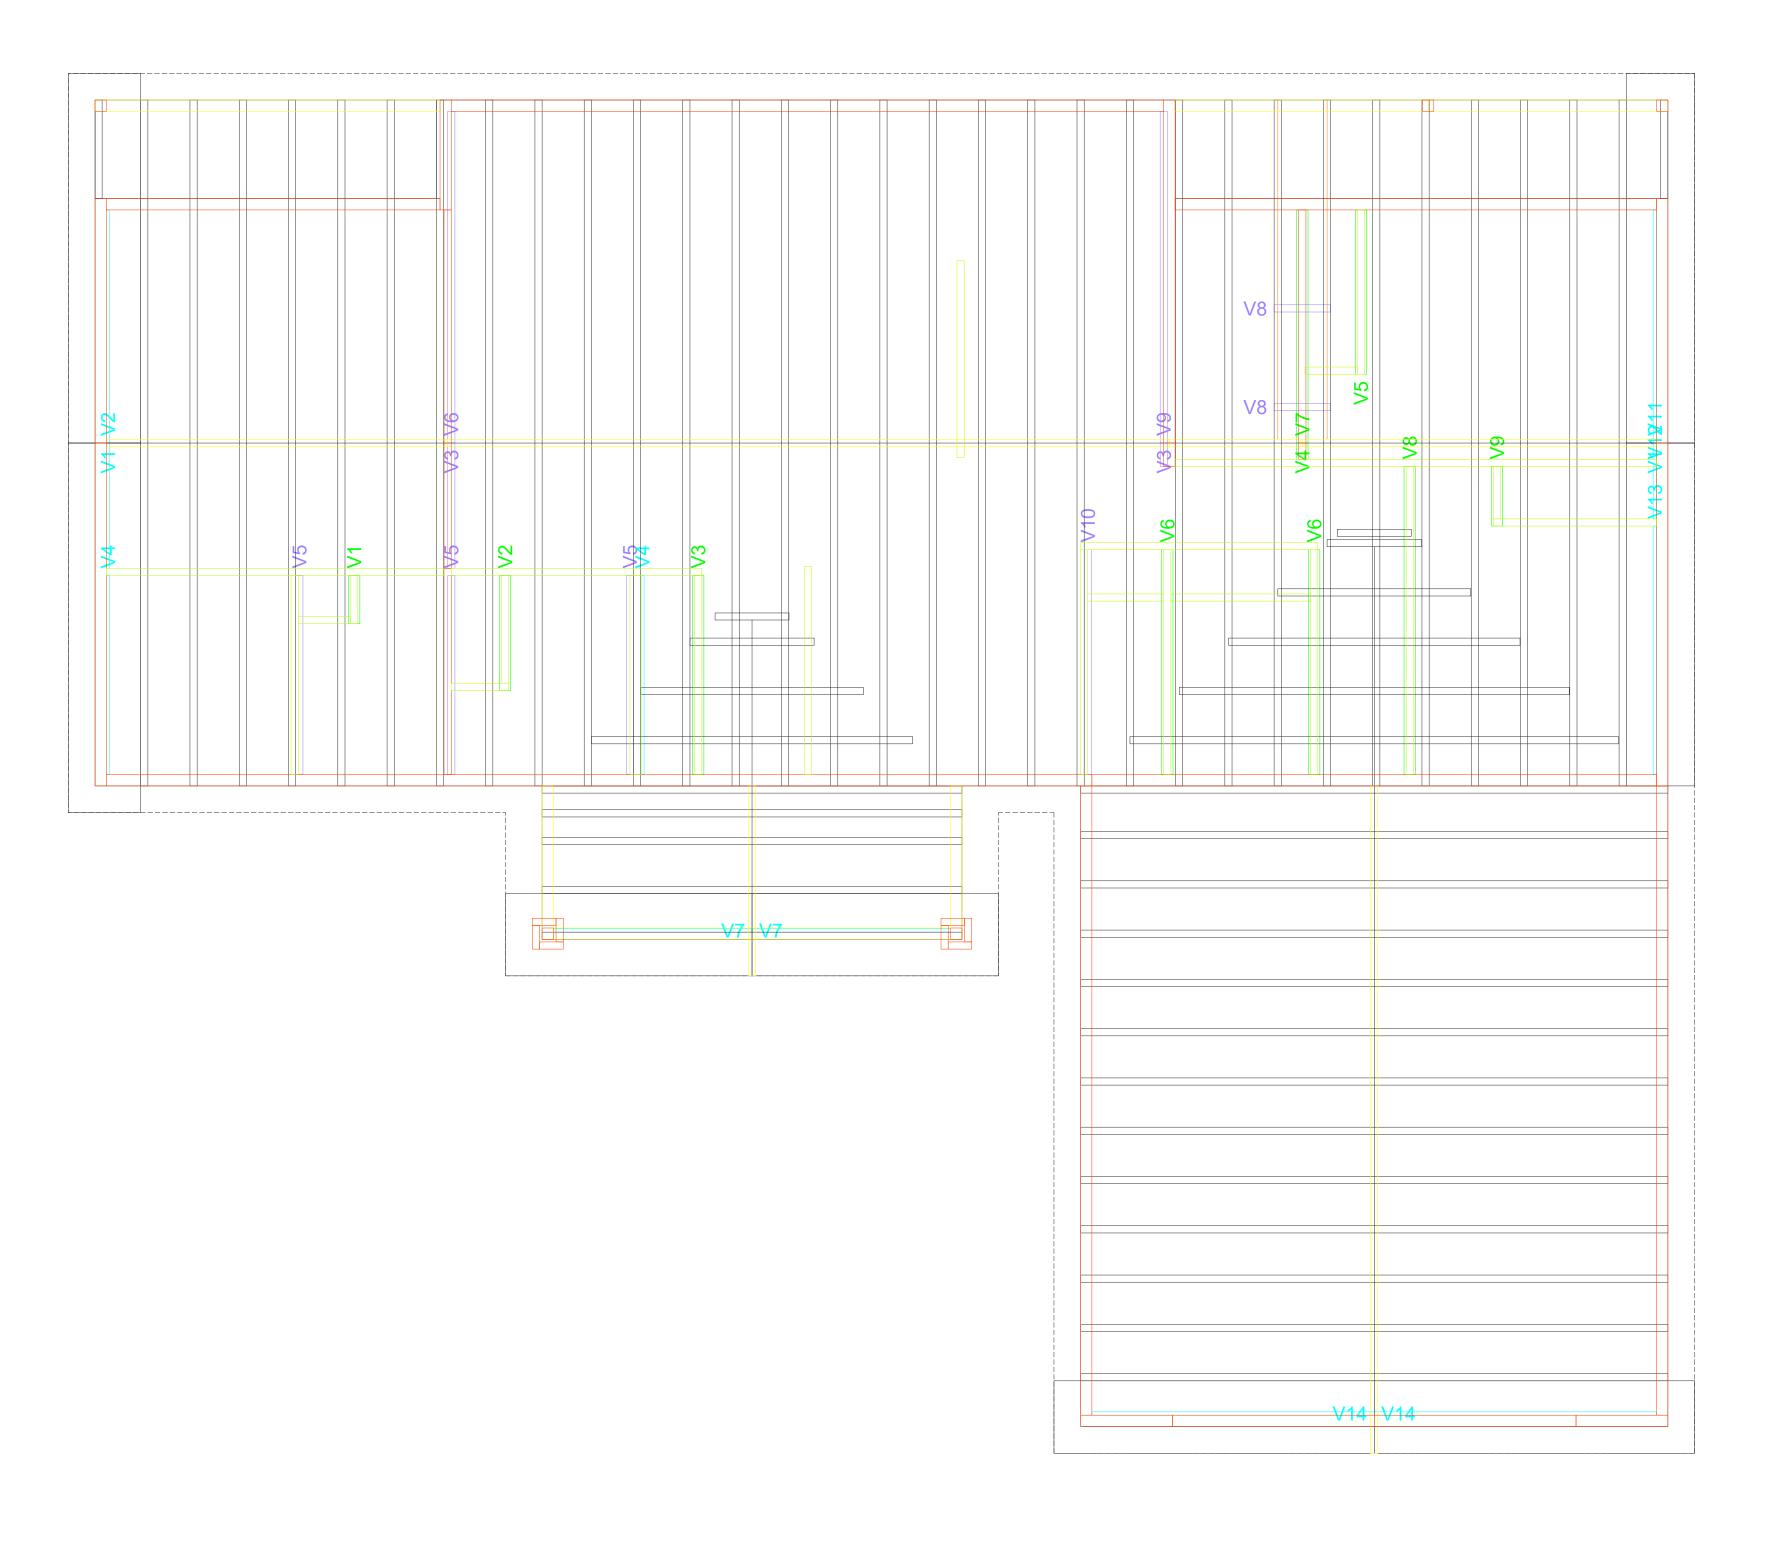

# **Sheetrock Backing** Scale- 1/4": 1'-0"

Frame up Now

© [2024] [FrameUpNow] . All rights reserved

JOB DETAILS Ember ADDRESS

DRAWN BA

DWG FILE 246-Ember-1650-3Bd2.5Ba-Craftsman-550 DATE DRAWN 04-30-2025 VIEW NAME 14 of 17

SCALE 1/4" : 1'-0" ON 36 x 24

JOB REFERENCE 500

REVISION

Truss Accessories

Truss Summary

Rafter Summary

22 16'-0" 14 20'-4"

32 227'-8"

10'-2 15/16"

2'-1 7/16" 9'-10 5/8"

8 11/16"

2'-3 5/8"

5'-11/16"

10'-11 1/16"

12'-4 15/16" 5'-6 1/8"

14'-6 15/16" 8'-9 1/16"

8'-9 1/16"

8'-9 1/16"

7'-2 11/16<u>"</u> 5'-6 1/8"

9'-10 5/8"

8'-8 13/16"

8 11/16"

2'-3 1/2"

13'-6 1/2"

1'-7/16"

2'-7 7/16"

10'-2 15/16"

672

32

FRAMECAD Batten 22

FRAMECAD Batten 40

FRAMECAD Tri Fix

FRAMECAD 10g-19mm HWH Hex

V1 350S162-33-50 2

V1 550S162-33-50

V10 350S162-33-50 V11 350S162-33-50

V12 350S162-33-50

V13 350S162-33-50 1

V14 350S162-33-50 2 V2 350S162-33-50 1

V3 350S162-33-50 2 V3 550S162-33-50 1

V4 350S162-33-50 2

V4 550S162-33-50 1

V5 350S162-33-50 3

V7 350S162-33-50 2

V7 550S162-33-50 1 V8 350S162-33-50 2

V8 550S162-33-50 1

V9 350S162-33-50 1


V9 550S162-33-50 1

V5 550S162-33-50 V6 350S162-33-50 V6 550S162-33-50 2

V2 550S162-33-50

COLD FORMED STEEL SKELETON ONLY

PC Parallel Truss V Rafter

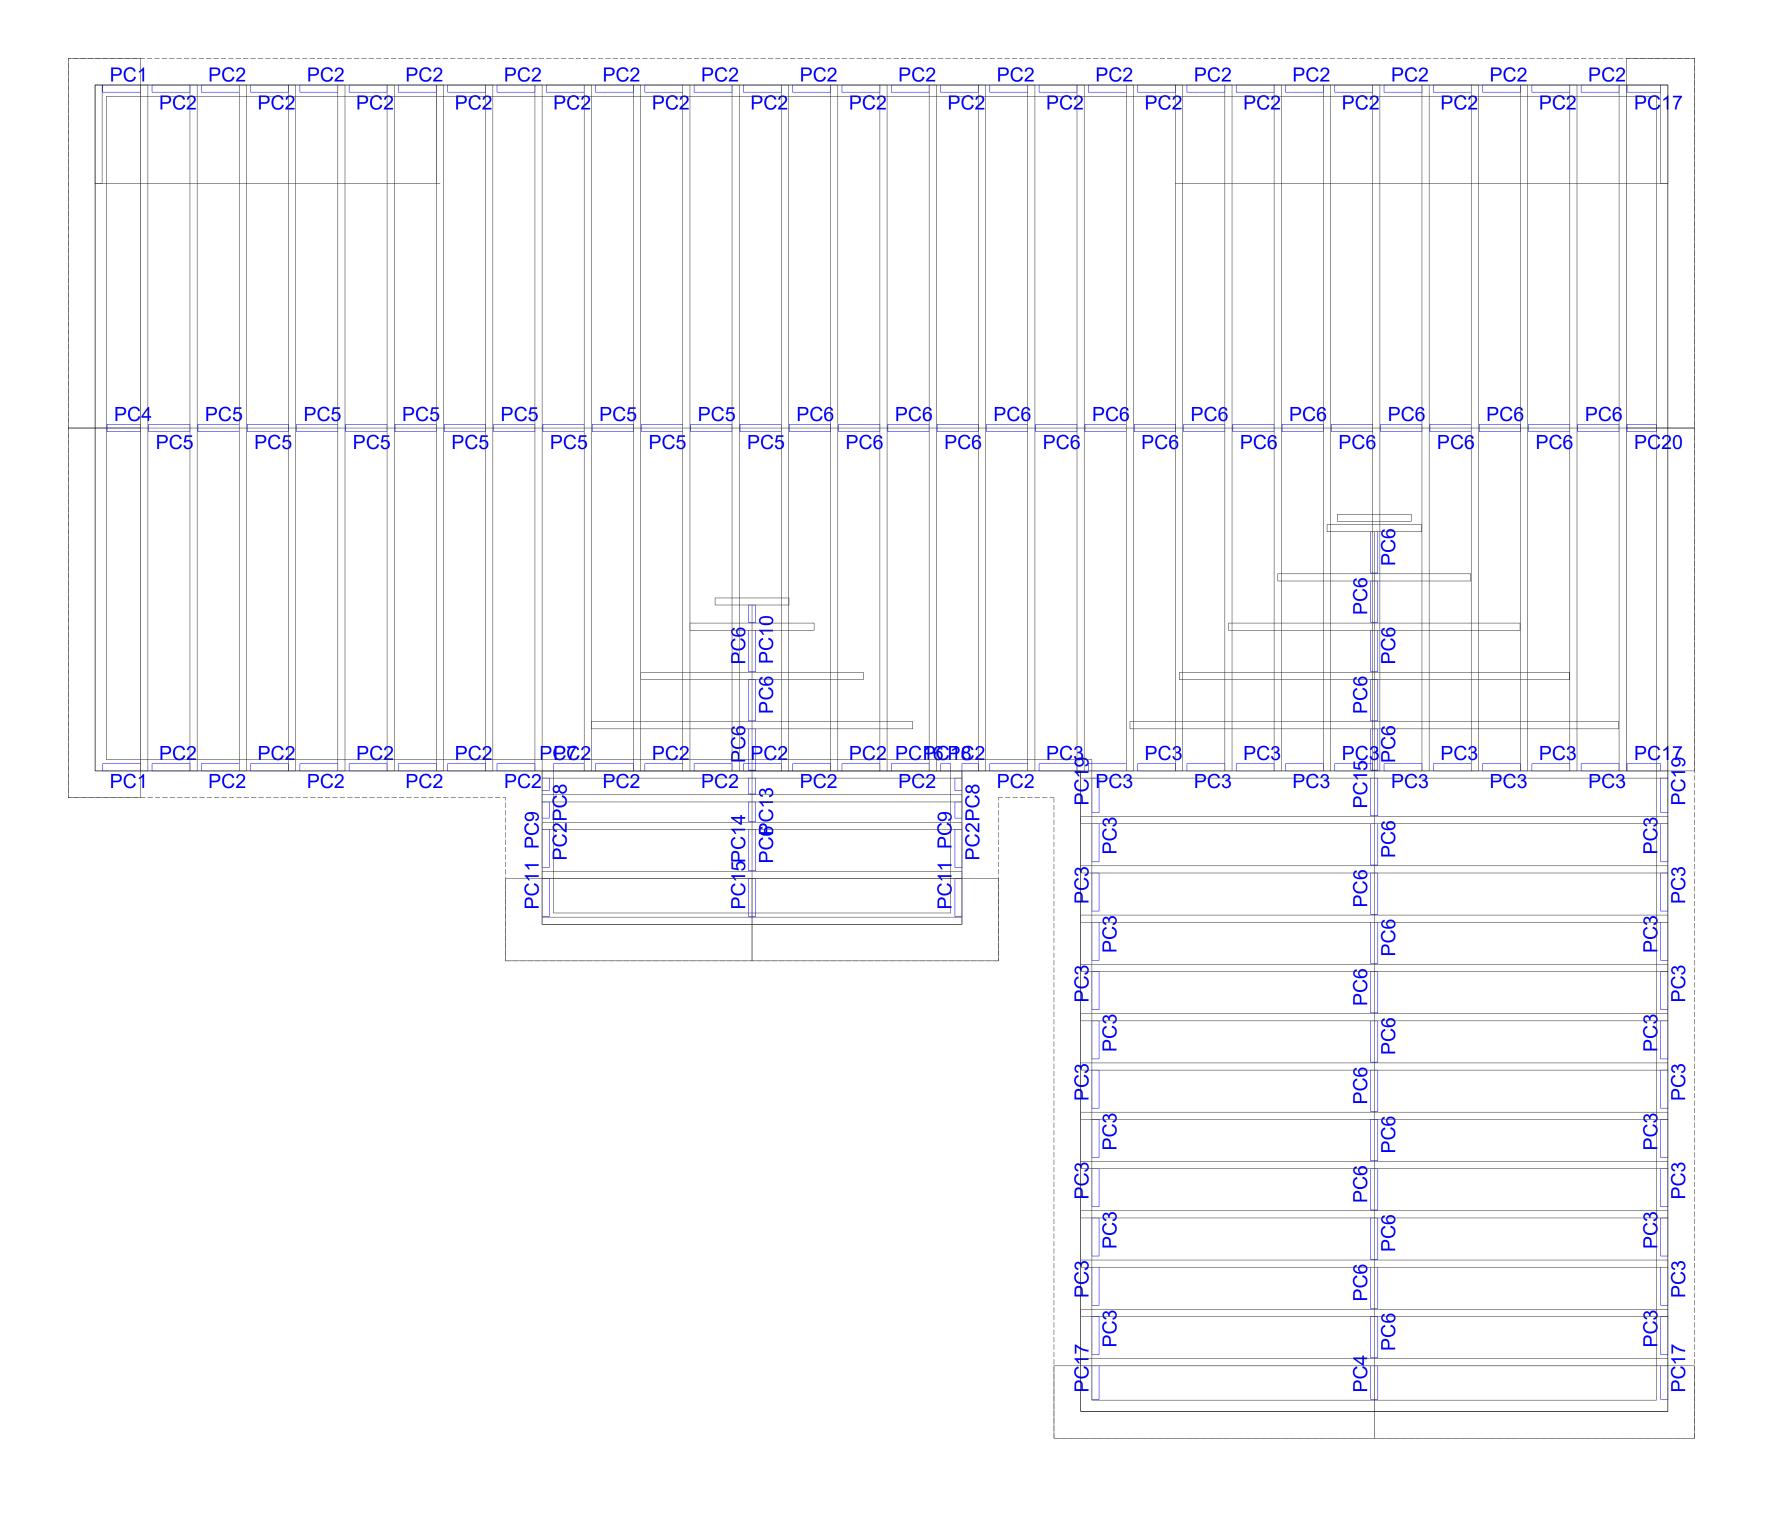

# Truss Blocking Layout Scale- 1/4": 1'-0"

© [2024] [FrameUpNow] . All rights reserved

JOB DETAILS Ember **ADDRESS** 

DRAWN BA DWG FILE

246-Ember-1650-3Bd2.5Ba-Craftsman-550

SCALE DATE DRAWN 1/4" : 1'-0" 04-30-2025 VIEW NAME ON 36 x 24

15 of 17

S10

JOB REFERENCE 500

REVISION

Truss Accessories

Truss Summary

FRAMECAD 10g-19mm HWH Hex 1256

FRAMECAD Batten 22 FRAMECAD Batten 40

Parallel Truss

1 16'-0" 2 20'-4"

157 238'-6"

COLD FORMED STEEL SKELETON ONLY


### **ROOF BRACING NOTES**

1- ALL DIMENSIONS ARE IN INCH, DIMENSIONS TO BE VERIFIED W/ARCH. DRAWINGS 2- ROOF TRUSS BRACINGS MADE UP OF 350 S 18 G FLAT STRAP


## 3-THE LENGTH OF ROOF BRACING IS MEASURED DIAGONALLY WHICH IS THE TRUE LENGTH.

### LEGEND;-

-ROOF TRUSS

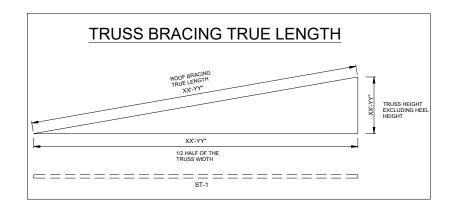

TRUSS BRACING SCHEDULE		
STRAP NO	STRAP LENGH (inche)	QTY
ST-1	11' 10"	4
ST-2	23' 9"	2
ST-3	18' 4"	2
ST-4	10' 3"	4
ST-5	27' 6"	4

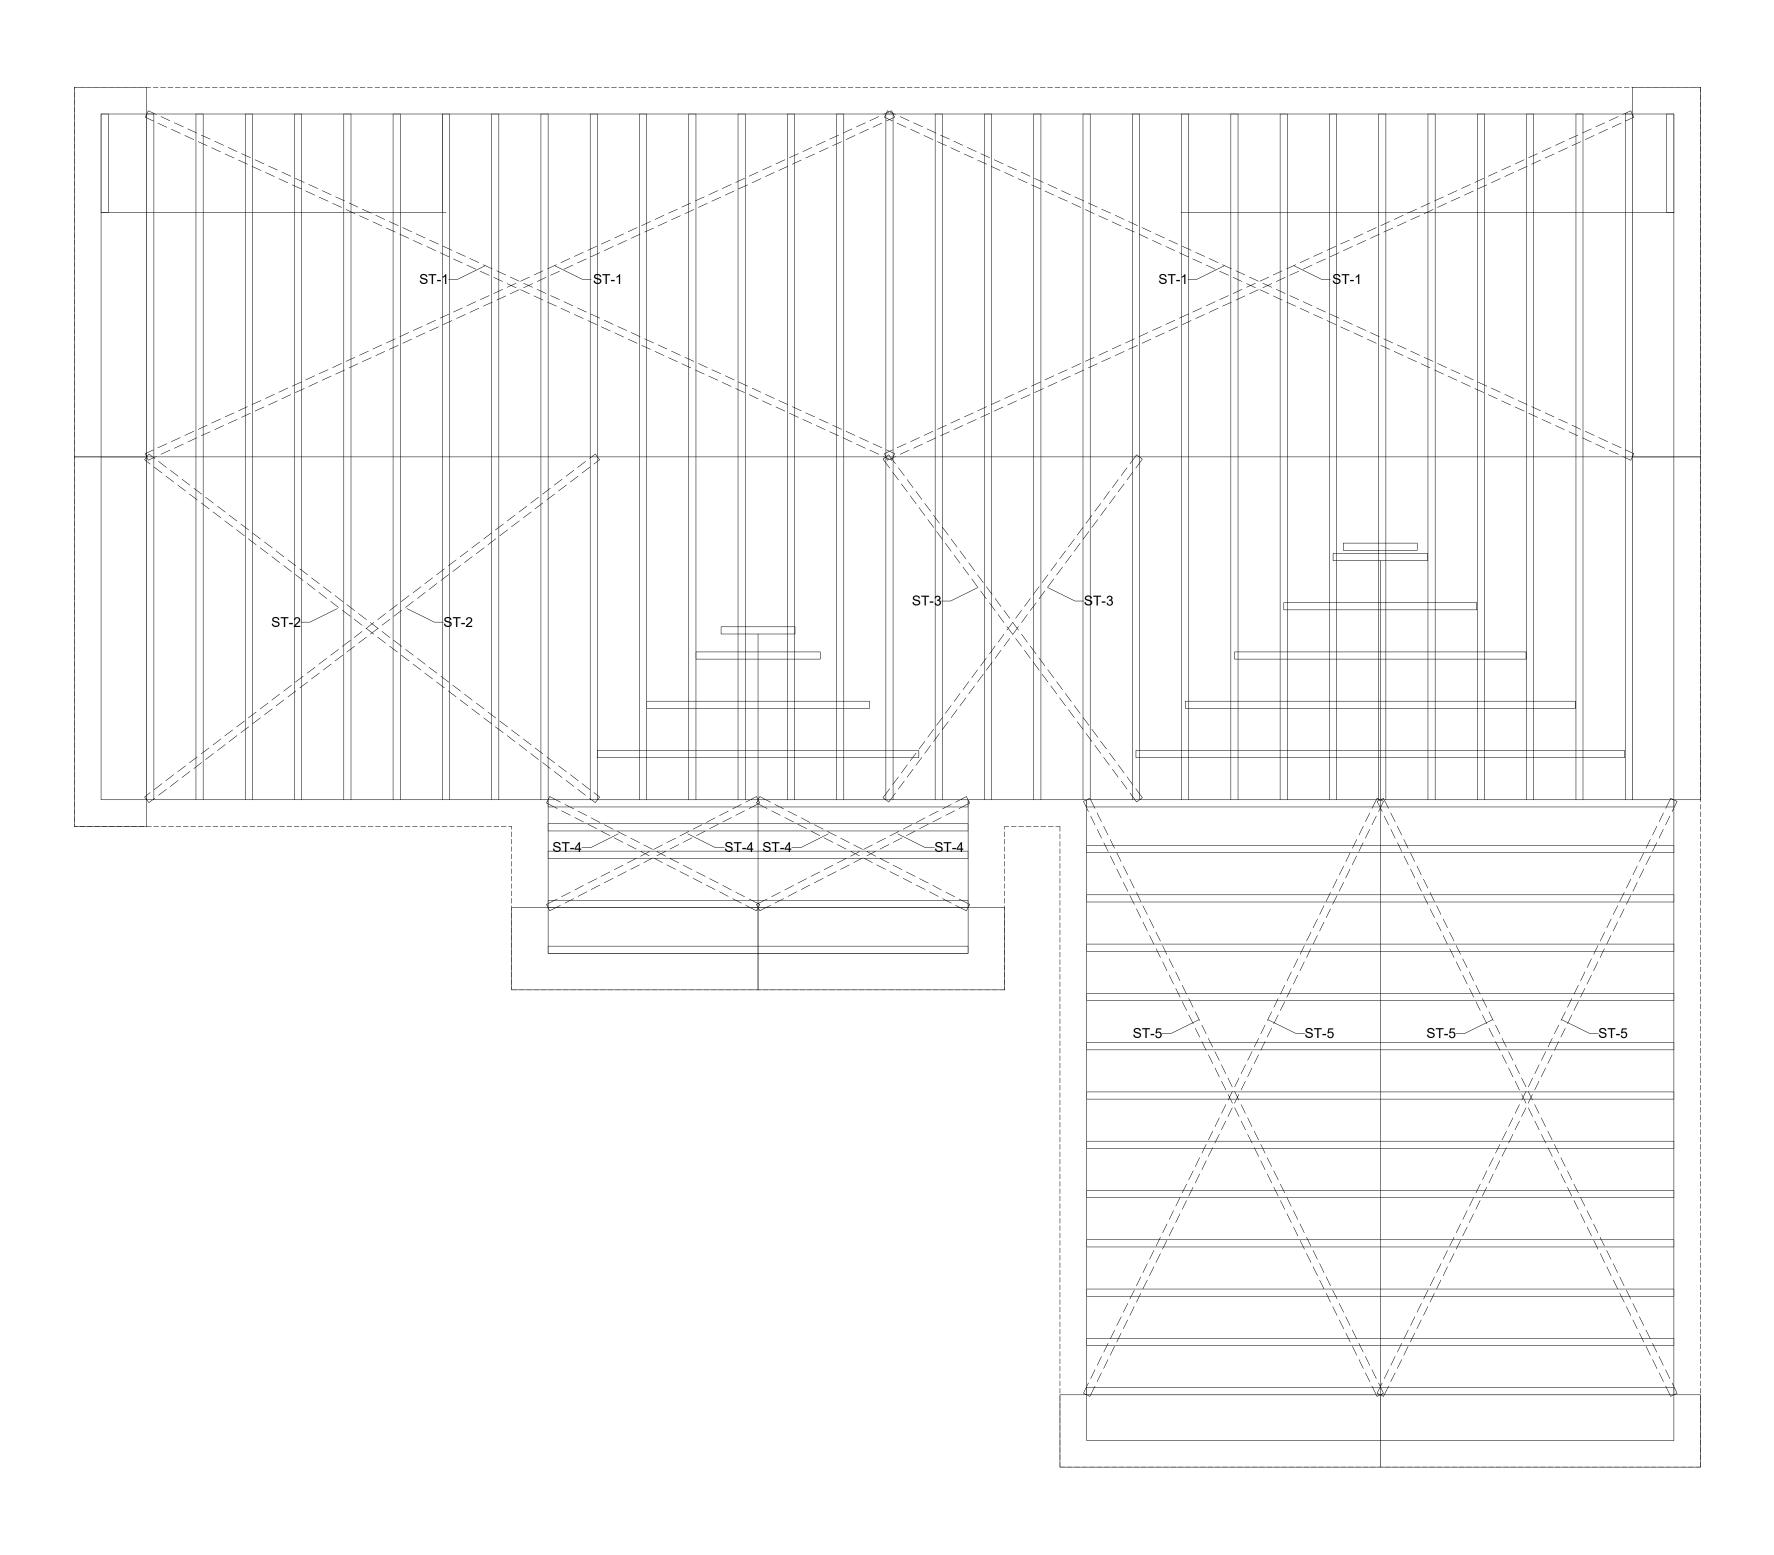

# Roof Bracing

© [2024] [FrameUpNow] . All rights reserved



JOB DETAILS Ember

ADDRESS

DRAWN BA

DWG FILE 246-Ember-1650-3Bd2.5Ba-Craftsman-550

DATE DRAWN 04-30-2025 VIEW NAME 16 of 17

SCALE 1/4" : 1'-0" ON 36 x 24

JOB REFERENCE 500

COLD FORMED STEEL SKELETON ONLY

### **GENERAL NOTES**

1. THIS DRAWING DEPICTS THE HVAC (HEATING, VENTILATION, AND AIR CONDITIONING) SYSTEM FOR THE EMBER 3BD 2BA CRAFTSMAN. IT PROVIDES A VISUAL REPRESENTATION OF THE SYSTEM LAYOUT AND COMPONENTS.

2.THE HVAC SYSTEM IS DESIGNED TO MEET THE SPECIFIC REQUIREMENTS OF THE BUILDING, INCLUDING HEATING, COOLING, AND VENTILATION NEEDS, AS PER THE PROJECT SPECIFICATIONS AND APPLICABLE CODES AND STANDARDS.

3. THE HVAC SYSTEM INSTALLATION SHALL COMPLY WITH THE LATEST EDITION OF THE INTERNATIONAL MECHANICAL CODE (IMC), INTERNATIONAL RESIDENTIAL CODE (IRC), AND ALL OTHER APPLICABLE LOCAL, STATE, AND NATIONAL CODES AND REGULATIONS.

4. THE EQUIPMENT SHOWN ON THIS DRAWING INCLUDES BUT IS NOT LIMITED TO AIR HANDLING UNITS (AHUS), CHILLERS, BOILERS, COOLING TOWERS, PUMPS, DUCTWORK, DIFFUSERS, GRILLES, AND CONTROL DEVICES.

5. ALL EQUIPMENT, DUCTWORK, AND PIPING SHALL BE INSTALLED IN ACCORDANCE WITH MANUFACTURER'S SPECIFICATIONS, LOCAL CODES, AND

6. ALL DUCTWORK SHALL BE SIZED, FABRICATED, AND INSTALLED IN ACCORDANCE WITH THE LATEST EDITION OF THE ACCA MANUAL D AND THE SMACNA HVAC DUCT CONSTRUCTION STANDARDS. DUCTWORK SHALL BE INSTALLED IN A NEAT AND WORKMANLIKE MANNER, PROPERLY SUPPORTED AND BRACED TO PREVENT SAGGING, AIR LEAKAGE, OR VIBRATION.

7. CONDENSATE DRAINAGE PIPING SHALL BE PROPERLY PITCHED TO ENSURE POSITIVE DRAINAGE TO AN APPROVED DISPOSAL LOCATION, SUCH AS A FLOOR DRAIN, SUMP PUMP, OR EXTERIOR GRADE. CONDENSATE LINES SHALL BE INSULATED TO PREVENT SWEATING.

8. THE LOCATION OF CONTROL PANELS AND SENSORS INDICATED ON THIS DRAWING CAN BEMODIFY WITH THE SPECIFIC LOCATIONS AND WIRING DETAILS WILL BE DETERMINED DURING THE CONTROL SYSTEM DESIGN AND INSTALLATION.

9. THE HVAC SYSTEM DESIGN CONSIDER ENERGY EFFICIENCY, INDOOR AIR QUALITY, OCCUPANT COMFORT, AND NOISE CONTROL, FOLLOWING APPLICABLE GUIDELINES AND REGULATIONS.

WITH THE LOCAL BUILDING DEPARTMENT AND UTILITY PROVIDERS TO ENSURE A TIMELY AND COMPLIANT INSTALLATION.

10. COORDINATION WITH OTHER TREADS HAS BEEN DONE ON A DESIGN LEVEL. THIS DRAWING SHALL BE READ TOGETHER WITH THE AR, EL AND SN DESIGN DRAWINGS TO ENSURE PROPER INSTALLATION AND INTEGRATION OF THE HVAC SYSTEMS.

11. THE HVAC CONTRACTOR IS RESPONSIBLE FOR OBTAINING ALL NECESSARY PERMITS AND LICENSES, AND FOR SCHEDULING AND COORDINATING

12. ALL DUCTWORK PENETRATIONS THROUGH WALLS, FLOORS, OR CEILINGS SHALL BE PROPERLY SEALED AND FIRE-STOPPED USING APPROVED METHODS AND MATERIALS TO MAINTAIN THE INTEGRITY OF THE BUILDING'S FIRE-RESISTANCE RATINGS.

13. HVAC EQUIPMENT SHALL BE INSTALLED LEVEL AND PLUMB, AND IN STRICT ACCORDANCE WITH THE MANUFACTURER'S INSTALLATION INSTRUCTIONS AND RECOMMENDATIONS. PROVIDE ADEQUATE CLEARANCES AROUND EQUIPMENT FOR PROPER AIRFLOW, SERVICE ACCESS, AND

CODE COMPLIANCE. 14. ALL HVAC EQUIPMENT AND COMPONENTS, INCLUDING THERMOSTATS, DAMPERS, AND ACCESS PANELS, SHALL BE LOCATED IN ACCESSIBLE AREAS


15. THE HVAC SYSTEM SHALL BE BALANCED AND ADJUSTED TO ENSURE PROPER AIRFLOW, TEMPERATURE DISTRIBUTION, AND SYSTEM PERFORMANCE THROUGHOUT THE RESIDENCE. PROVIDE A WRITTEN REPORT DOCUMENTING THE FINAL SYSTEM BALANCE.

FOR EASY SERVICING AND MAINTENANCE. PROVIDE ADEQUATE SPACE AROUND EQUIPMENT FOR PROPER AIRFLOW AND SERVICE ACCESS.

16. ANY DEVIATIONS OR MODIFICATIONS TO THE HVAC SYSTEM DESIGN SHALL BE REVIEWED AND APPROVED BY THE RESPONSIBLE DESIGN PROFESSIONALS AND COMMUNICATED TO ALL RELEVANT PARTIES INVOLVED IN THE CONSTRUCTION PROCESS.


17. FOR ANY INQUIRIES OR CLARIFICATIONS REGARDING THE HVAC SYSTEM DESIGN, PLEASE CONSULT THE RESPONSIBLE DESIGN PROFESSIONALS OR THE PROJECT MANAGEMENT TEAM.

### SYMBOLS

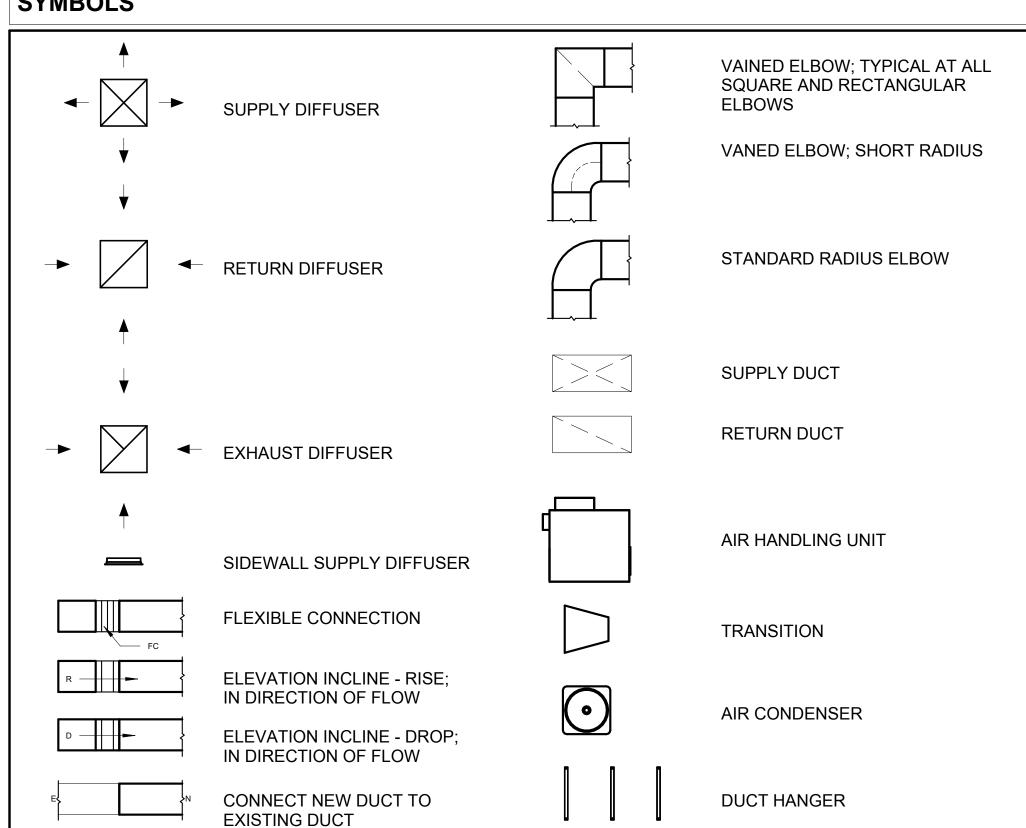



AIR CONDITIONING PIPE LINE

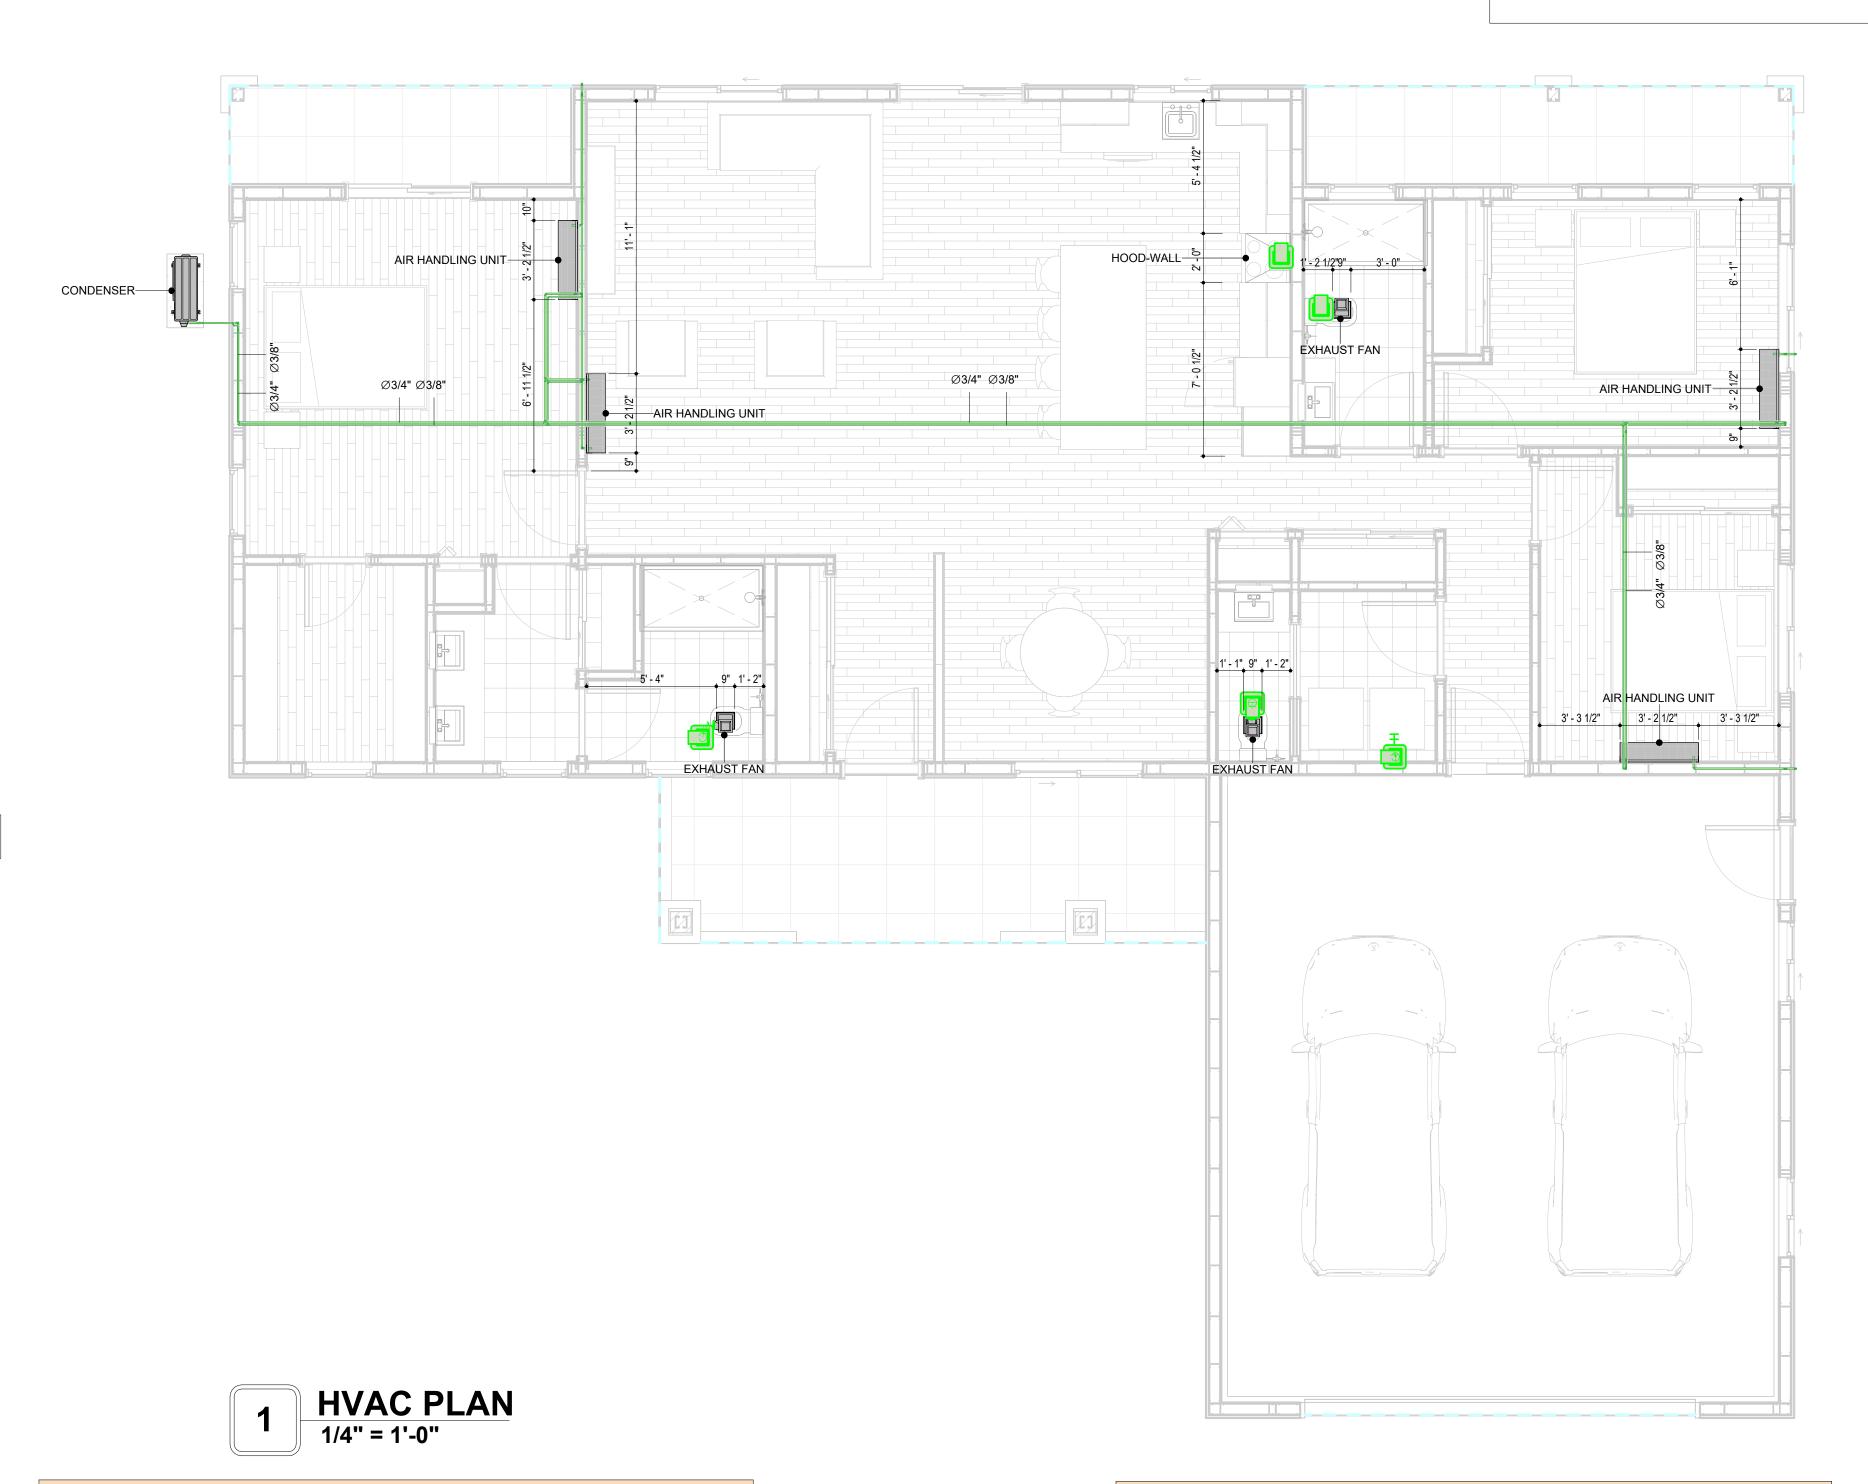

REFRIGERANT LINE SCHEDULE						
CATAGORY DESCRIPTION DIAMETER LENGTH						
PIPE TYPES	COPPER	3/8"	124.84			
PIPE TYPES	COPPER	3/4"	171.56			

REFRIGERANT LINE FITTING SCHEDULE					
CATAGORY	DESCRIPTION	Size	Count		
ELBOW - GENERIC	ELBOW - GENERIC: STANDARD/HVAC	1/2"ø-1/2"ø	1		
ELBOW - GENERIC	ELBOW - GENERIC: STANDARD/HVAC	3/4"ø-3/4"ø	30		
ELBOW - GENERIC	ELBOW - GENERIC: STANDARD/HVAC	3/8"ø-3/8"ø	25		
TEE - GENERIC	TEE - GENERIC: STANDARD	3/4"ø-3/4"ø-3/ 4"ø	4		
TEE - GENERIC	TEE - GENERIC: STANDARD	3/8"ø-3/8"ø-3/ 8"ø	3		
TRANSITION - GENERIC	TRANSITION - GENERIC: STANDARD	3/4"ø-1/2"ø	7		
TRANSITION - GENERIC	TRANSITION - GENERIC: STANDARD	3/4"ø-5/8"ø	4		
TRANSITION - GENERIC	TRANSITION - GENERIC: STANDARD	3/8"ø-1/4"ø	1		

MECHANICAL EQUIPMENT SCHEDULE						
CATAGORY		DESCRIPTION		COUNT		
A ID LIANDUNG LINUT	AID HANDI ING HAIT IA	/ALL MOUNTED		_		
AIR HANDLING UNIT	AIR HANDLING UNIT: W			4		
CONDENSER	CONDENSER: OUT DO			1		
EXHAUST FAN	EXHAUST FAN: 75 CFM			3		
	HOOD-WALL: VENT	TIMO COLLEGI		1		
	DUCT FII	TING SCHEDU	JLE			
CATAGOR	RY	DESCRIPTION	ON	COUNT		
CATAGORY	DUCT ACCE	SSORY SCHE	DULE	COUNT		
CATAGORY	DUCT ACCE	SSORY SCHE	DULE	COUNT		
CATAGORY ROOF VENT	DUCT ACCE  3" DIAMETER		DULE	COUNT 5		
	3" DIAMETER					
	3" DIAMETER	DESCRIPTION				
DESCRIPTION	3" DIAMETER  FLEX DU  DESCRIPTION	JCT SCHEDUL LENGTH	LE DIAMETER	5 COUNT		
ROOF VENT	3" DIAMETER  FLEX DU	DESCRIPTION  JCT SCHEDUL	.E	5		



**KEY PLAN** 

NO.	DESCRIPTION	DATE

NOTE:

LEGEND:

PROJECT

243-EMBER-1396-3Bd 2Ba **CRAFTSMAN-550** 

DRAWING NAME

**HVAC PLAN** 

CLIENT NAME: Owner PROJECT NUMBER 15\_0001 DATE: 5/8/2025 12:05:34 AM Designer DESIGNED BY: DRAWN BY: Author CHECKED BY: Checker

M101

### **ELECTRICAL NOTES**

- 1. THIS DRAWING DEPICTS THE ELECTRICAL SYSTEM FOR THE 246-EMBER-1650-3Bd 2.5Ba CRAFTSMAN-550. IT PROVIDES A VISUAL REPRESENTATION OF THE ELECTRICAL LAYOUT AND COMPONENTS, INCLUDING POWER DISTRIBUTION, LIGHTING, AND CONTROL SYSTEMS.
- 2. THE ELECTRICAL SYSTEM IS DESIGNED TO MEET THE SPECIFIC REQUIREMENTS OF THE BUILDING, INCLUDING POWER DISTRIBUTION, LIGHTING, AND SPECIALIZED ELECTRICAL EQUIPMENT NEEDS, AS PER THE PROJECT SPECIFICATIONS AND APPLICABLE CODES AND STANDARDS.
- 3. THE ELECTRICAL SYSTEM INSTALLATION SHALL COMPLY WITH THE LATEST EDITION OF THE NATIONAL ELECTRICAL CODE (NEC), INTERNATIONAL BUILDING CODE (IBC), AND ALL OTHER APPLICABLE LOCAL, STATE, AND NATIONAL CODES AND REGULATIONS.
- 4. LOCATIONS AS NEEDED, DEVICES ARE SHOWN ON PLANS IN APPROXIMATE IDEAL LOCATIONS, UNLESS SPECIFICALLY DIMMENSIONED.
- 5. OPEN WALLS AS NEEDED TO ALLOW FOR NEW ELECTRICAL INSTALLATIONS.
- 6. LABEL ALL CIRCUITS ON JUNCTION BOXES, RECEPTACLES, DATA, SMOKE DETECTOR, AND EQUIPMENT IN PANEL BOX.
- 7. INSTALL RACEWAY AS NEEDED FOR DDC, ACCESS CONTROL, LOW VOLTAGE WIRING & DATA.
- 8. RELABEL POWER, DATA & FIRE ALARM FOR ROOM #CHANGES.
- 9. VERIFY ALL CIRCUITS LABELED ON PRINT ARE CORRECT BEFORE WORKING ON THEM.
   10. NOTE ON SITE PLAN ALL CHANGES OR MISSING DETAIL TO BE INCORPORATED INTO THE MASTER PLAN.
- 11. DRAWINGS ARE DIAGRAMMATIC ONLY FOR THE PURPOSE OF SHOWING FIXTURE AND OUTLET LOCATIONS.
- 12. ELECTRICAL CONTRACTOR TO VERIFY SERVICE SIZE BY CALCULATION BASED UPON ACTUAL NAME PLATE RATINGS OF SELECTED FOLIPMENT
- PLATE RATINGS OF SELECTED EQUIPMENT.

  13. VERIFY LOCATION OF SERVICE ENTRANCE WITH POWER COMPANY. PROVIDE UFER GROUND IN
- BUILDING FOUNDATION AT SERVICE ENTRANCE LOCATION.
- 14. PROVIDE A MIN. OF 20 FEET OF ONE \*4 BARE COPPER UFER WIRE EMBEDDED IN CONCRETE FOOTING AT THE SERVICE ENTRANCE LOCATION WHERE APPROVED BY LOCAL SERVICE PROVIDER.
- 15. PROVIDE WATERPROOF FIXTURES IN ALL HIGH MOISTURE AREAS (EXTERIOR, SHOWER AND TUB
- CEILINGS ETC.)
  16. PROVIDE DEDICATED CIRCUITS TO EACH BATH, DEN, FAMILY ROOM, BEDROOM, LOFT, KITCHEN
- REFRIGERATOR, KITCHEN FREEZER DISHWASHER, AND ANY AREA/ITEM SPECIFIED BY OWNER.

  17. INCANDESCENT FIXTURES WITH OPEN OR PARTIALLY ENCLOSED LAMPS, PENDANT FIXTURES, AND
- LAMP HOLDERS ARE NOT PERMITTED IN CLOSETS.

  18. ALL WORKMANSHIP AND MATERIALS TO CONFORM WITH THE 2015 IRC.
- 19. PROVIDE A MIN. OF 20 FEET OF ONE \*4 BARE COPPER UFER WIRE EMBEDDED IN CONCRETE FOOTING AT THE SERVICE ENTRANCE LOCATION WHERE APPROVED BY LOCAL SERVICE PROVIDER.
- 20. PROVIDE A BONDING CONDUCTOR CONSISTING OF A MINIMUM OF ONE \*4 BARE COPPER WIRE CONNECTING THE BUILDING'S METAL WATER PIPING SYSTEM TO THE SERVICE EQUIPMENT ENCLOSURE GROUNDING.

### MAIN PANEL CALCS

ELECTRICAL CALCS	
LIGHT AND OUTLETS 1,650 @ 3W	4,950 W
3 APPLIANCE CIRCUITS	4,500 W
DRYER	2,000 W
WASHER	2,000 W
RANGE	5,000 W
WATER HEATER	5,000 W
REFRIG.	1,800 W
DISHWASHER & DISPOSAL	3000 W
TOTAL	28,250 W
FRIST 10,000 @ 100% REMAINDER @ 40% MINI. SPLIT UNITS	10,000 W 7,300 W 10,000 W

TOTAL 27,300 W

27,300 W DIVIDED BY 240V = 114 AMPS TOTAL

(USE 200 AMP SERVICE)

### **ELECTRICAL ABBREVIATIONS LIST**

1 P OLE (P. 3P, 4P. ETC.) A AMPERE ACIG ACIG ADO AUTOMATIC DOOR OPENER ACIG ADO AUTOMATIC DOOR OPENER ACIG ADO AUTOMATIC DOOR OPENER AFF ABOVE FINISHED FLOOR AFF ABOVE FINISHED FLOOR AFF AGOVE ABOVE AND AVERAGE OPENER AFF AGOVE ABOVE AND AVERAGE OPENER AGOVE ABOVE AND AVERAGE OPENER AFF AGOVE FINISHED FLOOR AFF AGOVE FINISHED GRADE AGOVE AND AVERAGE OPENER AGOVE ABOVE AVERAGE OPENER AGOVE AVERAGE OPENER A						
A AMPERÈ CU COPPER ACLG ACUG ACUG CEILING AC ACLG ABOVE COUNTER OR AIR CONDITIONER ADOVE CEILING ADOVE CHINGE PLOOR AFF AMP FAMME APPL ARCH ARCH ALL CIRCUIT INTERRUPTER APPL ANNUN AMPLER ANDIA ARCH ALL CORDITIONIS AMPLER AMPLER AMPLER AMPLER AMPLER AMPLER AMPLER AMPLER AMPLER ANDINICATOR APPROX APPROXIMATELY AQ-STAT ACH ACH ARCHITECT, ARCHITECTURAL ALL CEILING		4 201 2 (02 02 12 22 2				
AC ABOVE COUNTER OR AIR CONDITIONER ACIG ADOVE COLUNTER OR AIR CONDITIONER ABOVE CELLING ADOVE ABOVE CELLING ADOVE AND ABOVE CELLING ADOVE AND ABOVE FINISHED FLOOR AFE ABOVE FINISHED FLOOR AFF ABOVE FLOOR AFF ABOVE FINISHED FLOOR ANDING FINISHED FLOOR AFF ABOVE FINISHED FLOOR AFF ABOVE FINISHED						
ACLG ABOVE CELLING AUTOMATIC DOOR OPENER APPROXIMATELY APPROXIMATELY ALL ALLIMINUM AMPERE APPROXIMATELY AND FINISHED GRADE APPROXIMATELY AND FINISHED FLOOR ABOVE FINISHED FLOOR ABOVE FINISHED FLOOR ABOVE FINISHED GRADE DIST DIST DISTRIBUTION ID DISTRIBUT						
ADO AF AFF AFF AFF AFF AFF AFF AFF AFF AFF						
AF FAME AFF ABOVE FINISHED FLOOR AFG AFG AFG ABOVE FINISHED GARDE AFG AFG ABOVE FINISHED GARDE AFG AFG ABOVE FINISHED GARDE AFG						
AFF ABOVE FINISHED FLOOR AFG ALTER FLOOR AFG ALTER FLOOR AND ALTER FLOOR ALTER FLOOR ALTER FLOOR ALTER FLOOR ALTER FLOOR AMP AMPERE AMP AMPER AMP AMPERE						
AFG AFI ARF AND L'ORCUIT INTERRUPTER ART AND L'ORCUIT INTERRUPTER AHU ALL ALL ALLMINUM ALL ALLT ALT ALT ALTERNATE AMPL AMPL AMPL AMPL AMPL ANNUN ANUNICIATOR APPROX APPROXIMATELY ACSTAT ARCH ARCH ARCH ARCH AMPL AMPL AMPL AMPL AMPL AMPL AMPL AMPL						
AFI AR FAULT CIRCUIT INTERRUPTER AH. ALTERNATE ALTERNATE ALTERNATE AMP AMPER AMPER AMPER AMPER AMPER AMPER AMPER AMPL ANUNICATOR APPROX APPROXIMATELY ACSTAT ACH ACHITECT, ARCHITECTURAL ALTERNATE BATT AT						
AHU ALI HANDLING UNIT AL ALT ALIMINUM AL ALT ALTERNATE AMPL AMPL AMPL AMPLE AMPLE ANNUN AQ-STAT ACACH						
AL ALJMINUM AND AND SECRIT AMP AMPER AMPER AMPER AMPER AMPER DDC DAWNING INFARABED NAME AMPER AMPER AMPLIER DDC DAWNING INFARABED NAME AMPLIER DDC DAWNING INFARABED NAME AMPER AMPLIER DDC DAWNING INFARABED NAME AMPER AMPLIER DDC DAWNING INFARABED NAME AMPLIER DDC DAWNING						
ALT ALTERNATE AMPL AMPL AMPLER AMPL AMPLIFIER ANNUM AQ-STAT AQUISSTAT AQUISSTAT AQUISSTAT ARCH ARCH ARCHITECT, ARCHITECTURAL AS AMP SWITCH AT AM TRIP AUTO AUTOMATIC AUTOMATIC AUTOMATIC AUTOMATIC BATTERNATE BATT BATTERY BB BOARD BBAST BATTERY BB BOARD BLIDING MANAGEMENT SYSTEM BD BOARD BLOG BILDING MANAGEMENT SYSTEM C CATY C CATE C CATALOG C CATALOG C CIRCUIT C CIRCUIT C CIRCUIT C COMB COMBINATION C COMB C CONTRACTOR  BATE BATE BATT BATT BATTERY B C COMB C CONTRACTOR  BAS BUILDING BAS						
AMPERE AMPLIFIER AGCHTECT, ARCHITECTURAL ASCHITECT, ARCHITECTURAL ASCHITECT, ARCHITECTURAL BETT ATS AMP TRIP AMP TRIP BMF TRIP AMP TRIP BMF TRIP AUTOMATIC AUMILIARY AUGIO VISUAL AWA AUGIO VISUAL AWA AUGIO VISUAL AMERICAN WIRE GAUGE BATT BATTERY BATTERY BATTERY BATTERY BUILDING BUILDING BUILDING BUILDING COMBINATION CABINET CATALOG CORDUIT CARLOG COMBINATION CONTE CIRCUIT FREAKER COMB COMBINATION COMPR COMPR COMPRESSOR COMBINATION CONTE CONTINUITATION OR CONTINUOUS CONTECTION CONTROCTOR						
AMPL ANNUM AQSTAT AQUISTAT AQUISTAT AQUISTAT ACID ADVINITION ADRIVATOR APPROX APPROXIMATELY AQSTAT AS AUGUSTAT AS AMP SWITCH AND SWITCH SWITCH						
ANNUN AQSTAT AQUASTAT						
AQ-STAT ARCHITECT. ARCHITECTURAL AS AMP SWITCH AS AMP SWITCH AT AMP TRIP AT AUTOMATIC TRANSFER SWITCH AUTOMATIC TRANSFER S						
ARCH I ARCHITECT, ARCHITECTURAL AS MAY SWITCH AS MAY SWITCH AMP TRIP ATS AUTO ATS AUTOMATIC TRANSFER SWITCH AUX AVX AUXILIARY EQUIP EUCATE POLICA METALLIC TUBING LOCATE OR LOCA						
AS AMP SWITCH ATS AUTOMATIC TRANSFER SWITCH AUTO AUTOMATIC TRANSFER SWITCH AUX AUXILARY AV AUXILARY AV AUDIO VISUAL BATTERY BATTERY BATTERY BATTERY BOD BOARD BLDG BUILDING CORDITIT CONTECTION CONSTRUCTION CONSTRUCTION CONY CONY CONY CONY CONY CONY CONY CO						
ATT ANP TRIP ATS AUTOMATIC TRANSFER SWITCH AUX AUTOMATIC AUX AUXILIARY BO BOARD BUILDING BOARD BOARD BUILDING BOARD BOA						
ATS AUTOMATIC TRANSFER SWITCH AUX AUXILIARY AUXILIARY AUXILIARY AUXILIARY AV AUDIO VISUAL AV AUDIO VISUAL AV AUDIO VISUAL AWG AMERICAN WIRE GAUGE BATT BATTERY BATTERY BOD BOARD BUILDING BIND BOD BUILDING CONDUIT CONTE CONT						
AUTO AUX AUXILIARY AV AUDIO VISUAL AWG AWG AWG BATT BATTERY BD BOARD BUILDING BWS BUILDING MANAGEMENT SYSTEM C C CONDUIT CATALOG CATAL						
AUX AUXILLARY AUDIO VISUAL AUDIO VISUAL EQUIP EQUIPMENT ELECTRIC WATER COOLER LIGHTING LIGHTING AWG AMERICAN WIRE GAUGE EXIST EXISTING LV LOW VOLTAGE EXIST EXISTING LIGHTING LOW VOLTAGE EXIST EXISTING LIGHTING LOW VOLTAGE EXIST EXISTING LIGHTING LOW VOLTAGE EXIST EXISTING LV LOW VOLTAGE EXIST EXISTING LIGHTING LOW VOLTAGE EXIST EXAMS MACHAEL CONTRACTOR MACHAEL CONTRACTOR MICE CONDULT CATLED AND AMANUAL CONTROL CONTROL CONTROL CONTROL CENTER FIRE ALARM BOOSTER POWER MCC MOREOL CONTROL CONTROL CENTER FIRE ALARM BOOSTER POWER MCC MOREOL CONTROL CONTROL CONTROL CENTER FIRE ALARM CONTROL PANEL MCC MORTOR CONTROL CONTROL CENTER FIRE ALARM CONTROL PANEL MCC MORTOR CONTROL CENTER FIRE ALARM CONTROL PANEL MCC MAIN DISTRIBUTION CENTER FIXTURE MCC MAIN DISTRIBUTION CENTER FIXTURE MCC MAIN DISTRIBUTION CENTER FIXTURE MCC MAIN CICCURT EXIST EXAMPLE ON THE FIXTURE MCC MAIN CICCURT EXIST EXIST EXAMPLE ON THE FIXTURE MCC MAIN CICCURT EXIST EXAMPLE ON THE FIXTURE MCC MCC MAIN CICCURT EXIST EXAMPLE ON THE FIX						
AWG AMERICAN WIRE GAUGE  BATT BATTERY BD BOARD BLDG BLDG CONDUIT CATU CATU CATU CORSE CATU CATU COMB COMB COMB COMB COMB COMB CONNECTION CONST C						
AWG BATT BATTERY BATTERY BD BOARD BUILDING BLDG BUILDING BMS BUILDING SAMAGEMENT SYSTEM CAB CAB CAB CAT CATALOG CATU CATLOG CONST COMBINATION COMBINATION COMB CONST CON						
BATT BO BATTERY BOARD EXP EXHAUST MAG. MAG. MAG. MAG. MAG. MAG. MAG. MAG.						
BD BLDG BUILDING BMS BUILDING MANAGEMENT SYSTEM C C CONDUIT CAT CATALOG CAT CATALOG CCT CONCUIT BREAKER CAB CIRCUIT BREAKER CCTV CLOSED CIRCUIT TELEVISION CTC COMBINATION CMR COMBINATION CMR COMPRESSOR CMR COMPRESSOR CONN CONSTRUCTION CONSTRUCTION CONTR CONT						
BLDG BMS BUILDING MANAGEMENT SYSTEM C CONDUIT SUPPLY PANEL SUPPLY PANEL SUPPLY PANEL SUPPLY PANEL SUPPLY PANEL SUPPLY PANEL MCC MC MAIN CIRCUIT BREAKER CAT CATALOG FUR FIXT FIXTURE CB CIRCUIT BREAKER FLEVISION FIXT FUSE COMB COMBINATION GENET FUNDS FUSED SAFETY DISCONNECT SWITCH MINIMUM MINIMUM MINIMUM CONSTRUCTION GAL GALLON CONNECTION GALLON GALLON CONNECTION GALLON CONNECTION GALLON CONSTRUCTION GALLON GALVON CONTRUCTOR GALLON CONTRACTOR MAIN DISTRIBUTION CENTER DISCONNECT SWITCH MICH MINIMUM MINIMUM MINIMUM MINIMUM CONNECTION GALLON GALLON MINIMUM MINIMUM MINIMUM MINIMUM MINIMUM CONNECTION GALLON MINIMUM MINIMU						
BMS CONDUIT SUPPLY PANEL SUPPLY PANEL SUPPLY PANEL MCC CONDUIT SUPPLY PANEL SUPPLY PANEL MCC CONDUIT SUPPLY PANEL MCC MAIN CIRCUIT BREAKER FACP FACP FIXT FIXTURE MCC MAIN DISTRIBUTION CENTER MAIN DISTRIBUTION CENTER MAIN DISTRIBUTION CENTER MIDE MAIN DISTRIBUTION CENTER MIDE MAIN DISTRIBUTION PANEL FIXTURE MIDE MAIN DISTRIBUTION PANEL MIDE MIDE MAIN DISTRIBUTION PANEL MIDE MIDE MAIN DISTRIBUTION PANEL MIDE MIDE MIDE MIDE MIDE MIDE MIDE MIDE						
C CONDUIT CAB CABINET CAT CATALOG CAT CATALOG CATV CABLE TELLEVISION CCTV CABLE TELLEVISION CCTV CLOSED CIRCUIT TELEVISION CMB						
CAB CABINET FACP FIRE ALARM CONTROL PANEL MCC MAIN DISTRIBUTION CENTER FACY CATALOG FIXT FIXTURE MDP MAIN DISTRIBUTION CENTER FIXTURE MDP MAIN DISTRIBUTION CENTER FIXTURE MDP MAIN DISTRIBUTION PANEL MANUFACTURERMAIN FUSED DISCONNECT SWITCH CLOSED CIRCUIT TELEVISION FLUOR FLUOR FLUOR FLUOR SCENT DISCONNECT SWITCH MIC MICROPHONE MIN MINIMUM M						
CAT CATALOG FCU CABLE TELEVISION FIXT FIXTURE FIXTURE MDP MAIN DISTRIBUTION CENTER FIXTURE MDP MAIN DISTRIBUTION CENTER FIXTURE MDP MAIN DISTRIBUTION CENTER MDP MAIN DISTRIBUTION PANEL FIXTURE MDP MAIN DISTRIBUTION PANEL FIXTURE MDP MAIN DISTRIBUTION PANEL MAIN DISTRIBUTION PANEL FLOOR MICH MAIN DISTRIBUTION PANEL FLOOR MAIN DISTRIBUTION PANEL MAIN FUSED DISCONNECT SWITCH MAIN FUSED DISCONNECT SWITCH MAIN MINIMUM MINIM						
CATV CBLE TELEVISION FIXT FIXTURE MDP CIRCUIT BREAKER FLR FLOOR FLUOR CCTV CLOSED CIRCUIT TELEVISION CKT CIRCUIT FUSE FUSE FUSE SAFETY DISCONNECT SWITCH FUSE FUSE SAFETY DISCONNECT SWITCH MIC MICROPHONE MICROPHONE GAL GALLON MISC GALVANIZED MAIN UAR MOTOR STARTER CONT CONTRUCTION GC GENERAL CONTRACTOR GFI GROUND FAULT CIRCUIT INTERRUPTER CONV CONVECTOR GFI GROUND FAULT PROTECTOR MSD MAIN SWITCHBOARD GROUND GALVANIZED RIGID STEEL (CONDUIT)  CRT CATHODE-RAY TUBE  MDP MAIN DISTRIBUTION PANEL FLOOR MDD MAIN DISTRIBUTION PANEL MEAN DESTRICTION PANEL FLOOR MAIN DISTRIBUTION PANEL FLOOR MAIN DISTRIBUTION PANEL MANUAL MOTOR SWITCH MICROPHONE MICROPH						
CB CCTV CLOSED CIRCUIT TELEVISION FLUOR FLUOR FLUORESCENT CKT CIRCUIT FUSE CLG CEILING FUSE COMB COMBINATION GAL GAL GALVON CONNECTION GAL GALVANIZED CONST CONSTRUCTION GC GENERAL CONTRACTOR MANUAL MOTOR STARTER CONT CONTINUATION OR CONTINUOUS CONTR CONTRACTOR GFI GROUND FAULT CIRCUIT INTERRUPTER CONV CONVECTOR GROUND CONVECTOR						
CCTV CLOSED CIRCUIT TELEVISION FLUOR FUNCTORY CIRCUIT TELEVISION FUNCT SWITCH FUNCTORY FUNCTION FUNCTION FUNCTION FUNCTION GAL GALVANIZED GENERAL CONTRACTOR GENERATOR CONTRACTOR GAIL GROUND FAULT CIRCUIT INTERRUPTER CONV CONVECTOR GAP GROUND GROUN						
CKT CIRCUIT FUSE FUSE SAFETY DISCONNECT SWITCH MIC MICROPHONE COMB COMBINATION GA GAUGE MIN MINIMUM CMPR COMPRESSOR GAL GALLON MISC MISCELLANEOUS CONN CONNECTION GALV GALVANIZED MMS MANHOLE CONST CONSTRUCTION GENERAL CONTRACTOR MMS MANHAL MOTOR STARTER CONT CONTINUATION OR CONTINUOUS GEN GENERAL CONTRACTOR MOA MULTIOUTLET ASSEMBLY CONTR CONTRACTOR GFI GROUND FAULT CIRCUIT INTERRUPTER MSP MOTOR STARTER PANELBOARD CONV CONVECTOR GFP GROUND FAULT PROTECTOR MSD MAIN SWITCHBOARD CP CIRCULATING PUMP GND GROUND CRT CATHODE-RAY TUBE GRS GALVANIZED RIGID STEEL (CONDUIT) MT.C EMPTY CONDUIT						
CLG CEILING FUDS FUSED SAFETY DISCONNECT SWITCH MIC MICROPHONE COMB COMBINATION GA GAUGE CMPR COMPRESSOR GAL GALLON MISC MISCELLANEOUS CONN CONNECTION GAL GALVANIZED MLO MAIN LUGS ONLY CONST CONSTRUCTION GC GENERAL CONTRACTOR MMS MANUAL MOTOR STARTER CONT CONTINUATION OR CONTINUOUS GEN GENERATOR MOA CONTRACTOR GFI GROUND FAULT CIRCUIT INTERRUPTER MSP MOTOR STARTER PANELBOARD CONV CONVECTOR GFP GROUND FAULT PROTECTOR MSBD MAIN SWITCHBOARD CP CIRCULATING PUMP GND GROUND CRT CATHODE-RAY TUBE GRS GALVANIZED RIGID STEEL (CONDUIT) MT.C EMPTY CONDUIT					MH	
COMB CMPRCOMBINATIONGA COMPRESSORGAUGE GALV GALVANIZEDMIN GALVANIZEDMIN MISC MISC MISC MISC MISC MISC MISC MAIN LUGS ONLYCONST CONSTRUCTION CONT CONT CONTINUATION OR CONTINUOUS CONTR CONTR CONTR CONTR CONV CONVECTOR CP CIRCULATING PUMP CRTGENERAL CONTRACTOR GENERATOR GFI GROUND FAULT CIRCUIT INTERRUPTER GROUND FAULT PROTECTOR GROUND MT.C MT.C MT.C EMPTY CONDUIT						
CMPRCOMPRESSORGALGALVONIZEDMISCMISC MISCELLANEOUSCONNCONNECTIONGALVANIZEDMLOMAIN LUGS ONLYCONSTCONSTRUCTIONGCGENERAL CONTRACTORMMSMANUAL MOTOR STARTERCONTCONTINUATION OR CONTINUOUSGENGENERATORMOAMULTIOUTLET ASSEMBLYCONTRCONTRACTORGFIGROUND FAULT CIRCUIT INTERRUPTERMSPMOTOR STARTER PANELBOARDCONVCONVECTORGFPGROUND FAULT PROTECTORMSBDMAIN SWITCHBOARDCPCIRCULATING PUMPGNDGROUNDMTMOUNTCRTCATHODE-RAY TUBEGRSGALVANIZED RIGID STEEL (CONDUIT)MT.CEMPTY CONDUIT						
CONN CONSTRUCTION GC GENERAL CONTRACTOR MMS MAIN LUGS ONLY CONST CONSTRUCTION GC GENERAL CONTRACTOR MMS MANUAL MOTOR STARTER CONT CONTINUATION OR CONTINUOUS GEN GENERATOR MOA CONTRACTOR GFI GROUND FAULT CIRCUIT INTERRUPTER MSP MOTOR STARTER PANELBOARD CONV CONVECTOR GFP GROUND FAULT PROTECTOR MSBD MAIN SWITCHBOARD CP CIRCULATING PUMP GND GROUND MT MOUNT CRT CATHODE-RAY TUBE GRS GALVANIZED RIGID STEEL (CONDUIT) MT.C EMPTY CONDUIT						
CONST CONSTRUCTION GC GENERAL CONTRACTOR MMS MANUAL MOTOR STARTER CONT CONTINUATION OR CONTINUOUS GEN GENERATOR MOA MULTIOUTLET ASSEMBLY CONTR CONTRACTOR GFI GROUND FAULT CIRCUIT INTERRUPTER MSP MOTOR STARTER PANELBOARD CONV CONVECTOR GFP GROUND FAULT PROTECTOR MSBD MAIN SWITCHBOARD CP CIRCULATING PUMP GND GROUND CRT CATHODE-RAY TUBE GRS GALVANIZED RIGID STEEL (CONDUIT) MT.C EMPTY CONDUIT						
CONT CONTINUATION OR CONTINUOUS GEN GENERATOR GFI GROUND FAULT CIRCUIT INTERRUPTER MSP MOTOR STARTER PANELBOARD CONVECTOR GFP GROUND FAULT PROTECTOR MSBD MAIN SWITCHBOARD GROUND GROUND GROUND GROUND STEEL (CONDUIT) MT.C EMPTY CONDUIT						
CONTRCONTRACTORGFIGROUND FAULT CIRCUIT INTERRUPTERMSPMOTOR STARTER PANELBOARDCONVCONVECTORGFPGROUND FAULT PROTECTORMSBDMAIN SWITCHBOARDCPCIRCULATING PUMPGNDGROUNDMTMOUNTCRTCATHODE-RAY TUBEGRSGALVANIZED RIGID STEEL (CONDUIT)MT.CEMPTY CONDUIT						
CONVCONVECTORGFPGROUND FAULT PROTECTORMSBDMAIN SWITCHBOARDCPCIRCULATING PUMPGNDGROUNDMTMOUNTCRTCATHODE-RAY TUBEGRSGALVANIZED RIGID STEEL (CONDUIT)MT.CEMPTY CONDUIT						
CPCIRCULATING PUMPGNDGROUNDMTMOUNTCRTCATHODE-RAY TUBEGRSGALVANIZED RIGID STEEL (CONDUIT)MT.CEMPTY CONDUIT	CONV	CONVECTOR	GFP	GROUND FAULT PROTECTOR		MAIN SWITCHBOARD
CRT CATHODE-RAY TUBE GRS GALVANIZED RIGID STEEL (CONDUIT) MT.C EMPTY CONDUIT						

### **Branch Panel:**

Location: W/C 16
Supply From:
Mounting: Recessed
Enclosure: Type 1

Volts: 120/240 Single Phases: 1 Wires: 3 A.I.C. Rating:
Mains Type:
Mains Rating: 200 A
MCB Rating: 1 A

### Notes:

Circuit Numb er		Number of Elements	Rating	Length	Wire Size	A			В	Wire Size	Length	Rating	Number of Elements	Circuit Description	Circuit Numb er
1	MST BED LIGHT	12	15 A	52' - 0"	1-#14, 1-#14, 1-#14	688 VA	972 VA			1-#12, 1-#12, 1-#12	44' - 4 1/8"	20 A	12	MST BATH GFCI	2
3	OUTDOOR LIGHT	10	20 A	96' - 9 7/8"	1-#10, 1-#10, 1-#10			815 VA	876 VA	1-#12, 1-#12, 1-#12	72' - 11 17/32"	20 A	15	KITCHEN & DINNER LIGHT	4
5	LIVING LIGHT	9	15 A	59' - 1 5/32"	1-#14, 1-#14, 1-#14	269 VA	160 VA			1-#12, 1-#12, 1-#12	84' - 11 5/8"	20 A	5	GARAGE LIGHT	6
7	BED 1& 2 LIGHT	17	20 A	101' - 1 21/32"	1-#10, 1-#10, 1-#10			956 VA	396 VA	1-#12, 1-#12, 1-#12	86' - 8 3/8"	20 A	6	BATH 1 GFCI	8
9	HALL LIGHT	4	15 A	79' - 1 5/8"	1-#14, 1-#14, 1-#14	180 VA	576 VA			1-#12, 1-#12, 1-#12	70' - 5 11/16"	20 A	7	BATH 2 GFCI	10
11	CONDENSER	1	60 A	25' - 9 11/16"	2-#6, 1-#6, 1-#10			2500 VA	1620 VA	1-#8, 1-#8, 1-#8	91' - 3 27/32"	20 A	9	OUTDOOR GFCI	12
13						2500 VA	900 VA			1-#12, 1-#12, 1-#12	74' - 6 9/16"	20 A	5	KITCHEN GFCI	14
15	WASHER	1	20 A	58' - 10 29/32"	1-#12, 1-#12, 1-#12			1200 VA	2500 VA	2-#10, 1-#10, 1-#10	56' - 7 23/32"	30 A	1	DRYER	16
17	WATER HEATER	1	30 A	55' - 10 15/32"	2-#10, 1-#10, 1-#10	2250 VA	2500 VA								18
19								2250 VA	1260 VA	1-#8, 1-#8, 1-#8	97' - 3 31/32"	20 A	7	GARAGE GFCI	20
21	RANGE	1	50 A	70' - 2 3/4"	2-#8, 1-#8, 1-#10	2500 VA	180 VA			1-#12, 1-#12, 1-#12	64' - 3 13/16"	20 A	1	OVENHOOD	22
23								2500 VA	1800 VA	1-#10, 1-#10, 1-#10	64' - 5 7/16"	20 A	1	REFRIGERATOR	24
25	DISHWASHER	1	20 A	71' - 0 3/8"	1-#10, 1-#10, 1-#10	1200 VA	720 VA			1-#12, 1-#12, 1-#12	54' - 1 21/32"	20 A	4	LIVING RECEPATCEL	26
			_			15582		1	02 VA			_			
						130		1	3 A				1	1	

### Legend:

oad Classification	Connected Load	Demand Factor	Estimated Demand	Panel	Totals
GHTING - DWELLING UNIT	1360 VA	100.00%	1360 VA		
THER	3088 VA	100.00%	3088 VA	Total Conn. Load:	36384 VA
ECEPTACLE	10320 VA	98.45%	10160 VA	Total Est. Demand:	35224 VA
GHTING	400 VA	100.00%	400 VA	Total Conn.:	152 A
ONDENSER	5000 VA	100.00%	5000 VA	Total Est. Demand:	147 A
ATER HEATER	4500 VA	100.00%	4500 VA		
ANGE	5000 VA	80.00%	4000 VA		
RYER	5000 VA	100.00%	5000 VA		
EFRIGERATOR	1800 VA	100.00%	1800 VA		



**KEY PLAN** 

NO. DESCRIPTION DATE

NOTE:

LEGEND:

PROJECT

246-EMBER-1650-3Bd 2.5Ba CRAFTSMAN-550

DRAWING NAME

# **SCHEDULE**

CLIENT NAME:	Owner
PROJECT NUMBER:	0139_16
DATE:	5/6/2025 4:52:49 PM
DESIGNED BY:	Designer
DRAWN BY:	Author
CHECKED BY:	Checker

E101

SCALE: 1/4" = 1'-0"

© [2024] [FrameUpNow] . All rights reserved

### **ELECTRICAL NOTE**

- A. PROVIDE INTERCONNECTED SMOKE ALARMS IN EACH SLEEPING ROOMS, OUTSIDE EACH SLEEPING ROOM, ON EACH STORY, IN THE HALL OR ADJACENT ROOM LUHERE THE CEILING HEIGHT OF A ROOM OPEN TO THE HALL EXCEEDS THE HALL BY 24'. SMOKE ALARMS SHALL BE PERMANENTLY HARD WIRED WITH BATTERY BACKUP.
- B. RECEPTACLE OUTLETS FOR RANGES AND CLOTHES DRYERS SHALL BE A THREE POLE WITH GROUND TYPE. FOUR WIRE GROUNDING-TYPE FLEXIBLE CORDS WILL BE REQUIRED FOR CONNECTION OF RANGES AND CLOTHES DRYERS. THE BONDING JUMPER SHALL NOT BE CONNECTED BETWEEN NEUTRAL TERMINAL AND THE FRAME OF THE APPLIANCE.
- C. TWO OR MORE 20 AMP SMALL APPLIANCE CIRCUITS SHALL BE PROVIDED TO SERVE THE KITCHEN, BREAKFAST NOOK, AND DINING ROOM. SUCH CIRCUITS SHALL HAVE NO OTHER OUTLETS.
- D. AT LEAST ONE 20 AMP BRANCH CIRCUIT SHALL BE PROVIDED TO SERVICE THE LAUNDRY ROOM. THIS CIRCUIT SHALL HAVE NO OTHER OUTLETS.
- E. ALL RECEPTACLES WITH IN 6' OF A WET BAR SINK OR KITCHEN SINK TO SERVE COUNTER TOP SURFACES MUST BE GFCI. ON KITCHEN COUNTERS 12' OR WIDER NO POINT ALONG THE WALL SHALL BE MORE THAN 2' FROM A RECEPTACLE. ALL RECEPTACLES WITH IN 6' OF KITCHEN SINK MUST BE GFCI. AT LEAST ONE GFCI RECEPTACLE SHALL BE INSTALLED IN THE BATHROOM ADJACENT TO EACH BASIN.
- F. FIXTURES INCLUDING CEILING FANS THAT ARE LOCATED IN DAMP LOCATIONS SHALL BE LISTED TO BE SUITABLE FOR
- SUCH LOCATIONS PER 2012 IRC
  G. PROVIDE ONE (1) SWITCHED OUTLET @ ALL BEDROOMS AND DEN
- H. CEILING FANS NOT EXCEEDING 35 LBS. (WITH OR WITHOUT ACCESSORIES MAY BE SUPPORTED BY OUTLET BOXES PROVIDED THE OUTLET BOXES ARE IDENTIFIED FOR SUCH USE PER 2012 IRC
- I. ELECTRICAL OUTLET BOXES ON OPPOSITE SIDES OF FIRE RATED WALLS SHALL BE SEPARATED BY A HORIZONTAL DISTANCE OF NOT LESS THAN 24".
- J. OUTLET BOXES IN THE WALLS BETWEEN THE GARAGE AND DWELLING SHALL BE METAL OR U.L. APPROVED FIRE RESISTIVE PLASTIC. BOXES IN GARAGE CEILING SHALL BE METAL.
- K. ALL BRANCH CIRCUITS THAT SUPPLY 120 VOLTS SINGLE PHASE 15 AND 20 AMPS RECEPTACLE OUTLETS INSTALLED IN THE DWELLING SHALL BE PROTECTED BY AN ARC FAULT CIRCUIT INTERRUPTER, EXCEPT GFCI RECEPTICLES.

#### NOTE:

A. RECEPTACLES MUST BE PROVIDED IN HALLWAYS 10'-0" OR MORE IN LENGTH. FOR A ONE FAMILY DWELLINGS AND EACH OF A TWO FAMILY DWELLING THAT IS AT GRADE LEVEL, AT LEAST ONE WP-GFCI RECEPTACLE OUTLET ACCESSIBLE AT GRADE LEVEL AND NOT MORE THAN 6'-6" ABOVE GRADE SHALL BE INSTALLED AT THE FRONT AND BACK OF THE DWELLING.

### **NOTE: APPLIANCE DISCONNECT**

**E4001.5 GROUNDING OF ENCLOSURES.** 

METAL ENCLOSURES FOR SWITCHES OR CIRCUIT BREAKERS SHALL BE CONNECTED TO AN

EQUIPMENT GROUNDING CONDUCTOR.

METAL ENCLOSURES FOR SWITCHES OR CIRCUIT BREAKERS USED AS SERVICE


EQUIPMENT SHALL COMPLY WITH THE PROVISIONS OF SECTION E3609.4. WHERE NONMETALLIC ENCLOSURES ARE USED WITH METAL RACEWAYS OR METAL-ARMORED

CABLES, PROVISIONS SHALL BE MADE FOR CONNECTING THE EQUIPMENT GROUNDING


CONDUCTOR.
NONMETALLIC BOXES FOR SWITCHES SHALL BE INSTALLED WITH A WIRING METHOD THAT

PROVIDES OR INCLUDES AN EQUIPMENT GROUNDING CONDUCTOR. (404.12)

ELECTRICAL LEGEND				
	Electrical Lights With Fan			
0	Waterproof Recessed Can Light			
	Pendant Light			
0	Recessed Can Light			
<b>–</b>	Wall Lamp			
	Standalone linear			
<b>√1</b> 0	Single Switch			
₩	Three way Switch			
<b>₩</b>	Fan Switch			
	Duplex Receptacle			
	Triplex Receptacle			
GFCI	GFCI Receptacle			
	Exhaust Fan			
•	Smoke and heat detector			

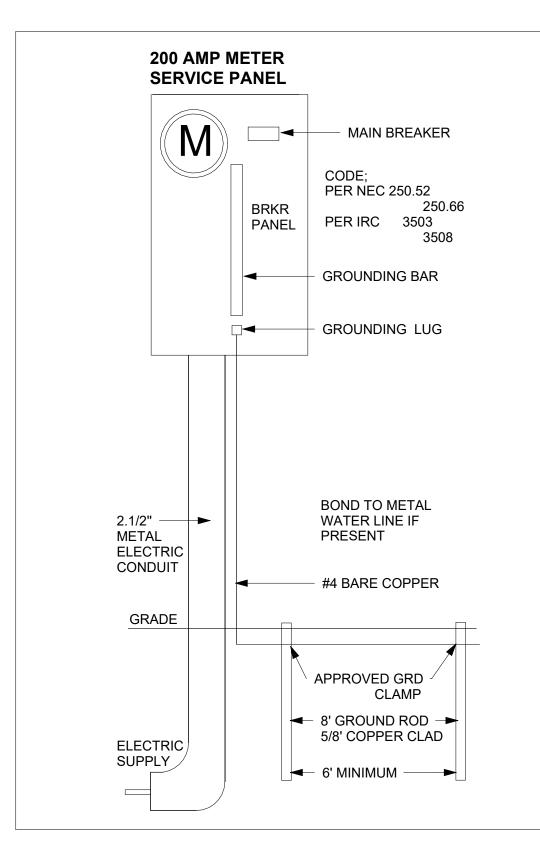



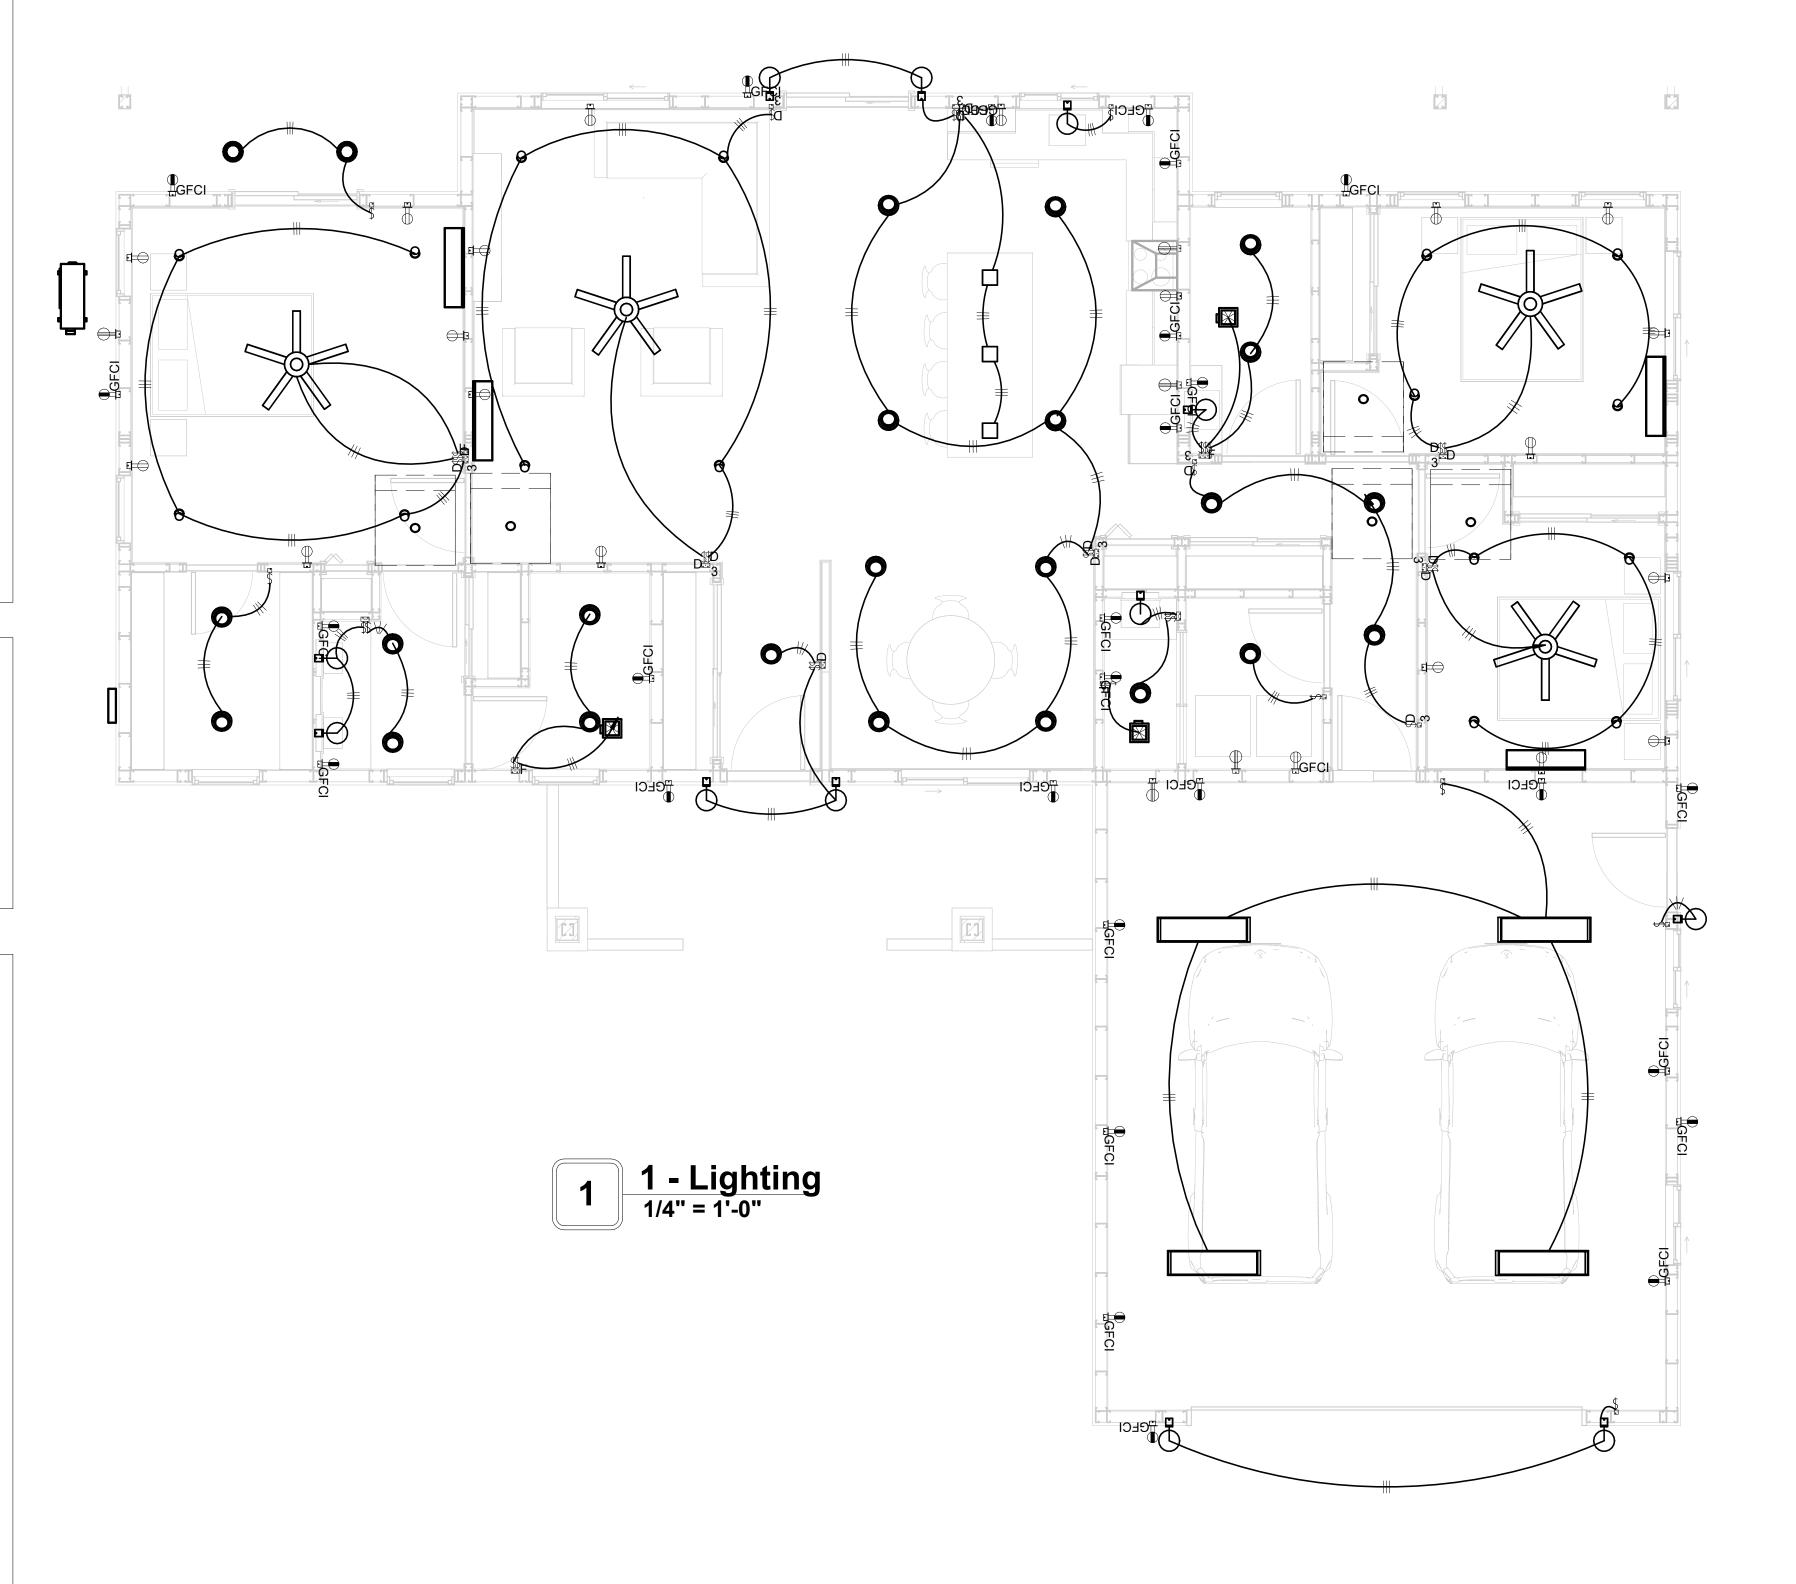



**KEY PLAN** 

NO. DESCRIPTION DATE

NOTE:

LEGEND:

PROJECT

246-EMBER-1650-3Bd 2.5Ba CRAFTSMAN-550

DRAWING NAME


# LIGHTING

Owner
0139_16
5/6/2025 4:52:53 PM
Designer
Author
Checker


E102

### **NOTES: CONDUIT, CABLE AND WIRING**


- Use Metalic Conduits (IMC) for cables running under concrete slabs.
   Use IMC for circuits with high voltage appliances (240 volts and above)
   For circuits with 120 volts consider using EMT or PVC conduits if needed.
   For Low voltage applications up to 50 volts consider using non metalic conduits.
   All conduits to be used in the project must conform to the latest National Electrical Code (NEC),
- All wiring and cables to be used in the project must also conform to the latest National Electrical Code (NEC), 2015.
- 7. All cables and wires used should be rated for their respective loading and should be gauged and conform to the NEC.

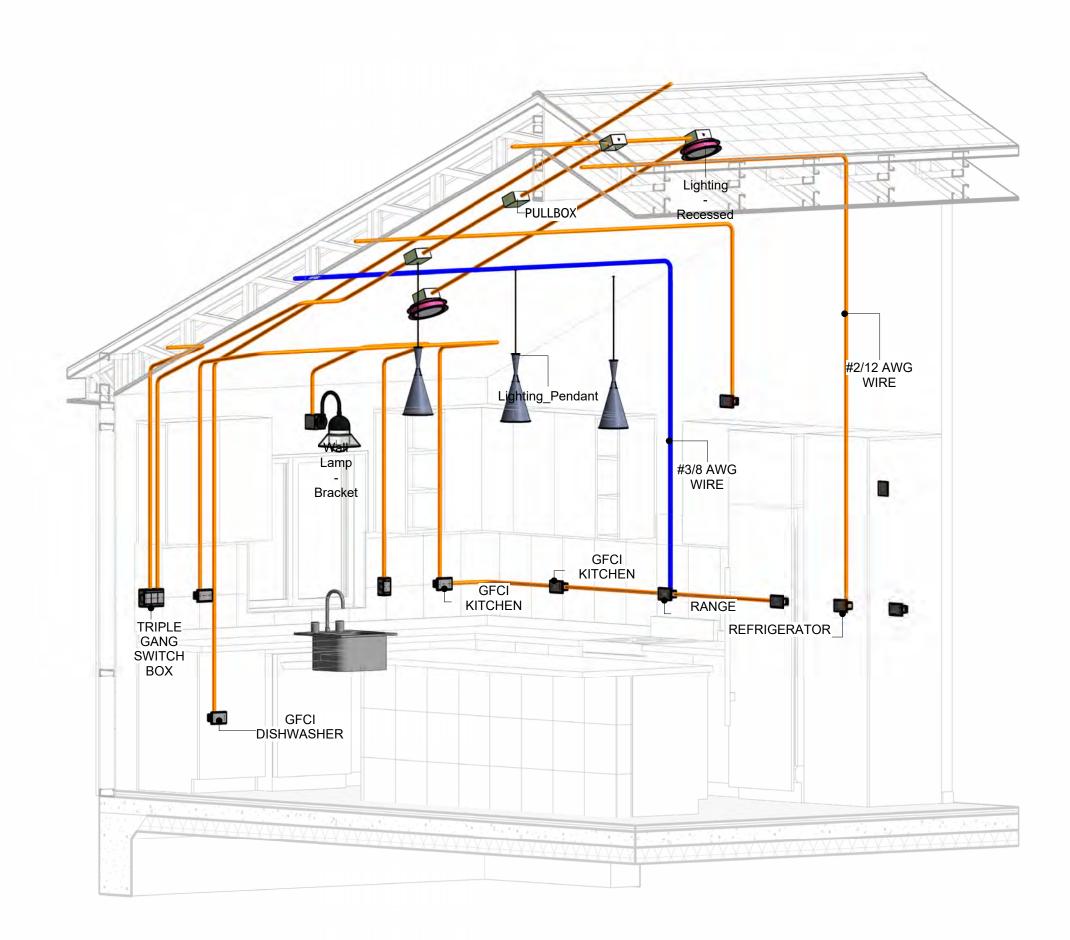


**3D-KITCHEN** 

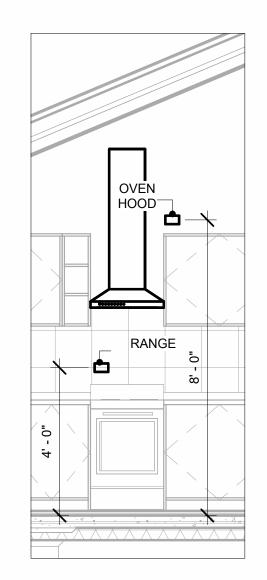


**RANGE & OVENHOOD** 3/8" = 1'-0"

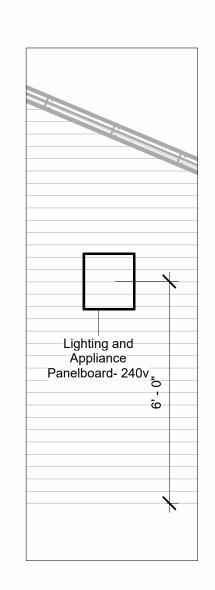

**PANEL** 3/8" = 1'-0"

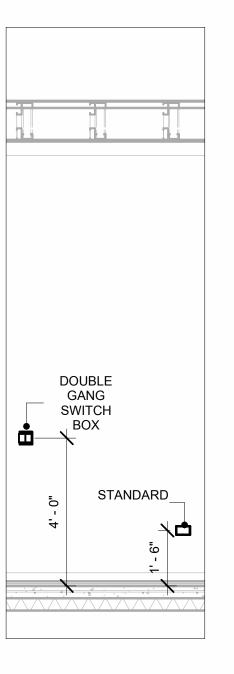


SWITCH BOX& RECEPTACLE
3/8" = 1'-0"

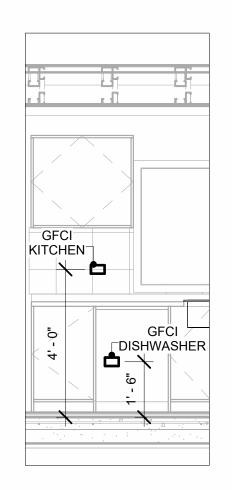

GFCI & DISHWASHER
3/8" = 1'-0"



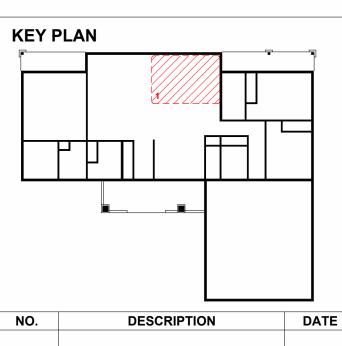

DATE

NOTE:

LEGEND:

PROJECT

246-EMBER-1650-3Bd 2.5Ba CRAFTSMAN-550

DRAWING NAME

# **POWER**

CLIENT NAME:	Owner
PROJECT NUMBER:	0139_16
DATE:	5/6/2025 4:53:20 PM
DESIGNED BY:	Designer
DRAWN BY:	Author
CHECKED BY:	Checker

E103

### **NOTES: LIGHT**

- 1. LIGHT FIXTURES AND LUMINARIES SHALL CONFORM TO THE NEC, THE IRC AND LOCAL SAFETY & BUILDING CODE.
- 2. ALL LIGHTING FIXTURES SHOULD CONFORM TO THE DESIGN ELECTRICAL LOAD AND SHALL BE PROPERLY WIRED AND MOUNTED BY QUALIFIED ELECTRICIAN FOLLOWING MANUFACTURERS SPECIFICATIONS.
- 3. CEILING FANS AND FANS WITH LIGHT WITH WEIGHT EXCEEDING 35 LBS SHOULD BE PROVIDED WITH STRUCTURAL BACKING FOR SUPPORT AND SHALL BE FIXED AS PER MANUFACTURERS SPECIFICATIONS.
- 4. EXTERIOR LIGHTS SHALL CONFORM TO LOCAL BUILDING CODE AND GUIDELINES.

### **NOTES: SWITCH JUNCTION BOX**


- 1. THE MINIMUM SIZE OF JUCTION BOX TO BE USED IS 2"X4"X(1.5" OR 3.5" DEEP) THIS ARE TO BE USED FOR SINGLE GANG SWITCH OR OUTLETS.
- 2. FOR DOUBLE GANG (2 GANG) OUTLETS AND SWITCHS THE MINIMUM SIZE OF THE
- JUCTION BOX TO BE PROVIDED SHALL NOT BE LESS THAN 4"X4"X(1.5" OR 3.5" DEEP)
- 3. FOR THREE GANG (3 GANG) OUTLETS AND SWITCHS THE MINIMUM SIZE OF THE JUCTION BOX SHALL NOT BE LESS THAN 6"X4"X(1.5" OR 3.5" DEEP).

FITTING SCHEDULE(PULL BOX)				
FAMILY COUNT DESCRIPTION				
PULLBOX1	54	#1/4 PULLBOX		

ELECTRICAL FIXTURE SCHEDULE (SWITCH BOX)	
TYPE	COUNT
DOUBLE GANG SWITCH BOX	8
SINGLE GANG SWITCH BOX	11
TRIPLE GANG SWITCH BOX	3

LIGH1	TING DEVICE
TYPE	COUNT
DIMMER	7
FAN SWITCH	4
SINGLE POLE 16	
THREE WAY WITH DIMMER	9

LIGHTING FIX	XTURE	
VOLTAGE	ELECTRICAL LOAD	COUNT
120 V/1-40 VA	200 A, 120 V/240 V, SINGLE PHASE, 3 WIRES	4
120 V/1-100 VA- 120 V/1-100 VA	200 A, 120 V/240 V, SINGLE PHASE, 3 WIRES	4
120 V/1-60 VA	200 A, 120 V/240 V, SINGLE PHASE, 3 WIRES	24
120 V/1-100 VA	200 A, 120 V/240 V, SINGLE PHASE, 3 WIRES	3
120 V/1-28 VA	200 A, 120 V/240 V, SINGLE PHASE, 3 WIRES	16
120 V/1-100 VA	200 A, 120 V/240 V, SINGLE PHASE, 3 WIRES	12
	VOLTAGE  120 V/1-40 VA  120 V/1-100 VA- 120 V/1-100 VA  120 V/1-60 VA  120 V/1-100 VA	120 V/1-40 VA  200 A, 120 V/240 V, SINGLE PHASE, 3 WIRES  120 V/1-100 VA- 120 V/1-100 VA  120 V/1-60 VA  200 A, 120 V/240 V, SINGLE PHASE, 3 WIRES  120 V/1-60 VA  200 A, 120 V/240 V, SINGLE PHASE, 3 WIRES  120 V/1-100 VA  200 A, 120 V/240 V, SINGLE PHASE, 3 WIRES  120 V/1-28 VA  200 A, 120 V/240 V, SINGLE PHASE, 3 WIRES  120 V/1-100 VA  200 A, 120 V/240 V, SINGLE PHASE, 3 WIRES

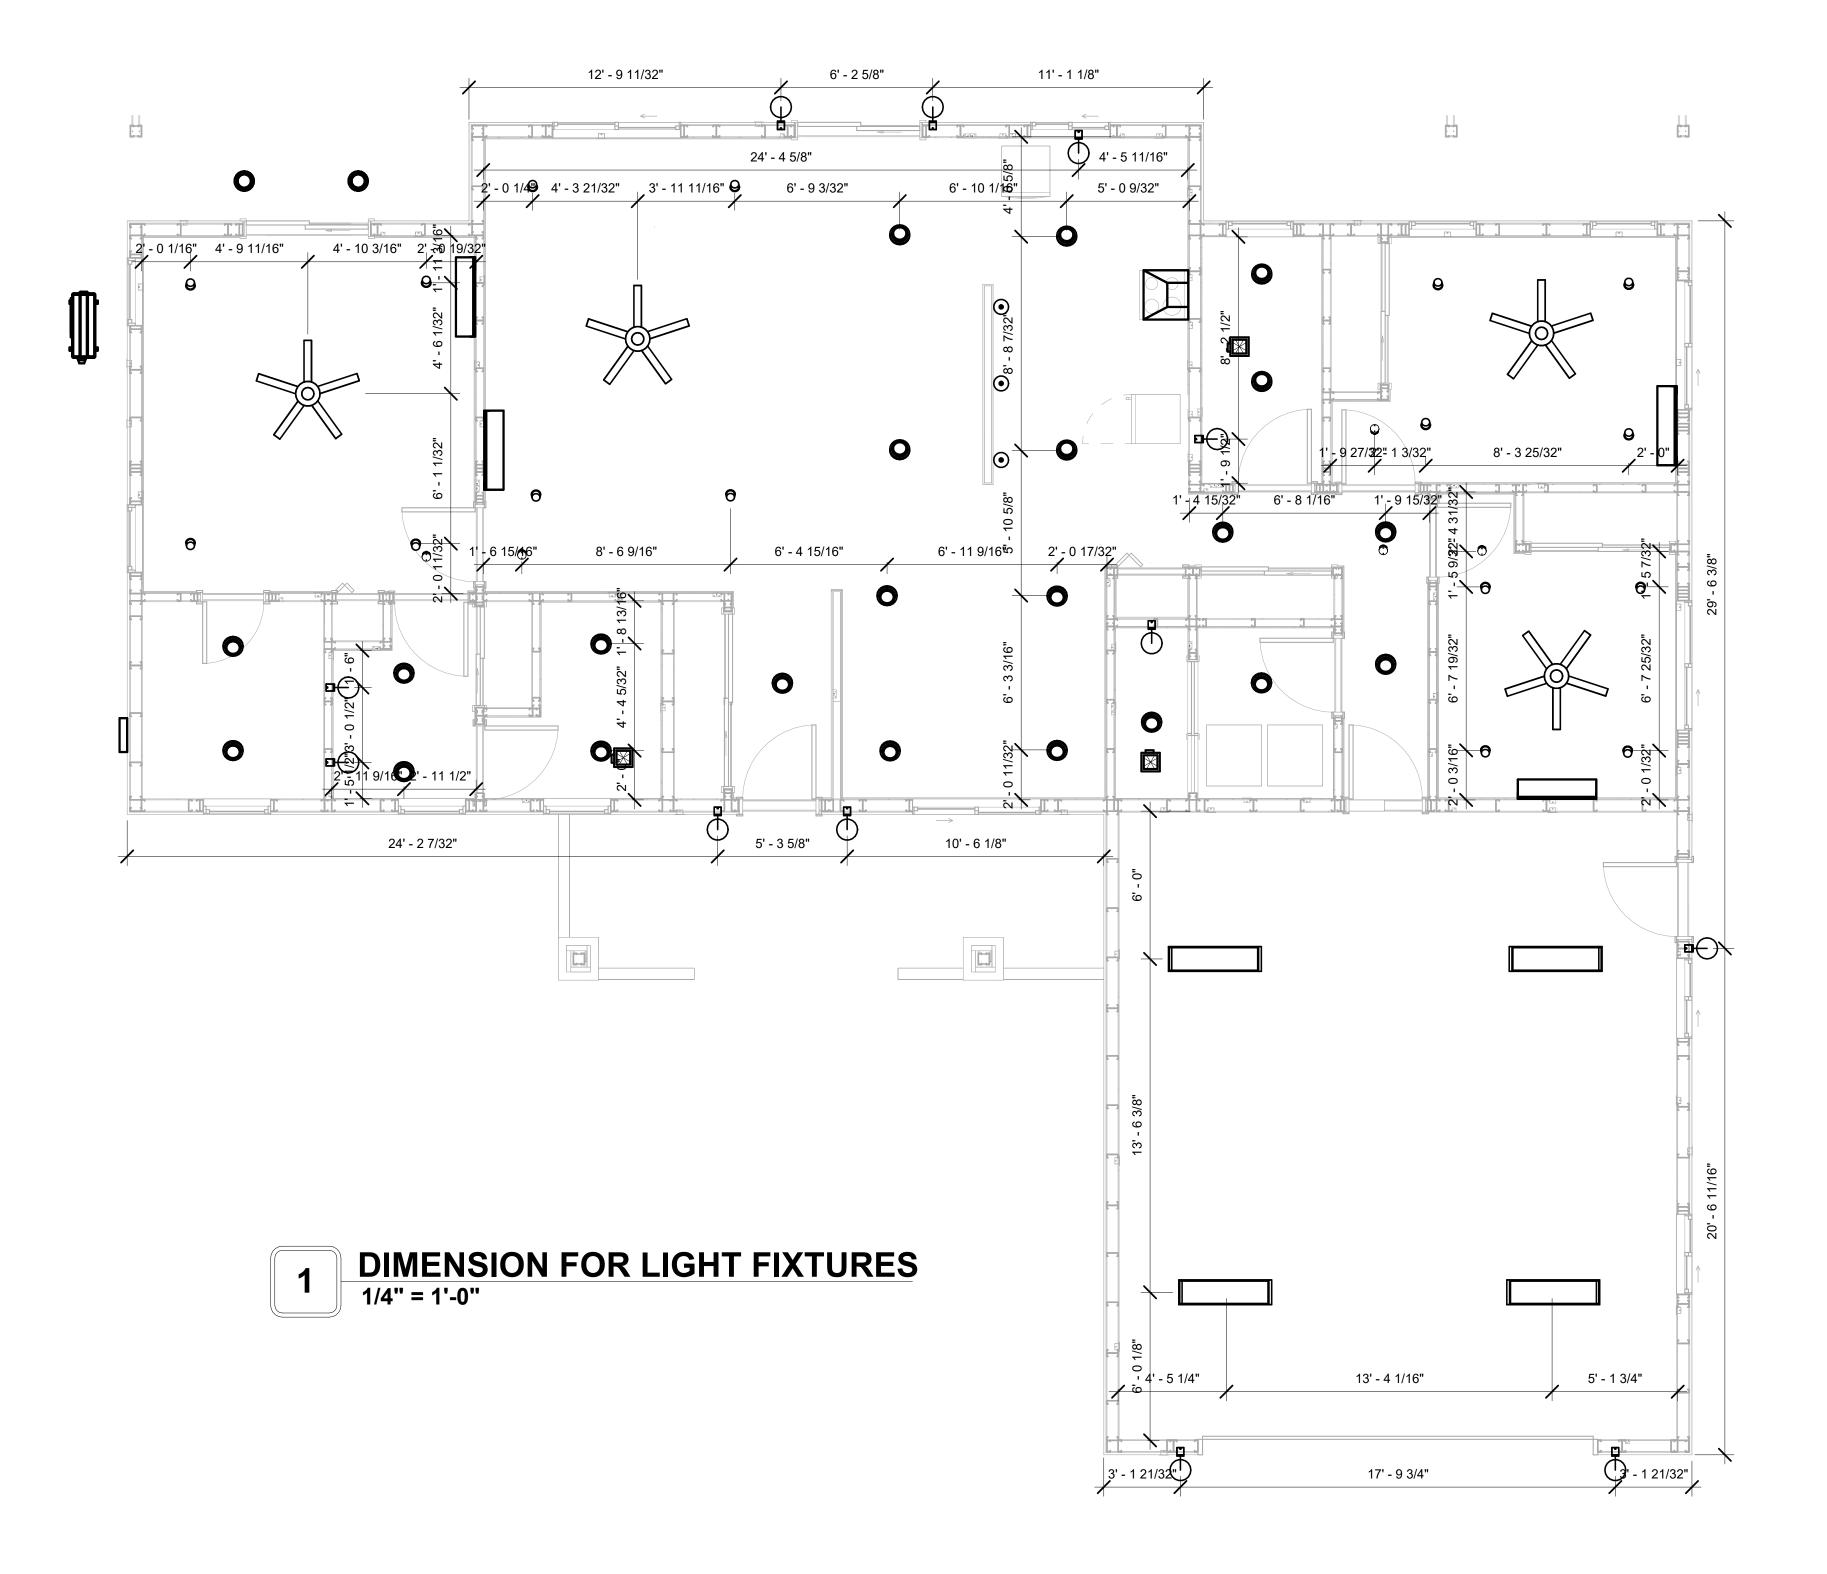



**KEY PLAN** 

DESCRIPTION DATE

NOTE:

LEGEND:

PROJECT

246-EMBER-1650-3Bd 2.5Ba CRAFTSMAN-550

DRAWING NAME

# **DIMENSION PLAN** FOR LIGHT FIXTURES

CLIENT NAME:	Owner
PROJECT NUMBER:	0139_16
DATE:	5/6/2025 4:53:22 PM
DESIGNED BY:	Designer
DRAWN BY:	Author
CHECKED BY:	Checker

E104


SCALE: 1/4" = 1'-0"

### NOTES;

- 1. VERIFY EQUIPMENT PLUG CONFIGURATION BEFORE PURCHASING RECEPTACLES
- 2. FOR ALL EQUIPMENT.
- 3. COORDINATE EXACT LOCATION OF LIGHT FIXTURES, WALL SWITCHES, RECEPTACLES AND OTHER DEVICES WITH ARCHITECTURAL DRAWINGS.
- 4. USE METALLIC JUNCTION BOX WITH THE GFCI RECEPTACLES, WITH HIGHT VOLTAGE.

ELECTRICAL FIXTURE SCHEDULE (RECEPTACLE)		
TYPE	COUNT	
CONDENSER	1	
DRYER	1	
GFCI BATH ROOM	6	
GFCI DISHWASHER	1	
GFCI GARAGE	7	
GFCI KITCHEN	5	
GFCI OUT DOOR	9	
GFCI WASHER	1	
OVEN HOOD	1	
RANGE	1	
REFRIGERATOR	1	
STANDARD	17	
WATER HEATER	1	

	ELECTRICAL O	UTLET SCHEDUL	E
TYPE	CIRCUIT NUMBER	ELECTRICAL DATA	COUNT
STANDARD		120 V/1-180 VA	1
GFCI BATH ROOM	2	120 V/1-180 VA	3
GFCI BATH ROOM	8	120 V/1-180 VA	1
GFCI BATH ROOM	10	120 V/1-180 VA	2
CONDENSER	11,13	240 V/2-5000 VA	1
GFCI OUT DOOR	12	120 V/1-180 VA	9
GFCI KITCHEN	14	120 V/1-180 VA	5
GFCI WASHER	15	120 V/1-1200 VA	1
DRYER	16,18	240 V/2-5000 VA	1
WATER HEATER	17,19	240 V/2-4500 VA	1
GFCI GARAGE	20	120 V/1-180 VA	7
RANGE	21,23	240 V/2-5000 VA	1
OVEN HOOD	22	120 V/1-180 VA	1
REFRIGERATOR	24	120 V/1-1800 VA	1
GFCI DISHWASHER	25	120 V/1-1200 VA	1
STANDARD	26	120 V/1-180 VA	4
STANDARD	27	120 V/1-180 VA	4
STANDARD	28	120 V/1-180 VA	8

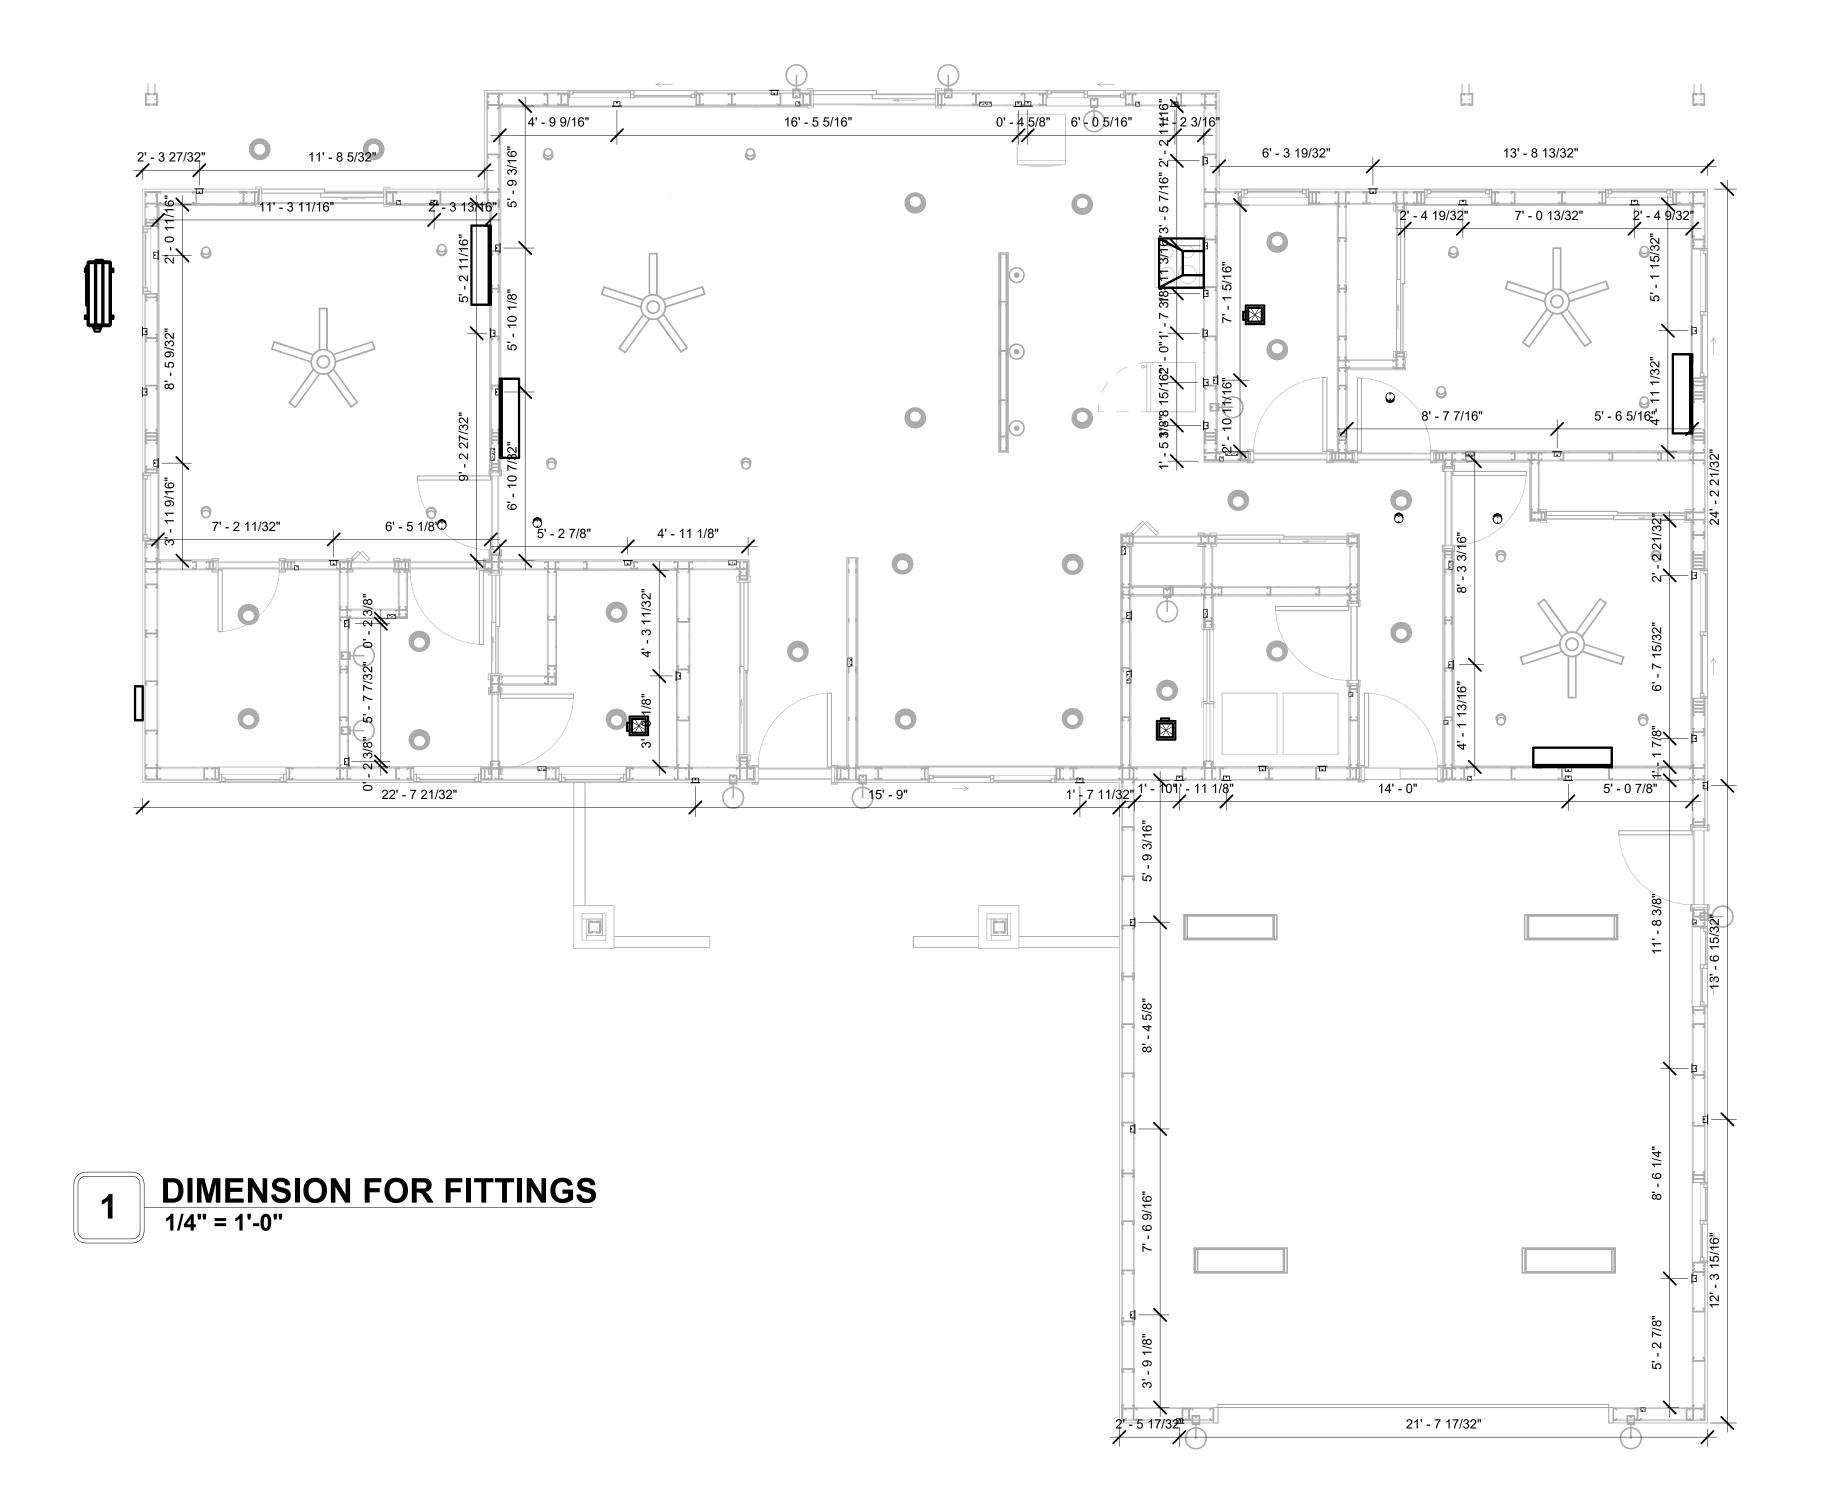



**KEY PLAN** 

NO.	DESCRIPTION	DATE
NO.	DESCRIPTION	DATE

NOTE:

LEGEND:

PROJECT

246-EMBER-1650-3Bd 2.5Ba CRAFTSMAN-550

DRAWING NAME

# DIMENSION PLAN FOR FITTINGS

Owner
0139_16
5/6/2025 4:53:25 PM
Designer
Author
Checker

E105

SCALE: 1/4" = 1'-0"

### SHEET LIST

**Sheet Name** Sheet Number

P101	NOTE AND SCHEDULE
P102	WATER SUPPLY
P103	SEWAGE SYSTEM

### PIPe Color SCHEME DOMESTIC COLD WATER DOMESTIC HOT WATER - - - SANITARY VENT SANITARY SEWER STORM DRAINAGE Gray Water GAS LINE

### **PLUMBING NOTES**

- The plumbing system is designed to meet the building's domestic water supply, sanitary drainage, and storm drainage requirements, as per project specifications and applicable codes.
- The system installation shall comply with the latest International Plumbing Code (IPC), International Residential Code (IRC), and all other relevant local, state, and national regulations.
- ALL PLUMBING WORK SHALL COMPLY WITH THE LATEST EDITION OF THE INTERNATIONAL PLUMBING CODE (IPC) AND THE LOCAL PLUMBING CODE.
- PLUMBING SYSTEMS SHALL BE TESTED AND INSPECTED IN ACCORDANCE WITH THE LOCAL PLUMBING CODE REQUIREMENTS.
- PLUMBING FIXTURES SHALL BE INSTALLED WITH THE APPROPRIATE TRIM, FITTINGS, AND ACCESSORIES, AS RECOMMENDED BY THE MANUFACTURER.
- 6. PIPING SHALL BE PROPERLY SUPPORTED AND SECURED TO PREVENT SAGGING,
- MOVEMENT, AND VIBRATION. SHUT-OFF VALVES SHALL BE PROVIDED AT ALL BRANCH CONNECTIONS AND AT THE
- INLET AND OUTLET OF EACH PIECE OF EQUIPMENT. BACKFLOW PREVENTION DEVICES SHALL BE INSTALLED AS REQUIRED BY THE LOCAL
- PLUMBING CODE TO PROTECT THE POTABLE WATER SYSTEM.
- PLUMBING FIXTURES AND EQUIPMENT SHALL BE ACCESSIBLE FOR MAINTENANCE AND SERVICING.
- 10. EXPOSED PLUMBING PIPING AND FIXTURES SHALL BE INSULATED TO PREVENT CONDENSATION AND ENERGY LOSS.
- 11. DEAD ENDS IN THE DRAINAGE SYSTEM MUST BE AVOIDED, EXCEPT WHERE NECESSARY TO INSTALL A CLEANOUT IN AN ACCESSIBLE LOCATION, AND MUST HAVE A VENTED CONNECTION TO THE OUTSIDE ATMOSPHERE.
- 12. THE VERTICAL DEFLECTION OF PVC PIPE MUST NOT EXCEED 5%, AND NO DEFLECTION IS PERMITTED FOR IRON PIPE.
- 13. WORK MUST BE PROPERLY COORDINATED WITH OTHER TRADES TO AVOID CONFLICTS, REFERRING TO THE ARCHITECTURAL AND STRUCTURAL DRAWINGS FOR INFORMATION REGARDING CEILING ELEVATIONS, SPACE CLEARANCES, WALL AND PARTITION LOCATIONS, ETC.
- 14. ALL FIXTURES SHALL HAVE ACCESSIBLE STOPS.
- 15. DOMESTIC WATER PIPING SHALL BE PEX, AND PVC PIPING IS NOT ACCEPTABLE FOR INTERIOR USE
- 16. VENT TERMINATIONS SHALL BE LOCATED AT LEAST 10 FEET FROM OR 3 FEET ABOVE ANY OPERABLE WINDOW, DOOR OPENING, AIR INTAKE, OR VENT SHAFT, AND AT LEAST 3 FEET IN EVERY DIRECTION FROM ANY LOT LINE, ALLEY, OR STREET,
- 17. PIPE AND FITTINGS UTILIZED IN THE WATER SUPPLY SYSTEM SHALL HAVE A MAXIMUM OF 8 PERCENT LEAD.
- 18. ACRYLONITRILE BUTADIENE STYRENE (ABS) SHALL BE USED FOR THE SEWERAGE AND VENTILATION SYSTEM.
- 19. CROSS-LINKED POLYETHYLENE (PEX) SHALL BE USED FOR THE WATER SUPPLY SYSTEM.
- 20. POLYVINYL CHLORIDE (PVC) SHALL BE USED FOR THE RAIN WATER SYSTEM.
- 21. THE MIMIMUM WATER SUPPLY DEPTH UNDER FLOOR FINISH SHOUD BE 1/2".
- ANY PIPE INSTALLED UNDERGROUND MUST HAVE AT LEAST 12 INCHES OF CLEARANCE
- BETWEEN THE OUTSIDE OF THE PIPE AND ANY OTHER UNDERGROUND STRUCTURE. 23. THE MINIMUM CLEARANCE BETWEEN COLD AND HOT WATER LINES IN RESIDENTIAL
- HOMES MAINTAIN A MINIMUM DISTANCE OF 6 INCHES.
- 24. HORIZONTAL SEPARATION BETWEEN WATER AND SEWER LINES: A MINIMUM OF 12 INCHES BETWEEN POTABLE WATER SUPPLY LINES (COLD AND HOT WATER) AND SANITARY SEWER LINES.

Α	BBF	REVI	ATI	ON

Ø	Diameter		
ABS	ACRYLONITRILE BUTADIENE STYRENE		
ABV	ABOVE		
AD	AREA DRAIN		
AFF	ABOVE FINISHED FLOOR		
ALT	ALTERNATE		
BFF	BELOW FINISHED FLOOR		
BLW	BELOW		
CO	CLEAN OUT		
CW	COLD WATER		
D	DEGREE		
DFU	Dranage FIXTURE UNIT		
DIA	DIAMETER		
DN	DOWN		
FCO	FLOOR CLEAN OUT		
FD	FLOOR DRAIN		
FL	FLOOR		
FS	FLOOR SINK		
FT	FOOT/FEET		
HB	HOSE BIB		
HW	HOT WATER		
IN	INCH		
MIN	MINIMUM		
NO	NUMBER		
NTS	NOT TO SCALE		
PEX	CROSS-LINKED POLYETHYLENE		
PLBG	PLUMBING		
PVC	POLYVINYL CHLORIDE		
QTY	Quantity		
RD	ROOF DRAIN		
RED	REDUCER		
RM	ROOM		
RW	RAIN WATER		
SF	SQUARE FOOT		
V	VENT		
VTR	VENT THROUGH ROOF		
W	WASTE		
WCO	WALL CLEAN OUT		
WSFU	WATER SUPPLY FIXTURE UNIT		

## **PLUMBING LEGEND**

D	Сар
	Bend 45 Deg
$\Box$	Bend 90 Deg
	Tee Reducing
	Tee
	Clean Two-Way
	Wye 45 Deg
	Wye 45 Deg Double
	Wye Combination
	P-Trap

PIPE SCHEDULE					
Material	Diameter	Length			
Acrylonitrile Butadiene Styrene (ABS)	1 1/2"	18 ft			
Acrylonitrile Butadiene Styrene (ABS)	2"	78 ft			
Acrylonitrile Butadiene Styrene (ABS)	3"	90 ft			
Cross-linked polyethylene (PEX)	1/2"	262 ft			
Cross-linked polyethylene (PEX)	3/4"	54 ft			
Cross-linked polyethylene (PEX)	1"	0 ft			
Polyvinyl Chloride - Rigid	2"	99 ft			

FITTING SCHEDULE						
FITTING Size QTY						
Domestic Cold Water						
PEX 90 Deg Elbow	1/2"ø-1/2"ø	2				
PEX 90 Degree Elbow	1/2"ø-1/2"ø	26				
PEX 90 Degree Elbow	3/4"ø-3/4"ø	3				
PEX Cross Elbow	1/2"ø-1/2"ø-1/2"ø	1				
PEX Tee Elbow	1/2"ø-1/2"ø-1/2"ø	8				
PEX Tee Elbow	3/4"ø-3/4"ø	2				
PEX Transition Elbow	1"ø-3/4"ø	2				
PEX Transition Elbow	3/4"ø-1/2"ø	1				
Domestic Hot Water PEX 90 Degree Elbow	1/2"ø-1/2"ø	20				
PEX 90 Degree Elbow	3/4"ø-3/4"ø	3				
PEX Tee Elbow	1/2"ø-1/2"ø	7				
PEX Transition Elbow	3/4"ø-1/2"ø	1				
Rain Water PVC 90 Deg Bend Elbow	2"ø-2"ø	39				
Sewage						
ABS 90 Degree Bend Elbow	1 1/2"ø-1 1/2"ø	3				
ABS 90 Degree Bend Elbow	2"ø-2"ø	3				
ABS 90 Degree Bend Elbow	3"ø-3"ø	6				
ABS P-Trap	2"ø-2"ø	3				
ABS P-Trap	3"ø-3"ø	2				
ABS Reducer Elbow	2"ø-1 1/2"ø	2				
ABS Reducer Elbow	3"ø-1 1/2"ø	3				
ABS Reducer Elbow	3"ø-2"ø	9				
ABS TEE Elbow	1 1/2"ø-1 1/2"ø-1 1/2"ø	2				
ABS TEE Elbow	2"ø-2"ø	3				
ABS TEE Elbow	3"ø-3"ø	14				
ABS Trap P	1 1/2"ø-1 1/2"ø	2				
•						
ABS Trap P ABS Trap P	2"ø-2"ø 3"ø-3"ø	3				

				T			T	T		T	
Family	W	V	Trap	CW	HW	QT Y	DFU	тот.	WF U	TOT	NOTES
Dishwasher	2"	1-1/2"	1-1/2"	1/2"	1/2"	1		0			Drain to sewer see plans
Dryer	N/A	N/A	N/A	N/A	N/A	1		0			
Hanging pipes clamp						26		0			
Shower Tray						2		0			
Shower Trim	-	-	-	1/2"	1/2"	2		0			
Sink Island Single	2"	1-1/2"	1-1/2"	1/2"	1/2"	1		0			
Vanity Sink	2"	1-1/2"	1-1/2"	1/2"	1/2"	4		0			
Washer	2"	1-1/2"	2"	1/2"	1/2"	1		0			DRAINS TO GRAY WATER OR SEWER SEE PLANS
Water Closet	3"	2"	3"	1/2"	1/2"	3		0			
Water Heater	N/A	N/A	N/A	3/4"	3/4"	1		0			

ABS Vent Cap Elbow

FIXTURE SCHEDULE					
fixture	QTY	Description			
[					
Dishwasher	1	Drain to sewer see plans			
Dryer	1				
Hanging pipes clamp	26				
Shower Tray	2				
Shower Trim	2				
Sink Island Single	1				
Vanity Sink	4				
Washer	1	DRAINS TO GRAY WATER OR SEWER SEE PLANS			
Water Closet	3				
Water Heater	1				

ACCESSORIES & FITTINGS SCHEDULE					
fixture	QTY	Descriptions			
DISHWASHER CONNECTOR	1				
Hose Bib	1				
LAUNDRY SWEAT CONNECTOR	1				
Shutoff Valve	12				

PLUMBING SCHEDULE						
FIXTURE	Trap	Waste	Vent	C.W	H.W	
Dishwasher	1-1/2"	2"	1-1/2"	1/2"	1/2"	
Dryer	N/A	N/A	N/A	N/A	N/A	
Shower Tray						
Shower Trim	-	-	-	1/2"	1/2"	
Sink Island Single	1-1/2"	2"	1-1/2"	1/2"	1/2"	
Vanity Sink	1-1/2"	2"	1-1/2"	1/2"	1/2"	
Washer	2"	2"	1-1/2"	1/2"	1/2"	
Water Closet	3"	3"	2"	1/2"	1/2"	
Water Heater	N/A	N/A	N/A	3/4"	3/4"	

WATER FIXTURE UNIT SCHEDULE					
Family	QTY	UNIT VALUE	TOTAL		
Dishwasher	1		0		
Dryer	1		0		
Shower Tray	2		0		
Shower Trim	2		0		
Sink Island Single	1		0		
Vanity Sink	4		0		
Washer	1		0		
Water Closet	3		0		
Water Heater	1		0		

WASTE FIXTURE UNIT SCHEDULE						
Family	QTY	DFU Values	TOTAL			
Dishwasher	1		0			
Dryer	1		0			
Hanging pipes clamp	26		0			
Shower Tray	2		0			
Shower Trim	2		0			
Sink Island Single	1		0			
Vanity Sink	4		0			
Washer	1		0			
Water Closet	3		0			
Water Heater	1		0			



**KEY PLAN** 

DESCRIPTION DATE

NOTE:

LEGEND:

PROJECT

246-EMBER-1650-3Bd 2.5Ba **CRAFTSMAN-550** 

DRAWING NAME


# **NOTE AND** SCHEDULE

CLIENT NAME:


PROJECT NUMBER: 0139\_16 DATE: 5/6/2025 2:04:58 AM Designer DESIGNED BY: DRAWN BY: CHECKED BY: Checker

P101

SCALE: 1/2" = 1'-0"

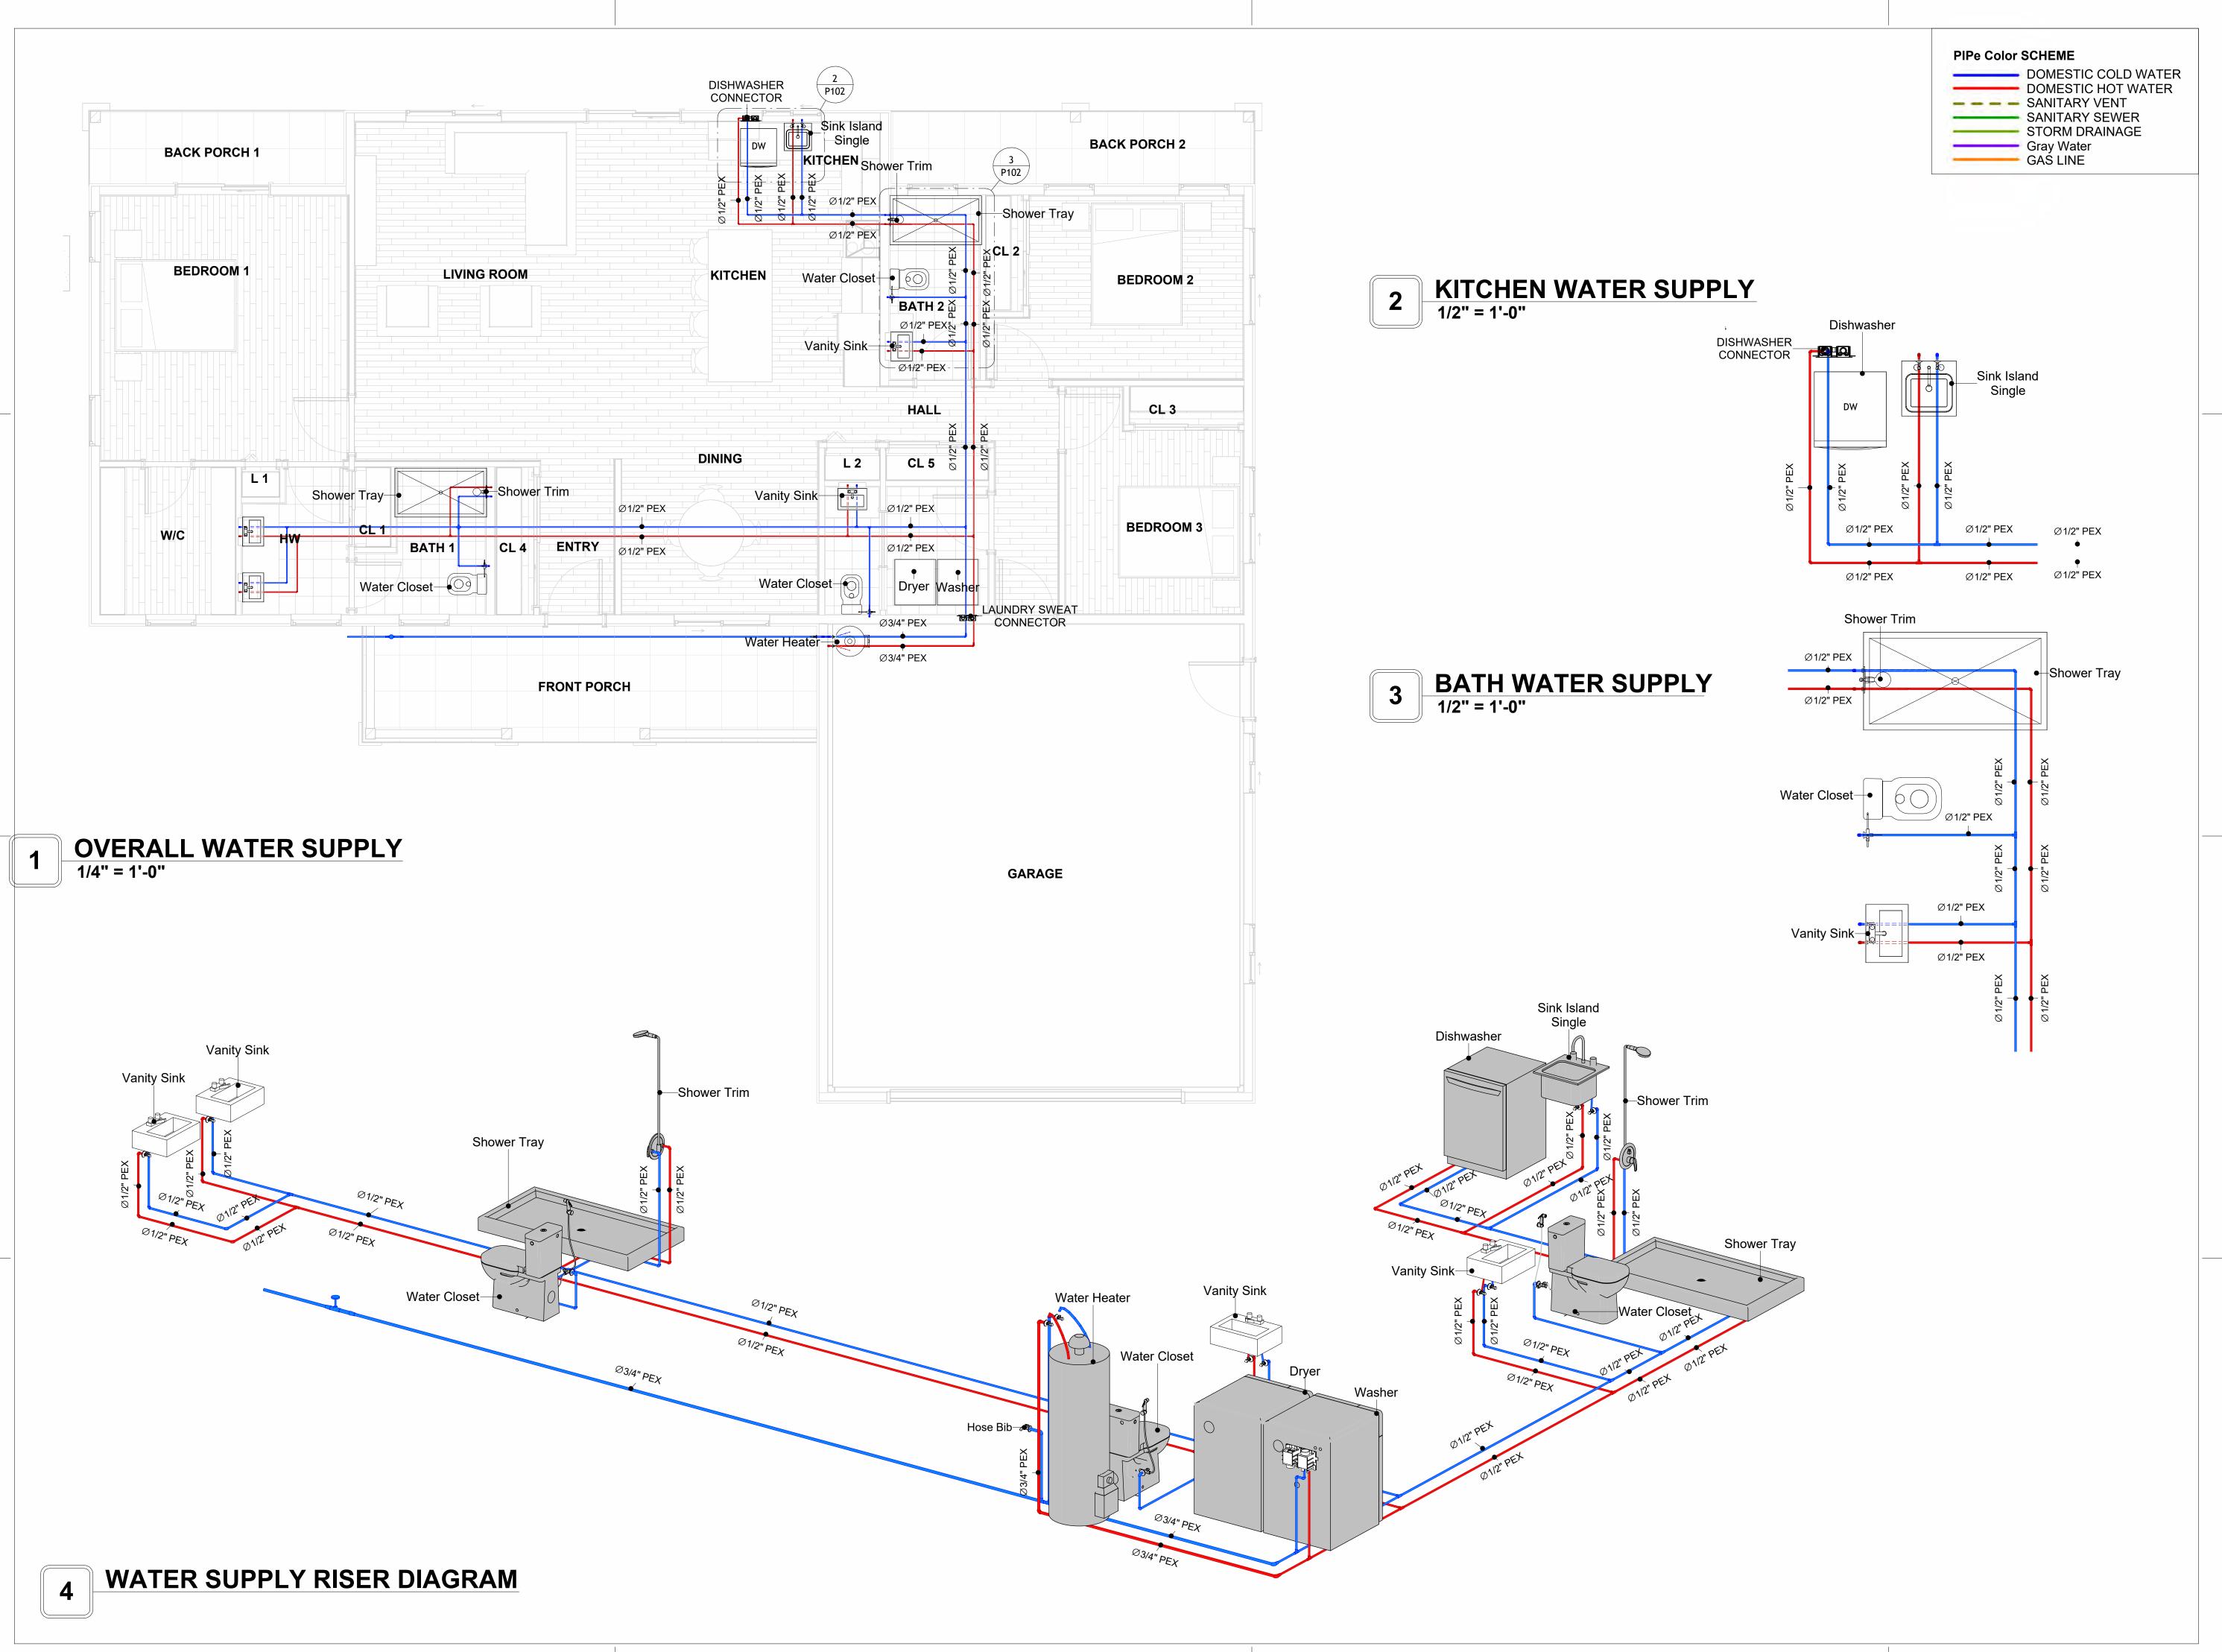



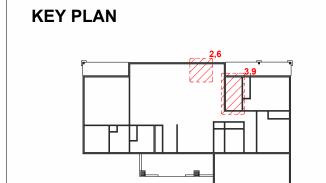

NO. DESCRIPTION DATE

NOTE:

LEGEND:

PROJECT

246-EMBER-1650-3Bd 2.5Ba CRAFTSMAN-550

DRAWING NAME

# **WATER SUPPLY**

CLIENT NAME:

PROJECT NUMBER:

0139\_16

DATE:

5/6/2025 2:05:22 AM

DESIGNED BY:

DRAWN BY:

CHECKED BY:

Checker

P102

© [2024] [FrameUpNow] . All rights reserved

SCALE: As indicated

# Materials Shopping List

Please print and take this Materials Shopping List to your favorite Home Depot and ask for assistance in selecting the materials, fixtures and fittings to complete your new home.

Record your selection and the price of the item. Then do the math to determine the cost for your selections and the total cost of finishing your home.

#### **Have It Your Way!**

The material types listed in this document were selected based on personal preferences. The Customer is encouraged to make changes to the material types in accordance with local customs, regulations, and personal preferences.

Have It Your Way!



# 20 good reasons to frame a home with metal and not wood



Why build your ADU with metal vs wood	Wood N	Vletal	Explanation
1 DIY Construction Benefit		<b>~</b>	The wall frames, trusses and beams can be erected in a just a few days
2 Minimal Construction Skills Required		<b>~</b>	Pre-assembled walls and trusses require no specialized skills to errect
3 Build as DIY, Hybrid or by a General Contractor		<b>Y</b>	Do it yourself, Hybrid (involve special contractors) or hire a General Contractor
4 Build It As You Can Afford It		<b>~</b>	Impervious to Weather - build as you have the time and money
5 Up Front Cost of Framing Materials	~		As to only the framing material, wood is less expensive
6 Total Cost To Build		<b>~</b>	Savings in time, labor, and other areas make light gauge steel LESS expensive
7 Termites and wood boring insects		<b>~</b>	Termites, carpenter ants and wood boring insects eat wood, not metal
8 Mold resistant		<b>~</b>	Metal does not attract mold
9 Damage caused by exterior and interior flooding		<b>~</b>	Metal needs no reconditioning after a flood
10 Fire Resistant		<b>Y</b>	Non-combustible
11 Lower insurance rates		<b>~</b>	Many insurance underwriters now provide lower rates for metal framed homes
12 Walls, trusses, and beams retain their original form		<b>~</b>	Perfectly straight walls - no shimming of drywall
13 Corners are 90 degrees		<b>~</b>	No need for templating of countertops to adjust for out of square corners
14 Strength and weight		<b>~</b>	Metal is stronger than wood and weighs less - no need for crane to lift ADU trusses
15 IBC Engineered Stamp		<b>~</b>	If an engineering stamp is necessary, months of waiting are saved
16 Complete BOM (Materials Shopping List)		<b>Y</b>	Take the materials shopping list to Home Depot and start shopping/pricing
17 Flexible in Seismic Areas - Won't Fracture		<b>~</b>	Light gauge steel is flexible and won't fracture when the earth moves
18 No Waste At Job Site		<b>~</b>	Steel is the most recycled material in the world. A typical wood home has 20-30% waste
19 Environmentally Friendly		<b>~</b>	Trees don't have to be destroyed and the source of most metal is from recycling
20 How-To Videos Included		<b>~</b>	How-to videos provide simple assembly instructions
21 Relationship Counselor		<b>~</b>	Eliminate emotional uphevels - save time, money, and preserve the relationship

#### Universal Requirements - some or all may be required

- 1 Site plan
- 2 Electrical Supply Connection
- 3 Sewer Connection
- 4 Fresh Water Supply Connection
- 5 Set Backs
- 6 Soils Evaluation

- 7 Earthquake (fault) evaluation
- 8 Foundation Plan subject to soils
- 9 Compliance with local energy codes: insulation home wrap and flashing
- 10 Engineering for wind speed and snow load.
- 11 State and Local ordinances regarding ADUs
- 12 Local Architect and/or Engineer may be necessary





# Ember-3Bd2.5Ba-Craftsman MATERIAL SHOPPING LIST

#### **Have It Your Way!**

The material types listed in this document were selected based on personal preferences. The Customer is encouraged to make changes to the material types in accordance with local customs, regulations, and personal preferences. Have It Your Way!

#### TOC



15

#### # Name Link Page No 1 Cover Page Cover Page 2 TOC TOC 2 3 ELECTRICAL BOM **ELECTRICAL BOM** 3 5 HVAC BOM **HVAC BOM** 7 PLUMBING BOM **4** PLUMBING BOM 10

**Table Of Content** 

#### Have It Your Way!

ARCHITECTURAL BOM

The material types listed in this document were selected based on personal preferences. The Customer is encouraged to make changes to the material types in accordance with local customs, regulations, and personal preferences. Have It Your Way!

#### **GENERAL NOTES**

- 1 This BOM (Bill of Materials) is prepared as a Materials Shopping List to help builders and DIYers gain a complete understanding of most if not all elements required for the complete construction of this structure, according to the original design documents provided by FrameUpNow.
- 2 All quantities and specifications are subject to change based on the final design, field measurements, availability of products and customer preferences. The customer should verify all information prior to purchasing materials.
- 3 All products and elements in the list shall conform to the International Residential Code (IRC), or any other local and international building codes, safety regulations, and standards that are applicable to the location of the structure.
- 4 If any changes are made by the customer to the list of materials specified in this document, the customer is responsible for assuring that the correct type and quantity of materials are utilized in accordance with local building codes.
- 5 FrameUpNow, will not be held responsible for any misuse of this document, the products listed, or for deviations from the content that are made due to changes in specifications, pricing, availability, or customer preferences.
- 6 The customer is advised to consult a qualified professional or technician prior to purchasing materials for specialized construction system items. Some items including but not limited to caseworks, doors and windows may require as built measurements prior to purchase to confirmation of final dimensions.
- 7 If there are additional trim elements or specific installation methods, the total amount of materials needed might vary. Consider any additional trim required for corners, intersections, or other architectural details that might cause this variations before procedding to purchase and construction.



		Emb	er-3Bd2.5E	Ba-Craftsma	an		
		ARCHITECTI					
No.	Item	Туре	Unit	Quantity	Unit Price	Total	Description
	APPLIANCES		DOG				
	Refrigerator		PCS PCS	1			
2	Range			1			
3	Washer		PCS	1			
4	Dryer		PCS	1			
5	Dish Washer		PCS	1			
6	Oven		PCS	0			
7	Microwave		PCS	0			
<u>^</u>	CASEWORKS		FT	04.75			
1	Kitchen Cabinet		FT	21.75			
2	Laundry Cabinet		FT	0			
3	Vanity Cabinet		FT	12.5			
4	Medicine Cabinet		PCS	4			
5	Kitchen countertop		SF	61.81			
6	Laundry Countertop		PCS	0			
7	Bathroom Countertop		SF	0			
8	Island		FT	8.3			
9	Peninsula		FT	0			
10	Closets		SF	308			
	CEILING						
1	Ceiling Board	Dry Wall	SF	2066			
	Dry Wall Fastener	Screw	PCS	3616			
3	Vapor Retarder	Polyethylene film	SF	2472			
4	Vapor Retarder Fastener	Nails with washer heads	PCS	7416			
5	Ceiling Board (MRD)	Moisture resistant drywall	SF	187			
6	MRD Fastener		PCS	327			
7	Ceiling Board	Marine Plywood	SF	219			
8	Marine Plywood Fastener	Screw	PCS	383			
9	Dry Wall Tape		FT	1236			
$\triangle$	FLOORING						
1	Main Living Space		SF	755.7			
2	Bathroom		SF	176.6			
3	Bedrooms		SF	495.4			
4	Garage		SF	565.3			
5	Porch		SF	290.9			
Δ	STRUCTURE						
1	Foundation		SF	2496.8			
	WALLS EXTERIOR						
1	Exterior Wall Siding		SF	1859			
2	Wall Paint		SF	1859			
	Wall Shteathing (OSB)		SF	1859			
	Shteathing Fastener	Self-drilling screws(100/pkt)	PKT	19			
5	Wall Insulation		SF	7144			
6	Wall Homewrap		SF	1859			
7	Home wrap Fastener	Stapled fastener (200/pkt)	PKT	7			
	Furring Strip		PCS	232			
	Furring Strip Fastener	Self-drilling screws(100/pkt)	PKT	18.59			
10	Stone Copping	Masonry stone	SF	4			
	Stone Veneer	Masonry stone	SF	32			
Δ	WALLS INTERIOR						
1	Cementitious Backer Board		SF	955			
2	Kerdi membrane		SF	955			
3	Kerdi membrane Fastener		SF	955			
4	Wall Ceramic Tile		SF	955			
	Drywall Board		SF	4735			
	Drywall Fastener	Self-drilling screws(100/pkt)	PKT	47.35			
				50			
6	Wall Paint		SF	4735			
6 7	Wall Paint Drywall Tape		SF FT	4735 862			



	DOORS				
1	Interior Swinging	3' - 0" X 6'-8"	PCS	6	
2	Exterior Swinging	3' - 0" X 6'-8"	PCS	2	
3	Interior Swinging	2' - 6" X 6'-8"	PCS	1	
4	Interior Swinging	3' - 0" X 6'-8"	PCS	2	
5	Patio Sliding	5' - 0" X 6'-8"	PCS	2	
	Interior Sliding	7' - 0" X 6'-8"	PCS	1	
	Interior Sliding	5' - 8" X 6'-8"	PCS	2	
	Pocket Door	3' - 0" X 6'-8"	PCS	1	
9	Interior Sliding	5' - 4" X 6'-8"	PCS	1	
10	Folding	2 - 8" X 6'-8"	PCS	1	
11	Folding	1' - 8" X 6'-8"	PCS	1	
12	Interior Sliding	4' - 0" X 6'-8"	PCS	1	
13	Garage Door	16' - 0" X 6'-6"	PCS	1	
	Exterior Door Trim		FT	109	
	Interior Door Trim		FT	624	
	Entry Lock set		PCS	5	
	Privacy Lock set		PCS	10	
	Passage Lock set		PCS	7	
	WINDOWS				
1	Sliding	3' - 3" X 3'-3"	PCS	3	
	Single Hung	2' - 9" X 3'-3"	PCS	8	
	Sliding	5' - 3" X 3'-9"	PCS	4	
	Exterior Window Trim		FT	210	
5	Interior Window Trim		FT	210	
Δ	ROOF				· · · · · · · · · · · · · · · · · · ·
1	Roof Covering		SF	3021.0	
2	Roof Covering Fastener		PCS	1511	
3	Roof Felt Paper		SF	3021.0	
4	Roof Felt Paper Fastener		PCS	9063.0	
5	Roof Sheathing		SF	3021	
6	Roof Sheathing Fastener		PCS	24168	
7	Batten		FT	0.0	
8	Batten Fastener		PCS	0.0	
9	405		SF	294.0	
10	Soffit Fastener		PCS	147.0	
11	Fascia		FT	268.0	
12	Fascia board fastener		PCS	134	
	Roof Insulation		SF	3021.0	



	Ember-3Bd2.5Ba-Craftsman									
	FI	ECTRICAL MATER	ZIAL SHOP	PINGII	ST					
No.	ltem	Type	Unit		Unit Price	Total	Description			
	LIGHTING FIXTURES									
1	Kitchen Ceiling Light		PCS	7						
2	Kitchen Wall Mounted Light		PCS	1						
3	Exterior Wall Mounted Light		PCS	8						
4	Livingroom Ceiling Light With Fan		PCS	1						
5	Bedroom Ceiling Light With Fan		PCS	3						
6	Dining Ceiling Light		PCS	4						
7	Bath Wall Mounted Light		PCS	4						
8	Bathroom Ceiling Light		PCS	8						
_	Livingroom Ceiling Light		PCS	4						
	Bedroom Ceiling Light		PCS	12						
	Hall & Entry Ceiling Light		PCS	4						
	Garage Ceiling Light		PCS	4						
	WIC Ceiling Light		PCS	2						
	Exterior Ceiling Light		PCS	2						
	Smoke Detector		PCS	5						
	ELECTRICAL FITTINGS		100							
	Standard Receptacle 120V	20A	PCS	17						
	GFCI Receptacle 120V	20 A	PCS	31						
	GFCI Receptacle 240V	30 A	PCS	2						
19	GFCI Receptacle 240V	50 A	PCS	1						
20	GFCI Receptacle 240V	60 A	PCS	1						
21	Fan Switch	0071	PCS	4						
22	Single Pole Switch		PCS	16						
	Three Way Switch		PCS	9						
	Dimmer Switch		PCS	7						
	ELECTRICAL CONDUITS & WIRING		FCG	,						
25	ROMEX 14 AWG	14/2/W/ground	FT	190						
	ROMEX 14 AWG	12/3/W/ground	FT	0						
	ROMEX 12 AWG	12/2/W/ground	FT	654						
	ROMEX 12 AWG	10/3/W/ground	FT	113						
	ROMEX 10 AWG	10/2/W/ground	FT	333						
	Romex 8 AWG	8/3/W/ground	FT	70						
	Romex 8 AWG	8/2/W/ground	FT							
_			FT	281						
	ROMEX 6 AWG Bare Copper Ground Wire 6 AWG	6/3/W/ground	FT	26						
	ELECTRICAL BOXES & CIRCUTES		ГІ							
_		000 4140	DCC							
	Panelboard -240V 1 Phase MLO	200 AMP	PCS	1						
	Circuit breaker	15 A	PCS	3						
	Circuit breaker	20 A	PCS	17						
	Circuit breaker	30 A	PCS	2						
	Circuit breaker	50 A	PCS	1						
	Circuit breaker	60 A	PCS	1						
	Single Gang Switch Box		PCS	11						
	Double Gang Switch Box		PCS	8						
	Triple Gang Switch Box	 	PCS	3						
	Pull Box	#1/4	PCS	54						
45	Receptacle Box		PCS	52						



Ember-3Bd2.5Ba-Craftsman									
	P	LUMBING SYSTEM I	MATERIAI						
Vo.	Item	Туре	Unit	Quantity	Unit Price	Total	Description		
<u> </u>	PLUMBING FIXTURES & ACCESSORIES		D00						
1	Bath Tub (Alcove Tub)		PCS	0					
2	Kitchen Sink Kitchen Faucets		PCS PCS	1					
4	Vanity Sink		PCS	1					
5	Bath room Faucets		PCS	2					
6	Water Closet		PCS	3					
7	Shower Trim		PCS	2					
8	Shower Tray		PCS	2					
9	Water Heater		PCS	1					
	Hose Bib		PCS	1					
11	Shutoff Valve		PCS	6					
	Hanging pipe clamp		PCS	26					
13	Gate Valve		PCS	1					
14	Dishwasher Supply Single Connector		PCS	1					
	Dishwasher Sewage Single Connector		PCS	1					
	Laundry Sweat Connector		PCS	1					
	SANITARY & PLUMBING PIPES	I	1 1 00	'					
1	ABS (Acrylonitrile Butadiene Styrene) Pipes	Ø 1"	FT	0					
	ABS (Acrylonitrile Butadiene Styrene) Pipes	ø 1 1/2"	FT	21					
3	ABS (Acrylonitrile Butadiene Styrene) Pipes	Ø 2"	FT	73					
4	ABS (Acrylonitrile Butadiene Styrene) Pipes	ø 3"	FT	87					
	PEX (Cross-linked polyethylene) Pipes	ø 1/2"	FT	221					
6	PEX (Cross-linked polyethylene) Pipes	ø 3/4"	FT	27					
	PEX (Cross-linked polyethylene) Pipes	ø 1"	FT	3					
8	PVC Pipes Sch.80 - Rigid	ø 1 1/2"	FT	0					
9	PVC Pipes Sch.80 - Rigid	ø 2"	FT	99					
	PVC Pipes Sch.80 - Rigid	ø 3"	FT	0					
	Flex Pipe Round	ø 1/2"	PCS	8					
	Flex Pipe Round	ø 3/4"	PCS	0					
	Flex Pipe Round	ø 1"	PCS	0					
	PIPE FITTINGS	, .	1 00						
	PEX 90 Deg Elbow	1/2"ø-1/2"ø	PCS	2					
	PEX 90 Degree Elbow	1/2"ø-1/2"ø	PCS	21					
3	PEX 90 Degree Elbow	3/4"ø-3/4"ø	PCS	3					
4	PEX Tee Elbow	1/2"ø-1/2"ø-1/2"ø	PCS	8					
5	PEX Tee Elbow	3/4"ø-3/4"ø-3/4"ø	PCS	2					
6	PEX Transition Elbow	1"ø-3/4"ø	PCS	2					
7	PEX Transition Elbow	3/4"ø-1/2"ø	PCS	1					
	PEX 90 Degree Elbow	1/2"ø-1/2"ø	PCS	16					
9	PEX 90 Degree Elbow	3/4"ø-3/4"ø	PCS	3					
10	PEX Tee Elbow	1/2"ø-1/2"ø-1/2"ø	PCS	5					
11	PEX Transition Elbow	3/4"ø-1/2"ø	PCS	1					
	PVC 90 Deg Bend Elbow	2"ø-2"ø	PCS	39					
	ABS 90 Degree Bend Elbow	1 1/2"ø-1 1/2"ø	PCS	3					
	ABS 90 Degree Bend Elbow	2"ø-2"ø	PCS	1					
	ABS 90 Degree Bend Elbow	3"ø-3"ø	PCS	5					
	ABS P-Trap	2"ø-2"ø	PCS	1					
	ABS P-Trap	3"ø-3"ø	PCS	2					
	ABS Reducer Elbow	2"ø-1 1/2"ø	PCS	2					
	ABS Reducer Elbow	3"ø-1 1/2"ø	PCS	3					
	ABS Reducer Elbow	3"ø-2"ø	PCS	7					
	ABS TEE Elbow	1 1/2"ø-1 1/2"ø-1 1/2"ø	PCS	2					
	ABS TEE Elbow	2"ø-2"ø-2"ø	PCS	3					
	ABS TEE Elbow	3"ø-3"ø-3"ø	PCS	12					
	ABS Trap P	1 1/2"ø-1 1/2"ø	PCS	2					
	ABS Trap P	2"ø-2"ø	PCS	3					
	ABS Trap P	3"ø-3"ø	PCS	1					
	ABS Vent Cap Elbow	1 1/2"ø	PCS	1					
	ABS Vent Cap Elbow	2"ø	PCS	5					

	Ember-3Bd2.5Ba-Craftsman									
		HVAC SYSTEM MA	TERIAL	SHOPP	ING LIST					
No.	Item	Туре	Unit	Quantity	Unit Price	Total	Description			
	HVAC_DUCTS									
1	PIPE (REFRIGERANT LINE)	3/8" (Ø)	FT	124.84						
2	PIPE (REFRIGERANT LINE)	3/4''' (Ø)	FT	171.56						
3	DRAYER HOSE	4" (Ø)	FT	10.2						
4	FLEX DUCT ROUND	4" (Ø)	FT	8.23						
<u></u>	DUCT FITTINGS & ACCESSORIES									
5	ELBOW (REFRIGERANT LINE)	1/2" (Ø)-1/2" (Ø)	PCS	1						
6	ELBOW (REFRIGERANT LINE)	3/4" (Ø)-3/4" (Ø)	PCS	30						
7	ELBOW (REFRIGERANT LINE)	3/8" (Ø)-3/8" (Ø)	PCS	25						
8	TEE (REFRIGERANT LINE)	3/4" (Ø)-3/4" (Ø)-3/4" (Ø)	PCS	4						
9	TEE (REFRIGERANT LINE)	3/8" (Ø)-3/8" (Ø)-3/8" (Ø)	PCS	3						
10	TRANSITION (REFRIGERANT	3/4" (Ø)-1/2" (Ø)	PCS	7						
11	TRANSITION (REFRIGERANT	3/4" (Ø)-5/8" (Ø)	PCS	4						
12	TRANSITION (REFRIGERANT	3/8" (Ø)-1/4" (Ø)	PCS	1						
	HVAC_EQUIPMENTS									
13	AIR HANDLING UNIT	WALL MOUNTED	PCS	4						
14	CONDENSER	OUTDOOR UNIT	PCS	1						
15	EXHAUST FAN	75 CFM	PCS	3						
16	EXHAUST HOOD	WALL MOUNTED	PCS	1						
17	HOOD-WALL: VENT	HOOD-WALL: VENT	PCS	1						
18	DRAYER: VENT	DRAYER: VENT	PCS	1						
19	ROOF VENT	3"(Ø)	PCS	3						



#### **Table Of Content**

#	Name	Link	Page	e No
1	Cover Page	<u>Cover Page</u>	1	L
2	TOC	TOC	2	2
3	ELECTRICAL BOM	ELECTRICAL BOM	3	3
5	HVAC BOM	HVAC BOM	7	7
4	PLUMBING BOM	PLUMBING BOM	10	0
6	ARCHITECTURAL BOM	ARCHITECTURAL BOM	1.	5

#### **Have It Your Way!**

The material types listed in this document were selected based on personal preferences. The Customer is encouraged to make changes to the material types in accordance with local customs, regulations, and personal preferences. Have It Your Way!

#### **GENERAL NOTES**

- This BOM (Bill of Materials) is prepared as a Materials Shopping List to help builders and DIYers gain a complete understanding of most if not all elements required for the complete construction of this structure, according to the original design documents provided by FrameUpNow.
- 2 All quantities and specifications are subject to change based on the final design, field measurements, availability of products and customer preferences. The customer should verify all information prior to purchasing materials.
- 3 All products and elements in the list shall conform to the International Residential Code (IRC), or any other local and international building codes, safety regulations, and standards that are applicable to the location of the structure.
- 4 If any changes are made by the customer to the list of materials specified in this document, the customer is responsible for assuring that the correct type and quantity of materials are utilized in accordance with local building codes.
- FrameUpNow, will not be held responsible for any misuse of this document, the products listed, or for deviations from the content that are made due to changes in specifications, pricing, availability, or customer preferences.
- The customer is advised to consult a qualified professional or technician prior to purchasing materials for specialized construction system items. Some items including but not limited to caseworks, doors and windows may require as built measurements prior to purchase to confirmation of final dimensions.
- 7 If there are additional trim elements or specific installation methods, the total amount of materials needed might vary. Consider any additional trim required for corners, intersections, or other architectural details that might cause this variations before procedding to purchase and construction.



			LIGHTING FIXTURES			
#	Item	Туре	Description, Manufacturer, SKU	Unit	Quantity Unit	Price Total
1	Kitchen Ceiling Light			PCS	7	
3	Kitchen Wall Mounted Light			PCS	1	
4	Exterior Wall Mounted Light			PCS	8	
5	Livingroom Ceiling Light With Fan			PCS	1	
6	Bedroom Ceiling Light With Fan			PCS	3	
7	Dining Ceiling Light			PCS	4	
8	Bath Wall Mounted Light			PCS	4	
9	Bathroom Ceiling Light			PCS	8	
10	Livingroom Ceiling Light			PCS	4	
11	Bedroom Ceiling Light			PCS	12	
12	Hall & Entry Ceiling Light			PCS	4	
12	Garage Ceiling Light			PCS	4	
13	WIC Ceiling Light			PCS	2	
14	Exterior Ceiling Light			PCS	2	
15	Smoke Detector			PCS	5	



			ELECTRICAL FITTINGS			
#	Item	Туре	Description, Manufacturer, SKU	Unit	Quantity Unit P	rice Total
1	Standard Receptacle 120V	20A		PCS	17	
2	GFCI Receptacle 120V	20 A		PCS	31	
3	GFCI Receptacle 240V	30 A		PCS	2	
l	GFCI Receptacle 240V	50 A		PCS	1	
5	GFCI Receptacle 240V	60 A		PCS	1	
5	Fan Switch			PCS	4	
,	Single Pole Switch			PCS	16	
3	Three Way Switch			PCS	9	
)	Dimmer Switch			PCS	7	
.0				'		
1						
.2						
.3						
L4						
.5						



		ELECTR	ICAL CONDUITS & WIRING				
#	Item	Туре	Description, Manufacturer, SKU	Unit	Quantity	Unit Price	Total
1	ROMEX 14 AWG	14/2/W/ground		FT	190		
3	ROMEX 12 AWG	12/3/W/ground		FT	0		
4	ROMEX 12 AWG	12/2/W/ground		FT	654		
6	ROMEX 10 AWG	10/3/W/ground		FT	113		
8	ROMEX 10 AWG	10/2/W/ground		FT	333		
9	Romex 8 AWG	8/3/W/ground		FT	70		
10	Romex 8 AWG	8/2/W/ground		FT	281		
11	ROMEX 6 AWG	6/3/W/ground		FT	26		
12	Bare Copper Ground Wire 6 AWG			FT			
13							
14							
15							
16							



		ELEC	CTRICAL BOXES & CIRCUTES			
#	Item	Туре	Description, Manufacturer, SKU	Unit	Quantity Unit Pric	e  Total
1	Panelboard -240V 1 Phase MLO	200 AMP		PCS	1	
2	Circuit breaker	15 A		PCS	3	
3	Circuit breaker	20 A		PCS	17	
4	Circuit breaker	30 A		PCS	2	
5	Circuit breaker	50 A		PCS	1	
6	Circuit breaker	60 A		PCS	1	
7	Single Gang Switch Box			PCS	11	
8	Double Gang Switch Box			PCS	8	
9	Triple Gang Switch Box			PCS	3	
10	Pull Box	#1/4		PCS	54	
11	Receptacle Box			PCS	52	
12						
13						
14						
15						

			HVAC_DUCTS 01									
			Description, Manufacturer, SKU	Unit	Quantity	Unit Price	Total					
	PIPE (REFRIGERANT LINE)			FT	124.84							
2	PIPE (REFRIGERANT LINE)	3/4''' (Ø)		FT	171.56							
		4" (Ø)		FT	10.2							
4	FLEX DUCT ROUND	4" (Ø)		FT	8.23							
5												
6												
7												
8												
9												
10												
11												
12												
13												
14												
15												
16												

			DUCT FITTINGS & ACCESSORIES				
#	Item	Туре	Description, Manufacturer, SKU	Unit	Quantity	Unit Price	Total
1	ELBOW (REFRIGERANT LINE)	1/2" (Ø)-1/2" (Ø)		PCS	1		
2	ELBOW (REFRIGERANT LINE)	3/4" (Ø)-3/4" (Ø)		PCS	30		
3	ELBOW (REFRIGERANT LINE)	3/8" (Ø)-3/8" (Ø)		PCS	25		
4	TEE (REFRIGERANT LINE)	3/4" (Ø)-3/4" (Ø)-3/4" (Ø)		PCS	4		
5	TEE (REFRIGERANT LINE)	3/8" (Ø)-3/8" (Ø)-3/8" (Ø)		PCS	3		
6	TRANSITION (REFRIGERANT LINE)	3/4" (Ø)-1/2" (Ø)		PCS	7		
7	TRANSITION (REFRIGERANT LINE)	3/4" (Ø)-5/8" (Ø)		PCS	4		
8	TRANSITION (REFRIGERANT LINE)	3/8" (Ø)-1/4" (Ø)		PCS	1		
9							
10							
11							
12							
13							
14							
15							
16							

			HVAC_EQUIPMENTS				
#	Item	Туре	Description, Manufacturer, SKU	Unit	Quantity	<b>Unit Price</b>	Total
1	AIR HANDLING UNIT	WALL MOUNTED		PCS	4		
2	CONDENSER	OUTDOOR UNIT		PCS	1		
3	EXHAUST FAN	75 CFM		PCS	3		
4	EXHAUST HOOD	WALL MOUNTED		PCS	1		
5	HOOD-WALL: VENT	HOOD-WALL: VENT		PCS	1		
6	DRAYER: VENT	DRAYER: VENT		PCS	1		
7	ROOF VENT	3"(Ø)		PCS	3		
8							
9							
10							
11							
12							
13							
14							



		PLUMBIN	IG FIXTURES & ACCESSORIES				
#	Item	Туре	Description, Manufacturer, SKU	Unit	Quantity	Unit Price	Total
1	Bath Tub (Alcove Tub)			PCS	C		
2	Kitchen Sink			PCS	1		
3	Kitchen faucets			PCS	1		
4	Vanity Sink			PCS	2		
5	Bath room faucets			PCS	2		
6	Water Closet			PCS	3		
7	Shower Trim			PCS	2		
8	Shower Tray			PCS	2		
9	Water Heater			PCS	1		
10	Hose Bib			PCS	1		
11	Shutoff Valve			PCS	6		
12	Hanging pipe clamp			PCS	26		
13	Globe Valve			PCS	1		
14	Dishwasher Supply Single Connector			PCS	1		
15	Dishwasher Sewage Single Connector			PCS	1		
16	Laundry Sweat Connector			PCS	1		



		SANI	TARY & PLUMBING PIPES				
#	Item	Туре	Description, Manufacturer, SKU	Unit	Quantity	Unit Price	Total
1	ABS (Acrylonitrile Butadiene Styrene) Pipes	ø 1"		FT	0		
2	ABS (Acrylonitrile Butadiene Styrene) Pipes	ø 1 1/2"		FT	21		
3	ABS (Acrylonitrile Butadiene Styrene) Pipes	ø 2"		FT	73		
4	ABS (Acrylonitrile Butadiene Styrene) Pipes	ø 3"		FT	87		
5	PEX (Cross-linked polyethylene) Pipes	ø 1/2"		FT	221		
6	PEX (Cross-linked polyethylene) Pipes	ø 3/4"		FT	27		
7	PEX (Cross-linked polyethylene) Pipes	ø 1"		FT	3		
8	PVC Pipes Sch.80 - Rigid	ø 1 1/2"		FT	0		
9	PVC Pipes Sch.80 - Rigid	ø 2"		FT	99		
10	PVC Pipes Sch.80 - Rigid	ø 3"		FT	0		
11	Flex Pipe Round	ø 1/2"		FT	8		
12	Flex Pipe Round	ø 3/4"		FT	0		
13	Flex Pipe Round	ø 1"		FT	0		
14							
15							



		PI	PE FITTINGS 01				
#	Item	Туре	Description, Manufacturer, SKU	Unit	Quantity	Unit Price	Total
	PEX 90 Deg Elbow	1/2"ø-1/2"ø		PCS	2		
	PEX 90 Degree Elbow	1/2"ø-1/2"ø		PCS	21		
	PEX 90 Degree Elbow	3/4"ø-3/4"ø		PCS	3		
	PEX Tee Elbow	1/2"ø-1/2"ø-1/2"ø		PCS	8		
	PEX Tee Elbow	3/4"ø-3/4"ø-3/4"ø		PCS	2		
	PEX Transition Elbow	1"ø-3/4"ø		PCS	2		
	PEX Transition Elbow	3/4"ø-1/2"ø		PCS	1		
	PEX 90 Degree Elbow	1/2"ø-1/2"ø		PCS	16		
	PEX 90 Degree Elbow	3/4"ø-3/4"ø		PCS	3		
0	PEX Tee Elbow	1/2"ø-1/2"ø-1/2"ø		PCS	5		
1	PEX Transition Elbow	3/4"ø-1/2"ø		PCS	1		
2	PVC 90 Deg Bend Elbow	2"ø-2"ø		PCS	39		
3	ABS 90 Degree Bend Elbow	1 1/2"ø-1 1/2"ø		PCS	3		
4	ABS 90 Degree Bend Elbow	2"ø-2"ø		PCS	1		
5	ABS 90 Degree Bend Elbow	3"ø-3"ø		PCS	5		
		PI	PE FITTINGS 02				
ł	Item	Туре	Description, Manufacturer, SKU	Unit	Quantity	Unit Price	Total
	ABS P-Trap	2"ø-2"ø		PCS	1		



2	ABS P-Trap	3"ø-3"ø	PCS	2	
3	ABS Reducer Elbow	2"ø-1 1/2"ø	PCS	2	
4	ABS Reducer Elbow	3"ø-1 1/2"ø	PCS	3	
5	ABS Reducer Elbow	3"ø-2"ø	PCS	7	
6	ABS TEE Elbow	1 1/2"ø-1 1/2"ø-1 1/2"ø	PCS	2	
7	ABS TEE Elbow	2"ø-2"ø	PCS	3	
8	ABS TEE Elbow	3"ø-3"ø-3"ø	PCS	12	
9	ABS Trap P	1 1/2"ø-1 1/2"ø	PCS	2	
10	ABS Trap P	2"ø-2"ø	PCS	3	
11	ABS Trap P	3"ø-3"ø	PCS	1	
12	ABS Vent Cap Elbow	1 1/2"ø	PCS	1	
13	ABS Vent Cap Elbow	2"Ø	PCS	5	



			APPLIANCES				
#	Item	Туре	Description, Manufacturer, SKU	Unit	Quantity	Unit Price	Total
1	Refrigerator			PCS		1	
2	Range			PCS		1	
3	Washer Front Load	Stackable		PCS		1	
4	Dryer Front Load	Stackable		PCS		1	
5	Dish Washer			PCS		1	
6	Oven			PCS	(	)	
7	Microwave			PCS	(		
8							
9							
10							
11							
12							
13							
14							
15							
16							



			CASEWORKS 01				
#	Item	Туре	Description, Manufacturer, SKU	Unit	Quantity	Unit Price	Total
1	Kitchen Cabinet			FT	21.75		
2	Laundry Cabinet			FT	0		
3	Vanity Cabinet			FT	12.5		
4	Medicine Cabinet			PCS	4		
5	Kitchen countertop			SF	61.81		
6	Laundry Countertop			PCS	0		
7	Bathroom Countertop			SF	0		
8	Island			FT	8.3		
9	Peninsula			FT	0		
10	Closets			SF	308		
11							
12							
13							
14							
15							



	1		CEILING 01				
‡	Item	Туре	Description, Manufacturer, SKU	Unit	Quantity	Unit Price	Total
	LIVING ROOM AND KITCHEN	V		SF	702.0		
l	Ceiling Board	Drywall		SF	702		
	Drywall Fastener	Screw		PCS	1229		
3	Vapor Retarder	Polyethylene film		SF	702		
ļ	Vapor Retarder Fastener	Nails with washer heads		PCS	2106		
	BATHROOM 1			SF	54.0		
5	Ceiling Board	MRD (Moisture resistant drywall)		SF	54		
j	MRD Fastener	Screw		PCS	95		
	BATHROOM 2			SF	24.0		
7	Ceiling Board	MRD (Moisture resistant drywall)		SF	24		
3	MRD Fastener	Screw		PCS	42		
	GARAGE			SF	633.0		
)	Ceiling Board	Drywall		SF	633		
.0	Drywall Fastener	Screw		PCS	1108		
l1	Vapor Retarder	Polyethylene film		SF	633		
L2	Vapor Retarder Fastener	Nails with washer heads		PCS	1899		



			CEILING 02				
#	Item	Туре	Description, Manufacturer, SKU	Unit	Quantity	Unit Price	Total
	PORCH 1			SF	99.0		
13	Ceiling Board	Marine Plywood		SF	99		
14	Exterior Grade Plywood	Screw		PCS	173		
	PORCH 2			SF	50.0		
15	Ceiling Board	Marine Plywood		SF	50		
16	Exterior Grade Plywood	Screw		PCS	88		
	PORCH 3			SF	70.0		
17	Ceiling Board	Marine Plywood		SF	70		
18	Exterior Grade Plywood	Screw		PCS	123		
	W/C			SF	66.0		
19	Ceiling Board	Drywall		SF	66		
20	Drywall Fastener	Screw		PCS	116		
21	Vapor Retarder	Polyethylene film		SF	66		
22	Vapor Retarder Fastener	Nails with washer heads		PCS	198		



			CEILING 03				
#	Item	Туре	Description, Manufacturer, SKU	Unit	Quantity	Unit Price	Total
	CLOSET 1			SF	15.0		
23	Ceiling Board	Drywall		SF	15		
24	Drywall Fastener	Screw		PCS	26		
25	Vapor Retarder	Polyethylene film		SF	15		
26	Vapor Retarder Fastener	Nails with washer heads		PCS	45		
	CLOSET 2			SF	14.0		
27	Ceiling Board	Drywall		SF	14		
28	Drywall Fastener	Screw		PCS	25		
29	Vapor Retarder	Polyethylene film		SF	14		
30	Vapor Retarder Fastener	Nails with washer heads		PCS	42		
	CLOSET 3			SF	11.0		
31	Ceiling Board	Drywall		SF	11		
32	Drywall Fastener	Screw		PCS	19		
33	Vapor Retarder	Polyethylene film		SF	11		
34	Vapor Retarder Fastener	Nails with washer heads		PCS	33		



			CEILING 04				
#	Item	Туре	Description, Manufacturer, SKU	Unit	Quantity	Unit Price	Total
	CLOSET 4			SF	18.0		
35	Ceiling Board	Drywall		SF	18		
36	Drywall Fastener	Screw		PCS	32		
37	Vapor Retarder	Polyethylene film		SF	18		
38	Vapor Retarder Fastener	Nails with washer heads		PCS	54		
	L1			SF	6.0		
39	Ceiling Board	Drywall		SF	6		
40	Drywall Fastener	Screw		PCS	11		
<b>ļ</b> 1	Vapor Retarder	Polyethylene film		SF	6		
12	Vapor Retarder Fastener	Nails with washer heads		PCS	18		
	L2			SF	4.0		
13	Ceiling Board	Drywall		SF	4		
14	Drywall Fastener	Screw		PCS	7		
15	Vapor Retarder	Polyethylene film		SF	4		
16	Vapor Retarder Fastener	Nails with washer heads		PCS	12		



			CEILING 05				
#	Item	Туре	Description, Manufacturer, SKU	Unit	Quantity	Unit Price	Total
	MASTER BEDROOM			SF	216.0		
47	Ceiling Board	Drywall		SF	216		
48	Drywall Fastener	Screw		PCS	378		
49	Vapor Retarder	Polyethylene film		SF	216		
50	Vapor Retarder Fastener	Nails with washer heads		PCS	648		
	MASTER BATHROOM			SF	109.0		
51	Ceiling Board	MRD (Moisture resistant drywall)		SF	109		
52	MRD Fastener	Screw		PCS	191		
	W/D			SF	43.0		
53	Ceiling Board	Drywall		SF	43		
54	Drywall Fastener	Screw		PCS	75		
55	Vapor Retarder	Polyethylene film		SF	43		
56	Vapor Retarder Fastener	Nails with washer heads		PCS	129		



			CEILING 06				
#	Item	Туре	Description, Manufacturer, SKU	Unit	Quantity	Unit Price	Total
	HALL			SF	84.0		
57	Ceiling Board	Drywall		SF	84		
58	Drywall Fastener	Screw		PCS	147		
59	Vapor Retarder	Polyethylene film		SF	84		
60	Vapor Retarder Fastener	Nails with washer heads		PCS	252		
	BEDROOM 1			SF	116.0		
61	Ceiling Board	Drywall		SF	116		
62	Drywall Fastener	Screw		PCS	203		
63	Vapor Retarder	Polyethylene film		SF	116		
54	Vapor Retarder Fastener	Nails with washer heads		PCS	348		
	BEDROOM 2			SF	138.0		
55	Ceiling Board	Drywall		SF	138		
56	Drywall Fastener	Screw		PCS	242		
57	Vapor Retarder	Polyethylene film		SF	138		
68	Vapor Retarder Fastener	Nails with washer heads		PCS	414		



			FLOORING INTERIOR 01				
#	Item	Туре	Description, Manufacturer, SKU	Unit	Quantity	Unit Price	Total
	BEDROOM #1						
1	Bedroom Flooring			SF	199		
2	Wood underlay	Foam Pad Polyethylene		SF	199		
3	Vapor Retarder	Vapor Barrier Polyethylene		SF	199		
	BEDROOM#2						
4	Bedroom Flooring			SF	128		
5	Wood underlay	Foam Pad Polyethylene		SF	128		
6	Vapor Retarder	Vapor Barrier Polyethylene		SF	128		
	BEDROOM#3						
7	Bedroom Flooring			SF	108		
8	Wood underlay	Foam Pad Polyethylene		SF	108		
9	Vapor Retarder	Vapor Barrier Polyethylene		SF	108		
	CL#1						
10	Closet Flooring			SF	21		
11	Wood underlay	Foam Pad Polyethylene		SF	21		
12	Vapor Retarder	Vapor Barrier Polyethylene		SF	21		



	1		FLOORING INTERIOR 02				
#	Item	Туре	Description, Manufacturer, SKU	Unit	Quantity	Unit Price	Total
	CL#2						
13	Closet Flooring			SF			
14	Wood underlay	Foam Pad Polyethylene		SF			
15	Vapor Retarder	Vapor Barrier Polyethylene		SF			
	CL#3						
16	Closet Flooring			SF	Ç		
17	Wood underlay	Foam Pad Polyethylene		SF	Ç		
18	Vapor Retarder	Vapor Barrier Polyethylene		SF	Ç	)	
	CL#4						
19	Closet Flooring			SF	17	,	
20	Wood underlay	Foam Pad Polyethylene		SF	17	,	
21	Vapor Retarder	Vapor Barrier Polyethylene		SF	17	,	
	CL#5						
22	Closet Flooring			SF	6		
23	Wood underlay	Foam Pad Polyethylene		SF	6		
24	Vapor Retarder	Vapor Barrier Polyethylene		SF	6		



			FLOORING INTERIOR 03				
#	Item	Туре	Description, Manufacturer, SKU	Unit	Quantity	Unit Price	Total
	CL#6						
25	Closet Flooring			SF	10		
26	Wood underlay	Foam Pad Polyethylene		SF	10		
27	Vapor Retarder	Vapor Barrier Polyethylene		SF	10		
	CL#7						
28	Closet Flooring			SF	13		
29	Wood underlay	Foam Pad Polyethylene		SF	13		
30	Vapor Retarder	Vapor Barrier Polyethylene		SF	13		
	CL#8						
31	Closet Flooring			SF	14		
32	Wood underlay	Foam Pad Polyethylene		SF	14		
33	Vapor Retarder	Vapor Barrier Polyethylene		SF	14		
	LIVING ROOM AND KITCH	EN					
34	Living Area Flooring			SF	723		
35	Wood underlay	Foam Pad Polyethylene		SF	723		
36	Vapor Retarder	Vapor Barrier Polyethylene		SF	723		



			FLOORING INTERIOR 04				
#	Item	Туре	Description, Manufacturer, SKU	Unit	Quantity	Unit Price	Total
	GARAGE						
37	Epoxy top coat	Sealant high build resin coat		SF	565		
38	Flake coat	Anti-slip quartz aggregate coat		SF	565		
39	Primer coat	damp proof membrane		SF	565		
	BATHROOM#1						
40	Tile Finish			SF	78		
41	Adhesive	1/2" Thin set Mortar		SF	78		
42	Vapor Retarder	Vapor Barrier Polyethylene		SF	78		
	BATHROOM#2						
43	Tile Finish			SF	37		
44	Adhesive	1/2" Thin set Mortar		SF	37		
45	Vapor Retarder	Vapor Barrier Polyethylene		SF	37		



			FLOORING INTERIOR 05				
#	Item	Туре	Description, Manufacturer, SKU	Unit	Quantity	Unit Price	Total
	BATHROOM#3						
46	Tile Finish			SF	22		
47	Adhesive	1/2" Thin set Mortar		SF	22		
48	Vapor Retarder	Vapor Barrier Polyethylene		SF	22		
	W/D	,					
49	Tile Finish			SF	40		
51	Adhesive	1/2" Thin set Mortar		SF	40		
51	Vapor Retarder	Vapor Barrier Polyethylene		SF	40		



			FLOORING EXTERIOR 01			
#	Item	Туре	Description, Manufacturer, SKU	Unit	Quantity	Unit Price
	STRUCTURE			SF	2496.8	
1	Concrete Slab	4"concrete cast in situ		CF	832	
2	Insulation	Rigid insulation		SF	561	
3	Hard core	Compacted soil		CF	710	
4	Re-bar	#4 re-bar		Ton	2	
5	Concrete Pad	4"concrete cast in situ		CF	2	
6	Slab edge	Turndown		CF	528	
7	Footing #1	Cast-in-place concrete		CF	4.68	
8	Footing #2	Cast-in-place concrete		CF	10	
	PORCH FRONT					
9	Tile Finish			SF	153	
10	Adhesive	1/2" Thin set Mortar		SF	153	
11	Vapor Retarder	Vapor Barrier Polyethylene		SF	153	
			FLOORING EXTERIOR 02			



#	Item	Туре	Description, Manufacturer, SKU	Unit	Quantity	Unit Price
	PORCH BACK #1					
12	Tile Finish			SF	57	
13	Adhesive	1/2" Thin set Mortar		SF	57	
14	Vapor Retarder	Vapor Barrier Polyethylene		SF	57	
	PORCH BACK #2					
15	Tile Finish			SF	81	
16	Adhesive	1/2" Thin set Mortar		SF	81	
17	Vapor Retarder	Vapor Barrier Polyethylene		SF	81	



			WALLS: EXTERIOR				
#	Item	Туре	Description, Manufacturer, SKU	Unit	Quantity	Unit Price	Total
1	Exterior-Grade Plywood Horizontal Siding			SF	1859		
2	Exterior-Grade Plywood Fastener 8/panel	Self-drilling screws(100/pkt)		PKT	18.59		
3	Wall Shteathing (OSB)			SF	1859		
4	Shteathing Fastener	Self-drilling screws(100/pkt)		PKT	18.59		
5	Wall Homewrap			SF	1859		
6	Homewrap Fastener	Stapled fastener (200/pkt)		PKT	7.06		
7	Furring Strip			PCS	232.38		
8	Furring Strip Fastener	Self-drilling screws(100/pkt)		PKT	18.59		
9	Wall Paint			SF	1859		
10	Stone Copping	Masonry stone		SF	4		
11	Stone Veneer	Masonry stone		SF	32		
12	Mortar for Stone Veneer			SF	32		
13	Wall Insulation			SF	7144		



			WALLS: INTERIOR 01				
#	Item	Туре	Description, Manufacturer, SKU	Unit	Quantity	Unit Price	Total
	BATHROOM 1			SF	48.0		
1	Cementitious Backer Board			SF	268	}	
2	Kerdi membrane			SF	268	3	
3	Kerdi membrane Fastener			SF	268	3	
4	Wall Ceramic Tile			SF	268	3	
	BATHROOM 2			SF	50.0		
5	Cementitious Backer Board			SF	322		
6	Kerdi membrane			SF	322		
7	Kerdi membrane Fastener			SF	322		
8	Wall Ceramic Tile			SF	322		
	BEDROOM 1			SF	198.0		
9	Drywall Board			SF	513	3	
10	Drywall Fastener	Self-drilling screws(100/pkt)		PKT	5.13		
11	Wall Paint			SF	513		
12	Drywall Tape			FT	96.2		



			WALLS: INTERIOR 02				
#	Item	Туре	Description, Manufacturer, SKU	Unit	Quantity	Unit Price	Total
	BEDROOM 2			SF	128.0		
13	Drywall Board			SF	476		
14	Drywall Fastener	Self-drilling screws(100/pkt)		PKT	4.76		
15	Wall Paint			SF	476		
16	Drywall Tape			FT	89.3		
	KITCHEN			SF	148.0		
17	Cementitious Backer Board			SF	31		
18	Drywall Board			SF	238		
19	Drywall Fastener	Self-drilling screws(100/pkt)		PKT	2.38		
20	Kerdi membrane			SF	31		
21	Kerdi membrane Fastener			SF	31		
22	Wall Ceramic Tile			SF	31		
23	Wall Paint			SF	238		
24	Drywall Tape			FT	44.9		



			WALLS: INTERIOR 03				
#	Item	Туре	Description, Manufacturer, SKU	Unit	Quantity	Unit Price	Total
	BEDROOM 3			SF	107.0		
25	Drywall Board			SF	390		
26	Drywall Fastener	Self-drilling screws(100/pkt)		PKT	3.9		
27	Wall Paint			SF	390		
28	Drywall Tape			FT	73.2		
	LIVING ROOM			SF	324.0		
29	Drywall Board			SF	399		
30	Drywall Fastener	Self-drilling screws(100/pkt)		PKT	3.99		
31	Wall Paint			SF	399		
32	Drywall Tape			FT	74.8		
	CL 1	'		SF	10.0		
33	Drywall Board			SF	95		
34	Drywall Fastener	Self-drilling screws(100/pkt)		PKT	0.95		
35	Wall Paint			SF	95		
36	Drywall Tape			FT	17.8		



		WALLS: INTERIOR 04							
#	Item	Туре	Description, Manufacturer, SKU	Unit	Quantity	Unit Price	Total		
	CL 2			SF	15.0				
37	Drywall Board			SF	127				
38	Drywall Fastener	Self-drilling screws(100/pkt)		PKT	1.27				
39	Wall Paint			SF	127				
40	Drywall Tape			FT	23.8				
	CL 3			SF	15.0				
41	Drywall Board			SF	177				
42	Drywall Fastener	Self-drilling screws(100/pkt)		PKT	1.77				
43	Wall Paint			SF	177				
44	Drywall Tape			FT	33				
	CL 4			SF	19.0				
45	Drywall Board			SF	149				
46	Drywall Fastener	Self-drilling screws(100/pkt)		PKT	1.49				
47	Wall Paint			SF	149				
48	Drywall Tape			FT	28				



			WALLS: INTERIOR 05				
#	Item	Туре	Description, Manufacturer, SKU	Unit	Quantity	Unit Price	Total
	CL 5			SF	11.0		
49	Drywall Board			SF	134		
50	Drywall Fastener	Self-drilling screws(100/pkt)		PKT	1.34		
51	Wall Paint			SF	134		
52	Drywall Tape			FT	25		
	DINING			SF	144.0		
53	Drywall Board			SF	195		
54	Drywall Fastener	Self-drilling screws(100/pkt)		PKT	1.95		
55	Wall Paint			SF	195		
56	Drywall Tape			FT	37		
	ENTRY			SF	35.0		
57	Drywall Board			SF	74		
58	Drywall Fastener	Self-drilling screws(100/pkt)		PKT	0.74		
59	Wall Paint			SF	74		
60	Drywall Tape			FT	14		



			WALLS: INTERIOR 06				
#	Item	Туре	Description, Manufacturer, SKU	Unit	Quantity	Unit Price	Total
	GARAGE			SF	593.0		
61	Drywall Board			SF	661		
62	Drywall Fastener	Self-drilling screws(100/pkt)		PKT	6.61		
63	Wall Paint			SF	661		
64	Drywall Tape			FT	125		
	HALL			SF	63.0		
65	Drywall Board			SF	326		
66	Drywall Fastener	Self-drilling screws(100/pkt)		PKT	3.26		
67	Wall Paint			SF	326		
68	Drywall Tape			FT	62		
	HW			SF	43.0		
69	Drywall Board			SF	193		
70	Drywall Fastener	Self-drilling screws(100/pkt)		PKT	1.93		
71	Wall Paint			SF	193		
72	Drywall Tape			FT	36		



			WALLS: INTERIOR 07				
#	Item	Туре	Description, Manufacturer, SKU	Unit	Quantity	Unit Price	Total
	L1			SF	4.0		
73	Drywall Board			SF	66		
74	Drywall Fastener	Self-drilling screws(100/pkt)		PKT	0.66		
75	Wall Paint			SF	66		
76	Drywall Tape			FT	12.5		
	L2			SF	6.0		
77	Drywall Board			SF	92		
78	Drywall Fastener	Self-drilling screws(100/pkt)		PKT	0.92		
79	Wall Paint			SF	92		
80	Drywall Tape			FT	17		
	wc			SF	23.0		
81	Cementitious Backer Board			SF	154		
82	Kerdi membrane			SF	154		
83	Kerdi membrane Fastener			SF	154		
84	Wall Ceramic Tile			SF	154		



			WALLS: INTERIOR 08				
#	Item	Туре	Description, Manufacturer, SKU	Unit	Quantity	Unit Price	Total
	WD			SF	40.0		
85	Cementitious Backer Board			SF	180		
86	Kerdi membrane			SF	180		
87	Kerdi membrane Fastener			SF	180		
88	Wall Ceramic Tile			SF	180.0		
	WIC			SF	59.0		
89	Drywall Board			SF	276		
90	Drywall Fastener	Self-drilling screws(100/pkt)		PKT	2.76		
91	Wall Paint			SF	276		
92	Drywall Tape			FT	52		
1	Wall Skirting	Ceramic		FT	301		



			DOORS				
#	Item	Туре	Description, Manufacturer, SKU	Unit	Quantity	Unit Price	Total
1	Interior Swinging	3' - 0" X 6'-8"		PCS	6		
2	Exterior Swinging	3' - 0" X 6'-8"		PCS	2		
3	Interior Swinging	2' - 6" X 6'-8"		PCS	1		
4	Interior Swinging	3' - 0" X 6'-8"		PCS	2		
5	Patio Sliding	5' - 0" X 6'-8"		PCS	2		
6	Interior Sliding	7' - 0" X 6'-8"		PCS	1		
7	Interior Sliding	5' - 8" X 6'-8"		PCS	2		
8	Pocket Door	3' - 0" X 6'-8"		PCS	1	-	
9	Interior Sliding	5' - 4" X 6'-8"		PCS	1		
10	Folding	2 - 8" X 6'-8"		PCS	1		
11	Folding	1' - 8" X 6'-8"		PCS	1		
12	Interior Sliding	4' - 0" X 6'-8"		PCS	1		
13	Garage Door	16' - 0" X 6'-6"		PCS	1		
14	Exterior Door Trim			FT	109	)	
15	Interior Door Trim			FT	624		
16	Entry Lock set			PCS	52.		
17	Privacy Lock set			PCS	10		
18	Passage Lock set			PCS	7		



		WINDOWS							
#	Item	Туре	Description, Manufacturer, SKU	Unit	Quantity	Unit Price	Total		
1	Sliding	3' - 3" X 3'-3"		PCS	3				
2	Single Hung	2' - 9" X 3'-3"		PCS	8				
3	Sliding	5' - 3" X 3'-9"		PCS	4				
4	Exterior Window Trim			FT	210				
5	Interior Window Trim			FT	210				
6									
7									
8									
9									
10									
11									
12									
13									
14									
15									



			ROOF 01				
#	Item	Туре	Description, Manufacturer, SKU	Unit	Quantity	Unit Price	Total
1	Roof Covering			SF	3021.0		
2	Roof Covering Fastener			PCS	1511		
3	Roof Felt Paper			SF	3021.0		
4	Roof Felt Paper Fastener			PCS	9063.0		
5	Roof Sheathing			SF	3021.0		
6	Roof Sheathing Fastener			PCS	24168		
7	Batten			FT	0.0		
8	Batten Fastener			PCS	0.0		
9	Soffit			SF	294.0		
10	Soffit Fastener			PCS	147.0		
11	Fascia			FT	268.0		
12	Fascia board fastener			PCS	134		
13	Roof Insulation			SF	3021.0		
14							
15							