



EMBER

The Ember is a charming 3 bedroom 2.5 bathroom home design. Its exterior showcases classic farmhouse architectural elements with a touch of modern simplicity. The walls are finished with horizontal siding in a light, neutral tone. Multiple simple gable roofs provide shelter while a welcoming covered porch extends from the main entrance, supported by slender white columns and featuring white railings.

Inside, the Ember features an L-shape layout. The living and kitchen areas are merged into one large room at the center of the house. The bedrooms are arranged on both sides of the living area, offering privacy. The garage protrudes from the main house, completing the L-shape and providing convenient parking.

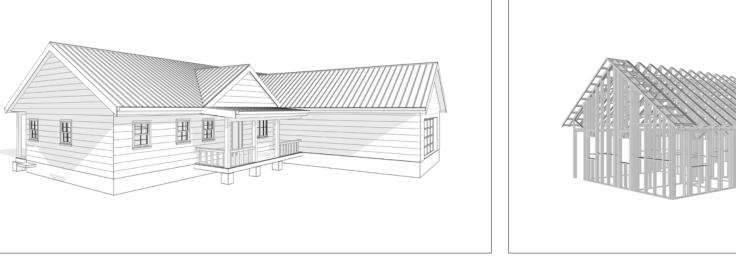


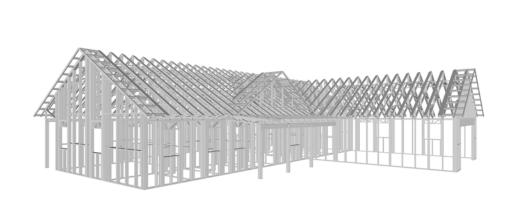

Materials Shopping List

Please print and take this Materials Shopping List to your favorite Home Depot and ask for assistance in selecting the materials, fixtures and fittings to complete your new home.

Record your selection and the price of the item. Then do the math to determine the cost for your selections and the total cost of finishing your home.

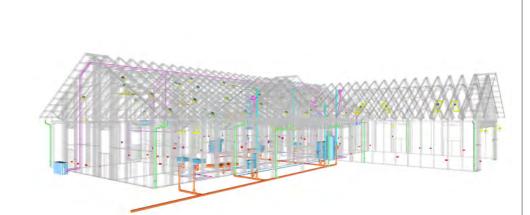

< CLICK HERE >

To Go To Materials Shopping List





FLOOR PLAN

1650 SF

3 Bed Rooms



PLUMBING

ARCHITECTURAL

STRUCTURAL

MATERIALS SHOPPING LIST

DISCLAIMER

marketing content.

DISCLAIMER: This documentation and all it's contents are the intellectual property of FrameUpNow. It is provided solely for marketing the services of FrameUpNow.

The preliminary information is not approved for actual construction use and is

not warranted to be complete or accurate. Unauthorized copying, distribution, or application of these proprietary materials, in any form or format, is strictly prohibited. FrameUpNow assumes no liability for any issues arising from improper use of this

TABLE OF CONTENTS

RENDERINGS	ABOUT THE HOME -	— 0 1
1	RENDERINGS -	— 0 1
FLOOR PLAN	SCHEMATIC FLOOR PLAN	— 0 1
1	HOME SPECS -	— 0 1
	DISCLAIMER -	— 01
ABOUT	ABOUT FrameUpNow ⊢	— 0 1
1	ABOUT HouseDocs -	— 01
DESCRIPTIONS	BOM (Bill Of Materials) ⊢	O2
2	STRUCTURAL -	 02
	ARCHITECTURAL	— 0 2
	MECHANICAL -	— O2
	ELECTRICAL	— 0 2
	PLUMBING -	02
MATERIALS LIST	MATERIALS LIST PREVIEW	─ 02

HOW TO BUILD CONSTRUCTION STEPS

COVER SHEET 03 FLOOR PLAN + DIMENSION PLAN + FOUNDATION PLAN STRUCTURAL FLOOR PLAN -WALL FRAME LAYOUT ROOF TRUSS LAYOUT ROOF PLAN + ARCHITECTURAL ELEVATIONS ARCHITECTURAL ELEVATIONS -ARCHITECTURAL SECTIONS -ARCHITECTURAL DETAILS

ARCHITECTURAL CASEWORK **COVER SHEET GENERAL NOTES** WALL FRAME LAYOUT WALL PANEL & LAYOUT PLAN 19 ROOF TRUSS LAYOUT 20 STRUCTURAL SECTIONS 21 WALL BRACING LAYOUT HOLD-DOWN PLAN STRUCTURAL DETAILS 1 **STRUCTURAL DETAILS 2 STRUCTURAL DETAILS 3 27** TRUSS BLOCKING LAYOUT 28 SHEETROCK BACKING 1 **ROOF BRACING LAYOUT** 29

MECHANICAL COVER SHEET 30 HVAC PLAN 31 **ELECTRICAL** SCHEDULE 32 LIGHTING POWER PLAN 34

> NOTES AND SCHEDULES WATER SUPPLY & SEWAGE SYSTEM # 38

DIMENSION FOR LIGHTING

DIMENSION FOR FITTING

MATERIALS SHOPPING LIST

ABOUT



FrameUpNow is a design and manufacturing company providing precision-engineered home framing solutions. We offer a catalog of Affordable Homes, Tiny Homes, Garages, Shops and Barndominiums. FrameUpNow manufactures cold-formed steel (CFS) also known as Light Gauge Steel (LGS) framing components that conform to our engineered metal house frame plans or can be purchased as DIY skeleton kits.

The CFS/LGS framing is lightweight, easily assembled, and does not require heavy equipment or specialized labor, enabling homeowners to erect the frame themselves in just a few days. Unlike wood, the steel framing is impervious termites and bores, warping, expansion, and fire.

Our home plans come complete with a structural engineered stamp for permit approvals. Customers receive a full BOM also known as a Materials Shopping List to purchase finish materials from a Building Materials retailer. FrameUpNow prides itself on the quality and efficiency of our precision-engineered home framing solutions for construction professionals and DIY homeowners.



KEY PLAN

NO.	DESCRIPTION	DATE
	•	

NOTE:

LEGEND:

PROJECT

247-Ember-1650-3Bd 2.5Ba-Farmhouse-550

DRAWING NAME

INTRODUCTION

CLIENT NAME:
PROJECT NUMBER:
DATE:
DESIGNED BY:
DRAWN BY:
CHECKED BY:

I101

SCALE:

© [2024] [FrameUpNow] . All rights reserved

DESCRIPTIONS

MATERIALS LIST

The BOM (Bill Of Materials) package, known as the Materials Shopping List document, provides:

Comprehensive Inventory: Detailed lists of essential materials sourced from architectural, mechanical, HVAC, electrical, and plumbing design drawing sets.

Precise Curation: Each item meticulously selected and organized for accuracy and efficiency in project planning.

Customizable Options: Customers can modify listed items to their preferences and calculate costs accordingly, ensuring alignment with personal project needs and budget.

Dedicated Space for Details: Includes tables for customers to note Home Depot SKU numbers or product descriptions for selected items, facilitating seamless purchasing and coordination with suppliers.

Customer Convenience: Take the list to Home Depot or preferred suppliers for accurate pricing, helping align the total home budget with personal financial plans.

Simplify your construction journey with our Materials Shopping List document, where detailed preparation meets streamlined implementation for your dream home.

STRUCTURAL

The structural drawings package provides an exhaustive set of detailed plans essential for the precise assembly of your building. This comprehensive package includes:

Framing Plans: Detailed layouts for all framing components. Truss Layouts: Clear instructions for truss placement and

Panel Length Plans: Specifications for panel dimensions. Framing Elevations and Sections: Precise elevation and sectional views for accurate construction.

Truss and Wall Blocking Plans: Plans for truss and wall blocking to ensure structural integrity.

Hold-Down Plan: Detailed hold-down requirements for stability. Snap Sheet: Reference sheet for quick identification of components

Structural Details and Bracing Plans: Complete details and bracing plans for all structural elements.

Accompanying these plans is a comprehensive Bill of Materials (BOM) that lists every necessary building component, from cold formed steel (CFS) frames to fasteners.

ARCHITECTURAL

With the comprehensive architectural package, both builders and DIY homeowners can confidently execute the construction.

The architectural package includes:

Furnished Floor Plans: Complete with furniture layouts for a clear understanding of space utilization.

Detailed Dimension Plans: Ensures precise measurements, from the overall footprint down to the exact placement of windows and

Foundation Plan: Detailed plan to establish a solid foundation.

Wall Framing and Truss Layout: Comprehensive plans for wall framing and truss placement.

Architectural Elevations: Exterior views showcasing the design.

Strategic Building Sections: Critical cross-sectional details for a thorough understanding of the build.

Casework Drawings and Diagrams: Suggested designs for built-in caseworks, such as kitchen cabinets.

MECHANICAL

The mechanical package includes everything needed to guide HVAC

Detailed HVAC Floor Plan: Precisely maps out the placement of air handlers, ductwork, and vents throughout the home's layout.

HVAC Sections and Riser Diagrams: Technical drawings offering critical cross-sectional details and piping schematics, ensuring proper integration of the heating and cooling system into the home's structure.

Bill of Materials: A complete list of all necessary HVAC components.

ELECTRICAL


The electrical package includes all the plans and documentation needed to guide the installation of your home's electrical system:

Detailed Power Plan: Precisely maps out the placement of outlets, switches, and other power components throughout the layout.

PLUMBING

The plumbing package includes everything needed to guide the installation of your home's water supply and drainage systems:

Detailed Water Supply System Plan: Precisely maps out the placement of pipes, valves, and plumbing fixtures throughout the

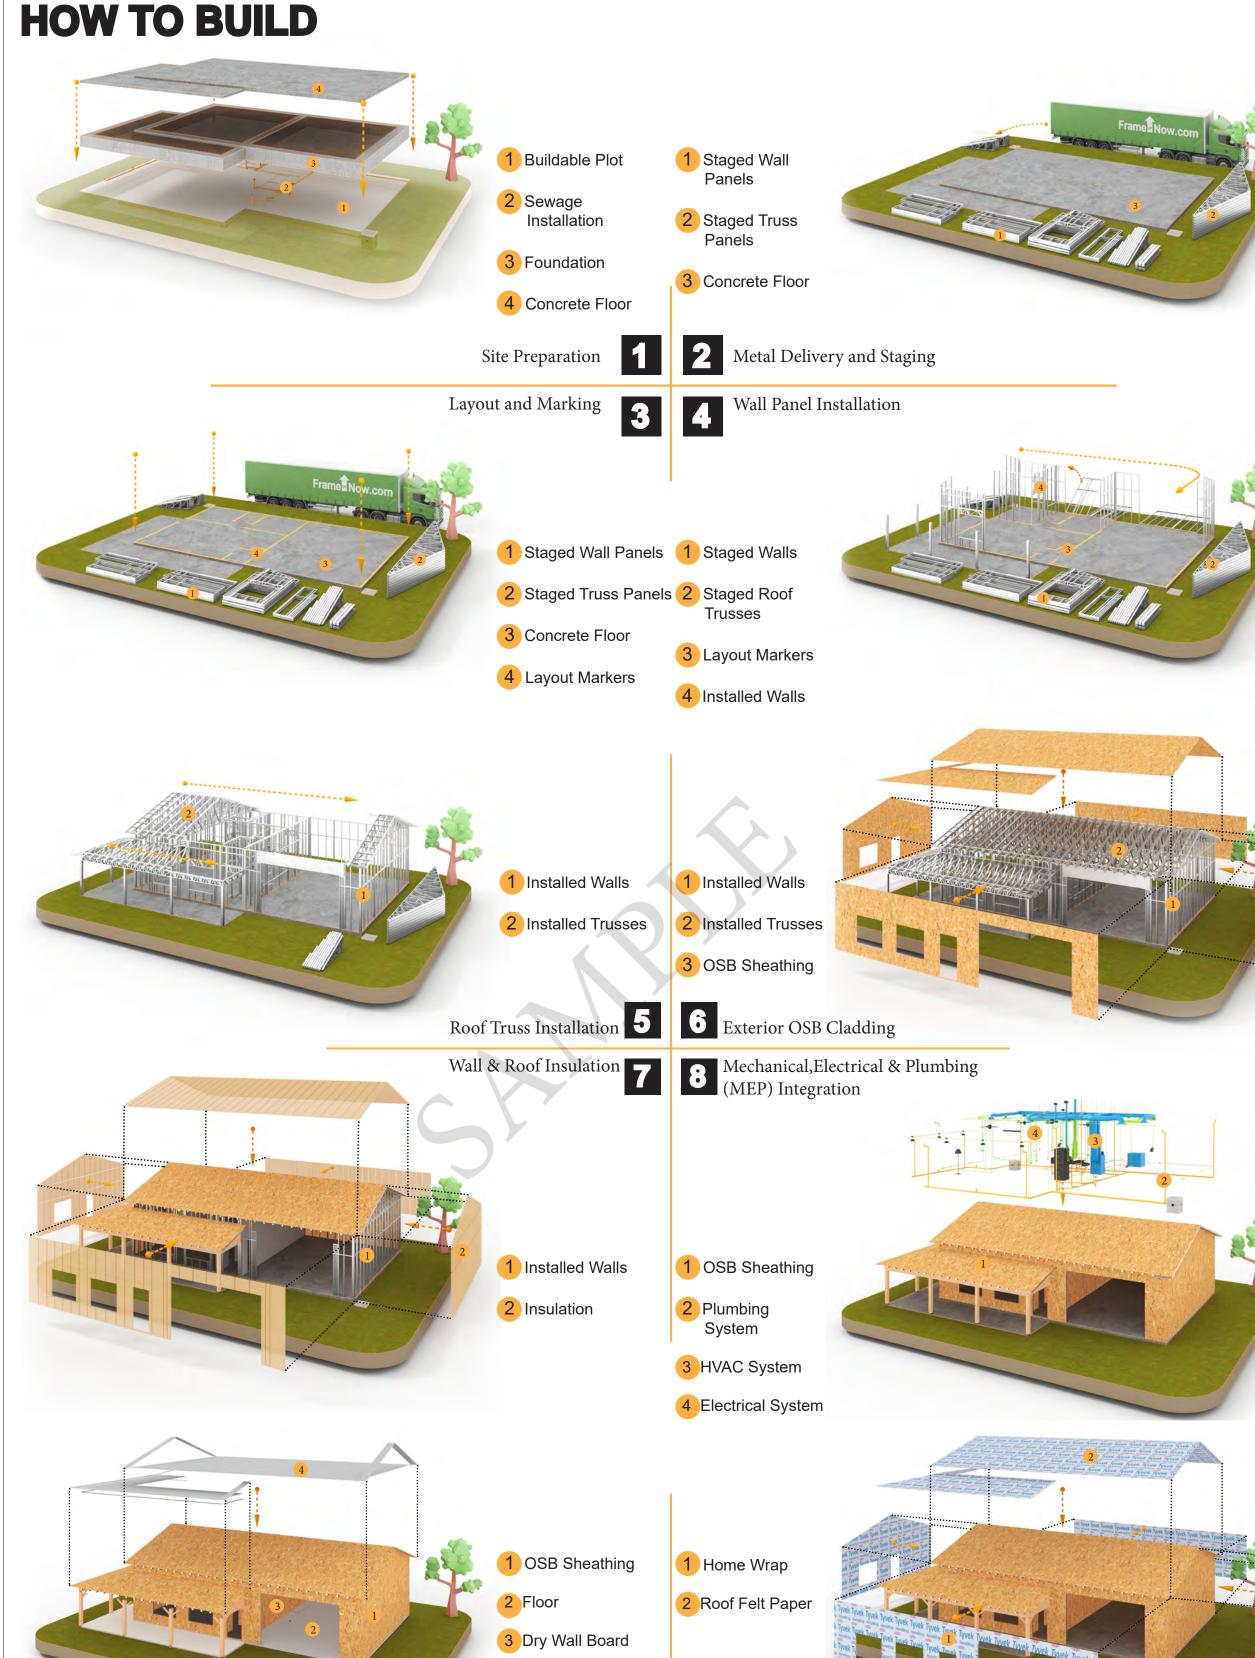

4 Ceiling Dry Wall

Corrugated

iron sheet

2 Home Wrap

3 Roof Felt Paper

4 Coronado Stone

5 Corrugated

iron sheet

ndows,Doors & Rain Gutters

Doors and

windows

2 Rain Gutters



KEY PLAN

NO.	DESCRIPTION	DATE

NOTE:

LEGEND:

PROJECT

247-Ember-1650-3Bd 2.5Ba-Farmhouse-550

DRAWING NAME


INTRODUCTION


CLIENT NAME: PROJECT NUMBER: DATE: **DESIGNED BY** DRAWN BY: CHECKED BY:

1102

SCALE:



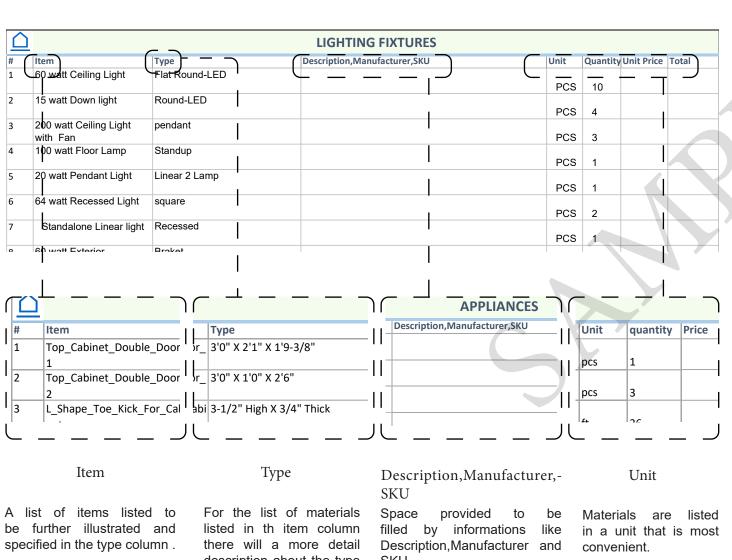

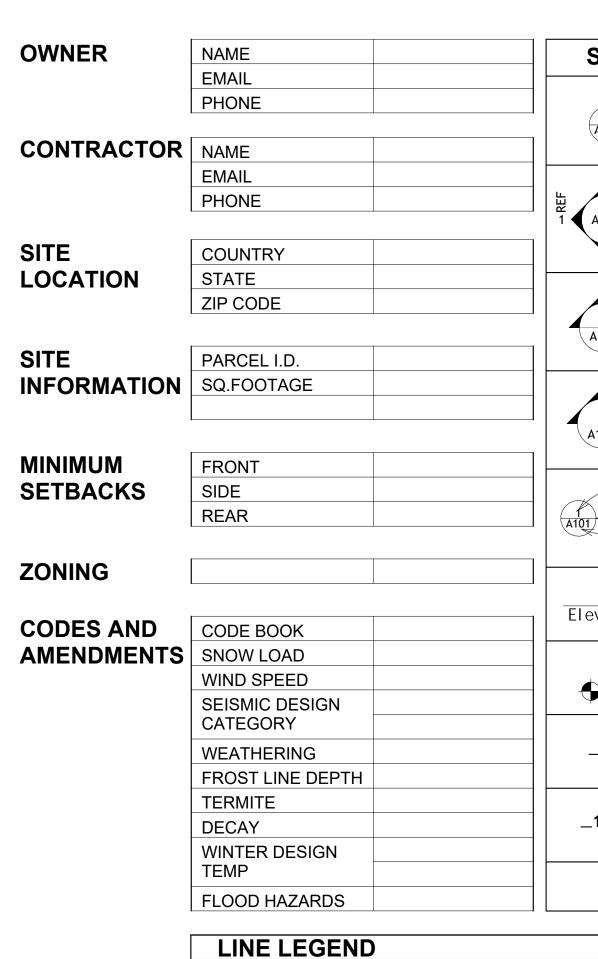

HIDDEN LINE

OVER HEAD

ROOM SEPARATOR

DOOR OPENING DIRECTION

SYMBOLS	SYMBOLS NAME		PAGE INDEX
VIEW		G101	COVER SHEET
NUMBER	0.44.04.74.74.7	A101	FLOOR PLAN
A101 SHEET	CALLOUT HEAD	A102	DIMENSION PLAN
NUMBER		S101	FOUNDATION PLAN
1 REF		S102	STRUCTURAL FLOOR PLAN
W NUMBER	R INTERIOR ELEVATION	S103	FRAME LAYOUT
$\begin{array}{ c c c c c c c c c c c c c c c c c c c$		S104	ROOF TRUSS LAYOUT
1 REF NUMBER		A103	ROOF PLAN
REF VIEW		A201	ELEVATIONS
NUMBER	BUILDING ELEVATION	A202	ELEVATIONS
A101		A301	SECTIONS
SHEET NUMBER		A401	DETAILS
VIEW	SECTION	A402	CASEWORK DETAILS
NUMBER		A403	CASEWORK DETAILS
A101		E101	SCHEDULE
SHEET NUMBER		E102	LIGHTING PLAN
VIEW		E103	POWER PLAN
NUMBER_	DETAIL MENA	E104	DIMENSION PLAN FOR LIGHT FIXTURE
SHEET	DETAIL VIEW	E105	DIMENSION PLAN FOR FITTING
NUMBER		P101	COVER SHEET
		P102	WATER SUPPLY SYSTEM
Name	ELEVATION LEVEL	P103	SEWAGE SYSTEM
Elevation		P104	RISER DIAGRAM
FLOOR		M101	HVAC PLAN
LEVEL	SPOT ELEVATION	M102	HVAC SECTION
-0 '-2"	J. J	M103	DISED DIACDAM

FLOOR SLOPE

ROOF SLOPE

CALL OUT BOUNDRY — - — - — - —

ROOF SLOPE ELEVATION

TAG	TAG'S NAME
CA01	CASEWORK TAG
1	DOOR TAG
<u> 1</u>	FURNITURE TAG
<u>(1)</u>	WINDOW TAG
SE01	SPECIALTY EQUIPMENT TAG
ME01	MECHANICAL EQUIPMENT TAG
PE01	PLUMBING EQUIPMENT TAG

M103 RISER DIAGRAM



- FLOOR SLOPE

SLOPE

ROOF SLOPE


SLOPE

CUT LINE

GROUND CUT

DIRECTION

DIRECTION

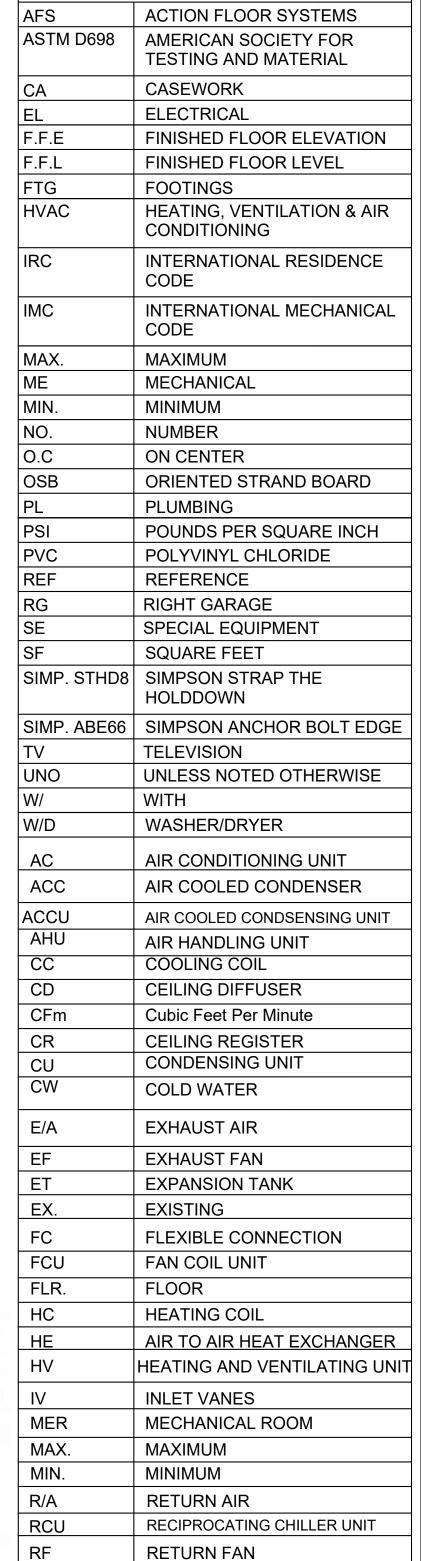


SUPPLY AIR


STATIC PRESSURE


SMOKE CONTROL DAMPER

SCD

ABBREVIATION

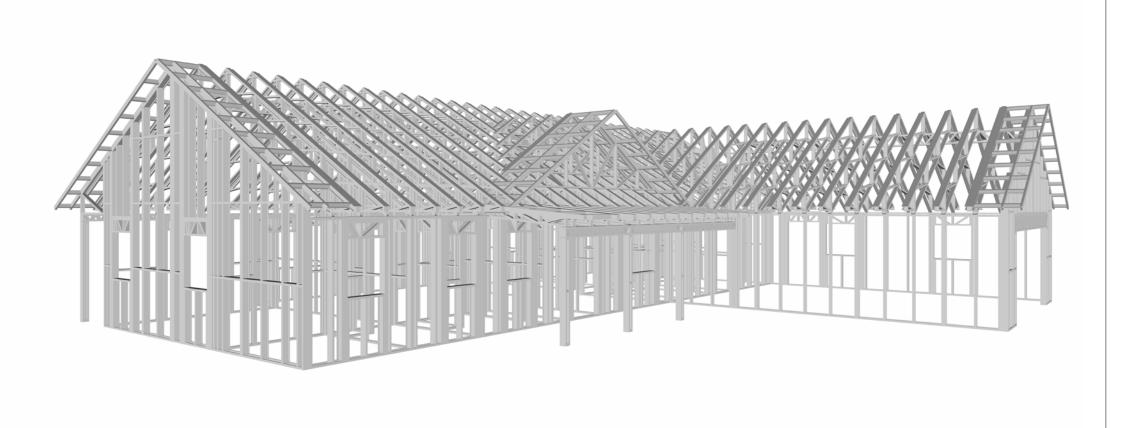

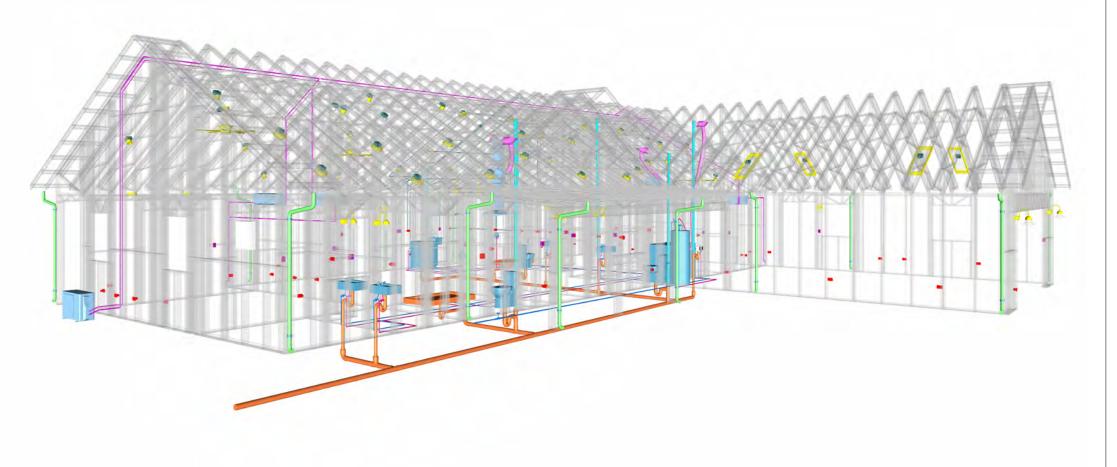

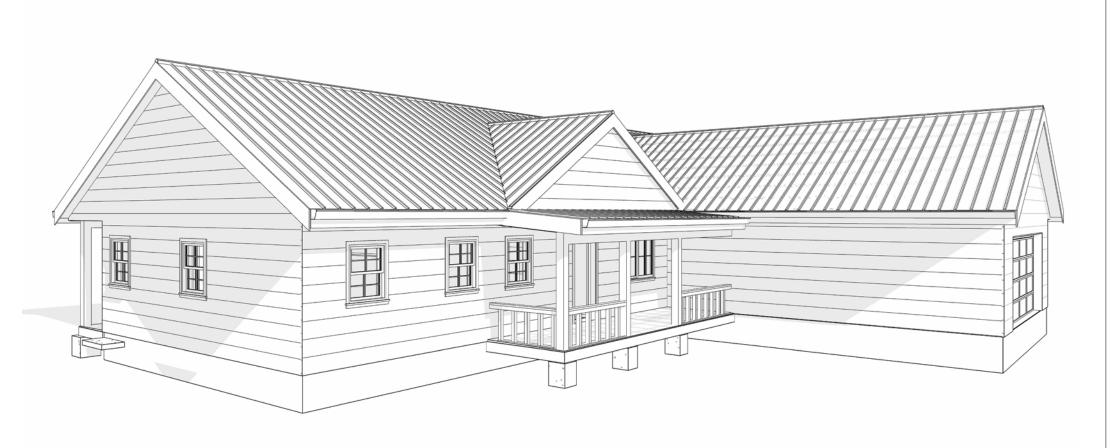

247-EMBER-1650-3Bd2.5Ba **FARMHOUSE-550**

SQUARE FOOTAGE			
LIVING	1650		
GARAGE	620		
PORCH	282		
TOTAL	2552		



KEY PI	LAN		
	<u>-</u>		
PERSPECT	IVE GLE		
NO.	DESCRIPT	ION	DA

NO.	DESCRIPTION	DATE
	·	

NOTE:

LEGEND:

PROJECT

247-EMBER-1650-3Bd2.5Ba **FARMHOUSE-550**

DRAWING NAME

COVER SHEET

CLIENT NAME:	Client Name
PROJECT NUMBER:	0061_12
DATE:	5/9/2025 3:44:27 PM
DESIGNED BY:	Designer
DRAWN BY:	Author
CHECKED BY:	Checker

G101

GENERAL NOTES

- THIS DRAWING DEPICTS THE ARCHITECTURAL (SPACE LAYOUT, FURNISHING, FLOOR, WALLS, ROOFS, FOUNDATION, WINDOWS AND DOORS) SYSTEMS. IT PROVIDES A VISUAL REPRESENTATION OF THE ARCHITECTURAL LAYOUT AND COMPONENTS.
- THE ARCHITECTURAL DRAWINGS ARE PREPARED TO MEET THE SPECIFIC REQUIREMENTS OF THE BUILDING, AS PER THE PROJECT SPECIFICATIONS AND APPLICABLE CODES AND STANDARDS.
- THE CONSTRUCTION OF THIS HOME SHALL COMPLY WITH THE LATEST EDITION OF THE INTERNATIONAL RESIDENTIAL CODE (IRC), INTERNATIONAL MECHANICAL CODE (IMC), THE INTERNATIONAL PLUMBING STANDARD, THE NATIONAL ELECTRICAL STANDARD AND ALL OTHER APPLICABLE LOCAL, STATE, AND NATIONAL CODES AND REGULATIONS.
- COORDINATION WITH OTHER TRADES HAS BEEN DONE ON A DESIGN LEVEL. THIS DRAWING SHALL BE READ TOGETHER WITH THE ME, EL AND PL DESIGN DRAWINGS TO ENSURE PROPER CONSTRUCTION AND INTEGRATION OF THE BUILDING SYSTEMS.

ABOUT WALLS:


- SHOWER WALL COVERING
- BATHTUB AND SHOWER SPACES (WALLS AND FLOORS) WITH INSTALLED SHOWER HEADS AND IN SHOWER COMPARTMENTS SHALL BE FINISHED WITH A NON-ABSORBENT SURFACE.
- WALL PAINT (INTERNAL)
 - THE TYPICAL THICKNESS OF LATEX WALL PAINT IS 1/32 OF AN INCH FOR A SINGLE COAT. AND DOUBLE COAT (1/16") SHALL BE APPLIED FOR DURABILITY.

THE ADVISABLE TYPE OF ADHESIVE FOR THIS PROJECT IS **EPOXY ADHESIVES**BECAUSE THEY ARE KNOWN FOR THEIR HIGH STRENGTH, DURABILITY, AND RESISTANCE TO MOISTURE, CHEMICALS AND

REFER TO SHEETS A201 & A202 FOR GENERAL NOTES ON EXTERNAL FINISHING MATERIALS

ABOUT FLOORS:

- THE SPOT ELEVATION INDICATES THE FINISHED FLOOR ELEVATION.
- FINISHED FLOORS PER PLANS.
- FIELD VERIFY FOR DIMENSION DROP 4" FOR SHOWER AND BATHTUB USE.
- 1% SLOPE ON OUTDOOR BALCONIES FOR WATER RUN OFF.
- 2% SLOPE TOWARDS THE SHOWER DRAIN FOR SUFFICIENT DRAINAGE.
- 4" DROP AT THE DOOR LEADING TO EXTERIOR BALCONY FROM THE MAIN LIVING AREA.
- 5% SLOPE FOR GARAGE IS USED, WHICH SHOULD BE CHECKED WITH THE LOCAL GARAGING
- ZONING LAWS.

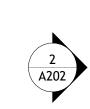

A301

FURNITURE SCHEDULE			
TYPE MARK	TYPE	COUNT	
0.4	KINO OIZE DED		
01	KING SIZE BED	3	
02	FOUR SIT 85" X 85"	1	
03	ONE SEAT SOFA	2	
04	COFFE TABLE	1	
05	DINING CHAIR	8	
06	TV STAND	1	

	ROOM FINISH SCHEDULE						
ROOM NUMBE R	ROOM NAME	FLOOR FINISH	BASE FINISH	WALL FINISH	CEILING FINISH	CEILING HEIGHT	COM MEN TS
01	ENTRY	HARDWOOD	CONCRETE	WALL PAINT	DRY WALL		
02	LIVING ROOM	HARDWOOD	CONCRETE	WALL PAINT	DRY WALL	8' - 0"	
03	KITCHEN	HARDWOOD	CONCRETE	WALL PAINT + CERAMIC	DRY WALL	8' - 0"	
04	DINING	HARDWOOD	CONCRETE	WALL PAINT	DRY WALL	8' - 0"	
05	BEDROOM 1	HARDWOOD	CONCRETE	WALL PAINT	DRY WALL	8' - 0"	
06	BEDROOM 2	HARDWOOD	CONCRETE	WALL PAINT	DRY WALL	8' - 0"	
07	BEDROOM 3	HARDWOOD	CONCRETE	WALL PAINT	DRY WALL	8' - 0"	
08	CL 1	HARDWOOD	CONCRETE	WALL PAINT	DRY WALL	8' - 0"	
09	CL 2	HARDWOOD	CONCRETE	WALL PAINT	DRY WALL	8' - 0"	
10	CL 3	HARDWOOD	CONCRETE	WALL PAINT	DRY WALL	8' - 0"	
11	CL 4	HARDWOOD	CONCRETE	WALL PAINT	DRY WALL	8' - 0"	
12	CL 5	HARDWOOD	CONCRETE	WALL PAINT	DRY WALL	8' - 0"	
13	BATH 1	VINYL TILES	CONCRETE	CERAMIC TILE	MRD	8' - 0"	
14	BATH 2	VINYL TILES	CONCRETE	CERAMIC TILE	MRD	8' - 0"	
15	WC	VINYL TILES	CONCRETE	CERAMIC TILE	DRY WALL	8' - 0"	
16	W/C	HARDWOOD	CONCRETE	WALL PAINT	DRY WALL	8' - 0"	
17	HALL	HARDWOOD	CONCRETE	WALL PAINT	DRY WALL	8' - 0"	
18	L 1	HARDWOOD	CONCRETE	WALL PAINT	DRY WALL	8' - 0"	
19	L 2	HARDWOOD	CONCRETE	WALL PAINT	DRY WALL	8' - 0"	
20	HW	VINYL TILES	CONCRETE	WALL PAINT	DRY WALL	8' - 0"	
21	WD	VINYL TILES	CONCRETE	CERAMIC TILE	DRY WALL	8' - 0"	
22	GARAGE	EPOXY	CONCRETE	WALL PAINT	DRY WALL	8' - 0"	
23	FRONT PORCH	PROCELAIN TILE	CONCRETE	EXTERIOR-GRADE PLYWOOD	PLYWOOD	8' - 0"	
24	BACK PORCH 1	PROCELAIN TILE	CONCRETE	EXTERIOR-GRADE PLYWOOD	PLYWOOD	8' - 0"	
25	BACK PORCH 2	PROCELAIN TILE	CONCRETE	EXTERIOR-GRADE PLYWOOD	PLYWOOD	8' - 0"	




A301 /



FLOOR PLAN 1/4" = 1'-0"



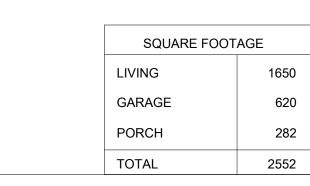



KEY PLAN

NO.	DESCRIPTION	DATE

NOTE:

LEGEND:

PROJECT

247-EMBER-1650-3Bd2.5Ba **FARMHOUSE-550**


DRAWING NAME

FLOOR PLAN

Client Name
0061_12
5/9/2025 3:44:30 PM
Designer
Author
Checker

A101

SCALE: 1/4" = 1'-0"

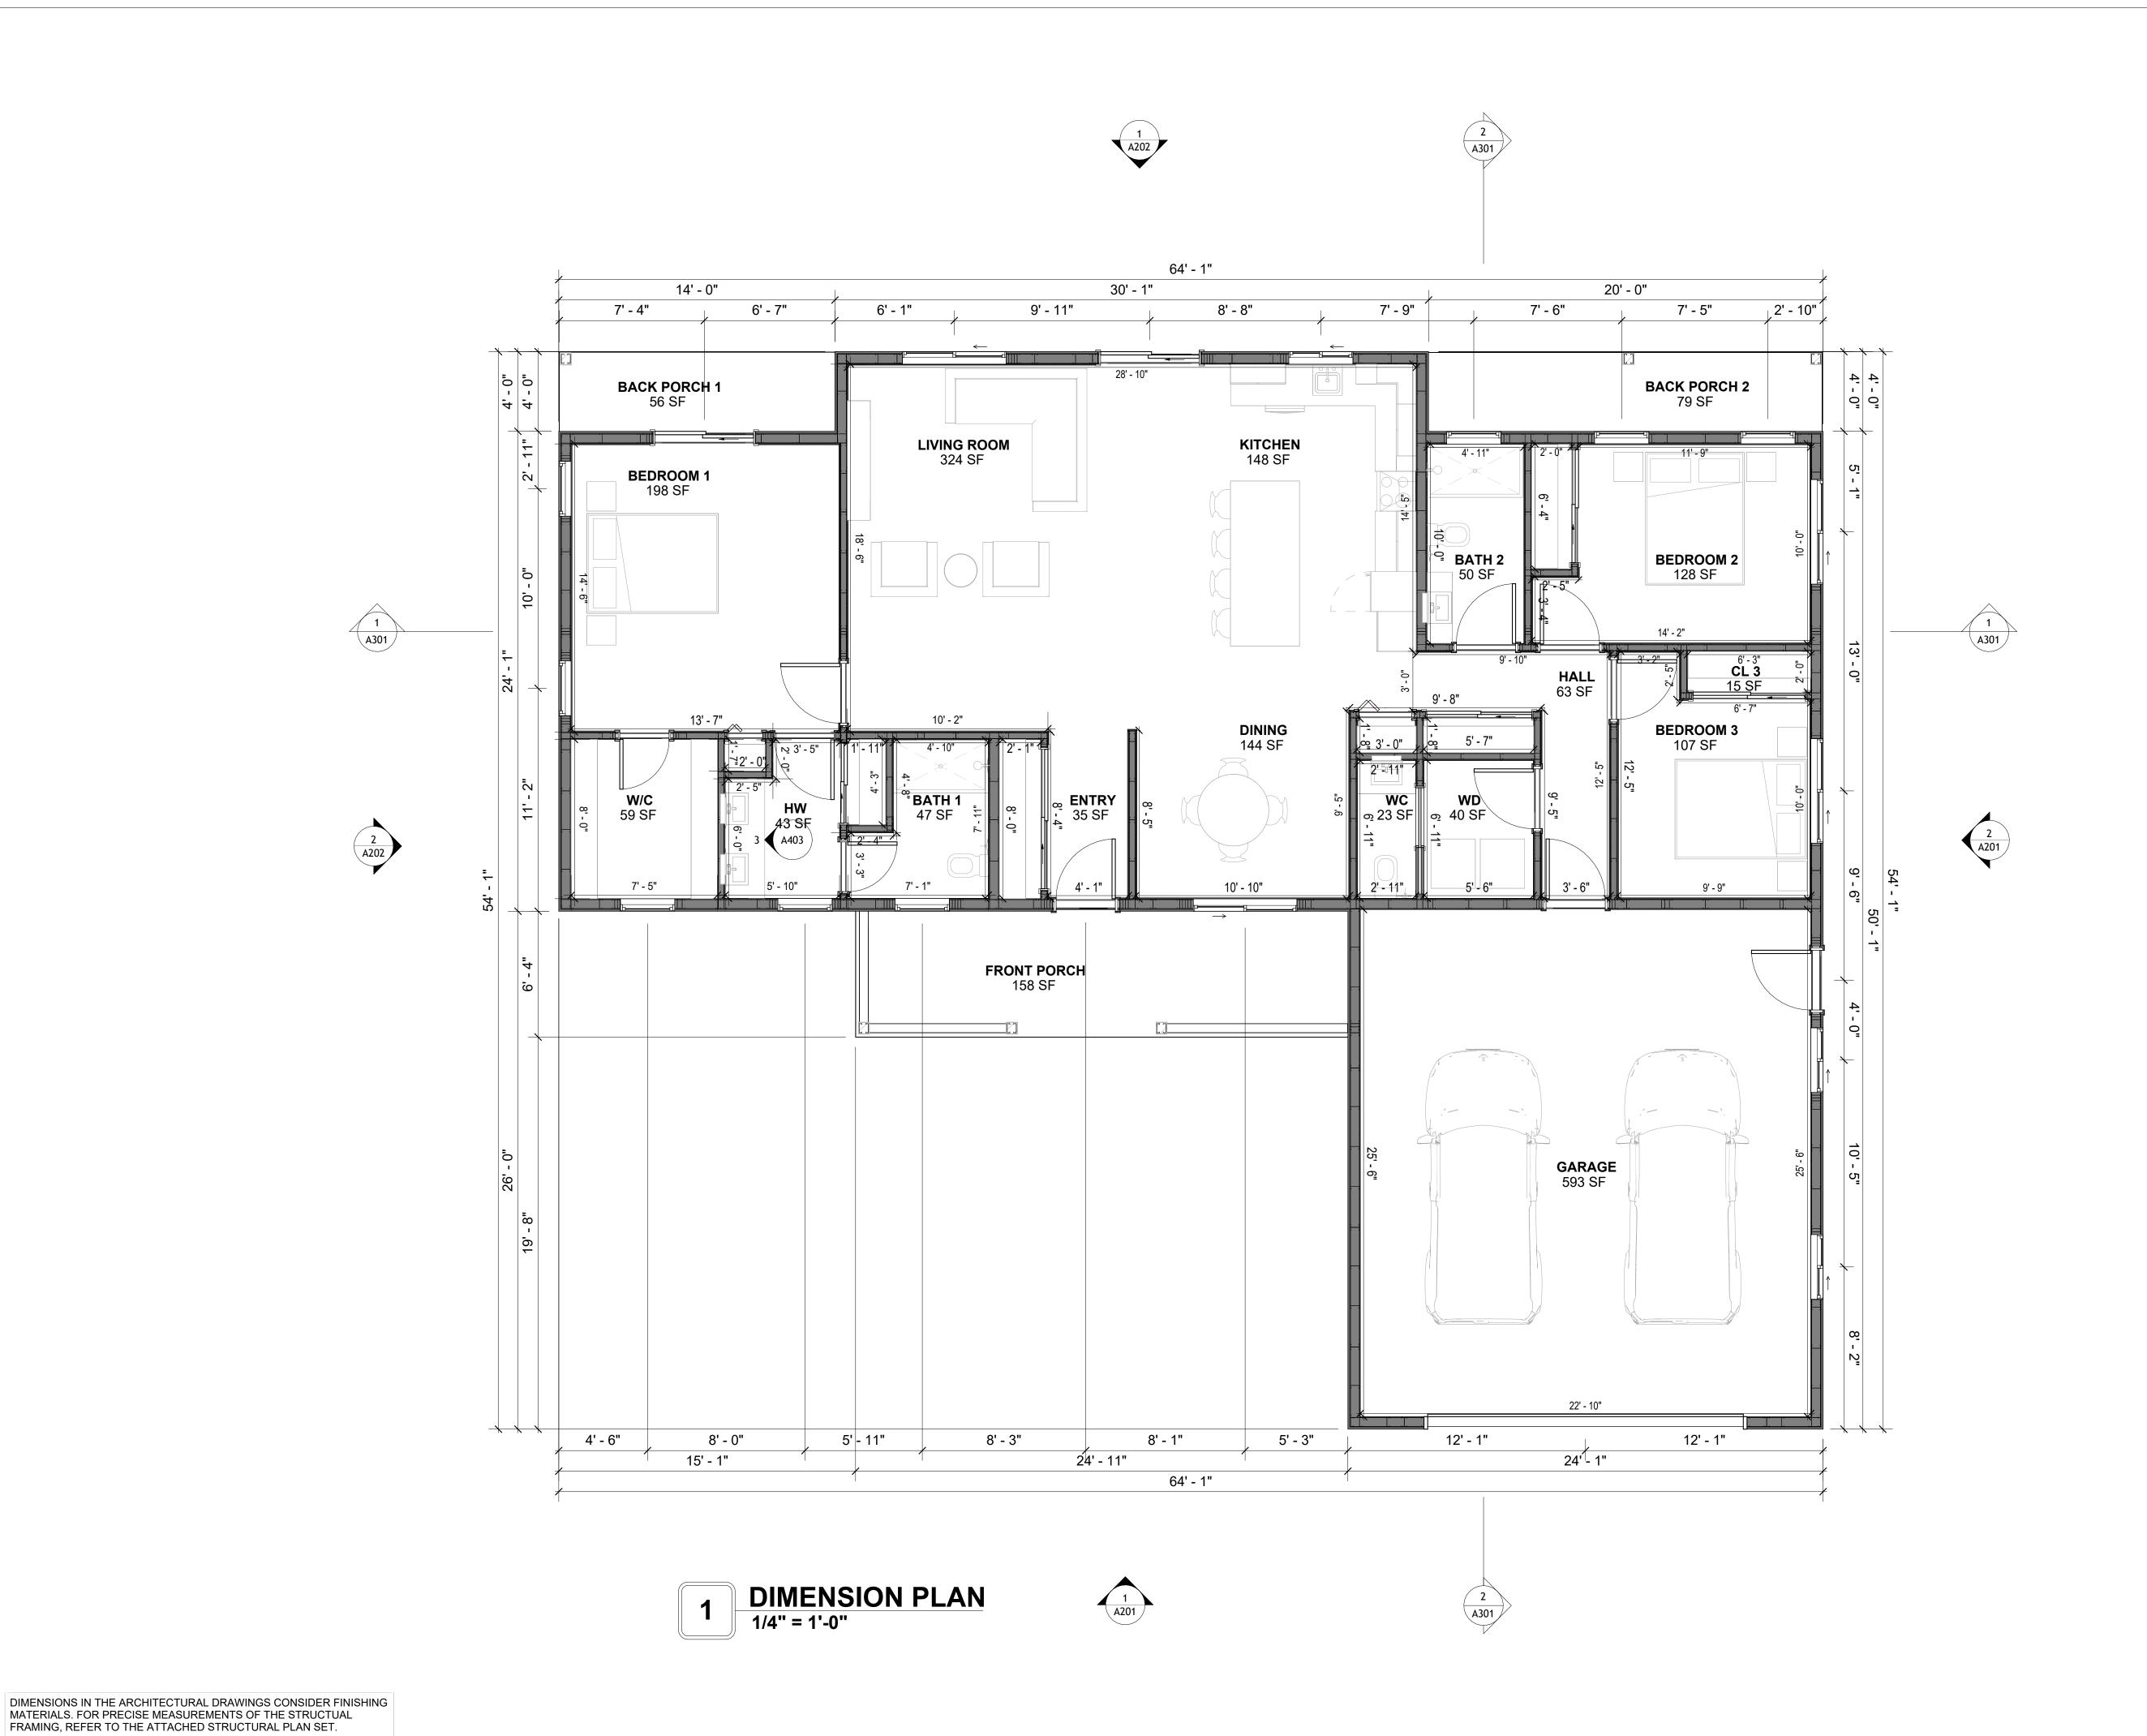



KEY PLAN

NO.	DESCRIPTION	DATE			

NOTE:

LEGEND:

PROJECT

247-EMBER-1650-3Bd2.5Ba **FARMHOUSE-550**

DRAWING NAME

DIMENSION PLAN

CLIENT NAME:	Client Name
PROJECT NUMBER:	0061_12
DATE:	5/9/2025 3:44:34 PM
DESIGNED BY:	Designer
DRAWN BY:	Author
CHECKED BY:	Checker

A102

SQUARE FOOTAGE 1650 GARAGE 620 PORCH 282 2552 TOTAL

FOUNDATION NOTES

TERMITES PRETREATMENT BY LICENSED CONTRACTOR UNDER SLAB AND AROUND FOOTINGS. ALL AREAS BELOW SLABS SHALL BE TREATED NO MORE THAN 24 HOURS PRIOR TO CONCRETE POUR. EVIDENCE OF TREATMENT MUST BE PROVIDED PRIOR TO PLACING OF CONCRETE.

ALL INTERIOR CONCRETE SLABS SHALL BE A MIN. OF 4" THICK CONCRETE OVER 4" COMPACTED AGGREGATE BASE (ASTM D698), FINISH ELEVATIONS AS NOTED ON DRAWINGS, 6" ABOVE ADJACENT GRADE, LEVEL SLABS TO 1/8"-10' MAX.. CONCRETE SLABS SHALL BE 2500# PSI AT 28 DAYS. A 4" ALLOWABLE SLUMP.

2. **PAD PREPARATION:**

- EXCAVATION FOR FOOTING SHALL BE NEAT.

- FOOTINGS SHALL BE POURED IMMEDIATELY AFTER EXCAVATION AND APPROPRIATE INSPECTION.
- ALL REINFORCING STEEL MARKED "CONTINUOUS" SHALL BE LAPPED 36 BAR DIAMETERS AT SPLICES AND AROUND CORNERS OR INTERSECTIONS WITH A STANDARD 90 DEGREE BEND ON CORNER BARS. LAP WIRE MESH ONE FULL MESH AT SIDE AND END LAPS.
- ALL HARDWARE TO BE SIMPSON OR EQUIVALENT. - EXTERIOR FRAME WALL TO BE SECURED WITH 1/2"X10" ANCHOR BOLTS 4'-0" O.C. FOR 1-STORY AND 2'-8" O.C. FOR 2-STORY. BOLTS SHALL BE LOCATED WITHIN 1'-0" OF EACH END
- PIECE AND SHALL HAVE A MIN. OF TWO BOLTS PER PIECE. -FOUNDATION ANCHOR STRAPS SHALL BE PERMITTED.ACCORDING TO RESIDENTIAL CODE
- ALL INTERIOR WALLS TO BE SECURED WITH POWER DRIVEN PINS PER MANUFACTURER SPECIFICATION USE PIN SPACING EQUIVALENT TO 1/2" ANCHOR BOLTS.
- ALL CONSTRUCTION TO CONFORM TO THE 2012 IRC
- R-10 RIGID INSULATION OUTSIDE OF EXTERIOR FOUNDATION WALLS UNDER LIVING AREA. CONCRETE PAD FOR CONDENSER THICKNESS IS 4" MIN UNLESS OTHERWISE NOTED.

3. CONCRETE CONSTRUCTION:

- THE SLAB SHALL BE UNDERLAIN BY A VAPOR BARRIER/RETARDER IN THE LIVING AREA (TYPICALLY POLYETHYLENE, UNLESS MORE STRINGENT PROTECTION REQUIRED BY THE ARCHITECT, ENGINEER, FLOOR COVERING MANUFACTURER, OR ACCEPTED PRACTICE). UNLESS OTHERWISE REQUIRED, BARRIER MAY BE OMITTED AT GARAGES, PORCHES AND PATIOS WITHOUT FLOOR COVERINGS. IT IS BEYOND THE SCOPE OF THESE PLANS TO DETERMINE THE APPLICABILITY OF THESE MORE STRINGENT REQUIREMENTS. BUILDER SHALL VERIFY PRIOR TO CONSTRUCTION.

4. REINFORCEMENT:


- IF CONSTRUCTED ON ACTIVE SOILS, THE LONG TERM PERFORMANCE OF THE FOUNDATION IS DEPENDENT ON MAINTENANCE BY THE OWNER. THUS THE BUILDER SHALL ADVISE THE OWNER OF THE FOLLOWING:

- 1. DRAINAGE MUST BE MAINTAINED. WATER SHALL NEVER BE ALLOWED TO POND NEAR THE FOUNDATION.
- 2. THE SOIL AROUND THE FOUNDATION SHALL BE MAINTAINED IN A RELATIVELY DAMP CONDITION, SUCH AS THAT REQUIRED TO KEEP A LAWN GREEN. IF IT DRIES OUT IT WILL SHRINK. IF IT GETS WET, IT WILL HEAVE UPWARD.
- SLABS ON THE SHORTER SIDE USES MAIN BARS ARE USED IN THIS DIRECTION ONLY WITH SMALLER DIAMETER DISTRIBUTION BARS ARE PLACED, FORMING A MAT OR GRID.
- 4. ALL REINFORCEMENT BARS SIZE 10MM OR LARGER IN ACCORDANCE TO ASTM ANCHOR BOLTS AT ALL EXTERIOR WALLS SHALL BE MINIMUM 1/2 INCH DIAMETER WITH A MAXIMUM SPACING OF 6'-0" ON CENTER, UNLESS NOTED OTHERWISE.
- 4. ANCHOR BOLTS SHALL BE INSTALLED WITHIN 12 INCHES OF EACH END OF EACH SILL PLATE WITH AT LEAST TWO ANCHOR BOLTS FOR EACH BOLTS FOR EACH SILL PLATE LONGER THAN 12 INCHES.
- 5. SIMPSONS SILL ANCHORS MAYBE SUBSTITUTED FOR ANCHOR BOLTS AT THE SAME SPACING.
- 6. EXTERIOR CONCRETE SLABS WHICH ARE NOT PART OF THE MAIN SLAB SHALL BE MINIMUM 4 INCHES THICK WITH NO STEEL REINFORCING BARS REQUIRED, UNLESS NOTED OTHERWISE ON FOUNDATION PLAN.

VERIFY THE FOLLOWING PRIOR TO POURING:

- ALL HOLDDOWNS, STRAP, AND POST LOCATIONS.
- CONCRETE FINISHES. PANEL RISER LOCATION WHERE APPLICABLE.
- 3. UNDERSLAB MECHANICAL REQUIREMENTS. 4. STEM WALL BLOCKOUTS.
- 5. UNDERSLAB ELECTRICAL REQUIREMENTS AND PANEL RISER LOCATION. WHERE **APPLICABLE**
- 6. PROVIDE THE FOLLOWING:
- PVC SLEEVES THROUGH FTG IF REQUIRED
- 20' #4 COPPER GROUND BAR.
- 7. SLOPE FINISH GRADE AWAY FROM FOOTING.

NOTE: FIELD VERIFY ALL DIMENSIONS SEE DIMENSIONED ARCHITECTURAL DRAWINGS

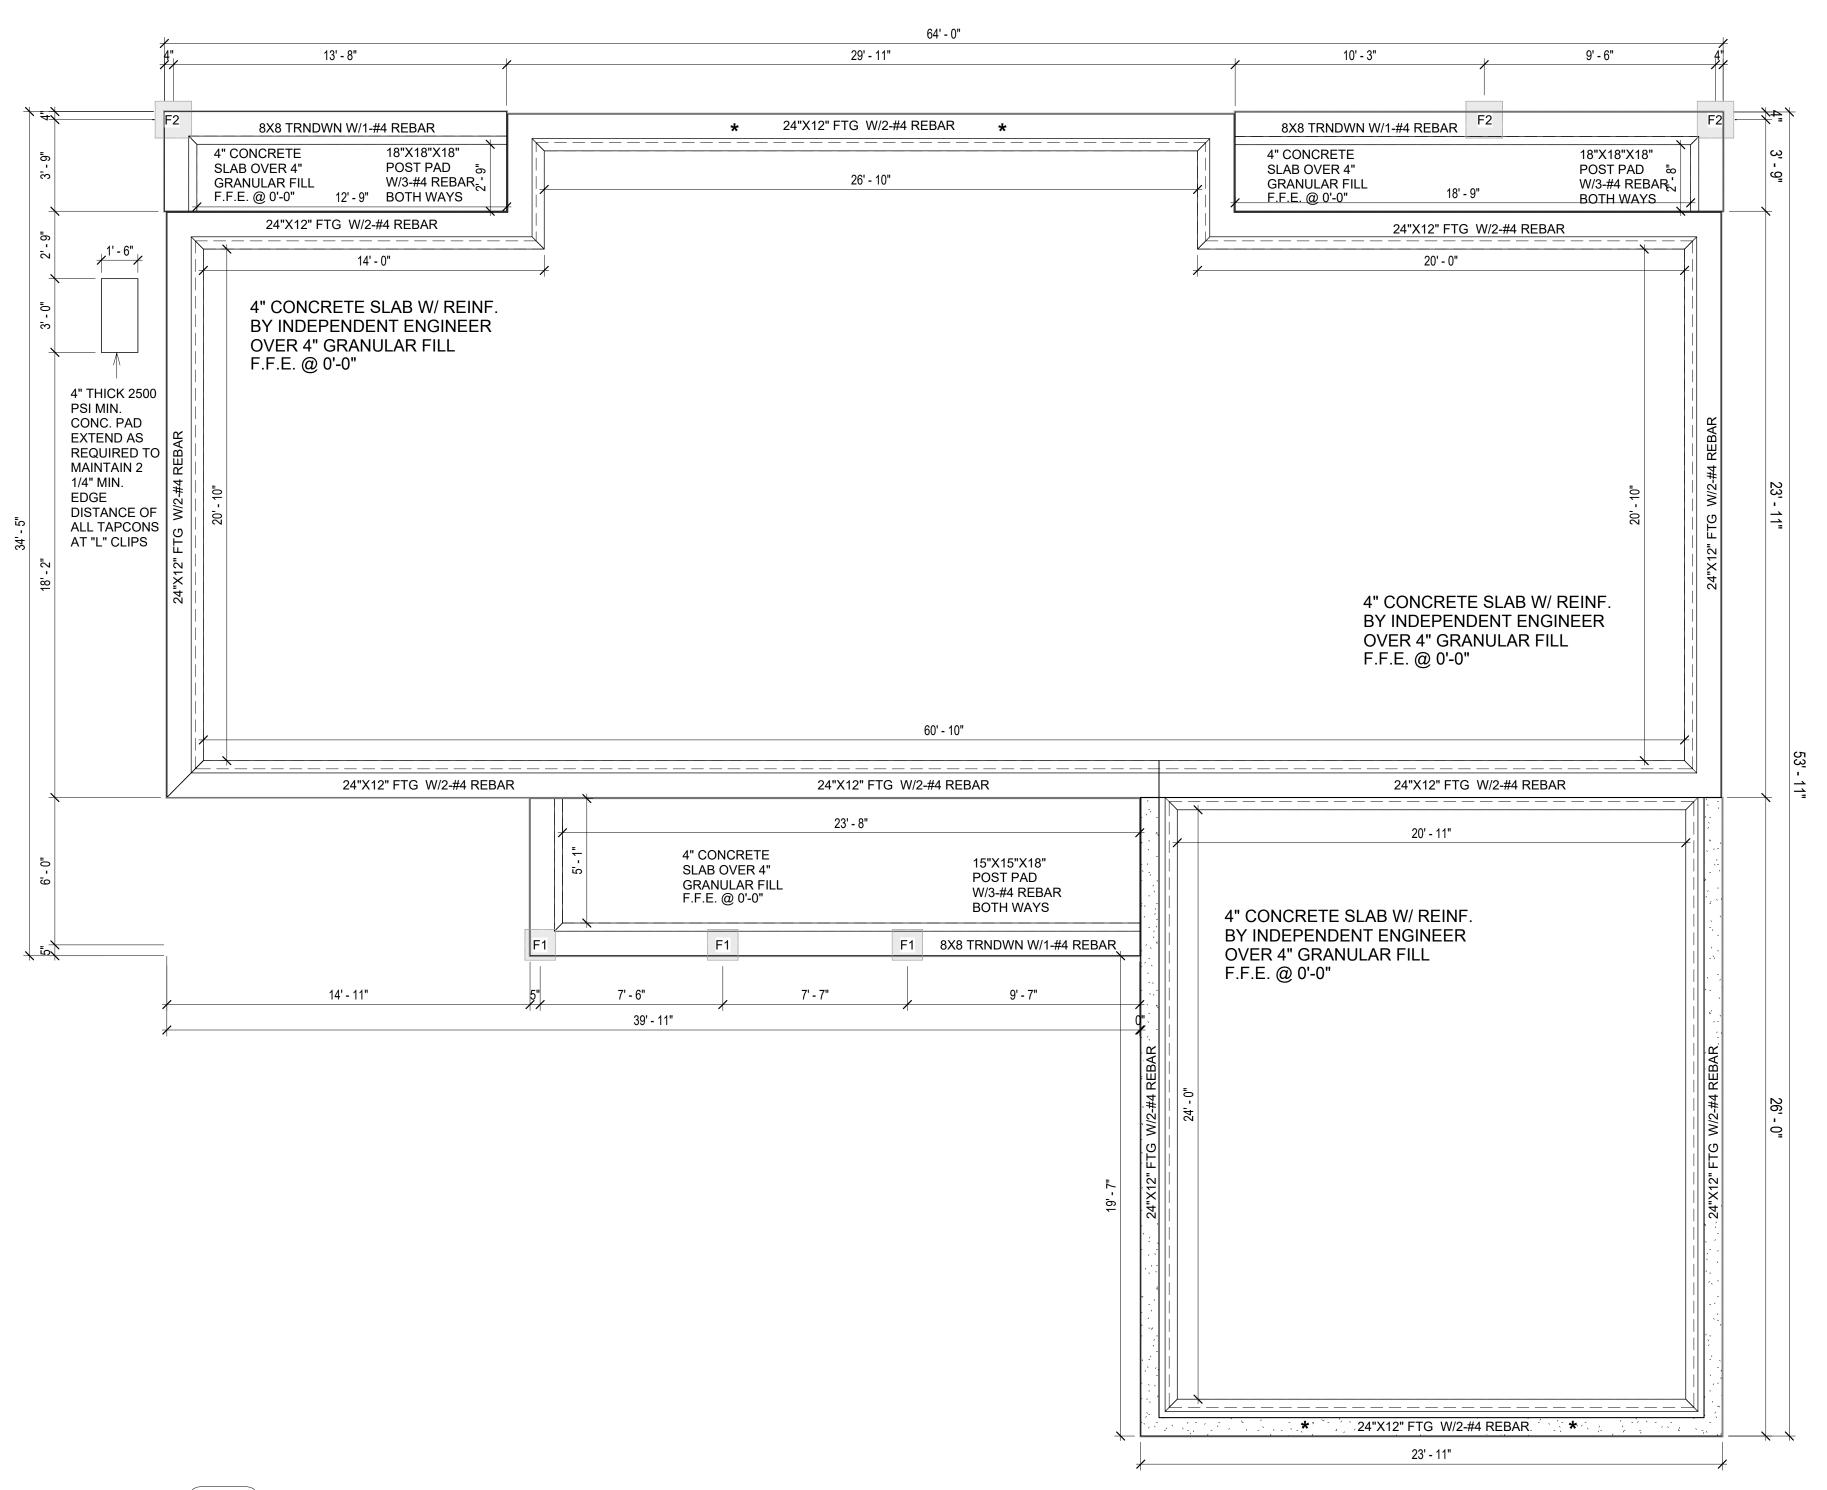

FOUNDATION PLAN 1/4" = 1'-0"

> SQUARE FOOTAGE **GARAGE** 620 PORCH 282 TOTAL 2552



KEY PLAN

NO.	DESCRIPTION	DATE	

NOTE:

LEGEND:

PROJECT

247-EMBER-1650-3Bd2.5Ba FARMHOUSE-550

DRAWING NAME

FOUNDATION PLAN

CLIENT NAME:	Client Name
PROJECT NUMBER:	0061_12
DATE:	5/9/2025 3:44:35 PM
DESIGNED BY:	Designer
DRAWN BY:	Author
CHECKED BY:	Checker

S101

SCALE: 1/4" = 1'-0"

GENERAL NOTES

NOTES:

-ALL BEARING WALLS SHOULD HAVE A THICKENED SLAB PER SECTION PER DETAIL A401/5.

A) **FOUNDATION PLAN NOTES**:

- CONCRETE SLAB SHALL BE 6" THICK WITH 1/2" DIAMETER TENDONS PER LAYOUT PLAN, CENTERED IN SLAB THICKNESS, OVER APPROVED SUBBASE PER GENERAL STRUCTURE NOTES.
- 2. TERMITE PROTECTION SHALL BE PROVIDED PER IRC SECTION R318.1 NONE TYPICAL ANCHOR BOLT SPACING AT SHEAR WALL AND HOLD DOWN
- SPECIFICATIONS PER APPROVED ARCHITECTURAL PLANS.
- 4. INSTALL HOLDOWNS BEFORE CONCRETE SLAB POUR. EXISTING FILL ON-SITE SHALL BE COMPACTED IN ACCORDANCE WITH THE
- REQUIREMENTS IN THE GEOTECHNICAL REPORT. 6. ALL FLOOR SLABS ARE REINFORCED ON CONCRETE SLABS.

SPECIAL INSPECTION IS REQUIRED FOR THICKENED FOUNDATION CONSTRUCTION

- 1. REINFORCEMENT
- 2. 2300 PSI CONCRETE POUR


B) **REINFORCEMENT FOR CONCRETE**:


1. ALL REINFORCING SLABS BARS SIZE 10MM OR LARGER SHALL BE DEFORMED IN ACCORDANCE TO ASTM-A706, AND BARS SMALLER THAN 10 MM MAYBE PLAIN. 2. UNLESS OTHERWISE NOTED IN PLANS, THE YIELD STRENGTH OF REINFORCING BARS SHALL BE:


> A) FOOTING = 40,000 PSI B) NON-LOAD BEARING WALLS AND PARAPETS= 40,000 PSI

- 3. SPLICES SHALL BE SECURELY WIRED TOGETHER AND SHALL LAP OR EXTEND
- 4. GRADE OF STEEL FOR RCC WORKS SHALL BE GRADE 4 10.
- BAR NOTATIONS GIVES INFORMATION
- A) BAR SIZE
- B) SPACING(IF REQUIRED) 6. LAP REINFORCEMENT ONLY AT LOCATION SHOWN IN THE DRAWINGS
- REINFORCEMENT SHALL NOT BE CUT, VENT OR HEATED ON SITE WITHOUT ENGINEERS' APPROVAL.
- C) **CONCRETE SLAB NOTES**
- 1. ALL SLAB REINFORCEMENT SHALL BE 20MM CLEAR MINIMUM FROM BOTTOM AND FROM TOP OF SLAB.
- 2. REINFORCEMENT IN CONTINUOUS ELEVATED SLAB SHALL BE CUT AS FOLLOWS.

- THIS IS A SCHEMATIC PLAN FOR THE PURPOSE OF LOCATING AND IDENTIFYING FOUNDATION REINFORCING ELEMENTS ONLY. VERIFY ALL DIMENSIONS, DROPS, OFFSETS AND FEATURES WITH THE ARCHITECTURAL PLANS BEFORE FORMING THE FOUNDATION.

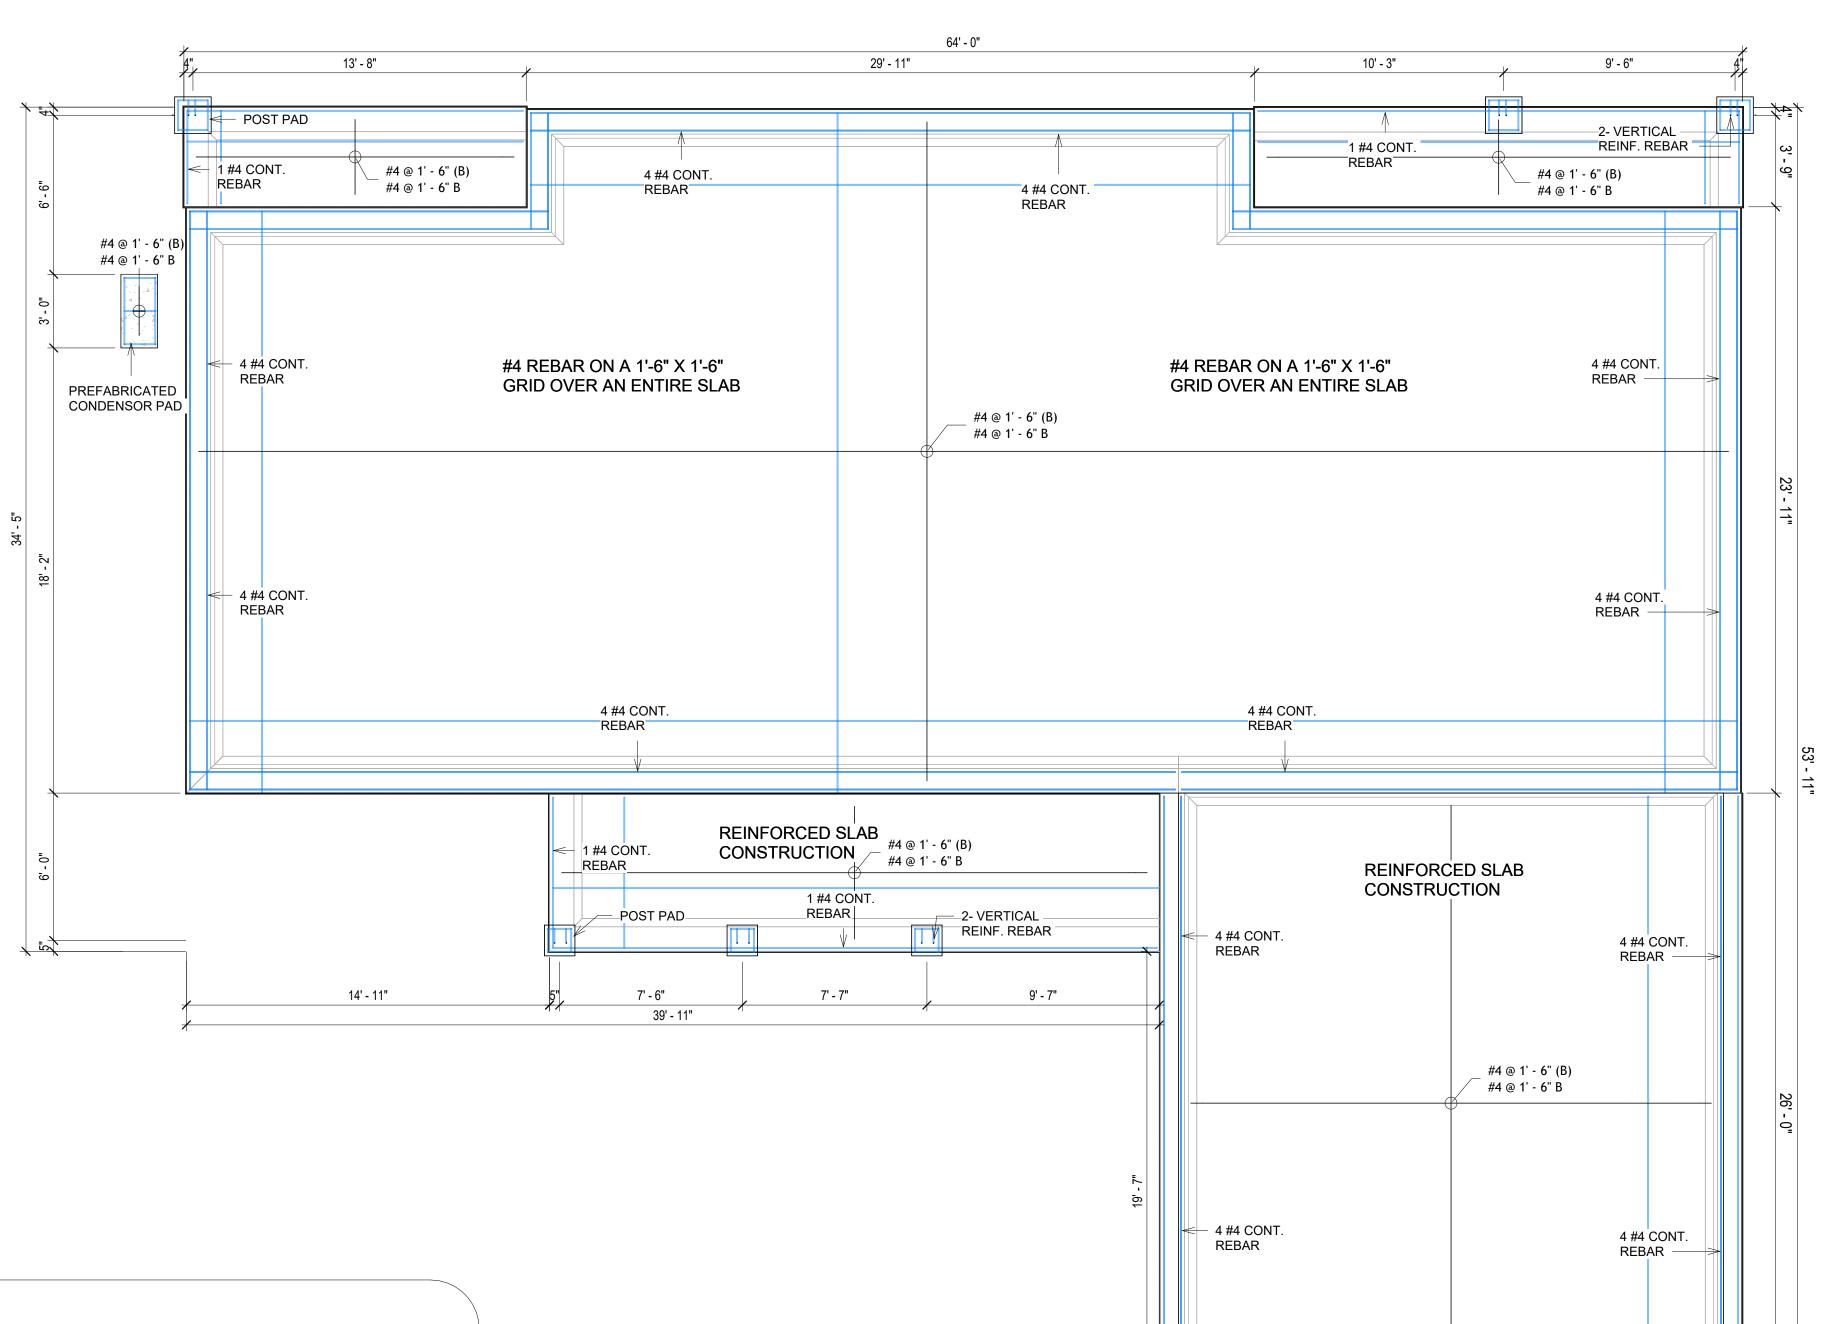

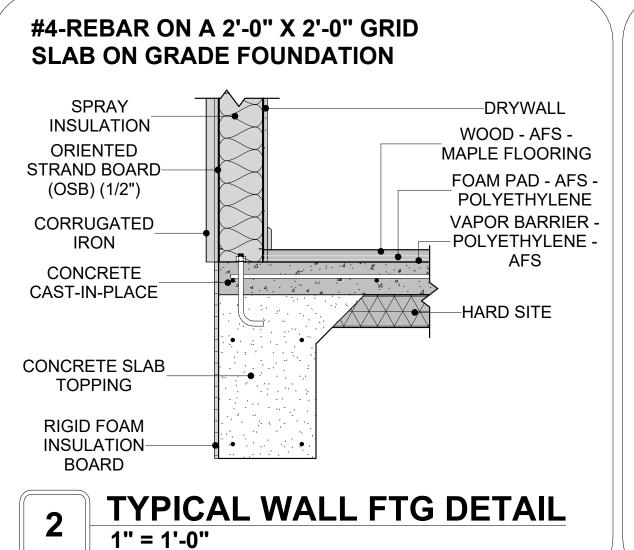

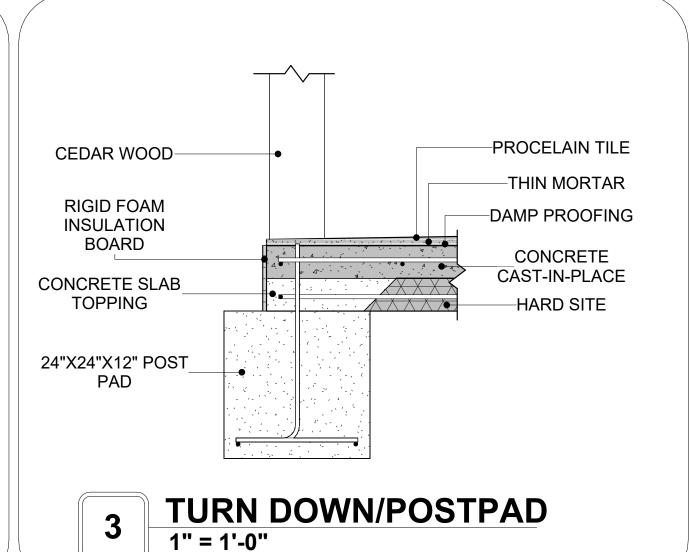

FOUNDATION REBAR PLAN 1/4" = 1'-0"

4 #4 CONT.

23' - 11"



KEY PLAN

NO.	DESCRIPTION	DATE

NOTE:

LEGEND:

PROJECT

247-EMBER-1650-3Bd2.5Ba **FARMHOUSE-550**

DRAWING NAME

STRUCTURAL FLOOR PLAN


CLIENT NAME:	Client Name
PROJECT NUMBER:	0061_12
DATE:	5/9/2025 3:44:36 PM
DESIGNED BY:	Designer
DRAWN BY:	Author
CHECKED BY:	Checker

S102

ROOF NOTES

- . ROOFING COMPOSITION ROOFING PER OWNERS/BUILDERS SPECIFICATIONS INSTALL PER MANUFACTURE SPECIFICATIONS ON 1/2" ORIENTED STRAND BOARD ON PRE-ENGINEERED TRUSS @ 24" O.C. (UNO.) 2. 73" OVERHANG AT EAVES (UNO.)
- 3. ENDS OF ALL TRUSSES AND JOISTS TO BE FULLY BLOCKED. PROVIDE SOLID BLOCKING AT ALL RIDGES AND VALLEYS
- 4. SHEATHING TO BE 1/2", 3/8" OSB SHEAR PANEL AND EQUIVALENT. UNDERSIDE OF PORCH TRUSSES TO BE FINISHED WITH MOISTURE
- RESISTANT DRYWALL, TAPED AND TEXTURED. 5. EXPOSED EAVES AND OTHER WEATHER EXPOSED AREAS TO BE SHEATHED WITH EXTERIOR GRADE PLYWOOD.
- 6. ALL MATERIALS THICKNESS AND SIZE ARE THE MINIMUM. Refer TO LOCAL
- STANDARDS FOR ACTUAL THICKNESS AND LAYERING OF MATERIALS. 7. ENGINEERED TRUSS CALCULATIONS TO BE SUBMITTED TO BUILDING DEPARTMENT PRIOR TO FABRICATION AND INSTALLATION.
- 8. TRUSS MANUFACTURER TO SPECIFY HANGER CONNECTORS FOR TRUSS COMPONENTS (TYPICAL)
- 9. DESIGNER ASSUMES THAT TRUSSES BEAR ON ALL EXTERIOR PERIMETER WALLS (TYPICAL) OR BEAMS.
- 10. PROVIDE GALVANIZED STEEL FLASHING WITH A LENGTH OF 10 FEET, WIDTH
- OF 12 INCHES, AND THICKNESS OF 24 GAUGE.



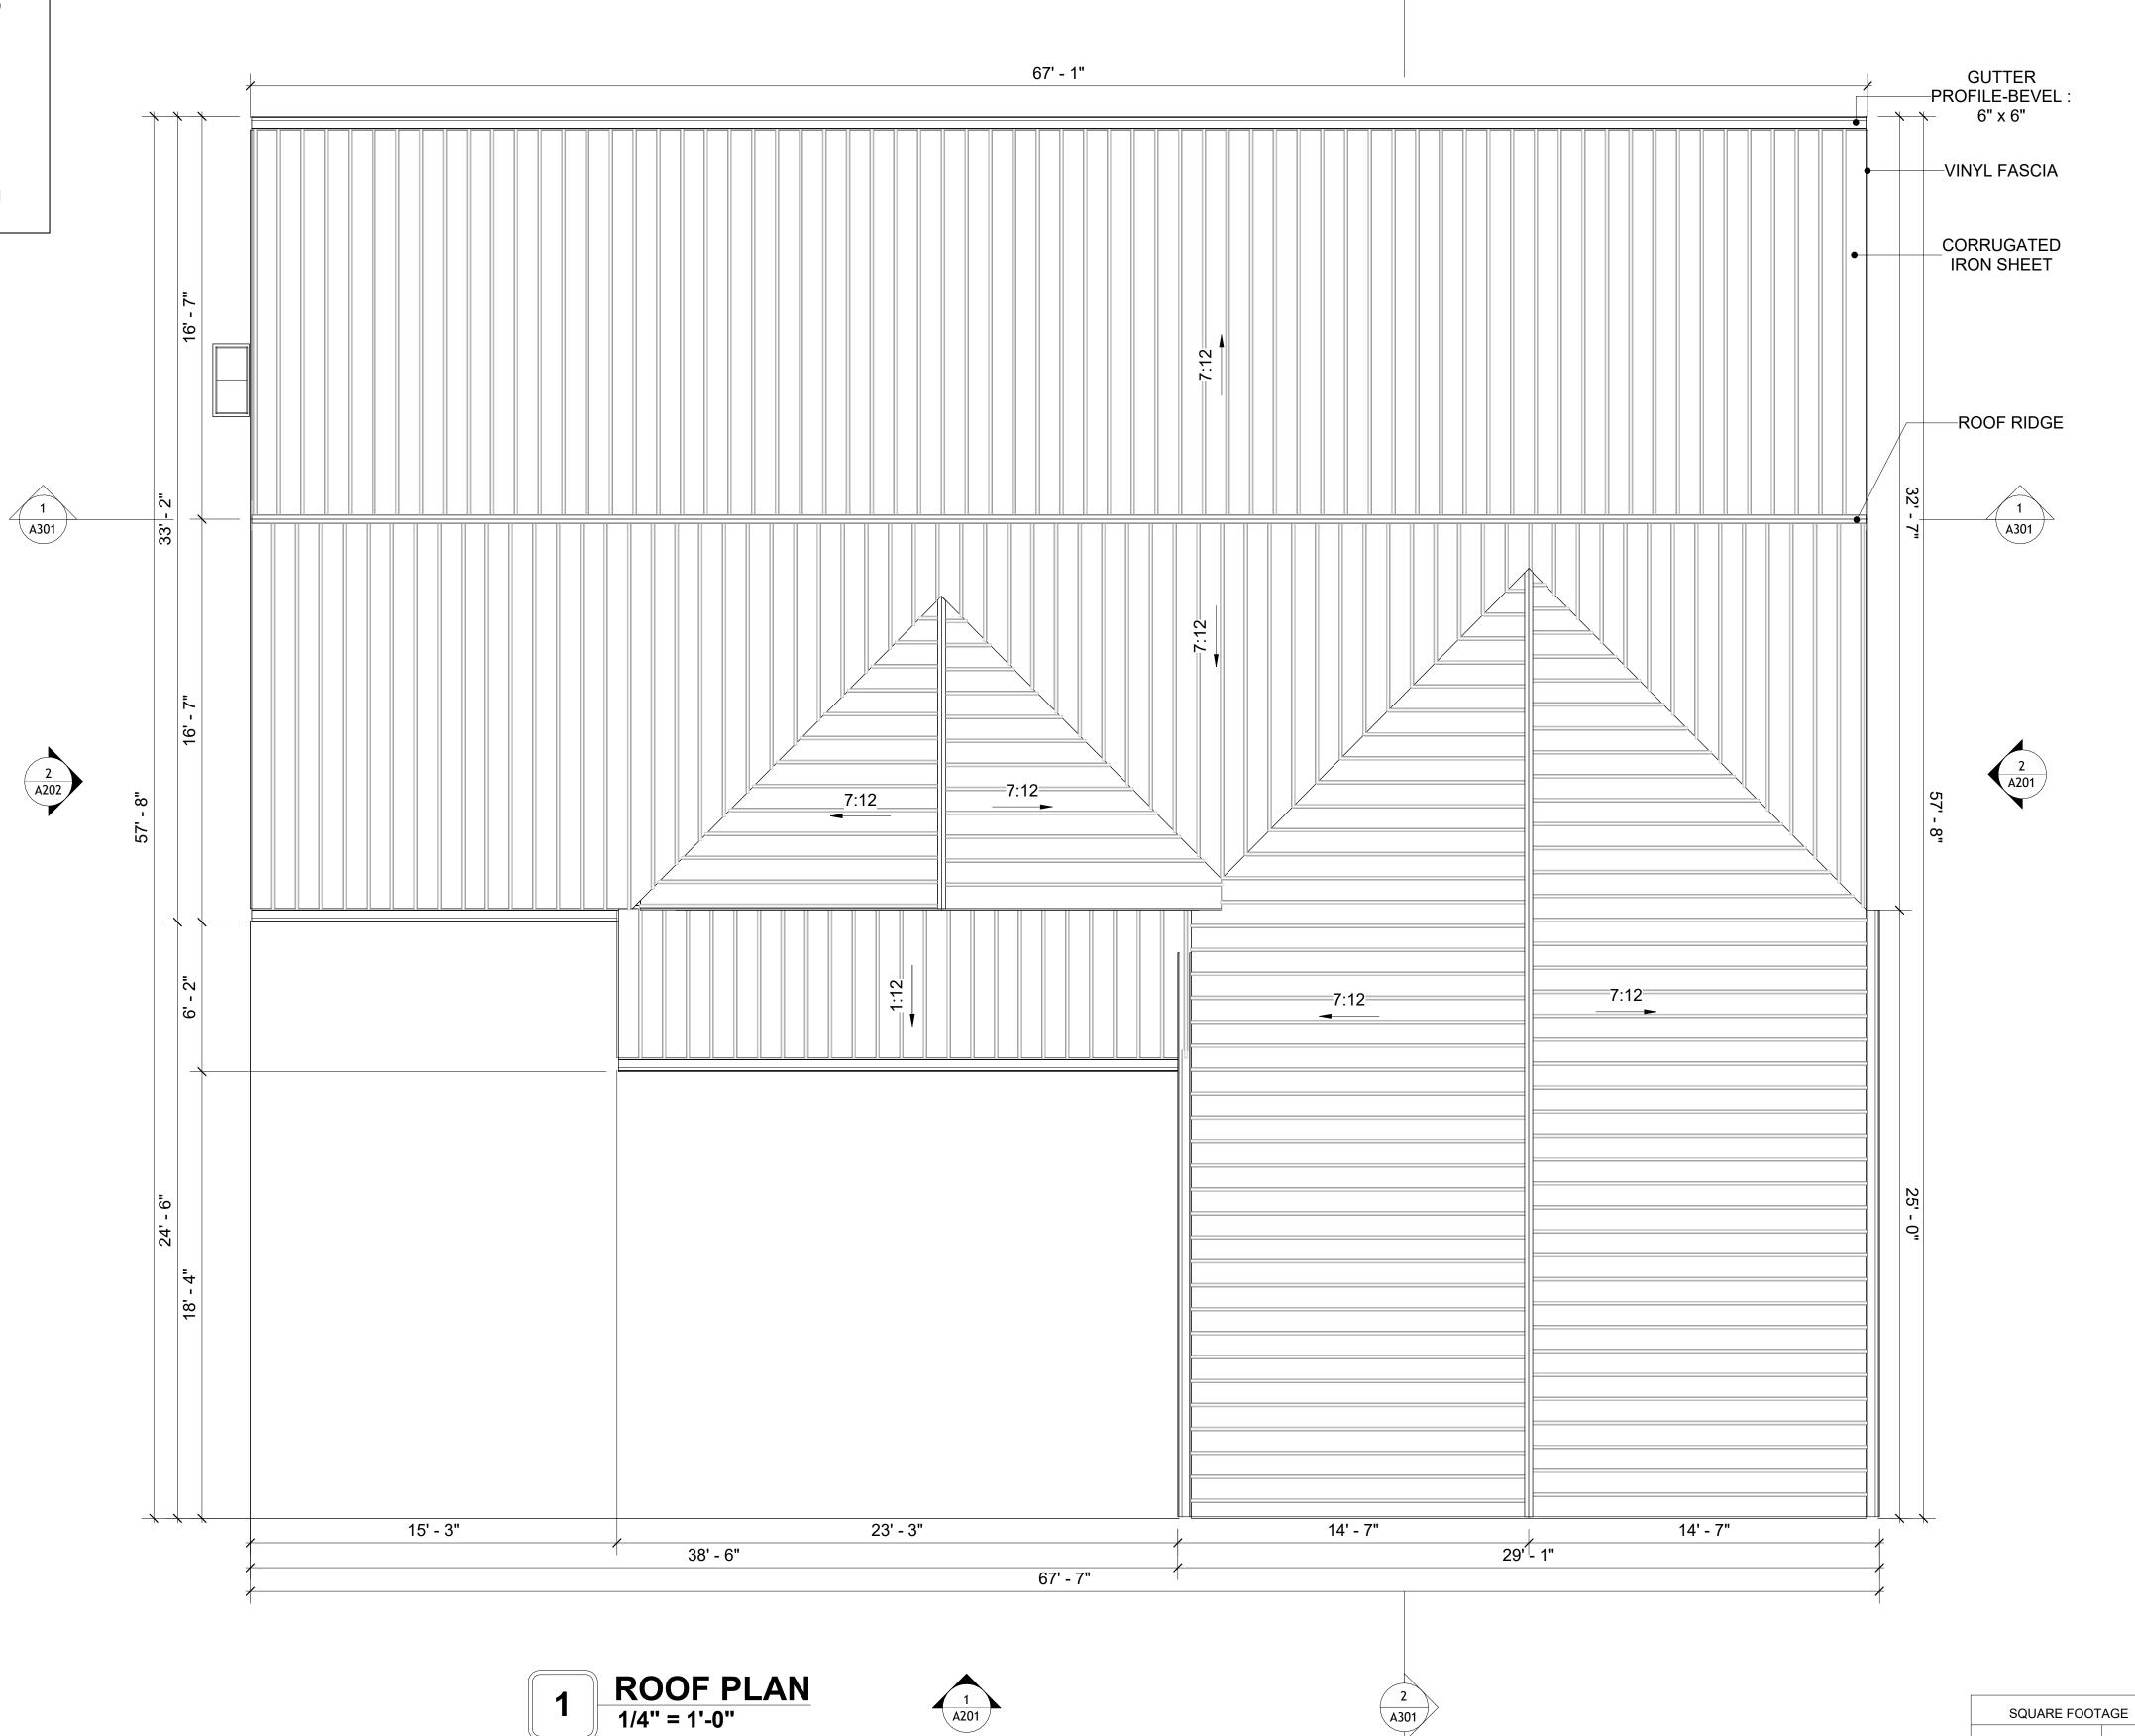



KEY PLAN

NO.	DESCRIPTION	DATE		

NOTE:

LEGEND:

PROJECT

247-EMBER-1650-3Bd2.5Ba **FARMHOUSE-550**

DRAWING NAME

ROOF PLAN

CLIENT NAME:	Client Name
PROJECT NUMBER:	0061_12
DATE:	5/9/2025 3:44:42 PM
DESIGNED BY:	Designer
DRAWN BY:	Author
CHECKED BY:	Checker

A103

SCALE: 1/4" = 1'-0"

1650

620

282

2552

GARAGE

PORCH

TOTAL

© [2024] [FrameUpNow] . All rights reserved

ABOUT WALL FINISHING

CORRUGATED IRON SHEET


CORRUGATED IRON IS A FINISHING MATERIAL MADE FROM STEEL THAT HAS BEEN GALVANIZED (COATED WITH A THIN LAYER OF ZINC) TO PROTECT IT FROM CORROSION AND RUST.

IN THIS SPECIFIC PROJECT, THE CORRUGATED IRON SHEETS ARE INSTALLED HORIZONTALLY ON VERTICAL FURRING STRIPS THAT ARE DIRECTLY ATTACHED ONTO THE PROPERLY INSTALLED AND SEALED HOME WRAP, USING SELF-DRILLING SCREWS THAT ARE DRIVEN THROUGH THE RIDGES OR VALLEYS OF THE CORRUGATIONS.


CEDAR WOOD

CEDAR WOOD REFERS TO THE WOOD FROM VARIOUS SPECIES OF CEDAR TREES, WHICH ARE CONIFEROUS EVERGREEN TREES KNOWN FOR THEIR DISTINCT AROMA AND NATURAL RESISTANCE TO DECAY AND INSECTS.

IN THIS SPECIFIC PROJECT, CEDAR WOOD IS USED A FINISH MATERIAL ON BEAMS AND COLUMNS.

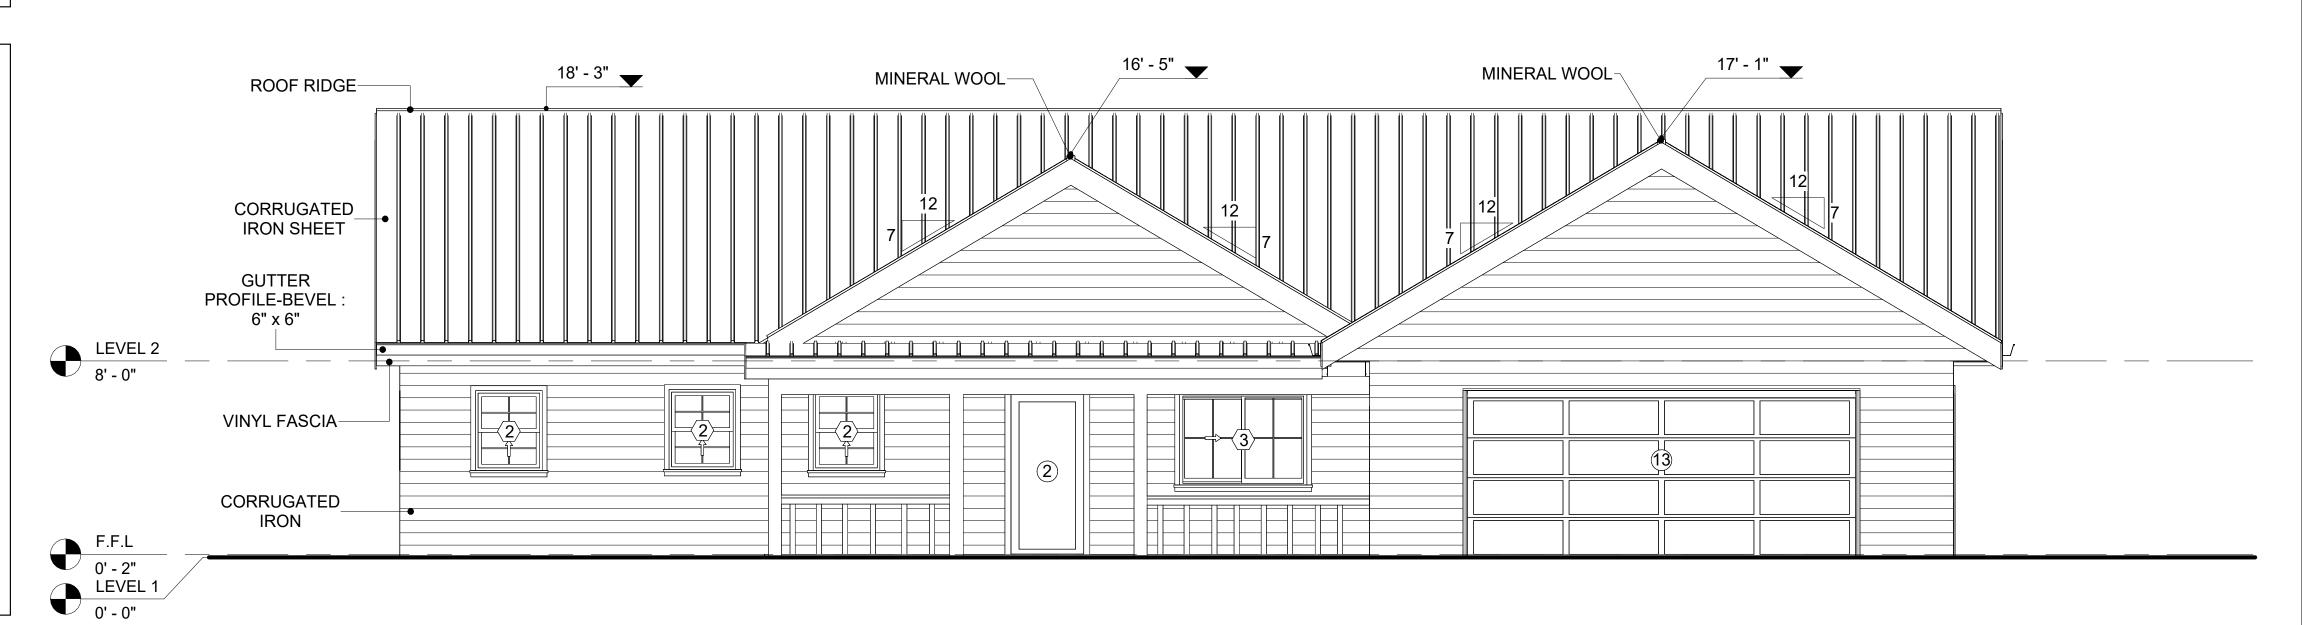

1 FRONT ELEVATION 1/4" = 1'-0"

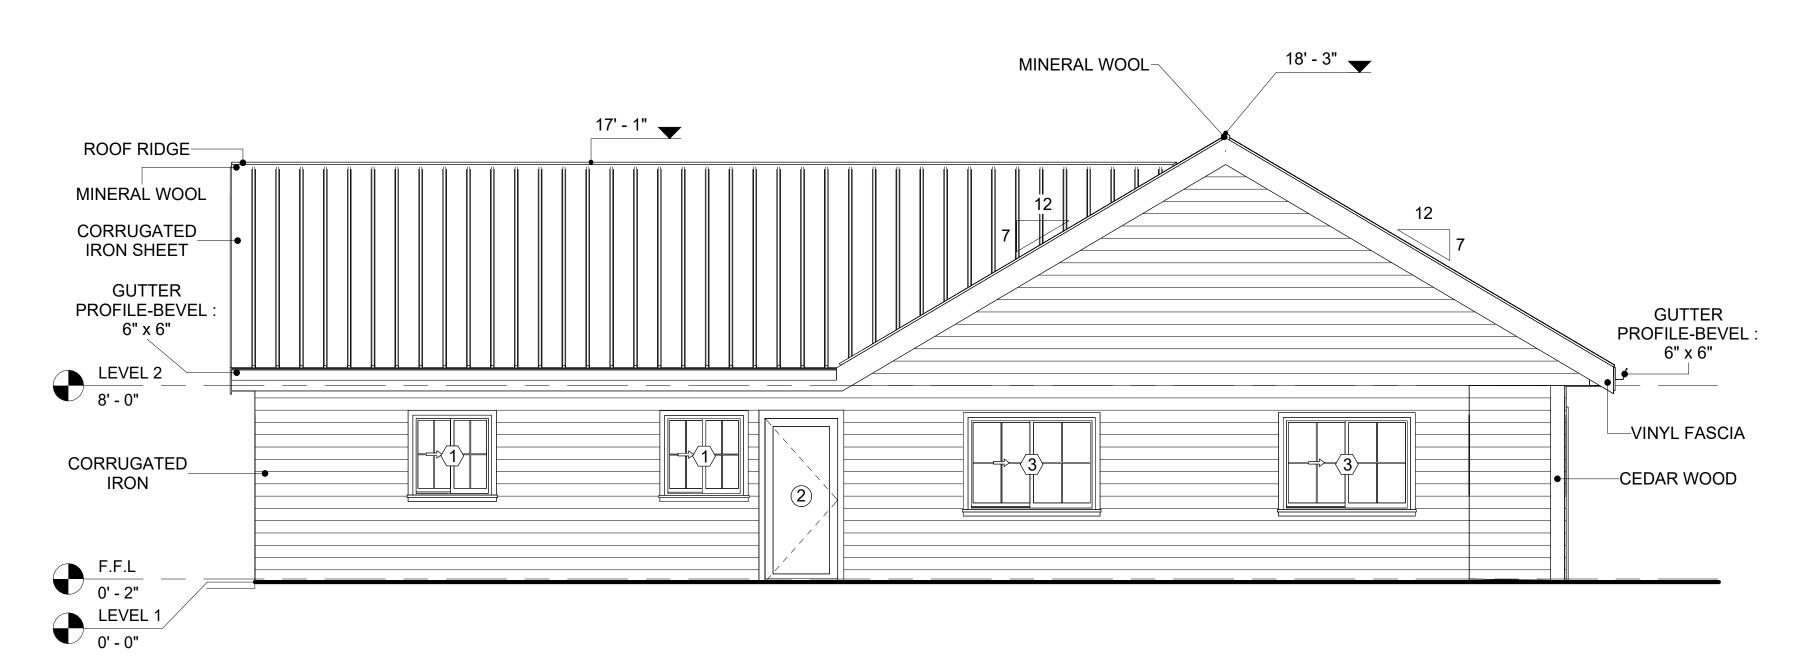


2 RIGHT SIDE ELEVATION 1/4" = 1'-0"

DOOR SCHEDULE						
TYPE				SIZE		
MAR K	SUPPLIER	DOOR TYPE	LOCATIO N	WIDTH	HEIGHT	COUNT
1	HOME DEPOT	INTERIOR SINGLE PANEL SWINGING	INTERIOR	3' - 0"	6' - 8"	6
2	HOME DEPOT	EXTERIOR SINGLE PANEL SWINGING	INTERIOR	3' - 0"	6' - 8"	2
3	HOME DEPOT	INTERIOR SINGLE PANEL SWINGING	INTERIOR	2' - 6"	6' - 8"	2
4	HOME DEPOT	INTERIOR SINGLE PANEL SWINGING	INTERIOR	3' - 0"	6' - 8"	1
5	HOME DEPOT	PATIO DOUBLE PANEL SLIDING	EXTERIOR	5' - 0"	6' - 8"	2
6	HOME DEPOT	INTERIOR DOUBLE PANEL SLIDING	INTERIOR	7' - 0"	6' - 8"	1
7	HOME DEPOT	INTERIOR DOUBLE PANEL SLIDING	INTERIOR	5' - 8"	6' - 8"	2
8	HOME DEPOT	DOOR-INTERIOR-SINGLE-POCKET-2_PANE L-WOOD	INTERIOR	3' - 0"	6' - 9"	1
9	HOME DEPOT	INTERIOR DOUBLE PANEL SLIDING	INTERIOR	5' - 4"	6' - 8"	1
10	HOME DEPOT	SINGLE FOLD 2	INTERIOR	2' - 8"	6' - 8"	1
11	HOME DEPOT	SINGLE FOLD 2	INTERIOR	1' - 8"	6' - 8"	1
12	HOME DEPOT	INTERIOR DOUBLE PANEL SLIDING	INTERIOR	4' - 0"	6' - 8"	1
13	HOME DEPOT	DOOR-GARAGE-EMBOSSED_PANEL	EXTERIOR	16' - 0"	6' - 6"	1

WINDOW SCHEDULE						
SIZE						
SUPPLIER	WINDOW TYPE	WIDTH	HEIGHT	COUNT		
			,			
HOME DEPOT	SLIDING	3' - 3"	3' - 3"	3		
HOME DEPOT	SINGLE HUNG	2' - 9"	3' - 3"	8		
HOME DEPOT	SLIDING	5' - 3"	3' - 9"	4		
	HOME DEPOT	SUPPLIER WINDOW TYPE HOME DEPOT SLIDING HOME DEPOT SINGLE HUNG	SUPPLIER WINDOW TYPE WIDTH HOME DEPOT SLIDING 3' - 3" HOME DEPOT SINGLE HUNG 2' - 9"	SIZE SUPPLIER WINDOW TYPE WIDTH HEIGHT HOME DEPOT SLIDING 3' - 3" 3' - 3" HOME DEPOT SINGLE HUNG 2' - 9" 3' - 3"		



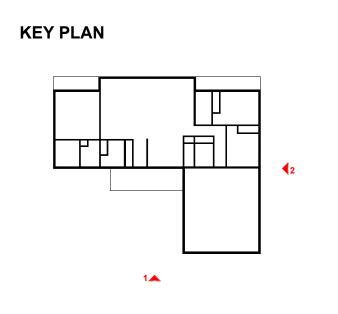

NO.	DESCRIPTION	DATE

NOTE:

LEGEND:

PROJECT

247-EMBER-1650-3Bd2.5Ba FARMHOUSE-550

DRAWING NAME

ARCHITECTURAL ELEVATIONS

CLIENT NAME:	Client Name
PROJECT NUMBER:	0061_12
DATE:	5/9/2025 3:44:51 PM
DESIGNED BY:	Designer
DRAWN BY:	Author
CHECKED BY:	Checker

A201

ABOUT WALL FINISHING

CORRUGATED IRON SHEET

CORRUGATED IRON IS A FINISHING MATERIAL MADE FROM STEEL THAT HAS BEEN GALVANIZED (COATED WITH A THIN LAYER OF ZINC) TO PROTECT IT FROM CORROSION AND RUST.

IN THIS SPECIFIC PROJECT, THE CORRUGATED IRON SHEETS ARE INSTALLED HORIZONTALLY ON VERTICAL FURRING STRIPS THAT ARE DIRECTLY ATTACHED ONTO THE PROPERLY INSTALLED AND SEALED HOME WRAP, USING SELF-DRILLING SCREWS THAT ARE DRIVEN THROUGH THE RIDGES OR VALLEYS OF THE CORRUGATIONS.


CEDAR WOOD

CEDAR WOOD REFERS TO THE WOOD FROM VARIOUS SPECIES OF CEDAR TREES, WHICH ARE CONIFEROUS EVERGREEN TREES KNOWN FOR THEIR DISTINCT AROMA AND NATURAL RESISTANCE TO DECAY AND INSECTS.

IN THIS SPECIFIC PROJECT, CEDAR WOOD IS USED A FINISH MATERIAL ON BEAMS AND COLUMNS.



1 REAR ELEVATION
1/4" = 1'-0"

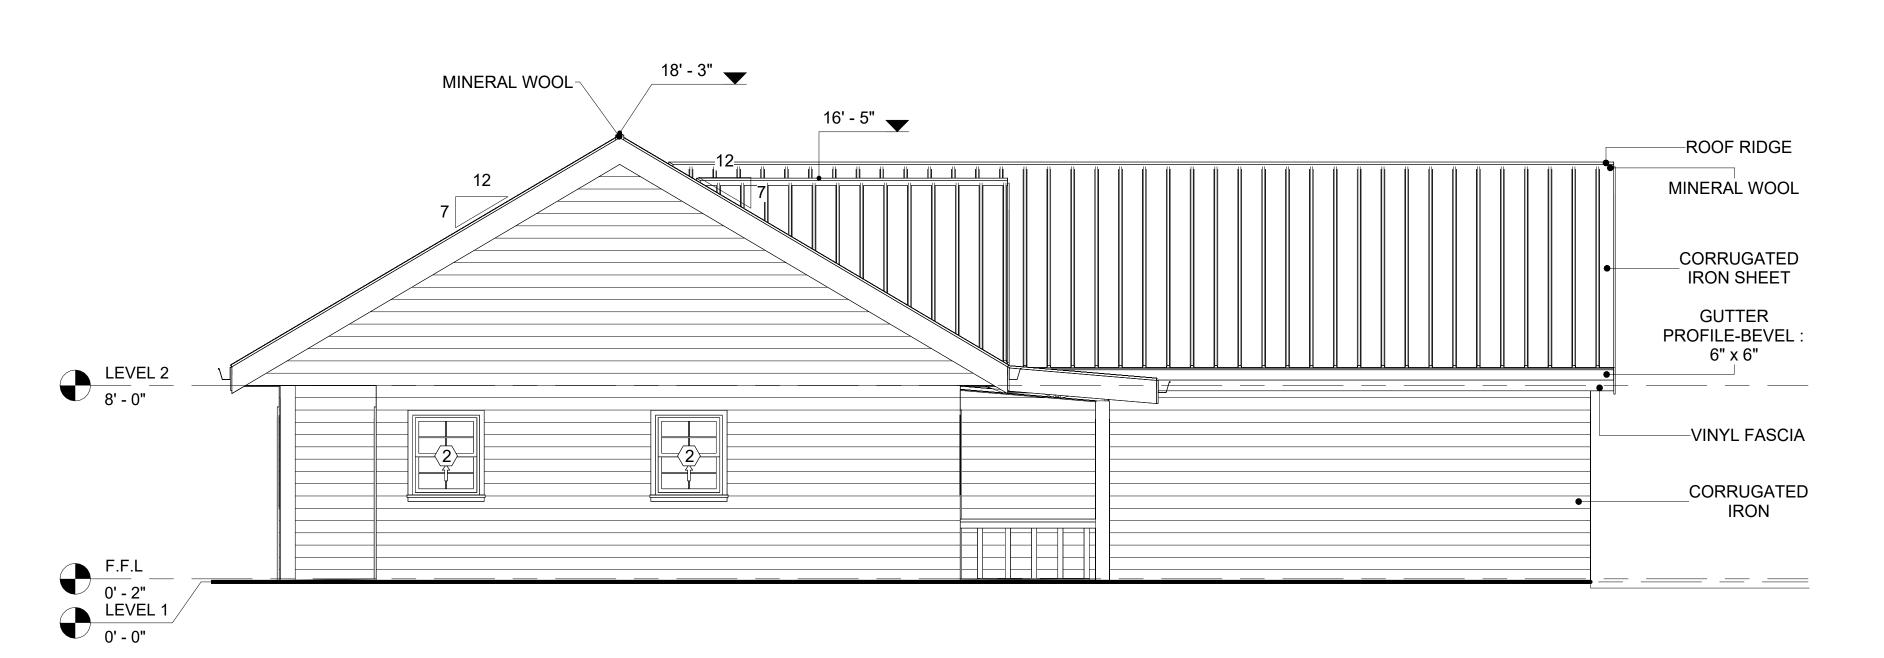

2 LEFT SIDE ELEVATION 1/4" = 1'-0"



KEY PLAN

1

2

NO.	DESCRIPTION	DATE

NOTE:

LEGEND:

PROJECT

247-EMBER-1650-3Bd2.5Ba FARMHOUSE-550

DRAWING NAME

ARCHITECTURAL ELEVATIONS

CLIENT NAME:

PROJECT NUMBER:

0061_12

DATE:

5/9/2025 3:45:00 PM


DESIGNED BY:


DRAWN BY:

CHECKED BY:

Checker

A202

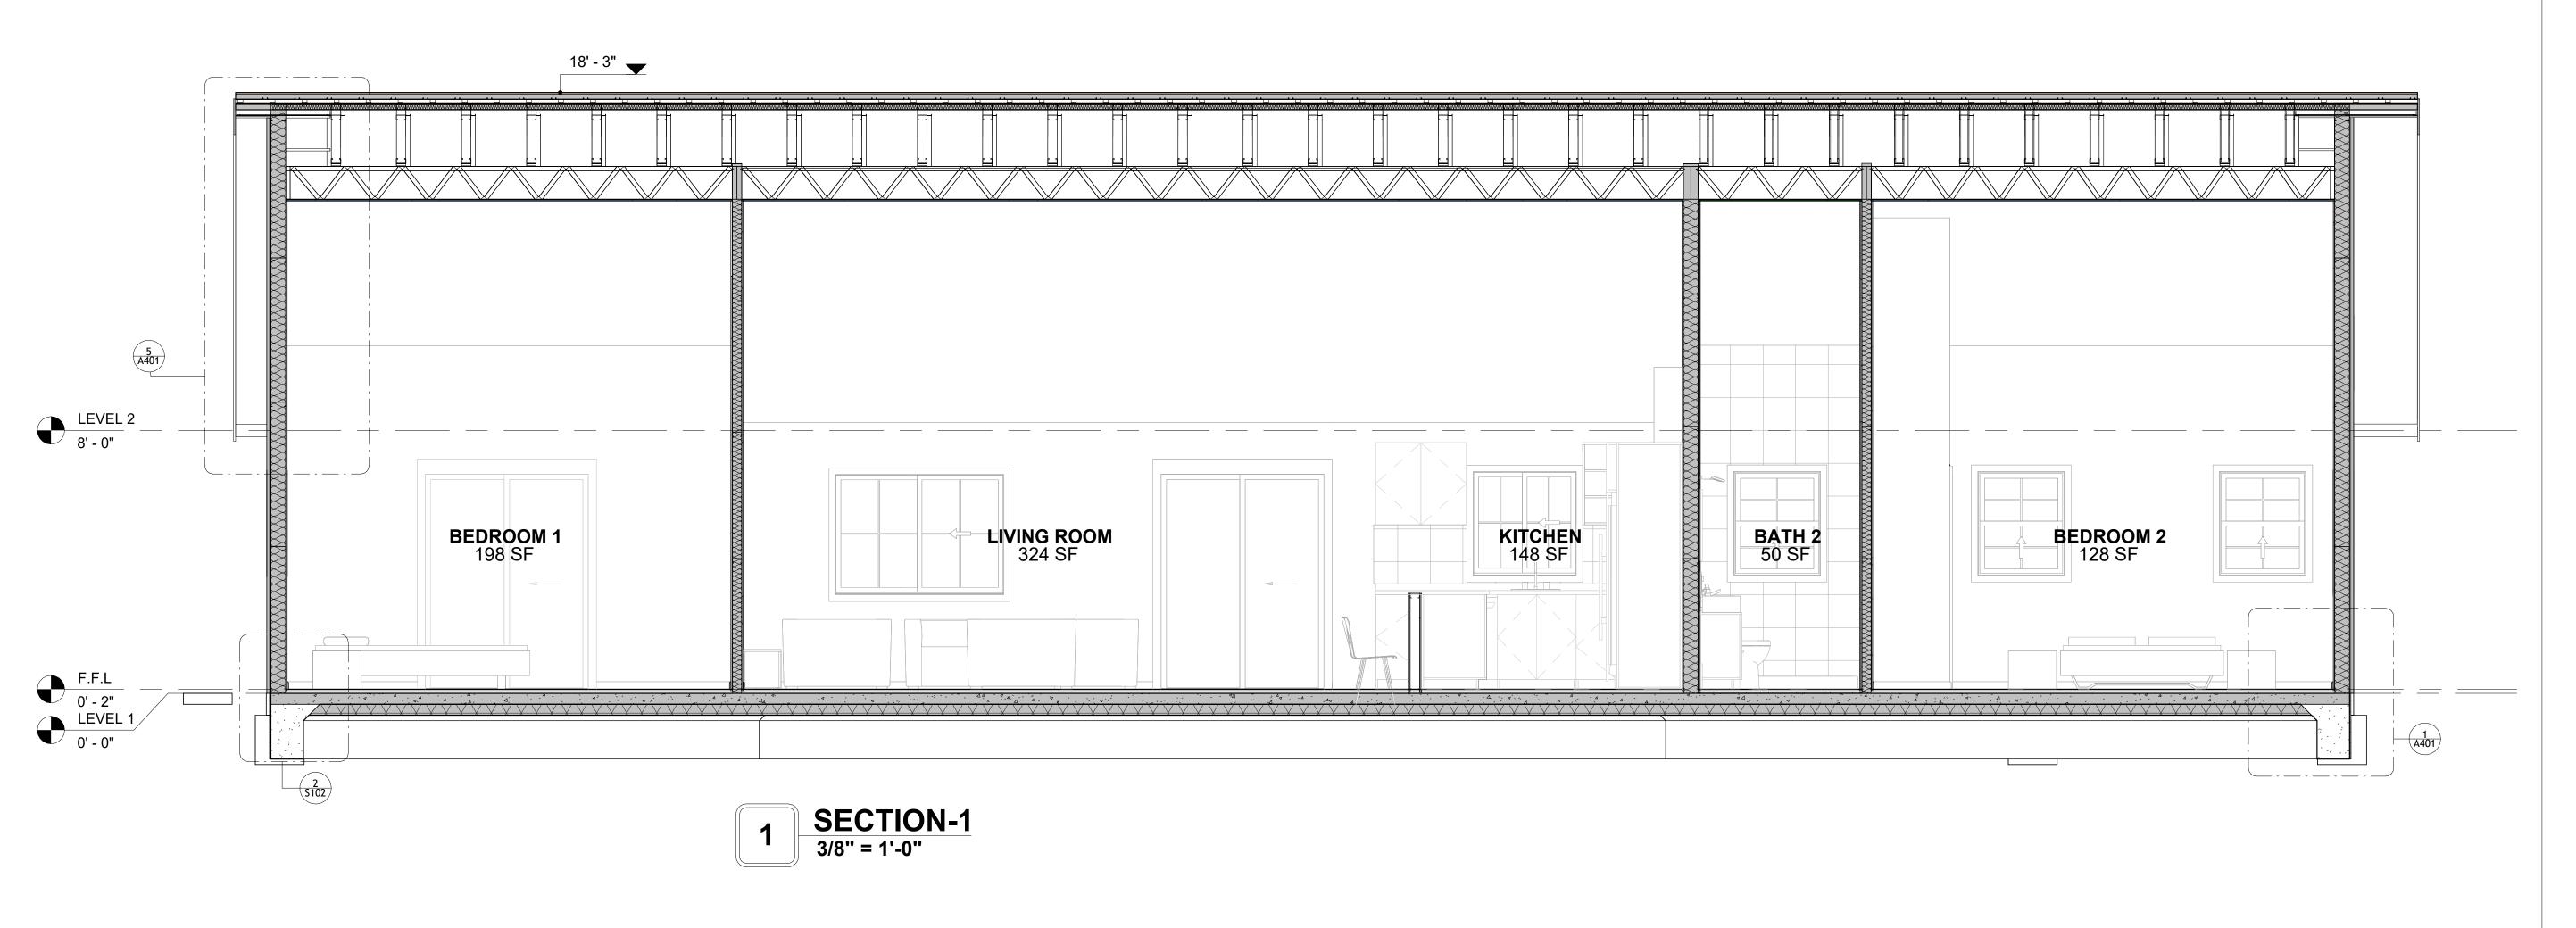


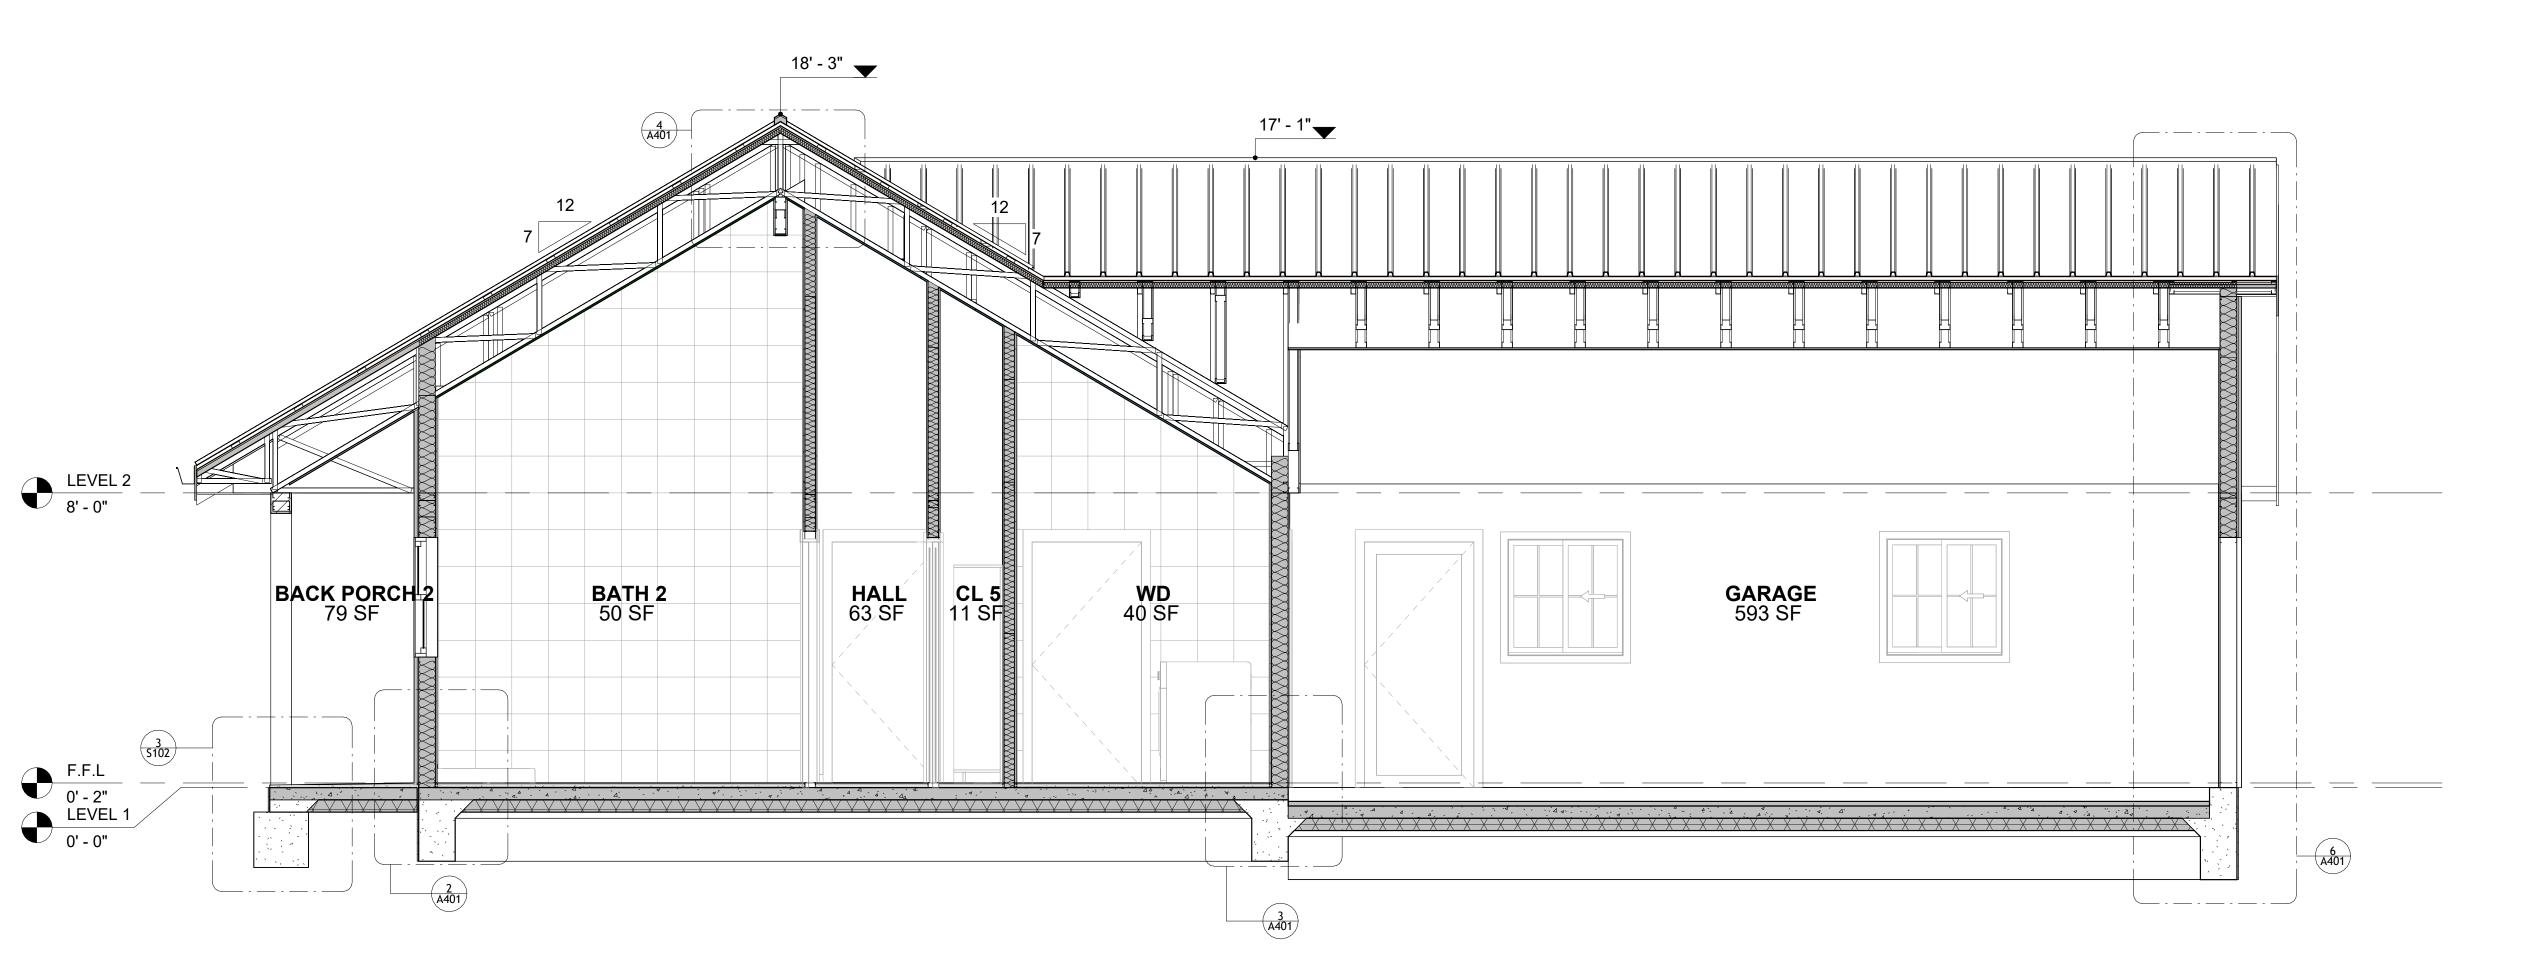

2 SECTION-2 3/8" = 1'-0"



KEY PLAN

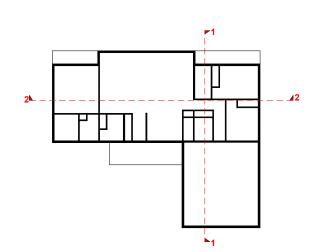

NO.	IO. DESCRIPTION	

NOTE:

LEGEND:

PROJECT


247-EMBER-1650-3Bd2.5Ba FARMHOUSE-550

DRAWING NAME

ARCHITECTURAL SECTIONS

CLIENT NAME:	Client Name
PROJECT NUMBER:	0061_12
DATE:	5/9/2025 3:45:03 PM
DESIGNED BY:	Designer
DRAWN BY:	Author
CHECKED BY:	Checker

A301

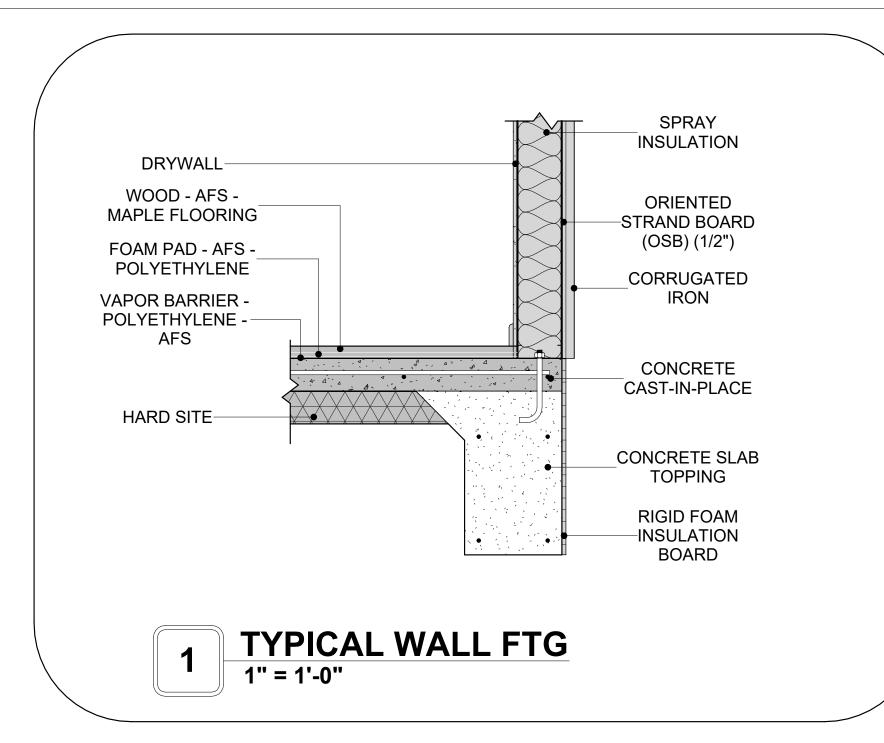

SPRAY

CEINSULATIONS

BACKER BOARD


-CERAMIC TILE


-VINYL TILE

THIN MORTAR

CONCRETE CAST-IN-PLACE

—HARD SITE

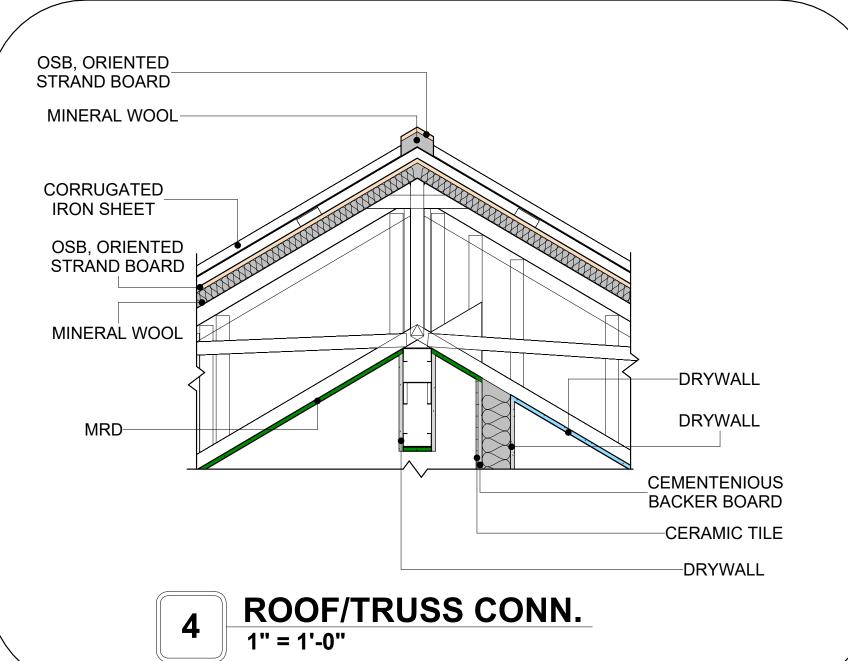


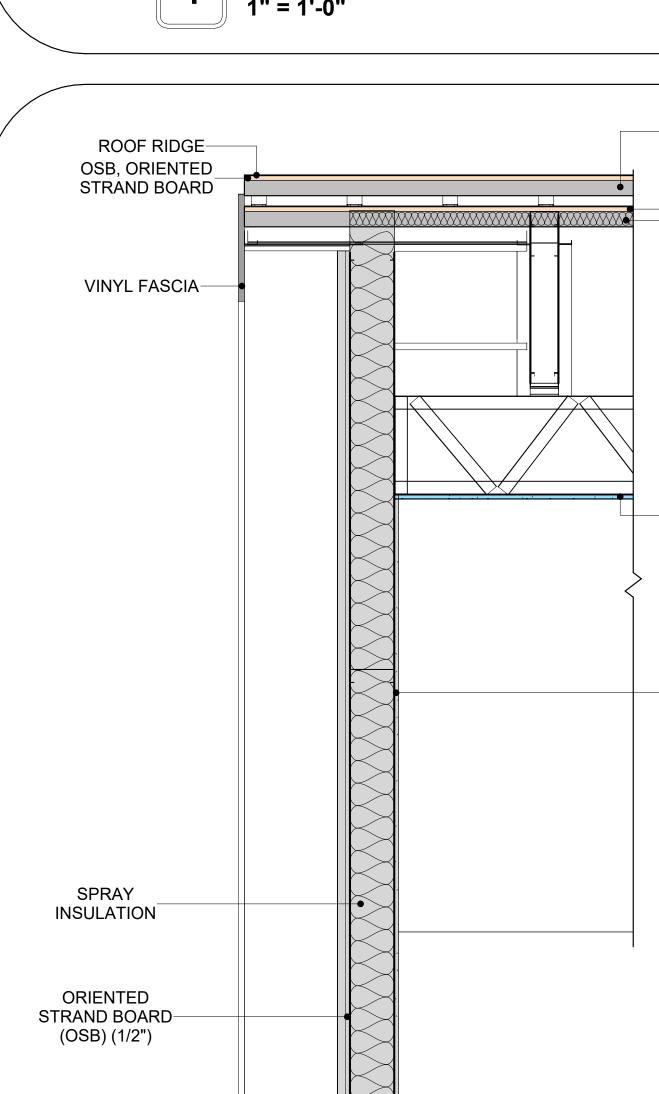

ROOF ON WALL

1" = 1'-0"

CORRUGATED

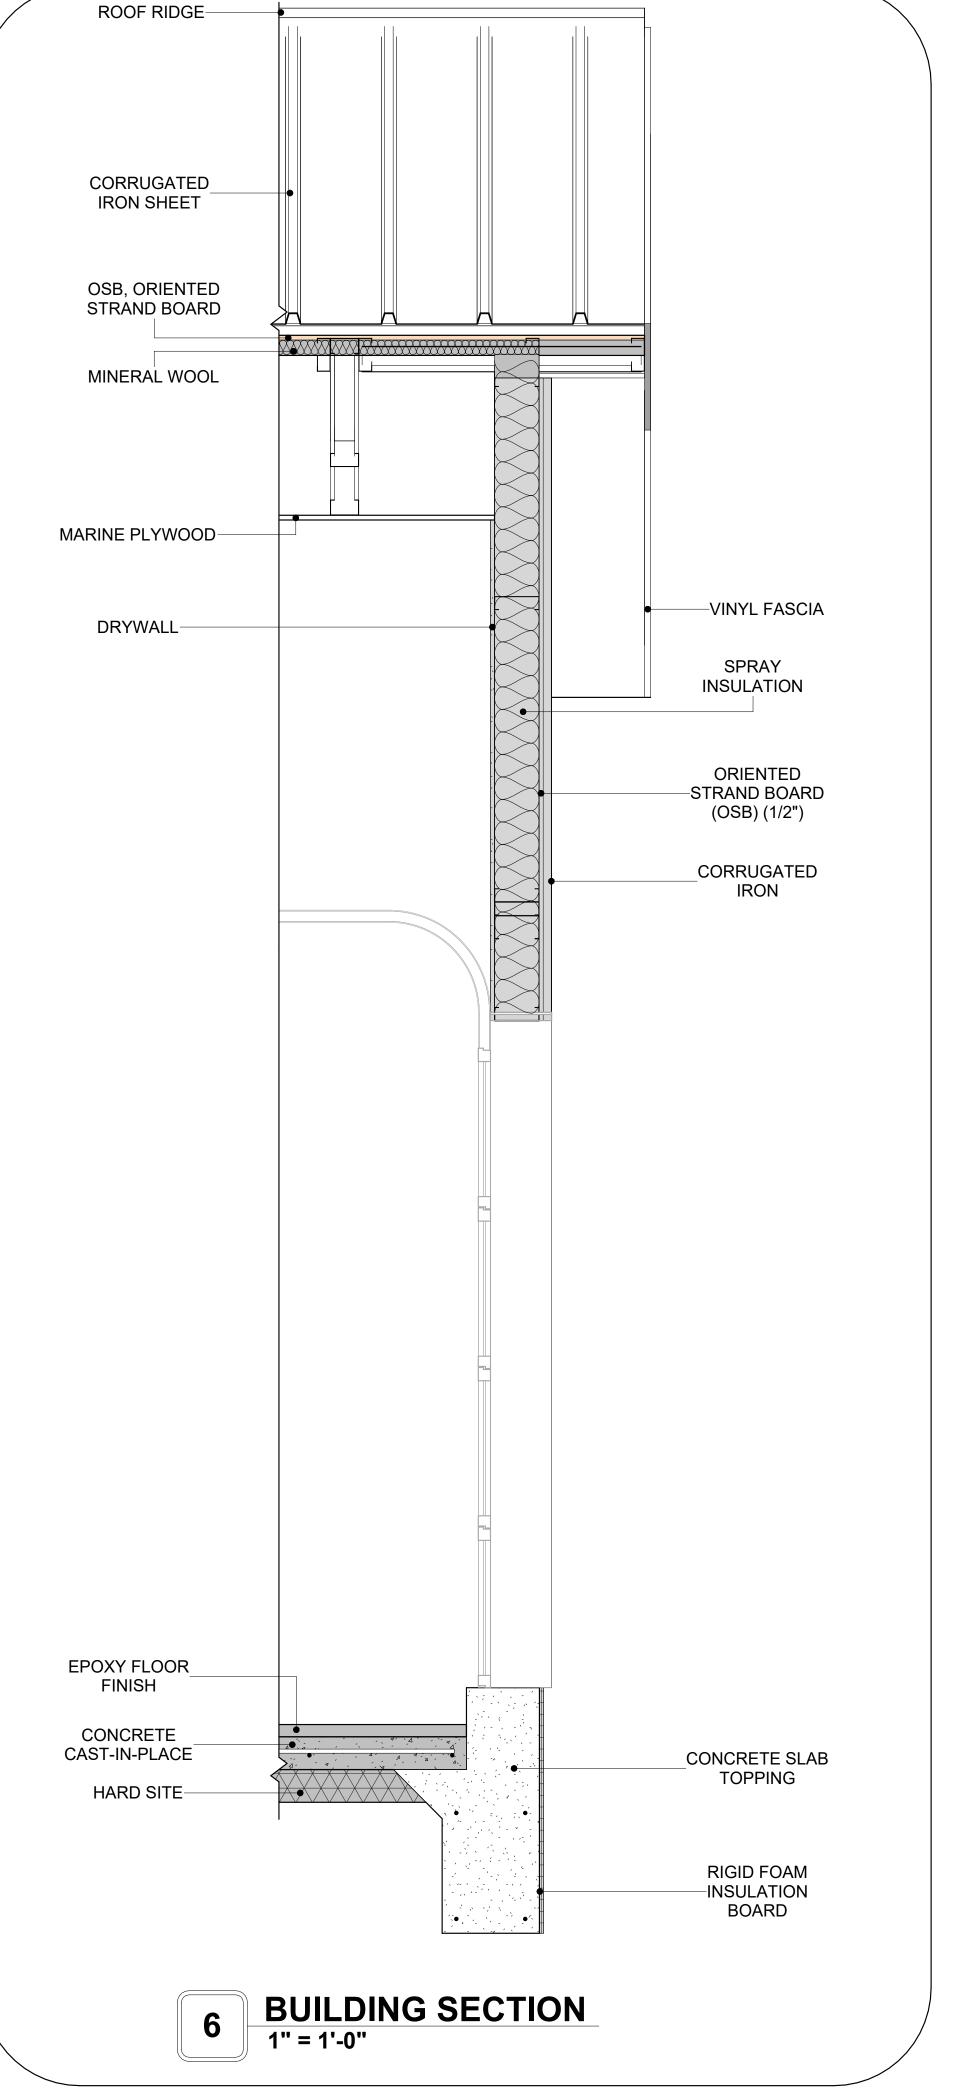



KEY PLAN

NO.	DESCRIPTION	DATE	

NOTE:

LEGEND:

PROJECT

247-EMBER-1650-3Bd2.5Ba FARMHOUSE-550


DRAWING NAME


ARCHITECTURAL DETAILS

CLIENT NAME:	Client Name
PROJECT NUMBER:	0061_12
DATE:	5/9/2025 3:45:04 PM
DESIGNED BY:	Designer
DRAWN BY:	Author
CHECKED BY:	Checker

A401

SCALE: 1" = 1'-0"

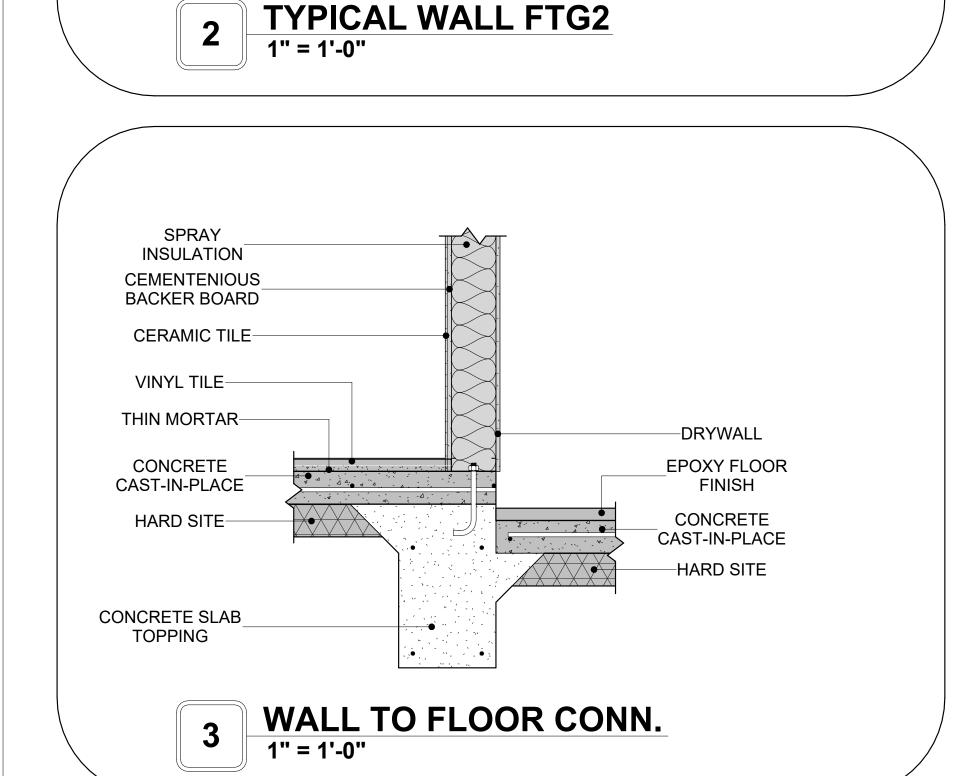

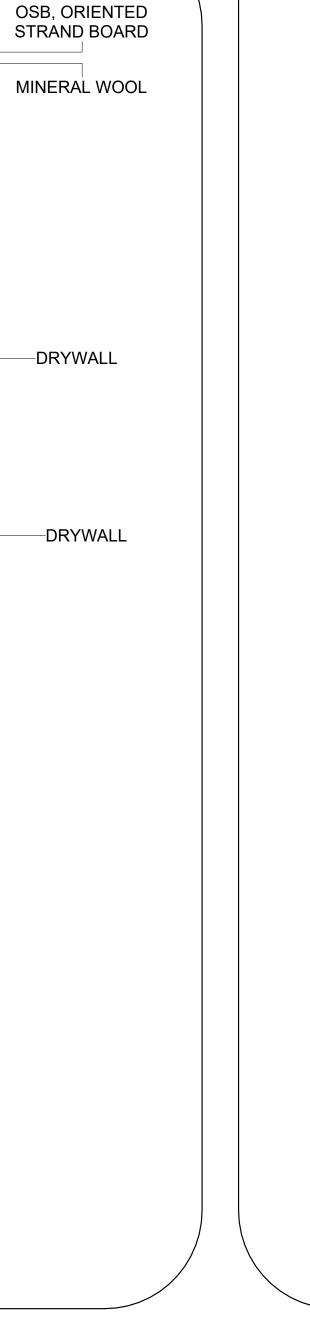

-MINERAL WOOL

ORIENTED

STRAND BOARD-

(OSB) (1/2")

CORRUGATED

IRON

PROCELAIN TILE

THIN MORTAR-

DAMP PROOFING-

CONCRETE

CAST-IN-PLACE

HARD SITE

CONCRETE SLAB_ TOPPING

> RIGID FOAM INSULATION-BOARD

CASEWORK GENERAL NOTES

- ALL CABINET HEIGHTS INCLUDE COUNTERTOPS. DIMENSIONS ARE TO THE NEAREST INCH. DIVISIONS IN CASEWORK ARE SHOWN FOR CLARITY AND DO NOT REPRESENT BREAKS IN THE COUNTERTOP.
- PROVIDE CONTINUOUS COUNTERTOP OVER ALL SIMILAR HEIGHT CASEWORK, UNLESS AND OTHERWISE NOTED.
- MANUFACTURER AND CATALOG NUMBERS ARE FOR REFERENCE AND ILLUSTRATION PURPOSES
- DOTTED LINES INDICATE WALL HUNG CABINETS, DIVISIONS OF BASE CABINETS BELOW THE
- COUNTERTOP, FURNITURE NOT IN THE CONTRACT OR PROJECTION SCREENS -SEE CASEWORK KEY AND SPECIFICATIONS.
- ALL CABINETS AND DRAWERS TO HAVE CAM LOCKS EXCEPT FOR SINK BASE CABINETS.
 ALL EXPOSED SURFACES (EXPOSED TO VIEW FROM ANY PERSPECTIVE) TO BE COVERED WITH
- LAMINATE. ALL CASEWORK WHICH MEETS A WALL AT ONE OR BOTH ENDS, TO BE PROVIDED WITH FILLER
- PANELS AND SCRIBED TO THE WALL(S) AS REQUIRED.
- 10. ALL CABINETS AND DRAWERS ARE PROVIDED WITH RECESSED HANDLES. 11. CONTRACTOR TO FIELD VERIFY ALL CLEAR OPENINGS PRIOR TO MILLWORK OR CASEWORK
- FABRICATION.
- 12. CASEWORK DRAWINGS ARE DIAGRAMMATIC IN NATURE TO SHOW DESIGN INTENT

CASEWORK SCHEDULE

TYPE						
MAR		COUN				
K	TYPE	T	HEIGHT	WIDTH	DEPTH	AREA
0.4				01 011	01 011	45.05
01	HD_TALL_CABINET_24	1	7' - 6"	2' - 0"	2' - 0"	15 SF
02	REFRIGERATOR TOP	1	1' - 6"	2' - 0"	2' - 4"	3 SF
03	WALL CABINET DOUBLE DOOR 211	1	2' - 6"	3' - 0"	1' - 0"	8 SF
04	LINEAR COUNTER TOP 2	1	0' - 4"	3' - 0"	2' - 1"	1 SF
05	BASE_CABINET_DOUBLE_DOOR	1	2' - 11"	3' - 0"	2' - 0"	9 SF
06	WALL FILLER	1	2' - 6"	0' - 9"	1' - 0"	2 SF
07	CLOSET	1	5' - 11"	3' - 0"	1' - 4"	18 SF
80	WALL_CABINET_L-SHAPE 3	1	2' - 6"	2' - 0"	2' - 0"	5 SF
09	WALL FILLER 2	1	2' - 6"	1' - 1"	1' - 0"	3 SF
10	HD_L-SHAPE_COUNTER_TOP W SINK HOLE 3	1	0' - 4"	4' - 6"	8' - 1"	1 SF
11	BASE CABINET DOUBLE DOOR 2	1	2' - 11"	2' - 2"	2' - 0"	6 SF
12	BASE_CABINET_L-SHAPED	1	2' - 11"	3' - 3"	3' - 3"	9 SF
13	BASE CABINET DOUBLE DOOR 2	1	2' - 11"	2' - 5"	2' - 0"	7 SF
14	BASE_CABINET_SINGLE_DOOR	1	2' - 7"	1' - 9"	2' - 0"	5 SF
15	WALL_CABINET_DOUBLE_DOOR	1	2' - 6"	2' - 10"	1' - 0"	7 SF
16	ISLAND_COUNTERTOP FLAT	1	0' - 2"	8' - 4"	3' - 6"	1 SF
17	HD_ISLAND_48X36 2	1	2' - 11"	4' - 1"	2' - 0"	12 SF
18	HD_ISLAND_48X36	1	2' - 11"	4' - 2"	2' - 0"	12 SF
19	VANITY 3	1	2' - 4"	3' - 7"	1' - 3"	8 SF
20	RECESSED_MED_CABINET 2	4	2' - 0"	1' - 6"	0' - 3"	3 SF
21	CLOSET 4	2	6' - 0"	6' - 3"	1' - 4"	37 SF
22	VANITY	1	2' - 4"	2' - 11"	1' - 8"	7 SF
23	LINEN	1	5' - 11"	5' - 7"	1' - 4"	33 SF
24	CLOSET 3	4	6' - 0"	8' - 0"	1' - 4"	48 SF
25	DOUBLE SINK VANITY	1	3' - 0"	6' - 0"	2' - 0"	18 SF
26	CLOSET 2	1	5' - 11"	2' - 0"	1' - 4"	12 SF
27	LINEN 2	1	5' - 11"	4' - 3"	1' - 4"	25 SF
28	WALL_CABINET_DOUBLE_DOOR 6	1	2' - 6"	2' - 7"	1' - 0"	7 SF

SPECIALTY EQUIPMENT SCHEDULE			
TYPE MARK	TYPE	COUNT	
01	WASHER-FRONT-LOAD	1	
02	REFRIGERATOR	1	
03	RANGE	1	
04	DRYER-FRONT-LOAD	1	
05	DISHWASHER	1	
GRAND TOTAL: 5		·	

5' - 7"

CA23


2' - 3"

SE01

CASEWORK PLAN


1/2" = 1'-0"


35

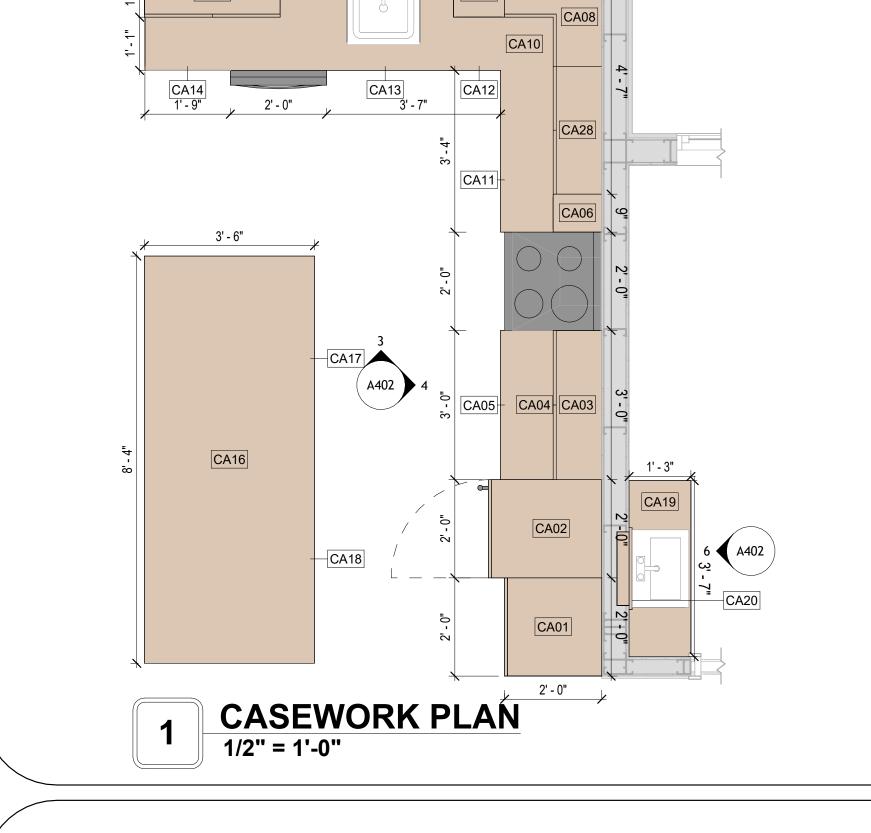



2' - 10"


CA15

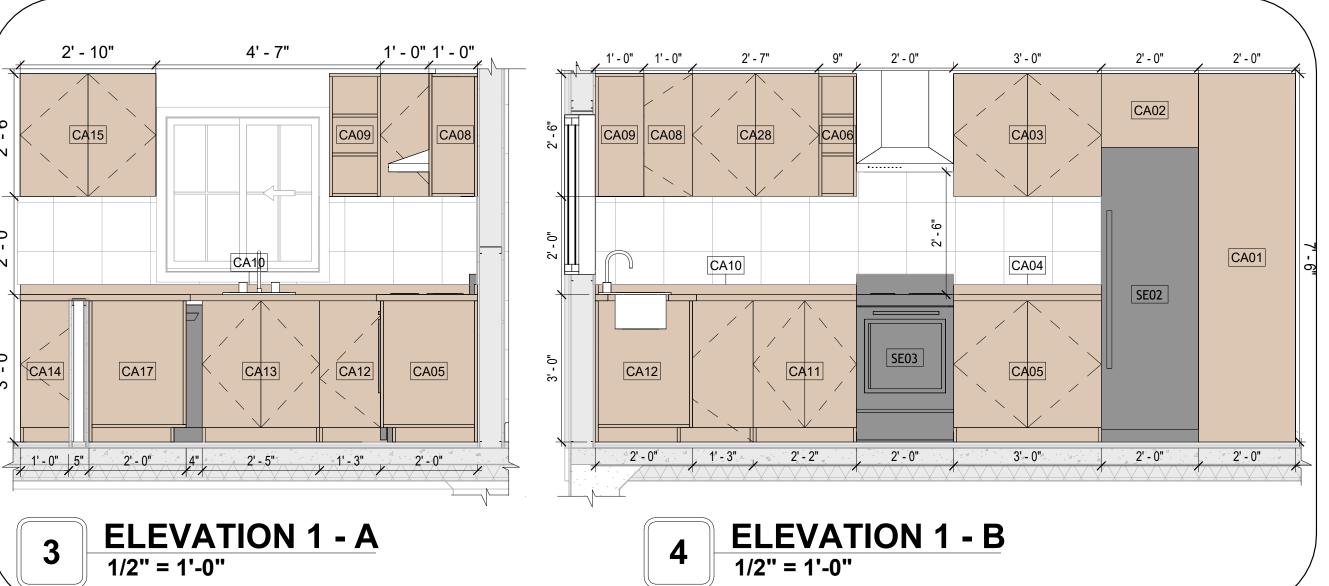

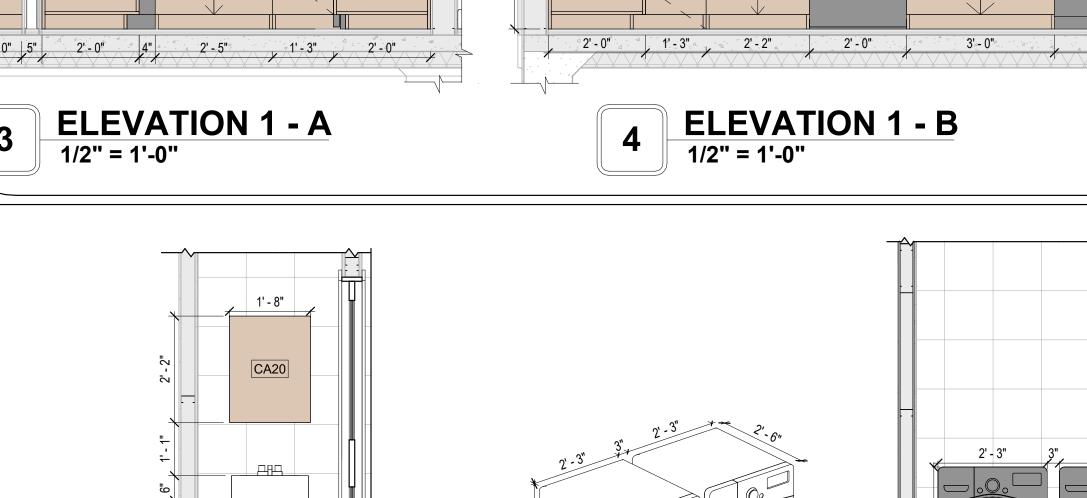


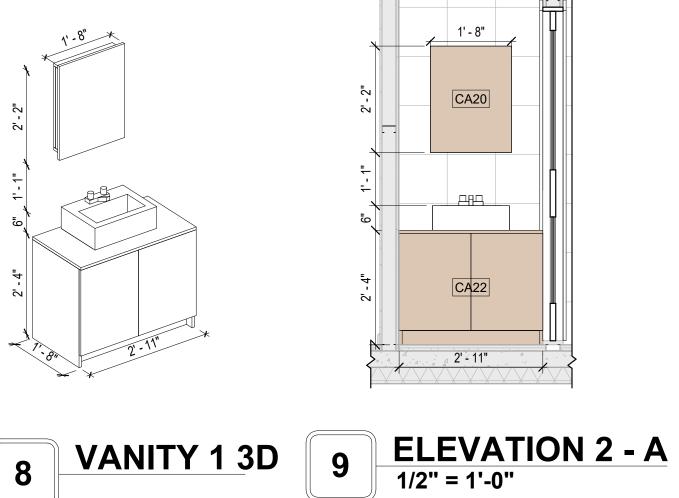

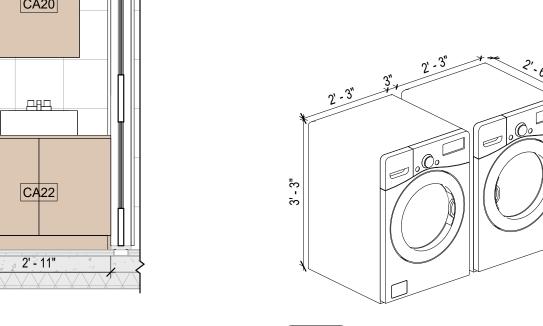

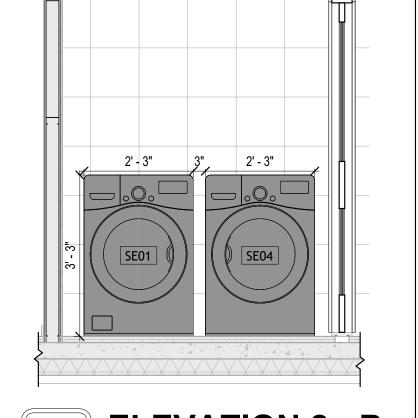


KITCHEN 3D

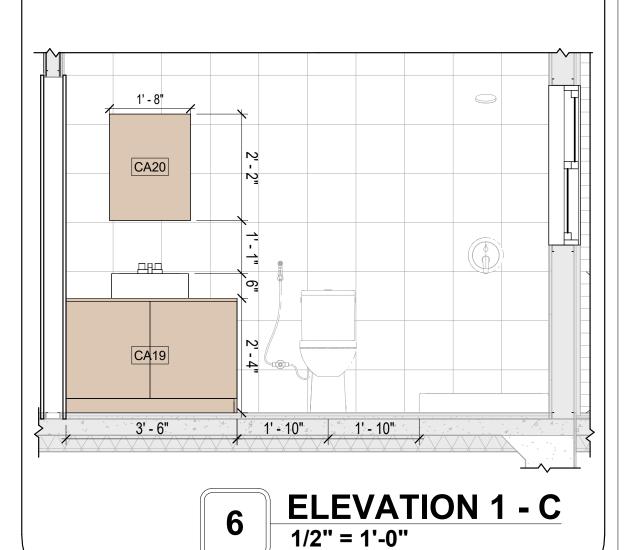

VANITY 3D



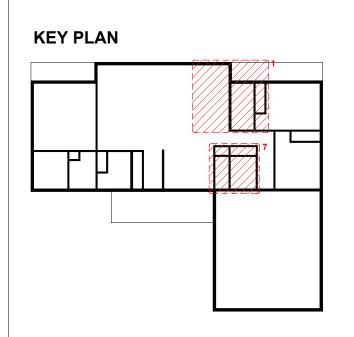

NO.	DESCRIPTION	DATE

NOTE:

LEGEND:

PROJECT

247-EMBER-1650-3Bd2.5Ba **FARMHOUSE-550**


DRAWING NAME


ARCHITECTURAL CASEWORK

CLIENT NAME:	Client Name
PROJECT NUMBER:	0061_12
DATE:	5/9/2025 3:45:08 PM
DESIGNED BY:	Designer
DRAWN BY:	Author
CHECKED BY:	Checker

A402

SCALE: As indicated

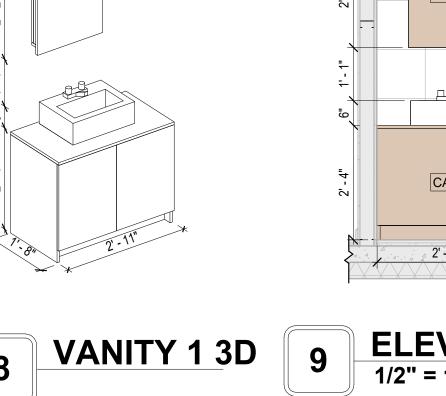

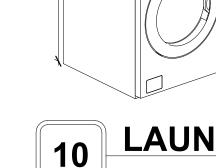

CA07

CA20

A402

GRAND TOTAL

GENERAL NOTES

1. THIS DRAWING DEPICTS THE HVAC (HEATING, VENTILATION, AND AIR CONDITIONING) SYSTEM FOR THE EMBER 3BD2.5BA FARMHOUSE. IT PROVIDES A VISUAL REPRESENTATION OF THE SYSTEM LAYOUT AND COMPONENTS.

2.THE HVAC SYSTEM IS DESIGNED TO MEET THE SPECIFIC REQUIREMENTS OF THE BUILDING, INCLUDING HEATING, COOLING, AND VENTILATION NEEDS AS PER THE PROJECT SPECIFICATIONS AND APPLICABLE CODES AND STANDARDS.

3. THE HVAC SYSTEM INSTALLATION SHALL COMPLY WITH THE LATEST EDITION OF THE INTERNATIONAL MECHANICAL CODE (IMC), INTERNATIONAL RESIDENTIAL CODE (IRC), AND ALL OTHER APPLICABLE LOCAL, STATE, AND NATIONAL CODES AND REGULATIONS.

4. THE EQUIPMENT SHOWN ON THIS DRAWING INCLUDES BUT IS NOT LIMITED TO AIR HANDLING UNITS (AHUS), CHILLERS, BOILERS, COOLING TOWERS, PUMPS, DUCTWORK, DIFFUSERS, GRILLES, AND CONTROL DEVICES.

5. ALL EQUIPMENT, DUCTWORK, AND PIPING SHALL BE INSTALLED IN ACCORDANCE WITH MANUFACTURER'S SPECIFICATIONS, LOCAL CODES, AND INDUSTRY BEST PRACTICES.

6. ALL DUCTWORK SHALL BE SIZED, FABRICATED, AND INSTALLED IN ACCORDANCE WITH THE LATEST EDITION OF THE ACCA MANUAL D AND THE SMACNA HVAC DUCT CONSTRUCTION STANDARDS. DUCTWORK SHALL BE INSTALLED IN A NEAT AND WORKMANLIKE MANNER, PROPERLY SUPPORTED AND BRACED TO PREVENT SAGGING, AIR LEAKAGE, OR VIBRATION.

7. CONDENSATE DRAINAGE PIPING SHALL BE PROPERLY PITCHED TO ENSURE POSITIVE DRAINAGE TO AN APPROVED DISPOSAL LOCATION, SUCH AS A FLOOR DRAIN, SUMP PUMP, OR EXTERIOR GRADE. CONDENSATE LINES SHALL BE INSULATED TO PREVENT SWEATING.

8. THE LOCATION OF CONTROL PANELS AND SENSORS INDICATED ON THIS DRAWING CAN BEMODIFY with THE SPECIFIC LOCATIONS AND WIRING DETAILS WILL BE DETERMINED DURING THE CONTROL SYSTEM DESIGN AND INSTALLATION.

9. THE HVAC SYSTEM DESIGN CONSIDER ENERGY EFFICIENCY, INDOOR AIR QUALITY, OCCUPANT COMFORT, AND NOISE CONTROL, FOLLOWING APPLICABLE GUIDELINES AND REGULATIONS.

10. COORDINATION WITH OTHER TREADS HAS BEEN DONE ON A DESIGN LEVEL. THIS DRAWING SHALL BE READ TOGETHER WITH THE AR, EL AND SN

DESIGN DRAWINGS TO ENSURE PROPER INSTALLATION AND INTEGRATION OF THE HVAC SYSTEMS.

11. THE HVAC CONTRACTOR IS RESPONSIBLE FOR OBTAINING ALL NECESSARY PERMITS AND LICENSES, AND FOR SCHEDULING AND COORDINATING

WITH THE LOCAL BUILDING DEPARTMENT AND UTILITY PROVIDERS TO ENSURE A TIMELY AND COMPLIANT INSTALLATION.

12. ALL DUCTWORK PENETRATIONS THROUGH WALLS, FLOORS, OR CEILINGS SHALL BE PROPERLY SEALED AND FIRE-STOPPED USING APPROVED

METHODS AND MATERIALS TO MAINTAIN THE INTEGRITY OF THE BUILDING'S FIRE-RESISTANCE RATINGS.

13. HVAC EQUIPMENT SHALL BE INSTALLED LEVEL AND PLUMB, AND IN STRICT ACCORDANCE WITH THE MANUFACTURER'S INSTALLATION

INSTRUCTIONS AND RECOMMENDATIONS. PROVIDE ADEQUATE CLEARANCES AROUND EQUIPMENT FOR PROPER AIRFLOW, SERVICE ACCESS, AND CODE COMPLIANCE.


14. ALL HVAC EQUIPMENT AND COMPONENTS, INCLUDING THERMOSTATS, DAMPERS, AND ACCESS PANELS, SHALL BE LOCATED IN ACCESSIBLE AREAS FOR EASY SERVICING AND MAINTENANCE. PROVIDE ADEQUATE SPACE AROUND EQUIPMENT FOR PROPER AIRFLOW AND SERVICE ACCESS.

15. THE HVAC SYSTEM SHALL BE BALANCED AND ADJUSTED TO ENSURE PROPER AIRFLOW, TEMPERATURE DISTRIBUTION, AND SYSTEM PERFORMANC THROUGHOUT THE RESIDENCE. PROVIDE A WRITTEN REPORT DOCUMENTING THE FINAL SYSTEM BALANCE.


16. ANY DEVIATIONS OR MODIFICATIONS TO THE HVAC SYSTEM DESIGN SHALL BE REVIEWED AND APPROVED BY THE RESPONSIBLE DESIGN PROFESSIONALS AND COMMUNICATED TO ALL RELEVANT PARTIES INVOLVED IN THE CONSTRUCTION PROCESS.

17. FOR ANY INQUIRIES OR CLARIFICATIONS REGARDING THE HVAC SYSTEM DESIGN, PLEASE CONSULT THE RESPONSIBLE DESIGN PROFESSIONALS OR THE PROJECT MANAGEMENT TEAM.

SYMBOLS

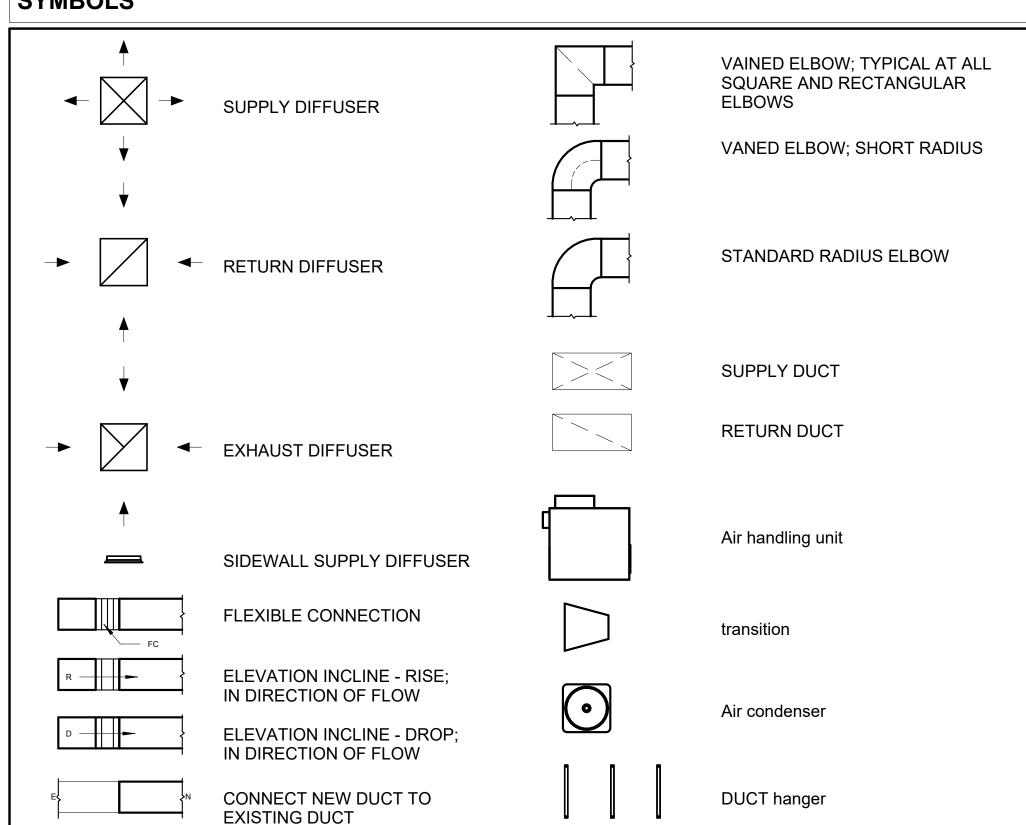



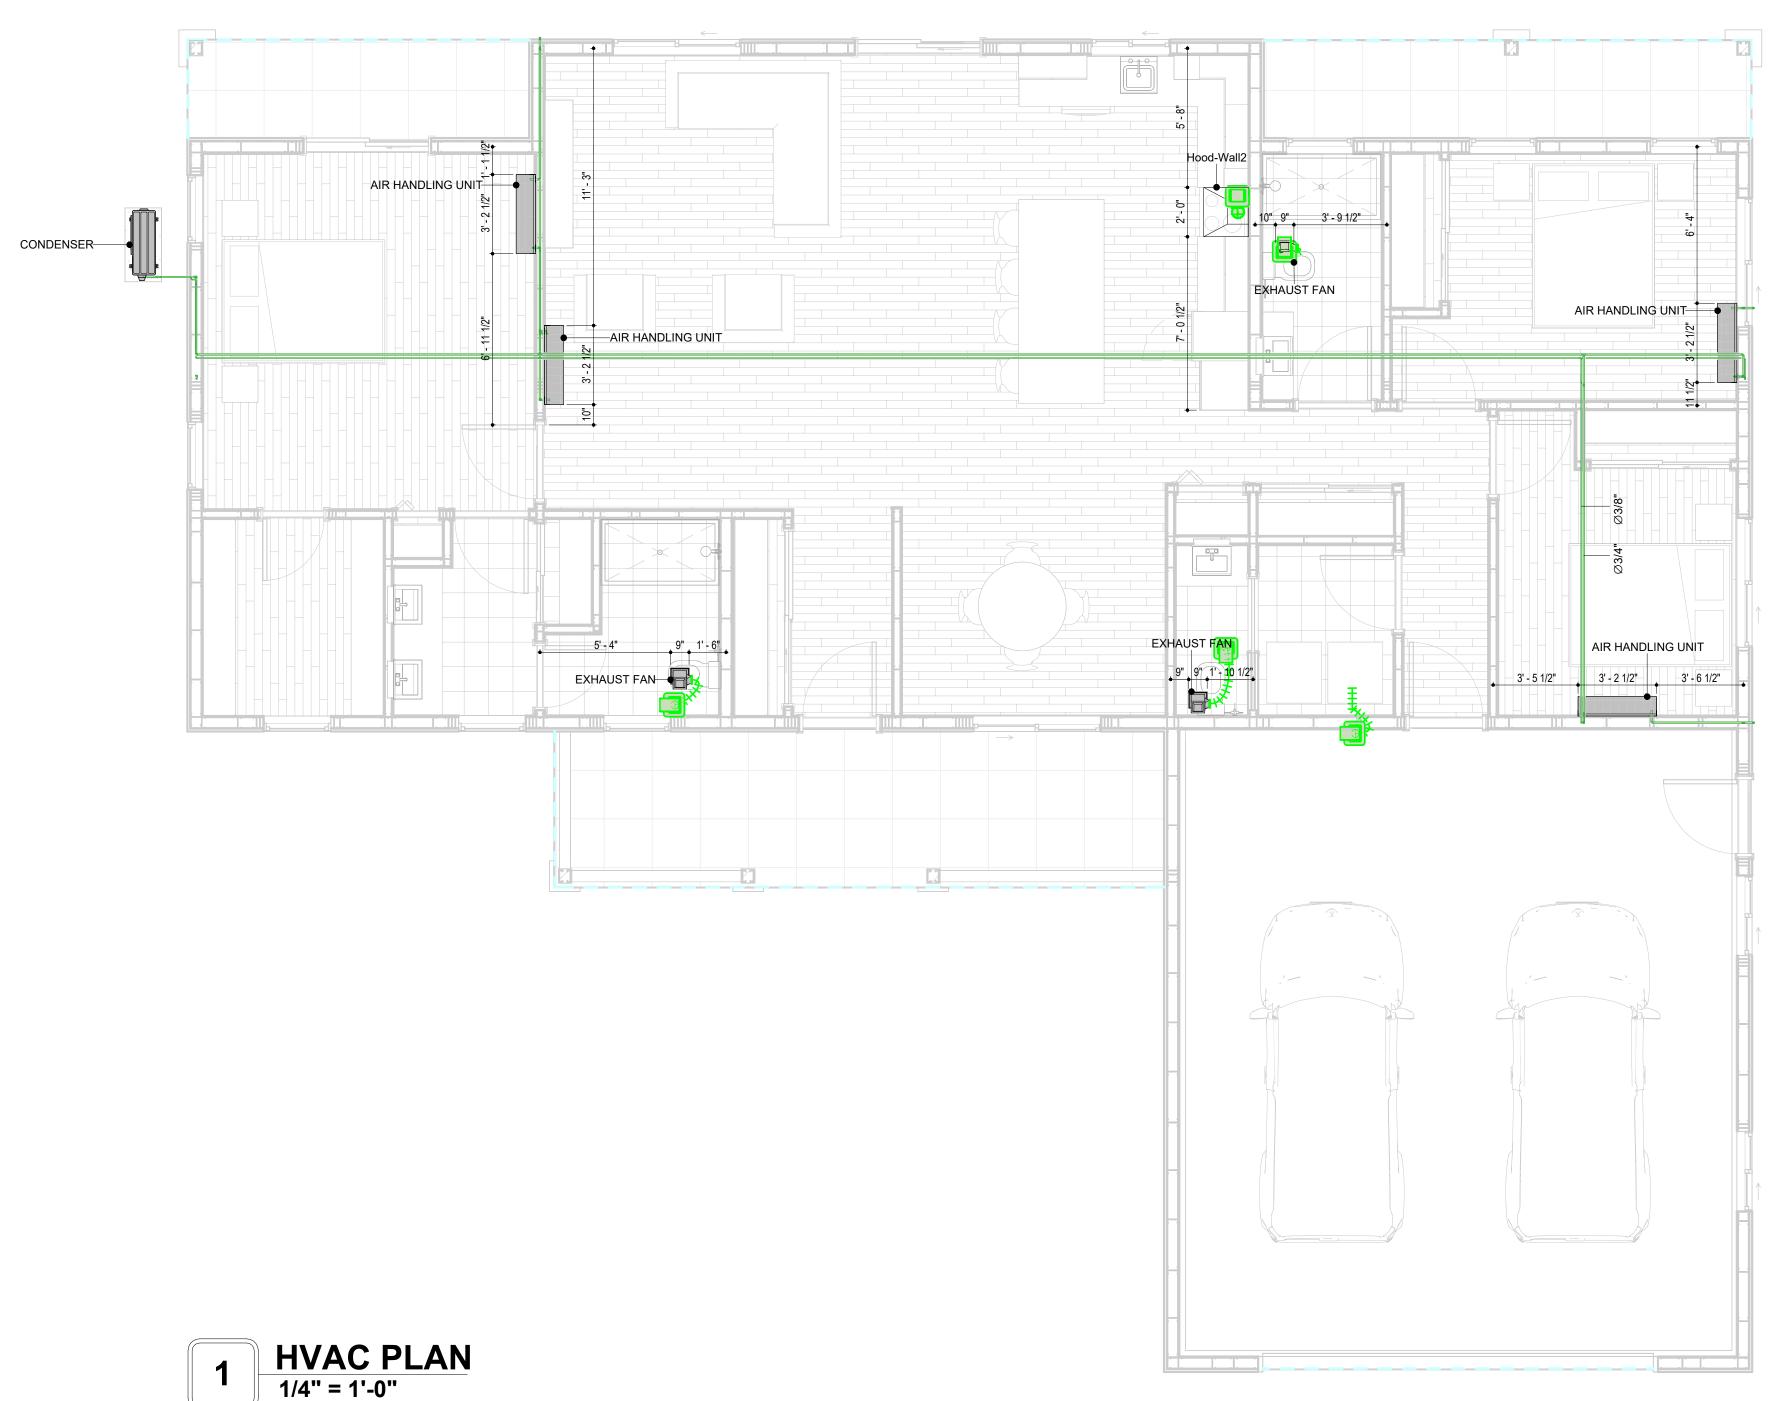

REFRIGERANT LINE SCHEDULE				
CATAGORY	DESCRIPTION	DESCRIPTION DIAMETER		
Pipe Types	Copper	3/8"	133.74	
Pipe Types	Copper	3/4"	181.35	

REFRIGERANT LINE FITTING SCHEDULE							
CATAGORY DESCRIPTION Size Co							
Elbow - Generic	Elbow - Generic: Standard/HVAC	3/4"ø-3/4"ø	31				
Elbow - Generic	Elbow - Generic: Standard/HVAC	3/8"ø-3/8"ø	25				
Tee - Generic	Tee - Generic: Standard	3/4"ø-3/4"ø-3/ 4"ø	4				
Tee - Generic	Tee - Generic: Standard	3/8"ø-3/8"ø-3/ 8"ø	3				
Transition - Generic	Transition - Generic: Standard	3/4"ø-1/2"ø	5				
Transition - Generic	Transition - Generic: Standard	3/4"ø-5/8"ø	4				
Transition - Generic	Transition - Generic: Standard	3/8"ø-1/4"ø	1				

MECHANICAL EQUIPMENT SCHEDULE						
CATAGORY DESCRIPTION COUNT						
AIR HANDLING UNIT	AIR HANDLING UNIT: WALL MOUNTED	4				
CONDENSER	CONDENSER: OUT DOOR	1				
Exhaust Fan	EXHAUST FAN: 75 CFM	3				
	Hood-Wall2: VENT 2	1				

DUCT FITTING SCHEDULE

CATAGOI	RY	DESCRIPTION				
Round Transition - Angle	45 Deg	ree		9		
	DUCT AC	CESSORY SCH	EDULE			
CATAGORY		DESCRIPTION		COUNT		
ROOF VENT	3" DIAMETER			5		
	FLEX	DUCT SCHEDU	LE			
DESCRIPTION	DESCRIPTIO	N LENGTH	DIAMETER	COUNT		
	'	1				
	T					
Flex Duct Round	FLEX-ROUND	21.54	4"	4		
Flex Duct Round Flex Duct Round	FLEX-ROUND FLEX-ROUND	21.54 6.88	4" 6"	1		



KEY PLAN

NO.	DESCRIPTION	DATE

NOTE:

LEGEND:

PROJECT

247-EMBER-1650-3Bd2.5Ba FARMHOUSE-550

DRAWING NAME

HVAC PLAN

CLIENT NAME:

PROJECT NUMBER:

15_0001

DATE:

5/8/2025 7:45:17 AM

DESIGNED BY:

DRAWN BY:

CHECKED BY:

Checker

M101

ELECTRICAL NOTES

- 1. THIS DRAWING DEPICTS THE ELECTRICAL SYSTEM FOR THE247-EMBER-1650-3Bd 2.5Ba FARMHOUSE-550. IT PROVIDES A VISUAL REPRESENTATION OF THE ELECTRICAL LAYOUT AND COMPONENTS, INCLUDING POWER DISTRIBUTION, LIGHTING, AND CONTROL SYSTEMS.
- 2. THE ELECTRICAL SYSTEM IS DESIGNED TO MEET THE SPECIFIC REQUIREMENTS OF THE BUILDING, INCLUDING POWER DISTRIBUTION, LIGHTING, AND SPECIALIZED ELECTRICAL EQUIPMENT NEEDS, AS PER THE PROJECT SPECIFICATIONS AND APPLICABLE CODES AND STANDARDS.
- 3. THE ELECTRICAL SYSTEM INSTALLATION SHALL COMPLY WITH THE LATEST EDITION OF THE NATIONAL ELECTRICAL CODE (NEC), INTERNATIONAL BUILDING CODE (IBC), AND ALL OTHER APPLICABLE LOCAL, STATE, AND NATIONAL CODES AND REGULATIONS.
- 4. LOCATIONS AS NEEDED, DEVICES ARE SHOWN ON PLANS IN APPROXIMATE IDEAL LOCATIONS, UNLESS SPECIFICALLY DIMMENSIONED.
- . OPEN WALLS AS NEEDED TO ALLOW FOR NEW ELECTRICAL INSTALLATIONS.
- 6. LABEL ALL CIRCUITS ON JUNCTION BOXES, RECEPTACLES, DATA, SMOKE DETECTOR, AND EQUIPMENT IN PANEL BOX.
- 7. INSTALL RACEWAY AS NEEDED FOR DDC, ACCESS CONTROL, LOW VOLTAGE WIRING & DATA.
- 8. RELABEL POWER, DATA & FIRE ALARM FOR ROOM #CHANGES.
 9. VERIFY ALL CIRCUITS LABELED ON PRINT ARE CORRECT BEFORE WORKING ON THEM.
- 10. NOTE ON SITE PLAN ALL CHANGES OR MISSING DETAIL TO BE INCORPORATED INTO THE MASTER PLAN.
- 11. DRAWINGS ARE DIAGRAMMATIC ONLY FOR THE PURPOSE OF SHOWING FIXTURE AND OUTLET LOCATIONS.
- 12. ELECTRICAL CONTRACTOR TO VERIFY SERVICE SIZE BY CALCULATION BASED UPON ACTUAL NAME PLATE RATINGS OF SELECTED FOLIPMENT
- PLATE RATINGS OF SELECTED EQUIPMENT.

 13. VERIFY LOCATION OF SERVICE ENTRANCE WITH POWER COMPANY. PROVIDE UFER GROUND IN
- BUILDING FOUNDATION AT SERVICE ENTRANCE LOCATION.
- 14. PROVIDE A MIN. OF 20 FEET OF ONE *4 BARE COPPER UFER WIRE EMBEDDED IN CONCRETE FOOTING AT THE SERVICE ENTRANCE LOCATION WHERE APPROVED BY LOCAL SERVICE PROVIDER.
- 15. PROVIDE WATERPROOF FIXTURES IN ALL HIGH MOISTURE AREAS (EXTERIOR, SHOWER AND TUB
- CEILINGS ETC.)
 16. PROVIDE DEDICATED CIRCUITS TO EACH BATH, DEN, FAMILY ROOM, BEDROOM, LOFT, KITCHEN
- REFRIGERATOR, KITCHEN FREEZER DISHWASHER, AND ANY AREA/ITEM SPECIFIED BY OWNER.

 17. INCANDESCENT FIXTURES WITH OPEN OR PARTIALLY ENCLOSED LAMPS, PENDANT FIXTURES, AND
- LAMP HOLDERS ARE NOT PERMITTED IN CLOSETS.

 18. ALL WORKMANSHIP AND MATERIALS TO CONFORM WITH THE 2015 IRC.
- 19. PROVIDE A MIN. OF 20 FEET OF ONE *4 BARE COPPER UFER WIRE EMBEDDED IN CONCRETE FOOTING AT THE SERVICE ENTRANCE LOCATION WHERE APPROVED BY LOCAL SERVICE PROVIDER.
- 20. PROVIDE A BONDING CONDUCTOR CONSISTING OF A MINIMUM OF ONE *4 BARE COPPER WIRE CONNECTING THE BUILDING'S METAL WATER PIPING SYSTEM TO THE SERVICE EQUIPMENT ENCLOSURE GROUNDING.

MAIN PANEL CALCS

MINI. SPLIT UNITS	10,000 W
RIST 10,000 @ 100% REMAINDER @ 40%	10,000 W 7,300 W
TOTAL	28,250 W
DISHWASHER & DISPOSAL	3000 W
REFRIG.	1,800 W
VATER HEATER	5,000 W
RANGE	5,000 W
VASHER	2,000 W
PRYER	2,000 W
APPLIANCE CIRCUITS	4,500 W
IGHT AND OUTLETS 1,650 @ 3W	4,950 W
ELECTRICAL CALCS	

27,300 W DIVIDED BY 240V = 114 AMPS TOTAL

27,300 W

(USE 200 AMP SERVICE)

TOTAL

ELECTRICAL ABBREVIATIONS LIST

1P	1 POLE (2P, 3P, 4P, ETC.)	CTR	CENTER	нт	HEIGHT
A	AMPERE	CU	COPPER	HTG	HEATING
AC	ABOVE COUNTER OR AIR CONDITIONER	DCP	DOMESTIC WATER CIRCULATING PUMP	HTR	HEATER
ACLG	ABOVE CEILING	DEPT	DEPARTMENT	HV	HIGH VOLTAGE
ADO	AUTOMATIC DOOR OPENER	DET	DETAIL	HVAC	HEATING, VENTILATING AND AIR
AF	AMP FRAME	DIA	DIAMETER	CONDITIONING	CONDITIONING
AFF	ABOVE FINISHED FLOOR	DISC	DISCONNECT	HWP	HYDRONIC WATER PUMP
AFG	ABOVE FINISHED GRADE	DIST	DISTRIBUTION	IC	INTERRUPTING CAPACITY
AFI	ARC FAULT CIRCUIT INTERRUPTER	DN	DOWN	IG	ISOLATED GROUND
AHU	AIR HANDLING UNIT	DPR	DAMPER	IMC	INTERMEDIATE METAL CONDUIT
AL	ALUMINUM	DS	SAFETY DISCONNECT SWITCH	INCAND	INCANDESCENT
ALT	ALTERNATE	DT	DOUBLE THROW	IR	INFRARED
AMP	AMPERE	DWG	DRAWING	I/W	INTERLOCK WITH
AMPL	AMPLIFIER	DDC	DIRECT DIGITAL CONTROL	J-BOX	JUNCTION BOX
ANNUN	ANNUNCIATOR APPROX APPROXIMATELY		ELECTRICAL CONTRACTOR	KV	KILOVOLT
AQ-STAT	AQUASTAT	ELEC	ELECTRIC, ELECTRICAL	KVA	KILOVOLT-AMPERE
ARCH	ARCHITECT, ARCHITECTURAL	ELEV	ELEVATOR	KVAR	KILOVOLT-AMPERE REACTIVE
AS	AMP SWITCH	EM	EMERGENCY	KW	KILOWATT
AT	AMP TRIP	EMS	ENERGY MANAGEMENT SYSTEM	KWH	KILOWATT HOUR
ATS	AUTOMATIC TRANSFER SWITCH	EMT	ELECTRICAL METALLIC TUBING	LOC	LOCATE OR LOCATION
AUTO	AUTOMATIC	EP	ELECTRIC PNEUMATIC	LT	LIGHT
AUX	AUXILIARY	EQUIP	EQUIPMENT	LTG	LIGHTING
AV	AUDIO VISUAL	EWC	ELECTRIC WATER COOLER	LTNG	LIGHTNING
AWG	AMERICAN WIRE GAUGE	EXIST	EXISTING	LV	LOW VOLTAGE
BATT	BATTERY	EXH	EXHAUST	MAX	MAXIMUM
BD	BOARD	EXP	EXPLOSION PROOF	MAG.S	MAGNETIC STARTER
BLDG	BUILDING	FA	FIRE ALARM	M/C	MOMENTARY CONTACT
BMS	BUILDING MANAGEMENT SYSTEM	FABP	FIRE ALARM BOOSTER POWER	MC	MECHANICAL CONTRACTOR
C	CONDUIT	SUPPLY PANEL	SUPPLY PANEL	MCB	MAIN CIRCUIT BREAKER
CAB	CABINET	FACP	FIRE ALARM CONTROL PANEL	MCC	MOTOR CONTROL CENTER
CAT	CATALOG	FCU	FAN COIL UNIT	MDC	MAIN DISTRIBUTION CENTER
CATV	CABLE TELEVISION	FIXT	FIXTURE	MDP	MAIN DISTRIBUTION PANEL
CB	CIRCUIT BREAKER	FLR	FLOOR	MFR	MANUFACTURERMAIN FUSED
CCTV	CLOSED CIRCUIT TELEVISION	FLUOR	FLUORESCENT	NAL I	DISCONNECT SWITCH
CKT	CIRCUIT	FUDS	FUSE	MH	MANHOLE
CLG COMB	CEILING	FUDS	FUSED SAFETY DISCONNECT SWITCH	MIC	MICROPHONE
CMPR	COMBINATION COMPRESSOR	GA GAL	GAUGE GALLON	MIN MISC	MINIMUM MISCELLANEOUS
CONN	CONNECTION	GALV	GALVANIZED	MLO	MAIN LUGS ONLY
CONST	CONSTRUCTION	GC	GENERAL CONTRACTOR	MMS	MANUAL MOTOR STARTER
CONST	CONTINUATION OR CONTINUOUS	GEN	GENERATOR	MOA	MULTIOUTLET ASSEMBLY
CONTR	CONTRACTOR	GFI	GROUND FAULT CIRCUIT INTERRUPTER	MSP	MOTOR STARTER PANELBOARD
CONT	CONVECTOR	GFP	GROUND FAULT PROTECTOR	MSBD	MAIN SWITCHBOARD
CP	CIRCULATING PUMP	GND	GROUND	MT	MOUNT
CRT	CATHODE-RAY TUBE	GRS	GALVANIZED RIGID STEEL (CONDUIT)	MT.C	EMPTY CONDUIT
CT	CURRENT TRANSFORMER	GYP BD	GYPSUM BOARD	UL	UNDERWRITERS LABORATORIES
			1 - 1 - 2 - 11 - 2 - 11 - 12		

Branch Panel:

Location: W/C 16
Supply From:
Mounting: Recessed

Enclosure: Type 1

Volts: 120/240 Single Phases: 1 Wires: 3 A.I.C. Rating:
Mains Type:
Mains Rating: 200 A
MCB Rating: 1 A

Notes:

MST BED LIGHT		Rating		Wire Size	A			3	Wire Size	Length	Rating	Number of Elements	Circuit Description	Numl er
	12	15 A	51' - 4 17/32"	1-#14, 1-#14, 1-#14	688 VA	972 VA			1-#12, 1-#12, 1-#12	43' - 0 17/32"	20 A	12	MST BATH GFCI	2
OUTDOOR LIGHT	10	20 A	96' - 9 7/8"	1-#10, 1-#10, 1-#10			815 VA	876 VA	1-#12, 1-#12, 1-#12	72' - 11 17/32"	20 A		KITCHEN & DINNER LIGHT	4
LIVING LIGHT	9	15 A	59' - 1 5/32"	1-#14, 1-#14, 1-#14	269 VA	160 VA			1-#12, 1-#12, 1-#12	102' - 4 1/8"	20 A	5	GARAGE LIGHT	6
BED 1& 2 LIGHT	17	20 A	100' - 6 11/16"	1-#10, 1-#10, 1-#10			956 VA	396 VA	1-#12, 1-#12, 1-#12	85' - 11 29/32"	20 A	6	BATH 1 GFCI	8
HALL LIGHT	4	15 A	77' - 1 1/8"	1-#14, 1-#14, 1-#14	180 VA	576 VA			1-#12, 1-#12, 1-#12	69' - 5 27/32"	20 A	7	BATH 2 GFCI	10
CONDENSER	1	60 A	25' - 9 11/16"	2-#6, 1-#6, 1-#10			2500 VA	1620 VA	1-#8, 1-#8, 1-#8	91' - 3 27/32"	20 A	9	OUTDOOR GFCI	12
					2500 VA	900 VA			1-#12, 1-#12, 1-#12	74' - 6 9/16"	20 A	5	KITCHEN GFCI	14
WASHER	1	20 A	58' - 10 29/32"	1-#12, 1-#12, 1-#12			1200 VA	2500 VA	2-#10, 1-#10, 1-#10	56' - 7 23/32"	30 A	1	DRYER	16
WATER HEATER	1	30 A	55' - 10 15/32"	2-#10, 1-#10, 1-#10	2250 VA	2500 VA								18
							2250 VA	1260 VA	1-#8, 1-#8, 1-#8	97' - 3 31/32"	20 A	7	GARAGE GFCI	20
RANGE	1	50 A	70' - 2 3/4"	2-#8, 1-#8, 1-#10	2500 VA	180 VA			1-#12, 1-#12, 1-#12	64' - 3 13/16"	20 A	1	OVENHOOD	22
							2500 VA	1800 VA	1-#10, 1-#10, 1-#10	64' - 5 7/16"	20 A	1	REFRIGERATOR	24
DISHWASHER	1	20 A	71' - 0 3/8"	1-#10, 1-#10, 1-#10	1200 VA	720 VA			1-#12, 1-#12, 1-#12	54' - 1 21/32"	20 A		LIVING RECEPATCEL	26
					15582	2 VA	2080	2 VA						
	LIVING LIGHT BED 1& 2 LIGHT HALL LIGHT CONDENSER - WASHER WATER HEATER - RANGE	IVING LIGHT 9	15 A 15 A 15 A 15 A 16 A 16 A 17 18 A 18	2.IVING LIGHT 9 15 A 59' - 1 5/32" 3ED 1& 2 LIGHT 17 20 A 100' - 6 11/16" HALL LIGHT 4 15 A 77' - 1 1/8" CONDENSER 1 60 A 25' - 9 11/16"	DUTDOOR LIGHT 10 20 A 96' - 9 7/8" 1-#10, 1-#10 LIVING LIGHT 9 15 A 59' - 1 5/32" 1-#14, 1-#14 BED 1& 2 LIGHT 17 20 A 100' - 6 11/16" 1-#10, 1-#10 HALL LIGHT 4 15 A 77' - 1 1/8" 1-#14, 1-#14 CONDENSER 1 60 A 25' - 9 11/16" 2-#6, 1-#6, 1-#10 WASHER 1 20 A 58' - 10 29/32" 1-#12, 1-#12 WATER HEATER 1 30 A 55' - 10 15/32" 1-#10, 1-#10 RANGE 1 50 A 70' - 2 3/4" 2-#8, 1-#8, 1-#10 DISHWASHER 1 20 A 71' - 0 3/8" 1-#10,	DUTDOOR LIGHT 10 20 A 96' - 9 7/8" 1.#10, 1.#10 1.#10, 1.#10 1.#14, 269 VA 1.#14 1.#14, 1.#14 1.#14, 1.#14 1.#14, 1.#14 1.#14, 1.#10, 1.#10, 1.#10, 1.#10, 1.#10, 1.#10, 1.#10, 1.#10, 1.#10, 1.#10, 1.#14, 1	DUTDOOR LIGHT 10 20 A 96' - 9 7/8" 1.#10, 1.#10 1.#110 1.#110 1.#110 1.#110 1.#114 1.#14 1.#14 1.#14 1.#14 1.#14 1.#14 1.#14 1.#10 1.#1	DUTDOOR LIGHT 10 20 A 96' - 9 7/8" 1.#10, 1.#10 815 VA I.VING LIGHT 9 15 A 59' - 1 5/32" 1.#14, 1.#14 269 VA 160 VA BED 1& 2 LIGHT 17 20 A 100' - 6 11/16" 1.#10, 1.#10 HALL LIGHT 4 15 A 77' - 1 1/8" 1.#14, 1.#14, 1.#10 CONDENSER 1 60 A 25' - 9 11/16" 2.#6, 1.#6, 1.#10 VASHER 1 20 A 58' - 10 29/32" 1.#12, 1.#12 VASHER 1 30 A 55' - 10 15/32" 2.#10, 1.#10 VATER HEATER 1 30 A 55' - 10 15/32" 2.#10, 1.#10 RANGE 1 50 A 70' - 2 3/4" 2.#8, 1.#8, 1.#10 DISHWASHER 1 20 A 71' - 0 3/8" 1.#10, 1.#10, 1.#10, 1.#10 DISHWASHER 1 20 A 71' - 0 3/8" 1.#10, 1	DUTDOOR LIGHT 10 20 A 96' - 9 7/8" 1-#10, 1-#10, 1-#10, 1-#14, 1-#14, 1-#14, 1-#14, 1-#14, 1-#14, 1-#14, 1-#14, 1-#14, 1-#10, 1-	DUTDOOR LIGHT 10 20 A 96' - 9 7/8" 1.#10, 1.#10 815 VA 876 VA 1.#12, 1.#12, 1.#12 IVING LIGHT 9 15 A 59' - 1 5/32" 1.#14, 1.#14 BED 18 2 LIGHT 17 20 A 100' - 6 11/16" 1.#10, 1.#10, 1.#10 HALL LIGHT 4 15 A 77' - 1 1/8" 1.#14, 1.#14 CONDENSER 1 60 A 25' - 9 11/16" 2.#6, 1.#6, 1.#12, 1.#12, 1.#12 VASHER 1 20 A 58' - 10 29/32" 1.#12, 1.#12 VASHER 1 30 A 55' - 10 15/32" 1.#10, 1.#10 VATER HEATER 1 50 A 70' - 2 3/4" 2.#8, 1.#8, 1.#8 RANGE 1 50 A 71' - 0 3/8" 1.#10, 1.#10 DISHWASHER 1 20 A 71' - 0 3/8" 1.#10, 1.#10 DISHWASHER 1 20 A 71' - 0 3/8" 1.#10, 1.#10 DISHWASHER 1 20 A 71' - 0 3/8" 1.#10, 1.#10 DISHWASHER 1 20 A 71' - 0 3/8" 1.#10, 1.#10 DISHWASHER 1 20 A 71' - 0 3/8" 1.#10, 1.#10, 1.#10 DISHWASHER 1 20 A 71' - 0 3/8" 1.#10, 1.#10, 1.#10 DISHWASHER 1 20 A 71' - 0 3/8" 1.#10, 1.#10, 1.#10 DISHWASHER 1 20 A 71' - 0 3/8" 1.#10, 1.#10, 1.#10 DISHWASHER 1 20 A 71' - 0 3/8" 1.#10, 1.#10, 1.#10 DISHWASHER 1 20 A 71' - 0 3/8" 1.#10, 1.#10, 1.#10 DISHWASHER 1 20 A 71' - 0 3/8" 1.#10, 1.#10, 1.#10 DISHWASHER 1 20 A 71' - 0 3/8" 1.#10, 1.#10, 1.#10, 1.#10 DISHWASHER 2000 A 1600 VA 20802 VA	DUTDOOR LIGHT 10 20 A 96'-9 7/8" 1.#10, 1.#10 815 VA 876 VA 1.#12, 72'-11 17/32" 1.#10 1.#10 1.#10 1.#12, 1	DUTDOOR LIGHT 10 20 A 96'-9 7/8" 1-#10, 1-#10 815 VA 876 VA 1-#12, 72'-11 17/32" 20 A 1-#10, 1-#10 1-#10 DUTDOOR LIGHT 9 15 A 59'-1 5/32" 1-#14, 1-#14 DUTING LIGHT 9 15 A 59'-1 5/32" 1-#14, 1-#14 DUTING LIGHT 17 20 A 100'-6 11/16" 1-#10, 1-#10, 1-#10 BED 18 2 LIGHT 17 20 A 100'-6 11/16" 1-#10, 1-#10 ALL LIGHT 4 15 A 77'-1 1/8" 1-#14, 1-#14 DONDENSER 1 60 A 25'-9 11/16" 2-#6, 1-#6, 1-#10 DONDENSER 1 60 A 25'-9 11/16" 2-#6, 1-#6, 1-#10 DONDENSER 1 20 A 58'-10 29/32" 1-#12, 1-#12 DONDENSER 1 30 A 58'-10 15/32" 1-#12, 1-#12 DONDENSER 1 30 A 55'-10 15/32" 1-#12, 1-#12 DONDENSER 1 30 A 55'-10 15/32" 1-#12, 1-#12 DONDENSER 1 30 A 55'-10 15/32" 1-#10, 1-#10 DONDENSER 1 30 A 70'-2 3/4" 2-#8, 1-#8, 1-#8, 1-#8, 1-#8, 1-#8, 1-#8, 1-#8, 1-#10 DONDENSER 1 30 A 70'-2 3/4" 2-#8, 1-#8, 1-#10, 1-#10 DONDENSER 1 50 A 70'-2 3/4" 2-#8, 1-#8, 1-#8, 1-#10, 1-#10 DONDENSER 1 50 A 70'-2 3/4" 2-#8, 1-#8, 1-#10, 1-#10 DONDENSER 1 50 A 70'-2 3/4" 2-#8, 1-#8, 1-#8, 1-#10, 1-#10 DONDENSER 1 20 A 71'-0 3/8" 1-#10,	DUTDOOR LIGHT 10 20 A 96' - 9 7/8" 1.#10,	DUIDOOR LIGHT 10 20 A 96'-978" 1-#10

Legend	:

oad Classification	Connected Load	Demand Factor	Estimated Demand	Panel	Totals
GHTING - DWELLING UNIT	1360 VA	100.00%	1360 VA		
THER	3088 VA	100.00%	3088 VA	Total Conn. Load:	36384 VA
ECEPTACLE	10320 VA	98.45%	10160 VA	Total Est. Demand:	35224 VA
GHTING	400 VA	100.00%	400 VA	Total Conn.:	152 A
ONDENSER	5000 VA	100.00%	5000 VA	Total Est. Demand:	147 A
/ATER HEATER	4500 VA	100.00%	4500 VA		
ANGE	5000 VA	80.00%	4000 VA		
RYER	5000 VA	100.00%	5000 VA		
EFRIGERATOR	1800 VA	100.00%	1800 VA		



www.frameupnow.com

KEY PLAN

NO. DESCRIPTION DATE

NOTE:

LEGEND:

PROJECT

247-EMBER-1650-3Bd 2.5Ba FARMHOUSE-550

DRAWING NAME

SCHEDULE

 CLIENT NAME:
 Owner

 PROJECT NUMBER:
 0138_16

 DATE:
 5/7/2025 10:30:54 AM

 DESIGNED BY:
 Designer

 DRAWN BY:
 Author

 CHECKED BY:
 Checker

E101

SCALE: 1/4" = 1'-0"

© [2024] [FrameUpNow] . All rights reserved

ELECTRICAL NOTE

- A. PROVIDE INTERCONNECTED SMOKE ALARMS IN EACH SLEEPING ROOMS, OUTSIDE EACH SLEEPING ROOM, ON EACH STORY, IN THE HALL OR ADJACENT ROOM LUHERE THE CEILING HEIGHT OF A ROOM OPEN TO THE HALL EXCEEDS THE HALL BY 24'. SMOKE ALARMS SHALL BE PERMANENTLY HARD WIRED WITH BATTERY BACKUP.
- B. RECEPTACLE OUTLETS FOR RANGES AND CLOTHES DRYERS SHALL BE A THREE POLE WITH GROUND TYPE. FOUR WIRE GROUNDING-TYPE FLEXIBLE CORDS WILL BE REQUIRED FOR CONNECTION OF RANGES AND CLOTHES DRYERS. THE BONDING JUMPER SHALL NOT BE CONNECTED BETWEEN NEUTRAL TERMINAL AND THE FRAME OF THE APPLIANCE.
- C. TWO OR MORE 20 AMP SMALL APPLIANCE CIRCUITS SHALL BE PROVIDED TO SERVE THE KITCHEN, BREAKFAST NOOK, AND DINING ROOM. SUCH CIRCUITS SHALL HAVE NO OTHER OUTLETS.
- D. AT LEAST ONE 20 AMP BRANCH CIRCUIT SHALL BE PROVIDED TO SERVICE THE LAUNDRY ROOM. THIS CIRCUIT SHALL HAVE NO OTHER OUTLETS.
- E. ALL RECEPTACLES WITH IN 6' OF A WET BAR SINK OR KITCHEN SINK TO SERVE COUNTER TOP SURFACES MUST BE GFCI. ON KITCHEN COUNTERS 12' OR WIDER NO POINT ALONG THE WALL SHALL BE MORE THAN 2' FROM A RECEPTACLE. ALL RECEPTACLES WITH IN 6' OF KITCHEN SINK MUST BE GFCI. AT LEAST ONE GFCI RECEPTACLE SHALL BE INSTALLED IN THE BATHROOM ADJACENT TO EACH BASIN.
- F. FIXTURES INCLUDING CEILING FANS THAT ARE LOCATED IN DAMP LOCATIONS SHALL BE LISTED TO BE SUITABLE FOR SUCH LOCATIONS PER 2012 IRC
- G. PROVIDE ONE (1) SWITCHED OUTLET @ ALL BEDROOMS AND DEN
- H. CEILING FANS NOT EXCEEDING 35 LBS. (WITH OR WITHOUT ACCESSORIES MAY BE SUPPORTED BY OUTLET BOXES PROVIDED THE OUTLET BOXES ARE IDENTIFIED FOR SUCH USE PER 2012 IRC
- I. ELECTRICAL OUTLET BOXES ON OPPOSITE SIDES OF FIRE RATED WALLS SHALL BE SEPARATED BY A HORIZONTAL DISTANCE OF NOT LESS THAN 24".
- J. OUTLET BOXES IN THE WALLS BETWEEN THE GARAGE AND DWELLING SHALL BE METAL OR U.L. APPROVED FIRE RESISTIVE PLASTIC. BOXES IN GARAGE CEILING SHALL BE METAL.
- K. ALL BRANCH CIRCUITS THAT SUPPLY 120 VOLTS SINGLE PHASE 15 AND 20 AMPS RECEPTACLE OUTLETS INSTALLED IN THE DWELLING SHALL BE PROTECTED BY AN ARC FAULT CIRCUIT INTERRUPTER, EXCEPT GFCI RECEPTICLES.

NOTE:

A. RECEPTACLES MUST BE PROVIDED IN HALLWAYS 10'-0" OR MORE IN LENGTH. FOR A ONE FAMILY DWELLINGS AND EACH OF A TWO FAMILY DWELLING THAT IS AT GRADE LEVEL, AT LEAST ONE WP-GFCI RECEPTACLE OUTLET ACCESSIBLE AT GRADE LEVEL AND NOT MORE THAN 6'-6" ABOVE GRADE SHALL BE INSTALLED AT THE FRONT AND BACK OF THE DWELLING.

NOTE: APPLIANCE DISCONNECT

E4001.5 GROUNDING OF ENCLOSURES.

METAL ENCLOSURES FOR SWITCHES OR CIRCUIT BREAKERS SHALL BE CONNECTED TO AN

EQUIPMENT GROUNDING CONDUCTOR.

METAL ENCLOSURES FOR SWITCHES OR CIRCUIT BREAKERS USED AS SERVICE EQUIPMENT SHALL COMPLY WITH THE PROVISIONS OF SECTION E3609.4. WHERE


NONMETALLIC ENCLOSURES ARE USED WITH METAL RACEWAYS OR METAL-ARMORED

CABLES, PROVISIONS SHALL BE MADE FOR CONNECTING THE EQUIPMENT GROUNDING


CONDUCTOR.
NONMETALLIC BOXES FOR SWITCHES SHALL BE INSTALLED WITH A WIRING METHOD THAT

PROVIDES OR INCLUDES AN EQUIPMENT GROUNDING CONDUCTOR. (404.12)

ELECTRI	CAL LEGEND
	Electrical Lights With Fan
0	Waterproof Recessed Can Light
	Pendant Light
0	Recessed Can Light
- \$	Wall Lamp
	Standalone linear
⊬ 13	Single Switch
₩.	Three way Switch
₩.	Fan Switch
	Duplex Receptacle
	Triplex Receptacle
⊕ GFCI	GFCI Receptacle
	Exhaust Fan
•	Smoke and heat detector

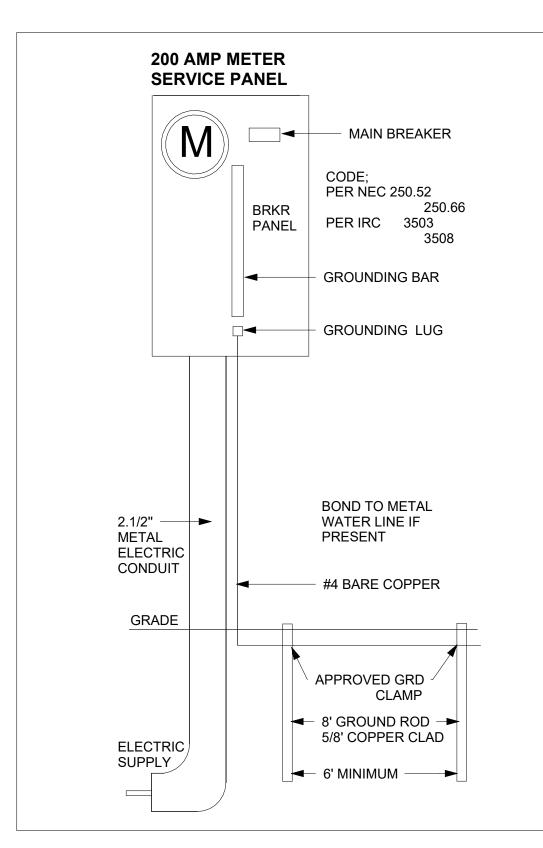



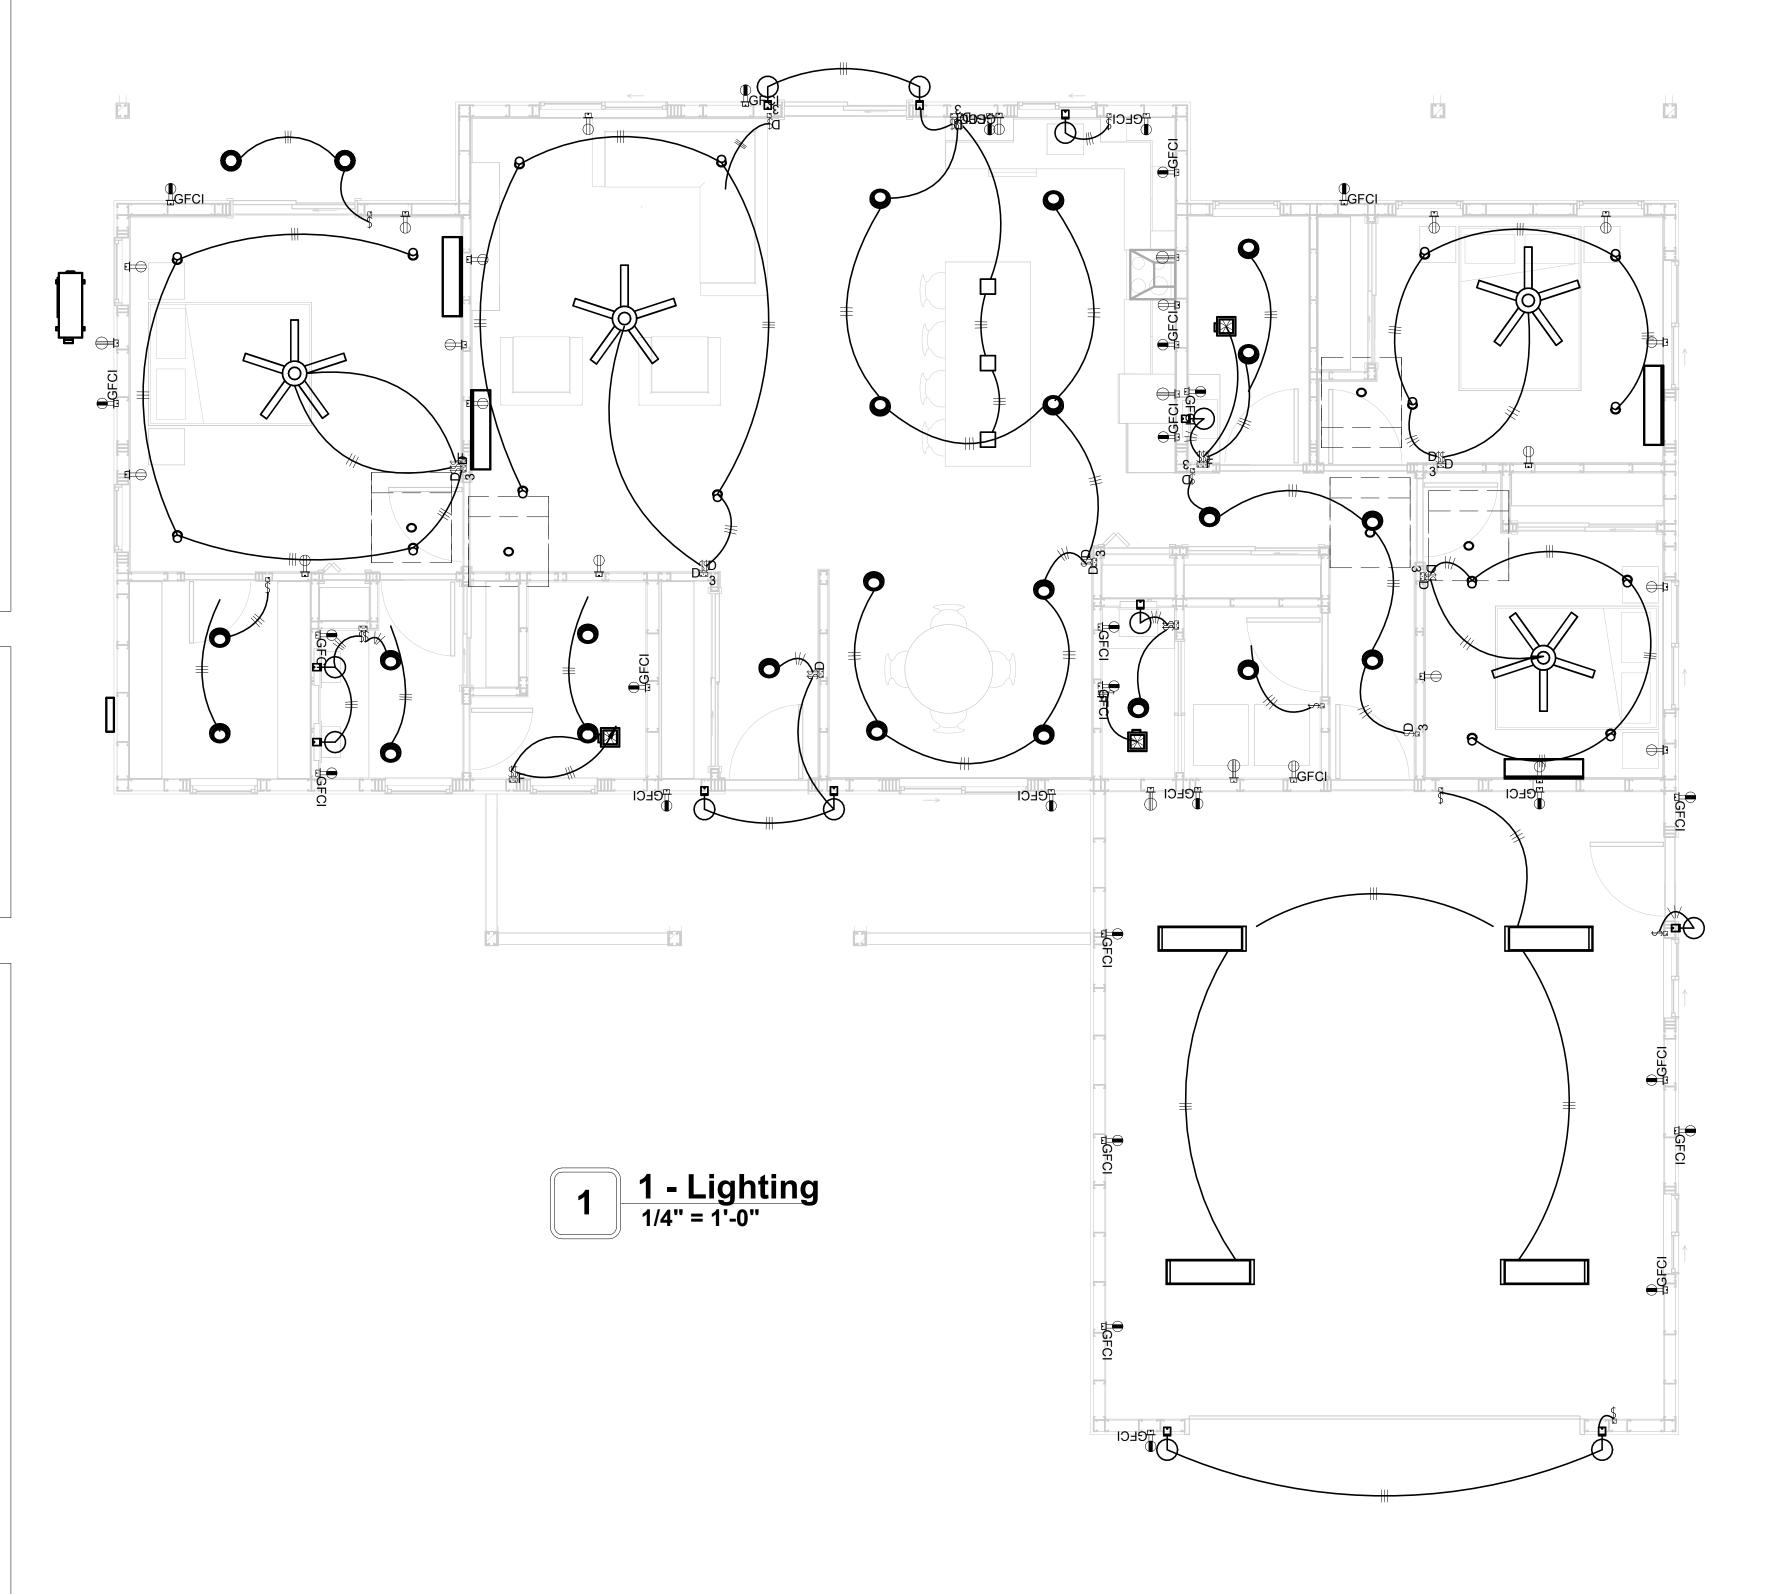



KEY PLAN

IO. DESCRIPTION DATE

NOTE:

LEGEND:

PROJECT

247-EMBER-1650-3Bd 2.5Ba FARMHOUSE-550

DRAWING NAME

LIGHTING

CLIENT NAME:

PROJECT NUMBER:

0138_16

DATE:

5/7/2025 10:30:59 AM

DESIGNED BY:

DRAWN BY:


CHECKED BY:

Checker


E102

NOTES: CONDUIT, CABLE AND WIRING


- Use Metalic Conduits (IMC) for cables running under concrete slabs.
 Use IMC for circuits with high voltage appliances (240 volts and above)
 For circuits with 120 volts consider using EMT or PVC conduits if needed.
 For Low voltage applications up to 50 volts consider using non metalic conduits.
 All conduits to be used in the project must conform to the latest National Electrical Code (NEC),
- 6. All wiring and cables to be used in the project must also conform to the latest National Electrical Code (NEC), 2015.
 7. All cables and wires used should be rated for their respective loading and should be gauged and
- conform to the NEC.

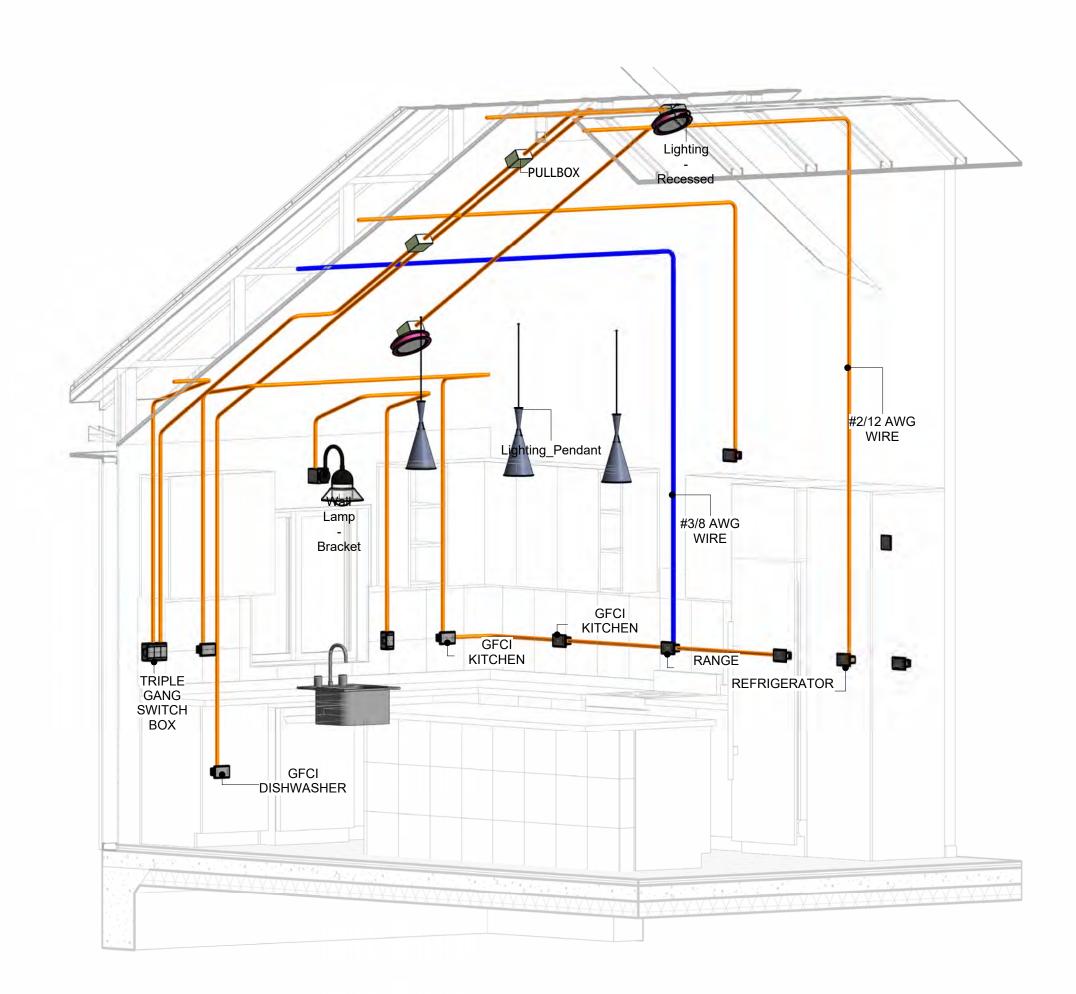


3D-KITCHEN

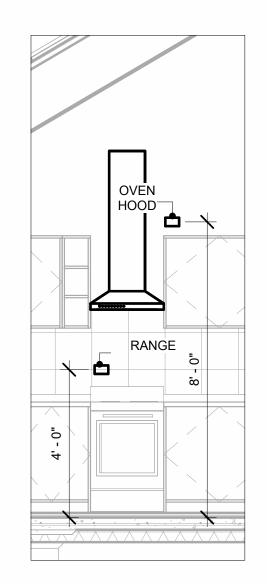


RANGE & OVENHOOD 3/8" = 1'-0"

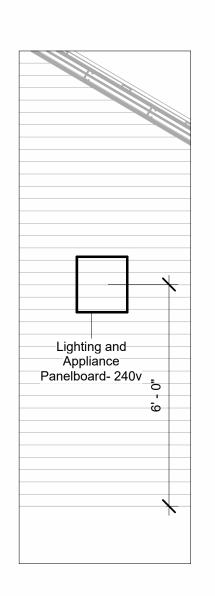

PANEL 3/8" = 1'-0"

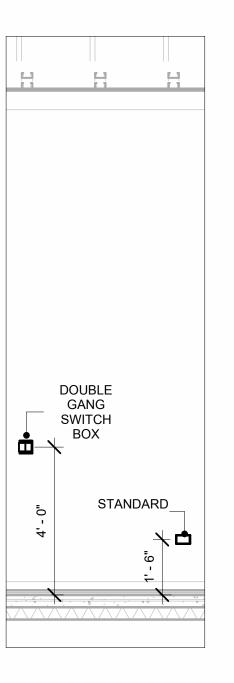


SWITCH BOX& RECEPTACLE
3/8" = 1'-0"

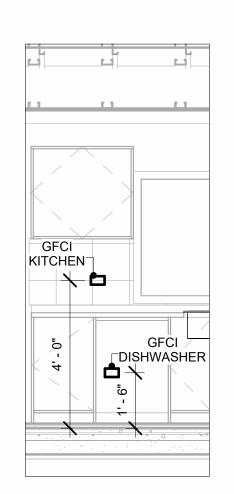

GFCI & DISHWASHER
3/8" = 1'-0"



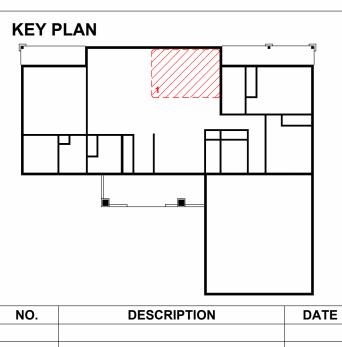

DATE

NOTE:

LEGEND:

PROJECT

247-EMBER-1650-3Bd 2.5Ba **FARMHOUSE-550**

DRAWING NAME

POWER

CLIENT NAME:	Owner
PROJECT NUMBER:	0138_16
DATE:	5/7/2025 10:31:26 AM
DESIGNED BY:	Designer
DRAWN BY:	Author
CHECKED BY:	Checker

E103

NOTES: LIGHT

- 1. LIGHT FIXTURES AND LUMINARIES SHALL CONFORM TO THE NEC, THE IRC AND LOCAL SAFETY & BUILDING CODE.
- 2. ALL LIGHTING FIXTURES SHOULD CONFORM TO THE DESIGN ELECTRICAL LOAD AND SHALL BE PROPERLY WIRED AND MOUNTED BY QUALIFIED ELECTRICIAN FOLLOWING MANUFACTURERS SPECIFICATIONS.
- 3. CEILING FANS AND FANS WITH LIGHT WITH WEIGHT EXCEEDING 35 LBS SHOULD BE PROVIDED WITH STRUCTURAL BACKING FOR SUPPORT AND SHALL BE FIXED AS PER MANUFACTURERS SPECIFICATIONS.
- 4. EXTERIOR LIGHTS SHALL CONFORM TO LOCAL BUILDING CODE AND GUIDELINES.

NOTES: SWITCH JUNCTION BOX


- 1. THE MINIMUM SIZE OF JUCTION BOX TO BE USED IS 2"X4"X(1.5" OR 3.5" DEEP) THIS ARE TO BE USED FOR SINGLE GANG SWITCH OR OUTLETS.
- 2. FOR DOUBLE GANG (2 GANG) OUTLETS AND SWITCHS THE MINIMUM SIZE OF THE
- JUCTION BOX TO BE PROVIDED SHALL NOT BE LESS THAN 4"X4"X(1.5" OR 3.5" DEEP)
- 3. FOR THREE GANG (3 GANG) OUTLETS AND SWITCHS THE MINIMUM SIZE OF THE JUCTION BOX SHALL NOT BE LESS THAN 6"X4"X(1.5" OR 3.5" DEEP).

FITTING SCHEDULE(PULL BOX)								
FAMILY COUNT DESCRIPTION								
PULLBOX1	54	#1/4 PULLBOX						

ELECTRICAL FIXTURE SCHEDULE (SWITCH BOX)			
TYPE COUNT			
DOUBLE GANG SWITCH BOX	8		
SINGLE GANG SWITCH BOX	11		
TRIPLE GANG SWITCH BOX	3		

LIGHT	ING DEVICE
TYPE	COUNT
DIMMER	7
FAN SWITCH	4
SINGLE POLE	16
THREE WAY WITH DIMMER	9

LIGHTING FIXTURE				
VOLTAGE	ELECTRICAL LOAD	COUNT		
120 V/1-40 VA	200 A, 120 V/240 V, SINGLE PHASE, 3 WIRES	4		
120 V/1-100 VA- 120 V/1-100 VA	200 A, 120 V/240 V, SINGLE PHASE, 3 WIRES	4		
120 V/1-60 VA	200 A, 120 V/240 V, SINGLE PHASE, 3 WIRES	24		
120 V/1-100 VA	200 A, 120 V/240 V, SINGLE PHASE, 3 WIRES	3		
120 V/1-28 VA	200 A, 120 V/240 V, SINGLE PHASE, 3 WIRES	16		
120 V/1-100 VA	200 A, 120 V/240 V, SINGLE PHASE, 3 WIRES	12		
	VOLTAGE 120 V/1-40 VA 120 V/1-100 VA- 120 V/1-100 VA 120 V/1-60 VA 120 V/1-100 VA	VOLTAGE ELECTRICAL LOAD 120 V/1-40 VA 200 A, 120 V/240 V, SINGLE PHASE, 3 WIRES 120 V/1-100 VA- 120 V/1-100 VA PHASE, 3 WIRES 120 V/1-60 VA 200 A, 120 V/240 V, SINGLE PHASE, 3 WIRES 120 V/1-100 VA 200 A, 120 V/240 V, SINGLE PHASE, 3 WIRES 120 V/1-28 VA 200 A, 120 V/240 V, SINGLE PHASE, 3 WIRES 120 V/1-28 VA 200 A, 120 V/240 V, SINGLE PHASE, 3 WIRES 120 V/1-100 VA 200 A, 120 V/240 V, SINGLE PHASE, 3 WIRES		

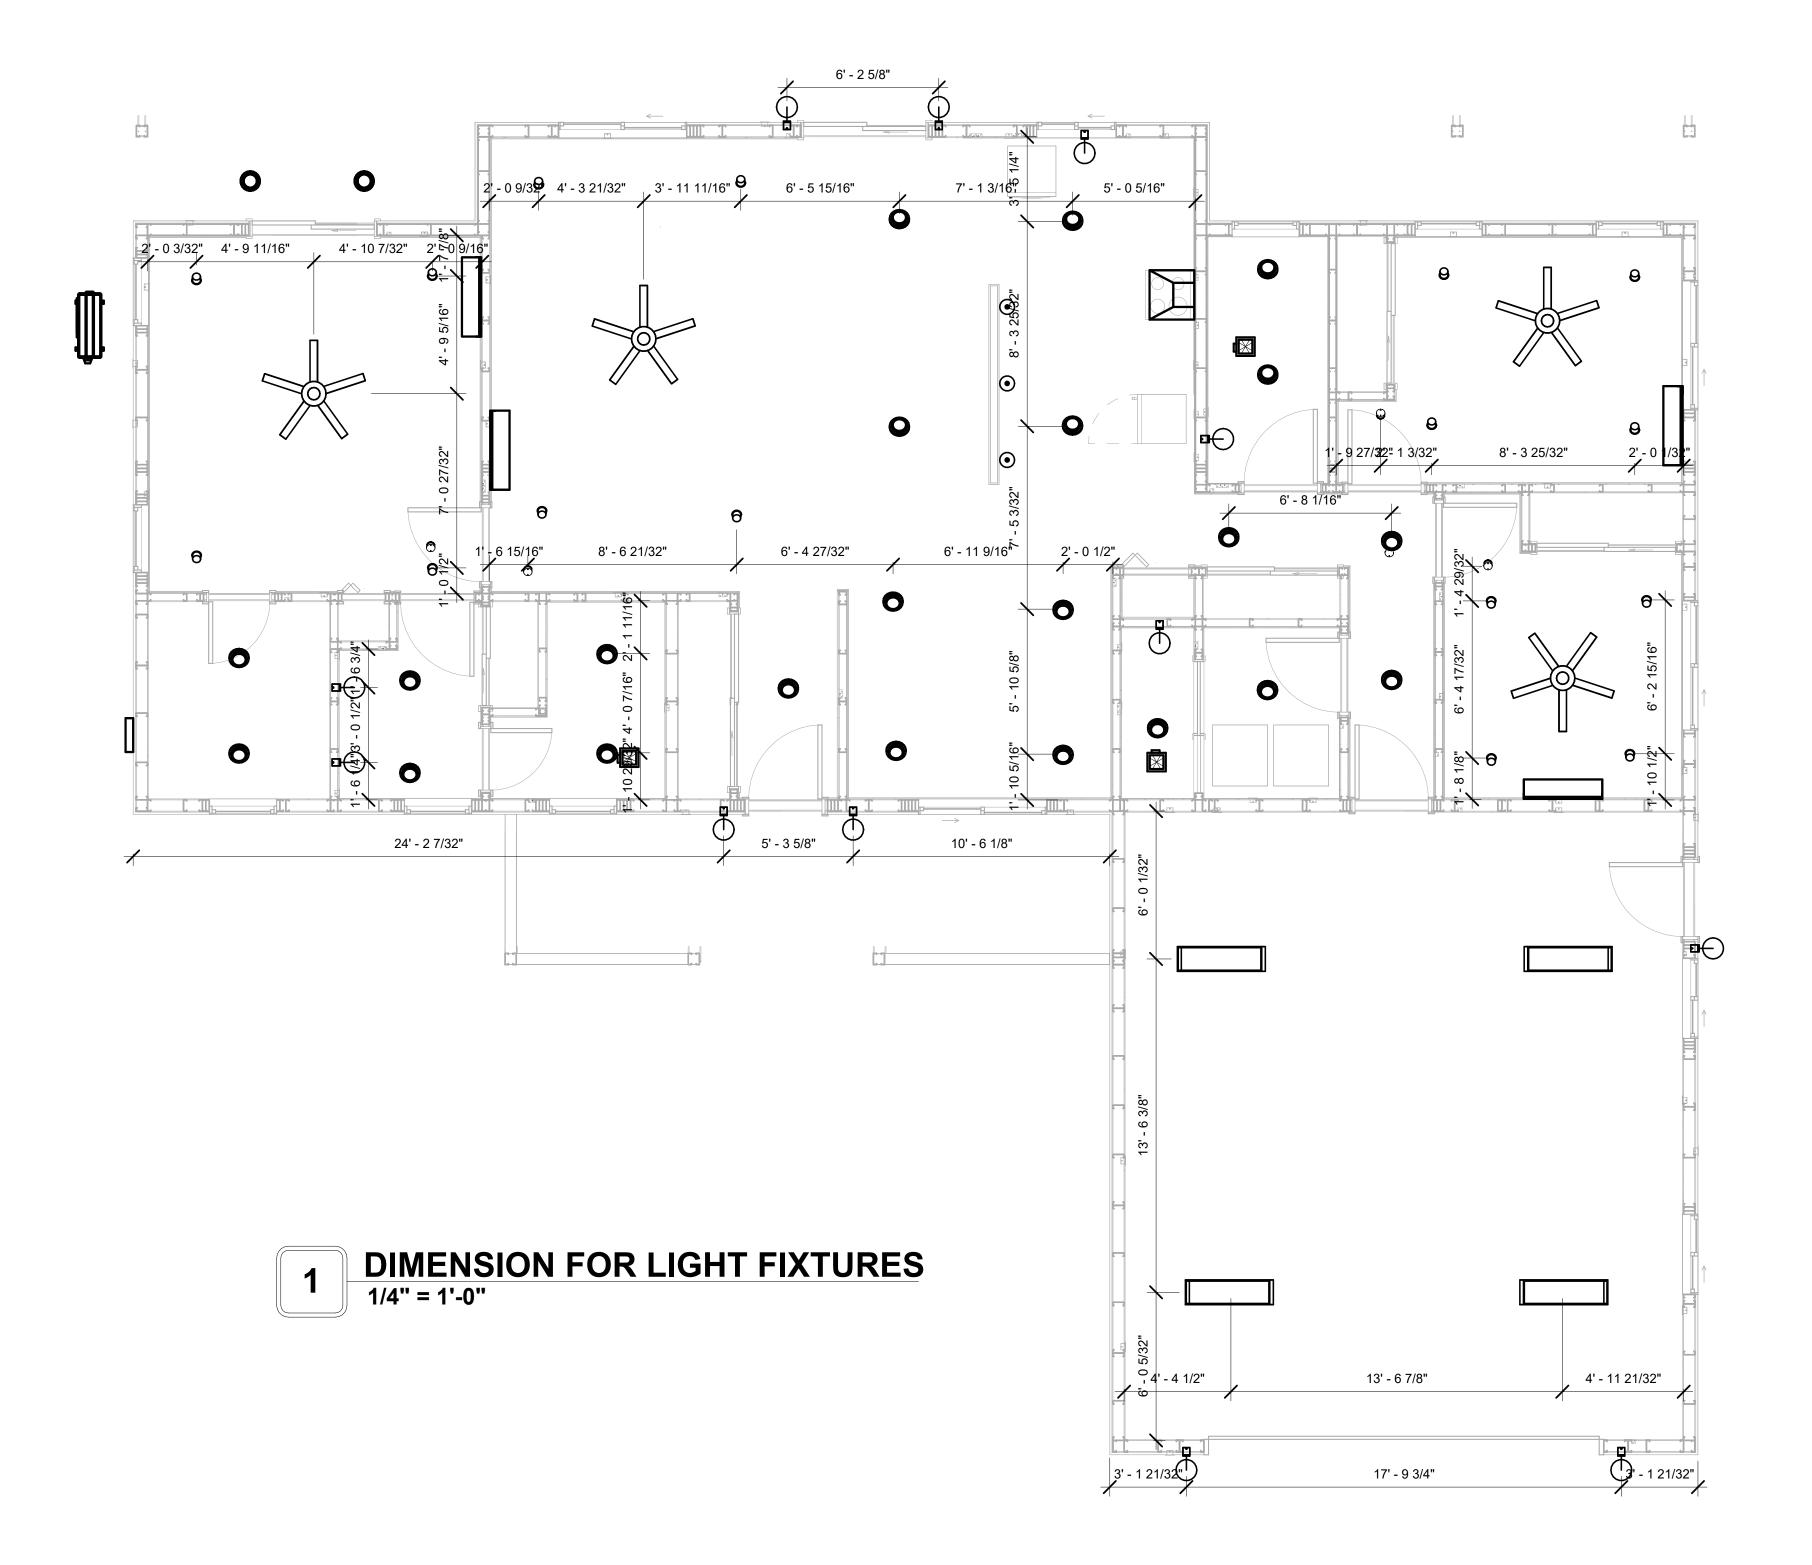



KEY PLAN

DESCRIPTION DATE

NOTE:

LEGEND:

PROJECT

247-EMBER-1650-3Bd 2.5Ba **FARMHOUSE-550**

DRAWING NAME

DIMENSION PLAN FOR LIGHT FIXTURES

CLIENT NAME:	Owner
PROJECT NUMBER:	0138_16
DATE:	5/7/2025 10:31:29 AM
DESIGNED BY:	Designer
DRAWN BY:	Author
CHECKED BY:	Checker

E104


SCALE: 1/4" = 1'-0"

NOTES;

- 1. VERIFY EQUIPMENT PLUG CONFIGURATION BEFORE PURCHASING RECEPTACLES
- 2. FOR ALL EQUIPMENT.
- 3. COORDINATE EXACT LOCATION OF LIGHT FIXTURES, WALL SWITCHES, RECEPTACLES AND OTHER DEVICES WITH ARCHITECTURAL DRAWINGS.
- 4. USE METALLIC JUNCTION BOX WITH THE GFCI RECEPTACLES, WITH HIGHT VOLTAGE.

ELECTRICAL FIXTURE SCHEDULE (RECEPTACLE)		
TYPE COUNT		
CONDENSER	1	
DRYER	1	
GFCI BATH ROOM	6	
GFCI DISHWASHER	1	
GFCI GARAGE	7	
GFCI KITCHEN	5	
GFCI OUT DOOR	9	
GFCI WASHER	1	
OVEN HOOD	1	
RANGE	1	
REFRIGERATOR	1	
STANDARD	17	
WATER HEATER	1	

			_
	ELECTRICAL O	UTLET SCHEDULE	
TYPE	CIRCUIT NUMBER	ELECTRICAL DATA	COUNT
	'		
STANDARD		120 V/1-180 VA	1
GFCI BATH ROOM	2	120 V/1-180 VA	3
GFCI BATH ROOM	8	120 V/1-180 VA	1
GFCI BATH ROOM	10	120 V/1-180 VA	2
CONDENSER	11,13	240 V/2-5000 VA	1
GFCI OUT DOOR	12	120 V/1-180 VA	9
GFCI KITCHEN	14	120 V/1-180 VA	5
GFCI WASHER	15	120 V/1-1200 VA	1
DRYER	16,18	240 V/2-5000 VA	1
WATER HEATER	17,19	240 V/2-4500 VA	1
GFCI GARAGE	20	120 V/1-180 VA	7
RANGE	21,23	240 V/2-5000 VA	1
OVEN HOOD	22	120 V/1-180 VA	1
REFRIGERATOR	24	120 V/1-1800 VA	1
GFCI DISHWASHER	25	120 V/1-1200 VA	1
STANDARD	26	120 V/1-180 VA	4
STANDARD	27	120 V/1-180 VA	4
STANDARD	28	120 V/1-180 VA	8

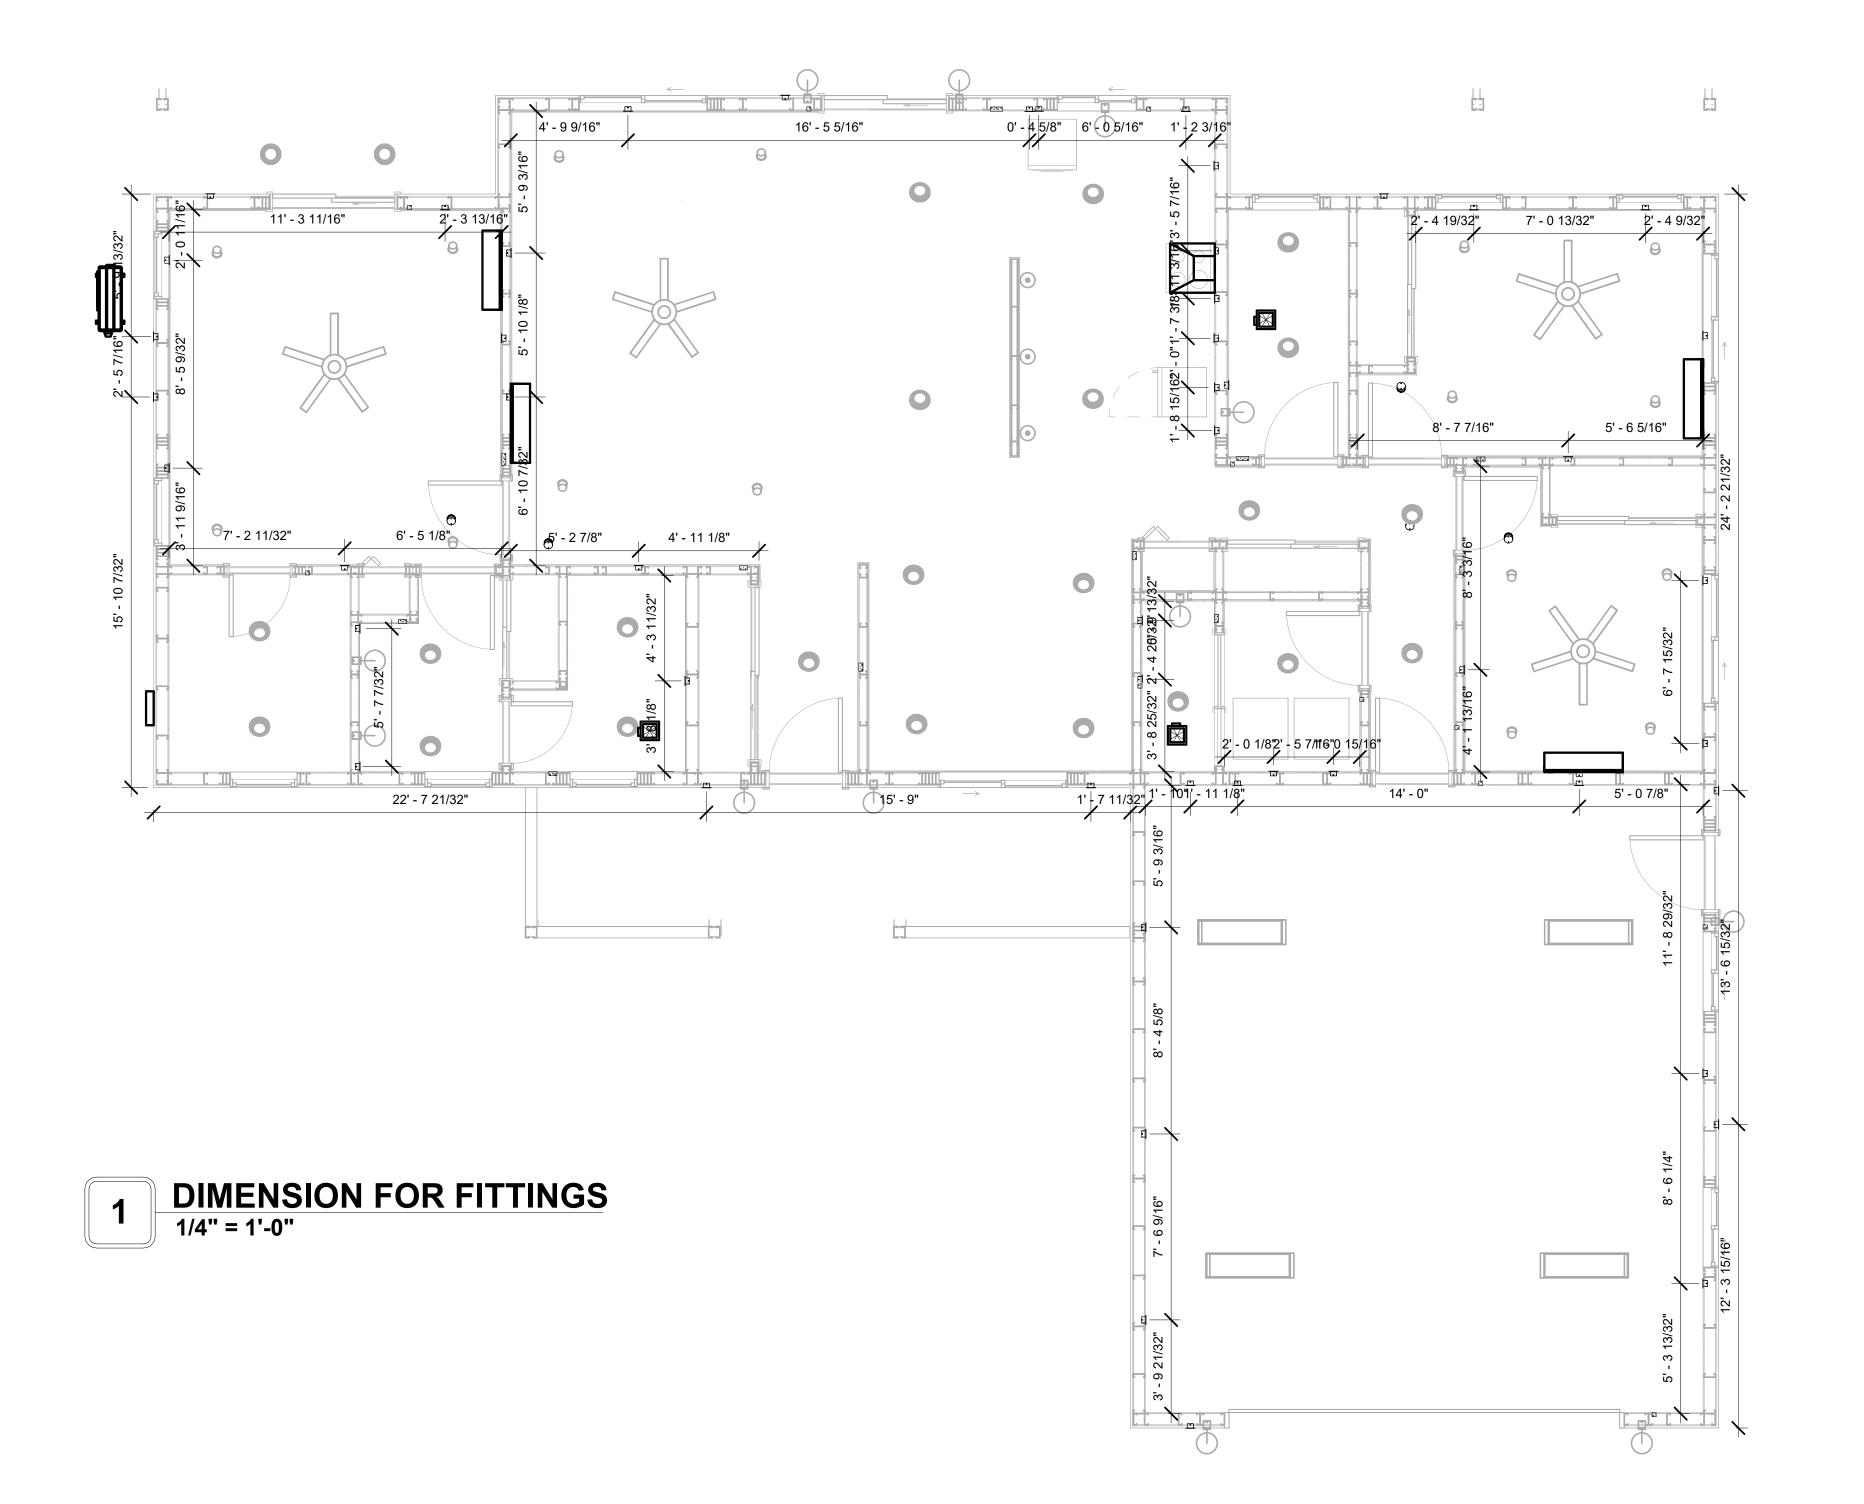



KEY PLAN

DESCRIPTION	DATE
	DESCRIPTION

NOTE:

LEGEND:

PROJECT

247-EMBER-1650-3Bd 2.5Ba **FARMHOUSE-550**

DRAWING NAME

DIMENSION PLAN FOR FITTINGS

CLIENT NAME:	Owner
PROJECT NUMBER:	0138_16
DATE:	5/7/2025 10:31:31 AM
DESIGNED BY:	Designer
DRAWN BY:	Author
CHECKED BY:	Checker

E105

SCALE: 1/4" = 1'-0"

© [2024] [FrameUpNow] . All rights reserved

SHEET LIST

Sheet Name Sheet Number

P101	NOTE AND SCHEDULE
P102	WATER SUPPLY
P103	SEWAGE SYSTEM

PIPe Color SCHEME DOMESTIC COLD WATER DOMESTIC HOT WATER - - - SANITARY VENT SANITARY SEWER STORM DRAINAGE Gray Water

GAS LINE

PLUMBING NOTES

- The plumbing system is designed to meet the building's domestic water supply, sanitary drainage, and storm drainage requirements, as per project specifications and applicable codes.
- The system installation shall comply with the latest International Plumbing Code (IPC), International Residential Code (IRC), and all other relevant local, state, and national regulations.
- ALL PLUMBING WORK SHALL COMPLY WITH THE LATEST EDITION OF THE INTERNATIONAL PLUMBING CODE (IPC) AND THE LOCAL PLUMBING CODE.
- PLUMBING SYSTEMS SHALL BE TESTED AND INSPECTED IN ACCORDANCE WITH THE LOCAL PLUMBING CODE REQUIREMENTS.
- PLUMBING FIXTURES SHALL BE INSTALLED WITH THE APPROPRIATE TRIM, FITTINGS, AND ACCESSORIES, AS RECOMMENDED BY THE MANUFACTURER.
- 6. PIPING SHALL BE PROPERLY SUPPORTED AND SECURED TO PREVENT SAGGING,
- MOVEMENT, AND VIBRATION.
- SHUT-OFF VALVES SHALL BE PROVIDED AT ALL BRANCH CONNECTIONS AND AT THE INLET AND OUTLET OF EACH PIECE OF EQUIPMENT.
- BACKFLOW PREVENTION DEVICES SHALL BE INSTALLED AS REQUIRED BY THE LOCAL PLUMBING CODE TO PROTECT THE POTABLE WATER SYSTEM.
- PLUMBING FIXTURES AND EQUIPMENT SHALL BE ACCESSIBLE FOR MAINTENANCE AND SERVICING.
- EXPOSED PLUMBING PIPING AND FIXTURES SHALL BE INSULATED TO PREVENT
- CONDENSATION AND ENERGY LOSS. 11. DEAD ENDS IN THE DRAINAGE SYSTEM MUST BE AVOIDED, EXCEPT WHERE NECESSARY TO INSTALL A CLEANOUT IN AN ACCESSIBLE LOCATION, AND MUST HAVE A VENTED
- CONNECTION TO THE OUTSIDE ATMOSPHERE. 12. THE VERTICAL DEFLECTION OF PVC PIPE MUST NOT EXCEED 5%, AND NO DEFLECTION IS
- PERMITTED FOR IRON PIPE. 13. WORK MUST BE PROPERLY COORDINATED WITH OTHER TRADES TO AVOID CONFLICTS, REFERRING TO THE ARCHITECTURAL AND STRUCTURAL DRAWINGS FOR INFORMATION REGARDING CEILING ELEVATIONS, SPACE CLEARANCES, WALL AND PARTITION LOCATIONS, ETC.
- 14. ALL FIXTURES SHALL HAVE ACCESSIBLE STOPS.
- 15. DOMESTIC WATER PIPING SHALL BE PEX, AND PVC PIPING IS NOT ACCEPTABLE FOR INTERIOR USE
- 16. VENT TERMINATIONS SHALL BE LOCATED AT LEAST 10 FEET FROM OR 3 FEET ABOVE ANY OPERABLE WINDOW, DOOR OPENING, AIR INTAKE, OR VENT SHAFT, AND AT LEAST 3 FEET IN EVERY DIRECTION FROM ANY LOT LINE, ALLEY, OR STREET,
- 17. PIPE AND FITTINGS UTILIZED IN THE WATER SUPPLY SYSTEM SHALL HAVE A MAXIMUM OF 8 PERCENT LEAD.
- 18. ACRYLONITRILE BUTADIENE STYRENE (ABS) SHALL BE USED FOR THE SEWERAGE AND VENTILATION SYSTEM.
- 19. CROSS-LINKED POLYETHYLENE (PEX) SHALL BE USED FOR THE WATER SUPPLY SYSTEM.
- 20. POLYVINYL CHLORIDE (PVC) SHALL BE USED FOR THE RAIN WATER SYSTEM.
- 21. THE MIMIMUM WATER SUPPLY DEPTH UNDER FLOOR FINISH SHOUD BE 1/2". ANY PIPE INSTALLED UNDERGROUND MUST HAVE AT LEAST 12 INCHES OF CLEARANCE
- BETWEEN THE OUTSIDE OF THE PIPE AND ANY OTHER UNDERGROUND STRUCTURE. 23. THE MINIMUM CLEARANCE BETWEEN COLD AND HOT WATER LINES IN RESIDENTIAL
- HOMES MAINTAIN A MINIMUM DISTANCE OF 6 INCHES
- 24. HORIZONTAL SEPARATION BETWEEN WATER AND SEWER LINES: A MINIMUM OF 12 INCHES BETWEEN POTABLE WATER SUPPLY LINES (COLD AND HOT WATER) AND SANITARY SEWER LINES.

ABBREVIATIONS

Ø	Diameter		
ABS	ACRYLONITRILE BUTADIENE STYRENE		
ABV	ABOVE	1	
AD	AREA DRAIN		
AFF	ABOVE FINISHED FLOOR		
ALT	ALTERNATE		
BFF	BELOW FINISHED FLOOR		
BLW	BELOW		
CO	CLEAN OUT		
CW	COLD WATER		
D	DEGREE		
DFU	Dranage FIXTURE UNIT		
DIA	DIAMETER		
DN	DOWN		
FCO	FLOOR CLEAN OUT		
FD	FLOOR DRAIN		
FL	FLOOR]	
FS	FLOOR SINK		
FT	FOOT/FEET		
HB	HOSE BIB		
HW	HOT WATER		
IN	INCH		
MIN	MINIMUM		
NO	NUMBER		
NTS	NOT TO SCALE		
PEX	CROSS-LINKED POLYETHYLENE		
PLBG	PLUMBING		
PVC	POLYVINYL CHLORIDE		
QTY	Quantity		
RD	ROOF DRAIN		
RED	REDUCER		
RM	ROOM		
RW	RAIN WATER		

Cap Bend 45 Deg Bend 90 Deg Tee Reducing Clean Two-Way Wye 45 Deg Wye 45 Deg Double Wye Combination

PLUMBING LEGEND

PIPE SCHEDULE		
Material	Diameter	Length
Acrylonitrile Butadiene Styrene (ABS)	1 1/2"	18 ft
Acrylonitrile Butadiene Styrene (ABS)	2"	78 ft
Acrylonitrile Butadiene Styrene (ABS)	3"	90 ft
Cross-linked polyethylene (PEX)	1/2"	262 ft
Cross-linked polyethylene (PEX)	3/4"	54 ft
Cross-linked polyethylene (PEX)	1"	0 ft
Polyvinyl Chloride - Rigid	2"	105 ft

FITTING SCHEDULE		
FITTING	Size	QTY
Domestic Cold Water		
PEX 90 Deg Elbow	1/2"ø-1/2"ø	2
PEX 90 Degree Elbow	1/2"ø-1/2"ø	26
PEX 90 Degree Elbow	3/4"ø-3/4"ø	3
PEX Cross Elbow	1/2"ø-1/2"ø-1/2"ø	1
PEX Tee Elbow	1/2"ø-1/2"ø-1/2"ø 1/2"ø-1/2"ø-1/2"ø	8
PEX Tee Elbow	3/4"ø-3/4"ø-3/4"ø	2
PEX Transition Elbow	1"ø-3/4"ø	2
PEX Transition Elbow	3/4"ø-1/2"ø	1
FEX ITALISMOTI EIDOW	3/4 6-1/2 6	I
Domestic Hot Water		
PEX 90 Degree Elbow	1/2"ø-1/2"ø	20
PEX 90 Degree Elbow	3/4"ø-3/4"ø	3
PEX Tee Elbow	1/2"ø-1/2"ø-1/2"ø	7
PEX Transition Elbow	3/4"ø-1/2"ø	1
Sewage		
ABS 90 Degree Bend Elbow	1 1/2"ø-1 1/2"ø	3
ABS 90 Degree Bend Elbow	2"ø-2"ø	3
ABS 90 Degree Bend Elbow	3"ø-3"ø	6
ABS P-Trap	2"ø-2"ø	3
ABS P-Trap	3"ø-3"ø	2
ABS Reducer Elbow	2"ø-1 1/2"ø	2
ABS Reducer Elbow	3"ø-1 1/2"ø	3
ABS Reducer Elbow	3"ø-2"ø	9
ABS TEE Elbow	1 1/2"ø-1 1/2"ø-1 1/2"ø	2
ABS TEE Elbow	2"ø-2"ø-2"ø	3
ABS TEE Elbow	3"ø-3"ø-3"ø	14
ABS Trap P	1 1/2"ø-1 1/2"ø	2
ABS Trap P	2"ø-2"ø	3
ABS Trap P	3"ø-3"ø	1
Vont		
Vent ABS Vent Cap Elbow	1 1/2"ø	1
ABS Vent Cap Elbow	2"ø	5
	_ ~	

FIXTURE CONNECTION SCHEDULE											
Family	w	V	Trap	cw	HW	QT Y	DFU	тот.	WF U	TOT	NOTES
Dishwasher	2"	1-1/2"	1-1/2"	1/2"	1/2"	1		0			Drain to sewer see plans
Dryer	N/A	N/A	N/A	N/A	N/A	1		0			Diain to sewer see plans
Hanging pipes clamp	1.47.			1 47 1	,,	26		0			
Shower Tray						2		0			
Shower Trim	-	-	-	1/2"	1/2"	2		0			
Sink Island Single	2"	1-1/2"	1-1/2"	1/2"	1/2"	1		0			
Vanity Sink	2"	1-1/2"	1-1/2"	1/2"	1/2"	4		0			
Washer	2"	1-1/2"	2"	1/2"	1/2"	1		0			DRAINS TO GRAY WATER OR SEWER SEE PLANS
Water Closet	3"	2"	3"	1/2"	1/2"	3		0			
Water Heater	N/A	N/A	N/A	3/4"	3/4"	1		0			

FIXTURE SCHEDULE							
fixture	QTY	Description					
Dishwasher	1	Drain to sewer see plans					
Dryer	1						
Hanging pipes clamp	26						
Shower Tray	2						
Shower Trim	2						
Sink Island Single	1						
Vanity Sink	4						
Washer	1	DRAINS TO GRAY WATER OR SEWER SEE PLANS					
Water Closet	3						
Water Heater	1						

ACCESSORIES & FITTINGS SCHEDULE								
fixture	QTY	Descriptions						
DISHWASHER CONNECTOR	1							
Hose Bib	1							
LAUNDRY SWEAT CONNECTOR	1							
Shutoff Valve	12							

PLUMBING SCHEDULE										
FIXTURE Trap Waste Vent C.W H.W										
Dishwasher	1-1/2"	2"	1-1/2"	1/2"	1/2"					
Dryer	N/A	N/A	N/A	N/A	N/A					
Shower Tray										
Shower Trim	-	-	-	1/2"	1/2"					
Sink Island Single	1-1/2"	2"	1-1/2"	1/2"	1/2"					
Vanity Sink	1-1/2"	2"	1-1/2"	1/2"	1/2"					
Washer	2"	2"	1-1/2"	1/2"	1/2"					
Water Closet	3"	3"	2"	1/2"	1/2"					
Water Heater	N/A	N/A	N/A	3/4"	3/4"					

WATER FIXTURE UNIT SCHEDULE									
Family QTY UNIT VALUE TOTAL									
Dishwasher 1 0									
Dryer	1		0						
Shower Tray	2		0						
Shower Trim	2		0						
Sink Island Single	1		0						
Vanity Sink	4		0						
Washer	1		0						
Water Closet	3		0						
Water Heater	1		0						

WASTE FIXTURE UNIT SCHEDULE							
Family	QTY	DFU Values	TOTAL				
	1.						
Dishwasher	1		0				
Dryer	1		0				
Hanging pipes clamp	26		0				
Shower Tray	2		0				
Shower Trim	2		0				
Sink Island Single	1		0				
Vanity Sink	4		0				
Washer	1		0				
Water Closet	3		0				
Water Heater	1		0				



KEY PLAN

DESCRIPTION DATE

NOTE:

LEGEND:

PROJECT

247-EMBER-1650-3Bd 2.5Ba **FARMHOUSE-550**

DRAWING NAME

NOTE AND SCHEDULE

CLIENT NAME: PROJECT NUMBER:

0138_16 DATE: 5/6/2025 5:15:57 AM Designer DESIGNED BY DRAWN BY: Author CHECKED BY: Checker

P101

SCALE: 1/2" = 1'-0"

SF SQUARE FOOT


WCO WALL CLEAN OUT

VTR VENT THROUGH ROOF


WSFU WATER SUPPLY FIXTURE UNIT

V VENT

W WASTE

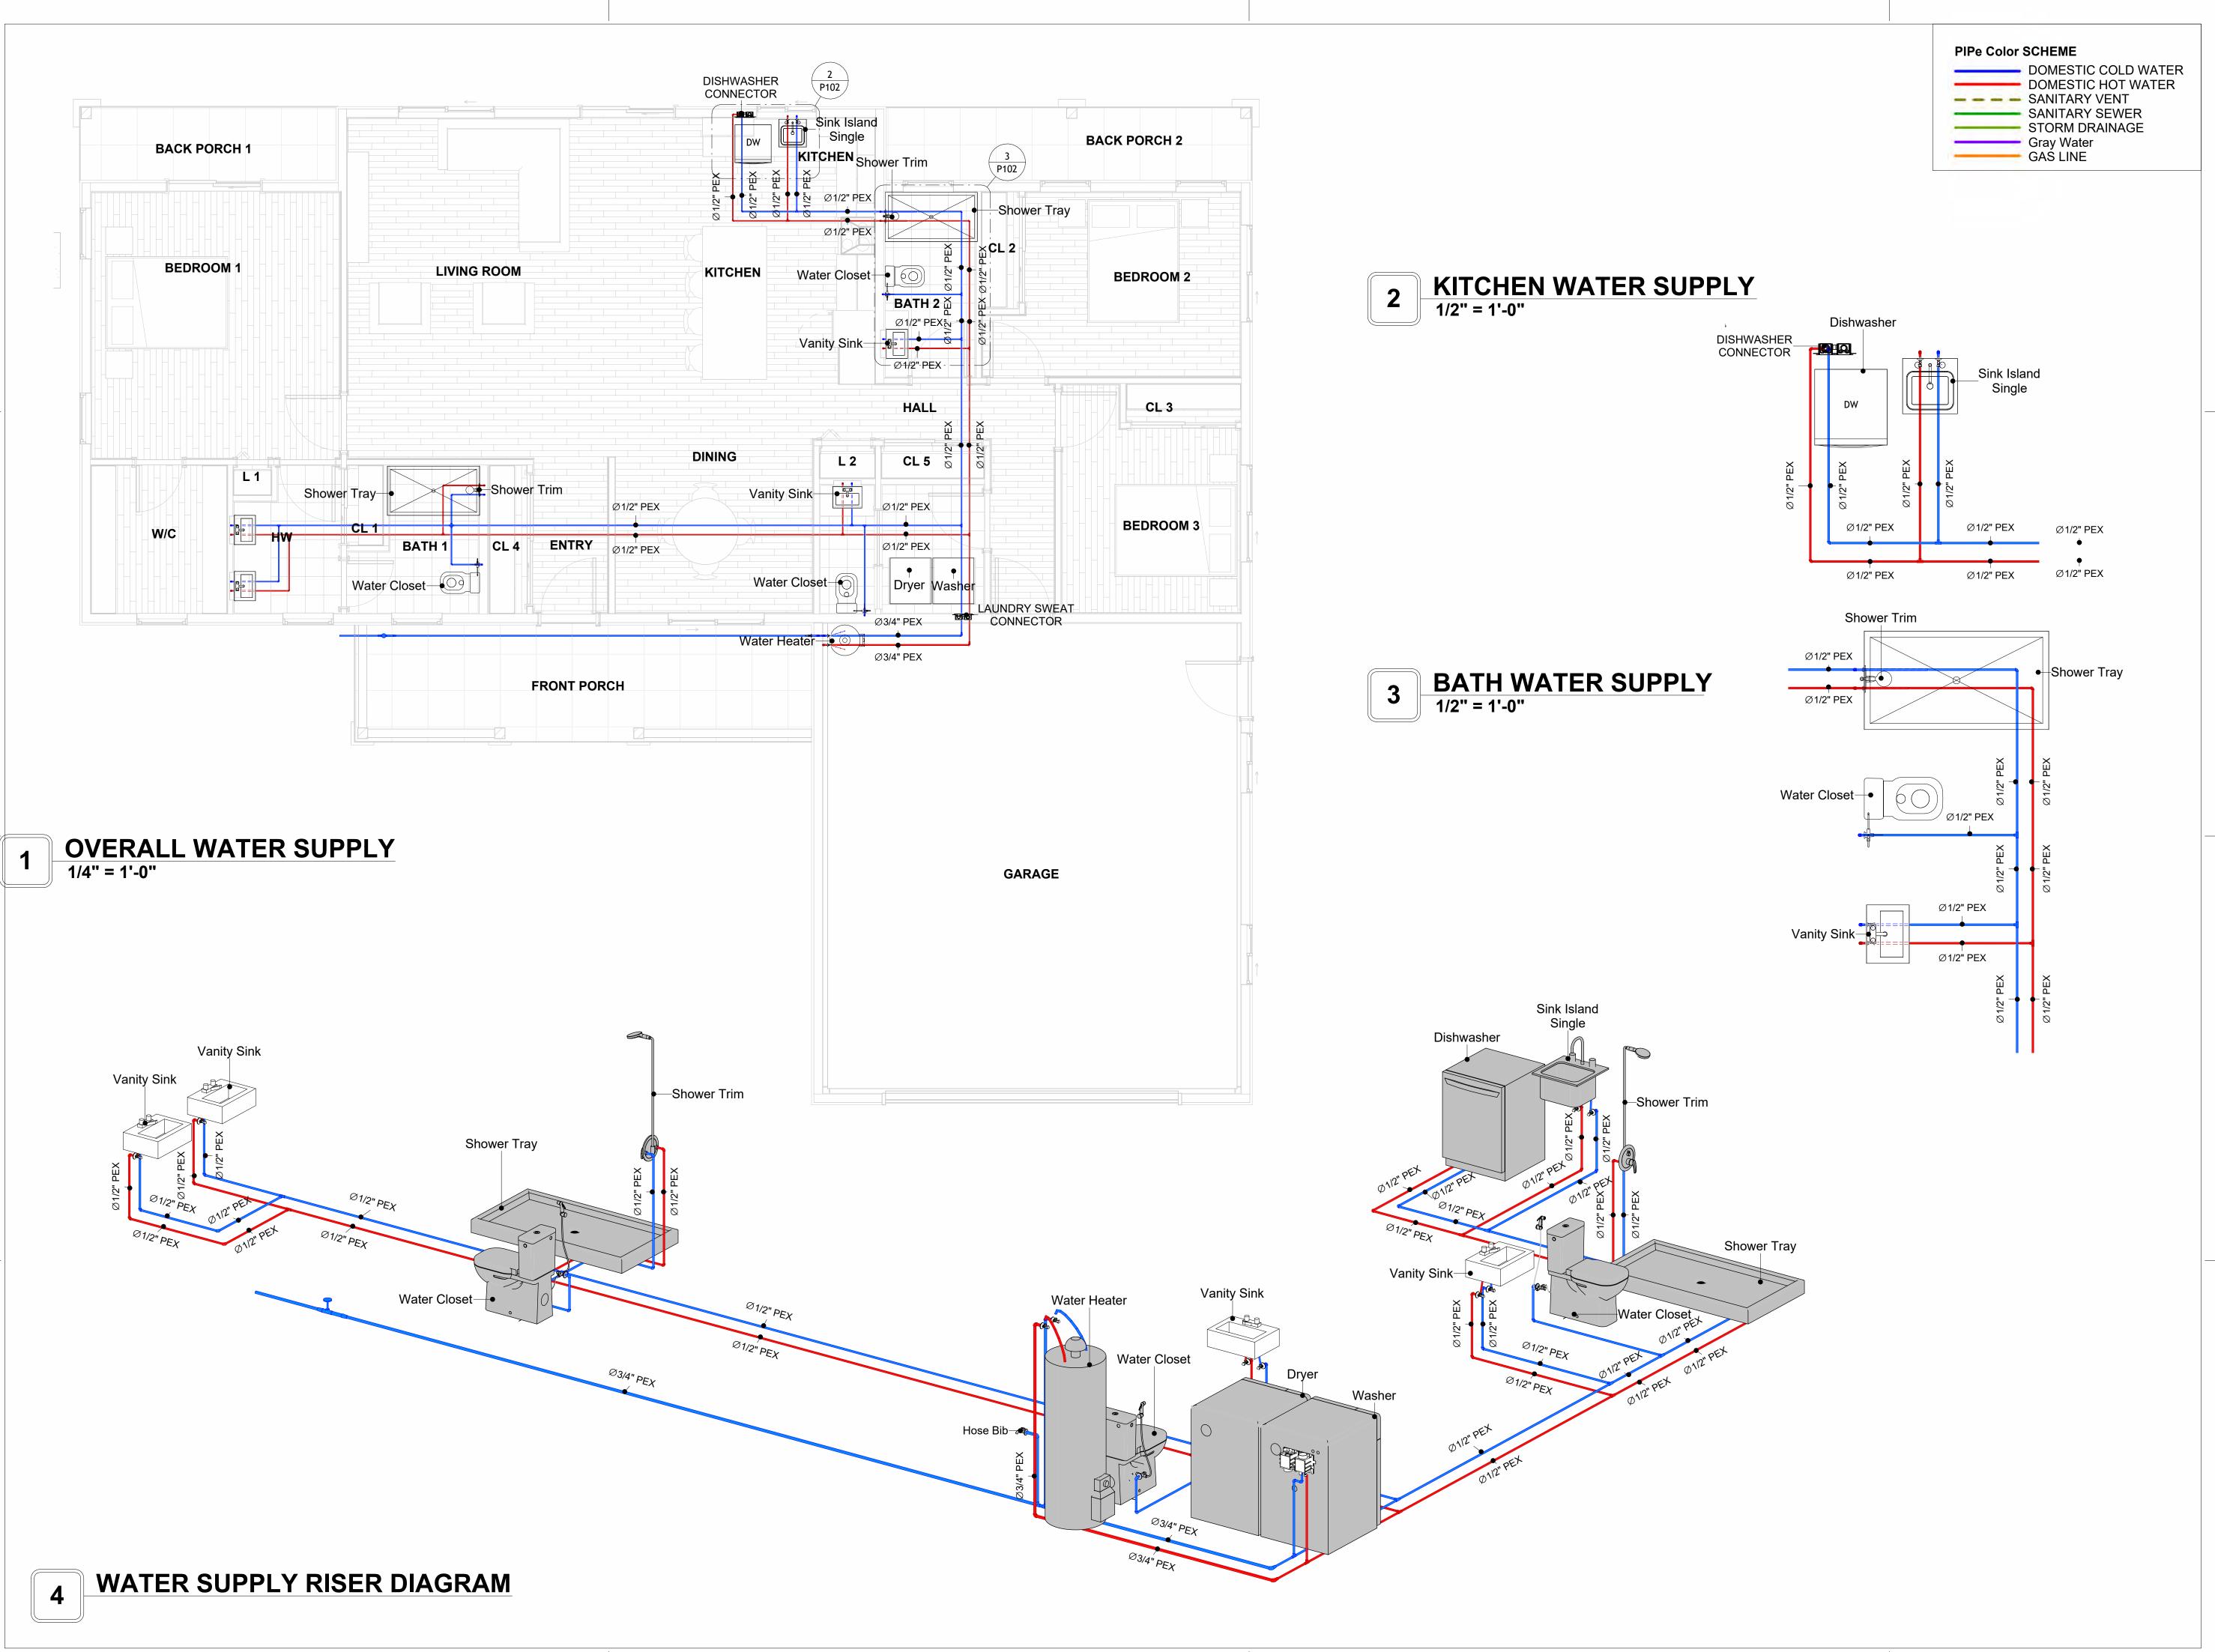



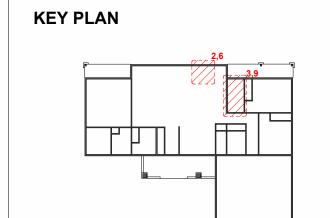

NO.	DESCRIPTION	DATE

NOTE:

LEGEND:

PROJECT

247-EMBER-1650-3Bd 2.5Ba FARMHOUSE-550

DRAWING NAME

WATER SUPPLY

0138_16
5/6/2025 5:16:21 AM
Designer
Author
Checker

P102

Materials Shopping List

Please print and take this Materials Shopping List to your favorite Home Depot and ask for assistance in selecting the materials, fixtures and fittings to complete your new home.

Record your selection and the price of the item. Then do the math to determine the cost for your selections and the total cost of finishing your home.

Have It Your Way!

The material types listed in this document were selected based on personal preferences. The Customer is encouraged to make changes to the material types in accordance with local customs, regulations, and personal preferences.

Have It Your Way!



20 good reasons to frame a home with metal and not wood



Why build your ADU with metal vs wood	Wood	Metal	Explanation
1 DIY Construction Benefit		~	The wall frames, trusses and beams can be erected in a just a few days
2 Minimal Construction Skills Required		~	Pre-assembled walls and trusses require no specialized skills to errect
Build as DIY, Hybrid or by a General Contractor		~	Do it yourself, Hybrid (involve special contractors) or hire a General Contractor
4 Build It As You Can Afford It		~	Impervious to Weather - build as you have the time and money
5 Up Front Cost of Framing Materials	~		As to only the framing material, wood is less expensive
6 Total Cost To Build		~	Savings in time, labor, and other areas make light gauge steel LESS expensive
7 Termites and wood boring insects		~	Termites, carpenter ants and wood boring insects eat wood, not metal
8 Mold resistant		~	Metal does not attract mold
9 Damage caused by exterior and interior flooding		~	Metal needs no reconditioning after a flood
10 Fire Resistant		~	Non-combustible
11 Lower insurance rates		~	Many insurance underwriters now provide lower rates for metal framed homes
12 Walls, trusses, and beams retain their original form		~	Perfectly straight walls - no shimming of drywall
13 Corners are 90 degrees		~	No need for templating of countertops to adjust for out of square corners
14 Strength and weight		~	Metal is stronger than wood and weighs less - no need for crane to lift ADU trusses
15 IBC Engineered Stamp		~	If an engineering stamp is necessary, months of waiting are saved
16 Complete BOM (Materials Shopping List)		~	Take the materials shopping list to Home Depot and start shopping/pricing
17 Flexible in Seismic Areas - Won't Fracture		~	Light gauge steel is flexible and won't fracture when the earth moves
18 No Waste At Job Site		~	Steel is the most recycled material in the world. A typical wood home has 20-30% waste
19 Environmentally Friendly		~	Trees don't have to be destroyed and the source of most metal is from recycling
20 How-To Videos Included		~	How-to videos provide simple assembly instructions
21 Relationship Counselor		~	Eliminate emotional uphevels - save time, money, and preserve the relationship

Universal Requirements - some or all may be required

- 1 Site plan
- 2 Electrical Supply Connection
- 3 Sewer Connection
- 4 Fresh Water Supply Connection
- 5 Set Backs
- 6 Soils Evaluation

- 7 Earthquake (fault) evaluation
- 8 Foundation Plan subject to soils
- 9 Compliance with local energy codes: insulation home wrap and flashing
- 10 Engineering for wind speed and snow load.
- 11 State and Local ordinances regarding ADUs
- 12 Local Architect and/or Engineer may be necessary







Ember-3Bd2.5Ba-Farmhouse MATERIAL SHOPPING LIST

Have It Your Way!

The material types listed in this document were selected based on personal preferences. The Customer is encouraged to make changes to the material types in accordance with local customs, regulations, and personal preferences. Have It Your Way!

TOC

5 HVAC BOM

4 PLUMBING BOM

6 ARCHITECTURAL BOM



7

10

15

Name Link Page No 1 Cover Page Cover Page 2 TOC TOC 2 3 ELECTRICAL BOM **ELECTRICAL BOM** 3

Table Of Content

Have It Your Way!

ARCHITECTURAL BOM

HVAC BOM

PLUMBING BOM

The material types listed in this document were selected based on personal preferences. The Customer is encouraged to make changes to the material types in accordance with local customs, regulations, and personal preferences. Have It Your Way!

GENERAL NOTES

- 1 This BOM (Bill of Materials) is prepared as a Materials Shopping List to help builders and DIYers gain a complete understanding of most if not all elements required for the complete construction of this structure, according to the original design documents provided by FrameUpNow.
- 2 All quantities and specifications are subject to change based on the final design, field measurements, availability of products and customer preferences. The customer should verify all information prior to purchasing materials.
- 3 All products and elements in the list shall conform to the International Residential Code (IRC), or any other local and international building codes, safety regulations, and standards that are applicable to the location of the structure.
- 4 If any changes are made by the customer to the list of materials specified in this document, the customer is responsible for assuring that the correct type and quantity of materials are utilized in accordance with local building
- 5 FrameUpNow, will not be held responsible for any misuse of this document, the products listed, or for deviations from the content that are made due to changes in specifications, pricing, availability, or customer preferences.
- 6 The customer is advised to consult a qualified professional or technician prior to purchasing materials for specialized construction system items. Some items including but not limited to caseworks, doors and windows may require as built measurements prior to purchase to confirmation of final dimensions.
- If there are additional trim elements or specific installation methods, the total amount of materials needed might vary. Consider any additional trim required for corners, intersections, or other architectural details that might cause this variations before procedding to purchase and construction.

ARCHITECTURAL BOM



	Ember-3Bd2.5Ba-Farmhouse								
	1	ARCHITECTU							
No.	Item	Туре	Unit	Quantity	Unit Price	Total	Description		
_	APPLIANCES		DOC.	4	ı				
1	Refrigerator		PCS	1					
2	Range		PCS	1					
3	Washer		PCS	1					
4	Dryer		PCS	1					
5	Dish Washer		PCS	1					
6	Oven		PCS	0					
7	Microwave		PCS	0					
<u> </u>	CASEWORKS			04.75					
	Kitchen Cabinet		FT	21.75					
2	Laundry Cabinet		FT	0					
3	Vanity Cabinet		FT	12.5					
4	Medicine Cabinet		PCS	4					
5	Kitchen countertop		SF	61.81					
6	Laundry Countertop		PCS	0					
7	Bathroom Countertop		SF	0					
8	Island		FT	8.3					
9	Peninsula		FT	0					
	Closets		SF	308					
<u> </u>	CEILING	I=							
1	Ceiling Board	Dry Wall	SF	2114					
	Dry Wall Fastener	Screw	PCS	3700					
3	Vapor Retarder	Polyethylene film	SF	2582					
4	Vapor Retarder Fastener	Nails with washer heads	PCS	7746					
5	Ceiling Board (MRD)	Moisture resistant drywall	SF	187					
6	MRD Fastener		PCS	327					
7	Ceiling Board	Marine Plywood	SF	281					
8	Marine Plywood Fastener	Screw	PCS	492					
	Dry Wall Tape		FT	1291					
	FLOORING								
1	Main Living Space		SF	755.7					
2	Bathroom		SF	176.6					
3	Bedrooms		SF	495.4					
4	Garage		SF	565.3					
5	Porch		SF	290.9					
	STRUCTURE								
1	Foundation		SF	2504.6					
	WALLS EXTERIOR								
	Exterior Wall Siding		SF	2000					
	Wall Paint		SF	2000					
	Wall Shteathing (OSB)		SF	2000					
4	Shteathing Fastener	Self-drilling screws(100/pkt)	PKT	20					
	Wall Insulation		SF	8120					
6	Wall Homewrap		SF	2000					
7	Home wrap Fastener	Stapled fastener (200/pkt)	PKT	8					
8	Furring Strip		PCS	250					
9	Furring Strip Fastener	Self-drilling screws(100/pkt)	PKT	20					
10	Stone Copping	Masonry stone	SF	0					
	Stone Veneer	Masonry stone	SF	0					
	WALLS INTERIOR								
	Cementitious Backer Board		SF	1052					
	Kerdi membrane		SF	1052					
	Kerdi membrane Fastener		SF	1052					
	Wall Ceramic Tile		SF	1052					
	Drywall Board		SF	5431					
	Drywall Fastener	Self-drilling screws(100/pkt)	PKT	54.31					
7	Wall Paint		SF	5431					
	Drywall Tape		FT	990					
	Wall Skerting		FT	301					

ARCHITECTURAL BOM



	DOORS				
1	Interior Swinging	3' - 0" X 6'-8"	PCS	6	
2	Exterior Swinging	3' - 0" X 6'-8"	PCS	2	
3	Interior Swinging	2' - 6" X 6'-8"	PCS	1	
4	Interior Swinging	3' - 0" X 6'-8"	PCS	2	
5	Patio Sliding	5' - 0" X 6'-8"	PCS	2	
	Interior Sliding	7' - 0" X 6'-8"	PCS	1	
	Interior Sliding	5' - 8" X 6'-8"	PCS	2	
8	Pocket Door	3' - 0" X 6'-8"	PCS	1	
9	Interior Sliding	5' - 4" X 6'-8"	PCS	1	
10	Folding	2 - 8" X 6'-8"	PCS	1	
11	Folding	1' - 8" X 6'-8"	PCS	1	
12	Interior Sliding	4' - 0" X 6'-8"	PCS	1	
13	Garage Door	16' - 0" X 6'-6"	PCS	1	
	Exterior Door Trim		FT	109	
	Interior Door Trim		FT	624	
	Entry Lock set		PCS	5	
	Privacy Lock set		PCS	10	
	Passage Lock set		PCS	7	
	WINDOWS				
1	Sliding	3' - 3" X 3'-3"	PCS	3	
	Single Hung	2' - 9" X 3'-3"	PCS	8	
	Sliding	5' - 3" X 3'-9"	PCS	4	
	Exterior Window Trim		FT	210	
5	Interior Window Trim		FT	210	
Δ	ROOF				<u> </u>
1	Roof Covering		SF	3491.0	
2	Roof Covering Fastener		PCS	1746	
3	Roof Felt Paper		SF	3491.0	
4	Roof Felt Paper Fastener		PCS	10473.0	
5	Roof Sheathing		SF	3491	
6	Roof Sheathing Fastener		PCS	27928	
7	Batten		FT	0.0	
8	Batten Fastener		PCS	0.0	
9	405		SF	477.0	
10	Soffit Fastener		PCS	238.5	
11	Fascia		FT	297.0	
12	Fascia board fastener		PCS	149	
	Roof Insulation		SF	3491.0	



Ember-3Bd2.5Ba-Farmhouse									
	ELECTRICAL MATER	IAL SHOP	PING LI	ST					
No. Item	Туре	Unit		Unit Price	Total	Description			
1 Kitchen Ceiling Light		PCS	7						
2 Kitchen Wall Mounted Light		PCS	1						
3 Exterior Wall Mounted Light		PCS	8						
4 Livingroom Ceiling Light With Fan		PCS	1						
5 Bedroom Ceiling Light With Fan		PCS	3						
6 Dining Ceiling Light		PCS	4						
7 Bath Wall Mounted Light		PCS	4						
8 Bathroom Ceiling Light		PCS	8						
9 Livingroom Ceiling Light		PCS	4						
10 Bedroom Ceiling Light		PCS	12						
11 Hall & Entry Ceiling Light		PCS	4						
12 Garage Ceiling Light		PCS	4						
13 WIC Ceiling Light	-	PCS	2						
14 Exterior Ceiling Light		PCS	2						
15 Smoke Detector		PCS	5						
△ ELECTRICAL FITTINGS									
16 Standard Receptacle 120V	20A	PCS	17						
17 GFCI Receptacle 120V	20 A	PCS	31						
18 GFCI Receptacle 240V	30 A	PCS	2						
19 GFCI Receptacle 240V	50 A	PCS	1						
20 GFCI Receptacle 240V	60 A	PCS	1						
21 Fan Switch	00 A	PCS	4						
22 Single Pole Switch		PCS	16						
23 Three Way Switch		PCS	9						
24 Dimmer Switch		PCS	7						
□ ELECTRICAL CONDUITS & WIRING		PC3	/						
25 ROMEX 14 AWG	1 4 /2 /\\/=======	FT	190		1				
26 ROMEX 14 AWG	14/2/W/ground	FT							
	12/3/W/ground	FT	0						
	12/2/W/ground	FT	654						
28 ROMEX 10 AWG	10/3/W/ground		113						
29 ROMEX 10 AWG	10/2/W/ground	FT	333						
30 Romex 8 AWG	8/3/W/ground	FT	70						
31 Romex 8 AWG	8/2/W/ground	FT	281						
32 ROMEX 6 AWG	6/3/W/ground	FT	26						
33 Bare Copper Ground Wire 6 AWG		FT							
□ ELECTRICAL BOXES & CIRCUTES	000 1115	500							
34 Panelboard -240V 1 Phase MLO	200 AMP	PCS	1						
35 Circuit breaker	15 A	PCS	3						
36 Circuit breaker	20 A	PCS	17						
37 Circuit breaker	30 A	PCS	2						
39 Circuit breaker	50 A	PCS	1						
40 Circuit breaker	60 A	PCS	1						
41 Single Gang Switch Box		PCS	11						
42 Double Gang Switch Box		PCS	8						
43 Triple Gang Switch Box		PCS	3						
44 Pull Box	#1/4	PCS	54						
45 Receptacle Box		PCS	52						

27 ABS Vent Cap Elbow

28 ABS Vent Cap Elbow

1 1/2"ø

2"a



Ember-3Bd2.5Ba-Farmhouse PLUMBING SYSTEM MATERIAL SHOPPING LIST Item Unit Quantity Unit Price Total Description 1 Bath Tub (Alcove Tub) PCS 2 Kitchen Sink PCS 1 3 Kitchen Faucets PCS 4 Vanity Sink PCS 4 5 Bath room Faucets PCS 4 6 Water Closet PCS 3 7 Shower Trim PCS 8 Shower Tray PCS 2 9 Water Heater PCS 10 Hose Bib PCS 1 11 Shutoff Valve PCS 10 12 Hanging pipe clamp PCS 26 13 Gate Valve PCS 14 Dishwasher Supply Single Connector PCS 1 15 Dishwasher Sewage Single Connector PCS 16 Laundry Sweat Connector PCS 1 △ SANITARY & PLUMBING PIPE 1 ABS (Acrylonitrile Butadiene Styrene) Pipes ø 1" FT 0 2 ABS (Acrylonitrile Butadiene Styrene) Pipes ø 1 1/2 FT 21 3 ABS (Acrylonitrile Butadiene Styrene) Pipes ø 2" FT 73 4 ABS (Acrylonitrile Butadiene Styrene) Pipes ø 3" FT 87 5 PEX (Cross-linked polyethylene) Pipes ø 1/2' FT 262 6 PEX (Cross-linked polyethylene) Pipes ø 3/4" FT 27 7 PEX (Cross-linked polyethylene) Pipes ø 1" FT 3 8 PVC Pipes Sch.80 - Rigid ø 1 1/2" FT 0 9 PVC Pipes Sch.80 - Rigid ø 2" FT 99 10 PVC Pipes Sch.80 - Rigid ø 3" FT 0 11 Flex Pipe Round ø 1/2" PCS 8 12 Flex Pipe Round ø 3/4" **PCS** 0 13 Flex Pipe Round ø 1" PCS 0 1 PEX 90 Deg Elbow 1/2"ø-1/2"ø PCS 2 PEX 90 Degree Elbow 1/2"ø-1/2"ø PCS 21 3 PEX 90 Degree Elbow 3/4"ø-3/4"ø PCS 4 PEX Tee Elbow 1/2"ø-1/2"ø **PCS** 8 5 PEX Tee Elbow 3/4"ø-3/4"ø-3/4"ø PCS 2 6 PEX Transition Elbow 1"ø-3/4"ø PCS 2 7 PEX Transition Elbow 3/4"ø-1/2"ø PCS 8 PEX 90 Degree Elbow 1/2"ø-1/2"ø **PCS** 16 9 PEX 90 Degree Elbow 3/4"ø-3/4"ø PCS 3 10 PEX Tee Elbow 1/2"ø-1/2"ø-1/2"ø **PCS** 5 11 PEX Transition Elbow 3/4"ø-1/2"ø PCS 12 PVC 90 Deg Bend Elbow 2"ø-2"ø PCS 39 13 ABS 90 Degree Bend Elbow 1 1/2"ø-1 1/2"ø PCS 3 14 ABS 90 Degree Bend Elbow PCS 2"ø-2"ø 15 ABS 90 Degree Bend Elbow 3"ø-3"ø PCS 16 ABS P-Trap 2"ø-2"ø PCS 17 ABS P-Trap 3"ø-3"ø PCS 2 18 ABS Reducer Elbow 2"ø-1 1/2"ø PCS 2 19 ABS Reducer Elbow 3"ø-1 1/2"ø **PCS** 20 ABS Reducer Elbow 3"ø-2"ø **PCS** 1 1/2"ø-1 1/2"ø-1 1/2"ø 21 ABS TEE Elbow PCS 2 22 ABS TEE Elbow 2"ø-2"ø-2"ø PCS 3 23 ABS TEE Elbow 3"ø-3"ø-3"ø PCS 12 24 ABS Trap P 1 1/2"ø-1 1/2"ø PCS 2 25 ABS Trap P 2"ø-2"ø PCS 3 26 ABS Trap P PCS 3"ø-3"ø 1

PCS

PCS

5

	Ember-3Bd2.5Ba-Farmhouse									
		HVAC SYSTEM MA	TERIAL	SHOPP	ING LIST					
No.	Item	Туре	Unit	Quantity	Unit Price	Total	Description			
	HVAC_DUCTS									
1	PIPE (REFRIGERANT LINE)	3/8" (Ø)	FT	133.74						
2	PIPE (REFRIGERANT LINE)	3/4''' (Ø)	FT	181.35						
3	DRAYER HOSE	4" (Ø)	FT	12.7						
4	FLEX DUCT ROUND	4" (Ø)	FT	10.76						
	DUCT FITTINGS & ACCESSORIES									
5	ELBOW (REFRIGERANT LINE)	3/4" (Ø)-3/4" (Ø)	PCS	31						
6	ELBOW (REFRIGERANT LINE)	3/8" (Ø)-3/8" (Ø)	PCS	25						
7	TEE (REFRIGERANT LINE)	3/4" (Ø)-3/4" (Ø)-3/4" (Ø)	PCS	4						
8	TEE (REFRIGERANT LINE)	3/8" (Ø)-3/8" (Ø)-3/8" (Ø)	PCS	3						
9	TRANSITION (REFRIGERANT	3/4" (Ø)-1/2" (Ø)	PCS	5						
10	TRANSITION (REFRIGERANT	3/4" (Ø)-5/8" (Ø)	PCS	4						
11	TRANSITION (REFRIGERANT	3/8" (Ø)-1/4" (Ø)	PCS	1						
12	ROUND TRANSITION(ANGLE)	#REF!	PCS	5						
	HVAC_EQUIPMENTS									
13	AIR HANDLING UNIT	WALL MOUNTED	PCS	4						
14	CONDENSER	OUTDOOR UNIT	PCS	1						
15	EXHAUST FAN	75 CFM	PCS	3						
16	EXHAUST HOOD	WALL MOUNTED	PCS	1						
17	HOOD-WALL: VENT	HOOD-WALL: VENT	PCS	1						
18	DRAYER: VENT	DRAYER: VENT	PCS	1						
19	ROOF VENT	3"(Ø)	PCS	3						



Table Of Content

#	Name	Link	Page No
1	Cover Page	<u>Cover Page</u>	1
2	TOC	TOC	2
3	ELECTRICAL BOM	ELECTRICAL BOM	3
5	HVAC BOM	HVAC BOM	7
4	PLUMBING BOM	PLUMBING BOM	10
6	ARCHITECTURAL BOM	ARCHITECTURAL BOM	15

Have It Your Way!

The material types listed in this document were selected based on personal preferences. The Customer is encouraged to make changes to the material types in accordance with local customs, regulations, and personal preferences. Have It Your Way!

GENERAL NOTES

- This BOM (Bill of Materials) is prepared as a Materials Shopping List to help builders and DIYers gain a complete understanding of most if not all elements required for the complete construction of this structure, according to the original design documents provided by FrameUpNow.
- 2 All quantities and specifications are subject to change based on the final design, field measurements, availability of products and customer preferences. The customer should verify all information prior to purchasing materials.
- 3 All products and elements in the list shall conform to the International Residential Code (IRC), or any other local and international building codes, safety regulations, and standards that are applicable to the location of the structure.
- 4 If any changes are made by the customer to the list of materials specified in this document, the customer is responsible for assuring that the correct type and quantity of materials are utilized in accordance with local building codes.
- FrameUpNow, will not be held responsible for any misuse of this document, the products listed, or for deviations from the content that are made due to changes in specifications, pricing, availability, or customer preferences.
- 6 The customer is advised to consult a qualified professional or technician prior to purchasing materials for specialized construction system items. Some items including but not limited to caseworks, doors and windows may require as built measurements prior to purchase to confirmation of final dimensions.
- 7 If there are additional trim elements or specific installation methods, the total amount of materials needed might vary. Consider any additional trim required for corners, intersections, or other architectural details that might cause this variations before procedding to purchase and construction.



			LIGHTING FIXTURES				
#	Item	Туре	Description, Manufacturer, SKU	Unit	Quantity	Unit Price	Total
1	Kitchen Ceiling Light			PCS	7		
3	Kitchen Wall Mounted Light			PCS	1		
4	Exterior Wall Mounted Light			PCS	8		
5	Livingroom Ceiling Light With Fan			PCS	1		
6	Bedroom Ceiling Light With Fan			PCS	3		
7	Dining Ceiling Light			PCS	4		
8	Bath Wall Mounted Light			PCS	4		
9	Bathroom Ceiling Light			PCS	8		
10	Livingroom Ceiling Light			PCS	4		
11	Bedroom Ceiling Light			PCS	12		
12	Hall & Entry Ceiling Light			PCS	4		
12	Garage Ceiling Light			PCS	4		
13	WIC Ceiling Light			PCS	2		
14	Exterior Ceiling Light			PCS	2		
15	Smoke Detector			PCS	5		



			ELECTRICAL FITTINGS				
#	Item	Туре	Description, Manufacturer, SKU	Unit	Quantity	Unit Price	Total
1	Standard Receptacle 120V	20A		PCS	17		
2	GFCI Receptacle 120V	20 A		PCS	31		
3	GFCI Receptacle 240V	30 A		PCS	2		
l	GFCI Receptacle 240V	50 A		PCS	1		
5	GFCI Receptacle 240V	60 A		PCS	1		
5	Fan Switch			PCS	4		
7	Single Pole Switch			PCS	16		
3	Three Way Switch			PCS	9		
)	Dimmer Switch			PCS	7		
LO		,	·	'			
l1							
L2							
L3							
14							
15							



		ELECTR	ICAL CONDUITS & WIRING				
#	Item	Туре	Description, Manufacturer, SKU	Unit	Quantity	Unit Price	Total
1	ROMEX 14 AWG	14/2/W/ground		FT	190		
3	ROMEX 12 AWG	12/3/W/ground		FT	0		
4	ROMEX 12 AWG	12/2/W/ground		FT	654		
6	ROMEX 10 AWG	10/3/W/ground		FT	113		
8	ROMEX 10 AWG	10/2/W/ground		FT	333		
9	Romex 8 AWG	8/3/W/ground		FT	70		
10	Romex 8 AWG	8/2/W/ground		FT	281		
11	ROMEX 6 AWG	6/3/W/ground		FT	26		
12	Bare Copper Ground Wire 6 AWG			FT			
13							
14							
15							
16							



		ELEC	CTRICAL BOXES & CIRCUTES				
#	Item	Туре	Description, Manufacturer, SKU	Unit	Quantity	Unit Price	Total
1	Panelboard -240V 1 Phase MLO	200 AMP		PCS	1		
2	Circuit breaker	15 A		PCS	3		
3	Circuit breaker	20 A		PCS	17		
4	Circuit breaker	30 A		PCS	2		
5	Circuit breaker	50 A		PCS	1		
6	Circuit breaker	60 A		PCS	1		
7	Single Gang Switch Box			PCS	11		
8	Double Gang Switch Box			PCS	8		
9	Triple Gang Switch Box			PCS	3		
10	Pull Box	#1/4		PCS	54		
11	Receptacle Box			PCS	52		
12							
13							
14							
15							

			HVAC_DUCTS 01				
#		Туре	Description, Manufacturer, SKU	Unit	Quantity	Unit Price	Total
1	PIPE (REFRIGERANT LINE)			FT	133.74		
2	PIPE (REFRIGERANT LINE)	3/4''' (Ø)		FT	181.35		
3		4" (Ø)		FT	12.7		
4	FLEX DUCT ROUND	4" (Ø)		FT	10.76		
5							
6							
7							
8							
9							
10							
11							
12							
13							
14							
15							
16							

			DUCT FITTINGS & ACCESSORIES				
#	Item	Туре	Description, Manufacturer, SKU	Unit	Quantity	Unit Price	Total
1	ELBOW (REFRIGERANT LINE)	3/4" (Ø)-3/4" (Ø)		PCS	31		
2	ELBOW (REFRIGERANT LINE)	3/8" (Ø)-3/8" (Ø)		PCS	25		
3	TEE (REFRIGERANT LINE)	3/4" (Ø)-3/4" (Ø)-3/4" (Ø)		PCS	4		
4	TEE (REFRIGERANT LINE)	3/8" (Ø)-3/8" (Ø)-3/8" (Ø)		PCS	3		
5	TRANSITION (REFRIGERANT LINE)	3/4" (Ø)-1/2" (Ø)		PCS	5		
6	TRANSITION (REFRIGERANT LINE)	3/4" (Ø)-5/8" (Ø)		PCS	4		
7	TRANSITION (REFRIGERANT LINE)	3/8" (Ø)-1/4" (Ø)		PCS	1		
8							
9							
10							
11							
12							
13							
14							
15							
16							

			HVAC_EQUIPMENTS				
#	Item	Туре	Description, Manufacturer, SKU	Unit	Quantity	Unit Price	Total
1	AIR HANDLING UNIT	WALL MOUNTED		PCS	4		
2	CONDENSER	OUTDOOR UNIT		PCS	1		
3	EXHAUST FAN	75 CFM		PCS	3		
4	EXHAUST HOOD	WALL MOUNTED		PCS	1		
5	HOOD-WALL: VENT	HOOD-WALL: VENT		PCS	1		
6	DRAYER: VENT	DRAYER: VENT		PCS	1		
7	ROOF VENT	3"(Ø)		PCS	3		
8							
9							
10							
11							
12							
13							
14							



		PLUMBII	NG FIXTURES & ACCESSORIES				
#	Item	Туре	Description, Manufacturer, SKU	Unit	Quantity	Unit Price	Total
1	Bath Tub (Alcove Tub)			PCS	C		
2	Kitchen Sink			PCS	1		
3	Kitchen faucets			PCS	1		
4	Vanity Sink			PCS	4		
5	Bath room faucets			PCS	4		
6	Water Closet			PCS	3		
7	Shower Trim			PCS	2		
8	Shower Tray			PCS	2		
9	Water Heater			PCS	1		
10	Hose Bib			PCS	1		
11	Shutoff Valve			PCS	10		
12	Hanging pipe clamp			PCS	26		
13	Globe Valve			PCS	1		
14	Dishwasher Supply Single Connector			PCS	1		
15	Dishwasher Sewage Single Connector			PCS	1		
16	Laundry Sweat Connector			PCS	1		



		SANI	TARY & PLUMBING PIPES				
#	Item	Туре	Description, Manufacturer, SKU	Unit	Quantity	Unit Price	Total
1	ABS (Acrylonitrile Butadiene Styrene) Pipes	ø 1"		FT	0		
2	ABS (Acrylonitrile Butadiene Styrene) Pipes	ø 1 1/2"		FT	21		
3	ABS (Acrylonitrile Butadiene Styrene) Pipes	ø 2"		FT	73		
4	ABS (Acrylonitrile Butadiene Styrene) Pipes	ø 3"		FT	87		
5	PEX (Cross-linked polyethylene) Pipes	ø 1/2"		FT	262		
6	PEX (Cross-linked polyethylene) Pipes	ø 3/4"		FT	27		
7	PEX (Cross-linked polyethylene) Pipes	ø 1"		FT	3		
8	PVC Pipes Sch.80 - Rigid	ø 1 1/2"		FT	0		
9	PVC Pipes Sch.80 - Rigid	ø 2"		FT	99		
10	PVC Pipes Sch.80 - Rigid	ø 3"		FT	0		
11	Flex Pipe Round	ø 1/2"		FT	8		
12	Flex Pipe Round	ø 3/4"		FT	0		
13	Flex Pipe Round	ø 1"		FT	0		
14							
15							



		PI	PE FITTINGS 01				
#	Item	Туре	Description, Manufacturer, SKU	Unit	Quantity	Unit Price	Total
1	PEX 90 Deg Elbow	1/2"ø-1/2"ø		PCS	2		
2	PEX 90 Degree Elbow	1/2"ø-1/2"ø		PCS	21		
}	PEX 90 Degree Elbow	3/4"ø-3/4"ø		PCS	3		
ļ.	PEX Tee Elbow	1/2"ø-1/2"ø-1/2"ø		PCS	8		
)	PEX Tee Elbow	3/4"ø-3/4"ø-3/4"ø		PCS	2		
<u>,</u>	PEX Transition Elbow	1"ø-3/4"ø		PCS	2		
1	PEX Transition Elbow	3/4"ø-1/2"ø		PCS	1		
}	PEX 90 Degree Elbow	1/2"ø-1/2"ø		PCS	16		
)	PEX 90 Degree Elbow	3/4"ø-3/4"ø		PCS	3		
0	PEX Tee Elbow	1/2"ø-1/2"ø-1/2"ø		PCS	5		
1	PEX Transition Elbow	3/4"ø-1/2"ø		PCS	1		
2	PVC 90 Deg Bend Elbow	2"ø-2"ø		PCS	39		
13	ABS 90 Degree Bend Elbow	1 1/2"ø-1 1/2"ø		PCS	3		
4	ABS 90 Degree Bend Elbow	2"ø-2"ø		PCS	1		
15	ABS 90 Degree Bend Elbow	3"ø-3"ø		PCS	5		
		PI	PE FITTINGS 02				
#	Item	Туре	Description, Manufacturer, SKU	Unit	Quantity	Unit Price	Total
	ABS P-Trap	2"ø-2"ø		PCS	1		



2	ABS P-Trap	3"ø-3"ø	PCS	2	
3	ABS Reducer Elbow	2"ø-1 1/2"ø	PCS	2	
4	ABS Reducer Elbow	3"ø-1 1/2"ø	PCS	3	
5	ABS Reducer Elbow	3"ø-2"ø	PCS	7	
6	ABS TEE Elbow	1 1/2"ø-1 1/2"ø-1 1/2"ø	PCS	2	
7	ABS TEE Elbow	2"ø-2"ø	PCS	3	
8	ABS TEE Elbow	3"ø-3"ø-3"ø	PCS	12	
9	ABS Trap P	1 1/2"ø-1 1/2"ø	PCS	2	
10	ABS Trap P	2"ø-2"ø	PCS	3	
11	ABS Trap P	3"ø-3"ø	PCS	1	
12	ABS Vent Cap Elbow	1 1/2"ø	PCS	1	
13	ABS Vent Cap Elbow	2"Ø	PCS	5	



			APPLIANCES				
#	Item	Туре	Description, Manufacturer, SKU	Unit	Quantity	Unit Price	Total
1	Refrigerator			PCS	1		
2	Range			PCS	1		
3	Washer Front Load	Stackable		PCS	1		
4	Dryer Front Load	Stackable		PCS	1		
5	Dish Washer			PCS	1		
6	Oven			PCS	(
7	Microwave			PCS	(
8							
9							
10							
11							
12							
13							
14							
15							
16							



			CASEWORKS 01				
#	Item	Туре	Description, Manufacturer, SKU	Unit	Quantity	Unit Price	Total
1	Kitchen Cabinet			FT	21.75		
2	Laundry Cabinet			FT	0		
3	Vanity Cabinet			FT	12.5		
4	Medicine Cabinet			PCS	4		
5	Kitchen countertop			SF	61.81		
6	Laundry Countertop			PCS	0		
7	Bathroom Countertop			SF	0		
8	Island			FT	8.3		
9	Peninsula			FT	0		
10	Closets			SF	308		
11							
12							
13							
14							
15							



	1		CEILING 01				
‡	Item	Туре	Description, Manufacturer, SKU	Unit	Quantity	Unit Price	Total
	LIVING ROOM AND KITCHEN	V		SF	702.0		
l	Ceiling Board	Drywall		SF	702		
	Drywall Fastener	Screw		PCS	1229		
3	Vapor Retarder	Polyethylene film		SF	702		
ļ	Vapor Retarder Fastener	Nails with washer heads		PCS	2106		
	BATHROOM 1			SF	54.0		
5	Ceiling Board	MRD (Moisture resistant drywall)		SF	54		
j	MRD Fastener	Screw		PCS	95		
	BATHROOM 2			SF	24.0		
7	Ceiling Board	MRD (Moisture resistant drywall)		SF	24		
3	MRD Fastener	Screw		PCS	42		
	GARAGE			SF	633.0		
)	Ceiling Board	Drywall		SF	633		
.0	Drywall Fastener	Screw		PCS	1108		
l1	Vapor Retarder	Polyethylene film		SF	633		
L2	Vapor Retarder Fastener	Nails with washer heads		PCS	1899		



			CEILING 02				
#	Item	Туре	Description, Manufacturer, SKU	Unit	Quantity	Unit Price	Total
	PORCH 1			SF	142.0		
13	Ceiling Board	Marine Plywood		SF	142		
14	Exterior Grade Plywood	Screw		PCS	249		
	PORCH 2			SF	57.0		
15	Ceiling Board	Marine Plywood		SF	57		
16	Exterior Grade Plywood	Screw		PCS	100		
	PORCH 3			SF	82.0		
17	Ceiling Board	Marine Plywood		SF	82		
18	Exterior Grade Plywood	Screw		PCS	144		
	W/C			SF	70.0		
19	Ceiling Board	Drywall		SF	70		
20	Drywall Fastener	Screw		PCS	123		
21	Vapor Retarder	Polyethylene film		SF	70		
22	Vapor Retarder Fastener	Nails with washer heads		PCS	210		



			CEILING 03				
#	Item	Туре	Description, Manufacturer, SKU	Unit	Quantity	Unit Price	Total
	CLOSET 1			SF	15.0		
23	Ceiling Board	Drywall		SF	15		
24	Drywall Fastener	Screw		PCS	26		
25	Vapor Retarder	Polyethylene film		SF	15		
26	Vapor Retarder Fastener	Nails with washer heads		PCS	45		
	CLOSET 2			SF	14.0		
27	Ceiling Board	Drywall		SF	14		
28	Drywall Fastener	Screw		PCS	25		
29	Vapor Retarder	Polyethylene film		SF	14		
30	Vapor Retarder Fastener	Nails with washer heads		PCS	42		
	CLOSET 3			SF	11.0		
31	Ceiling Board	Drywall		SF	11		
32	Drywall Fastener	Screw		PCS	19		
33	Vapor Retarder	Polyethylene film		SF	11		
34	Vapor Retarder Fastener	Nails with washer heads		PCS	33		



			CEILING 04				
#	Item	Туре	Description, Manufacturer, SKU	Unit	Quantity	Unit Price	Total
	CLOSET 4			SF	18.0		
35	Ceiling Board	Drywall		SF	18		
36	Drywall Fastener	Screw		PCS	32		
37	Vapor Retarder	Polyethylene film		SF	18		
38	Vapor Retarder Fastener	Nails with washer heads		PCS	54		
	L1			SF	6.0		
39	Ceiling Board	Drywall		SF	6		
40	Drywall Fastener	Screw		PCS	11		
ļ 1	Vapor Retarder	Polyethylene film		SF	6		
12	Vapor Retarder Fastener	Nails with washer heads		PCS	18		
	L2			SF	4.0		
13	Ceiling Board	Drywall		SF	4		
14	Drywall Fastener	Screw		PCS	7		
15	Vapor Retarder	Polyethylene film		SF	4		
16	Vapor Retarder Fastener	Nails with washer heads		PCS	12		



			CEILING 05				
#	Item	Туре	Description, Manufacturer, SKU	Unit	Quantity	Unit Price	Total
	MASTER BEDROOM			SF	216.0		
47	Ceiling Board	Drywall		SF	216		
48	Drywall Fastener	Screw		PCS	378		
49	Vapor Retarder	Polyethylene film		SF	216		
50	Vapor Retarder Fastener	Nails with washer heads		PCS	648		
	MASTER BATHROOM			SF	109.0		
51	Ceiling Board	MRD (Moisture resistant drywall)		SF	109		
52	MRD Fastener	Screw		PCS	191		
	W/D			SF	46.0		
53	Ceiling Board	Drywall		SF	46		
54	Drywall Fastener	Screw		PCS	81		
55	Vapor Retarder	Polyethylene film		SF	46		
56	Vapor Retarder Fastener	Nails with washer heads		PCS	138		



			CEILING 06				
#	Item	Туре	Description, Manufacturer, SKU	Unit	Quantity	Unit Price	Total
	HALL			SF	89.0		
57	Ceiling Board	Drywall		SF	89		
58	Drywall Fastener	Screw		PCS	156		
59	Vapor Retarder	Polyethylene film		SF	89		
60	Vapor Retarder Fastener	Nails with washer heads		PCS	267		
	BEDROOM 1			SF	142.0		
61	Ceiling Board	Drywall		SF	142		
62	Drywall Fastener	Screw		PCS	249		
63	Vapor Retarder	Polyethylene film		SF	142		
64	Vapor Retarder Fastener	Nails with washer heads		PCS	426		
	BEDROOM 2			SF	148.0		
65	Ceiling Board	Drywall		SF	148		
66	Drywall Fastener	Screw		PCS	259		
67	Vapor Retarder	Polyethylene film		SF	148		
68	Vapor Retarder Fastener	Nails with washer heads		PCS	444		



	<u>1</u>		FLOORING INTERIOR 01				
#	Item	Туре	Description, Manufacturer, SKU	Unit	Quantity	Unit Price	Total
	BEDROOM #1						
1	Bedroom Flooring			SF	199		
2	Wood underlay	Foam Pad Polyethylene		SF	199		
3	Vapor Retarder	Vapor Barrier Polyethylene		SF	199		
	BEDROOM#2						
4	Bedroom Flooring			SF	128		
5	Wood underlay	Foam Pad Polyethylene		SF	128		
6	Vapor Retarder	Vapor Barrier Polyethylene		SF	128		
	BEDROOM#3						
7	Bedroom Flooring			SF	108		
8	Wood underlay	Foam Pad Polyethylene		SF	108		
9	Vapor Retarder	Vapor Barrier Polyethylene		SF	108		
	CL#1						
10	Closet Flooring			SF	21		
11	Wood underlay	Foam Pad Polyethylene		SF	21		
12	Vapor Retarder	Vapor Barrier Polyethylene		SF	21		



			FLOORING INTERIOR 02				
#	Item	Туре	Description, Manufacturer, SKU	Unit	Quantity	Unit Price	Total
	CL#2						
13	Closet Flooring			SF	4		
14	Wood underlay	Foam Pad Polyethylene		SF	4		
15	Vapor Retarder	Vapor Barrier Polyethylene		SF	4		
	CL#3						
16	Closet Flooring			SF	9		
17	Wood underlay	Foam Pad Polyethylene		SF	9		
18	Vapor Retarder	Vapor Barrier Polyethylene		SF	9		
	CL#4						
19	Closet Flooring			SF	17		
20	Wood underlay	Foam Pad Polyethylene		SF	17		
21	Vapor Retarder	Vapor Barrier Polyethylene		SF	17		
	CL#5						
22	Closet Flooring			SF	6		
23	Wood underlay	Foam Pad Polyethylene		SF	6		
24	Vapor Retarder	Vapor Barrier Polyethylene		SF	6		



	1		FLOORING INTERIOR 03				
#	Item	Туре	Description, Manufacturer, SKU	Unit	Quantity	Unit Price	Total
	CL#6						
25	Closet Flooring			SF	10		
26	Wood underlay	Foam Pad Polyethylene		SF	10		
27	Vapor Retarder	Vapor Barrier Polyethylene		SF	10		
	CL#7						
28	Closet Flooring			SF	13		
29	Wood underlay	Foam Pad Polyethylene		SF	13		
30	Vapor Retarder	Vapor Barrier Polyethylene		SF	13		
	CL#8						
31	Closet Flooring			SF	14		
32	Wood underlay	Foam Pad Polyethylene		SF	14		
33	Vapor Retarder	Vapor Barrier Polyethylene		SF	14		
	LIVING ROOM AND KITCH	EN					
34	Living Area Flooring			SF	723		
35	Wood underlay	Foam Pad Polyethylene		SF	723		
36	Vapor Retarder	Vapor Barrier Polyethylene		SF	723		



			FLOORING INTERIOR 04				
#	Item	Туре	Description, Manufacturer, SKU	Unit	Quantity	Unit Price	Total
	GARAGE						
37	Epoxy top coat	Sealant high build resin coat		SF	565		
38	Flake coat	Anti-slip quartz aggregate coat		SF	565		
39	Primer coat	damp proof membrane		SF	565		
	BATHROOM#1						
40	Tile Finish			SF	78		
41	Adhesive	1/2" Thin set Mortar		SF	78		
42	Vapor Retarder	Vapor Barrier Polyethylene		SF	78		
	BATHROOM#2						
43	Tile Finish			SF	37		
44	Adhesive	1/2" Thin set Mortar		SF	37		
45	Vapor Retarder	Vapor Barrier Polyethylene		SF	37		



			FLOORING INTERIOR 05				
#	Item	Туре	Description, Manufacturer, SKU	Unit	Quantity	Unit Price	Total
	BATHROOM#3						
46	Tile Finish			SF	22		
47	Adhesive	1/2" Thin set Mortar		SF	22		
48	Vapor Retarder	Vapor Barrier Polyethylene		SF	22		
	W/D						
49	Tile Finish			SF	40		
50	Adhesive	1/2" Thin set Mortar		SF	40		
51	Vapor Retarder	Vapor Barrier Polyethylene		SF	40		



			FLOORING EXTERIOR 01			
#	Item	Туре	Description, Manufacturer, SKU	Unit	Quantity	Unit Price
	STRUCTURE			SF	2504.6	
1	Concrete Slab	4"concrete cast in situ		CF	835	
2	Insulation	Rigid insulation		SF	563	
3	Hard core	Compacted soil		CF	712	
4	Re-bar	#4 re-bar		Ton	2	
5	Concrete Pad	4"concrete cast in situ		CF	2	
6	Slab edge	Turndown		CF	529	
7	Footing #1	Cast-in-place concrete		CF	7	
8	Footing #2	Cast-in-place concrete		CF	10	
	PORCH FRONT					
9	Tile Finish			SF	161	
10	Adhesive	1/2" Thin set Mortar		SF	161	
11	Vapor Retarder	Vapor Barrier Polyethylene		SF	161	



			FLOORING EXTERIOR 02			
#	Item	Туре	Description, Manufacturer, SKU	Unit	Quantity	Unit Price
	PORCH BACK #1					
12	Tile Finish			SF	57	
13	Adhesive	1/2" Thin set Mortar		SF	57	
14	Vapor Retarder	Vapor Barrier Polyethylene		SF	57	
	PORCH BACK #2					
15	Tile Finish			SF	81	
16	Adhesive	1/2" Thin set Mortar		SF	81	
17	Vapor Retarder	Vapor Barrier Polyethylene		SF	81	



			WALLS: EXTERIOR				
#	Item	Туре	Description, Manufacturer, SKU	Unit	Quantity	Unit Price	Total
1	Exterior-Grade Plywood						
	Horizontal Siding			SF	2000		
2	Exterior-Grade Plywood Fastener 8/panel	Self-drilling screws(100/pkt)		PKT	20		
3	Wall Shteathing (OSB)			SF	2000		
4	Shteathing Fastener	Self-drilling screws(100/pkt)		PKT	20		
5	Wall Homewrap			SF	2000		
6	Homewrap Fastener	Stapled fastener (200/pkt)		PKT	7.60		
7	Furring Strip			PCS	250.00		
8	Furring Strip Fastener	Self-drilling screws(100/pkt)		PKT	20		
9	Wall Paint			SF	2000		
10	Stone Copping	Masonry stone		SF	0		
11	Stone Veneer	Masonry stone		SF	0		
12	Mortar for Stone Veneer			SF	0		
13	Wall Insulation			SF	8120		



			WALLS: INTERIOR 01				
#	Item	Туре	Description, Manufacturer, SKU	Unit	Quantity	Unit Price	Total
	BATHROOM 1			SF	48.0		
1	Cementitious Backer Board			SF	287		
2	Kerdi membrane			SF	287		
3	Kerdi membrane Fastener			SF	287		
4	Wall Ceramic Tile			SF	287		
	BATHROOM 2			SF	50.0		
5	Cementitious Backer Board			SF	369		
6	Kerdi membrane			SF	369		
7	Kerdi membrane Fastener			SF	369		
8	Wall Ceramic Tile			SF	369		
	BEDROOM 1			SF	198.0		
9	Drywall Board			SF	581		
10	Drywall Fastener	Self-drilling screws(100/pkt)		PKT	5.81		
11	Wall Paint			SF	581		
12	Drywall Tape			FT	108.9		



			WALLS: INTERIOR 02				
#	Item	Туре	Description, Manufacturer, SKU	Unit	Quantity	Unit Price	Total
	BEDROOM 2			SF	128.0		
13	Drywall Board			SF	553		
14	Drywall Fastener	Self-drilling screws(100/pkt)		PKT	5.53		
15	Wall Paint			SF	553		
16	Drywall Tape			FT	103.7		
	KITCHEN			SF	148.0		
17	Cementitious Backer Board			SF	31		
18	Drywall Board			SF	257		
19	Drywall Fastener	Self-drilling screws(100/pkt)		PKT	2.57		
20	Kerdi membrane			SF	31		
21	Kerdi membrane Fastener			SF	31		
22	Wall Ceramic Tile			SF	31		
23	Wall Paint			SF	257		
24	Drywall Tape			FT	48.5		



			WALLS: INTERIOR 03				
#	Item	Туре	Description, Manufacturer, SKU	Unit	Quantity	Unit Price	Total
	BEDROOM 3			SF	107.0		
25	Drywall Board			SF	437		
26	Drywall Fastener	Self-drilling screws(100/pkt)		PKT	4.37		
27	Wall Paint			SF	437		
28	Drywall Tape			FT	82.0		
	LIVING ROOM			SF	324.0		
29	Drywall Board			SF	441		
30	Drywall Fastener	Self-drilling screws(100/pkt)		PKT	4.41		
31	Wall Paint			SF	441		
32	Drywall Tape			FT	82.7		
	CL 1	<u> </u>		SF	10.0		
33	Drywall Board			SF	119		
34	Drywall Fastener	Self-drilling screws(100/pkt)		PKT	1.19		
35	Wall Paint			SF	119		
36	Drywall Tape			FT	22.3		



			WALLS: INTERIOR 04				
#	Item	Туре	Description, Manufacturer, SKU	Unit	Quantity	Unit Price	Total
	CL 2			SF	15.0		
37	Drywall Board			SF	169		
38	Drywall Fastener	Self-drilling screws(100/pkt)		PKT	1.69		
39	Wall Paint			SF	169		
40	Drywall Tape			FT	31.7		
	CL 3			SF	15.0		
41	Drywall Board			SF	210		
42	Drywall Fastener	Self-drilling screws(100/pkt)		PKT	2.1		
43	Wall Paint			SF	210		
44	Drywall Tape			FT	40		
	CL 4			SF	19.0		
45	Drywall Board			SF	166		
46	Drywall Fastener	Self-drilling screws(100/pkt)		PKT	1.66		
47	Wall Paint			SF	166		
48	Drywall Tape			FT	31		



			WALLS: INTERIOR 05				
#	Item	Туре	Description, Manufacturer, SKU	Unit	Quantity	Unit Price	Total
	CL 5			SF	11.0		
49	Drywall Board			SF	155		
50	Drywall Fastener	Self-drilling screws(100/pkt)		PKT	1.55		
51	Wall Paint			SF	155		
52	Drywall Tape			FT	29		
	DINING			SF	144.0	ı	
53	Drywall Board			SF	269		
54	Drywall Fastener	Self-drilling screws(100/pkt)		PKT	2.69		
55	Wall Paint			SF	269		
56	Drywall Tape			FT	51		
	ENTRY			SF	35.0		
57	Drywall Board			SF	142		
58	Drywall Fastener	Self-drilling screws(100/pkt)		PKT	1.42		
59	Wall Paint			SF	142		
60	Drywall Tape			FT	27		



			WALLS: INTERIOR 06				
#	Item	Туре	Description, Manufacturer, SKU	Unit	Quantity	Unit Price	Total
	GARAGE			SF	593.0		
61	Drywall Board			SF	688		
62	Drywall Fastener	Self-drilling screws(100/pkt)		PKT	6.88		
63	Wall Paint			SF	688		
64	Drywall Tape			FT	130		
	HALL			SF	63.0		
65	Drywall Board			SF	385		
66	Drywall Fastener	Self-drilling screws(100/pkt)		PKT	3.85		
67	Wall Paint			SF	385		
68	Drywall Tape			FT	73		
	HW			SF	43.0		
69	Drywall Board			SF	213		
70	Drywall Fastener	Self-drilling screws(100/pkt)		PKT	2.13		
71	Wall Paint			SF	213		
72	Drywall Tape			FT	40		



			WALLS: INTERIOR 07				
#	Item	Туре	Description, Manufacturer, SKU	Unit	Quantity	Unit Price	Total
	L1			SF	4.0		
73	Drywall Board			SF	73		
74	Drywall Fastener	Self-drilling screws(100/pkt)		PKT	0.73		
75	Wall Paint			SF	73		
76	Drywall Tape			FT	14		
	L2			SF	6.0		
77	Drywall Board			SF	106		
78	Drywall Fastener	Self-drilling screws(100/pkt)		PKT	1.06		
79	Wall Paint			SF	106		
80	Drywall Tape			FT	20		
	WC			SF	23.0		
81	Cementitious Backer Board			SF	168		
82	Kerdi membrane			SF	168		
83	Kerdi membrane Fastener			SF	168		
84	Wall Ceramic Tile			SF	168		



			WALLS: INTERIOR 08				
#	Item	Туре	Description, Manufacturer, SKU	Unit	Quantity	Unit Price	Total
	WD			SF	40.0		
85	Cementitious Backer Board			SF	197		
86	Kerdi membrane			SF	197		
87	Kerdi membrane Fastener			SF	197		
88	Wall Ceramic Tile			SF	197		
	WIC			SF	59.0		
89	Drywall Board			SF	299		
90	Drywall Fastener	Self-drilling screws(100/pkt)		PKT	2.99		
91	Wall Paint			SF	299		
92	Drywall Tape			FT	56		
1	Wall Skirting	Ceramic		FT	301		
				1 1	301		



			DOORS				
#	Item	Туре	Description, Manufacturer, SKU	Unit	Quantity	Unit Price	Total
1	Interior Swinging	3' - 0" X 6'-8"		PCS	6		
2	Exterior Swinging	3' - 0" X 6'-8"		PCS	2		
3	Interior Swinging	2' - 6" X 6'-8"		PCS	2		
4	Interior Swinging	3' - 0" X 6'-8"		PCS	1		
5	Patio Sliding	5' - 0" X 6'-8"		PCS	2		
6	Interior Sliding	7' - 0" X 6'-8"		PCS	1		
7	Interior Sliding	5' - 8" X 6'-8"		PCS	2		
8	Pocket Door	3' - 0" X 6'-8"		PCS	1		
9	Interior Sliding	5' - 4" X 6'-8"		PCS	1		
10	Folding	2 - 8" X 6'-8"		PCS	1		
11	Folding	1' - 8" X 6'-8"		PCS	1		
12	Interior Sliding	4' - 0" X 6'-8"		PCS	1		
13	Garage Door	16' - 0" X 6'-6"		PCS	1		
14	Exterior Door Trim			FT	109)	
15	Interior Door Trim			FT	624		
16	Entry Lock set			PCS	5		
17	Privacy Lock set			PCS	10		
18	Passage Lock set			PCS	7		



			WINDOWS				
#	Item	Туре	Description, Manufacturer, SKU	Unit	Quantity	Unit Price	Total
1	Sliding	3' - 3" X 3'-3"		PCS	3		
2	Single Hung	2' - 9" X 3'-3"		PCS	8		
3	Sliding	5' - 3" X 3'-9"		PCS	4		
4	Exterior Window Trim			FT	210		
5	Interior Window Trim			FT	210		
6							
7							
8							
9							
10							
11							
12							
13							
14							
15							



			ROOF 01				
#	Item	Туре	Description, Manufacturer, SKU	Unit	Quantity	Unit Price	Total
1	Roof Covering			SF	3491.0		
2	Roof Covering Fastener			PCS	1746		
3	Roof Felt Paper			SF	3491.0		
4	Roof Felt Paper Fastener			PCS	10473.0		
5	Roof Sheathing			SF	3491.0		
6	Roof Sheathing Fastener			PCS	27928		
7	Batten			FT	0.0		
8	Batten Fastener			PCS	0.0		
9	Soffit			SF	477.0		
10	Soffit Fastener			PCS	238.5		
11	Fascia			FT	297.0		
12	Fascia board fastener			PCS	149		
13	Roof Insulation			SF	3491.0		
14							
15							