


MAGNOLIA

The Magnolia is a contemporary two-bedroom, two-bathroom home. Its exterior showcases clean lines and a minimalist aesthetic. The walls are clad in horizontal siding in a warm, earthy tone, creating a sleek and unified look. A simple gable roof with a slight overhang provides shelter.


Inside, the Magnolia features a rectangular layout with the living and kitchen spaces merged into a single room on one side, creating a spacious living area. The bedrooms are placed side by side on the other side of the plan. Laundry is strategically placed, protruding slightly from the main plan to define the entrance porch and add a touch of architectural interest.

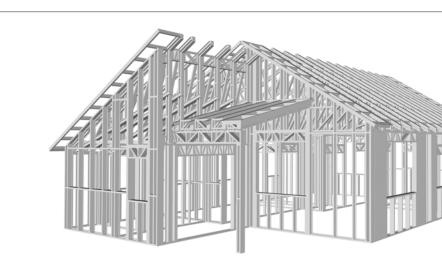

Materials Shopping List

Please print and take this Materials Shopping List to your favorite Home Depot and ask for assistance in selecting the materials, fixtures and fittings to complete your new home.

Record your selection and the price of the item. Then do the math to determine the cost for your selections and the total cost of finishing your home.

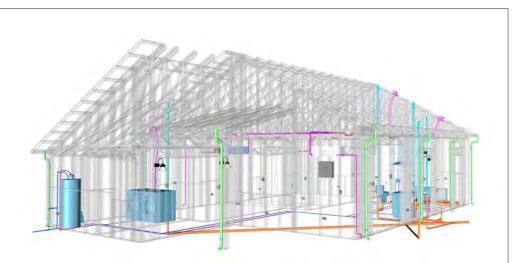

< CLICK HERE >

To Go To Materials Shopping List






FLOOR PLAN

997 SF

2 Bed Rooms

TABLE OF CONTENTS

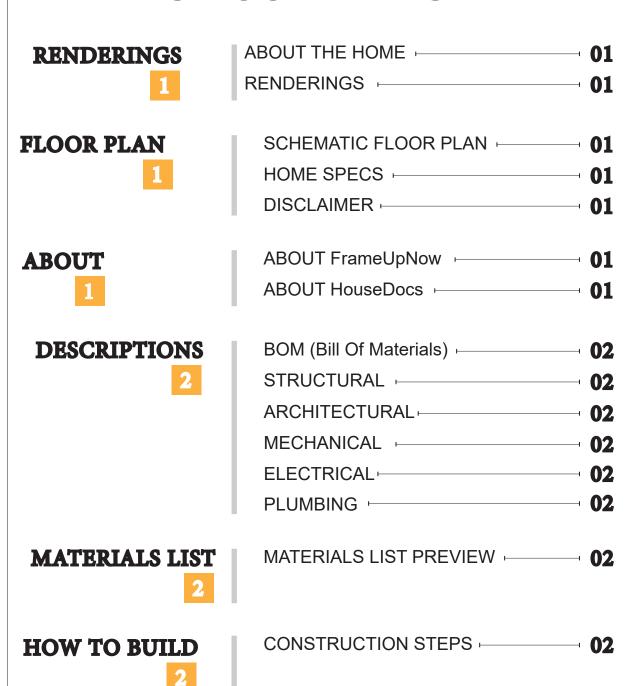

ARCHITECTURAL COVER SHEET FLOOR PLAN + DIMENSION PLAN +

FOUNDATION PLAN STRUCTURAL FLOOR PLAN -WALL FRAME LAYOUT ROOF TRUSS LAYOUT + ROOF PLAN + ARCHITECTURAL ELEVATIONS ARCHITECTURAL ELEVATIONS -ARCHITECTURAL SECTIONS -ARCHITECTURAL DETAILS ARCHITECTURAL CASEWORK

03

19

31

35

DISCLAIMER

marketing content.

DISCLAIMER: This documentation and all it's contents are the intellectual property of FrameUpNow. It is provided solely for marketing the services of FrameUpNow.

The preliminary information is not approved for actual construction use and is

not warranted to be complete or accurate. Unauthorized copying, distribution, or application of these proprietary materials, in any form or format, is strictly prohibited. FrameUpNow assumes no liability for any issues arising from improper use of this

COVER SHEET STRUCTURAL **GENERAL NOTES** WALL FRAME LAYOUT WALL PANEL & LAYOUT PLAN

20 ROOF TRUSS LAYOUT STRUCTURAL SECTIONS 21 WALL BRACING LAYOUT 22 HOLD-DOWN PLAN **STRUCTURAL DETAILS 1 STRUCTURAL DETAILS 2 STRUCTURAL DETAILS 3 27** TRUSS BLOCKING LAYOUT

28 SHEETROCK BACKING **ROOF BRACING LAYOUT** 29 **MECHANICAL COVER SHEET** 30

ELECTRICAL SCHEDULE 32 LIGHTING POWER PLAN 34

DIMENSION FOR LIGHTING

DIMENSION FOR FITTING

HVAC PLAN

PLUMBING

NOTES AND SCHEDULES WATER SUPPLY & SEWAGE SYSTEM # 38

MATERIALS SHOPPING LIST MATERIALS SHOPPING LIST

ABOUT



FrameUpNow is a design and manufacturing company providing precision-engineered home framing solutions. We offer a catalog of Affordable Homes, Tiny Homes, Garages, Shops and Barndominiums. FrameUpNow manufactures cold-formed steel (CFS) also known as Light Gauge Steel (LGS) framing components that conform to our engineered metal house frame plans or can be purchased as DIY skeleton kits.

The CFS/LGS framing is lightweight, easily assembled, and does not require heavy equipment or specialized labor, enabling homeowners to erect the frame themselves in just a few days. Unlike wood, the steel framing is impervious termites and bores, warping, expansion, and fire.

Our home plans come complete with a structural engineered stamp for permit approvals. Customers receive a full BOM also known as a Materials Shopping List to purchase finish materials from a Building Materials retailer. FrameUpNow prides itself on the quality and efficiency of our precision-engineered home framing solutions for construction professionals and DIY homeowners.



KEY PLAN

NO.	DESCRIPTION	DATE

NOTE:

LEGEND:

PROJECT

272-Magnolia-997-2Bd2Ba-Coop-550

DRAWING NAME

INTRODUCTION

CLIENT NAME:
PROJECT NUMBER:
DATE:
DESIGNED BY:
DRAWN BY:
CHECKED BY:

I101

SCALE:

© [2024] [FrameUpNow] . All rights reserved

DESCRIPTIONS

MATERIALS LIST

The BOM (Bill Of Materials) package, known as the Materials Shopping List document, provides:

Comprehensive Inventory: Detailed lists of essential materials sourced from architectural, mechanical, HVAC, electrical, and plumbing design drawing sets.

Precise Curation: Each item meticulously selected and organized for accuracy and efficiency in project planning.

Customizable Options: Customers can modify listed items to their preferences and calculate costs accordingly, ensuring alignment with personal project needs and budget.

Dedicated Space for Details: Includes tables for customers to note Home Depot SKU numbers or product descriptions for selected items, facilitating seamless purchasing and coordination with suppliers.

Customer Convenience: Take the list to Home Depot or preferred suppliers for accurate pricing, helping align the total home budget with personal financial plans.

Simplify your construction journey with our Materials Shopping List document, where detailed preparation meets streamlined implementation for your dream home.

MECHANICAL

STRUCTURAL

The structural drawings package provides an exhaustive set of detailed plans essential for the precise assembly of your building. This comprehensive package includes:

Framing Plans: Detailed layouts for all framing components. Truss Layouts: Clear instructions for truss placement and

Panel Length Plans: Specifications for panel dimensions. Framing Elevations and Sections: Precise elevation and sectional views for accurate construction.

Truss and Wall Blocking Plans: Plans for truss and wall blocking to ensure structural integrity.

Hold-Down Plan: Detailed hold-down requirements for stability. Snap Sheet: Reference sheet for quick identification of components

Structural Details and Bracing Plans: Complete details and bracing plans for all structural elements.

Accompanying these plans is a comprehensive Bill of Materials (BOM) that lists every necessary building component, from cold formed steel (CFS) frames to fasteners.

ARCHITECTURAL

With the comprehensive architectural package, both builders and DIY homeowners can confidently execute the construction.

The architectural package includes:

Furnished Floor Plans: Complete with furniture layouts for a clear understanding of space utilization.

Detailed Dimension Plans: Ensures precise measurements, from the overall footprint down to the exact placement of windows and

Foundation Plan: Detailed plan to establish a solid foundation.

Wall Framing and Truss Layout: Comprehensive plans for wall framing and truss placement.

Architectural Elevations: Exterior views showcasing the design.

Strategic Building Sections: Critical cross-sectional details for a thorough understanding of the build.

Casework Drawings and Diagrams: Suggested designs for built-in caseworks, such as kitchen cabinets.

ELECTRICAL

The mechanical package includes everything needed to guide HVAC

Detailed HVAC Floor Plan: Precisely maps out the placement of air handlers, ductwork, and vents throughout the home's layout.

HVAC Sections and Riser Diagrams: Technical drawings offering critical cross-sectional details and piping schematics, ensuring proper integration of the heating and cooling system into the home's structure.

Bill of Materials: A complete list of all necessary HVAC components.

The electrical package includes all the plans and documentation needed to guide the installation of your home's electrical system:

Detailed Power Plan: Precisely maps out the placement of outlets, switches, and other power components throughout the layout.

Comprehensive Lighting Plan: Shows the optimal locations for lighting fixtures, sconces, and other illumination sources to create a well-lit, functional interior.

Dimensioned Electrical Layout: Provides exact dimensions and measurements to ensure proper placement of all electrical elements.

Bill of Materials: A complete list of every component needed, from circuit breakers to wiring.

The plumbing package includes everything needed to guide the

Detailed Water Supply System Plan: Precisely maps out the placement of pipes, valves, and plumbing fixtures throughout the

Comprehensive Sewage System Plan: Shows the optimal routing and sizing of drain lines to effectively remove waste and ensure

Detailed Riser Diagrams: Provide information needed to properly

PLUMBING

installation of your home's water supply and drainage systems:

proper drainage.

install all vertical plumbing risers and vent stacks.

Bill of Materials: A complete list of every component needed, from pipes to fixtures.


BOM (Bill Of Materials) (Separately Attached)





The Bill of Materials (BOM) is a crucial document that compiles the material requirements from different disciplines into a centralized inventory, enabling efficient procurement, inventory management, and cost estimation for a specified project or

ELECTRICAL BOM



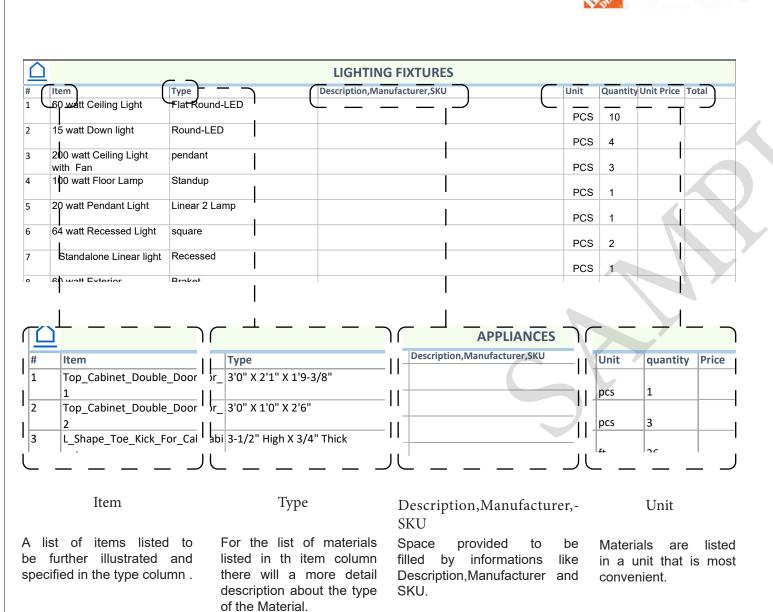

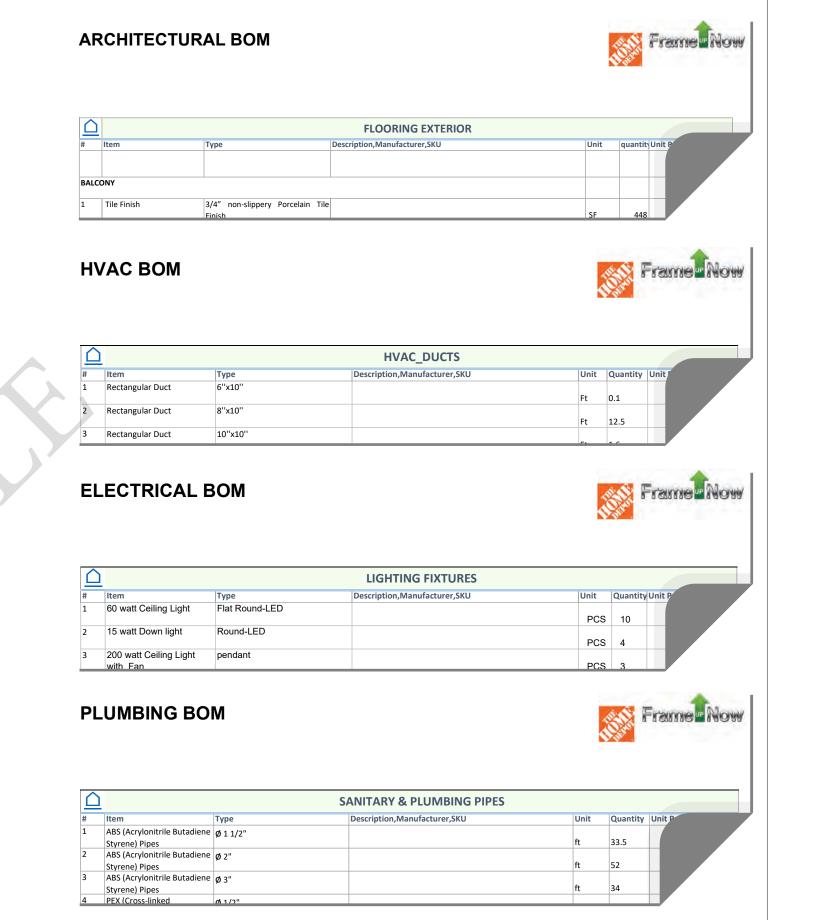

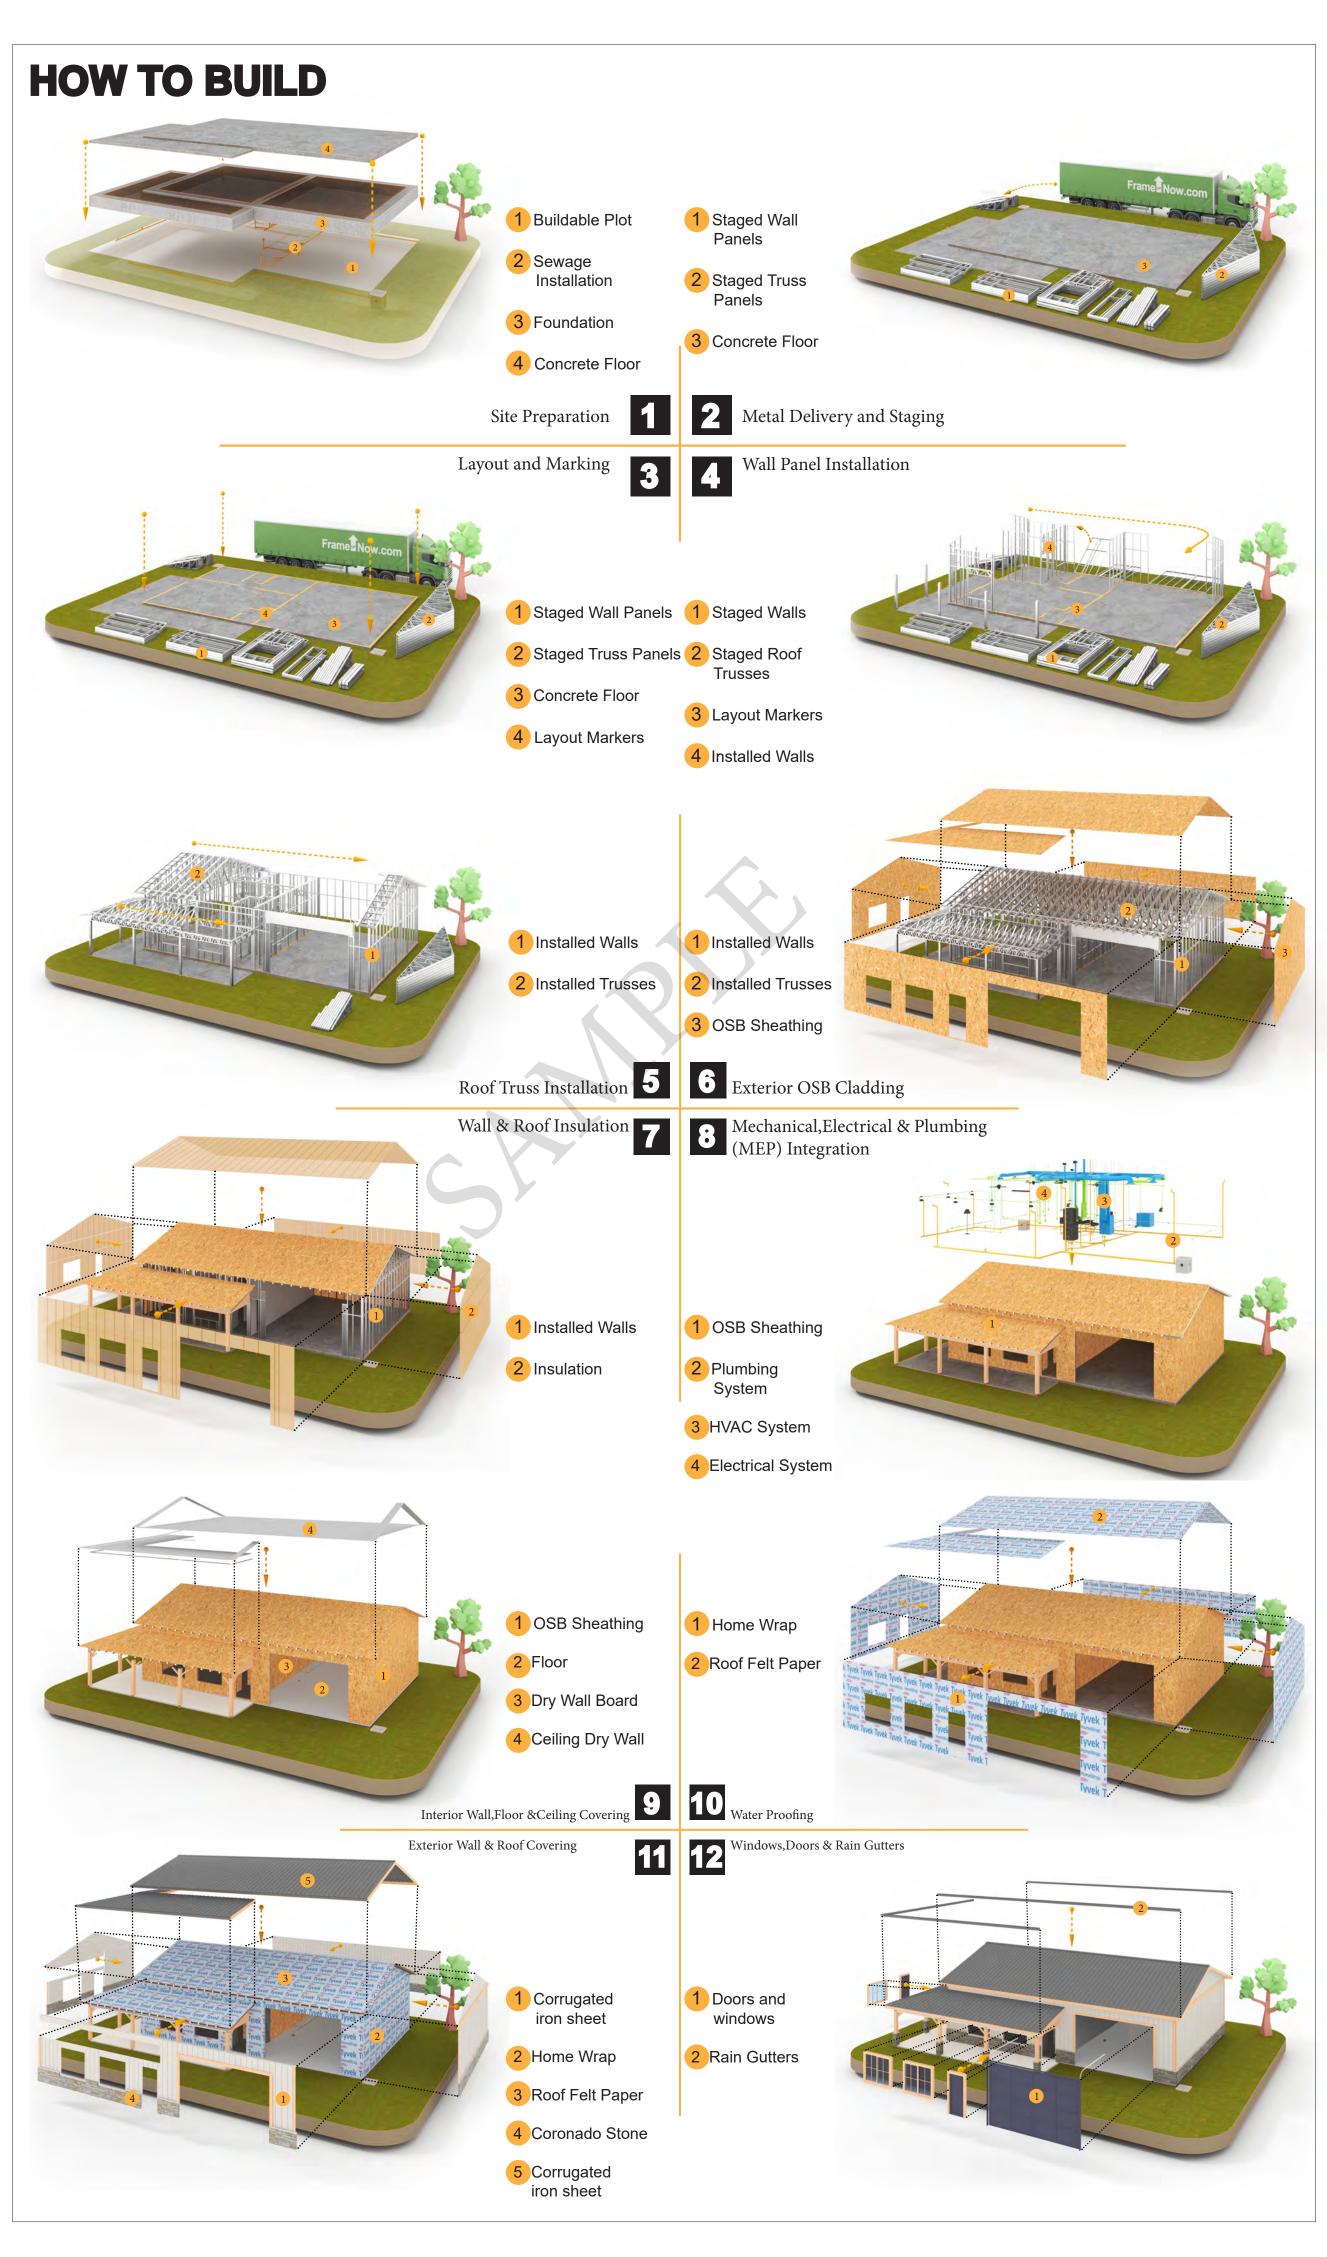



KEY PLAN

NO.	DESCRIPTION	DATE

NOTE:

LEGEND:

PROJECT

272-Magnolia-997-2Bd2Ba-**Coop-550**


DRAWING NAME

INTRODUCTION

CLIENT NAME: PROJECT NUMBER: DATE: **DESIGNED BY** DRAWN BY: CHECKED BY:

1102

SCALE:

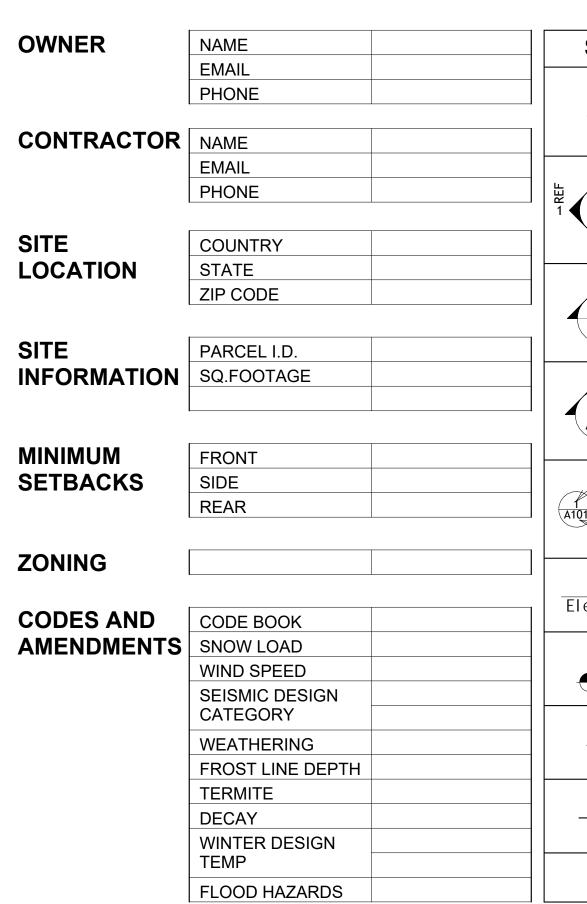

SYMBOLS	SYMBOLS NAME
VIEW NUMBER A101 SHEET NUMBER	CALLOUT HEAD
1 REF VIEW NUMBER 1 SHEET NUMBER	R INTERIOR ELEVATION
REF VIEW NUMBER 1 A101 SHEET NUMBER	BUILDING ELEVATION
VIEW NUMBER A101 SHEET NUMBER	SECTION
VIEW NUMBER A101 SHEET NUMBER	DETAIL VIEW
Name Elevation	ELEVATION LEVEL
FLOOR LEVEL	SPOT ELEVATION

FLOOR SLOPE

ROOF SLOPE

ROOF SLOPE ELEVATION

LINE LEGEND	
HIDDEN LINE	CUT LINE ————————————————————————————————————
ROOM SEPARATOR	CALL OUT BOUNDRY — — — — — —
DOOR OPENING DIRECTION — — — —	LEVEL
OVER HEAD	GROUND CUT ————

FLOOR SLOPE

SLOPE

ROOF SLOPE

SLOPE

DIRECTION

DIRECTION

A403	CASEVIORA DETAILS		CODE
E101	SCHEDULE	MAX.	MAXIMUM
E102	LIGHTING PLAN	ME	MECHANICAL
E103	POWER PLAN	MIN.	MINIMUM
E104	DIMENSION PLAN FOR LIGHT FIXTURE	NO.	NUMBER
E105	DIMENSION PLAN FOR FITTING	O.C	ON CENTER
P101	COVER SHEET	OSB	ORIENTED STRAND BOARD
P102	WATER SUPPLY SYSTEM	PL	PLUMBING
P103	SEWAGE SYSTEM	PSI	POUNDS PER SQUARE INCH
P104	RISER DIAGRAM	PVC	POLYVINYL CHLORIDE
M101	HVAC PLAN	REF	REFERENCE
M102	HVAC SECTION	RG	RIGHT GARAGE
M103	RISER DIAGRAM	SE	SPECIAL EQUIPMENT
		SF	SQUARE FEET
		SIMP. STHD8	SIMPSON STRAP THE
TAG	TAG'S NAME		HOLDDOWN
		SIMP. ABE66	HOLDDOWN SIMPSON ANCHOR BOLT EDGE
TAG CA01	TAG'S NAME CASEWORK TAG	SIMP. ABE66	
CA01			SIMPSON ANCHOR BOLT EDGE
(TA01)	CASEWORK TAG DOOR TAG	TV	SIMPSON ANCHOR BOLT EDGE TELEVISION
CA01	CASEWORK TAG	TV UNO	SIMPSON ANCHOR BOLT EDGE TELEVISION UNLESS NOTED OTHERWISE
(TA01)	CASEWORK TAG DOOR TAG	TV UNO W/	SIMPSON ANCHOR BOLT EDGE TELEVISION UNLESS NOTED OTHERWISE WITH
(1)	CASEWORK TAG DOOR TAG FURNITURE TAG	TV UNO W/ W/D	SIMPSON ANCHOR BOLT EDGE TELEVISION UNLESS NOTED OTHERWISE WITH WASHER/DRYER
1 1 1 SE01	CASEWORK TAG DOOR TAG FURNITURE TAG WINDOW TAG SPECIALTY EQUIPMENT TAG	TV UNO W/ W/D	SIMPSON ANCHOR BOLT EDGE TELEVISION UNLESS NOTED OTHERWISE WITH WASHER/DRYER AIR CONDITIONING UNIT
(1) (1)	CASEWORK TAG DOOR TAG FURNITURE TAG WINDOW TAG	TV UNO W/ W/D AC ACC	SIMPSON ANCHOR BOLT EDGE TELEVISION UNLESS NOTED OTHERWISE WITH WASHER/DRYER AIR CONDITIONING UNIT AIR COOLED CONDENSER
1 1 1 SE01	CASEWORK TAG DOOR TAG FURNITURE TAG WINDOW TAG SPECIALTY EQUIPMENT TAG	TV UNO W/ W/D AC ACC	SIMPSON ANCHOR BOLT EDGE TELEVISION UNLESS NOTED OTHERWISE WITH WASHER/DRYER AIR CONDITIONING UNIT AIR COOLED CONDENSER AIR COOLED CONDSENSING UNIT
1 1 1 SE01 ME01	CASEWORK TAG DOOR TAG FURNITURE TAG WINDOW TAG SPECIALTY EQUIPMENT TAG MECHANICAL EQUIPMENT TAG	TV UNO W/ W/D AC ACC ACCU AHU	SIMPSON ANCHOR BOLT EDGE TELEVISION UNLESS NOTED OTHERWISE WITH WASHER/DRYER AIR CONDITIONING UNIT AIR COOLED CONDENSER AIR COOLED CONDSENSING UNIT AIR HANDLING UNIT
1 1 1 SE01 ME01	CASEWORK TAG DOOR TAG FURNITURE TAG WINDOW TAG SPECIALTY EQUIPMENT TAG MECHANICAL EQUIPMENT TAG	TV UNO W/ W/D AC ACC ACCU AHU CC	SIMPSON ANCHOR BOLT EDGE TELEVISION UNLESS NOTED OTHERWISE WITH WASHER/DRYER AIR CONDITIONING UNIT AIR COOLED CONDENSER AIR COOLED CONDSENSING UNIT AIR HANDLING UNIT COOLING COIL
1 1 1 SE01 ME01	CASEWORK TAG DOOR TAG FURNITURE TAG WINDOW TAG SPECIALTY EQUIPMENT TAG MECHANICAL EQUIPMENT TAG	TV UNO W/ W/D AC ACC ACCU AHU CC CD	SIMPSON ANCHOR BOLT EDGE TELEVISION UNLESS NOTED OTHERWISE WITH WASHER/DRYER AIR CONDITIONING UNIT AIR COOLED CONDENSER AIR COOLED CONDSENSING UNIT AIR HANDLING UNIT COOLING COIL CEILING DIFFUSER

CU

AFS

F.F.E

F.F.L

FTG

IRC

CEILING REGISTER CONDENSING UNIT

COLD WATER

EXHAUST AIR

EXHAUST FAN

FAN COIL UNIT

HEATING COIL

INLET VANES

MAXIMUM

MINIMUM

RETURN AIR

RETURN FAN SUPPLY AIR

STATIC PRESSURE

MECHANICAL ROOM

EXISTING

FLOOR

EXPANSION TANK

FLEXIBLE CONNECTION

AIR TO AIR HEAT EXCHANGER

HEATING AND VENTILATING UNI

RECIPROCATING CHILLER UNIT

SMOKE CONTROL DAMPER

HVAC

PAGE INDEX

G101 | COVER SHEET

A101 FLOOR PLAN

A102 DIMENSION PLAN

S103 | FRAME LAYOUT

A103 ROOF PLAN

A201 | ELEVATIONS

A202 ELEVATIONS

A301 SECTIONS

A401 DETAILS

S101 | FOUNDATION PLAN


S104 ROOF TRUSS LAYOUT


A402 | CASEWORK DETAILS


A403 CASEWORK DETAILS

S102 | STRUCTURAL FLOOR PLAN



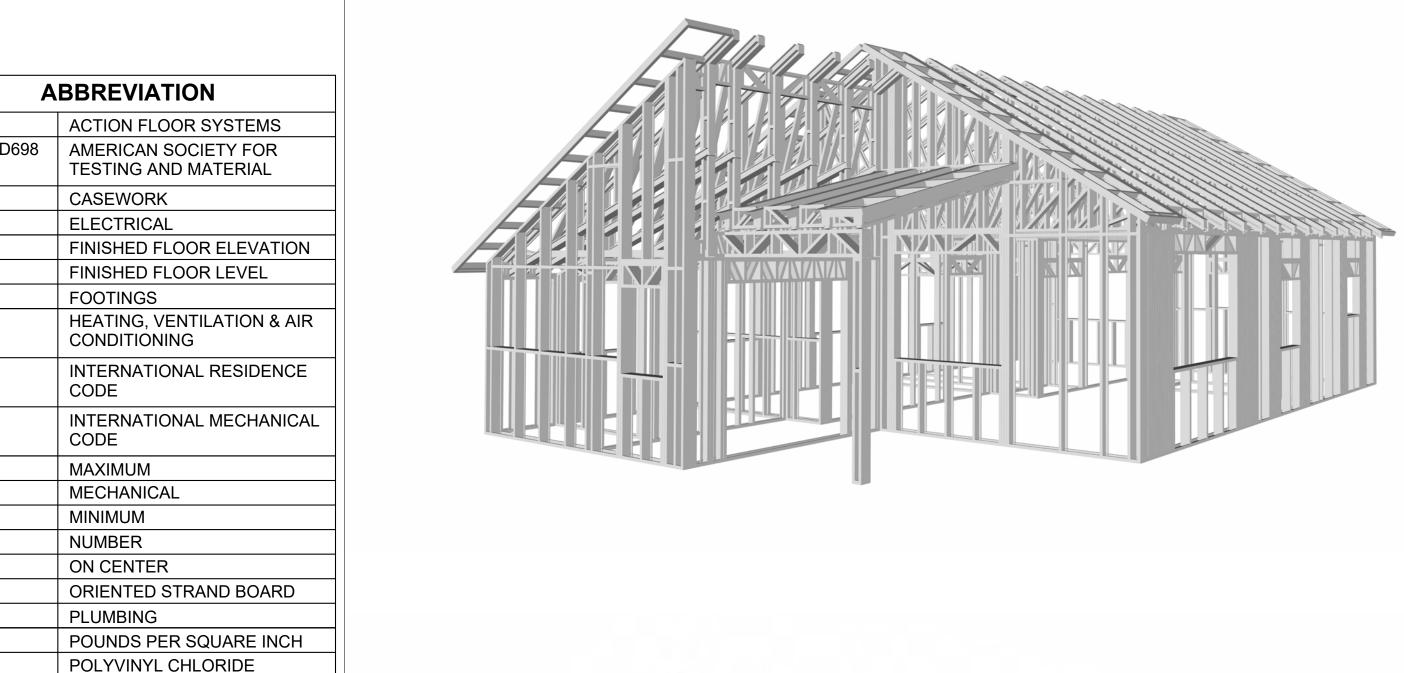

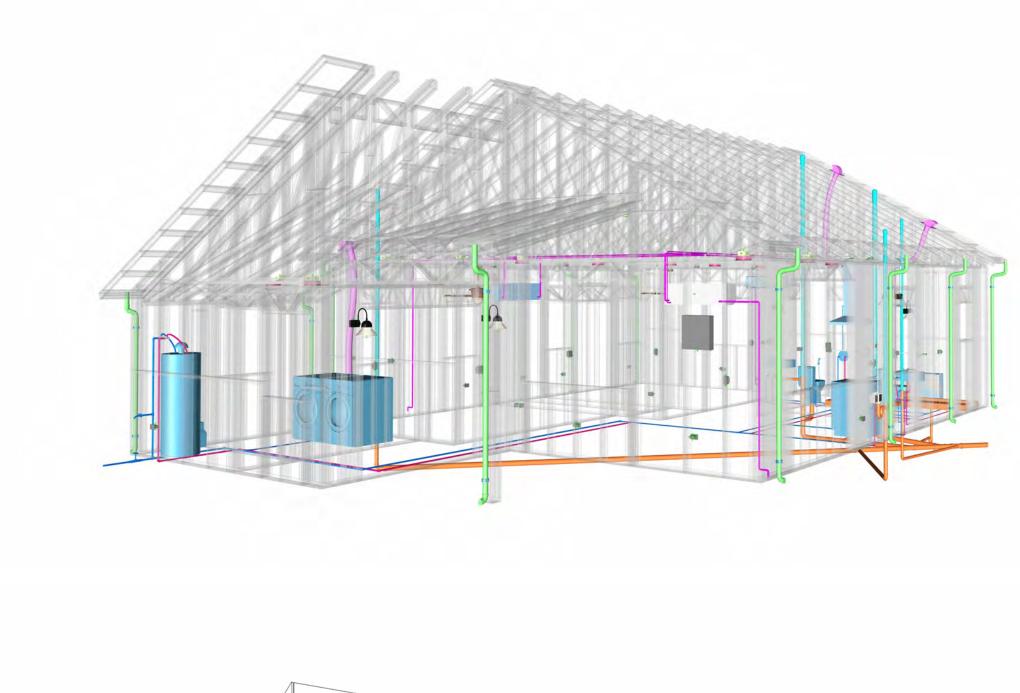


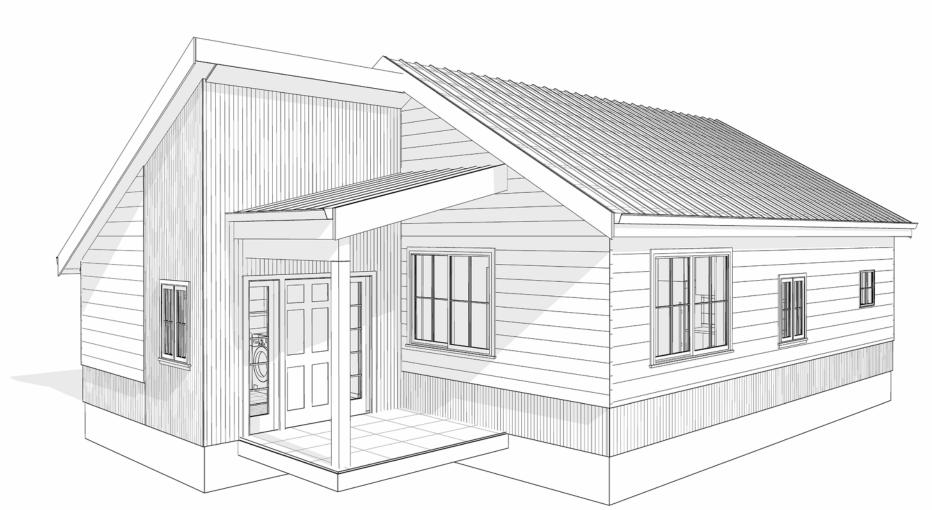

272-MAGNOLIA-997-2Bd2Ba-**COOP-550**

SQUARE FOO	TAGE
LIVING	997
PORCH	65
TOTAL	1062



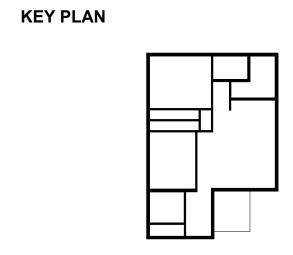



NOTE:

LEGEND:

PROJECT

272-MAGNOLIA-997-2Bd2Ba-**COOP-550**

DRAWING NAME

COVER SHEET

CLIENT NAME:	Client Name
PROJECT NUMBER:	0061_12
DATE:	5/13/2025 5:36:24 PM
DESIGNED BY:	Designer
DRAWN BY:	Author
CHECKED BY:	Checker

G101

GENERAL NOTES

- THIS DRAWING DEPICTS THE ARCHITECTURAL (SPACE LAYOUT, FURNISHING, FLOOR, WALLS, ROOFS, FOUNDATION, WINDOWS AND DOORS) SYSTEMS. IT PROVIDES A VISUAL REPRESENTATION OF THE ARCHITECTURAL LAYOUT AND COMPONENTS.
- THE ARCHITECTURAL DRAWINGS ARE PREPARED TO MEET THE SPECIFIC REQUIREMENTS OF THE BUILDING, AS PER THE PROJECT SPECIFICATIONS AND APPLICABLE CODES AND STANDARDS. THE CONSTRUCTION OF THIS HOME SHALL COMPLY WITH THE LATEST EDITION OF THE
- INTERNATIONAL RESIDENTIAL CODE (IRC), INTERNATIONAL MECHANICAL CODE (IMC), THE INTERNATIONAL PLUMBING STANDARD, THE NATIONAL ELECTRICAL STANDARD AND ALL OTHER APPLICABLE LOCAL, STATE, AND NATIONAL CODES AND REGULATIONS.
- COORDINATION WITH OTHER TRADES HAS BEEN DONE ON A DESIGN LEVEL. THIS DRAWING SHALL BE READ TOGETHER WITH THE ME, EL AND PL DESIGN DRAWINGS TO ENSURE PROPER CONSTRUCTION AND INTEGRATION OF THE BUILDING SYSTEMS.

ABOUT WALLS:

- SHOWER WALL COVERING
- BATHTUB AND SHOWER SPACES (WALLS AND FLOORS) WITH INSTALLED SHOWER HEADS AND IN SHOWER COMPARTMENTS SHALL BE FINISHED WITH A NON-ABSORBENT SURFACE.
- 2. WALL PAINT (INTERNAL)
- THE TYPICAL THICKNESS OF LATEX WALL PAINT IS 1/32 OF AN INCH FOR A SINGLE COAT. AND DOUBLE COAT (1/16") SHALL BE APPLIED FOR DURABILITY.

THE ADVISABLE TYPE OF ADHESIVE FOR THIS PROJECT IS **EPOXY ADHESIVES**BECAUSE THEY ARE KNOWN FOR THEIR HIGH STRENGTH, DURABILITY, AND RESISTANCE TO MOISTURE, CHEMICALS AND


REFER TO SHEETS A201 & A202 FOR GENERAL NOTES ON EXTERNAL FINISHING MATERIALS


ABOUT FLOORS:

- THE SPOT ELEVATION INDICATES THE FINISHED FLOOR ELEVATION.
- FINISHED FLOORS PER PLANS.
- FIELD VERIFY FOR DIMENSION DROP 4" FOR SHOWER AND BATHTUB USE.
- 1% SLOPE ON OUTDOOR BALCONIES FOR WATER RUN OFF.
- 2% SLOPE TOWARDS THE SHOWER DRAIN FOR SUFFICIENT DRAINAGE.
- 4" DROP AT THE DOOR LEADING TO EXTERIOR BALCONY FROM THE MAIN LIVING AREA.
- 5% SLOPE FOR GARAGE IS USED, WHICH SHOULD BE CHECKED WITH THE LOCAL GARAGING ZONING LAWS.


	FURNITURE SCHEDULE			
	TYPE MARK	TYPE	COUNT	
01		THREE SEAT SOFA	1	
02		DINING CHAIR	4	
03		DOUBLE 53" X 74"	2	
04		25" X 60" DINING	1	

		ROC	OM FINISH	SCHEDULE			
ROOM NUMBE R	ROOM NAME	FLOOR FINISH	BASE FINISH	WALL FINISH	CEILING FINISH	CEILING HEIGHT	COM MEN TS
01	LIVING ROOM	HARDWOOD	CONCRETE	WALL PAINT	DRY WALL	8' - 0"	
02	KITCHEN	HARDWOOD	CONCRETE	WALL PAINT + CERAMIC	DRY WALL	8' - 0"	
03	BEDROOM 1	HARDWOOD	CONCRETE	WALL PAINT	DRY WALL	8' - 0"	
04	BEDROOM 2	HARDWOOD	CONCRETE	WALL PAINT	DRY WALL	8' - 0"	
05	BATH 1	VINYL TILES	CONCRETE	CERAMIC TILE	MRD	8' - 0"	
06	BATH 2	VINYL TILES	CONCRETE	CERAMIC TILE	MRD	8' - 0"	
07	CL 1	HARDWOOD	CONCRETE	WALL PAINT	DRY WALL	8' - 0"	
08	CL 2	HARDWOOD	CONCRETE	WALL PAINT	DRY WALL	8' - 0"	
09	CL 3	HARDWOOD	CONCRETE	WALL PAINT	DRY WALL	8' - 0"	
10	HALL	HARDWOOD	CONCRETE	WALL PAINT	DRY WALL	8' - 0"	
11	ENTRY	HARDWOOD	CONCRETE	WALL PAINT	DRY WALL	8' - 0"	
12	LAUNDRY	VINYL TILES	CONCRETE	CERAMIC TILE	DRY WALL	8' - 0"	
13	WH	VINYL TILES	CONCRETE	CERAMIC TILE	DRY WALL	8' - 0"	
14	FRONT PORCH	PROCELAIN TILE	CONCRETE	CORUGATED IRON	PLYWOOD	8' - 0"	

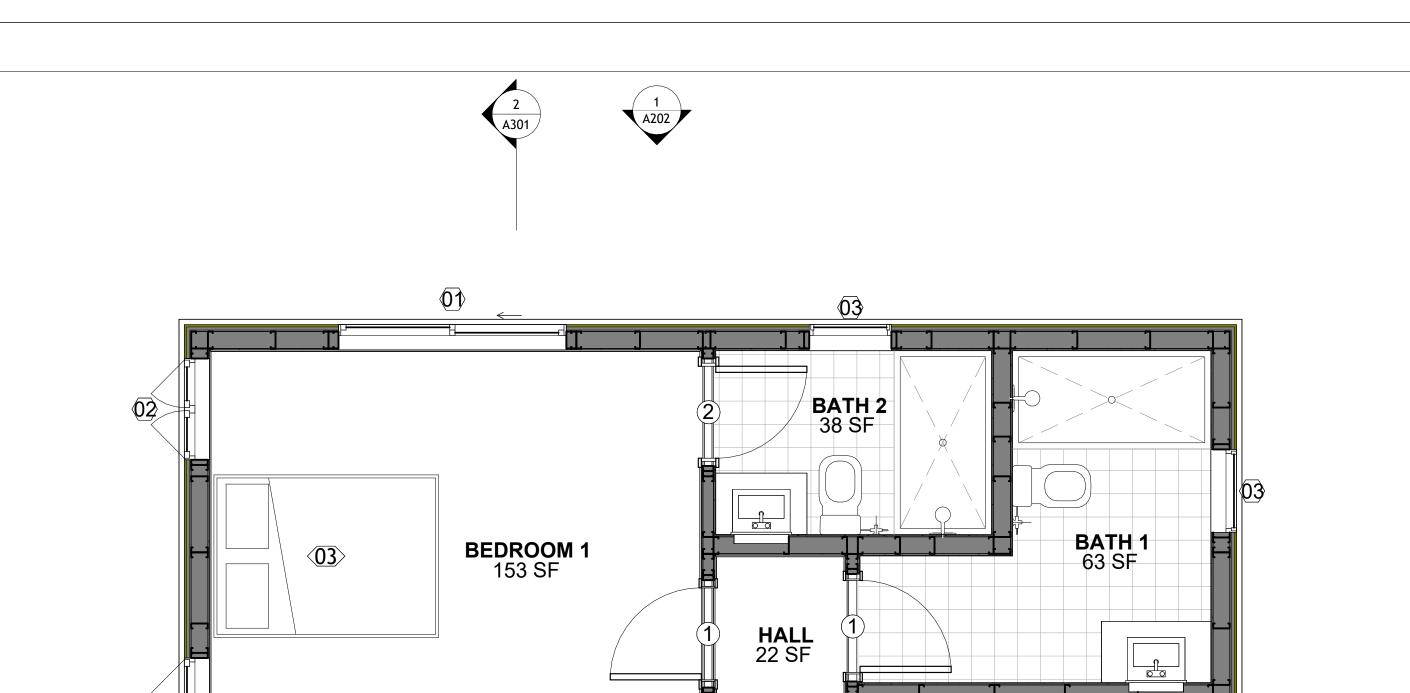

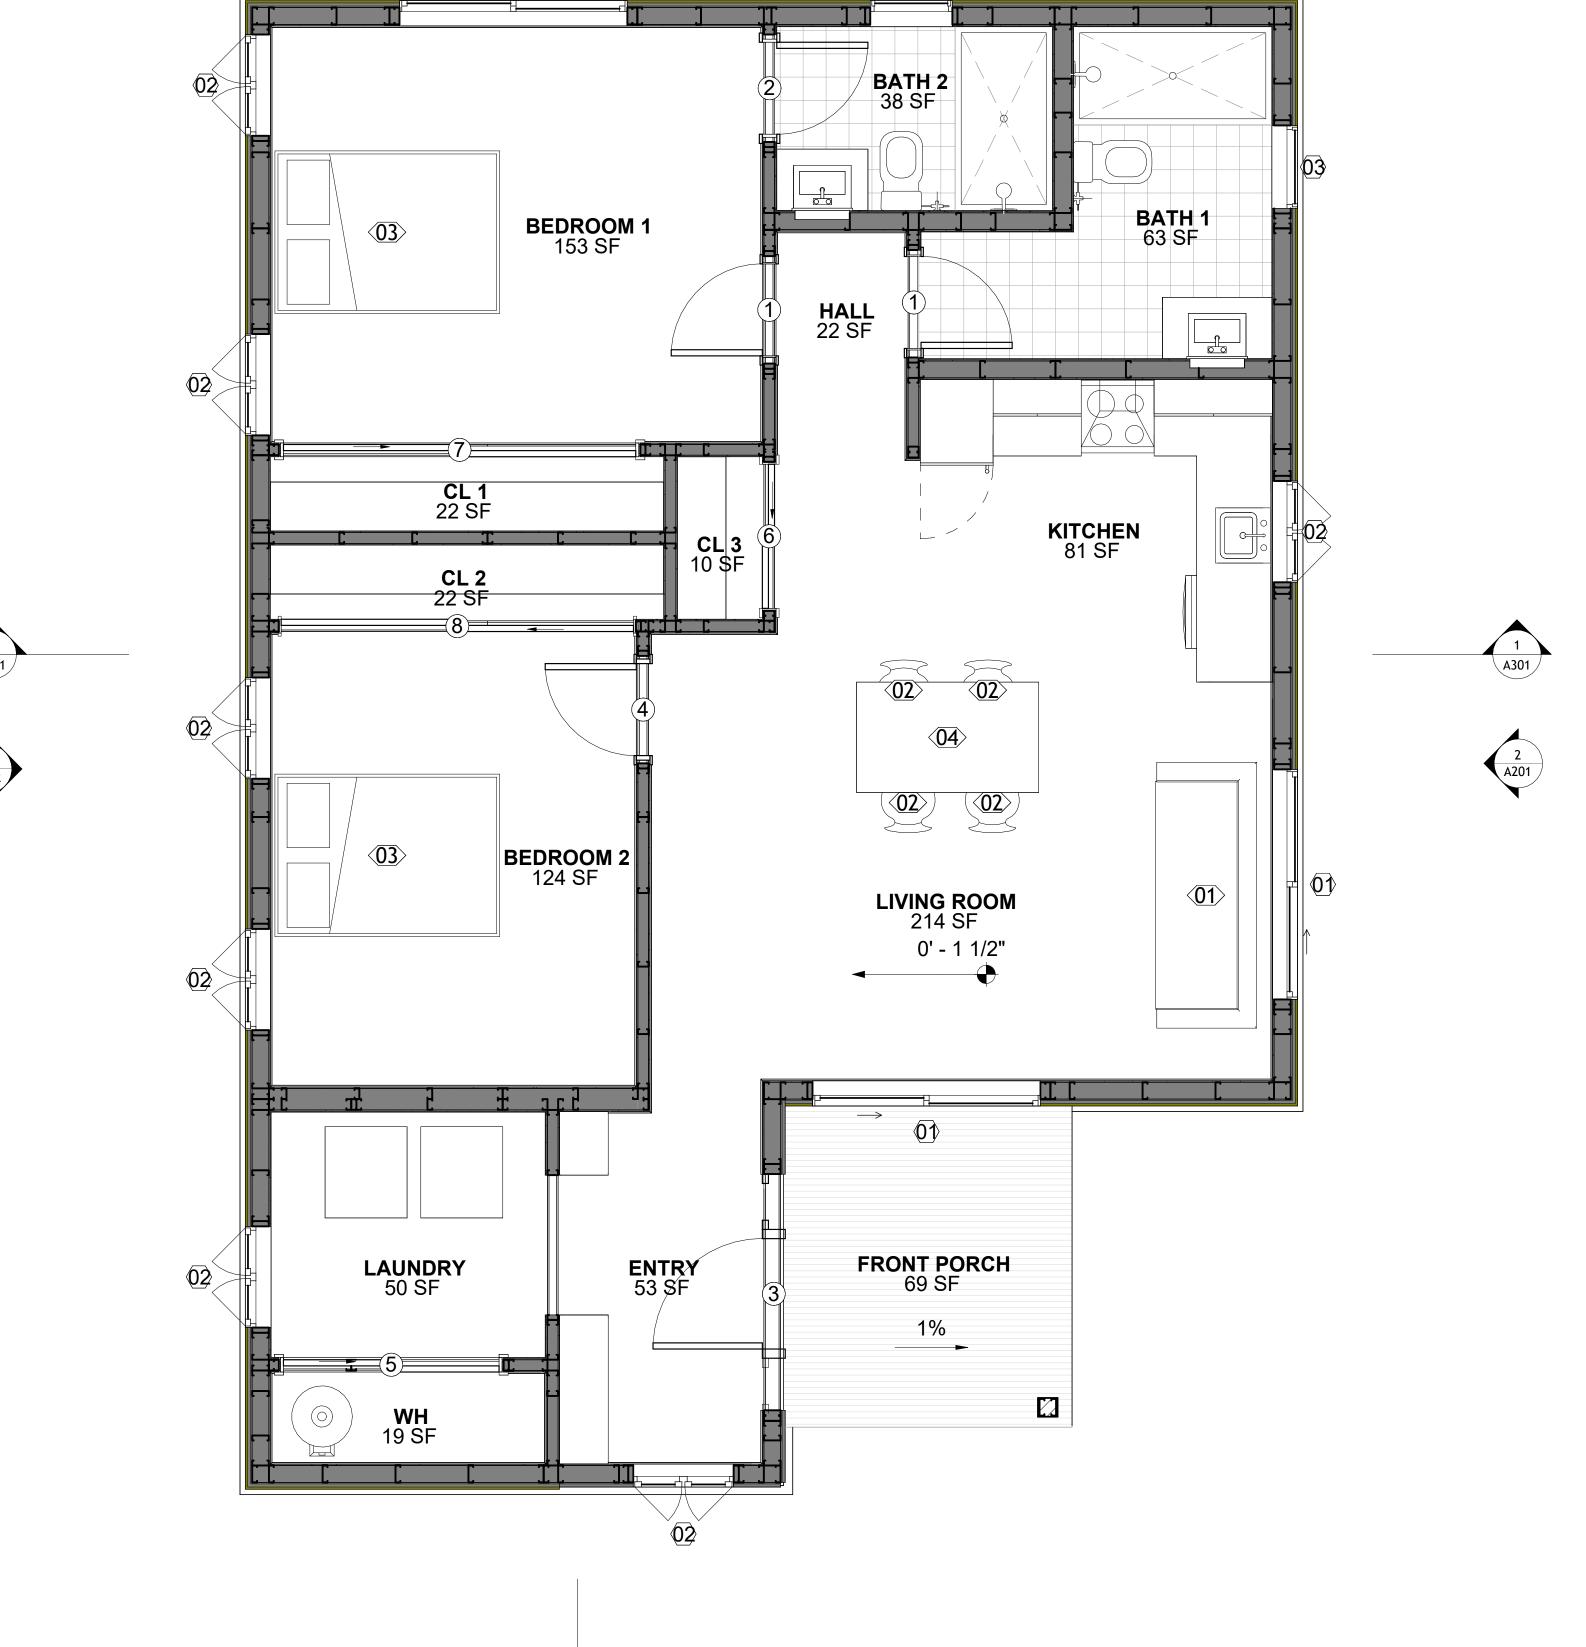

FLOOR PLAN

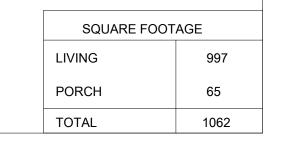



KEY PLAN

NO.	DESCRIPTION	DATE

NOTE:

LEGEND:

PROJECT

272-MAGNOLIA-997-2Bd2Ba-**COOP-550**

DRAWING NAME

FLOOR PLAN

CLIENT NAME:	Client Name
PROJECT NUMBER:	0061_12
DATE:	5/13/2025 5:36:24 PM
DESIGNED BY:	Designer
DRAWN BY:	Author
CHECKED BY:	Checker

A101





KEY PLAN

NO.	DESCRIPTION	DATE

NOTE:

LEGEND:

PROJECT

272-MAGNOLIA-997-2Bd2Ba-COOP-550

DRAWING NAME

DIMENSION PLAN

CLIENT NAME:	Client Name
PROJECT NUMBER:	0061_12
DATE:	5/13/2025 5:36:26 PM
DESIGNED BY:	Designer
DRAWN BY:	Author
CHECKED BY:	Checker

A102

SCALE: 3/8" = 1'-0"

SQUARE FOOTAGE

PORCH

TOTAL

997

65

1062

DIMENSIONS IN THE ARCHITECTURAL DRAWINGS CONSIDER FINISHING MATERIALS. FOR PRECISE MEASUREMENTS OF THE STRUCTUAL FRAMING, REFER TO THE ATTACHED STRUCTURAL PLAN SET.

FOUNDATION NOTES

NOTES

TERMITES PRETREATMENT BY LICENSED CONTRACTOR UNDER SLAB AND AROUND FOOTINGS. ALL AREAS BELOW SLABS SHALL BE TREATED NO MORE THAN 24 HOURS PRIOR TO CONCRETE POUR. EVIDENCE OF TREATMENT MUST BE PROVIDED PRIOR TO PLACING OF CONCRETE.

1. MATERIALS:

ALL INTERIOR CONCRETE SLABS SHALL BE A MIN. OF 4" THICK CONCRETE OVER 4" COMPACTED AGGREGATE BASE (ASTM D698), FINISH ELEVATIONS AS NOTED ON DRAWINGS, 6" ABOVE ADJACENT GRADE, LEVEL SLABS TO 1/8"-10' MAX.. CONCRETE SLABS SHALL BE 2500# PSI AT 28 DAYS. A 4" ALLOWABLE SLUMP.

2. PAD PREPARATION:

- EXCAVATION FOR FOOTING SHALL BE NEAT.
- FOOTINGS SHALL BE POURED IMMEDIATELY AFTER EXCAVATION AND APPROPRIATE
- ALL REINFORCING STEEL MARKED "CONTINUOUS" SHALL BE LAPPED 36 BAR DIAMETERS AT SPLICES AND AROUND CORNERS OR INTERSECTIONS WITH A STANDARD 90 DEGREE BEND ON CORNER BARS. LAP WIRE MESH ONE FULL MESH AT SIDE AND END LAPS.
 ALL HARDWARE TO BE SIMPSON OR EQUIVALENT.
- EXTERIOR FRAME WALL TO BE SECURED WITH 1/2"X10" ANCHOR BOLTS 4'-0" O.C. FOR 1-STORY AND 2'-8" O.C. FOR 2-STORY. BOLTS SHALL BE LOCATED WITHIN 1'-0" OF EACH END PIECE AND SHALL HAVE A MIN. OF TWO BOLTS PER PIECE.
- -FOUNDATION ANCHOR STRAPS SHALL BE PERMITTED, ACCORDING TO RESIDENTIAL CODE
- ALL INTERIOR WALLS TO BE SECURED WITH POWER DRIVEN PINS PER MANUFACTURER SPECIFICATION USE PIN SPACING EQUIVALENT TO 1/2" ANCHOR BOLTS.
- ALL CONSTRUCTION TO CONFORM TO THE 2012 IRC
- R-10 RIGID INSULATION OUTSIDE OF EXTERIOR FOUNDATION WALLS UNDER LIVING AREA.

 CONCRETE PAD FOR CONDENSER THICKNESS IS 4" MIN UNLESS OTHERWISE NOTED.

3. CONCRETE CONSTRUCTION:

- THE SLAB SHALL BE UNDERLAIN BY A VAPOR BARRIER/RETARDER IN THE LIVING AREA (TYPICALLY POLYETHYLENE, UNLESS MORE STRINGENT PROTECTION REQUIRED BY THE ARCHITECT, ENGINEER, FLOOR COVERING MANUFACTURER, OR ACCEPTED PRACTICE). UNLESS OTHERWISE REQUIRED, BARRIER MAY BE OMITTED AT GARAGES, PORCHES AND PATIOS WITHOUT FLOOR COVERINGS. IT IS BEYOND THE SCOPE OF THESE PLANS TO DETERMINE THE APPLICABILITY OF THESE MORE STRINGENT REQUIREMENTS. BUILDER SHALL VERIFY PRIOR TO CONSTRUCTION.

4. REINFORCEMENT:


- IF CONSTRUCTED ON ACTIVE SOILS, THE LONG TERM PERFORMANCE OF THE FOUNDATION IS DEPENDENT ON MAINTENANCE BY THE OWNER. THUS THE BUILDER SHALL ADVISE THE OWNER OF THE FOLLOWING:
- 1. DRAINAGE MUST BE MAINTAINED. WATER SHALL NEVER BE ALLOWED TO POND NEAR THE FOUNDATION.
- 2. THE SOIL AROUND THE FOUNDATION SHALL BE MAINTAINED IN A RELATIVELY DAMP CONDITION, SUCH AS THAT REQUIRED TO KEEP A LAWN GREEN. IF IT DRIES OUT IT WILL
- SHRINK. IF IT GETS WET, IT WILL HEAVE UPWARD.

 3. SLABS ON THE SHORTER SIDE USES MAIN BARS ARE USED IN THIS DIRECTION ONLY WITH SMALLER DIAMETER DISTRIBUTION BARS ARE PLACED, FORMING A MAT OR GRID.
- ALL REINFORCEMENT BARS SIZE 10MM OR LARGER IN ACCORDANCE TO ASTM
 ANCHOR BOLTS AT ALL EXTERIOR WALLS SHALL BE MINIMUM 1/2 INCH DIAMETER WITH A MAXIMUM SPACING OF 6'-0" ON CENTER, UNLESS NOTED OTHERWISE.
- 4. ANCHOR BOLTS SHALL BE INSTALLED WITHIN 12 INCHES OF EACH END OF EACH SILL PLATE WITH AT LEAST TWO ANCHOR BOLTS FOR EACH BOLTS FOR EACH SILL PLATE LONGER THAN 12 INCHES.
- 5. SIMPSONS SILL ANCHORS MAYBE SUBSTITUTED FOR ANCHOR BOLTS AT THE SAME SPACING.
- 6. EXTERIOR CONCRETE SLABS WHICH ARE NOT PART OF THE MAIN SLAB SHALL BE MINIMUM 4 INCHES THICK WITH NO STEEL REINFORCING BARS REQUIRED, UNLESS NOTED OTHERWISE ON FOUNDATION PLAN.

VERIFY THE FOLLOWING PRIOR TO POURING:

- 1. ALL HOLDDOWNS, STRAP, AND POST LOCATIONS.
- 2. CONCRETE FINISHES. PANEL RISER LOCATION WHERE APPLICABLE.
- 3. UNDERSLAB MECHANICAL REQUIREMENTS.
- STEM WALL BLOCKOUTS.
 UNDERSLAB ELECTRICAL
- UNDERSLAB ELECTRICAL REQUIREMENTS AND PANEL RISER LOCATION. WHERE APPLICABLE.
- 6. PROVIDE THE FOLLOWING:
- PVC SLEEVES THROUGH FTG IF REQUIRED
- 20' #4 COPPER GROUND BAR.
- 7. SLOPE FINISH GRADE AWAY FROM FOOTING.

NOTE: FIELD VERIFY ALL DIMENSIONS SEE DIMENSIONED ARCHITECTURAL DRAWINGS

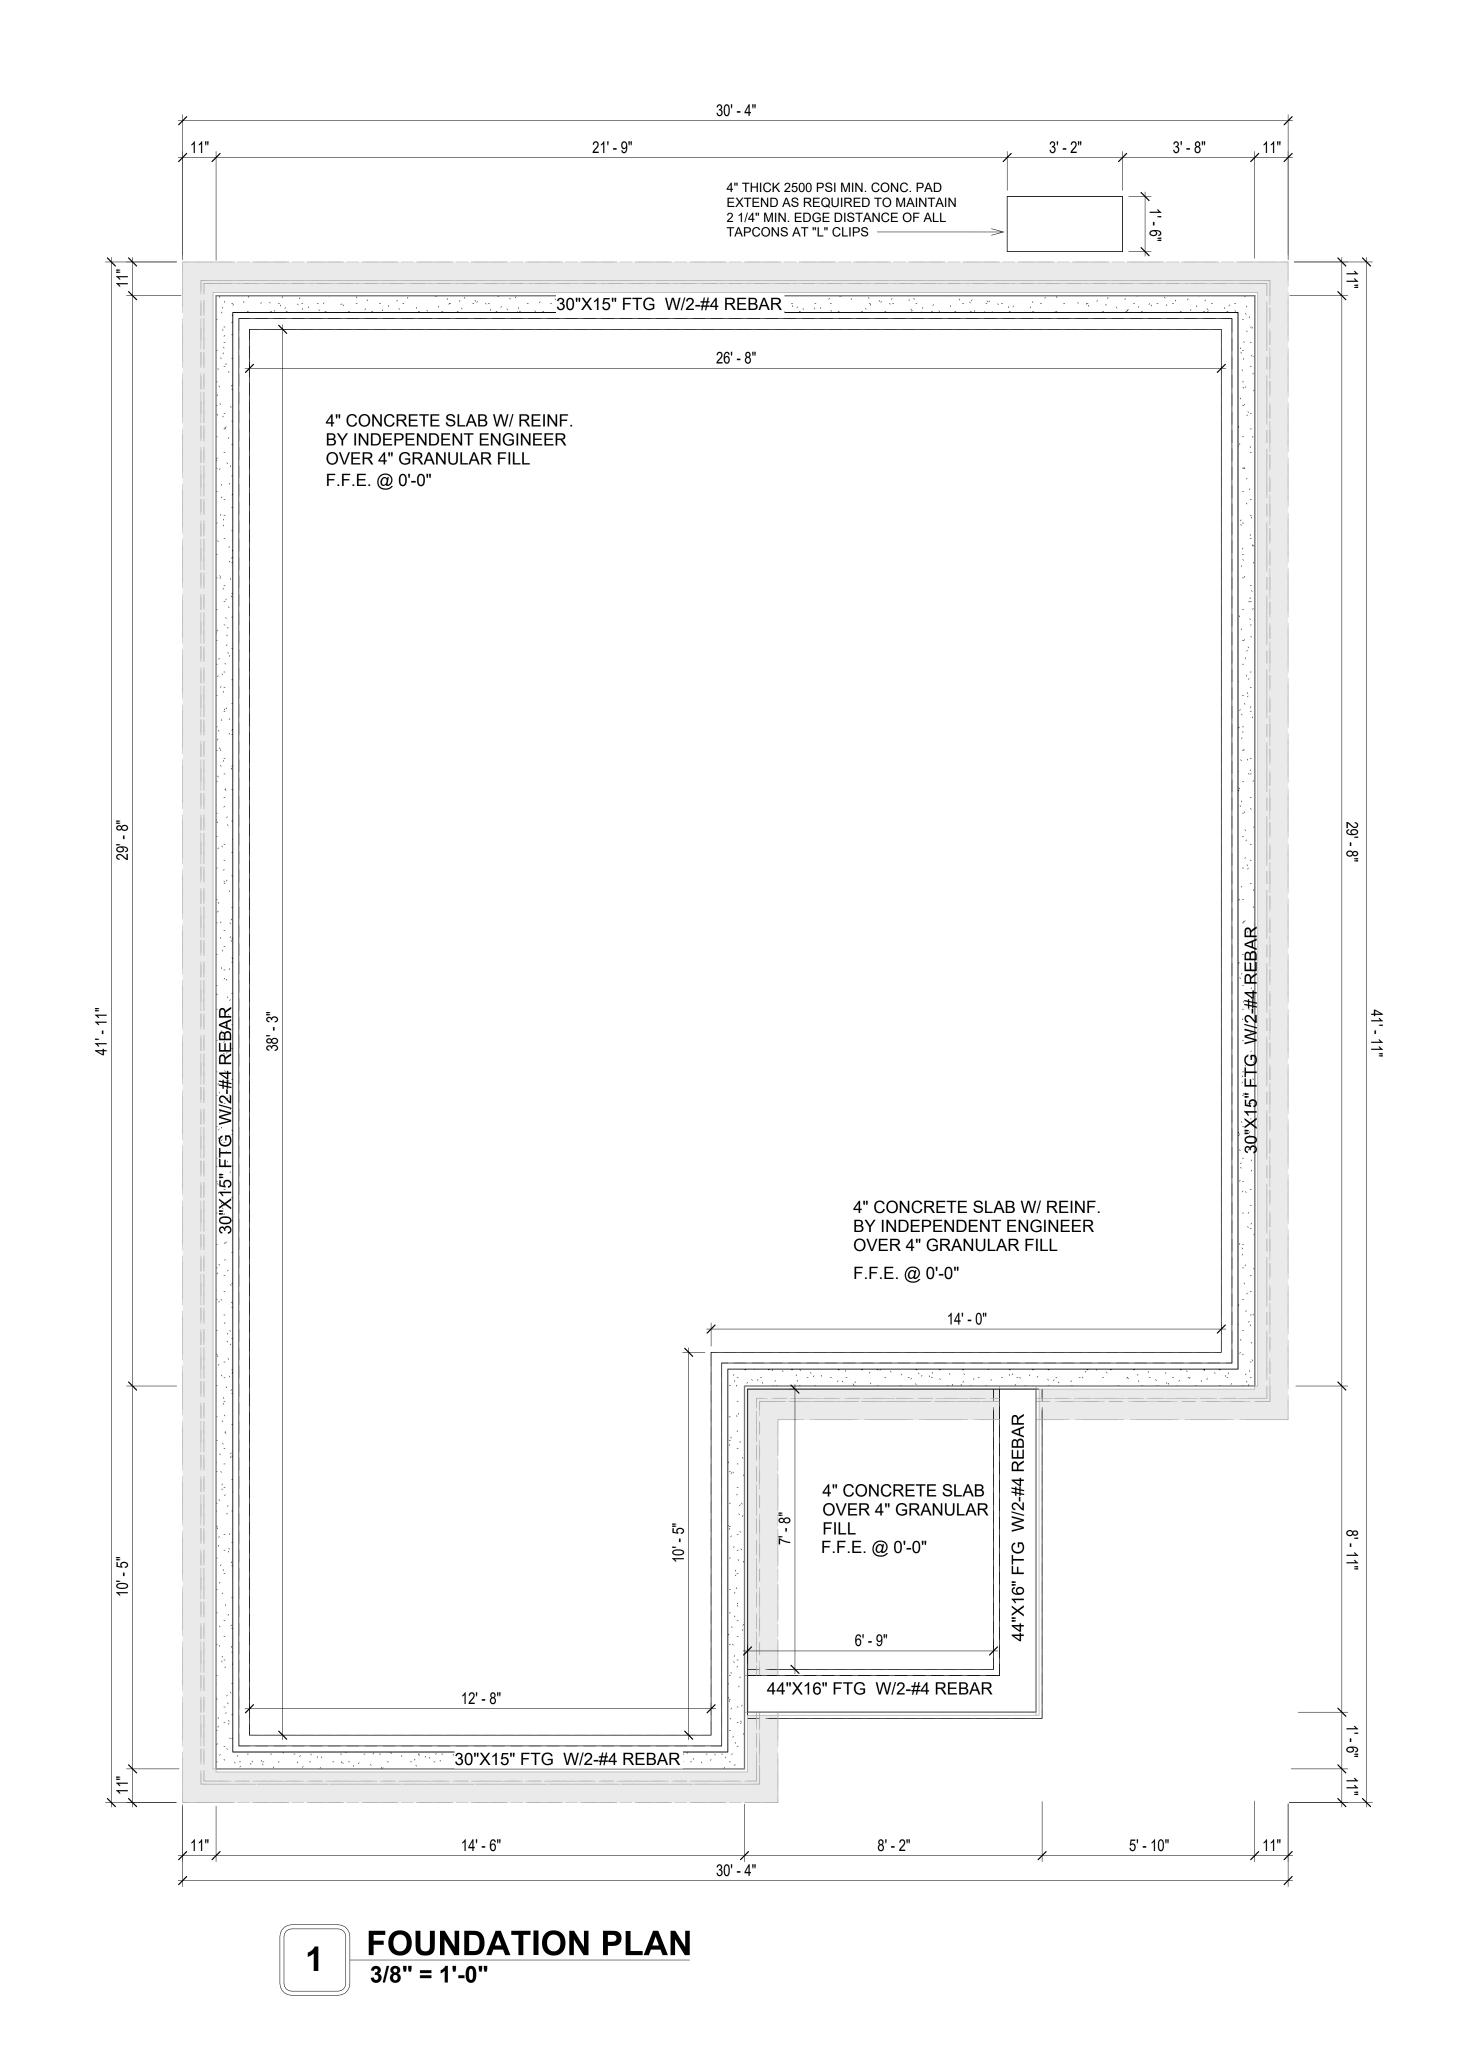

SQUARE FOOTAGE	
LIVING	997
PORCH	65
TOTAL	1062



KEY PLAN

NO.	DESCRIPTION	DATE
	220011111111	

NOTE:

LEGEND:

PROJECT

272-MAGNOLIA-997-2Bd2Ba-COOP-550

DRAWING NAME

FOUNDATION PLAN

CLIENT NAME: Client Name
PROJECT NUMBER: 0061_12

DATE: 5/13/2025 5:36:26 PM

DESIGNED BY: Designer

DRAWN BY: Author

CHECKED BY: Checker

S101

SCALE: 3/8" = 1'-0"

GENERAL NOTES

NOTES:

-ALL BEARING WALLS SHOULD HAVE A THICKENED SLAB PER SECTION PER DETAIL A401/5.

A) FOUNDATION PLAN NOTES:

- 1. CONCRETE SLAB SHALL BE 6" THICK WITH 1/2" DIAMETER TENDONS PER LAYOUT PLAN, CENTERED IN SLAB THICKNESS, OVER APPROVED SUBBASE PER GENERAL STRUCTURE NOTES.
- TERMITE PROTECTION SHALL BE PROVIDED PER IRC SECTION R318.1
 NONE TYPICAL ANCHOR BOLT SPACING AT SHEAR WALL AND HOLD DOWN
- SPECIFICATIONS PER APPROVED ARCHITECTURAL PLANS.
 4. INSTALL HOLDOWNS BEFORE CONCRETE SLAB POUR.
- 5. EXISTING FILL ON-SITE SHALL BE COMPACTED IN ACCORDANCE WITH THE
- REQUIREMENTS IN THE GEOTECHNICAL REPORT.
- 6. ALL FLOOR SLABS ARE REINFORCED ON CONCRETE SLABS.

SPECIAL INSPECTION IS REQUIRED FOR THICKENED FOUNDATION CONSTRUCTION

- 1. REINFORCEMENT
- 2. 2300 PSI CONCRETE POUR

B) REINFORCEMENT FOR CONCRETE:


 ALL REINFORCING SLABS BARS SIZE 10MM OR LARGER SHALL BE DEFORMED IN ACCORDANCE TO ASTM-A706, AND BARS SMALLER THAN 10 MM MAYBE PLAIN.
 UNLESS OTHERWISE NOTED IN PLANS, THE YIELD STRENGTH OF REINFORCING BARS SHALL BE:


> A) FOOTING = 40,000 PSI B) NON-LOAD BEARING WALLS AND PARAPETS= 40,000 PSI

- 3. SPLICES SHALL BE SECURELY WIRED TOGETHER AND SHALL LAP OR EXTEND
- 4. GRADE OF STEEL FOR RCC WORKS SHALL BE GRADE 4 10.
- 5. BAR NOTATIONS GIVES INFORMATION
- A) BAR SIZE
- B) SPACING(IF REQUIRED)
- 6. LAP REINFORCEMENT ONLY AT LOCATION SHOWN IN THE DRAWINGS
- 7. REINFORCEMENT SHALL NOT BE CUT, VENT OR HEATED ON SITE WITHOUT ENGINEERS' APPROVAL.
- C) CONCRETE SLAB NOTES
- 1. ALL SLAB REINFORCEMENT SHALL BE 20MM CLEAR MINIMUM FROM BOTTOM AND FROM TOP OF SLAB.
- 2. REINFORCEMENT IN CONTINUOUS ELEVATED SLAB SHALL BE CUT AS FOLLOWS.

NOTE

- THIS IS A SCHEMATIC PLAN FOR THE PURPOSE OF LOCATING AND IDENTIFYING FOUNDATION REINFORCING ELEMENTS ONLY. VERIFY ALL DIMENSIONS, DROPS, OFFSETS AND FEATURES WITH THE ARCHITECTURAL PLANS BEFORE FORMING THE FOUNDATION.

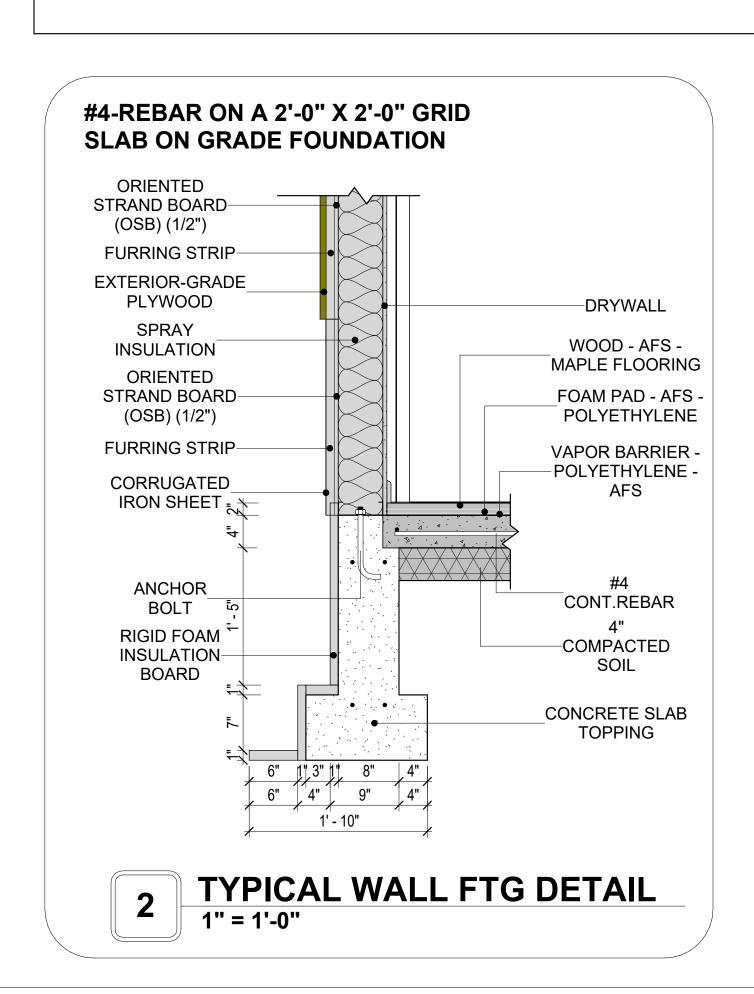

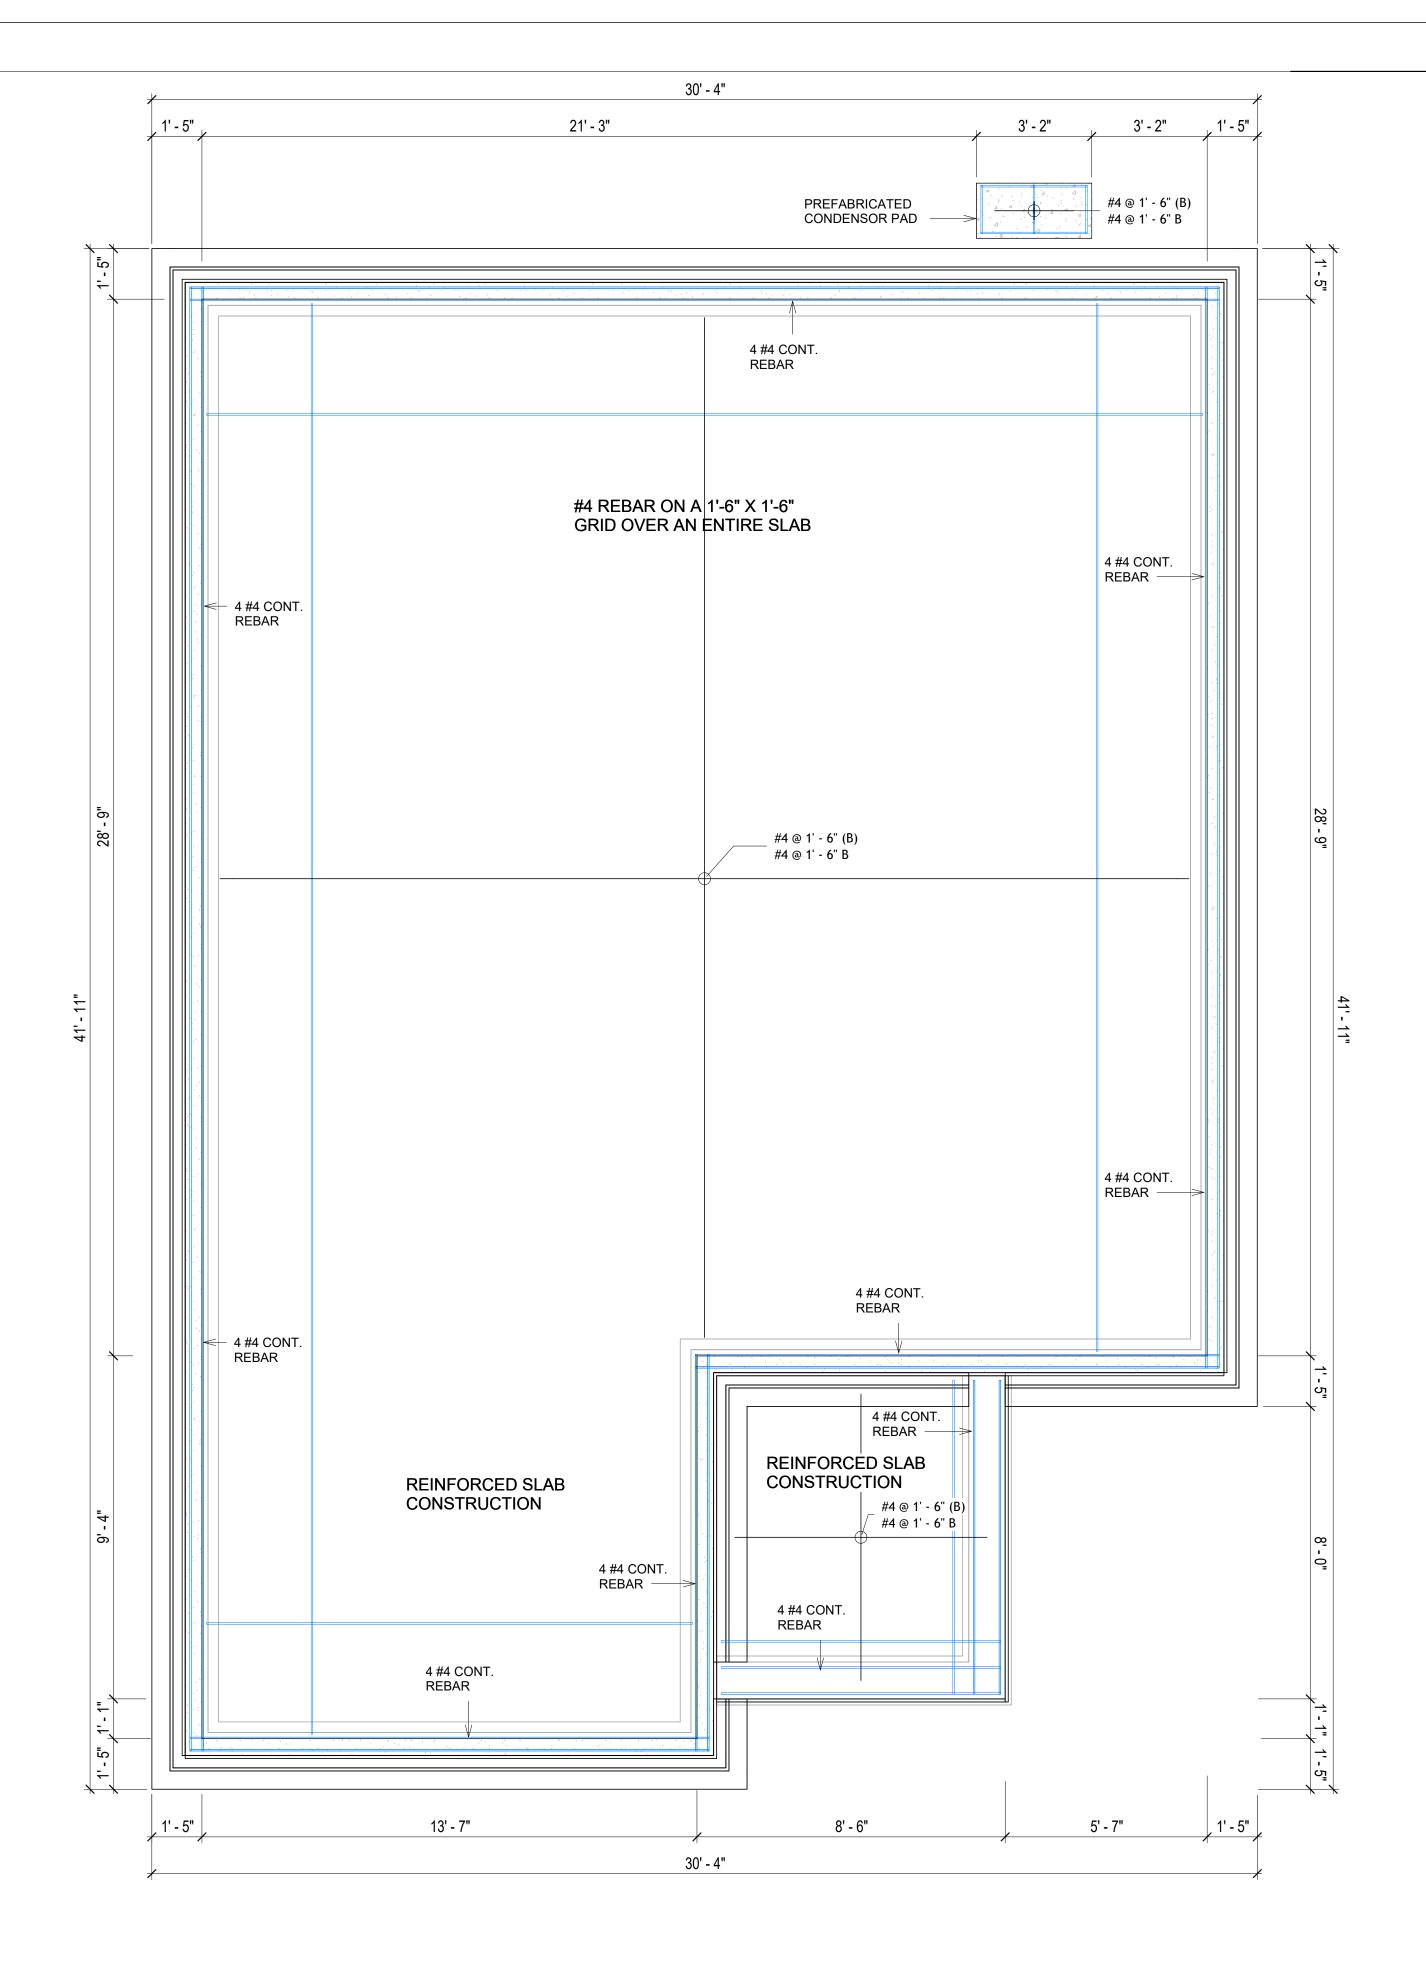

1 FOUNDATION REBAR PLAN
3/8" = 1'-0"



KEY PLAN

NO.	DESCRIPTION	DATE

NOTE:

LEGEND:

PROJECT

272-MAGNOLIA-997-2Bd2Ba-COOP-550

DRAWING NAME


STRUCTURAL FLOOR PLAN

0==	
CLIENT NAME:	Client Name
PROJECT NUMBER:	0061_12
DATE:	5/13/2025 5:36:27 PM
DESIGNED BY:	Designer
DRAWN BY:	Author
CHECKED BY:	Checker

S102

ROOF NOTES

- ROOFING COMPOSITION ROOFING PER OWNERS/BUILDERS SPECIFICATIONS INSTALL PER MANUFACTURE SPECIFICATIONS ON 1/2" ORIENTED STRAND BOARD ON PRE-ENGINEERED TRUSS @ 24" O.C. (UNO.) 2. 73" OVERHANG AT EAVES (UNO.)
- 3. ENDS OF ALL TRUSSES AND JOISTS TO BE FULLY BLOCKED. PROVIDE SOLID BLOCKING AT ALL RIDGES AND VALLEYS
- 4. SHEATHING TO BE 1/2", 3/8" OSB SHEAR PANEL AND EQUIVALENT. UNDERSIDE OF PORCH TRUSSES TO BE FINISHED WITH MOISTURE RESISTANT DRYWALL, TAPED AND TEXTURED.
- 5. EXPOSED EAVES AND OTHER WEATHER EXPOSED AREAS TO BE SHEATHED WITH EXTERIOR GRADE PLYWOOD.
- 6. ALL MATERIALS THICKNESS AND SIZE ARE THE MINIMUM. Refer TO LOCAL STANDARDS FOR ACTUAL THICKNESS AND LAYERING OF MATERIALS.
- ENGINEERED TRUSS CALCULATIONS TO BE SUBMITTED TO BUILDING DEPARTMENT PRIOR TO FABRICATION AND INSTALLATION.
- 8. TRUSS MANUFACTURER TO SPECIFY HANGER CONNECTORS FOR TRUSS COMPONENTS (TYPICAL)
- 9. DESIGNER ASSUMES THAT TRUSSES BEAR ON ALL EXTERIOR PERIMETER
- WALLS (TYPICAL) OR BEAMS.
- 10. PROVIDE GALVANIZED STEEL FLASHING WITH A LENGTH OF 10 FEET, WIDTH OF 12 INCHES, AND THICKNESS OF 24 GAUGE.

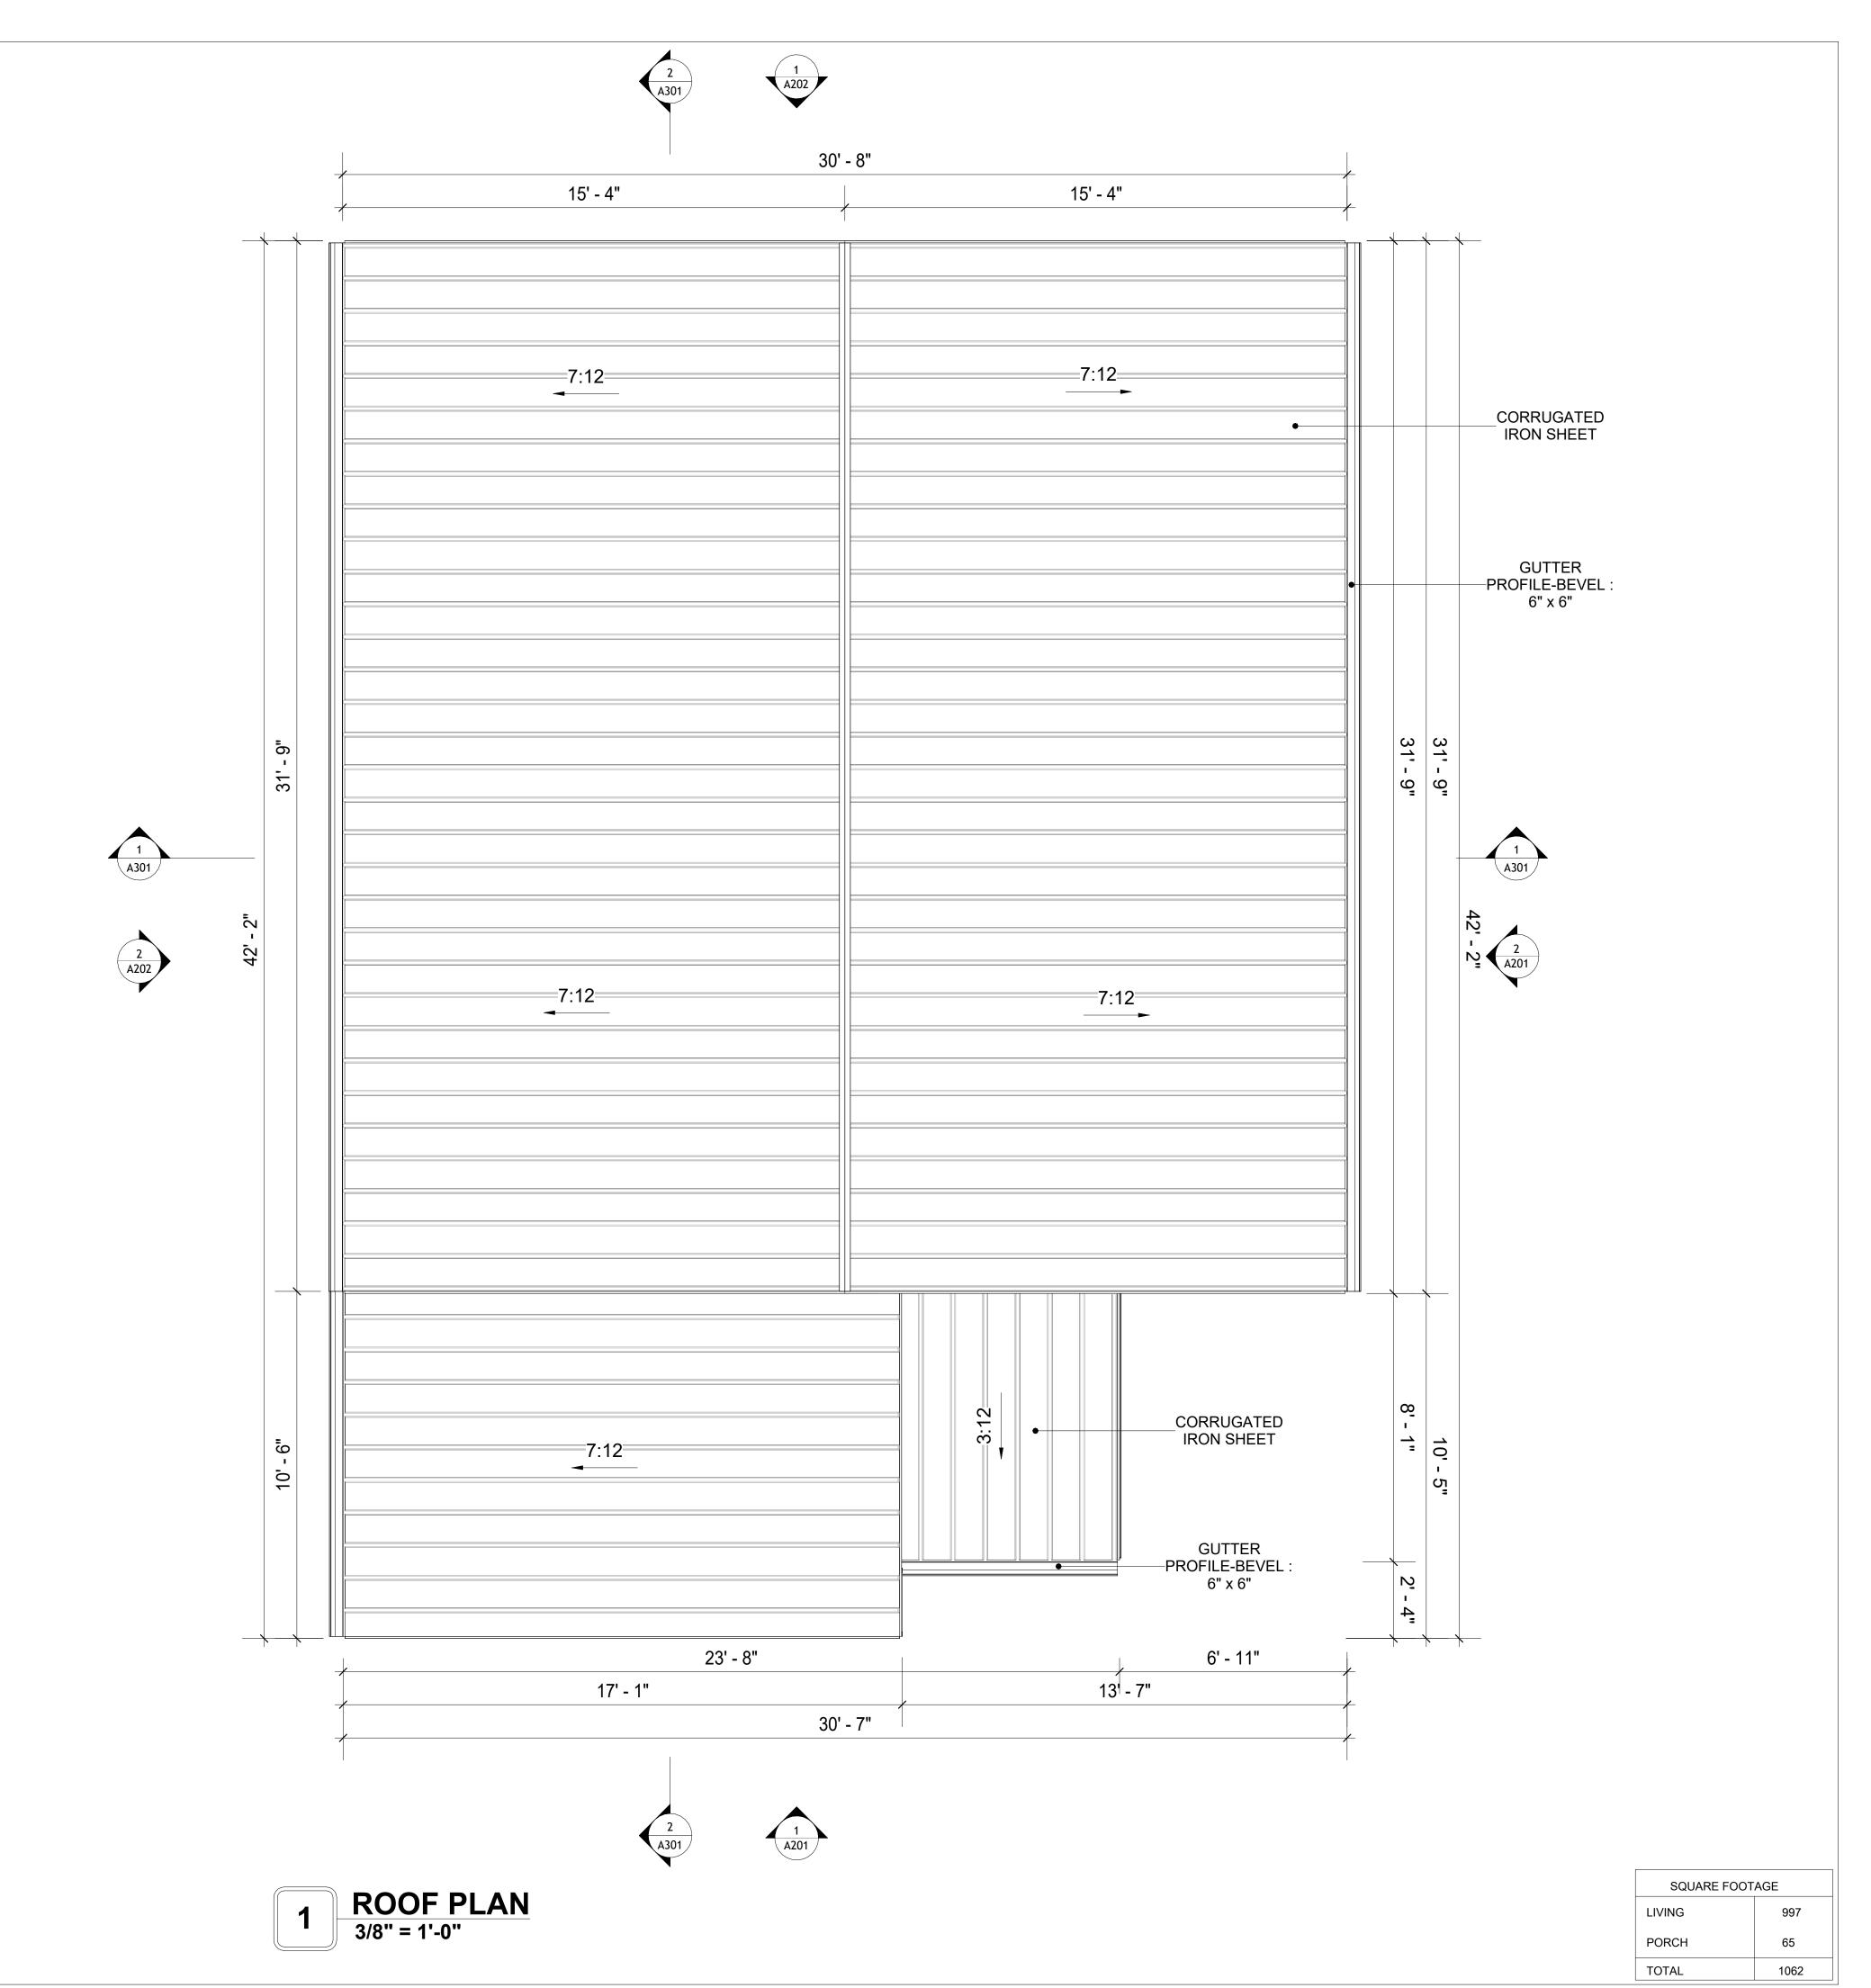



KEY PLAN

NO.	DESCRIPTION	DATE

NOTE:

LEGEND:

PROJECT

272-MAGNOLIA-997-2Bd2Ba-**COOP-550**

DRAWING NAME

ROOF PLAN

CLIENT NAME:	Client Name
PROJECT NUMBER:	0061_12
DATE:	5/13/2025 5:36:30 PM
DESIGNED BY:	Designer
DRAWN BY:	Author
CHECKED BY:	Checker

A103

ABOUT WALL FINISHING

PLYWOOD WALL SIDING

WALL SIDING IS AN EXTERIOR CLADDING MATERIAL USED TO COVER AND PROTECT THE WALLS OF A BUILDING, PROVIDING BOTH FUNCTIONAL AND AESTHETIC BENEFITS.

IN THIS SPECIFIC PROJECT, PLYWOOD WALL PANELS ARE USED AS A FINISH SIDING BECAUSE THIS TYPE OF SIDING PROVIDES A DURABLE, COST-EFFECTIVE, AND VERSATILE EXTERIOR CLADDING THAT CAN BE EASILY INSTALLED, FINISHED, AND MAINTAINED TO ENHANCE THE AESTHETIC AND PROTECTIVE QUALITIES OF A BUILDING'S EXTERIOR.

STANDARD SIZES OF 1' X 8' EXTERIOR-GRADE PLYWOOD PANELS ARE INSTALLED ON THE FURRING STRIPS USING GALVANIZED STEEL SELF-DRILLING SCREWS.

CORRUGATED IRON SHEET


CORRUGATED IRON IS A FINISHING MATERIAL MADE FROM STEEL THAT HAS BEEN GALVANIZED (COATED WITH A THIN LAYER OF ZINC) TO PROTECT IT FROM CORROSION AND RUST


IN THIS SPECIFIC PROJECT, THE CORRUGATED IRON SHEETS ARE INSTALLED HORIZONTALLY ON VERTICAL FURRING STRIPS THAT ARE DIRECTLY ATTACHED ONTO THE PROPERLY INSTALLED AND SEALED HOME WRAP, USING SELF-DRILLING SCREWS THAT ARE DRIVEN THROUGH THE RIDGES OR VALLEYS OF THE CORRUGATIONS.


CEDAR WOOD

CEDAR WOOD REFERS TO THE WOOD FROM VARIOUS SPECIES OF CEDAR TREES, WHICH ARE CONIFEROUS EVERGREEN TREES KNOWN FOR THEIR DISTINCT AROMA AND NATURAL RESISTANCE TO DECAY AND INSECTS.

IN THIS SPECIFIC PROJECT, CEDAR WOOD IS USED A FINISH MATERIAL ON BEAMS AND COLUMNS.

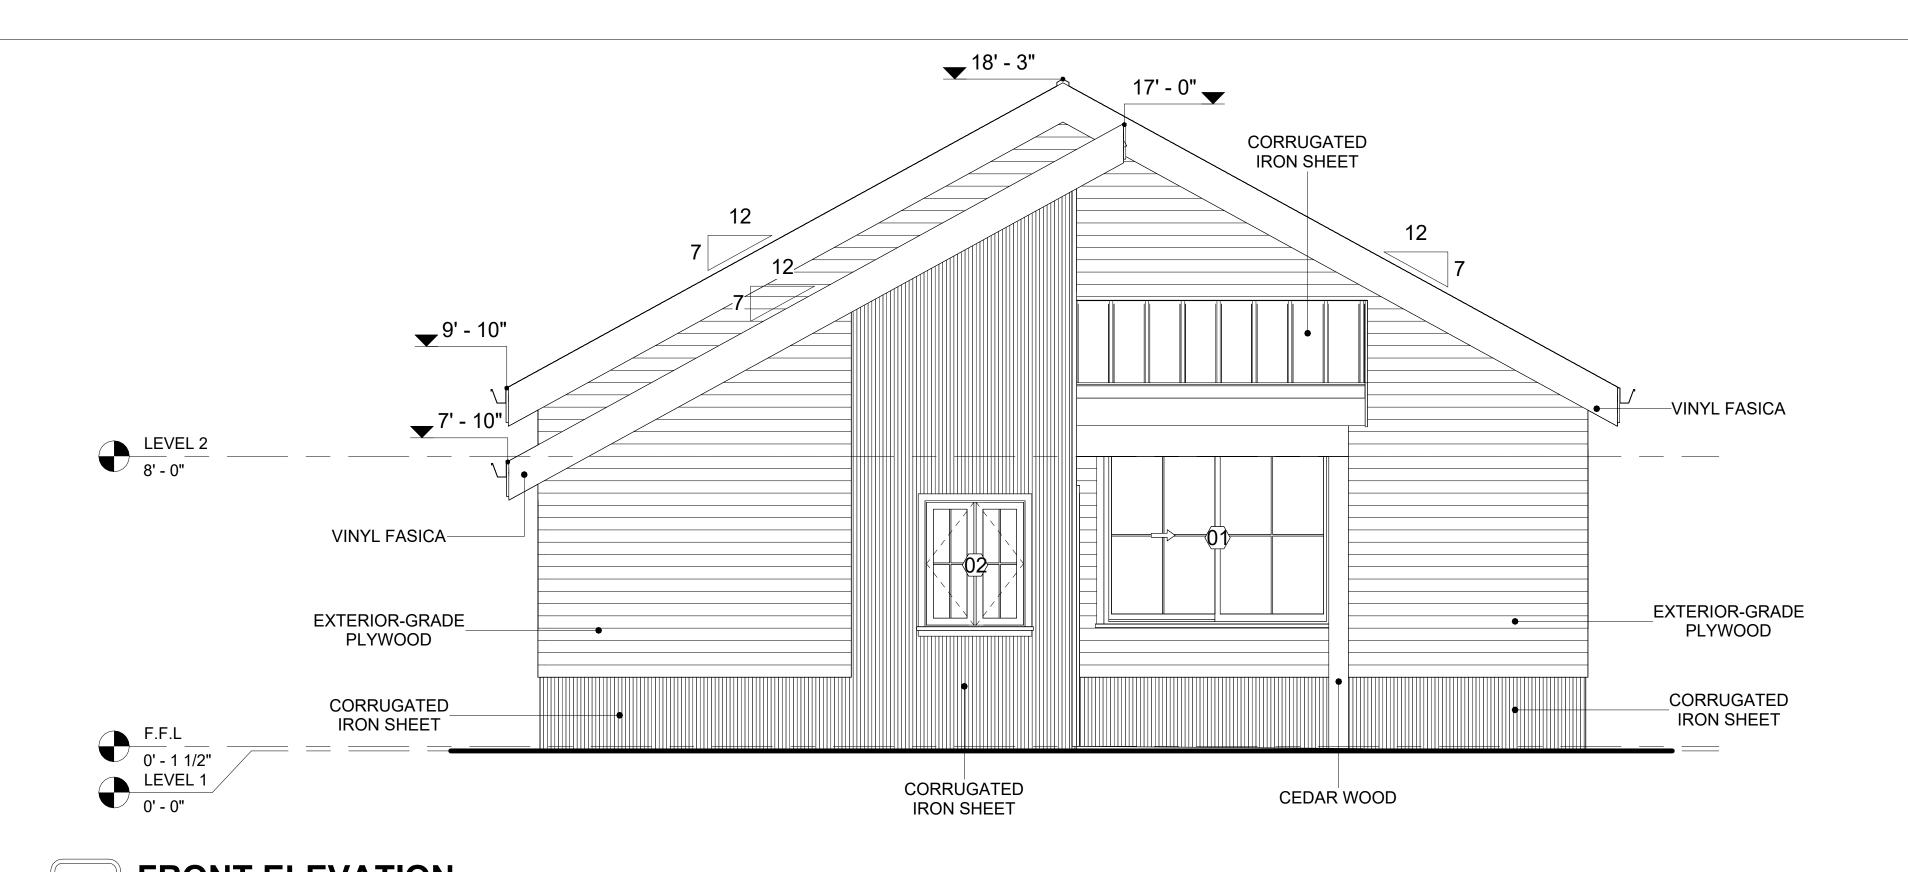

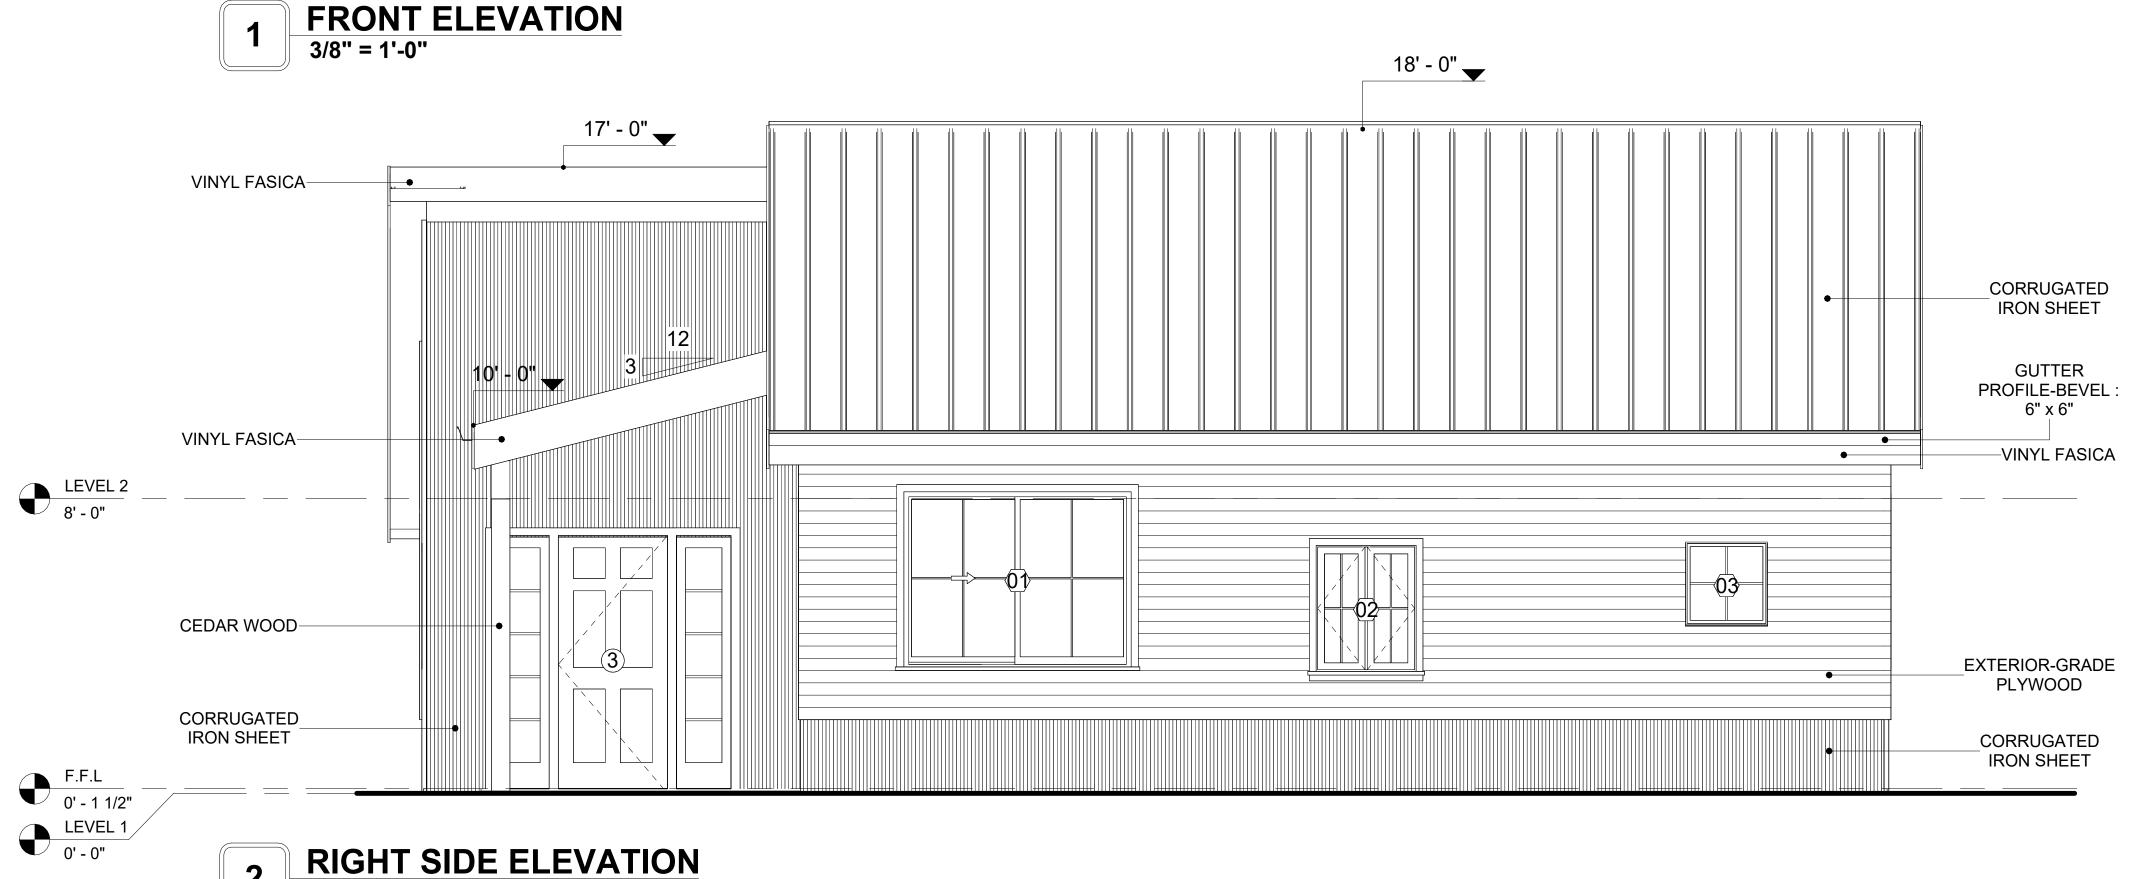

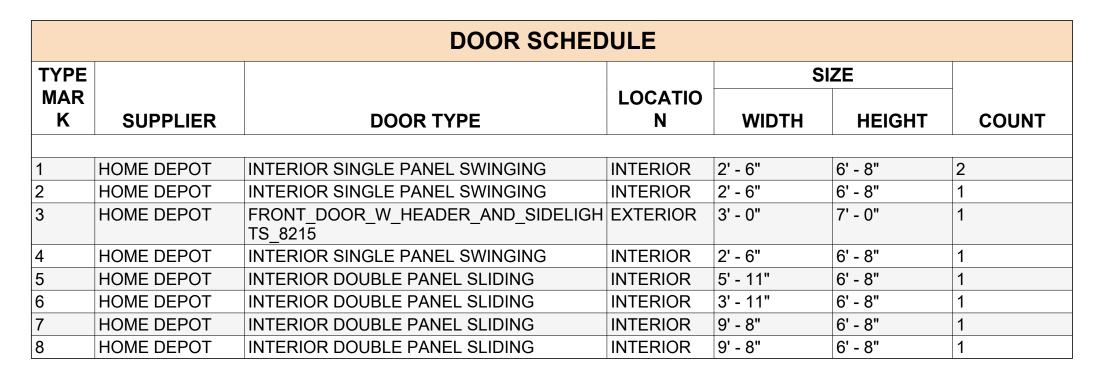


3/8" = 1'-0"

WINDOW SCHEDULE					
				SIZE	
TYPE MARK	SUPPLIER	WINDOW TYPE	WIDTH	HEIGHT	COUNT
01	HOME DEPOT	SLIDING	6' - 3"	4' - 9"	3
02	HOME DEPOT	DOUBLE SWING	2' - 9"	3' - 5"	7
03	HOME DEPOT	FIXED	2' - 3"	2' - 3"	2



KEY PLAN

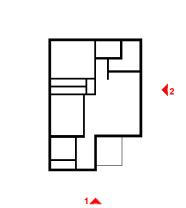

NO.	DESCRIPTION	DATE

NOTE:

LEGEND:

PROJECT

272-MAGNOLIA-997-2Bd2Ba-COOP-550

DRAWING NAME

ARCHITECTURAL ELEVATIONS

CLIENT NAME:	Client Name
PROJECT NUMBER:	0061_12
DATE:	5/13/2025 5:36:33 PM
DESIGNED BY:	Designer
DRAWN BY:	Author
CHECKED BY:	Checker

A201

ABOUT WALL FINISHING

PLYWOOD WALL SIDING

WALL SIDING IS AN EXTERIOR CLADDING MATERIAL USED TO COVER AND PROTECT THE WALLS OF A BUILDING, PROVIDING BOTH FUNCTIONAL AND AESTHETIC BENEFITS.

IN THIS SPECIFIC PROJECT, PLYWOOD WALL PANELS ARE USED AS A FINISH SIDING BECAUSE THIS TYPE OF SIDING PROVIDES A DURABLE, COST-EFFECTIVE, AND VERSATILE EXTERIOR CLADDING THAT CAN BE EASILY INSTALLED, FINISHED, AND MAINTAINED TO ENHANCE THE AESTHETIC AND PROTECTIVE QUALITIES OF A BUILDING'S EXTERIOR.

STANDARD SIZES OF 1' X 8' EXTERIOR-GRADE PLYWOOD PANELS ARE INSTALLED ON THE FURRING STRIPS USING GALVANIZED STEEL SELF-DRILLING SCREWS.

CORRUGATED IRON SHEET


CORRUGATED IRON IS A FINISHING MATERIAL MADE FROM STEEL THAT HAS BEEN GALVANIZED (COATED WITH A THIN LAYER OF ZINC) TO PROTECT IT FROM CORROSION AND RUST

IN THIS SPECIFIC PROJECT, THE CORRUGATED IRON SHEETS ARE INSTALLED HORIZONTALLY ON VERTICAL FURRING STRIPS THAT ARE DIRECTLY ATTACHED ONTO THE PROPERLY INSTALLED AND SEALED HOME WRAP, USING SELF-DRILLING SCREWS THAT ARE DRIVEN THROUGH THE RIDGES OR VALLEYS OF THE CORRUGATIONS.


CEDAR WOOD

CEDAR WOOD REFERS TO THE WOOD FROM VARIOUS SPECIES OF CEDAR TREES, WHICH ARE CONIFEROUS EVERGREEN TREES KNOWN FOR THEIR DISTINCT AROMA AND NATURAL RESISTANCE TO DECAY AND INSECTS.

IN THIS SPECIFIC PROJECT, CEDAR WOOD IS USED A FINISH MATERIAL ON BEAMS AND COLUMNS.

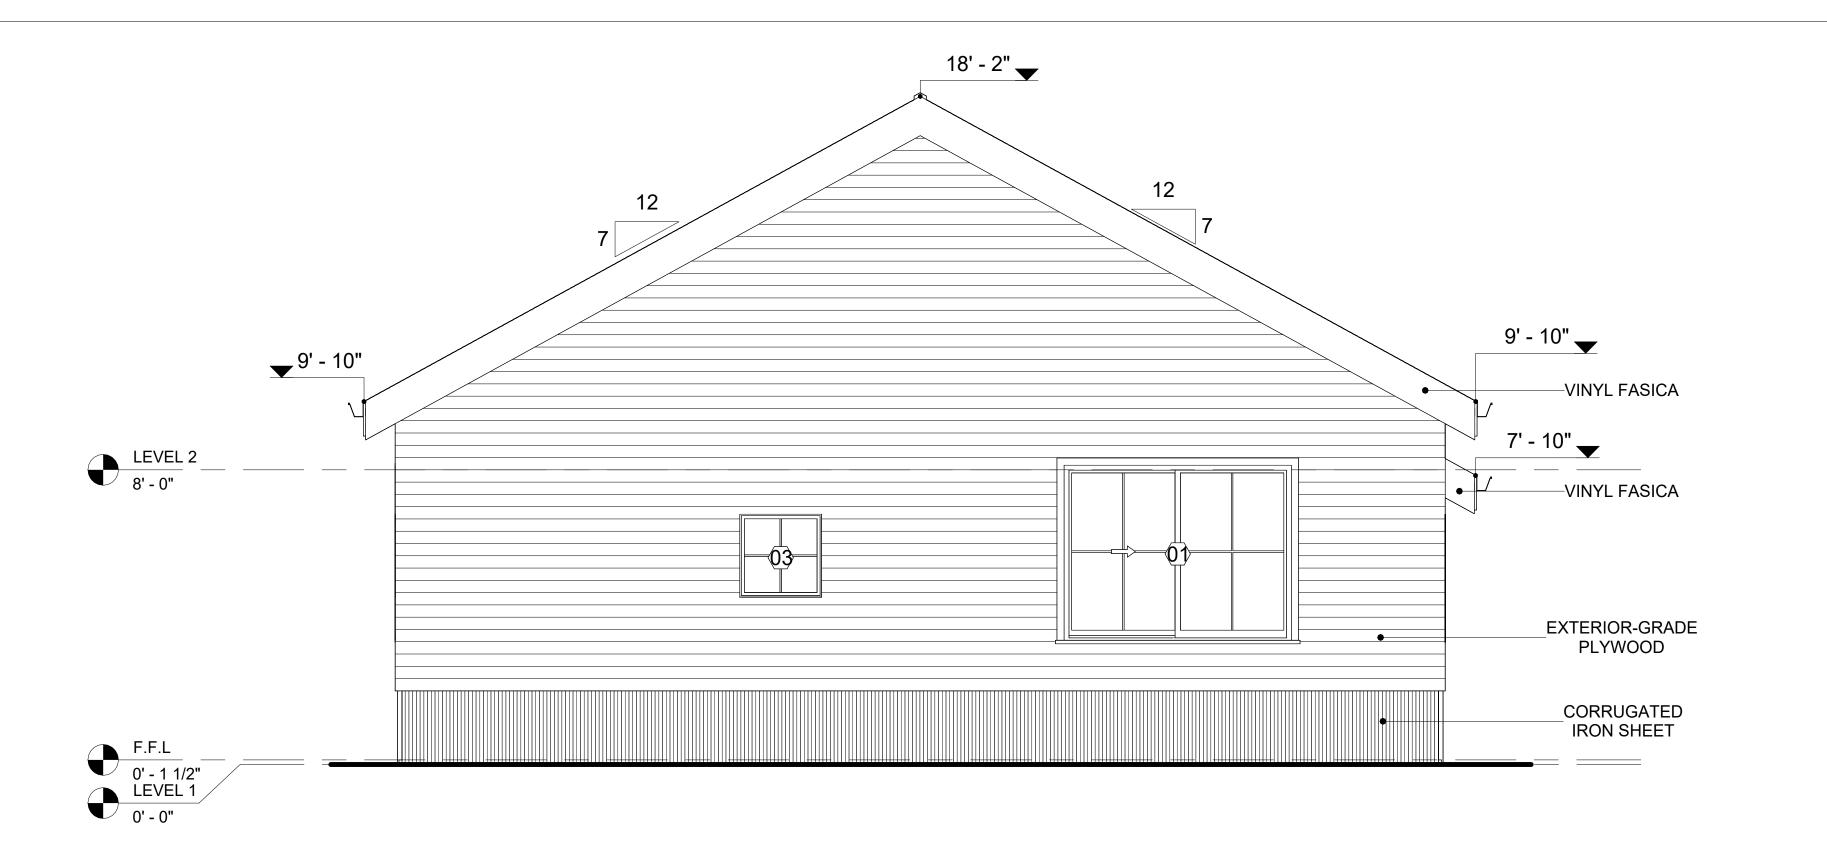


1 REAR ELEVATION 3/8" = 1'-0"

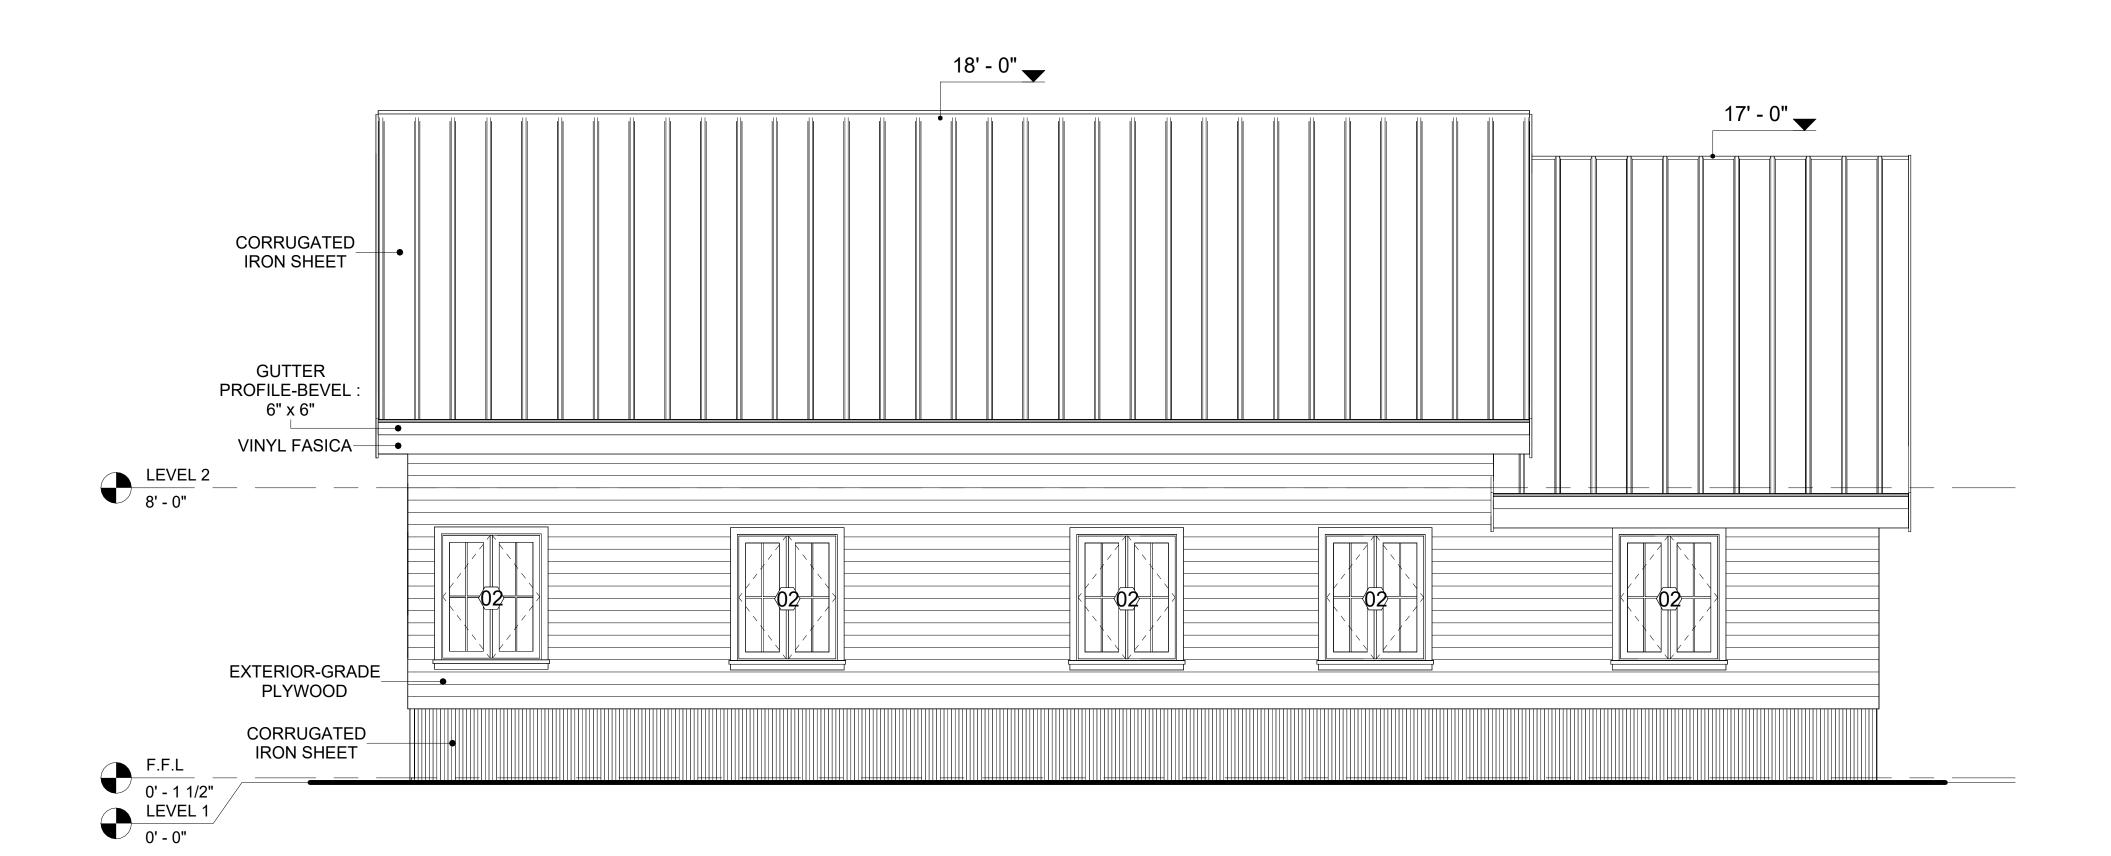

2 LEFT SIDE ELEVATION
3/8" = 1'-0"



KEY PLAN

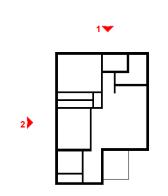

NO.	DESCRIPTION	DATE

NOTE:

LEGEND:

PROJECT


272-MAGNOLIA-997-2Bd2Ba-COOP-550

DRAWING NAME

ARCHITECTURAL ELEVATIONS


CLIENT NAME:	Client Name
PROJECT NUMBER:	0061_12
DATE:	5/13/2025 5:36:36 PM
DESIGNED BY:	Designer
DRAWN BY:	Author
CHECKED BY:	Checker

A202

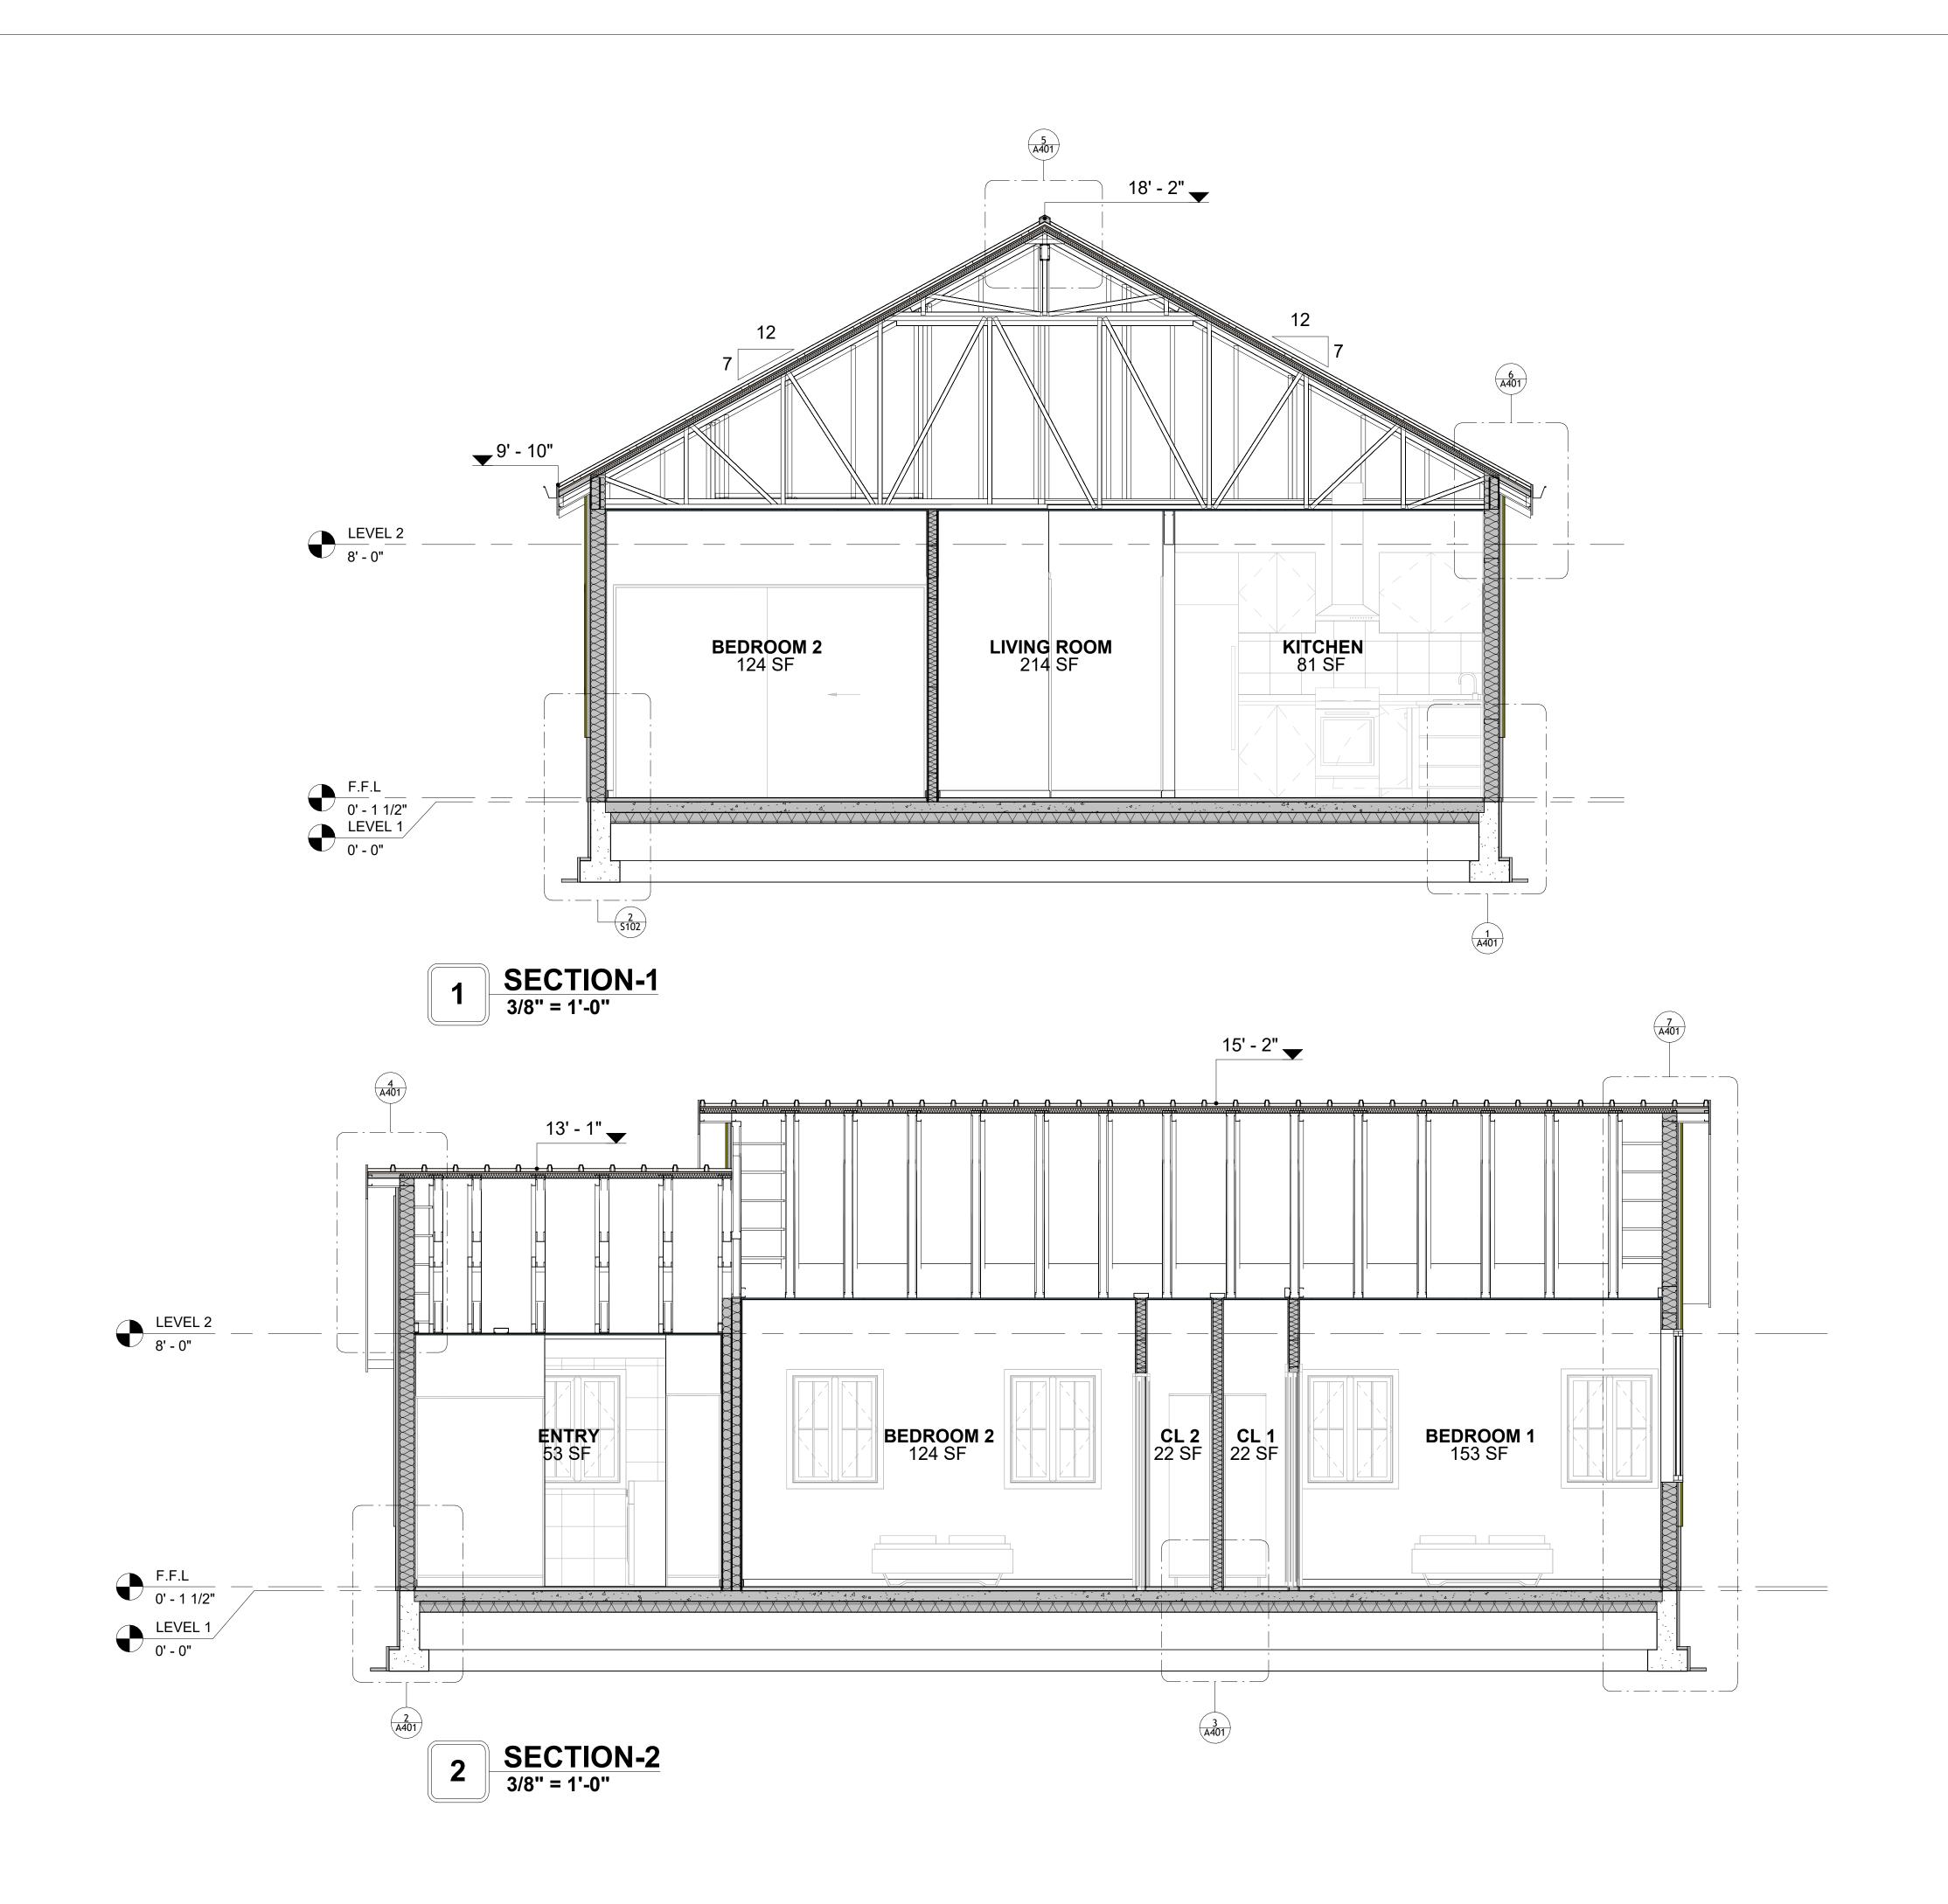



KEY PLAN

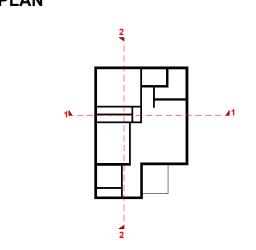

DESCRIPTION	DATE
·	
	DESCRIPTION

NOTE:

LEGEND:

PROJECT


272-MAGNOLIA-997-2Bd2Ba-COOP-550


DRAWING NAME


ARCHITECTURAL SECTIONS

CLIENT NAME:	Client Name
PROJECT NUMBER:	0061_12
DATE:	5/13/2025 5:36:38 PM
DESIGNED BY:	Designer
DRAWN BY:	Author
CHECKED BY:	Checker


A301

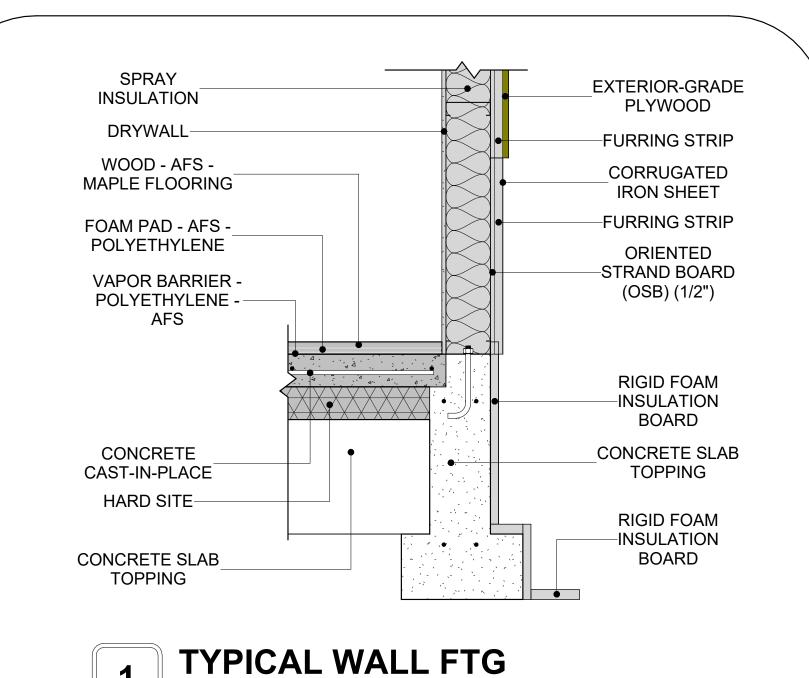


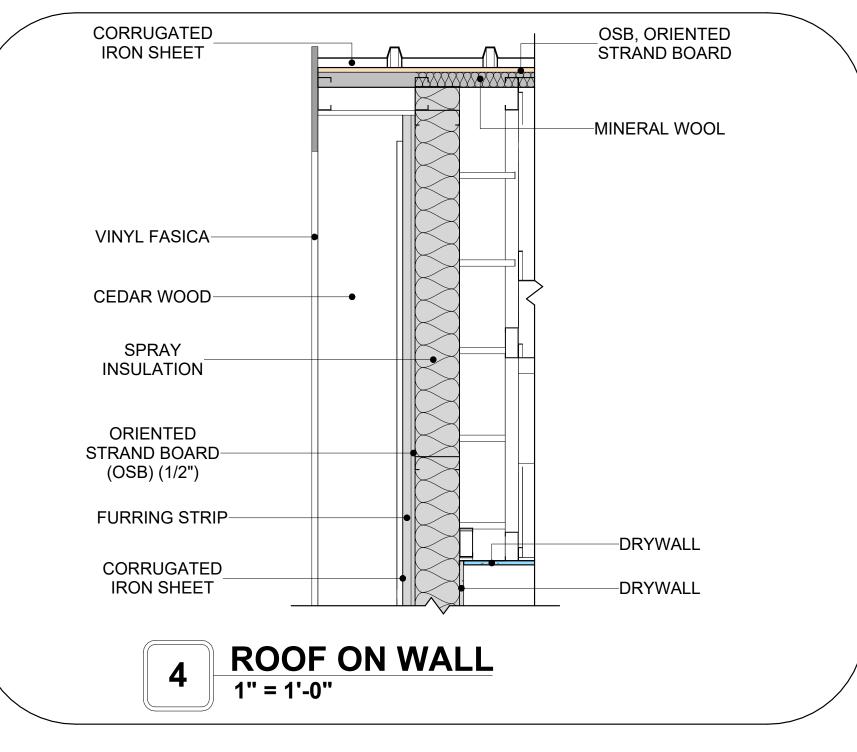


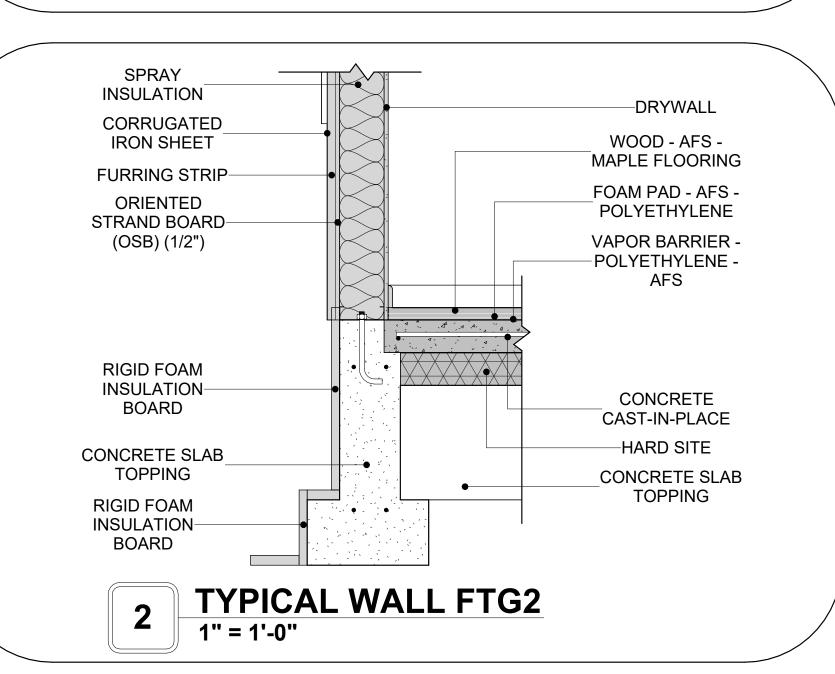


1" = 1'-0"

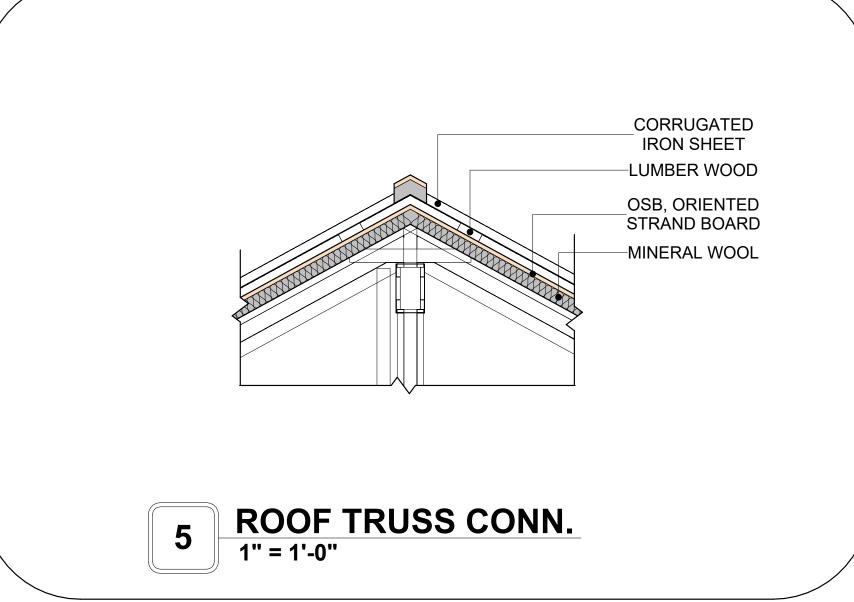

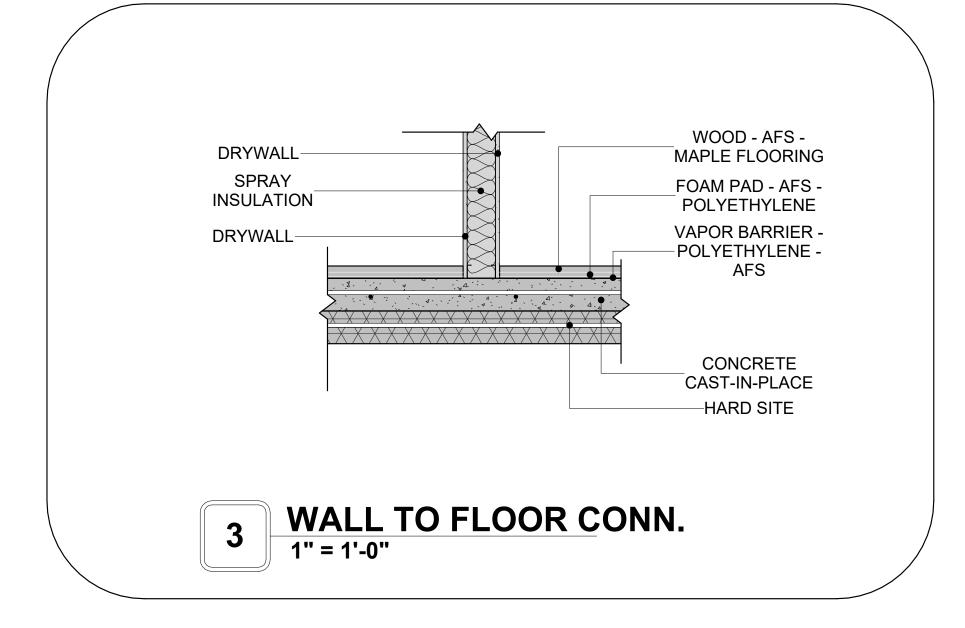

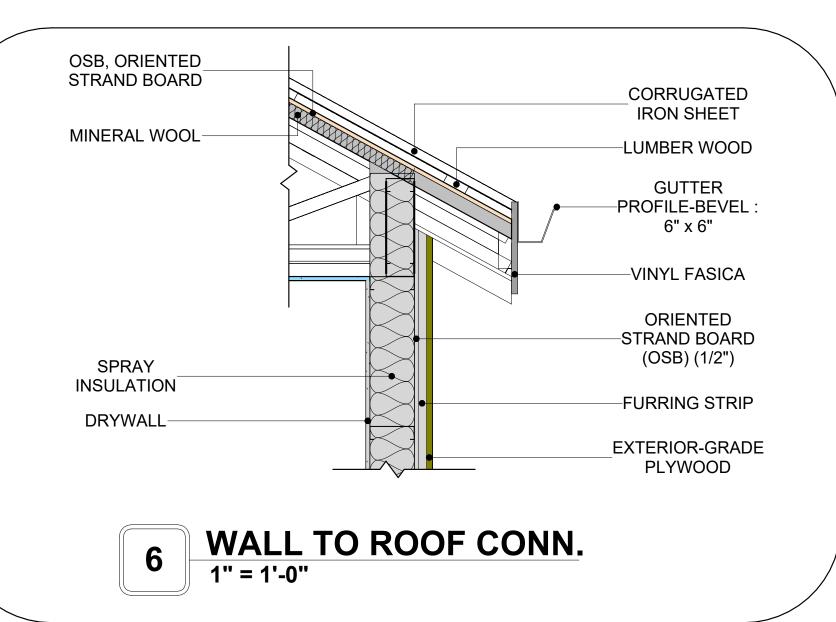

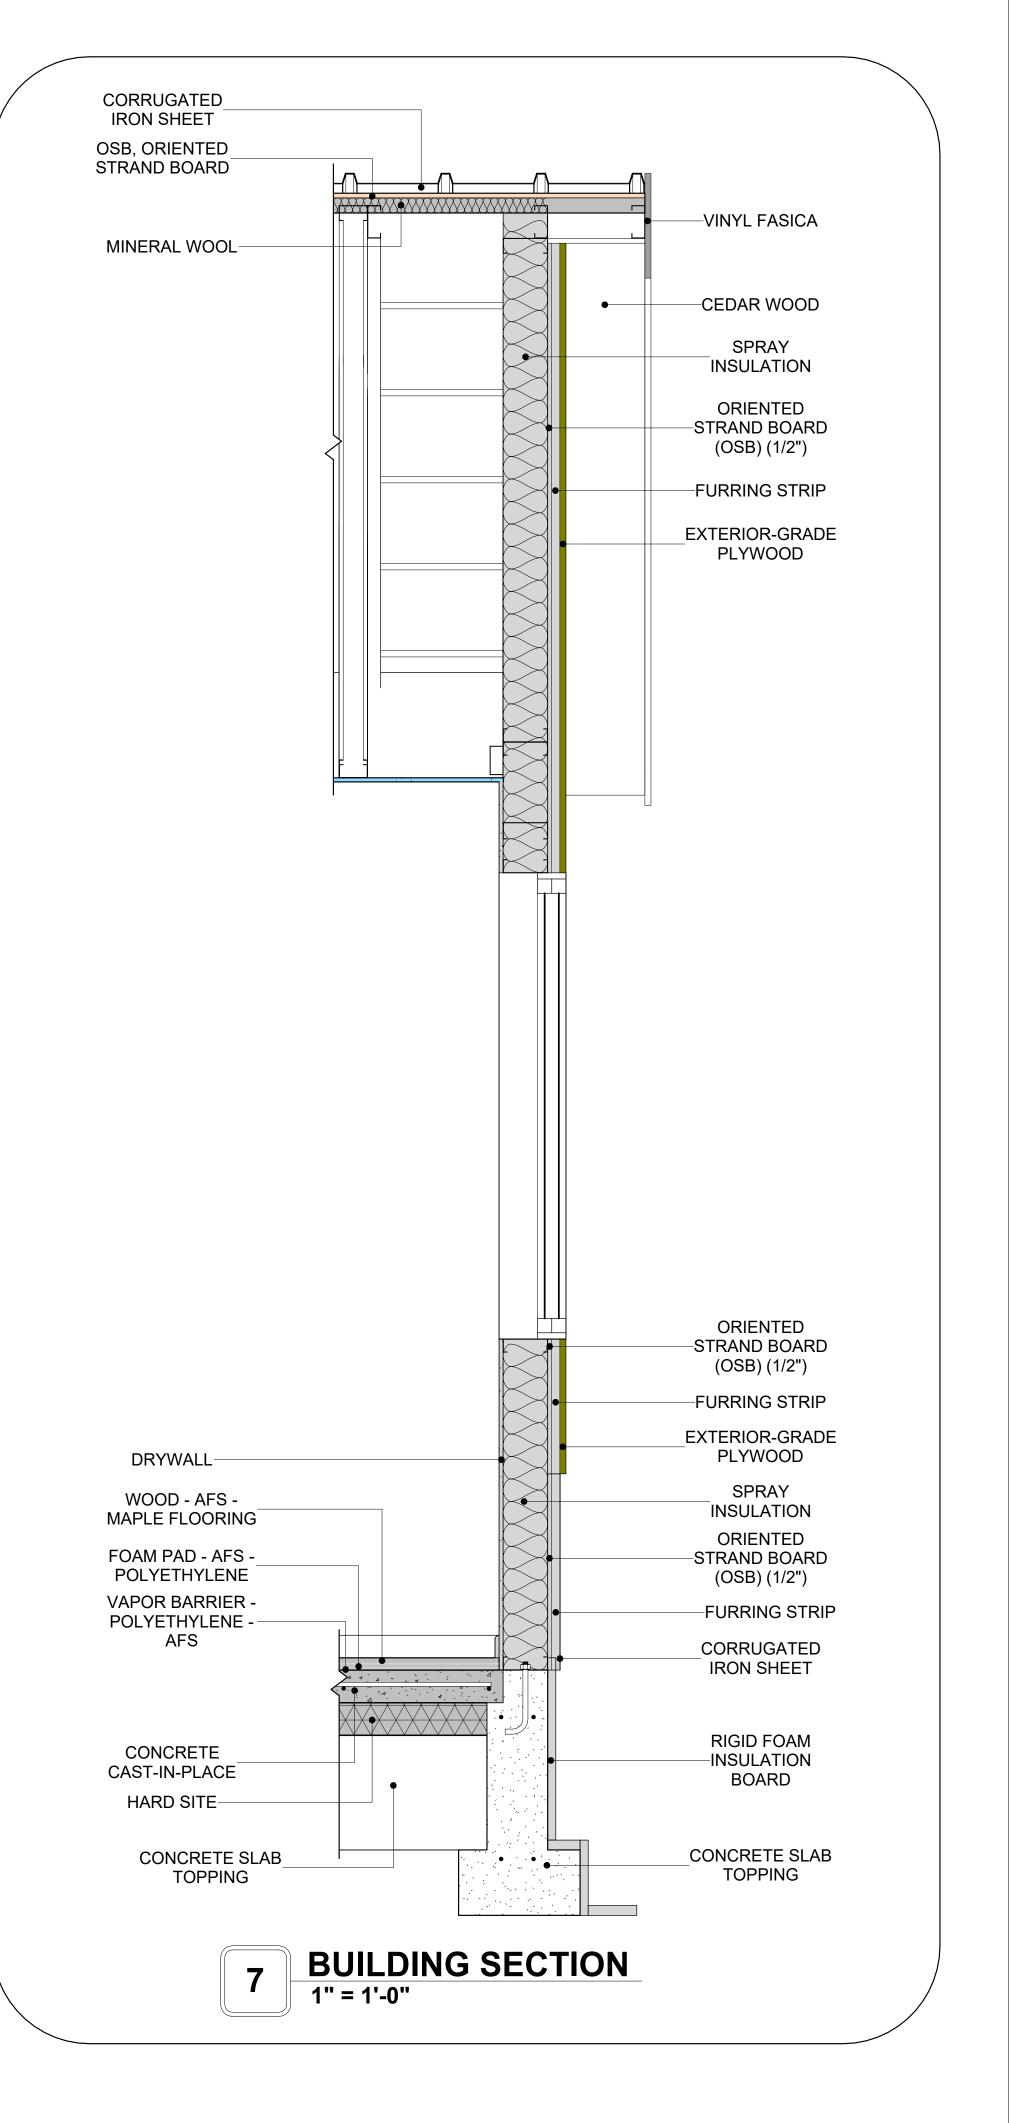



KEY PLAN

NO.	DESCRIPTION	DATE

NOTE:

LEGEND:

PROJECT

272-MAGNOLIA-997-2Bd2Ba-COOP-550

DRAWING NAME

ARCHITECTURAL DETAILS

CLIENT NAME:	Client Name
PROJECT NUMBER:	0061_12
DATE:	5/13/2025 5:36:40 PM
DESIGNED BY:	Designer
DRAWN BY:	Author
CHECKED BY:	Checker

A401


SCALE: 1" = 1'-0"


CASEWORK GENERAL NOTES


- ALL CABINET HEIGHTS INCLUDE COUNTERTOPS. DIMENSIONS ARE TO THE NEAREST INCH. DIVISIONS IN CASEWORK ARE SHOWN FOR CLARITY AND DO NOT REPRESENT BREAKS IN THE COUNTERTOP.
- PROVIDE CONTINUOUS COUNTERTOP OVER ALL SIMILAR HEIGHT CASEWORK, UNLESS AND OTHERWISE NOTED.
- MANUFACTURER AND CATALOG NUMBERS ARE FOR REFERENCE AND ILLUSTRATION PURPOSES
- DOTTED LINES INDICATE WALL HUNG CABINETS, DIVISIONS OF BASE CABINETS BELOW THE
- COUNTERTOP, FURNITURE NOT IN THE CONTRACT OR PROJECTION SCREENS -SEE CASEWORK KEY AND SPECIFICATIONS.
- ALL CABINETS AND DRAWERS TO HAVE CAM LOCKS EXCEPT FOR SINK BASE CABINETS.
 ALL EXPOSED SURFACES (EXPOSED TO VIEW FROM ANY PERSPECTIVE) TO BE COVERED WITH LAMINATE.
- ALL CASEWORK WHICH MEETS A WALL AT ONE OR BOTH ENDS, TO BE PROVIDED WITH FILLER PANELS AND SCRIBED TO THE WALL(S) AS REQUIRED.
- 10. ALL CABINETS AND DRAWERS ARE PROVIDED WITH RECESSED HANDLES.
- 11. CONTRACTOR TO FIELD VERIFY ALL CLEAR OPENINGS PRIOR TO MILLWORK OR CASEWORK FABRICATION.
- 12. CASEWORK DRAWINGS ARE DIAGRAMMATIC IN NATURE TO SHOW DESIGN INTENT.


	CASEWORK SCHEDULE					
TYPE MAR K	TYPE	COUN	HEIGHT	WIDTH	DEPTH	AREA
				44 20		
01	RECESSED_MED_CABINET 2	2	2' - 0"	1' - 6"	0' - 3"	3 SF
02	HD_L-SHAPE_COUNTER_TOP W SINK HOLE 2	1	0' - 4"	4' - 5 1/2"	8' - 1 1/2"	1 SF
03	LINEAR COUNTER TOP	1	0' - 4"	2' - 5"	2' - 1"	1 SF
04	WALL CABINET DOUBLE DOOR 2	1	2' - 6"	2' - 5"	1' - 0"	6 SF
05	VANITY	1	2' - 4"	2' - 6"	1' - 8"	6 SF
06	CLOSET 3	2	6' - 0"	10' - 9 1/2"	1' - 4"	65 SF
07	BASE_CABINET_DOUBLE_DOOR_2	1	2' - 10 1/2"	2' - 5"	2' - 0"	7 SF
08	BASE_FILLER_1	1	2' - 10 1/2"	0' - 11"	2' - 0"	3 SF
09	REFRIGERATOR TOP	1	1' - 7 1/2"	2' - 0"	2' - 4"	3 SF
10	WALL_CABINET_DOUBLE_DOOR 2	1	2' - 6"	3' - 3"	1' - 0"	8 SF
11	BASE_CABINET_SINGLE_DOOR	1	2' - 10 1/2"	2' - 1"	2' - 0"	6 SF
12	VANITY 4	1	2' - 4"	3' - 0"	1' - 8"	7 SF
13	CLOSET_1	1	6' - 0"	4' - 5"	1' - 4"	27 SF
14	CLOSET_1 2 L	1	6' - 0"	1' - 9"	1' - 4"	10 SF
15	CLOSET_1 2 R	1	5' - 11"	4' - 0 1/2"	1' - 4"	24 SF
16	BASE_CABINET_L-SHAPED	1	2' - 10 1/2"	3' - 3"	3' - 3"	9 SF
GRAND	TOTAL	18				

SPECIALTY EQUIPMENT SCHEDULE			
TYPE MARK	TYPE	COUNT	
01	WASHER-FRONT-LOAD	1	
02	REFRIGERATOR	1	
03	RANGE	1	
04	DRYER-FRONT-LOAD	1	
05	DISHWASHER	1	
GRAND TOTAL: 5			

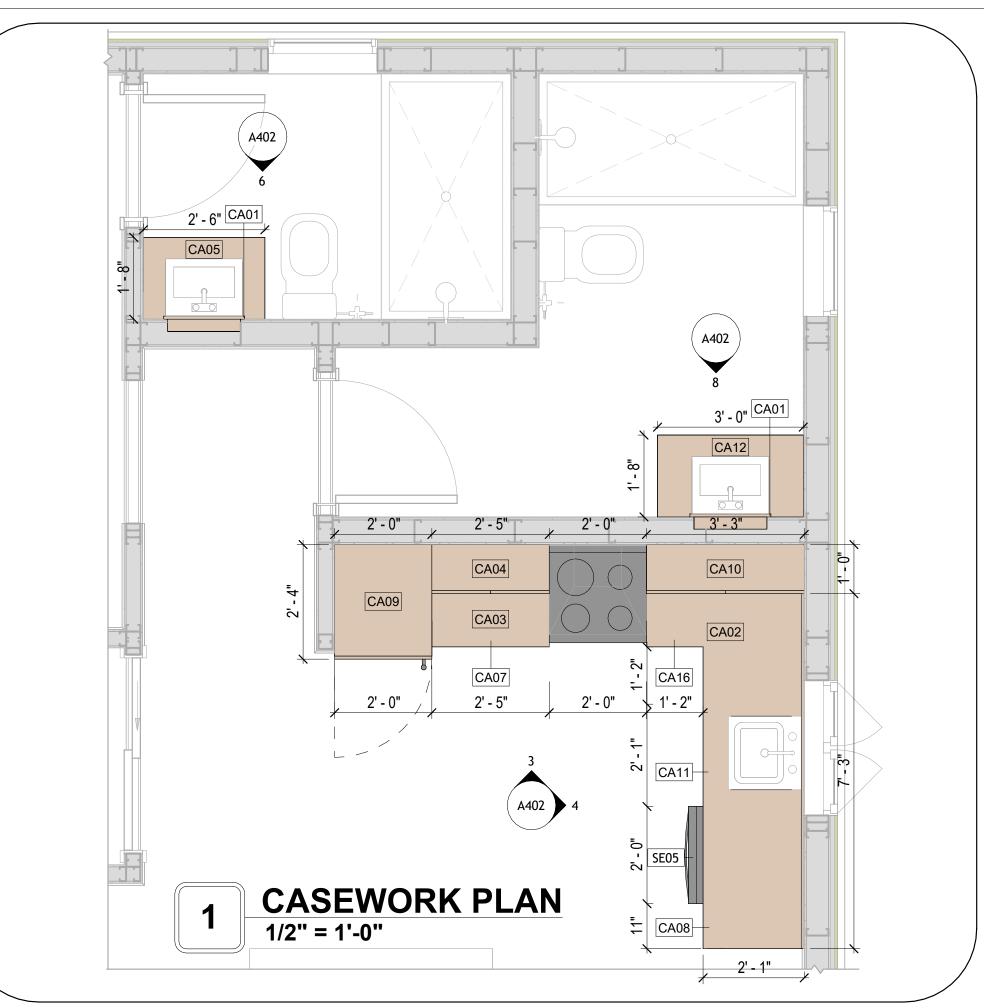

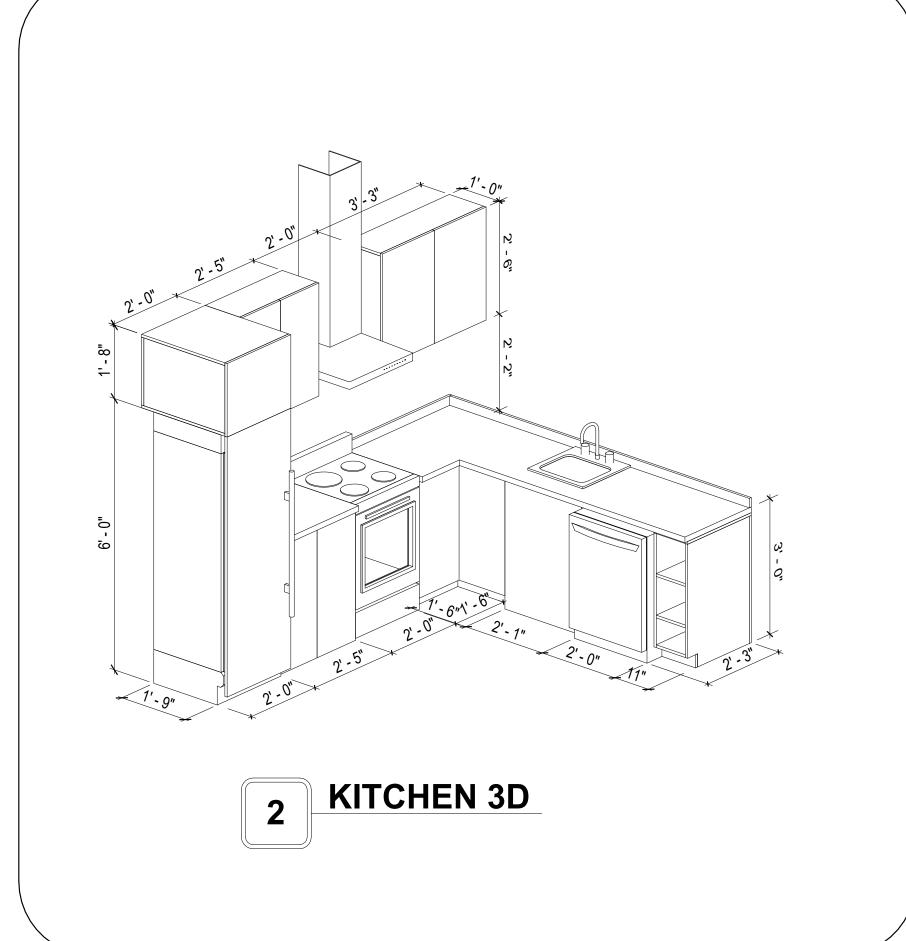


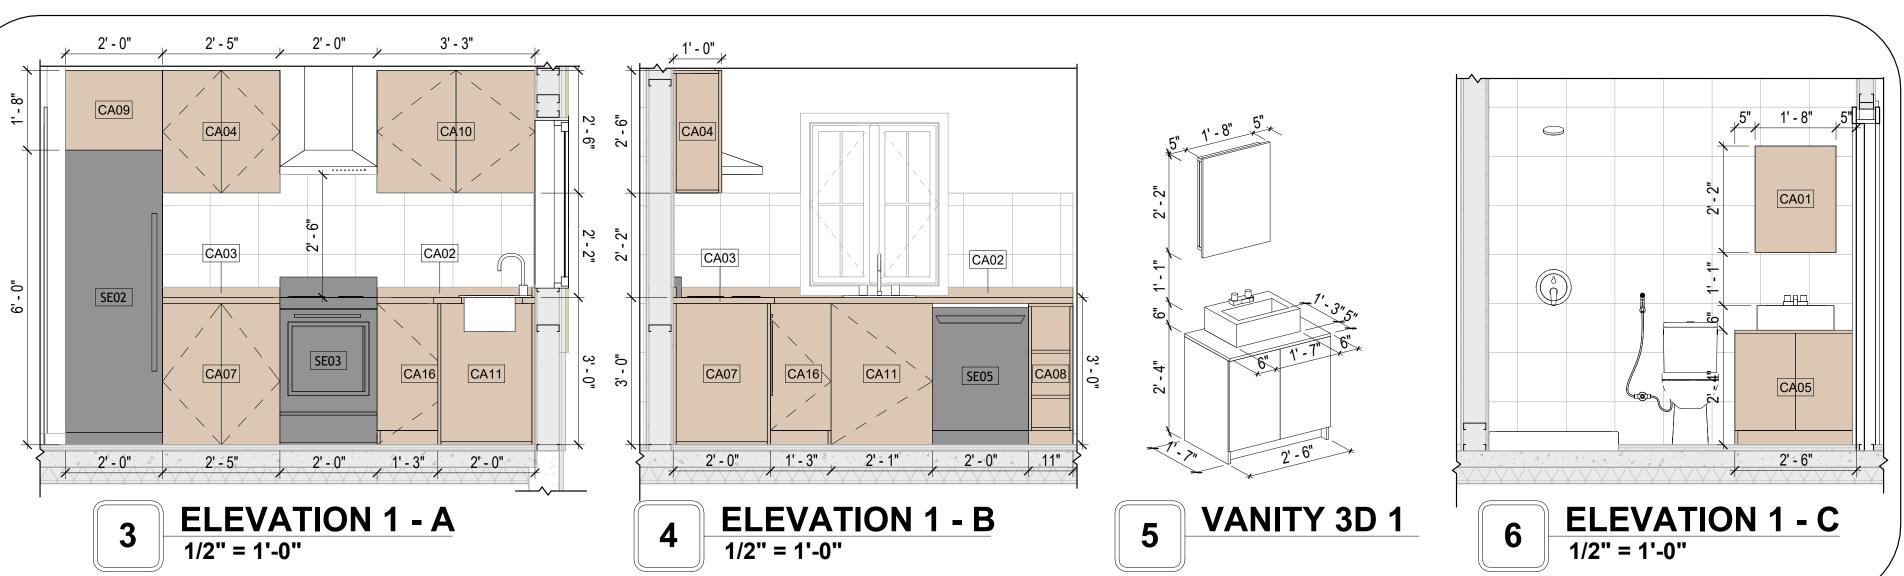

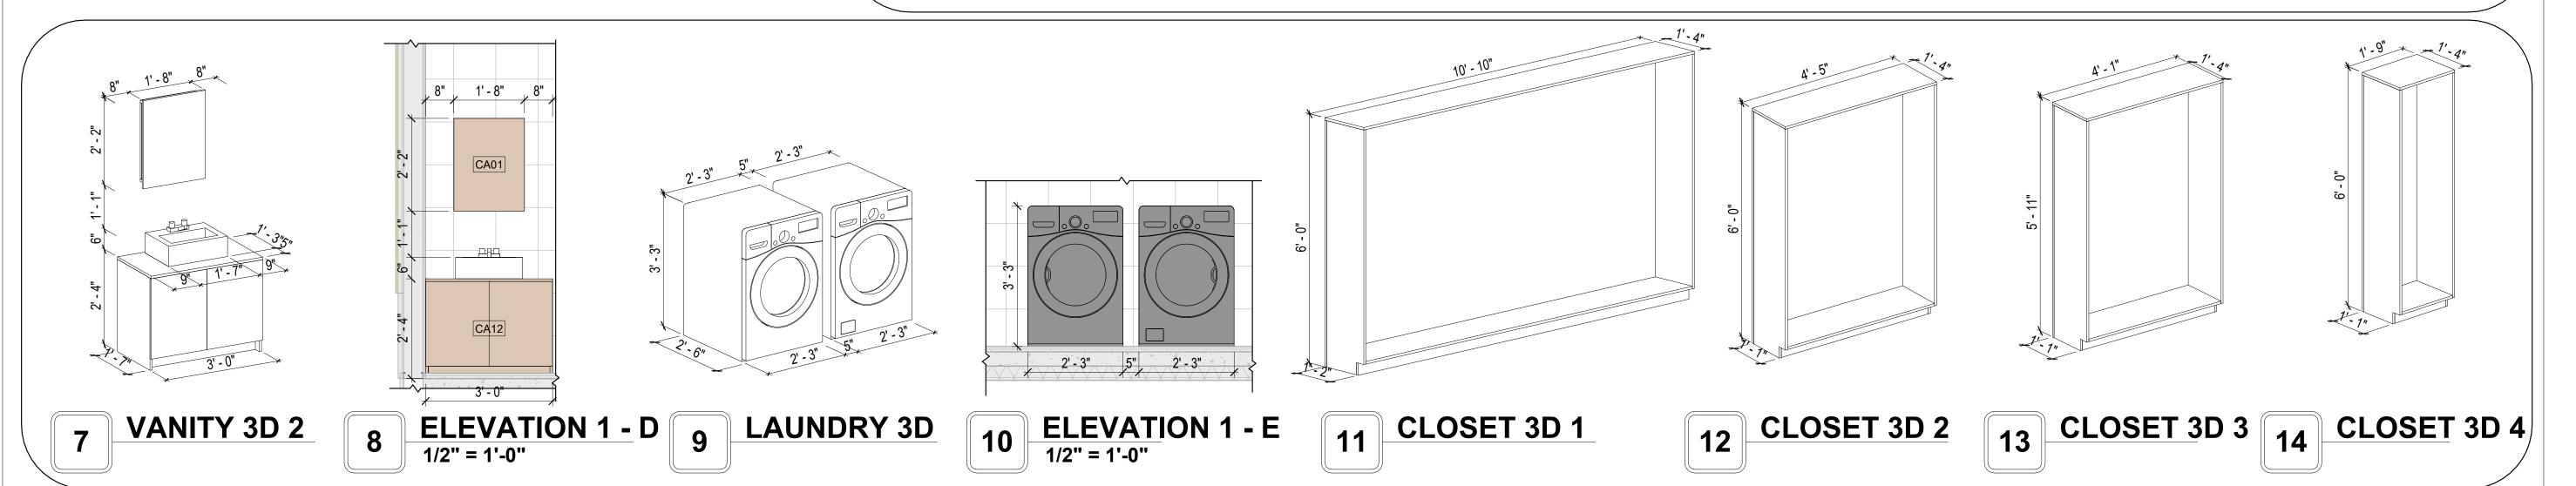



KEY PLAN

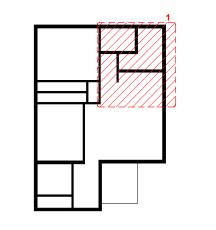

NO.	DESCRIPTION	DATE

NOTE:

LEGEND:

PROJECT

272-MAGNOLIA-997-2Bd2Ba-COOP-550

DRAWING NAME

ARCHITECTURAL CASEWORK

CLIENT NAME:	Client Name
PROJECT NUMBER:	0061_12
DATE:	5/13/2025 5:36:43 PM
DESIGNED BY:	Designer
DRAWN BY:	Author
CHECKED BY:	Checker

A402

GENERAL NOTES

1. THIS DRAWING DEPICTS THE HVAC (HEATING, VENTILATION, AND AIR CONDITIONING) SYSTEM FOR THE -----__NG. IT PROVIDES A VISUAL REPRESENTATION OF THE SYSTEM LAYOUT AND COMPONENTS.

2.THE HVAC SYSTEM IS DESIGNED TO MEET THE SPECIFIC REQUIREMENTS OF THE BUILDING, INCLUDING HEATING, COOLING, AND VENTILATION NEEDS, AS PER THE PROJECT SPECIFICATIONS AND APPLICABLE CODES AND STANDARDS.

3. THE HVAC SYSTEM INSTALLATION SHALL COMPLY WITH THE LATEST EDITION OF THE INTERNATIONAL MECHANICAL CODE (IMC), INTERNATIONAL RESIDENTIAL CODE (IRC), AND ALL OTHER APPLICABLE LOCAL, STATE, AND NATIONAL CODES AND REGULATIONS.

4. THE EQUIPMENT SHOWN ON THIS DRAWING INCLUDES BUT IS NOT LIMITED TO AIR HANDLING UNITS (AHUS), CHILLERS, BOILERS, COOLING TOWERS, PUMPS, DUCTWORK, DIFFUSERS, GRILLES, AND CONTROL DEVICES.

5. ALL EQUIPMENT, DUCTWORK, AND PIPING SHALL BE INSTALLED IN ACCORDANCE WITH MANUFACTURER'S SPECIFICATIONS, LOCAL CODES, AND INDUSTRY BEST DRACTICES

6. ALL DUCTWORK SHALL BE SIZED, FABRICATED, AND INSTALLED IN ACCORDANCE WITH THE LATEST EDITION OF THE ACCA MANUAL D AND THE SMACNA HVAC DUCT CONSTRUCTION STANDARDS. DUCTWORK SHALL BE INSTALLED IN A NEAT AND WORKMANLIKE MANNER, PROPERLY SUPPORTED AND BRACED TO PREVENT SAGGING, AIR LEAKAGE, OR VIBRATION.

7. CONDENSATE DRAINAGE PIPING SHALL BE PROPERLY PITCHED TO ENSURE POSITIVE DRAINAGE TO AN APPROVED DISPOSAL LOCATION, SUCH AS A FLOOR DRAIN, SUMP PUMP, OR EXTERIOR GRADE. CONDENSATE LINES SHALL BE INSULATED TO PREVENT SWEATING.

8. THE LOCATION OF CONTROL PANELS AND SENSORS INDICATED ON THIS DRAWING CAN BEMODIFY WITH THE SPECIFIC LOCATIONS AND WIRING DETAILS WILL BE DETERMINED DURING THE CONTROL SYSTEM DESIGN AND INSTALLATION.

9. THE HVAC SYSTEM DESIGN CONSIDER ENERGY EFFICIENCY, INDOOR AIR QUALITY, OCCUPANT COMFORT, AND NOISE CONTROL, FOLLOWING APPLICABLE GUIDELINES AND REGULATIONS.

WITH THE LOCAL BUILDING DEPARTMENT AND UTILITY PROVIDERS TO ENSURE A TIMELY AND COMPLIANT INSTALLATION.

10. COORDINATION WITH OTHER TREADS HAS BEEN DONE ON A DESIGN LEVEL. THIS DRAWING SHALL BE READ TOGETHER WITH THE AR, EL AND SN DESIGN DRAWINGS TO ENSURE PROPER INSTALLATION AND INTEGRATION OF THE HVAC SYSTEMS.

11. THE HVAC CONTRACTOR IS RESPONSIBLE FOR OBTAINING ALL NECESSARY PERMITS AND LICENSES, AND FOR SCHEDULING AND COORDINATING

12. ALL DUCTWORK PENETRATIONS THROUGH WALLS, FLOORS, OR CEILINGS SHALL BE PROPERLY SEALED AND FIRE-STOPPED USING APPROVED

METHODS AND MATERIALS TO MAINTAIN THE INTEGRITY OF THE BUILDING'S FIRE-RESISTANCE RATINGS.

13. HVAC EQUIPMENT SHALL BE INSTALLED LEVEL AND PLUMB, AND IN STRICT ACCORDANCE WITH THE MANUFACTURER'S INSTALLATION INSTRUCTIONS AND RECOMMENDATIONS. PROVIDE ADEQUATE CLEARANCES AROUND EQUIPMENT FOR PROPER AIRFLOW, SERVICE ACCESS, AND CODE COMPLIANCE.


14. ALL HVAC EQUIPMENT AND COMPONENTS, INCLUDING THERMOSTATS, DAMPERS, AND ACCESS PANELS, SHALL BE LOCATED IN ACCESSIBLE AREAS FOR EASY SERVICING AND MAINTENANCE. PROVIDE ADEQUATE SPACE AROUND EQUIPMENT FOR PROPER AIRFLOW AND SERVICE ACCESS.

15. THE HVAC SYSTEM SHALL BE BALANCED AND ADJUSTED TO ENSURE PROPER AIRFLOW, TEMPERATURE DISTRIBUTION, AND SYSTEM PERFORMANCE THROUGHOUT THE RESIDENCE. PROVIDE A WRITTEN REPORT DOCUMENTING THE FINAL SYSTEM BALANCE.

16. ANY DEVIATIONS OR MODIFICATIONS TO THE HVAC SYSTEM DESIGN SHALL BE REVIEWED AND APPROVED BY THE RESPONSIBLE DESIGN PROFESSIONALS AND COMMUNICATED TO ALL RELEVANT PARTIES INVOLVED IN THE CONSTRUCTION PROCESS.

17. FOR ANY INQUIRIES OR CLARIFICATIONS REGARDING THE HVAC SYSTEM DESIGN, PLEASE CONSULT THE RESPONSIBLE DESIGN PROFESSIONALS OR THE PROJECT MANAGEMENT TEAM.

SYMBOLS

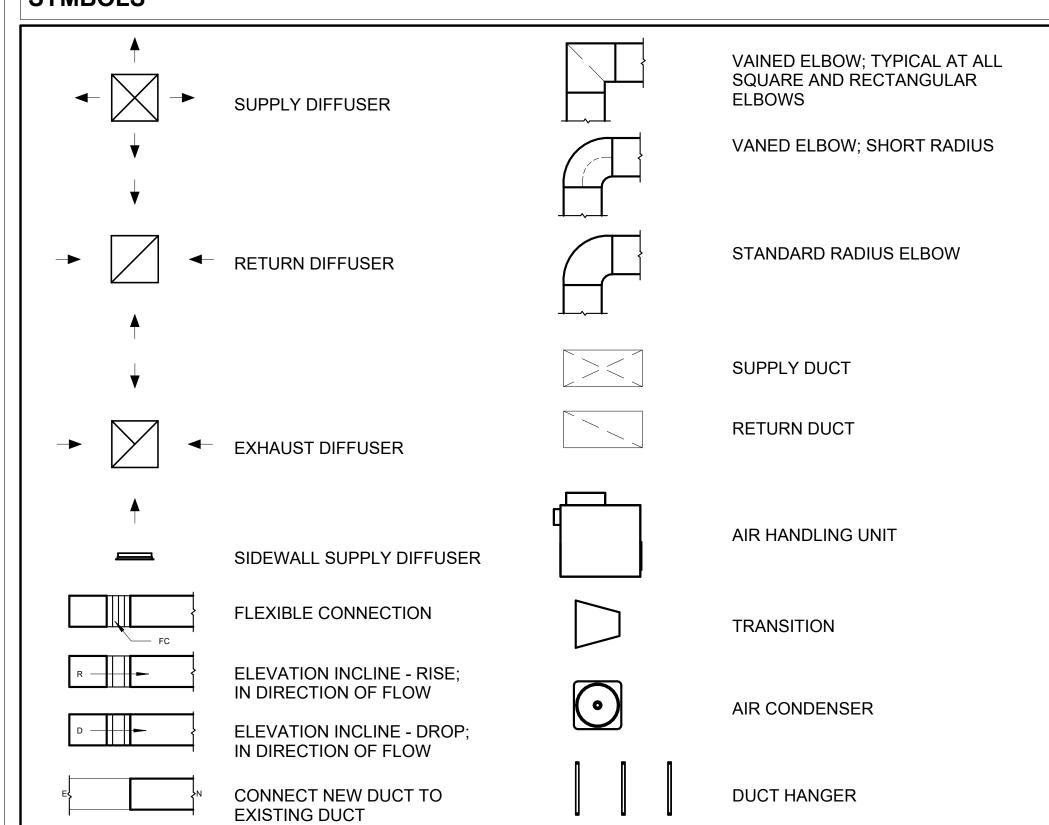



AIR CONDITIONING PIPE

REFRIGERANT LINE SCHEDULE			
CATAGORY	DESCRIPTION	DIAMETER	LENGTH
PIPE TYPES	COPPER	3/8"	70.08
PIPE TYPES	COPPER	3/4"	107.92

REFRIGERANT LINE FITTING SCHEDULE				
CATAGORY	DESCRIPTION	Size	Count	
ELBOW - GENERIC	ELBOW - GENERIC: STANDARD/HVAC	3/4"ø-3/4"ø	24	
ELBOW - GENERIC	ELBOW - GENERIC: STANDARD/HVAC	3/8"ø-3/8"ø	20	
TEE - GENERIC	TEE - GENERIC: STANDARD	3/4"ø-3/4"ø-3/ 4"ø	2	
TEE - GENERIC	TEE - GENERIC: STANDARD	3/8"ø-3/8"ø-3/ 8"ø	2	
TRANSITION - GENERIC	TRANSITION - GENERIC: STANDARD	3/4"ø-1/2"ø	4	
TRANSITION - GENERIC	TRANSITION - GENERIC: STANDARD	3/4"ø-5/8"ø	3	
TRANSITION - GENERIC	TRANSITION - GENERIC: STANDARD	3/8"ø-1/4"ø	1	

MECHANICAL EQUIPMENT SCHEDULE			
CATAGORY	DESCRIPTION	COUNT	
AIR HANDLING UNIT	AIR HANDLING UNIT: WALL MOUNTED	3	
CONDENSER	CONDENSER: OUT DOOR	1	
EXHAUST FAN	EXHAUST FAN: 75 CFM	2	
	HOOD-WALL: VENT	1	

DUCT FITTING SCHEDULE							
CATAGORY DESCRIPTION COUNT							
ROUND TRANSITION - ANGLE	45 DEGREE	5					

DUCT ACCESSORY SCHEDULE						
CATAGORY DESCRIPTION COUNT						
ROOF VENT	3" DIAMETER	3				

FLEX DUCT SCHEDULE								
DESCRIPTION	DESCRIPTION	LENGTH	DIAMETER	COUNT				
FLEX DUCT ROUND	FLEX-ROUND	17.37	4"	3				
GRAND TOTAL: 3		17.37						



KEY PLAN

NO.	DESCRIPTION	DATE

NOTE:

LEGEND:

PROJECT

272-MAGNOLIA-997-2Bd2Ba COOP-550


DRAWING NAME

HVAC PLAN

CLIENT NAME:	Owner
PROJECT NUMBER:	15_0001
DATE:	5/12/2025 7:01:26 AM
DESIGNED BY:	Designer
DRAWN BY:	Author
CHECKED BY:	Checker

M101

SCALE: As indicated

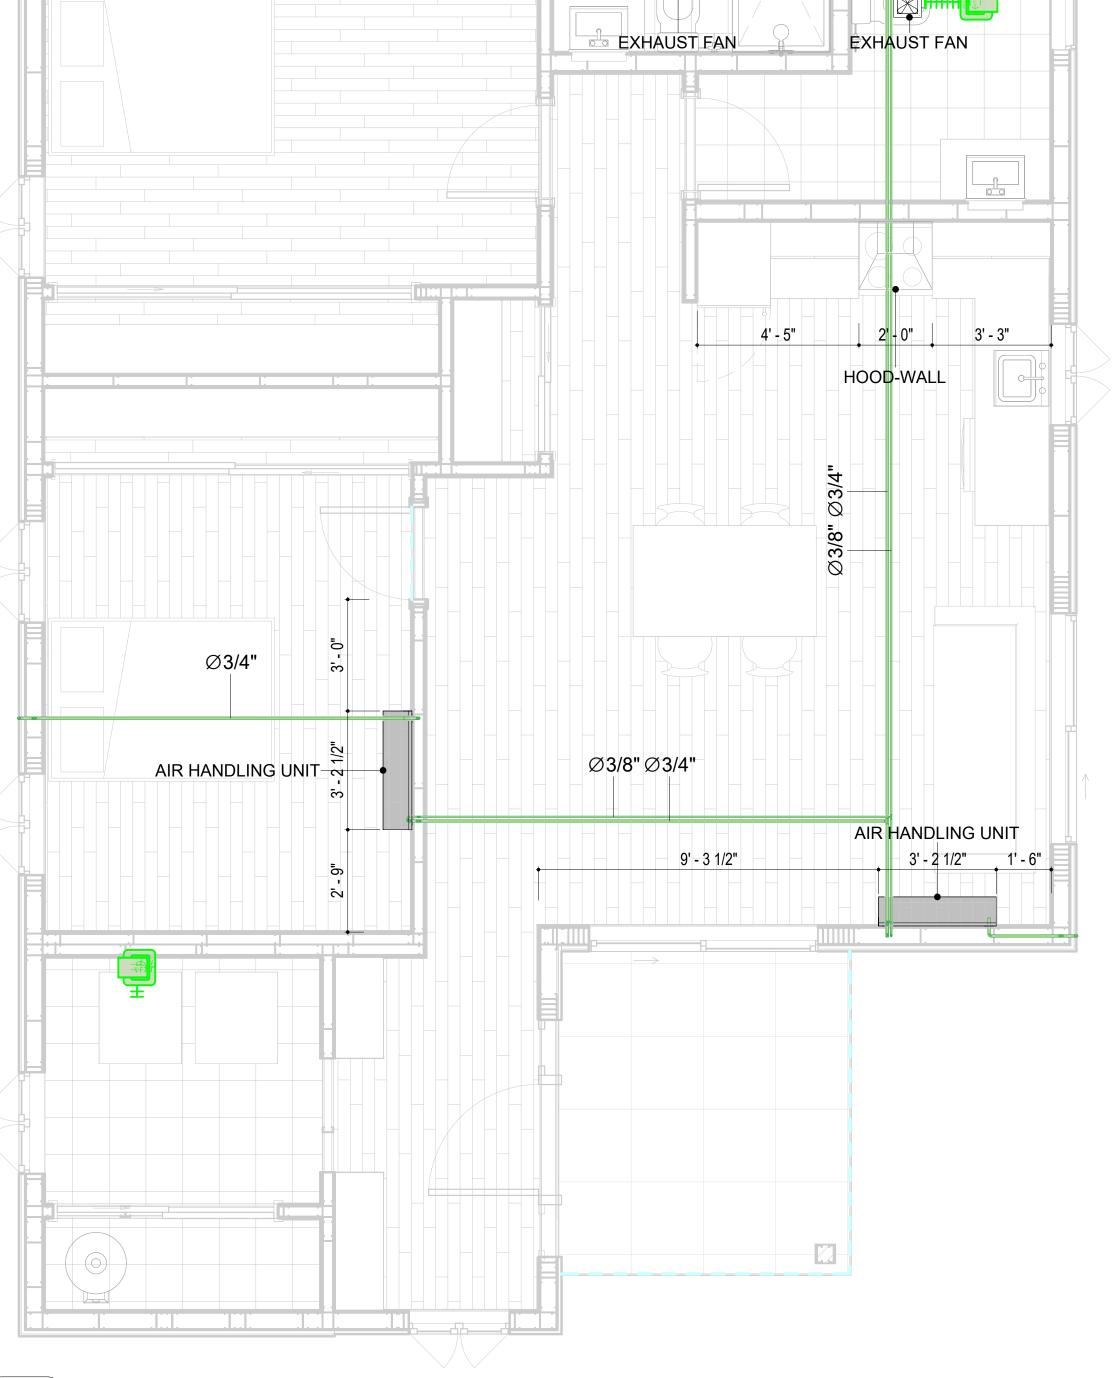

Ø3/8" Ø3/4"

1' - 2" 9" 3' - 6 1/2"

3' - 0 1/2" **9**+++++ 3' - 9 1/2"

3' - 2 1/2"

AIR HANDLING UNIT

10' - 1 1/2"

HVAC PLAN

3/8" = 1'-0"

ELECTRICAL NOTES

- 1. THIS DRAWING DEPICTS THE ELECTRICAL SYSTEM FOR THE272-MAGNOLIA-997-2Bd2Ba COOP-550. IT PROVIDES A VISUAL REPRESENTATION OF THE ELECTRICAL LAYOUT AND COMPONENTS, INCLUDING POWER DISTRIBUTION, LIGHTING, AND CONTROL SYSTEMS.
- 2. THE ELECTRICAL SYSTEM IS DESIGNED TO MEET THE SPECIFIC REQUIREMENTS OF THE BUILDING, INCLUDING POWER DISTRIBUTION, LIGHTING, AND SPECIALIZED ELECTRICAL EQUIPMENT NEEDS, AS PER THE PROJECT SPECIFICATIONS AND APPLICABLE CODES AND STANDARDS.
- 3. THE ELECTRICAL SYSTEM INSTALLATION SHALL COMPLY WITH THE LATEST EDITION OF THE NATIONAL ELECTRICAL CODE (NEC), INTERNATIONAL BUILDING CODE (IBC), AND ALL OTHER APPLICABLE LOCAL, STATE, AND NATIONAL CODES AND REGULATIONS.
- 4. LOCATIONS AS NEEDED, DEVICES ARE SHOWN ON PLANS IN APPROXIMATE IDEAL LOCATIONS, UNLESS SPECIFICALLY DIMMENSIONED.
- 5. OPEN WALLS AS NEEDED TO ALLOW FOR NEW ELECTRICAL INSTALLATIONS.
- 6. LABEL ALL CIRCUITS ON JUNCTION BOXES, RECEPTACLES, DATA, SMOKE DETECTOR, AND EQUIPMENT IN PANEL BOX.
- 7. INSTALL RACEWAY AS NEEDED FOR DDC, ACCESS CONTROL, LOW VOLTAGE WIRING & DATA.
- 8. RELABEL POWER, DATA & FIRE ALARM FOR ROOM #CHANGES.
- VERIFY ALL CIRCUITS LABELED ON PRINT ARE CORRECT BEFORE WORKING ON THEM.
 NOTE ON SITE PLAN ALL CHANGES OR MISSING DETAIL TO BE INCORPORATED INTO THE MASTER PLAN.
- 11. DRAWINGS ARE DIAGRAMMATIC ONLY FOR THE PURPOSE OF SHOWING FIXTURE AND OUTLET LOCATIONS.
- 12. ELECTRICAL CONTRACTOR TO VERIFY SERVICE SIZE BY CALCULATION BASED UPON ACTUAL NAME PLATE RATINGS OF SELECTED FOLLIPMENT
- PLATE RATINGS OF SELECTED EQUIPMENT.

 13. VERIEV LOCATION OF SERVICE ENTRANCE WITH POWER COMPANY PROVIDE LIFER GROUND IN
- 13. VERIFY LOCATION OF SERVICE ENTRANCE WITH POWER COMPANY. PROVIDE UFER GROUND IN BUILDING FOUNDATION AT SERVICE ENTRANCE LOCATION.
- 14. PROVIDE A MIN. OF 20 FEET OF ONE *4 BARE COPPER UFER WIRE EMBEDDED IN CONCRETE FOOTING AT THE SERVICE ENTRANCE LOCATION WHERE APPROVED BY LOCAL SERVICE PROVIDER.
- 15. PROVIDE WATERPROOF FIXTURES IN ALL HIGH MOISTURE AREAS (EXTERIOR, SHOWER AND TUB CEILINGS ETC.)
- 16. PROVIDE DEDICATED CIRCUITS TO EACH BATH, DEN, FAMILY ROOM, BEDROOM, LOFT, KITCHEN
- REFRIGERATOR, KITCHEN FREEZER DISHWASHER, AND ANY AREA/ITEM SPECIFIED BY OWNER.

 17. INCANDESCENT FIXTURES WITH OPEN OR PARTIALLY ENCLOSED LAMPS, PENDANT FIXTURES, AND
- LAMP HOLDERS ARE NOT PERMITTED IN CLOSETS.

 18. ALL WORKMANSHIP AND MATERIALS TO CONFORM WITH THE 2015 IRC.
- 19. PROVIDE A MIN. OF 20 FEET OF ONE *4 BARE COPPER UFER WIRE EMBEDDED IN CONCRETE FOOTING AT THE SERVICE ENTRANCE LOCATION WHERE APPROVED BY LOCAL SERVICE PROVIDER.
- 20. PROVIDE A BONDING CONDUCTOR CONSISTING OF A MINIMUM OF ONE *4 BARE COPPER WIRE CONNECTING THE BUILDING'S METAL WATER PIPING SYSTEM TO THE SERVICE EQUIPMENT ENCLOSURE GROUNDING.

MAIN PANEL CALCS

ELECTRICAL CALCS	
LIGHT AND OUTLETS 997 @ 3W	2,991 W
3 APPLIANCE CIRCUITS	4,500 W
DRYER	2,000 W
WASHER	2,000 W
RANGE	5,000 W
WATER HEATER	5,000 W
REFRIG.	1,800 W
DISHWASHER & DISPOSAL	3000 W
TOTAL	26,291 W
FRIST 10,000 @ 100% REMAINDER @ 40% MINI. SPLIT UNITS	10,000 W 6,516W 10,000 W
TOTAL	26,516W

26,516 W DIVIDED BY 240V = 111 AMPS TOTAL

(USE 200 AMP SERVICE)

ELECTRICAL ABBREVIATIONS LIST

1P	1 POLE (2P, 3P, 4P, ETC.)	CTR	CENTER	HT	HEIGHT
A	AMPERE	CU	COPPER	HTG	HEATING
AC	ABOVE COUNTER OR AIR CONDITIONER	DCP	DOMESTIC WATER CIRCULATING PUMP	HTR	HEATER
ACLG	ABOVE CEILING	DEPT	DEPARTMENT	HV	HIGH VOLTAGE
ADO	AUTOMATIC DOOR OPENER	DET	DETAIL	HVAC	HEATING, VENTILATING AND AIR
				I .	
AF	AMP FRAME	DIA	DIAMETER	CONDITIONING	CONDITIONING
AFF	ABOVE FINISHED FLOOR	DISC	DISCONNECT	HWP	HYDRONIC WATER PUMP
AFG	ABOVE FINISHED GRADE	DIST	DISTRIBUTION	IC	INTERRUPTING CAPACITY
AFI	ARC FAULT CIRCUIT INTERRUPTER	DN	DOWN	IG	ISOLATED GROUND
AHU	AIR HANDLING UNIT	DPR	DAMPER	IMC	INTERMEDIATE METAL CONDUIT
AL	ALUMINUM	DS	SAFETY DISCONNECT SWITCH	INCAND	INCANDESCENT
ALT	ALTERNATE	DT	DOUBLE THROW	IR	INFRARED
AMP	AMPERE	DWG	DRAWING	I/W	INTERLOCK WITH
AMPL			DIRECT DIGITAL CONTROL	1	
	AMPLIFIER	DDC		J-BOX	JUNCTION BOX
ANNUN	ANNUNCIATOR APPROX APPROXIMATELY		ELECTRICAL CONTRACTOR	KV	KILOVOLT
AQ-STAT	AQUASTAT	ELEC	ELECTRIC, ELECTRICAL	KVA	KILOVOLT-AMPERE
ARCH	ARCHITECT, ARCHITECTURAL	ELEV	ELEVATOR	KVAR	KILOVOLT-AMPERE REACTIVE
AS	AMP SWITCH	EM	EMERGENCY	KW	KILOWATT
AT	AMP TRIP	EMS	ENERGY MANAGEMENT SYSTEM	KWH	KILOWATT HOUR
ATS	AUTOMATIC TRANSFER SWITCH	EMT	ELECTRICAL METALLIC TUBING	LOC	LOCATE OR LOCATION
AUTO	AUTOMATIC	EP	ELECTRIC PNEUMATIC	LT	LIGHT
AUX	AUXILIARY	EQUIP	EQUIPMENT	LTG	LIGHTING
AV	AUDIO VISUAL	EWC	ELECTRIC WATER COOLER	LTNG	LIGHTNING
				I .	
AWG	AMERICAN WIRE GAUGE	EXIST	EXISTING	LV	LOW VOLTAGE
BATT	BATTERY	EXH	EXHAUST	MAX	MAXIMUM
BD	BOARD	EXP	EXPLOSION PROOF	MAG.S	MAGNETIC STARTER
BLDG	BUILDING	FA	FIRE ALARM	M/C	MOMENTARY CONTACT
BMS	BUILDING MANAGEMENT SYSTEM	FABP	FIRE ALARM BOOSTER POWER	MC	MECHANICAL CONTRACTOR
C	CONDUIT	SUPPLY PANEL	SUPPLY PANEL	MCB	MAIN CIRCUIT BREAKER
CAB	CABINET	FACP	FIRE ALARM CONTROL PANEL	MCC	MOTOR CONTROL CENTER
CAT	CATALOG	FCU	FAN COIL UNIT	MDC	MAIN DISTRIBUTION CENTER
CATV	CABLE TELEVISION	FIXT	FIXTURE	MDP	MAIN DISTRIBUTION PANEL
CB	CIRCUIT BREAKER	FLR	FLOOR	MFR	MANUFACTURERMAIN FUSED
				IVIFR	
CCTV	CLOSED CIRCUIT TELEVISION	FLUOR	FLUORESCENT		DISCONNECT SWITCH
CKT	CIRCUIT	FU	FUSE	MH	MANHOLE
CLG	CEILING	FUDS	FUSED SAFETY DISCONNECT SWITCH	MIC	MICROPHONE
COMB	COMBINATION	GA	GAUGE	MIN	MINIMUM
CMPR	COMPRESSOR	GAL	GALLON	MISC	MISCELLANEOUS
CONN	CONNECTION	GALV	GALVANIZED	MLO	MAIN LUGS ONLY
CONST	CONSTRUCTION	GC	GENERAL CONTRACTOR	MMS	MANUAL MOTOR STARTER
CONT	CONTINUATION OR CONTINUOUS	GEN	GENERATOR	MOA	MULTIOUTLET ASSEMBLY
CONTR	CONTRACTOR	GFI	GROUND FAULT CIRCUIT INTERRUPTER	MSP	MOTOR STARTER PANELBOARD
CONV	CONVECTOR	GFP	GROUND FAULT PROTECTOR	MSBD	MAIN SWITCHBOARD
CP	CIRCULATING PUMP	GND	GROUND	MT	MOUNT
CRT	CATHODE-RAY TUBE	GRS	GALVANIZED RIGID STEEL (CONDUIT)	MT.C	EMPTY CONDUIT
CT	CURRENT TRANSFORMER	GYP BD	GYPSUM BOARD	UL	UNDERWRITERS LABORATORIES

Branch Panel:

Location:
Supply From:
Mounting: Recessed
Enclosure: Type 1

Volts: 120/240 Single
Phases: 1
Wires: 3

A.I.C. Rating:
Mains Type:
Mains Rating: 200 A
MCB Rating: 1 A

Notes:

ircuit Numb er	Circuit Description	Number of Elements	Rating	Length	Wire Size	A		E	3	Wire Size	Length	Rating	Number of Elements	Circuit Description	Circuit Numb er
1	BATH 2 GFCI	7	20 A	37' - 9 9/32"	1-#12, 1-#12, 1-#12	576 VA	336 VA			1-#12, 1-#12, 1-#12	45' - 0 3/8"	20 A	4	BATH 1 GFCI	2
3	BED 1 LIGHT	9	15 A	53' - 10 1/2"	1-#14, 1-#14, 1-#14			568 VA	396 VA	1-#14, 1-#14, 1-#14	34' - 1 13/32"	15 A	8	KITCHEN LIGHT	4
5	BED 2 LIGHT	8	15 A	37' - 4 1/8"	1-#14, 1-#14, 1-#14	568 VA	240 VA			1-#14, 1-#14, 1-#14	24' - 9 7/8"	15 A	5	LIVING LIGHT	6
7	ENTRY & LAUNDRY LIGHT	6	15 A	31' - 6 9/16"	1-#14, 1-#14, 1-#14			240 VA	200 VA	1-#14, 1-#14, 1-#14	24' - 9 15/32"	15 A	2	OUTDOOR LIGHT	8
9	BED 1 RECEPTACLE	4	20 A	63' - 5 5/16"	1-#12, 1-#12, 1-#12	720 VA	720 VA			1-#12, 1-#12, 1-#12	46' - 4 1/4"	20 A	4	BED 2 RECEPTACLE	10
11	LIVING RECEPTACLE	4	20 A	35' - 11 15/16"	1-#12, 1-#12, 1-#12			720 VA	2500 VA	2-#10, 1-#10, 1-#10	30' - 11 15/16"	30 A	1	DRYER	12
13	WASHER	1	20 A	27' - 7 13/32"	1-#12, 1-#12, 1-#12	1200 VA	2500 VA								14
15	OUTDOOR RECEPTACLE	4	20 A	58' - 7 21/32"	1-#12, 1-#12, 1-#12			720 VA	2500 VA	2-#6, 1-#6, 1-#10	40' - 3 11/32"	60 A	1	CONDENSER	16
17	WATER HEATER	1	30 A	44' - 3 5/16"	2-#10, 1-#10, 1-#10	2250 VA	2500 VA								18
19								2250 VA	180 VA	1-#12, 1-#12, 1-#12	24' - 3 1/8"	20 A	1	OVENHOOD	20
21	KITCHEN GFCI	4	20 A	31' - 10"	1-#12, 1-#12, 1-#12	720 VA	1800 VA			1-#12, 1-#12, 1-#12	34' - 0 1/2"	20 A	1	REFRIGERATOR	22
23	RANGE	1	50 A	30' - 0 1/4"	2-#8, 1-#8, 1-#10			2500 VA	1200 VA	1-#12, 1-#12, 1-#12	25' - 11 1/4"	20 A	1	DISHWASHER	24
25						2500 VA									26
						16627	7 VA	1396	3 VA						
						139	Α	110	6 A						

Legend:

Load Classification	Connected Load	Demand Factor	Estimated Demand	Panel	Totals
LIGHTING - DWELLING UNIT	500 VA	100.00%	500 VA		
OTHER	1904 VA	100.00%	1904 VA	Total Conn. Load:	30590 VA
RECEPTACLE	6720 VA	100.00%	6720 VA	Total Est. Demand:	29590 VA
LIGHTING	200 VA	100.00%	200 VA	Total Conn.:	127 A
CONDENSER	5000 VA	100.00%	5000 VA	Total Est. Demand:	123 A
WATER HEATER	4500 VA	100.00%	4500 VA		
RANGE	5000 VA	80.00%	4000 VA		
DRYER	5000 VA	100.00%	5000 VA		
REFRIGERATOR	1800 VA	100.00%	1800 VA		



KEY PLAN

NO. DESCRIPTION DATE

NOTE:

LEGEND:

PROJECT

272-MAGNOLIA-997-2Bd2Ba COOP-550

DRAWING NAME

SCHEDULE

CLIENT NAME:	Owner
PROJECT NUMBER:	0420_14
DATE:	5/12/2025 5:19:19 PM
DESIGNED BY:	Designer
DRAWN BY:	Author
CHECKED BY:	Checker

E101

SCALE: 1/4" = 1'-0"

© [2024] [FrameUpNow] . All rights reserved

ELECTRICAL NOTE

- A. PROVIDE INTERCONNECTED SMOKE ALARMS IN EACH SLEEPING ROOMS, OUTSIDE EACH SLEEPING ROOM, ON EACH STORY, IN THE HALL OR ADJACENT ROOM LUHERE THE CEILING HEIGHT OF A ROOM OPEN TO THE HALL EXCEEDS THE HALL BY 24'. SMOKE ALARMS SHALL BE PERMANENTLY HARD WIRED WITH BATTERY BACKUP.
- B. RECEPTACLE OUTLETS FOR RANGES AND CLOTHES DRYERS SHALL BE A THREE POLE WITH GROUND TYPE. FOUR WIRE GROUNDING-TYPE FLEXIBLE CORDS WILL BE REQUIRED FOR CONNECTION OF RANGES AND CLOTHES DRYERS. THE BONDING JUMPER SHALL NOT BE CONNECTED BETWEEN NEUTRAL TERMINAL AND THE FRAME OF THE APPLIANCE.
- C. TWO OR MORE 20 AMP SMALL APPLIANCE CIRCUITS SHALL BE PROVIDED TO SERVE THE KITCHEN, BREAKFAST NOOK, AND DINING ROOM. SUCH CIRCUITS SHALL HAVE NO OTHER OUTLETS.
- D. AT LEAST ONE 20 AMP BRANCH CIRCUIT SHALL BE PROVIDED TO SERVICE THE LAUNDRY ROOM. THIS CIRCUIT SHALL HAVE NO OTHER OUTLETS.
- E. ALL RECEPTACLES WITH IN 6' OF A WET BAR SINK OR KITCHEN SINK TO SERVE COUNTER TOP SURFACES MUST BE GFCI. ON KITCHEN COUNTERS 12' OR WIDER NO POINT ALONG THE WALL SHALL BE MORE THAN 2' FROM A RECEPTACLE. ALL RECEPTACLES WITH IN 6' OF KITCHEN SINK MUST BE GFCI. AT LEAST ONE GFCI RECEPTACLE SHALL
- BE INSTALLED IN THE BATHROOM ADJACENT TO EACH BASIN.

 F. FIXTURES INCLUDING CEILING FANS THAT ARE LOCATED IN DAMP LOCATIONS SHALL BE LISTED TO BE SUITABLE FOR
- SUCH LOCATIONS PER 2012 IRC
- G. PROVIDE ONE (1) SWITCHED OUTLET @ ALL BEDROOMS AND DEN
 H. CEILING FANS NOT EXCEEDING 35 LBS. (WITH OR WITHOUT ACCESSORIES MAY BE SUPPORTED BY OUTLET BOXES PROVIDED THE OUTLET BOXES ARE IDENTIFIED FOR SUCH USE PER 2012 IRC
- I. ELECTRICAL OUTLET BOXES ON OPPOSITE SIDES OF FIRE RATED WALLS SHALL BE SEPARATED BY A HORIZONTAL DISTANCE OF NOT LESS THAN 24".
- J. OUTLET BOXES IN THE WALLS BETWEEN THE GARAGE AND DWELLING SHALL BE METAL OR U.L. APPROVED FIRE RESISTIVE PLASTIC. BOXES IN GARAGE CEILING SHALL BE METAL.
- K. ALL BRANCH CIRCUITS THAT SUPPLY 120 VOLTS SINGLE PHASE 15 AND 20 AMPS RECEPTACLE OUTLETS INSTALLED IN THE DWELLING SHALL BE PROTECTED BY AN ARC FAULT CIRCUIT INTERRUPTER, EXCEPT GFCI RECEPTICLES.

NOTE:

A. RECEPTACLES MUST BE PROVIDED IN HALLWAYS 10'-0" OR MORE IN LENGTH. FOR A ONE FAMILY DWELLINGS AND EACH OF A TWO FAMILY DWELLING THAT IS AT GRADE LEVEL, AT LEAST ONE WP-GFCI RECEPTACLE OUTLET ACCESSIBLE AT GRADE LEVEL AND NOT MORE THAN 6'-6" ABOVE GRADE SHALL BE INSTALLED AT THE FRONT AND BACK OF THE DWELLING.

NOTE: APPLIANCE DISCONNECT

E4001.5 GROUNDING OF ENCLOSURES.

METAL ENCLOSURES FOR SWITCHES OR CIRCUIT BREAKERS SHALL BE CONNECTED TO AN

EQUIPMENT GROUNDING CONDUCTOR.

METAL ENCLOSURES FOR SWITCHES OR CIRCUIT BREAKERS USED AS SERVICE

EQUIPMENT SHALL COMPLY WITH THE PROVISIONS OF SECTION E3609.4. WHERE


NONMETALLIC ENCLOSURES ARE USED WITH METAL RACEWAYS OR METAL-ARMORED CABLES, PROVISIONS SHALL BE MADE FOR CONNECTING THE EQUIPMENT GROUNDING

CONDUCTOR.


NONMETALLIC BOXES FOR SWITCHES SHALL BE INSTALLED WITH A WIRING METHOD THAT

PROVIDES OR INCLUDES AN EQUIPMENT GROUNDING CONDUCTOR. (404.12)

ELECTRI	CAL LEGEND
	Electrical Lights With Fan
0	Waterproof Recessed Can Light
	Pendant Light
0	Recessed Can Light
- Ø	Wall Lamp
	Standalone linear
⊬1 0	Single Switch
₩.	Three way Switch
₩.	Fan Switch
	Duplex Receptacle
	Triplex Receptacle
⊕ □GFCI	GFCI Receptacle
	Exhaust Fan
•	Smoke and heat detector

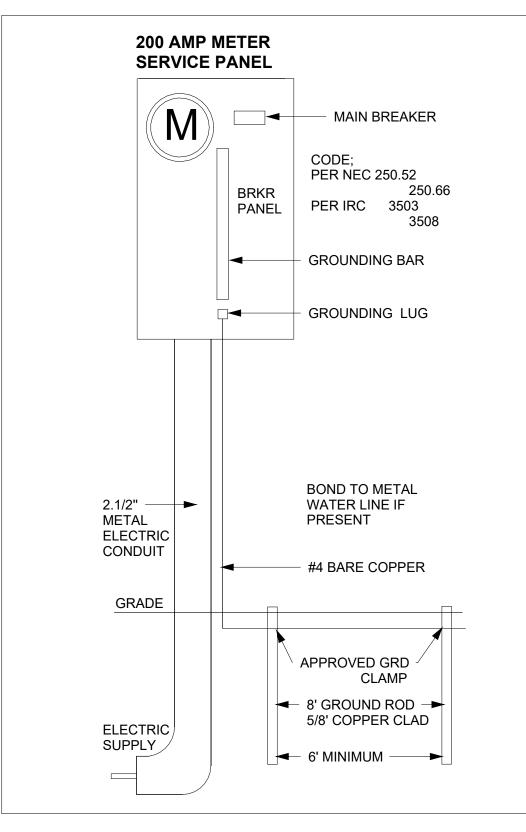



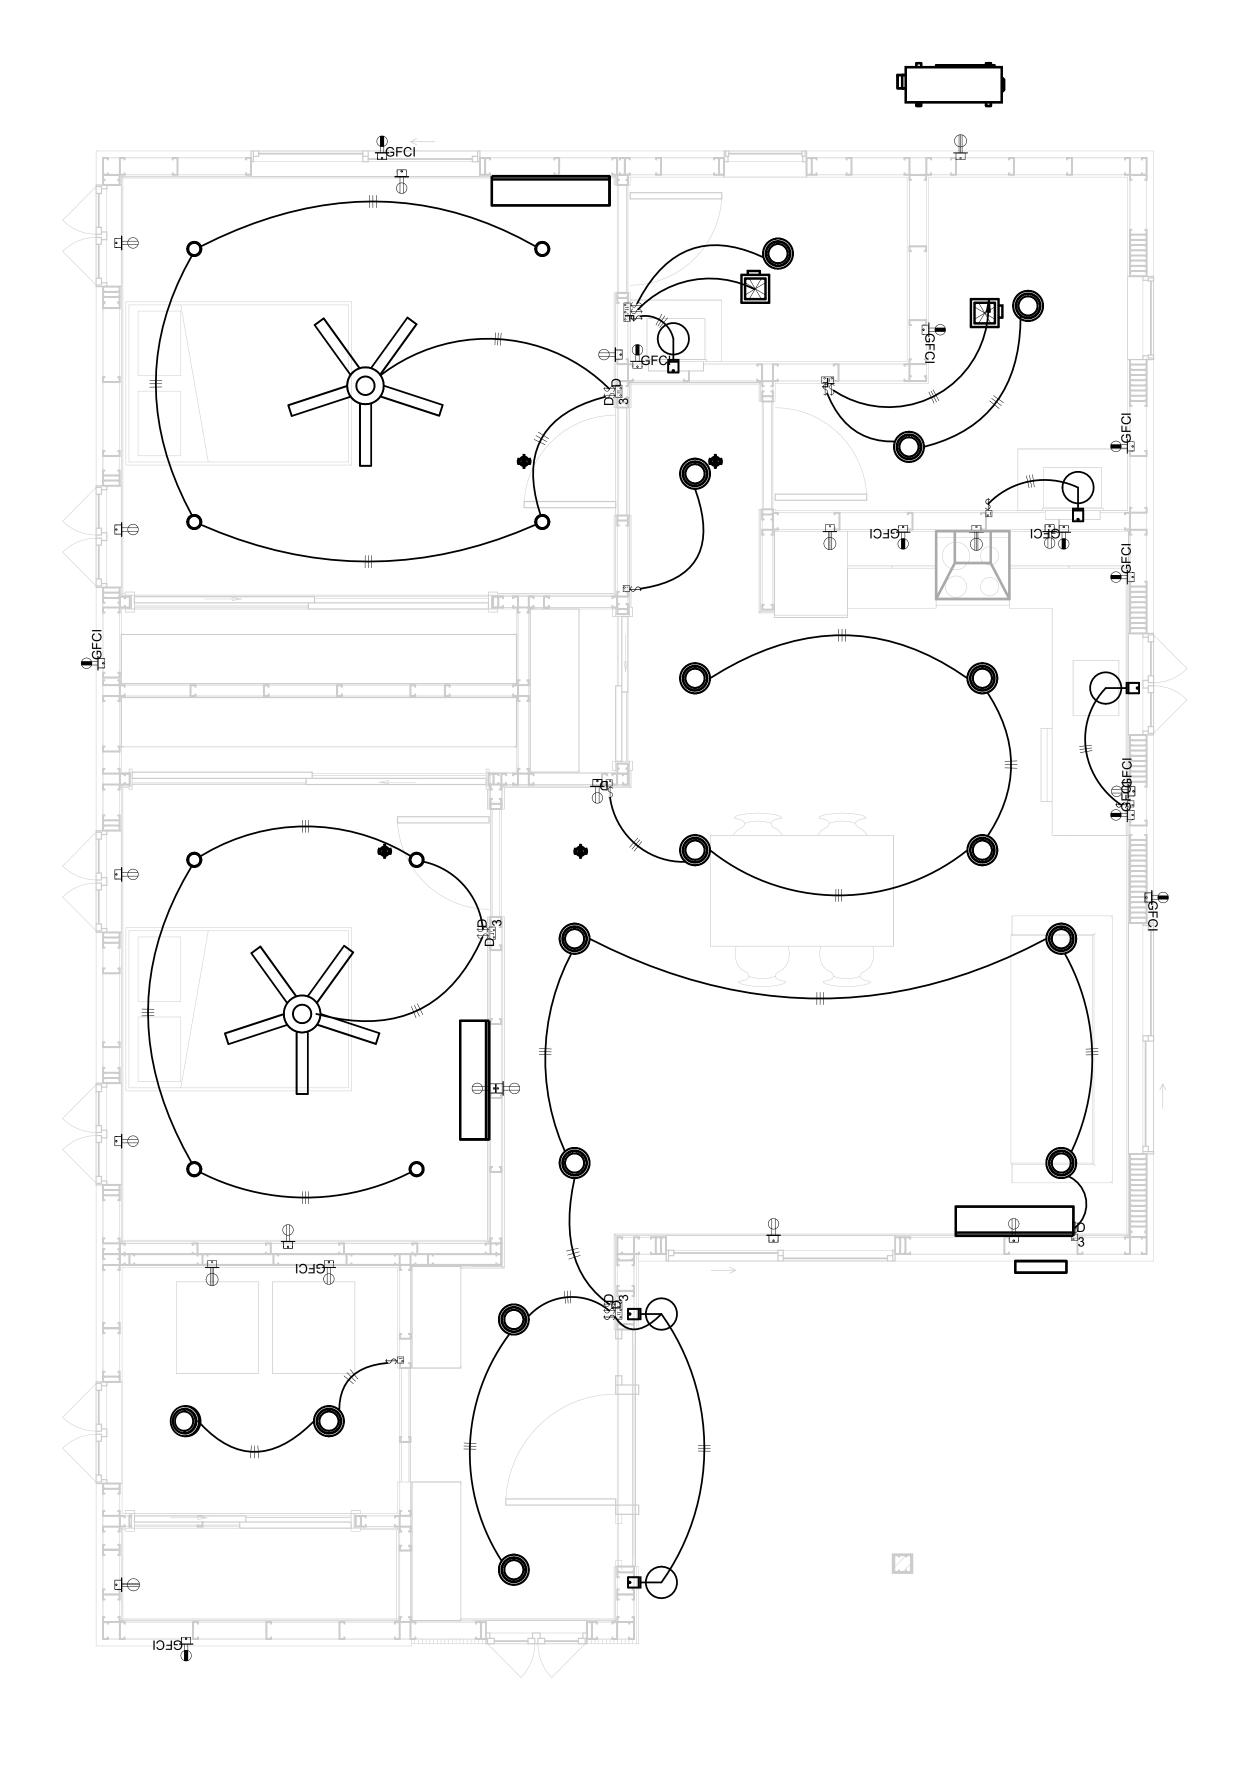

1 - Lighting 3/8" = 1'-0"



KEY PLAN

NO.	DESCRIPTION	DATE

NOTE:

LEGEND:

PROJECT

272-MAGNOLIA-997-2Bd2Ba COOP-550

DRAWING NAME


LIGHTING

CLIENT NAME:	Owner
PROJECT NUMBER:	0420_14
DATE:	5/12/2025 5:19:21 PM
DESIGNED BY:	Designer
DRAWN BY:	Author
CHECKED BY:	Checker


E102

NOTES: CONDUIT, CABLE AND WIRING


- Use Metalic Conduits (IMC) for cables running under concrete slabs.
 Use IMC for circuits with high voltage appliances (240 volts and above)
 For circuits with 120 volts consider using EMT or PVC conduits if needed.
 For Low voltage applications up to 50 volts consider using non metalic conduits.
 All conduits to be used in the project must conform to the latest National Electrical Code (NEC),
- 6. All wiring and cables to be used in the project must also conform to the latest National Electrical Code (NEC), 2015.
 7. All cables and wires used should be rated for their respective loading and should be gauged and conform to the NEC.

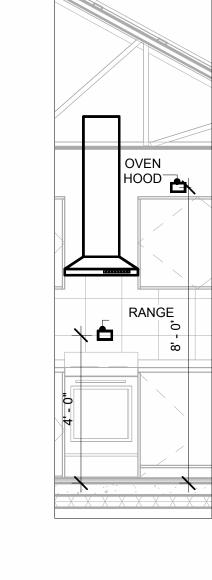


RANGE & OVENHOOD 3/8" = 1'-0"

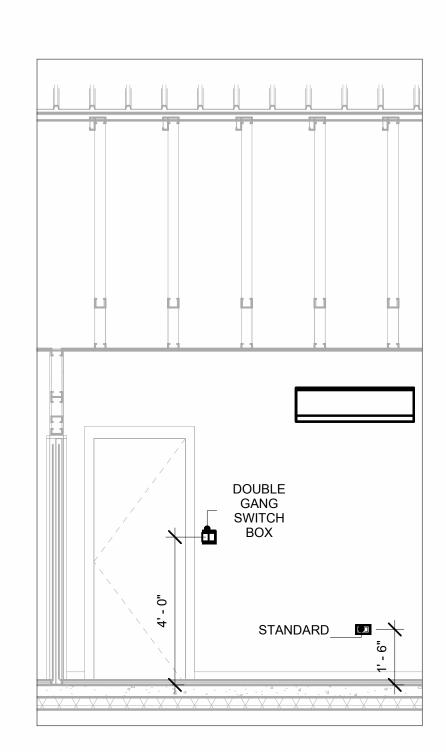

SWITCH & RECEPTACLE

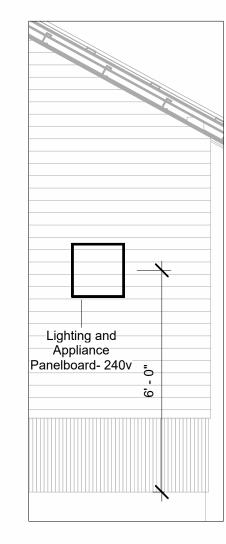


PANEL 3/8" = 1'-0"

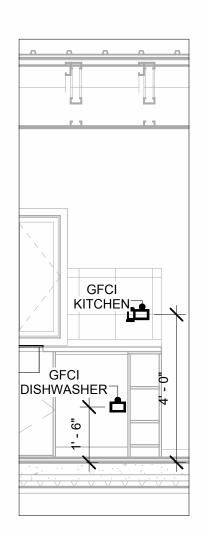

GFCI & DISHWASHER 3/8" = 1'-0"



KEY PLAN

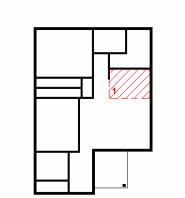

NO.	DESCRIPTION	DATE

NOTE:

LEGEND:

PROJECT

272-MAGNOLIA-997-2Bd2Ba COOP-550


DRAWING NAME

POWER

CLIENT NAME:	Owner
PROJECT NUMBER:	0420_14
DATE:	5/12/2025 5:19:46 PM
DESIGNED BY:	Designer
DRAWN BY:	Author
CHECKED BY:	Checker

E103

SCALE: As indicated

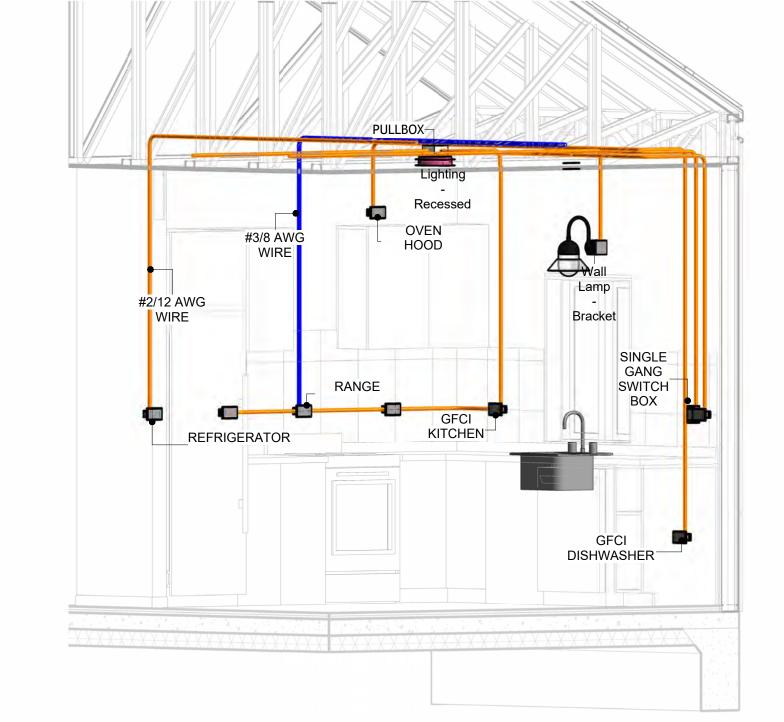

3D-KITCHEN

NOTES: LIGHT

- 1. LIGHT FIXTURES AND LUMINARIES SHALL CONFORM TO THE NEC, THE IRC AND LOCAL SAFETY & BUILDING CODE.
- 2. ALL LIGHTING FIXTURES SHOULD CONFORM TO THE DESIGN ELECTRICAL LOAD AND SHALL BE PROPERLY WIRED AND MOUNTED BY QUALIFIED ELECTRICIAN FOLLOWING MANUFACTURERS SPECIFICATIONS.
- 3. CEILING FANS AND FANS WITH LIGHT WITH WEIGHT EXCEEDING 35 LBS SHOULD BE PROVIDED WITH STRUCTURAL BACKING FOR SUPPORT AND SHALL BE FIXED AS PER MANUFACTURERS SPECIFICATIONS.
- 4. EXTERIOR LIGHTS SHALL CONFORM TO LOCAL BUILDING CODE AND GUIDELINES.

NOTES: SWITCH JUNCTION BOX


- THE MINIMUM SIZE OF JUCTION BOX TO BE USED IS 2"X4"X(1.5" OR 3.5" DEEP) THIS ARE TO BE USED FOR SINGLE GANG SWITCH OR OUTLETS.
- 2. FOR DOUBLE GANG (2 GANG) OUTLETS AND SWITCHS THE MINIMUM SIZE OF THE
- JUCTION BOX TO BE PROVIDED SHALL NOT BE LESS THAN 4"X4"X(1.5" OR 3.5" DEEP)
- 3. FOR THREE GANG (3 GANG) OUTLETS AND SWITCHS THE MINIMUM SIZE OF THE JUĆTION BOX SHALL NOT BE LESS THAN 6"X4"X(1.5" OR 3.5" DEEP).

FITTING SCHEDULE(PULL BOX)			
FAMILY COUNT DESCRIPTIO			
PULLBOX1 30 #1/4 PULLBOX			

ELECTRICAL FIXTURE SCHEDULE (SWITCH BOX)			
TYPE COUNT			
DOUBLE GANG SWITCH BOX	3		
SINGLE GANG SWITCH BOX	6		
TRIPLE GANG SWITCH BOX	2		

LIGHTING DEVICE		
TYPE	COUNT	
DIMMER	4	
FAN SWITCH	2	
SINGLE POLE	8	
THREE WAY WITH DIMMER	4	

LIGHTING FIXTURE				
LIGHTING FIXTURE TYPE	VOLTAGE	ELECTRICAL LOAD	COUNT	
ELECTRICAL_LIGHTS_FAN-LIGHT1	120 V/1-100 VA- 120 V/1-100 VA	200 A, 120 V/240 V, SINGLE PHASE, 3 WIRES	2	
LIGHTING - RECESSED	120 V/1-60 VA	200 A, 120 V/240 V, SINGLE PHASE, 3 WIRES	16	
SASSO 100 ROUND WALLWASHER TRIM	120 V/1-28 VA	200 A, 120 V/240 V, SINGLE PHASE, 3 WIRES	8	
WALL LAMP - BRACKET	120 V/1-100 VA	200 A, 120 V/240 V, SINGLE PHASE, 3 WIRES	5	

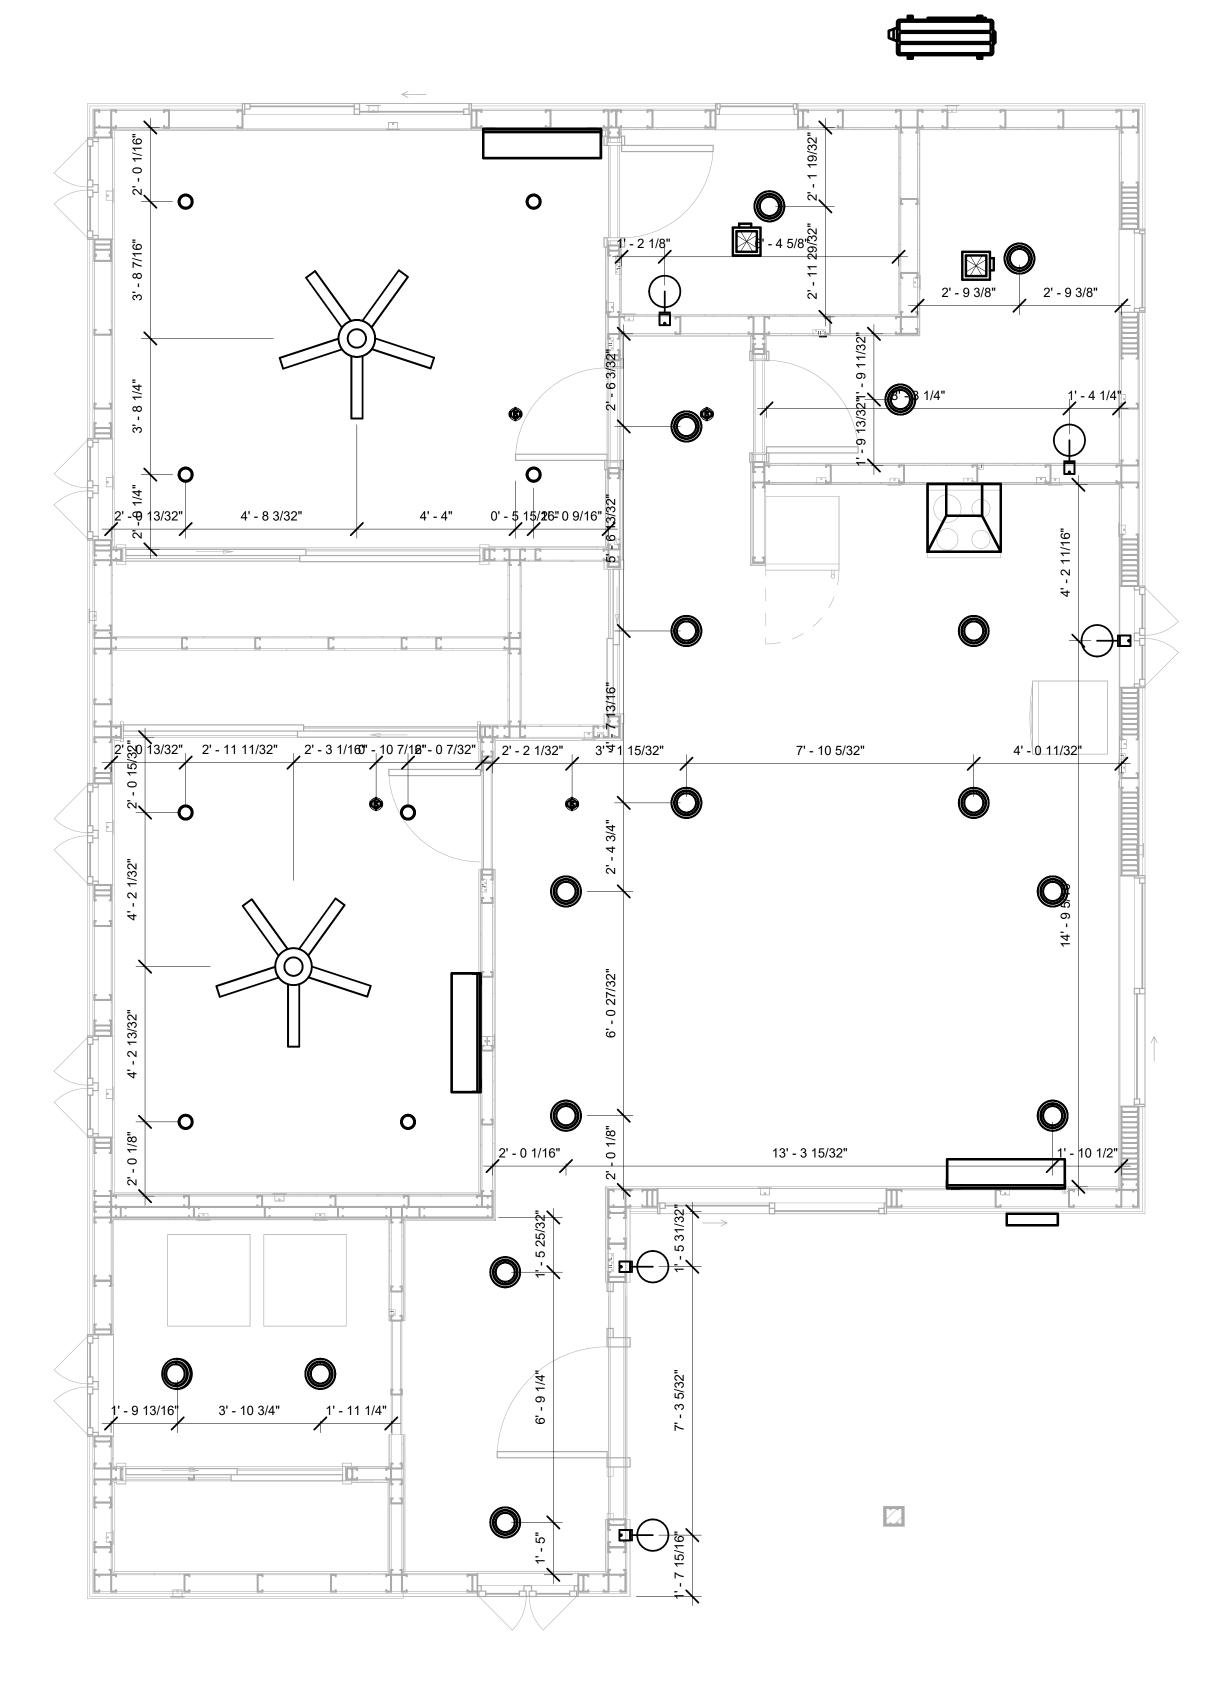

1 DIMENSION FOR LIGHT FIXTURES
3/8" = 1'-0"



KEY PLAN

NOTE:

LEGEND:

PROJECT

272-MAGNOLIA-997-2Bd2Ba COOP-550

DRAWING NAME

DIMENSION PLAN FOR LIGHT FIXTURES

CLIENT NAME:	Owner
PROJECT NUMBER:	0420_14
DATE:	5/12/2025 5:19:48 PM
DESIGNED BY:	Designer
DRAWN BY:	Author
CHECKED BY:	Checker


E104

NOTES;

- 1. VERIFY EQUIPMENT PLUG CONFIGURATION BEFORE PURCHASING RECEPTACLES
- 2. FOR ALL EQUIPMENT.
- 3. COORDINATE EXACT LOCATION OF LIGHT FIXTURES, WALL SWITCHES, RECEPTACLES AND OTHER DEVICES WITH ARCHITECTURAL DRAWINGS.
- 4. USE METALLIC JUNCTION BOX WITH THE GFCI RECEPTACLES, WITH HIGHT VOLTAGE.

ELECTRICAL FIXTURE SCHEDULE (RECEPTACLE)		
TYPE	COUNT	
CONDENSER	1	
DRYER	1	
GFCI BATH ROOM	3	
GFCI DISHWASHER	1	
GFCI KITCHEN	4	
GFCI OUT DOOR	4	
GFCI WASHER	1	
OVEN HOOD	1	
RANGE	1	
REFRIGERATOR	1	
STANDARD	12	
WATER HEATER	1	

ELECTRICAL OUTLET SCHEDULE			
TYPE	CIRCUIT NUMBER	ELECTRICAL DATA	COUNT
GFCI BATH ROOM	1	120 V/1-180 VA	2
GFCI BATH ROOM	2	120 V/1-180 VA	1
STANDARD	9	120 V/1-180 VA	4
STANDARD	10	120 V/1-180 VA	4
STANDARD	11	120 V/1-180 VA	4
DRYER	12,14	240 V/2-5000 VA	1
GFCI WASHER	13	120 V/1-1200 VA	1
GFCI OUT DOOR	15	120 V/1-180 VA	4
CONDENSER	16,18	240 V/2-5000 VA	1
WATER HEATER	17,19	240 V/2-4500 VA	1
OVEN HOOD	20	120 V/1-180 VA	1
GFCI KITCHEN	21	120 V/1-180 VA	4
REFRIGERATOR	22	120 V/1-1800 VA	1
RANGE	23,25	240 V/2-5000 VA	1
GFCI DISHWASHER	24	120 V/1-1200 VA	1

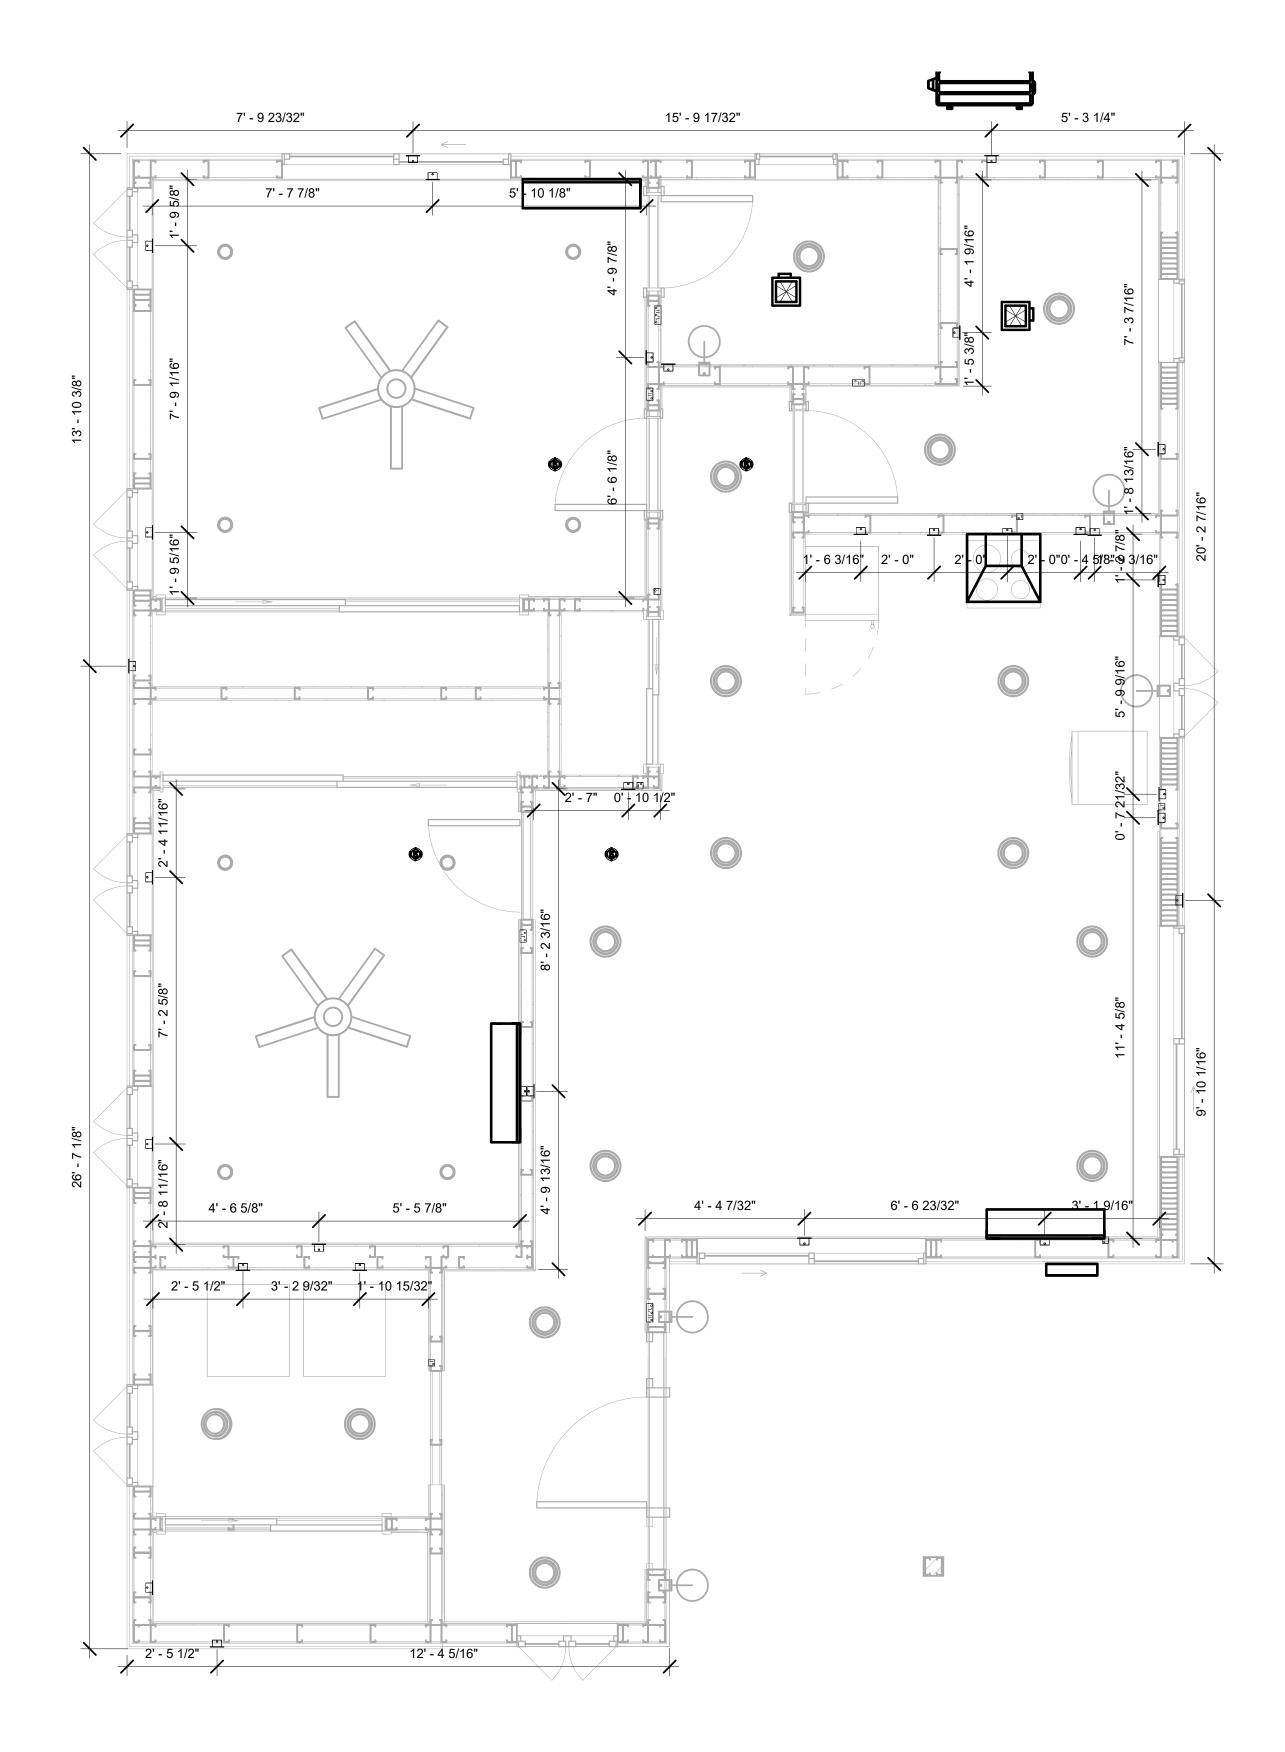

1 DIMENSION FOR FITTINGS 3/8" = 1'-0"



KEY PLAN

NO.	DESCRIPTION	DATE

NOTE:

LEGEND:

PROJECT

272-MAGNOLIA-997-2Bd2Ba COOP-550

DRAWING NAME

DIMENSION PLAN FOR FITTINGS

CLIENT NAME:	Owner
PROJECT NUMBER:	0420_14
DATE:	5/12/2025 5:19:49 PM
DESIGNED BY:	Designer
DRAWN BY:	Author
CHECKED BY:	Checker

E105

SHEET LIST

SHEET NUMBER SHEET NAME

P101 NOTE AND SCHEDULE
P102 WATER SUPPLY AND SEWAGE
SYSTEM

PIPE COLO	R SCHEME
	DOMESTIC COLD WATER
	SANITARY VENT SANITARY SEWER
	STORM DRAINAGE
	GRAY WATER
	GAS LINE

PLUMBING NOTES

- . THE PLUMBING SYSTEM IS DESIGNED TO MEET THE BUILDING'S DOMESTIC WATER SUPPLY, SANITARY DRAINAGE, AND STORM DRAINAGE REQUIREMENTS, AS PER PROJECT SPECIFICATIONS AND APPLICABLE CODES.
- THE SYSTEM INSTALLATION SHALL COMPLY WITH THE LATEST INTERNATIONAL PLUMBING CODE (IPC), INTERNATIONAL RESIDENTIAL CODE (IRC), AND ALL OTHER RELEVANT LOCAL, STATE, AND NATIONAL REGULATIONS.
- ALL PLUMBING WORK SHALL COMPLY WITH THE LATEST EDITION OF THE INTERNATIONAL PLUMBING CODE (IPC) AND THE LOCAL PLUMBING CODE.
- 4. PLUMBING SYSTEMS SHALL BE TESTED AND INSPECTED IN ACCORDANCE WITH THE LOCAL PLUMBING CODE REQUIREMENTS.
- 5. PLUMBING FIXTURES SHALL BE INSTALLED WITH THE APPROPRIATE TRIM, FITTINGS, AND
- ACCESSORIES, AS RECOMMENDED BY THE MANUFACTURER.

 6. PIPING SHALL BE PROPERLY SUPPORTED AND SECURED TO PREVENT SAGGING,
- MOVEMENT, AND VIBRATION.
 7. SHUT-OFF VALVES SHALL BE PROVIDED AT ALL BRANCH CONNECTIONS AND AT THE
- INLET AND OUTLET OF EACH PIECE OF EQUIPMENT.

 8. BACKFLOW PREVENTION DEVICES SHALL BE INSTALLED AS REQUIRED BY THE LOCAL
- PLUMBING CODE TO PROTECT THE POTABLE WATER SYSTEM.

 9. PLUMBING FIXTURES AND EQUIPMENT SHALL BE ACCESSIBLE FOR MAINTENANCE AND
- SERVICING.
- 10. EXPOSED PLUMBING PIPING AND FIXTURES SHALL BE INSULATED TO PREVENT CONDENSATION AND ENERGY LOSS.
- 11. DEAD ENDS IN THE DRAINAGE SYSTEM MUST BE AVOIDED, EXCEPT WHERE NECESSARY TO INSTALL A CLEANOUT IN AN ACCESSIBLE LOCATION, AND MUST HAVE A VENTED CONNECTION TO THE OUTSIDE ATMOSPHERE.
- 12. THE VERTICAL DEFLECTION OF PVC PIPE MUST NOT EXCEED 5%, AND NO DEFLECTION IS PERMITTED FOR IRON PIPE.
- 13. WORK MUST BE PROPERLY COORDINATED WITH OTHER TRADES TO AVOID CONFLICTS, REFERRING TO THE ARCHITECTURAL AND STRUCTURAL DRAWINGS FOR INFORMATION REGARDING CEILING ELEVATIONS, SPACE CLEARANCES, WALL AND PARTITION LOCATIONS, ETC.
- 14. ALL FIXTURES SHALL HAVE ACCESSIBLE STOPS.
- 15. DOMESTIC WATER PIPING SHALL BE PEX, AND PVC PIPING IS NOT ACCEPTABLE FOR INTERIOR USE.
- 16. VENT TERMINATIONS SHALL BE LOCATED AT LEAST 10 FEET FROM OR 3 FEET ABOVE ANY OPERABLE WINDOW, DOOR OPENING, AIR INTAKE, OR VENT SHAFT, AND AT LEAST 3 FEET IN EVERY DIRECTION FROM ANY LOT LINE, ALLEY, OR STREET.
- 17. PIPE AND FITTINGS UTILIZED IN THE WATER SUPPLY SYSTEM SHALL HAVE A MAXIMUM OF 8 PERCENT LEAD.
- 18. ACRYLONITRILE BUTADIENE STYRENE (ABS) SHALL BE USED FOR THE SEWERAGE AND VENTILATION SYSTEM.
- 19. CROSS-LINKED POLYETHYLENE (PEX) SHALL BE USED FOR THE WATER SUPPLY SYSTEM.
- 20. POLYVINYL CHLORIDE (PVC) SHÀLL BÉ USED FOR THE RAIN WATER SYSTEM.
- 21. THE MIMIMUM WATER SUPPLY DEPTH UNDER FLOOR FINISH SHOUD BE 1/2".
- 22. ANY PIPE INSTALLED UNDERGROUND MUST HAVE AT LEAST 12 INCHES OF CLEARANCE BETWEEN THE OUTSIDE OF THE PIPE AND ANY OTHER UNDERGROUND STRUCTURE.
- 23. THE MINIMUM CLEARANCE BETWEEN COLD AND HOT WATER LINES IN RESIDENTIAL HOMES MAINTAIN A MINIMUM DISTANCE OF 6 INCHES.
- 24. HORIZONTAL SEPARATION BETWEEN WATER AND SEWER LINES: A MINIMUM OF 12 INCHES BETWEEN POTABLE WATER SUPPLY LINES (COLD AND HOT WATER) AND

ABBREVIATIONS

SANITARY SEWER LINES.

Ø	DIAMETER
ABS	ACRYLONITRILE BUTADIENE STYRENE
ABV	ABOVE
AD	AREA DRAIN
AFF	ABOVE FINISHED FLOOR
ALT	ALTERNATE
BFF	BELOW FINISHED FLOOR
BLW	BELOW
CO	CLEAN OUT
CW	COLD WATER
D	DEGREE
DFU	DRANAGE FIXTURE UNIT
DIA	DIAMETER
DN	DOWN
FCO	FLOOR CLEAN OUT
FD	FLOOR DRAIN
FL	FLOOR
FS	FLOOR SINK
FT_	FOOT/FEET
HB	HOSE BIB
HW	HOT WATER
IN	INCH
MIN	MINIMUM
NO	NUMBER
NTS	NOT TO SCALE
PEX	CROSS-LINKED POLYETHYLENE
PLBG	PLUMBING
PVC	POLYVINYL CHLORIDE
QTY	QUANTITY
RD	ROOF DRAIN
RED	REDUCER
RM	ROOM
RW	RAIN WATER
SF	SQUARE FOOT
V	VENT
VTR	VENT THROUGH ROOF
W	WASTE
WCO	WALL CLEAN OUT
WSFU	WATER SUPPLY FIXTURE UNIT

PLUMBING LEGEND

D	CAP
	BEND 45 DEG
\Box	BEND 90 DEG
	TEE REDUCING
	TEE
	CLEAN TWO-WAY
	WYE 45 DEG
	WYE 45 DEG DOUBLE
	WYE COMBINATION
	P-TRAP

PIPE SCHEE	DULE	
MATERIAL	DIAMETER	LENGTH
ACRYLONITRILE BUTADIENE STYRENE (ABS)	1 1/2"	32 FT
ACRYLONITRILE BUTADIENE STYRENE (ABS)	2"	38 FT
ACRYLONITRILE BUTADIENE STYRENE (ABS)	3"	77 FT
CROSS-LINKED POLYETHYLENE (PEX)	1/2"	177 FT
CROSS-LINKED POLYETHYLENE (PEX)	3/4"	76 FT
POLYVINYL CHLORIDE - RIGID	2"	94 FT

F	ITTING SCHEDULE	
FITTING	SIZE	QTY
DOMESTIC COLD WATER		
DOMESTIC COLD WATER	4/01 4/01	0
PEX 90 DEG ELBOW	1/2"ø-1/2"ø	2
PEX 90 DEGREE ELBOW	1/2"ø-1/2"ø	20
PEX 90 DEGREE ELBOW	3/4"ø-3/4"ø	4
PEX TEE ELBOW	1/2"ø-1/2"ø	7
PEX TEE ELBOW	3/4"ø-3/4"ø	3
PEX TRANSITION ELBOW	1"ø-3/4"ø	2
PEX TRANSITION ELBOW	3/4"ø-1/2"ø	2
DOMESTIC HOT WATER		
PEX 90 DEGREE ELBOW	1/2"ø-1/2"ø	14
PEX 90 DEGREE ELBOW	3/4"ø-3/4"ø	5
PEX TEE ELBOW	1/2"ø-1/2"ø	5
PEX TEE ELBOW	3/4"ø-3/4"ø	1
PEX TRANSITION ELBOW	3/4"ø-1/2"ø	2
RAIN WATER PVC 90 DEG BEND ELBOW	2"ø-2"ø	33
SEWAGE		
ABS 90 DEGREE BEND ELBOW	1 1/2"ø-1 1/2"ø	3
ABS 90 DEGREE BEND ELBOW	2"ø-2"ø	2
ABS 90 DEGREE BEND ELBOW	3"ø-3"ø	4
ABS P-TRAP	1 1/2"ø-1 1/2"ø	5
ABS P-TRAP	2"ø-2"ø	1
ABS REDUCER ELBOW	2"ø-1 1/2"ø	1
ABS REDUCER ELBOW	3"ø-2"ø	1
ABS TEE ELBOW	1 1/2"ø-1 1/2"ø-1 1/2"ø	1
ABS TEE ELBOW	2"ø-2"ø-2"ø	1
ABS TEE ELBOW	3"ø-3"ø-3"ø	4
ABS TEE ELBOW ABS TEE REDUCER ELBOW	3"ø-3"ø-3"ø 3"ø-3"ø-1 1/2"ø	3
ABS TEE REDUCER ELBOW	3"ø-3"ø-1 1/2"ø	3
ABS TEE REDUCER ELBOW ABS TEE REDUCER ELBOW	3"ø-3"ø-1 1/2"ø 3"ø-3"ø-2"ø	3
ABS TEE REDUCER ELBOW ABS TEE REDUCER ELBOW ABS TRAP P	3"ø-3"ø-1 1/2"ø 3"ø-3"ø-2"ø 2"ø-2"ø	3 1 1
ABS TEE REDUCER ELBOW ABS TEE REDUCER ELBOW ABS TRAP P PVC TEE REDUCER ELBOW	3"ø-3"ø-1 1/2"ø 3"ø-3"ø-2"ø 2"ø-2"ø 3"ø-3"ø-1 1/2"ø	3 1 1 1
ABS TEE REDUCER ELBOW ABS TEE REDUCER ELBOW ABS TRAP P PVC TEE REDUCER ELBOW WASTE DOUBLE TEE	3"ø-3"ø-1 1/2"ø 3"ø-3"ø-2"ø 2"ø-2"ø 3"ø-3"ø-1 1/2"ø	3 1 1 1
ABS TEE REDUCER ELBOW ABS TEE REDUCER ELBOW ABS TRAP P PVC TEE REDUCER ELBOW WASTE DOUBLE TEE	3"ø-3"ø-1 1/2"ø 3"ø-3"ø-2"ø 2"ø-2"ø 3"ø-3"ø-1 1/2"ø 2"ø-2"ø-2"ø-2"ø	3 1 1 1 1

	FIX	TURE CONNECTION SCHEDULE	
FAMILY	WV	TRAP CW HW QTY DFU TOT. WFU TOT.	NOTES

DISHWASHER	2"	1-1/2"	1-1/2"	1/2"	1/2"	1	0	DRAIN TO SEWER SEE PLANS
DRYER	N/A	N/A	N/A	N/A	N/A	1	0	
HANGING PIPES CLAMP						22	0	
SHOWER TRAY	2"	1-1/2"	1-1/2"	1/2"	1/2"	2	0	
SHOWER TRIM	-	-	-	1/2"	1/2"	2	0	
SINK ISLAND SINGLE	2"	1-1/2"	1-1/2"	1/2"	1/2"	1	0	
VANITY SINK	2"	1-1/2"	1-1/2"	1/2"	1/2"	2	0	
WASHER	2"	1-1/2"	2"	1/2"	1/2"	1	0	DRAINS TO GRAY WATER OR SEWER SEE PLANS
WATER CLOSET	3"	2"	3"	1/2"	1/2"	2	0	
WATER HEATER	N/A	N/A	N/A	3/4"	3/4"	1	0	

	FIX	ΓURE SCHEDULE
FIXTURE	QTY	DESCRIPTION
DISHWASHER	1	DRAIN TO SEWER SEE PLANS
DRYER	1	
HANGING PIPES CLAMP	22	
SHOWER TRAY	2	
SHOWER TRIM	2	
SINK ISLAND SINGLE	1	
VANITY SINK	2	
WASHER	1	DRAINS TO GRAY WATER OR SEWER SEE PLANS
WATER CLOSET	2	
WATER HEATER	1	

ACC	ESSORIE	S & FITTINGS SCHEDULE
FIXTURE	QTY	DESCRIPTIONS
DISHWASHER CONNECTOR	1	
HOSE BIB	1	
LAUNDRY SWEAT CONNECTOR1	1	
SHUTOFF VALVE	8	

	PLUMBING SCHEDULE					
FIXTURE	TRAP	WASTE	VENT	C.W	H.W	
DISHWASHER	1-1/2"	2"	1-1/2"	1/2"	1/2"	
DRYER	N/A	N/A	N/A	N/A	N/A	
SHOWER TRAY	1-1/2"	2"	1-1/2"	1/2"	1/2"	
SHOWER TRIM	-	-	-	1/2"	1/2"	
SINK ISLAND SINGLE	1-1/2"	2"	1-1/2"	1/2"	1/2"	
VANITY SINK	1-1/2"	2"	1-1/2"	1/2"	1/2"	
WASHER	2"	2"	1-1/2"	1/2"	1/2"	
WATER CLOSET	3"	3"	2"	1/2"	1/2"	
WATER HEATER	N/A	N/A	N/A	3/4"	3/4"	

WATER FIXTURE UNIT SCHEDULE						
FAMILY	QTY	UNIT VALUE	TOTAL			
DICHWACHED	4	1				
DISHWASHER	1		-			
DRYER	1)			
HANGING PIPES CLAMP	22)			
SHOWER TRAY	2)			
SHOWER TRIM	2)			
SINK ISLAND SINGLE	1)			
VANITY SINK	2)			
WASHER	1)			
WATER CLOSET	2)			
WATER HEATER	1)			

WASTE FIXTURE UNIT SCHEDULE									
FAMILY	QTY	DFU VALUES	TOTAL						
DISHWASHER	1	0							
DRYER	1	0							
HANGING PIPES CLAMP	22	0							
SHOWER TRAY	2	0							
SHOWER TRIM	2	0							
SINK ISLAND SINGLE	1	0							
VANITY SINK	2	0							
WASHER	1	0							
WATER CLOSET	2	0							
WATER HEATER	1	0							



KEY PLAN

NO. DESCRIPTION DATE

NOTE:

LEGEND:

PROJECT

272-MAGNOLIA-997-2Bd2Ba COOP-550

DRAWING NAME

NOTE AND SCHEDULE

CLIENT NAME:

 PROJECT NUMBER:
 0420_14


 DATE:
 5/14/2025 9:40:48 AM

 DESIGNED BY:
 Designer

 DRAWN BY:
 Author


 CHECKED BY:
 Checker

P101

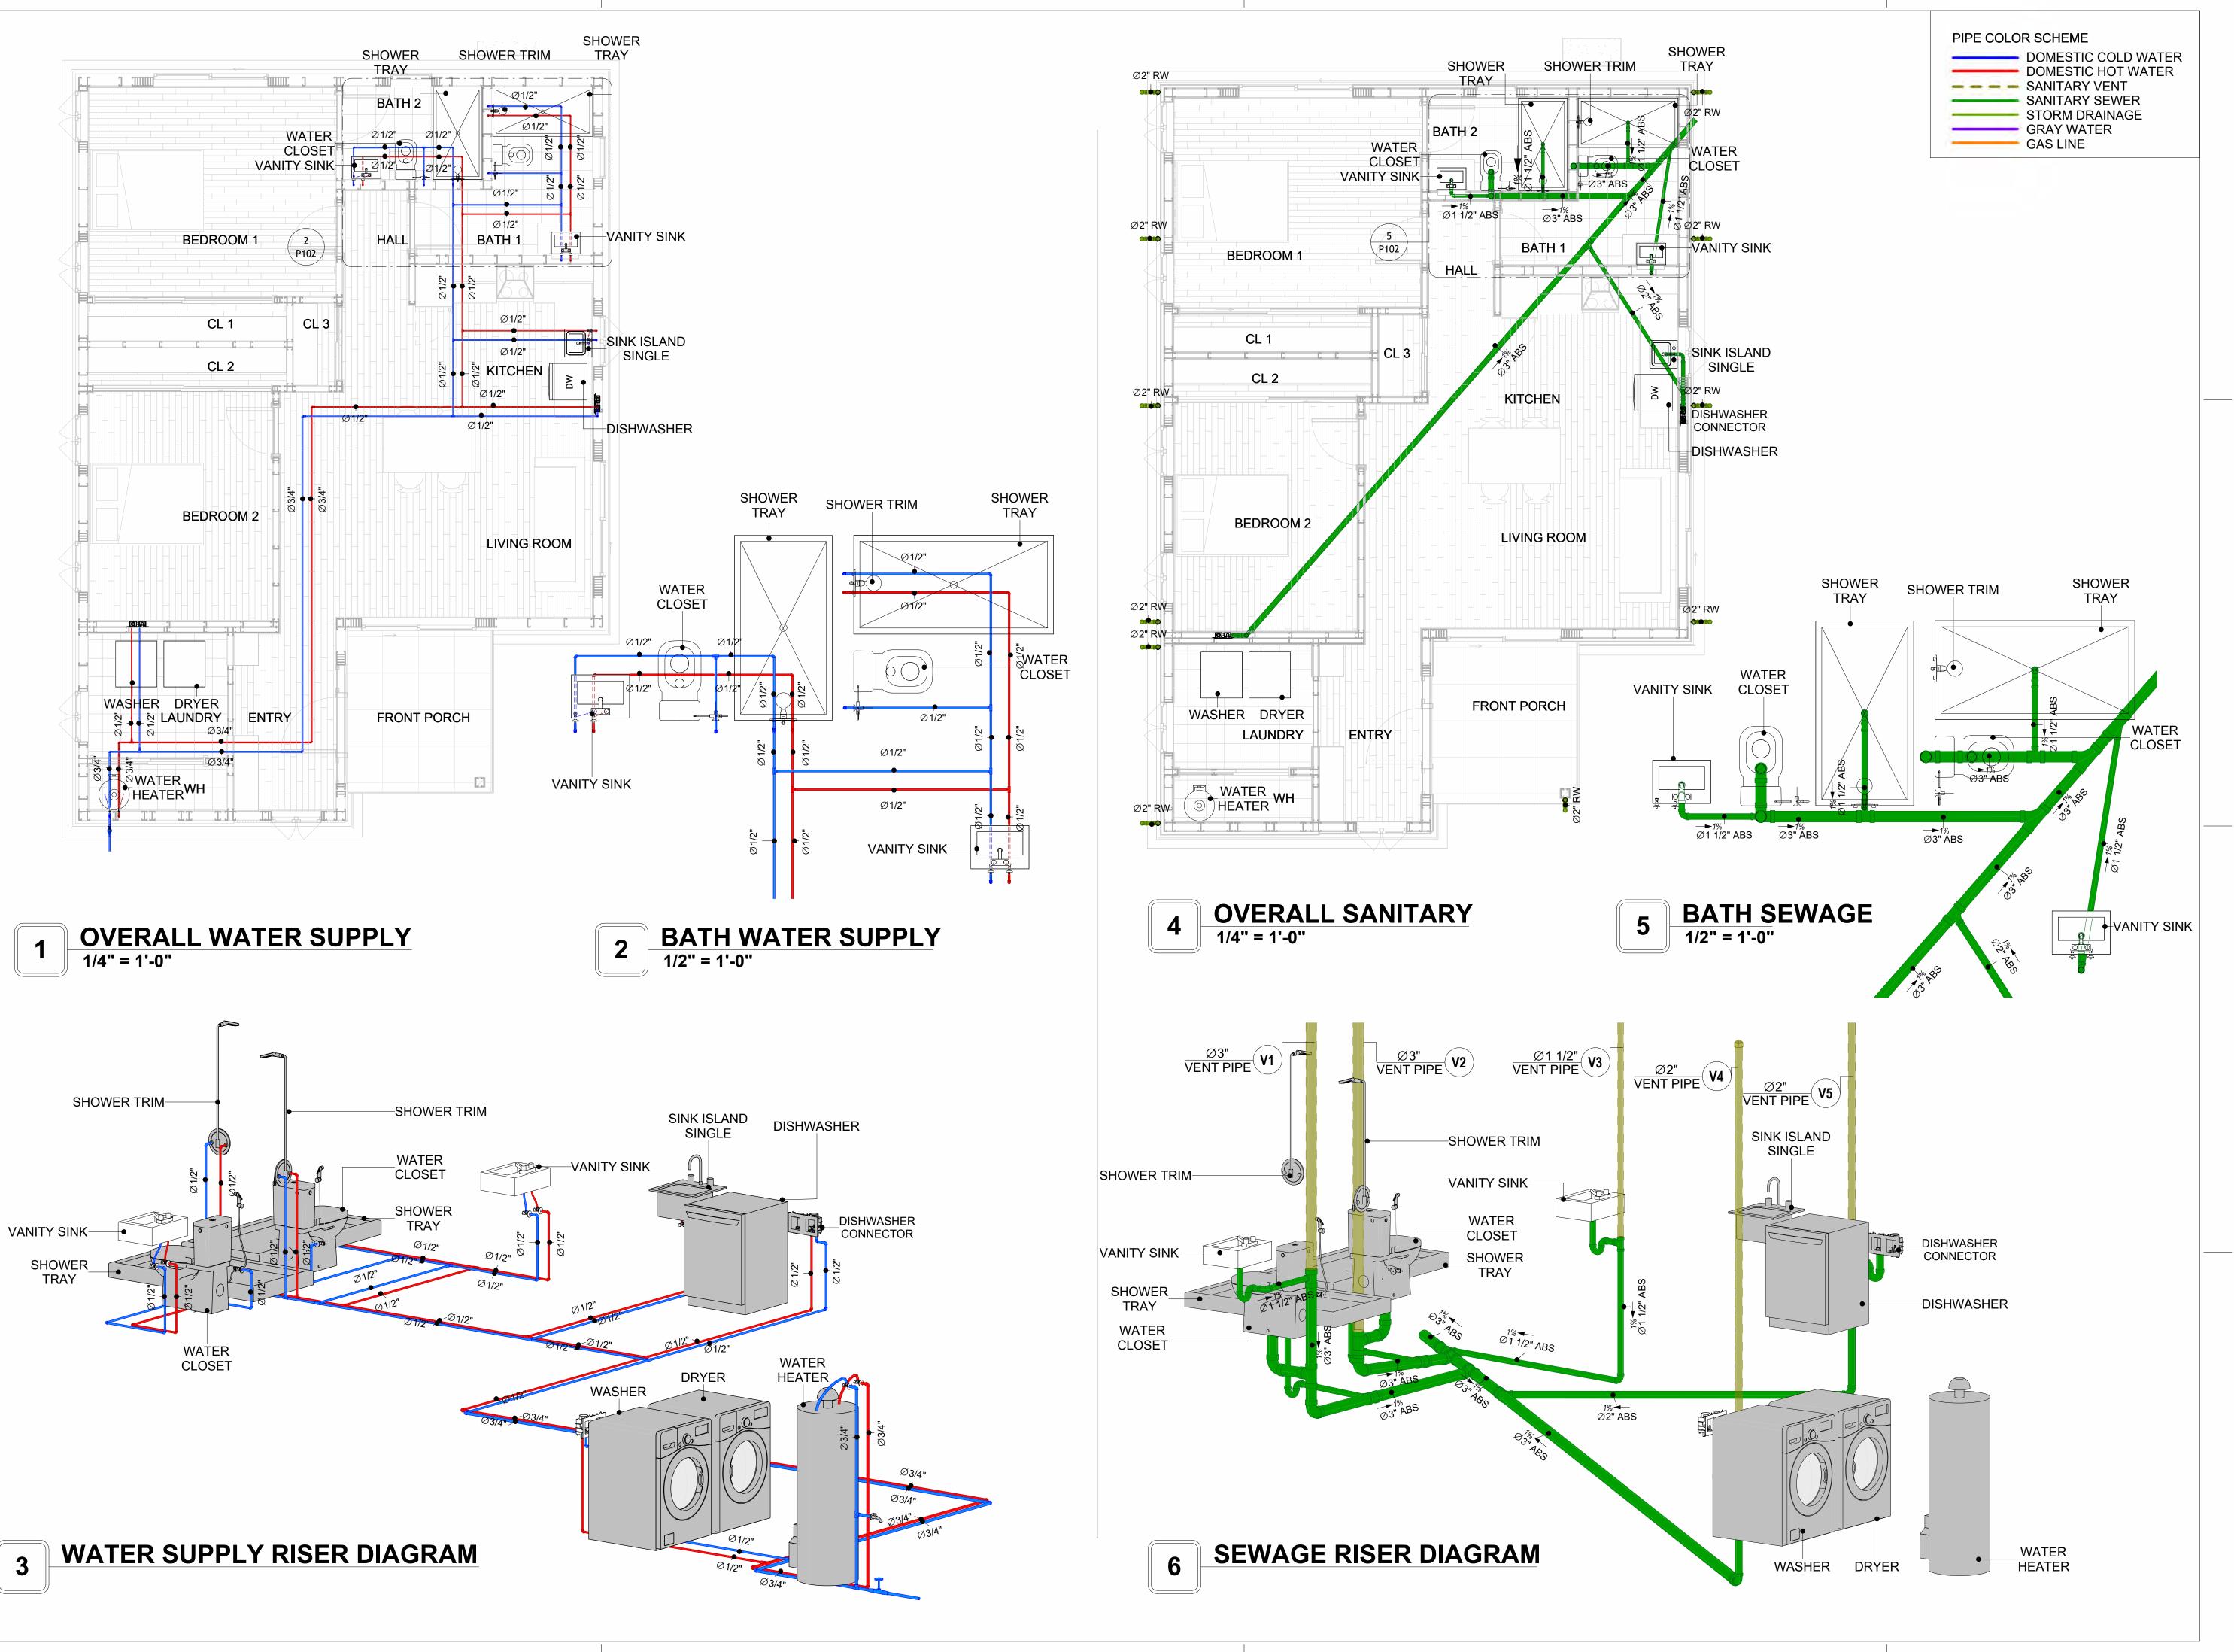



KEY PLAN

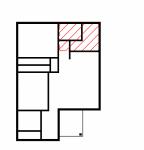

DATE

DESCRIPTION

NOTE:

LEGEND:

PROJECT

272-MAGNOLIA-997-2Bd2Ba COOP-550

DRAWING NAME

WATER SUPPLY AND SEWAGE SYSTEM

 CLIENT NAME:

 PROJECT NUMBER:
 0420_14

 DATE:
 5/14/2025 9:41:22 AM

 DESIGNED BY:
 Designer

 DRAWN BY:
 Author

 CHECKED BY:
 Checker

P102

Materials Shopping List

Please print and take this Materials Shopping List to your favorite Home Depot and ask for assistance in selecting the materials, fixtures and fittings to complete your new home.

Record your selection and the price of the item. Then do the math to determine the cost for your selections and the total cost of finishing your home.

Have It Your Way!

The material types listed in this document were selected based on personal preferences. The Customer is encouraged to make changes to the material types in accordance with local customs, regulations, and personal preferences.

Have It Your Way!



20 good reasons to frame a home with metal and not wood



Why build your ADU with metal vs wood	Wood	Metal	Explanation
1 DIY Construction Benefit		~	The wall frames, trusses and beams can be erected in a just a few days
2 Minimal Construction Skills Required		~	Pre-assembled walls and trusses require no specialized skills to errect
3 Build as DIY, Hybrid or by a General Contractor		~	Do it yourself, Hybrid (involve special contractors) or hire a General Contractor
4 Build It As You Can Afford It		~	Impervious to Weather - build as you have the time and money
5 Up Front Cost of Framing Materials	\checkmark		As to only the framing material, wood is less expensive
6 Total Cost To Build		~	Savings in time, labor, and other areas make light gauge steel LESS expensive
7 Termites and wood boring insects		~	Termites, carpenter ants and wood boring insects eat wood, not metal
8 Mold resistant		~	Metal does not attract mold
9 Damage caused by exterior and interior flooding		~	Metal needs no reconditioning after a flood
10 Fire Resistant		~	Non-combustible
11 Lower insurance rates		~	Many insurance underwriters now provide lower rates for metal framed homes
12 Walls, trusses, and beams retain their original form		~	Perfectly straight walls - no shimming of drywall
13 Corners are 90 degrees		~	No need for templating of countertops to adjust for out of square corners
14 Strength and weight		~	Metal is stronger than wood and weighs less - no need for crane to lift ADU trusses
15 IBC Engineered Stamp		~	If an engineering stamp is necessary, months of waiting are saved
16 Complete BOM (Materials Shopping List)		~	Take the materials shopping list to Home Depot and start shopping/pricing
17 Flexible in Seismic Areas - Won't Fracture		~	Light gauge steel is flexible and won't fracture when the earth moves
18 No Waste At Job Site		~	Steel is the most recycled material in the world. A typical wood home has 20-30% waste
19 Environmentally Friendly		~	Trees don't have to be destroyed and the source of most metal is from recycling
20 How-To Videos Included		~	How-to videos provide simple assembly instructions
21 Relationship Counselor		~	Eliminate emotional uphevels - save time, money, and preserve the relationship

Universal Requirements - some or all may be required

- 1 Site plan
- 2 Electrical Supply Connection
- 3 Sewer Connection
- 4 Fresh Water Supply Connection
- 5 Set Backs
- 6 Soils Evaluation

- 7 Earthquake (fault) evaluation
- 8 Foundation Plan subject to soils
- 9 Compliance with local energy codes: insulation home wrap and flashing
- 10 Engineering for wind speed and snow load.
- 11 State and Local ordinances regarding ADUs
- 12 Local Architect and/or Engineer may be necessary





Magnolia-2Bd2Ba-Coop MATERIAL SHOPPING LIST

Have It Your Way!

The material types listed in this document were selected based on personal preferences. The Customer is encouraged to make changes to the material types in accordance with local customs, regulations, and personal preferences. Have It Your Way!

TOC



Table Of Content

#	Name	Link	Page No
1	Cover Page	<u>Cover Page</u>	1
2	TOC	TOC	2
3	ELECTRICAL BOM	ELECTRICAL BOM	3
5	HVAC BOM	HVAC BOM	7
4	PLUMBING BOM	PLUMBING BOM	10
6	ARCHITECTURAL BOM	ARCHITECTURAL BOM	15

Have It Your Way!

The material types listed in this document were selected based on personal preferences. The Customer is encouraged to make changes to the material types in accordance with local customs, regulations, and personal preferences. Have It Your Way!

GENERAL NOTES

- 1 This BOM (Bill of Materials) is prepared as a Materials Shopping List to help builders and DIYers gain a complete understanding of most if not all elements required for the complete construction of this structure, according to the original design documents provided by FrameUpNow.
- 2 All quantities and specifications are subject to change based on the final design, field measurements, availability of products and customer preferences. The customer should verify all information prior to purchasing materials.
- 3 All products and elements in the list shall conform to the International Residential Code (IRC), or any other local and international building codes, safety regulations, and standards that are applicable to the location of the structure.
- 4 If any changes are made by the customer to the list of materials specified in this document, the customer is responsible for assuring that the correct type and quantity of materials are utilized in accordance with local building codes.
- 5 FrameUpNow, will not be held responsible for any misuse of this document, the products listed, or for deviations from the content that are made due to changes in specifications, pricing, availability, or customer preferences.
- 6 The customer is advised to consult a qualified professional or technician prior to purchasing materials for specialized construction system items. Some items including but not limited to caseworks, doors and windows may require as built measurements prior to purchase to confirmation of final dimensions.
- 7 If there are additional trim elements or specific installation methods, the total amount of materials needed might vary. Consider any additional trim required for corners, intersections, or other architectural details that might cause this variations before proceeding to purchase and construction.

ARCHITECTURAL BOM



		Ma	agnolia-2Bo	d2Ba-Coop			
		ARCHITECTI					
No.	Item	Туре	Unit	Quantity	Unit Price	Total	Description
<u>^</u>	APPLIANCES		200				
1	Refrigerator		PCS	1			
2	Range		PCS	1			
3	Washer		PCS	1			
4	Dryer		PCS	1			
5	Dish Washer		PCS	1			
6	Oven		PCS	0			
7	Microwave		PCS	0			
<u> </u>	CASEWORKS		FT	15.01			
1	Kitchen Cabinet		FT	15.81			
2	Laundry Cabinet		FT	0			
3	Vanity Cabinet		FT	5.5			
	Medicine Cabinet		PCS	2			
5	Kitchen countertop		SF	24.44			
6	Laundry Countertop		PCS	0			
7	Bathroom Countertop		SF	0			
8	Island		FT	0			
9	Peninsula		FT	0			
	Closets		SF	194.5			
<u>^</u>	CEILING	D. W.II	or.	70:1	-	-	
1	Ceiling Board	Dry Wall	SF	784			
2	Dry Wall Fastener	Screw	PCS	1372			
3	Vapor Retarder	Polyethylene film	SF	953			
4	Vapor Retarder Fastener	Nails with washer heads	PCS	2859			
5	Ceiling Board (MRD)	Moisture resistant drywall	SF	105			
6	MRD Fastener		PCS	184			
7	Ceiling Board	Marine Plywood	SF	64			
8	Marine Plywood Fastener	Screw	PCS	112			
9	Dry Wall Tape		FT	477			
	FLOORING						
1	Main Living Space		SF	374.8			
2	Bathroom		SF	147.7			
3	Bedroom		SF	334.5			
4	Porch		SF	69.9			
	STRUCTURE						
1	Foundation		SF	1004.1			
	WALLS EXTERIOR						
1	Siding		SF	1377			
2	Siding Fastener	Self-drilling screws(100/pkt)	PKT	14			
3	Stone Veneer		SF	0			
4	Mortar Stone Veneer		SF	0			
5	Wall Homewrap		SF	1377			
6	Homewrap Fastener	Stapled fastener (200/pkt)	PKT	5			
7	Furring Strip	0.15.1.00	PCS	172			
8	Furring Strip Fastner	Self-drilling screws(100/pkt)	PKT	14			
9	Wall Shteathing (OSB)		SF	1377			
	Shteathing Fastener	Self-drilling screws(100/pkt)	PKT	13.77			
	Wall Paint		SF	1377			
	Wall Insulation		FT	2170			
<u>^</u>	WALLS INTERIOR		lor.	105	-		
	Cementitious Backer Board		SF	695			
	Kerdi membrane		SF	695			
	Kerdi membrane Fastener		SF	695			
4	Wall Ceramic Tile		SF	695			
5	Drywall Board		SF	1879			
	Drywall Fastener	Self-drilling screws(100/pkt)	PKT	18.79			
7	Wall Paint		SF	1879			
	Drywall Tape		FT	355			
9	Wall Sweep		FT	206			

ARCHITECTURAL BOM



Δ	DOORS				
1	Exterior Swinging	6' - 0" X 6'-8"	PCS	1	
2	Interior Swinging	2' - 6" X 6'-8"	PCS	4	
3	Interior Sliding	3' - 11" X 6'-8"	PCS	1	
4	Interior Sliding	5' - 11" X 6'-8"	PCS	1	
5	Interior Sliding	9' - 8" X 6'-8"	PCS	2	
6	Exterior Door Trim	7 0 70 0	FT	19.34	
7	Interior Door Trim		FT	312.26	
8	Entry Lock set		PCS	1	
9	Privacy Lock set		PCS	4	
	Passage Lock set		PCS	3	
	WINDOWS		1.00	-	
1	Sliding	6' - 3" X 4'-9"	PCS	3	
2	Casement	2' - 9" X 3'-5"	PCS	7	
3	Fixed	2' - 3" X 2'-3"	PCS	2	
4	Exterior Window Trim		FT	176	
5	Interior Window Trim		FT	176	
Δ	ROOF				
1	Roof Covering		SF	1393.0	
2	Roof Covering Fastener		PCS	697	
3	Roof Felt Paper		SF	1393.0	
4	Roof Felt Paper Fastener		PCS	4179.0	
5	Roof Sheathing		SF	1393	
6	Roof Sheathing Fastener		PCS	11144	
7	Batten		FT	713.0	
8	Batten Fastener		PCS	536.1	
9	Soffit		SF	184.0	
10	Soffit Fastener		PCS	92.0	
11	Fascia		FT	192.0	
12	Fascia board fastener		PCS	96	
13	Roof Insulation		SF	1393.0	



	Magnolia-2B	d2Ba-Coo	р			
FI	ECTRICAL MATER	IAL SHOP	PING LI	ST		
No. Item	Type	Unit		Unit Price	Total	Description
1 Kitchen Ceiling Light		PCS	2			
2 Kitchen Wall Mounted Light		PCS	1			
3 Exterior Wall Mounted Light		PCS	2			
4 Livingroom Ceiling Light With Fan		PCS	0			
5 Bedroom Ceiling Light With Fan		PCS	2			
6 Dining Ceiling Light		PCS	0			
7 Bath Wall Mounted Light		PCS	2			
8 Bathroom Ceiling Light		PCS	3			
9 Livingroom Ceiling Light		PCS	6			
10 Bedroom Ceiling Light		PCS	8			
11 Hall & Entry Ceiling Light	+	PCS	3			
12 Garage Ceiling Light	+	PCS	2			
		PCS	4			
13 Smoke Detector		1.03	4			
☐ ELECTRICAL FITTINGS	004	DOO	42			
14 Standard Receptacle 120V	20A	PCS	12			
15 GFCI Receptacle 120V	20 A	PCS	15			
16 GFCI Receptacle 240V	30 A	PCS	2			
17 GFCI Receptacle 240V	50 A	PCS	1			
18 GFCI Receptacle 240V	60 A	PCS	1			
19 Fan Switch		PCS	2			
20 Single Pole Switch		PCS	8			
21 Three Way Switch		PCS	4			
22 Dimmer Switch		PCS	4			
23 ROMEX 14 AWG	14/2/W/ground	FT	207			
24 ROMEX 12 AWG	12/3/W/ground	FT	0			
25 ROMEX 12 AWG	12/2/W/ground	FT	431			
26 ROMEX 10 AWG	10/3/W/ground	FT	75			
27 ROMEX 10 AWG	10/2/W/ground	FT	0			
28 Romex 8 AWG	8/3/W/ground	FT	30			
29 Romex 8 AWG	8/2/W/ground	FT	0			
30 ROMEX 6 AWG	6/3/W/ground	FT	41			
31 Bare Copper Ground Wire 6 AWG	, <u></u>	FT	<u> </u>			
△ ELECTRICAL BOXES & CIRCUTES						
32 Panelboard -240V 1 Phase MLO	200 AMP	PCS	1			
33 Circuit breaker	15 A	PCS	6			
34 Circuit breaker	20 A	PCS	11			
36 Circuit breaker	30 A	PCS	2			
37 Circuit breaker	50 A	PCS	1			
		PCS	1			
39 Circuit breaker	60 A	PCS				
40 Single Gang Switch Box			6			
Double Gang Switch Box		PCS	3			
42 Triple Gang Switch Box	114.14	PCS	2			
43 Pull Box	#1/4	PCS	30			
44 Receptacle Box		PCS	31			

PLUMBING BOM

25 PVC Tee Reducer Elbow

26 WASTE DOUBLE TEE



Magnolia-2Bd2Ba-Coop PLUMBING SYSTEM MATERIAL SHOPPING LIST Quantity Unit Price Unit Total Description 1 Bath Tub (Alcove Tub) PCS 2 Kitchen Sink PCS 1 PCS 3 Kitchen Faucets 4 Vanity Sink PCS 2 5 Bath room Faucets PCS 6 Water Closet PCS 7 Shower Trim PCS 8 Shower Tray PCS 9 Water Heater PCS 10 Hose Bib PCS 2 11 Shutoff Valve PCS 8 12 Hanging pipe clamp PCS 22 13 Globe Valve PCS 14 Dishwasher Supply Single Connector PCS 1 15 Dishwasher Sewage Single Connector PCS 16 Laundry Sweat Connector PCS 1 △ SANITARY & PLUMBING PIPE 1 ABS (Acrylonitrile Butadiene Styrene) Pipes 2 ABS (Acrylonitrile Butadiene Styrene) Pipes ø 2 1/2' FT 24 ø 1 1/2" FT 38 3 ABS (Acrylonitrile Butadiene Styrene) Pipes ø 2" FT 78 4 PEX (Cross-linked polyethylene) Pipes ø 3" FT 177 5 PEX (Cross-linked polyethylene) Pipes ø 1/2' FT 76 6 PVC Pipes Sch.80 - Rigid ø 3/4" FT 94 7 Flex Pipe Round 1 1/2" FT 8 1 ABS 90 Degree Bend Elbow 1 1/2"ø-1 1/2"ø PCS 2 ABS 90 Degree Bend Elbow PCS 2 2"ø-2"ø 3 ABS 90 Degree Bend Elbow PCS 3"ø-3"ø PCS 4 ABS P-Trap 1 1/2"ø-1 1/2"ø 3 5 ABS P-Trap PCS 2"ø-2"ø 6 ABS Reducer Elbow 2"ø-1 1/2"ø PCS 7 ABS Reducer Elbow 3"ø-2"ø PCS 8 ABS TEE Elbow PCS 1 1/2"ø-1 1/2"ø-1 1/2"ø 9 ABS TEE Elbow 2"ø-2"ø-2"ø PCS 10 ABS TEE Elbow 3"ø-3"ø-3"ø **PCS** 11 ABS Tee Reducer Elbow 3"ø-3"ø-1 1/2"ø PCS 12 ABS Tee Reducer Elbow PCS 3"ø-3"ø-2"ø 13 ABS Trap P 2"ø-2"ø PCS 14 ABS Vent Cap Elbow 1 1/2"ø PCS 15 ABS Vent Cap Elbow 2"ø PCS 16 ABS Vent Cap Elbow PCS 3"ø 17 PEX 90 Deg Elbow 1/2"ø-1/2"ø PCS 18 PEX 90 Degree Elbow 1/2"ø-1/2"ø PCS 34 19 PEX 90 Degree Elbow 3/4"ø-3/4"ø PCS 9 PCS 20 PEX Tee Elbow 1/2"ø-1/2"ø-1/2"ø 12 21 PEX Tee Elbow 3/4"ø-3/4"ø-3/4"ø PCS 4 22 PEX Transition Elbow 1"ø-3/4"ø PCS 2 23 PEX Transition Elbow 3/4"ø-1/2"ø PCS 24 PVC 90 Deg Bend Elbow PCS 33 2"ø-2"ø

PCS

PCS

3"ø-3"ø-1 1/2"ø

2"ø-2"ø-2"ø

		Magnolia	-2Bd2B	a-Coop			
		HVAC SYSTEM MA	TERIAL	SHOPP	ING LIST		
No.	Item	Туре	Unit	Quantity	Unit Price	Total	Description
	HVAC_DUCTS						
1	PIPE (REFRIGERANT LINE)	3/8" (Ø)	FT	70.08			
2	PIPE (REFRIGERANT LINE)	3/4''' (Ø)	FT	107.92			
3	DRAYER HOSE	4" (Ø)	FT	7			
4	FLEX DUCT ROUND	4" (Ø)	FT	10.37			
	DUCT FITTINGS & ACCESSORIES						
5	ELBOW (REFRIGERANT LINE)	3/4" (Ø)-3/4" (Ø)	PCS	24			
6	ELBOW (REFRIGERANT LINE)	3/8" (Ø)-3/8" (Ø)	PCS	20			
7	TEE (REFRIGERANT LINE)	3/4" (Ø)-3/4" (Ø)-3/4" (Ø)	PCS	2			
8	TEE (REFRIGERANT LINE)	3/8" (Ø)-3/8" (Ø)-3/8" (Ø)	PCS	2			
9	TRANSITION (REFRIGERANT	3/4" (Ø)-1/2" (Ø)	PCS	4			
10	TRANSITION (REFRIGERANT	3/4" (Ø)-5/8" (Ø)	PCS	3			
11	TRANSITION (REFRIGERANT	3/8" (Ø)-1/4" (Ø)	PCS	1			
12	ROUND TRANSITION(ANGLE)	45 DEGREE	PCS	5			
	HVAC_EQUIPMENTS						
13	AIR HANDLING UNIT	WALL MOUNTED	PCS	3			
14	CONDENSER	OUTDOOR UNIT	PCS	1			
15	EXHAUST FAN	75 CFM	PCS	2			
16	EXHAUST HOOD	WALL MOUNTED	PCS	1			
17	HOOD-WALL: VENT	HOOD-WALL: VENT	PCS	1			
18	DRAYER: VENT	DRAYER: VENT	PCS	1			
19	ROOF VENT	3"(Ø)	PCS	2			



Table Of Content

#	Name	Link	Page No
1	Cover Page	<u>Cover Page</u>	1
2	TOC	TOC	2
3	ELECTRICAL BOM	ELECTRICAL BOM	3
5	HVAC BOM	HVAC BOM	7
4	PLUMBING BOM	PLUMBING BOM	10
6	ARCHITECTURAL BOM	ARCHITECTURAL BOM	15

Have It Your Way!

The material types listed in this document were selected based on personal preferences. The Customer is encouraged to make changes to the material types in accordance with local customs, regulations, and personal preferences. Have It Your Way!

GENERAL NOTES

- 1 This BOM (Bill of Materials) is prepared as a Materials Shopping List to help builders and DIYers gain a complete understanding of most if not all elements required for the complete construction of this structure, according to the original design documents provided by FrameUpNow.
- 2 All quantities and specifications are subject to change based on the final design, field measurements, availability of products and customer preferences. The customer should verify all information prior to purchasing materials.
- 3 All products and elements in the list shall conform to the International Residential Code (IRC), or any other local and international building codes, safety regulations, and standards that are applicable to the location of the structure.
- 4 If any changes are made by the customer to the list of materials specified in this document, the customer is responsible for assuring that the correct type and quantity of materials are utilized in accordance with local building codes.
- FrameUpNow, will not be held responsible for any misuse of this document, the products listed, or for deviations from the content that are made due to changes in specifications, pricing, availability, or customer preferences.
- The customer is advised to consult a qualified professional or technician prior to purchasing materials for specialized construction system items. Some items including but not limited to caseworks, doors and windows may require as built measurements prior to purchase to confirmation of final dimensions.
- 7 If there are additional trim elements or specific installation methods, the total amount of materials needed might vary. Consider any additional trim required for corners, intersections, or other architectural details that might cause this variations before procedding to purchase and construction.



			LIGHTING FIXTURES				
#	Item	Туре	Description, Manufacturer, SKU	Unit	Quantity	Unit Price	Total
1	Kitchen Ceiling Light			PCS	2		
3	Kitchen Wall Mounted Light			PCS	1		
4	Exterior Wall Mounted Light			PCS	2		
5	Livingroom Ceiling Light With Fan			PCS	0		
6	Bedroom Ceiling Light With Fan			PCS	2		
7	Dining Ceiling Light			PCS	0		
8	Bath Wall Mounted Light			PCS	2		
9	Bathroom Ceiling Light			PCS	3		
10	Livingroom Ceiling Light			PCS	6		
11	Bedroom Ceiling Light			PCS	8		
12	Hall & Entry Ceiling Light			PCS	3		
12	WD Ceiling Light			PCS	2		
13	Smoke Detector			PCS	4		
14							
15							



			ELECTRICAL FITTINGS			
#	Item	Туре	Description, Manufacturer, SKU	Unit	Quantity Unit	Price Total
1	Standard Receptacle 120V	20A		PCS	12	
2	GFCI Receptacle 120V	20 A		PCS	15	
3	GFCI Receptacle 240V	30 A		PCS	2	
4	GFCI Receptacle 240V	50 A		PCS	1	
5	GFCI Receptacle 240V	60 A		PCS	1	
6	Fan Switch			PCS	2	
7	Single Pole Switch			PCS	8	
8	Three Way Switch			PCS	4	
9	Dimmer Switch			PCS	4	
10			,	'		
11						
12						
13						
14						
15						



		ELECTR	ICAL CONDUITS & WIRING				
#	Item	Туре	Description, Manufacturer, SKU	Unit	Quantity	Unit Price	Total
1	ROMEX 14 AWG	14/2/W/ground		FT	207		
3	ROMEX 12 AWG	12/3/W/ground		FT	0		
4	ROMEX 12 AWG	12/2/W/ground		FT	431		
6	ROMEX 10 AWG	10/3/W/ground		FT	75		
8	ROMEX 10 AWG	10/2/W/ground		FT	0		
9	Romex 8 AWG	8/3/W/ground		FT	30		
10	Romex 8 AWG	8/2/W/ground		FT	0		
11	ROMEX 6 AWG	6/3/W/ground		FT	41		
12	Bare Copper Ground Wire 6 AWG			FT			
13							
14							
15							
16							



		ELEC	CTRICAL BOXES & CIRCUTES				
#	Item	Туре	Description, Manufacturer, SKU	Unit	Quantity	Unit Price	Total
1	Panelboard -240V 1 Phase MLO	200 AMP		PCS	1		
2	Circuit breaker	15 A		PCS	6		
3	Circuit breaker	20 A		PCS	11		
4	Circuit breaker	30 A		PCS	2		
5	Circuit breaker	50 A		PCS	1		
6	Circuit breaker	60 A		PCS	1		
7	Single Gang Switch Box			PCS	6		
8	Double Gang Switch Box			PCS	3		
9	Triple Gang Switch Box			PCS	2		
10	Pull Box	#1/4		PCS	30		
11	Receptacle Box			PCS	31		
12							
13							
14							
15							

			HVAC_DUCTS 01				
#		Туре	Description, Manufacturer, SKU	Unit	Quantity	Unit Price	Total
1	PIPE (REFRIGERANT LINE)			FT	70.08		
2	PIPE (REFRIGERANT LINE)	3/4"' (Ø)		FT	107.92		
3	DRAYER HOSE	4" (Ø)		FT	7		
4	FLEX DUCT ROUND	4" (Ø)		FT	10.37		
5							
6							
7							
8							
9							
10							
11							
12							
13							
14							
15							
16							

DUCT FITTINGS & ACCESSORIES							
#	Item	Туре	Description, Manufacturer, SKU	Unit	Quantity	Unit Price	Total
1	ELBOW (REFRIGERANT LINE)	3/4" (Ø)-3/4" (Ø)		PCS	24		
-	ELBOW (REFRIGERANT LINE)	3/8" (Ø)-3/8" (Ø)		PCS	20		
}	TEE (REFRIGERANT LINE)	3/4" (Ø)-3/4" (Ø)-3/4" (Ø)		PCS	2		
ļ	TEE (REFRIGERANT LINE)	3/8" (Ø)-3/8" (Ø)-3/8" (Ø)		PCS	2		
5	TRANSITION (REFRIGERANT LINE)	3/4" (Ø)-1/2" (Ø)		PCS	4		
õ	TRANSITION (REFRIGERANT LINE)	3/4" (Ø)-5/8" (Ø)		PCS	3		
7	TRANSITION (REFRIGERANT LINE)	3/8" (Ø)-1/4" (Ø)		PCS	1		
3	ROUND TRANSITION(ANGLE)	45 DEGREE		PCS	5		
9							
LO							
l1							
12							
13							
L4							
15							
16							

			HVAC_EQUIPMENTS				
#	Item	Туре	Description, Manufacturer, SKU	Unit	Quantity	Unit Price	Total
1	AIR HANDLING UNIT	WALL MOUNTED		PCS	3		
2	CONDENSER	OUTDOOR UNIT		PCS	1		
3	EXHAUST FAN	75 CFM		PCS	2		
4	EXHAUST HOOD	WALL MOUNTED		PCS	1		
5	HOOD-WALL: VENT	HOOD-WALL: VENT		PCS	1		
6	DRAYER: VENT	DRAYER: VENT		PCS	1		
7	ROOF VENT	3"(Ø)		PCS	2		
8							
9							
10							
11							
12							
13							
14							



		PLUMBI	NG FIXTURES & ACCESSORIES				
#	Item	Туре	Description, Manufacturer, SKU	Unit	Quantity	Unit Price	Total
1	Bath Tub (Alcove Tub)			PCS	C		
2	Kitchen Sink			PCS	1		
3	Kitchen faucets			PCS	1		
4	Vanity Sink			PCS	2		
5	Bath room faucets			PCS	2		
6	Water Closet			PCS	2		
7	Shower Trim			PCS	2		
8	Shower Tray			PCS	2		
9	Water Heater			PCS	1		
10	Hose Bib			PCS	1		
11	Shutoff Valve			PCS	8		
12	Hanging pipe clamp			PCS	22		
13	Globe Valve			PCS	1		
14	Dishwasher Supply Single Connector			PCS	1		
15	Dishwasher Sewage Single Connector			PCS	1		
16	Laundry Sweat Connector			PCS	1		



		SANI	TARY & PLUMBING PIPES				
#	Item	Туре	Description, Manufacturer, SKU	Unit	Quantity	Unit Price	Total
1	ABS (Acrylonitrile Butadiene Styrene) Pipes	ø 2 1/2"		FT	0		
2	ABS (Acrylonitrile Butadiene Styrene) Pipes	ø 1 1/2"		FT	24		
3	ABS (Acrylonitrile Butadiene Styrene) Pipes	ø 2"		FT	38		
4	ABS (Acrylonitrile Butadiene Styrene) Pipes	ø 3"		FT	78		
5	PEX (Cross-linked polyethylene) Pipes	ø 1/2"		FT	177		
6	PEX (Cross-linked polyethylene) Pipes	ø 3/4"		FT	76		
7	PEX (Cross-linked polyethylene) Pipes	ø 1"		FT	0		
8	PVC Pipes Sch.80 - Rigid	ø 1 1/2"		FT	0		
9	PVC Pipes Sch.80 - Rigid	ø 2"		FT	94		
10	PVC Pipes Sch.80 - Rigid	ø 3"		FT	0		
11	Flex Pipe Round	ø 1/2"		FT	8		
12	Flex Pipe Round	ø 3/4"		FT	0		
13	Flex Pipe Round	ø 1"		FT	0		
14							
15							



		PIPE	FITTINGS 01				
#	Item	Туре	Description, Manufacturer, SKU	Unit	Quantity	Unit Price	Total
1	ABS 90 Degree Bend Elbow	1 1/2"ø-1 1/2"ø		PCS	3		
2	ABS 90 Degree Bend Elbow	2"ø-2"ø		PCS	2		
3	ABS 90 Degree Bend Elbow	3"ø-3"ø		PCS	4		
4	ABS P-Trap	1 1/2"ø-1 1/2"ø		PCS	3		
5	ABS P-Trap	2"ø-2"ø		PCS	1		
6	ABS Reducer Elbow	2"ø-1 1/2"ø		PCS	1		
7	ABS Reducer Elbow	3"ø-2"ø		PCS	1		
8	ABS TEE Elbow	1 1/2"ø-1 1/2"ø-1 1/2"ø		PCS	1		
9	ABS TEE Elbow	2"ø-2"ø-2"ø		PCS	1		
10	ABS TEE Elbow	3"ø-3"ø-3"ø		PCS	4		
11	ABS Tee Reducer Elbow	3"ø-3"ø-1 1/2"ø		PCS	1		
12	ABS Tee Reducer Elbow	3"ø-3"ø-2"ø		PCS	1		
13	ABS Trap P	2"ø-2"ø		PCS	1		
14	ABS Vent Cap Elbow	1 1/2"ø		PCS	1		
15	ABS Vent Cap Elbow	2"Ø		PCS	2		



		PI	PE FITTINGS 02				
#	Item	Туре	Description, Manufacturer, SKU	Unit	Quantity	Unit Price	Total
1	ABS Vent Cap Elbow	3"ø		PCS	2		
2	PEX 90 Deg Elbow	1/2"ø-1/2"ø		PCS	2		
3	PEX 90 Degree Elbow	1/2"ø-1/2"ø		PCS	34		
4	PEX 90 Degree Elbow	3/4"ø-3/4"ø		PCS	9		
5	PEX Tee Elbow	1/2"ø-1/2"ø-1/2"ø		PCS	12		
6	PEX Tee Elbow	3/4"ø-3/4"ø-3/4"ø		PCS	4		
7	PEX Transition Elbow	1"ø-3/4"ø		PCS	2		
8	PEX Transition Elbow	3/4"ø-1/2"ø		PCS	4		
9	PVC 90 Deg Bend Elbow	2"ø-2"ø		PCS	33		
10	PVC Tee Reducer Elbow	3"ø-3"ø-1 1/2"ø		PCS	1		
11	WASTE DOUBLE TEE	2"ø-2"ø-2"ø		PCS	1		



			APPLIANCES				
#	Item	Туре	Description, Manufacturer, SKU	Unit	Quantity	Unit Price	Total
1	Refrigerator			PCS	1		
2	Range			PCS	1		
3	Washer Front Load	Stackable		PCS	1		
4	Dryer Front Load	Stackable		PCS	1		
5	Dish Washer			PCS	1		
6	Oven			PCS	(
7	Microwave			PCS	(
8							
9							
10							
11							
12							
13							
14							
15							
16							



			CASEWORKS 01				
#	Item	Туре	Description, Manufacturer, SKU	Unit	Quantity	Unit Price	Total
1	Kitchen Cabinet			FT	25.07		
2	Laundry Cabinet			FT	0		
3	Vanity Cabinet			FT	2.5		
4	Medicine Cabinet			PCS	1		
5	Kitchen countertop			SF	35		
6	Laundry Countertop			PCS	0		
7	Bathroom Countertop			SF	0		
8	Island			FT	0		
9	Peninsula			FT	0		
10	Closets			SF	105.29		
11							
12							
13							
14							
15							



	1		CEILING 01				
#	Item	Туре	Description, Manufacturer, SKU	Unit	Quantity	Unit Price	Total
	LIVING+KITCHEN			SF	319.0		
1	Ceiling Board	Drywall		SF	319		
2	Drywall Fastener	Screw		PCS	558		
3	Vapor Retarder	Polyethylene film		SF	319		
4	Vapor Retarder Fastener	Nails with washer heads		PCS	957		
	BATH ROOM 1			SF	39.0		
5	Ceiling Board	MRD (Moisture resistant drywall)		SF	39		
5	MRD Fastener	Screw		PCS	68		
	BATH ROOM 2			SF	66.0		
7	Ceiling Board	MRD (Moisture resistant drywall)		SF	66		
3	MRD Fastener	Screw		PCS	116		
	BED ROOM 1			SF	155.0		
)	Ceiling Board	Drywall		SF	155		
LO	Drywall Fastener	Screw		PCS	271		
l1	Vapor Retarder	Polyethylene film		SF	155		
12	Vapor Retarder Fastener	Nails with washer heads		PCS	465		



			CEILING 02				
#	Item	Туре	Description, Manufacturer, SKU	Unit	Quantity	Unit Price	Total
	BED ROOM 2			SF	126.0		
13	Ceiling Board	Drywall		SF	126		
14	Drywall Fastener	Screw		PCS	221		
15	Vapor Retarder	Polyethylene film		SF	126		
16	Vapor Retarder Fastener	Nails with washer heads		PCS	378		
	CLOSET 1			SF	23.0		
17	Ceiling Board	Drywall		SF	23		
18	Drywall Fastener	Screw		PCS	40		
19	Vapor Retarder	Polyethylene film		SF	23		
20	Vapor Retarder Fastener	Nails with washer heads		PCS	69		
	CLOSET 2			SF	23.0		
21	Ceiling Board	Drywall		SF	23		
22	Drywall Fastener	Screw		PCS	40		
23	Vapor Retarder	Polyethylene film		SF	23		
24	Vapor Retarder Fastener	Nails with washer heads		PCS	69		



			CEILING 03				
#	Item	Туре	Description, Manufacturer, SKU	Unit	Quantity	Unit Price	Total
	ENTRY			SF	54.0		
25	Ceiling Board	Drywall		SF	54		
26	Drywall Fastener	Screw		PCS	95		
27	Vapor Retarder	Polyethylene film		SF	54		
28	Vapor Retarder Fastener	Nails with washer heads		PCS	162		
	LAUNDRY			SF	53.0		
29	Ceiling Board	Drywall		SF	53		
30	Drywall Fastener	Screw		PCS	93		
31	Vapor Retarder	Polyethylene film		SF	53		
32	Vapor Retarder Fastener	Nails with washer heads		PCS	159		
	STORAGE			SF	11.0		
33	Ceiling Board	Drywall		SF	11		
34	Drywall Fastener	Screw		PCS	19		
35	Vapor Retarder	Polyethylene film		SF	11		
36	Vapor Retarder Fastener	Nails with washer heads		PCS	33		



			CEILING 04				
#	Item	Туре	Description, Manufacturer, SKU	Unit	Quantity	Unit Price	Total
	WH			SF	20.0		
37	Ceiling Board	Drywall		SF	20		
38	Drywall Fastener	Screw		PCS	35		
39	Vapor Retarder	Polyethylene film		SF	20		
40	Vapor Retarder Fastener	Nails with washer heads		PCS	60		
	COVERED PATIO			SF	64.0		
41	Ceiling Board	Marine Plywood		SF	64		
42	Exterior Grade Plywood	Screw		PCS	112		



			FLOORING INTERIOR 01				
#	Item	Туре	Description, Manufacturer, SKU	Unit	Quantity	Unit Price	Total
	CLOSET 1						
1	Closet Flooring			SF	22		
2	Wood underlay	Foam Pad Polyethylene		SF	22		
3	Vapor Retarder	Vapor Barrier Polyethylene		SF	22		
	CLOSET 2						
4	Closet Flooring			SF	22		
5	Wood underlay	Foam Pad Polyethylene		SF	22		
6	Vapor Retarder	Vapor Barrier Polyethylene		SF	22)	
	CLOSET 3						
7	Closet Flooring			SF	11		
8	Wood underlay	Foam Pad Polyethylene		SF	11		
9	Vapor Retarder	Vapor Barrier Polyethylene		SF	11		
	BEDROOM 1	'					
10	Bedroom Flooring			SF	155		
11	Wood underlay	Foam Pad Polyethylene		SF	155		
12	Vapor Retarder	Vapor Barrier Polyethylene		SF	155		



			FLOORING INTERIOR 02				
#	Item	Туре	Description, Manufacturer, SKU	Unit	Quantity	Unit Price	Total
	BEDROOM 2						
13	Bedroom Flooring			SF	124		
14	Wood underlay	Foam Pad Polyethylene		SF	124		
15	Vapor Retarder	Vapor Barrier Polyethylene		SF	124		
	LIVING ROOM AND KITCH	HEN					
16	Tile Finish			SF	375		
17	Adhesive	1/2" Thin set Mortar		SF	375		
18	Vapor Retarder	Vapor Barrier Polyethylene		SF	375		
	BATHROOM #1						
19	Tile Finish			SF	51		
20	Adhesive	1/2" Thin set Mortar		SF	51		
21	Vapor Retarder	Vapor Barrier Polyethylene		SF	51		
	BATHROOM #2						
22	Tile Finish			SF	25		
23	Adhesive	1/2" Thin set Mortar		SF	25		
24	Vapor Retarder	Vapor Barrier Polyethylene		SF	25		



			FLOORING INTERIOR 03				
#	Item	Туре	Description, Manufacturer, SKU	Unit	Quantity	Unit Price	Total
	W/D						
25	Tile Finish			SF	52		
26	Adhesive	1/2" Thin set Mortar		SF	52		
27	Vapor Retarder	Vapor Barrier Polyethylene		SF	52		
	BOILER ROOM						
28	Tile Finish			SF	20		
29	Adhesive	1/2" Thin set Mortar		SF	20		
30	Vapor Retarder	Vapor Barrier Polyethylene		SF	20		



			FLOORING EXTERIOR			
#	Item	Туре	Description, Manufacturer, SKU	Unit	Quantity	Unit Price
	STRUCTURE			SF	1004.1	
1	Concrete Slab	4"concrete cast in situ		CF	334.7	
2	Insulation	Rigid insulation		SF	445	
3	Hard core	Compacted soil		CF	322.1	
4	Re-bar	#4 re-bar		Ton	0.96	
5	Concrete Pad	4"concrete cast in situ		CF	1.58	
6	Slab edge	Turndown		CF	320	
	PORCH					
7	Tile Finish			SF	69.9	
8	Adhesive	1/2" Thin set Mortar		SF	69.9	
9	Vapor Retarder	Vapor Barrier Polyethylene		SF	69.9	



			WALLS: EXTERIOR				
#	Item	Туре	Description, Manufacturer, SKU	Unit	Quantity	Unit Price	Total
1	Horizontal Siding			SF	941		
2	Horizontal Siding Fastner	Self-drilling screws(100/pkt)		PKT	9.41		
3	Vertical Siding Siding			SF	436		
4	Vertical Siding Fastner			SF	4.36		
5	Wall Homewrap			SF	1377.0		
6	Homewrap Fastener	Stapled fastener (200/pkt)		PKT	5.2		
7	Furring Strip			PCS	172.125		
8	Furring Strip Fastner	Self-drilling screws(100/pkt)		PKT	13.77		
9	Wall Shteathing (OSB)			SF	1377		
10	Shteathing Fastener	Self-drilling screws(100/pkt)		PKT	13.77		
11	Wall Paint			SF	1377		
12	Wall Insulation			FT	2170		
					·		



			WALLS: INTERIOR 01				
#	Item	Туре	Description, Manufacturer, SKU	Unit	Quantity	Unit Price	Total
	BATHROOM 1			SF	63.0		
1	Cementitious Backer Board			SF	314		
2	Kerdi membrane			SF	314		
3	Kerdi membrane Fastener			SF	314		
4	Wall Ceramic Tile			SF	314		
	BATHROOM 2			SF	38.0		
5	Cementitious Backer Board			SF	204		
6	Kerdi membrane			SF	204		
7	Kerdi membrane Fastener			SF	204		
8	Wall Ceramic Tile			SF	204		
	BEDROOM 1			SF	153.0		
9	Drywall Board			SF	296		
10	Drywall Fastener	Self-drilling screws(100/pkt)		PKT	2.96		
11	Wall Paint			SF	296		
12	Drywall Tape			FT	55.5		



			WALLS: INTERIOR 02				
#	Item	Туре	Description, Manufacturer, SKU	Unit	Quantity	Unit Price	Total
	BEDROOM 2			SF	124.0		
13	Drywall Board			SF	301		
14	Drywall Fastener	Self-drilling screws(100/pkt)		PKT	3.01		
15	Wall Paint			SF	301		
16	Drywall Tape			FT	56		
	KITCHEN			SF	82.0		
17	Cementitious Backer Board			SF	31		
18	Drywall Board			SF	171		
19	Drywall Fastener	Self-drilling screws(100/pkt)		PKT	1.71		
20	Kerdi membrane			SF	31		
21	Kerdi membrane Fastener			SF	31		
22	Wall Ceramic Tile			SF	31		
23	Wall Paint			SF	171		
24	Drywall Tape			FT	32.3		



			WALLS: INTERIOR 03				
#	Item	Туре	Description, Manufacturer, SKU	Unit	Quantity	Unit Price	Total
	LIVING ROOM			SF	214.0		
25	Drywall Board			SF	297		
26	Drywall Fastener	Self-drilling screws(100/pkt)		PKT	2.97		
27	Wall Paint			SF	297		
28	Drywall Tape			FT	55.7		
	CLOSET 1			SF	22.0		
29	Drywall Board			SF	166		
30	Drywall Fastener	Self-drilling screws(100/pkt)		PKT	1.66		
31	Wall Paint			SF	166		
32	Drywall Tape			FT	31.1		
	CLOSET 2			SF	22.0		
33	Drywall Board			SF	167		
34	Drywall Fastener	Self-drilling screws(100/pkt)		PKT	1.67		
35	Wall Paint			SF	167		
36	Drywall Tape			FT	31.3		



			WALLS: INTERIOR 04				
#	Item	Туре	Description, Manufacturer, SKU	Unit	Quantity	Unit Price	Total
	CLOSET 3			SF	10.0		
37	Drywall Board			SF	96		
38	Drywall Fastener	Self-drilling screws(100/pkt)		PKT	0.96		
39	Wall Paint			SF	96		
40	Drywall Tape			FT	18.0		
	WH			SF	19.0		
41	Drywall Board			SF	119		
42	Drywall Fastener	Self-drilling screws(100/pkt)		PKT	1.19		
43	Wall Paint			SF	119		
44	Drywall Tape			FT	22		
	HALL			SF	22.0		
45	Drywall Board			SF	120		
46	Drywall Fastener	Self-drilling screws(100/pkt)		PKT	1.2		
47	Wall Paint			SF	120		
48	Drywall Tape			FT	23		



			WALLS: INTERIOR 04				
#	Item	Туре	Description, Manufacturer, SKU	Unit	Quantity	Unit Price	Total
	LAUNDRY			SF	50.0		
49	Cementitious Backer Board			SF	146		
50	Kerdi membrane			SF	146		
51	Kerdi membrane Fastener			SF	146		
52	Wall Ceramic Tile			SF	146		
	ENTRY			SF	54.0		
53	Drywall Board			SF	146		
54	Drywall Fastener	Self-drilling screws(100/pkt)		PKT	1		
55	Wall Paint			SF	146		
56	Drywall Tape			FT	28		
1	Wall Skirting	Ceramic					
				FT	206		



			DOORS				
#	Item	Туре	Description, Manufacturer, SKU	Unit	Quantity	Unit Price	Total
1	Exterior Swinging	6' - 0" X 6'-8"		PCS	1		
2	Interior Swinging	2' - 6" X 6'-8"		PCS	4		
3	Interior Sliding	3' - 11" X 6'-8"		PCS	1		
4	Interior Sliding	5' - 11" X 6'-8"		PCS	1		
5	Interior Sliding	9' - 8" X 6'-8"		PCS	2		
6	Exterior Door Trim			FT	19.34		
7	Interior Door Trim			FT	312.26		
8	Entry Lock set			PCS	1		
9	Privacy Lock set			PCS	4		
10	Passage Lock set			PCS	3		



			WINDOWS				
#	Item	Туре	Description, Manufacturer, SKU	Unit	Quantity	Unit Price	Total
1	Sliding	6' - 3" X 4'-9"		PCS	3		
2	Casement	2' - 9" X 3'-5"		PCS	7		
3	Fixed	2' - 3" X 2'-3"		PCS	2		
4	Exterior Window Trim			FT	176		
5	Interior Window Trim			FT	176		



			ROOF 01				
#	Item	Туре	Description, Manufacturer, SKU	Unit	Quantity	Unit Price	Total
1	Roof Covering			SF	1393.0		
2	Roof Covering Fastener			PCS	697		
3	Roof Felt Paper			SF	1393.0		
4	Roof Felt Paper Fastener			PCS	4179.0		
5	Roof Sheathing			SF	1393.0		
6	Roof Sheathing Fastener			PCS	11144		
7	Batten			FT	713.0		
8	Batten Fastener			PCS	536.1		
9	Soffit			SF	184.0		
10	Soffit Fastener			PCS	92.0		
11	Fascia			FT	192.0		
12	Fascia board fastener			PCS	96		
13	Roof Insulation			SF	1393.0		
14							
15							