

WISDOM

The Wisdom is a modern Traditional style studio home with a clean and inviting exterior. The light-colored siding and gray roof create a timeless and balanced appearance. The covered porch with wooden beams offers a shaded outdoor space, perfect for relaxing or entertaining. The inside of this studio home is an open plan hosting living, dinging and bedroom areas on one side and other functional spaces like bathrooms and laundry on anther side and away from the eye. this creates both functional and efficient layout while maintaining a spacious feel.

Materials Shopping List

Please print and take this Materials Shopping List to your favorite Home Depot and ask for assistance in selecting the materials, fixtures and fittings to complete your new home.

Record your selection and the price of the item. Then do the math to determine the cost for your selections and the total cost of finishing your home.

< CLICK HERE >

To Go To Materials Shopping List



POWGH STUDIO AREA 100 GROUND FLOOR PLAN 4935F

FLOOR PLAN

499 SF

Studio

MATERIALS SHOPPING LIST

MECHANICAL

ELECTRICAL

PLUMBING

TABLE OF CONTENTS

RENDERINGS	ABOUT THE HOME -	— 01
1	RENDERINGS -	— 01
FLOOR PLAN	SCHEMATIC FLOOR PLAN -	— 01
1	HOME SPECS -	 01
	DISCLAIMER -	— 01
ABOUT	ABOUT FrameUpNow -	— 01
1	ABOUT HouseDocs ⊢	— 01
DESCRIPTIONS	BOM (Bill Of Materials) ⊢	02
2	STRUCTURAL -	 02
	ARCHITECTURAL	 02
	MECHANICAL -	 02
	ELECTRICAL	02
	PLUMBING -	 02

MATERIALS LIST MATERIALS LIST PREVIEW :

HOW TO BUILD CONSTRUCTION STEPS -

ARCHITECTURAL

COVER SHEET
FLOOR PLAN
DIMENSION PLAN
FOUNDATION PLAN
STRUCTURAL FLOOR PLAN-
WALL FRAME LAYOUT
ROOF TRUSS LAYOUT
ROOF PLAN
ARCHITECTURAL ELEVATIONS
ARCHITECTURAL ELEVATIONS ;
ARCHITECTURAL SECTIONS
ARCHITECTURAL DETAILS
ARCHITECTURAL CASEWORK ⊢— ;

COVER SHEET

STRUCTURAL 16

GENERAL NOTES	— 17
WALL FRAME LAYOUT	— 18
WALL PANEL & LAYOUT PLAN	⊸ 19
ROOF TRUSS LAYOUT	— 20
STRUCTURAL SECTIONS	─ 21
WALL BRACING LAYOUT	22
HOLD-DOWN PLAN	— 23
STRUCTURAL DETAILS 1	⊸ 24
STRUCTURAL DETAILS 2	─ 25
STRUCTURAL DETAILS 3	─ 26
TRUSS BLOCKING LAYOUT	─ 27
SHEETROCK BACKING	─ 28
ROOF BRACING LAYOUT	 29
HVAC PLAN	⊸ 30
SCHEDIII E	. 21
SCHEDULE -	
POWER PLAN -	-
DIMENSION FOR LIGHTING	
	-
DIMENSION FOR FITTING -	55

NOTES AND SCHEDULES -

MATERIALS SHOPPING LIST -

WATER SUPPLY & SEWAGE SYSTEM + 37

ABOUT



FrameUpNow is a design and manufacturing company providing precision-engineered home framing solutions. We offer a catalog of Affordable Homes, Tiny Homes, Garages, Shops and Barndominiums. FrameUpNow manufactures cold-formed steel (CFS) also known as Light Gauge Steel (LGS) framing components that conform to our engineered metal house frame plans or can be purchased as DIY skeleton kits.

The CFS/LGS framing is lightweight, easily assembled, and does not require heavy equipment or specialized labor, enabling homeowners to erect the frame themselves in just a few days. Unlike wood, the steel framing is impervious termites and bores, warping, expansion, and fire.

Our home plans come complete with a structural engineered stamp for permit approvals. Customers receive a full BOM also known as a Materials Shopping List to purchase finish materials from a Building Materials retailer. FrameUpNow prides itself on the quality and efficiency of our precision-engineered home framing solutions for construction professionals and DIY homeowners.



KEY PLAN

NO.	DESCRIPTION	DATE

NOTE:

LEGEND:

PROJECT

02-Wisdom-499 Studio Traditional-550

DRAWING NAME

INTRODUCTION

CLIENT NAME:	
PROJECT NUMBER:	
DATE:	
DESIGNED BY:	
DRAWN BY:	
CHECKED BY:	

1101

SCALE:

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DISCLAIMER: This documentation and all it's contents are the intellectual property of FrameUpNow. It is provided solely for marketing the services of FrameUpNow. The preliminary information is not approved for actual construction use and is not warranted to be complete or accurate. Unauthorized copying, distribution, or application of these proprietary materials, in any form or format, is strictly prohibited. FrameUpNow assumes no liability for any issues arising from improper use of this marketing content.

DISCLAIMER

DESCRIPTIONS

MATERIALS LIST

The BOM (Bill Of Materials) package, known as the Materials Shopping List document, provides:

Comprehensive Inventory: Detailed lists of essential materials sourced from architectural, mechanical, HVAC, electrical, and plumbing design drawing sets.

Precise Curation: Each item meticulously selected and organized for accuracy and efficiency in project planning.

Customizable Options: Customers can modify listed items to their preferences and calculate costs accordingly, ensuring alignment with personal project needs and budget.

Dedicated Space for Details: Includes tables for customers to note Home Depot SKU numbers or product descriptions for selected items,

facilitating seamless purchasing and coordination with suppliers.

Customer Convenience: Take the list to Home Depot or preferred suppliers for accurate pricing, helping align the total home budget with personal financial plans.

Simplify your construction journey with our Materials Shopping List document, where detailed preparation meets streamlined implementation for your dream home.

The mechanical package includes everything needed to guide HVAC

Detailed HVAC Floor Plan: Precisely maps out the placement of air

HVAC Sections and Riser Diagrams: Technical drawings offering

critical cross-sectional details and piping schematics, ensuring

proper integration of the heating and cooling system into the home's

Bill of Materials: A complete list of all necessary HVAC components.

handlers, ductwork, and vents throughout the home's layout.

MECHANICAL

structure.

STRUCTURAL

The structural drawings package provides an exhaustive set of detailed plans essential for the precise assembly of your building. This comprehensive package includes:

Framing Plans: Detailed layouts for all framing components. Truss Layouts: Clear instructions for truss placement and

Panel Length Plans: Specifications for panel dimensions. Framing Elevations and Sections: Precise elevation and sectional views for accurate construction.

Truss and Wall Blocking Plans: Plans for truss and wall blocking to ensure structural integrity.

Hold-Down Plan: Detailed hold-down requirements for stability. Snap Sheet: Reference sheet for quick identification of components

Structural Details and Bracing Plans: Complete details and bracing plans for all structural elements.

Accompanying these plans is a comprehensive Bill of Materials (BOM) that lists every necessary building component, from cold formed steel (CFS) frames to fasteners.

ARCHITECTURAL

With the comprehensive architectural package, both builders and DIY homeowners can confidently execute the construction.

The architectural package includes:

Furnished Floor Plans: Complete with furniture layouts for a clear understanding of space utilization.

Detailed Dimension Plans: Ensures precise measurements, from the overall footprint down to the exact placement of windows and

Foundation Plan: Detailed plan to establish a solid foundation.

Wall Framing and Truss Layout: Comprehensive plans for wall framing and truss placement.

Architectural Elevations: Exterior views showcasing the design.

Strategic Building Sections: Critical cross-sectional details for a thorough understanding of the build.

Casework Drawings and Diagrams: Suggested designs for built-in caseworks, such as kitchen cabinets.

ELECTRICAL

The electrical package includes all the plans and documentation needed to guide the installation of your home's electrical system:

Detailed Power Plan: Precisely maps out the placement of outlets, switches, and other power components throughout the layout.

Comprehensive Lighting Plan: Shows the optimal locations for lighting fixtures, sconces, and other illumination sources to create a well-lit, functional interior.

Dimensioned Electrical Layout: Provides exact dimensions and measurements to ensure proper placement of all electrical elements.

Bill of Materials: A complete list of every component needed, from circuit breakers to wiring.

The plumbing package includes everything needed to guide the installation of your home's water supply and drainage systems:

Detailed Water Supply System Plan: Precisely maps out the placement of pipes, valves, and plumbing fixtures throughout the

Comprehensive Sewage System Plan: Shows the optimal routing and sizing of drain lines to effectively remove waste and ensure

Detailed Riser Diagrams: Provide information needed to properly install all vertical plumbing risers and vent stacks.

Bill of Materials: A complete list of every component needed, from

PLUMBING

proper drainage.

pipes to fixtures.


BOM (Bill Of Materials) (Separately Attached)





The Bill of Materials (BOM) is a crucial document that compiles the material requirements from different disciplines into a centralized inventory, enabling efficient procurement, inventory management, and cost estimation for a specified project or

ELECTRICAL BOM



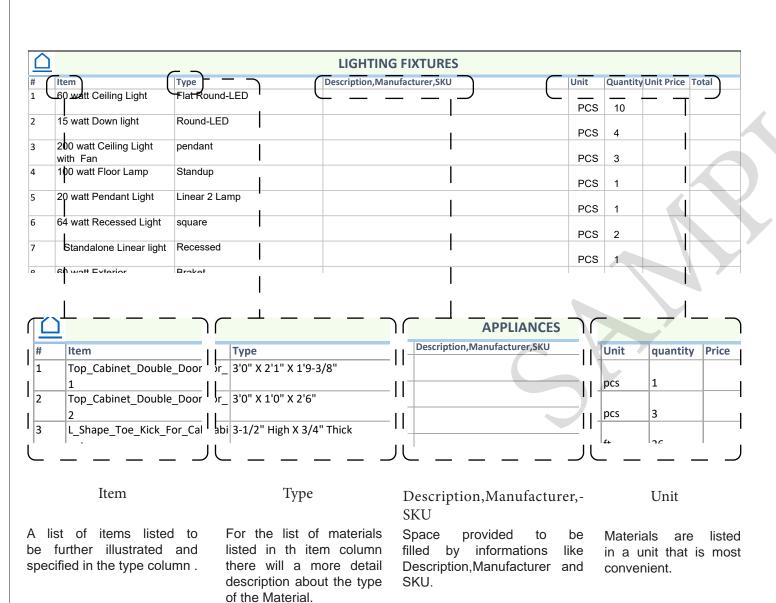

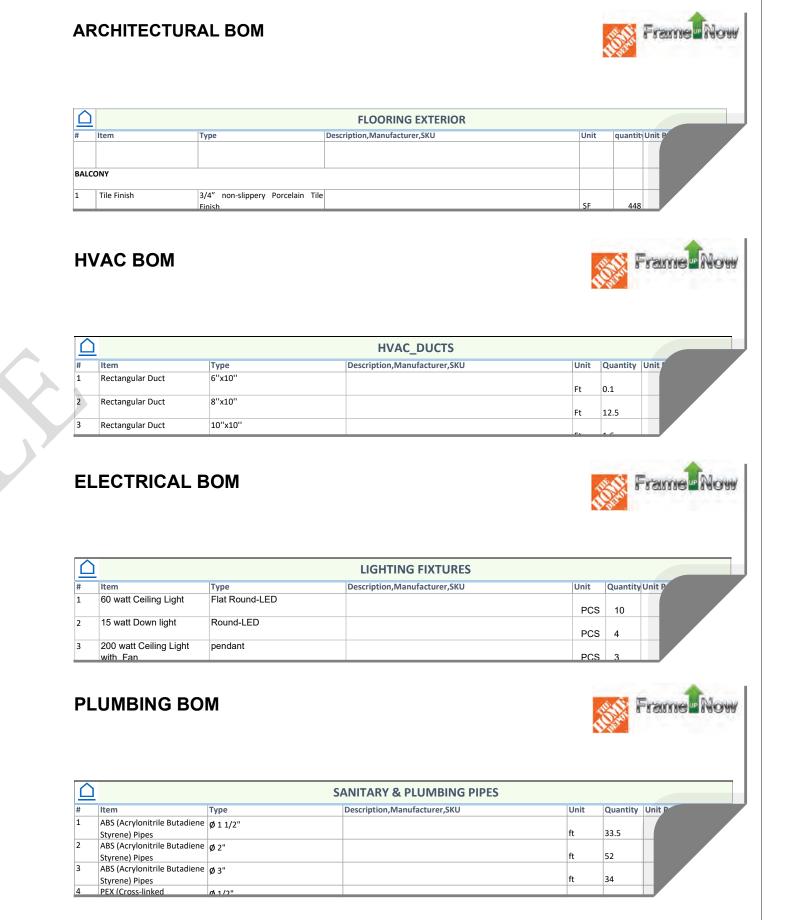

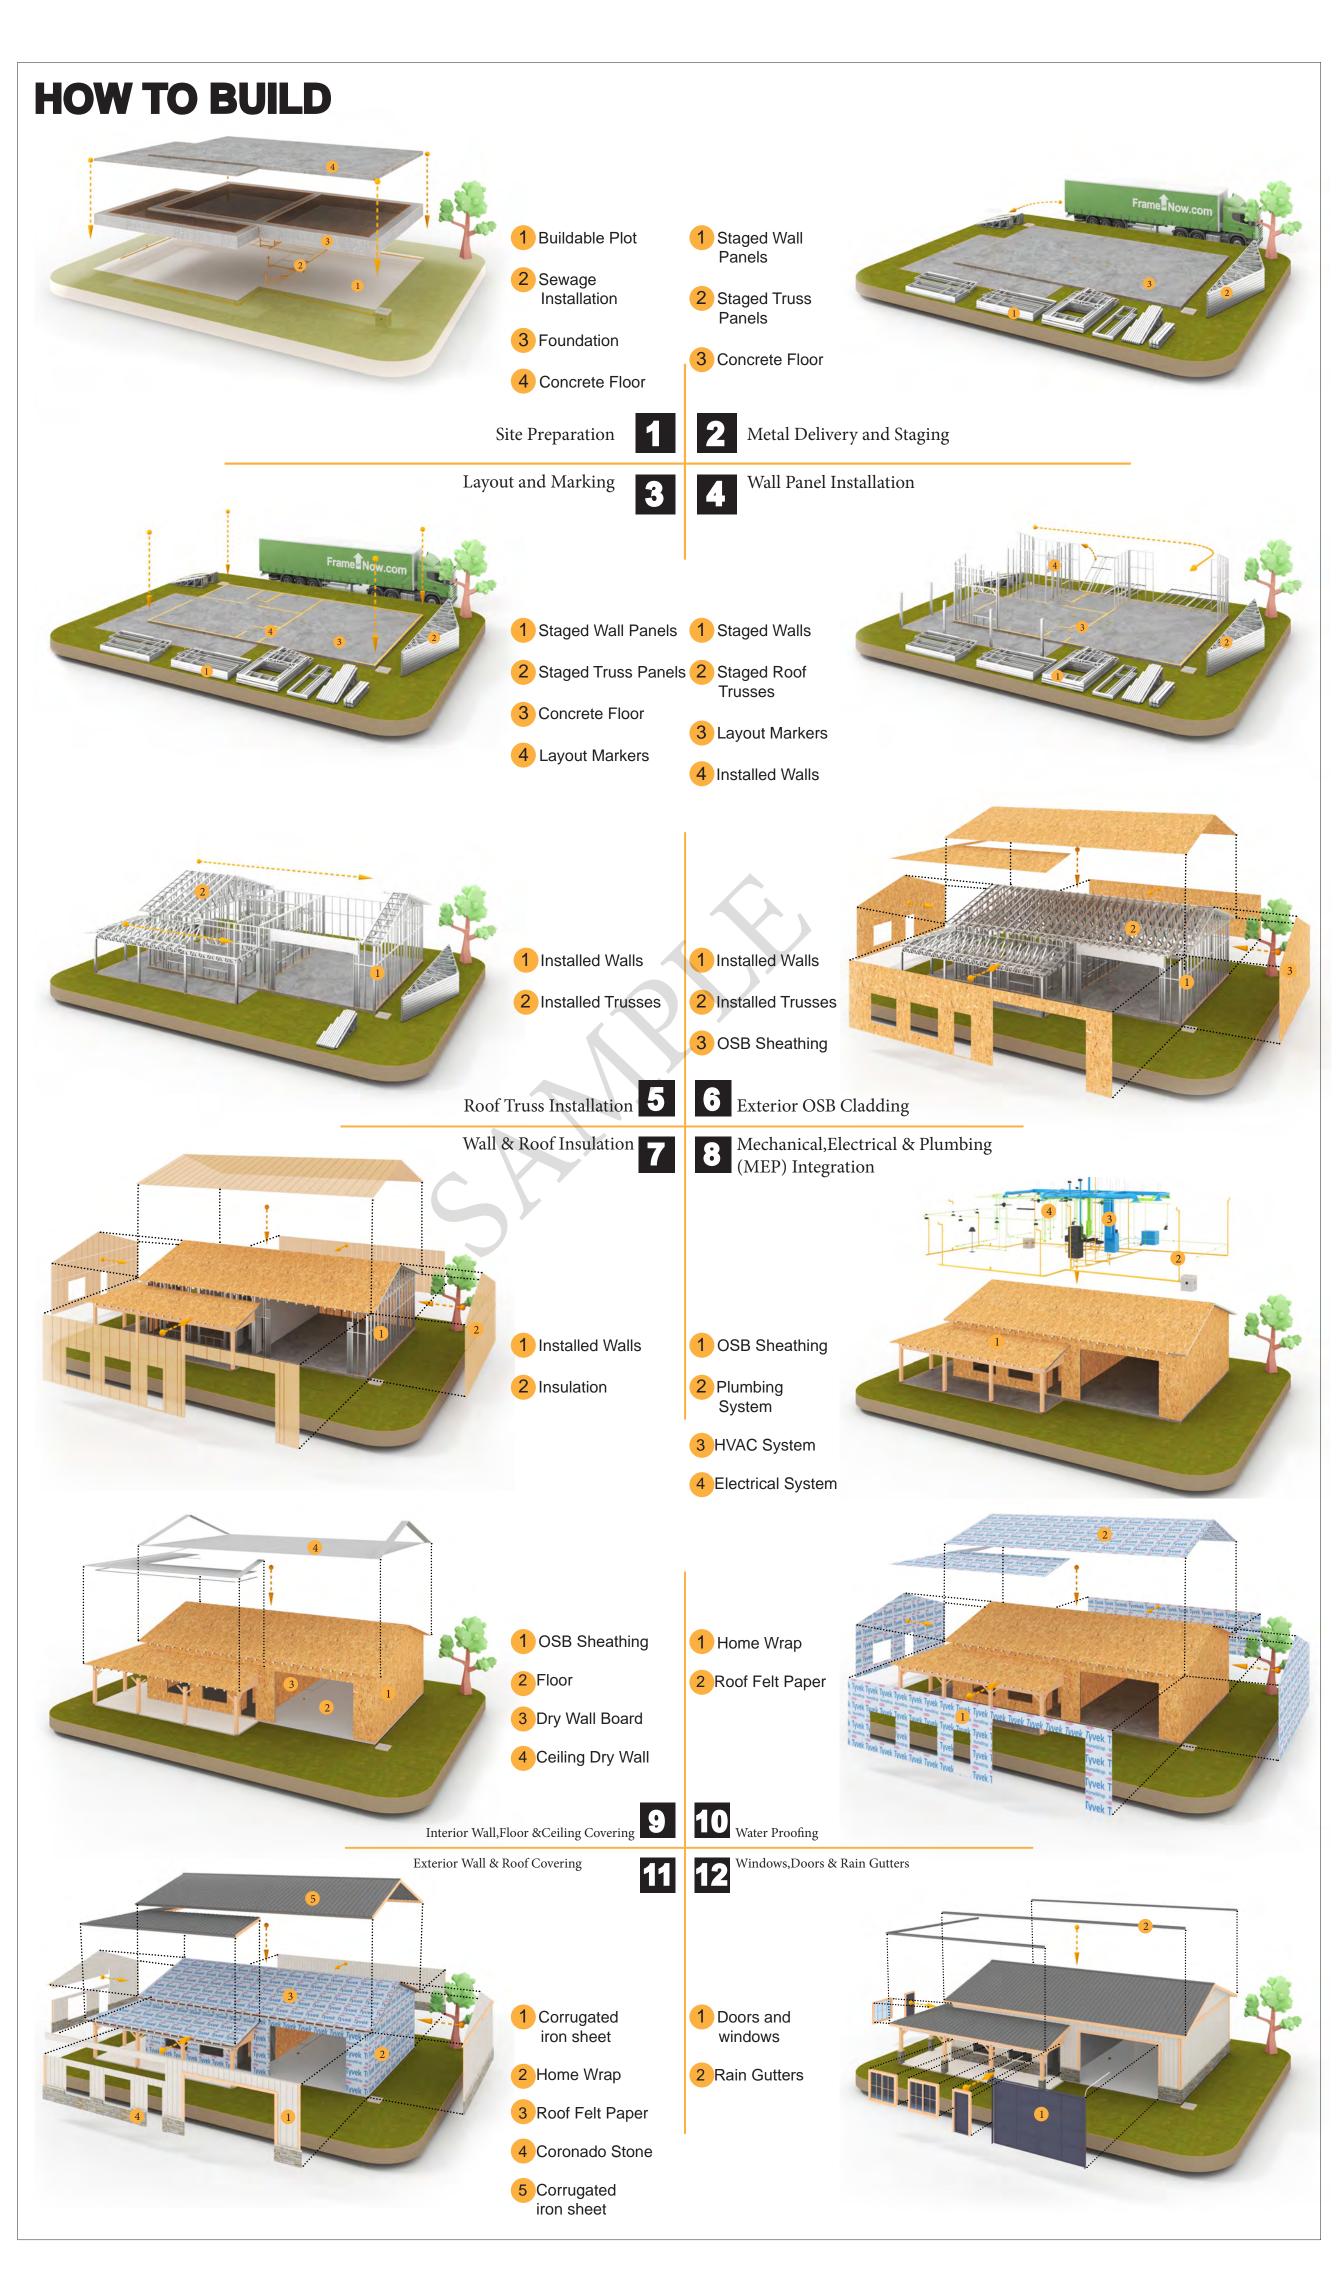



KEY PLAN

NO.	DESCRIPTION	DATE

NOTE:

LEGEND:

PROJECT

02-Wisdom-499 **Studio Traditional-550**


DRAWING NAME

INTRODUCTION


CLIENT NAME: PROJECT NUMBER: DATE: **DESIGNED BY** DRAWN BY: CHECKED BY:

1102

SCALE:

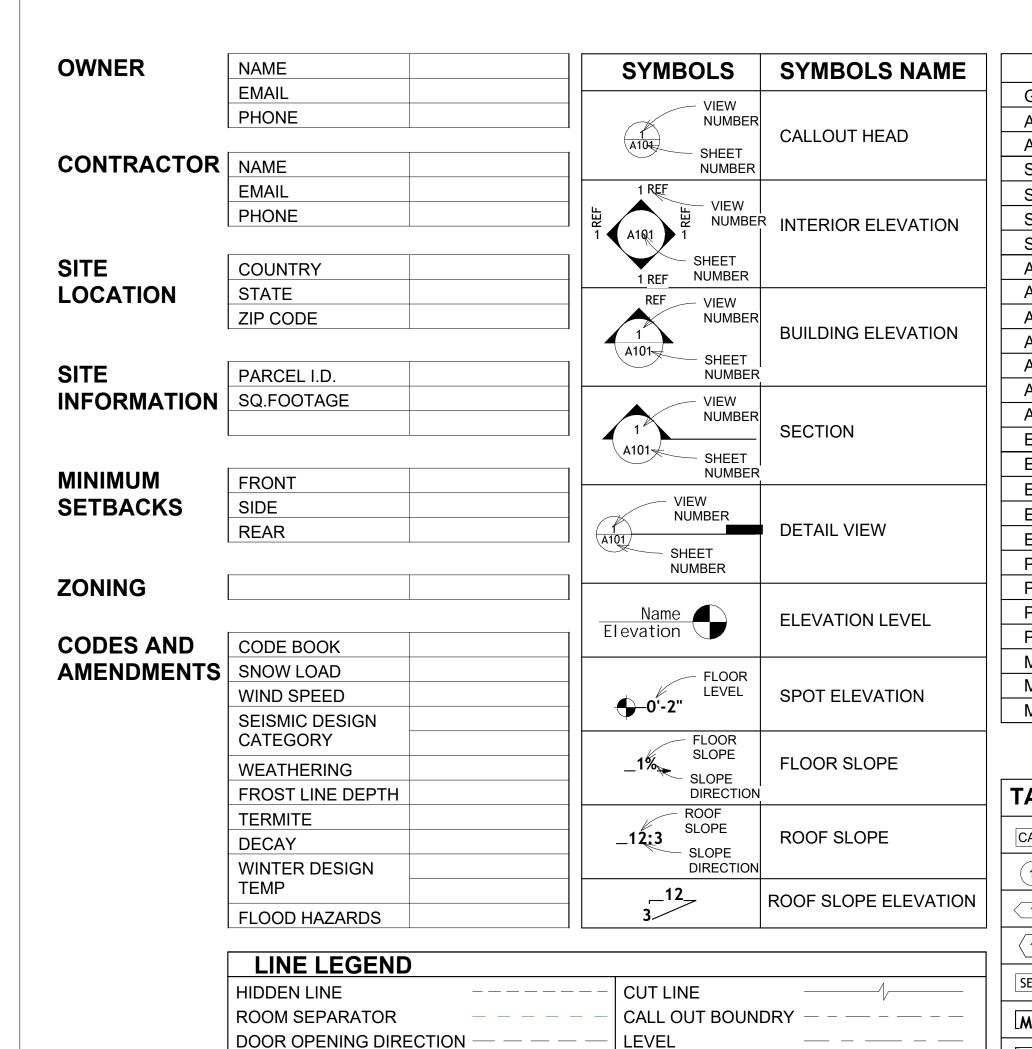

PAGE INDEX					
G101	COVER SHEET				
A101	FLOOR PLAN				
A102	DIMENSION PLAN				
S101	FOUNDATION PLAN				
S102	STRUCTURAL FLOOR PLAN				
S103	FRAME LAYOUT				
<u> </u>	ROOF TRUSS LAYOUT				
103	ROOF PLAN				
1201	ELEVATIONS				
1202	ELEVATIONS				
\ 301	SECTIONS				
4401	DETAILS				
\ 402	CASEWORK DETAILS				
4403	CASEWORK DETAILS				
E101	SCHEDULE				
E102	LIGHTING PLAN				
E103	POWER PLAN				
E104	DIMENSION PLAN FOR LIGHT FIXTURE				
E105	DIMENSION PLAN FOR FITTING				
P101	COVER SHEET				
P102	WATER SUPPLY SYSTEM				
P103 P104	SEWAGE SYSTEM				
M101	RISER DIAGRAM HVAC PLAN				
M101 M102	HVAC SECTION				
M103	RISER DIAGRAM				
AG	TAG'S NAME				
A01	CASEWORK TAG				
1	DOOR TAG				
1	FURNITURE TAG				
1	WINDOW TAG				
E01	SPECIALTY EQUIPMENT TAG				
NEO 1	MECHANICAL EQUIPMENT TAG				
E01	PLUMBING EQUIPMENT TAG				

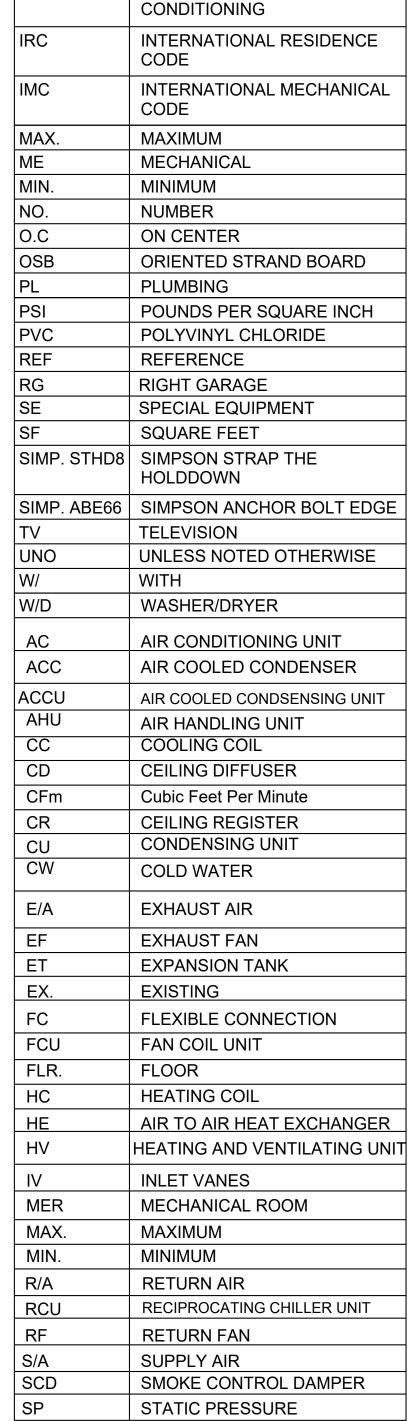

ABBREVIATION

CASEWORK ELECTRICAL

FOOTINGS

ASTM D698

ACTION FLOOR SYSTEMS


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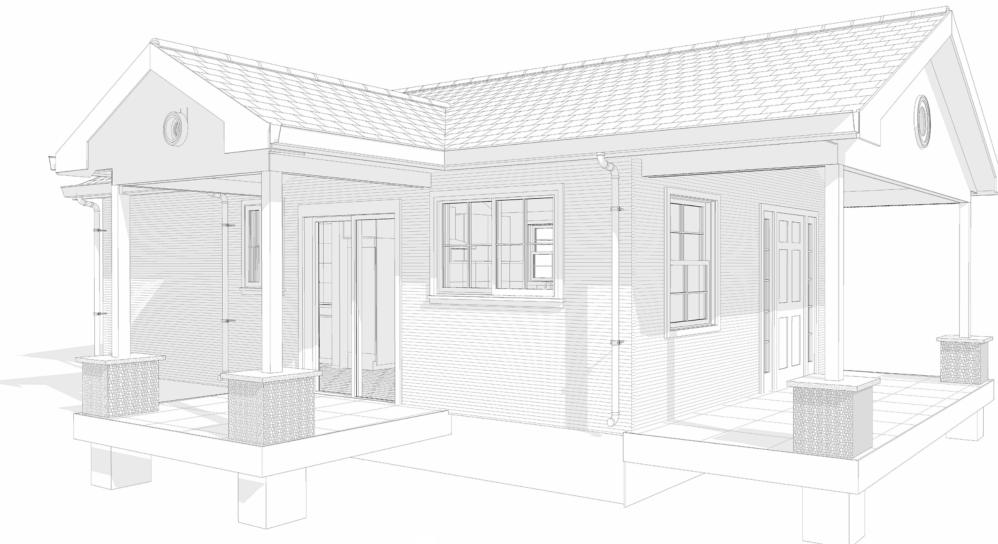
TESTING AND MATERIAL

FINISHED FLOOR LEVEL

FINISHED FLOOR ELEVATION

HEATING, VENTILATION & AIR




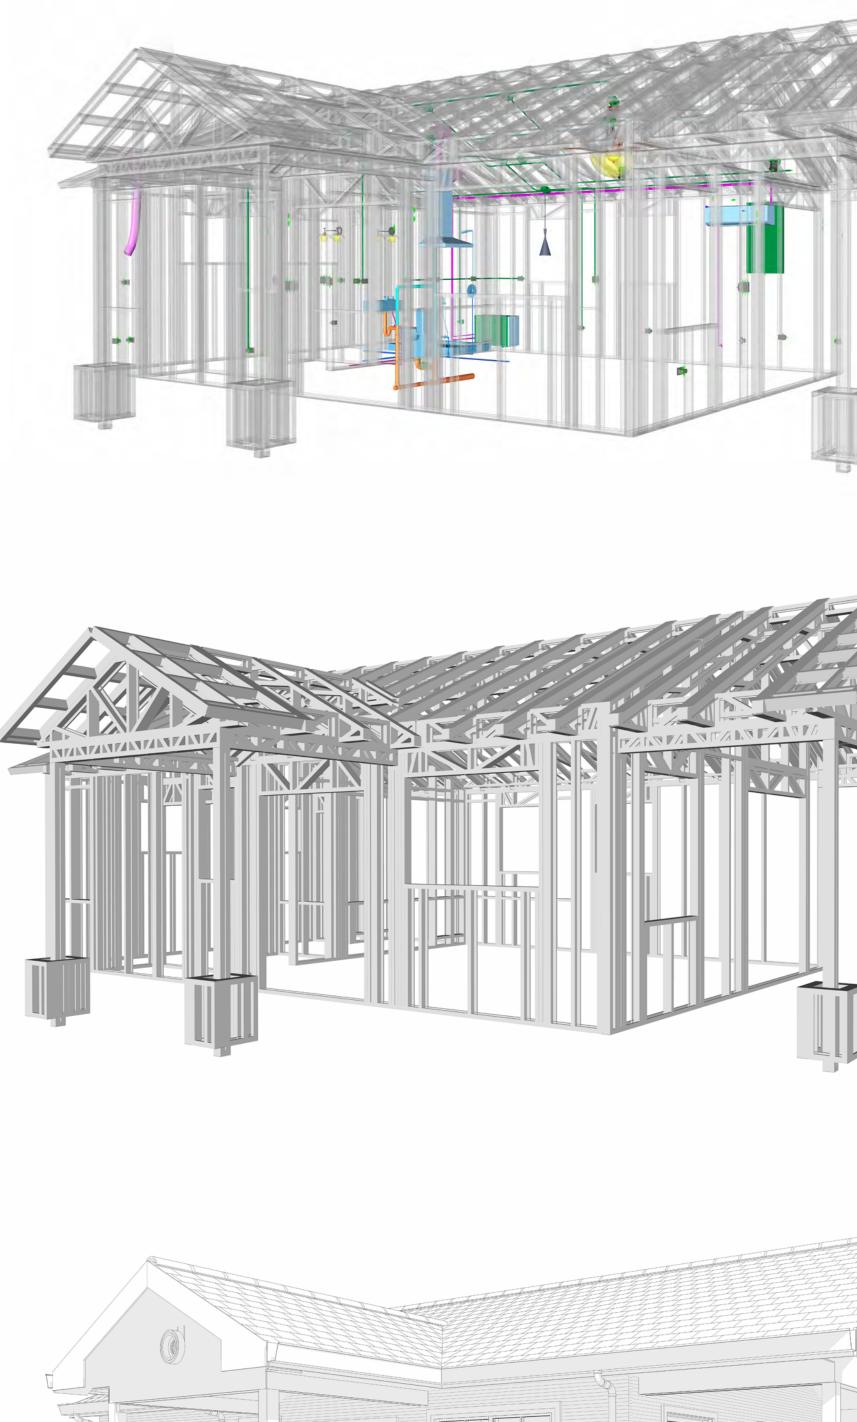

02 WISDOM 499 STUDIO TRADITIONAL 550

SQUARE FOOTAGE		
LIVING	493	
PORCH	151	
TOTAL	644	



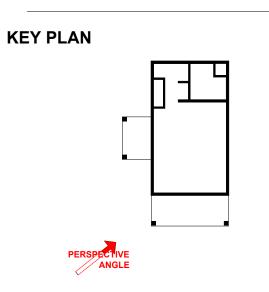

NO.	DESCRIPTION	DATE

NOTE

LEGEND:

PROJECT

02 Wisdom 499 Studio Traditional 550

DRAWING NAME

COVER SHEET

Client Name
0033_15
2/1/2025 5:14:16 PM
Designer
Author
Checker

G101

SCALE: As indicated



GROUND CUT

OVER HEAD

GENERAL NOTES

- 1. THIS DRAWING DEPICTS THE ARCHITECTURAL (SPACE LAYOUT, FURNISHING, FLOOR, WALLS, ROOFS, FOUNDATION, WINDOWS AND DOORS) SYSTEMS. IT PROVIDES A VISUAL REPRESENTATION OF THE ARCHITECTURAL LAYOUT AND COMPONENTS.
- 2. THE ARCHITECTURAL DRAWINGS ARE PREPARED TO MEET THE SPECIFIC REQUIREMENTS OF THE BUILDING, AS PER THE PROJECT SPECIFICATIONS AND APPLICABLE CODES AND STANDARDS.
- 3. THE CONSTRUCTION OF THIS HOME SHALL COMPLY WITH THE LATEST EDITION OF THE INTERNATIONAL RESIDENTIAL CODE (IRC), INTERNATIONAL MECHANICAL CODE (IMC), THE INTERNATIONAL PLUMBING STANDARD, THE NATIONAL ELECTRICAL STANDARD AND ALL OTHER APPLICABLE LOCAL, STATE, AND NATIONAL CODES AND REGULATIONS.
- 4. COORDINATION WITH OTHER TRADES HAS BEEN DONE ON A DESIGN LEVEL. THIS DRAWING SHALL BE READ TOGETHER WITH THE ME, EL AND PL DESIGN DRAWINGS TO ENSURE PROPER CONSTRUCTION AND INTEGRATION OF THE BUILDING SYSTEMS.

ABOUT WALLS:

1. SHOWER WALL COVERING

BATHTUB AND SHOWER SPACES (WALLS AND FLOORS) WITH INSTALLED SHOWER HEADS AND IN SHOWER COMPARTMENTS SHALL BE FINISHED WITH A NON-ABSORBENT SURFACE.

2. WALL PAINT (INTERNAL)

THE TYPICAL THICKNESS OF LATEX WALL PAINT IS 1/32 OF AN INCH FOR A SINGLE COAT. AND DOUBLE COAT (1/16") SHALL BE APPLIED FOR DURABILITY.

3. ADHESIVES:

THE ADVISABLE TYPE OF ADHESIVE FOR THIS PROJECT IS **EPOXY ADHESIVES** BECAUSE THEY ARE KNOWN FOR THEIR HIGH STRENGTH, DURABILITY, AND RESISTANCE TO MOISTURE, CHEMICALS AND HEAT.

REFER TO SHEETS A201 & A202 FOR GENERAL NOTES ON EXTERNAL FINISHING MATERIALS

ABOUT FLOORS:

- . THE SPOT ELEVATION INDICATES THE FINISHED FLOOR ELEVATION.
- 2. FINISHED FLOORS PER PLANS.
- 3. FIELD VERIFY FOR DIMENSION DROP 4" FOR SHOWER AND BATHTUB USE.
- 4. 1% SLOPE ON OUTDOOR BALCONIES FOR WATER RUN OFF.
- 5. 2% SLOPE TOWARDS THE SHOWER DRAIN FOR SUFFICIENT DRAINAGE.
- 6. 4" DROP AT THE DOOR LEADING TO EXTERIOR BALCONY FROM THE MAIN LIVING AREA.
 7. 5% SLOPE FOR GARAGE IS USED, WHICH SHOULD BE CHECKED WITH THE LOCAL
- GARAGING ZONING LAWS.

	FURNITURE SCHEDULE				
	TYPE MARK	TYPE	COUNT		
01		500MM DIAMETER	1		
02	THREE SEAT SOFA 2		1		
03		DINING CHAIR	2		
04		COFFE TABLE	1		

ROOM FINISH SCHEDULE							
ROOM NUMBE R	ROOM NAME	FLOOR FINISH	BASE FINISH	WALL FINISH	CEILING FINISH	CEILING HEIGHT	COMMENT S
04		LIABDWOOD	CONCRETE	MALL DAINT	DDV MALL	0! 0"	
01	STUDIO AREA	HARDWOOD	CONCRETE	WALL PAINT	DRY WALL	8' - 0"	
02	BATH	VINYL TILES	CONCRETE	CERAMIC TILE	MRD	8' - 0"	
03	WH	VINYL TILES	CONCRETE	WALL PAINT	DRY WALL	8' - 0"	
04	KITCHEN	HARDWOOD	CONCRETE	WALL PAINT	DRY WALL	8' - 0"	
05	HW	VINYL TILES	CONCRETE	WALL PAINT	DRY WALL	8' - 0"	
06	CL	HARDWOOD	CONCRETE	WALL PAINT	DRY WALL	8' - 0"	
07	W/D	VINYL TILES	CONCRETE	CERAMIC TILE	DRY WALL	8' - 0"	
08	PORCH 2	PROCELAIN TILE	CONCRETE	EXTERIOR-GRADE PLYWOOD	PLYWOOD	8' - 0"	
09	PORCH	PROCELAIN TILE	CONCRETE	EXTERIOR-GRADE PLYWOOD	PLYWOOD	8' - 0"	
10	HALL	HARDWOOD	CONCRETE	WALL PAINT	DRY WALL	8' - 0"	



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KEY PLAN

NO.	DESCRIPTION	DATE

NOTE:

LEGEND:

PROJECT


02 Wisdom 499 Studio Traditional 550

DRAWING NAME

FLOOR PLAN

CLIENT NAME:	Client Name	
PROJECT NUMBER:	0033_15	
DATE:	2/1/2025 5:14:18 PI	
DESIGNED BY:	Designe	
DRAWN BY:	Autho	
CHECKED BY:	Checke	

A101

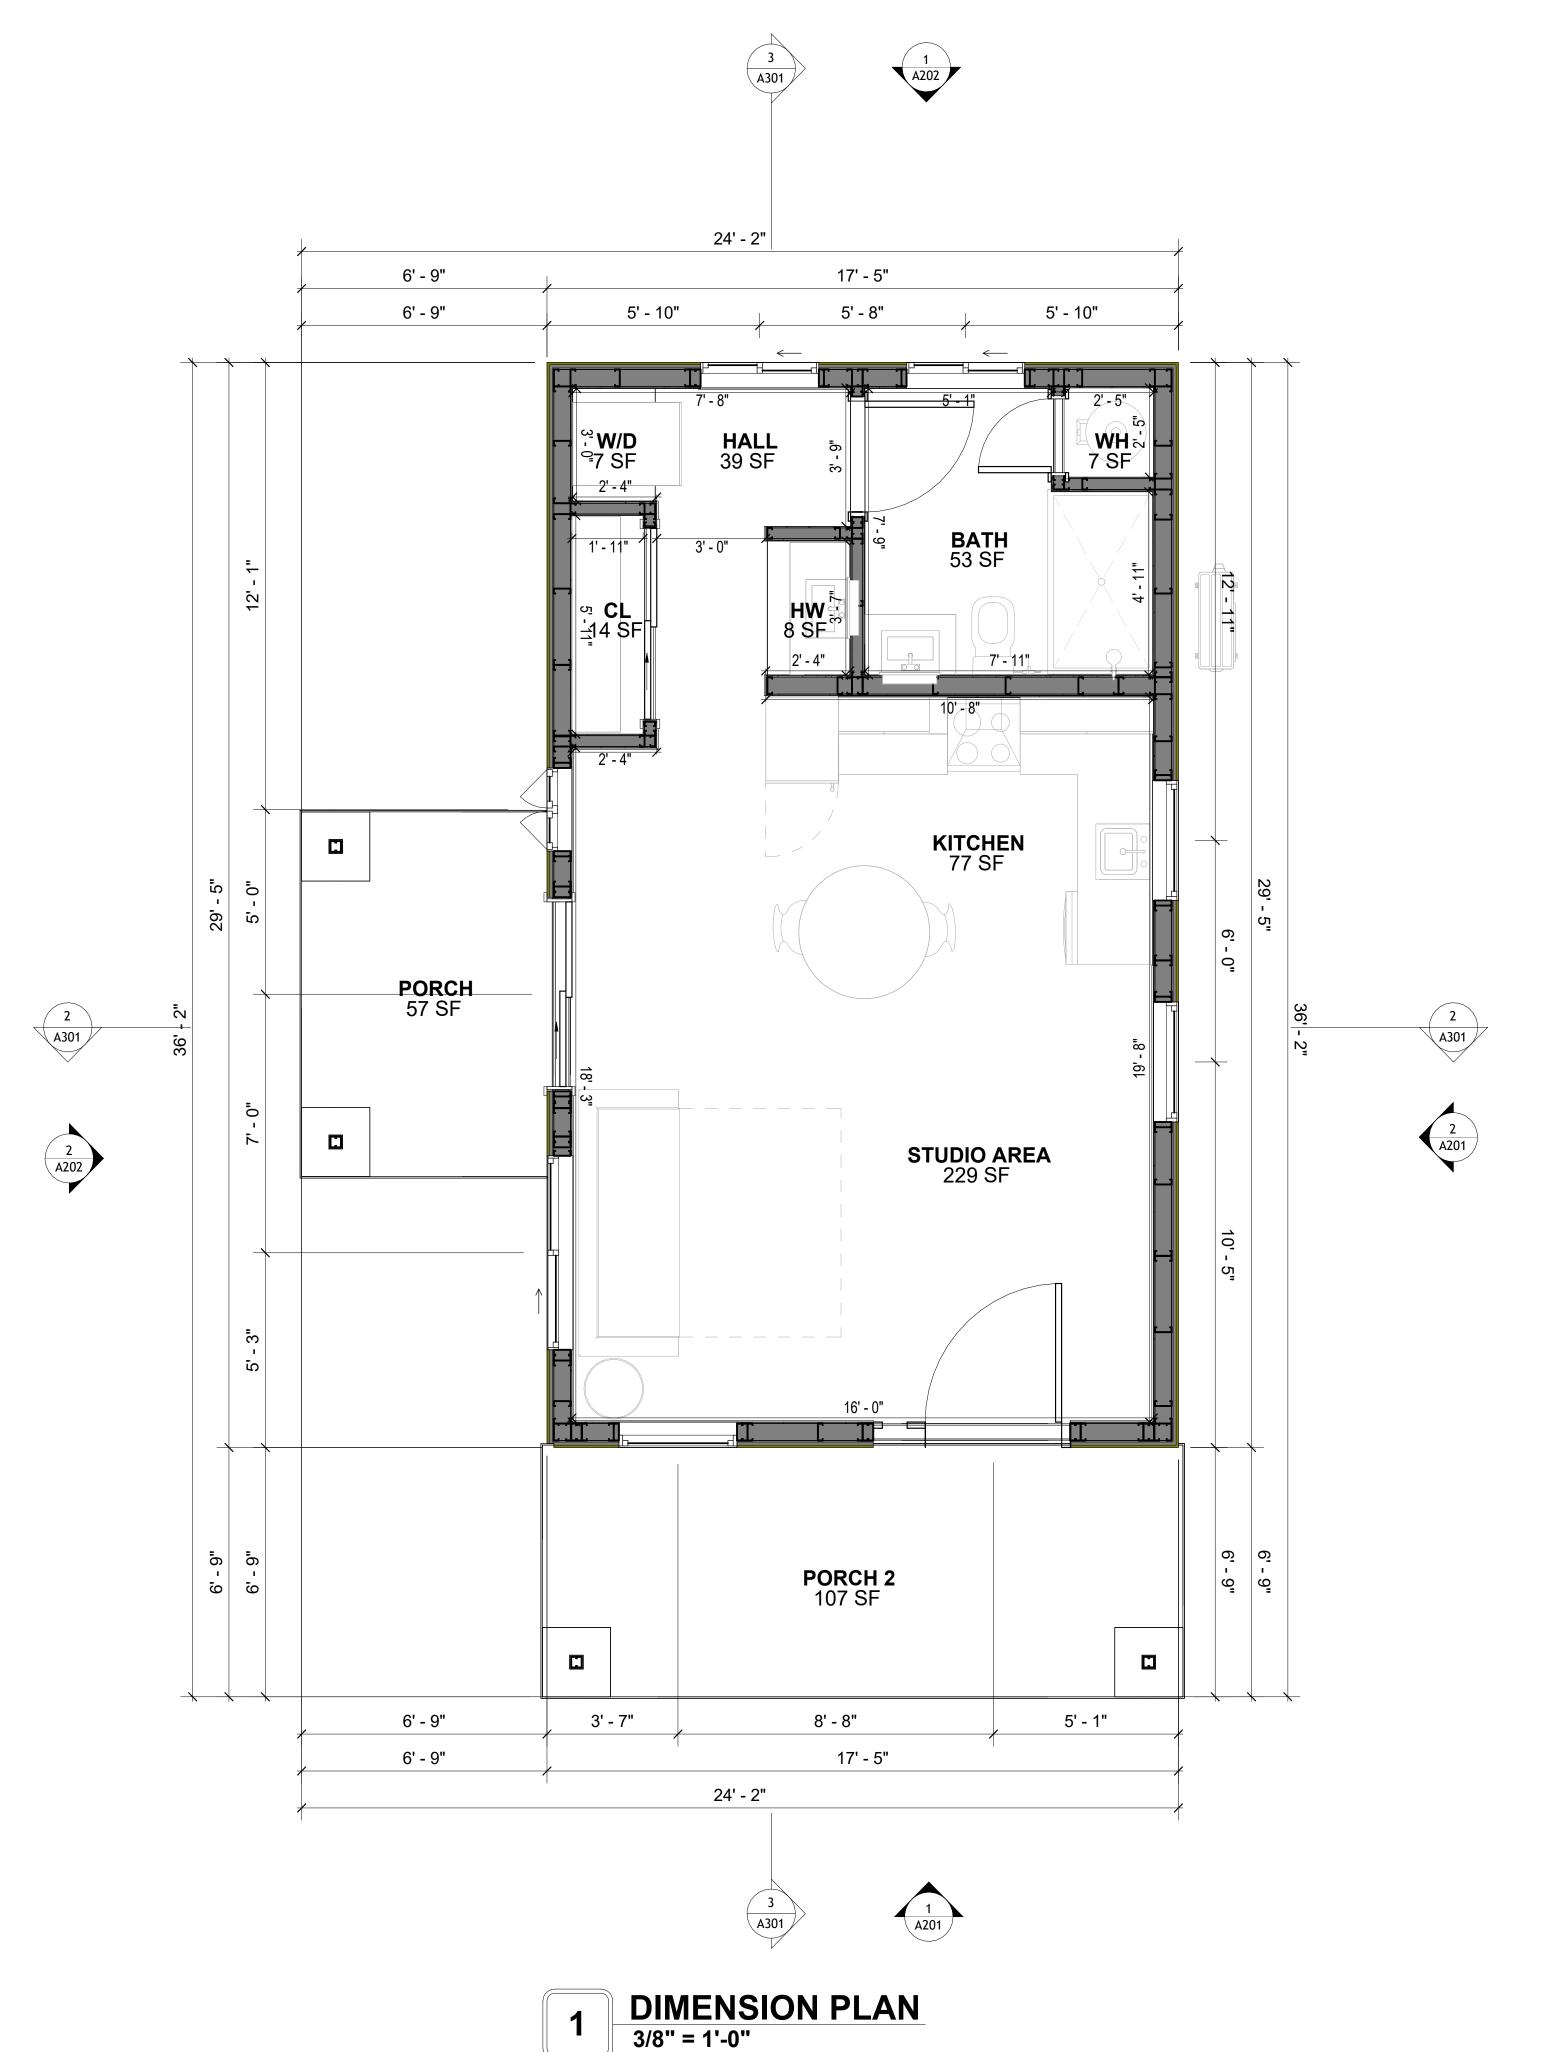

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KEY PLAN

DATE

NOTE:

LEGEND:

PROJECT

02 Wisdom 499 Studio Traditional 550

DRAWING NAME

DIMENSION PLAN

CLIENT NAME:	Client Name
PROJECT NUMBER:	0033_15
DATE:	2/1/2025 5:14:19 PM
DESIGNED BY:	Designer
DRAWN BY:	Author
CHECKED BY:	Checker

A102

SCALE: 3/8" = 1'-0"

151

644

SQUARE FOOTAGE
LIVING 4
PORCH 1
TOTAL 64

DIMENSIONS IN THE ARCHITECTURAL DRAWINGS CONSIDER FINISHING MATERIALS. FOR PRECISE MEASUREMENTS OF THE STRUCTUAL FRAMING, REFER TO THE ATTACHED STRUCTURAL PLAN SET.

FOUNDATION NOTES

NOTES:

TERMITES PRETREATMENT BY LICENSED CONTRACTOR UNDER SLAB AND AROUND FOOTINGS. ALL AREAS BELOW SLABS SHALL BE TREATED NO MORE THAN 24 HOURS PRIOR TO CONCRETE POUR. EVIDENCE OF TREATMENT MUST BE PROVIDED PRIOR TO PLACING OF CONCRETE.

. MATERIALS:

ALL INTERIOR CONCRETE SLABS SHALL BE A MIN. OF 4" THICK CONCRETE OVER 4" COMPACTED AGGREGATE BASE (ASTM D698), FINISH ELEVATIONS AS NOTED ON DRAWINGS, 6" ABOVE ADJACENT GRADE, LEVEL SLABS TO 1/8"-10' MAX.. CONCRETE SLABS SHALL BE 2500# PSI AT 28 DAYS. A 4" ALLOWABLE SLUMP.

2. PAD PREPARATION:

- EXCAVATION FOR FOOTING SHALL BE NEAT.
- FOOTINGS SHALL BE POURED IMMEDIATELY AFTER EXCAVATION AND APPROPRIATE
- INSPECTION. ALL REINFORCING STEEL MARKED "CONTINUOUS" SHALL BE LAPPED 36 BAR DIAMETERS AT SPLICES AND AROUND CORNERS OR INTERSECTIONS WITH A STANDARD 90 DEGREE BEND ON CORNER BARS. LAP WIRE MESH ONE FULL MESH AT SIDE AND END LAPS.
- ALL HARDWARE TO BE SIMPSON OR EQUIVALENT. EXTERIOR FRAME WALL TO BE SECURED WITH 1/2"X10" ANCHOR BOLTS 4'-0" O.C. FOR 1-STORY AND 2'-8" O.C. FOR 2-STORY. BOLTS SHALL BE LOCATED WITHIN 1'-0" OF EACH END
- PIECE AND SHALL HAVE A MIN. OF TWO BOLTS PER PIECE. -FOUNDATION ANCHOR STRAPS SHALL BE PERMITTED, ACCORDING TO RESIDENTIAL CODE
- ALL INTERIOR WALLS TO BE SECURED WITH POWER DRIVEN PINS PER MANUFACTURER
- SPECIFICATION USE PIN SPACING EQUIVALENT TO 1/2" ANCHOR BOLTS. - ALL CONSTRUCTION TO CONFORM TO THE 2012 IRC R-10 RIGID INSULATION OUTSIDE OF EXTERIOR FOUNDATION WALLS UNDER LIVING AREA.
- CONCRETE PAD FOR CONDENSER THICKNESS IS 4" MIN UNLESS OTHERWISE NOTED.

B. CONCRETE CONSTRUCTION:

- THE SLAB SHALL BE UNDERLAIN BY A VAPOR BARRIER/RETARDER IN THE LIVING AREA (TYPICALLY POLYETHYLENE, UNLESS MORE STRINGENT PROTECTION REQUIRED BY THE ARCHITECT, ENGINEER, FLOOR COVERING MANUFACTURER, OR ACCEPTED PRACTICE). UNLESS OTHERWISE REQUIRED, BARRIER MAY BE OMITTED AT GARAGES, PORCHES AND PATIOS WITHOUT FLOOR COVERINGS. IT IS BEYOND THE SCOPE OF THESE PLANS TO DETERMINE THE APPLICABILITY OF THESE MORE STRINGENT REQUIREMENTS. BUILDER SHALL VERIFY PRIOR TO CONSTRUCTION.


I. REINFORCEMENT:

- IF CONSTRUCTED ON ACTIVE SOILS, THE LONG TERM PERFORMANCE OF THE FOUNDATION IS DEPENDENT ON MAINTENANCE BY THE OWNER. THUS THE BUILDER SHALL ADVISE THE OWNER OF THE FOLLOWING:
- DRAINAGE MUST BE MAINTAINED. WATER SHALL NEVER BE ALLOWED TO POND NEAR THE FOUNDATION.
- 2. THE SOIL AROUND THE FOUNDATION SHALL BE MAINTAINED IN A RELATIVELY DAMP CONDITION, SUCH AS THAT REQUIRED TO KEEP A LAWN GREEN. IF IT DRIES OUT IT WILL SHRINK. IF IT GETS WET, IT WILL HEAVE UPWARD.
- 3. SLABS ON THE SHORTER SIDE USES MAIN BARS ARE USED IN THIS DIRECTION ONLY WITH SMALLER DIAMETER DISTRIBUTION BARS ARE PLACED, FORMING A MAT OR GRID. ALL REINFORCEMENT BARS SIZE 10MM OR LARGER IN ACCORDANCE TO ASTM
- ANCHOR BOLTS AT ALL EXTERIOR WALLS SHALL BE MINIMUM 1/2 INCH DIAMETER WITH A MAXIMUM SPACING OF 6'-0" ON CENTER, UNLESS NOTED OTHERWISE.
- 1. ANCHOR BOLTS SHALL BE INSTALLED WITHIN 12 INCHES OF EACH END OF EACH SILL PLATE WITH AT LEAST TWO ANCHOR BOLTS FOR EACH BOLTS FOR EACH SILL PLATE LONGER THAN 12 INCHES.
- 5. SIMPSONS SILL ANCHORS MAYBE SUBSTITUTED FOR ANCHOR BOLTS AT THE SAME SPACING.
- 6. EXTERIOR CONCRETE SLABS WHICH ARE NOT PART OF THE MAIN SLAB SHALL BE MINIMUM 4 INCHES THICK WITH NO STEEL REINFORCING BARS REQUIRED, UNLESS NOTED OTHERWISE ON FOUNDATION PLAN.

VERIFY THE FOLLOWING PRIOR TO POURING:

- ALL HOLDDOWNS, STRAP, AND POST LOCATIONS.
- CONCRETE FINISHES. PANEL RISER LOCATION WHERE APPLICABLE.
- UNDERSLAB MECHANICAL REQUIREMENTS.
- . STEM WALL BLOCKOUTS.
- 5. UNDERSLAB ELECTRICAL REQUIREMENTS AND PANEL RISER LOCATION. WHERE APPLICABLE.
- 6. PROVIDE THE FOLLOWING:
- PVC SLEEVES THROUGH FTG IF REQUIRED
- 20' #4 COPPER GROUND BAR.
- SLOPE FINISH GRADE AWAY FROM FOOTING.

NOTE: FIELD VERIFY ALL DIMENSIONS SEE DIMENSIONED ARCHITECTURAL DRAWINGS

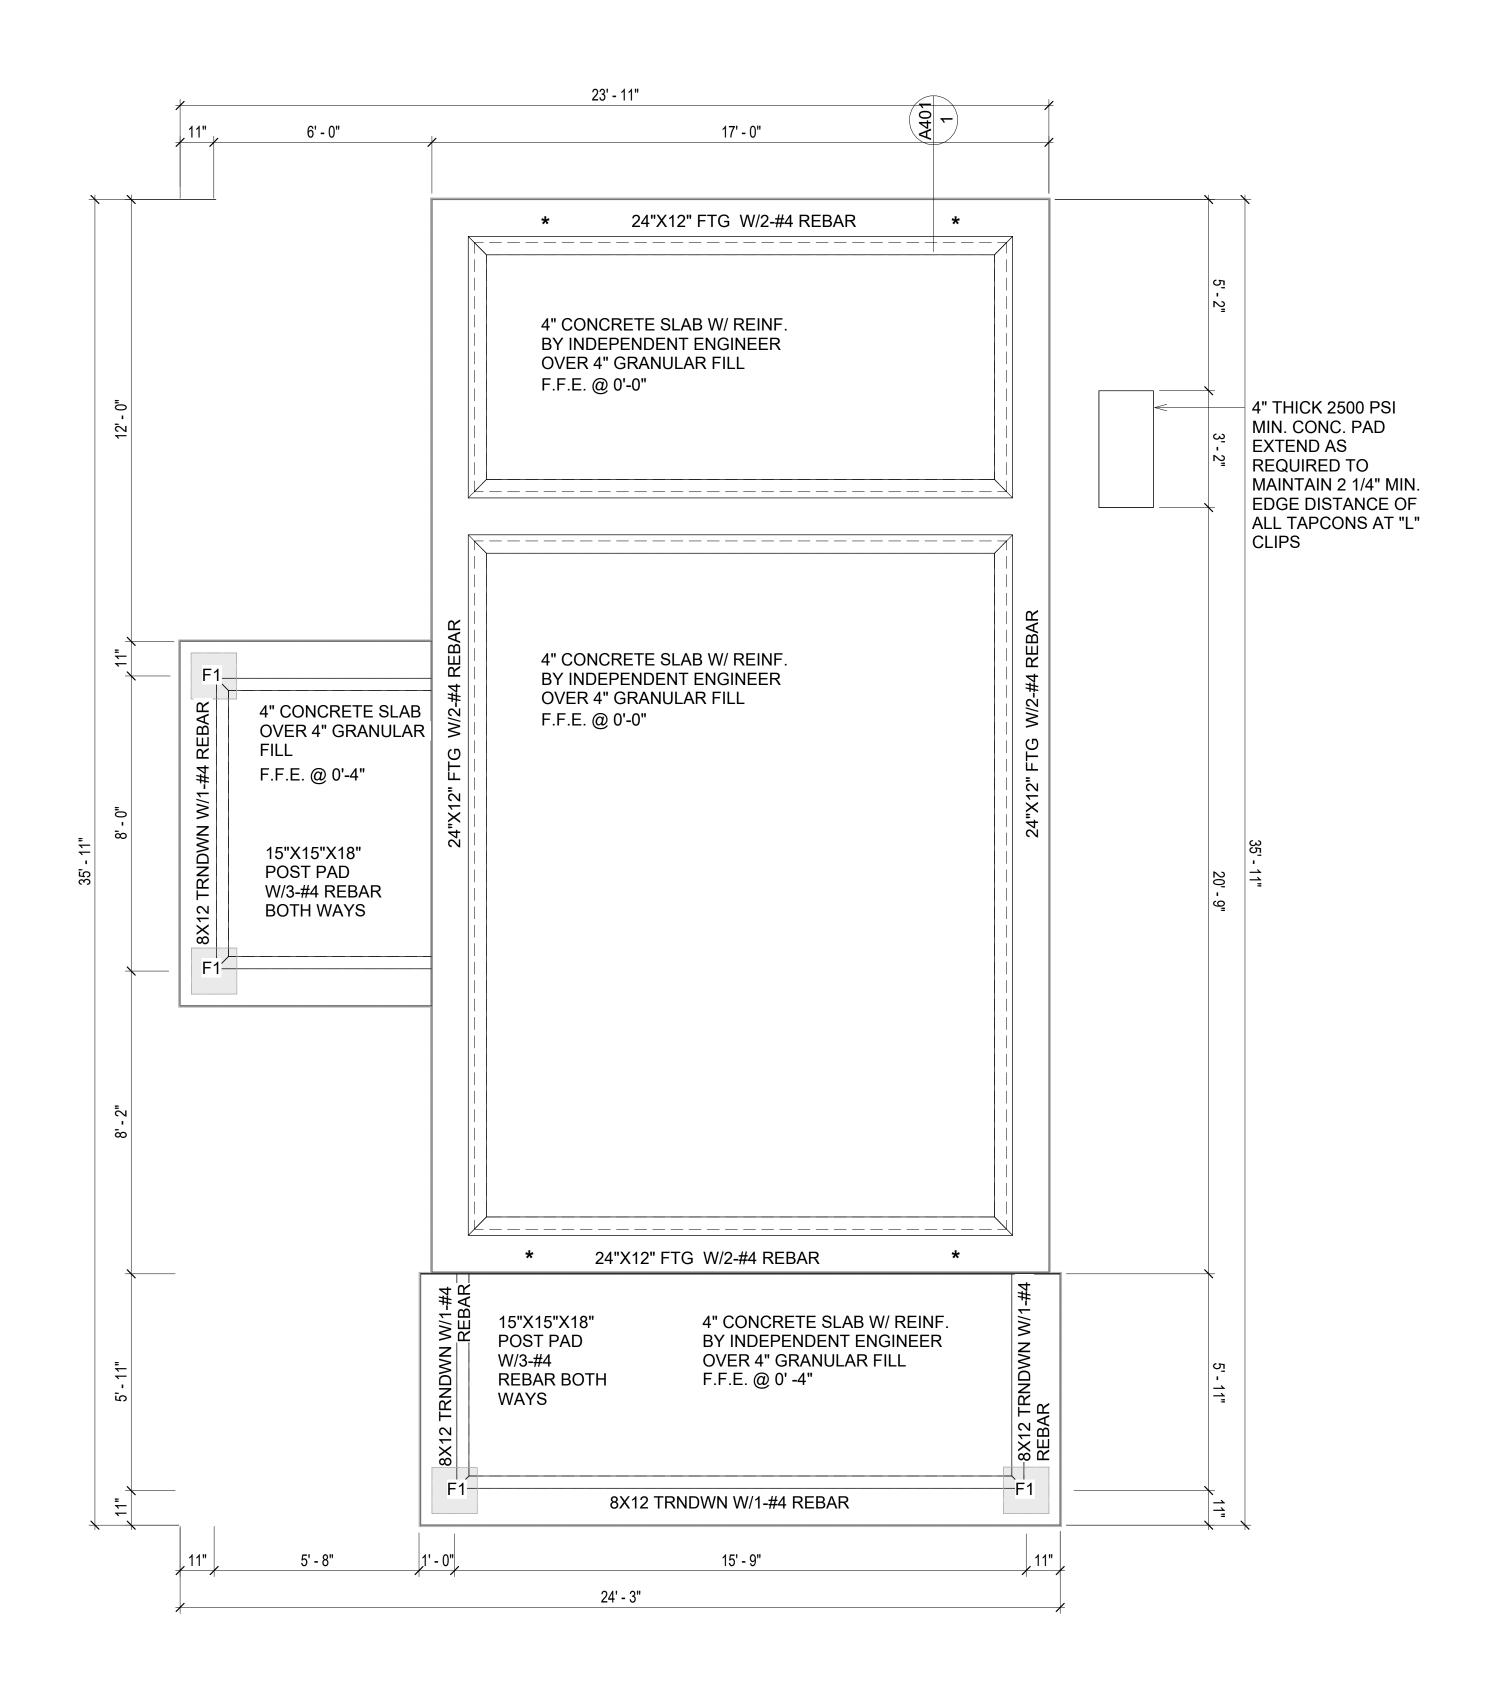



SQUARE FOOTAGE LIVING PORCH 151 TOTAL 644



KEY PLAN

NO.	DESCRIPTION	DATE	

NOTE:

LEGEND:

PROJECT

02 Wisdom 499 Studio Traditional 550

DRAWING NAME

FOUNDATION PLAN

CLIENT NAME:	Client Name
PROJECT NUMBER:	0033_15
DATE:	2/1/2025 5:14:20 PM
DESIGNED BY:	Designer
DRAWN BY:	Author
CHECKED BY:	Checker

S101

SCALE: 3/8" = 1'-0"

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GENERAL NOTES

-ALL BEARING WALLS SHOULD HAVE A THICKENED SLAB PER SECTION PER DETAIL A401/5.

A) FOUNDATION PLAN NOTES:

- CONCRETE SLAB SHALL BE 6" THICK WITH 1/2" DIAMETER TENDONS PER LAYOUT PLAN. CENTERED IN SLAB THICKNESS, OVER APPROVED SUBBASE PER GENERAL STRUCTURE NOTES.
- 2. TERMITE PROTECTION SHALL BE PROVIDED PER IRC SECTION R318.1
- NONE TYPICAL ANCHOR BOLT SPACING AT SHEAR WALL AND HOLD DOWN
- SPECIFICATIONS PER APPROVED ARCHITECTURAL PLANS. 4. INSTALL HOLDOWNS BEFORE CONCRETE SLAB POUR.
- EXISTING FILL ON-SITE SHALL BE COMPACTED IN ACCORDANCE WITH THE
- REQUIREMENTS IN THE GEOTECHNICAL REPORT.
- 6. ALL FLOOR SLABS ARE REINFORCED ON CONCRETE SLABS.


SPECIAL INSPECTION IS REQUIRED FOR THICKENED FOUNDATION CONSTRUCTION


- 1. REINFORCEMENT
- 2. 2300 PSI CONCRETE POUR

B) REINFORCEMENT FOR CONCRETE:

- 1. ALL REINFORCING SLABS BARS SIZE 10MM OR LARGER SHALL BE DEFORMED IN ACCORDANCE TO ASTM-A706, AND BARS SMALLER THAN 10 MM MAYBE PLAIN. 2. UNLESS OTHERWISE NOTED IN PLANS, THE YIELD STRENGTH OF REINFORCING BARS SHALL BE:
 - A) FOOTING = 40,000 PSI
 - B) NON-LOAD BEARING WALLS AND PARAPETS= 40,000 PSI
- SPLICES SHALL BE SECURELY WIRED TOGETHER AND SHALL LAP OR EXTEND
- GRADE OF STEEL FOR RCC WORKS SHALL BE GRADE 4 10.
- BAR NOTATIONS GIVES INFORMATION
 - A) BAR SIZE B) SPACING(IF REQUIRED)
- 6. LAP REINFORCEMENT ONLY AT LOCATION SHOWN IN THE DRAWINGS REINFORCEMENT SHALL NOT BE CUT, VENT OR HEATED ON SITE WITHOUT ENGINEERS'
- APPROVAL. C) **CONCRETE SLAB NOTES**
- 1. ALL SLAB REINFORCEMENT SHALL BE 20MM CLEAR MINIMUM FROM BOTTOM AND FROM TOP OF SLAB.
- 2. REINFORCEMENT IN CONTINUOUS ELEVATED SLAB SHALL BE CUT AS FOLLOWS.

- THIS IS A SCHEMATIC PLAN FOR THE PURPOSE OF LOCATING AND IDENTIFYING FOUNDATION REINFORCING ELEMENTS ONLY. VERIFY ALL DIMENSIONS, DROPS, OFFSETS AND FEATURES WITH THE ARCHITECTURAL PLANS BEFORE FORMING THE FOUNDATION.

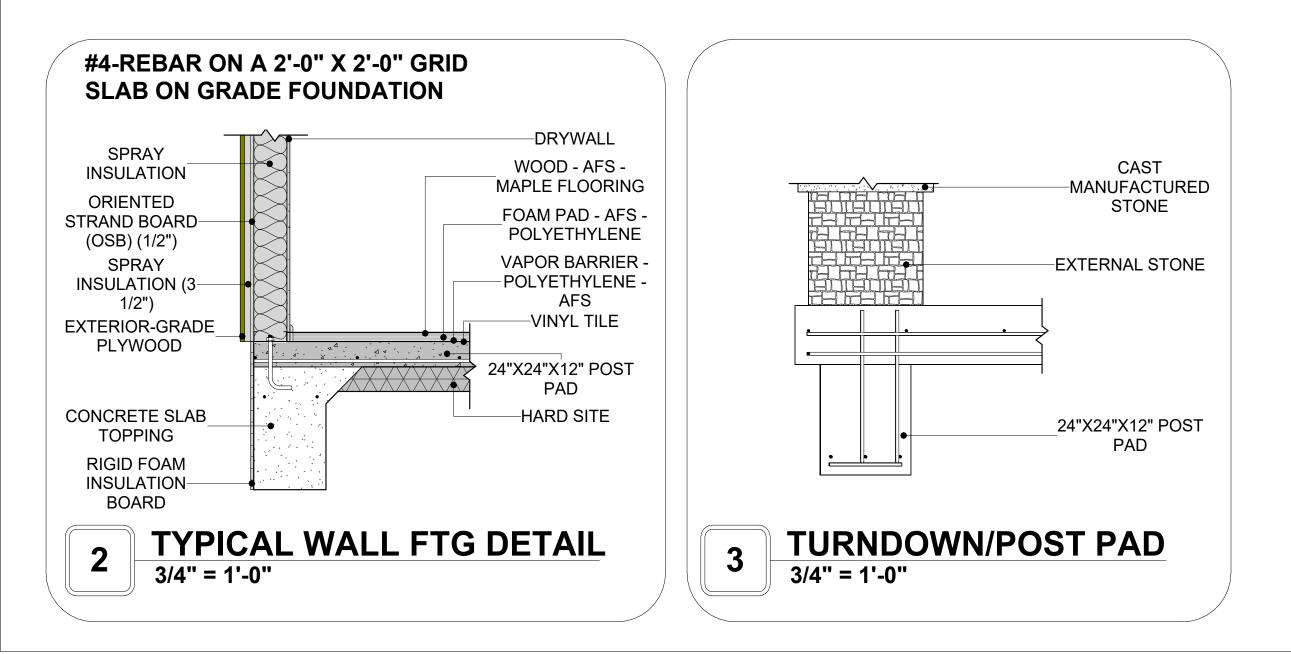

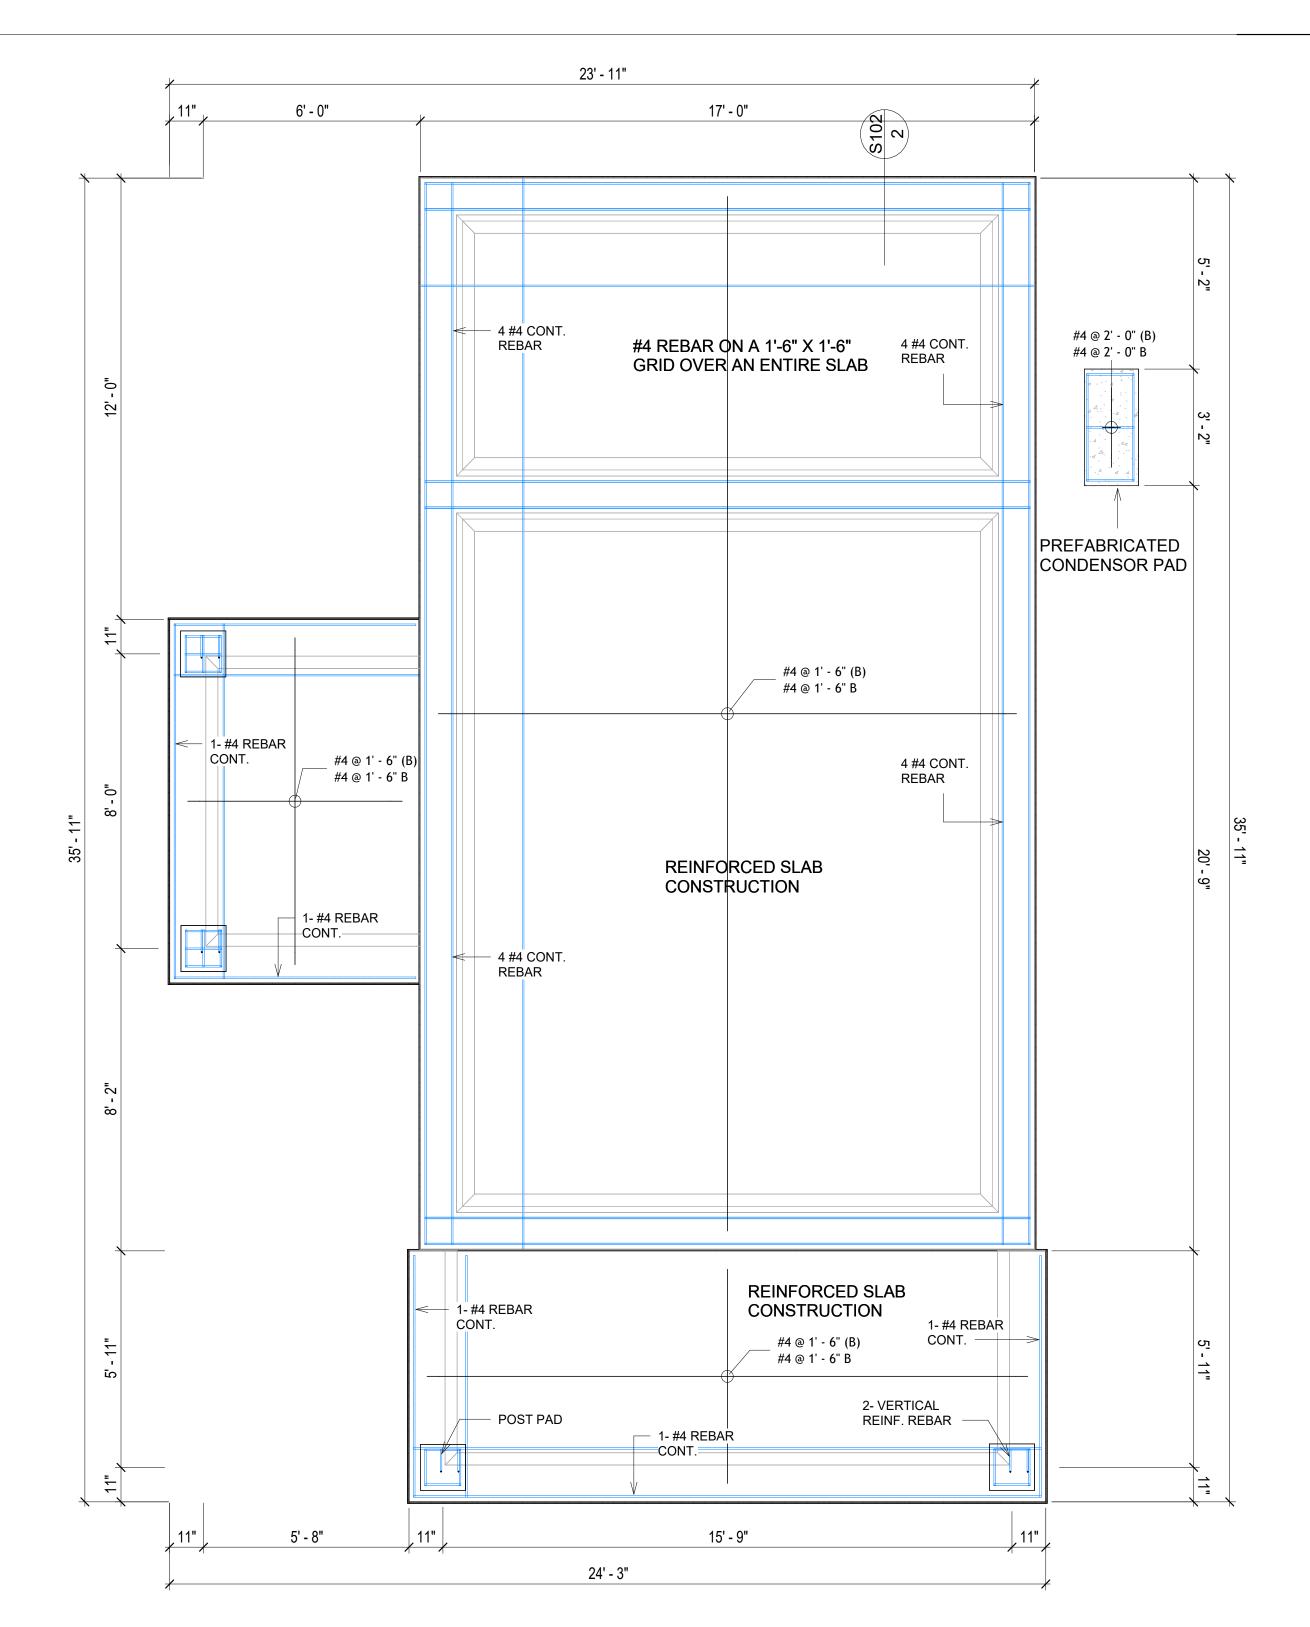

FOUNDATION REBAR PLAN 3/8" = 1'-0"

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KEY PLAN

DESCRIPTION DATE

NOTE:

LEGEND:

PROJECT

02 Wisdom 499 Studio Traditional 550

DRAWING NAME

STRUCTURAL FLOOR **PLAN**


Client Name CLIENT NAME: PROJECT NUMBER 0033_15 2/1/2025 5:14:21 PM DATE: Designer **DESIGNED BY:** DRAWN BY: **Author** CHECKED BY: Checker

S102

ROOF NOTES

- 1. ROOFING COMPOSITION ROOFING PER OWNERS/BUILDERS SPECIFICATIONS INSTALL PER MANUFACTURE SPECIFICATIONS ON 1/2" ORIENTED STRAND BOARD ON PRE-ENGINEERED TRUSS @ 24" O.C. (UNO.)
- 2. 73" OVERHANG AT EAVES (UNO.)
- 3. ENDS OF ALL TRUSSES AND JOISTS TO BE FULLY BLOCKED. PROVIDE SOLID BLOCKING AT ALL RIDGES AND VALLEYS
- 4. SHEATHING TO BE 1/2", 3/8" OSB SHEAR PANEL AND EQUIVALENT. UNDERSIDE OF PORCH TRUSSES TO BE FINISHED WITH MOISTURE RESISTANT DRYWALL, TAPED AND
- 5. EXPOSED EAVES AND OTHER WEATHER EXPOSED AREAS TO BE SHEATHED WITH EXTERIOR GRADE PLYWOOD.
- 6. ALL MATERIALS THICKNESS AND SIZE ARE THE MINIMUM. Refer TO LOCAL STANDARDS FOR ACTUAL THICKNESS AND LAYERING OF MATERIALS.
- 7. ENGINEERED TRUSS CALCULATIONS TO BE SUBMITTED TO BUILDING DEPARTMENT PRIOR TO FABRICATION AND INSTALLATION.
- 8. TRUSS MANUFACTURER TO SPECIFY HANGER CONNECTORS FOR TRUSS
- COMPONENTS (TYPICAL) 9. DESIGNER ASSUMES THAT TRUSSES BEAR ON ALL EXTERIOR PERIMETER WALLS
- (TYPICAL) OR BEAMS.
- 10. PROVIDE GALVANIZED STEEL FLASHING WITH A LENGTH OF 10 FEET, WIDTH OF 12 INCHES, AND THICKNESS OF 24 GAUGE.

A301

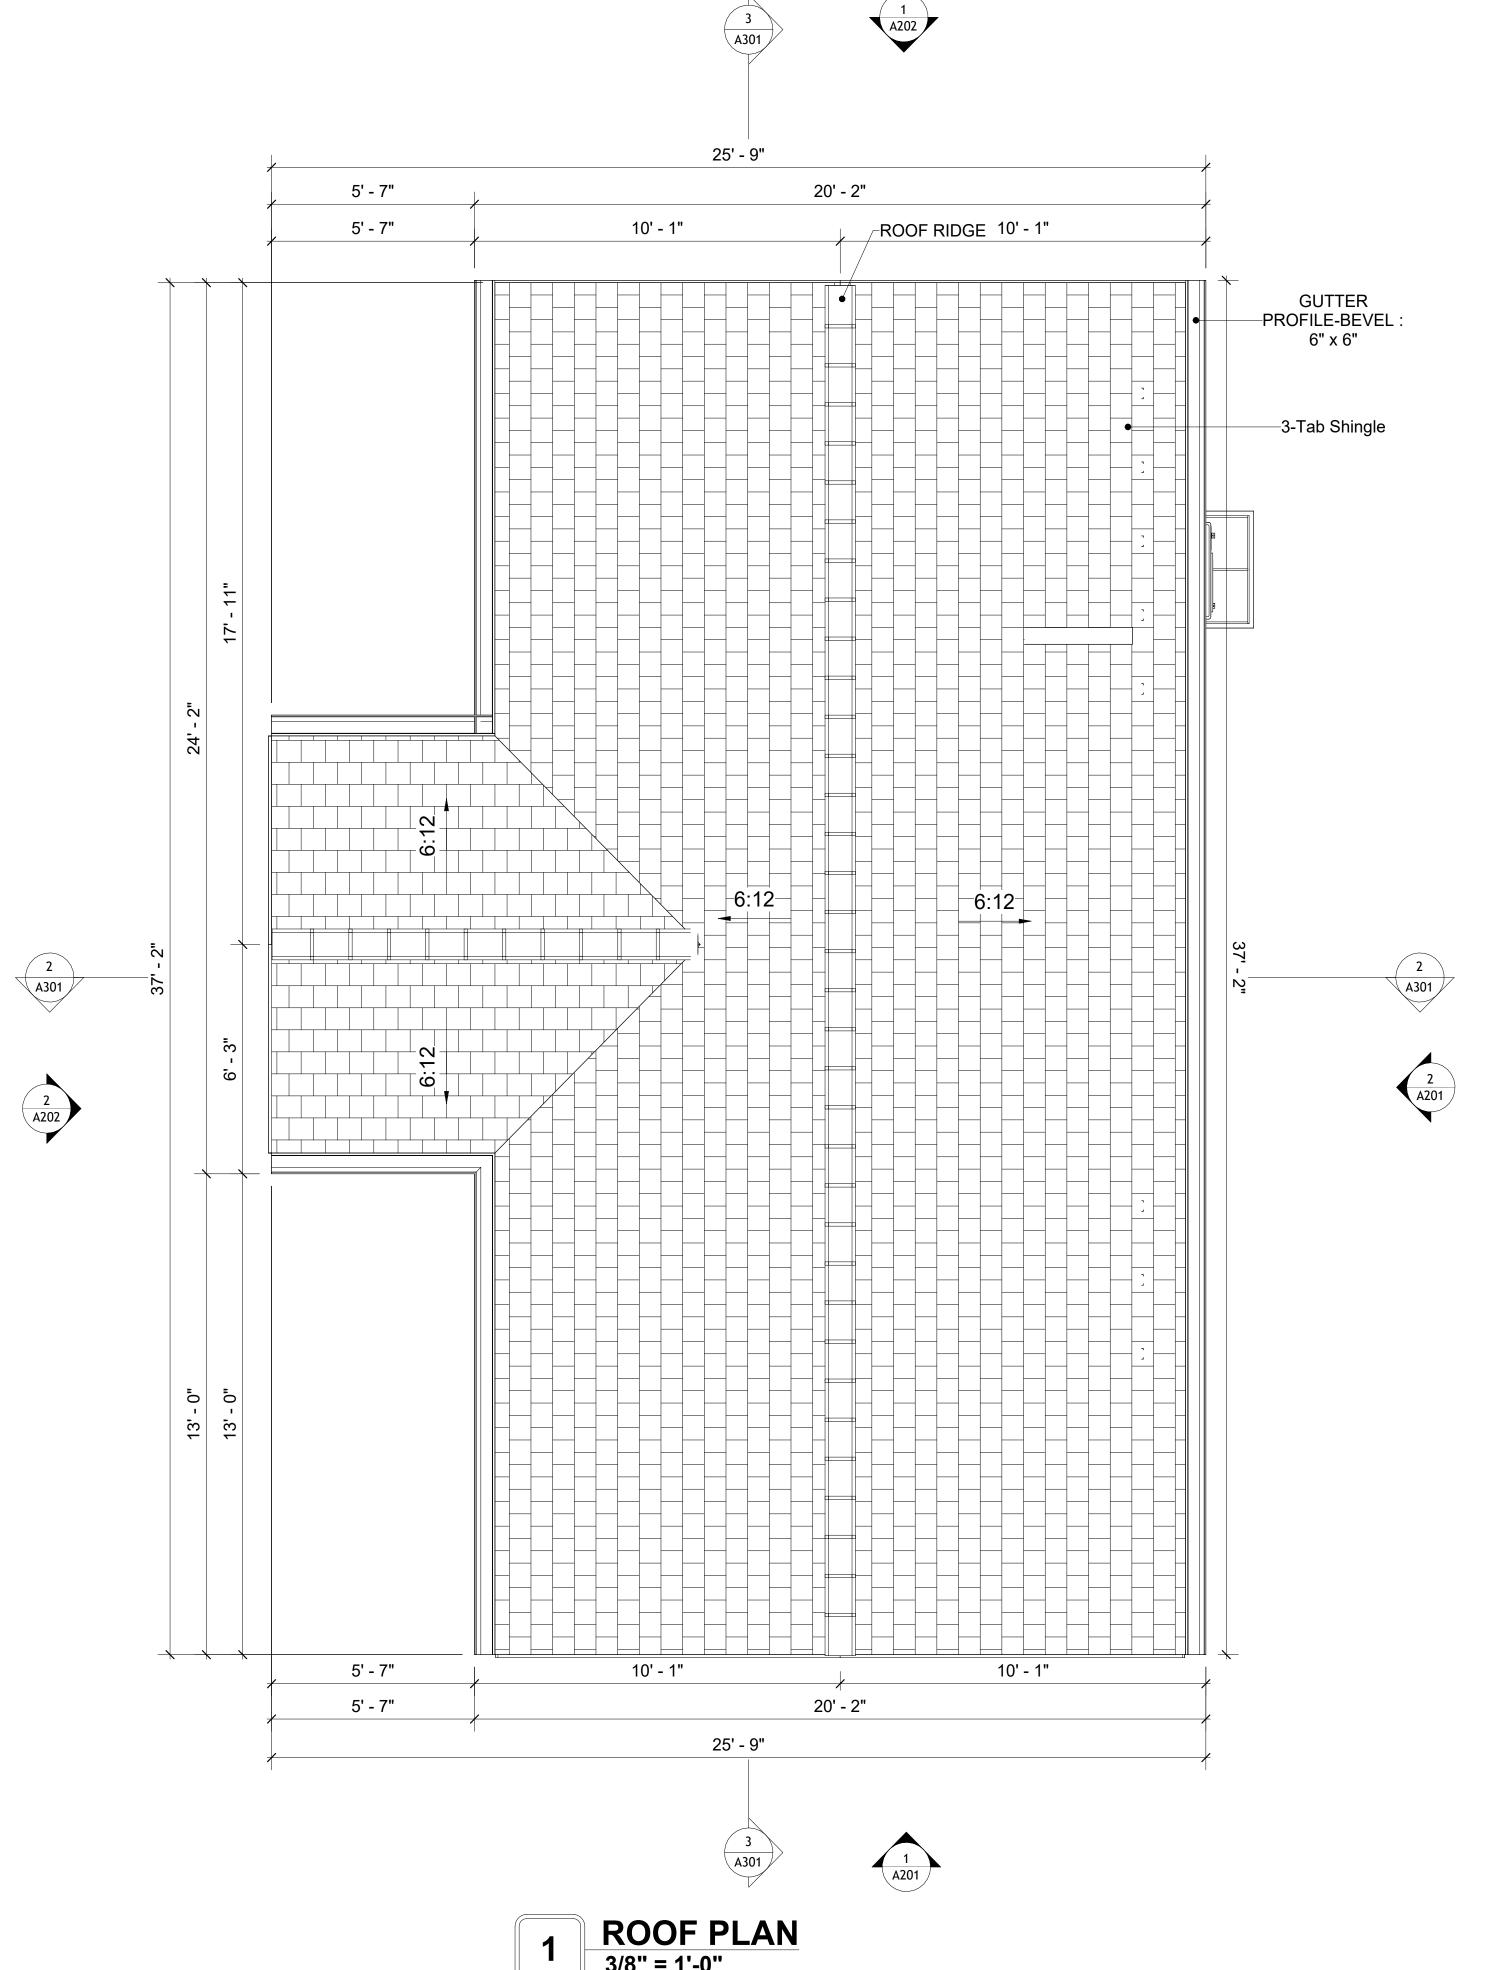



SQUARE FOOTAGE PORCH 151 TOTAL 644



KEY PLAN

NO.	DESCRIPTION	DATE

NOTE:

LEGEND:

PROJECT

02 Wisdom 499 Studio Traditional 550

DRAWING NAME

ROOF PLAN

CLIENT NAME:	Client Name
PROJECT NUMBER:	0033_15
DATE:	2/1/2025 5:14:24 PM
DESIGNED BY:	Designer
DRAWN BY:	Author
CHECKED BY:	Checker

A103

ABOUT WALL FINISHING

PLYWOOD WALL SIDING

WALL SIDING IS AN EXTERIOR CLADDING MATERIAL USED TO COVER AND PROTECT THE WALLS OF A BUILDING, PROVIDING BOTH FUNCTIONAL AND AESTHETIC BENEFITS.

IN THIS SPECIFIC PROJECT, PLYWOOD WALL PANELS ARE USED AS A FINISH SIDING BECAUSE THIS TYPE OF SIDING PROVIDES A DURABLE, COST-EFFECTIVE, AND VERSATILE EXTERIOR CLADDING THAT CAN BE EASILY INSTALLED, FINISHED, AND MAINTAINED TO ENHANCE THE AESTHETIC AND PROTECTIVE QUALITIES OF A BUILDING'S EXTERIOR.

STANDARD SIZES OF 1' X 8' EXTERIOR-GRADE PLYWOOD PANELS ARE INSTALLED ON THE FURRING STRIPS USING GALVANIZED STEEL SELF-DRILLING SCREWS.

EXTERNAL STONE

THESE STONE PRODUCTS ARE MADE FROM A BLEND OF NATURAL AGGREGATES, CEMENT, AND OTHER PROPRIETARY MATERIALS.

THE STONE FINISH IS DIRECTLY ATTACHED TO COLD-FORMED STEEL (CS) FRAMING. (FOR COLUMN FINISH) EXTERNAL STONE CAN BE AN EXCELLENT EXTERIOR CLADDING OPTION FOR CS-FRAMED BUILDINGS. IN THIS SCENARIO, THE EXTERNAL STONE WOULD BE ADHERED TO THE CS FRAME USING A SCRATCH COAT AND MORTAR-BASED ADHESIVE.

CAST MANUFACTURED STONE

MANUFACTURED STONE, ALSO KNOWN AS CULTURED OR ARTIFICIAL STONE, IS A SYNTHETIC BUILDING MATERIAL MADE FROM A BLEND OF CEMENT, AGGREGATES, AND PIGMENTS TO MIMIC THE APPEARANCE OF NATURAL STONE. IT IS LIGHTWEIGHT, DURABLE, AND CUSTOMIZABLE IN COLOR AND TEXTURE.


IN THIS PROJECT, MANUFACTURED STONE IS USED AS THE COPING MATERIAL, PROVIDING A DURABLE AND AESTHETIC FINISH THAT MIMICS THE APPEARANCE OF NATURAL STONE.

CEDAR WOOD


CEDAR WOOD REFERS TO THE WOOD FROM VARIOUS SPECIES OF CEDAR TREES, WHICH ARE CONIFEROUS EVERGREEN TREES KNOWN FOR THEIR DISTINCT AROMA AND NATURAL RESISTANCE TO DECAY AND INSECTS.

IN THIS SPECIFIC PROJECT, CEDAR WOOD IS USED AS A FURRING STRIP AND A FINISH MATERIAL ON BEAMS AND COLUMNS

CEDAR WOOD AS A FURRING STRIPS PROVIDE THERMAL INSULATION AND MOISTURE MANAGEMENT. THE VERTICAL CEDAR WOOD FURRING STRIPS ARE ATTACHED TO HOME WRAP USING CORROSION-RESISTANT FASTENERS (HOT-DIP GALVANIZED SCREWS), ENSURING PROPER PENETRATION INTO THE WALL FRAMING.

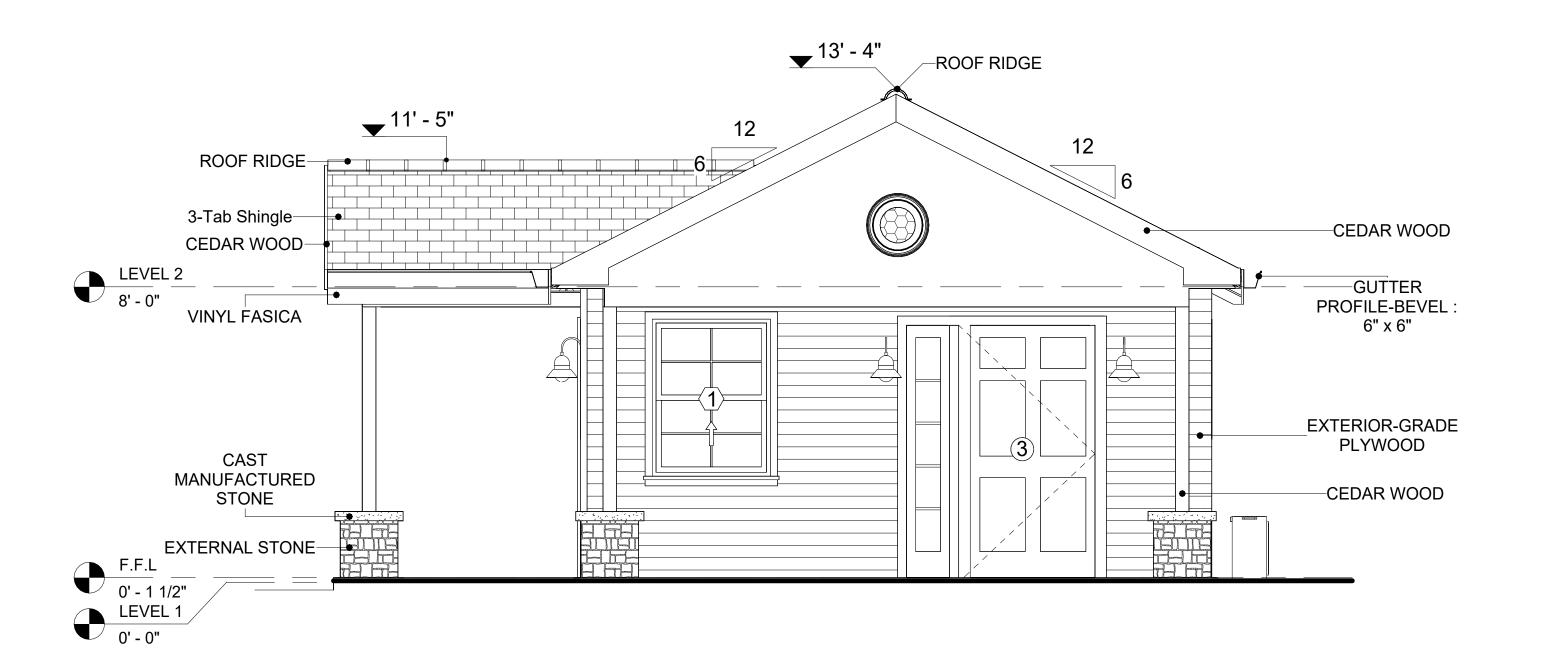


1 FRONT ELEVATION
3/8" = 1'-0"

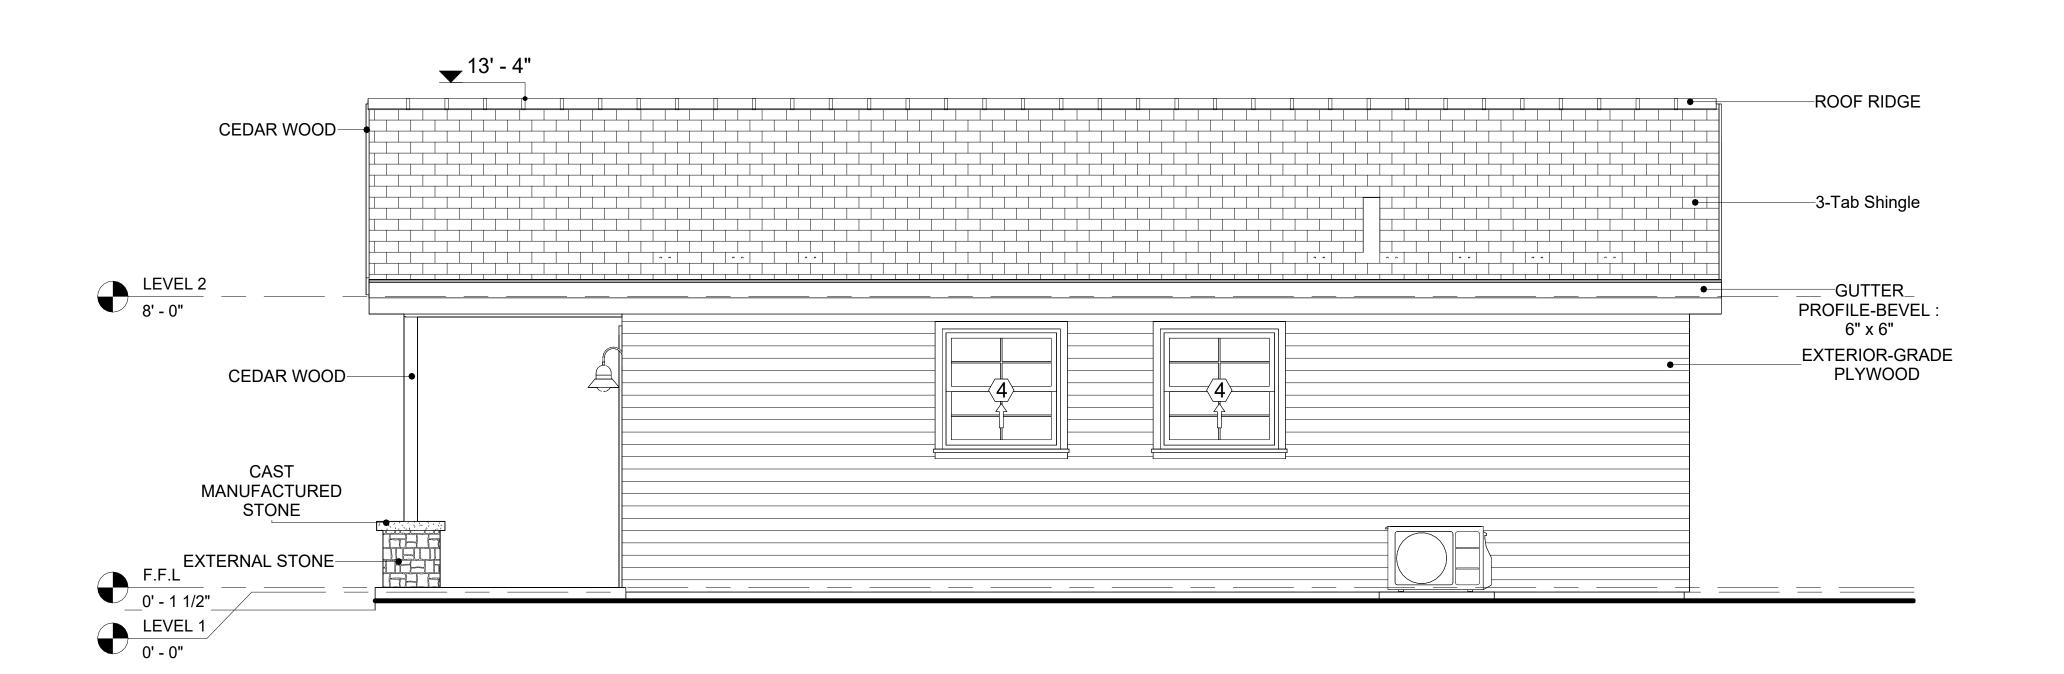

2 RIGHT SIDE ELEVATION
3/8" = 1'-0"

DOOR SCHEDULE						
TYPE MAR				SIZE		
K	SUPPLIER	DOOR TYPE	LOCATION	WIDTH	HEIGHT	COUNT
1	HOME DEPOT	INTERIOR SINGLE PANEL SWINGING	INTERIOR	3' - 0"	6' - 8"	1
2	HOME DEPOT	INTERIOR SINGLE PANEL SWINGING	INTERIOR	2' - 0"	6' - 8"	1
3	HOME DEPOT	FRONT_DOOR_W_HEADER_AND_SIDELIGH TS_8215	INTERIOR	3' - 9"	6' - 11 1/2"	1
4	HOME DEPOT	INTERIOR DOUBLE PANEL SLIDING	INTERIOR	5' - 2"	6' - 8"	1
5	HOME DEPOT	PATIO DOUBLE PANEL SLIDING	INTERIOR	5' - 0"	6' - 8"	1

WINDOW SCHEDULE					
			SI		
TYPE MARK	SUPPLIER	WINDOW TYPE	WIDTH	HEIGHT	COUNT
1	HOME DEPOT	SINGLE HUNG	3' - 3"	4' - 3"	1
2	HOME DEPOT	SLIDING	3' - 3"	2' - 3"	2
3	HOME DEPOT	SLIDING	5' - 3"	3' - 3"	1
4	HOME DEPOT	SINGLE HUNG	3' - 3"	3' - 3"	2
5	HOME DEPOT	CASEMENT	1' - 6"	1' - 6"	1
6	HOME DEPOT	CASEMENT	1' - 0"	1' - 0"	1
7	HOME DEPOT	CASEMENT	2' - 3"	3' - 3"	1

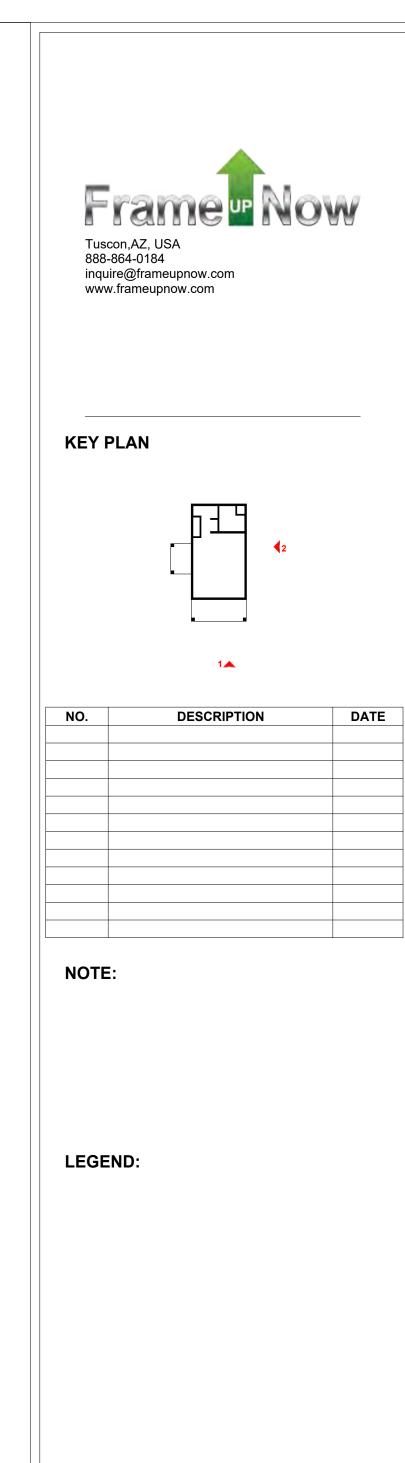

PROJECT

02 Wisdom 499 Studio Traditional 550

DRAWING NAME

ARCHITECTURAL ELEVATIONS

CLIENT NAME:	Client Name
PROJECT NUMBER:	0033_15
DATE:	2/1/2025 5:14:27 PM
DESIGNED BY:	Designer
DRAWN BY:	Author
CHECKED BY:	Checker

A201

ABOUT WALL FINISHING

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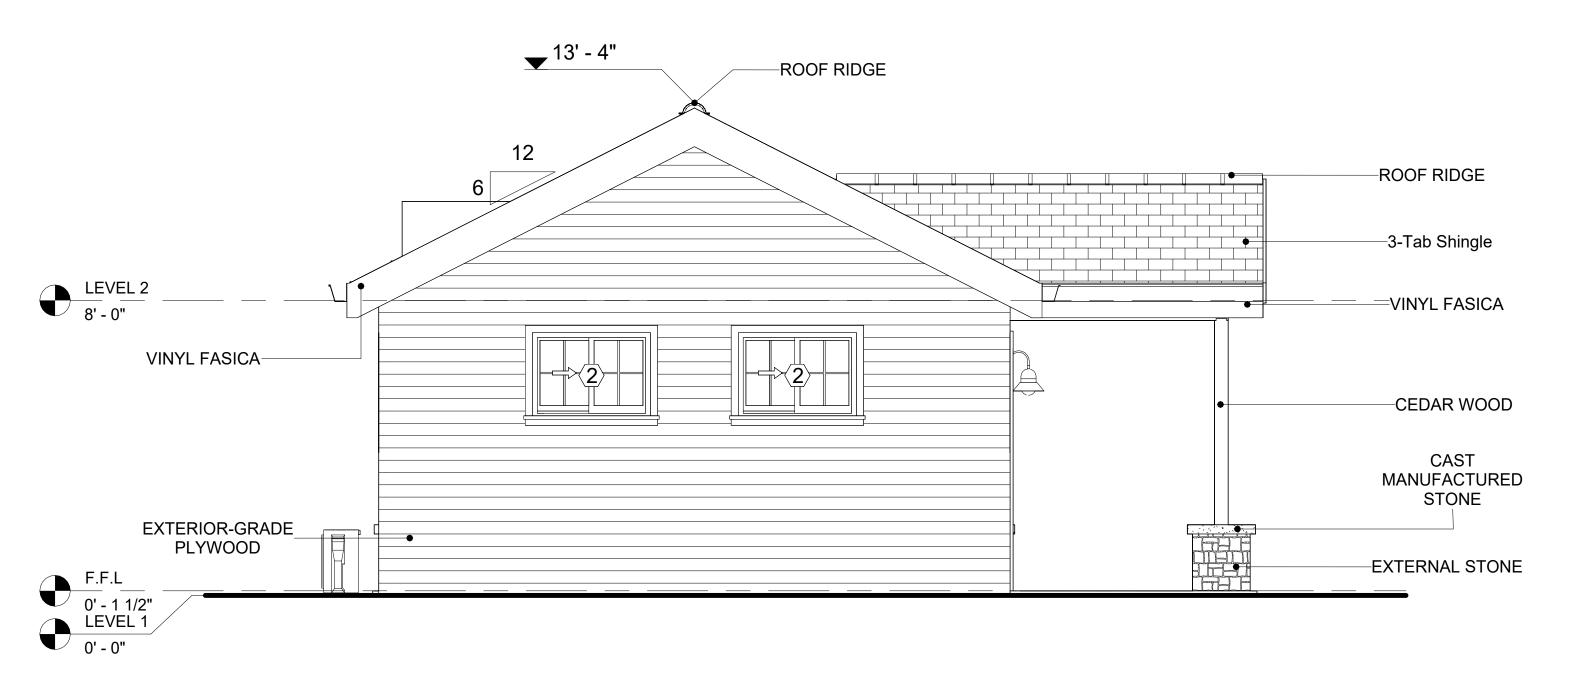
IN THIS PROJECT, MANUFACTURED STONE IS USED AS THE COPING MATERIAL, PROVIDING A DURABLE AND AESTHETIC FINISH THAT MIMICS THE APPEARANCE OF NATURAL STONE.

CEDAR WOOD


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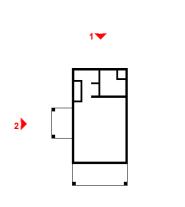
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2 LEFT SIDE ELEVATION
3/8" = 1'-0"



KEY PLAN



NO.	DESCRIPTION	DATE

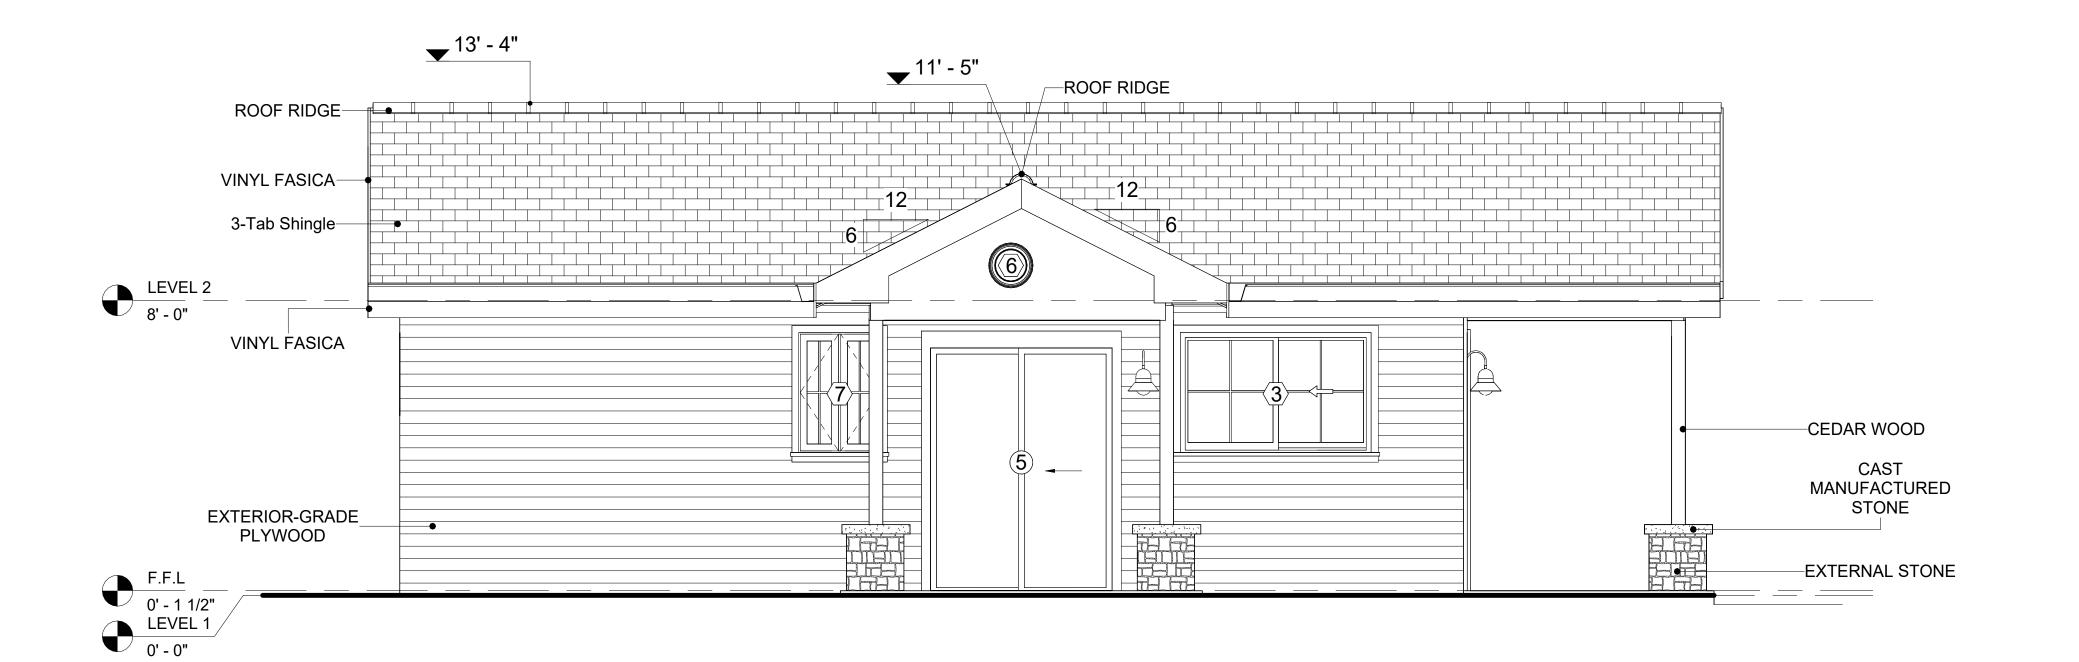NOTE:

LEGEND:

PROJE


02 Wisdom 499 Studio Traditional 550

DRAWING NAME


ARCHITECTURAL ELEVATIONS

CLIENT NAME:	Client Name
PROJECT NUMBER:	0033_15
DATE:	2/1/2025 5:14:31 PM
DESIGNED BY:	Designer
DRAWN BY:	Author
CHECKED BY:	Checker

A202

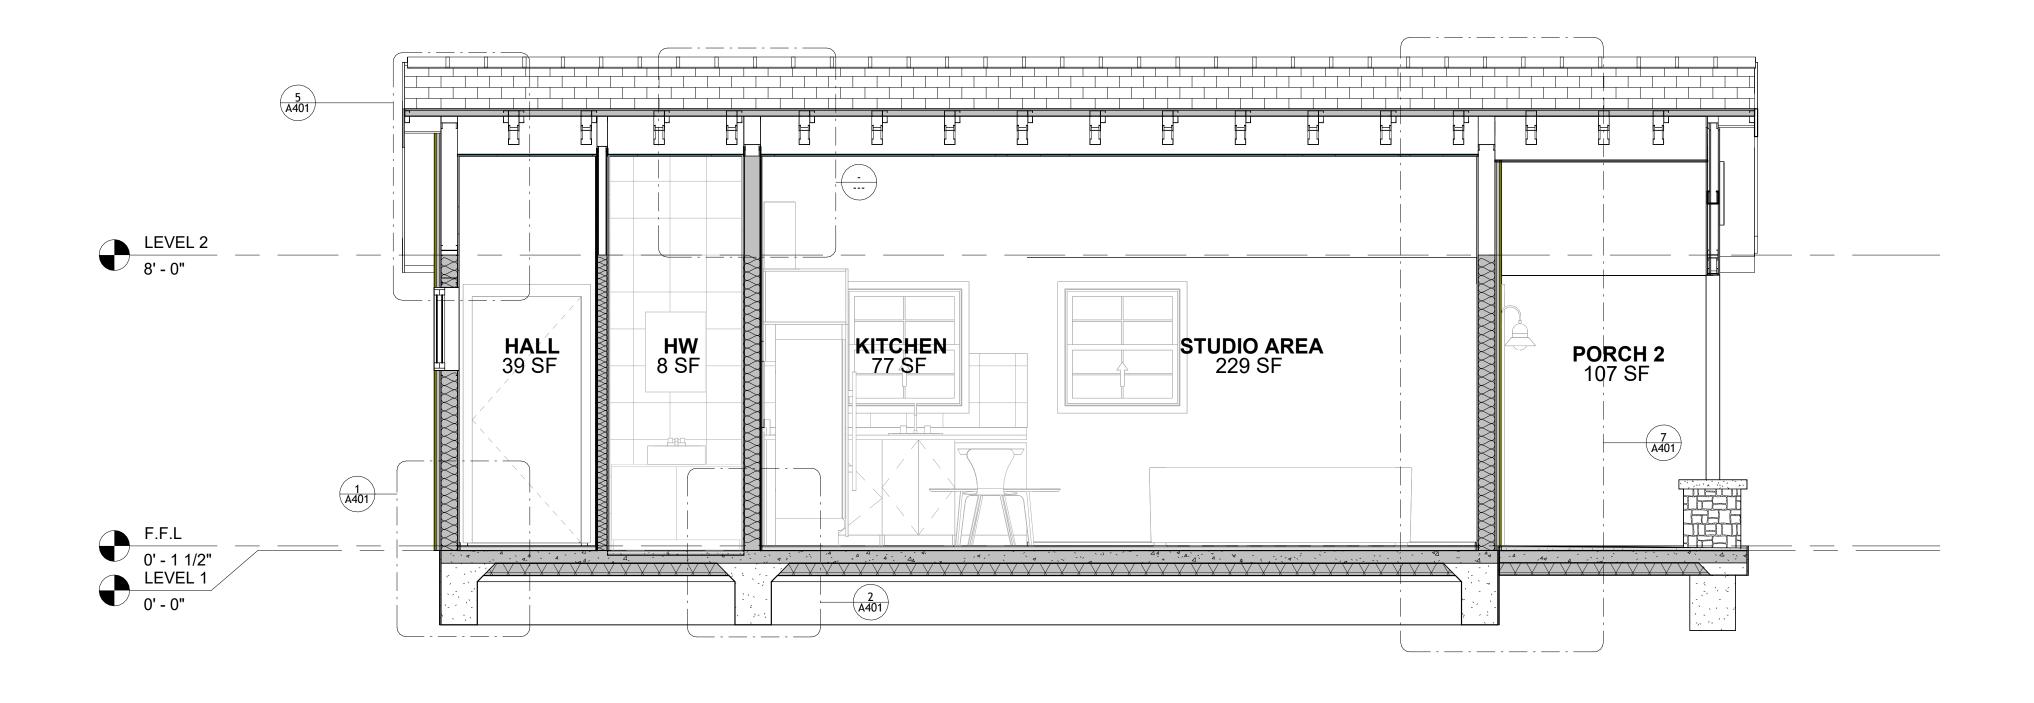


3 SECTION-3 3/8" = 1'-0"

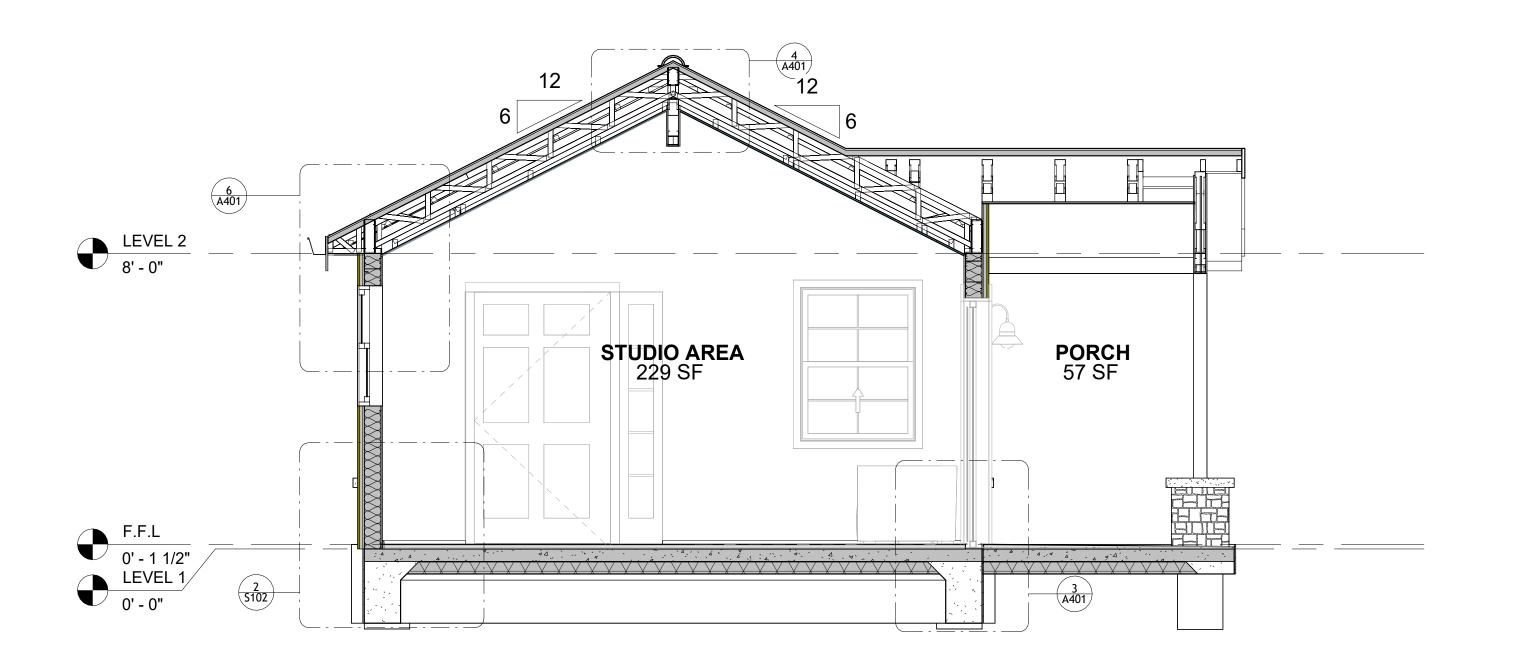

2 SECTION-2 3/8" = 1'-0"



KEY PLAN

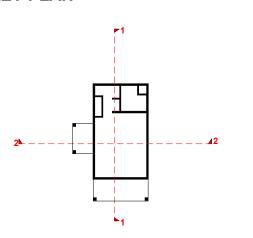

NO.	DESCRIPTION	DAT

NOIE

LEGEND:

PROJECT


02 Wisdom 499 Studio Traditional 550

DRAWING NAME

ARCHITECTURAL SECTIONS


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0033_15
2/1/2025 5:14:32 PM
Designer
Author
Checker


A301

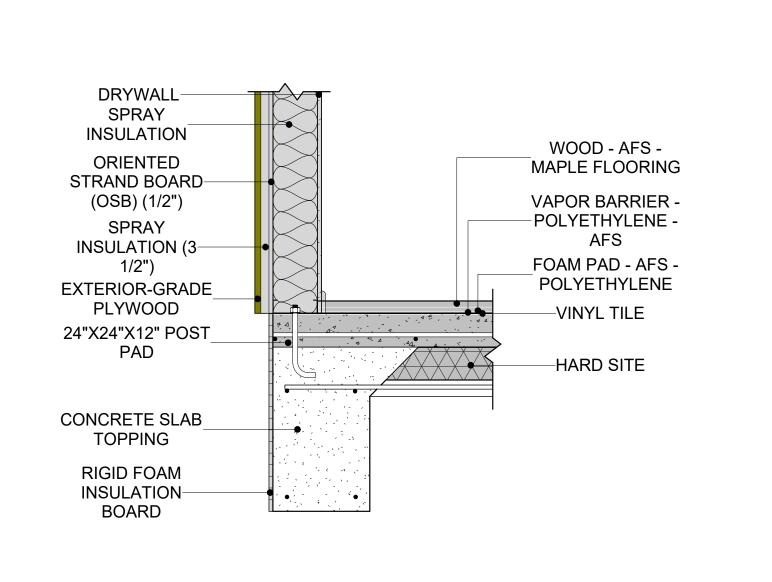


TYPICAL WALL FTG


1" = 1'-0"

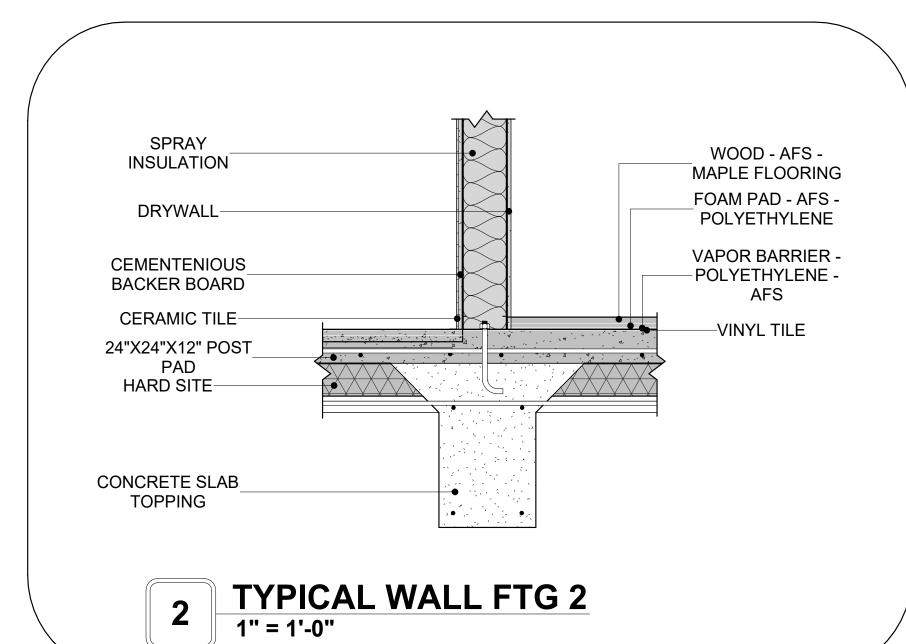


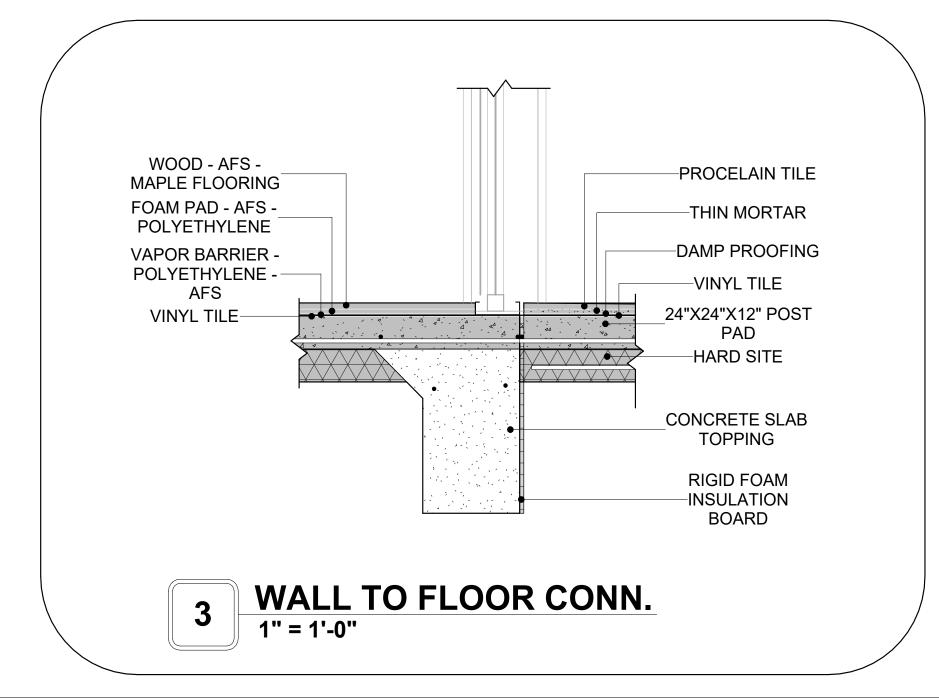


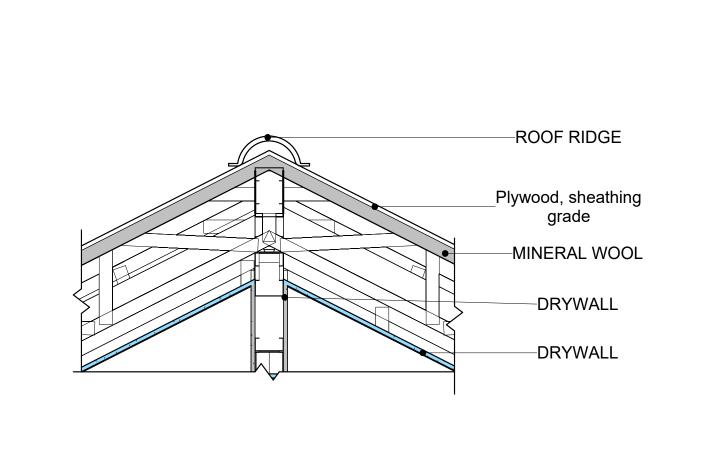

4 ROOF/TRUSS CONN.
1" = 1'-0"

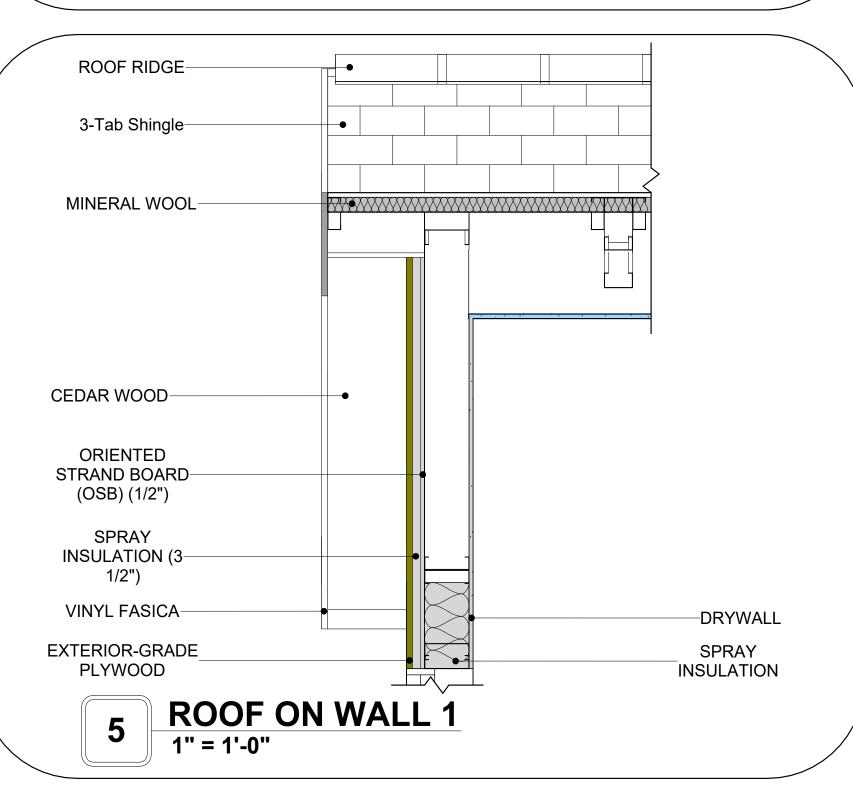

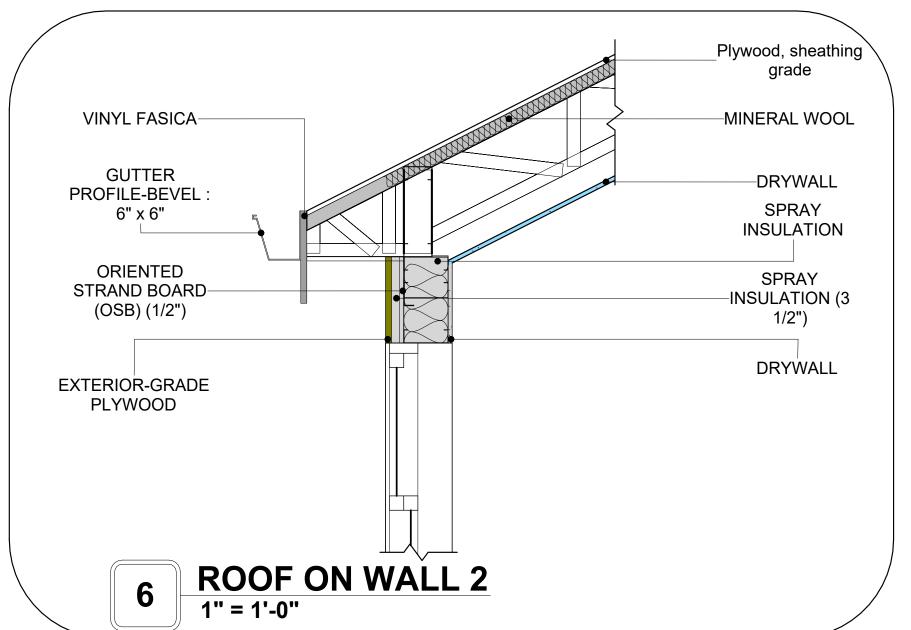

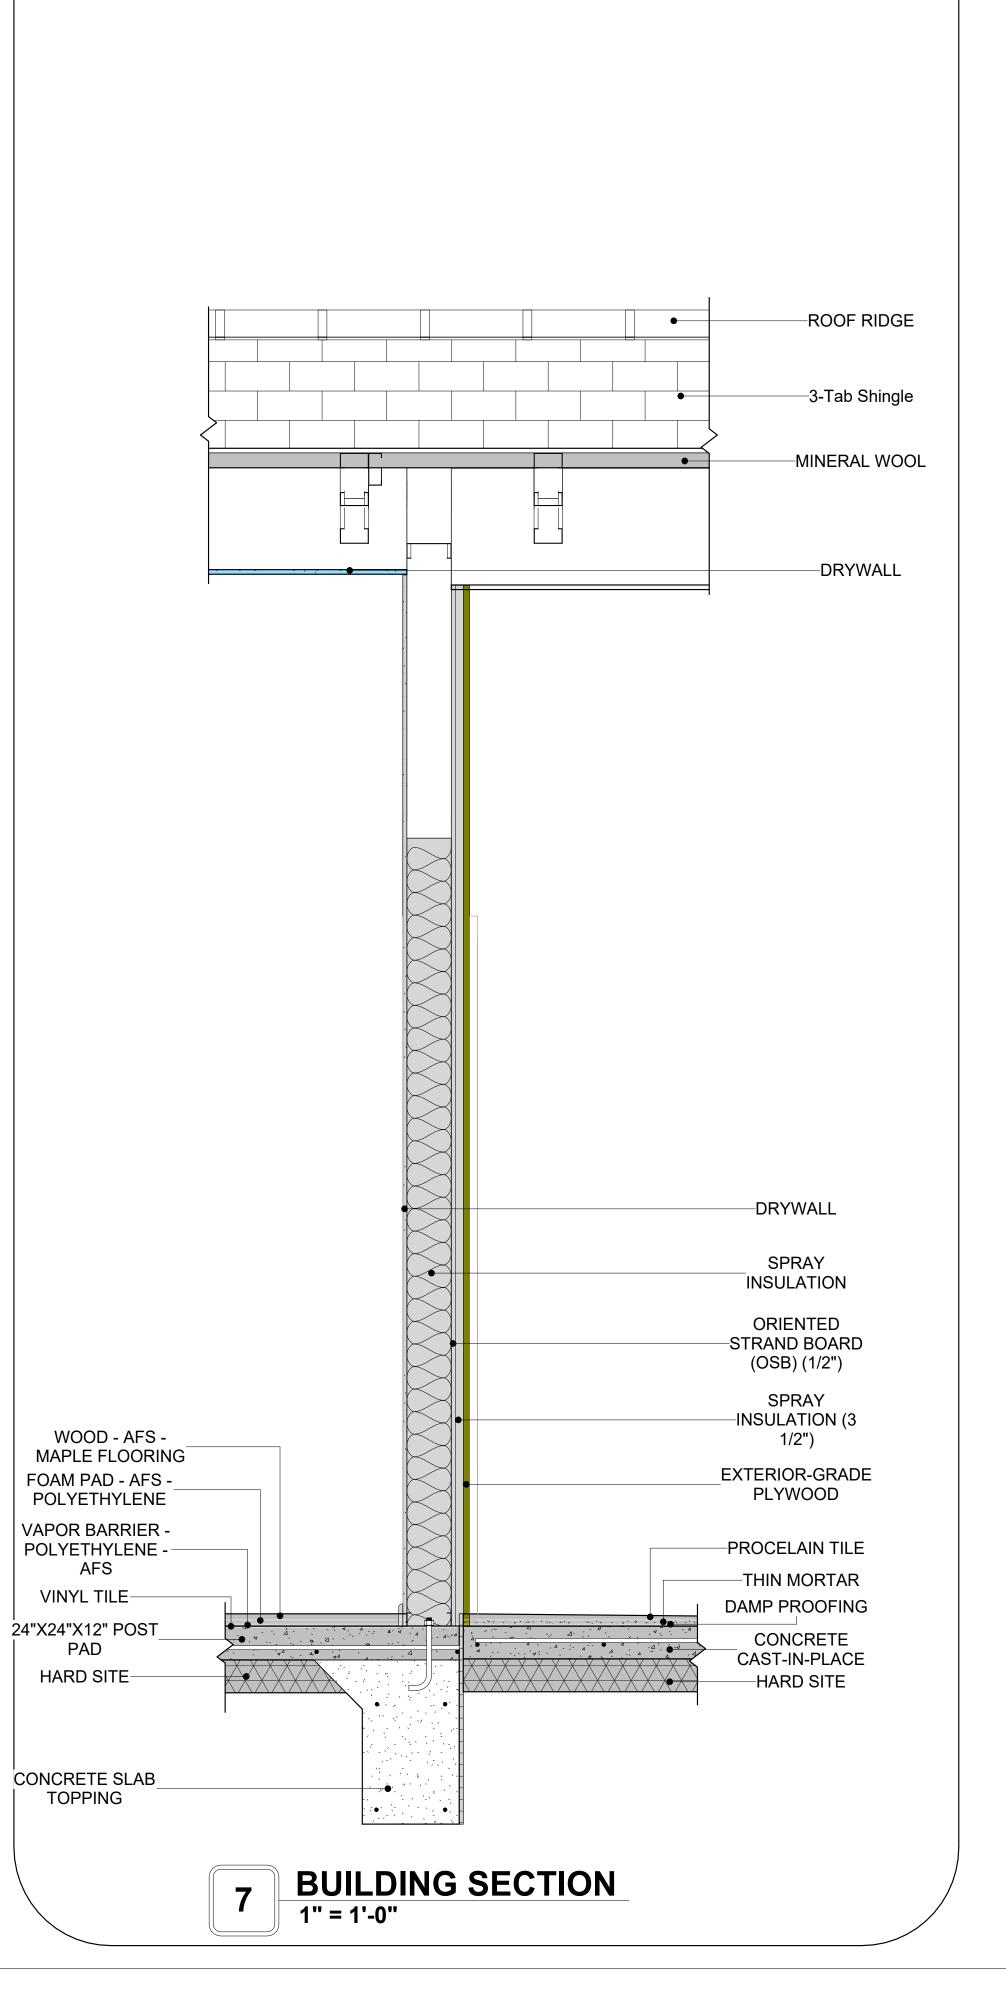



KEY PLAN

DESCRIPTION	DAT

PROJECT

LEGEND:

02 Wisdom 499 Studio Traditional 550

DRAWING NAME

ARCHITECTURAL DETAILS

CLIENT NAME:	Client Name
PROJECT NUMBER:	0033_15
DATE:	2/1/2025 5:14:34 PM
DESIGNED BY:	Designer
DRAWN BY:	Author
CHECKED BY:	Checker

A401

SCALE: 1" = 1'-0"

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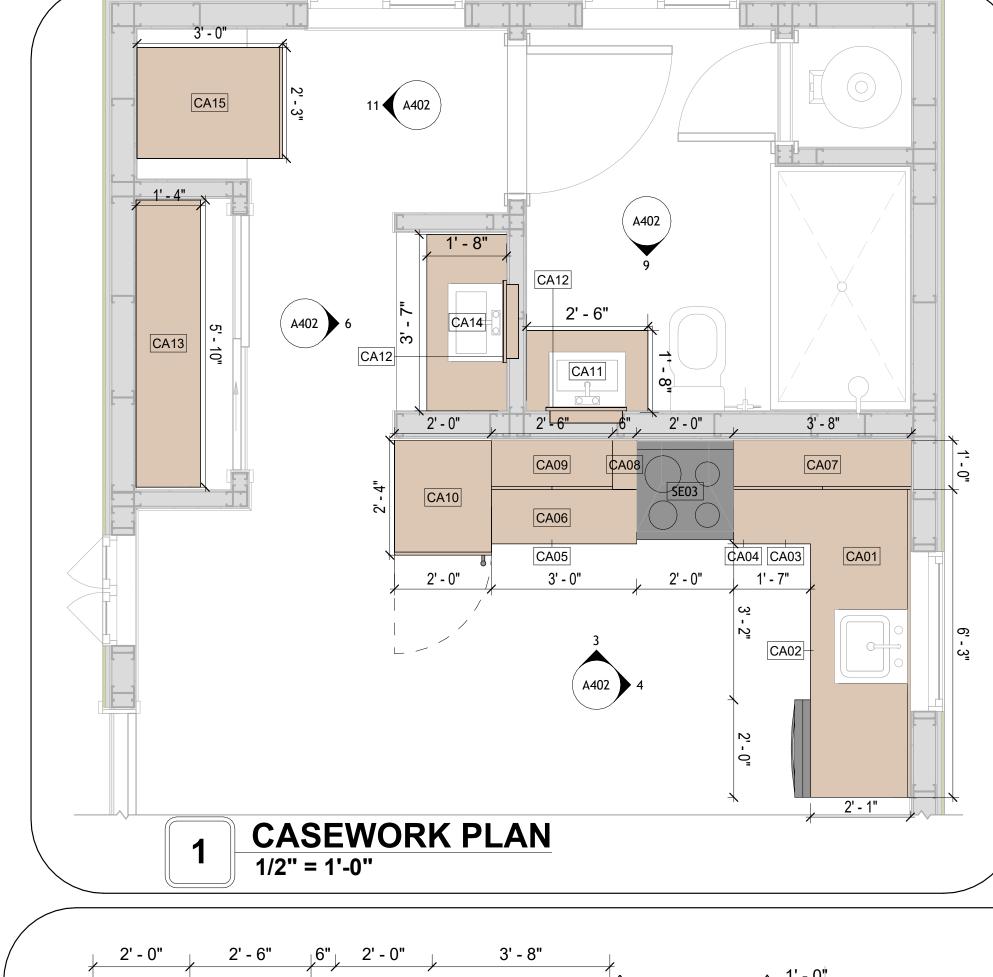
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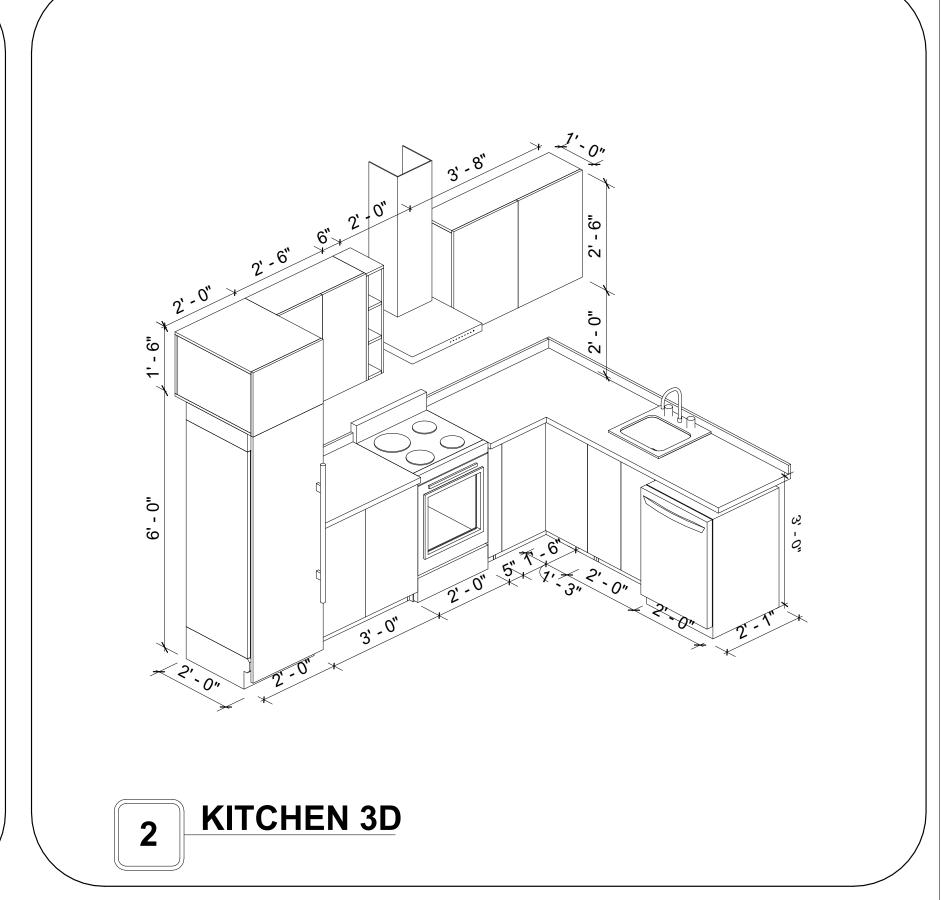
CASEWORK GENERAL NOTES


- ALL CABINET HEIGHTS INCLUDE COUNTERTOPS. DIMENSIONS ARE TO THE NEAREST INCH. DIVISIONS IN CASEWORK ARE SHOWN FOR CLARITY AND DO NOT REPRESENT BREAKS IN THE
- COUNTERTOP. PROVIDE CONTINUOUS COUNTERTOP OVER ALL SIMILAR HEIGHT CASEWORK, UNLESS AND
- OTHERWISE NOTED.
- MANUFACTURER AND CATALOG NUMBERS ARE FOR REFERENCE AND ILLUSTRATION PURPOSES
- DOTTED LINES INDICATE WALL HUNG CABINETS, DIVISIONS OF BASE CABINETS BELOW THE
- COUNTERTOP, FURNITURE NOT IN THE CONTRACT OR PROJECTION SCREENS -SEE CASEWORK KEY AND SPECIFICATIONS.
- ALL CABINETS AND DRAWERS TO HAVE CAM LOCKS EXCEPT FOR SINK BASE CABINETS. ALL EXPOSED SURFACES (EXPOSED TO VIEW FROM ANY PERSPECTIVE) TO BE COVERED WITH
- ALL CASEWORK WHICH MEETS A WALL AT ONE OR BOTH ENDS, TO BE PROVIDED WITH FILLER
- PANELS AND SCRIBED TO THE WALL(S) AS REQUIRED.
- 10. ALL CABINETS AND DRAWERS ARE PRÓVIDED WITH RECESSED HANDLES.
 11. CONTRACTOR TO FIELD VERIFY ALL CLEAR OPENINGS PRIOR TO MILLWORK OR CASEWORK FABRICATION.
- 12. CASEWORK DRAWINGS ARE DIAGRAMMATIC IN NATURE TO SHOW DESIGN INTENT.


	CASEWORK SCHEDULE							
TYPE MAR K	TYPE	COUN	HEIGHT	WIDTH	DEPTH	AREA		
		1.		I	T-1 -11			
01	L-SHAPE COUNTER TOP	1	0' - 4"	7' - 0"	7' - 0"	2 SF		
02	BASE CABINET DOUBLE DOOR 1	1	2' - 10 1/2"	2' - 0"	2' - 0"	6 SF		
03	BASE CABINET L-SHAPED	1	2' - 10 1/2"	3' - 3"	3' - 3"	9 SF		
04	WALL FILLER	1	2' - 10 1/2"	0' - 4 3/4"	2' - 0"	1 SF		
05	BASE CABINET DOUBLE DOOR 2	1	2' - 10 1/2"	3' - 0"	2' - 0"	9 SF		
06	LINEAR COUNTER TOP	1	0' - 4"	3' - 0"	2' - 1"	1 SF		
07	WALL CABINET DOUBLE DOOR 1	1	2' - 6"	3' - 8"	1' - 0"	9 SF		
08	WALL FILLER	1	2' - 6"	0' - 6"	1' - 0"	1 SF		
09	WALL CABINET DOUBLE DOOR 2	1	2' - 6"	2' - 6"	1' - 0"	6 SF		
10	LAUNDRY OPEN CABINET	1	1' - 6"	2' - 0"	2' - 4"	3 SF		
11	VANITY 2	1	2' - 4"	2' - 6"	1' - 8"	6 SF		
12	RECESSED_MED_CABINET	2	2' - 0"	1' - 6"	0' - 3"	3 SF		
13	CLOSET 1	1	6' - 0"	5' - 10"	1' - 4"	35 SF		
14	VANITY 3	1	2' - 4"	3' - 7"	1' - 8"	8 SF		
15	LAUNDRY OPEN CABINET 2	1	1' - 2"	2' - 3"	3' - 0"	3 SF		
GRAND	GRAND TOTAL 16							


TYPE MARK	TYPE	COUNT
)1	WASHER-FRONT-LOAD	1
)2	REFRIGERATOR	1
)3	RANGE	1
)4	DRYER-FRONT-LOAD	1
05	DISHWASHER	1





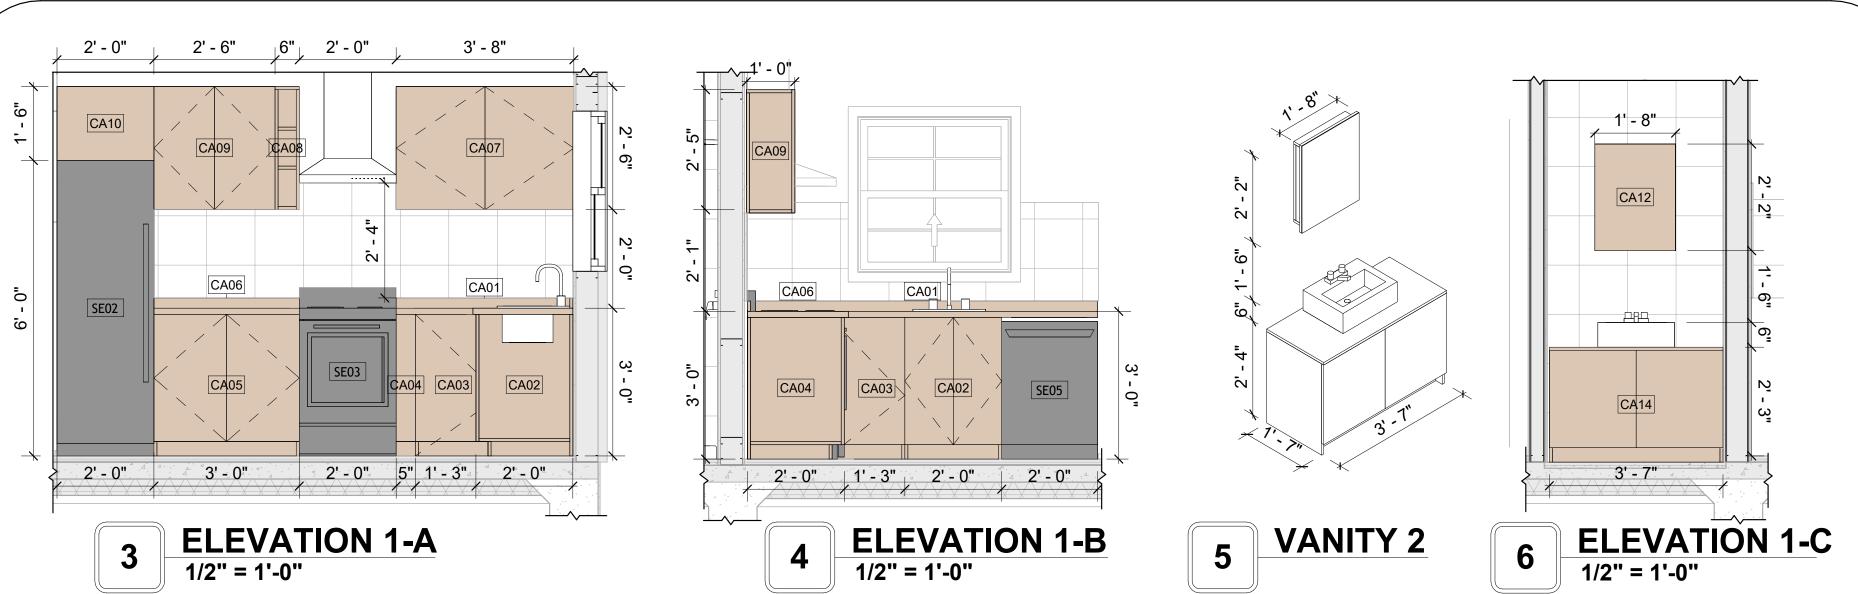


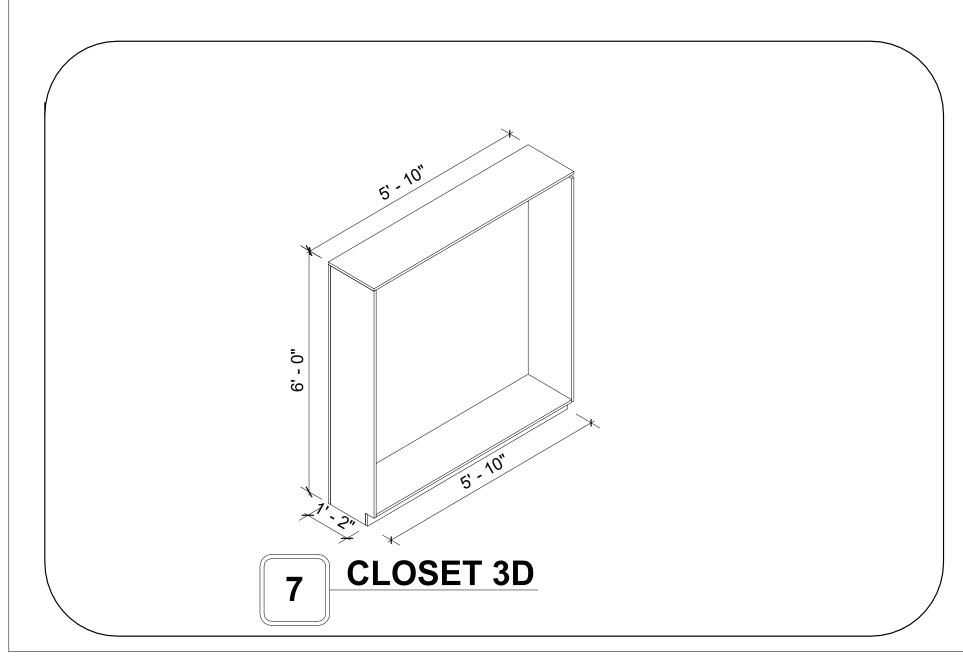

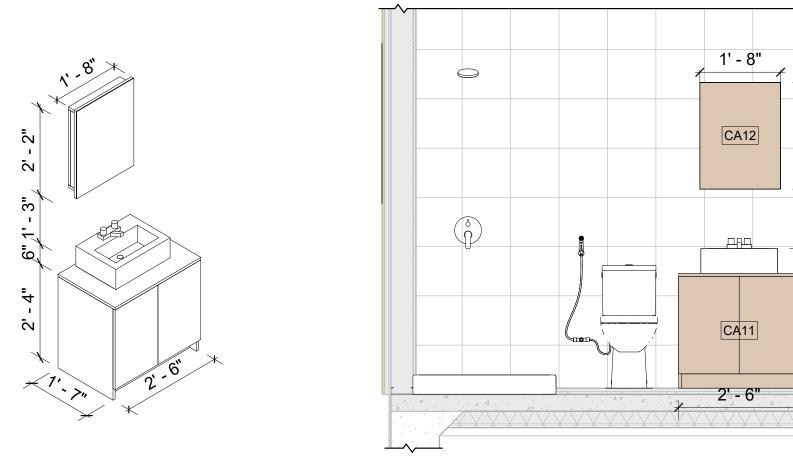


1/2" = 1'-0"

VANITY 3D

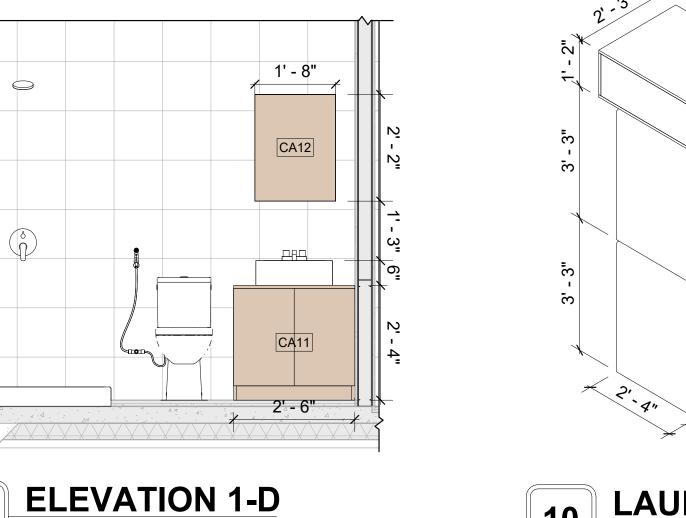



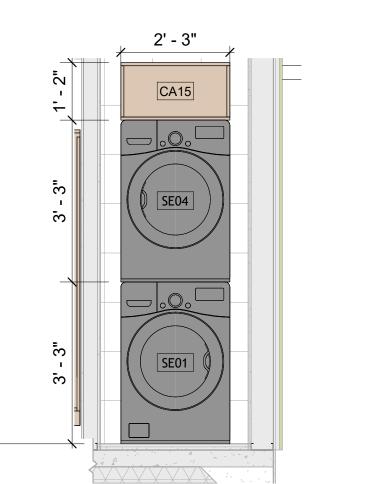

1/2" = 1'-0"

ELEVATION 1-E



DESCRIPTION DATE NOTE:

LEGEND:

PROJECT

02 Wisdom 499 Studio Traditional 550

DRAWING NAME

ARCHITECTURAL CASEWORK

CLIENT NAME: **Client Name** 0033_15 PROJECT NUMBER: 2/1/2025 5:14:38 PM Designer DESIGNED BY: DRAWN BY: **Author** Checker CHECKED BY:

A402

GENERAL NOTES

1. THIS DRAWING DEPICTS THE HVAC (HEATING, VENTILATION, AND AIR CONDITIONING) SYSTEM FOR THE WISDOM_TM_T_550. IT PROVIDES A VISUAL REPRESENTATION OF THE SYSTEM LAYOUT AND COMPONENTS.

2.THE HVAC SYSTEM IS DESIGNED TO MEET THE SPECIFIC REQUIREMENTS OF THE BUILDING, INCLUDING HEATING, COOLING, AND VENTILATION NEEDS, AS PER THE PROJECT SPECIFICATIONS AND APPLICABLE CODES AND STANDARDS.

3. THE HVAC SYSTEM INSTALLATION SHALL COMPLY WITH THE LATEST EDITION OF THE INTERNATIONAL MECHANICAL CODE (IMC), INTERNATIONAL RESIDENTIAL CODE (IRC), AND ALL OTHER APPLICABLE LOCAL, STATE, AND NATIONAL CODES AND REGULATIONS.

4. THE EQUIPMENT SHOWN ON THIS DRAWING INCLUDES BUT IS NOT LIMITED TO AIR HANDLING UNITS (AHUS), CHILLERS, BOILERS, COOLING TOWERS, PUMPS, DUCTWORK, DIFFUSERS, GRILLES, AND CONTROL DEVICES.

5. ALL EQUIPMENT, DUCTWORK, AND PIPING SHALL BE INSTALLED IN ACCORDANCE WITH MANUFACTURER'S SPECIFICATIONS, LOCAL CODES, AND

6. ALL DUCTWORK SHALL BE SIZED, FABRICATED, AND INSTALLED IN ACCORDANCE WITH THE LATEST EDITION OF THE ACCA MANUAL D AND THE SMACNA HVAC DUCT CONSTRUCTION STANDARDS. DUCTWORK SHALL BE INSTALLED IN A NEAT AND WORKMANLIKE MANNER, PROPERLY SUPPORTED AND BRACED TO PREVENT SAGGING, AIR LEAKAGE, OR VIBRATION.

7. CONDENSATE DRAINAGE PIPING SHALL BE PROPERLY PITCHED TO ENSURE POSITIVE DRAINAGE TO AN APPROVED DISPOSAL LOCATION, SUCH AS A FLOOR DRAIN, SUMP PUMP, OR EXTERIOR GRADE. CONDENSATE LINES SHALL BE INSULATED TO PREVENT SWEATING.

8. THE LOCATION OF CONTROL PANELS AND SENSORS INDICATED ON THIS DRAWING CAN BEMODIFY WITH THE SPECIFIC LOCATIONS AND WIRING DETAILS WILL BE DETERMINED DURING THE CONTROL SYSTEM DESIGN AND INSTALLATION.

9. THE HVAC SYSTEM DESIGN CONSIDER ENERGY EFFICIENCY, INDOOR AIR QUALITY, OCCUPANT COMFORT, AND NOISE CONTROL, FOLLOWING APPLICABLE GUIDELINES AND REGULATIONS.

WITH THE LOCAL BUILDING DEPARTMENT AND UTILITY PROVIDERS TO ENSURE A TIMELY AND COMPLIANT INSTALLATION.

10. COORDINATION WITH OTHER TREADS HAS BEEN DONE ON A DESIGN LEVEL. THIS DRAWING SHALL BE READ TOGETHER WITH THE AR, EL AND SN

DESIGN DRAWINGS TO ENSURE PROPER INSTALLATION AND INTEGRATION OF THE HVAC SYSTEMS. 11. THE HVAC CONTRACTOR IS RESPONSIBLE FOR OBTAINING ALL NECESSARY PERMITS AND LICENSES, AND FOR SCHEDULING AND COORDINATING

12. ALL DUCTWORK PENETRATIONS THROUGH WALLS, FLOORS, OR CEILINGS SHALL BE PROPERLY SEALED AND FIRE-STOPPED USING APPROVED

METHODS AND MATERIALS TO MAINTAIN THE INTEGRITY OF THE BUILDING'S FIRE-RESISTANCE RATINGS. 13. HVAC EQUIPMENT SHALL BE INSTALLED LEVEL AND PLUMB, AND IN STRICT ACCORDANCE WITH THE MANUFACTURER'S INSTALLATION

INSTRUCTIONS AND RECOMMENDATIONS. PROVIDE ADEQUATE CLEARANCES AROUND EQUIPMENT FOR PROPER AIRFLOW, SERVICE ACCESS, AND CODE COMPLIANCE. 14. ALL HVAC EQUIPMENT AND COMPONENTS, INCLUDING THERMOSTATS, DAMPERS, AND ACCESS PANELS, SHALL BE LOCATED IN ACCESSIBLE AREAS

15. THE HVAC SYSTEM SHALL BE BALANCED AND ADJUSTED TO ENSURE PROPER AIRFLOW, TEMPERATURE DISTRIBUTION, AND SYSTEM


PERFORMANCE THROUGHOUT THE RESIDENCE. PROVIDE A WRITTEN REPORT DOCUMENTING THE FINAL SYSTEM BALANCE.

FOR EASY SERVICING AND MAINTENANCE. PROVIDE ADEQUATE SPACE AROUND EQUIPMENT FOR PROPER AIRFLOW AND SERVICE ACCESS.

16. ANY DEVIATIONS OR MODIFICATIONS TO THE HVAC SYSTEM DESIGN SHALL BE REVIEWED AND APPROVED BY THE RESPONSIBLE DESIGN PROFESSIONALS AND COMMUNICATED TO ALL RELEVANT PARTIES INVOLVED IN THE CONSTRUCTION PROCESS.


17. FOR ANY INQUIRIES OR CLARIFICATIONS REGARDING THE HVAC SYSTEM DESIGN, PLEASE CONSULT THE RESPONSIBLE DESIGN PROFESSIONALS OR THE PROJECT MANAGEMENT TEAM.

SYMBOLS

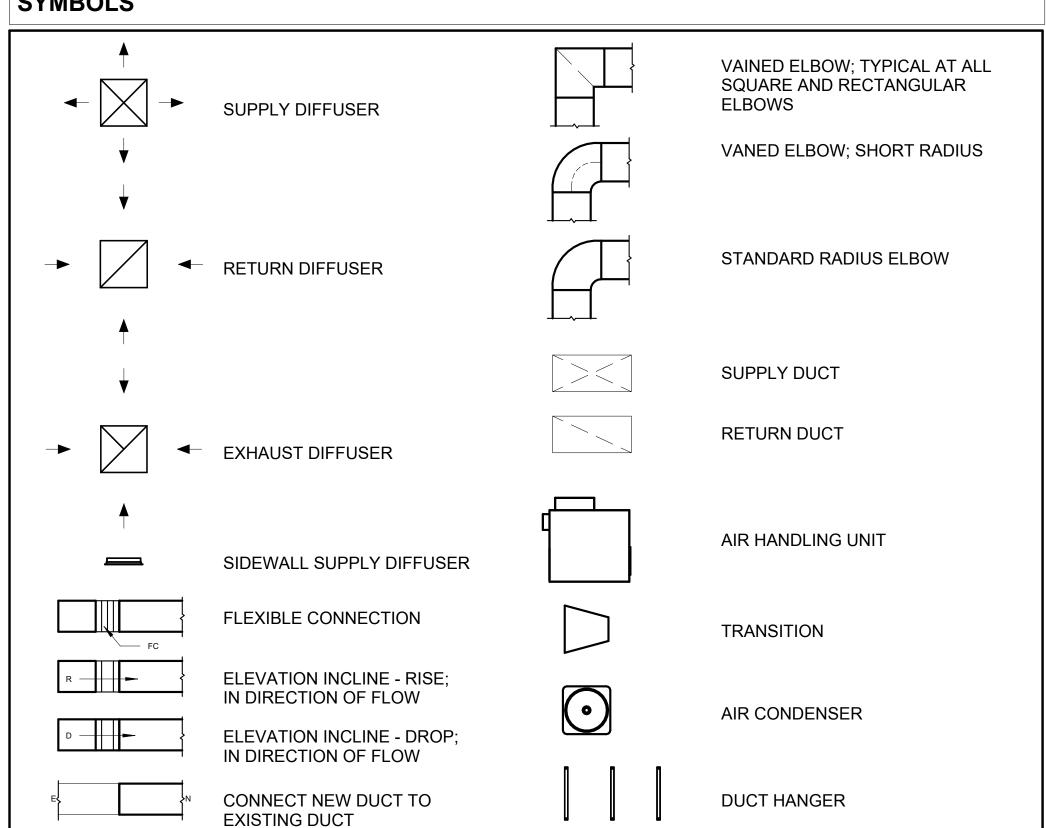



AIR CONDITIONING PIPE LINE

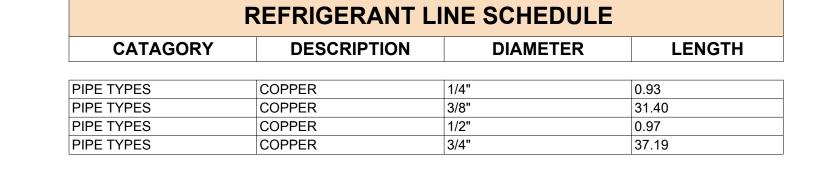

	REFRIGERANT LINE FITTING SCHEDULE				
<u>/ [/]</u>	CATAGORY	DESCRIPTION	Size	Count	
ISER	ELBOW - GENERIC	ELBOW - GENERIC: STANDARD/HVAC	1/2"ø-1/2"ø	1	
	ELBOW - GENERIC	ELBOW - GENERIC: STANDARD/HVAC	1/4"ø-1/4"ø	1	
	ELBOW - GENERIC	ELBOW - GENERIC: STANDARD/HVAC	3/4"ø-3/4"ø	10	
	ELBOW - GENERIC	ELBOW - GENERIC: STANDARD/HVAC	3/8"ø-3/8"ø	7	
	TRANSITION - GENERIC	TRANSITION - GENERIC: STANDARD	3/4"ø-1/2"ø	2	
	TRANSITION - GENERIC	TRANSITION - GENERIC: STANDARD	3/4"ø-5/8"ø	1	
	TRANSITION - GENERIC	TRANSITION - GENERIC: STANDARD	3/8"ø-1/4"ø	1	

MECHANICAL EQUIPMENT SCHEDULE				
CATAGORY DESCRIPTION (
AIR HANDLING UNIT AIR HANDLING UNIT: WALL MOUNTED 1				
CONDENSER	CONDENSER: OUT DOOR	1		
EXHAUST FAN	EXHAUST FAN: 75 CFM 1			
	HOOD-WALL2: VENT 2 1			

DUCT FITTING SCHEDULE				
CATAGORY DESCRIPTION CO				
ROUND TRANSITION - ANGLE	45 DEGREE	5		

DUCT ACCESSORY SCHEDULE					
CATAGORY	DESCRIPTION	COUNT			
ROOF VENT	3" DIAMETER	3			

FLEX DUCT SCHEDULE					
DESCRIPTION	DESCRIPTION	LENGTH	DIAMETER	COUNT	
FLEX DUCT ROUND	FLEX-ROUND	9.53	4"	3	
GRAND TOTAL: 3	1	9.53			



10' - 3 1/2"

EXHAUST FAN

3' - 8"

AIR HANDLING UNIT

2' + 0"

HOOD-WALL2



KEY PLAN

NO.	DESCRIPTION	DATE

NOTE:

LEGEND:

PROJECT

02-Wisdom-499-Studio **Traditional-550**

DRAWING NAME

HVAC PLAN

CLIENT NAME: Owner PROJECT NUMBER 15_0001 DATE: 1/31/2025 5:59:04 AM Designer DESIGNED BY: DRAWN BY: Author CHECKED BY: Checker

M101

SCALE: As indicated

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ELECTRICAL NOTES

- 1. THIS DRAWING DEPICTS THE ELECTRICAL SYSTEM FOR THE 02-WISDOM-499-STUDIO-TRADITIONAL-550. IT PROVIDES A VISUAL REPRESENTATION OF THE ELECTRICAL LAYOUT AND COMPONENTS, INCLUDING POWER DISTRIBUTION, LIGHTING, AND CONTROL SYSTEMS.
- 2. THE ELECTRICAL SYSTEM IS DESIGNED TO MEET THE SPECIFIC REQUIREMENTS OF THE BUILDING, INCLUDING POWER DISTRIBUTION, LIGHTING, AND SPECIALIZED ELECTRICAL EQUIPMENT NEEDS, AS PER THE PROJECT SPECIFICATIONS AND APPLICABLE CODES AND STANDARDS.
- 3. THE ELECTRICAL SYSTEM INSTALLATION SHALL COMPLY WITH THE LATEST EDITION OF THE NATIONAL ELECTRICAL CODE (NEC), INTERNATIONAL BUILDING CODE (IBC), AND ALL OTHER APPLICABLE LOCAL, STATE, AND NATIONAL CODES AND REGULATIONS.
- 4. LOCATIONS AS NEEDED, DEVICES ARE SHOWN ON PLANS IN APPROXIMATE IDEAL LOCATIONS, UNLESS SPECIFICALLY DIMMENSIONED.
- 5. OPEN WALLS AS NEEDED TO ALLOW FOR NEW ELECTRICAL INSTALLATIONS.
- 6. LABEL ALL CIRCUITS ON JUNCTION BOXES, RECEPTACLES, DATA, SMOKE DETECTOR, AND EQUIPMENT IN PANEL BOX.
- 7. INSTALL RACEWAY AS NEEDED FOR DDC, ACCESS CONTROL, LOW VOLTAGE WIRING & DATA.
- 8. RELABEL POWER, DATA & FIRE ALARM FOR ROOM #CHANGES.
- 9. VERIFY ALL CIRCUITS LABELED ON PRINT ARE CORRECT BEFORE WORKING ON THEM.
 10. NOTE ON SITE PLAN ALL CHANGES OR MISSING DETAIL TO BE INCORPORATED INTO THE MASTER PLAN.
- 11. DRAWINGS ARE DIAGRAMMATIC ONLY FOR THE PURPOSE OF SHOWING FIXTURE AND OUTLET LOCATIONS.
- 12. ELECTRICAL CONTRACTOR TO VERIFY SERVICE SIZE BY CALCULATION BASED UPON ACTUAL NAME PLATE RATINGS OF SELECTED FOLIPMENT
- PLATE RATINGS OF SELECTED EQUIPMENT.

 13. VERIEV LOCATION OF SERVICE ENTRANCE WITH POWER COMPANY PROVIDE LIFER GROUND IN
- 13. VERIFY LOCATION OF SERVICE ENTRANCE WITH POWER COMPANY. PROVIDE UFER GROUND IN BUILDING FOUNDATION AT SERVICE ENTRANCE LOCATION.
- 14. PROVIDE A MIN. OF 20 FEET OF ONE *4 BARE COPPER UFER WIRE EMBEDDED IN CONCRETE FOOTING AT THE SERVICE ENTRANCE LOCATION WHERE APPROVED BY LOCAL SERVICE PROVIDER.
- 15. PROVIDE WATERPROOF FIXTURES IN ALL HIGH MOISTURE AREAS (EXTERIOR, SHOWER AND TUB CEILINGS ETC.)
- 16. PROVIDE DEDICATED CIRCUITS TO EACH BATH, DEN, FAMILY ROOM, BEDROOM, LOFT, KITCHEN
- REFRIGERATOR, KITCHEN FREEZER DISHWASHER, AND ANY AREA/ITEM SPECIFIED BY OWNER.

 17. INCANDESCENT FIXTURES WITH OPEN OR PARTIALLY ENCLOSED LAMPS, PENDANT FIXTURES, AND
- LAMP HOLDERS ARE NOT PERMITTED IN CLOSETS.

 18. ALL WORKMANSHIP AND MATERIALS TO CONFORM WITH THE 2015 IRC.
- 19. PROVIDE A MIN. OF 20 FEET OF ONE *4 BARE COPPER UFER WIRE EMBEDDED IN CONCRETE FOOTING AT THE SERVICE ENTRANCE LOCATION WHERE APPROVED BY LOCAL SERVICE PROVIDER.
- 20. PROVIDE A BONDING CONDUCTOR CONSISTING OF A MINIMUM OF ONE *4 BARE COPPER WIRE CONNECTING THE BUILDING'S METAL WATER PIPING SYSTEM TO THE SERVICE EQUIPMENT ENCLOSURE GROUNDING.

MAIN PANEL CALCS

ELECTRICAL CALCS	
LIGHT AND OUTLETS 499 @ 3W	1,497 W
3 APPLIANCE CIRCUITS	4,500 W
DRYER	2,000 W
WASHER	2,000 W
RANGE	5,000 W
WATER HEATER	5,000 W
REFRIG.	1,800 W
DISHWASHER & DISPOSAL	3000 W
TOTAL	24,797 W
FRIST 10,000 @ 100% REMAINDER @ 40%	10,000 W 5,919W 10,000 W

25.919 W

25,919 W DIVIDED BY 240V = 109 AMPS TOTAL

(USE 200 AMP SERVICE)

TOTAL

ELECTRICAL ABBREVIATIONS LIST

1P A AC ACLG ADO AF AFF AFG AFI AHU ALT AMP AMPL ANNUN AQ-STAT ARCH AS AT ATS AUTO AUX AWG BATT BD	1 POLE (2P, 3P, 4P, ETC.) AMPERE ABOVE COUNTER OR AIR CONDITIONER ABOVE CEILING AUTOMATIC DOOR OPENER AMP FRAME ABOVE FINISHED FLOOR ABOVE FINISHED GRADE ARC FAULT CIRCUIT INTERRUPTER AIR HANDLING UNIT ALUMINUM ALTERNATE AMPERE AMPLIFIER ANNUNCIATOR APPROX APPROXIMATELY AQUASTAT ARCHITECT, ARCHITECTURAL AMP SWITCH AMP TRIP AUTOMATIC TRANSFER SWITCH AUTOMATIC AUXILIARY AUDIO VISUAL AMERICAN WIRE GAUGE BATTERY BOARD	CTR CU DCP DEPT DET DIA DISC DIST DN DPR DS DT DWG DDC ELEC ELEV EM EMS EMT EP EQUIP EWC EXIST EXH EXP	CENTER COPPER DOMESTIC WATER CIRCULATING PUMP DEPARTMENT DETAIL DIAMETER DISCONNECT DISTRIBUTION DOWN DAMPER SAFETY DISCONNECT SWITCH DOUBLE THROW DRAWING DIRECT DIGITAL CONTROL ELECTRICAL CONTRACTOR ELECTRIC, ELECTRICAL ELEVATOR EMERGENCY ENERGY MANAGEMENT SYSTEM ELECTRICAL METALLIC TUBING ELECTRIC PNEUMATIC EQUIPMENT ELECTRIC WATER COOLER EXISTING EXHAUST EXPLOSION PROOF	HT HTG HTR HV HVAC CONDITIONING HWP IC IG IMC INCAND IR I/W J-BOX KV KVA KVAR KW KWH LOC LT LTG LTNG LV MAX MAG.S	HEIGHT HEATING HEATER HIGH VOLTAGE HEATING, VENTILATING AND AIR CONDITIONING HYDRONIC WATER PUMP INTERRUPTING CAPACITY ISOLATED GROUND INTERMEDIATE METAL CONDUIT INCANDESCENT INFRARED INTERLOCK WITH JUNCTION BOX KILOVOLT KILOVOLT-AMPERE KILOVOLT-AMPERE REACTIVE KILOWATT KILOWATT KILOWATT HOUR LOCATE OR LOCATION LIGHT LIGHTING LIGHTNING LOW VOLTAGE MAXIMUM MAGNETIC STARTER
C CAB	CONDUIT CABINET	SUPPLY PANEL FACP	SUPPLY PANEL FIRE ALARM CONTROL PANEL	MCB MCC	MAIN CIRCUIT BREAKER MOTOR CONTROL CENTER
CAT	CATALOG	FCU	FAN COIL UNIT	MDC	MAIN DISTRIBUTION CENTER
CATV	CABLE TELEVISION	FIXT	FIXTURE	MDP	MAIN DISTRIBUTION PANEL
СВ	CIRCUIT BREAKER	FLR	FLOOR	MFR	MANUFACTURERMAIN FUSED
CCTV	CLOSED CIRCUIT TELEVISION	FLUOR	FLUORESCENT	NAL I	DISCONNECT SWITCH
CKT CLG	CIRCUIT CEILING	FU FUDS	FUSE FUSED SAFETY DISCONNECT SWITCH	MH MIC	MANHOLE MICROPHONE
COMB	COMBINATION	GA	GAUGE	MIN	MINIMUM
CMPR	COMPRESSOR	GAL	GALLON	MISC	MISCELLANEOUS
CONN	CONNECTION	GALV	GALVANIZED	MLO	MAIN LUGS ONLY
CONST	CONSTRUCTION	GC	GENERAL CONTRACTOR	MMS	MANUAL MOTOR STARTER
CONT	CONTINUATION OR CONTINUOUS	GEN	GENERATOR	MOA	MULTIOUTLET ASSEMBLY
CONTR	CONTRACTOR CONVECTOR	GFI GFP	GROUND FAULT BROTECTOR	MSP MSBD	MOTOR STARTER PANELBOARD
CONV CP	CIRCULATING PUMP	GND	GROUND FAULT PROTECTOR GROUND	MT	MAIN SWITCHBOARD MOUNT
CRT	CATHODE-RAY TUBE	GRS	GALVANIZED RIGID STEEL (CONDUIT)	MT.C	EMPTY CONDUIT
CT	CURRENT TRANSFORMER	GYP BD	GYPSUM BOARD	UL	UNDERWRITERS LABORATORIES

Branch Panel:

Location: STUDIO 16
Supply From:
Mounting: Recessed

Enclosure: Type 1

Volts: 120/240 Single
Phases: 1
Wires: 3

A.I.C. Rating: Mains Type: Mains Rating: 200 A MCB Rating: 1 A

Notes:

Circuit Numb er	Circuit Description	Number of Elements	Rating	Length	Wire Size	A		ı	3	Wire Size	Length	Rating	Number of Elements	Circuit Description	Circuit Numb er
1	HALL&KITCHEN LIGHT	7	20 A	39' - 2 13/16"	1-#12, 1-#12, 1-#12	420 VA	260 VA			1-#14, 1-#14, 1-#14	35' - 11 17/32"	15 A	8	KITCHEN LIGHT	2
3	OUTDOOR LIGHT	6	15 A	35' - 9 7/16"	1-#14, 1-#14, 1-#14			152 VA	89 VA	1-#14, 1-#14, 1-#14	24' - 2 29/32"	15 A	7	LIV. LIGHT	4
5	BATH GFCI	8	20 A	36' - 8 31/32"	1-#12, 1-#12, 1-#12	520 VA	540 VA			1-#12, 1-#12, 1-#12	30' - 11 3/16"	20 A	3	KITCHEN GFCI	6
7	HOOD&DISH WASHER GFCI	2	30 A	24' - 2 9/16"	1-#10, 1-#10, 1-#10			1380 VA	2000 VA	1-#10, 1-#10, 1-#10	49' - 11"	20 A		WASHING MASHEIN	8
9	OUTDOOR GFCI	1	20 A	50' - 4"	1-#12, 1-#12, 1-#12	180 VA	900 VA			1-#14, 1-#14, 1-#14	41' - 0 1/8"	15 A	5	RECEPTACLE	10
11	DRYER	1	30 A	47' - 8 7/8"	2-#10, 1-#10, 1-#10			750 VA	2250 VA	2-#10, 1-#10, 1-#10	34' - 4"	30 A	1	WATER HEATER	12
13						750 VA	2250 VA								14
15	RANGE	1	40 A	28' - 10 7/16"	2-#8, 1-#8, 1-#10			2500 VA	2500 VA	2-#6, 1-#6, 1-#10	29' - 8 7/32"	60 A	1	CONDENSER	16
17						2500 VA	2500 VA								18
19															20
21															22
23															24
25															26
						10820			2 VA						
						90	Α	97	' A						

Legend:

Load Classification	Connected Load	Demand Factor	Estimated Demand	Panel Totals
LIGHTING - DWELLING UNIT	152 VA	100.00%	152 VA	
OTHER	460 VA	100.00%	460 VA	Total Conn. Load: 22432 VA
RECEPTACLE	5540 VA	100.00%	5540 VA	Total Est. Demand: 21432 VA
LIGHTING	288 VA	100.00%	288 VA	Total Conn.: 93 A
CONDENSER	5000 VA	100.00%	5000 VA	Total Est. Demand: 89 A
WATER HEATER	4500 VA	100.00%	4500 VA	
RANGE	5000 VA	80.00%	4000 VA	
DRYER	1500 VA	100.00%	1500 VA	



KEY PLAN

NO. DESCRIPTION DATE

NOTE:

LEGEND:

PROJECT

02-Wisdom-499-Studio Traditional-550

DRAWING NAME

SCHEDULE

CLIENT NAME:

PROJECT NUMBER:

0054_11

DATE:

1/25/2025 12:03:40 PM

DESIGNED BY:

DRAWN BY:

CHECKED BY:

Checker

E101

SCALE: 1/4" = 1'-0"

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ELECTRICAL NOTE

- A. PROVIDE INTERCONNECTED SMOKE ALARMS IN EACH SLEEPING ROOMS, OUTSIDE EACH SLEEPING ROOM, ON EACH STORY, IN THE HALL OR ADJACENT ROOM LUHERE THE CEILING HEIGHT OF A ROOM OPEN TO THE HALL EXCEEDS THE HALL BY 24'. SMOKE ALARMS SHALL BE PERMANENTLY HARD WIRED WITH BATTERY BACKUP.
- B. RECEPTACLE OUTLETS FOR RANGES AND CLOTHES DRYERS SHALL BE A THREE POLE WITH GROUND TYPE. FOUR WIRE GROUNDING-TYPE FLEXIBLE CORDS WILL BE REQUIRED FOR CONNECTION OF RANGES AND CLOTHES DRYERS. THE BONDING JUMPER SHALL NOT BE CONNECTED BETWEEN NEUTRAL TERMINAL AND THE FRAME OF THE APPLIANCE.
- C. TWO OR MORE 20 AMP SMALL APPLIANCE CIRCUITS SHALL BE PROVIDED TO SERVE THE KITCHEN, BREAKFAST NOOK, AND DINING ROOM. SUCH CIRCUITS SHALL HAVE NO OTHER OUTLETS.
- D. AT LEAST ONE 20 AMP BRANCH CIRCUIT SHALL BE PROVIDED TO SERVICE THE LAUNDRY ROOM. THIS CIRCUIT SHALL HAVE NO OTHER OUTLETS.
- E. ALL RECEPTACLES WITH IN 6' OF A WET BAR SINK OR KITCHEN SINK TO SERVE COUNTER TOP SURFACES MUST BE GFCI. ON KITCHEN COUNTERS 12' OR WIDER NO POINT ALONG THE WALL SHALL BE MORE THAN 2' FROM A RECEPTACLE. ALL RECEPTACLES WITH IN 6' OF KITCHEN SINK MUST BE GFCI. AT LEAST ONE GFCI RECEPTACLE SHALL BE INSTALLED IN THE BATHROOM ADJACENT TO EACH BASIN.
- F. FIXTURES INCLUDING CEILING FANS THAT ARE LOCATED IN DAMP LOCATIONS SHALL BE LISTED TO BE SUITABLE FOR
- SUCH LOCATIONS PER 2012 IRC
 G. PROVIDE ONE (1) SWITCHED OUTLET @ ALL BEDROOMS AND DEN
- H. CEILING FANS NOT EXCEEDING 35 LBS. (WITH OR WITHOUT ACCESSORIES MAY BE SUPPORTED BY OUTLET BOXES PROVIDED THE OUTLET BOXES ARE IDENTIFIED FOR SUCH USE PER 2012 IRC
- I. ELECTRICAL OUTLET BOXES ON OPPOSITE SIDES OF FIRE RATED WALLS SHALL BE SEPARATED BY A HORIZONTAL DISTANCE OF NOT LESS THAN 24".
- J. OUTLET BOXES IN THE WALLS BETWEEN THE GARAGE AND DWELLING SHALL BE METAL OR U.L. APPROVED FIRE RESISTIVE PLASTIC. BOXES IN GARAGE CEILING SHALL BE METAL.
- K. ALL BRANCH CIRCUITS THAT SUPPLY 120 VOLTS SINGLE PHASE 15 AND 20 AMPS RECEPTACLE OUTLETS INSTALLED IN THE DWELLING SHALL BE PROTECTED BY AN ARC FAULT CIRCUIT INTERRUPTER, EXCEPT GFCI RECEPTICLES.

NOTE:

A. RECEPTACLES MUST BE PROVIDED IN HALLWAYS 10'-0" OR MORE IN LENGTH. FOR A ONE FAMILY DWELLINGS AND EACH OF A TWO FAMILY DWELLING THAT IS AT GRADE LEVEL, AT LEAST ONE WP-GFCI RECEPTACLE OUTLET ACCESSIBLE AT GRADE LEVEL AND NOT MORE THAN 6'-6" ABOVE GRADE SHALL BE INSTALLED AT THE FRONT AND BACK OF THE DWELLING.

NOTE: APPLIANCE DISCONNECT

E4001.5 GROUNDING OF ENCLOSURES.

METAL ENCLOSURES FOR SWITCHES OR CIRCUIT BREAKERS SHALL BE CONNECTED TO AN

EQUIPMENT GROUNDING CONDUCTOR.

METAL ENCLOSURES FOR SWITCHES OR CIRCUIT BREAKERS USED AS SERVICE


EQUIPMENT SHALL COMPLY WITH THE PROVISIONS OF SECTION E3609.4. WHERE


NONMETALLIC ENCLOSURES ARE USED WITH METAL RACEWAYS OR METAL-ARMORED CABLES, PROVISIONS SHALL BE MADE FOR CONNECTING THE EQUIPMENT GROUNDING

CONDUCTOR.


NONMETALLIC BOXES FOR SWITCHES SHALL BE INSTALLED WITH A WIRING METHOD THAT


PROVIDES OR INCLUDES AN EQUIPMENT GROUNDING CONDUCTOR. (404.12)

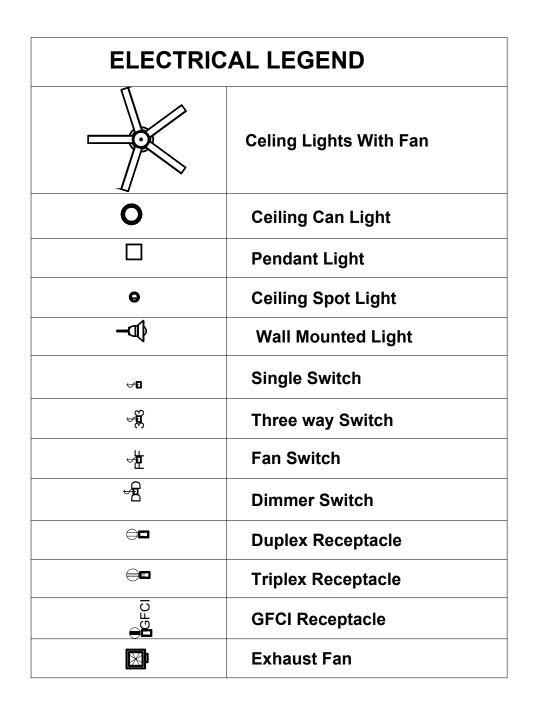

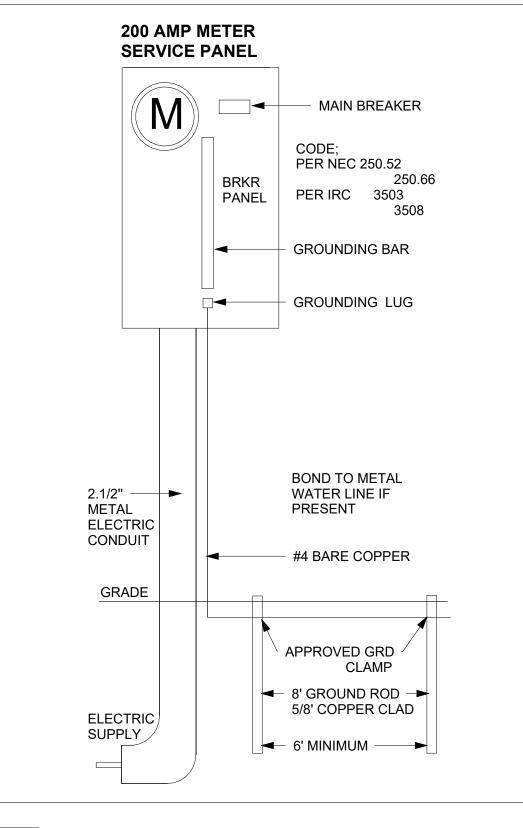



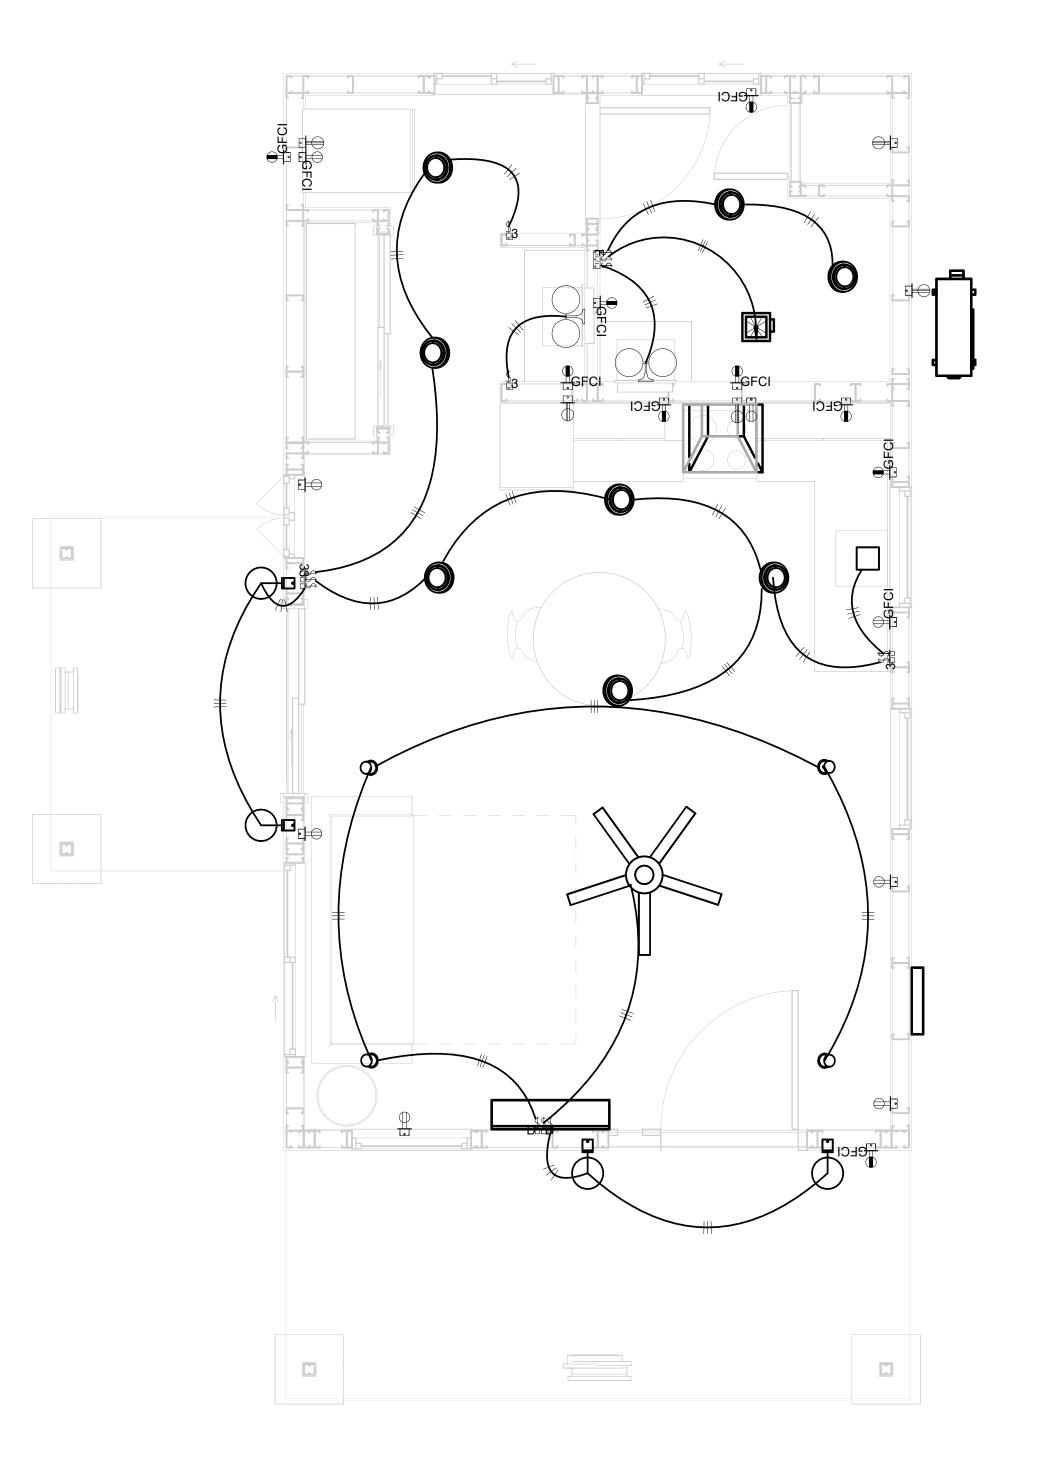

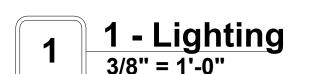



KEY PLAN

NO.	DESCRIPTION	DATE

NOTE:

LEGEND:

PROJECT

02-Wisdom-499-Studio Traditional-550

DRAWING NAME


LIGHTING

CLIENT NAME:	Owner
PROJECT NUMBER:	0054_11
DATE:	1/25/2025 12:03:42 PM
DESIGNED BY:	Designer
DRAWN BY:	Author
CHECKED BY:	Checker


E102

NOTES: CONDUIT, CABLE AND WIRING


- Use Metalic Conduits (IMC) for cables running under concrete slabs.
 Use IMC for circuits with high voltage appliances (240 volts and above)
 For circuits with 120 volts consider using EMT or PVC conduits if needed.
 For Low voltage applications up to 50 volts consider using non metalic conduits.
 All conduits to be used in the project must conform to the latest National Electrical Code (NEC),
- 5. All conduits to be used in the project must comorn to the latest National Electrical Code (NEC), 2015.
 6. All wiring and cables to be used in the project must also conform to the latest National Electrical Code (NEC), 2015.
 7. All cables and wires used should be rated for their respective loading and should be gauged and conform to the NEC.

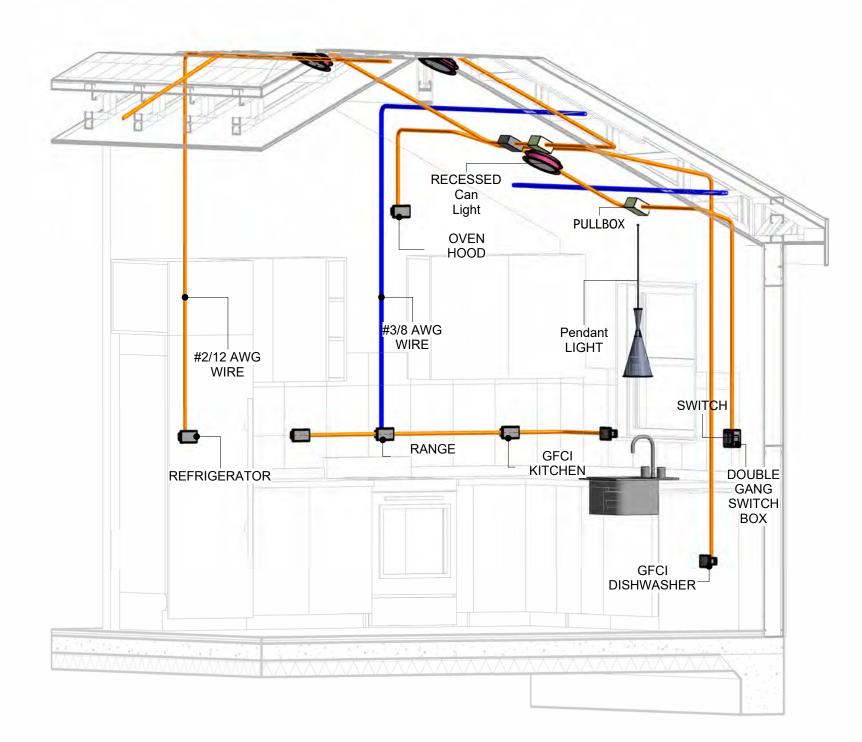




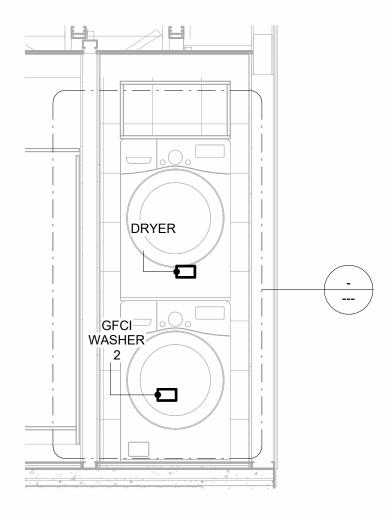


2 Section 1 1/2" = 1'-0"

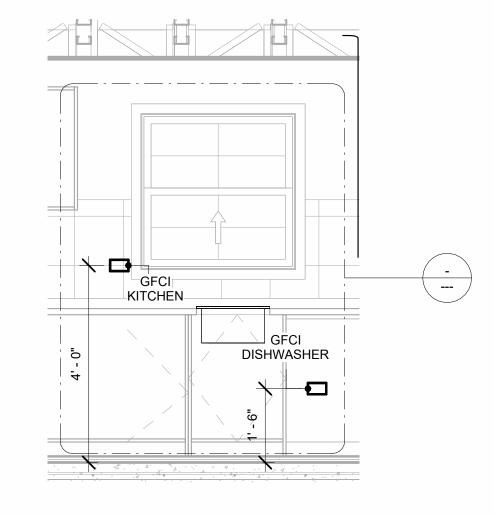

3 Section 2 1/2" = 1'-0"

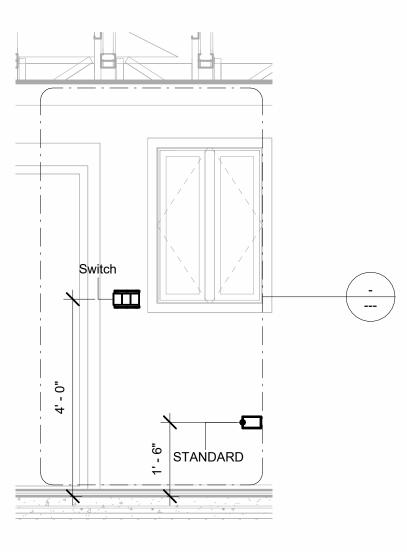


4 Section 3 1/2" = 1'-0"

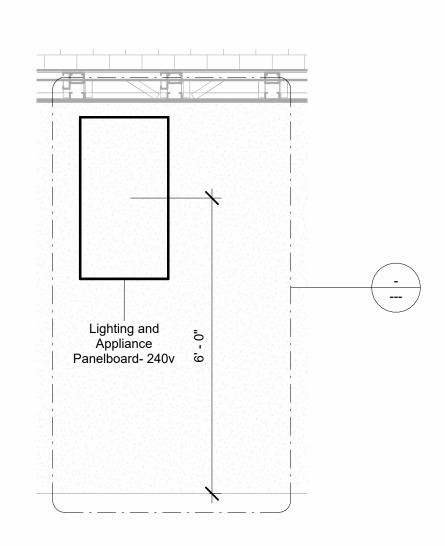

6 Section 4 1/2" = 1'-0"



KEY PLAN

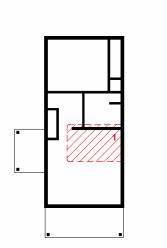

NO.	DESCRIPTION	DATE

NOTE:

LEGEND:

PROJECT

02-Wisdom-499-Studio Traditional-550

DRAWING NAME

POWER

CLIENT NAME:	Owner
PROJECT NUMBER:	0054_11
DATE:	1/25/2025 12:04:08 PM
DESIGNED BY:	Designer
DRAWN BY:	Author
CHECKED BY:	Checker

E103

NOTES: LIGHT

- 1. LIGHT FIXTURES AND LUMINARIES SHALL CONFORM TO THE NEC, THE IRC AND LOCAL SAFETY & BUILDING CODE.
- 2. ALL LIGHTING FIXTURES SHOULD CONFORM TO THE DESIGN ELECTRICAL LOAD AND SHALL BE PROPERLY WIRED AND MOUNTED BY QUALIFIED ELECTRICIAN FOLLOWING MANUFACTURERS SPECIFICATIONS.
- 3. CEILING FANS AND FANS WITH LIGHT WITH WEIGHT EXCEEDING 35 LBS SHOULD BE PROVIDED WITH STRUCTURAL BACKING FOR SUPPORT AND SHALL BE FIXED AS PER MANUFACTURERS SPECIFICATIONS.
- 4. EXTERIOR LIGHTS SHALL CONFORM TO LOCAL BUILDING CODE AND GUIDELINES.

NOTES: SWITCH JUNCTION BOX


- 1. THE MINIMUM SIZE OF JUCTION BOX TO BE USED IS 2"X4"X(1.5" OR 3.5" DEEP) THIS ARE TO BE USED FOR SINGLE GANG SWITCH OR OUTLETS.
- 2. FOR DOUBLE GANG (2 GANG) OUTLETS AND SWITCHS THE MINIMUM SIZE OF THE
- JUCTION BOX TO BE PROVIDED SHALL NOT BE LESS THAN 4"X4"X(1.5" OR 3.5" DEEP)
- 3. FOR THREE GANG (3 GANG) OUTLETS AND SWITCHS THE MINIMUM SIZE OF THE JUĆTION BOX SHALL NOT BE LESS THAN 6"X4"X(1.5" OR 3.5" DEEP).

FITTING SCHEDULE(JUNCTION BOX AND PULLBOX)						
FAMILY	COUNT	DESCRIPTION				
CONDUIT JUNCTION BOX - TEE - ALUMINUM	1					
PULLBOX1	14	#1/4 PULLBOX				

ELECTRICAL FIXTURE SCHEDULE (SWITCH BOX)							
TYPE	COUNT						
DOUBLE GANG SWITCH BOX	1						
SINGLE GANG SWITCH BOX	2						
TRIPLE GANG SWITCH BOX	3						

LIGHTING DEVICE						
TYPE	COUNT					
DIMMER	2					
FAN SWITCH	1					
SINGLE POLE	5					
THREE WAY	5					

LIGHTING FIXTURE			
LIGHTING FIXTURE TYPE	VOLTAGE	ELECTRICAL LOAD	COUNT
ELECTRICAL_LIGHTS_FAN-LI GHT2	120 V/1-50 VA- 120 V/1-80 VA	200 A, 120 V/240 V, SINGLE PHASE, 3 WIRES	1
LIGHT_FIXTURE-WALL_SCON CE-KOHLER-TONE-K-31769	ONE DEDICATED CIRCUIT REQUIRED 120 V/1-120 VA	200 A, 120 V/240 V, SINGLE PHASE, 3 WIRES	2
LIGHTING_OTHER_LUMENWE RX_SHELL-RECESSED1	120 V/1-20 VA	200 A, 120 V/240 V, SINGLE PHASE, 3 WIRES	2
LIGHTING_PENDANT1	120 V/1-20 VA	200 A, 120 V/240 V, SINGLE PHASE, 3 WIRES	1
LIGHTING_RECESSED	120 V/1-60 VA	200 A, 120 V/240 V, SINGLE PHASE, 3 WIRES	6
SASSO 100 ROUND WALLWASHER TRIM2	120 V/1-10 VA	200 A, 120 V/240 V, SINGLE PHASE, 3 WIRES	4
WALL LAMP - BRACKET1	120 V/1-38 VA	200 A, 120 V/240 V, SINGLE PHASE, 3 WIRES	4

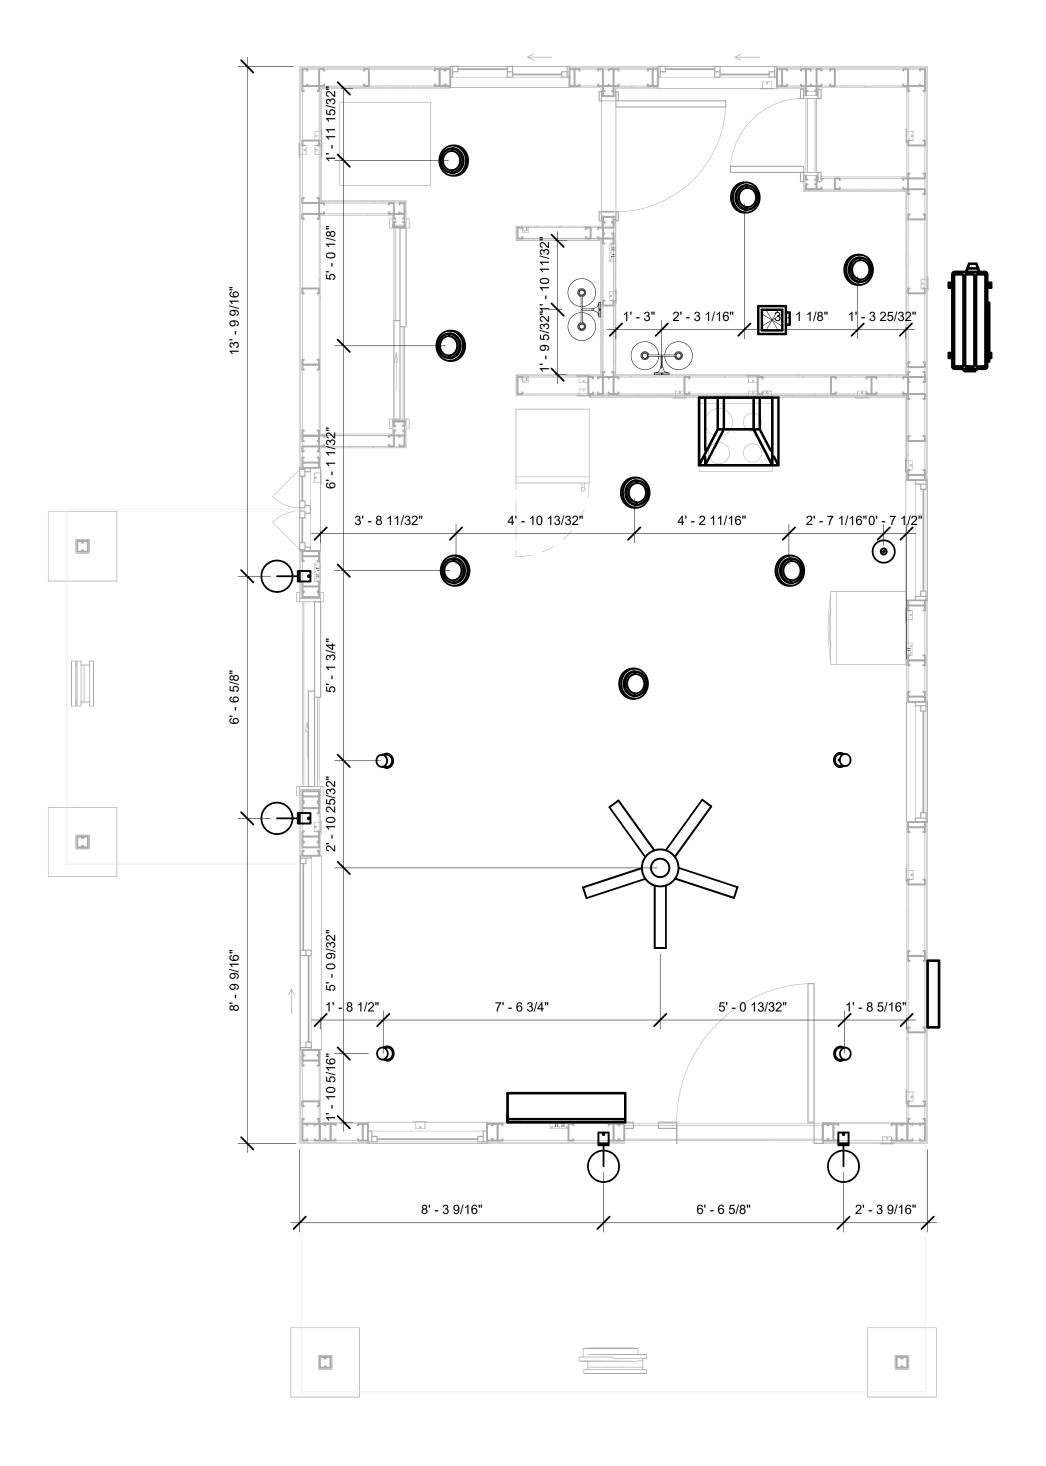

DIMENSION FOR LIGHT FIXTURES



KEY PLAN

NO.	DESCRIPTION	DATE

NOTE:

LEGEND:

PROJECT

02-Wisdom-499-Studio **Traditional-550**

DRAWING NAME

DIMENSION PLAN FOR LIGHT FIXTURES

CLIENT NAME:	Owner
PROJECT NUMBER:	0054_11
DATE:	1/25/2025 12:04:09 PM
DESIGNED BY:	Designer
DRAWN BY:	Author
CHECKED BY:	Checker


E104

NOTES;

- 1. VERIFY EQUIPMENT PLUG CONFIGURATION BEFORE PURCHASING RECEPTACLES
- 2. FOR ALL EQUIPMENT.
- 3. COORDINATE EXACT LOCATION OF LIGHT FIXTURES, WALL SWITCHES, RECEPTACLES AND OTHER DEVICES WITH ARCHITECTURAL DRAWINGS.
- 4. USE METALLIC JUNCTION BOX WITH THE GFCI RECEPTACLES, WITH HIGHT VOLTAGE.

ELECTRICAL FIXTURE SCHEDULE (RECEPTACLE)		
TYPE	COUNT	
CONDENSER	1	
DRYER	1	
GFCI BATH ROOM	4	
GFCI DISHWASHER	1	
GFCI KITCHEN	3	
GFCI OUT DOOR	2	
GFCI WASHER 2	1	
OVEN HOOD	1	
RANGE	1	
REFRIGERATOR	1	
STANDARD	5	
WATER HEATER	1	

ELECTRICAL OUTLET SCHEDULE			
TYPE	CIRCUIT NUMBER	ELECTRICAL DATA	COUNT
GFCI BATH ROOM		120 V/1-180 VA	1
GFCI OUT DOOR		120 V/1-180 VA	1
REFRIGERATOR		120 V/1-1500 VA	1
GFCI BATH ROOM	1	120 V/1-180 VA	1
GFCI BATH ROOM	5	120 V/1-180 VA	2
GFCI KITCHEN	6	120 V/1-180 VA	3
GFCI DISHWASHER	7	120 V/1-1200 VA	1
OVEN HOOD	7	120 V/1-180 VA	1
GFCI WASHER 2	8	120 V/1-2000 VA	1
GFCI OUT DOOR	9	120 V/1-180 VA	1
STANDARD	10	120 V/1-180 VA	5
DRYER	11,13	240 V/2-1500 VA	1
WATER HEATER	12,14	240 V/2-4500 VA	1
RANGE	15,17	240 V/2-5000 VA	1
CONDENSER	16,18	240 V/2-5000 VA	1

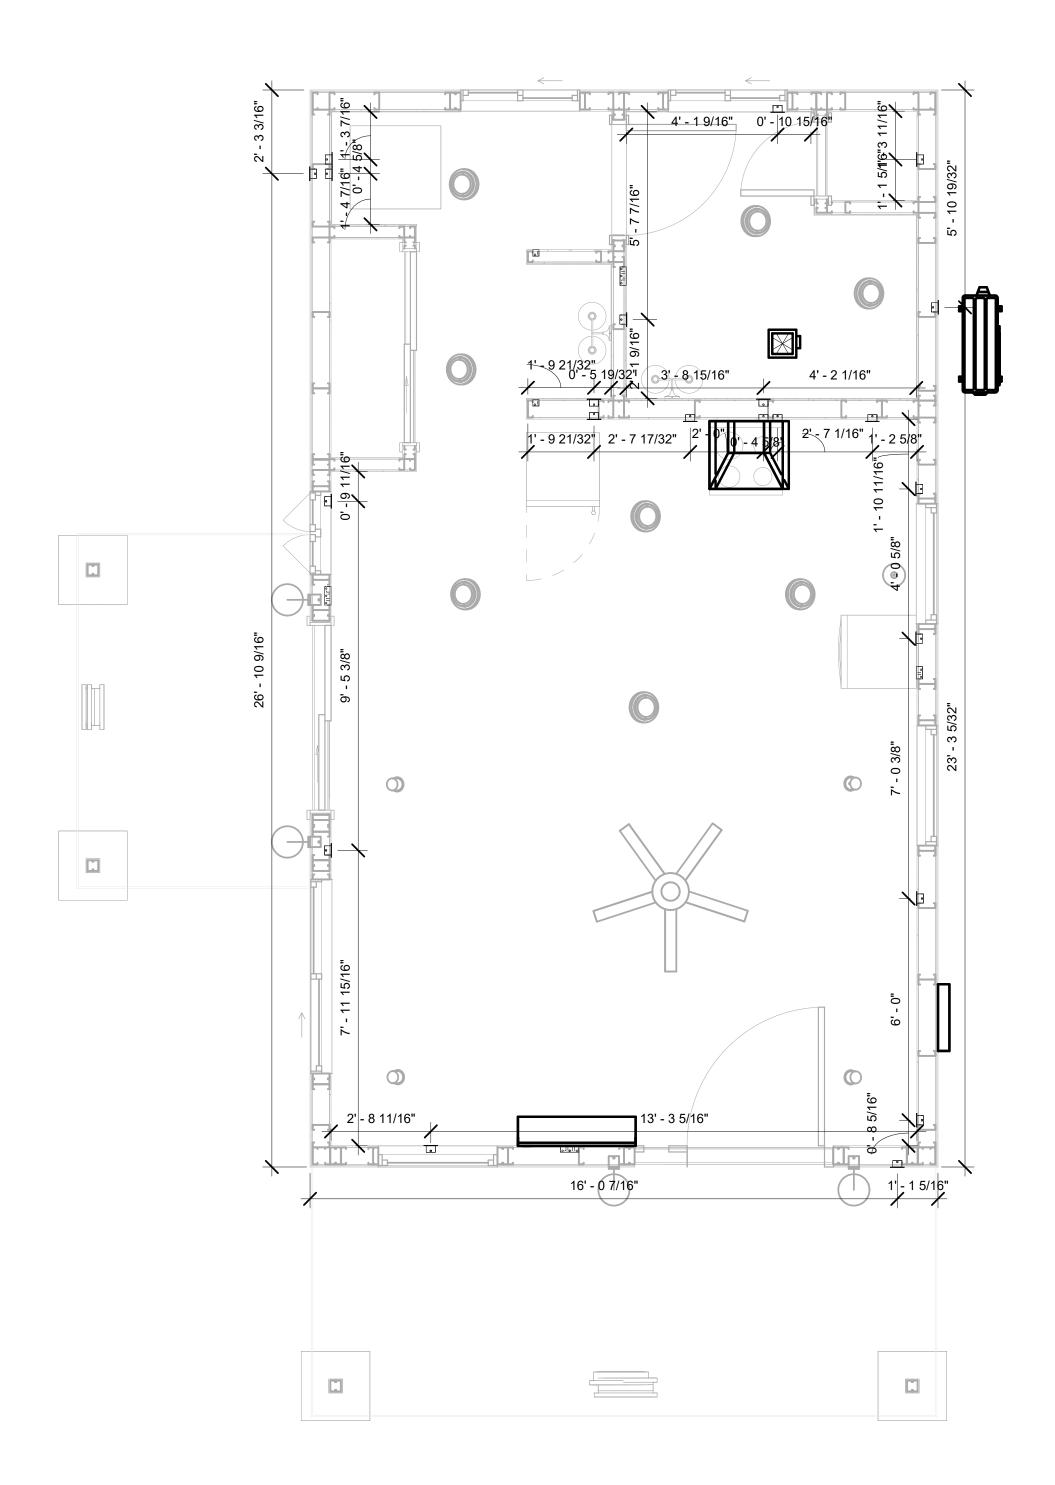

1 DIMENSION FOR FITTINGS 3/8" = 1'-0"



KEY PLAN

NO.	DESCRIPTION	DATE

NOTE:

LEGEND:

PROJECT

02-Wisdom-499-Studio Traditional-550

DRAWING NAME

DIMENSION PLAN FOR FITTINGS

Owner	CLIENT NAME:	
0054_11	PROJECT NUMBER:	
1/25/2025 12:04:10 PM	DATE:	
Designer	DESIGNED BY:	
Author	DRAWN BY:	
Checker	CHECKED BY:	

E105

SHEET LIST

SHEET NUMBER SHEET NAME

P101 NOTE AND SCHEDULE P102 WATER SUPPLY AND SEWAGE SYSTEM

PIPE COLOR SCHEME

DOMESTIC COLD WATER DOMESTIC HOT WATER - - - SANITARY VENT ----- SANITARY SEWER STORM DRAINAGE

PLUMBING NOTES

- THE PLUMBING SYSTEM IS DESIGNED TO MEET THE BUILDING'S DOMESTIC WATER SUPPLY, SANITARY DRAINAGE, AND STORM DRAINAGE REQUIREMENTS, AS PER PROJECT SPECIFICATIONS AND APPLICABLE CODES.
- THE SYSTEM INSTALLATION SHALL COMPLY WITH THE LATEST INTERNATIONAL PLUMBING CODE (IPC), INTERNATIONAL RESIDENTIAL CODE (IRC), AND ALL OTHER RELEVANT LOCAL, STATE, AND NATIONAL REGULATIONS.
- ALL PLUMBING WORK SHALL COMPLY WITH THE LATEST EDITION OF THE INTERNATIONAL PLUMBING CODE (IPC) AND THE LOCAL PLUMBING CODE.
- 4. PLUMBING SYSTEMS SHALL BE TESTED AND INSPECTED IN ACCORDANCE WITH THE LOCAL PLUMBING CODE REQUIREMENTS.
- 5. PLUMBING FIXTURES SHALL BE INSTALLED WITH THE APPROPRIATE TRIM, FITTINGS, AND
- ACCESSORIES, AS RECOMMENDED BY THE MANUFACTURER. 6. PIPING SHALL BE PROPERLY SUPPORTED AND SECURED TO PREVENT SAGGING,
- MOVEMENT, AND VIBRATION. SHUT-OFF VALVES SHALL BE PROVIDED AT ALL BRANCH CONNECTIONS AND AT THE
- INLET AND OUTLET OF EACH PIECE OF EQUIPMENT. BACKFLOW PREVENTION DEVICES SHALL BE INSTALLED AS REQUIRED BY THE LOCAL
- PLUMBING CODE TO PROTECT THE POTABLE WATER SYSTEM. PLUMBING FIXTURES AND EQUIPMENT SHALL BE ACCESSIBLE FOR MAINTENANCE AND
- 10. EXPOSED PLUMBING PIPING AND FIXTURES SHALL BE INSULATED TO PREVENT CONDENSATION AND ENERGY LOSS.
- 11. DEAD ENDS IN THE DRAINAGE SYSTEM MUST BE AVOIDED, EXCEPT WHERE NECESSARY TO INSTALL A CLEANOUT IN AN ACCESSIBLE LOCATION, AND MUST HAVE A VENTED CONNECTION TO THE OUTSIDE ATMOSPHERE.
- 12. THE VERTICAL DEFLECTION OF PVC PIPE MUST NOT EXCEED 5%, AND NO DEFLECTION IS PERMITTED FOR IRON PIPE.
- 13. WORK MUST BE PROPERLY COORDINATED WITH OTHER TRADES TO AVOID CONFLICTS, REFERRING TO THE ARCHITECTURAL AND STRUCTURAL DRAWINGS FOR INFORMATION REGARDING CEILING ELEVATIONS, SPACE CLEARANCES, WALL AND PARTITION LOCATIONS, ETC.
- 14. ALL FIXTURES SHALL HAVE ACCESSIBLE STOPS.
- 15. DOMESTIC WATER PIPING SHALL BE PEX, AND PVC PIPING IS NOT ACCEPTABLE FOR INTERIOR USE.
- 16. VENT TERMINATIONS SHALL BE LOCATED AT LEAST 10 FEET FROM OR 3 FEET ABOVE ANY OPERABLE WINDOW, DOOR OPENING, AIR INTAKE, OR VENT SHAFT, AND AT LEAST 3 FEET IN EVERY DIRECTION FROM ANY LOT LINE, ALLEY, OR STREET.
- 17. PIPE AND FITTINGS UTILIZED IN THE WATER SUPPLY SYSTEM SHALL HAVE A MAXIMUM OF 8 PERCENT LEAD.
- 18. ACRYLONITRILE BUTADIENE STYRENE (ABS) SHALL BE USED FOR THE SEWERAGE AND VENTILATION SYSTEM.
- 19. CROSS-LINKED POLYETHYLENE (PEX) SHALL BE USED FOR THE WATER SUPPLY SYSTEM.
- POLYVINYL CHLORIDE (PVC) SHALL BE USED FOR THE RAIN WATER SYSTEM. 21. THE MIMIMUM WATER SUPPLY DEPTH UNDER FLOOR FINISH SHOUD BE 1/2".
- 22. ANY PIPE INSTALLED UNDERGROUND MUST HAVE AT LEAST 12 INCHES OF CLEARANCE
- BETWEEN THE OUTSIDE OF THE PIPE AND ANY OTHER UNDERGROUND STRUCTURE
- 23. THE MINIMUM CLEARANCE BETWEEN COLD AND HOT WATER LINES IN RESIDENTIAL HOMES MAINTAIN A MINIMUM DISTANCE OF 6 INCHES.
- HORIZONTAL SEPARATION BETWEEN WATER AND SEWER LINES: A MINIMUM OF 12
- INCHES BETWEEN POTABLE WATER SUPPLY LINES (COLD AND HOT WATER) AND SANITARY SEWER LINES.

ABBREVIATIONS

Ø	DIAMETER
ABS	ACRYLONITRILE BUTADIENE STYRENE
ABV	ABOVE
AD	AREA DRAIN
AFF	ABOVE FINISHED FLOOR
ALT	ALTERNATE
BFF	BELOW FINISHED FLOOR
BLW	BELOW
CO	CLEAN OUT
CW	COLD WATER
D	DEGREE
DFU	DRANAGE FIXTURE UNIT
DIA	DIAMETER
DN	DOWN
FCO	FLOOR CLEAN OUT
FD	FLOOR DRAIN
FL	FLOOR
FS	FLOOR SINK
FT	FOOT/FEET
HB	HOSE BIB
HW	HOT WATER
IN	INCH
MIN	MINIMUM
NO	NUMBER
NTS	NOT TO SCALE
PEX	CROSS-LINKED POLYETHYLENE
PLBG	PLUMBING
PVC	POLYVINYL CHLORIDE
QTY	QUANTITY
RD	ROOF DRAIN
RED	REDUCER
RM	ROOM
RW	RAIN WATER
SF	SQUARE FOOT
V	VENT
VTR	VENT THROUGH ROOF
W	WASTE
WCO	WALL CLEAN OUT
WSFU	WATER SUPPLY FIXTURE UNIT

PLUMBING LEGEND

D	CAP
	BEND 45 DEG
囚	BEND 90 DEG
	TEE REDUCING
	TEE
	CLEAN TWO-WAY
	WYE 45 DEG
	WYE 45 DEG DOUBLE
	WYE COMBINATION
	P-TRAP

PIPE SCHEDULE		
MATERIAL	DIAMETER	LENGTH
ACRYLONITRILE BUTADIENE STYRENE (ABS)	1 1/2"	22 FT
ACRYLONITRILE BUTADIENE STYRENE (ABS)	2"	47 FT
ACRYLONITRILE BUTADIENE STYRENE (ABS)	3"	6 FT
CROSS-LINKED POLYETHYLENE (PEX)	1/2"	88 FT
CROSS-LINKED POLYETHYLENE (PEX)	3/4"	38 FT
POLYVINYL CHLORIDE - RIGID	2"	70 FT

FITTING	SIZE	QTY
		· · · · · · · · · · · · · · · · · · ·
DOMESTIC COLD WATER		
PEX 90 DEGREE ELBOW	1/2"ø-1/2"ø	19
PEX 90 DEGREE ELBOW	3/4"ø-3/4"ø	1
PEX CROSS ELBOW	3/4"ø-3/4"ø-3/4"ø	1
PEX TEE ELBOW	1/2"ø-1/2"ø-1/2"ø	3
PEX TEE ELBOW	3/4"ø-3/4"ø	4
PEX TRANSITION ELBOW	1"ø-3/4"ø	2
PEX TRANSITION ELBOW	3/4"ø-1/2"ø	6
DOMESTIC HOT WATER	4/01/ 4/01/	40
PEX 90 DEGREE ELBOW	1/2"ø-1/2"ø	13
PEX 90 DEGREE ELBOW	3/4"ø-3/4"ø	3
PEX CROSS ELBOW	1/2"ø-1/2"ø-1/2"ø	1
PEX TEE ELBOW	1/2"ø-1/2"ø	2
PEX TEE ELBOW	3/4"ø-3/4"ø-3/4"ø	1
PEX TRANSITION ELBOW	3/4"ø-1/2"ø	4
RAIN WATER		
PVC 90 DEG BEND ELBOW	2"ø-2"ø	30
FVC 90 DEG BEND ELBOW	2 0-2 0	30
SEWAGE		
ABS 90 DEGREE BEND ELBOW	1 1/2"ø-1 1/2"ø	1
ABS 90 DEGREE BEND ELBOW	2"ø-2"ø	3
ABS 90 DEGREE BEND ELBOW	3"ø-3"ø	1
ABS BEND LONG SWEEP ELBOW	2"ø-2"ø	2
ABS P-TRAP	1 1/2"ø-1 1/2"ø	4
ABS P-TRAP	2"ø-2"ø	1
ABS REDUCER ELBOW	2"ø-1 1/2"ø	3
ABS REDUCER ELBOW	3"ø-2"ø	2
ABS TEE ELBOW	1 1/2"ø-1 1/2"ø-1 1/2"ø	2
ABS TEE ELBOW	2"ø-2"ø	1
ABS TEE ELBOW	3"ø-3"ø-3"ø	2
ABS TEE REDUCER ELBOW	2"ø-2"ø	1
ABS TRAP P	2"ø-2"ø	1
ABS VENT CAP ELBOW	2"ø	1
ABS WASTE DOUBLE TEE	2"ø-2"ø-2"ø-2"ø	1
ABS WYE COMBINATION WITH 8TH BEND ELBOW	2"ø-2"ø-2"ø	1
ABS WYE COMBINATION WITH 8TH BEND ELBOW	3"ø-3"ø-1 1/2"ø	1
ABS WYE COMBINATION WITH 8TH BEND ELBOW	3"ø-3"ø-2"ø	1
ASS WILL COMBINATION WITH SITE DEND LEDOW		ı
VENT		
ABS 90 DEGREE BEND ELBOW	1 1/2"ø-1 1/2"ø	1
ABS TEE REDUCER ELBOW	2"ø-2"ø-1 1/2"ø	1
ABS VENT CAP ELBOW	1 1/2"ø	1
ABS VENT CAP ELBOW	2"ø	2

WATER FIXTURE UNIT SCHEDULE			
FAMILY	QTY	UNIT VALUE	TOTAL
DISHWASHER	1	1.4	1.4
SHOWER TRAY	1	***	0
SHOWER TRIM	1	1.4	1.4
SINK ISLAND SINGLE	1	1.4	1.4
VANITY SINK	2	0.7	1.4
WASHER	1	1.4	1.4
WATER CLOSET	1	2.2	2.2

WASTE FIXTURE UNIT SCHEDULE								
FAMILY QTY DFU VALUES TOTAL								
DISHWASHER	1	2	2					
SHOWER TRAY	1		0					
SINK ISLAND SINGLE	1	2	2					
VANITY SINK	2	1	2					
WASHER	1	2	2					
WATER CLOSET	1	3	3					

FIXTURE SCHEDULE								
FIXTURE	QTY	DESCRIPTION						
DISHWASHER	1							
DRYER	1							
SHOWER TRAY	1							
SHOWER TRIM	1							
SINK ISLAND SINGLE	1							
VANITY SINK	2							
WASHER	1							
WATER CLOSET	1							
WATER HEATER	1							

PLUMBING SCHEDULE						
FIXTURE	TRAP	WASTE	VENT	C.W	H.W	
DISHWASHER	1-1/2"	2"	1-1/2"	1/2"	1/2"	
DRYER	N/A	N/A	N/A	N/A	N/A	
SHOWER TRAY						
SHOWER TRIM	-	-	-	1/2"	1/2"	
SINK ISLAND SINGLE	1-1/2"	2"	1-1/2"	1/2"	1/2"	
VANITY SINK	1-1/2"	2"	1-1/2"	1/2"	1/2"	
WASHER	2"	2"	1-1/2"	1/2"	1/2"	
WATER CLOSET	3"	3"	2"	1/2"	1/2"	
WATER HEATER	N/A	N/A	N/A	3/4"	3/4"	

ACCESSORIES & FITTINGS SCHEDULE								
FIXTURE	QTY	DESCRIPTIONS						
DISHWASHER SUPPLY SINGLE CONNECTOR	1							
DISHWASHER SEWAGE SINGLE CONNECTOR	1							
HANGING PIPES CLAMP	20							
HOSE BIB	2							
LAUNDRY SWEAT CONNECTOR	1							
SHUTOFF VALVE	8							



KEY PLAN

NO.	DESCRIPTION	DATE

NOTE:

LEGEND:

PROJECT

02-Wisdom-499-Studio Spanish-550


DRAWING NAME

NOTE AND SCHEDULE


CLIENT NAME: PROJECT NUMBER: 0054_11 DATE: 2/1/2025 4:45:32 PM Designer DESIGNED BY DRAWN BY: Author CHECKED BY: Checker

P101

SCALE: 1/2" = 1'-0"

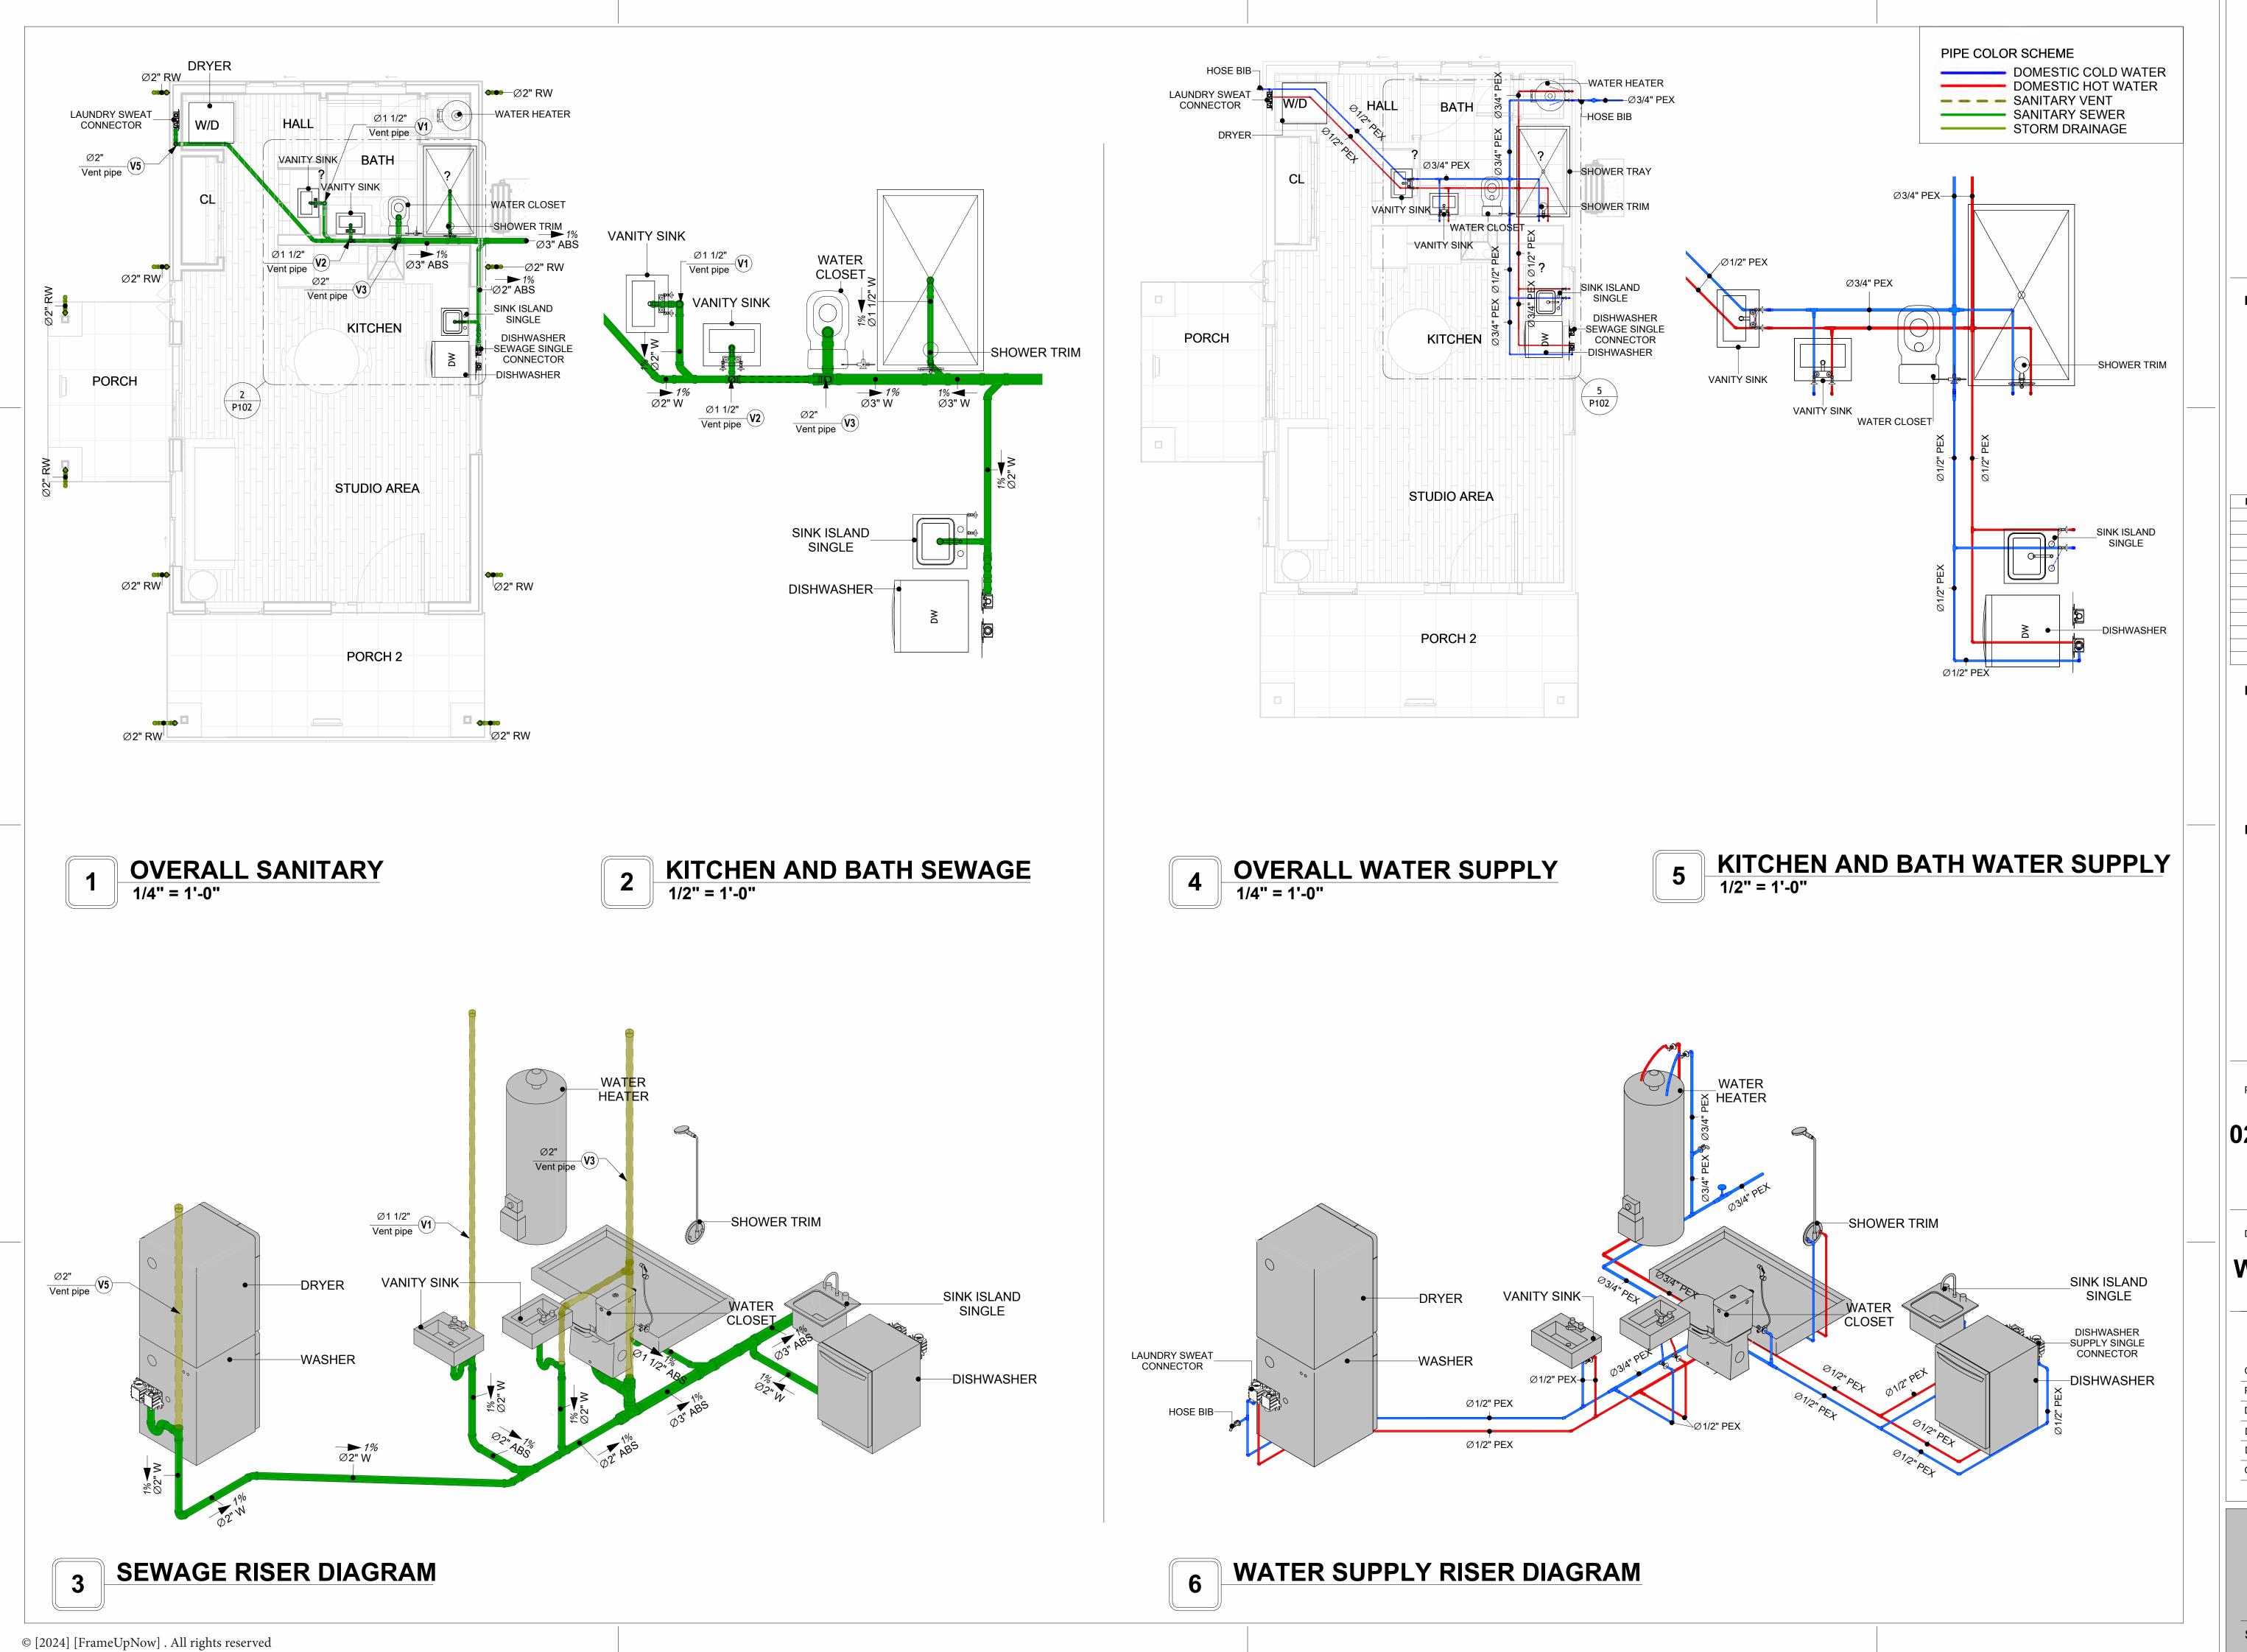



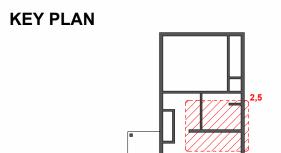

NO.	DESCRIPTION	DATE
		·
NOTE:		

LEGEND:


PROJECT

02-Wisdom-499-Studio Spanish-550

DRAWING NAME

WATER SUPPLY AND **SEWAGE SYSTEM**

PROJECT NUMBER: 0054_11 2/1/2025 4:46:06 PM DESIGNED BY DRAWN BY: CHECKED BY: Checker

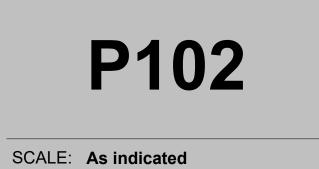

Materials Shopping List

Please print and take this Materials Shopping List to your favorite Home Depot and ask for assistance in selecting the materials, fixtures and fittings to complete your new home.

Record your selection and the price of the item. Then do the math to determine the cost for your selections and the total cost of finishing your home.

Have It Your Way!

The material types listed in this document were selected based on personal preferences. The Customer is encouraged to make changes to the material types in accordance with local customs, regulations, and personal preferences.

Have It Your Way!



20 good reasons to frame a home with metal and not wood



Why build your ADU with metal vs wood	Wood Me	tal Explanation
1 DIY Construction Benefit		The wall frames, trusses and beams can be erected in a just a few days
2 Minimal Construction Skills Required		Pre-assembled walls and trusses require no specialized skills to errect
3 Build as DIY, Hybrid or by a General Contractor		Do it yourself, Hybrid (involve special contractors) or hire a General Contractor
4 Build It As You Can Afford It		Impervious to Weather - build as you have the time and money
5 Up Front Cost of Framing Materials	✓ [As to only the framing material, wood is less expensive
6 Total Cost To Build		Savings in time, labor, and other areas make light gauge steel LESS expensive
7 Termites and wood boring insects		Termites, carpenter ants and wood boring insects eat wood, not metal
8 Mold resistant		Metal does not attract mold
9 Damage caused by exterior and interior flooding		Metal needs no reconditioning after a flood
10 Fire Resistant		Non-combustible
11 Lower insurance rates		Many insurance underwriters now provide lower rates for metal framed homes
12 Walls, trusses, and beams retain their original form		Perfectly straight walls - no shimming of drywall
13 Corners are 90 degrees		No need for templating of countertops to adjust for out of square corners
14 Strength and weight		Metal is stronger than wood and weighs less - no need for crane to lift ADU trusses
15 IBC Engineered Stamp		If an engineering stamp is necessary, months of waiting are saved
16 Complete BOM (Materials Shopping List)		Take the materials shopping list to Home Depot and start shopping/pricing
17 Flexible in Seismic Areas - Won't Fracture		Light gauge steel is flexible and won't fracture when the earth moves
18 No Waste At Job Site		Steel is the most recycled material in the world. A typical wood home has 20-30% waste
19 Environmentally Friendly		Trees don't have to be destroyed and the source of most metal is from recycling
20 How-To Videos Included		How-to videos provide simple assembly instructions
21 Relationship Counselor		Eliminate emotional uphevels - save time, money, and preserve the relationship

Universal Requirements - some or all may be required

- 1 Site plan
- 2 Electrical Supply Connection
- 3 Sewer Connection
- 4 Fresh Water Supply Connection
- 5 Set Backs
- 6 Soils Evaluation

- 7 Earthquake (fault) evaluation
- 8 Foundation Plan subject to soils
- 9 Compliance with local energy codes: insulation home wrap and flashing
- 10 Engineering for wind speed and snow load.
- 11 State and Local ordinances regarding ADUs
- 12 Local Architect and/or Engineer may be necessary



TOC



#	Name	Link	Page No
1	COVER PAGE	COVER PAGE	1
2	TOC	TOC	2
3	ELECTRICAL BOM	ELECTRICAL BOM	3
5	HVAC BOM	HVAC BOM	7
4	PLUMBING BOM	PLUMBING BOM	10
6	ARCHITECTURAL BOM	ARCHITECTURAL BOM	15

Table Of Content

Have It Your Way!

The material types listed in this document were selected based on personal preferences. The Customer is encouraged to make changes to the material types in accordance with local customs, regulations, and personal preferences. Have It Your Way!

GENERAL NOTES

- 1 This BOM (Bill of Materials) is prepared as a Materials Shopping List to help builders and DIYers gain a complete understanding of most if not all elements required for the complete construction of this structure, according to the original design documents provided by FrameUpNow.
- 2 All quantities and specifications are subject to change based on the final design, field measurements, availability of products and customer preferences. The customer should verify all information prior to purchasing materials.
- 3 All products and elements in the list shall conform to the International Residential Code (IRC), or any other local and international building codes, safety regulations, and standards that are applicable to the location of the structure.
- 4 If any changes are made by the customer to the list of materials specified in this document, the customer is responsible for assuring that the correct type and quantity of materials are utilized in accordance with local building codes
- 5 FrameUpNow, will not be held responsible for any misuse of this document, the products listed, or for deviations from the content that are made due to changes in specifications, pricing, availability, or customer preferences.
- 6 The customer is advised to consult a qualified professional or technician prior to purchasing materials for specialized construction system items. Some items including but not limited to caseworks, doors and windows may require as built measurements prior to purchase to confirmation of final dimensions.
- 7 If there are additional trim elements or specific installation methods, the total amount of materials needed might vary Consider any additional trim required for corners, intersections, or other architectural details that might cause this variations before procedding to purchase and construction.



WISDOM-STUDIO-TRADITIONAL

MATERIAL SHOPPING LIST

Have It Your Way!

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WISDOM-STUDIO-TRADITIONAL					
NI.a	Item	ARCHITECTURAL MATE			Description
No.	APPLIANCES	Туре	Unit	Quantity	Description
1			PCS	1	
1	Refrigerator			1	
2	Range		PCS	1	
3	Washer		PCS	1	
4	Dryer		PCS	1	
5	Dish Washer		PCS	1	
6	Oven		PCS	0	
7	Microwave		PCS	0	
\triangle	CASEWORKS				
8	Kitchen Cabinet		FT	15.82	
9	Laundry Cabinet		FT	2.25	
10	Vanity Cabinet		FT	6.08	
11	Medicine Cabinet		PCS	2	
12	Kitchen countertop		SF	24.46	
13	Laundry Countertop		PCS	0	
14	Bathroom Countertop		SF	0	
15	Island		FT	0	
16	Peninsula		FT	0	
17	Closets		SF	35.49	
	CEILING		Oi	00.40	
18	Ceiling Board	Dry Wall	SF	442	
19	Dry Wall Fastener	Screw	PCS	774	
	·		SF	582	
20	Vapor Retarder	Polyethylene film			
21	Vapor Retarder Fastener	Nails with washer heads	PCS	1746	
22	Ceiling Board (MRD)	Moisture resistant drywall	SF	64	
23	MRD Fastener		PCS	112	
24	Ceiling Board	Marine Plywood	SF	76	
25	Marine Plywood Fastener	Screw	PCS	133	
26	Dry Wall Tape		FT	291	
	ROOF				
27	Roof Covering		SF	867	
28	Roof Covering Fastener		PCS	433.5	
29	Roof Felt Paper		SF	867	
30	Roof Felt Paper Fastener		PCS	2601	
	Roof Sheathing		SF	867	
32	Roof Sheathing Fastener		PCS	6936	
33	Batten		FT	0	
	Batten Fastener		PCS	0	
			SF	138	
	Soffit Fastener		PCS	69	
	Fascia		FT	97	
	Fascia board fastener		PCS	48.5	
			SF	867	
) SF	100	
40	FLOORING Main Living Coope		0.5	270.05	
	Main Living Space		SF	372.25	
41	Bathroom		SF	81.29	
	Porch		SF	189.71	
	STRUCTURE				
43	Foundation		SF	682.62	

ζC	CHITECTURAL	BOM		Ö	Frame Nov
Δ	WALLS EXTERIOR				
44	Exterior Wall Siding		SF	681	
45	Wall Paint		SF	681	
46	Wall Shteathing (OSB)		SF	681	
47	Shteathing Fastener	Self-drilling screws(100/pkt)	PKT	6.81	
48	Wall Insulation	3 (SF	906	
49	Wall Homewrap		SF	681	
50	Home wrap Fastener	Stapled fastener (200/pkt)	PKT	2.6	
51	Furring Strip	Ctapies issue: (200, piny	SF	85.1	
52	Furring Strip Fastener	Self-drilling screws(100/pkt)	PKT	6.8	
	WALLS INTERIOR	Con animing control (100) ping	1111	0.0	
	Cementitious Backer Board		SF	468	
54	Kerdi membrane		SF	468	
55	Kerdi membrane Fastener		SF	468	
56	Wall Ceramic Tile		SF	468	
57	Drywall Board		SF	661	
58	Drywall Fastener	Self-drilling screws(100/pkt)	PKT	5.02	
59	Wall Paint	z on animing out one (real pring	SF	661	
60	Drywall Tape		FT	124.24958	
61	Wall Sweep		FT	53.6	
Δ	DOORS			00.0	
= 62	Interior Swinging	3' - 0" X 6'-8"	PCS	1	
63	Interior Swinging	2' - 0" X 6'-8"	PCS	1	
64	Front Door With Sidelight	5' - 5" X 6'-11 1/2"	PCS	1	
65	Interior Sliding	5' - 0" X 6'-8"	PCS	1	
66	Patio Sliding	5' - 2" X 6'-8"	PCS	1	
67	Exterior Door Trim	0 2 X 0 0	FT	37.8	
68	Interior Door Trim		FT	137.8	
69	Entry Lock set			2	
70	Privacy Lock set			1	
71	Passage Lock set			2	
Δ	WINDOWS				
 72	Single Hung	3' - 3" X 4'-3"	PCS	1	
74	Sliding	5' - 3" X 3'-3"	PCS	1	
75	Sliding	3' - 3" X 2'-3"	PCS	2	
76	Casement	2' - 3" X 3'-3"	PCS	1	
77	Fixed	1' - 6" X 1'-6"	PCS	1	
78	Fixed	1' - 0" X 1'-0"	PCS	1	
79	Exterior Window Trim	1 0 1 1 -0	FT	102.4	
80	Interior Window Trim		FT	102.4	

ELECTRICAL BOM



WISDOM-STUDIO-TRADITIONAL ELECTRICAL MATERIAL SHOPPING LIST						
Δ	LIGHTING FIXTURES	<u>'</u>	·			
1	Kitchen Ceiling Light		PCS	5		
2	Exterior Wall Mounted Light		PCS	4		
3	Livingroom Ceiling Light With Fan		PCS	1		
4	Bedroom Ceiling Light With Fan		PCS	0		
5	Dining Ceiling Light		PCS	0		
6	Bath Wall Mounted Light		PCS	2		
7	Bathroom Ceiling Light		PCS	2		
8	Livingroom Ceiling Light		PCS	4		
9	Hall & Entry Ceiling Light		PCS	2		
10	Smoke Detector		PCS	0		
\triangle	ELECTRICAL FITTINGS					
11	Standard Receptacle 120V	15 A	PCS	5		
12	GFCI Receptacle 120V	20 A	PCS	11		
13	GFCI Receptacle 240V	30 A	PCS	4		
14	GFCI Receptacle 240V	40 A	PCS	1		
15	GFCI Receptacle 240V	60 A	PCS	0		
16	Fan Switch		PCS	1		
17	Single Pole Switch		PCS	6		
18	Three Way Switch		PCS	4		
19	Dimmer Switch		PCS	2		

ELECTRICAL BOM



	ELECTRICAL CONDUITS & WIRING				
20	ROMEX 14 AWG	14/2 w/ground	FT	177.3	
21	ROMEX 12 AWG	12/2 w/ground	FT	119	
22	ROMEX 10 AWG	10/2 w/ground	FT	74.4	
23	ROMEX 10 AWG	10/3 w/ground	FT	82.13	
24	ROMEX 10 AWG	8/2 w/ground		0	
25	ROMEX 8 AWG	8/3 w/ground	FT	29.02	
26	ROMEX 6 AWG	6/3 w/ground	FT	29.68	
27	Bare Copper Ground Wire 6 AWG				
28	Panelboard -240V 1 Phase MLO	200 AMP	PCS	1	
30	Circuit breaker	15 A	PCS	5	
31	Circuit breaker	20 A	PCS	4	
33	Circuit breaker	30 A	PCS	3	
35	Circuit breaker	40 A	PCS	1	
36	Circuit breaker	60 A	PCS	1	
37	Single Gang Switch Box		PCS	2	
39	Double Gang Switch Box		PCS	1	
40	Triple Gang Switch Box		PCS	3	
41	Pull Box	#1/4	PCS	14	
42	Receptacle Box		PCS	22	

PLUMBING BOM



		WISDOM-STUDIO-TRA	ADITIONA	L	
	PLUMBI	NG SYSTEM MATERIA	AL SHOPE	PING LIST	
No.	Item	Туре	Unit	Quantity	Description
Δ	PLUMBING FIXTURES & ACCESSORIES	-			
1	Bath Tub (Alcove Tub)		PCS	2	
2	Kitchen Sink		PCS	1	
3	Kitchen Faucets		PCS	1	
4	Vanity Sink		PCS	5	
5	Bath room Faucets		PCS	5	
6	Water Closet		PCS	3	
7	Shower Trim		PCS	0	
8	Shower Tray		PCS	0	
9	Water Heater		PCS	1	
10	Hose Bib		PCS	2	
11	Shutoff Valve		PCS	8	
	Hanging pipe clamp		PCS	8	
13	Gate Valve		PCS	1	
14	Dishwasher Supply Single Connector		PCS	1	
15	Dishwasher Sewage Single Connector		PCS	1	
	Laundry Sweat Connector		PCS	0	
	SANITARY & PLUMBING PIPES				
	ABS (Acrylonitrile Butadiene Styrene) Pipes	ø 1"	FT	0	
	ABS (Acrylonitrile Butadiene Styrene) Pipes	ø 1 1/2"	FT	22	
	ABS (Acrylonitrile Butadiene Styrene) Pipes	ø 2"	FT	46	
	ABS (Acrylonitrile Butadiene Styrene) Pipes	ø 3"	FT	6	
	PEX (Cross-linked polyethylene) Pipes	ø 1/2"	FT	89	
	PEX (Cross-linked polyethylene) Pipes	ø 3/4"	FT	38	
	PEX (Cross-linked polyethylene) Pipes	ø 1"	FT	0	
	PVC Pipes Sch.80 - Rigid	ø 1 1/2"	FT	0	
	PVC Pipes Sch.80 - Rigid	ø 2"	FT	37	
	PVC Pipes Sch.80 - Rigid	ø 3"	FT	0	
	Flex Pipe Round	ø 1/2"	PCS	8	
	Flex Pipe Round	ø 3/4"	PCS	0	
	Flex Pipe Round	ø 1"	PCS	0	
	PIPE FITTINGS	ו ש	1 00	U	
30	PEX 90 Degree Elbow	1/2"ø-1/2"ø	PCS	19	
	PEX 90 Degree Elbow	3/4"ø-3/4"ø	PCS	19	
	PEX Cross Elbow	3/4"ø-3/4"ø-3/4"ø-3/4"ø	PCS	1	
	PEX Tee Elbow	1/2"ø-1/2"ø-1/2"ø	PCS	3	
	PEX Tee Elbow	3/4"ø-3/4"ø-3/4"ø	PCS	4	
	PEX Tree Elbow PEX Transition Elbow		PCS	2	
		1"ø-3/4"ø			
	PEX Transition Elbow	3/4"ø-1/2"ø	PCS	13	
	PEX 90 Degree Elbow	1/2"ø-1/2"ø	PCS		
	PEX 700 Degree Elbow	3/4"ø-3/4"ø	PCS	3	
	PEX Tee Elbow	3/4"ø-3/4"ø-3/4"ø	PCS	1 15	
	PVC 90 Deg Bend Elbow	2"ø-2"ø	PCS	15	
	ABS 90 Degree Bend Elbow	1 1/2"ø-1 1/2"ø	PCS	1	
	ABS 90 Degree Bend Elbow	2"ø-2"ø	PCS	3	
	ABS 90 Degree Bend Elbow	3"ø-3"ø	PCS	1	
	ABS Bend Long Sweep Elbow	2"ø-2"ø	PCS	2	
49	ABS P-Trap	1 1/2"ø-1 1/2"ø	PCS	4	

PLUMBING BOM



50	ABS P-Trap	2"ø-2"ø	PCS	1	
51	ABS Reducer Elbow	2"ø-1 1/2"ø	PCS	3	
52	ABS Reducer Elbow	3"ø-2"ø	PCS	2	
53	ABS TEE Elbow	1 1/2"ø-1 1/2"ø-1 1/2"ø	PCS	2	
54	ABS TEE Elbow	2"ø-2"ø-2"ø	PCS	1	
55	ABS TEE Elbow	3"ø-3"ø-3"ø	PCS	2	
56	ABS Tee Reducer Elbow	2"ø-2"ø-2"ø	PCS	1	
57	ABS Trap P	2"ø-2"ø	PCS	1	
58	ABS Vent Cap Elbow	2"ø	PCS	1	
59	ABS WASTE DOUBLE TEE	2"ø-2"ø-2"ø	PCS	1	
60	ABS Wye Combination with 8th Bend Elbow	2"ø-2"ø-2"ø	PCS	1	
61	ABS Wye Combination with 8th Bend Elbow	3"ø-3"ø-1 1/2"ø	PCS	1	
62	ABS Wye Combination with 8th Bend Elbow	3"ø-3"ø-2"ø	PCS	1	
63	ABS 90 Degree Bend Elbow	1 1/2"ø-1 1/2"ø	PCS	1	
64	ABS Tee Reducer Elbow	2"ø-2"ø-1 1/2"ø	PCS	1	
65	ABS Vent Cap Elbow	1 1/2"ø	PCS	1	
66	ABS Vent Cap Elbow	2"ø	PCS	2	

HVAC BOM



		WISDOM-STUDIO-	TRADITION	IAL	
	Н	VAC SYSTEM MATERI	AL SHOPP	ING LIST	
No.	Item	Туре	Unit	Quantity	Description
Δ	HVAC_DUCTS	<u> </u>			
1	PIPE (REFRIGERANT LINE)	1/2" Ø	FT	0.46	
2	PIPE (REFRIGERANT LINE)	1/4" Ø	FT	32.41	
3	PIPE (REFRIGERANT LINE)	3/4" Ø	FT	0.45	
4	PIPE (REFRIGERANT LINE)	4" Ø	FT	38.18	
5	DRAYER HOSE	5" Ø	FT	4.3	
6	FLEX DUCT ROUND	4"	FT	5.58	
Δ	DUCT FITTINGS & ACCESSORIES		•		
7	ELBOW (REFRIGERANT LINE)	1/2" (Ø)-1/2" (Ø)	PCS	1	
8	ELBOW (REFRIGERANT LINE)	1/4" (Ø)-1/4" (Ø)	PCS	1	
9	ELBOW (REFRIGERANT LINE)	3/4" (Ø)-3/4" (Ø)	PCS	10	
10	ELBOW (REFRIGERANT LINE)	3/8" (Ø)-3/8" (Ø)	PCS	7	
11	TRANSITION (REFRIGERANT	3/4" (Ø)-1/2" (Ø)	PCS	2	
12	TRANSITION (REFRIGERANT	3/4" (Ø)-3/8" (Ø)	PCS	1	
13	TRANSITION (REFRIGERANT	3/8" (Ø)-1/4" (Ø)	PCS	1	
14	ROUND TRANSITION(ANGLE)	45 DEGREE	PCS	5	
Δ	HVAC_EQUIPMENTS	·			
15	AIR HANDLING UNIT	WALL MOUNTED	PCS	1	
16	CONDENSER	OUTDOOR UNIT	PCS	1	
17	EXHAUST FAN	75 CFM	PCS	1	
18	EXHAUST HOOD	WALL MOUNTED	PCS	1	
19	HOOD-WALL: VENT	HOOD-WALL: VENT	PCS	1	
20	DRAYER: VENT	DRAYER: VENT	PCS	1	
21	ROOF VENT	3"(Ø)	PCS	1	



Table Of Content

#	Name	Link	Page No
1	COVER PAGE	COVER PAGE	1
2	TOC	TOC	2
3	ELECTRICAL BOM	ELECTRICAL BOM	3
5	HVAC BOM	HVAC BOM	7
4	PLUMBING BOM	PLUMBING BOM	10
6	ARCHITECTURAL BOM	ARCHITECTURAL BOM	15

Have It Your Way!

The material types listed in this document were selected based on personal preferences. The Customer is encouraged to make changes to the material types in accordance with local customs, regulations, and personal preferences. Have It Your Way!

GENERAL NOTES

- This BOM (Bill of Materials) is prepared as a Materials Shopping List to help builders and DIYers gain a complete understanding of most if not all elements required for the complete construction of this structure, according to the original design documents provided by FrameUpNow.
- 2 All quantities and specifications are subject to change based on the final design, field measurements, availability of products and customer preferences. The customer should verify all information prior to purchasing materials.
- 3 All products and elements in the list shall conform to the International Residential Code (IRC), or any other local and international building codes, safety regulations, and standards that are applicable to the location of the structure.
- 4 If any changes are made by the customer to the list of materials specified in this document, the customer is responsible for assuring that the correct type and quantity of materials are utilized in accordance with local building codes.
- FrameUpNow, will not be held responsible for any misuse of this document, the products listed, or for deviations from the content that are made due to changes in specifications, pricing, availability, or customer preferences.
- The customer is advised to consult a qualified professional or technician prior to purchasing materials for specialized construction system items. Some items including but not limited to caseworks, doors and windows may require as built measurements prior to purchase to confirmation of final dimensions.
- 7 If there are additional trim elements or specific installation methods, the total amount of materials needed might vary. Consider any additional trim required for corners, intersections, or other architectural details that might cause this variations before procedding to purchase and construction.



	APPLIANCES								
#	Item	Туре	Description, Manufacturer, SKU	Unit	Quantity	Unit Price	Total		
1	Refrigerator			PCS	1				
2	Range			PCS	1				
3	Washer Front Load	Stackable		PCS	1				
4	Dryer Front Load	Stackable		PCS	1				
5	Dish Washer			PCS	1				
6	Oven			PCS	0				
7	Microwave			PCS	0				



			CASEWORKS				
#	Item	Туре	Description, Manufacturer, SKU	Unit	Quantity	Unit Price	Total
1	Kitchen Cabinet			FT	15.82		
2	Laundry Cabinet			FT	2.25		
3	Vanity Cabinet			FT	6.08		
4	Medicine Cabinet			PCS	2		
5	Kitchen countertop			SF	24.46		
6	Laundry Countertop			PCS	0		
7	Bathroom Countertop			SF	0		
8	Island			FT	0		
9	Peninsula			FT	0		
10	Closets			SF	35.49		



			ROOF 01				
#	Item	Туре	Description, Manufacturer, SKU	Unit	Quantity	Unit Price	Total
1	Roof Covering			SF	867.0		
2	Roof Covering Fastener			PCS	434		
3	Roof Felt Paper			SF	867.0		
4	Roof Felt Paper Fastener			PCS	2601.0		
5	Roof Sheathing			SF	867.0		
6	Roof Sheathing Fastener			PCS	6936		
7	Batten			FT	0.0		
8	Batten Fastener			PCS	0.0		
9	Soffit			SF	138.0		
10	Soffit Fastener			PCS	69.0		
11	Fascia			FT	97.0		
12	Fascia board fastener			PCS	49		
13	Roof Insulation			SF	867.0		



			CEILING 01				
#	Item	Туре	Description, Manufacturer, SKU	Unit	Quantity	Unit Price	Γotal
	STUDIO AREA AND KITCH	HEN		SF	419.0		
1	Ceiling Board	Drywall		SF	419		
2	Drywall Fastener	Screw		PCS	733		
3	Vapor Retarder	Polyethylene film		SF	419.0		
4	Vapor Retarder Fastener	Nails with washer heads		PCS	1257.0		
	BATH ROOM			SF	64.0		
5	Ceiling Board	MRD (Moisture resistant drywall)		SF	64		
6	MRD Fastener	Screw		PCS	112		
	CLOSET	·		SF	15.0		
7	Ceiling Board	Drywall		SF	15		
8	Drywall Fastener	Screw		PCS	26		
9	Vapor Retarder	Polyethylene film		SF	15.0		
10	Vapor Retarder Fastener	Nails with washer heads		PCS	45.0		
	PATIO 1			SF	26.0		
11	Ceiling Board	Marine Plywood		SF	26		
12	Exterior Grade Plywood	Screw		PCS	46		



			CEILING 02				
#	Item	Туре	Description, Manufacturer, SKU	Unit	Quantity	Unit Price T	otal
	WH			SF	8.0		
13	Ceiling Board	Drywall		SF	8		
14	Drywall Fastener	Screw		PCS	14		
15	Vapor Retarder	Polyethylene film		SF	8.0		
16	Vapor Retarder Fastener	Nails with washer heads		PCS	24.0		
	PATIO 2			SF	50.0		
17	Ceiling Board	Marine Plywood		SF	50		
18	Exterior Grade Plywood	Screw		PCS	88		



			FLOORING EXTERIOR				
!	Item	Туре	Description, Manufacturer, SKU	Unit	quantity	Unit Price	Total
	STRUCTURE			SF	682.62		
	Concrete Slab	4"concrete cast in situ		CF	279.38		
	Insulation	Rigid insulation		SF	237		
	Hard core	Compacted soil		CF	160.64		
	Re-bar	#4 re-bar		Ton	0.83		
	Concrete Pad	4"concrete cast in situ		CF	1.58		
	Slab edge	Turndown		CF	176.58		
	Footing	Cast-in-place concrete		CF	9.36		
	PORCH FRONT						
	Tile Finish			SF	121.55		
	Adhesive	1/2" Thin set Mortar		SF	121.55		
	Vapor Retarder	Vapor Barrier Polyethylene		SF	121.55		
	PORCH SIDE						
	Tile Finish			SF	68.16		
	Adhesive	1/2" Thin set Mortar		SF	68.16		
	Vapor Retarder	Vapor Barrier Polyethylene		SF	68.16		



			FLOORING INTERIOR 01				
#	Item	Туре	Description, Manufacturer, SKU	Unit	quantity	Unit Price	Total
	CLOSET						
1	Closet Flooring			SF	13.25		
2	Wood underlay	Foam Pad Polyethylene		SF	13.25		
3	Vapor Retarder	Vapor Barrier Polyethylene		SF	13.25		
4	LIVING ROOM AND KITCHE	N					
5	Living Area Flooring			SF	359		
6	Wood underlay	Foam Pad Polyethylene		SF	359		
	Vapor Retarder	Vapor Barrier Polyethylene		SF	359		
7	BATHROOM						
8	Tile Finish			SF	57.25		
9	Adhesive	1/2" Thin set Mortar		SF	57.25		
	Vapor Retarder	Vapor Barrier Polyethylene		SF	57.25		
10	LAUNDRY						
11	Tile Finish			SF	7.78		
12	Adhesive	1/2" Thin set Mortar		SF	7.78		
13	Vapor Retarder	Vapor Barrier Polyethylene		SF	7.78		



			FLOORING INTERIOR 02				
#	Item	Туре	Description, Manufacturer, SKU	Unit	quantity	Unit Price	Total
	HANDWASH						
1	Tile Finish			SF	8.83		
2	Adhesive	1/2" Thin set Mortar		SF	8.83		
3	Vapor Retarder	Vapor Barrier Polyethylene		SF	8.83		
	BOILER ROOM						
4	Tile Finish			SF	7.43		
5	Adhesive	1/2" Thin set Mortar		SF	7.43		
6	Vapor Retarder	Vapor Barrier Polyethylene		SF	7.43		



			WALLS: EXTERIOR 01				
#	Item	Туре	Description, Manufacturer, SKU	Unit	quantity	Unit Price	Total
1	Exterior-Grade Plywood Horizon	tal Siding		SF	681		
2	Exterior-Grade Plywood Fastener	Self-drilling screws(100/pkt)		PKT	6.81		
3	Wall Shteathing (OSB)			SF	681		
4	Shteathing Fastener	Self-drilling screws(100/pkt)		PKT	6.81		
5	Wall Homewrap			SF	681		
	Homewrap Fastener	Stapled fastener (200/pkt)		PKT	2.6		
6	Furring Strip			PCS	85.1		
7	Furring Strip Fastener	Self-drilling screws(100/pkt)		PKT	6.81		
8	Wall Paint			SF	681		
9	Stone Copping	Masonry stone		SF	2		
10	Stone Veneer	Masonry stone		SF	60		
11	Mortar for Stone Veneer			SF	60		
12	Wall Insulation			SF	906		



			WALLS: INTERIOR 01				
	Item	Туре	Description, Manufacturer, SKU	Unit	quantity	Unit Price	Total
	BATHROOM			SF	273		
1	Cementitious Backer Board			SF	273		
2	Kerdi membrane			SF	273		
3	Kerdi membrane Fastener			SF	273		
4	Wall Ceramic Tile			SF	273		
	HALL	-		SF	122		
5	Drywall Board			SF	122		
6	Drywall Fastener	Self-drilling screws(100/pkt)		PKT	1.22		
7	Wall Paint			SF	122		
8	Drywall Tape			FT	22.9		
		-					



			WALLS: INTERIOR 02				
#	Item	Туре	Description, Manufacturer, SKU	Unit	quantity	Unit Price	Total
	LIVING ROOM			SF	306		
1	Drywall Board			SF	306		
2	Drywall Fastener	Self-drilling screws(100/pkt)		PKT	3.06		
3	Wall Paint			SF	306		
4	Drywall Tape			FT	57.4		
	KITCHEN			SF	159		
5	Cementitious Backer Board			SF	25		
6	Drywall Board			SF	159		
7	Drywall Fastener	Self-drilling screws(100/pkt)		PKT	1.59		
8	Kerdi membrane			SF	25		
	Kerdi membrane Fastener			SF	25		
9	Wall Ceramic Tile			SF	25		
10	Wall Paint			SF	159		
11	Drywall Tape			FT	30.0		



			WALLS: INTERIOR 03			
#	Item	Туре	Description, Manufacturer, SKU	Unit	quantity Unit	Price Total
	WASHROOM			SF	95	
13	Cementitious Backer Board			SF	95	
14	Kerdi membrane			SF	95	
15	Kerdi membrane Fastener			SF	95	
16	Wall Ceramic Tile			SF	95	
	WD			SF	75	
17	Cementitious Backer Board			SF	75	
18	Kerdi membrane			SF	75	
19	Kerdi membrane Fastener			SF	75	
20	Wall Ceramic Tile			SF	75	
21	WH			SF	74	
22	Drywall Board			SF	74	
23	Drywall Fastener	Self-drilling screws(100/pkt)		PKT	0.74	
24	Wall Paint			SF	74	
25	Drywall Tape			FT	14	
26	Wall Sweep			FT	54	



			DOORS			
#	Item	Туре	Description, Manufacturer, SKU	Unit	Quantity Unit Pr	ice Total
1	Interior Swinging	3' - 0" X 6'-8"		PCS	1	
2	Interior Swinging	2' - 0" X 6'-8"		PCS	1	
3	Front Door With Sidelight	5' - 5" X 6'-11 1/2"		PCS	1	
4	Interior Sliding	5' - 0" X 6'-8"		PCS	1	
5	Patio Sliding	5' - 0" X 6'-8"		PCS	1	
6						
7						
6						
7						
8						
9						
10						
11						
12						
13						
14						
15						



			WINDOWS				
#	Item	Туре	Description, Manufacturer, SKU	Unit	Quantity	Unit Price	Total
1	Single Hung	3' - 3" X 4'-3"		PCS	1		
2	Single Hung	3' - 3" X 3'-3"		PCS	2		
3	Sliding	5' - 3" X 3'-3"		PCS	1		
4	Sliding	3' - 3" X 2'-3"		PCS	2		
5	Casement	2' - 3" X 3'-3"		PCS	1		
6	Fixed	1' - 6" X 1'-6"		PCS	1		
7	Fixed	1' - 0" X 1'-0"		PCS	1		
8							
9							



			LIGHTING FIXTURES				
#	Lighting	Туре	Description, Manufacturer, SKU	Unit	Quantity	Unit Price	Total
1	Kitchen Ceiling Light			PCS	5		
2	Exterior Wall Mounted Light			PCS	4		
3	Livingroom Ceiling Light With Fan			PCS	1		
ı	Bedroom Ceiling Light With Fan			PCS	0		
5	Dining Ceiling Light			PCS	0		
ò	Bath Wall Mounted Light			PCS	2		
,	Bathroom Ceiling Light			PCS	2		
3	Livingroom Ceiling Light			PCS	4		
)	Hall & Entry Ceiling Light			PCS	2		
LO	Smoke Detector			PCS	0		



			ELECTRICAL FITTINGS				
#	Item	Туре	Description, Manufacturer, SKU	Unit	Quantity	Unit Price	Total
1	Standard Receptacle 120V	15A		PCS	5		
2	GFCI Receptacle 120V	20 A		PCS	11		
3	GFCI Receptacle 240V	30 A		PCS	3		
4	GFCI Receptacle 240V	40 A		PCS	1		
5	GFCI Receptacle 240V	60 A		PCS	1		
6	Fan Switch			PCS	1		
7	Single Pole Switch			PCS	6		
8	Three Way Switch			PCS	4		
9	Dimmer			PCS	2		



			ELECTRICAL CONDUITS & WIRING				
#	Item	Туре	Description, Manufacturer, SKU	Unit	Quantity	Unit Price	Total
1	ROMEX 14 AWG	14/2/W/ground		FT	177.3		
2	ROMEX 12 AWG	12/2/W/ground		FT	119		
3	Romex 10 AWG	10/2/W/ground		FT	74.4		
4		10/3/W/ground		FT	82.13		
5	ROMEX 8 AWG	8/3/W/ground		FT	29.02		
6	ROMEX 6 AWG	6/3/W/ground		FT	29.68		
7	Bare Copper Ground Wire 6 AWG						



			ELECTRICAL BOXES & CIRCUTES				
#	Item	Туре	Description, Manufacturer, SKU	Unit	Quantity	Unit Price	Total
1	Lightind and Appliance panelboard -240V 1 PHASE	200 AMP		PCS	1		
2	Circuit breaker	15 A		PCS	5		
3	Circuit breaker	20 A		PCS	4		
4	Circuit breaker	30 A		PCS	3		
5	Circuit breaker	40 A		PCS	1		
6	Circuit breaker	60 A		PCS	1		
7	Single Gang Switch Box			PCS	2		
8	Double Gang Switch Box			PCS	1		
9	Triple Gang Switch Box			PCS	3		
10	Pull Box	#1/4		PCS	14		
11	Receptacle Box			PCS	22		

HVAC BOM



			HVAC_DUCTS 01				
#	Item	Туре	Description, Manufacturer, SKU	Unit	Quantity	Unit Price	Total
1	PIPE (REFRIGERANT LINE)	1/4" (Ø)		FT	0.46		
2	PIPE (REFRIGERANT LINE)	3/8" (Ø)		FT	32.41		
3	PIPE (REFRIGERANT LINE)	1/2" (Ø)		FT	0.45		
4	PIPE (REFRIGERANT LINE)	5/8" (Ø)		FT	38.18		
5	DRAYER HOSE	4" (Ø)		FT	4.3		
6	FLEX DUCT ROUND	4" (Ø)		FT	5.58		
7							
8							
9							
10							
11							
12							
13							
14							
15							
16							

HVAC BOM



		DUCT FITTINGS & ACCESSORIES						
#	Item	Туре	Description, Manufacturer, SKU	Unit	Quantity	Unit Price	Total	
1	ELBOW (REFRIGERANT	1/2" (Ø)-1/2" (Ø)		PCS	1			
2	ELBOW (REFRIGERANT	1/4" (Ø)-1/4" (Ø)		PCS	1			
3	ELBOW (REFRIGERANT	3/4" (Ø)-3/4" (Ø)		PCS	10			
l	ELBOW (REFRIGERANT	3/8" (Ø)-3/8" (Ø)		PCS	7			
5	TRANSITION (REERIGERANT LINE)	3/4" (Ø)-1/2" (Ø)		PCS	2			
5	TRANSITION (REERIGERANT LINE)	3/4" (Ø)-3/8" (Ø)		PCS	1			
,	TRANSITION (REERIGERANT LINE)	3/8" (Ø)-1/4" (Ø)		PCS	1			
3	ROUND TRANSITION(ANGLE)	45 DEGREE		PCS	5			
9	TO THE TOTAL PROPERTY OF THE TOTAL PROPERTY							
LO								
1								
L2								
13								
L4								
L5								
L 6								

HVAC BOM



			HVAC_EQUIPMENTS				
#	Item	Туре	Description, Manufacturer, SKU	Unit	Quantity	Unit Price	Total
1	AIR HANDLING UNIT	WALL MOUNTED		PCS	1		
-	CONDENSER	OUTDOOR UNIT		PCS	1		
}	EXHAUST FAN	75 CFM		PCS	1		
ļ	EXHAUST HOOD	WALL MOUNTED		PCS	1		
5	HOOD-WALL: VENT	HOOD-WALL: VENT		PCS	1		
5	DRAYER: VENT	DRAYER: VENT		PCS	1		
,	ROOF VENT	3"(Ø)		PCS	1		
3							
)							
LO							
1							
12							
.3							
L4							
15							
16							



PLUMBING FIXTURES & ACCESSORIES									
#	Item Type	Description, Manufacturer, SKU	Unit	Quantity Unit Price	e Total				
1	Bath Tub (Alcove Tub)		PCS	2					
2	Kitchen Sink		PCS	1					
3	Kitchen faucets		PCS	1					
1	Vanity Sink		PCS	5					
5	Bath room faucets		PCS	5					
5	Water Closet		PCS	3					
7	Shower Trim		PCS	0					
8	Shower Tray		PCS	0					
9	Water Heater		PCS	1					
10	Hose Bib		PCS	2					
l1	Shutoff Valve		PCS	8					
L2	Hanging pipe clamp		PCS	8					
13	Globe Valve		PCS	1					
L4	Dishwasher Supply Single Connector		PCS	1					
15	Dishwasher Sewage Single Connector		PCS	1					
16	Laundry Sweat Connector		PCS	1					
17	Laundry Sink		PCS	0					



			SANITARY & PLUMBING PIPES				
#	Item	Туре	Description, Manufacturer, SKU	Unit	Quantity	Unit Price	Total
1	ABS (Acrylonitrile Butadiene	ø 1"					
	Styrene) Pipes			FT	0		
2	ABS (Acrylonitrile Butadiene	ø 1 1/2"					
	Styrene) Pipes			FT	22		
3	ABS (Acrylonitrile Butadiene	ø 2"					
	Styrene) Pipes			FT	46		
4	ABS (Acrylonitrile Butadiene	ø 3"					
	Styrene) Pipes			FT	6		
5	,	ø 1/2"					
	polvethylene) Pipes			FT	89		
6		ø 3/4"			200		
	polvethylene) Pipes			FT	38		
7	,	ø 1"		l _{CT}			
	polvethylene) Pipes			FT	0		
8	PVC Pipes Sch.80 - Rigid	ø 1 1/2"		FT	0		
9	PVC Pipes Sch.80 - Rigid	ø 2"		FT	37		
10	PVC Pipes Sch.80 - Rigid	ø 3"		FT	0		
11	Flex Pipe Round	ø 1/2"		FT	8		
12	Flex Pipe Round	ø 3/4"		FT	0		
13	Flex Pipe Round	ø 1"		FT	0		
14							
15							



	PIPE FITTINGS 01								
#	Item	Туре	Description, Manufacturer, SKU	Unit	Quantity	Unit Price	Total		
1	PEX 90 Degree Elbow	1/2"ø-1/2"ø		PCS	19				
2	PEX 90 Degree Elbow	3/4"ø-3/4"ø		PCS	1				
3	PEX Cross Elbow	3/4"ø-3/4"ø-3/4"ø		PCS	1				
1	PEX Tee Elbow	1/2"ø-1/2"ø-1/2"ø		PCS	3				
5	PEX Tee Elbow	3/4"ø-3/4"ø-3/4"ø		PCS	4				
5	PEX Transition Elbow	1"ø-3/4"ø		PCS	2				
7	PEX Transition Elbow	3/4"ø-1/2"ø		PCS	6				
3	PEX 90 Degree Elbow	1/2"ø-1/2"ø		PCS	13				
)	PEX 90 Degree Elbow	3/4"ø-3/4"ø		PCS	3				
10	PEX Cross Elbow	1/2"ø-1/2"ø-1/2"ø		PCS	1				
11	PEX Tee Elbow	1/2"ø-1/2"ø-1/2"ø		PCS	2				
12	PEX Tee Elbow	3/4"ø-3/4"ø-3/4"ø		PCS	1				
13	PEX Transition Elbow	3/4"ø-1/2"ø		PCS	4				
L4	PVC 90 Deg Bend Elbow	2"ø-2"ø		PCS	15				
15	ABS 90 Degree Bend Elbow	1 1/2"ø-1 1/2"ø		PCS	1				



		PIPE FITTINGS 02								
#	Item	Туре	Description, Manufacturer, SKU	Unit	Quantity	Unit Price	Total			
1	ABS 90 Degree Bend Elbow	2"ø-2"ø		PCS	3					
2	ABS 90 Degree Bend Elbow	3"ø-3"ø		PCS	1					
3	ABS Bend Long Sweep Elbow	2"ø-2"ø		PCS	2					
1	ABS P-Trap	1 1/2"ø-1 1/2"ø		PCS	4					
5	ABS P-Trap	2"Ø-2"Ø		PCS	1					
5	ABS Reducer Elbow	2"ø-1 1/2"ø		PCS	3					
7	ABS Reducer Elbow	3"Ø-2"Ø		PCS	2					
8	ABS TEE Elbow	1 1/2"ø-1 1/2"ø-1 1/2"ø		PCS	2					
)	ABS TEE Elbow	2"ø-2"ø-2"ø		PCS	1					
LO	ABS TEE Elbow	3"ø-3"ø-3"ø		PCS	2					
l1	ABS Tee Reducer Elbow	2"ø-2"ø-2"ø		PCS	1					
12	ABS Trap P	2"ø-2"ø		PCS	1					
13	ABS Vent Cap Elbow	2"ø		PCS	1					
14	ABS WASTE DOUBLE TEE	2"ø-2"ø-2"ø		PCS	1					
15	ABS Wye Combination with 8th Bend Flbow	2"ø-2"ø-2"ø		PCS	1					
16	OIII DEHU EIDUW									



	PIPE FITTINGS 03									
‡	Item	Туре	Description, Manufacturer, SKU	Unit	Quantity	Unit Price	Total			
1	ABS Wye Combination with 8th Bend Elbow	3"ø-3"ø-1 1/2"ø		PCS	1					
)	ABS Wye Combination with 8th Bend Elbow	3"ø-3"ø-2"ø		PCS	1					
	ABS 90 Degree Bend Elbow	1 1/2"ø-1 1/2"ø		PCS	1					
ļ	ABS Tee Reducer Elbow	2"ø-2"ø-1 1/2"ø		PCS	1					
)	ABS Vent Cap Elbow	1 1/2"ø		PCS	1					
5	ABS Vent Cap Elbow	2"ø		PCS	2					
7										
}										
)										
10										
1										
2										
3										
4										
5										