


WISDOM

The Wisdom is a charming Spanish-style home with a warm and inviting exterior. The stucco walls, clay tile roof, and arched entryway create a classic and timeless aesthetic. The covered porch with wooden beams offers a shaded outdoor space, perfect for relaxing or entertaining.


The interior features an open floor plan that seamlessly combines the living and kitchen areas, maximizing space and creating a sense of openness. The single bedroom and bathroom provide comfortable and private living quarters.

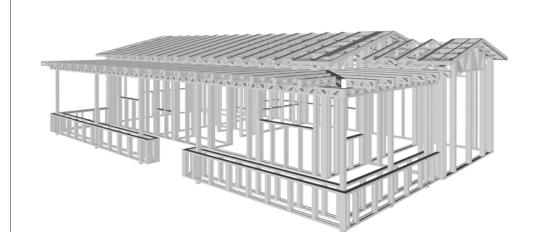

Materials Shopping List

Please print and take this Materials Shopping List to your favorite Home Depot and ask for assistance in selecting the materials, fixtures and fittings to complete your new home.


Record your selection and the price of the item. Then do the math to determine the cost for your selections and the total cost of finishing your home.

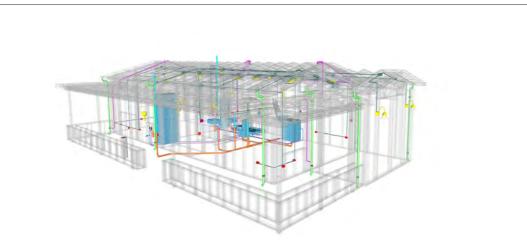

< CLICK HERE >

To Go To Materials Shopping List




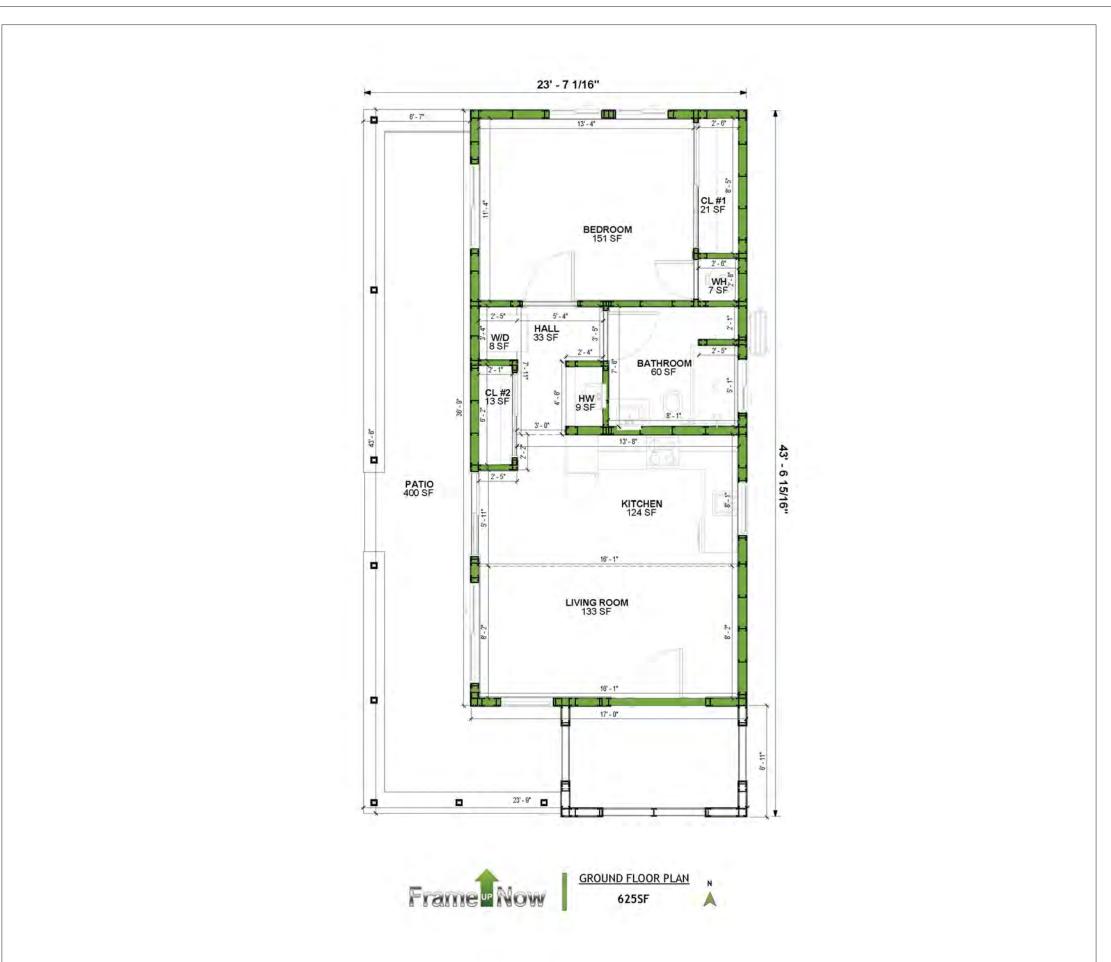

FLOOR PLAN

625 SF

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	DIMENSION PLAN
F	FOUNDATION PLAN
(STRUCTURAL FLOOR PLAN
ł	WALL FRAME LAYOUT
F	ROOF TRUSS LAYOUT
F	ROOF PLAN
A	ARCHITECTURAL ELEVATIONS
A	ARCHITECTURAL ELEVATIONS -
A	ARCHITECTURAL SECTIONS
/	ARCHITECTURAL DETAILS
A	ARCHITECTURAL CASEWORK

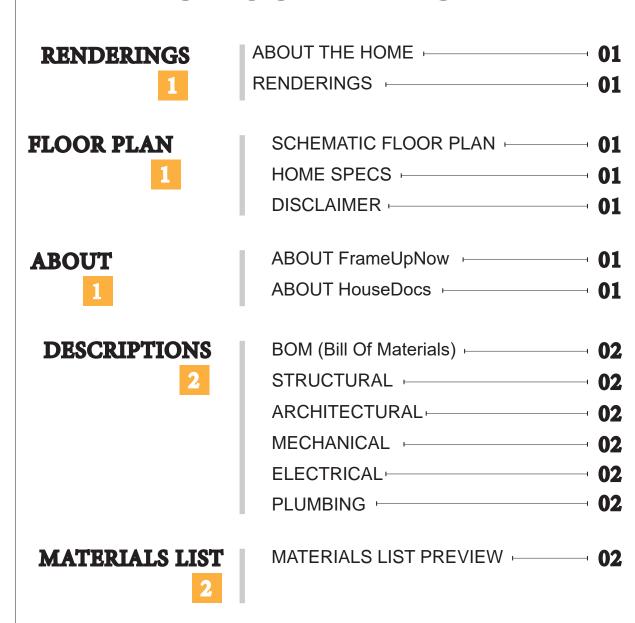
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PLUMBING

SHOPPING LIST

WATER SUPPLY & SEWAGE SYSTEM + 37 **MATERIALS** MATERIALS SHOPPING LIST -

NOTES AND SCHEDULES

ABOUT

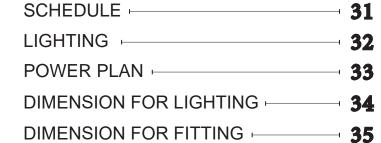

FrameUpNow is a design and manufacturing company providing precision-engineered home framing solutions. We offer a catalog of Affordable Homes, Tiny Homes, Garages, Shops and Barndominiums. FrameUpNow manufactures cold-formed steel (CFS) also known as Light Gauge Steel (LGS) framing components that conform to our engineered metal house frame plans or can be purchased as DIY skeleton kits.

The CFS/LGS framing is lightweight, easily assembled, and does not require heavy equipment or specialized labor, enabling homeowners to erect the frame themselves in just a few days. Unlike wood, the steel framing is impervious termites and bores, warping, expansion, and fire.

Our home plans come complete with a structural engineered stamp for permit approvals. Customers receive a full BOM also known as a Materials Shopping List to purchase finish materials from a Building Materials retailer. FrameUpNow prides itself on the quality and efficiency of our precision-engineered home framing solutions for construction professionals and DIY homeowners.



KEY PLAN

NO.	DESCRIPTION	DATE

NOTE:

LEGEND:

PROJECT

04-Wisdom-909 1Bd1Ba-Spanish-550

DRAWING NAME

INTRODUCTION

CLIENT NAME:
PROJECT NUMBER:
DATE:
DESIGNED BY:
DRAWN BY:
CHECKED BY:

1101

SCALE:

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DISCLAIMER

DISCLAIMER: This documentation and all it's contents are the intellectual property of FrameUpNow. It is provided solely for marketing the services of FrameUpNow. The preliminary information is not approved for actual construction use and is not warranted to be complete or accurate. Unauthorized copying, distribution, or application of these proprietary materials, in any form or format, is strictly prohibited. FrameUpNow assumes no liability for any issues arising from improper use of this marketing content.

DESCRIPTIONS

MATERIALS LIST

The BOM (Bill Of Materials) package, known as the Materials Shopping List document, provides:

Comprehensive Inventory: Detailed lists of essential materials sourced from architectural, mechanical, HVAC, electrical, and plumbing design drawing sets.

Precise Curation: Each item meticulously selected and organized for accuracy and efficiency in project planning.

Customizable Options: Customers can modify listed items to their preferences and calculate costs accordingly, ensuring alignment with personal project needs and budget.

Dedicated Space for Details: Includes tables for customers to note Home Depot SKU numbers or product descriptions for selected items,

facilitating seamless purchasing and coordination with suppliers.

Customer Convenience: Take the list to Home Depot or preferred suppliers for accurate pricing, helping align the total home budget with personal financial plans.

Simplify your construction journey with our Materials Shopping List document, where detailed preparation meets streamlined implementation for your dream home.

STRUCTURAL

The structural drawings package provides an exhaustive set of detailed plans essential for the precise assembly of your building. This comprehensive package includes:

Framing Plans: Detailed layouts for all framing components. Truss Layouts: Clear instructions for truss placement and

Panel Length Plans: Specifications for panel dimensions. Framing Elevations and Sections: Precise elevation and sectional views for accurate construction.

Truss and Wall Blocking Plans: Plans for truss and wall blocking to ensure structural integrity.

Hold-Down Plan: Detailed hold-down requirements for stability. Snap Sheet: Reference sheet for quick identification of components

Structural Details and Bracing Plans: Complete details and bracing plans for all structural elements.

Accompanying these plans is a comprehensive Bill of Materials (BOM) that lists every necessary building component, from cold formed steel (CFS) frames to fasteners.

ARCHITECTURAL

With the comprehensive architectural package, both builders and DIY homeowners can confidently execute the construction.

The architectural package includes:

Furnished Floor Plans: Complete with furniture layouts for a clear understanding of space utilization.

Detailed Dimension Plans: Ensures precise measurements, from the overall footprint down to the exact placement of windows and

Foundation Plan: Detailed plan to establish a solid foundation.

Wall Framing and Truss Layout: Comprehensive plans for wall framing and truss placement.

Architectural Elevations: Exterior views showcasing the design.

Strategic Building Sections: Critical cross-sectional details for a thorough understanding of the build.

Casework Drawings and Diagrams: Suggested designs for built-in caseworks, such as kitchen cabinets.

MECHANICAL

The mechanical package includes everything needed to guide HVAC

Detailed HVAC Floor Plan: Precisely maps out the placement of air handlers, ductwork, and vents throughout the home's layout.

HVAC Sections and Riser Diagrams: Technical drawings offering critical cross-sectional details and piping schematics, ensuring proper integration of the heating and cooling system into the home's structure.

Bill of Materials: A complete list of all necessary HVAC components.

ELECTRICAL

The electrical package includes all the plans and documentation needed to guide the installation of your home's electrical system:

Detailed Power Plan: Precisely maps out the placement of outlets, switches, and other power components throughout the layout.

Comprehensive Lighting Plan: Shows the optimal locations for lighting fixtures, sconces, and other illumination sources to create a well-lit, functional interior.

Dimensioned Electrical Layout: Provides exact dimensions and measurements to ensure proper placement of all electrical elements.

Bill of Materials: A complete list of every component needed, from circuit breakers to wiring.

ARCHITECTURAL BOM

The plumbing package includes everything needed to guide the

Detailed Water Supply System Plan: Precisely maps out the placement of pipes, valves, and plumbing fixtures throughout the

Comprehensive Sewage System Plan: Shows the optimal routing and sizing of drain lines to effectively remove waste and ensure

Detailed Riser Diagrams: Provide information needed to properly


PLUMBING

installation of your home's water supply and drainage systems:


proper drainage.

install all vertical plumbing risers and vent stacks.

Bill of Materials: A complete list of every component needed, from pipes to fixtures.

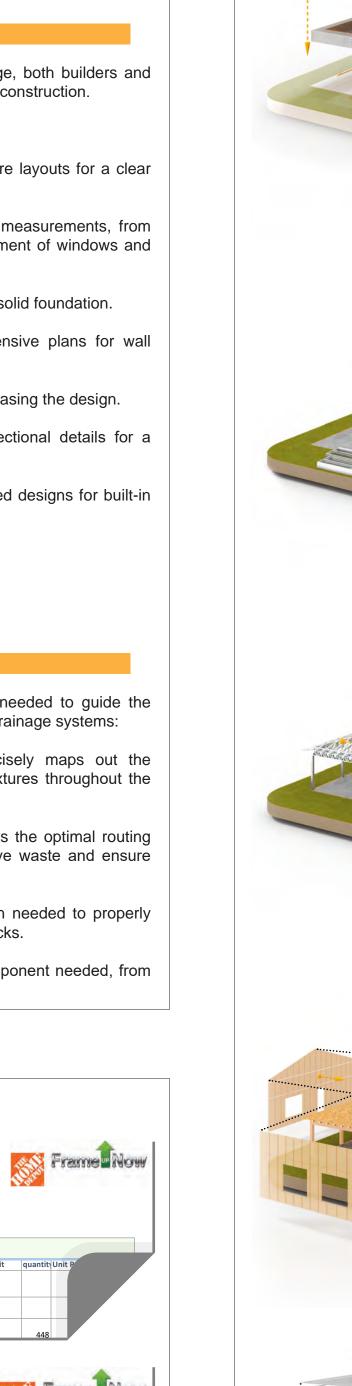

HOW TO BUILD

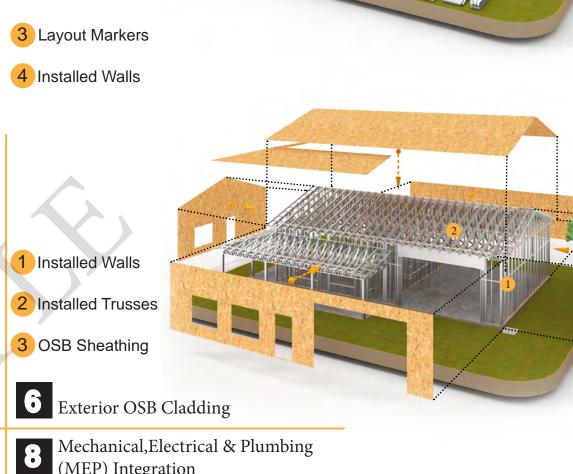

1 Staged Wall

Panels

2 Staged Truss

3 Concrete Floor

Metal Delivery and Staging

Wall Panel Installation

2 Sewage

Installation


4 Concrete Floor

1 Staged Wall Panels 1 Staged Walls


2 Staged Truss Panels 2 Staged Roof


3 Foundation


Layout and Marking

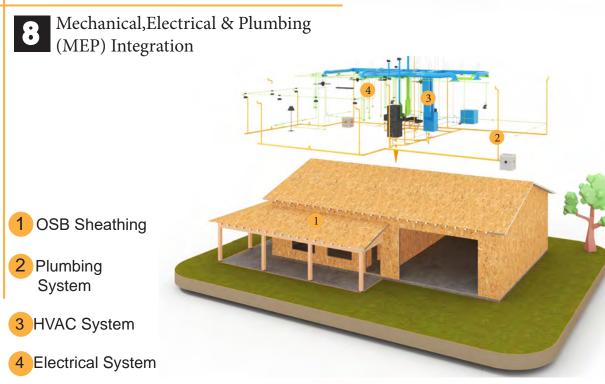



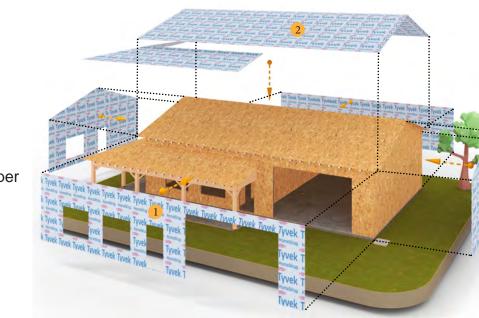

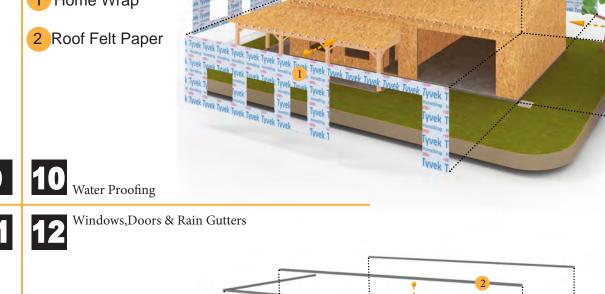

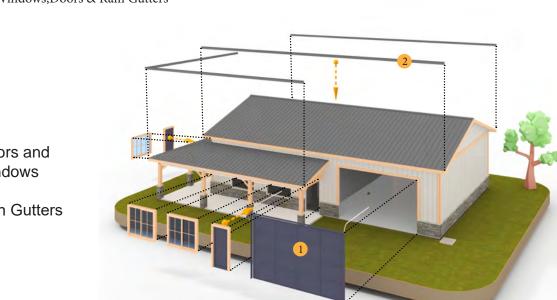



KEY PLAN

DESCRIPTION DATE

NOTE:

LEGEND:

PROJECT

04-Wisdom-909 1Bd1Ba-Spanish-550

DRAWING NAME

INTRODUCTION

CLIENT NAME: PROJECT NUMBER: DATE: **DESIGNED BY** DRAWN BY: CHECKED BY:

1102

SCALE:


BOM (Bill Of Materials) (Separately Attached)




The Bill of Materials (BOM) is a crucial document that compiles the material requirements from different disciplines into a centralized inventory, enabling efficient procurement, inventory management, and cost estimation for a specified project or

ELECTRICAL BOM



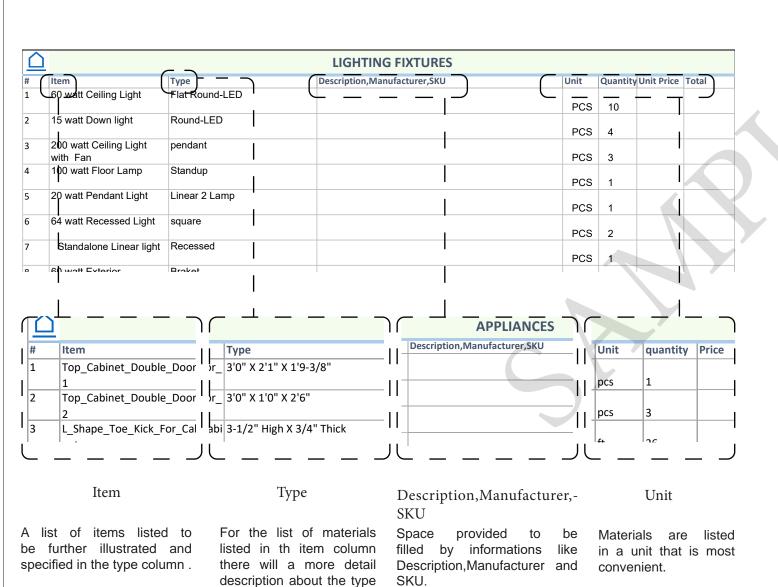


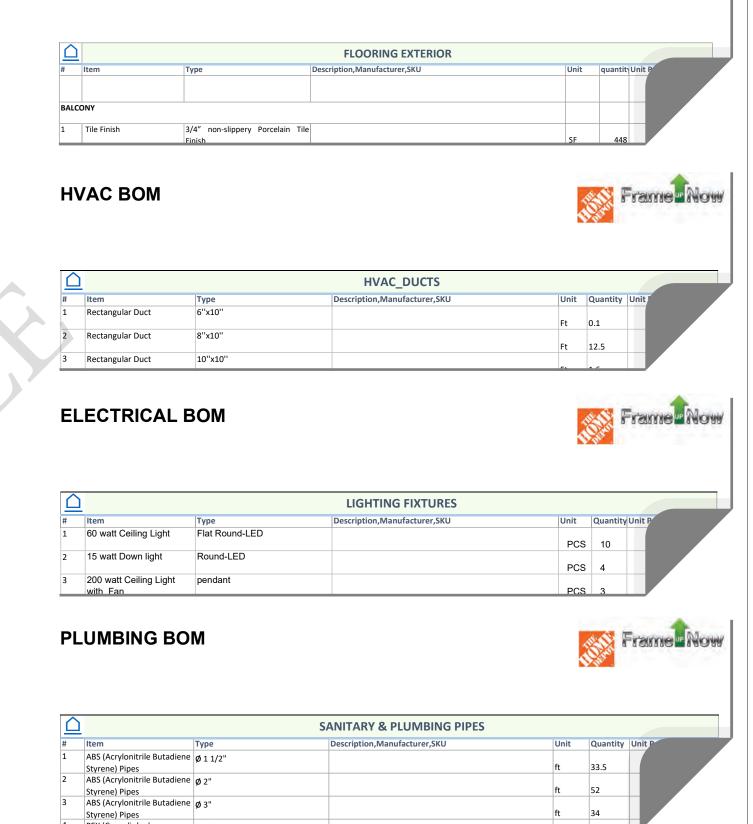

3 Concrete Floor 4 Layout Markers Installed Walls 2 Installed Trusses Roof Truss Installation **5** Exterior OSB Cladding Mechanical, Electrica (MEP) Integration Wall & Roof Insulation 1 Installed Walls 2 Insulation 2 Plumbing 3 HVAC System 1 OSB Sheathing 1 Home Wrap 2 Floor 3 Dry Wall Board 4 Ceiling Dry Wall Exterior Wall & Roof Covering Corrugated Doors and iron sheet windows 2 Rain Gutters 2 Home Wrap 3 Roof Felt Paper 4 Coronado Stone 5 Corrugated iron sheet

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of the Material.

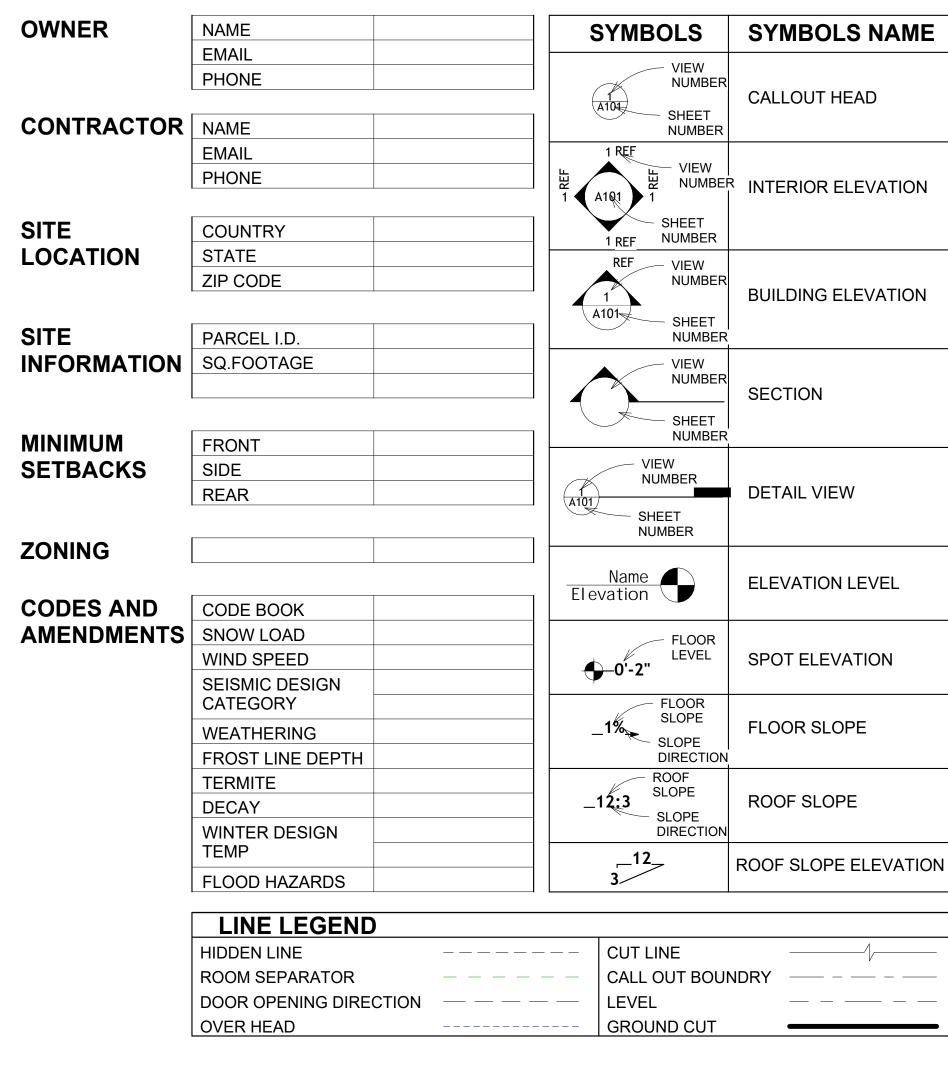


G101	COVER SHEET	AFS	ACTION FLOOR SYSTEMS
A101	FLOOR PLAN	ASTM D698	AMERICAN SOCIETY FOR
A102	DIMENSION PLAN		TESTING AND MATERIAL
S101	FOUNDATION PLAN	CA	CASEWORK
S102	STRUCTURAL FLOOR PLAN	EL	ELECTRICAL
S103	FRAME LAYOUT	F.F.E	FINISHED FLOOR ELEVATION
S104	ROOF TRUSS LAYOUT	F.F.L	FINISHED FLOOR LEVEL
A103	ROOF PLAN	FTG	FOOTINGS
A201	ELEVATIONS	HVAC	HEATING, VENTILATION & AIR
A202	ELEVATIONS		CONDITIONING
A301	SECTIONS	IRC	INTERNATIONAL RESIDENCE
A401	DETAILS		CODE
A402	CASEWORK DETAILS	IMC	INTERNATIONAL MECHANICAL
A403	CASEWORK DETAILS		CODE
E101	SCHEDULE	MAX.	MAXIMUM
E102	LIGHTING PLAN	ME	MECHANICAL
E103	POWER PLAN	MIN.	MINIMUM
E104	DIMENSION PLAN FOR LIGHT FIXTURE	NO.	NUMBER
E105	DIMENSION PLAN FOR FITTING	O.C	ON CENTER
P101	COVER SHEET	OSB	ORIENTED STRAND BOARD
P102	WATER SUPPLY SYSTEM	PL	PLUMBING
P103	SEWAGE SYSTEM	PSI	POUNDS PER SQUARE INCH
P104	RISER DIAGRAM	PVC	POLYVINYL CHLORIDE
M101	HVAC PLAN	REF	REFERENCE
M102	HVAC SECTION	RG	RIGHT GARAGE
M103	RISER DIAGRAM	SE	SPECIAL EQUIPMENT
		SF	SQUARE FEET
TAG	TAG'S NAME	SIMP. STHD8	SIMPSON STRAP THE HOLDDOWN
	CASENAGRIC TAG	SIMP. ABE66	SIMPSON ANCHOR BOLT EDGE
CA01	CASEWORK TAG	TV	TELEVISION
(1)	DOOR TAG	UNO	UNLESS NOTED OTHERWISE
1	FURNITURE TAG	W/	WITH
1	TOTAL TAG	W/D	WASHER/DRYER
<u>_1</u>	WINDOW TAG	AC	AIR CONDITIONING UNIT
SE01	SPECIALTY EQUIPMENT TAG	ACC	AIR COOLED CONDENSER
MEO1	MECHANICAL EQUIPMENT TAG	ACCU	AIR COOLED CONDSENSING UNIT
	DILIMPING FOLUDATATE TAG	AHU	AIR HANDLING UNIT
LPE01	PLUMBING EQUIPMENT TAG	CC	COOLING COIL
		CD	CEILING DIFFUSER
		CFm	Cubic Feet Per Minute

ABBREVIATION

PAGE INDEX



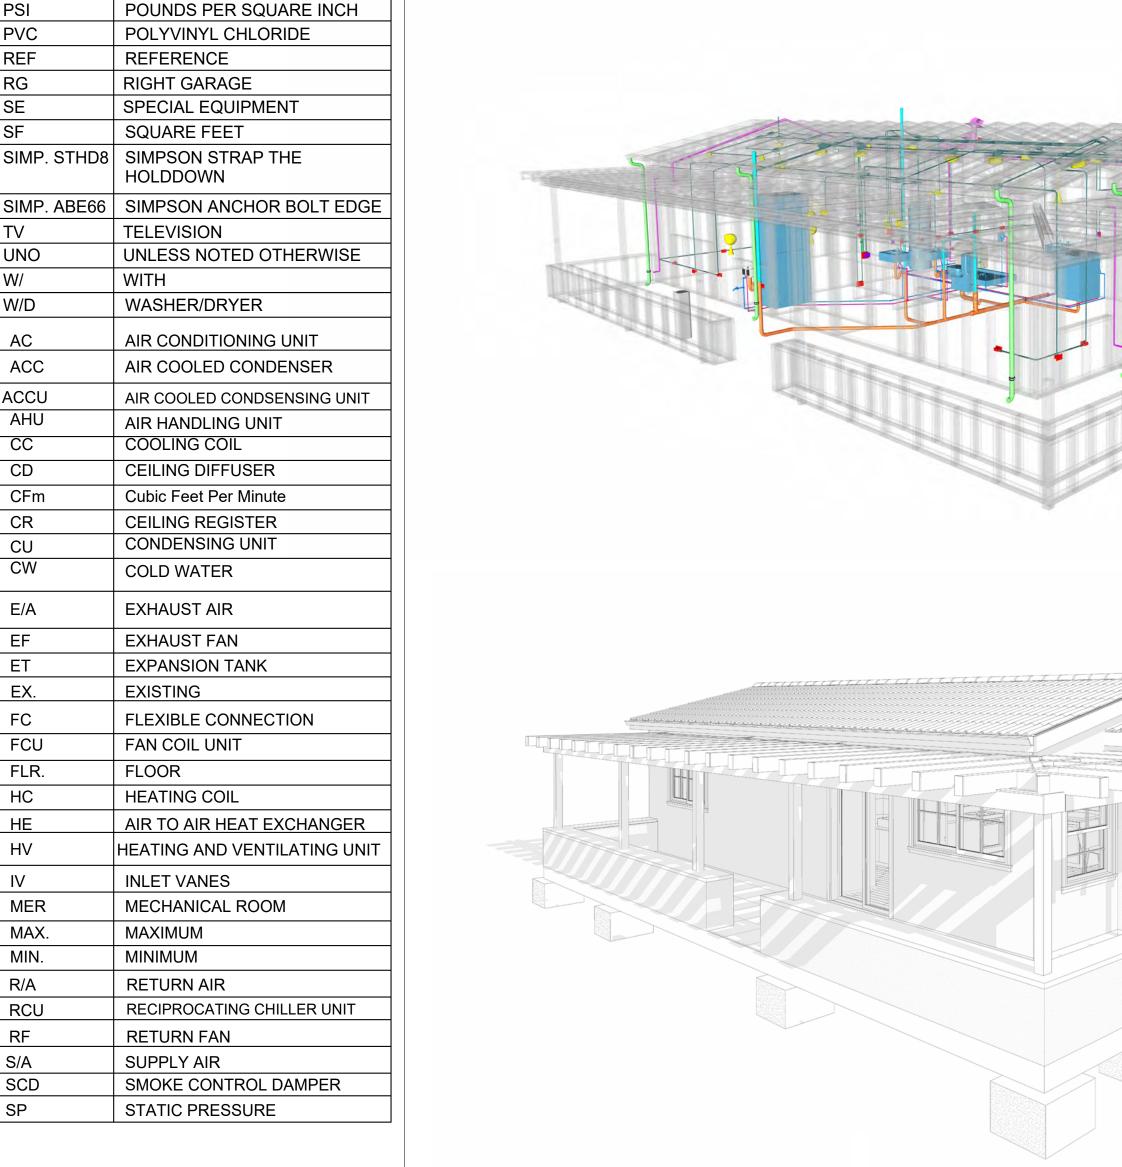


04-Wisdom-625-1Bd/1Ba-Spanish-550

SQUARE FO	OTAGE
LIVING	625
PATIO	400
TOTAL	1025



KEY PLAN

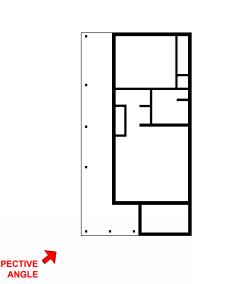

A	NGLE	
NO.	DESCRIPTION	DATE

LEGEND:

PROJECT

04 Wisdom 625 1Bd/1Ba Spanish **550**

COVER SHEET

	CLIENT NAME:	Client Name
	PROJECT NUMBER:	0059_12
	DATE:	2/3/2025 9:35:29 AM
	DESIGNED BY:	Designer
	DRAWN BY:	Author
	CHECKED BY:	Checker
1		

G101

GENERAL NOTES

- 1. THIS DRAWING DEPICTS THE ARCHITECTURAL (SPACE LAYOUT, FURNISHING, FLOOR, WALLS, ROOFS, FOUNDATION, WINDOWS AND DOORS) SYSTEMS. IT PROVIDES A VISUAL REPRESENTATION OF THE ARCHITECTURAL LAYOUT AND COMPONENTS.
- 2. THE ARCHITECTURAL DRAWINGS ARE PREPARED TO MEET THE SPECIFIC REQUIREMENTS OF THE BUILDING, AS PER THE PROJECT SPECIFICATIONS AND APPLICABLE CODES AND STANDARDS.
- 3. THE CONSTRUCTION OF THIS HOME SHALL COMPLY WITH THE LATEST EDITION OF THE INTERNATIONAL RESIDENTIAL CODE (IRC), INTERNATIONAL MECHANICAL CODE (IMC), THE INTERNATIONAL PLUMBING STANDARD, THE NATIONAL ELECTRICAL STANDARD AND ALL OTHER APPLICABLE LOCAL, STATE, AND NATIONAL CODES AND REGULATIONS.
- 4. COORDINATION WITH OTHER TRADES HAS BEEN DONE ON A DESIGN LEVEL. THIS DRAWING SHALL BE READ TOGETHER WITH THE ME, EL AND PL DESIGN DRAWINGS TO ENSURE PROPER CONSTRUCTION AND INTEGRATION OF THE BUILDING SYSTEMS.

ABOUT WALLS:

SHOWER WALL COVERING

BATHTUB AND SHOWER SPACES (WALLS AND FLOORS) WITH INSTALLED SHOWER HEADS AND IN SHOWER COMPARTMENTS SHALL BE FINISHED WITH A NON-ABSORBENT SURFACE.

2. WALL PAINT (INTERNAL)

THE TYPICAL THICKNESS OF LATEX WALL PAINT IS 1/32 OF AN INCH FOR A SINGLE COAT. AND DOUBLE COAT (1/16") SHALL BE APPLIED FOR DURABILITY.

ADHESIVES:

THE ADVISABLE TYPE OF ADHESIVE FOR THIS PROJECT IS **EPOXY ADHESIVES** BECAUSE THEY ARE KNOWN FOR THEIR HIGH STRENGTH, DURABILITY, AND RESISTANCE TO MOISTURE, CHEMICALS AND HEAT.


REFER TO SHEETS A201 & A202 FOR GENERAL NOTES ON EXTERNAL FINISHING MATERIALS

ABOUT FLOORS:

- 1. THE SPOT ELEVATION INDICATES THE FINISHED FLOOR ELEVATION.
- 2. FINISHED FLOORS PER PLANS.
- 3. MINIMUM 1% SLOPE ON OUTDOOR BALCONIES FOR WATER RUN OFF.
- 4. ALL FINISHING MATERIAL MUST MEET ALL APPLICATION FIRE, LIFE SAFETY AND BUILDING
- 5. ANY INTERIOR FINISH SYSTEMS SHALL COMPLY WITH EMISSION STANDARDS.
- 6. LANDING OR FLOOR REQUIRED AT EACH SIDE OF EXTERIOR DOOR.

FURNITURE SCHEDULE				
TYPE MARK		TYPE	COUNT	
01	KING SIZE BED		1	
02	THREE SEAT SOFA		1	
03	DINING CHAIR		2	
04	Coffe Table		1	

ROOM FINISH SCHEDULE							
ROOM NUMBER	ROOM NAME	FLOOR FINISH	BASE FINISH	WALL FINISH	CEILING FINISH	CEILING HEIGHT	
01	BEDROOM	HARDWOOD	CONCRETE	WALL PAINT	DRY WALL	8' - 0"	
02	BATHROOM	VINYL TILES	CONCRETE	CERAMIC TILE	MRD	8' - 0"	
03	CL #2	HARDWOOD	CONCRETE	WALL PAINT	DRY WALL	8' - 0"	
04	W/D	VINYL TILES	CONCRETE	CERAMIC TILE	MRD	8' - 0"	
05	HALL	HARDWOOD	CONCRETE	WALL PAINT	DRY WALL	8' - 0"	
06	HW	VINYL TILES	CONCRETE	CERAMIC TILE	DRY WALL	8' - 0"	
07	KITCHEN	HARDWOOD	CONCRETE	WALL PAINT + CERAMIC	DRY WALL	8' - 0"	
08	PATIO	balcony tile	CONCRETE	STUCCO FINISH	PLYWOOD	8' - 0"	
09	CL #1	HARDWOOD	CONCRETE	WALL PAINT	DRY WALL	8' - 0"	
10	WH	HARDWOOD	CONCRETE	WALL PAINT	DRY WALL	8' - 0"	
11	LIVING ROOM	HARDWOOD	CONCRETE	WALL PAINT	DRY WALL	8' - 0"	

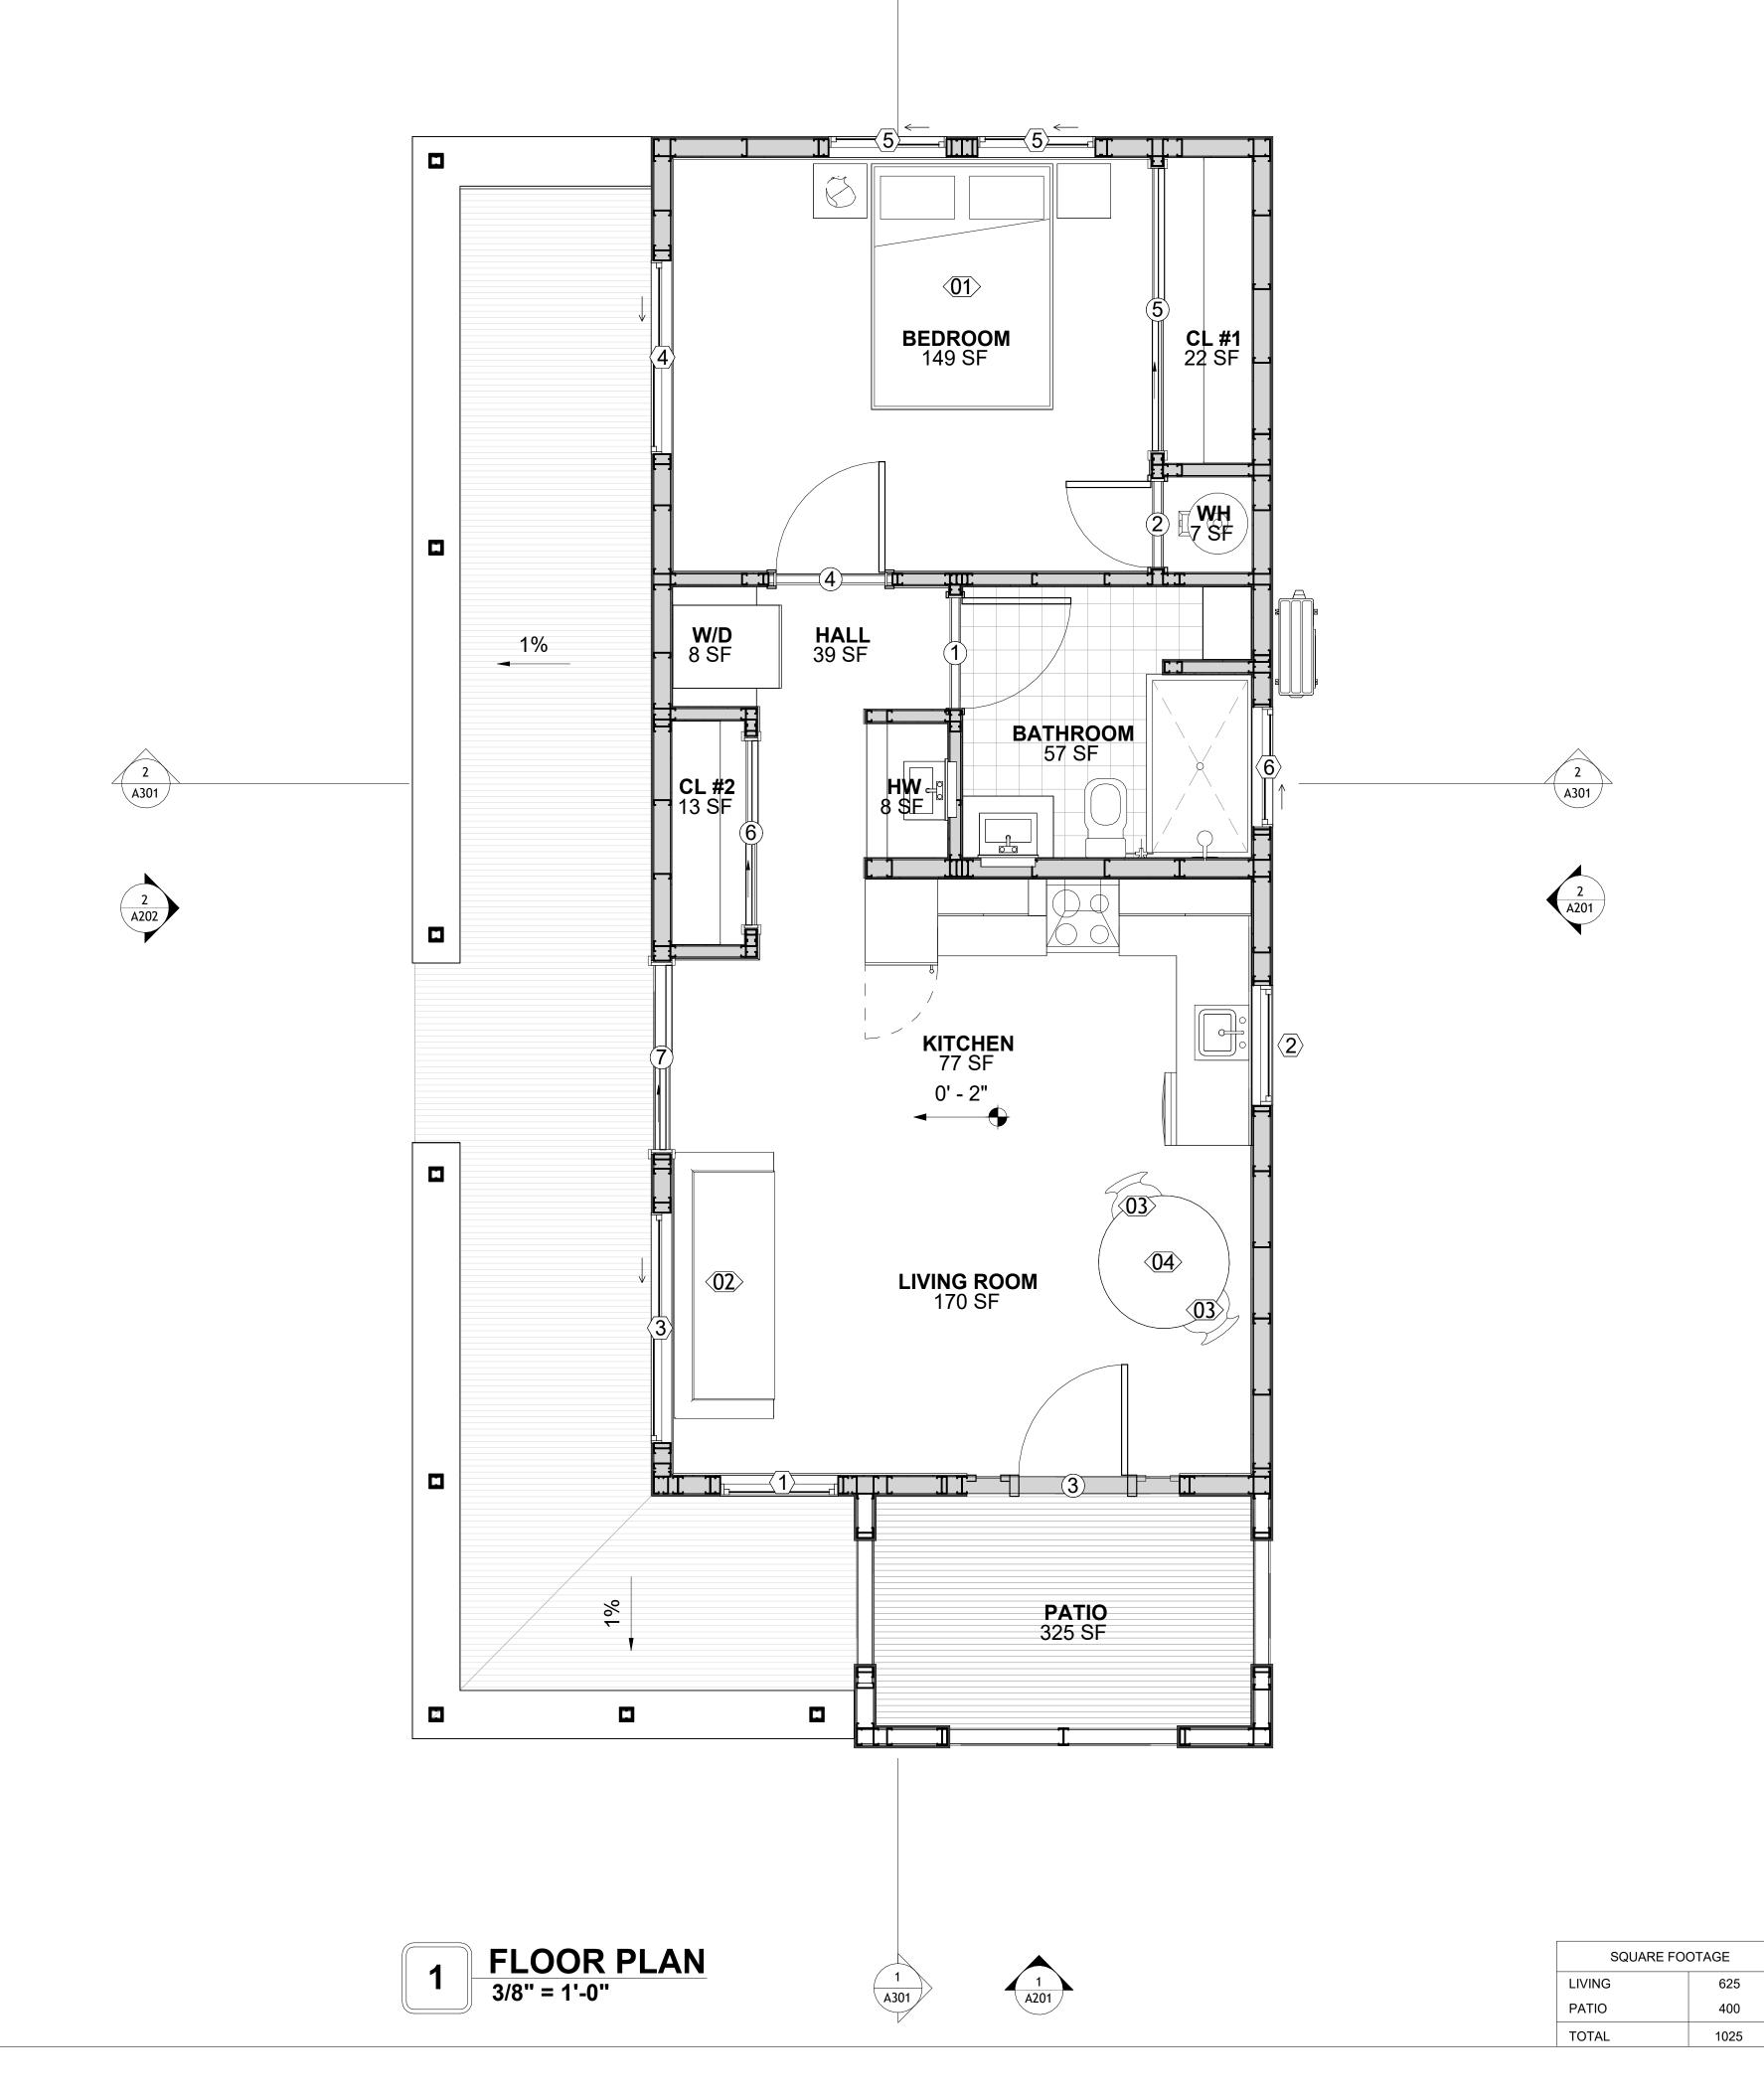



KEY PLAN

NO.	DESCRIPTION	DATE

NOTE:

LEGEND:


04 Wisdom 625 1Bd/1Ba Spanish **550**

DRAWING NAME

FLOOR PLAN

CLIENT NAME:	Client Name
PROJECT NUMBER:	0059_12
DATE:	2/3/2025 9:35:30 AM
DESIGNED BY:	Designer
DRAWN BY:	Author
CHECKED BY:	Checker

A101

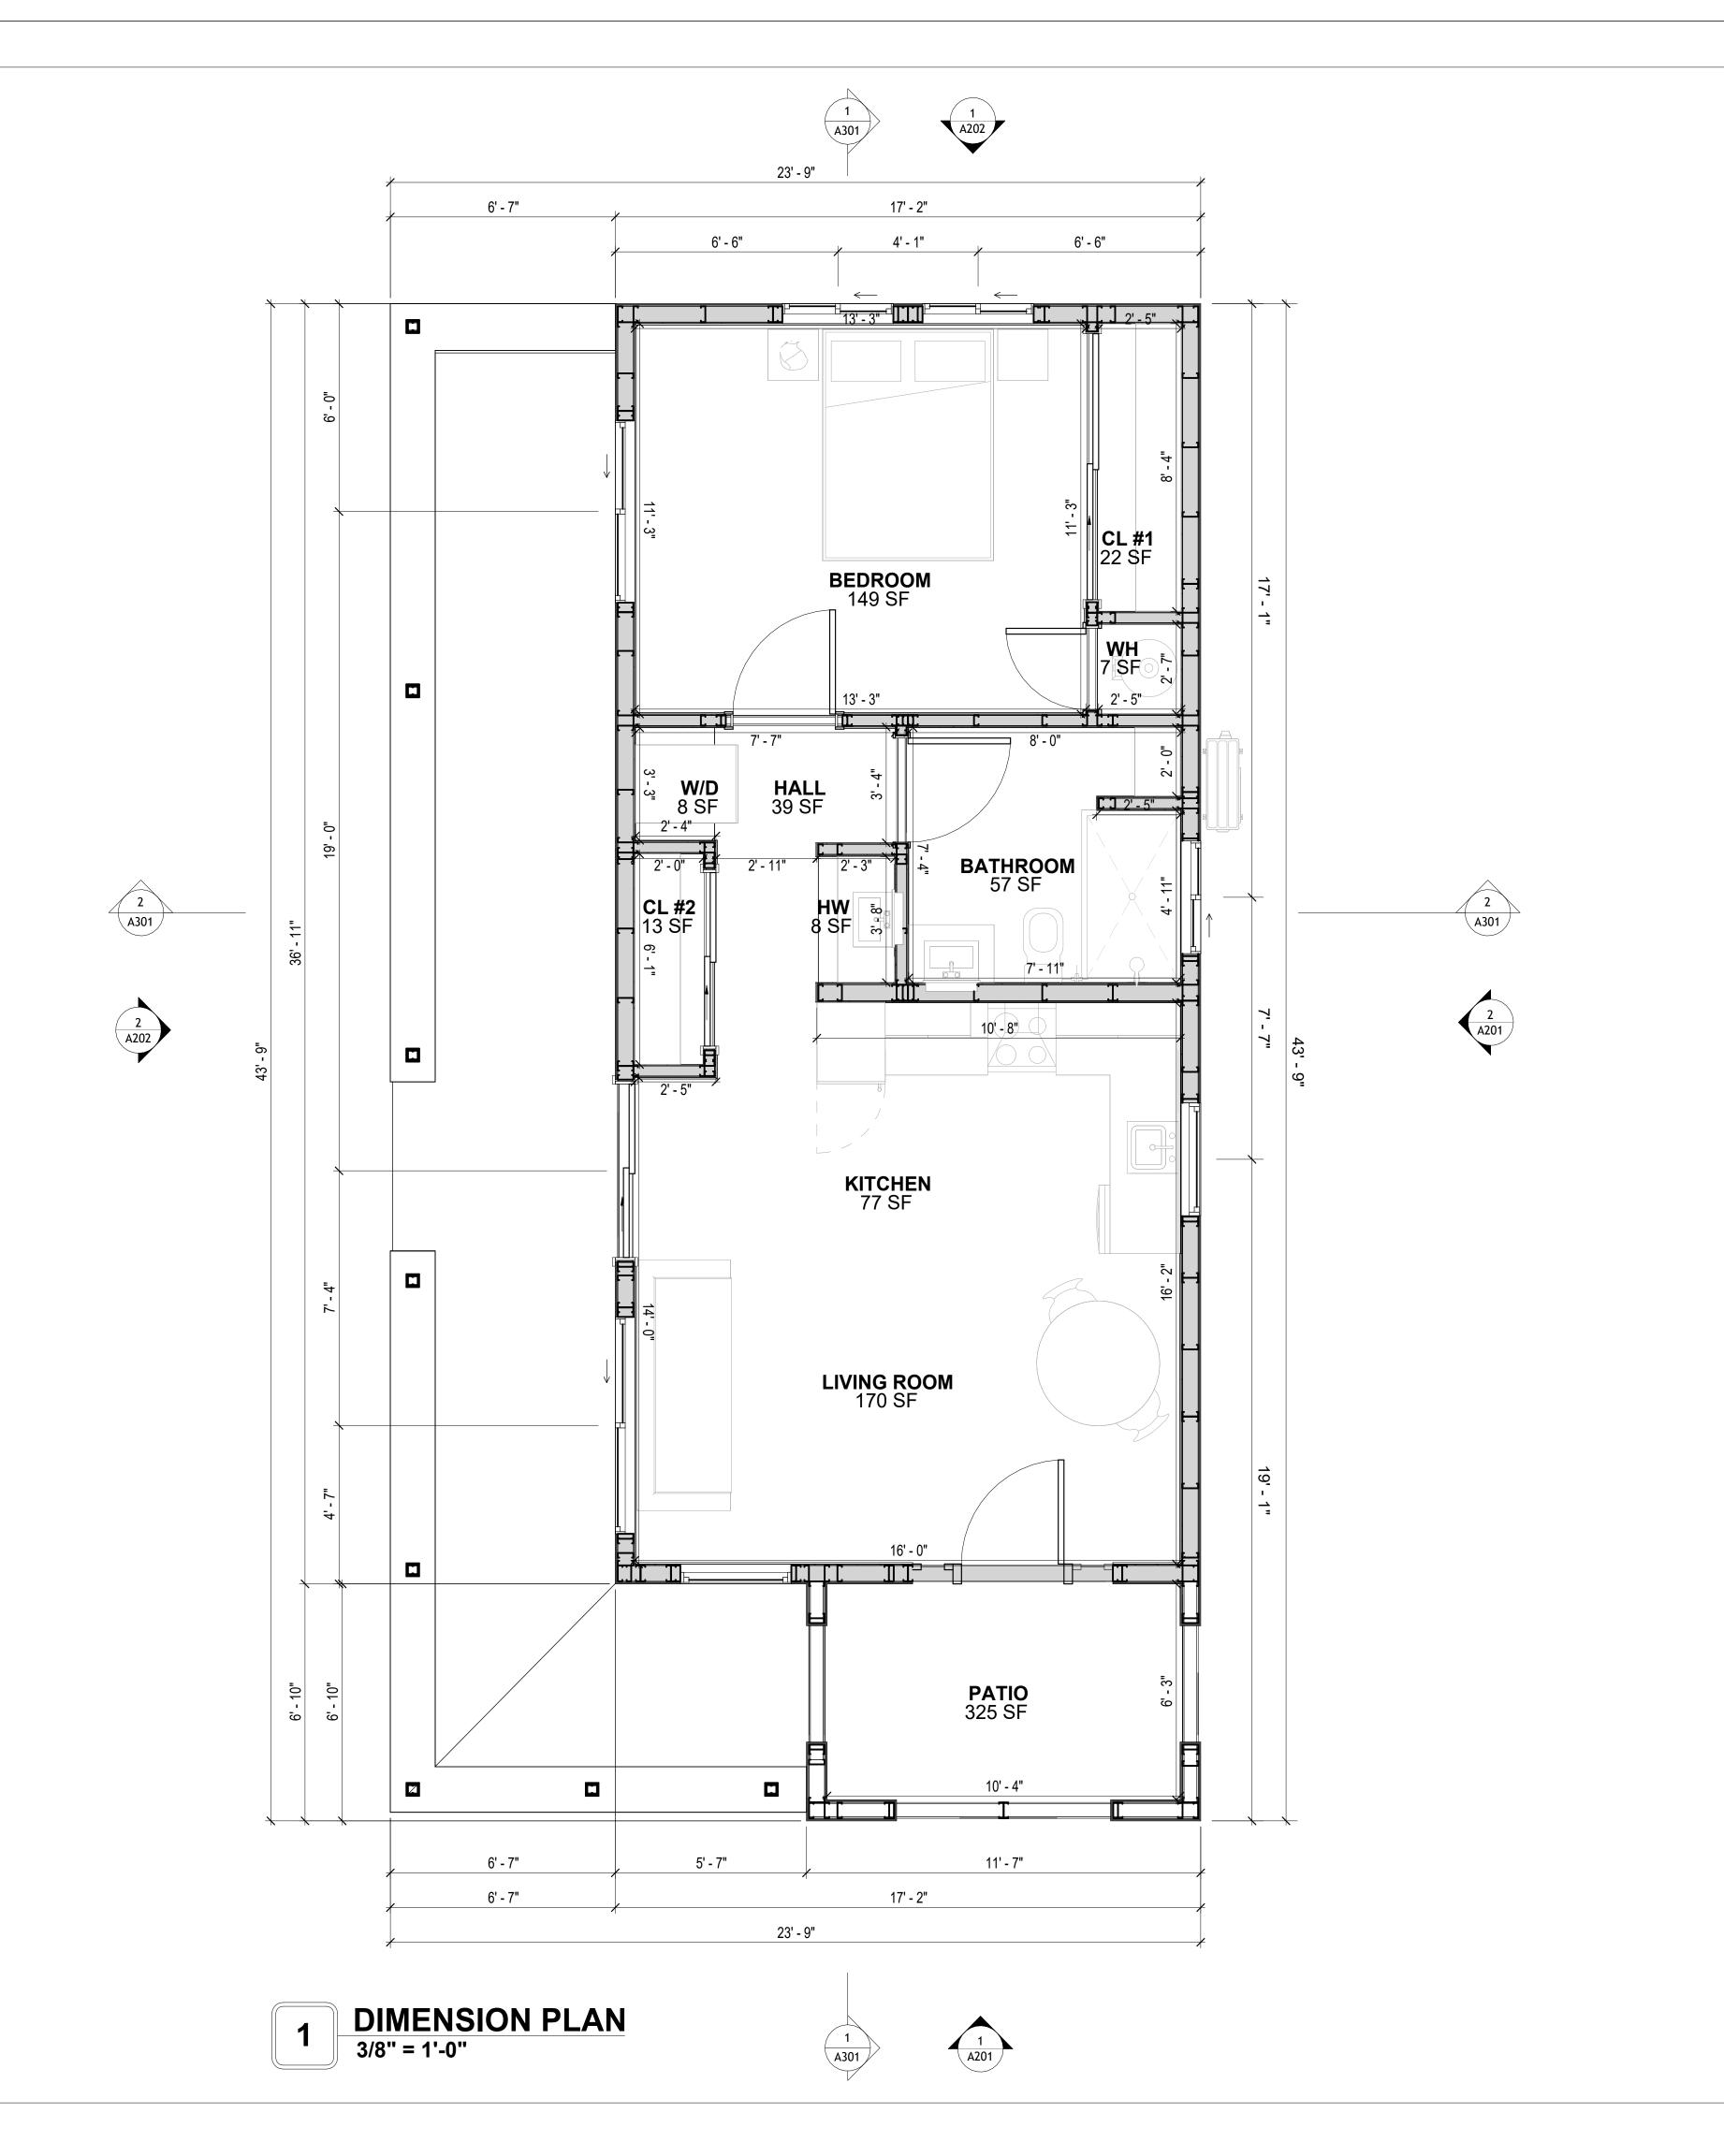



KEY PLAN

NO.	DESCRIPTION	DATE

NOT

LEGEND:

PROJEC

04 Wisdom 625 1Bd/1Ba Spanish 550

DRAWING NAME

DIMENSION PLAN

ENT NAME:	Client Name
DJECT NUMBER:	0059_12
E:	2/3/2025 9:35:32 AM
SIGNED BY:	Designer
AWN BY:	Author
ECKED BY:	Checker

A102

SCALE: 3/8" = 1'-0"

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DIMENSIONS IN THE ARCHITECTURAL DRAWINGS CONSIDER FINISHING MATERIALS. FOR PRECISE MEASUREMENTS OF THE STRUCTUAL FRAMING, REFER TO THE ATTACHED STRUCTURAL PLAN SET.

 LIVING
 625

 PATIO
 400

 TOTAL
 1025

SQUARE FOOTAGE

FOUNDATION NOTES

NOTES:

TERMITES PRETREATMENT BY LICENSED CONTRACTOR UNDER SLAB AND AROUND FOOTINGS. ALL AREAS BELOW SLABS SHALL BE TREATED NO MORE THAN 24 HOURS PRIOR TO CONCRETE POUR. EVIDENCE OF TREATMENT MUST BE PROVIDED PRIOR TO PLACING OF CONCRETE.

1. MATERIALS:

ALL INTERIOR CONCRETE SLABS SHALL BE A MIN. OF 4" THICK CONCRETE OVER 4" COMPACTED AGGREGATE BASE (ASTM D698), FINISH ELEVATIONS AS NOTED ON DRAWINGS, 6" ABOVE ADJACENT GRADE, LEVEL SLABS TO 1/8"-10' MAX.. CONCRETE SLABS SHALL BE 2500# PSI AT 28 DAYS. A 4" ALLOWABLE SLUMP.

2. **PAD PREPARATION:**

- EXCAVATION FOR FOOTING SHALL BE NEAT.

FOOTINGS SHALL BE POURED IMMEDIATELY AFTER EXCAVATION AND APPROPRIATE INSPECTION.
 ALL REINFORCING STEEL MARKED "CONTINUOUS" SHALL BE LAPPED 36 BAR DIAMETERS AT SPLICES AND AROUND CORNERS OR INTERSECTIONS WITH A STANDARD 90 DEGREE BEND ON CORNER BARS. LAP WIRE MESH ONE FULL MESH AT SIDE AND END LAPS.
 ALL HARDWARE TO BE SIMPSON OR EQUIVALENT.

- EXTERIOR FRAME WALL TO BE SECURED WITH 1/2"X10" ANCHOR BOLTS 4'-0" O.C. FOR 1-STORY AND 2'-8" O.C. FOR 2-STORY. BOLTS SHALL BE LOCATED WITHIN 1'-0" OF EACH END PIECE AND SHALL HAVE A MIN. OF TWO BOLTS PER PIECE.

-FOUNDATION ANCHOR STRAPS SHALL BE PERMITTED, ACCORDING TO RESIDENTIAL CODE 2021
- ALL INTERIOR WALLS TO BE SECURED WITH POWER DRIVEN PINS PER MANUFACTURER
SPECIFICATION USE PIN SPACING EQUIVALENT TO 1/2" ANCHOR BOLTS.
- ALL CONSTRUCTION TO CONFORM TO THE 2012 IRC

- R-10 RIGID INSULATION OUTSIDE OF EXTERIOR FOUNDATION WALLS UNDER LIVING AREA.

- CONCRETE PAD FOR CONDENSER THICKNESS IS 4" MIN UNLESS OTHERWISE NOTED.

3. CONCRETE CONSTRUCTION:

- THE SLAB SHALL BE UNDERLAIN BY A VAPOR BARRIER/RETARDER IN THE LIVING AREA (TYPICALLY POLYETHYLENE, UNLESS MORE STRINGENT PROTECTION REQUIRED BY THE ARCHITECT, ENGINEER, FLOOR COVERING MANUFACTURER, OR ACCEPTED PRACTICE). UNLESS OTHERWISE REQUIRED, BARRIER MAY BE OMITTED AT GARAGES, PORCHES AND PATIOS WITHOUT FLOOR COVERINGS. IT IS BEYOND THE SCOPE OF THESE PLANS TO DETERMINE THE APPLICABILITY OF THESE MORE STRINGENT REQUIREMENTS. BUILDER SHALL VERIFY PRIOR TO CONSTRUCTION.

4. REINFORCEMENT

- IF CONSTRUCTED ON ACTIVE SOILS, THE LONG TERM PERFORMANCE OF THE FOUNDATION IS DEPENDENT ON MAINTENANCE BY THE OWNER. THUS THE BUILDER SHALL ADVISE THE OWNER OF THE FOLLOWING:


- 1. DRAINAGE MUST BE MAINTAINED. WATER SHALL NEVER BE ALLOWED TO POND NEAR THE FOUNDATION.
- 2. THE SOIL AROUND THE FOUNDATION SHALL BE MAINTAINED IN A RELATIVELY DAMP CONDITION, SUCH AS THAT REQUIRED TO KEEP A LAWN GREEN. IF IT DRIES OUT IT WILL SHRINK. IF IT GETS WET, IT WILL HEAVE UPWARD.
- 3. SLABS ON THE SHORTER SIDE USES MAIN BARS ARE USED IN THIS DIRECTION ONLY WITH SMALLER DIAMETER DISTRIBUTION BARS ARE PLACED, FORMING A MAT OR GRID.
- ALL REINFORCEMENT BARS SIZE 10MM OR LARGER IN ACCORDANCE TO ASTM
- 3. ANCHOR BOLTS AT ALL EXTERIOR WALLS SHALL BE MINIMUM 1/2 INCH DIAMETER WITH A
- MAXIMUM SPACING OF 6'-0" ON CENTER, UNLESS NOTED OTHERWISE.

 4. ANCHOR BOLTS SHALL BE INSTALLED WITHIN 12 INCHES OF EACH END OF EACH SILL PLATE WITH AT LEAST TWO ANCHOR BOLTS FOR EACH BOLTS FOR EACH SILL PLATE LONGER THAN 12 INCHES.
- 5. SIMPSONS SILL ANCHORS MAYBE SUBSTITUTED FOR ANCHOR BOLTS AT THE SAME SPACING.
 6. EXTERIOR CONCRETE SLABS WHICH ARE NOT PART OF THE MAIN SLAB SHALL BE MINIMUM 4
 INCHES THICK WITH NO STEEL REINFORCING BARS REQUIRED, UNLESS NOTED OTHERWISE ON
 FOUNDATION PLAN.

VERIFY THE FOLLOWING PRIOR TO POURING:

- I. ALL HOLDDOWNS , STRAP, AND POST LOCATIONS.
- 2. CONCRETE FINISHES. PANEL RISER LOCATION WHERE APPLICABLE.
- 3. UNDERSLAB MECHANICAL REQUIREMENTS.
- 4. STEM WALL BLOCKOUTS.
- UNDERSLAB ELECTRICAL REQUIREMENTS AND PANEL RISER LOCATION. WHERE APPLICABLE.
 PROVIDE THE FOLLOWING:
- PVC SLEEVES THROUGH FTG IF REQUIRED
- 20' #4 COPPER GROUND BAR.
- SLOPE FINISH GRADE AWAY FROM FOOTING.

NOTE: FIELD VERIFY ALL DIMENSIONS SEE DIMENSIONED ARCHITECTURAL DRAWINGS

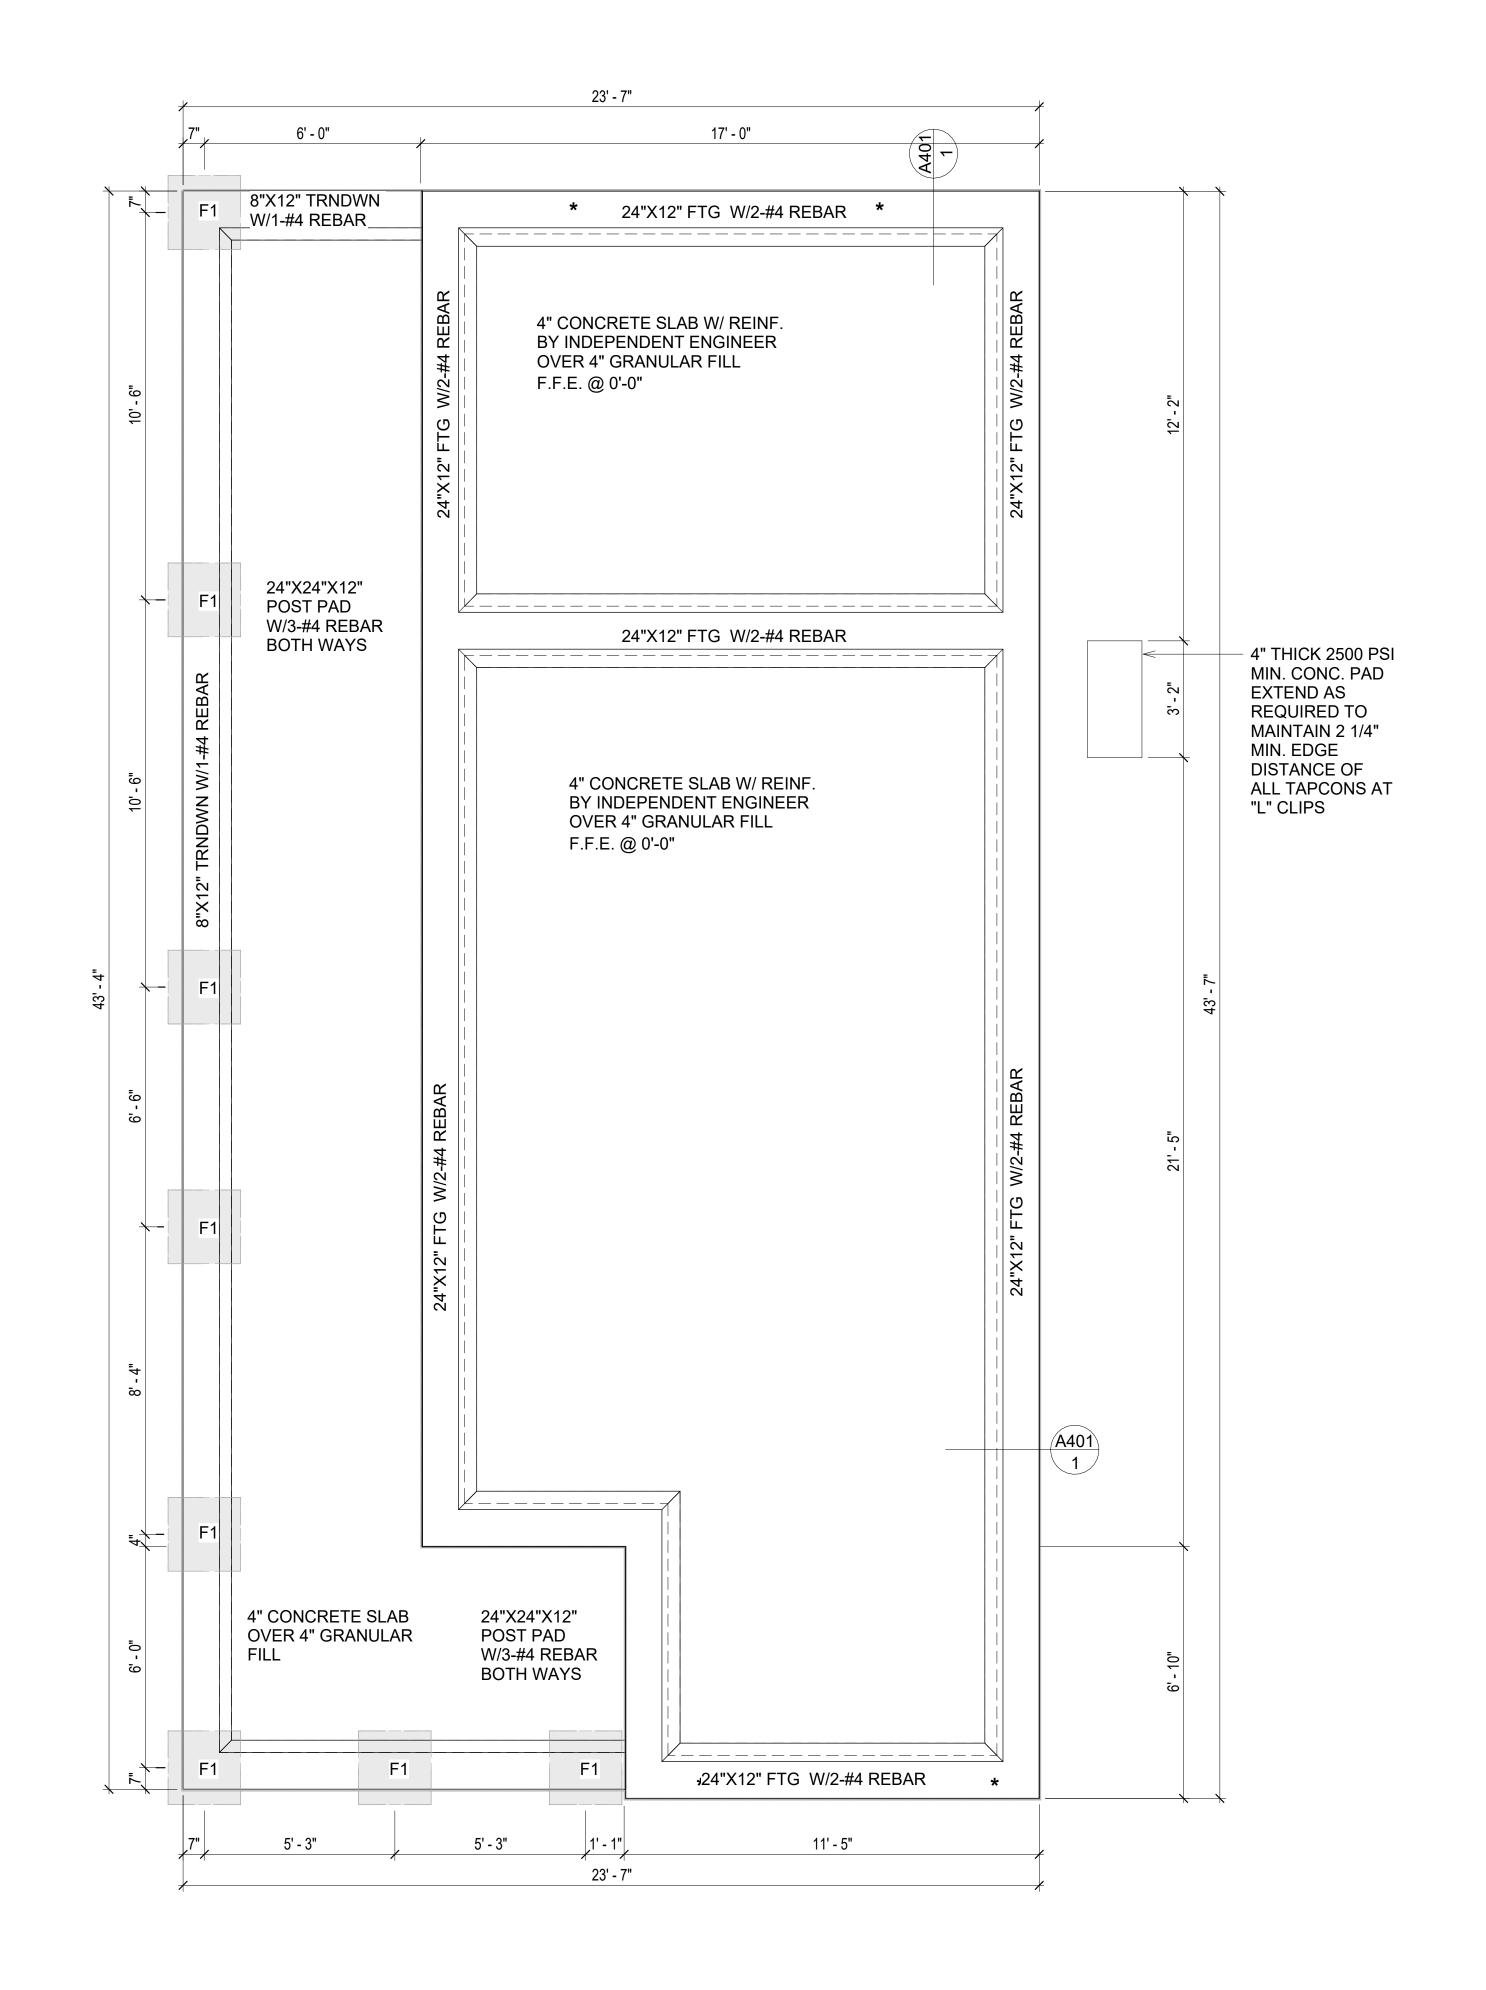



SQUARE FOOTAGE

LIVING 625
PATIO 400

TOTAL 1025



KEY PLAN

NO. DESCRIPTION DATE

NOTE:

LEGEND:

PROJECT

04 Wisdom 625 1Bd/1Ba Spanish 550

DRAWING NAME

FOUNDATION PLAN

Client Name 0059_12
0/0/0005 0.05.00 AM
2/3/2025 9:35:32 AM
Designer
Author
Checker

S101

SCALE: 3/8" = 1'-0"

GENERAL NOTES

NOTES:

-ALL BEARING WALLS SHOULD HAVE A THICKENED SLAB PER SECTION PER DETAIL A401/5.

A) **FOUNDATION PLAN NOTES**:

- 1. CONCRETE SLAB SHALL BE 6" THICK WITH #4 REBAR, CENTERED IN SLAB THICKNESS, OVER APPROVED SUBBASE PER GENERAL STRUCTURE NOTES.
- TERMITE PROTECTION SHALL BE PROVIDED PER IRC SECTION R318.1
 NONE TYPICAL ANCHOR BOLT SPACING AT SHEAR WALL AND HOLD DOWN SPECIFICATIONS
- NONE TYPICAL ANCHOR BOLT SPACING AT SHEAR WALL AND HOLD DOWN SPECIFICATIO PER APPROVED ARCHITECTURAL PLANS.
- 4. INSTALL HOLDOWNS BEFORE CONCRETE SLAB POUR.
- 5. EXISTING FILL ON-SITE SHALL BE COMPACTED IN ACCORDANCE WITH THE REQUIREMENTS IN THE GEOTECHNICAL REPORT.
- 6. ALL FLOOR SLABS ARE REINFORCED ON CONCRETE SLABS.

SPECIAL INSPECTION IS REQUIRED FOR THICKENED FOUNDATION CONSTRUCTION

- 1. REINFORCEMENT
- 2. 2500 PSI CONCRETE POUR


B) **REINFORCEMENT FOR CONCRETE**:


- ALL REINFORCING SLABS BARS SIZE 3/8 INCHES OR LARGER SHALL BE DEFORMED IN ACCORDANCE TO ASTM-A706, AND BARS SMALLER THAN 10 MM MAYBE PLAIN.
 UNLESS OTHERWISE NOTED IN PLANS, THE YIELD STRENGTH OF REINFORCING BARS SHALL
 - A) FOOTING = 40,000 PSI B) NON-LOAD BEARING WALLS AND PARAPETS= 40,000 PSI
- 3. SPLICES SHALL BE SECURELY WIRED TOGETHER AND SHALL LAP OR EXTEND
- 4. GRADE OF STEEL FOR RCC WORKS SHALL BE GRADE 4 10.
- BAR NOTATIONS GIVES INFORMATION


 A) BAR SIZE
- B) SPACING(IF REQUIRED)
- 6. LAP REINFORCEMENT ONLY AT LOCATION SHOWN IN THE DRAWINGS
- 7. REINFORCEMENT SHALL NOT BE CUT, VENT OR HEATED ON SITE WITHOUT ENGINEERS' APPROVAL.
- C) CONCRETE SLAB NOTES
- 1. ALL SLAB REINFORCEMENT SHALL BE 3/4 INCHES CLEAR MINIMUM FROM BOTTOM AND FROM TOP OF SLAB.
- 2. REINFORCEMENT IN CONTINUOUS ELEVATED SLAB SHALL BE CUT AS FOLLOWS.

NOIE:

- THIS IS A SCHEMATIC PLAN FOR THE PURPOSE OF LOCATING AND IDENTIFYING FOUNDATION REINFORCING ELEMENTS ONLY. VERIFY ALL DIMENSIONS, DROPS, OFFSETS AND FEATURES WITH THE ARCHITECTURAL PLANS BEFORE FORMING THE FOUNDATION.

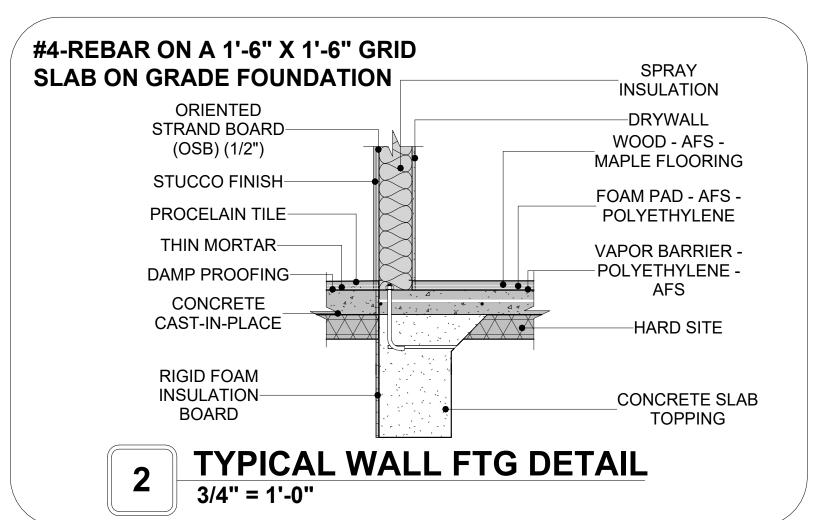

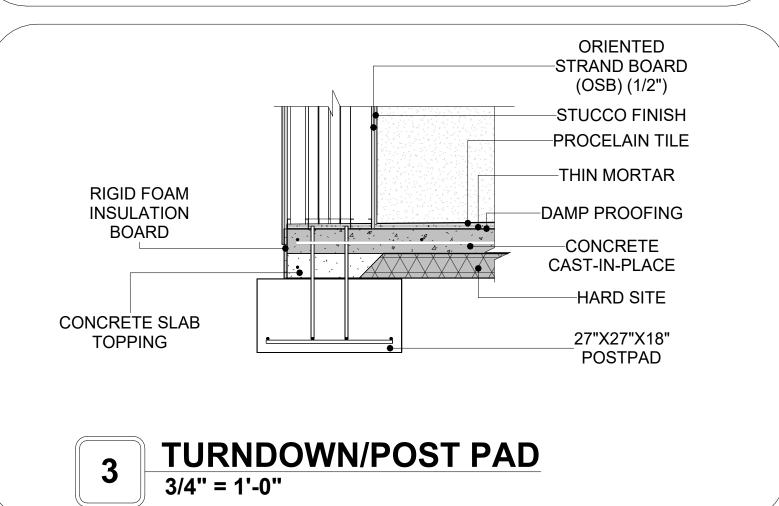

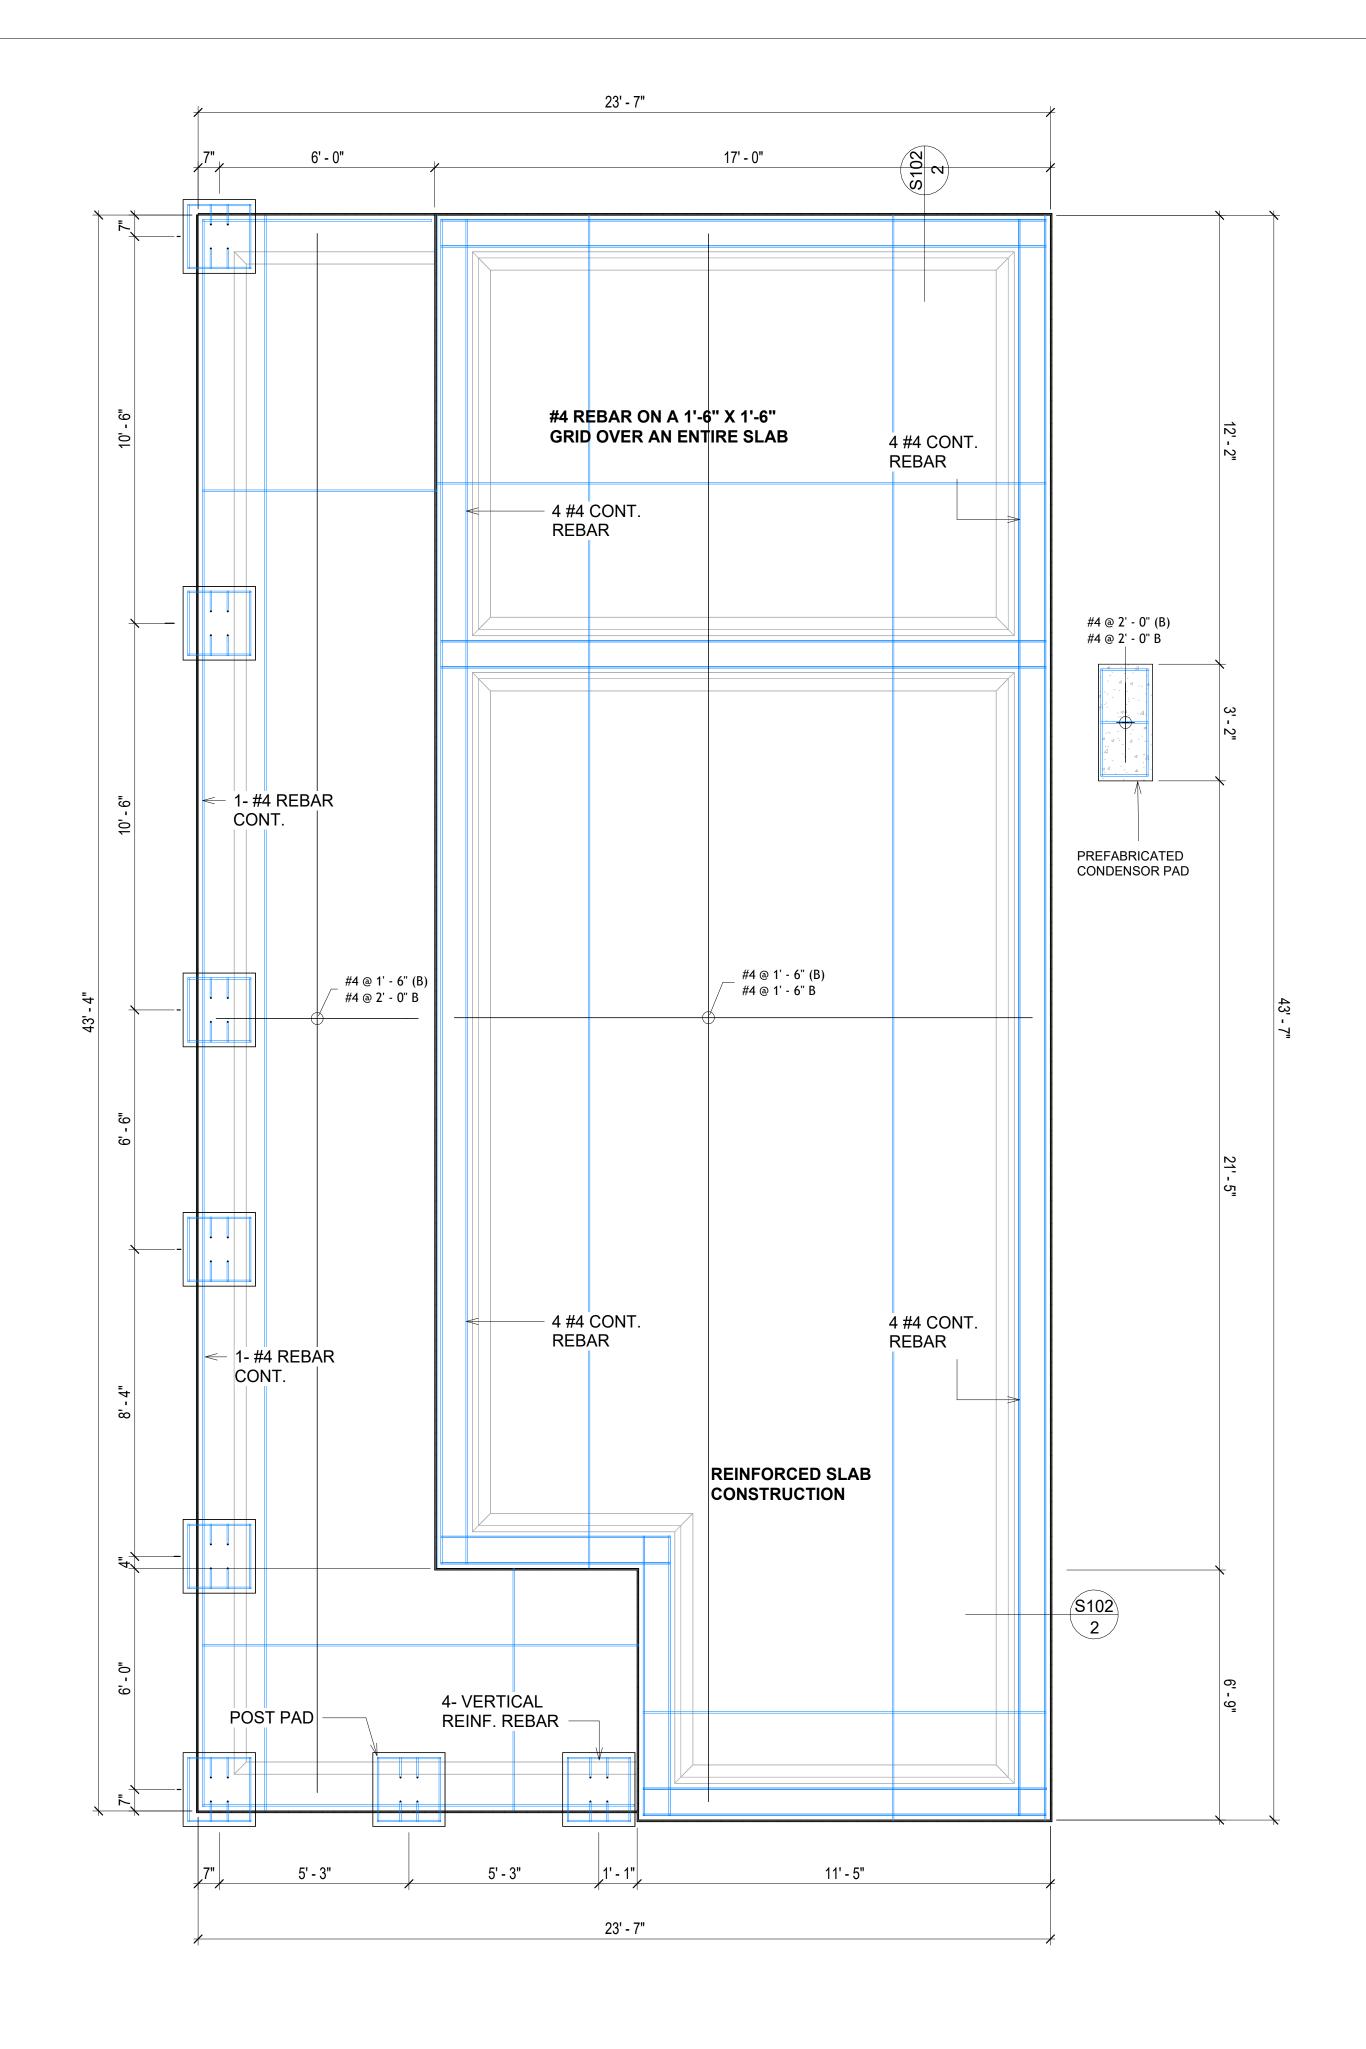

1 FOUNDATION REBAR PLAN
3/8" = 1'-0"



KEY PLAN

NO. DESCRIPTION DATE

NOTE:

LEGEND:

PROJECT

04 Wisdom 625 1Bd/1Ba Spanish 550

DRAWING NAME


STRUCTURAL FLOOR PLAN

CLIENT NAME:	Client Name
PROJECT NUMBER:	0059_12
DATE:	2/3/2025 9:35:33 AM
DESIGNED BY:	Designer
DRAWN BY:	Author
CHECKED BY:	Checker

S102

ROOF NOTES

- ROOFING COMPOSITION ROOFING PER OWNERS/BUILDERS SPECIFICATIONS INSTALL PER MANUFACTURE SPECIFICATIONS ON 1/2" ORIENTED STRAND BOARD ON PRE-ENGINEERED TRUSS @ 24" O.C. (UNO.)
- 2. 73" OVERHANG AT EAVES (UNO.)
- 3. ENDS OF ALL TRUSSES AND JOISTS TO BE FULLY BLOCKED. PROVIDE SOLID BLOCKING AT ALL RIDGES AND VALLEYS
- SHEATHING TO BE 1/2", 3/8" OSB SHEAR PANEL AND EQUIVALENT. UNDERSIDE OF PORCH TRUSSES TO BE FINISHED WITH MOISTURE RESISTANT DRYWALL, TAPED AND TEXTURED.
- EXPOSED EAVES AND OTHER WEATHER EXPOSED AREAS TO BE SHEATHED WITH
- EXTERIOR GRADE PLYWOOD.
- 6. ALL MATERIALS THICKNESS AND SIZE ARE THE MINIMUM. Refer TO LOCAL STANDARDS FOR ACTUAL THICKNESS AND LAYERING OF MATERIALS.
- ENGINEERED TRUSS CALCULATIONS TO BE SUBMITTED TO BUILDING DEPARTMENT PRIOR
- TO FABRICATION AND INSTALLATION. 8. TRUSS MANUFACTURER TO SPECIFY HANGER CONNECTORS FOR TRUSS COMPONENTS
- 9. DESIGNÉR ASSUMES THAT TRUSSES BEAR ON ALL EXTERIOR PERIMETER WALLS
- 10. PROVIDE GALVANIZED STEEL FLASHING WITH A LENGTH OF 10 FEET, WIDTH OF 12 INCHES, AND THICKNESS OF 24 GAUGE.

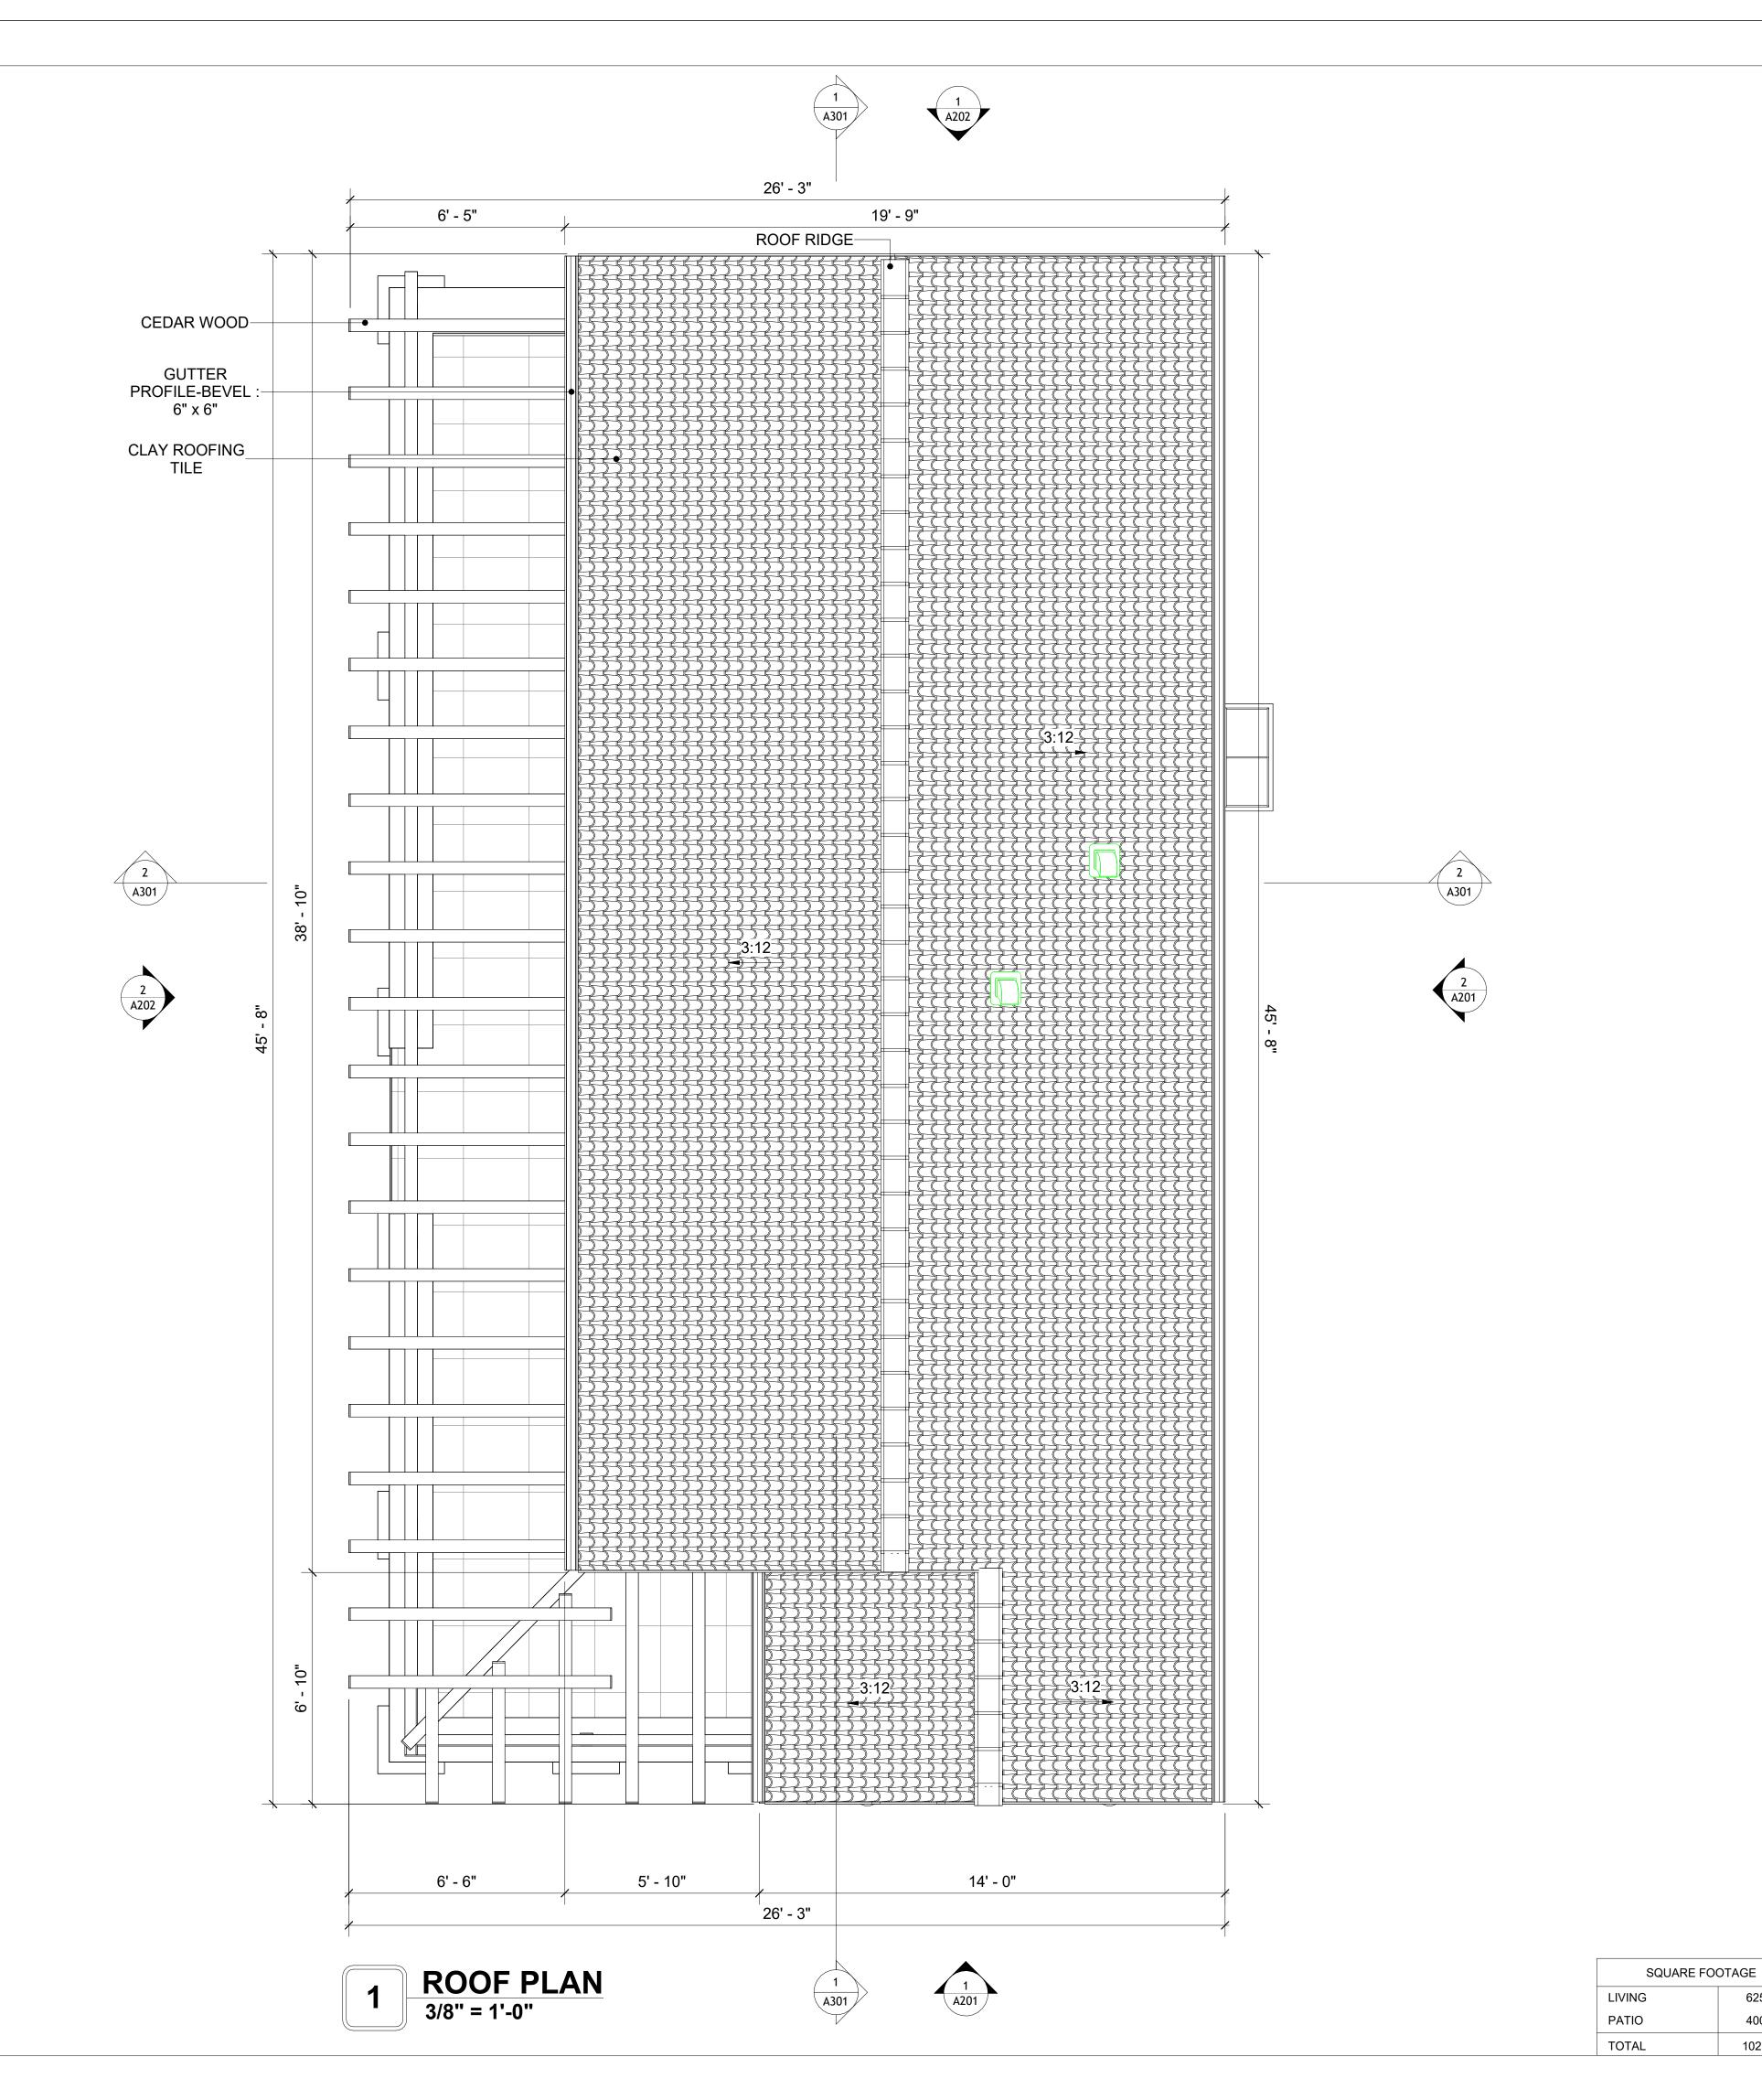



KEY PLAN

NO.	DESCRIPTION	DATE

LEGEND:

04 Wisdom 625 1Bd/1Ba Spanish **550**

DRAWING NAME

ROOF PLAN

CLIENT NAME:	Client Name
PROJECT NUMBER:	0059_12
DATE:	2/3/2025 9:35:36 AM
DESIGNED BY:	Designer
DRAWN BY:	Author
CHECKED BY:	Checker

A103

SCALE: As indicated

625

400

1025

ABOUT WALL FINISHING

STUCCO FINISH

STUCCO IS A CEMENT-BASED EXTERIOR WALL FINISH THAT OFFERS A DURABLE, WEATHER-RESISTANT, AND CUSTOMIZABLE CLADDING SOLUTION FOR BUILDINGS.

IN THIS SPECIFIC PROJECT, **AMERICAN STUCCO SYSTEMS** IS USED AS A FINISH MATERIAL BECAUSE IT IS GENERALLY CONSIDERED A WATER-RESISTANT EXTERIOR FINISH AND USES A THREE-COAT APPLICATION PROCESS.

3/8-INCH OF IT IS APPLIED AS AN EXTERNAL WALL FINISH AS IT IS THE MOST COMMON AND WIDELY ACCEPTED STANDARD THICKNESS FOR STUCCO EXTERIOR WALL FINISHES. THIS MULTILAYER APPROACH ALSO HELPS CREATE A STRONG, CRACK-RESISTANT STUCCO SURFACE.

THIS STANDARD STUCCO IS APPLIED OVER OSB SHEATHINGS (FOR COLD FORMED STRUCTURE CONSTRUCTION).

IT IS NOT DIRECTLY TROWELED OVER THE OSB BUT OVER A WATER-RESISTANT BARRIER (HOMEWRAP) AND METAL/PLASTIC LATH THAT ARE INSTALLED ON TOP SURFACE OF THE OSB TO PROVIDE AN ADDITIONAL LAYER OF PROTECTION AGAINST MOISTURE INTRUSION.


GRANITE COPPING

IN THIS SPECIFIC PROJECT, GRANITE COPPING IS USED ALONG THE EDGES OF THE PORCH TO PROVIDE A DURABLE, WEATHER-RESISTANT FINISH. THE STONE ADDS AN ELEGANT TOUCH WHILE PROTECTING THE PORCH FROM MOISTURE AND WEAR. ITS STRENGTH ENSURES LONG-LASTING PERFORMANCE AND ENHANCES THE OVERALL AESTHETIC.


CEDAR WOOD

CEDAR WOOD REFERS TO THE WOOD FROM VARIOUS SPECIES OF CEDAR TREES, WHICH ARE CONIFEROUS EVERGREEN TREES KNOWN FOR THEIR DISTINCT AROMA AND NATURAL RESISTANCE TO DECAY AND INSECTS.

IN THIS SPECIFIC PROJECT, CEDAR WOOD IS USED AS A FINISH MATERIAL ON BEAMS AND COLUMNS.

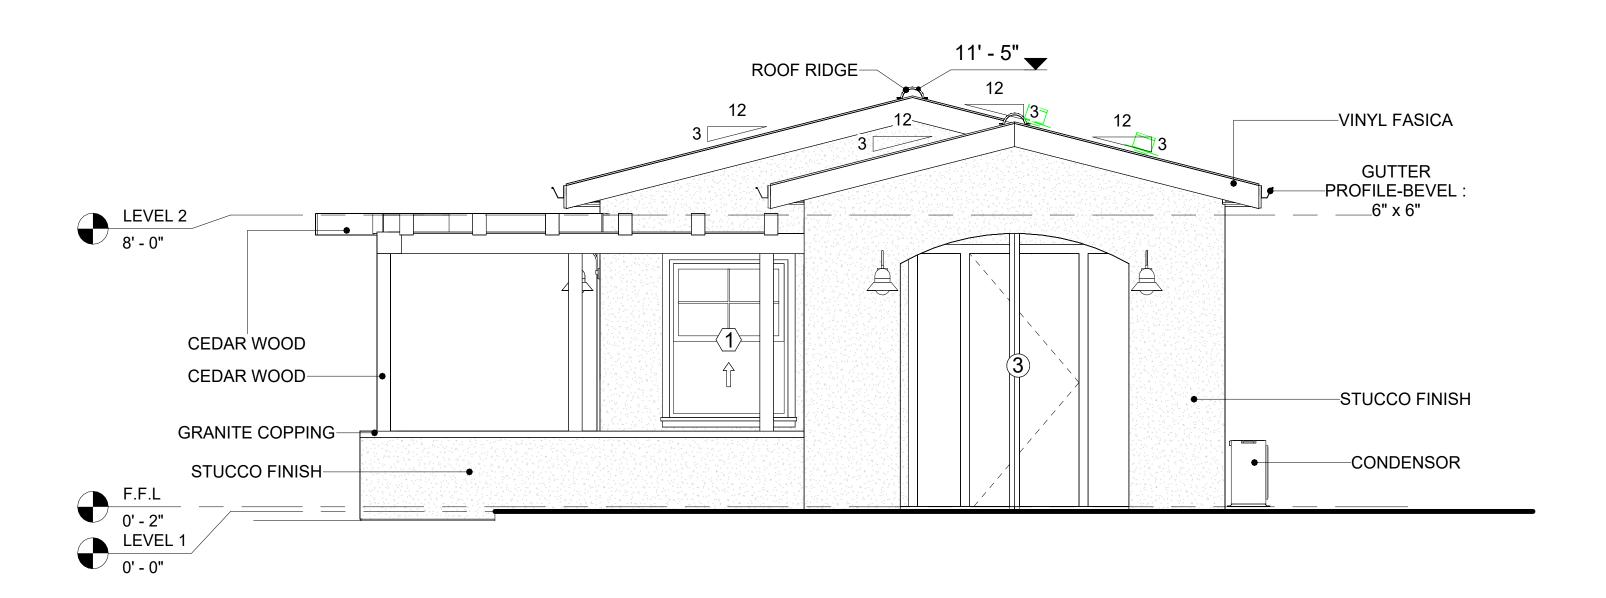

1 FRONT ELEVATION 3/8" = 1'-0"

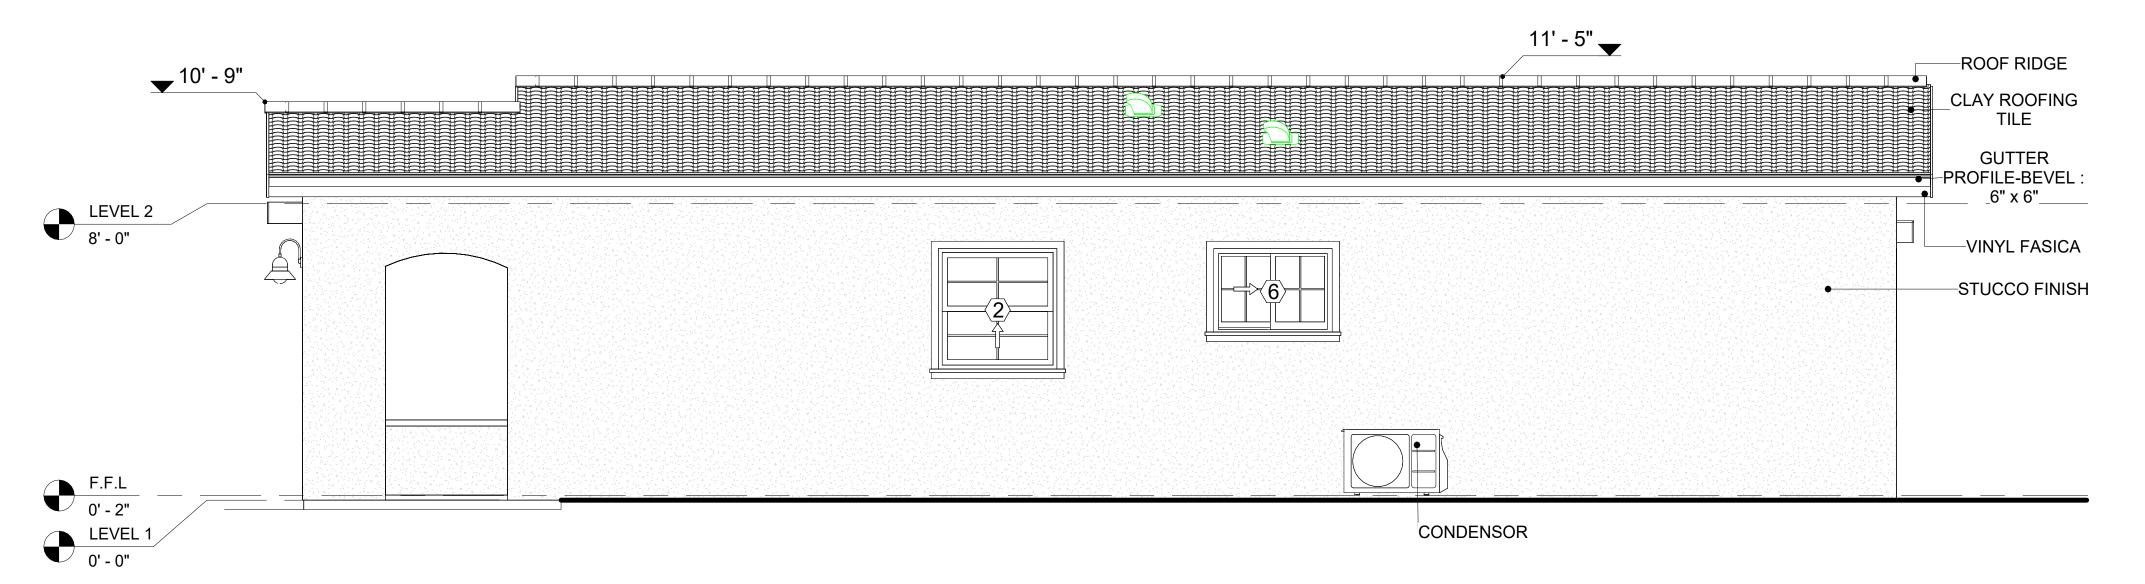


2 RIGHT SIDE ELEVATION
3/8" = 1'-0"

DOOR SCHEDULE						
WEY	Υ			SIZE		
ER	SUPPLIER	SUPPLIER DOOR TYPE LOCATION		WIDTH	HEIGHT	COUNT
1	HOME DEPOT	Interior Swinging	Interior	3' - 0"	6' - 8"	1
2	HOME DEPOT	Interior Swinging	Interior	2' - 4"	6' - 8"	1
3	HOME DEPOT	Front door w header and sidelights	Interior	3' - 0"	7' - 0"	1
4	HOME DEPOT	Interior Swinging	Interior	3' - 0"	6' - 8"	1
5	HOME DEPOT	Interior Sliding	Interior	7' - 8"	6' - 8"	1
6	HOME DEPOT	Interior Sliding	Interior	5' - 0"	6' - 8"	1
7	HOME DEPOT	Patio Sliding	Interior	5' - 0"	6' - 8"	1

WINDOW SCHEDULE					
			SIZE		
TYPE MARK	SUPPLIER	WINDOW TYPE	WIDTH	HEIGHT	COUNT
1	Home Depot	Single Hung	3' - 3"	4' - 3"	1
2	Home Depot	Single Hung	3' - 3"	3' - 3"	1
3	Home Depot	Sliding	6' - 3"	3' - 3"	1
4	Home Depot	Sliding	5' - 3"	3' - 3"	1
5	Home Depot	Sliding	3' - 3"	3' - 3"	2
6	Home Depot	Sliding	3' - 3"	2' - 3"	1



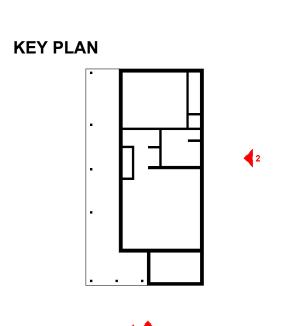

NO.	DESCRIPTION	DATE

INO

LEGEND:

PROJECT

04 Wisdom 625 1Bd/1Ba Spanish 550

DRAWING NAME

ARCHITECTURAL ELEVATIONS

CLIENT NAME:	Client Name
PROJECT NUMBER:	0059_12
DATE:	2/3/2025 9:35:40 AM
DESIGNED BY:	Designer
DRAWN BY:	Author
CHECKED BY:	Checker

A201

ABOUT WALL FINISHING

STUCCO FINISH

STUCCO IS A CEMENT-BASED EXTERIOR WALL FINISH THAT OFFERS A DURABLE, WEATHER-RESISTANT, AND CUSTOMIZABLE CLADDING SOLUTION FOR BUILDINGS.

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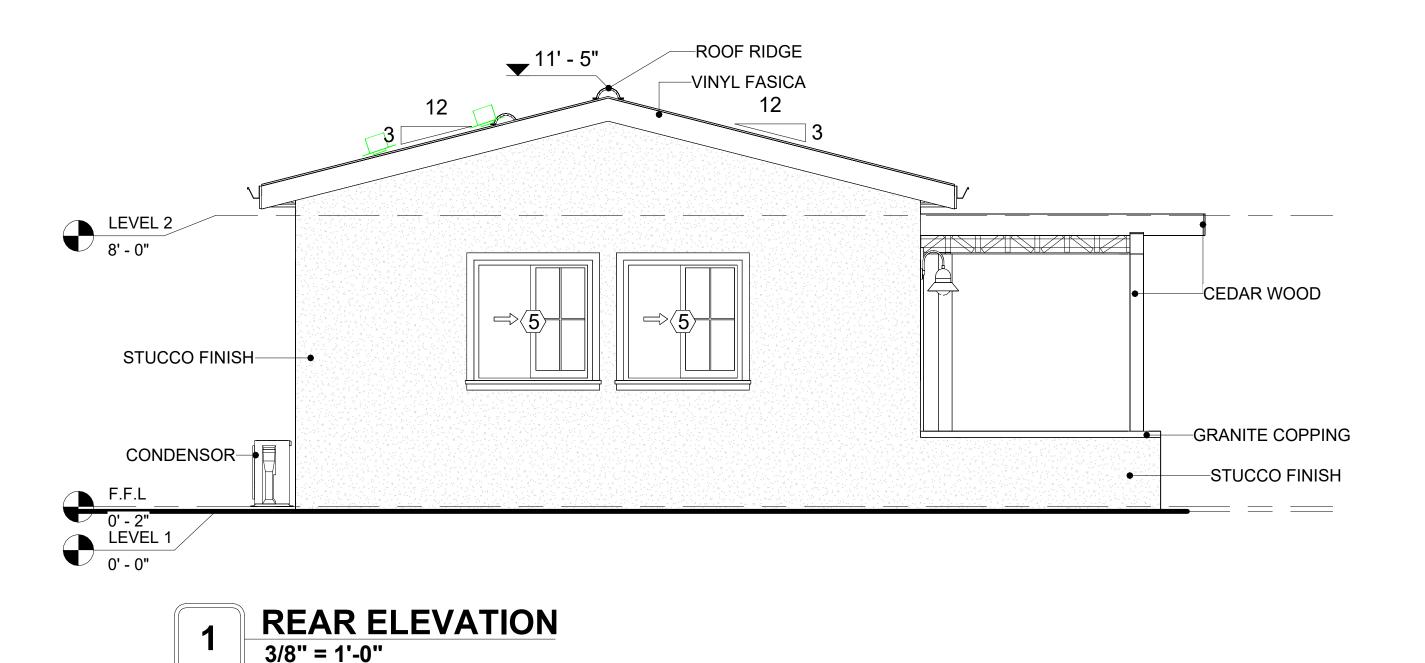
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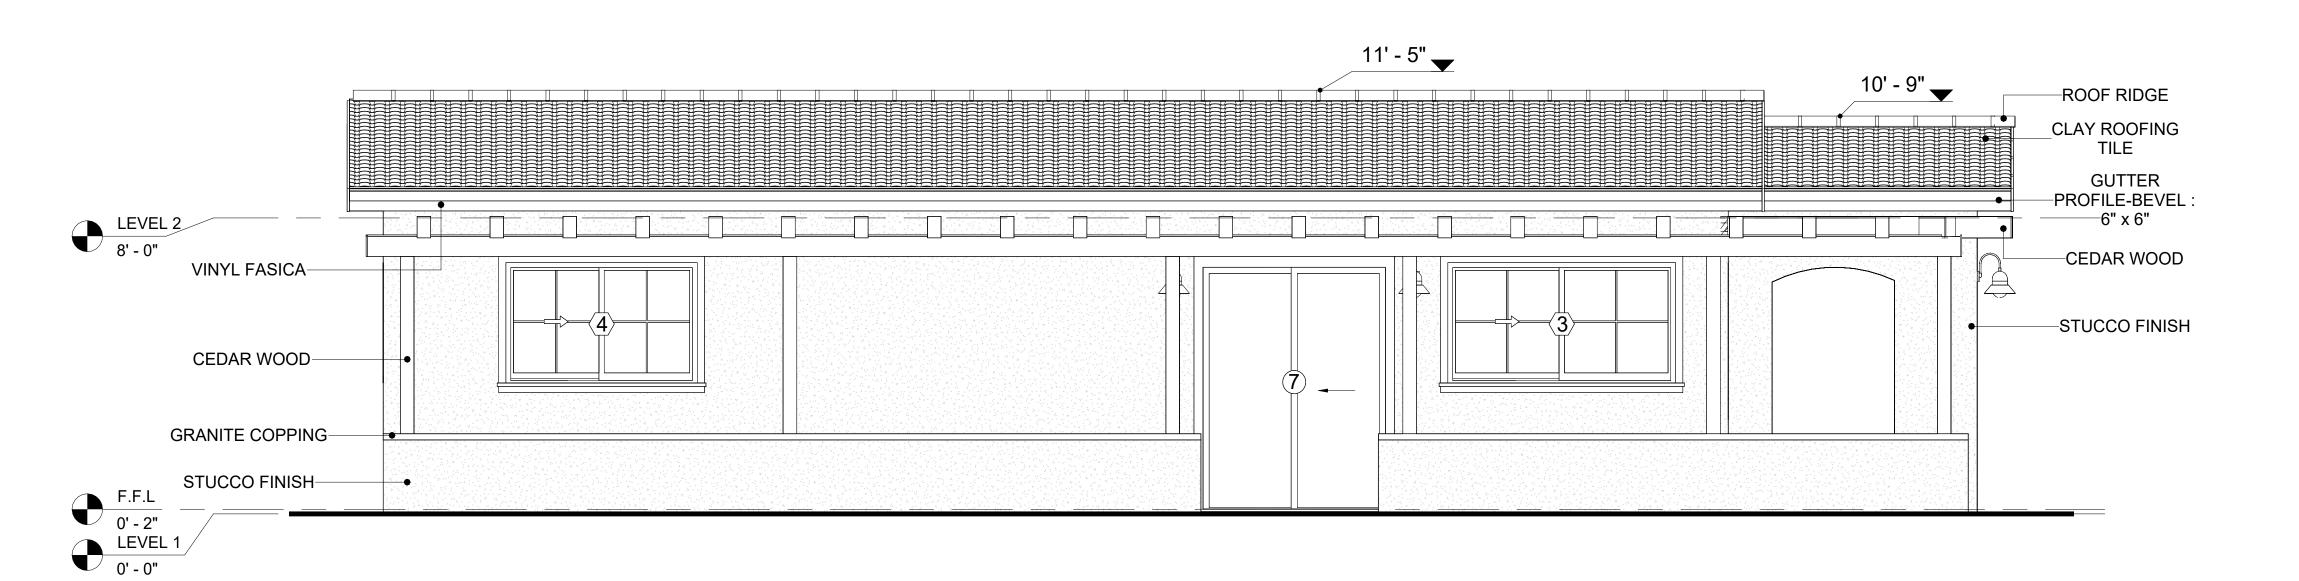
IN THIS SPECIFIC PROJECT, GRANITE COPPING IS USED ALONG THE EDGES OF THE PORCH TO PROVIDE A DURABLE, WEATHER-RESISTANT FINISH. THE STONE ADDS AN ELEGANT TOUCH WHILE PROTECTING THE PORCH FROM MOISTURE AND WEAR. ITS STRENGTH ENSURES LONG-LASTING PERFORMANCE AND ENHANCES THE OVERALL AESTHETIC.

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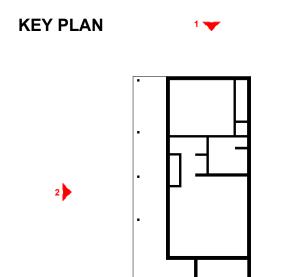
IN THIS SPECIFIC PROJECT, CEDAR WOOD IS USED AS A FINISH MATERIAL ON BEAMS AND COLUMNS.





2 LEFT SIDE ELEVATION
3/8" = 1'-0"





NO.	DESCRIPTION	DATE

NOTE:

LEGEND:

PROJECT


04 Wisdom 625 1Bd/1Ba Spanish 550

DRAWING NAME


ARCHITECTURAL ELEVATIONS

CLIENT NAME:	Client Name
PROJECT NUMBER:	0059_12
DATE:	2/3/2025 9:35:43 AM
DESIGNED BY:	Designer
DRAWN BY:	Author
CHECKED BY:	Checker

A202

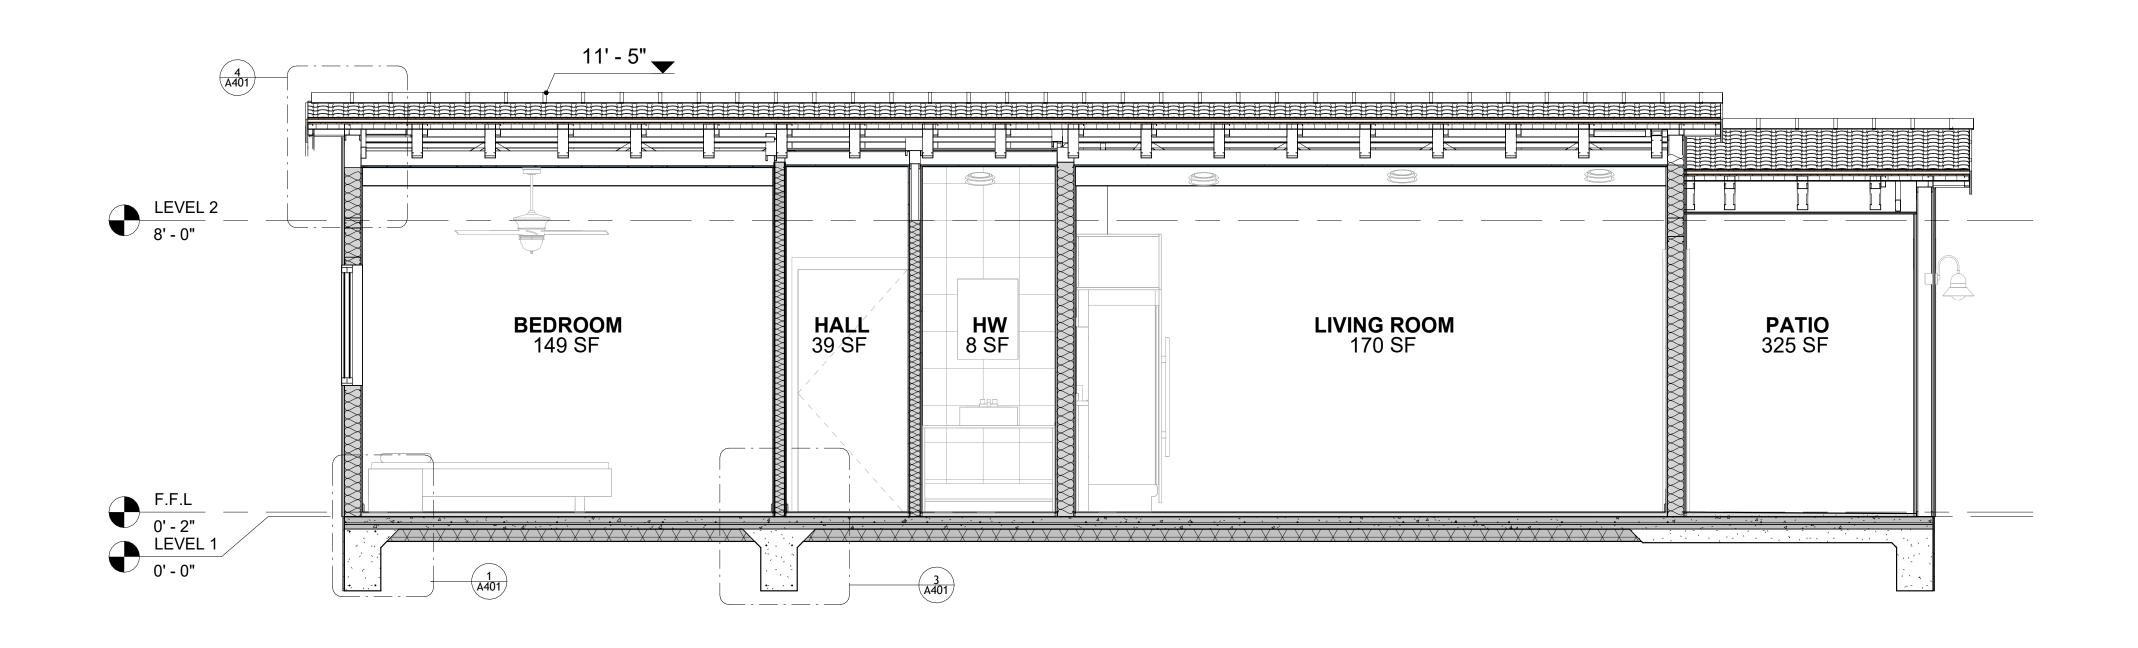


1 SECTION-1 3/8" = 1'-0"

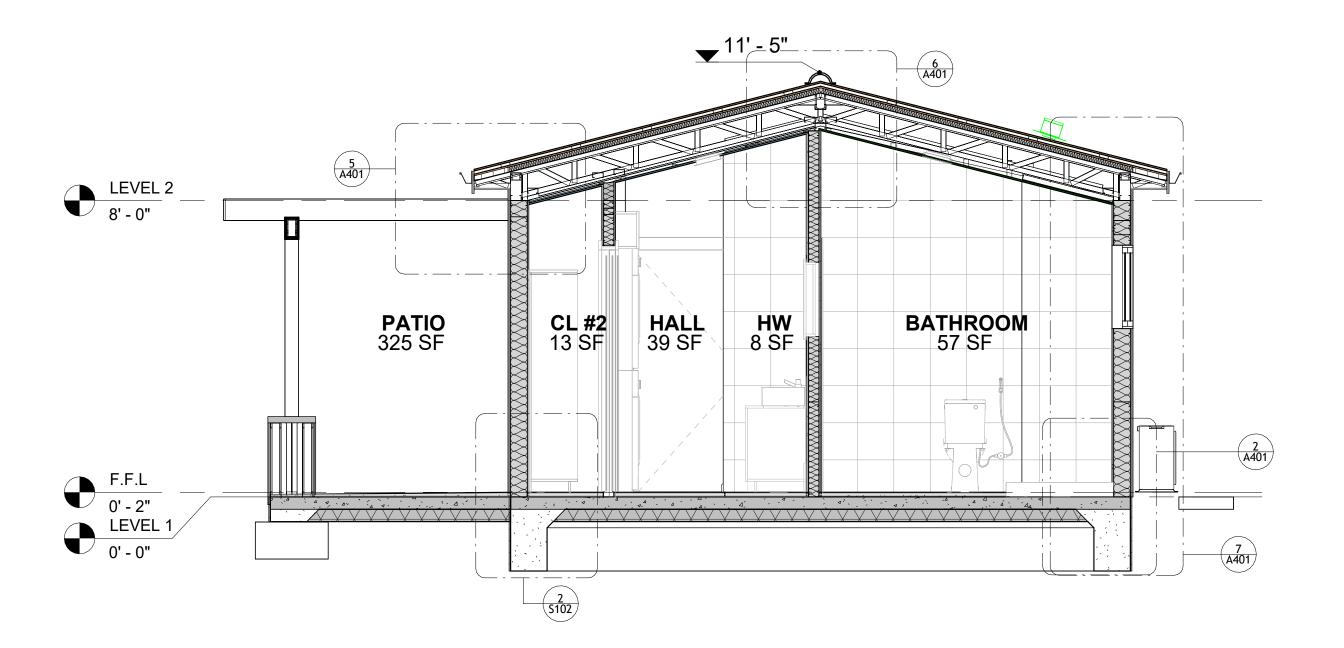

2 SECTION-2 3/8" = 1'-0"



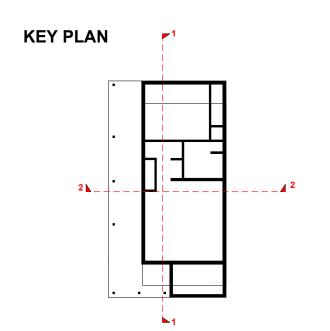

NO.	DESCRIPTION	DATE	

NOTE

LEGEND:

PROJECT


04 Wisdom 625 1Bd/1Ba Spanish 550


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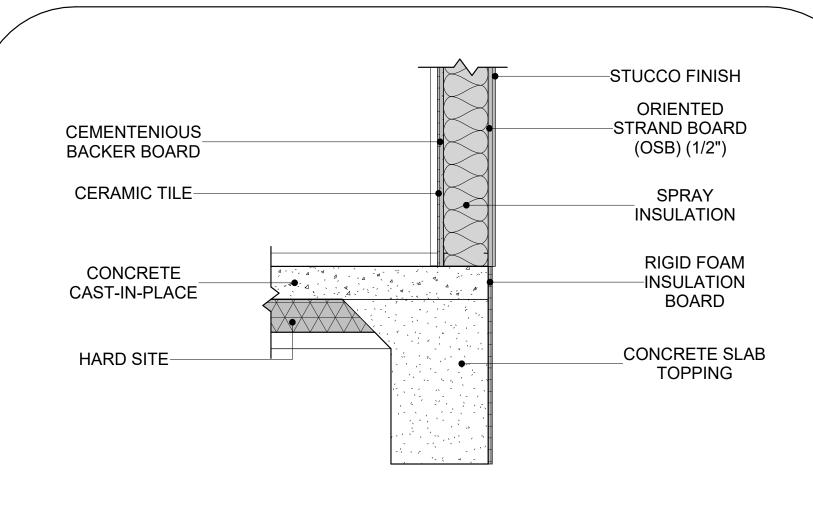
ARCHITECTURAL SECTIONS

CLIENT NAME:	Client Name
PROJECT NUMBER:	0059_12
DATE:	2/3/2025 9:35:45 AM
DESIGNED BY:	Designer
DRAWN BY:	Author
CHECKED BY:	Checker


A301




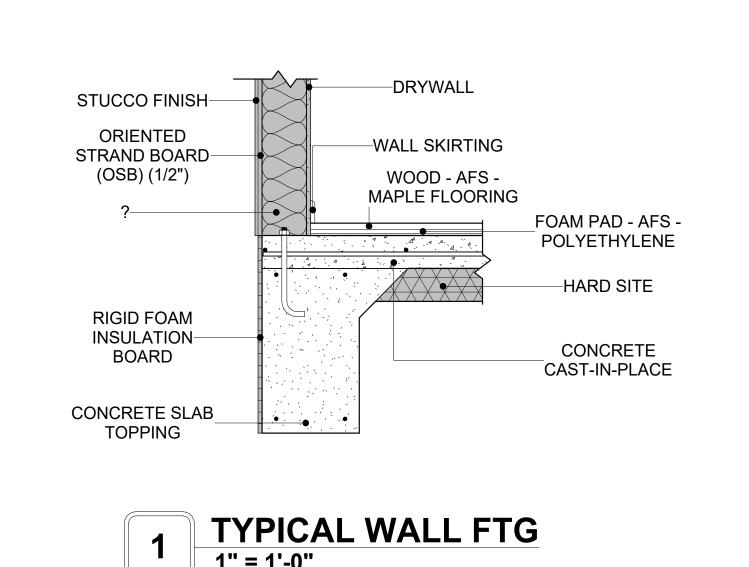


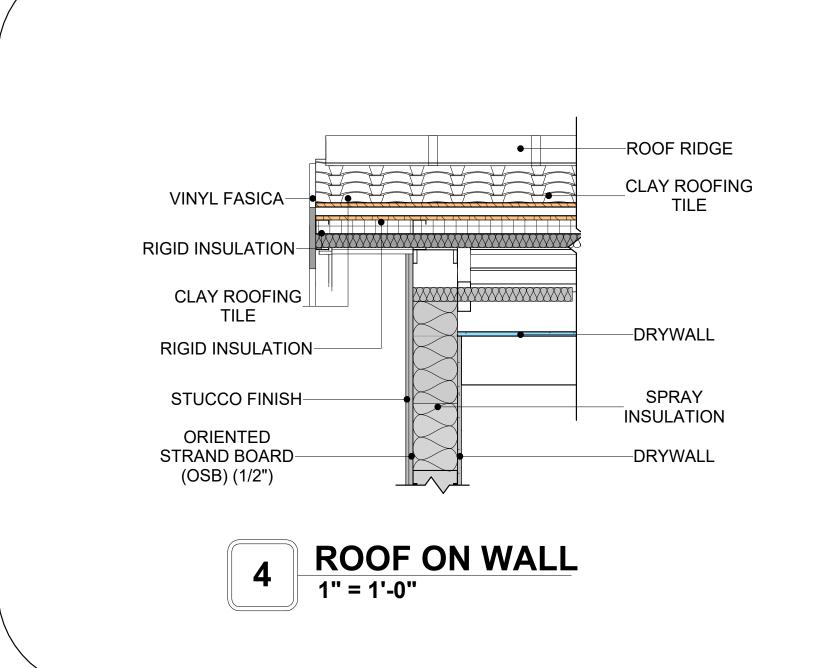




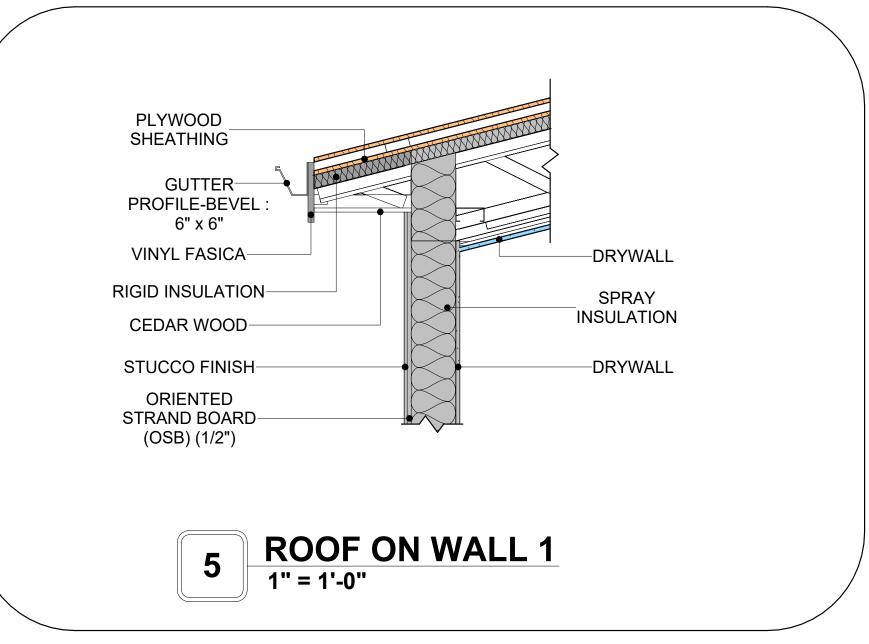

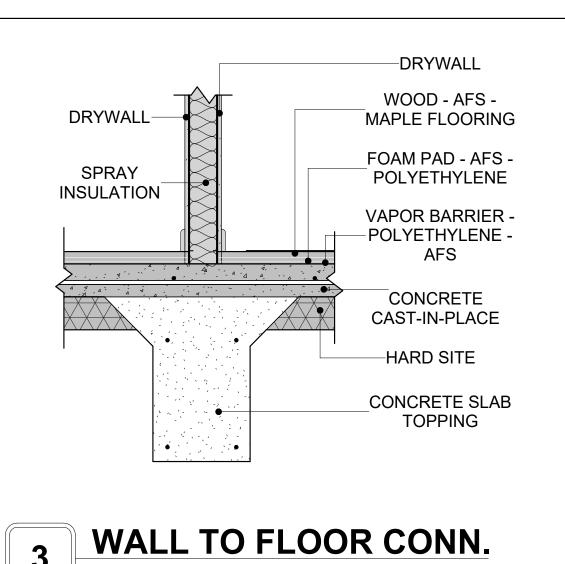

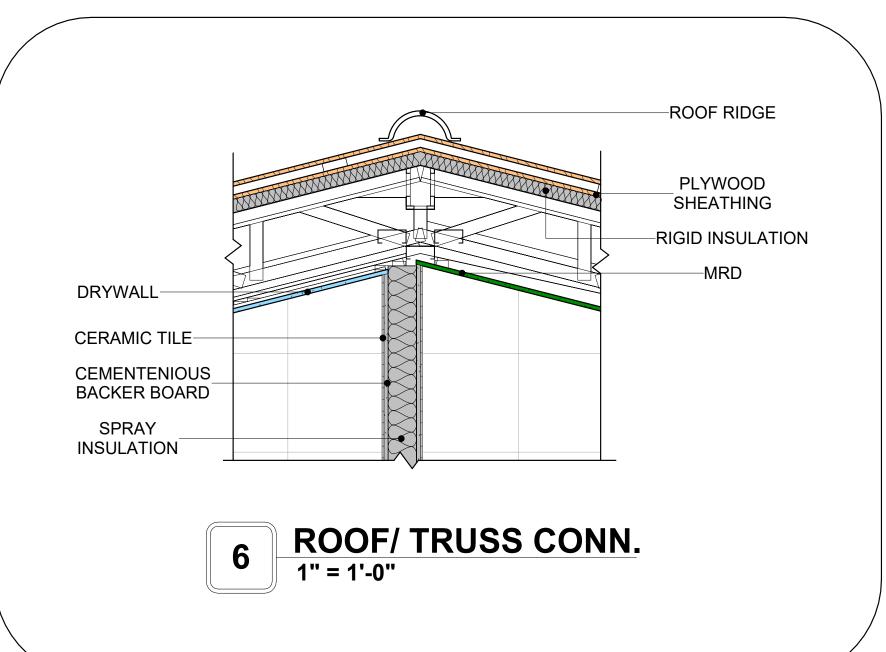

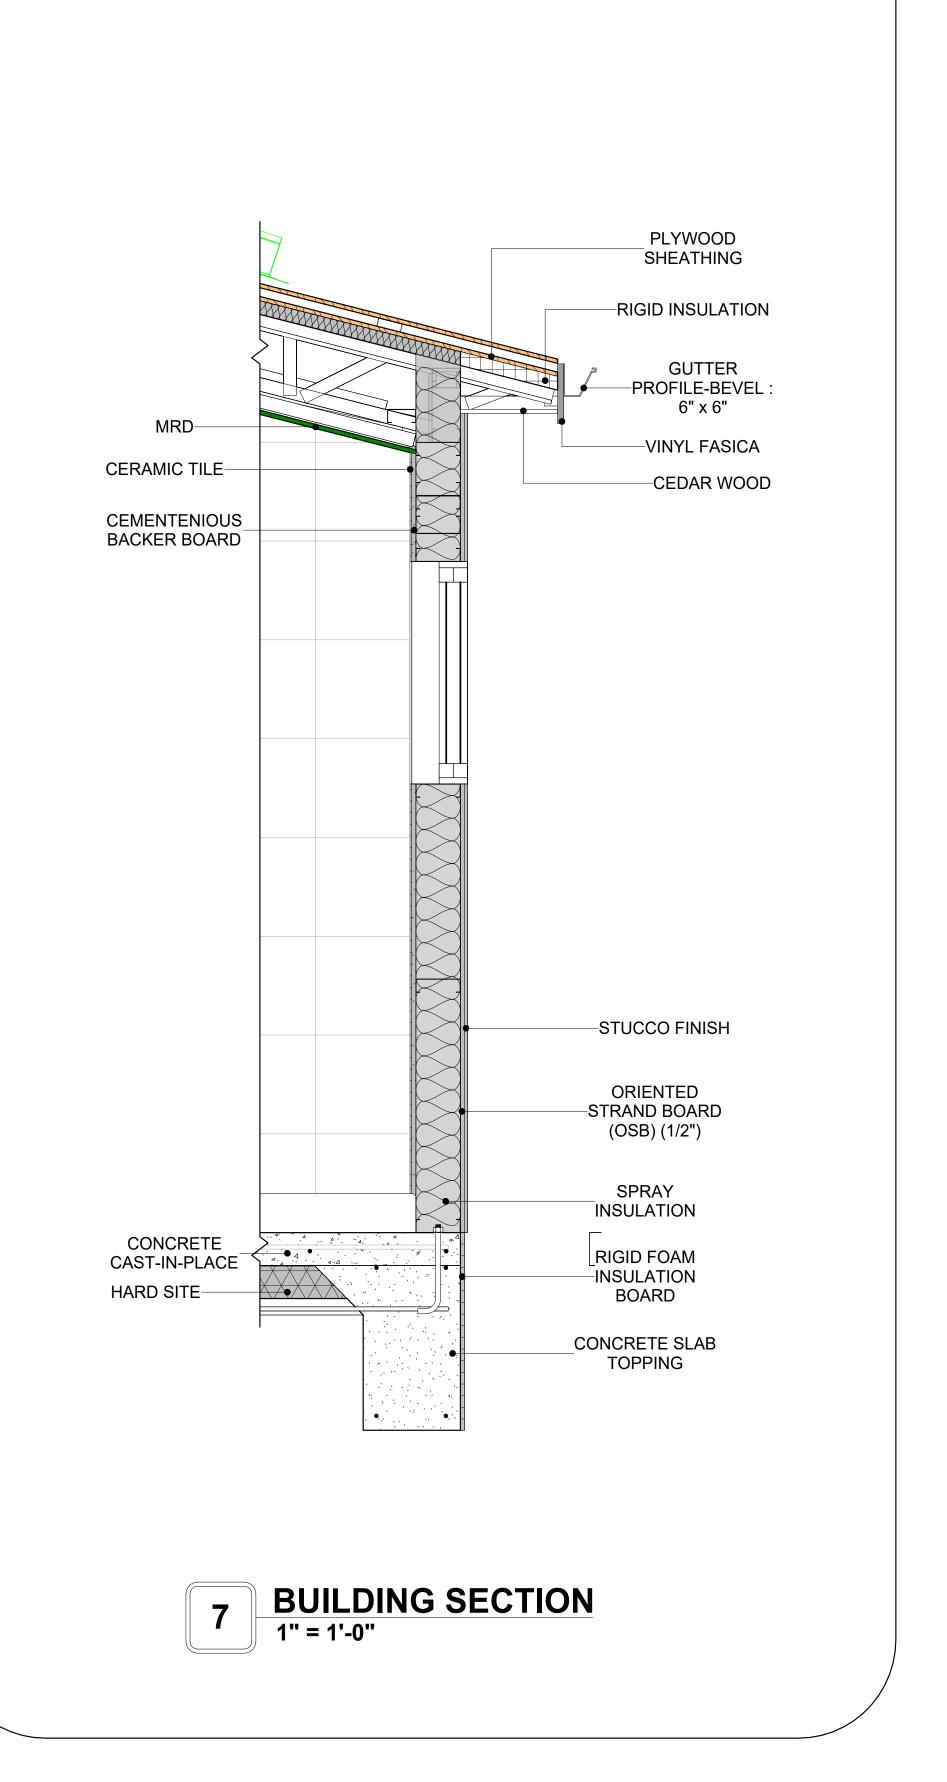



KEY PLAN

NO.	DESCRIPTION	DATE

NOTE:

PROJECT

04 Wisdom 625 1Bd/1Ba Spanish

DRAWING NAME 550

ARCHITECTURAL DETAILS

CLIENT NAME:	Client Name
PROJECT NUMBER:	0059_12
DATE:	2/3/2025 9:35:47 AM
DESIGNED BY:	Designer
DRAWN BY:	Author
CHECKED BY:	Checker

A401


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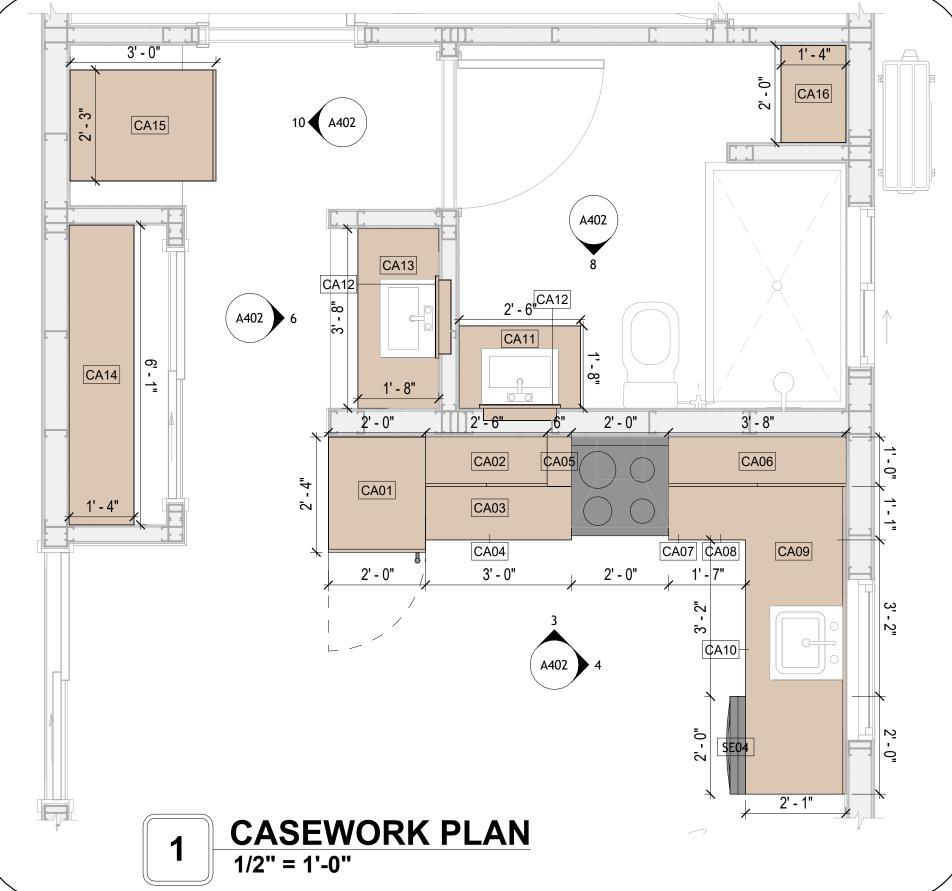
CASEWORK GENERAL NOTES


- ALL CABINET HEIGHTS INCLUDE COUNTERTOPS. DIMENSIONS ARE TO THE NEAREST INCH. DIVISIONS IN CASEWORK ARE SHOWN FOR CLARITY AND DO NOT REPRESENT BREAKS IN THE COUNTERTOP.
- PROVIDE CONTINUOUS COUNTERTOP OVER ALL SIMILAR HEIGHT CASEWORK, UNLESS AND
- MANUFACTURER AND CATALOG NUMBERS ARE FOR REFERENCE AND ILLUSTRATION PURPOSES
- DOTTED LINES INDICATE WALL HUNG CABINETS, DIVISIONS OF BASE CABINETS BELOW THE COUNTERTOP, FURNITURE NOT IN THE CONTRACT OR PROJECTION SCREENS -SEE CASEWORK KEY
- AND SPECIFICATIONS. ALL CABINETS AND DRAWERS TO HAVE CAM LOCKS EXCEPT FOR SINK BASE CABINETS. ALL EXPOSED SURFACES (EXPOSED TO VIEW FROM ANY PERSPECTIVE) TO BE COVERED WITH
- ALL CASEWORK WHICH MEETS A WALL AT ONE OR BOTH ENDS, TO BE PROVIDED WITH FILLER PANELS AND SCRIBED TO THE WALL(S) AS REQUIRED.
- 10. ALL CABINETS AND DRAWERS ARE PROVIDED WITH RECESSED HANDLES.
- 11. CONTRACTOR TO FIELD VERIFY ALL CLEAR OPENINGS PRIOR TO MILLWORK OR CASEWORK
- 12. CASEWORK DRAWINGS ARE DIAGRAMMATIC IN NATURE TO SHOW DESIGN INTENT.


	CASEWORK SCHEDULE						
TYPE MAR K	TYPE	COUN	HEIGHT	WIDTH	DEPTH	AREA	
01	LAUNDRY OPEN CABINET	1	1' - 6"	2' - 0"	2' - 4"	3 SF	
02	Wall Cabinet Double Door 2	1	2' - 6"	2' - 6"	1' - 0"	6 SF	
03	Linear Counter Top	1	0' - 4"	3' - 0"	2' - 1"	1 SF	
04	Base Cabinet Double Door 2	1	2' - 11"	3' - 0"	2' - 0"	9 SF	
05	Wall Filler	1	2' - 6"	0' - 6"	1' - 0"	1 SF	
06	Wall Cabinet Double Door 1	1	2' - 6"	3' - 8"	1' - 0"	9 SF	
07	Wall Filler	1	2' - 11"	0' - 5"	2' - 0"	1 SF	
08	Base Cabinet L-Shaped	1	2' - 11"	3' - 3"	3' - 3"	9 SF	
09	L-SHAPE COUNTER TOP	1	0' - 4"	7' - 0"	7' - 0"	2 SF	
10	Base Cabinet Double Door 1	1	2' - 11"	2' - 0"	2' - 0"	6 SF	
11	VANITY 2	1	2' - 4"	2' - 6"	1' - 8"	6 SF	
12	RECESSED_MED_CABINET	2	2' - 0"	1' - 6"	0' - 3"	3 SF	
13	VANITY 3	1	2' - 4"	3' - 8"	1' - 8"	8 SF	
14	Closet 1	1	6' - 0"	6' - 1"	1' - 4"	36 SF	
15	LAUNDRY OPEN CABINET 2	1	1' - 0"	2' - 3"	3' - 0"	2 SF	
16	Closet 3	1	7' - 6"	2' - 0"	1' - 4"	15 SF	
17	Closet 2	1	6' - 0"	8' - 4"	1' - 4"	50 SF	
Grand t	otal	18		•	,		

SPECIALTY EQUIPMENT SCHEDULE			
TYPE MARK	TYPE	COUNT	
01	WASHER-FRONT-LOAD	1	
02	REFRIGERATOR	1	
03	RANGE	1	
04	Dishwasher	1	
05	DRYER-FRONT-LOAD	1	
Grand total: 5	1	'	



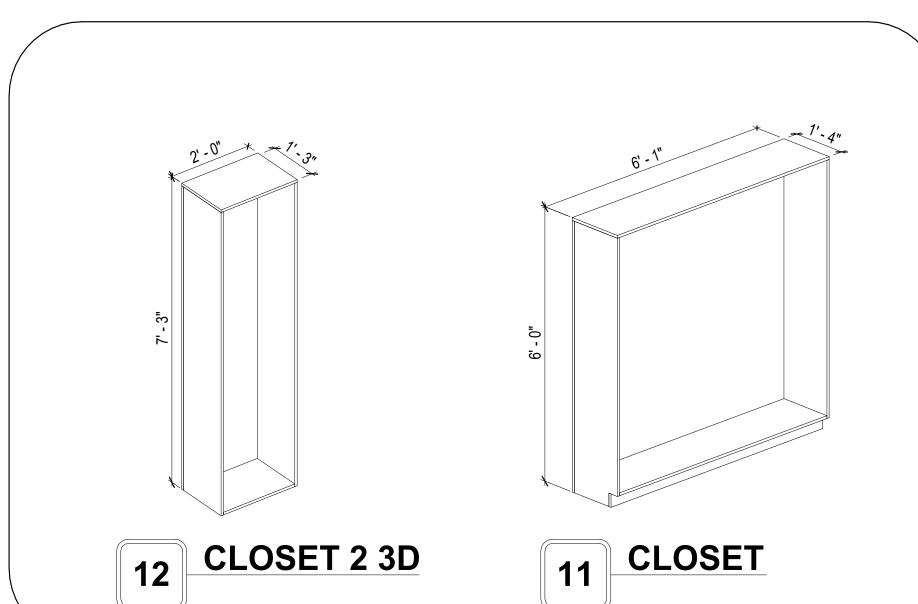

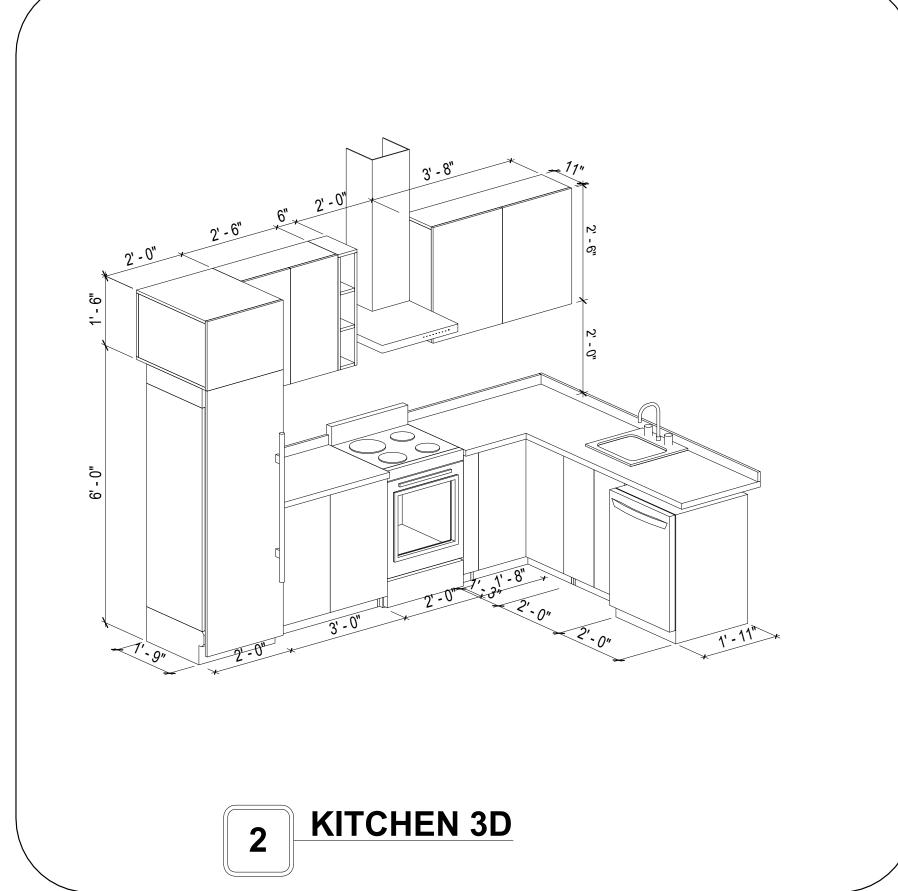

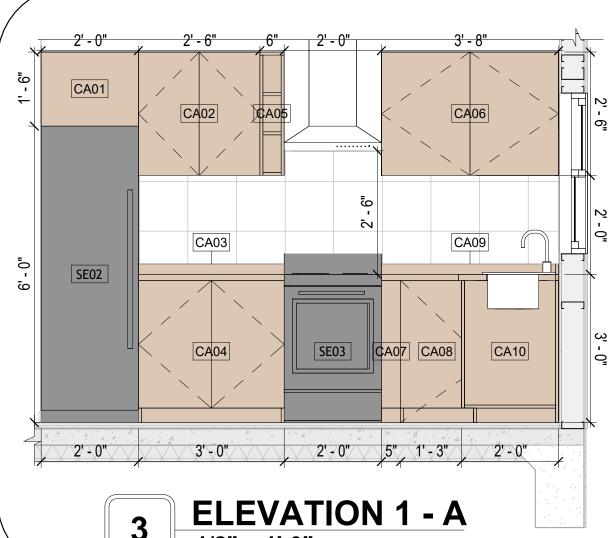

A402

04 Wisdom 625

1Bd/1Ba Spanish

550

ARCHITECTURAL

CASEWORK

Client Name

2/3/2025 9:35:49 AM

0059_12

Designer

Checker

Author

SCALE: As indicated

888-864-0184

KEY PLAN

NOTE:

LEGEND:

PROJECT

DRAWING NAME

CLIENT NAME:

DESIGNED BY:


DRAWN BY:

CHECKED BY:

PROJECT NUMBER:

inquire@frameupnow.com www.frameupnow.com

DESCRIPTION

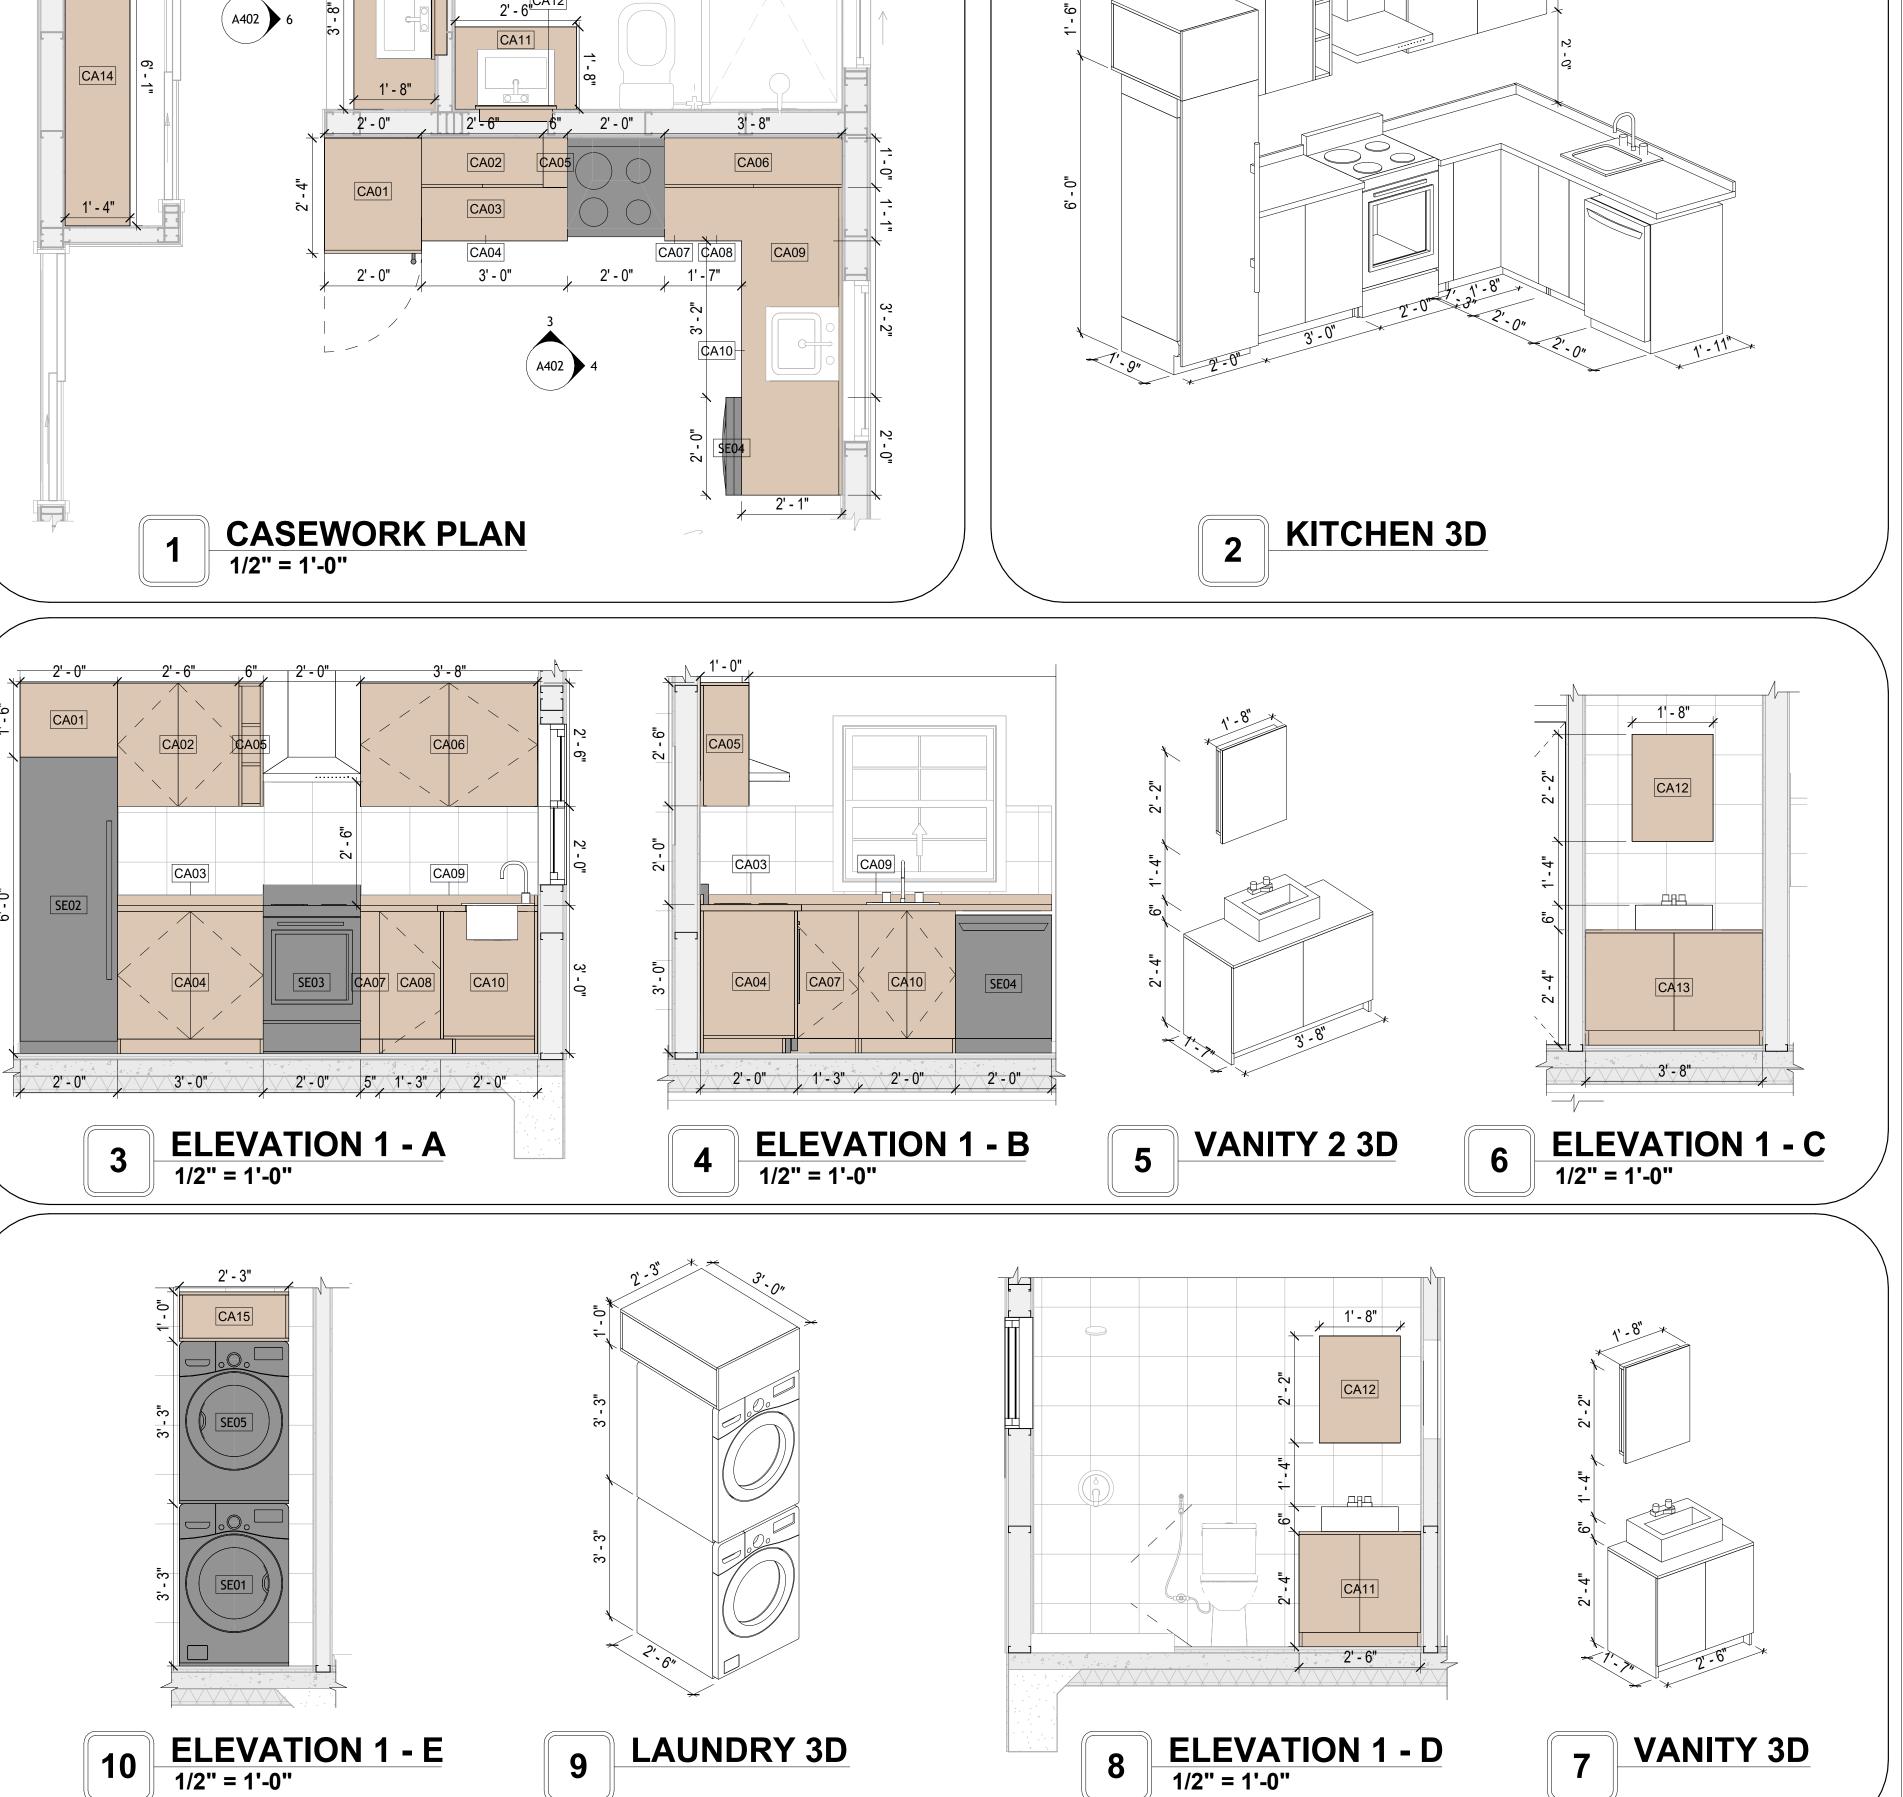



GENERAL NOTES

1. THIS DRAWING DEPICTS THE HVAC (HEATING, VENTILATION, AND AIR CONDITIONING) SYSTEM FOR THE WISDOM_TM_S_550. IT PROVIDES A VISUAL REPRESENTATION OF THE SYSTEM LAYOUT AND COMPONENTS.

2.THE HVAC SYSTEM IS DESIGNED TO MEET THE SPECIFIC REQUIREMENTS OF THE BUILDING, INCLUDING HEATING, COOLING, AND VENTILATION NEEDS, AS PER THE PROJECT SPECIFICATIONS AND APPLICABLE CODES AND STANDARDS.

3. THE HVAC SYSTEM INSTALLATION SHALL COMPLY WITH THE LATEST EDITION OF THE INTERNATIONAL MECHANICAL CODE (IMC), INTERNATIONAL RESIDENTIAL CODE (IRC), AND ALL OTHER APPLICABLE LOCAL, STATE, AND NATIONAL CODES AND REGULATIONS.

4. THE EQUIPMENT SHOWN ON THIS DRAWING INCLUDES BUT IS NOT LIMITED TO AIR HANDLING UNITS (AHUS), CHILLERS, BOILERS, COOLING TOWERS, PUMPS, DUCTWORK, DIFFUSERS, GRILLES, AND CONTROL DEVICES.

5. ALL EQUIPMENT, DUCTWORK, AND PIPING SHALL BE INSTALLED IN ACCORDANCE WITH MANUFACTURER'S SPECIFICATIONS, LOCAL CODES, AND

6. ALL DUCTWORK SHALL BE SIZED, FABRICATED, AND INSTALLED IN ACCORDANCE WITH THE LATEST EDITION OF THE ACCA MANUAL D AND THE SMACNA HVAC DUCT CONSTRUCTION STANDARDS. DUCTWORK SHALL BE INSTALLED IN A NEAT AND WORKMANLIKE MANNER, PROPERLY SUPPORTED AND BRACED TO PREVENT SAGGING, AIR LEAKAGE, OR VIBRATION.

7. CONDENSATE DRAINAGE PIPING SHALL BE PROPERLY PITCHED TO ENSURE POSITIVE DRAINAGE TO AN APPROVED DISPOSAL LOCATION, SUCH AS A FLOOR DRAIN, SUMP PUMP, OR EXTERIOR GRADE. CONDENSATE LINES SHALL BE INSULATED TO PREVENT SWEATING.

8. THE LOCATION OF CONTROL PANELS AND SENSORS INDICATED ON THIS DRAWING CAN BEMODIFY WITH THE SPECIFIC LOCATIONS AND WIRING

DETAILS WILL BE DETERMINED DURING THE CONTROL SYSTEM DESIGN AND INSTALLATION. 9. THE HVAC SYSTEM DESIGN CONSIDER ENERGY EFFICIENCY, INDOOR AIR QUALITY, OCCUPANT COMFORT, AND NOISE CONTROL, FOLLOWING

APPLICABLE GUIDELINES AND REGULATIONS. 10. COORDINATION WITH OTHER TREADS HAS BEEN DONE ON A DESIGN LEVEL. THIS DRAWING SHALL BE READ TOGETHER WITH THE AR, EL AND SN

DESIGN DRAWINGS TO ENSURE PROPER INSTALLATION AND INTEGRATION OF THE HVAC SYSTEMS.

11. THE HVAC CONTRACTOR IS RESPONSIBLE FOR OBTAINING ALL NECESSARY PERMITS AND LICENSES, AND FOR SCHEDULING AND COORDINATING WITH THE LOCAL BUILDING DEPARTMENT AND UTILITY PROVIDERS TO ENSURE A TIMELY AND COMPLIANT INSTALLATION.

12. ALL DUCTWORK PENETRATIONS THROUGH WALLS, FLOORS, OR CEILINGS SHALL BE PROPERLY SEALED AND FIRE-STOPPED USING APPROVED METHODS AND MATERIALS TO MAINTAIN THE INTEGRITY OF THE BUILDING'S FIRE-RESISTANCE RATINGS.


13. HVAC EQUIPMENT SHALL BE INSTALLED LEVEL AND PLUMB, AND IN STRICT ACCORDANCE WITH THE MANUFACTURER'S INSTALLATION INSTRUCTIONS AND RECOMMENDATIONS. PROVIDE ADEQUATÉ CLEARANCES AROUND EQUIPMENT FOR PROPER AIRFLOW, SERVICE ACCESS, AND CODE COMPLIANCE.


14. ALL HVAC EQUIPMENT AND COMPONENTS, INCLUDING THERMOSTATS, DAMPERS, AND ACCESS PANELS, SHALL BE LOCATED IN ACCESSIBLE AREAS FOR EASY SERVICING AND MAINTENANCE. PROVIDE ADEQUATE SPACE AROUND EQUIPMENT FOR PROPER AIRFLOW AND SERVICE ACCESS.

15. THE HVAC SYSTEM SHALL BE BALANCED AND ADJUSTED TO ENSURE PROPER AIRFLOW, TEMPERATURE DISTRIBUTION, AND SYSTEM PERFORMANCE THROUGHOUT THE RESIDENCE. PROVIDE A WRITTEN REPORT DOCUMENTING THE FINAL SYSTEM BALANCE.

16. ANY DEVIATIONS OR MODIFICATIONS TO THE HVAC SYSTEM DESIGN SHALL BE REVIEWED AND APPROVED BY THE RESPONSIBLE DESIGN PROFESSIONALS AND COMMUNICATED TO ALL RELEVANT PARTIES INVOLVED IN THE CONSTRUCTION PROCESS.

17. FOR ANY INQUIRIES OR CLARIFICATIONS REGARDING THE HVAC SYSTEM DESIGN, PLEASE CONSULT THE RESPONSIBLE DESIGN PROFESSIONALS OR THE PROJECT MANAGEMENT TEAM.

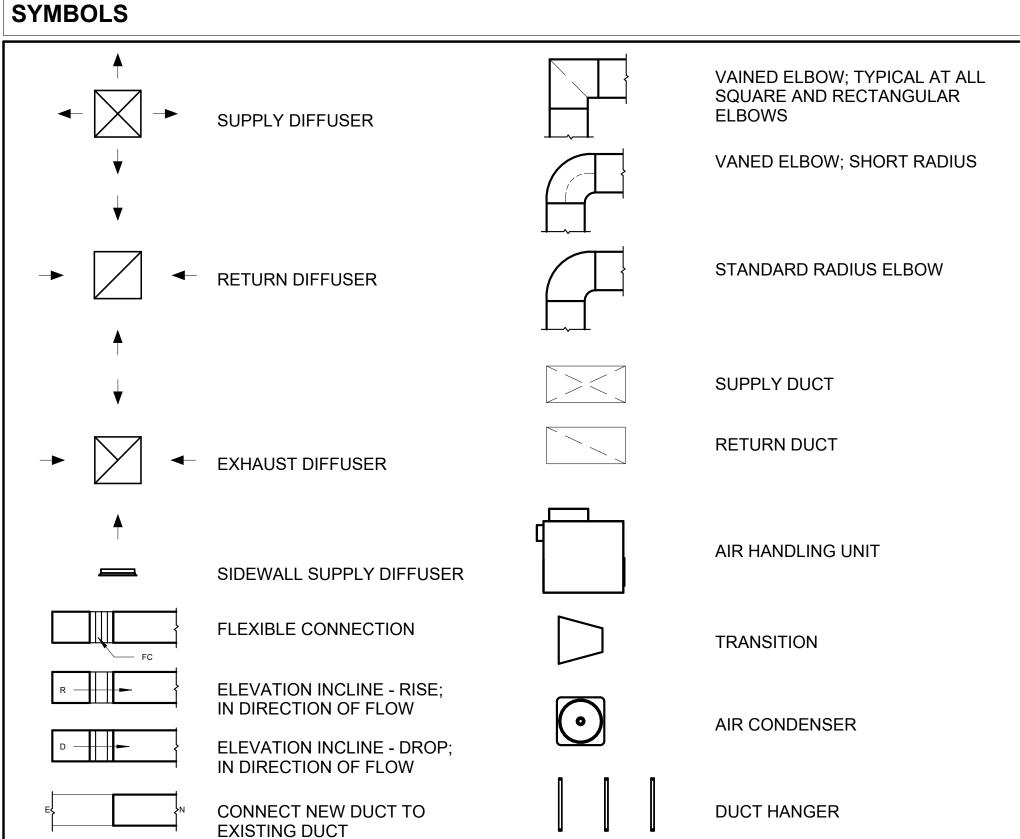

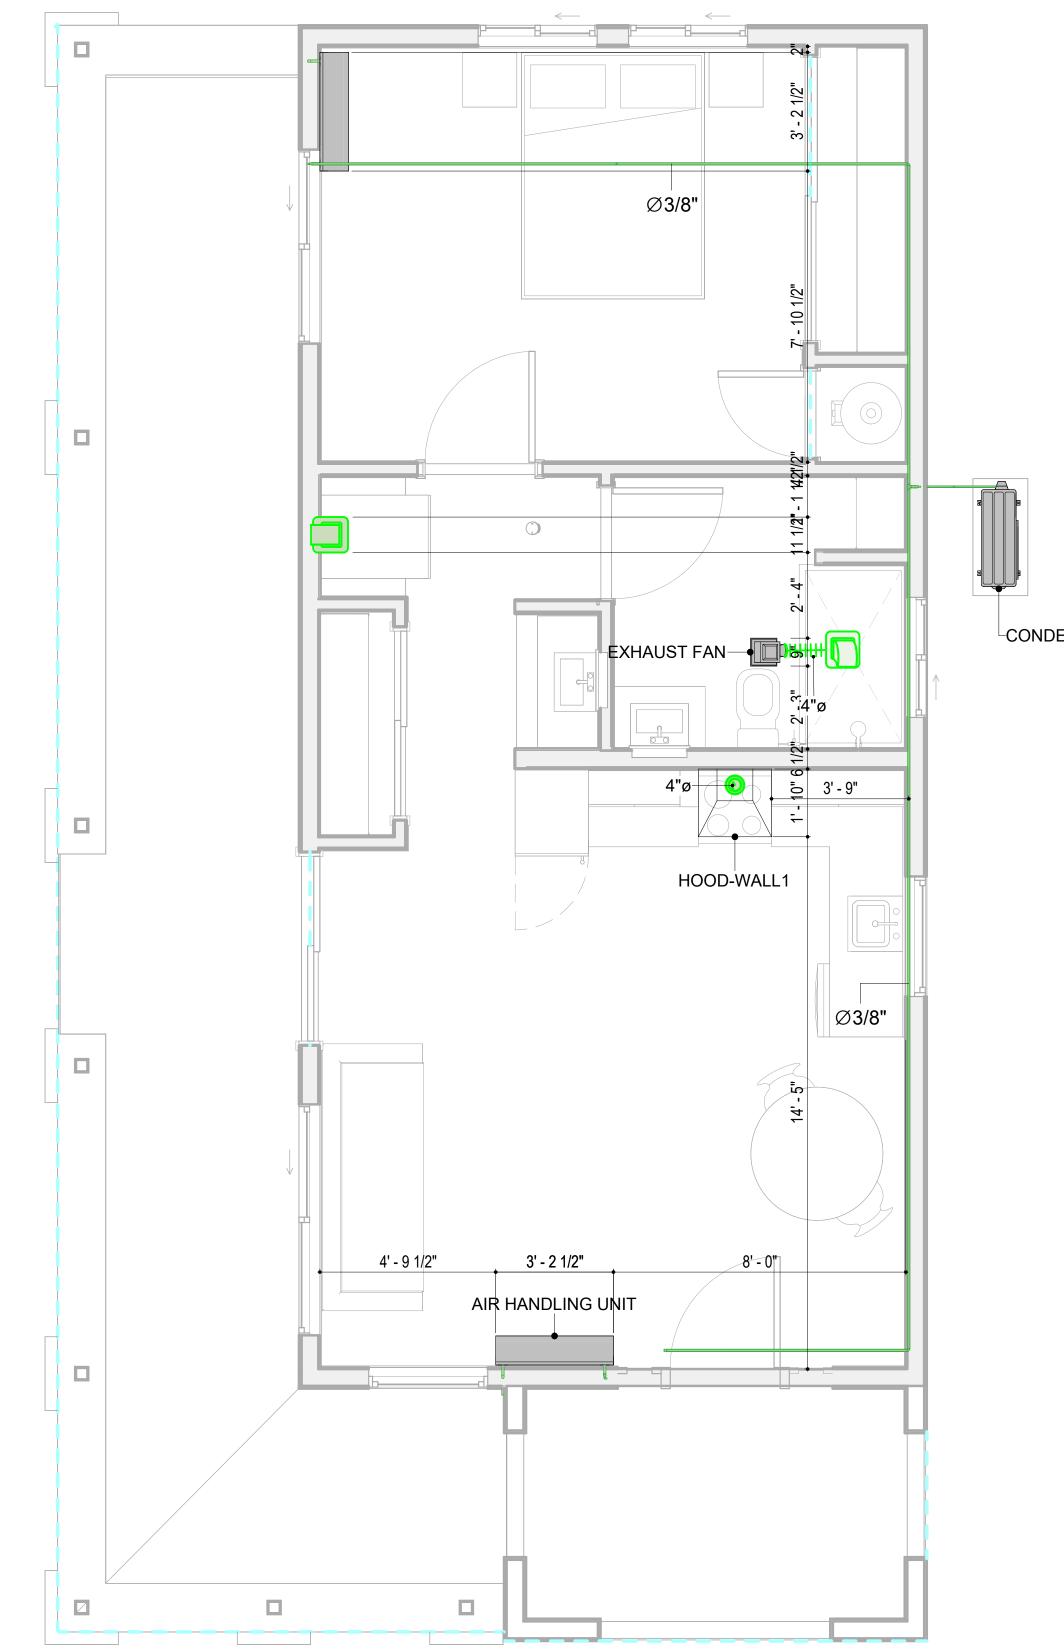

REFRIGERANT LINE SCHEDULE							
CATAGORY	CATAGORY DESCRIPTION DIAMETER LENGTH						
PIPE TYPES	COPPER	1/4"	2.19				
PIPE TYPES	COPPER	3/8"	72.14				
PIPE TYPES	COPPER	1/2"	2.26				
PIPE TYPES	<by category=""></by>	5/8"	0.24				
PIPE TYPES	COPPER	3/4"	84.98				

HVAC COLOR SCHEME

AIR CONDITIONING PIPE

LINE

CATAGORY	DESCRIPTION	Size	Count	
ELBOW - GENERIC	ELBOW - GENERIC: STANDARD/HVAC	1/2"ø-1/2"ø	2	
ELBOW - GENERIC	ELBOW - GENERIC: STANDARD/HVAC	1/4"ø-1/4"ø	2	
ELBOW - GENERIC	ELBOW - GENERIC: STANDARD/HVAC	3/4"ø-3/4"ø	16	
ELBOW - GENERIC	ELBOW - GENERIC: STANDARD/HVAC	3/8"ø-3/8"ø	13	
ELBOW - GENERIC	ELBOW - GENERIC: STANDARD/HVAC	5/8"ø-5/8"ø	1	
TEE - GENERIC	TEE - GENERIC: STANDARD	3/4"ø-3/4"ø-3/ 4"ø	1	
TEE - GENERIC	TEE - GENERIC: STANDARD	3/8"ø-3/8"ø-3/ 8"ø	1	
TRANSITION - GENERIC	TRANSITION - GENERIC: STANDARD	3/4"ø-1/2"ø	3	
RANSITION - GENERIC	TRANSITION - GENERIC: STANDARD	3/4"ø-5/8"ø	2	
TRANSITION - GENERIC	TRANSITION - GENERIC: STANDARD	3/8"ø-1/4"ø	1	

MECHANICAL EQUIPMENT SCHEDULE			
CATAGORY	COUNT		
AIR HANDLING UNIT	AIR HANDLING UNIT: WALL MOUNTED	5	
CONDENSER	CONDENSER: AOTH18KNTA 1		
EXHAUST FAN	EXHAUST FAN: 75 CFM 1		
	HOOD-WALL1: VENT 2		

DUCT FITTING SCHEDULE				
CATAGORY DESCRIPTION COUNT				
ROUND TRANSITION - ANGLE	45 DEGREE	5		

DUCT ACCESSORY SCHEDULE			
CATAGORY	DESCRIPTION	COUNT	
ROOF VENT	3" DIAMETER	3	

FLEX DUCT SCHEDULE					
DESCRIPTION	DESCRIPTION	LENGTH	DIAMETER	COUNT	
FLEX DUCT ROUND	FLEX-ROUND	8.90	4"	3	
GRAND TOTAL: 3		8.90			

HVAC PLAN 3/8" = 1'-0"



KEY PLAN

NO.	DESCRIPTION	DATE	

NOTE:

LEGEND:

PROJECT

04-Wisdom-625-1Bd-1Ba Spanish-550

DRAWING NAME

HVAC PLAN

CLIENT NAME:	Owner
PROJECT NUMBER:	15_0001
DATE:	1/31/2025 12:01:50 AM
DESIGNED BY:	Designer
DRAWN BY:	Author
CHECKED BY:	Checker
DATE: DESIGNED BY: DRAWN BY:	1/31/2025 12:01:50 A Designe

M101

ELECTRICAL NOTES

- 1. THIS DRAWING DEPICTS THE ELECTRICAL SYSTEM FOR THE 04_Wisdom_625_1Bd/Ba_Spanish_550. IT PROVIDES A VISUAL REPRESENTATION OF THE ELECTRICAL LAYOUT AND COMPONENTS, INCLUDING POWER DISTRIBUTION, LIGHTING, AND CONTROL SYSTEMS.
- 2. THE ELECTRICAL SYSTEM IS DESIGNED TO MEET THE SPECIFIC REQUIREMENTS OF THE BUILDING, INCLUDING POWER DISTRIBUTION, LIGHTING, AND SPECIALIZED ELECTRICAL EQUIPMENT NEEDS, AS PER THE PROJECT SPECIFICATIONS AND APPLICABLE CODES AND STANDARDS.
- 3. THE ELECTRICAL SYSTEM INSTALLATION SHALL COMPLY WITH THE LATEST EDITION OF THE NATIONAL ELECTRICAL CODE (NEC), INTERNATIONAL BUILDING CODE (IBC), AND ALL OTHER APPLICABLE LOCAL, STATE, AND NATIONAL CODES AND REGULATIONS.
- 4. LOCATIONS AS NEEDED, DEVICES ARE SHOWN ON PLANS IN APPROXIMATE IDEAL LOCATIONS, UNLESS SPECIFICALLY DIMMENSIONED.
- 5. OPEN WALLS AS NEEDED TO ALLOW FOR NEW ELECTRICAL INSTALLATIONS.
- 6. LABEL ALL CIRCUITS ON JUNCTION BOXES, RECEPTACLES, DATA, SMOKE DETECTOR, AND EQUIPMENT IN PANEL BOX.
- 7. INSTALL RACEWAY AS NEEDED FOR DDC, ACCESS CONTROL, LOW VOLTAGE WIRING & DATA.
- 8. RELABEL POWER, DATA & FIRE ALARM FOR ROOM #CHANGES.
- 9. VERIFY ALL CIRCUITS LABELED ON PRINT ARE CORRECT BEFORE WORKING ON THEM.
 10. NOTE ON SITE PLAN ALL CHANGES OR MISSING DETAIL TO BE INCORPORATED INTO THE MASTER PLAN.
- 11. DRAWINGS ARE DIAGRAMMATIC ONLY FOR THE PURPOSE OF SHOWING FIXTURE AND OUTLET LOCATIONS.
- 12. ELECTRICAL CONTRACTOR TO VERIFY SERVICE SIZE BY CALCULATION BASED UPON ACTUAL NAME PLATE RATINGS OF SELECTED EQUIPMENT.
- PLATE RATINGS OF SELECTED EQUIPMENT.

 13. VERIFY LOCATION OF SERVICE ENTRANCE WITH POWER COMPANY. PROVIDE UFER GROUND IN
- BUILDING FOUNDATION AT SERVICE ENTRANCE WITH POWER COMPANY. PROVIDE UPER GROUND IN
- 14. PROVIDE A MIN. OF 20 FEET OF ONE *4 BARE COPPER UFER WIRE EMBEDDED IN CONCRETE FOOTING AT THE SERVICE ENTRANCE LOCATION WHERE APPROVED BY LOCAL SERVICE PROVIDER.
- 15. PROVIDE WATERPROOF FIXTURES IN ALL HIGH MOISTURE AREAS (EXTERIOR, SHOWER AND TUB
- CEILINGS ETC.)
- 16. PROVIDE DEDICATED CIRCUITS TO EACH BATH, DEN, FAMILY ROOM, BEDROOM, LOFT, KITCHEN
- REFRIGERATOR, KITCHEN FREEZER DISHWASHER, AND ANY AREA/ITEM SPECIFIED BY OWNER.

 17. INCANDESCENT FIXTURES WITH OPEN OR PARTIALLY ENCLOSED LAMPS, PENDANT FIXTURES, AND LAMP HOLDERS ARE NOT PERMITTED IN CLOSETS.
- 18. ALL WORKMANSHIP AND MATERIALS TO CONFORM WITH THE 2015 IRC.
- 19. PROVIDE A MIN. OF 20 FEET OF ONE *4 BARE COPPER UFER WIRE EMBEDDED IN CONCRETE FOOTING AT THE SERVICE ENTRANCE LOCATION WHERE APPROVED BY LOCAL SERVICE PROVIDER.
- 20. PROVIDE A BONDING CONDUCTOR CONSISTING OF A MINIMUM OF ONE *4 BARE COPPER WIRE CONNECTING THE BUILDING'S METAL WATER PIPING SYSTEM TO THE SERVICE EQUIPMENT ENCLOSURE GROUNDING.

MAIN PANEL CALCS

ELECTRICAL CALCS	
LIGHT AND OUTLETS 625 @ 3W	1,875 W
3 APPLIANCE CIRCUITS	4,500 W
DRYER	2,000 W
WASHER	2,000 W
RANGE	5,000 W
WATER HEATER	5,000 W
REFRIG.	1,800 W
DISHWASHER & DISPOSAL	3000 W
TOTAL	25,175 W
FRIST 10,000 @ 100% REMAINDER @ 40% MINI. SPLIT UNITS	10,000 W 6,070W 10,000 W
TOTAL	26,070 W
26,070 W DIVIDED BY 240V = 10	09 AMPS TOTAL

(USE 200 AMP SERVICE)

ELECTRICAL ABBREVIATIONS LIST

1P AC ACLG ADO AFF AFF AFF AFF AFF AHU ALT AMP ANNUN AC ACLG AFF AFF AFF AFF ANNUN AC ACLG AMP ANNUN AC	1 POLE (2P, 3P, 4P, ETC.) AMPERE ABOVE COUNTER OR AIR CONDITIONER ABOVE CEILING AUTOMATIC DOOR OPENER AMP FRAME ABOVE FINISHED FLOOR ABOVE FINISHED GRADE ARC FAULT CIRCUIT INTERRUPTER AIR HANDLING UNIT ALUMINUM ALTERNATE AMPERE AMPLIFIER ANNUNCIATOR APPROX APPROXIMATELY AQUASTAT ARCHITECT, ARCHITECTURAL AMP SWITCH AMP TRIP AUTOMATIC TRANSFER SWITCH AUTOMATIC AUXILIARY AUDIO VISUAL AMERICAN WIRE GAUGE BATTERY BOARD BUILDING BUILDING BUILDING MANAGEMENT SYSTEM CONDUIT CABINET CATALOG CABLE TELEVISION CIRCUIT BREAKER CLOSED CIRCUIT TELEVISION CIRCUIT CEILING COMBINATION COMPRESSOR CONNECTION CONTINUATION OR CONTINUOUS CONTRACTOR CIRCULATING PUMP	CTR CU DCPT DIA DISCT DIA	CENTER COPPER DOMESTIC WATER CIRCULATING PUMP DEPARTMENT DETAIL DIAMETER DISCONNECT DISTRIBUTION DOWN DAMPER SAFETY DISCONNECT SWITCH DOUBLE THROW DRAWING DIRECT DIGITAL CONTROL ELECTRICAL CONTRACTOR ELECTRICAL CONTRACTOR ELECTRIC, ELECTRICAL ELEVATOR EMERGENCY ENERGY MANAGEMENT SYSTEM ELECTRICAL METALLIC TUBING ELECTRIC PNEUMATIC EQUIPMENT ELECTRIC WATER COOLER EXISTING EXHAUST EXPLOSION PROOF FIRE ALARM FIRE ALARM BOOSTER POWER SUPPLY PANEL FAN COIL UNIT FIXTURE FLOOR FLUORESCENT FUSE FUSED SAFETY DISCONNECT SWITCH GAUGE GALLON GALVANIZED GENERAL CONTRACTOR GENERATOR GROUND FAULT CIRCUIT INTERRUPTER GROUND FAULT PROTECTOR	HTG HTR HVAC GIMENT STATE STAT	HEIGHT HEATING HEATER HIGH VOLTAGE HEATING, VENTILATING AND AIR CONDITIONING HYDRONIC WATER PUMP INTERRUPTING CAPACITY ISOLATED GROUND INTERMEDIATE METAL CONDUIT INCANDESCENT INFRARED INTERLOCK WITH JUNCTION BOX KILOVOLT KILOVOLT-AMPERE KILOVOLT-AMPERE REACTIVE KILOWATT KILOWATT HOUR LOCATE OR LOCATION LIGHT LIGHTING LIGHTNING LOW VOLTAGE MAXIMUM MAGNETIC STARTER MOMENTARY CONTACT MECHANICAL CONTRACTOR MAIN CIRCUIT BREAKER MOTOR CONTROL CENTER MAIN DISTRIBUTION CENTER MAIN DISTRIBUTION PANEL MANUFACTURERMAIN FUSED DISCONNECT SWITCH MANHOLE MICROPHONE MINIMUM MISCELLANEOUS MAIN LUGS ONLY MANUAL MOTOR STARTER MULTIOUTLET ASSEMBLY MOTOR STARTER PANELBOARD MAIN SWITCHBOARD MOUNT
CONV CP	CONVECTOR CIRCULATING PUMP	GFP GND	GROUND FAULT PROTECTOR GROUND	MSBD MT	MAIN SWITCHBOARD MOUNT
CRT CT	CATHODE-RAY TUBE CURRENT TRANSFORMER	GRS GYP BD	GALVANIZED RIGID STEEL (CONDUIT) GYPSUM BOARD	MT.C UL	EMPTY CONDUIT UNDERWRITERS LABORATORIES

Branch Panel:

Location: LIVING ROOM 11
Supply From:
Mounting: Recessed

Enclosure: Type 1

Volts: 120/240 Single
Phases: 1
Wires: 3

A.I.C. Rating:
Mains Type:
Mains Rating: 200 A
MCB Rating: 1 A

Notes:

Circuit Description	Number of Elements	Rating	Length	Wire Size	A			В	Wire Size	Length	Rating	Number of Elements		Circui Numb er
BED / HALL LIGHT	13	15 A	48' - 10 9/16"	1-#14, 1-#14, 1-#14	616 VA	900 VA			1-#12, 1-#12, 1-#12	57' - 3 19/32"	15 A	5	RECEPTACLE	2
WATER HEATER	1	30 A	34' - 0 27/32"	2-#10, 1-#10, 1-#10			2250 VA	2500 VA	2-#10, 1-#10, 1-#10	29' - 8 29/32"	30 A	1	CONDENSER	4
					2250 VA	2500 VA								6
BATH GFCI	11	20 A	33' - 5 1/32"	1-#12, 1-#12, 1-#12			1115 VA	2500 VA	2-#10, 1-#10, 1-#10	43' - 8 23/32"	30 A	1	DRYER	8
WASHING MASHEIN	1	20 A	45' - 10 7/8"	1-#12, 1-#12, 1-#12	1200 VA	2500 VA								10
OUTDOOR LIGHT	6	15 A	35' - 2 15/32"	1-#14, 1-#14, 1-#14			400 VA	456 VA	1-#14, 1-#14, 1-#14	33' - 6 1/32"	15 A	10	LIV LIGHT	12
RIFRIGRATOR	1	20 A	31' - 5 15/16"	1-#12, 1-#12, 1-#12	180 VA	720 VA			1-#14, 1-#14, 1-#14	28' - 3 11/16"	15 A	4	RECEPTACLE	14
RANGE	1	40 A	25' - 11 1/16"	2-#8, 1-#8, 1-#10			2500 VA	1380 VA	1-#12, 1-#12, 1-#12	20' - 10 15/32"	20 A	2	HOOD/ DISHWASHER	16
					2500 VA	360 VA			1-#12, 1-#12, 1-#12	58' - 8 19/32"	20 A	2	OUTDOOR GFCI	18
														20
														22
														24
														26
					13725	VA	1308	B1 VA						-
\ \ \ \ \ \ \ \ \ \ \ \ \ \ \ \ \ \ \	WATER HEATER BATH GFCI WASHING MASHEIN OUTDOOR LIGHT RIFRIGRATOR RANGE	WATER HEATER 1 BATH GFCI 11 WASHING 1 OUTDOOR LIGHT 6 RIFRIGRATOR 1 RANGE 1	WATER HEATER 1 30 A BATH GFCI 11 20 A WASHING 1 20 A OUTDOOR LIGHT 6 15 A RIFRIGRATOR 1 20 A RANGE 1 40 A	WATER HEATER 1 30 A 34' - 0 27/32" BATH GFCI 11 20 A 33' - 5 1/32" WASHING 1 20 A 45' - 10 7/8" OUTDOOR LIGHT 6 15 A 35' - 2 15/32" RIFRIGRATOR 1 20 A 31' - 5 15/16" RANGE 1 40 A 25' - 11 1/16"	BED / HALL LIGHT 13 15 A 48' - 10 9/16" 1-#14, 1-#14 WATER HEATER 1 30 A 34' - 0 27/32" 1-#10, 1-#10	BED / HALL LIGHT 13 15 A 48' - 10 9/16" 1.#14, 1.#14 616 VA WATER HEATER 1 30 A 34' - 0 27/32" 1.#10, 1.#10 2250 VA BATH GFCI 11 20 A 33' - 5 1/32" 1.#12, 1.#12, 1.#12 WASHING 1 20 A 45' - 10 7/8" 1.#12, 1.#12, 1.#12 OUTDOOR LIGHT 6 15 A 35' - 2 15/32" 1.#14, 1.#14, 1.#14 RIFRIGRATOR 1 20 A 31' - 5 15/16" 1.#12, 1.#12, 1.#12 RANGE 1 40 A 25' - 11 1/16" 2.#8, 1.#8, 1.#10 2500 VA	BED / HALL LIGHT 13 15 A 48' - 10 9/16" 1-#14, 1-#14 616 VA 900 VA WATER HEATER 1 30 A 34' - 0 27/32" 2-#10, 1-#10, 1-#10, 1-#10 2250 VA 2500 VA BATH GFCI 11 20 A 33' - 5 1/32" 1-#12, 1-#12, 1-#12 WASHING 1 20 A 45' - 10 7/8" 1-#12, 1-#12 OUTDOOR LIGHT 6 15 A 35' - 2 15/32" 1-#14, 1-#14 RIFRIGRATOR 1 20 A 31' - 5 15/16" 1-#12, 1-#12 RANGE 1 40 A 25' - 11 1/16" 2-#8, 1-#8, 1-#10	BED / HALL LIGHT 13 15 A 48' - 10 9/16" 1.#14, 1.#14 616 VA 900 VA 2.#10, 1.#10, 1.#10 2.#10, 1.#10 2.#250 VA 2.#10, 1.#10, 1.#10 2.#10, 1.#10 2.#10, 1.#10 2.#10, 1.#10 2.#10, 1.#10 2.#10, 1.#12, 1.#12, 1.#12 2.#12, 1.#12 2.#12, 1.#12 2.#12, 1.#12 2.#12, 1.#12 2.#12, 1.#12 2.#12, 1.#12 2.#12, 1.#12 2.#12, 1.#12 2.#12, 1.#12 2.#12, 1.#12 2.#12, 1.#12 2.#12, 1.#12, 1.#12, 1.#12, 1.#14, 1.#14, 1.#14, 1.#14, 1.#14, 1.#14, 1.#14, 1.#14, 1.#14, 1.#14, 1.#12,	BED / HALL LIGHT 13 15 A 48' - 10 9/16" 1.#14, 1.#14 616 VA 900 VA 2250 VA 2500 VA	BED / HALL LIGHT 13 15 A 48' - 10 9/16" 1.#14, 1.#14 616 VA 900 VA 1.#12, 1.#12 2.#10, 1.#10, 1.#10 WATER HEATER 1 30 A 34' - 0 27/32" 1.#10, 1.#10, 1.#10	BED / HALL LIGHT 13 15 A 48' - 10 9/16" 1.#14, 1.#14 616 VA 900 VA 1.#12, 1.#12 57' - 3 19/32" 1.#10, 1.#10, 1.#10 2250 VA 2500 VA 2500 VA 1.#10, 1.#10, 1.#10 29' - 8 29/32" 1.#10, 1.#10 29' - 8 29/32" 1.#10, 1.#10 29' - 8 29/32" 1.#10, 1.#10 29' - 8 29/32" 1.#10, 1.#10 20 A 33' - 5 1/32" 1.#12, 1.#12 1115 VA 2500 VA 1.#10, 1.#10 43' - 8 23/32" 1.#12, 1.#12 1.#12 1.#12 1.#12 1.#12 1.#12 1.#12 1.#14	BED / HALL LIGHT 13 15 A 48' - 10 9/16' 1-#14, 1-#14, 1-#14, 1-#12, 15'' - 3 19/32'' 15 A 1-#12, 1-#	BED / HALL LIGHT 13 15 A 48'- 10 9/16' 1-#14, 1-#14, 1-#14 WATER HEATER 1 30 A 34'- 0 27/32' 1-#10, 2-#10, 1-#10,	BED / HALL LIGHT 13 15 A 48'-10 9/10" 1-#14, 1-#14 1-#14 1-#14 1-#14 1-#14 1-#14 1-#14 1-#14 1-#14 1-#14 1-#14 1-#14 1-#14 1-#14 1-#14 1-#14 1-#16 1-#14 1-#16 1-#14 1-#16 1-#

	Lege
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Load Classification	Connected Load	Demand Factor	Estimated Demand	Panel	Totals
LIGHTING - DWELLING UNIT	600 VA	100.00%	600 VA		
OTHER	1000 VA	100.00%	1000 VA	Total Conn. Load:	26806 VA
RECEPTACLE	5640 VA	100.00%	5640 VA	Total Est. Demand:	25806 VA
LIGHTING	100 VA	100.00%	100 VA	Total Conn.:	112 A
CONDENSER	5000 VA	100.00%	5000 VA	Total Est. Demand:	108 A
WATER HEATER	4500 VA	100.00%	4500 VA		
RANGE	5000 VA	80.00%	4000 VA		
DRYER	5000 VA	100.00%	5000 VA		



KEY PLAN

NO.	DESCRIPTION	DATE

NOTE:

LEGEND:

PROJECT

04-Wisdom-625-1Bd/1Ba Spanish-550

DRAWING NAME

SCHEDULE

CLIENT NAME:	Owner
PROJECT NUMBER:	0059_12
DATE:	1/31/2025 2:53:57 PM
DESIGNED BY:	Designer
DRAWN BY:	Author
CHECKED BY:	Checker

E101

SCALE: 1/4" = 1'-0"

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ELECTRICAL NOTE

- A. PROVIDE INTERCONNECTED SMOKE ALARMS IN EACH SLEEPING ROOMS, OUTSIDE EACH SLEEPING ROOM, ON EACH STORY, IN THE HALL OR ADJACENT ROOM LUHERE THE CEILING HEIGHT OF A ROOM OPEN TO THE HALL EXCEEDS THE HALL BY 24'. SMOKE ALARMS SHALL BE PERMANENTLY HARD WIRED WITH BATTERY BACKUP.
- B. RECEPTACLE OUTLETS FOR RANGES AND CLOTHES DRYERS SHALL BE A THREE POLE WITH GROUND TYPE. FOUR WIRE GROUNDING-TYPE FLEXIBLE CORDS WILL BE REQUIRED FOR CONNECTION OF RANGES AND CLOTHES DRYERS. THE BONDING JUMPER SHALL NOT BE CONNECTED BETWEEN NEUTRAL TERMINAL AND THE FRAME OF THE APPLIANCE.
- C. TWO OR MORE 20 AMP SMALL APPLIANCE CIRCUITS SHALL BE PROVIDED TO SERVE THE KITCHEN, BREAKFAST NOOK, AND DINING ROOM. SUCH CIRCUITS SHALL HAVE NO OTHER OUTLETS.
- D. AT LEAST ONE 20 AMP BRANCH CIRCUIT SHALL BE PROVIDED TO SERVICE THE LAUNDRY ROOM. THIS CIRCUIT SHALL HAVE NO OTHER OUTLETS.
- E. ALL RECEPTACLES WITH IN 6' OF A WET BAR SINK OR KITCHEN SINK TO SERVE COUNTER TOP SURFACES MUST BE GFCI. ON KITCHEN COUNTERS 12' OR WIDER NO POINT ALONG THE WALL SHALL BE MORE THAN 2' FROM A RECEPTACLE. ALL RECEPTACLES WITH IN 6' OF KITCHEN SINK MUST BE GFCI. AT LEAST ONE GFCI RECEPTACLE SHALL BE INSTALLED IN THE BATHROOM ADJACENT TO EACH BASIN.
- F. FIXTURES INCLUDING CEILING FANS THAT ARE LOCATED IN DAMP LOCATIONS SHALL BE LISTED TO BE SUITABLE FOR SUCH LOCATIONS PER 2012 IRC
- G. PROVIDE ONE (1) SWITCHED OUTLET @ ALL BEDROOMS AND DEN
- H. CEILING FANS NOT EXCEEDING 35 LBS. (WITH OR WITHOUT ACCESSORIES MAY BE SUPPORTED BY OUTLET BOXES PROVIDED THE OUTLET BOXES ARE IDENTIFIED FOR SUCH USE PER 2012 IRC
- I. ELECTRICAL OUTLET BOXES ON OPPOSITE SIDES OF FIRE RATED WALLS SHALL BE SEPARATED BY A HORIZONTAL DISTANCE OF NOT LESS THAN 24".
- J. OUTLET BOXES IN THE WALLS BETWEEN THE GARAGE AND DWELLING SHALL BE METAL OR U.L. APPROVED FIRE RESISTIVE PLASTIC. BOXES IN GARAGE CEILING SHALL BE METAL.
- K. ALL BRANCH CIRCUITS THAT SUPPLY 120 VOLTS SINGLE PHASE 15 AND 20 AMPS RECEPTACLE OUTLETS INSTALLED IN THE DWELLING SHALL BE PROTECTED BY AN ARC FAULT CIRCUIT INTERRUPTER. EXCEPT GFCI RECEPTICLES.

NOTE:

A. RECEPTACLES MUST BE PROVIDED IN HALLWAYS 10'-0" OR MORE IN LENGTH. FOR A ONE FAMILY DWELLINGS AND EACH OF A TWO FAMILY DWELLING THAT IS AT GRADE LEVEL, AT LEAST ONE WP-GFCI RECEPTACLE OUTLET ACCESSIBLE AT GRADE LEVEL AND NOT MORE THAN 6'-6" ABOVE GRADE SHALL BE INSTALLED AT THE FRONT AND BACK OF THE DWELLING.

NOTE: APPLIANCE DISCONNECT

E4001.5 GROUNDING OF ENCLOSURES.

METAL ENCLOSURES FOR SWITCHES OR CIRCUIT BREAKERS SHALL BE CONNECTED TO AN

EQUIPMENT GROUNDING CONDUCTOR.

METAL ENCLOSURES FOR SWITCHES OR CIRCUIT BREAKERS USED AS SERVICE EQUIPMENT SHALL COMPLY WITH THE PROVISIONS OF SECTION E3609.4. WHERE


NONMETALLIC ENCLOSURES ARE USED WITH METAL RACEWAYS OR METAL-ARMORED

CABLES, PROVISIONS SHALL BE MADE FOR CONNECTING THE EQUIPMENT GROUNDING


CONDUCTOR.
NONMETALLIC BOXES FOR SWITCHES SHALL BE INSTALLED WITH A WIRING METHOD THAT


PROVIDES OR INCLUDES AN EQUIPMENT GROUNDING CONDUCTOR. (404.12)

ELECTRICAL LEGEND Electrical Lights With Fan 0 **Recessed Can Ceiling Light −**Ø **Wall Lamp Spot Ceiling Light Three way with Dimmer Switch** Single Switch ₩ ₩ **Three way Switch** Fan Switch ₩ **Duplex Receptacle Triplex Receptacle GFCI Receptacle** \mathbb{X} **Exhaust Fan** Smoke and heat detector

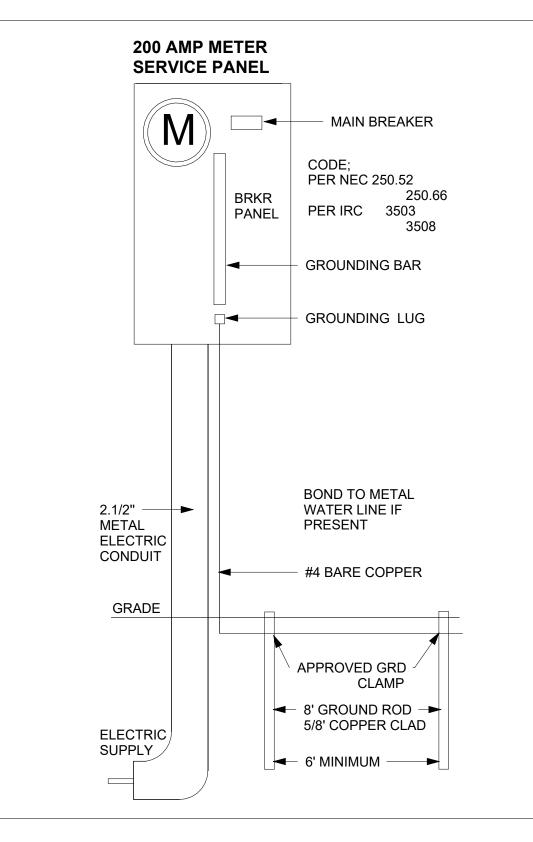



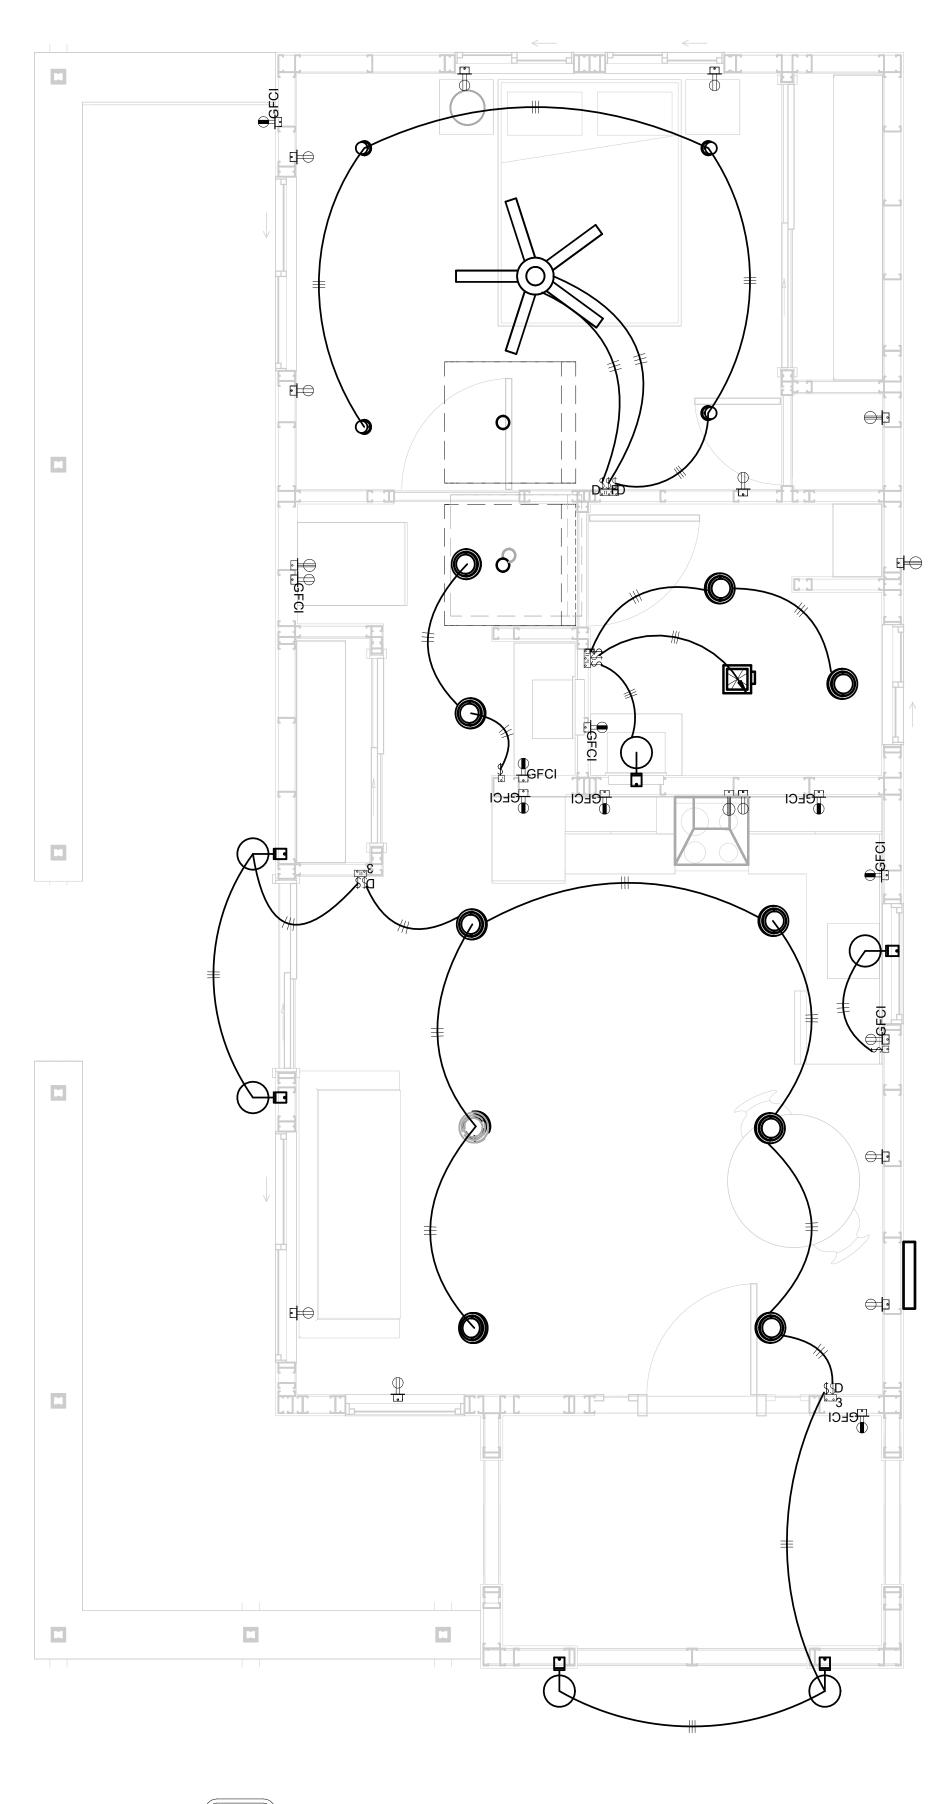

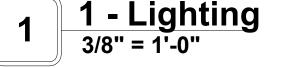



KEY PLAN

NO		
NO.	DESCRIPTION	DATE

NOTE:

LEGEND:

PROJECT

04-Wisdom-625-1Bd/1Ba Spanish-550

DRAWING NAME


LIGHTING

CLIENT NAME:	Owner
PROJECT NUMBER:	0059_12
DATE:	1/31/2025 2:53:59 PM
DESIGNED BY:	Designer
DRAWN BY:	Author
CHECKED BY:	Checker


E102

NOTES: CONDUIT, CABLE AND WIRING


- Use Metalic Conduits (IMC) for cables running under concrete slabs.
 Use IMC for circuits with high voltage appliances (240 volts and above)
 For circuits with 120 volts consider using EMT or PVC conduits if needed.
 For Low voltage applications up to 50 volts consider using non metalic conduits.
 All conduits to be used in the project must conform to the latest National Electrical Code (NEC),
- 6. All wiring and cables to be used in the project must also conform to the latest National Electrical
- 7. All cables and wires used should be rated for their respective loading and should be gauged and conform to the NEC.

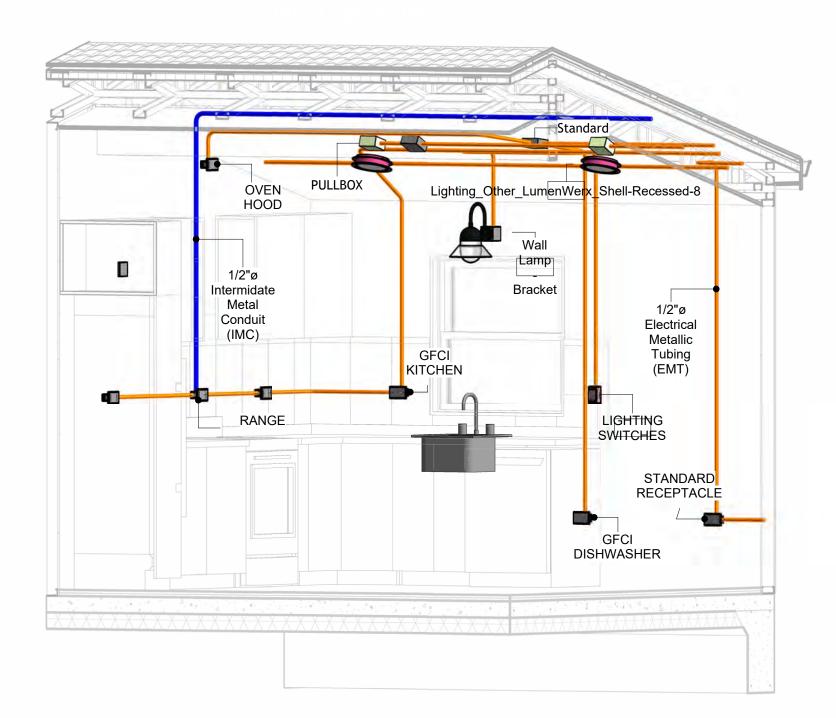


3D-KITCHEN

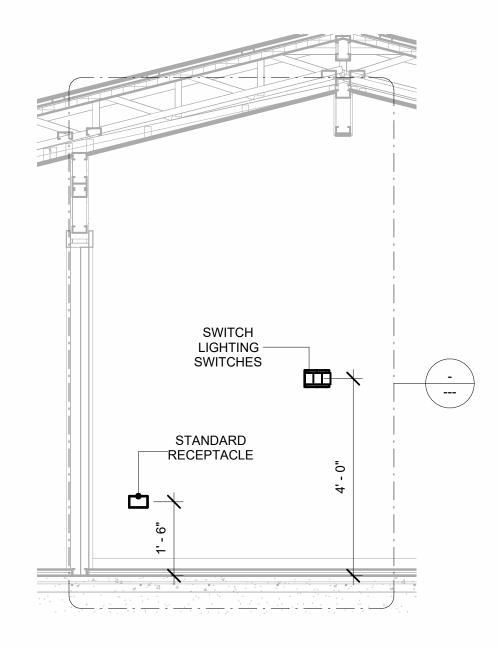


Section 1
1/2" = 1'-0"

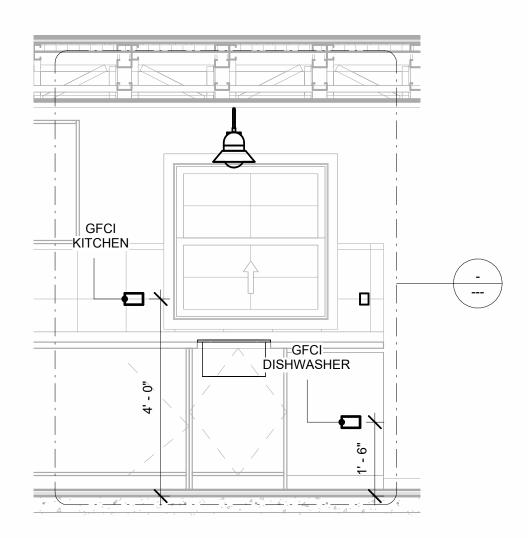

Section 3

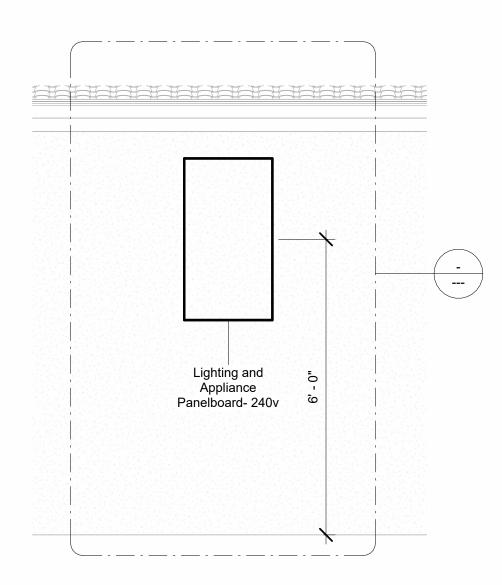


Section 2 1/2" = 1'-0"

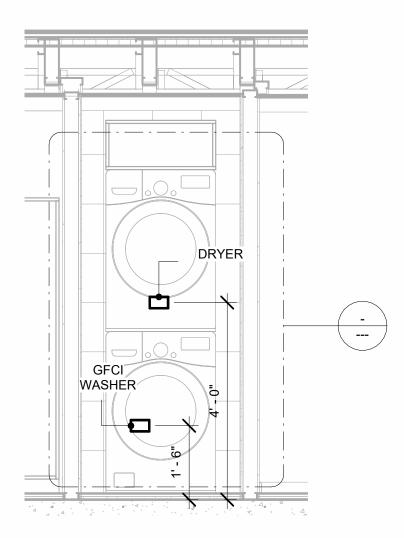

Section 4
1/2" = 1'-0"



KEY PLAN

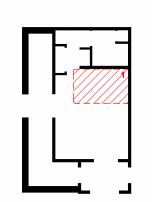

١٥.	DESCRIPTION	DATE

NOTE:

LEGEND:

PROJECT

04-Wisdom-625-1Bd/1Ba Spanish-550

DRAWING NAME

POWER

Owner
0059_12
1/31/2025 2:54:24 PM
Designer
Author
Checker

E103

SCALE: As indicated

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NOTES: LIGHT

- 1. LIGHT FIXTURES AND LUMINARIES SHALL CONFORM TO THE NEC, THE IRC AND LOCAL SAFETY & BUILDING CODE.
- 2. ALL LIGHTING FIXTURES SHOULD CONFORM TO THE DESIGN ELECTRICAL LOAD AND SHALL BE PROPERLY WIRED AND MOUNTED BY QUALIFIED ELECTRICIAN FOLLOWING MANUFACTURERS SPECIFICATIONS.
- 3. CEILING FANS AND FANS WITH LIGHT WITH WEIGHT EXCEEDING 35 LBS SHOULD BE PROVIDED WITH STRUCTURAL BACKING FOR SUPPORT AND SHALL BE FIXED AS PER MANUFACTURERS SPECIFICATIONS.
- 4. EXTERIOR LIGHTS SHALL CONFORM TO LOCAL BUILDING CODE AND GUIDELINES.

NOTES: SWITCH JUNCTION BOX


- 1. THE MINIMUM SIZE OF JUCTION BOX TO BE USED IS 2"X4"X(1.5" OR 3.5" DEEP) THIS ARE TO BE USED FOR SINGLE GANG SWITCH OR OUTLETS.
- 2. FOR DOUBLE GANG (2 GANG) OUTLETS AND SWITCHS THE MINIMUM SIZE OF THE
- JUCTION BOX TO BE PROVIDED SHALL NOT BE LESS THAN 4"X4"X(1.5" OR 3.5" DEEP)
- 3. FOR THREE GANG (3 GANG) OUTLETS AND SWITCHS THE MINIMUM SIZE OF THE JUĆTION BOX SHALL NOT BE LESS THAN 6"X4"X(1.5" OR 3.5" DEEP).

FITTING SCHE	EDULE(PULL BOX)	
FAMILY	COUNT	DESCRIPTION
CONDUIT JUNCTION BOX - TEE - ALUMINUM	3	
PULLBOX1	18	#1/4 PULLBOX

ELECTRICAL FIXTURE SCHEDULE (SWITCH BOX)		
TYPE	COUNT	
DOUBLE GANG SWITCH BOX	2	
SINGLE GANG SWITCH BOX	2	
TRIPLE GANG SWITCH BOX	2	

LIGHTING DEVICE		
TYPE	COUNT	
DIMMER	2	
FAN SWITCH	2	
SINGLE POLE	6	
THREE WAY WITH DIMMER SWITCH	2	

LIGHTING FIXTURE			
LIGHTING FIXTURE TYPE	VOLTAGE	ELECTRICAL LOAD	COUNT
ELECTRICAL_LIGHTS_FAN-LIGHT1	120 V/1-100 VA- 120 V/1-100 VA	200 A, 120 V/240 V, SINGLE PHASE, 3 WIRES	1
LIGHTING_OTHER_LUMENWE RX_SHELL-RECESSED-8	120 V/1-60 VA	200 A, 120 V/240 V, SINGLE PHASE, 3 WIRES	8
LIGHTING_RECESSED	120 V/1-60 VA	200 A, 120 V/240 V, SINGLE PHASE, 3 WIRES	2
SASSO 100 ROUND WALLWASHER TRIM2	120 V/1-10 VA	200 A, 120 V/240 V, SINGLE PHASE, 3 WIRES	4
WALL LAMP - BRACKET	120 V/1-100 VA	200 A, 120 V/240 V, SINGLE PHASE, 3 WIRES	6

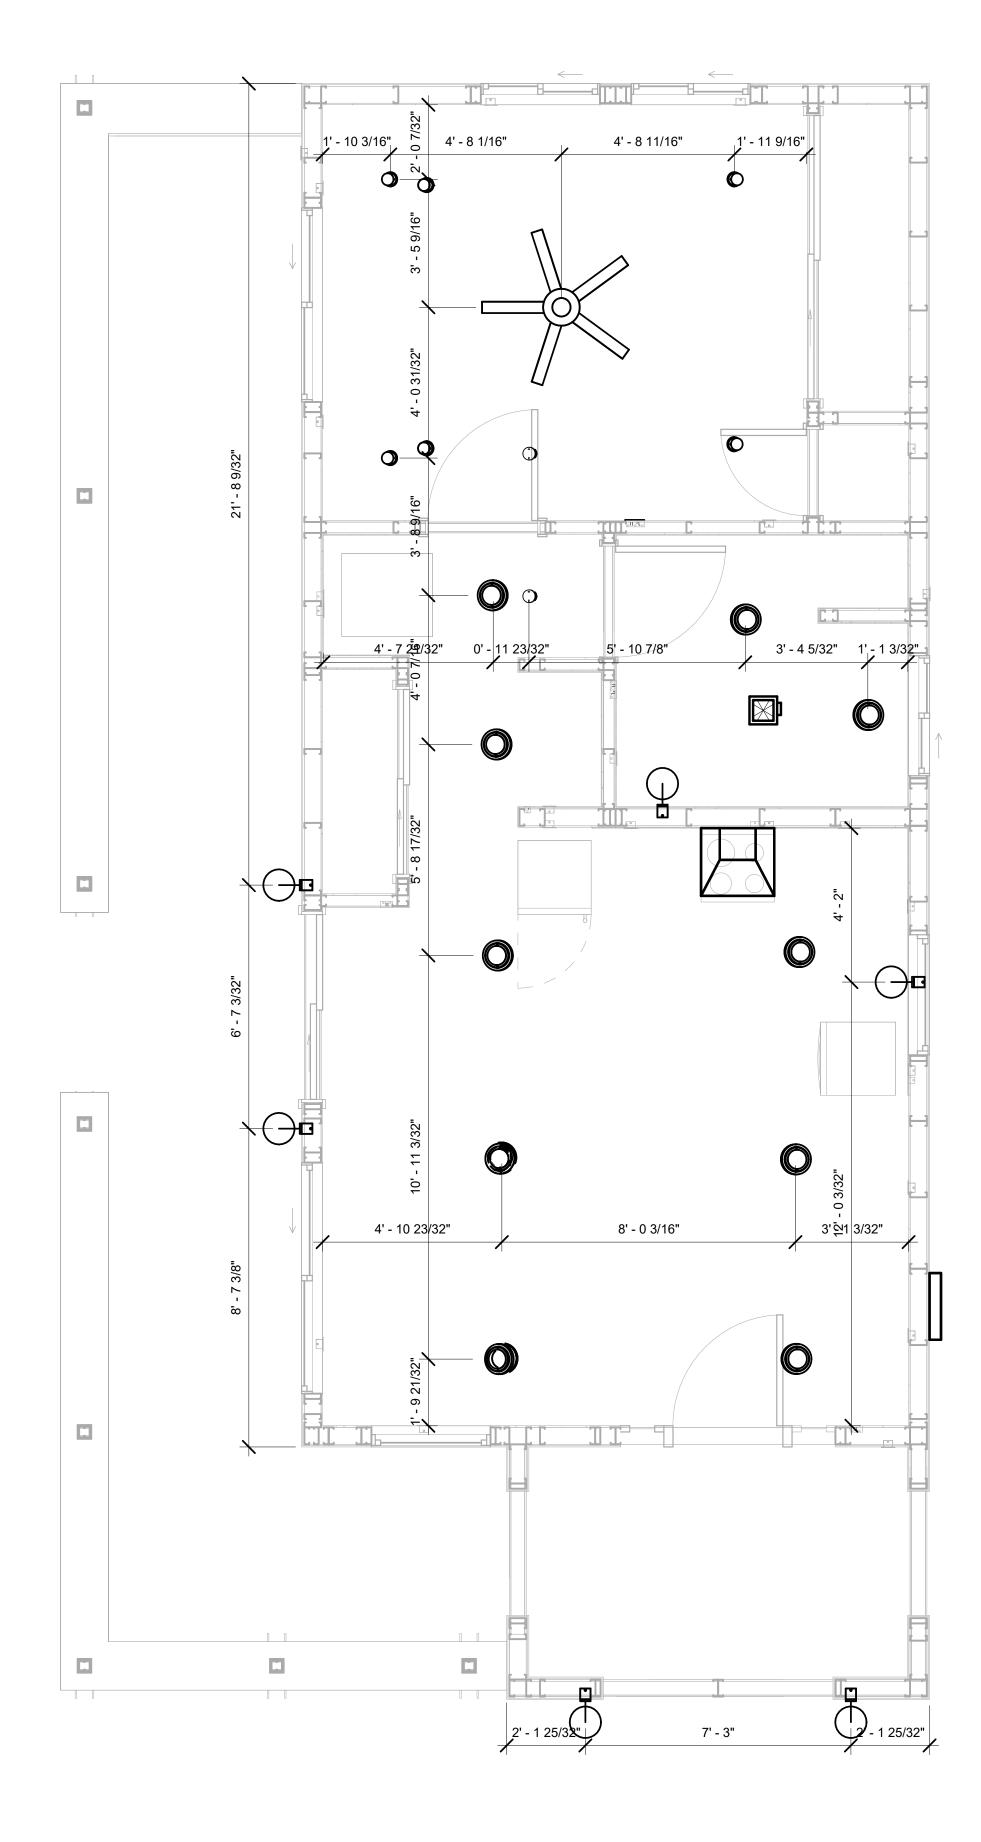





KEY PLAN

NO.	DESCRIPTION	DATE

NOTE:

LEGEND:

PROJECT

04-Wisdom-625-1Bd/1Ba Spanish-550

DRAWING NAME

DIMENSION PLAN FOR LIGHT FIXTURES

Owner	CLIENT NAME:
0059_12	PROJECT NUMBER:
1/31/2025 2:54:25 PM	DATE:
Designer	DESIGNED BY:
Author	DRAWN BY:
Checker	CHECKED BY:


E104

NOTES;

- 1. VERIFY EQUIPMENT PLUG CONFIGURATION BEFORE PURCHASING RECEPTACLES
- 2. FOR ALL EQUIPMENT.
- 3. COORDINATE EXACT LOCATION OF LIGHT FIXTURES, WALL SWITCHES, RECEPTACLES AND OTHER DEVICES WITH ARCHITECTURAL DRAWINGS.
- 4. USE METALLIC JUNCTION BOX WITH THE GFCI RECEPTACLES, WITH HIGHT VOLTAGE.

ELECTRICAL FIXTURE SCHEDULE (RECEPTACLE)		
TYPE	COUNT	
CONDENSER	1	
DRYER	1	
GFCI BATH ROOM	2	
GFCI DISHWASHER	1	
GFCI KITCHEN	3	
GFCI OUT DOOR	2	
GFCI RIFRIGERATOR	1	
GFCI WASHER	1	
OVEN HOOD	1	
RANGE	1	
STANDARD RECEPTACLE	9	
WATER HEATER	1	

	ELECTRICAL OUTLET SCHEDULE		
TYPE	CIRCUIT NUMBER	ELECTRICAL DATA	COUNT
STANDARD RECEPTACLE	2	120 V/1-180 VA	5
WATER HEATER	3,5	240 V/2-4500 VA	1
CONDENSER	4,6	240 V/2-5000 VA	1
GFCI BATH ROOM	7	120 V/1-180 VA	2
GFCI KITCHEN	7	120 V/1-180 VA	3
DRYER	8,10	240 V/2-5000 VA	1
GFCI WASHER	9	120 V/1-1200 VA	1
GFCI RIFRIGERATOR	13	120 V/1-180 VA	1
STANDARD RECEPTACLE	14	120 V/1-180 VA	4
RANGE	15,17	240 V/2-5000 VA	1
GFCI DISHWASHER	16	120 V/1-1200 VA	1
OVEN HOOD	16	120 V/1-180 VA	1
GFCI OUT DOOR	18	120 V/1-180 VA	2

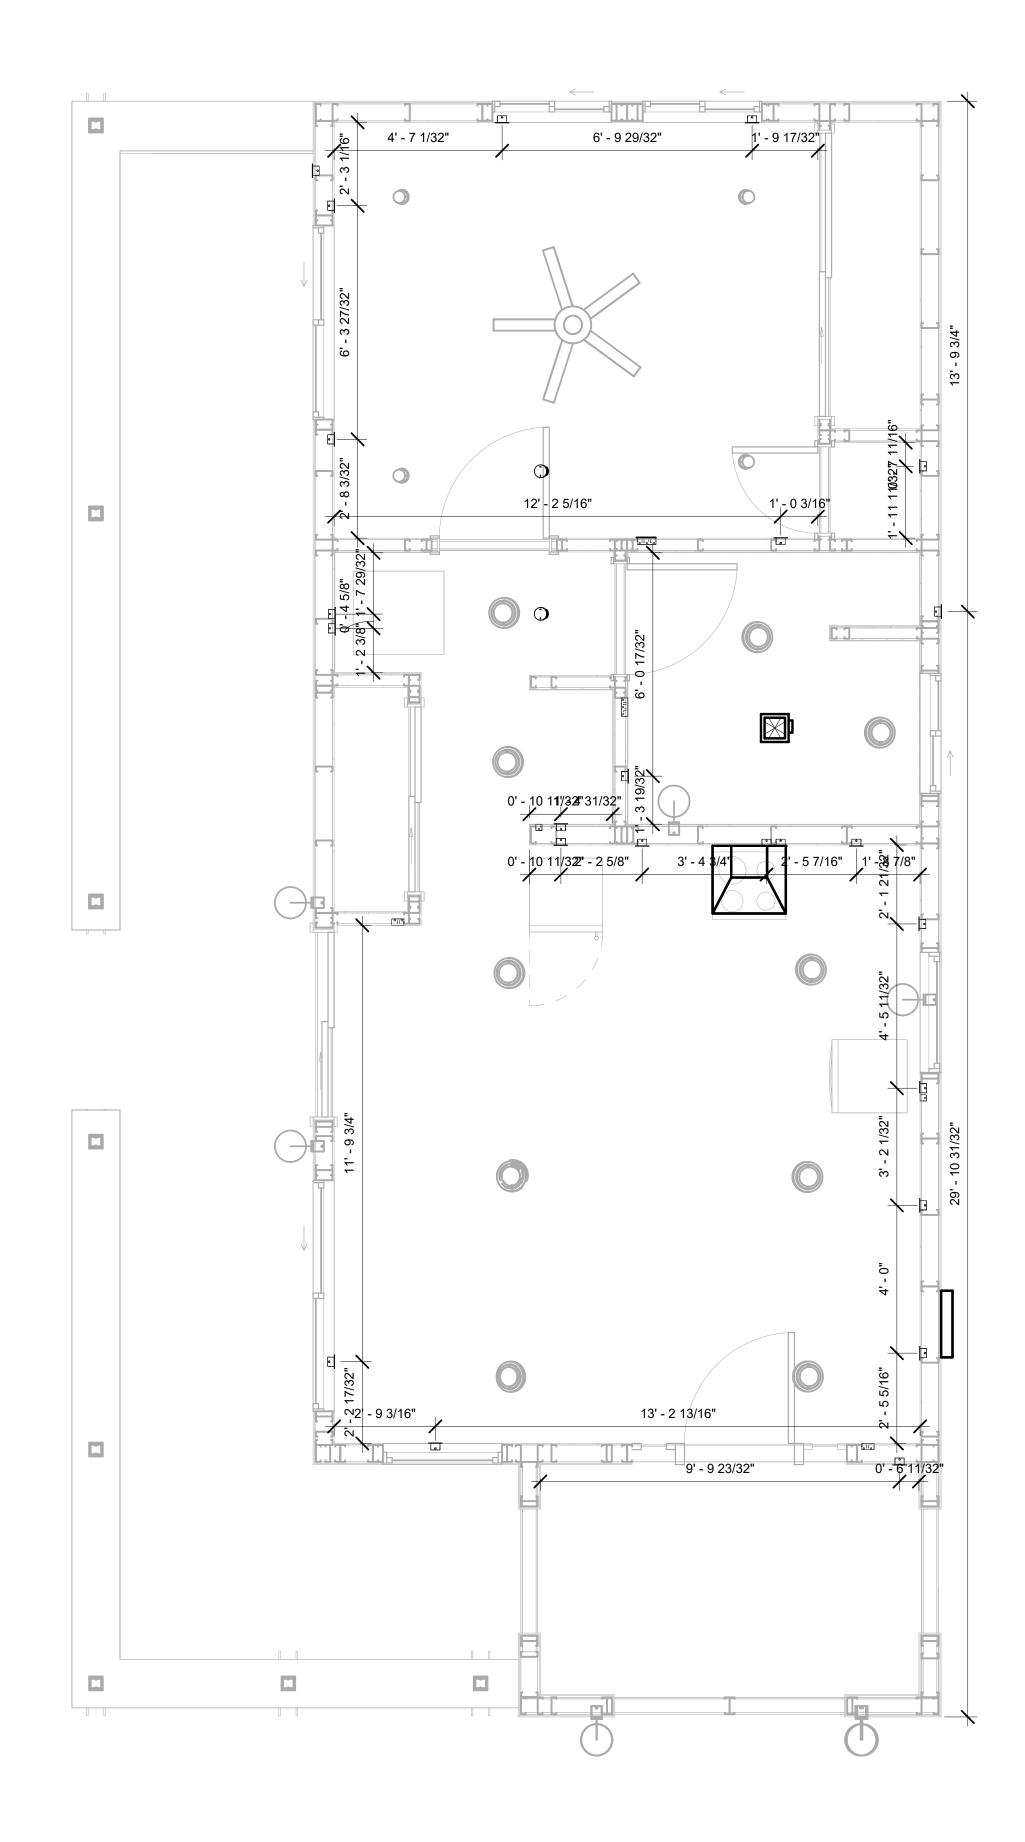

1 DIMENSION FOR FITTINGS 3/8" = 1'-0"



KEY PLAN

NO.	DESCRIPTION	DATE

NOTE:

LEGEND:

PROJECT

04-Wisdom-625-1Bd/1Ba Spanish-550

DRAWING NAME

DIMENSION PLAN FOR FITTINGS

CLIENT NAME:	Owner
PROJECT NUMBER:	0059_12
DATE:	1/31/2025 2:54:26 PM
DESIGNED BY:	Designer
DRAWN BY:	Author
CHECKED BY:	Checker

E105

SHEET LIST

SHEET NUMBER SHEET NAME

P101	NOTE AND SCHEDULE
-	WATER SUPPLY AND SEWAGE SYSTEM

PIPE COLOR SCHEME

DOMESTIC COLD WATER
DOMESTIC HOT WATER
SANITARY VENT
SANITARY SEWER
STORM DRAINAGE

PLUMBING NOTES

- THE PLUMBING SYSTEM IS DESIGNED TO MEET THE BUILDING'S DOMESTIC WATER SUPPLY, SANITARY DRAINAGE, AND STORM DRAINAGE REQUIREMENTS, AS PER PROJECT SPECIFICATIONS AND APPLICABLE CODES.
- 2. THE SYSTEM INSTALLATION SHALL COMPLY WITH THE LATEST INTERNATIONAL PLUMBING CODE (IPC), INTERNATIONAL RESIDENTIAL CODE (IRC), AND ALL OTHER RELEVANT LOCAL, STATE, AND NATIONAL REGULATIONS.
- 3. ALL PLUMBING WORK SHALL COMPLY WITH THE LATEST EDITION OF THE INTERNATIONAL PLUMBING CODE (IPC) AND THE LOCAL PLUMBING CODE.
- 4. PLUMBING SYSTEMS SHALL BE TESTED AND INSPECTED IN ACCORDANCE WITH THE LOCAL PLUMBING CODE REQUIREMENTS.
- 5. PLUMBING FIXTURES SHALL BE INSTALLED WITH THE APPROPRIATE TRIM, FITTINGS, AND ACCESSORIES, AS RECOMMENDED BY THE MANUFACTURER.
- 6. PIPING SHALL BE PROPERLY SUPPORTED AND SECURED TO PREVENT SAGGING,
- MOVEMENT, AND VIBRATION.
 7. SHUT-OFF VALVES SHALL BE PROVIDED AT ALL BRANCH CONNECTIONS AND AT THE
- INLET AND OUTLET OF EACH PIECE OF EQUIPMENT.

 8. BACKFLOW PREVENTION DEVICES SHALL BE INSTALLED AS REQUIRED BY THE LOCAL
- PLUMBING CODE TO PROTECT THE POTABLE WATER SYSTEM.

 9. PLUMBING FIXTURES AND EQUIPMENT SHALL BE ACCESSIBLE FOR MAINTENANCE AND
- SERVICING.

 10. EXPOSED PLUMBING PIPING AND FIXTURES SHALL BE INSULATED TO PREVENT
- CONDENSATION AND ENERGY LOSS.

 11. DEAD ENDS IN THE DRAINAGE SYSTEM MUST BE AVOIDED, EXCEPT WHERE NECESSARY TO INSTALL A CLEANOUT IN AN ACCESSIBLE LOCATION, AND MUST HAVE A VENTED CONNECTION TO THE OUTSIDE ATMOSPHERE.
- 12. THE VERTICAL DEFLECTION OF PVC PIPE MUST NOT EXCEED 5%, AND NO DEFLECTION IS PERMITTED FOR IRON PIPE.
- 13. WORK MUST BE PROPERLY COORDINATED WITH OTHER TRADES TO AVOID CONFLICTS, REFERRING TO THE ARCHITECTURAL AND STRUCTURAL DRAWINGS FOR INFORMATION REGARDING CEILING ELEVATIONS, SPACE CLEARANCES, WALL AND PARTITION LOCATIONS, ETC.
- 14. ALL FIXTURES SHALL HAVE ACCESSIBLE STOPS.
- 15. DOMESTIC WATER PIPING SHALL BE PEX, AND PVC PIPING IS NOT ACCEPTABLE FOR INTERIOR USE.
- 16. VENT TERMINATIONS SHALL BE LOCATED AT LEAST 10 FEET FROM OR 3 FEET ABOVE ANY OPERABLE WINDOW, DOOR OPENING, AIR INTAKE, OR VENT SHAFT, AND AT LEAST 3 FEET IN EVERY DIRECTION FROM ANY LOT LINE, ALLEY, OR STREET.
- 17. PIPE AND FITTINGS UTILIZED IN THE WATER SUPPLY SYSTEM SHALL HAVE A MAXIMUM OF 8 PERCENT LEAD.
- 18. ACRYLONITRILE BUTADIENE STYRENE (ABS) SHALL BE USED FOR THE SEWERAGE AND
- VENTILATION SYSTEM.

 19. CROSS-LINKED POLYETHYLENE (PEX) SHALL BE USED FOR THE WATER SUPPLY SYSTEM.
- 20. POLYVINYL CHLORIDE (PVC) SHALL BÉ USED FOR THE RAIN WATER SYSTEM.
- 21. THE MIMIMUM WATER SUPPLY DEPTH UNDER FLOOR FINISH SHOUD BE 1/2".
- 22. ANY PIPE INSTALLED UNDERGROUND MUST HAVE AT LEAST 12 INCHES OF CLEARANCE BETWEEN THE OUTSIDE OF THE PIPE AND ANY OTHER UNDERGROUND STRUCTURE.
- 23. THE MINIMUM CLEARANCE BETWEEN COLD AND HOT WATER LINES IN RESIDENTIAL
- HOMES MAINTAIN A MINIMUM DISTANCE OF 6 INCHES.

 24. HORIZONTAL SEPARATION BETWEEN WATER AND SEWER LINES: A MINIMUM OF 12 INCHES BETWEEN POTABLE WATER SUPPLY LINES (COLD AND HOT WATER) AND

ABBREVIATIONS

SANITARY SEWER LINES.

Ø	DIAMETER
ABS	ACRYLONITRILE BUTADIENE STYRENE
ABV	ABOVE
AD	AREA DRAIN
AFF	ABOVE FINISHED FLOOR
ALT	ALTERNATE
BFF	BELOW FINISHED FLOOR
BLW	BELOW
CO	CLEAN OUT
CW	COLD WATER
D	DEGREE
DFU	DRANAGE FIXTURE UNIT
DIA	DIAMETER
DN	DOWN
FCO	FLOOR CLEAN OUT
FD	FLOOR DRAIN
FL	FLOOR
FS	FLOOR SINK
FT	FOOT/FEET
HB	HOSE BIB
HW	HOT WATER
IN	INCH
MIN	MINIMUM
NO	NUMBER
NTS	NOT TO SCALE
PEX	CROSS-LINKED POLYETHYLENE
PLBG	PLUMBING
PVC	POLYVINYL CHLORIDE
QTY	QUANTITY
RD	ROOF DRAIN
RED	REDUCER
RM	ROOM
RW	RAIN WATER
SF	SQUARE FOOT
V	VENT
VTR	VENT THROUGH ROOF
W	WASTE
WCO	WALL CLEAN OUT
WSFU	WATER SUPPLY FIXTURE UNIT

PLUMBING LEGEND

D	CAP
	BEND 45 DEG
g	BEND 90 DEG
	TEE REDUCING
	TEE
	CLEAN TWO-WAY
	WYE 45 DEG
	WYE 45 DEG DOUBLE
	WYE COMBINATION
	P-TRAP

PIPE SCHEDULE				
MATERIAL	DIAMETER	LENGTH		
ACRYLONITRILE BUTADIENE STYRENE (ABS)	1 1/2"	20 FT		
ACRYLONITRILE BUTADIENE STYRENE (ABS)	2"	46 FT		
ACRYLONITRILE BUTADIENE STYRENE (ABS)	3"	6 FT		
CROSS-LINKED POLYETHYLENE (PEX)	1/2"	87 FT		
CROSS-LINKED POLYETHYLENE (PEX) 3/4" 4				
POLYVINYL CHLORIDE - RIGID	2"	73 FT		

FITTING	SIZE	QTY
DOMESTIC COLD WATER		
PEX 90 DEGREE ELBOW	1/2"ø-1/2"ø	19
PEX 90 DEGREE ELBOW	3/4"ø-3/4"ø	1
PEX CROSS ELBOW	3/4"ø-3/4"ø-3/4"ø	1
PEX TEE ELBOW	1/2"ø-1/2"ø-1/2"ø	3
PEX TEE ELBOW	3/4"ø-3/4"ø-3/4"ø	4
PEX TRANSITION ELBOW	1"ø-3/4"ø	2
PEX TRANSITION ELBOW	3/4"ø-1/2"ø	6
DOMESTIC HOT WATER		
PEX 90 DEGREE ELBOW	1/2"ø-1/2"ø	13
PEX 90 DEGREE ELBOW	3/4"ø-3/4"ø	3
PEX CROSS ELBOW	1/2"ø-1/2"ø-1/2"ø	1
PEX TEE ELBOW	1/2"ø-1/2"ø-1/2"ø	2
PEX TEE ELBOW	3/4"ø-3/4"ø	1
PEX TRANSITION ELBOW	3/4"ø-1/2"ø	4
RAIN WATER	1	
PVC 90 DEG BEND ELBOW	2"ø-2"ø	27
SEWAGE		
ABS 90 DEGREE BEND ELBOW	1 1/2"ø-1 1/2"ø	1
ABS 90 DEGREE BEND ELBOW	2"ø-2"ø	2
ABS 90 DEGREE BEND ELBOW	3"ø-3"ø	1
ABS BEND LONG SWEEP ELBOW	2"ø-2"ø	3
ABS P-TRAP	1 1/2"ø-1 1/2"ø	4
ABS P-TRAP	2"ø-2"ø	1
ABS REDUCER ELBOW	2"ø-1 1/2"ø	3
ABS REDUCER ELBOW	3"ø-2"ø	2
ABS TEE ELBOW	1 1/2"ø-1 1/2"ø-1 1/2"ø	2
ABS TEE ELBOW	2"ø-2"ø-2"ø	1
ABS TEE ELBOW	3"ø-3"ø-3"ø	2
ABS TEE REDUCER ELBOW	2"ø-2"ø	1
ABS TRAP P	2"ø-2"ø	1
ABS VENT CAP ELBOW	2"ø	1
ABS WASTE DOUBLE TEE	2"ø-2"ø-2"ø	1
ABS WYE COMBINATION WITH 8TH BEND ELBOW	2"ø-2"ø	1
ABS WYE COMBINATION WITH 8TH BEND ELBOW	3"ø-3"ø-1 1/2"ø	1
ABS WYE COMBINATION WITH 8TH BEND ELBOW	3"ø-3"ø-2"ø	1
VENIT		
VENT ABS 90 DEGREE BEND ELBOW	1 1/2"ø-1 1/2"ø	1
ABS TEE REDUCER ELBOW	2"ø-2"ø-1 1/2"ø	1
ABS VENT CAP ELBOW	1 1/2"ø	1

WATER FIXTURE UNIT SCHEDULE						
FAMILY QTY UNIT VALUE TOTAL						
DISHWASHER	1	1.4	1.4			
SHOWER TRAY	1	1.4	1.4			
SHOWER TRIM	1	1.4	1.4			
SINK ISLAND SINGLE	1	1.4	1.4			
VANITY SINK	2	0.7	1.4			
WASHER	1	1.4	1.4			
WATER CLOSET	1	2.2	2.2			

WASTE FIXTURE UNIT SCHEDULE						
FAMILY QTY DFU VALUES TOTAL						
DISHWASHER	1	2	2			
SHOWER TRAY	1	2	2			
SINK ISLAND SINGLE	1	2	2			
VANITY SINK	2	1	2			
WASHER	1	2	2			
WATER CLOSET	1	3	3			


FIXTURE SCHEDULE				
FIXTURE	QTY	DESCRIPTION		
DISHWASHER	1			
DRYER	1			
SHOWER TRAY	1			
SHOWER TRIM	1			
SINK ISLAND SINGLE	1			
VANITY SINK	2			
WASHER	1			
WATER CLOSET	1			
WATER HEATER	1			

PLUMBING SCHEDULE					
FIXTURE	TRAP	WASTE	VENT	C.W	H.W
DISHWASHER	1-1/2"	2"	1-1/2"	1/2"	1/2"
DRYER	N/A	N/A	N/A	N/A	N/A
SHOWER TRAY	1-1/2"	2"	N/A	1/2"	1/2"
SHOWER TRIM	-	-	-	1/2"	1/2"
SINK ISLAND SINGLE	1-1/2"	2"	1-1/2"	1/2"	1/2"
VANITY SINK	1-1/2"	2"	1-1/2"	1/2"	1/2"
WASHER	2"	2"	1-1/2"	1/2"	1/2"
WATER CLOSET	3"	3"	2"	1/2"	1/2"
WATER HEATER	N/A	N/A	N/A	3/4"	3/4"

ACCESSORIES & FITTINGS SCHEDULE					
FIXTURE QTY DESCRIPTIONS					
DISHWASHER SUPPLY SINGLE CONNECTOR	1				
DISHWASHER SEWAGE SINGLE CONNECTOR	1				
HANGING PIPES CLAMP	18				
HOSE BIB	2				
LAUNDRY SWEAT CONNECTOR	1				
SHUTOFF VALVE	8				



KEY PLAN

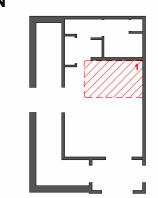

NO.	DESCRIPTION	DATE

NOTE:

LEGEND:

PROJECT

04-Wisdom-625-1Bd/1Ba Spanish-550


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NOTE AND SCHEDULE

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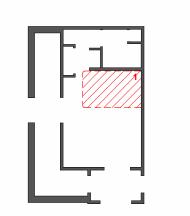
0059_12	PROJECT NUMBER:	
2/1/2025 5:23:37 PM	DATE:	
Designer	DESIGNED BY:	
Author	DRAWN BY:	
Checker	CHECKED BY:	

P101



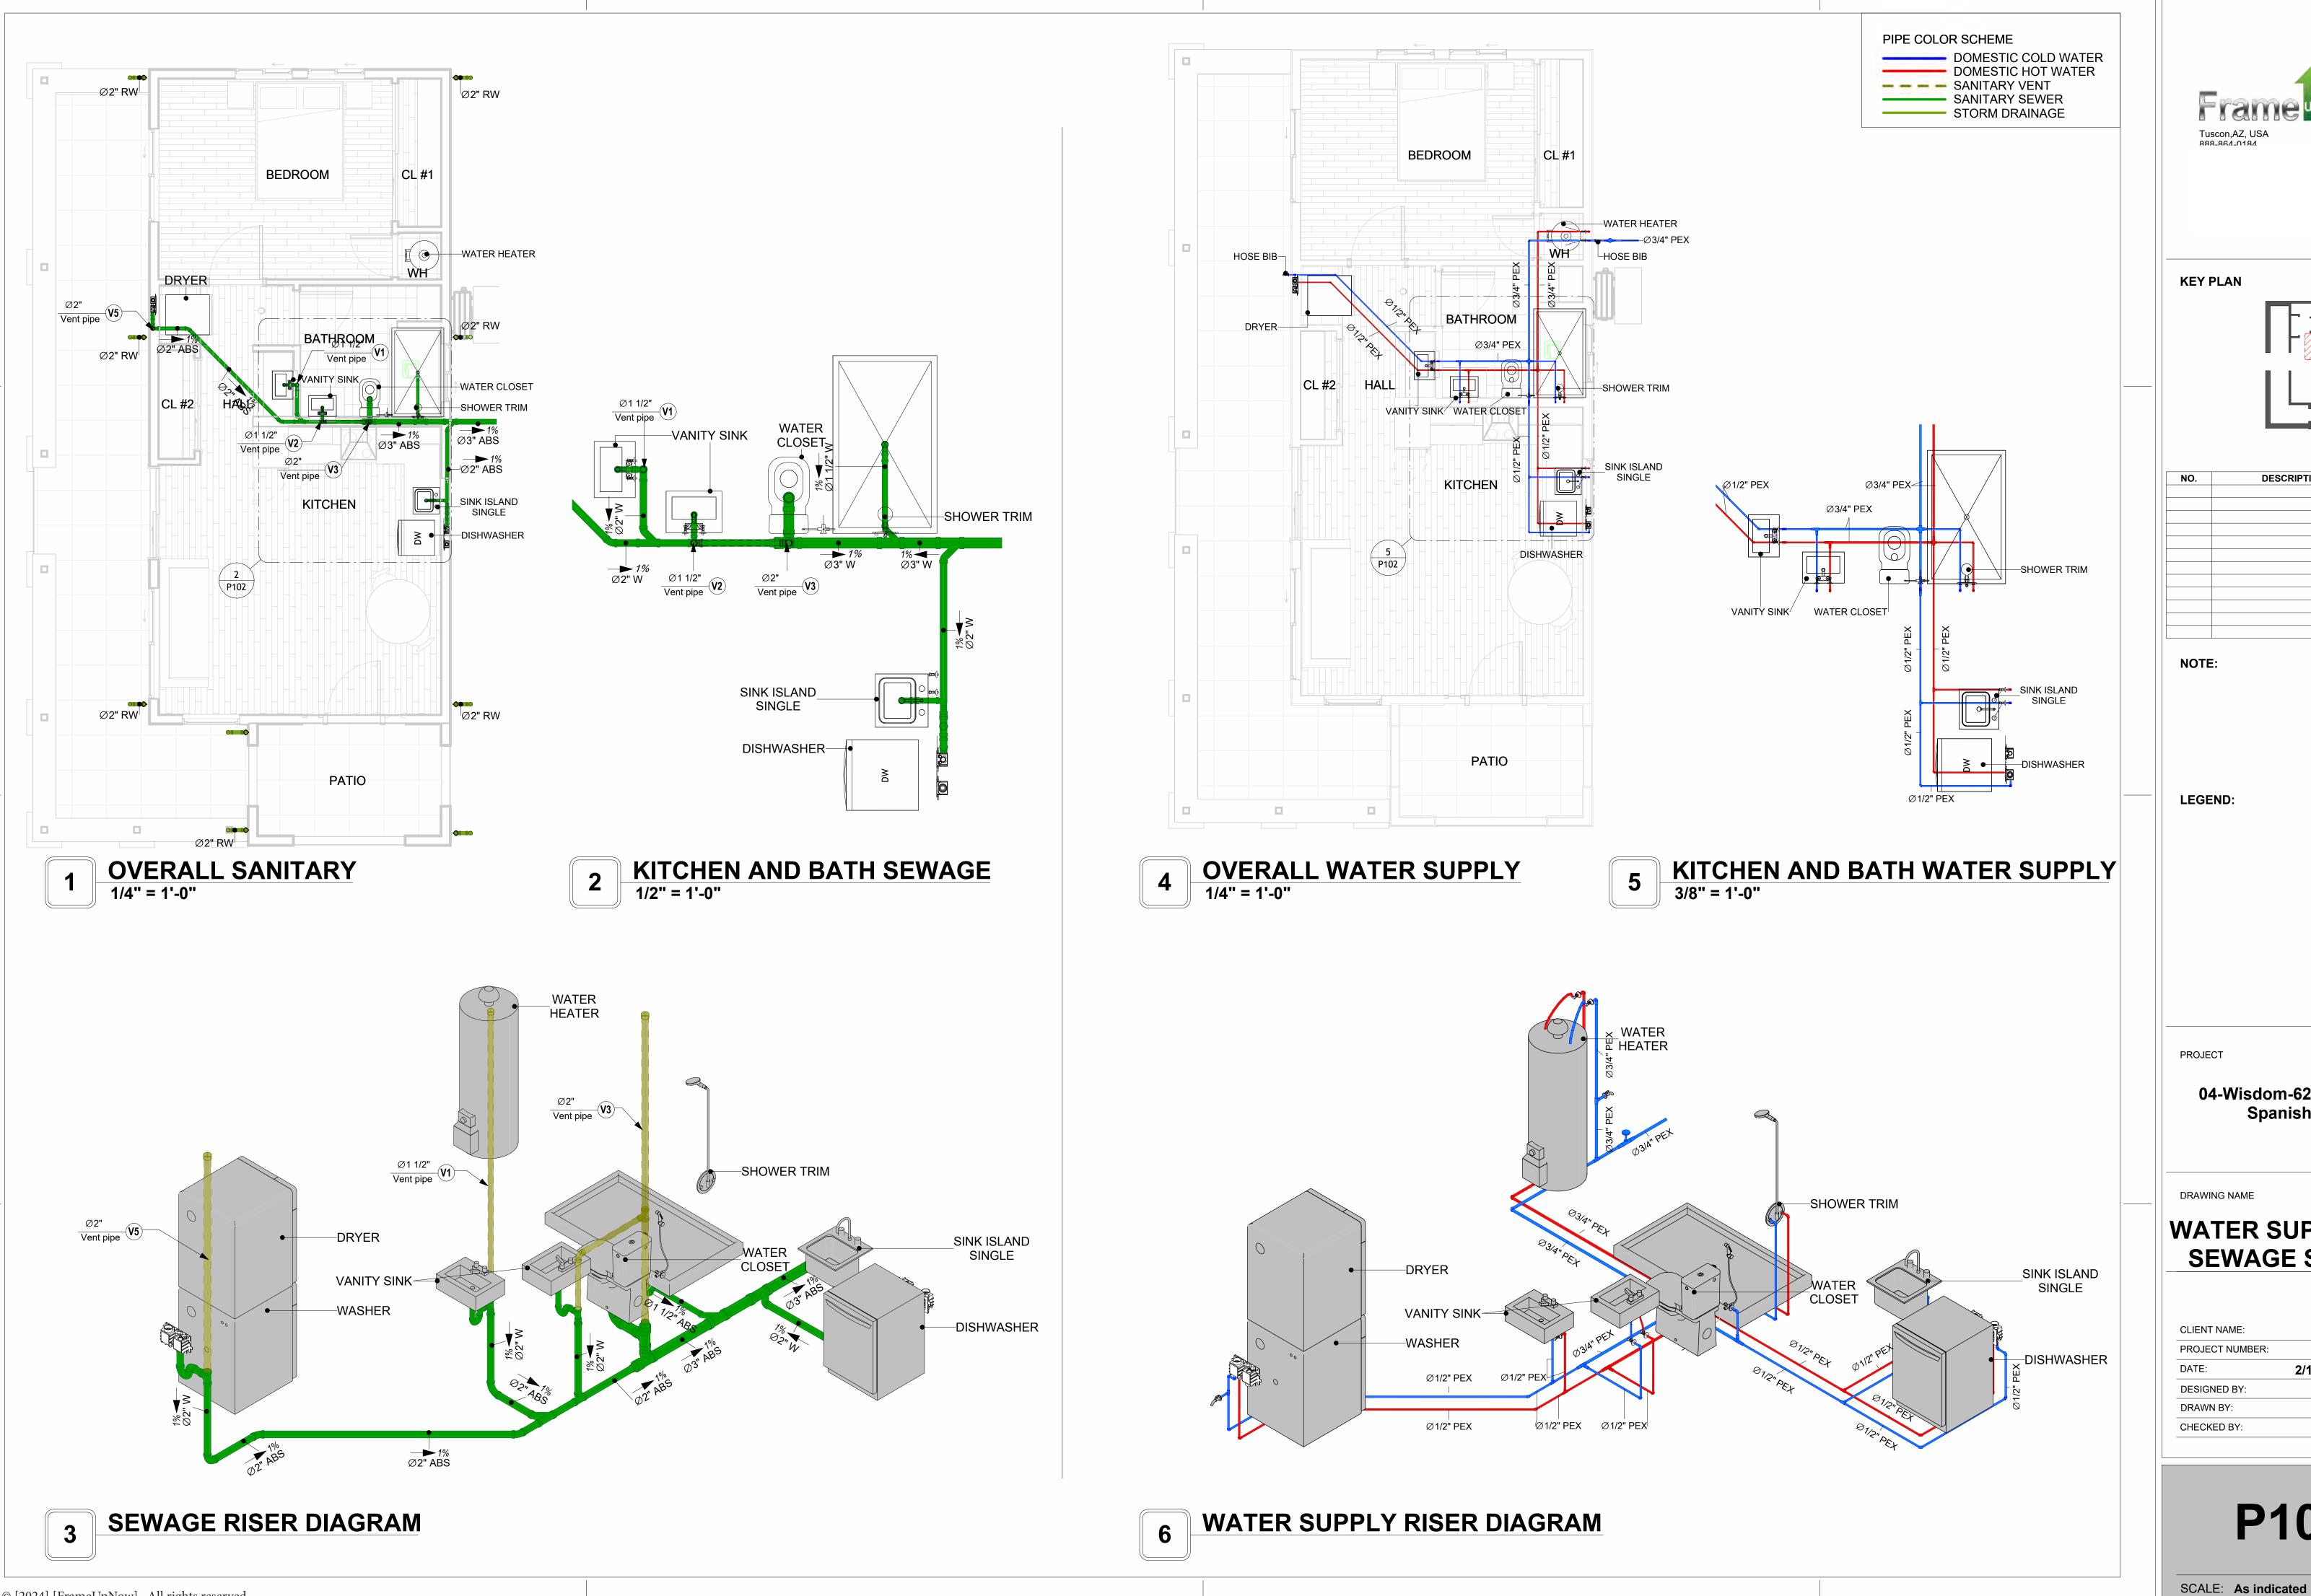

KEY PLAN



NO.	DESCRIPTION	DATE
		•

LEGEND:

PROJECT

04-Wisdom-625-1Bd/1Ba Spanish-550

DRAWING NAME

WATER SUPPLY AND **SEWAGE SYSTEM**

CLIENT NAME: 0059_12 PROJECT NUMBER: 2/1/2025 5:24:07 PM DATE: Designer DESIGNED BY: DRAWN BY: CHECKED BY: Checker

P102

Materials Shopping List

Please print and take this Materials Shopping List to your favorite Home Depot and ask for assistance in selecting the materials, fixtures and fittings to complete your new home.

Record your selection and the price of the item. Then do the math to determine the cost for your selections and the total cost of finishing your home.

Have It Your Way!

The material types listed in this document were selected based on personal preferences. The Customer is encouraged to make changes to the material types in accordance with local customs, regulations, and personal preferences.

Have It Your Way!



20 good reasons to frame a home with metal and not wood



Why build your ADU with metal vs wood	Wood Meta	Explanation
1 DIY Construction Benefit		The wall frames, trusses and beams can be erected in a just a few days
2 Minimal Construction Skills Required		Pre-assembled walls and trusses require no specialized skills to errect
3 Build as DIY, Hybrid or by a General Contractor		Do it yourself, Hybrid (involve special contractors) or hire a General Contractor
4 Build It As You Can Afford It		Impervious to Weather - build as you have the time and money
5 Up Front Cost of Framing Materials		As to only the framing material, wood is less expensive
6 Total Cost To Build		Savings in time, labor, and other areas make light gauge steel LESS expensive
7 Termites and wood boring insects		Termites, carpenter ants and wood boring insects eat wood, not metal
8 Mold resistant		Metal does not attract mold
9 Damage caused by exterior and interior flooding		Metal needs no reconditioning after a flood
10 Fire Resistant		Non-combustible
11 Lower insurance rates		Many insurance underwriters now provide lower rates for metal framed homes
12 Walls, trusses, and beams retain their original form		Perfectly straight walls - no shimming of drywall
13 Corners are 90 degrees		No need for templating of countertops to adjust for out of square corners
14 Strength and weight		Metal is stronger than wood and weighs less - no need for crane to lift ADU trusses
15 IBC Engineered Stamp		If an engineering stamp is necessary, months of waiting are saved
16 Complete BOM (Materials Shopping List)		Take the materials shopping list to Home Depot and start shopping/pricing
17 Flexible in Seismic Areas - Won't Fracture		Light gauge steel is flexible and won't fracture when the earth moves
18 No Waste At Job Site		Steel is the most recycled material in the world. A typical wood home has 20-30% waste
19 Environmentally Friendly		Trees don't have to be destroyed and the source of most metal is from recycling
20 How-To Videos Included		How-to videos provide simple assembly instructions
21 Relationship Counselor		Eliminate emotional uphevels - save time, money, and preserve the relationship

Universal Requirements - some or all may be required

- 1 Site plan
- 2 Electrical Supply Connection
- 3 Sewer Connection
- 4 Fresh Water Supply Connection
- 5 Set Backs
- 6 Soils Evaluation

- 7 Earthquake (fault) evaluation
- 8 Foundation Plan subject to soils
- 9 Compliance with local energy codes: insulation home wrap and flashing
- 10 Engineering for wind speed and snow load.
- 11 State and Local ordinances regarding ADUs
- 12 Local Architect and/or Engineer may be necessary



10

15

WISDOM -1BD1BA-SPANISH

MATERIAL SHOPPING LIST

Have It Your Way!

The material types listed in this document were selected based on personal preferences. The Customer is encouraged to make changes to the material types in accordance with local customs, regulations, and personal preferences. Have It Your Way!

Name | Link | Page No | 1 COVER PAGE | COVER PAGE | 1 | 2 TOC | TOC | 2 | 3 ELECTRICAL BOM | ELECTRICAL BOM | 3 | 5 HVAC BOM | HVAC BOM | 7

Table Of Content

Have It Your Way!

PLUMBING BOM

ARCHITECTURAL BOM

The material types listed in this document were selected based on personal preferences. The Customer is encouraged to make changes to the material types in accordance with local customs, regulations, and personal preferences. Have It Your Way!

GENERAL NOTES

4 PLUMBING BOM

- 1 This BOM (Bill of Materials) is prepared as a Materials Shopping List to help builders and DIYers gain a complete understanding of most if not all elements required for the complete construction of this structure, according to the original design documents provided by FrameUpNow.
- 2 All quantities and specifications are subject to change based on the final design, field measurements, availability of products and customer preferences. The customer should verify all information prior to purchasing materials.
- 3 All products and elements in the list shall conform to the International Residential Code (IRC), or any other local and international building codes, safety regulations, and standards that are applicable to the location of the structure.
- 4 If any changes are made by the customer to the list of materials specified in this document, the customer is responsible for assuring that the correct type and quantity of materials are utilized in accordance with local building codes.
- 5 FrameUpNow, will not be held responsible for any misuse of this document, the products listed, or for deviations from the content that are made due to changes in specifications, pricing, availability, or customer preferences.
- The customer is advised to consult a qualified professional or technician prior to purchasing materials for specialized construction system items. Some items including but not limited to caseworks, doors and windows may require as built measurements prior to purchase to confirmation of final dimensions.
- 7 If there are additional trim elements or specific installation methods, the total amount of materials needed might vary. Consider any additional trim required for corners, intersections, or other architectural details that might cause this variations before procedding to purchase and construction.



		WISDOM-1BD1E			
		ARCHITECTURAL MATER	RIAL SHOPE	PING LIST	
lo.	Item	Туре	Unit	Quantity	Description
	APPLIANCES				
1	Refrigerator		PCS	1	
2	Range		PCS	1	
3	Washer		PCS	1	
4	Dryer		PCS	1	
5	Dish Washer		PCS	1	
6	Oven		PCS	0	
7	Microwave		PCS	0	
	CASEWORKS				
8	Kitchen Cabinet		FT	15.7	
9	Laundry Cabinet		FT	2.25	
10	Vanity Cabinet		FT	6.1	
11	Medicine Cabinet		PCS	2	
12	Kitchen countertop		SF	24.46	
13	Laundry Countertop		PCS	0	
14	Bathroom Countertop		SF	0	
15	Island		FT	0	
16	Peninsula		FT	0	
17	Closets		SF	102.54	
	CEILING		1 5.	- 1	
18	Ceiling Board	Dry Wall	SF	527	
19	Dry Wall Fastener	Screw	PCS	922	
20	Vapor Retarder	Polyethylene film	SF	663	
21	Vapor Retarder Fastener	Nails with washer heads	PCS	1990	
22	Ceiling Board (MRD)	Moisture resistant drywall	SF	64	
23	MRD Fastener	inoistare resistant drywan	PCS	111	
<u>23</u> 24	Ceiling Board	Marine Plywood	SF	73	
24 25	Marine Plywood Fastener	Screw	PCS	127	
25 26	Dry Wall Tape	OUEW	FT	332	
	ROOF		ГІ	332	
<u> </u>	Roof Covering		SF	1707	
27	· ·			1707	
28 20	Roof Covering Fastener		PCS	854	
	Roof Felt Paper		SF	1707	
30	Roof Felt Paper Fastener		PCS	5121	
31	Roof Sheathing		SF	1707	
32	Roof Sheathing Fastener		PCS	13656	
33	Batten		FT	447	
34	Batten Fastener		PCS	336	
	Soffit		SF	133	
36	Soffit Fastener		PCS	67	
	Fascia		FT	137	
38	Fascia board fastener		PCS	69	
39	Roof Insulation		SF	1707	
	FLOORING				
40	Main Living Space		SF	310.44	
41	Bathroom		SF	63.77	
42	Bedrooms		SF	184.67	
	Porch		SF	404.6	
	STRUCTURE				
	Foundation		SF	1027.29	

Cŀ	HITECTURAL BO	М		THE S	🟅 Frame No
				100	<u> </u>
	WALLS EXTERIOR				
	Exterior Wall Siding		SF	1262	
_	Wall Paint		SF	1262	
_	Wall Shteathing (OSB)		SF	1262	
	Shteathing Fastener	Self-drilling screws(100/pkt)	PKT	12.62	
49	Wall Insulation		SF	1683	
50	Wall Homewrap		SF	1262	
51	Home wrap Fastener	Stapled fastener (200/pkt)	PKT	4.8	
	WALLS INTERIOR				
57	Cementitious Backer Board		SF	454	
58	Kerdi membrane		SF	454	
59	Kerdi membrane Fastener		SF	454	
60	Wall Ceramic Tile		SF	454	
61	Drywall Board		SF	1059	
	Drywall Fastener	Self-drilling screws(100/pkt)	PKT	10.59	
63	Wall Paint		SF	1059	
64	Drywall Tape		FT	199	
	DOORS				
	Interior Swinging	3' - 0" X 6'-8"	PCS	1	
	Interior Swinging	2' - 8" X 6'-8"	PCS	1	
	Interior Swinging	2' - 4" X 6'-8"	PCS	1	
	Front Door With Sidelight	5' - 5" X 6'-11 1/2"	PCS	1	
_	Interior Sliding	7' - 8" X 6'-8"	PCS	1	
_	Interior Sliding	5' - 2" X 6'-8"	PCS	1	
	Patio Sliding	5' - 0" X 6'-8"	PCS	1	
_	Exterior Door Trim			37.7	
-	Interior Door Trim			249.5	
	Entry Lock set			2	
_	Privacy Lock set			2	
	Passage Lock set			3	
	WINDOWS			J	
	Single Hung	3' - 3" X 4'-3"	PCS	1	
	Sliding	3' - 3" X 3'-3"	PCS	2	
_	Sliding	5' - 3" X 3'-3"	PCS	1	
	Sliding	6' - 3" X 3'-3"	PCS	1	
_	Sliding	3' - 3" X 2'-3"	PCS	1	
	Exterior Window Trim	J - J A Z -J	703	108.4	
	Interior Window Trim				
84	IIILETIOI WIIILIOW IIIIII			108.4	

ELECTRICAL BOM



		WISDOM-1BD1E	BA-SPANISH		
	EL	ECTRICAL MATERI	AL SHOPPIN	IG LIST	
No.	Item	Туре	Unit	Quantity	Description
Δ	LIGHTING FIXTURES		'		
1	Kitchen Ceiling Light		PCS	2	
2	Exterior Wall Mounted Light		PCS	4	
3	Livingroom Ceiling Light With Fan		PCS	0	
4	Bedroom Ceiling Light With Fan		PCS	1	
5	Dining Ceiling Light		PCS	0	
6	Bath Wall Mounted Light		PCS	1	
7	Bathroom Ceiling Light		PCS	2	
8	Livingroom Ceiling Light		PCS	4	
9	Besroom Ceiling Light		PCS	4	
10	Hall & Entry Ceiling Light		PCS	2	
11	Smoke Detector		PCS	2	
	ELECTRICAL FITTINGS	<u> </u>			
13	Standard Receptacle 120V	15A	PCS	9	
14	GFCI Receptacle 120V	20 A	PCS	11	
15	GFCI Receptacle 240V	30 A	PCS	2	
16	GFCI Receptacle 240V	40 A	PCS	1	
17	GFCI Receptacle 240V	60 A	PCS	1	
18	Fan Switch		PCS	2	
19	Single Pole Switch		PCS	6	
20	Three Way with Dimmer Switch		PCS	2	
21	Dimmer		PCS	2	
Δ	ELECTRICAL CONDUITS & WIRING				
23	ROMEX 14 AWG	14/2 w/ground	FT	146.3	
24	ROMEX 12 AWG	12/2 w/ground	FT	248	
25	ROMEX 10 AWG	10/2 w/ground	FT	0	
	ROMEX 10 AWG	10/3 w/ground	FT	78	
	ROMEX 8 AWG	8/3 w/ground	FT	26	
	ROMEX 6 AWG	6/3 w/ground	FT	30	
	Bare Copper Ground Wire 6 AWG				
	ELECTRICAL BOXES & CIRCUTES				
	Panelboard -240V 1 Phase MLO	200 AMP	PCS	1	
34	Circuit breaker	15 A	PCS	5	
36	Circuit breaker	30 A	PCS	2	
37	Circuit breaker	31 A	PCS	1	
38	Circuit breaker	40 A	PCS	1	
39	Circuit breaker	60 A	PCS	1	
40	Single Gang Switch Box	<u> </u>	PCS	2	
41	Double Gang Switch Box		PCS	3	
	Double Gang Switch Box		PCS	2	
43	Triple Gang Switch Box		PCS	2	
	Pull Box	#1/4	PCS	18	
	Receptacle Box	· ·	PCS	24	

PLUMBING BOM



		WISDOM-1BD1BA-S	SPANISH		
	PLUMBIN	NG SYSTEM MATERIA	AL SHOPF	PING LIST	
No.	Item	Туре	Unit	Quantity	Description
Δ	PLUMBING FIXTURES & ACCESSORIES				
1	Bath Tub (Alcove Tub)		PCS	0	
2	Kitchen Sink		PCS	1	
3	Kitchen Faucets		PCS	1	
4	Vanity Sink		PCS	2	
5	Bath room Faucets		PCS	2	
6	Water Closet		PCS	1	
7	Shower Trim		PCS	1	
8	Shower Tray		PCS	1	
9	Water Heater		PCS	1	
10	Hose Bib		PCS	2	
11	Shutoff Valve		PCS	8	
	Hanging pipe clamp		PCS	18	
13	Gate Valve		PCS	1	
14	Dishwasher Supply Single Connector		PCS	1	
	Dishwasher Sewage Single Connector		PCS	1	
	Laundry Sweat Connector		PCS	1	
Δ	SANITARY & PLUMBING PIPES				
	ABS (Acrylonitrile Butadiene Styrene) Pipes	ø 1"	FT	0	
	ABS (Acrylonitrile Butadiene Styrene) Pipes	ø 1 1/2"	FT	22	
	ABS (Acrylonitrile Butadiene Styrene) Pipes	ø 2"	FT	177	
	ABS (Acrylonitrile Butadiene Styrene) Pipes	ø 3"	FT	6	
	PEX (Cross-linked polyethylene) Pipes	ø 1/2"	FT	67	
	PEX (Cross-linked polyethylene) Pipes	ø 3/4"	FT	43	
	PEX (Cross-linked polyethylene) Pipes	ø 1"	FT	0	
	PVC Pipes Sch.80 - Rigid	ø 1 1/2"	FT	0	
	PVC Pipes Sch.80 - Rigid	ø 2"	FT	0	
	PVC Pipes Sch.80 - Rigid	ø 3"	FT	0	
	Flex Pipe Round	ø 1/2"	PCS	8	
	PIPE FITTINGS	0 1/2	1 00	0	
	ABS 90 Degree Bend Elbow	2"ø-2"ø	PCS	3	
		1 1/2"ø-1 1/2"ø	PCS	23	
	ABS 90 Degree Bend Elbow	2"ø-2"ø	PCS		
	ABS 90 Degree Bend Elbow	3"ø-3"ø	PCS	7	
	ABS Bend Long Sweep Elbow	2"ø-2"ø	PCS	4	
	ABS P-Trap	2"ø-2"ø	PCS		
	ABS Reducer Elbow	2 0-2 0 2"ø-1 1/2"ø	PCS	3	
	ABS Reducer Elbow	3"ø-2"ø	PCS		
	ABS Reducer Elbow			2	
	ABS TEE Elbow	1 1/2"ø-1 1/2"ø-1 1/2"ø	PCS	3	
	ABS TEE Elbow	2"ø-2"ø-2"ø	PCS	2	
	ABS TEE Elbow	3"ø-3"ø-3"ø	PCS	1	
	ABS Tee Reducer Elbow	2"ø-2"ø-2"ø	PCS	3	
	ABS Tee Reducer Elbow	2"ø-2"ø	PCS	1	
	ABS Vent Cap Elbow	2"ø	PCS	1	
	ABS Vent Cap Elbow	2"ø-2"ø-2"ø	PCS	3	
46	ABS WASTE DOUBLE TEE ABS Wye Combination with 8th Bend Elbow	2"ø-2"ø-2"ø 3"ø-3"ø-1 1/2"ø	PCS PCS	1 1	
47					

PLUMBING BOM



49	PEX 90 Degree Elbow	1/2"ø-1/2"ø	PCS	4	
50	PEX Cross Elbow	3/4"ø-3/4"ø	PCS	1	
51	PEX Cross Elbow	1/2"ø-1/2"ø-1/2"ø	PCS	1	
52	PEX Tee Elbow	3/4"ø-3/4"ø-3/4"ø	PCS	4	
53	PEX Tee Elbow	1/2"ø-1/2"ø-1/2"ø	PCS	5	
54	PEX Transition Elbow	3/4"ø-3/4"ø-3/4"ø	PCS	2	
55	PEX Transition Elbow	1"ø-3/4"ø	PCS	10	

HVAC BOM



		WISDOM-1BD1BA-SF	PANISH		
	HV	AC SYSTEM MATERIAL S	SHOPPI	NG LIST	
No.	Item	Туре	Unit	Quantity	Description
Δ	HVAC_DUCTS				
1	PIPE (REFRIGERANT LINE)	1/2" Ø	FT	0.65	
2	PIPE (REFRIGERANT LINE)	1/4" Ø	FT	77.55	
3	PIPE (REFRIGERANT LINE)	3/4" ø	FT	0.63	
4	PIPE (REFRIGERANT LINE)	4" Ø	FT	83.16	
5	DRAYER HOSE	5" Ø	FT	5	
6	FLEX DUCT ROUND	4"	FT	6.58	
	DUCT FITTINGS & ACCESSORIES				
7	ELBOW (REFRIGERANT LINE)	1/2" (Ø)-1/2" (Ø)	PCS	1	
8	ELBOW (REFRIGERANT LINE)	1/4" (Ø)-1/4" (Ø)	PCS	1	
9	ELBOW (REFRIGERANT LINE)	3/4" (Ø)-3/4" (Ø)	PCS	19	
10	ELBOW (REFRIGERANT LINE)	3/8" (Ø)-3/8" (Ø)	PCS	12	
11	TRANSITION (REFRIGERANT LINE)	3/4" (Ø)-1/2" (Ø)	PCS	3	
12	TRANSITION (REFRIGERANT LINE)	3/4" (Ø)-3/8" (Ø)	PCS	1	
13	TRANSITION (REFRIGERANT LINE)	3/8" (Ø)-1/4" (Ø)	PCS	1	
14	TEE (REFRIGERANT LINE)	3/4" (Ø)-3/4" (Ø)-3/4" (Ø)	PCS	1	
15	TEE (REFRIGERANT LINE)	3/8" (Ø)-3/8" (Ø)-3/8" (Ø)	PCS	1	
16	ROUND TRANSITION(ANGLE)	45 DEGREE	PCS	5	
\triangle	HVAC_EQUIPMENTS				
17	AIR HANDLING UNIT	WALL MOUNTED	PCS	2	
18	CONDENSER	OUTDOOR UNIT	PCS	1	
19	EXHAUST FAN	75 CFM	PCS	1	
20	EXHAUST HOOD	WALL MOUNTED	PCS	1	
21	HOOD-WALL: VENT	HOOD-WALL: VENT	PCS	1	
22	DRAYER: VENT	DRAYER: VENT	PCS	1	
23	ROOF VENT	3"(Ø)	PCS	1	



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Have It Your Way!

The material types listed in this document were selected based on personal preferences. The Customer is encouraged to make changes to the material types in accordance with local customs, regulations, and personal preferences. Have It Your Way!

GENERAL NOTES

- This BOM (Bill of Materials) is prepared as a **Materials Shopping List** to help builders and DIYers gain a complete understanding of most if not all elements required for the complete construction of this structure, according to the original design documents provided by FrameUpNow.
- All quantities and specifications are subject to change based on the final design, field measurements, availability of products and customer preferences. The customer should verify all information prior to purchasing materials.
- All products and elements in the list shall conform to the International Residential Code (IRC), or any other local and international building codes, safety regulations, and standards that are applicable to the location of the structure.
- 4 If any changes are made by the customer to the list of materials specified in this document, the customer is responsible for assuring that the correct type and quantity of materials are utilized in accordance with local building codes.
- FrameUpNow ,will not be held responsible for any misuse of this document, the products listed, or for deviations from the content that are made due to changes in specifications, pricing, availability, or customer preferences.
- The customer is advised to consult a qualified professional or technician prior to purchasing materials for specialized construction system items. Some items including but not limited to caseworks, doors and windows may require as built measurements prior to purchase to confirmation of final dimensions.
- If there are additional trim elements or specific installation methods, the total amount of materials needed might vary. Consider any additional trim required for corners, intersections, or other architectural details that might cause this variations before procedding to purchase and construction.



			APPLIANCES				
#	Item	Туре	Description, Manufacturer, SKU	Unit	Quantity	Unit Price	Total
1	Refrigerator			PCS	1		
2	Range			PCS	1		
3	Washer Front Load	Stackable		PCS	1		
4	Dryer Front Load	Stackable		PCS	1		
5	Dish Washer			PCS	1		
6	Oven			PCS	0		
7	Microwave			PCS	0		



			CASEWORKS			
#	Item	Туре	Description, Manufacturer, SKU	Unit	Quantity Unit	Price Total
1	Kitchen Cabinet			FT	15.7	
2	Laundry Cabinet			FT	2.25	
3	Vanity Cabinet			FT	6.1	
4	Medicine Cabinet			PCS	2	
5	Kitchen countertop			SF	24.46	
6	Laundry Countertop			PCS	0	
7	Bathroom Countertop			SF	0	
8	Island			FT	0	
9	Peninsula			FT	0	
10	Closets			SF	102.54	



			ROOF 01				
#	Item	Туре	Description, Manufacturer, SKU	Unit	Quantity U	nit Price	Total
1	Roof Covering			SF	1707.0		
2	Roof Covering Fastener			PCS	854		
3	Roof Felt Paper			SF	1707.0		
4	Roof Felt Paper Fastener			PCS	5121.0		
5	Roof Sheathing			SF	1707.0		
6	Roof Sheathing Fastener			PCS	13656		
7	Batten			FT	447.0		
8	Batten Fastener			PCS	336.1		
9	Soffit			SF	133.0		
10	Soffit Fastener			PCS	66.5		
11	Fascia			FT	137.0		
12	Fascia board fastener			PCS	69		
13	Roof Insulation			SF	1707.0		



			CEILING 01				
ŧ	Item	Туре	Description, Manufacturer, SKU	Unit	Quantity	Unit Price	Total
	LIVING ROOM + KITCHEN			SF	271.8		
	Ceiling Board	Drywall		SF	272		
	Drywall Fastener	Screw		PCS	476		
	Vapor Retarder	Polyethylene film		SF	271.8		
	Vapor Retarder Fastener	Nails with washer heads		PCS	815.3		
	BATH ROOM			SF	63.5		
	Ceiling Board	MRD (Moisture resistant drywall)		SF	64		
	MRD Fastener	Screw		PCS	111		
	HALL + WD			SF	50.6		
	Ceiling Board	Drywall		SF	51		
	Drywall Fastener	Screw		PCS	89		
	Vapor Retarder	Polyethylene film		SF	50.6		
0	Vapor Retarder Fastener	Nails with washer heads		PCS	151.9		
	PORCH	'		SF	72.8		
1	Ceiling Board	Marine Plywood		SF	73		
2	Exterior Grade Plywood	Screw		PCS	127		



			CEILING 02				
#	Item	Туре	Description, Manufacturer, SKU	Unit	Quantity	Unit Price	Total
	BED ROOM 1			SF	159.5		
13	Ceiling Board	Drywall		SF	159		
14	Drywall Fastener	Screw		PCS	279		
15	Vapor Retarder	Polyethylene film		SF	159.5		
16	Vapor Retarder Fastener	Nails with washer heads		PCS	478.4		
	CL 1			SF	14.3		
17	Ceiling Board	Drywall		SF	14		
18	Drywall Fastener	Screw		PCS	25		
19	Vapor Retarder	Polyethylene film		SF	14.3		
20	Vapor Retarder Fastener	Nails with washer heads		PCS	42.8		
	CL 2			SF	23.0		
17	Ceiling Board	Drywall		SF	23		
18	Drywall Fastener	Screw		PCS	40		
19	Vapor Retarder	Polyethylene film		SF	23.0		
20	Vapor Retarder Fastener	Nails with washer heads		PCS	69.1		



	CEILING 03									
#	Item	Туре	Description, Manufacturer, SKU	Unit	Quantity	Unit Price	Total			
	WH			SF	7.8					
13	Ceiling Board	Drywall		SF	8					
14	Drywall Fastener	Screw		PCS	14					
15	Vapor Retarder	Polyethylene film		SF	7.8					
16	Vapor Retarder Fastener	Nails with washer heads		PCS	23.4					



			FLOORING EXTERIOR				
#	Item	Туре	Description, Manufacturer, SKU	Unit	quantity	Unit Price	Total
	STRUCTURE			SF	1027.29		
1	Concrete Slab	4"concrete cast in situ		CF	353.13		
2	Insulation	Rigid insulation		SF	274		
3	Hard core	Compacted soil		CF	259.11		
4	Re-bar	#4 re-bar		Ton	0.99		
5	Concrete Pad	4"concrete cast in situ		CF	1.58		
6	Slab edge	Turndown		CF	243.06		
7	Footing	Cast-in-place concrete		CF	28		
	PORCH						
1	Tile Finish			SF	404.78		
2	Adhesive	1/2" Thin set Mortar		SF	404.78		
3	Vapor Retarder	Vapor Barrier Polyethylene		SF	404.78		



			FLOORING INTERIOR 01			
#	Item	Туре	Description, Manufacturer, SKU	Unit	quantity Unit	Price Total
	BEDROOM					
1	Bedroom Flooring			SF	154.78	
2	Wood underlay	Foam Pad Polyethylene		SF	154.78	
3	Vapor Retarder	Vapor Barrier Polyethylene		SF	154.78	
	CL #1					
4	Closet Flooring			SF	22.33	
5	Wood underlay	Foam Pad Polyethylene		SF	22.33	
6	Vapor Retarder	Vapor Barrier Polyethylene		SF	22.33	
	CL#2					
7	Closet Flooring			SF	13.86	
8	Wood underlay	Foam Pad Polyethylene		SF	13.86	
9	Vapor Retarder	Vapor Barrier Polyethylene		SF	13.86	
	LIVING ROOM AND KITCHEN					
10	Living Area Flooring			SF	296.58	
11	Wood underlay	Foam Pad Polyethylene		SF	296.58	
12	Vapor Retarder	Vapor Barrier Polyethylene		SF	296.58	



		FLOORING INTERIOR 02			
# Item	Туре	Description, Manufacturer, SKU	Unit	quantity Unit F	Price Total
BATHROOM					
1 Tile Finish			SF	47.18	
Adhesive	1/2" Thin set Mortar		SF	47.18	
Vapor Retarder	Vapor Barrier Polyethylene		SF	47.18	
W/D					
Tile Finish			SF	7.99	
Adhesive	1/2" Thin set Mortar		SF	7.99	
Vapor Retarder	Vapor Barrier Polyethylene		SF	7.99	
HANDWASH					
7 Tile Finish			SF	8.6	
Adhesive	1/2" Thin set Mortar		SF	8.6	
9 Vapor Retarder	Vapor Barrier Polyethylene		SF	8.6	
BOILER ROOM					
Tile Finish			SF	7.56	
Adhesive	1/2" Thin set Mortar		SF	7.56	
12 Vapor Retarder	Vapor Barrier Polyethylene		SF	7.56	



			WALLS: EXTERIOR 01				
#	Item	Туре	Description, Manufacturer, SKU	Unit	quantity	Unit Price	Total
1	Stocco Finish			SF	1262		
2	Wall Homewrap			SF	1262		
3	Homewrap Fastener	Stapled fastener (200/pkt)		PKT	4.8		
4	Wall Shteathing (OSB)			SF	1262		
5	Shteathing Fastener	Self-drilling screws(100/pkt)		PKT	12.62		
6	Stone Copping			SF	162		
7	Mortar for Stone Veneer			SF	162		
8	Wall Paint			SF	1262		
9	Wall Insulation			SF	1683		



			WALLS: INTERIOR 01			
Ħ	Item	Туре	Description, Manufacturer, SKU	Unit	quantity	it Price Total
	BATHROOM			SF	287	
L	Cementitious Backer Board			SF	287	
	Kerdi membrane			SF	287	
	Kerdi membrane Fastener			SF	287	
	Wall Ceramic Tile			SF	287	
	BEDROOM			SF	297	
	Drywall Board			SF	297	
	Drywall Fastener	Self-drilling screws(100/pkt)		PKT	2.97	
	Wall Paint			SF	297	
	Drywall Tape			FT	55.7	
	HALL			SF	84	
	Drywall Board			SF	84	
0	Drywall Fastener	Self-drilling screws(100/pkt)		PKT	0.84	
1	Wall Paint			SF	84	
2	Drywall Tape			FT	15.8	



			WALLS: INTERIOR 02				
#	Item	Туре	Description, Manufacturer, SKU	Unit	quantity	Unit Price	Total
	LIVING ROOM			SF	283		
13	Drywall Board			SF	283		
14	Drywall Fastener	Self-drilling screws(100/pkt)		PKT	2.83		
15	Wall Paint			SF	283		
16	Drywall Tape			FT	53.1		
	KITCHEN			SF	98		
17	Cementitious Backer Board			SF	24		
18	Drywall Board			SF	98		
19	Drywall Fastener	Self-drilling screws(100/pkt)		PKT	0.98		
20	Kerdi membrane			SF	24		
21	Kerdi membrane Fastener			SF	24		
22	Wall Ceramic Tile			SF	24		
23	Wall Paint			SF	98		
24	Drywall Tape			FT	18.5		



			WALLS: INTERIOR 03				
#	Item	Туре	Description, Manufacturer, SKU	Unit	quantity	Unit Price	Total
	CLOSET 1			SF	99		
25	Drywall Board			SF	99		
26	Drywall Fastener	Self-drilling screws(100/pkt)		PKT	0.99		
27	Wall Paint			SF	99		
28	Drywall Tape			FT	18.6		
	CLOSET 2			SF	127		
29	Drywall Board			SF	127		
30	Drywall Fastener	Self-drilling screws(100/pkt)		PKT	1.27		
31	Wall Paint			SF	127		
32	Drywall Tape			FT	23.8		
	WASHROOM			SF	76		
33	Cementitious Backer Board			SF	76		
34	Kerdi membrane			SF	76		
35	Kerdi membrane Fastener			SF	76		
36	Wall Ceramic Tile			SF	76		



			WALLS: INTERIOR 04			
#	Item	Туре	Description, Manufacturer, SKU	Unit	Quantity	Jnit Price Total
	WD			SF	67	
37	Cementitious Backer Board			SF	67	
38	Kerdi membrane			SF	67	
39	Kerdi membrane Fastener			SF	67	
40	Wall Ceramic Tile			SF	67	
	WH			SF	71	
41	Drywall Board			SF	71	
42	Drywall Fastener	Self-drilling screws(100/pkt)		PKT	0.71	
43	Wall Paint			SF	71	
44	Drywall Tape			FT	13	
45	Wall Skirting	Ceramic		FT	82	



		DOORS				
t Item	Туре	Description, Manufacturer, SKU	Unit	Quantity	Unit Price	Total
Interior Swinging	3' - 0" X 6'-8"		PCS	1		
Interior Swinging	2' - 8" X 6'-8"		PCS	1		
Interior Swinging	2' - 4" X 6'-8"		PCS	1		
Front Door With Sidelight	5' - 5" X 6'-11 1/2"		PCS	1		
Interior Sliding	7' - 8" X 6'-8"		PCS	1		
Interior Sliding	5' - 2" X 6'-8"		PCS	1		
Patio Sliding	5' - 0" X 6'-8"		PCS	1		
Exterior Door Trim			FT	37.7		
Interior Door Trim			FT	249.5		
Entry Lock set			PCS	2		
Privacy Lock set			PCS	2		
0 Passage Lock set			PCS	3		



			WINDOWS				
#	Item	Туре	Description, Manufacturer, SKU	Unit	Quantity	Unit Price	Total
1	Single Hung	3' - 3" X 4'-3"		PCS	1		
2	Single Hung	3' - 3" X 3'-3"		PCS	1		
3	Sliding	3' - 3" X 3'-3"		PCS	2		
4	Sliding	5' - 3" X 3'-3"		PCS	1		
5	Sliding	6' - 3" X 3'-3"		PCS	1		
6	Sliding	3' - 3" X 2'-3"		PCS	1		
7	Exterior Window Trim			FT	108.4		
8	Interior Window Trim			FT	108.4		



			LIGHTING FIXTURES				
#	Lighting	Туре	Description, Manufacturer, SKU	Unit	Quantity	Unit Price	Total
1	Kitchen Ceiling Light			PCS	2		
2	Exterior Wall Mounted Light			PCS	4		
3	Livingroom Ceiling Light With Fan			PCS	0		
4	Bedroom Ceiling Light With Fan			PCS	1		
5	Dining Ceiling Light			PCS	0		
6	Bath Wall Mounted Light			PCS	1		
7	Bathroom Ceiling Light			PCS	2		
8	Livingroom Ceiling Light			PCS	4		
9	Besroom Ceiling Light			PCS	4		
10	Hall & Entry Ceiling Light			PCS	2		
11	Smoke Detector			PCS	2		



			ELECTRICAL FITTINGS				
#	Item	Туре	Description, Manufacturer, SKU	Unit	Quantity	Unit Price	Total
1	Standard Receptacle 120V	15A		PCS	9		
2	GFCI Receptacle 120V	20 A		PCS	11		
3	GFCI Receptacle 240V	30 A		PCS	2		
4	GFCI Receptacle 240V	40 A		PCS	1		
5	GFCI Receptacle 240V	60 A		PCS	1		
6	Fan Switch			PCS	2		
7	Single Pole Switch			PCS	6		
8	Three Way with Dimmer S	Switch		PCS	2		
9	Dimmer			PCS	2		



			ELECTRICAL CONDUITS & WIRING				
#	Item	Туре	Description, Manufacturer, SKU	Unit	Quantity	Unit Price	Total
1	ROMEX 14 AWG	14/2/W/ground		FT	146.3		
2	ROMEX 12 AWG	12/2/W/ground		FT	248		
3	Romex 10 AWG	10/3/W/ground		FT	78		
4	ROMEX 8 AWG	8/3/W/ground		FT	26		
5	ROMEX 6 AWG	6/3/W/ground		FT	30		
	Bare Copper Ground Wire 6 AWG						



			ELECTRICAL BOXES & CIRCUTES				
#	Item	Туре	Description, Manufacturer, SKU	Unit	Quantity	Unit Price	Total
1	Lightind and Appliance panelboard -240V 1 PHASE	200 AMP		PCS	1		
2	Circuit breaker	15 A		PCS	5		
3	Circuit breaker	20 A		PCS	5		
4	Circuit breaker	30 A		PCS	2		
5	Circuit breaker	40 A		PCS	1		
5	Circuit breaker	60 A		PCS	1		
7	Single Gang Switch Box			PCS	2		
3	Double Gang Switch Box			PCS	2		
)	Triple Gang Switch Box			PCS			
LO	Pull Box	#1/4		PCS	18		
11	Receptacle Box			PCS	24		



		SANITARY & PLUMBING PIPES				
Item	Туре	Description, Manufacturer, SKU	Unit	Quantity	Unit Price	Total
ABS (Acrylonitrile Butadiene Styrene) Pipes	ø 1"		FT	0		
ABS (Acrylonitrile Butadiene Styrene) Pipes	ø 1 1/2"		FT	22		
Styrene) Pipes			FT	177		
ABS (Acrylonitrile Butadiene Styrene) Pipes	ø 3"		FT	6		
PEX (Cross-linked polyethylene) Pipes	ø 1/2"		FT			
PEX (Cross-linked polvethylene) Pipes	ø 3/4"		FT	43		
PEX (Cross-linked polyethylene) Pipes	ø 1"		FT	0		
			FT	0		
			FT	0		
			FT	0		
Flex Pipe Round	ø 1/2"		PCS	8		
	ABS (Acrylonitrile Butadiene Styrene) Pipes PEX (Cross-linked polyethylene) Pipes PEX (Cross-linked polyethylene) Pipes PEX (Cross-linked polyethylene) Pipes PEX (Cross-linked polyethylene) Pipes	ABS (Acrylonitrile Butadiene Styrene) Pipes PEX (Cross-linked S	Item Type Description, Manufacturer, SKU ABS (Acrylonitrile Butadiene Styrene) Pipes	Item Type Description, Manufacturer, SKU Unit ABS (Acrylonitrile Butadiene Styrene) Pipes FT PEX (Cross-linked polyethylene) Pipes FT PVC Pipes Sch.80 - Rigid PT PVC Pipes Sch.80 - Rigid PT PVC Pipes Sch.80 - Rigid PT FT FT FT FT FT FT FT FT FT	Item	Item



			PIPE FITTINGS 01				
‡	Item	Туре	Description, Manufacturer, SKU	Unit	Quantity	Unit Price	Total
L	ABS 90 Deg Bend Elbow	2"ø-2"ø		PCS	23		
	ABS 90 Degree Bend Elbow	1 1/2"ø-1 1/2"ø		PCS	2		
	ABS 90 Degree Bend Elbow	2"ø-2"ø		PCS	4		
	ABS 90 Degree Bend Elbow	3"ø-3"ø		PCS	1		
,	ABS Bend Long Sweep Elbow	2"ø-2"ø		PCS	3		
j	ABS P-Trap	1 1/2"ø-1 1/2"ø		PCS	4		
,	ABS P-Trap	2"ø-2"ø		PCS	1		
3	ABS Reducer Elbow	2"ø-1 1/2"ø		PCS	3		
	ABS Reducer Elbow	3"ø-2"ø		PCS	2		
.0	ABS TEE Elbow	1 1/2"ø-1 1/2"ø-1 1/2"ø		PCS	2		
1	ABS TEE Elbow	2"ø-2"ø-2"ø		PCS	5		
2	ABS TEE Elbow	3"ø-3"ø-3"ø		PCS	2		
3	ABS Tee Reducer Elbow	2"ø-2"ø-1 1/2"ø		PCS	1		
4	ABS Tee Reducer Elbow	2"ø-2"ø-2"ø		PCS	1		
.5	ABS Trap P	2"ø-2"ø		PCS	1		



			PIPE FITTINGS 02				
#	Item	Туре	Description, Manufacturer, SKU	Unit	Quantity	Unit Price	Total
1	ABS Vent Cap Elbow	1 1/2"ø		PCS	1		
2	ABS Vent Cap Elbow	2"ø		PCS	3		
3	ABS WASTE DOUBLE TEE	2"ø-2"ø-2"ø		PCS	1		
4	ABS Wye Combination with 8	2"ø-2"ø-2"ø		PCS	1		
5	ABS Wye Combination with 8	3"ø-3"ø-1 1/2"ø		PCS	1		
6	ABS Wye Combination with 8	3"ø-3"ø-2"ø		PCS	1		
7	PEX 90 Degree Elbow	1/2"ø-1/2"ø		PCS	32		
8	PEX 90 Degree Elbow	3/4"ø-3/4"ø		PCS	4		
9	PEX Cross Elbow	1/2"ø-1/2"ø-1/2"ø		PCS	1		
10	PEX Cross Elbow	3/4"ø-3/4"ø-3/4"ø		PCS	1		
11	PEX Tee Elbow	1/2"ø-1/2"ø-1/2"ø		PCS	5		
12	PEX Tee Elbow	3/4"ø-3/4"ø-3/4"ø		PCS	5		
13	PEX Transition Elbow	1"ø-3/4"ø		PCS	2		
14	PEX Transition Elbow	3/4"ø-1/2"ø		PCS	10		



			PLUMBING FIXTURES & ACCESSORIES	5			
‡	Item	Туре	Description, Manufacturer, SKU	Unit	Quantity	Unit Price	Total
L	Bath Tub (Alcove Tub)			PCS	0		
2	Kitchen Sink			PCS	1		
3	Kitchen faucets			PCS	1		
ļ.	Vanity Sink			PCS	2		
5	Bath room faucets			PCS	2		
5	Water Closet			PCS	1		
7	Shower Trim			PCS	1		
3	Shower Tray			PCS	1		
)	Water Heater			PCS	1		
LO	Hose Bib			PCS	2		
l1	Shutoff Valve			PCS	8		
12	Hanging pipe clamp			PCS	18		
13	Gate Valve			PCS	1		
L4	Dishwasher Supply Single Connector			PCS	1		
15	Dishwasher Sewage Single Connector			PCS	1		
L6	Laundry Sweat Connector			PCS	1		

HVAC BOM



			HVAC_DUCTS 01				
#	Item	Туре	Description, Manufacturer, SKU	Unit	Quantity	Unit Price	Total
1	PIPE (REFRIGERANT LINE)			FT	0.65		
2	PIPE (REFRIGERANT LINE)	3/8" (Ø)		FT	77.55		
3	PIPE (REFRIGERANT LINE)	1/2" (Ø)		FT	0.63		
4	PIPE (REFRIGERANT LINE)	5/8" (Ø)		FT	83.16		
5	DRAYER HOSE	4" (Ø)		FT	5		
6	FLEX DUCT ROUND	4" (Ø)		FT	6.58		

HVAC BOM



			DUCT FITTINGS & ACCESSORIES				
#	Item	Туре	Description, Manufacturer, SKU	Unit	Quantity	Unit Price	Total
1	ELBOW (REFRIGERANT	1/2" (Ø)-1/2" (Ø)		PCS	1		
2	ELBOW (REFRIGERANT	1/4" (Ø)-1/4" (Ø)		PCS	1		
3	ELBOW (REFRIGERANT	3/4" (Ø)-3/4" (Ø)		PCS	19		
4	ELBOW (REFRIGERANT LINF)	3/8" (Ø)-3/8" (Ø)		PCS	12		
5	TRANSITION (REERIGERANT LINE)	3/4" (Ø)-1/2" (Ø)		PCS	3		
6	TRANSITION (REFRIGERANT LINE)	3/4" (Ø)-3/8" (Ø)		PCS	1		
7	TRANSITION (REERIGERANT LINE)	3/8" (Ø)-1/4" (Ø)		PCS	1		
8	TEE (REFRIGERANT LINE)	3/4" (Ø)-3/4" (Ø)-3/4" (Ø)		PCS	1		
9	TEE (REFRIGERANT LINE)	3/8" (Ø)-3/8" (Ø)-3/8" (Ø)		PCS	1		
10	ROUND TRANSITION(ANGLE)	45 DEGREE		PCS	5		

HVAC BOM



			HVAC_EQUIPMENTS				
#	Item	Туре	Description, Manufacturer, SKU	Unit	Quantity	Unit Price	Total
1	AIR HANDLING UNIT	WALL MOUNTED		PCS	2		
<u> </u>	CONDENSER	OUTDOOR UNIT		PCS	1		
3	EXHAUST FAN	75 CFM		PCS	1		
1	EXHAUST HOOD	WALL MOUNTED		PCS	1		
5	HOOD-WALL: VENT	HOOD-WALL: VENT		PCS	1		
5	DRAYER: VENT	DRAYER: VENT		PCS	1		
7	ROOF VENT	3"(Ø)		PCS	1		