


# WISDOM

The Wisdom is a charming Craftsman-style home with a warm and inviting exterior. The classic gable roof, covered porch with sturdy columns, and decorative trim details create a timeless aesthetic. The covered porch with wooden beams offers a shaded outdoor space, perfect for relaxing or entertaining.

The interior features an open floor plan that seamlessly combines the living and kitchen areas, maximizing space and creating a sense of openness. The two bedrooms with one common bathroom and an extra bathroom provide comfortable and private living quarters.

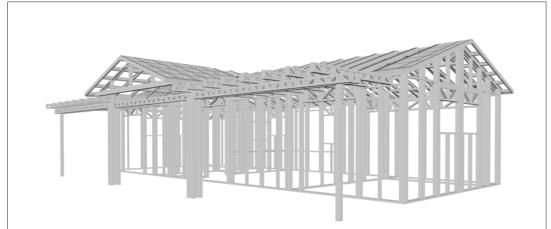

## Materials Shopping List

Please print and take this Materials Shopping List to your favorite Home Depot and ask for assistance in selecting the materials, fixtures and fittings to complete your new home.

Record your selection and the price of the item. Then do the math to determine the cost for your selections and the total cost of finishing your home.



#### < CLICK HERE >

To Go To Materials Shopping List





# **FLOOR PLAN**

749 SF

2Bed

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ARCHITECTURAL

**HOW TO BUILD** 

STRUCTURAL

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CONSTRUCTION STEPS

**COVER SHEET** GENERAL NOTES WALL FRAME LAYOUT WALL PANEL & LAYOUT PLAN 19 20 ROOF TRUSS LAYOUT **STRUCTURAL SECTIONS** -21 WALL BRACING LAYOUT HOLD-DOWN PLAN **STRUCTURAL DETAILS 1 STRUCTURAL DETAILS 2 STRUCTURAL DETAILS 3 27** TRUSS BLOCKING LAYOUT SHEETROCK BACKING **ROOF BRACING LAYOUT** 

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**DISCLAIMER** 

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**PLUMBING** 

SHOPPING LIST

WATER SUPPLY & SEWAGE SYSTEM + 37 **MATERIALS** MATERIALS SHOPPING LIST **⊣ 38** 

NOTES AND SCHEDULES

# **ABOUT**



FrameUpNow is a design and manufacturing company providing precision-engineered home framing solutions. We offer a catalog of Affordable Homes, Tiny Homes, Garages, Shops and Barndominiums. FrameUpNow manufactures cold-formed steel (CFS) also known as Light Gauge Steel (LGS) framing components that conform to our engineered metal house frame plans or can be purchased as DIY skeleton kits.

The CFS/LGS framing is lightweight, easily assembled, and does not require heavy equipment or specialized labor, enabling homeowners to erect the frame themselves in just a few days. Unlike wood, the steel framing is impervious termites and bores, warping, expansion, and fire.

Our home plans come complete with a structural engineered stamp for permit approvals. Customers receive a full BOM also known as a Materials Shopping List to purchase finish materials from a Building Materials retailer. FrameUpNow prides itself on the quality and efficiency of our precision-engineered home framing solutions for construction professionals and DIY homeowners.



**KEY PLAN** 

NO.	DESCRIPTION	DATE

NOTE:

LEGEND:

09-Wisdom-749-2Bd1Ba-Craftsman-550

DRAWING NAME

# INTRODUCTION

CLIENT NAME:
PROJECT NUMBER:
DATE:
DESIGNED BY:
DRAWN BY:
CHECKED BY:

1101

SCALE:

# **DESCRIPTIONS**

## MATERIALS LIST

The BOM (Bill Of Materials) package, known as the Materials Shopping List document, provides:

Comprehensive Inventory: Detailed lists of essential materials sourced from architectural, mechanical, HVAC, electrical, and plumbing design drawing sets.

Precise Curation: Each item meticulously selected and organized for accuracy and efficiency in project planning.

Customizable Options: Customers can modify listed items to their preferences and calculate costs accordingly, ensuring alignment with personal project needs and budget.

Dedicated Space for Details: Includes tables for customers to note Home Depot SKU numbers or product descriptions for selected items, facilitating seamless purchasing and coordination with suppliers.

Customer Convenience: Take the list to Home Depot or preferred suppliers for accurate pricing, helping align the total home budget with personal financial plans.

Simplify your construction journey with our Materials Shopping List document, where detailed preparation meets streamlined implementation for your dream home.

## STRUCTURAL

The structural drawings package provides an exhaustive set of detailed plans essential for the precise assembly of your building. This comprehensive package includes:

Framing Plans: Detailed layouts for all framing components. Truss Layouts: Clear instructions for truss placement and

Panel Length Plans: Specifications for panel dimensions. Framing Elevations and Sections: Precise elevation and sectional views for accurate construction.

Truss and Wall Blocking Plans: Plans for truss and wall blocking to ensure structural integrity.

Hold-Down Plan: Detailed hold-down requirements for stability. Snap Sheet: Reference sheet for quick identification of components

Structural Details and Bracing Plans: Complete details and bracing plans for all structural elements.

Accompanying these plans is a comprehensive Bill of Materials (BOM) that lists every necessary building component, from cold formed steel (CFS) frames to fasteners.

## ARCHITECTURAL

With the comprehensive architectural package, both builders and DIY homeowners can confidently execute the construction.

The architectural package includes:

Furnished Floor Plans: Complete with furniture layouts for a clear understanding of space utilization.

Detailed Dimension Plans: Ensures precise measurements, from the overall footprint down to the exact placement of windows and

Foundation Plan: Detailed plan to establish a solid foundation.

Wall Framing and Truss Layout: Comprehensive plans for wall framing and truss placement.

Architectural Elevations: Exterior views showcasing the design.

Strategic Building Sections: Critical cross-sectional details for a thorough understanding of the build.

Casework Drawings and Diagrams: Suggested designs for built-in caseworks, such as kitchen cabinets.

#### **MECHANICAL ELECTRICAL**

The mechanical package includes everything needed to guide HVAC

Detailed HVAC Floor Plan: Precisely maps out the placement of air handlers, ductwork, and vents throughout the home's layout.

HVAC Sections and Riser Diagrams: Technical drawings offering critical cross-sectional details and piping schematics, ensuring proper integration of the heating and cooling system into the home's structure.

Bill of Materials: A complete list of all necessary HVAC components.

The electrical package includes all the plans and documentation needed to guide the installation of your home's electrical system:

Detailed Power Plan: Precisely maps out the placement of outlets, switches, and other power components throughout the layout.

Comprehensive Lighting Plan: Shows the optimal locations for lighting fixtures, sconces, and other illumination sources to create a well-lit, functional interior.

Dimensioned Electrical Layout: Provides exact dimensions and measurements to ensure proper placement of all electrical elements.

Bill of Materials: A complete list of every component needed, from circuit breakers to wiring.

The plumbing package includes everything needed to guide the

Detailed Water Supply System Plan: Precisely maps out the placement of pipes, valves, and plumbing fixtures throughout the

Comprehensive Sewage System Plan: Shows the optimal routing and sizing of drain lines to effectively remove waste and ensure

pipes to fixtures.

# **PLUMBING**

installation of your home's water supply and drainage systems:

proper drainage.

Detailed Riser Diagrams: Provide information needed to properly install all vertical plumbing risers and vent stacks.

Bill of Materials: A complete list of every component needed, from


# BOM (Bill Of Materials) (Separately Attached)





The Bill of Materials (BOM) is a crucial document that compiles the material requirements from different disciplines into a centralized inventory, enabling efficient procurement, inventory management, and cost estimation for a specified project or

**ELECTRICAL BOM** 



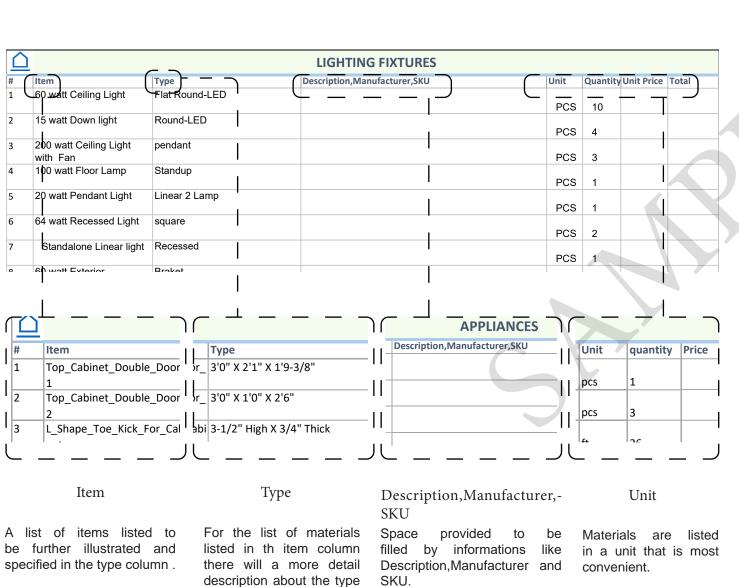

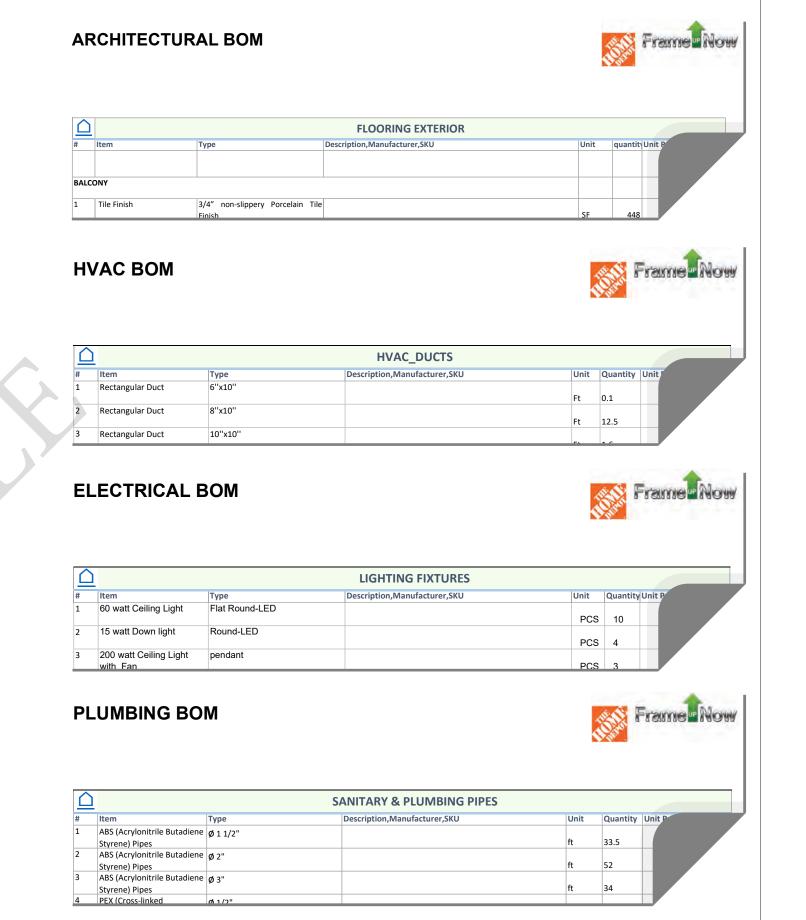

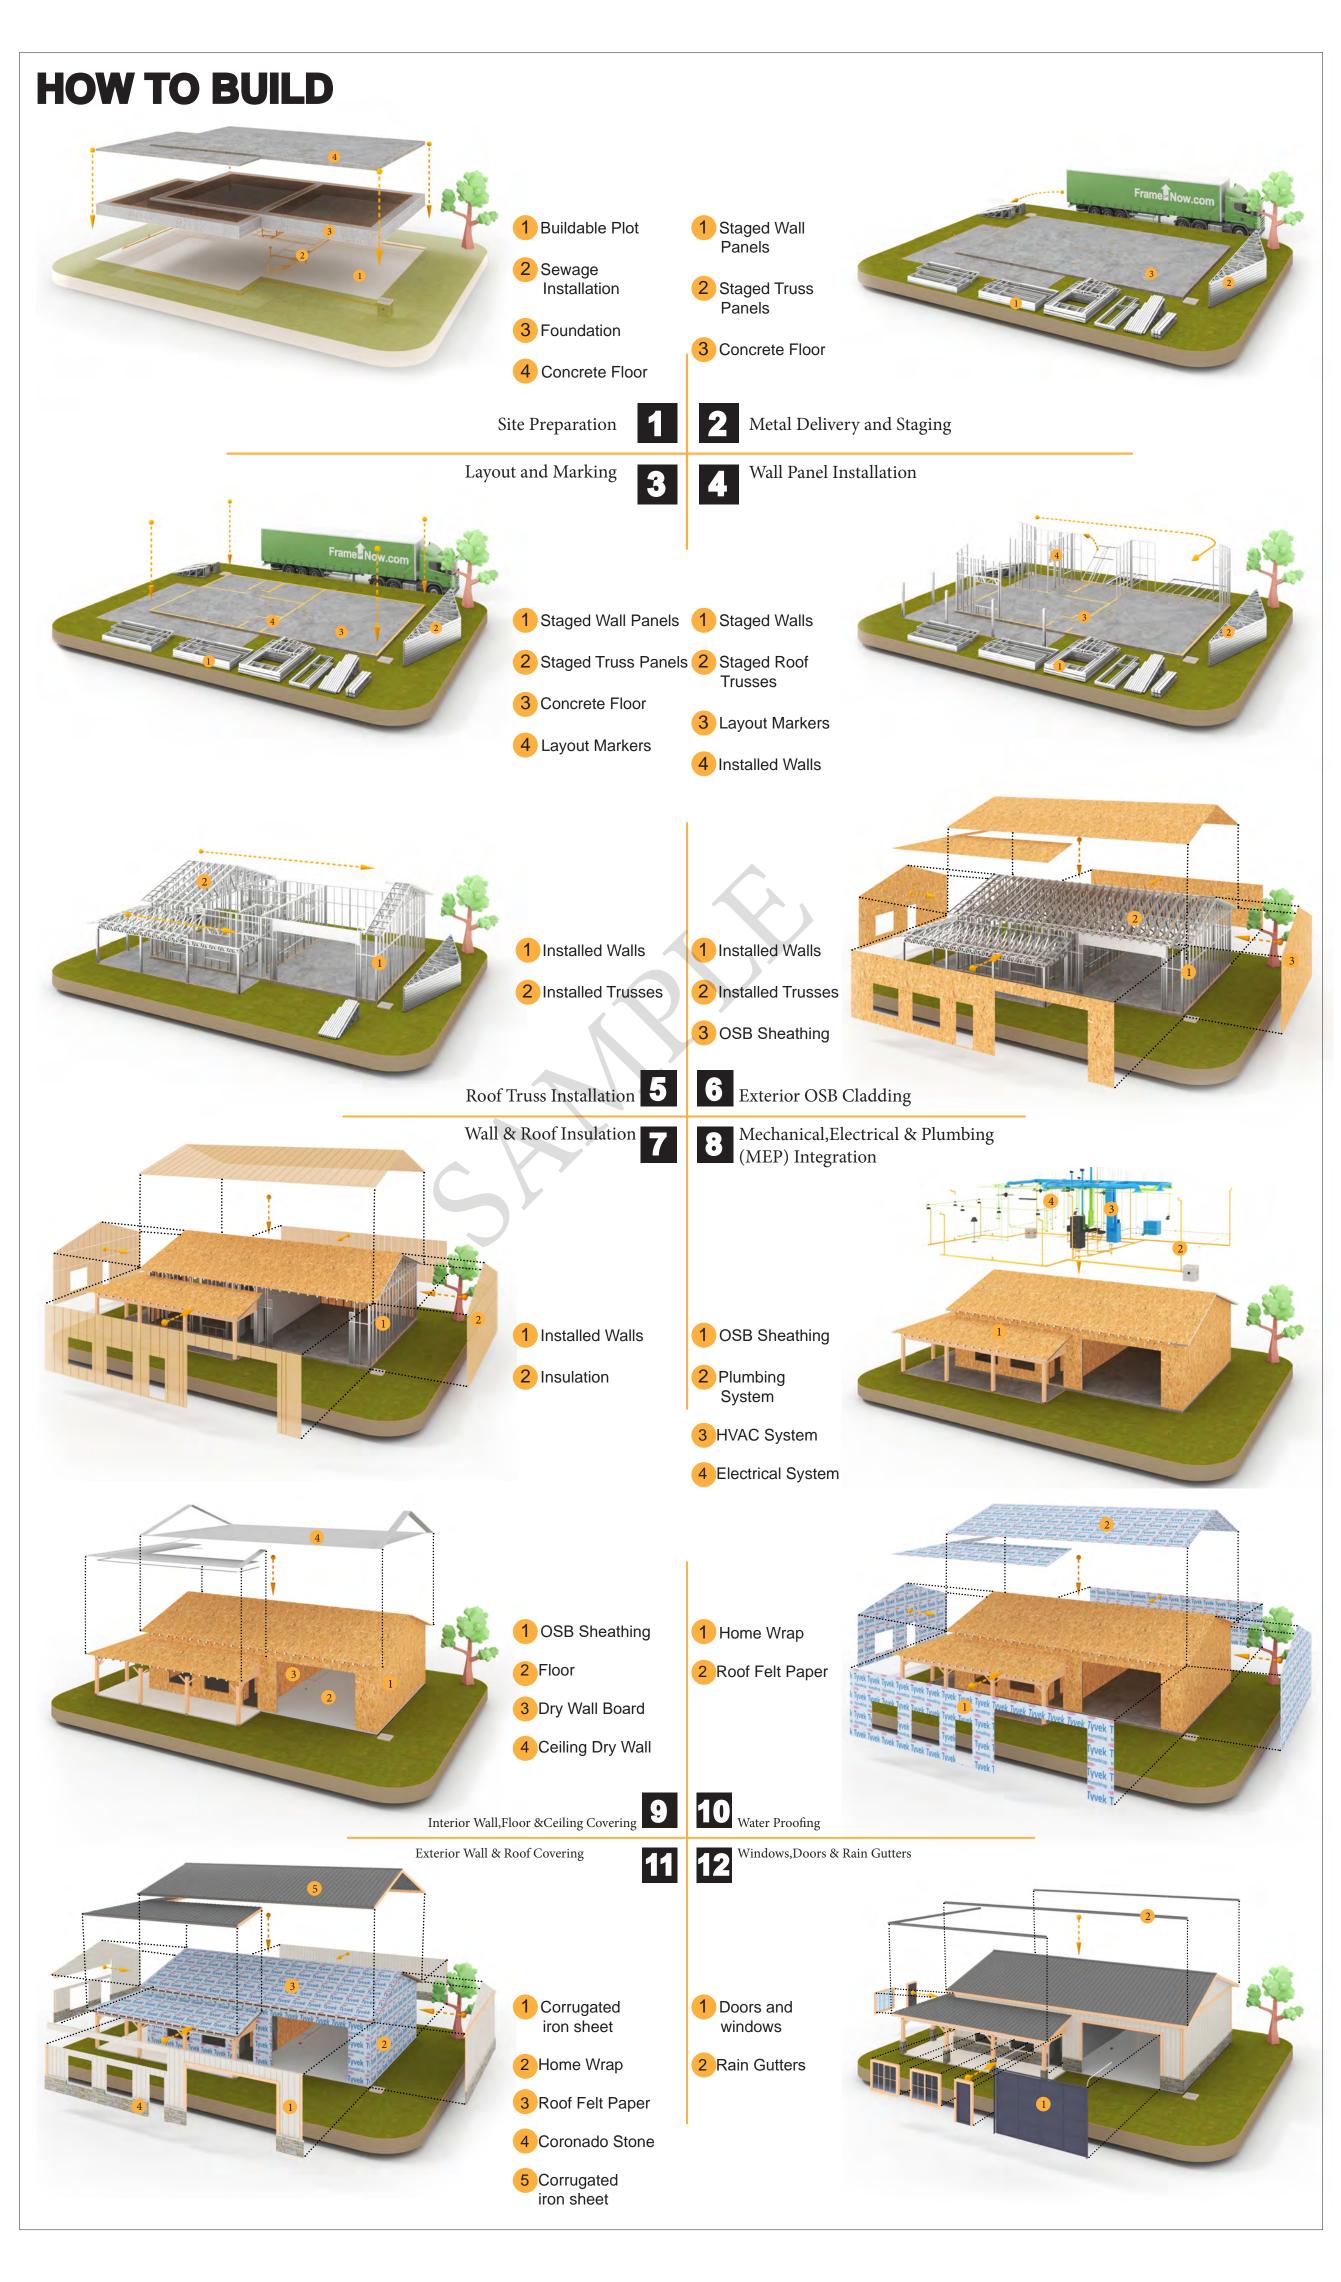



**KEY PLAN** 

NO.	DESCRIPTION	DATE

NOTE:

LEGEND:

PROJECT 09-Wisdom-749-2Bd1Ba-

DRAWING NAME

# INTRODUCTION

Craftsman-550


CLIENT NAME: PROJECT NUMBER: DATE: **DESIGNED BY** DRAWN BY: CHECKED BY:

1102

SCALE:

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of the Material.

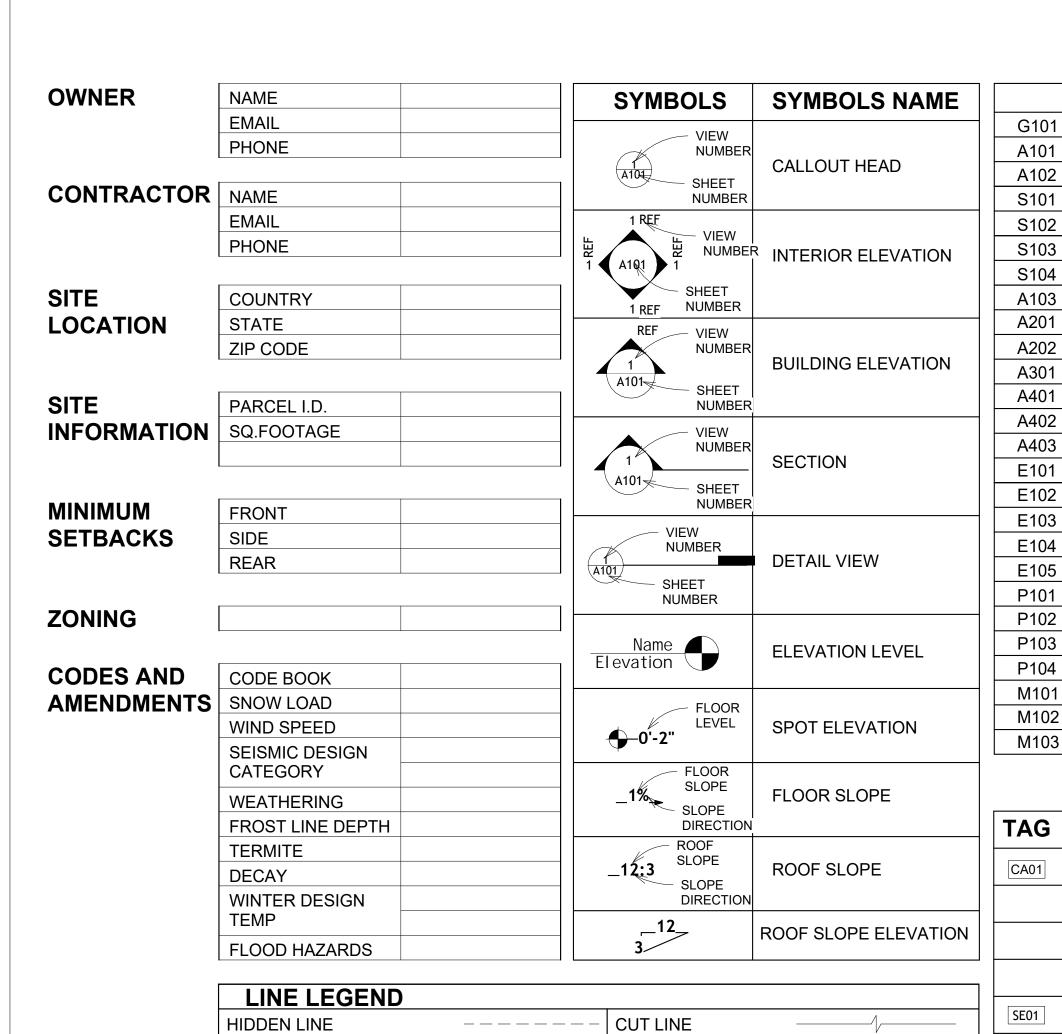

ROOM SEPARATOR

OVER HEAD

DOOR OPENING DIRECTION

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1	HVAC PLAN	REF
2	HVAC SECTION	RG
3	RISER DIAGRAM	SE
		SF
		SIMP. S
	TAG'S NAME	
	CASEMORK TAC	SIMP. A
	CASEWORK TAG	TV
	DOOR TAG	UNO
	FURNITURE TAG	W/
	. 3.441.31.2 17.3	W/D
	· · · · · · · - · - · · - · · - · · · ·	

WINDOW TAG

ME01

SPECIALTY EQUIPMENT TAG

PLUMBING EQUIPMENT TAG

MECHANICAL EQUIPMENT TAG

IVIIIN.	IVIIIVIIVIOIVI
NO.	NUMBER
O.C	ON CENTER
OSB	ORIENTED STRAND BOARD
PL	PLUMBING
PSI	POUNDS PER SQUARE INCH
PVC	POLYVINYL CHLORIDE
REF	REFERENCE
RG	RIGHT GARAGE
SE	SPECIAL EQUIPMENT
SF	SQUARE FEET
SIMP. STHD8	SIMPSON STRAP THE HOLDDOWN
SIMP. ABE66	SIMPSON ANCHOR BOLT EDGE
TV	TELEVISION
UNO	UNLESS NOTED OTHERWISE
W/	WITH
W/D	WASHER/DRYER
AC	AIR CONDITIONING UNIT
ACC	AIR COOLED CONDENSER
ACCU	AIR COOLED CONDSENSING UNIT
AHU	AIR HANDLING UNIT
CC	COOLING COIL
CD	CEILING DIFFUSER
CFm	Cubic Feet Per Minute
CR	CEILING REGISTER CONDENSING UNIT
CW	
CVV	COLD WATER
E/A	EXHAUST AIR
EF	EXHAUST FAN
ET	EXPANSION TANK
EX.	EXISTING
FC	FLEXIBLE CONNECTION
FCU	FAN COIL UNIT
FLR.	FLOOR
HC	HEATING COIL
HE	AIR TO AIR HEAT EXCHANGER
HV	HEATING AND VENTILATING UNI
IV	INLET VANES
MER	MECHANICAL ROOM
MAX.	MAXIMUM
MIN.	MINIMUM
R/A	RETURN AIR
RCU	RECIPROCATING CHILLER UNIT
RF	RETURN FAN
S/A	SUPPLY AIR
SCD	SMOKE CONTROL DAMPER
	STATIC PRESSURE

**ABBREVIATION** 

CASEWORK

ELECTRICAL

**FOOTINGS** 

MAXIMUM

MINIMUM

**MECHANICAL** 

CONDITIONING

ACTION FLOOR SYSTEMS

AMERICAN SOCIETY FOR

**TESTING AND MATERIAL** 


FINISHED FLOOR LEVEL

FINISHED FLOOR ELEVATION

HEATING, VENTILATION & AIR

INTERNATIONAL RESIDENCE


INTERNATIONAL MECHANICAL

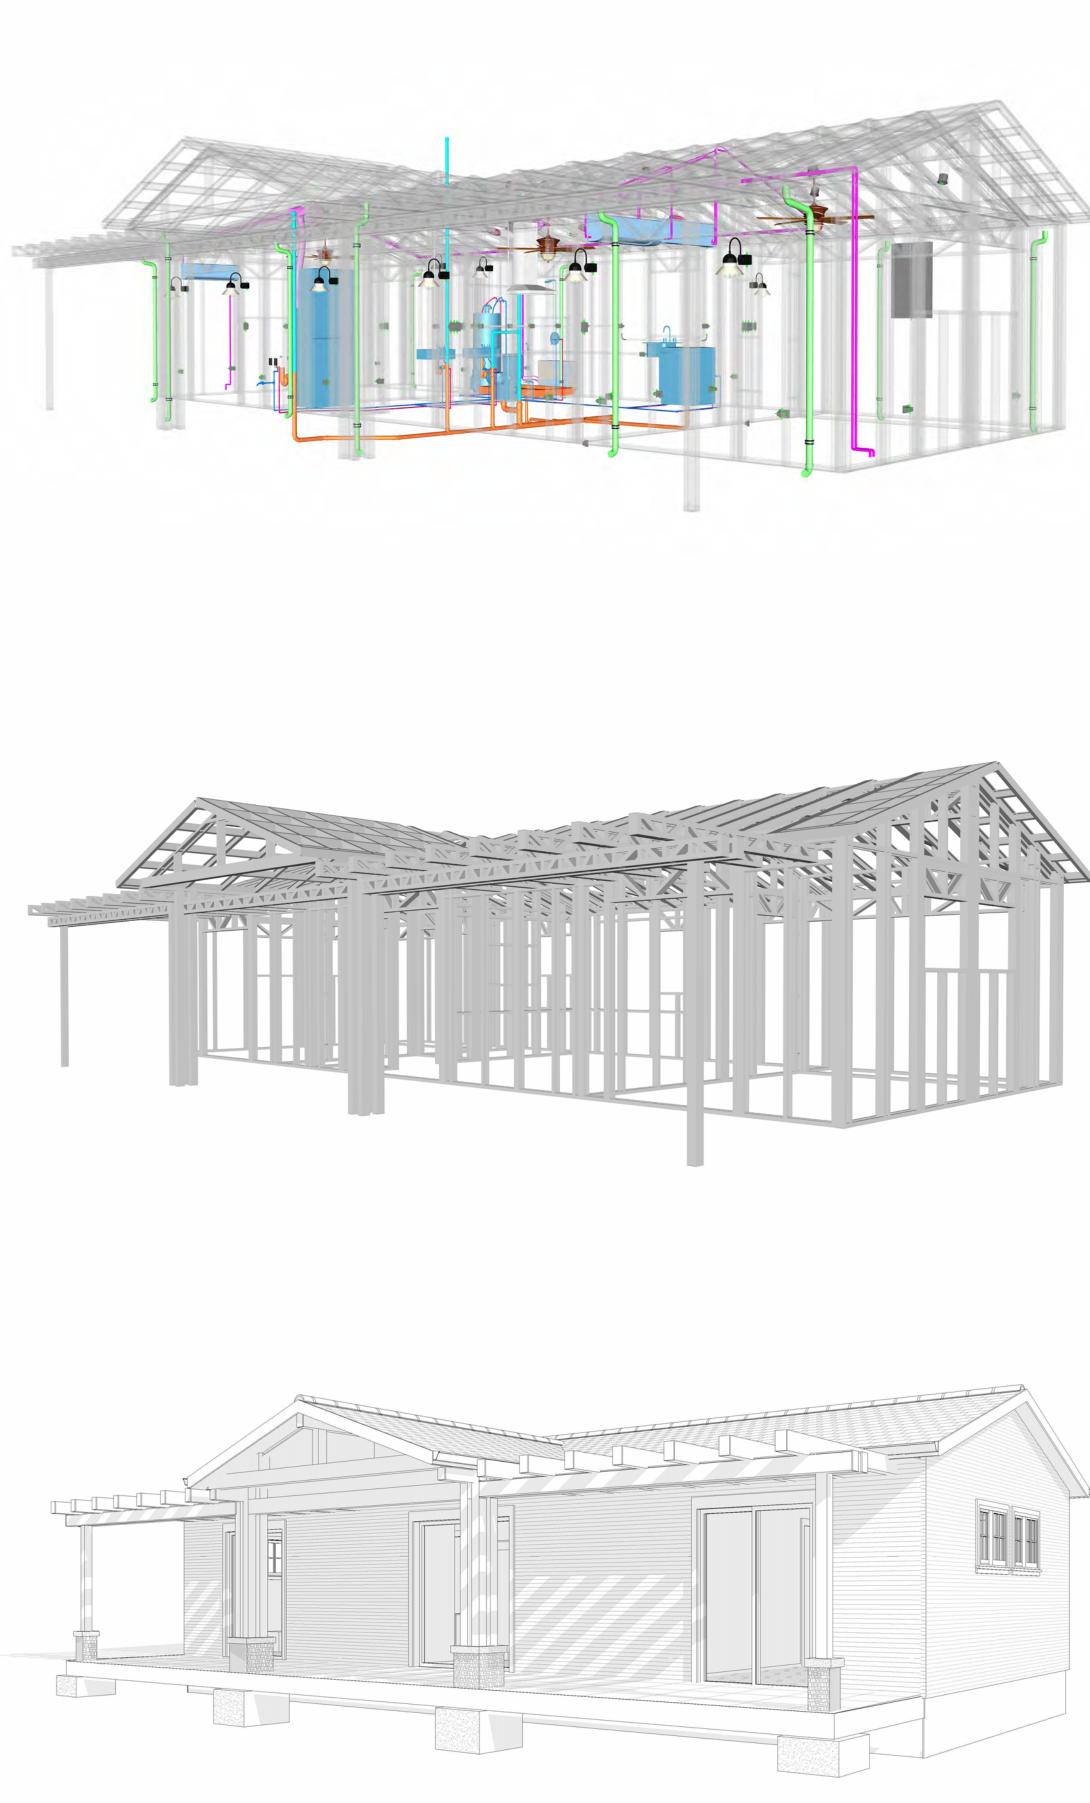

09-Wisdom-749-2Bd/1Ba-Traditional-550

SQUARE FOOT	AGE
LIVING	748 SF
PATIO	250 SF
TOTAL	998 SF



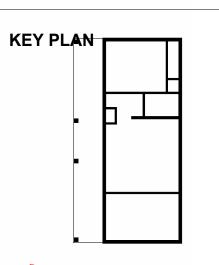

RSPECTIVE ANGLE		
NO.	DESCRIPTION	DATE

NOTE:

LEGEND:

PROJECT

09-Wisdom-749-2Bd1Ba Craftsman-550

DRAWING NAME

**COVER SHEET** 

CLIENT NAME:	Client Name
PROJECT NUMBER:	0033_15
DATE:	2/1/2025 7:23:32 PM
DESIGNED BY:	Designer
DRAWN BY:	Author
CHECKED BY:	Checker

G101

SCALE: **As indicated** 



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#### **GENERAL NOTES**

- 1. THIS DRAWING DEPICTS THE ARCHITECTURAL (SPACE LAYOUT, FURNISHING, FLOOR, WALLS, ROOFS, FOUNDATION, WINDOWS AND DOORS) SYSTEMS. IT PROVIDES A VISUAL REPRESENTATION OF THE ARCHITECTURAL LAYOUT AND COMPONENTS.
- 2. THE ARCHITECTURAL DRAWINGS ARE PREPARED TO MEET THE SPECIFIC REQUIREMENTS OF THE BUILDING, AS PER THE PROJECT SPECIFICATIONS AND APPLICABLE CODES AND STANDARDS.
- 3. THE CONSTRUCTION OF THIS HOME SHALL COMPLY WITH THE LATEST EDITION OF THE INTERNATIONAL RESIDENTIAL CODE (IRC), INTERNATIONAL MECHANICAL CODE (IMC), THE INTERNATIONAL PLUMBING STANDARD, THE NATIONAL ELECTRICAL STANDARD AND ALL OTHER APPLICABLE LOCAL, STATE, AND NATIONAL CODES AND REGULATIONS.
- 4. COORDINATION WITH OTHER TRADES HAS BEEN DONE ON A DESIGN LEVEL. THIS DRAWING SHALL BE READ TOGETHER WITH THE ME, EL AND PL DESIGN DRAWINGS TO ENSURE PROPER CONSTRUCTION AND INTEGRATION OF THE BUILDING SYSTEMS.

#### **ABOUT WALLS:**

#### 1. SHOWER WALL COVERING

BATHTUB AND SHOWER SPACES (WALLS AND FLOORS) WITH INSTALLED SHOWER HEADS AND IN SHOWER COMPARTMENTS SHALL BE FINISHED WITH A NON-ABSORBENT SURFACE.

#### 2. WALL PAINT (INTERNAL)

THE TYPICAL THICKNESS OF LATEX WALL PAINT IS 1/32 OF AN INCH FOR A SINGLE COAT. AND DOUBLE COAT (1/16") SHALL BE APPLIED FOR DURABILITY.

#### 3. ADHESIVES:

THE ADVISABLE TYPE OF ADHESIVE FOR THIS PROJECT IS **EPOXY ADHESIVES** BECAUSE THEY ARE KNOWN FOR THEIR HIGH STRENGTH, DURABILITY, AND RESISTANCE TO MOISTURE, CHEMICALS AND HEAT.


REFER TO SHEETS A201 & A202 FOR GENERAL NOTES ON EXTERNAL FINISHING MATERIALS

#### **ABOUT FLOORS:**

- . THE SPOT ELEVATION INDICATES THE FINISHED FLOOR ELEVATION.
- 2. FINISHED FLOORS PER PLANS.
- 3. FIELD VERIFY FOR DIMENSION DROP 4" FOR SHOWER AND BATHTUB USE.
- 4. 1% SLOPE ON OUTDOOR BALCONIES FOR WATER RUN OFF.
- 5. 2% SLOPE TOWARDS THE SHOWER DRAIN FOR SUFFICIENT DRAINAGE.
- 6. 4" DROP AT THE DOOR LEADING TO EXTERIOR BALCONY FROM THE MAIN LIVING AREA.
- 7. 5% SLOPE FOR GARAGE IS USED, WHICH SHOULD BE CHECKED WITH THE LOCAL GARAGING ZONING LAWS
- GARAGING ZONING LAWS.

FURNITURE SCHEDULE			
TYPE MARK	TYPE	COUNT	
1	KING SIZE BED	2	
3	<varies></varies>	3	
6	COFFE TABLE	1	

	ROOM FINISH SCHEDULE						
ROOM NUMBE R	ROOM NAME	FLOOR FINISH	BASE FINISH	WALL FINISH	CEILING FINISH	CEILING HEIGHT	COMMENT S
15	DEDDOOM 2	LIADDWOOD	CONCRETE	MALL DAINT	DRY WALL		
15 16	BEDROOM 2 KITCHEN	HARDWOOD HARDWOOD	CONCRETE	WALL PAINT WALL PAINTT + CERAMIC	DRY WALL		
19	LIVING	HARDWOOD	CONCRETE	WALL PAINT	DRY WALL		
20	BATHROOM	HARDWOOD	CONCRETE	CERAMIC TILE	MRD		
21	BEDROOM 1	HARDWOOD	CONCRETE	WALL PAINT	DRY WALL		
22	FRONT PATIO	PROCELAIN TILE	CONCRETE	EXTERIOR-GRADE-PLYWO OD			
23	WD	HARDWOOD	CONCRETE	WALL PAINT	DRY WALL		
24	CL 2	HARDWOOD	CONCRETE	WALL PAINT	DRY WALL		
25	HALL	HARDWOOD	CONCRETE	WALL PAINT	DRY WALL		
26	WH 2	HARDWOOD	CONCRETE	WALL PAINT	DRY WALL		
27	WH	HARDWOOD	CONCRETE	WALL PAINT	DRY WALL		
28	CL 1	HARDWOOD	CONCRETE	WALL PAINT	DRY WALL		

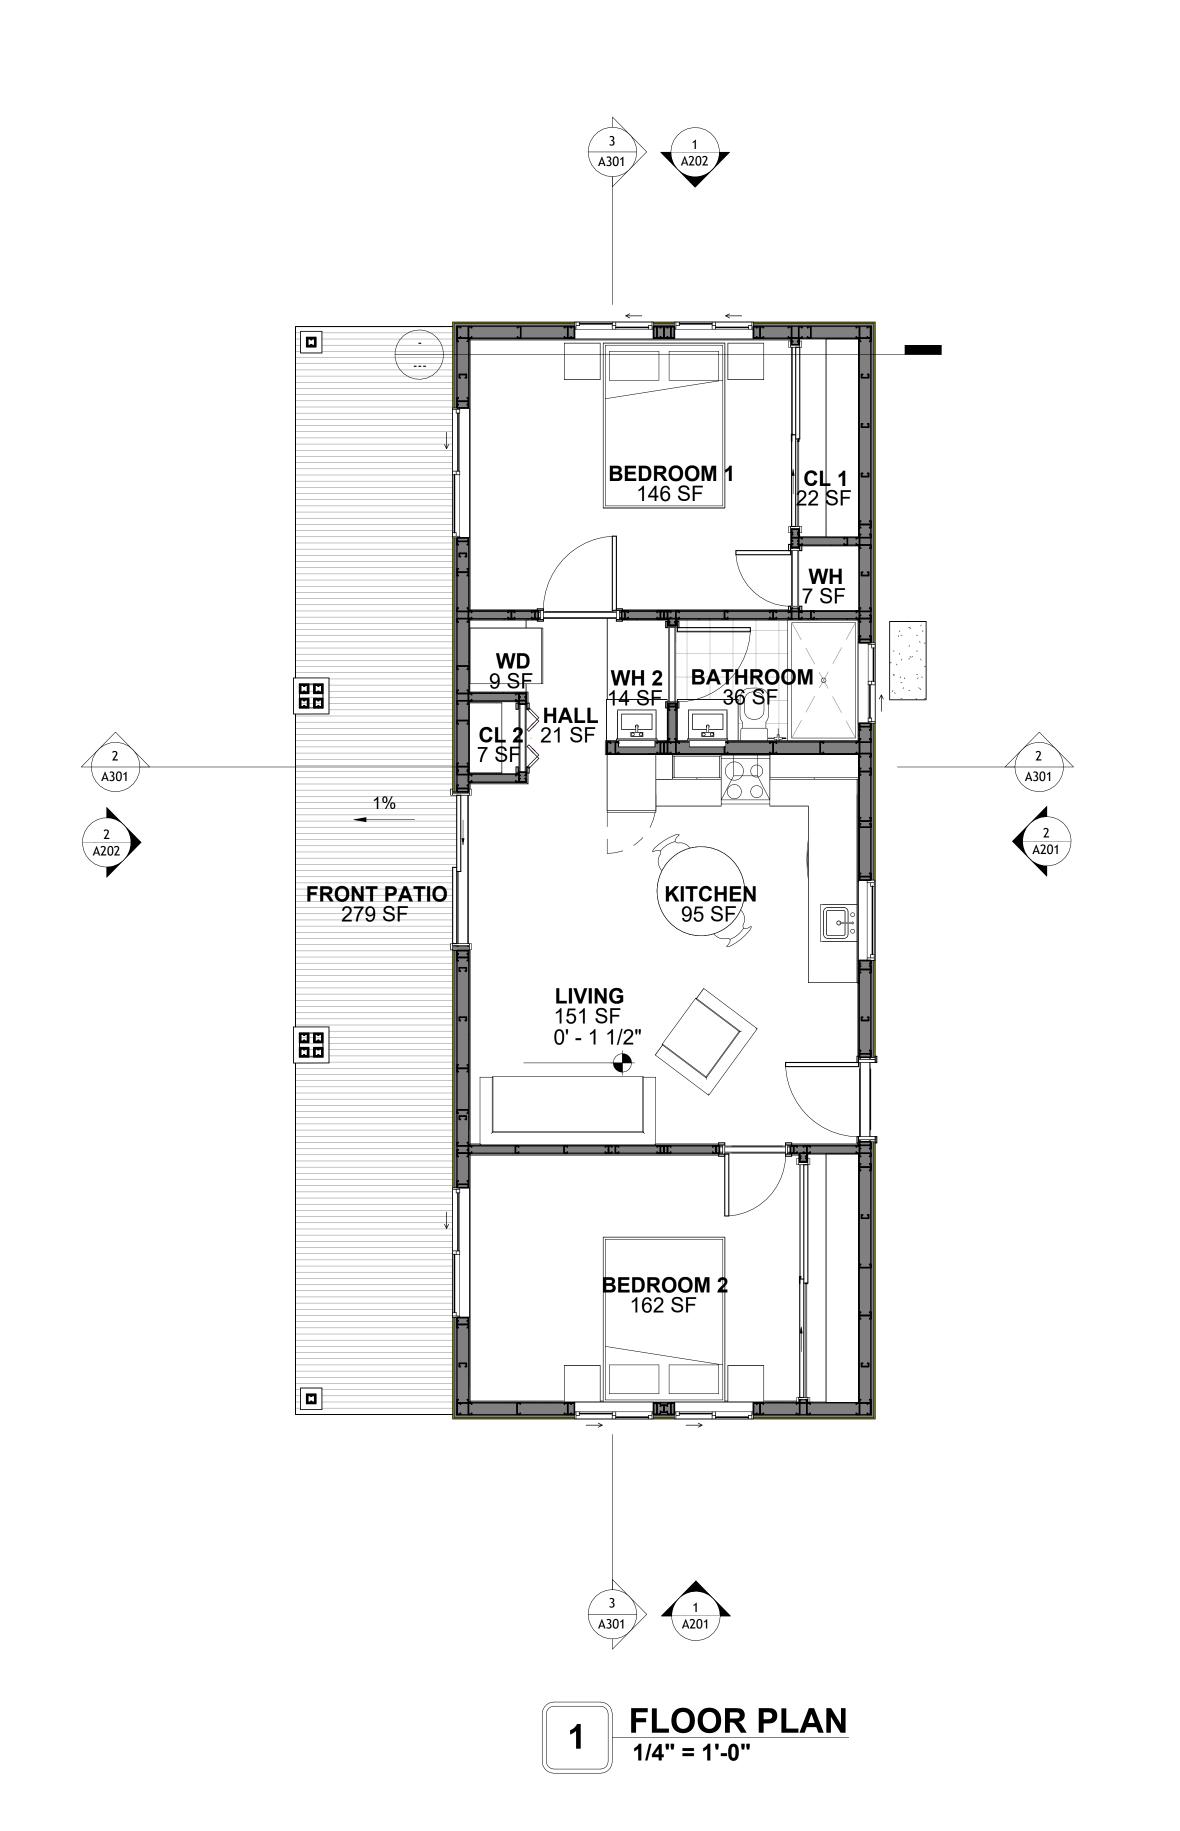

SQUARE FOOTAGE		
LIVING	748 SF	
PATIO	250 SF	
TOTAL	998 SF	



**KEY PLAN** 

NO.	DESCRIPTION	DATE	
		I	

NOIE.

LEGEND:

PROJEC

09-Wisdom-749-2Bd1Ba Craftsman-550

DRAWING NAME


FLOOR PLAN

	CLIENT NAME:	Client Name
	PROJECT NUMBER:	0033_15
	DATE:	2/1/2025 7:23:35 PM
	DESIGNED BY:	Designer
	DRAWN BY:	Author
	CHECKED BY:	Checker
- 1		

A101

SCALE: 1/4" = 1'-0"

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Tuscon,AZ, USA 888-864-0184 inquire@frameupnow.com www.frameupnow.com

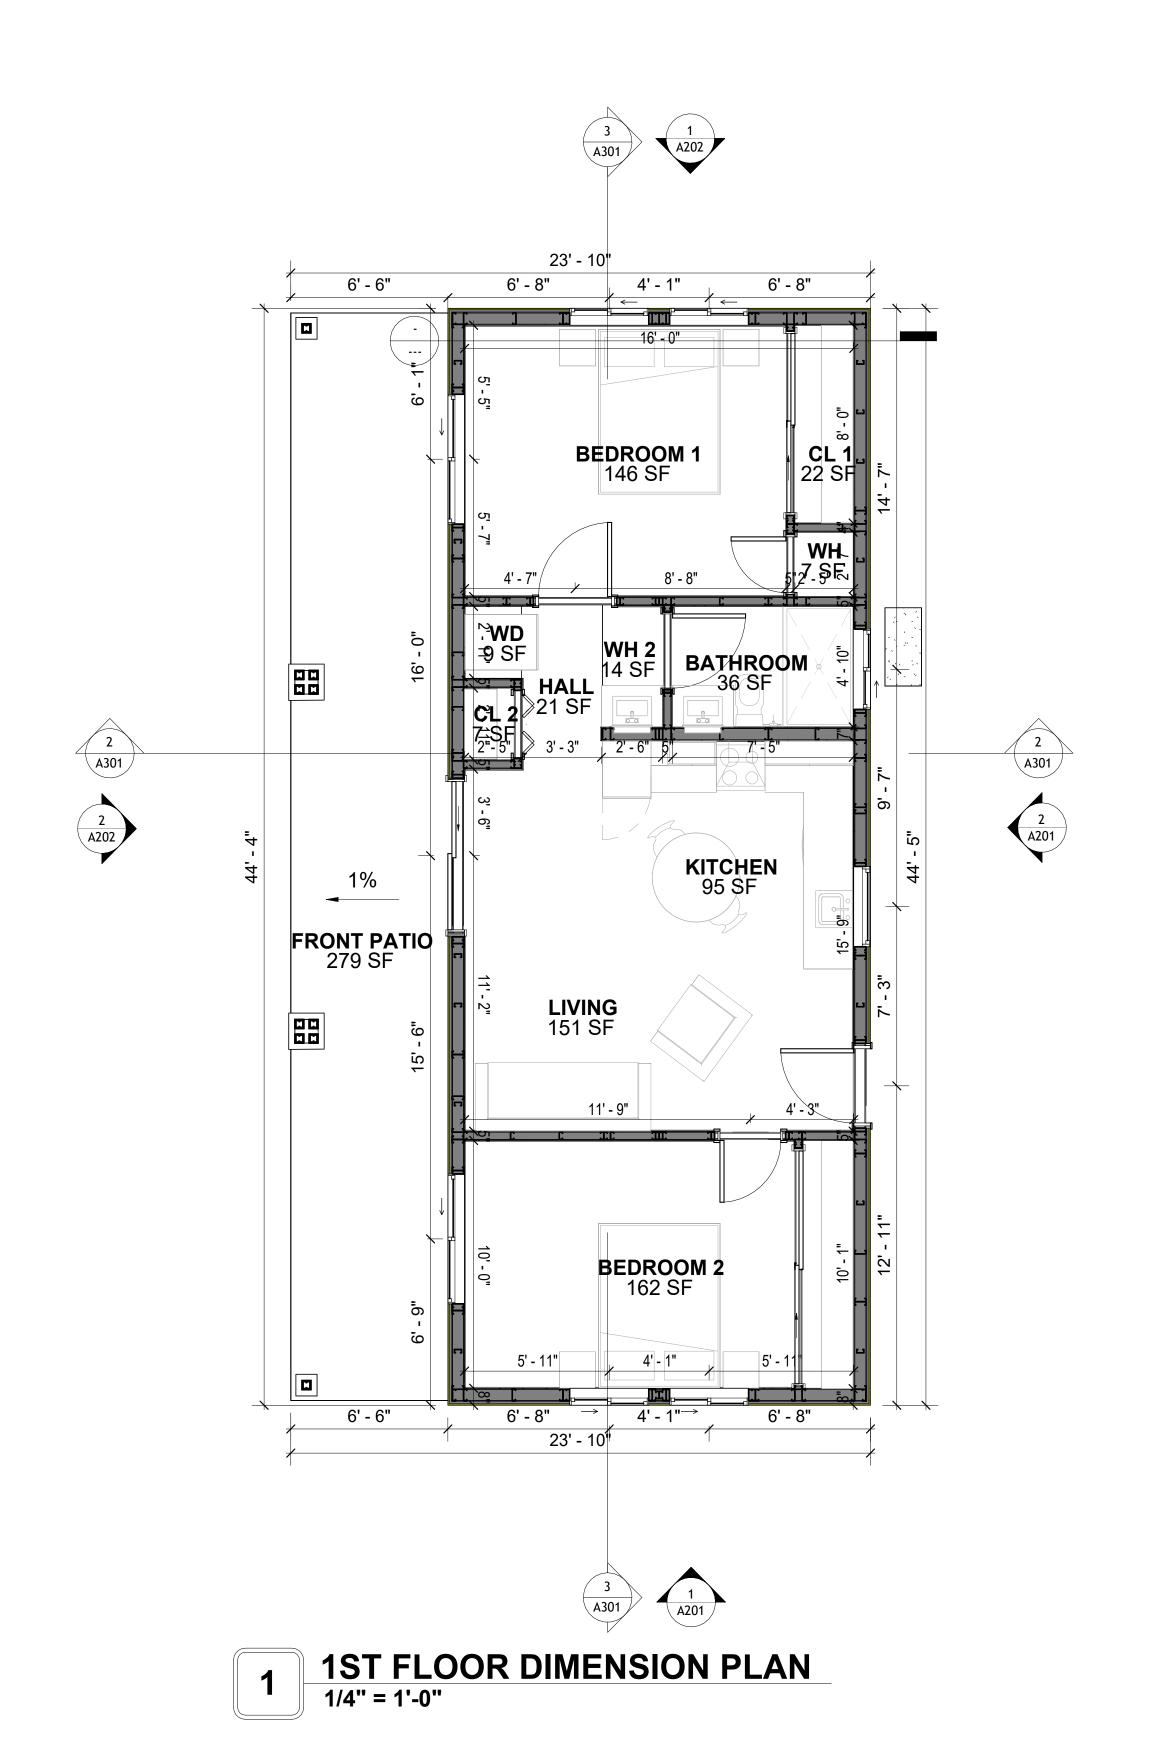**KEY PLAN** 

NO. DESCRIPTION		DATE

NOTE:

LEGEND:

PROJEC

09-Wisdom-749-2Bd1Ba Craftsman-550

DRAWING NAME

FLOOR DIMENSION PLAN

A103

SCALE: 1/4" = 1'-0"

DIMENSIONS IN THE ARCHITECTURAL DRAWINGS CONSIDER FINISHING MATERIALS. FOR PRECISE MEASUREMENTS OF THE STRUCTUAL FRAMING, REFER TO THE ATTACHED STRUCTURAL PLAN SET.

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PATIO 250 SF

TOTAL 998 SF

SQUARE FOOTAGE

#### **FOUNDATION NOTES**

#### NOTES

TERMITES PRETREATMENT BY LICENSED CONTRACTOR UNDER SLAB AND AROUND FOOTINGS. ALL AREAS BELOW SLABS SHALL BE TREATED NO MORE THAN 24 HOURS PRIOR TO CONCRETE POUR. EVIDENCE OF TREATMENT MUST BE PROVIDED PRIOR TO PLACING OF CONCRETE.

#### MATERIALS:

ALL INTERIOR CONCRETE SLABS SHALL BE A MIN. OF 4" THICK CONCRETE OVER 4" COMPACTED AGGREGATE BASE (ASTM D698), FINISH ELEVATIONS AS NOTED ON DRAWINGS, 6" ABOVE ADJACENT GRADE, LEVEL SLABS TO 1/8"-10' MAX.. CONCRETE SLABS SHALL BE 2500# PSI AT 28 DAYS. A 4" ALLOWABLE SLUMP.

#### 2. PAD PREPARATION:

- EXCAVATION FOR FOOTING SHALL BE NEAT.

- FOOTINGS SHALL BE POURED IMMEDIATELY AFTER EXCAVATION AND APPROPRIATE INSPECTION.

- ALL REINFORCING STEEL MARKED "CONTINUOUS" SHALL BE LAPPED 36 BAR DIAMETERS AT SPLICES AND AROUND CORNERS OR INTERSECTIONS WITH A STANDARD 90 DEGREE BEND ON CORNER BARS. LAP WIRE MESH ONE FULL MESH AT SIDE AND END LAPS.

- ALL HARDWARE TO BE SIMPSON OR EQUIVALENT.
- EXTERIOR FRAME WALL TO BE SECURED WITH 1/2"X10" ANCHOR BOLTS 4'-0" O.C. FOR 1-

STORY AND 2'-8" O.C. FOR 2-STORY. BOLTS SHALL BE LOCATED WITHIN 1'-0" OF EACH END PIECE AND SHALL HAVE A MIN. OF TWO BOLTS PER PIECE.

-FOUNDATION ANCHOR STRAPS SHALL BE PERMITTED, ACCORDING TO RESIDENTIAL CODE 2021

- ALL INTERIOR WALLS TO BE SECURED WITH POWER DRIVEN PINS PER MANUFACTURER SPECIFICATION USE PIN SPACING EQUIVALENT TO 1/2" ANCHOR BOLTS.

ALL CONSTRUCTION TO CONFORM TO THE 2012 IRC
 R-10 RIGID INSULATION OUTSIDE OF EXTERIOR FOUNDATION WALLS UNDER LIVING AREA.

- R-10 RIGID INSULATION OUTSIDE OF EXTERIOR FOUNDATION WALLS UNDER LIVING AF - CONCRETE PAD FOR CONDENSER THICKNESS IS 4" MIN UNLESS OTHERWISE NOTED.

#### 3. CONCRETE CONSTRUCTION:

- THE SLAB SHALL BE UNDERLAIN BY A VAPOR BARRIER/RETARDER IN THE LIVING AREA (TYPICALLY POLYETHYLENE, UNLESS MORE STRINGENT PROTECTION REQUIRED BY THE ARCHITECT, ENGINEER, FLOOR COVERING MANUFACTURER, OR ACCEPTED PRACTICE). UNLESS OTHERWISE REQUIRED, BARRIER MAY BE OMITTED AT GARAGES, PORCHES AND PATIOS WITHOUT FLOOR COVERINGS. IT IS BEYOND THE SCOPE OF THESE PLANS TO DETERMINE THE APPLICABILITY OF THESE MORE STRINGENT REQUIREMENTS. BUILDER SHALL VERIFY PRIOR TO CONSTRUCTION.

#### 4. REINFORCEMENT

- IF CONSTRUCTED ON ACTIVE SOILS, THE LONG TERM PERFORMANCE OF THE FOUNDATION IS DEPENDENT ON MAINTENANCE BY THE OWNER. THUS THE BUILDER SHALL ADVISE THE OWNER OF THE FOLLOWING:

1. DRAINAGE MUST BE MAINTAINED. WATER SHALL NEVER BE ALLOWED TO POND NEAR THE

FOUNDATION.

2. THE SOIL AROUND THE FOUNDATION SHALL BE MAINTAINED IN A RELATIVELY DAMP CONDITION, SUCH AS THAT REQUIRED TO KEEP A LAWN GREEN. IF IT DRIES OUT IT WILL SHRINK IF IT GETS WET IT WILL HEAVE LIPWARD.

SHRINK. IF IT GETS WET, IT WILL HEAVE UPWARD.

3. SLABS ON THE SHORTER SIDE USES MAIN BARS ARE USED IN THIS DIRECTION ONLY WITH SMALLER DIAMETER DISTRIBUTION BARS ARE PLACED, FORMING A MAT OR GRID.

4. ALL REINFORCEMENT BARS SIZE 10MM OR LARGER IN ACCORDANCE TO ASTM

ANCHOR BOLTS AT ALL EXTERIOR WALLS SHALL BE MINIMUM 1/2 INCH DIAMETER WITH A MAXIMUM SPACING OF 6'-0" ON CENTER, UNLESS NOTED OTHERWISE.
 ANCHOR BOLTS SHALL BE INSTALLED WITHIN 12 INCHES OF EACH END OF EACH SILL PLATE WITH AT LEAST TWO ANCHOR BOLTS FOR EACH BOLTS FOR EACH SILL PLATE LONGER

THAN 12 INCHES.


5. SIMPSONS SILL ANCHORS MAYBE SUBSTITUTED FOR ANCHOR BOLTS AT THE SAME

SPACING.
6. EXTERIOR CONCRETE SLABS WHICH ARE NOT PART OF THE MAIN SLAB SHALL BE MINIMUM 4 INCHES THICK WITH NO STEEL REINFORCING BARS REQUIRED, UNLESS NOTED OTHERWISE ON FOUNDATION PLAN.

#### VERIFY THE FOLLOWING PRIOR TO POURING:

- I. ALL HOLDDOWNS , STRAP, AND POST LOCATIONS.
- CONCRETE FINISHES. PANEL RISER LOCATION WHERE APPLICABLE.
- 3. UNDERSLAB MECHANICAL REQUIREMENTS.
- 4. STEM WALL BLOCKOUTS.
- 5. UNDERSLAB ELECTRICAL REQUIREMENTS AND PANEL RISER LOCATION. WHERE APPLICABLE.
- 6. PROVIDE THE FOLLOWING:
- PVC SLEEVES THROUGH FTG IF REQUIRED
- 20' #4 COPPER GROUND BAR.
- 7. SLOPE FINISH GRADE AWAY FROM FOOTING.

**NOTE**: FIELD VERIFY ALL DIMENSIONS SEE DIMENSIONED ARCHITECTURAL DRAWINGS

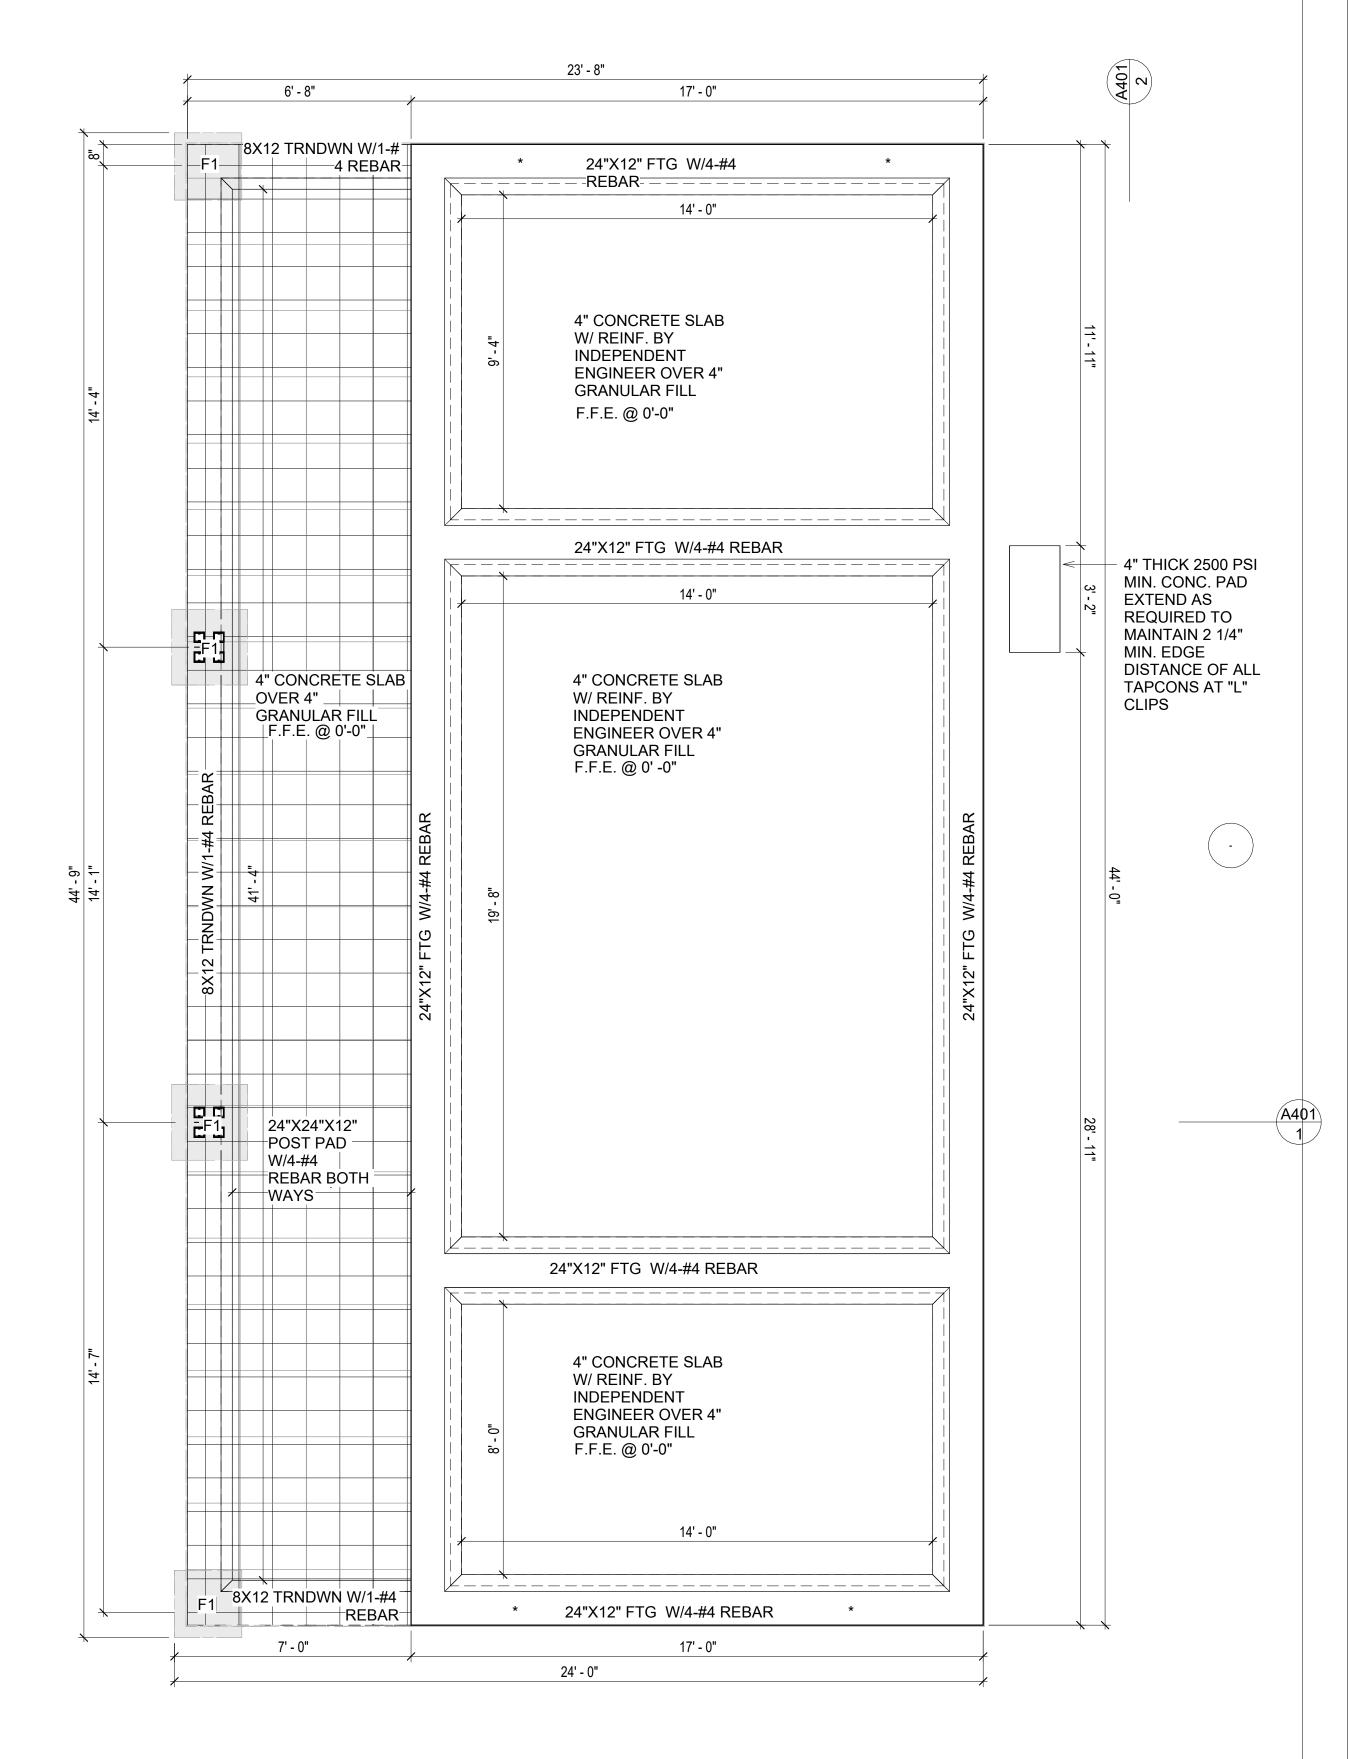

1 FOUNDATION PLAN
3/8" = 1'-0"

SQUARE FOOTAGE

LIVING 748 SF
PATIO 250 SF

TOTAL 998 SF



**KEY PLAN** 

NO. DESCRIPTION DATE

NOTE:

LEGEND:

PROJECT

09-WISDOM-749-2Bd1Ba CRAFTSMAN-350

DRAWING NAME

FOUNDATION PLAN

CLIENT NAME: Client Name
PROJECT NUMBER: 0033\_15

DATE: 2/6/2025 2:36:53 PM
DESIGNED BY: Designer
DRAWN BY: Author
CHECKED BY: Checker

S101

SCALE: 3/8" = 1'-0"

#### **GENERAL NOTES**

#### NOTES:

-ALL BEARING WALLS SHOULD HAVE A THICKENED SLAB PER SECTION PER DETAIL A401/5.

#### A) **FOUNDATION PLAN NOTES**:

- 1. CONCRETE SLAB SHALL BE 6" THICK WITH 1/2" DIAMETER TENDONS PER LAYOUT PLAN, CENTERED IN SLAB THICKNESS, OVER APPROVED SUBBASE PER GENERAL STRUCTURE NOTES
- TERMITE PROTECTION SHALL BE PROVIDED PER IRC SECTION R318.1
   NONE TYPICAL ANCHOR BOLT SPACING AT SHEAR WALL AND HOLD DOWN
- SPECIFICATIONS PER APPROVED ARCHITECTURAL PLANS.
- 4. INSTALL HOLDOWNS BEFORE CONCRETE SLAB POUR.
- 5. EXISTING FILL ON-SITE SHALL BE COMPACTED IN ACCORDANCE WITH THE REQUIREMENTS IN THE GEOTECHNICAL REPORT.
- 6. ALL FLOOR SLABS ARE REINFORCED ON CONCRETE SLABS.

#### SPECIAL INSPECTION IS REQUIRED FOR THICKENED FOUNDATION CONSTRUCTION

- 1. REINFORCEMENT
- 2. 2300 PSI CONCRETE POUR

#### B) **REINFORCEMENT FOR CONCRETE**:


 ALL REINFORCING SLABS BARS SIZE 10MM OR LARGER SHALL BE DEFORMED IN ACCORDANCE TO ASTM-A706, AND BARS SMALLER THAN 10 MM MAYBE PLAIN.
 UNLESS OTHERWISE NOTED IN PLANS, THE YIELD STRENGTH OF REINFORCING BARS SHALL BE:


> A) FOOTING = 40,000 PSI B) NON-LOAD BEARING WALLS AND PARAPETS= 40,000 PSI


- 3. SPLICES SHALL BE SECURELY WIRED TOGETHER AND SHALL LAP OR EXTEND
- 4. GRADE OF STEEL FOR RCC WORKS SHALL BE GRADE 4 10.
- 5. BAR NOTATIONS GIVES INFORMATION
  - A) BAR SIZE
  - B) SPACING(IF REQUIRED)
- . LAP REINFORCEMENT ONLY AT LOCATION SHOWN IN THE DRAWINGS
- 7. REINFORCEMENT SHALL NOT BE CUT, VENT OR HEATED ON SITE WITHOUT ENGINEERS' APPROVAL.
- C) CONCRETE SLAB NOTES
- 1. ALL SLAB REINFORCEMENT SHALL BE 20MM CLEAR MINIMUM FROM BOTTOM AND FROM TOP OF SLAB.
- 2. REINFORCEMENT IN CONTINUOUS ELEVATED SLAB SHALL BE CUT AS FOLLOWS.

#### <u>NOTE</u>

- THIS IS A SCHEMATIC PLAN FOR THE PURPOSE OF LOCATING AND IDENTIFYING FOUNDATION REINFORCING ELEMENTS ONLY. VERIFY ALL DIMENSIONS, DROPS, OFFSETS AND FEATURES WITH THE ARCHITECTURAL PLANS BEFORE FORMING THE FOUNDATION.

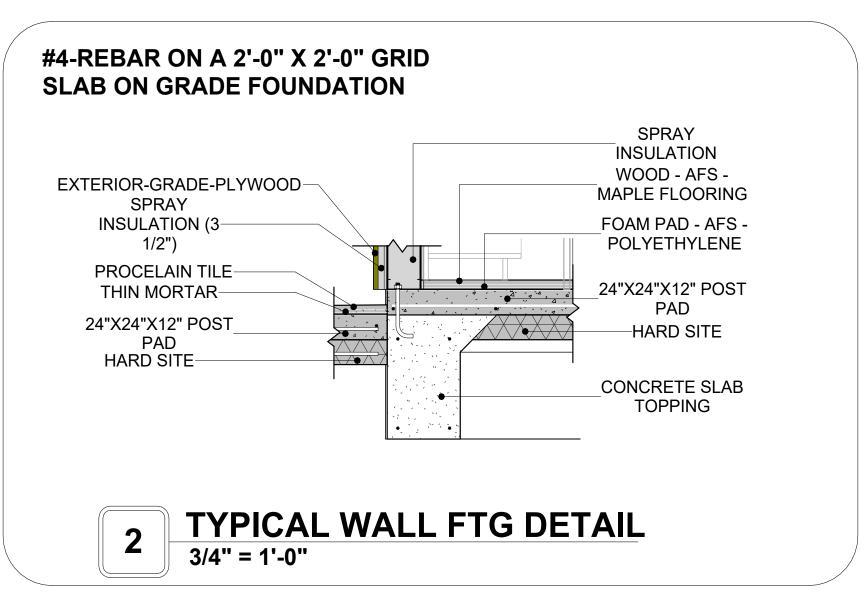

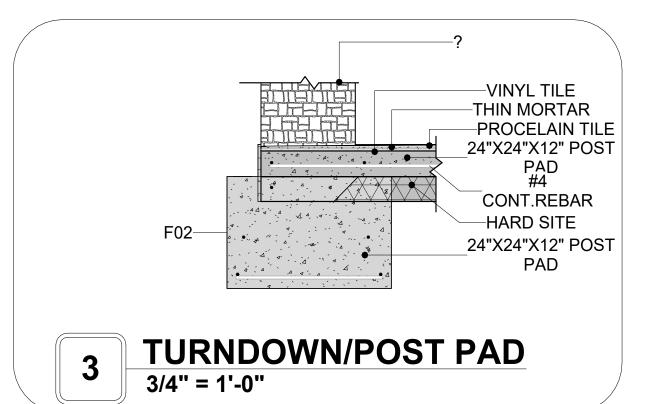

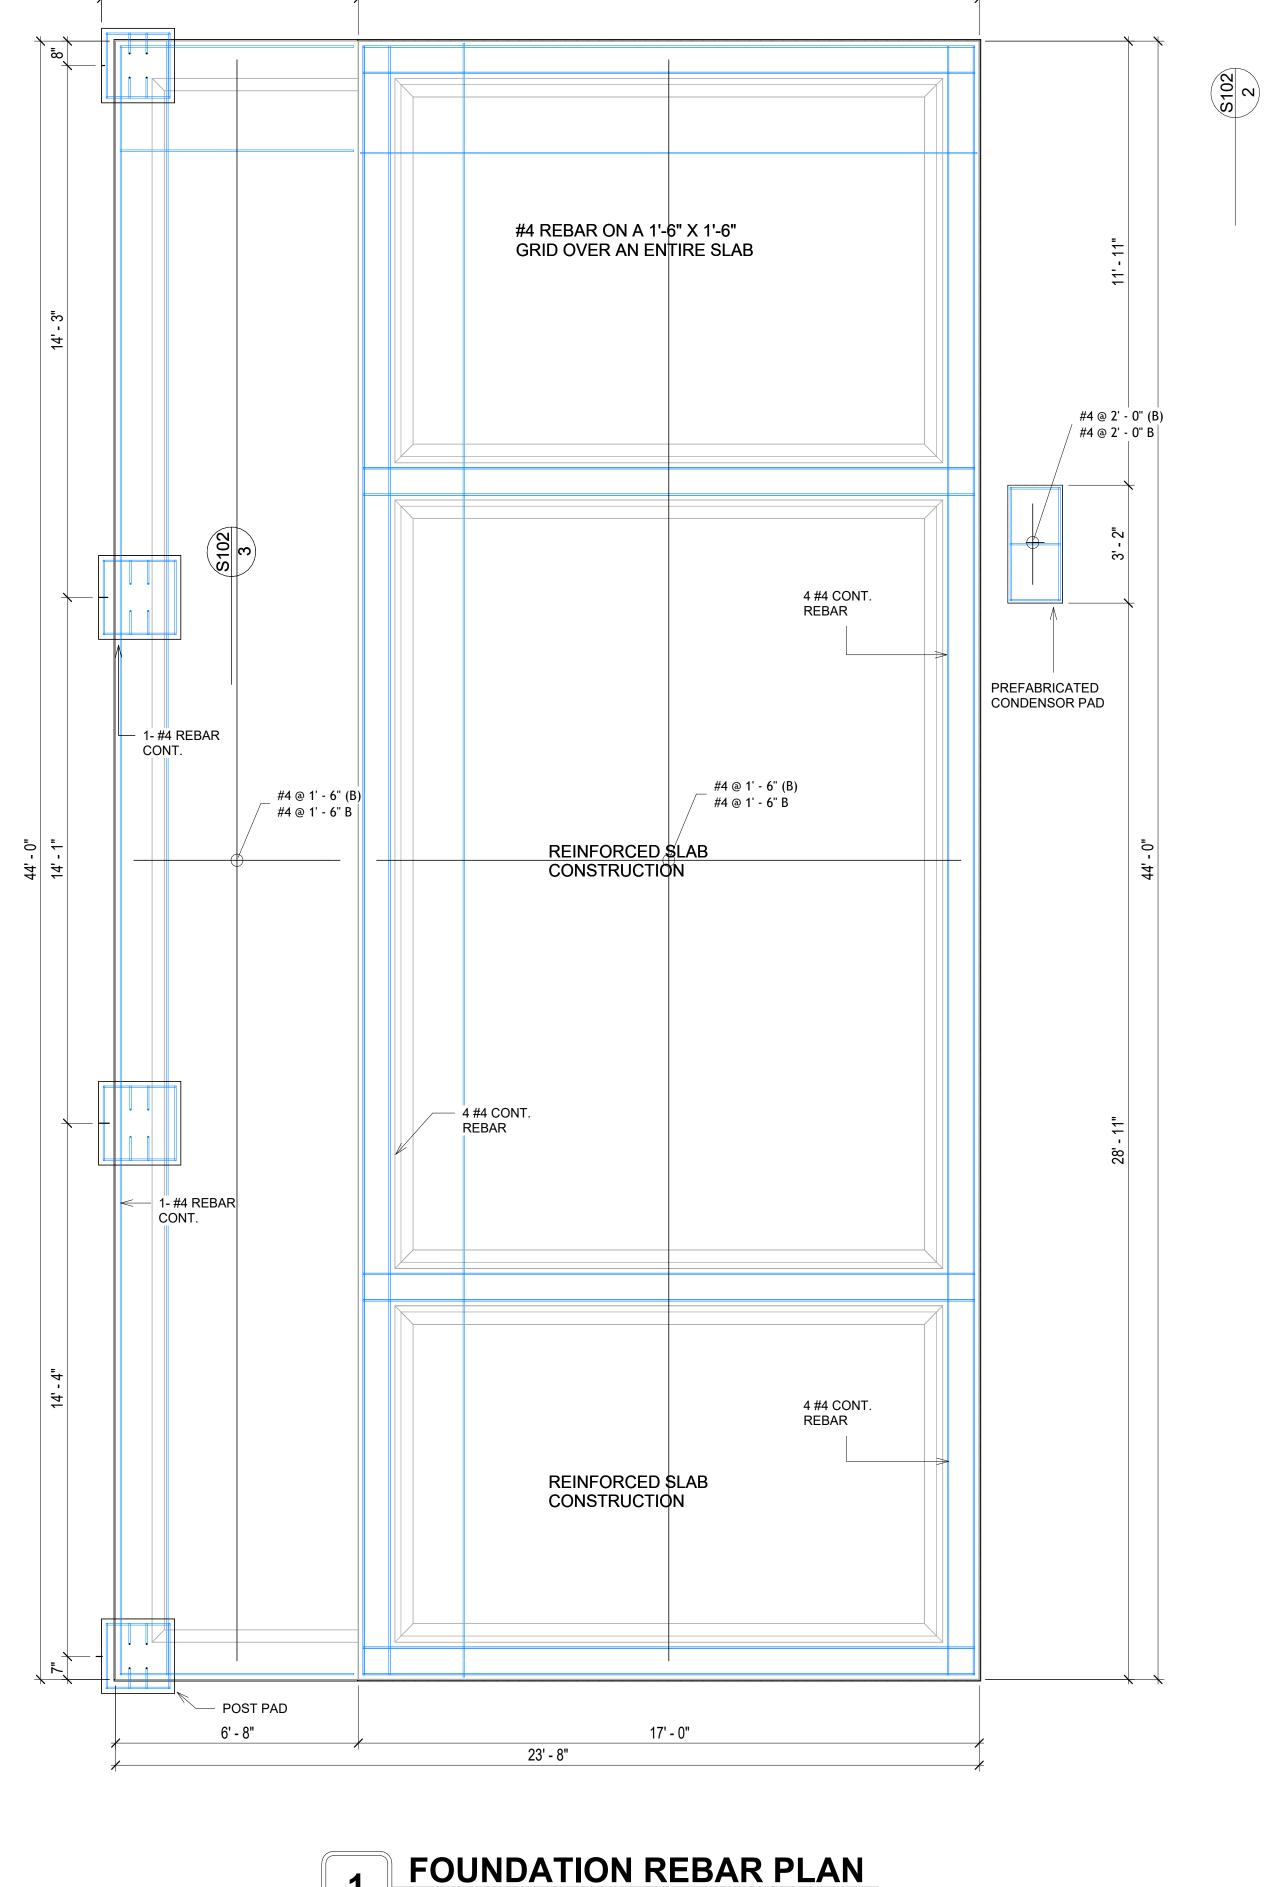

3/8" = 1'-0"

24' - 0"

17' - 0"

7' - 0"



**KEY PLAN** 

NO. DESCRIPTION DATE

NOTE:

LEGEND:

PROJECT

09-Wisdom-749-2Bd1Ba Craftsman-550

DRAWING NAME

STRUCTURAL FLOOR PLAN

CLIENT NAME:

PROJECT NUMBER:

0033\_15

DATE:

2/1/2025 7:23:39 PM

DESIGNED BY:

DRAWN BY:

CHECKED BY:


Checker

**S102** 

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#### **ROOF NOTES**

- 1. ROOFING COMPOSITION ROOFING PER OWNERS/BUILDERS SPECIFICATIONS INSTALL PER MANUFACTURE SPECIFICATIONS ON 1/2" ORIENTED STRAND BOARD ON PRE-ENGINEERED TRUSS @ 24" O.C. (UNO.)
- 2. 73" OVERHANG AT EAVES (UNO.)
- 3. ENDS OF ALL TRUSSES AND JOISTS TO BE FULLY BLOCKED. PROVIDE SOLID BLOCKING AT ALL RIDGES AND VALLEYS
- 4. SHEATHING TO BE 1/2", 3/8" OSB SHEAR PANEL AND EQUIVALENT. UNDERSIDE OF PORCH TRUSSES TO BE FINISHED WITH MOISTURE RESISTANT DRYWALL, TAPED AND
- 5. EXPOSED EAVES AND OTHER WEATHER EXPOSED AREAS TO BE SHEATHED WITH EXTERIOR GRADE PLYWOOD.
- 6. ALL MATERIALS THICKNESS AND SIZE ARE THE MINIMUM. Refer TO LOCAL STANDARDS
- FOR ACTUAL THICKNESS AND LAYERING OF MATERIALS. ENGINEERED TRUSS CALCULATIONS TO BE SUBMITTED TO BUILDING DEPARTMENT PRIOR TO FABRICATION AND INSTALLATION.
- 8. TRUSS MANUFACTURER TO SPECIFY HANGER CONNECTORS FOR TRUSS
- COMPONENTS (TYPICAL) 9. DESIGNER ASSUMES THAT TRUSSES BEAR ON ALL EXTERIOR PERIMETER WALLS
- (TYPICAL) OR BEAMS.
- 10. PROVIDE GALVANIZED STEEL FLASHING WITH A LENGTH OF 10 FEET, WIDTH OF 12 INCHES, AND THICKNESS OF 24 GAUGE.



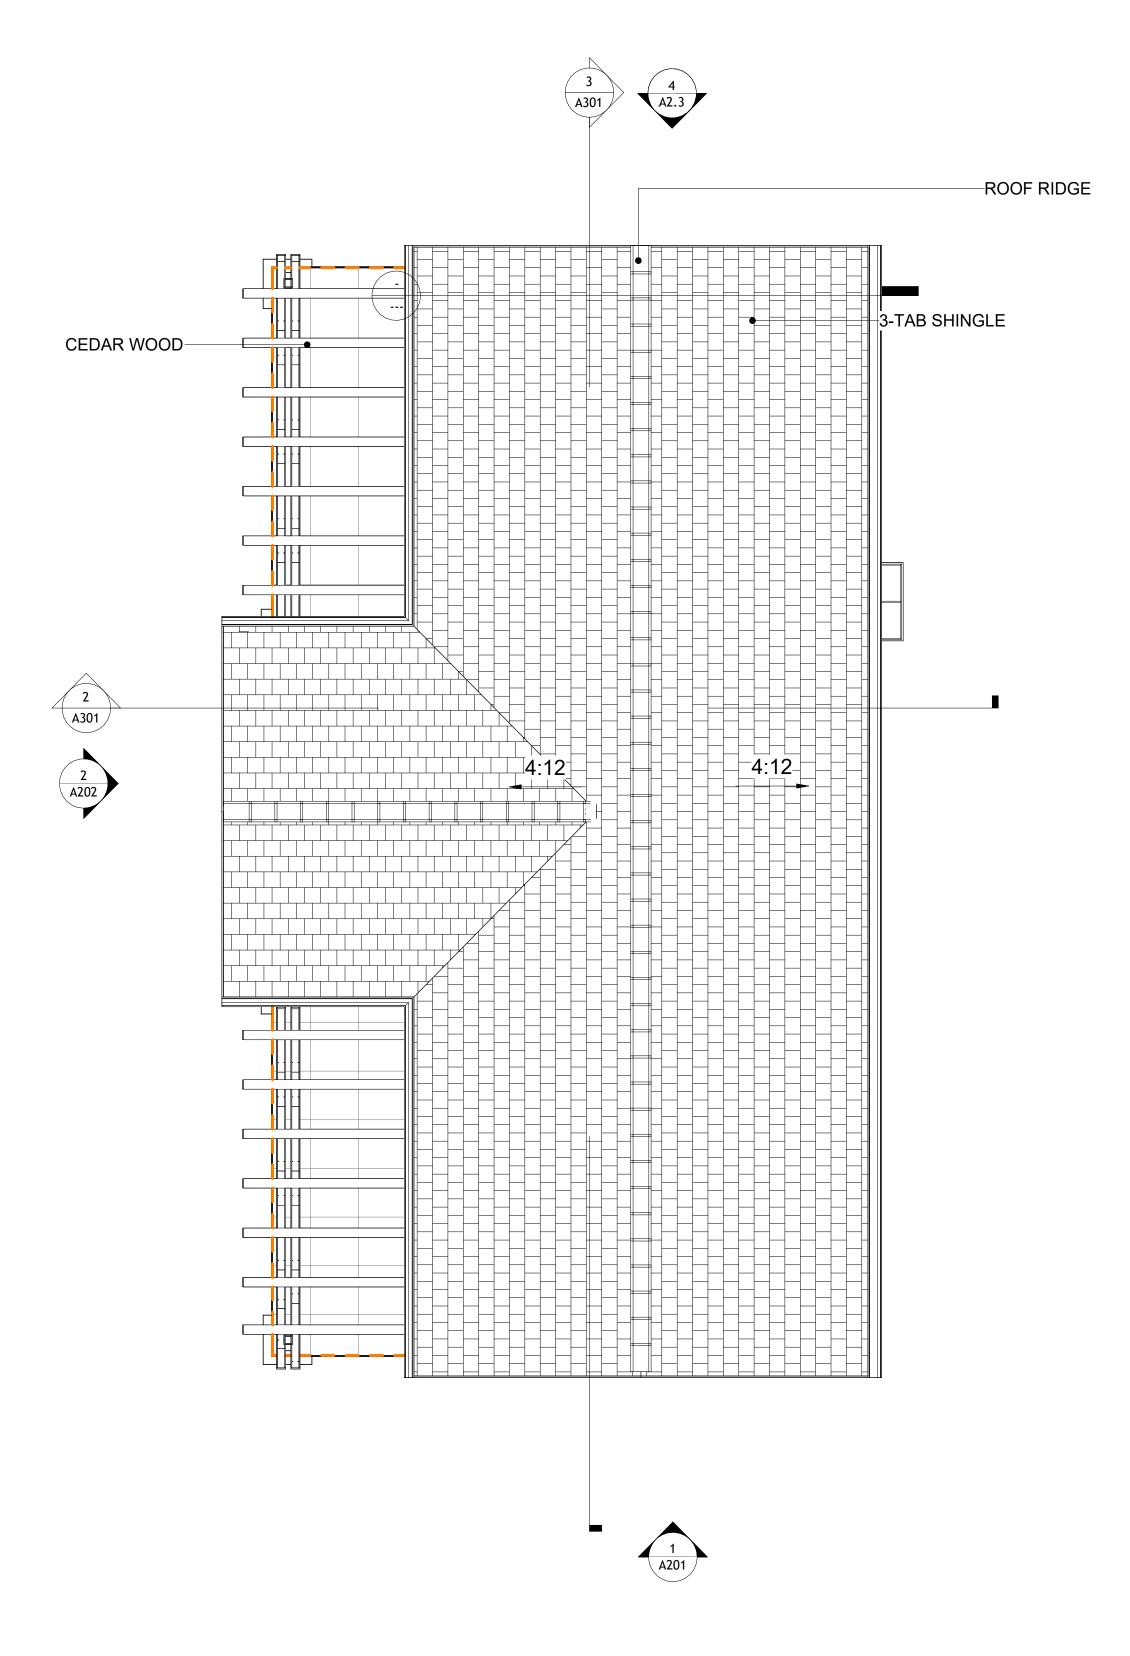



**KEY PLAN** 

NO.	DESCRIPTION	DATE

LEGEND:

09-Wisdom-749-2Bd1Ba Craftsman-550

DRAWING NAME

**ROOF PLAN** 

Client Name	CLIENT NAME:
0033_15	PROJECT NUMBER:
2/1/2025 7:23:44 PN	DATE:
Designer	DESIGNED BY:
Author	DRAWN BY:
Checker	CHECKED BY:

A105

SCALE: 1/4" = 1'-0"

SQUARE FOOTAGE PATIO 250 SF TOTAL 998 SF

#### **ABOUT WALL FINISHING**

#### **CORRUGATED IRON SHEET**

CORRUGATED IRON IS A FINISHING MATERIAL MADE FROM STEEL THAT HAS BEEN GALVANIZED (COATED WITH A THIN LAYER OF ZINC) TO PROTECT IT FROM CORROSION AND RUST.

IN THIS SPECIFIC PROJECT, THE CORRUGATED IRON SHEETS ARE INSTALLED HORIZONTALLY ON VERTICAL FURRING STRIPS THAT ARE DIRECTLY ATTACHED ONTO THE PROPERLY INSTALLED AND SEALED HOME WRAP, USING SELF-DRILLING SCREWS THAT ARE DRIVEN THROUGH THE RIDGES OR VALLEYS OF THE CORRUGATIONS.

#### **EXTERNAL STONE**

THESE STONE PRODUCTS ARE MADE FROM A BLEND OF NATURAL AGGREGATES, CEMENT, AND OTHER PROPRIETARY MATERIALS.

THE STONE FINISH IS DIRECTLY ATTACHED TO COLD-FORMED STEEL (CS) FRAMING. (FOR COLUMN FINISH) EXTERNAL STONE CAN BE AN EXCELLENT EXTERIOR CLADDING OPTION FOR CS-FRAMED BUILDINGS. IN THIS SCENARIO, THE EXTERNAL STONE WOULD BE ADHERED TO THE CS FRAME USING A SCRATCH COAT AND MORTAR-BASED ADHESIVE.

#### CAST IN PLACE CONCRETE COPPING

CAST IN PLACE CONCRETE COPPING IS TYPICALLY MADE FROM A MIXTURE OF CEMENT, AGGREGATES, AND OTHER ADDITIVES. THIS COMPOSITE MATERIAL IS MOLDED AND CURED TO CREATE A DURABLE, STONE-LIKE APPEARANCE AND TEXTURE.


IN THIS PROJECT, THE CAST IN PLACE CONCRETE COPPING IS ATTACHED ON TOP OF THE EXTERNAL STONE VENEER WALL OR SURFACE. THE PROCESS OF INSTALLING INVOLVES SURFACE PREPARATION (ENSURE THE STONE WALL OR SURFACE IS CLEAN, DRY, AND FREE OF ANY DEBRIS OR PROTRUSIONS AND VERIFY THAT THE STONE INSTALLATION IS SECURE AND PROPERLY ADHERED TO THE UNDERLYING SUBSTRATE.)

#### **CEDAR WOOD**


CEDAR WOOD REFERS TO THE WOOD FROM VARIOUS SPECIES OF CEDAR TREES, WHICH ARE CONIFEROUS EVERGREEN TREES KNOWN FOR THEIR DISTINCT AROMA AND NATURAL RESISTANCE TO DECAY AND INSECTS.

IN THIS SPECIFIC PROJECT, CEDAR WOOD IS USED AS A FURRING STRIP AND A FINISH MATERIAL ON BEAMS AND COLUMNS.

CEDAR WOOD AS A FURRING STRIPS PROVIDE THERMAL INSULATION AND MOISTURE MANAGEMENT. THE VERTICAL CEDAR WOOD FURRING STRIPS ARE ATTACHED TO HOME WRAP USING CORROSION-RESISTANT FASTENERS (HOT-DIP GALVANIZED SCREWS), ENSURING PROPER PENETRATION INTO THE WALL FRAMING.

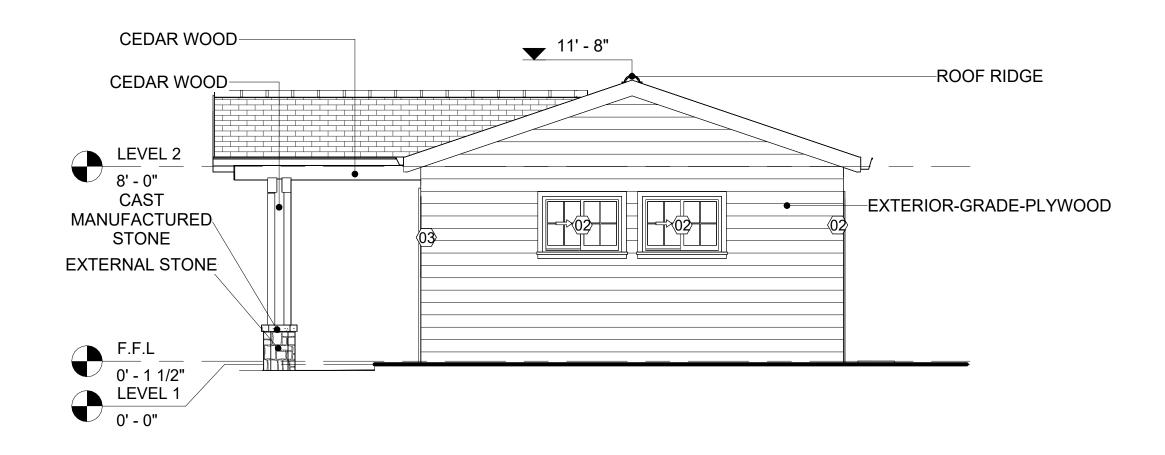

FRONT ELEVATION 1/4" = 1'-0"

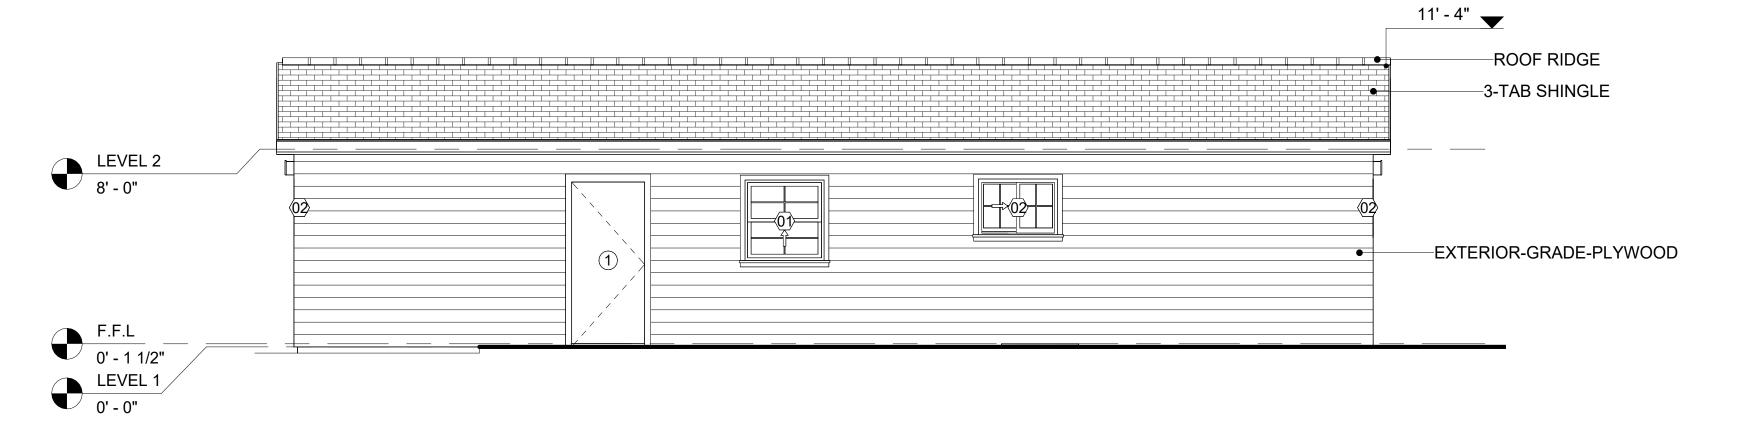


RIGHT SIDE ELEVATION 1/4" = 1'-0"

DOOR SCHEDULE						
TYPE MAR				SIZE		
K		LOCATION	WIDTH	HEIGHT	COUNT	
1	HOME DEPOT	INTERIOR SINGLE PANEL SWINGING	INTERIOR	3' - 0"	6' - 8"	3
2	HOME DEPOT	INTERIOR SINGLE PANEL SWINGING	INTERIOR	2' - 6"	6' - 8"	1
3	HOME DEPOT	INTERIOR DOUBLE PANEL SLIDING	INTERIOR	7' - 3"	6' - 8"	1
4	HOME DEPOT	INTERIOR SINGLE PANEL SWINGING	INTERIOR	2' - 3"	6' - 8"	1
5	HOME DEPOT	DOOR-BIFOLD_9052	INTERIOR	2' - 4"	6' - 8"	1
6	HOME DEPOT	PATIO_DOUBLE PANEL_SLIDING	INTERIOR	6' - 0"	6' - 8"	1
22		INTERIOR DOUBLE PANEL SLIDING	INTERIOR	9' - 5"	6' - 8"	1

WINDOW SCHEDULE					
SIZE					
TYPE MARK	SUPPLIER	WINDOW TYPE	WIDTH	HEIGHT	COUNT
01	HOME DEPOT	SINGLE HUNG	3' - 3"	3' - 3"	1
)2	HOME DEPOT	SLIDING	3' - 3"	2' - 3"	5
03	HOME DEPOT	SLIDING	5' - 3"	3' - 3"	2

Tuscon,AZ, USA 888-864-0184 inquire@frameupnow.com www.frameupnow.com

**KEY PLAN** 

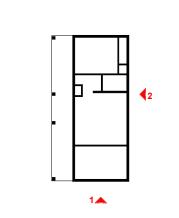

NO.	DESCRIPTION	DATE	

**LEGEND**:

PROJECT

09-Wisdom-749-2Bd1Ba Craftsman-550

DRAWING NAME

**ARCHITECTURAL ELEVATIONS** 

- 1		
	CLIENT NAME:	Client Name
	PROJECT NUMBER:	0033_15
	DATE:	2/1/2025 7:23:48 PM
	DESIGNED BY:	Designer
	DRAWN BY:	Author
	CHECKED BY:	Checker

**A201** 

SCALE: As indicated

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#### **ABOUT WALL FINISHING**

#### **CORRUGATED IRON SHEET**

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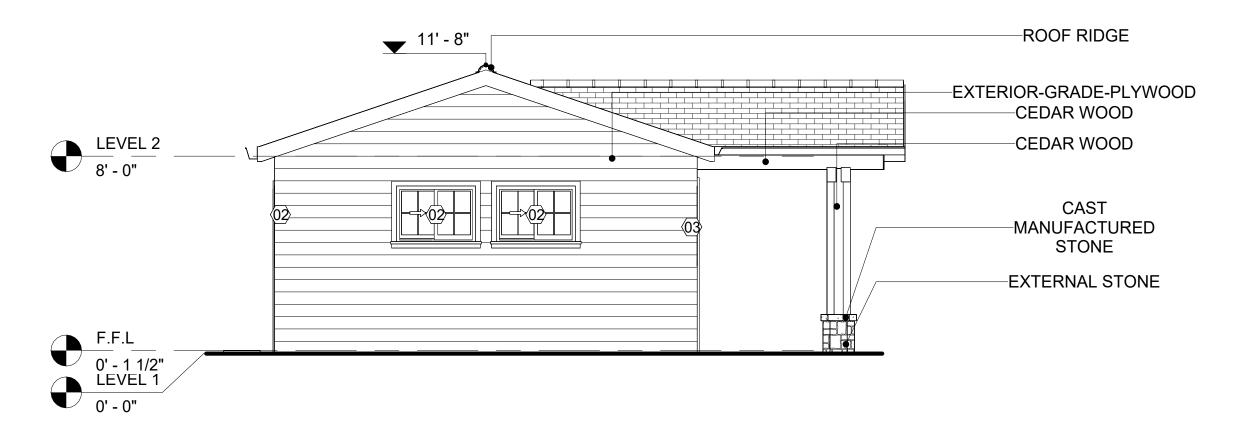
IN THIS PROJECT, THE **CAST IN PLACE CONCRETE** COPPING IS ATTACHED ON TOP OF A EXTERNAL STONE VENEER WALL OR SURFACE. THE PROCESS OF INSTALLING INVOLVES SURFACE PREPARATION (ENSURE THE STONE WALL OR SURFACE IS CLEAN, DRY, AND FREE OF ANY DEBRIS OR PROTRUSIONS AND VERIFY THAT THE STONE INSTALLATION IS SECURE AND PROPERLY ADHERED TO THE UNDERLYING SUBSTRATE.)

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CEDAR WOOD AS A FURRING STRIPS PROVIDE THERMAL INSULATION, MOISTURE MANAGEMENT, AND AN AESTHETICALLY PLEASING, VERSATILE FRAMING SOLUTION WHEN INTEGRATED WITH CORONADO STONE AND CORRUGATED IRON SHEET CLADDING. THE VERTICAL CEDAR WOOD FURRING STRIPS ARE ATTACHED TO HOME WRAP USING CORROSION-RESISTANT FASTENERS (HOT-DIP GALVANIZED SCREWS), ENSURING PROPER PENETRATION INTO THE WALL FRAMING.




**REAR ELEVATION** 1/4" = 1'-0"



**LEFT SIDE ELEVATION** 



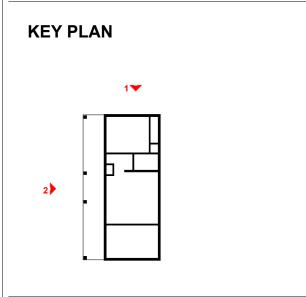

DESCRIPTION	DATE
	DESCRIPTION

NOTE:

**LEGEND**:

PROJECT

09-Wisdom-749-2Bd1Ba Craftsman-550

DRAWING NAME


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CLIENT NAME:	Client Name
PROJECT NUMBER:	0033_15
DATE:	2/1/2025 7:23:52 PM
DESIGNED BY:	Designer
DRAWN BY:	Author
CHECKED BY:	Checker


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SCALE: As indicated



# 2 SECTION-2 1/4" = 1'-0"

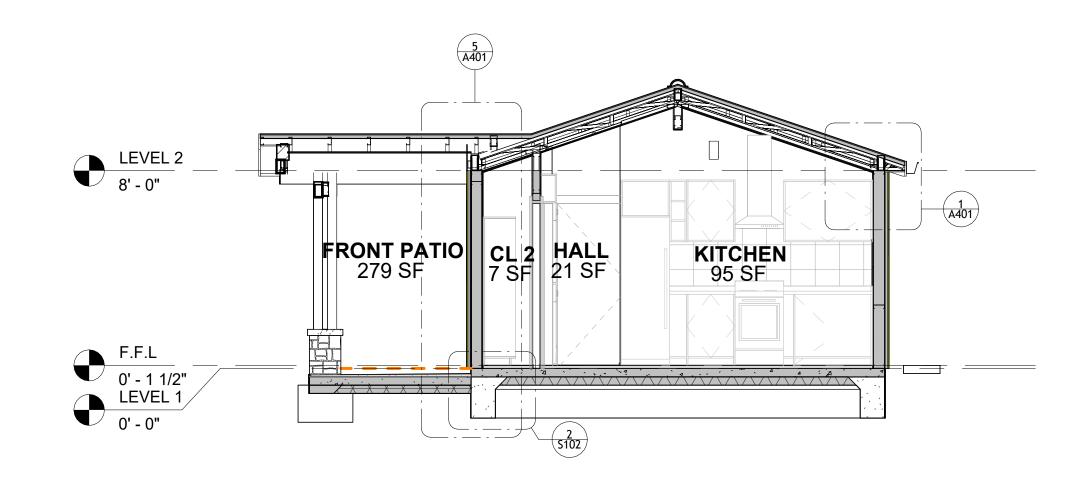

3 SECTION-3 1/4" = 1'-0"

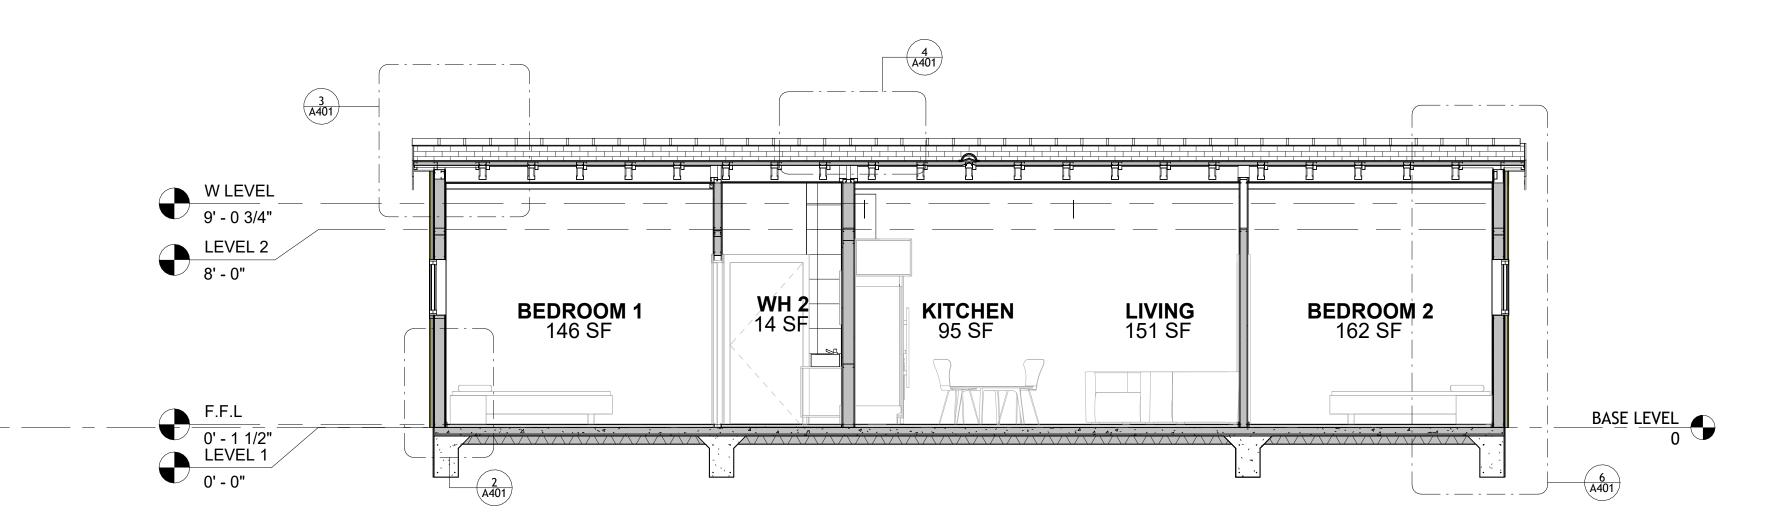

KEY PLAN

NO.	DESCRIPTION	DATE

NOTE

LEGEND:

PROJEC

09-Wisdom-749-2Bd1Ba Craftsman-550


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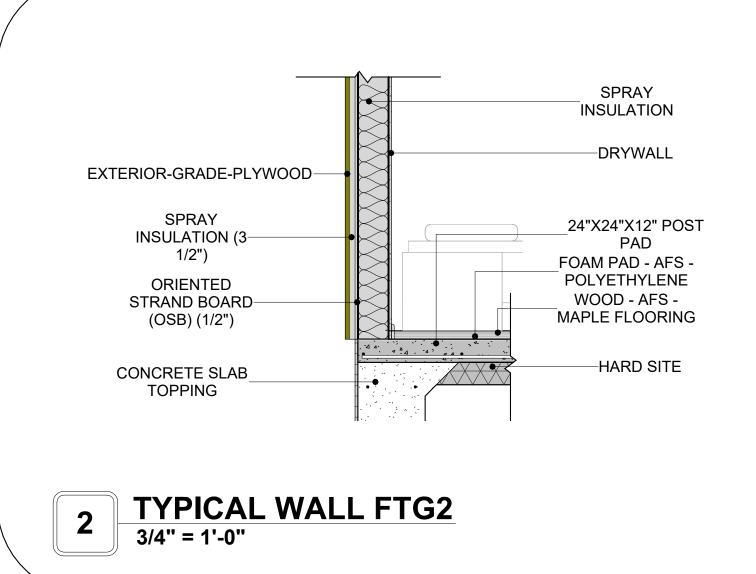
ARCHITECTURAL SECTIONS


Client Name	CLIENT NAME:
0033_15	PROJECT NUMBER:
2/1/2025 7:23:53 PM	DATE:
Designer	DESIGNED BY:
Author	DRAWN BY:
Checker	CHECKED BY:


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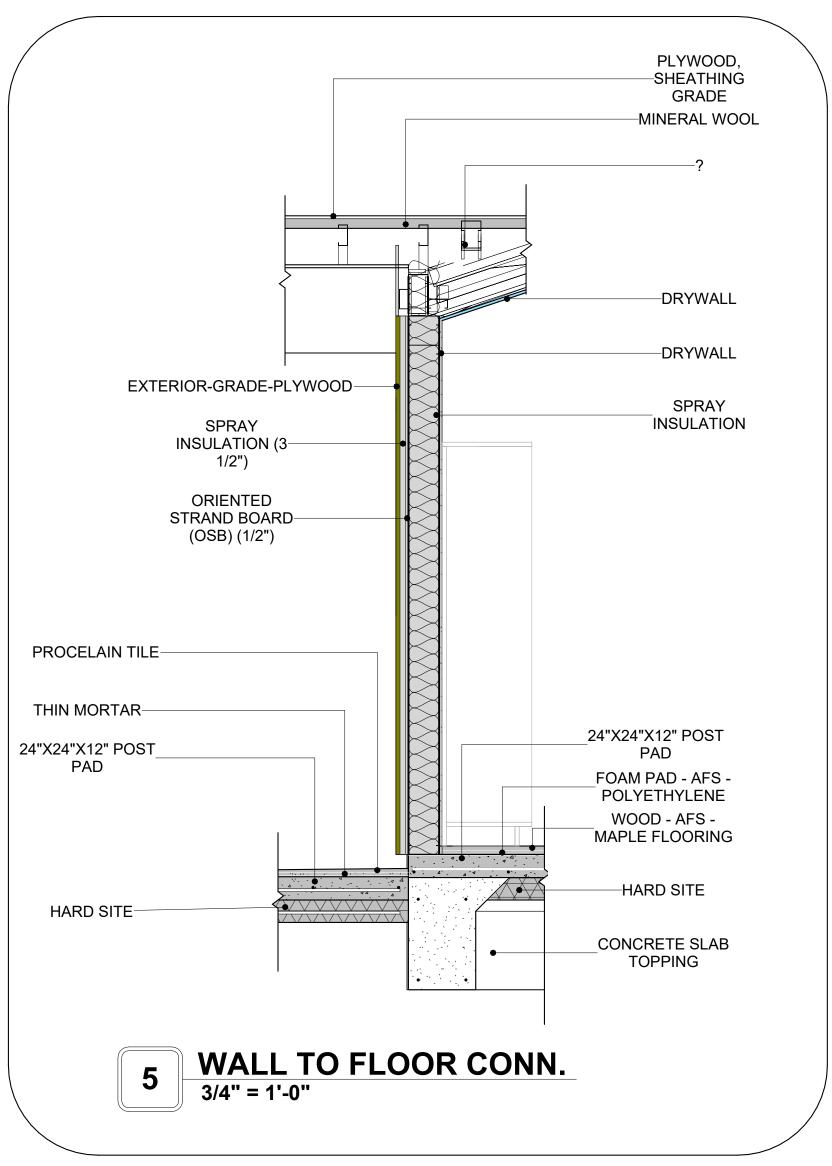
SCALE: As indicated






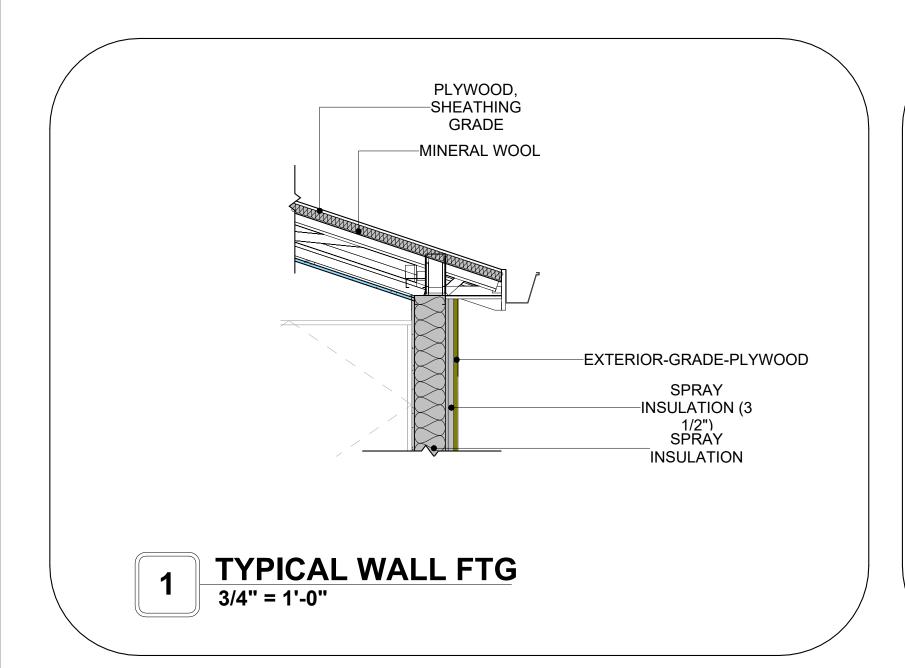

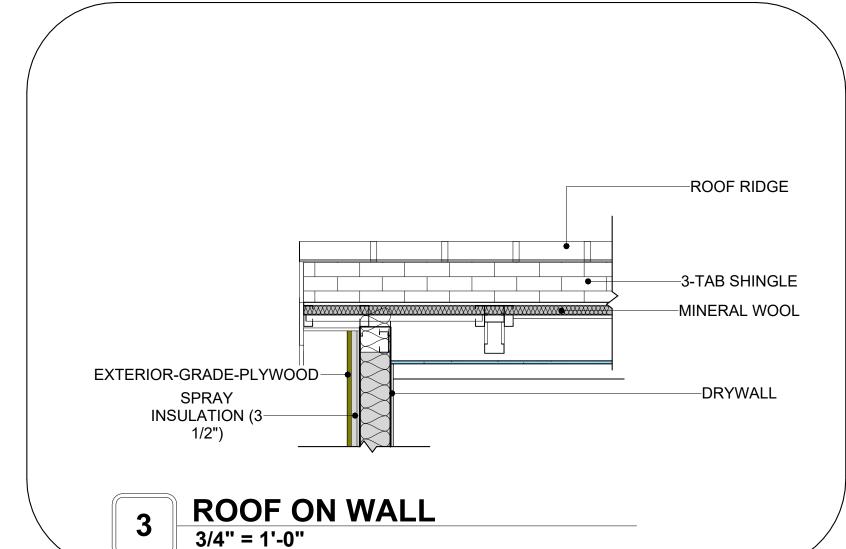

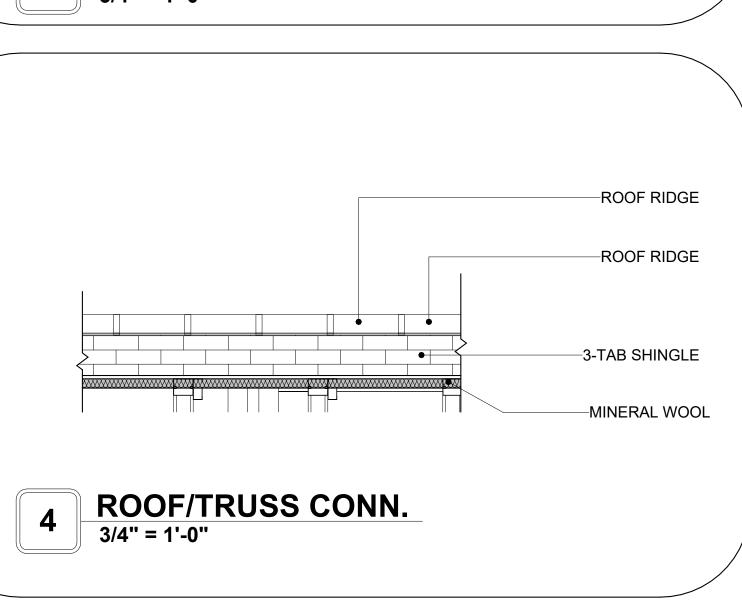

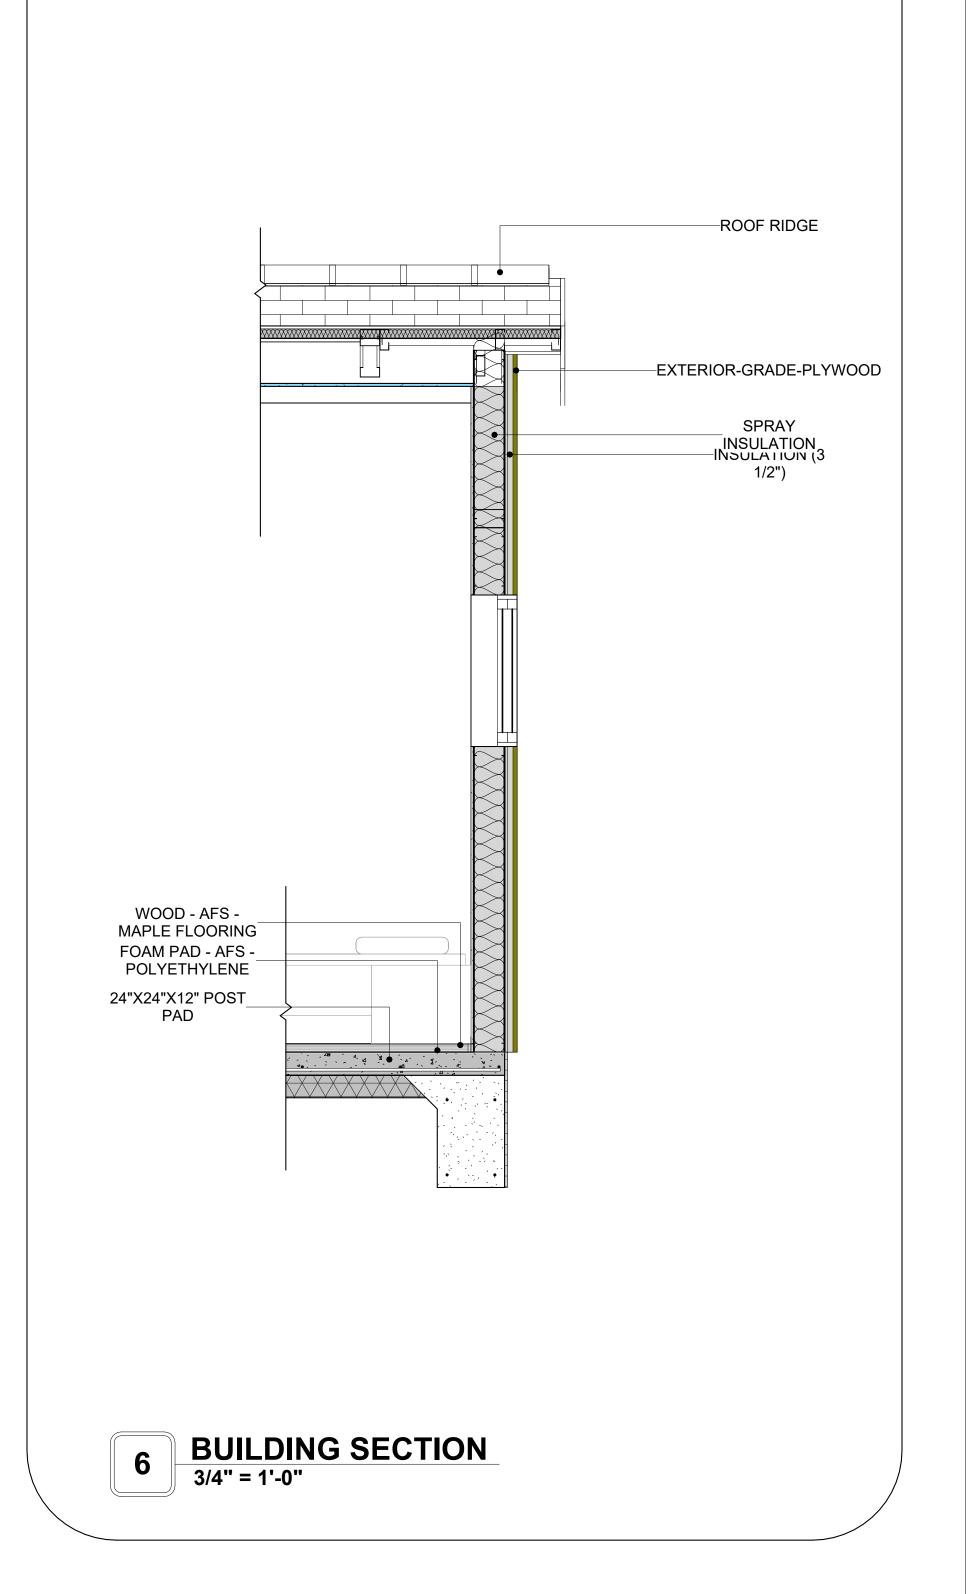



**KEY PLAN** 

NO.	DESCRIPTION	DATE

NOTE:

LEGEND:

PROJECT

09-Wisdom-749-2Bd1Ba Craftsman-550

DRAWING NAME

ARCHITECTURAL DETAILS

CLIENT NAME:	Client Name
PROJECT NUMBER:	0033_15
DATE:	2/3/2025 3:58:34 PM
DESIGNED BY:	Designer
DRAWN BY:	Author
CHECKED BY:	Checker

A401


SCALE: 3/4" = 1'-0"

#### **CASEWORK GENERAL NOTES**


- ALL CABINET HEIGHTS INCLUDE COUNTERTOPS. DIMENSIONS ARE TO THE NEAREST INCH. DIVISIONS IN CASEWORK ARE SHOWN FOR CLARITY AND DO NOT REPRESENT BREAKS IN THE COUNTERTOP.
- PROVIDE CONTINUOUS COUNTERTOP OVER ALL SIMILAR HEIGHT CASEWORK, UNLESS AND
- MANUFACTURER AND CATALOG NUMBERS ARE FOR REFERENCE AND ILLUSTRATION PURPOSES
- DOTTED LINES INDICATE WALL HUNG CABINETS, DIVISIONS OF BASE CABINETS BELOW THE COUNTERTOP, FURNITURE NOT IN THE CONTRACT OR PROJECTION SCREENS -SEE CASEWORK KEY AND SPECIFICATIONS.
- ALL CABINETS AND DRAWERS TO HAVE CAM LOCKS EXCEPT FOR SINK BASE CABINETS. ALL EXPOSED SURFACES (EXPOSED TO VIEW FROM ANY PERSPECTIVE) TO BE COVERED WITH
- LAMINATE.
- ALL CASEWORK WHICH MEETS A WALL AT ONE OR BOTH ENDS, TO BE PROVIDED WITH FILLER PANELS AND SCRIBED TO THE WALL(S) AS REQUIRED.
- 10. ALL CABINETS AND DRAWERS ARE PROVIDED WITH RECESSED HANDLES.
- 11. CONTRACTOR TO FIELD VERIFY ALL CLEAR OPENINGS PRIOR TO MILLWORK OR CASEWORK
- 12. CASEWORK DRAWINGS ARE DIAGRAMMATIC IN NATURE TO SHOW DESIGN INTENT.

	CASEWORK SCHEDULE					
TYPE MAR K	TYPE	COUN T	HEIGHT	WIDTH	DEPTH	AREA
	CLOSET 4	1	6' - 0"	10' - 0 1/2"	1' - 4"	60 SF
01	L-SHAPE COUNTER TOP 2	1	0' - 4"	7' - 0"	7' - 0"	2 SF
02	CLOSET 3	1	6' - 0"	2' - 10"	1' - 4"	17 SF
03	BASE CABINET L-SHAPED	1	2' - 10 1/2"	3' - 3"	3' - 3"	9 SF
04	WALL FILLER	1	2' - 10 1/2"	0' - 4 3/4"	2' - 0"	1 SF
05	WALL FILLER 2	1	2' - 6"	0' - 8 1/4"	1' - 0"	2 SF
06	BASE_CABINET_DOUBLE_DOOR 5	1	2' - 6"	2' - 0"	1' - 0"	5 SF
07	WALL CABINET DOUBLE DOOR 1	1	2' - 6"	3' - 7 3/4"	1' - 0"	9 SF
80	HD_LINEAR_COUNTER_TOP 3	1	0' - 4"	2' - 8 1/4"	2' - 1"	1 SF
09	WALL FILLER 3	1	2' - 10 1/2"	0' - 8 1/4"	2' - 0"	2 SF
10	LAUNDRY OPEN CABINET	1	1' - 6"	2' - 0"	2' - 4"	3 SF
11	VANITY 2	2	2' - 4"	2' - 6"	1' - 8"	6 SF
12	RECESSED_MED_CABINET	2	2' - 0"	1' - 6"	0' - 3"	3 SF
13	BASE_CABINET_DOUBLE_DOOR	1	2' - 7"	2' - 0"	2' - 0"	5 SF
14	CLOSET 2	1	6' - 0"	8' - 0"	1' - 4"	48 SF
15	BASE_CABINET_DOUBLE_DOOR	1	2' - 10 1/2"	3' - 6"	2' - 0"	10 SF
16	LAUNDRY OPEN CABINET 2	1	1' - 2"	2' - 3"	3' - 0"	3 SF
17	HD BASE FILLER 6	1	2' - 6"	0' - 6"	2' - 0"	1 SF
GRAND	TOTAL	20				


SPECIALTY EQUIPMENT SCHEDULE		
TYPE MARK	TYPE	COUNT
	·	
01	WASHER-FRONT-LOAD	1
02	REFRIGERATOR	1
03	RANGE	1
04	<varies></varies>	2
GRAND TOTAL: 5		1

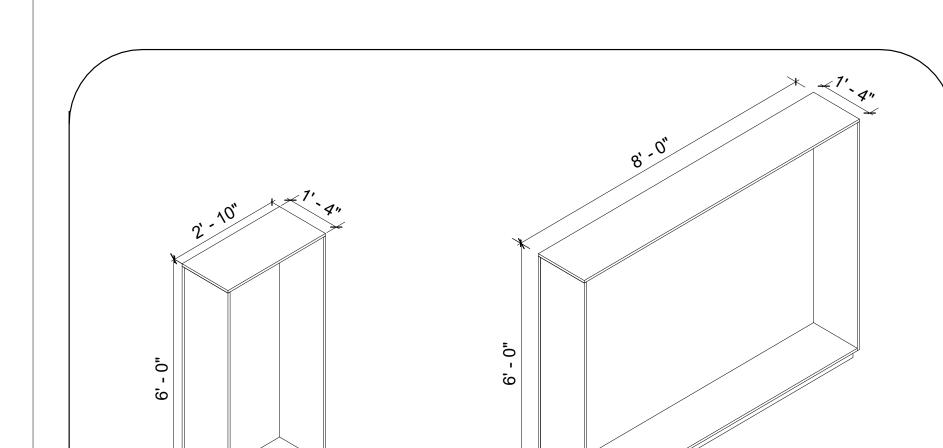



8 CLOSET 2 3D

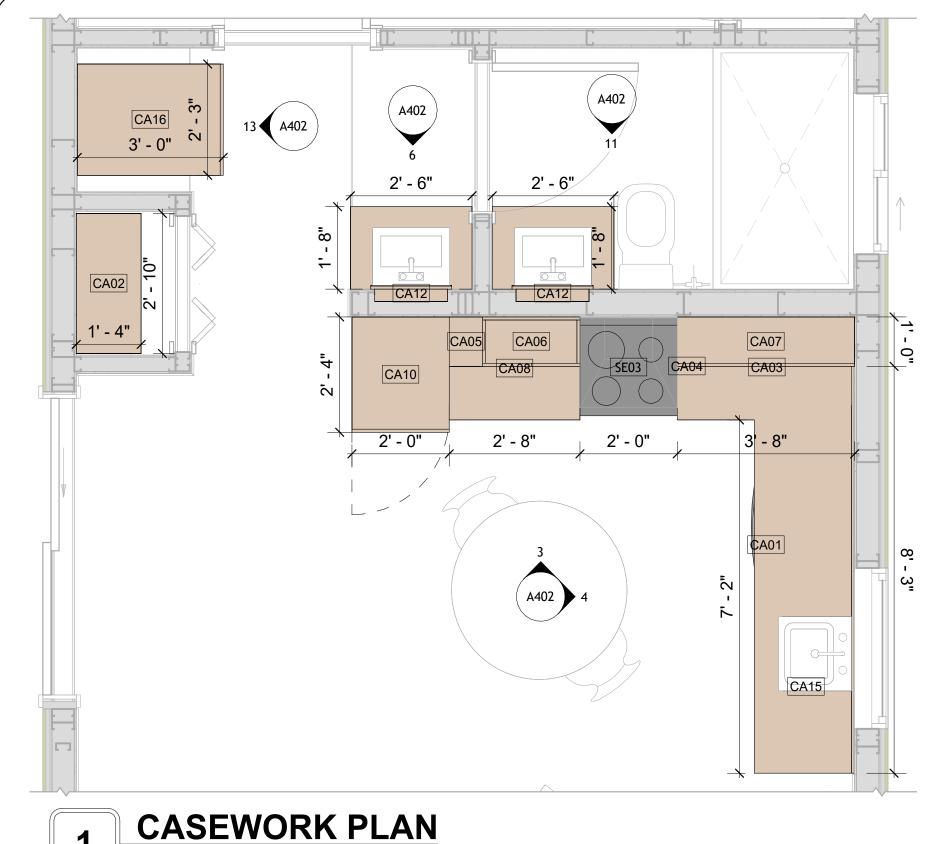



1/2" = 1'-0"

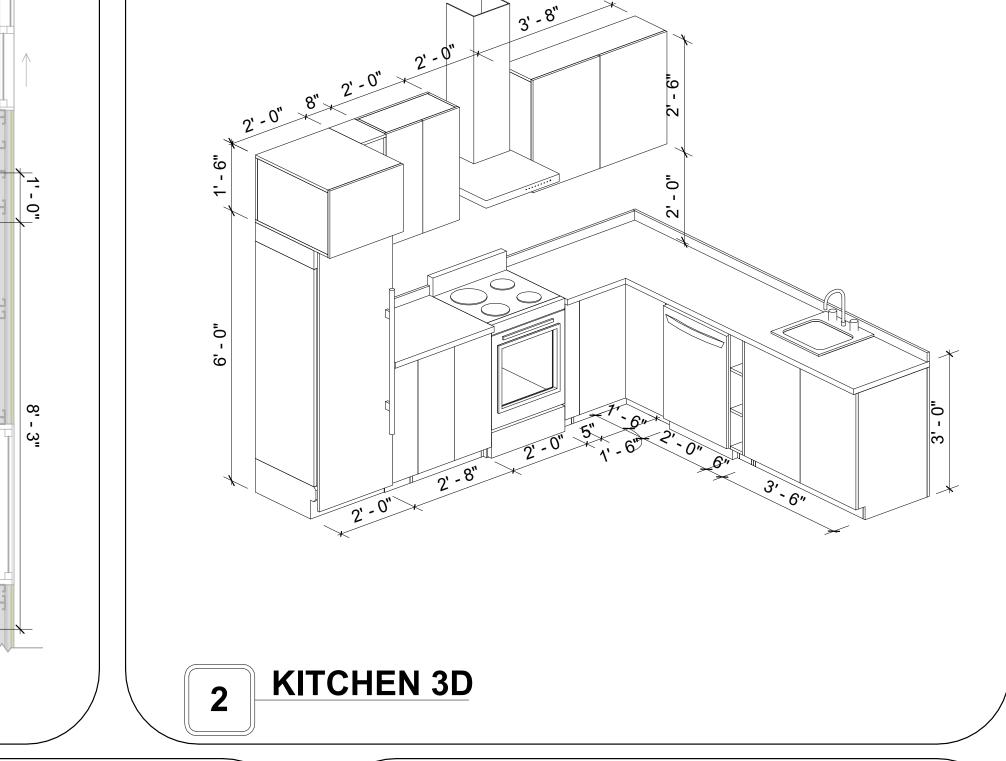

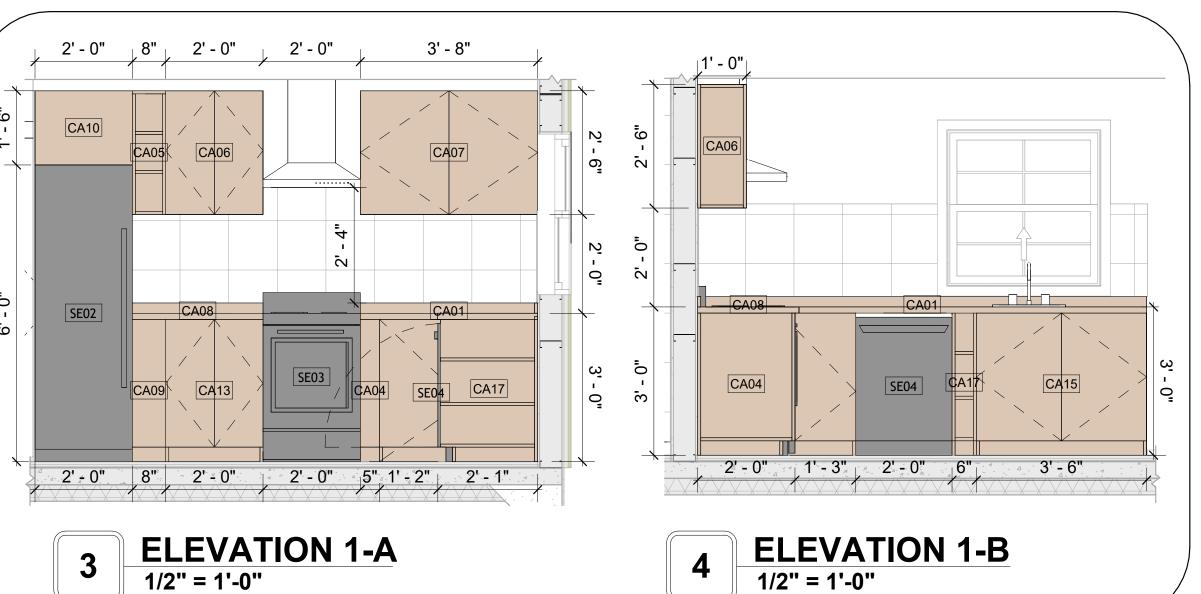


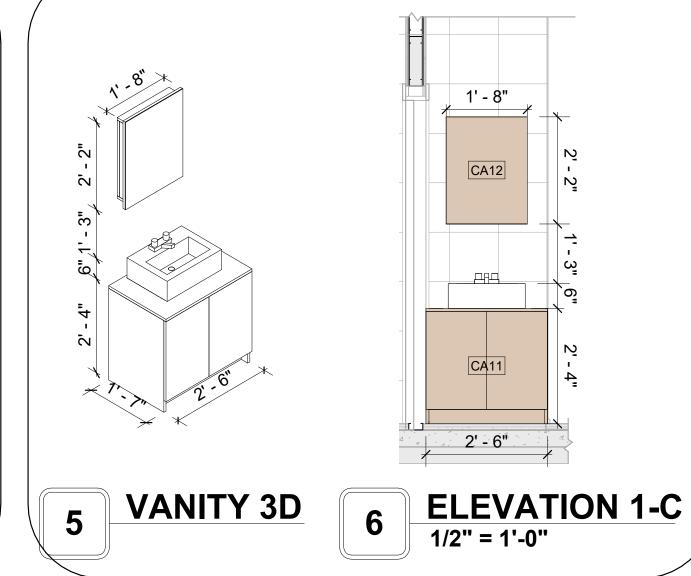

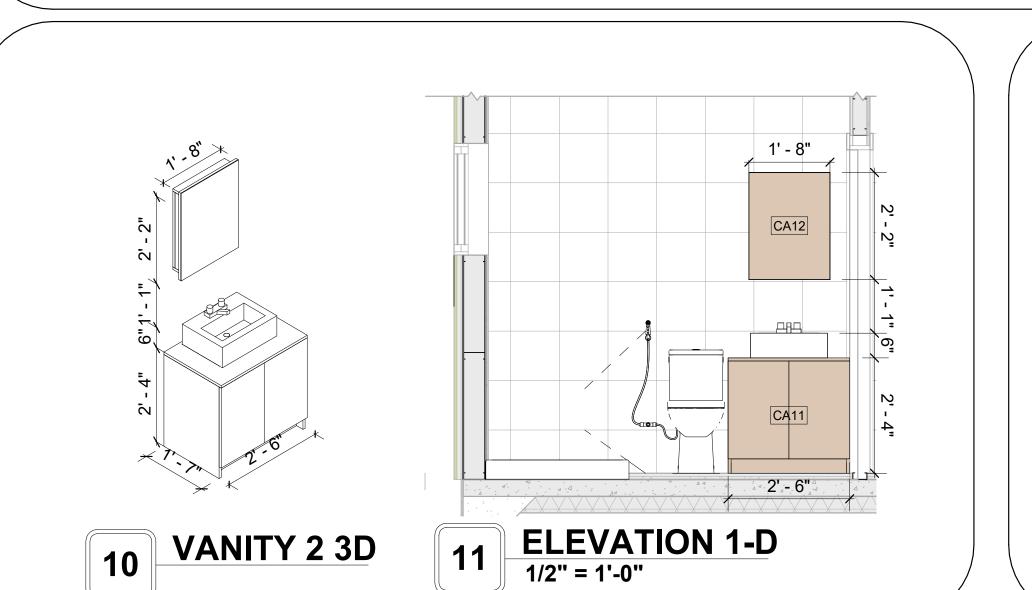

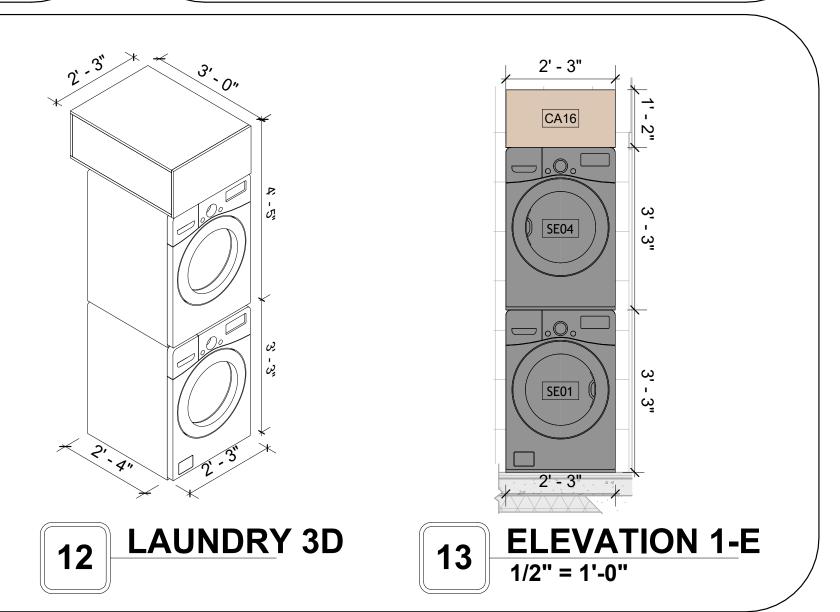



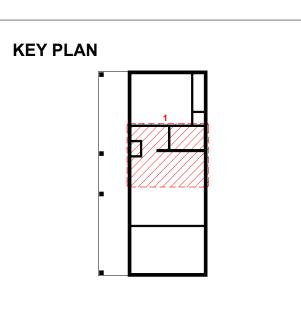

NO.	DESCRIPTION	DATE

**LEGEND**:

PROJECT

09-Wisdom-749-2Bd1Ba Craftsman-550

DRAWING NAME

ARCHITECTURAL CASEWORK

CLIENT NAME:	Client Name
PROJECT NUMBER:	0033_15
DATE:	2/1/2025 7:23:58 PM
DESIGNED BY:	Designer
DRAWN BY:	Author
CHECKED BY:	Checker

A402

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**CLOSET 3D** 

SCALE: As indicated

#### **GENERAL NOTES**

AND BRACED TO PREVENT SAGGING, AIR LEAKAGE, OR VIBRATION.

1. THIS DRAWING DEPICTS THE HVAC (HEATING, VENTILATION, AND AIR CONDITIONING) SYSTEM FOR WISDOM\_TM\_C\_550. IT PROVIDES A VISUAL REPRESENTATION OF THE SYSTEM LAYOUT AND COMPONENTS.

2.THE HVAC SYSTEM IS DESIGNED TO MEET THE SPECIFIC REQUIREMENTS OF THE BUILDING, INCLUDING HEATING, COOLING, AND VENTILATION NEEDS, AS PER THE PROJECT SPECIFICATIONS AND APPLICABLE CODES AND STANDARDS.

3. THE HVAC SYSTEM INSTALLATION SHALL COMPLY WITH THE LATEST EDITION OF THE INTERNATIONAL MECHANICAL CODE (IMC), INTERNATIONAL RESIDENTIAL CODE (IRC), AND ALL OTHER APPLICABLE LOCAL, STATE, AND NATIONAL CODES AND REGULATIONS.

4. THE EQUIPMENT SHOWN ON THIS DRAWING INCLUDES BUT IS NOT LIMITED TO AIR HANDLING UNITS (AHUS), CHILLERS, BOILERS, COOLING TOWERS, PUMPS, DUCTWORK, DIFFUSERS, GRILLES, AND CONTROL DEVICES.

5. ALL EQUIPMENT, DUCTWORK, AND PIPING SHALL BE INSTALLED IN ACCORDANCE WITH MANUFACTURER'S SPECIFICATIONS, LOCAL CODES, AND

6. ALL DUCTWORK SHALL BE SIZED, FABRICATED, AND INSTALLED IN ACCORDANCE WITH THE LATEST EDITION OF THE ACCA MANUAL D AND THE SMACNA HVAC DUCT CONSTRUCTION STANDARDS. DUCTWORK SHALL BE INSTALLED IN A NEAT AND WORKMANLIKE MANNER, PROPERLY SUPPORTED

7. CONDENSATE DRAINAGE PIPING SHALL BE PROPERLY PITCHED TO ENSURE POSITIVE DRAINAGE TO AN APPROVED DISPOSAL LOCATION, SUCH AS A FLOOR DRAIN, SUMP PUMP, OR EXTERIOR GRADE. CONDENSATE LINES SHALL BE INSULATED TO PREVENT SWEATING.

8. THE LOCATION OF CONTROL PANELS AND SENSORS INDICATED ON THIS DRAWING CAN BEMODIFY WITH THE SPECIFIC LOCATIONS AND WIRING

DETAILS WILL BE DETERMINED DURING THE CONTROL SYSTEM DESIGN AND INSTALLATION. 9. THE HVAC SYSTEM DESIGN CONSIDER ENERGY EFFICIENCY, INDOOR AIR QUALITY, OCCUPANT COMFORT, AND NOISE CONTROL, FOLLOWING

APPLICABLE GUIDELINES AND REGULATIONS.

DESIGN DRAWINGS TO ENSURE PROPER INSTALLATION AND INTEGRATION OF THE HVAC SYSTEMS. 11. THE HVAC CONTRACTOR IS RESPONSIBLE FOR OBTAINING ALL NECESSARY PERMITS AND LICENSES, AND FOR SCHEDULING AND COORDINATING

10. COORDINATION WITH OTHER TREADS HAS BEEN DONE ON A DESIGN LEVEL. THIS DRAWING SHALL BE READ TOGETHER WITH THE AR. EL AND SN

WITH THE LOCAL BUILDING DEPARTMENT AND UTILITY PROVIDERS TO ENSURE A TIMELY AND COMPLIANT INSTALLATION. 12. ALL DUCTWORK PENETRATIONS THROUGH WALLS, FLOORS, OR CEILINGS SHALL BE PROPERLY SEALED AND FIRE-STOPPED USING APPROVED

METHODS AND MATERIALS TO MAINTAIN THE INTEGRITY OF THE BUILDING'S FIRE-RESISTANCE RATINGS.


13. HVAC EQUIPMENT SHALL BE INSTALLED LEVEL AND PLUMB, AND IN STRICT ACCORDANCE WITH THE MANUFACTURER'S INSTALLATION INSTRUCTIONS AND RECOMMENDATIONS. PROVIDE ADEQUATE CLEARANCES AROUND EQUIPMENT FOR PROPER AIRFLOW, SERVICE ACCESS, AND CODE COMPLIANCE.


14. ALL HVAC EQUIPMENT AND COMPONENTS, INCLUDING THERMOSTATS, DAMPERS, AND ACCESS PANELS, SHALL BE LOCATED IN ACCESSIBLE AREAS FOR EASY SERVICING AND MAINTENANCE. PROVIDE ADEQUATE SPACE AROUND EQUIPMENT FOR PROPER AIRFLOW AND SERVICE ACCESS.

15. THE HVAC SYSTEM SHALL BE BALANCED AND ADJUSTED TO ENSURE PROPER AIRFLOW, TEMPERATURE DISTRIBUTION, AND SYSTEM PERFORMANCE THROUGHOUT THE RESIDENCE. PROVIDE A WRITTEN REPORT DOCUMENTING THE FINAL SYSTEM BALANCE.

16. ANY DEVIATIONS OR MODIFICATIONS TO THE HVAC SYSTEM DESIGN SHALL BE REVIEWED AND APPROVED BY THE RESPONSIBLE DESIGN PROFESSIONALS AND COMMUNICATED TO ALL RELEVANT PARTIES INVOLVED IN THE CONSTRUCTION PROCESS.

17. FOR ANY INQUIRIES OR CLARIFICATIONS REGARDING THE HVAC SYSTEM DESIGN, PLEASE CONSULT THE RESPONSIBLE DESIGN PROFESSIONALS OR THE PROJECT MANAGEMENT TEAM.

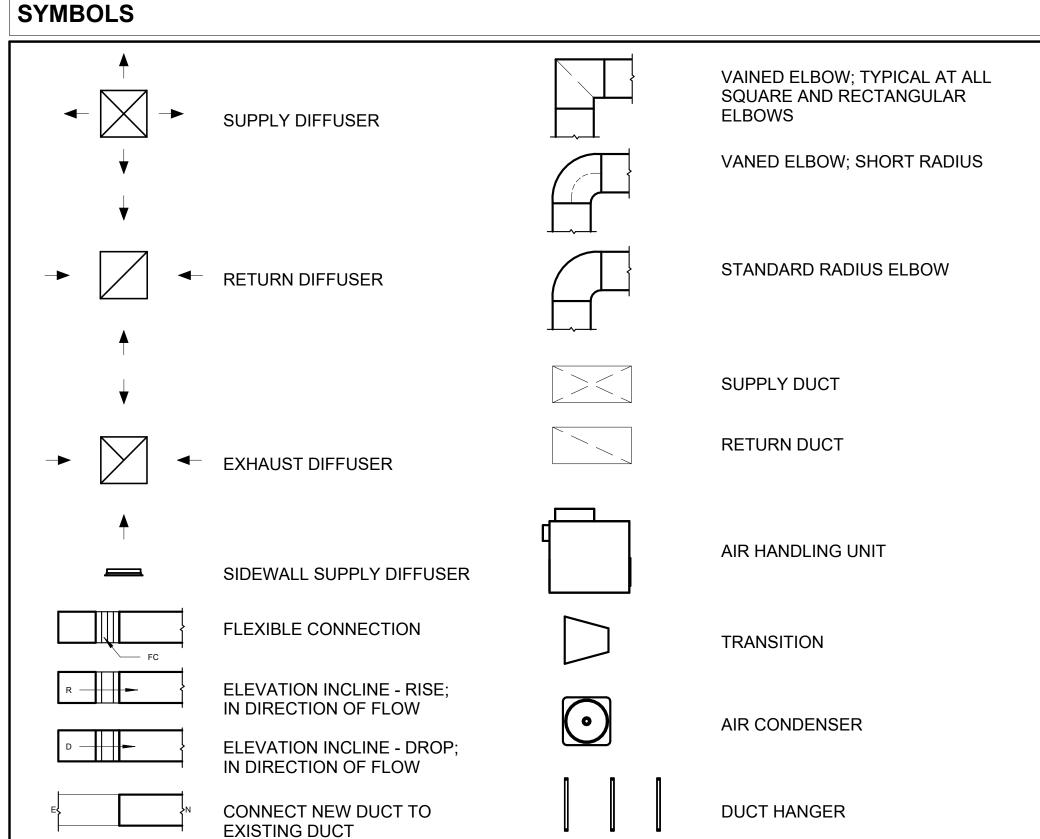

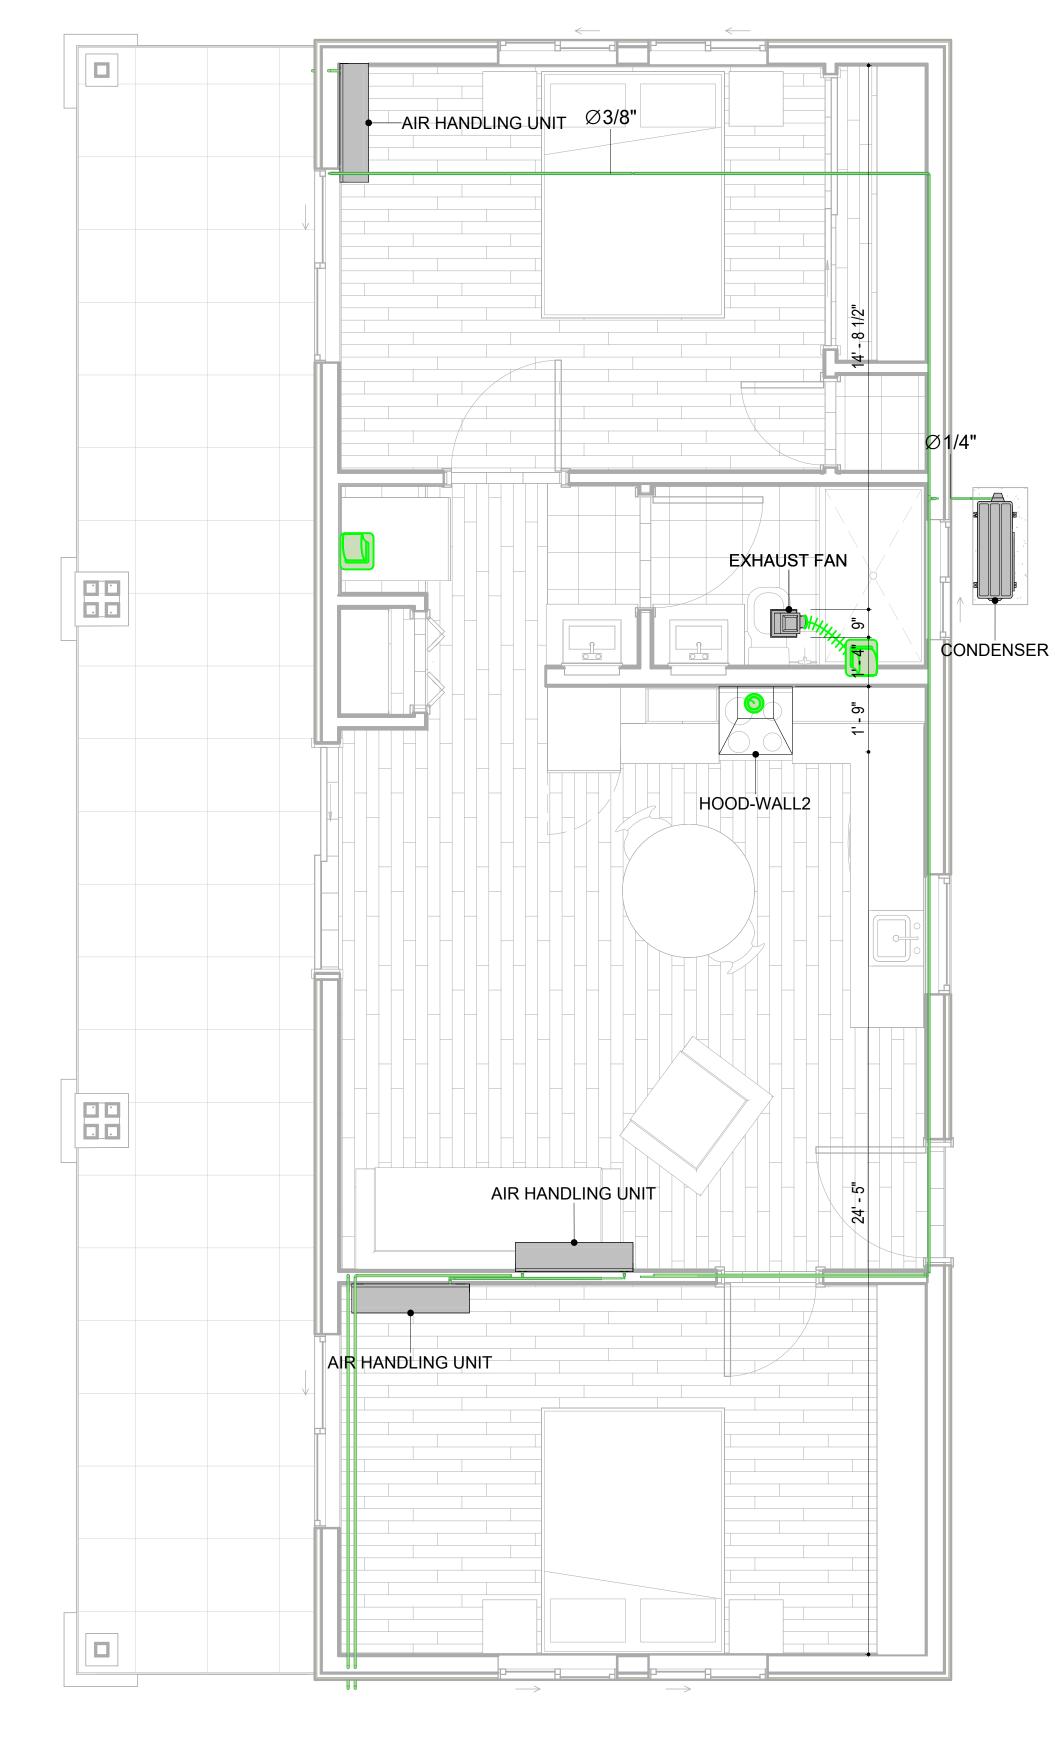

REFRIGERANT LINE SCHEDULE			
CATAGORY	DESCRIPTION	DIAMETER	LENGTH
			<u> </u>
PIPE TYPES	COPPER	1/4"	1.57
PIPE TYPES	COPPER	3/8"	77.73
PIPE TYPES	COPPER	1/2"	1.63
PIPE TYPES	<by category=""></by>	5/8"	0.35

3/4"

COPPER

PIPE TYPES

HVAC COLOR SCHEME

AIR CONDITIONING PIPE

LINE

129.41

CATAGORY	DESCRIPTION	Size	Count
ELBOW - GENERIC	ELBOW - GENERIC: STANDARD/HVAC	1/2"ø-1/2"ø	2
ELBOW - GENERIC	ELBOW - GENERIC: STANDARD/HVAC	1/4"ø-1/4"ø	2
ELBOW - GENERIC	ELBOW - GENERIC: STANDARD/HVAC	3/4"ø-3/4"ø	30
ELBOW - GENERIC	ELBOW - GENERIC: STANDARD/HVAC	3/8"ø-3/8"ø	16
ELBOW - GENERIC	ELBOW - GENERIC: STANDARD/HVAC	5/8"ø-5/8"ø	2
TEE - GENERIC	TEE - GENERIC: STANDARD	3/4"ø-3/4"ø-3/ 4"ø	2
TEE - GENERIC	TEE - GENERIC: STANDARD	3/8"ø-3/8"ø-3/ 8"ø	2
TRANSITION - GENERIC	TRANSITION - GENERIC: STANDARD	3/4"ø-1/2"ø	4
TRANSITION - GENERIC	TRANSITION - GENERIC: STANDARD	3/4"ø-5/8"ø	3
TRANSITION - GENERIC	TRANSITION - GENERIC: STANDARD	3/8"ø-1/4"ø	1

MECHANICAL EQUIPMENT SCHEDULE		
CATAGORY	DESCRIPTION	COUNT
AIR HANDLING UNIT	AIR HANDLING UNIT: WALL MOUNTED	3
CONDENSER	CONDENSER: AOTH18KNTA	1
EXHAUST FAN	EXHAUST FAN: 75 CFM	1
	HOOD-WALL2: VENT 2	1

DUCT FITTING SCHEDULE		
CATAGORY	DESCRIPTION	COUNT

DUCT ACCESSORY SCHEDULE						
CATAGORY	DESCRIPTION	COUNT				
ROOF VENT	3" DIAMETER	3				

	FLEX DU	JCT SCHEDULE		
DESCRIPTION	DESCRIPTION	LENGTH	DIAMETER	COUNT
FLEX DUCT ROUND	FLEX-ROUND	9.73	4"	3
GRAND TOTAL: 3		9.73	•	•

**HVAC PLAN** 3/8" = 1'-0"



**KEY PLAN** 

NO.	DESCRIPTION	DATE

NOTE:

LEGEND:

PROJECT

09-Wisdom-749-2Bd1Ba Craftsman-550

DRAWING NAME

**HVAC PLAN** 

CLIENT NAME: Owner PROJECT NUMBER: 15\_0001 DATE: 1/30/2025 11:19:43 PM Designer DESIGNED BY: DRAWN BY: Author CHECKED BY: Checker

M101

SCALE: As indicated

#### **ELECTRICAL NOTES**

- 1. THIS DRAWING DEPICTS THE ELECTRICAL SYSTEM FOR THE 09\_Wisdom\_749\_2Bd1Ba\_Craftsman\_350. IT PROVIDES A VISUAL REPRESENTATION OF THE ELECTRICAL LAYOUT AND COMPONENTS, INCLUDING POWER DISTRIBUTION, LIGHTING, AND CONTROL SYSTEMS.
- 2. THE ELECTRICAL SYSTEM IS DESIGNED TO MEET THE SPECIFIC REQUIREMENTS OF THE BUILDING, INCLUDING POWER DISTRIBUTION, LIGHTING, AND SPECIALIZED ELECTRICAL EQUIPMENT NEEDS, AS PER THE PROJECT SPECIFICATIONS AND APPLICABLE CODES AND STANDARDS.
- 3. THE ELECTRICAL SYSTEM INSTALLATION SHALL COMPLY WITH THE LATEST EDITION OF THE NATIONAL ELECTRICAL CODE (NEC), INTERNATIONAL BUILDING CODE (IBC), AND ALL OTHER APPLICABLE LOCAL, STATE, AND NATIONAL CODES AND REGULATIONS.
- 4. LOCATIONS AS NEEDED, DEVICES ARE SHOWN ON PLANS IN APPROXIMATE IDEAL LOCATIONS, UNLESS SPECIFICALLY DIMMENSIONED.
- 5. OPEN WALLS AS NEEDED TO ALLOW FOR NEW ELECTRICAL INSTALLATIONS.
- 6. LABEL ALL CIRCUITS ON JUNCTION BOXES, RECEPTACLES, DATA, SMOKE DETECTOR, AND EQUIPMENT IN PANEL BOX.
- 7. INSTALL RACEWAY AS NEEDED FOR DDC, ACCESS CONTROL, LOW VOLTAGE WIRING & DATA.
- 8. RELABEL POWER, DATA & FIRE ALARM FOR ROOM #CHANGES.
- 9. VERIFY ALL CIRCUITS LABELED ON PRINT ARE CORRECT BEFORE WORKING ON THEM.
  10. NOTE ON SITE PLAN ALL CHANGES OR MISSING DETAIL TO BE INCORPORATED INTO THE MASTER PLAN.
- 11. DRAWINGS ARE DIAGRAMMATIC ONLY FOR THE PURPOSE OF SHOWING FIXTURE AND OUTLET LOCATIONS.
- 12. ELECTRICAL CONTRACTOR TO VERIFY SERVICE SIZE BY CALCULATION BASED UPON ACTUAL NAME PLATE RATINGS OF SELECTED EQUIPMENT.
- PLATE RATINGS OF SELECTED EQUIPMENT.

  13. VERIFY LOCATION OF SERVICE ENTRANCE WITH POWER COMPANY. PROVIDE UFER GROUND IN
- BUILDING FOUNDATION AT SERVICE ENTRANCE WITH POWER COMPANY, PROVIDE UPER GROUND IN
- 14. PROVIDE A MIN. OF 20 FEET OF ONE \*4 BARE COPPER UFER WIRE EMBEDDED IN CONCRETE FOOTING AT THE SERVICE ENTRANCE LOCATION WHERE APPROVED BY LOCAL SERVICE PROVIDER.
- 15. PROVIDE WATERPROOF FIXTURES IN ALL HIGH MOISTURE AREAS (EXTERIOR, SHOWER AND TUB
- CEILINGS ETC.)

  16. PROVIDE DEDICATED CIRCUITS TO EACH BATH, DEN, EAMILY ROOM, REDROOM, LOET, KITCHEN
- 16. PROVIDE DEDICATED CIRCUITS TO EACH BATH, DEN, FAMILY ROOM, BEDROOM, LOFT, KITCHEN REFRIGERATOR, KITCHEN FREEZER DISHWASHER, AND ANY AREA/ITEM SPECIFIED BY OWNER.
- 17. INCANDESCENT FIXTURES WITH OPEN OR PARTIALLY ENCLOSED LAMPS, PENDANT FIXTURES, AND LAMP HOLDERS ARE NOT PERMITTED IN CLOSETS.
- 18. ALL WORKMANSHIP AND MATERIALS TO CONFORM WITH THE 2015 IRC.
- 19. PROVIDE A MIN. OF 20 FEET OF ONE \*4 BARE COPPER UFER WIRE EMBEDDED IN CONCRETE FOOTING AT THE SERVICE ENTRANCE LOCATION WHERE APPROVED BY LOCAL SERVICE PROVIDER.
- 20. PROVIDE A BONDING CONDUCTOR CONSISTING OF A MINIMUM OF ONE \*4 BARE COPPER WIRE CONNECTING THE BUILDING'S METAL WATER PIPING SYSTEM TO THE SERVICE EQUIPMENT ENCLOSURE GROUNDING.

#### MAIN PANEL CALCS

ELECTRICAL CALCS	
LIGHT AND OUTLETS 749 @ 3W	2,249 W
3 APPLIANCE CIRCUITS	4,500 W
DRYER	2,000 W
WASHER	2,000 W
RANGE	5,000 W
WATER HEATER	5,000 W
REFRIG.	1,800 W
DISHWASHER	3,000 W
TOTAL	25,549 W
FRIST 10,000 @ 100% REMAINDER @ 40% MINI. SPLIT UNITS	10,000 W 6,219 W 2880 W
TOTAL	19,099 W

19,099 W DIVIDED BY 240V = 80 AMPS TOTAL

(USE 200 AMP SERVICE)

#### **ELECTRICAL ABBREVIATIONS LIST**

1P	1 POLE (2P, 3P, 4P, ETC.)	CTR	CENTER	HT	HEIGHT
A	AMPERE	CU	COPPER	HTG	HEATING
AC	ABOVE COUNTER OR AIR CONDITIONER	DCP	DOMESTIC WATER CIRCULATING PUMP	HTR	HEATER
ACLG	ABOVE CEILING	DEPT	DEPARTMENT	HV	HIGH VOLTAGE
ADO	AUTOMATIC DOOR OPENER	DET	DETAIL	HVAC	HEATING, VENTILATING AND AIR
ADO	AMP FRAME	DIA	DIAMETER	CONDITIONING	CONDITIONING
I I				1	
AFF	ABOVE FINISHED FLOOR	DISC	DISCONNECT	HWP	HYDRONIC WATER PUMP
AFG	ABOVE FINISHED GRADE	DIST	DISTRIBUTION	IC	INTERRUPTING CAPACITY
AFI	ARC FAULT CIRCUIT INTERRUPTER	DN	DOWN	IG	ISOLATED GROUND
AHU	AIR HANDLING UNIT	DPR	DAMPER	IMC	INTERMEDIATE METAL CONDUIT
AL	ALUMINUM	DS	SAFETY DISCONNECT SWITCH	INCAND	INCANDESCENT
ALT	ALTERNATE	DT	DOUBLE THROW	IR	INFRARED
AMP	AMPERE	DWG	DRAWING	I/W	INTERLOCK WITH
AMPL	AMPLIFIER	DDC	DIRECT DIGITAL CONTROL	J-BOX	JUNCTION BOX
ANNUN	ANNUNCIATOR APPROX APPROXIMATELY	EC	ELECTRICAL CONTRACTOR	KV	KILOVOLT
AQ-STAT	AQUASTAT	ELEC	ELECTRIC, ELECTRICAL	KVA	KILOVOLT-AMPERE
ARCH	ARCHITECT, ARCHITECTURAL	ELEV	ELEVATOR	KVAR	KILOVOLT-AMPERE REACTIVE
AS	AMP SWITCH	EM	EMERGENCY	KW	KILOWATT
AT	AMP TRIP	EMS	ENERGY MANAGEMENT SYSTEM	KWH	KILOWATT HOUR
ATS	AUTOMATIC TRANSFER SWITCH	EMT	ELECTRICAL METALLIC TUBING	LOC	LOCATE OR LOCATION
AUTO	AUTOMATIC	EP	ELECTRIC PNEUMATIC	LT	LIGHT
AUX	AUXILIARY	EQUIP	EQUIPMENT	LTG	LIGHTING
AV	AUDIO VISUAL	EWC	ELECTRIC WATER COOLER	LTNG	LIGHTNING
AWG	AMERICAN WIRE GAUGE	EXIST	EXISTING	LV	LOW VOLTAGE
BATT	BATTERY	EXH	EXHAUST	MAX	MAXIMUM
BD	BOARD	EXP	EXPLOSION PROOF	MAG.S	MAGNETIC STARTER
BLDG	BUILDING	FA	FIRE ALARM	M/C	MOMENTARY CONTACT
BMS	BUILDING MANAGEMENT SYSTEM	FABP	FIRE ALARM BOOSTER POWER	MC	MECHANICAL CONTRACTOR
C	CONDUIT	SUPPLY PANEL	SUPPLY PANEL	MCB	MAIN CIRCUIT BREAKER
CAB	CABINET	FACP	FIRE ALARM CONTROL PANEL	MCC	MOTOR CONTROL CENTER
CAT	CATALOG	FCU	FAN COIL UNIT	MDC	MAIN DISTRIBUTION CENTER
CATV	CABLE TELEVISION	FIXT	FIXTURE	MDP	MAIN DISTRIBUTION PANEL
CB	CIRCUIT BREAKER	FLR	FLOOR	MFR	MANUFACTURERMAIN FUSED
CCTV	CLOSED CIRCUIT TELEVISION	FLUOR	FLUORESCENT	IVIIIX	DISCONNECT SWITCH
CKT	CIRCUIT	FU	FUSE	MH	MANHOLE
CLG	CEILING	FUDS	FUSED SAFETY DISCONNECT SWITCH	MIC	MICROPHONE
COMB	COMBINATION	GA	GAUGE	MIN	MINIMUM
CMPR	COMPRESSOR	GAL	GALLON	MISC	MISCELLANEOUS
CONN	CONNECTION	GALV	GALVANIZED	MLO	MAIN LUGS ONLY
CONST		GALV		MMS	
	CONSTRUCTION		GENERAL CONTRACTOR		MANUAL MOTOR STARTER
CONT	CONTINUATION OR CONTINUOUS	GEN	GENERATOR	MOA	MULTIOUTLET ASSEMBLY
CONTR	CONTRACTOR	GFI	GROUND FAULT CIRCUIT INTERRUPTER	MSP	MOTOR STARTER PANELBOARD
CONV	CONVECTOR	GFP	GROUND FAULT PROTECTOR	MSBD	MAIN SWITCHBOARD
CP	CIRCULATING PUMP	GND	GROUND	MT	MOUNT
CRT	CATHODE-RAY TUBE	GRS	GALVANIZED RIGID STEEL (CONDUIT)	MT.C	EMPTY CONDUIT
CT	CURRENT TRANSFORMER	GYP BD	GYPSUM BOARD	UL	UNDERWRITERS LABORATORIES
1		1			

#### **Branch Panel:**

Location: BEDROOM 15
Supply From:
Mounting: Recessed
Enclosure: Type 1

Volts: 120/240 Single
Phases: 1
Wires: 3

A.I.C. Rating: Mains Type: Mains Rating: 200 A MCB Rating: 1 A

Notes:

Circuit Numb er	Circuit Description	Number of Elements	Rating	Length	Wire Size	A		E	3	Wire Size	Length	Rating	Number of Elements	Circuit Description	Circu Numl er
1	CONDENSER	1	60 A	35' - 4 11/32"	2-#6, 1-#6, 1-#10	750 VA	750 VA			2-#10, 1-#10, 1-#10	36' - 1 1/16"	30 A	1	WATER HEATER	2
3								750 VA	750 VA						4
5	BATH ROOM UNITS	6	20 A	37' - 11 5/16"	1-#12, 1-#12, 1-#12	613 VA	720 VA			1-#12, 1-#12, 1-#12	60' - 3 15/32"	20 A		BED ROOM 1 RECEPTACLES	6
7	OUT DOOR GFCI RECEPTACLES	3	20 A	49' - 11 3/8"	1-#12, 1-#12, 1-#12			540 VA	720 VA	1-#12, 1-#12, 1-#12	44' - 4 1/32"	20 A	4	LIVING ROOM RECEPTACLES	8
9	REFRIGERATOR	1	20 A	38' - 10 15/32"	1-#12, 1-#12, 1-#12	1500 VA	1200 VA			1-#10, 1-#10, 1-#10	25' - 2 29/32"	30 A	1	DISH WASHER	10
11	KITCHEN GFCI	6	20 A	35' - 9 11/16"	1-#12, 1-#12, 1-#12			1080 VA	750 VA	2-#8, 1-#8, 1-#10	33' - 11 9/16"	50 A	1	RANGE	12
13	BED ROOM 2 LIGHT UNITS & SMOKE	7	20 A	21' - 3 3/16"	1-#12, 1-#12, 1-#12	568 VA	750 VA								14
15	LIVING ROOM & KITCHEN LIGHT UNITS	8	20 A	31' - 8 31/32"	1-#12, 1-#12, 1-#12			388 VA	688 VA	1-#12, 1-#12, 1-#12	52' - 4 31/32"	20 A	9	BED ROOM 1 LIGHT UNITS AND SMOKE	16
17	BED ROOM 2 RECEPTACLES	5	20 A	31' - 9 11/16"	1-#12, 1-#12, 1-#12	900 VA	700 VA			1-#12, 1-#12, 1-#12	58' - 2 9/16"	20 A	7	OUT DOOR LIGHT UNITS	18
19	DRYER	1	30 A	48' - 3 7/16"	2-#10, 1-#10, 1-#10			750 VA	1200 VA	1-#12, 1-#12, 1-#12	49' - 7 1/16"	20 A	1	WASHER GFCI	20
21						750 VA									22
23															24
25															26
	1					9167	VA	761	1 VA						
						76	A	63	Α						

Legend:	
---------	--

Lighting - Dwelling Unit       900 VA       100.00%       900 VA         Other       1416 VA       100.00%       1416 VA         Receptacle       14220 VA       85.16%       12110 VA         Lighting       300 VA       100.00%       300 VA			Demand Factor	Connected Load	Load Classification
Receptacle 14220 VA 85.16% 12110 VA		900 VA	100.00%	900 VA	Lighting - Dwelling Unit
· · · · · · · · · · · · · · · · · · ·	Total Conn. Load: 16780 VA	1416 VA	100.00%	1416 VA	Other
Lighting 300 VA 100 00% 300 VA	Total Est. Demand: 14671 VA	12110 VA	85.16%	14220 VA	Receptacle
Lighting 100.00% 000 V/t	Total Conn.: 70 A	300 VA	100.00%	300 VA	Lighting
	Total Est. Demand: 61 A				



**KEY PLAN** 

NO. DESCRIPTION DATE

NOTE:

LEGEND:

PROJECT

09-WISDOM-749-2Bd1Ba CRAFTSMAN-350

DRAWING NAME

# SCHEDULE

CLIENT NAME:

PROJECT NUMBER:

0037\_14

DATE:

1/30/2025 5:08:40 AM

DESIGNED BY:

DRAWN BY:

CHECKED BY:

Checker

E101

SCALE: 1/4" = 1'-0"

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#### **ELECTRICAL NOTE**

- PROVIDE INTERCONNECTED SMOKE ALARMS IN EACH SLEEPING ROOMS, OUTSIDE EACH SLEEPING ROOM, ON EACH STORY, IN THE HALL OR ADJACENT ROOM LUHERE THE CEILING HEIGHT OF A ROOM OPEN TO THE HALL EXCEEDS THE HALL BY 24'. SMOKE ALARMS SHALL BE PERMANENTLY HARD WIRED WITH BATTERY BACKUP.
- B. RECEPTACLE OUTLETS FOR RANGES AND CLOTHES DRYERS SHALL BE A THREE POLE WITH GROUND TYPE. FOUR WIRE GROUNDING-TYPE FLEXIBLE CORDS WILL BE REQUIRED FOR CONNECTION OF RANGES AND CLOTHES DRYERS. THE BONDING JUMPER SHALL NOT BE CONNECTED BETWEEN NEUTRAL TERMINAL AND THE FRAME OF THE
- C. TWO OR MORE 20 AMP SMALL APPLIANCE CIRCUITS SHALL BE PROVIDED TO SERVE THE KITCHEN, BREAKFAST NOOK, AND DINING ROOM. SUCH CIRCUITS SHALL HAVE NO OTHER OUTLETS.
- D. AT LEAST ONE 20 AMP BRANCH CIRCUIT SHALL BE PROVIDED TO SERVICE THE LAUNDRY ROOM. THIS CIRCUIT SHALL HAVE NO OTHER OUTLETS.
- E. ALL RECEPTACLES WITH IN 6' OF A WET BAR SINK OR KITCHEN SINK TO SERVE COUNTER TOP SURFACES MUST BE GFCI. ON KITCHEN COUNTERS 12' OR WIDER NO POINT ALONG THE WALL SHALL BE MORE THAN 2' FROM A RECEPTACLE. ALL RECEPTACLES WITH IN 6' OF KITCHEN SINK MUST BE GFCI. AT LEAST ONE GFCI RECEPTACLE SHALL BE INSTALLED IN THE BATHROOM ADJACENT TO EACH BASIN.
- . FIXTURES INCLUDING CEILING FANS THAT ARE LOCATED IN DAMP LOCATIONS SHALL BE LISTED TO BE SUITABLE FOR
- SUCH LOCATIONS PER 2012 IRC
- G. PROVIDE ONE (1) SWITCHED OUTLET @ ALL BEDROOMS AND DEN
- H. CEILING FANS NOT EXCEEDING 35 LBS. (WITH OR WITHOUT ACCESSORIES MAY BE SUPPORTED BY OUTLET BOXES PROVIDED THE OUTLET BOXES ARE IDENTIFIED FOR SUCH USE PER 2012 IRC
- ELECTRICAL OUTLET BOXES ON OPPOSITE SIDES OF FIRE RATED WALLS SHALL BE SEPARATED BY A HORIZONTAL DISTANCE OF NOT LESS THAN 24".
- OUTLET BOXES IN THE WALLS BETWEEN THE GARAGE AND DWELLING SHALL BE METAL OR U.L. APPROVED FIRE RESISTIVE PLASTIC. BOXES IN GARAGE CEILING SHALL BE METAL.
- K. ALL BRANCH CIRCUITS THAT SUPPLY 120 VOLTS SINGLE PHASE 15 AND 20 AMPS RECEPTACLE OUTLETS INSTALLED IN THE DWELLING SHALL BE PROTECTED BY AN ARC FAULT CIRCUIT INTERRUPTER, EXCEPT GFCI RECEPTICLES.

RECEPTACLES MUST BE PROVIDED IN HALLWAYS 10'-0" OR MORE IN LENGTH. FOR A ONE FAMILY DWELLINGS AND EACH OF A TWO FAMILY DWELLING THAT IS AT GRADE LEVEL, AT LEAST ONE WP-GFCI RECEPTACLE OUTLET ACCESSIBLE AT GRADE LEVEL AND NOT MORE THAN 6'-6" ABOVE GRADE SHALL BE INSTALLED AT THE FRONT AND BACK OF THE DWELLING.

#### NOTE: APPLIANCE DISCONNECT

#### **E4001.5 GROUNDING OF ENCLOSURES.**

METAL ENCLOSURES FOR SWITCHES OR CIRCUIT BREAKERS SHALL BE CONNECTED TO AN

EQUIPMENT GROUNDING CONDUCTOR.

METAL ENCLOSURES FOR SWITCHES OR CIRCUIT BREAKERS USED AS SERVICE EQUIPMENT SHALL COMPLY WITH THE PROVISIONS OF SECTION E3609.4. WHERE


NONMETALLIC ENCLOSURES ARE USED WITH METAL RACEWAYS OR METAL-ARMORED

CABLES, PROVISIONS SHALL BE MADE FOR CONNECTING THE EQUIPMENT GROUNDING


NONMETALLIC BOXES FOR SWITCHES SHALL BE INSTALLED WITH A WIRING METHOD THAT

PROVIDES OR INCLUDES AN EQUIPMENT GROUNDING CONDUCTOR. (404.12)

ELECTRIC	ELECTRICAL LEGEND					
	Electrical Lights With Fan					
0	Waterproof Recessed Can Light					
	Pendant Light					
0	Recessed Can Light					
<b>-</b> □	Wall Lamp					
	Standalone linear					
<b>₩</b>	Single Switch					
₩	Three way Switch					
<b>₽</b>	Fan Switch					
⊜■	Duplex Receptacle					
	Triplex Receptacle					
⊕ GFCI	GFCI Receptacle					
	Exhaust Fan					
•	Smoke and heat detector					

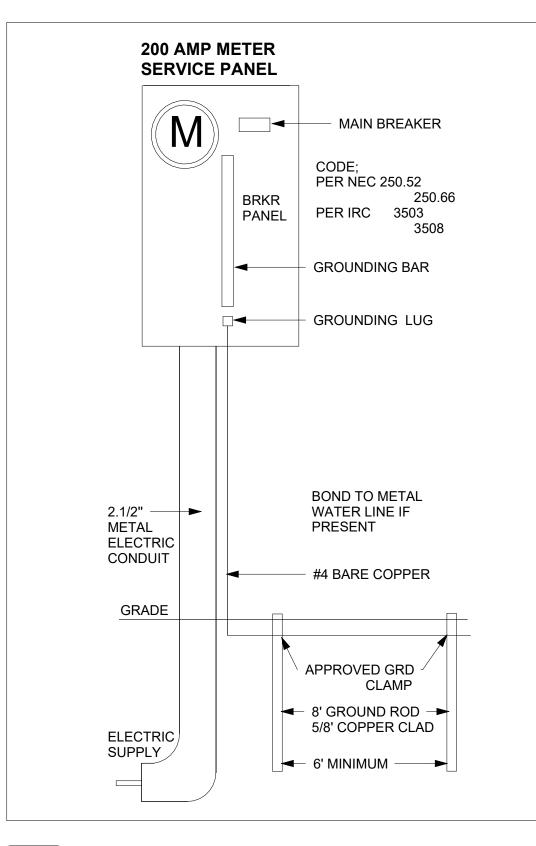



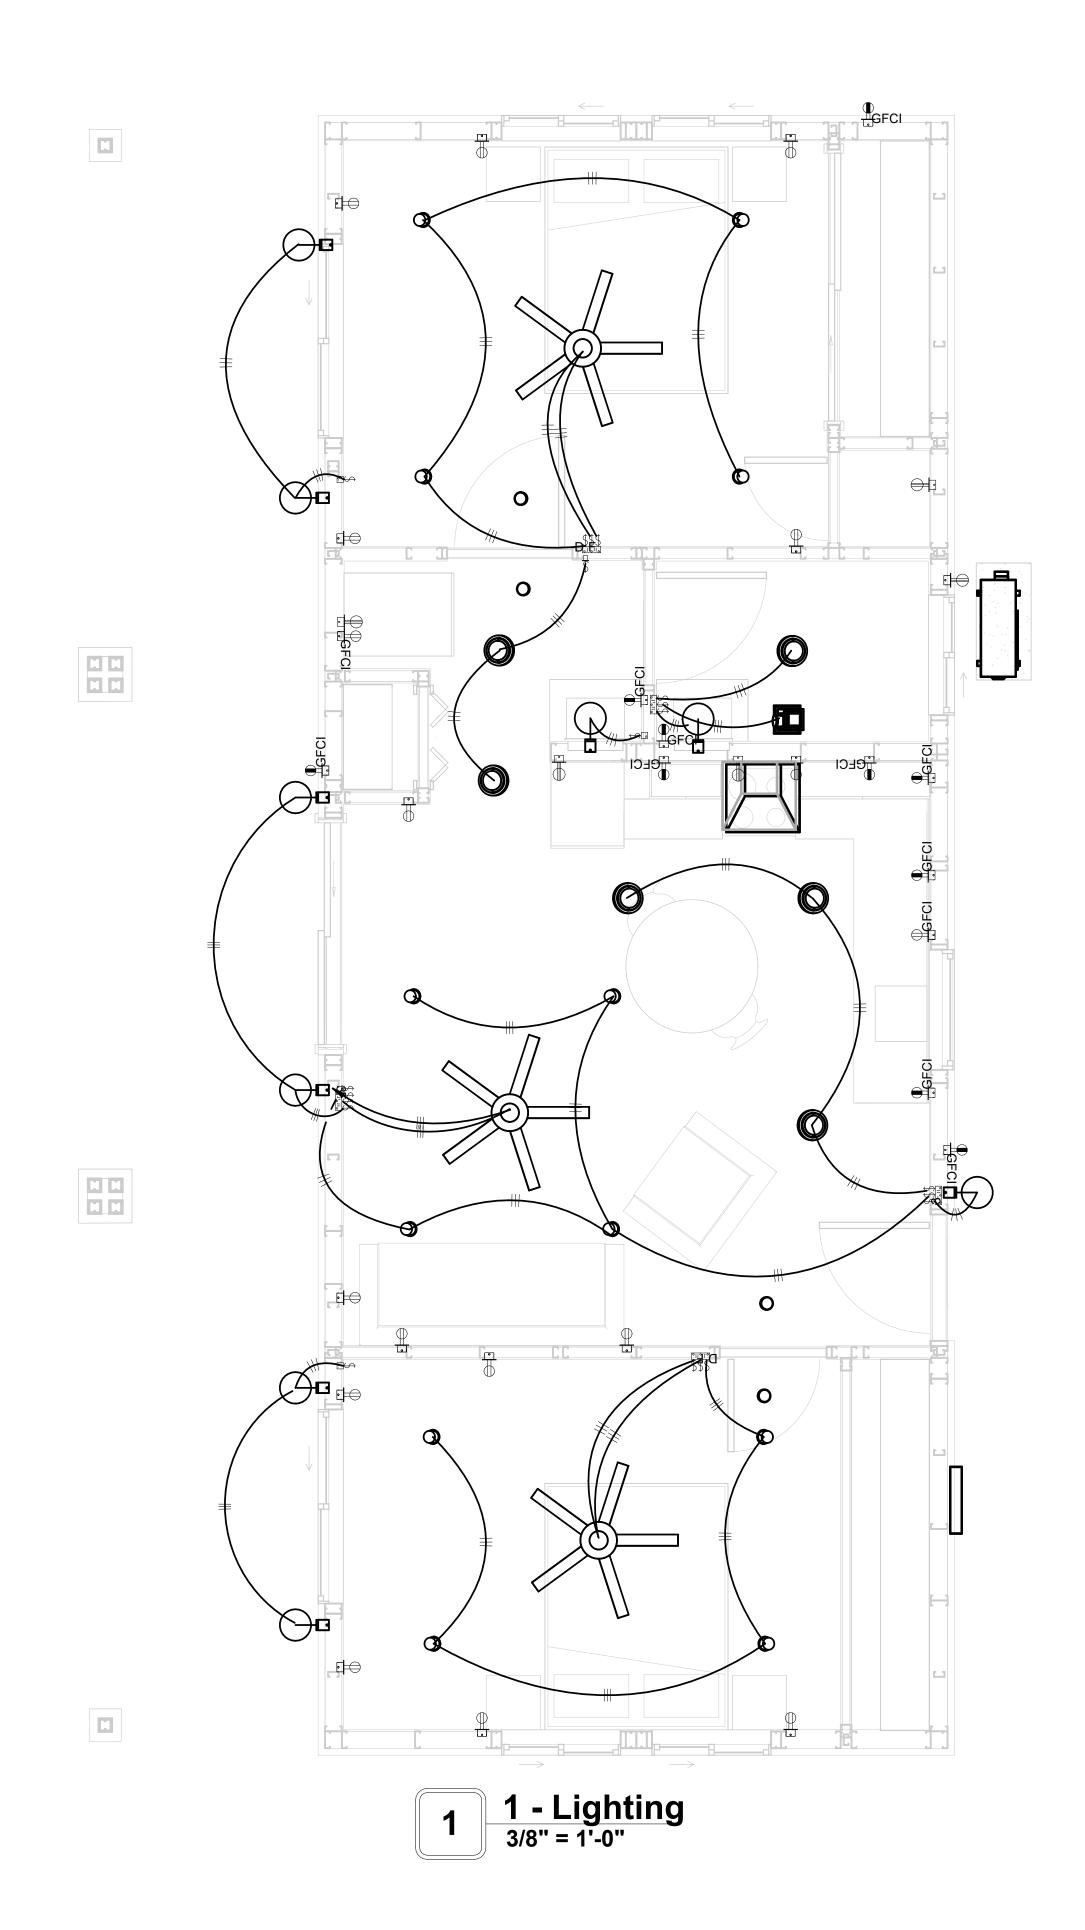



**KEY PLAN** 

NO.	DESCRIPTION	DATE

NOTE:

LEGEND:

PROJECT

09-WISDOM-749-2Bd1Ba **CRAFTSMAN-350** 

DRAWING NAME

# LIGHTING

CLIENT NAME:	Owner
PROJECT NUMBER:	0037_14
DATE:	1/30/2025 5:08:43 AM
DESIGNED BY:	Designer
DRAWN BY:	Author
CHECKED BY:	Checker

E102

SCALE: As indicated

— INTERMIDIATE METAL CONDUIT —— ELECTRICAL METAL TUBING CONDUIT

**KEY PLAN** 

# DESCRIPTION DATE

NOTE:

LEGEND:

PROJECT

09-WISDOM-749-2Bd1Ba **CRAFTSMAN-350** 

DRAWING NAME

# **POWER**

CLIENT NAME:	Owner
PROJECT NUMBER:	0037_14
DATE:	1/30/2025 5:09:10 AM
DESIGNED BY:	Designer
DRAWN BY:	Author
CHECKED BY:	Checker


E103


# **NOTES: CONDUIT, CABLE AND WIRING**

#8/3 AWG WIRE

GFCI Kitchen

- Use Metalic Conduits (IMC) for cables running under concrete slabs.
   Use IMC for circuits with high voltage appliances (240 volts and above)
   For circuits with 120 volts consider using EMT or PVC conduits if needed.
   For Low voltage applications up to 50 volts consider using non metalic conduits.
   All conduits to be used in the project must conform to the latest National Electrical Code (NEC),
- 2015.
  6. All wiring and cables to be used in the project must also conform to the latest National Electrical Code (NEC), 2015.
  7. All cables and wires used should be rated for their respective loading and should be gauged and conform to the NEC.

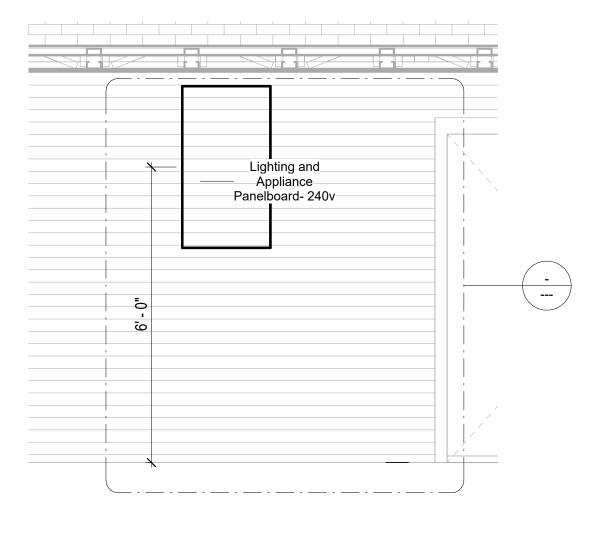

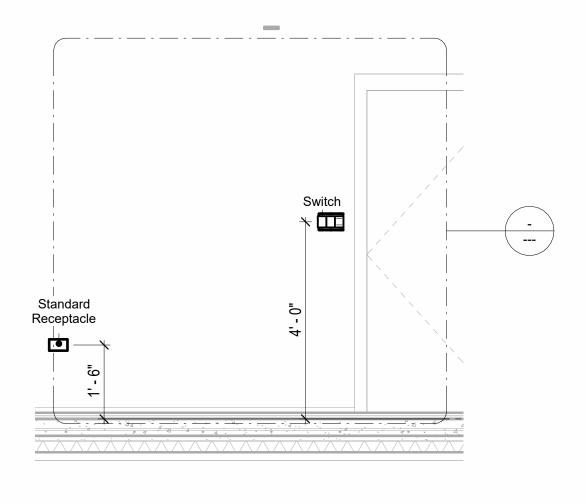


2 Section 1 1/2" = 1'-0"


4 Section 3 1/2" = 1'-0"

GFCI WASHER ••

6 Section 4 1/2" = 1'-0"

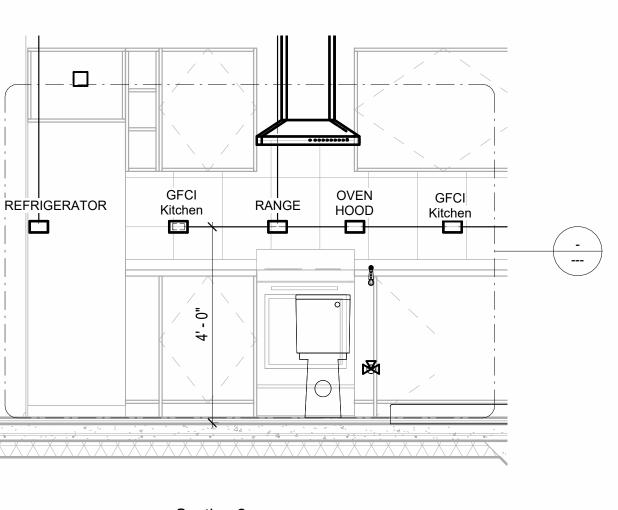

3 Section 2 1/2" = 1'-0"

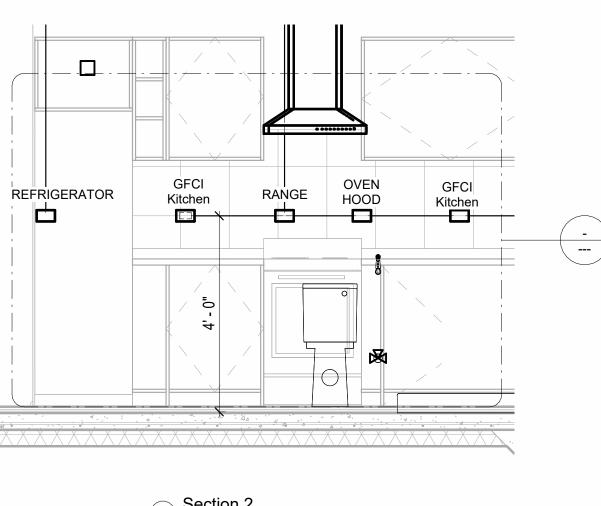

**3D-KITCHEN** 

#10/3 AWG WIRE

GFCI Kitchen

GFCI DISHWASHER

#12/2 AWG WIRE

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#12/2 AWG WIRE

REFRIGERATOR

SCALE: As indicated

INTERMIDIATE METAL CONDUITELECTRICAL METAL TUBING CONDUIT

**KEY PLAN** 

NO.	DESCRIPTION	DATE

NOTE:

LEGEND:

PROJECT

09-WISDOM-749-2Bd1Ba CRAFTSMAN-350

DRAWING NAME

# DIMENSION PLAN FOR LIGHT FIXTURES

Owner	CLIENT NAME:
0037_14	PROJECT NUMBER:
1/30/2025 5:09:12 AM	DATE:
Designer	DESIGNED BY:
Author	DRAWN BY:
Checker	CHECKED BY:

E104

SCALE: As indicated

## NOTES: LIGHT

- 1. LIGHT FIXTURES AND LUMINARIES SHALL CONFORM TO THE NEC, THE IRC AND LOCAL SAFETY & BUILDING CODE.
- 2. ALL LIGHTING FIXTURES SHOULD CONFORM TO THE DESIGN ELECTRICAL LOAD AND SHALL BE PROPERLY WIRED AND MOUNTED BY QUALIFIED ELECTRICIAN FOLLOWING MANUFACTURERS SPECIFICATIONS.
- CEILING FANS AND FANS WITH LIGHT WITH WEIGHT EXCEEDING 35 LBS SHOULD BE PROVIDED WITH STRUCTURAL BACKING FOR SUPPORT AND SHALL BE FIXED AS PER MANUFACTURERS SPECIFICATIONS.
- 4. EXTERIOR LIGHTS SHALL CONFORM TO LOCAL BUILDING CODE AND GUIDELINES.

#### **NOTES: SWITCH JUNCTION BOX**

- 1. THE MINIMUM SIZE OF JUCTION BOX TO BE USED IS 2"X4"X(1.5" OR 3.5" DEEP) THIS ARE
- TO BE USED FOR SINGLE GANG SWITCH OR OUTLETS.


  2. FOR DOUBLE GANG (2 GANG) OUTLETS AND SWITCHS THE MINIMUM SIZE OF THE
- JUCTION BOX TO BE PROVIDED SHALL NOT BE LESS THAN 4"X4"X(1.5" OR 3.5" DEEP)
- 3. FOR THREE GANG (3 GANG) OUTLETS AND SWITCHS THE MINIMUM SIZE OF THE JUĆTION BOX SHALL NOT BE LESS THAN 6"X4"X(1.5" OR 3.5" DEEP).

Conduit Fitting Schedule(junction box)			
Family	Count	Description	

Electrical Fixture Schedule (SWITCH BOX)		
Туре	Count	
Single Gang Switch Box	3	
Triple Gang Switch Box	5	

Lighting Device		
Туре	Count	
Dimmer	2	
Fan switch	3	
Single Pole	13	
Single Pole Three Way	2	

Lighting Fixture			
Lighting Fixture Type	Voltage	Electrical Load	Count
Electrical_Lights_Fan-Light1	120 V/1-100 VA- 120 V/1-100 VA	200 A, 120 V/240 V, Single Phase, 3 Wires	3
Lighting_Other_LumenWerx_Shell-Recessed-8	120 V/1-60 VA	200 A, 120 V/240 V, Single Phase, 3 Wires	6
SASSO 100 round wallwasher trim	120 V/1-28 VA	200 A, 120 V/240 V, Single Phase, 3 Wires	12
Wall Lamp - Bracket	120 V/1-100 VA	200 A, 120 V/240 V, Single Phase, 3 Wires	9

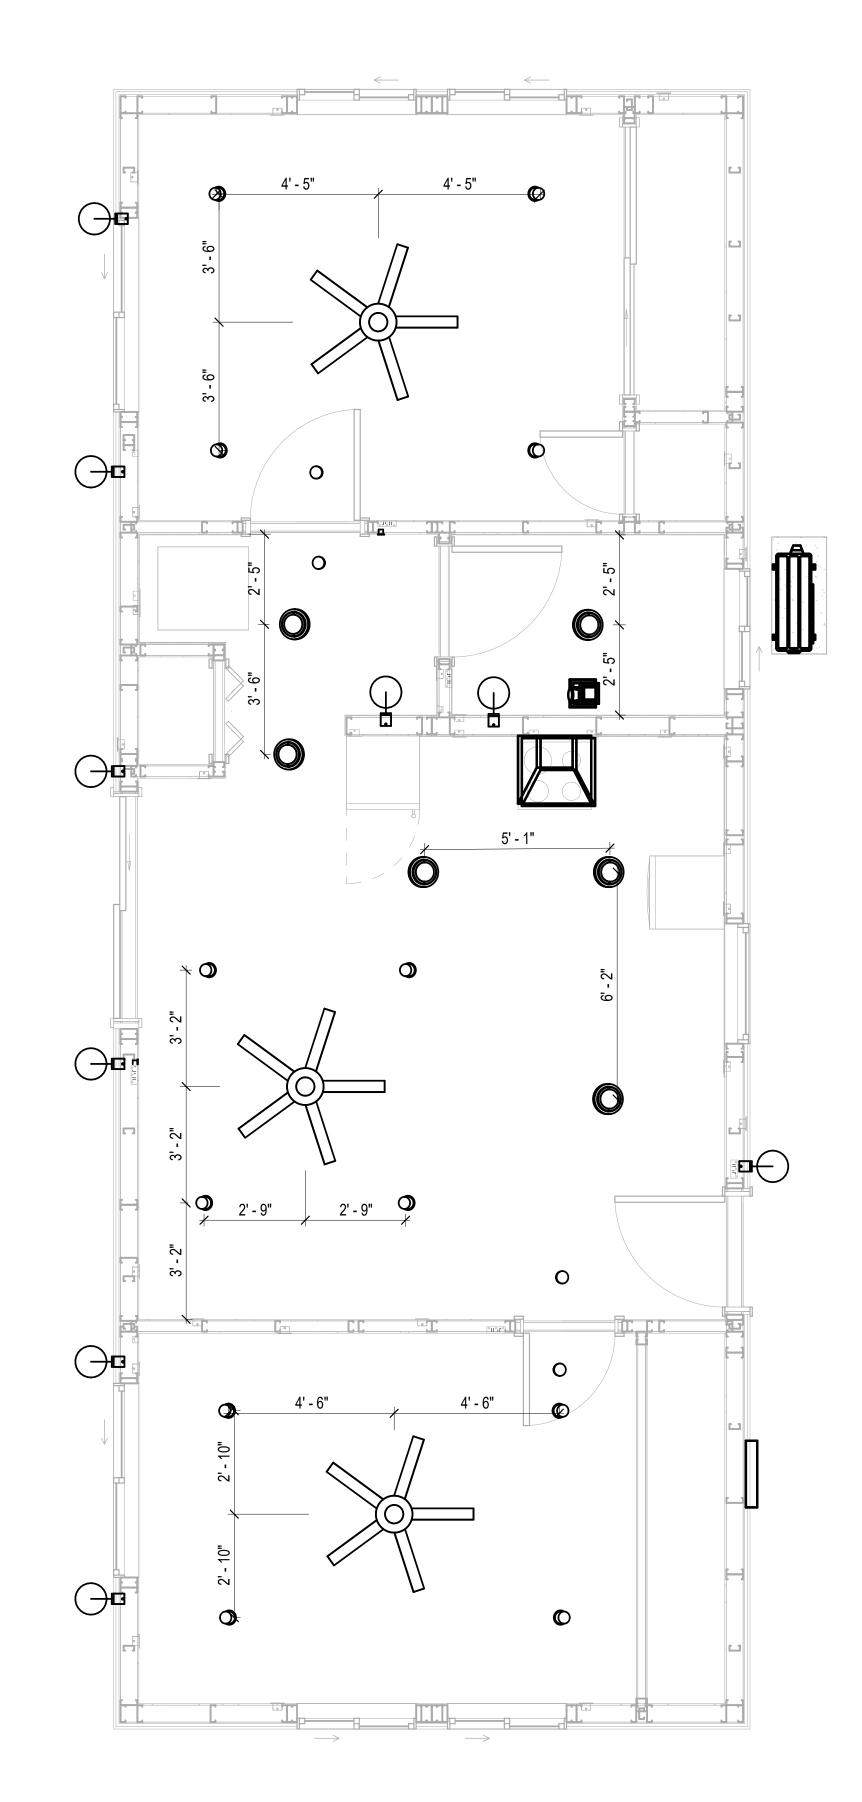

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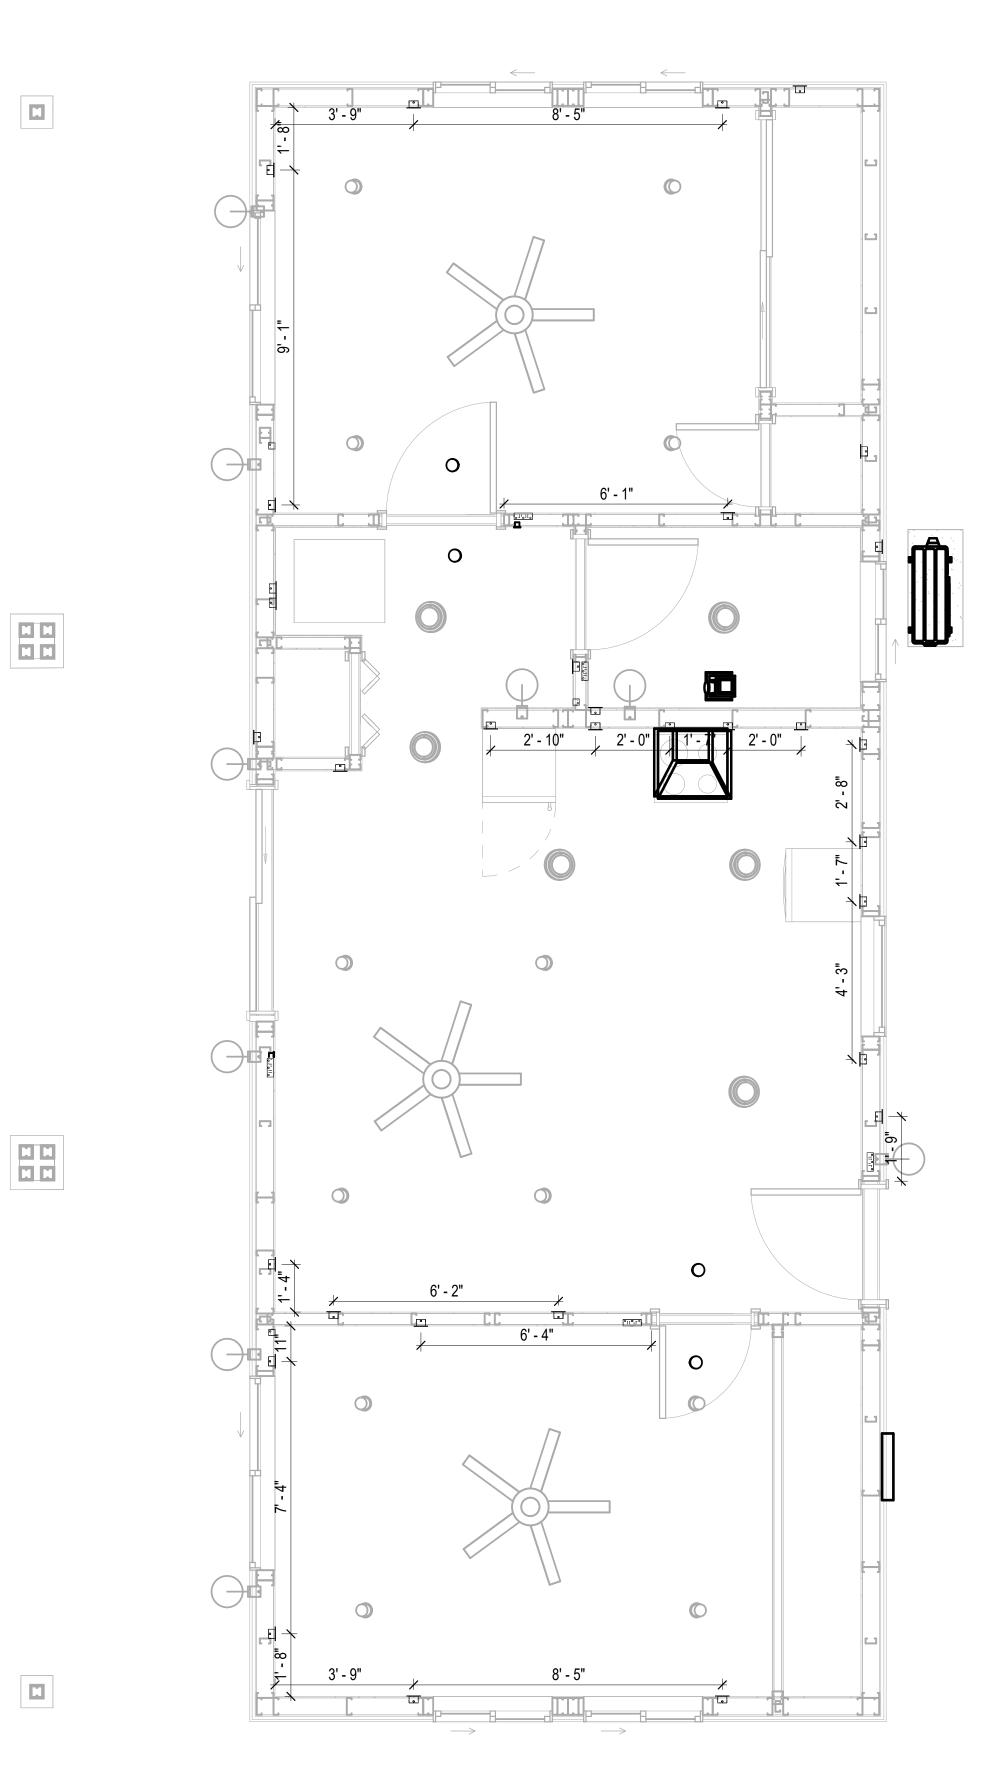
1 DIMENSION FOR LIGHT FIXTURES
3/8" = 1'-0"

## NOTES;

- VERIFY EQUIPMENT PLUG CONFIGURATION BEFORE PURCHASING RECEPTACLES
   FOR ALL EQUIPMENT.
- 3. COORDINATE EXACT LOCATION OF LIGHT FIXTURES, WALL SWITCHES, RECEPTACLES AND OTHER DEVICES WITH ARCHITECTURAL DRAWINGS.
- 4. USE METALLIC JUNCTION BOX WITH THE GFCI RECEPTACLES, WITH HIGHT VOLTAGE.

Electrical Fixture Schedule (Receptacle)	
Туре	Count
CONDENSER	1
DRYER	1
GFCI BATH ROOM	2
GFCI DISHWASHER	1
GFCI Kitchen	5
GFCI OUT DOOR	3
GFCI WASHER	1
OVEN HOOD	1
RANGE	1
REFRIGERATOR	1
Standard Receptacle	14
water heater	1

Electrical Outlet Schedule			
Туре	Circuit Number	Electrical Data	Count
Ctandard Decented		120 \//1 120 \//4	4
Standard Receptacle	1.0	120 V/1-180 VA	1
CONDENSER	1,3	240 V/2-1500 VA	1
water heater	2,4	240 V/2-1500 VA	1
GFCI BATH ROOM	5	120 V/1-180 VA	2
Standard Receptacle	6	120 V/1-180 VA	4
GFCI OUT DOOR	7	120 V/1-180 VA	3
Standard Receptacle	8	120 V/1-180 VA	4
REFRIGERATOR	9	120 V/1-1500 VA	1
GFCI DISHWASHER	10	120 V/1-1200 VA	1
GFCI Kitchen	11	120 V/1-180 VA	5
OVEN HOOD	11	120 V/1-180 VA	1
RANGE	12,14	240 V/2-1500 VA	1
Standard Receptacle	17	120 V/1-180 VA	5
DRYER	19,21	240 V/2-1500 VA	1
GFCI WASHER	20	120 V/1-1200 VA	1



DIMENSION FOR FITTINGS 3/8" = 1'-0"



**KEY PLAN** 

NO.	DESCRIPTION	DATE

NOTE:

LEGEND:

PROJECT

09-WISDOM-749-2Bd1Ba CRAFTSMAN-350

DRAWING NAME

# **DIMENSION PLAN** FOR FITTINGS

Owner	CLIENT NAME:
0037_14	PROJECT NUMBER:
1/30/2025 5:09:13 AM	DATE:
Designer	DESIGNED BY:
Author	DRAWN BY:
Checker	CHECKED BY:

E105

SCALE: 3/8" = 1'-0"

#### SHEET LIST

SHEET NUMBER SHEET NAME

P101 NOTE AND SCHEDULE
P102 WATER SUPPLY AND SEWAGE
SYSTEM

#### PIPE COLOR SCHEME

DOMESTIC COLD WATER
DOMESTIC HOT WATER
SANITARY VENT
SANITARY SEWER
STORM DRAINAGE

#### PLUMBING NOTES

- THE PLUMBING SYSTEM IS DESIGNED TO MEET THE BUILDING'S DOMESTIC WATER SUPPLY, SANITARY DRAINAGE, AND STORM DRAINAGE REQUIREMENTS, AS PER PROJECT SPECIFICATIONS AND APPLICABLE CODES.
- THE SYSTEM INSTALLATION SHALL COMPLY WITH THE LATEST INTERNATIONAL PLUMBING CODE (IPC), INTERNATIONAL RESIDENTIAL CODE (IRC), AND ALL OTHER RELEVANT LOCAL, STATE, AND NATIONAL REGULATIONS.
- 3. ALL PLUMBING WORK SHALL COMPLY WITH THE LATEST EDITION OF THE INTERNATIONAL PLUMBING CODE (IPC) AND THE LOCAL PLUMBING CODE.
- 4. PLUMBING SYSTEMS SHALL BE TESTED AND INSPECTED IN ACCORDANCE WITH THE LOCAL PLUMBING CODE REQUIREMENTS.
- 5. PLUMBING FIXTURES SHALL BE INSTALLED WITH THE APPROPRIATE TRIM, FITTINGS, AND ACCESSORIES, AS RECOMMENDED BY THE MANUFACTURER.
- 6. PIPING SHALL BE PROPERLY SUPPORTED AND SECURED TO PREVENT SAGGING,
- MOVEMENT, AND VIBRATION.

  7. SHUT-OFF VALVES SHALL BE PROVIDED AT ALL BRANCH CONNECTIONS AND AT THE
- INLET AND OUTLET OF EACH PIECE OF EQUIPMENT.

  8. BACKFLOW PREVENTION DEVICES SHALL BE INSTALLED AS REQUIRED BY THE LOCAL
- PLUMBING CODE TO PROTECT THE POTABLE WATER SYSTEM.

  9. PLUMBING FIXTURES AND EQUIPMENT SHALL BE ACCESSIBLE FOR MAINTENANCE AND
- 10. EXPOSED PLUMBING PIPING AND FIXTURES SHALL BE INSULATED TO PREVENT CONDENSATION AND ENERGY LOSS.
- 11. DEAD ENDS IN THE DRAINAGE SYSTEM MUST BE AVOIDED, EXCEPT WHERE NECESSARY TO INSTALL A CLEANOUT IN AN ACCESSIBLE LOCATION, AND MUST HAVE A VENTED CONNECTION TO THE OUTSIDE ATMOSPHERE.
- 12. THE VERTICAL DEFLECTION OF PVC PIPE MUST NOT EXCEED 5%, AND NO DEFLECTION IS PERMITTED FOR IRON PIPE.
- 13. WORK MUST BE PROPERLY COORDINATED WITH OTHER TRADES TO AVOID CONFLICTS, REFERRING TO THE ARCHITECTURAL AND STRUCTURAL DRAWINGS FOR INFORMATION REGARDING CEILING ELEVATIONS, SPACE CLEARANCES, WALL AND PARTITION LOCATIONS, ETC.
- 14. ALL FIXTURES SHALL HAVE ACCESSIBLE STOPS.
- 15. DOMESTIC WATER PIPING SHALL BE PEX, AND PVC PIPING IS NOT ACCEPTABLE FOR INTERIOR USE.
- 16. VENT TERMINATIONS SHALL BE LOCATED AT LEAST 10 FEET FROM OR 3 FEET ABOVE ANY OPERABLE WINDOW, DOOR OPENING, AIR INTAKE, OR VENT SHAFT, AND AT LEAST 3 FEET IN EVERY DIRECTION FROM ANY LOT LINE, ALLEY, OR STREET.
- 17. PIPE AND FITTINGS UTILIZED IN THE WATER SUPPLY SYSTEM SHALL HAVE A MAXIMUM OF 8 PERCENT LEAD.
- 18. ACRYLONITRILE BUTADIENE STYRENE (ABS) SHALL BE USED FOR THE SEWERAGE AND
- VENTILATION SYSTEM.

  19. CROSS-LINKED POLYETHYLENE (PEX) SHALL BE USED FOR THE WATER SUPPLY SYSTEM.
- 20. POLYVINYL CHLORIDE (PVC) SHÀLL BÉ USED FOR THE RAIN WATER SYSTEM.
- 21. THE MIMIMUM WATER SUPPLY DEPTH UNDER FLOOR FINISH SHOUD BE 1/2".
- 22. ANY PIPE INSTALLED UNDERGROUND MUST HAVE AT LEAST 12 INCHES OF CLEARANCE BETWEEN THE OUTSIDE OF THE PIPE AND ANY OTHER UNDERGROUND STRUCTURE.
- 23. THE MINIMUM CLEARANCE BETWEEN COLD AND HOT WATER LINES IN RESIDENTIAL
- HOMES MAINTAIN A MINIMUM DISTANCE OF 6 INCHES.

  24. HORIZONTAL SEPARATION BETWEEN WATER AND SEWER LINES: A MINIMUM OF 12 INCHES BETWEEN POTABLE WATER SUPPLY LINES (COLD AND HOT WATER) AND

#### **ABBREVIATIONS**

SANITARY SEWER LINES.

Ø	DIAMETER
ABS	ACRYLONITRILE BUTADIENE STYRENE
ABV	ABOVE
AD	AREA DRAIN
AFF	ABOVE FINISHED FLOOR
ALT	ALTERNATE
BFF	BELOW FINISHED FLOOR
BLW	BELOW
CO	CLEAN OUT
CW	COLD WATER
D	DEGREE
DFU	DRANAGE FIXTURE UNIT
DIA	DIAMETER
DN	DOWN
FCO	FLOOR CLEAN OUT
FD	FLOOR DRAIN
FL	FLOOR
FS	FLOOR SINK
FT	FOOT/FEET
HB	HOSE BIB
HW	HOT WATER
IN	INCH
MIN	MINIMUM
NO	NUMBER
NTS	NOT TO SCALE
PEX	CROSS-LINKED POLYETHYLENE
PLBG	PLUMBING
PVC	POLYVINYL CHLORIDE
QTY	QUANTITY
RD	ROOF DRAIN
RED	REDUCER
RM	ROOM
RW	RAIN WATER
SF	SQUARE FOOT
V	VENT
VTR	VENT THROUGH ROOF
W	WASTE
WCO	WALL CLEAN OUT
WSFU	WATER SUPPLY FIXTURE UNIT

## PLUMBING LEGEND

D	CAP
	BEND 45 DEG
B	BEND 90 DEG
	TEE REDUCING
	TEE
	CLEAN TWO-WAY
	WYE 45 DEG
	WYE 45 DEG DOUBLE
	WYE COMBINATION
	P-TRAP

PIPE SCHEDULE		
MATERIAL	DIAMETER	LENGTH
ACRYLONITRILE BUTADIENE STYRENE (ABS)	1/2"	0 FT
ACRYLONITRILE BUTADIENE STYRENE (ABS)	1 1/2"	20 FT
ACRYLONITRILE BUTADIENE STYRENE (ABS)	2"	47 FT
ACRYLONITRILE BUTADIENE STYRENE (ABS)	3"	6 FT
CROSS-LINKED POLYETHYLENE (PEX)	1/2"	94 FT
CROSS-LINKED POLYETHYLENE (PEX)	3/4"	38 FT
POLYVINYL CHLORIDE - RIGID	2"	74 FT

	FITTING SCHEDULE				
FITTING	SIZE	QTY			
DOMESTIC COLD WATER					
PEX 90 DEGREE ELBOW	1/2"ø-1/2"ø	20			
PEX 90 DEGREE ELBOW	3/4"ø-3/4"ø	1			
PEX CROSS ELBOW	3/4"ø-3/4"ø-3/4"ø	1			
PEX TEE ELBOW	1/2"ø-1/2"ø	4			
PEX TEE ELBOW	3/4"ø-3/4"ø	3			
PEX TRANSITION ELBOW	1"ø-3/4"ø	2			
PEX TRANSITION ELBOW	3/4"ø-1/2"ø	8			
DOMESTIC HOT WATER					
PEX 90 DEGREE ELBOW	1/2"ø-1/2"ø	14			
PEX 90 DEGREE ELBOW	3/4"ø-3/4"ø	3			
PEX CROSS ELBOW	3/4"ø-3/4"ø-3/4"ø	1			
PEX TEE ELBOW	1/2"ø-1/2"ø	3			
PEX TRANSITION ELBOW	3/4"ø-1/2"ø	3			
RAIN WATER	100				
PVC 90 DEG BEND ELBOW	2"ø-2"ø	30			
SEWAGE ABS 90 DEGREE BEND ELBOW	1 1/2"ø-1 1/2"ø	1			
ABS 90 DEGREE BEND ELBOW	2"ø-2"ø	2			
ABS 90 DEGREE BEND ELBOW	3"ø-3"ø	1			
ABS BEND LONG SWEEP ELBOW	2"ø-2"ø	2			
ABS P-TRAP	1 1/2"ø-1 1/2"ø	4			
ABS P-TRAP	2"ø-2"ø	1			
ABS REDUCER ELBOW	2"ø-1 1/2"ø	3			
ABS REDUCER ELBOW	3"ø-1 1/2"ø	1			
ABS REDUCER ELBOW	3"ø-2"ø	2			
ABS TEE ELBOW	1 1/2"ø-1 1/2"ø-1 1/2"ø	2			
ABS TEE ELBOW	2"ø-2"ø-2"ø	2			
ABS TEE ELBOW	3"ø-3"ø-3"ø	3			
ABS TEE REDUCER ELBOW	2"ø-2"ø-2"ø	1			
ABS TRAP P	2"ø-2"ø	1			
ABS VENT CAP ELBOW	2"ø	1			
ABS WASTE DOUBLE TEE	2"ø-2"ø-2"ø	1			
ABS WYE COMBINATION WITH 8TH BEND ELBOW	3"ø-3"ø-2"ø	1			
(FAIT					
VENT	1 1/0" = 1 1/0" =	4			
ABS 90 DEGREE BEND ELBOW ABS TEE REDUCER ELBOW	1 1/2"ø-1 1/2"ø	1			
ADD THE RELIEUER ELBUM	2"ø-2"ø-1 1/2"ø	1			
ABS VENT CAP ELBOW	1 1/2"ø	1			

WATER FIXTURE UNIT SCHEDULE				
FAMILY	QTY	UNIT VALUE	TOTAL	
DISHWASHER	1	1.4	1.4	
SHOWER TRAY	1		0	
SHOWER TRIM	1	1.4	1.4	
SINK ISLAND SINGLE	1	1.4	1.4	
VANITY SINK	2		0	
WASHER	1	1.4	1.4	
WATER CLOSET	1	2.2	2.2	

WASTE FIXTURE UNIT SCHEDULE				
FAMILY	QTY	DFU VALUES	TOTAL	
DISHWASHER	1	2	2	
SHOWER TRAY	1		0	
SINK ISLAND SINGLE	1	2	2	
VANITY SINK	2		0	
WASHER	1	2	2	
WATER CLOSET	1	3	3	

	FIXTURE SCHEDULE			
FIXTURE	QTY	DESCRIPTION		
DISHWASHER	1			
DRYER	1			
SHOWER TRAY	1			
SHOWER TRIM	1			
SINK ISLAND SINGLE	1			
VANITY SINK	2			
WASHER	1			
WATER CLOSET	1			
WATER HEATER	1			

PLUMBING SCHEDULE					
FIXTURE	TRAP	WASTE	VENT	C.W	H.W
DISHWASHER	1-1/2"	2"	1-1/2"	1/2"	1/2"
DRYER	N/A	N/A	N/A	N/A	N/A
SHOWER TRAY					
SHOWER TRIM	-	-	-	1/2"	1/2"
SINK ISLAND SINGLE	1-1/2"	2"	1-1/2"	1/2"	1/2"
VANITY SINK	1-1/2"	2"	1-1/2"	1/2"	1/2"
WASHER	2"	2"	1-1/2"	1/2"	1/2"
WATER CLOSET	3"	3"	2"	1/2"	1/2"
WATER HEATER	N/A	N/A	N/A	3/4"	3/4"

ACCESSORIES & FITTINGS SCHEDULE					
FIXTURE	QTY	DESCRIPTIONS			
DISHWASHER SUPPLY SINGLE CONNECTOR	1				
DISHWASHER SEWAGE SINGLE CONNECTOR	1				
HANGING PIPES CLAMP	20				
HOSE BIB	2				
LAUNDRY SWEAT CONNECTOR	1				
SHUTOFF VALVE	8				



**KEY PLAN** 

NO.	DESCRIPTION	DATE

NOTE:

LEGEND:

PROJECT

09-Wisdom-749-2Bd/1Ba Craftsman-550


DRAWING NAME

# NOTE AND SCHEDULE


CLIENT NAME:

PROJECT NUMBER:	0067_13
DATE:	2/1/2025 4:38:51 PM
DESIGNED BY:	Designer
DRAWN BY:	Author
CHECKED BY:	Checker

P101

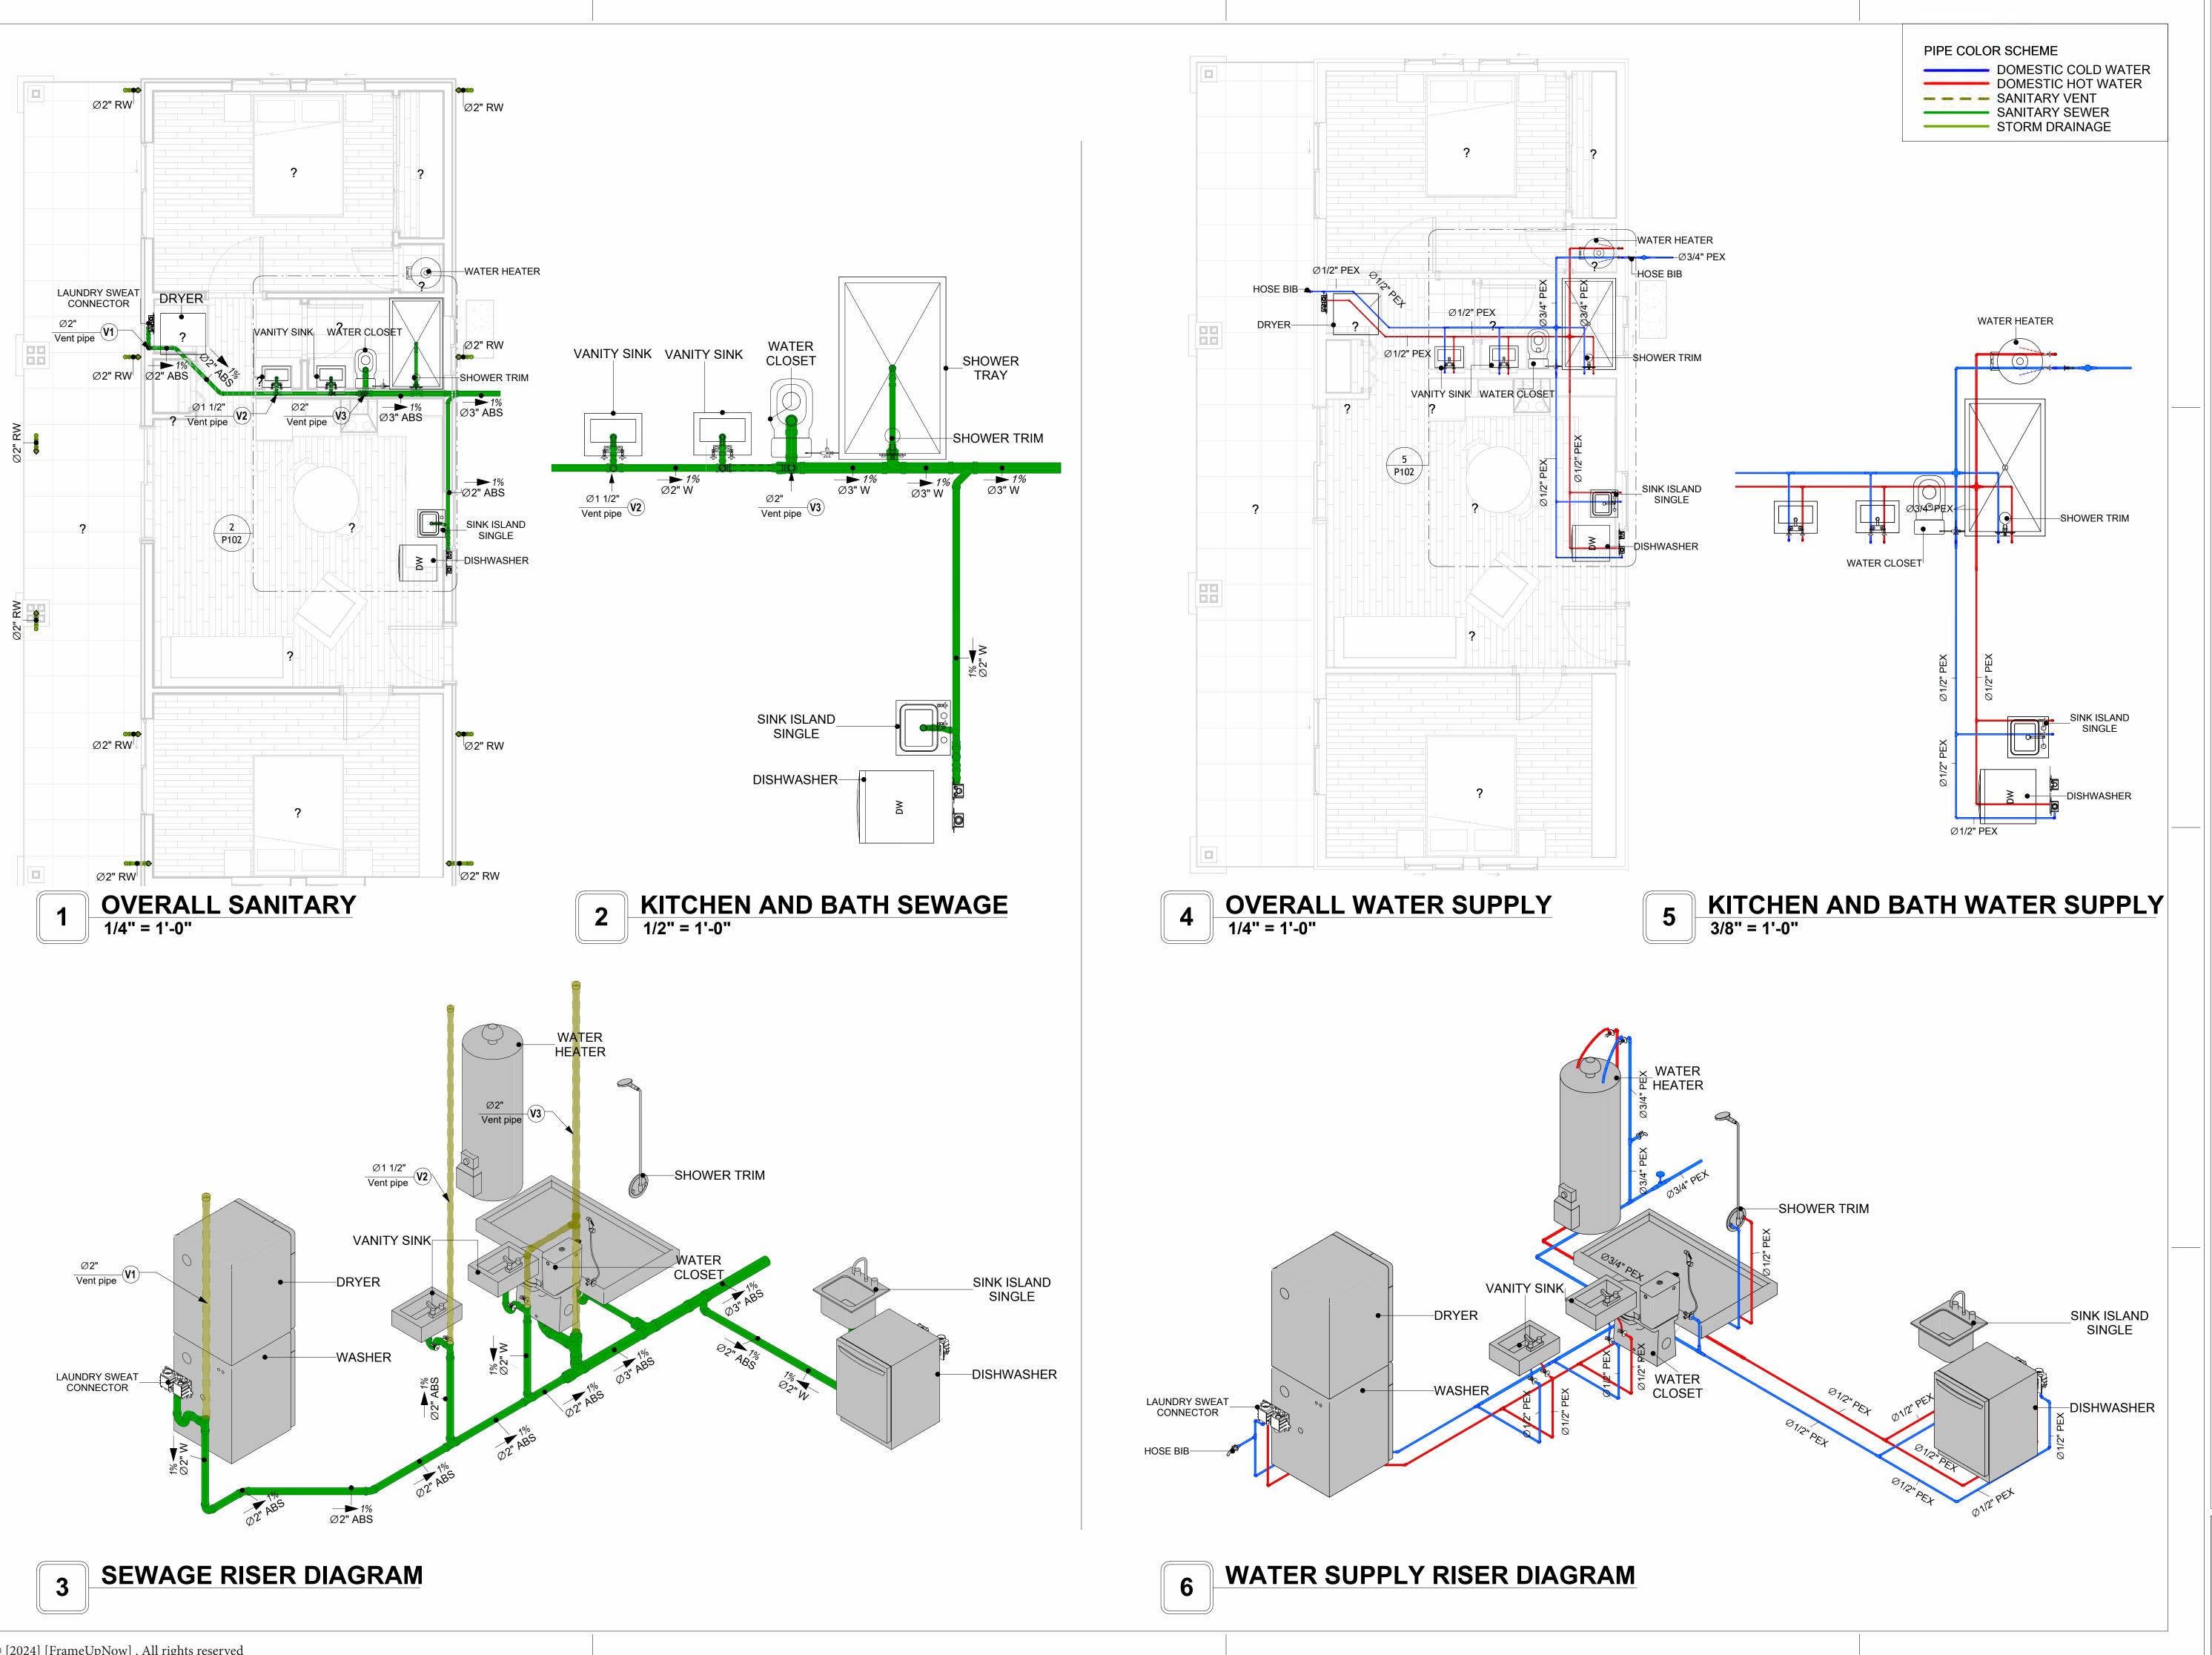



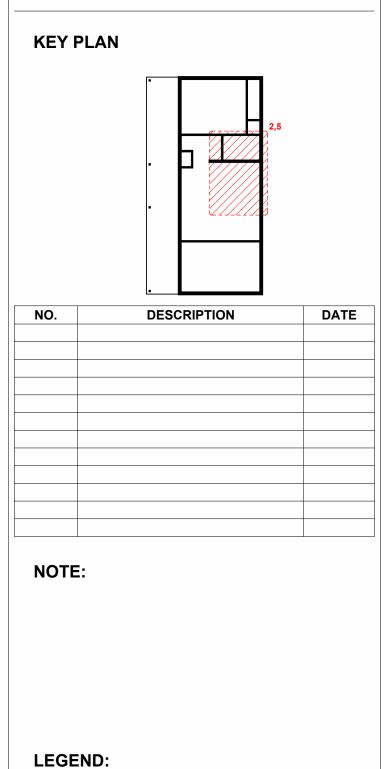

PROJECT

09-Wisdom-749-2Bd/1Ba Craftsman-550

DRAWING NAME

# WATER SUPPLY AND **SEWAGE SYSTEM**

0067_13
2/1/2025 4:39:21 PM
Designer
Author
Checker

P102

SCALE: As indicated

# Materials Shopping List

Please print and take this Materials Shopping List to your favorite Home Depot and ask for assistance in selecting the materials, fixtures and fittings to complete your new home.

Record your selection and the price of the item. Then do the math to determine the cost for your selections and the total cost of finishing your home.

#### **Have It Your Way!**

The material types listed in this document were selected based on personal preferences. The Customer is encouraged to make changes to the material types in accordance with local customs, regulations, and personal preferences.

Have It Your Way!



# 20 good reasons to frame a home with metal and not wood



Why build your ADU with metal vs wood	Wood Meta	Explanation
1 DIY Construction Benefit		The wall frames, trusses and beams can be erected in a just a few days
2 Minimal Construction Skills Required		Pre-assembled walls and trusses require no specialized skills to errect
3 Build as DIY, Hybrid or by a General Contractor		Do it yourself, Hybrid (involve special contractors) or hire a General Contractor
4 Build It As You Can Afford It		Impervious to Weather - build as you have the time and money
5 Up Front Cost of Framing Materials		As to only the framing material, wood is less expensive
6 Total Cost To Build		Savings in time, labor, and other areas make light gauge steel LESS expensive
7 Termites and wood boring insects		Termites, carpenter ants and wood boring insects eat wood, not metal
8 Mold resistant		Metal does not attract mold
9 Damage caused by exterior and interior flooding		Metal needs no reconditioning after a flood
10 Fire Resistant		Non-combustible
11 Lower insurance rates		Many insurance underwriters now provide lower rates for metal framed homes
12 Walls, trusses, and beams retain their original form		Perfectly straight walls - no shimming of drywall
13 Corners are 90 degrees		No need for templating of countertops to adjust for out of square corners
14 Strength and weight		Metal is stronger than wood and weighs less - no need for crane to lift ADU trusses
15 IBC Engineered Stamp		If an engineering stamp is necessary, months of waiting are saved
16 Complete BOM (Materials Shopping List)		Take the materials shopping list to Home Depot and start shopping/pricing
17 Flexible in Seismic Areas - Won't Fracture		Light gauge steel is flexible and won't fracture when the earth moves
18 No Waste At Job Site		Steel is the most recycled material in the world. A typical wood home has 20-30% waste
19 Environmentally Friendly		Trees don't have to be destroyed and the source of most metal is from recycling
20 How-To Videos Included		How-to videos provide simple assembly instructions
21 Relationship Counselor		Eliminate emotional uphevels - save time, money, and preserve the relationship

#### Universal Requirements - some or all may be required

- 1 Site plan
- 2 Electrical Supply Connection
- 3 Sewer Connection
- 4 Fresh Water Supply Connection
- 5 Set Backs
- 6 Soils Evaluation

- 7 Earthquake (fault) evaluation
- 8 Foundation Plan subject to soils
- 9 Compliance with local energy codes: insulation home wrap and flashing
- 10 Engineering for wind speed and snow load.
- 11 State and Local ordinances regarding ADUs
- 12 Local Architect and/or Engineer may be necessary





# Wisdom-2Bd1Ba Craftsman MATERIAL SHOPPING LIST

#### Have It Your Way!

The material types listed in this document were selected based on personal preferences. The Customer is encouraged to make changes to the material types in accordance with local customs, regulations, and personal preferences. Have It Your Way!

#### TOC



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6	ARCHITECTURAL BOM	ARCHITECTURAL BOM	15

#### Have It Your Way!

The material types listed in this document were selected based on personal preferences. The Customer is encouraged to make changes to the material types in accordance with local customs, regulations, and personal preferences. Have It Your Way!

#### **GENERAL NOTES**

- 1 This BOM (Bill of Materials) is prepared as a Materials Shopping List to help builders and DIYers gain a complete understanding of most if not all elements required for the complete construction of this structure, according to the original design documents provided by FrameUpNow.
- 2 All quantities and specifications are subject to change based on the final design, field measurements, availability of products and customer preferences. The customer should verify all information prior to purchasing materials.
- 3 All products and elements in the list shall conform to the International Residential Code (IRC), or any other local and international building codes, safety regulations, and standards that are applicable to the location of the structure.
- 4 If any changes are made by the customer to the list of materials specified in this document, the customer is responsible for assuring that the correct type and quantity of materials are utilized in accordance with local building codes.
- FrameUpNow, will not be held responsible for any misuse of this document, the products listed, or for deviations from the content that are made due to changes in specifications, pricing, availability, or customer preferences.
- 6 The customer is advised to consult a qualified professional or technician prior to purchasing materials for specialized construction system items. Some items including but not limited to caseworks, doors and windows may require as built measurements prior to purchase to confirmation of final dimensions.
- 7 If there are additional trim elements or specific installation methods, the total amount of materials needed might vary. Consider any additional trim required for corners, intersections, or other architectural details that might cause this variations before proceeding to purchase and construction.

#### **ARCHITECTURAL BOM**



		09-Wisdom-749-2Bd/	1Ba-Craft	sman	
		ARCHITECTURAL MATER	RIAL SHOP	PING LIST	
No.	Item	Туре	Unit	Quantity	Description
	APPLIANCES				
1	Refrigerator		PCS	1	
2	Range		PCS	1	
3	Washer		PCS	1	
4	Dryer		PCS	1	
5	Dish Washer		PCS	1	
6	Oven		PCS	0	
7	Microwave		PCS	0	
$\triangle$	CASEWORKS				
8	Kitchen Cabinet		FT	17.79	
9	Laundry Cabinet		FT	2.25	
10	Vanity Cabinet		FT	2.5	
11	Medicine Cabinet		PCS	2	
12	Kitchen countertop		SF	28.39	
13	Laundry Countertop		PCS	1	
14	Bathroom Countertop		SF	0	
15	Island		FT	0	
16	Peninsula		FT	0	
17	Closets		SF	126	
	CEILING				
18	Ceiling Board	Dry Wall	SF	683	
19	Dry Wall Fastener	Screw	PCS	1195	
20	Vapor Retarder	Polyethylene film	SF	841	
21	Vapor Retarder Fastener	Nails with washer heads	PCS	2523	
22	Ceiling Board (MRD)	Moisture resistant drywall	SF	41	
23	MRD Fastener		PCS	72	
24	Ceiling Board	Marine Plywood	SF	117	
25	Marine Plywood Fastener	Screw	PCS	205	
26	Dry Wall Tape		FT	421	
	FLOORING				
27	Main Living Space		SF	276	
28	Bathroom		SF	46	
29	Bedrooms		SF	346	
30	Porch		SF	292	
Δ	STRUCTURE				
31	Foundation		SF	1040	
	WALLS EXTERIOR				
32	Exterior Wall Siding		SF	779	
33	Wall Paint		SF	7.79	
34	Wall Shteathing (OSB)		SF	779	
35	Shteathing Fastener	Self-drilling screws(100/pkt)	PKT	811	
36	Wall Insulation		SF	779	
37	Wall Homewrap		SF	779	
38	Home wrap Fastener	Stapled fastener (200/pkt)	PKT	3.0	

#### **ARCHITECTURAL BOM**



	WALLCINTEDIOD				
20	WALLS INTERIOR		CF	474	
39	Cementitious Backer Board		SF	474	
40	Kerdi membrane		SF	474	
41	Kerdi membrane Fastener		SF	474	
42	Wall Ceramic Tile		SF	474	
43	Drywall Board		SF	1108	
44	Drywall Fastener	Self-drilling screws(100/pkt)	PKT	11.08	
45	Wall Paint		SF	1108	
46	Drywall Tape		FT	208	
47	Wall Sweep		FT	90	
	DOORS				
48	Interior Swinging	3' - 0" X 6'-8"	PCS	1	
49	Interior Swinging	2' - 8" X 6'-8"	PCS	1	
50	Interior Swinging	2' - 4" X 6'-8"	PCS	1	
51	Front Door With Sidelight	5' - 5" X 7'- 0"	PCS	1	
52	Interior Sliding	7' - 6" X 6'-8"	PCS	1	
53	Interior Sliding	5' - 0" X 6'-8"	PCS	1	
54	Patio Sliding	5' - 0" X 6'-8"	PCS	1	
55	Exterior Door Trim			37.7	
56	Interior Door Trim			249.5	
57	Entry Lock set			2	
58	Privacy Lock set			2	
59	Passage Lock set			3	
	WINDOWS				
60	Interior Swinging	3' - 0" X 6'-8"	PCS	1	
61	Interior Swinging	2' - 8" X 6'-8"	PCS	1	
62	Interior Swinging	2' - 4" X 6'-8"	PCS	1	
63	Front Door With Sidelight	5' - 5" X 7'- 0"	PCS	1	
64	Interior Sliding	7' - 6" X 6'-8"	PCS	1 1	
65	Interior Sliding	5' - 0" X 6'-8"	PCS	1	
66	Patio Sliding	5' - 0" X 6'-8"	PCS	1	
67	Exterior Door Trim			37.7	
68	Interior Door Trim			249.5	
69	Entry Lock set			2	
70	Privacy Lock set			2	
	Passage Lock set			3	
	ROOF			0	
	Roof Covering		SF	1022.0	
	Roof Covering Fastener		PCS	511	
	Roof Felt Paper		SF	1022.0	
75	Roof Felt Paper Fastener		PCS	3066.0	
	Roof Sheathing		SF	1022	
77	Roof Sheathing Fastener		PCS	8176	
78	Batten		FT	0.0	
79	Batten Fastener		PCS	0.0	
80	Soffit		SF	92.0	
81	Soffit Fastener		PCS	46.0	
82	Fascia		FT	147.0	
83	Fascia board fastener		PCS		
84	Roof Insulation		SF	74	
04	NUUI IIISUIA(IUII		ЭГ	1022.0	

#### **PLUMBING BOM**



09-Wisdom-749-2Bd/1Ba-Craftsman								
	PLUMBIN	IG SYSTEM MATERI	AL SHO	PPING LIST				
lo.	Item	Туре	Unit	Quantity	Description			
	SANITARY & PLUMBING PIPES							
1	ABS (Acrylonitrile Butadiene Styrene) Pipes	ø 1 1/2"	FT	28				
2	ABS (Acrylonitrile Butadiene Styrene) Pipes	ø 2"	FT	46				
3	ABS (Acrylonitrile Butadiene Styrene) Pipes	ø 3"	FT	31				
4	PEX (Cross-linked polyethylene) Pipes	ø 1/2"	FT	124.5				
5	PEX (Cross-linked polyethylene) Pipes	ø 3/4"	FT	21.5				
6	PVC Pipes Sch.80 - Rigid	ø 2"	FT	74				
7	Flex Pipe Round	ø 1/2"	PCS	7				
Δ	PIPE FITTINGS							
8	PEX 90 Degree Elbow	1/2"ø-1/2"ø	PCS	26				
9	PEX 90 Degree Elbow	3/4"ø-3/4"ø	PCS	1				
10	PEX Cross Elbow	1/2"ø-1/2"ø-1/2"ø	PCS	0				
11	PEX Tee Elbow	1/2"ø-1/2"ø-1/2"ø	PCS	6				
12	PEX Tee Elbow	3/4"ø-3/4"ø-3/4"ø	PCS	3				
13	PEX Transition Elbow	1"ø-3/4"ø	PCS	0				
14	PEX Transition Elbow	3/4"ø-1/2"ø	PCS	6				
15	PVC 90 Degree Bend Elbow	2"ø-2"ø	PCS	23				
16	ABS 90 Degree Bend Elbow	1 1/2"ø-1 1/2"ø	PCS	2				
17	ABS 90 Degree Bend Elbow	2"ø-2"ø	PCS	3				
18	ABS 90 Degree Bend Elbow	3"ø-3"ø	PCS	1				
19	ABS Bend Long Sweep Elbow	2"ø-2"ø	PCS	0				
20	ABS Reducer Elbow	2"ø-1 1/2"ø	PCS	2				
21	ABS Reducer Elbow	3"ø-1 1/2"ø	PCS	0				
22	ABS Reducer Elbow	3"ø-2"ø	PCS	3				
23	ABS TEE Elbow	1 1/2"ø-1 1/2"ø-1 1/2"ø	PCS	2				
24	ABS TEE Elbow	2"ø-2"ø-2"ø	PCS	0				
25	ABS TEE Elbow	3"ø-3"ø-3"ø	PCS	1				
	ABS TEE Reducer Elbow	2"ø-2"ø-1 1/2"ø	PCS	0				
	ABS TEE Reducer Elbow	2"ø-2"ø-2"ø	PCS	1				
	ABS P-Trap	1 1/2"ø-1 1/2"ø	PCS	3				
29	ABS P-Trap	2"ø-2"ø	PCS	4				
30	ABS Vent Cap Elbow	1 1/2"ø	PCS	0				
31	ABS End Cap Elbow	2"ø	PCS	2				
	ABS WASTE DOUBLE TEE	2"ø-2"ø-2"ø	PCS	0				
33	ABS Wye Combination with 8th Bend	2"ø-2"ø-2"ø	PCS	3				
	ABS Clean Two-Way Elbow	3"ø-3"ø-3"ø	PCS	1				
	ABS Wye Combination with 8th Bend	3"ø-3"ø-1 1/2"ø	PCS	2				
36	ABS Wye Combination with 8th Bend	3"ø-3"ø-2"ø	PCS	1				
37	ABS Vent End Cap	3"ø	PCS	0				
38	ABS Vent End Cap	1 1/2"ø	PCS	1				
39	ABS Vent End Cap	2"ø	PCS	1				
40	ABS Closet Bend	4"ø-3"ø	PCS	2				
41	PVC 90 Degree Bend Elbow	2"ø-2"ø	PCs	23				

#### **PLUMBING BOM**



	PLUMBING FIXTURES & ACCESSORIES			
41	Bath Tub (Alcove Tub)	PCS	1	
42	Kitchen Sink	PCS	1	
42	Kitchen Sink	PCS	1	
43	Kitchen Faucets	PCS	1	
44	Vanity Sink	PCS	1	
45	Bath room Faucets	PCS	1	
46	Water Closet	PCS	1	
47	Shower Trim	PCS	0	
48	Shower Tray	PCS	0	
49	Water Heater	PCS	1	
50	Hose Bib	PCS	3	
51	Shutoff Valve	PCS	6	
52	Hanging pipe clamp	PCS	18	
53	Gate Valve	PCS	1	
54	Dishwasher Supply Single Connector	PCS	1	
55	Dishwasher Sewage Single Connector	PCS	0	
56	Laundry Sweat Connector	PCS	1	

#### **HVAC BOM**



		09-Wisdom-749-2Bd/1Ba	a-Crafts	sman	
	H\	AC SYSTEM MATERIAL S	SHOPP	ING LIST	
No.	Item	Туре	Unit	Quantity	Description
	HVAC_DUCTS				
1	PIPE (REFRIGERANT LINE)	1/2" Ø	FT	8.58	
2	PIPE (REFRIGERANT LINE)	1/4" Ø	FT	0.37	
3	PIPE (REFRIGERANT LINE)	3/4" Ø	FT	8.33	
4	Flex Duct Round	4" Ø	FT	7.27	
5	Drayer hose	4" Ø	FT	11.2	
6	Flex Duct Round	5" Ø	FT	10.42	
7	Flex Duct Round	6"	FT	23.18	
8	Flex Duct Round	9"	FT	11.96	
9	Flex Duct Round	10"	FT	0.23	
10	Flex Duct Round	12"	FT	22.82	
11	Rectangular Duct	4"x4"	FT	1.06	
12	Rectangular Duct	6"x10"	FT	0.08	
	Rectangular Duct	8"x10"	FT	12.48	
14	Rectangular Duct	10"x10"	FT	1.6	
15	Rectangular Duct	10"x14"	FT	6.72	
16	Rectangular Duct	10"x18"	FT	0.33	
17	Rectangular Duct	12"x10"	FT	2.79	
18	Rectangular Duct	14"x10"	FT	22.63	
19	Round Duct	6" Ø	PCS	10.27	
	DUCT FITTINGS & ACCESSORIES	0		10.21	
	Elbow (REFRIGERANT LINE)	1/2" Ø-1/2" Ø	PCS	4	
21	Elbow (REFRIGERANT LINE)	1/4" Ø-1/4" Ø	PCS	1	
22	Elbow (REFRIGERANT LINE)	3/4" Ø-3/4" Ø	PCS	2	
23	Elbow (REFRIGERANT LINE)	3/4" Ø-3/4" Ø	PCS	3	
24	Transition (REFRIGERANT LINE)	1/2" Ø-1/4" Ø	PCS	2	
25	Transition (REFRIGERANT LINE)	2" Ø-1/2" Ø	PCS	1	
26	Transition (REFRIGERANT LINE)	7/8" Ø-3/4" Ø	PCS	1	
27	Roof vent	3" Ø	PCS	4	
28	Rectangular ELBOW	1.5W	PCS	2	
29	Transition	45 DEGREE	PCS	15	
30	Transition - Angle	45 Degree	PCS	5	
31	Round Transition - Angle	46 Degree	PCS	2	
32	Rectangular ELBOW	Standard	PCS	8	
33	Rectangular ELBOW	Standard	PCS	5	
34	Duct Hanger	Standard	PCS	3	
<u> </u>	HVAC_EQUIPMENTS		F C 3	J	
	RETURN DIFFUSER	18 x 18 Face 12 x 12 Connection	PCS	1	
	SUPPLY DIFFUSER	8 x 8 Face 4 x 4 Connection	PCS	1	
	SUPPLY DIFFUSER	12x 12 Face 6 x 6 Connection	PCS	1	
	SUPPLY DIFFUSER	12 x 12 Face 8 x 8 Connection	PCS	3	
	SUPPLY DIFFUSER	12 x 12 Face 6 x 6 Connection	PCS	1	
		VPAC - Air Cooled - 3 Tons	PCS	1	
	Condenser  Exhaust Fan		PCS		
11	Exhaust Fan	FAN: 75 CFM	PCS	2	
12	Roof vent	Roof vent		2	
13	Drayer Vent	Drayer: VENT	PCS	1	
14	Hood-Wall: Vent	Hood-Wall: VENT	PCS	1	
45	Heat pump	VERTICAL - LEFT RETURN -	PCS	1	



		09-Wisdom-749-2Bd	/1Ba-Crafts	sman	
	E	LECTRICAL MATERIA	AL SHOPPI	NG LIST	
No.	Item	Туре	Unit	Quantity	Description
	LIGHTING FIXTURES	<u>'</u>			
1	Kitchen Ceiling Light		PCS	2	
2	Exterior Wall Mounted Light		PCS	7	
3	Livingroom Ceiling Light With Fan		PCS	1	
4	Bedroom Ceiling Light With Fan		PCS	2	
5	Dining Ceiling Light		PCS	0	
6	Bath Wall Mounted Light		PCS	2	
7	Bathroom Ceiling Light		PCS	1	
8	Livingroom Ceiling Light		PCS	5	
9	Bed Ceiling Light		PCS	8	
10	Hall & Entry Ceiling Light		PCS	2	
11	Smoke Detector		PCS	4	
	ELECTRICAL FITTINGS		ı		
	Standard Receptacle 120V	15 A	PCS	14	
11	GFCI Receptacle 120V	20 A	PCS	13	
12	GFCI Receptacle 240V	30 A	PCS	3	
13	GFCI Receptacle 240V	40 A	PCS	0	
14	GFCI Receptacle 240V	50 A	PCS	1	
15	GFCI Receptacle 240V	60 A	PCS	1	
16	Fan Switch	0071	PCS	3	
17	Single Pole Switch		PCS	13	
18	Three Way Switch		PCS	2	
19	Dimmer Switch		PCS	2	
	ELECTRICAL CONDUITS & WIRING		1 03		
	ROMEX 14 AWG	14/2 w/ground	FT	0	
21	ROMEX 12 AWG	12/2 w/ground	FT	512.4	
22	ROMEX 10 AWG	10/2 w/ground	FT	25	
23	ROMEX 10 AWG	10/3 w/ground	FT	84	
24	ROMEX 10 AWG	8/2 w/ground		0	
25	ROMEX 8 AWG	8/3 w/ground	FT	34	
	ROMEX 6 AWG	6/3 w/ground	FT	35	
26 27	Bare Copper Ground Wire 6 AWG	0/3 W/ground		33	
		200 AMP	PCS	1	
29	Panelboard -240V 1 Phase MLO	15 A	PCS	1	
30	Circuit breaker		PCS	12	
31	Circuit breaker	20 A			
32	Circuit breaker	30 A	PCS	3	
34	Circuit breaker	40 A	PCS	0	
25	Circuit breaker	50 A	PCS	1	
35	Circuit breaker	60 A	PCS	1	
36	Single Gang Switch Box		PCS	3	
	Double Gang Switch Box		PCS	0	
39	Triple Gang Switch Box	"414	PCS	5	
40	Pull Box	#1/4	PCS	24	
43	Receptacle Box		PCS	32	



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#### **Have It Your Way!**

The material types listed in this document were selected based on personal preferences. The Customer is encouraged to make changes to the material types in accordance with local customs, regulations, and personal preferences. Have It Your Way!

#### **GENERAL NOTES**

- 1 This BOM (Bill of Materials) is prepared as a Materials Shopping List to help builders and DIYers gain a complete understanding of most if not all elements required for the complete construction of this structure, according to the original design documents provided by FrameUpNow.
- 2 All quantities and specifications are subject to change based on the final design, field measurements, availability of products and customer preferences. The customer should verify all information prior to purchasing materials.
- 3 All products and elements in the list shall conform to the International Residential Code (IRC), or any other local and international building codes, safety regulations, and standards that are applicable to the location of the structure.
- 4 If any changes are made by the customer to the list of materials specified in this document, the customer is responsible for assuring that the correct type and quantity of materials are utilized in accordance with local building codes.
- 5 FrameUpNow, will not be held responsible for any misuse of this document, the products listed, or for deviations from the content that are made due to changes in specifications, pricing, availability, or customer preferences.
- The customer is advised to consult a qualified professional or technician prior to purchasing materials for specialized construction system items. Some items including but not limited to caseworks, doors and windows may require as built measurements prior to purchase to confirmation of final dimensions.
- 7 If there are additional trim elements or specific installation methods, the total amount of materials needed might vary. Consider any additional trim required for corners, intersections, or other architectural details that might cause this variations before procedding to purchase and construction.



			LIGHTING FIXTURES				
#	Lighting	Туре	Description, Manufacturer, SKU	Unit	Quantity	Unit Price	Total
1	Kitchen Ceiling Light			PCS	2		
2	Exterior Wall Mounted Light			PCS	7		
3	Livingroom Ceiling Light With Fan			PCS	1		
4	Bedroom Ceiling Light With Fan			PCS	2		
5	Dining Ceiling Light			PCS	0		
6	Bath Wall Mounted Light			PCS	2		
7	Bathroom Ceiling Light			PCS	1		
8	Livingroom Ceiling Light			PCS	5		
9	Bed Ceiling Light			PCS	8		
10	Hall & Entry Ceiling Light			PCS	2		
11	Smoke Detector			PCS	4		
12							
13							
14							
15							



		ELECTRICAL FITTINGS				
Item	Туре	Description, Manufacturer, SKU	Unit	Quantity	Unit Price	Total
Standard Receptacle 120V	20A		PCS	14		
GFCI Receptacle 120V	20 A		PCS	13		
GFCI Receptacle 240V	30 A					
GFCI Receptacle 240V	50 A			1		
GFCI Receptacle 240V	60 A			1		
Fan Switch				3		
Single Pole Switch						
Three Way Switch						
Dimmer Switch						
			103			
	Standard Receptacle 120V  GFCI Receptacle 120V  GFCI Receptacle 240V  GFCI Receptacle 240V  GFCI Receptacle 240V  Fan Switch  Single Pole Switch  Three Way Switch	Standard Receptacle 120V  GFCI Receptacle 120V  GFCI Receptacle 240V  Three Way Switch	Item Type Description, Manufacturer, SKU Standard Receptacle 120V 20A  GFCI Receptacle 120V 30 A  GFCI Receptacle 240V 50 A  GFCI Receptacle 240V 60 A  Fan Switch Single Pole Switch Three Way Switch	Item Type Description, Manufacturer, SKU Unit Standard Receptacle 120V 20A PCS GFCI Receptacle 120V 30 A PCS GFCI Receptacle 240V 30 A PCS GFCI Receptacle 240V 50 A PCS GFCI Receptacle 240V 50 A PCS GFCI Receptacle 240V 60 A PCS Fan Switch PCS Single Pole Switch PCS Three Way Switch	Item Type Description, Manufacturer, SKU Unit Quantity Standard Receptacle 120V 20A PCS 14  GFCI Receptacle 120V 20 A PCS 13  GFCI Receptacle 240V 30 A PCS 3  GFCI Receptacle 240V 50 A PCS 1  GFCI Receptacle 240V 60 A PCS 1  Fan Switch PCS 3  Single Pole Switch PCS 13  Dimmer Switch PCS 2	Item Type Description, Manufacturer, SKU Unit Quantity Unit Price Standard Receptacle 120V 20A PCS 14  GFCI Receptacle 120V 20 A PCS 13  GFCI Receptacle 240V 30 A PCS 3  GFCI Receptacle 240V 50 A PCS 1  GFCI Receptacle 240V 60 A PCS 1  Fan Switch PCS 3  Single Pole Switch PCS 2  Dimmer Switch



tem	Туре	Description, Manufacturer, SKU	Unit	Quantity	Unit Price	Total
ROMEX 12 AWG	12/2/W/ground		FT	512.4		
ROMEX 10 AWG	10/2/W/ground		FT	25.1		
	10/3/W/ground					
Romex 8 AWG	8/3/W/ground		FT			
ROMEX 6 AWG	6/3/W/ground					
Bare Copper Ground Wire 6 AWG						
Bare Copper Ground Wire 6 AWG						
	ROMEX 10 AWG Romex 8 AWG ROMEX 6 AWG Bare Copper Ground Wire 6 AWG	ROMEX 10 AWG  10/2/W/ground  10/3/W/ground  Romex 8 AWG  8/3/W/ground  ROMEX 6 AWG  6/3/W/ground  Bare Copper Ground Wire 6 AWG	ROMEX 10 AWG  10/2/W/ground  10/3/W/ground  Romex 8 AWG  8/3/W/ground  ROMEX 6 AWG  6/3/W/ground  Bare Copper Ground Wire 6 AWG	ROMEX 10 AWG  10/2/W/ground  FT  10/3/W/ground  FT  Romex 8 AWG  8/3/W/ground  FT  ROMEX 6 AWG  6/3/W/ground  FT  Bare Copper Ground Wire 6 AWG  FT	FT   512.4	ROMEX 10 AWG 10/2/W/ground FT 25.1 10/3/W/ground FT 84.4 Romex 8 AWG 8/3/W/ground FT 34 ROMEX 6 AWG 6/3/W/ground FT 35.4 Bare Copper Ground Wire 6 AWG FT T



			ELECTRICAL BOXES & CIRCUTES				
#	Item	Туре	Description, Manufacturer, SKU	Unit	Quantity	Unit Price	Total
1	Panelboard -240V 1 Phase MLO	200 AMP		PCS	1		
2	Circuit breaker	20 A		PCS	12		
3	Circuit breaker	30 A		PCS	3		
4	Circuit breaker	50 A		PCS	1		
5	Circuit breaker	60 A		PCS	1		
6	Single Gang Switch Box			PCS	3		
7	Triple Gang Switch Box			PCS	5		
8	Pull Box	#1/4		PCS	24		
9	Receptacle Box			PCS	32		
10							
11							
12							
13							
14							
15							

#### **HVAC BOM**



		HVAC_DUCTS 01				
Item	Туре	Description, Manufacturer, SKU	Unit	Quantity	Unit Price	Total
LINE)			FT	1.57		
PIPE (REFRIGERANT LINE)	3/8" (Ø)		FT	79.52		
PIPE (REFRIGERANT LINE)	1/2" (Ø)					
PIPE (REFRIGERANT LINE)	5/8" (Ø)					
PIPE (REFRIGERANT LINE)	3/4" (Ø)					
DRAYER HOSE	4" (Ø)					
FLEX DUCT ROUND	4" (Ø)					
				3.1		
	PIPE (REFRIGERANT LINE) DRAYER HOSE	PIPE (REFRIGERANT LINE) 3/8" (Ø)  PIPE (REFRIGERANT LINE) 3/8" (Ø)  PIPE (REFRIGERANT LINE) 1/2" (Ø)  PIPE (REFRIGERANT LINE) 5/8" (Ø)  PIPE (REFRIGERANT LINE) 3/4" (Ø)  DRAYER HOSE  4" (Ø)	Item Type Description, Manufacturer, SKU  PIPE (REFRIGERANT LINE) 1/4" (Ø) LINE)  PIPE (REFRIGERANT LINE) 3/8" (Ø)  PIPE (REFRIGERANT LINE) 1/2" (Ø)  PIPE (REFRIGERANT LINE) 5/8" (Ø)  PIPE (REFRIGERANT LINE) 3/4" (Ø)  DRAYER HOSE 4" (Ø)	Item Type Description, Manufacturer, SKU Unit PIPE (REFRIGERANT LINE) 1/4" (Ø) LINE) PIPE (REFRIGERANT LINE) 3/8" (Ø) FT  PIPE (REFRIGERANT LINE) 1/2" (Ø) FT  PIPE (REFRIGERANT LINE) 5/8" (Ø) FT  PIPE (REFRIGERANT LINE) 3/4" (Ø) FT  DRAYER HOSE 4" (Ø) FT	Item Type Description, Manufacturer, SKU Unit Quantity PIPE (REFRIGERANT 1/4" (Ø) LINE) FT 1.57 PIPE (REFRIGERANT LINE) 3/8" (Ø) FT 79.52 PIPE (REFRIGERANT LINE) 1/2" (Ø) FT 1.63 PIPE (REFRIGERANT LINE) 5/8" (Ø) FT 0.43 PIPE (REFRIGERANT LINE) 3/4" (Ø) FT 131.02 DRAYER HOSE 4" (Ø) FT 4.3 FLEX DUCT ROUND 4" (Ø)	Item Type Description, Manufacturer, SKU Unit Quantity Unit Price PIPE (REFRIGERANT 1/4" (Ø) LINE) FT 1.57  PIPE (REFRIGERANT LINE) 3/8" (Ø) FT 79.52  PIPE (REFRIGERANT LINE) 1/2" (Ø) FT 1.63  PIPE (REFRIGERANT LINE) 5/8" (Ø) FT 0.43  PIPE (REFRIGERANT LINE) 3/4" (Ø) FT 131.02  DRAYER HOSE 4" (Ø) FT 4.3  FLEX DUCT ROUND 4" (Ø)

#### **HVAC BOM**



	DUCT FITTINGS & ACCESSORIES						
#	Item	Туре	Description, Manufacturer, SKU	Unit	Quantity	Unit Price	Total
1	ELBOW (REFRIGERANT LINE)	1/2" (Ø)-1/2" (Ø)		PCS	2		
2	ELBOW (REFRIGERANT LINE)	1/4" (Ø)-1/4" (Ø)		PCS	2		
3	ELBOW (REFRIGERANT LINE)	3/4" (Ø)-3/4" (Ø)		PCS	32		
4	ELBOW (REFRIGERANT LINE)	3/8" (Ø)-3/8" (Ø)		PCS	19		
5	ELBOW (REFRIGERANT LINE)	5/8" (Ø)-5/8" (Ø)		PCS	3		
6	TRANSITION (REFRIGERANT LINE)	3/4" (Ø)-1/2" (Ø)		PCS	4		
7	TRANSITION (REFRIGERANT LINE)	3/4" (Ø)-3/8" (Ø)		PCS	3		
8	TRANSITION (REFRIGERANT LINE)	3/8" (Ø)-1/4" (Ø)		PCS	1		
9	TEE (REFRIGERANT LINE)	3/4" (Ø)-3/4" (Ø)-3/4" (Ø)		PCS	2		
10	TEE (REFRIGERANT LINE)	3/8" (Ø)-3/8" (Ø)-3/8" (Ø)		PCS	2		
11	ROUND TRANSITION(ANGLE)	45 DEGREE		PCS	3		
12				, 55			
13							
14							
15							

# **HVAC BOM**



	HVAC_EQUIPMENTS								
#	Item	Туре	Description, Manufacturer, SKU	Unit	Quantity	Unit Price	Total		
1	AIR HANDLING UNIT	WALL MOUNTED		PCS	3				
2	CONDENSER	OUTDOOR UNIT		PCS	1				
3	EXHAUST FAN	75 CFM		PCS	1				
1	EXHAUST HOOD	WALL MOUNTED		PCS					
5	HOOD-WALL: VENT	HOOD-WALL: VENT		PCS					
5	DRAYER: VENT	DRAYER: VENT		PCS	1				
7	ROOF VENT	3"(Ø)		PCS	1				
3				103	'				
9									
10									
11									
12									
13									
14									
15									

# **PLUMBING BOM**



	△ PLUMBING FIXTURES & ACCESSORIES							
#	Item	Туре	Description, Manufacturer, SKU	Unit	Quantity	Unit Price	Total	
1	Bath Tub (Alcove Tub)	5' 0" * 2' 8" * 1' 6"		PCS	1			
2	Kitchen Sink	Single 3' 6" * 1' 9"		PCS	1			
3	Vanity Sink	Vessel sink 1' 2" * 1' 7"		PCS	1			
4	Water Closet	Elongated 1' 6" * 1' 2"		PCS	1			
5	Water Heater	By Customer		PCS	1			
6	Hose Bib	Bronze ø 3/4"		PCS	1			
7	Shutoff Valve	ø 1/2"		PCS	6			
8	Hanging pipe clamp	Adjustable Clamp ø 2"		PCS	15			
9	Gate Valve	ø 1"		PCS	1			
10	Laundry Sweat Connector	Copper Sweat Connector		PCS	1			
11								
12								
13								
14								
15								

# **PLUMBING BOM**



		SANITARY & PLUMBING PIPES							
#	Item	Туре	Description, Manufacturer, SKU	Unit	Quantity	Unit Price	Total		
1	ABS 90 Degree Bend Elbow	1 1/2"ø-1 1/2"ø		FT	2				
2	ABS 90 Degree Bend Elbow	2"ø-2"ø		FT	2				
3	ABS 90 Degree Bend Elbow	3"ø-3"ø		FT	1				
4	ABS Bend Long Sweep Elbov	2"ø-2"ø		FT	2				
5	ABS P-Trap	1 1/2"ø-1 1/2"ø		FT	4				
6	ABS P-Trap	2"ø-2"ø		FT	1				
7	ABS Reducer Elbow	2"ø-1 1/2"ø		FT	3				
8	ABS Reducer Elbow	3"ø-1 1/2"ø		FT	1				
9	ABS Reducer Elbow	3"ø-2"ø		FT	2				
10	ABS TEE Elbow	1 1/2"ø-1 1/2"ø-1 1/2"ø		FT	2				
11	ABS TEE Elbow	2"ø-2"ø-2"ø		PCS	2				
12		3"ø-3"ø-3"ø		PCS	3				
13		2"ø-2"ø-1 1/2"ø		PCS	1				
14		2"ø-2"ø-2"ø		PCS	1				
15	ABS Trap P	2"ø-2"ø		PCS	1				

# **PLUMBING BOM**



			PIPE FITTINGS 01				
#	Item	Туре	Description, Manufacturer, SKU	Unit	Quantity	Unit Price	Total
1	ABS Vent Cap Elbow	1 1/2"ø		FT	1		
2	ABS Vent Cap Elbow	2"Ø		FT	3		
3	ABS WASTE DOUBLE TEE	2"ø-2"ø-2"ø		FT	1		
4	ABS Wye Combination with 8	3"ø-3"ø-2"ø		FT	1		
5		1/2"ø-1/2"ø		FT	33		
6		3/4"ø-3/4"ø		FT	5		
7	PEX Cross Elbow	3/4"ø-3/4"ø-3/4"ø		FT	2		
8	PEX Tee Elbow	1/2"ø-1/2"ø-1/2"ø		FT	7		
9		3/4"ø-3/4"ø		FT	3		
10	PEX Transition Elbow	1"ø-3/4"ø		FT	2		
11		3/4"ø-1/2"ø		FT	11		
12		2"ø-2"ø		FT	30		
13	. 13 73 Dog Dona Libon	-~-~					
14							
15							

	APPLIANCES					
#	Item	Туре	Description, Manufacturer, SKU	Unit	Quantity Unit Price Total	
1	Refrigerator			PCS	1	
2	Range			PCS	1	
3	Washer Front Load	Stackable		PCS	1	
4	Dryer Front Load	Stackable		PCS	1	
5	Dish Washer			PCS	1	
6	Oven			PCS	0	
7	Microwave			PCS	0	
8						
9						
10						
11						
12						
13						
14						
15						
16						

	CASEWORKS							
#	Item	Туре	Description, Manufacturer, SKU	Unit	Quantity Unit Price Total			
1	Kitchen Cabinet			FT	13.81			
2	Laundry Cabinet			FT	2.25			
3	Vanity Cabinet			FT	2.5			
4	Medicine Cabinet			PCS	2			
5	Kitchen countertop			SF	28.39			
6	Laundry Countertop			PCS	1			
7	Bathroom Countertop			SF	0			
8	Island			FT	0			
9	Peninsula			FT	0			
10	Closets			SF	126			
11								
12								
13								
14								
15								
16								

			CEILING 01				
#	Item	Туре	Description, Manufacturer, SKU	Unit	Quantity	Unit Price	Total
	LIVING ROOM + KITCHEN	+ DINING		SF	273.0		
1	Ceiling Board	Drywall		SF	273		
2	Drywall Fastener	Screw		PCS	478		
3	Vapor Retarder	Polyethylene film		SF	273.0		
4	Vapor Retarder Fastener	Nails with washer heads		PCS	819.0		
	BATH ROOM			SF	41.0		
5	Ceiling Board	MRD (Moisture resistant drywall)		SF	41		
6	MRD Fastener	Screw		PCS	72		
	W/D			SF	7.0		
7	Ceiling Board	Drywall		SF	7		
8	Drywall Fastener	Screw		PCS	12		
9	Vapor Retarder	Polyethylene film		SF	7.0		
10	Vapor Retarder Fastener	Nails with washer heads		PCS	21.0		
11							
12							
13							
14							
15		·					

			CEILING 02			
#	Item	Туре	Description, Manufacturer, SKU	Unit	Quantity	Unit Price Total
	BED ROOM 1			SF	158.0	
12	Ceiling Board	Drywall		SF	158	
13	Drywall Fastener	Screw		PCS	277	
14	Vapor Retarder	Polyethylene film		SF	158.0	
15	Vapor Retarder Fastener	Nails with washer heads		PCS	474.0	
	BED ROOM 2			SF	149.0	
16	Ceiling Board	Drywall		SF	149	
17	Drywall Fastener	Screw		PCS	261	
18	Vapor Retarder	Polyethylene film		SF	149.0	
19	Vapor Retarder Fastener	Nails with washer heads		PCS	447.0	
	WH			SF	8.0	
20	Ceiling Board	Drywall		SF	8	
21	Drywall Fastener	Screw		PCS	14	
22	Vapor Retarder	Polyethylene film		SF	8.0	
23	Vapor Retarder Fastener	Nails with washer heads		PCS	24.0	

			CEILING 03				
#	Item	Туре	Description, Manufacturer, SKU	Unit	Quantity	Unit Price Tot	tal
	CORRIDOR			SF	40.0		
13	Ceiling Board	Drywall		SF	40		
14	Drywall Fastener	Screw		PCS	70		
15	Vapor Retarder	Polyethylene film		SF	40.0		
16	Vapor Retarder Fastener	Nails with washer heads		PCS	120.0		
	CLOSET 1			SF	23.0		
13	Ceiling Board	Drywall		SF	23		
14	Drywall Fastener	Screw		PCS	40		
15	Vapor Retarder	Polyethylene film		SF	23.0		
16	Vapor Retarder Fastener	Nails with washer heads		PCS	69.0		
	CLOSET 2			SF	25.0		
13	Ceiling Board	Drywall		SF	25		
14	Drywall Fastener	Screw		PCS	44		
15	Vapor Retarder	Polyethylene film		SF	25.0		
16	Vapor Retarder Fastener	Nails with washer heads		PCS	75.0		
17							
18							

	CEILING 02						
#	Item	Туре	Description, Manufacturer, SKU	Unit	Quantity	Unit Price Total	
	FRONT PORCH			SF	117.0		
19	Ceiling Board	Marine Plywood		SF	117		
20	Exterior Grade Plywood	Screw		PCS	205		
21							
22							
23							
24							
25							
26							
27							
28							
29							
30							
31							
32							
33							

	FLOORING INTERIOR 01						
#	Item	Туре	Description, Manufacturer, SKU	Unit	quantity	Jnit Price Total	
	BEDROOM #1						
1	Bedroom Flooring			SF	151		
2	Wood underlay	Foam Pad Polyethylene		SF	151		
3	Vapor Retarder	Vapor Barrier Polyethylene		SF	151		
	BEDROOM #2						
4	Bedroom Flooring			SF	142		
5	Wood underlay	Foam Pad Polyethylene		SF	142		
6	Vapor Retarder	Vapor Barrier Polyethylene		SF	142		
	CL #1						
7	Closet Flooring			SF	22		
8	Wood underlay	Foam Pad Polyethylene		SF	22		
9	Vapor Retarder	Vapor Barrier Polyethylene		SF	22		
	CL#2						
10	Closet Flooring			SF	24		
11	Wood underlay	Foam Pad Polyethylene		SF	24		
12	Vapor Retarder	Vapor Barrier Polyethylene		SF	24		
13							
14							

			FLOORING INTERIOR 02				
#	Item	Туре	Description, Manufacturer, SKU	Unit	quantity	Unit Price	Total
	CL#3						
15	Closet Flooring			SF	7		
16	Wood underlay	Foam Pad Polyethylene		SF	7		
17	Vapor Retarder LIVING ROOM AND KITCHEN	Vapor Barrier Polyethylene		SF	7		
18	Living Area Flooring			SF	276		
19	Wood underlay	Foam Pad Polyethylene		SF	276		
20	Vapor Retarder	Vapor Barrier Polyethylene		SF	276		
	BATHROOM						
21	Tile Finish			SF	25		
22	Adhesive	1/2" Thin set Mortar		SF	25		
23	Vapor Retarder	Vapor Barrier Polyethylene		SF	25		
	W/D						
24	Tile Finish			SF	8		
25	Adhesive	1/2" Thin set Mortar		SF	8		
26	Vapor Retarder	Vapor Barrier Polyethylene		SF	8		
27							
28							

	FLOORING INTERIOR 03							
#	Item	Туре	Description, Manufacturer, SKU	Unit	quantity L	Init Price Total		
	HANDWASH							
29	Tile Finish			SF	13			
30	Adhesive	1/2" Thin set Mortar		SF	13			
31	Vapor Retarder	Vapor Barrier Polyethylene		SF	13			
32								
33								
34								
35								
36								
37								
38								
39								
40								
41								

			FLOORING EXTERIOR		
#	Item	Туре	Description, Manufacturer, SKU	Unit	quantity Unit Price
	STRUCTURE			SF	1040
1	Concrete Slab	4"concrete cast in situ		CF	346.8
2	Insulation	Rigid insulation		SF	199
3	Hard core	Compacted soil		CF	194.33
4	Re-bar	#4 re-bar		Ton	1.02
5	Concrete Pad	4"concrete cast in situ		CF	1.58
6	Slab edge	Turndown		CF	267.42
7	Footing	Cast-in-place concrete		CF	23.2
	PORCH				
1	Tile Finish			SF	292
2	Adhesive	1/2" Thin set Mortar		SF	292
3	Vapor Retarder	Vapor Barrier Polyethylene		SF	292

			WALLS: EXTERIOR			
	Item	Туре	Description, Manufacturer, SKU	Unit	quantity Ur	nit Price   Total
1	Exterior-Grade Plywood Ho	orizontal Siding		SF	779	
2	Exterior-Grade Plywood Fas	ste Self-drilling screws(100/pkt)		PKT	7.79	
3	Wall Shteathing (OSB)			SF	779	
4	Shteathing Fastener	Self-drilling screws(100/pkt)		PKT	7.79	
5	Wall Homewrap			SF	779	
6	Homewrap Fastener	Stapled fastener (200/pkt)		PKT	3.0	
7	Furring Strip			PCS	97.4	
8	Furring Strip Fastener	Self-drilling screws(100/pkt)		PKT	7.79	
9	Wall Paint			SF	779	
10	Stone Copping	Masonry stone		SF	6	
11	Stone Veneer	Masonry stone		SF	32	
12	Mortar for Stone Veneer			SF	32	
13	Wall Insulation			SF	1746	
14					17.10	
15						

			WALLS: INTERIOR 01				
#	Item	Туре	Description, Manufacturer, SKU	Unit	quantity	Unit Price	Total
	BATHROOM			SF	299		
1	Cementitious Backer Board			SF	299		
2	Kerdi membrane			SF	299		
3	Kerdi membrane Fastener			SF	299		
4	Wall Ceramic Tile			SF	299		
	BEDROOM			SF	321		
5	Drywall Board			SF	321		
6	Drywall Fastener	Self-drilling screws(100/pkt)		PKT	3.21		
7	Wall Paint			SF	321		
8	Drywall Tape			FT	60.2		
	HALL			SF	91		
9	Drywall Board			SF	91		
10	Drywall Fastener	Self-drilling screws(100/pkt)		PKT	0.91		
11	Wall Paint			SF	91		
12	Drywall Tape			FT	17.1		
13							
14							
15							

			WALLS: INTERIOR 02				
#	Item	Туре	Description, Manufacturer, SKU	Unit	quantity	Unit Price	Total
	LIVING ROOM			SF	243		
16	Drywall Board			SF	243		
17	Drywall Fastener	Self-drilling screws(100/pkt)		PKT	2.43		
18	Wall Paint			SF	243		
19	Drywall Tape			FT	45.6		
	KITCHEN			SF	150		
20	Cementitious Backer Board			SF	24		
21	Drywall Board			SF	150		
22	Drywall Fastener	Self-drilling screws(100/pkt)		PKT	1.5		
23	Kerdi membrane			SF	24		
24	Kerdi membrane Fastener			SF	24		
25	Wall Ceramic Tile			SF	24		
26	Wall Paint			SF	150		
27	Drywall Tape			FT	28.3		
28							
29							

			WALLS: INTERIOR 03				
#	Item	Туре	Description, Manufacturer, SKU	Unit	quantity	Unit Price	Total
	CLOSET 1			SF	131		
30	Drywall Board			SF	131		
31	Drywall Fastener	Self-drilling screws(100/pkt)		PKT	1.31		
32	Wall Paint			SF	131		
33	Drywall Tape			FT	24.6		
	CLOSET 2			SF	102		
34	Drywall Board			SF	102		
35	Drywall Fastener	Self-drilling screws(100/pkt)		PKT	1.02		
36	Wall Paint			SF	102		
37	Drywall Tape			FT	19.1		
	WASHROOM			SF	82		
38	Cementitious Backer Board			SF	82		
39	Kerdi membrane			SF	82		
40	Kerdi membrane Fastener			SF	82		
41	Wall Ceramic Tile			SF	82		

			WALLS: INTERIOR 04				
#	Item	Туре	Description, Manufacturer, SKU	Unit	quantity	Unit Price	Total
	WD			SF	69		
42	Cementitious Backer Board			SF	69		
43	Kerdi membrane			SF	69		
44	Kerdi membrane Fastener			SF	69		
45	Wall Ceramic Tile			SF	69		
	WH			SF	70		
46	Drywall Board			SF	70		
47	Drywall Fastener	Self-drilling screws(100/pkt)		PKT	0.7		
48	Wall Paint			SF	70		
49	Drywall Tape			FT	13		
50	Wall Skirting	Ceramic		FT	90.3		
51							
52							
53							

			DOORS				
#	Item	Туре	Description, Manufacturer, SKU	Unit	Quantity	Unit Price	Total
1	Interior Swinging	3' - 0" X 6'-8"		PCS	1		
2	Interior Swinging	2' - 8" X 6'-8"		PCS	1		
3	Interior Swinging	2' - 4" X 6'-8"		PCS	1		
4	Front Door With Sidelight	5' - 5" X 7'- 0"		PCS	1		
5	Interior Sliding	7' - 6" X 6'-8"		PCS	1		
6	Interior Sliding	5' - 0" X 6'-8"		PCS	1		
7	Patio Sliding	5' - 0" X 6'-8"		PCS	1		
8	Exterior Door Trim			FT	37.7		
9	Interior Door Trim			FT	249.5		
10	Entry Lock set			PCS	2		
11	Privacy Lock set			PCS	2		
12	Passage Lock set			PCS	3		
13							
14							
15							

			WINDOWS			
#	Item	Туре	Description, Manufacturer, SKU	Unit	Quantity Uni	t Price Total
1	Single Hung	3' - 3" X 4'-3"		PCS	1	
2	Single Hung	3' - 3" X 3'-3"		PCS	1	
3	Sliding	3' - 3" X 3'-3"		PCS	2	
4	Sliding	5' - 3" X 3'-3"		PCS	1	
5	Sliding	6' - 3" X 3'-3"		PCS	1	
6	Sliding	3' - 3" X 2'-3"		PCS	1	
	Exterior Window Trim			FT	108.4	
	Interior Window Trim			FT	108.4	
9						
10						
11						
12						
13						
14						
15						

			ROOF 01			
#	Item	Туре	Description, Manufacturer, SKU	Unit	Quantity	Unit Price Total
1	Roof Covering			SF	1022.0	
2	Roof Covering Fastener			PCS	511	
3	Roof Felt Paper			SF	1022.0	
4	Roof Felt Paper Fastener			PCS	3066.0	
5	Roof Sheathing			SF	1022.0	
6	Roof Sheathing Fastener			PCS	8176	
7	Batten			FT	0.0	
8	Batten Fastener			PCS	0.0	
9	Soffit			SF	92.0	
10	Soffit Fastener			PCS	46.0	
11	Fascia			FT	147.0	
12	Fascia board fastener			PCS	74	
13	Roof Insulation			SF	1022.0	