

# **WISDOM**

The Wisdom is a charming craftsman style 2 bedroom 2 bathroom home with a warm and inviting exterior. The classic gable roof, covered porch with sturdy columns, and decorative trim details create a timeless aesthetic. The covered porch with wooden beams offers a shaded outdoor space, perfect for relaxing or entertaining. The inside of this home offers an open plan hosting living, dinging and two bedrooms. This creates both functional and efficient layout while maintaining a spacious feel.

# Materials Shopping List

Please print and take this Materials Shopping List to your favorite Home Depot and ask for assistance in selecting the materials, fixtures and fittings to complete your new home.

Record your selection and the price of the item. Then do the math to determine the cost for your selections and the total cost of finishing your home.

# < CLICK HERE >

To Go To Materials Shopping List



# BEDROOM 1 LIVING ROOM PATIO 465 SF 28'-9"

# **FLOOR PLAN**

909 SF

2 Bed Rooms




# **TABLE OF CONTENTS**



**ARCHITECTURAL** 

**HOW TO BUILD** 

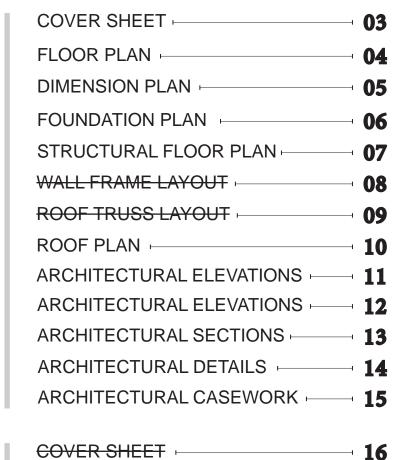

CONSTRUCTION STEPS

STRUCTURAL

**MATERIALS** 

**SHOPPING LIST** 

16	GENERAL NOTES	· 1
	WALL FRAME LAYOUT	1
	WALL PANEL & LAYOUT PLAN	1
	ROOF TRUSS LAYOUT	· 2
	STRUCTURAL SECTIONS	· 2
	WALL BRACING LAYOUT	<b>2</b>
	HOLD-DOWN PLAN	<b>2</b>
	STRUCTURAL DETAILS 1	· 2
	STRUCTURAL DETAILS 2	· 2
	STRUCTURAL DETAILS 3	1 2
	TRUSS BLOCKING LAYOUT	· 2
	SHEETROCK BACKING	<b>2</b>
	ROOF BRACING LAYOUT	₁ 2
ECHANICAL	COVER SHEET -	<b>₃</b> 3
30	HVAC PLAN -	<b>3</b>
LECTRICAL	SCHEDULE -	· 3
32	LIGHTING -	· 3
_	POWER PLAN -	· 3
	DIMENSION FOR LIGHTING -	· 3
	DIMENSION FOR FITTING -	₁ 3
LUMBING	NOTES AND SCHEDULES -	· 3
<b>37</b>	WATER SUPPLY & SEWAGE SYSTEM	· 3

MATERIALS SHOPPING LIST

# **ABOUT**



FrameUpNow is a design and manufacturing company providing precision-engineered home framing solutions. We offer a catalog of Affordable Homes, Tiny Homes, Garages, Shops and Barndominiums. FrameUpNow manufactures cold-formed steel (CFS) also known as Light Gauge Steel (LGS) framing components that conform to our engineered metal house frame plans or can be purchased as DIY skeleton kits.

The CFS/LGS framing is lightweight, easily assembled, and does not require heavy equipment or specialized labor, enabling homeowners to erect the frame themselves in just a few days. Unlike wood, the steel framing is impervious termites and bores, warping, expansion, and fire.

Our home plans come complete with a structural engineered stamp for permit approvals. Customers receive a full BOM also known as a Materials Shopping List to purchase finish materials from a Building Materials retailer. FrameUpNow prides itself on the quality and efficiency of our precision-engineered home framing solutions for construction professionals and DIY homeowners.



**KEY PLAN** 

NO.	DESCRIPTION	DATE
·		

NOTE:

LEGEND:

PROJECT

12-Wisdom-909-2Bd2Ba-Craftsman-550

DRAWING NAME

# INTRODUCTION

CLIENT NAME:	
PROJECT NUMBER:	
DATE:	
DESIGNED BY:	
DRAWN BY:	
CHECKED BY:	

1101

SCALE:

© [2024] [FrameUpNow] . All rights reserved

DISCLAIMER: This documentation and all it's contents are the intellectual property of FrameUpNow. It is provided solely for marketing the services of FrameUpNow. The preliminary information is not approved for actual construction use and is not warranted to be complete or accurate. Unauthorized copying, distribution, or application of these proprietary materials, in any form or format, is strictly prohibited. FrameUpNow assumes no liability for any issues arising from improper use of this marketing content.

**DISCLAIMER** 

# **DESCRIPTIONS**

# MATERIALS LIST

The BOM (Bill Of Materials) package, known as the Materials Shopping List document, provides:

Comprehensive Inventory: Detailed lists of essential materials sourced from architectural, mechanical, HVAC, electrical, and plumbing design drawing sets.

Precise Curation: Each item meticulously selected and organized for accuracy and efficiency in project planning.

Customizable Options: Customers can modify listed items to their preferences and calculate costs accordingly, ensuring alignment with personal project needs and budget.

Dedicated Space for Details: Includes tables for customers to note Home Depot SKU numbers or product descriptions for selected items,

facilitating seamless purchasing and coordination with suppliers.

Customer Convenience: Take the list to Home Depot or preferred suppliers for accurate pricing, helping align the total home budget with personal financial plans.

Simplify your construction journey with our Materials Shopping List document, where detailed preparation meets streamlined implementation for your dream home.

Detailed HVAC Floor Plan: Precisely maps out the placement of air

HVAC Sections and Riser Diagrams: Technical drawings offering

critical cross-sectional details and piping schematics, ensuring

proper integration of the heating and cooling system into the home's

Bill of Materials: A complete list of all necessary HVAC components.

handlers, ductwork, and vents throughout the home's layout.

**MECHANICAL** 

### STRUCTURAL

The structural drawings package provides an exhaustive set of detailed plans essential for the precise assembly of your building. This comprehensive package includes:

Framing Plans: Detailed layouts for all framing components. Truss Layouts: Clear instructions for truss placement and

Panel Length Plans: Specifications for panel dimensions. Framing Elevations and Sections: Precise elevation and sectional views for accurate construction.

Truss and Wall Blocking Plans: Plans for truss and wall blocking to ensure structural integrity.

Hold-Down Plan: Detailed hold-down requirements for stability. Snap Sheet: Reference sheet for quick identification of components

Structural Details and Bracing Plans: Complete details and bracing plans for all structural elements.

Accompanying these plans is a comprehensive Bill of Materials (BOM) that lists every necessary building component, from cold formed steel (CFS) frames to fasteners.

## ARCHITECTURAL

With the comprehensive architectural package, both builders and DIY homeowners can confidently execute the construction.

The architectural package includes:

Furnished Floor Plans: Complete with furniture layouts for a clear understanding of space utilization.

Detailed Dimension Plans: Ensures precise measurements, from the overall footprint down to the exact placement of windows and

Foundation Plan: Detailed plan to establish a solid foundation.

Wall Framing and Truss Layout: Comprehensive plans for wall framing and truss placement.

Architectural Elevations: Exterior views showcasing the design.

Strategic Building Sections: Critical cross-sectional details for a thorough understanding of the build.

Casework Drawings and Diagrams: Suggested designs for built-in caseworks, such as kitchen cabinets.

# **ELECTRICAL**

The mechanical package includes everything needed to guide HVAC The electrical package includes all the plans and documentation needed to guide the installation of your home's electrical system:

> Detailed Power Plan: Precisely maps out the placement of outlets, switches, and other power components throughout the layout.

Comprehensive Lighting Plan: Shows the optimal locations for lighting fixtures, sconces, and other illumination sources to create a well-lit, functional interior.

Dimensioned Electrical Layout: Provides exact dimensions and measurements to ensure proper placement of all electrical elements.

Bill of Materials: A complete list of every component needed, from circuit breakers to wiring.

# **PLUMBING**

The plumbing package includes everything needed to guide the installation of your home's water supply and drainage systems:

Detailed Water Supply System Plan: Precisely maps out the placement of pipes, valves, and plumbing fixtures throughout the

Comprehensive Sewage System Plan: Shows the optimal routing and sizing of drain lines to effectively remove waste and ensure

Detailed Riser Diagrams: Provide information needed to properly

pipes to fixtures.

proper drainage.

install all vertical plumbing risers and vent stacks.

Bill of Materials: A complete list of every component needed, from

# BOM (Bill Of Materials) (Separately Attached)





structure.


The Bill of Materials (BOM) is a crucial document that compiles the material requirements from different disciplines into a centralized inventory, enabling efficient procurement, inventory management, and cost estimation for a specified project or

#### **ELECTRICAL BOM**



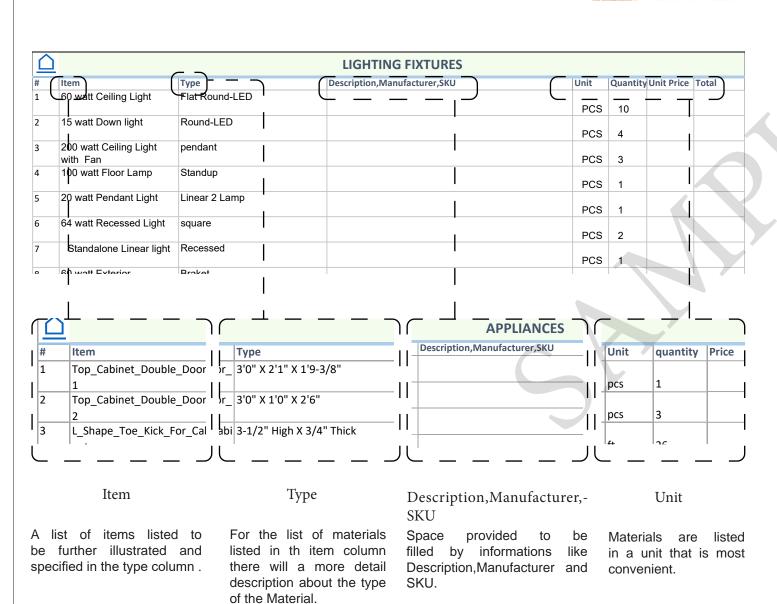

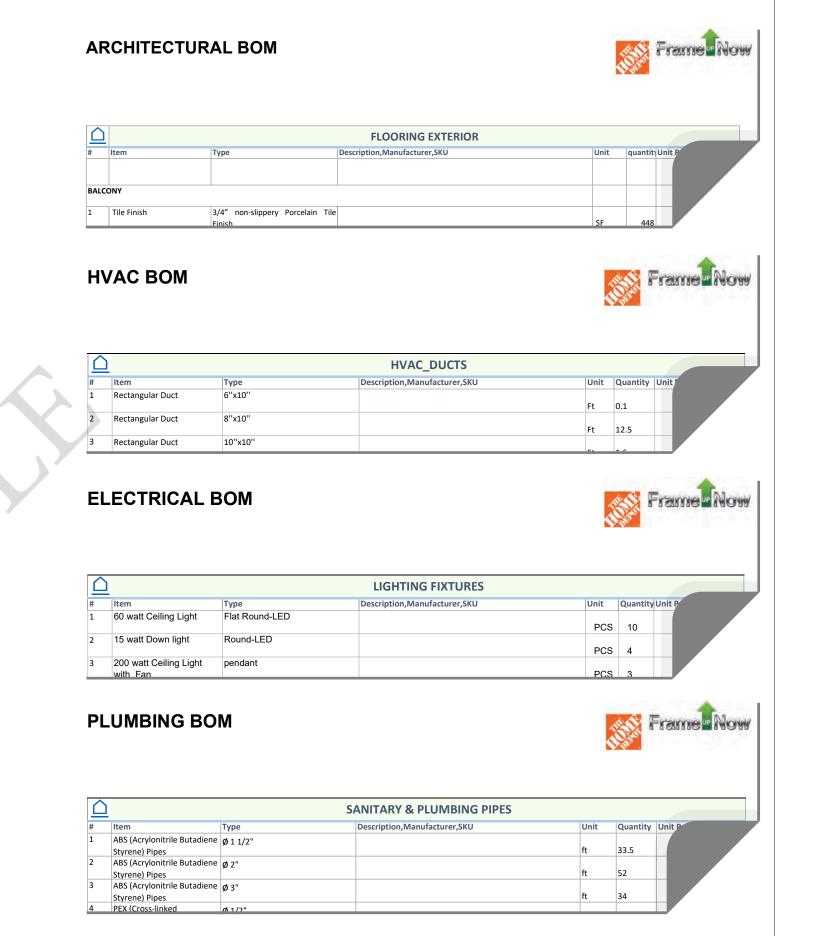

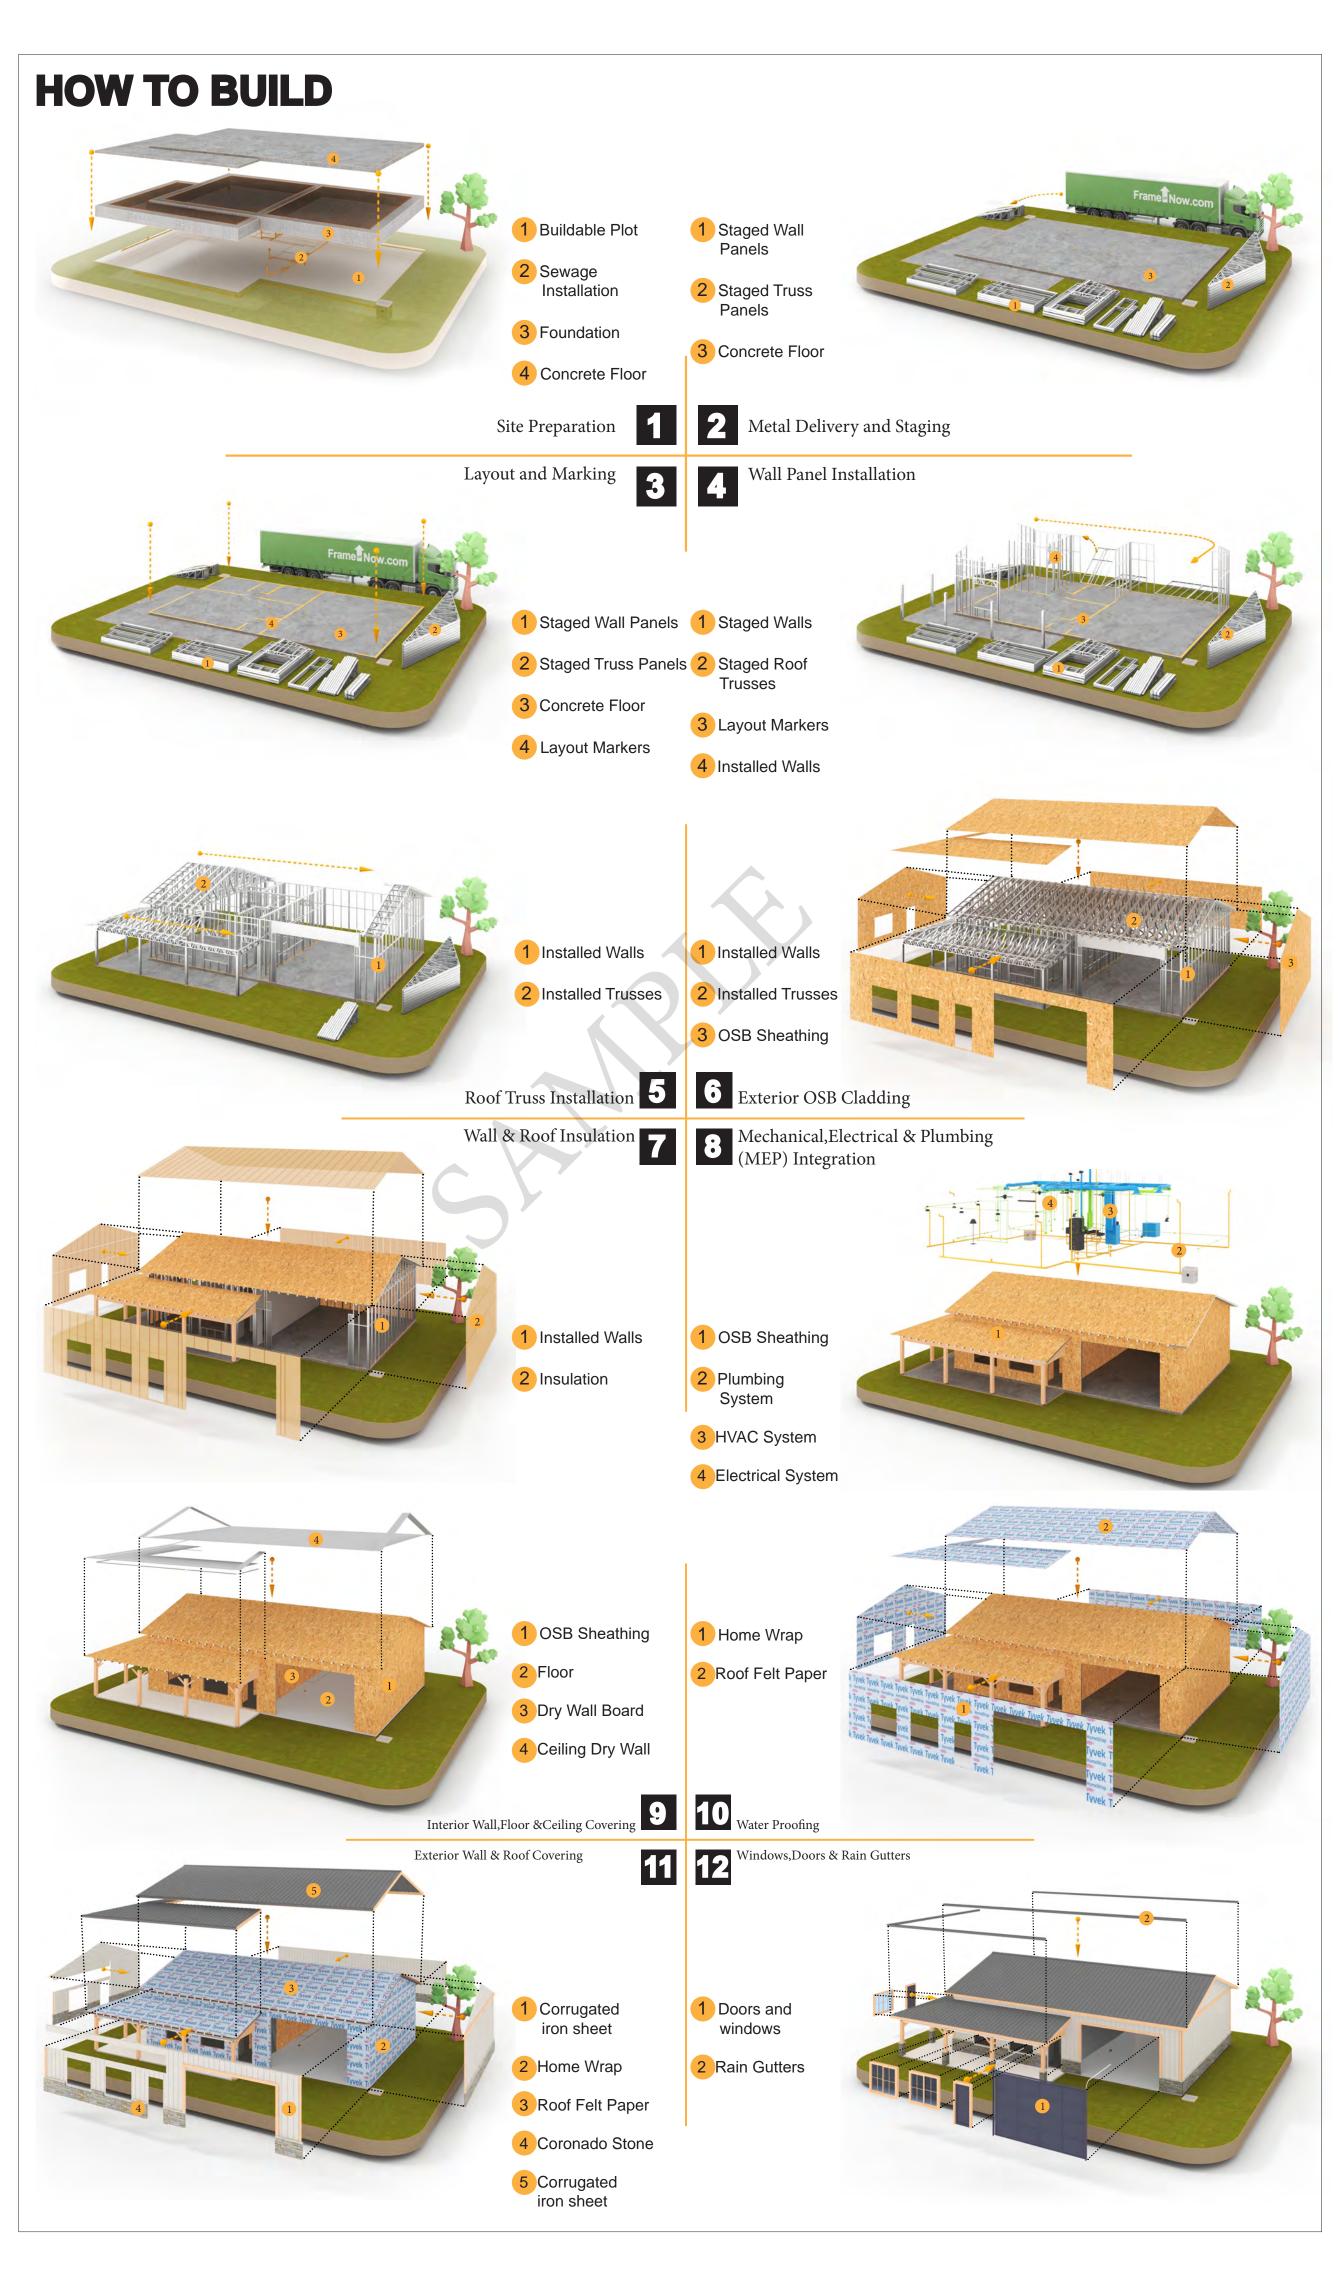



**KEY PLAN** 

NO.	DESCRIPTION	DATE

NOTE:

LEGEND:

12-Wisdom-909-2Bd2Ba-Craftsman-550


**DRAWING NAME** 

# INTRODUCTION


CLIENT NAME: PROJECT NUMBER: DATE: **DESIGNED BY** DRAWN BY: CHECKED BY:

1102

SCALE:

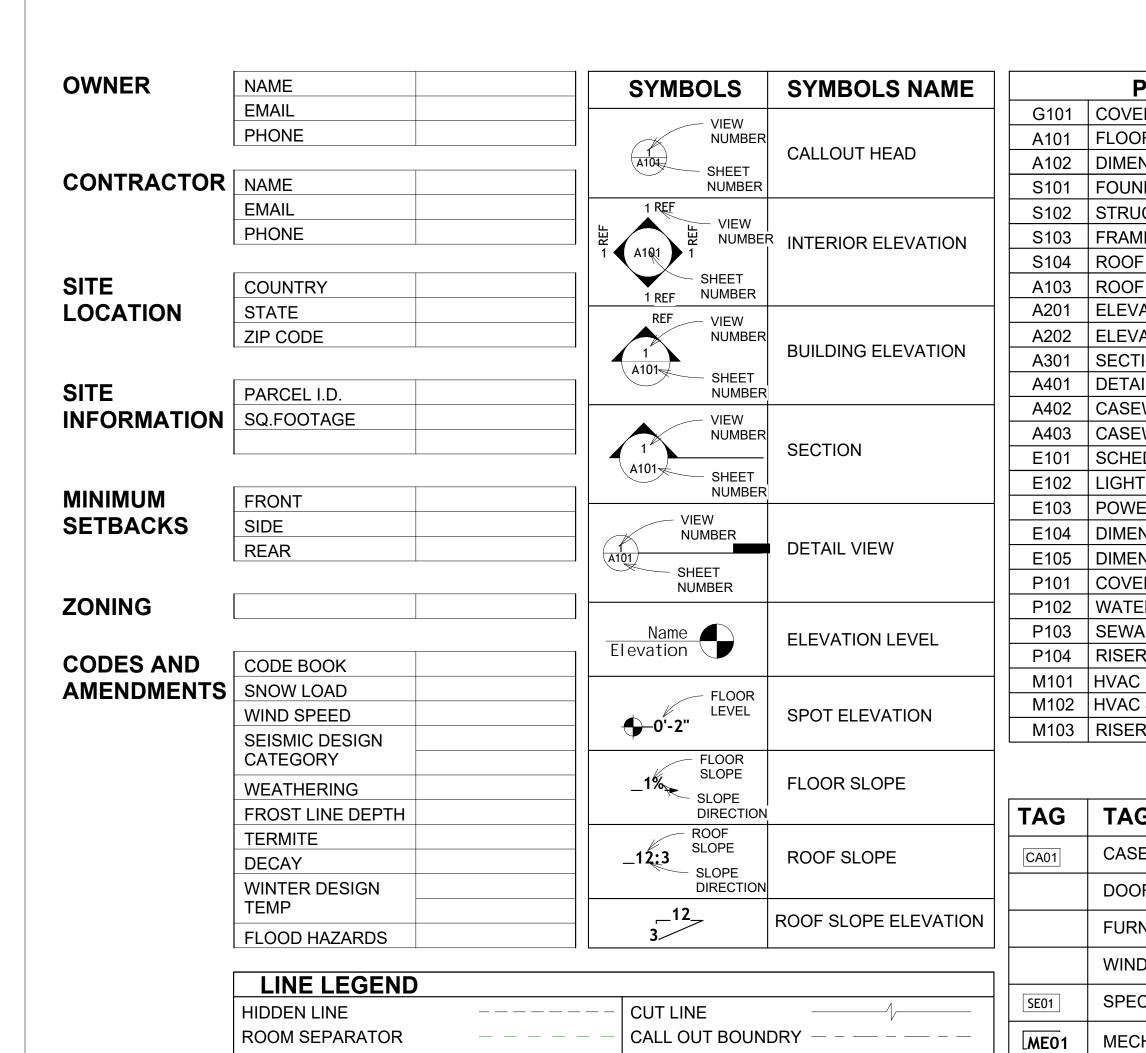

	PAGE INDEX	
G101	COVER SHEET	AFS
A101	FLOOR PLAN	ASTM D
A102	DIMENSION PLAN	
S101	FOUNDATION PLAN	CA
S102	STRUCTURAL FLOOR PLAN	EL
S103	FRAME LAYOUT	F.F.E
S104	ROOF TRUSS LAYOUT	F.F.L
A103	ROOF PLAN	FTG
A201	ELEVATIONS	HVAC
A202	ELEVATIONS	
A301	SECTIONS	IRC
A401	DETAILS	
A402	CASEWORK DETAILS	IMC
A403	CASEWORK DETAILS	
E101	SCHEDULE	MAX.
E102	LIGHTING PLAN	ME
E103	POWER PLAN	MIN.
E104	DIMENSION PLAN FOR LIGHT FIXTURE	NO.
E105	DIMENSION PLAN FOR FITTING	O.C
P101	COVER SHEET	OSB
P102	WATER SUPPLY SYSTEM	PL
P103	SEWAGE SYSTEM	PSI
P104	RISER DIAGRAM	PVC
M101	HVAC PLAN	REF
M102	HVAC SECTION	RG
M103	RISER DIAGRAM	SE
		SF
		SIMP. S
TAG	TAG'S NAME	01145
CA01	CASEWORK TAG	SIMP. A
	DOOR TAG	UNO
		W/
	FURNITURE TAG	W/D
	WINDOW TAG	AC
SE01	SPECIALTY EQUIPMENT TAG	ACC
ME01	MECHANICAL EQUIPMENT TAG	ACCU
		AHU
PE01	PLUMBING EQUIPMENT TAG	CD
		OF THE

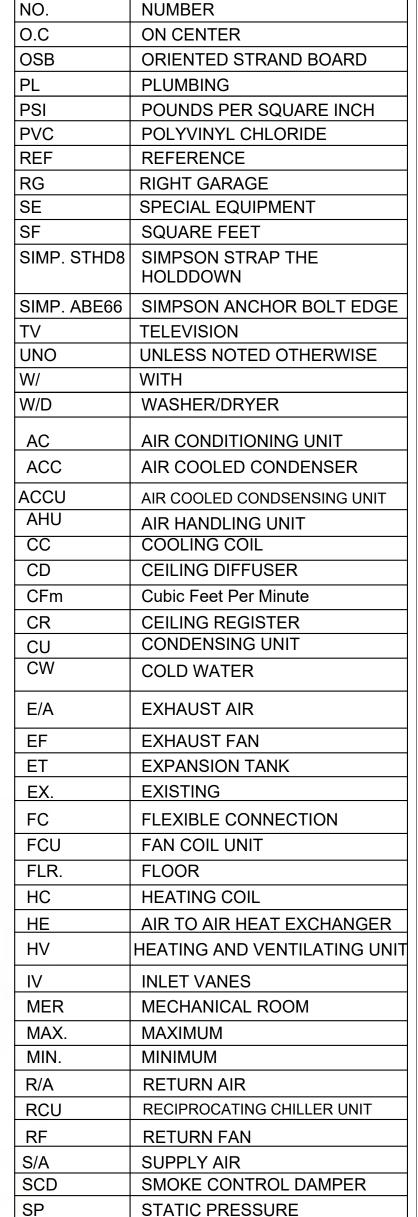

**ABBREVIATION** 

CASEWORK

**ELECTRICAL** 

**FOOTINGS** 

MAXIMUM

MINIMUM

**MECHANICAL** 

CONDITIONING

ACTION FLOOR SYSTEMS

AMERICAN SOCIETY FOR

**TESTING AND MATERIAL** 


FINISHED FLOOR LEVEL


FINISHED FLOOR ELEVATION


HEATING, VENTILATION & AIR

INTERNATIONAL RESIDENCE

INTERNATIONAL MECHANICAL

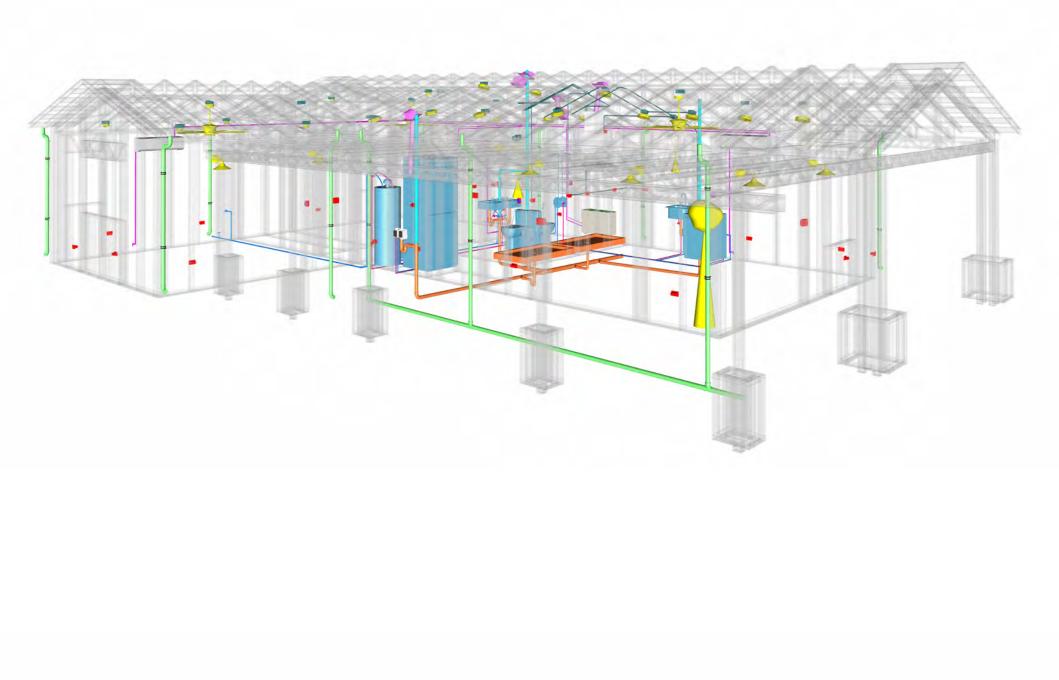

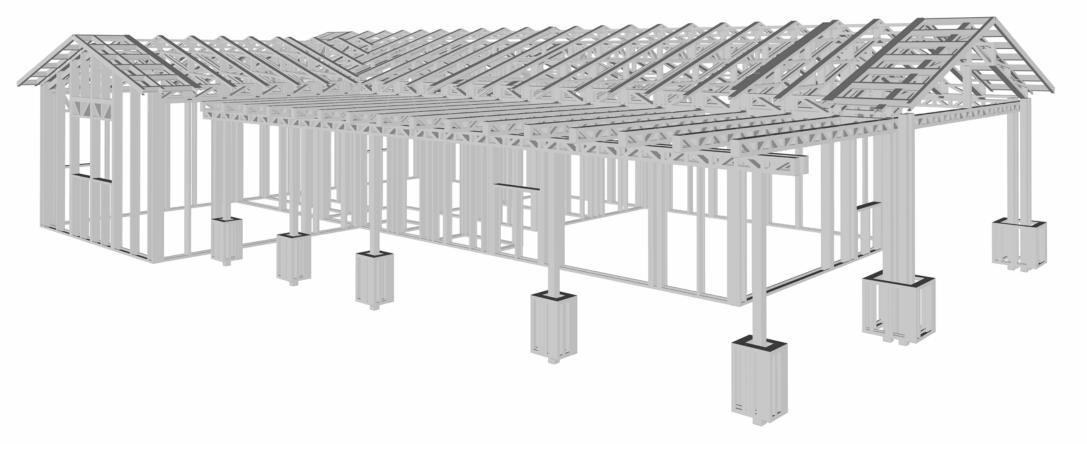


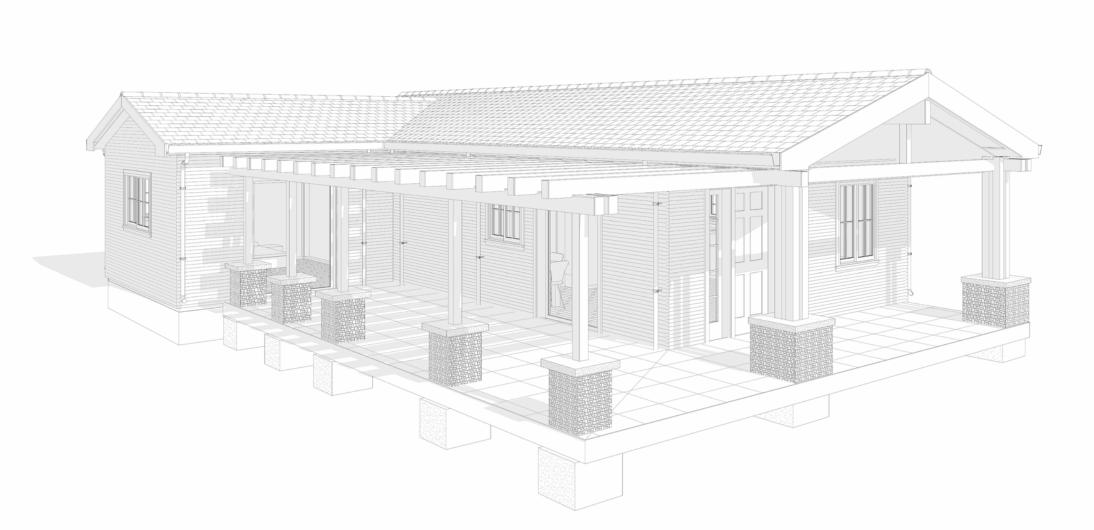

12-Wisdom-909-2Bd/2Ba-Craftsman-550

SQUARE FOOTAGE		
LIVING	909	
PORCH	465	
TOTAL	1,374	



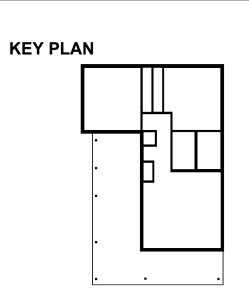

NO.	DESCRIPTION	

LEGEND:

PROJECT

12-Wisdom-909-2Bd/2Ba-Craftsman-550

DRAWING NAME

**COVER SHEET** 

CLIENT NAME:	Client Name
PROJECT NUMBER:	0033_15
DATE:	1/27/2025 3:21:20 PM
DESIGNED BY:	Designer
DRAWN BY:	Author
CHECKED BY:	Checker
-	

G101

© [2024] [FrameUpNow] . All rights reserved

OVER HEAD

#### **GENERAL NOTES**

- . THIS DRAWING DEPICTS THE ARCHITECTURAL (SPACE LAYOUT, FURNISHING, FLOOR, WALLS, ROOFS, FOUNDATION, WINDOWS AND DOORS) SYSTEMS. IT PROVIDES A VISUAL REPRESENTATION OF THE ARCHITECTURAL LAYOUT AND COMPONENTS.
- THE ARCHITECTURAL DRAWINGS ARE PREPARED TO MEET THE SPECIFIC REQUIREMENTS OF THE BUILDING, AS PER THE PROJECT SPECIFICATIONS AND APPLICABLE CODES AND STANDARDS.
- THE CONSTRUCTION OF THIS HOME SHALL COMPLY WITH THE LATEST EDITION OF THE INTERNATIONAL RESIDENTIAL CODE (IRC), INTERNATIONAL MECHANICAL CODE (IMC), THE INTERNATIONAL PLUMBING STANDARD, THE NATIONAL ELECTRICAL STANDARD AND ALL OTHER APPLICABLE LOCAL, STATE, AND NATIONAL CODES AND REGULATIONS.
- . COORDINATION WITH OTHER TRADES HAS BEEN DONE ON A DESIGN LEVEL. THIS DRAWING SHALL BE READ TOGETHER WITH THE ME, EL AND PL DESIGN DRAWINGS TO ENSURE PROPER CONSTRUCTION AND INTEGRATION OF THE BUILDING SYSTEMS.

#### **ABOUT WALLS:**

#### SHOWER WALL COVERING

BATHTUB AND SHOWER SPACES (WALLS AND FLOORS) WITH INSTALLED SHOWER HEADS AND IN SHOWER COMPARTMENTS SHALL BE FINISHED WITH A NON-ABSORBENT SURFACE.

#### WALL PAINT (INTERNAL)

THE TYPICAL THICKNESS OF LATEX WALL PAINT IS 1/32 OF AN INCH FOR A SINGLE COAT. AND DOUBLE COAT (1/16") SHALL BE APPLIED FOR DURABILITY.

#### **ADHESIVES:**

THE ADVISABLE TYPE OF ADHESIVE FOR THIS PROJECT IS **EPOXY ADHESIVES** BECAUSE THEY ARE KNOWN FOR THEIR HIGH STRENGTH, DURABILITY, AND RESISTANCE TO MOISTURE, CHEMICALS AND HEAT.


REFER TO SHEETS A201 & A202 FOR GENERAL NOTES ON EXTERNAL FINISHING MATERIALS

#### **ABOUT FLOORS:**

- . THE SPOT ELEVATION INDICATES THE FINISHED FLOOR ELEVATION.
- 2. FINISHED FLOORS PER PLANS.
- 3. FIELD VERIFY FOR DIMENSION DROP 4" FOR SHOWER AND BATHTUB USE.
- 4. 1% SLOPE ON OUTDOOR BALCONIES FOR WATER RUN OFF.
- 5. 2% SLOPE TOWARDS THE SHOWER DRAIN FOR SUFFICIENT DRAINAGE. 6. 4" DROP AT THE DOOR LEADING TO EXTERIOR BALCONY FROM THE MAIN LIVING AREA.
- 7. 5% SLOPE FOR GARAGE IS USED, WHICH SHOULD BE CHECKED WITH THE LOCAL GARAGING ZONING LAWS.

	F	URNITURE SC	HEDULE A		
TYPE MARK		TYPE		COUNT	
01	KING SIZE BED		2		
02	DINING CHAIR		2		
03	FOUR SIT 65" X 95"		1		
04	25" X 60" DINING 2		1		

	ROOM FINISH SCHEDULE A						
ROOM NUMBE R	ROOM NAME	FLOOR FINISH	BASE FINISH	WALL FINISH	CEILING FINISH	CEILING HEIGHT	COMMENT S
01	BATH 1	VINYL TILES	CONCRETE	CERAMIC TILE	MRD	8' - 0"	
02	BEDROOM 1	HARDWOOD	CONCRETE	WALL PAINT	DRY WALL	8' - 0"	
03	BATH 2	VINYL TILES	CONCRETE	CERAMIC TILE	MRD	8' - 0"	
04	KITCHEN	HARDWOOD	CONCRETE	WALL PAINTT + CERAMIC	DRY WALL	8' - 0"	
05	LIVING ROOM	HARDWOOD	CONCRETE	WALL PAINT	DRY WALL	8' - 0"	
06	CL 3	HARDWOOD	CONCRETE	WALL PAINT	DRY WALL	8' - 0"	
07	WD	HARDWOOD	CONCRETE	WALL PAINT	DRY WALL	8' - 0"	
08	WH	HARDWOOD	CONCRETE	WALL PAINT	DRY WALL	8' - 0"	
09	CL 2	HARDWOOD	CONCRETE	WALL PAINT	DRY WALL	8' - 0"	
10	CL 1	HARDWOOD	CONCRETE	WALL PAINT	DRY WALL	8' - 0"	
11	PATIO	PROCELAIN TILE	CONCRETE	EXTERIOR-GRADE PLYWOOD	PLYWOOD	8' - 0"	
12	BEDROOM 2	HARDWOOD	CONCRETE	WALL PAINT	DRY WALL	8' - 0"	
13	HALL	HARDWOOD	CONCRETE	WALL PAINT	DRY WALL	8' - 0"	

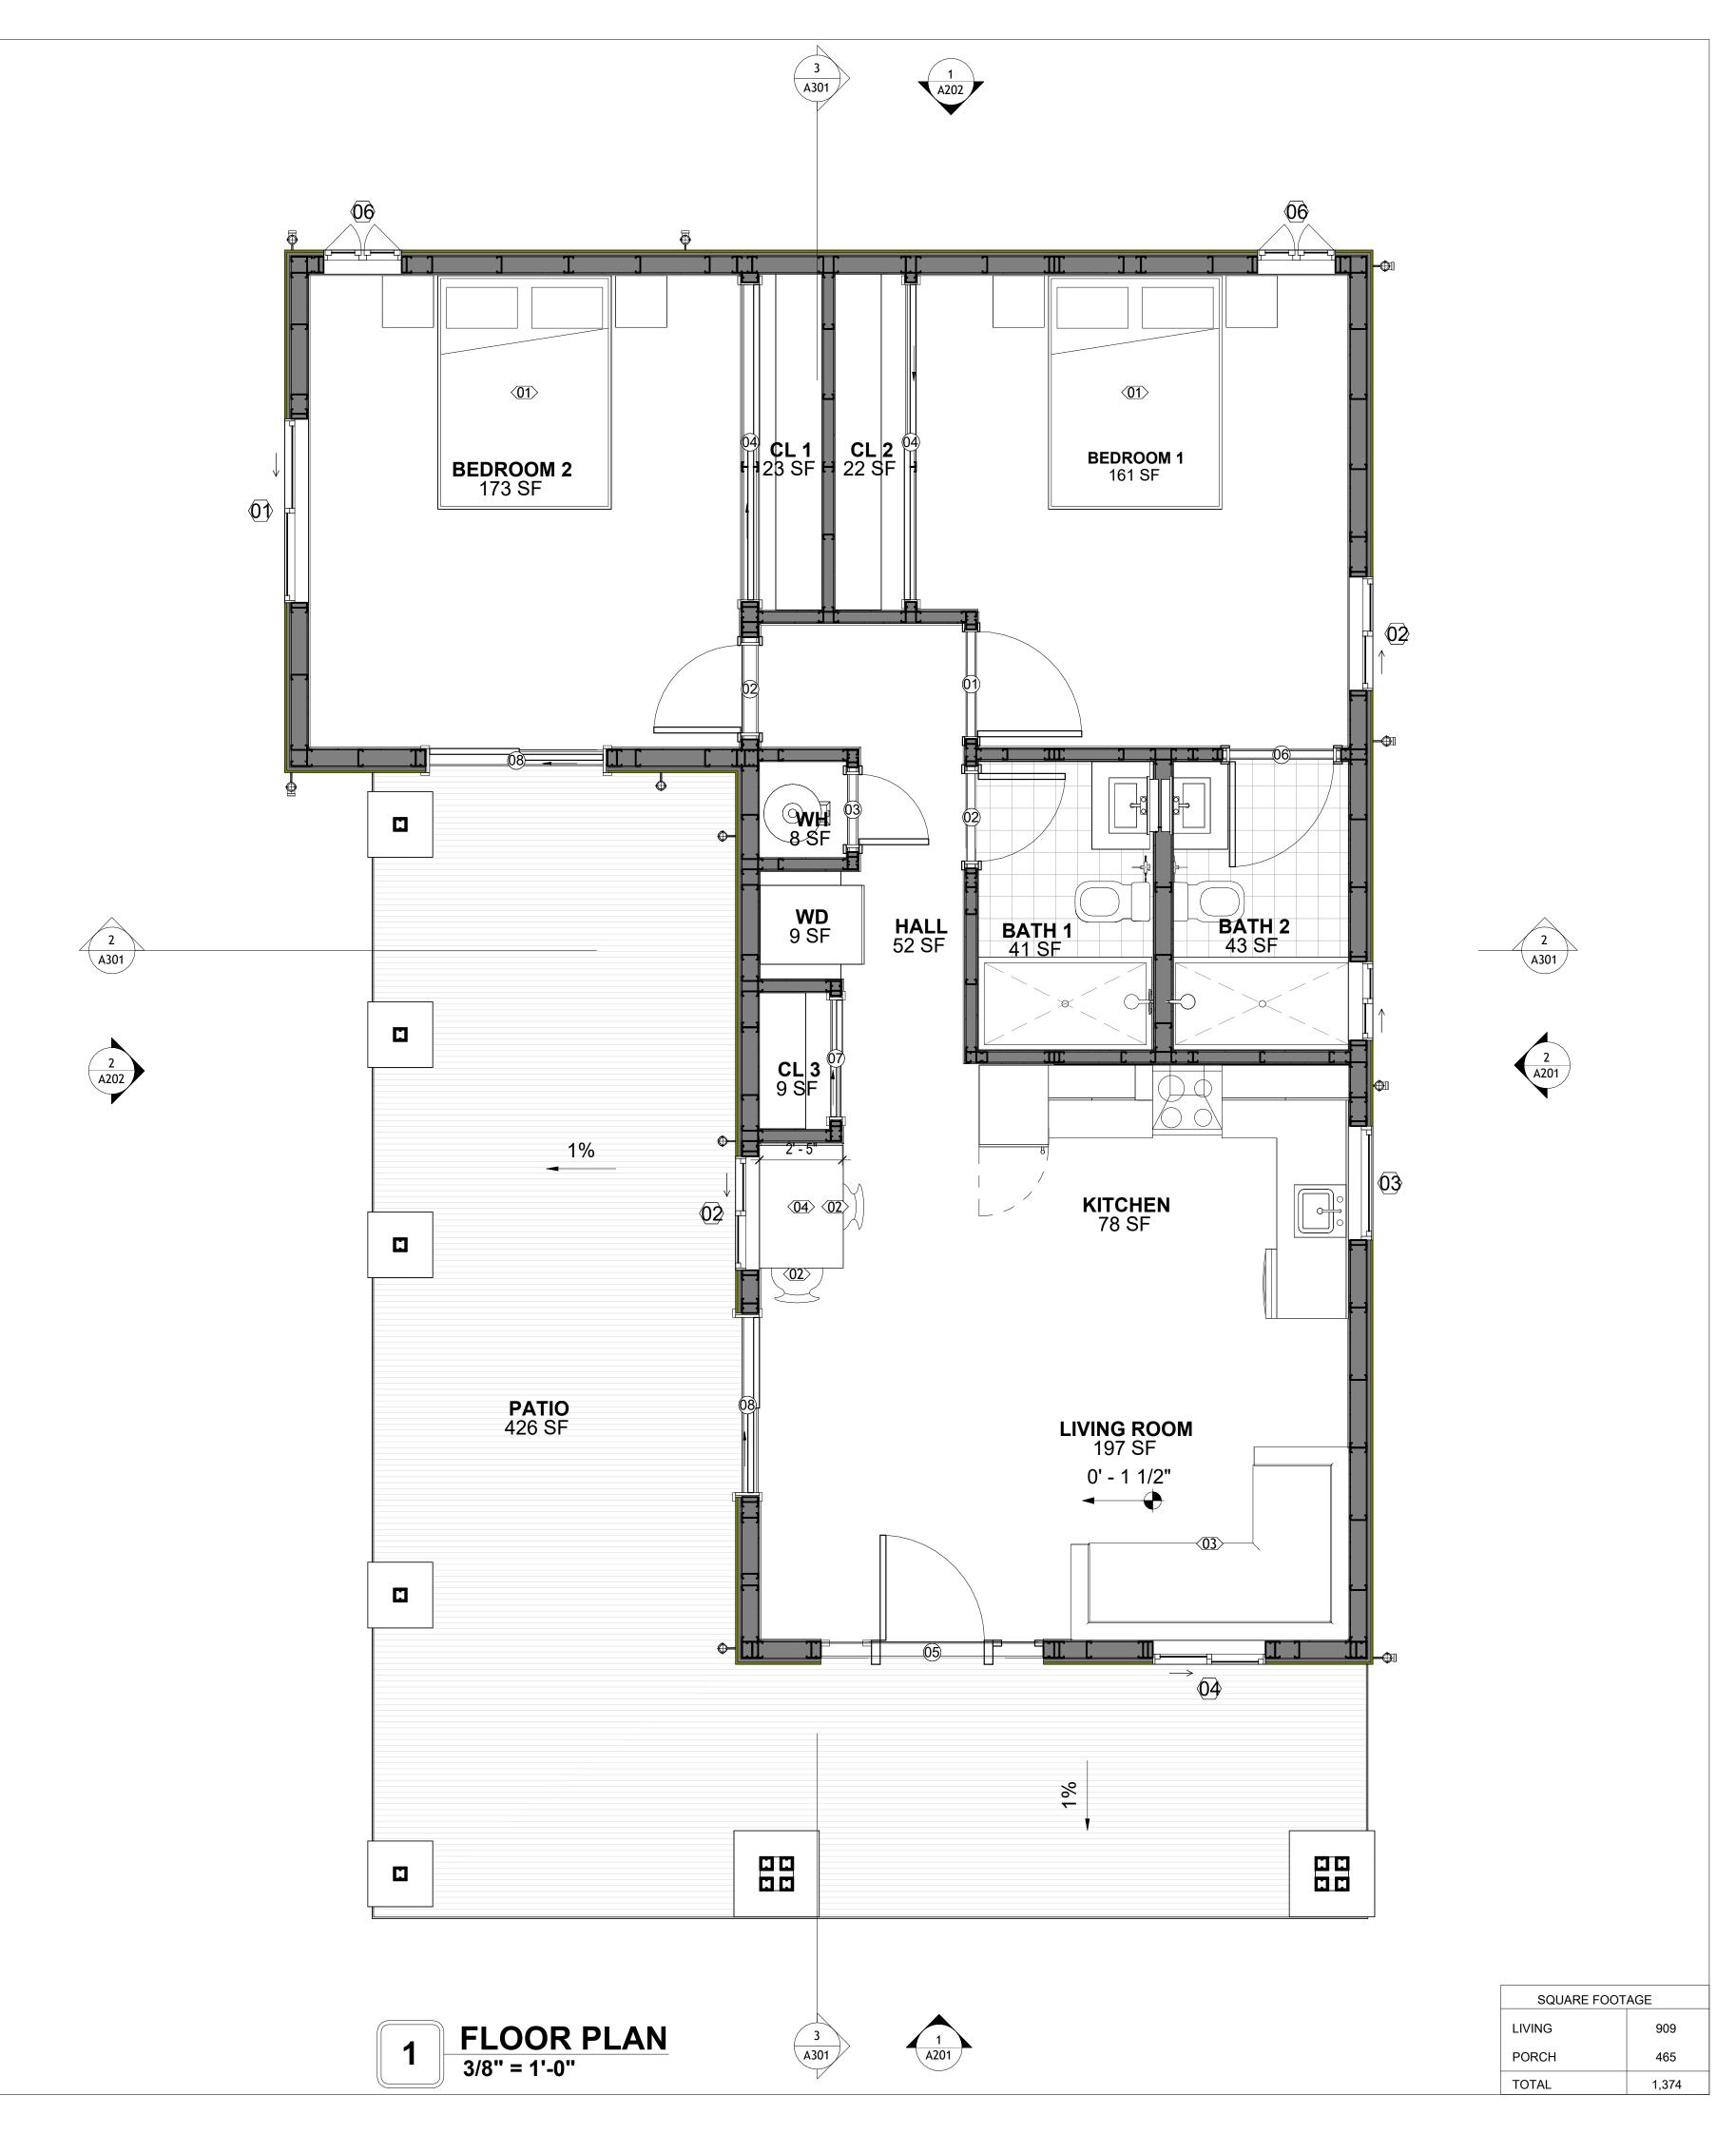



**KEY PLAN** 

NO.	DESCRIPTION	DATE

NOTE:

LEGEND:

PROJECT


12-Wisdom-909-2Bd/2Ba-Craftsman-550

DRAWING NAME

**FLOOR PLAN** 

CLIENT NAME:	Client Name
PROJECT NUMBER:	0033_15
DATE:	1/27/2025 3:21:22 PM
DESIGNED BY:	Designer
DRAWN BY:	Author
CHECKED BY:	Checker

A101

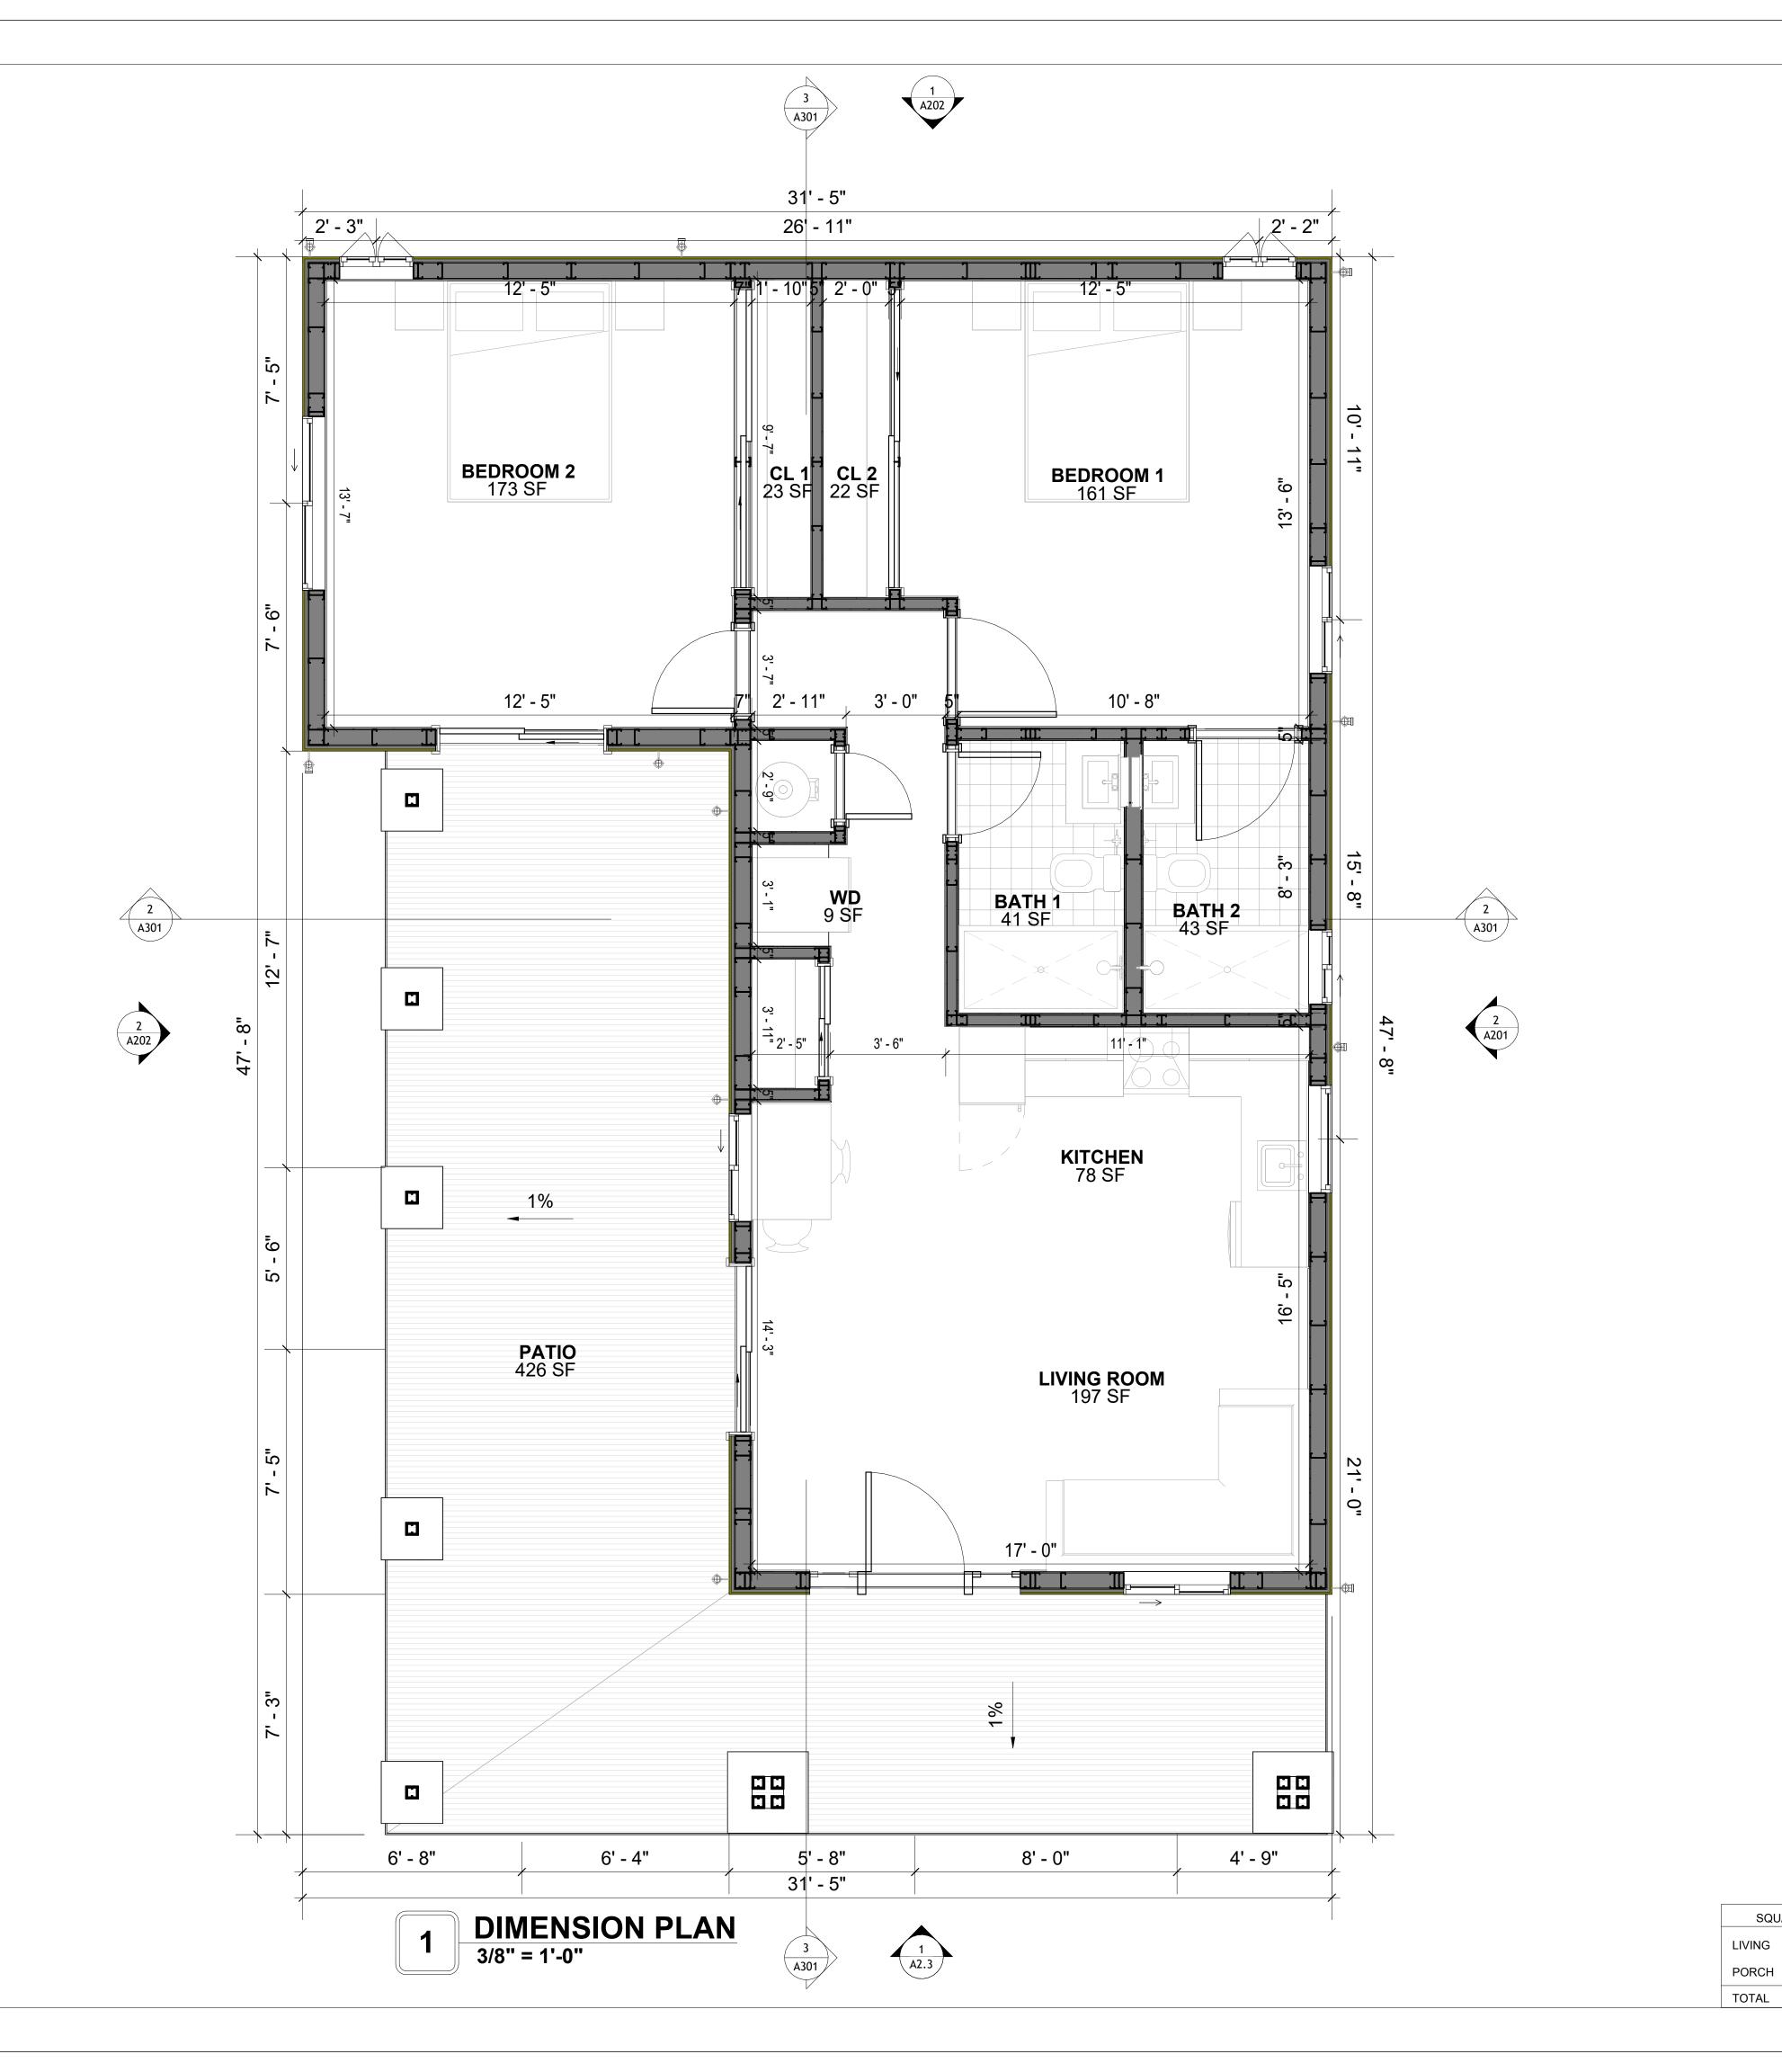



**KEY PLAN** 

NO.	DESCRIPTION	DATE

NOTE:

LEGEND:

PROJECT

12-Wisdom-909-2Bd/2Ba-Craftsman-550

DRAWING NAME

FLOOR DIMENSION PLAN

Client Name
0033_15
1/27/2025 3:21:26 PM
Designer
Author
Checker

A102

SCALE: 3/8" = 1'-0"

SQUARE FOOTAGE

909

465

1,374

DIMENSIONS IN THE ARCHITECTURAL DRAWINGS CONSIDER FINISHING MATERIALS. FOR PRECISE MEASUREMENTS OF THE STRUCTUAL FRAMING, REFER TO THE ATTACHED STRUCTURAL PLAN SET.

#### **FOUNDATION NOTES**

TERMITES PRETREATMENT BY LICENSED CONTRACTOR UNDER SLAB AND AROUND FOOTINGS. ALL AREAS BELOW SLABS SHALL BE TREATED NO MORE THAN 24 HOURS PRIOR TO CONCRETE POUR. EVIDENCE OF TREATMENT MUST BE PROVIDED PRIOR TO PLACING OF CONCRETE.

#### MATERIALS:

ALL INTERIOR CONCRETE SLABS SHALL BE A MIN. OF 4" THICK CONCRETE OVER 4" COMPACTED AGGREGATE BASE (ASTM D698), FINISH ELEVATIONS AS NOTED ON DRAWINGS, 6" ABOVE ADJACENT GRADE, LEVEL SLABS TO 1/8"-10' MAX.. CONCRETE SLABS SHALL BE 2500# PSI AT 28 DAYS, A 4" ALLOWABLE SLUMP.

#### 2. **PAD PREPARATION:**

- EXCAVATION FOR FOOTING SHALL BE NEAT.
- FOOTINGS SHALL BE POURED IMMEDIATELY AFTER EXCAVATION AND APPROPRIATE
- ALL REINFORCING STEEL MARKED "CONTINUOUS" SHALL BE LAPPED 36 BAR DIAMETERS AT SPLICES AND AROUND CORNERS OR INTERSECTIONS WITH A STANDARD 90 DEGREE BEND ON CORNER BARS. LAP WIRE MESH ONE FULL MESH AT SIDE AND END LAPS.
- ALL HARDWARE TO BE SIMPSON OR EQUIVALENT. - EXTERIOR FRAME WALL TO BE SECURED WITH 1/2"X10" ANCHOR BOLTS 4'-0" O.C. FOR 1-
- STORY AND 2'-8" O.C. FOR 2-STORY. BOLTS SHALL BE LOCATED WITHIN 1'-0" OF EACH END PIECE AND SHALL HAVE A MIN. OF TWO BOLTS PER PIECE.
- -FOUNDATION ANCHOR STRAPS SHALL BE PERMITTED, ACCORDING TO RESIDENTIAL CODE
- ALL INTERIOR WALLS TO BE SECURED WITH POWER DRIVEN PINS PER MANUFACTURER SPECIFICATION USE PIN SPACING EQUIVALENT TO 1/2" ANCHOR BOLTS.
- ALL CONSTRUCTION TO CONFORM TO THE 2012 IRC
- R-10 RIGID INSULATION OUTSIDE OF EXTERIOR FOUNDATION WALLS UNDER LIVING AREA.
- CONCRETE PAD FOR CONDENSER THICKNESS IS 4" MIN UNLESS OTHERWISE NOTED.

#### 3. CONCRETE CONSTRUCTION:

- THE SLAB SHALL BE UNDERLAIN BY A VAPOR BARRIER/RETARDER IN THE LIVING AREA (TYPICALLY POLYETHYLENE, UNLESS MORE STRINGENT PROTECTION REQUIRED BY THE ARCHITECT, ENGINEER, FLOOR COVERING MANUFACTURER, OR ACCEPTED PRACTICE). UNLESS OTHERWISE REQUIRED, BARRIER MAY BE OMITTED AT GARAGES, PORCHES AND PATIOS WITHOUT FLOOR COVERINGS. IT IS BEYOND THE SCOPE OF THESE PLANS TO DETERMINE THE APPLICABILITY OF THESE MORE STRINGENT REQUIREMENTS. BUILDER SHALL VERIFY PRIOR TO CONSTRUCTION.


#### REINFORCEMENT

- IF CONSTRUCTED ON ACTIVE SOILS, THE LONG TERM PERFORMANCE OF THE FOUNDATION IS DEPENDENT ON MAINTENANCE BY THE OWNER. THUS THE BUILDER SHALL ADVISE THE OWNER OF THE FOLLOWING:
- 1. DRAINAGE MUST BE MAINTAINED. WATER SHALL NEVER BE ALLOWED TO POND NEAR THE FOUNDATION.
- 2. THE SOIL AROUND THE FOUNDATION SHALL BE MAINTAINED IN A RELATIVELY DAMP CONDITION, SUCH AS THAT REQUIRED TO KEEP A LAWN GREEN. IF IT DRIES OUT IT WILL
- SHRINK. IF IT GETS WET, IT WILL HEAVE UPWARD. SLABS ON THE SHORTER SIDE USES MAIN BARS ARE USED IN THIS DIRECTION ONLY
- WITH SMALLER DIAMETER DISTRIBUTION BARS ARE PLACED, FORMING A MAT OR GRID. 4. ALL REINFORCEMENT BARS SIZE 10MM OR LARGER IN ACCORDANCE TO ASTM
- ANCHOR BOLTS AT ALL EXTERIOR WALLS SHALL BE MINIMUM 1/2 INCH DIAMETER WITH A MAXIMUM SPACING OF 6'-0" ON CENTER. UNLESS NOTED OTHERWISE
- ANCHOR BOLTS SHALL BE INSTALLED WITHIN 12 INCHES OF EACH END OF EACH SILL PLATE WITH AT LEAST TWO ANCHOR BOLTS FOR EACH BOLTS FOR EACH SILL PLATE LONGER THAN 12 INCHES.
- 5. SIMPSONS SILL ANCHORS MAYBE SUBSTITUTED FOR ANCHOR BOLTS AT THE SAME SPACING.
- EXTERIOR CONCRETE SLABS WHICH ARE NOT PART OF THE MAIN SLAB SHALL BE MINIMUM 4 INCHES THICK WITH NO STEEL REINFORCING BARS REQUIRED, UNLESS NOTED OTHERWISE ON FOUNDATION PLAN.

#### **VERIFY THE FOLLOWING PRIOR TO POURING:**

- ALL HOLDDOWNS . STRAP. AND POST LOCATIONS.
- CONCRETE FINISHES. PANEL RISER LOCATION WHERE APPLICABLE.
- UNDERSLAB MECHANICAL REQUIREMENTS.
- 4. STEM WALL BLOCKOUTS.
- 5. UNDERSLAB ELECTRICAL REQUIREMENTS AND PANEL RISER LOCATION. WHERE
- APPLICABLE. 6. PROVIDE THE FOLLOWING:
- PVC SLEEVES THROUGH FTG IF REQUIRED
- 20' #4 COPPER GROUND BAR.
- SLOPE FINISH GRADE AWAY FROM FOOTING.

**NOTE**: FIELD VERIFY ALL DIMENSIONS SEE DIMENSIONED ARCHITECTURAL DRAWINGS

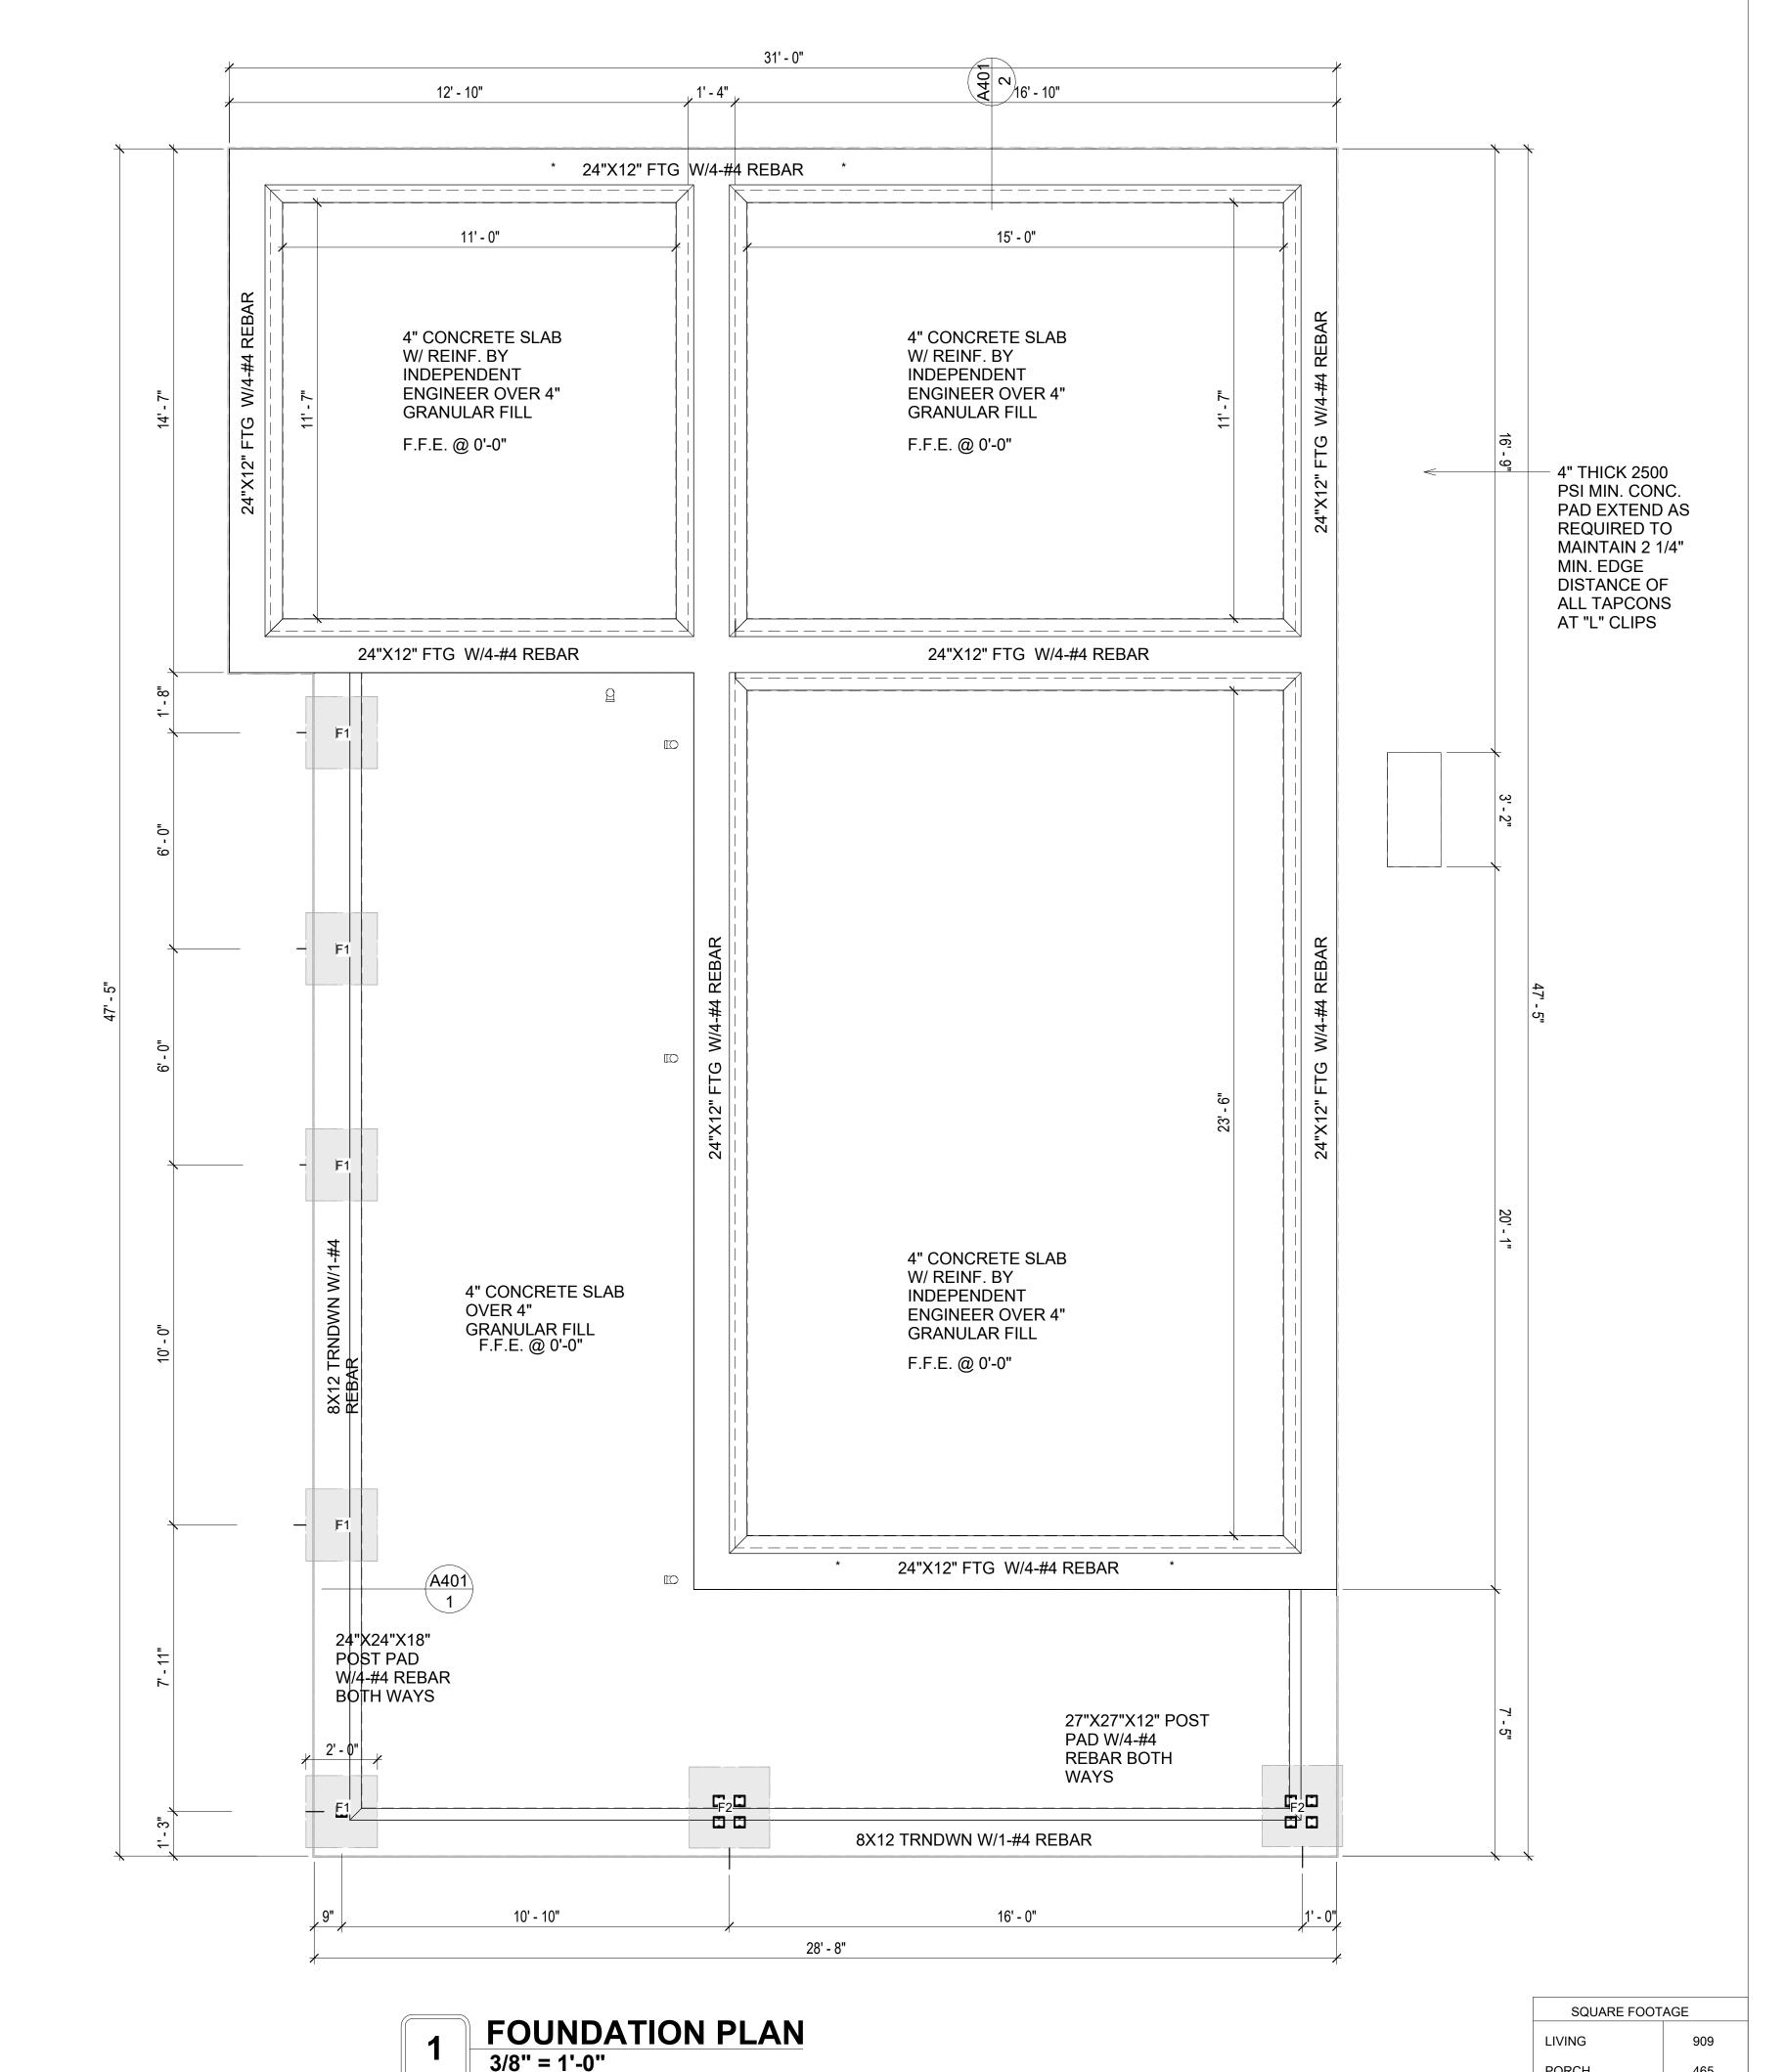



**KEY PLAN** 

DESCRIPTION DATE

NOTE:

**LEGEND:** 

PROJECT

12-Wisdom-909-2Bd/2Ba-Craftsman-550

DRAWING NAME

FOUNDATION PLAN

CLIENT NAME: Client Name PROJECT NUMBER: 0033\_15 1/27/2025 3:21:27 PM Designer DESIGNED BY: **Author** DRAWN BY: CHECKED BY: Checker

**S101** 

SCALE: 3/8" = 1'-0"

PORCH

TOTAL

465

1,374

#### **GENERAL NOTES**

#### NOTES:

-ALL BEARING WALLS SHOULD HAVE A THICKENED SLAB PER SECTION PER DETAIL A401/5.

#### A) **FOUNDATION PLAN NOTES**:

- 1. CONCRETE SLAB SHALL BE 6" THICK WITH 1/2" DIAMETER TENDONS PER LAYOUT PLAN, CENTERED IN SLAB THICKNESS, OVER APPROVED SUBBASE PER GENERAL STRUCTURE NOTES.
- TERMITE PROTECTION SHALL BE PROVIDED PER IRC SECTION R318.1
   NONE TYPICAL ANCHOR BOLT SPACING AT SHEAR WALL AND HOLD DOWN
- SPECIFICATIONS PER APPROVED ARCHITECTURAL PLANS.
  4. INSTALL HOLDOWNS BEFORE CONCRETE SLAB POUR.
- 5. EXISTING FILL ON-SITE SHALL BE COMPACTED IN ACCORDANCE WITH THE REQUIREMENTS IN THE GEOTECHNICAL REPORT.
- 6. ALL FLOOR SLABS ARE REINFORCED ON CONCRETE SLABS.

#### SPECIAL INSPECTION IS REQUIRED FOR THICKENED FOUNDATION CONSTRUCTION

- 1. REINFORCEMENT
- 2. 2300 PSI CONCRETE POUR

#### B) REINFORCEMENT FOR CONCRETE:

 ALL REINFORCING SLABS BARS SIZE 10MM OR LARGER SHALL BE DEFORMED IN ACCORDANCE TO ASTM-A706, AND BARS SMALLER THAN 10 MM MAYBE PLAIN.
 UNLESS OTHERWISE NOTED IN PLANS, THE YIELD STRENGTH OF REINFORCING BARS SHALL BE:


> A) FOOTING = 40,000 PSI B) NON-LOAD BEARING WALLS AND PARAPETS= 40,000 PSI


- 3. SPLICES SHALL BE SECURELY WIRED TOGETHER AND SHALL LAP OR EXTEND
- 4. GRADE OF STEEL FOR RCC WORKS SHALL BE GRADE 4 10.
- 5. BAR NOTATIONS GIVES INFORMATION
- A) BAR SIZE
- B) SPACING(IF REQUIRED)
- LAP REINFORCEMENT ONLY AT LOCATION SHOWN IN THE DRAWINGS
   REINFORCEMENT SHALL NOT BE CUT, VENT OR HEATED ON SITE WITHOUT ENGINEERS' APPROVAL.
- C) CONCRETE SLAB NOTES
- 1. ALL SLAB REINFORCEMENT SHALL BE 20MM CLEAR MINIMUM FROM BOTTOM AND FROM TOP OF SLAB.
- 2. REINFORCEMENT IN CONTINUOUS ELEVATED SLAB SHALL BE CUT AS FOLLOWS.

#### NOTE

- THIS IS A SCHEMATIC PLAN FOR THE PURPOSE OF LOCATING AND IDENTIFYING FOUNDATION REINFORCING ELEMENTS ONLY. VERIFY ALL DIMENSIONS, DROPS, OFFSETS AND FEATURES WITH THE ARCHITECTURAL PLANS BEFORE FORMING THE FOUNDATION.

# #4-REBAR ON A 2'-0" X 2'-0" GRID SLAB ON GRADE FOUNDATION CERAMIC TILE CEMENTENIOUS BACKER BOARD #4 CONT.REBAR CONCRETE PAD HARD SITE TYPICAL WALL FTG DETAIL 3/4" = 1'-0"

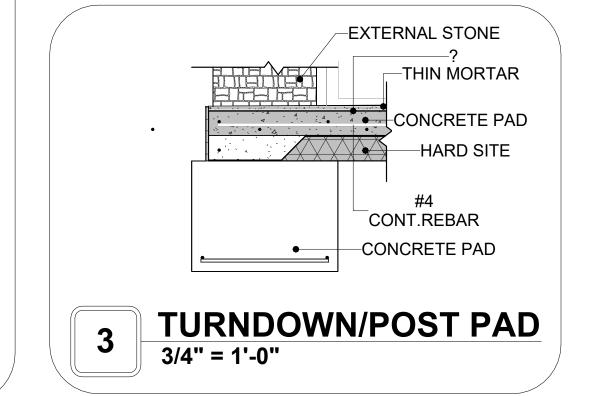

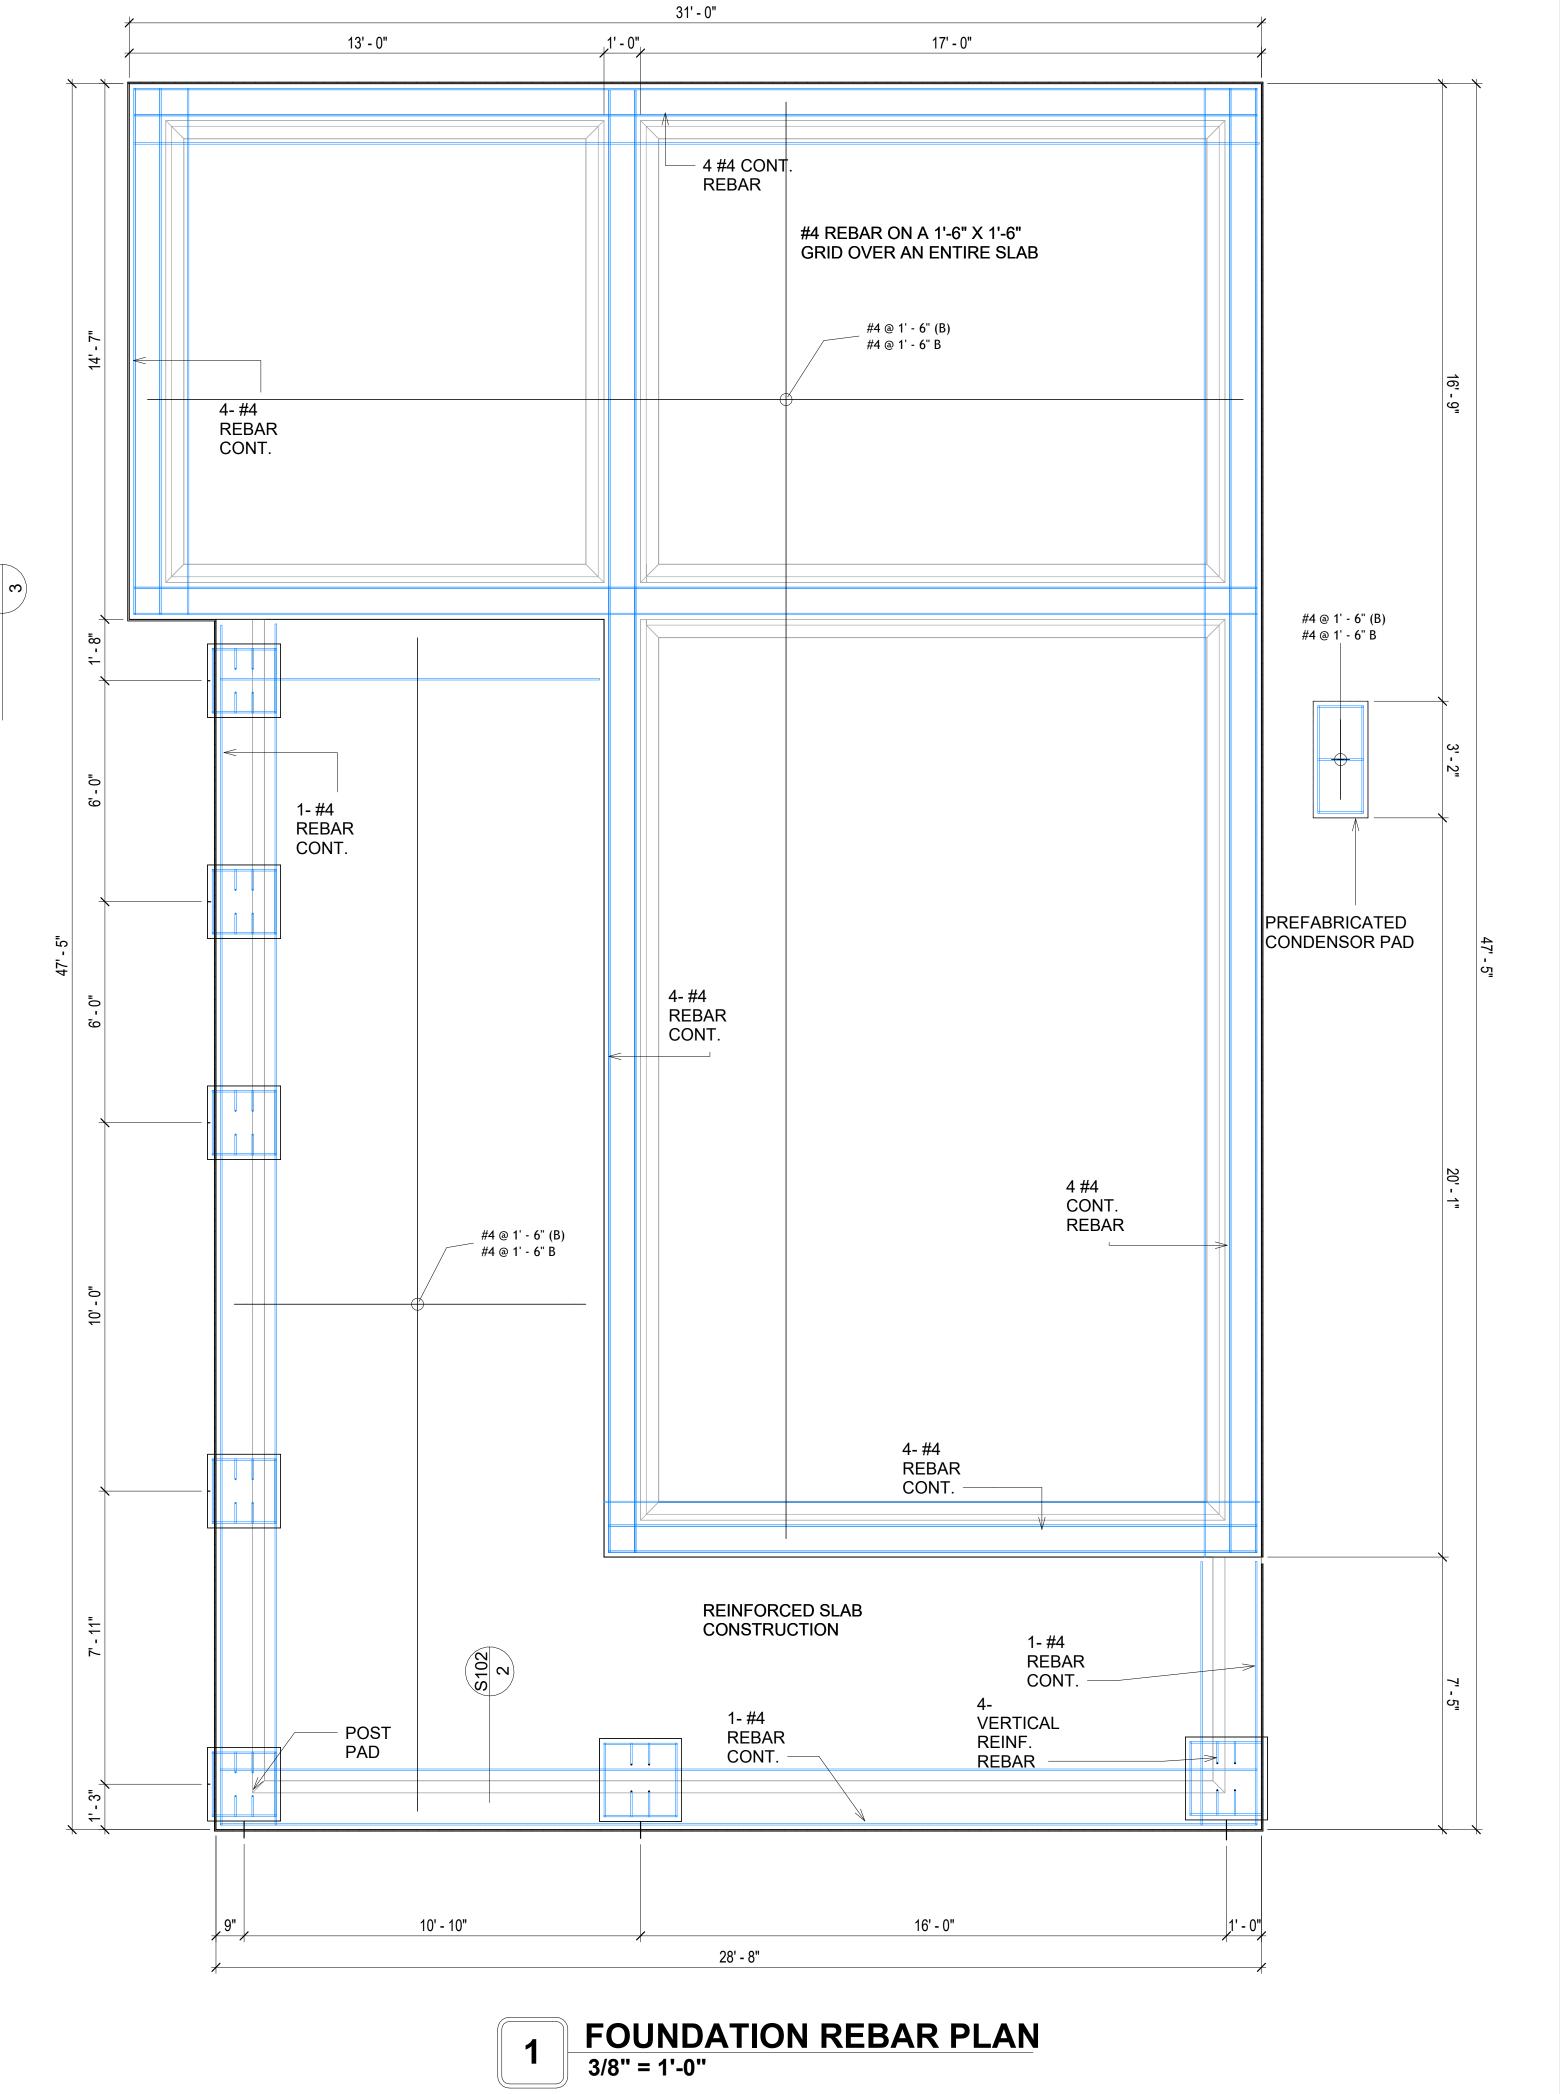



**KEY PLAN** 

NO.	DESCRIPTION	DATE

NOTE:

LEGEND:

PROJECT

12-Wisdom-909-2Bd/2Ba-Craftsman-550

DRAWING NAME

STRUCTURAL FLOOR PLAN


Client Name
0033_15
1/27/2025 3:21:29 PM
Designer
Author
Checker

**S102** 

#### **ROOF NOTES**

- 1. ROOFING COMPOSITION ROOFING PER OWNERS/BUILDERS SPECIFICATIONS INSTALL PER MANUFACTURE SPECIFICATIONS ON 1/2" ORIENTED STRAND BOARD ON PRE-ENGINEERED TRUSS @ 24" O.C. (UNO.)
- ENGINEERED TRUSS @ 24" O.C. (UNO.)
  2. 73" OVERHANG AT EAVES (UNO.)
- 3. ENDS OF ALL TRUSSES AND JOISTS TO BE FULLY BLOCKED. PROVIDE SOLID BLOCKING AT ALL RIDGES AND VALLEYS

  4. SHEATHING TO BE 1/3", 3/8", OSB SHEAB BANEL AND FOLUVALENT LINDERSIDE OF
- 4. SHEATHING TO BE 1/2", 3/8" OSB SHEAR PANEL AND EQUIVALENT. UNDERSIDE OF PORCH TRUSSES TO BE FINISHED WITH MOISTURE RESISTANT DRYWALL, TAPED AND TEXTURED.
- EXPOSED EAVES AND OTHER WEATHER EXPOSED AREAS TO BE SHEATHED WITH EXTERIOR GRADE PLYWOOD.
- 6. ALL MATERIALS THICKNESS AND SIZE ARE THE MINIMUM. Refer TO LOCAL STANDARDS FOR ACTUAL THICKNESS AND LAYERING OF MATERIALS.
- 7. ENGINEERED TRUSS CALCULATIONS TO BE SUBMITTED TO BUILDING DEPARTMENT PRIOR TO FABRICATION AND INSTALLATION.
- 8. TRUSS MANUFACTURER TO SPECIFY HANGER CONNECTORS FOR TRUSS COMPONENTS (TYPICAL)
- 9. DESIGNER ASSUMES THAT TRUSSES BEAR ON ALL EXTERIOR PERIMETER WALLS (TYPICAL) OR BEAMS.
- 10. PROVIDE GALVANIZED STEEL FLASHING WITH A LENGTH OF 10 FEET, WIDTH OF 12 INCHES. AND THICKNESS OF 24 GAUGE.

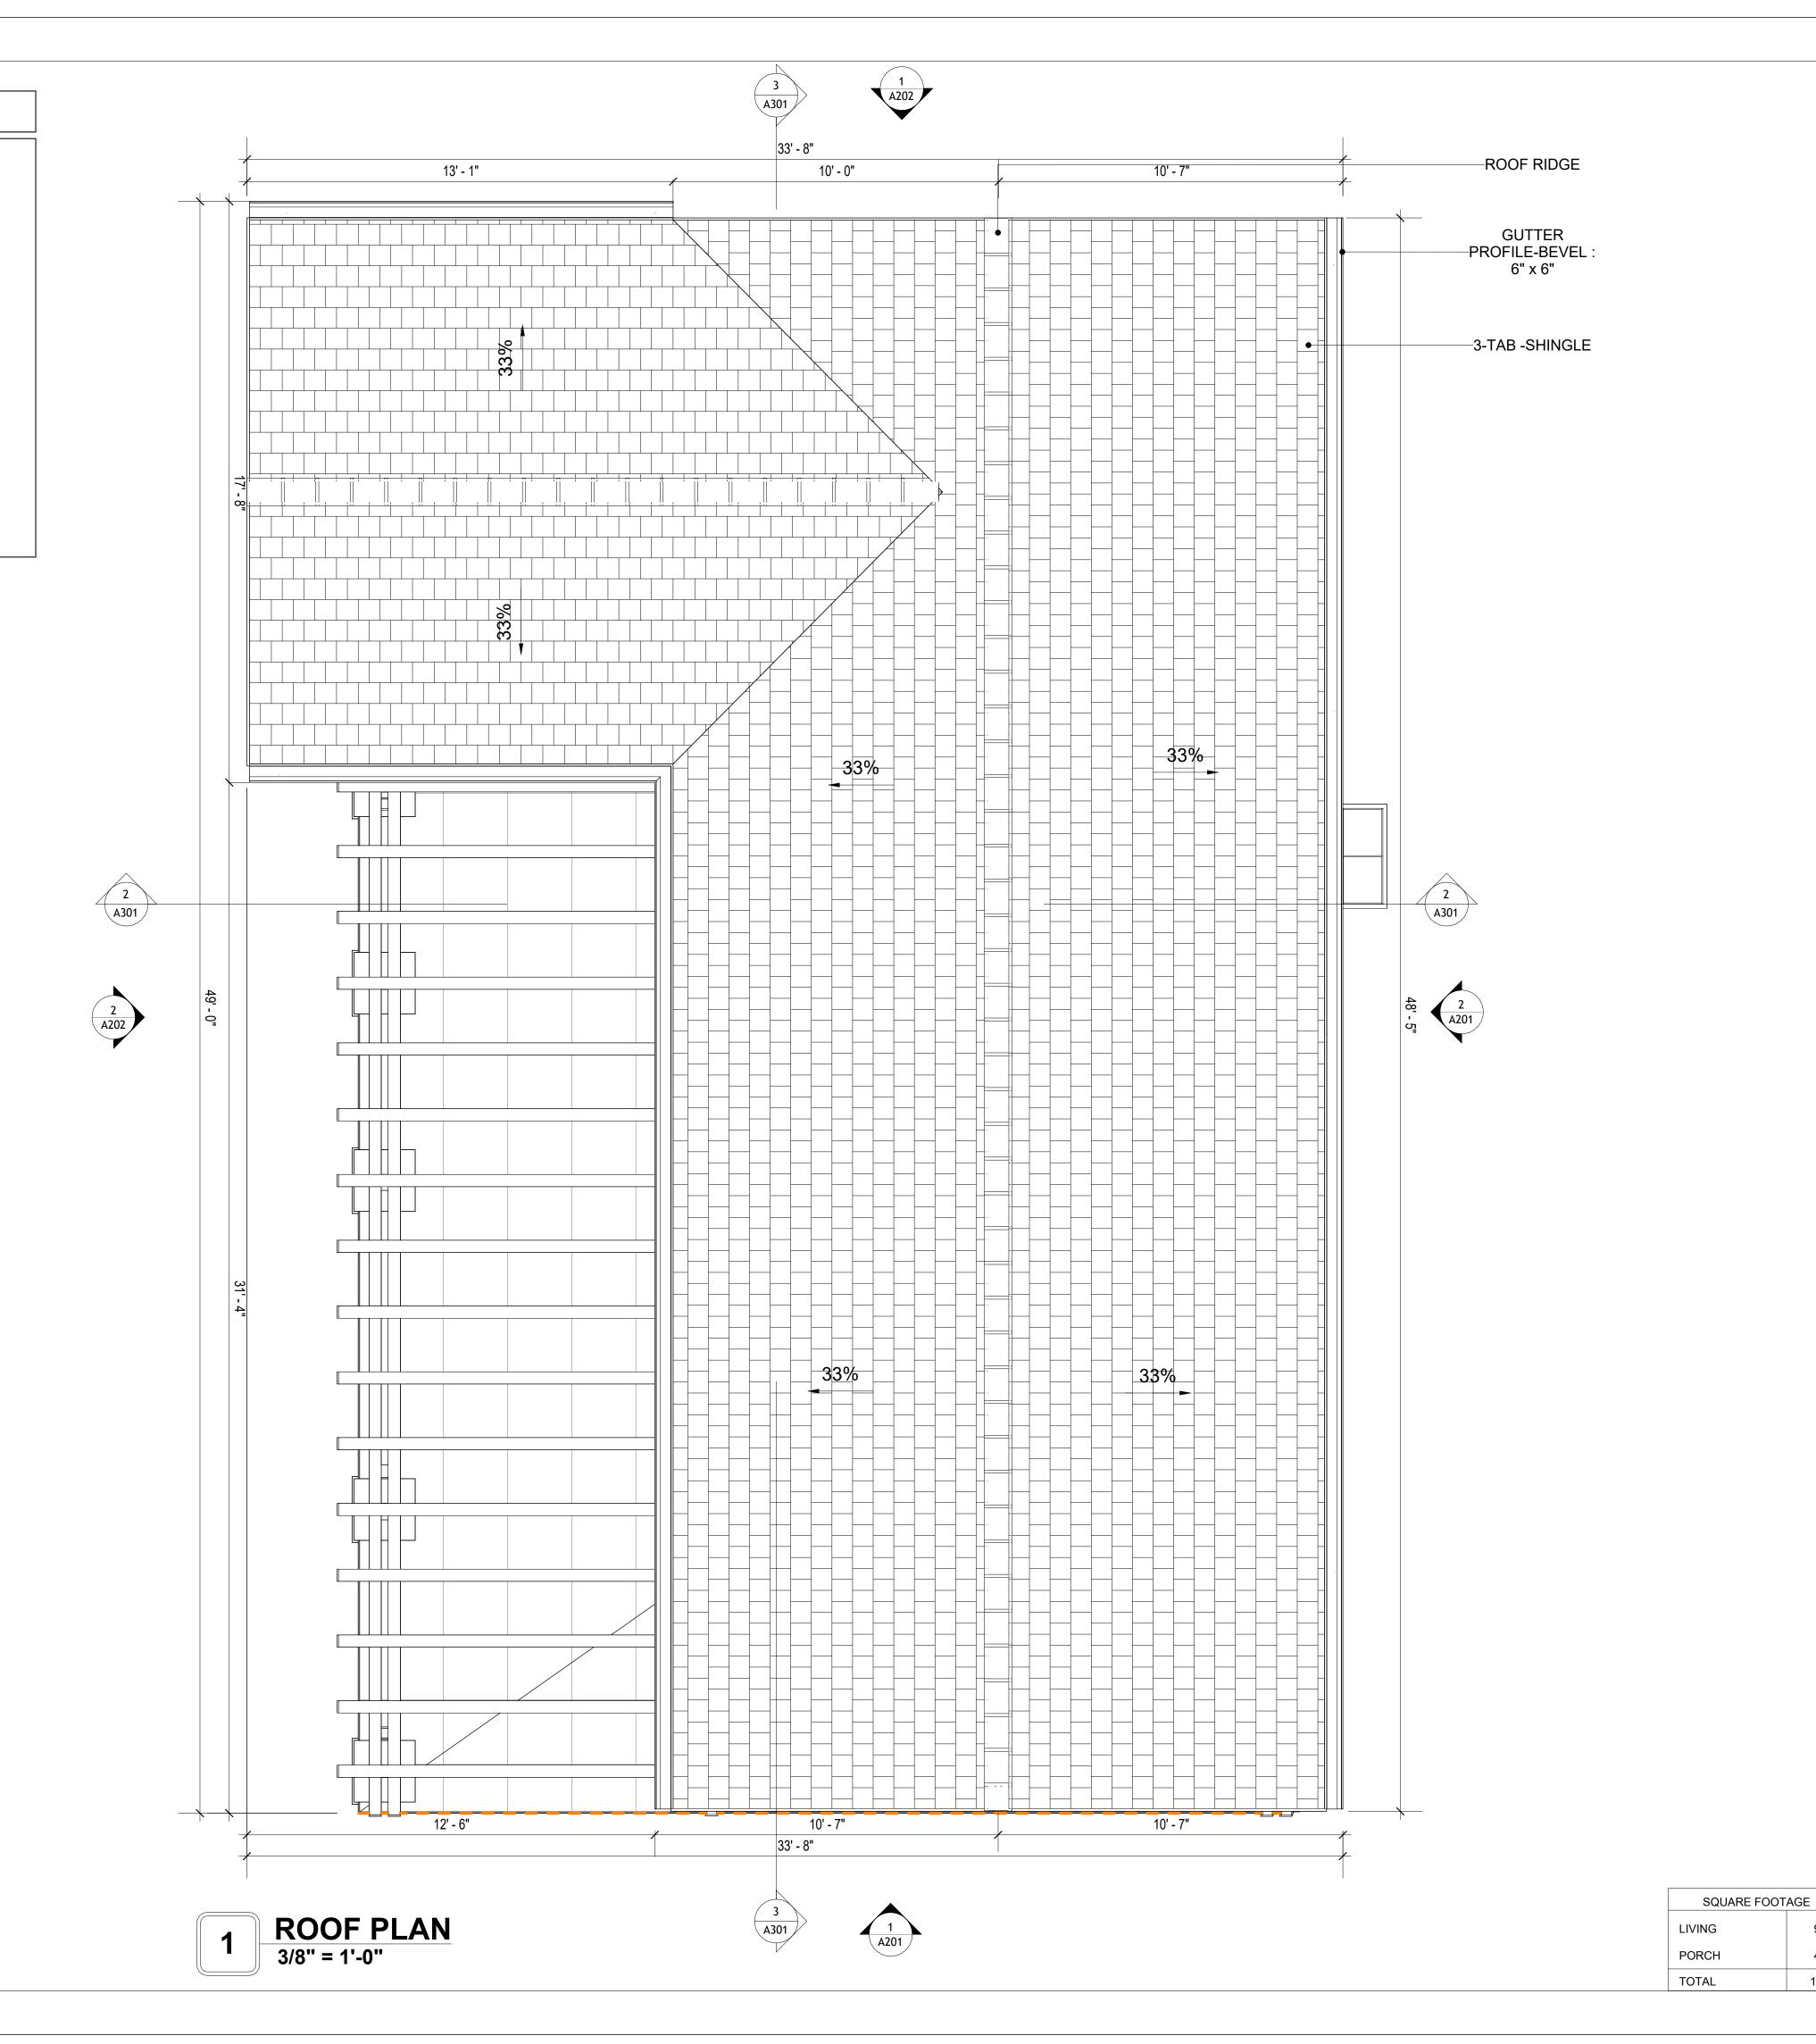



**KEY PLAN** 

NO.	DESCRIPTION	DATE

NOTE:

LEGEND:

PROJECT

12-Wisdom-909-2Bd/2Ba-Craftsman-550

DRAWING NAME

ROOF PLAN

Client Name	CLIENT NAME:
0033_15	PROJECT NUMBER:
1/27/2025 3:21:36 PM	DATE:
Designer	DESIGNED BY:
Author	DRAWN BY:
Checker	CHECKED BY:

A103

SCALE: As indicated

909

465

1,374

#### **ABOUT WALL FINISHING**

#### **CORRUGATED IRON SHEET**

CORRUGATED IRON IS A FINISHING MATERIAL MADE FROM STEEL THAT HAS BEEN GALVANIZED (COATED WITH A THIN LAYER OF ZINC) TO PROTECT IT FROM CORROSION AND RUST.

IN THIS SPECIFIC PROJECT, THE CORRUGATED IRON SHEETS ARE INSTALLED HORIZONTALLY ON VERTICAL FURRING STRIPS THAT ARE DIRECTLY ATTACHED ONTO THE PROPERLY INSTALLED AND SEALED HOME WRAP, USING SELF-DRILLING SCREWS THAT ARE DRIVEN THROUGH THE RIDGES OR VALLEYS OF THE CORRUGATIONS.

#### **EXTERNAL STONE**

THESE STONE PRODUCTS ARE MADE FROM A BLEND OF NATURAL AGGREGATES, CEMENT, AND OTHER PROPRIETARY MATERIALS.

THE STONE FINISH IS DIRECTLY ATTACHED TO COLD-FORMED STEEL (CS) FRAMING. (FOR COLUMN FINISH) EXTERNAL STONE CAN BE AN EXCELLENT EXTERIOR CLADDING OPTION FOR CS-FRAMED BUILDINGS. IN THIS SCENARIO, THE EXTERNAL STONE WOULD BE ADHERED TO THE CS FRAME USING A SCRATCH COAT AND MORTAR-BASED ADHESIVE.

#### **CAST MANUFACTURED STONE**

MANUFACTURED STONE, ALSO KNOWN AS CULTURED OR ARTIFICIAL STONE, IS A SYNTHETIC BUILDING MATERIAL MADE FROM A BLEND OF CEMENT, AGGREGATES, AND PIGMENTS TO MIMIC THE APPEARANCE OF NATURAL STONE. IT IS LIGHTWEIGHT, DURABLE, AND CUSTOMIZABLE IN COLOR AND TEXTURE.


IN THIS PROJECT, MANUFACTURED STONE IS USED AS THE COPING MATERIAL, PROVIDING A DURABLE AND AESTHETIC FINISH THAT MIMICS THE APPEARANCE OF NATURAL STONE.


#### **CEDAR WOOD**

CEDAR WOOD REFERS TO THE WOOD FROM VARIOUS SPECIES OF CEDAR TREES, WHICH ARE CONIFEROUS EVERGREEN TREES KNOWN FOR THEIR DISTINCT AROMA AND NATURAL RESISTANCE TO DECAY AND INSECTS.

IN THIS SPECIFIC PROJECT, CEDAR WOOD IS USED AS A FURRING STRIP AND A FINISH MATERIAL ON BEAMS AND COLUMNS.

CEDAR WOOD AS A FURRING STRIPS PROVIDE THERMAL INSULATION AND MOISTURE MANAGEMENT. THE VERTICAL CEDAR WOOD FURRING STRIPS ARE ATTACHED TO HOME WRAP USING CORROSION-RESISTANT FASTENERS (HOT-DIP GALVANIZED SCREWS), ENSURING PROPER PENETRATION INTO THE WALL FRAMING.

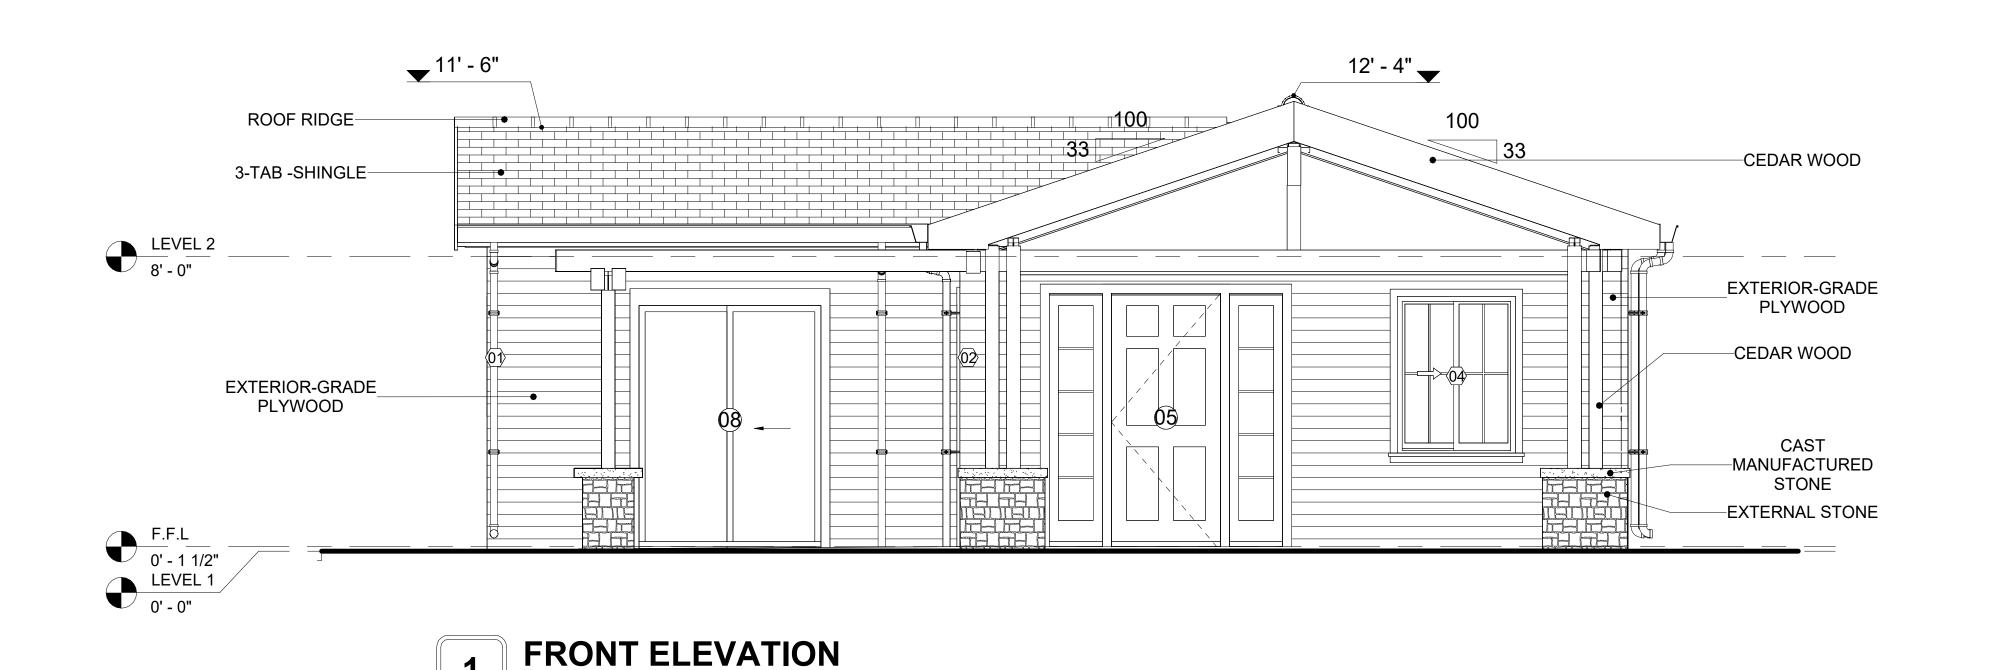

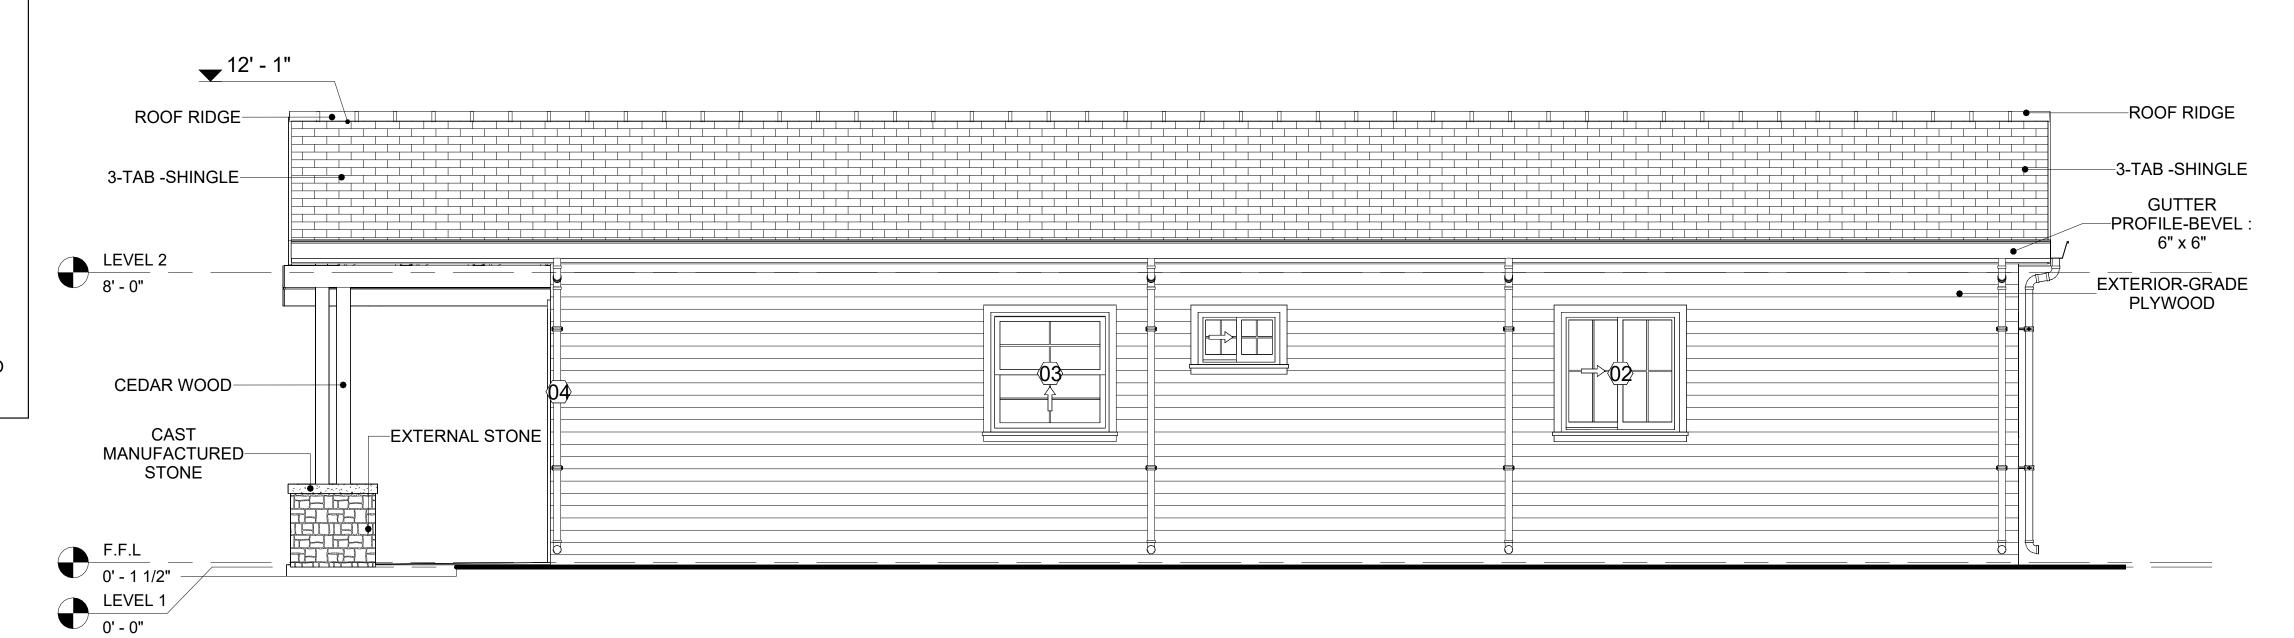

2 RIGHT SIDE ELEVATION
3/8" = 1'-0"

3/8" = 1'-0"

DOOR SCHEDULE						
TYPE MAR				SIZE		
K	SUPPLIER	DOOR TYPE	LOCATION	WIDTH	HEIGHT	COUNT
01	HOME DEPOT	INTERIOR SINGLE PANEL SWINGING	INTERIOR	3' - 0"	6' - 8"	1
02	HOME DEPOT	INTERIOR SINGLE PANEL SWINGING	INTERIOR	2' - 6"	6' - 8"	2
03	HOME DEPOT	INTERIOR SINGLE PANEL SWINGING	INTERIOR	2' - 0"	6' - 8"	1
04	HOME DEPOT	INTERIOR DOUBLE PANEL SLIDING	INTERIOR	9' - 0"	6' - 8"	2
05	HOME DEPOT	FRONT_DOOR_W_HEADER_AND_SIDELIGH TS_8215	INTERIOR	3' - 0"	7' - 0"	1
06	HOME DEPOT	INTERIOR SINGLE PANEL SWINGING	INTERIOR	3' - 0"	6' - 8"	1
07	HOME DEPOT	INTERIOR DOUBLE PANEL SLIDING	INTERIOR	3' - 4"	6' - 8"	1
80	HOME DEPOT	PATIO_DOUBLE PANEL_SLIDING	INTERIOR	5' - 0"	6' - 8"	2

WINDOW SCHEDULE					
			SIZE		
TYPE MARK	SUPPLIER	WINDOW TYPE	WIDTH	HEIGHT	COUNT
01	HOME DEPOT	SLIDING	5' - 3"	3' - 3"	1
02	HOME DEPOT	SLIDING	3' - 3"	3' - 3"	2
03	HOME DEPOT	SINGLE HUNG	3' - 3"	3' - 3"	1
04	HOME DEPOT	SLIDING	3' - 3"	4' - 3"	1
05	HOME DEPOT	SLIDING	2' - 3"	1' - 5"	1
06	HOME DEPOT	DOUBLE HUNG	2' - 3"	3' - 3"	2



**1**2

**KEY PLAN** 

NO.	DESCRIPTION	DATE

NOTE:

LEGEND:

PROJECT


12-Wisdom-909-2Bd/2Ba-Craftsman-550


DRAWING NAME

#### ARCHITECTURAL ELEVATIONS

CLIENT NAME:	Client Name
PROJECT NUMBER:	0033_15
DATE:	1/27/2025 3:21:44 PM
DESIGNED BY:	Designer
DRAWN BY:	Author
CHECKED BY:	Checker


A201

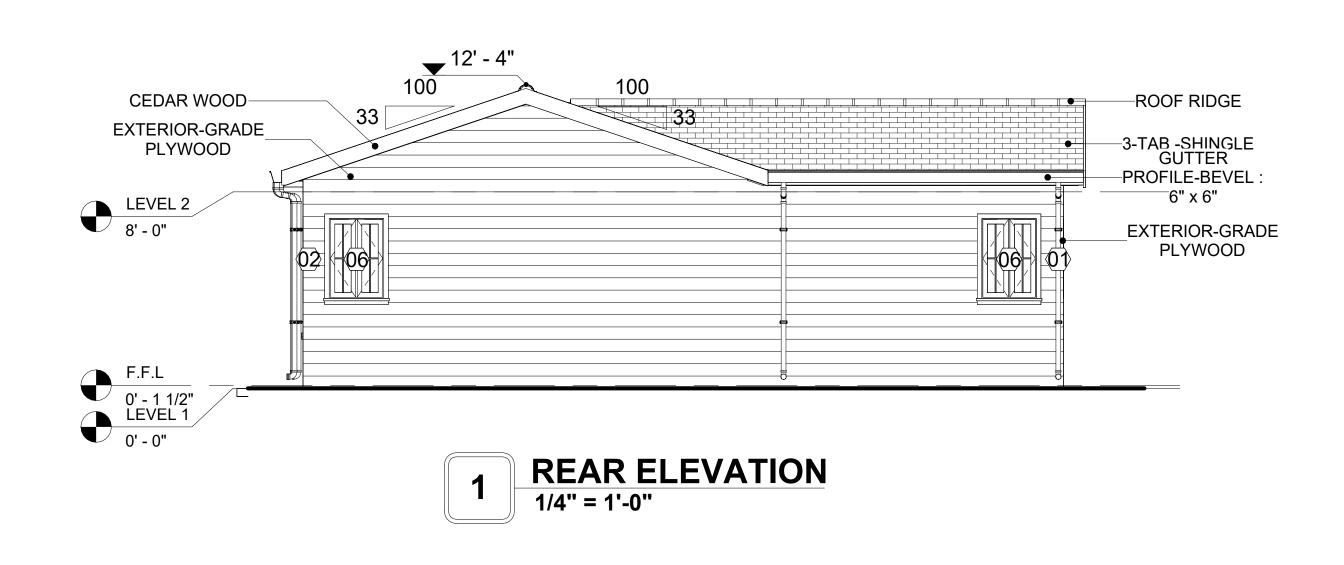

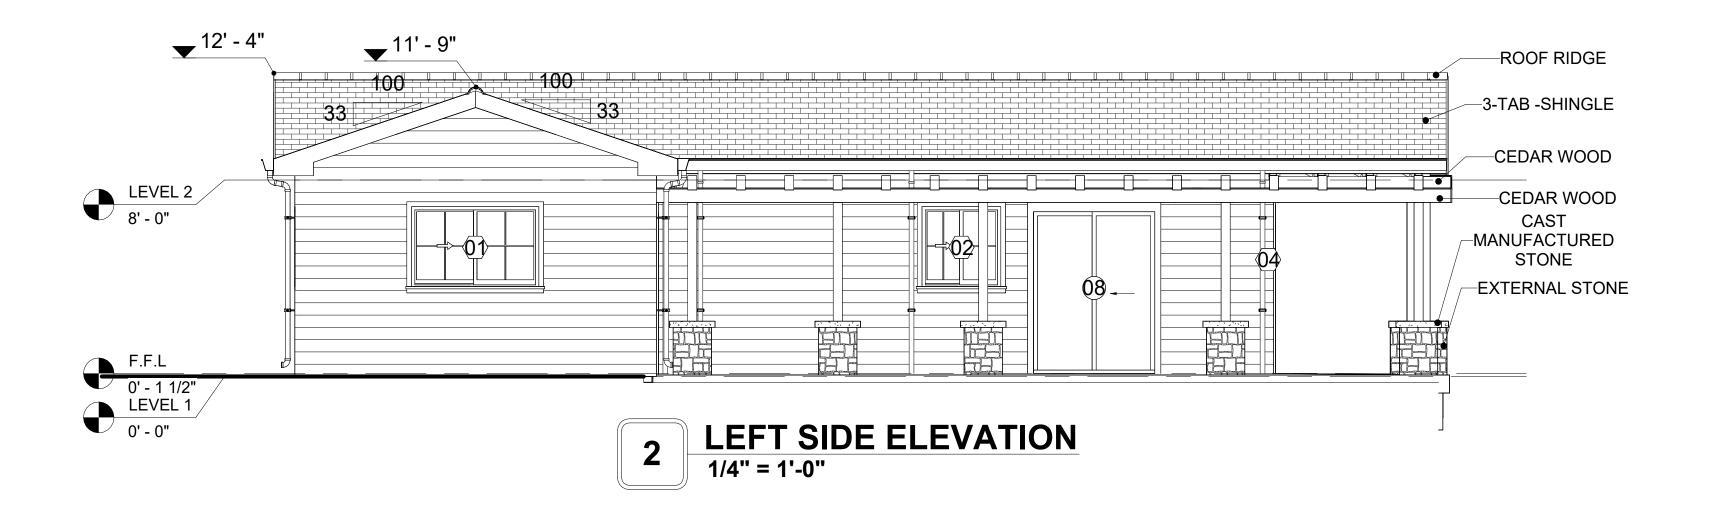



**KEY PLAN** 

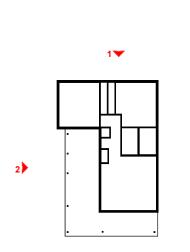

NO.	DESCRIPTION	DATE

NOTE:

LEGEND:

PROJECT

12-Wisdom-909-2Bd/2Ba-Craftsman-550

DRAWING NAME

ARCHITECTURAL ELEVATIONS

CLIENT NAME:

PROJECT NUMBER:

0033\_15

DATE:

1/27/2025 3:21:49 PM


DESIGNED BY:


DRAWN BY:

CHECKED BY:

Checker

**A202** 

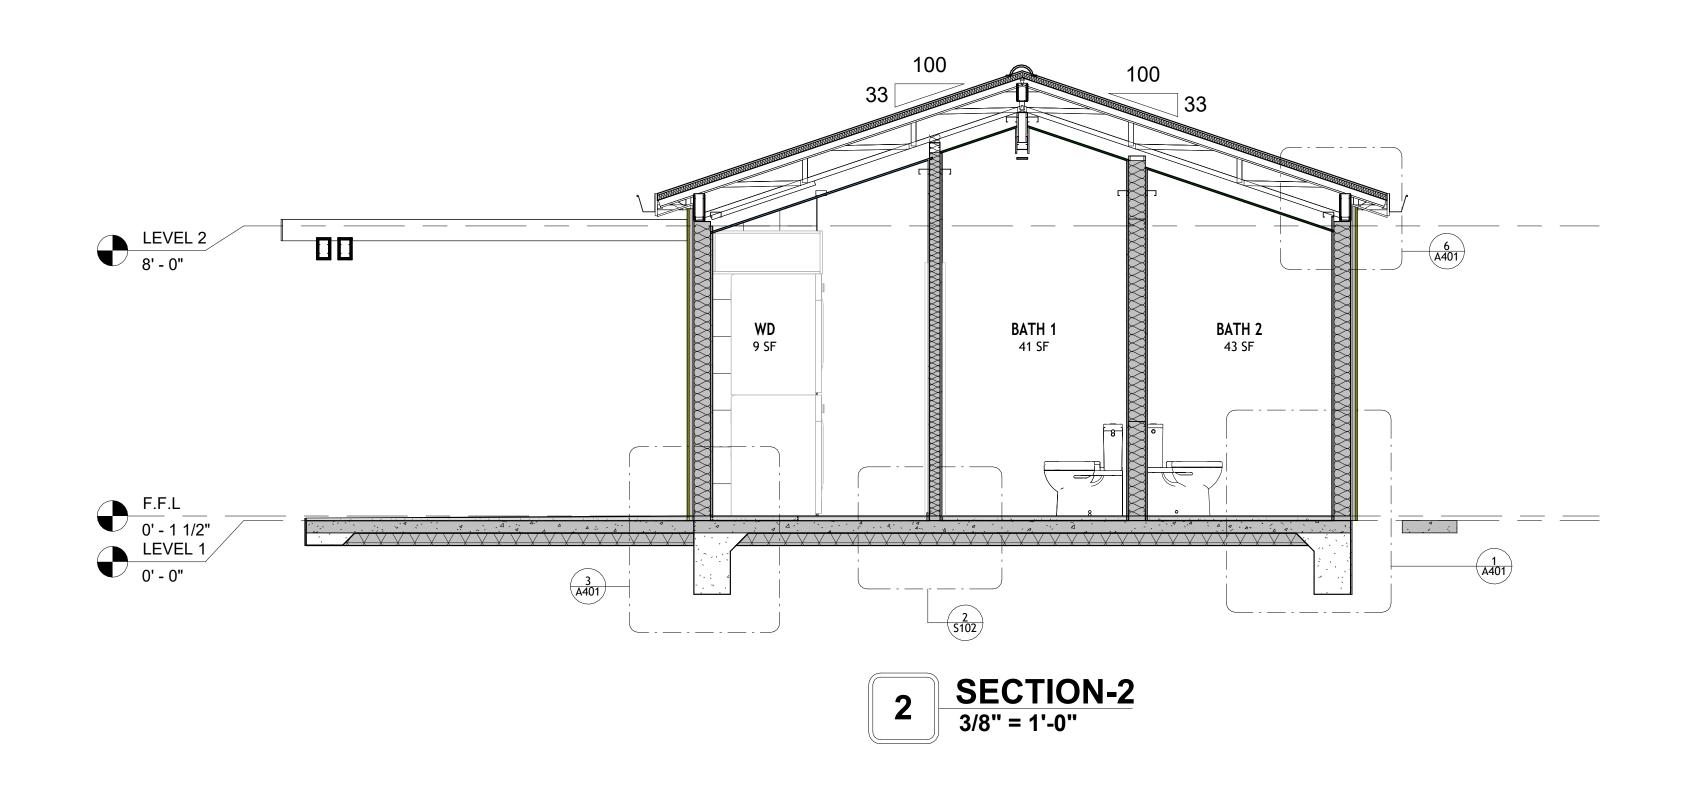


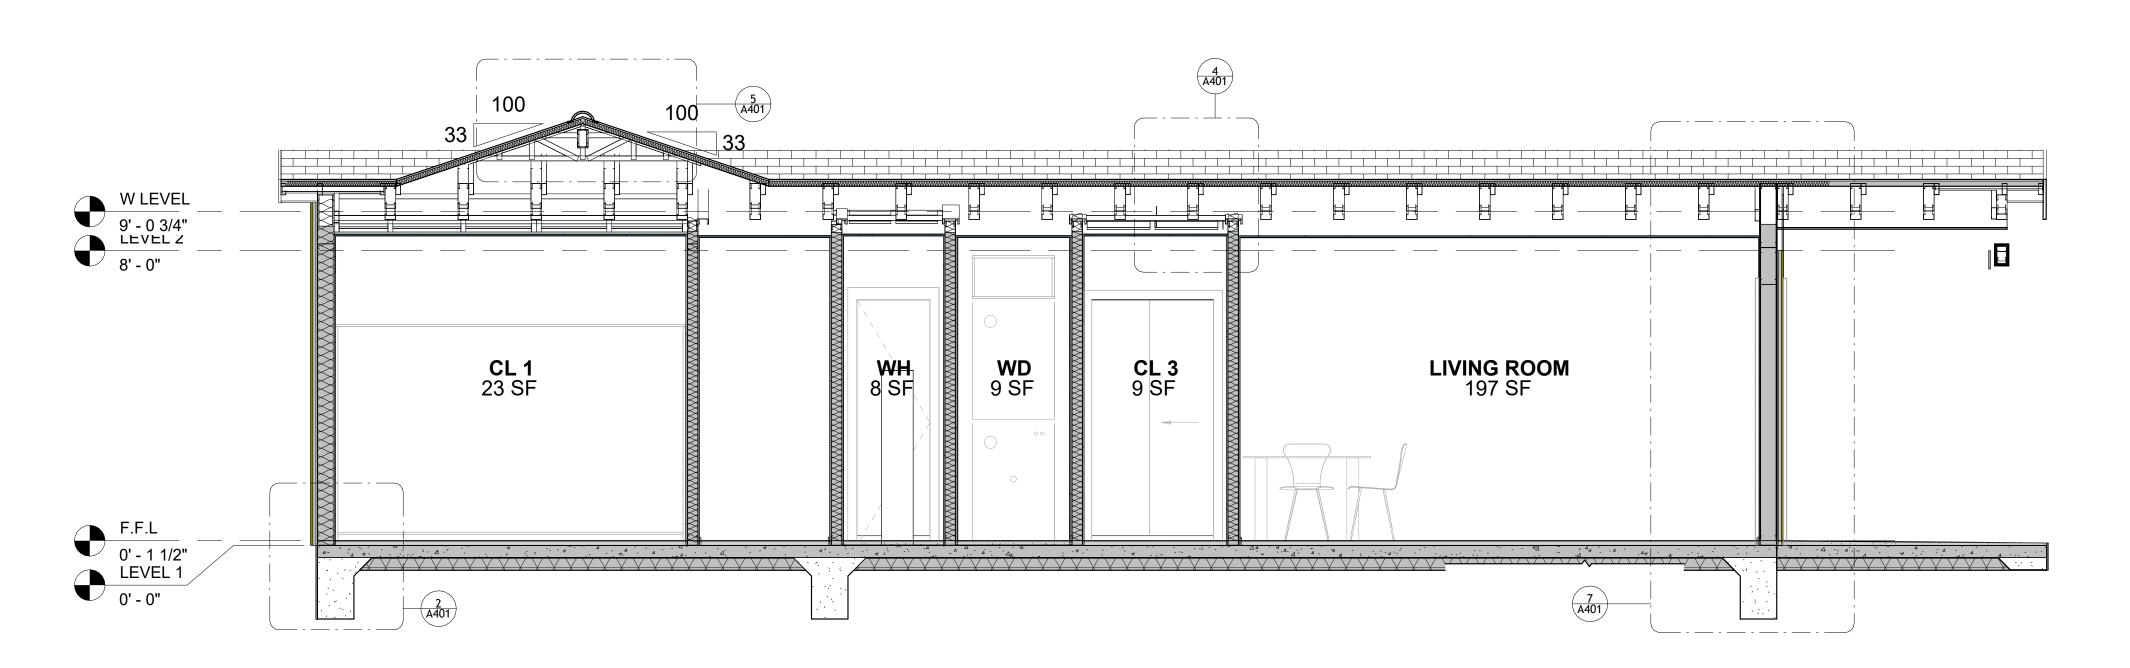

3 SECTION-3 3/8" = 1'-0"



**KEY PLAN** 

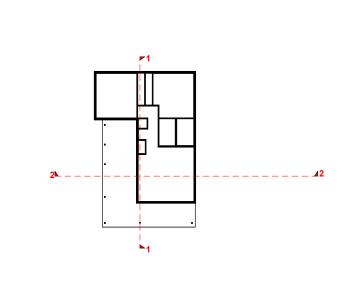

NO.	DESCRIPTION	DATE

NOTE:

LEGEND:

PROJECT


12-Wisdom-909-2Bd/2Ba-Craftsman-550


DRAWING NAME


ARCHITECTURAL SECTIONS


Client Name	CLIENT NAME:
0033_15	PROJECT NUMBER:
1/27/2025 3:21:51 PM	DATE:
Designer	DESIGNED BY:
Author	DRAWN BY:
Checker	CHECKED BY:


A301

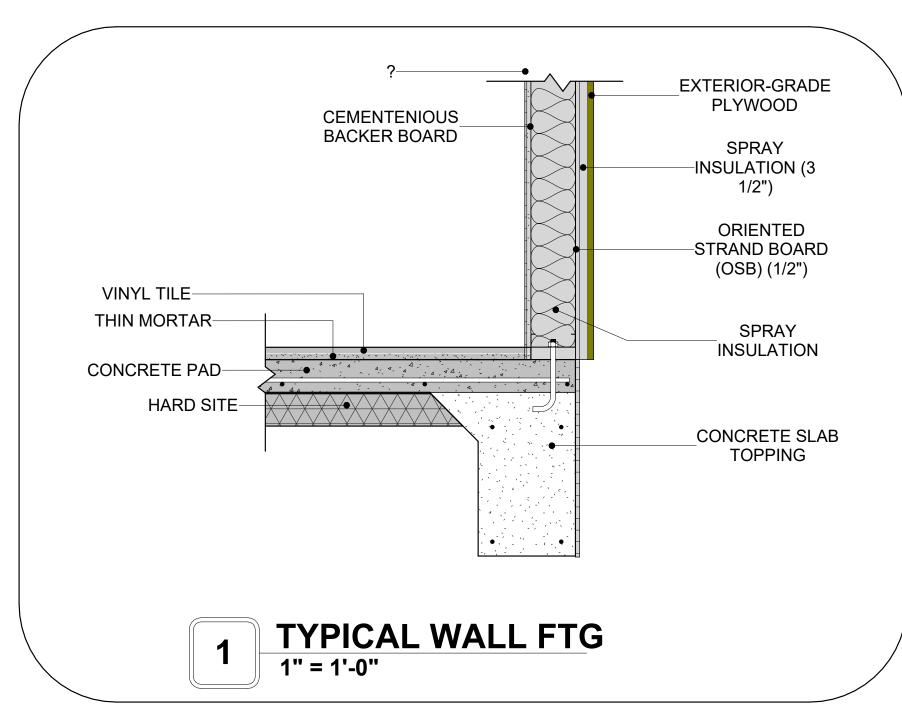

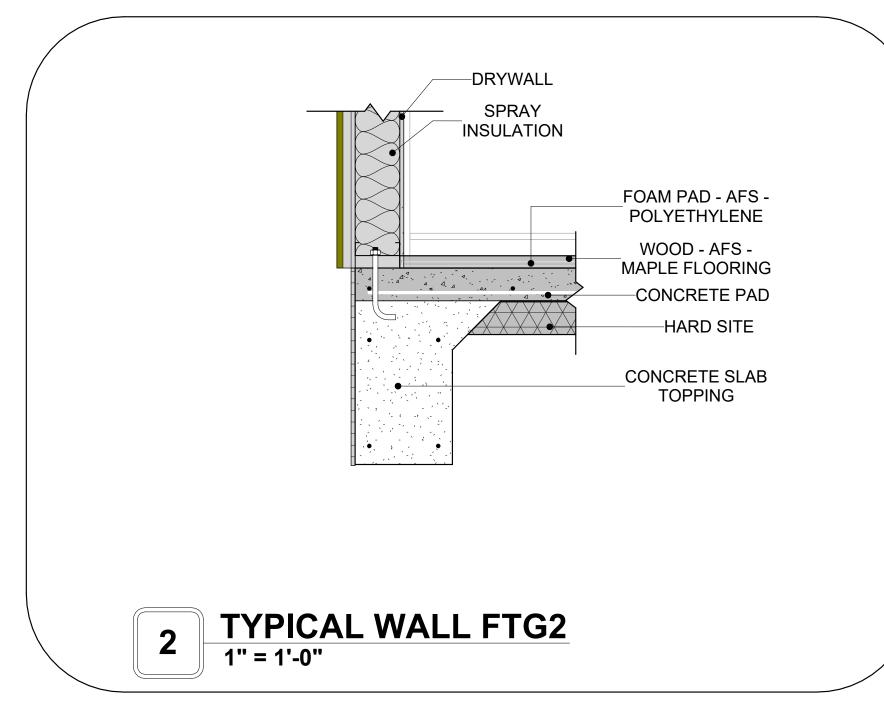

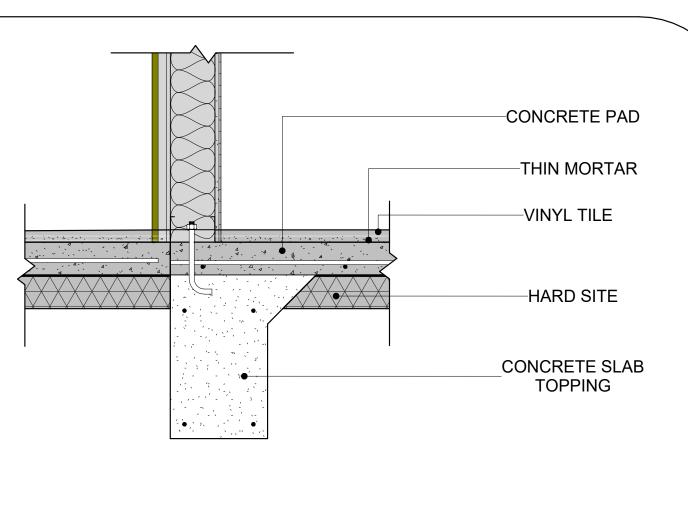


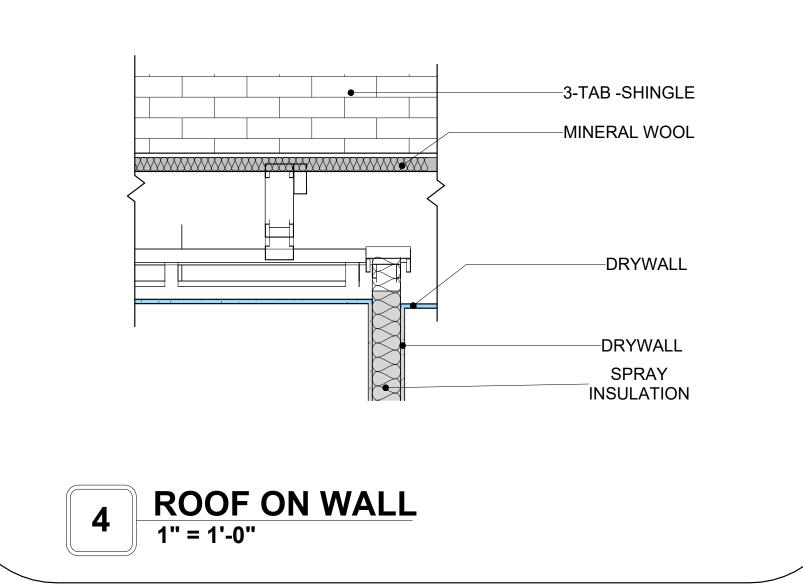


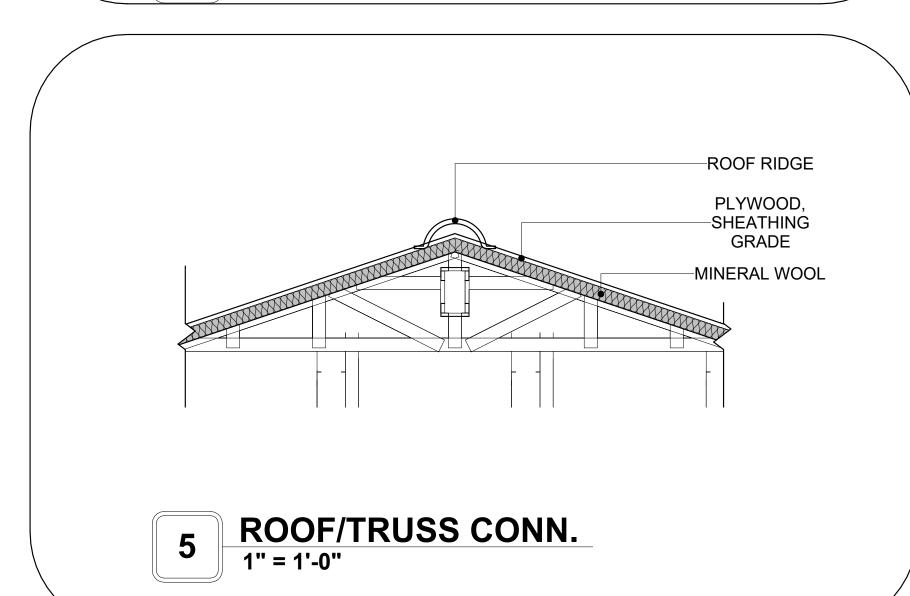

WALL TO FLOOR CONN.

1" = 1'-0"

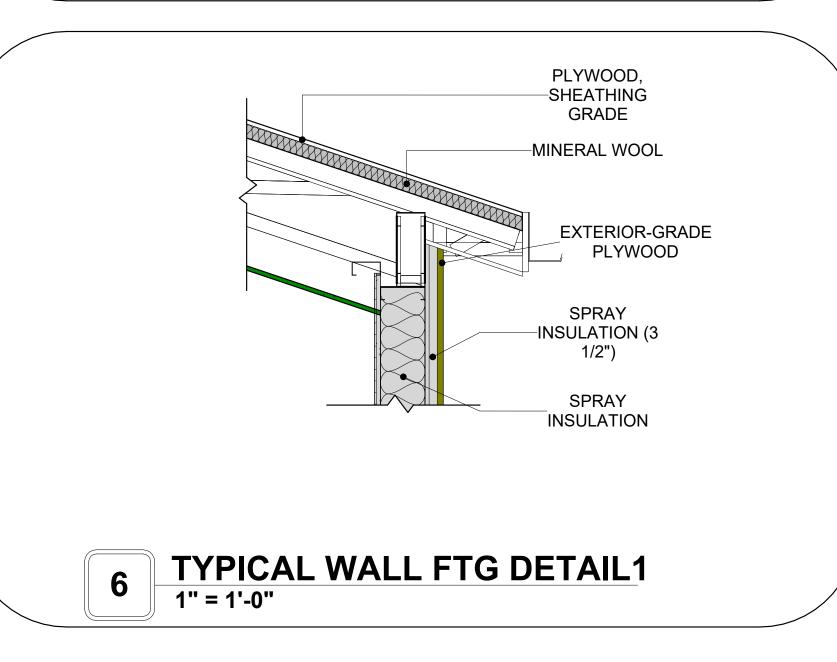

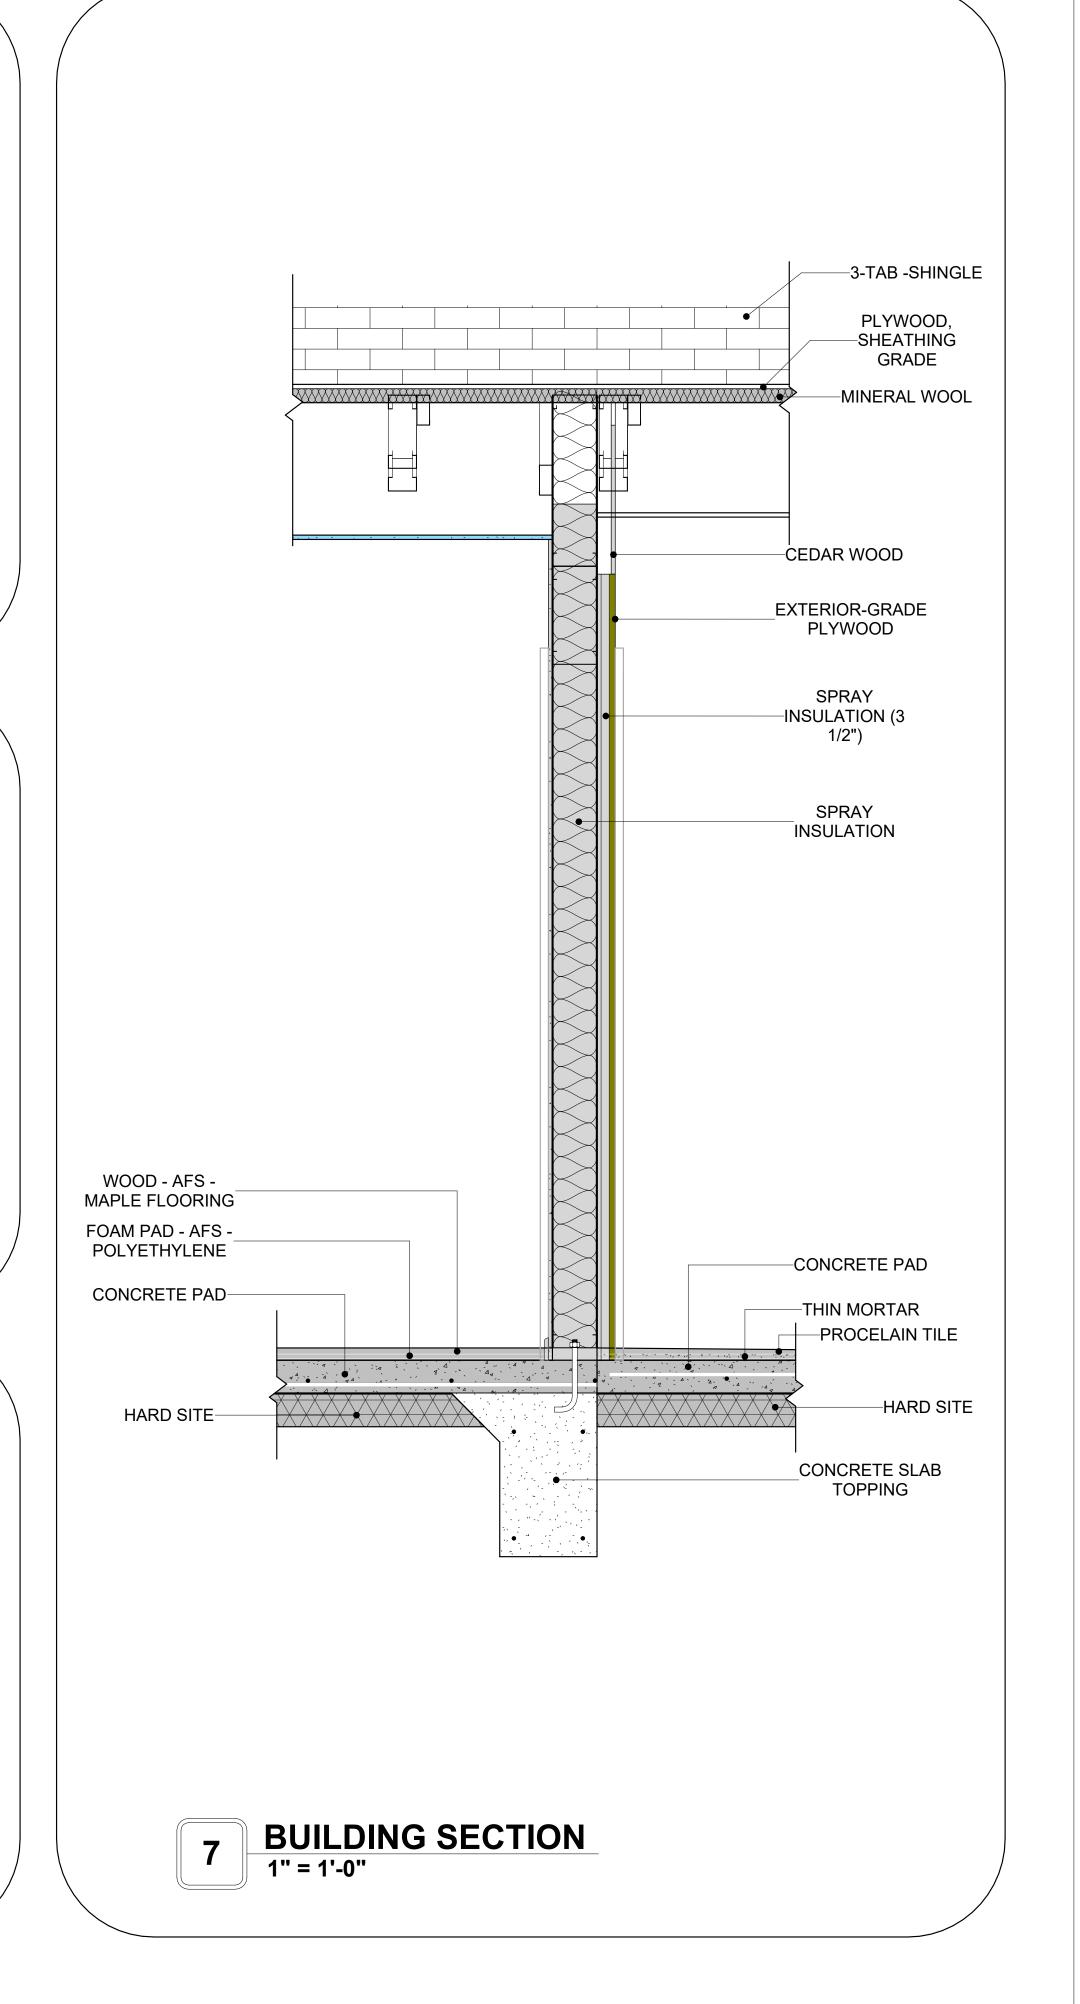



**KEY PLAN** 

NO.	DESCRIPTION	DATE

NOTE:

LEGEND:

PROJECT

12-Wisdom-909-2Bd/2Ba-Craftsman-550

DRAWING NAME

ARCHITECTURAL DETAILS

CLIENT NAME:	Client Name
PROJECT NUMBER:	0033_15
DATE:	1/27/2025 3:21:53 PM
DESIGNED BY:	Designer
DRAWN BY:	Author
CHECKED BY:	Checker

A401


SCALE: 1" = 1'-0"


#### **CASEWORK GENERAL NOTES**


- ALL CABINET HEIGHTS INCLUDE COUNTERTOPS. DIMENSIONS ARE TO THE NEAREST INCH.
   DIVISIONS IN CASEWORK ARE SHOWN FOR CLARITY AND DO NOT REPRESENT BREAKS IN THE COUNTERTOP.
- 3. PROVIDE CONTINUOUS COUNTERTOP OVER ALL SIMILAR HEIGHT CASEWORK, UNLESS AND OTHERWISE NOTED.
- 4. MANUFACTURER AND CATALOG NUMBERS ARE FOR REFERENCE AND ILLUSTRATION PURPOSES
- 5. DOTTED LINES INDICATE WALL HUNG CABINETS, DIVISIONS OF BASE CABINETS BELOW THE
- 6. COUNTERTOP, FURNITURE NOT IN THE CONTRACT OR PROJECTION SCREENS -SEE CASEWORK KEY AND SPECIFICATIONS.
- 7. ALL CABINETS AND DRAWERS TO HAVE CAM LOCKS EXCEPT FOR SINK BASE CABINETS.
  8. ALL EXPOSED SURFACES (EXPOSED TO VIEW FROM ANY PERSPECTIVE) TO BE COVERED WITH
- | 8. ALL EXPOSED SURFACES (EXPOSED TO VIEW FROM ANY PERSPECTIVE) TO BE COVERED WITH | LAMINATE.
- 9. ALL CASEWORK WHICH MEETS A WALL AT ONE OR BOTH ENDS, TO BE PROVIDED WITH FILLER PANELS AND SCRIBED TO THE WALL(S) AS REQUIRED.
- 10. ALL CABINETS AND DRAWERS ARE PROVIDED WITH RECESSED HANDLES.
- 11. CONTRACTOR TO FIELD VERIFY ALL CLEAR OPENINGS PRIOR TO MILLWORK OR CASEWORK FABRICATION.
- 12. CASEWORK DRAWINGS ARE DIAGRAMMATIC IN NATURE TO SHOW DESIGN INTENT.

	CASEWORK SCHEDULE						
TYPE MAR K	TYPE	COUN	HEIGHT	WIDTH	DEPTH	AREA	
	BASE CABINET L-SHAPED 2	1	2' - 10 1/2"	3' - 3"	3' - 3"	9 SF	
01	L-SHAPE COUNTER TOP	1	0' - 4"	7' - 0"	7' - 0"	2 SF	
02	BASE CABINET DOUBLE DOOR 1	1	2' - 10 1/2"	2' - 0"	2' - 0"	6 SF	
04	WALL FILLER	1	2' - 10 1/2"	0' - 4 3/4"	2' - 0"	1 SF	
05	BASE CABINET DOUBLE DOOR 2	1	2' - 10 1/2"	3' - 0"	2' - 0"	9 SF	
06	LINEAR COUNTER TOP	1	0' - 4"	3' - 0"	2' - 1"	1 SF	
07	WALL CABINET DOUBLE DOOR 1	1	2' - 6"	3' - 8"	1' - 0"	9 SF	
08	WALL FILLER	1	2' - 6"	0' - 6"	1' - 0"	1 SF	
09	WALL CABINET DOUBLE DOOR 2	1	2' - 6"	2' - 6"	1' - 0"	6 SF	
10	LAUNDRY OPEN CABINET	1	1' - 6"	2' - 0"	2' - 4"	3 SF	
11	CLOSET 1	1	6' - 0"	3' - 10 5/8"	1' - 4"	23 SF	
12	RECESSED_MED_CABINET	2	2' - 0"	1' - 6"	0' - 3"	3 SF	
13	LAUNDRY OPEN CABINET 2	1	1' - 2"	2' - 3"	3' - 0"	3 SF	
14	VANITY	2	2' - 4"	2' - 6"	1' - 8"	6 SF	
15	CLOSET 2	2	6' - 0"	9' - 7"	1' - 4"	58 SF	
GRAND	TOTAL	18					

SPECIALTY EQUIPMENT SCHEDULE					
TYPE MARK	TYPE MARK TYPE CO				
01	WASHER-FRONT-LOAD	1			
02	REFRIGERATOR	1			
03	RANGE	1			
04	DRYER-FRONT-LOAD	1			
05	DISHWASHER	1			
GRAND TOTAL: 5					

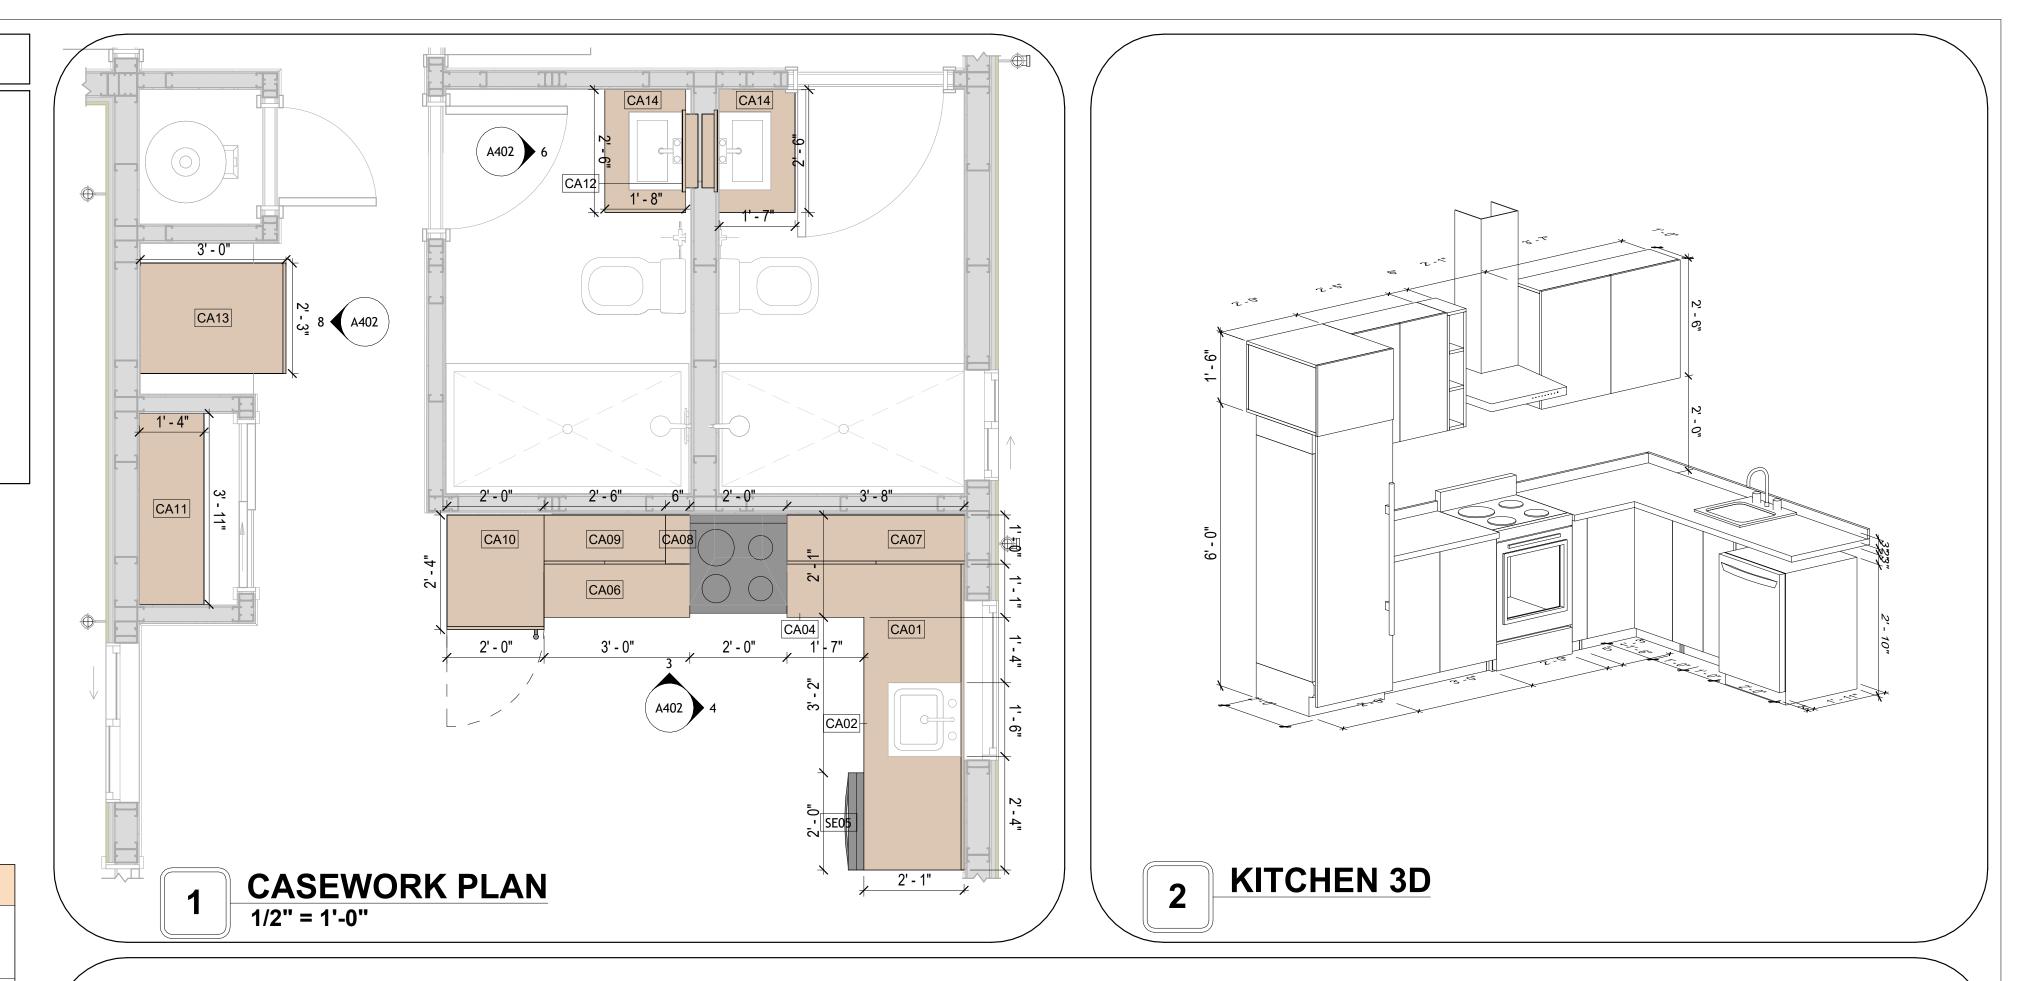


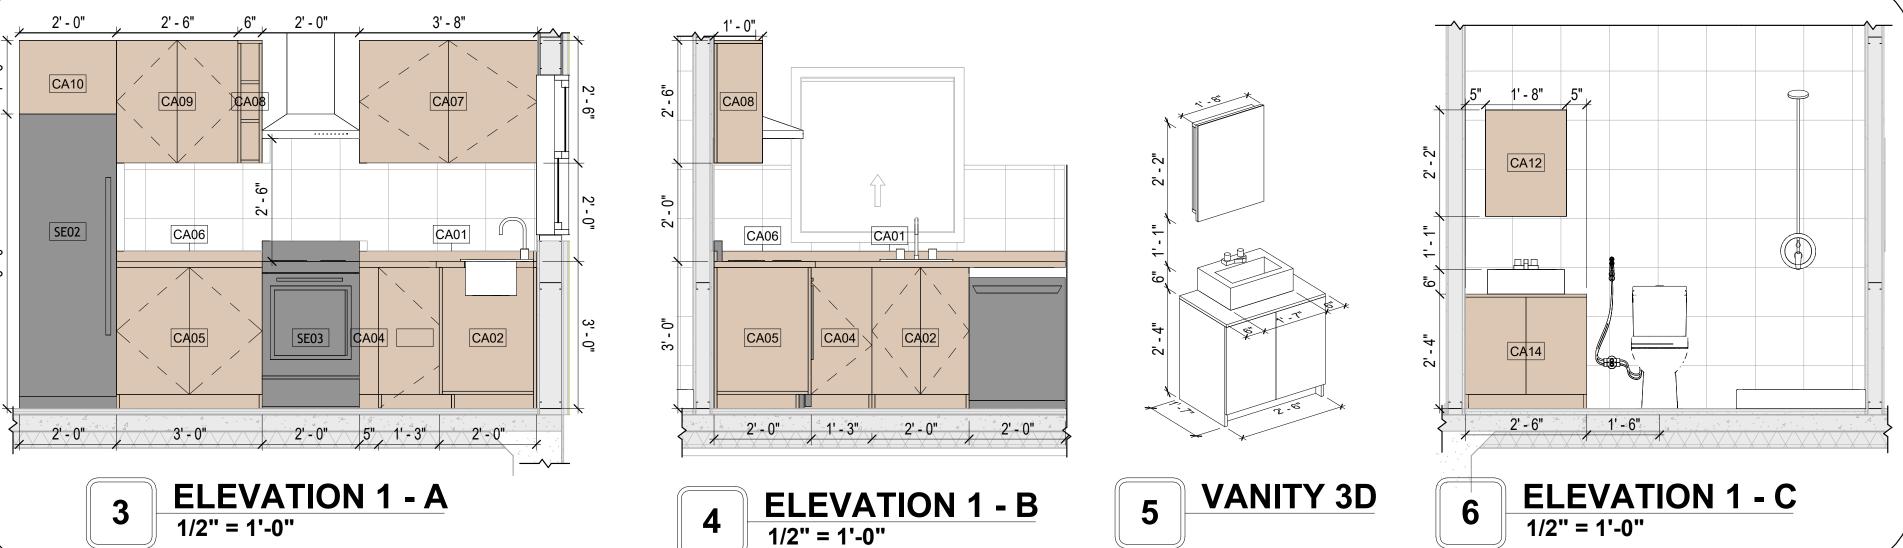

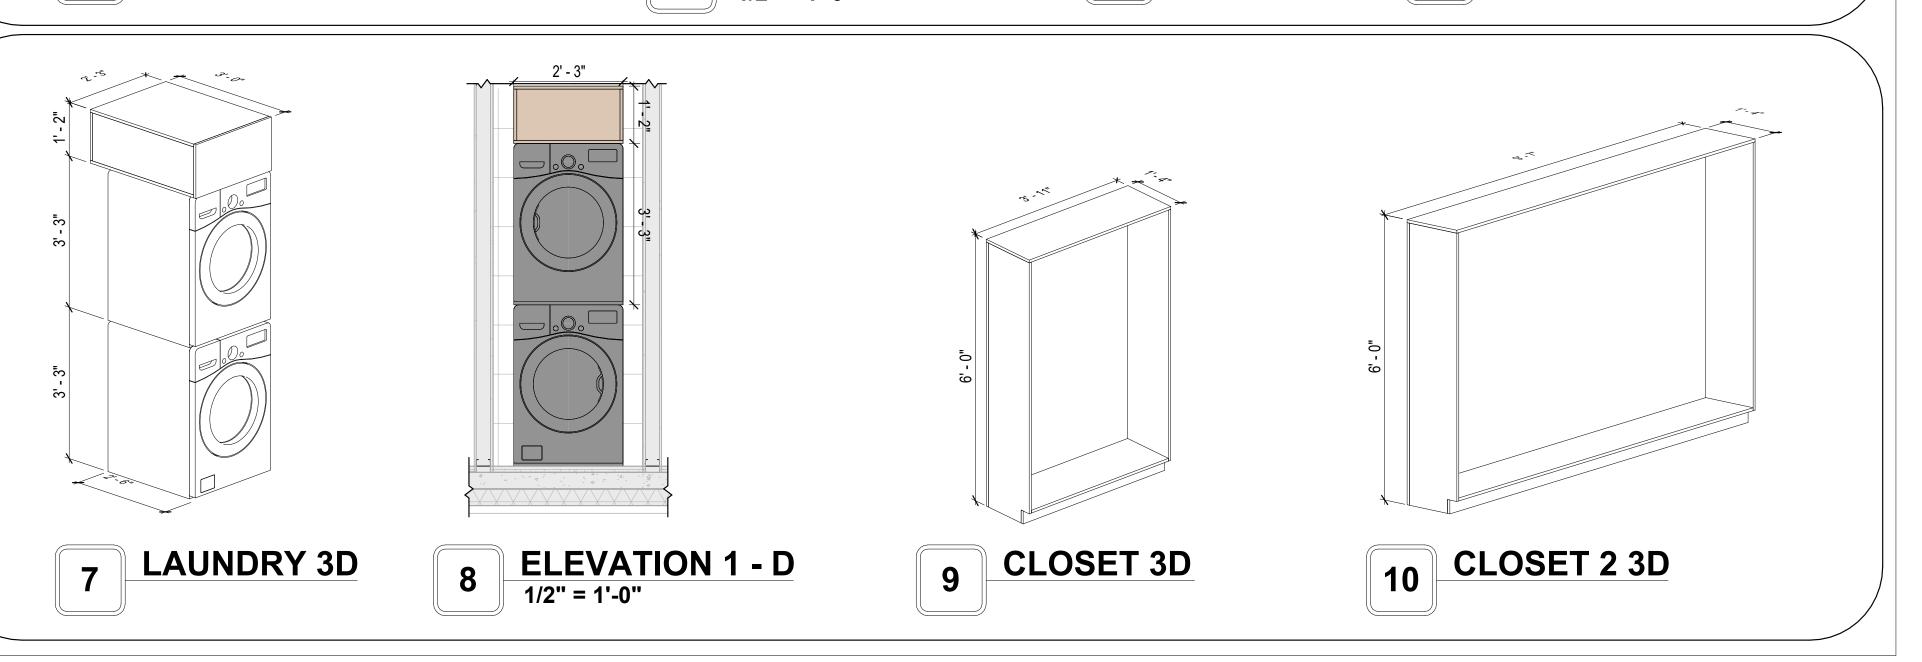



**KEY PLAN** 

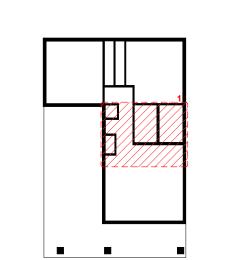

DESCRIPTION	DATE

NOTE:

LEGEND:

PROJECT

12-Wisdom-909-2Bd/2Ba-Craftsman-550

DRAWING NAME

ARCHITECTURAL CASEWORK

CLIENT NAME:	Client Name
PROJECT NUMBER:	0033_15
DATE:	1/27/2025 3:21:57 PM
DESIGNED BY:	Designer
RAWN BY:	Author
CHECKED BY:	Checker

A402

#### **GENERAL NOTES**

1. THIS DRAWING DEPICTS THE HVAC (HEATING, VENTILATION, AND AIR CONDITIONING) SYSTEM FOR THE WISDOM\_TM\_C\_550. IT PROVIDES A VISUAL REPRESENTATION OF THE SYSTEM LAYOUT AND COMPONENTS.

2.THE HVAC SYSTEM IS DESIGNED TO MEET THE SPECIFIC REQUIREMENTS OF THE BUILDING, INCLUDING HEATING, COOLING, AND VENTILATION NEEDS, AS PER THE PROJECT SPECIFICATIONS AND APPLICABLE CODES AND STANDARDS.

3. THE HVAC SYSTEM INSTALLATION SHALL COMPLY WITH THE LATEST EDITION OF THE INTERNATIONAL MECHANICAL CODE (IMC), INTERNATIONAL RESIDENTIAL CODE (IRC), AND ALL OTHER APPLICABLE LOCAL, STATE, AND NATIONAL CODES AND REGULATIONS.

4. THE EQUIPMENT SHOWN ON THIS DRAWING INCLUDES BUT IS NOT LIMITED TO AIR HANDLING UNITS (AHUS), CHILLERS, BOILERS, COOLING TOWERS, PUMPS, DUCTWORK, DIFFUSERS, GRILLES, AND CONTROL DEVICES.

5. ALL EQUIPMENT, DUCTWORK, AND PIPING SHALL BE INSTALLED IN ACCORDANCE WITH MANUFACTURER'S SPECIFICATIONS, LOCAL CODES, AND

6. ALL DUCTWORK SHALL BE SIZED, FABRICATED, AND INSTALLED IN ACCORDANCE WITH THE LATEST EDITION OF THE ACCA MANUAL D AND THE SMACNA HVAC DUCT CONSTRUCTION STANDARDS. DUCTWORK SHALL BE INSTALLED IN A NEAT AND WORKMANLIKE MANNER, PROPERLY SUPPORTED

AND BRACED TO PREVENT SAGGING, AIR LEAKAGE, OR VIBRATION.

7. CONDENSATE DRAINAGE PIPING SHALL BE PROPERLY PITCHED TO ENSURE POSITIVE DRAINAGE TO AN APPROVED DISPOSAL LOCATION, SUCH AS A

FLOOR DRAIN, SUMP PUMP, OR EXTERIOR GRADE. CONDENSATE LINES SHALL BE INSULATED TO PREVENT SWEATING.

8. THE LOCATION OF CONTROL PANELS AND SENSORS INDICATED ON THIS DRAWING CAN BEMODIFY WITH THE SPECIFIC LOCATIONS AND WIRING DETAILS WILL BE DETERMINED DURING THE CONTROL SYSTEM DESIGN AND INSTALLATION.

9. THE HVAC SYSTEM DESIGN CONSIDER ENERGY EFFICIENCY, INDOOR AIR QUALITY, OCCUPANT COMFORT, AND NOISE CONTROL, FOLLOWING APPLICABLE GUIDELINES AND REGULATIONS.

10. COORDINATION WITH OTHER TREADS HAS BEEN DONE ON A DESIGN LEVEL. THIS DRAWING SHALL BE READ TOGETHER WITH THE AR, EL AND SN DESIGN DRAWINGS TO ENSURE PROPER INSTALLATION AND INTEGRATION OF THE HVAC SYSTEMS.

11. THE HVAC CONTRACTOR IS RESPONSIBLE FOR OBTAINING ALL NECESSARY PERMITS AND LICENSES, AND FOR SCHEDULING AND COORDINATING

WITH THE LOCAL BUILDING DEPARTMENT AND UTILITY PROVIDERS TO ENSURE A TIMELY AND COMPLIANT INSTALLATION.

12. ALL DUCTWORK PENETRATIONS THROUGH WALLS, FLOORS, OR CEILINGS SHALL BE PROPERLY SEALED AND FIRE-STOPPED USING APPROVED

METHODS AND MATERIALS TO MAINTAIN THE INTEGRITY OF THE BUILDING'S FIRE-RESISTANCE RATINGS.

13. HVAC EQUIPMENT SHALL BE INSTALLED LEVEL AND PLUMB, AND IN STRICT ACCORDANCE WITH THE MANUFACTURER'S INSTALLATION INSTRUCTIONS AND RECOMMENDATIONS. PROVIDE ADEQUATE CLEARANCES AROUND EQUIPMENT FOR PROPER AIRFLOW, SERVICE ACCESS, AND CODE COMPLIANCE.

14. ALL HVAC EQUIPMENT AND COMPONENTS, INCLUDING THERMOSTATS, DAMPERS, AND ACCESS PANELS, SHALL BE LOCATED IN ACCESSIBLE AREAS

15. THE HVAC SYSTEM SHALL BE BALANCED AND ADJUSTED TO ENSURE PROPER AIRFLOW, TEMPERATURE DISTRIBUTION, AND SYSTEM PERFORMANCE THROUGHOUT THE RESIDENCE. PROVIDE A WRITTEN REPORT DOCUMENTING THE FINAL SYSTEM BALANCE.


16. ANY DEVIATIONS OR MODIFICATIONS TO THE HVAC SYSTEM DESIGN SHALL BE REVIEWED AND APPROVED BY THE RESPONSIBLE DESIGN

FOR EASY SERVICING AND MAINTENANCE. PROVIDE ADEQUATE SPACE AROUND EQUIPMENT FOR PROPER AIRFLOW AND SERVICE ACCESS.

PROFESSIONALS AND COMMUNICATED TO ALL RELEVANT PARTIES INVOLVED IN THE CONSTRUCTION PROCESS.

17. FOR ANY INQUIRIES OR CLARIFICATIONS REGARDING THE HVAC SYSTEM DESIGN, PLEASE CONSULT THE RESPONSIBLE DESIGN PROFESSIONALS OR THE PROJECT MANAGEMENT TEAM.

#### SYMBOLS

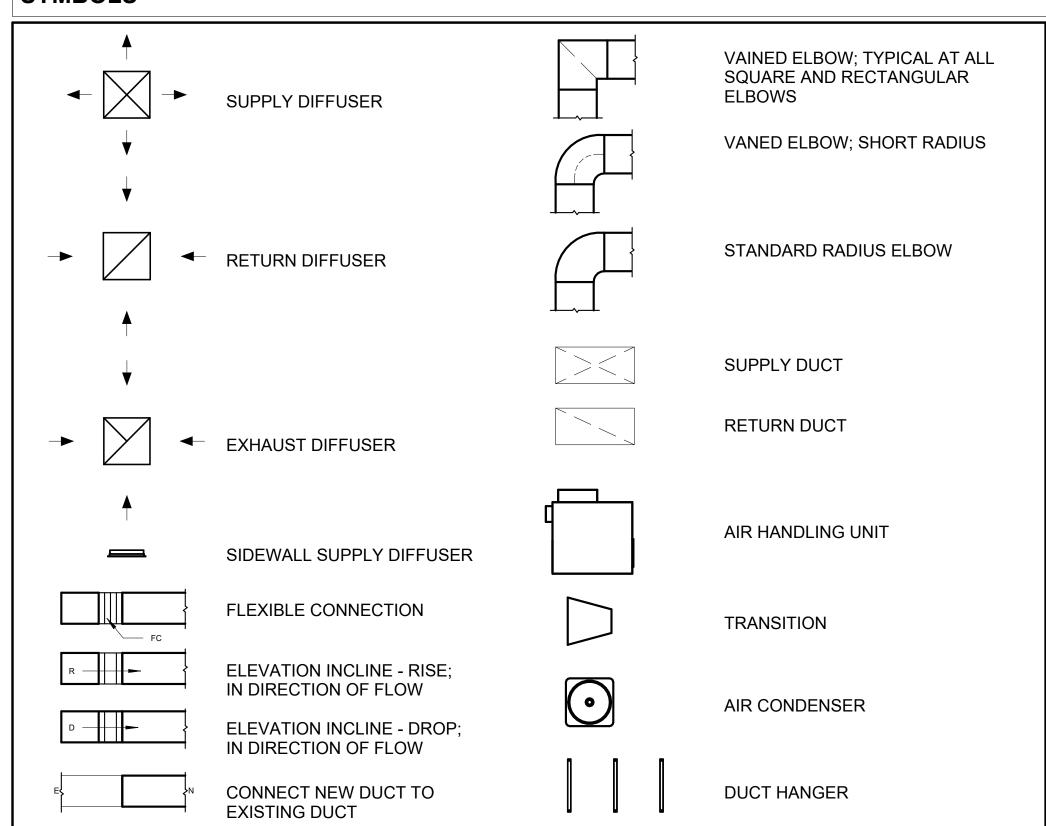

REFRIGERANT LINE SCHEDULE				
CATAGORY	DESCRIPTION	DIAMETER	LENGTH	
PIPE TYPES	COPPER	1/4"	9.10	
PIPE TYPES	COPPER	3/8"	68.64	
PIPE TYPES	COPPER	1/2"	9.15	
PIPE TYPES	<by category=""></by>	5/8"	0.19	
PIPE TYPES	COPPER	3/4"	94.19	

REFRIGERANT LINE FITTING SCHEDULE					
CATAGORY	DESCRIPTION	Size	Count		
ELBOW - GENERIC	ELBOW - GENERIC: STANDARD/HVAC	1/2"ø-1/2"ø	2		
ELBOW - GENERIC	ELBOW - GENERIC: STANDARD/HVAC	1/4"ø-1/4"ø	2		
ELBOW - GENERIC	ELBOW - GENERIC: STANDARD/HVAC	3/4"ø-3/4"ø	19		
ELBOW - GENERIC	ELBOW - GENERIC: STANDARD/HVAC	3/8"ø-3/8"ø	11		
ELBOW - GENERIC	ELBOW - GENERIC: STANDARD/HVAC	5/8"ø-5/8"ø	1		
TEE - GENERIC	TEE - GENERIC: STANDARD	3/4"ø-3/4"ø-3/ 4"ø	2		
TEE - GENERIC	TEE - GENERIC: STANDARD	3/8"ø-3/8"ø-3/ 8"ø	2		
TRANSITION - GENERIC	TRANSITION - GENERIC: STANDARD	3/4"ø-1/2"ø	4		
TRANSITION - GENERIC	TRANSITION - GENERIC: STANDARD	3/4"ø-5/8"ø	3		
TRANSITION - GENERIC	TRANSITION - GENERIC: STANDARD	3/8"ø-1/4"ø	1		

MECHANICAL EQUIPMENT SCHEDULE				
CATAGORY DESCRIPTION COUNT				
AIR HANDLING UNIT	AIR HANDLING UNIT: WALL MOUNTED	3		
CONDENSER	CONDENSER: AOTH18KNTA 1			
EXHAUST FAN	EXHAUST FAN: 75 CFM 2			
	HOOD-WALL2: VENT 2	1		

DUCT FITTING SCHEDULE				
CATAGORY	DESCRIP	TION COUN	1T	
ROUND TRANSITION - ANGLE	45 DEGREE	I 4		

DUCT ACCESSORY SCHEDULE				
CATAGORY	DESCRIPTION	COUNT		
ROOF VENT	3" DIAMETER	4		

FLEX DUCT SCHEDULE						
DESCRIPTION	DESCRIPTION	LENGTH	DIAMETER	COUNT		
			·			
FLEX DUCT ROUND	FLEX-ROUND	9.82	4"	4		
GRAND TOTAL: 4		9.82		·		



#### **KEY PLAN**

NO.	DESCRIPTION	DATE

NOTE:

LEGEND:

PROJECT

12-Wisdom-909-2Bd/2Ba Craftsman-550

DRAWING NAME

# **HVAC COVER**


CLIENT NAME:	Owner
PROJECT NUMBER:	15_0001
DATE:	1/30/2025 3:18:28 AM
DESIGNED BY:	Designer
DRAWN BY:	Author
CHECKED BY:	Checker

M101

SCALE: 1:50

HVAC COLOR SCHEME

AIR CONDITIONING PIPE LINE

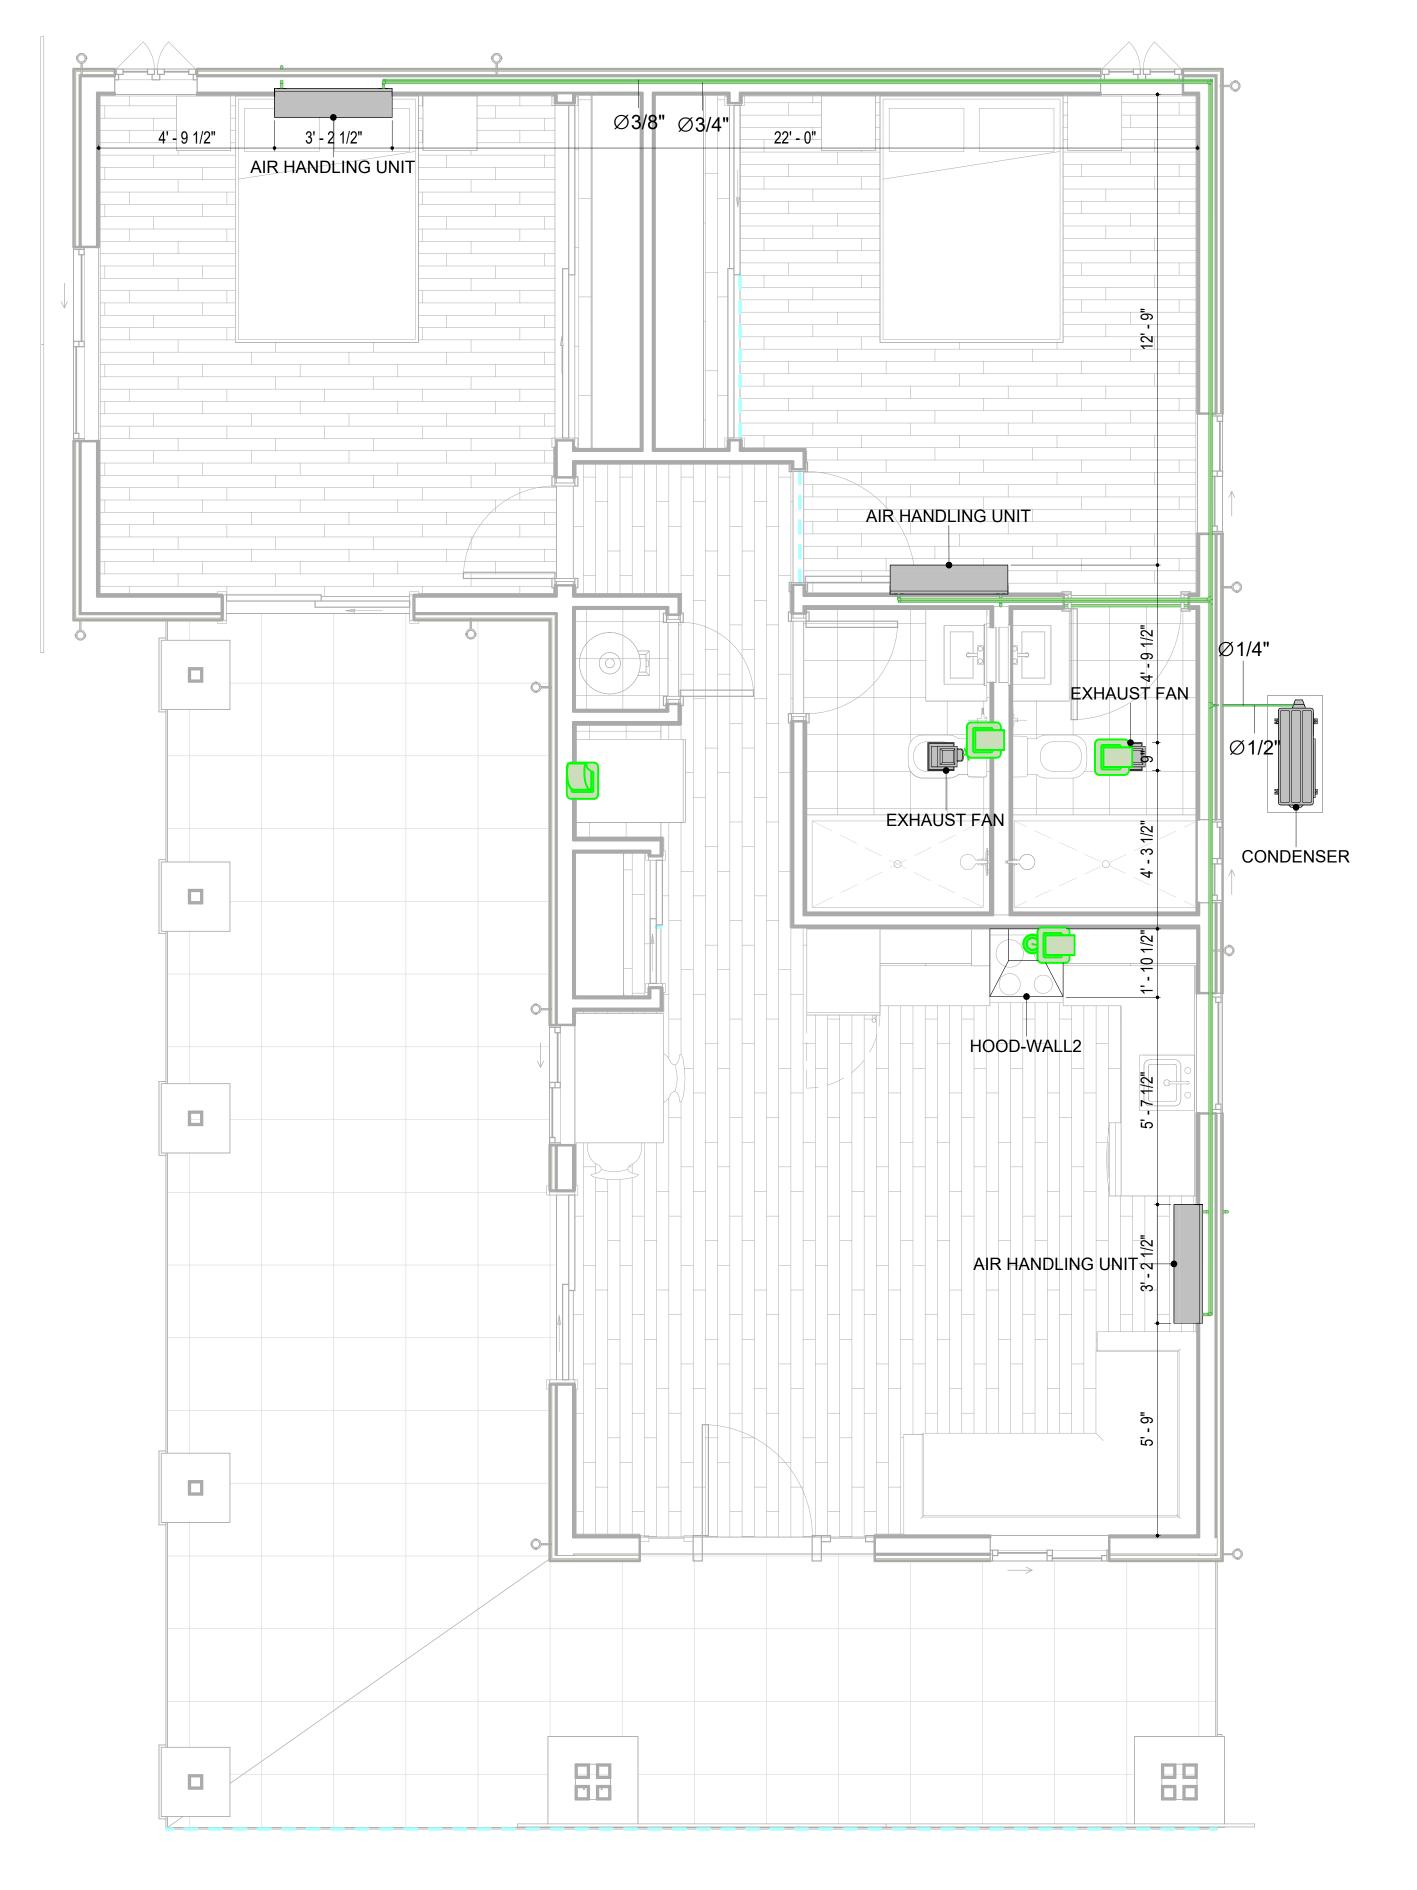

1 HVAC PLAN 3/8" = 1'-0"



**KEY PLAN** 

NO.	DESCRIPTION	DATE

NOTE:

LEGEND:

PROJECT

12-Wisdom-909-2Bd/2Ba Craftsman-550

DRAWING NAME

**HVAC PLAN** 

CLIENT NAME:	Owner
PROJECT NUMBER:	15_0001
DATE:	1/30/2025 3:18:29 AM
DESIGNED BY:	Designer
DRAWN BY:	Author
CHECKED BY:	Checker

M102

#### **ELECTRICAL NOTES**

- 1. THIS DRAWING DEPICTS THE ELECTRICAL SYSTEM FOR THE 12-WISDOM-909-2Bb/Ba-CRAFTSMAN-550. IT PROVIDES A VISUAL REPRESENTATION OF THE ELECTRICAL LAYOUT AND COMPONENTS, INCLUDING POWER DISTRIBUTION, LIGHTING, AND CONTROL SYSTEMS.
- 2. THE ELECTRICAL SYSTEM IS DESIGNED TO MEET THE SPECIFIC REQUIREMENTS OF THE BUILDING, INCLUDING POWER DISTRIBUTION, LIGHTING, AND SPECIALIZED ELECTRICAL EQUIPMENT NEEDS, AS PER THE PROJECT SPECIFICATIONS AND APPLICABLE CODES AND STANDARDS.
- 3. THE ELECTRICAL SYSTEM INSTALLATION SHALL COMPLY WITH THE LATEST EDITION OF THE NATIONAL ELECTRICAL CODE (NEC), INTERNATIONAL BUILDING CODE (IBC), AND ALALL OTHER APPLICABLE LOCAL, STATE, AND NATIONAL CODES AND REGULATIONS.
- 4. LOCATIONS AS NEEDED, DEVICES ARE SHOWN ON PLANS IN APPROXIMATE IDEAL LOCATIONS, UNLESS SPECIFICALLY DIMMENSIONED.
- OPEN WALLS AS NEEDED TO ALLOW FOR NEW ELECTRICAL INSTALLATIONS.
- 6. LABEL ALL CIRCUITS ON JUNCTION BOXES, RECEPTACLES, DATA, SMOKE DETECTOR, AND EQUIPMENT IN PANEL BOX.
- 7. INSTALL RACEWAY AS NEEDED FOR DDC, ACCESS CONTROL, LOW VOLTAGE WIRING & DATA.
- 8. RELABEL POWER, DATA & FIRE ALARM FOR ROOM #CHANGES.
- 9. VERIFY ALL CIRCUITS LABELED ON PRINT ARE CORRECT BEFORE WORKING ON THEM. 10. NOTE ON SITE PLAN – ALL CHANGES OR MISSING DETAIL TO BE INCORPORATED INTO THE MASTER PLAN.
- 11. DRAWINGS ARE DIAGRAMMATIC ONLY FOR THE PURPOSE OF SHOWING FIXTURE AND OUTLET LOCATIONS.
- 12. ELECTRICAL CONTRACTOR TO VERIFY SERVICE SIZE BY CALCULATION BASED UPON ACTUAL NAME
- PLATE RATINGS OF SELECTED EQUIPMENT.
- 13. VERIFY LOCATION OF SERVICE ENTRANCE WITH POWER COMPANY. PROVIDE UFER GROUND IN BUILDING FOUNDATION AT SERVICE ENTRANCE LOCATION.
- 14. PROVIDE A MIN. OF 20 FEET OF ONE \*4 BARE COPPER UFER WIRE EMBEDDED IN CONCRETE FOOTING
- AT THE SERVICE ENTRANCE LOCATION WHERE APPROVED BY LOCAL SERVICE PROVIDER.
- 15. PROVIDE WATERPROOF FIXTURES IN ALL HIGH MOISTURE AREAS (EXTERIOR, SHOWER AND TUB CEILINGS ETC.)
- 16. PROVIDE DEDICATED CIRCUITS TO EACH BATH, DEN, FAMILY ROOM, BEDROOM, LOFT, KITCHEN
- REFRIGERATOR, KITCHEN FREEZER DISHWASHER, AND ANY AREA/ITEM SPECIFIED BY OWNER. 17. INCANDESCENT FIXTURES WITH OPEN OR PARTIALLY ENCLOSED LAMPS, PENDANT FIXTURES, AND LAMP HOLDERS ARE NOT PERMITTED IN CLOSETS.
- 18. ALL WORKMANSHIP AND MATERIALS TO CONFORM WITH THE 2015 IRC.
- 19. PROVIDE A MIN. OF 20 FEET OF ONE \*4 BARE COPPER UFER WIRE EMBEDDED IN CONCRETE FOOTING AT THE SERVICE ENTRANCE LOCATION WHERE APPROVED BY LOCAL SERVICE PROVIDER.
- 20. PROVIDE A BONDING CONDUCTOR CONSISTING OF A MINIMUM OF ONE \*4 BARE COPPER WIRE CONNECTING THE BUILDING'S METAL WATER PIPING SYSTEM TO THE SERVICE EQUIPMENT ENCLOSURE GROUNDING.

#### MAIN PANEL CALCS

ELECTRICAL CALCS			
LIGHT AND OUTLETS	909	@ 3W	2,727 W
3 APPLIANCE CIRCUITS	3		4,500 W
DRYER			2,000 W
WASHER			2,000 W
RANGE			5,000 W
WATER HEATER			5,000 W
REFRIG.			1,800 W
DISHWASHER			3000 W
TOTAL			26,027 W
FRIST 10,000 @ 100% REMAINDER @ 40% MINL SPLIT UNITS			10,000 W 6,411W 10,000 W
			,

26,411 W DIVIDED BY 240V = 110 AMPS TOTAL

26, 411 W

(USE 200 AMP SERVICE)

TOTAL

#### **ELECTRICAL ABBREVIATIONS LIST**

	1P	1 POLE (2P, 3P, 4P, ETC.)	CTR	CENTER	HT	HEIGHT
	Α	AMPERÈ	CU	COPPER	HTG	HEATING
	AC	ABOVE COUNTER OR AIR CONDITIONER	DCP	DOMESTIC WATER CIRCULATING PUMP	HTR	HEATER
	ACLG	ABOVE CEILING	DEPT	DEPARTMENT	HV	HIGH VOLTAGE
	ADO	AUTOMATIC DOOR OPENER	DET	DETAIL	HVAC	HEATING, VENTILATING AND AIR
	AF	AMP FRAME	DIA	DIAMETER	CONDITIONING	CONDITIONING
	AFF	ABOVE FINISHED FLOOR	DISC	DISCONNECT	HWP	HYDRONIC WATER PUMP
	AFG	ABOVE FINISHED GRADE	DIST	DISTRIBUTION	IC	INTERRUPTING CAPACITY
	AFI	ARC FAULT CIRCUIT INTERRUPTER	DN	DOWN	IG	ISOLATED GROUND
	AHU	AIR HANDLING UNIT	DPR	DAMPER	IMC	INTERMEDIATE METAL CONDUIT
	AL	ALUMINUM	DS	SAFETY DISCONNECT SWITCH	INCAND	INCANDESCENT
	ALT	ALTERNATE	DT	DOUBLE THROW	IR	INFRARED
	AMP	AMPERE	DWG	DRAWING	I/W	INTERLOCK WITH
	AMPL	AMPLIFIER	DDC	DIRECT DIGITAL CONTROL	J-BOX	JUNCTION BOX
	ANNUN	ANNUNCIATOR APPROX APPROXIMATELY	EC	ELECTRICAL CONTRACTOR	KV	KILOVOLT
	AQ-STAT	AQUASTAT	ELEC	ELECTRIC, ELECTRICAL	KVA	KILOVOLT-AMPERE
	ARCH	ARCHITECT, ARCHITECTURAL	ELEV	ELEVATOR	KVAR	KILOVOLT-AMPERE REACTIVE
	AS	AMP SWITCH	EM	EMERGENCY	KW	KILOWATT
	AT	AMP TRIP	EMS	ENERGY MANAGEMENT SYSTEM	KWH	KILOWATT HOUR
	ATS	AUTOMATIC TRANSFER SWITCH	EMT	ELECTRICAL METALLIC TUBING	LOC	LOCATE OR LOCATION
	AUTO	AUTOMATIC	EP	ELECTRIC PNEUMATIC	LT	LIGHT
	AUX	AUXILIARY	EQUIP	EQUIPMENT	LTG	LIGHTING
	AV	AUDIO VISUAL	EWC	ELECTRIC WATER COOLER	LTNG	LIGHTNING
	AWG	AMERICAN WIRE GAUGE	EXIST	EXISTING	LV	LOW VOLTAGE
	BATT	BATTERY	EXH	EXHAUST	MAX	MAXIMUM
	BD	BOARD	EXP	EXPLOSION PROOF	MAG.S	MAGNETIC STARTER
	BLDG	BUILDING	FA	FIRE ALARM	M/C	MOMENTARY CONTACT
	BMS	BUILDING MANAGEMENT SYSTEM	FABP	FIRE ALARM BOOSTER POWER	MC	MECHANICAL CONTRACTOR
	С	CONDUIT	SUPPLY PANEL	SUPPLY PANEL	MCB	MAIN CIRCUIT BREAKER
	CAB	CABINET	FACP	FIRE ALARM CONTROL PANEL	MCC	MOTOR CONTROL CENTER
	CAT	CATALOG	FCU	FAN COIL UNIT	MDC	MAIN DISTRIBUTION CENTER
	CATV	CABLE TELEVISION	FIXT	FIXTURE	MDP	MAIN DISTRIBUTION PANEL
	СВ	CIRCUIT BREAKER	FLR	FLOOR	MFR	MANUFACTURERMAIN FUSED
	CCTV	CLOSED CIRCUIT TELEVISION	FLUOR	FLUORESCENT		DISCONNECT SWITCH
	CKT	CIRCUIT	FU	FUSE	MH	MANHOLE
	CLG	CEILING	FUDS	FUSED SAFETY DISCONNECT SWITCH	MIC	MICROPHONE
	COMB	COMBINATION	GA	GAUGE	MIN	MINIMUM
	CMPR	COMPRESSOR	GAL	GALLON	MISC	MISCELLANEOUS
	CONN	CONNECTION	GALV	GALVANIZED	MLO	MAIN LUGS ONLY
	CONST	CONSTRUCTION	GC	GENERAL CONTRACTOR	MMS	MANUAL MOTOR STARTER
	CONT	CONTINUATION OR CONTINUOUS	GEN	GENERATOR	MOA	MULTIOUTLET ASSEMBLY
	CONTR	CONTRACTOR	GFI	GROUND FAULT CIRCUIT INTERRUPTER	MSP	MOTOR STARTER PANELBOARD
	CONV	CONVECTOR	GFP	GROUND FAULT PROTECTOR	MSBD	MAIN SWITCHBOARD
	CP	CIRCULATING PUMP	GND	GROUND	MT	MOUNT
	CRT	CATHODE-RAY TUBE	GRS	GALVANIZED RIGID STEEL (CONDUIT)	MT.C	EMPTY CONDUIT
	CT	CURRENT TRANSFORMER	GYP BD	GYPSUM BOARD	UL	UNDERWRITERS LABORATORIES
L						

**Branch Panel:** 

Location: LIVING ROOM 05 **Supply From:** Mounting: Recessed

Enclosure: Type 1

Volts: 120/240 Single Phases: 1 Wires: 3

A.I.C. Rating: Mains Type: Mains Rating: 200 A MCB Rating: 1 A

Circuit Numb er		Number of Elements	Rating	Length	Wire Size	A		E	3	Wire Size	Length	Rating	Number of Elements	Circuit Description	Circui Numb er
1	RANGE	1	50 A	27' - 7 19/32"	2-#8, 1-#8, 1-#10	2500 VA	750 VA			2-#10, 1-#10, 1-#10	49' - 4 1/2"	30 A	1	WATER HEATER	2
3								2500 VA	750 VA					_	4
5	CONDENSER	1	60 A	29' - 2 13/16"	2-#6, 1-#6, 1-#10	2500 VA	496 VA			1-#12, 1-#12, 1-#12	30' - 10 3/32"	20 A	14	KITCHEN AND LIVING ROOM LIGHT UNITS	6
7								2500 VA	900 VA	1-#12, 1-#12, 1-#12	58' - 2 7/8"	20 A	5	BED ROOM 1 RECEPTACLES	8
9	OUT DOOR LIGHT UNITS	8	20 A	55' - 2 9/16"	1-#12, 1-#12, 1-#12	360 VA	454 VA			1-#12, 1-#12, 1-#12	66' - 8 7/32"	20 A	13	BED ROOM LIGHT UNITS	10
11	GFCI WASHER	1	20 A	45' - 5"	1-#12, 1-#12, 1-#12			1200 VA	840 VA	1-#12, 1-#12, 1-#12	50' - 0 13/32"	20 A	13	BATH ROOM UNITS	12
13	DRYER	1	30 A	43' - 5 3/4"	2-#10, 1-#10, 1-#10	2500 VA	180 VA			1-#14, 1-#14, 1-#14	42' - 8 1/4"	15 A	5	HALL LIGHT	14
15								2500 VA	900 VA	1-#12, 1-#12, 1-#12	74' - 6 5/16"	20 A	5	OUT DOOR RECEPTACLES	16
17	KITCHEN GFCI	3	20 A	29' - 4 17/32"	1-#12, 1-#12, 1-#12	540 VA	900 VA			1-#12, 1-#12, 1-#12	37' - 8 1/8"	20 A	5	LIVING ROOM RECEPTACLES	18
19	DISH WASHER& HOOD	2	30 A	21' - 7 23/32"	1-#10, 1-#10, 1-#10			1380 VA	720 VA	1-#12, 1-#12, 1-#12	74' - 10 1/8"	20 A	4	BED ROOM 2 RECEPTACLES	20
21	RIFRIGRATOR	1	20 A	33' - 2 13/32"	1-#12, 1-#12, 1-#12	1800 VA									22
23															24
25															26
	1					12975	VA	1419	0 VA						1
						108	Α	118	3 A						

Load Classification	Connected Load	<b>Demand Factor</b>	<b>Estimated Demand</b>	Panel	Totals
Motor	60 VA	125.00%	75 VA		
Other	1380 VA	100.00%	1380 VA	Total Conn. Load:	27165 VA
Receptacle	6900 VA	100.00%	6900 VA	Total Est. Demand:	26180 VA
Lighting	533 VA	100.00%	533 VA	Total Conn.:	113 A
CONDENSER	5000 VA	100.00%	5000 VA	Total Est. Demand:	109 A
WATER HEATER	1500 VA	100.00%	1500 VA		
RANGE	5000 VA	80.00%	4000 VA		
DRYER	5000 VA	100.00%	5000 VA		
REFRIGERATOR	1800 VA	100.00%	1800 VA		



Tuscon.AZ. USA

**KEY PLAN** 

DESCRIPTION DATE

NOTE:

LEGEND:

PROJECT

12-Wisdom-909-2Bd/2Ba Craftsman-550

DRAWING NAME

**SCHEDULE** 

CLIENT NAME: Owner PROJECT NUMBER 0073\_14 2/1/2025 4:40:57 AM Designer DESIGNED BY: DRAWN BY: CHECKED BY: Checker

E101

SCALE: 1/4" = 1'-0"

© [2024] [FrameUpNow] . All rights reserved

#### **ELECTRICAL NOTE**

- PROVIDE INTERCONNECTED SMOKE ALARMS IN EACH SLEEPING ROOMS, OUTSIDE EACH SLEEPING ROOM, ON EACH STORY, IN THE HALL OR ADJACENT ROOM LUHERE THE CEILING HEIGHT OF A ROOM OPEN TO THE HALL EXCEEDS THE HALL BY 24'. SMOKE ALARMS SHALL BE PERMANENTLY HARD WIRED WITH BATTERY BACKUP.
- B. RECEPTACLE OUTLETS FOR RANGES AND CLOTHES DRYERS SHALL BE A THREE POLE WITH GROUND TYPE. FOUR WIRE GROUNDING-TYPE FLEXIBLE CORDS WILL BE REQUIRED FOR CONNECTION OF RANGES AND CLOTHES DRYERS. THE BONDING JUMPER SHALL NOT BE CONNECTED BETWEEN NEUTRAL TERMINAL AND THE FRAME OF THE **APPLIANCE**
- C. TWO OR MORE 20 AMP SMALL APPLIANCE CIRCUITS SHALL BE PROVIDED TO SERVE THE KITCHEN, BREAKFAST NOOK, AND DINING ROOM. SUCH CIRCUITS SHALL HAVE NO OTHER OUTLETS.
- D. AT LEAST ONE 20 AMP BRANCH CIRCUIT SHALL BE PROVIDED TO SERVICE THE LAUNDRY ROOM. THIS CIRCUIT SHALL HAVE NO OTHER OUTLETS.
- E. ALL RECEPTACLES WITH IN 6' OF A WET BAR SINK OR KITCHEN SINK TO SERVE COUNTER TOP SURFACES MUST BE GFCI. ON KITCHEN COUNTERS 12' OR WIDER NO POINT ALONG THE WALL SHALL BE MORE THAN 2' FROM A RECEPTACLE. ALL RECEPTACLES WITH IN 6' OF KITCHEN SINK MUST BE GFCI. AT LEAST ONE GFCI RECEPTACLE SHALL BE INSTALLED IN THE BATHROOM ADJACENT TO EACH BASIN.
- FIXTURES INCLUDING CEILING FANS THAT ARE LOCATED IN DAMP LOCATIONS SHALL BE LISTED TO BE SUITABLE FOR
- SUCH LOCATIONS PER 2012 IRC
- G. PROVIDE ONE (1) SWITCHED OUTLET @ ALL BEDROOMS AND DEN
- H. CEILING FANS NOT EXCEEDING 35 LBS. (WITH OR WITHOUT ACCESSORIES MAY BE SUPPORTED BY OUTLET BOXES PROVIDED THE OUTLET BOXES ARE IDENTIFIED FOR SUCH USE PER 2012 IRC
- ELECTRICAL OUTLET BOXES ON OPPOSITE SIDES OF FIRE RATED WALLS SHALL BE SEPARATED BY A HORIZONTAL DISTANCE OF NOT LESS THAN 24".
- OUTLET BOXES IN THE WALLS BETWEEN THE GARAGE AND DWELLING SHALL BE METAL OR U.L. APPROVED FIRE RESISTIVE PLASTIC. BOXES IN GARAGE CEILING SHALL BE METAL.
- K. ALL BRANCH CIRCUITS THAT SUPPLY 120 VOLTS SINGLE PHASE 15 AND 20 AMPS RECEPTACLE OUTLETS INSTALLED IN THE DWELLING SHALL BE PROTECTED BY AN ARC FAULT CIRCUIT INTERRUPTER, EXCEPT GFCI RECEPTICLES.

RECEPTACLES MUST BE PROVIDED IN HALLWAYS 10'-0" OR MORE IN LENGTH. FOR A ONE FAMILY DWELLINGS AND EACH OF A TWO FAMILY DWELLING THAT IS AT GRADE LEVEL, AT LEAST ONE WP-GFCI RECEPTACLE OUTLET ACCESSIBLE AT GRADE LEVEL AND NOT MORE THAN 6'-6" ABOVE GRADE SHALL BE INSTALLED AT THE FRONT AND BACK OF THE DWELLING.

#### NOTE: APPLIANCE DISCONNECT

#### **E4001.5 GROUNDING OF ENCLOSURES.**

METAL ENCLOSURES FOR SWITCHES OR CIRCUIT BREAKERS SHALL BE CONNECTED TO AN

**EQUIPMENT GROUNDING CONDUCTOR.** 

METAL ENCLOSURES FOR SWITCHES OR CIRCUIT BREAKERS USED AS SERVICE


EQUIPMENT SHALL COMPLY WITH THE PROVISIONS OF SECTION E3609.4. WHERE


NONMETALLIC ENCLOSURES ARE USED WITH METAL RACEWAYS OR METAL-ARMORED CABLES, PROVISIONS SHALL BE MADE FOR CONNECTING THE EQUIPMENT GROUNDING

CONDUCTOR.


NONMETALLIC BOXES FOR SWITCHES SHALL BE INSTALLED WITH A WIRING METHOD THAT

PROVIDES OR INCLUDES AN EQUIPMENT GROUNDING CONDUCTOR. (404.12)

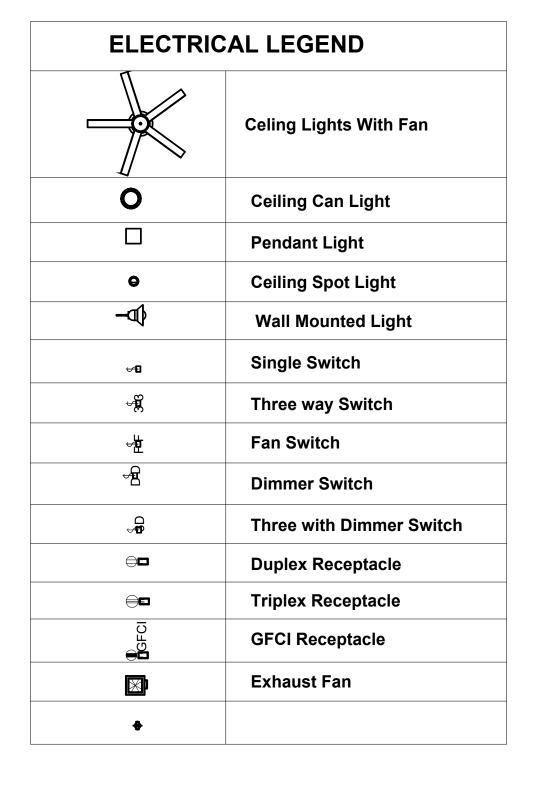

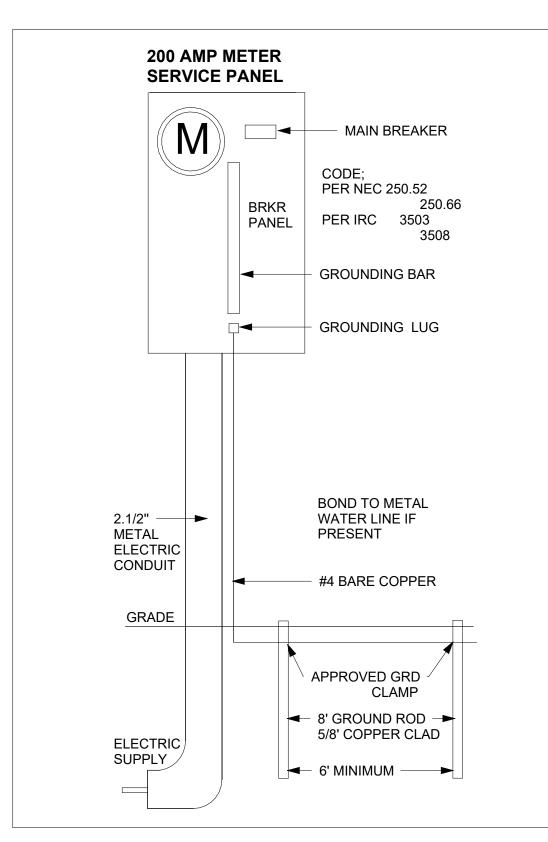

SERVICE PANEL DIAGRAM 12" = 1'-0"

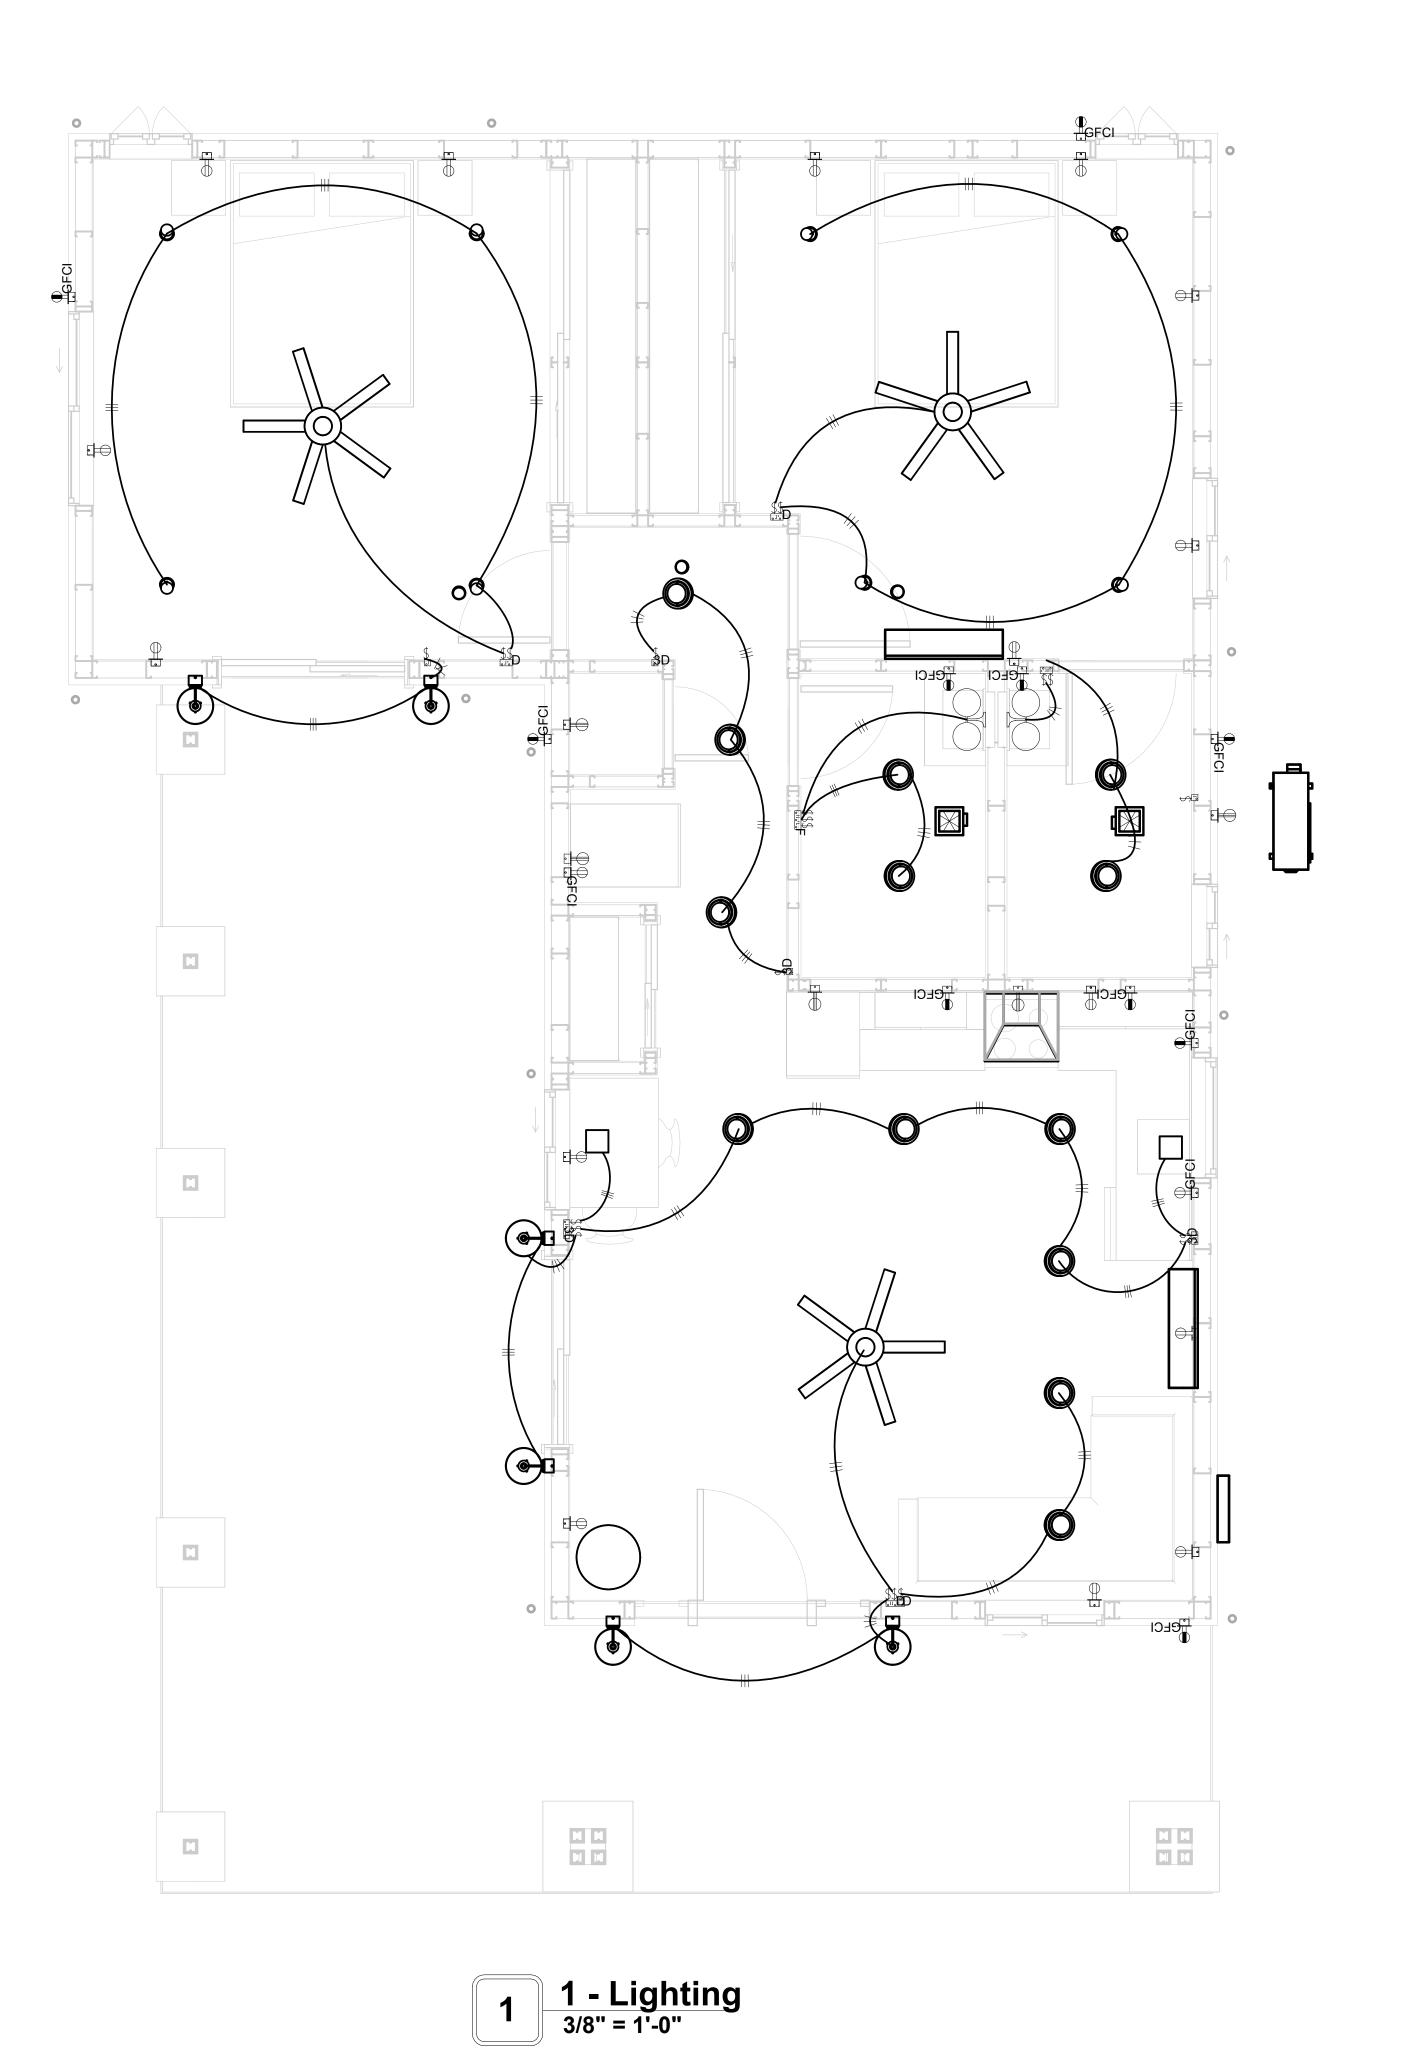

# LIGHTING

Owner
0073_14
2/1/2025 4:41:00 AM
Designer
Author
Checker

E102

SCALE: As indicated

© [2024] [FrameUpNow] . All rights reserved

**KEY PLAN** 

Tuscon, AZ, USA 888-864-0184

inquire@frameupnow.com

www.frameupnow.com

DESCRIPTION DATE

NOTE:

LEGEND:


PROJECT


12-Wisdom-909-2Bd/2Ba Craftsman-550


DRAWING NAME


#### **NOTES: CONDUIT, CABLE AND WIRING**

- Use Metalic Conduits (IMC) for cables running under concrete slabs.
   Use IMC for circuits with high voltage appliances (240 volts and above)
   For circuits with 120 volts consider using EMT or PVC conduits if needed.
   For Low voltage applications up to 50 volts consider using non metalic conduits.
   All conduits to be used in the project must conform to the latest National Electrical Code (NEC),
- 5. All conduits to be used in the project must comorn to the latest National Electrical Code (NEC), 2015.
  6. All wiring and cables to be used in the project must also conform to the latest National Electrical Code (NEC), 2015.
  7. All cables and wires used should be rated for their respective loading and should be gauged and conform to the NEC.

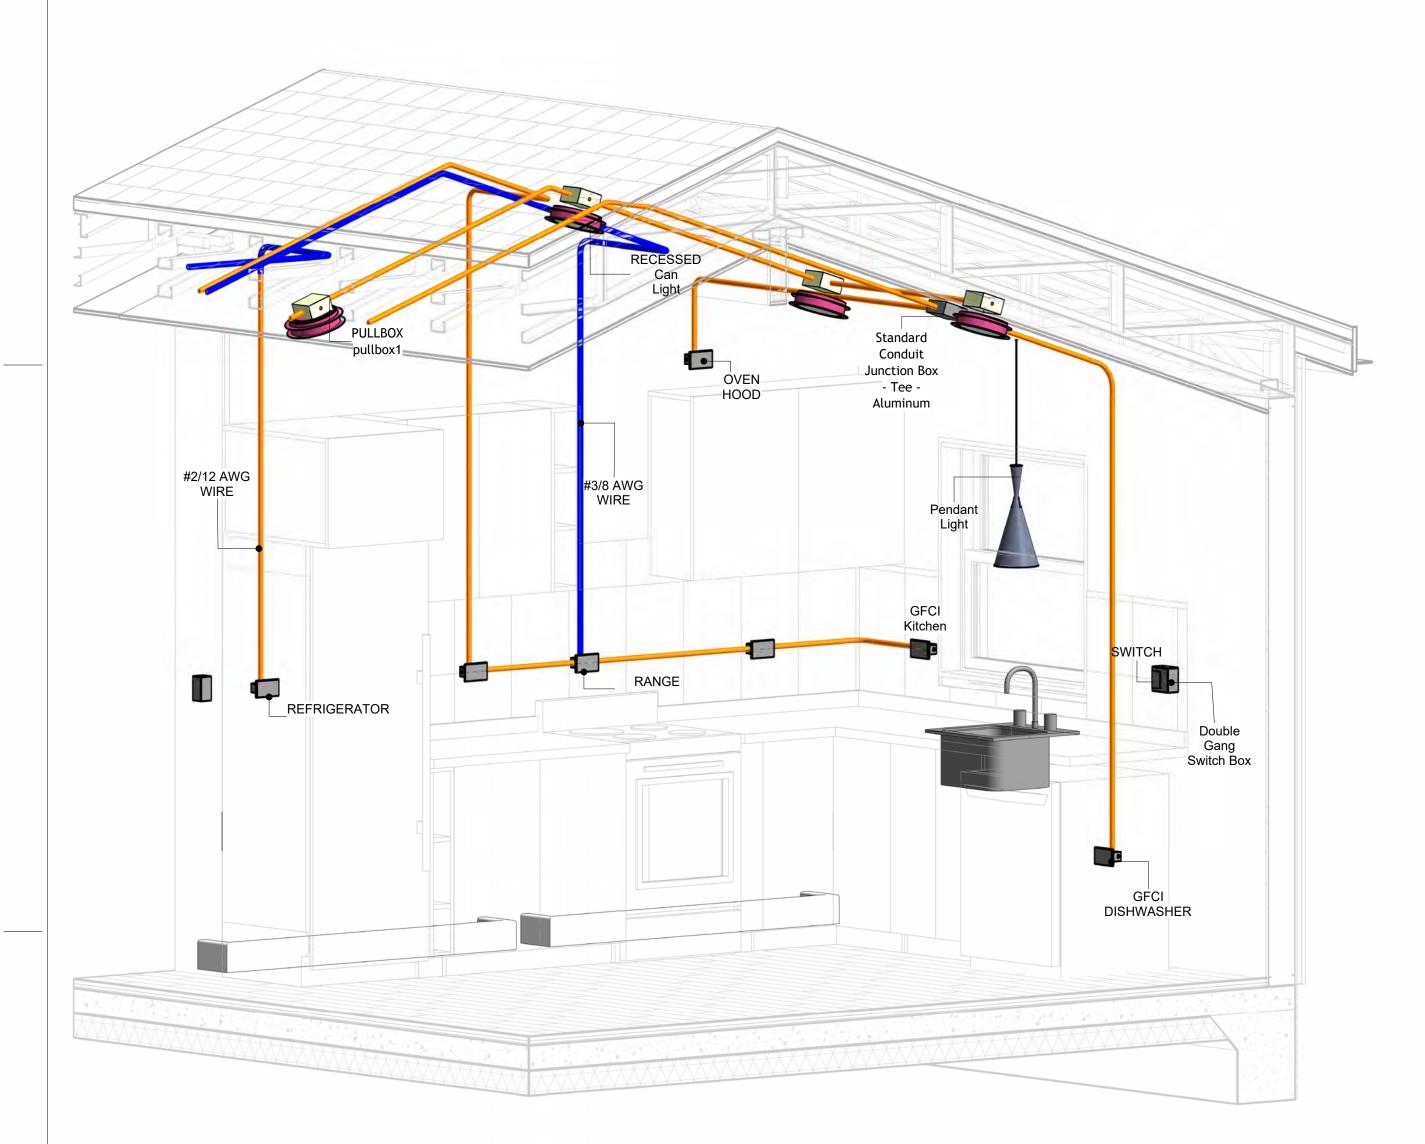


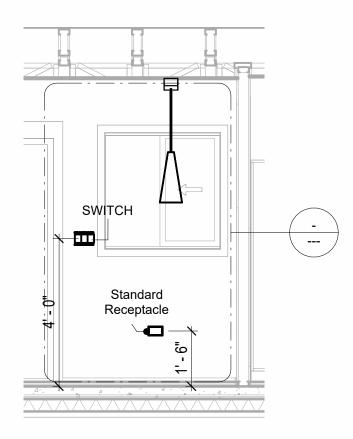


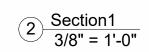


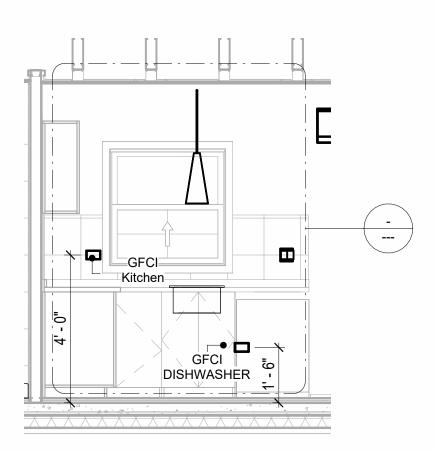


4 Section 3 3/8" = 1'-0"

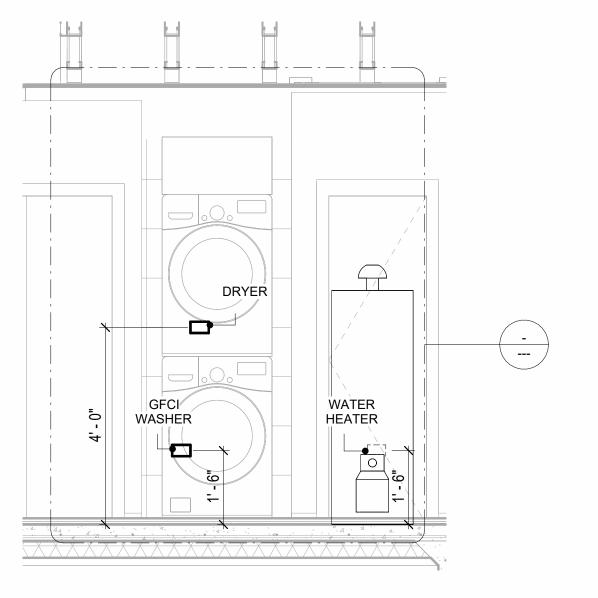

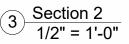


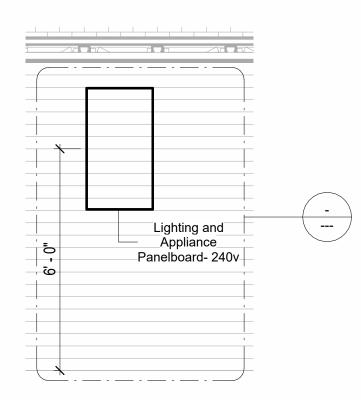

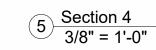



**KEY PLAN** 

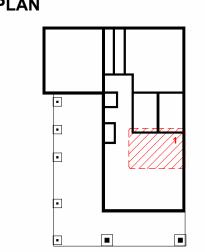

NO.	DESCRIPTION	DATE
110.	DECCIAII HOI	DAIL

NOTE:

LEGEND:

PROJECT

12-Wisdom-909-2Bd/2Ba Craftsman-550

DRAWING NAME

**POWER** 

CLIENT NAME:	Owner
PROJECT NUMBER:	0073_14
DATE:	2/1/2025 4:41:26 AM
DESIGNED BY:	Designer
DRAWN BY:	Author
CHECKED BY:	Checker

E103

SCALE: As indicated

**3D-KITCHEN** 

#### **NOTES: LIGHT**

- 1. LIGHT FIXTURES AND LUMINARIES SHALL CONFORM TO THE NEC, THE IRC AND LOCAL SAFETY & BUILDING CODE.
- 2. ALL LIGHTING FIXTURES SHOULD CONFORM TO THE DESIGN ELECTRICAL LOAD AND SHALL BE PROPERLY WIRED AND MOUNTED BY QUALIFIED ELECTRICIAN FOLLOWING MANUFACTURERS SPECIFICATIONS.
- 3. CEILING FANS AND FANS WITH LIGHT WITH WEIGHT EXCEEDING 35 LBS SHOULD BE PROVIDED WITH STRUCTURAL BACKING FOR SUPPORT AND SHALL BE FIXED AS PER MANUFACTURERS SPECIFICATIONS.
- 4. EXTERIOR LIGHTS SHALL CONFORM TO LOCAL BUILDING CODE AND GUIDELINES.

#### **NOTES: SWITCH JUNCTION BOX**


- 1. THE MINIMUM SIZE OF JUCTION BOX TO BE USED IS 2"X4"X(1.5" OR 3.5" DEEP) THIS ARE TO BE USED FOR SINGLE GANG SWITCH OR OUTLETS.
- 2. FOR DOUBLE GANG (2 GANG) OUTLETS AND SWITCHS THE MINIMUM SIZE OF THE
- JUCTION BOX TO BE PROVIDED SHALL NOT BE LESS THAN 4"X4"X(1.5" OR 3.5" DEEP)
- 3. FOR THREE GANG (3 GANG) OUTLETS AND SWITCHS THE MINIMUM SIZE OF THE JUĆTION BOX SHALL NOT BE LESS THAN 6"X4"X(1.5" OR 3.5" DEEP).

Fitting Schedule(junction box and Pullbox)			
Family Count Description			
Conduit Junction Box - Tee - Aluminum	1		
pullbox1	28	#1/4 pullbox	

Electrical Fixture Schedule (SWITCH BOX)		
Type Count		
Double Gang Switch Box	4	
Single Gang Switch Box	4	
Triple Gang Switch Box	3	

Lighting Device		
Туре	Count	
Dimmer	4	
Fan switch	1	
Single Pole	12	
Three With Dimmmer	4	

Lighting Fixture				
Lighting Fixture Type	Voltage	Electrical Load	Count	
651331	120 V/1-60 VA	200 A, 120 V/240 V, Single Phase, 3 Wires	6	
Electrical_Lights_Fan-Light1	120 V/1-100 VA- 120 V/1-100 VA	200 A, 120 V/240 V, Single Phase, 3 Wires	3	
Light_Fixture-Wall_Sconce-KOH LER-Tone-K-31769	One Dedicated Circuit Required 120 V/1-120 VA	200 A, 120 V/240 V, Single Phase, 3 Wires	2	
Lighting_Other_LumenWerx_Sh ell-Recessed-8	120 V/1-60 VA	200 A, 120 V/240 V, Single Phase, 3 Wires	13	
Lighting_Pendant1	120 V/1-20 VA	200 A, 120 V/240 V, Single Phase, 3 Wires	2	
Melt Cone Fat Floor LED			1	
SASSO 100 round wallwasher trim2	120 V/1-10 VA	200 A, 120 V/240 V, Single Phase, 3 Wires	8	

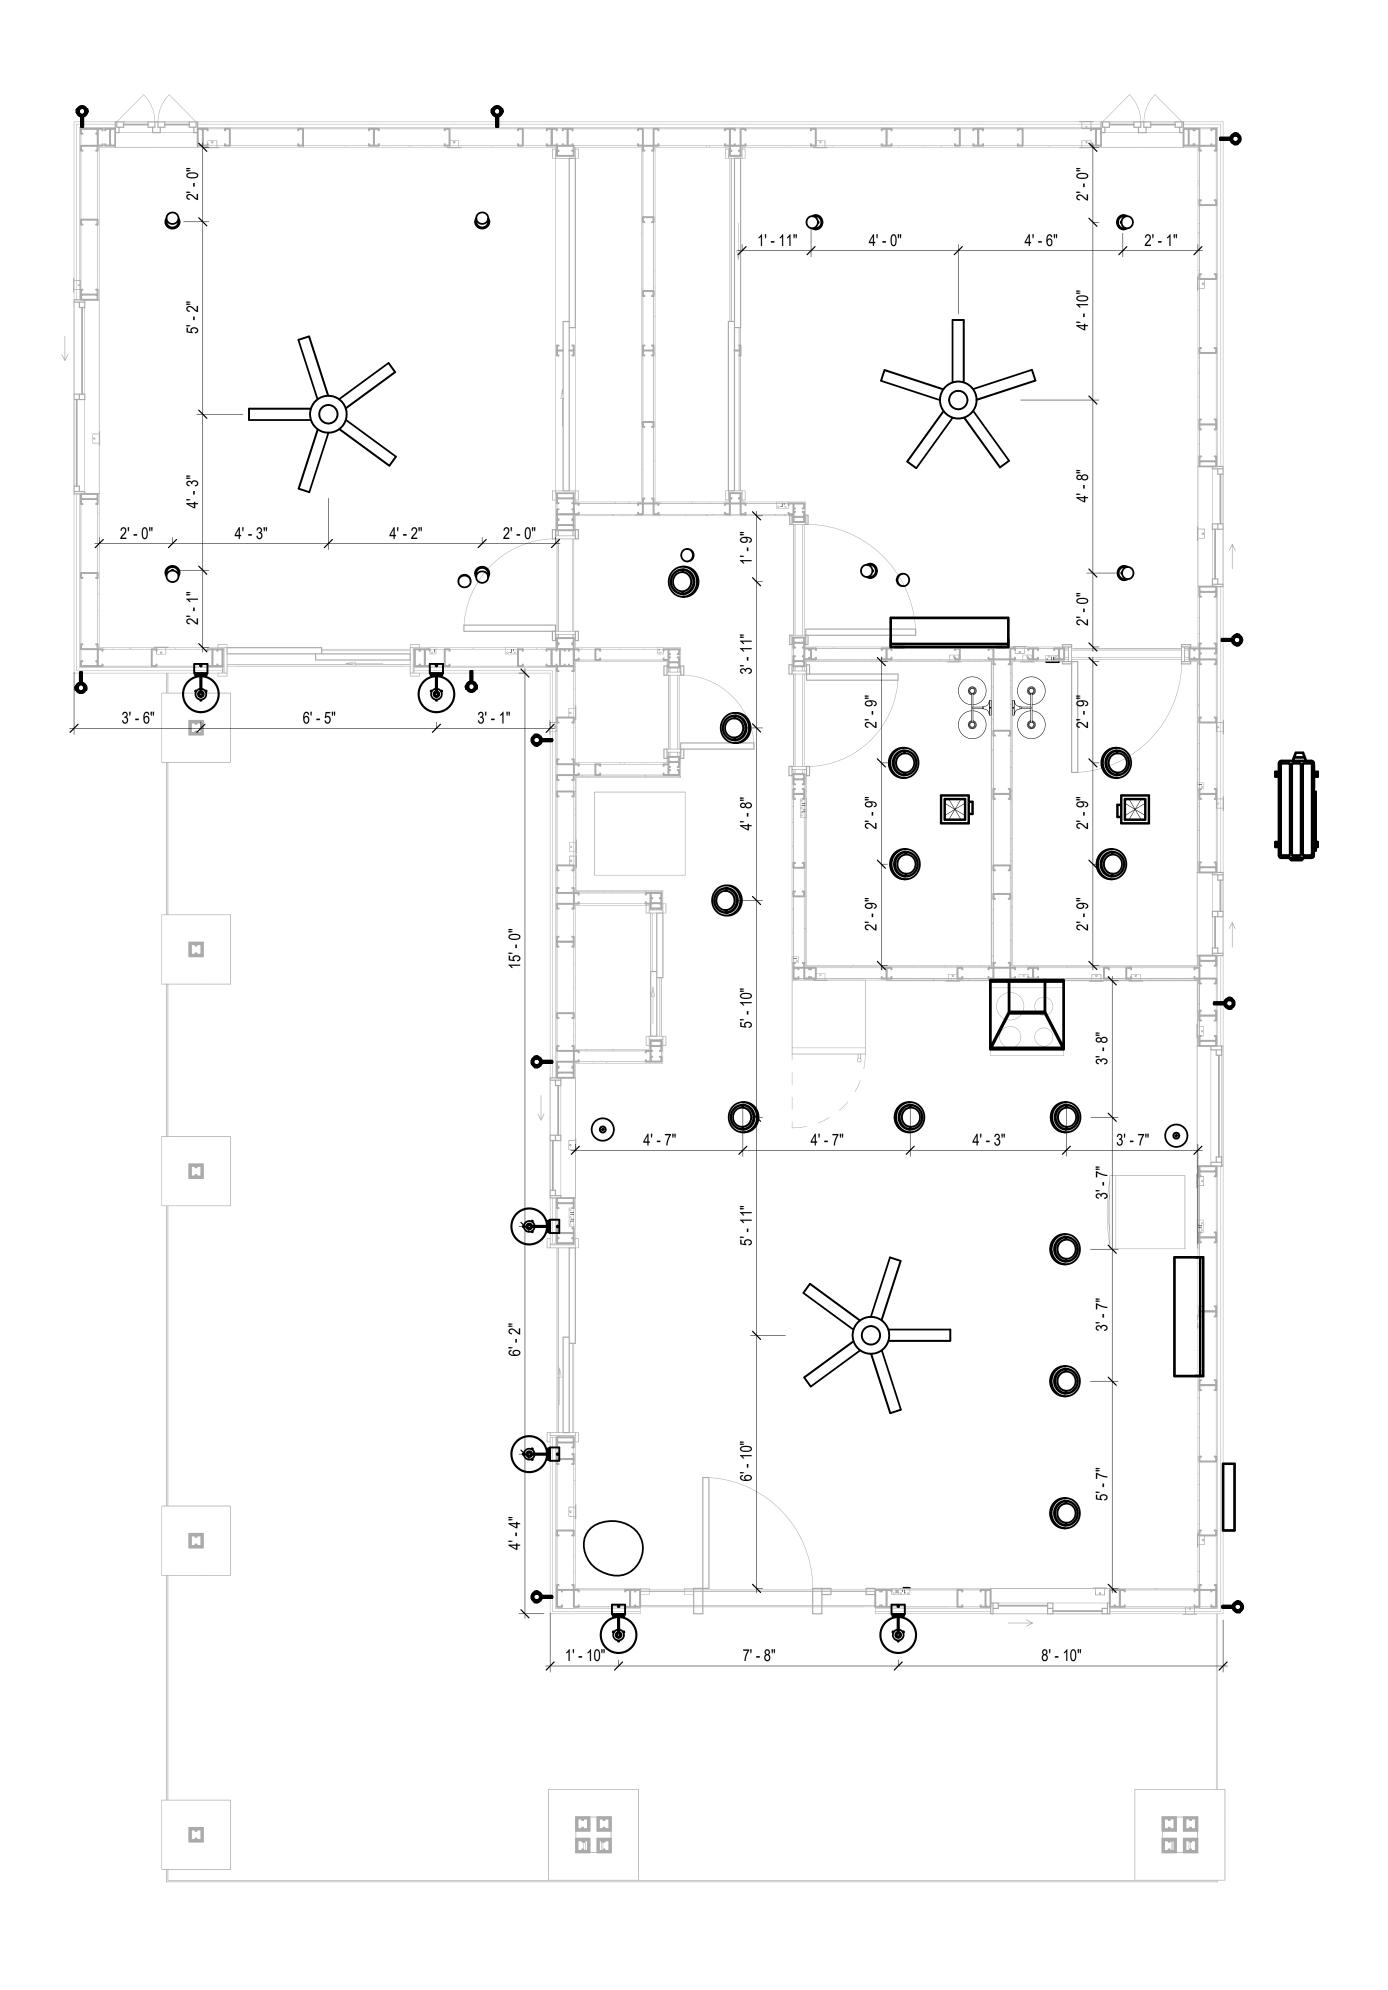

**DIMENSION FOR LIGHT FIXTURES** 3/8" = 1'-0"



Tuscon.AZ. USA

**KEY PLAN** 

DESCRIPTION DATE

NOTE:

LEGEND:

PROJECT

12-Wisdom-909-2Bd/2Ba Craftsman-550

DRAWING NAME

# **DIMENSION PLAN** FOR LIGHT FIXTURES

CLIENT NAME:	Owner
PROJECT NUMBER:	0073_14
DATE:	2/1/2025 4:41:28 AM
DESIGNED BY:	Designer
DRAWN BY:	Author
CHECKED BY:	Checker


E104

#### NOTES;

- 1. VERIFY EQUIPMENT PLUG CONFIGURATION BEFORE PURCHASING RECEPTACLES
- 2. FOR ALL EQUIPMENT.
- 3. COORDINATE EXACT LOCATION OF LIGHT FIXTURES, WALL SWITCHES, RECEPTACLES AND OTHER DEVICES WITH ARCHITECTURAL DRAWINGS.
- 4. USE METALLIC JUNCTION BOX WITH THE GFCI RECEPTACLES, WITH HIGHT VOLTAGE.

Electrical Fixture Schedule (Receptacle)		
Type Count		
CONDENSER	1	
DRYER	1	
GFCI BATH ROOM	2	
GFCI DISHWASHER	1	
GFCI Kitchen	3	
GFCI OUT DOOR	5	
GFCI WASHER	1	
OVEN HOOD	1	
RANGE	1	
REFRIGERATOR	1	
Standard Receptacle	14	
WATER HEATER	1	

Electrical Outlet Schedule					
Type Circuit Number Electrical Data Count					
RANGE	1,3	240 V/2-5000 VA	1		
WATER HEATER	2,4	240 V/2-1500 VA	1		
CONDENSER	5,7	240 V/2-5000 VA	1		
Standard Receptacle	8	120 V/1-180 VA	5		
GFCI WASHER	11	120 V/1-1200 VA	1		
GFCI BATH ROOM	12	120 V/1-180 VA	2		
DRYER	13,15	240 V/2-5000 VA	1		
GFCI OUT DOOR	16	120 V/1-180 VA	5		
GFCI Kitchen	17	120 V/1-180 VA	3		
Standard Receptacle	18	120 V/1-180 VA	5		
GFCI DISHWASHER	19	120 V/1-1200 VA	1		
OVEN HOOD	19	120 V/1-180 VA	1		
Standard Receptacle	20	120 V/1-180 VA	4		
REFRIGERATOR	21	120 V/1-1800 VA	1		

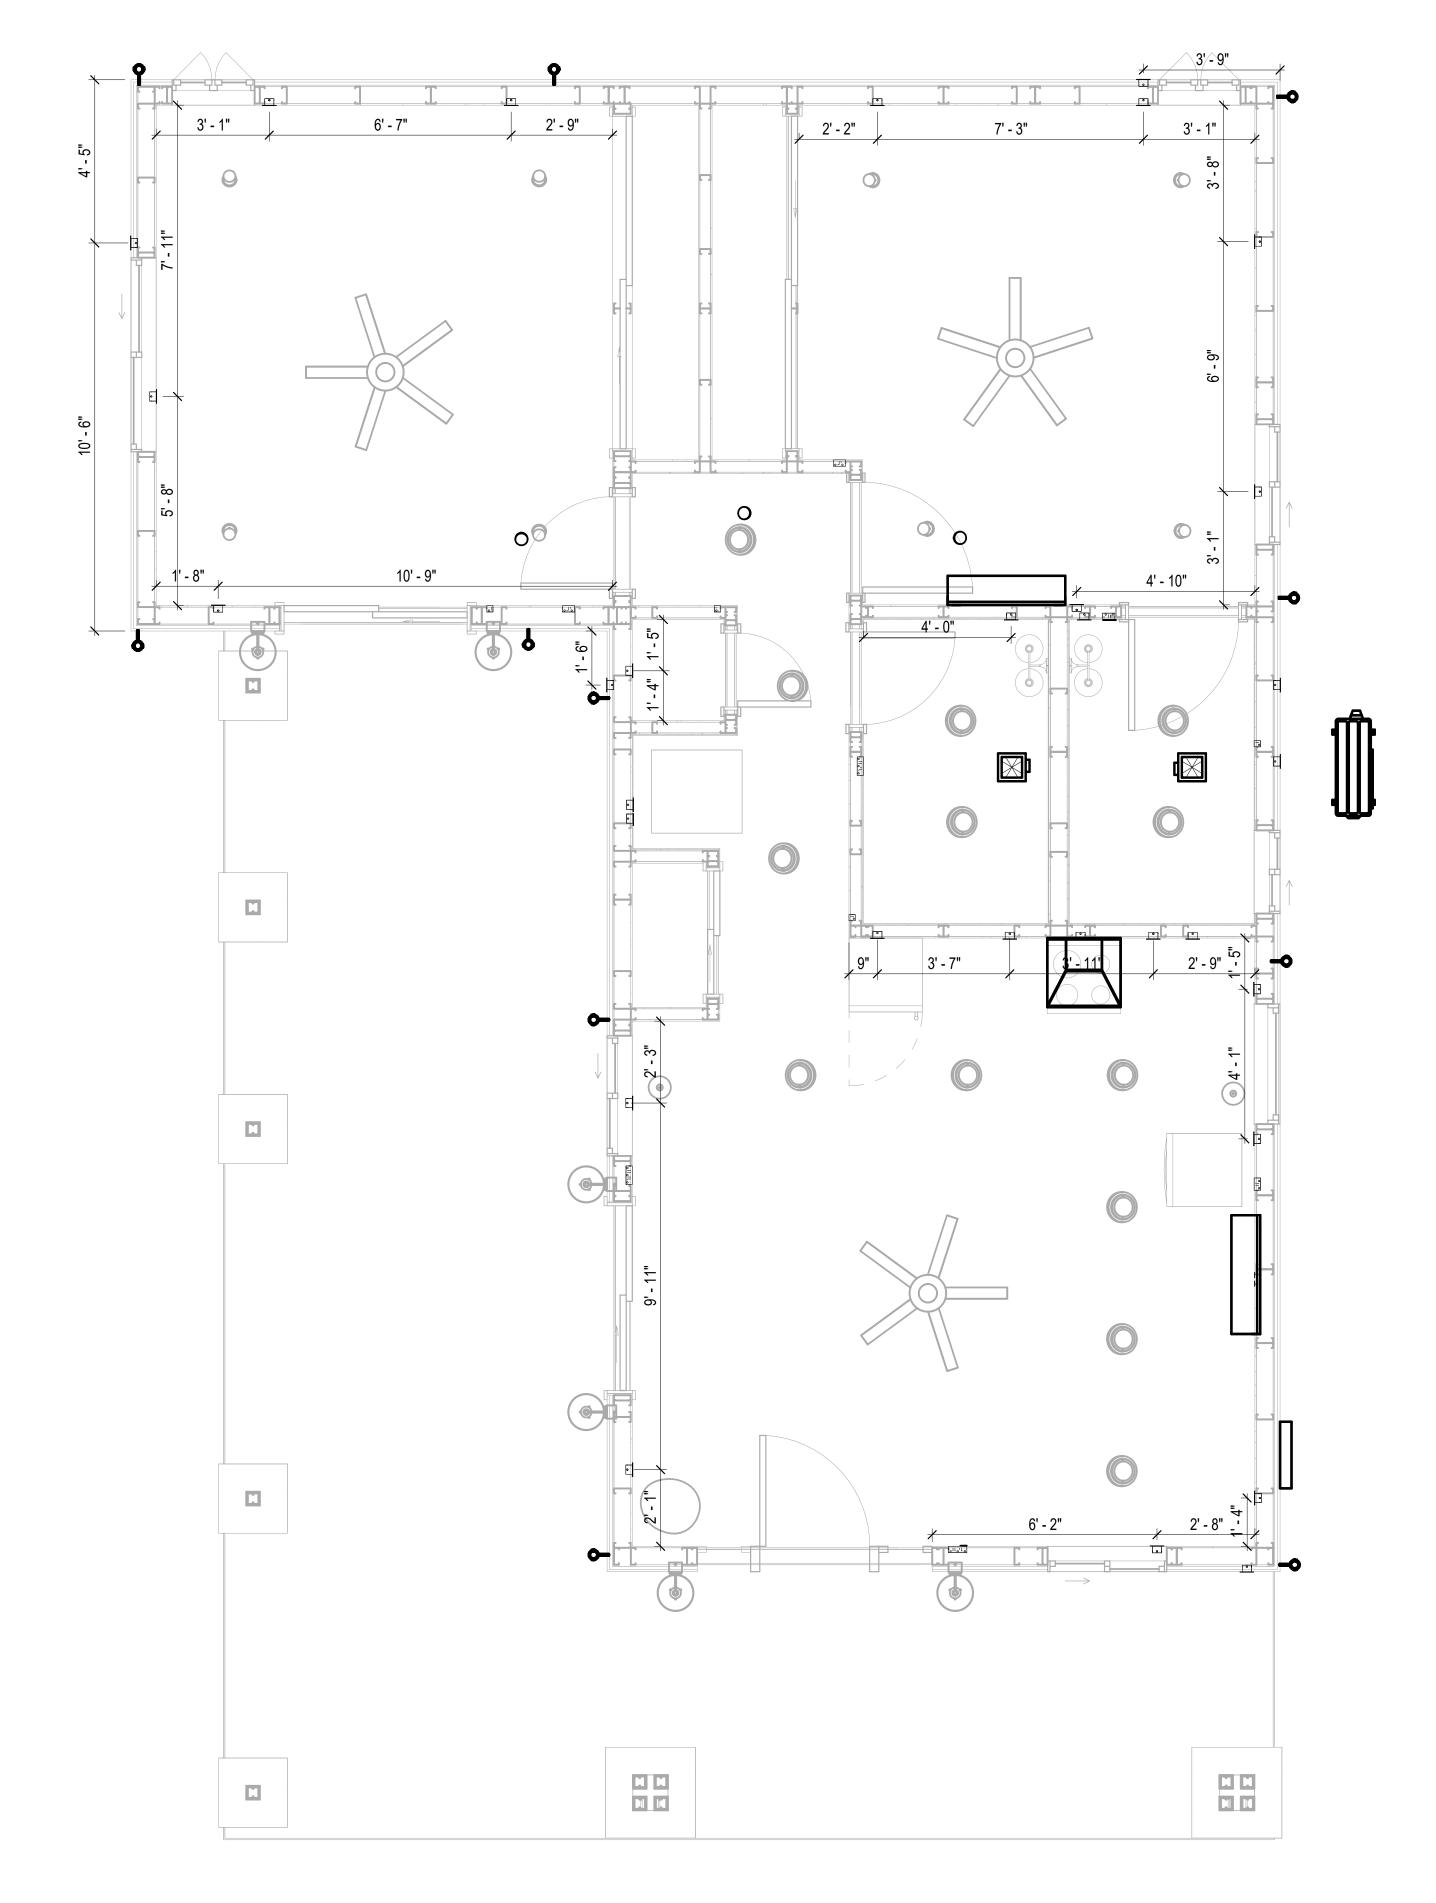

1 DIMENSION FOR FITTINGS 3/8" = 1'-0"



**KEY PLAN** 

NO.	DESCRIPTION	DATE

NOTE:

LEGEND:

PROJECT

12-Wisdom-909-2Bd/2Ba Craftsman-550

DRAWING NAME

# DIMENSION PLAN FOR FITTINGS

CLIENT NAME:	Owner
PROJECT NUMBER:	0073_14
DATE:	2/1/2025 4:41:31 AM
DESIGNED BY:	Designer
DRAWN BY:	Author
CHECKED BY:	Checker

E105

#### SHEET LIST

SHEET NUMBER SHEET NAME

P101 NOTE AND SCHEDULE
P102 WATER SUPPLY AND SEWAGE
SYSTEM

#### PIPE COLOR SCHEME

DOMESTIC COLD WATER
DOMESTIC HOT WATER
SANITARY VENT
SANITARY SEWER
STORM DRAINAGE

#### PLUMBING NOTES

- . THE PLUMBING SYSTEM IS DESIGNED TO MEET THE BUILDING'S DOMESTIC WATER SUPPLY, SANITARY DRAINAGE, AND STORM DRAINAGE REQUIREMENTS, AS PER PROJECT SPECIFICATIONS AND APPLICABLE CODES.
- THE SYSTEM INSTALLATION SHALL COMPLY WITH THE LATEST INTERNATIONAL PLUMBING CODE (IPC), INTERNATIONAL RESIDENTIAL CODE (IRC), AND ALL OTHER RELEVANT LOCAL, STATE, AND NATIONAL REGULATIONS.
- 3. ALL PLUMBING WORK SHALL COMPLY WITH THE LATEST EDITION OF THE INTERNATIONAL PLUMBING CODE (IPC) AND THE LOCAL PLUMBING CODE.
- 4. PLUMBING SYSTEMS SHALL BE TESTED AND INSPECTED IN ACCORDANCE WITH THE LOCAL PLUMBING CODE REQUIREMENTS.
- 5. PLUMBING FIXTURES SHALL BE INSTALLED WITH THE APPROPRIATE TRIM, FITTINGS, AND ACCESSORIES, AS RECOMMENDED BY THE MANUFACTURER.
- 6. PIPING SHALL BE PROPERLY SUPPORTED AND SECURED TO PREVENT SAGGING, MOVEMENT, AND VIBRATION.
- 7. SHUT-OFF VALVES SHALL BE PROVIDED AT ALL BRANCH CONNECTIONS AND AT THE INLET AND OUTLET OF EACH PIECE OF EQUIPMENT.
- 8. BACKFLOW PREVENTION DEVICES SHALL BE INSTALLED AS REQUIRED BY THE LOCAL
- PLUMBING CODE TO PROTECT THE POTABLE WATER SYSTEM.

  9. PLUMBING FIXTURES AND EQUIPMENT SHALL BE ACCESSIBLE FOR MAINTENANCE AND
- 10. EXPOSED PLUMBING PIPING AND FIXTURES SHALL BE INSULATED TO PREVENT
- CONDENSATION AND ENERGY LOSS.

  11. DEAD ENDS IN THE DRAINAGE SYSTEM MUST BE AVOIDED, EXCEPT WHERE NECESSARY TO INSTALL A CLEANOUT IN AN ACCESSIBLE LOCATION, AND MUST HAVE A VENTED CONNECTION TO THE OUTSIDE ATMOSPHERE.
- 12. THE VERTICAL DEFLECTION OF PVC PIPE MUST NOT EXCEED 5%, AND NO DEFLECTION IS PERMITTED FOR IRON PIPE.
- 13. WORK MUST BE PROPERLY COORDINATED WITH OTHER TRADES TO AVOID CONFLICTS, REFERRING TO THE ARCHITECTURAL AND STRUCTURAL DRAWINGS FOR INFORMATION REGARDING CEILING ELEVATIONS, SPACE CLEARANCES, WALL AND PARTITION LOCATIONS, ETC.
- 14. ALL FIXTURES SHALL HAVE ACCESSIBLE STOPS.
- 15. DOMESTIC WATER PIPING SHALL BE PEX, AND PVC PIPING IS NOT ACCEPTABLE FOR INTERIOR USE.
- 16. VENT TERMINATIONS SHALL BE LOCATED AT LEAST 10 FEET FROM OR 3 FEET ABOVE ANY OPERABLE WINDOW, DOOR OPENING, AIR INTAKE, OR VENT SHAFT, AND AT LEAST 3 FEET IN EVERY DIRECTION FROM ANY LOT LINE, ALLEY, OR STREET.
- 17. PIPE AND FITTINGS UTILIZED IN THE WATER SUPPLY SYSTEM SHALL HAVE A MAXIMUM OF 8 PERCENT LEAD.
- 18. ACRYLONITRILE BUTADIENE STYRENE (ABS) SHALL BE USED FOR THE SEWERAGE AND
- VENTILATION SYSTEM.

  19. CROSS-LINKED POLYETHYLENE (PEX) SHALL BE USED FOR THE WATER SUPPLY SYSTEM.
- 20. POLYVINYL CHLORIDE (PVC) SHÀLL BÉ USED FOR THE RAIN WATER SYSTEM.
- 21. THE MIMIMUM WATER SUPPLY DEPTH UNDER FLOOR FINISH SHOUD BE 1/2".
- 22. ANY PIPE INSTALLED UNDERGROUND MUST HAVE AT LEAST 12 INCHES OF CLEARANCE BETWEEN THE OUTSIDE OF THE PIPE AND ANY OTHER UNDERGROUND STRUCTURE.
- 23. THE MINIMUM CLEARANCE BETWEEN COLD AND HOT WATER LINES IN RESIDENTIAL HOMES MAINTAIN A MINIMUM DISTANCE OF 6 INCHES.
- 24. HORIZONTAL SEPARATION BETWEEN WATER AND SEWER LINES: A MINIMUM OF 12 INCHES BETWEEN POTABLE WATER SUPPLY LINES (COLD AND HOT WATER) AND

#### ABBREVIATIONS

SANITARY SEWER LINES.

ABS ACRYLONITRILE BUTADIENE STYRENE ABV ABOVE AD AREA DRAIN AFF ABOVE FINISHED FLOOR ALT ALTERNATE BFF BELOW FINISHED FLOOR BLW BELOW CO CLEAN OUT CW COLD WATER D DEGREE DFU DRANAGE FIXTURE UNIT DIA DIAMETER DN DOWN FCO FLOOR CLEAN OUT FD FLOOR DRAIN FL FLOOR FS FLOOR SINK FT FOOT/FEET HB HOSE BIB HW HOT WATER IN INCH MIN MINIMUM NO NUMBER NTS NOT TO SCALE PEX CROSS-LINKED POLYETHYLENE PLBG PLUMBING PVC POLYVINYL CHLORIDE QTY QUANTITY RD ROOF DRAIN RED REDUCER RM ROOM RW RAIN WATER SF SQUARE FOOT V VENT VTR VENT THROUGH ROOF W WASTE WSFU WATER SUPPLY FIXTURE UNIT		
ABV ABOVE AD AREA DRAIN AFF ABOVE FINISHED FLOOR ALT ALTERNATE BFF BELOW FINISHED FLOOR BLW BELOW CO CLEAN OUT CW COLD WATER D DEGREE DFU DRANAGE FIXTURE UNIT DIA DIAMETER DN DOWN FCO FLOOR CLEAN OUT FD FLOOR DRAIN FL FLOOR FS FLOOR SINK FT FOOT/FEET HB HOSE BIB HW HOT WATER IN INCH MIN MINIMUM NO NUMBER NTS NOT TO SCALE PEX CROSS-LINKED POLYETHYLENE PLBG PLUMBING PVC POLYVINYL CHLORIDE QTY QUANTITY RD ROOF DRAIN RED REDUCER RM ROOM RW RAIN WATER SF SQUARE FOOT V VENT VTR VENT THROUGH ROOF W WASTE WCO WALL CLEAN OUT		
AD AREA DRAIN  AFF ABOVE FINISHED FLOOR  ALT ALTERNATE  BFF BELOW FINISHED FLOOR  BLW BELOW  CO CLEAN OUT  CW COLD WATER  D DEGREE  DFU DRANAGE FIXTURE UNIT  DIA DIAMETER  DN DOWN  FCO FLOOR CLEAN OUT  FD FLOOR DRAIN  FL FLOOR  FS FLOOR SINK  FT FOOT/FEET  HB HOSE BIB  HW HOT WATER  IN INCH  MIN MINIMUM  NO NUMBER  NTS NOT TO SCALE  PEX CROSS-LINKED POLYETHYLENE  PLBG PLUMBING  PVC POLYVINYL CHLORIDE  QTY QUANTITY  RD ROOF DRAIN  RED REDUCER  RM ROOM  RW RAIN WATER  SF SQUARE FOOT  V VENT  VTR VENT THROUGH ROOF  W WASTE  WCO WALL CLEAN OUT	ABS	ACRYLONITRILE BUTADIENE STYRENE
AFF ABOVE FINISHED FLOOR ALT ALTERNATE BFF BELOW FINISHED FLOOR BLW BELOW CO CLEAN OUT CW COLD WATER D DEGREE DFU DRANAGE FIXTURE UNIT DIA DIAMETER DN DOWN FCO FLOOR CLEAN OUT FD FLOOR SINK FT FOOT/FEET HB HOSE BIB HW HOT WATER IN INCH MIN MINIMUM NO NUMBER NTS NOT TO SCALE PEX CROSS-LINKED POLYETHYLENE PLBG PLUMBING PVC POLYVINYL CHLORIDE QTY QUANTITY RD ROOF DRAIN RED REDUCER RM ROOM RW RAIN WATER SF SQUARE FOOT V VENT VTR VENT THROUGH ROOF W WASTE WCO WALL CLEAN OUT	ABV	ABOVE
ALT ALTERNATE BFF BELOW FINISHED FLOOR BLW BELOW CO CLEAN OUT CW COLD WATER D DEGREE DFU DRANAGE FIXTURE UNIT DIA DIAMETER DN DOWN FCO FLOOR CLEAN OUT FD FLOOR DRAIN FL FLOOR FS FLOOR SINK FT FOOT/FEET HB HOSE BIB HW HOT WATER IN INCH MIN MINIMUM NO NUMBER NTS NOT TO SCALE PEX CROSS-LINKED POLYETHYLENE PLBG PLUMBING PVC POLYVINYL CHLORIDE QTY QUANTITY RD ROOF DRAIN RED REDUCER RM ROOM RW RAIN WATER SF SQUARE FOOT V VENT VTR VENT THROUGH ROOF W WASTE WCO WALL CLEAN OUT	AD	AREA DRAIN
BFF BELOW FINISHED FLOOR BLW BELOW CO CLEAN OUT CW COLD WATER D DEGREE DFU DRANAGE FIXTURE UNIT DIA DIAMETER DN DOWN FCO FLOOR CLEAN OUT FD FLOOR DRAIN FL FLOOR FS FLOOR SINK FT FOOT/FEET HB HOSE BIB HW HOT WATER IN INCH MIN MINIMUM NO NUMBER NTS NOT TO SCALE PEX CROSS-LINKED POLYETHYLENE PLBG PLUMBING PVC POLYVINYL CHLORIDE QTY QUANTITY RD ROOF DRAIN RED REDUCER RM ROOM RW RAIN WATER SF SQUARE FOOT V VENT VTR VENT THROUGH ROOF W WASTE WCO WALL CLEAN OUT	AFF	ABOVE FINISHED FLOOR
BLW BELOW CO CLEAN OUT CW COLD WATER D DEGREE DFU DRANAGE FIXTURE UNIT DIA DIAMETER DN DOWN FCO FLOOR CLEAN OUT FD FLOOR DRAIN FL FLOOR FS FLOOR SINK FT FOOT/FEET HB HOSE BIB HW HOT WATER IN INCH MIN MINIMUM NO NUMBER NTS NOT TO SCALE PEX CROSS-LINKED POLYETHYLENE PLBG PLUMBING PVC POLYVINYL CHLORIDE QTY QUANTITY RD ROOF DRAIN RED REDUCER RM ROOM RW RAIN WATER SF SQUARE FOOT V VENT VTR VENT THROUGH ROOF W WASTE WCO WALL CLEAN OUT	ALT	ALTERNATE
CO CLEAN OUT CW COLD WATER D DEGREE DFU DRANAGE FIXTURE UNIT DIA DIAMETER DN DOWN FCO FLOOR CLEAN OUT FD FLOOR DRAIN FL FLOOR FS FLOOR SINK FT FOOT/FEET HB HOSE BIB HW HOT WATER IN INCH MIN MINIMUM NO NUMBER NTS NOT TO SCALE PEX CROSS-LINKED POLYETHYLENE PLBG PLUMBING PVC POLYVINYL CHLORIDE QTY QUANTITY RD ROOF DRAIN RED REDUCER RM ROOM RW RAIN WATER SF SQUARE FOOT V VENT VTR VENT THROUGH ROOF W WASTE WCO WALL CLEAN OUT	BFF	BELOW FINISHED FLOOR
CW COLD WATER D DEGREE DFU DRANAGE FIXTURE UNIT DIA DIAMETER DN DOWN FCO FLOOR CLEAN OUT FD FLOOR DRAIN FL FLOOR FS FLOOR SINK FT FOOT/FEET HB HOSE BIB HW HOT WATER IN INCH MIN MINIMUM NO NUMBER NTS NOT TO SCALE PEX CROSS-LINKED POLYETHYLENE PLBG PLUMBING PVC POLYVINYL CHLORIDE QTY QUANTITY RD ROOF DRAIN RED REDUCER RM ROOM RW RAIN WATER SF SQUARE FOOT V VENT VTR VENT THROUGH ROOF W WASTE WCO WALL CLEAN OUT	BLW	BELOW
D DEGREE DFU DRANAGE FIXTURE UNIT DIA DIAMETER DN DOWN FCO FLOOR CLEAN OUT FD FLOOR DRAIN FL FLOOR FS FLOOR SINK FT FOOT/FEET HB HOSE BIB HW HOT WATER IN INCH MIN MINIMUM NO NUMBER NTS NOT TO SCALE PEX CROSS-LINKED POLYETHYLENE PLBG PLUMBING PVC POLYVINYL CHLORIDE QTY QUANTITY RD ROOF DRAIN RED REDUCER RM ROOM RW RAIN WATER SF SQUARE FOOT V VENT VTR VENT THROUGH ROOF W WASTE WCO WALL CLEAN OUT	CO	CLEAN OUT
DFU DRANAGE FIXTURE UNIT DIA DIAMETER DN DOWN FCO FLOOR CLEAN OUT FD FLOOR DRAIN FL FLOOR FS FLOOR SINK FT FOOT/FEET HB HOSE BIB HW HOT WATER IN INCH MIN MINIMUM NO NUMBER NTS NOT TO SCALE PEX CROSS-LINKED POLYETHYLENE PLBG PLUMBING PVC POLYVINYL CHLORIDE QTY QUANTITY RD ROOF DRAIN RED REDUCER RM ROOM RW RAIN WATER SF SQUARE FOOT V VENT VTR VENT THROUGH ROOF W WASTE WCO WALL CLEAN OUT	CW	COLD WATER
DIA DIAMETER DN DOWN FCO FLOOR CLEAN OUT FD FLOOR DRAIN FL FLOOR FS FLOOR SINK FT FOOT/FEET HB HOSE BIB HW HOT WATER IN INCH MIN MINIMUM NO NUMBER NTS NOT TO SCALE PEX CROSS-LINKED POLYETHYLENE PLBG PLUMBING PVC POLYVINYL CHLORIDE QTY QUANTITY RD ROOF DRAIN RED REDUCER RM ROOM RW RAIN WATER SF SQUARE FOOT V VENT VTR VENT THROUGH ROOF W WASTE WCO WALL CLEAN OUT	D	DEGREE
DN DOWN FCO FLOOR CLEAN OUT FD FLOOR DRAIN FL FLOOR FS FLOOR SINK FT FOOT/FEET HB HOSE BIB HW HOT WATER IN INCH MIN MINIMUM NO NUMBER NTS NOT TO SCALE PEX CROSS-LINKED POLYETHYLENE PLBG PLUMBING PVC POLYVINYL CHLORIDE QTY QUANTITY RD ROOF DRAIN RED REDUCER RM ROOM RW RAIN WATER SF SQUARE FOOT V VENT VTR VENT THROUGH ROOF W WASTE WCO WALL CLEAN OUT	DFU	DRANAGE FIXTURE UNIT
FCO FLOOR CLEAN OUT FD FLOOR DRAIN FL FLOOR FS FLOOR SINK FT FOOT/FEET HB HOSE BIB HW HOT WATER IN INCH MIN MINIMUM NO NUMBER NTS NOT TO SCALE PEX CROSS-LINKED POLYETHYLENE PLBG PLUMBING PVC POLYVINYL CHLORIDE QTY QUANTITY RD ROOF DRAIN RED REDUCER RM ROOM RW RAIN WATER SF SQUARE FOOT V VENT VTR VENT THROUGH ROOF W WASTE WCO WALL CLEAN OUT	DIA	DIAMETER
FD FLOOR DRAIN FL FLOOR FS FLOOR SINK FT FOOT/FEET HB HOSE BIB HW HOT WATER IN INCH MIN MINIMUM NO NUMBER NTS NOT TO SCALE PEX CROSS-LINKED POLYETHYLENE PLBG PLUMBING PVC POLYVINYL CHLORIDE QTY QUANTITY RD ROOF DRAIN RED REDUCER RM ROOM RW RAIN WATER SF SQUARE FOOT V VENT VTR VENT THROUGH ROOF W WASTE WCO WALL CLEAN OUT	DN	DOWN
FL FLOOR FS FLOOR SINK FT FOOT/FEET HB HOSE BIB HW HOT WATER IN INCH MIN MINIMUM NO NUMBER NTS NOT TO SCALE PEX CROSS-LINKED POLYETHYLENE PLBG PLUMBING PVC POLYVINYL CHLORIDE QTY QUANTITY RD ROOF DRAIN RED REDUCER RM ROOM RW RAIN WATER SF SQUARE FOOT V VENT VTR VENT THROUGH ROOF W WASTE WCO WALL CLEAN OUT	FCO	FLOOR CLEAN OUT
FS FLOOR SINK FT FOOT/FEET HB HOSE BIB HW HOT WATER IN INCH MIN MINIMUM NO NUMBER NTS NOT TO SCALE PEX CROSS-LINKED POLYETHYLENE PLBG PLUMBING PVC POLYVINYL CHLORIDE QTY QUANTITY RD ROOF DRAIN RED REDUCER RM ROOM RW RAIN WATER SF SQUARE FOOT V VENT VTR VENT THROUGH ROOF W WASTE WCO WALL CLEAN OUT	FD	FLOOR DRAIN
FT FOOT/FEET HB HOSE BIB HW HOT WATER IN INCH MIN MINIMUM NO NUMBER NTS NOT TO SCALE PEX CROSS-LINKED POLYETHYLENE PLBG PLUMBING PVC POLYVINYL CHLORIDE QTY QUANTITY RD ROOF DRAIN RED REDUCER RM ROOM RW RAIN WATER SF SQUARE FOOT V VENT VTR VENT THROUGH ROOF W WASTE WCO WALL CLEAN OUT	FL	FLOOR
HB HOSE BIB HW HOT WATER IN INCH MIN MINIMUM NO NUMBER NTS NOT TO SCALE PEX CROSS-LINKED POLYETHYLENE PLBG PLUMBING PVC POLYVINYL CHLORIDE QTY QUANTITY RD ROOF DRAIN RED REDUCER RM ROOM RW RAIN WATER SF SQUARE FOOT V VENT VTR VENT THROUGH ROOF W WASTE WCO WALL CLEAN OUT	FS	FLOOR SINK
HW HOT WATER IN INCH MIN MINIMUM NO NUMBER NTS NOT TO SCALE PEX CROSS-LINKED POLYETHYLENE PLBG PLUMBING PVC POLYVINYL CHLORIDE QTY QUANTITY RD ROOF DRAIN RED REDUCER RM ROOM RW RAIN WATER SF SQUARE FOOT V VENT VTR VENT THROUGH ROOF W WASTE WCO WALL CLEAN OUT	FT	FOOT/FEET
IN INCH MIN MINIMUM NO NUMBER NTS NOT TO SCALE PEX CROSS-LINKED POLYETHYLENE PLBG PLUMBING PVC POLYVINYL CHLORIDE QTY QUANTITY RD ROOF DRAIN RED REDUCER RM ROOM RW RAIN WATER SF SQUARE FOOT V VENT VTR VENT THROUGH ROOF W WASTE WCO WALL CLEAN OUT	HB	HOSE BIB
MIN MINIMUM  NO NUMBER  NTS NOT TO SCALE  PEX CROSS-LINKED POLYETHYLENE  PLBG PLUMBING  PVC POLYVINYL CHLORIDE  QTY QUANTITY  RD ROOF DRAIN  RED REDUCER  RM ROOM  RW RAIN WATER  SF SQUARE FOOT  V VENT  VTR VENT THROUGH ROOF  W WASTE  WCO WALL CLEAN OUT	HW	HOT WATER
NO NUMBER NTS NOT TO SCALE PEX CROSS-LINKED POLYETHYLENE PLBG PLUMBING PVC POLYVINYL CHLORIDE QTY QUANTITY RD ROOF DRAIN RED REDUCER RM ROOM RW RAIN WATER SF SQUARE FOOT V VENT VTR VENT THROUGH ROOF W WASTE WCO WALL CLEAN OUT	IN	INCH
NTS NOT TO SCALE PEX CROSS-LINKED POLYETHYLENE PLBG PLUMBING PVC POLYVINYL CHLORIDE QTY QUANTITY RD ROOF DRAIN RED REDUCER RM ROOM RW RAIN WATER SF SQUARE FOOT V VENT VTR VENT THROUGH ROOF W WASTE WCO WALL CLEAN OUT	MIN	MINIMUM
PEX CROSS-LINKED POLYETHYLENE PLBG PLUMBING PVC POLYVINYL CHLORIDE QTY QUANTITY RD ROOF DRAIN RED REDUCER RM ROOM RW RAIN WATER SF SQUARE FOOT V VENT VTR VENT THROUGH ROOF W WASTE WCO WALL CLEAN OUT	NO	NUMBER
PLBG PLUMBING PVC POLYVINYL CHLORIDE QTY QUANTITY RD ROOF DRAIN RED REDUCER RM ROOM RW RAIN WATER SF SQUARE FOOT V VENT VTR VENT THROUGH ROOF W WASTE WCO WALL CLEAN OUT	NTS	NOT TO SCALE
PVC POLYVINYL CHLORIDE QTY QUANTITY RD ROOF DRAIN RED REDUCER RM ROOM RW RAIN WATER SF SQUARE FOOT V VENT VTR VENT THROUGH ROOF W WASTE WCO WALL CLEAN OUT	PEX	CROSS-LINKED POLYETHYLENE
QTY QUANTITY  RD ROOF DRAIN  RED REDUCER  RM ROOM  RW RAIN WATER  SF SQUARE FOOT  V VENT  VTR VENT THROUGH ROOF  W WASTE  WCO WALL CLEAN OUT	PLBG	PLUMBING
RD ROOF DRAIN RED REDUCER RM ROOM RW RAIN WATER SF SQUARE FOOT V VENT VTR VENT THROUGH ROOF W WASTE WCO WALL CLEAN OUT	PVC	POLYVINYL CHLORIDE
RED REDUCER RM ROOM RW RAIN WATER SF SQUARE FOOT V VENT VTR VENT THROUGH ROOF W WASTE WCO WALL CLEAN OUT	QTY	QUANTITY
RM ROOM RW RAIN WATER SF SQUARE FOOT V VENT VTR VENT THROUGH ROOF W WASTE WCO WALL CLEAN OUT	RD	ROOF DRAIN
RW RAIN WATER SF SQUARE FOOT V VENT VTR VENT THROUGH ROOF W WASTE WCO WALL CLEAN OUT	RED	REDUCER
SF SQUARE FOOT  V VENT  VTR VENT THROUGH ROOF  W WASTE  WCO WALL CLEAN OUT	RM	ROOM
V VENT VTR VENT THROUGH ROOF W WASTE WCO WALL CLEAN OUT	RW	RAIN WATER
VTR VENT THROUGH ROOF W WASTE WCO WALL CLEAN OUT	SF	SQUARE FOOT
W WASTE WCO WALL CLEAN OUT	V	VENT
WCO WALL CLEAN OUT	VTR	VENT THROUGH ROOF
	W	WASTE
WSFU WATER SUPPLY FIXTURE UNIT	WCO	WALL CLEAN OUT
-	WSFU	WATER SUPPLY FIXTURE UNIT

#### PLUMBING LEGEND

D	CAP
	BEND 45 DEG
B	BEND 90 DEG
	TEE REDUCING
	TEE
	CLEAN TWO-WAY
	WYE 45 DEG
	WYE 45 DEG DOUBLE
	WYE COMBINATION
	P-TRAP

PIPE SCHEDULE		
MATERIAL	DIAMETER	LENGTH
ACRYLONITRILE BUTADIENE STYRENE (ABS)	1 1/2"	13 FT
ACRYLONITRILE BUTADIENE STYRENE (ABS)	2"	56 FT
ACRYLONITRILE BUTADIENE STYRENE (ABS)	3"	9 FT
CROSS-LINKED POLYETHYLENE (PEX)	1/2"	85 FT
CROSS-LINKED POLYETHYLENE (PEX)	3/4"	63 FT
CROSS-LINKED POLYETHYLENE (PEX)	3"	0 FT
POLYVINYL CHLORIDE - RIGID	2"	112 FT

FITTING	SIZE	QTY
11111110	OIZL	QII
DOMESTIC COLD WATER		
PEX 90 DEGREE ELBOW	1/2"ø-1/2"ø	14
PEX 90 DEGREE ELBOW	3/4"ø-3/4"ø	4
PEX TEE ELBOW	1/2"ø-1/2"ø-1/2"ø	4
PEX TEE ELBOW	3/4"ø-3/4"ø-3/4"ø	7
PEX TRANSITION ELBOW	1"ø-3/4"ø	2
PEX TRANSITION ELBOW	3/4"ø-1/2"ø	6
DOMESTIC HOT WATER		
PEX 90 DEGREE ELBOW	1/2"ø-1/2"ø	7
PEX 90 DEGREE ELBOW	3/4"ø-3/4"ø	3
PEX TEE ELBOW	1/2"ø-1/2"ø-1/2"ø	6
PEX TRANSITION ELBOW	3/4"ø-1/2"ø	5
RAIN WATER SYSTEM	011 011	00
BEND RAIN WATER SYSTEM	2"ø-2"ø	22
BEND SEWERAGE SYSTEM	2"ø-2"ø	7
PVC 90 DEGREE BEND ELBOW	2"ø-2"ø	1
PVC TEE ELBOW	2"ø-2"ø-2"ø	3
SEWAGE		
ABS 90 DEGREE BEND ELBOW	1 1/2"ø-1 1/2"ø	2
ABS 90 DEGREE BEND ELBOW	2"ø-2"ø	2
ABS 90 DEGREE BEND ELBOW	3"ø-3"ø	2
ABS BEND LONG SWEEP ELBOW	2"ø-2"ø	1
ABS P-TRAP	1 1/2"ø-1 1/2"ø	4
ABS P-TRAP	2"ø-2"ø	1
ABS REDUCER ELBOW	2"ø-1 1/2"ø	2
ABS REDUCER ELBOW	3"ø-2"ø	3
ABS TEE ELBOW	2"ø-2"ø-2"ø	1
ABS TEE ELBOW	3"ø-3"ø-3"ø	1
ABS TRAP P	2"ø-2"ø	1
ABS WASTE DOUBLE TEE	1 1/2"ø-1 1/2"ø-1 1/2"ø	1
ABS WASTE DOUBLE TEE	2"ø-2"ø-2"ø	1
ABS WASTE DOUBLE TEE	3"ø-3"ø-3"ø	1
ABS WYE COMBINATION WITH 8TH BEND ELBOW	2"ø-2"ø-1 1/2"ø	1
ABS WYE COMBINATION WITH 8TH BEND ELBOW	3"ø-3"ø-1 1/2"ø	1
ABS WYE COMBINATION WITH 8TH BEND ELBOW	3"ø-3"ø-2"ø	1
ABS WYE COMBINATION WITH 8TH BEND ELBOW	3"ø-3"ø-3"ø	1
VENT		
ABS 90 DEGREE BEND ELBOW	1 1/2"ø-1 1/2"ø	1
ABS REDUCER ELBOW	2"ø-1 1/2"ø	1
ABS TEE ELBOW	2"ø-2"ø	1

WATER FIXTURE UNIT SCHEDULE							
FAMILY QTY UNIT VALUE TOTAL							
DISHWASHER	1	1.4	1.4				
SHOWER TRAY	2		0				
SHOWER TRIM	2	1.4	2.8				
SINK ISLAND SINGLE	1	1.4	1.4				
VANITY SINK	2		0				
WASHER	1	1.4	1.4				
WATER CLOSET	2	<varies></varies>	2.2				

WASTE FIXTURE UNIT SCHEDULE							
FAMILY QTY DFU VALUES TOTAL							
DISHWASHER	1	2	2				
SHOWER TRAY	2		0				
SINK ISLAND SINGLE	1	2	2				
VANITY SINK	2		0				
WASHER	1	2	2				
WATER CLOSET	2	<varies></varies>	3				

FIXTURE SCHEDULE					
FIXTURE	QTY	DESCRIPTION			
DISHWASHER	1				
DRYER	1				
SHOWER TRAY	2				
SHOWER TRIM	2				
SINK ISLAND SINGLE	1				
VANITY SINK	2				
WASHER	1				
WATER CLOSET	2				
WATER HEATER	1				

PLUMBING SCHEDULE						
FIXTURE	TRAP	WASTE	VENT	C.W	H.W	
DISHWASHER	1-1/2"	2"	1-1/2"	1/2"	1/2"	
DRYER	N/A	N/A	N/A	N/A	N/A	
SHOWER TRAY						
SHOWER TRIM	-	-	-	1/2"	1/2"	
SINK ISLAND SINGLE	1-1/2"	2"	1-1/2"	1/2"	1/2"	
VANITY SINK	1-1/2"	2"	1-1/2"	1/2"	1/2"	
WASHER	2"	2"	1-1/2"	1/2"	1/2"	
WATER CLOSET	3"	3"	2"	1/2"	1/2"	
WATER HEATER	N/A	N/A	N/A	3/4"	3/4"	

ACCESSORIES & FITTINGS SCHEDULE							
FIXTURE QTY DESCRIPTIONS							
DISHWASHER SUPPLY SINGLE CONNECTOR	1						
DISHWASHER SEWAGE SINGLE CONNECTOR	1						
HANGING PIPE CLAMP	22						
HOSE BIB	2						
LAUNDRY SWEAT CONNECTOR	1						
SHUTOFF VALVE	8						



Tuscon, AZ, USA

**KEY PLAN** 

NO.	DESCRIPTION	DATE

NOTE:

LEGEND:

PROJECT

12-Wisdom-909-2Bd/2Ba Craftsman-550


DRAWING NAME

# NOTE AND SCHEDULE

CLIENT NAME:

PROJECT NUMBER:	0073_14
DATE:	2/1/2025 7:00:00 PM
DESIGNED BY:	Designer
DRAWN BY:	Author
CHECKED BY:	Checker

P101

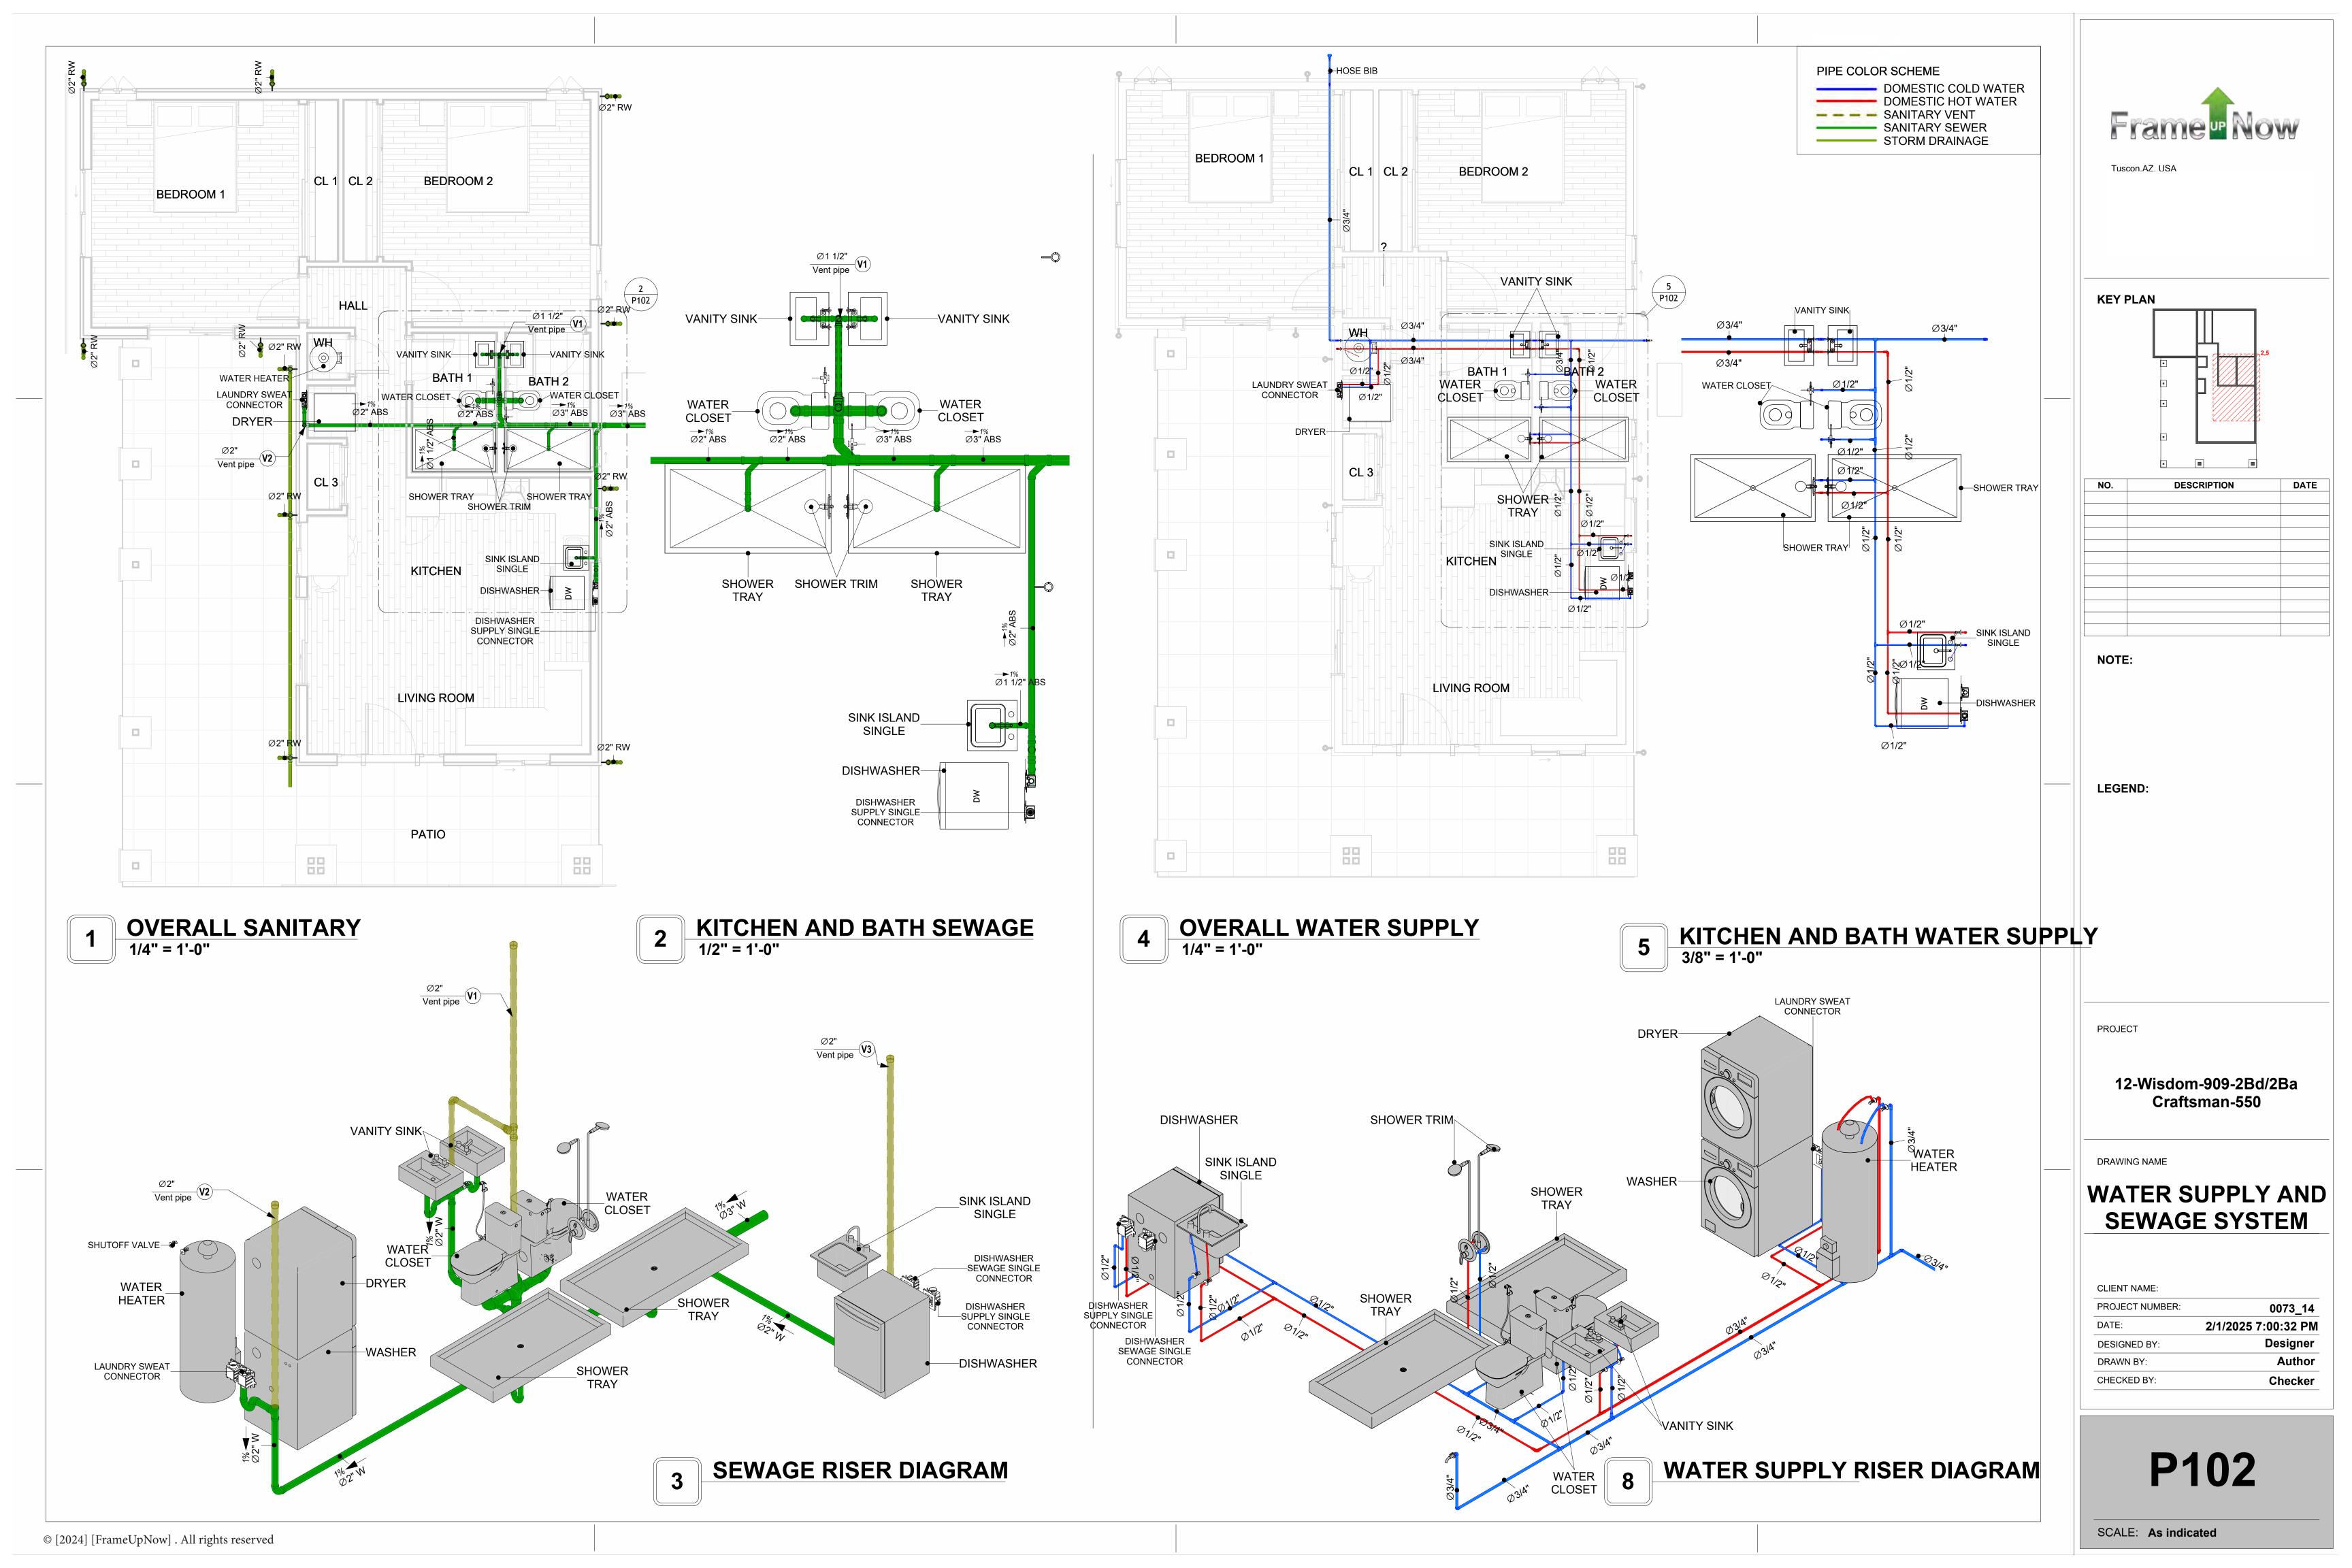

# Materials Shopping List

Please print and take this Materials Shopping List to your favorite Home Depot and ask for assistance in selecting the materials, fixtures and fittings to complete your new home.

Record your selection and the price of the item. Then do the math to determine the cost for your selections and the total cost of finishing your home.

#### **Have It Your Way!**

The material types listed in this document were selected based on personal preferences. The Customer is encouraged to make changes to the material types in accordance with local customs, regulations, and personal preferences.

Have It Your Way!



# 20 good reasons to frame a home with metal and not wood



Why build your ADU with metal vs wood	Wood	Metal	Explanation
1 DIY Construction Benefit		<b>~</b>	The wall frames, trusses and beams can be erected in a just a few days
2 Minimal Construction Skills Required		<b>~</b>	Pre-assembled walls and trusses require no specialized skills to errect
3 Build as DIY, Hybrid or by a General Contractor		<b>✓</b>	Do it yourself, Hybrid (involve special contractors) or hire a General Contractor
4 Build It As You Can Afford It		<b>~</b>	Impervious to Weather - build as you have the time and money
5 Up Front Cost of Framing Materials	<b>~</b>		As to only the framing material, wood is less expensive
6 Total Cost To Build		<b>~</b>	Savings in time, labor, and other areas make light gauge steel LESS expensive
7 Termites and wood boring insects		<b>Y</b>	Termites, carpenter ants and wood boring insects eat wood, not metal
8 Mold resistant		<b>~</b>	Metal does not attract mold
9 Damage caused by exterior and interior flooding		<b>~</b>	Metal needs no reconditioning after a flood
10 Fire Resistant		<b>~</b>	Non-combustible
11 Lower insurance rates		<b>Y</b>	Many insurance underwriters now provide lower rates for metal framed homes
12 Walls, trusses, and beams retain their original form		<b>~</b>	Perfectly straight walls - no shimming of drywall
13 Corners are 90 degrees		<b>✓</b>	No need for templating of countertops to adjust for out of square corners
14 Strength and weight		<b>✓</b>	Metal is stronger than wood and weighs less - no need for crane to lift ADU trusses
15 IBC Engineered Stamp		<b>~</b>	If an engineering stamp is necessary, months of waiting are saved
16 Complete BOM (Materials Shopping List)		<b>~</b>	Take the materials shopping list to Home Depot and start shopping/pricing
17 Flexible in Seismic Areas - Won't Fracture		<b>~</b>	Light gauge steel is flexible and won't fracture when the earth moves
18 No Waste At Job Site		~	Steel is the most recycled material in the world. A typical wood home has 20-30% waste
19 Environmentally Friendly		<b>~</b>	Trees don't have to be destroyed and the source of most metal is from recycling
20 How-To Videos Included		<b>~</b>	How-to videos provide simple assembly instructions
21 Relationship Counselor		<b>~</b>	Eliminate emotional uphevels - save time, money, and preserve the relationship

#### Universal Requirements - some or all may be required

- 1 Site plan
- 2 Electrical Supply Connection
- 3 Sewer Connection
- 4 Fresh Water Supply Connection
- 5 Set Backs
- 6 Soils Evaluation

- 7 Earthquake (fault) evaluation
- 8 Foundation Plan subject to soils
- 9 Compliance with local energy codes: insulation home wrap and flashing
- 10 Engineering for wind speed and snow load.
- 11 State and Local ordinances regarding ADUs
- 12 Local Architect and/or Engineer may be necessary

#### Wisdom-2Bd2Ba-Craftsman





# Wisdom-2Bd2Ba-Craftsman MATERIAL SHOPPING LIST

#### Have It Your Way!

The material types listed in this document were selected based on personal preferences. The Customer is encouraged to make changes to the material types in accordance with local customs, regulations, and personal preferences. Have It Your Way!

#### TOC



	Table Of Content						
#	k Name Link Page No						
1	Cover Page	Cover Page	1				
2	TOC	TOC	2				
3	ELECTRICAL BOM	ELECTRICAL BOM	3				
5	HVAC BOM	HVAC BOM	7				
4	PLUMBING BOM	PLUMBING BOM	10				
6	ARCHITECTURAL BOM	ARCHITECTURAL BOM	15				

#### Have It Your Way!

The material types listed in this document were selected based on personal preferences. The Customer is encouraged to make changes to the material types in accordance with local customs, regulations, and personal preferences. Have It Your Way!

#### **GENERAL NOTES**

- 1 This BOM (Bill of Materials) is prepared as a Materials Shopping List to help builders and DIYers gain a complete understanding of most if not all elements required for the complete construction of this structure, according to the original design documents provided by FrameUpNow.
- 2 All quantities and specifications are subject to change based on the final design, field measurements, availability of products and customer preferences. The customer should verify all information prior to purchasing materials.
- 3 All products and elements in the list shall conform to the International Residential Code (IRC), or any other local and international building codes, safety regulations, and standards that are applicable to the location of the structure.
- 4 If any changes are made by the customer to the list of materials specified in this document, the customer is responsible for assuring that the correct type and quantity of materials are utilized in accordance with local building codes.
- 5 FrameUpNow, will not be held responsible for any misuse of this document, the products listed, or for deviations from the content that are made due to changes in specifications, pricing, availability, or customer preferences.
- 6 The customer is advised to consult a qualified professional or technician prior to purchasing materials for specialized construction system items. Some items including but not limited to caseworks, doors and windows may require as built measurements prior to purchase to confirmation of final dimensions.
- 7 If there are additional trim elements or specific installation methods, the total amount of materials needed might vary Consider any additional trim required for corners, intersections, or other architectural details that might cause this variations before procedding to purchase and construction.

#### **ARCHITECTURAL BOM**

12-WISDOM-909-2Bd2Ba-Craftsman-550							
ARCHITECTURAL MATERIAL SHOPPING LIST							
Item ADDI IANCES	Туре	Unit	Quantity	Description			
Refrigerator		PCS	1				
Range							
-							
		PCS	1				
Kitchen Cabinets		FT	16.2				
Laundry Cabinets		FT	3				
Vanity Cabinets		FT	2.25				
Kitchen countertop		SF	2				
Medicine Cabinets		PCS	24.58				
Island		FT	0				
Peninsula		FT	0				
Closets	Cupboard	SF	81				
CEILING							
Ceiling Board	Dry Wall	SF	654				
Dry Wall Fastener	Screw						
Vapor Retarder	Polyethylene film						
Vapor Retarder Fastener	Nails with washer heads						
Ceiling Board (MRD)	Moisture resistant drywall						
	•						
	Marine Plywood						
·	Sciew		0				
		FT	671				
FLOORING							
Main Living Space		SF	330				
Bathroom		SF	101				
		SF	383				
			482				
STRUCTURE		, J.					
Foundation		QE	1391				
	Refrigerator Range Washer Dryer Dish Washer CASEWORKS Kitchen Cabinets Laundry Cabinets Vanity Cabinets Kitchen countertop Medicine Cabinets Island Peninsula Closets CEILING Ceiling Board Dry Wall Fastener Vapor Retarder Fastener Ceiling Board (MRD) MRD Fastener Ceiling Board Marine Plywood Fastener Dry Wall Tape FLOORING Main Living Space Bathroom Bedrooms Porch	Refrigerator Range Washer Dryer Dish Washer CASEWORKS Kitchen Cabinets Laundry Cabinets Vanity Cabinets Island Peninsula Closets Celling Board Dry Wall Fastener Vapor Retarder Fastener Ceiling Board Marine Plywood Marine Plywood Fastener Ceiling Space Bathroom Bedrooms Porch STRUCTURE	Item   Type   Unit	Name			

#### **ARCHITECTURAL BOM**

	WALLS EXTERIOR				
28	Exterior Wall Siding		SF	1053	
29	Wall Paint		SF	1053	
30	Wall Shteathing (OSB)		SF	1053	
31	Shteathing Fastener	Self-drilling screws(100/pkt)	PKT	10.53	
32	Wall Insulation		SF	1591	
33	Wall Homewrap		SF	1053	
34	Home wrap Fastener	Stapled fastener (200/pkt)	PKT	4	
<u></u>	WALLS INTERIOR				
35	Cementitious Backer Board		SF	541.0	
36	Kerdi membrane		SF	541	
37	Kerdi membrane Fastener		SF	541	
38	Wall Ceramic Tile		SF	541	
39	Drywall Board		SF	1667	
40	Drywall Fastener	Self-drilling screws(100/pkt)	PKT	16.67	
41	Wall Paint		SF	2720	
42	Drywall Tape		FT	314	
Δ	DOORS				
43	Interior Swinging	3' - 0" X 6'-8"	PCS	1	
44	Interior Swinging	2' - 6" X 6'-8"	PCS	2	
45	Interior Swinging	2' - 0" X 6'-8"	PCS	1	
46	Interior Sliding	9' - 0" X 6'-8"	PCS	2	
47	Front Door With Sidelights	6' - 5" X 6'-8"	PCS	1	
48	Interior Swinging	3' - 0" X 6'-8"	PCS	1	
49	Interior Sliding	3' - 4" X 6'-8"	PCS	1	
50	Patio Sliding	5' - 0" X 6'-8"	PCS	2	

#### **ARCHITECTURAL BOM**

△	WINDOWS				
51	Sliding	5' - 3" X 3'-3"	PCS	1	
52	Sliding	2' - 3" X 3'-3"	PCS	1	
53	Sliding	3' - 3" X 3'-3"	PCS	2	
54	Single Hung	3' - 3" X 3'-3"	PCS	1	
55	Sliding	3' - 3" X 4'-3"	PCS	1	
56	Casement	2' - 3" X 3'-3"	PCS	2	
Δ	ROOF	'		'	
57	Roof Covering		SF	1245.0	
58	Roof Covering Fastener		PCS	623	
59	Roof Covering Fastener		PCS	623.0	
60	Roof Felt Paper		SF	3735.0	
61	Roof Felt Paper Fastener		PCS	9960	
62	Roof Sheathing		SF	1245	
63	Roof Sheathing Fastener		PCS	19.3	
64	Batten		FT	0.0	
65	Batten Fastener		PCS	0.0	
66	Soffit		SF	162.0	
67	Soffit Fastener		PCS	81.0	
68	Fascia		FT	145	
69	Fascia board fastener		PCS	73.0	
70	Roof Insulation		SF	1245.0	



		LECTRICAL MATE	DIVI CHUDDIY	IC LIST	
lo.	Item E		Unit	Quantity	Description
10.	LIGHTING FIXTURES	Туре	Uiill	Quantity	Description
1	Kitchen Ceiling Light		PCS	5	
2	Exterior Wall Mounted Light		PCS	6	
3	Livingroom Ceiling Light With Fan		PCS	1	
4	Bedroom Ceiling Light With Fan		PCS	2	
5	Bedroom Ceiling Light		PCS	8	
6	Dining Ceiling Light		PCS	1	
7	Bathroom Wall Mounted Light		PCS	2	
8	Bathroom Ceiling Light		PCS	4	
9	Livingroom Ceiling Light		PCS	2	
10	Hall & Entry Ceiling Light		PCS	3	
	Smoke Detector		PCS	3	
<u> </u>	ELECTRICAL FITTINGS		1 00		
11	Standard Receptacle 120V	15A	PCS	14	
12	GFCI Receptacle 120V	20 A	PCS	12	
13	GFCI Receptacle 240V	30 A	PCS	4	
14	GFCI Receptacle 240V	40 A	PCS	1	
15	GFCI Receptacle 240V	60	PCS	1	
16	Fan Switch		PCS	1	
17	Single Pole Switch		PCS	12	
18	ThreeWay With Dimmer Switch		PCS	4	
19	Dimmer		PCS	4	
<u> </u>	ELECTRICAL CONDUITS & WIRING	·	'		
	ROMEX 14 AWG	14/2 w/ground	FT	202.26	
23	ROMEX 12 AWG	12/2 w/ground	FT	396.76	
24	ROMEX 10 AWG	10/2 w/ground	FT	21.64	
25	ROMEX 10 AWG	10/3 w/ground	FT	92.85	
26	ROMEX 10 AWG	8/2 w/ground		0	
27	ROMEX 8 AWG	8/3 w/ground	FT	27.63	
28	ROMEX 6 AWG	6/3 w/ground	FT	29.23	



29	Bare Copper Ground Wire 6 AWG				
30	ELECTRICAL BOXES & CIRCUTES				
31	Panelboard -240V 1 Phase MLO	200 AMP	PCS	1	
32	Circuit breaker	15 A	PCS	6	
33	Circuit breaker	20 A	PCS	6	
34	Circuit breaker	30 A	PCS	3	
35	Circuit breaker	31 A	PCS	1	
36	Circuit breaker	40 A	PCS	1	
37	Circuit breaker	60 A	PCS	1	
38	Single Gang Switch Box		PCS	4	
39	Double Gang Switch Box		PCS	1	
40	Double Gang Switch Box		PCS	3	
41	Triple Gang Switch Box		PCS	3	
42	Pull Box	#1/4	PCS	28	
43	Junction Box	Tee-Aluminum-Rectangle	PCS	1	
44	Junction Box	Cross-Aluminum-Rectangle	PCS	0	
45	Receptacle Box		PCS	32	



		DI LIMDINO OVOTER	A MATEDIA!	CHODDIA	IC LICT					
PLUMBING SYSTEM MATERIAL SHOPPING LIST  No.   Item   Type   Unit   Quantity   Unit Price   Total   Description										
	PLUMBING FIXTURES & ACCESSORIES	туре	Onit	Quantity	Unit Frice	I Oldi	Description			
<u> </u>	Bath Tub (Alcove Tub)		PCS							
	Dati   Tab (		1.00	0						
2	Kitchen Sink		PCS	-						
_			. 55	1						
3	Kitchen Faucets		PCS	'						
Ŭ	THEORETT GUODE		1.00	1						
4	Vanity Sink		PCS	<u>'</u>						
	,			2						
5	Bath room Faucets		PCS							
				2						
6	Water Closet		PCS	_						
				1						
7	Shower Trim		PCS	<u>'</u>						
				2						
8	Shower Tray		PCS	_						
				2						
9	Water Heater		PCS							
				1						
10	Hose Bib		PCS							
				2						
11	Shutoff Valve		PCS							
				8						
12	Hanging pipe clamp		PCS							
				18						
13	Gate Valve		PCS							
				1						
14	Dishwasher Supply Single Connector		PCS							
				1						
15	Dishwasher Sewage Single Connector		PCS							
				1						
16	Laundry Sweat Connector		PCS							
				1						
	SANITARY & PLUMBING PIPES									
1	ABS (Acrylonitrile Butadiene Styrene) Pipes	ø 1"	FT							
_				0						
2	ABS (Acrylonitrile Butadiene Styrene) Pipes	ø 1 1/2"	FT							
2	ADC (Application Date discuss Ct. ADC)	~ O"		18.5						
3	ABS (Acrylonitrile Butadiene Styrene) Pipes	ø 2"	FT							
1	ABS (Acrylonitrile Butadiene Styrene) Pipes	g 2"		51						
4	ADS (ACIVIOLIILIIIE BULAUIEIIE STYFERE) PIPES	ø 3"	FT							
5	PEX (Cross-linked polyethylene) Pipes	ø 1/2"		14						
J	Lat (01000-illined polyetilyletie) Fipes	ש ווע	FT	126						
6	PEX (Cross-linked polyethylene) Pipes	ø 3/4"		120						
J	Las (01000-illined polyetilyletie) Fipes	F10 0	FT	22						
7	PEX (Cross-linked polyethylene) Pipes	ø 1"								
	. 2. (Stoce limes porjoiny) i ipos	"	FT	0						
8	PVC Pipes Sch.80 - Rigid	ø 1 1/2"		0						
_	. 15 1 ipod Gorillou Taigliu	D 1 1/2	FT	59						
9	PVC Pipes Sch.80 - Rigid	ø 2"		33						
-		-	FT	0						
10	PVC Pipes Sch.80 - Rigid	ø 3"								
•	F		FT	8						
11	Flex Pipe Round	ø 1/2"								
			PCS	8						
_										
	+			+						
_										

#### **PLUMBING BOM**



	PURE EITTINGS						
^	PIPE FITTINGS						
<u>0</u> 24							
27	ABS 90 Degree Bend Elbow	1 1/2"ø-1 1/2"ø		PCS	3		
25	ABS 30 Degree Bend Libow	11/2 9-11/2 9		1 63			
	ABS 90 Degree Bend Elbow	2"ø-2"ø		PCS	2		
26							
	ABS 90 Degree Bend Elbow	3"ø-3"ø		PCS	2		
27	-						
	ABS Bend Long Sweep Elbow	2"ø-2"ø		PCS	1		
28							
	ABS P-Trap	1 1/2"ø-1 1/2"ø		PCS	4		
29							
	ABS P-Trap	2"ø-2"ø		PCS	1		
30							
	ABS Reducer Elbow	2"ø-1 1/2"ø		PCS	3		
31							
20	ABS Reducer Elbow	3"ø-2"ø		PCS	3		
32	ADS TEE EIL	2114 2114 2114		DCC.	_		
33	ABS TEE Elbow	2"ø-2"ø-2"ø		PCS	2		
JJ	ABS TEE Elbow	3"ø-3"ø-3"ø		PCS	1		
34	ADD TEE CIDOW	ע כיע כיע כ		1.03	1		
• 1	ABS Trap P	2"ø-2"ø		PCS	1		
35	ALS TRUPT	2 9 2 9		1 65			
	ABS Vent Cap Elbow	2"ø		PCS	3		
36		- F					
	ABS WASTE DOUBLE TEE	1 1/2"ø-1 1/2"ø-1 1/2"ø-1 1/2	2"ø	PCS	1		
37							
	ABS WASTE DOUBLE TEE	2"ø-2"ø-2"ø		PCS	1		
38							
	ABS WASTE DOUBLE TEE	3"ø-3"ø-3"ø		PCS	1		
39							
	ABS Wye Combination with 8th Bend Elbow	2"ø-2"ø-1 1/2"ø		PCS	1		
40							
	ABS Wye Combination with 8th Bend Elbow	3"ø-3"ø-1 1/2"ø		PCS	1		
41							
40	ABS Wye Combination with 8th Bend Elbow	3"ø-3"ø-2"ø		PCS	1		
42							
43	ABS Wye Combination with 8th Bend Elbow	3"ø-3"ø-3"ø		PCS	1		
43	Book Boile Webs Contains	211 4 211 4		nec	22		
44	Bend Rain Water System	2"ø-2"ø		PCS	22		
	Bend Sewerage System	2"ø-2"ø		PCS	7		
45	benu Sewerage System	2 9-2 9		rG.	,		
	PEX 90 Degree Elbow	1/2"ø-1/2"ø		PCS	21		
46		-1- > -1- >		1			
	PEX 90 Degree Elbow	3/4"ø-3/4"ø		PCS	7		
47							
	PEX Tee Elbow	1/2"ø-1/2"ø-1/2"ø		PCS	10		
48							
	PEX Tee Elbow	3/4"ø-3/4"ø-3/4"ø		PCS	7		
49							
	PEX Transition Elbow	1"ø-3/4"ø		PCS	2		
50							
	PEX Transition Elbow	3/4"ø-1/2"ø		PCS	11		
51							
	PVC 90 Degree Bend Elbow	2"ø-2"ø		PCS	1		
52							
	PVC TEE Elbow	2"ø-2"ø-2"ø		PCS	3		



	1.	2-WISDOM-909-2Bd2B	a-Craftsm	an-550	A Car	
	HVAC SYSTEM N	ATERIAL SHOPPING				
No.	Item HVAC_DUCTS	Туре	Unit	Quantity	Description	
<u></u>	HVAC_DUCIS					
1	PIPE (REFRIGERANT LINE)	1/4" (Ø)	FT	9.1		
2	PIPE (REFRIGERANT LINE)	3/8" (Ø)	FT	68.64		
3	PIPE (REFRIGERANT LINE)	1/2" (Ø)	FT	9.15		
4	PIPE (REFRIGERANT LINE)	5/8" (Ø)	FT	0.19		
5	PIPE (REFRIGERANT LINE)	3/4" (Ø)	FT	94.27		
6	Drayer hose	4" Ø	FT	3.3		
7	FLEX DUCT ROUND	4" (Ø)	FT	6.1		
Δ	DUCT FITTINGS & ACCESSORIE	S				
8	Elbow (REFRIGERANT LINE)	1/2" (Ø)-1/2" (Ø)	PCS	2		
9	Elbow (REFRIGERANT LINE)	1/4" (Ø)-1/4" (Ø)	PCS	2		
10	Elbow (REFRIGERANT LINE)	3/4" (Ø)-3/4" (Ø)	PCS	19		
11	Elbow (REFRIGERANT LINE)	3/8" (Ø)-3/8" (Ø)	PCS	11		
12	Elbow (REFRIGERANT LINE)	5/8" (Ø)-5/8" (Ø)	PCS	1		
13	Transition (REFRIGERANT LINE)	3/4" (Ø)-1/2" (Ø)	PCS	4		
14	Transition (REFRIGERANT LINE)	3/4" (Ø)-3/8" (Ø)	PCS	3		
15	Transition (REFRIGERANT LINE)	3/8" (Ø)-1/4" (Ø)	PCS	1		
16	TEE (REFRIGERANT LINE)	3/4" (Ø)-3/4" (Ø)-3/4" (Ø)	PCS	2		
17	TEE (REFRIGERANT LINE)	3/8" (Ø)-3/8" (Ø)-3/8" (Ø)	PCS	2		
18	ROUND TRANSITION(ANGLE)	45 DEGREE	PCS	4		
19	ROOF VENT	3"(Ø)	PCS	2		
Δ	HVAC_EQUIPMENTS	I	I			
1	AIR HANDLING UNIT	WALL MOUNTED	PCS	3		
2	CONDENSER	OUTDOOR UNIT	PCS	1		
3	EXHAUST FAN	75 CFM	PCS	2		
4	EXHAUST HOOD	WALL MOUNTED	PCS	1		
5	Drayer: VENT	Drayer: VENT	PCS	1		
6	Hood-Wall: VENT	Hood-Wall: VENT	PCS	1		



# Nam	ne	Link	Page No
1 COV	VER PAGE	COVER PAGE	1
2 TOC	C	TOC	2
3 ARC	CHITECTURAL BOM	ARCHITECTURAL BOM_	3
3 ELE	ECTRICAL BOM	ELECTRICAL BOM	5
4 PLU	JMBING BOM	PLUMBING BOM	6
5 HVA	AC BOM	HVAC BOM	7

#### **Have It Your Way!**

The material types listed in this document were selected based on personal preferences. The Customer is encouraged to make changes to the material types in accordance with local customs, regulations, and personal preferences. Have It Your Way!

#### **GENERAL NOTES**

- This BOM (Bill of Materials) is prepared as a **Materials Shopping List** to help builders and DIYers gain a complete understanding of most if not all elements required for the complete construction of this structure, according to the original design documents provided by FrameUpNow.
  - All quantities and specifications are subject to change based on the final design, field measurements, availability of products and customer preferences. The customer should verify all information prior to purchasing materials.
  - All products and elements in the list shall conform to the International Residential Code (IRC), or any other local and international building codes, safety regulations, and standards that are applicable to the location of the structure.
  - 4 If any changes are made by the customer to the list of materials specified in this document, the customer is responsible for assuring that the correct type and quantity of materials are utilized in accordance with local building codes.
  - FrameUpNow ,will not be held responsible for any misuse of this document, the products listed, or for deviations from the content that are made due to changes in specifications, pricing, availability, or customer preferences.
  - The customer is advised to consult a qualified professional or technician prior to purchasing materials for specialized construction system items. Some items including but not limited to caseworks, doors and windows may require as built measurements prior to purchase to confirmation of final dimensions.
  - 7 If there are additional trim elements or specific installation methods, the total amount of materials needed might vary. Consider any additional trim required for corners, intersections, or other architectural details that might cause this variations before procedding to purchase and construction.

#### **ELECTRICAL BOM**



	LIGHTING FIXTURES								
#	Item	Туре	Description, Manufacturer, SKU	Unit	Quantity	Unit Price	Total		
1	Kitchen Ceiling Light			PCS	5				
2	Exterior Wall Mounted Light			PCS	6				
3	Livingroom Ceiling Light With Fan			PCS	1				
4	Bedroom Ceiling Light With Fan			PCS	2				
5	Bedroom Ceiling Light			PCS	8				
6	Dining Ceiling Light			PCS	1				
7	Bathroom Wall Mounted Light			PCS	2				
8	Bathroom Ceiling Light			PCS	4				
9	Livingroom Ceiling Light			PCS	2				
10	Hall & Entry Ceiling Light			PCS	3				
11	Smoke Detector			PCS	3				
12									
13									
14									
15									
16									

#### **ELECTRICAL BOM**



#	ELECTRICAL FITTING			lee o	I	l	
	Item	Туре	Description,Manufacturer,SKU	Unit	Quantity	Unit Price	Total
_	Standard Receptacle 120V	15A		PCS	14		
2	GFCI Receptacle 120V	20 A		PCS	12		
	GFCI Receptacle 240V	30 A		PCS	4		
ļ	GFCI Receptacle 240V	40 A		PCS	1		
5	GFCI Receptacle 240V	60		PCS	1		
5	Fan Switch			PCS	1		
7	Single Pole Switch			PCS	12		
3	ThreeWay With Dimmer Switch			PCS	4		
)	Dimmer			PCS	4		
.0							
.1							
2							
.3							
.4							
.5							
.6							

#### **ELECTRICAL BOM**



	ELECTRICAL COND	UITS & WIRING				
#	Item	Туре	Description,Manufacturer,SKU	Unit	Quantity Unit P	rice Total
1	ROMEX 14 AWG	14/2/W/ground		FT	202.26	
2	ROMEX 12 AWG	12/2/W/ground		FT	396.76	
3	Romex 10 AWG	10/2/W/ground		FT	21.64	
4		10/3/W/ground		FT	92.85	
5	ROMEX 8 AWG	8/3/W/ground		FT	27.63	
6	ROMEX 6 AWG	6/3/W/ground		FT	29.23	
7	Bare Copper Ground Wire 6 AWG					
8						
9						
10						
11						
12						
13						
14						

## **ELECTRICAL BOM**



	Item	Туре	Description,Manufacturer,SKU	Unit	Quantity	Unit Price ☐	Total
•	panelboard -240V 1 PHASE	200 AMP		PCS	1		
	Circuit breaker	15 A		PCS	6		
	Circuit breaker	20 A		PCS	6		
	Circuit breaker	30 A		PCS	3		
5	Circuit breaker	40 A		PCS	1		
ò	Circuit breaker	60 A		PCS	1		
,	Single Gang Switch Box			PCS	4		
3	Double Gang Switch Box			PCS	4		
)	Triple Gang Switch Box			PCS	3		
.0	Pull Box	#1/4		PCS	28		
.1	Junction Box	Tee-Aluminum- rectangle		PCS	1		
.2	Receptacle Box			PCS	32		
.3							
.4							
15							

# **HVAC BOM**



			HVAC_DUCTS				
#	Item	Туре	Description, Manufacturer, SKU	Unit	Quantity	Unit Price	Total
1	PIPE (REFRIGERANT LINE)	1/4'' (Ø)		FT	9.1		
2	PIPE (REFRIGERANT LINE)	3/8" (Ø)		FT	68.64		
3	PIPE (REFRIGERANT LINE)	1/2" (Ø)		FT	9.15		
4	PIPE (REFRIGERANT LINE)	5/8'' (Ø)		FT	0.19		
5	PIPE (REFRIGERANT LINE)	3/4" (Ø)		FT	94.27		
6	Drayer hose	4'' (Ø)		FT	3.3		
7	FLEX DUCT ROUND	4'' (Ø)		FT	6.1		
7							
8							
9							
10							
11							
12							
13							
14							
15							

 $\ @\ [2024]$  [FrameUpNow]. All rights reserved

# **HVAC BOM**



			OUCT FITTINGS & ACCESSORIES				
#	Item	Туре	Description, Manufacturer, SKU	Unit	Quantity	Unit Price	Total
1	Elbow (REFRIGERANT LINE)	1/2" (Ø)-1/2" (Ø)		PCS	2		
2	Elbow (REFRIGERANT LINE)	1/4'' (Ø)-1/4'' (Ø)		PCS	2		
3	Elbow (REFRIGERANT LINE)	3/4'' (Ø)-3/4'' (Ø)		PCS	19		
4	Elbow (REFRIGERANT LINE)	3/8" (Ø)-3/8" (Ø)		PCS	11		
5	Elbow (REFRIGERANT LINE)	5/8'' (Ø)-5/8'' (Ø)		PCS	1		
6	Transition (REFRIGERANT LINE)	3/4'' (Ø)-1/2'' (Ø)		PCS	4		
7	Transition (REFRIGERANT LINE)	3/4'' (Ø)-3/8'' (Ø)		PCS	3		
8	Transition (REFRIGERANT LINE)	3/8'' (Ø)-1/4'' (Ø)		PCS	1		
9	TEE (REFRIGERANT LINE)	3/4'' (Ø)-3/4'' (Ø)-3/4'' (Ø)		PCS	2		
10	TEE (REFRIGERANT LINE)	3/8" (Ø)-3/8" (Ø)-3/8" (Ø)		PCS	2		
11	ROUND TRANSITION(ANGLE)	45 DEGREE		PCS	4		
12	ROOF VENT	3''(Ø)		PCS	2		
13							
14							
15							
16							

# **HVAC BOM**



			HVAC_EQUIPMENTS				
#	Item	Туре	Description, Manufacturer, SKU	Unit	Quantity	Unit Price	Total
1	AIR HANDLING UNIT	WALL MOUNTED		PCS	3		
2	CONDENSER	OUTDOOR UNIT		PCS	1		
3	EXHAUST FAN	75 CFM		PCS	2		
4	Hood-Wall: VENT	Hood-Wall: VENT		PCS	1		
5	EXHAUST HOOD	WALL MOUNTED		PCS	1		
6	Drayer: VENT	Drayer: VENT		PCS	1		
7							
8							
9							
10							
11							
12							
13							
14							
15							



$\triangle$	PLUMBING FIXTURES & ACCESSORIES									
<b>#</b>	Item	Туре	Description, Manufacturer, SKU	Unit	Quantity	Unit Price	Total			
1	Bath Tub (Alcove Tub)			PCS	0					
2	Kitchen Sink			PCS	1					
3	Kitchen faucets			PCS	1					
1	Vanity Sink			PCS	2					
5	Bath room faucets			PCS	2					
3	Water Closet			PCS	1					
7	Shower Trim			PCS	2					
3	Shower Tray			PCS	2					
)	Water Heater			PCS	1					
10	Hose Bib			PCS	2					
11	Shutoff Valve			PCS	8					
12	Hanging pipe clamp			PCS	18					
13	Gate Valve			PCS	1					
14	Dishwasher Supply Single Connector			PCS	1					
15	Dishwasher Sewage Single Connector			PCS	1					
6	Laundry Sweat Connector			PCS	1					



		SANI	TARY & PLUMBING PIPES				
#	Item	Туре	Description, Manufacturer, SKU	Unit	Quantity	Unit Price	Total
	ABS (Acrylonitrile Butadiene Styrene) Pipes	ø 1"		FT	0		
	ABS (Acrylonitrile Butadiene Styrene) Pipes	ø 1 1/2"		FT	18.5		
3	ABS (Acrylonitrile Butadiene Styrene) Pipes	ø 2"		FT	51		
ļ	ABS (Acrylonitrile Butadiene Styrene) Pipes	ø 3"		FT	14		
5	PEX (Cross-linked polyethylene) Pipes	ø 1/2"		FT	126		
6	PEX (Cross-linked polyethylene) Pipes	ø 3/4"		FT	22		
7	PEX (Cross-linked polyethylene) Pipes	ø 1"		FT	0		
}	PVC Pipes Sch.80 - Rigid	ø 1 1/2"		FT	8		
)	PVC Pipes Sch.80 - Rigid	ø 2"		FT	59		
0	PVC Pipes Sch.80 - Rigid	ø 3"		FT	0		
1	Flex Pipe Round	ø 1/2"		PCS	8		
12							
13							
4							
5							

 $\ @\ [2024]$  [FrameUpNow]. All rights reserved



		PIPE I	FITTINGS 01				
#	Item	Туре	Description, Manufacturer, SKU	Unit	Quantity	Unit Price	Total
1	ABS 90 Degree Bend Elbow	1 1/2"ø-1 1/2"ø	,	PCS	3		
2	ABS 90 Degree Bend Elbow	2"ø-2"ø		PCS	2		
3	ABS 90 Degree Bend Elbow	3"ø-3"ø		PCS	2		
4	ABS Bend Long Sweep Elbow	2"ø-2"ø		PCS	1		
5	ABS P-Trap	1 1/2"ø-1 1/2"ø		PCS	4		
6	ABS P-Trap	2"ø-2"ø		PCS	1		
7	ABS Reducer Elbow	2"ø-1 1/2"ø		PCS	3		
8	ABS Reducer Elbow	3"ø-2"ø		PCS	3		
9	ABS TEE Elbow	2"ø-2"ø-2"ø		PCS	2		
10	ABS TEE Elbow	3"ø-3"ø		PCS	1		
11	ABS Trap P	2"ø-2"ø		PCS	1		
12	ABS Vent Cap Elbow	2"ø		PCS	3		
13	ABS WASTE DOUBLE TEE	1 1/2"ø-1 1/2"ø-1 1/2"ø-1 1/2"ø		PCS	1		
14	ABS WASTE DOUBLE TEE	2"ø-2"ø-2"ø		PCS	1		
15	ABS WASTE DOUBLE TEE	3"ø-3"ø-3"ø		PCS	1		



		PIPE FITTINGS 02									
‡	Item	Туре	Description, Manufacturer, SKU	Unit	Quantity	Unit Price	Total				
1	ABS Wye Combination with 8th Bend Elbow	2"ø-2"ø-1 1/2"ø		PCS	1						
2	ABS Wye Combination with 8th Bend Elbow	3"ø-3"ø-1 1/2"ø		PCS	1						
3	ABS Wye Combination with 8th Bend Elbow	3"ø-3"ø-2"ø		PCS	1						
4	ABS Wye Combination with 8th Bend Elbow	3"ø-3"ø-3"ø		PCS	1						
5	Bend Rain Water System	2"ø-2"ø		PCS	22						
6	Bend Sewerage System	2"ø-2"ø		PCS	7						
7	PEX 90 Degree Elbow	1/2"ø-1/2"ø		PCS	21						
8	PEX 90 Degree Elbow	3/4"ø-3/4"ø		PCS	7	,					
9	PEX Tee Elbow	1/2"ø-1/2"ø-1/2"ø		PCS	10						
10	PEX Tee Elbow	3/4"ø-3/4"ø-3/4"ø		PCS	7						
11	PEX Transition Elbow	1"ø-3/4"ø		PCS	2						
12	PEX Transition Elbow	3/4"ø-1/2"ø		PCS	11						
13	PVC 90 Degree Bend Elbow	2"ø-2"ø		PCS	1						
14	PVC TEE Elbow	2"ø-2"ø-2"ø		PCS	3						
15											



			APPLIANCES				
#	Item	Туре	Description, Manufacturer, SKU	Unit	Quantity U	nit Price	Total
1	Refrigerator			PCS	1		
2	Range			PCS	1		
3	Washer Front Load	Stackable		PCS	1		
4	Dryer Front Load	Stackable		PCS	1		
5	Dish Washer			PCS	1		
6							
7							
8							
9							
10							
11							
12							
13							
14							
15							
16							



			CASEWORKS 01				
#	Item	Туре	Description, Manufacturer, SKU	Unit	Quantity	Unit Price	Total
1	Kitchen Cabinet			FT	16.2		
2	Laundry Cabinet			FT	3		
3	Vanity Cabinet			FT	2.25		
4	Medicine Cabinet			PCS	2		
5	Kitchen countertop			SF	24.58		
6	Laundry Countertop			PCS	0		
7	Bathroom Countertop			SF	0		
8	Island			FT	0		
9	Peninsula			FT	0		
10	Closets	cupboard		SF	81		
11							
12							
13							
14							
15							
16							



			CEILING 01				
#	Item	Туре	Description, Manufacturer, SKU	Unit	Quantity	Unit Price	Total
	LIVING ROOM + KITCHEN	+ DINING		SF	487.5		
1	Ceiling Board	Drywall		SF	488		
2	Drywall Fastener	Screw		PCS	853		
3	Vapor Retarder	Polyethylene film		SF	487.5		
4	Vapor Retarder Fastener	Nails with washer heads		PCS	1462.6		
	BATH ROOM			SF	39.8		
5	Ceiling Board	MRD (Moisture resistant drywall)		SF	40		
6	MRD Fastener	Screw		PCS	70		
	HALL			SF	17.5		
7	Ceiling Board	Drywall		SF	18		
8	Drywall Fastener	Screw		PCS	31		
9	Vapor Retarder	Polyethylene film		SF	17.5		
10	Vapor Retarder Fastener	Nails with washer heads		PCS	52.5		
	COVERED PORCH			PCS	53.0		
11	Ceiling Board	Marine Plywood		SF	416		
12	Exterior Grade Plywood	Screw		PCS	728		



#	Item	Туре	Description, Manufacturer, SKU	Unit	Quantity	Jnit Price	Total
	BED ROOM 1	'		SF	124.3		
L3	Ceiling Board	Drywall		SF	124		
4	Drywall Fastener	Screw		PCS	217		
.5	Vapor Retarder	Polyethylene film		SF	124.3		
.6	Vapor Retarder Fastener	Nails with washer heads		PCS	372.8		
	BED ROOM 2			SF	126.2		
17	Ceiling Board	Drywall		SF	126		
.8	Drywall Fastener	Screw		PCS	221		
19	Vapor Retarder	Polyethylene film		SF	126.2		
20	Vapor Retarder Fastener	Nails with washer heads		PCS	378.6		
	ENTRY			SF	42.6		
21	Ceiling Board	Drywall		SF	43		
22	Drywall Fastener	Screw		PCS	75		
23	Vapor Retarder	Polyethylene film		SF	42.6		
24	Vapor Retarder Fastener	Nails with washer heads		PCS	127.8		



			CEILING 02				
#	Item	Туре	Description, Manufacturer, SKU	Unit	Quantity	Unit Price	Total
	CL 2			SF	19.3		
25	Ceiling Board	Drywall		SF	19		
26	Drywall Fastener	Screw		PCS	34		
27	Vapor Retarder	Polyethylene film		SF	19.3		
28	Vapor Retarder Fastener	Nails with washer heads		PCS	57.8		
	CL 3			SF	8.8		
29	Ceiling Board	Drywall		SF	9		
30	Drywall Fastener	Screw		PCS	15		
31	Vapor Retarder	Polyethylene film		SF	8.8		
32	Vapor Retarder Fastener	Nails with washer heads		PCS	26.4		
	WH	'		SF	7.7		
33	Ceiling Board	Drywall		SF	8		
34	Drywall Fastener	Screw		PCS	13		
35	Vapor Retarder	Polyethylene film		SF	7.7		
36	Vapor Retarder Fastener	Nails with washer heads		PCS	23.1		
		1	CEILING 02	1	1	1	
#	Item	Туре	Description, Manufacturer, SKU	Unit	Quantity	Unit Price	Total
	PORCH			SF	114.0		
37	Ceiling Board	Marine Plywood		SF	114		
38	Exterior Grade Plywood	Screw		PCS	199		



			FLOORING INTERIOR	01			
	Item	Туре	Description, Manufacturer, SKU	Unit	quantity	Unit Price	Total
	BEDROOM #1						
	Bedroom Flooring			SF	164		
	Wood underlay	Foam Pad Polyethylene		SF	164		
	Vapor Retarder	Vapor Barrier Polyethylene		SF	164		
	CL #1						
	Closet Flooring			SF	20		
	Wood underlay	Foam Pad Polyethylene		SF	20		
	Vapor Retarder	Vapor Barrier Polyethylene		SF	20		
	BATH#1						
	Tile Finish			SF	43		
	Adhesive	1/2" Thin set Mortar		SF	43		
	Vapor Retarder	Vapor Barrier Polyethylene		SF	43		
	LIVING ROOM AND KITCHEN						
)	Living Room Flooring			SF	330		
1	Wood underlay	Foam Pad Polyethylene		SF	330		
2	Vapor Retarder	Vapor Barrier Polyethylene		SF	330		



_			FLOORING INTERIOR				
	Item	Туре	Description, Manufacturer, SKU	Unit	quantity	Unit Price	Total
	BEDROOM #2						
3	Bedroom Flooring			SF	171		
4	Wood underlay	Foam Pad Polyethylene		SF	171		
5	Vapor Retarder	Vapor Barrier Polyethylene		SF	171		
	CL#2						
6	Closet Flooring			SF	20		
7	Wood underlay	Foam Pad Polyethylene		SF	20		
8	Vapor Retarder	Vapor Barrier Polyethylene		SF	20		
	W/D						
9	Tile Finish			SF	8		
0	Adhesive	1/2" Thin set Mortar		SF	8		
1	Vapor Retarder	Vapor Barrier Polyethylene		SF	8		
	BATH #2						
2	Tile Finish			SF	43		
3	Adhesive	1/2" Thin set Mortar		SF	43		
4	Vapor Retarder	Vapor Barrier Polyethylene		SF	43		



	FLOORING INTERIOR 02								
‡	Item	Туре	Description, Manufacturer, SKU	Unit	quantity Unit Price	Total			
	BOILER RM.								
25	Tile Finish			SF	7				
6	Adhesive	1/2" Thin set Mortar		SF	7				
7	Vapor Retarder	Vapor Barrier Polyethylene		SF	7				
	CL#3								
8	Closet Flooring			SF	8				
9	Wood underlay	Foam Pad Polyethylene		SF	8				
0	Vapor Retarder	Vapor Barrier Polyethylene		SF	8				



		FLOORING EXTERIOR						
	Item	Туре	Description, Manufacturer, SKU	Unit	quantity	Unit Price		
	PORCH							
	Tile Finish	3/4" non-slippery Porcelain Tile	Finish	SF	482			
2	Adhesive	1/2" Thin set Mortar		SF	482			
3	Vapor Retarder	Vapor Barrier Polyethylene		SF	482			
	STRUCTURE							
1	Concrete Slab	4"concrete cast in situ		CF	312.5			
5	Insulation	Rigid insulation		SF	224			
5	Hard core	Compacted soil		CF	362.1			
•	Re-bar	#4 re-bar		Ton	0.36			
3	Concrete Pad	4"concrete cast in situ		CF	1.58			
)	Slab edge	Turndown		CF	326.33			
10	Footing	Cast-in-place concrete		CF	40			



			WALLS: EXTERIOR			
	Item	Туре	Description, Manufacturer, SKU	Unit	quantity Unit Price	Total
	Exterior-Grade Plywood Horizontal Siding			SF	1053	
	Exterior-Grade Plywood Fastener	Self-drilling screws(100/pkt)		PKT	10.53	
3	Wall Paint			SF	1053	
•	Stone Copping	Masonry stone		SF	9	
,	Stone Veneer	Masonry stone		SF	89	
i	Mortar for Stone Veneer			SF	98	
7	Wall Shteathing (OSB)			SF	1053	
3	Shteathing Fastener	Self-drilling screws(100/pkt)		PKT	10.53	
	Wall Insulation			SF	1591	
.0	Wall Homewrap			SF	1053	
.1	Homewrap Fastener	Stapled fastener (200/pkt)		PKT	4	
12	Furring Strip			PCS	131.6	
L3	Furring Strip Fastener	Self-drilling screws(100/pkt)		PKT	10.53	



‡	Item	Туре	Description, Manufacturer, SKU	Unit	quantity U	nit Price	Total
	BATHROOM 1			SF	202		
L	Cementitious Backer Board			SF	202		
	Kerdi membrane			SF	202		
3	Kerdi membrane Fastener			SF	202		
1	Wall Ceramic Tile			SF	202		
	BATHROOM 2			SF	248		
5	Cementitious Backer Board			SF	248		
6	Kerdi membrane			SF	248		
7	Kerdi membrane Fastener			SF	248		
3	Wall Ceramic Tile			SF	248		
	BEDROOM 1			SF	345		
9	Drywall Board			SF	345		
10	Drywall Fastener	Self-drilling screws(100/pkt)		PKT	3.45		
l1	Wall Paint			SF	345		
12	Drywall Tape			FT	64.7		



			WALLS: INTERIOR 02				
‡	Item	Туре	Description, Manufacturer, SKU	Unit	quantity	Unit Price	Total
	BEDROOM 2			SF	297		
13	Drywall Board			SF	297		
L4	Drywall Fastener	Self-drilling screws(100/pkt)		PKT	2.97		
L5	Wall Paint			SF	297		
16	Drywall Tape			FT	56		
	CLOSET 1	·		SF	146		
17	Drywall Board			SF	146		
.8	Drywall Fastener	Self-drilling screws(100/pkt)		PKT	1.46		
19	Wall Paint			SF	146		
20	Drywall Tape			FT	27.5		
	CLOSET 2	1		SF	124		
21	Drywall Board			SF	124		
2	Drywall Fastener	Self-drilling screws(100/pkt)		PKT	1.24		
23	Wall Paint			SF	124		
24	Drywall Tape			FT	23.4		



			WALLS: INTERIOR 03	}		
#	Item	Туре	Description, Manufacturer, SKU	Unit	quantity Unit Price	Total
	CLOSET 3			SF	75	
25	Drywall Board			SF	75	
26	Drywall Fastener	Self-drilling screws(100/pkt)		PKT	0.75	
27	Wall Paint			SF	75	
28	Drywall Tape			FT	14.2	
	KITCHEN			SF	153	
29	Cementitious Backer Board			SF	23	
80	Drywall Board			SF	153	
31	Drywall Fastener	Self-drilling screws(100/pkt)		PKT	1.53	
32	Kerdi membrane			SF	23	
33	Kerdi membrane Fastener			SF	23	
34	Wall Ceramic Tile			SF	23	
35	Wall Paint			SF	153	
36	Drywall Tape			FT	28.7	



			WALLS: INTERIOR 04				
#	Item	Туре	Description, Manufacturer, SKU	Unit	Quantity Unit	t Price To	otal
	WD			SF	68		
37	Cementitious Backer Board			SF	68		
38	Kerdi membrane			SF	68		
39	Kerdi membrane Fastener			SF	68		
40	Wall Ceramic Tile			SF	68		
	WH			SF	72		
41	Drywall Board			SF	72		
42	Drywall Fastener	Self-drilling screws(100/pkt)		PKT	0.72		
43	Wall Paint			SF	72		
44	Drywall Tape			FT	13.5		
			WALLS: INTERIOR 05	· ·	14.4		
#	Item	Туре	Description, Manufacturer, SKU	Unit	Quantity Unit	t Price To	otal
	HALL			SF	196		
45	Drywall Board			SF	196		
46	Drywall Fastener	Self-drilling screws(100/pkt)		PKT	1.96		
47	Wall Paint			SF	196		
48	Drywall Tape			FT	36.8		
	LIVING ROOM			SF	259		
49	Drywall Board			SF	259		
50	Drywall Fastener	Self-drilling screws(100/pkt)		PKT	2.59		
51	Wall Paint			SF	259		
52	Drywall Tape			FT	48.9		

© [2024] [FrameUpNow]. All rights reserved



			DOORS			
‡	Item	Туре	Description, Manufacturer, SKU	Unit	Quantity Unit Price	Total
1	Interior Swinging	3' - 0" X 6'-8"		PCS	1	
2	Interior Swinging	2' - 6" X 6'-8"		PCS	2	
3	Interior Swinging	2' - 0" X 6'-8"		PCS	1	
ļ	Interior Sliding	9' - 0" X 6'-8"		PCS	2	
5	Front Door With Sidelights	6' - 5" X 6'-8"		PCS	1	
ĵ	Interior Swinging	3' - 0" X 6'-8"		PCS	1	
7	Interior Sliding	3' - 4" X 6'-8"		PCS	1	
3	Patio Sliding	5' - 0" X 6'-8"		PCS	2	
9	Interior Door Trim			FT	175.02	
10	Exterior Door Trim			FT	53.01	
12	Passage Lockset			PCS	4	
13	Entry Lockset			PCS	3	
14	Privacy Lockset			PCS	4	
9						
10						
11						
12						
13						
L4						
15						



			WINDOWS			
#	Item	Туре	Description, Manufacturer, SKU	Unit	Quantity Unit Price	Total
1	Sliding	5' - 3" X 3'-3"		PCS	1	
2	Sliding	2' - 3" X 3'-3"		PCS	1	
3	Sliding	3' - 3" X 3'-3"		PCS	2	
4	Single Hung	3' - 3" X 3'-3"		PCS	1	
5	Sliding	3' - 3" X 4'-3"		PCS	1	
6	Casement	2' - 3" X 3'-3"		PCS	2	
4	Interior Window Trim			FT	104	
5	Exterior Winodw Trim			FT	104	
6						
7						
8						
9						
10						
11						
12						
13						
14						
15						



	ROOF 01						
#	Item	Туре	Description, Manufacturer, SKU	Unit	Quantity	Unit Price	Total
1	Roof Covering			SF	1245.0		
2	Roof Covering Fastener			PCS	623		
3	Roof Felt Paper			SF	1245.0		
ļ	Roof Felt Paper Fastener			PCS	3735.0		
5	Roof Sheathing			SF	1245.0		
i	Roof Sheathing Fastener			PCS	9960		
1	Batten			FT	0.0		
3	Batten Fastener			PCS	0.0		
	Soffit			SF	162.0		
0	Soffit Fastener			PCS	81.0		
1	Fascia			FT	145.0		
2	Fascia board fastener			PCS	73		
3	Roof Insulation			SF	1245.0		