

## **WISDOM**

The Wisdom is a modern Traditional style 3 bedroom 2 bathroom home with a clean and inviting exterior. The light-colored siding and gray roof create a timeless and balanced appearance. The covered porch with wooden beams offers a shaded outdoor space, perfect for relaxing or entertaining. The inside of this home offers a simple open plan hosting living, dinging areas in one corner and three bedrooms on each corner of the house. This creates both functional and efficient layout while maintaining a spacious feel.

### Materials Shopping List

Please print and take this Materials Shopping List to your favorite Home Depot and ask for assistance in selecting the materials, fixtures and fittings to complete your new home.

Record your selection and the price of the item. Then do the math to determine the cost for your selections and the total cost of finishing your home.

## < CLICK HERE >

To Go To Materials Shopping List



# 37' - 8" BEDROOM 3 127 SF KITCHEN 163 SF LIVING ROOM 226 SF FRONT PORCH 122 SF PRIMARY SUITE BEDROOM 2 131 SF


## **FLOOR PLAN**

1194 SF

3 Bed Rooms




## **TABLE OF CONTENTS**

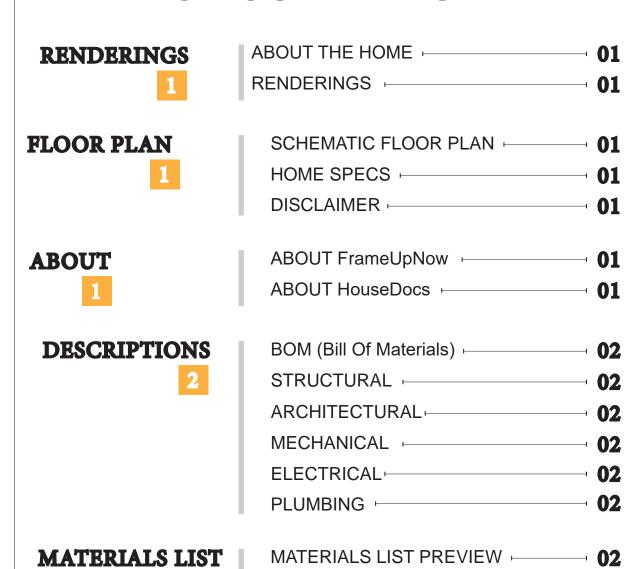

**HOW TO BUILD** 

CONSTRUCTION STEPS

**ARCHITECTURAL** 

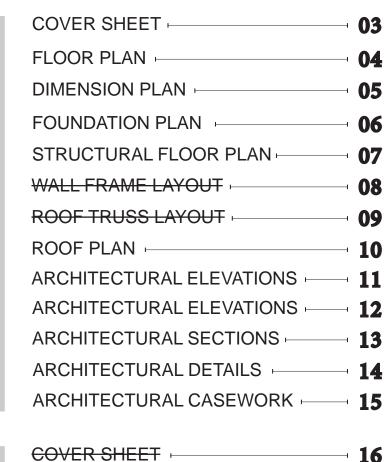

STRUCTURAL

**MATERIALS** 

**SHOPPING LIST** 

	WALL FRAME LAYOUT
	WALL PANEL & LAYOUT PLAN
	ROOF TRUSS LAYOUT
	STRUCTURAL SECTIONS
	WALL BRACING LAYOUT
	HOLD-DOWN PLAN
	STRUCTURAL DETAILS 1
	STRUCTURAL DETAILS 2
	STRUCTURAL DETAILS 3
	TRUSS BLOCKING LAYOUT
	SHEETROCK BACKING
	ROOF BRACING LAYOUT
MECHANICAL	COVER SHEET
30	HVAC PLAN
ELECTRICAL	SCHEDULE -
<b>32</b>	LIGHTING -
	POWER PLAN
	DIMENSION FOR LIGHTING
	DIMENSION FOR FITTING
	NOTES AND SOLIED III ES
PLUMBING	NOTES AND SCHEDULES
37	WATER SUPPLY & SEWAGE SYSTEM #

MATERIALS SHOPPING LIST

**GENERAL NOTES** 

## **ABOUT**



FrameUpNow is a design and manufacturing company providing precision-engineered home framing solutions. We offer a catalog of Affordable Homes, Tiny Homes, Garages, Shops and Barndominiums. FrameUpNow manufactures cold-formed steel (CFS) also known as Light Gauge Steel (LGS) framing components that conform to our engineered metal house frame plans or can be purchased as DIY skeleton kits.

The CFS/LGS framing is lightweight, easily assembled, and does not require heavy equipment or specialized labor, enabling homeowners to erect the frame themselves in just a few days. Unlike wood, the steel framing is impervious termites and bores, warping, expansion, and fire.

Our home plans come complete with a structural engineered stamp for permit approvals. Customers receive a full BOM also known as a Materials Shopping List to purchase finish materials from a Building Materials retailer. FrameUpNow prides itself on the quality and efficiency of our precision-engineered home framing solutions for construction professionals and DIY homeowners.



**KEY PLAN** 

NO.	DESCRIPTION	DATE		

NOTE:

LEGEND:

PROJECT

14-Wisdom-1194-3Bd2Ba-**Traditional-550** 

DRAWING NAME

## INTRODUCTION

CLIENT NAME:
PROJECT NUMBER:
DATE:
DESIGNED BY:
DRAWN BY:
CHECKED BY:

1101

SCALE:

© [2024] [FrameUpNow] . All rights reserved

application of these proprietary materials, in any form or format, is strictly prohibited. FrameUpNow assumes no liability for any issues arising from improper use of this marketing content.

DISCLAIMER: This documentation and all it's contents are the intellectual property of FrameUpNow. It is provided solely for marketing the services of FrameUpNow.

The preliminary information is not approved for actual construction use and is

not warranted to be complete or accurate. Unauthorized copying, distribution, or

**DISCLAIMER** 

## **DESCRIPTIONS**

## MATERIALS LIST

The BOM (Bill Of Materials) package, known as the Materials Shopping List document, provides:

Comprehensive Inventory: Detailed lists of essential materials sourced from architectural, mechanical, HVAC, electrical, and plumbing design drawing sets.

Precise Curation: Each item meticulously selected and organized for accuracy and efficiency in project planning.

Customizable Options: Customers can modify listed items to their preferences and calculate costs accordingly, ensuring alignment with personal project needs and budget.

Dedicated Space for Details: Includes tables for customers to note Home Depot SKU numbers or product descriptions for selected items,

facilitating seamless purchasing and coordination with suppliers.

Customer Convenience: Take the list to Home Depot or preferred suppliers for accurate pricing, helping align the total home budget with personal financial plans.

Simplify your construction journey with our Materials Shopping List document, where detailed preparation meets streamlined implementation for your dream home.

## STRUCTURAL

The structural drawings package provides an exhaustive set of detailed plans essential for the precise assembly of your building. This comprehensive package includes:

Framing Plans: Detailed layouts for all framing components. Truss Layouts: Clear instructions for truss placement and

Panel Length Plans: Specifications for panel dimensions. Framing Elevations and Sections: Precise elevation and sectional views for accurate construction.

Truss and Wall Blocking Plans: Plans for truss and wall blocking to ensure structural integrity.

Hold-Down Plan: Detailed hold-down requirements for stability. Snap Sheet: Reference sheet for quick identification of components

Structural Details and Bracing Plans: Complete details and bracing plans for all structural elements.

Accompanying these plans is a comprehensive Bill of Materials (BOM) that lists every necessary building component, from cold formed steel (CFS) frames to fasteners.

## ARCHITECTURAL

With the comprehensive architectural package, both builders and DIY homeowners can confidently execute the construction.

The architectural package includes:

Furnished Floor Plans: Complete with furniture layouts for a clear understanding of space utilization.

Detailed Dimension Plans: Ensures precise measurements, from the overall footprint down to the exact placement of windows and

Foundation Plan: Detailed plan to establish a solid foundation.

Wall Framing and Truss Layout: Comprehensive plans for wall framing and truss placement.

Architectural Elevations: Exterior views showcasing the design.

Strategic Building Sections: Critical cross-sectional details for a thorough understanding of the build.

Casework Drawings and Diagrams: Suggested designs for built-in caseworks, such as kitchen cabinets.

## **MECHANICAL**

The mechanical package includes everything needed to guide HVAC

Detailed HVAC Floor Plan: Precisely maps out the placement of air handlers, ductwork, and vents throughout the home's layout.

HVAC Sections and Riser Diagrams: Technical drawings offering critical cross-sectional details and piping schematics, ensuring proper integration of the heating and cooling system into the home's structure.

Bill of Materials: A complete list of all necessary HVAC components.

## **ELECTRICAL**

The electrical package includes all the plans and documentation needed to guide the installation of your home's electrical system:

Detailed Power Plan: Precisely maps out the placement of outlets, switches, and other power components throughout the layout.

Comprehensive Lighting Plan: Shows the optimal locations for lighting fixtures, sconces, and other illumination sources to create a well-lit, functional interior.

Dimensioned Electrical Layout: Provides exact dimensions and measurements to ensure proper placement of all electrical elements.

Bill of Materials: A complete list of every component needed, from circuit breakers to wiring.

Styrene) Pipes

## **PLUMBING**


The plumbing package includes everything needed to guide the installation of your home's water supply and drainage systems:

Detailed Water Supply System Plan: Precisely maps out the placement of pipes, valves, and plumbing fixtures throughout the

Comprehensive Sewage System Plan: Shows the optimal routing and sizing of drain lines to effectively remove waste and ensure proper drainage.

Detailed Riser Diagrams: Provide information needed to properly install all vertical plumbing risers and vent stacks.

Bill of Materials: A complete list of every component needed, from pipes to fixtures.

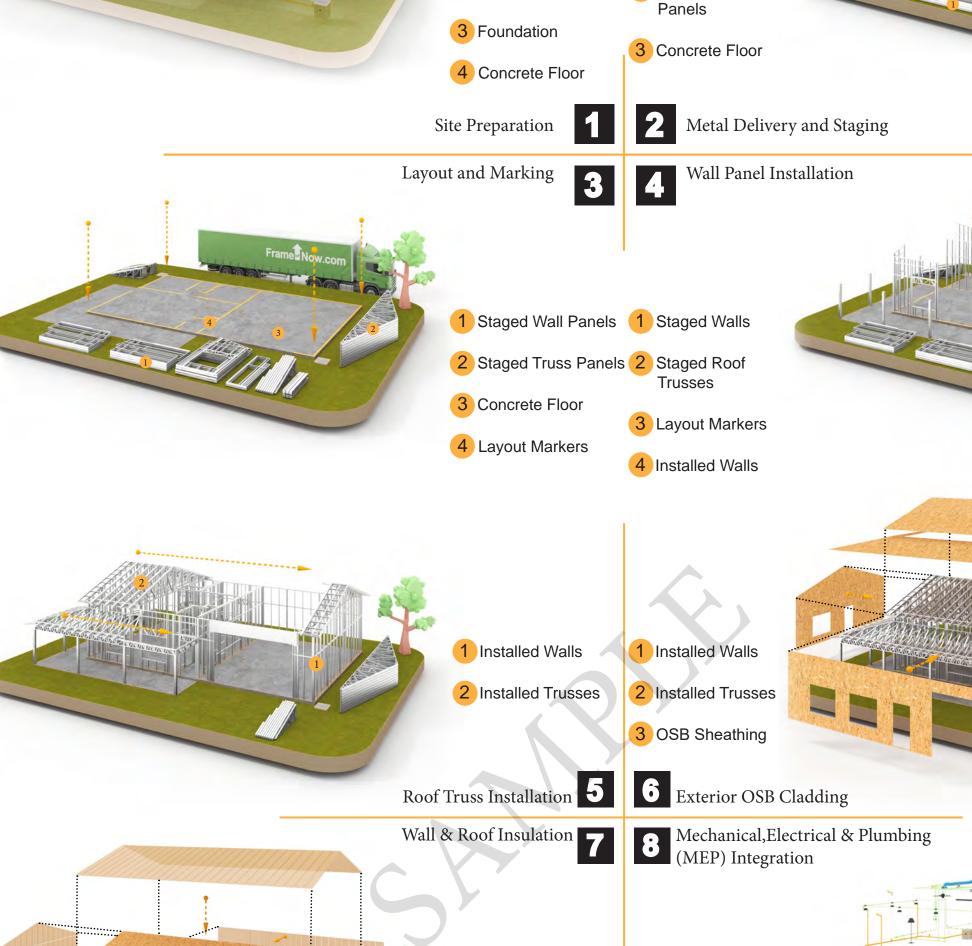

1 Installed Walls

1 OSB Sheathing

3 Dry Wall Board

4 Ceiling Dry Wall

Corrugated

iron sheet

2 Home Wrap

3 Roof Felt Paper

4 Coronado Stone

5 Corrugated

iron sheet

2 Floor

Exterior Wall & Roof Covering

1 Home Wrap

2 Insulation

Buildable Plot


Installation


2 Sewage

1 Staged Wall


Panels

2 Staged Truss

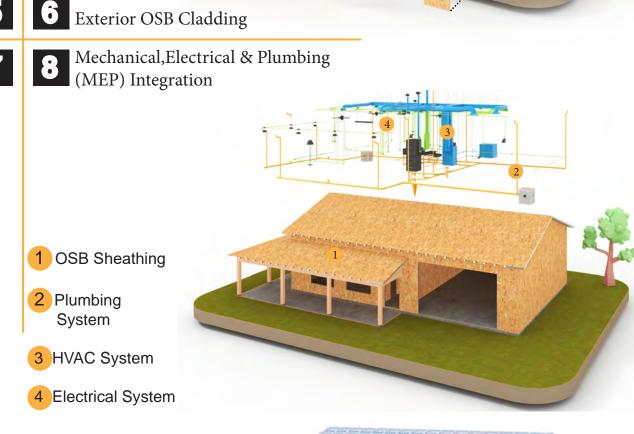

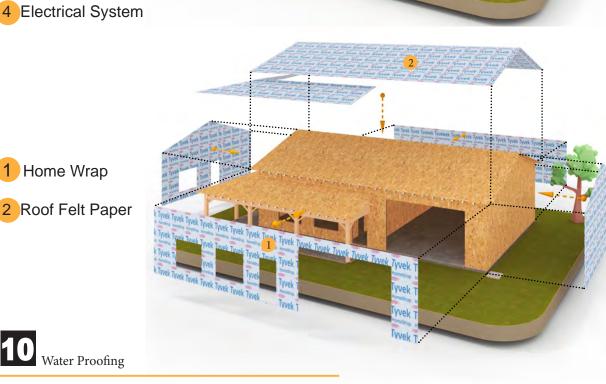



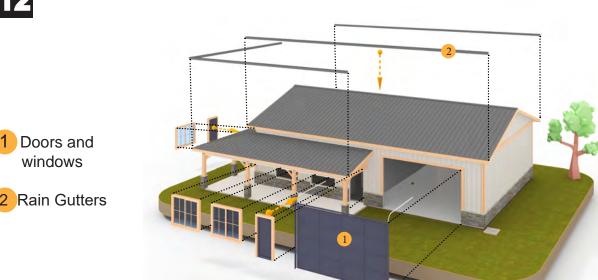



**KEY PLAN** 

NO.	DESCRIPTION	DATE

NOTE:

LEGEND:

14-Wisdom-1194-3Bd2Ba-**Traditional-550** 

DRAWING NAME

INTRODUCTION

CLIENT NAME: PROJECT NUMBER: DATE: **DESIGNED BY** DRAWN BY: CHECKED BY:

1102

SCALE:


## BOM (Bill Of Materials) (Separately Attached)




The Bill of Materials (BOM) is a crucial document that compiles the material requirements from different disciplines into a centralized inventory, enabling efficient procurement, inventory management, and cost estimation for a specified project or


**ELECTRICAL BOM** 



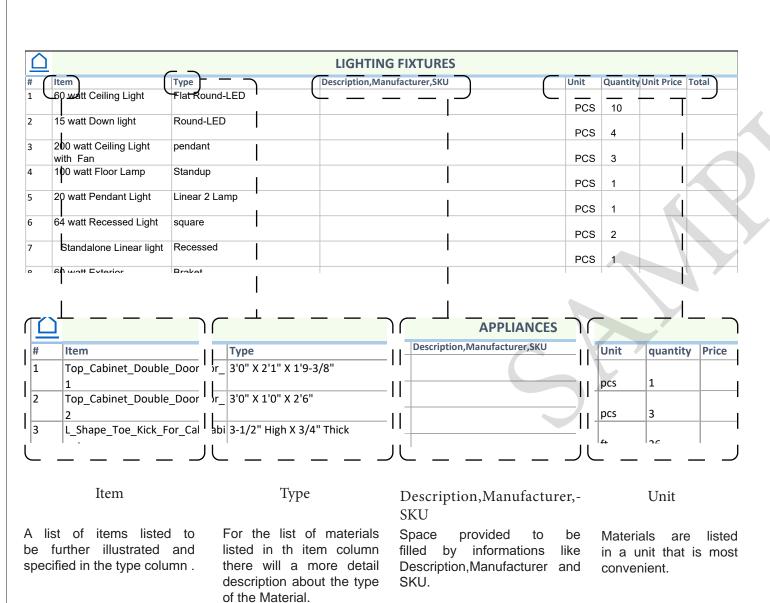

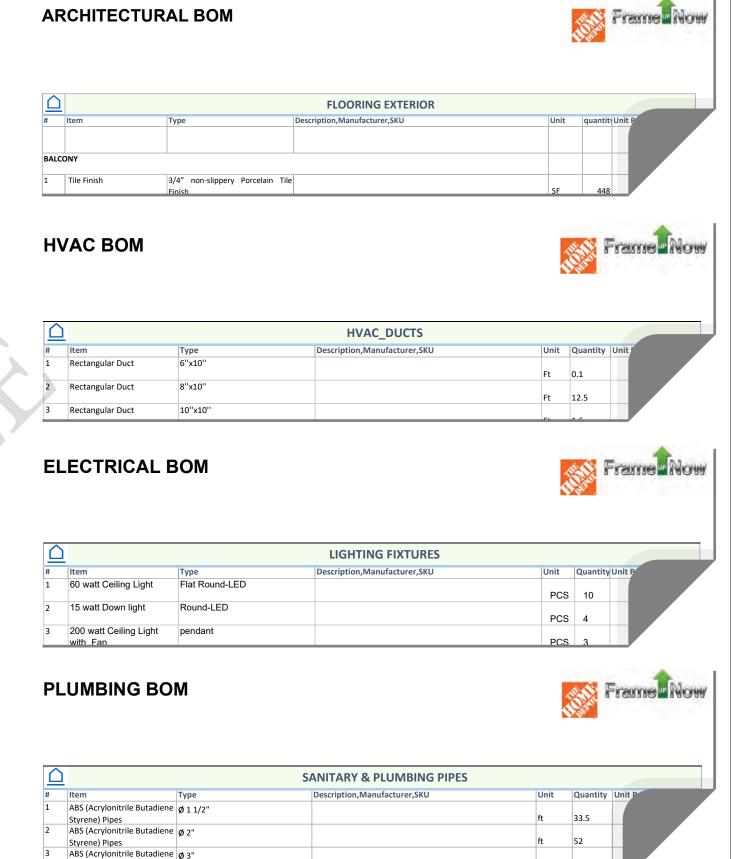

**HOW TO BUILD** 

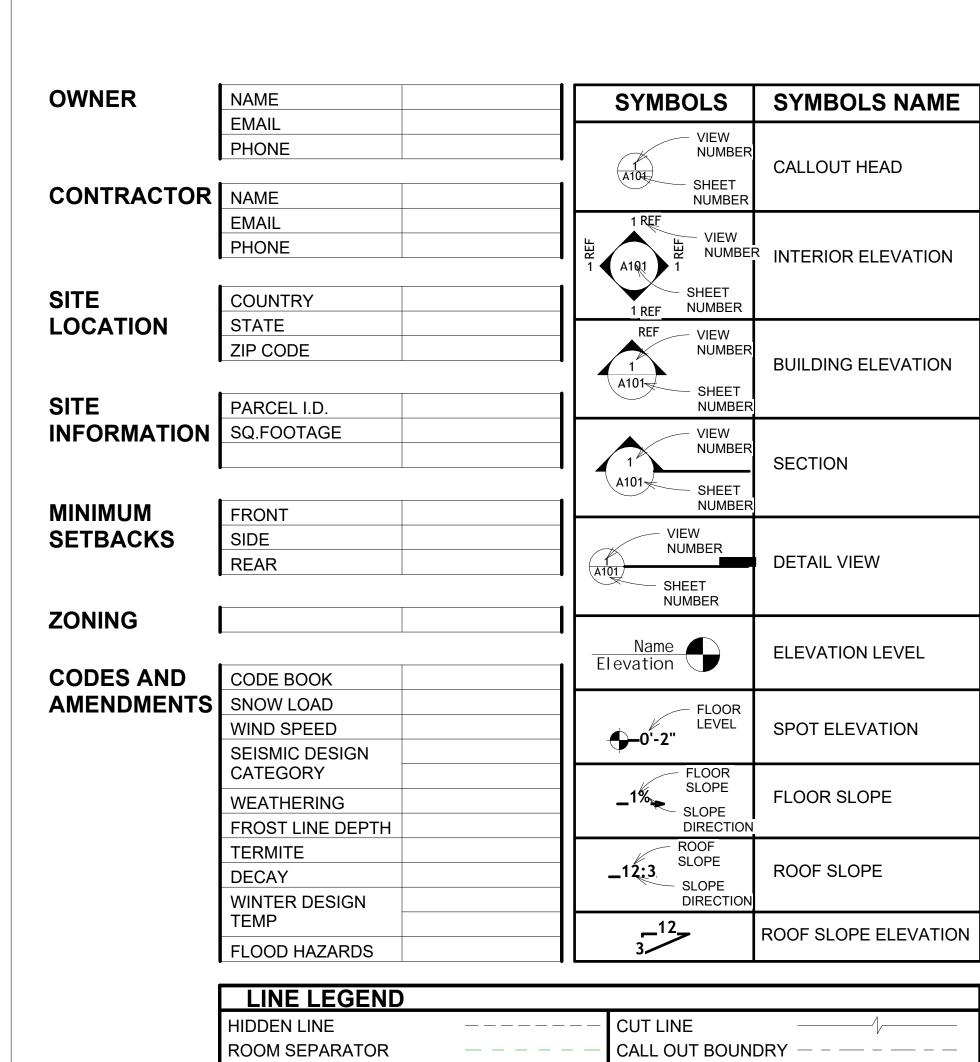

DOOR OPENING DIRECTION

	PAGE INDEX	Α	BBREVIATION
G101	COVER SHEET	AFS	ACTION FLOOR SYSTEMS
A101	FLOOR PLAN	ASTM D698	AMERICAN SOCIETY FOR
A102	DIMENSION PLAN		TESTING AND MATERIAL
S101	FOUNDATION PLAN	CA	CASEWORK
S102	STRUCTURAL FLOOR PLAN	EL	ELECTRICAL
S103	FRAME LAYOUT	F.F.E	FINISHED FLOOR ELEVATION
S104	ROOF TRUSS LAYOUT	F.F.L	FINISHED FLOOR LEVEL
A103	ROOF PLAN	FTG	FOOTINGS
A201	ELEVATIONS	HVAC	HEATING, VENTILATION & A
A202	ELEVATIONS		CONDITIONING
A301	SECTIONS	IRC	INTERNATIONAL RESIDENC
A401	DETAILS		CODE
A402	CASEWORK DETAILS	IMC	INTERNATIONAL MECHANIC
A403	CASEWORK DETAILS	IIVIO	CODE
E101	SCHEDULE	MAX.	MAXIMUM
E102	LIGHTING PLAN	ME	MECHANICAL
E103	POWER PLAN	MIN.	MINIMUM
E104	DIMENSION PLAN FOR LIGHT FIXTURE	NO.	NUMBER
E105	DIMENSION PLAN FOR FITTING	O.C	ON CENTER
P101	COVER SHEET	OSB	ORIENTED STRAND BOARD
P102	WATER SUPPLY SYSTEM	PL	PLUMBING
P103	SEWAGE SYSTEM	PSI	POUNDS PER SQUARE INC
P104	RISER DIAGRAM	PVC	POLYVINYL CHLORIDE
M101	HVAC PLAN	REF	REFERENCE
M102	HVAC SECTION	RG	RIGHT GARAGE
M103	RISER DIAGRAM	SE	SPECIAL EQUIPMENT
		SF	SQUARE FEET
		SIMP. STHD8	
TAO	TA OLO NIANE	SIMP. STRUG	HOLDDOWN
TAG	TAG'S NAME	SIMP. ABE66	SIMPSON ANCHOR BOLT EI
	CASEWORK TAG	SIIVIF . ADEUU	SIMIT SOM AMORION BOLT EL

DOOR TAG

FURNITURE TAG

SPECIALTY EQUIPMENT TAG

MECHANICAL EQUIPMENT TAG

PLUMBING EQUIPMENT TAG

WINDOW TAG


MIN.	MINIMUM
NO.	NUMBER
O.C	ON CENTER
OSB	ORIENTED STRAND BOARD
PL	PLUMBING
PSI	POUNDS PER SQUARE INCH
PVC	POLYVINYL CHLORIDE
REF	REFERENCE
RG	RIGHT GARAGE
SE	SPECIAL EQUIPMENT
SF	SQUARE FEET
SIMP. STHD8	SIMPSON STRAP THE HOLDDOWN
SIMP. ABE66	SIMPSON ANCHOR BOLT EDGE
TV	TELEVISION
UNO	UNLESS NOTED OTHERWISE
W/	WITH
W/D	WASHER/DRYER
۸۰	AID CONDITIONING LINET
ACC	AIR CONDITIONING UNIT
ACC	AIR COOLED CONDENSER
ACCU	AIR COOLED CONDSENSING UNIT
AHU	AIR HANDLING UNIT
CC	COOLING COIL
CD	CEILING DIFFUSER
CFm	Cubic Feet Per Minute
CR	CEILING REGISTER
CU	CONDENSING UNIT
CW	COLD WATER
E/A	EXHAUST AIR
EF	EXHAUST FAN
ET	EXPANSION TANK
EX.	EXISTING
FC	FLEXIBLE CONNECTION
FCU	FAN COIL UNIT
FLR.	FLOOR
HC	HEATING COIL
HE	AIR TO AIR HEAT EXCHANGER
HV	HEATING AND VENTILATING UNIT
IV	INLET VANES
MER	MECHANICAL ROOM
MAX.	MAXIMUM
MIN.	MINIMUM
R/A	RETURN AIR
RCU	RECIPROCATING CHILLER UNIT
RF	RETURN FAN
S/A	SUPPLY AIR
SCD	SMOKE CONTROL DAMPER
000	


FINISHED FLOOR ELEVATION


HEATING, VENTILATION & AIR

INTERNATIONAL RESIDENCE

INTERNATIONAL MECHANICAL

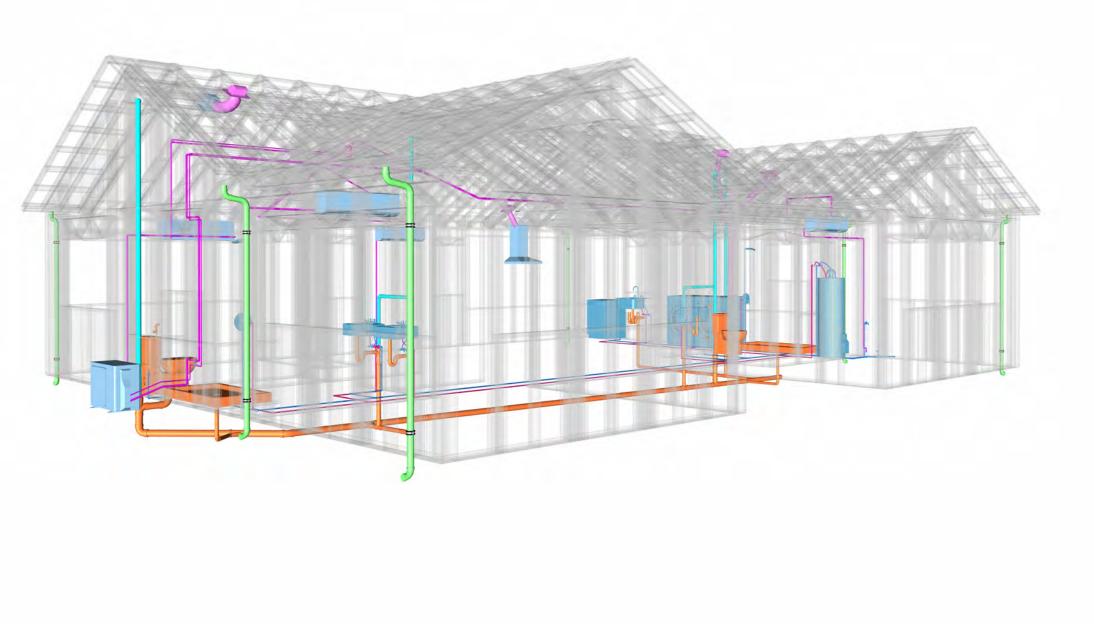

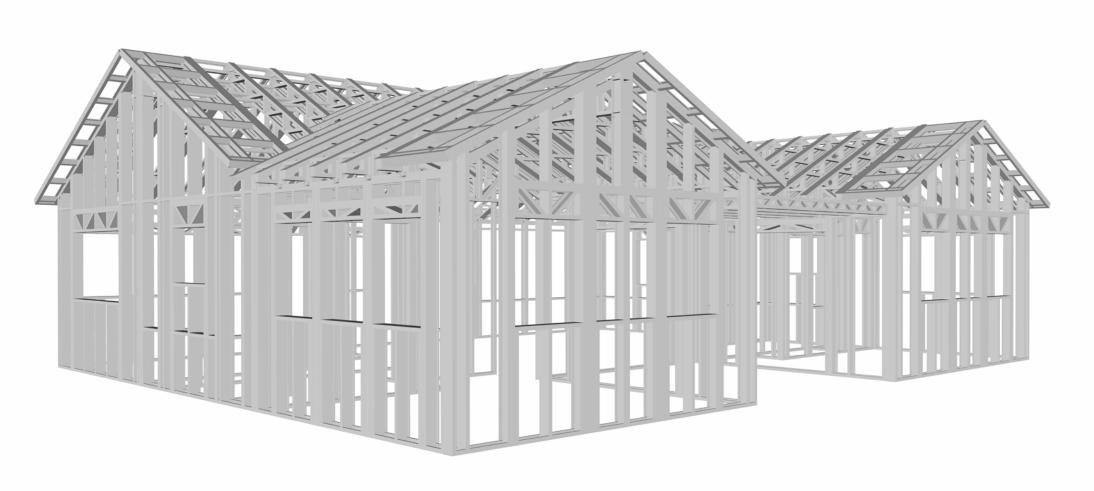

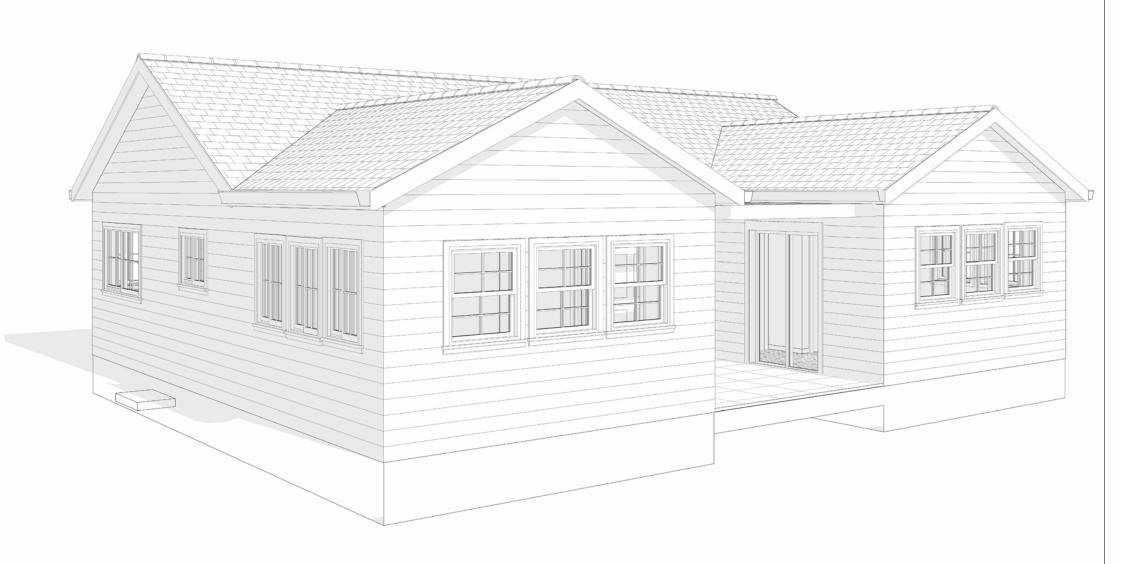




SQUARE FOOT	AGE
1ST FLOOR	1082
2ND FLOOR	1082
GARAGE	1150
PORCH	353
TOTAL	3667



**KEY PLAN** 

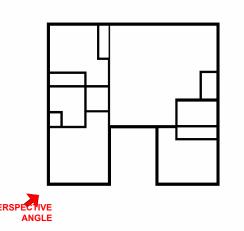

10.	DESCRIPTION	DATE

NOTE:

LEGEND:

PROJECT


14 Wisdom 1194-3Bd/2Ba Traditional-550

DRAWING NAME

**COVER SHEET** 

CLIENT NAME:	Client Name
PROJECT NUMBER:	Project Number
DATE:	2/8/2025 5:37:51 PM
DESIGNED BY:	Designer
DRAWN BY:	Author
CHECKED BY:	Checker

G101

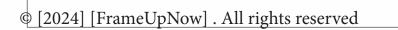

#### **GENERAL NOTES**

- THIS DRAWING DEPICTS THE ARCHITECTURAL (SPACE LAYOUT, FURNISHING, FLOOR, WALLS, ROOFS, FOUNDATION, WINDOWS AND DOORS) SYSTEMS. IT PROVIDES A VISUAL REPRESENTATION OF THE ARCHITECTURAL LAYOUT AND COMPONENTS.
- 2. THE ARCHITECTURAL DRAWINGS ARE PREPARED TO MEET THE SPECIFIC REQUIREMENTS OF THE BUILDING, AS PER THE PROJECT SPECIFICATIONS AND APPLICABLE CODES AND
- 3. THE CONSTRUCTION OF THIS HOME SHALL COMPLY WITH THE LATEST EDITION OF THE INTERNATIONAL RESIDENTIAL CODE (IRC), INTERNATIONAL MECHANICAL CODE (IMC), THE INTERNATIONAL PLUMBING STANDARD, THE NATIONAL ELECTRICAL STANDARD AND ALL OTHER APPLICABLE LOCAL, STATE, AND NATIONAL CODES AND REGULATIONS.
- 4. COORDINATION WITH OTHER TRADES HAS BEEN DONE ON A DESIGN LEVEL. THIS DRAWING SHALL BE READ TOGETHER WITH THE ME, EL AND PL DESIGN DRAWINGS TO ENSURE PROPER CONSTRUCTION AND INTEGRATION OF THE BUILDING SYSTEMS.

#### **ABOUT WALLS:**

#### SHOWER WALL COVERING

BATHTUB AND SHOWER SPACES (WALLS AND FLOORS) WITH INSTALLED SHOWER HEADS AND IN SHOWER COMPARTMENTS SHALL BE FINISHED WITH A NON-ABSORBENT SURFACE.

#### WALL PAINT (INTERNAL)

THE TYPICAL THICKNESS OF LATEX WALL PAINT IS 1/32 OF AN INCH FOR A SINGLE COAT. AND DOUBLE COAT (1/16") SHALL BE APPLIED FOR DURABILITY.

#### 3. **ADHESIVES**:

THE ADVISABLE TYPE OF ADHESIVE FOR THIS PROJECT IS **EPOXY ADHESIVES** BECAUSE THEY ARE KNOWN FOR THEIR HIGH STRENGTH, DURABILITY, AND RESISTANCE TO MOISTURE, CHEMICALS AND HEAT.

REFER TO SHEETS A201 & A202 FOR GENERAL NOTES ON EXTERNAL FINISHING MATERIALS


#### **ABOUT FLOORS:**

- THE SPOT ELEVATION INDICATES THE FINISHED FLOOR ELEVATION.
- 2. FINISHED FLOORS PER PLANS.
- FIELD VERIFY FOR DIMENSION DROP 4" FOR SHOWER AND BATHTUB USE.
- 4. 1% SLOPE ON OUTDOOR BALCONIES FOR WATER RUN OFF.
- 5. 2% SLOPE TOWARDS THE SHOWER DRAIN FOR SUFFICIENT DRAINAGE.
- 6. 4" DROP AT THE DOOR LEADING TO EXTERIOR BALCONY FROM THE MAIN LIVING AREA.
- 7. 5% SLOPE FOR GARAGE IS USED, WHICH SHOULD BE CHECKED WITH THE LOCAL

•	070 0201 21 011 07 110 102 10
	GARAGING ZONING LAWS.

FURNITURE SCHEDULE				
TYPE MARK	TYPE	COUNT		
1	DINING CHAIR	4		
2	COFFE TABLE	1		
3	TV STAND	1		
4	32"	1		
5	ROUND TABLE 2	1		
6	FOUR SIT 85" X 85"	1		
7	60" X 80" - QUEEN	1		
8	DOUBLE 53" X 74"	2		

	ROOM FINISH SCHEDULE						
ROOM NUMBE R	ROOM NAME	FLOOR FINISH	BASE FINISH	WALL FINISH	CEILING FINISH	CEILING HEIGHT	COMMENT S
1	LIVING ROOM	HARDWOOD	CONCRETE	WALL PAINT	DRY WALL	8' - 0"	
2	BEDROOM 3	HARDWOOD	CONCRETE	WALL PAINT	DRY WALL	8' - 0"	
3	BEDROOM 2	HARDWOOD	CONCRETE	WALL PAINT	DRY WALL	8' - 0"	
4	PRIMARY SUITE	HARDWOOD	CONCRETE	WALL PAINT	DRY WALL	8' - 0"	
5	BATH 2	VINYL TILES	CONCRETE	CERAMIC TILE	MRD	8' - 0"	
6	FRONT PORCH	PROCELAIN TILE	CONCRETE	WALL PAINT	PLYWOOD	8' - 0"	
7	ENTRY	HARDWOOD	CONCRETE	WALL PAINT	DRY WALL	8' - 0"	
8	BATH 1	HARDWOOD	CONCRETE	WALL PAINT	MRD	8' - 0"	
9	KITCHEN	HARDWOOD	CONCRETE	WALL PAINT	DRY WALL	8' - 0"	
10	WD	HARDWOOD	CONCRETE	WALL PAINT	DRY WALL	8' - 0"	
11	CL 1	HARDWOOD	CONCRETE	WALL PAINT	DRY WALL	8' - 0"	
12	CL 2	HARDWOOD	CONCRETE	WALL PAINT	DRY WALL	8' - 0"	
13	CL 3	HARDWOOD	CONCRETE	WALL PAINT	DRY WALL	8' - 0"	
14	WH	HARDWOOD	CONCRETE	WALL PAINT	DRY WALL	8' - 0"	
15	FAU	HARDWOOD	CONCRETE	WALL PAINT	DRY WALL	8' - 0"	

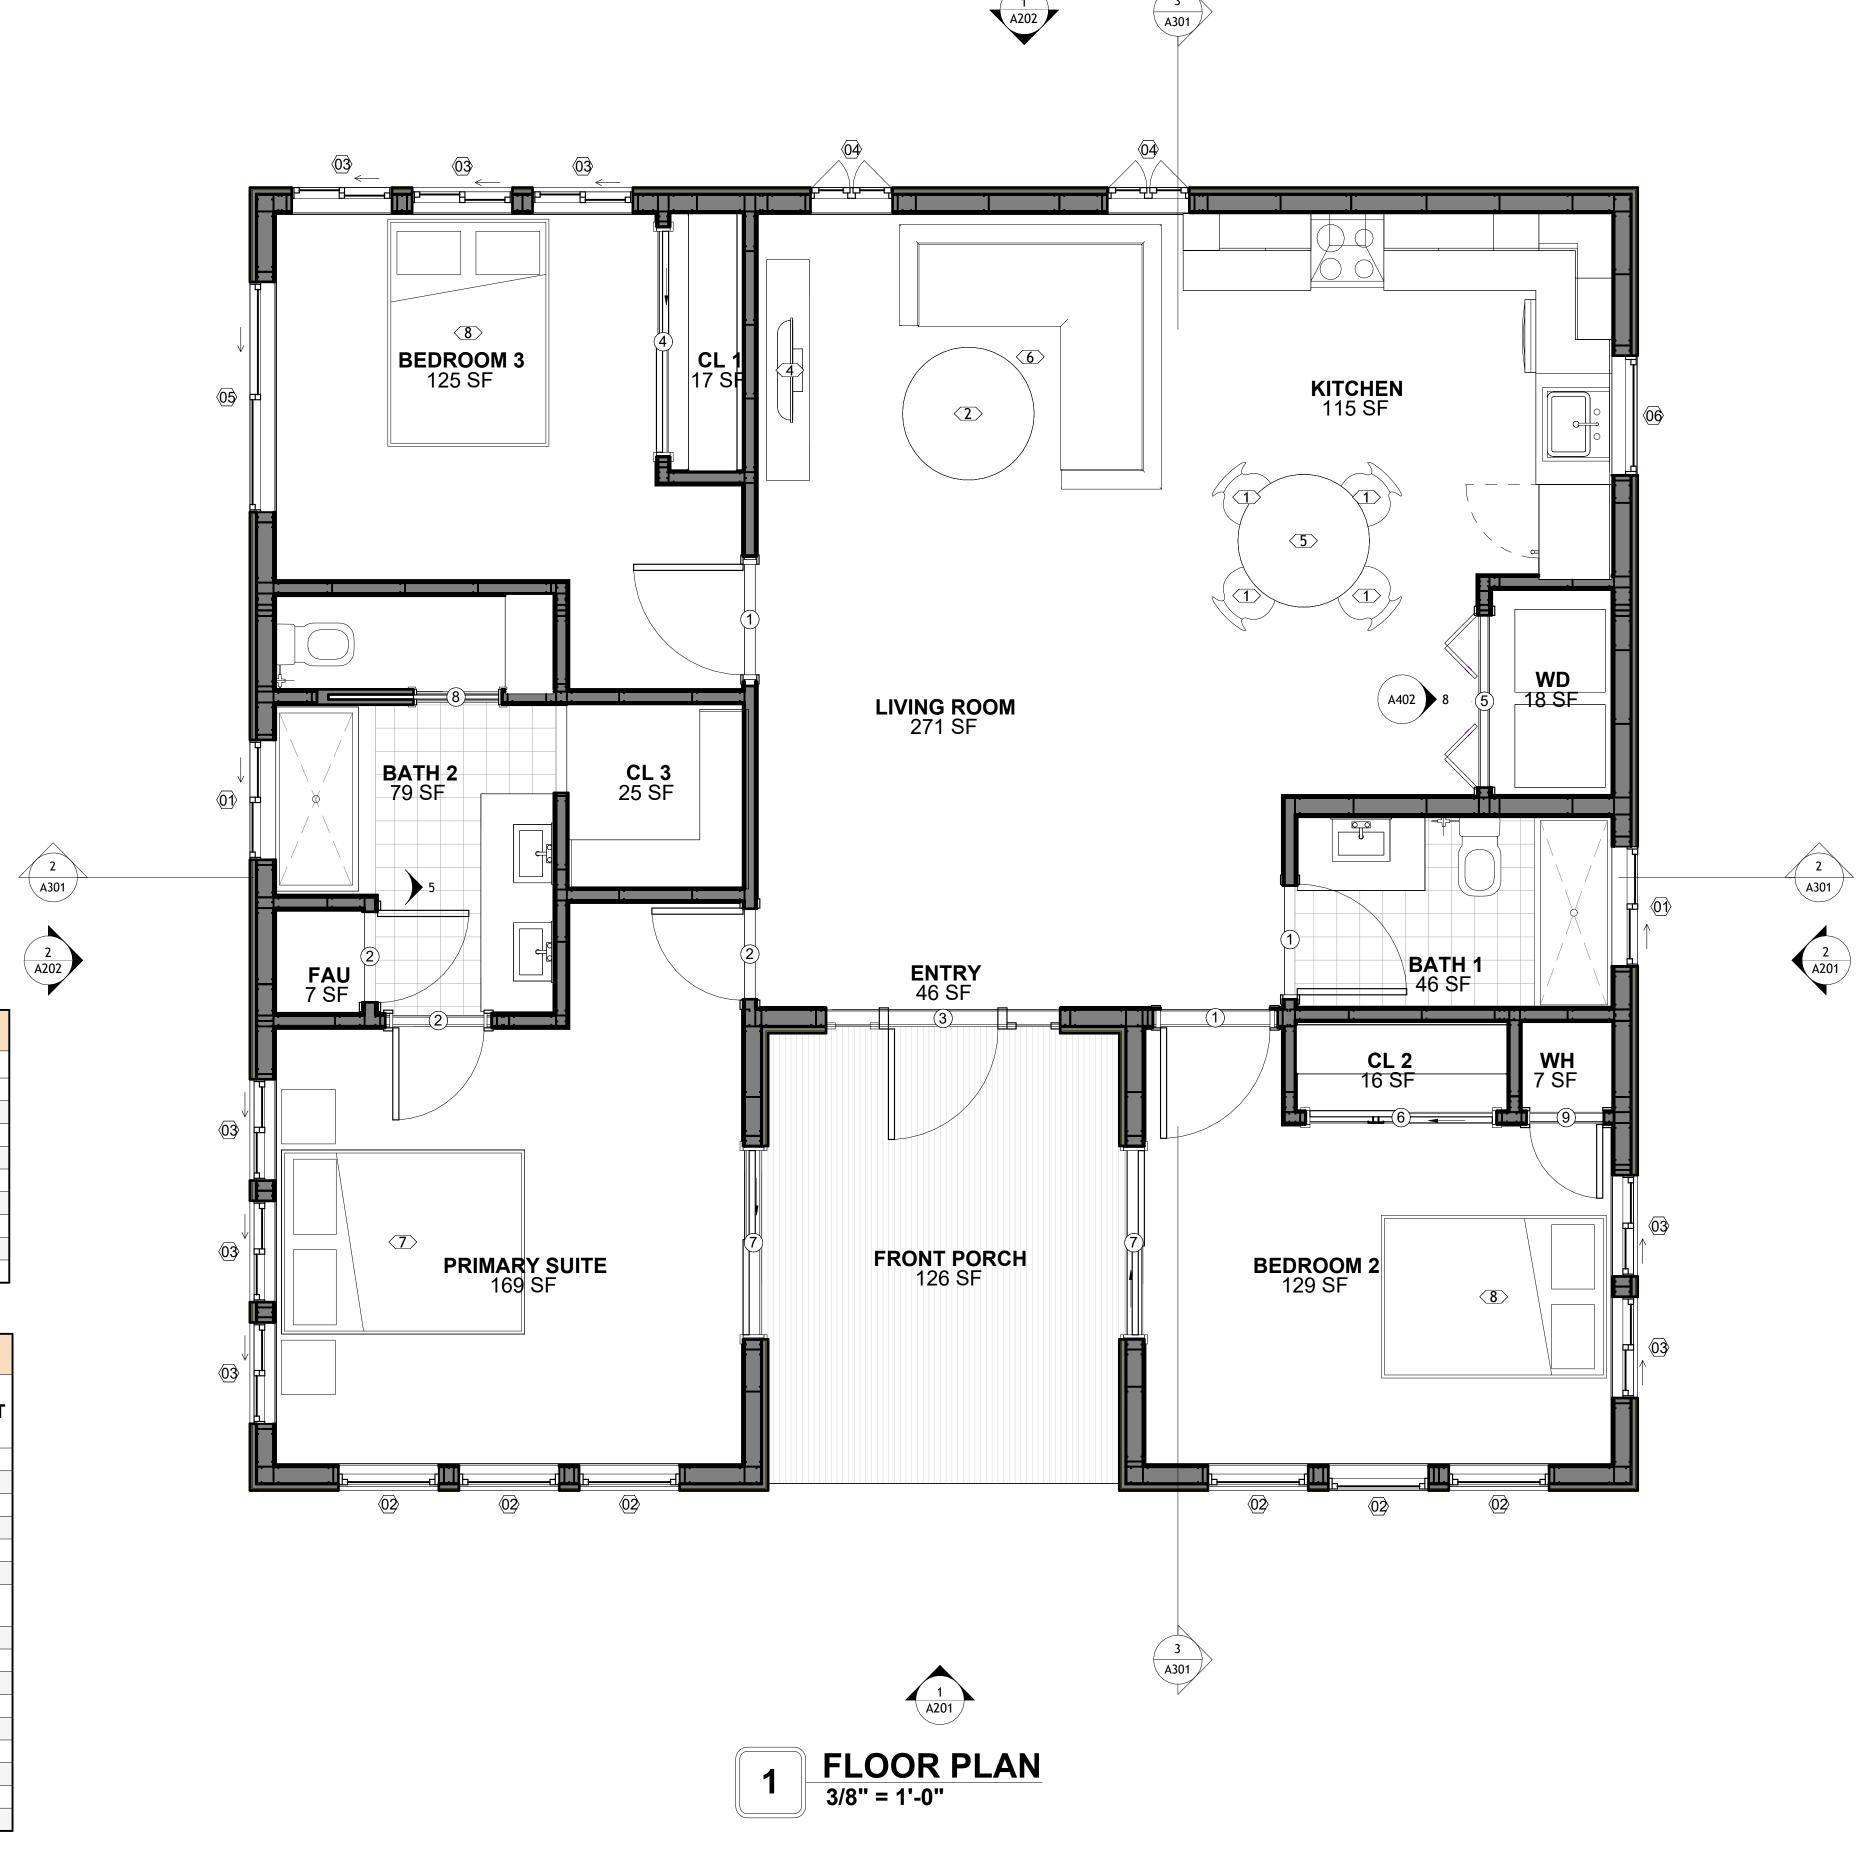

SQUARE FOOTAGE			
1ST FLOOR	1082		
2ND FLOOR	1082		
GARAGE	1150		
PORCH	353		
TOTAL			
TOTAL	3667		



**KEY PLAN** 

NO DECODIDEION DATE				
NO.	DESCRIPTION	DATE		

NOTE:

LEGEND:

PROJECT


14 Wisdom 1194-3Bd/2Ba **Traditional-550** 

DRAWING NAME

**FLOOR PLAN** 

CLIENT NAME:	Client Name
PROJECT NUMBER:	Project Number
DATE:	2/8/2025 5:38:00 PM
DESIGNED BY:	Designer
DRAWN BY:	Author
CHECKED BY:	Checker

A101

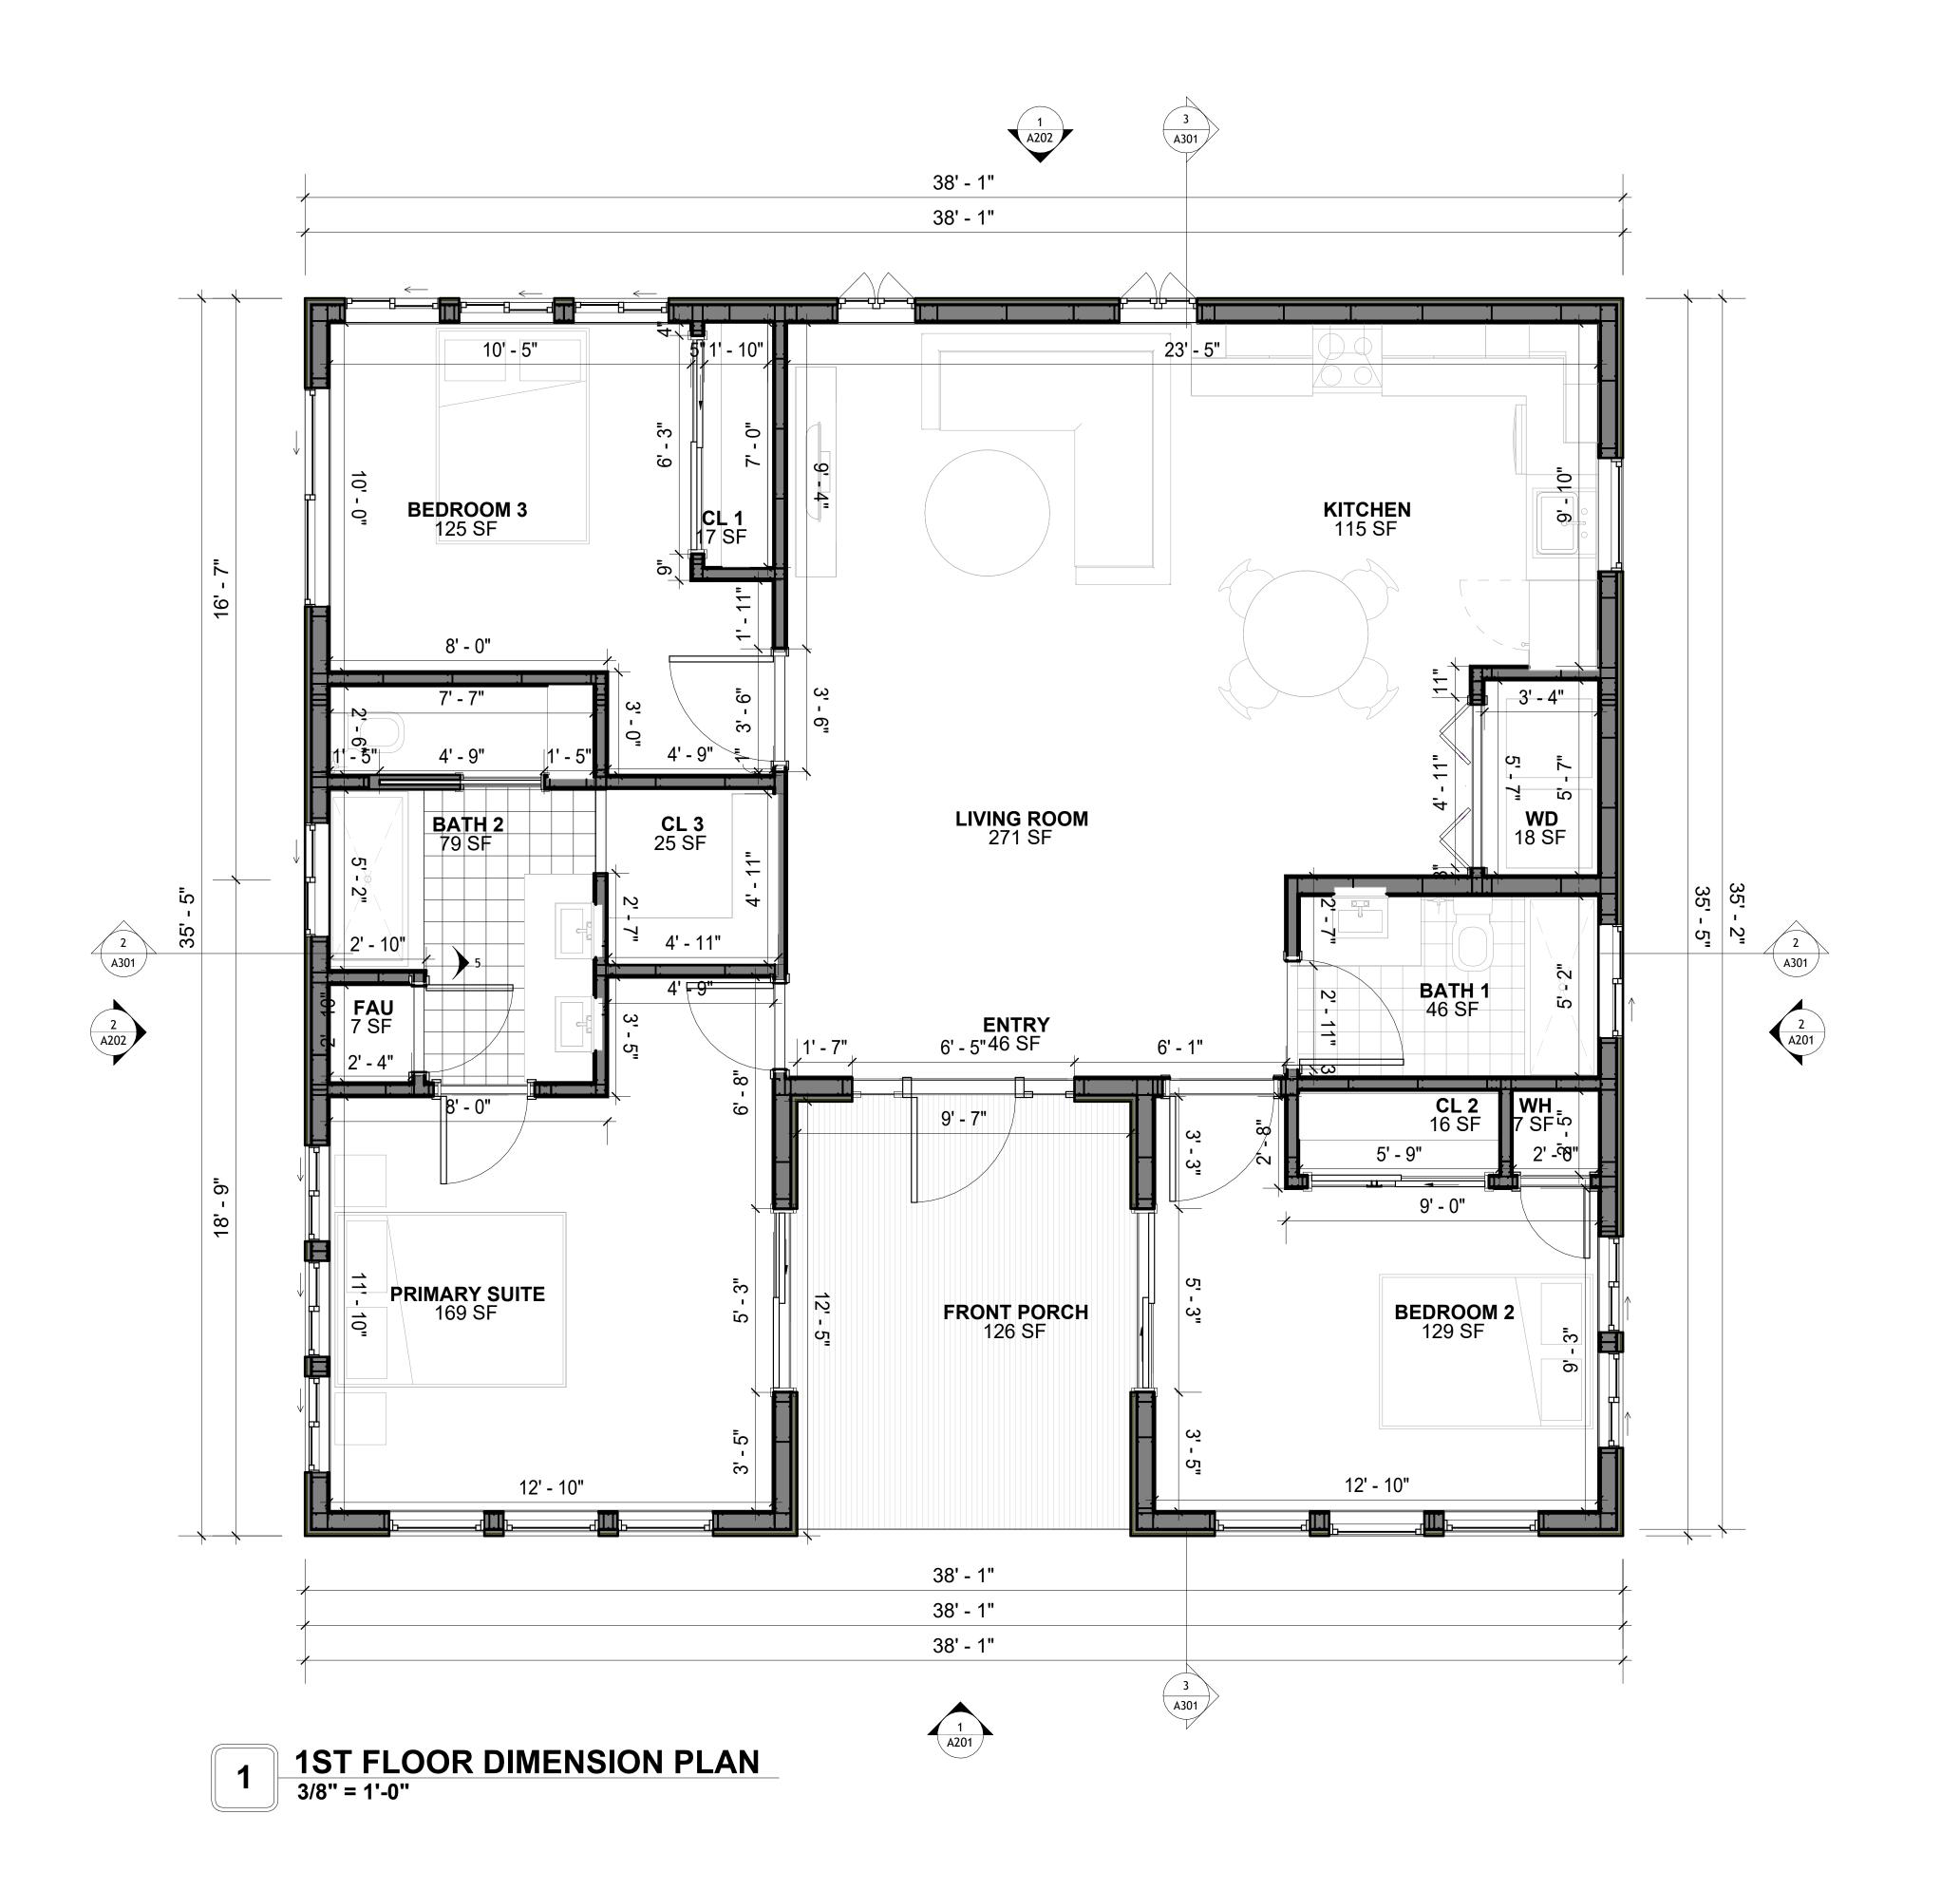

Tuscon,AZ, USA 888-864-0184 inquire@frameupnow.com www.frameupnow.com

**KEY PLAN** 

NO.	DESCRIPTION	DATE

NOTE:

LEGEND:

PROJECT

14 Wisdom 1194-3Bd/2Ba Traditional-550

DRAWING NAME

DIMENSION PLAN

Client Name	CLIENT NAME:
Project Number	PROJECT NUMBER:
2/8/2025 5:38:03 PM	DATE:
Designer	DESIGNED BY:
Author	DRAWN BY:
Checker	CHECKED BY:

A102

SQUARE FOOTAGE

1ST FLOOR 1082
2ND FLOOR 1082
GARAGE 1150
PORCH 353

TOTAL 3667

DIMENSIONS IN THE ARCHITECTURAL DRAWINGS CONSIDER FINISHING MATERIALS. FOR PRECISE MEASUREMENTS OF THE STRUCTUAL FRAMING, REFER TO THE ATTACHED STRUCTURAL PLAN SET.

SCALE: 3/8" = 1'-0"

#### FOUNDATION NOTES

#### **NOTES:**

TERMITES PRETREATMENT BY LICENSED CONTRACTOR UNDER SLAB AND AROUND FOOTINGS. ALL AREAS BELOW SLABS SHALL BE TREATED NO MORE THAN 24 HOURS PRIOR TO CONCRETE POUR. EVIDENCE OF TREATMENT MUST BE PROVIDED PRIOR TO PLACING OF CONCRETE.

#### 1. **MATERIALS**:

ALL INTERIOR CONCRETE SLABS SHALL BE A MIN. OF 4" THICK CONCRETE OVER 4" COMPACTED AGGREGATE BASE (ASTM D698), FINISH ELEVATIONS AS NOTED ON DRAWINGS, 6" ABOVE ADJACENT GRADE, LEVEL SLABS TO 1/8"-10' MAX.. CONCRETE SLABS SHALL BE 2500# PSI AT 28 DAYS. A 4" ALLOWABLE SLUMP.

#### 2. **PAD PREPARATION:**

- EXCAVATION FOR FOOTING SHALL BE NEAT.

- FOOTINGS SHALL BE POURED IMMEDIATELY AFTER EXCAVATION AND APPROPRIATE INSPECTION.

- ALL REINFORCING STEEL MARKED "CONTINUOUS" SHALL BE LAPPED 36 BAR DIAMETERS AT SPLICES AND AROUND CORNERS OR INTERSECTIONS WITH A STANDARD 90 DEGREE BEND ON CORNER BARS. LAP WIRE MESH ONE FULL MESH AT SIDE AND END LAPS.
- ALL HARDWARE TO BE SIMPSON OR EQUIVALENT.

- EXTERIOR FRAME WALL TO BE SECURED WITH 1/2"X10" ANCHOR BOLTS 4'-0" O.C. FOR 1-STORY AND 2'-8" O.C. FOR 2-STORY. BOLTS SHALL BE LOCATED WITHIN 1'-0" OF EACH END PIECE AND SHALL HAVE A MIN. OF TWO BOLTS PER PIECE.

-FOUNDATION ANCHOR STRAPS SHALL BE PERMITTED, ACCORDING TO RESIDENTIAL CODE 2021

- ALL INTERIOR WALLS TO BE SECURED WITH POWER DRIVEN PINS PER MANUFACTURER SPECIFICATION USE PIN SPACING EQUIVALENT TO 1/2" ANCHOR BOLTS.

- ALL CONSTRUCTION TO CONFORM TO THE 2012 IRC

- R-10 RIGID INSULATION OUTSIDE OF EXTERIOR FOUNDATION WALLS UNDER LIVING AREA.

- CONCRETE PAD FOR CONDENSER THICKNESS IS 4" MIN UNLESS OTHERWISE NOTED.

#### 3. CONCRETE CONSTRUCTION:

- THE SLAB SHALL BE UNDERLAIN BY A VAPOR BARRIER/RETARDER IN THE LIVING AREA (TYPICALLY POLYETHYLENE, UNLESS MORE STRINGENT PROTECTION REQUIRED BY THE ARCHITECT, ENGINEER, FLOOR COVERING MANUFACTURER, OR ACCEPTED PRACTICE). UNLESS OTHERWISE REQUIRED, BARRIER MAY BE OMITTED AT GARAGES, PORCHES AND PATIOS WITHOUT FLOOR COVERINGS. IT IS BEYOND THE SCOPE OF THESE PLANS TO DETERMINE THE APPLICABILITY OF THESE MORE STRINGENT REQUIREMENTS. BUILDER SHALL VERIFY PRIOR TO CONSTRUCTION.

#### 4. REINFORCEMENT:

- IF CONSTRUCTED ON ACTIVE SOILS, THE LONG TERM PERFORMANCE OF THE FOUNDATION IS DEPENDENT ON MAINTENANCE BY THE OWNER. THUS THE BUILDER SHALL ADVISE THE OWNER OF THE FOLLOWING:

1. DRAINAGE MUST BE MAINTAINED. WATER SHALL NEVER BE ALLOWED TO POND NEAR THE FOUNDATION.

2. THE SOIL AROUND THE FOUNDATION SHALL BE MAINTAINED IN A RELATIVELY DAMP CONDITION, SUCH AS THAT REQUIRED TO KEEP A LAWN GREEN. IF IT DRIES OUT IT WILL SHRINK. IF IT GETS WET, IT WILL HEAVE UPWARD.

3. SLABS ON THE SHORTER SIDE USES MAIN BARS ARE USED IN THIS DIRECTION ONLY WITH SMALLER DIAMETER DISTRIBUTION BARS ARE PLACED, FORMING A MAT OR GRID.

ALL REINFORCEMENT BARS SIZE 10MM OR LARGER IN ACCORDANCE TO ASTM
 ANCHOR BOLTS AT ALL EXTERIOR WALLS SHALL BE MINIMUM 1/2 INCH DIAMETER WITH A MAXIMUM SPACING OF 6'-0" ON CENTER, UNLESS NOTED OTHERWISE.
 ANCHOR BOLTS SHALL BE INSTALLED WITHIN 12 INCHES OF EACH END OF EACH SILL

PLATE WITH AT LEAST TWO ANCHOR BOLTS FOR EACH BOLTS FOR EACH SILL PLATE LONGER THAN 12 INCHES.

5. SIMPSONS SILL ANCHORS MAYBE SUBSTITUTED FOR ANCHOR BOLTS AT THE SAME SPACING.

6. EXTERIOR CONCRETE SLABS WHICH ARE NOT PART OF THE MAIN SLAB SHALL BE MINIMUM 4 INCHES THICK WITH NO STEEL REINFORCING BARS REQUIRED, UNLESS NOTED OTHERWISE ON FOUNDATION PLAN.

#### **VERIFY THE FOLLOWING PRIOR TO POURING:**

. ALL HOLDDOWNS , STRAP, AND POST LOCATIONS.

2. CONCRETE FINISHES. PANEL RISER LOCATION - WHERE APPLICABLE.

3. UNDERSLAB MECHANICAL REQUIREMENTS.

4. STEM WALL BLOCKOUTS.

5. UNDERSLAB ELECTRICAL REQUIREMENTS AND PANEL RISER LOCATION. WHERE APPLICABLE.


6. PROVIDE THE FOLLOWING:

- PVC SLEEVES THROUGH FTG IF REQUIRED

- 20' #4 COPPER GROUND BAR.

SLOPE FINISH GRADE AWAY FROM FOOTING.

**NOTE**: FIELD VERIFY ALL DIMENSIONS SEE DIMENSIONED ARCHITECTURAL DRAWINGS

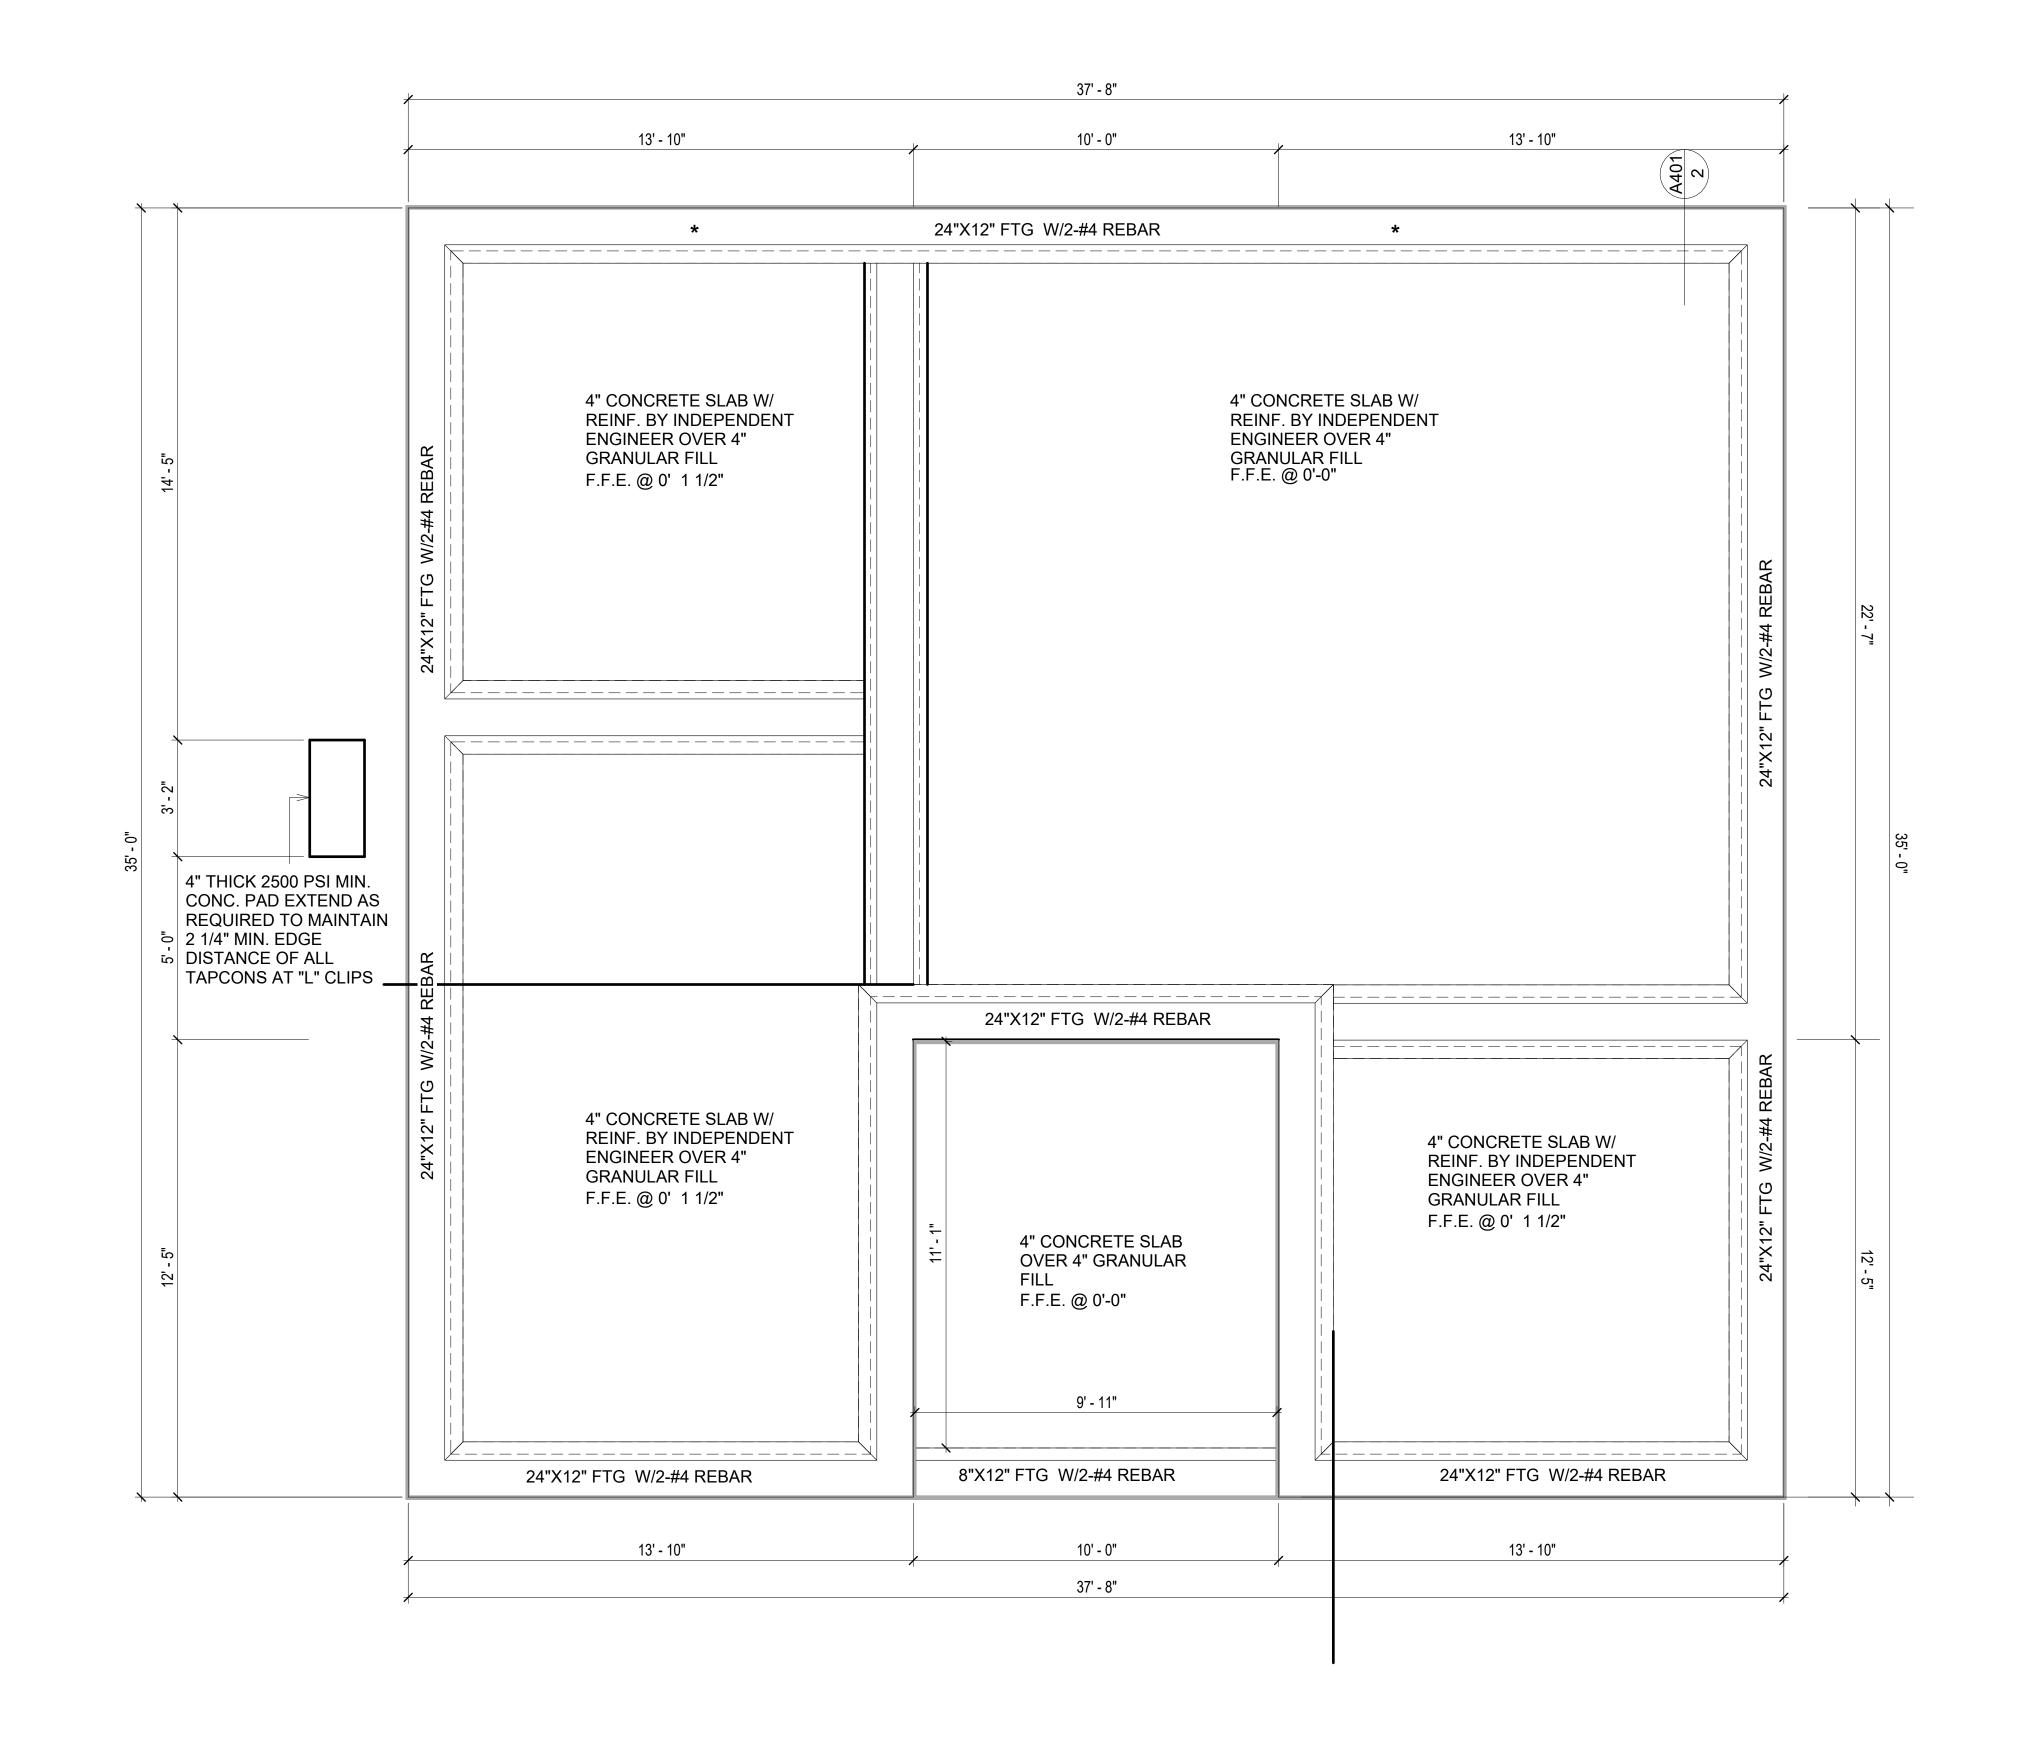

1 FOUNDATION PLAN
3/8" = 1'-0"

SQUARE FOO	SQUARE FOOTAGE					
1ST FLOOR	1ST FLOOR 1082					
2ND FLOOR	1082					
GARAGE	1150					
PORCH	353					
TOTAL	3667					



**KEY PLAN** 

NO	DESCRIPTION	DATE
NO.	DESCRIPTION	DATE

NOTE:

LEGEND:

PROJECT

14 Wisdom 1194-3Bd/2Ba Traditional-550

DRAWING NAME

**FOUNDATION PLAN** 

CLIENT NAME:	Client Name
PROJECT NUMBER:	Project Number
DATE:	2/8/2025 5:38:04 PM
DESIGNED BY:	Designer
DRAWN BY:	Author
CHECKED BY:	Checker

**S101** 

#### **GENERAL NOTES**

NOTES:

-ALL BEARING WALLS SHOULD HAVE A THICKENED SLAB PER SECTION PER DETAIL A401/5.

#### A) **FOUNDATION PLAN NOTES**:

- 1. CONCRETE SLAB SHALL BE 6" THICK WITH 1/2" DIAMETER TENDONS PER LAYOUT PLAN, CENTERED IN SLAB THICKNESS, OVER APPROVED SUBBASE PER GENERAL STRUCTURE NOTES.
- TERMITE PROTECTION SHALL BE PROVIDED PER IRC SECTION R318.1
   NONE TYPICAL ANCHOR BOLT SPACING AT SHEAR WALL AND HOLD DOWN SPECIFICATIONS PER APPROVED ARCHITECTURAL PLANS.
- INSTALL HOLDOWNS BEFORE CONCRETE SLAB POUR.
   EXISTING FILL ON-SITE SHALL BE COMPACTED IN ACCORDANCE WITH THE
- REQUIREMENTS IN THE GEOTECHNICAL REPORT.

  6. ALL FLOOR SLABS ARE REINFORCED ON CONCRETE SLABS.

#### SPECIAL INSPECTION IS REQUIRED FOR THICKENED FOUNDATION CONSTRUCTION

- 1. REINFORCEMENT
- 2. 2300 PSI CONCRETE POUR

#### B) **REINFORCEMENT FOR CONCRETE**:


 ALL REINFORCING SLABS BARS SIZE 10MM OR LARGER SHALL BE DEFORMED IN ACCORDANCE TO ASTM-A706, AND BARS SMALLER THAN 10 MM MAYBE PLAIN.
 UNLESS OTHERWISE NOTED IN PLANS, THE YIELD STRENGTH OF REINFORCING BARS SHALL BE:


> A) FOOTING = 40,000 PSI B) NON-LOAD BEARING WALLS AND PARAPETS= 40,000 PSI

- 3. SPLICES SHALL BE SECURELY WIRED TOGETHER AND SHALL LAP OR EXTEND
- 4. GRADE OF STEEL FOR RCC WORKS SHALL BE GRADE 4 10.
- 5. BAR NOTATIONS GIVES INFORMATION
- A) BAR SIZE
- B) SPACING(IF REQUIRED)
- 6. LAP REINFORCEMENT ONLY AT LOCATION SHOWN IN THE DRAWINGS
- 7. REINFORCEMENT SHALL NOT BE CUT, VENT OR HEATED ON SITE WITHOUT ENGINEERS' APPROVAL.
- C) CONCRETE SLAB NOTES
- 1. ALL SLAB REINFORCEMENT SHALL BE 20MM CLEAR MINIMUM FROM BOTTOM AND FROM TOP OF SLAB.
- 2. REINFORCEMENT IN CONTINUOUS ELEVATED SLAB SHALL BE CUT AS FOLLOWS.


#### NOTE:

- THIS IS A SCHEMATIC PLAN FOR THE PURPOSE OF LOCATING AND IDENTIFYING FOUNDATION REINFORCING ELEMENTS ONLY. VERIFY ALL DIMENSIONS, DROPS, OFFSETS AND FEATURES WITH THE ARCHITECTURAL PLANS BEFORE FORMING THE FOUNDATION.

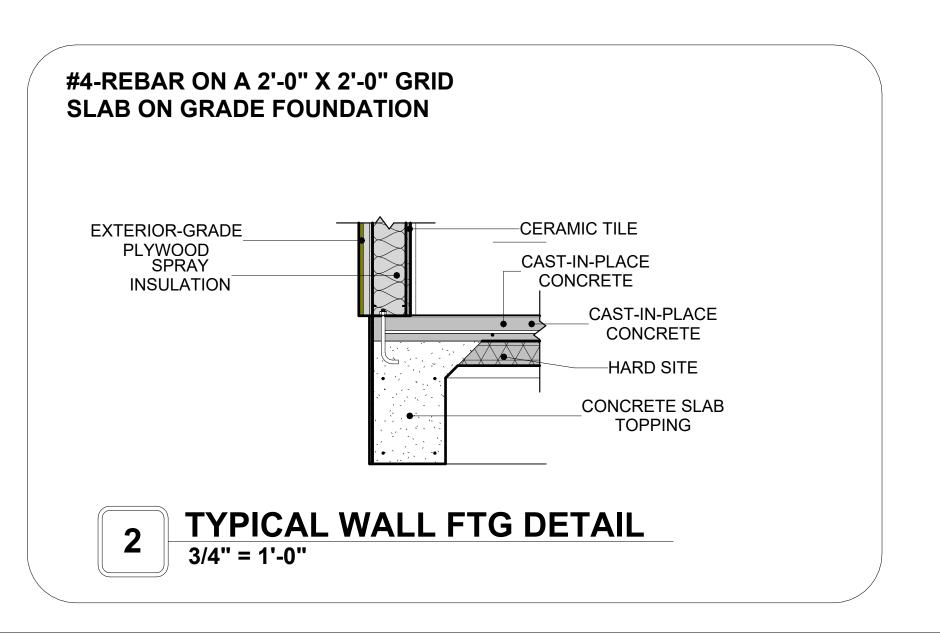

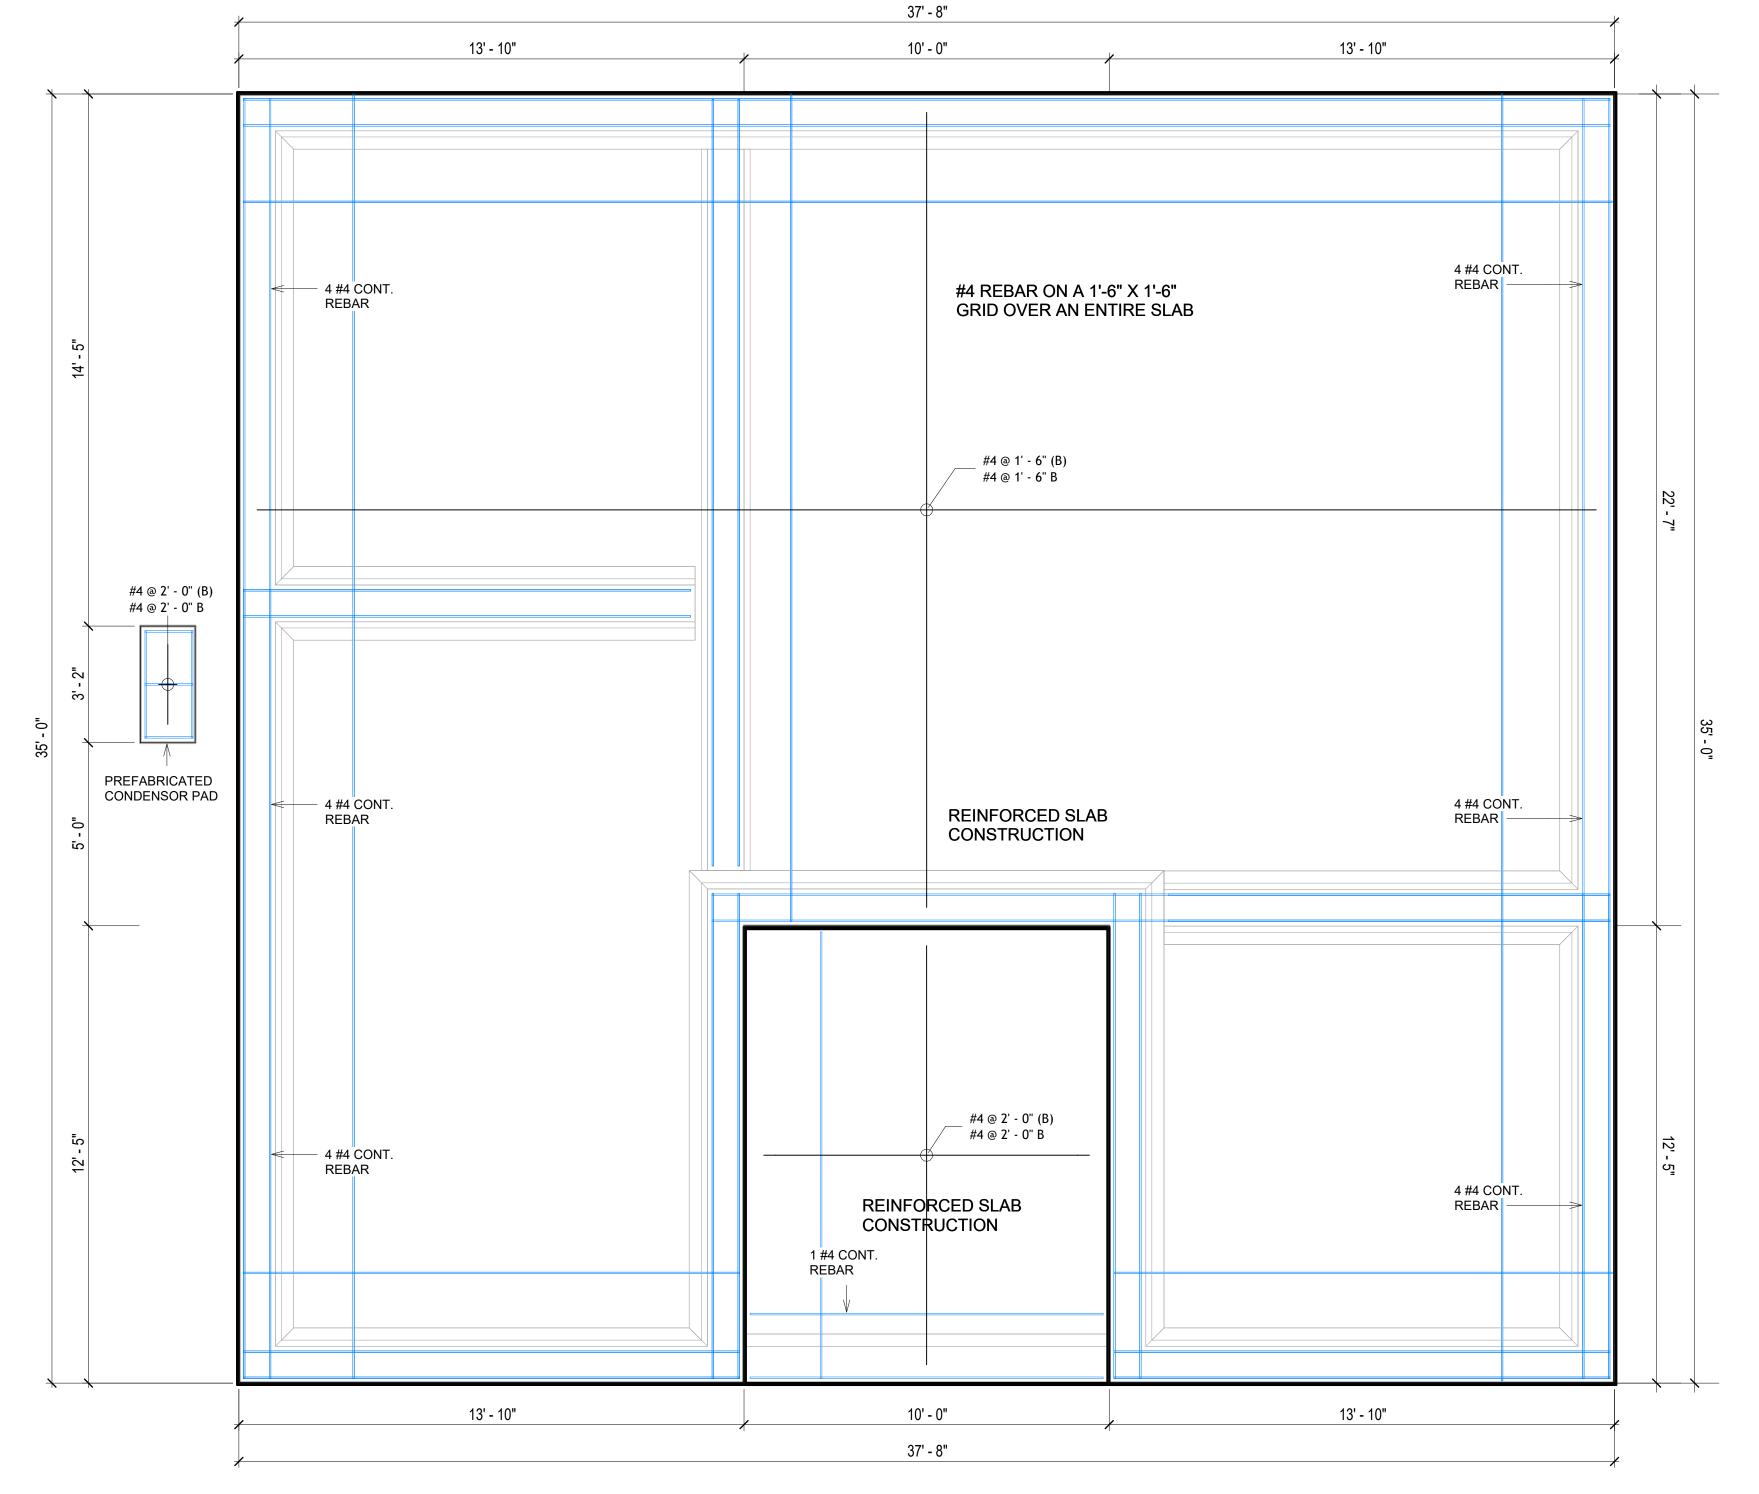



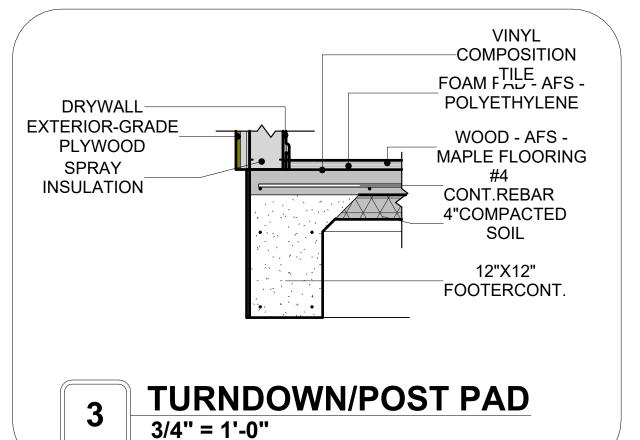



**KEY PLAN** 

NO.	DESCRIPTION	DATE

NOTE:

LEGEND:

PROJECT

14 Wisdom 1194-3Bd/2Ba Traditional-550

DRAWING NAME


STRUCTURAL FLOOR PLAN


CLIENT NAME:	Client Name
PROJECT NUMBER:	Project Number
DATE:	2/8/2025 5:38:06 PM
DESIGNED BY:	Designer
DRAWN BY:	Author
CHECKED BY:	Checker

**S102** 

#### **ROOF NOTES**

- ROOFING COMPOSITION ROOFING PER OWNERS/BUILDERS SPECIFICATIONS INSTALL PER MANUFACTURE SPECIFICATIONS ON 1/2" ORIENTED STRAND BOARD ON PRE-ENGINEERED TRUSS @ 24" O.C. (UNO.)
- 2. 73" OVERHANG AT EAVES (UNO.)
- ENDS OF ALL TRUSSES AND JOISTS TO BE FULLY BLOCKED. PROVIDE SOLID BLOCKING AT ALL RIDGES AND VALLEYS
- 4. SHEATHING TO BE 1/2", 3/8" OSB SHEAR PANEL AND EQUIVALENT. UNDERSIDE OF PORCH TRUSSES TO BE FINISHED WITH MOISTURE RESISTANT DRYWALL, TAPED AND TEXTURED.
- 5. EXPOSED EAVES AND OTHER WEATHER EXPOSED AREAS TO BE SHEATHED WITH EXTERIOR GRADE PLYWOOD.
- 6. ALL MATERIALS THICKNESS AND SIZE ARE THE MINIMUM. Refer TO LOCAL STANDARDS FOR ACTUAL THICKNESS AND LAYERING OF MATERIALS.
- 7. ENGINEERED TRUSS CALCULATIONS TO BE SUBMITTED TO BUILDING DEPARTMENT PRIOR TO FABRICATION AND INSTALLATION.
- 8. TRUSS MANUFACTURER TO SPECIFY HANGER CONNECTORS FOR TRUSS COMPONENTS (TYPICAL)
- 9. DESIGNER ASSUMES THAT TRUSSES BEAR ON ALL EXTERIOR PERIMETER WALLS (TYPICAL) OR BEAMS.
- 10. PROVIDE GALVANIZED STEEL FLASHING WITH A LENGTH OF 10 FEET, WIDTH OF 12 INCHES, AND THICKNESS OF 24 GAUGE.

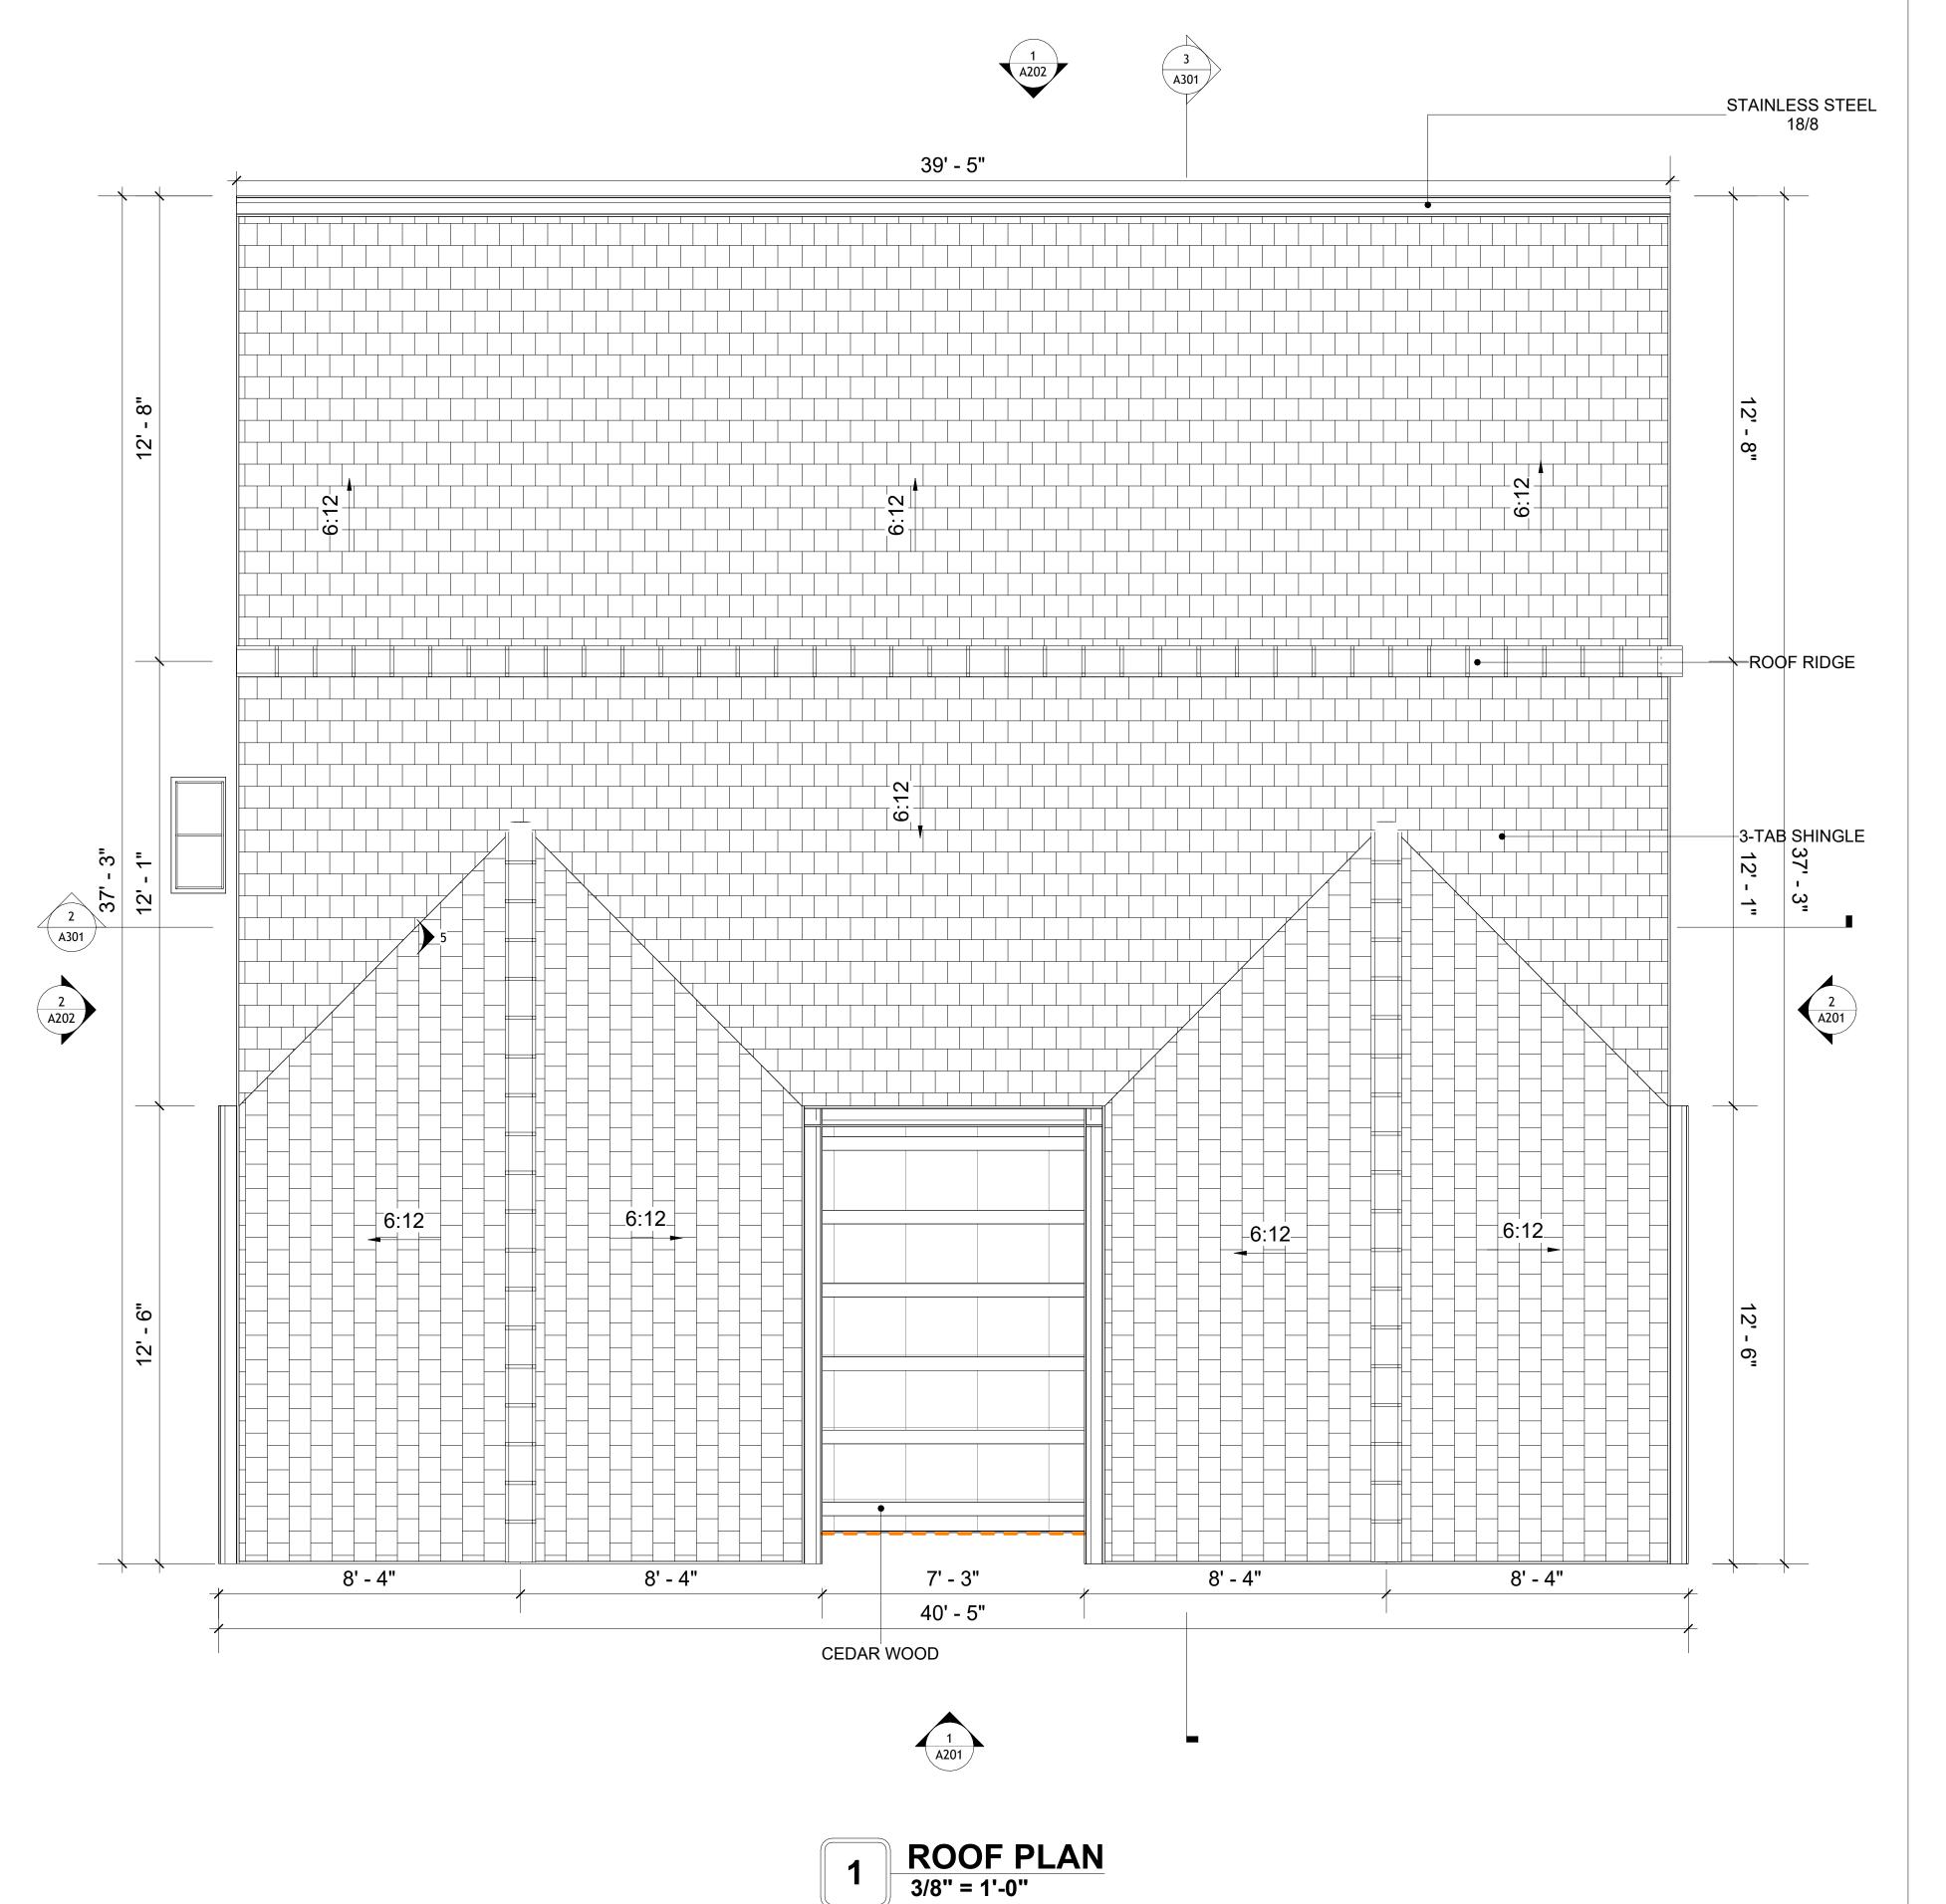

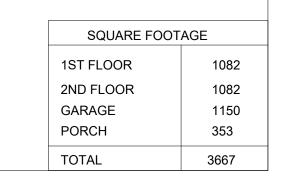



**KEY PLAN** 

NO. DESCRIPTION DATE

NOTE:

LEGEND:

PROJECT

14 Wisdom 1194-3Bd/2Ba **Traditional-550** 

DRAWING NAME

**ROOF PLAN** 

CLIENT NAME: **Client Name** PROJECT NUMBER **Project Number** 2/8/2025 5:38:11 PM Designer DESIGNED BY: DRAWN BY: **Author** Checker CHECKED BY:

A103

#### **ABOUT WALL FINISHING**

#### PLYWOOD WALL SIDING

WALL SIDING IS AN EXTERIOR CLADDING MATERIAL USED TO COVER AND PROTECT THE WALLS OF A BUILDING, PROVIDING BOTH FUNCTIONAL AND AESTHETIC BENEFITS.

IN THIS SPECIFIC PROJECT, PLYWOOD WALL PANELS ARE USED AS A FINISH SIDING BECAUSE THIS TYPE OF SIDING PROVIDES A DURABLE, COST-EFFECTIVE, AND VERSATILE EXTERIOR CLADDING THAT CAN BE EASILY INSTALLED, FINISHED, AND MAINTAINED TO ENHANCE THE AESTHETIC AND PROTECTIVE QUALITIES OF A BUILDING'S EXTERIOR.

STANDARD SIZES OF 1' X 8' EXTERIOR-GRADE PLYWOOD PANELS ARE INSTALLED ON THE FURRING STRIPS USING GALVANIZED STEEL SELF-DRILLING SCREWS.

#### **CEDAR WOOD**


CEDAR WOOD REFERS TO THE WOOD FROM VARIOUS SPECIES OF CEDAR TREES, WHICH ARE CONIFEROUS EVERGREEN TREES KNOWN FOR THEIR DISTINCT AROMA AND NATURAL RESISTANCE TO DECAY AND INSECTS.

IN THIS SPECIFIC PROJECT, CEDAR WOOD IS USED AS A FURRING STRIP AND A FINISH MATERIAL ON BEAMS AND COLUMNS.

CEDAR WOOD AS A FURRING STRIPS PROVIDE THERMAL INSULATION AND MOISTURE MANAGEMENT. THE VERTICAL CEDAR WOOD FURRING STRIPS ARE ATTACHED TO HOME WRAP USING CORROSION-RESISTANT FASTENERS (HOT-DIP GALVANIZED SCREWS), ENSURING PROPER PENETRATION INTO THE WALL FRAMING.



## 1 FRONT ELEVATION 3/8" = 1'-0"

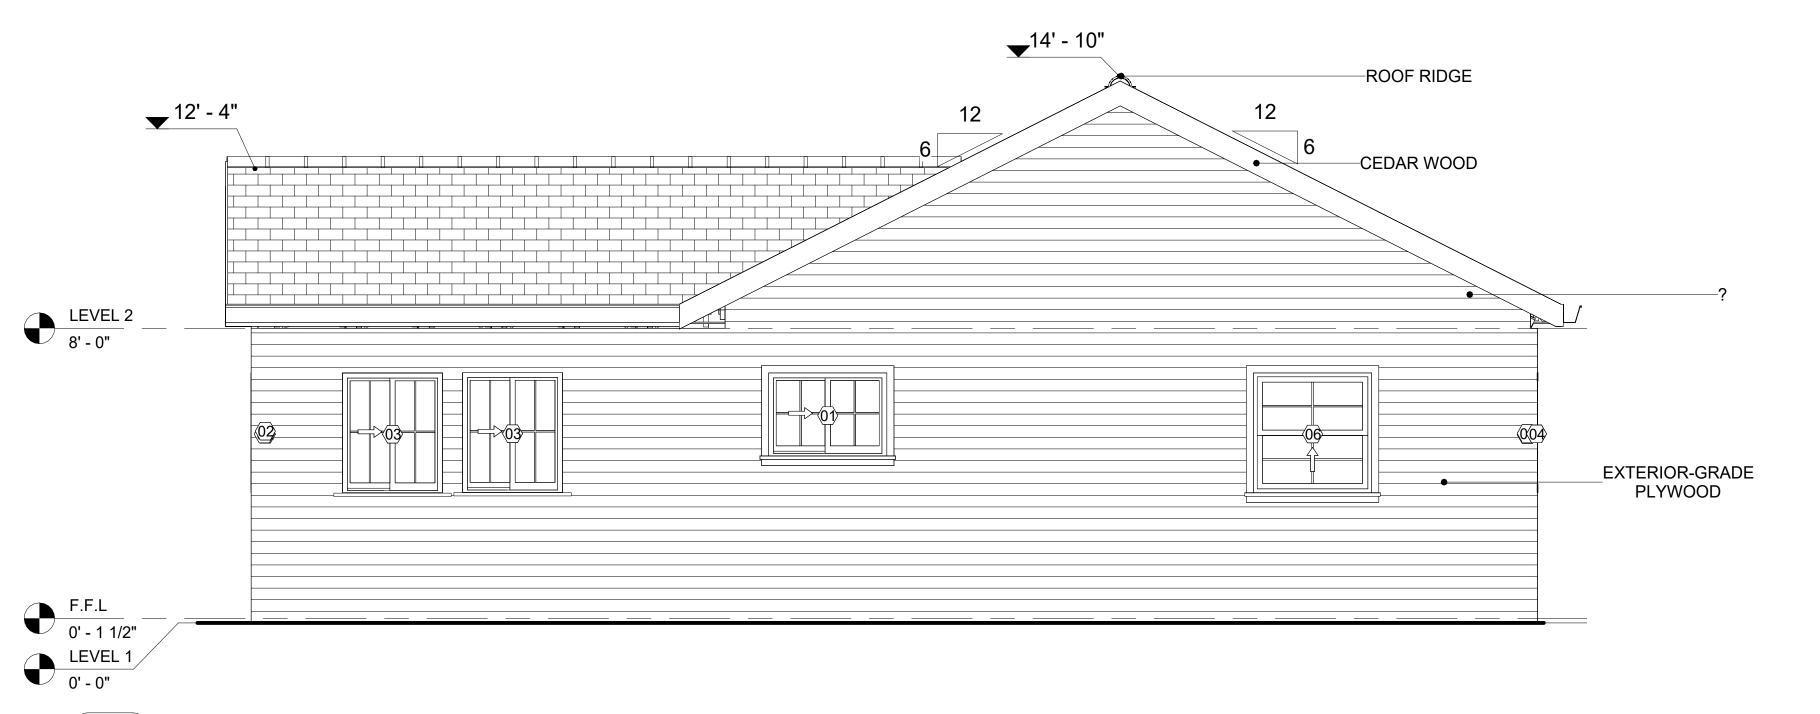


## 2 RIGHT SIDE ELEVATION 3/8" = 1'-0"

DOOR SCHEDULE						
TYPE MAR				SIZE		
K	SUPPLIER	DOOR TYPE	LOCATION	WIDTH	HEIGHT	COUNT
1	HOME DEPOT	INTERIOR SINGLE PANEL SWINGING	INTERIOR	3' - 0"	6' - 8"	3
2	HOME DEPOT	INTERIOR SINGLE PANEL SWINGING	INTERIOR	2' - 6"	6' - 8"	3
3	HOME DEPOT	FRONT_DOOR_W_HEADER_AND_SIDELIGH TS 8215	INTERIOR	3' - 0"	7' - 0"	1
4	HOME DEPOT	INTERIOR DOUBLE PANEL SLIDING	INTERIOR	6' - 0"	6' - 8"	1
5	HOME DEPOT	DOOR-BIFOLD 9052	INTERIOR	4' - 8"	6' - 8"	1
6	HOME DEPOT	INTERIOR DOUBLE PANEL SLIDING	INTERIOR	5' - 0"	6' - 8"	1
7	HOME DEPOT	PATIO DOUBLE PANEL SLIDING	INTERIOR	5' - 0"	6' - 8"	2
8	HOME DEPOT	DOOR-INTERIOR-SINGLE-POCKET-2_PANE L-WOOD	INTERIOR	2' - 4"	6' - 8"	1
9	HOME DEPOT	INTERIOR SINGLE PANEL SWINGING	INTERIOR	2' - 0"	6' - 8"	1

WINDOW SCHEDULE					
SIZE					
<b>TYPE MARK</b>	SUPPLIER	WINDOW TYPE	WIDTH	HEIGHT	COUNT
01	HOME DEPOT	SLIDING	3' - 3"	2' - 3"	2
02	HOME DEPOT	SINGLE HUNG	2' - 9"	3' - 3"	6
03	HOME DEPOT	SLIDING	2' - 9"	3' - 3"	8
04	HOME DEPOT	DOUBLE HUNG	2' - 3"	3' - 3"	2
05	HOME DEPOT	SLIDING	6' - 3"	3' - 3"	1
06	HOME DEPOT	SINGLE HUNG	3' - 3"	3' - 3"	1



**KEY PLAN** 

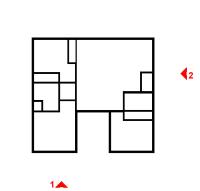

NO.	DESCRIPTION	DAT

NOTE:

LEGEND:

PROJECT

14 Wisdom 1194-3Bd/2Ba Traditional-550

DRAWING NAME

## ARCHITECTURAL ELEVATIONS

Client Name	CLIENT NAME:
Project Number	PROJECT NUMBER:
2/8/2025 5:38:16 PM	DATE:
Designer	DESIGNED BY:
Author	DRAWN BY:
Checker	CHECKED BY:

A201

#### **ABOUT WALL FINISHING**

#### **CORRUGATED IRON SHEET**

CORRUGATED IRON IS A FINISHING MATERIAL MADE FROM STEEL THAT HAS BEEN GALVANIZED (COATED WITH A THIN LAYER OF ZINC) TO PROTECT IT FROM CORROSION AND RUST.

IN THIS SPECIFIC PROJECT, THE CORRUGATED IRON SHEETS ARE INSTALLED HORIZONTALLY ON VERTICAL FURRING STRIPS THAT ARE DIRECTLY ATTACHED ONTO THE PROPERLY INSTALLED AND SEALED HOME WRAP, USING SELF-DRILLING SCREWS THAT ARE DRIVEN THROUGH THE RIDGES OR VALLEYS OF THE CORRUGATIONS.

#### **EXTERNAL STONE**

THESE STONE PRODUCTS ARE MADE FROM A BLEND OF NATURAL AGGREGATES, CEMENT, AND OTHER PROPRIETARY MATERIALS.

THE STONE FINISH IS DIRECTLY ATTACHED TO COLD-FORMED STEEL (CS) FRAMING. (FOR COLUMN FINISH) EXTERNAL STONE CAN BE AN EXCELLENT EXTERIOR CLADDING OPTION FOR CS-FRAMED BUILDINGS. IN THIS SCENARIO, THE EXTERNAL STONE WOULD BE ADHERED TO THE CS FRAME USING A SCRATCH COAT AND MORTAR-BASED ADHESIVE.

#### CAST IN PLACE CONCRETE COPPING

CAST IN PLACE CONCRETE COPPING IS TYPICALLY MADE FROM A MIXTURE OF CEMENT, AGGREGATES, AND OTHER ADDITIVES. THIS COMPOSITE MATERIAL IS MOLDED AND CURED TO CREATE A DURABLE, STONE-LIKE APPEARANCE AND TEXTURE.


IN THIS PROJECT, THE **CAST IN PLACE CONCRETE** COPPING IS ATTACHED ON TOP OF A EXTERNAL STONE VENEER WALL OR SURFACE. THE PROCESS OF INSTALLING INVOLVES SURFACE PREPARATION (ENSURE THE STONE WALL OR SURFACE IS CLEAN, DRY, AND FREE OF ANY DEBRIS OR PROTRUSIONS AND VERIFY THAT THE STONE INSTALLATION IS SECURE AND PROPERLY ADHERED TO THE UNDERLYING SUBSTRATE.)

#### **CEDAR WOOD**


CEDAR WOOD REFERS TO THE WOOD FROM VARIOUS SPECIES OF CEDAR TREES, WHICH ARE CONIFEROUS EVERGREEN TREES KNOWN FOR THEIR DISTINCT AROMA AND NATURAL RESISTANCE TO DECAY AND INSECTS.

IN THIS SPECIFIC PROJECT, CEDAR WOOD IS USED AS A FURRING STRIP AND A FINISH MATERIAL ON BEAMS AND COLUMNS.

CEDAR WOOD AS A FURRING STRIPS PROVIDE THERMAL INSULATION, MOISTURE MANAGEMENT, AND AN AESTHETICALLY PLEASING, VERSATILE FRAMING SOLUTION WHEN INTEGRATED WITH CORONADO STONE AND CORRUGATED IRON SHEET CLADDING. THE VERTICAL CEDAR WOOD FURRING STRIPS ARE ATTACHED TO HOME WRAP USING CORROSION-RESISTANT FASTENERS (HOT-DIP GALVANIZED SCREWS), ENSURING PROPER PENETRATION INTO THE WALL FRAMING.

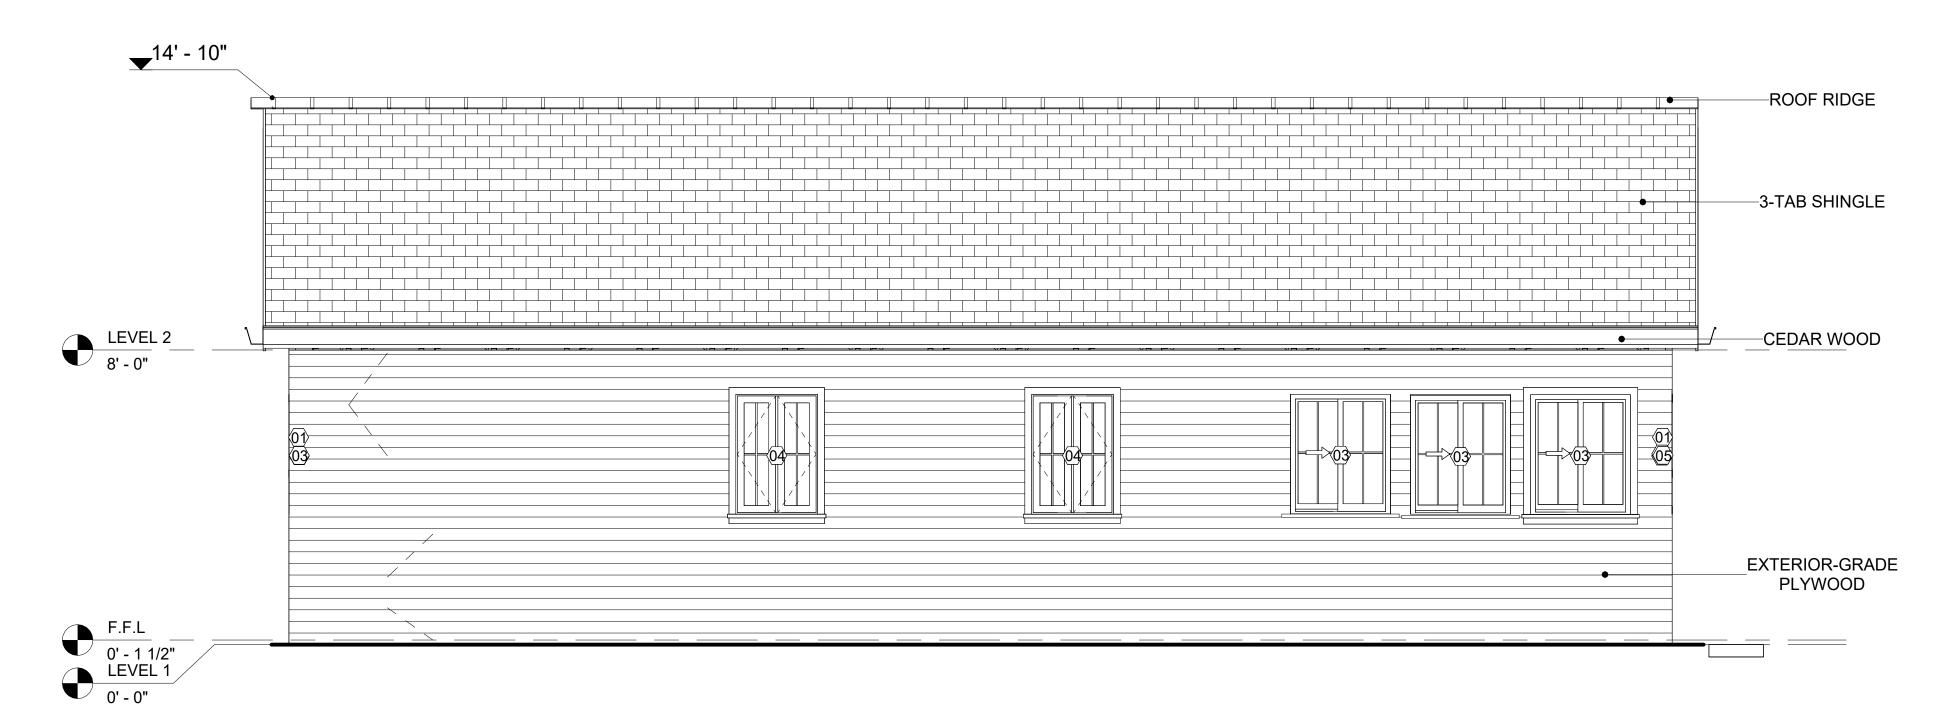


1 REAR ELEVATION 3/8" = 1'-0"

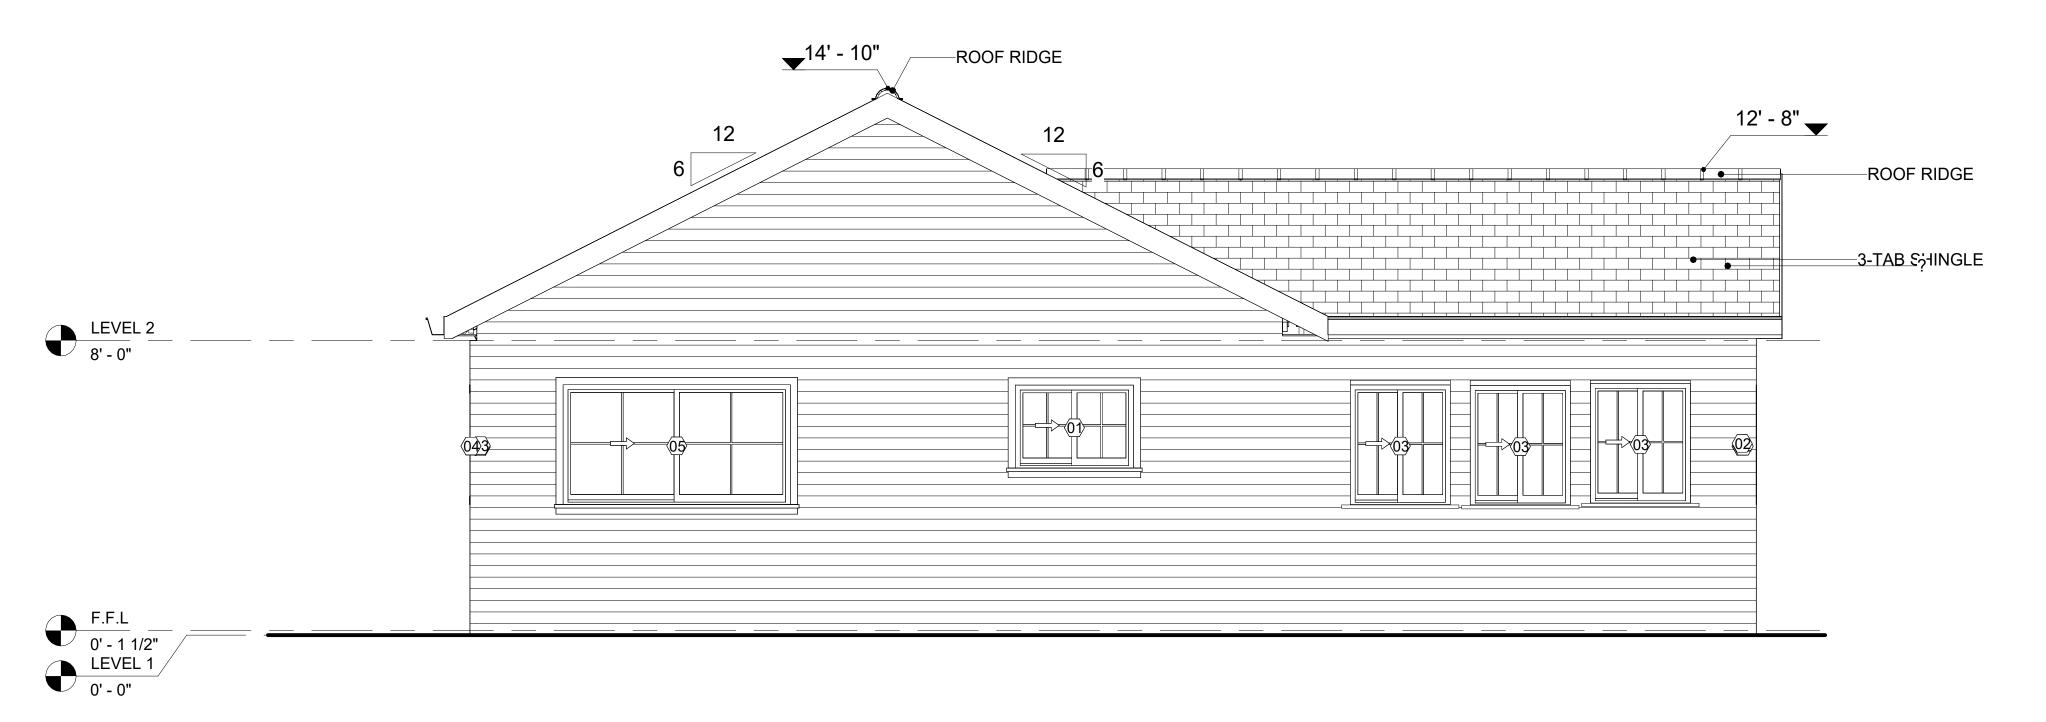

2 LEFT SIDE ELEVATION
3/8" = 1'-0"



KEY PLAN

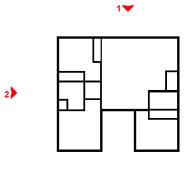

NO.	DESCRIPTION	DATE

NOTE:

LEGEND:

PROJECT

14 Wisdom 1194-3Bd/2Ba Traditional-550

DRAWING NAME

ARCHITECTURAL ELEVATIONS

CLIENT NAME:

PROJECT NUMBER:

Project Number

DATE:

2/8/2025 5:38:21 PM


DESIGNED BY:

DRAWN BY:

CHECKED BY:


Checker

A202

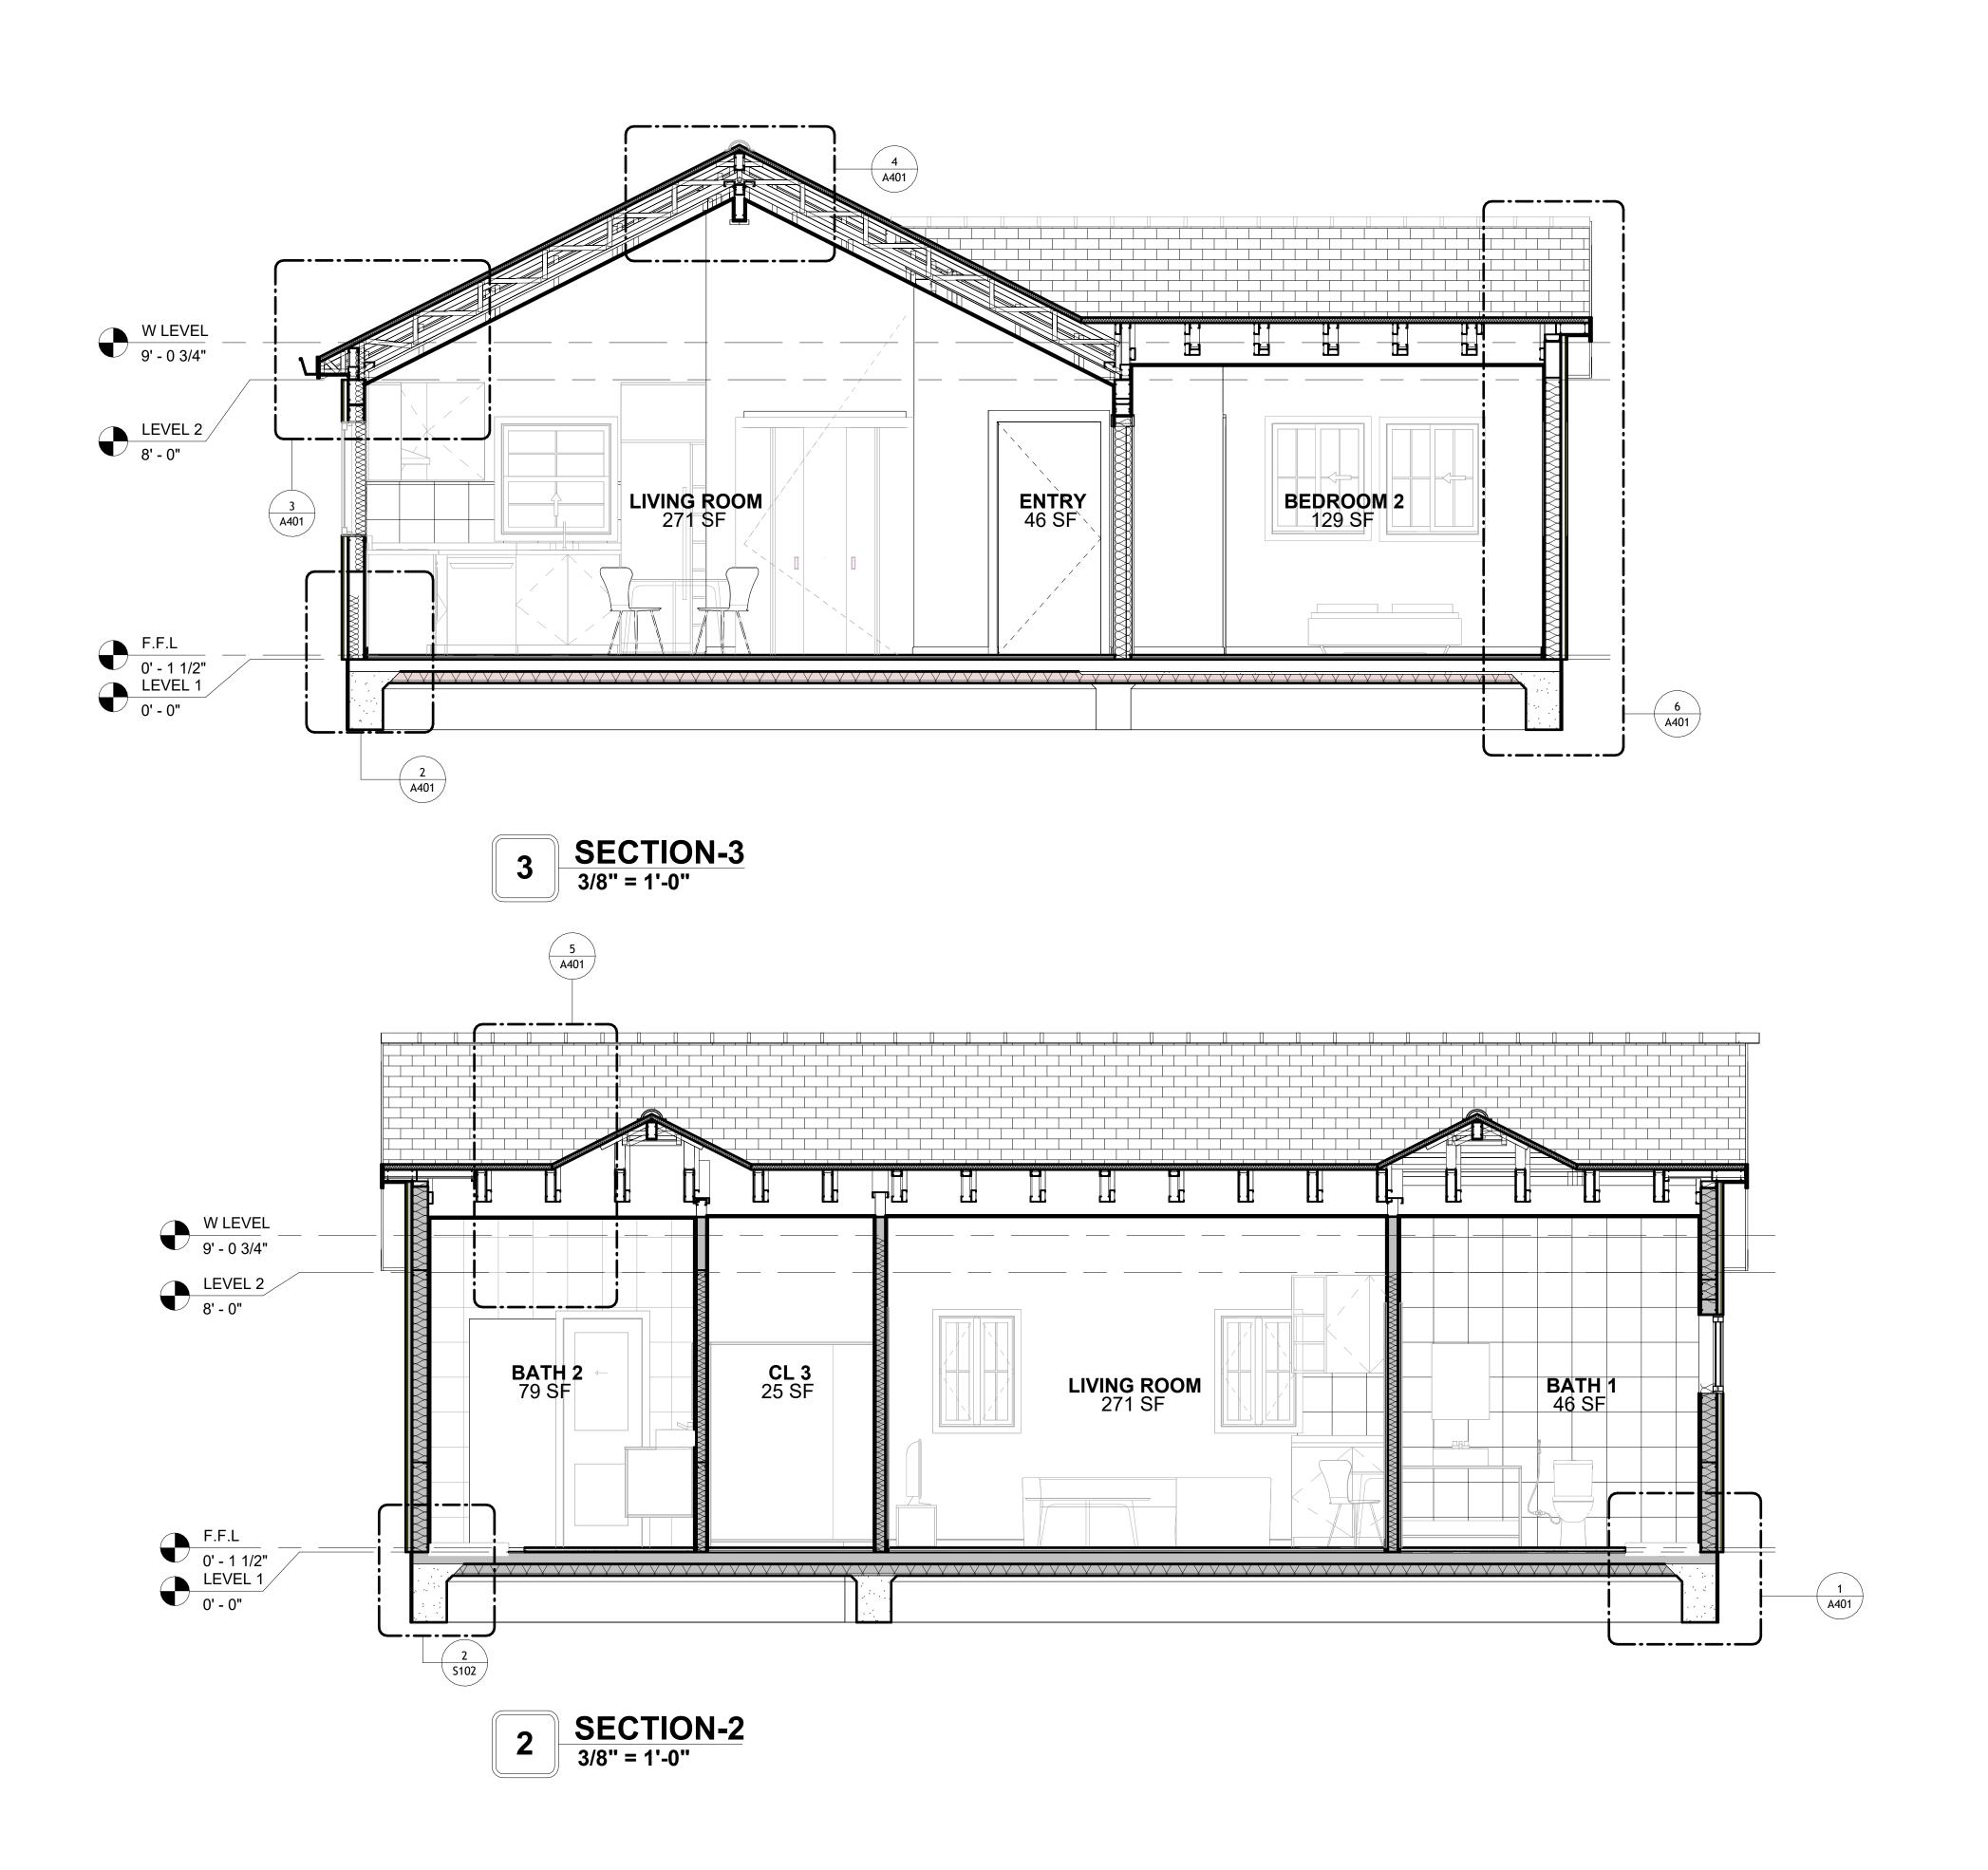



**KEY PLAN** 

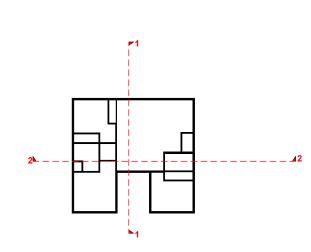

DESCRIPTION	DATE
	DESCRIPTION

NOTE:

LEGEND:

PROJECT


14 Wisdom 1194-3Bd/2Ba Traditional-550


DRAWING NAME


## ARCHITECTURAL SECTIONS


CLIENT NAME:	Client Name
PROJECT NUMBER:	Project Number
DATE:	2/8/2025 5:38:23 PM
DESIGNED BY:	Designer
DRAWN BY:	Author
CHECKED BY:	Checker


A301

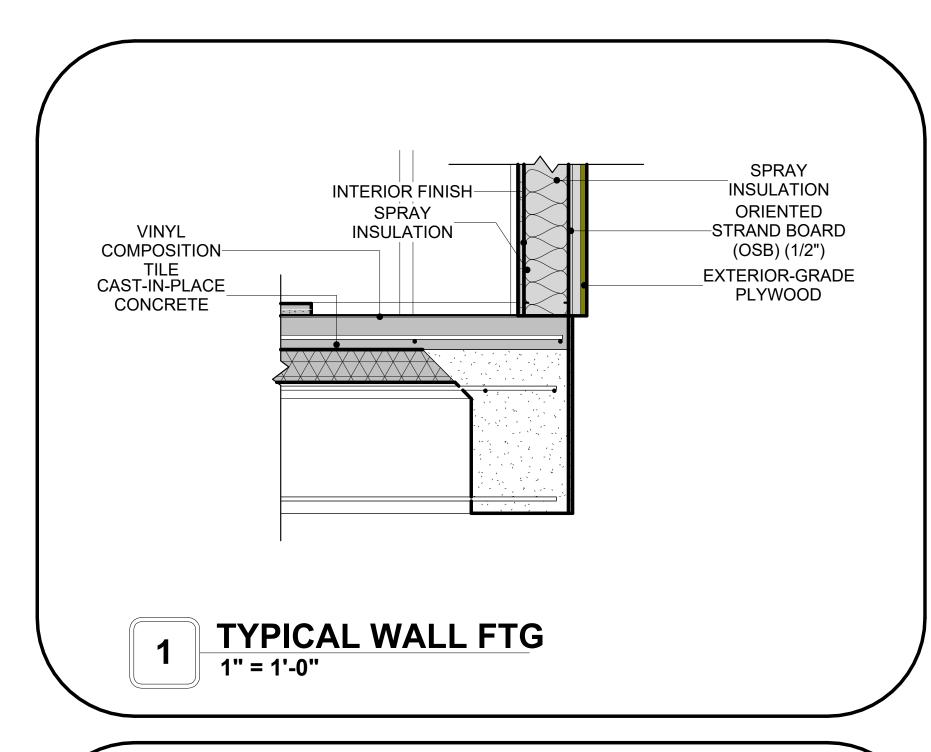


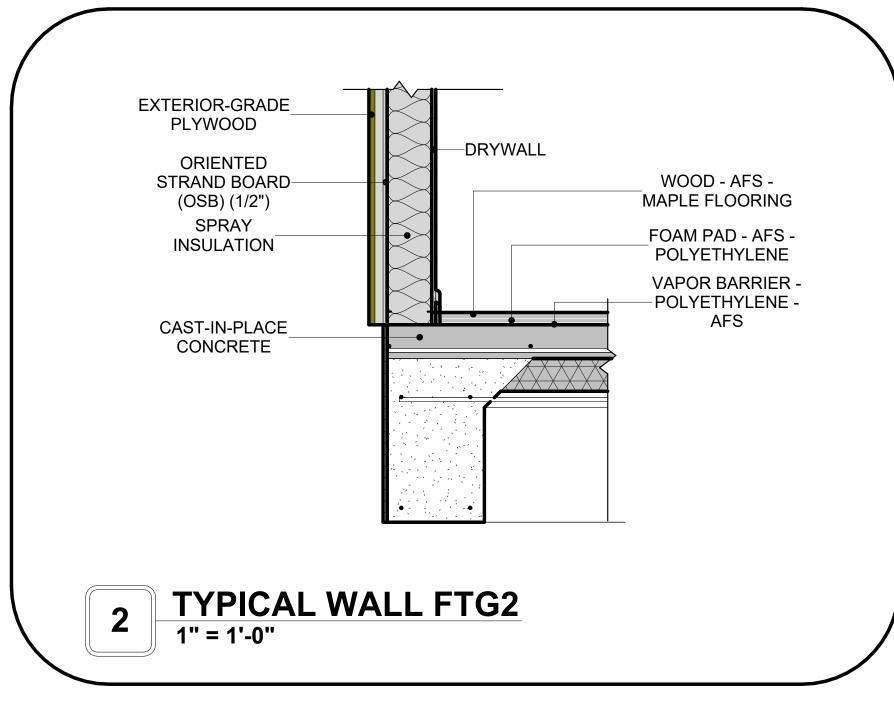

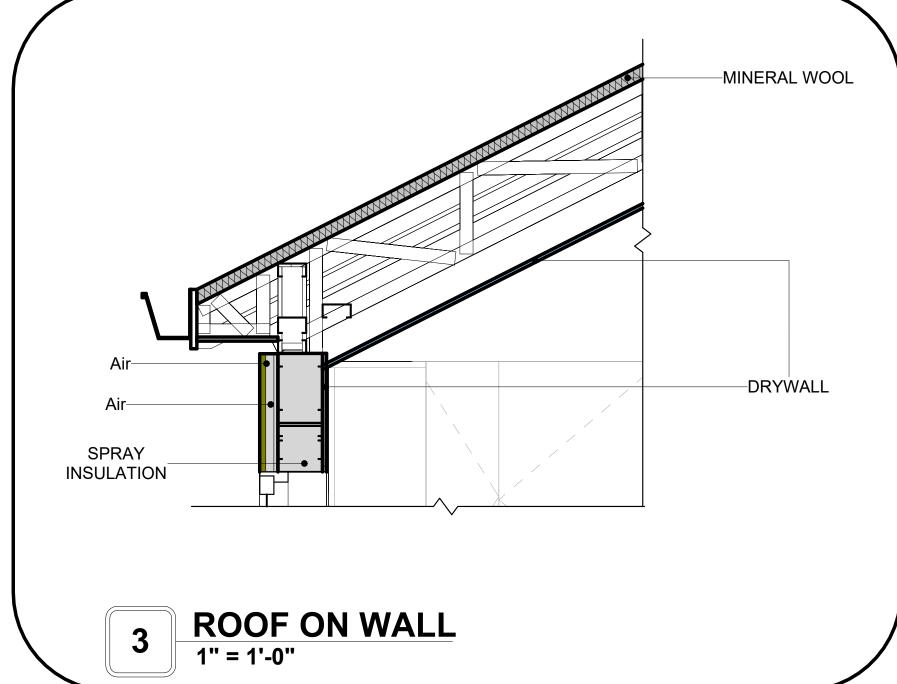

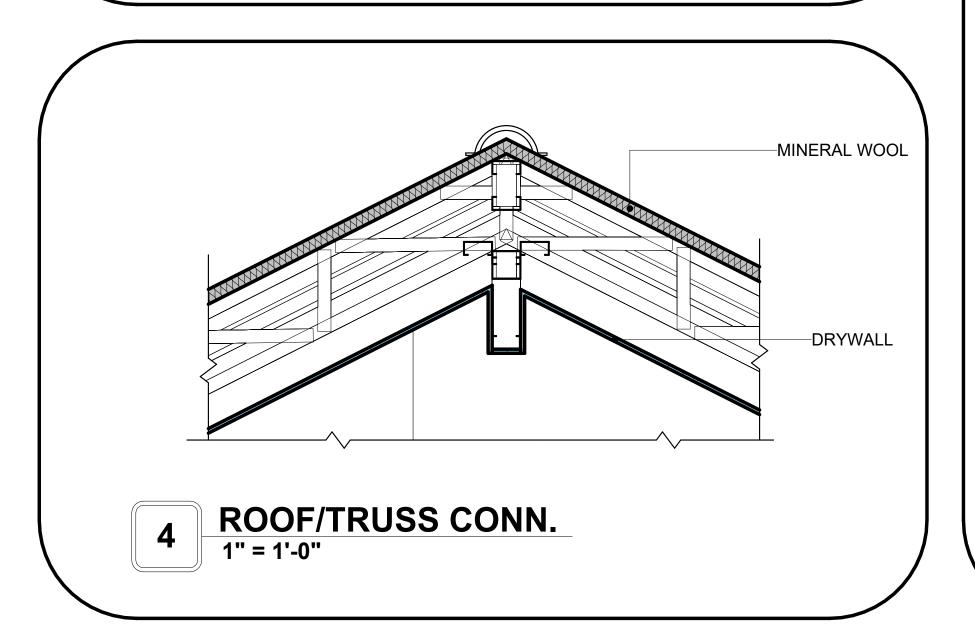

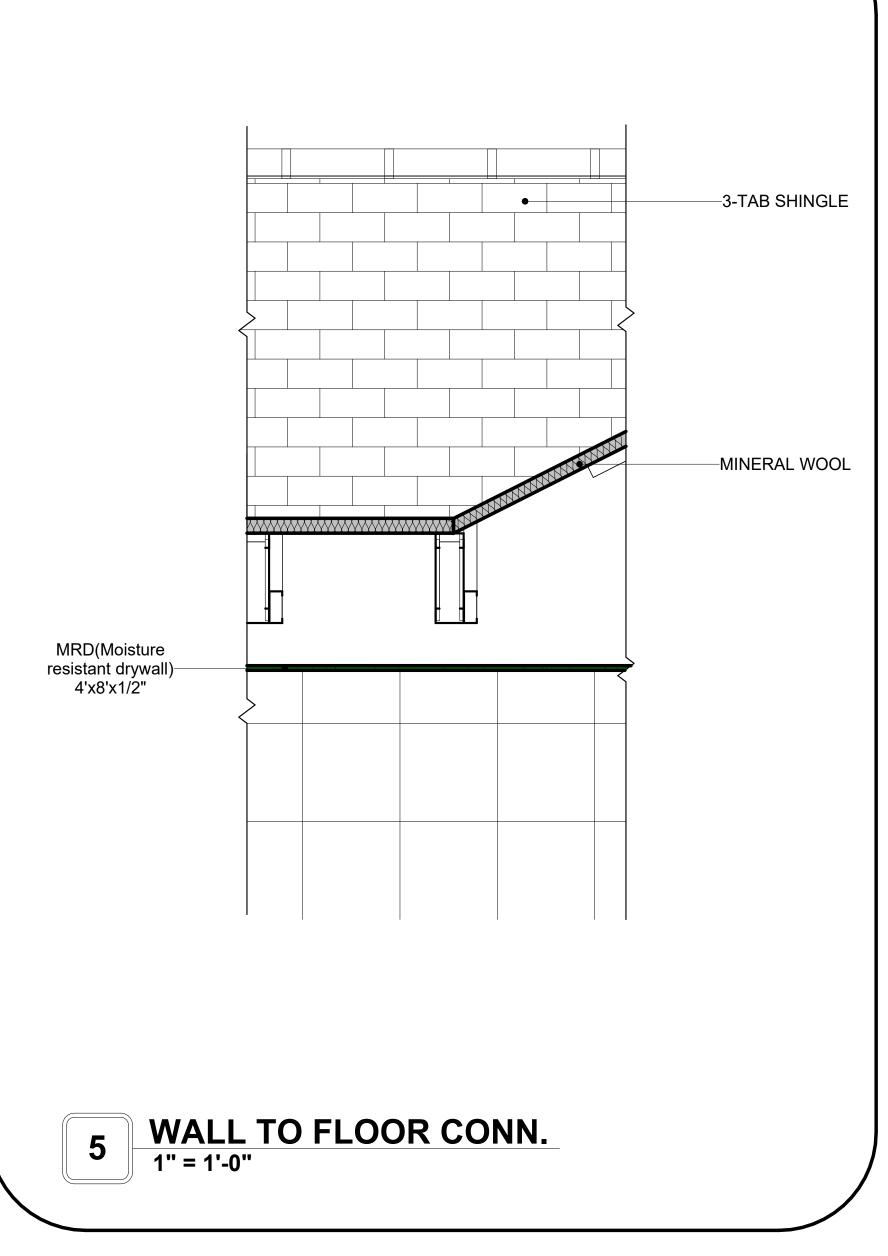

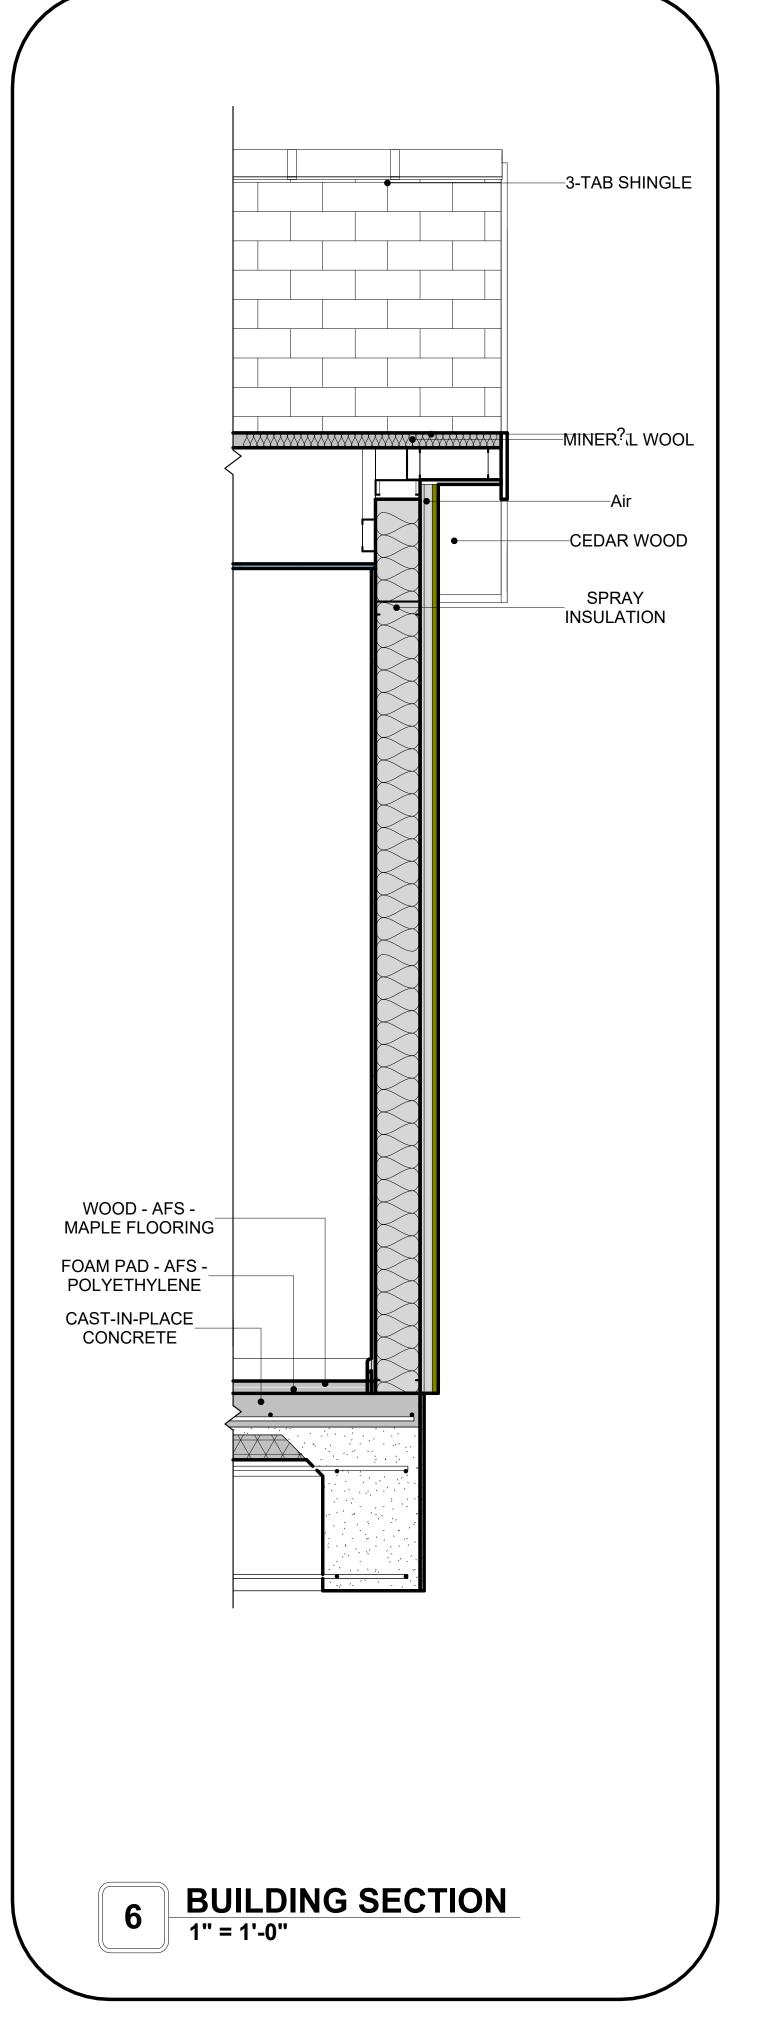



**KEY PLAN** 

NO.	DESCRIPTION	DATE

NOTE:

LEGEND:

PROJECT

14 Wisdom 1194-3Bd/2Ba Traditional-550

DRAWING NAME

ARCHITECTURAL DETAILS

CLIENT NAME:	Client Name
PROJECT NUMBER:	Project Number
DATE:	2/8/2025 5:38:25 PM
DESIGNED BY:	Designer
DRAWN BY:	Author
CHECKED BY:	Checker

A401

SCALE: 1" = 1'-0"

#### **CASEWORK GENERAL NOTES**

- 1. ALL CABINET HEIGHTS INCLUDE COUNTERTOPS. DIMENSIONS ARE TO THE NEAREST INCH. 2. DIVISIONS IN CASEWORK ARE SHOWN FOR CLARITY AND DO NOT REPRESENT BREAKS IN THE
- COUNTERTOP. 3. PROVIDE CONTINUOUS COUNTERTOP OVER ALL SIMILAR HEIGHT CASEWORK, UNLESS AND
- OTHERWISE NOTED.
- 4. MANUFACTURER AND CATALOG NUMBERS ARE FOR REFERENCE AND ILLUSTRATION PURPOSES
- 5. DOTTED LINES INDICATE WALL HUNG CABINETS, DIVISIONS OF BASE CABINETS BELOW THE
- 6. COUNTERTOP, FURNITURE NOT IN THE CONTRACT OR PROJECTION SCREENS -SEE CASEWORK KEY AND SPECIFICATIONS.
- ALL CABINETS AND DRAWERS TO HAVE CAM LOCKS EXCEPT FOR SINK BASE CABINETS.
   ALL EXPOSED SURFACES (EXPOSED TO VIEW FROM ANY PERSPECTIVE) TO BE COVERED WITH LAMINATE.
- 9. ALL CASEWORK WHICH MEETS A WALL AT ONE OR BOTH ENDS, TO BE PROVIDED WITH FILLER
- PANELS AND SCRIBED TO THE WALL(S) AS REQUIRED.


  10. ALL CABINETS AND DRAWERS ARE PROVIDED WITH RECESSED HANDLES.


  11. CONTRACTOR TO FIELD VERIFY ALL CLEAR OPENINGS PRIOR TO MILLWORK OR CASEWORK

- 12. CASEWORK DRAWINGS ARE DIAGRAMMATIC IN NATURE TO SHOW DESIGN INTENT.


	CAS	EWOR	K SCHEDU	ILE		
TYPE MAR K	TYPE	COUN T	HEIGHT	WIDTH	DEPTH	AREA
01	DOUBLE SINK VANITY 2	1	3' - 0"	5' - 11"	2' - 0"	18 SF
02	RECESSED MED CABINET 2	3	2' - 0"	1' - 6"	0' - 3"	3 SF
03	WALL CABINET DOUBLE DOOR 2'6	1	2' - 9 1/2"	2' - 6"	1' - 0"	7 SF
04	TOP FILLER 1	1	2' - 9 1/2"	1' - 0"	1' - 0"	3 SF
05	WALL CABINET SINGLE DOOR 2	1	2' - 9 1/2"	1' - 3"	1' - 0"	3 SF
06	WALL CABINET DOUBLE DOOR 5	1	2' - 9 1/2"	3' - 0"	1' - 0"	8 SF
07	WALL CABINET L-SHAPE 4	1	2' - 9 1/2"	1' - 9"	2' - 0"	5 SF
08	BASE CABINET DOUBLE DOOR 3	1	2' - 10 1/2"	3' - 0"	2' - 0"	9 SF
09	HD L-SHAPE COUNTER TOP	1	0' - 4"	4' - 4"	6' - 3"	1 SF
10	HD_LINEAR_COUNTER_TOP	1	0' - 4"	7' - 6 1/2"	2' - 1"	3 SF
11	BASE CABINET DOUBLE DOOR 5	1	2' - 10 1/2"	3' - 0"	2' - 0"	9 SF
12	HD LAUNDRY OPEN CABINET 2'0 2	1	1' - 8 1/2"	2' - 7"	2' - 0"	4 SF
13	WALL_CABINET_SINGLE_DOOR	1	2' - 9 1/2"	1' - 8"	1' - 0"	5 SF
14	HD WALL FILLER 4' HIGH 2	1	6' - 1"	0' - 7"	2' - 0"	4 SF
15	BASE_CABINET_DOUBLE_DOOR 4	1	2' - 10 1/2"	3' - 6"	2' - 0"	10 SF
16	BASE_CABINET_L-SHAPED 3	1	2' - 10 1/2"	2' - 4"	3' - 3"	7 SF
17	LINEN 6'	1	6' - 0"	5' - 9 1/2"	1' - 4"	35 SF
18	HD_LINEAR_COUNTER_TOP 2	1	0' - 4"	3' - 6"	2' - 1"	1 SF
19	VANITY_CABINET_3	1	2' - 4"	3' - 6"	2' - 0"	8 SF
20	LINEN	1	6' - 0"	2' - 8 1/2"	1' - 4"	16 SF
21	LINEN 7'	1	6' - 0"	7' - 0"	1' - 4"	42 SF
22	CLOSET_L_SHAPE 2	1	6' - 0"	4' - 11"	4' - 10 1/2"	30 SF
GRAND	TOTAL	24				


	SPECIALTY EQUIPMENT SC	HEDULE
TYPE MARK	TYPE	COUNT
02	REFRIGERATOR	1
03	STACKABLE-WASHER-FRONT-LOAD	1
04	DRYER-FRONT-LOAD	1
05	RANGE	1
06	DISHWASHER	1

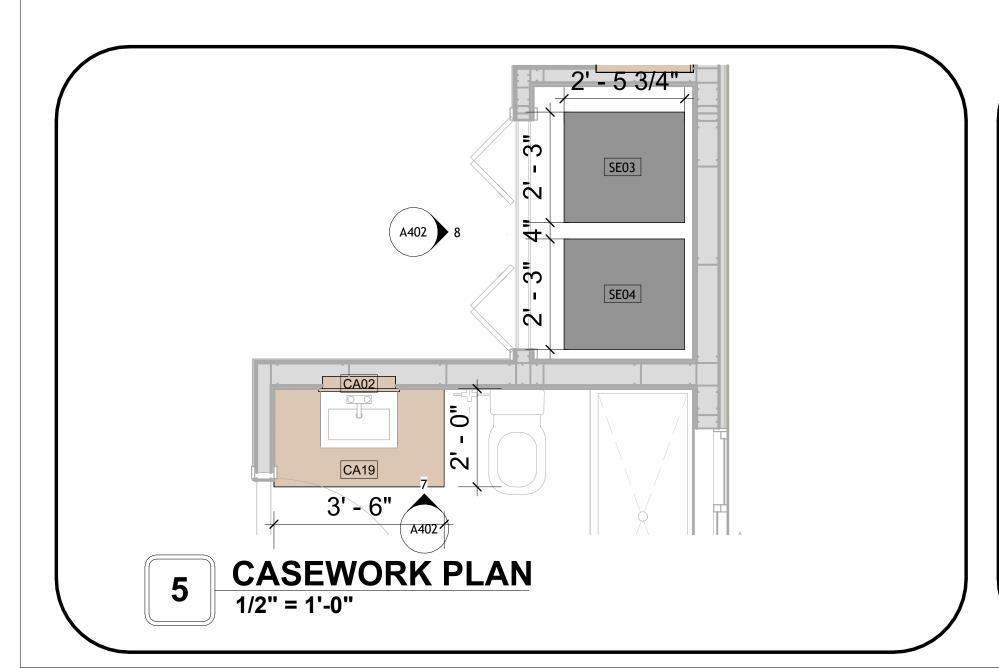


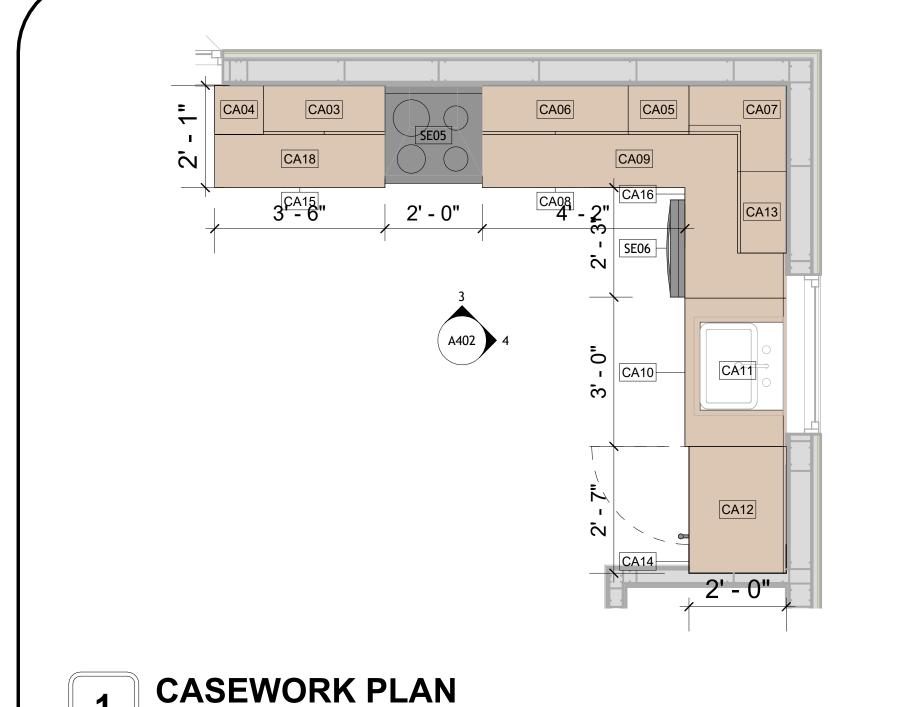



1/2" = 1'-0"

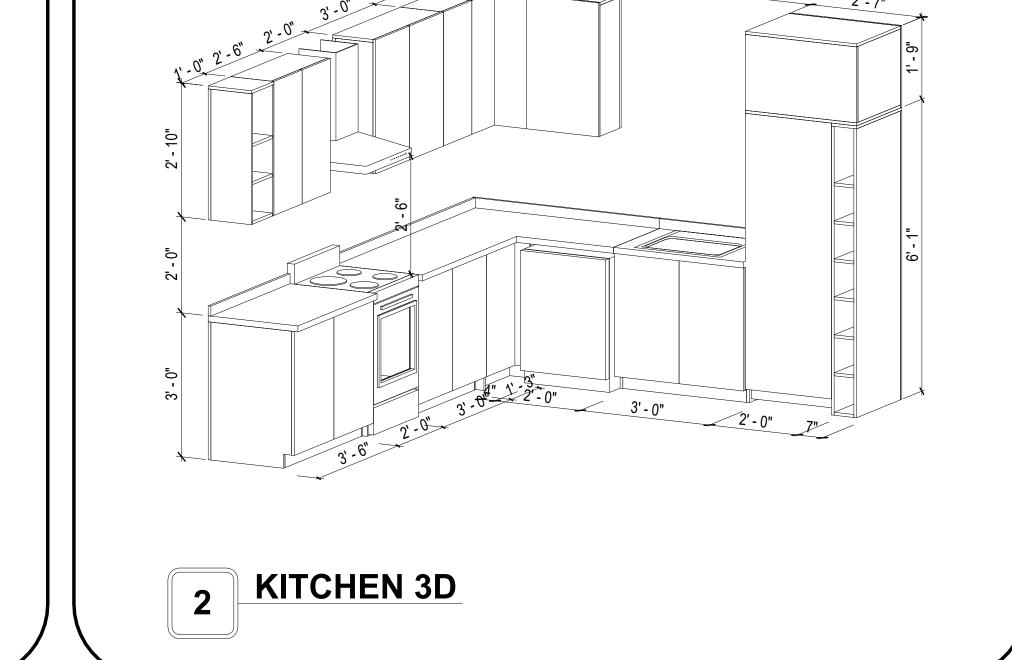

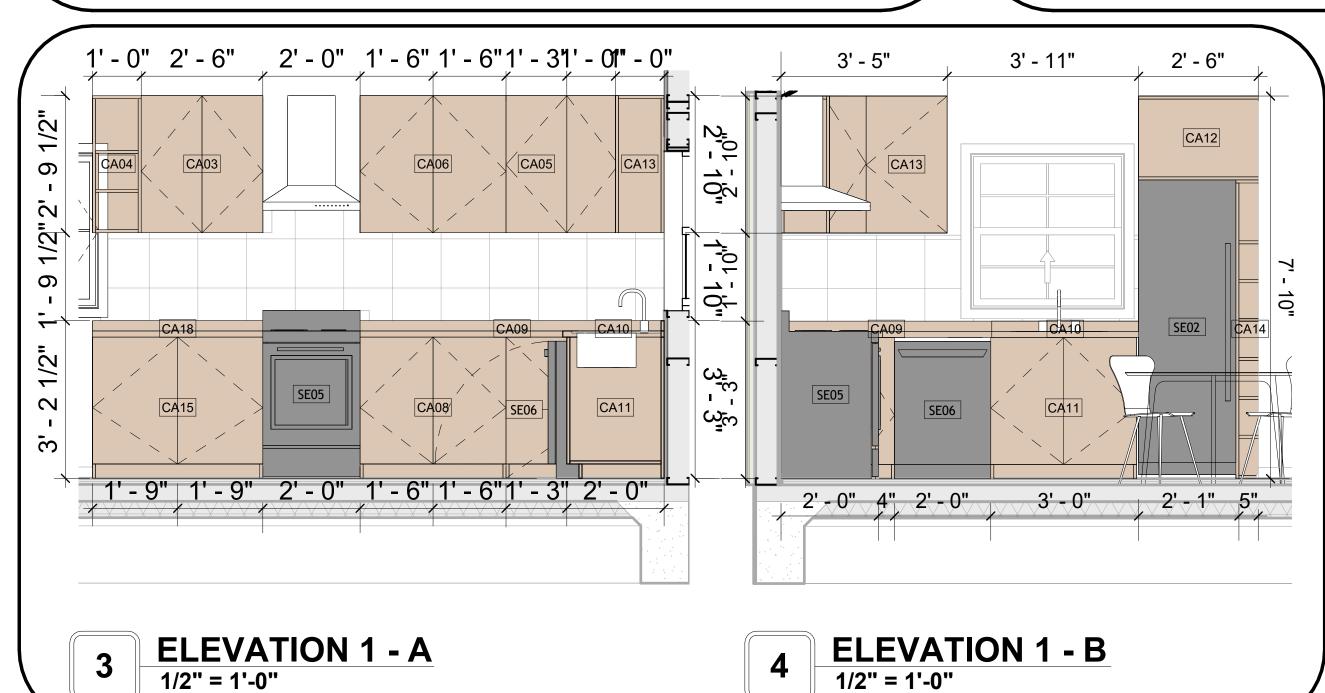

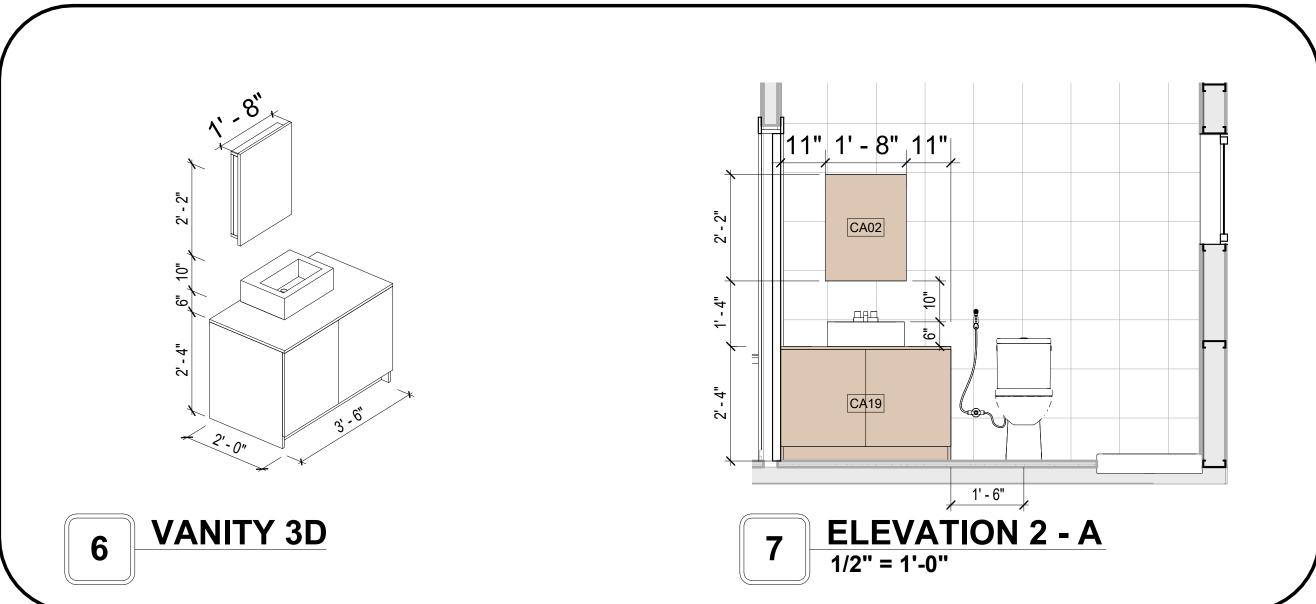

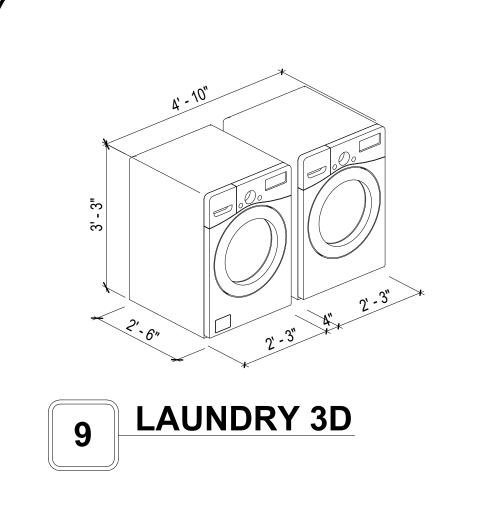


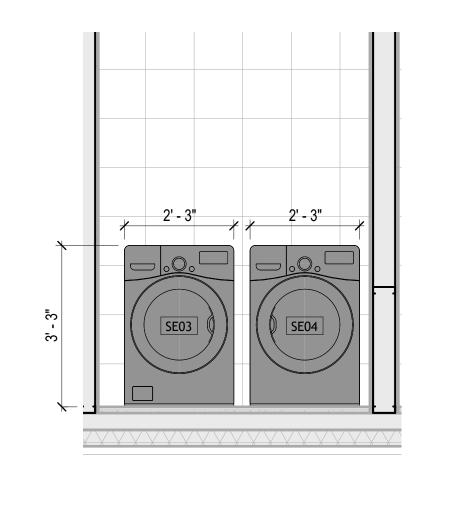

**ELEVATION 2 - B** 1/2" = 1'-0"

Tuscon,AZ, USA 888-864-0184 inquire@frameupnow.com www.frameupnow.com

**KEY PLAN** 

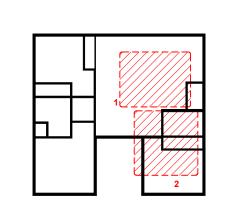

NO.	DESCRIPTION	DATE

NOTE:

LEGEND:

PROJECT

14 Wisdom 1194-3Bd/2Ba **Traditional-550** 

DRAWING NAME

**ARCHITECTURAL CASEWORK** 

CLIENT NAME: **Client Name** PROJECT NUMBER: **Project Number** 2/8/2025 5:38:28 PM Designer **DESIGNED BY:** DRAWN BY: Author CHECKED BY: Checker


A402


#### **CASEWORK GENERAL NOTES**

- ALL CABINET HEIGHTS INCLUDE COUNTERTOPS. DIMENSIONS ARE TO THE NEAREST INCH.
  DIVISIONS IN CASEWORK ARE SHOWN FOR CLARITY AND DO NOT REPRESENT BREAKS IN THE
- COUNTERTOP. PROVIDE CONTINUOUS COUNTERTOP OVER ALL SIMILAR HEIGHT CASEWORK, UNLESS AND
- OTHERWISE NOTED. MANUFACTURER AND CATALOG NUMBERS ARE FOR REFERENCE AND ILLUSTRATION PURPOSES
- DOTTED LINES INDICATE WALL HUNG CABINETS, DIVISIONS OF BASE CABINETS BELOW THE COUNTERTOP, FURNITURE NOT IN THE CONTRACT OR PROJECTION SCREENS -SEE CASEWORK KEY AND SPECIFICATIONS.
- ALL CABINETS AND DRAWERS TO HAVE CAM LOCKS EXCEPT FOR SINK BASE CABINETS.
  ALL EXPOSED SURFACES (EXPOSED TO VIEW FROM ANY PERSPECTIVE) TO BE COVERED WITH
- LAMINATE.
- ALL CASEWORK WHICH MEETS A WALL AT ONE OR BOTH ENDS, TO BE PROVIDED WITH FILLER
- PANELS AND SCRIBED TO THE WALL(S) AS REQUIRED.

  10. ALL CABINETS AND DRAWERS ARE PROVIDED WITH RECESSED HANDLES.

  11. CONTRACTOR TO FIELD VERIFY ALL CLEAR OPENINGS PRIOR TO MILLWORK OR CASEWORK FABRICATION.
- 12. CASEWORK DRAWINGS ARE DIAGRAMMATIC IN NATURE TO SHOW DESIGN INTENT.

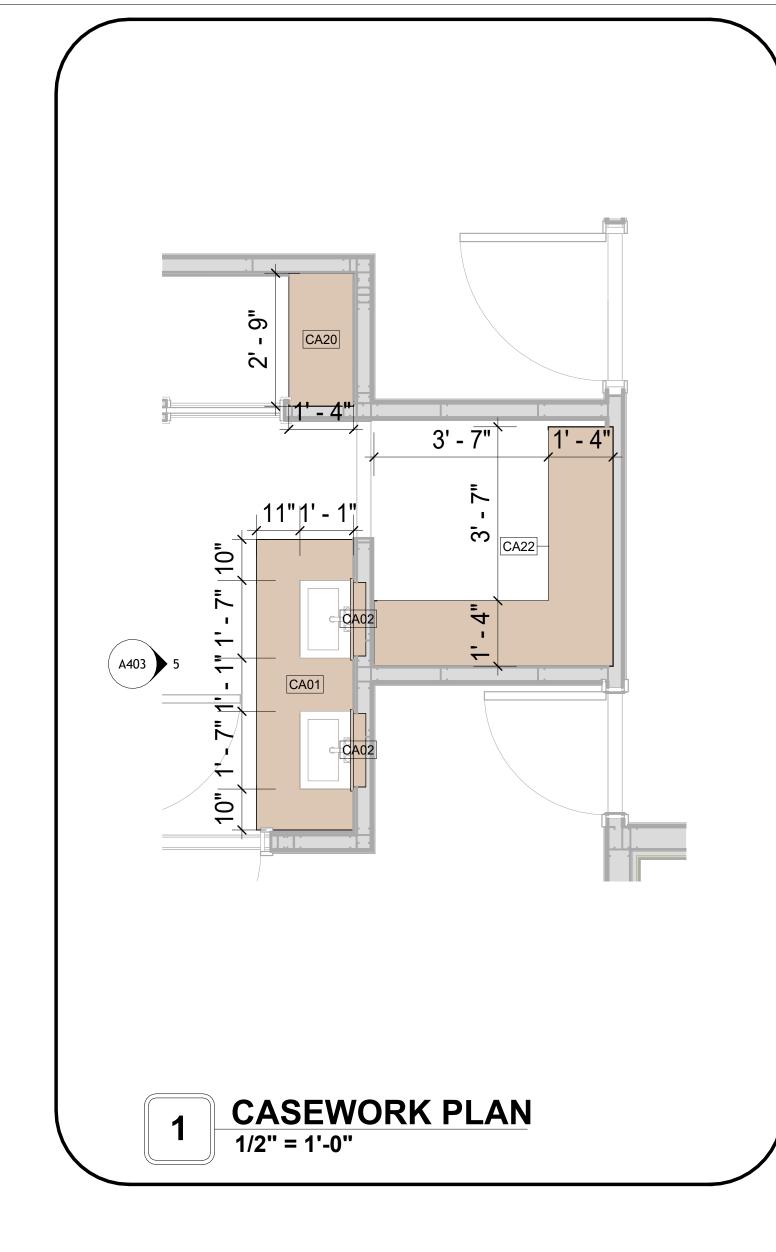

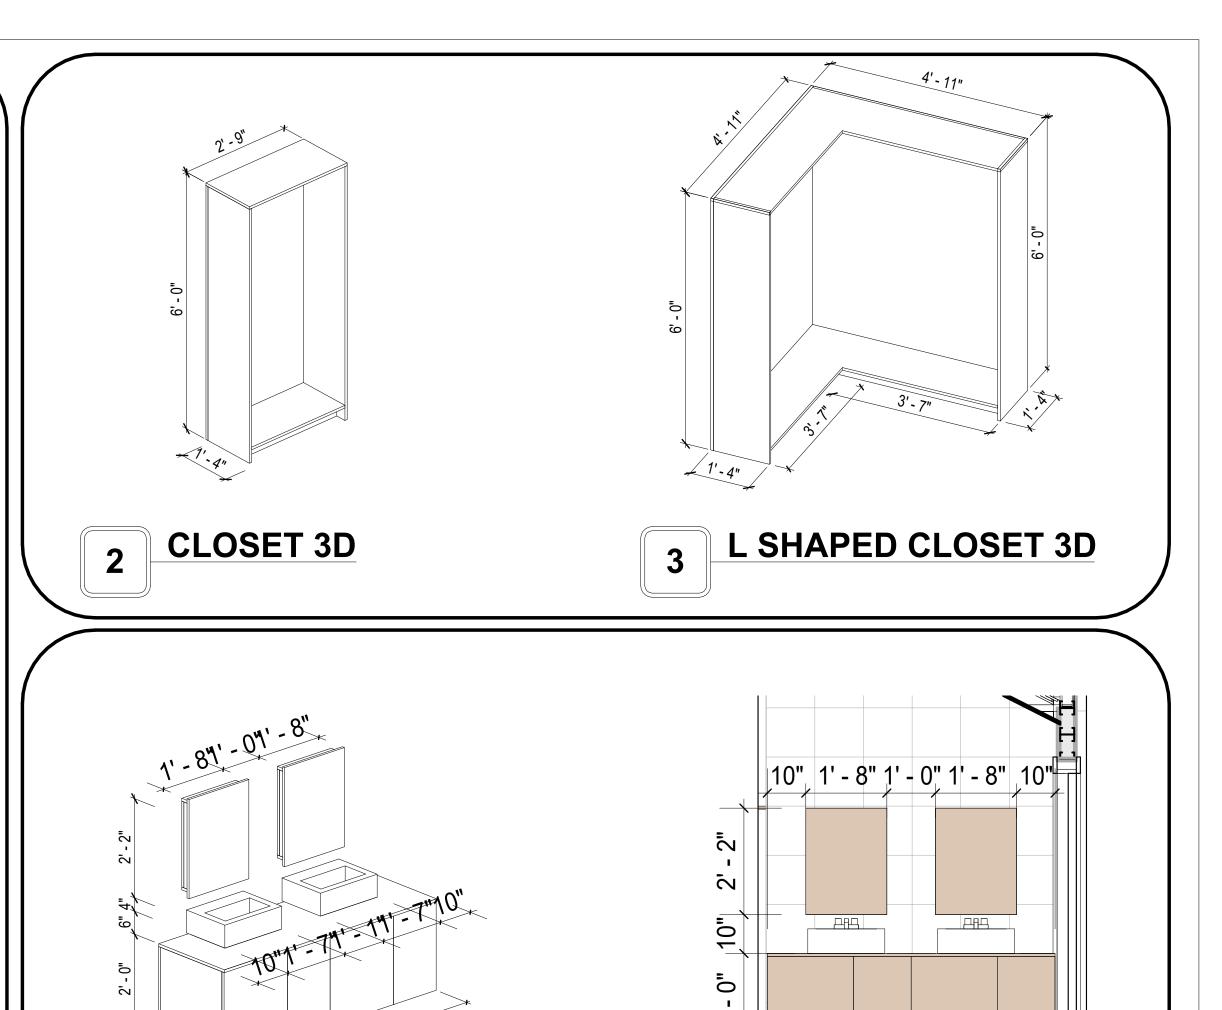

**DOUBLE VANITY 3D** 


7

1 - a

1/2" = 1'-0"



**KEY PLAN** 

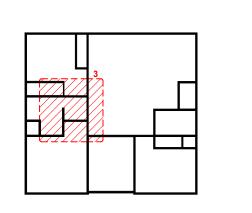

NO.	DESCRIPTION	DATE

NOTE:

LEGEND:

PROJECT

14 Wisdom 1194-3Bd/2Ba Traditional-550

DRAWING NAME

#### ARCHITECTURAL CASEWORK

Client Name	CLIENT NAME:
Project Number	PROJECT NUMBER:
2/8/2025 5:38:30 PM	DATE:
Designer	DESIGNED BY:
Author	DRAWN BY:
Checker	CHECKED BY:

A403

#### **GENERAL NOTES**

T1. THIS DRAWING DEPICTS THE HVAC (HEATING, VENTILATION, AND AIR CONDITIONING) SYSTEM FOR THE -WISDOM\_TM\_T\_550\_NG. IT PROVIDES A VISUAL REPRESENTATION OF THE SYSTEM LAYOUT AND COMPONENTS.

2.THE HVAC SYSTEM IS DESIGNED TO MEET THE SPECIFIC REQUIREMENTS OF THE BUILDING, INCLUDING HEATING, COOLING, AND VENTILATION NEEDS AS PER THE PROJECT SPECIFICATIONS AND APPLICABLE CODES AND STANDARDS.

3. THE HVAC SYSTEM INSTALLATION SHALL COMPLY WITH THE LATEST EDITION OF THE INTERNATIONAL MECHANICAL CODE (IMC), INTERNATIONAL RESIDENTIAL CODE (IRC), AND ALL OTHER APPLICABLE LOCAL, STATE, AND NATIONAL CODES AND REGULATIONS.

4. THE EQUIPMENT SHOWN ON THIS DRAWING INCLUDES BUT IS NOT LIMITED TO AIR HANDLING UNITS (AHUS), CHILLERS, BOILERS, COOLING TOWERS, PUMPS, DUCTWORK, DIFFUSERS, GRILLES, AND CONTROL DEVICES.

5. ALL EQUIPMENT, DUCTWORK, AND PIPING SHALL BE INSTALLED IN ACCORDANCE WITH MANUFACTURER'S SPECIFICATIONS, LOCAL CODES, AND INDUSTRY BEST PRACTICES.

6. ALL DUCTWORK SHALL BE SIZED, FABRICATED, AND INSTALLED IN ACCORDANCE WITH THE LATEST EDITION OF THE ACCA MANUAL D AND THE SMACNA HVAC DUCT CONSTRUCTION STANDARDS. DUCTWORK SHALL BE INSTALLED IN A NEAT AND WORKMANLIKE MANNER, PROPERLY SUPPORTED AND BRACED TO PREVENT SAGGING, AIR LEAKAGE, OR VIBRATION.

7. CONDENSATE DRAINAGE PIPING SHALL BE PROPERLY PITCHED TO ENSURE POSITIVE DRAINAGE TO AN APPROVED DISPOSAL LOCATION, SUCH AS A FLOOR DRAIN, SUMP PUMP, OR EXTERIOR GRADE. CONDENSATE LINES SHALL BE INSULATED TO PREVENT SWEATING.

8. THE LOCATION OF CONTROL PANELS AND SENSORS INDICATED ON THIS DRAWING CAN BEMODIFY with THE SPECIFIC LOCATIONS AND WIRING DETAILS WILL BE DETERMINED DURING THE CONTROL SYSTEM DESIGN AND INSTALLATION.

9. THE HVAC SYSTEM DESIGN CONSIDER ENERGY EFFICIENCY, INDOOR AIR QUALITY, OCCUPANT COMFORT, AND NOISE CONTROL, FOLLOWING APPLICABLE GUIDELINES AND REGULATIONS.

10. COORDINATION WITH OTHER TREADS HAS BEEN DONE ON A DESIGN LEVEL. THIS DRAWING SHALL BE READ TOGETHER WITH THE AR, EL AND SN DESIGN DRAWINGS TO ENSURE PROPER INSTALLATION AND INTEGRATION OF THE HVAC SYSTEMS.

11. THE HVAC CONTRACTOR IS RESPONSIBLE FOR OBTAINING ALL NECESSARY PERMITS AND LICENSES, AND FOR SCHEDULING AND COORDINATING WITH THE LOCAL BUILDING DEPARTMENT AND UTILITY PROVIDERS TO ENSURE A TIMELY AND COMPLIANT INSTALLATION.

12. ALL DUCTWORK PENETRATIONS THROUGH WALLS, FLOORS, OR CEILINGS SHALL BE PROPERLY SEALED AND FIRE-STOPPED USING APPROVED METHODS AND MATERIALS TO MAINTAIN THE INTEGRITY OF THE BUILDING'S FIRE-RESISTANCE RATINGS.

13. HVAC EQUIPMENT SHALL BE INSTALLED LEVEL AND PLUMB, AND IN STRICT ACCORDANCE WITH THE MANUFACTURER'S INSTALLATION INSTRUCTIONS AND RECOMMENDATIONS. PROVIDE ADEQUATE CLEARANCES AROUND EQUIPMENT FOR PROPER AIRFLOW, SERVICE ACCESS, AND CODE COMPLIANCE.

14. ALL HVAC EQUIPMENT AND COMPONENTS, INCLUDING THERMOSTATS, DAMPERS, AND ACCESS PANELS, SHALL BE LOCATED IN ACCESSIBLE AREAS


15. THE HVAC SYSTEM SHALL BE BALANCED AND ADJUSTED TO ENSURE PROPER AIRFLOW, TEMPERATURE DISTRIBUTION, AND SYSTEM PERFORMANC THROUGHOUT THE RESIDENCE. PROVIDE A WRITTEN REPORT DOCUMENTING THE FINAL SYSTEM BALANCE.

16. ANY DEVIATIONS OR MODIFICATIONS TO THE HVAC SYSTEM DESIGN SHALL BE REVIEWED AND APPROVED BY THE RESPONSIBLE DESIGN PROFESSIONALS AND COMMUNICATED TO ALL RELEVANT PARTIES INVOLVED IN THE CONSTRUCTION PROCESS.

FOR EASY SERVICING AND MAINTENANCE. PROVIDE ADEQUATE SPACE AROUND EQUIPMENT FOR PROPER AIRFLOW AND SERVICE ACCESS.

17. FOR ANY INQUIRIES OR CLARIFICATIONS REGARDING THE HVAC SYSTEM DESIGN, PLEASE CONSULT THE RESPONSIBLE DESIGN PROFESSIONALS OR THE PROJECT MANAGEMENT TEAM.

#### SYMBOLS

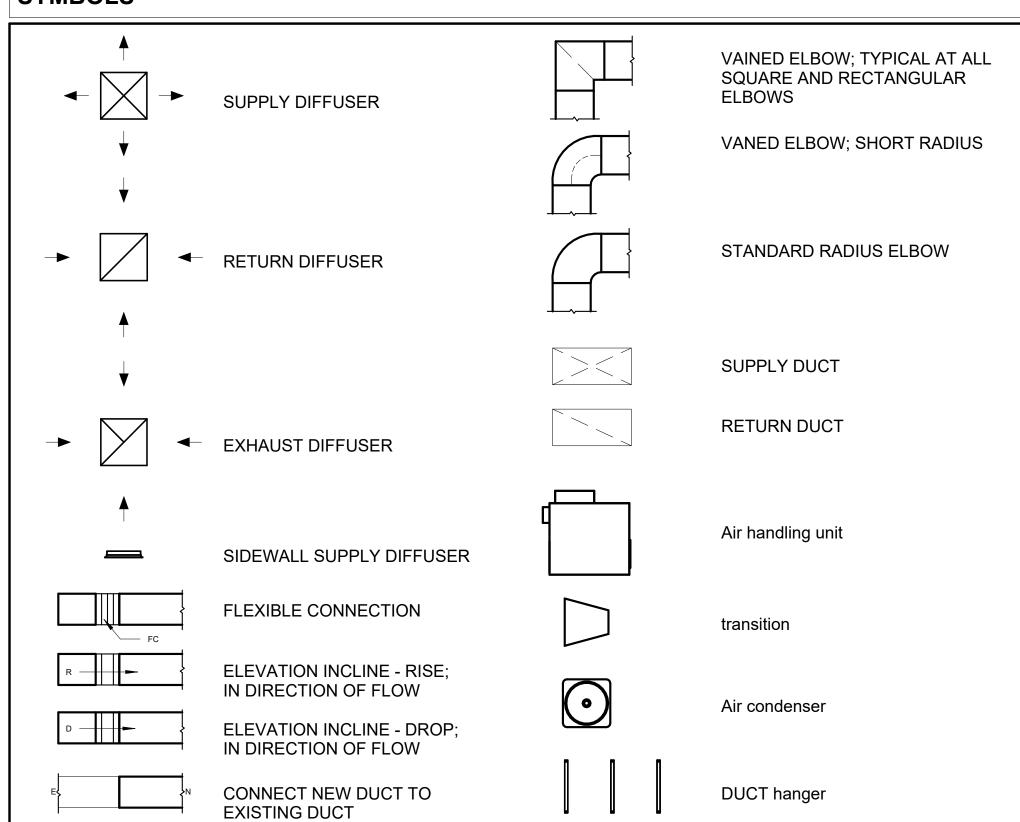

#### **HVAC COLOR SCHEME**

AIR CONDITIONING PIPE

REFRIGERANT LINE SCHEDULE						
CATAGORY	DESCRIPTION	DIAMETER	LENGTH			
Pipe Types	Copper	3/8"	116.12			
Pipe Types	<by category=""></by>	1/2"	0.13			
Pipe Types	Copper	3/4"	155.96			

CATAGORY	DESCRIPTION	Size	Count
CATAGORT	DESCRIPTION	Size	Count
Elbow - Generic	Elbow - Generic: Standard/HVAC	1/2"ø-1/2"ø	1
Elbow - Generic	Elbow - Generic: Standard/HVAC	3/4"ø-3/4"ø	39
Elbow - Generic	Elbow - Generic: Standard/HVAC	3/8"ø-3/8"ø	30
Tee - Generic	Tee - Generic: Standard	3/4"ø-3/4"ø-3/ 4"ø	3
Tee - Generic	Tee - Generic: Standard	3/8"ø-3/8"ø-3/ 8"ø	3
Transition - Generic	Transition - Generic: Standard	3/4"ø-1/2"ø	4
Transition - Generic	Transition - Generic: Standard	3/4"ø-5/8"ø	4

6' - 3 1/2"

4' - 7 1/2"

3' - 2 1/2" 2' - 2 1/2"

AIR HANDLING UNIT

Ø3/4" Ø3/8"

AIR HANDLING UNIT

EXHAUST FAN

2' - 4" 3' - 2 1/2"

AIR HANDLING UNIT

5' - 8 1/2"

Ø3/4"Ø3/8"

**HVAC PLAN** 

1/4" = 1'-0"

1' - 4 1/2" 3' - 2 1/2"

8' - 3 1/2"

N	MECHANICAL EQUIPMENT SCHED	ULE
CATAGORY	DESCRIPTION	COUNT
AIR HANDLING UNIT	AIR HANDLING UNIT: WALL MOUNTED	4
CONDENSER	CONDENSER: OUT DOOR	1
Exhaust Fan	EXHAUST FAN: 75 CFM	2
	HOOD WALL: VENT	1

DU	CT FITTING SCHEDULE	
CATAGORY	DESCRIPTION	COUNT
Round Transition - Angle	45 Degree	8

	DUCT ACCESSORY SCHEDU	JLE
CATAGORY	DESCRIPTION	COUNT
ROOF VENT	3" DIAMETER	4

	FLEX DU	ICT SCHEDULE		
DESCRIPTION	DESCRIPTION	LENGTH	DIAMETER	COUNT
Flex Duct Round	FLEX-ROUND	18.41	4"	4
Grand total: 4		18.41		



AA, Ethiopia
Info@housedocs.store
www.housedocs.store

#### **KEY PLAN**

NO.	DESCRIPTION	DATE

NOTE:

LEGEND:

PROJECT

15-Wisdom-1194-3Bd-2Ba Traditional-550

DRAWING NAME

## **HVAC COVER SHEET**

CLIENT NAME:	Owner
PROJECT NUMBER:	15_0001
DATE:	2/9/2025 2:05:24 AM
DESIGNED BY:	Designer
DRAWN BY:	Author
CHECKED BY:	Checker

M101

SCALE: As indicated

© [2024] [FrameUpNow] . All rights reserved

#### **ELECTRICAL NOTES**

- 1. THIS DRAWING DEPICTS THE ELECTRICAL SYSTEM FOR THE 14-Wisdom-1194-3Bd-2Ba-Tradtional-550. IT PROVIDES A VISUAL REPRESENTATION OF THE ELECTRICAL LAYOUT AND COMPONENTS, INCLUDING POWER DISTRIBUTION, LIGHTING, AND CONTROL SYSTEMS.
- 2. THE ELECTRICAL SYSTEM IS DESIGNED TO MEET THE SPECIFIC REQUIREMENTS OF THE BUILDING, INCLUDING POWER DISTRIBUTION, LIGHTING, AND SPECIALIZED ELECTRICAL EQUIPMENT NEEDS, AS PER THE PROJECT SPECIFICATIONS AND APPLICABLE CODES AND STANDARDS.
- 3. THE ELECTRICAL SYSTEM INSTALLATION SHALL COMPLY WITH THE LATEST EDITION OF THE NATIONAL ELECTRICAL CODE (NEC), INTERNATIONAL BUILDING CODE (IBC), AND ALL OTHER APPLICABLE LOCAL, STATE, AND NATIONAL CODES AND REGULATIONS.
- 4. LOCATIONS AS NEEDED, DEVICES ARE SHOWN ON PLANS IN APPROXIMATE IDEAL LOCATIONS, UNLESS SPECIFICALLY DIMMENSIONED.
- 5. OPEN WALLS AS NEEDED TO ALLOW FOR NEW ELECTRICAL INSTALLATIONS.
- 6. LABEL ALL CIRCUITS ON JUNCTION BOXES, RECEPTACLES, DATA, SMOKE DETECTOR, AND EQUIPMENT IN PANEL BOX.
- 7. INSTALL RACEWAY AS NEEDED FOR DDC, ACCESS CONTROL, LOW VOLTAGE WIRING & DATA.
- 8. RELABEL POWER, DATA & FIRE ALARM FOR ROOM #CHANGES.
  9. VERIFY ALL CIRCUITS LABELED ON PRINT ARE CORRECT BEFORE WORKING ON THEM.
- 10. NOTE ON SITE PLAN ALL CHANGES OR MISSING DETAIL TO BE INCORPORATED INTO THE MASTER PLAN.
- 11. DRAWINGS ARE DIAGRAMMATIC ONLY FOR THE PURPOSE OF SHOWING FIXTURE AND OUTLET LOCATIONS.
- 12. ELECTRICAL CONTRACTOR TO VERIFY SERVICE SIZE BY CALCULATION BASED UPON ACTUAL NAME PLATE RATINGS OF SELECTED FOLIPMENT
- PLATE RATINGS OF SELECTED EQUIPMENT.

  13. VERIEV LOCATION OF SERVICE ENTRANCE WITH POWER COMPANY PROVIDE LIFER GROUND IN
- 13. VERIFY LOCATION OF SERVICE ENTRANCE WITH POWER COMPANY. PROVIDE UFER GROUND IN BUILDING FOUNDATION AT SERVICE ENTRANCE LOCATION.
- 14. PROVIDE A MIN. OF 20 FEET OF ONE \*4 BARE COPPER UFER WIRE EMBEDDED IN CONCRETE FOOTING
- AT THE SERVICE ENTRANCE LOCATION WHERE APPROVED BY LOCAL SERVICE PROVIDER.

  15. PROVIDE WATERPROOF FIXTURES IN ALL HIGH MOISTURE AREAS (EXTERIOR, SHOWER AND TUB
- CEILINGS ETC.)
- 16. PROVIDE DEDICATED CIRCUITS TO EACH BATH, DEN, FAMILY ROOM, BEDROOM, LOFT, KITCHEN
- REFRIGERATOR, KITCHEN FREEZER DISHWASHER, AND ANY AREA/ITEM SPECIFIED BY OWNER.

  17. INCANDESCENT FIXTURES WITH OPEN OR PARTIALLY ENCLOSED LAMPS, PENDANT FIXTURES, AND LAMP HOLDERS ARE NOT PERMITTED IN CLOSETS.
- 18. ALL WORKMANSHIP AND MATERIALS TO CONFORM WITH THE 2015 IRC.
- 19. PROVIDE A MIN. OF 20 FEET OF ONE \*4 BARE COPPER UFER WIRE EMBEDDED IN CONCRETE FOOTING AT THE SERVICE ENTRANCE LOCATION WHERE APPROVED BY LOCAL SERVICE PROVIDER.
- 20. PROVIDE A BONDING CONDUCTOR CONSISTING OF A MINIMUM OF ONE \*4 BARE COPPER WIRE CONNECTING THE BUILDING'S METAL WATER PIPING SYSTEM TO THE SERVICE EQUIPMENT ENCLOSURE GROUNDING.

#### MAIN PANEL CALCS

(USE 200 AMP SERVICE)

ELECTRICAL CALCS	
LIGHT AND OUTLETS 1,194 @ 3W	3,582 W
3 APPLIANCE CIRCUITS	4,500 W
DRYER	2,000 W
WASHER	2,000 W
RANGE	5,000 W
WATER HEATER	5,000 W
REFRIG.	1,800 W
DISHWASHER & DISPOSAL	3000 W
TOTAL	26,882 W
FRIST 10,000 @ 100% REMAINDER @ 40% MINI. SPLIT UNITS	10,000 W 6,753W 10,000 W
TOTAL	26,753 W
26,753 W DIVIDED BY 240V = 11	2 AMPS TOTAL

#### **ELECTRICAL ABBREVIATIONS LIST**

1							
A		1P	1 POLE (2P, 3P, 4P, ETC.)		CENTER	I I	
ACLG ABOVE CEILING ADD COPENER DET DETAIL DATE OF A DOWN AUTOMATIC DOOR OPENER DET DETAIL DIAMETER CONDITIONING CONDITIONI		Α		CU	COPPER	HTG	HEATING
ADO AFF AFF AFF AFF AFF AFF AFF AFF AFF AF		AC	ABOVE COUNTER OR AIR CONDITIONER	DCP	DOMESTIC WATER CIRCULATING PUMP	HTR	HEATER
AF ABOVE FINISHED FLOOR AFF ABOVE FINISHED FLOOR AFF ABOVE FINISHED FLOOR AFF ABOVE FINISHED GRADE AFF AFF ABOVE FINISHED GRADE AFF ABOVE FINISHED GRADE ALLUMINUM AND AMPERE ARCH ALLUMINUM AND AMPERE ARCH ALLUMINUM AND AMPERE ABOVE FINISHED GRADE ARCH ALLUMINUM AND AMPERE ABOVE FINISHED GRADE ARCH ABOVE FINISHED GRADE ABOVE FINISHED GRADE ALLUMINUM INTERLICIONUM INTERLI		ACLG	ABOVE CEILING	DEPT	DEPARTMENT	HV	HIGH VOLTAGE
AFF		ADO	AUTOMATIC DOOR OPENER	DET	DETAIL	HVAC	HEATING, VENTILATING AND AIR
AFG ABOVE FINISHED GRADE AFI ARC FAULT CIRCUIT INTERRUPTER AFI ALT ALTENATE ALL MINIUM ALL ALL MINIUM ALL ALL MINIUM ALT ALTENATE AMP AMPLER AMPL AMPLIFIER ANDI ANNUNCIATOR APPROX APPROXIMATELY AQ-STAT AQUASTAT ACQUASTAT ACQUA		AF	AMP FRAME	DIA	DIAMETER	CONDITIONING	CONDITIONING
AFI		AFF	ABOVE FINISHED FLOOR	DISC	DISCONNECT	HWP	HYDRONIC WATER PUMP
AHU ALT ALUMINUM DS SAFETY DISCONNECT SWITCH INCAND INCANDE STAFET ALLER ALUMINUM ALT ALT ALTERNATE DT DOUBLE THROW IR INCANDE STAFETY DISCONNECT SWITCH DOUBLE THROW IR INCANDE STAFETY DISCONNECT SWITCH DOUBLE THROW IR INCANDE STAFETY DISCONNECT SWITCH DOUBLE THROW IR INCANDES STAFETY DISCONNECT SWITCH DOUBLE THROW INCANDES THROW INCANDES STAFETY DISCONNECT SWITCH DISCONNECT SWITCH DISCONNECT SWITCH DOUBLE THROW INCANDES STAFETY DISCONNECT SWITCH DISCONNECT SWITCH DISCONNECT SWITCH DISCONNECT SWITCH DISCONNECT SWITCH DOUBLE THROW INCANDES THREE DATE OF THE POPULAR DATE OF THE		AFG	ABOVE FINISHED GRADE	DIST	DISTRIBUTION		INTERRUPTING CAPACITY
ALL ALUMINUM ALTERNATE DT DT DUBLE THROW INFORMED INFORME		AFI	ARC FAULT CIRCUIT INTERRUPTER	DN	DOWN		ISOLATED GROUND
ALT ALTERNATE D'UNG D'OUBLET HIROW IR INFRARED (MAP) AMPL AMPLER AMPLE D'ONG D'ORAWING D'ONG D'O		AHU	AIR HANDLING UNIT	DPR	DAMPER	IMC	INTERMEDIATE METAL CONDUIT
AMPER AMPLIFIER ANDIVACIATOR APPROX APPROXIMATELY ACSTAT AGUASTAT AMP SWITCH ASCHITECT, ARCHITECTURAL ASCHITECT, ARCHITECTURAL ASCHITECT, ARCHITECTURAL CELEV ELECTRIC, ELECTRICAL ELECTRICAL CONTROL ELECTRICAL ELECTRICAL CONTROL ELECTRICAL ELCTRICAL ELECTRICAL ELECTRICAL ELECTRICAL ELECTRICAL ELECTRICAL ELECTRICAL ELECTRICAL ELCTRICAL ELCTRIC		AL	ALUMINUM			INCAND	INCANDESCENT
AMPL ANNUM AQSTAT AQUASTAT AQUASTAT ACH AS AMP SWITCH AS ATS AUTOMATIC TRANSFER SWITCH AUX AVIDIATION AVIDIATION BOX AMPERTE BATT BATT BATT BATT BATT BATT BATT BA		ALT	ALTERNATE	DT	DOUBLE THROW	IR	INFRARED
ANNUN ANNUNCIATOR APPROX APPROXIMATELY AQUISTAT AQUISTAT ARCH ARCHITECT, ARCHITECTURAL AS AS AT AMP TRIP AUX AUTOMATIC TRANSFER SWITCH AUX AUXILIARY AUXILIA			AMPERE	DWG		I/W	INTERLOCK WITH
AQSTAT AQUASTAT AQUASTAT AQUASTAT ARCHITECTURAL ARCHITECTURAL AS AMP SWITCH ARCHITECT, ARCHITECTURAL BELECTRIC BELEC		AMPL	AMPLIFIER		DIRECT DIGITAL CONTROL	J-BOX	JUNCTION BOX
ARCH ACHITECT, ARCHITECTURAL AS AMP SWITCH AT AMP TRIP AUTOMATIC TRANSFER SWITCH AUTO AUTOMATIC AUX AVX AUXILIARY AUX AUXILIARY AUX AUXILIARY AUX AUXILIARY BATTERY BATTERY BB BOARD BUILDING BUILDING BMS BUILDING MANAGEMENT SYSTEM C C C CONDUIT CATL CATL CATL CATL CATL CATL CATL CAT		ANNUN	ANNUNCIATOR APPROX APPROXIMATELY		ELECTRICAL CONTRACTOR	I I	
AS   AMP SWITCH	Α	Q-STAT			ELECTRIC, ELECTRICAL		KILOVOLT-AMPERE
AT AMP TRIP ATS AUTOMATIC TRANSFER SWITCH AUTO AUTOMATIC AUX AUXILIARY BATT BATTERY BATT BB BOARD			· ·				
ATS AUTOMATIC TRANSFER SWITCH AUTO AUTO AUTOMATIC AUX AUXILIARY AV AUDIO VISUAL AV AUDIO VISUAL AV AUDIO SUSUAL AV AUDIO SUSUAL BATTERY BATTERY BATTERY BO BOARD BUILDING C C CONDUIT C CATALOG C CAT C CATALOG C CAT C CATU C CAT C CATU C CAT C CAT C CAT C CAT C CONDUIT C CIRCUIT C CIRCUIT C CIRCUIT C CIRCUIT C CONPECTOR C CONPECTOR C CONT C CONTECTOR C CONT C CONTECTOR C CONT C C CONT C C CONT C C C C C C C C C C C C C C C C C C C			AMP SWITCH			KW	KILOWATT
AUTO AUXILIARY AUXILIARY EQUIP  AUX AUXILIARY EQUIP  AVY AUDIO VISUAL  AWG AMERICAN WIRE GAUGE  BATT  BATTERY  BD BOARD  BUIL DING  BMS  BUIL DING  C CONDUIT  C CAT  C CA					ENERGY MANAGEMENT SYSTEM		KILOWATT HOUR
AUX AUXILIARY EQUIP AV AUDIO VISUAL EWE EQUIP AUDIO VISUAL EECTRIC WATER COOLER EXIST EXISTING LTNG LIGHTNING LIGHTNING ELECTRIC WATER COOLER EXIST EXISTING LTNG LIGHTNING LIGHTNING EXISTING LTNG LIGHTNING LIGHTNING LIGHTNING EXISTING LTNG MAX MAXIMUM MA							
AWG AMERICAN WIRE GAUGE EXIST BATTERY EXH BD BOARD EXP BLDG BUILDING MANAGEMENT SYSTEM FABP CAT CATALOG CAT CATALOG CAT CATALOG CONTROL TELEVISION FLOOR CONTROL TELEVISION FLOOR FLOOR CONDITION GAL CONTROL TELEVISION FLOOR FLOOR FLOOR CONDITION GAL CONTROL TELEVISION GAL CONTROL SWITCH CONST CONSTRUCTION GAL CONTROL ON GAL CONTROL TO GENERAL CONTROL TO MAIN MINIMUM MINIMUM CONTROL CONTRO							
AWG BATT BATT BATTERY BATTERY BATTERY BO BOARD BUILDING BLDG BUILDING BMS BUILDING MANAGEMENT SYSTEM C CONDUIT CAB CAB CAB CAT CATALOG CCTV CLOSED CIRCUIT TELEVISION COMB COMBINATION CMPR CONN CONNECTION CONST CONST CONST CONST CONST CONST CONST CONTRUCTION CONT CONTRACTOR CONV CONV CONV CONCR CONV CONV CONCR CONV CONCR CONV CONV CONCR CONV CONV CONV CONV CONV CONV CONV CONV						I I	
BATT BO ARD BOARD EXPLOSION PROOF MAG.S MAG.S MAGNETIC STARTER MAGNETIC ST							
BD BDARD BLDG BULDING BMS BUILDING BMS BMS BUILDING BMS BUILDING BMS BUILDING BMS BUILDING BMS BMS BUILDING BMS BUILDING BMS BUILDING BMS BUILDING BMS BMS BMS BMS BMS BMS BUILDING BMS BMS BMS BMS BUILDING BMS BMS BMS BMS BUILDING BMS							
BLDG BMS BUILDING MANAGEMENT SYSTEM C CONDUIT CAB CAB CAT CATALOG CT CATOLOGED CIRCUIT TELEVISION CMC CMC CMC CMC CMC CMC CMC CMC CMC CM							
BMS CONDUIT SUPPLY PANEL SUPPLY PANEL MC MAIN CIRCUIT BREAKER SUPPLY PANEL MC MAIN CIRCUIT BREAKER FACP FACE FACE CAT CATALOG CATU CABLE TELEVISION FIXT FIXT FIXTURE FLOOR CCTV CLOSED CIRCUIT TELEVISION FLUOR FLUOR FLUOR FUNDS COMBINATION GROUND GALVANIZED CONST CONSTRUCTION CONSTRUCTION GALV CONSTRUCTION GALV CONSTRUCTION GALVANIZED GEN GENERAL CONTRACTOR GROUND FAULT PROTECTOR GROUND FAULT PROTECTOR MSD MAIN CIRCUIT BREAKER MC MC MAIN CIRCUIT BREAKER MDC MAIN DISTRIBUTION CENTER MIN DISTRIBUTION CENTER MIN DISTRIBUTION CENTER MIN DISTRIBUTION CENTER MIN DISTRIBUTION CENTER FIXTURE FIXTURE MDD MAIN DISTRIBUTION CENTER FIXTURE MDD MAIN DISTRIBUTION CENTER MIN DISTRIBUTI							
C CONDUIT CABINET CAT CATALOG CAT CATALOG CATV CABLE TELEVISION CB CIRCUIT BREAKER FIRE CATV CASBLE TELEVISION CCTV CLOSED CIRCUIT TELEVISION CLG CAG CAG CAG CAG CAG CAG CAT CAG CAG CAG CAT CAG							
CAB CABINET FACP CATALOG FEU FAC CATALOG FEU FAN COIL UNIT MDC MAIN DISTRIBUTION CENTER MDP MAIN DISTRIBUTION CENTER MDP MAIN DISTRIBUTION PANEL MISTRIBUTION PANEL MISTRIBUTION PANEL MISTRIBUTION PANEL MISTRIBUTION PANEL MAIN DISTRIBUTION PANEL MISTRIBUTION PANEL MISTRIBUTION PANEL MAIN DISTRIBUTION PANEL MISTRIBUTION PANEL MISTRIBUTION PANEL MAIN DISTRIBUTION PANEL MISTRIBUTION PANEL MAIN DISTRIBUTION PANEL MAIN DISTRIBUTION PANEL MISTRIBUTION PANEL MAIN DISTRIBUTION PANEL						I I	
CAT CATALOG FCU FAN COIL UNIT MDC CABLE TELEVISION FIXT FIXTURE MDP MAIN DISTRIBUTION CENTER FIXTURE MDP MAIN DISTRIBUTION CENTER FIXTURE MDP MAIN DISTRIBUTION CENTER FIXTURE MDP MAIN DISTRIBUTION PANEL FLOOR CCTV CLOSED CIRCUIT TELEVISION FLUOR FLUOR FLUORESCENT DISCONNECT SWITCH CIRCUIT FUSE MIN MANHOLE FUSE MIN MANHOLE FUSE MIN MINIMUM M							
CATV CABLE TELEVISION FIXT FIXTURE MDP CIRCUIT BREAKER FLOOR FLOOR FLOOR FLOOR MAIN DISTRIBUTION PANEL FLOOR MAIN DISTRIBUTION PANEL FLOOR MAIN FUSED DISCONNECT SWITCH CLOSED CIRCUIT TELEVISION FLUORESCENT FUSE MAIN FUSED DISCONNECT SWITCH MIC MICROPHONE GAIN MICROPHONE						I I	
CB CCTV CLOSED CIRCUIT TELEVISION FLUOR FLUOR FLUORESCENT FLUORESCENT FLUORESCENT FLUORESCENT FLUORESCENT FLUORESCENT FLUORESCENT FLUORESCENT MH MANHOLE MICROPHONE M						I I	
CCTV CLOSED CIRCUIT TELEVISION FLUOR FUSE MH MANHOLE CLG CEILING FUSE FUSE SAFETY DISCONNECT SWITCH COMB COMBINATION GA GAUGE MIN MINIMUM CMPR COMPRESSOR GAL GALVANIZED MISC CONSTRUCTION GC GENERAL CONTRACTOR MMS MANUAL MOTOR STARTER CONT CONTRACTOR GFI GROUND FAULT CIRCUIT INTERRUPTER CONV CONVECTOR GFP GROUND FAULT PROTECTOR MSD MAIN SWITCHBOARD CP CIRCULATING PUMP GND GRS GALVANIZED MISC MISC MISC MISC MISC MISC MISC MISC							
CKT CIRCUIT FUSE FUDS FUSE SAFETY DISCONNECT SWITCH COMB COMBINATION GA GAUGE GALLON MISC COMPRESSOR GALLON GALV GALVANIZED GALVANIZED MISC CONST CONSTRUCTION GC GENERAL CONTRACTOR MISC MISCELLANEOUS MISC CONTRUCTION GENERATOR MISC MISCELLANEOUS MISCELLANEOUS MISC CONTRUCTION GC GENERATOR MISC MISCELLANEOUS M						MFR	
CLG CEILING FUDS FUSED SAFETY DISCONNECT SWITCH MIC COMB COMBINATION GA GAUGE MIN MINIMUM MISCELLANEOUS GALVON CONNECTION GALVONSTRUCTION GC GENERAL CONTRACTOR MMS MANUAL MOTOR STARTER GENERATOR CONTRACTOR GFI GROUND FAULT CIRCUIT INTERRUPTER MSP CONVECTOR GFP GROUND FAULT PROTECTOR MSBD MAIN SWITCHBOARD GROUND GROUND GROUND GROUND MAIN SWITCHBOARD MAIN SWITCHB							
COMB COMPRESSOR GAL GALON MISC MISCELLANEOUS CONN CONNECTION GAL GALVANIZED MAIN LUGS ONLY CONST CONSTRUCTION GC GENERAL CONTRACTOR MMS MANUAL MOTOR STARTER CONT CONTINUATION OR CONTINUOUS GEN GENERATOR CONTR CONTRACTOR GFI GROUND FAULT CIRCUIT INTERRUPTER MSP MOTOR STARTER PANELBOARD CONV CONVECTOR GFP GROUND FAULT PROTECTOR MSBD MAIN SWITCHBOARD CP CIRCULATING PUMP GND GROUND CRT CATHODE-RAY TUBE GRS GALVANIZED RIGID STEEL (CONDUIT) MT.C EMPTY CONDUIT							
CMPR CONN CONN CONNECTIONCOMPRESSOR CONSTRUCTION CONST CONT CONT CONTRACTORGALV CONTINUATION OR CONTINUOUS CONTRACTOR CONT CONTRACTORGALV GENERAL CONTRACTOR GENERATOR GENERATOR GROUND FAULT CIRCUIT INTERRUPTER GROUND FAULT PROTECTOR GROUND FAULT PROTECTOR GROUND GROUND GROUND GROUND GROUND GROUND GROUND GROUND GROUND GROUND GROUND GROUND GROUND GROUND GROUND MT.CMISC MISCELLANEOUS MAIN LUGS ONLY MAIN LUGS ONLY MAIN LUGS ONLY MAIN ULTIOUTLET ASSEMBLY MOTOR STARTER PANELBOARD MAIN SWITCHBOARD MT MOUNT MT.CCATHODE-RAY TUBEGRSGALVANIZED RIGID STEEL (CONDUIT)MT.CEMPTY CONDUIT							
CONN CONSTRUCTION GC GENERAL CONTRACTOR MMS MAIN LUGS ONLY CONST CONSTRUCTION GC GENERAL CONTRACTOR MMS MANUAL MOTOR STARTER CONT CONTINUATION OR CONTINUOUS GEN GENERATOR GROUND FAULT CIRCUIT INTERRUPTER MSP MOTOR STARTER PANELBOARD CONV CONVECTOR GFP GROUND FAULT PROTECTOR MSBD MAIN SWITCHBOARD CP CIRCULATING PUMP GND GROUND MT MOUNT CRT CATHODE-RAY TUBE GRS GALVANIZED RIGID STEEL (CONDUIT) MT.C EMPTY CONDUIT							
CONST CONSTRUCTION GC GENERAL CONTRACTOR MMS CONTINUATION OR CONTINUOUS GEN GENERATOR GCONTRACTOR GFI GROUND FAULT CIRCUIT INTERRUPTER GROUND FAULT PROTECTOR MSP MOTOR STARTER PANELBOARD GROUND FAULT PROTECTOR MSBD MAIN SWITCHBOARD GROUND GROUND GROUND MT MOUNT CATHODE-RAY TUBE GRS GALVANIZED RIGID STEEL (CONDUIT) MT.C EMPTY CONDUIT							
CONT CONTINUATION OR CONTINUOUS GEN GENERATOR GOUND FAULT CIRCUIT INTERRUPTER MSP MOTOR STARTER PANELBOARD GROUND FAULT PROTECTOR MSBD MAIN SWITCHBOARD GROUND GROUND GROUND GROUND GROUND GROUND GROUND GROUND TAIL TO THE MOTOR STARTER PANELBOARD MAIN SWITCHBOARD MT MOUNT GROUND GROUND GROUND GROUND STEEL (CONDUIT) MT.C EMPTY CONDUIT							
CONTRCONTRACTORGFIGROUND FAULT CIRCUIT INTERRUPTERMSPMOTOR STARTER PANELBOARDCONVCONVECTORGFPGROUND FAULT PROTECTORMSBDMAIN SWITCHBOARDCPCIRCULATING PUMPGNDGROUNDMTMOUNTCRTCATHODE-RAY TUBEGRSGALVANIZED RIGID STEEL (CONDUIT)MT.CEMPTY CONDUIT							
CONVCONVECTORGFPGROUND FAULT PROTECTORMSBDMAIN SWITCHBOARDCPCIRCULATING PUMPGNDGROUNDMTMOUNTCRTCATHODE-RAY TUBEGRSGALVANIZED RIGID STEEL (CONDUIT)MT.CEMPTY CONDUIT							
CP CIRCULATING PUMP GND GROUND MT MOUNT CRT CATHODE-RAY TUBE GRS GALVANIZED RIGID STEEL (CONDUIT) MT.C EMPTY CONDUIT							
CRT CATHODE-RAY TUBE GRS GALVANIZED RIGID STEEL (CONDUIT) MT.C EMPTY CONDUIT							
GIP BU   GIPSUM BUAKU					,		
		C1	CURRENT TRANSFURIMER	GIPBU	G 1 POUIVI DUARD	UL	UNDERWRITERS LABORATURIES

#### **Branch Panel:**

Location: WD 10
Supply From:
Mounting: Recessed
Enclosure: Type 1

Volts: 120/240 Single
Phases: 1
Wires: 3

A.I.C. Rating:
Mains Type:
Mains Rating: 200 A
MCB Rating: 1 A

Notes:

Legend:

Circuit Numb er		Number of Elements	Rating	Length	Wire Size	A		E	3	Wire Size	Length	Rating	Number of Elements	Circuit Description	Circuit Numb er
1	BED 1 LIGHT	11	15 A	52' - 3 17/32"	1-#14, 1-#14, 1-#14	628 VA	720 VA			1-#12, 1-#12, 1-#12	62' - 1 19/32"	20 A	4	BED 1 RECEPTACLE	2
3	MST BATH GFCI	11	20 A	56' - 7 11/32"	1-#12, 1-#12, 1-#12			792 VA	568 VA	1-#14, 1-#14, 1-#14	54' - 11 9/32"	15 A	9	MST BED LIGHT	4
5	MST RECEPTACLE	4	20 A	63' - 7 13/32"	1-#12, 1-#12, 1-#12	720 VA	360 VA			1-#14, 1-#14, 1-#14	39' - 3 3/32"	15 A	8	LIV. LIGHT	6
7	OUTDOOR LIGHT	9	15 A	45' - 0 9/16"	1-#14, 1-#14, 1-#14			600 VA	720 VA	1-#12, 1-#12, 1-#12	65' - 2 3/8"	20 A	4	OUTDOOR GFCI	8
9	KITCHEN GFCI	4	20 A	33' - 9 23/32"	1-#12, 1-#12, 1-#12	720 VA	1200 VA			1-#12, 1-#12, 1-#12	23' - 5 23/32"	20 A	1	DISHWASHER	10
11	OVENHOOD	1	20 A	25' - 11 31/32"	1-#12, 1-#12, 1-#12			180 VA	2500 VA	2-#8, 1-#8, 1-#10	31' - 9 25/32"	40 A	1	RANGE	12
13	KITCHEN LIGHT	6	15 A	26' - 6"	1-#14, 1-#14, 1-#14	240 VA	2500 VA								14
15	BATH 1 GFCI	6	20 A	19' - 5 1/8"	1-#12, 1-#12, 1-#12			396 VA	2500 VA	2-#10, 1-#10, 1-#10	16' - 3 13/32"	30 A	1	WATER HEATER	16
17	BED 2 LIGHT	6	15 A	31' - 1 3/4"	1-#14, 1-#14, 1-#14	209 VA	2500 VA								18
19	BED 2 RECEPTACLE	4	20 A	40' - 2 21/32"	1-#12, 1-#12, 1-#12			720 VA	1200 VA	1-#12, 1-#12, 1-#12	14' - 9 13/16"	20 A	1	WASHING MASHEIN	20
21	DRYER	1	30 A	13' - 0 1/16"	2-#10, 1-#10, 1-#10	2500 VA	2500 VA			2-#6, 1-#6, 1-#10	46' - 1 1/8"	60 A	1	CONDENSER	22
23								2500 VA	2500 VA						24
25	REFRIGERATOR	1	20 A	16' - 2 13/16"	1-#12, 1-#12, 1-#12	1800 VA									26
						16594		1514							
						138	Α	120	6 A						

Load Classification	Connected Load	Demand Factor	Estimated Demand	Panel Totals
LIGHTING - DWELLING UNIT	900 VA	100.00%	900 VA	
OTHER	2076 VA	100.00%	2076 VA	Total Conn. Load: 31738 VA
RECEPTACLE	6720 VA	100.00%	6720 VA	Total Est. Demand: 30738 VA
LIGHTING	300 VA	100.00%	300 VA	Total Conn.: 132 A
CONDENSER	5000 VA	100.00%	5000 VA	Total Est. Demand: 128 A
WATER HEATER	5000 VA	100.00%	5000 VA	
RANGE	5000 VA	80.00%	4000 VA	
DRYER	5000 VA	100.00%	5000 VA	
REFRIGERATOR	1800 VA	100.00%	1800 VA	

Tuscon,AZ, USA 888-864-0184 inquire@frameupnow.com

www.frameupnow.com

**KEY PLAN** 

NO. DESCRIPTION DATE

NOTE:

LEGEND:

PROJECT

14-Wisdom-1194-3Bd-2Ba Tradtional-550

DRAWING NAME

**SCHEDULE** 

CLIENT NAME: Owner
PROJECT NUMBER: 0078\_15

DATE: 2/9/2025 12:04:30 PM

DESIGNED BY: Designer

DRAWN BY: Author

CHECKED BY: Checker

E101

SCALE: 1/4" = 1'-0"

© [2024] [FrameUpNow] . All rights reserved

#### **ELECTRICAL NOTE**

- PROVIDE INTERCONNECTED SMOKE ALARMS IN EACH SLEEPING ROOMS, OUTSIDE EACH SLEEPING ROOM, ON EACH STORY, IN THE HALL OR ADJACENT ROOM LUHERE THE CEILING HEIGHT OF A ROOM OPEN TO THE HALL EXCEEDS THE HALL BY 24'. SMOKE ALARMS SHALL BE PERMANENTLY HARD WIRED WITH BATTERY BACKUP.
- B. RECEPTACLE OUTLETS FOR RANGES AND CLOTHES DRYERS SHALL BE A THREE POLE WITH GROUND TYPE. FOUR WIRE GROUNDING-TYPE FLEXIBLE CORDS WILL BE REQUIRED FOR CONNECTION OF RANGES AND CLOTHES DRYERS. THE BONDING JUMPER SHALL NOT BE CONNECTED BETWEEN NEUTRAL TERMINAL AND THE FRAME OF THE **APPLIANCE**
- C. TWO OR MORE 20 AMP SMALL APPLIANCE CIRCUITS SHALL BE PROVIDED TO SERVE THE KITCHEN, BREAKFAST NOOK, AND DINING ROOM. SUCH CIRCUITS SHALL HAVE NO OTHER OUTLETS.
- D. AT LEAST ONE 20 AMP BRANCH CIRCUIT SHALL BE PROVIDED TO SERVICE THE LAUNDRY ROOM. THIS CIRCUIT SHALL HAVE NO OTHER OUTLETS.
- E. ALL RECEPTACLES WITH IN 6' OF A WET BAR SINK OR KITCHEN SINK TO SERVE COUNTER TOP SURFACES MUST BE GFCI. ON KITCHEN COUNTERS 12' OR WIDER NO POINT ALONG THE WALL SHALL BE MORE THAN 2' FROM A RECEPTACLE. ALL RECEPTACLES WITH IN 6' OF KITCHEN SINK MUST BE GFCI. AT LEAST ONE GFCI RECEPTACLE SHALL BE INSTALLED IN THE BATHROOM ADJACENT TO EACH BASIN.
- FIXTURES INCLUDING CEILING FANS THAT ARE LOCATED IN DAMP LOCATIONS SHALL BE LISTED TO BE SUITABLE FOR
- SUCH LOCATIONS PER 2012 IRC
- G. PROVIDE ONE (1) SWITCHED OUTLET @ ALL BEDROOMS AND DEN
- H. CEILING FANS NOT EXCEEDING 35 LBS. (WITH OR WITHOUT ACCESSORIES MAY BE SUPPORTED BY OUTLET BOXES PROVIDED THE OUTLET BOXES ARE IDENTIFIED FOR SUCH USE PER 2012 IRC
- ELECTRICAL OUTLET BOXES ON OPPOSITE SIDES OF FIRE RATED WALLS SHALL BE SEPARATED BY A HORIZONTAL DISTANCE OF NOT LESS THAN 24".
- OUTLET BOXES IN THE WALLS BETWEEN THE GARAGE AND DWELLING SHALL BE METAL OR U.L. APPROVED FIRE RESISTIVE PLASTIC. BOXES IN GARAGE CEILING SHALL BE METAL.
- K. ALL BRANCH CIRCUITS THAT SUPPLY 120 VOLTS SINGLE PHASE 15 AND 20 AMPS RECEPTACLE OUTLETS INSTALLED IN THE DWELLING SHALL BE PROTECTED BY AN ARC FAULT CIRCUIT INTERRUPTER, EXCEPT GFCI RECEPTICLES.

RECEPTACLES MUST BE PROVIDED IN HALLWAYS 10'-0" OR MORE IN LENGTH. FOR A ONE FAMILY DWELLINGS AND EACH OF A TWO FAMILY DWELLING THAT IS AT GRADE LEVEL, AT LEAST ONE WP-GFCI RECEPTACLE OUTLET ACCESSIBLE AT GRADE LEVEL AND NOT MORE THAN 6'-6" ABOVE GRADE SHALL BE INSTALLED AT THE FRONT AND BACK OF THE DWELLING.

#### NOTE: APPLIANCE DISCONNECT

#### **E4001.5 GROUNDING OF ENCLOSURES.**

METAL ENCLOSURES FOR SWITCHES OR CIRCUIT BREAKERS SHALL BE CONNECTED TO AN

EQUIPMENT GROUNDING CONDUCTOR.

METAL ENCLOSURES FOR SWITCHES OR CIRCUIT BREAKERS USED AS SERVICE

EQUIPMENT SHALL COMPLY WITH THE PROVISIONS OF SECTION E3609.4. WHERE


NONMETALLIC ENCLOSURES ARE USED WITH METAL RACEWAYS OR METAL-ARMORED CABLES, PROVISIONS SHALL BE MADE FOR CONNECTING THE EQUIPMENT GROUNDING

CONDUCTOR.


NONMETALLIC BOXES FOR SWITCHES SHALL BE INSTALLED WITH A WIRING METHOD THAT

PROVIDES OR INCLUDES AN EQUIPMENT GROUNDING CONDUCTOR. (404.12)

## **ELECTRICAL LEGEND Electrical Lights With Fan Recessed Can Light** 0 **Recessed Can Light -a Wall Lamp Single Switch** ₩ ₩ **Three way Switch** Fan Switch Three way Switch $\ominus$ **Duplex Receptacle** Triplex Receptacle **GFCI** Receptacle $\mathbb{X}$ **Exhaust Fan** Smoke and heat detector

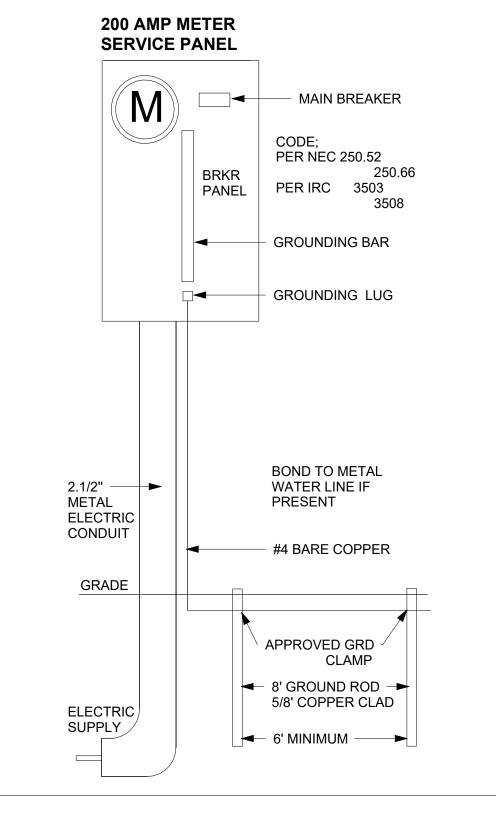



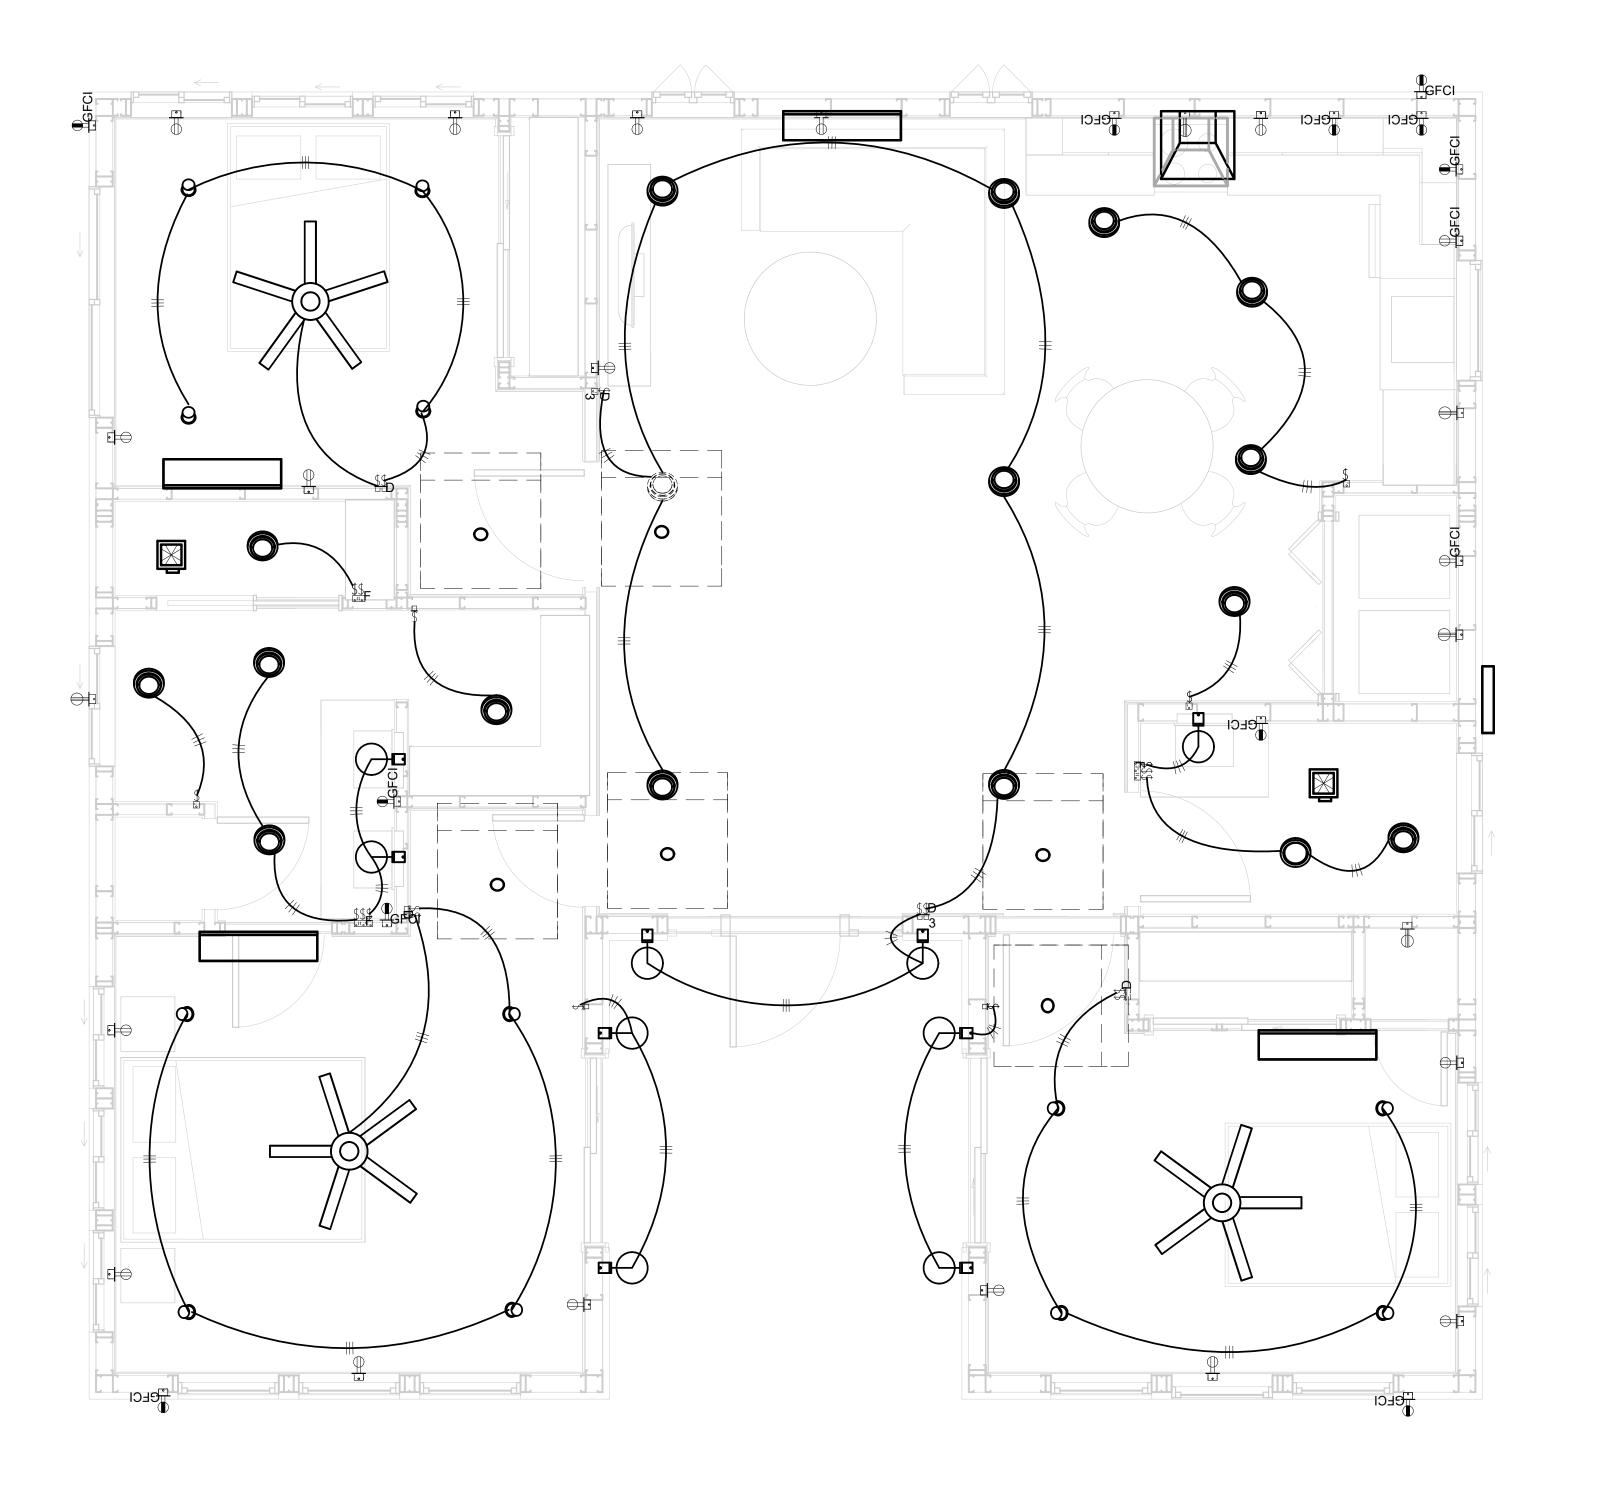

1 - Lighting 3/8" = 1'-0"



**KEY PLAN** 

DESCRIPTION DATE

NOTE:

LEGEND:

PROJECT

14-Wisdom-1194-3Bd-2Ba **Tradtional-550** 

DRAWING NAME


## LIGHTING

CLIENT NAME:	Owner
PROJECT NUMBER:	0078_15
DATE:	2/9/2025 12:04:32 PM
DESIGNED BY:	Designer
DRAWN BY:	Author
CHECKED BY:	Checker


E102

#### **NOTES: CONDUIT, CABLE AND WIRING**


- Use Metalic Conduits (IMC) for cables running under concrete slabs.
   Use IMC for circuits with high voltage appliances (240 volts and above)
   For circuits with 120 volts consider using EMT or PVC conduits if needed.
   For Low voltage applications up to 50 volts consider using non metalic conduits.
   All conduits to be used in the project must conform to the latest National Electrical Code (NEC),
- 6. All wiring and cables to be used in the project must also conform to the latest National Electrical Code (NEC), 2015.
  7. All cables and wires used should be rated for their respective loading and should be gauged and
- conform to the NEC.

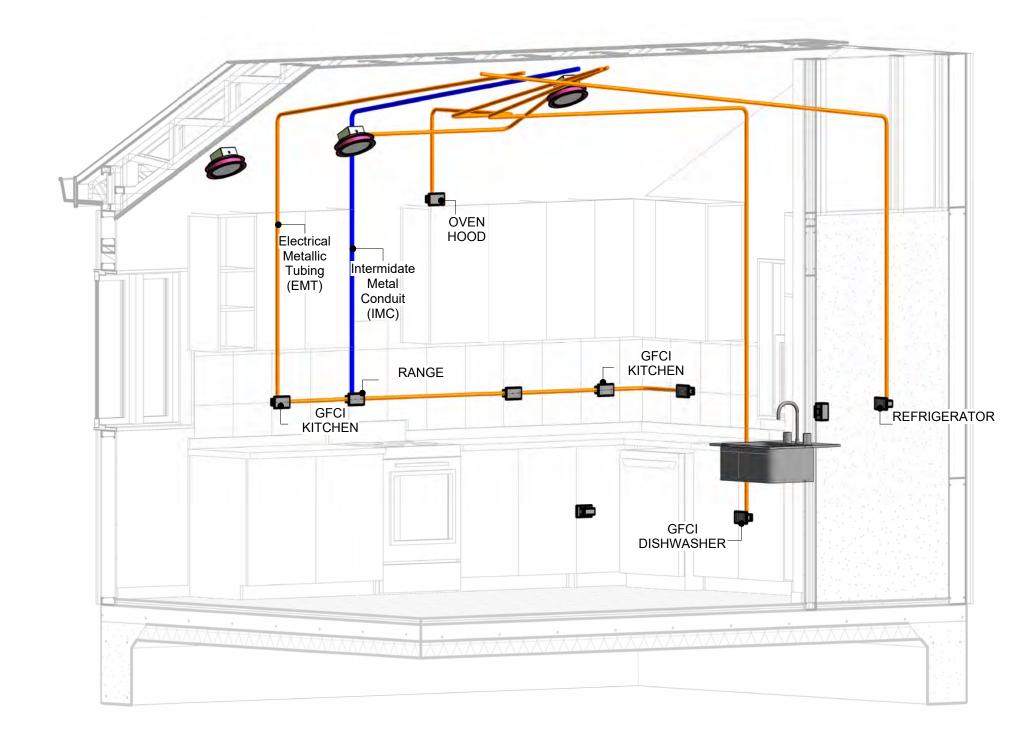


**3D-KITCHEN** 

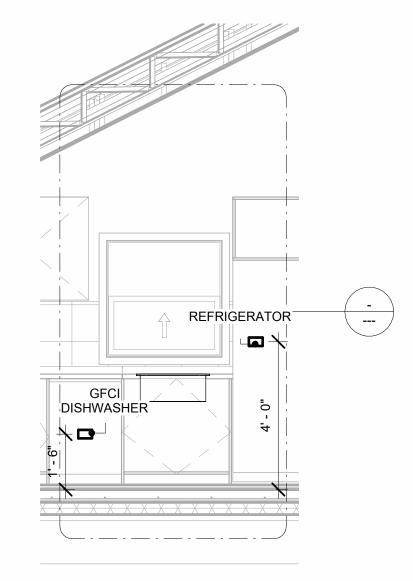


Section 1 3/8" = 1'-0"

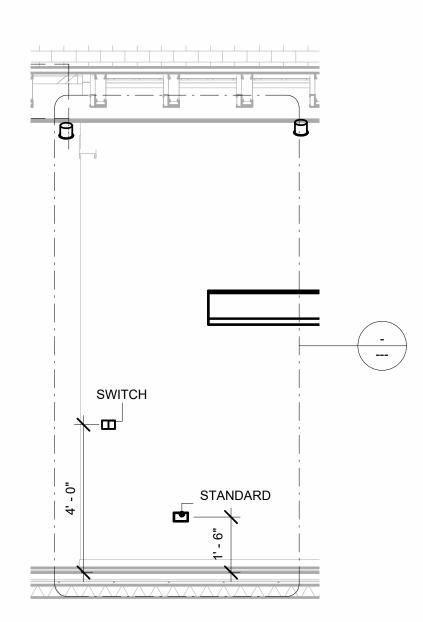

Section 3 3/8" = 1'-0"

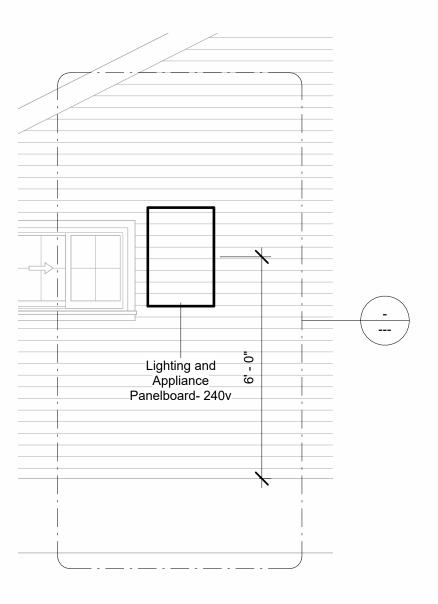


Section 2

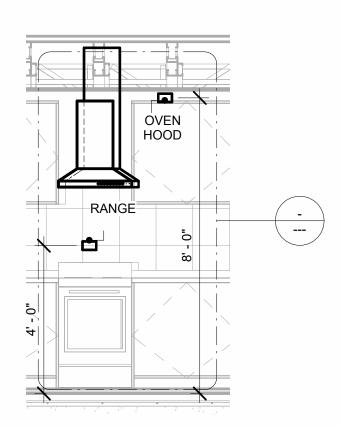

Section 4 3/8" = 1'-0"



**KEY PLAN** 

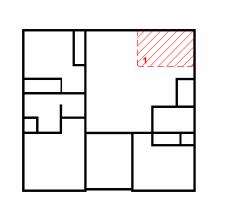

NO.	DESCRIPTION	DATE

NOTE:

LEGEND:

PROJECT

14-Wisdom-1194-3Bd-2Ba Tradtional-550

DRAWING NAME

**POWER** 

CLIENT NAME:	Owner
PROJECT NUMBER:	0078_15
DATE:	2/9/2025 12:04:57 PM
DESIGNED BY:	Designer
DRAWN BY:	Author
CHECKED BY:	Checker

E103

SCALE: As indicated

© [2024] [FrameUpNow] . All rights reserved

#### **NOTES: LIGHT**

- 1. LIGHT FIXTURES AND LUMINARIES SHALL CONFORM TO THE NEC, THE IRC AND LOCAL SAFETY & BUILDING CODE.
- 2. ALL LIGHTING FIXTURES SHOULD CONFORM TO THE DESIGN ELECTRICAL LOAD AND SHALL BE PROPERLY WIRED AND MOUNTED BY QUALIFIED ELECTRICIAN FOLLOWING MANUFACTURERS SPECIFICATIONS.
- 3. CEILING FANS AND FANS WITH LIGHT WITH WEIGHT EXCEEDING 35 LBS SHOULD BE PROVIDED WITH STRUCTURAL BACKING FOR SUPPORT AND SHALL BE FIXED AS PER MANUFACTURERS SPECIFICATIONS.
- 4. EXTERIOR LIGHTS SHALL CONFORM TO LOCAL BUILDING CODE AND GUIDELINES.

#### NOTES: SWITCH JUNCTION BOX


- 1. THE MINIMUM SIZE OF JUCTION BOX TO BE USED IS 2"X4"X(1.5" OR 3.5" DEEP) THIS ARE TO BE USED FOR SINGLE GANG SWITCH OR OUTLETS.
- 2. FOR DOUBLE GANG (2 GANG) OUTLETS AND SWITCHS THE MINIMUM SIZE OF THE
- JUCTION BOX TO BE PROVIDED SHALL NOT BE LESS THAN 4"X4"X(1.5" OR 3.5" DEEP)
- 3. FOR THREE GANG (3 GANG) OUTLETS AND SWITCHS THE MINIMUM SIZE OF THE JUĆTION BOX SHALL NOT BE LESS THAN 6"X4"X(1.5" OR 3.5" DEEP).

FITTING SCHEDULE(PULL BOX)			
FAMILY COUNT DESCRIPTION			
PULLBOX1 38 #1/4 PULLBOX			

ELECTRICAL FIXTURE SCHEDULE (SWITCH BOX)		
TYPE	COUNT	
DOUBLE GANG SWITCH BOX	1	
SINGLE GANG SWITCH BOX	4	
TRIPLE GANG SWITCH BOX	2	

LIGHTING DEVICE			
TYPE	COUNT		
DIMMER	3		
FAN SWITCH	3		
SINGLE POLE	10		
SINGLE POLE 2	5		
THREE WAY WITH DIMMER	2		

LIGHTING FIXTURE			
LIGHTING FIXTURE TYPE	VOLTAGE	ELECTRICAL LOAD	COUNT
ELECTRICAL_LIGHTS_FAN-LIGHT1	120 V/1-100 VA- 120 V/1-100 VA	200 A, 120 V/240 V, SINGLE PHASE, 3 WIRES	3
LIGHTING_RECESSED	120 V/1-60 VA	200 A, 120 V/240 V, SINGLE PHASE, 3 WIRES	17
SASSO 100 ROUND WALLWASHER TRIM	120 V/1-28 VA	200 A, 120 V/240 V, SINGLE PHASE, 3 WIRES	12
WALL LAMP - BRACKET	120 V/1-100 VA	200 A, 120 V/240 V, SINGLE PHASE, 3 WIRES	9

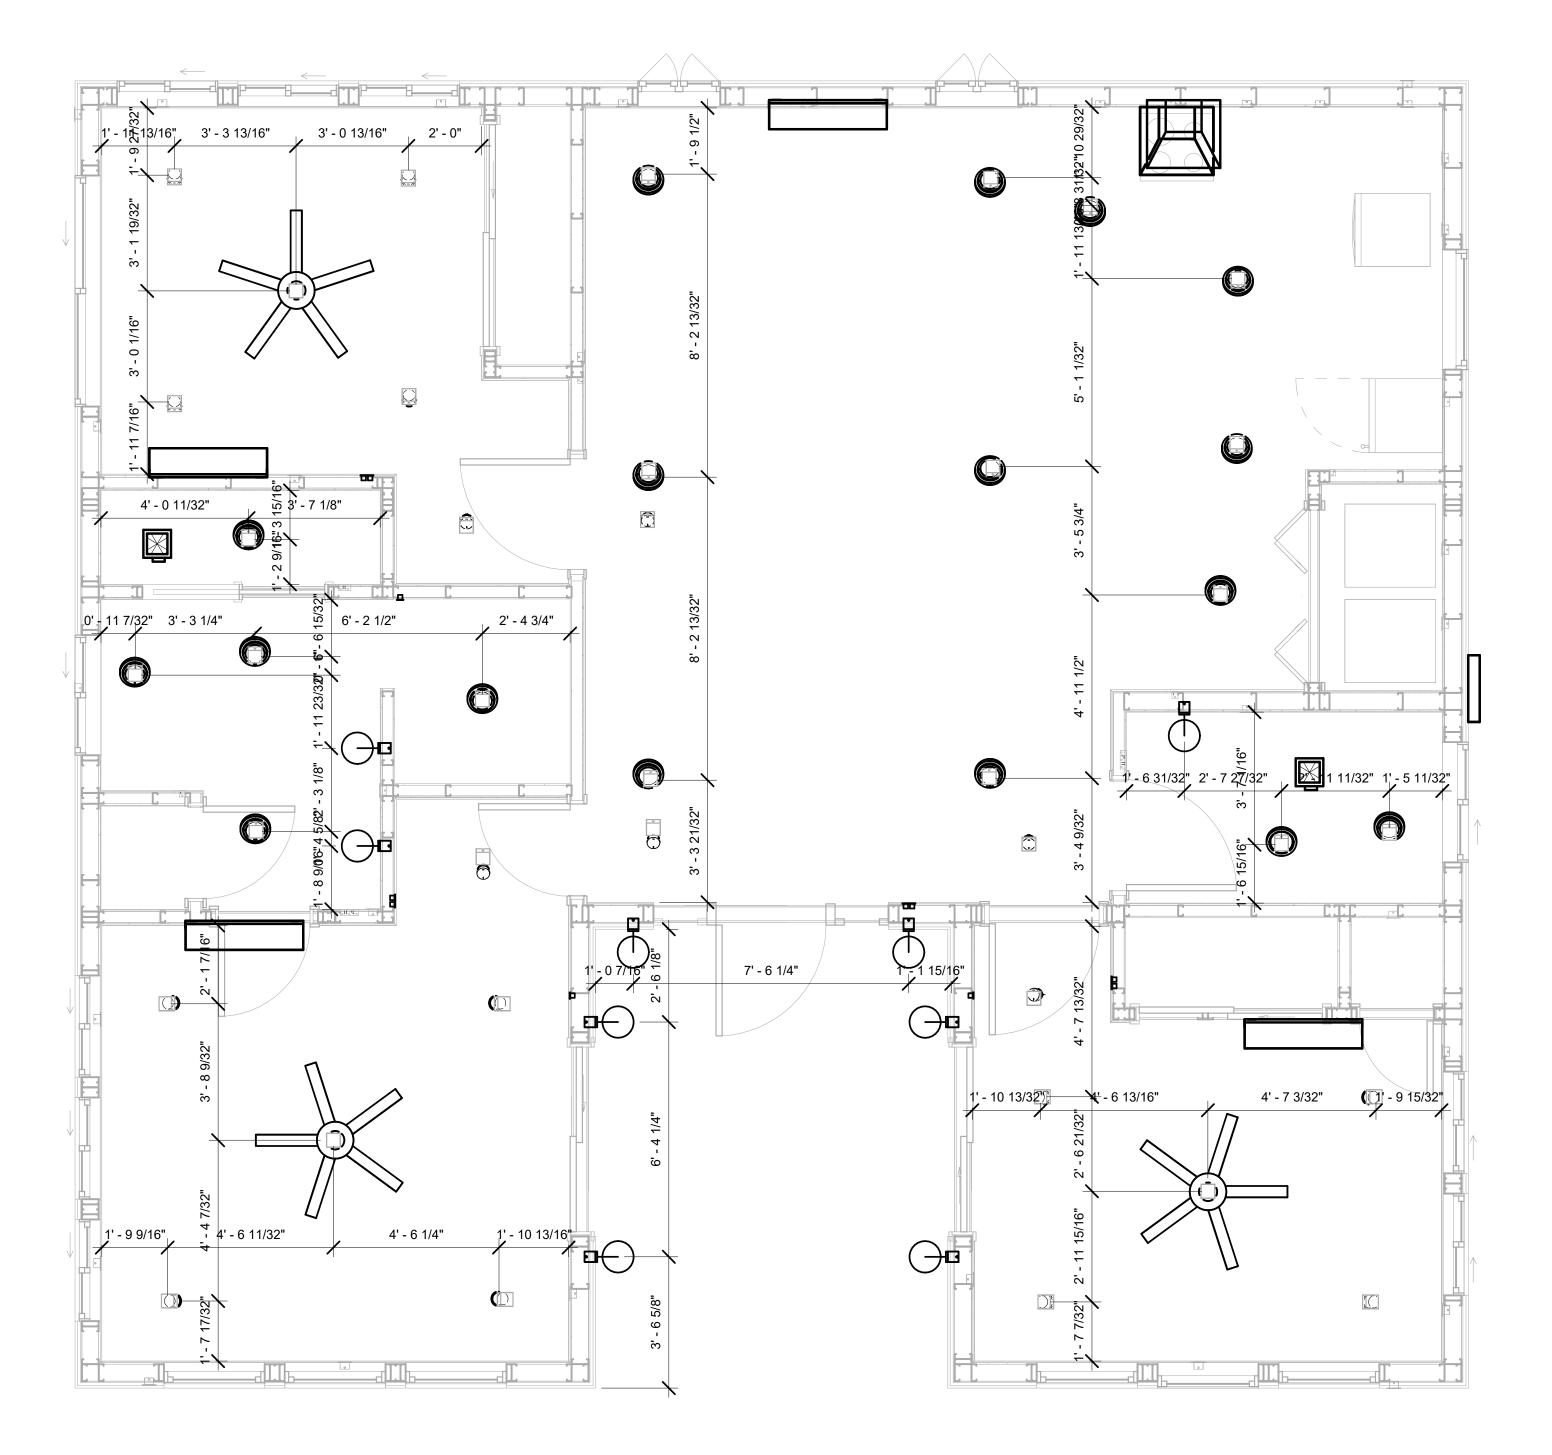

**DIMENSION FOR LIGHT FIXTURES** 3/8" = 1'-0"



**KEY PLAN** 

NO.	DESCRIPTION	DATE

NOTE:

LEGEND:

PROJECT

14-Wisdom-1194-3Bd-2Ba Tradtional-550

DRAWING NAME

## **DIMENSION PLAN** FOR LIGHT FIXTURES

CLIENT NAME:	Owner
PROJECT NUMBER:	0078_15
DATE:	2/9/2025 12:04:59 PM
DESIGNED BY:	Designer
DRAWN BY:	Author
CHECKED BY:	Checker


E104

#### NOTES;

- 1. VERIFY EQUIPMENT PLUG CONFIGURATION BEFORE PURCHASING RECEPTACLES
- 2. FOR ALL EQUIPMENT.
- 3. COORDINATE EXACT LOCATION OF LIGHT FIXTURES, WALL SWITCHES, RECEPTACLES AND OTHER DEVICES WITH ARCHITECTURAL DRAWINGS.
- 4. USE METALLIC JUNCTION BOX WITH THE GFCI RECEPTACLES, WITH HIGHT VOLTAGE.

ELECTRICAL FIXTURE SCHEDULE (RECEPTACLE)		
TYPE	COUNT	
CONDENSER	1	
DRYER	1	
GFCI BATH ROOM	3	
GFCI DISHWASHER	1	
GFCI KITCHEN	4	
GFCI OUT DOOR	4	
GFCI WASHER	1	
OVEN HOOD	1	
RANGE	1	
REFRIGERATOR	1	
STANDARD	15	
WATER HEATER	1	

ELECTRICAL OUTLET SCHEDULE			
TYPE	CIRCUIT NUMBER	ELECTRICAL DATA	COUNT
STANDARD		120 V/1-180 VA	3
STANDARD	2	120 V/1-180 VA	4
GFCI BATH ROOM	3	120 V/1-180 VA	2
STANDARD	5	120 V/1-180 VA	4
GFCI OUT DOOR	8	120 V/1-180 VA	4
GFCI KITCHEN	9	120 V/1-180 VA	4
GFCI DISHWASHER	10	120 V/1-1200 VA	1
OVEN HOOD	11	120 V/1-180 VA	1
RANGE	12,14	240 V/2-5000 VA	1
GFCI BATH ROOM	15	120 V/1-180 VA	1
WATER HEATER	16,18	240 V/2-5000 VA	1
STANDARD	19	120 V/1-180 VA	4
GFCI WASHER	20	120 V/1-1200 VA	1
DRYER	21,23	240 V/2-5000 VA	1
CONDENSER	22,24	240 V/2-5000 VA	1
REFRIGERATOR	25	120 V/1-1800 VA	1

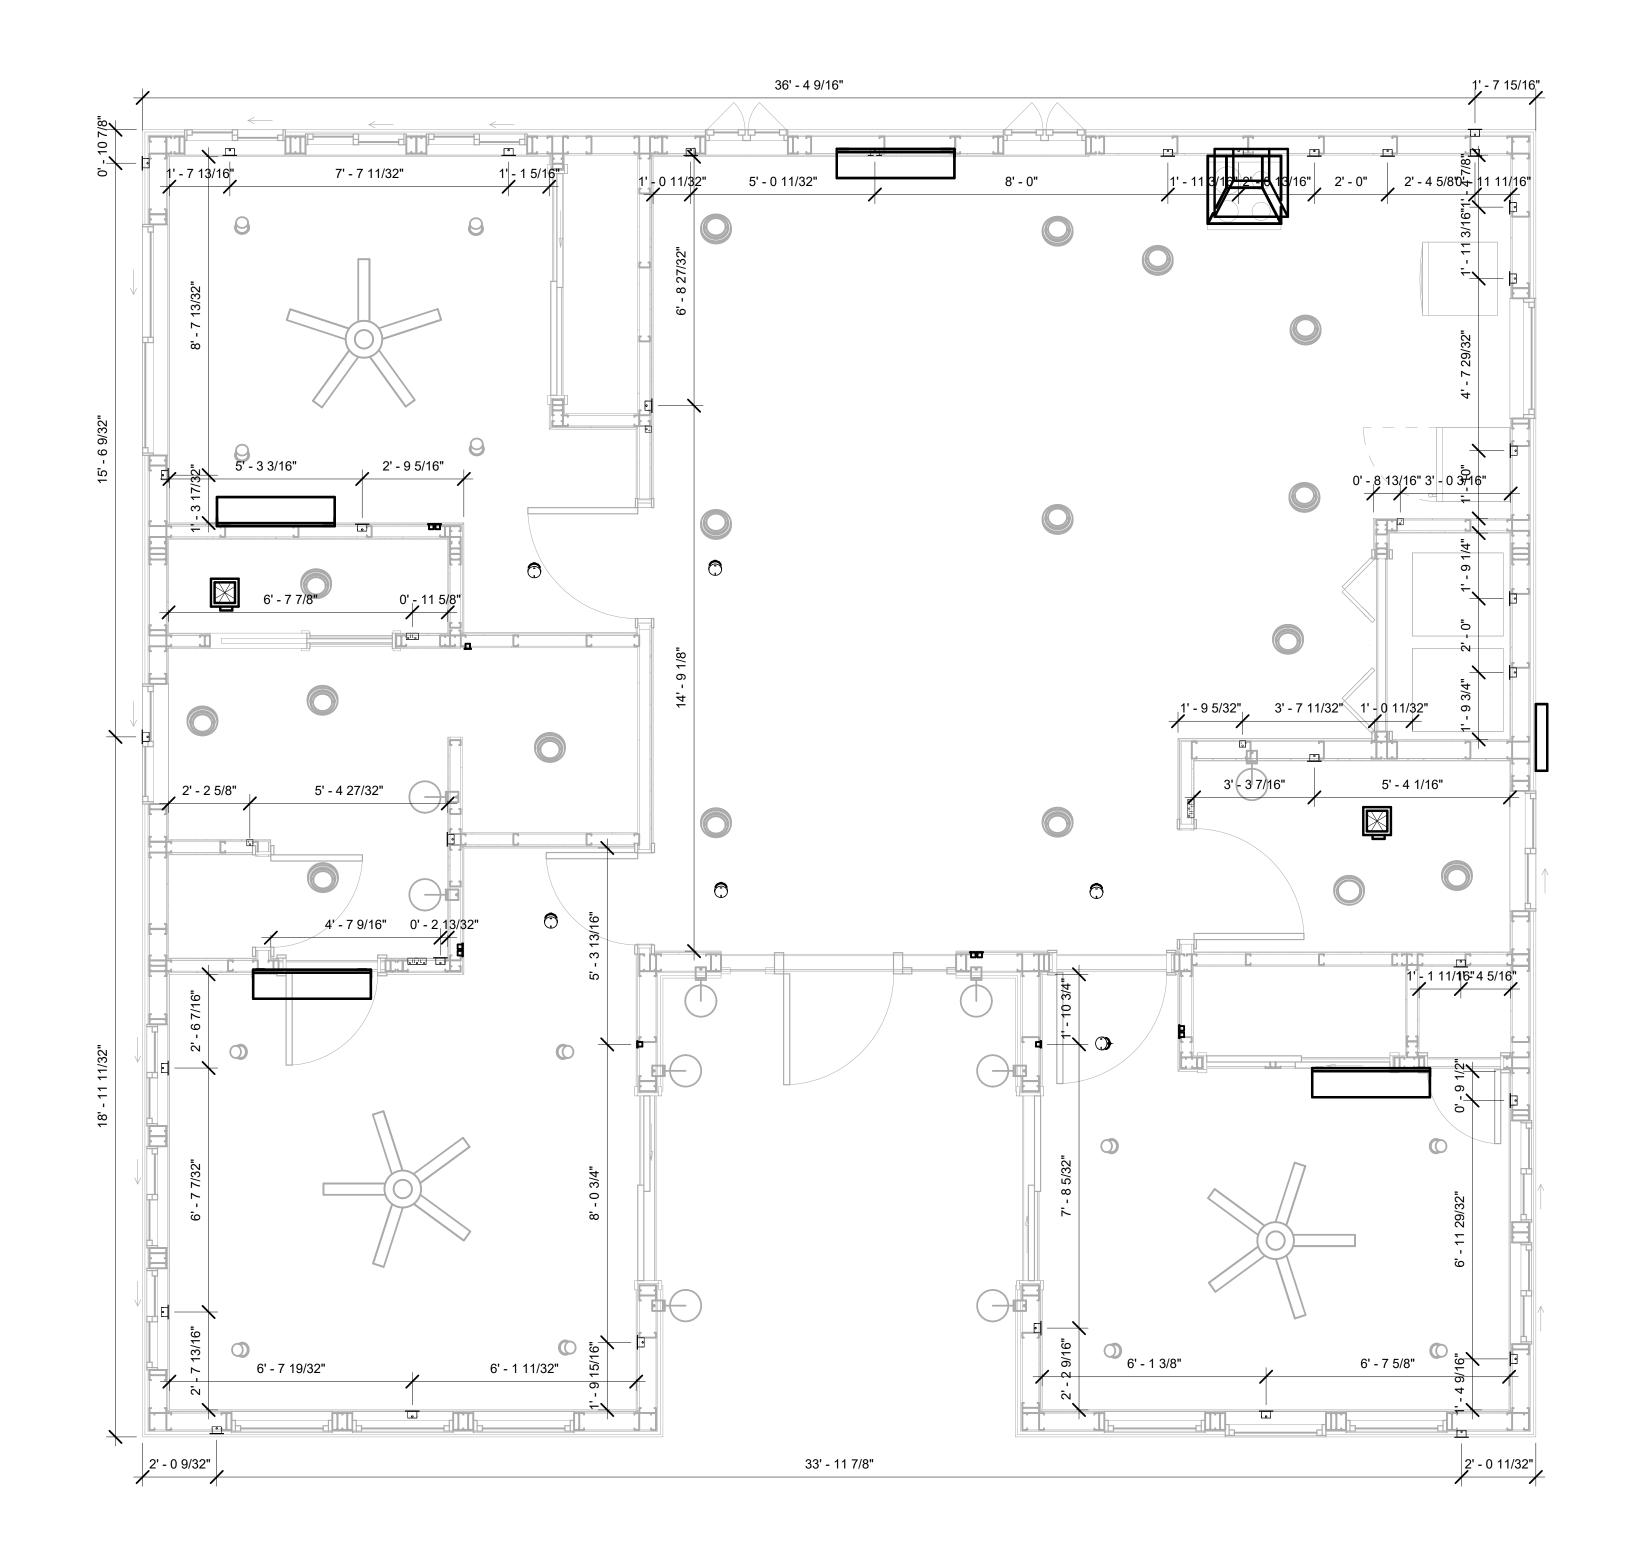

DIMENSION FOR FITTINGS
3/8" = 1'-0"



**KEY PLAN** 

NO.	DESCRIPTION	DATE

NOTE:

LEGEND:

PROJECT

14-Wisdom-1194-3Bd-2Ba Tradtional-550

DRAWING NAME

## DIMENSION PLAN FOR FITTINGS

CLIENT NAME:	Owner
PROJECT NUMBER:	0078_15
DATE:	2/9/2025 12:05:00 PM
DESIGNED BY:	Designer
DRAWN BY:	Author
CHECKED BY:	Checker

E105

#### SHEET LIST

SHEET NUMBER SHEET NAME

P101 NOTE AND SCHEDULE
P102 WATER SUPPLY AND SEWAGE
SYSTEM

#### PIPE COLOR SCHEME

DOMESTIC COLD WATER
DOMESTIC HOT WATER
SANITARY VENT
SANITARY SEWER
STORM DRAINAGE

#### PLUMBING NOTES

- THE PLUMBING SYSTEM IS DESIGNED TO MEET THE BUILDING'S DOMESTIC WATER SUPPLY, SANITARY DRAINAGE, AND STORM DRAINAGE REQUIREMENTS, AS PER PROJECT SPECIFICATIONS AND APPLICABLE CODES.
- THE SYSTEM INSTALLATION SHALL COMPLY WITH THE LATEST INTERNATIONAL PLUMBING CODE (IPC), INTERNATIONAL RESIDENTIAL CODE (IRC), AND ALL OTHER RELEVANT LOCAL, STATE, AND NATIONAL REGULATIONS.
- 3. ALL PLUMBING WORK SHALL COMPLY WITH THE LATEST EDITION OF THE INTERNATIONAL PLUMBING CODE (IPC) AND THE LOCAL PLUMBING CODE.
- 4. PLUMBING SYSTEMS SHALL BE TESTED AND INSPECTED IN ACCORDANCE WITH THE LOCAL PLUMBING CODE REQUIREMENTS.
- 5. PLUMBING FIXTURES SHALL BE INSTALLED WITH THE APPROPRIATE TRIM, FITTINGS, AND ACCESSORIES, AS RECOMMENDED BY THE MANUFACTURER.
- 6. PIPING SHALL BE PROPERLY SUPPORTED AND SECURED TO PREVENT SAGGING,
- MOVEMENT, AND VIBRATION.
  7. SHUT-OFF VALVES SHALL BE PROVIDED AT ALL BRANCH CONNECTIONS AND AT THE
- INLET AND OUTLET OF EACH PIECE OF EQUIPMENT.

  8. BACKFLOW PREVENTION DEVICES SHALL BE INSTALLED AS REQUIRED BY THE LOCAL
- PLUMBING CODE TO PROTECT THE POTABLE WATER SYSTEM.

  9. PLUMBING FIXTURES AND EQUIPMENT SHALL BE ACCESSIBLE FOR MAINTENANCE AND
- 10. EXPOSED PLUMBING PIPING AND FIXTURES SHALL BE INSULATED TO PREVENT
- CONDENSATION AND ENERGY LOSS.

  11. DEAD ENDS IN THE DRAINAGE SYSTEM MUST BE AVOIDED, EXCEPT WHERE NECESSARY TO INSTALL A CLEANOUT IN AN ACCESSIBLE LOCATION, AND MUST HAVE A VENTED CONNECTION TO THE OUTSIDE ATMOSPHERE.
- 12. THE VERTICAL DEFLECTION OF PVC PIPE MUST NOT EXCEED 5%, AND NO DEFLECTION IS PERMITTED FOR IRON PIPE.
- 13. WORK MUST BE PROPERLY COORDINATED WITH OTHER TRADES TO AVOID CONFLICTS, REFERRING TO THE ARCHITECTURAL AND STRUCTURAL DRAWINGS FOR INFORMATION REGARDING CEILING ELEVATIONS, SPACE CLEARANCES, WALL AND PARTITION LOCATIONS, ETC.
- 14. ALL FIXTURES SHALL HAVE ACCESSIBLE STOPS.
- 15. DOMESTIC WATER PIPING SHALL BE PEX, AND PVC PIPING IS NOT ACCEPTABLE FOR INTERIOR USE.
- 16. VENT TERMINATIONS SHALL BE LOCATED AT LEAST 10 FEET FROM OR 3 FEET ABOVE ANY OPERABLE WINDOW, DOOR OPENING, AIR INTAKE, OR VENT SHAFT, AND AT LEAST 3 FEET IN EVERY DIRECTION FROM ANY LOT LINE, ALLEY, OR STREET.
- 17. PIPE AND FITTINGS UTILIZED IN THE WATER SUPPLY SYSTEM SHALL HAVE A MAXIMUM OF 8 PERCENT LEAD.
- 18. ACRYLONITRILE BUTADIENE STYRENE (ABS) SHALL BE USED FOR THE SEWERAGE AND
- VENTILATION SYSTEM.

  19. CROSS-LINKED POLYETHYLENE (PEX) SHALL BE USED FOR THE WATER SUPPLY SYSTEM.
- 20. POLYVINYL CHLORIDE (PVC) SHALL BÉ USED FOR THE RAIN WATER SYSTEM.
- 21. THE MIMIMUM WATER SUPPLY DEPTH UNDER FLOOR FINISH SHOUD BE 1/2".
- 22. ANY PIPE INSTALLED UNDERGROUND MUST HAVE AT LEAST 12 INCHES OF CLEARANCE BETWEEN THE OUTSIDE OF THE PIPE AND ANY OTHER UNDERGROUND STRUCTURE.
- 23. THE MINIMUM CLEARANCE BETWEEN COLD AND HOT WATER LINES IN RESIDENTIAL
- HOMES MAINTAIN A MINIMUM DISTANCE OF 6 INCHES.

  24. HORIZONTAL SEPARATION BETWEEN WATER AND SEWER LINES: A MINIMUM OF 12 INCHES BETWEEN POTABLE WATER SUPPLY LINES (COLD AND HOT WATER) AND

#### **ABBREVIATIONS**

SANITARY SEWER LINES.

Ø DIAMETER ABS ACRYLONITRILE BUTADIENE STYREN ABV ABOVE AD AREA DRAIN AFF ABOVE FINISHED FLOOR ALT ALTERNATE BFF BELOW FINISHED FLOOR	IE
ABV ABOVE AD AREA DRAIN AFF ABOVE FINISHED FLOOR ALT ALTERNATE BFF BELOW FINISHED FLOOR	IE —
AD AREA DRAIN AFF ABOVE FINISHED FLOOR ALT ALTERNATE BFF BELOW FINISHED FLOOR	
AFF ABOVE FINISHED FLOOR ALT ALTERNATE BFF BELOW FINISHED FLOOR	
ALT ALTERNATE BFF BELOW FINISHED FLOOR	
BFF BELOW FINISHED FLOOR	
BLW BELOW	
CO CLEAN OUT	
CW COLD WATER	
D DEGREE	
DFU DRANAGE FIXTURE UNIT	
DIA DIAMETER	
DN DOWN	
FCO FLOOR CLEAN OUT	
FD FLOOR DRAIN	
FL FLOOR	
FS FLOOR SINK	
FT FOOT/FEET	
HB HOSE BIB	
HW HOT WATER	
IN INCH	
MIN MINIMUM	
NO NUMBER	
NTS NOT TO SCALE	
PEX CROSS-LINKED POLYETHYLENE	
PLBG PLUMBING	
PVC POLYVINYL CHLORIDE	
QTY QUANTITY	
RD ROOF DRAIN	
RED REDUCER	
RM ROOM	
RW RAIN WATER	
SF SQUARE FOOT	
V VENT	
VTR VENT THROUGH ROOF	
W WASTE	
WCO WALL CLEAN OUT	
WSFU WATER SUPPLY FIXTURE UNIT	

### PLUMBING LEGEND

D	CAP
	BEND 45 DEG
B	BEND 90 DEG
	TEE REDUCING
	TEE
	CLEAN TWO-WAY
	WYE 45 DEG
	WYE 45 DEG DOUBLE
	WYE COMBINATION
	P-TRAP

PIPE SCHEDULE			
MATERIAL	DIAMETER	LENGTH	
ACRYLONITRILE BUTADIENE STYRENE (ABS)	1 1/2"	31 FT	
ACRYLONITRILE BUTADIENE STYRENE (ABS)	2"	61 FT	
ACRYLONITRILE BUTADIENE STYRENE (ABS)	3"	39 FT	
CROSS-LINKED POLYETHYLENE (PEX)	1/2"	180 FT	
CROSS-LINKED POLYETHYLENE (PEX)	3/4"	18 FT	
POLYVINYL CHLORIDE - RIGID	2"	58 FT	

FITTING SCHEDULE			
FITTING	SIZE	QTY	
DOMESTIC COLD WATER			
PEX 90 DEGREE ELBOW	1/2"ø-1/2"ø	24	
PEX 90 DEGREE ELBOW	3/4"ø-3/4"ø	3	
PEX TEE ELBOW	1/2"ø-1/2"ø	9	
PEX TEE ELBOW	3/4"ø-3/4"ø	2	
PEX TRANSITION ELBOW	1"ø-3/4"ø	2	
PEX TRANSITION ELBOW	3/4"ø-1/2"ø	2	
DOMESTIC HOT WATER			
PEX 90 DEGREE ELBOW	1/2"ø-1/2"ø	16	
PEX 90 DEGREE ELBOW	3/4"ø-3/4"ø	1	
PEX TEE ELBOW	1/2"ø-1/2"ø	7	
PEX TRANSITION ELBOW	3/4"ø-1/2"ø	1	
	<u>'</u>		
RAIN WATER			
PVC 90 DEG BEND ELBOW	2"ø-2"ø	21	
SEWAGE			
ABS 90 DEGREE BEND ELBOW	1 1/2"ø-1 1/2"ø	3	
ABS 90 DEGREE BEND ELBOW	2"ø-2"ø	2	
ABS 90 DEGREE BEND ELBOW	3"ø-3"ø	4	
ABS P-TRAP	1 1/2"ø-1 1/2"ø	4	
ABS P-TRAP	2"ø-2"ø	1	
ABS REDUCER ELBOW	2"ø-1 1/2"ø	4	
ABS REDUCER ELBOW	3"ø-2"ø	2	
ABS TEE ELBOW	1 1/2"ø-1 1/2"ø-1 1/2"ø	3	
ABS TEE ELBOW	2"ø-2"ø-2"ø	3	
ABS TEE ELBOW	3"ø-3"ø-3"ø	3	
ABS TEE REDUCER ELBOW	3"ø-3"ø-1 1/2"ø	1	
ABS TEE REDUCER ELBOW	3"ø-3"ø-2"ø	1	
ABS TRAP P	2"ø-2"ø	1	
ABS VENT CAP ELBOW	2"ø	1	
ABS WASTE DOUBLE TEE	2"ø-2"ø-2"ø	1	
ABS WYE COMBINATION WITH 8TH BEND ELBOW	3"ø-3"ø-1 1/2"ø	1	
ABS WYE COMBINATION WITH 8TH BEND ELBOW	3"ø-3"ø-2"ø	2	
VENT	4.4/014.4/01.		
ABS 90 DEGREE BEND ELBOW	1 1/2"ø-1 1/2"ø	2	
ABS TEE ELBOW	1 1/2"ø-1 1/2"ø	1	
ABS TEE REDUCER ELBOW	2"ø-2"ø-1 1/2"ø	1	
ABS VENT CAP ELBOW	1 1/2"ø	1	
ABS VENT CAP ELBOW	2"ø	3	

WATER FIXTURE UNIT SCHEDULE					
FAMILY QTY UNIT VALUE TOTAL					
DISHWASHER	1	1.4	1.4		
SHOWER TRIM	2	1.4	2.8		
SINK ISLAND SINGLE	1		0		
VANITY SINK	3		0		
WASHER	1	1.4	1.4		
WATER CLOSET	2	2.2	4.4		

WASTE FIXTURE UNIT SCHEDULE				
FAMILY	QTY	DFU VALUES	TOTAL	
DISHWASHER	1	2	2	
SHOWER TRAY	2		0	
SINK ISLAND SINGLE	1		0	
VANITY SINK	3		0	
WASHER	1	2	2	
WATER CLOSET	2	3	6	

FIXTURE SCHEDULE				
FIXTURE	QTY	DESCRIPTION		
DISHWASHER	1			
DRYER	1			
SHOWER TRAY	2			
SHOWER TRIM	2			
SINK ISLAND SINGLE	1			
VANITY SINK	3			
WASHER	1			
WATER CLOSET	2			
WATER HEATER	1			

PLUMBING SCHEDULE					
FIXTURE	TRAP	WASTE	VENT	C.W	H.W
DISHWASHER	1-1/2"	2"	1-1/2"	1/2"	1/2"
DRYER	N/A	N/A	N/A	N/A	N/A
SHOWER TRAY	<varies></varies>	<varies></varies>	<varies></varies>	<varies></varies>	<varies></varies>
SHOWER TRIM	-	-	-	1/2"	1/2"
SINK ISLAND SINGLE					
VANITY SINK	1-1/2"	2"	1-1/2"	1/2"	1/2"
WASHER	2"	2"	1-1/2"	1/2"	1/2"
WATER CLOSET	3"	3"	2"	1/2"	1/2"
WATER HEATER	N/A	N/A	N/A	3/4"	3/4"

ACCESSORIES & FITTINGS SCHEDULE					
FIXTURE QTY DESCRIPTIONS					
DISHWASHER SUPPLY SINGLE 2 CONNECTOR					
DISHWASHER SEWAGE SINGLE CONNECTOR	2				
HANGING PIPES CLAMP					
HOSE BIB	1				
SHUTOFF VALVE	10				



**KEY PLAN** 

NO.	DESCRIPTION	DATE

NOTE:

LEGEND:

PROJECT

14-Wisdom-1194-3Bd/2Ba Traditiona-550

DRAWING NAME


## NOTE AND SCHEDULE

CLIENT NAME:


PROJECT NUMBER:	0078_14
DATE:	2/8/2025 4:39:51 PM
DESIGNED BY:	Designer
DRAWN BY:	Author
CHECKED BY:	Checker

P101

SCALE: 1/2" = 1'-0"

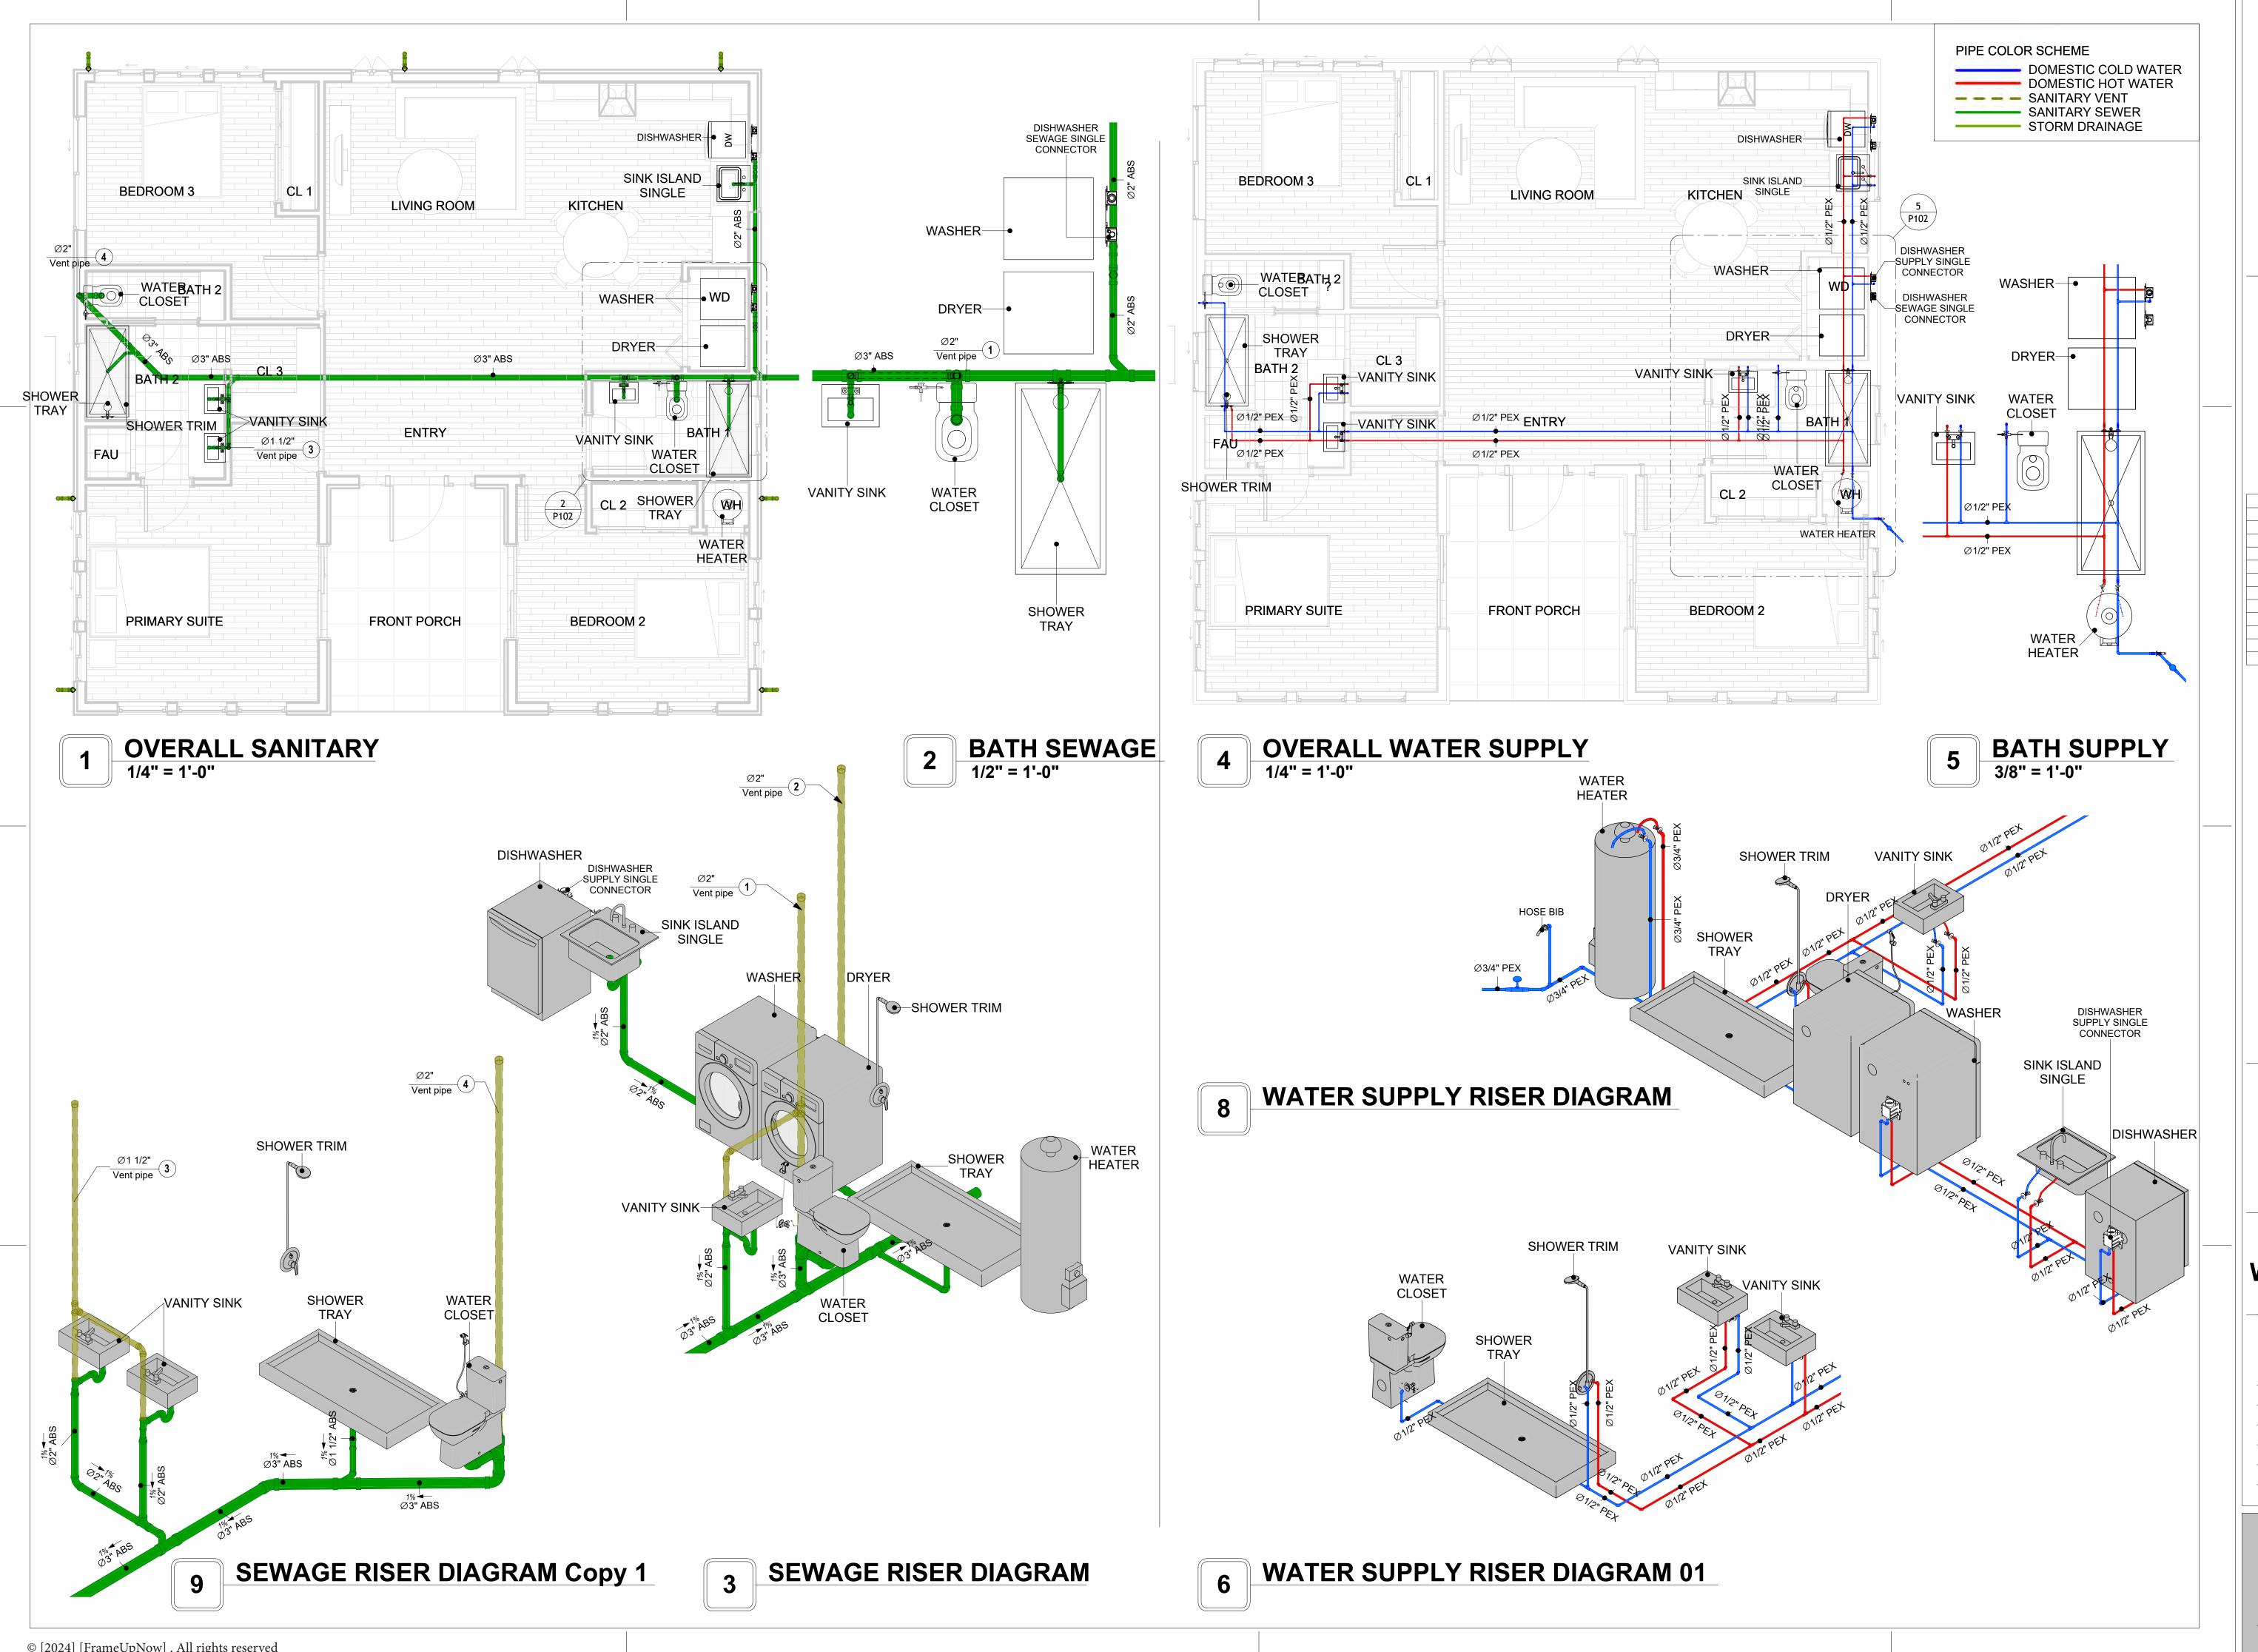



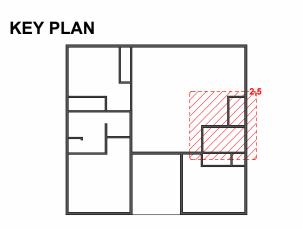

NO.	DESCRIPTION	DATE

NOTE:

LEGEND:

PROJECT

14-Wisdom-1194-3Bd/2Ba Traditiona-550

DRAWING NAME

## WATER SUPPLY AND **SEWAGE SYSTEM**

CLIENT NAME:	
PROJECT NUMBER:	0078_14
DATE:	2/8/2025 4:40:34 PM
DESIGNED BY:	Designer
DRAWN BY:	Author
CHECKED BY:	Checker

## Materials Shopping List

Please print and take this Materials Shopping List to your favorite Home Depot and ask for assistance in selecting the materials, fixtures and fittings to complete your new home.

Record your selection and the price of the item. Then do the math to determine the cost for your selections and the total cost of finishing your home.

#### **Have It Your Way!**

The material types listed in this document were selected based on personal preferences. The Customer is encouraged to make changes to the material types in accordance with local customs, regulations, and personal preferences.

Have It Your Way!



## 20 good reasons to frame a home with metal and not wood



Why build your ADU with metal vs wood	Wood	Metal	Explanation
1 DIY Construction Benefit		<b>~</b>	The wall frames, trusses and beams can be erected in a just a few days
2 Minimal Construction Skills Required		<b>~</b>	Pre-assembled walls and trusses require no specialized skills to errect
3 Build as DIY, Hybrid or by a General Contractor		<b>✓</b>	Do it yourself, Hybrid (involve special contractors) or hire a General Contractor
4 Build It As You Can Afford It		<b>✓</b>	Impervious to Weather - build as you have the time and money
5 Up Front Cost of Framing Materials	<b>~</b>		As to only the framing material, wood is less expensive
6 Total Cost To Build		<b>~</b>	Savings in time, labor, and other areas make light gauge steel LESS expensive
7 Termites and wood boring insects		<b>Y</b>	Termites, carpenter ants and wood boring insects eat wood, not metal
8 Mold resistant		<b>~</b>	Metal does not attract mold
9 Damage caused by exterior and interior flooding		<b>~</b>	Metal needs no reconditioning after a flood
10 Fire Resistant		<b>~</b>	Non-combustible
11 Lower insurance rates		<b>Y</b>	Many insurance underwriters now provide lower rates for metal framed homes
12 Walls, trusses, and beams retain their original form		<b>~</b>	Perfectly straight walls - no shimming of drywall
13 Corners are 90 degrees		<b>✓</b>	No need for templating of countertops to adjust for out of square corners
14 Strength and weight		<b>✓</b>	Metal is stronger than wood and weighs less - no need for crane to lift ADU trusses
15 IBC Engineered Stamp		<b>✓</b>	If an engineering stamp is necessary, months of waiting are saved
16 Complete BOM (Materials Shopping List)		<b>~</b>	Take the materials shopping list to Home Depot and start shopping/pricing
17 Flexible in Seismic Areas - Won't Fracture		<b>~</b>	Light gauge steel is flexible and won't fracture when the earth moves
18 No Waste At Job Site		~	Steel is the most recycled material in the world. A typical wood home has 20-30% waste
19 Environmentally Friendly		<b>~</b>	Trees don't have to be destroyed and the source of most metal is from recycling
20 How-To Videos Included		<b>~</b>	How-to videos provide simple assembly instructions
21 Relationship Counselor		<b>~</b>	Eliminate emotional uphevels - save time, money, and preserve the relationship

#### Universal Requirements - some or all may be required

- 1 Site plan
- 2 Electrical Supply Connection
- 3 Sewer Connection
- 4 Fresh Water Supply Connection
- 5 Set Backs
- 6 Soils Evaluation

- 7 Earthquake (fault) evaluation
- 8 Foundation Plan subject to soils
- 9 Compliance with local energy codes: insulation home wrap and flashing
- 10 Engineering for wind speed and snow load.
- 11 State and Local ordinances regarding ADUs
- 12 Local Architect and/or Engineer may be necessary

#### Wisdom-3Bd2Ba-Traditional





## Wisdom-3Bd2Ba-Traditional MATERIAL SHOPPING LIST

#### **Have It Your Way!**

The material types listed in this document were selected based on personal preferences. The Customer is encouraged to make changes to the material types in accordance with local customs, regulations, and personal preferences. Have It Your Way!

#### TOC



#### Table Of Content

#	Name	Link	Page No
1	Cover Page	<u>Cover Page</u>	1
2	TOC	TOC	2
3	ELECTRICAL BOM	ELECTRICAL BOM	3
5	HVAC BOM	HVAC BOM	7
4	PLUMBING BOM	PLUMBING BOM	10
6	ARCHITECTURAL BOM	ARCHITECTURAL BOM	15

#### **Have It Your Way!**

The material types listed in this document were selected based on personal preferences. The Customer is encouraged to make changes to the material types in accordance with local customs, regulations, and personal preferences. Have It Your Way!

#### **GENERAL NOTES**

- 1 This BOM (Bill of Materials) is prepared as a Materials Shopping List to help builders and DIYers gain a complete understanding of most if not all elements required for the complete construction of this structure, according to the original design documents provided by FrameUpNow.
- 2 All quantities and specifications are subject to change based on the final design, field measurements, availability of products and customer preferences. The customer should verify all information prior to purchasing materials.
- 3 All products and elements in the list shall conform to the International Residential Code (IRC), or any other local and international building codes, safety regulations, and standards that are applicable to the location of the structure.
- 4 If any changes are made by the customer to the list of materials specified in this document, the customer is responsible for assuring that the correct type and quantity of materials are utilized in accordance with local building codes.
- FrameUpNow, will not be held responsible for any misuse of this document, the products listed, or for deviations from the content that are made due to changes in specifications, pricing, availability, or customer preferences.
- 6 The customer is advised to consult a qualified professional or technician prior to purchasing materials for specialized construction system items. Some items including but not limited to caseworks, doors and windows may require as built measurements prior to purchase to confirmation of final dimensions.
- 7 If there are additional trim elements or specific installation methods, the total amount of materials needed might vary. Consider any additional trim required for corners, intersections, or other architectural details that might cause this variations before procedding to purchase and construction.

#### **ARCHITECTURAL BOM**



	Wisdom-3Bd2Ba-Traditional								
		ARCHITECTUR	AL MATERI	AL SHOPPI	NG LIST				
No.	Item	Туре	Unit	Quantity	Unit Price	Total	Description		
_	APPLIANCES								
1	Refrigerator		PCS	1					
2	Range		PCS	1					
3	Washer		PCS	1					
4	Dryer		PCS	1					
5	Dish Washer		PCS	1					
6	Oven		PCS	0					
7	Microwave		PCS	0					
<u></u>	CASEWORKS								
1	Kitchen Cabinet		FT	19.6					
2	Laundry Cabinet		FT	0					
3	Vanity Cabinet		FT	9.42					
4	Medicine Cabinet		PCS	3					
5	Kitchen countertop		SF	31.29					
6	Laundry Countertop		PCS	0					
7	Bathroom Countertop		SF	0					
8	Island		FT	0					
9	Peninsula		FT	0					
10	Closets		SF	106.25					
△	CEILING								
	Ceiling Board	Dry Wall	SF	1055					
	Dry Wall Fastener	Screw	PCS	1846					
3	Vapor Retarder	Polyethylene film	SF	1211					
4	Vapor Retarder Fastener	Nails with washer heads	PCS	3632					
5	Ceiling Board (MRD)	Moisture resistant drywall	SF	156					
	MRD Fastener		PCS	273					
7	Ceiling Board	Marine Plywood	SF	0					
	Marine Plywood Fastener	Screw	PCS	0					
_	Dry Wall Tape		FT	605					
△	FLOORING								
	Main Living Space		SF	435.9					
2	Bathroom		SF	130.8					
3	Bedrooms		SF	480.6					
4	Porch		SF	124.2					
<u></u>	STRUCTURE		0.5	404:5					
-	Foundation		SF	1316.9					
<u></u>	WALLS EXTERIOR		CF	1000					
1	Exterior Wall Siding		SF	1280					
2	Wall Paint		SF	1280					
3	Wall Shteathing (OSB)	0 15 1 1111 (4204 : : 2	SF	1280					
4	Shteathing Fastener	Self-drilling screws(100/pkt)	PKT	12.8					
5	Wall Insulation		SF	4273					
6	Wall Homewrap		SF	1280					
7	Home wrap Fastener	Stapled fastener (200/pkt)	PKT	4.864					
8	Furring Strip		SF	160					
9	Furring Strip Fastener	Self-drilling screws(100/pkt)	PKT	12.8					

#### **ARCHITECTURAL BOM**



	WALLS INTERIOR				
1	Cementitious Backer Board		SF	908	
2	Kerdi membrane		SF	908	
3	Kerdi membrane Fastener		SF	908	
4	Wall Ceramic Tile		SF	908	
5	Drywall Board		SF	2270	
_	Drywall Fastener	Self-drilling screws(100/pkt)	PKT	22.7	
	Wall Paint	Sell-drilling Screws(100/pkt)	SF	22.7	
	Drywall Tape		FT	425.7	
0	DOORS DOORS		FI	425.7	
	Interior Swinging	3' - 0" X 6'-8"	PCS	3.0	
	Interior Swinging	2' - 6" X 6'-8"	PCS	3.0	
3	Exterior Door With Sidelight	6' - 5" X 7'-0"	PCS	1.0	
_		6' - 0" X 6'-8"	PCS	1.0	
5	Interior Sliding	5' - 0" X 6'-8"	PCS	-	
6	Interior Sliding	5 - 0 X 6-8 5' - 0" X 6'-8"	PCS	1.0	
	Patio Sliding Bifold Door	5' - 0" X 6'-8"	PCS	2.0	
	Pocket Door		PCS	-	
		2' - 4" X 6'-8"		1.0	
	Interior Swinging	2' - 0" X 6'-8"	PCS	1.0	
	Exterior Door Trim		FT	57.1	
	Interior Door Trim		FT	429.5	
	Entry Lock set		PCS	3.0	
	Privacy Lock set		PCS	6.0	
_	Passage Lock set		PCS	5.0	
1	WINDOWS	3' - 3" X 2'-3"	PCS	2	
	Sliding		PCS	2	
2	Hung	2' - 9" X 3'-3"	PCS	6	
3	Sliding	2' - 9" X 3'-3"		8	
4	Casement	2' - 3" X 3'-3"	PCS	2	
5	Sliding	6' - 3" X 3'-3"	PCS	1	
6	Hung	3' - 3" X 3'-3"	PCS	1	
7	Exterior Window Trim		FT	248	
8	Interior Window Trim		FT	248	
<u></u>	ROOF		СГ	1/4/	
1	Roof Covering		SF	1646	
2	Roof Covering Fastener		PCS	823	
3	Roof Felt Paper		SF	1646	
4	Roof Felt Paper Fastener		PCS	4939	
5	Roof Sheathing		SF	1646	
6	Roof Sheathing Fastener		PCS	13169	
7	Batten		FT	0	
8	Batten Fastener		PCS	0	
9	Soffit		SF	153	
10	Soffit Fastener		PCS	77	
	Fascia		FT	186	
_	Fascia board fastener		PCS	93	
13	Roof Insulation		SF	1646	



		Wis	sdome-3Bd2	Ba-Traditional					
ELECTRICAL MATERIAL SHOPPING LIST									
No.	Item	Туре	Unit	Quantity Unit Price	Total	Description			
Δ	LIGHTING FIXTURES	·							
1	Kitchen Ceiling Light		PCS	3					
2	Exterior Wall Mounted Light		PCS	6					
3	Livingroom Ceiling Light With Fan		PCS	0					
4	Bedroom Ceiling Light With Fan		PCS	3					
5	Dining Ceiling Light		PCS	0					
6	Bath Wall Mounted Light		PCS	3					
7	Bathroom Ceiling Light		PCS	6					
8	Livingroom Ceiling Light		PCS	7					
9	Bedroom Ceiling Light		PCS	12					
	Hall & Entry Ceiling Light		PCS	0					
11	Closet Ceiling Light		PCS	1					
	Smoke Detector		PCS	6					
	ELECTRICAL FITTINGS		1 00						
13	Standard Receptacle 120V	20A	PCS	16					
14	GFCI Receptacle 120V	20 A	PCS	14					
15	GFCI Receptacle 240V	30 A	PCS	2					
16	GFCI Receptacle 240V	40 A	PCS	1					
17	GFCI Receptacle 240V	60 A	PCS	1					
18	Fan Switch	00 A	PCS	3					
19			PCS	15					
	Single Pole Switch			-					
20	Three Way Switch		PCS	2					
21	Dimmer Switch		PCS	3					
<u>^</u>	ELECTRICAL CONDUITS & WIRING		ET	100					
	ROMEX 14 AWG	14/2 w/ground	FT	192					
	ROMEX 12 AWG	12/2 w/ground	FT	420					
	ROMEX 12 AWG	12/3 w/ground	FT	0					
	ROMEX 10 AWG	10/2 w/ground	FT	0					
	ROMEX 10 AWG	10/3 w/ground	FT	20					
	ROMEX 8 AWG	8/3 w/ground	FT	41					
	ROMEX 6 AWG	6/3 w/ground	FT	19					
	<b>ELECTRICAL BOXES &amp; CIRCUTES</b>								
	Panelboard -240V 1 Phase MLO	200 AMP	PCS	1					
29	Panelboard -240V 1 Phase MLO	200 AMP	PCS	1					
	Circuit breaker	15 A	PCS	5					
31	Circuit breaker	20 A	PCS	13					
32	Circuit breaker	30 A	PCS	2					
33	Circuit breaker	40 A	PCS	1					
34	Circuit breaker	50 A	PCS	0					
35	Circuit breaker	60 A	PCS	1					
36	Single Gang Switch Box		PCS	7					
37	Double Gang Switch Box		PCS	4					
38	Triple Gang Switch Box		PCS	2					
39	Pull Box	#1/4	PCS	37					
	Receptacle Box		PCS	34					

#### **PLUMBING BOM**



#### Wisdom-3Bd2Ba-Traditional

	Wisdom-3Bd2Ba-Traditional								
	PL	UMBING SYSTEN	/ MATERIA	L SHOPE	PING LIST	•			
No.	Item	Туре	Unit		Unit Price	Total	Description		
Δ	PLUMBING FIXTURES & ACCESSORIES								
1	Bath Tub (Alcove Tub)		PCS	0					
2	Kitchen Sink		PCS	1					
3	Kitchen Faucets		PCS	1					
4	Vanity Sink		PCS	3					
5	Bath room Faucets		PCS	3					
6	Water Closet		PCS	2					
7	Shower Trim		PCS	2					
8	Shower Tray		PCS	2					
9	Water Heater		PCS	1					
10	Hose Bib		PCS	1					
11	Shutoff Valve		PCS	10					
12	Hanging pipe clamp		PCS	19					
13	Gate Valve		PCS	1					
14	Dishwasher Supply Single Connector		PCS	1					
15	Dishwasher Sewage Single Connector		PCS	1					
16	Laundry Sweat Connector		PCS	1					
Δ	SANITARY & PLUMBING PIPES								
1	ABS (Acrylonitrile Butadiene Styrene) Pipes	ø 1"	FT	0					
2	ABS (Acrylonitrile Butadiene Styrene) Pipes	ø 1 1/2"	FT	31					
3	ABS (Acrylonitrile Butadiene Styrene) Pipes	ø 2"	FT	61					
4	ABS (Acrylonitrile Butadiene Styrene) Pipes	ø 3"	FT	39					
5	PEX (Cross-linked polyethylene) Pipes	ø 1/2"	FT	180					
6	PEX (Cross-linked polyethylene) Pipes	ø 3/4"	FT	18					
7	PEX (Cross-linked polyethylene) Pipes	ø 1"	FT	0					
8	PVC Pipes Sch.80 - Rigid	ø 1 1/2"	FT	0					
9	PVC Pipes Sch.80 - Rigid	ø 2"	FT	58					
10	PVC Pipes Sch.80 - Rigid	ø 3"	FT	0					
11	Flex Pipe Round	ø 1/2"	PCS	10					

#### **PLUMBING BOM**



Δ	PIPE FITTINGS				
1	ABS 90 Degree Bend Elbow	1 1/2"ø-1 1/2"ø	PCS	5	
2	ABS 90 Degree Bend Elbow	2"ø-2"ø	PCS	2	
3	ABS 90 Degree Bend Elbow	3"ø-3"ø	PCS	4	
4	ABS P-Trap	1 1/2"ø-1 1/2"ø	PCS	4	
5	ABS P-Trap	2"ø-2"ø	PCS	1	
6	ABS Reducer Elbow	2"ø-1 1/2"ø	PCS	4	
7	ABS Reducer Elbow	3"ø-2"ø	PCS	2	
8	ABS TEE Elbow	1 1/2"ø-1 1/2"ø-1 1/2"ø	PCS	4	
9	ABS TEE Elbow	2"ø-2"ø-2"ø	PCS	3	
10	ABS TEE Elbow	3"ø-3"ø-3"ø	PCS	3	
11	ABS Tee Reducer Elbow	2"ø-2"ø-1 1/2"ø	PCS	1	
12	ABS Tee Reducer Elbow	3"ø-3"ø-1 1/2"ø	PCS	1	
13	ABS Tee Reducer Elbow	3"ø-3"ø-2"ø	PCS	1	
14	ABS Trap P	2"ø-2"ø	PCS	1	
15	ABS Vent Cap Elbow	1 1/2"ø	PCS	1	
16	ABS Vent Cap Elbow	2"ø	PCS	4	
17	ABS WASTE DOUBLE TEE	2"ø-2"ø-2"ø	PCS	1	
18	ABS Wye Combination with 8th Bend Elbow	3"ø-3"ø-1 1/2"ø	PCS	1	
19	ABS Wye Combination with 8th Bend Elbow	3"ø-3"ø-2"ø	PCS	2	
20	PEX 90 Degree Elbow	1/2"ø-1/2"ø	PCS	40	
21	PEX 90 Degree Elbow	3/4"ø-3/4"ø	PCS	4	
22	PEX Tee Elbow	1/2"ø-1/2"ø-1/2"ø	PCS	16	
23	PEX Tee Elbow	3/4"ø-3/4"ø-3/4"ø	PCS	2	
24	PEX Transition Elbow	1"ø-3/4"ø	PCS	2	
25	PEX Transition Elbow	3/4"ø-1/2"ø	PCS	3	
26	PVC 90 Deg Bend Elbow	2"ø-2"ø	PCS	21	

#### **HVAC BOM**



	Wisdom-3Bd2Ba-Traditional										
	HVAC SYSTEM MATERIAL SHOPPING LIST										
No.	Item	Туре	Unit	Quantity	Unit Price	Total	Description				
$\triangle$	HVAC_DUCTS										
1	PIPE (REFRIGERANT LINE)	3/8" (Ø)	FT	116.12							
2	PIPE (REFRIGERANT LINE)	3/4" (Ø)	FT	155.96							
3	DRAYER HOSE	4" (Ø)	FT	11.2							
4	FLEX DUCT ROUND	4" (Ø)	FT	7.21							
$\triangle$	DUCT FITTINGS & ACCESSORIES										
8	ELBOW (REFRIGERANT LINE)	1/2" (Ø)-1/2" (Ø)	PCS	1							
9	ELBOW (REFRIGERANT LINE)	3/4" (Ø)-3/4" (Ø)	PCS	39							
10	ELBOW (REFRIGERANT LINE)	3/8" (Ø)-3/8" (Ø)	PCS	30							
11	TEE (REFRIGERANT LINE)	3/4" (Ø)-3/4" (Ø)-3/4" (Ø)	PCS	3							
12	TEE (REFRIGERANT LINE)	3/8" (Ø)-3/8" (Ø)-3/8" (Ø)	PCS	3							
13	TRANSITION (REFRIGERANT	3/4" (Ø)-1/2" (Ø)	PCS	4							
14	TRANSITION (REFRIGERANT	3/4" (Ø)-5/8" (Ø)	PCS	4							
15	ROUND TRANSITION (DUCT)	45 DEGREE	PCS	8							
$\triangle$	HVAC_EQUIPMENTS										
19	AIR HANDLING UNIT	WALL MOUNTED	PCS	4							
20	CONDENSER	OUTDOOR UNIT	PCS	1							
21	EXHAUST FAN	75 CFM	PCS	2							
22	HOOD-WALL: VENT	HOOD-WALL: VENT	PCS	1							
23	DRAYER: VENT	DRAYER: VENT	PCS	1							
24	ROOF VENT	3"(Ø)	PCS	3							



#### **Table Of Content**

#	Name	Link	Page No
1	Cover Page	<u>Cover Page</u>	1
2	TOC	TOC	2
3	ELECTRICAL BOM	ELECTRICAL BOM	3
5	HVAC BOM	HVAC BOM	7
4	PLUMBING BOM	PLUMBING BOM	10
6	ARCHITECTURAL BOM	ARCHITECTURAL BOM_	15

#### **Have It Your Way!**

The material types listed in this document were selected based on personal preferences. The Customer is encouraged to make changes to the material types in accordance with local customs, regulations, and personal preferences. Have It Your Way!

#### **GENERAL NOTES**

- This BOM (Bill of Materials) is prepared as a Materials Shopping List to help builders and DIYers gain a complete understanding of most if not all elements required for the complete construction of this structure, according to the original design documents provided by FrameUpNow.
- <sup>2</sup> All quantities and specifications are subject to change based on the final design, field measurements, availability of products and customer preferences. The customer should verify all information prior to purchasing materials.
- 3 All products and elements in the list shall conform to the International Residential Code (IRC), or any other local and international building codes, safety regulations, and standards that are applicable to the location of the structure.
- 4 If any changes are made by the customer to the list of materials specified in this document, the customer is responsible for assuring that the correct type and quantity of materials are utilized in accordance with local building codes.
- FrameUpNow, will not be held responsible for any misuse of this document, the products listed, or for deviations from the content that are made due to changes in specifications, pricing, availability, or customer preferences.
- The customer is advised to consult a qualified professional or technician prior to purchasing materials for specialized construction system items. Some items including but not limited to caseworks, doors and windows may require as built measurements prior to purchase to confirmation of final dimensions.
- 7 If there are additional trim elements or specific installation methods, the total amount of materials needed might vary. Consider any additional trim required for corners, intersections, or other architectural details that might cause this variations before procedding to purchase and construction.



			LIGHTING FIXTURES				
#	Lighting	Туре	Description, Manufacturer, SKU	Unit	Quantity	Unit Price	Total
1	Kitchen Ceiling Light			PCS	3		
2	Exterior Wall Mounted Light			PCS	6		
3	Livingroom Ceiling Light With Fan			PCS	0		
4	Bedroom Ceiling Light With Fan			PCS	3		
5	Dining Ceiling Light			PCS	0		
6	Bath Wall Mounted Light			PCS	3		
7	Bathroom Ceiling Light			PCS	6		
8	Livingroom Ceiling Light			PCS	7		
9	Bedroom Ceiling Light			PCS	12		
10	Hall & Entry Ceiling Light			PCS	0		
11	Closet Ceiling Light			PCS	1		
12	Smoke Detector			PCS	6		
13							
14							
15							



			ELECTI	RICAL FITTINGS				
#	Item	Туре	Description	, Manufacturer, SKU	Unit	Quantity	Unit Price	Total
1	Standard Receptacle 120V	20A			PCS	16		
2	GFCI Receptacle 120V	20 A			PCS	14		
3	GFCI Receptacle 240V	30 A			PCS	2		
4	GFCI Receptacle 240V	40 A			PCS	1		
5	GFCI Receptacle 240V	60 A			PCS	1		
6	Fan Switch				PCS	3		
7	Single Pole Switch				PCS	15		
8	Three Way Switch				PCS	2		
9	Dimmer Switch				PCS	3		
10								
11								
12								
13								
14								
15								



			ELECTRICAL CONDUITS & WIRING				
#	Item	Туре	Description, Manufacturer, SKU	Unit	Quantity	Unit Price	Total
1	ROMEX 14 AWG	14/2/W/ground		FT	192		
2	ROMEX 12 AWG	12/2/W/ground		FT	420		
3	ROMEX 10 AWG	10/3/W/ground		FT	20		
1	ROMEX 8 AWG	8/3/W/ground		FT	41		
5	ROMEX 6 AWG	6/3/W/ground		FT	19		
5	Bare Copper Ground Wire 6 AWG			FT			
7							
3							
.0							
.1							
.2							
L3							
.4							
.5							



		ELI	ECTRICAL BOXES & CIRCUTES				
#	Item	Туре	Description, Manufacturer, SKU	Unit	Quantity	Unit Price	Total
1	Panelboard -240V 1 Phase MLO	200 AMP		PCS	1		
2	Circuit breaker	15 A		PCS	5		
3	Circuit breaker	20 A		PCS	13		
4	Circuit breaker	30 A		PCS	2		
5	Circuit breaker	40 A		PCS	1		
6	Circuit breaker	60 A		PCS	1		
7	Single Gang Switch Box			PCS	7		
8	Double Gang Switch Box			PCS	4		
9	Triple Gang Switch Box			PCS	2		
10	Pull Box	#1/4		PCS	37		
11	Receptacle Box			PCS	34		
12							
13							
14							
15							
16							

#### **HVAC BOM**



		HVAC_DUCTS 01							
#	Item	Туре	Description, Manufacturer, SKU	Unit	Quantity	Unit Price	Total		
1	PIPE (REFRIGERANT LINE)			FT	116.12				
2	PIPE (REFRIGERANT LINE)			FT	155.96				
		4" (Ø)		FT	11.2				
4	FLEX DUCT ROUND	4" (Ø)		FT	7.21				
5									
6									
7									
8									
9									
10									
11									
12									
13									
14									
15									

# **HVAC BOM**



		ı	OUCT FITTINGS & ACCESSORIES				
#	Item	Туре	Description, Manufacturer, SKU	Unit	Quantity	Unit Price	Total
1	ELBOW (REFRIGERANT LINE)	1/2" (Ø)-1/2" (Ø)		PCS	1		
	ELBOW (REFRIGERANT LINE)	3/4" (Ø)-3/4" (Ø)		PCS	39		
3	ELBOW (REFRIGERANT LINE)	3/8" (Ø)-3/8" (Ø)		PCS	30		
4	TEE (REFRIGERANT LINE)	3/4" (Ø)-3/4" (Ø)-3/4" (Ø)		PCS	3		
5	TEE (REFRIGERANT LINE)			PCS	3		
6	TRANSITION (REFRIGERANT LINE)	3/4" (Ø)-1/2" (Ø)		PCS	4		
7	TRANSITION (REFRIGERANT LINE)	3/4" (Ø)-5/8" (Ø)		PCS	4		
8	ROUND TRANSITION (DUCT)	45 DEGREE		PCS	8		
9							
10							
11							
12							
13							
14							
15							

# **HVAC BOM**



			HVAC_EQUIPMENTS				
#	Item	Туре	Description, Manufacturer, SKU	Unit	Quantity	Unit Price	Total
1	AIR HANDLING UNIT	WALL MOUNTED		PCS		4	
2	CONDENSER	OUTDOOR UNIT		PCS		1	
3	EXHAUST FAN	75 CFM		PCS		2	
4	HOOD-WALL: VENT	HOOD-WALL: VENT		PCS		1	
5	DRAYER: VENT	DRAYER: VENT		PCS		1	
6	ROOF VENT	3"(Ø)		PCS		3	
7							
8							
9							
10							
11							
12							
13							
14							
15							



		PLUMBI	NG FIXTURES & ACCESSORIES			
#	Item	Туре	Description, Manufacturer, SKU	Unit	Quantity Unit	Price  Total
1	Bath Tub (Alcove Tub)			PCS	0	
2	Kitchen Sink			PCS	1	
3	Kitchen faucets			PCS	1	
4	Vanity Sink			PCS	3	
5	Bath room faucets			PCS	3	
6	Water Closet			PCS	2	
7	Shower Trim			PCS	2	
8	Shower Tray			PCS	2	
9	Water Heater			PCS	1	
10	Hose Bib			PCS	1	
11	Shutoff Valve			PCS	10	
12	Hanging pipe clamp			PCS	14	
13	Gate Valve			PCS	1	
14	Dishwasher Supply Single Connector			PCS	1	
15	Dishwasher Sewage Single Connector			PCS	1	
16	Laundry Sweat Connector			PCS	1	



		SANI	TARY & PLUMBING PIPES				
ŧ	Item	Туре	Description, Manufacturer, SKU	Unit	Quantity	Unit Price	Total
	ABS (Acrylonitrile Butadiene Styrene) Pipes	ø 1"		FT	0		
!	ABS (Acrylonitrile Butadiene Styrene) Pipes	ø 1 1/2"		FT	31		
	ABS (Acrylonitrile Butadiene Styrene) Pipes	ø 2"		FT	61		
	ABS (Acrylonitrile Butadiene Styrene) Pipes	ø 3"		FT	39		
)	PEX (Cross-linked polyethylene) Pipes	ø 1/2"		FT	180		
)	PEX (Cross-linked polyethylene) Pipes	ø 3/4"		FT	18		
1	PEX (Cross-linked polyethylene) Pipes	ø 1"		FT	0		
}	PVC Pipes Sch.80 - Rigid	ø 1 1/2"		FT	0		
	PVC Pipes Sch.80 - Rigid	ø 2"		FT	58		
0	PVC Pipes Sch.80 - Rigid	ø 3"		FT	0		
1	Flex Pipe Round	ø 1/2"		PCS	10		
2							
3							
4							
5							



		PIPI	FITTINGS 01				
#	Item	Туре	Description, Manufacturer, SKU	Unit	Quantity	Unit Price	Total
1	ABS 90 Degree Bend Elbow	1 1/2"ø-1 1/2"ø		PCS	5		
2	ABS 90 Degree Bend Elbow	2"ø-2"ø		PCS	2		
3	ABS 90 Degree Bend Elbow	3"ø-3"ø		PCS	4		
4	ABS P-Trap	1 1/2"ø-1 1/2"ø		PCS	4		
5	ABS P-Trap	2"ø-2"ø		PCS	1		
6	ABS Reducer Elbow	2"ø-1 1/2"ø		PCS	4		
7	ABS Reducer Elbow	3"ø-2"ø		PCS	2		
8	ABS TEE Elbow	1 1/2"ø-1 1/2"ø-1 1/2"ø		PCS	4		
9	ABS TEE Elbow	2"ø-2"ø-2"ø		PCS	3		
10	ABS TEE Elbow	3"ø-3"ø-3"ø		PCS	3		
11	ABS Tee Reducer Elbow	2"ø-2"ø-1 1/2"ø		PCS	1		
12	ABS Tee Reducer Elbow	3"ø-3"ø-1 1/2"ø		PCS	1		
13	ABS Tee Reducer Elbow	3"ø-3"ø-2"ø		PCS	1		
14	ABS Trap P	2"ø-2"ø		PCS	1		
15	ABS Vent Cap Elbow	1 1/2"ø		PCS	1		



		PI	PE FITTINGS 02				
#	Item	Туре	Description, Manufacturer, SKU	Unit	Quantity	Unit Price	Total
1	ABS Vent Cap Elbow	2"ø		PCS	4		
2	ABS WASTE DOUBLE TEE	2"ø-2"ø-2"ø		PCS	1		
3	ABS Wye Combination with 8th Bend Elbow	3"ø-3"ø-1 1/2"ø		PCS	1		
4	ABS Wye Combination with 8th Bend Elbow	3"ø-3"ø-2"ø		PCS	2		
5	PEX 90 Degree Elbow	1/2"ø-1/2"ø		PCS	40		
6	PEX 90 Degree Elbow	3/4"ø-3/4"ø		PCS	4		
7	PEX Tee Elbow	1/2"ø-1/2"ø-1/2"ø		PCS	16		
8	PEX Tee Elbow	3/4"ø-3/4"ø-3/4"ø		PCS	2		
9	PEX Transition Elbow	1"ø-3/4"ø		PCS	2		
10	PEX Transition Elbow	3/4"ø-1/2"ø		PCS	3		
11	PVC 90 Deg Bend Elbow	2"ø-2"ø		PCS	21		



			APPLIANCES			
#	Item	Туре	Description, Manufacturer, SKU	Unit	Quantity Unit Price	Total
1	Refrigerator			PCS	1	
2	Range			PCS	1	
3	Washer Front Load	Stackable		PCS	1	
4	Dryer Front Load	Stackable		PCS	1	
5	Dish Washer			PCS	1	
6	Oven			PCS	0	
7	Microwave			PCS	0	
8						
9						
10						
11						
12						
13						
14						
15						



			CASEWORKS 01			
#	Item	Туре	Description, Manufacturer, SKU	Unit	Quantity Unit Pr	ice Total
1	Kitchen Cabinet			FT	19.6	
2	Laundry Cabinet			FT	0	
3	Vanity Cabinet			FT	9.42	
4	Medicine Cabinet			PCS	3	
5	Kitchen countertop			SF	31.29	
6	Laundry Countertop			PCS	0	
7	Bathroom Countertop			SF	0	
8	Island			FT	0	
9	Peninsula			FT	0	
10	Closets			SF	106.25	
11						
12						
13						
14						
15						



			CEILING 01				
#	Item	Туре	Description, Manufacturer, SKU	Unit	Quantity	Jnit Price	Total
	LIVING ROOM + KITCHEN			SF	486.6		
_	Ceiling Board	Drywall		SF	487		
	Drywall Fastener	Screw		PCS	852		
l	Vapor Retarder	Polyethylene film		SF	486.6		
ļ	Vapor Retarder Fastener	Nails with washer heads		PCS	1459.8		
	BATHROOM 1			SF	86.4		
i	Ceiling Board	MRD (Moisture resistant drywall)		SF	86		
5	MRD Fastener	Screw		PCS	151		
	BATHROOM 2			SF	61.6		
•	Ceiling Board	MRD (Moisture resistant drywall)		SF	62		
l	MRD Fastener	Screw		PCS	108		
)	WD			SF	21.7		
.0	Ceiling Board	Drywall		SF	22		
	Drywall Fastener	Screw		PCS	38		
1	Vapor Retarder	Polyethylene film		SF	21.7		
12	Vapor Retarder Fastener	Nails with washer heads		PCS	65.1		



			CEILING 02				
#	Item	Туре	Description, Manufacturer, SKU	Unit	Quantity Unit F	rice	Total
	BED ROOM 1			SF	190.7		
13	Ceiling Board	Drywall		SF	191		
14	Drywall Fastener	Screw		PCS	334		
15	Vapor Retarder	Polyethylene film		SF	190.7		
16	Vapor Retarder Fastener	Nails with washer heads		PCS	572.1		
	BEDROOM 2			SF	145.6		
17	Ceiling Board	Drywall		SF	146		
18	Drywall Fastener	Screw		PCS	255		
19	Vapor Retarder	Polyethylene film		SF	145.6		
20	Vapor Retarder Fastener	Nails with washer heads		PCS	436.7		
	BEDROOM 3			SF	142.3		
21	Ceiling Board	Drywall		SF	142		
22	Drywall Fastener	Screw		PCS	249		
23	Vapor Retarder	Polyethylene film		SF	142.3		
24	Vapor Retarder Fastener	Nails with washer heads		PCS	426.9		



		CEILING 03									
#	Item	Туре	Description, Manufacturer, SKU	Unit	Quantity Unit Price	Total					
	W/C			SF	28.5						
25	Ceiling Board	Drywall		SF	29						
26	Drywall Fastener	Screw		PCS	50						
15	Vapor Retarder	Polyethylene film		SF	28.5						
16	Vapor Retarder Fastener	Nails with washer heads		PCS	85.6						
	CLOSET 2			SF	15.5						
17	Ceiling Board	Drywall		SF	16						
18	Drywall Fastener	Screw		PCS	27						
19	Vapor Retarder	Polyethylene film		SF	15.5						
20	Vapor Retarder Fastener	Nails with washer heads		PCS	46.5						
	CLOSET 3			SF	16.5						
21	Ceiling Board	Drywall		SF	16						
22	Drywall Fastener	Screw		PCS	29						
23	Vapor Retarder	Polyethylene film		SF	16.5						
24	Vapor Retarder Fastener	Nails with washer heads		PCS	49.5						
	FAU	·		SF	8.0						
25	Ceiling Board	MRD (Moisture resistant drywall)		SF	8						
26	MRD Fastener	Screw		PCS	14						



			CEILING 04				
#	Item	Туре	Description, Manufacturer, SKU	Unit	Quantity	Unit Price	Total
	WH			SF	7.3		
25	Ceiling Board	Drywall		SF	7		
6	Drywall Fastener	Screw		PCS	13		
.5	Vapor Retarder	Polyethylene film		SF	7.3		
16	Vapor Retarder Fastener	Nails with washer heads		PCS	22.0		
17							
.8							
9							
.0							
1							
2							
!3							
!4							
.5							



			FLOORING INTERIOR 01			
#	Item	Туре	Description, Manufacturer, SKU	Unit	Quantity Unit Price	Total
	BEDROOM #1					
1	Bedroom Flooring			SF	171.1	
2	Wood underlay	Foam Pad Polyethylene		SF	171.1	
3	Vapor Retarder	Vapor Barrier Polyethylene		SF	171.1	
	BEDROOM #2					
4	Bedroom Flooring			SF	130.8	
5	Wood underlay	Foam Pad Polyethylene		SF	130.8	
6	Vapor Retarder	Vapor Barrier Polyethylene		SF	130.8	
	BEDROOM#3					
7	Bedroom Flooring			SF	127.1	
8	Wood underlay	Foam Pad Polyethylene		SF	127.1	
9	Vapor Retarder	Vapor Barrier Polyethylene		SF	127.1	
	CL #1					
10	Closet Flooring			SF	24.8	
11	Wood underlay	Foam Pad Polyethylene		SF	24.8	
12	Vapor Retarder	Vapor Barrier Polyethylene		SF	24.8	



			FLOORING INTERIOR 02			
#	Item	Туре	Description, Manufacturer, SKU	Unit	Quantity Unit Price	Total
	CL #2					
13	Closet Flooring			SF	14.7	
14	Wood underlay	Foam Pad Polyethylene		SF	14.7	
15	Vapor Retarder	Vapor Barrier Polyethylene		SF	14.7	
	CL#3					
16	Closet Flooring			SF	12.1	
17	Wood underlay	Foam Pad Polyethylene		SF	12.1	
18	Vapor Retarder	Vapor Barrier Polyethylene		SF	12.1	
	LIVING ROOM AND KITCH	EN				
19	Living Area Flooring			SF	435.9	
20	Wood underlay	Foam Pad Polyethylene		SF	435.9	
21	Vapor Retarder	Vapor Barrier Polyethylene		SF	435.9	
	BATHROOM #1					
22	Tile Finish			SF	42.1	
23	Adhesive	1/2" Thin set Mortar		SF	42.1	
23	Vapor Retarder	Vapor Barrier Polyethylene		SF	42.1	



			FLOORING INTERIOR 03	3		
#	Item	Туре	Description, Manufacturer, SKU	Unit	Quantity Unit Price	Total
	BATHROOM #2					
24	Tile Finish			SF	34.8	
25	Adhesive	1/2" Thin set Mortar		SF	34.8	
26	Vapor Retarder	Vapor Barrier Polyethylene		SF	34.8	
	BATHROOM #3					
27	Tile Finish			SF	20.6	
28	Adhesive	1/2" Thin set Mortar		SF	20.6	
29	Vapor Retarder	Vapor Barrier Polyethylene		SF	20.6	
	W/D					
30	Tile Finish			SF	19.5	
31	Adhesive	1/2" Thin set Mortar		SF	19.5	
32	Vapor Retarder	Vapor Barrier Polyethylene		SF	19.5	
	BOILER ROOM #1					
33	Tile Finish			SF	7.3	
34	Adhesive	1/2" Thin set Mortar		SF	7.3	
35	Vapor Retarder	Vapor Barrier Polyethylene		SF	7.3	



			FLOORING INTERIOR 04				
#	Item	Туре	Description, Manufacturer, SKU	Unit	Quantity	Unit Price	Total
	BOILER ROOM #2						
	Tile Finish			SF	6.5		
	Adhesive	1/2" Thin set Mortar		SF	6.5		
	Vapor Retarder	Vapor Barrier Polyethylene		SF	6.5		



			FLOORING EXTERIOR				
#	Item	Туре	Description, Manufacturer, SKU	Unit	Quantity Un	it Price	Total
	STRUCTURE			SF	1,316.90		
1	Concrete Slab	4"concrete cast in situ		CF	452.5		
3	Insulation	Rigid insulation		SF	351		
4	Hard core	Compacted soil		CF	355.17		
5	Re-bar	#4 re-bar		Ton	1.19		
6	Concrete Pad	4"concrete cast in situ		CF	1.58		
7	Slab edge	Turndown		CF	370.81		
	PORCH						
1	Tile Finish			SF	124.2		
2	Adhesive	1/2" Thin set Mortar		SF	124.2		
3	Vapor Retarder	Vapor Barrier Polyethylene		SF	124.2		



			WALLS: EXTERIOR				
	Item	Туре	Description, Manufacturer, SKU	Unit	Quantity	Unit Price	Total
1	Exterior-Grade Plywood Horizontal Siding			SF	1280		
2	Exterior-Grade Plywood Fastener 8	Self-drilling screws(100/pkt)		PKT	12.8		
3	Wall Shteathing (OSB)			SF	1280		
4	Shteathing Fastener	Self-drilling screws(100/pkt)		PKT	12.8		
5	Wall Homewrap			SF	1280		
6	Homewrap Fastener	Stapled fastener (200/pkt)		PKT	4.864		
7	Furring Strip			PCS	160		
8	Furring Strip Fastener	Self-drilling screws(100/pkt)		PKT	12.8		
9	Wall Paint			SF	1280		
10	Stone Copping	Masonry stone		SF	0		
11	Stone Veneer	Masonry stone		SF	0		
12	Mortar for Stone Veneer			SF	0		
13	Wall Insulation			SF	4273		



			WALLS: INTERIOR 01			
#	Item	Туре	Description, Manufacturer, SKU	Unit	Quantity Unit Price	Total
	BATHROOM			SF	78	
1	Cementitious Backer Board			SF	414	
2	Kerdi membrane			SF	414	
3	Kerdi membrane Fastener			SF	414	
4	Wall Ceramic Tile			SF	414	
	BATHROOM			SF	46	
5	Cementitious Backer Board			SF	227	
6	Kerdi membrane			SF	227	
7	Kerdi membrane Fastener			SF	227	
8	Wall Ceramic Tile			SF	227	
	PRIMARY SUITE			SF	172	
9	Drywall Board			SF	370	
10	Drywall Fastener	Self-drilling screws(100/pkt)		PKT	3.7	
11	Wall Paint			SF	370	
12	Drywall Tape			FT	69.4	



			WALLS: INTERIOR 02			
#	Item	Туре	Description, Manufacturer, SKU	Unit	Quantity Unit Pri	ce Total
	BEDROOM 2			SF	131	
13	Drywall Board			SF	285	
14	Drywall Fastener	Self-drilling screws(100/pkt)		PKT	2.85	
15	Wall Paint			SF	285	
16	Drywall Tape			FT	53.5	
	BEDROOM 3			SF	126	
17	Drywall Board			SF	418	
18	Drywall Fastener	Self-drilling screws(100/pkt)		PKT	4.18	
19	Wall Paint			SF	418	
20	Drywall Tape			FT	78.42	
21	CLOSET 2			SF	16	
22	Drywall Board			SF	132	
23	Drywall Fastener	Self-drilling screws(100/pkt)		PKT	1.32	
24	Wall Paint			SF	132.0	
	Drywall Tape			FT	24.77	



			WALLS: INTERIOR 03			
#	Item	Туре	Description, Manufacturer, SKU	Unit	Quantity Unit Price	Total
	CLOSET 3			SF	16	
37	Drywall Board			SF	133	
38	Drywall Fastener	Self-drilling screws(100/pkt)		PKT	1.33	
39	Wall Paint			SF	133	
40	Drywall Tape			FT	25.0	
	KITCHEN			SF	116	
41	Cementitious Backer Board			SF	34	
42	Drywall Board			SF	232	
43	Drywall Fastener	Self-drilling screws(100/pkt)		PKT	2.32	
44	Kerdi membrane			SF	34	
	Kerdi membrane Fastener			SF	34	
45	Wall Ceramic Tile			SF	34	
46	Wall Paint			SF	232	
47	Drywall Tape			FT	43.77	



			WALLS: INTERIOR 04			
#	Item	Туре	Description, Manufacturer, SKU	Unit	Quantity Unit Pri	ce Total
	LIVING ROOM			SF	271	
49	Drywall Board			SF	445	
50	Drywall Fastener	Self-drilling screws(100/pkt)		PKT	4.45	
51	Wall Paint			SF	445	
52	Drywall Tape			FT	83.4	
	WD			SF	20	
53	Cementitious Backer Board			SF	160	
54	Kerdi membrane			SF	160	
55	Kerdi membrane Fastener			SF	160	
56	Wall Ceramic Tile			SF	160	
	WH			SF	7	
57	Drywall Board			SF	71	
58	Drywall Fastener	Self-drilling screws(100/pkt)		PKT	0.71	
59	Wall Paint			SF	71	
60	Drywall Tape			FT	13.31	



			WALLS: INTERIOR 05				
#	Item	Туре	Description, Manufacturer, SKU	Unit	Quantity U	Jnit Price	Total
	WIC			SF	24		
61	Drywall Board			SF	184		
62	Drywall Fastener	Self-drilling screws(100/pkt)		PKT	1.84		
63	Wall Paint			SF	184		
64	Drywall Tape			FT	35		
65	FAU			SF	9		
	Cementitious Backer Board			SF	73		
	Kerdi membrane			SF	73		
	Kerdi membrane Fastener			SF	73		
	Wall Ceramic Tile			SF	73		
	Wall Skirting	Ceramic		FT	198.9		



			DOORS			
	Item	Туре	Description, Manufacturer, SKU	Unit	Quantity Unit Price	Total
	Interior Swinging	3' - 0" X 6'-8"		PCS	3	
	Interior Swinging	2' - 6" X 6'-8"		PCS	3	
	Exterior Door With Sidelight	6' - 5" X 7'-0"		PCS	1	
	Interior Sliding	6' - 0" X 6'-8"		PCS	1	
<b>i</b>	Interior Sliding	5' - 0" X 6'-8"		PCS	1	
<b>.</b>	Patio Sliding	5' - 0" X 6'-8"		PCS	2	
1	Bifold Door	4' - 8" X 6'-8"		PCS	1	
3	Pocket Door	2' - 4" X 6'-8"		PCS	1	
)	Interior Swinging	2' - 0" X 6'-8"		PCS	1	
10	Exterior Door Trim			FT	57.1	
	Interior Door Trim			FT	429.48	
.2	Entry Lock set			PCS	3	
13	Privacy Lock set			PCS	6	
L <b>4</b>	Passage Lock set			PCS	5	



	WINDOWS								
#	Item	Туре	Description, Manufacturer, SKU	Unit	Quantity Unit Price	Total			
1	Sliding	3' - 3" X 2'-3"		PCS	2				
2	Hung	2' - 9" X 3'-3"		PCS	6				
3	Sliding	2' - 9" X 3'-3"		PCS	8				
4	Casement	2' - 3" X 3'-3"		PCS	2				
5	Sliding	6' - 3" X 3'-3"		PCS	1				
6	Hung	3' - 3" X 3'-3"		PCS	1				
7	Exterior Window Trim			FT	248				
8	Interior Window Trim			FT	248				
9									
10									
11									
12									
13									
14									
15									
16									



#	ROOF 01								
	Item	Туре	Description, Manufacturer, SKU	Unit	Quantity Unit P	rice Total			
1	Roof Covering			SF	1646.2				
2	Roof Covering Fastener			PCS	823				
3	Roof Felt Paper			SF	1646.2				
4	Roof Felt Paper Fastener			PCS	4938.5				
5	Roof Sheathing			SF	1646.2				
6	Roof Sheathing Fastener			PCS	13169				
7	Batten			FT	0.0				
8	Batten Fastener			PCS	0.0				
9	Soffit			SF	153.0				
10	Soffit Fastener			PCS	76.5				
11	Fascia			FT	186.0				
12	Fascia board fastener			PCS	93				
13	Roof Insulation			SF	1646.2				
14									
15									
16									