


PINNACLE

The Pinnacle is a one-bedroom, one-bathroom home that blends Traditional and Ranch styles. The exterior features light-colored walls with vertical siding and stone veneers. The roof is a simple gable design with a moderate pitch. A prominent covered entryway is supported by slender posts offer a welcoming approach to the front door.


Inside, the home features a rectangular plan. The living and kitchen areas are merged into one room at one end of the plan. The bedroom is located on the opposite end. The bathroom is strategically placed between the living and sleeping areas, enhancing convenience and functionality.

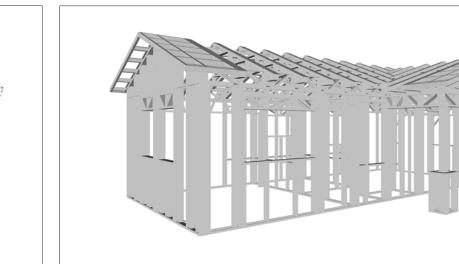

Materials Shopping List

Please print and take this Materials Shopping List to your favorite Home Depot and ask for assistance in selecting the materials, fixtures and fittings to complete your new home.


Record your selection and the price of the item. Then do the math to determine the cost for your selections and the total cost of finishing your home.

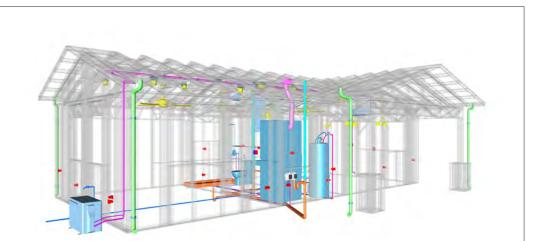

< CLICK HERE >

To Go To Materials Shopping List




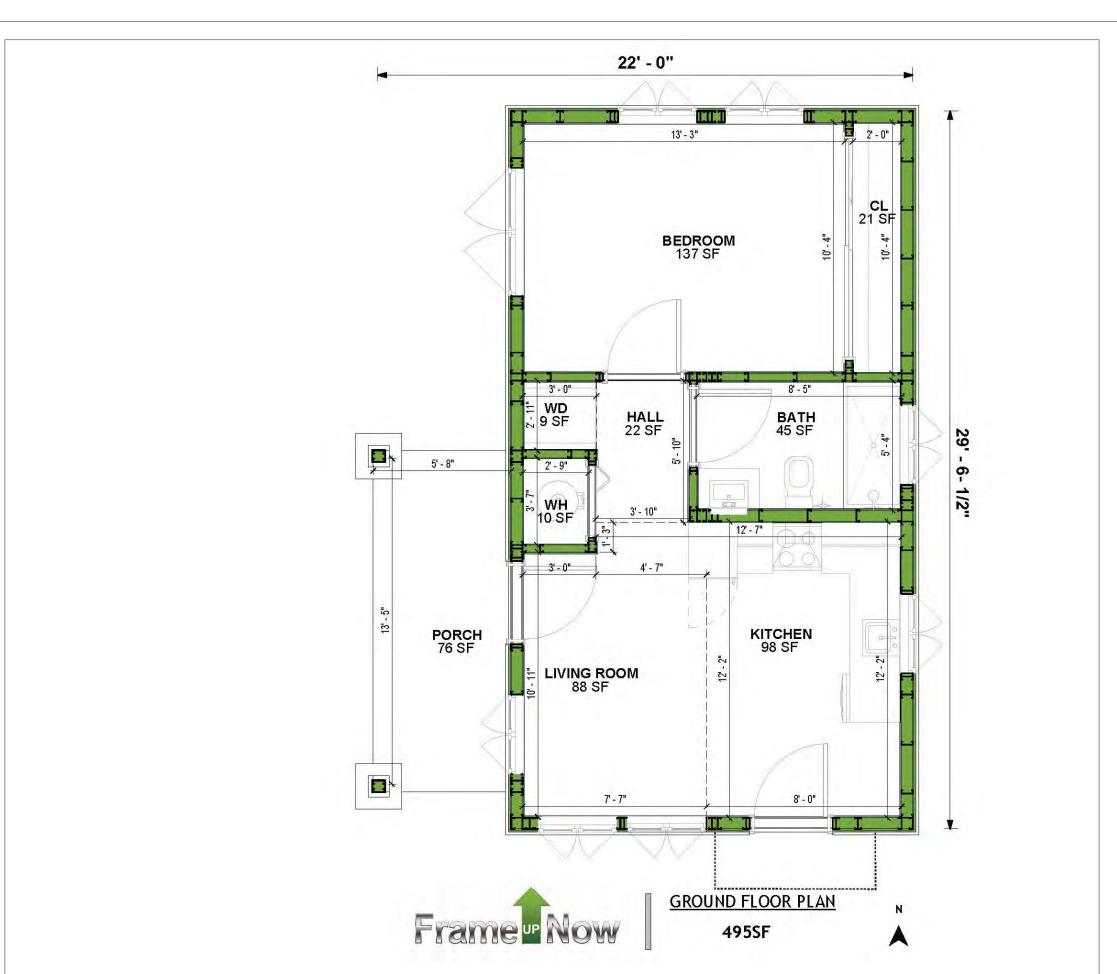

FLOOR PLAN

495 SF

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MATERIALS SHOPPING LIST

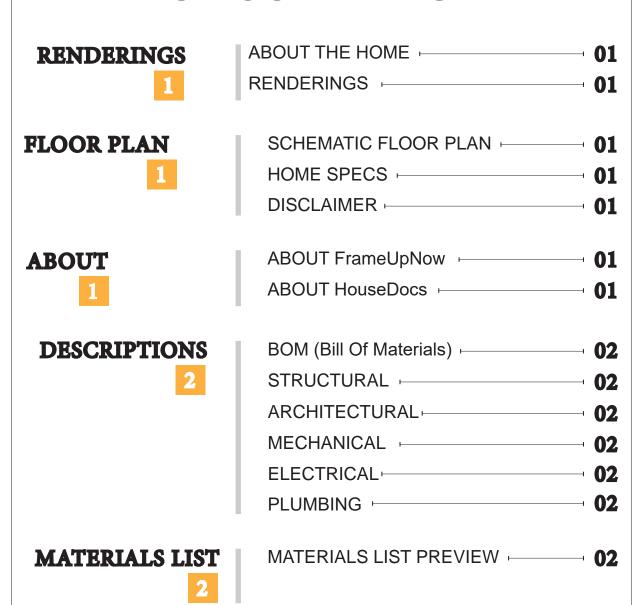COVER SHEET

ABOUT



FrameUpNow is a design and manufacturing company providing precision-engineered home framing solutions. We offer a catalog of Affordable Homes, Tiny Homes, Garages, Shops and Barndominiums. FrameUpNow manufactures cold-formed steel (CFS) also known as Light Gauge Steel (LGS) framing components that conform to our engineered metal house frame plans or can be purchased as DIY skeleton kits.

The CFS/LGS framing is lightweight, easily assembled, and does not require heavy equipment or specialized labor, enabling homeowners to erect the frame themselves in just a few days. Unlike wood, the steel framing is impervious termites and bores, warping, expansion, and fire.

Our home plans come complete with a structural engineered stamp for permit approvals. Customers receive a full BOM also known as a Materials Shopping List to purchase finish materials from a Building Materials retailer. FrameUpNow prides itself on the quality and efficiency of our precision-engineered home framing solutions for construction professionals and DIY homeowners.



KEY PLAN

NO.	DESCRIPTION	DATE

NOTE:

LEGEND:

PROJECT

286-Pinnacle-495-1Bd1Ba-**Traditional-550**

DRAWING NAME

INTRODUCTION

CLIENT NAME:	
PROJECT NUMBER:	
DATE:	
DESIGNED BY:	
DRAWN BY:	
CHECKED BY:	

1101

SCALE:

DISCLAIMER

DISCLAIMER: This documentation and all it's contents are the intellectual property of FrameUpNow. It is provided solely for marketing the services of FrameUpNow. The preliminary information is not approved for actual construction use and is not warranted to be complete or accurate. Unauthorized copying, distribution, or application of these proprietary materials, in any form or format, is strictly prohibited. FrameUpNow assumes no liability for any issues arising from improper use of this marketing content.

DESCRIPTIONS

MATERIALS LIST

The BOM (Bill Of Materials) package, known as the Materials Shopping List document, provides:

Comprehensive Inventory: Detailed lists of essential materials sourced from architectural, mechanical, HVAC, electrical, and plumbing design drawing sets.

Precise Curation: Each item meticulously selected and organized for accuracy and efficiency in project planning.

Customizable Options: Customers can modify listed items to their preferences and calculate costs accordingly, ensuring alignment with personal project needs and budget.

Dedicated Space for Details: Includes tables for customers to note Home Depot SKU numbers or product descriptions for selected items,

facilitating seamless purchasing and coordination with suppliers.

Customer Convenience: Take the list to Home Depot or preferred suppliers for accurate pricing, helping align the total home budget with personal financial plans.

Simplify your construction journey with our Materials Shopping List document, where detailed preparation meets streamlined implementation for your dream home.

STRUCTURAL

The structural drawings package provides an exhaustive set of detailed plans essential for the precise assembly of your building. This comprehensive package includes:

Framing Plans: Detailed layouts for all framing components. Truss Layouts: Clear instructions for truss placement and

Panel Length Plans: Specifications for panel dimensions. Framing Elevations and Sections: Precise elevation and sectional views for accurate construction.

Truss and Wall Blocking Plans: Plans for truss and wall blocking to ensure structural integrity.

Hold-Down Plan: Detailed hold-down requirements for stability. Snap Sheet: Reference sheet for quick identification of components

Structural Details and Bracing Plans: Complete details and bracing plans for all structural elements.

Accompanying these plans is a comprehensive Bill of Materials (BOM) that lists every necessary building component, from cold formed steel (CFS) frames to fasteners.

ARCHITECTURAL

With the comprehensive architectural package, both builders and DIY homeowners can confidently execute the construction.

The architectural package includes:

Furnished Floor Plans: Complete with furniture layouts for a clear understanding of space utilization.

Detailed Dimension Plans: Ensures precise measurements, from the overall footprint down to the exact placement of windows and

Foundation Plan: Detailed plan to establish a solid foundation.

Wall Framing and Truss Layout: Comprehensive plans for wall framing and truss placement.

Architectural Elevations: Exterior views showcasing the design.

Strategic Building Sections: Critical cross-sectional details for a thorough understanding of the build.

Casework Drawings and Diagrams: Suggested designs for built-in caseworks, such as kitchen cabinets.

MECHANICAL

The mechanical package includes everything needed to guide HVAC

Detailed HVAC Floor Plan: Precisely maps out the placement of air handlers, ductwork, and vents throughout the home's layout.

HVAC Sections and Riser Diagrams: Technical drawings offering critical cross-sectional details and piping schematics, ensuring proper integration of the heating and cooling system into the home's structure.

Bill of Materials: A complete list of all necessary HVAC components.

ELECTRICAL

The electrical package includes all the plans and documentation needed to guide the installation of your home's electrical system:

Detailed Power Plan: Precisely maps out the placement of outlets, switches, and other power components throughout the layout.

Comprehensive Lighting Plan: Shows the optimal locations for lighting fixtures, sconces, and other illumination sources to create a well-lit, functional interior.

Dimensioned Electrical Layout: Provides exact dimensions and measurements to ensure proper placement of all electrical elements.

Bill of Materials: A complete list of every component needed, from circuit breakers to wiring.

The plumbing package includes everything needed to guide the

Detailed Water Supply System Plan: Precisely maps out the placement of pipes, valves, and plumbing fixtures throughout the

Comprehensive Sewage System Plan: Shows the optimal routing and sizing of drain lines to effectively remove waste and ensure

Detailed Riser Diagrams: Provide information needed to properly

PLUMBING

installation of your home's water supply and drainage systems:

proper drainage.

install all vertical plumbing risers and vent stacks.

Bill of Materials: A complete list of every component needed, from pipes to fixtures.


BOM (Bill Of Materials) (Separately Attached)





The Bill of Materials (BOM) is a crucial document that compiles the material requirements from different disciplines into a centralized inventory, enabling efficient procurement, inventory management, and cost estimation for a specified project or

ELECTRICAL BOM



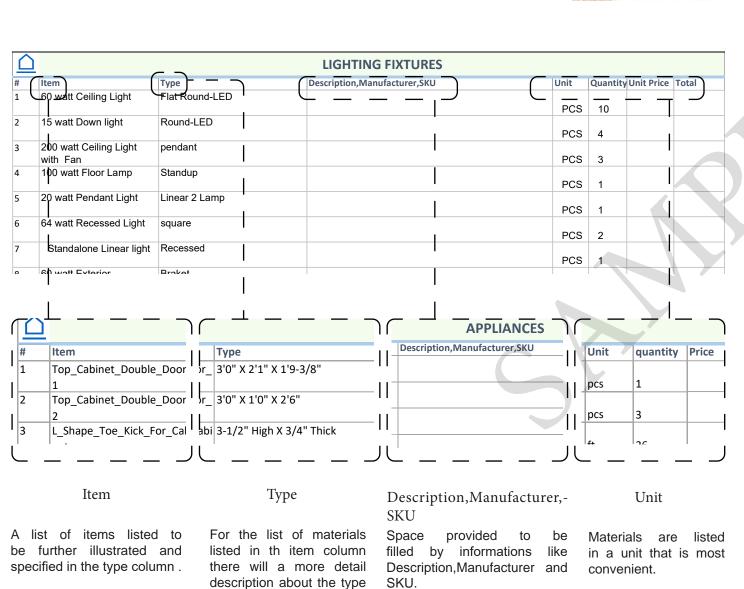

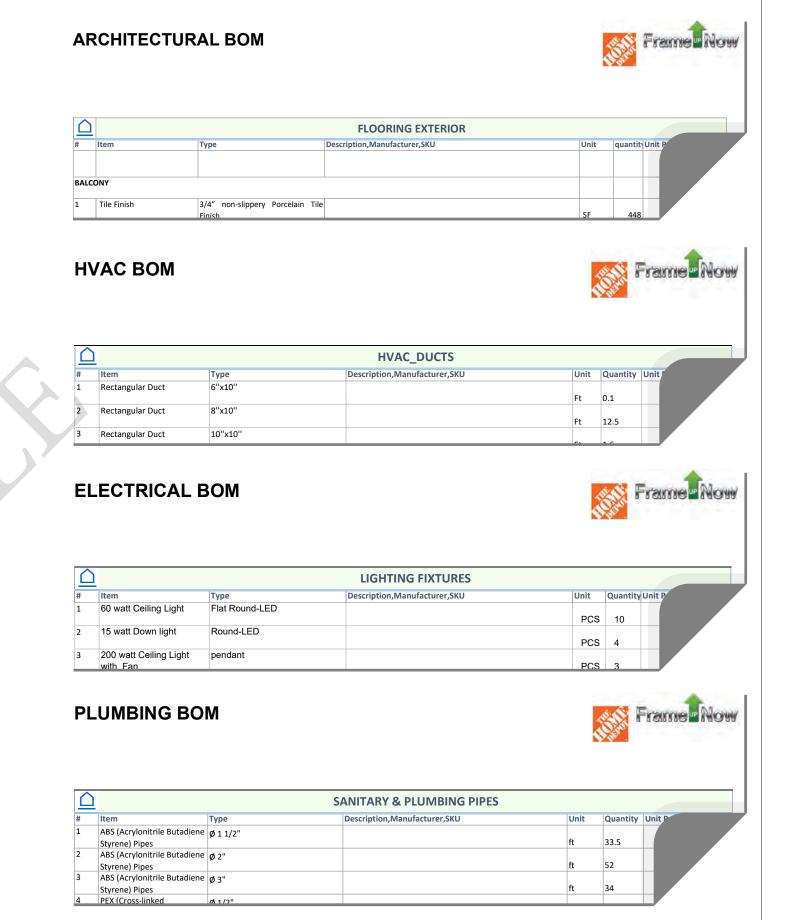

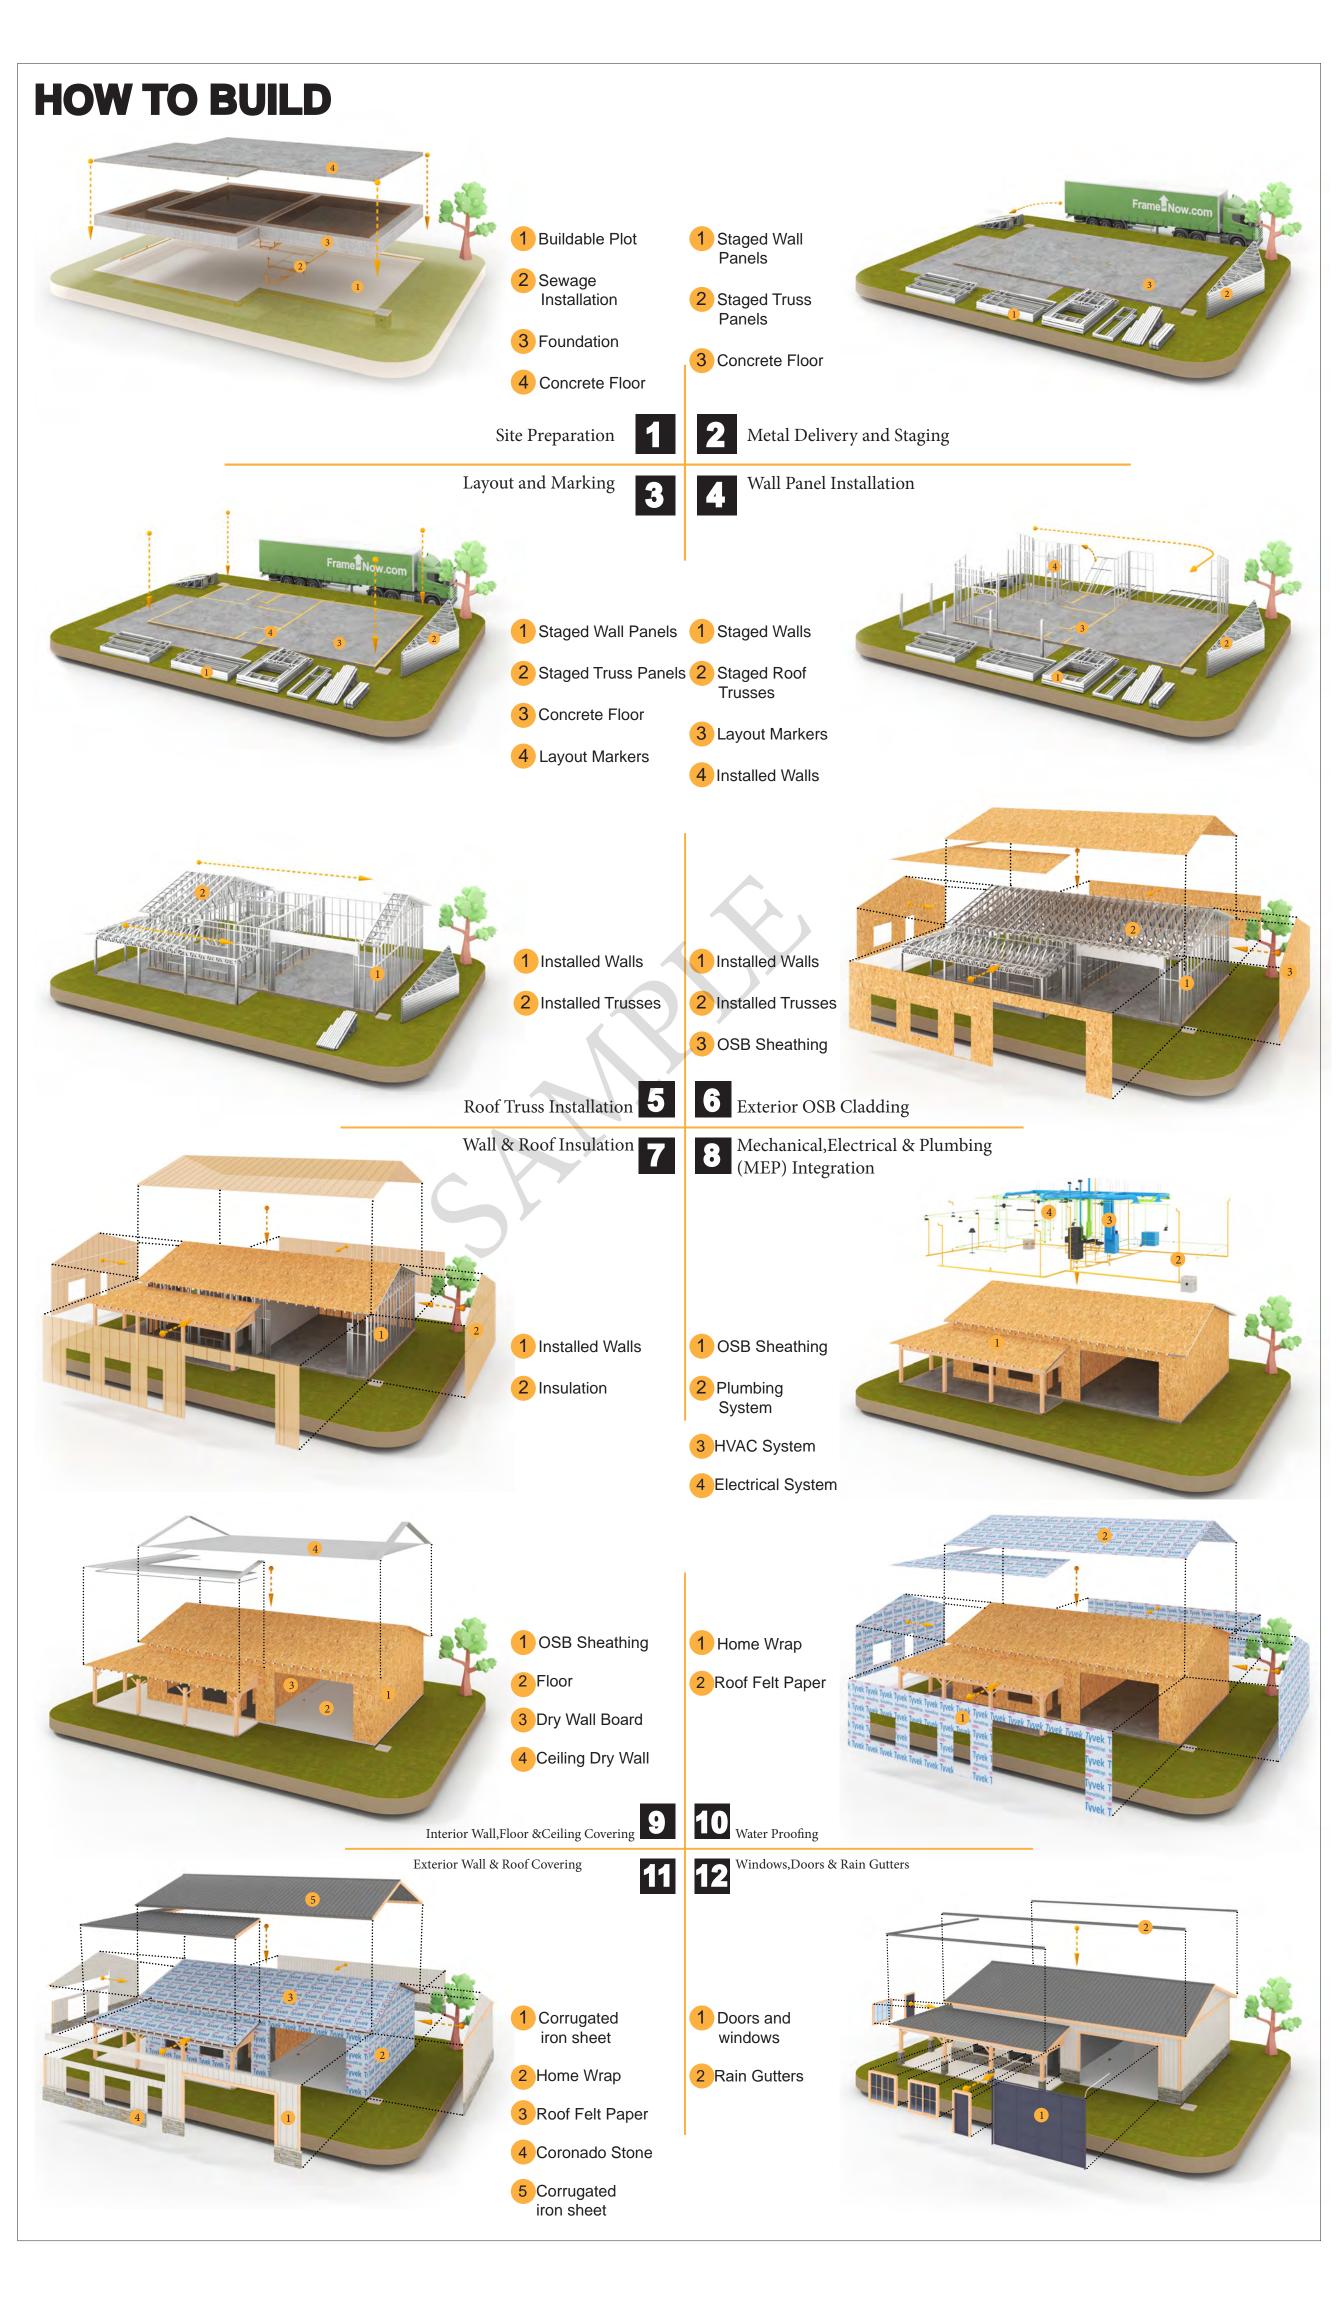



KEY PLAN

NO.	DESCRIPTION	DATE

NOTE:

LEGEND:

PROJECT

286-Pinnacle-495-1Bd1Ba-**Traditional-550**

DRAWING NAME


INTRODUCTION

CLIENT NAME: PROJECT NUMBER: DATE: **DESIGNED BY** DRAWN BY: CHECKED BY:

1102

SCALE:

of the Material.

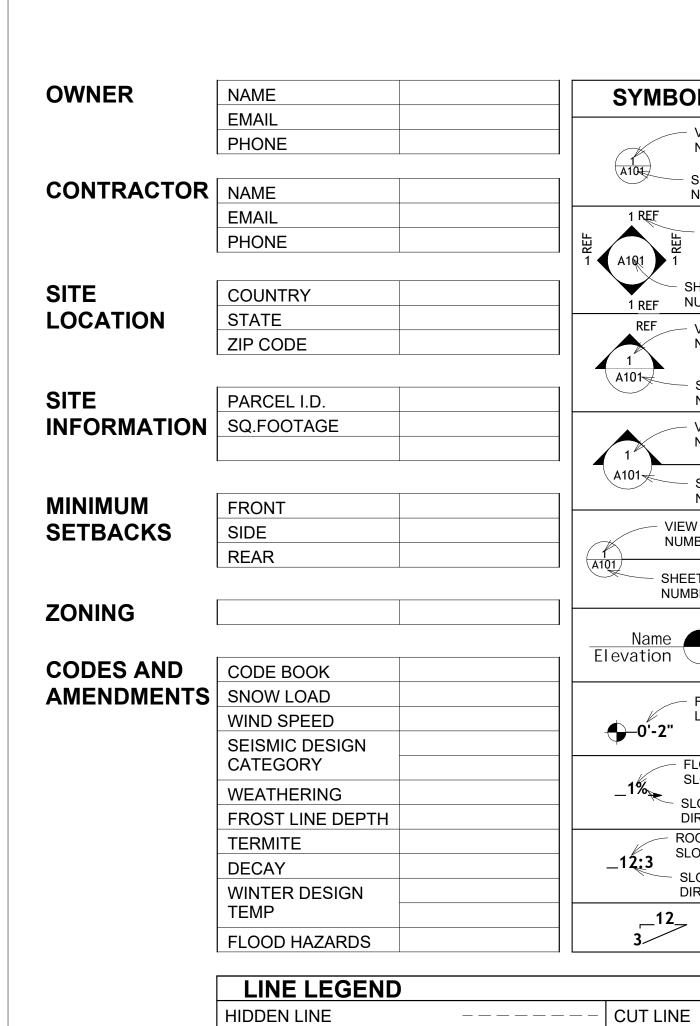

HIDDEN LINE

OVER HEAD

ROOM SEPARATOR

DOOR OPENING DIRECTION

/IBOLS	SYMBOLS NAME		PAGE INDEX
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VIEW NUMBER		A101	FLOOR PLAN
SHEET	CALLOUT HEAD	A102	DIMENSION PLAN
NUMBER		S101	FOUNDATION PLAN
F VIEW		S102	STRUCTURAL FLOOR PLAN
MOMBER OF A	INTERIOR ELEVATION	S103	FRAME LAYOUT
) 1		S104	ROOF TRUSS LAYOUT
SHEET NUMBER		A103	ROOF PLAN
F VIEW		A201	ELEVATIONS
NUMBER	D D 51 51 44 710 11	A202	ELEVATIONS
	BUILDING ELEVATION	A301	SECTIONS
SHEET NUMBER		A401	DETAILS
VIEW		A402	CASEWORK DETAILS
NUMBER		A403	CASEWORK DETAILS
		E101	SCHEDULE
SHEET NUMBER		E102	LIGHTING PLAN
- VIEW		E103	POWER PLAN
NUMBER	DETAIL \ ((E)A(E104	DIMENSION PLAN FOR LIGHT FIXTURE
OUEET	DETAIL VIEW	E105	DIMENSION PLAN FOR FITTING
SHEET NUMBER		P101	COVER SHEET
		P102	WATER SUPPLY SYSTEM
me 🔼	ELEVATION LEVEL	P103	SEWAGE SYSTEM
on 📗		P104	RISER DIAGRAM
- :		M101	HVAC PLAN
FLOOR LEVEL	SPOT ELEVATION	M102	HVAC SECTION
-2"	or or ellevition	M103	RISER DIAGRAM
FLOOR SLOPE SLOPE	FLOOR SLOPE		

W103	RISER DIAGRAM	
TAG	TAG'S NAME	
CA01	CASEWORK TAG	
1	DOOR TAG	
1	FURNITURE TAG	
1	WINDOW TAG	
SE01	SPECIALTY EQUIPMENT TAG	
ME01	MECHANICAL EQUIPMENT TAG	
PE01	PLUMBING EQUIPMENT TAG	



SLOPE DIRECTION

SLOPE DIRECTION

ROOF SLOPE

CALL OUT BOUNDRY — — — — — —

ROOF SLOPE ELEVATION

ROOF SLOPE

GROUND CUT

IVIAA.	
ME	MECHANICAL
MIN.	MINIMUM
NO.	NUMBER
O.C	ON CENTER
OSB	ORIENTED STRAND BOARD
PL	PLUMBING
PSI	POUNDS PER SQUARE INCH
PVC	POLYVINYL CHLORIDE
REF	REFERENCE
RG	RIGHT GARAGE
SE	SPECIAL EQUIPMENT
SF	SQUARE FEET
SIMP. STHD8	SIMPSON STRAP THE HOLDDOWN
SIMP. ABE66	SIMPSON ANCHOR BOLT EDGE
TV	TELEVISION
UNO	UNLESS NOTED OTHERWISE
W/	WITH
W/D	WASHER/DRYER
AC	AIR CONDITIONING UNIT
ACC	AIR COOLED CONDENSER
ACCU	AIR COOLED CONDSENSING UNIT
AHU	AIR HANDLING UNIT
CC	COOLING COIL
CD	CEILING DIFFUSER
CFm	Cubic Feet Per Minute
CR	CEILING REGISTER
CU	CONDENSING UNIT
CW	COLD WATER
E/A	EXHAUST AIR
EF	EXHAUST FAN
ET	EXPANSION TANK
EX.	EXISTING
FC	FLEXIBLE CONNECTION
FCU	FAN COIL UNIT
FLR.	FLOOR
HC	HEATING COIL
HE	AIR TO AIR HEAT EXCHANGER
HV	HEATING AND VENTILATING UNIT
IV	INLET VANES
MER	MECHANICAL ROOM
MAX.	MAXIMUM
MIN.	MINIMUM
R/A	RETURN AIR
RCU	RECIPROCATING CHILLER UNIT
RF	RETURN FAN
	SUPPLY AIR
S/A	SMOKE CONTROL DAMPER
SCD	

ABBREVIATION

CASEWORK ELECTRICAL

FOOTINGS

MAXIMUM

F.F.L

HVAC

ACTION FLOOR SYSTEMS

AMERICAN SOCIETY FOR TESTING AND MATERIAL


FINISHED FLOOR ELEVATION


HEATING, VENTILATION & AIR CONDITIONING


INTERNATIONAL RESIDENCE

INTERNATIONAL MECHANICAL

FINISHED FLOOR LEVEL

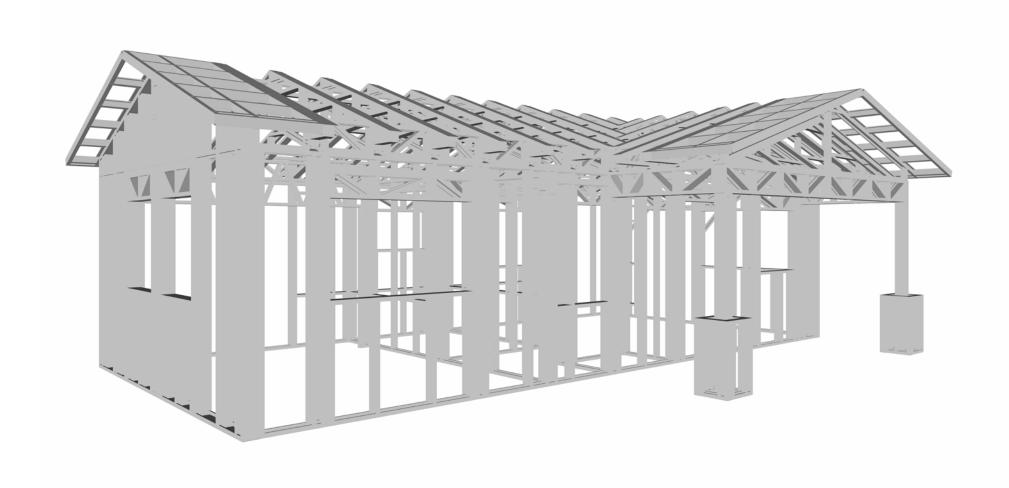

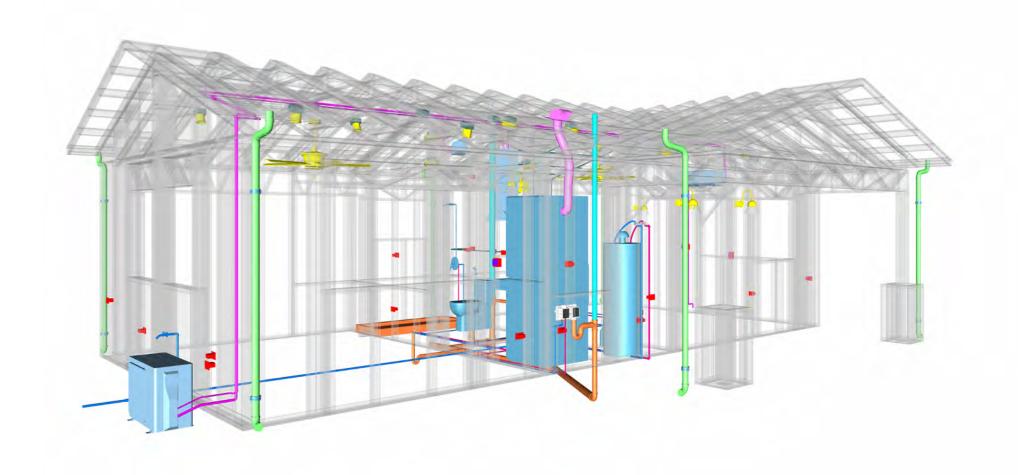

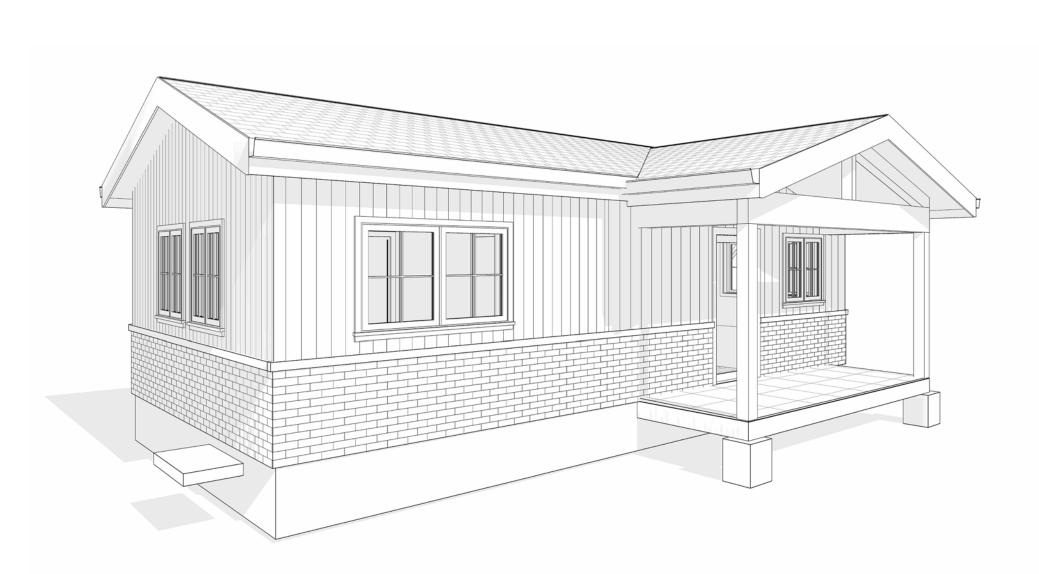


286-PINNACLE-495-1Bd1Ba **TRADITIONAL-550**

SQUARE FOOT	AGE
LIVING	495
PORCH	76
TOTAL	571



KEY PLAN

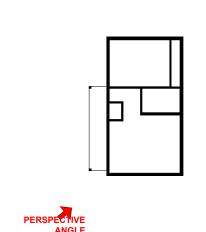

NO.	DESCRIPTION	DATE

NOTE:

LEGEND:

PROJECT

286-PINNACLE-495-1Bd1Ba **TRADITIONAL-550**

DRAWING NAME

COVER SHEET

CLIENT NAME:	Client Name
PROJECT NUMBER:	0061_12
DATE:	5/22/2025 11:06:33 AM
DESIGNED BY:	Designer
DRAWN BY:	Author
CHECKED BY:	Checker

G101

GENERAL NOTES

- THIS DRAWING DEPICTS THE ARCHITECTURAL (SPACE LAYOUT, FURNISHING, FLOOR, WALLS, ROOFS, FOUNDATION, WINDOWS AND DOORS) SYSTEMS. IT PROVIDES A VISUAL REPRESENTATION OF THE ARCHITECTURAL LAYOUT AND COMPONENTS.
- THE ARCHITECTURAL DRAWINGS ARE PREPARED TO MEET THE SPECIFIC REQUIREMENTS OF THE BUILDING, AS PER THE PROJECT SPECIFICATIONS AND APPLICABLE CODES AND STANDARDS.
- THE CONSTRUCTION OF THIS HOME SHALL COMPLY WITH THE LATEST EDITION OF THE INTERNATIONAL RESIDENTIAL CODE (IRC), INTERNATIONAL MECHANICAL CODE (IMC), THE INTERNATIONAL PLUMBING STANDARD, THE NATIONAL ELECTRICAL STANDARD AND ALL OTHER APPLICABLE LOCAL, STATE, AND NATIONAL CODES AND REGULATIONS.
- COORDINATION WITH OTHER TRADES HAS BEEN DONE ON A DESIGN LEVEL. THIS DRAWING SHALL BE READ TOGETHER WITH THE ME, EL AND PL DESIGN DRAWINGS TO ENSURE PROPER CONSTRUCTION AND INTEGRATION OF THE BUILDING SYSTEMS.

ABOUT WALLS:

- SHOWER WALL COVERING
- BATHTUB AND SHOWER SPACES (WALLS AND FLOORS) WITH INSTALLED SHOWER HEADS AND IN SHOWER COMPARTMENTS SHALL BE FINISHED WITH A NON-ABSORBENT SURFACE.
- 2. WALL PAINT (INTERNAL)
 - THE TYPICAL THICKNESS OF LATEX WALL PAINT IS 1/32 OF AN INCH FOR A SINGLE COAT. AND DOUBLE COAT (1/16") SHALL BE APPLIED FOR DURABILITY.

3. ADHESIVES: THE ADVISABLE TYPE OF ADHESIVE FOR THIS PROJECT IS **EPOXY ADHESIVES**BECAUSE THEY ARE KNOWN FOR THEIR HIGH STRENGTH, DURABILITY, AND RESISTANCE TO MOISTURE, CHEMICALS AND


REFER TO SHEETS A201 & A202 FOR GENERAL NOTES ON EXTERNAL FINISHING MATERIALS


ABOUT FLOORS:

- THE SPOT ELEVATION INDICATES THE FINISHED FLOOR ELEVATION.
- FINISHED FLOORS PER PLANS.
- FIELD VERIFY FOR DIMENSION DROP 4" FOR SHOWER AND BATHTUB USE.
- 1% SLOPE ON OUTDOOR BALCONIES FOR WATER RUN OFF.
- 2% SLOPE TOWARDS THE SHOWER DRAIN FOR SUFFICIENT DRAINAGE.
- 4" DROP AT THE DOOR LEADING TO EXTERIOR BALCONY FROM THE MAIN LIVING AREA.
- 5% SLOPE FOR GARAGE IS USED, WHICH SHOULD BE CHECKED WITH THE LOCAL GARAGING
- ZONING LAWS.

	FURNITURE SCHEDULE			
	TYPE MARK	TYPE	COUNT	
0	1	KING SIZE BED	1	
0:	2	TWO SEAT SOFA	1	

	ROOM FINISH SCHEDULE							
ROOM NUMBE R	ROOM NAME	FLOOR FINISH	BASE FINISH	WALL FINISH	CEILING FINISH	CEILING HEIGHT	COM MEN TS	
01	LIVING ROOM	HARDWOOD	CONCRETE	WALL PAINT	DRY WALL	8' - 0"		
02	KITCHEN	HARDWOOD	CONCRETE	WALL PAINT + CERAMIC	DRY WALL	8' - 0"		
03	BEDROOM	HARDWOOD	CONCRETE	WALL PAINT	DRY WALL	8' - 0"		
04	BATH	VINYL TILES	CONCRETE	CERAMIC TILE	MRD	8' - 0"		
05	CL	HARDWOOD	CONCRETE	WALL PAINT	DRY WALL	8' - 0"		
06	WD	HARDWOOD	CONCRETE	WALL PAINT	DRY WALL	8' - 0"		
07	WH	HARDWOOD	CONCRETE	WALL PAINT	DRY WALL	8' - 0"		
08	HALL	HARDWOOD	CONCRETE	WALL PAINT	DRY WALL	8' - 0"		
09	PORCH	PROCELAIN TILE	CONCRETE	CORRUGATED IRON	PLYWOOD	8' - 0"		

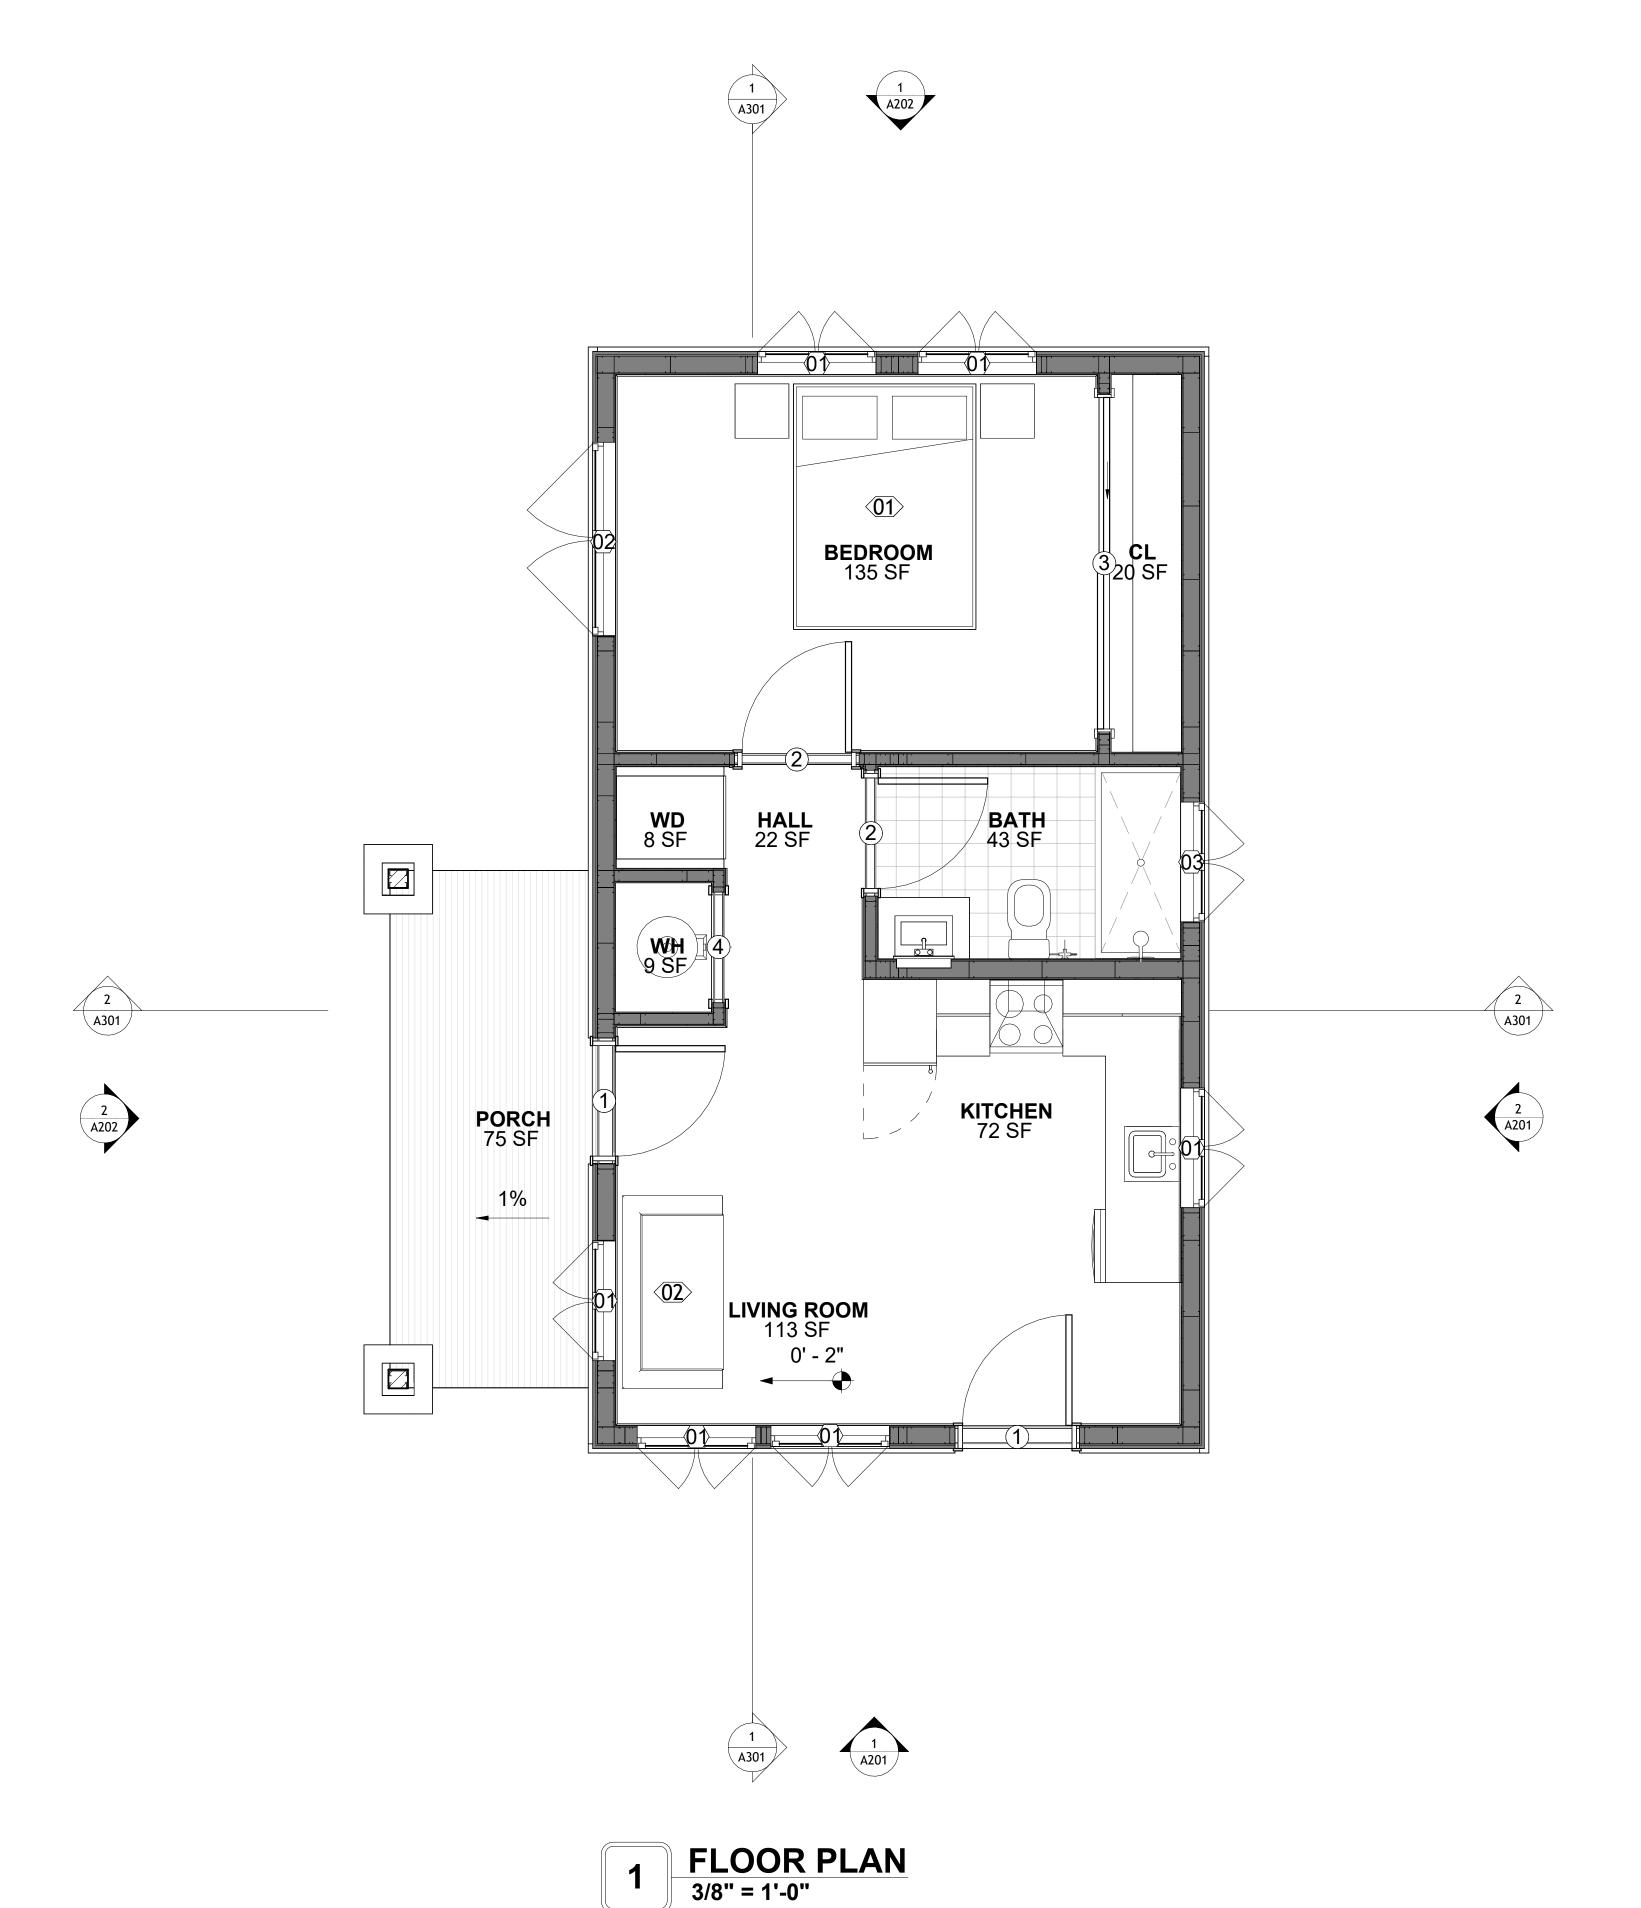

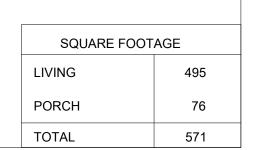



KEY PLAN

NO.	DESCRIPTION	DATE

NOTE:

LEGEND:

PROJECT


286-PINNACLE-495-1Bd1Ba **TRADITIONAL-550**

DRAWING NAME

FLOOR PLAN

CLIENT NAME:	Client Name
PROJECT NUMBER:	0061_12
DATE:	5/22/2025 11:06:34 AM
DESIGNED BY:	Designer
DRAWN BY:	Author
CHECKED BY:	Checker

A101

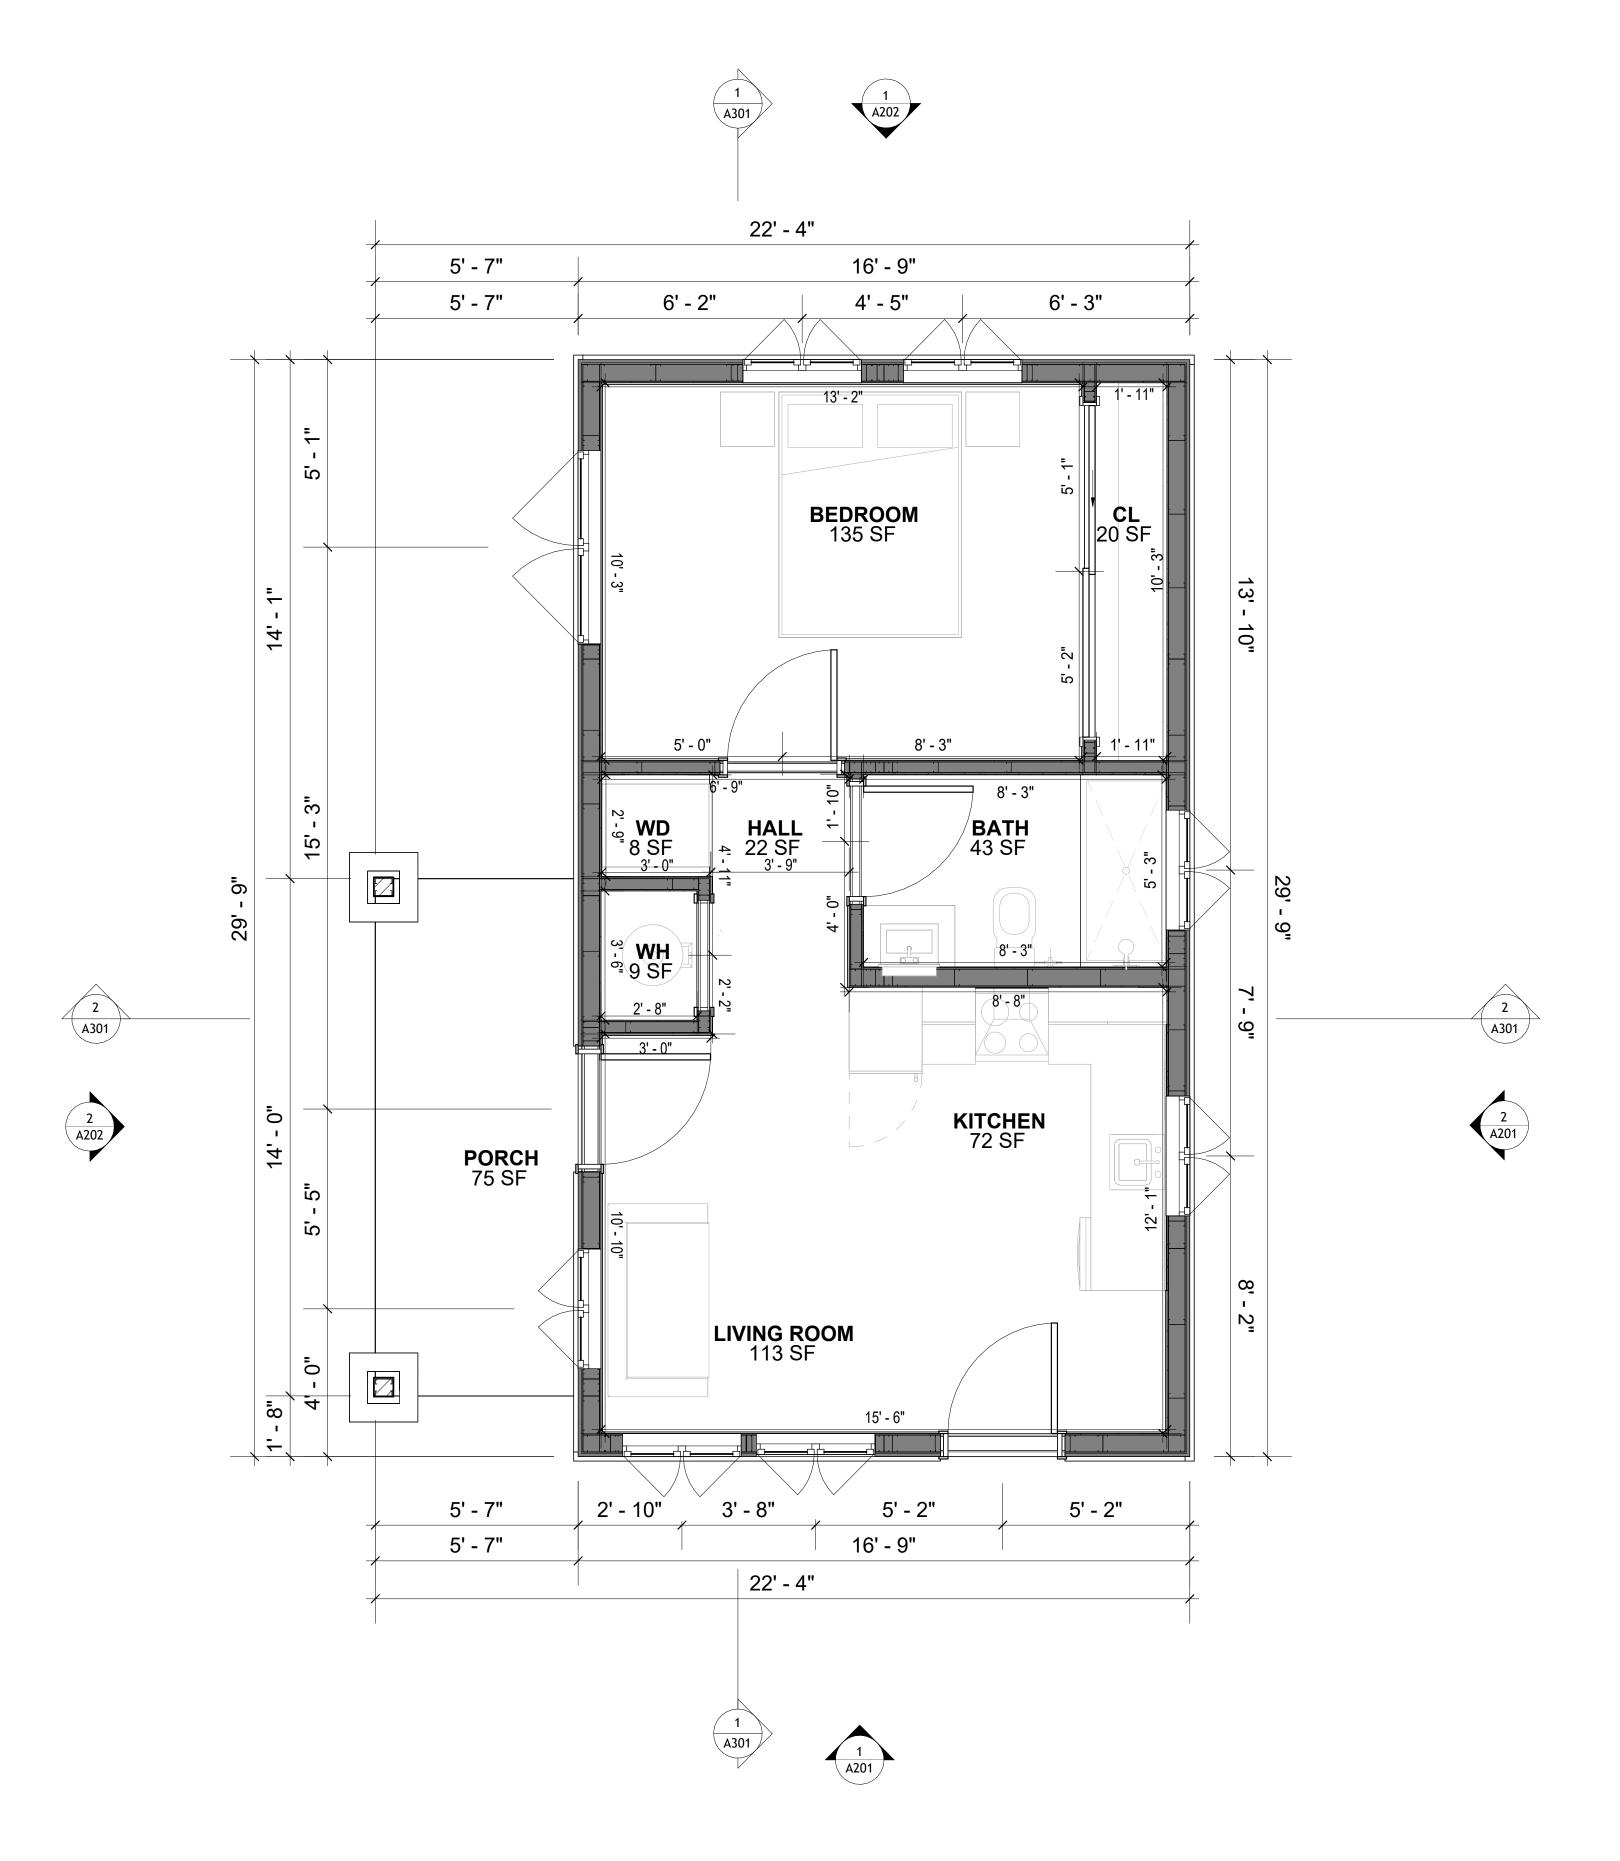

1 DIMENSION PLAN
3/8" = 1'-0"

DIMENSIONS IN THE ARCHITECTURAL DRAWINGS CONSIDER FINISHING MATERIALS. FOR PRECISE MEASUREMENTS OF THE STRUCTUAL FRAMING, REFER TO THE ATTACHED STRUCTURAL PLAN SET.

SQUARE FOOTAGE

LIVING 495

PORCH 76

TOTAL 571



KEY PLAN

NO.	DESCRIPTION	DATE	

NOTE:

LEGEND:

PROJECT

286-PINNACLE-495-1Bd1Ba TRADITIONAL-550

DRAWING NAME

DIMENSION PLAN

Client Name 0061_12 5/22/2025 11:06:35 AM
_
5/22/2025 11:06:35 AM
O'LL'LULU I I I UU I U AIII
Designer
Author
Checker

A102

SCALE: 3/8" = 1'-0"

FOUNDATION NOTES

NOTES:

TERMITES PRETREATMENT BY LICENSED CONTRACTOR UNDER SLAB AND AROUND FOOTINGS. ALL AREAS BELOW SLABS SHALL BE TREATED NO MORE THAN 24 HOURS PRIOR TO CONCRETE POUR. EVIDENCE OF TREATMENT MUST BE PROVIDED PRIOR TO PLACING OF CONCRETE.

MATERIALS:

ALL INTERIOR CONCRETE SLABS SHALL BE A MIN. OF 4" THICK CONCRETE OVER 4" COMPACTED AGGREGATE BASE (ASTM D698), FINISH ELEVATIONS AS NOTED ON DRAWINGS, 6" ABOVE ADJACENT GRADE, LEVEL SLABS TO 1/8"-10' MAX.. CONCRETE SLABS SHALL BE 2500# PSI AT 28 DAYS. A 4" ALLOWABLE SLUMP.

2. **PAD PREPARATION:**

EXCAVATION FOR FOOTING SHALL BE NEAT.

FOOTINGS SHALL BE POURED IMMEDIATELY AFTER EXCAVATION AND APPROPRIATE INSPECTION.

ALL REINFORCING STEEL MARKED "CONTINUOUS" SHALL BE LAPPED 36 BAR DIAMETERS AT SPLICES AND AROUND CORNERS OR INTERSECTIONS WITH A STANDARD 90 DEGREE BEND ON CORNER BARS. LAP WIRE MESH ONE FULL MESH AT SIDE AND END LAPS. ALL HARDWARE TO BE SIMPSON OR EQUIVALENT.

EXTERIOR FRAME WALL TO BE SECURED WITH 1/2"X10" ANCHOR BOLTS 4'-0" O.C. FOR 1-STORY AND 2'-8" O.C. FOR 2-STORY. BOLTS SHALL BE LOCATED WITHIN 1'-0" OF EACH END PIECE AND SHALL HAVE A MIN. OF TWO BOLTS PER PIECE.

-FOUNDATION ANCHOR STRAPS SHALL BE PERMITTED, ACCORDING TO RESIDENTIAL CODE

ALL INTERIOR WALLS TO BE SECURED WITH POWER DRIVEN PINS PER MANUFACTURER SPECIFICATION USE PIN SPACING EQUIVALENT TO 1/2" ANCHOR BOLTS.

ALL CONSTRUCTION TO CONFORM TO THE 2012 IRC R-10 RIGID INSULATION OUTSIDE OF EXTERIOR FOUNDATION WALLS UNDER LIVING AREA. CONCRETE PAD FOR CONDENSER THICKNESS IS 4" MIN UNLESS OTHERWISE NOTED.

3. CONCRETE CONSTRUCTION:

- THE SLAB SHALL BE UNDERLAIN BY A VAPOR BARRIER/RETARDER IN THE LIVING AREA (TYPICALLY POLYETHYLENE, UNLESS MORE STRINGENT PROTECTION REQUIRED BY THE ARCHITECT, ENGINEER, FLOOR COVERING MANUFACTURER, OR ACCEPTED PRACTICE). UNLESS OTHERWISE REQUIRED, BARRIER MAY BE OMITTED AT GARAGES, PORCHES AND PATIOS WITHOUT FLOOR COVERINGS. IT IS BEYOND THE SCOPE OF THESE PLANS TO DETERMINE THE APPLICABILITY OF THESE MORE STRINGENT REQUIREMENTS. BUILDER SHALL VERIFY PRIOR TO CONSTRUCTION.

4. **REINFORCEMENT**:

- IF CONSTRUCTED ON ACTIVE SOILS, THE LONG TERM PERFORMANCE OF THE FOUNDATION IS DEPENDENT ON MAINTENANCE BY THE OWNER. THUS THE BUILDER SHALL ADVISE THE OWNER OF THE FOLLOWING:

1. DRAINAGE MUST BE MAINTAINED. WATER SHALL NEVER BE ALLOWED TO POND NEAR THE FOUNDATION.

2. THE SOIL AROUND THE FOUNDATION SHALL BE MAINTAINED IN A RELATIVELY DAMP CONDITION.SUCH AS THAT REQUIRED TO KEEP A LAWN GREEN. IF IT DRIES OUT IT WILL

SHRINK. IF IT GETS WET, IT WILL HEAVE UPWARD. 3. SLABS ON THE SHORTER SIDE USES MAIN BARS ARE USED IN THIS DIRECTION ONLY WITH SMALLER DIAMETER DISTRIBUTION BARS ARE PLACED, FORMING A MAT OR GRID.

ALL REINFORCEMENT BARS SIZE 10MM OR LARGER IN ACCORDANCE TO ASTM

ANCHOR BOLTS AT ALL EXTERIOR WALLS SHALL BE MINIMUM 1/2 INCH DIAMETER WITH A MAXIMUM SPACING OF 6'-0" ON CENTER, UNLESS NOTED OTHERWISE.

4. ANCHOR BOLTS SHALL BE INSTALLED WITHIN 12 INCHES OF EACH END OF EACH SILL PLATE WITH AT LEAST TWO ANCHOR BOLTS FOR EACH BOLTS FOR EACH SILL PLATE LONGER THAN 12 INCHES.

5. SIMPSONS SILL ANCHORS MAYBE SUBSTITUTED FOR ANCHOR BOLTS AT THE SAME


SPACING.

6. EXTERIOR CONCRETE SLABS WHICH ARE NOT PART OF THE MAIN SLAB SHALL BE MINIMUM 4 INCHES THICK WITH NO STEEL REINFORCING BARS REQUIRED, UNLESS NOTED OTHERWISE ON FOUNDATION PLAN.

VERIFY THE FOLLOWING PRIOR TO POURING:

- ALL HOLDDOWNS, STRAP, AND POST LOCATIONS.
- CONCRETE FINISHES. PANEL RISER LOCATION WHERE APPLICABLE.
- 3. UNDERSLAB MECHANICAL REQUIREMENTS.
- . STEM WALL BLOCKOUTS.
- 5. UNDERSLAB ELECTRICAL REQUIREMENTS AND PANEL RISER LOCATION. WHERE
- APPLICABLE. 3. PROVIDE THE FOLLOWING:
- PVC SLEEVES THROUGH FTG IF REQUIRED
- 20' #4 COPPER GROUND BAR.
- SLOPE FINISH GRADE AWAY FROM FOOTING.

NOTE: FIELD VERIFY ALL DIMENSIONS SEE DIMENSIONED ARCHITECTURAL DRAWINGS

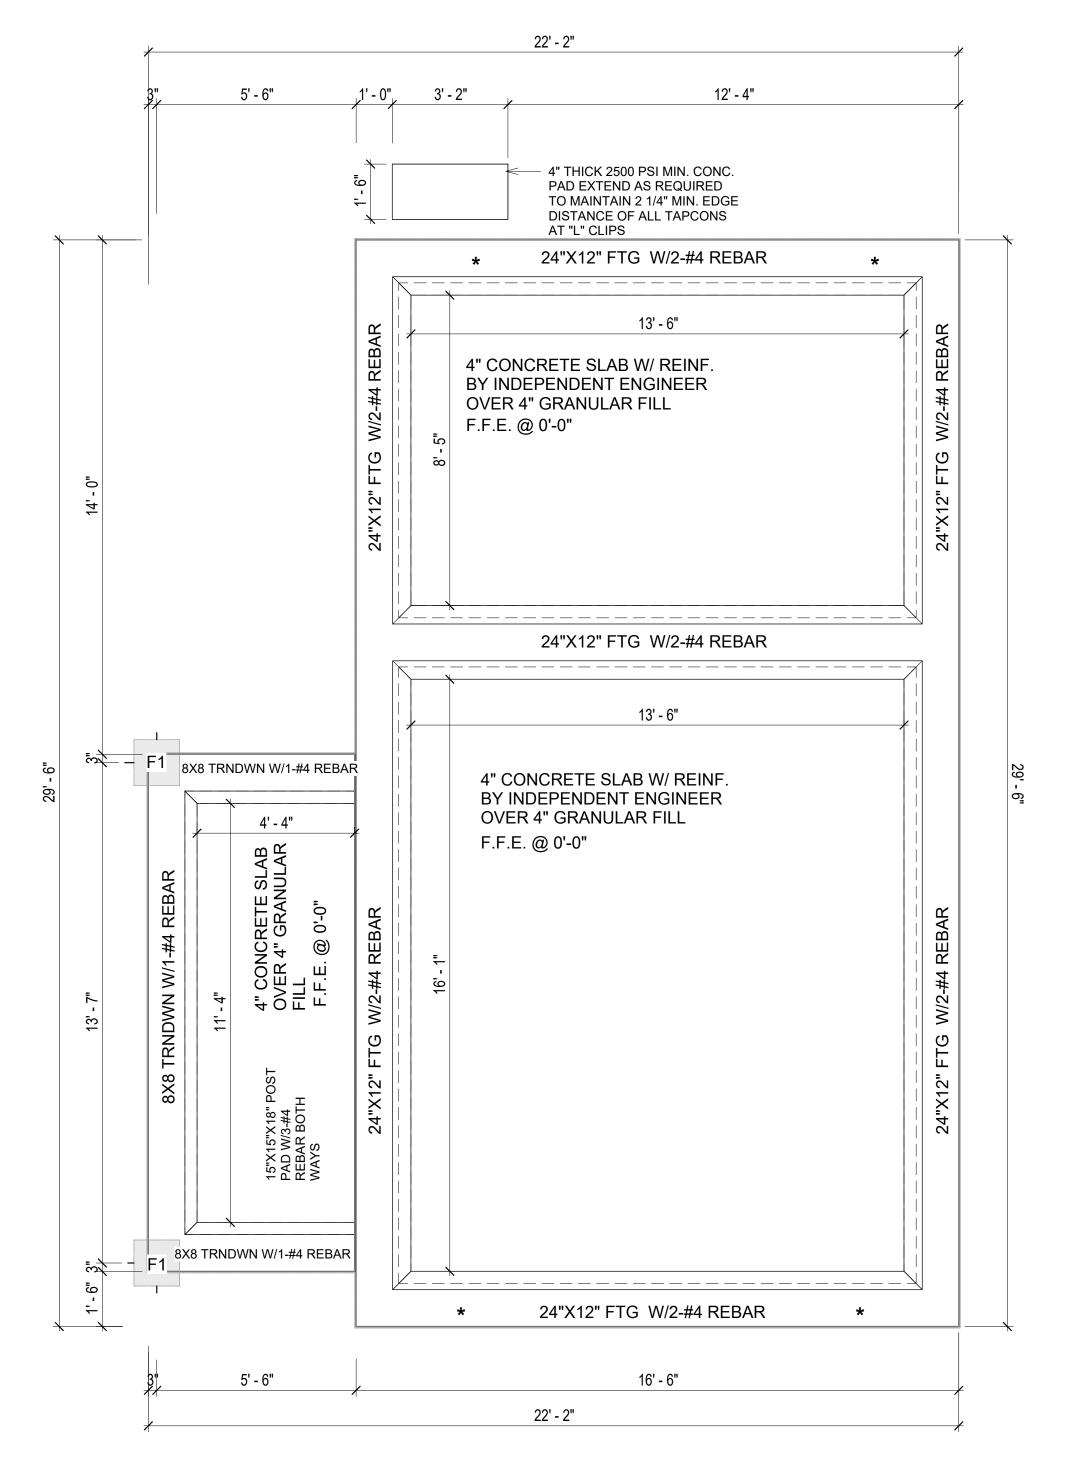





KEY PLAN

NO.	DESCRIPTION	DATE

NOTE:

LEGEND:

PROJECT

286-PINNACLE-495-1Bd1Ba **TRADITIONAL-550**

DRAWING NAME

FOUNDATION PLAN

CLIENT NAME:	Client Name
PROJECT NUMBER:	0061_12
DATE:	5/22/2025 11:06:35 AM
DESIGNED BY:	Designer
DRAWN BY:	Author
CHECKED BY:	Checker

S101

SCALE: 3/8" = 1'-0"

SQUARE FOOTAGE			
LIVING	495		
PORCH	76		
TOTAL	571		

GENERAL NOTES

NOTES:

-ALL BEARING WALLS SHOULD HAVE A THICKENED SLAB PER SECTION PER DETAIL A401/5.

A) **FOUNDATION PLAN NOTES**:

- CONCRETE SLAB SHALL BE 6" THICK WITH 1/2" DIAMETER TENDONS PER LAYOUT PLAN, CENTERED IN SLAB THICKNESS, OVER APPROVED SUBBASE PER GENERAL STRUCTURE NOTES.
- 2. TERMITE PROTECTION SHALL BE PROVIDED PER IRC SECTION R318.1 NONE TYPICAL ANCHOR BOLT SPACING AT SHEAR WALL AND HOLD DOWN
- SPECIFICATIONS PER APPROVED ARCHITECTURAL PLANS.
- 4. INSTALL HOLDOWNS BEFORE CONCRETE SLAB POUR. EXISTING FILL ON-SITE SHALL BE COMPACTED IN ACCORDANCE WITH THE
- REQUIREMENTS IN THE GEOTECHNICAL REPORT.
- 6. ALL FLOOR SLABS ARE REINFORCED ON CONCRETE SLABS.

SPECIAL INSPECTION IS REQUIRED FOR THICKENED FOUNDATION CONSTRUCTION

- 1. REINFORCEMENT
- 2. 2300 PSI CONCRETE POUR


B) **REINFORCEMENT FOR CONCRETE**:


1. ALL REINFORCING SLABS BARS SIZE 10MM OR LARGER SHALL BE DEFORMED IN ACCORDANCE TO ASTM-A706, AND BARS SMALLER THAN 10 MM MAYBE PLAIN. 2. UNLESS OTHERWISE NOTED IN PLANS, THE YIELD STRENGTH OF REINFORCING BARS SHALL BE:


> A) FOOTING = 40,000 PSI B) NON-LOAD BEARING WALLS AND PARAPETS= 40,000 PSI

- 3. SPLICES SHALL BE SECURELY WIRED TOGETHER AND SHALL LAP OR EXTEND
- 4. GRADE OF STEEL FOR RCC WORKS SHALL BE GRADE 4 10.
- BAR NOTATIONS GIVES INFORMATION
- A) BAR SIZE
- B) SPACING(IF REQUIRED)
- 6. LAP REINFORCEMENT ONLY AT LOCATION SHOWN IN THE DRAWINGS
- REINFORCEMENT SHALL NOT BE CUT, VENT OR HEATED ON SITE WITHOUT ENGINEERS' APPROVAL.
- C) **CONCRETE SLAB NOTES**
- 1. ALL SLAB REINFORCEMENT SHALL BE 20MM CLEAR MINIMUM FROM BOTTOM AND FROM TOP OF SLAB.
- 2. REINFORCEMENT IN CONTINUOUS ELEVATED SLAB SHALL BE CUT AS FOLLOWS.

- THIS IS A SCHEMATIC PLAN FOR THE PURPOSE OF LOCATING AND IDENTIFYING FOUNDATION REINFORCING ELEMENTS ONLY. VERIFY ALL DIMENSIONS, DROPS, OFFSETS AND FEATURES WITH THE ARCHITECTURAL PLANS BEFORE FORMING THE FOUNDATION.

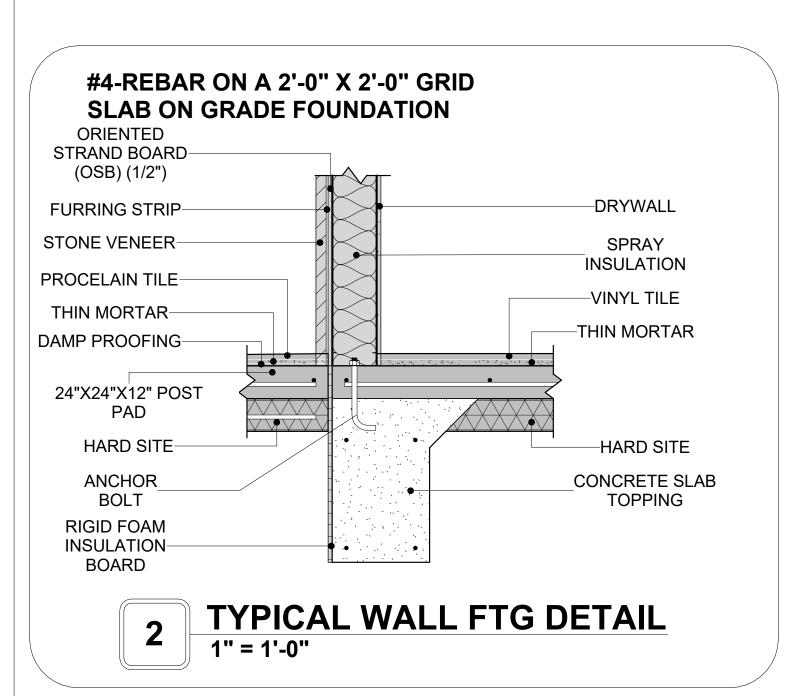

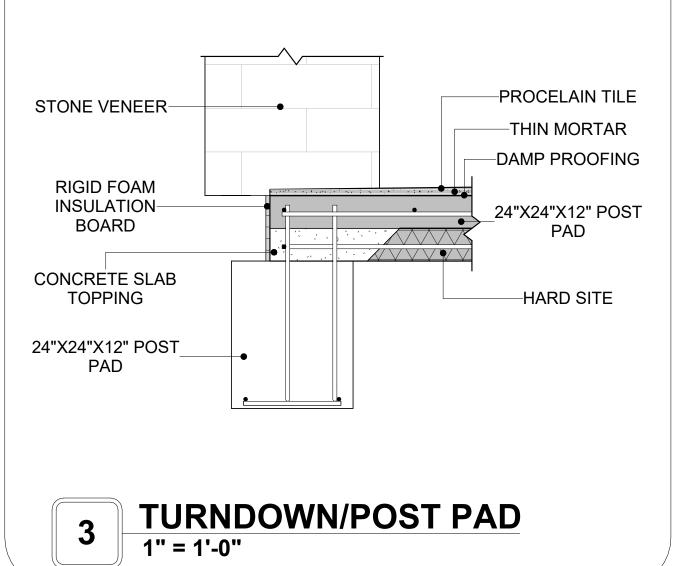

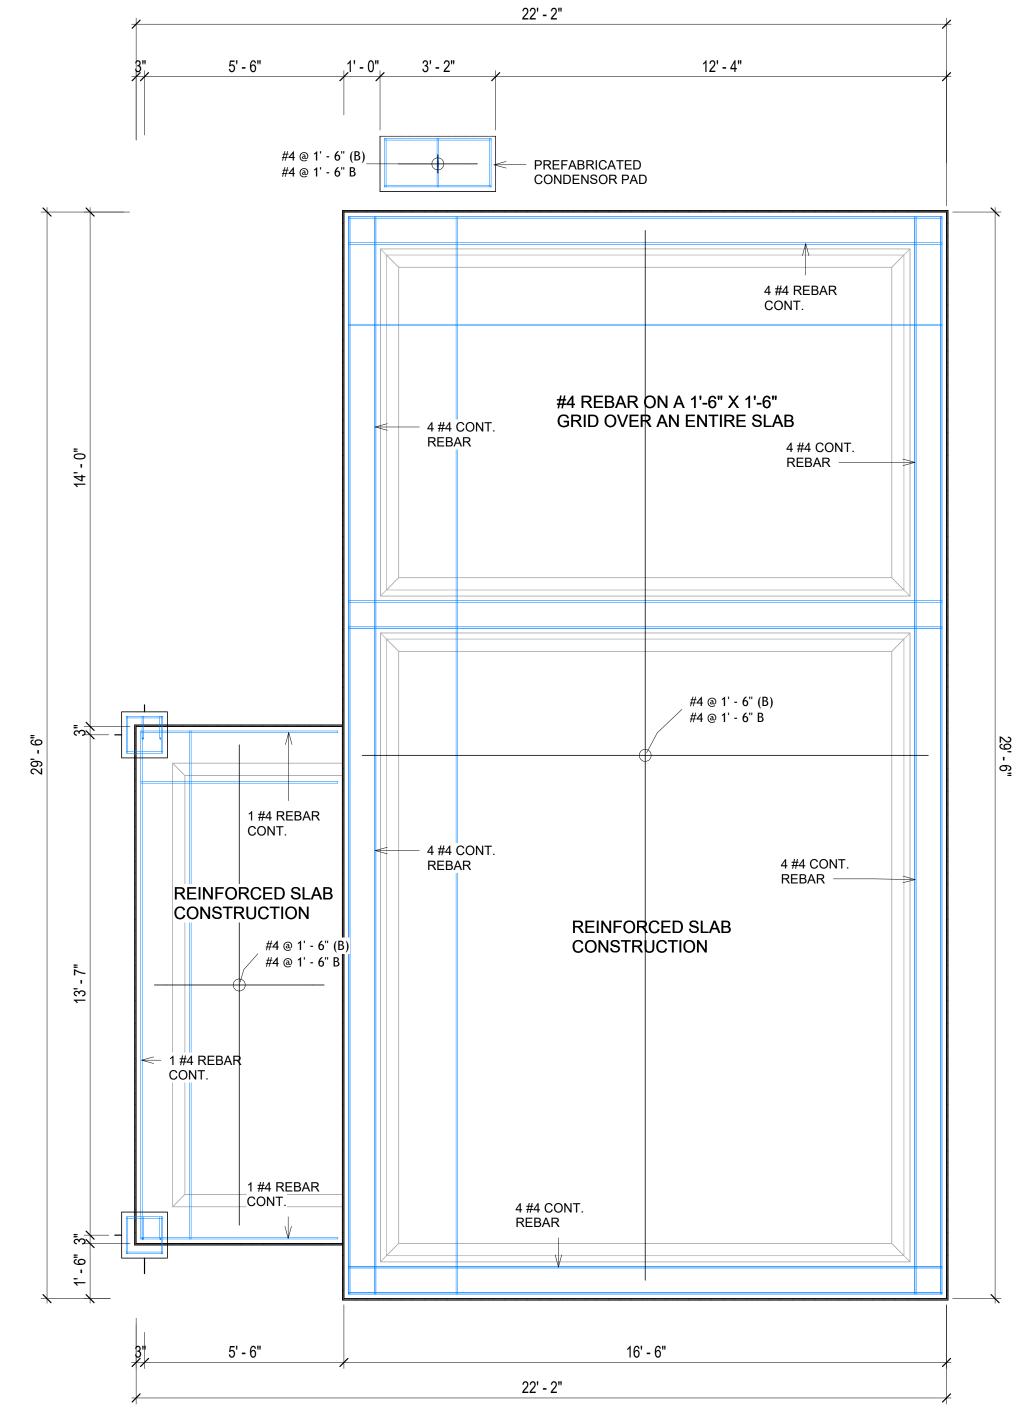

FOUNDATION REBAR PLAN 3/8" = 1'-0"



KEY PLAN

NO.	DESCRIPTION	DATE

NOTE:

LEGEND:

PROJECT

286-PINNACLE-495-1Bd1Ba **TRADITIONAL-550**

DRAWING NAME


STRUCTURAL FLOOR PLAN

CLIENT NAME: **Client Name** PROJECT NUMBER: 0061_12 5/22/2025 11:06:36 AM Designer **DESIGNED BY:** DRAWN BY: **Author** CHECKED BY: Checker


S102

ROOF NOTES

- ROOFING COMPOSITION ROOFING PER OWNERS/BUILDERS SPECIFICATIONS INSTALL PER MANUFACTURE SPECIFICATIONS ON 1/2" ORIENTED STRAND BOARD ON PRE-ENGINEERED TRUSS @ 24" O.C. (UNO.)
 73" OVERHANG AT EAVES (UNO.)
- 3. ENDS OF ALL TRUSSES AND JOISTS TO BE FULLY BLOCKED. PROVIDE SOLID
- BLOCKING AT ALL RIDGES AND VALLEYS
 4. SHEATHING TO BE 1/2", 3/8" OSB SHEAR PANEL AND EQUIVALENT.
- UNDERSIDE OF PORCH TRUSSES TO BE FINISHED WITH MOISTURE RESISTANT DRYWALL, TAPED AND TEXTURED.
- 5. EXPOSED EAVES AND OTHER WEATHER EXPOSED AREAS TO BE SHEATHED WITH EXTERIOR GRADE PLYWOOD.
- 6. ALL MATERIALS THICKNESS AND SIZE ARE THE MINIMUM. Refer TO LOCAL STANDARDS FOR ACTUAL THICKNESS AND LAYERING OF MATERIALS.
- 7. ENGINEERED TRUSS CALCULATIONS TO BE SUBMITTED TO BUILDING DEPARTMENT PRIOR TO FABRICATION AND INSTALLATION.
- 8. TRUSS MANUFACTURER TO SPECIFY HANGER CONNECTORS FOR TRUSS COMPONENTS (TYPICAL)
- 9. DESIGNER ASSUMES THAT TRUSSES BEAR ON ALL EXTERIOR PERIMETER
- WALLS (TYPICAL) OR BEAMS.
- 10. PROVIDE GALVANIZED STEEL FLASHING WITH A LENGTH OF 10 FEET, WIDTH OF 12 INCHES, AND THICKNESS OF 24 GAUGE.

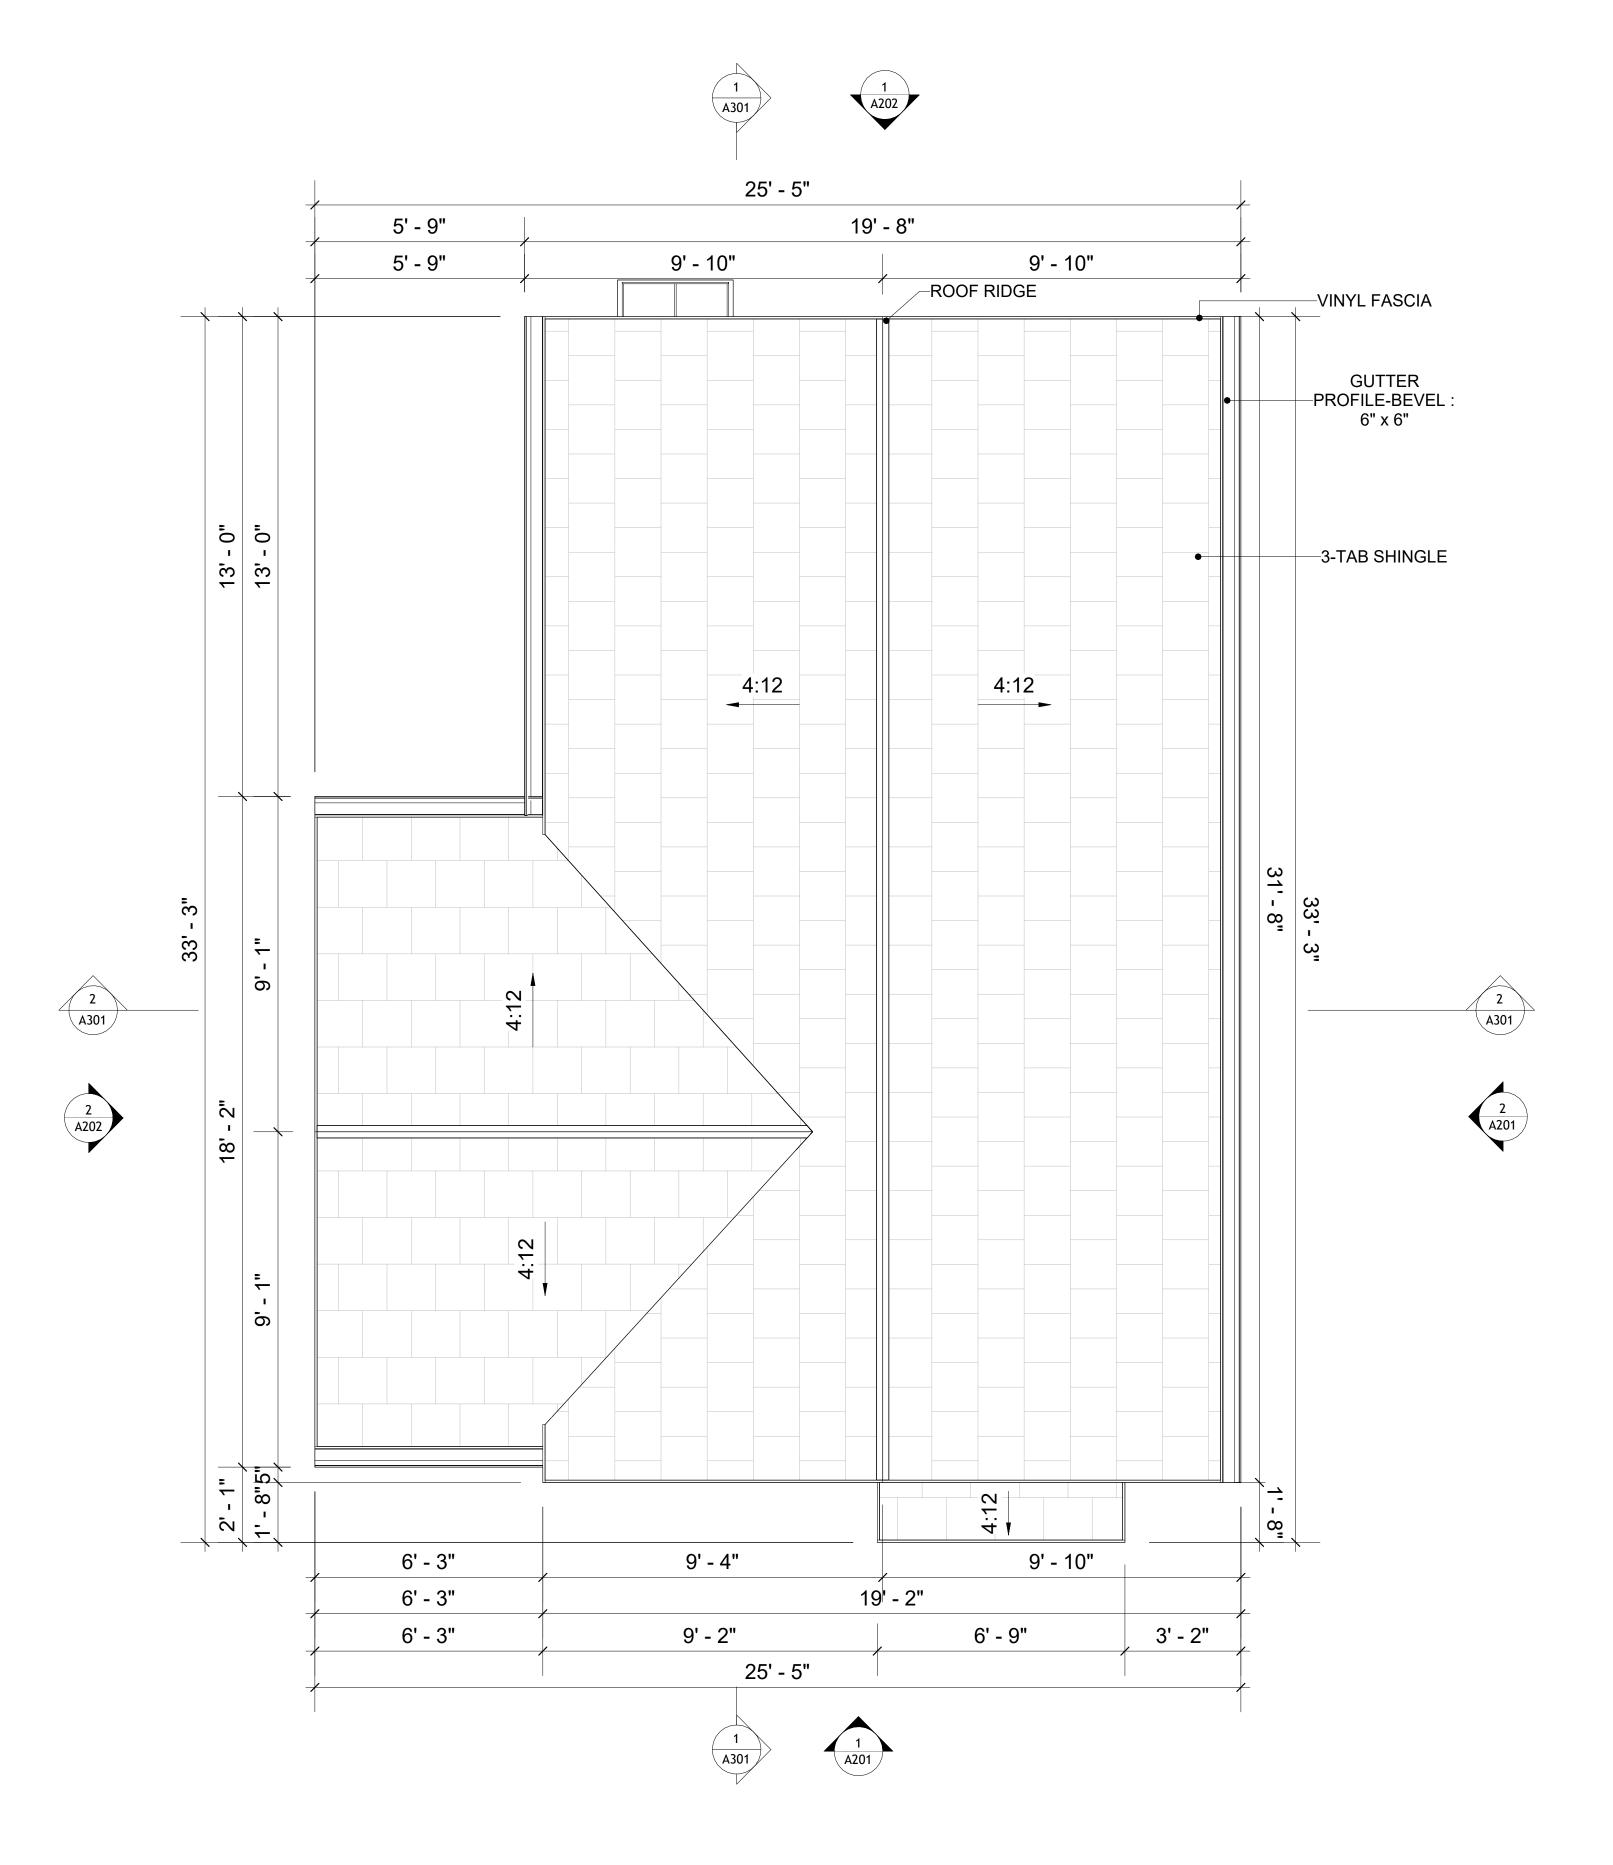



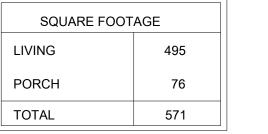



KEY PLAN

NO.	DESCRIPTION	DATE

NOTE:

LEGEND:

PROJECT

286-PINNACLE-495-1Bd1Ba TRADITIONAL-550

DRAWING NAME

ROOF PLAN

E:	Client Name
JMBER:	0061_12
	/22/2025 11:06:38 AM
BY:	Designer
	Author
Y:	Checker
Y:	

A103

ABOUT WALL FINISHING

CORRUGATED IRON SHEET

CORRUGATED IRON IS A FINISHING MATERIAL MADE FROM STEEL THAT HAS BEEN GALVANIZED (COATED WITH A THIN LAYER OF ZINC) TO PROTECT IT FROM CORROSION AND RUST.

IN THIS SPECIFIC PROJECT, THE CORRUGATED IRON SHEETS ARE INSTALLED HORIZONTALLY ON VERTICAL FURRING STRIPS THAT ARE DIRECTLY ATTACHED ONTO THE PROPERLY INSTALLED AND SEALED HOME WRAP, USING SELF-DRILLING SCREWS THAT ARE DRIVEN THROUGH THE RIDGES OR VALLEYS OF THE CORRUGATIONS.

CEDAR WOOD


CEDAR WOOD REFERS TO THE WOOD FROM VARIOUS SPECIES OF CEDAR TREES, WHICH ARE CONIFEROUS EVERGREEN TREES KNOWN FOR THEIR DISTINCT AROMA AND NATURAL RESISTANCE TO DECAY AND INSECTS.

IN THIS SPECIFIC PROJECT, CEDAR WOOD IS USED A FINISH MATERIAL ON BEAMS AND COLUMNS.


STONE VENEER

STONE VENEER REFERS TO THIN LAYERS OF NATURAL OR MANUFACTURED STONE APPLIED TO A STRUCTURAL WALL, KNOWN FOR THEIR REALISTIC APPEARANCE AND RELATIVE LIGHTNESS. THESE VENEERS PROVIDE THE AESTHETIC OF STONE WITHOUT THE COST AND WEIGHT OF FULL STONE CONSTRUCTION, CONTRIBUTING TO A BEAUTIFUL AND COST-EFFECTIVE EXTERIOR FINISH.

IN THIS SPECIFIC PROJECT, STONE VENEER IS USED A FINISH MATERIAL ON EXTERIOR FINISH.

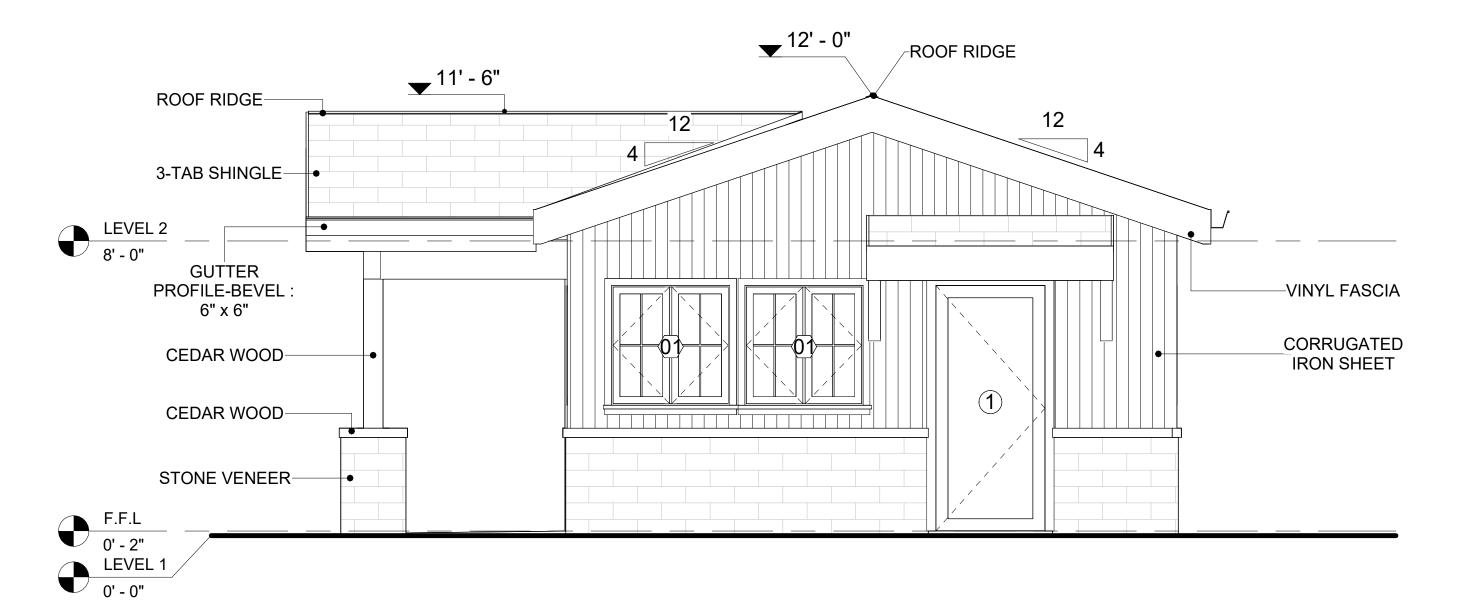

1 FRONT ELEVATION 3/8" = 1'-0"

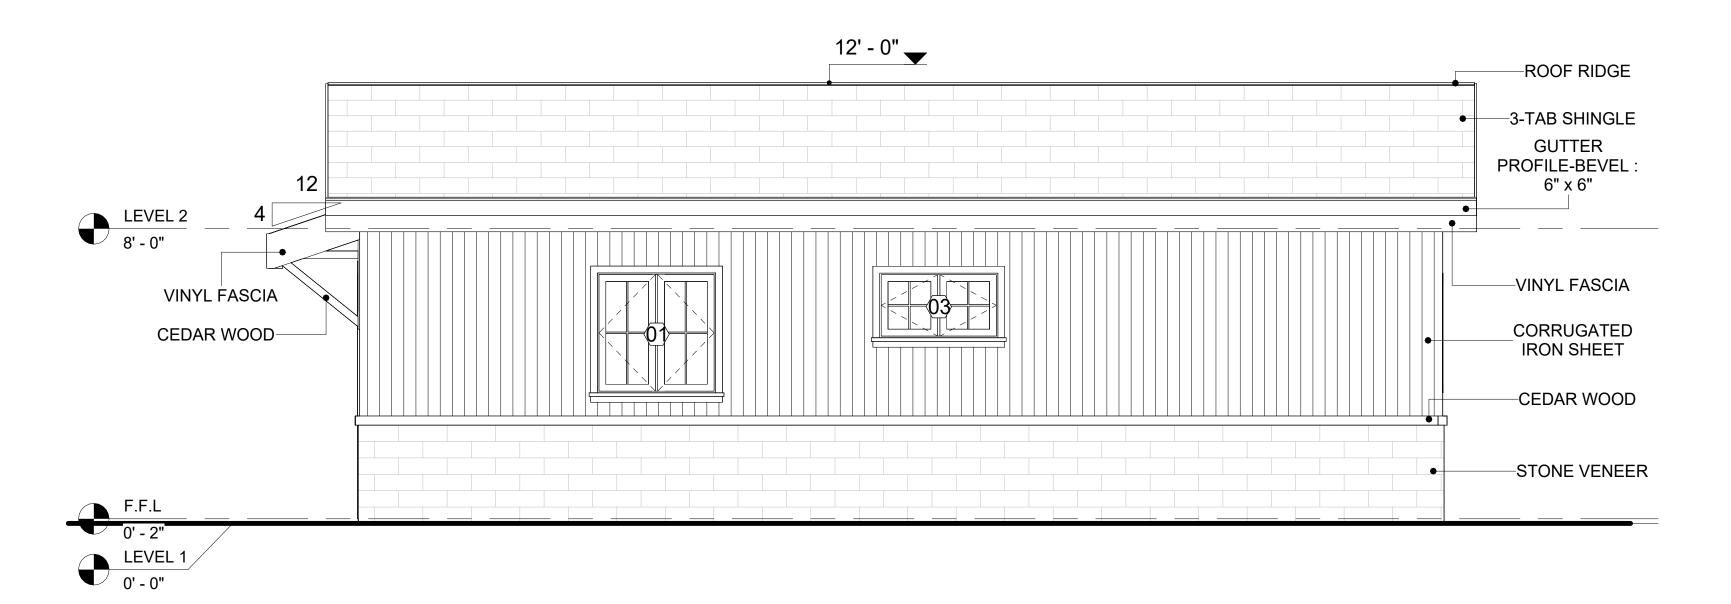


2 RIGHT SIDE ELEVATION 3/8" = 1'-0"

	DOOR SCHEDULE						
TYPE			LOCATIO	SIZE			
MAR K	SUPPLIER	DOOR TYPE	LOCATIO	WIDTH	HEIGHT	COUNT	
1	HOME DEPOT	EXTERIOR SINGLE PANEL SWINGING	INTERIOR	3' - 0"	6' - 8"	2	
2	HOME DEPOT	INTERIOR SINGLE PANEL SWINGING	INTERIOR	3' - 0"	6' - 8"	2	
3	HOME DEPOT	INTERIOR DOUBLE PANEL SLIDING	INTERIOR	9' - 0"	6' - 8"	1	
4	HOME DEPOT	SINGLE FOLD 2	INTERIOR	2' - 10"	6' - 8"	1	

WINDOW SCHEDULE					
			SI	ZE	
TYPE MARK	SUPPLIER	WINDOW TYPE	WIDTH	HEIGHT	COUNT
01	HOME DEPOT	CASEMENT	3' - 3"	3' - 3"	6
02	HOME DEPOT	CASEMENT	5' - 3"	3' - 3"	1
03	HOME DEPOT	CASEMENT	3' - 3"	1' - 9"	1



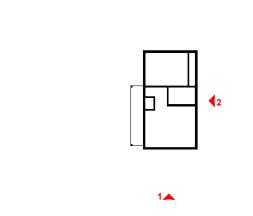

NO.	DESCRIPTION	DA

NOTE:

LEGEND:

PROJECT

286-PINNACLE-495-1Bd1Ba TRADITIONAL-550

DRAWING NAME

ARCHITECTURAL ELEVATIONS

CLIENT NAME:	Client Name
PROJECT NUMBER:	0061_12
DATE:	5/22/2025 11:06:40 AM
DESIGNED BY:	Designer
DRAWN BY:	Author
CHECKED BY:	Checker

A201

ABOUT WALL FINISHING

CORRUGATED IRON SHEET

CORRUGATED IRON IS A FINISHING MATERIAL MADE FROM STEEL THAT HAS BEEN GALVANIZED (COATED WITH A THIN LAYER OF ZINC) TO PROTECT IT FROM CORROSION AND RUST.

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CEDAR WOOD


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IN THIS SPECIFIC PROJECT, CEDAR WOOD IS USED A FINISH MATERIAL ON BEAMS AND COLUMNS.


STONE VENEER

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IN THIS SPECIFIC PROJECT, STONE VENEER IS USED A FINISH MATERIAL ON EXTERIOR FINISH.




1 REAR ELEVATION
3/8" = 1'-0"

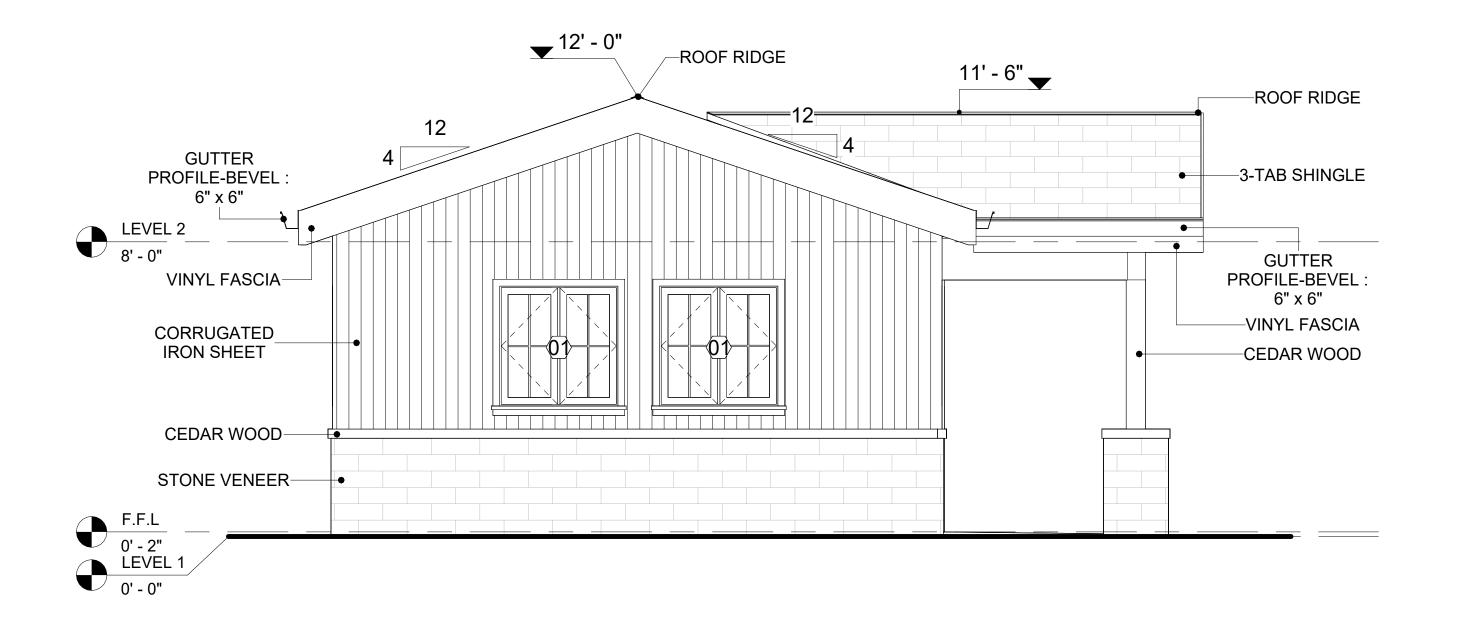

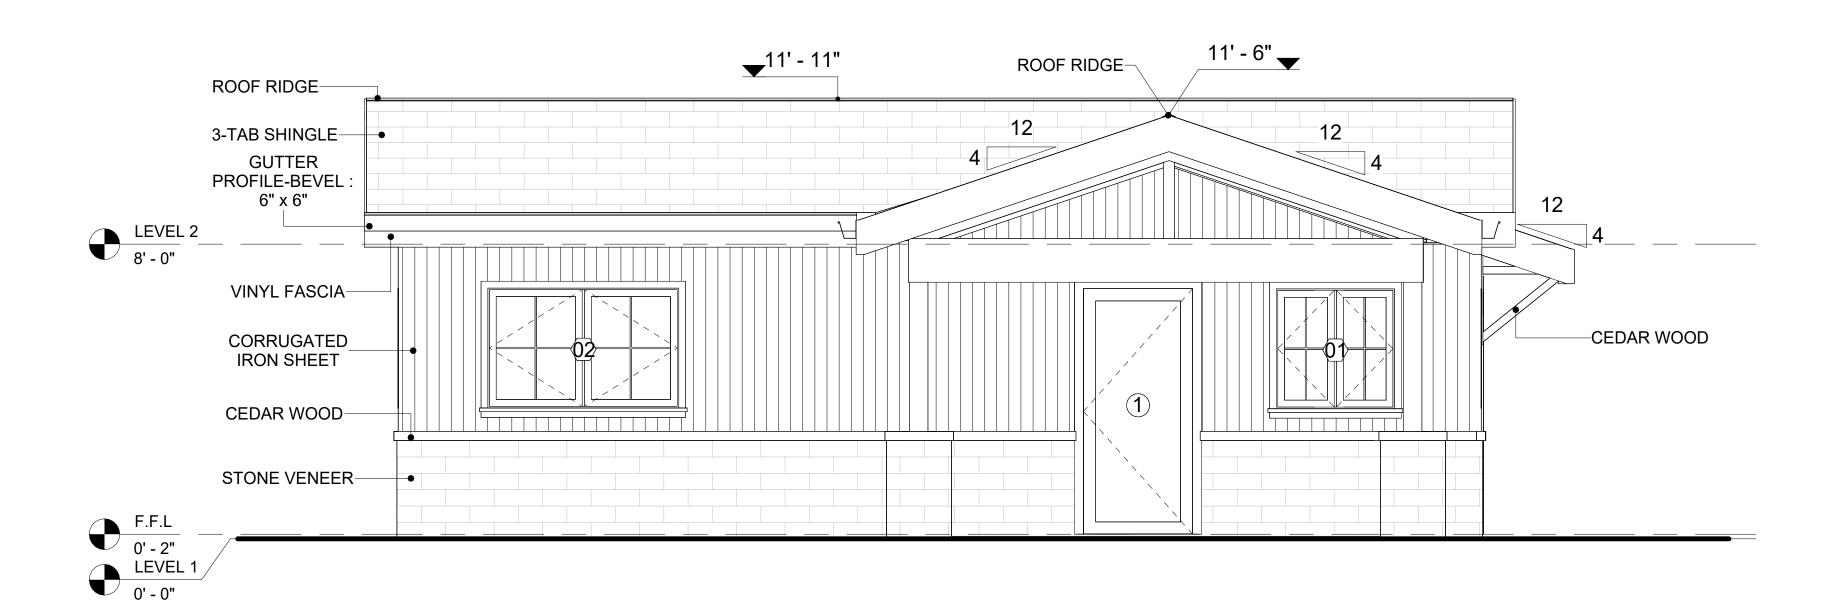2 LEFT SIDE ELEVATION
3/8" = 1'-0"



KEY PLAN

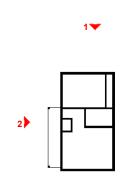

NO.	DESCRIPTION	DATE

NOTE:

LEGEND:

PROJECT

286-PINNACLE-495-1Bd1Ba TRADITIONAL-550

DRAWING NAME

ARCHITECTURAL ELEVATIONS

CLIENT NAME:

PROJECT NUMBER:

0061_12

DATE:

5/22/2025 11:06:43 AM


DESIGNED BY:

DRAWN BY:


CHECKED BY:

Checker

A202

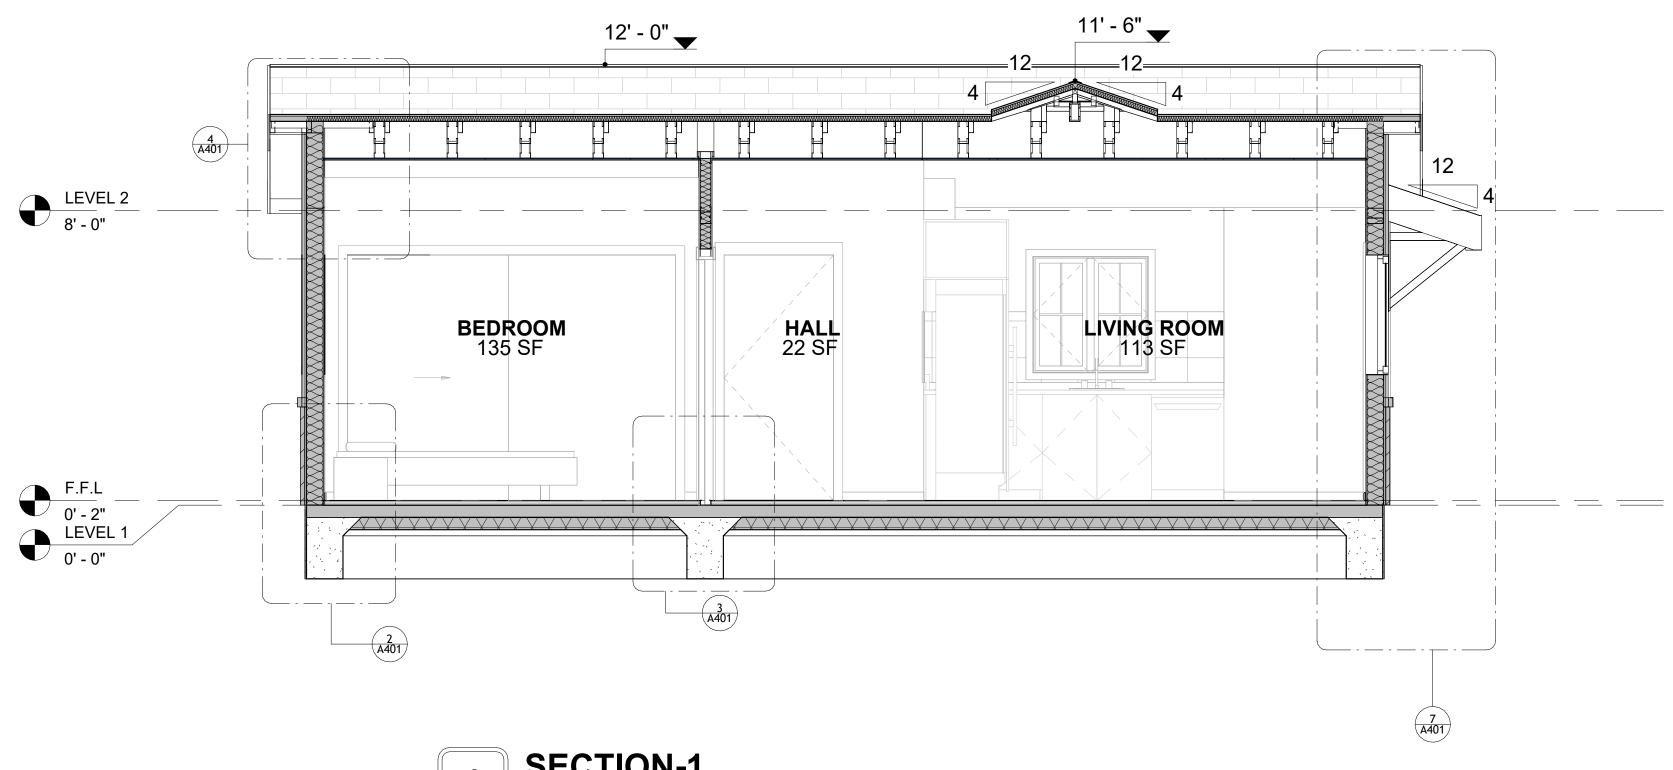




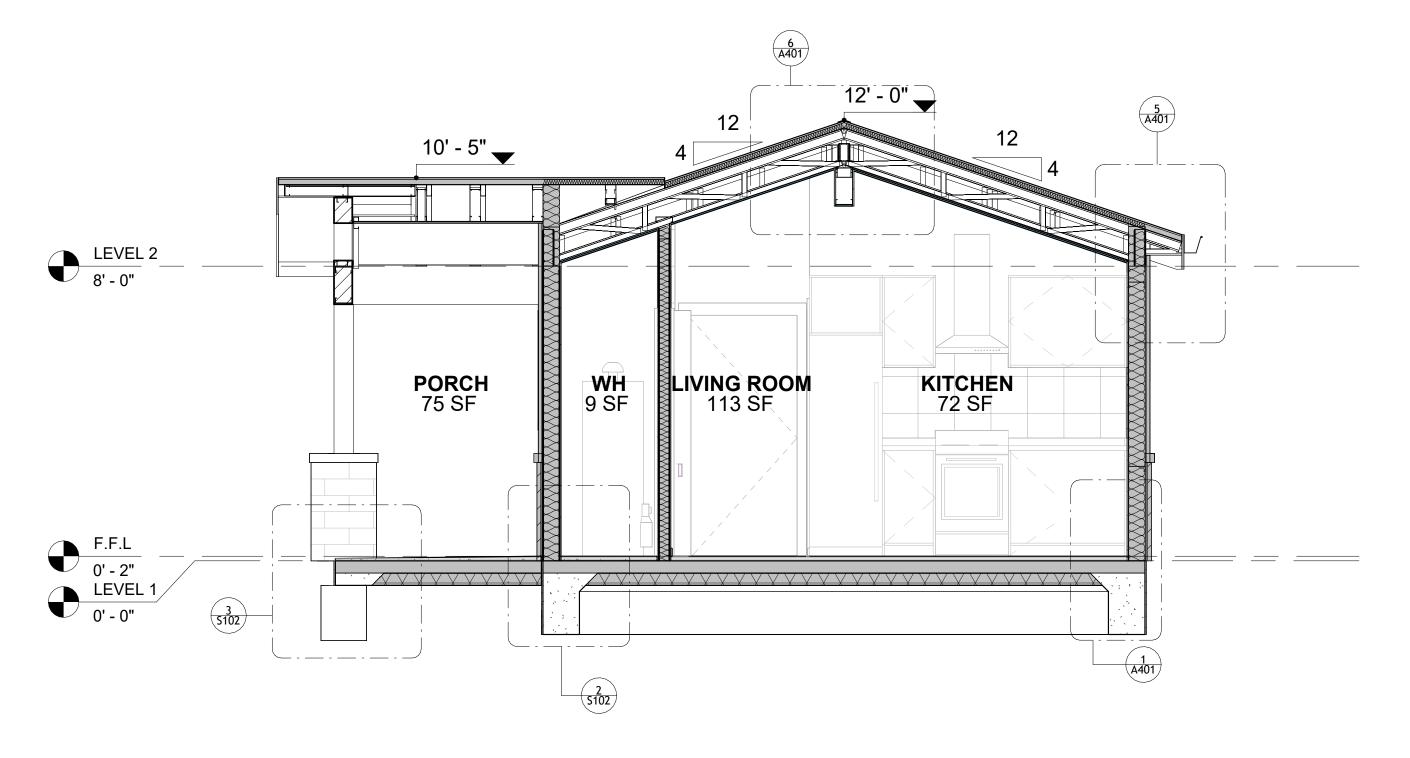

2 SECTION-2 3/8" = 1'-0"



KEY PLAN

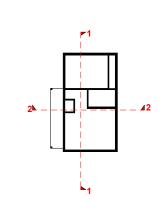

NO.	DESCRIPTION	DATE

NOTE:

LEGEND:

PROJECT


286-PINNACLE-495-1Bd1Ba TRADITIONAL-550


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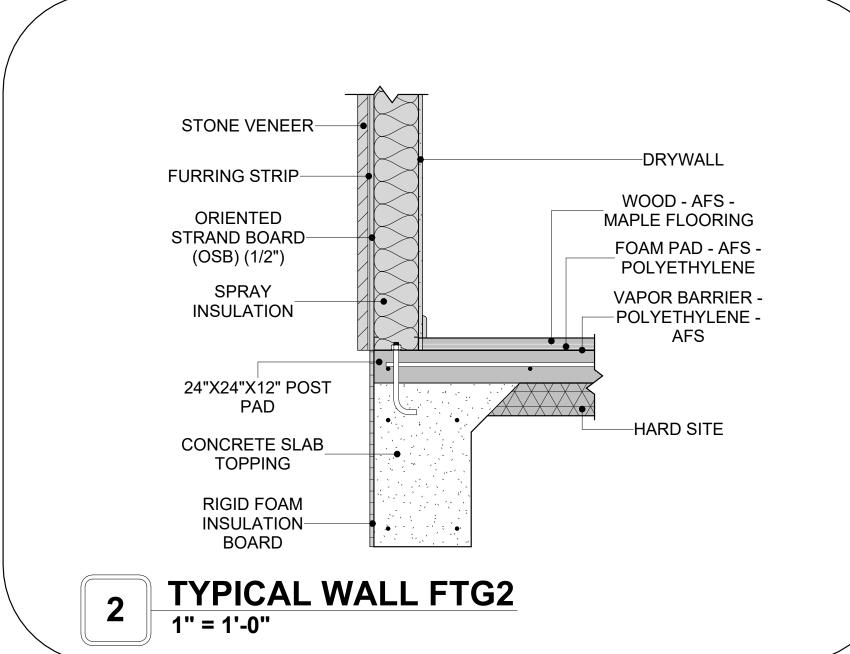
ARCHITECTURAL SECTIONS


Client Name	CLIENT NAME:
0061_12	PROJECT NUMBER:
5/22/2025 11:06:44 AM	DATE:
Designer	DESIGNED BY:
Author	DRAWN BY:
Checker	CHECKED BY:


A301




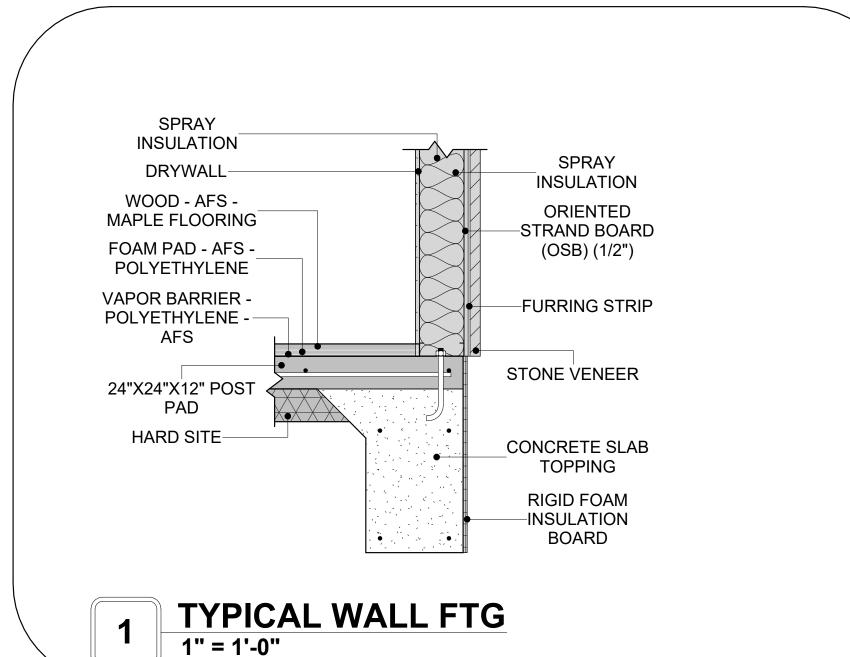


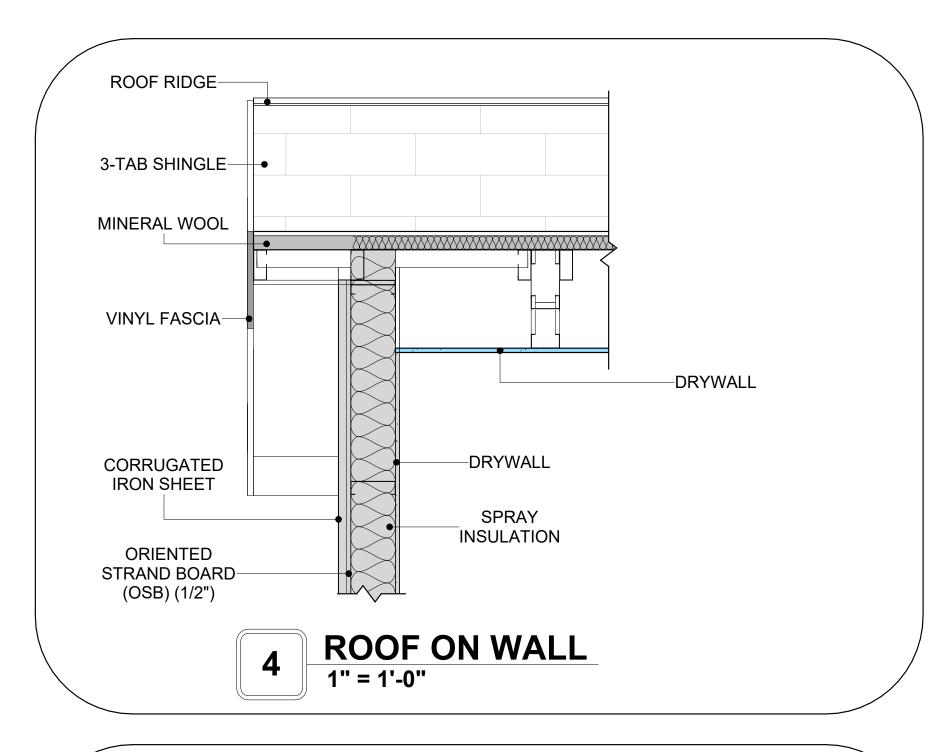

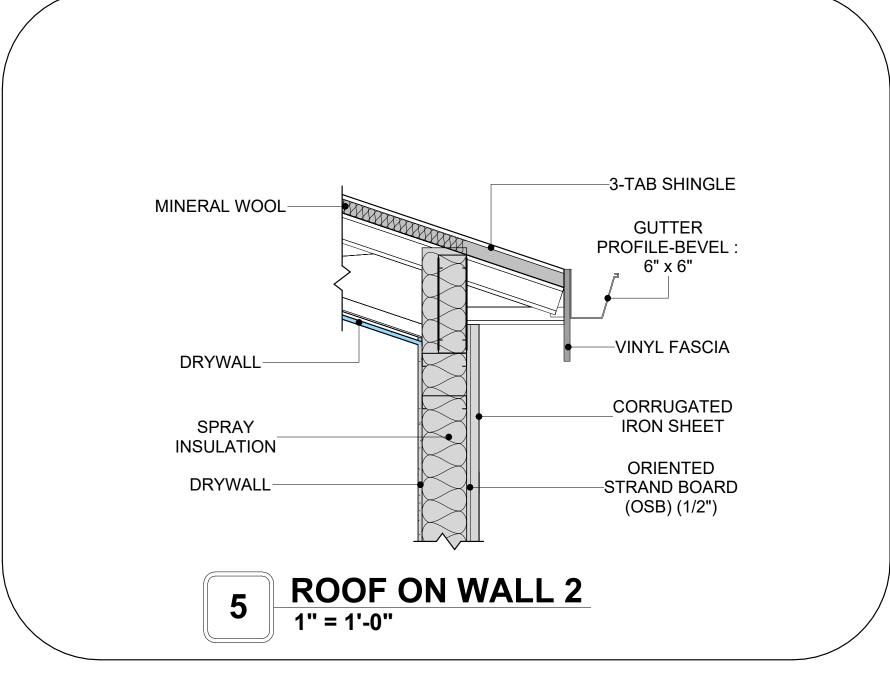

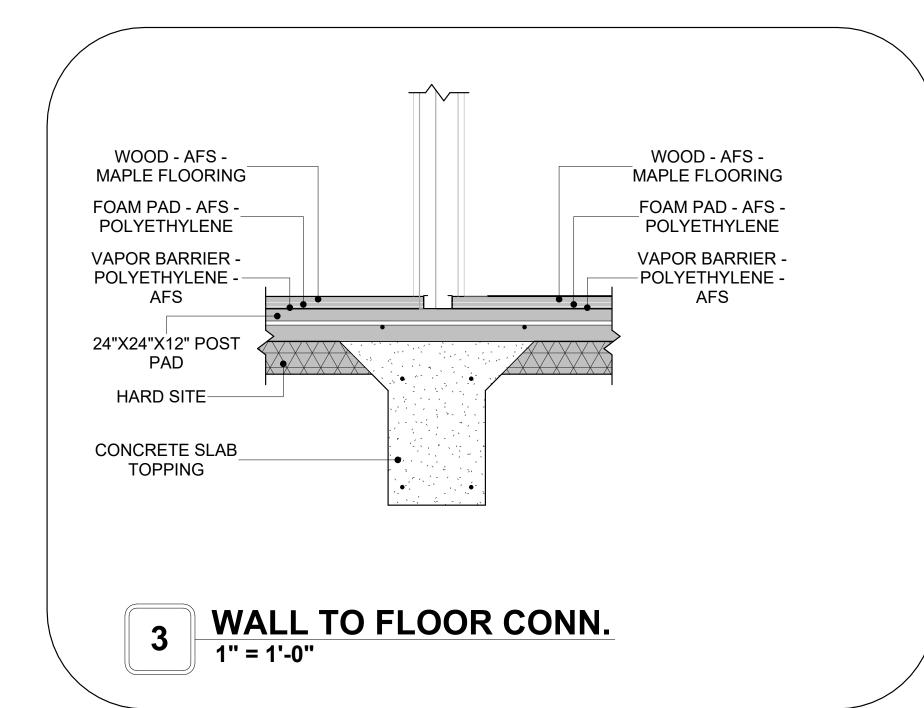

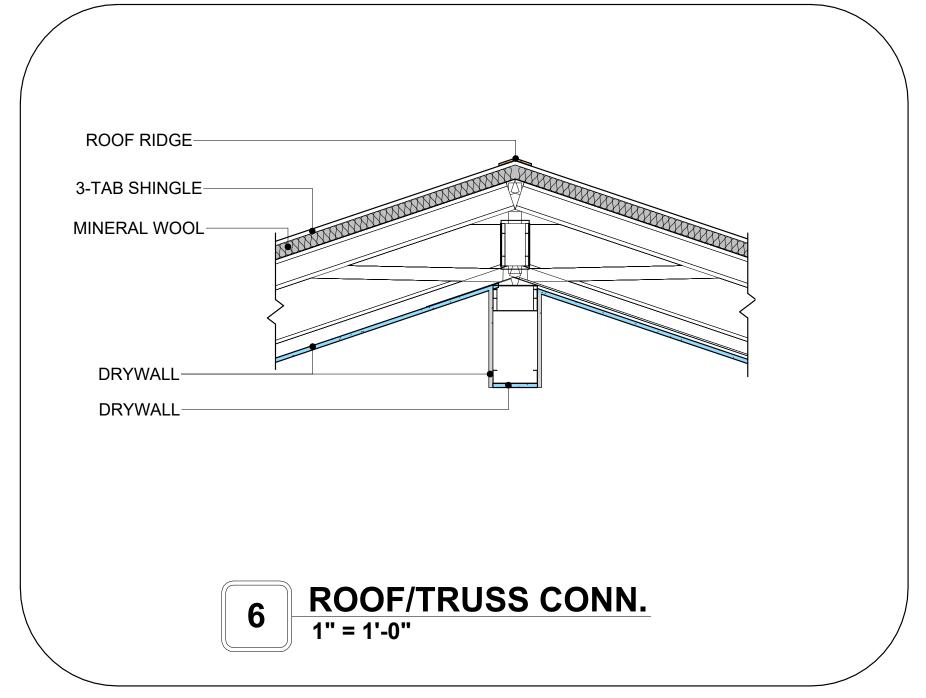

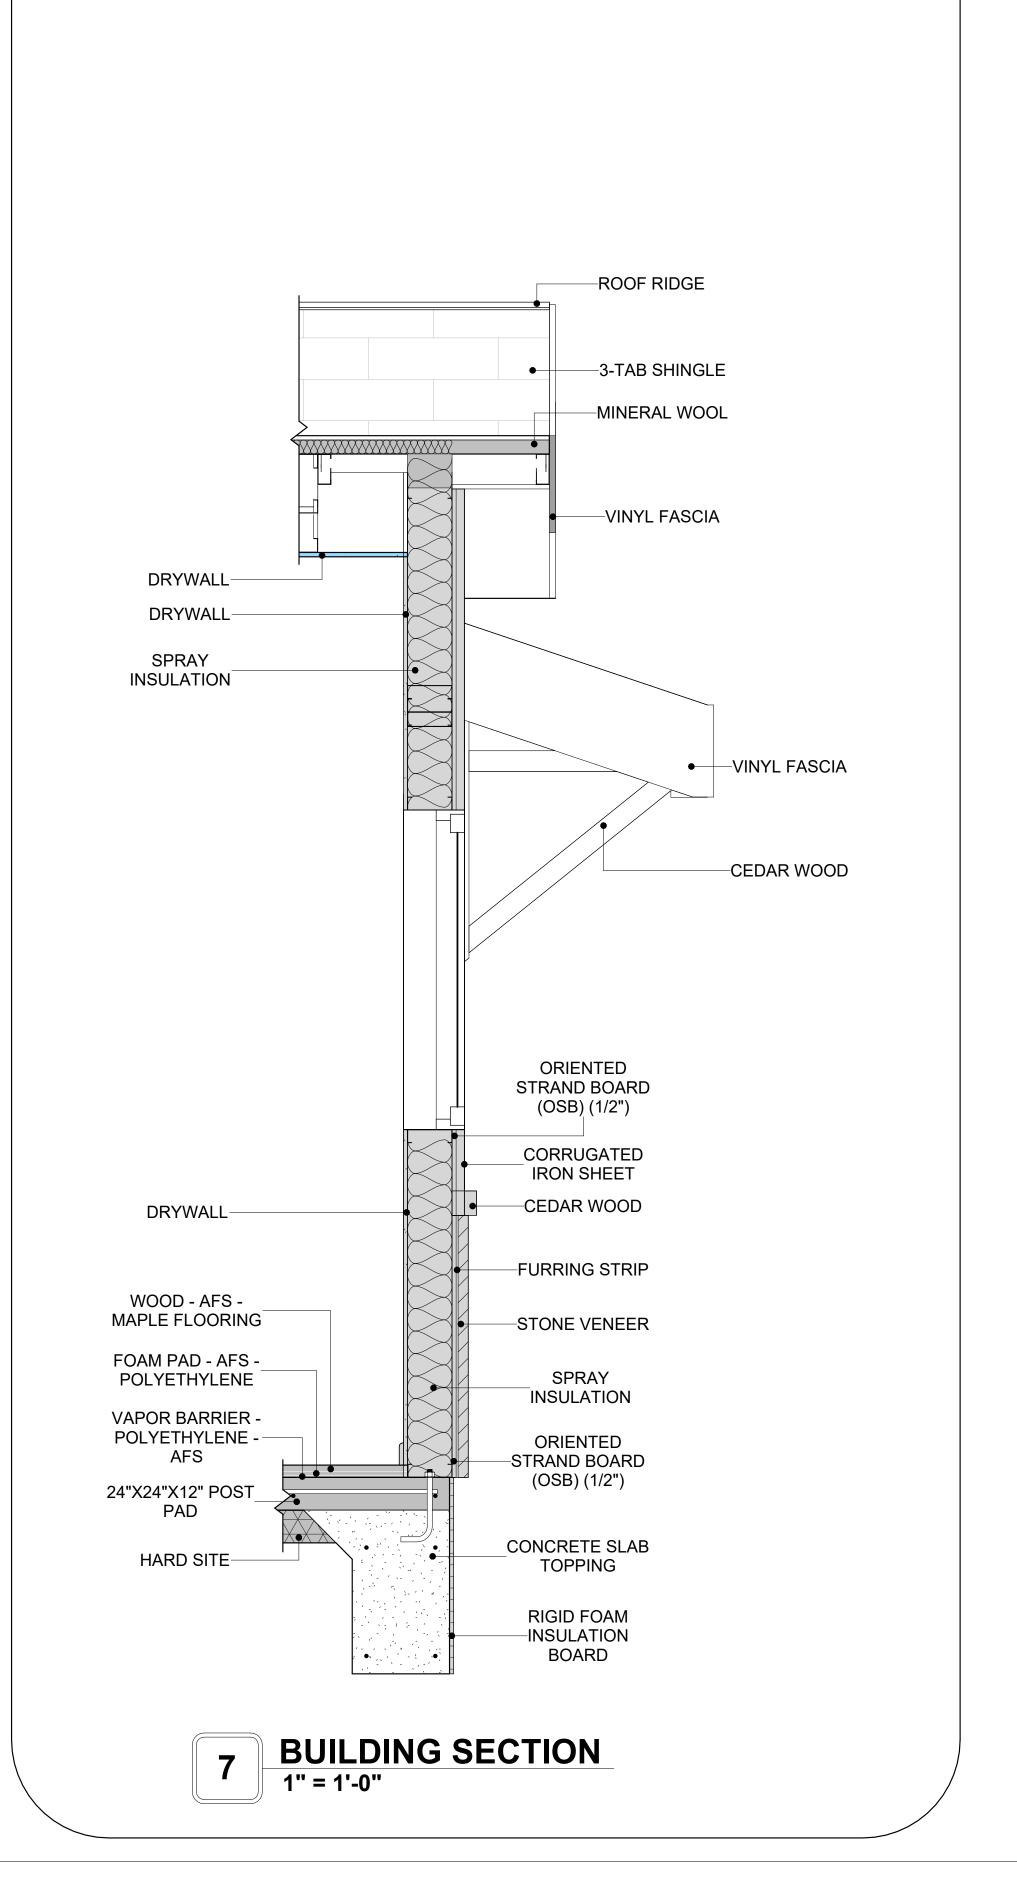



KEY PLAN

NO.	DESCRIPTION	DATE

NOTE:

LEGEND:

PROJECT

286-PINNACLE-495-1Bd1Ba TRADITIONAL-550

DRAWING NAME

ARCHITECTURAL DETAILS

CLIENT NAME:	Client Name
PROJECT NUMBER:	0061_12
DATE:	5/22/2025 11:06:46 AM
DESIGNED BY:	Designer
DRAWN BY:	Author
CHECKED BY:	Checker

A401

SCALE: 1" = 1'-0"


CASEWORK GENERAL NOTES


- ALL CABINET HEIGHTS INCLUDE COUNTERTOPS. DIMENSIONS ARE TO THE NEAREST INCH. DIVISIONS IN CASEWORK ARE SHOWN FOR CLARITY AND DO NOT REPRESENT BREAKS IN THE COUNTERTOP.
- PROVIDE CONTINUOUS COUNTERTOP OVER ALL SIMILAR HEIGHT CASEWORK, UNLESS AND OTHERWISE NOTED.
- MANUFACTURER AND CATALOG NUMBERS ARE FOR REFERENCE AND ILLUSTRATION PURPOSES
- DOTTED LINES INDICATE WALL HUNG CABINETS, DIVISIONS OF BASE CABINETS BELOW THE
- COUNTERTOP, FURNITURE NOT IN THE CONTRACT OR PROJECTION SCREENS -SEE CASEWORK KEY AND SPECIFICATIONS.
- ALL CABINETS AND DRAWERS TO HAVE CAM LOCKS EXCEPT FOR SINK BASE CABINETS.
 ALL EXPOSED SURFACES (EXPOSED TO VIEW FROM ANY PERSPECTIVE) TO BE COVERED WITH LAMINATE.
- ALL CASEWORK WHICH MEETS A WALL AT ONE OR BOTH ENDS, TO BE PROVIDED WITH FILLER PANELS AND SCRIBED TO THE WALL(S) AS REQUIRED.
- 10. ALL CABINETS AND DRAWERS ARE PROVIDED WITH RECESSED HANDLES. 11. CONTRACTOR TO FIELD VERIFY ALL CLEAR OPENINGS PRIOR TO MILLWORK OR CASEWORK
- FABRICATION. 12. CASEWORK DRAWINGS ARE DIAGRAMMATIC IN NATURE TO SHOW DESIGN INTENT.

	CASEWORK SCHEDULE					
TYPE MAR K	TYPE	COUN	HEIGHT	WIDTH	DEPTH	AREA
01	WALL_CABINET_SINGLE_DOOR	1	2' - 6"	1' - 6"	1' - 0"	4 SF
02	REFRIGERATOR TOP	1	1' - 8"	2' - 0"	2' - 4"	3 SF
03	RECESSED_MED_CABINET	1	2' - 0"	1' - 6"	0' - 3"	3 SF
04	CLOSET 4	1	6' - 0"	10' - 3"	1' - 4"	62 SF
05	BASE_CABINET_SINGLE_DOOR	1	2' - 7"	1' - 6"	2' - 0"	4 SF
06	LINEAR COUNTER TOP	1	0' - 4"	1' - 6"	2' - 1"	0 SF
07	VANITY	1	2' - 4"	2' - 6"	1' - 8"	6 SF
08	WALL_CABINET_DOUBLE_DOOR 2	1	2' - 6"	3' - 3"	1' - 0"	8 SF
09	HD_L-SHAPE_COUNTER_TOP W SINK HOLE 2	1	0' - 4"	4' - 6"	8' - 1"	1 SF
10	BASE CABINET DOUBLE DOOR	1	2' - 11"	3' - 0"	2' - 0"	9 SF
11	LAUNDRY OPEN CABINET 2	1	1' - 2"	2' - 3"	3' - 0"	3 SF
12	BASE_CABINET_L-SHAPED	1	2' - 11"	3' - 3"	3' - 3"	9 SF
GRAND	TOTAL	12	•			

SPECIALTY EQUIPMENT SCHEDULE				
TYPE MARK	TYPE	COUNT		
01	WASHER-FRONT-LOAD	1		
02	REFRIGERATOR	1		
03	RANGE	1		
04	DRYER-FRONT-LOAD	1		
05	DISHWASHER	1		
GRAND TOTAL : 5	-	'		




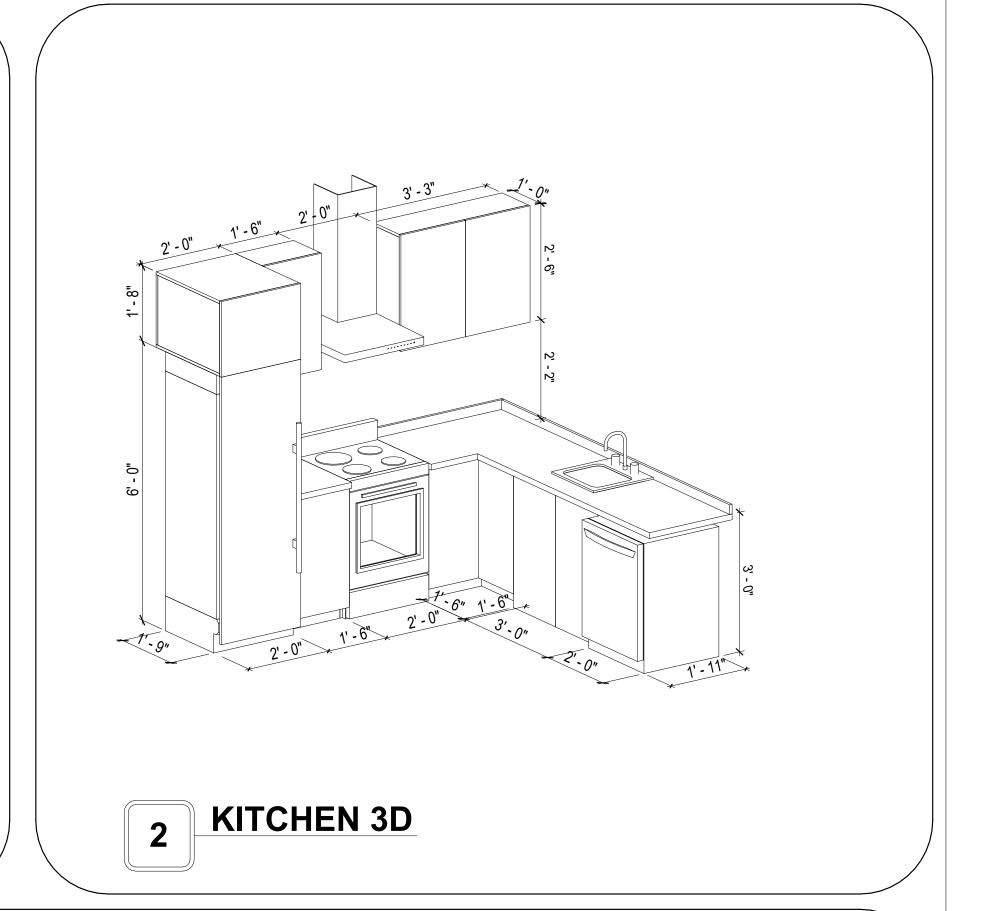

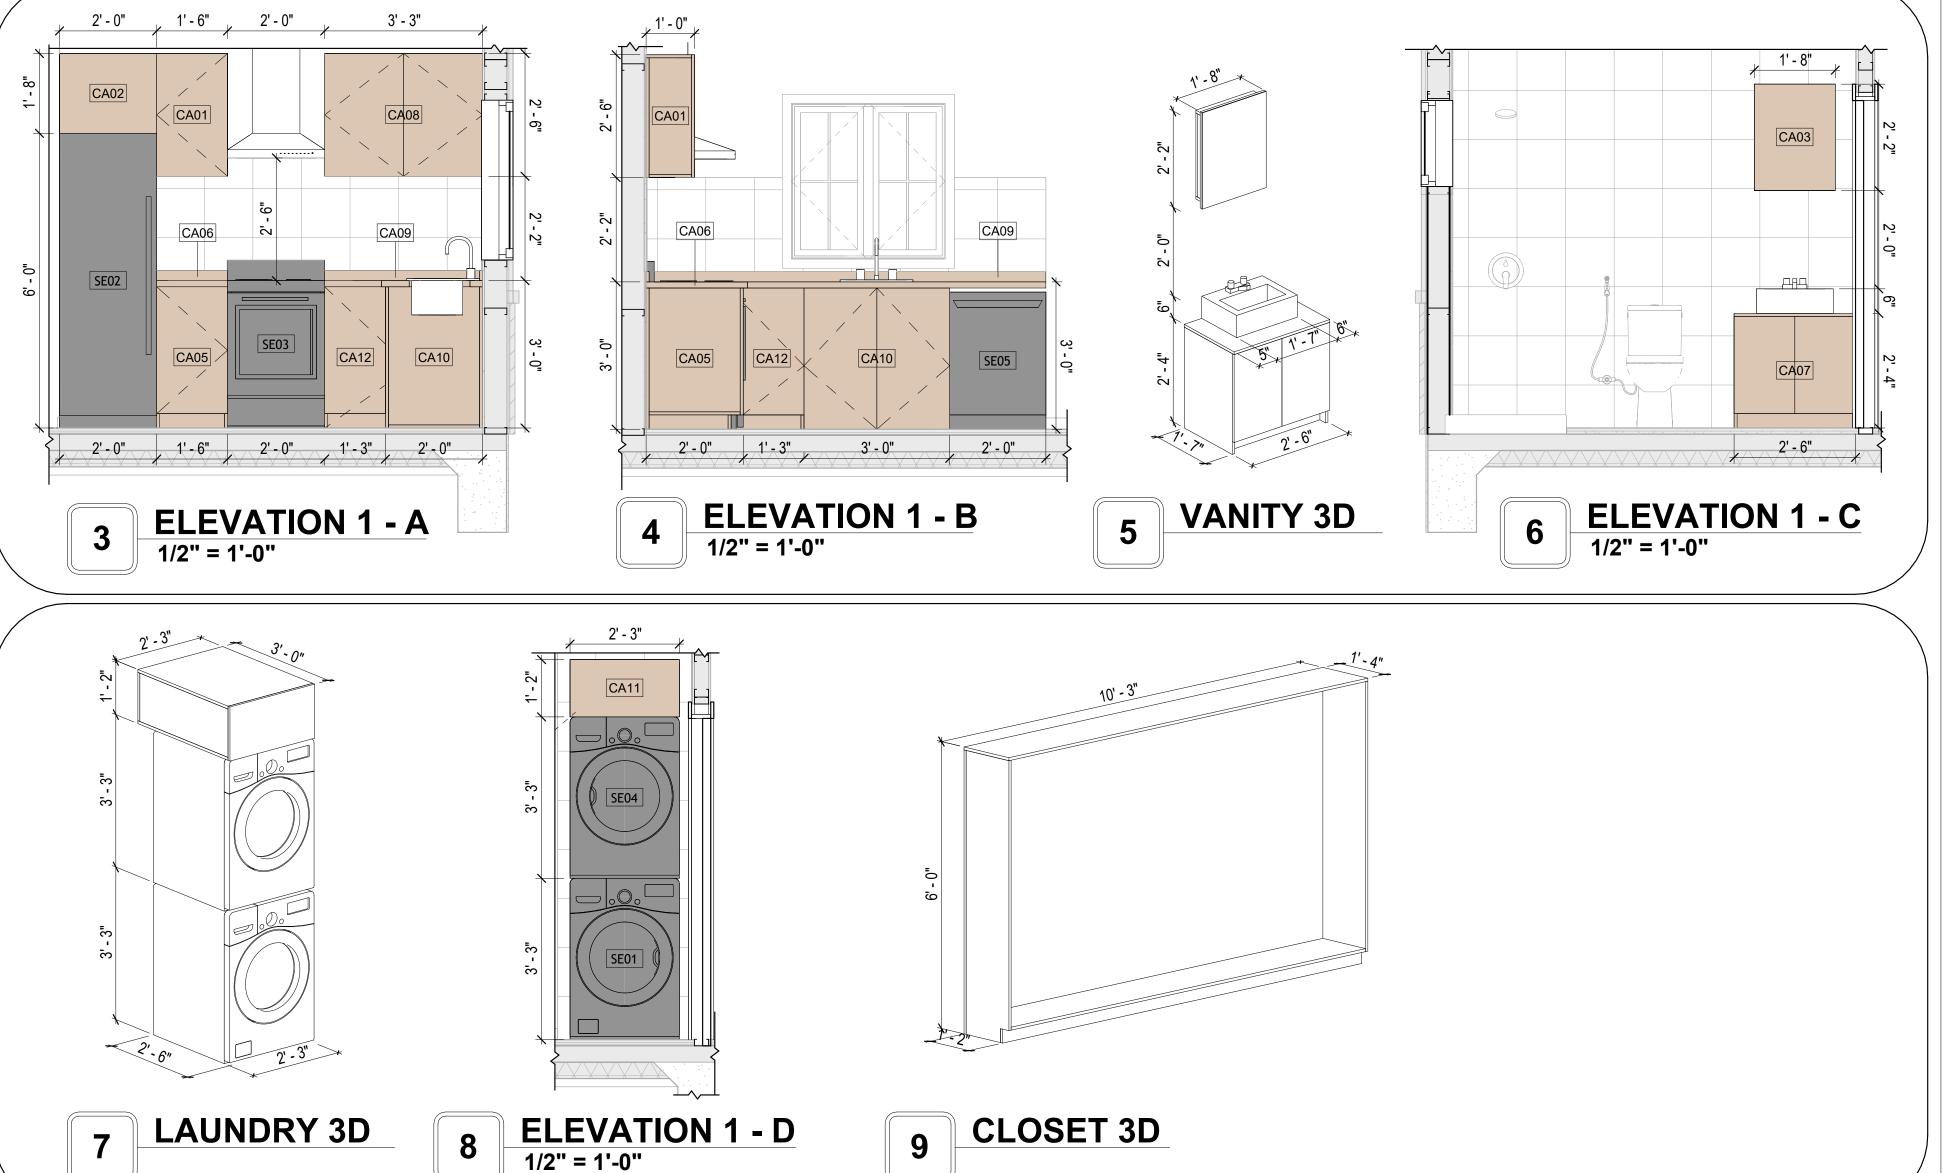



KEY PLAN

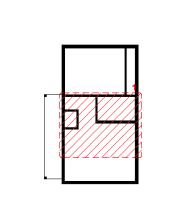

NO.	DESCRIPTION	DATE

NOTE:

LEGEND:

PROJECT

286-PINNACLE-495-1Bd1Ba **TRADITIONAL-550**

DRAWING NAME

ARCHITECTURAL CASEWORK

CLIENT NAME:	Client Name
PROJECT NUMBER:	0061_12
DATE:	5/22/2025 11:06:48 AM
DESIGNED BY:	Designer
DRAWN BY:	Author
CHECKED BY:	Checker

A402

GENERAL NOTES

1. THIS DRAWING DEPICTS THE HVAC (HEATING, VENTILATION, AND AIR CONDITIONING) SYSTEM FOR THEPINNACLE 1BD1BA TRADITIONAL . IT PROVIDES A VISUAL REPRESENTATION OF THE SYSTEM LAYOUT AND COMPONENTS.

2.THE HVAC SYSTEM IS DESIGNED TO MEET THE SPECIFIC REQUIREMENTS OF THE BUILDING, INCLUDING HEATING, COOLING, AND VENTILATION NEEDS, AS PER THE PROJECT SPECIFICATIONS AND APPLICABLE CODES AND STANDARDS.

3. THE HVAC SYSTEM INSTALLATION SHALL COMPLY WITH THE LATEST EDITION OF THE INTERNATIONAL MECHANICAL CODE (IMC), INTERNATIONAL RESIDENTIAL CODE (IRC), AND ALL OTHER APPLICABLE LOCAL, STATE, AND NATIONAL CODES AND REGULATIONS.

4. THE EQUIPMENT SHOWN ON THIS DRAWING INCLUDES BUT IS NOT LIMITED TO AIR HANDLING UNITS (AHUS), CHILLERS, BOILERS, COOLING TOWERS, PUMPS, DUCTWORK, DIFFUSERS, GRILLES, AND CONTROL DEVICES.

5. ALL EQUIPMENT, DUCTWORK, AND PIPING SHALL BE INSTALLED IN ACCORDANCE WITH MANUFACTURER'S SPECIFICATIONS, LOCAL CODES, AND

6. ALL DUCTWORK SHALL BE SIZED, FABRICATED, AND INSTALLED IN ACCORDANCE WITH THE LATEST EDITION OF THE ACCA MANUAL D AND THE SMACNA HVAC DUCT CONSTRUCTION STANDARDS. DUCTWORK SHALL BE INSTALLED IN A NEAT AND WORKMANLIKE MANNER, PROPERLY SUPPORTED AND BRACED TO PREVENT SAGGING, AIR LEAKAGE, OR VIBRATION.

CONDENSER

Ø3/4" Ø3/8"

EXHAUST FAN

3' - 5 1/2" 2' - 0" 3' - 3"

HOOD-WALL

4' - 0"

AIR HANDLING UNIT

5' - 6 1/2"

HVAC PLAN

3/8" = 1'-0"

3' - 2 1/2" 9"

7. CONDENSATE DRAINAGE PIPING SHALL BE PROPERLY PITCHED TO ENSURE POSITIVE DRAINAGE TO AN APPROVED DISPOSAL LOCATION, SUCH AS A FLOOR DRAIN, SUMP PUMP, OR EXTERIOR GRADE. CONDENSATE LINES SHALL BE INSULATED TO PREVENT SWEATING.

8. THE LOCATION OF CONTROL PANELS AND SENSORS INDICATED ON THIS DRAWING CAN BEMODIFY WITH THE SPECIFIC LOCATIONS AND WIRING DETAILS WILL BE DETERMINED DURING THE CONTROL SYSTEM DESIGN AND INSTALLATION.

9. THE HVAC SYSTEM DESIGN CONSIDER ENERGY EFFICIENCY, INDOOR AIR QUALITY, OCCUPANT COMFORT, AND NOISE CONTROL, FOLLOWING

APPLICABLE GUIDELINES AND REGULATIONS. 10. COORDINATION WITH OTHER TREADS HAS BEEN DONE ON A DESIGN LEVEL. THIS DRAWING SHALL BE READ TOGETHER WITH THE AR, EL AND SN

DESIGN DRAWINGS TO ENSURE PROPER INSTALLATION AND INTEGRATION OF THE HVAC SYSTEMS. 11. THE HVAC CONTRACTOR IS RESPONSIBLE FOR OBTAINING ALL NECESSARY PERMITS AND LICENSES, AND FOR SCHEDULING AND COORDINATING

WITH THE LOCAL BUILDING DEPARTMENT AND UTILITY PROVIDERS TO ENSURE A TIMELY AND COMPLIANT INSTALLATION. 12. ALL DUCTWORK PENETRATIONS THROUGH WALLS, FLOORS, OR CEILINGS SHALL BE PROPERLY SEALED AND FIRE-STOPPED USING APPROVED

METHODS AND MATERIALS TO MAINTAIN THE INTEGRITY OF THE BUILDING'S FIRE-RESISTANCE RATINGS.

13. HVAC EQUIPMENT SHALL BE INSTALLED LEVEL AND PLUMB, AND IN STRICT ACCORDANCE WITH THE MANUFACTURER'S INSTALLATION INSTRUCTIONS AND RECOMMENDATIONS. PROVIDE ADEQUATE CLEARANCES AROUND EQUIPMENT FOR PROPER AIRFLOW, SERVICE ACCESS, AND CODE COMPLIANCE.


14. ALL HVAC EQUIPMENT AND COMPONENTS, INCLUDING THERMOSTATS, DAMPERS, AND ACCESS PANELS, SHALL BE LOCATED IN ACCESSIBLE AREAS FOR EASY SERVICING AND MAINTENANCE. PROVIDE ADEQUATE SPACE AROUND EQUIPMENT FOR PROPER AIRFLOW AND SERVICE ACCESS.

15. THE HVAC SYSTEM SHALL BE BALANCED AND ADJUSTED TO ENSURE PROPER AIRFLOW, TEMPERATURE DISTRIBUTION, AND SYSTEM PERFORMANCE THROUGHOUT THE RESIDENCE. PROVIDE A WRITTEN REPORT DOCUMENTING THE FINAL SYSTEM BALANCE.

16. ANY DEVIATIONS OR MODIFICATIONS TO THE HVAC SYSTEM DESIGN SHALL BE REVIEWED AND APPROVED BY THE RESPONSIBLE DESIGN PROFESSIONALS AND COMMUNICATED TO ALL RELEVANT PARTIES INVOLVED IN THE CONSTRUCTION PROCESS.

17. FOR ANY INQUIRIES OR CLARIFICATIONS REGARDING THE HVAC SYSTEM DESIGN, PLEASE CONSULT THE RESPONSIBLE DESIGN PROFESSIONALS OR THE PROJECT MANAGEMENT TEAM.

SYMBOLS

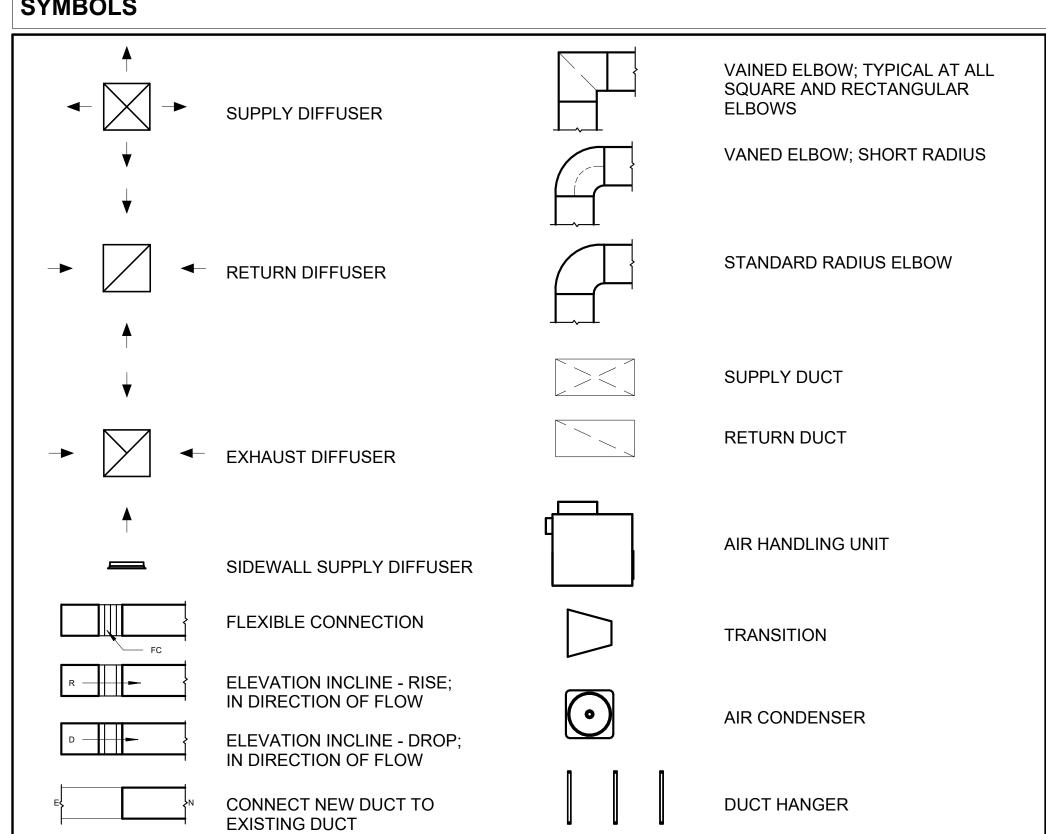



AIR CONDITIONING PIPE

REFRIGERANT LINE SCHEDULE						
CATAGORY	DESCRIPTION	DIAMETER	LENGTH			
PIPE TYPES	COPPER	3/8"	45.72			
PIPE TYPES	COPPER	3/4"	53.99			

REFRIGERANT LINE FITTING SCHEDULE							
CATAGORY	DESCRIPTION	Size	Count				
ELBOW - GENERIC	ELBOW - GENERIC: STANDARD/HVAC	3/4"ø-3/4"ø	11				
ELBOW - GENERIC	ELBOW - GENERIC: STANDARD/HVAC	3/8"ø-3/8"ø	11				
TRANSITION - GENERIC	TRANSITION - GENERIC: STANDARD	3/4"ø-1/2"ø	2				
TRANSITION - GENERIC	TRANSITION - GENERIC: STANDARD	3/4"ø-5/8"ø	1				
TRANSITION - GENERIC	TRANSITION - GENERIC: STANDARD	3/8"ø-1/4"ø	1				

MECHANICAL EQUIPMENT SCHEDULE				
CATAGORY	DESCRIPTION	COUNT		
AIR HANDLING UNIT	AIR HANDLING UNIT: WALL MOUNTED	1		
CONDENSER	CONDENSER: OUT DOOR	1		
EXHAUST FAN	EXHAUST FAN: 75 CFM	1		
LXII/XOOT I/XIV				

DUCT FITTING SCHEDULE					
CATAGORY	DESCRIPTION	COUNT			
ROUND TRANSITION - ANGLE	45 DEGREE	5			

DUCT ACCESSORY SCHEDULE					
CATAGORY	DESCRIPTION	COUNT			
ROOF VENT	3" DIAMETER	3			

FLEX DUCT SCHEDULE							
DESCRIPTION	DESCRIPTION	LENGTH	DIAMETER	COUNT			
FLEX DUCT ROUND	FLEX-ROUND	9.61	4"	3			
GRAND TOTAL: 3		9.61		·			



KEY PLAN

NO.	DESCRIPTION	DATE

NOTE:

LEGEND:

PROJECT

286-PINNACLE-495-1Bd1Ba **TRADITIONAL-550**

DRAWING NAME

HVAC PLAN

CLIENT NAME: Owner PROJECT NUMBER 15_0001 5/19/2025 11:55:24 PM Designer DESIGNED BY: DRAWN BY: Author CHECKED BY: Checker

M101

SCALE: As indicated

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ELECTRICAL NOTES

- 1. THIS DRAWING DEPICTS THE ELECTRICAL SYSTEM FOR THE 286-PINNACLE-495-1Bd1Ba-TRADITIONAL-550. IT PROVIDES A VISUAL REPRESENTATION OF THE ELECTRICAL LAYOUT AND COMPONENTS, INCLUDING POWER DISTRIBUTION, LIGHTING, AND CONTROL SYSTEMS.
- 2. THE ELECTRICAL SYSTEM IS DESIGNED TO MEET THE SPECIFIC REQUIREMENTS OF THE BUILDING, INCLUDING POWER DISTRIBUTION, LIGHTING, AND SPECIALIZED ELECTRICAL EQUIPMENT NEEDS, AS PER THE PROJECT SPECIFICATIONS AND APPLICABLE CODES AND STANDARDS.
- 3. THE ELECTRICAL SYSTEM INSTALLATION SHALL COMPLY WITH THE LATEST EDITION OF THE NATIONAL ELECTRICAL CODE (NEC), INTERNATIONAL BUILDING CODE (IBC), AND ALL OTHER APPLICABLE LOCAL, STATE, AND NATIONAL CODES AND REGULATIONS.
- 4. LOCATIONS AS NEEDED, DEVICES ARE SHOWN ON PLANS IN APPROXIMATE IDEAL LOCATIONS, UNLESS SPECIFICALLY DIMMENSIONED.
- 5. OPEN WALLS AS NEEDED TO ALLOW FOR NEW ELECTRICAL INSTALLATIONS.
- 6. LABEL ALL CIRCUITS ON JUNCTION BOXES, RECEPTACLES, DATA, SMOKE DETECTOR, AND EQUIPMENT IN PANEL BOX.
- 7. INSTALL RACEWAY AS NEEDED FOR DDC, ACCESS CONTROL, LOW VOLTAGE WIRING & DATA.
- 8. RELABEL POWER, DATA & FIRE ALARM FOR ROOM #CHANGES.
- 9. VERIFY ALL CIRCUITS LABELED ON PRINT ARE CORRECT BEFORE WORKING ON THEM.
 10. NOTE ON SITE PLAN ALL CHANGES OR MISSING DETAIL TO BE INCORPORATED INTO THE MASTER PLAN.
- 11. DRAWINGS ARE DIAGRAMMATIC ONLY FOR THE PURPOSE OF SHOWING FIXTURE AND OUTLET LOCATIONS.
- 12. ELECTRICAL CONTRACTOR TO VERIFY SERVICE SIZE BY CALCULATION BASED UPON ACTUAL NAME PLATE RATINGS OF SELECTED FOLIPMENT
- PLATE RATINGS OF SELECTED EQUIPMENT.

 13. VERIFY LOCATION OF SERVICE ENTRANCE WITH POWER COMPANY. PROVIDE UFER GROUND IN
- BUILDING FOUNDATION AT SERVICE ENTRANCE WITH POWER COMPANY. PROVIDE UPER GROUND IN
- BUILDING FOUNDATION AT SERVICE ENTRANCE LOCATION.

 14. PROVIDE A MIN. OF 20 FEET OF ONE *4 BARE COPPER UFER WIRE EMBEDDED IN CONCRETE FOOTING
- AT THE SERVICE ENTRANCE LOCATION WHERE APPROVED BY LOCAL SERVICE PROVIDER.

 15. PROVIDE WATERPROOF FIXTURES IN ALL HIGH MOISTURE AREAS (EXTERIOR, SHOWER AND TUB
- CEILINGS ETC.)

 16. PROVIDE DEDICATED CIRCUITS TO EACH BATH, DEN, EAMILY ROOM, BEDROOM, LOFT, KITCHEN
- 16. PROVIDE DEDIĆATED CIRCUITS TO EACH BATH, DEN, FAMILY ROOM, BEDROOM, LOFT, KITCHEN REFRIGERATOR. KITCHEN FREEZER DISHWASHER. AND ANY AREA/ITEM SPECIFIED BY OWNER.
- 17. INCANDESCENT FIXTURES WITH OPEN OR PARTIALLY ENCLOSED LAMPS, PENDANT FIXTURES, AND LAMP HOLDERS ARE NOT PERMITTED IN CLOSETS.
- 18. ALL WORKMANSHIP AND MATERIALS TO CONFORM WITH THE 2015 IRC.
- 19. PROVIDE A MIN. OF 20 FEET OF ONE *4 BARE COPPER UFER WIRE EMBEDDED IN CONCRETE FOOTING AT THE SERVICE ENTRANCE LOCATION WHERE APPROVED BY LOCAL SERVICE PROVIDER.
- 20. PROVIDE A BONDING CONDUCTOR CONSISTING OF A MINIMUM OF ONE *4 BARE COPPER WIRE CONNECTING THE BUILDING'S METAL WATER PIPING SYSTEM TO THE SERVICE EQUIPMENT ENCLOSURE GROUNDING.

MAIN PANEL CALCS

ELECTRICAL CALCS	
LIGHT AND OUTLETS 495 @ 3W	1,485 W
3 APPLIANCE CIRCUITS	4,500 W
DRYER	2,000 W
WASHER	2,000 W
Range	5,000 W
WATER HEATER	5,000 W
REFRIG.	1,800 W
DISHWASHER & DISPOSAL	3000 W
TOTAL	24,785 W
FRIST 10,000 @ 100% REMAINDER @ 40% MINI. SPLIT UNITS	10,000 W 5,914W 10,000 W
TOTAL	25,914 W

25,914 W DIVIDED BY 240V = 108 AMPS TOTAL

(USE 200 AMP SERVICE)

ELECTRICAL ABBREVIATIONS LIST

1P	1 POLE (2P, 3P, 4P, ETC.)	CTR	CENTER	нт	HEIGHT
A	AMPERE	CU	COPPER	HTG	HEATING
AC	ABOVE COUNTER OR AIR CONDITIONER	DCP	DOMESTIC WATER CIRCULATING PUMP	HTR	HEATER
ACLG	ABOVE COUNTER OR AIR CONDITIONER	DEPT	DEPARTMENT	HV	HIGH VOLTAGE
ADO	AUTOMATIC DOOR OPENER	DET	DETAIL	HVAC	HEATING, VENTILATING AND AIR
AF	AMP FRAME	DIA	DIAMETER	CONDITIONING	CONDITIONING
AFF	ABOVE FINISHED FLOOR	DISC	DISCONNECT	HWP	HYDRONIC WATER PUMP
AFG	ABOVE FINISHED GRADE	DIST	DISTRIBUTION	IC	INTERRUPTING CAPACITY
AFI	ARC FAULT CIRCUIT INTERRUPTER	DN	DOWN	IG	ISOLATED GROUND
AHU	AIR HANDLING UNIT	DPR	DAMPER	IMC	INTERMEDIATE METAL CONDUIT
AL	ALUMINUM	DS	SAFETY DISCONNECT SWITCH	INCAND	INCANDESCENT
ALT	ALTERNATE	DT	DOUBLE THROW	IR	INFRARED
AMP	AMPERE	DWG	DRAWING	I/W	INTERLOCK WITH
AMPL	AMPLIFIER	DDC	DIRECT DIGITAL CONTROL	J-BOX	JUNCTION BOX
ANNUN	ANNUNCIATOR APPROX APPROXIMATELY	EC	ELECTRICAL CONTRACTOR	KV	KILOVOLT
AQ-STAT	AQUASTAT	ELEC	ELECTRIC, ELECTRICAL	KVA	KILOVOLT-AMPERE
ARCH	ARCHITECT, ARCHITECTURAL	ELEV	ELEVATOR	KVAR	KILOVOLT-AMPERE REACTIVE
AS	AMP SWITCH	EM	EMERGENCY	KW	KILOWATT
AT	AMP TRIP	EMS	ENERGY MANAGEMENT SYSTEM	KWH	KILOWATT HOUR
ATS	AUTOMATIC TRANSFER SWITCH	EMT	ELECTRICAL METALLIC TUBING	LOC	LOCATE OR LOCATION
AUTO	AUTOMATIC	EP	ELECTRIC PNEUMATIC	LT	LIGHT
AUX	AUXILIARY	EQUIP	EQUIPMENT	LTG	LIGHTING
AV	AUDIO VISUAL	EWC	ELECTRIC WATER COOLER	LTNG	LIGHTNING
AWG	AMERICAN WIRE GAUGE	EXIST	EXISTING	LV	LOW VOLTAGE
BATT	BATTERY	EXH	EXHAUST	MAX	MAXIMUM
BD	BOARD	EXP	EXPLOSION PROOF	MAG.S	MAGNETIC STARTER
BLDG	BUILDING	FA	FIRE ALARM	M/C	MOMENTARY CONTACT
BMS	BUILDING MANAGEMENT SYSTEM	FABP	FIRE ALARM BOOSTER POWER	MC	MECHANICAL CONTRACTOR
C	CONDUIT	SUPPLY PANEL	SUPPLY PANEL	MCB	MAIN CIRCUIT BREAKER
CAB	CABINET	FACP	FIRE ALARM CONTROL PANEL	MCC	MOTOR CONTROL CENTER
CAT	CATALOG	FCU	FAN COIL UNIT	MDC	MAIN DISTRIBUTION CENTER
CATV	CATALOG CABLE TELEVISION	FIXT	FIXTURE	MDP	MAIN DISTRIBUTION PANEL
CB	CIRCUIT BREAKER	FLR	FLOOR	MFR	MANUFACTURERMAIN FUSED
CCTV	CLOSED CIRCUIT TELEVISION	FLUOR	FLUORESCENT	IVIFIX	DISCONNECT SWITCH
CKT			FUSE	MH	MANHOLE
	CIRCUIT	FU	FUSED SAFETY DISCONNECT SWITCH		
CLG	CEILING	FUDS		MIC	MICROPHONE
COMB	COMBINATION	GA	GAUGE	MIN	MINIMUM
CMPR	COMPRESSOR	GAL	GALLON	MISC	MISCELLANEOUS
CONN	CONNECTION	GALV	GALVANIZED	MLO	MAIN LUGS ONLY
CONST	CONSTRUCTION	GC	GENERAL CONTRACTOR	MMS	MANUAL MOTOR STARTER
CONT	CONTINUATION OR CONTINUOUS	GEN	GENERATOR	MOA	MULTIOUTLET ASSEMBLY
CONTR	CONTRACTOR	GFI	GROUND FAULT CIRCUIT INTERRUPTER	MSP	MOTOR STARTER PANELBOARD
CONV	CONVECTOR	GFP	GROUND FAULT PROTECTOR	MSBD	MAIN SWITCHBOARD
CP	CIRCULATING PUMP	GND	GROUND	MT	MOUNT
CRT	CATHODE-RAY TUBE	GRS	GALVANIZED RIGID STEEL (CONDUIT)	MT.C	EMPTY CONDUIT
СТ	CURRENT TRANSFORMER	GYP BD	GYPSUM BOARD	UL	UNDERWRITERS LABORATORIES

Branch Panel:

Location: KITCHEN 02
Supply From:
Mounting: Recessed

Enclosure: Type 1

Volts: 120/240 Single
Phases: 1
Wires: 3

A.I.C. Rating:
Mains Type:
Mains Rating: 200 A
MCB Rating: 1 A

Notes:

Circuit Numb er	Circuit Description	Number of Elements	Rating	Length	Wire Size	A			3	Wire Size	Length	Rating	Number of Elements	Circuit Description	Circui Numb er
	BED LIGHT& SMOKE DETECTOR	12	20 A	32' - 10 1/2"	1-#12, 1-#12, 1-#12	688 VA	720 VA			1-#12, 1-#12, 1-#12	40' - 10 29/32"	20 A	4	BED RECEPTACLE	2
3	BATH GFCI & LIGHT	7	20 A	19' - 11 21/32"	1-#12, 1-#12, 1-#12			576 VA							4
5	LIVING LIGHT	9	15 A	25' - 9 17/32"	1-#14, 1-#14, 1-#14	435 VA	400 VA			1-#14, 1-#14, 1-#14	28' - 5 1/32"	15 A	6	OUTDOOR LIGHT	6
7	WATER HEATER	1	30 A	28' - 6 5/32"	2-#10, 1-#10, 1-#10			2250 VA	2500 VA	2-#10, 1-#10, 1-#10	29' - 11 5/32"	30 A	1	DRYER	8
9						2250 VA	2500 VA								10
11	REFRIGERATOR	1	20 A	17' - 5 17/32"	1-#12, 1-#12, 1-#12			1800 VA	2500 VA	2-#8, 1-#8, 1-#10	13' - 7 23/32"	50 A	1	RANGE	12
13	OVEN HOOD	1	20 A	7' - 10 31/32"	1-#12, 1-#12, 1-#12	180 VA	2500 VA								14
15	KITCHEN GFCI	3	20 A	15' - 3 27/32"	1-#12, 1-#12, 1-#12			540 VA	1200 VA	1-#12, 1-#12, 1-#12	17' - 4 25/32"	20 A	1	DISHWASHER	16
17	LIVING RECEPTACLE	4	20 A	34' - 0 9/32"	1-#12, 1-#12, 1-#12	720 VA	540 VA			1-#12, 1-#12, 1-#12	36' - 10 17/32"	20 A	3	OUTDOOR GFCI	18
19	WASHING MASHEIN	1	20 A	32' - 10 17/32"	1-#12, 1-#12, 1-#12			1200 VA	2500 VA	2-#6, 1-#6, 1-#10	42' - 9 11/32"	60 A	1	CONDENSER	20
21							2500 VA								22
23															24
25															26
						13409) VA	1506	55 VA						
						112			6 A						

Legen

Load Classification	Connected Load	Demand Factor	Estimated Demand	Panel	Totals
Lighting - Dwelling Unit	600 VA	100.00%	600 VA		
Other	952 VA	100.00%	952 VA	Total Conn. Load:	28473 VA
Receptacle	1440 VA	100.00%	1440 VA	Total Est. Demand:	27473 VA
Lighting	200 VA	100.00%	200 VA	Total Conn.:	119 A
CONDENSER	5000 VA	100.00%	5000 VA	Total Est. Demand:	114 A
WATER HEATER	4500 VA	100.00%	4500 VA		
RANGE	5000 VA	80.00%	4000 VA		
DRYER	5000 VA	100.00%	5000 VA		
REFRIGERATOR	1800 VA	100.00%	1800 VA		
OVEN HOOD	1620 VA	100.00%	1620 VA		
WASHING MASHEIN	2400 VA	100.00%	2400 VA		



KEY PLAN

NO. DESCRIPTION DATE

NOTE:

LEGEND:

PROJECT

286-PINNACLE-495-1Bd1Ba TRADITIONAL-550

DRAWING NAME

SCHEDULE

CLIENT NAME:

PROJECT NUMBER:

0090_12

DATE:

5/24/2025 5:49:28 AM

DESIGNED BY:

DRAWN BY:

CHECKED BY:

Checker

E101

SCALE: 1/4" = 1'-0"

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ELECTRICAL NOTE

- PROVIDE INTERCONNECTED SMOKE ALARMS IN EACH SLEEPING ROOMS, OUTSIDE EACH SLEEPING ROOM, ON EACH STORY, IN THE HALL OR ADJACENT ROOM LUHERE THE CEILING HEIGHT OF A ROOM OPEN TO THE HALL EXCEEDS THE HALL BY 24'. SMOKE ALARMS SHALL BE PERMANENTLY HARD WIRED WITH BATTERY BACKUP.
- B. RECEPTACLE OUTLETS FOR RANGES AND CLOTHES DRYERS SHALL BE A THREE POLE WITH GROUND TYPE. FOUR WIRE GROUNDING-TYPE FLEXIBLE CORDS WILL BE REQUIRED FOR CONNECTION OF RANGES AND CLOTHES DRYERS. THE BONDING JUMPER SHALL NOT BE CONNECTED BETWEEN NEUTRAL TERMINAL AND THE FRAME OF THE **APPLIANCE**
- C. TWO OR MORE 20 AMP SMALL APPLIANCE CIRCUITS SHALL BE PROVIDED TO SERVE THE KITCHEN, BREAKFAST NOOK, AND DINING ROOM. SUCH CIRCUITS SHALL HAVE NO OTHER OUTLETS.
- D. AT LEAST ONE 20 AMP BRANCH CIRCUIT SHALL BE PROVIDED TO SERVICE THE LAUNDRY ROOM. THIS CIRCUIT SHALL HAVE NO OTHER OUTLETS.
- E. ALL RECEPTACLES WITH IN 6' OF A WET BAR SINK OR KITCHEN SINK TO SERVE COUNTER TOP SURFACES MUST BE GFCI. ON KITCHEN COUNTERS 12' OR WIDER NO POINT ALONG THE WALL SHALL BE MORE THAN 2' FROM A RECEPTACLE. ALL RECEPTACLES WITH IN 6' OF KITCHEN SINK MUST BE GFCI. AT LEAST ONE GFCI RECEPTACLE SHALL BE INSTALLED IN THE BATHROOM ADJACENT TO EACH BASIN.
- FIXTURES INCLUDING CEILING FANS THAT ARE LOCATED IN DAMP LOCATIONS SHALL BE LISTED TO BE SUITABLE FOR
- SUCH LOCATIONS PER 2012 IRC
- G. PROVIDE ONE (1) SWITCHED OUTLET @ ALL BEDROOMS AND DEN
- H. CEILING FANS NOT EXCEEDING 35 LBS. (WITH OR WITHOUT ACCESSORIES MAY BE SUPPORTED BY OUTLET BOXES PROVIDED THE OUTLET BOXES ARE IDENTIFIED FOR SUCH USE PER 2012 IRC
- ELECTRICAL OUTLET BOXES ON OPPOSITE SIDES OF FIRE RATED WALLS SHALL BE SEPARATED BY A HORIZONTAL DISTANCE OF NOT LESS THAN 24".
- OUTLET BOXES IN THE WALLS BETWEEN THE GARAGE AND DWELLING SHALL BE METAL OR U.L. APPROVED FIRE RESISTIVE PLASTIC. BOXES IN GARAGE CEILING SHALL BE METAL.
- K. ALL BRANCH CIRCUITS THAT SUPPLY 120 VOLTS SINGLE PHASE 15 AND 20 AMPS RECEPTACLE OUTLETS INSTALLED IN THE DWELLING SHALL BE PROTECTED BY AN ARC FAULT CIRCUIT INTERRUPTER, EXCEPT GFCI RECEPTICLES.

NOTE:

RECEPTACLES MUST BE PROVIDED IN HALLWAYS 10'-0" OR MORE IN LENGTH. FOR A ONE FAMILY DWELLINGS AND EACH OF A TWO FAMILY DWELLING THAT IS AT GRADE LEVEL, AT LEAST ONE WP-GFCI RECEPTACLE OUTLET ACCESSIBLE AT GRADE LEVEL AND NOT MORE THAN 6'-6" ABOVE GRADE SHALL BE INSTALLED AT THE FRONT AND BACK OF THE DWELLING.

NOTE: APPLIANCE DISCONNECT

E4001.5 GROUNDING OF ENCLOSURES.

METAL ENCLOSURES FOR SWITCHES OR CIRCUIT BREAKERS SHALL BE CONNECTED TO AN

EQUIPMENT GROUNDING CONDUCTOR.

METAL ENCLOSURES FOR SWITCHES OR CIRCUIT BREAKERS USED AS SERVICE


EQUIPMENT SHALL COMPLY WITH THE PROVISIONS OF SECTION E3609.4. WHERE NONMETALLIC ENCLOSURES ARE USED WITH METAL RACEWAYS OR METAL-ARMORED


CABLES, PROVISIONS SHALL BE MADE FOR CONNECTING THE EQUIPMENT GROUNDING

CONDUCTOR.


NONMETALLIC BOXES FOR SWITCHES SHALL BE INSTALLED WITH A WIRING METHOD THAT


PROVIDES OR INCLUDES AN EQUIPMENT GROUNDING CONDUCTOR. (404.12)

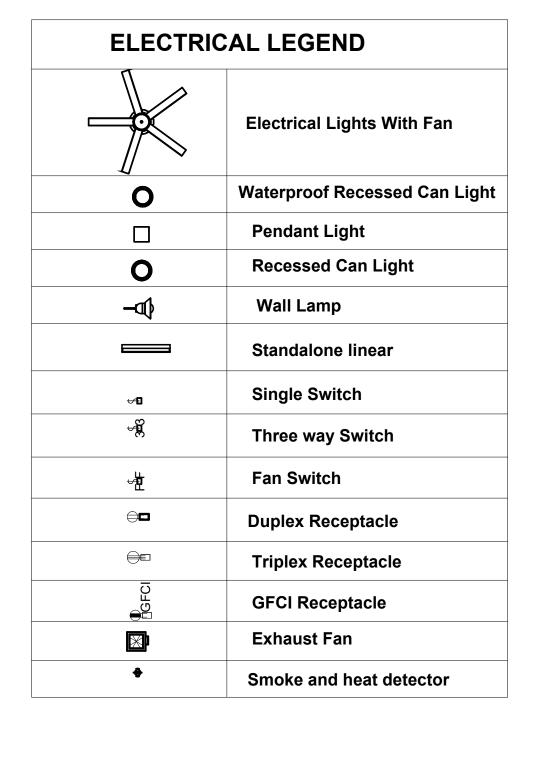

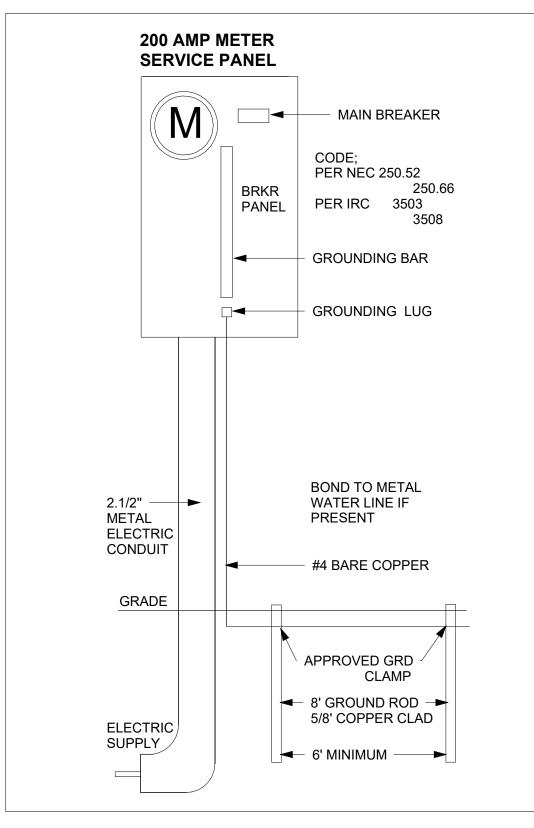



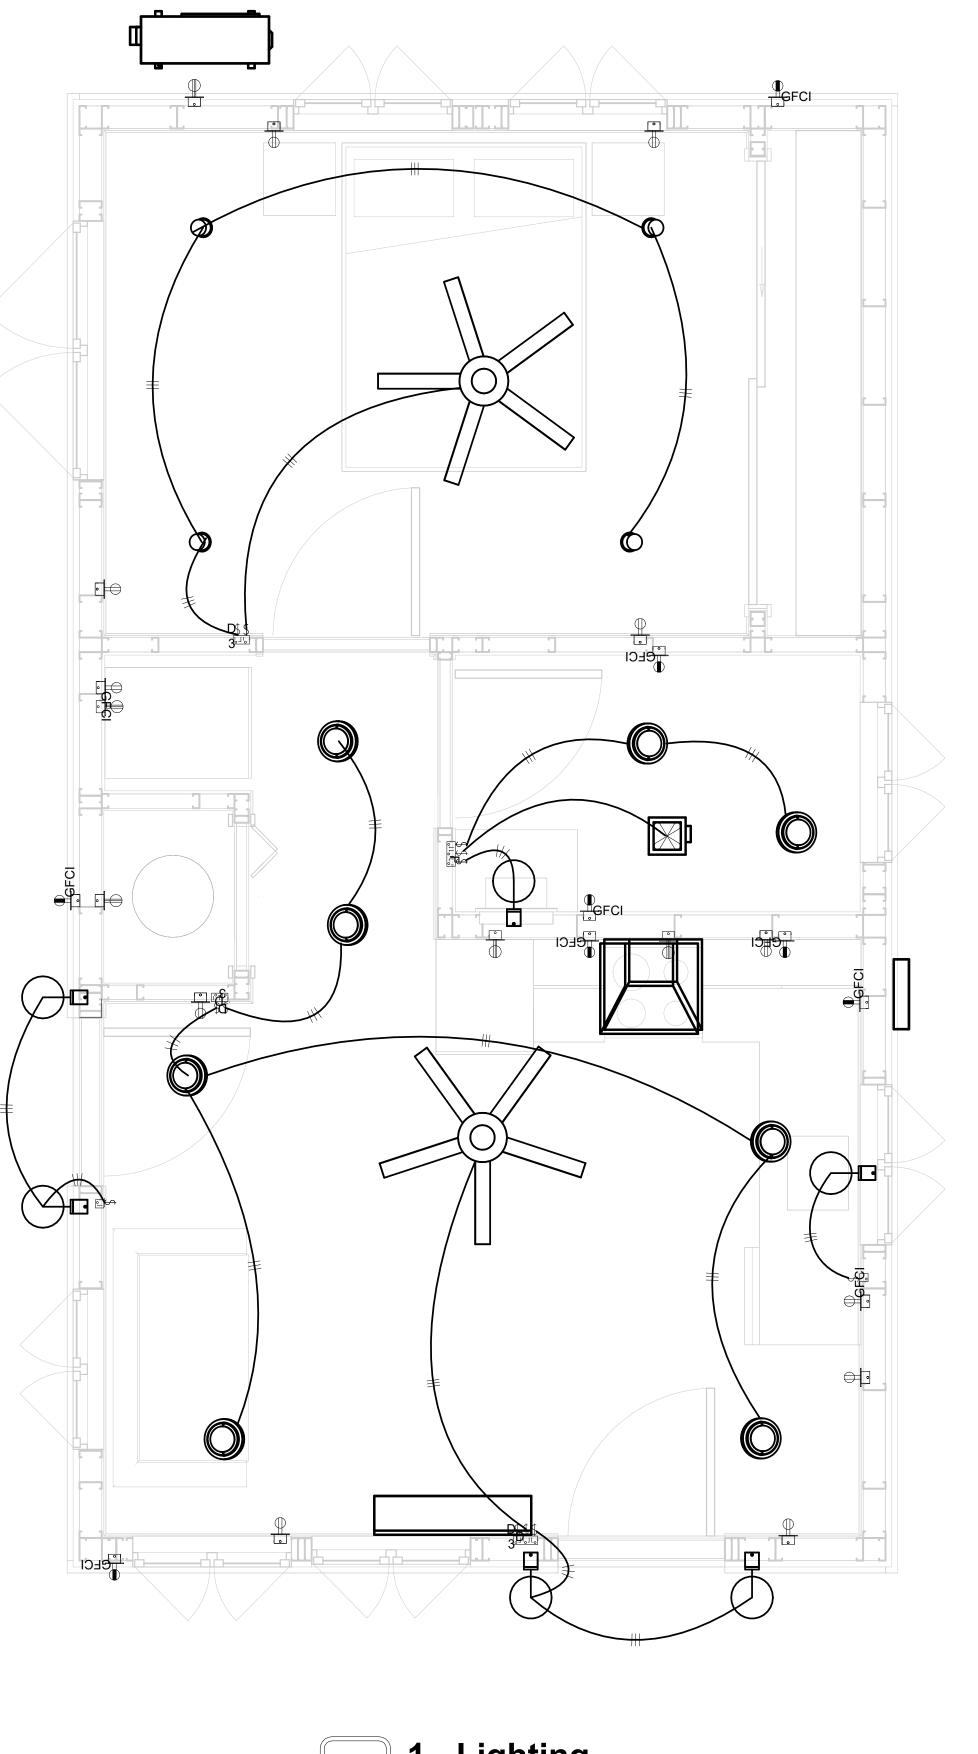

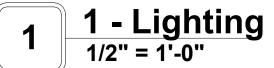



KEY PLAN

DESCRIPTION DATE

NOTE:

LEGEND:

PROJECT

286-PINNACLE-495-1Bd1Ba **TRADITIONAL-550**

DRAWING NAME


LIGHTING

Owner CLIENT NAME: PROJECT NUMBER 0090_12 DATE: 5/24/2025 5:49:31 AM DESIGNED BY: Designer DRAWN BY: **Author** CHECKED BY: Checker


E102

NOTES: CONDUIT, CABLE AND WIRING


- Use Metalic Conduits (IMC) for cables running under concrete slabs.
 Use IMC for circuits with high voltage appliances (240 volts and above)
 For circuits with 120 volts consider using EMT or PVC conduits if needed.
 For Low voltage applications up to 50 volts consider using non metalic conduits.
 All conduits to be used in the project must conform to the latest National Electrical Code (NEC),
- 6. All wiring and cables to be used in the project must also conform to the latest National Electrical Code (NEC), 2015.
 7. All cables and wires used should be rated for their respective loading and should be gauged and
- conform to the NEC.

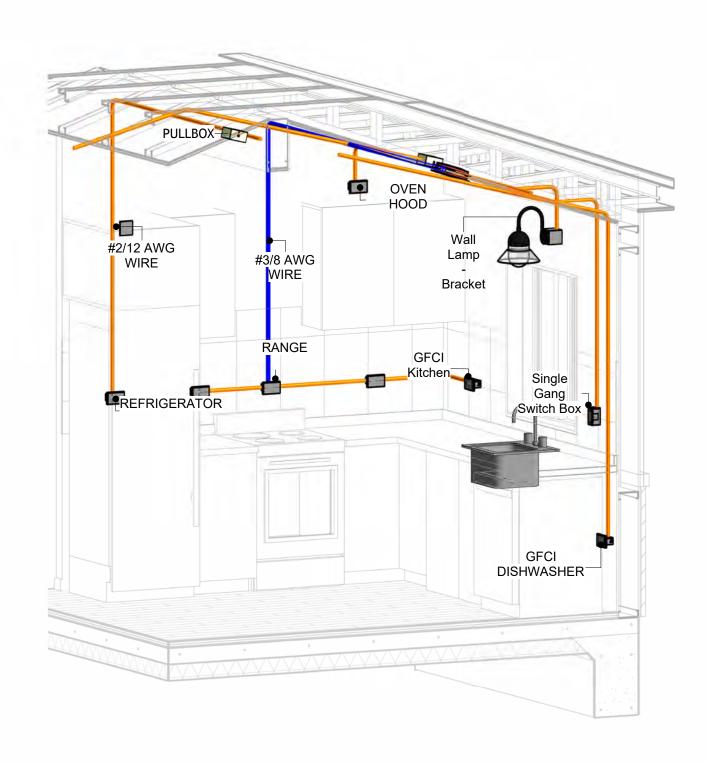


3D-KITCHEN

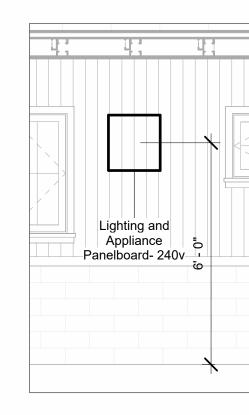


PANEL 3/8" = 1'-0"

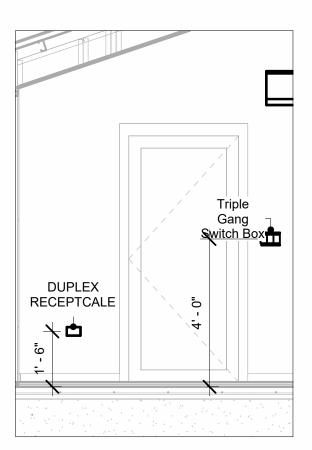

SWITCH & RECEPTACLE
3/8" = 1'-0"

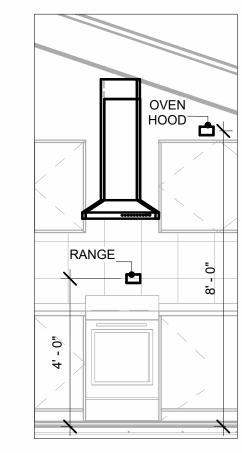


RANGE & OVENHOOD 3/8" = 1'-0"

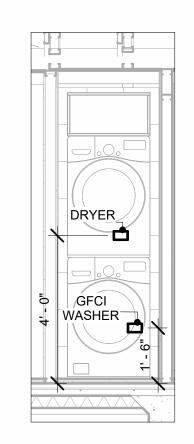

DRYER & WASHER 3/8" = 1'-0"



KEY PLAN

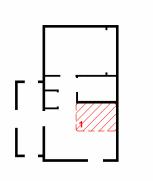

10.	DESCRIPTION	DATE

NOTE:

LEGEND:

PROJECT

286-PINNACLE-495-1Bd1Ba **TRADITIONAL-550**

DRAWING NAME

POWER

CLIENT NAME:	Owner
PROJECT NUMBER:	0090_12
DATE:	5/24/2025 5:49:56 AM
DESIGNED BY:	Designer
DRAWN BY:	Author
CHECKED BY:	Checker

E103

NOTES: LIGHT

- 1. LIGHT FIXTURES AND LUMINARIES SHALL CONFORM TO THE NEC, THE IRC AND LOCAL SAFETY & BUILDING CODE.
- 2. ALL LIGHTING FIXTURES SHOULD CONFORM TO THE DESIGN ELECTRICAL LOAD AND SHALL BE PROPERLY WIRED AND MOUNTED BY QUALIFIED ELECTRICIAN FOLLOWING MANUFACTURERS SPECIFICATIONS.
- CEILING FANS AND FANS WITH LIGHT WITH WEIGHT EXCEEDING 35 LBS SHOULD BE PROVIDED WITH STRUCTURAL BACKING FOR SUPPORT AND SHALL BE FIXED AS PER MANUFACTURERS SPECIFICATIONS.
- 4. EXTERIOR LIGHTS SHALL CONFORM TO LOCAL BUILDING CODE AND GUIDELINES.

NOTES: SWITCH JUNCTION BOX


- THE MINIMUM SIZE OF JUCTION BOX TO BE USED IS 2"X4"X(1.5" OR 3.5" DEEP) THIS ARE TO BE USED FOR SINGLE GANG SWITCH OR OUTLETS.
- 2. FOR DOUBLE GANG (2 GANG) OUTLETS AND SWITCHS THE MINIMUM SIZE OF THE
- JUCTION BOX TO BE PROVIDED SHALL NOT BE LESS THAN 4"X4"X(1.5" OR 3.5" DEEP)
- 3. FOR THREE GANG (3 GANG) OUTLETS AND SWITCHS THE MINIMUM SIZE OF THE JUĆTION BOX SHALL NOT BE LESS THAN 6"X4"X(1.5" OR 3.5" DEEP).

Fitting Schedule(Pull box)				
Family	Family Count Description			
pullbox1	16	#1/4 pullbox		

Electrical Fixture Schedule (SWITCH BOX)		
Type Count		
Double Gang Switch Box	2	
Single Gang Switch Box	2	
Triple Gang Switch Box	2	

Lighting Device		
Type Count		
Dimmer	2	
Fan switch	1	
Single Pole	6	
Three Way With Dimmer	3	

Lighting Fixture					
Lighting Fixture Type Voltage Electrical Load Coun					
Electrical_Lights_Fan-Light1	120 V/1-100 VA- 120 V/1-100 VA	200 A, 120 V/240 V, Single Phase, 3 Wires	2		
Lighting_Other_LumenWerx_Sh ell-Recessed-8	120 V/1-60 VA	200 A, 120 V/240 V, Single Phase, 3 Wires	7		
Lighting_Recessed	120 V/1-60 VA	200 A, 120 V/240 V, Single Phase, 3 Wires	1		
SASSO 100 round wallwasher trim	120 V/1-28 VA	200 A, 120 V/240 V, Single Phase, 3 Wires	4		
Wall Lamp - Bracket	120 V/1-100 VA	200 A, 120 V/240 V, Single Phase, 3 Wires	6		

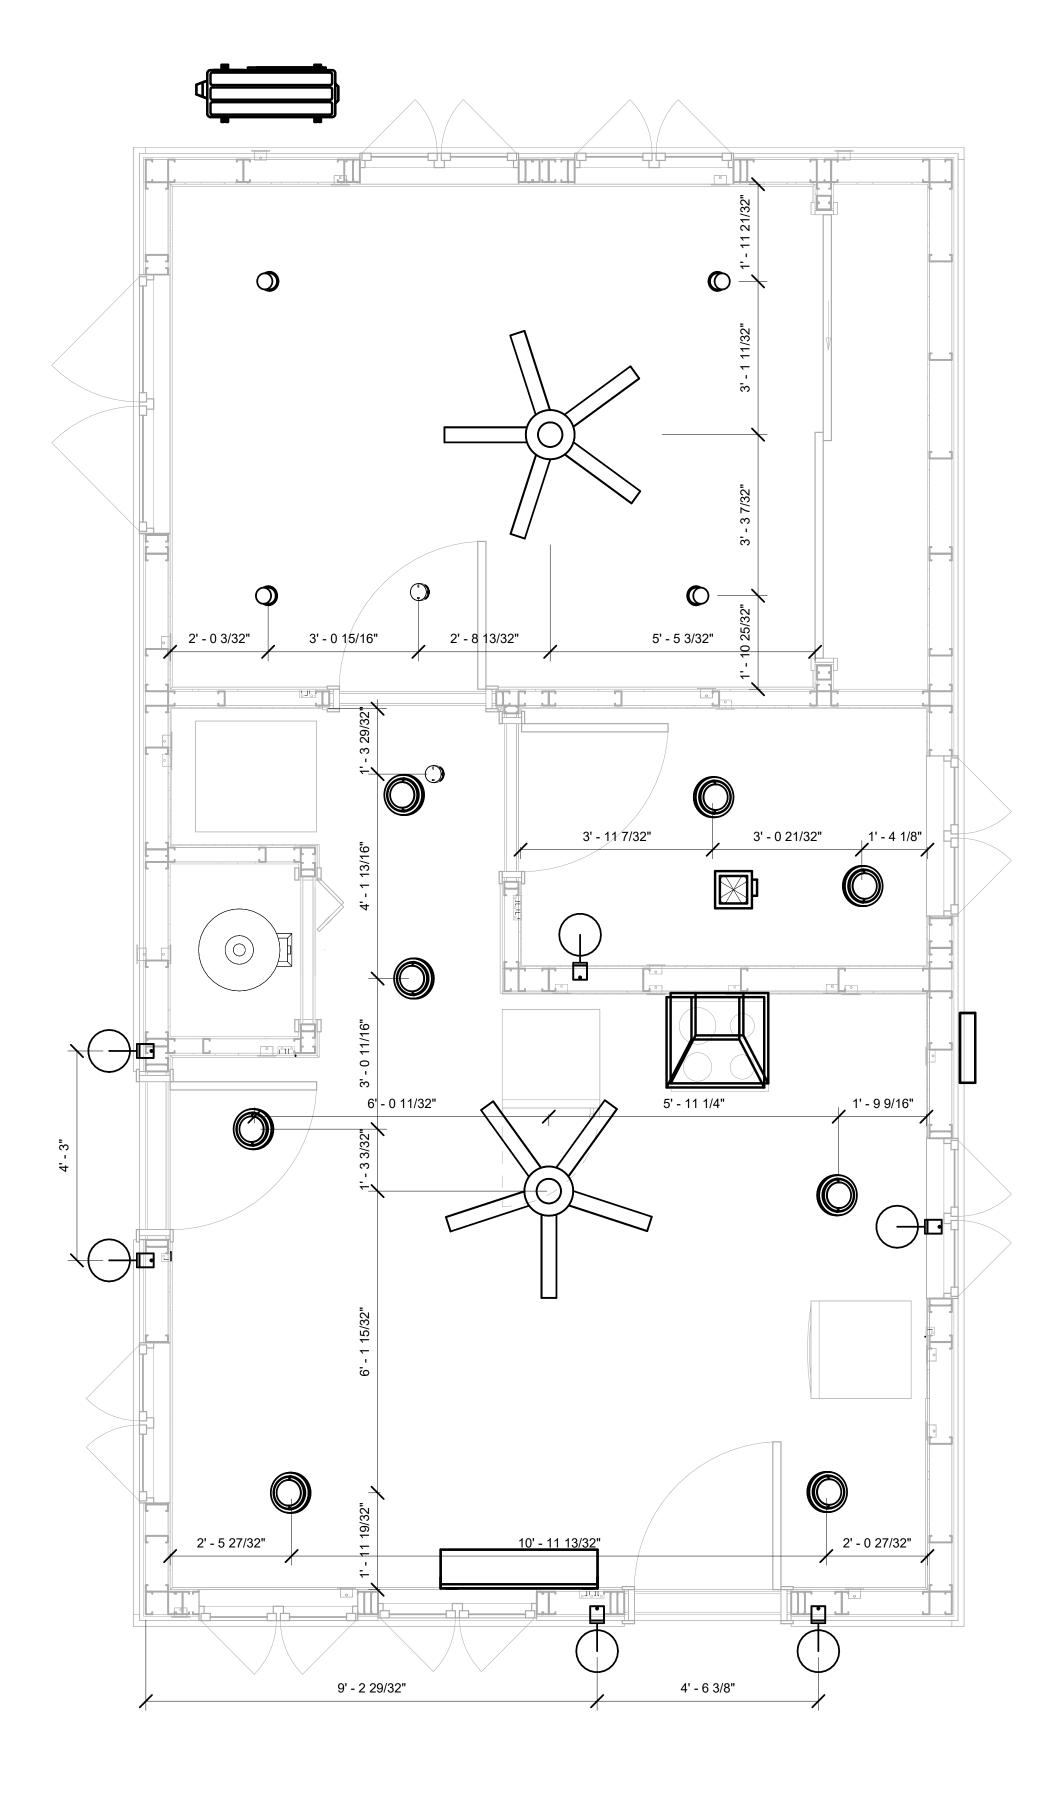

1 DIMENSION FOR LIGHT FIXTURES
1/2" = 1'-0"



KEY PLAN

NO.	DESCRIPTION	DATE

NOTE:

LEGEND:

PROJECT

286-PINNACLE-495-1Bd1Ba TRADITIONAL-550

DRAWING NAME

DIMENSION PLAN FOR LIGHT FIXTURES

CLIENT NAME:	Owner
PROJECT NUMBER:	0090_12
DATE:	5/24/2025 5:49:57 AM
DESIGNED BY:	Designer
DRAWN BY:	Author
CHECKED BY:	Checker


E104

NOTES;

- 1. VERIFY EQUIPMENT PLUG CONFIGURATION BEFORE PURCHASING RECEPTACLES
- 2. FOR ALL EQUIPMENT.
- 3. COORDINATE EXACT LOCATION OF LIGHT FIXTURES, WALL SWITCHES, RECEPTACLES AND OTHER DEVICES WITH ARCHITECTURAL DRAWINGS.
- 4. USE METALLIC JUNCTION BOX WITH THE GFCI RECEPTACLES, WITH HIGHT VOLTAGE.

Electrical Fixture Schedule (Receptacle)		
Type Count		
CONDENSER	1	
DRYER	1	
DUPLEX RECEPTCALE	8	
GFCI BATH ROOM	2	
GFCI DISHWASHER	1	
GFCI Kitchen	3	
GFCI OUT DOOR	3	
GFCI WASHER	1	
OVEN HOOD	1	
RANGE	1	
REFRIGERATOR	1	
water heater	1	

Electrical Outlet Schedule				
Type Circuit Number Electrical Data Count				
DUPLEX RECEPTCALE	2	120 V/1-180 VA	4	
GFCI BATH ROOM	3	120 V/1-180 VA	2	
water heater	7,9	240 V/2-4500 VA	1	
DRYER	8,10	240 V/2-5000 VA	1	
REFRIGERATOR	11	120 V/1-1800 VA	1	
RANGE	12,14	240 V/2-5000 VA	1	
OVEN HOOD	13	120 V/1-180 VA	1	
GFCI Kitchen	15	120 V/1-180 VA	3	
GFCI DISHWASHER	16	120 V/1-1200 VA	1	
DUPLEX RECEPTCALE	17	120 V/1-180 VA	4	
GFCI OUT DOOR	18	120 V/1-180 VA	3	
GFCI WASHER	19	120 V/1-1200 VA	1	
CONDENSER	20,22	240 V/2-5000 VA	1	

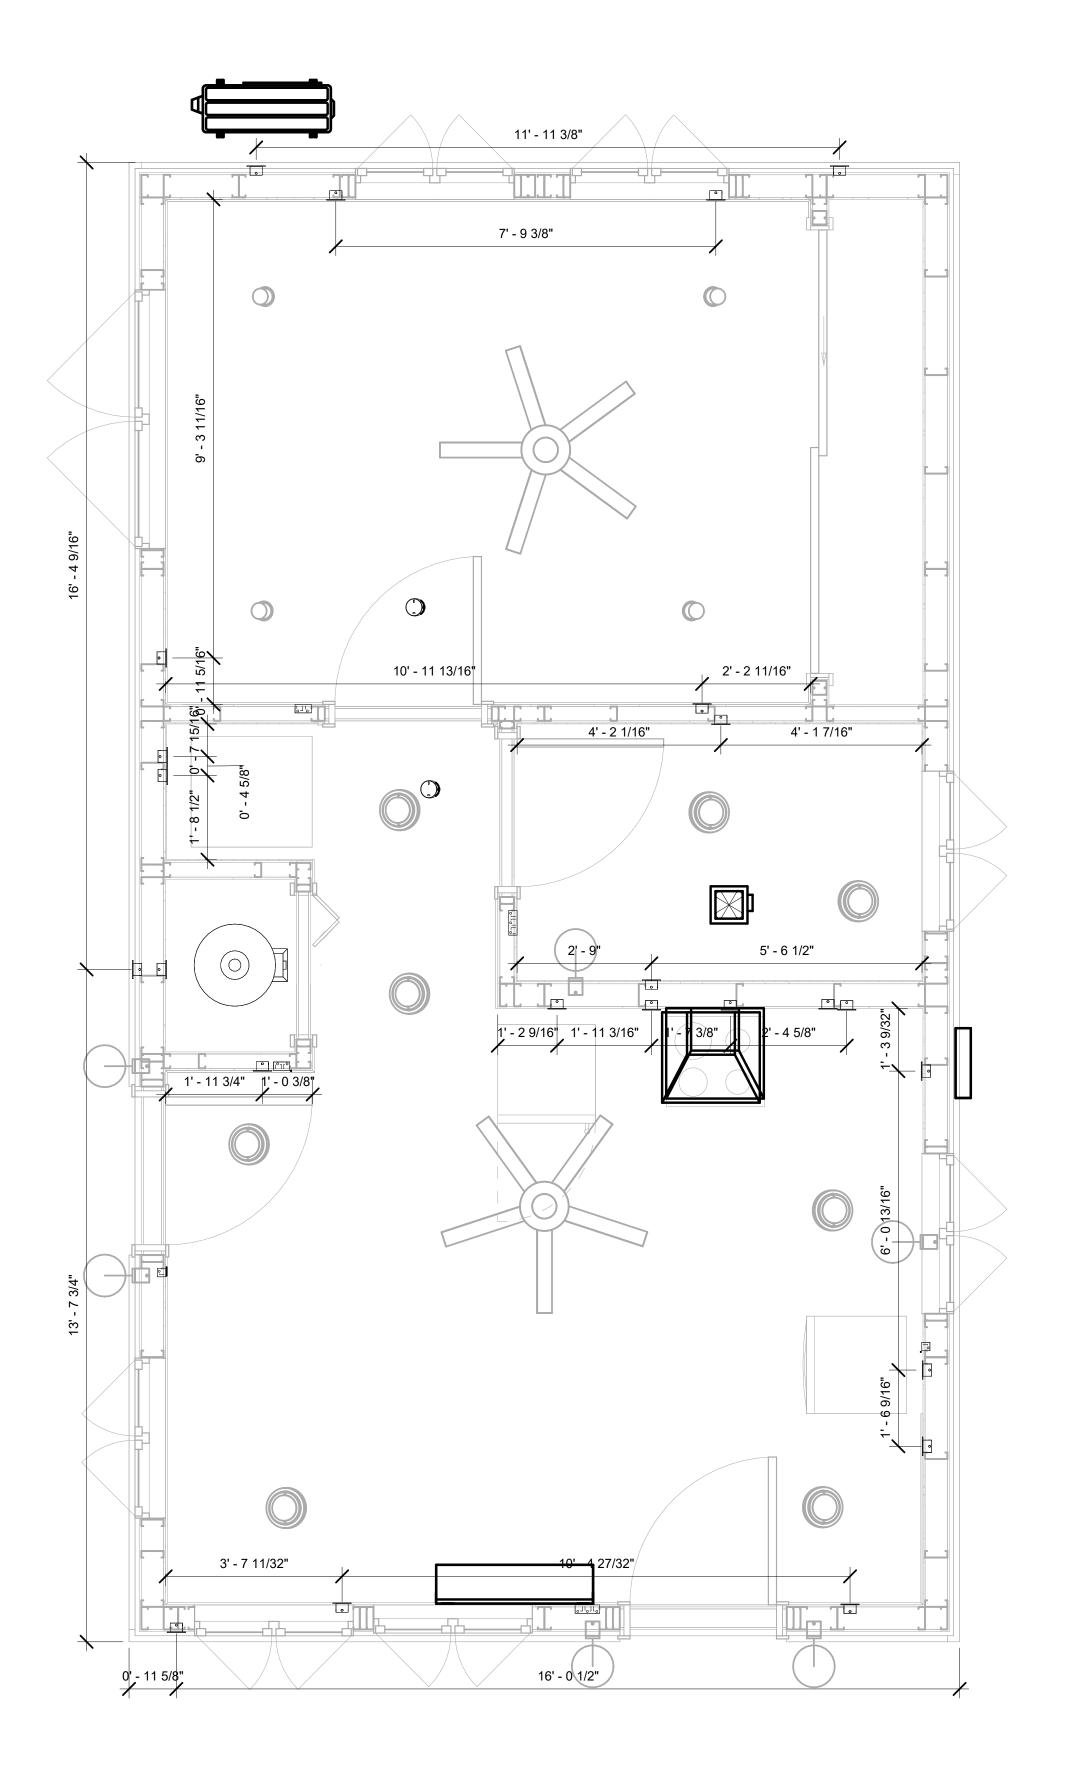





KEY PLAN

NO.	DESCRIPTION	DATE

NOTE:

LEGEND:

PROJECT

286-PINNACLE-495-1Bd1Ba TRADITIONAL-550

DRAWING NAME

DIMENSION PLAN FOR FITTINGS

	I .	
Owner	CLIENT NAME:	
0090_12	PROJECT NUMBER:	
5/24/2025 5:49:58 AN	DATE:	
Designer	DESIGNED BY:	
Author	DRAWN BY:	
Checker	CHECKED BY:	

E105

SHEET LIST

SHEET NUMBER SHEET NAME

P101 NOTE AND SCHEDULE
P102 WATER SUPPLY AND SEWAGE
SYSTEM

PIPE COLOR SCHEME
DOMESTIC COLD WATER DOMESTIC HOT WATER SANITARY VENT
SANITARY SEWER STORM DRAINAGE
GRAY WATER GAS LINE

PLUMBING NOTES

- THE PLUMBING SYSTEM IS DESIGNED TO MEET THE BUILDING'S DOMESTIC WATER SUPPLY, SANITARY DRAINAGE, AND STORM DRAINAGE REQUIREMENTS, AS PER PROJECT SPECIFICATIONS AND APPLICABLE CODES.
- THE SYSTEM INSTALLATION SHALL COMPLY WITH THE LATEST INTERNATIONAL PLUMBING CODE (IPC), INTERNATIONAL RESIDENTIAL CODE (IRC), AND ALL OTHER RELEVANT LOCAL, STATE, AND NATIONAL REGULATIONS.
- 3. ALL PLUMBING WORK SHALL COMPLY WITH THE LATEST EDITION OF THE INTERNATIONAL PLUMBING CODE (IPC) AND THE LOCAL PLUMBING CODE.
- 4. PLUMBING SYSTEMS SHALL BE TESTED AND INSPECTED IN ACCORDANCE WITH THE LOCAL PLUMBING CODE REQUIREMENTS.
- 5. PLUMBING FIXTURES SHALL BE INSTALLED WITH THE APPROPRIATE TRIM, FITTINGS, AND ACCESSORIES, AS RECOMMENDED BY THE MANUFACTURER.
- 6. PIPING SHALL BE PROPERLY SUPPORTED AND SECURED TO PREVENT SAGGING, MOVEMENT, AND VIBRATION.
- 7. SHUT-OFF VALVES SHALL BE PROVIDED AT ALL BRANCH CONNECTIONS AND AT THE INLET AND OUTLET OF EACH PIECE OF EQUIPMENT.
- 8. BACKFLOW PREVENTION DEVICES SHALL BE INSTALLED AS REQUIRED BY THE LOCAL PLUMBING CODE TO PROTECT THE POTABLE WATER SYSTEM.
- 9. PLUMBING FIXTURES AND EQUIPMENT SHALL BE ACCESSIBLE FOR MAINTENANCE AND SERVICING
- 10. EXPOSED PLUMBING PIPING AND FIXTURES SHALL BE INSULATED TO PREVENT CONDENSATION AND ENERGY LOSS.
- 11. DEAD ENDS IN THE DRAINAGE SYSTEM MUST BE AVOIDED, EXCEPT WHERE NECESSARY TO INSTALL A CLEANOUT IN AN ACCESSIBLE LOCATION, AND MUST HAVE A VENTED CONNECTION TO THE OUTSIDE ATMOSPHERE.
- 12. THE VERTICAL DEFLECTION OF PVC PIPE MUST NOT EXCEED 5%, AND NO DEFLECTION IS PERMITTED FOR IRON PIPE.
- 13. WORK MUST BE PROPERLY COORDINATED WITH OTHER TRADES TO AVOID CONFLICTS, REFERRING TO THE ARCHITECTURAL AND STRUCTURAL DRAWINGS FOR INFORMATION REGARDING CEILING ELEVATIONS, SPACE CLEARANCES, WALL AND PARTITION LOCATIONS, ETC.
- 14. ALL FIXTURES SHALL HAVE ACCESSIBLE STOPS.
- 15. DOMESTIC WATER PIPING SHALL BE PEX, AND PVC PIPING IS NOT ACCEPTABLE FOR INTERIOR USE.
- 16. VENT TERMINATIONS SHALL BE LOCATED AT LEAST 10 FEET FROM OR 3 FEET ABOVE ANY OPERABLE WINDOW, DOOR OPENING, AIR INTAKE, OR VENT SHAFT, AND AT LEAST 3 FEET IN EVERY DIRECTION FROM ANY LOT LINE, ALLEY, OR STREET.
- 17. PIPE AND FITTINGS UTILIZED IN THE WATER SUPPLY SYSTEM SHALL HAVE A MAXIMUM OF 8 PERCENT LEAD.
- 18. ACRYLONITRILE BUTADIENE STYRENE (ABS) SHALL BE USED FOR THE SEWERAGE AND
- VENTILATION SYSTEM.
- 19. CROSS-LINKED POLYETHYLENE (PEX) SHALL BE USED FOR THE WATER SUPPLY SYSTEM.
- 20. POLYVINYL CHLORIDE (PVC) SHALL BE USED FOR THE RAIN WATER SYSTEM.
 21. THE MIMIMUM WATER SUPPLY DEPTH UNDER FLOOR FINISH SHOUD BE 1/2".
- 22. ANY PIPE INSTALLED UNDERGROUND MUST HAVE AT LEAST 12 INCHES OF CLEARANCE
- BETWEEN THE OUTSIDE OF THE PIPE AND ANY OTHER UNDERGROUND STRUCTURE.

 23. THE MINIMUM CLEARANCE BETWEEN COLD AND HOT WATER LINES IN RESIDENTIAL
- HOMES MAINTAIN A MINIMUM DISTANCE OF 6 INCHES.
- 24. HORIZONTAL SEPARATION BETWEEN WATER AND SEWER LINES: A MINIMUM OF 12 INCHES BETWEEN POTABLE WATER SUPPLY LINES (COLD AND HOT WATER) AND SANITARY SEWER LINES.

ABBREVIATIONS

Ø	DIAMETER								
ABS	ACRYLONITRILE BUTADIENE STYRENE								
ABV	ABOVE								
AD	AREA DRAIN								
AFF	AFF ABOVE FINISHED FLOOR								
ALT									
BFF	BELOW FINISHED FLOOR								
BLW	BELOW								
CO	CLEAN OUT								
CW	COLD WATER								
D	DEGREE								
DFU	DRANAGE FIXTURE UNIT								
DIA	DIAMETER								
DN	DOWN								
FCO	FLOOR CLEAN OUT								
FD FLOOR DRAIN									
FL									
FS FLOOR SINK									
FT FOOT/FEET									
HB HOSE BIB									
HW	HOT WATER								
IN	INCH								
MIN	MINIMUM								
NO	NO NUMBER								
NTS NOT TO SCALE									
PEX	CROSS-LINKED POLYETHYLENE								
PLBG	PLUMBING								
PVC	POLYVINYL CHLORIDE								
QTY	QUANTITY								
RD	ROOF DRAIN								
RED	REDUCER								
RM	ROOM								
RW	RAIN WATER								
SF	SQUARE FOOT								
V	VENT								
VTR	VENT THROUGH ROOF								
W	WASTE								
WCO	WALL CLEAN OUT								
WSFU	WATER SUPPLY FIXTURE UNIT								

PLUMBING LEGEND

D	CAP				
	BEND 45 DEG				
\Box	BEND 90 DEG				
	TEE REDUCING				
	TEE				
	CLEAN TWO-WAY				
	WYE 45 DEG				
	WYE 45 DEG DOUBLE				
	WYE COMBINATION				
	P-TRAP				

PIPE SCHEDULE							
MATERIAL	DIAMETER	LENGTH					
ACRYLONITRILE BUTADIENE STYRENE (ABS)	1 1/2"	19 FT					
ACRYLONITRILE BUTADIENE STYRENE (ABS)	2"	18 FT					
ACRYLONITRILE BUTADIENE STYRENE (ABS)	3"	27 FT					
CROSS-LINKED POLYETHYLENE (PEX)	1/2"	100 FT					
CROSS-LINKED POLYETHYLENE (PEX)	3/4"	58 FT					
POLYVINYL CHLORIDE - RIGID	2"	48 FT					

FITTING SCHEDULE					
FITTING	SIZE	QTY			
DO VENT OAD ELDOW	4.4/01				
ABS VENT CAP ELBOW	1 1/2"ø	1			
ABS VENT CAP ELBOW	2"ø	1			
ABS VENT CAP ELBOW	3"ø	1			
ABS 90 DEGREE BEND ELBOW	1 1/2"ø-1 1/2"ø	2			
ABS 90 DEGREE BEND ELBOW	2"ø-2"ø	2			
ABS 90 DEGREE BEND ELBOW	3"ø-3"ø	2			
ABS P-TRAP	1 1/2"ø-1 1/2"ø	3			
ABS P-TRAP	2"ø-2"ø	2			
ABS REDUCER ELBOW	2"ø-1 1/2"ø	1			
ABS REDUCER ELBOW	3"ø-2"ø	1			
ABS TEE ELBOW	2"ø-2"ø-2"ø	1			
ABS TEE ELBOW	3"ø-3"ø-3"ø	2			
ABS TEE REDUCER ELBOW	3"ø-3"ø-1 1/2"ø	2			
ABS TEE REDUCER ELBOW	3"ø-3"ø-2"ø	1			
VASTE DOUBLE TEE	1 1/2"ø-1 1/2"ø-1 1/2"ø	1			
PVC 90 DEG BEND ELBOW	2"ø-2"ø	18			
PEX 90 DEGREE ELBOW	1/2"ø-1/2"ø	13			
PEX 90 DEGREE ELBOW	3/4"ø-3/4"ø	2			
PEX TEE ELBOW	1/2"ø-1/2"ø-1/2"ø	2			
PEX TEE ELBOW	3/4"ø-3/4"ø-3/4"ø	2			
PEX TRANSITION ELBOW	3/4"ø-1/2"ø	5			
PEX 90 DEGREE ELBOW	1/2"ø-1/2"ø	11			
PEX 90 DEGREE ELBOW	3/4"ø-3/4"ø	5			
PEX TEE ELBOW	1/2"ø-1/2"ø-1/2"ø	2			
PEX TEE ELBOW	3/4"ø-3/4"ø	5			
PEX TRANSITION ELBOW	1"ø-3/4"ø	2			
PEX TRANSITION ELBOW	3/4"ø-1/2"ø	4			

		FIX	TURE	CC	NN	ECT	ΓΙΟΝ	SC	HEDI	JLE	
FAMILY	W	V	TRAP	CW	HW	QTY	DFU	TOT.	WFU	TOT.	NOTES
DIOLIMAGUED	011	4 4 (0)	4.4/01	4 /0"	4 (0)	4					DRAIN TO SEWER SEE
DISHWASHER	2"	1-1/2"	1-1/2"	1/2"	1/2"	1		0			PLANS
DRYER	N/A	N/A	N/A	N/A	N/A	1		0			
HANGING PIPES CLAMP						12		0			
SHOWER TRAY	2"	1-1/2"	1-1/2"	1/2"	1/2"	1		0			
SHOWER TRIM	-	-	-	1/2"	1/2"	1		0			
SINK ISLAND SINGLE	2"	1-1/2"	1-1/2"	1/2"	1/2"	1		0			
VANITY SINK	2"	1-1/2"	1-1/2"	1/2"	1/2"	1		0			
WASHER	2"	1-1/2"	2"	1/2"	1/2"	1		0			DRAINS TO GRAY WATER OR SEWER SEE PLANS
WATER CLOSET	3"	2"	3"	1/2"	1/2"	1		0			
WATER HEATER	N/A	N/A	N/A	3/4"	3/4"	1		0			

FIXTURE SCHEDULE							
FIXTURE	QTY	DESCRIPTION					
DISHWASHER	1	DRAIN TO SEWER SEE PLANS					
DRYER	1						
HANGING PIPES CLAMP	12						
SHOWER TRAY	1						
SHOWER TRIM	1						
SINK ISLAND SINGLE	1						
VANITY SINK	1						
WASHER	1	DRAINS TO GRAY WATER OR SEWER SEE PLANS					
WATER CLOSET	1						
WATER HEATER	1						

ACCESSORIES & FITTINGS SCHEDULE								
FIXTURE QTY DESCRIPTIONS								
DISHWASHER CONNECTOR	1							
HOSE BIB	1							
LAUNDRY SWEAT CONNECTOR	1							
SHUTOFF VALVE	6							

PLUMBING SCHEDULE								
FIXTURE	TRAP	WASTE	VENT	C.W	H.W			
DISHWASHER	1-1/2"	2"	1-1/2"	1/2"	1/2"			
DRYER	N/A	N/A	N/A	N/A	N/A			
SHOWER TRAY	1-1/2"	2"	1-1/2"	1/2"	1/2"			
SHOWER TRIM	-	-	-	1/2"	1/2"			
SINK ISLAND SINGLE	1-1/2"	2"	1-1/2"	1/2"	1/2"			
VANITY SINK	1-1/2"	2"	1-1/2"	1/2"	1/2"			
WASHER	2"	2"	1-1/2"	1/2"	1/2"			
WATER CLOSET	3"	3"	2"	1/2"	1/2"			
WATER HEATER	N/A	N/A	N/A	3/4"	3/4"			

WATER FIXTURE UNIT SCHEDULE						
FAMILY	QTY	UNIT VALUE	TOTAL			
DISHWASHER	1		0			
DRYER	1		0			
HANGING PIPES CLAMP	12		0			
SHOWER TRAY	1		0			
SHOWER TRIM	1		0			
SINK ISLAND SINGLE	1		0			
VANITY SINK	1		0			
WASHER	1		0			
WATER CLOSET	1		0			
WATER HEATER	1		0			

WASTE FIXTURE UNIT SCHEDULE								
FAMILY		QTY	DFU VALUES	TOTAL				
	,		'	·				
DISHWASHER	1			0				
DRYER	1			0				
HANGING PIPES CLAMP	12			0				
SHOWER TRAY	1			0				
SHOWER TRIM	1			0				
SINK ISLAND SINGLE	1			0				
VANITY SINK	1			0				
WASHER	1			0				
WATER CLOSET	1			0				
WATER HEATER	1			0				



KEY PLAN

NO. DESCRIPTION DATE

NOTE:

LEGEND:

PROJECT

286-PINNACLE-495-1Bd1Ba TRADITIONAL-550

DRAWING NAME

NOTE AND SCHEDULE

CLIENT NAME:

 PROJECT NUMBER:
 0090_12

 DATE:
 5/20/2025 3:12:51 PM


 DESIGNED BY:
 Designer


 DRAWN BY:
 Author

 CHECKED BY:
 Checker


P101


SCALE: 1/2" = 1'-0"

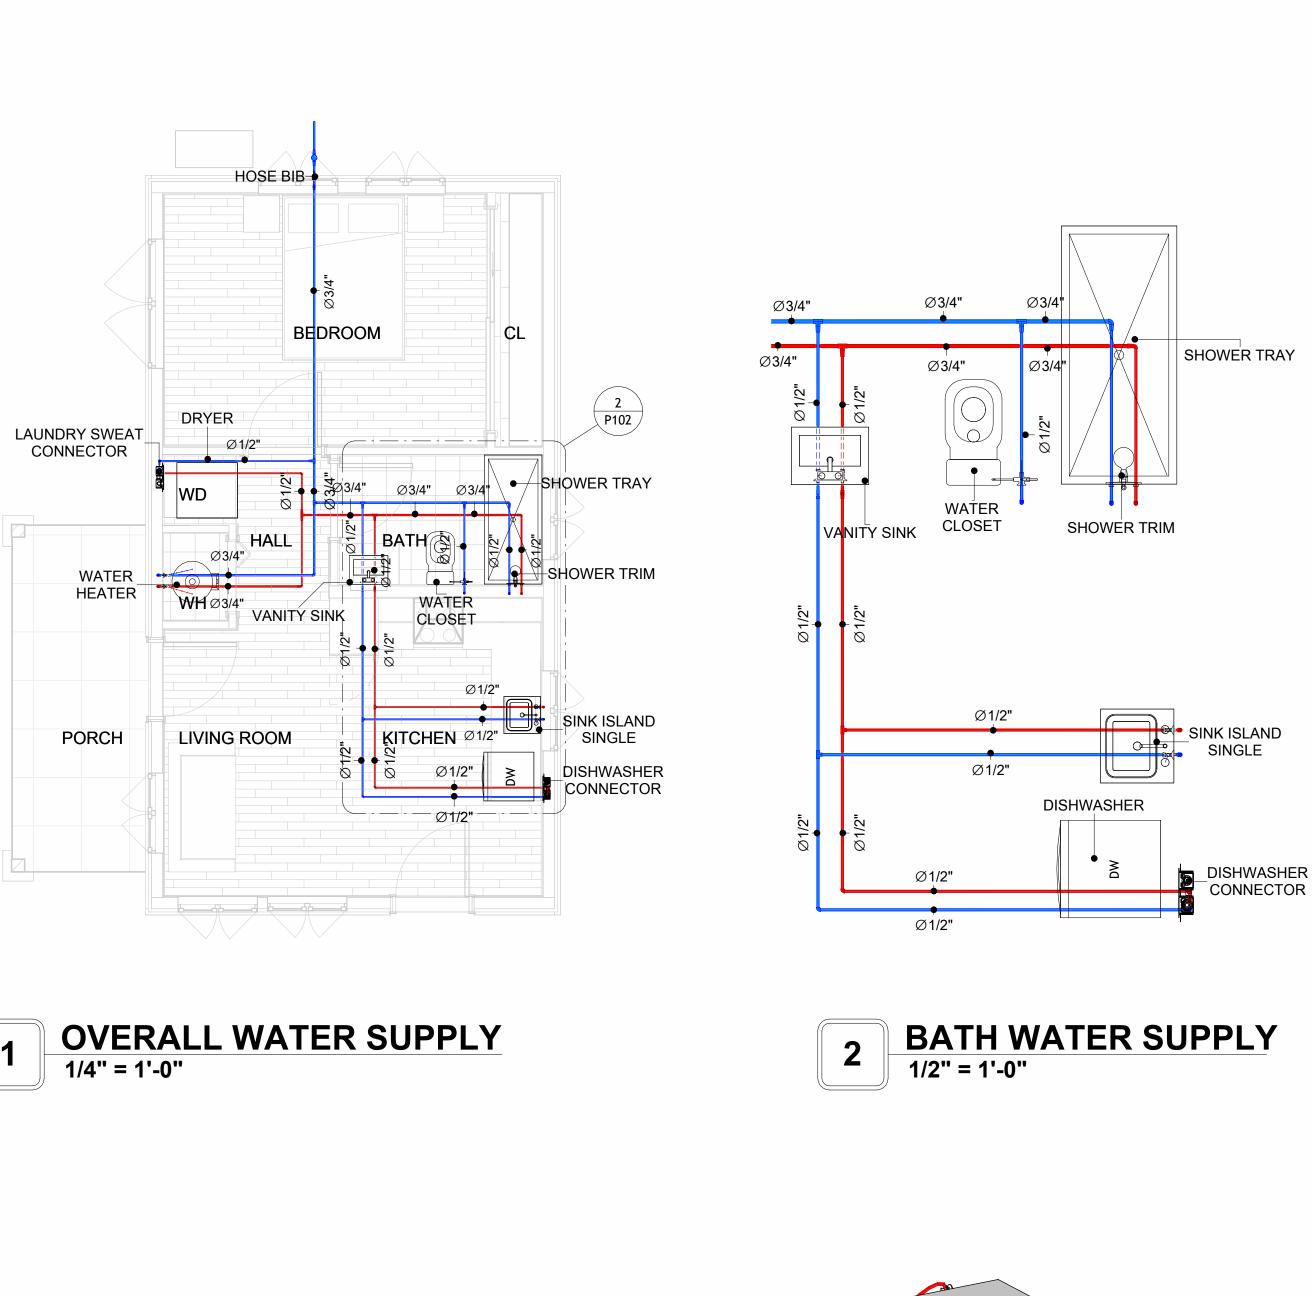

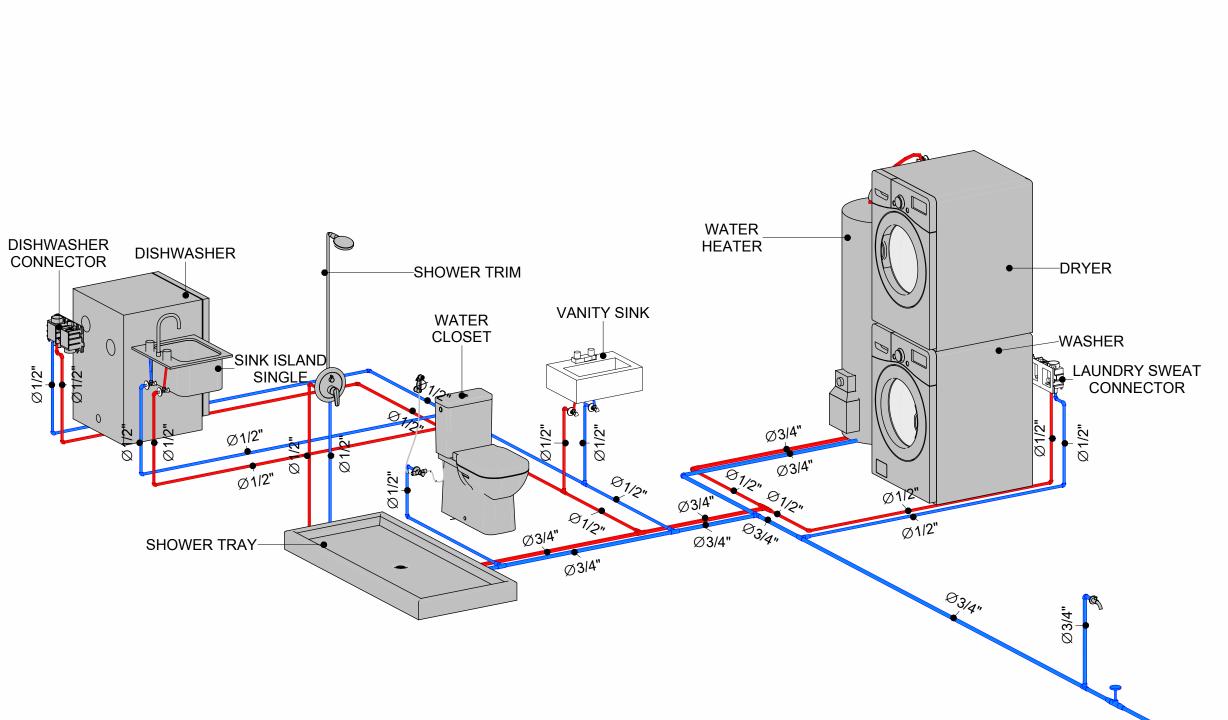

WATER SUPPLY RISER DIAGRAM

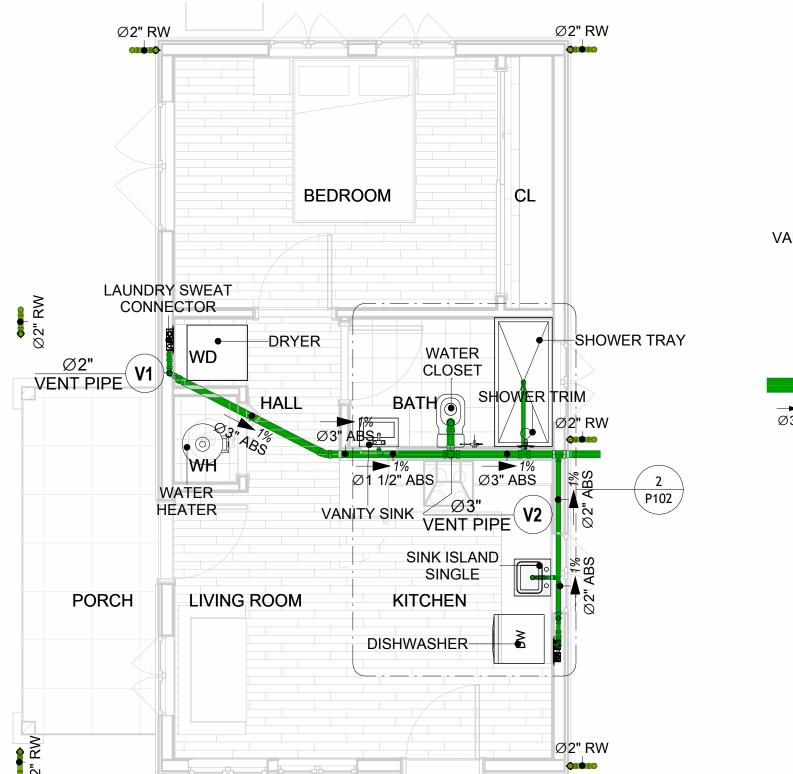

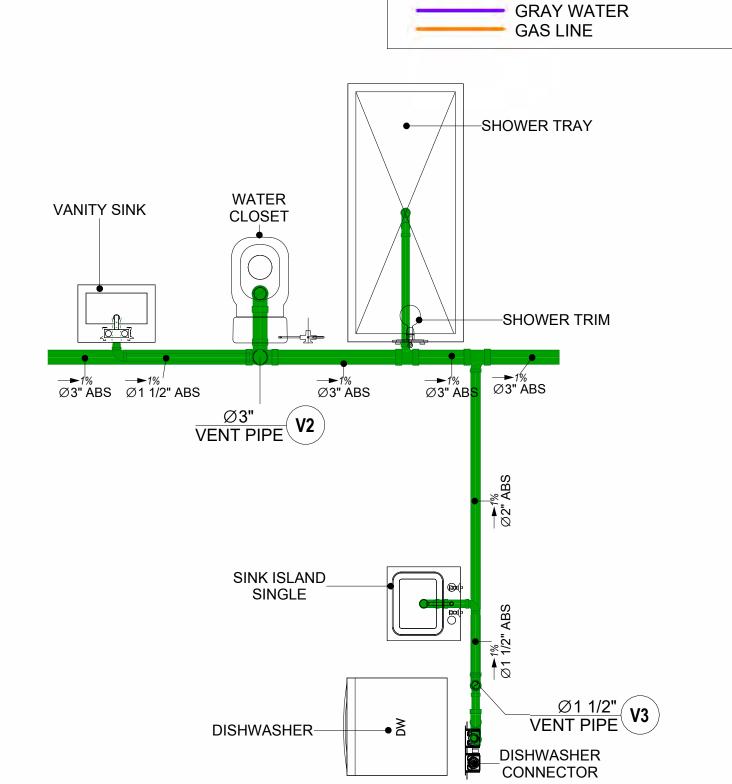

BATH SEWAGE

1/2" = 1'-0"


PIPE COLOR SCHEME

--- SANITARY VENT

DOMESTIC COLD WATER
DOMESTIC HOT WATER

SANITARY SEWER
STORM DRAINAGE


4 OVERALL SANITARY
1/4" = 1'-0"

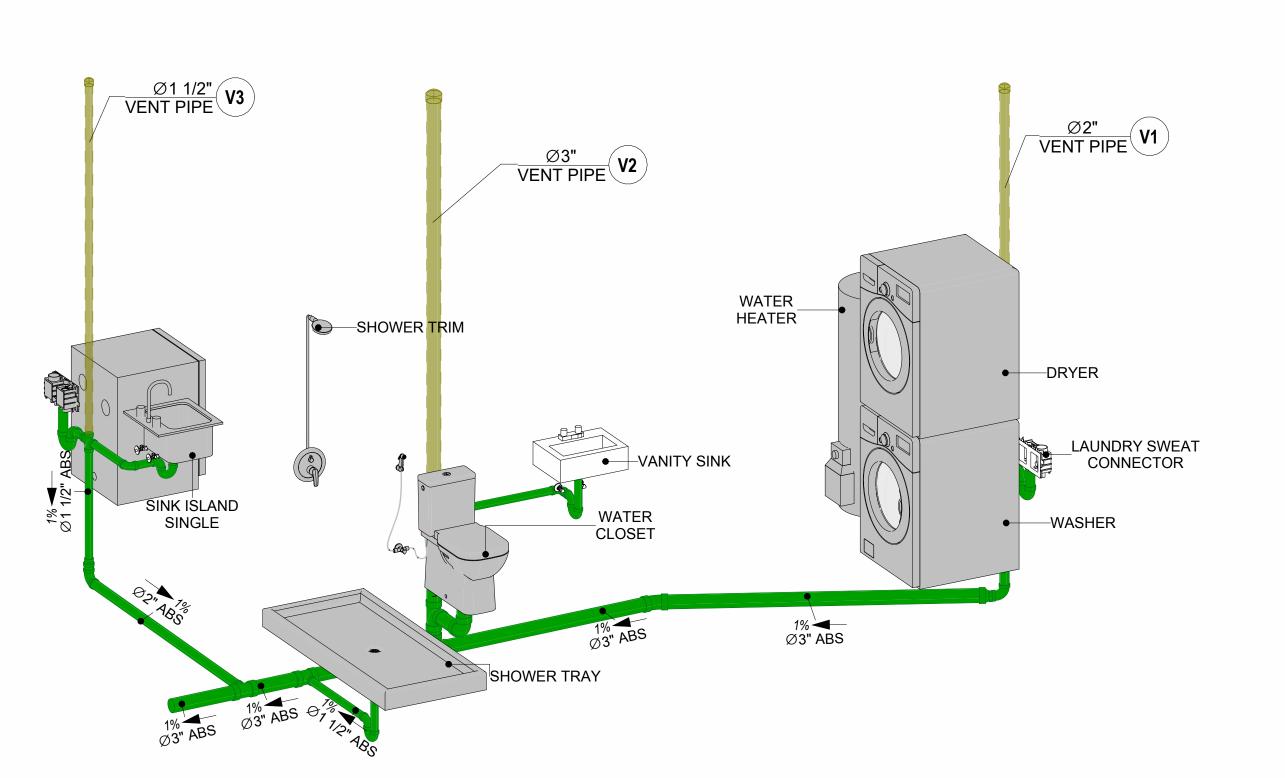

6 SEWAGE RISER DIAGRAM



KEY PLAN

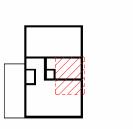

NO.	DESCRIPTION	DATE
•		

LEGEND:

NOTE:

PROJECT

286-PINNACLE-495-1Bd1Ba TRADITIONAL-550

DRAWING NAME

WATER SUPPLY AND SEWAGE SYSTEM

 CLIENT NAME:

 PROJECT NUMBER:
 0090_12

 DATE:
 5/20/2025 3:13:31 PM

 DESIGNED BY:
 Designer

 DRAWN BY:
 Author

 CHECKED BY:
 Checker

P102

Materials Shopping List

Please print and take this Materials Shopping List to your favorite Home Depot and ask for assistance in selecting the materials, fixtures and fittings to complete your new home.

Record your selection and the price of the item. Then do the math to determine the cost for your selections and the total cost of finishing your home.

Have It Your Way!

The material types listed in this document were selected based on personal preferences. The Customer is encouraged to make changes to the material types in accordance with local customs, regulations, and personal preferences.

Have It Your Way!



20 good reasons to frame a home with metal and not wood



Why build your ADU with metal vs wood	Wood	Metal	Explanation
1 DIY Construction Benefit		~	The wall frames, trusses and beams can be erected in a just a few days
2 Minimal Construction Skills Required		~	Pre-assembled walls and trusses require no specialized skills to errect
3 Build as DIY, Hybrid or by a General Contractor		✓	Do it yourself, Hybrid (involve special contractors) or hire a General Contractor
4 Build It As You Can Afford It		✓	Impervious to Weather - build as you have the time and money
5 Up Front Cost of Framing Materials	~		As to only the framing material, wood is less expensive
6 Total Cost To Build		~	Savings in time, labor, and other areas make light gauge steel LESS expensive
7 Termites and wood boring insects		Y	Termites, carpenter ants and wood boring insects eat wood, not metal
8 Mold resistant		~	Metal does not attract mold
9 Damage caused by exterior and interior flooding		~	Metal needs no reconditioning after a flood
10 Fire Resistant		~	Non-combustible
11 Lower insurance rates		Y	Many insurance underwriters now provide lower rates for metal framed homes
12 Walls, trusses, and beams retain their original form		~	Perfectly straight walls - no shimming of drywall
13 Corners are 90 degrees		✓	No need for templating of countertops to adjust for out of square corners
14 Strength and weight		✓	Metal is stronger than wood and weighs less - no need for crane to lift ADU trusses
15 IBC Engineered Stamp		✓	If an engineering stamp is necessary, months of waiting are saved
16 Complete BOM (Materials Shopping List)		~	Take the materials shopping list to Home Depot and start shopping/pricing
17 Flexible in Seismic Areas - Won't Fracture		~	Light gauge steel is flexible and won't fracture when the earth moves
18 No Waste At Job Site		~	Steel is the most recycled material in the world. A typical wood home has 20-30% waste
19 Environmentally Friendly		~	Trees don't have to be destroyed and the source of most metal is from recycling
20 How-To Videos Included		~	How-to videos provide simple assembly instructions
21 Relationship Counselor		✓	Eliminate emotional uphevels - save time, money, and preserve the relationship

Universal Requirements - some or all may be required

- 1 Site plan
- 2 Electrical Supply Connection
- 3 Sewer Connection
- 4 Fresh Water Supply Connection
- 5 Set Backs
- 6 Soils Evaluation

- 7 Earthquake (fault) evaluation
- 8 Foundation Plan subject to soils
- 9 Compliance with local energy codes: insulation home wrap and flashing
- 10 Engineering for wind speed and snow load.
- 11 State and Local ordinances regarding ADUs
- 12 Local Architect and/or Engineer may be necessary







Pinnacle-1Bd1Ba-Traditional MATERIAL SHOPPING LIST

Have It Your Way!

The material types listed in this document were selected based on personal preferences. The Customer is encouraged to make changes to the material types in accordance with local customs, regulations, and personal preferences. Have It Your Way!

TOC



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Have It Your Way!

The material types listed in this document were selected based on personal preferences. The Customer is encouraged to make changes to the material types in accordance with local customs, regulations, and personal preferences. Have It Your Way!

GENERAL NOTES

- 1 This BOM (Bill of Materials) is prepared as a Materials Shopping List to help builders and DIYers gain a complete understanding of most if not all elements required for the complete construction of this structure, according to the original design documents provided by FrameUpNow.
- 2 All quantities and specifications are subject to change based on the final design, field measurements, availability of products and customer preferences. The customer should verify all information prior to purchasing materials.
- 3 All products and elements in the list shall conform to the International Residential Code (IRC), or any other local and international building codes, safety regulations, and standards that are applicable to the location of the structure.
- 4 If any changes are made by the customer to the list of materials specified in this document, the customer is responsible for assuring that the correct type and quantity of materials are utilized in accordance with local building
- 5 FrameUpNow, will not be held responsible for any misuse of this document, the products listed, or for deviations from the content that are made due to changes in specifications, pricing, availability, or customer preferences.
- 6 The customer is advised to consult a qualified professional or technician prior to purchasing materials for specialized construction system items. Some items including but not limited to caseworks, doors and windows may require as built measurements prior to purchase to confirmation of final dimensions.
- If there are additional trim elements or specific installation methods, the total amount of materials needed might vary. Consider any additional trim required for corners, intersections, or other architectural details that might cause this variations before procedding to purchase and construction.

ARCHITECTURAL BOM



	Pinnacle-1Bd1Ba-Traditional									
		ARCHITECTU								
No.	Item	Туре	Unit	Quantity	Unit Price	Total	Description			
<u>△</u> 1	APPLIANCES		PCS	1						
2	Refrigerator Range		PCS	1						
			PCS							
3	Washer			1						
4	Dryer		PCS	1						
5	Dish Washer		PCS	1						
6	Oven		PCS	0						
7	Microwave		PCS	0						
<u> </u>	CASEWORKS		FT	14.05						
1	Kitchen Cabinet		FT	14.85						
2	Laundry Cabinet		FT	2.25						
3	Vanity Cabinet		FT	2.5						
4	Medicine Cabinet		PCS	1						
5	Kitchen countertop		SF	22.61						
6	Laundry Countertop		PCS	0						
7	Bathroom Countertop		SF	0						
8	Island		FT	0						
9	Peninsula		FT	0						
	Closets		SF	61.49						
△	CEILING									
1	Ceiling Board	Dry Wall	SF	408						
2	Dry Wall Fastener	Screw	PCS	714						
3	Vapor Retarder	Polyethylene film	SF	541						
4	Vapor Retarder Fastener	Nails with washer heads	PCS	1623						
5	Ceiling Board (MRD)	Moisture resistant drywall	SF	47						
6	MRD Fastener		PCS	82						
7	Ceiling Board	Marine Plywood	SF	86						
8	Marine Plywood Fastener	Screw	PCS	151						
9	Dry Wall Tape		FT	271						
Δ	FLOORING	-		-						
1	Main Living Space		SF	208.58						
2	Bathroom		SF	50.16						
3	Bedroom		SF	158.01						
4	Porch		SF	79.3						
Δ	STRUCTURE									
_	Foundation		SF	566.04						
	WALLS EXTERIOR		1							
1	Stone Veneer		SF	229						
2	Corrugated Iron Sheet		SF	466						
3	8/panel	Self-drilling screws(100/pkt)	PKT	3.64						
4	Wall Shteathing (OSB)	Jen drining serews (100/pkt)	SF	695						
5	Shteathing Fastener	Self-drilling screws(100/pkt)	PKT	7						
6	Wall Homewrap	Sell-drilling screws (100/pkt)	SF	695						
7	Homewrap Fastener	Stapled fastener (200/pkt)	PKT	3						
		Stapieu iasterier (200/pkt)	PCS	58						
9	Furring Strip	Solf drilling coroug/100/pld\								
	Furring Strip Fastener	Self-drilling screws(100/pkt)	PKT	4.66						
	Wall Paint	Manager	SF	695						
	Stone Copping	Masonry stone	SF	22						
	Stone Veneer	Masonry stone	SF	0						
	Mortar for Stone Veneer		SF	0						
	Wall Insulation		SF	2103						
	WALLS INTERIOR									
	Cementitious Backer Board		SF	325						
	Kerdi membrane		SF	325						
3	Kerdi membrane Fastener		SF	325						
4	Wall Ceramic Tile		SF	325						
5	Drywall Board		SF	956						
6	Drywall Fastener	Self-drilling screws(100/pkt)	PKT	9.56						
7	Wall Paint		SF	956						
8	Drywall Tape		FT	180						
	Wall Sweep		FT	94						

ARCHITECTURAL BOM



	DOORS				
1	Exterior Swinging	3' - 0" X 6'-8"	PCS	2	
2	Interior Swinging	3' - 0" X 6'-8"	PCS	2	
3	Interior Sliding	9' - 0" X 6'-8"	PCS	1	
4	Folding	2' - 10" X 6'-8"	PCS	1	
5	Exterior Door Trim		FT	33	
6	Interior Door Trim		FT	175	
7	Entry Lock set			2	
8	Privacy Lock set			2	
9	Passage Lock set			2	
Δ	WINDOWS				
1	Casement	3' - 3" X 3'-3"	PCS	6	
2	Casement	5' - 3" X 3'-3"	PCS	1	
3	Casement	3' - 3" X 1'-9"	PCS	1	
4	Exterior Window Trim		FT	107	
5	Interior Window Trim		FT	107	
Δ	ROOF				
1	Roof Covering		SF	746.0	
2	Roof Covering Fastener		PCS	373	
3	Roof Felt Paper		SF	746.0	
4	Roof Felt Paper Fastener		PCS	2238.0	
5	Roof Sheathing		SF	746	
6	Roof Sheathing Fastener		PCS	5968	
7	Batten		FT	0.0	
8	Batten Fastener		PCS	0.0	
9	Soffit		SF	127.0	
10	Soffit Fastener		PCS	63.5	
	Fascia		FT	129.0	
12	Fascia board fastener		PCS	65	
13	Roof Insulation		SF	746.0	



	Pinnacle-1Bd1	Ba-Traditio	nal			
	ELECTRICAL MATER	IAL SHOP	PING I I	ST		
No. Item	Type	Unit		Unit Price	Total	Description
1 Kitchen Ceiling Light		PCS	2			
2 Kitchen Wall Mounted Light		PCS	1			
3 Exterior Wall Mounted Light		PCS	4			
4 Livingroom Ceiling Light With Fan		PCS	1			
5 Bedroom Ceiling Light With Fan		PCS	1			
6 Dining Ceiling Light		PCS	0			
7 Bath Wall Mounted Light		PCS	1			
8 Bathroom Ceiling Light		PCS	2			
9 Livingroom Ceiling Light		PCS	2			
10 Bedroom Ceiling Light		PCS	4			
11 Hall & Entry Ceiling Light		PCS	2			
12 WD Ceiling Light		PCS	0			
13 Smoke Detector		PCS	2			
☐ ELECTRICAL FITTINGS		. 55				
14 Standard Receptacle 120V	20A	PCS	8			
15 GFCI Receptacle 120V	20 A	PCS	14			
16 GFCI Receptacle 240V	30 A	PCS	2			
17 GFCI Receptacle 240V	50 A	PCS	1			
18 GFCI Receptacle 240V	60 A	PCS	1			
19 Fan Switch	00 A	PCS	1			
		PCS	6			
20 Single Pole Switch21 Three Way Switch		PCS	3			
		PCS	2			
22 Dimmer Switch		F C 3	2			
☐ ELECTRICAL CONDUITS & WIRING	4.410.0041	FT	55			
23 ROMEX 14 AWG	14/2/W/ground	FT	0			
24 ROMEX 12 AWG	12/3/W/ground					
25 ROMEX 12 AWG	12/2/W/ground	FT	255			
26 ROMEX 10 AWG	10/3/W/ground	FT	58			
27 ROMEX 10 AWG	10/2/W/ground	FT	0			
28 Romex 8 AWG	8/3/W/ground	FT	14			
29 Romex 8 AWG	8/2/W/ground	FT	0			
30 ROMEX 6 AWG	6/3/W/ground	FT	43			
31 Bare Copper Ground Wire 6 AWG		FT				
△ ELECTRICAL BOXES & CIRCUTES						
32 Panelboard -240V 1 Phase MLO	200 AMP	PCS	1			
33 Circuit breaker	15 A	PCS	2			
34 Circuit breaker	20 A	PCS	10			
36 Circuit breaker	30 A	PCS	2			
37 Circuit breaker	50 A	PCS	1			
39 Circuit breaker	60 A	PCS	1			
40 Single Gang Switch Box		PCS	2			
41 Double Gang Switch Box		PCS	2			
42 Triple Gang Switch Box		PCS	2			
43 Pull Box	#1/4	PCS	16			
44 Receptacle Box		PCS	24			

PLUMBING BOM

25 PEX Transition Elbow

26 PEX Transition Elbow



Pinnacle-1Bd1Ba-Traditional PLUMBING SYSTEM MATERIAL SHOPPING LIST Item Unit Quantity Unit Price Total Description □ PLUMBING FIXTURES & ACCESSORIES 1 Bath Tub (Alcove Tub) PCS 2 Kitchen Sink PCS 1 3 Kitchen Faucets PCS 4 Vanity Sink PCS 2 5 Bath room Faucets PCS 6 Water Closet PCS 7 Shower Trim PCS 8 Shower Tray PCS 9 Water Heater PCS 10 Hose Bib PCS 2 11 Shutoff Valve PCS 6 12 Hanging pipe clamp PCS 12 13 Globe Valve PCS 14 Dishwasher Supply Single Connector PCS 0 15 Dishwasher Sewage Single Connector PCS 0 16 Laundry Sweat Connector PCS 1 △ SANITARY & PLUMBING PIPE 1 ABS (Acrylonitrile Butadiene Styrene) Pipes 2 ABS (Acrylonitrile Butadiene Styrene) Pipes ø 1 1/2" FT 19 ø 2" FT 18 3 ABS (Acrylonitrile Butadiene Styrene) Pipes ø 3" FT 27 4 PEX (Cross-linked polyethylene) Pipes ø 1/2" FT 100 5 PEX (Cross-linked polyethylene) Pipes ø 3/4" FT 58 ø 2" 6 PVC Pipes Sch.80 - Rigid FT 48 7 Flex Pipe Round ø 1/2" FT 6 1 ABS Vent Cap Elbow 1 1/2"ø PCS 2 ABS Vent Cap Elbow PCS 2"ø 3 ABS Vent Cap Elbow 3"ø PCS 4 ABS 90 Degree Bend Elbow 1 1/2"ø-1 1/2"ø PCS 2 5 ABS 90 Degree Bend Elbow PCS 2"ø-2"ø 6 ABS 90 Degree Bend Elbow 3"ø-3"ø PCS 2 7 ABS P-Trap 1 1/2"ø-1 1/2"ø PCS 3 8 ABS P-Trap PCS 2"ø-2"ø 9 ABS Reducer Elbow 2"ø-1 1/2"ø PCS 10 ABS Reducer Elbow 3"ø-2"ø **PCS** 11 ABS TEE Elbow 2"ø-2"ø-2"ø PCS 12 ABS TEE Elbow 3"ø-3"ø-3"ø PCS 2 13 ABS Tee Reducer Elbow 3"ø-3"ø-1 1/2"ø PCS 14 ABS Tee Reducer Elbow 3"ø-3"ø-2"ø PCS 15 WASTE DOUBLE TEE 1 1/2"ø-1 1/2"ø-1 1/2"ø-1 PCS 16 PEX 90 Degree Elbow 1/2"ø-1/2"ø **PCS** 13 17 PEX 90 Degree Elbow 3/4"ø-3/4"ø PCS 18 PEX Tee Elbow 1/2"ø-1/2"ø-1/2"ø PCS 2 19 PEX Tee Elbow 3/4"ø-3/4"ø-3/4"ø PCS 20 PEX Transition Elbow PCS 3/4"ø-1/2"ø 5 21 PEX 90 Degree Elbow 1/2"ø-1/2"ø PCS 11 22 PEX 90 Degree Elbow 3/4"ø-3/4"ø PCS 5 23 PEX Tee Elbow 1/2"ø-1/2"ø-1/2"ø PCS 2 24 PEX Tee Elbow 3/4"ø-3/4"ø-3/4"ø PCS 5

PCS

PCS

4

1"ø-3/4"ø

3/4"ø-1/2"ø



		Pinnacle-1B	d1Ba-T	radition	al		
		HVAC SYSTEM MA	TERIAL	SHOPP	ING LIST		
No.	Item	Туре	Unit	Quantity	Unit Price	Total	Description
	HVAC_DUCTS						
1	PIPE (REFRIGERANT LINE)	3/8" (Ø)	FT	45.75			
2	PIPE (REFRIGERANT LINE)	3/4''' (Ø)	FT	54.04			
3	DRAYER HOSE	4" (Ø)	FT	4.5			
4	FLEX DUCT ROUND	4" (Ø)	FT	5.11			
	DUCT FITTINGS & ACCESSORIES						
5	ELBOW (REFRIGERANT LINE)	3/4" (Ø)-3/4" (Ø)	PCS	11			
6	ELBOW (REFRIGERANT LINE)	3/8" (Ø)-3/8" (Ø)	PCS	11			
7	TRANSITION (REFRIGERANT	3/4" (Ø)-1/2" (Ø)	PCS	2			
8	TRANSITION (REFRIGERANT	3/4" (Ø)-5/8" (Ø)	PCS	1			
9	TRANSITION (REFRIGERANT	3/8" (Ø)-1/4" (Ø)	PCS	1			
\triangle	HVAC_EQUIPMENTS						
10	AIR HANDLING UNIT	WALL MOUNTED	PCS	1			
11	CONDENSER	OUTDOOR UNIT	PCS	1			
12	EXHAUST FAN	75 CFM	PCS	1			
13	EXHAUST HOOD	WALL MOUNTED	PCS	1			
14	HOOD-WALL: VENT	HOOD-WALL: VENT	PCS	1			
15	DRAYER: VENT	DRAYER: VENT	PCS	1			
16	ROOF VENT	3"(Ø)	PCS	1			



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Have It Your Way!

The material types listed in this document were selected based on personal preferences. The Customer is encouraged to make changes to the material types in accordance with local customs, regulations, and personal preferences. Have It Your Way!

GENERAL NOTES

- This BOM (Bill of Materials) is prepared as a Materials Shopping List to help builders and DIYers gain a complete understanding of most if not all elements required for the complete construction of this structure, according to the original design documents provided by FrameUpNow.
- 2 All quantities and specifications are subject to change based on the final design, field measurements, availability of products and customer preferences. The customer should verify all information prior to purchasing materials.
- 3 All products and elements in the list shall conform to the International Residential Code (IRC), or any other local and international building codes, safety regulations, and standards that are applicable to the location of the structure.
- 4 If any changes are made by the customer to the list of materials specified in this document, the customer is responsible for assuring that the correct type and quantity of materials are utilized in accordance with local building codes.
- FrameUpNow, will not be held responsible for any misuse of this document, the products listed, or for deviations from the content that are made due to changes in specifications, pricing, availability, or customer preferences.
- The customer is advised to consult a qualified professional or technician prior to purchasing materials for specialized construction system items. Some items including but not limited to caseworks, doors and windows may require as built measurements prior to purchase to confirmation of final dimensions.
- 7 If there are additional trim elements or specific installation methods, the total amount of materials needed might vary. Consider any additional trim required for corners, intersections, or other architectural details that might cause this variations before procedding to purchase and construction.



			LIGHTING FIXTURES				
#	Item	Туре	Description, Manufacturer, SKU	Unit	Quantity	Unit Price	Total
1	Kitchen Ceiling Light			PCS	2		
3	Kitchen Wall Mounted Light			PCS	1		
4	Exterior Wall Mounted Light			PCS	4		
5	Livingroom Ceiling Light With Fan			PCS	1		
6	Bedroom Ceiling Light With Fan			PCS	1		
7	Dining Ceiling Light			PCS	0		
8	Bath Wall Mounted Light			PCS	1		
9	Bathroom Ceiling Light			PCS	2		
10	Livingroom Ceiling Light			PCS	2		
11	Bedroom Ceiling Light			PCS	4		
12	Hall & Entry Ceiling Light			PCS	2		
12	WD Ceiling Light			PCS	0		
13	Smoke Detector			PCS	2		
14							
15							



			ELECTRICAL FITTINGS				
#	Item	Туре	Description, Manufacturer, SKU	Unit	Quantity	Unit Price	Total
1	Standard Receptacle 120V	20A		PCS	8		
2	GFCI Receptacle 120V	20 A		PCS	14		
3	GFCI Receptacle 240V	30 A		PCS	2		
4	GFCI Receptacle 240V	50 A		PCS	1		
5	GFCI Receptacle 240V	60 A		PCS	1		
6	Fan Switch			PCS	1		
7	Single Pole Switch			PCS	6		
8	Three Way Switch			PCS	3		
9	Dimmer Switch			PCS	2		
10							
11							
12							
13							
14							
15							



		ELECTR	ICAL CONDUITS & WIRING			
#	Item	Туре	Description, Manufacturer, SKU	Unit	Quantity Unit P	rice Total
1	ROMEX 14 AWG	14/2/W/ground		FT	55	
3	ROMEX 12 AWG	12/3/W/ground		FT	0	
4	ROMEX 12 AWG	12/2/W/ground		FT	255	
6	ROMEX 10 AWG	10/3/W/ground		FT	58	
8	ROMEX 10 AWG	10/2/W/ground		FT	0	
9	Romex 8 AWG	8/3/W/ground		FT	14	
10	Romex 8 AWG	8/2/W/ground		FT	0	
11	ROMEX 6 AWG	6/3/W/ground		FT	43	
12	Bare Copper Ground Wire 6 AWG			FT		
13						
14						
15						
16						



		ELEC	CTRICAL BOXES & CIRCUTES				
#	Item	Туре	Description, Manufacturer, SKU	Unit	Quantity	Unit Price	Total
1	Panelboard -240V 1 Phase MLO	200 AMP		PCS	1		
2	Circuit breaker	15 A		PCS	2		
3	Circuit breaker	20 A		PCS	10		
4	Circuit breaker	30 A		PCS	2		
5	Circuit breaker	50 A		PCS	1		
6	Circuit breaker	60 A		PCS	1		
7	Single Gang Switch Box			PCS	2		
8	Double Gang Switch Box			PCS	2		
9	Triple Gang Switch Box			PCS	2		
10	Pull Box	#1/4		PCS	16		
11	Receptacle Box			PCS	24		
12							
13							
14							
15							



			HVAC_DUCTS 01				
#	Item	Туре	Description, Manufacturer, SKU	Unit	Quantity	Unit Price	Total
1	PIPE (REFRIGERANT LINE)			FT	45.75		
2	PIPE (REFRIGERANT LINE)			FT	54.04		
3	DRAYER HOSE	4" (Ø)		FT	4.5		
4	FLEX DUCT ROUND	4" (Ø)		FT	5.11		
5							
6							
7							
8							
9							
10							
11							
12							
13							
14							
15							
16							



			DUCT FITTINGS & ACCESSORIES				
#	Item	Туре	Description, Manufacturer, SKU	Unit	Quantity	Unit Price	Total
	ELBOW (REFRIGERANT LINE)	3/4" (Ø)-3/4" (Ø)		PCS	11		
	ELBOW (REFRIGERANT LINE)	3/8" (Ø)-3/8" (Ø)		PCS	11		
	TRANSITION (REFRIGERANT LINE)	3/4" (Ø)-1/2" (Ø)		PCS	2		
	TRANSITION (REFRIGERANT LINE)	3/4" (Ø)-5/8" (Ø)		PCS	1		
	TRANSITION (REFRIGERANT LINE)	3/8" (Ø)-1/4" (Ø)		PCS	1		
5							
'							
3							
)							
0							
.1							
.2							
.3							
.4							
.5							
16							



			HVAC_EQUIPMENTS				
#	Item	Туре	Description, Manufacturer, SKU	Unit	Quantity	Unit Price	Total
l	AIR HANDLING UNIT	WALL MOUNTED		PCS	1		
<u>)</u>	CONDENSER	OUTDOOR UNIT		PCS	1		
3	EXHAUST FAN	75 CFM		PCS	1		
ļ	EXHAUST HOOD	WALL MOUNTED		PCS	1		
5	HOOD-WALL: VENT	HOOD-WALL: VENT		PCS	1		
6	DRAYER: VENT	DRAYER: VENT		PCS	1		
7	ROOF VENT	3"(Ø)		PCS	1		
3							
9							
10							
11							
12							
13							
14							



		PLUMBII	NG FIXTURES & ACCESSORIES				
#	Item	Туре	Description, Manufacturer, SKU	Unit	Quantity	Unit Price	Total
1	Bath Tub (Alcove Tub)			PCS	0		
2	Kitchen Sink			PCS	1		
3	Kitchen faucets			PCS	1		
4	Vanity Sink			PCS	1		
5	Bath room faucets			PCS	1		
6	Water Closet			PCS	1		
7	Shower Trim			PCS	1		
8	Shower Tray			PCS	1		
9	Water Heater			PCS	1		
10	Hose Bib			PCS	1		
11	Shutoff Valve			PCS	6		
12	Hanging pipe clamp			PCS	12		
13	Globe Valve			PCS	1		
14	Dishwasher Supply Single Connector			PCS	0		
15	Dishwasher Sewage Single Connector			PCS	0		
16	Laundry Sweat Connector			PCS	1		



		SANITA	ARY & PLUMBING PIPES				
#	Item	Туре	Description, Manufacturer, SKU	Unit	Quantity	Unit Price	Total
1	ABS (Acrylonitrile Butadiene Styrene) Pipes	ø 2 1/2"		FT	0		
2	ABS (Acrylonitrile Butadiene Styrene) Pipes	ø 1 1/2"		FT	19		
3	ABS (Acrylonitrile Butadiene Styrene) Pipes	ø 2"		FT	18		
4	ABS (Acrylonitrile Butadiene Styrene) Pipes	ø 3"		FT	27		
5	PEX (Cross-linked polyethylene) Pipes	ø 1/2"		FT	100		
6	PEX (Cross-linked polyethylene) Pipes	ø 3/4"		FT	58		
7	PEX (Cross-linked polyethylene) Pipes	ø 1"		FT	0		
8	PVC Pipes Sch.80 - Rigid	ø 1 1/2"		FT	0		
9	PVC Pipes Sch.80 - Rigid	ø 2"		FT	48		
10	PVC Pipes Sch.80 - Rigid	ø 3"		FT	0		
11	Flex Pipe Round	ø 1/2"		FT	6		
12	Flex Pipe Round	ø 3/4"		FT	0		
13	Flex Pipe Round	ø 1"		FT	0		
14							
15							



		PIPE FI	ITTINGS 01				
#	Item	Туре	Description, Manufacturer, SKU	Unit	Quantity	Unit Price	Total
1	ABS Vent Cap Elbow	1 1/2"ø		PCS	1		
2	ABS Vent Cap Elbow	2"ø		PCS	1		
3	ABS Vent Cap Elbow	3"ø		PCS	1		
4	ABS 90 Degree Bend Elbow	1 1/2"ø-1 1/2"ø		PCS	2		
5	ABS 90 Degree Bend Elbow	2"ø-2"ø		PCS	2		
6	ABS 90 Degree Bend Elbow	3"ø-3"ø		PCS	2		
7	ABS P-Trap	1 1/2"ø-1 1/2"ø		PCS	3		
8	ABS P-Trap	2"ø-2"ø		PCS	2		
9	ABS Reducer Elbow	2"ø-1 1/2"ø		PCS	1		
10	ABS Reducer Elbow	3"ø-2"ø		PCS	1		
11	ABS TEE Elbow	2"ø-2"ø-2"ø		PCS	1		
12	ABS TEE Elbow	3"ø-3"ø-3"ø		PCS	2		
13	ABS Tee Reducer Elbow	3"ø-3"ø-1 1/2"ø		PCS	2		
14	ABS Tee Reducer Elbow	3"ø-3"ø-2"ø		PCS	1		
15	WASTE DOUBLE TEE	1 1/2"ø-1 1/2"ø-1 1/2"ø-1 1/2"ø		PCS	1		



		PI	PE FITTINGS 02				
#	Item	Туре	Description, Manufacturer, SKU	Unit	Quantity	Unit Price	Total
1	PEX 90 Degree Elbow	1/2"ø-1/2"ø		PCS	13		
2	PEX 90 Degree Elbow	3/4"ø-3/4"ø		PCS	2		
3	PEX Tee Elbow	1/2"ø-1/2"ø-1/2"ø		PCS	2		
4	PEX Tee Elbow	3/4"ø-3/4"ø-3/4"ø		PCS	2		
5	PEX Transition Elbow	3/4"ø-1/2"ø		PCS	5		
6	PEX 90 Degree Elbow	1/2"ø-1/2"ø		PCS	11		
7	PEX 90 Degree Elbow	3/4"ø-3/4"ø		PCS	5		
8	PEX Tee Elbow	1/2"ø-1/2"ø-1/2"ø		PCS	2		
9	PEX Tee Elbow	3/4"ø-3/4"ø-3/4"ø		PCS	5		
10	PEX Transition Elbow	1"ø-3/4"ø		PCS	2		
11	PEX Transition Elbow	3/4"ø-1/2"ø		PCS	4		



			APPLIANCES				
#	Item	Туре	Description, Manufacturer, SKU	Unit	Quantity	Unit Price	Total
1	Refrigerator			PCS			
2	Range			PCS			
3	Washer Front Load	Stackable		PCS			
4	Dryer Front Load	Stackable		PCS			
5	Dish Washer			PCS			
6	Oven			PCS	(
7	Microwave			PCS	(
8							
9							
10							
11							
12							
13							
14							
15							
16							



			CASEWORKS 01				
#	Item	Туре	Description, Manufacturer, SKU	Unit	Quantity	Unit Price	Total
1	Kitchen Cabinet			FT	14.85		
2	Laundry Cabinet			FT	2.25		
3	Vanity Cabinet			FT	2.5		
4	Medicine Cabinet			PCS	1		
5	Kitchen countertop			SF	22.61		
6	Laundry Countertop			PCS	0		
7	Bathroom Countertop			SF	0		
8	Island			FT	0		
9	Peninsula			FT	0		
10	Closets			SF	61.49		
11							
12							
13							
14							
15							



	1		CEILING 01				
#	Item	Туре	Description, Manufacturer, SKU	Unit	Quantity	Unit Price	Total
	LIVING ROOM AND KITCHEN	V		SF	198.0		
l	Ceiling Board	Drywall		SF	198		
	Drywall Fastener	Screw		PCS	347		
3	Vapor Retarder	Polyethylene film		SF	198		
1	Vapor Retarder Fastener	Nails with washer heads		PCS	594		
	BATHROOM	'		SF	47.0		
5	Ceiling Board	MRD (Moisture resistant drywall)		SF	47		
j	MRD Fastener	Screw		PCS	82		
	WH			SF	10.0		
7	Ceiling Board	Drywall		SF	10		
3	Drywall Fastener	Screw		PCS	18		
)	Vapor Retarder	Polyethylene film		SF	10		
LO	Vapor Retarder Fastener	Nails with washer heads		PCS	30		
	PORCH			SF	71.0		
11	Ceiling Board	Marine Plywood		SF	71		
12	Exterior Grade Plywood	Screw		PCS	124		



			CEILING 02				
#	Item	Туре	Description, Manufacturer, SKU	Unit	Quantity	Unit Price	Total
	HALL+W/D			SF	33.0		
13	Ceiling Board	Drywall		SF	33		
14	Drywall Fastener	Screw		PCS	58		
15	Vapor Retarder	Polyethylene film		SF	33		
16	Vapor Retarder Fastener	Nails with washer heads		PCS	99		
	BEDROOM			SF	145.0		
17	Ceiling Board	Drywall		SF	145		
18	Drywall Fastener	Screw		PCS	254		
19	Vapor Retarder	Polyethylene film		SF	145		
20	Vapor Retarder Fastener	Nails with washer heads		PCS	435		
	CLOSET			SF	22.0		
21	Ceiling Board	Drywall		SF	22		
22	Drywall Fastener	Screw		PCS	39		
23	Vapor Retarder	Polyethylene film		SF	22		
24	Vapor Retarder Fastener	Nails with washer heads		PCS	66		
	SHADE			SF	15.0		
25	Ceiling Board	Marine Plywood		SF	15		
26	Exterior Grade Plywood	Screw		PCS	26.3		



			FLOORING INTERIOR 01				
#	Item	Туре	Description, Manufacturer, SKU	Unit	Quantity	Unit Price	Total
	CLOSET						
1	Closet Flooring			SF	21		
2	Wood underlay	Foam Pad Polyethylene		SF	21		
3	Vapor Retarder	Vapor Barrier Polyethylene		SF	21		
	BEDROOM						
4	Bedroom Flooring			SF	137		
5	Wood underlay	Foam Pad Polyethylene		SF	137		
6	Vapor Retarder	Vapor Barrier Polyethylene		SF	137		
	LIVING ROOM AND KITCH	HEN					
7	Tile Finish			SF	209		
8	Adhesive	1/2" Thin set Mortar		SF	209		
9	Vapor Retarder	Vapor Barrier Polyethylene		SF	209		
	BATHROOM						
10	Tile Finish			SF	32		
11	Adhesive	1/2" Thin set Mortar		SF	32		
12	Vapor Retarder	Vapor Barrier Polyethylene		SF	32		



			FLOORING INTERIOR 02				
#	Item	Туре	Description, Manufacturer, SKU	Unit	Quantity	Unit Price	Total
	W/D						
13	Tile Finish			SF	9		
14	Adhesive	1/2" Thin set Mortar		SF	9		
15	Vapor Retarder	Vapor Barrier Polyethylene		SF	9		
	BOILER ROOM	·					
16	Tile Finish			SF	10		
17	Adhesive	1/2" Thin set Mortar		SF	10		
18	Vapor Retarder	Vapor Barrier Polyethylene		SF	10		



	1		FLOORING EXTERIOR			
#	Item	Туре	Description, Manufacturer, SKU	Unit	Quantity	Unit Price
	STRUCTURE			SF	566.0	
1	Concrete Slab	4"concrete cast in situ		CF	189	
2	Insulation	Rigid insulation		SF	201.29	
3	Hard core	Compacted soil		CF	134.24	
4	Re-bar	#4 re-bar		Ton	0.59	
5	Concrete Pad	4"concrete cast in situ		CF	2	
6	Slab edge	Turndown		CF	193.78	
7	Footing	Cast-in-place concrete		CF	4.68	
	PORCH					
8	Tile Finish			SF	79	
9	Adhesive	1/2" Thin set Mortar		SF	79	
10	Vapor Retarder	Vapor Barrier Polyethylene		SF	79	



			WALLS: EXTERIOR				
#	Item	Туре	Description, Manufacturer, SKU	Unit	Quantity	Unit Price	Total
1	Stone Veneer			SF	229		
2	Corrugated Iron Sheet			SF	466		
3	Corrugated Iron Sheet Fastener 8/panel	Self-drilling screws(100/pkt)		PKT	5		
4	Wall Shteathing (OSB)			SF	695		
5	Shteathing Fastener	Self-drilling screws(100/pkt)		PKT	7		
6	Wall Homewrap			SF	695		
7	Homewrap Fastener	Stapled fastener (200/pkt)		PKT	3		
8	Furring Strip			PCS	58		
9	Furring Strip Fastener	Self-drilling screws(100/pkt)		PKT	5		
10	Wall Paint			SF	695		
11	Stone Copping	Masonry stone		SF	22		
12	Stone Veneer	Masonry stone		SF	0		
13	Mortar for Stone Veneer			SF	0		
14	Wall Insulation			SF	2103		



			WALLS: INTERIOR 01				
#	Item	Туре	Description, Manufacturer, SKU	Unit	Quantity	Unit Price	Total
	BATHROOM			SF	47.0		
1	Cementitious Backer Board			SF	226		
2	Kerdi membrane			SF	226		
3	Kerdi membrane Fastener			SF	226		
4	Wall Ceramic Tile			SF	226		
	BEDROOM			SF	160.0		
5	Drywall Board			SF	304		
6	Drywall Fastener	Self-drilling screws(100/pkt)		PKT	3.04		
7	Wall Paint			SF	304		
8	Drywall Tape			FT	57.0		
	HALL			SF	37.0		
9	Drywall Board			SF	68		
10	Drywall Fastener	Self-drilling screws(100/pkt)		PKT	0.68		
11	Wall Paint			SF	68		
12	Drywall Tape			FT	13		



			WALLS: INTERIOR 02				
#	Item	Туре	Description, Manufacturer, SKU	Unit	Quantity	Unit Price	Total
	LIVING ROOM			SF	116.0		
13	Drywall Board			SF	214		
14	Drywall Fastener	Self-drilling screws(100/pkt)		PKT	2.14		
15	Wall Paint			SF	214		
16	Drywall Tape			FT	40.2		
	KITCHEN			SF	78.0		
17	Cementitious Backer Board			SF	24		
18	Drywall Board			SF	139		
19	Drywall Fastener	Self-drilling screws(100/pkt)		PKT	1.39		
20	Kerdi membrane			SF	24		
21	Kerdi membrane Fastener			SF	24		
22	Wall Ceramic Tile			SF	24		
23	Wall Paint			SF	139		
24	Drywall Tape			FT	26.2		



			WALLS: INTERIOR 03				
#	Item	Туре	Description, Manufacturer, SKU	Unit	Quantity	Unit Price	Total
	CL			SF	33.0		
25	Drywall Board			SF	145		
26	Drywall Fastener	Self-drilling screws(100/pkt)		PKT	1.45		
27	Wall Paint			SF	145		
28	Drywall Tape			FT	27.2		
	WD			SF	8.0		
29	Cementitious Backer Board			SF	75		
30	Kerdi membrane			SF	75		
31	Kerdi membrane Fastener			SF	75		
32	Wall Ceramic Tile			SF	75		
	WH			SF	7.0		
33	Drywall Board			SF	86		
34	Drywall Fastener	Self-drilling screws(100/pkt)		PKT	0.86		
35	Wall Paint			SF	86		
36	Drywall Tape			FT	16		
1	Wall Skirting	Ceramic		FT	94		



			DOORS				
#	Item	Туре	Description, Manufacturer, SKU	Unit	Quantity	Unit Price	Total
1	Exterior Swinging	3' - 0" X 6'-8"		PCS	2		
2	Interior Swinging	3' - 0" X 6'-8"		PCS	2		
3	Interior Sliding	9' - 0" X 6'-8"		PCS	1		
4	Folding	2' - 10" X 6'-8"		PCS	1		
5	Exterior Door Trim			FT	33		
6	Interior Door Trim			FT	175		
7	Entry Lock set			PCS	2		
8	Privacy Lock set			PCS	2		
9	Passage Lock set			PCS	2		



			WINDOWS				
#	Item	Туре	Description, Manufacturer, SKU	Unit	Quantity	Unit Price	Total
1	Casement	3' - 3" X 3'-3"		PCS	6		
2	Casement	5' - 3" X 3'-3"		PCS	1		
3	Casement	3' - 3" X 1'-9"		PCS	1		
4	Exterior Window Trim			FT	107		
5	Interior Window Trim			FT	107		



			ROOF 01				
#	Item	Туре	Description, Manufacturer, SKU	Unit	Quantity	Unit Price	Total
1	Roof Covering			SF	746.0		
2	Roof Covering Fastener			PCS	373		
3	Roof Felt Paper			SF	746.0		
4	Roof Felt Paper Fastener			PCS	2238.0		
5	Roof Sheathing			SF	746.0		
6	Roof Sheathing Fastener			PCS	5968		
7	Batten			FT	0.0		
8	Batten Fastener			PCS	0.0		
9	Soffit			SF	127.0		
10	Soffit Fastener			PCS	63.5		
11	Fascia			FT	129.0		
12	Fascia board fastener			PCS	65		
13	Roof Insulation			SF	746.0		
14					1 1010		
15							